CMS Garinger HS - Security Gate

Modifications

1100 Eastway Dr Charlotte, NC 28205



Charlotte
Mecklenburg
Schools

205 1/2 KING STREET
CHARLESTON, SOUTH CAROLINA 29401
TEL. 843.577.4444 FAX. 843.722.4789
WWW.LS3P.COM



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Garinger HS - Security Modifications

CS Ga 1100 E

SHEET NAME: COVER SHEET

ORIG SUBMISSION: 10/28/2

SHEET:

G-00

LSJP


ARCHITECTURAL LS3P


227 WEST TRADE STREET SUITE 700 CHARLOTTE, NC 28202 tel: 704.333.6686 email: trevorholmes@ls3p.com



ELECTRICAL CMTA

8801 JM KEYNES DR.
SUITE 240
CHARLOTTE, NC 28262
tel: 704.376.7072
email: zschneider@cmta.com

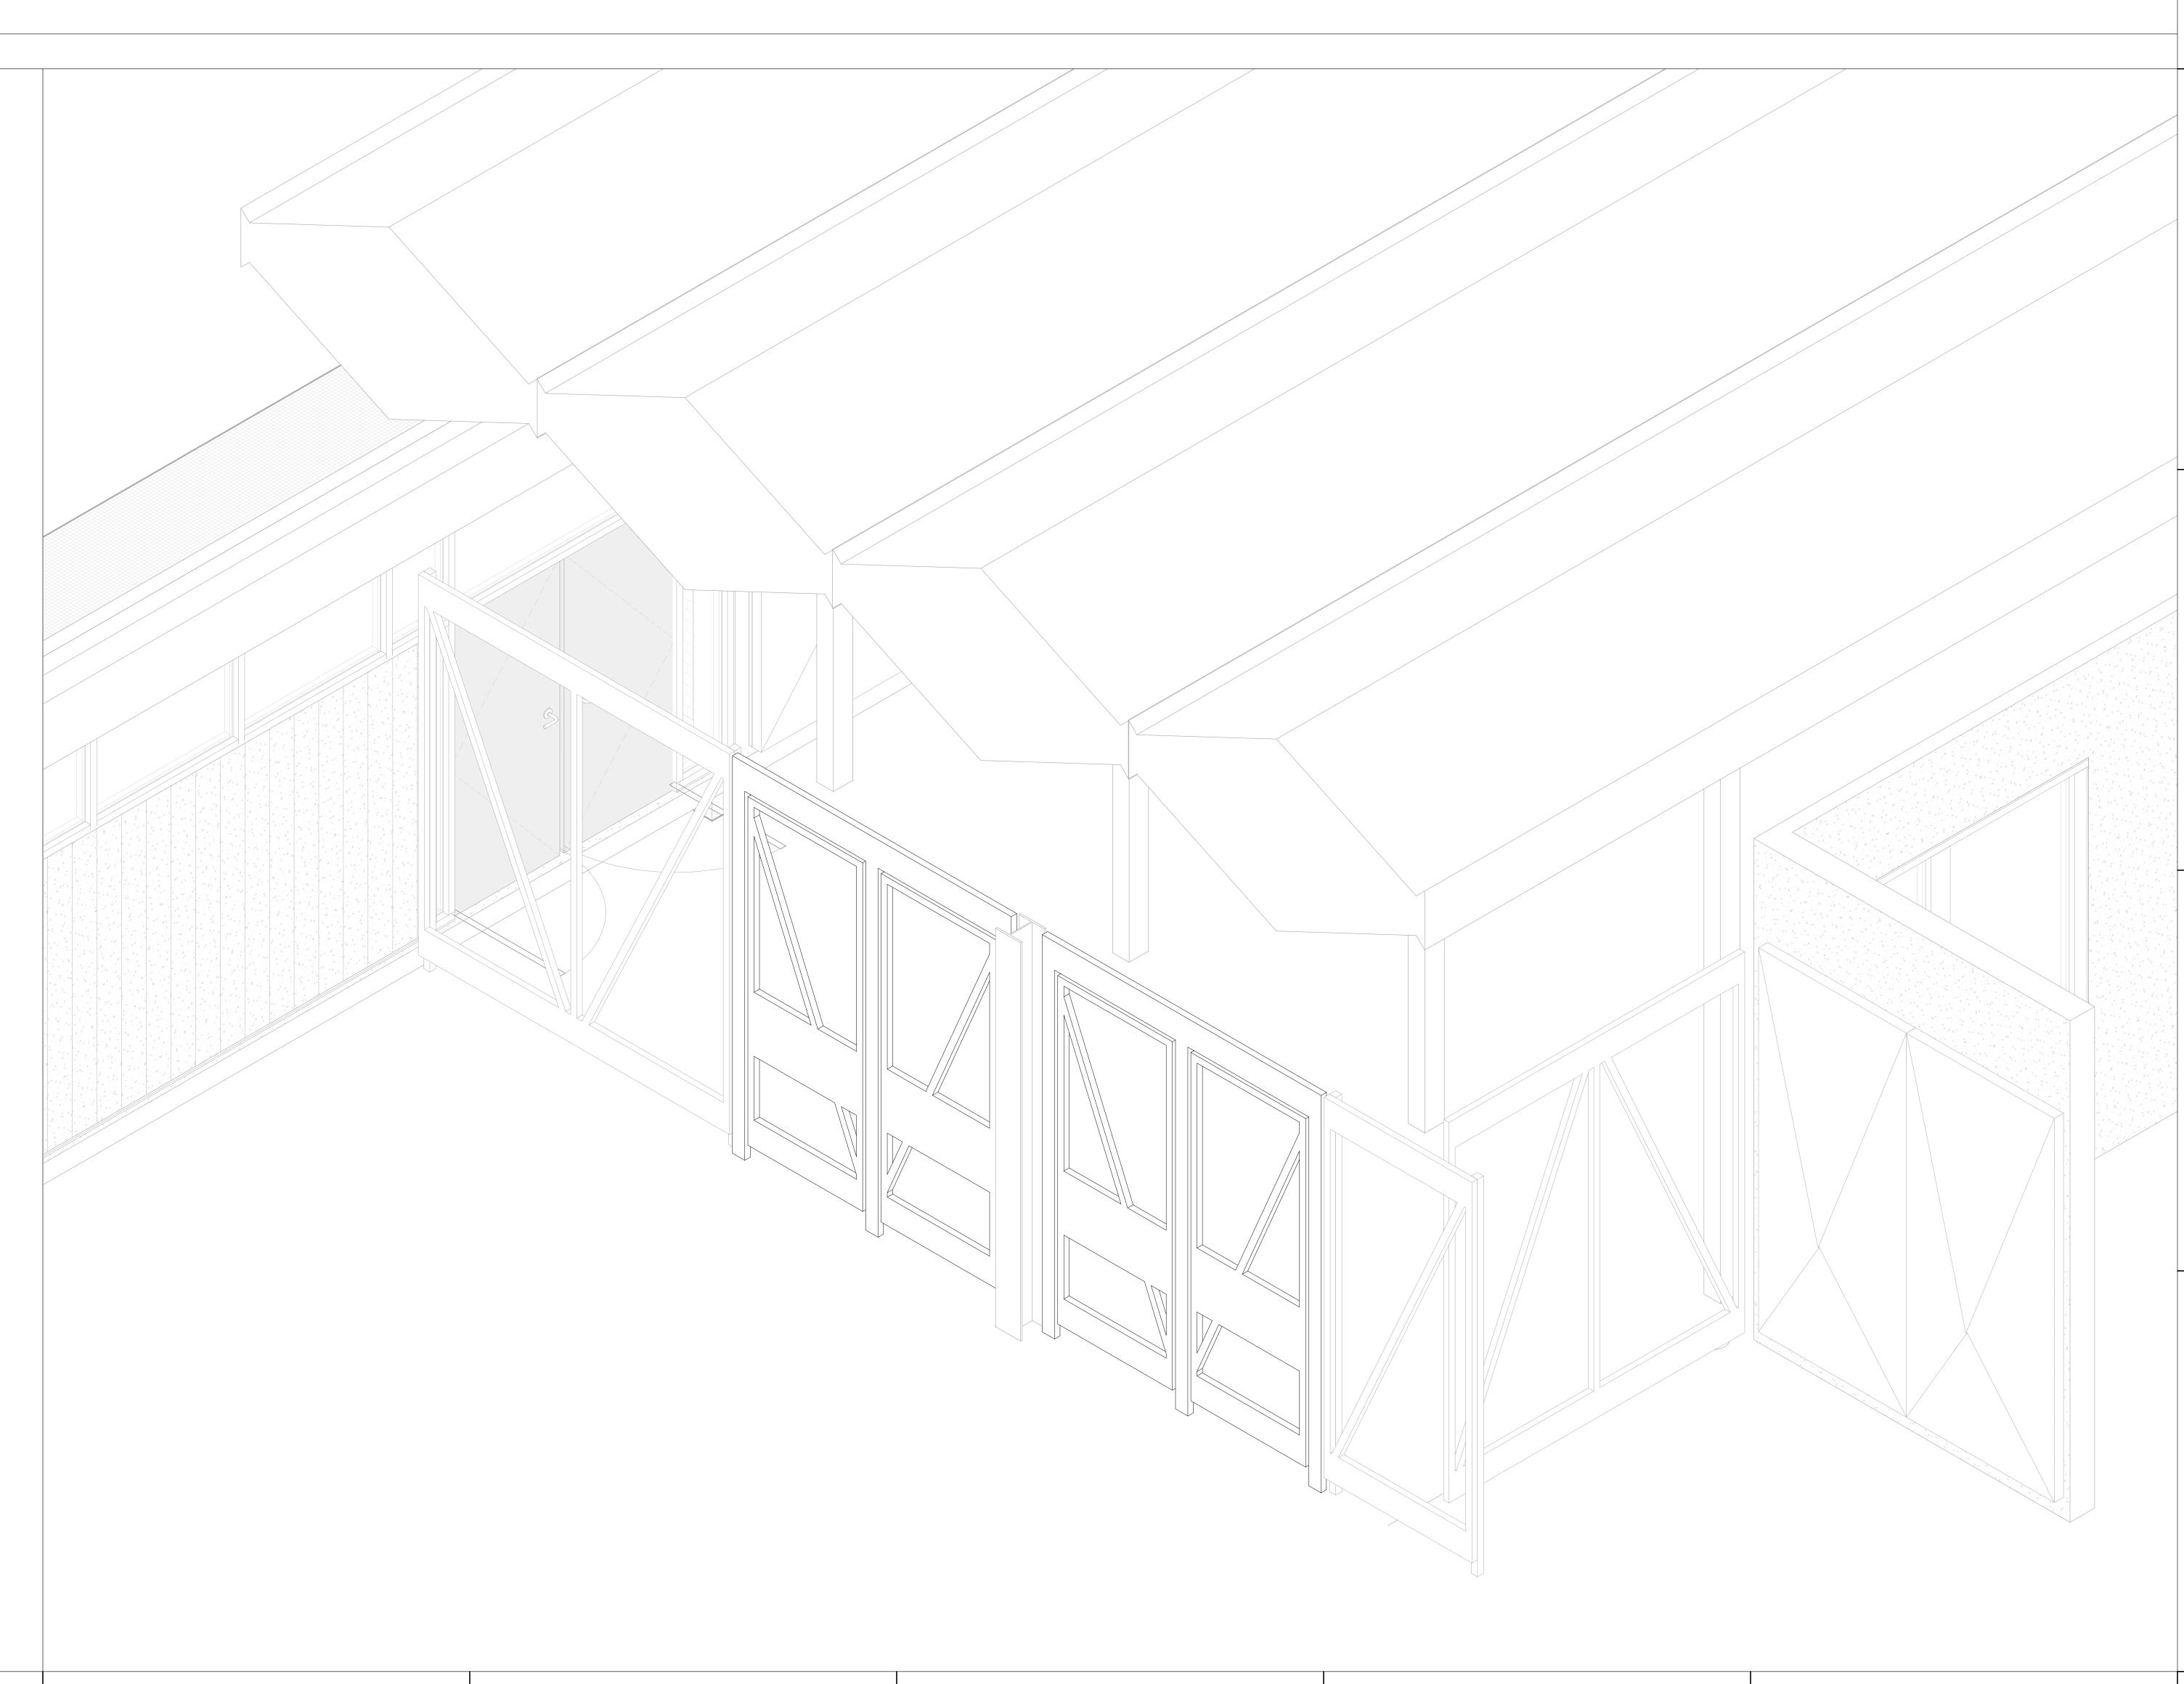

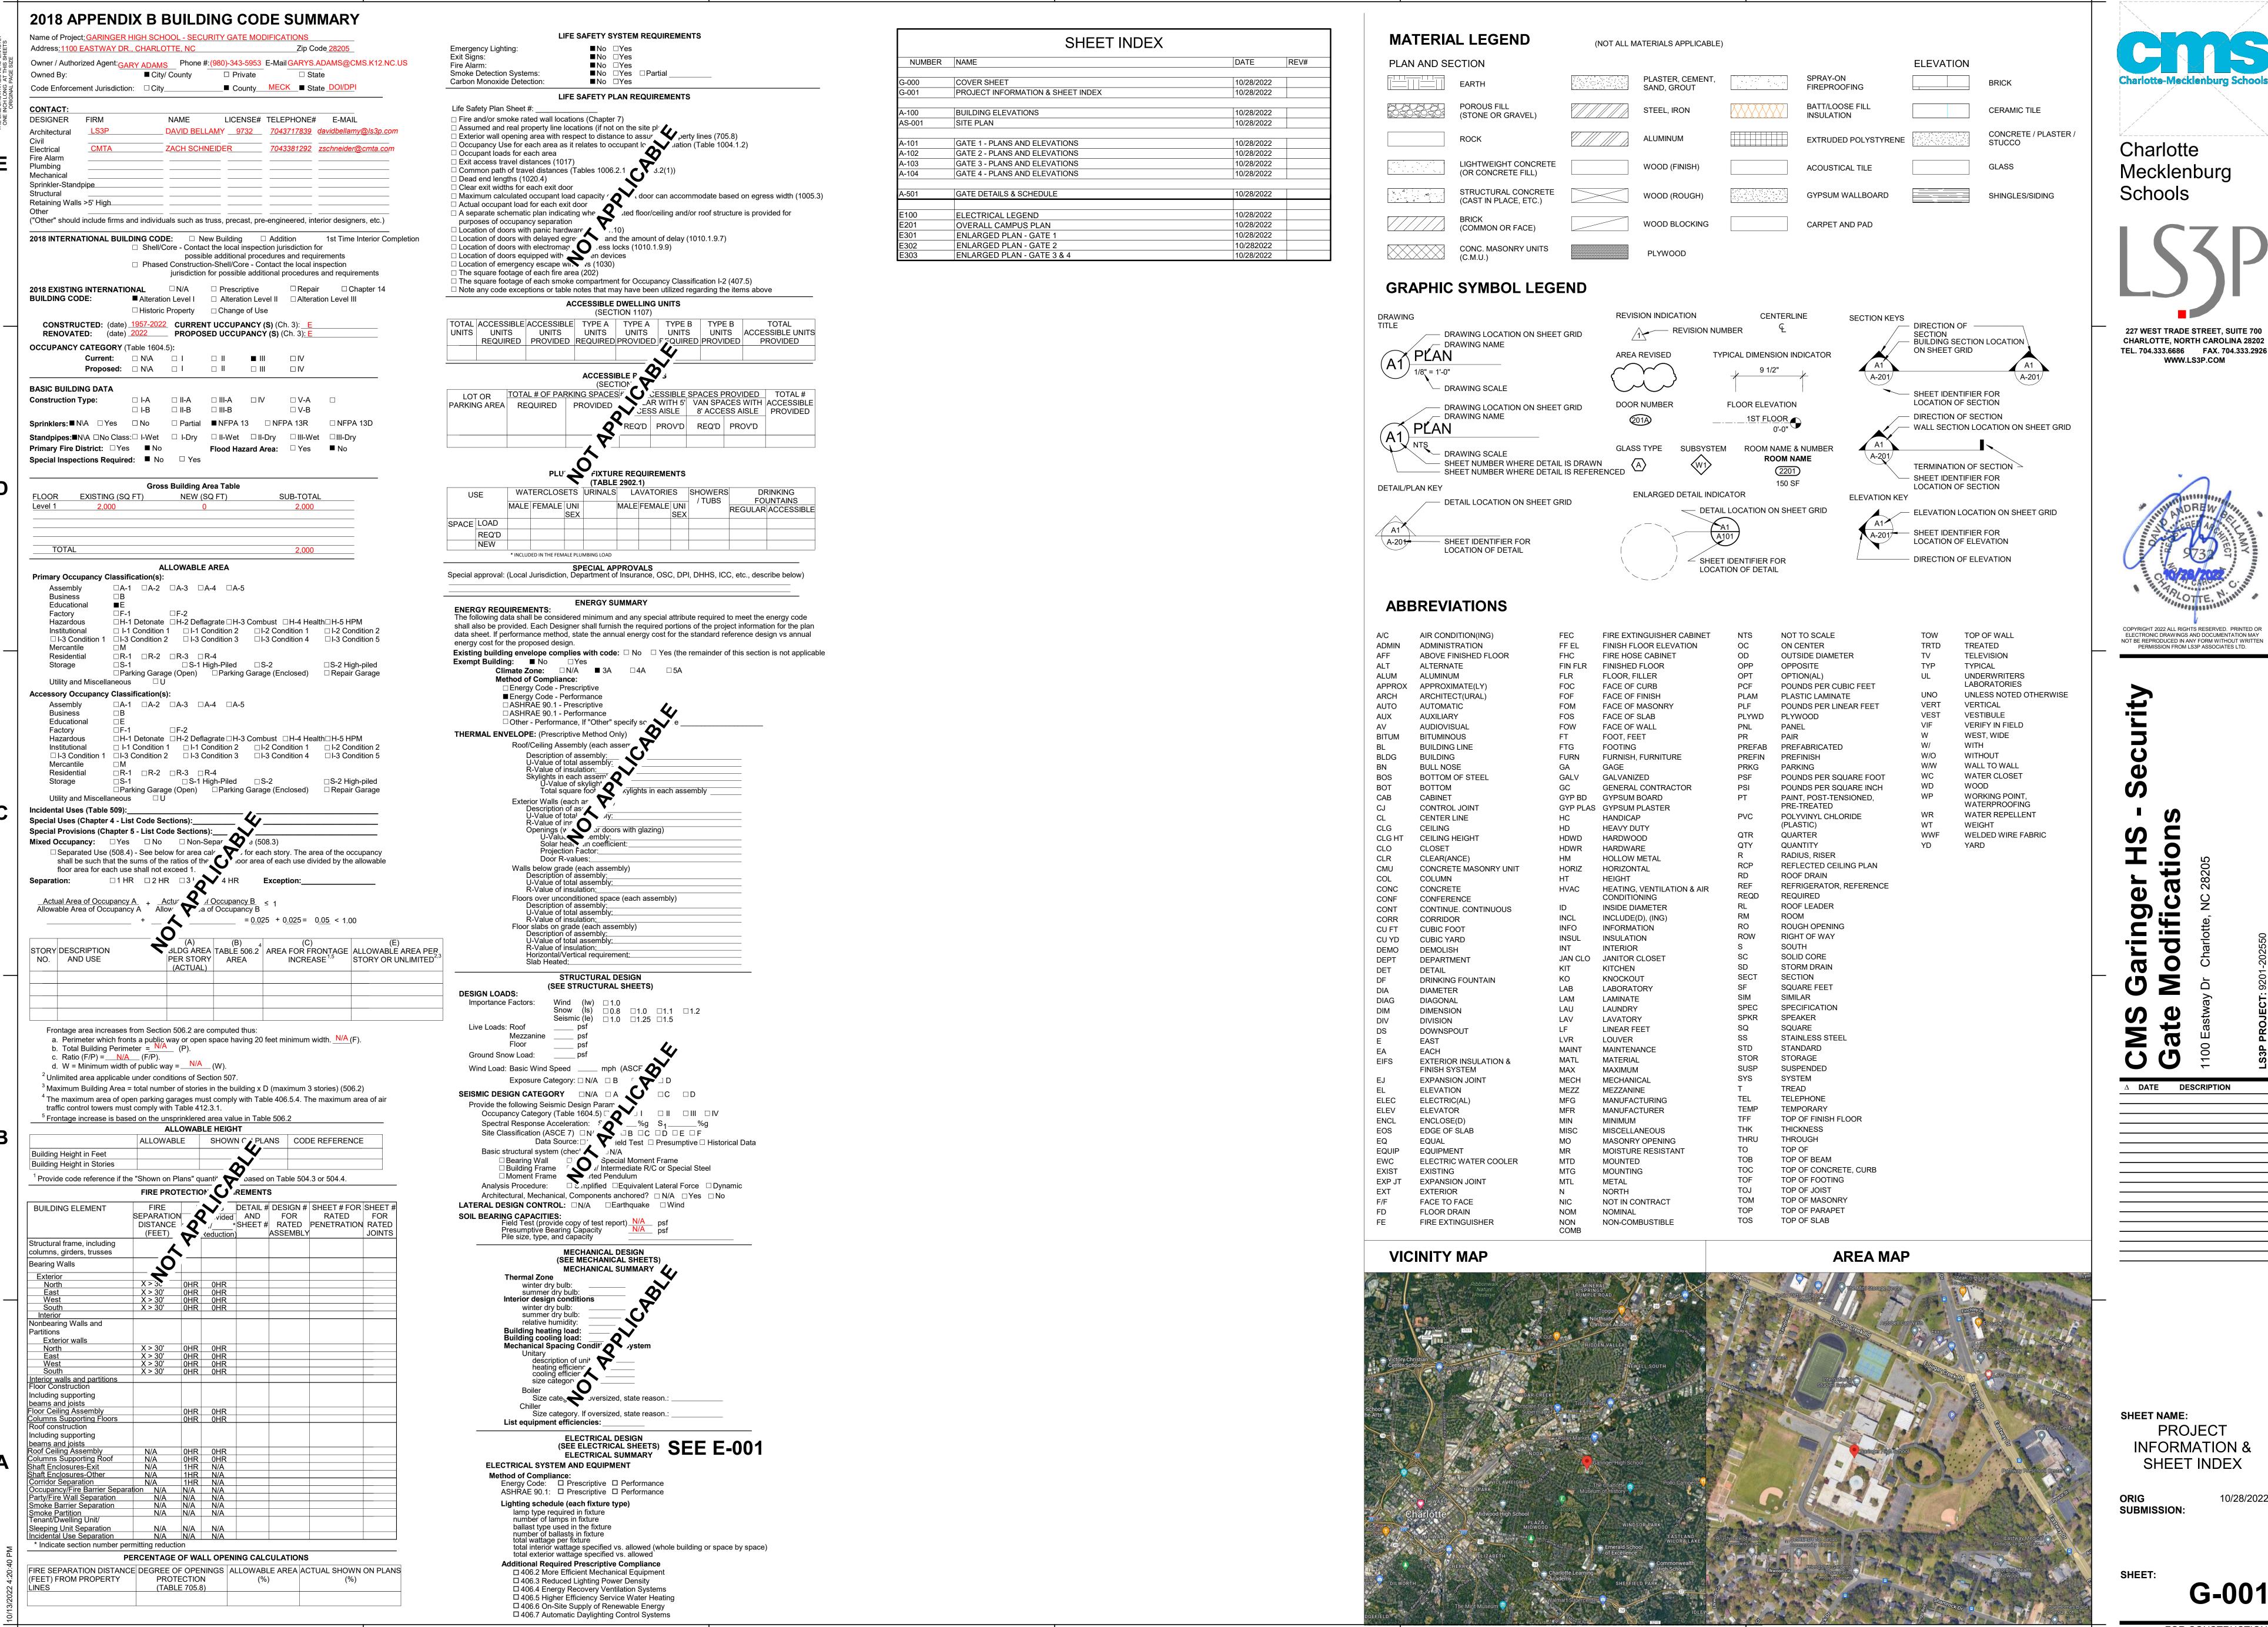

Charlotte Mecklenburg Schools



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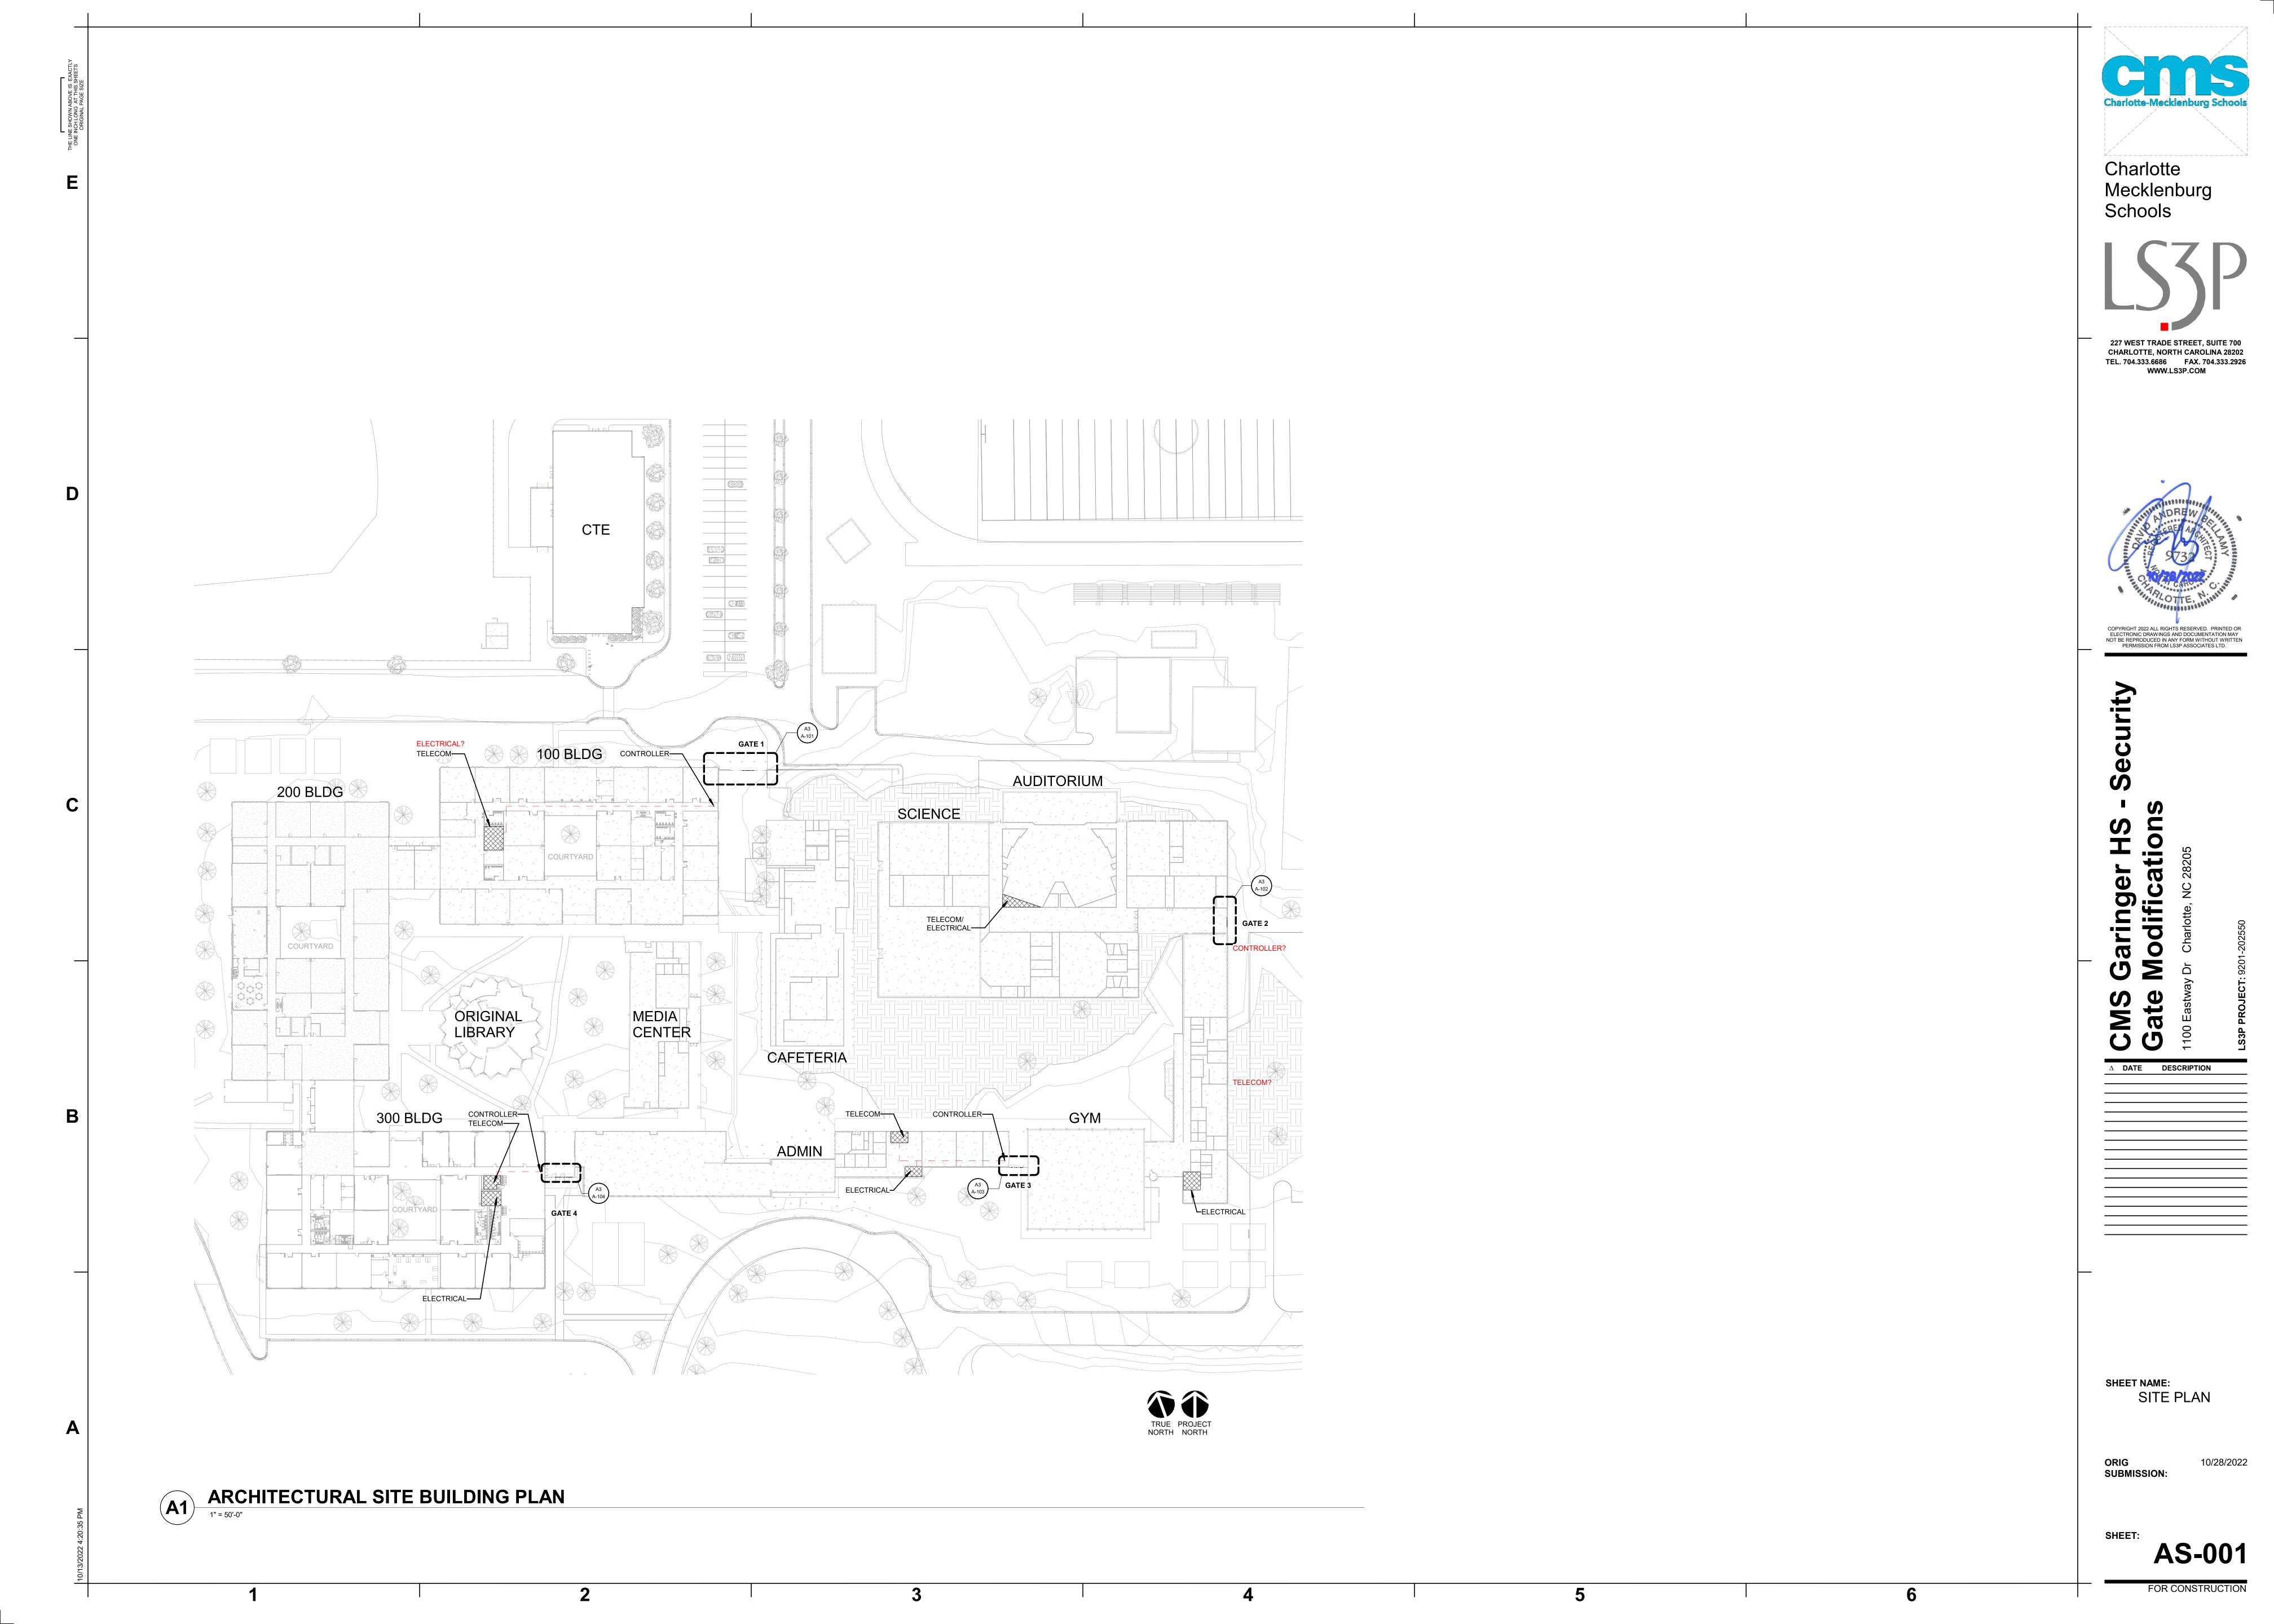
SHEET NAME: PROJECT INFORMATION & SHEET INDEX

SUBMISSION:

G-001

10/28/2022

FOR CONSTRUCTION






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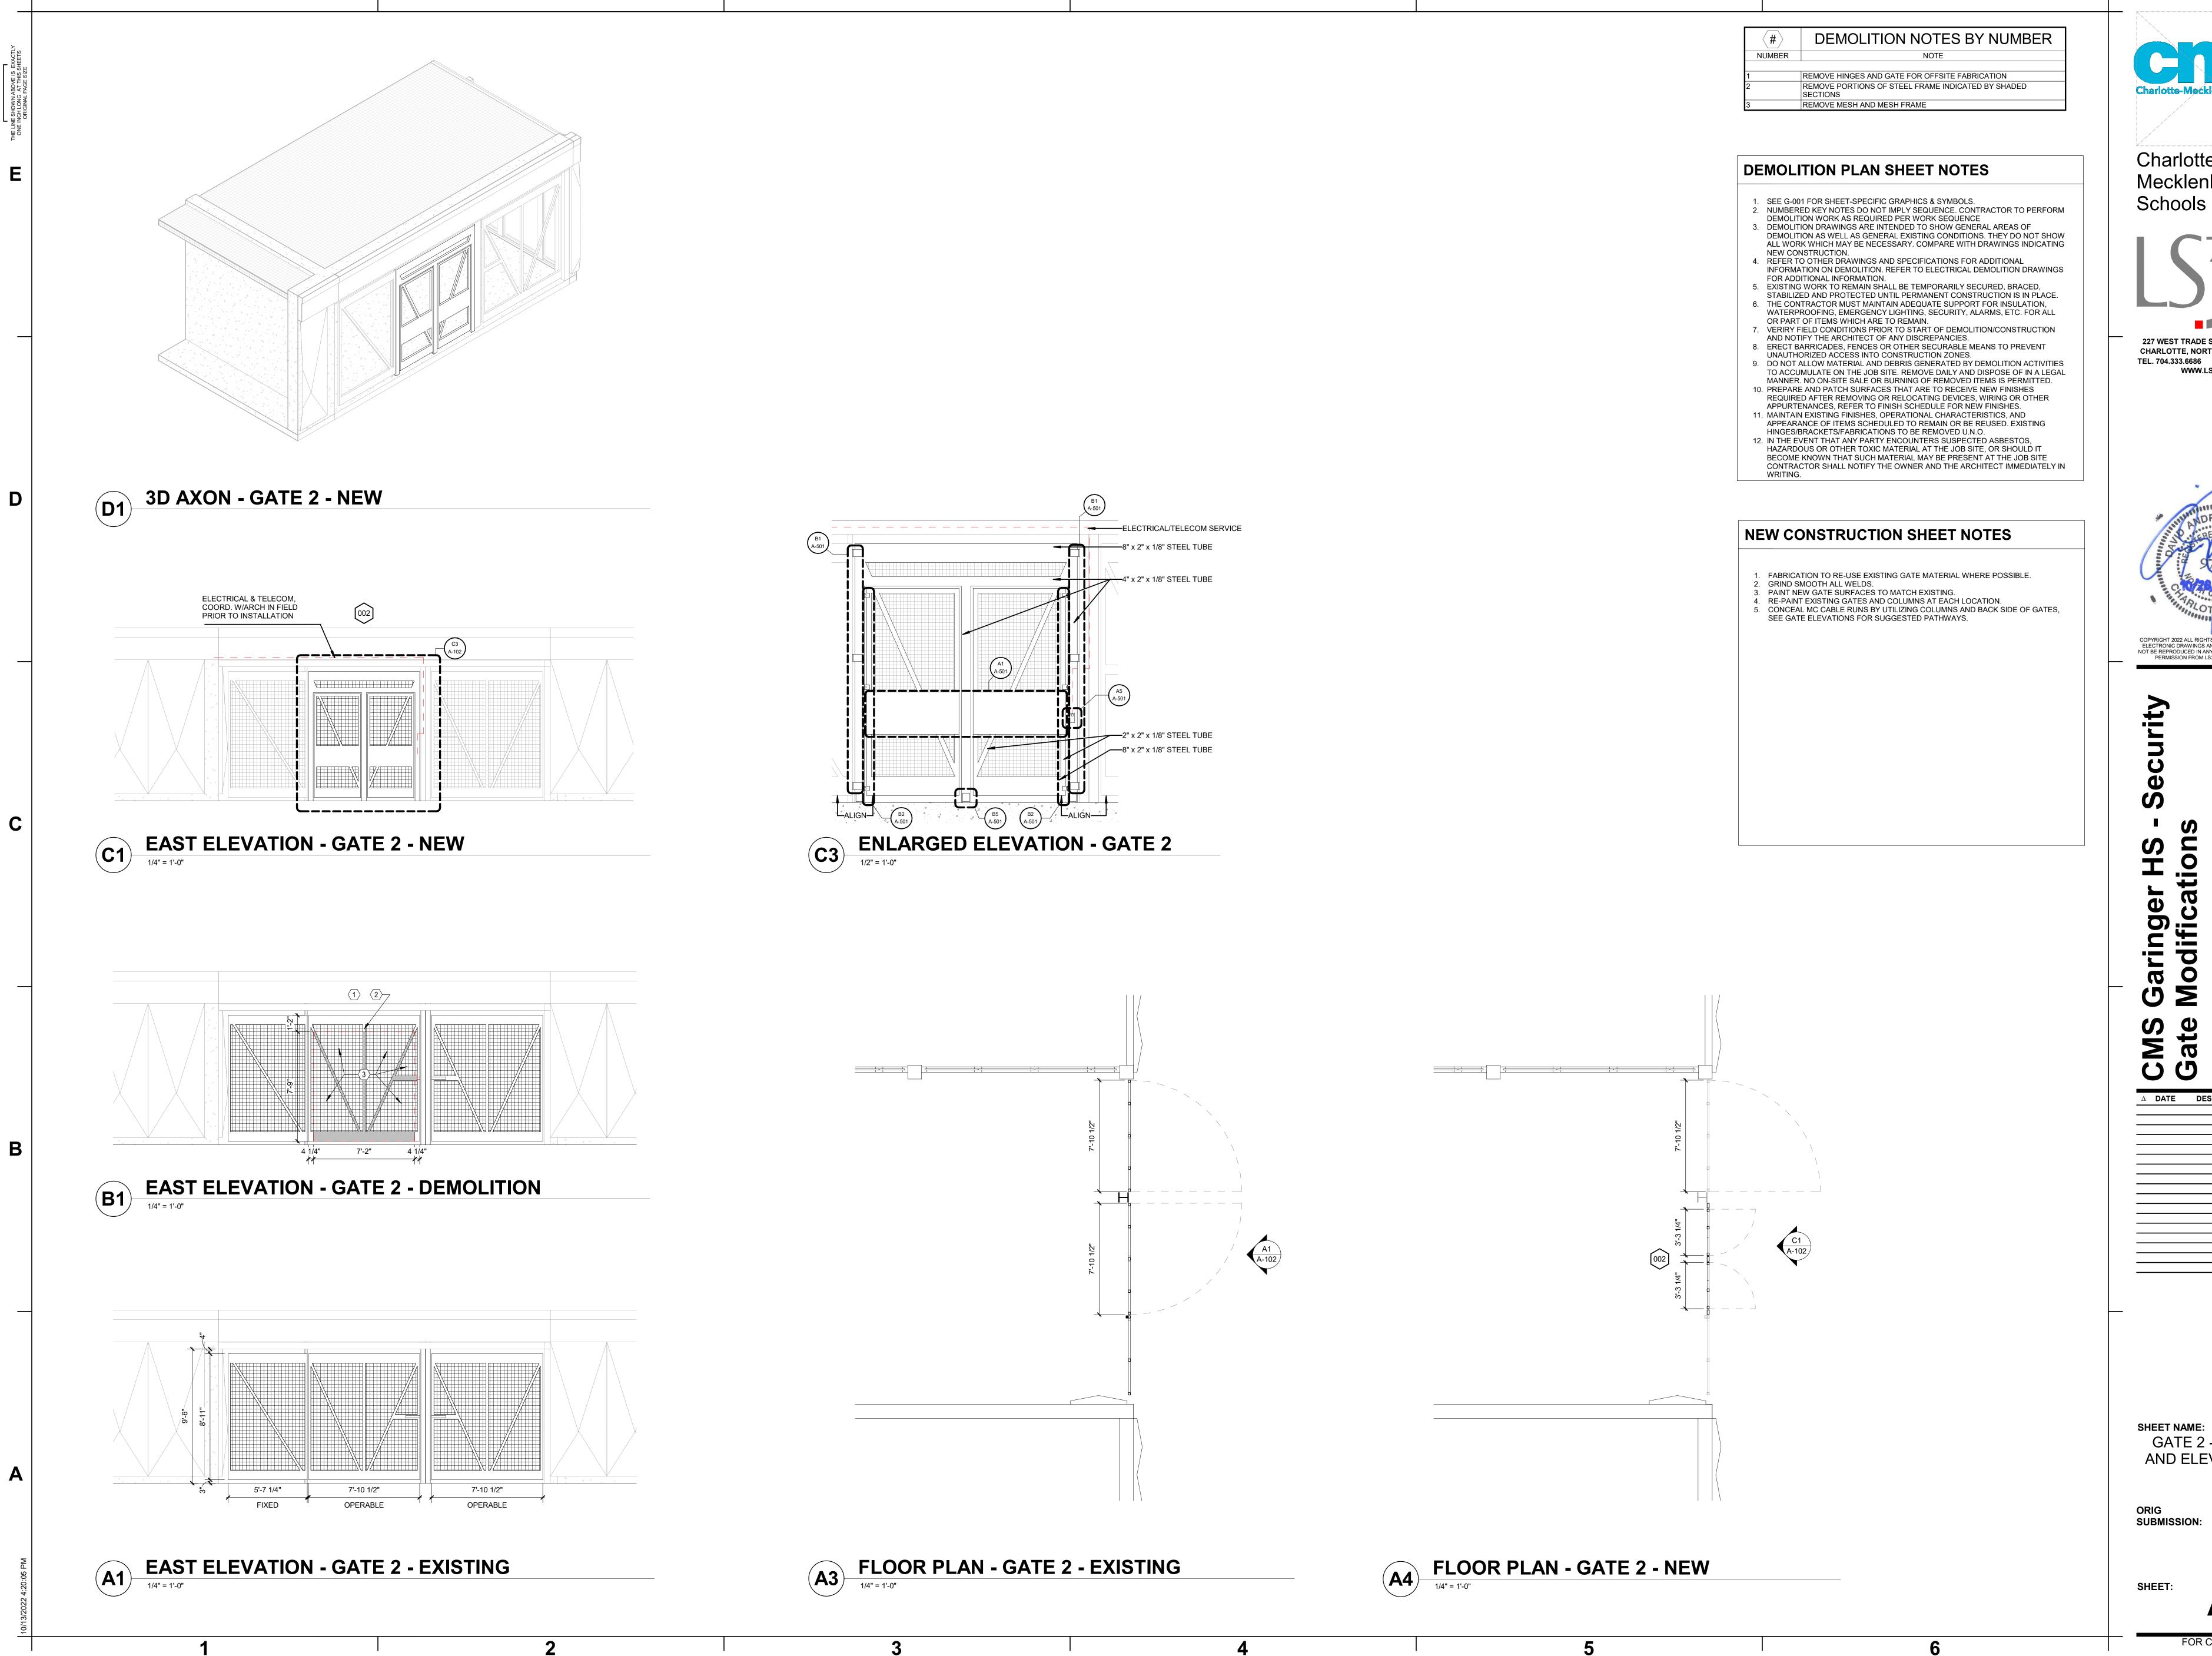
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SHEET NAME: GATE 1 - PLANS

A-101 FOR CONSTRUCTION

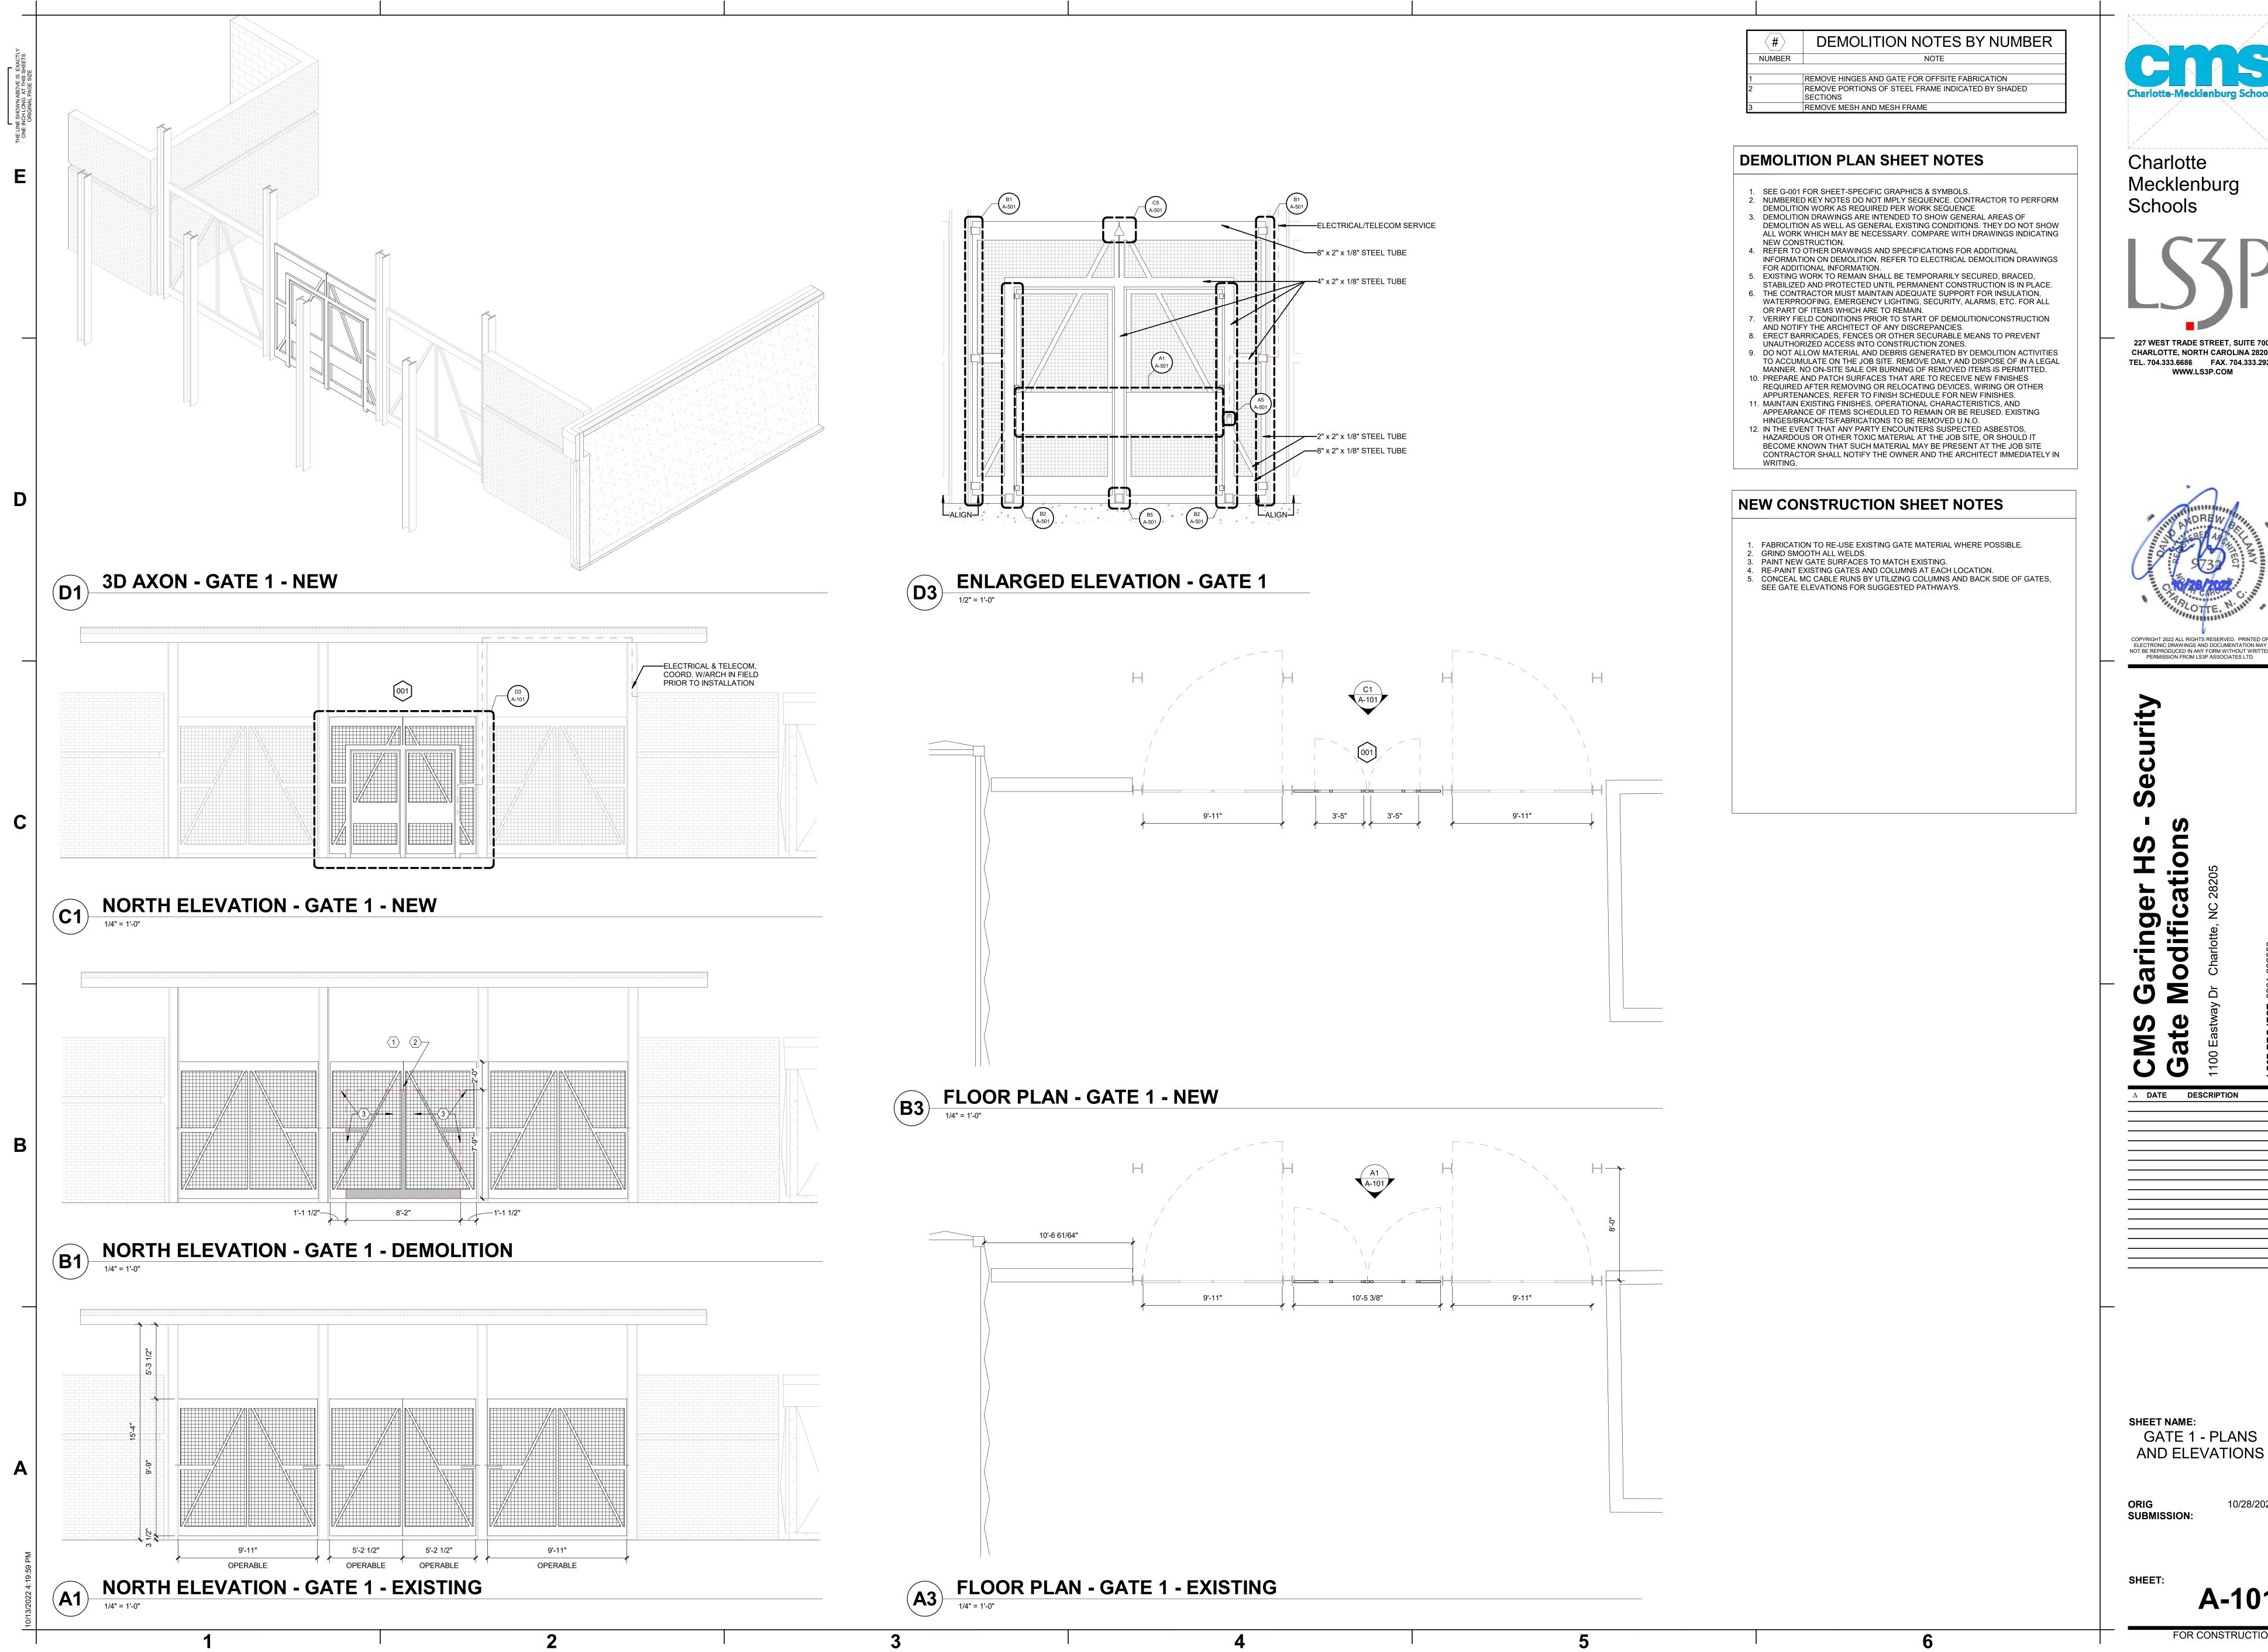

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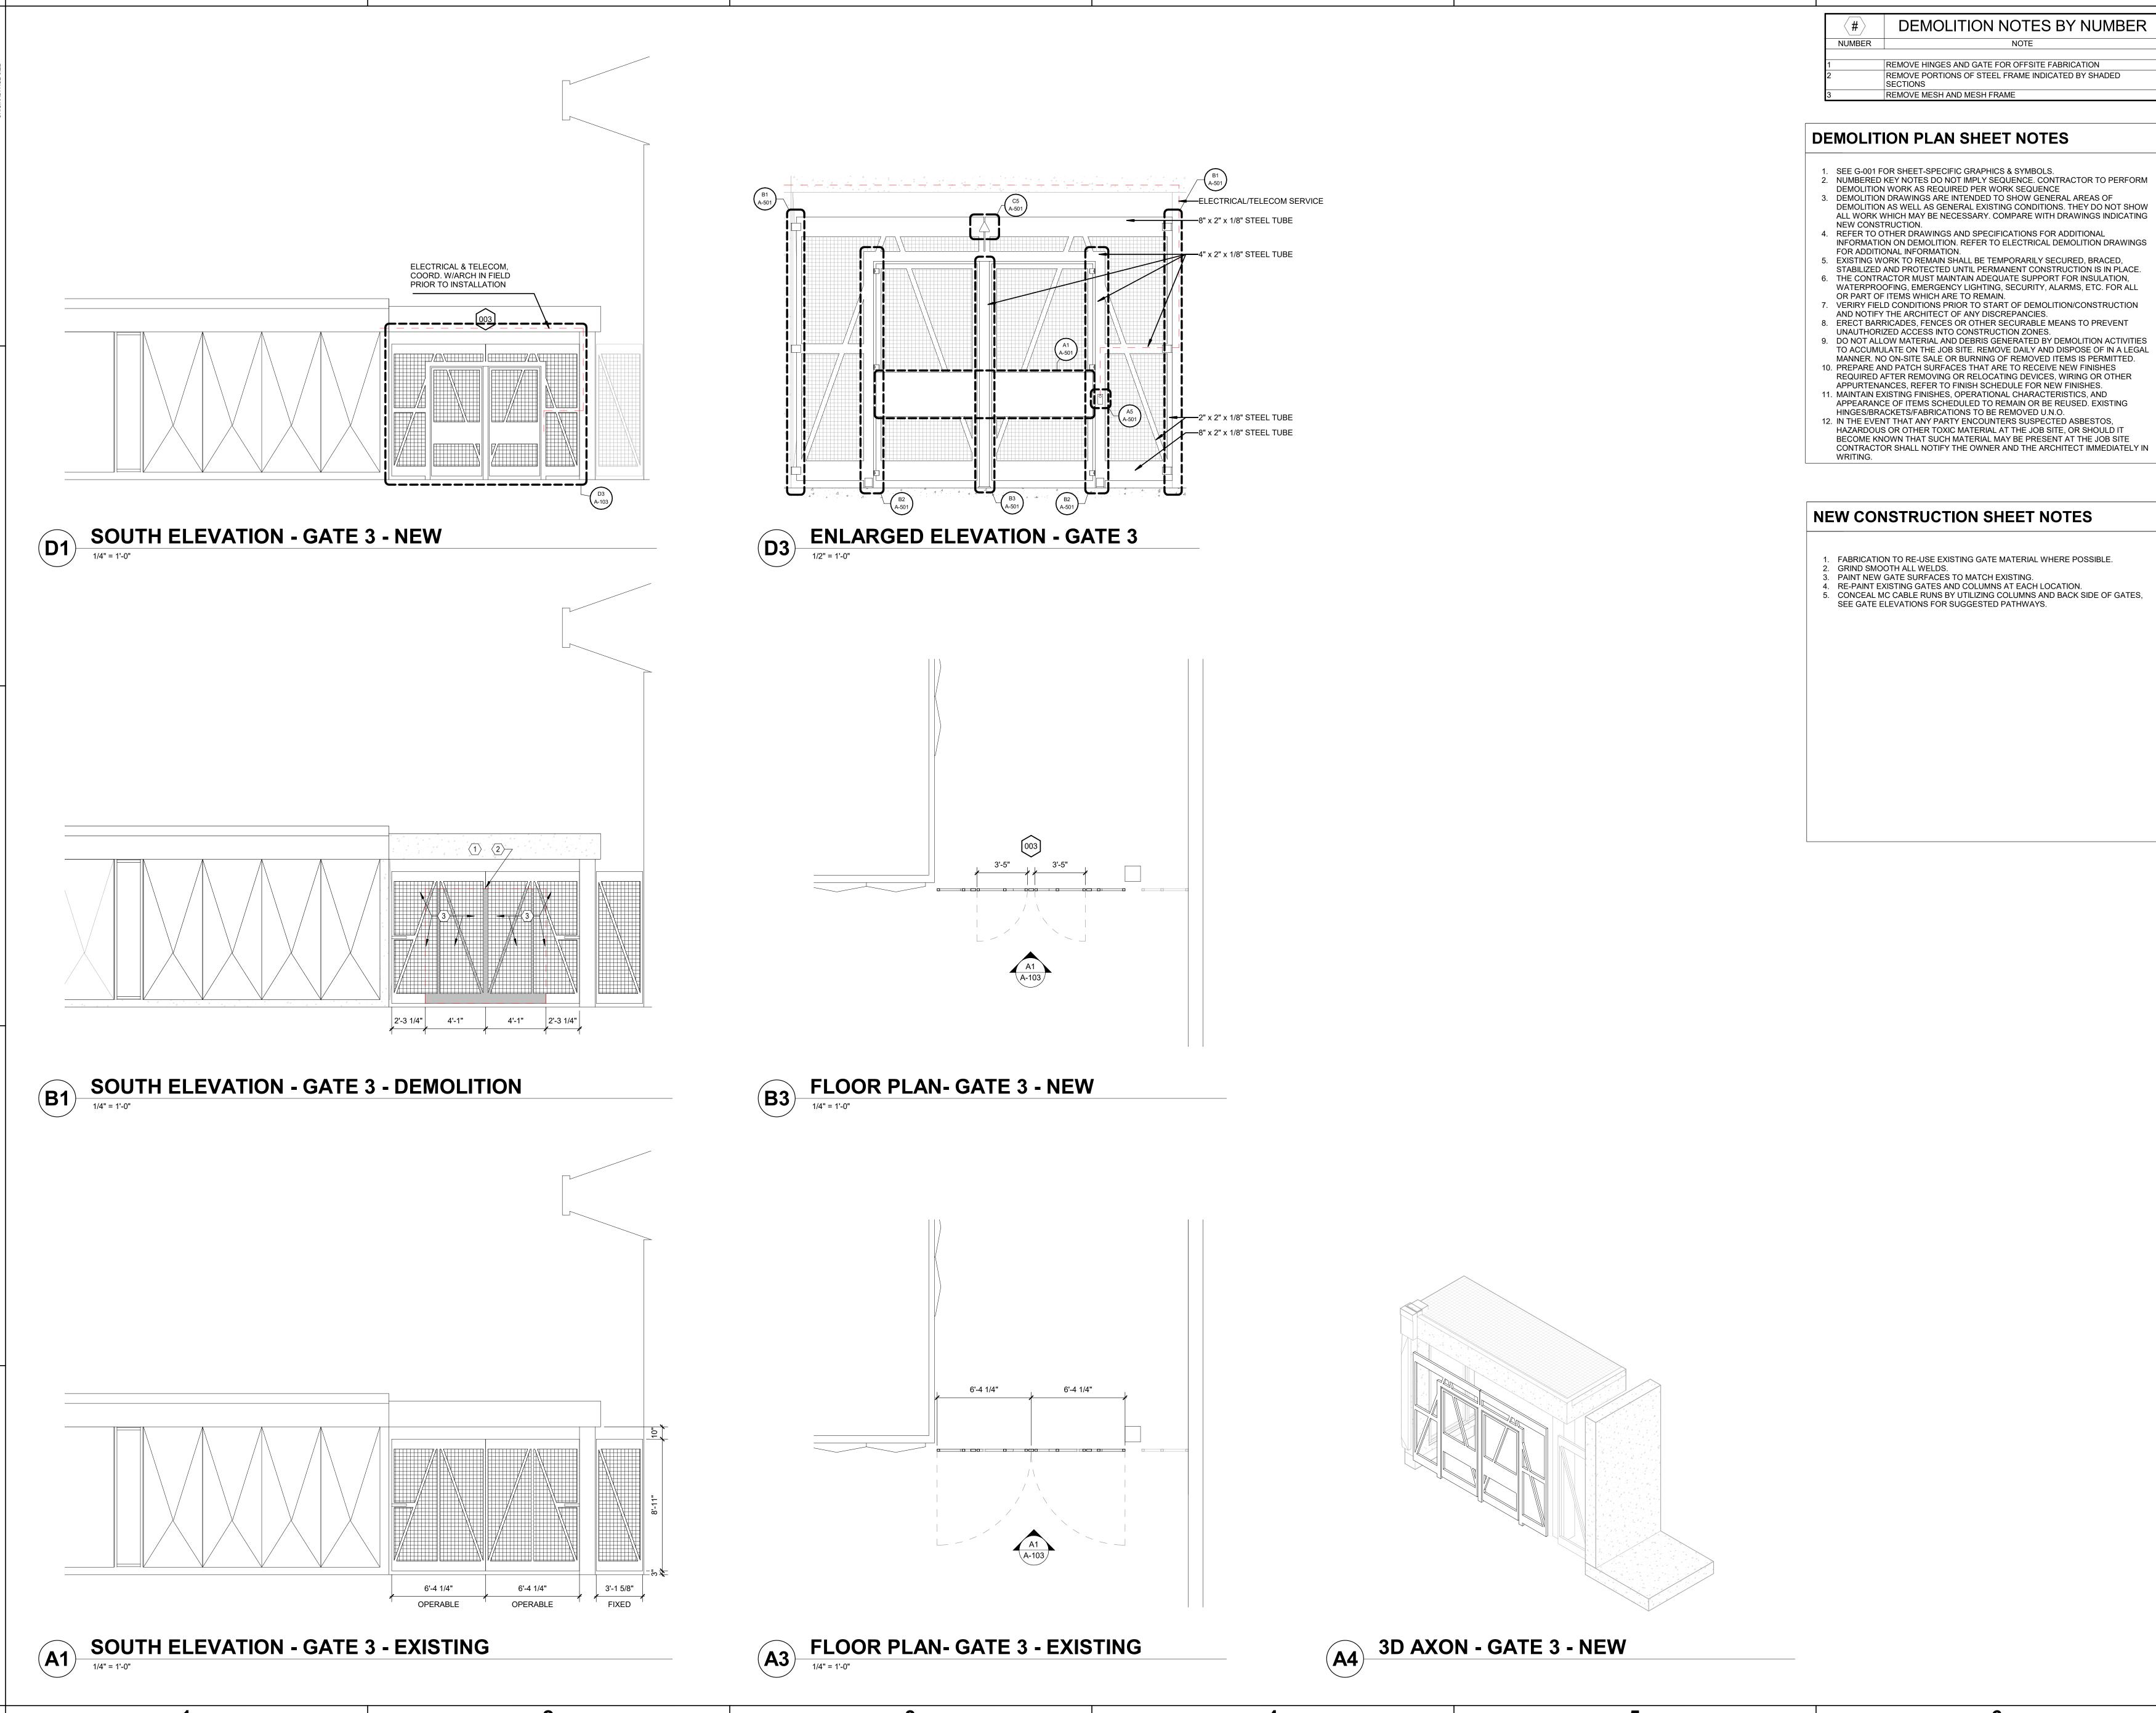
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SHEET NAME: GATE 2 - PLANS AND ELEVATIONS

ORIG SUBMISSION:

A-102

FOR CONSTRUCTION



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Charlotte-Mecklenburg Schools

Charlotte Mecklenburg Schools

227 WEST TRADE STREET, SUITE 700

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SMS Garinger HS - Security 3ate Modifications

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SHEET NAME:
GATE 3 - PLANS
AND ELEVATIONS


ORIG SUBMISSION:

SHEET:

A-103

FOR CONSTRUCTION

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SMS Garinger HS - Security

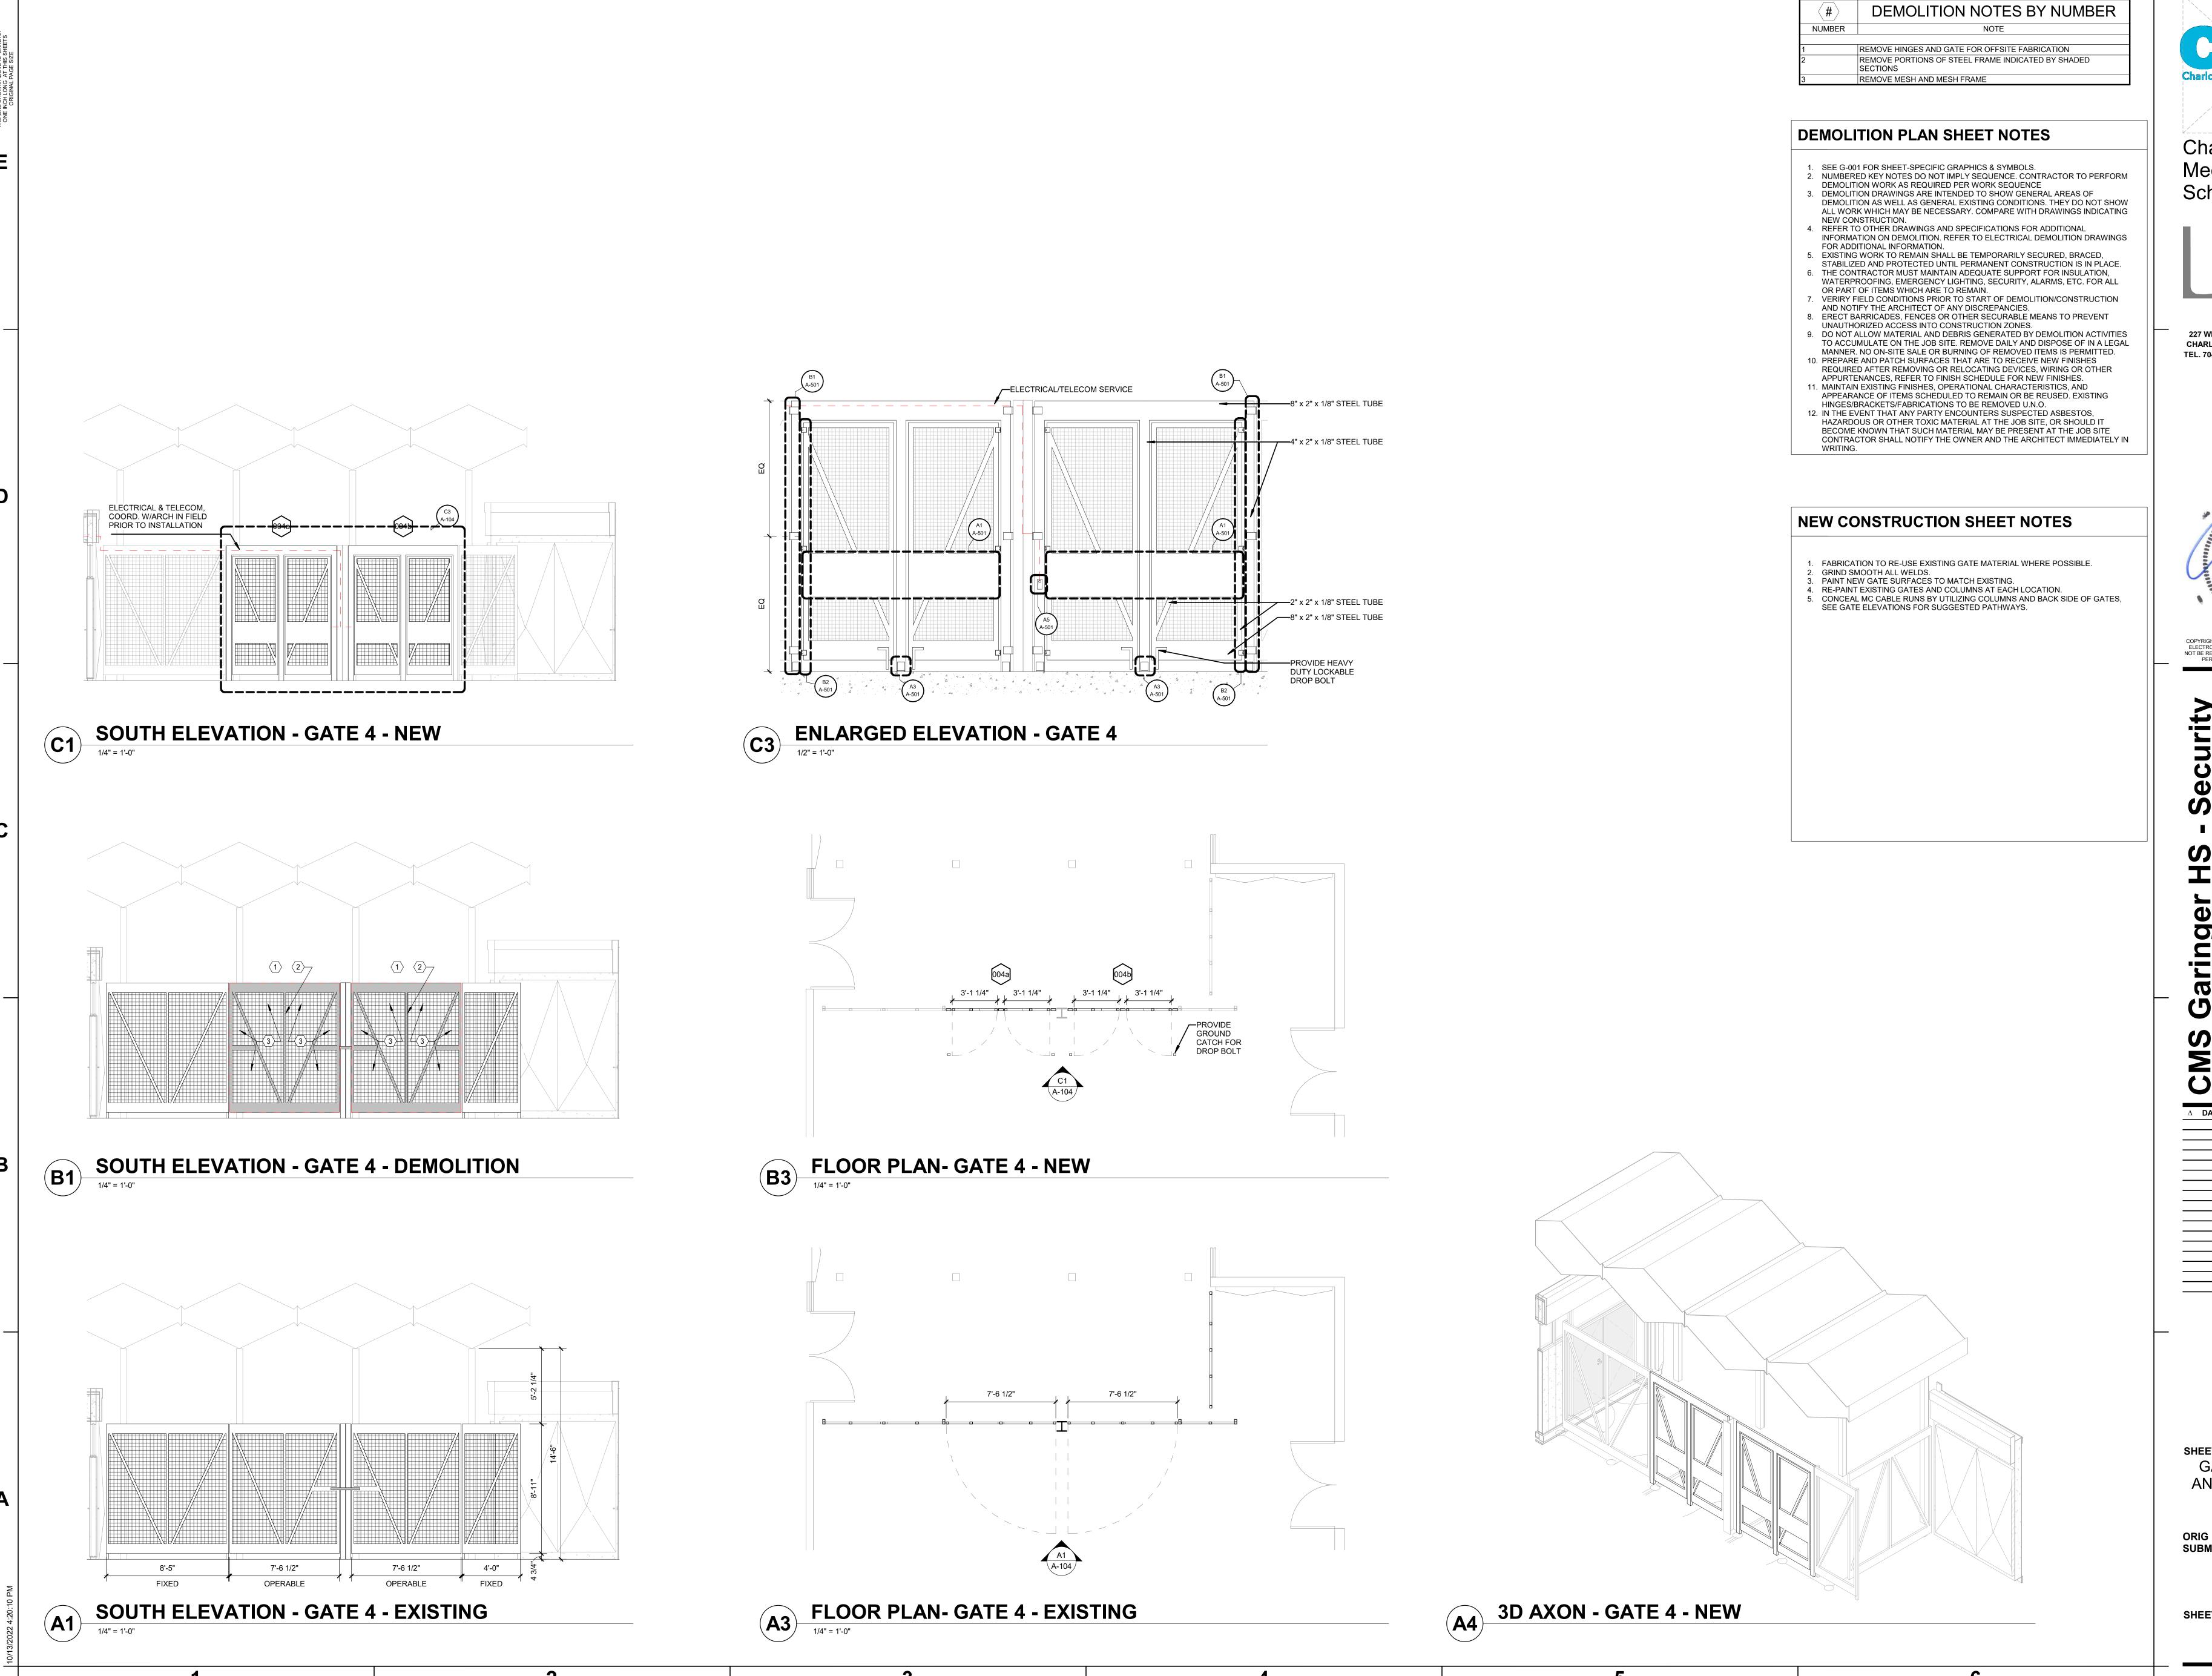Sate Modifications

100 Eastway Dr. Charlotte, NC 28205

DATE DESCRIPTION


SHEET NAME:
GATE 4 - PLANS
AND ELEVATIONS

ORIG SUBMISSION:

A-104

FOR CONSTRUCTION


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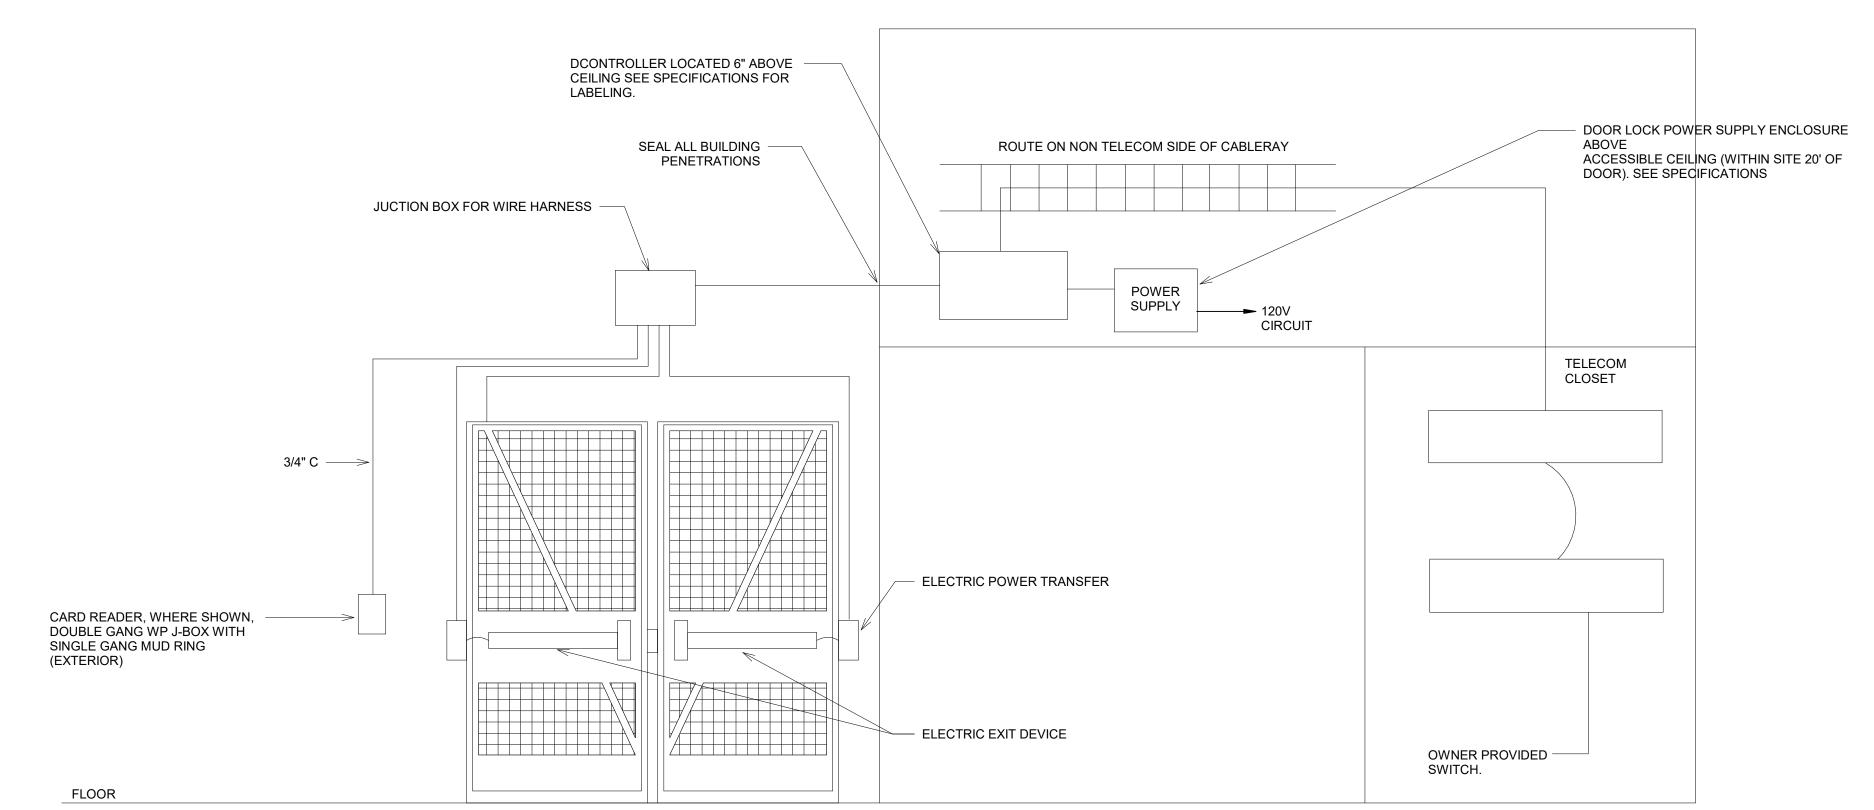


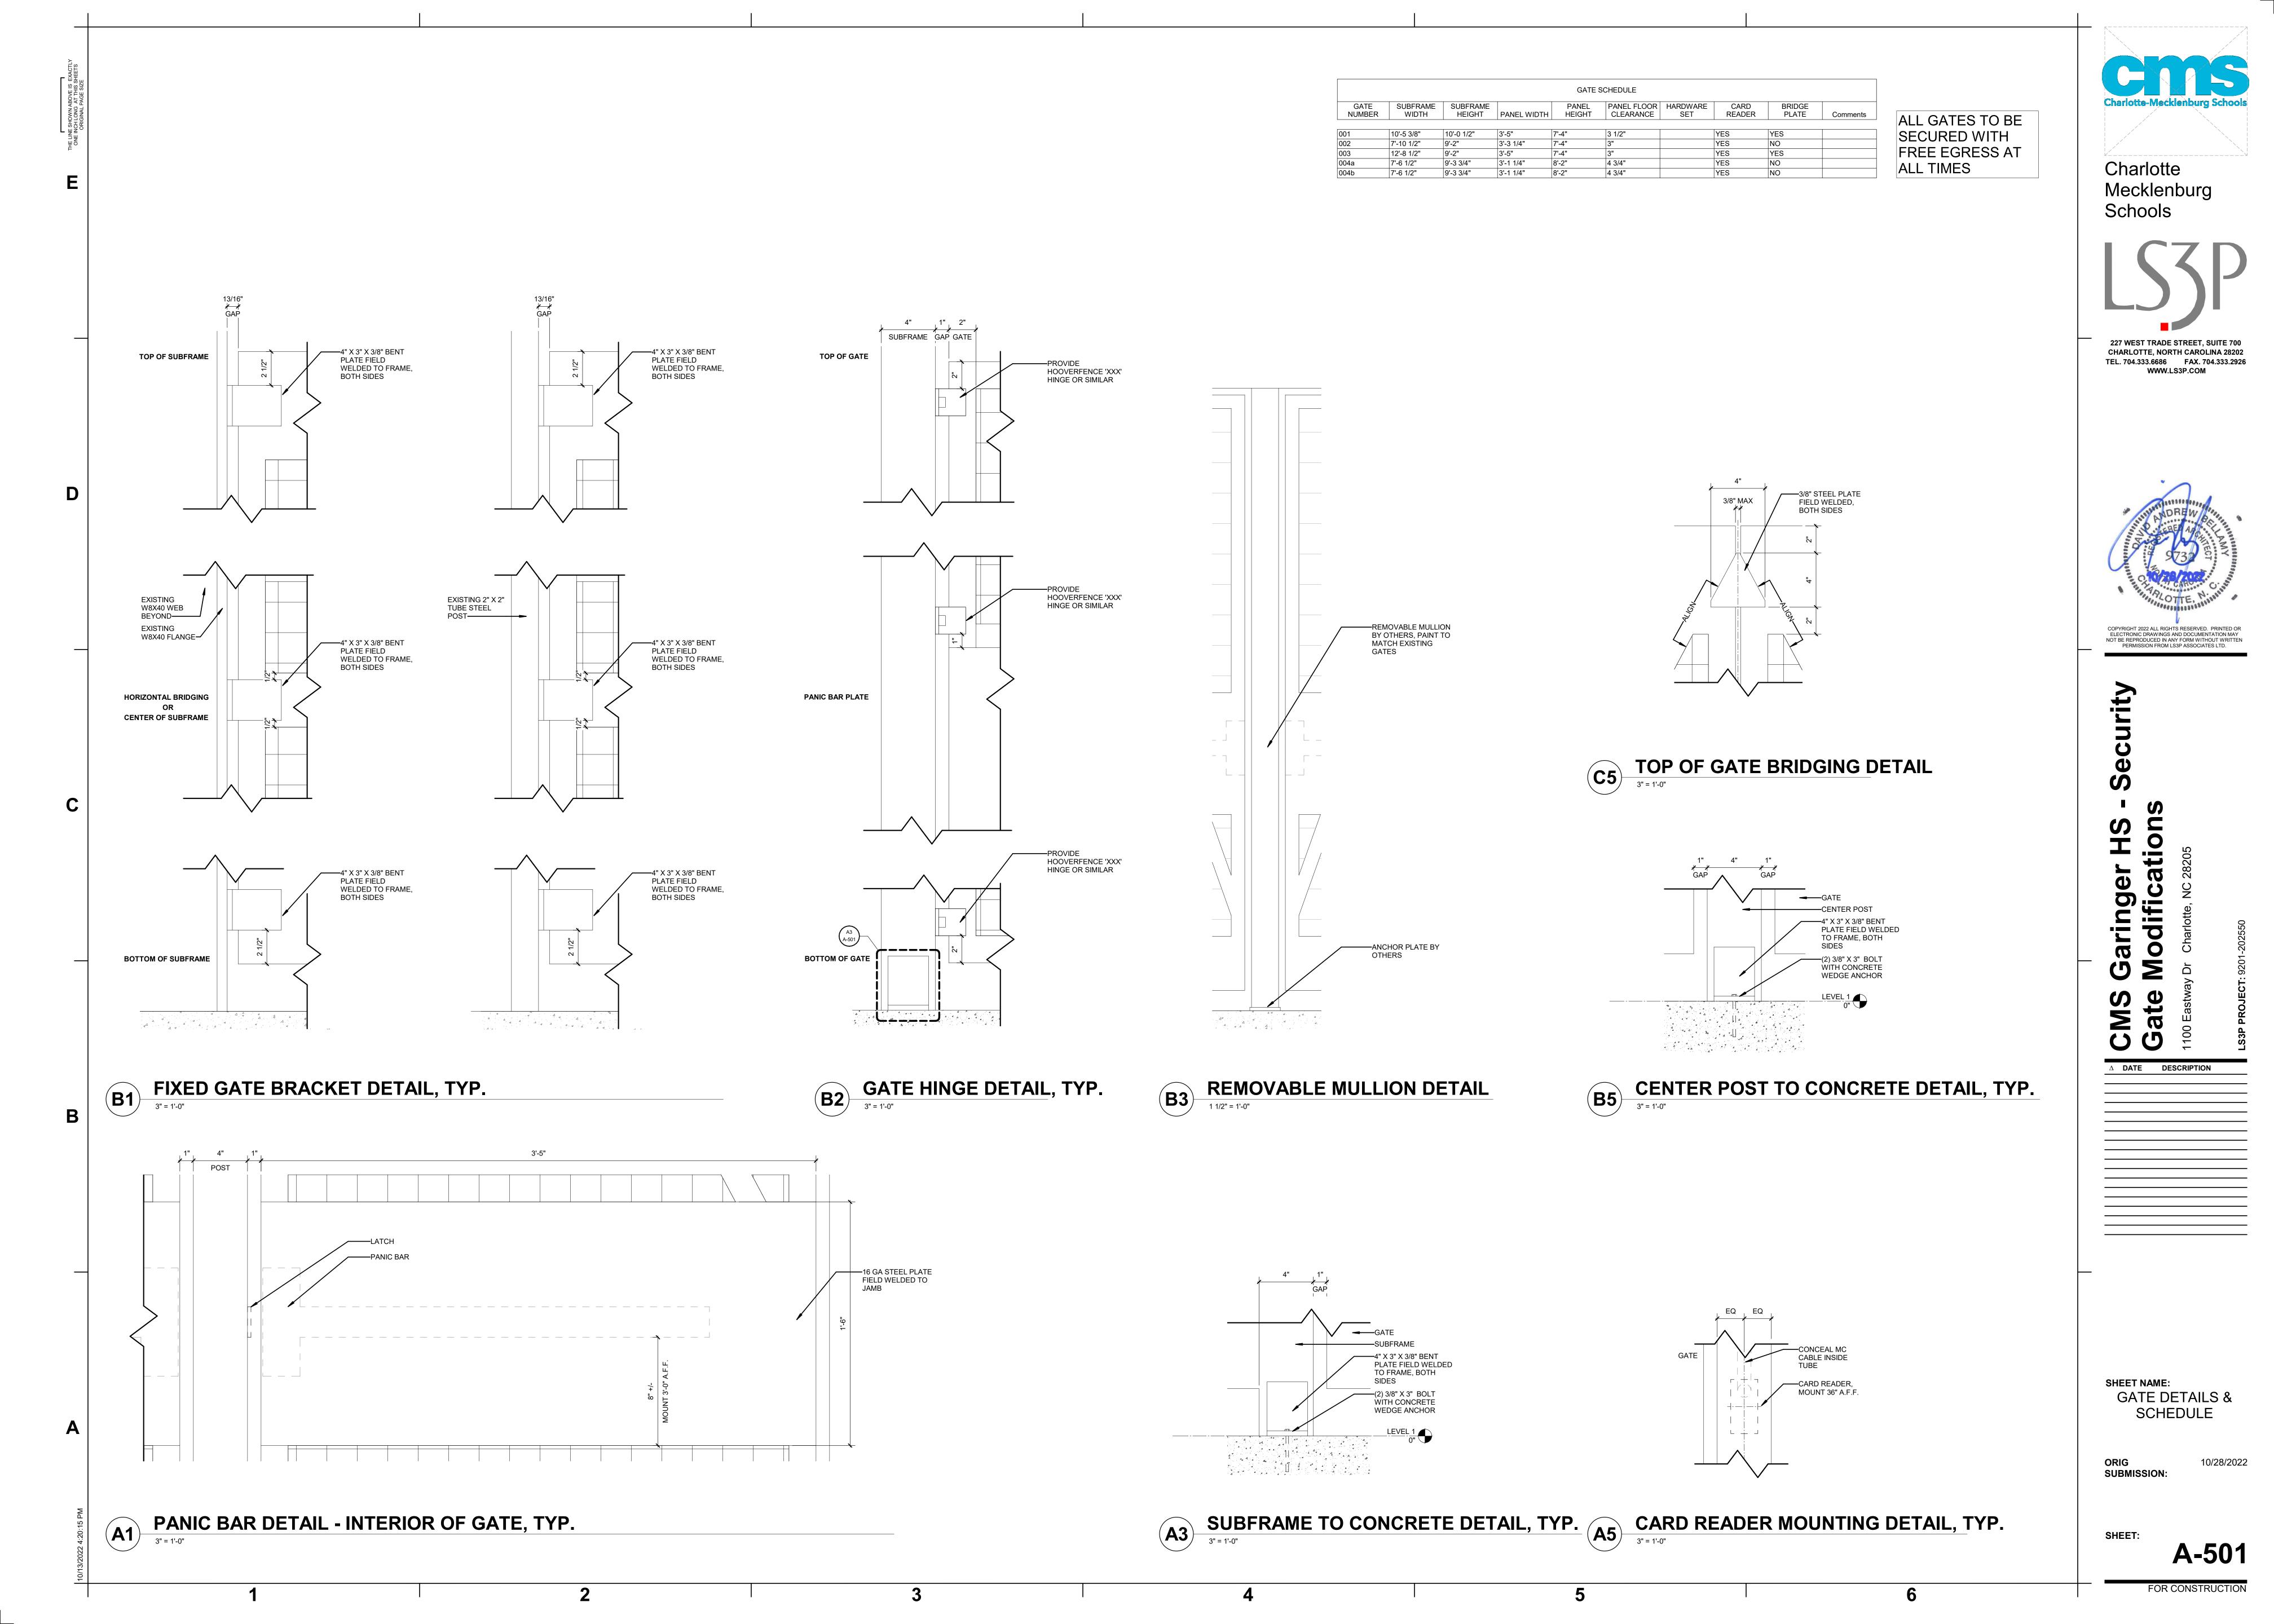- A. EACH CONTRACTOR, PROPOSER, SUPPLIER AND/OR MANUFACTURER SHALL REFER TO ALL DOCUMENTS PERTAINING TO THIS PROJECT AND COORDINATE ACCORDINGLY SO AS TO ENSURE ADEQUACY OF FIT. COMPLIANCE WITH SPECIFICATIONS, PROPER VOLTAGE AND CURRENT CHARACTERISTICS TO AVOID CONFLICT WITH ANY OTHER BUILDINGS SYSTEMS. VERIFY SAME WITH SHOP DRAWINGS.
- . ADDITIONAL ELECTRICAL REQUIREMENTS MAY BE SHOWN ON PLANS FROM OTHER DISCIPLINES IN THIS SET. IT IS THE CONTRACTOR'S RESPONSIBILITY TO REVIEW ALL PLANS AND SPECIFICATIONS FOR A COMPLETE UNDERSTANDING OF THE PROJECT REQUIREMENTS.
- WORK SHALL BE IN ACCORDANCE WITH THE LATEST EDITION OF ALL LOCAL, STATE, AND NATIONAL CODES. INCLUDING BUT NOT LIMITED TO NFPA 70 (NEC), NFPA 72, INTERNATIONAL BUILDING CODES, ETC. IN ADDITION OBSERVE ALL APPLICABLE RULES AND REGULATIONS THAT MAY APPLY TO THE WORK UNDER THIS CONTRACT FROM CITY, COUNTY, LOCAL, STATE, FEDERAL, MUNICIPALITY, UTILITY COMPANY, OSHA, ETC.
- D. CONTRACTOR SHALL FOLLOW SEISMIC RESTRAINT AND DESIGN REQUIREMENTS CONTAINED IN LATEST ADOPTED STATE AND INTERNATIONAL BUILDING CODES, WITH ALL AMENDMENTS AS ADOPTED BY THE CURRENT LEGISLATION. REFER TO ELECTRICAL AND STRUCTURAL SPECIFICATIONS FOR ADDITIONAL INFORMATION.
- ADVISE THE ENGINEER OF ANY CONFLICTS, ERRORS, OMISSIONS, ETC. AT LEAST TEN DAYS PRIOR TO BID DATE, TO ALLOW CLARIFICATION BY WRITTEN ADDENDUM.
- F. WHERE CONFLICTS ARE FOUND BETWEEN DRAWINGS, DETAILS, OR SPECIFICATIONS, THE MORE STRINGENT REQUIREMENT SHALL APPLY. NOTIFY ARCHITECT OF DISCREPANCY IN WRITING.
- G. DEVIATION FROM SPECIFICATIONS OR PLANS REQUIRES PRIOR WRITTEN APPROVAL FROM THE ENGINEERS AND MUST BE SUBMITTED IN WRITING NO LATER THAN TEN DAYS PRIOR TO THE BID DATE.
- H. ALL ELECTRICAL COMPONENTS OR EQUIPMENT SHALL BE LISTED AND LABELED BY UNDERWRITER'S LABORATORIES OR OTHER APPROVED LISTING AGENCY. APPROVAL AND LABELING OF INDIVIDUAL COMPONENTS ON AN ASSEMBLY IS NOT ACCEPTABLE AS MEETING THIS REQUIREMENT, UNLESS WAIVED BY THE ENGINEER IN
- I. ALL MATERIALS FURNISHED AND ALL WORK INSTALLED SHALL COMPLY WITH THE CURRENT EDITION OF THE NATIONAL ELECTRICAL CODES, NATIONAL FIRE CODES OF THE NATIONAL FIRE PROTECTION ASSOCIATION, THE REQUIREMENTS OF LOCAL UTILITY COMPANIES, AND WITH THE REQUIREMENTS OF ALL GOVERNMENTAL AGENCIES OR DEPARTMENTS HAVING JURISDICTION. IF ANY CONFLICTS OR DISCREPANCIES OCCUR THE MOST STRINGENT
- MOUNTING HEIGHTS FOR WALL MOUNTED DEVICES INDICATED ABOVE FINISHED FLOOR ARE TO CENTER OF DEVICE UNO. MOUNTING HEIGHTS TO CEILING SUSPENDED DEVICES ARE TO BOTTOM OF DEVICE UNO. WHERE MOUNTING HEIGHTS ARE NOT INDICATED OR ARE IN CONFLICT WITH ANY OTHER BUILDING SYSTEM, CONTACT THE ENGINEER BEFORE AFFECTING INSTALLATION. REFER ALSO TO ARCHITECTURAL INTERIOR AND EXTERIOR ELEVATIONS, CEILING HEIGHTS AND OTHER DETAILS OF THESE DOCUMENTS, AS APPLICABLE.
- . DO NOT SCALE FROM DRAWINGS, AS PRINTING DISTORTS SCALE. WORK SHALL BE LAID OUT FROM DIMENSIONED DRAWINGS, OR DIMENSIONS SUPPLIED TO THE CONTRACTOR.
- REFER TO ARCHITECTURAL WALL ELEVATIONS (WHERE GIVEN) FOR HEIGHTS AND MOUNTING RELATIONSHIP OF OUTLETS AND FURNITURE, CASEWORK, AND/OR EQUIPMENT. ADDITIONAL OUTLETS MAY BE SHOWN ON ARCHITECTURAL DRAWINGS AND SHALL BE INCLUDED IN THE CONTRACT.
- M. FLUSH OR PEDESTAL TYPE FLOOR OUTLETS/BOXES, AS INDICATED ON PLAN, SHALL BE LOCATED BY DIMENSIONS PROVIDED BY THE ARCHITECT, UNLESS OTHERWISE SHOWN ON PLANS. IF IN DOUBT, CONTACT THE ENGINEER
- N. INSTALL EQUIPMENT, MATERIALS, ETC. IN STRICT ACCORDANCE WITH MANUFACTURER'S RECOMMENDATIONS AND DIRECTIONS. IF IN CONFLICT WITH THE DESIGN INDICATED IN CONTRACT DOCUMENTS, ADVISE THE ENGINEER PRIOR TO INSTALLATION FOR CLARIFICATION.
- O. THE CONSTRUCTION MANAGER, GENERAL CONTRACTOR, OR WHOMEVER HOLDS THE PRIME CONTRACT(S) FOR THIS CONSTRUCTION IS RESPONSIBLE FOR THE COORDINATION, APPEARANCE, SCHEDULING AND TIMELINESS OF THE WORK OF ALL TRADES, CONTRACTORS, SUPPLIERS, INSTALLERS, ETC. POOR OR UNTIMELY WORK ON THE PART OF ANY SUBCONTRACTOR SHALL BE RESOLVED BY THE PARTY WHO ENGAGED THEM ON THIS PROJECT.
- P. THE PURPOSE AND INTENT OF ALL OF THE DOCUMENTS PERTAINING TO THIS PROJECT IS TO PROVIDE A COMPLETE, FUNCTIONAL, SAFE, LIKE-NEW FACILITY. ANYTHING LESS SHALL BE UNACCEPTABLE.
- Q. ALL SYSTEMS, EQUIPMENT AND MATERIALS ARE TO BE INSTALLED IN A NEAT AND WORKMANLIKE MANNER. WORK NOT MEETING THIS CRITERION SHALL BE REMOVED AND REINSTALLED SATISFACTORILY. FINAL DETERMINATION OF THE ACCEPTABILITY OF THE QUALITY OF WORK RESIDES WITH THE ENGINEER
- R. ALL WORK, MATERIALS, EQUIPMENT, ETC. SHALL BE FULLY GUARANTEED FOR ONE FULL CALENDAR YEAR FROM THE DATE OF SUBSTANTIAL COMPLETION AS DOCUMENTED BY THE ENGINEER, UNLESS LONGER WARRANTY PERIODS FOR EQUIPMENT ARE SPECIFIED.
- S. ALL WORK SHALL BE CONCEALED UNLESS SPECIFICALLY INDICATED TO BE EXPOSED, OR REQUIRED TO BE EXPOSED. IF IN DOUBT, CONTACT THE ENGINEER FOR CLARIFICATIONS PRIOR TO INSTALLING ANY SUCH WORK.
- T. UNLESS OTHERWISE SPECIFIED OR INDICATED. ALL EQUIPMENT AND/OR MATERIALS WITHIN OCCUPIED SPACES OR EXPOSED TO VIEW ON THE BUILDING EXTERIOR SHALL BE PRIMED AND FINISHED SO AS TO COMPLEMENT ADJACENT SURFACE, UNLESS OTHERWISE NOTED. COORDINATE WORK AND COLORS WITH ARCHITECT.
- . WHERE PENETRATING ROOFING MEMBRANE OR OTHER MATERIALS USED FOR WEATHERPROOFING THE BUILDING, MAKE SUCH PENETRATION IN A WAY THAT WILL NOT VOID OR DIMINISH THE ROOFING WARRANTY OR INTEGRITY IN ANYWAY, COORDINATE ALL SUCH PENETRATIONS WITH THE ROOFING MANUFACTURER AND ARCHITECT.
- V. CEILING-MOUNTED ELECTRICAL DEVICES SHALL BE CENTERED IN 2'X2' CEILING TILE AND INSTALLED CENTERED ON 2' DIMENSION OF 2'X4' TILE AND ON CENTERLINE OR A QUARTER POINT ON 4' DIMENSION.
- W. PROVIDE DETAILED SHOP DRAWINGS TO ENGINEER PRIOR TO PURCHASING OR INSTALLING ANY EQUIPMENT DEVIATIONS IN SIZES, CAPACITIES, FIT. FINISH, ETC. FOR EQUIPMENT FROM THAT PRIME SPECIFIED SHALL BE THE RESPONSIBILITY OF THE PURCHASER OF THAT EQUIPMENT. ANY PROVISIONS REQUIRED TO ACCOMMODATE A DEVIATION, WHETHER APPROVED BY THE ENGINEER OR NOT, SHALL BE THE RESPONSIBILITY OF THE PURCHASER.
- X. WHERE FIRE-RATED CEILING ASSEMBLIES ARE NOTED, PROVIDE UL-LISTED FIRE-RATED GYPSUM BOARD OR PRE-MANUFACTURED ENCLOSURES ABOVE LUMINAIRES, CEILING DEVICES, ETC. IN OR ON CEILING, AS REQUIRED TO MAINTAIN CEILING RATINGS.
- Y. ALL OFFSETS, TURNS, FITTINGS, TRIM, DETAIL, ETC. MAY NOT BE INDICATED, BUT SHALL BE PROVIDED AS REQUIRED. ADDITIONAL ALLOWANCES SHALL BE INCLUDED FOR SAME AT EACH PROPOSER'S DISCRETION.
- Z. INSTALL NO PIPING, CONDUIT, DUCTWORK, ETC. IN A LOCATION OR IN A MANNER WHICH WILL ALLOW FREEZING OR THE COLLECTION OF CONDENSATION THEREON. IF IN DOUBT, CONTACT THE ENGINEER. AA. ALL WIRING SYSTEMS SHALL BE INSTALLED WITH A MINIMUM OF SPLICES. CONDUCTORS, WHETHER SINGLE OR
- MULTI-PAIR, SHALL BE INSTALLED CONTINUOUS INSOFAR AS POSSIBLE FROM TERMINAL POINT TO TERMINAL POINT.
- BB. NO CONDUIT, SUPPORTS, ETC. SHALL BE RUN THROUGH ACCESS CLEARANCES OF EQUIPMENT BY OTHER TRADES (I.E. VAV BOXES). COORDINATE WITH ALL TRADES PRIOR TO CONSTRUCTION. CC. ALL SUPPORTS FOR EQUIPMENT. DEVICES OR FIXTURES SHALL BE UNIQUE. DIRECTLY FROM THE BUILDING
- STRUCTURE. DO NOT SUPPORT WORK FROM OTHER TRADES EQUIPMENT OR SUPPORTS WITHOUT WRITTEN PERMISSION FROM THE ENGINEER AND CONSENT OF THE OTHER TRADE, IN WRITING.
- LEVEL. LABEL EACH BOX IN AREA OF WORK WITH A PERMANENT MARKER OR IN ACCORDANCE WITH SPECIFICATIONS, WHICHEVER IS MORE STRINGENT.

DD. JUNCTION BOXES LOCATED ABOVE ACCESSIBLE CEILINGS SHALL BE LOCATED NO MORE THAN 36" ABOVE CEILING

- EE. ANY VIBRATING, OSCILLATING OR OTHER NOISE OR MOTION PRODUCING EQUIPMENT SHALL BE ISOLATED FROM SURROUNDING SYSTEMS IN AN APPROVED MANNER. NOISY OR STRUCTURALLY DAMAGING INSTALLATIONS SHALL BE SATISFACTORILY REPLACED OR REPAIRED AT THE INSTALLING CONTRACTORS' EXPENSE. THE FINAL DECISION ON THE SUITABILITY OF A PARTICULAR INSTALLATION'S ACCEPTABILITY SHALL BE THAT OF THE ENGINEER.
- FF. ALL ITEMS HAVING KEYED LOCKS/OPERATORS SHALL HAVE CORED LOCKS/OPERATORS. ALL KEYING SHALL MATCH THE OWNER'S EXISTING KEY-WAYS. COORDINATE EXACT REQUIREMENTS WITH OWNER PRIOR TO CONSTRUCTION.
- GG. NOISY WORK, WORK OUTSIDE CONSTRUCTION BARRIERS, WORK IN OCCUPIED AREAS, ETC. SHALL BE PERFORMED AFTER HOURS OR ON WEEKENDS. COORDINATE EXACT SCHEDULING WITH FACILITY PRIOR TO CONSTRUCTION.
- HH. THIS CONTRACTOR SHALL BE RESPONSIBLE FOR ALL CUTTING AND PATCHING REQUIRED FOR HIS WORK. ALL CUTTING AND PATCHING SHALL BE IN ACCORDANCE WITH THE ARCHITECT'S STANDARDS FOR SUCH WORK.
- II. ALL CONTRACTORS SHALL EXERCISE EXTREME CARE IN THE COURSE OF THEIR WORK SO AS TO ENSURE THAT THEY DO NOT INTERRUPT ANY EXISTING SERVICE OR SUB-SERVICE FOR SAFETY PURPOSES. PAY PARTICULAR ATTENTION TO THIS PRECAUTION RELATIVE TO NATURAL GAS AND ELECTRICAL LINES. VERIFY THE LOCATION, SIZE. TYPE, ETC. OF EACH UNDERGROUND OR OVERHEAD UTILITY. ALL WORK SHALL BE PERFORMED IN ACCORDANCE WITH ALL FEDERAL, STATE AND/OR LOCAL RULES, REGULATIONS, STANDARD AND SAFETY REQUIREMENTS. UTILITIES SHALL BE INSTALLED IN ACCORDANCE WITH THE APPLICABLE MUNICIPALITY OR UTILITY COMPANY STANDARDS. IN ALL CASES. THE MOST STRINGENT REQUIREMENT SHALL APPLY.
- J. INTERRUPTION OF ANY EXISTING SERVICES SHALL BE COORDINATED WITH THE OWNER, GENERAL CONTRACTOR, UTILITY COMPANY AS NECESSARY, AND THE ARCHITECT, AT LEAST TWO WEEKS IN ADVANCE OF ANTICIPATED INTERRUPTION. A SCHEDULE FOR THESE OUTAGES SHALL BE DEVELOPED AND AGREED UPON BETWEEN THE PARTIES MENTIONED TO AVOID UNNECESSARY INCONVENIENCE TO THE OWNER OR ANY AFFECTED PARTY. NOTIFY THE UTILITY COMPANY OF ANY ANTICIPATED SERVICES REQUIRED TWO WEEKS IN ADVANCE, IN WRITING. IF UTILITY COMPANY REQUIRES A LONGER NOTIFICATION PERIOD. SO PROVIDE.



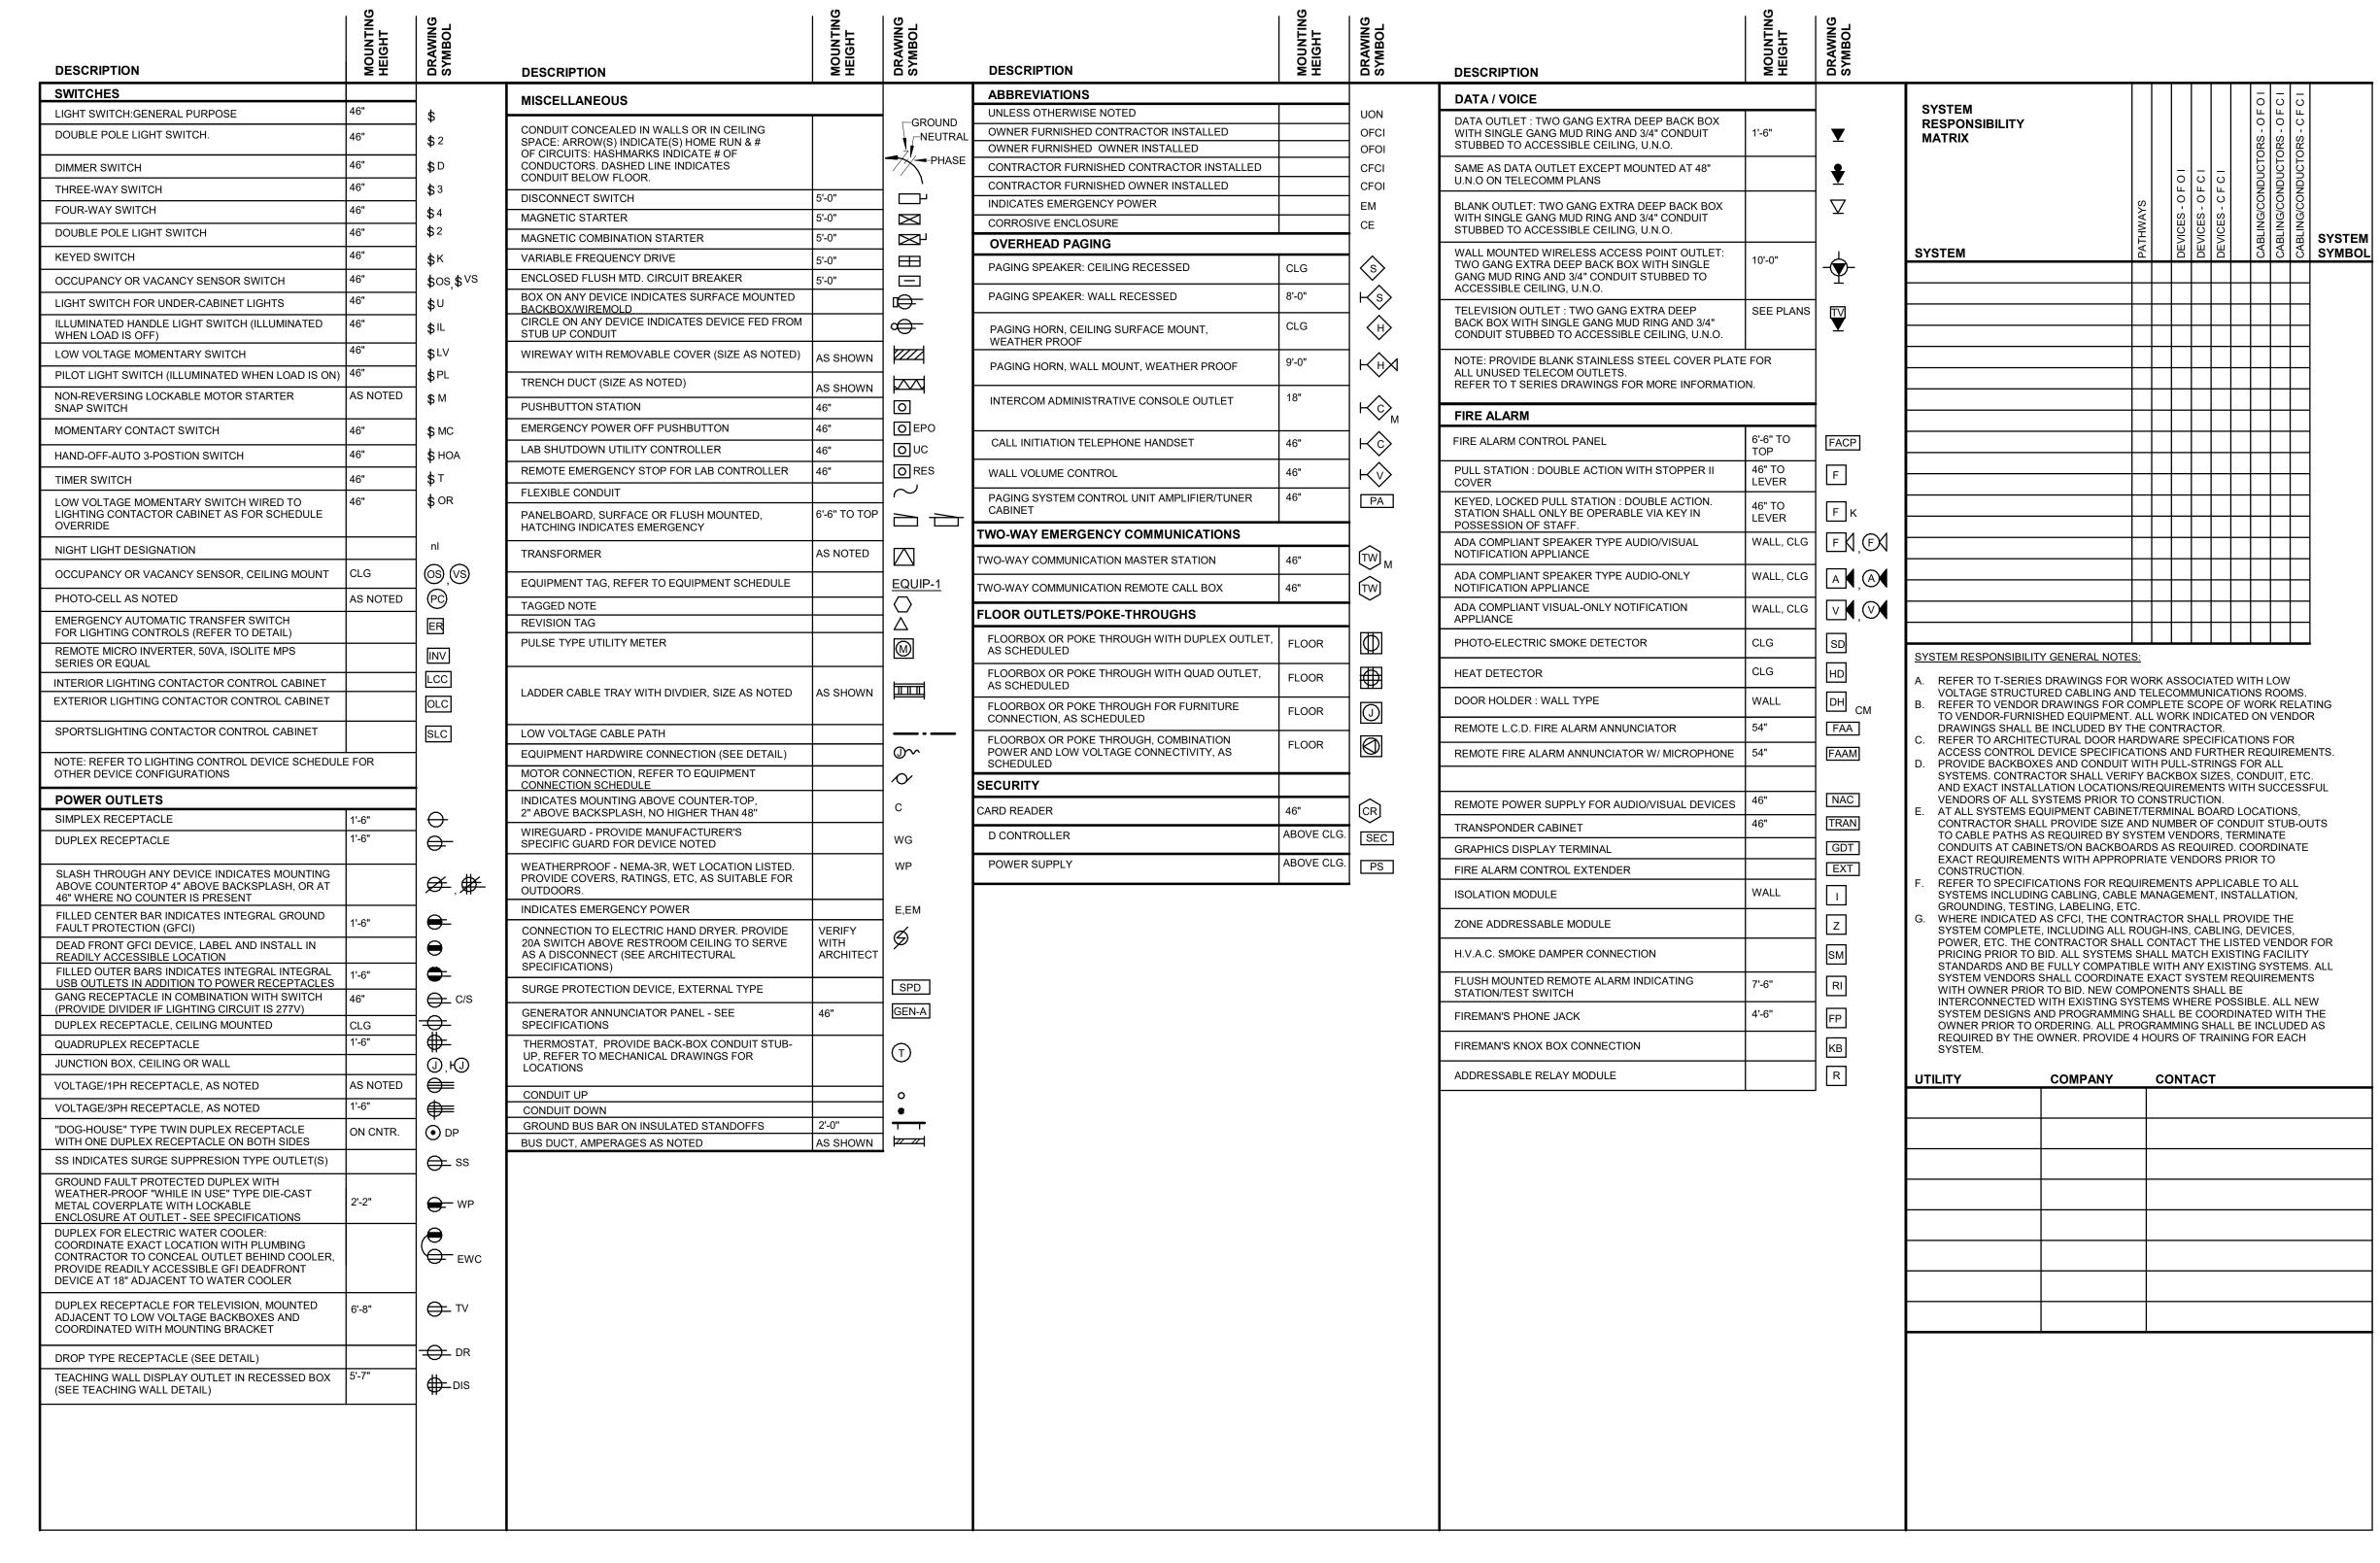

1. SEE SPECIFICATIONS FOR CABLING AND DEVICE REQUIREMENTS. 2. SEE DOOR SCHEDULE ON ARCHITECTURAL PLANS FOR LOCK TYPES.


3. DETAIL IS TYPICAL FOR EACH DOOR. SEE PLANS FOR LOCATIONS. 4. PROVIDE ALL PATHWAYS FOR SYSTEM. PROVIDE ALL JUNCTION BOXES FOR SYSTEM UNLESS OTHERWISE NOTED.

D CONTROLLER DOOR ACCESS CONTROLS



CHARLOTTE, NORTH CAROLINA 28202



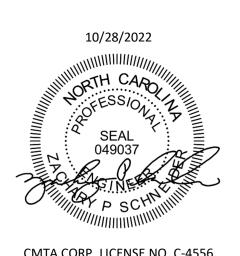

CMTA CORP. LICENSE NO. C-4556

2

△ DATE DESCRIPTION


SHEET NAME: ELECTRICAL LEGEND

ORIG SUBMISSION: 10/28/2022

E100


FOR CONSTRUCTION

SHEET:

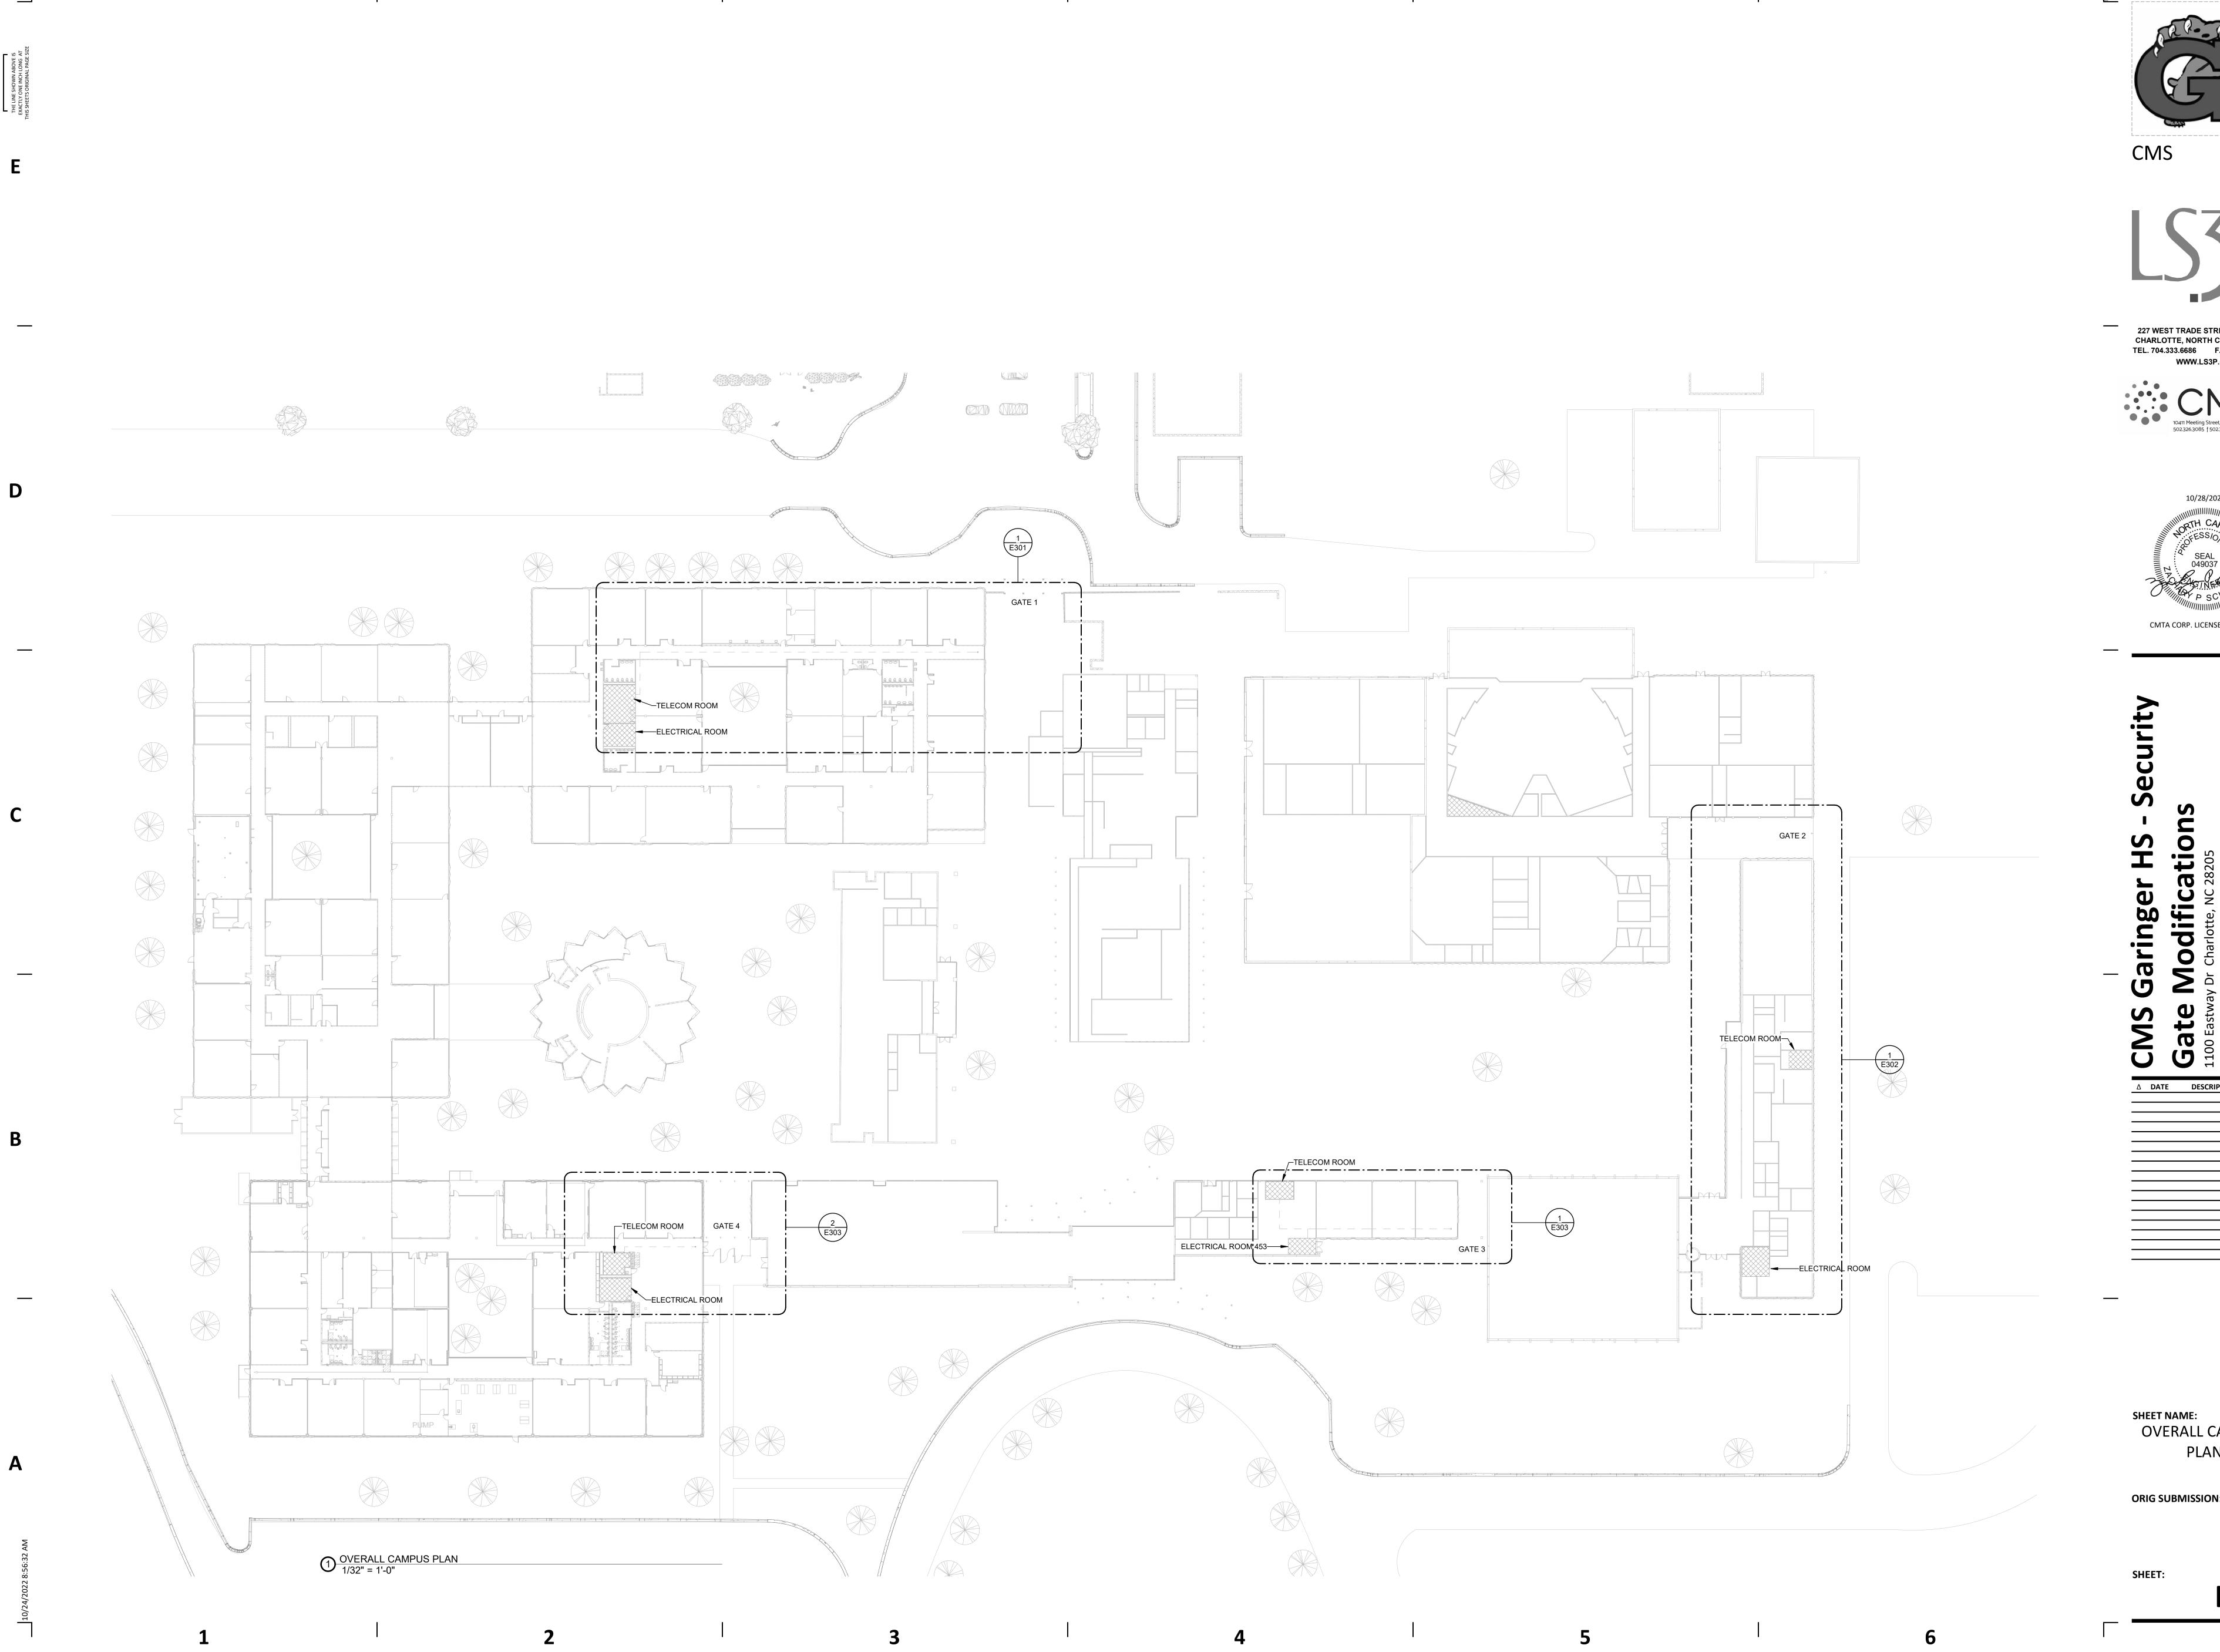

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OVERALL CAMPUS PLAN

ORIG SUBMISSION: 10/28/2022

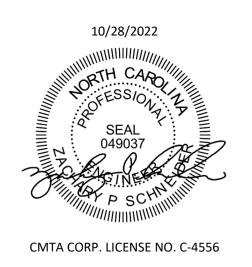E201

10/20/22

EXISTING PANELBOARD AND WIRING... PANEL: AC MAINS TYPE: MCB **VOLTAGE:** 208Y/120V,3P,4W SPD: AMPERES: 225 A (E) RM 119 (OVEN) (E) RM 119 (OVEN) EQUIP - GATE 1 POWER SUPPLY (E) RM 119 (OVEN) (E) RM 119 (STORE) (E) RM 119 (E) RM 119 (E) RM 119 COMPUTER RECP RM 206 COMPUTER RECP RM 206 COMPUTER RECP RM 206 COMPUTER RECP RM 206 LOAD CLASSIFICATION 100.00% 250 VA 3240 VA 100.00% 3240 VA 24000 VA 80.00% 19200 VA 19440 VA 75.72% 14720 VA

SCCR (kA): 10 AVAIL FAULT CURRENT (kA): **MOUNTING: SURFACE** SUPPLY FROM: CIRCUIT DESCRIPTION WIRE GND C OCP P CKT A B C CKT P OCP C GND WIRE CIRCUIT DESCRIPTION (E) EXISTING LOAD (E) AC UNIT RM 115 (E) AC UNIT RM 115 (E) AIR HANDLER (E) RM 119 (E) RM 119 (E) RM 119 (E) EXISTING LOAD (E) EXISTING LOAD (E) COMPUTER RECP RM 206 (E) COMPUTER RECP RM 206 (E) DISHWASHER RM 118 **TOTAL LOAD (kVA):** 20.1 kVA 13.3 kVA 13.6 kVA **TOTAL CURRENT (A):** 168 A 111 A 113 A CONNECTED LOAD | DEMAND FACTOR | ESTIMATED DEMAND PANEL TOTALS TOTAL CONNECTED LOAD: 47 kVA TOTAL ESTIMATED DEMAND: 37 kVA TOTAL CONNECTED CURRENT: 130 A TOTAL ESTIMATED DEMAND CURRENT: 104 A NOTES: WHERE NOT LISTED, WIRE AND CONDUIT SHALL BE MINIMUM PER SPECIFICATIONS. SPARE BREAKERS TO BE 20A/1P.

GENERAL NOTES (POWER/SYSTEMS):

- A. REFER TO THE ARCHITECT'S REFLECTED CEILING PLANS, ELEVATIONS, AND CASEWORK DETAILS FOR EXACT LOCATIONS OF ALL WALL AND CEILING MOUNTED ELECTRICAL DEVICES.
- B. CONTRACTOR SHALL FOLLOW BRANCH CIRCUITING LAY-OUT, AS INDICATED ON THE FLOOR PLANS, WITH A MAXIMUM OF THREE (3) BRANCH CIRCUITS PER HOMERUN. EACH BRANCH CIRCUIT SHALL BE PROVIDED WITH A DEDICATED NEUTRAL CONDUCTOR. DEDICATED NEUTRAL CONDUCTORS SHALL BE CONSIDERED CURRENT CARRYING. IF ADDITIONAL CONDUCTORS ARE RAN IN THE SAME CONDUIT WITH THOSE INDICATED. CONTRACTOR SHALL DERATE ALL CURRENT CARRYING CONDUCTORS PER NEC 310.15(B)(3), AND UPSIZE CONDUIT AS REQUIRED PER NEC 300.17 AND ANNEX C. MULTIWIRE BRANCH CIRCUITS AS DEFINED IN NEC 100 / 210.4 (CIRCUITS SHARING A COMMON NEUTRAL CONDUCTOR) SHALL NOT BE PERMITTED.
- C. IDENTIFY THE PANEL AND CIRCUIT NUMBER FOR ALL RECEPTACLES, SWITCHES, ETC. IN AREA OF CONSTRUCTION. PROVIDE CLEAR ADHESIVE LABELS WITH BLACK LETTERING.

KEYNOTES



227 WEST TRADE STREET, SUITE 700 CHARLOTTE, NORTH CAROLINA 28202 TEL. 704.333.6686 FAX. 704.333.2926 WWW.LS3P.COM





SHEET NAME: ENLARGED PLAN -GATE 1

ORIG SUBMISSION: 10/28/2022

SHEET:

E301

ENLARGED FLOOR PLAN - GATE 1 SCALE: 1/8" = 1'-0"

TELECOM ROOM

AC EXISTING PANEL

ELECTRICAL ROOM

PROVIDE D CONTROLLER ABOVE———ACCESSIBLE CEILING WITH Cat6 DATA DROP BACK TO NEAREST TELECOM

PROVIDE (2) #12, #12 GND IN 3/4"C TO

NEW 20A/1P CIRCUIT BREAKER IN

EXISTING PANEL INDICATED.

ROOM. REFER TO ACCESS CONTROL DETAIL FOR MORE INFORMATION.

GATE 1

—PROVIDE 250W POWER SUPPLY ABOVE CEILING FOR DOOR HARDWARE.

10/20/22

PROVIDE D CONTROLLER ABOVE—— ACCESSIBLE CEILING WITH Cat6 DATA GATE 2 DROP BACK TO NEAREST TELECOM ROOM. REFER TO ACCESS CONTROL DETAIL FOR MORE INFORMATION. —PROVIDE 250W POWER SUPPLY ABOVE CEILING FOR DOOR HARDWARE. TO NEW 20A/1P CIRCUIT BREAKER PP103B-32 IN EXISTING PANEL INDICATED.

GENERAL NOTES (POWER/SYSTEMS):

A. REFER TO THE ARCHITECT'S REFLECTED CEILING PLANS, ELEVATIONS, AND CASEWORK DETAILS FOR EXACT LOCATIONS OF ALL WALL AND CEILING MOUNTED ELECTRICAL DEVICES.

B. CONTRACTOR SHALL FOLLOW BRANCH CIRCUITING LAY-OUT, AS INDICATED ON THE FLOOR PLANS, WITH A MAXIMUM OF THREE (3) BRANCH CIRCUITS PER HOMERUN. EACH BRANCH CIRCUIT SHALL BE PROVIDED WITH A DEDICATED NEUTRAL CONDUCTOR. DEDICATED NEUTRAL CONDUCTORS SHALL BE CONSIDERED CURRENT CARRYING. IF ADDITIONAL CONDUCTORS ARE RAN IN THE SAME CONDUIT WITH THOSE INDICATED, CONTRACTOR SHALL DERATE ALL CURRENT CARRYING CONDUCTORS PER NEC 310.15(B)(3), AND UPSIZE CONDUIT AS REQUIRED PER NEC 300.17 AND ANNEX C. MULTIWIRE BRANCH CIRCUITS AS DEFINED IN NEC 100 / 210.4 (CIRCUITS SHARING A COMMON NEUTRAL CONDUCTOR) SHALL NOT BE PERMITTED.

C. IDENTIFY THE PANEL AND CIRCUIT NUMBER FOR ALL RECEPTACLES, SWITCHES, ETC. IN AREA OF CONSTRUCTION. PROVIDE CLEAR ADHESIVE LABELS WITH BLACK LETTERING.

KEYNOTES

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PANEL: PP103E	3							MAIN	NS TYPE	. MCD								800	CD (LA): 10			
VOLTAGE: 208Y/120V,3P,4W									NS ITPE SPD					SCCR (kA): 10 AVAIL FAULT CURRENT (kA): SUPPLY FROM:								
AMPERES: 225 A	МО	_	: : SURFA	CE																		
	2112		222	_	21/2							T	_	222	_		• • •					
CIRCUIT DESCRIPTION	WIRE	GND	С	OCP		CKT		A		В	(C	СКТ		OCP	С	GND	WIRE	CIRCUIT DESCRIPTION			
E) RECEPTACLES RM 125				20	1	1	1.1	1.1					2	1	20				(E) RECEPTACLES RM 106, 109			
(E) RECEPTACLES RM 125				20	1				1.1	1.1				1	20				(E) RECEPTACLES RM 108			
(E) RECEPTACLES RM 122, 124				20	1	5					1.1	1.1	6	1	20				(E) RECEPTACLES RM 108			
(E) EXISTING LOAD				20	1	7	1.1	1.1						1	20				(E) RECEPTACLES RM 108			
(E) RECEPTACLES RM 127				20	1	9			1.1	1.1				1	20				(E) WATER COOLER RM 100			
(E) RECEPTACLES RM 125				20	1	11					1.1	1.1		1	20				(E) RECEPTACLES RM 116			
(E) RECEPTACLES RM 111				20	1	13	1.1	1.1						1	20				(E) RECEPTACLES RM 112,113			
(E) RECEPTACLES RM 115				20	1	15			1.1	1.1				1	20				(E) RECEPTACLES RM 112,113			
(E) RECEPTACLES RM 120, 117				20	1	17					1.1	1.1		1	20				(E) RECEPTACLES RM 112			
(E) RECEPTACLES RM 121				20	1	19	1.1	1.1						1	20				(E) RECEPTACLES RM 127			
(E) RECEPTACLES RM 121				20	1	21			1.1	1.1			22	1	20				(E) RECEPTACLES RM 113			
(E) RECEPTACLES RM 121				20	1	23					1.1	1.1	1	1	20				(E) WHIRLPOOL RM 112			
(E) RECEPTACLES RM 116				20	1	25	1.1	1.1						1	20				(E) WHIRLPOOL RM 112			
(E) RECEPTACLES RM 116				20	1	27			1.1	1.1			28	1	20				(E) ICE MAKER			
(E)RECEPTACLE RM				20	1	29					1.1	1.1	30	1	20				(E) EXISTING LOAD			
(E) EXISTING LOAD				20	1	31	1.1	0.3					32	1	20				EQUIP - GATE 2 POWER SUPPL			
(É) EXISTING LOAD				20	1	33			1.1	0.0			34						SPACE			
(E) EXISTING LOAD				20	1	35					1.1	0.0	36						SPACE			
(É) EXISTING LOAD				20	1	37	1.1	0.0					38						SPACE			
(E) EXISTING LOAD				20	1	39			1.1	0.0			40						SPACE			
SPACE						41					0.0	0.0	42						SPACE			
		TOTA	AL LOA	D (I	kVA):	VA): 13.2 kVA			13.0 kVA 11.9			kVA										
	-	TOTAL CURRENT (A)					1 A	10	9 A	99) A											
LOAD CLASSIFICATION				ED LO		_ , , ,		ACTOR	ESTIM	ATED DE	MAND		PANEL TOTALS									
EQUIP			250 VA				100.00			250 VA			TOTAL CONNECTED LOAD: 38 kVA									
REC		37800 VA				63.23			23900 VA	1		-					24 kVA					
									20000 1/1								106 A					
												TOT						RENT:				

NOTES: WHERE NOT LISTED, WIRE AND CONDUIT SHALL BE MINIMUM PER SPECIFICATIONS. SPARE BREAKERS TO BE 20A/1P.

SHEET NAME: ENLARGED PLAN -GATE 2

ORIG SUBMISSION: 10/28/2022

SHEET:

E302

ENLARGED FLOOR PLAN - GATE 2

EXISTING PANEL

★ TELECOM ROOM

TELECOM ROOM

PROVIDE D CONTROLLER ABOVE— ACCESSIBLE CEILING WITH Cat6 DATA DROP BACK TO NEAREST TELECOM ROOM. REFER TO ACCESS CONTROL DETAIL FOR MORE INFORMATION. —PROVIDE 250W POWER SUPPLY ABOVE CEILING FOR DOOR HARDWARE. EXISTING PANEL— PROVIDE (2) #12, #12 GND IN 3/4"C TO-NEW 20A/1P CIRCUIT BREAKER IN APP-32 EXISTING PANEL INDICATED. ELECTRICAL ROOM 453 ENLARGED FLOOR PLAN - GATE 3

PROVIDE D CONTROLLER ABOVE ACCESSIBLE CEILING WITH Cat6 DATA DROP BACK TO NEAREST TELECOM ROOM, REFER TO ACCESS CONTROL DETAIL FOR MORE INFORMATION. PROVIDE 250W POWER SUPPLY ABOVE CEILING TELECOM ROOM— FOR DOOR HARDWARE. PROVIDE (2) #12, #12 GND IN 3/4"C TO NEW 20A/1P CIRCUIT BREAKER IN EXISTING PANEL INDICATED. BB-16 ELECTRICAL ROOM

ENLARGED FLOOR PLAN - GATE 4

SCALE: 1/8" = 1'-0"

PANEL: APP VOLTAGE: 208Y/120V,3					NS TYPE SPD	:	.=	SCCR (kA): 10 AVAIL FAULT CURRENT (kA):													
AMPERES: 100 A			_		-					: SURFA		_		_		_			/ FROM:		
CIRCUIT DESCRIPTION	WIRE	GND	С			CKT		A		В	(2	СКТ	Р	OCP	С	GND	WIRE			
(E) RECEPTACLES MECH RM				20	1		1.1	1.1					2	1	20				(E) RECEPTACLES RM 448		
(E) RECEPTACLES RM 447				20	1				1.1	1.1			4	1	20				(E) RECEPTACLES RM 450		
(E) RECEPTACLES RM 446				20	1	5					1.1	1.1	6	1	20				(E) RECP RM 450, BATH, BOOK		
(E) RECEPTACLES RM 444				20	1		1.1	1.1					8	1	20				(E) EWC		
(E) REC MENS, WOMENS BATH,				20	1	9			1.1	1.1			10	1	20				(E) WIREMOLD RM 407		
(E) RECEPTACLES RM 443				20	1						1.1	1.1	12	1	20				(E) WIREMOLD RM 407		
(E) LTG - OVERHANG				20	1	13	0.2	1.1					14	1	20				(E) WIREMOLD RM 408		
(E) RECEPTS - CLASSROOM 406				20	1				1.1	1.1			16	1	20				(E) WIREMOLD RM 408		
(E) RECEPTS - CLASSROOM 407				20	1	17					1.1	1.1	18	1	20				(E) WIREMOLD BOOKSTORE		
(E) RECEPTS - CLASSROOM 408				20	1	19	1.1	1.1					20	1	20				(E) WIREMOLD BOOKSTORE		
(E) INTERCOM HEAD-END EQUIP				20	1	21			0.8	1.1			22	1	20				(E) WIREMOLD RM 406		
(E) RECEPTS - TELCO RM				20	1	23					1.1	1.1	24	1	20				(E) WIREMOLD RM 406		
(E) RECEPTS - TELCO RM				20	1	25	1.1	1.1					26	1	20				(E) AHU CONT		
(E) RECEPTS - TELCO RM				20	1	27			1.1	1.1			28	1	20				(E) AHU CONT		
(E) BATH FANS				20	1	29					0.6	1.1	30	1	20				(E) GATE		
(E) INTERCOM EQUIP P.A.				20	1	31	0.8	0.3					32	1	20				EQUIP - GATE 3 - POWER PACK		
(E) CONFERNCE ROOM				20	1	33			1.1	0.0			34						SPACE		
(E) CONFERNCE ROOM				20	1	35					1.1	0.0	36						SPACE		
						37	0.0	0.0					38						SPACE		
EXISTING LOAD				100	3	39			0.0	0.0			40						SPACE		
						41					0.0	0.0	42						SPACE		
		TOTAL LOAD (kVA):	11.0) kVA	11.6 kVA		11.4	kVA									
				CURF	REN.	T (A):	9	1 A	97	97 A 9			1								
LOAD CLASSIFICATION		CON	NECT	ED LO	AD	DE	MAND I	ACTOR	ESTIM	IATED DI	MAND		PANEL TOTALS								
EQUIP			2930	VA			100.00%			2930 VA			TOTAL CONNECTED LOAD: 34 kVA								
HVAC			2760	VA			100.00%			2760 VA		TOTAL ESTIMATED DEMAND:							25 kVA		
LTNG			200 VA				100.00%			200 VA			TC	DTA	L CON	NECT	: 94 A				
REC		28080 VA				67.81%			19040 VA			TOTAL ESTIMATED DEMAND CURRENT: 69 A									
NOTES: WHERE NOT LISTED, WIF	RE AND	CONDI	UIT SH	ALL BE	E MI	<u> </u> NIMUI	M PER S	SPECIFIC/	ATIONS.	SPARF	BREAKF	RS TO P	BE 20A	/1P.							

PANEL: BB VOLTAGE: 208Y/120V							MAIN	IS TYPE: SPD:				SCCR (kA): 10 AVAIL FAULT CURRENT (kA):									
AMPERES: 100 A		MOUNTING: SURFACE													AIL I			FROM:			
CIRCUIT DESCRIPTION	WIRE	GND	С	ОСР	Р	СКТ	,	A		3	ì	С	CKT	Р	ОСР	С	GND	WIRE	CIRCUIT DESCRIPTION		
						1	0.0	1.1					2	1	20				(E) REC IT RACK		
(E) MAIN				100	3	3			0.0	1.1			4	1	20				(E) REC IT RACK		
						5					0.0	1.1	6	1	20				(E) REC IDF		
(E) SPARE				20		7	0.0	1.1					8	1	20				(E) REC IDF		
		-			3	9			0.0	1.1			10	1	20				(E) REC IDF		
						11					0.0	1.1	12	1	20				(E) REC-ROOF		
(E) REC CLASSROOM				20	1		1.1	1.1					14	1	20				(E) SECURITY PANEL		
(E) REC CLASSROOM				20	1				1.1	0.3			16	1	20				EQUIP - GATE 4 POWER SUPPL'		
(E) REC CLASSROOM				20	1						1.1	0.5	18	1	20				(E) CAMERA		
(E) REC CLASSROOM				20	1	19	1.1	0.5					20	1	20				(E) CAMERA		
(E) REC CLASSROOM				20	1	21			1.1				22								
						23							24								
TOTAL LOA						OAD (kVA): 5.9 kVA				4.6 kVA 3.7 I			VA								
TOTAL					L CURRENT (A):			50 A		39 A		1 A									
LOAD CLASSIFICATION CO			ONNECTED LOAD				MAND F	ACTOR	ESTIM	ATED DE	PANEL TOTALS										
EQUIP			1250 VA				100.00	0%		1250 VA		TOTAL CONNECTED LOAD: 14 kVA									
REC			12960 VA				88.58			11480 VA			TOTAL ESTIMATED DEMAND: 13 kVA								
			.200							11100 17	TOTAL CONNECTED CURRENT: 39 A										
										TOT	TOTAL ESTIMATED DEMAND CURRENT: 35 A										
												101	AL ES	I IIVI <i>F</i>	41 ED D	LIVIAI	אט כטו	XKENI.	33 A		
												1									
NOTES: WHERE NOT LISTED, W	IRE AND	CONDU	JIT SH	ALL BE	MI	NIMUI	M PER S	PECIFICA	ATIONS.	SPARE	BREAKE	RS TO E	3E 20A	/1P.							

GENERAL NOTES (POWER/SYSTEMS):

A. REFER TO THE ARCHITECT'S REFLECTED CEILING PLANS, ELEVATIONS, AND CASEWORK DETAILS FOR EXACT LOCATIONS OF ALL WALL AND CEILING MOUNTED ELECTRICAL DEVICES.

B. CONTRACTOR SHALL FOLLOW BRANCH CIRCUITING LAY-OUT, AS INDICATED ON THE FLOOR PLANS, WITH A MAXIMUM OF THREE (3) BRANCH CIRCUITS PER HOMERUN. EACH BRANCH CIRCUIT SHÀLL BE PROVIDED WITH A DEDICATED NEUTRAL CONDUCTOR. DEDICATED NEUTRAL CONDUCTORS SHALL BE CONSIDERED CURRENT CARRYING. IF ADDITIONAL CONDUCTORS ARE RAN IN THE SAME CONDUIT WITH THOSE INDICATED, CONTRACTOR SHALL DERATE ALL CURRENT CARRYING CONDUCTORS PER NEC 310.15(B)(3), AND UPSIZE CONDUIT AS REQUIRED PER NEC 300.17 AND ANNEX C. MULTIWIRE BRANCH CIRCUITS AS DEFINED IN NEC 100 / 210.4 (CIRCUITS SHARING A COMMON NEUTRAL CONDUCTOR) SHALL NOT BE PERMITTED.

C. IDENTIFY THE PANEL AND CIRCUIT NUMBER FOR ALL RECEPTACLES, SWITCHES, ETC. IN AREA OF CONSTRUCTION. PROVIDE CLEAR ADHESIVE LABELS WITH BLACK LETTERING.

KEYNOTES

P2 EXISTING POWER PANEL "BB" PREVIOUS LOAD WAS 8300W, 23A. ADDING NEW LOAD OF 500W RESULTING IN NEW LOAD ON PANEL BEING 8700W, OR 24A.

227 WEST TRADE STREET, SUITE 700 CHARLOTTE, NORTH CAROLINA 28202 TEL. 704.333.6686 FAX. 704.333.2926 WWW.LS3P.COM





△ DATE DESCRIPTION

SHEET NAME: ENLARGED PLAN -**GATES 3 & 4**

ORIG SUBMISSION: 10/28/2022

SHEET:

E303