
YORK SCHOOL DISTRICT 1

YORK INTERMEDIATE SCHOOL ROOF REPLACEMENT


1280 JOHNSON RD. YORK, SOUTH CAROLINA 29745


REI PROJECT NO. 024CLT-112

DATE: 01-30-2025

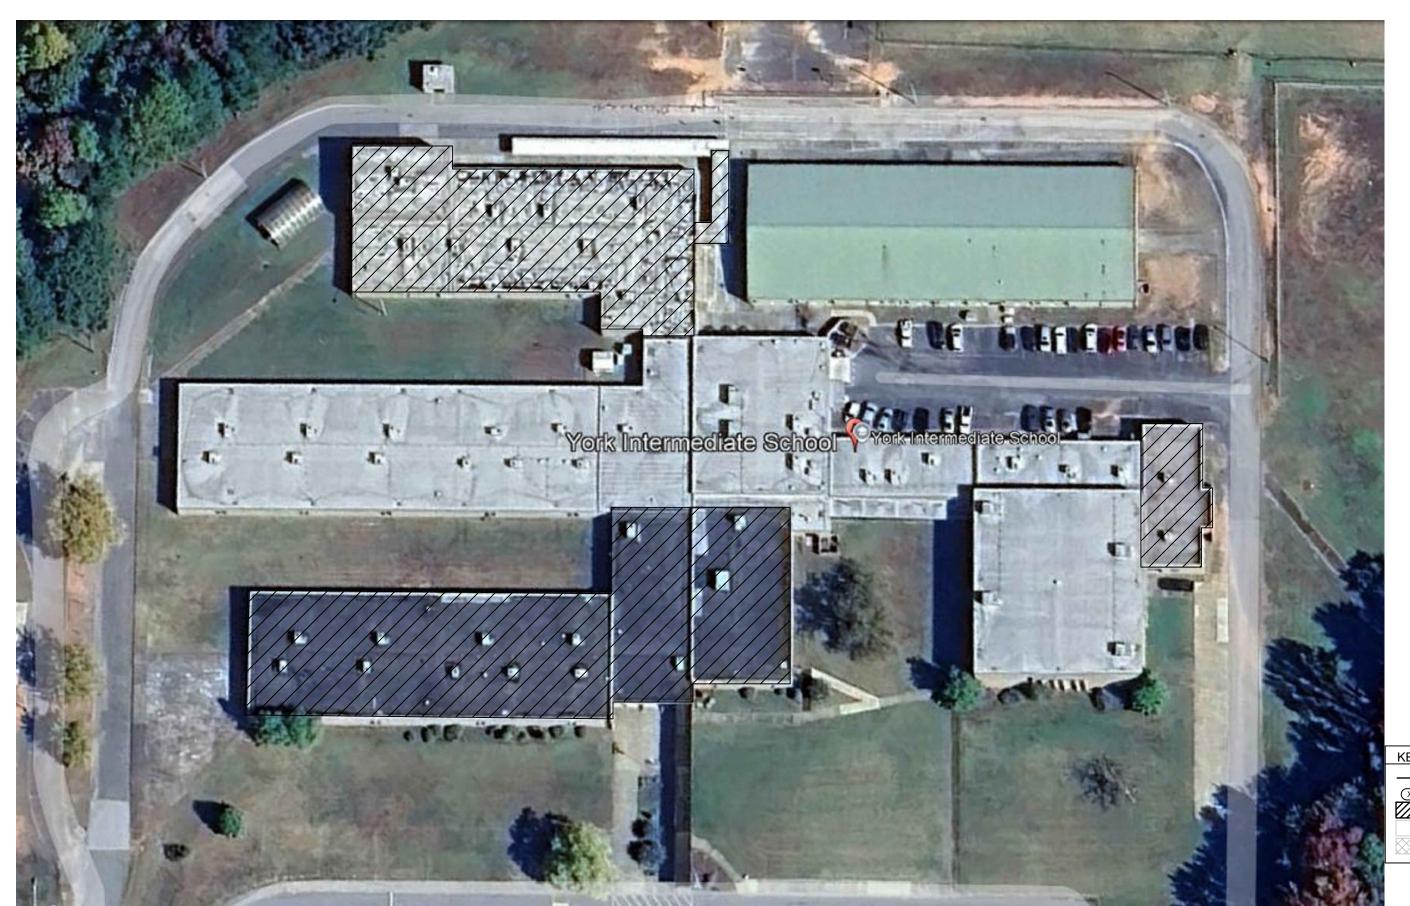


SITE PLAN

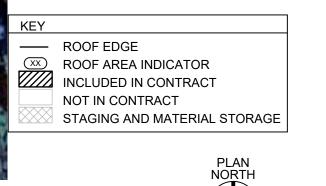

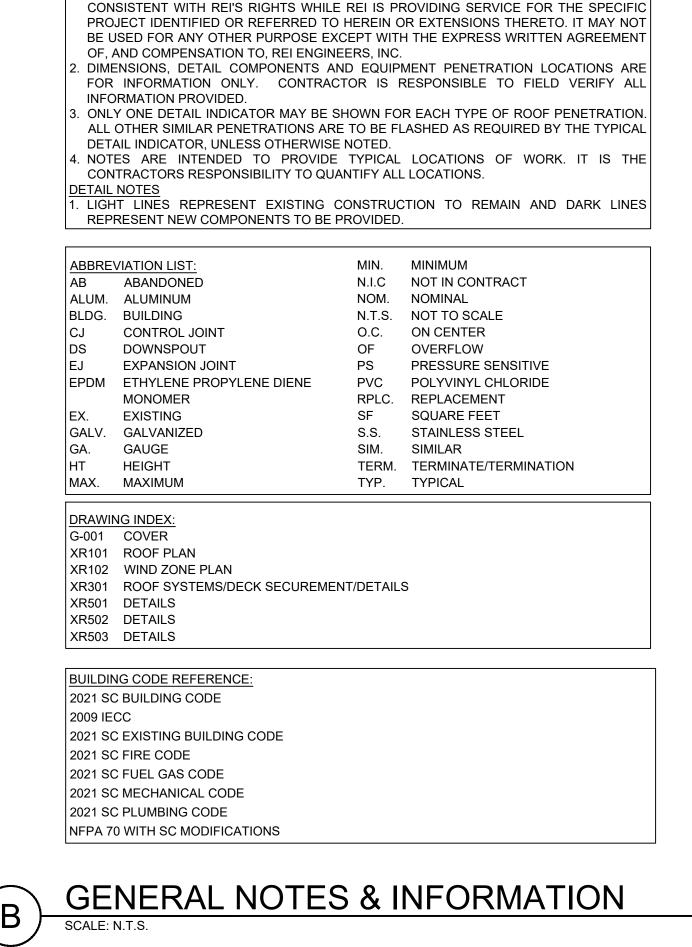


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SEALS:

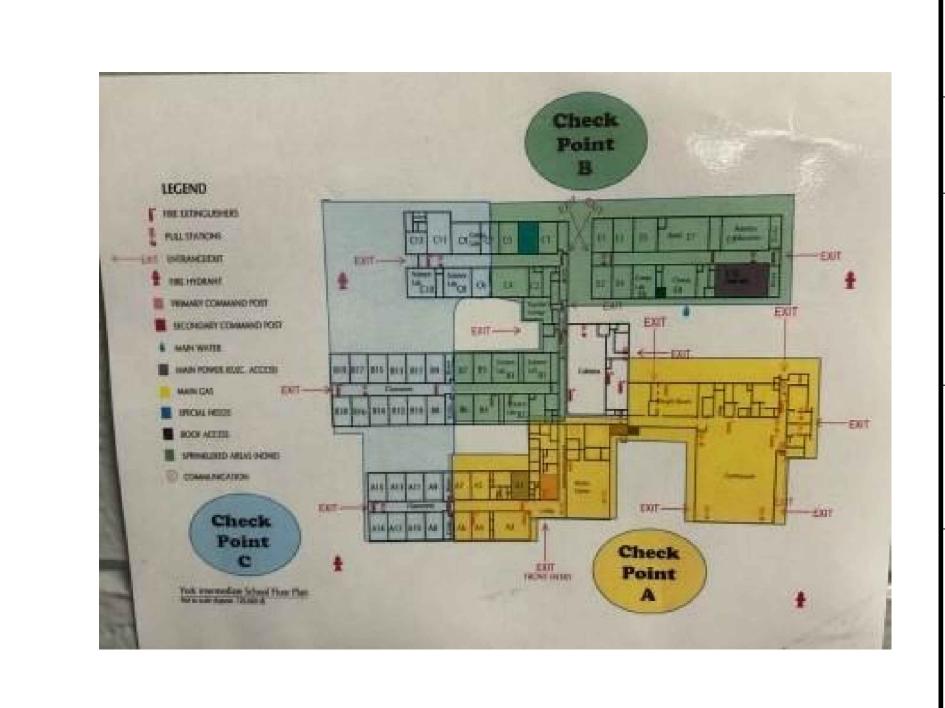

YORK SCHOOL
DISTRICT 1

YORK INTERMEDIATE
SCHOOL ROOF

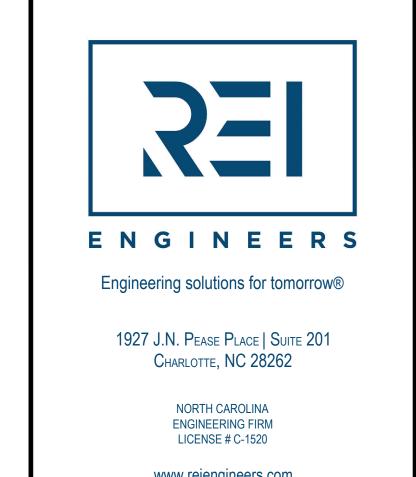1280 JOHNSON RD. YORK, SOUTH CAROLINA 29745

REPLACEMENT

PROJ. NO:

024CLT-112

SSUE:
NO. DATE DESCRIPTION

CD 01-30-2025 CONTRACT DOCUMENTS

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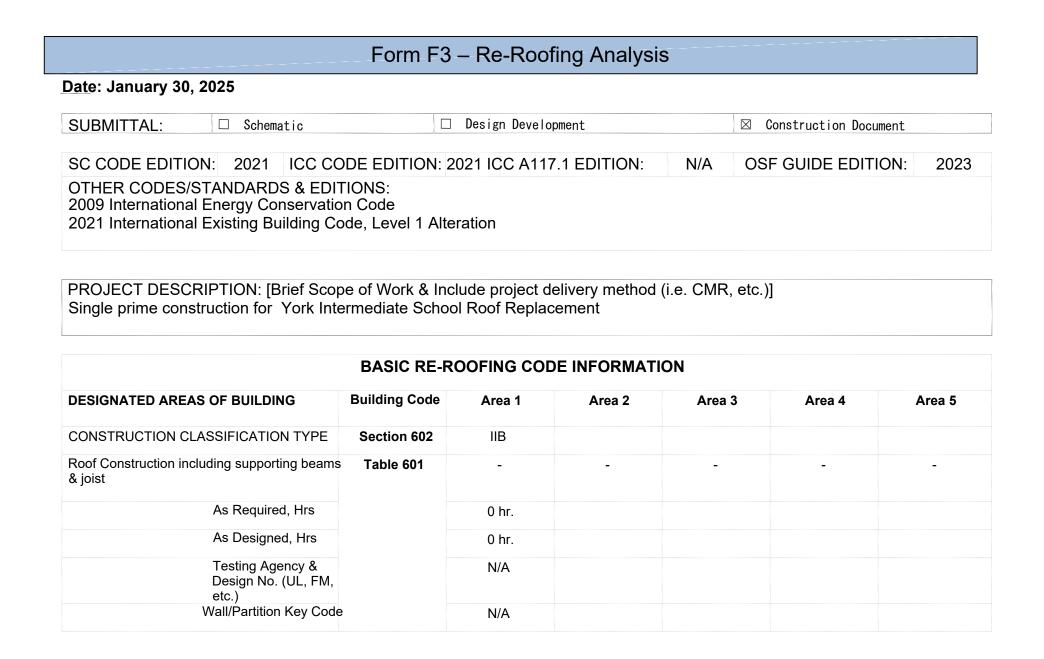
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SHEET TITLE:

COVER

DRAWING:

G-001



1 of 2

Version May 2021

Form F3 – Re-Roofing Analysis STRUCTURAL DESIGN INFORMATION, BUILDING CONSTRUCTION DOCUMENTS WIND Analysis Procedure (ASCE 7 or SCBC ASCE 7-16 LOADS 1609.6) Signed, sealed and dated drawings Basic design Wind Speed, MPH 120 = V Fully coordinated within and with the Project Manual. (3 sec gust IBC Fig 1609.3) Exposure Category PROJECT MANUAL Wind Importance Factor (ASCE 7 Table 1.15 = Iw Internal Pressure Coefficient (ASCE 7) -1.18 = GCpi Signed, sealed and dated External Pressure Coefficient (ASCE 7) -1.00 = GCp | Fully coordinated within and with the Construction Documents This information shall be part and within the drawing sheet set. ADDITIONAL QUESTIONS 1. Prepare a site plan showing the life safety plan during construction and Included any additional details on how the contractor will keep the school administration informed about issues that may affect daily operations in the building 2. Will there be additional weight added to the existing structure? 3. What will the insulation values be in areas being reroofed? Confirm the R-20 minimum insulation will meet current energy codes. 4. Will the existing roof drainage stay the same and meet current code? Yes 5. What will the new roof assembly consist of? 2-ply modified bitumen over coverboard over roof insulation system over metal

2 of 2

REI will perform weekly quality assurance observation site visits

Version May 2021


RE-ROOF ANNALYSIS FORM
SCALE: N.T.S.

6. What type of inspections will be performed?

equipment curbs or curb adaptors would be needed.

7. Once the project is complete send a copy of the Warranty Letter to OSF. Agreed

8. Is there roof mounted equipment (mechanical or other) and if new Yes, and new curbs will not be needed

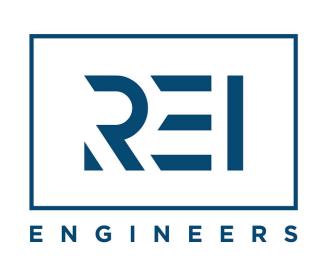


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SEALS:



PROJECT NAME:

YORK SCHOOL DISTRICT 1

YORK INTERMEDIATE
SCHOOL ROOF
REPLACEMENT

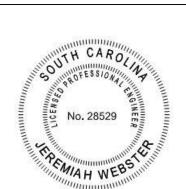1280 JOHNSON RD. YORK, SOUTH CAROLINA 29745

PROJ. NO:

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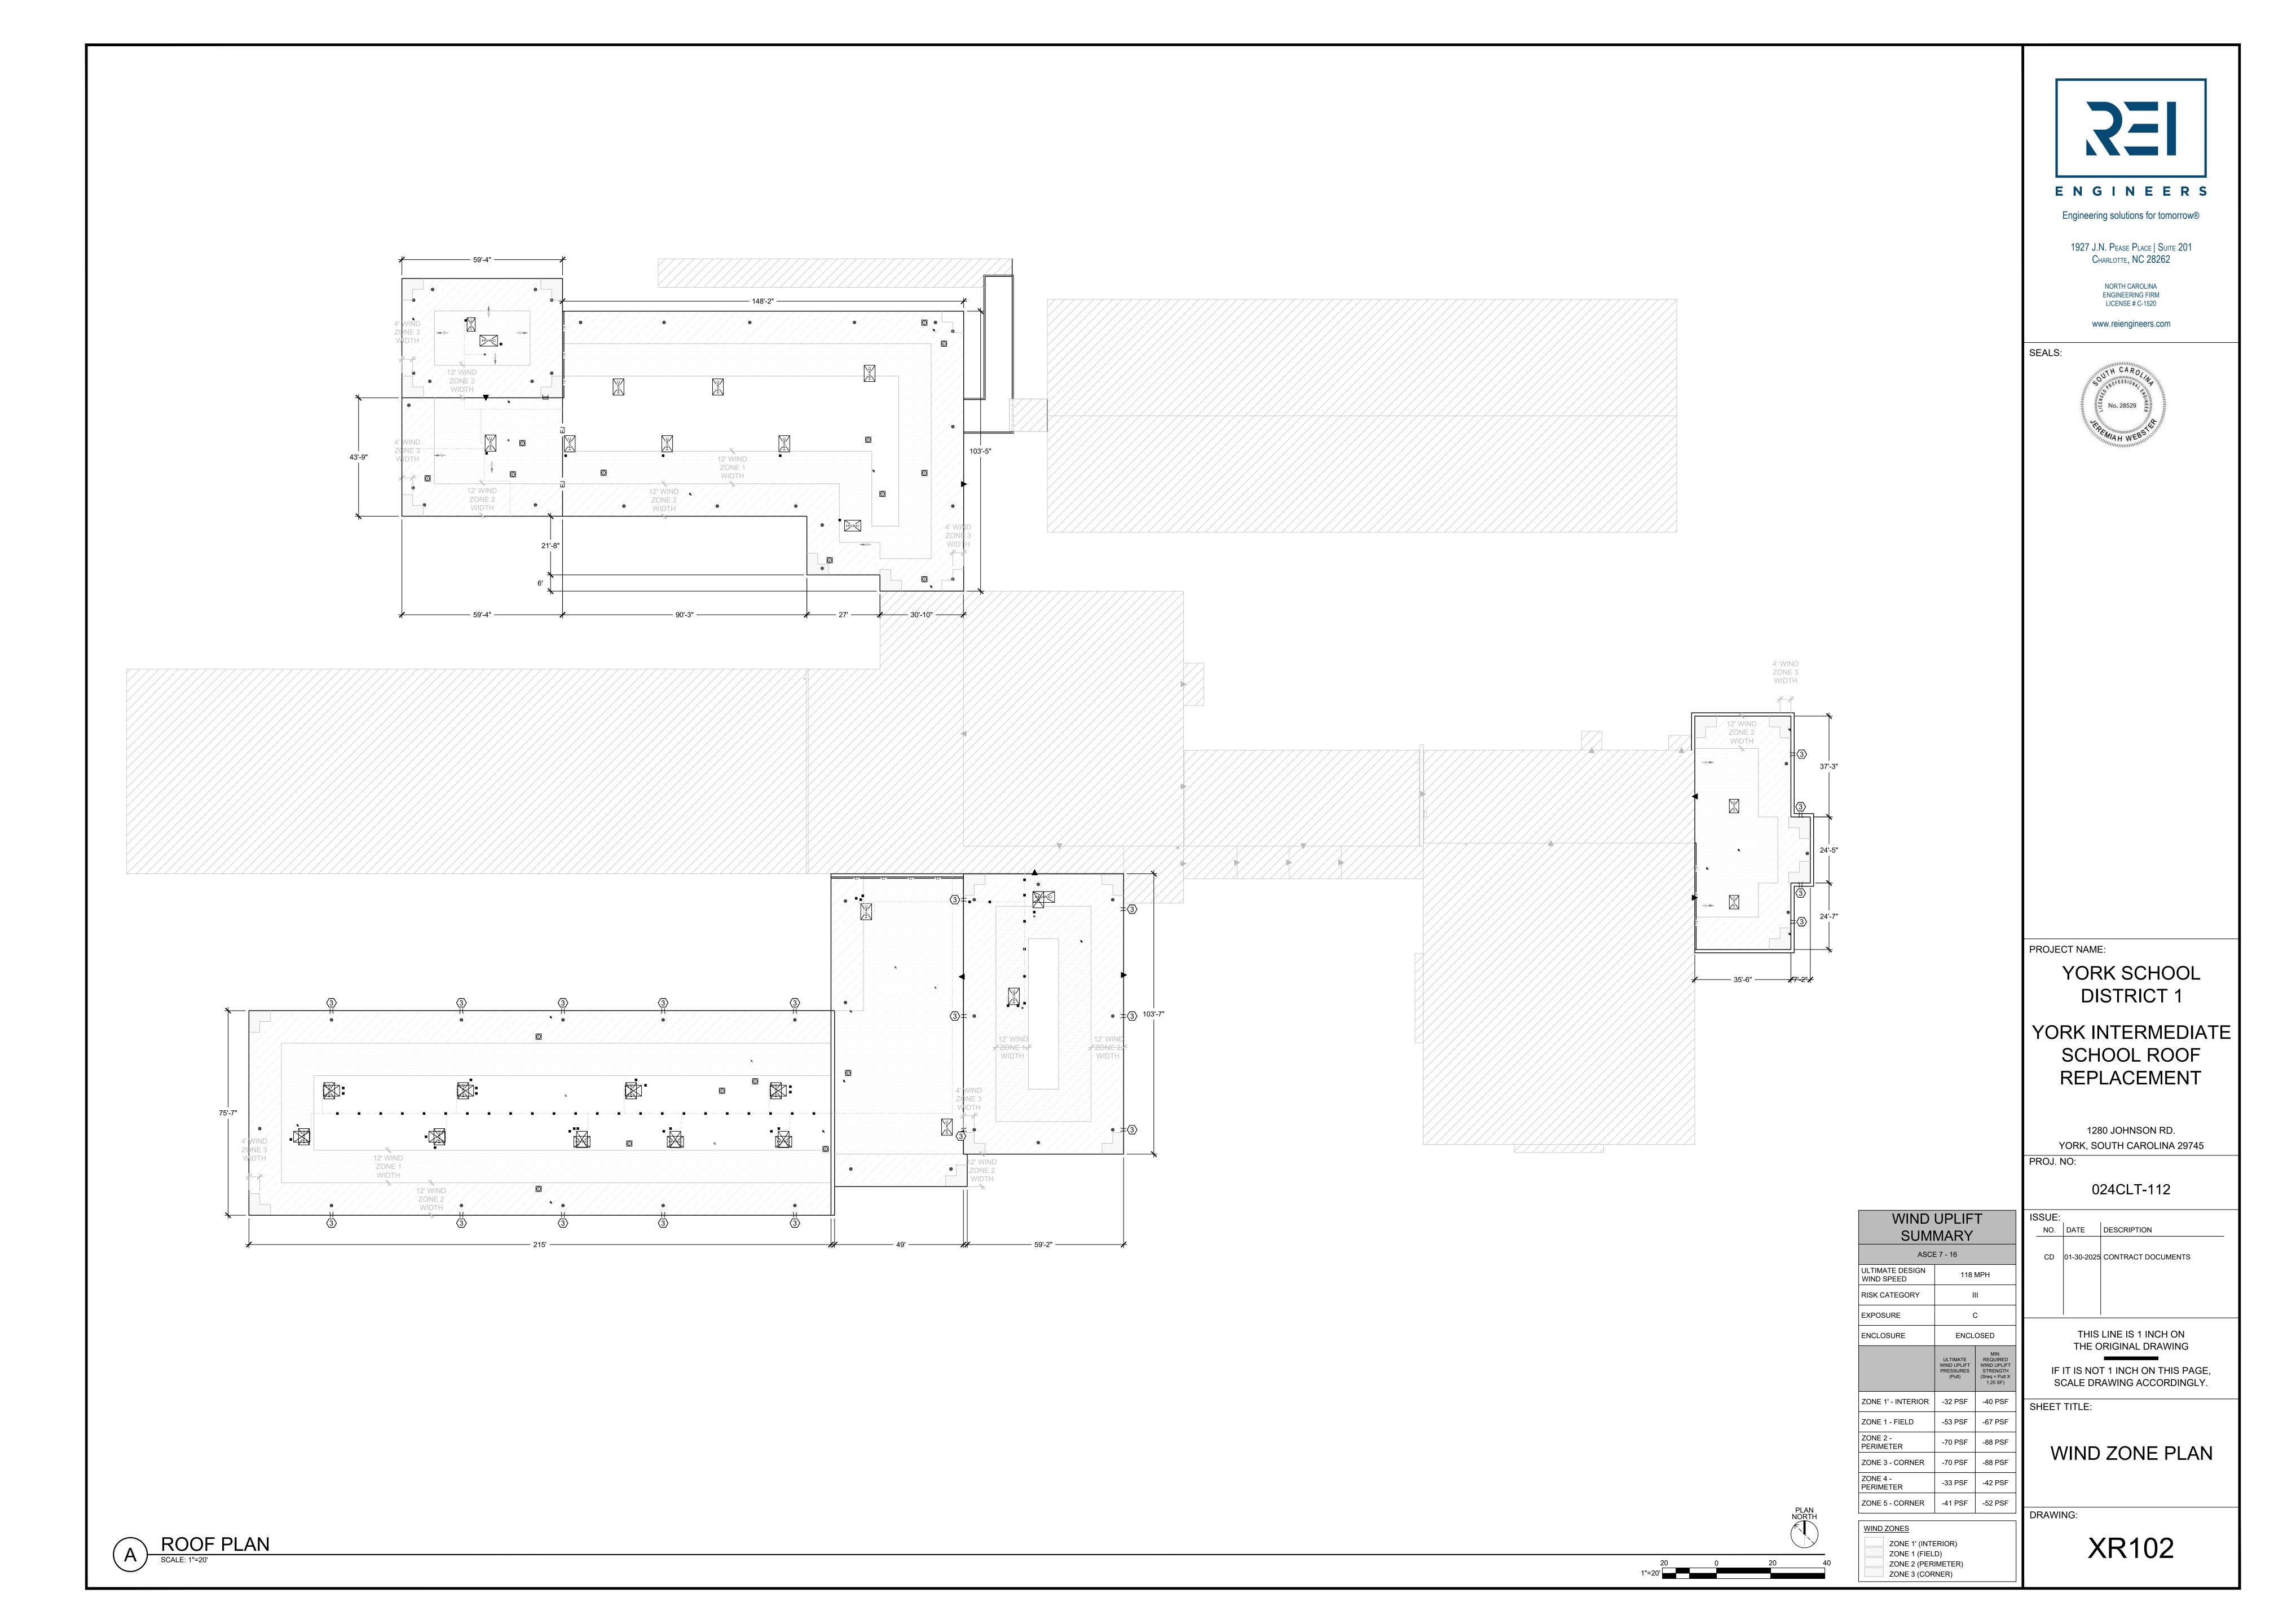
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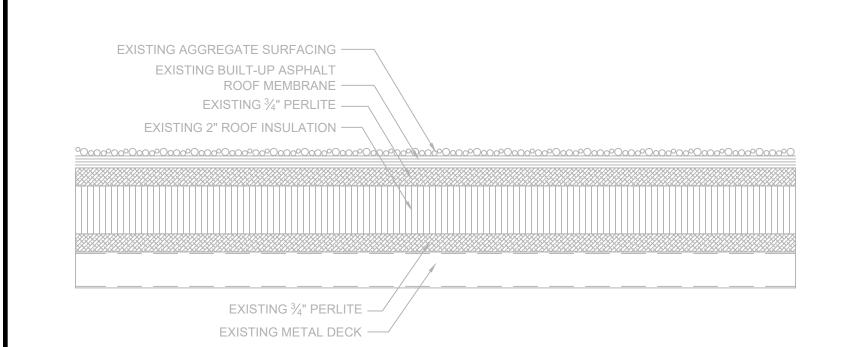
RE-ROOF ANALYISIS


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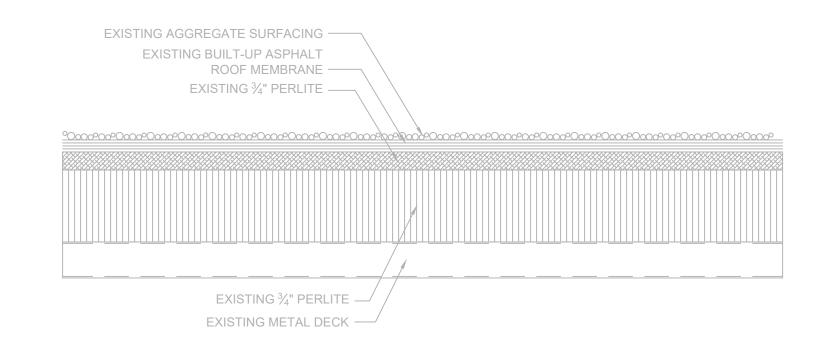
G-002











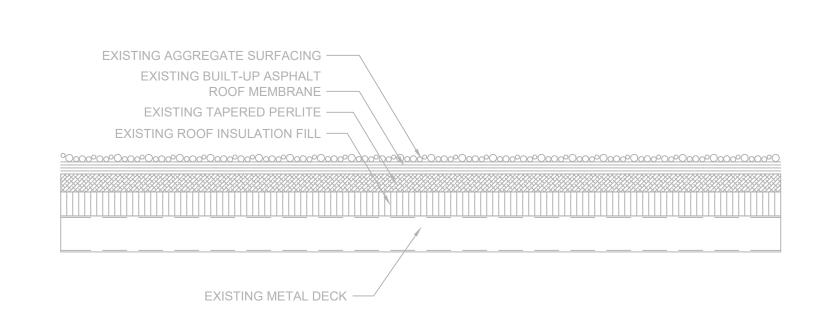

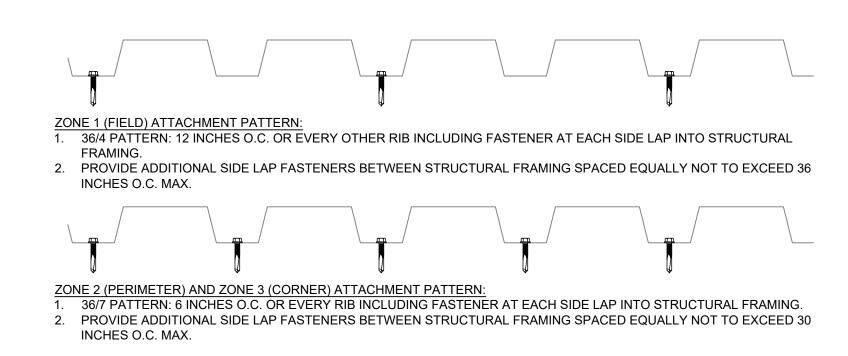








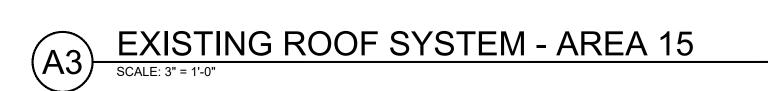




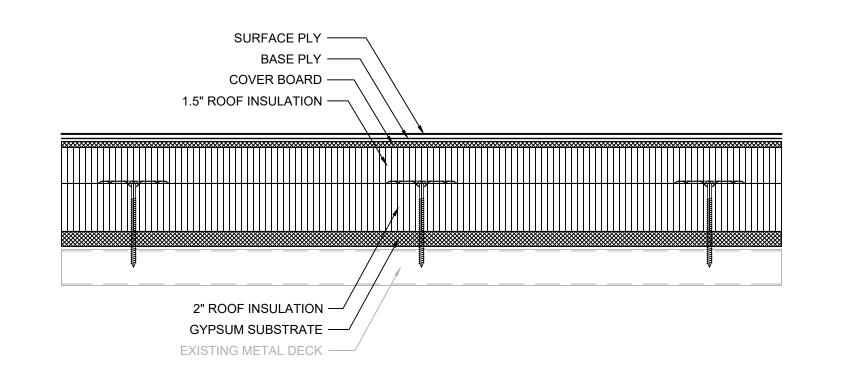

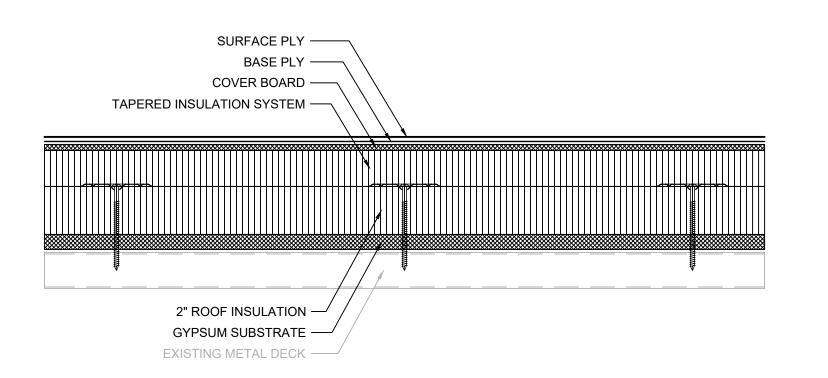


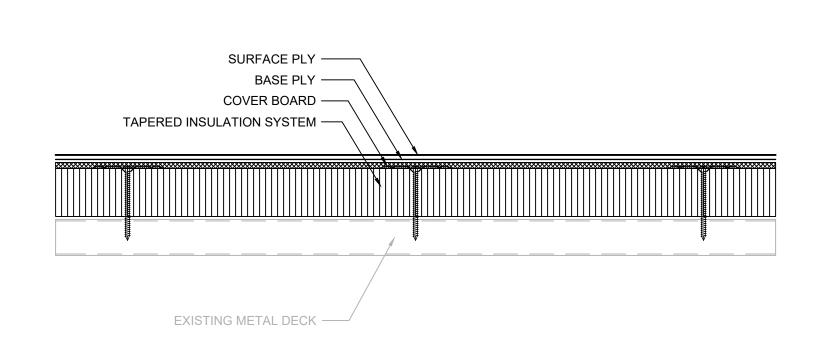


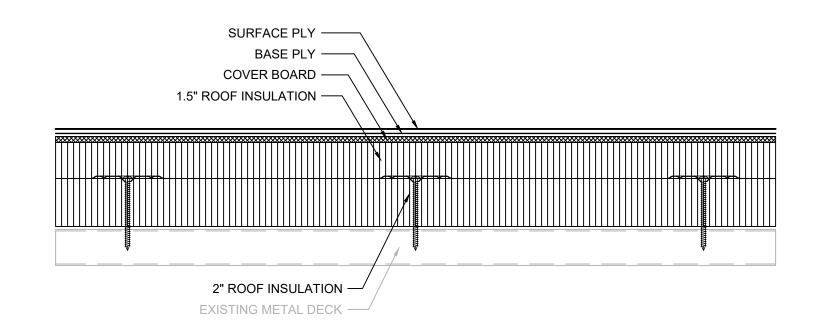


B1 RPLC. ROOF SYSTEM - AREAS 1-3, & 6-8 SCALE: 3" = 1'-0"




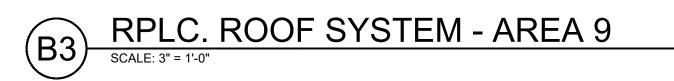


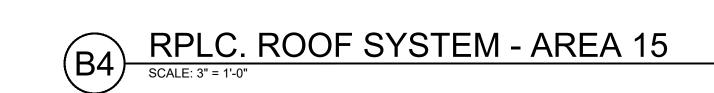

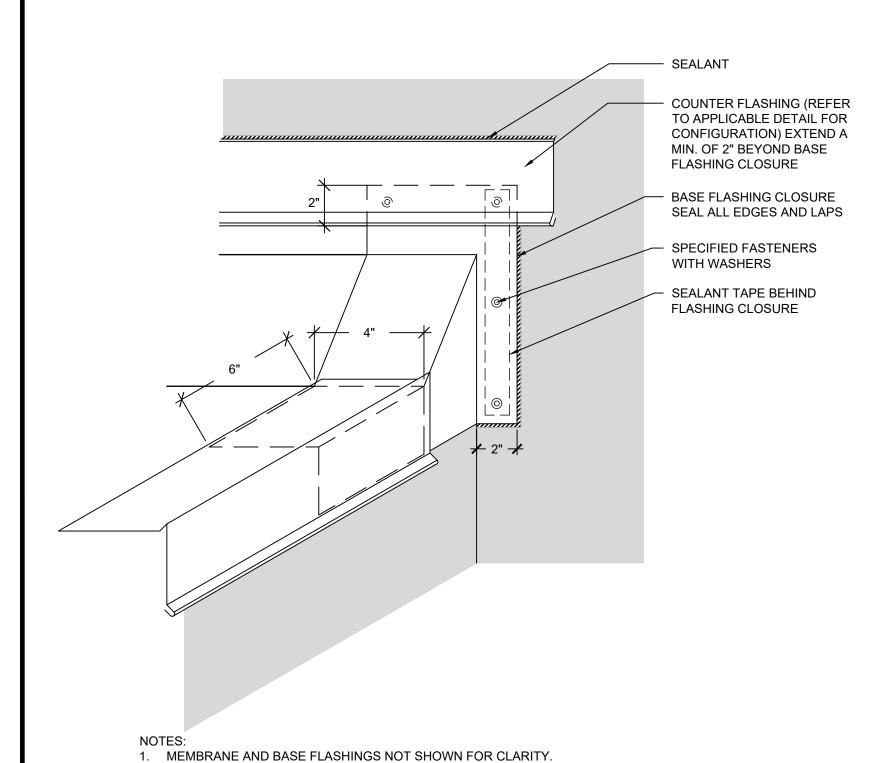

2. BASE FLASHING CLOSURE TO BE INSTALLED CONCURRENTLY WITH METAL EDGE AND STRIPPED INTO

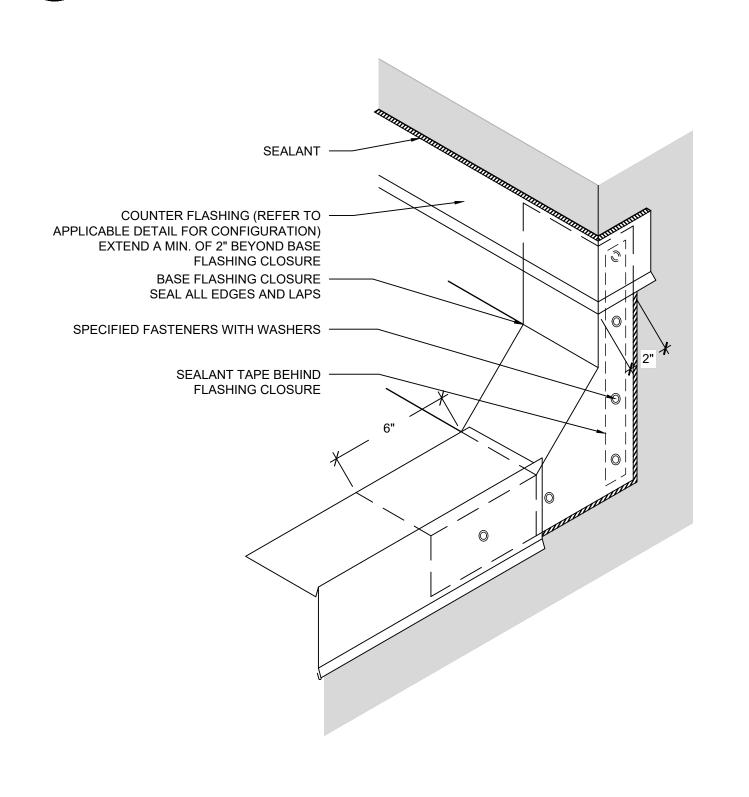

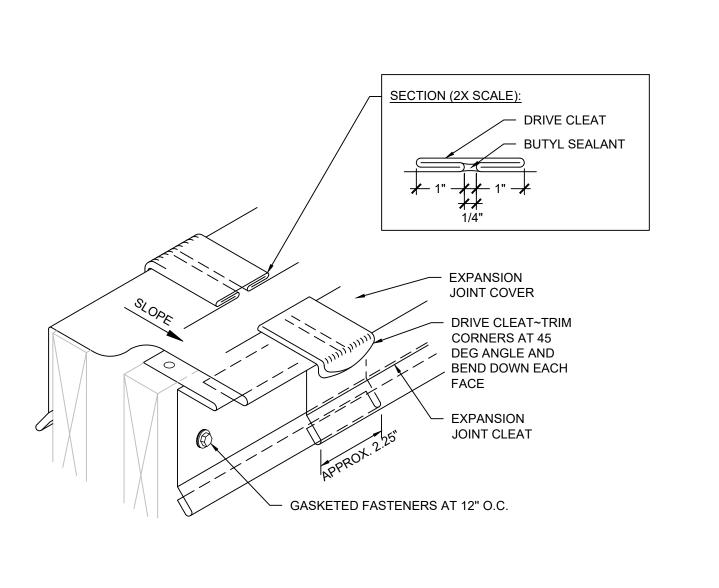


NOTES:
1. STAGGER JOINTS OF CLEAT AND COVER MINIMUM OF 12 INCHES.

D BASE FLASHING CLOSURE

SCALE: 3" = 1'-0"

BASE PLY/REINFORCING PLY PRIOR TO SURFACE PLY APPLICATION.



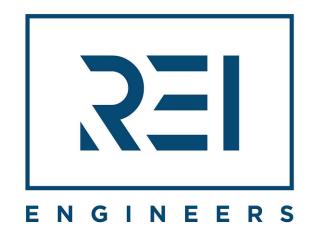

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PROJECT NAME:

THE ENTIRE BOARD.

YORK SCHOOL DISTRICT 1

YORK INTERMEDIATE
SCHOOL ROOF
REPLACEMENT

1280 JOHNSON RD. YORK, SOUTH CAROLINA 29745

PROJ. NO:

024CLT-112

ISSUE:
NO. DATE DESCRIPTION

CD 01-30-2025 CONTRACT DOCUMENTS

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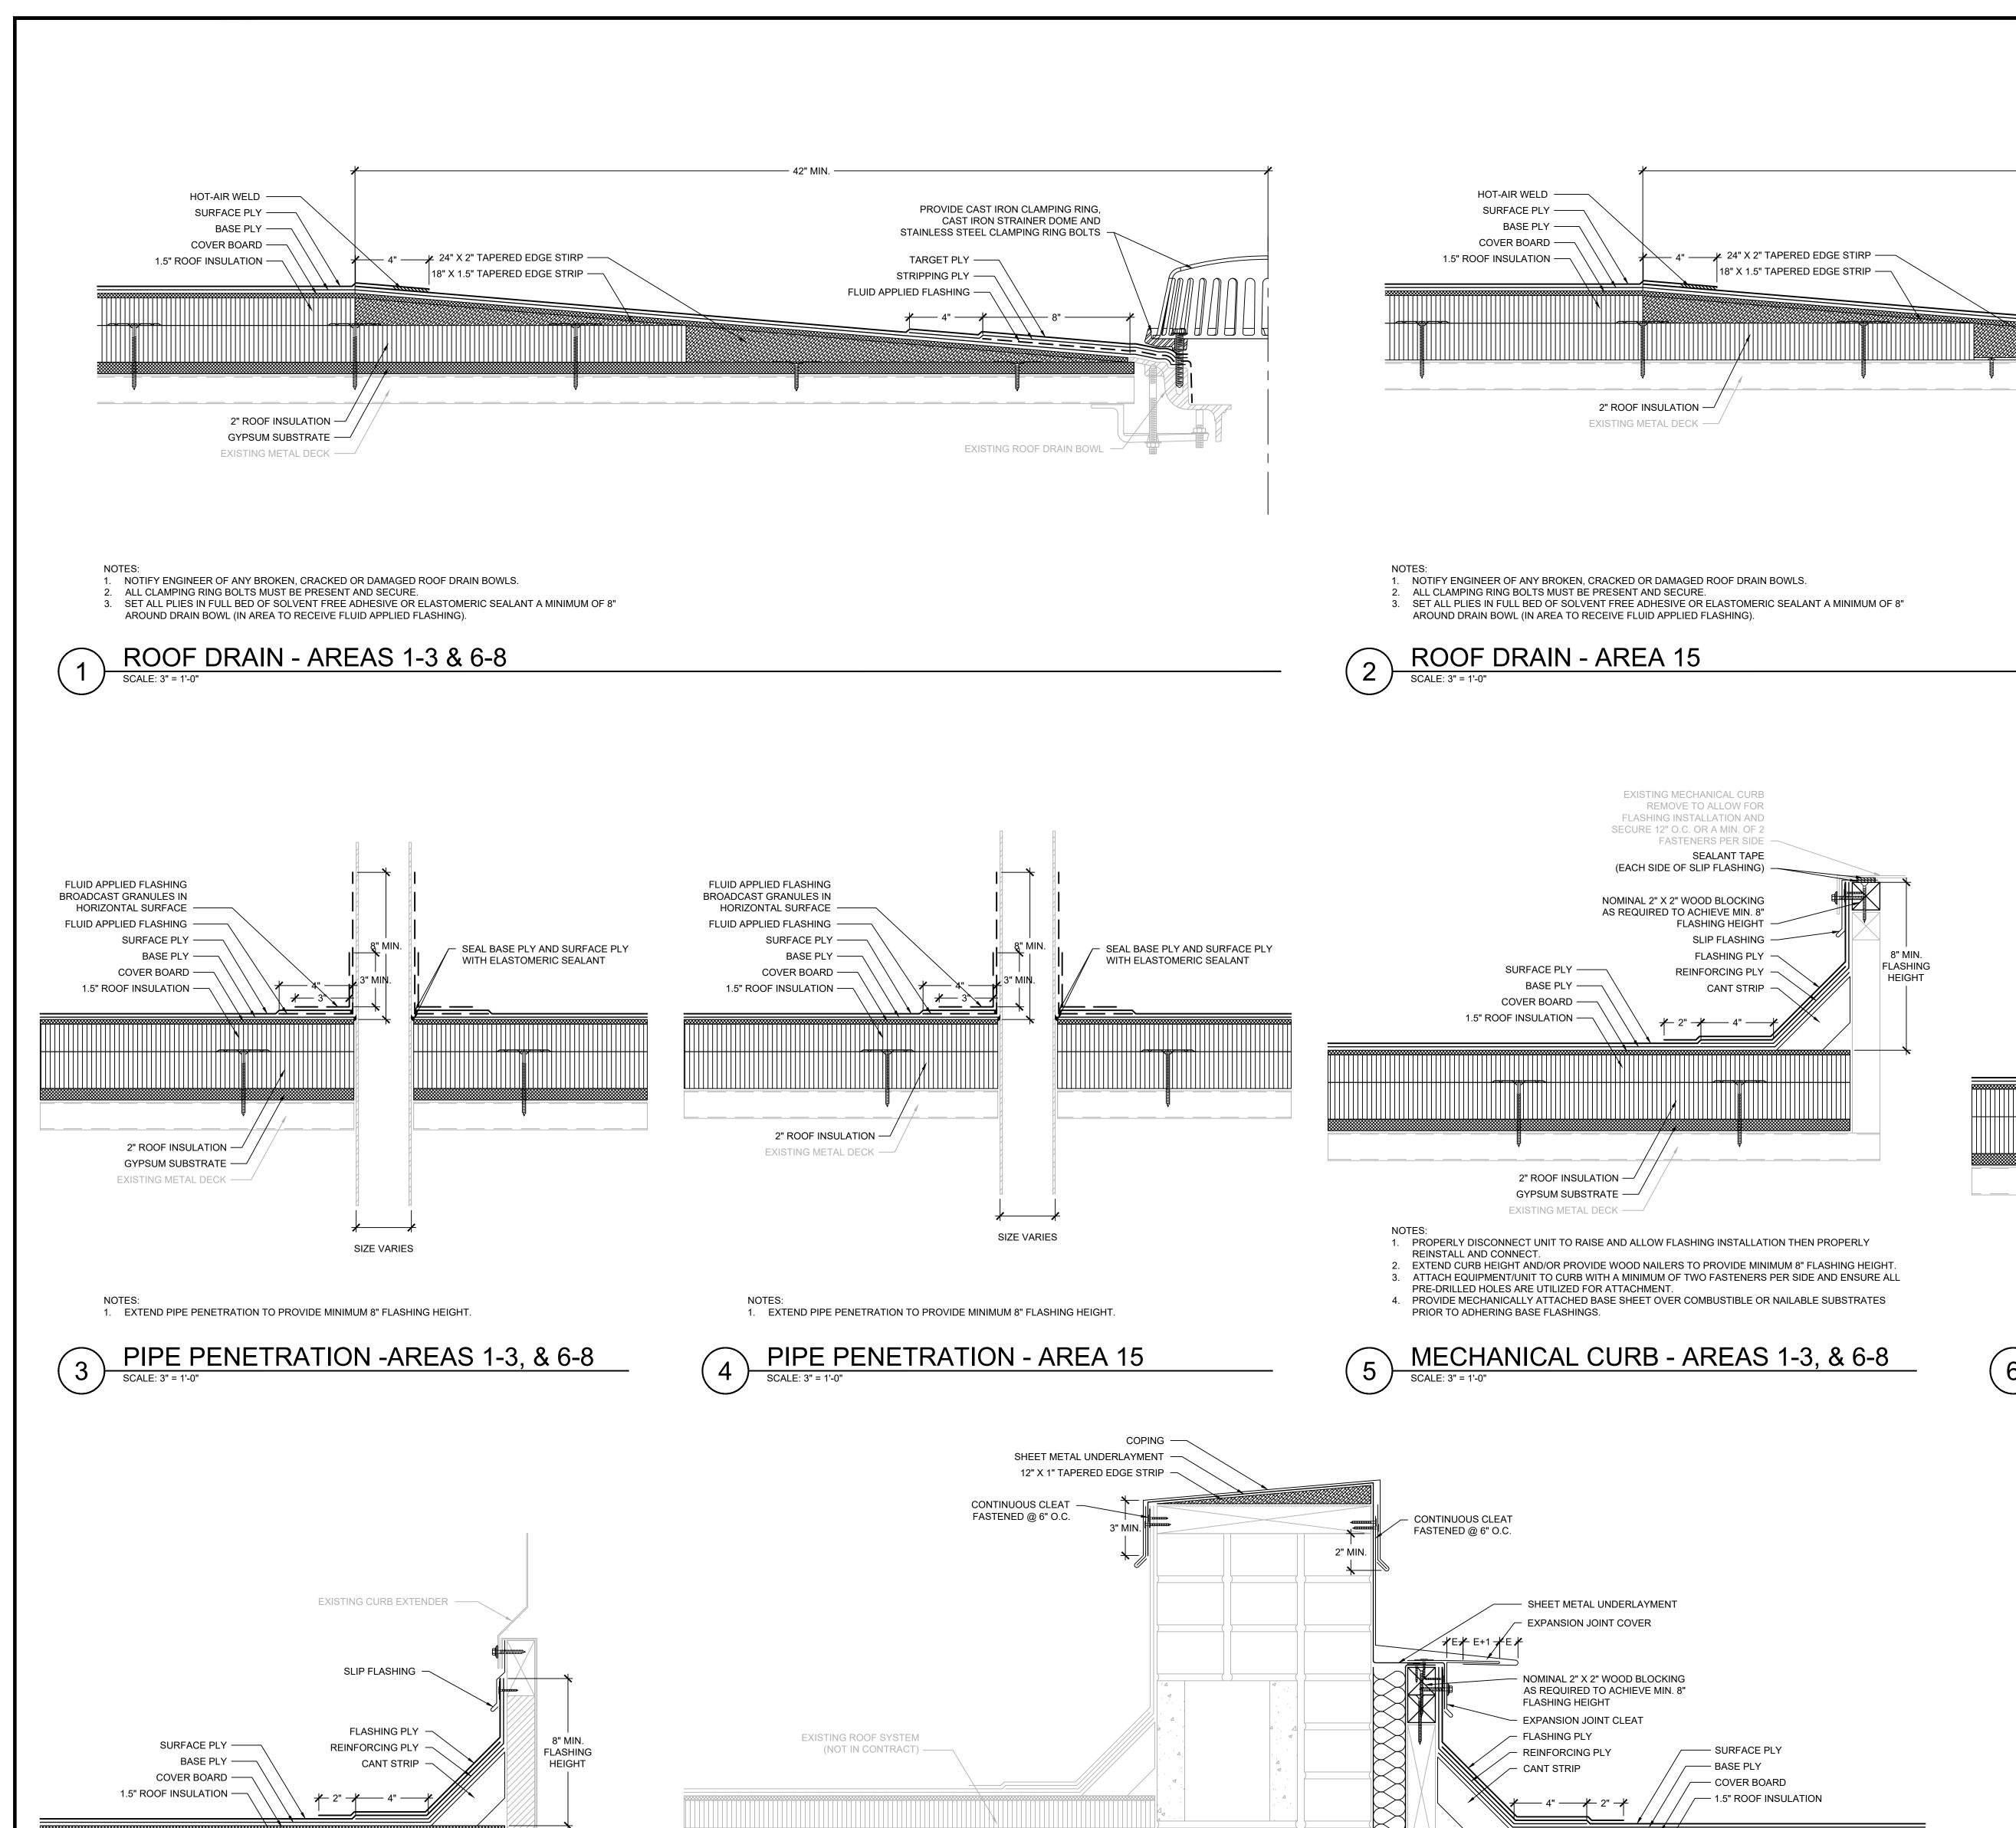
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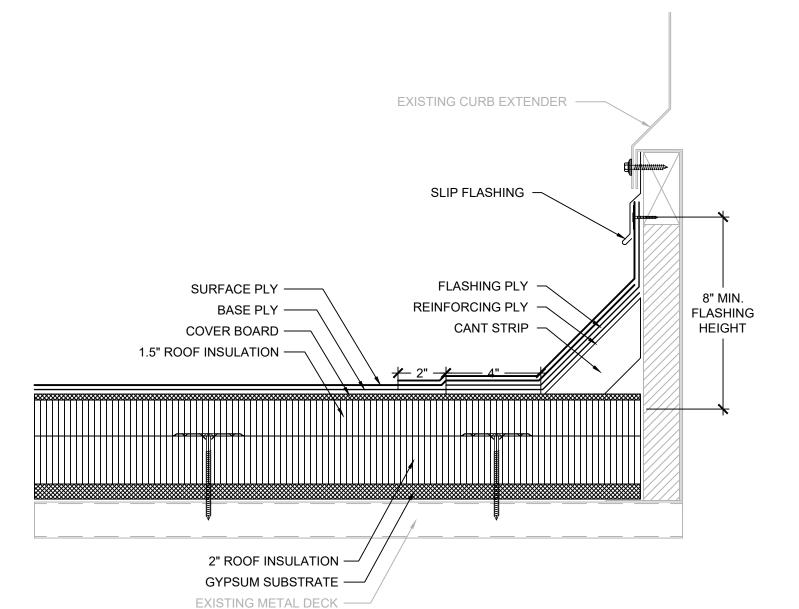
ROOF SYSTEMS / DECK SECUREMENT / DETAILS

DRAWING:

XR301




PROVIDE CAST IRON CLAMPING RING, CAST IRON STRAINER DOME AND STAINLESS STEEL CLAMPING RING BOLTS TARGET PLY —— STRIPPING PLY ----FLUID APPLIED FLASHING -EXISTING ROOF DRAIN BOWL -




1. PROPERLY DISCONNECT UNIT, EXTEND CURB HEIGHT WITH HVAC UNIT MANUFACTURER APPROVED CURB EXTENSION TO PROVIDE MINIMUM 8" FLASHING HEIGHT, AND PROPERLY REINSTALL AND RECONNECT UNIT.

6 HVAC UNIT - AREAS 1-3, & 6-8

SCALE: 3" = 1'-0"

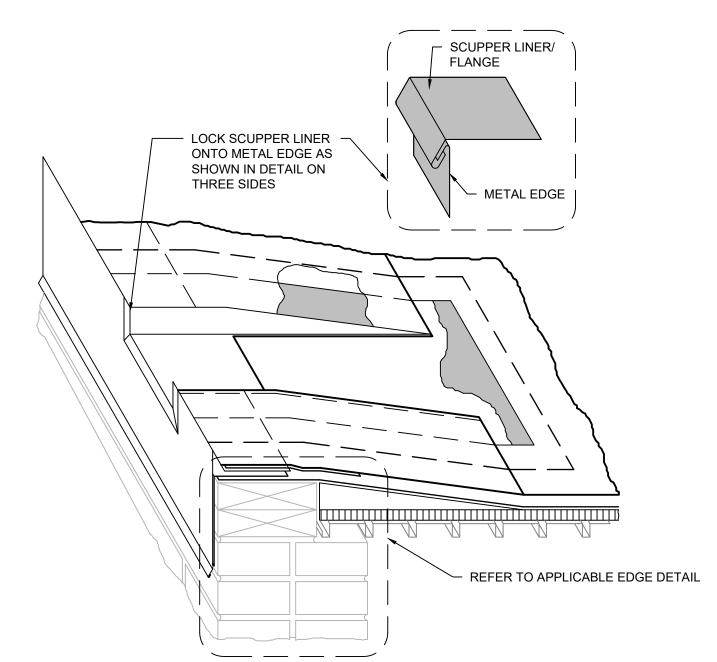

- 1. DETAIL IS FOR GENERAL REPRESENTATION ONLY. REFER TO CROSS SECTION FOR SPECIFIC ORDER AND CALLOUT OF COMPONENTS. PRIME FLANGES OF SCUPPER LINER AND SET IN FULL BED OF ROOF CEMENT. 3. SCUPPER LINER/FLANGE SHALL BE ONE PIECE WITH JOINTS FULLY SOLDERED.
- THROUGH EDGE SCUPPER AREAS 1 & 3

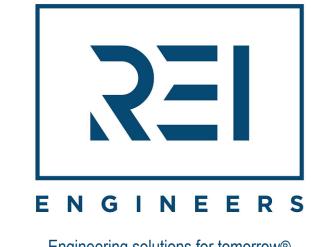

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THE HIGHEST WIND ZONE ENCOUNTERED, ACROSS

THE ENTIRE BOARD. PROJECT NAME:

> YORK SCHOOL DISTRICT 1

YORK INTERMEDIATE SCHOOL ROOF REPLACEMENT

> 1280 JOHNSON RD. YORK, SOUTH CAROLINA 29745

PROJ. NO:

024CLT-112

NO. DATE DESCRIPTION CD 01-30-2025 CONTRACT DOCUMENTS

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SHEET TITLE:

DETAILS

DRAWING:

XR501

1. CONTRACTOR SHALL FIELD VERIFY EXISTING CONSTRUCTION AND COMPONENTS PRIOR TO SHEET METAL FABRICATION. 2. COPING SHALL BE TESTED FOR RESISTANCE TO WIND UPLIFT PRESSURES SPECIFIED IN ACCORDANCE WITH ANSI/SPRI ES-1 TEST METHOD RE-3. CONTRACTOR SHALL PROVIDE SHOP DRAWING DEPICTING — COMPRESSIBLE INSULATION — 2" ROOF INSULATION SHEET METAL COMPONENTS WITH DIMENSIONS AND PROVIDE EVIDENCE OF TESTING TO RESIST THE PVC ENVELOPE GYPSUM SUBSTRATE SPECIFIED WIND UPLIFT PRESSURES. SHEET METAL COPING SHALL BE SLOPED A MINIMUM OF 1"/FT. TOWARDS ROOF SURFACE. —— EXISTING METAL DECK PROVIDE SEPARATE FASCIA COVER EXTENSION WHERE EDGE METAL DIMENSIONS EXCEED

PARAPET WALL - AREAS 2, & 6 TO NIC

ALLOWABLE TESTED ASSEMBLY REQUIREMENTS.


2" ROOF INSULATION —

EXISTING METAL DECK ——

HVAC UNIT - AREA 15

1. PROPERLY DISCONNECT UNIT, EXTEND CURB HEIGHT WITH HVAC UNIT MANUFACTURER APPROVED

CURB EXTENSION TO PROVIDE MINIMUM 8" FLASHING HEIGHT, AND PROPERLY REINSTALL AND

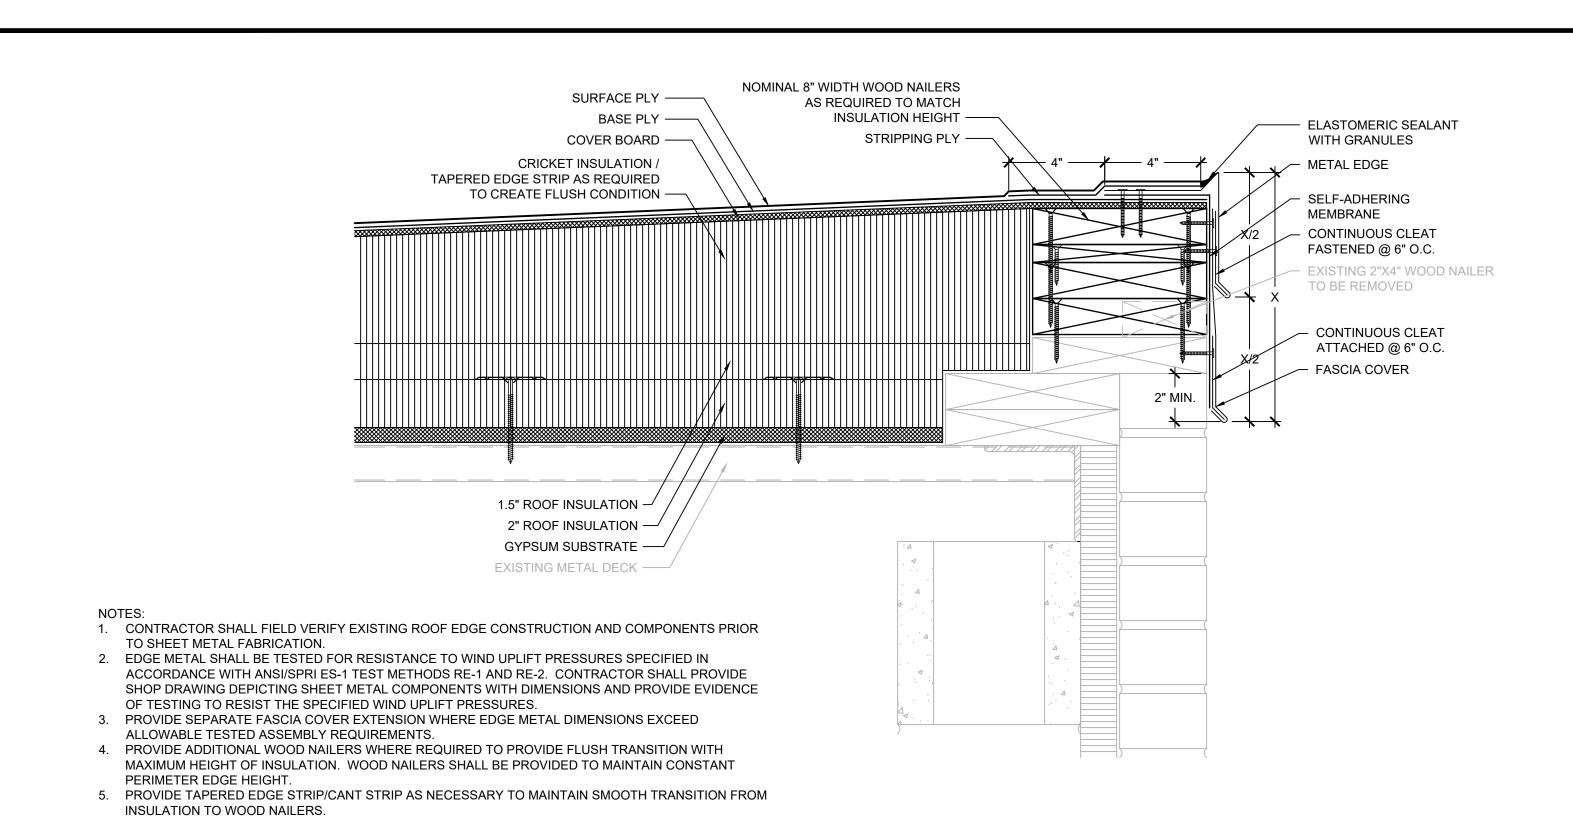

SAW-CUT REGLET -BACKER ROD & SILICONE SEALANT SEALANT TAPE EXISTING REGLET — RECEIVER FLASHING LEAD BASED WEDGE 18" O.C. COUNTER FLASHING SILICONE SEALANT -RECEIVER FLASHING (SPRING LOCK) -COUNTER FLASHING -3 COURSE ROOF 3 COURSE ROOF CEMENT AND FABRIC CEMENT AND FABRIC -TERMINATION BAR **TERMINATION BAR** FASTENED AT 8" O.C. FASTENED AT 8" O.C. FLASHING PLY -FLASHING PLY SURFACE PLY ----REINFORCING PLY FLASHING SURFACE PLY ----REINFORCING PLY -BASE PLY ----CANT STRIP BASE PLY ----CANT STRIP COVER BOARD — COVER BOARD — TAPERED INSULATION SYSTEM — 1.5" ROOF INSULATION — EXISTING METAL DECK —— 2" ROOF INSULATION — GYPSUM SUBSTRATE —


ELEVATION WALL - AREA 7

SCALE: 3" = 1'-0"

EXISTING METAL DECK ——


ELEVATION WALL FLASHING - AREA 9

SCALE: 3" = 1'-0"

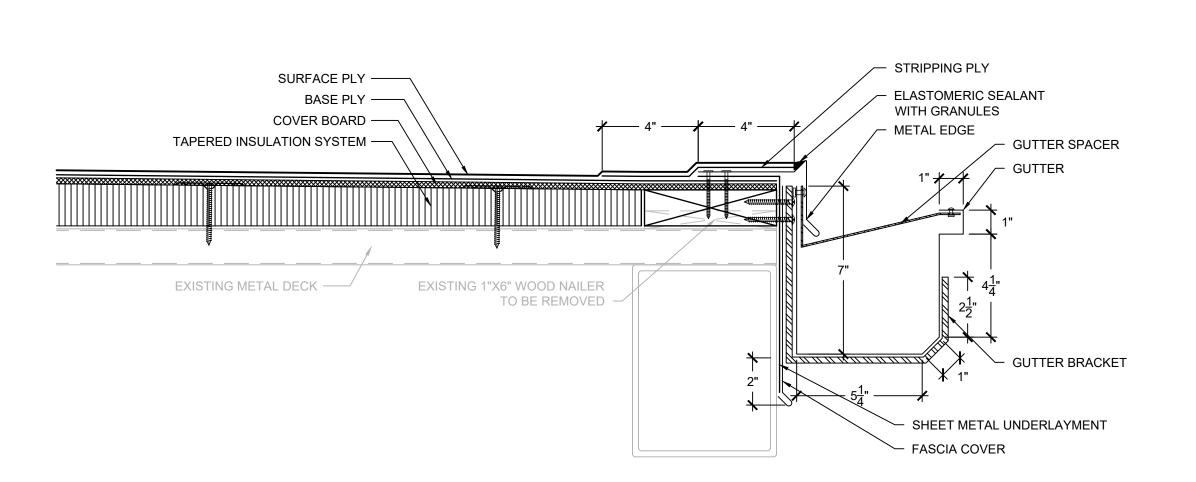

1. CONTRACTOR SHALL FIELD VERIFY EXISTING ROOF EDGE CONSTRUCTION AND COMPONENTS PRIOR TO SHEET METAL FABRICATION AND TO CONFIRM DETAIL AS SHOWN WILL PROVIDE POSITIVE DRAINAGE WITHOUT PONDING WATER. NOTIFY ENGINEER OF ANY DISCREPANCIES PRIOR TO INSTALLATION.

GUTTER EDGE - AREA 9

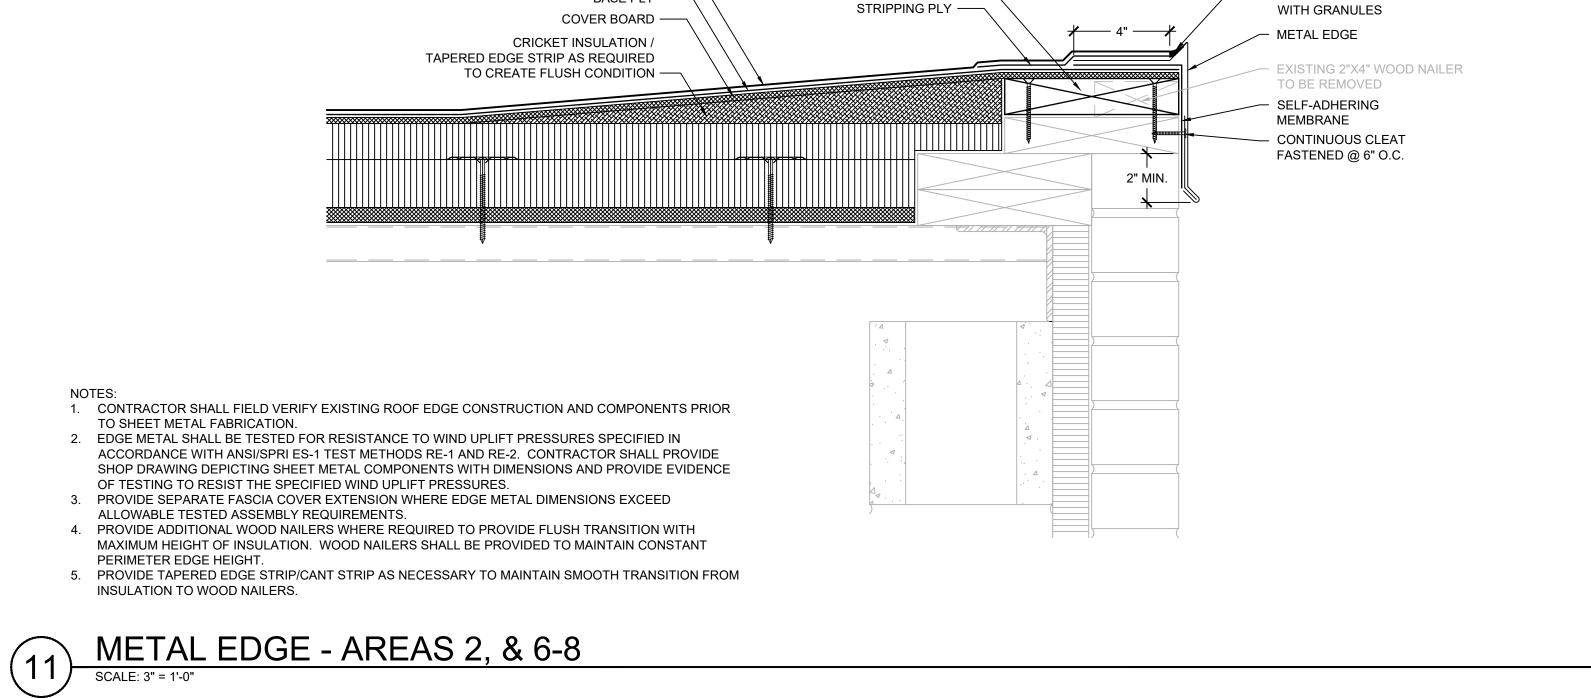


2" X 8" WIDTH WOOD NAILER —

ELASTOMERIC SEALANT


SURFACE PLY ----

BASE PLY ----

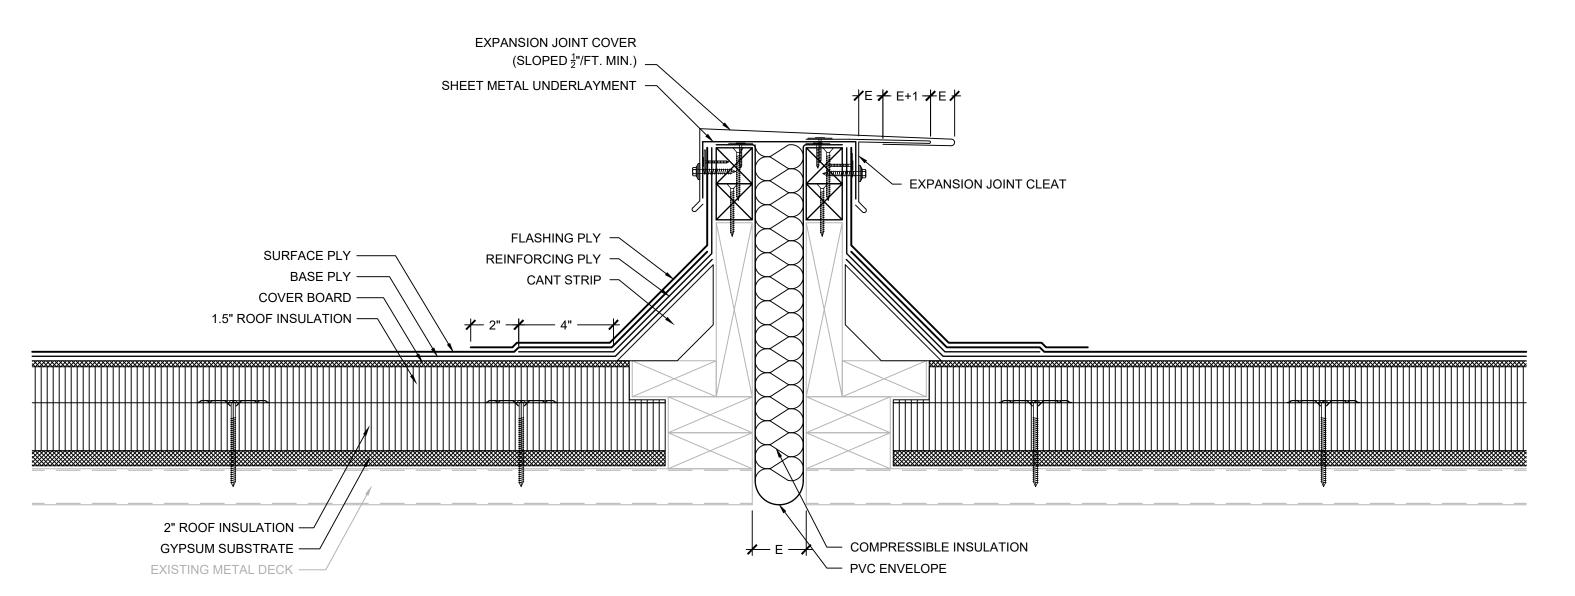


EXPANSION JOINT

SCALE: 3" = 1'-0"

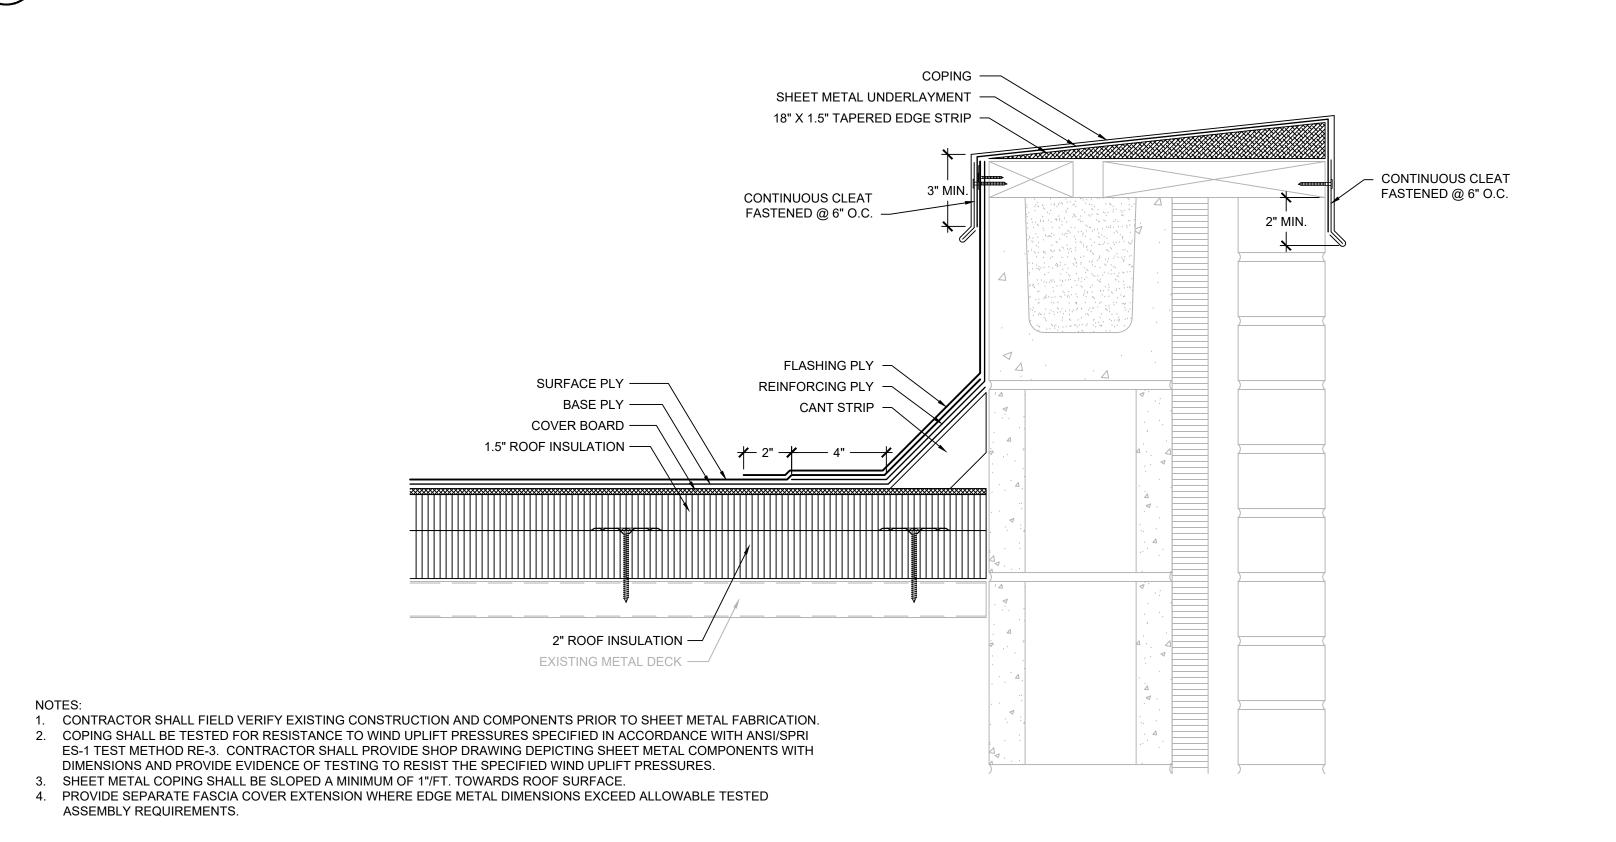

PARAPET WALL - AREA 15

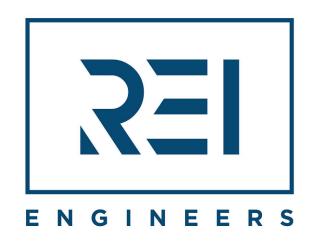

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THE ENTIRE BOARD. PROJECT NAME:

> YORK SCHOOL DISTRICT 1

YORK INTERMEDIATE SCHOOL ROOF REPLACEMENT

1280 JOHNSON RD. YORK, SOUTH CAROLINA 29745

PROJ. NO:

024CLT-112

NO. DATE DESCRIPTION CD 01-30-2025 CONTRACT DOCUMENTS

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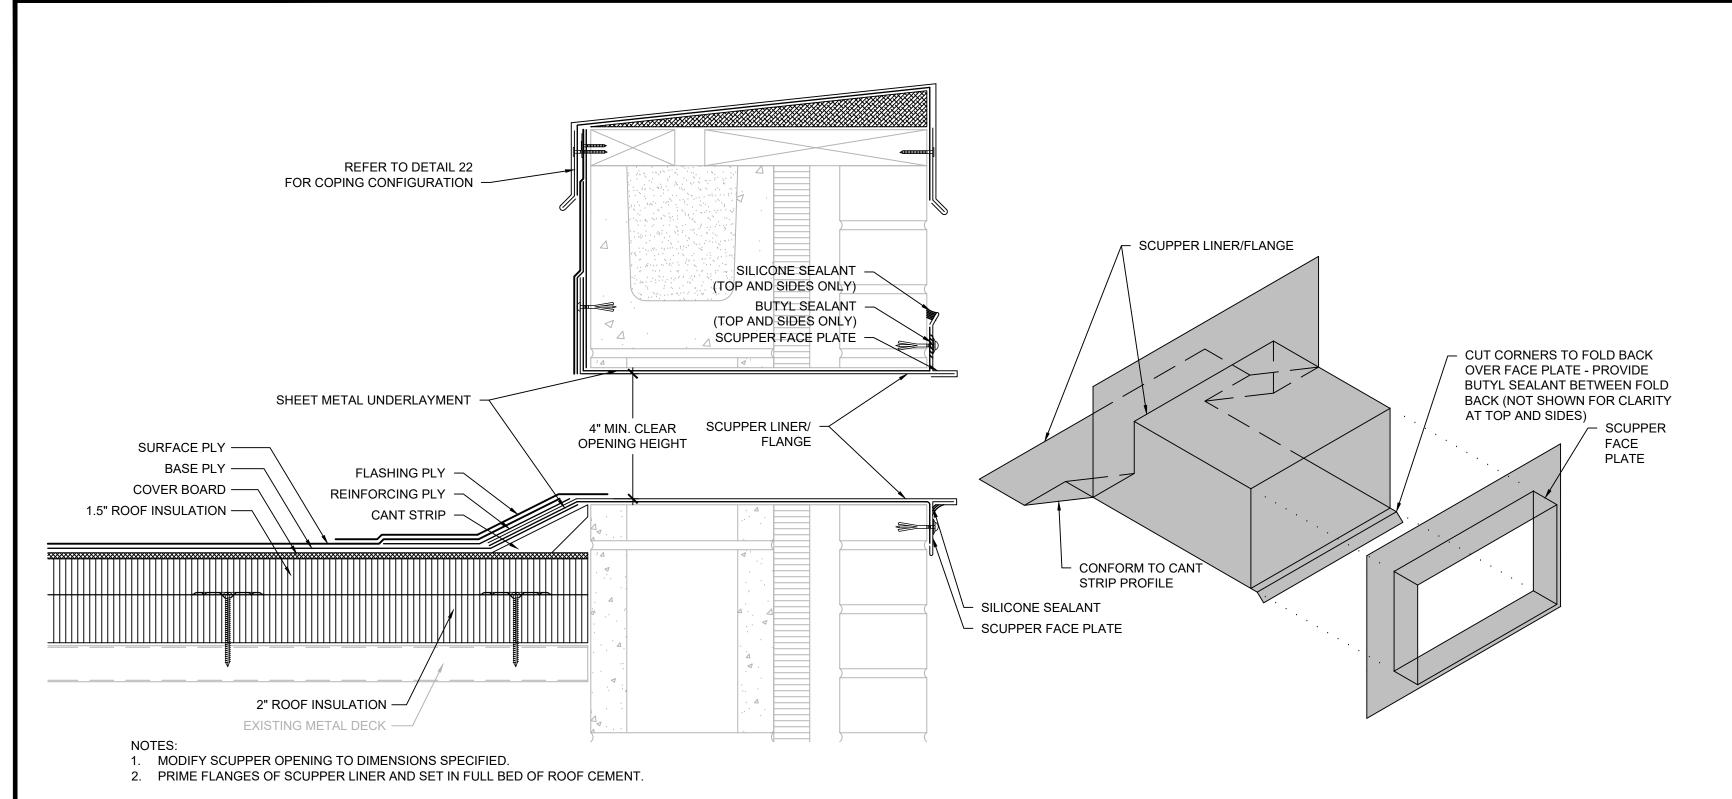
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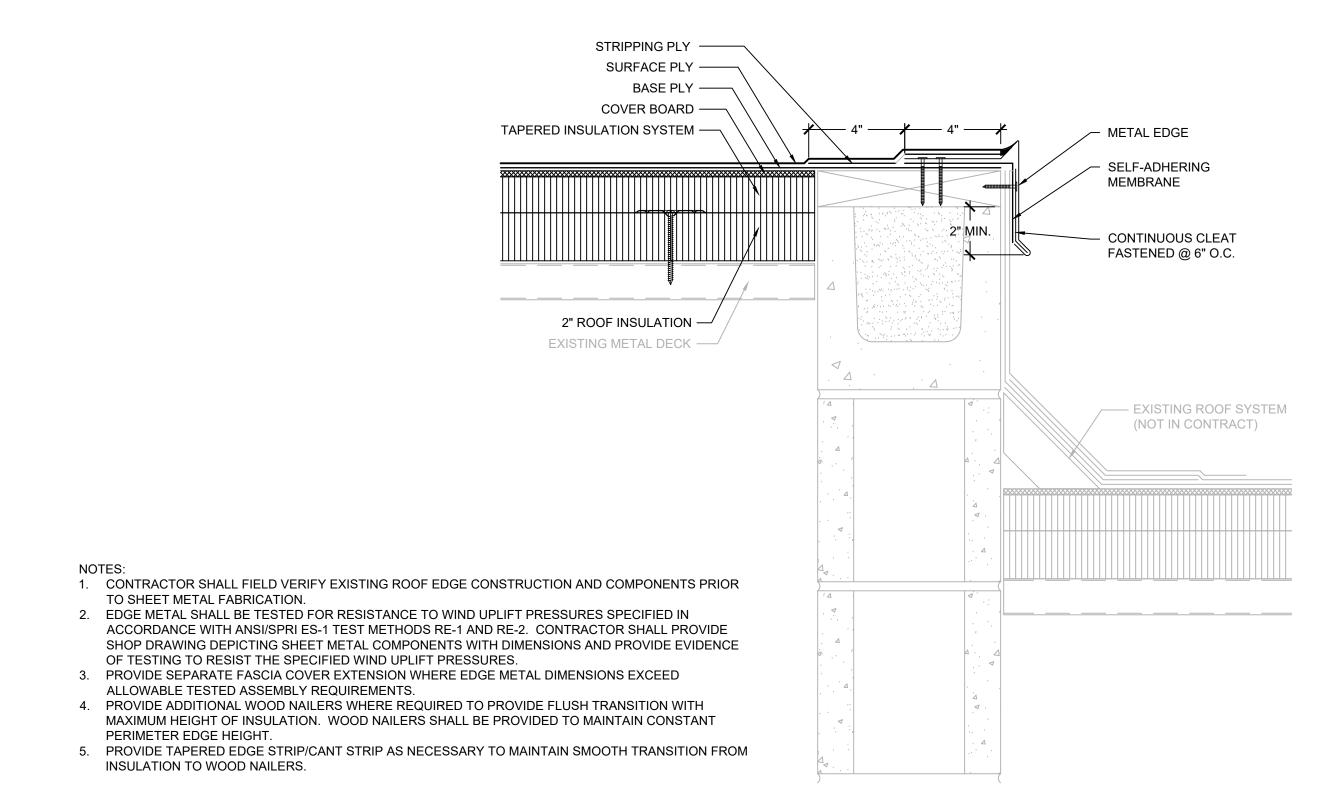
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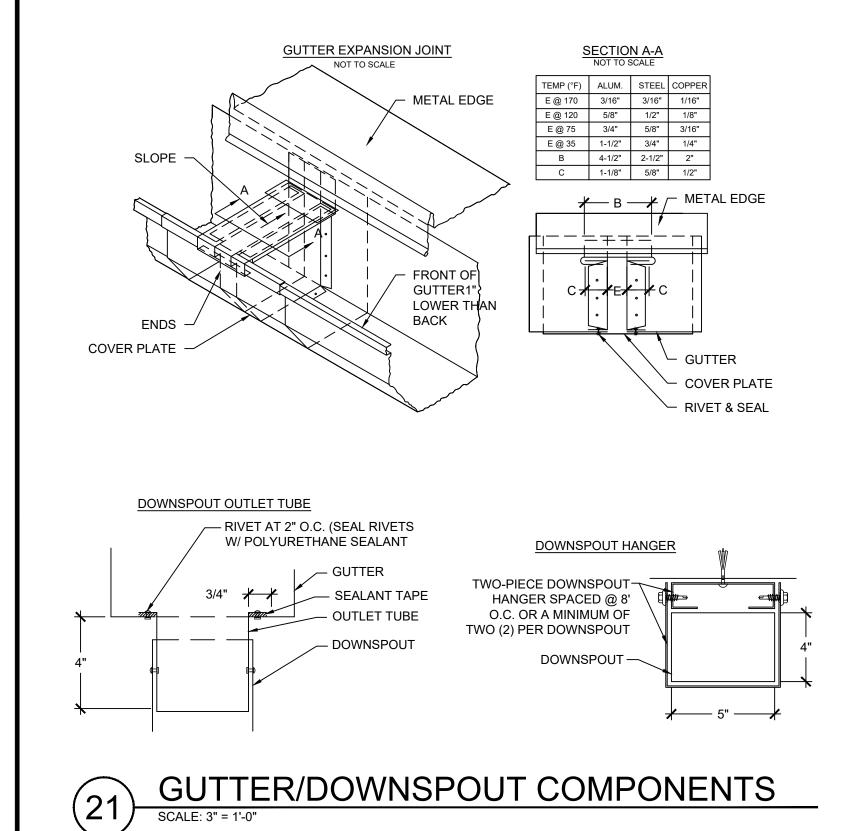
XR502




OVERFLOW SCUPPER - AREA 15



19 METAL EDGE - AREA 15 @ NIC SCALE: 3" = 1'-0"



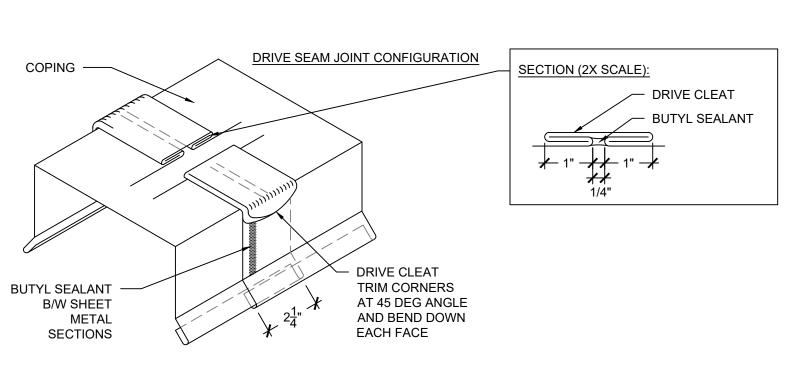

COPING JOINTS (DRIVE SEAM)


SCALE: 3" = 1'-0"

VERTICAL: ZONE 2: -88 PSF ZONE 3: -88 PSF —— 12" MAX. ——— HORIZTONAL OUTWARD: ZONE 4: -42 PSF ▼ **ZONE 5: -52 PSF** CONTINUOUS CLEAT FASTENED 6" O.C.


> 1. COPING SHALL BE TESTED FOR RESISTANCE TO PRESSURES SHOWN ABOVE IN ACCORDANCE WITH ANSI/SPRI ES-1 TEST METHOD RE-3. 2. CONTRACTOR SHALL PROVIDE SHOP DRAWING DEPICTING SHEET METAL COMPONENTS WITH DIMENSIONS AND PROVIDE EVIDENCE OF TESTING TO RESIST THE SPECIFIED PRESSURES. 3. PROVIDE SEPARATE FASCIA COVER EXTENSION WHERE EDGE METAL DIMENSIONS EXCEED ALLOWABLE TESTED ASSEMBLY REQUIREMENTS.

COPING ATTACHMENT

SCALE: 3" = 1'-0"

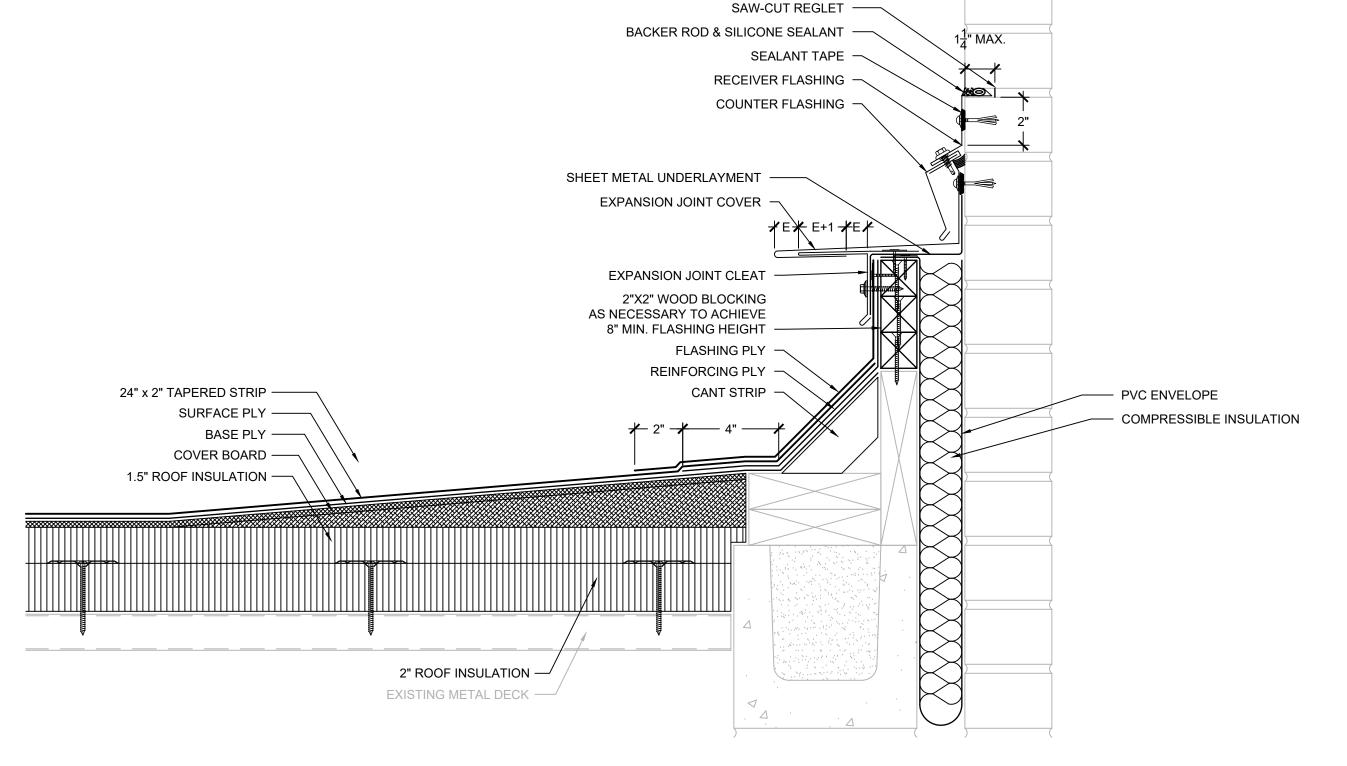



WALL EXPANSION JOINT - AREA 15 SCALE: 3" = 1'-0"

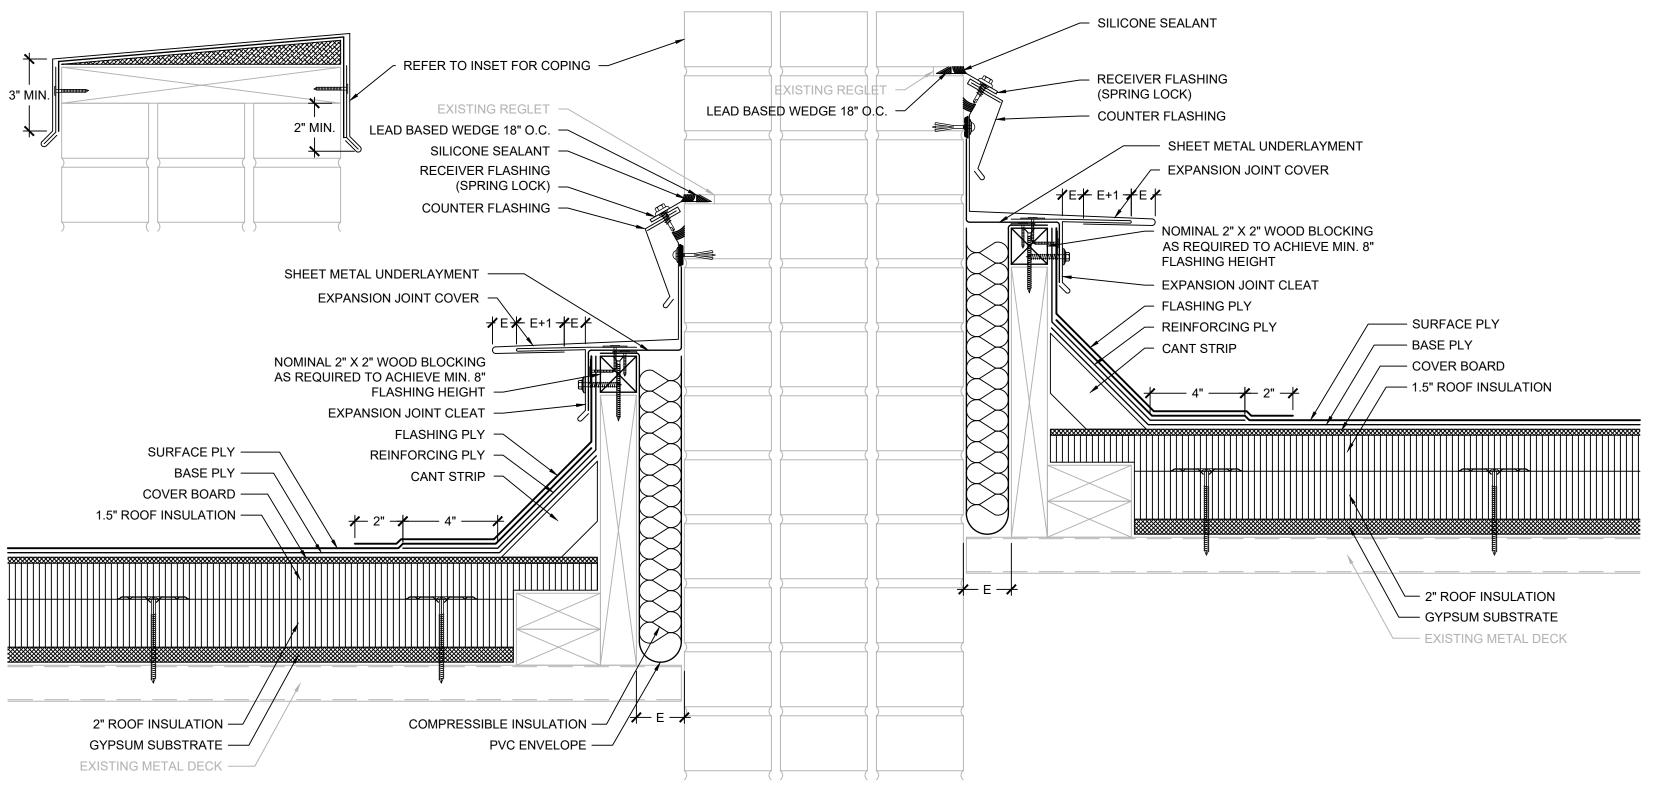

PARPPET WALL - AREA 1 TO 2

SCALE: 3" = 1'-0"

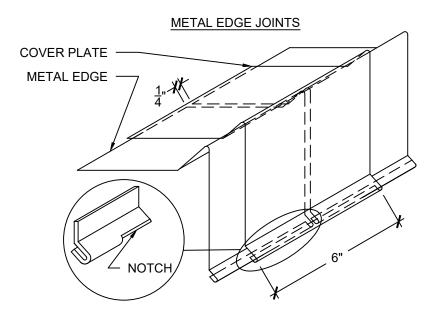

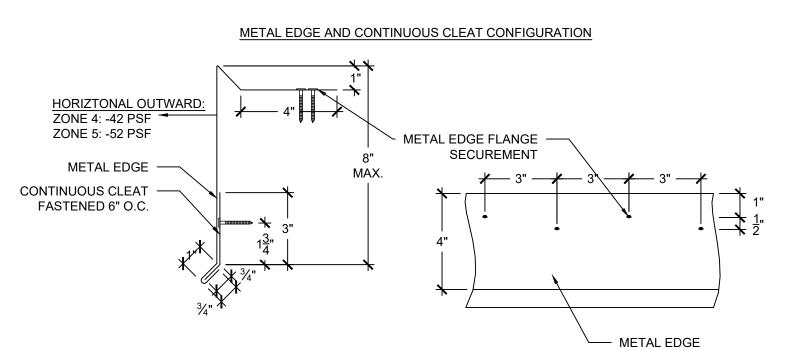

1. EDGE METAL SHALL BE TESTED FOR RESISTANCE TO WIND PRESSURES SPECIFIED IN WIND UPLIFT SUMMARY IN ACCORDANCE WITH ANSI/SPRI ES-1 TEST METHODS RE-1 AND RE-2. CONTRACTOR SHALL PROVIDE SHOP DRAWING DEPICTING SHEET METAL COMPONENTS WITH DIMENSIONS AND PROVIDE EVIDENCE OF TESTING TO RESIST THE SPECIFIED WIND PRESSURES. PROVIDE SEPARATE FASCIA COVER EXTENSION WHERE EDGE METAL DIMENSIONS EXCEED ALLOWABLE

METAL EDGE ATTACHMENT AND LAPS

TESTED ASSEMBLY REQUIREMENTS.




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PROJECT NAME:

THE ENTIRE BOARD.

YORK SCHOOL DISTRICT 1

YORK INTERMEDIATE SCHOOL ROOF REPLACEMENT
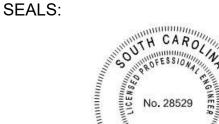
> 1280 JOHNSON RD. YORK, SOUTH CAROLINA 29745

PROJ. NO:

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DETAILS

DRAWING:

XR503