

### **Bulletin**

Date January 13, 2025

Project Name Troy School District – New Smith Middle School

TMP Project No(s). 22102 Bid Package No. 03

Bulletin No. Seven (7)

This Bulletin, issued after the award of contracts, describes a proposed deviation from the contract documents for the above project(s). All work shall conform with the standards and intent of the contract documents. Each contractor whose work is affected shall submit, within (14) days, an itemized proposal for performing this work. This Bulletin IS NOT an authorization for making a change.

The following Drawing(s) and Attachment(s) are issued with this Bulletin:

**Drawing No(s).:** AD.S, AD.S2, A2.1E, A2.1F, A2.2E, A3.2, A7.2, A7.6, A9.1A, A9.1B, A9.1C,

A9.1D, A9.1E, A9.1F, A9.2C, A9.2D, A9.2E

**Attachment(s):** Specification Section(s): 10 1416, 10 1419, 10 1423, 10 1426, 10 1500

Item No.	Specification Changes
SC-1	Refer to Section No. 10 1416 – PLAQUES (reissued):  A. Reissue section complete for bidding.
SC-2	Refer to Section No. 10 1419 – DIMENSIONAL LETTER AND SIGNAGE (reissued):  A. Reissue section complete for bidding.
SC-3	Refer to Section No. 10 1423 – PANEL SIGNAGE (reissued):  A. Reissue section complete for bidding.
SC-4	Refer to Section No. 10 1426 – EXTERIOR SIGNAGE (reissued):  A. Reissue section complete for bidding.
SC-5	Refer to Section No. 10 1500 – VIDEO DISPLAY SYSTEMS (reissued):  A. Reissue section complete for bidding.

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Item No.	Architectural Drawing Changes
AD-1	Refer to Drawing No. AD.S (reissued):  A. Reissue sheet complete for bidding.
AD-2	Refer to Drawing No. AD.S2 (reissued):  A. Reissue sheet complete for bidding.
AD-3	Refer to Drawing No. A2.1E (reissued):  A. Reissue sheet complete for bidding.
AD-4	Refer to Drawing No. A2.1F (reissued):  A. Reissue sheet complete for bidding.
AD-5	Refer to Drawing No. A2.2E (reissued):  A. Reissue sheet complete for bidding.
AD-6	Refer to Drawing No. A3.2 (reissued):  A. Reissue sheet complete for bidding.
AD-7	Refer to Drawing No. A7.2 (reissued):  A. Reissue sheet complete for bidding.
AD-8	Refer to Drawing No. A7.6 (reissued):  A. Reissue sheet complete for bidding.
AD-9	Refer to Drawing No. A9.1A (reissued):  A. Reissue sheet complete for bidding.
AD-10	Refer to Drawing No. A9.1B (reissued):  A. Reissue sheet complete for bidding.
AD-11	Refer to Drawing No. A9.1C (reissued):  A. Reissue sheet complete for bidding.

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AD-12	Refer to Drawing No. A9.1D (reissued):  A. Reissue sheet complete for bidding.
AD-13	Refer to Drawing No. A9.1E (reissued):  A. Reissue sheet complete for bidding.
AD-14	Refer to Drawing No. A9.1F (reissued):  A. Reissue sheet complete for bidding.
AD-15	Refer to Drawing No. A9.2C (reissued):  A. Reissue sheet complete for bidding.
AD-16	Refer to Drawing No. A9.2D (reissued):  A. Reissue sheet complete for bidding.
AD-17	Refer to Drawing No. A9.2E (reissued):  A. Reissue sheet complete for bidding.

\*\*\*END OF BULLETIN NO. 7 - BID PACKAGE NO. 03\*\*\*

#### **SECTION 10 1416 - PLAQUES**

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#### PART 1 GENERAL 1.01SECTION INCLUDES

A. Plaques.

#### 1.02 REFERENCE STANDARDS

- A. 36 CFR 1191 Americans with Disabilities Act (ADA) Accessibility Guidelines for Buildings and Facilities; Architectural Barriers Act (ABA) Accessibility Guidelines; current edition.
- B. ADA Standards 2010 ADA Standards for Accessible Design; 2010.
- C. ICC A117.1 Accessible and Usable Buildings and Facilities; 2017.

#### 1.03 SUBMITTALS

- A. See Section 01 3000 Administrative Requirements for submittal procedures.
- B. Product Data: Manufacturer's product literature for each type of plaque sign, indicating style, font, foreground and background colors, locations, and overall dimensions of each sign.
- C. Shop Drawings: Indicate dimensions, locations, elevations, materials, text and graphic layout, and attachment details.
- D. Samples: One sample of each type of plaque sign, of size similar to that required for project, indicating style, font, and method of attachment.
- E. Selection Samples: Where materials, colors, and finishes are not specified, submit two sets of color selection charts or chips.
- F. Manufacturer's qualification statement.

#### 1.04 QUALITY ASSURANCE

- A. Manufacturer Qualifications: Company specializing in manufacturing the products specified in this section with minimum five years of documented experience.
- B. Installer Qualifications: Company experienced in installing the products specified in this section with minimum five years documented experience.

#### 1.05 DELIVERY, STORAGE, AND HANDLING

- A. Package plaque signs as required to prevent damage before installation.
- B. Store under cover and elevated above grade.

#### PART 2 PRODUCTS

#### 2.01 MANUFACTURERS

- A. Plaques:
  - 1. A.R.K. Ramos: www.arkramos.com/#sle.
  - 2. DMP Sign Co. (Formerly Detroit Marketing Products): www.dmpsignco.com
  - 3. Gemini Inc.: www.geminisignproducts.com.
  - 4. Substitutions: See Section 01 6000 Product Requirements.

#### 2.02 REGULATORY REQUIREMENTS

A. Accessibility Requirements: Comply with ADA Standards and ICC A117.1 and applicable building codes, unless otherwise indicated; in the event of conflicting requirements, comply with the most restrictive requirements.

#### 2.03 PLAQUES

- A. Metal Plaques:
  - 1. Material: Aluminum casting.
  - 2. Material Thickness: 1/8 inch, minimum.
  - 3. Size: As indicated on drawings.
  - 4. Text and Typeface:
    - a. Character Font: As indicated on drawings..
    - b. Character Case: Upper case only.

- c. Character Color: Contrast with background color.
- 5. Border Style: Double line.
- 6. Background Texture: Pebble.
- 7. Surface Finish: As selected by Architect from manufacturer's full range.
- 8. Painted Background Color: As selected by Architect from manufacturer's standard background colors.
- 9. Protective Coating: Manufacturer's standard clear coating.
- 10. Mounting: Blind studs.

#### 2.04 ACCESSORIES

A. Concealed Screws: Noncorroding metal; stainless steel or galvanized steel.

#### **PART 3 EXECUTION**

#### 3.01 EXAMINATION

- A. Verify that substrate surfaces are ready to receive work.
- B. Notify Architect if conditions are not suitable for installation of signs; do not proceed until conditions are satisfactory.

#### 3.02 INSTALLATION

- A. Install in accordance with manufacturer's instructions.
- B. Install with horizontal edges level.
- C. Protect from damage until Date of Substantial Completion; repair or replace damaged items.
- D. Protect from damage until mm-dd-yyyy; repair or replace damaged items.

#### **END OF SECTION**

#### **SECTION 10 1419 - DIMENSIONAL LETTER SIGNAGE**

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#### PART 1 GENERAL 1.01SECTION INCLUDES

- Dimensional letter signage.
- B. Illumination system.

#### 1.02 REFERENCE STANDARDS

- A. 36 CFR 1191 Americans with Disabilities Act (ADA) Accessibility Guidelines for Buildings and Facilities; Architectural Barriers Act (ABA) Accessibility Guidelines; current edition.
- B. ADA Standards 2010 ADA Standards for Accessible Design; 2010.
- C. ICC A117.1 Accessible and Usable Buildings and Facilities; 2017.
- D. UL 879 Electric Sign Components; Current Edition, Including All Revisions.

#### 1.03 SUBMITTALS

- A. See Section 01 3000 Administrative Requirements for submittal procedures.
- B. Product Data: Manufacturer's product literature for each type of dimensional letter sign, indicating style, font, colors, locations, and overall dimensions of each sign.
- C. Shop Drawings:
  - Include dimensions, locations, elevations, materials, text and graphic layout, and attachment details.
- D. Samples: Submit one sample of each type of dimensional letter sign of size similar to that required for project, indicating sign style, font, and method of attachment.
- E. Selection Samples: Where materials, colors, and finishes are not specified, submit two sets of selection charts or chips.
- F. Verification Samples: Submit samples showing colors and finishes specified.
- G. Manufacturer's Installation Instructions: Include installation templates and attachment devices.
- H. Manufacturer's qualification statement.

#### 1.04 QUALITY ASSURANCE

- A. Manufacturer Qualifications: Company specializing in manufacturing the products specified in this section with minimum five years of documented experience.
- B. Installer Qualifications: Company specializing in manufacturing the products specified in this section with minimum five years of documented experience.

#### 1.05 DELIVERY, STORAGE, AND HANDLING

- A. Package dimensional letter signs as required to prevent damage before installation.
- B. Store under cover and elevated above grade.
- C. Store tape adhesive at a normal room temperature of 68 to 72 degrees F.

#### 1.06 FIELD CONDITIONS

- A. Do not install tape adhesive when ambient temperature is lower than recommended by manufacturer.
- B. Maintain minimum ambient temperature during and after installation.

#### **PART 2 PRODUCTS**

#### 2.01 MANUFACTURERS

- A. Dimensional Letter Signs:
  - 1. 3M: www.3m.com
  - 2. A.R.K. Ramos: www.arkramos.com/#sle.
  - 3. DMP Sign Co. (Formerly Detroit Marketing Products): www.dmpsignco.com
  - 4. Gemini Inc.: www.geminisignproducts.com.
  - 5. Inpro Corporation: www.inprocorp.com/#sle.
  - 6. Substitutions: See Section 01 6000 Product Requirements.

#### 2.02 REGULATORY REQUIREMENTS

A. Accessibility Requirements: Comply with ADA Standards and ICC A117.1 and applicable building codes, unless otherwise indicated; in the event of conflicting requirements, comply with the most restrictive requirements.

#### 2.03 DIMENSIONAL LETTERS

- A. Applications: Interior.
  - 1. Use individual metal letters.
  - 2. Mounting Location: Interior as indicated on drawings.
  - Metal Letters:
    - a. Material: Aluminum casting.
    - b. Thickness: Manufacturer's standard for letter size.
    - c. Letter Height: As indicated on drawings.
    - d. Text and Typeface:
      - 1) Character Font: Helvetica, Arial, or other sans serif font.
      - 2) Character Case: As indicated on drawings..
    - e. Finish: Anodized.
    - f. Color: Up to two custom colors.
      - 1) Color A: To match Sherwin Williams SW 7069 Iron Ore
      - 2) Color B: To match Sherwin Williams SW 6381 Anjou Pear
      - Mounting: Concealed screws.
- B. Applications: Building identification and Room Identification at Interior locations.
  - 1. Use individual metal letters.
  - 2. Mounting Location: Exterior and Interior as indicated on drawings.
  - 3. Metal Letters:
    - a. Material: Aluminum casting.
    - b. Thickness: Manufacturer's standard for letter size.
    - c. Letter Height: As indicated on drawings.
    - d. Text and Typeface:
      - 1) Character Font: Helvetica, Arial, or other sans serif font.
      - 2) Character Case: As indicated on drawings...
    - e. Finish: Anodized.
    - f. Color: Up to two custom colors.
      - 1) Color A: To match Sherwin Williams SW 7069 Iron Ore
      - 2) Color B: To match Sherwin Williams SW 6381 Anjou Pear
    - g. Mounting: Concealed screws.
    - h. Illumination System: Halo-lit reverse channel letters.
      - 1) Provide products that are listed and labeled as complying with UL 879, where applicable.
      - 2) Power: 120 V, 60 Hz, 1 phase, 15 A.
- C. Applications: Logo.
  - 1. Precision cut metal logo.
  - 2. Mounting Location: Interior as indicated on drawings.
  - Metal:
    - a. Material: Cut aluminum...
    - b. Thickness: 1/4 inch minimum.
    - c. Logo Height: As indicated on drawings.
    - d. Finish: Glossy.
    - e. Color: Up to six custom colors.
      - Custom colors to match school logo.
    - f. Mounting: Concealed Screws on Standoffs.
- D. Plastic Letters:
  - 1. Material: Vinyl sheet, flat cutout.
    - a. Opaque, non-reflective film with pressure-sensitive adhesive backing.

b. Signs shall be cut from sufficiently large rolls of material to minimize seams or joining of material to create one sign.

- 2. Thickness: Manufacturer's standard for letter size.
- 3. Letter Height: As indicated on drawings.
- 4. Text and Typeface:
  - a. Character Font: Helvetica, Arial, or other sans serif font.
  - b. Character Case: As indicated on drawings...
- 5. Finish: As selected by Architect from manufacturer's full range.
- 6. Color: White.
- 7. Mounting: Pressure-sensitive adhesive.
- 8. Installation Method:
  - a. Signs shall be installed free of bubbles, wrinkles, or other anomalies.
  - b. Provide signs as either front applied (first surface) or reverse applied (second surface) as required.

#### 2.04 ACCESSORIES

- A. Concealed Screws: Noncorroding metal; stainless steel, galvanized steel, chrome plated, or other.
- B. Tape Adhesive: Double-sided tape, permanent adhesive.

#### **PART 3 EXECUTION**

#### 3.01 EXAMINATION

- A. Verify that substrate surfaces are ready to receive work.
- B. Verify that electrical service is correctly sized and located to accommodate dimensional letter signs.
- C. Notify Architect if conditions are not suitable for installation of signs; do not proceed until conditions are satisfactory.

#### 3.02 INSTALLATION

- A. Install in accordance with manufacturer's instructions.
- B. Install with horizontal edges level.
- C. Protect from damage until Date of Substantial Completion; repair or replace damaged items.

#### **END OF SECTION**

#### **SECTION 10 1423 - PANEL SIGNAGE**

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#### PART 1 GENERAL 1.01SECTION INCLUDES

A. Panel signage.

#### 1.02 REFERENCE STANDARDS

- A. ADA Standards 2010 ADA Standards for Accessible Design; 2010.
- B. ICC A117.1 Accessible and Usable Buildings and Facilities; 2017.

#### 1.03 SUBMITTALS

- A. See Section 01 3000 Administrative Requirements for submittal procedures.
- B. Product Data: Manufacturer's product literature for each type of panel sign, indicating styles, font, foreground and background colors, locations, and overall dimensions of each sign.
- C. Shop Drawings:
  - 1. Include dimensions, locations, elevations, materials, text and graphic layout, attachment details, and schedules.
  - 2. Schedule: Provide information sufficient to completely define each panel sign for fabrication, including room number, room name, other text to be applied, sign and letter sizes, fonts, and colors.
    - a. When room numbers to appear on signs differ from those on drawings, include the drawing room number on schedule.
    - b. When content of signs is indicated to be determined later, request such information from Owner through Architect at least 2 months prior to start of fabrication; upon request, submit preliminary schedule.
    - c. Submit for approval by Owner through Architect prior to fabrication.
- D. Samples: Submit two samples of each type of sign, of size similar to that required for project, indicating sign style, font, and method of attachment.
- E. Selection Samples: Where colors, materials, and finishes are not specified, submit two sets of color selection charts or chips.
- F. Verification Samples: Submit samples showing colors, materials, and finishes specified.
- G. Manufacturer's Installation Instructions: Include installation templates and attachment devices.
- H. Manufacturer's qualification statement.
- I. Maintenance Materials: Furnish the following for Owner's use in maintenance of project.
  - 1. See Section 01 6000 Product Requirements for additional provisions.

#### 1.04 QUALITY ASSURANCE

- A. Manufacturer Qualifications: Company specializing in manufacturing the products specified in this section with minimum five years of documented experience.
- B. Manufacturer Qualifications: Company specializing in manufacturing the products specified in this section with minimum five years of documented experience.

#### 1.05 DELIVERY, STORAGE, AND HANDLING

- A. Package signs as required to prevent damage before installation.
- B. Package room and door signs in sequential order of installation, labeled by floor or building.
- C. Store under cover and elevated above grade.
- D. Store tape adhesive at normal room temperature.

#### 1.06 FIELD CONDITIONS

- A. Do not install tape adhesive when ambient temperature is lower than recommended by manufacturer.
- B. Maintain minimum ambient temperature during and after installation.

#### **PART 2 PRODUCTS**

#### 2.01 MANUFACTURERS

- A. Panel Signage:
  - 1. ASI Signage Innovation: www.asisignage.com.
  - 2. DMP Sign Co. (Formerly Detroit Marketing Products): www.dmpsignco.com.
  - 3. Foresight Supersign: www.foresightsupersign.net.
  - 4. Inpro Corporation: www.inprocorp.com/#sle.
  - 5. Summit Advertising, Inc.: www.summit-signco.com
  - 6. The Supersine Company: www.supersine.com.
  - 7. Substitutions: See Section 01 6000 Product Requirements.

#### 2.02 REGULATORY REQUIREMENTS

A. Accessibility Requirements: Comply with ADA Standards and ICC A117.1 and applicable building codes, unless otherwise indicated; in the event of conflicting requirements, comply with the most restrictive requirements.

#### 2.03 PANEL SIGNAGE

- A. Panel Signage:
  - 1. Application: Room and door signs.
  - 2. Description: Flat signs UV/LED-cured digitally printed ink media, tactile characters and Braille shall be integral to sign face; separate adhesively-fixed characters are not permitted. Frameless.
  - 3. Sign Size: As indicated on drawings.
  - 4. Total Thickness: 1/8 inch.
  - 5. Sign Edges: As indicated.
  - 6. Letter Edges: As indicated.
  - 7. Corners: As indicated.
  - 8. Color and Font, unless otherwise indicated:
    - a. Character Font: Helvetica, Arial, or other sans serif font.
    - b. Character Case: Upper and lower case (title case).
    - c. Background Color: As scheduled.
    - d. Character Color: Contrasting color.
  - 9. Profile: Flat panel without frame.
    - Clear Cover: For customer produced sign media, provide clear cover of polycarbonate plastic, glossy on back, nonglare on front.
      - Signage manufacturer to provide template to owner for layout. Insert printed by owner.
  - 10. Tactile Letters: Raised 1/32 inch minimum.
  - 11. Braille: Grade II, ADA-compliant.
  - 12. One-Sided Wall Mounting: Tape adhesive.

#### 2.04 SIGNAGE APPLICATIONS

- A. Room and Door Signs:
  - 1. Classroom and Office Doors: Identify with room names and numbers as indicated on signage schedule; provide "window" section for replaceable occupant name.
  - 2. Conference and Meeting Rooms: Identify with room names and numbers as indicated on signage schedule.
  - 3. Service Rooms: Identify with room names as indicated on signage schedule.
  - 4. Rest Rooms: Identify with pictograms, the names "MEN" or "BOYS" and "WOMEN" or "GIRLS", and braille.
  - 5. Stairways: Identify with pictograms and the name "STAIR", and braille.
  - Elevators: Identify with pictograms and the name "ELEVATOR", and braille.
    - Emergency text and Pictograms: Comply with requirements of authorities having jurisdiction indicating that in case of fire, elevators are out of service and stairway exits should be used instead.

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PANEL SIGNAGE
10 1423-2

- 7. Exits: Identify with text and braille.
- B. Interior Directional and Informational Panel Signs:
  - 1. Where suspended, ceiling mounted, or projecting from wall signs are indicated, provide two-sided signs with same information on both sides.

#### 2.05 ACCESSORIES

A. Tape Adhesive: Double-sided tape, permanent adhesive.

#### **PART 3 EXECUTION**

#### 3.01 EXAMINATION

- A. Verify that substrate surfaces are ready to receive work.
- B. Notify Architect if conditions are not suitable for installation of signs; do not proceed until conditions are satisfactory.

#### 3.02 INSTALLATION

- A. Install in accordance with manufacturer's instructions.
- B. Install with horizontal edges level.
- C. Locate panel signs and mount at heights indicated on drawings and in accordance with ADA Standards and ICC A117.1.
- D. Protect from damage until date of Substantial Completion; repair or replace damaged items.

#### **END OF SECTION**

#### **SECTION 10 1426 - EXTERIOR SIGNAGE**

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#### **PART 1 GENERAL**

#### 1.01RELATED DOCUMENTS

A. Drawings and general provisions of the Contract, including General and Supplementary Conditions and Division 01 Specification Sections, apply to this Section.

#### 1.02 SUMMARY

- A. Section Includes:
  - Exterior illuminated panel signs.
- B. Related Requirements:
  - 1. Division 26 Sections for Electrical Systems for power, labels, tags, and nameplates for electrical equipment.

#### 1.03 DEFINITIONS

A. Illuminated: Illuminated by lighting source integrally constructed as part of the sign unit.

#### 1.04 COORDINATION

A. Fabricate signage to utilize existing sign-anchorage devices and electrical service embedded in existing concrete base construction.

#### 1.05 ACTION SUBMITTALS

- A. Product Data: For each type of product.
- B. Shop Drawings: For panel signs.
  - 1. Include fabrication and installation details and attachments to other work.
  - 2. Show sign mounting heights, locations of supplementary supports to be provided by others, and accessories.
  - 3. Show message list, typestyles, graphic elements and layout for each sign.
  - 4. Show locations of electrical service connections.
  - 5. Include diagrams for power, signal, and control wiring.
- C. Samples for Initial Selection: For each type of sign assembly, exposed component, and exposed finish.
  - 1. Include representative Samples of typestyles and graphic symbols.
- D. Samples for Verification: For each type of sign assembly showing all components and with the required finish(es), in manufacturer's standard size unless otherwise indicated and as follows:
  - 1. Panel Signs: Not less than 12 inches (300 mm) square, including corner.
- E. Delegated-Design Submittal:
  - 1. Include structural analysis calculations for signs indicated to comply with design loads; signed and sealed by the qualified professional engineer responsible for their preparation.

#### 1.06 INFORMATIONAL SUBMITTALS

- A. Qualification Data: For installer and manufacturer.
- B. Sample Warranty: For special warranty.

#### 1.07 CLOSEOUT SUBMITTALS

A. Maintenance Data: For signs to include in maintenance manuals.

#### 1.08 FIELD CONDITIONS

A. Field Measurements: Verify locations of existing anchorage devices and electrical service embedded in permanent construction by other installers by field measurements before fabrication, and indicate measurements on Shop Drawings.

#### 1.09 WARRANTY

- A. Special Warranty: Manufacturer agrees to repair or replace components of signs that fail in materials or workmanship within specified warranty period.
  - 1. Failures include, but are not limited to, the following:
    - a. Deterioration of finishes beyond normal weathering.

- b. Deterioration of embedded graphic image.
- c. Separation or delamination of sheet materials and components.
- 2. Warranty Period: Five (5) years from date of Substantial Completion.

#### **PART 2 PRODUCTS**

#### 2.01 PERFORMANCE REQUIREMENTS

- A. Delegated Design: Engage a qualified professional engineer, as defined in Division 1 Section "Quality Requirements," to design sign structure and anchorage of illuminated panel sign with reader board to withstand design loads.
- B. Thermal Movements: For exterior signs, allow for thermal movements from ambient and surface temperature changes.
  - Temperature Change: 120 deg F (67 deg C), ambient; 180 deg F (100 deg C), material surfaces.
- C. Accessibility Standard: Comply with applicable provisions in the U.S. Architectural & Transportation Barriers Compliance Board's ADA-ABA Accessibility Guidelines for Buildings and Facilities and ICC A117.1 for signs.
- D. Electrical Components, Devices, and Accessories: Listed and labeled as defined in NFPA 70, by a qualified testing agency, and marked for intended location and application.

#### 2.02 **SIGNS**

- A. Manufacturers:
  - 1. ASI Sign Systems, Inc. Troy, MI (248)680-8970; www.asisignage.com
  - 2. Diskey Architectural Signage, Inc. Fort Wayne, IN (800)669-4472; www.diskeysign.com
  - 3. J. L. Geisler Corporation, Warren, MI (888) 637-7111
  - 4. Poblocki Sign Company, LLC Milwaukee, WI (800)776-7064; www.poblocki.com
  - 5. Stamprite Supersine Lansing, MI (517)487-5071; www.supersignstamps.com
  - 6. Phillips Sign & Lighting, Harrison Twp., MI 586-468-7110; www.phillipssign.com
  - 7. Universal Sign, Inc., Grand Rapids, MI 616-554-9999; www.universalsignsystems.com
- 3. Panel Sign: Sign with smooth, uniform surfaces; with message and characters having uniform faces, sharp corners, and precisely formed lines and profiles; and as follows:
  - Illuminated Panel Sign: Backlighted construction with LED lighting including transformers, insulators, and other accessories for operability, with provision for servicing and concealing connections to building electrical system. Use tight or sealed joint construction to prevent unintentional light leakage. Space lamps apart from each other and away from sign surfaces as needed to illuminate evenly.
  - 2. Sign-Panel Faces:
    - Prefinished aluminum face sheet with computer-routed text and white translucent fiberglass-reinforced acrylic modified polyester backer panels. All materials to be UV stable.
  - 3. Sign-Panel Perimeter: Finish edges smooth.
    - a. Edge Condition: Vertical and Horizontal Edges: Square cut.
    - b. Corner Condition in Elevation: Square.
  - 4. Frame: Entire perimeter and horizontal and vertical retainers.
    - a. Material: Aluminum.
    - b. Material Thickness: 0.125" (3.2mm).
    - c. Frame Depth: Match existing.
    - d. Profile: Square.
    - e. Corner Condition in Elevation: Square.
    - f. Finish and Color: Match Architect's sample.
  - 5. Mounting: Utilize existing anchor bolts embedded in concrete base. If a different bolt layout is required, include installation of new drilled chemical adhesive anchors. Cut off existing bolts if necessary for clearance.
  - Surface Finish:
    - a. Baked enamel or powder coat finish: in color to match Architect's sample.

7. Text and Typeface: Cutout letters in face of panel to expose white acrylic lighted lens behind. Sizes and fonts as indicated on drawings.

8. Flatness Tolerance: Sign panel shall remain flat under installed conditions as indicated and within a tolerance of plus or minus 1/16 inch (1.5 mm)

#### 2.03 PANEL-SIGN MATERIALS

- A. Aluminum Sheet and Plate: ASTM B 209 (ASTM B 209M), alloy and temper recommended by aluminum producer and finisher for type of use and finish indicated.
- B. Aluminum Extrusions: ASTM B 221 (ASTM B 221M), alloy and temper recommended by aluminum producer and finisher for type of use and finish indicated.
- C. Steel Materials:
  - 1. Steel Members Fabricated from Plate or Bar Stock: ASTM A 529/A 529M or ASTM A 572/A 572M, 42,000-psi (290-MPa) minimum yield strength.
  - 2. For steel exposed to view on completion, provide materials having flat, smooth surfaces without blemishes. Do not use materials whose surfaces exhibit pitting, seam marks, roller marks, rolled trade names, or roughness.
- D. Fiberglass-Reinforced Acrylic Sheet: Multiple laminations of translucent glass-fiber-reinforced acrylic-modified polyester resin with UV-light stable, colorfast, nonfading, weather- and stain-resistant, colored polyester gel coat, and with manufacturer's standard finish.

#### 2.04 ELECTRONIC READER BOARDS

A. See Section 10 1500 - Video Display Systems.

#### 2.05 DIMENSIONAL CHARACTERS

A. See Section 10 1419 - Dimensional Letter Signage.

#### 2.06 ACCESSORIES

- A. Fasteners and Anchors: Manufacturer's standard as required for secure anchorage of signage, noncorrosive and compatible with each material joined, and complying with the following:
  - 1. Use concealed fasteners and anchors unless indicated to be exposed.
  - 2. For exterior exposure, furnish stainless-steel or hot-dip galvanized devices unless otherwise indicated.
  - 3. Exposed Metal-Fastener Components, General:
    - a. Fabricated from same basic metal and finish of fastened metal unless otherwise indicated.
    - b. Fastener Heads: For nonstructural connections, use flathead or oval countersunk screws and bolts with tamper-resistant slots unless otherwise indicated.
  - 4. Sign Mounting Fasteners:
    - a. Concealed Studs: Concealed (blind), threaded studs welded or brazed to back of sign material or screwed into back of sign assembly, unless otherwise indicated. Letter centers should be mounted to acrylic backup in this manner, along with adhesive.
    - b. Projecting Studs: Threaded studs with sleeve spacer, welded or brazed to back of sign material or screwed into back of sign assembly, unless otherwise indicated.
    - c. Through Fasteners: Exposed metal fasteners matching sign finish, with type of head indicated, installed in predrilled holes.
- B. Adhesive: As recommended by sign manufacturer.
- C. Bituminous Paint: Cold-applied asphalt emulsion complying with ASTM D 1187.

#### 2.07 FABRICATION

- A. General: Provide manufacturer's standard sign assemblies according to requirements indicated.
  - Preassemble signs and assemblies in the shop to greatest extent possible. Disassemble signs and assemblies only as necessary for shipping and handling limitations. Clearly mark units for reassembly and installation; apply markings in locations concealed from view after final assembly.

EXTERIOR SIGNAGE 10 1426-3

2. Mill joints to a tight, hairline fit. Form assemblies and joints exposed to weather to resist water penetration and retention.

- 3. Comply with AWS for recommended practices in welding and brazing. Provide welds and brazes behind finished surfaces without distorting or discoloring exposed side. Clean exposed welded and brazed connections of flux, and dress exposed and contact surfaces.
- 4. Conceal connections if possible; otherwise, locate connections where they are inconspicuous.
- 5. Internally brace signs for stability and for securing fasteners.
- 6. Provide rebates, lugs, and brackets necessary to assemble components and to attach to existing work. Drill and tap for required fasteners. Use concealed fasteners where possible; use exposed fasteners that match sign finish.

#### 2.08 GENERAL FINISH REQUIREMENTS

- A. Protect mechanical finishes on exposed surfaces from damage by applying a strippable, temporary protective covering before shipping.
- B. Appearance of Finished Work: Noticeable variations in same piece are not acceptable. Variations in appearance of adjoining components are acceptable if they are within the range of approved Samples and are assembled or installed to minimize contrast.

#### 2.09 ALUMINUM FINISHES

- A. Baked-Enamel or Powder-Coat Finish: AAMA 2603 except with a minimum dry film thickness of 1.5 mils (0.04 mm). Comply with coating manufacturer's written instructions for cleaning, conversion coating, and applying and baking finish.
- B. Silkscreen Text: Shop-applied silkscreen text shall be UV-stable, weather and abrasion resistant, and compatible with base sign finish.

#### 2.10 METALLIC-COATED STEEL FINISHES

- A. Factory Prime Finish: After cleaning and pretreating, apply an air-dried primer compatible with the organic coating to be applied over it.
- B. Baked-Enamel or Powder-Coat Finish: After cleaning and pretreating, apply manufacturer's standard two-coat, baked-on finish consisting of prime coat and thermosetting topcoat to a minimum dry film thickness of 2 mils (0.05 mm).

#### 2.11 STEEL FINISHES

- A. Surface Preparation: Remove mill scale and rust, if present, from uncoated steel, and prepare for coating according to coating manufacturer's written instructions.
  - For Baked-Enamel or Powder-Coat Finish: After cleaning, apply a conversion coating compatible with the organic coating to be applied over it.
- B. Baked-Enamel or Powder-Coat Finish: After cleaning and pretreating, apply manufacturer's standard two-coat, baked-on finish consisting of prime coat and thermosetting topcoat to a minimum dry film thickness of 2 mils (0.05 mm).

#### **PART 3 EXECUTION**

#### 3.01 EXAMINATION

- A. Examine substrates, areas, and conditions, with Installer present, for compliance with requirements for installation tolerances and other conditions affecting performance of signage work.
- B. Verify that sign-support surfaces are within tolerances to accommodate signs without gaps or irregularities between backs of signs and support surfaces unless otherwise indicated.
- C. Verify that anchor inserts are correctly sized and located to accommodate signs.
- D. Verify that electrical service is correctly sized and located to accommodate signs.
- E. Proceed with installation only after unsatisfactory conditions have been corrected.

#### 3.02 INSTALLATION

- A. General: Install signs using mounting methods indicated and according to manufacturer's written instructions.
  - 1. Install signs level, plumb, true to line, and at locations and heights indicated, with sign surfaces free of distortion and other defects in appearance.
  - 2. Install signs so they do not protrude or obstruct according to the accessibility standard.
  - 3. Before installation, verify that sign surfaces are clean and free of materials or debris that would impair installation.
  - 4. Corrosion Protection: Coat concealed surfaces of exterior aluminum in contact with grout, concrete, masonry, wood, or dissimilar metals, with a heavy coat of bituminous paint.

#### B. Mounting Methods:

- Concealed Studs: Reuse existing studs embedded in concrete base. Where not possible, install new studs using a template for layout, drill holes in substrate aligning with studs on bottom of sign. Remove loose debris from hole and substrate surface and install chemical adhesive anchors. Cut off existing studs if necessary for clearance.
- 2. Shim-Plate Mounting: Provide 1/8-inch- (3-mm-) thick, concealed aluminum shim plates with predrilled and countersunk holes, at locations indicated, and where other direct mounting methods are impractical. Attach plate with fasteners and anchors suitable for secure attachment to substrate. Attach signs to plate using method specified above.

#### 3.03 ADJUSTING AND CLEANING

- A. Remove and replace damaged or deformed signs and signs that do not comply with specified requirements. Replace signs with damaged or deteriorated finishes or components that cannot be successfully repaired by finish touchup or similar minor repair procedures.
- B. Remove temporary protective coverings and strippable films as signs are installed.
- C. On completion of installation, clean exposed surfaces of signs according to manufacturer's written instructions, and touch up minor nicks and abrasions in finish. Maintain signs in a clean condition during construction and protect from damage until acceptance by Owner.

#### **END OF SECTION**

#### **SECTION 10 1500 - VIDEO DISPLAY SYSTEMS**

\*\*BUL7\*\*

#### **PART 1 GENERAL**

#### **1.01SECTION INCLUDES**

A. Panelized LED video display systems.

#### 1.02 REFERENCE STANDARDS

A. ANSI/Infocomm 10 - Audiovisual Systems Performance Verification; 2013.

#### 1.03 ADMINISTRATIVE REQUIREMENTS

A. Preinstallation Meeting: Conduct a preinstallation meeting two weeks prior to the start of the work of this section; require attendance by all affected installers.

#### 1.04 SUBMITTALS

- A. See Section 01 3000 Administrative Requirements, for submittal procedures.
- B. Product Data: Provide manufacturer's data sheets on panelized LED display systems including recommendations for preparation, storage and handling, and installation.
- C. Shop Drawings: Indicate cable routing, connections between equipment, anchor and support details, and adjacent construction.
- D. Manufacturer's Certificates: Certify products meet or exceed specified requirements.
- E. Project Record Documents: Provide quantities, type, and location for components, cabling and accessories.
- F. System Setting Backup: Provide an electronic file of all system settings.
- G. Security Items:
  - 1. Provide one set of keys for each locked equipment enclosure.
  - 2. Provide passwords to access control functions for hardware and software user interfaces.

#### 1.05 QUALITY ASSURANCE

- A. Manufacturer Qualifications: Company specializing in manufacturing products specified in this section, with not less than three years of documented experience.
- B. Authorized Manufacturer Representative: System shall be configured and commissioned by an authorized manufacturer representative.
- C. Installer Qualifications: Company specializing in performing the work of this section with minimum five years of experience.

#### 1.06 DELIVERY, STORAGE, AND HANDLING

#### 1.07 WARRANTY

A. See Section 01 7800 - Closeout Submittals, for additional warranty requirements.

#### PART 2 PRODUCTS

#### 2.01 MANUFACTURERS

- A. Barco, Inc.: www.barco.com/#sle.
- B. Daktronics, Inc.: www.daktronics.com/#sle.
- C. LG Electronics: www.lg.com/us/business/#sle.
- D. Watchfire Signs, LLC: www.watchfiresigns.com
- E. Substitutions: See Section 01 6000 Product Requirements.

#### 2.02 PANELIZED LED VIDEO DISPLAY

- A. Performance Requirements:
  - Comply with performance standards based on tests conducted in accordance with ANSI/Infocomm 10.
- B. System Type: Flat.
  - 1. Pixel Pitch: 10mm
  - 2. Horizontal Viewing Angle: 60 degrees.
  - 3. Vertical Viewing Angle: 70 degrees.

- 4. Brightness: 8,000 maximum; adjustable
- 5. Mount Type: Free Standing/Self Supporting.
- 6. Location: Outdoor.
- 7. Panel Height: 35 inches (0.89 meters).
- 8. Panel Length: 104 inches (2.64 meters).
- 9. Panel Depth: 7 inches (0.18 meters).
- 10. Service Access: Front.
- 11. Data Connections: Shielded twisted pair CAT 5e/6e (Ethercon), Fiber Optic, or Remote Cellular.
- 12. Input Source Compatibility: HDMI.
- 13. Message Capability: Text, graphics, logos, basic animation, video clips, multiple font styles and sizes.
- 14. Display Dimming: 64 levels (Automatic, Scheduled or Manual Control).
- C. Basis of Design: Daktronics Galaxy GT6x 10 MM

#### 2.03 CONTROLS

- A. Interface Unit:
  - 1. Working Voltage: 120 VAC / 240 VAC at 60Hz.

#### PART 3 EXECUTION

#### 3.01 EXAMINATION

- A. Verify that substrates and support structure is in place and properly prepared.
- B. Verify that required power and data sources are provided.
- C. Verify that space is available for centrally located components.
- D. Notify Architect of unsatisfactory preparation before proceeding.

#### 3.02 PREPARATION

- A. Prepare substrates using the methods recommended by the manufacturer for achieving the best result under the project conditions.
- B. Do not proceed with installation until support structure and substrates have been prepared using the methods recommended by the manufacturer and deviations from manufacturer's recommended tolerances are corrected. Commencement of installation constitutes acceptance of conditions.

#### 3.03 INSTALLATION

- A. Install in accordance with manufacturer's instructions .
- B. Install message center and signs level and plumb with fasteners reccommended by the manufacturer.
- Record any necessary changes to the system design.


#### 3.04 CLOSEOUT ACTIVITIES


- A. See Section 01 7800 Closeout Submittals, for closeout submittals.
- B. See Section 01 7900 Demonstration and Training, for additional requirements.
- C. Demonstrate proper operation and maintenance of equipment to Owner's designated representative.
- D. Review service and support contacts.


#### 3.05 PROTECTION

A. Protect installed products from subsequent construction operations.

#### **END OF SECTION**

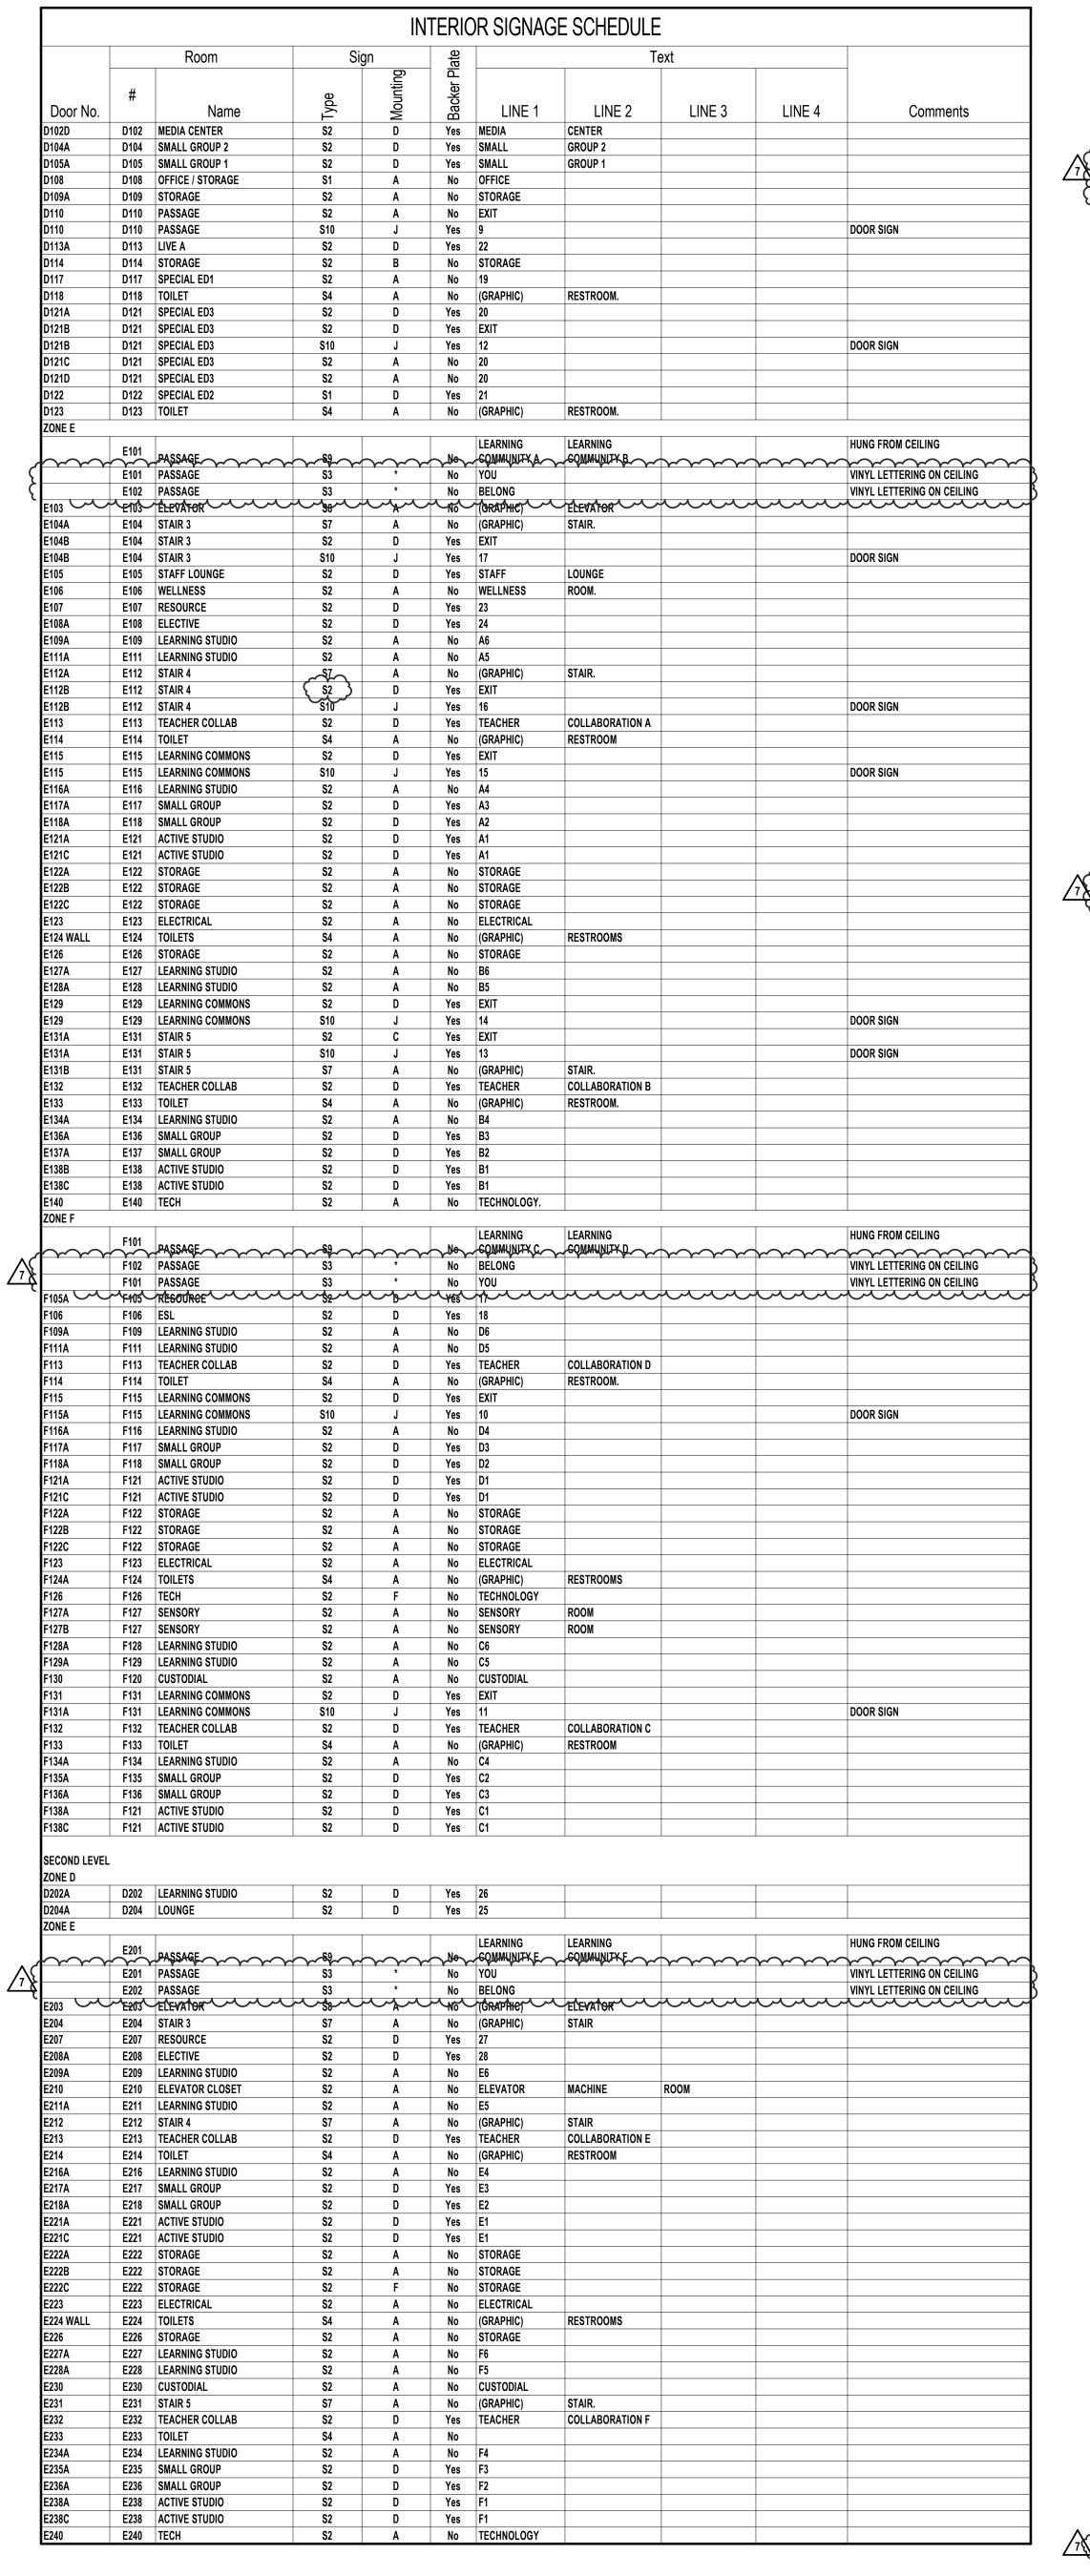

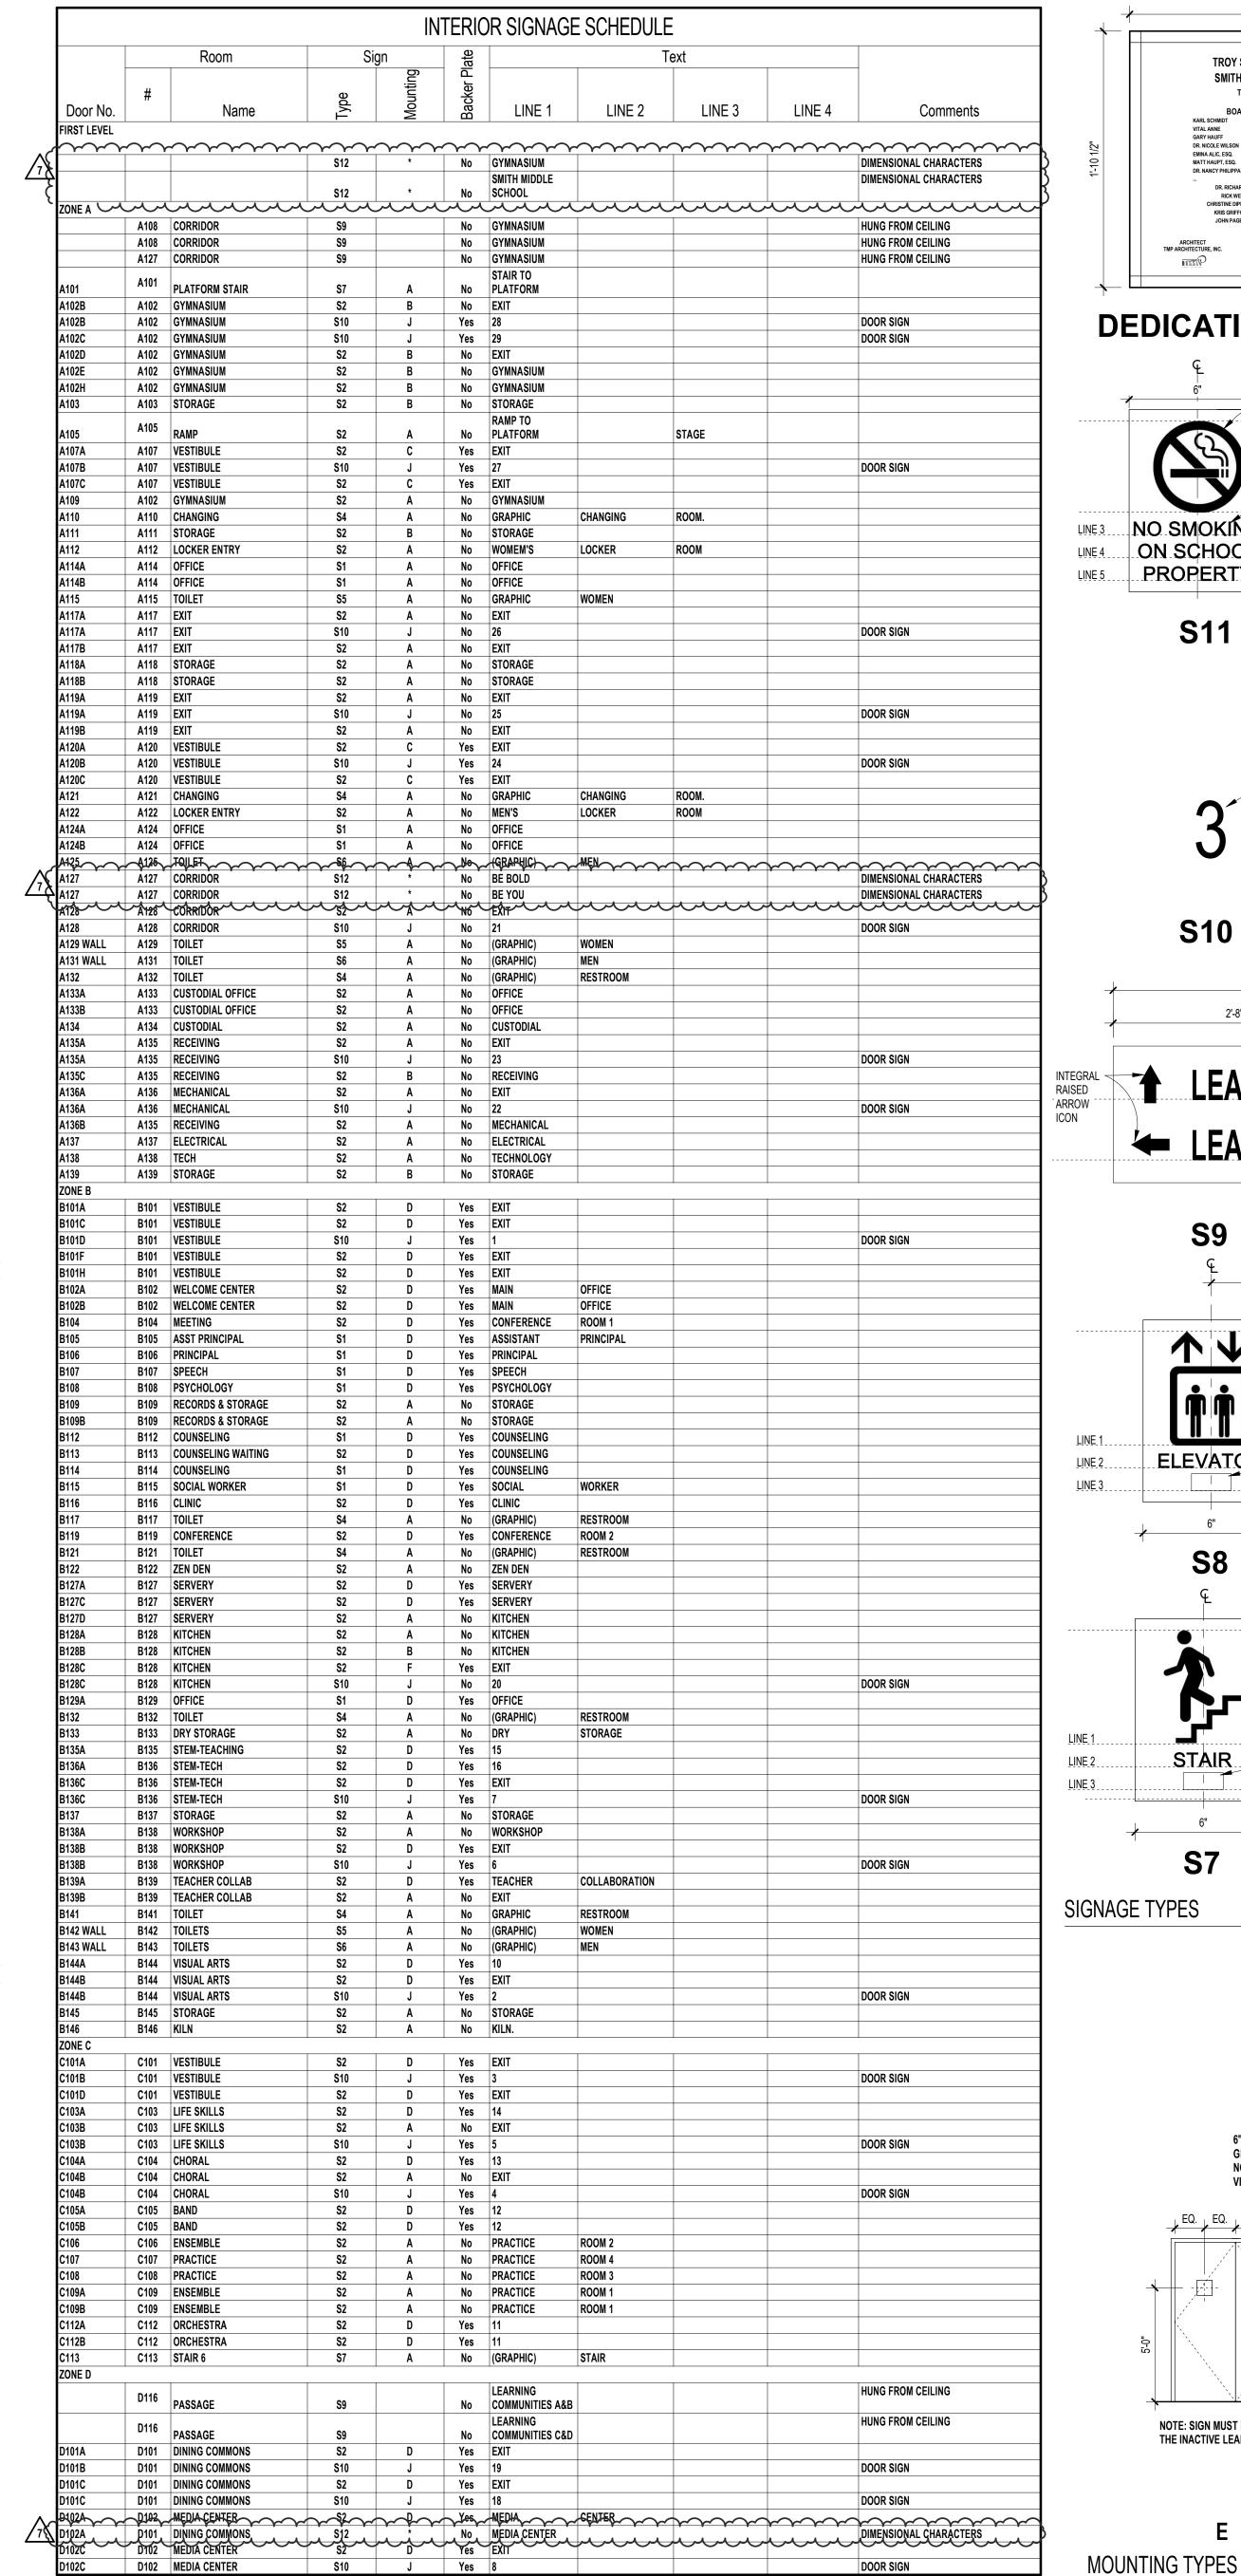

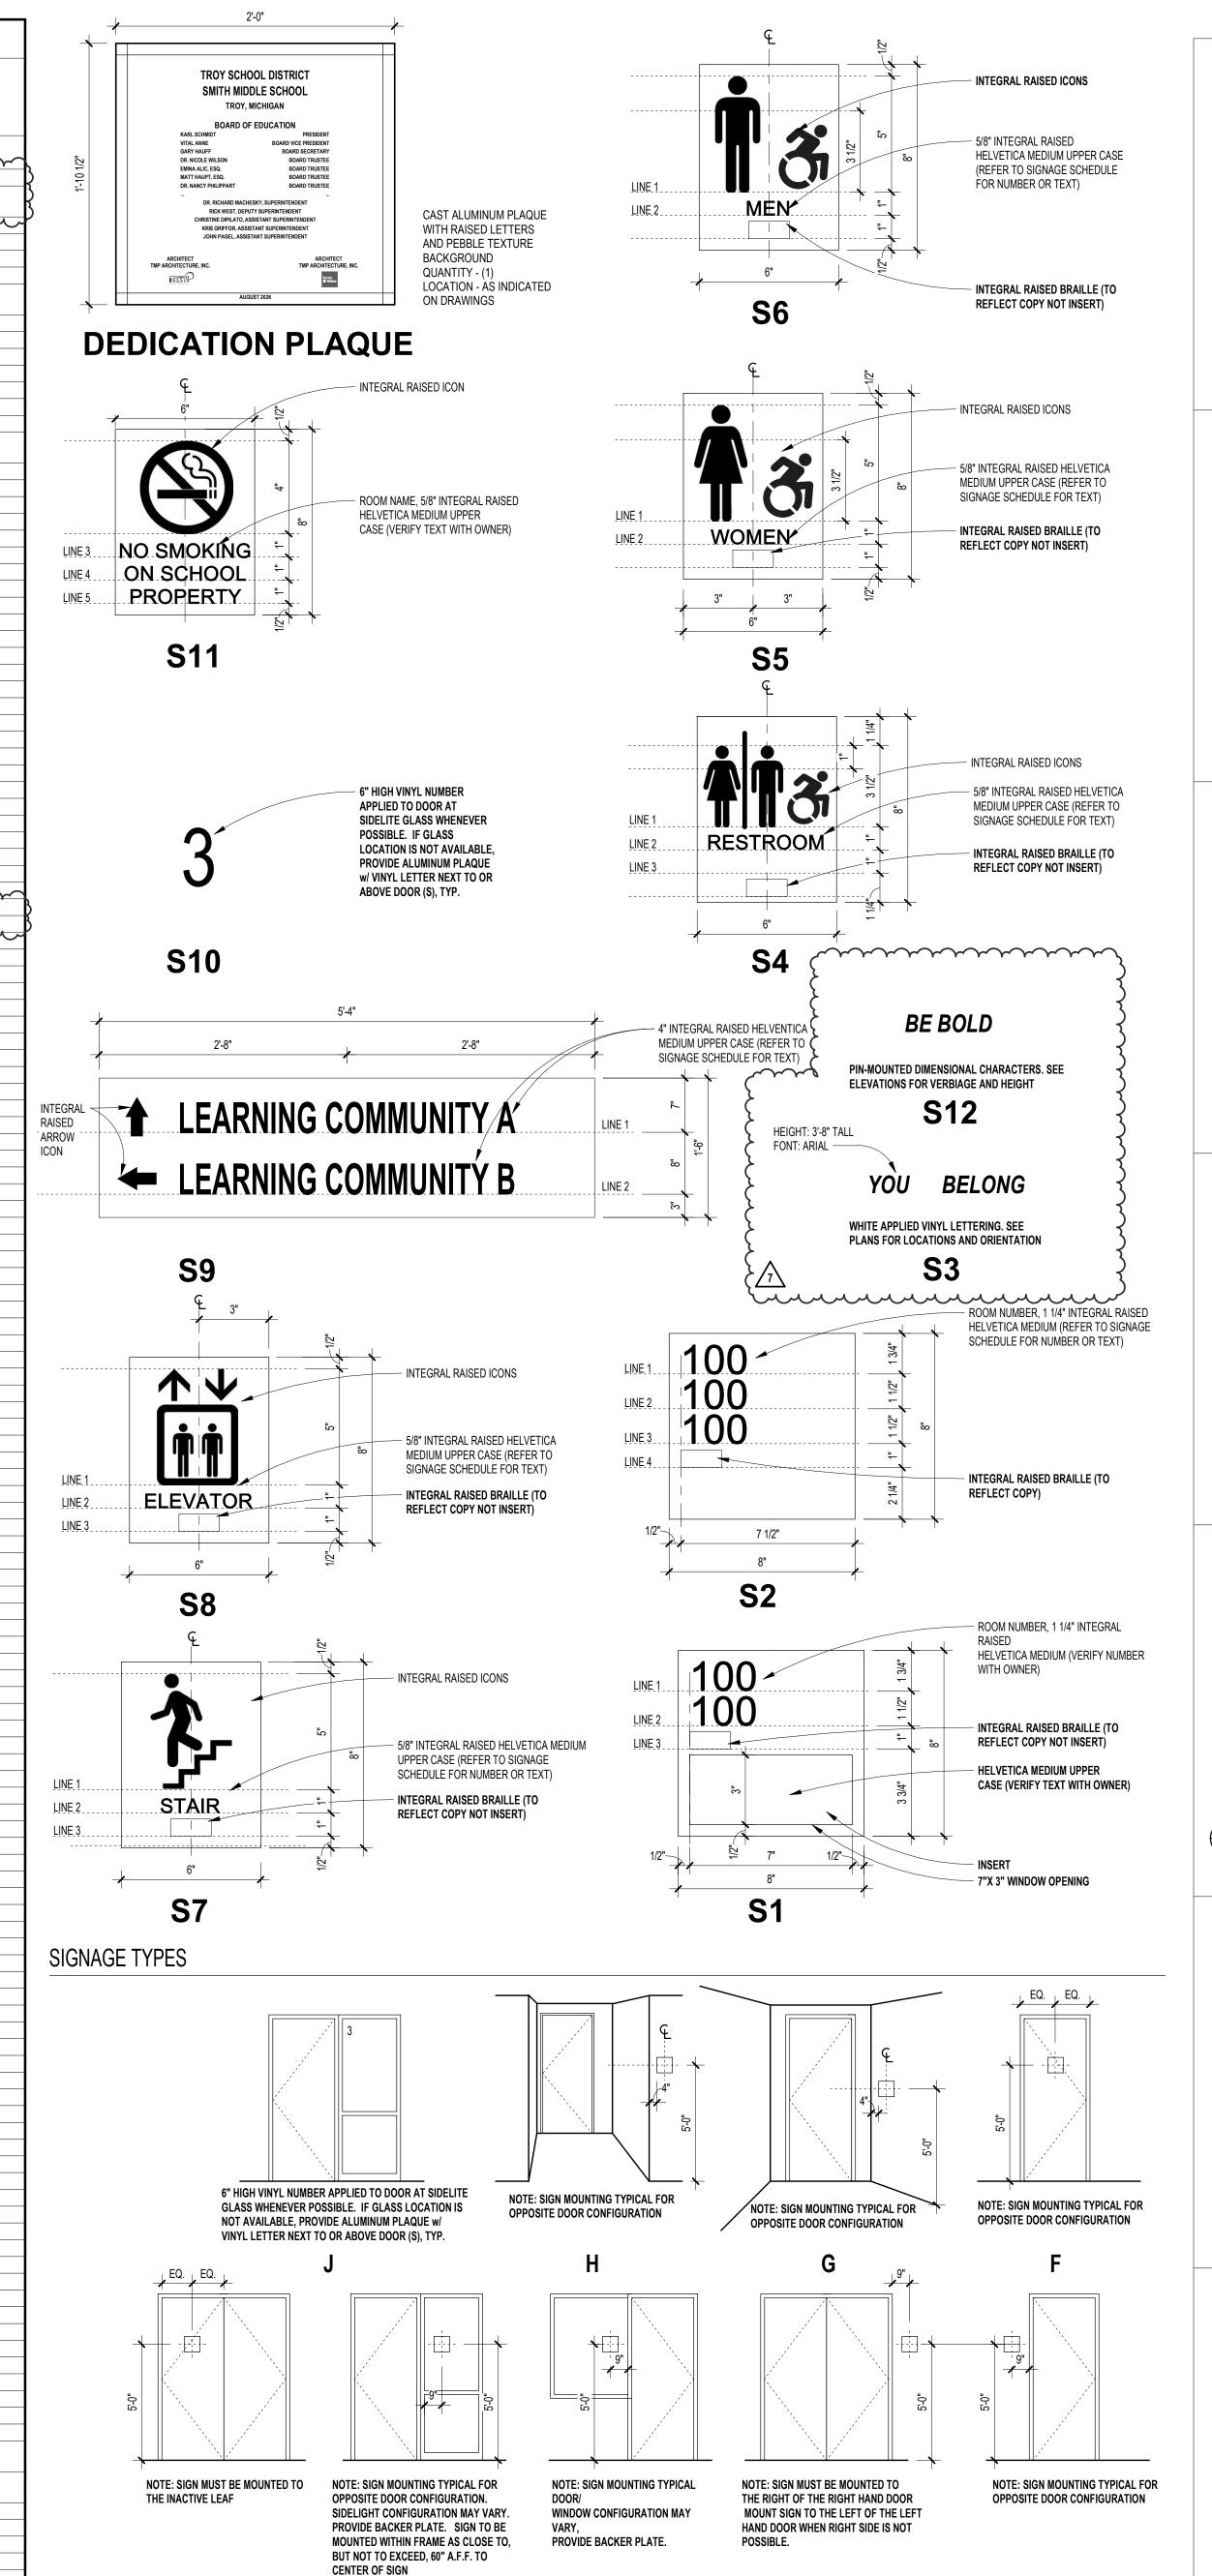



consultant


**PROJECT TITLE NEW SMITH** MIDDLE SCHOOL

Bid Package No. 03B

**Troy School District** Troy, Michigan


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Signage Schedule and Details

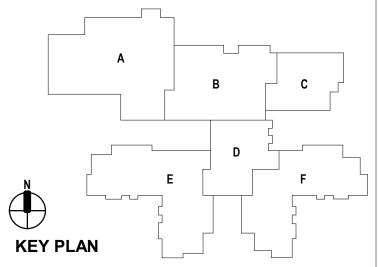

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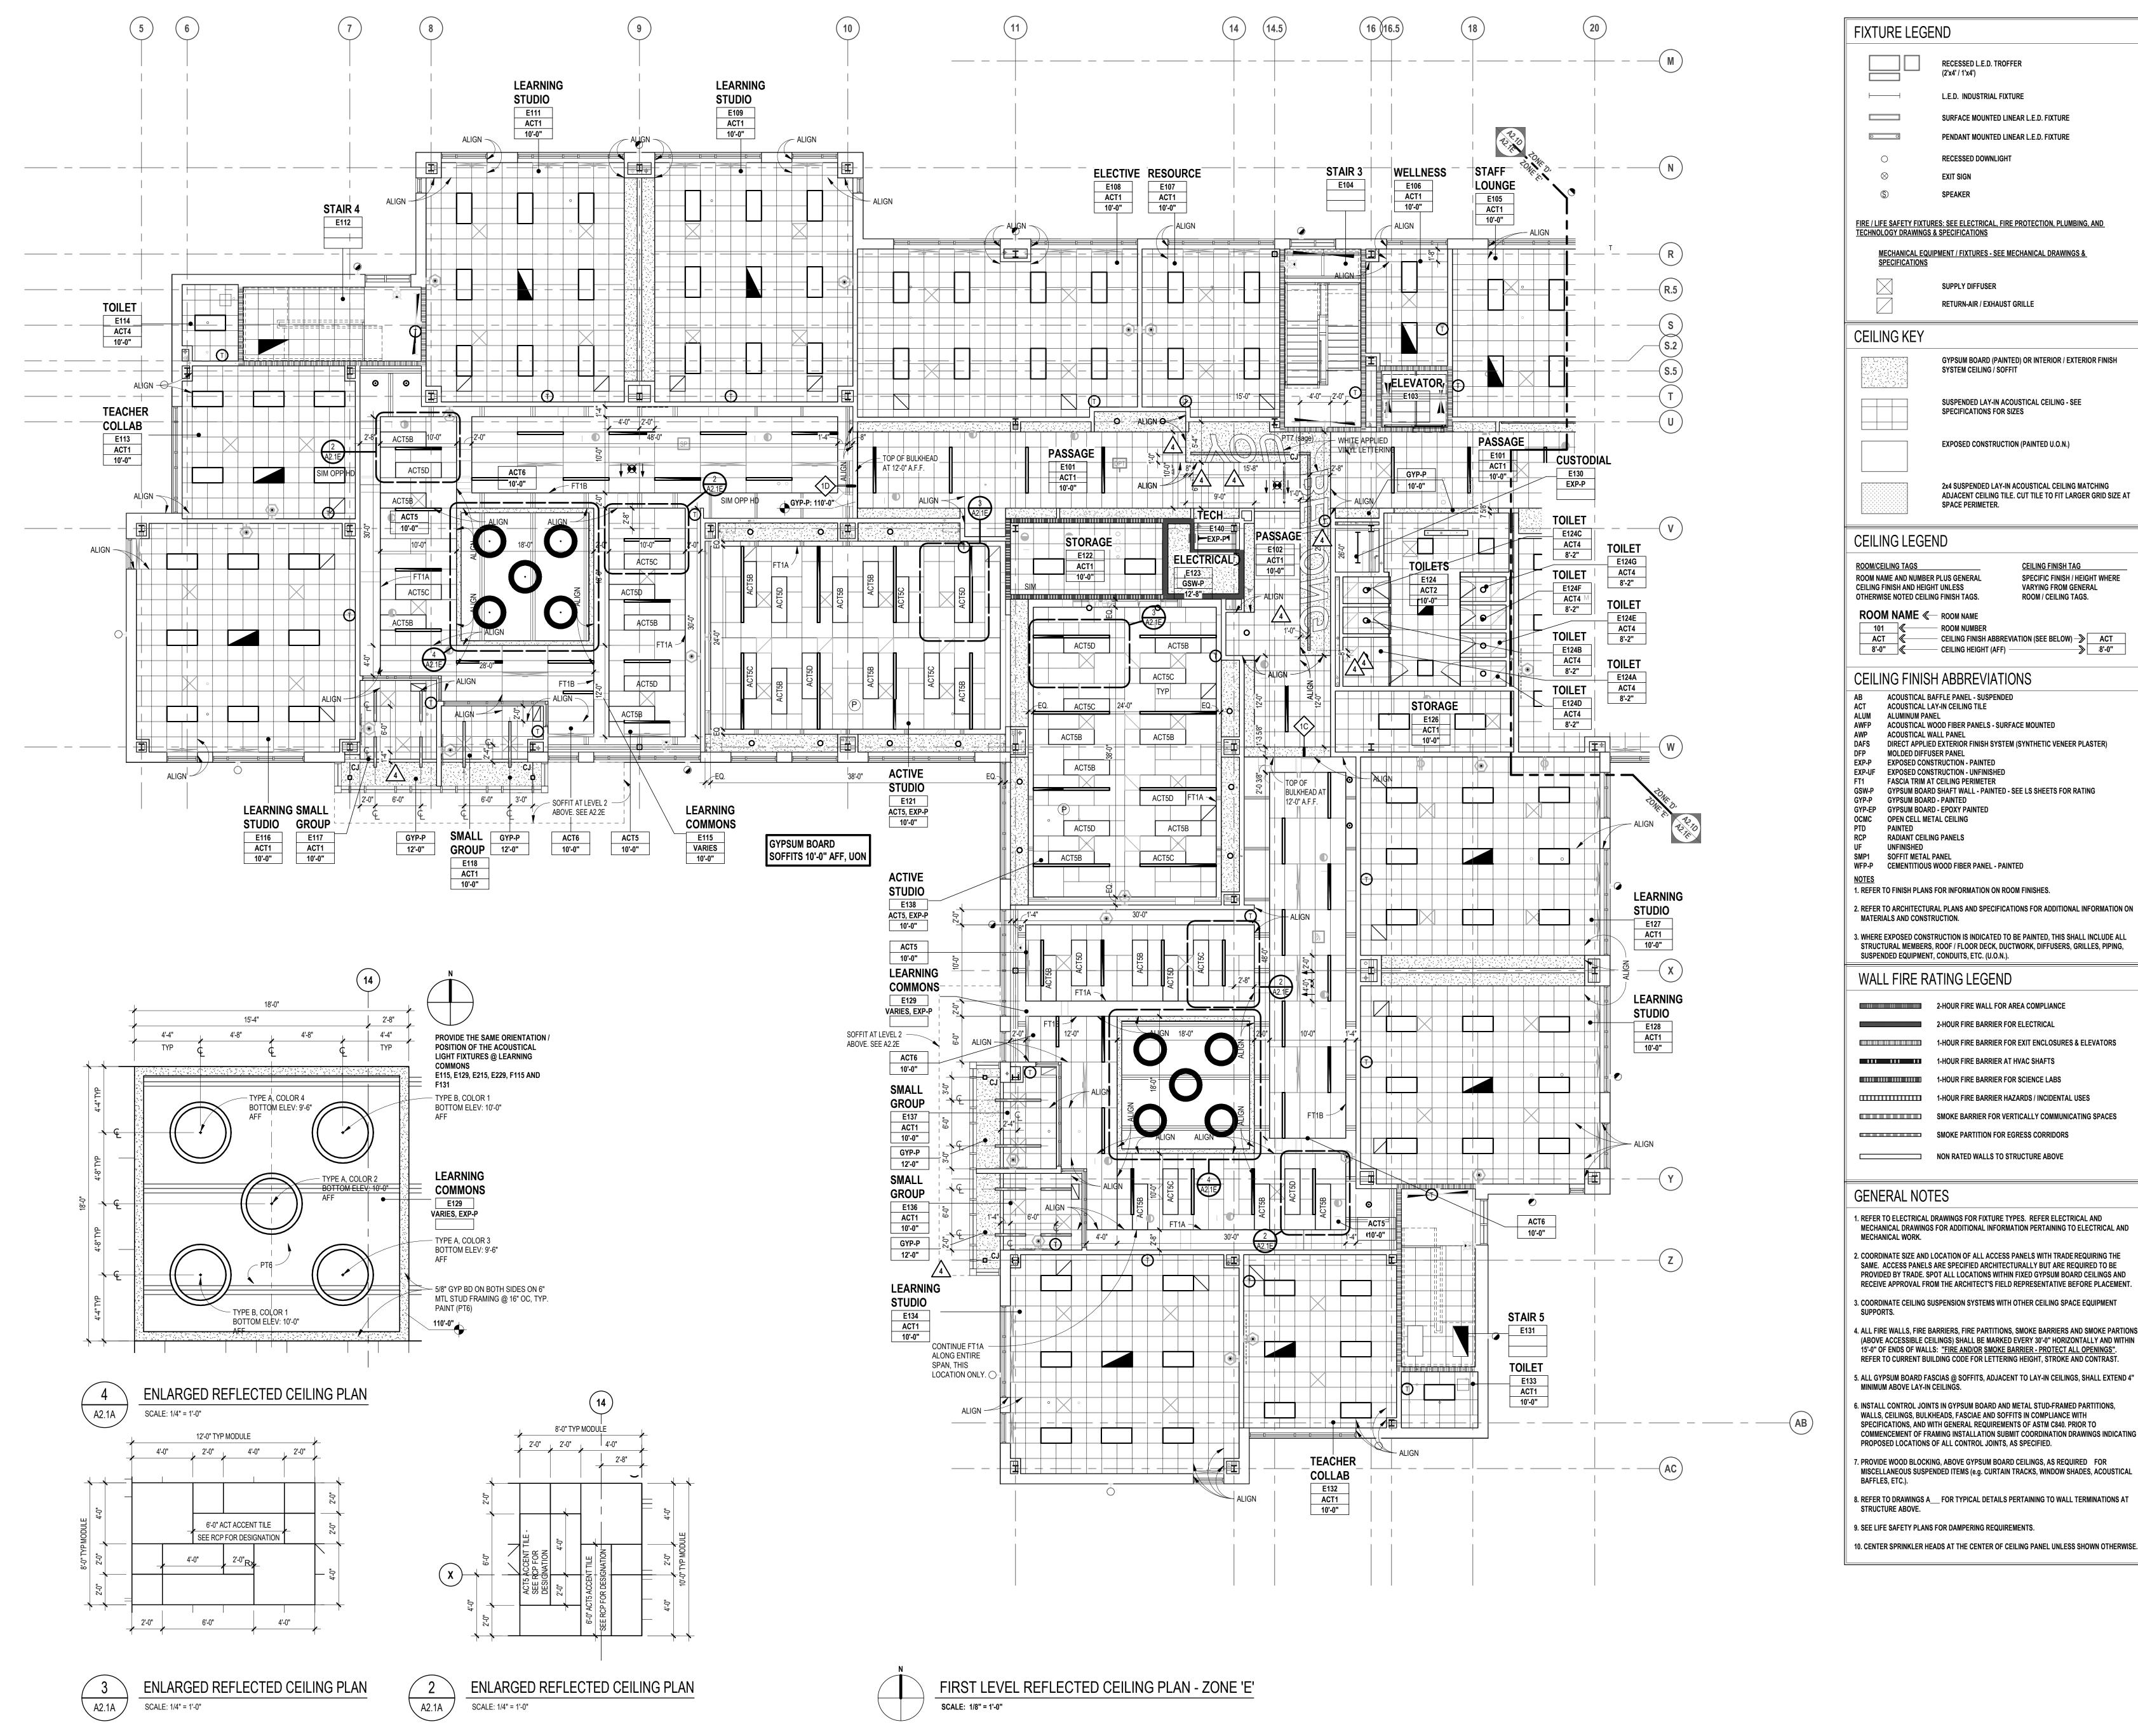
## **NEW SMITH** MIDDLE SCHOOL


Bid Package No. 03B

**Troy School District** 

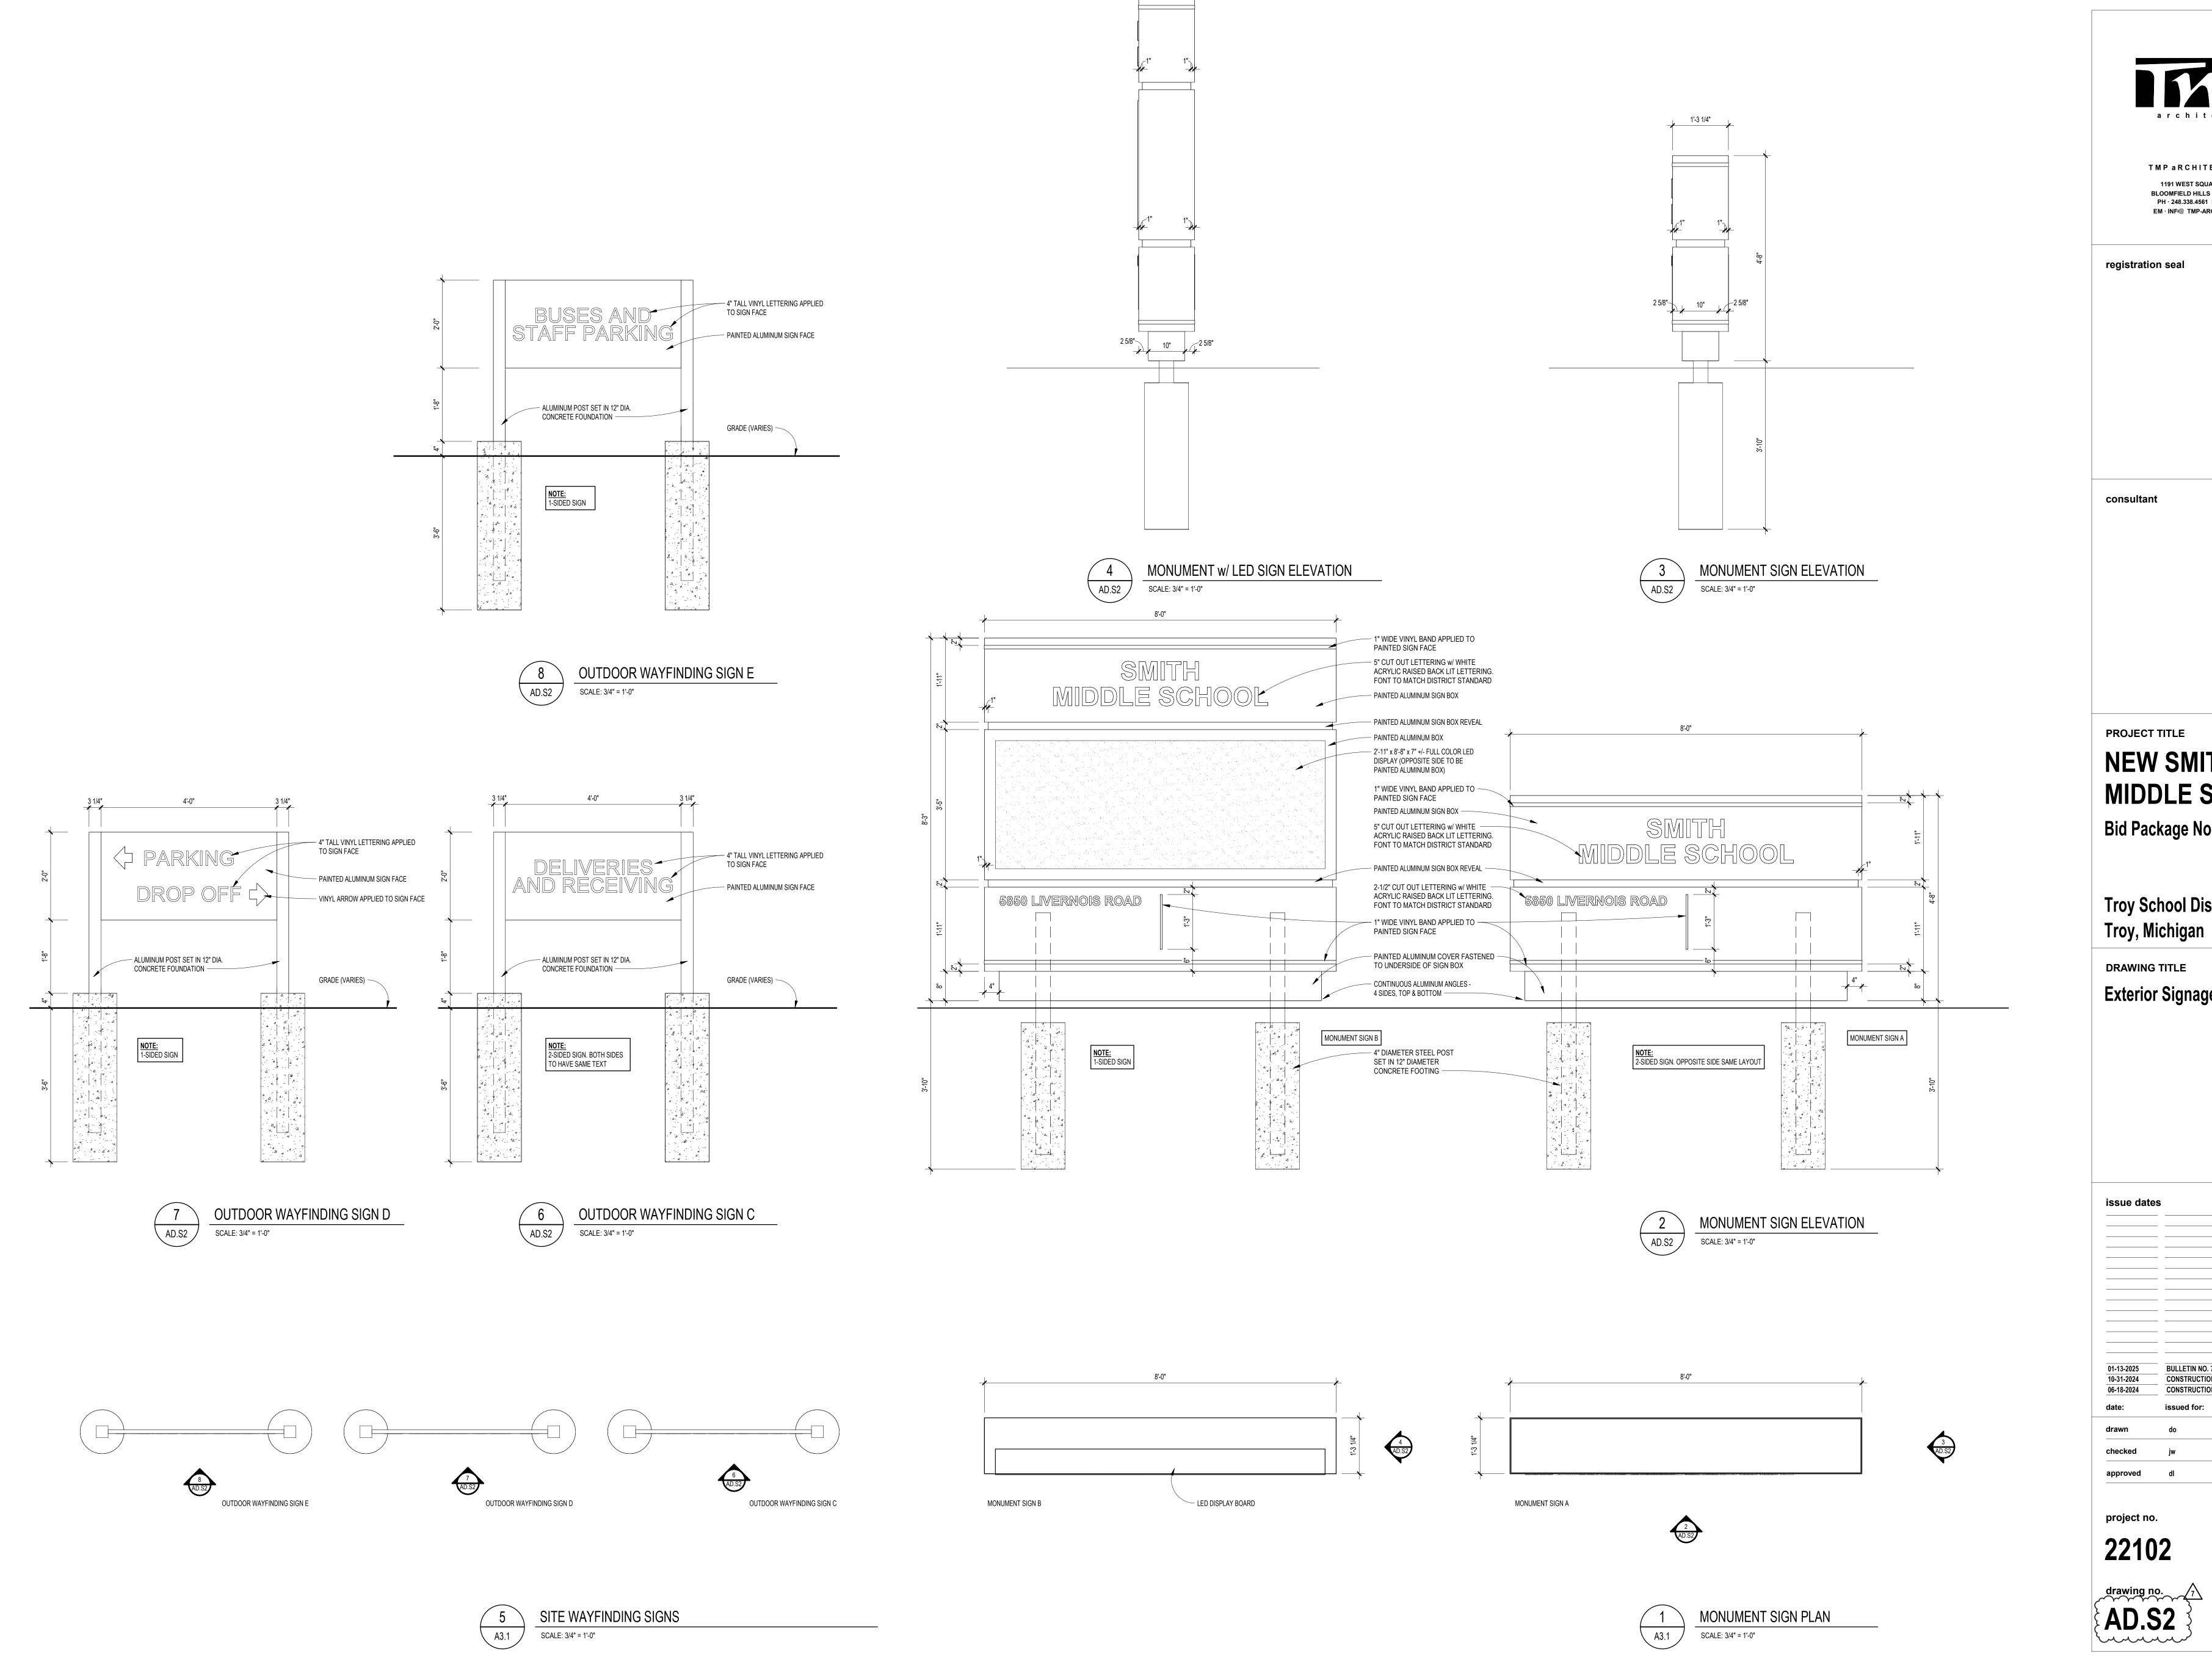**Exterior Signage** 

BULLETIN NO. 7 CONSTRUCTION SET CONSTRUCTION DOCUMENTS



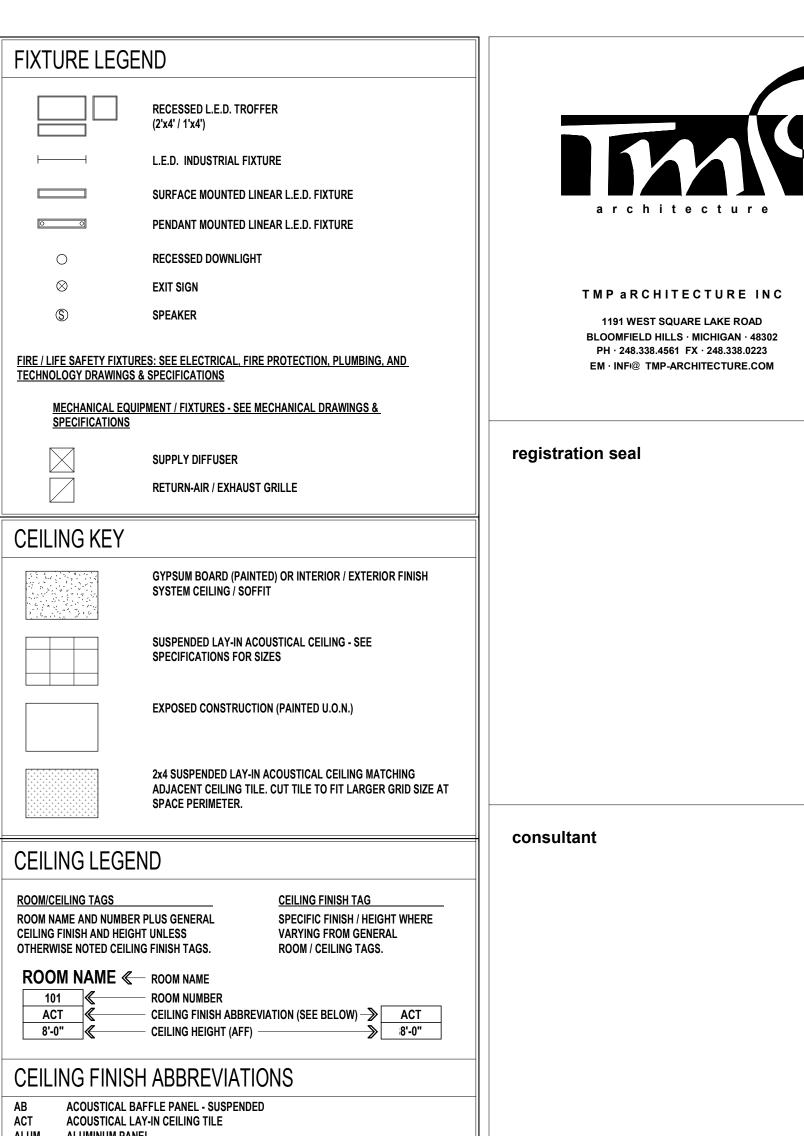

**PROJECT TITLE NEW SMITH** MIDDLE SCHOOL

Bid Package No. 03B

**Troy School District** Troy, Michigan

**DRAWING TITLE** 

issue dates

11-13-2024

10-31-2024

06-18-2024

checked

First Level Reflected Ceiling Plan - Zone 'E'

**KEY PLAN** 

1. REFER TO ELECTRICAL DRAWINGS FOR FIXTURE TYPES. REFER ELECTRICAL AND MECHANICAL DRAWINGS FOR ADDITIONAL INFORMATION PERTAINING TO ELECTRICAL AND

. COORDINATE SIZE AND LOCATION OF ALL ACCESS PANELS WITH TRADE REQUIRING THE SAME. ACCESS PANELS ARE SPECIFIED ARCHITECTURALLY BUT ARE REQUIRED TO BE PROVIDED BY TRADE. SPOT ALL LOCATIONS WITHIN FIXED GYPSUM BOARD CEILINGS AND RECEIVE APPROVAL FROM THE ARCHITECT'S FIELD REPRESENTATIVE BEFORE PLACEMENT 3. COORDINATE CEILING SUSPENSION SYSTEMS WITH OTHER CEILING SPACE EQUIPMENT

4. ALL FIRE WALLS, FIRE BARRIERS, FIRE PARTITIONS, SMOKE BARRIERS AND SMOKE PARTIONS (ABOVE ACCESSIBLE CEILINGS) SHALL BE MARKED EVERY 30'-0" HORIZONTALLY AND WITHIN 15'-0" OF ENDS OF WALLS: "FIRE AND/OR SMOKE BARRIER - PROTECT ALL OPENINGS". REFER TO CURRENT BUILDING CODE FOR LETTERING HEIGHT, STROKE AND CONTRAST.

5. ALL GYPSUM BOARD FASCIAS @ SOFFITS, ADJACENT TO LAY-IN CEILINGS, SHALL EXTEND 4 MINIMUM ABOVE LAY-IN CEILINGS.

SPECIFICATIONS, AND WITH GENERAL REQUIREMENTS OF ASTM C840. PRIOR TO COMMENCEMENT OF FRAMING INSTALLATION SUBMIT COORDINATION DRAWINGS INDICATING PROPOSED LOCATIONS OF ALL CONTROL JOINTS, AS SPECIFIED. PROVIDE WOOD BLOCKING, ABOVE GYPSUM BOARD CEILINGS, AS REQUIRED FOR

MISCELLANEOUS SUSPENDED ITEMS (e.g. CURTAIN TRACKS, WINDOW SHADES, ACOUSTICAL

8. REFER TO DRAWINGS A\_\_ FOR TYPICAL DETAILS PERTAINING TO WALL TERMINATIONS AT

9. SEE LIFE SAFETY PLANS FOR DAMPERING REQUIREMENTS. 10. CENTER SPRINKLER HEADS AT THE CENTER OF CEILING PANEL UNLESS SHOWN OTHERWISE.

project no.

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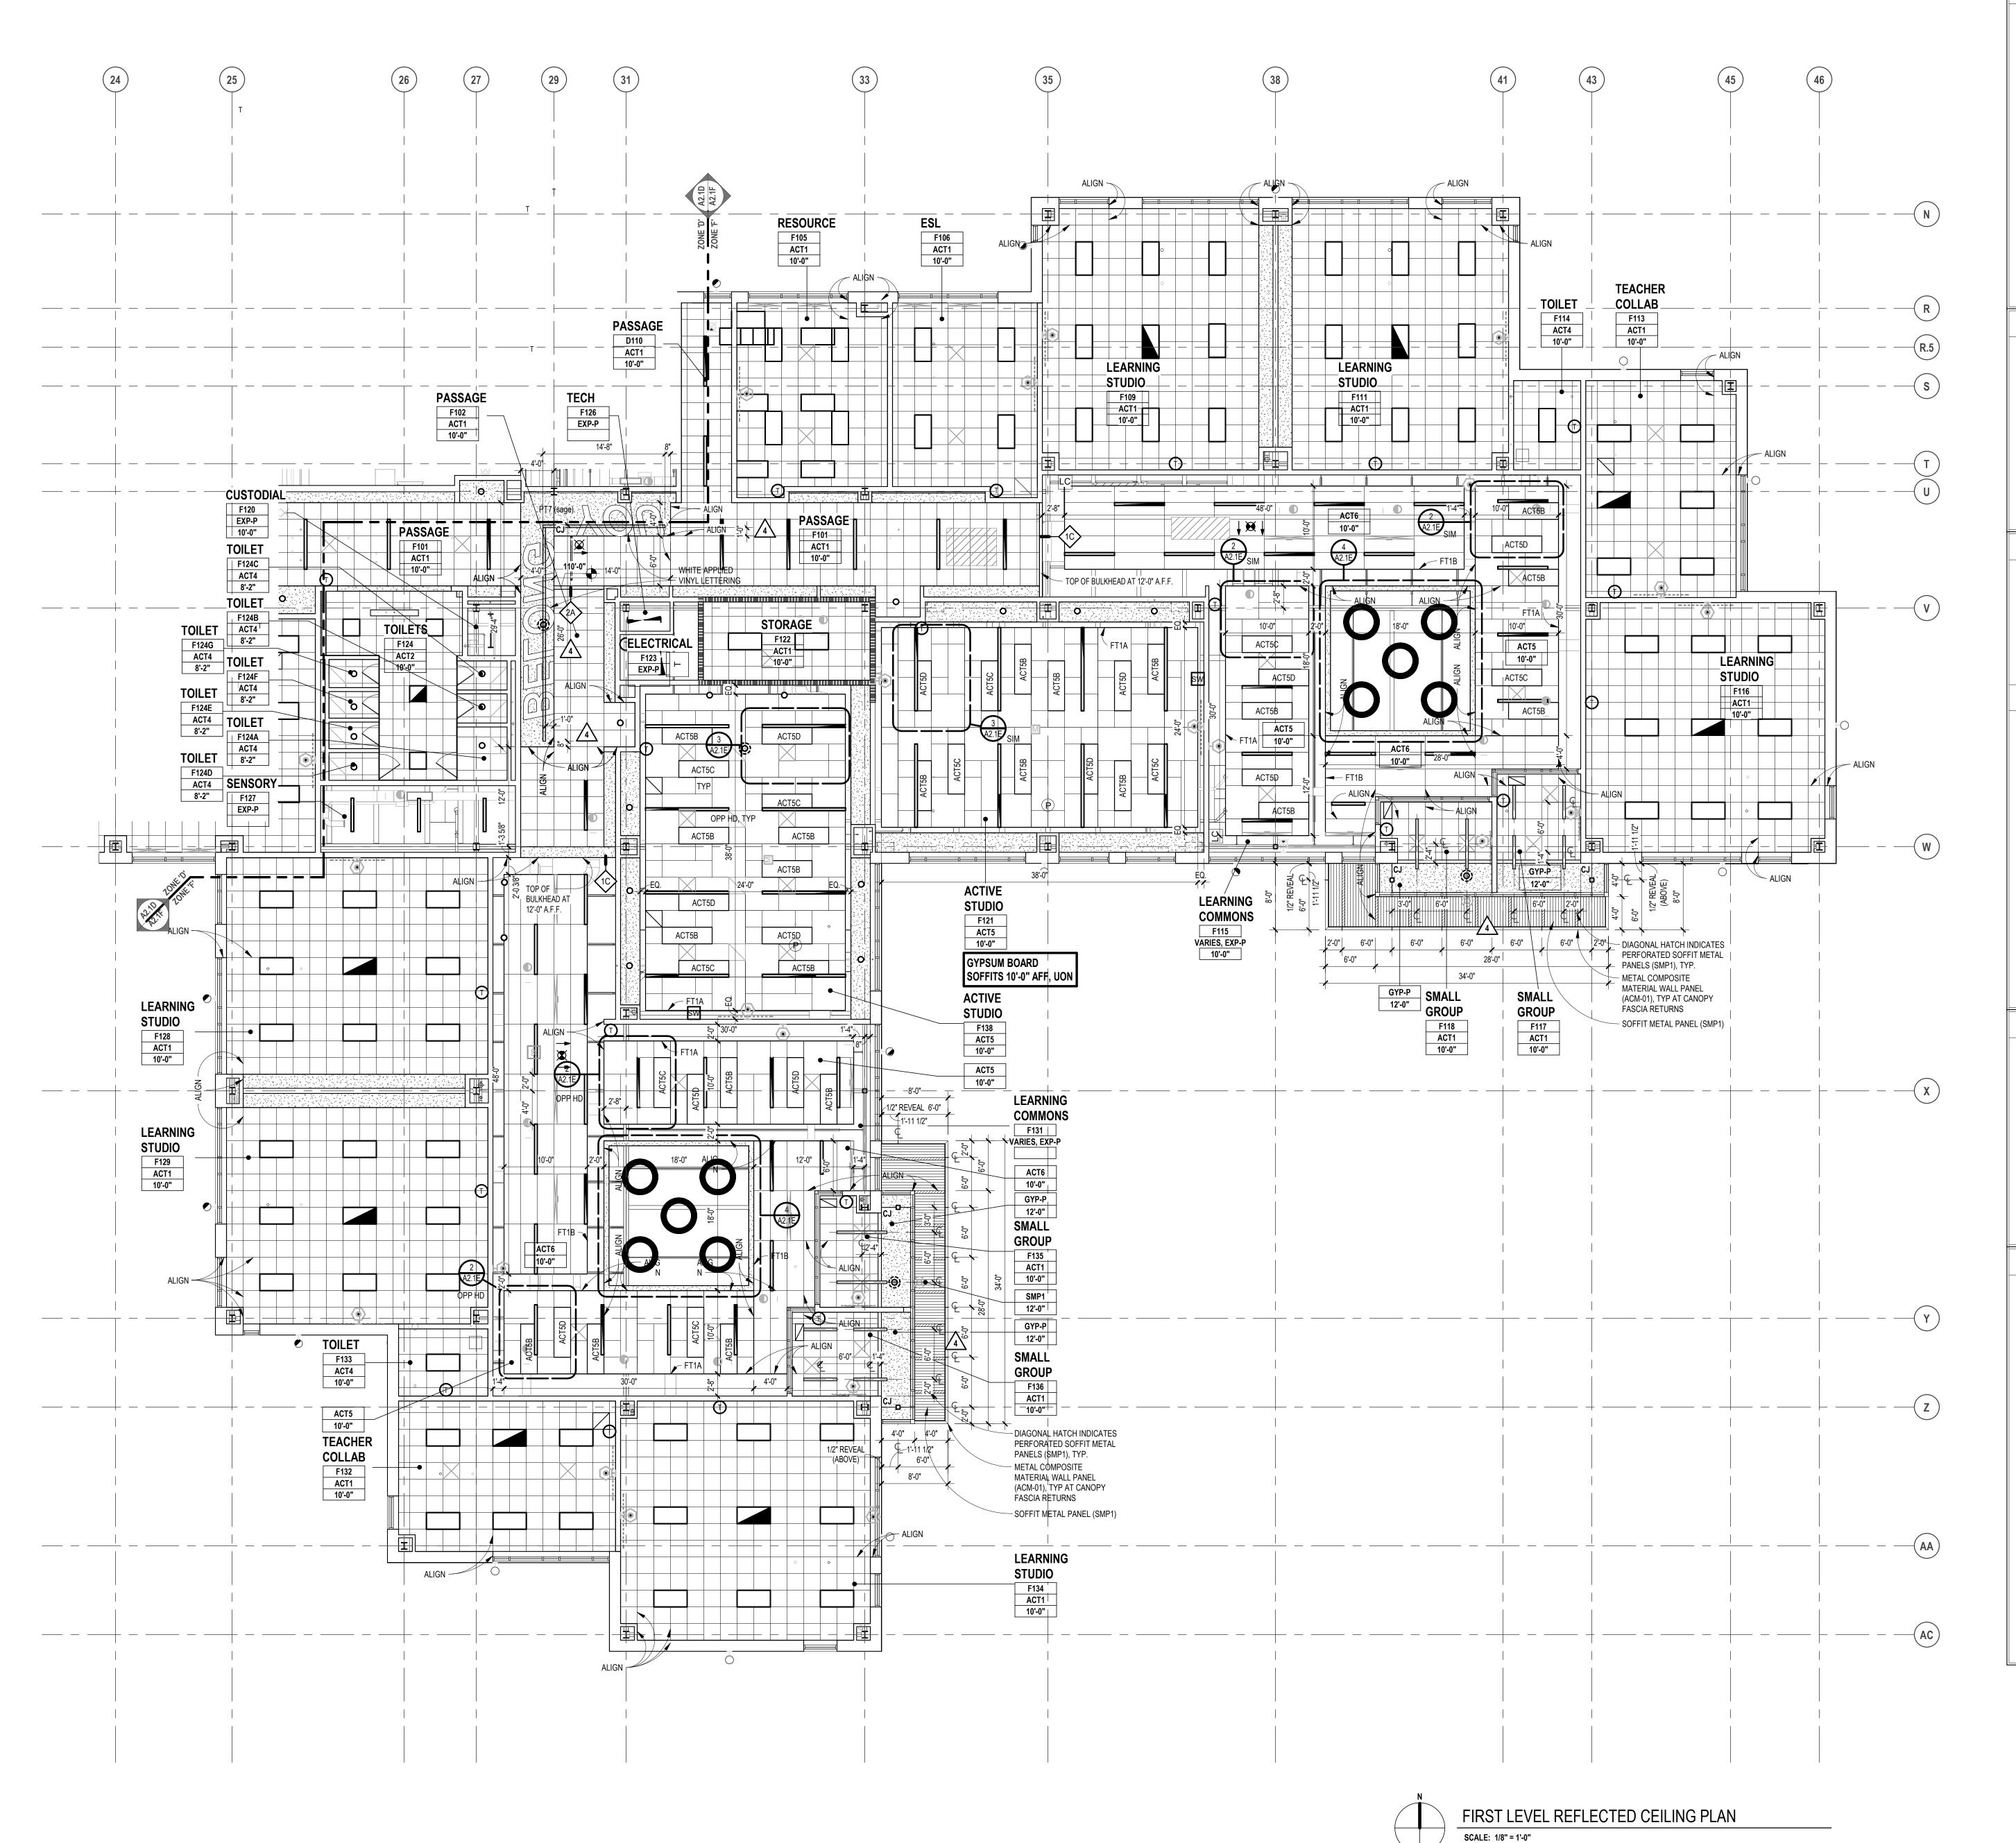
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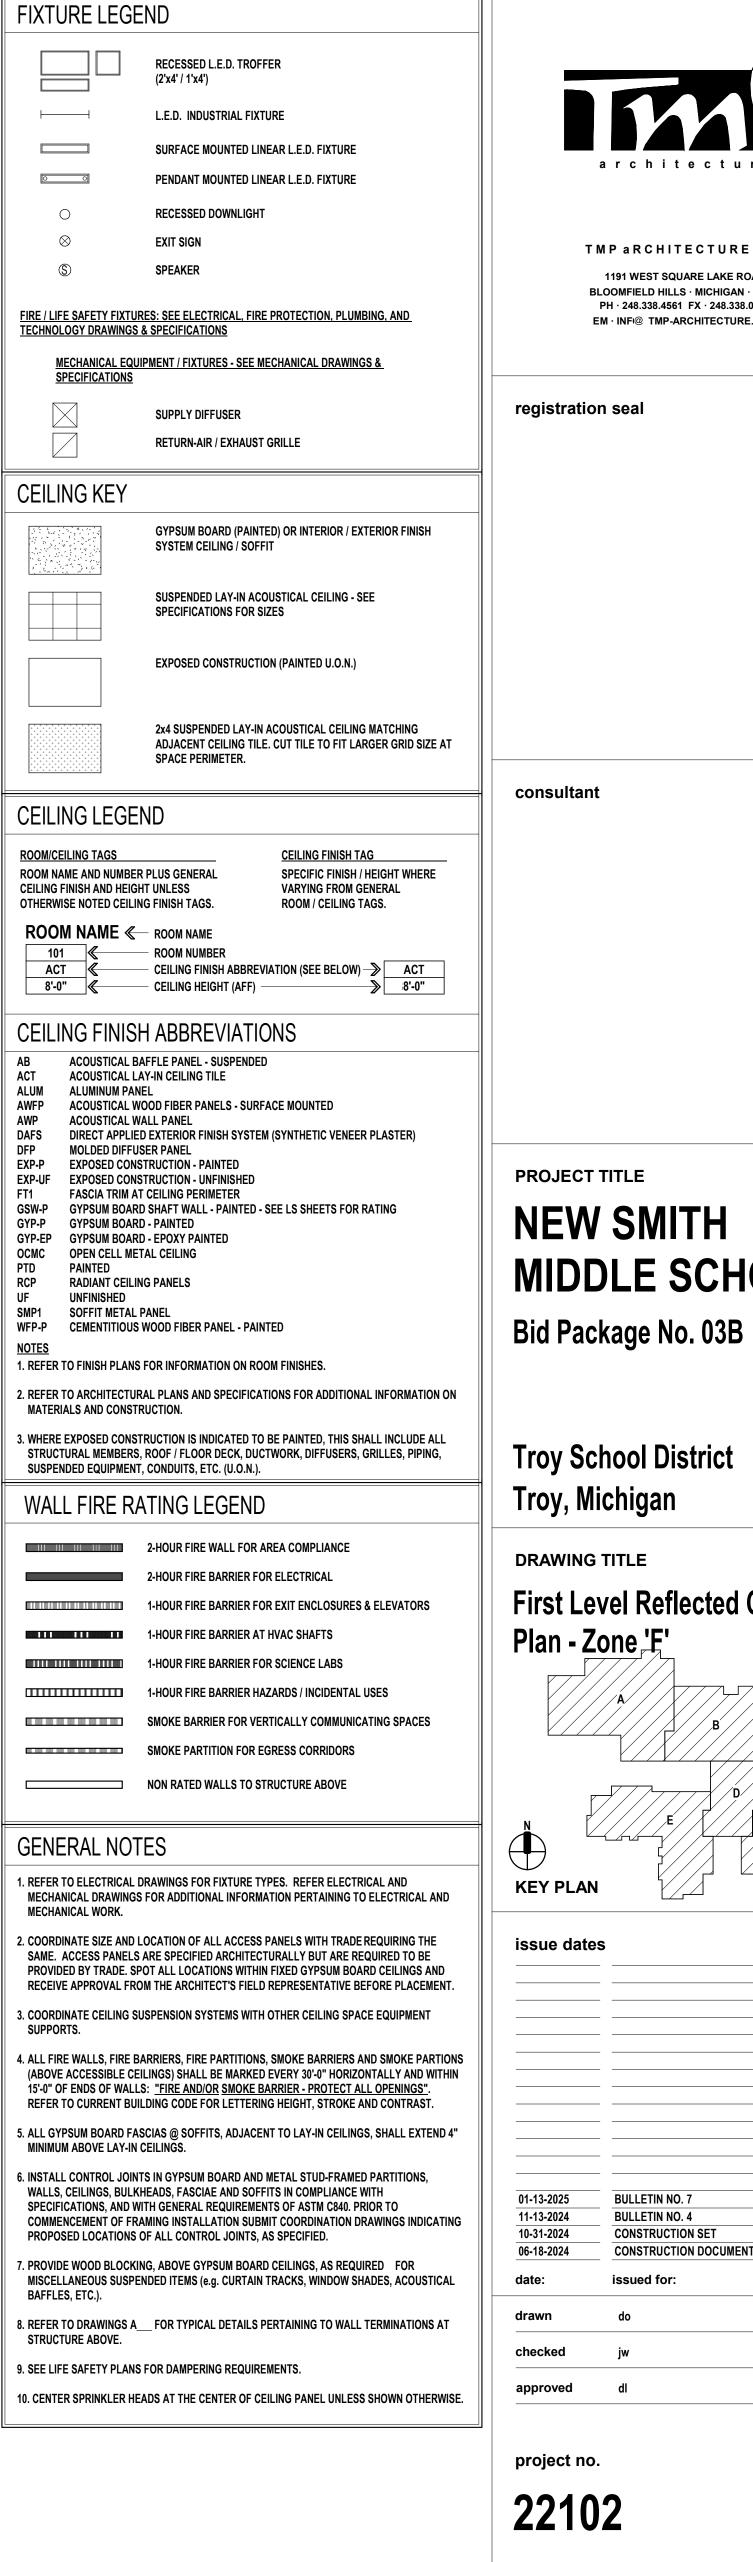
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**BULLETIN NO. 4** 

**CONSTRUCTION SET** 

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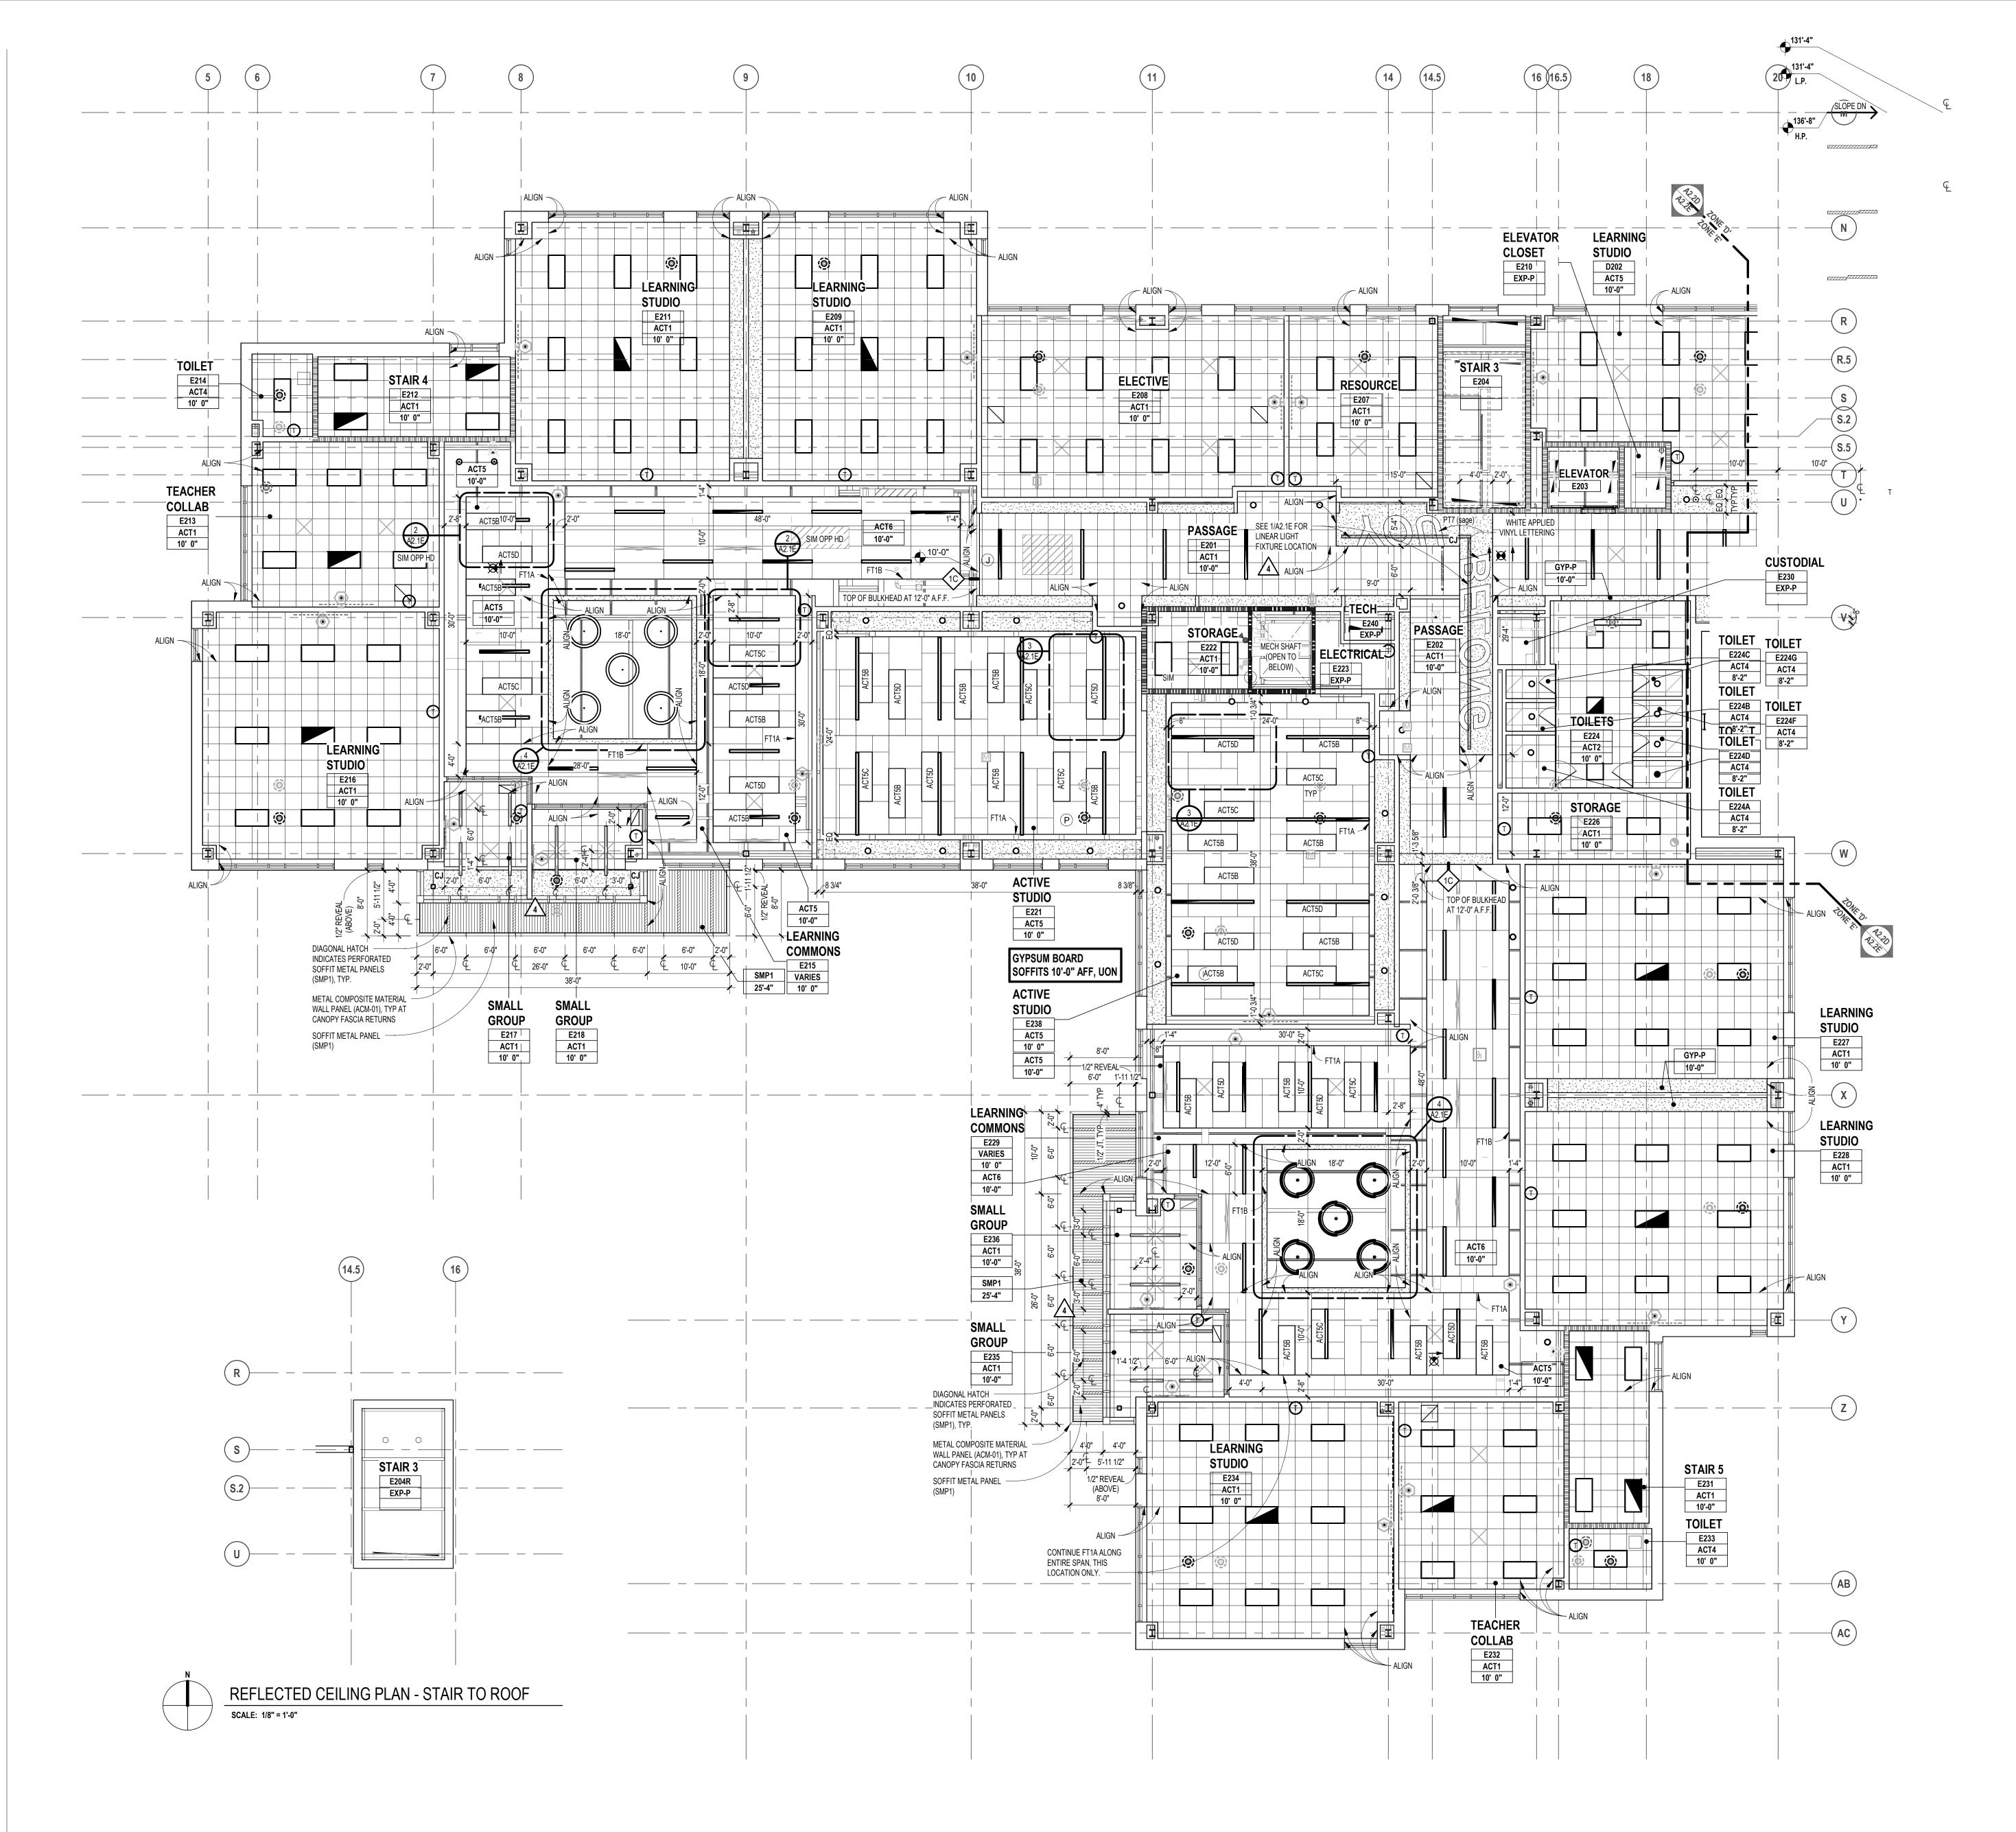
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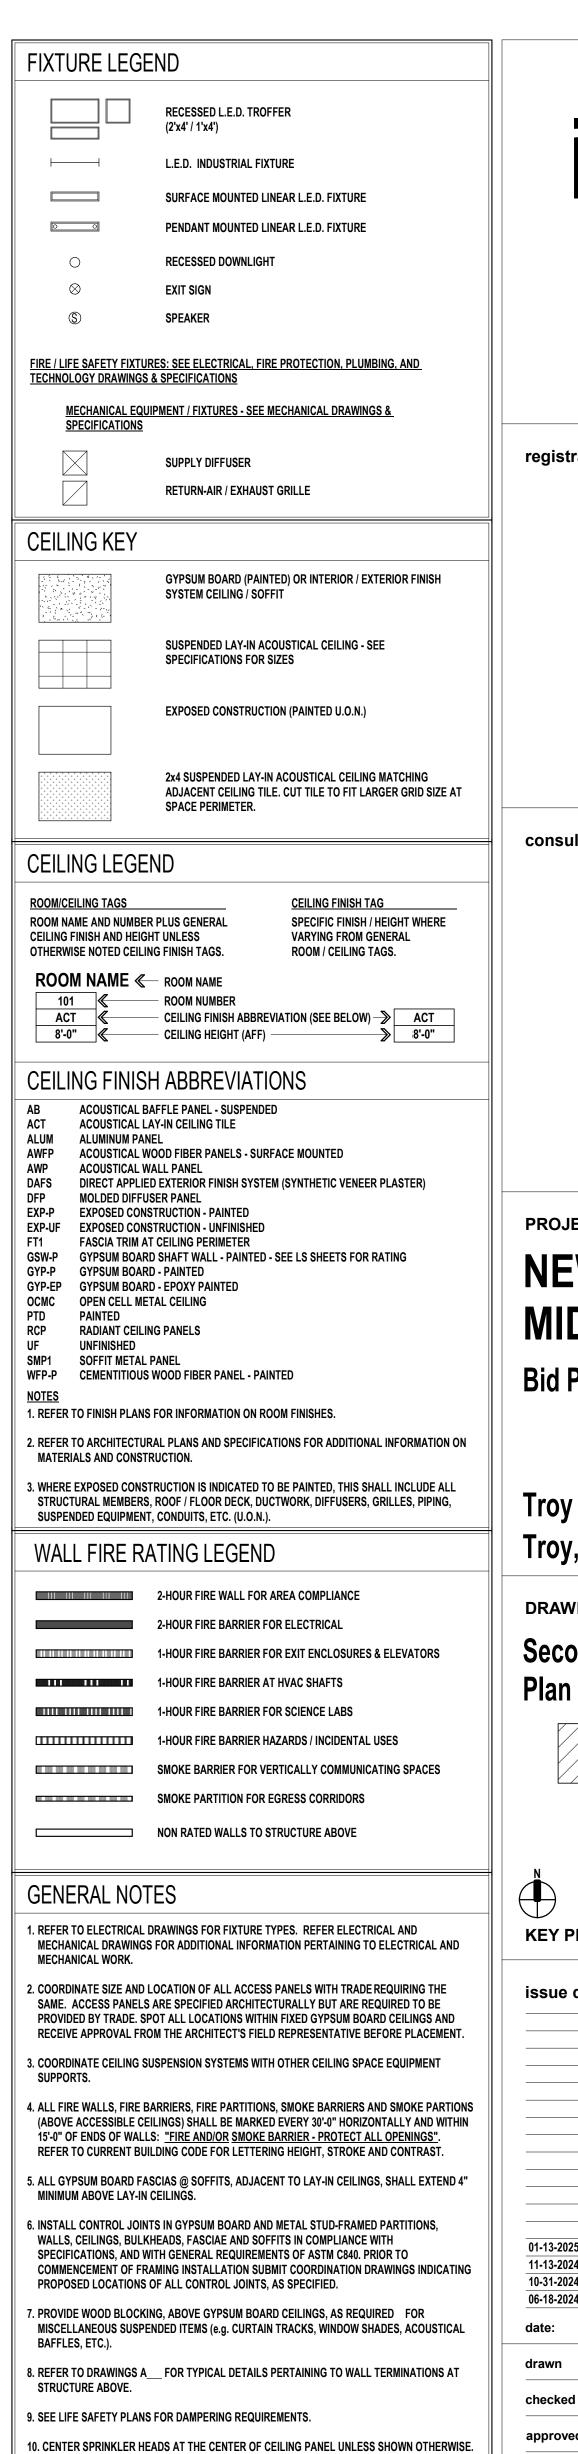
### **NEW SMITH** MIDDLE SCHOOL


**Troy School District** 

First Level Reflected Ceiling

**CONSTRUCTION SET** CONSTRUCTION DOCUMENTS






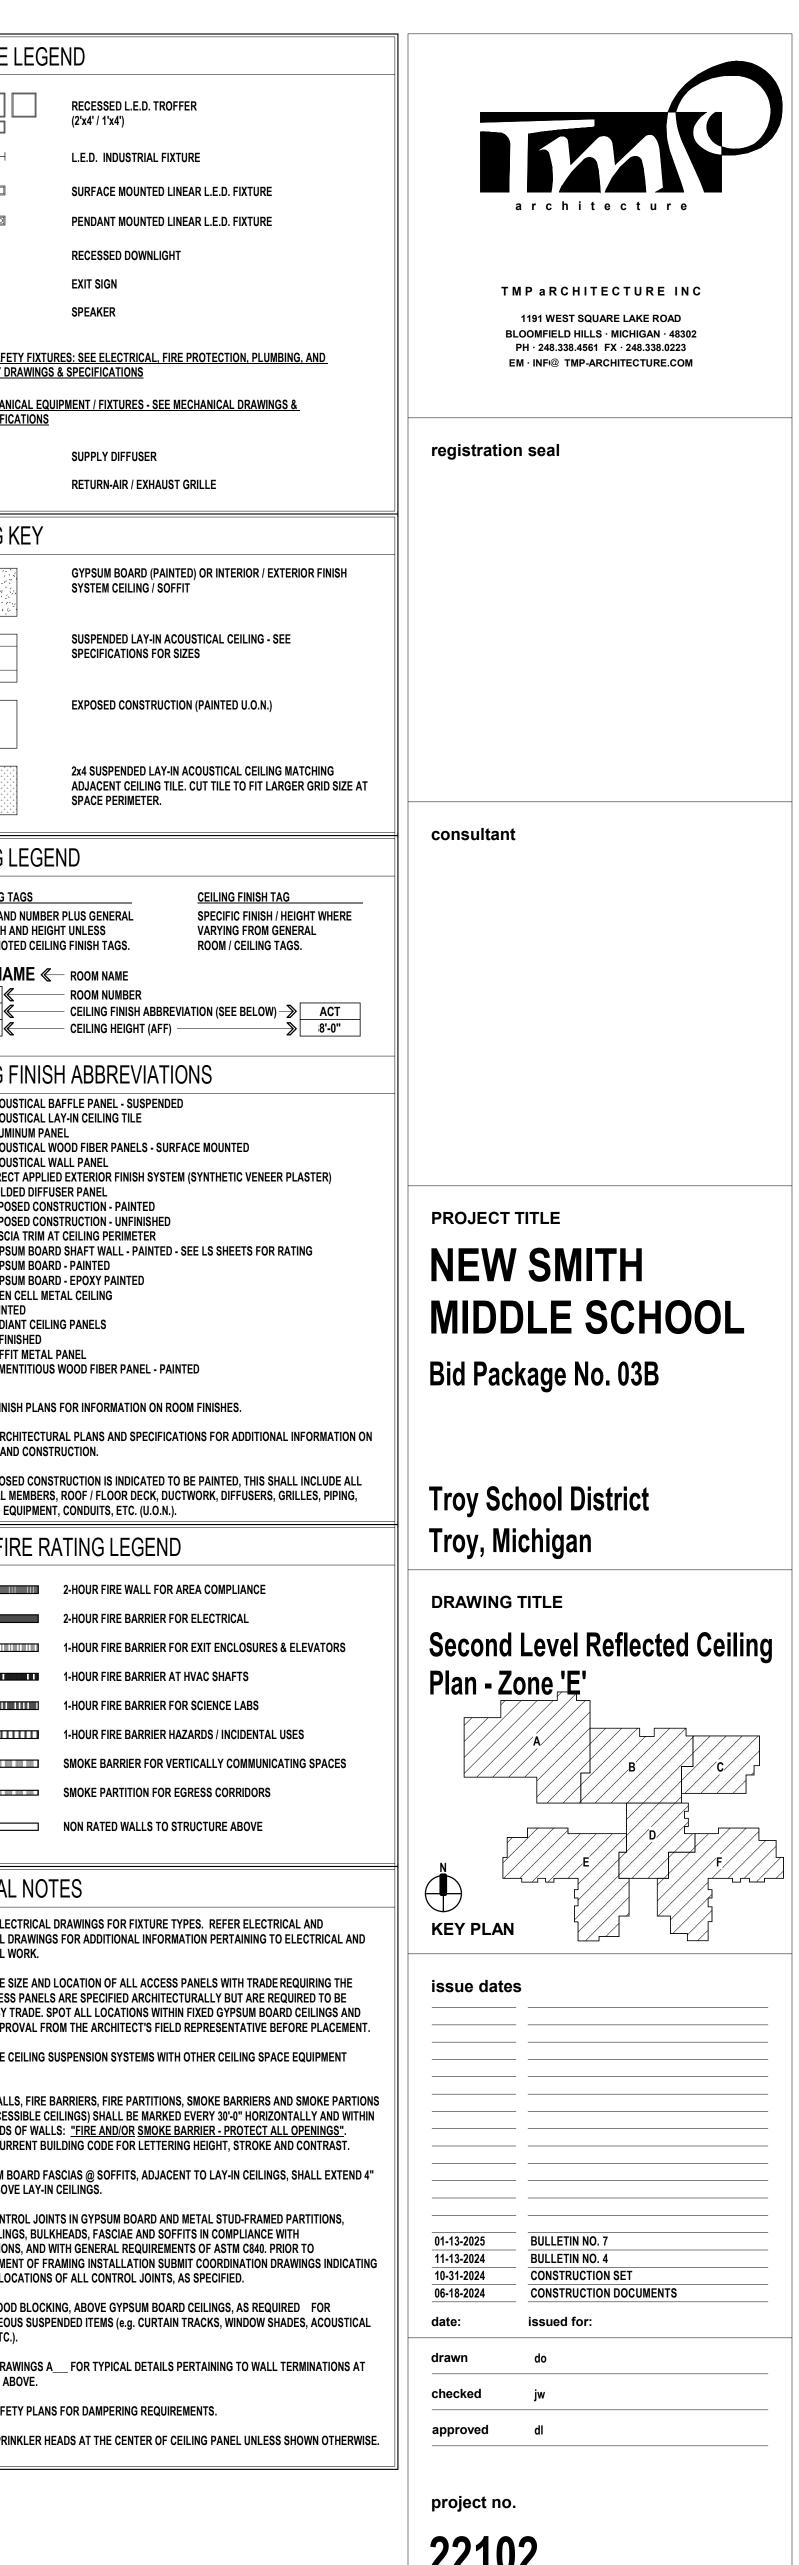


SECOND LEVEL REFLECTED CEILING PLAN - ZONE 'E' SCALE: 1/8" = 1'-0"


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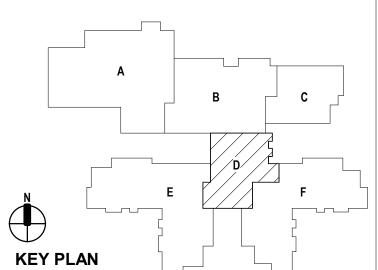
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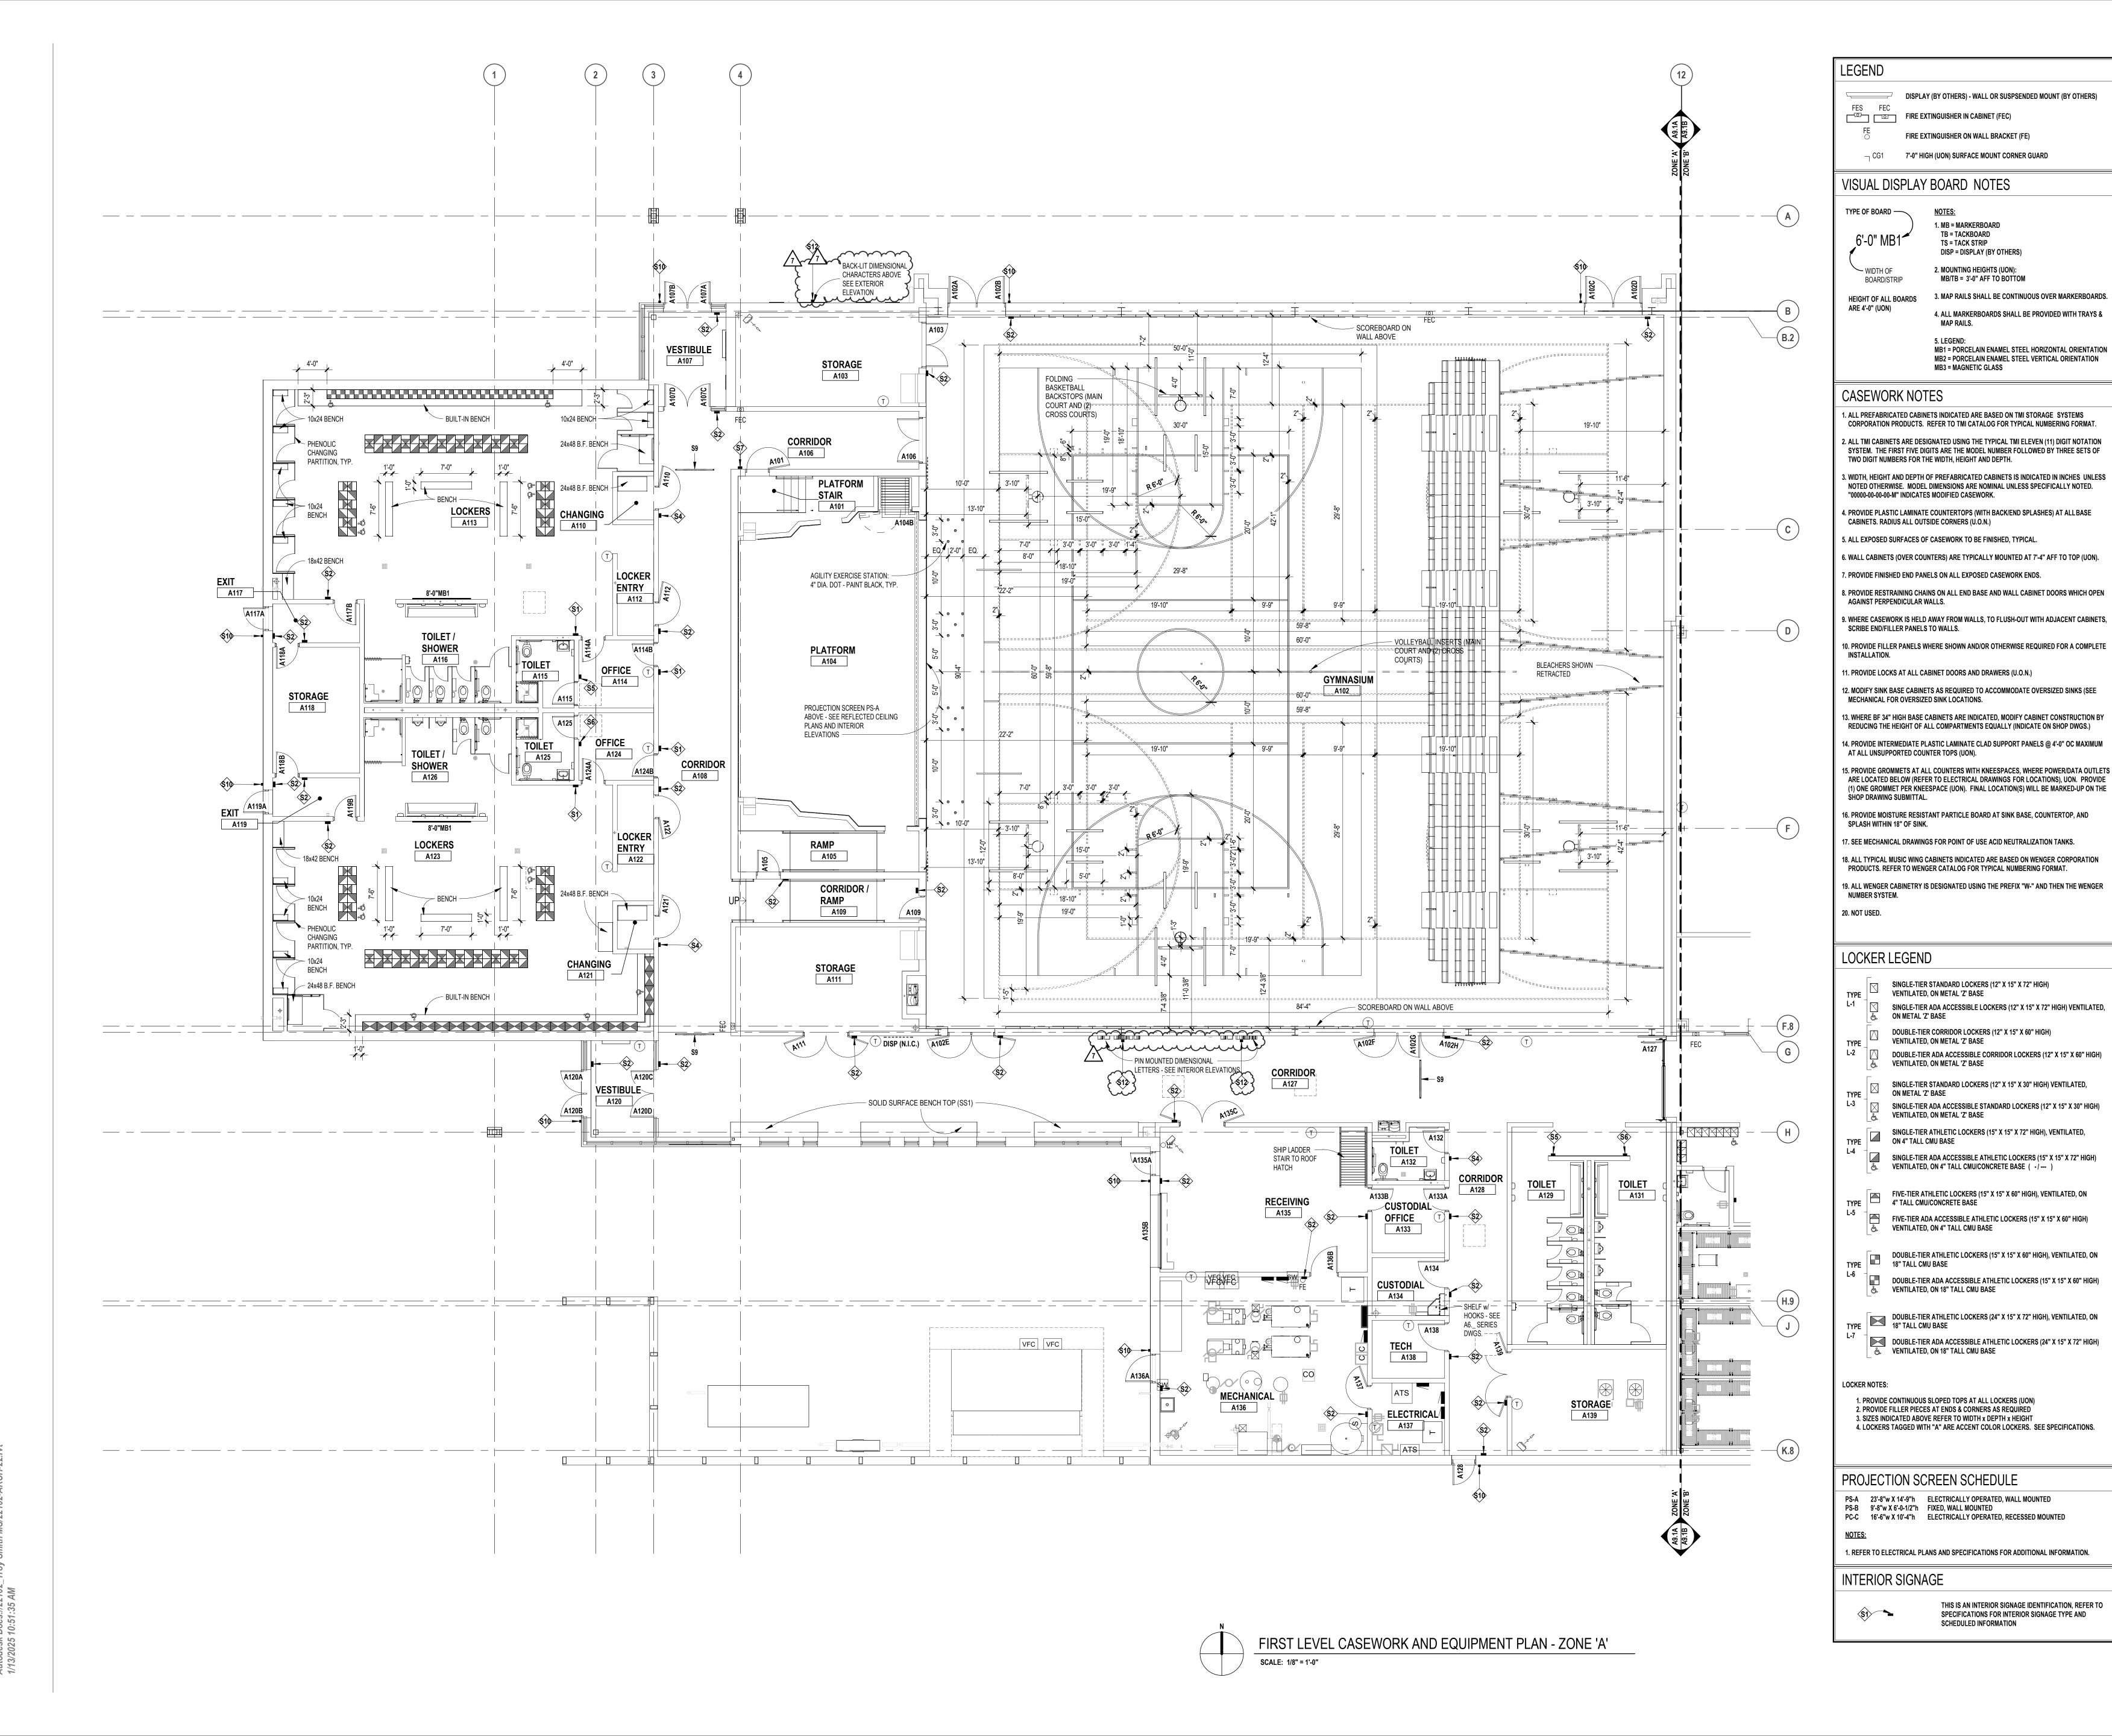
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**GLAZING TYPES** 

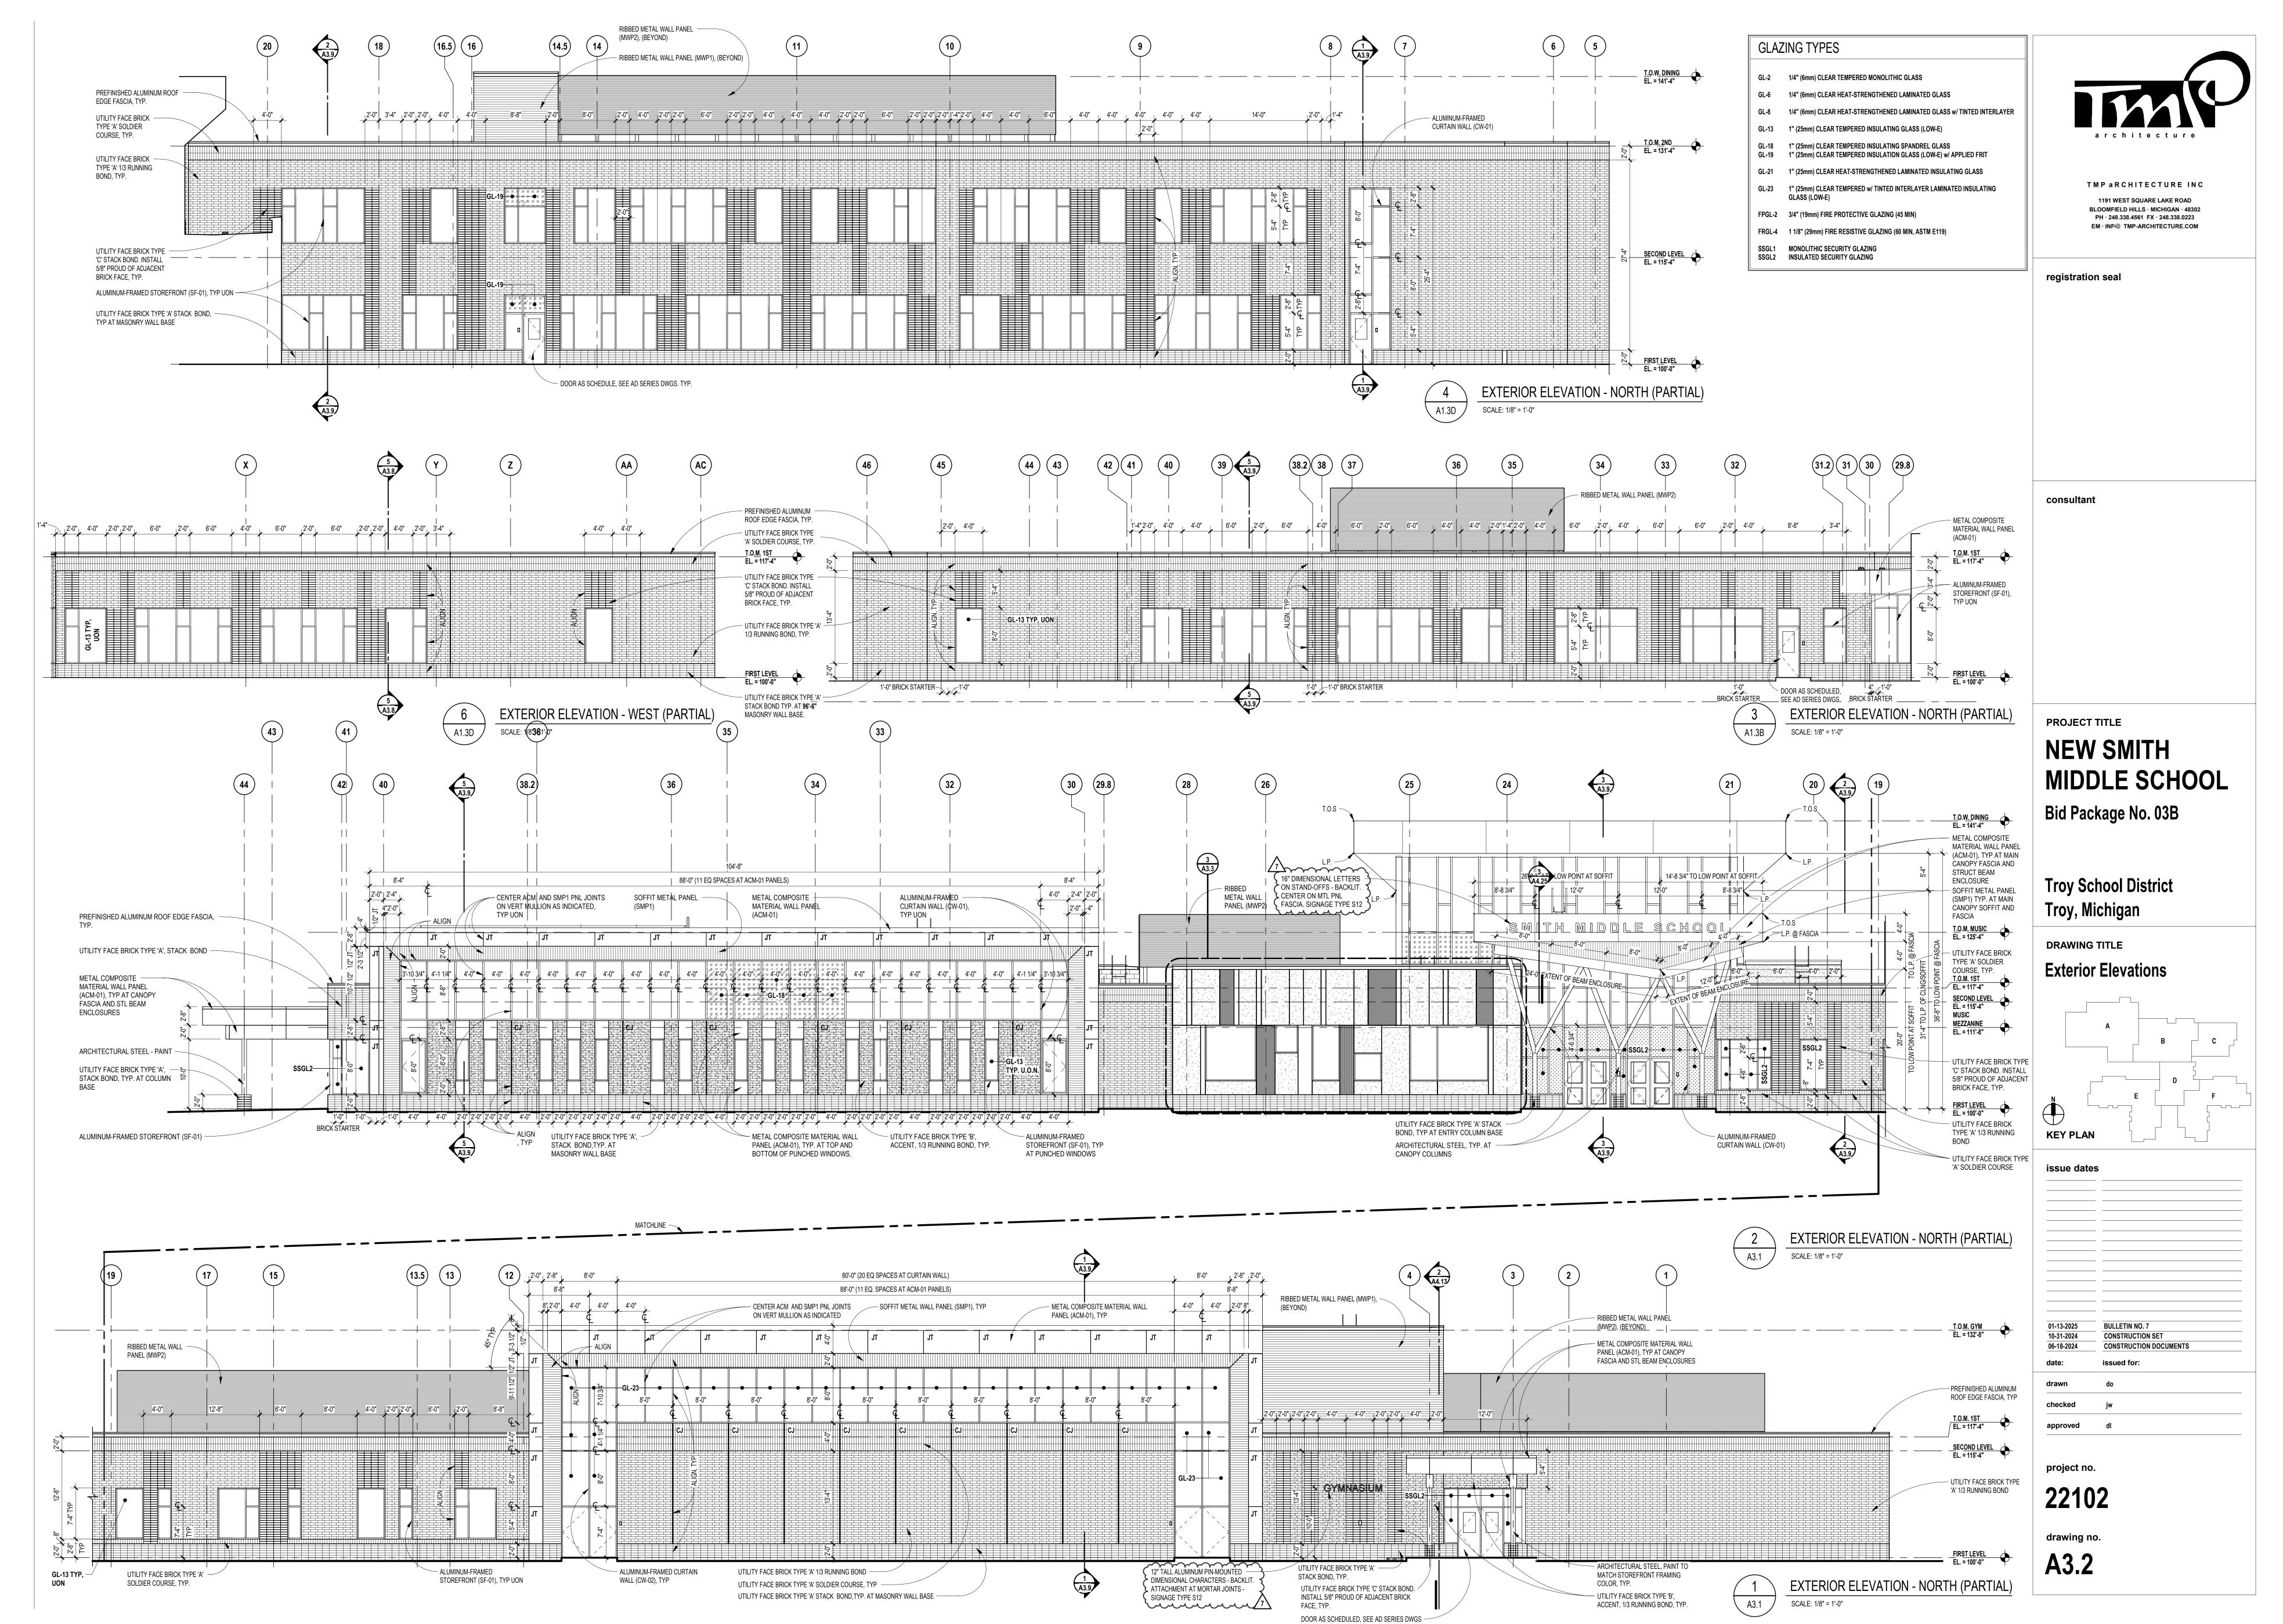

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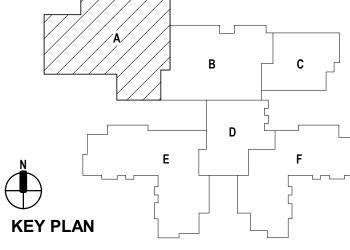
# NEW SMITH MIDDLE SCHOOL

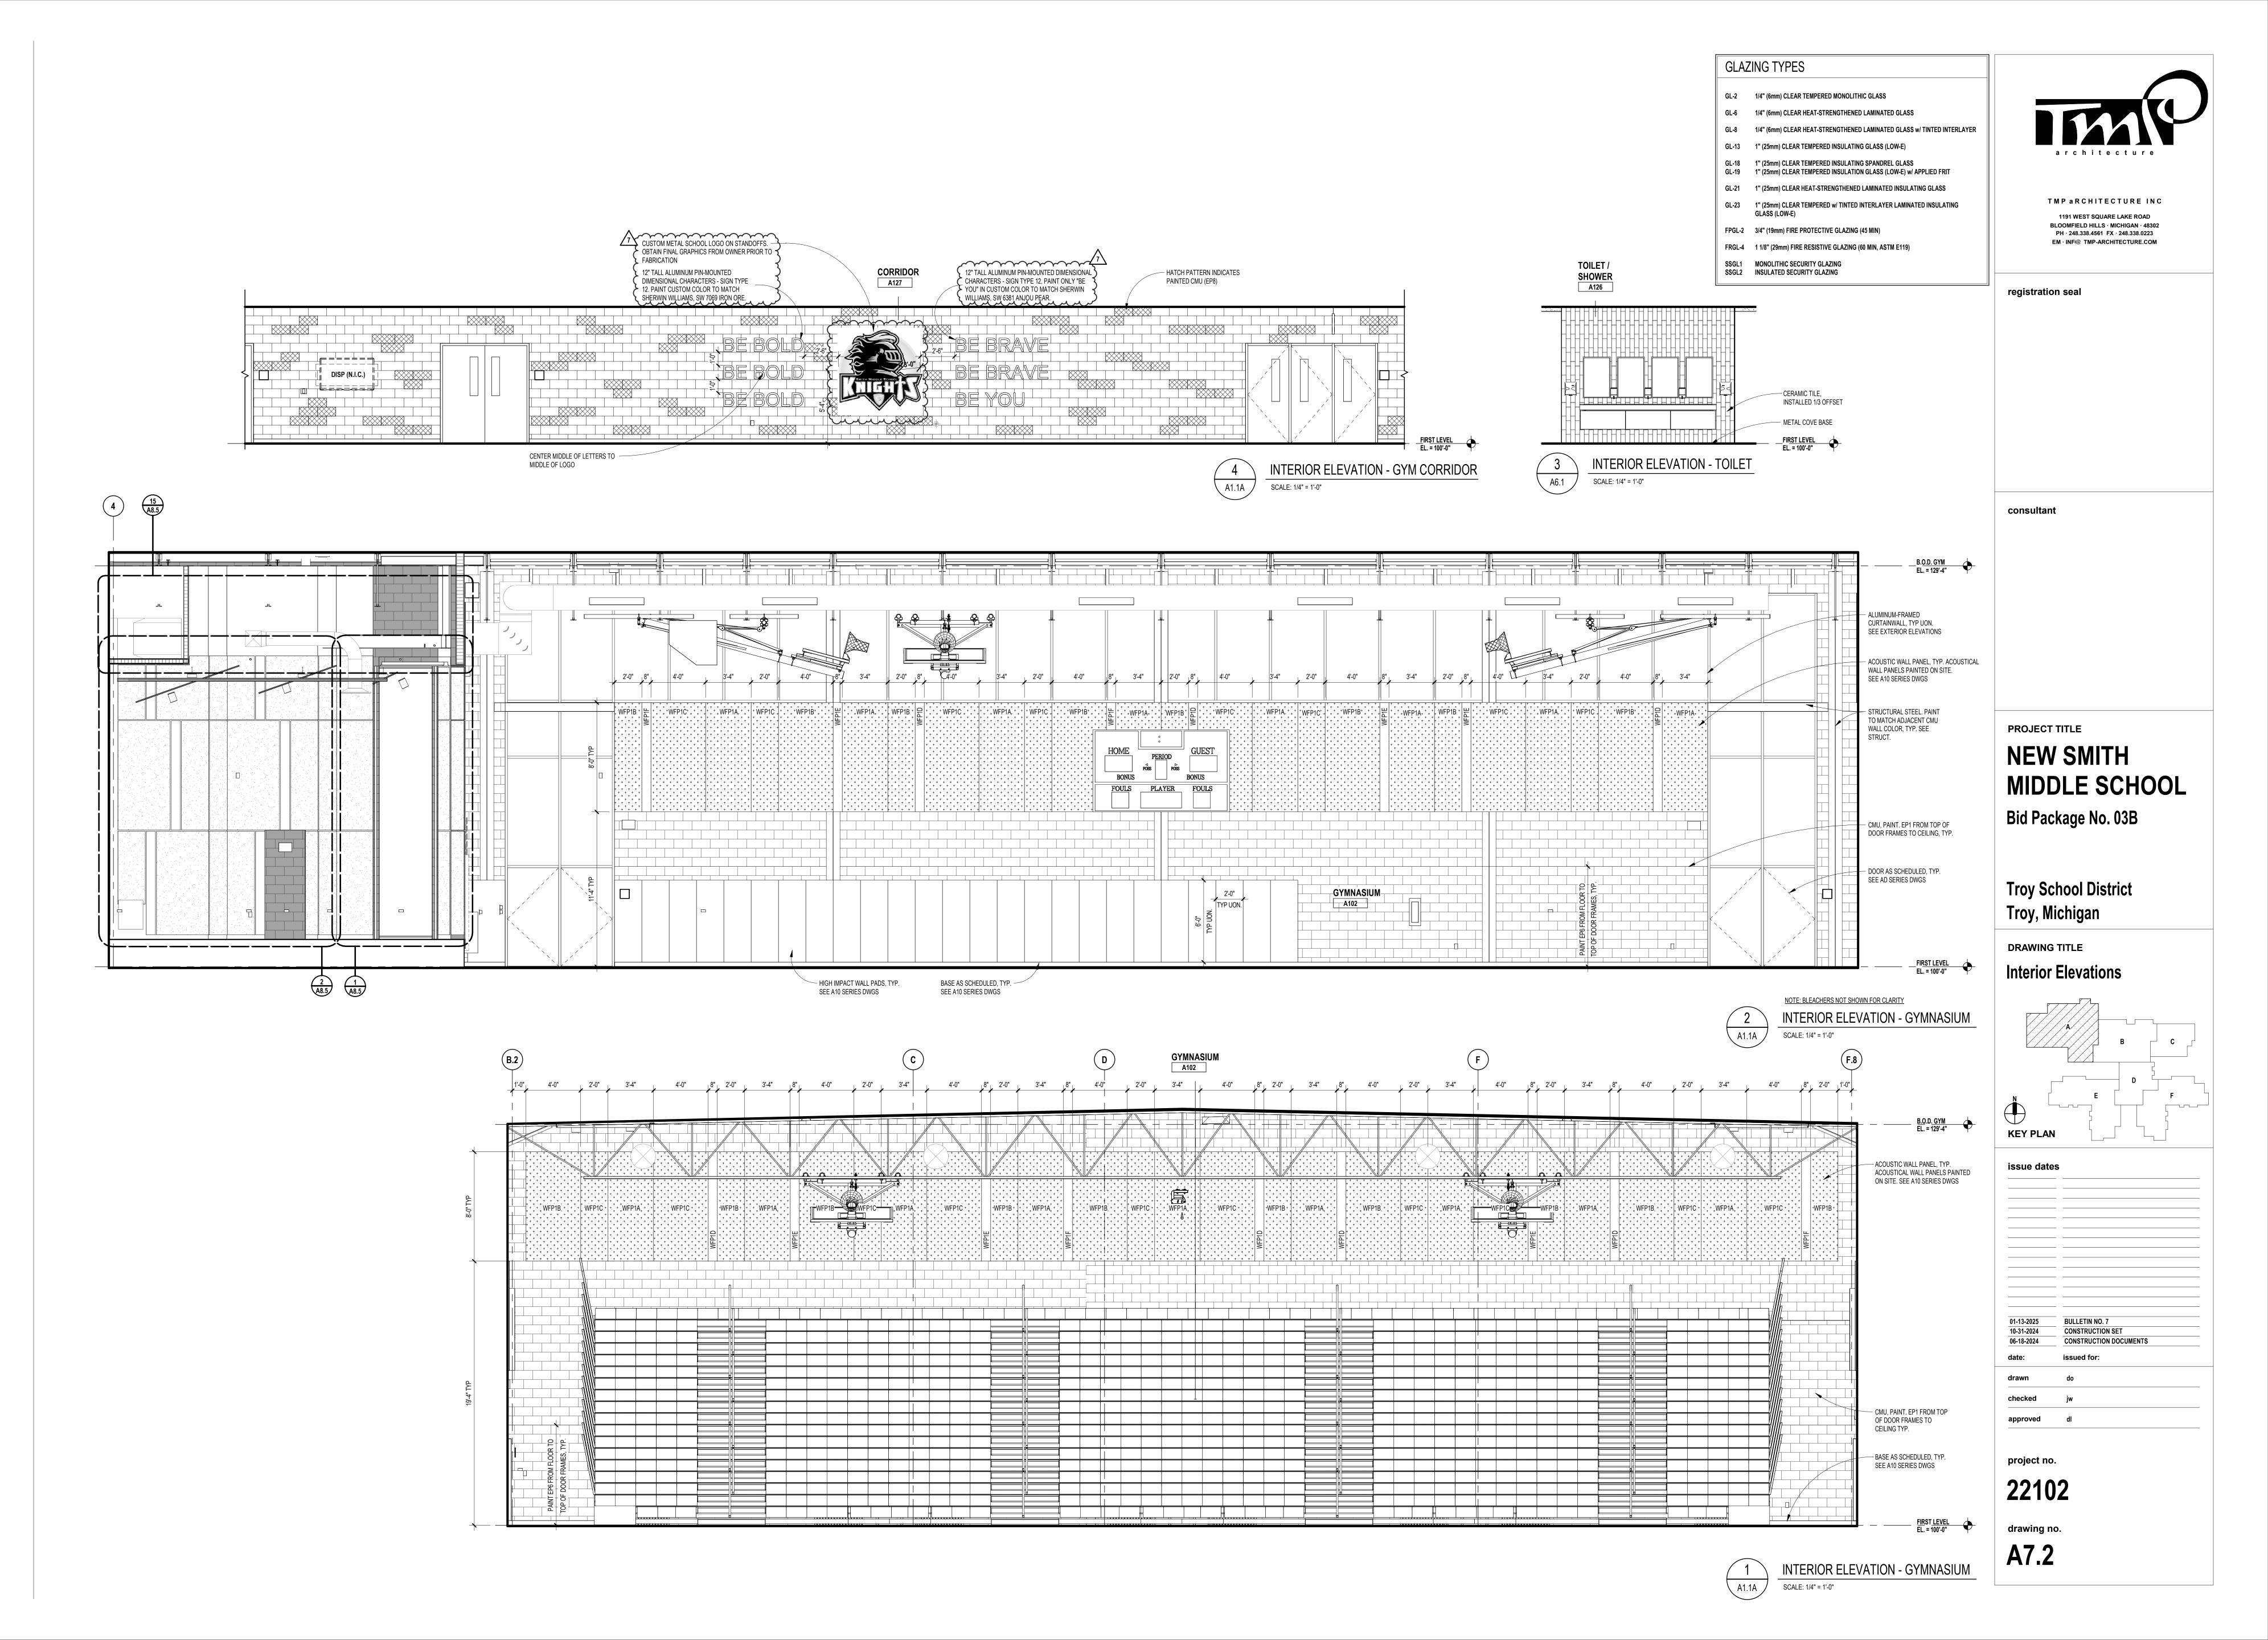Bid Package No. 03B

Troy School District Troy, Michigan

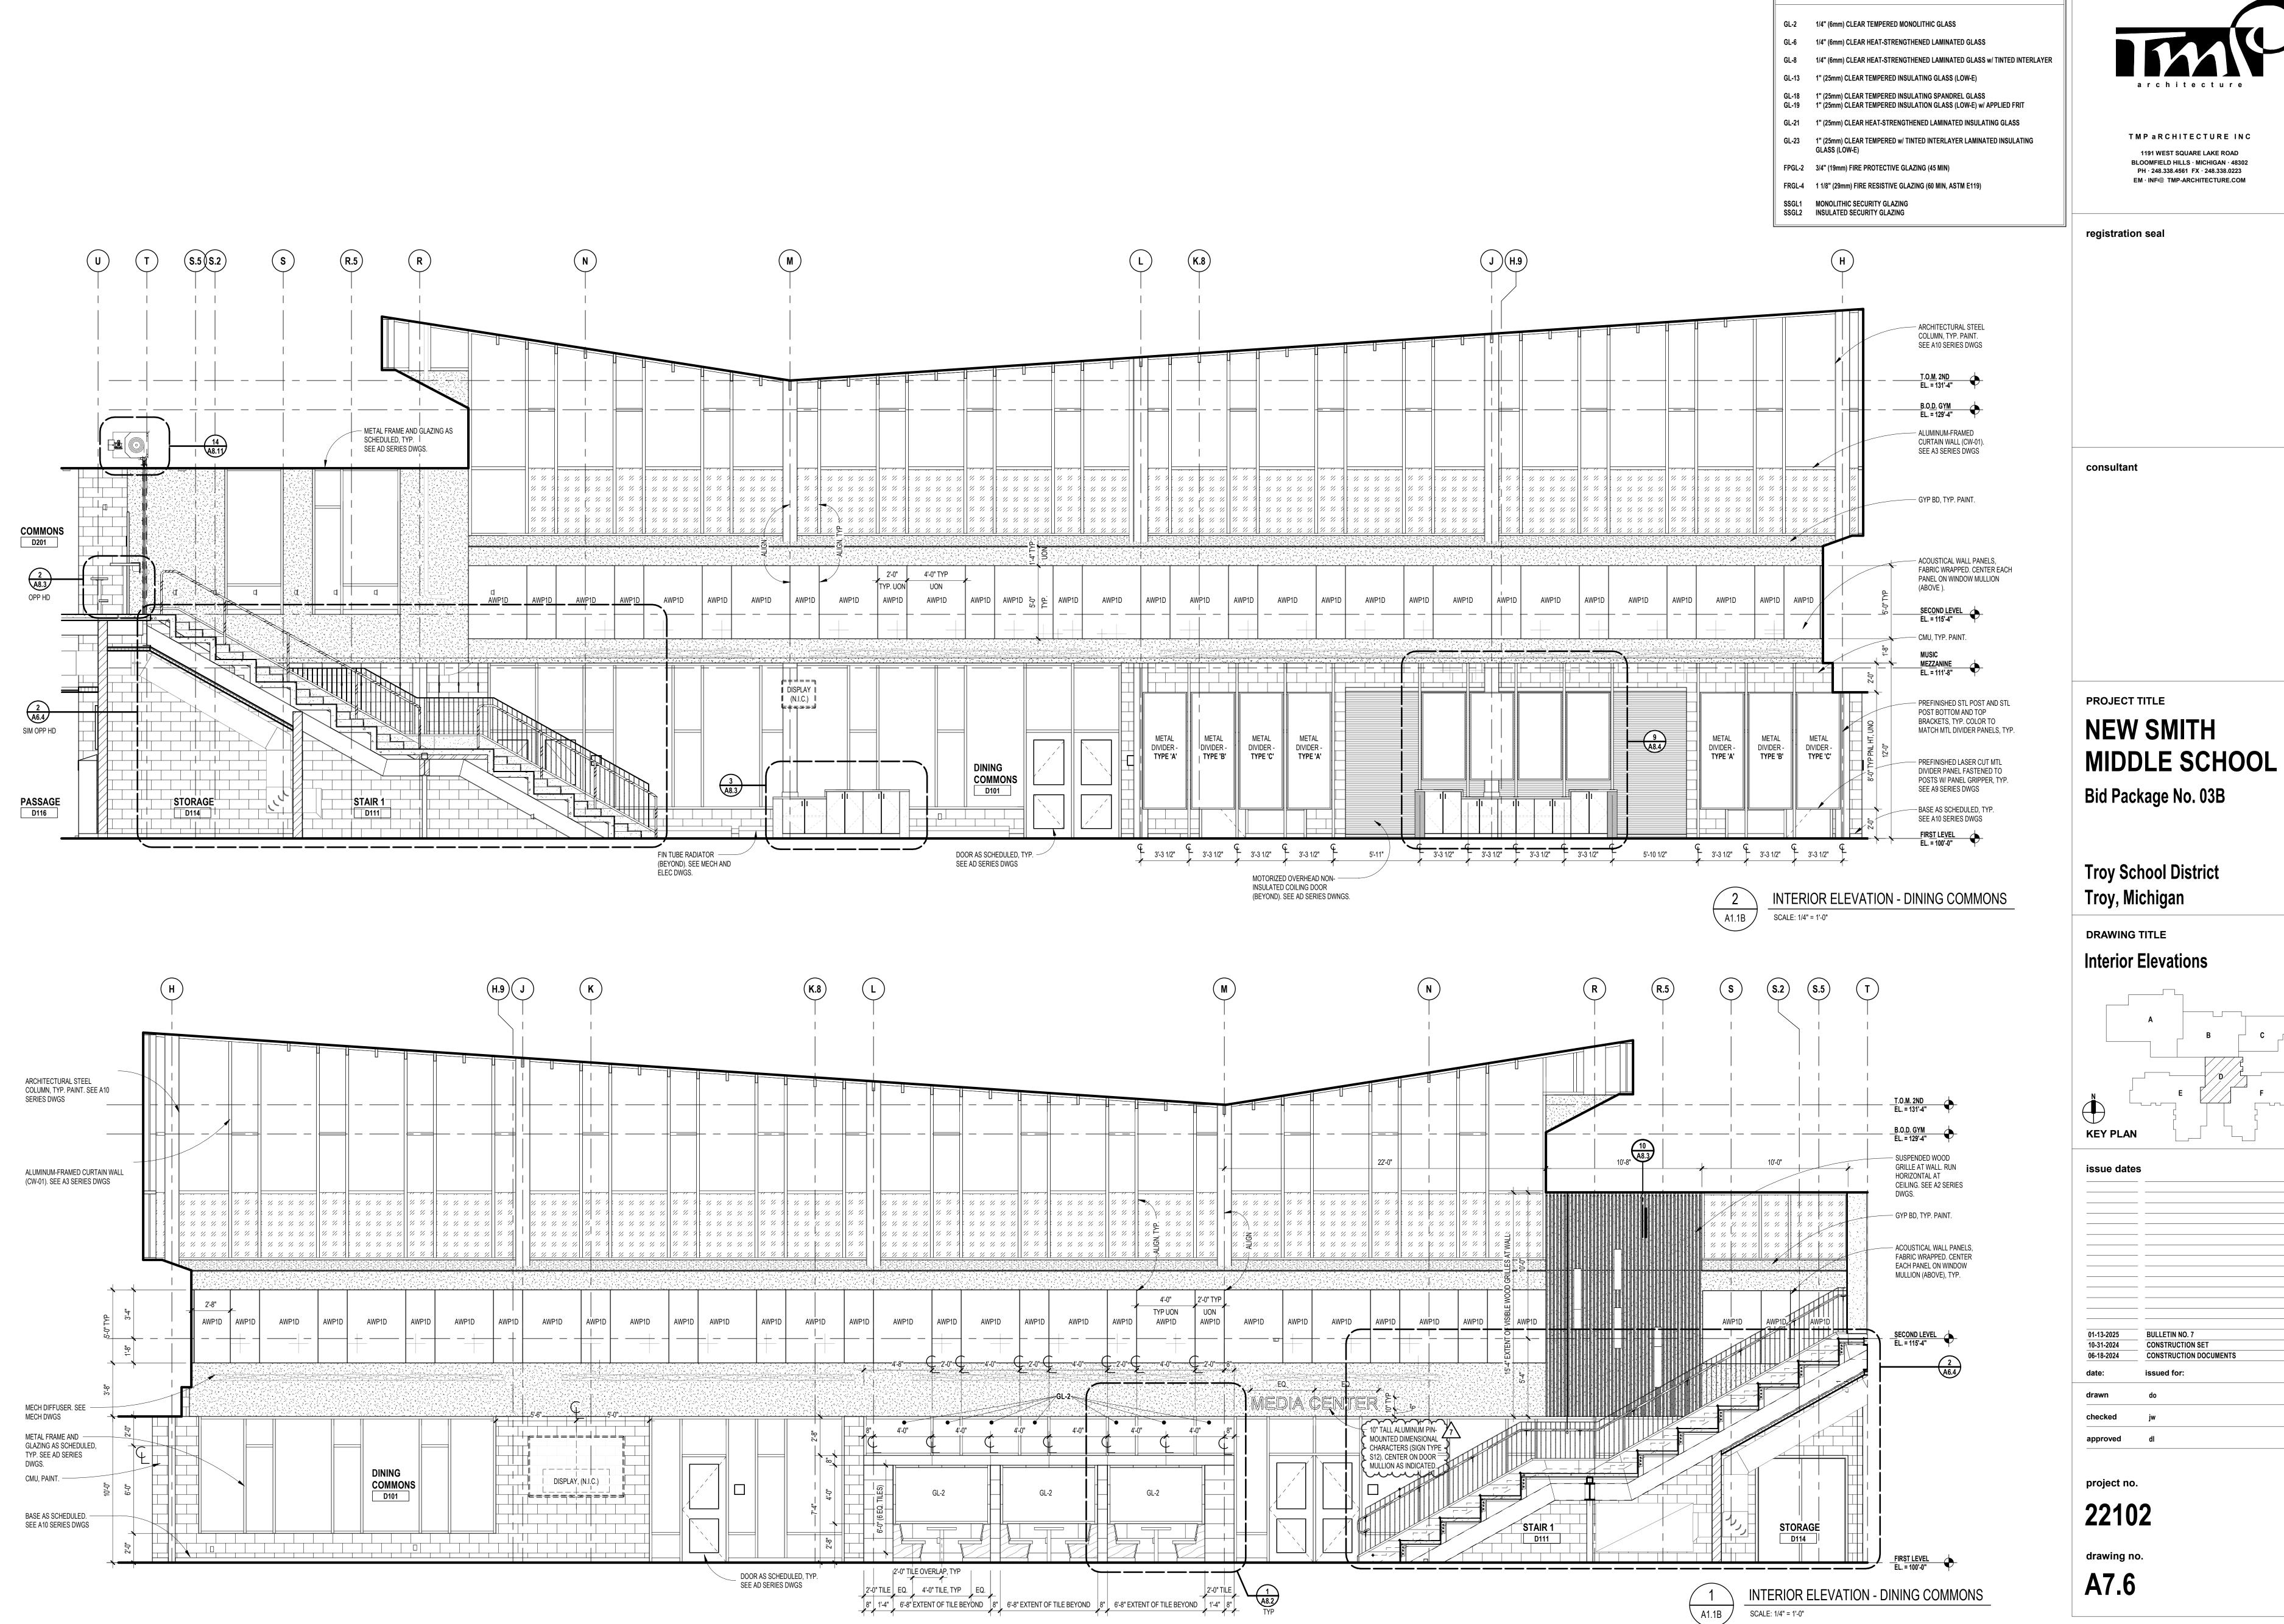DRAWING TITLE

First Level Casework & Equipment Plan - Zone 'A'



issue dates

01-13-2025 BULLETIN NO. 7
10-31-2024 CONSTRUCTION SET
07-16-2024 ADDENDUM NO. 3 (N.R.)
07-12-2024 ADDENDUM NO. 2

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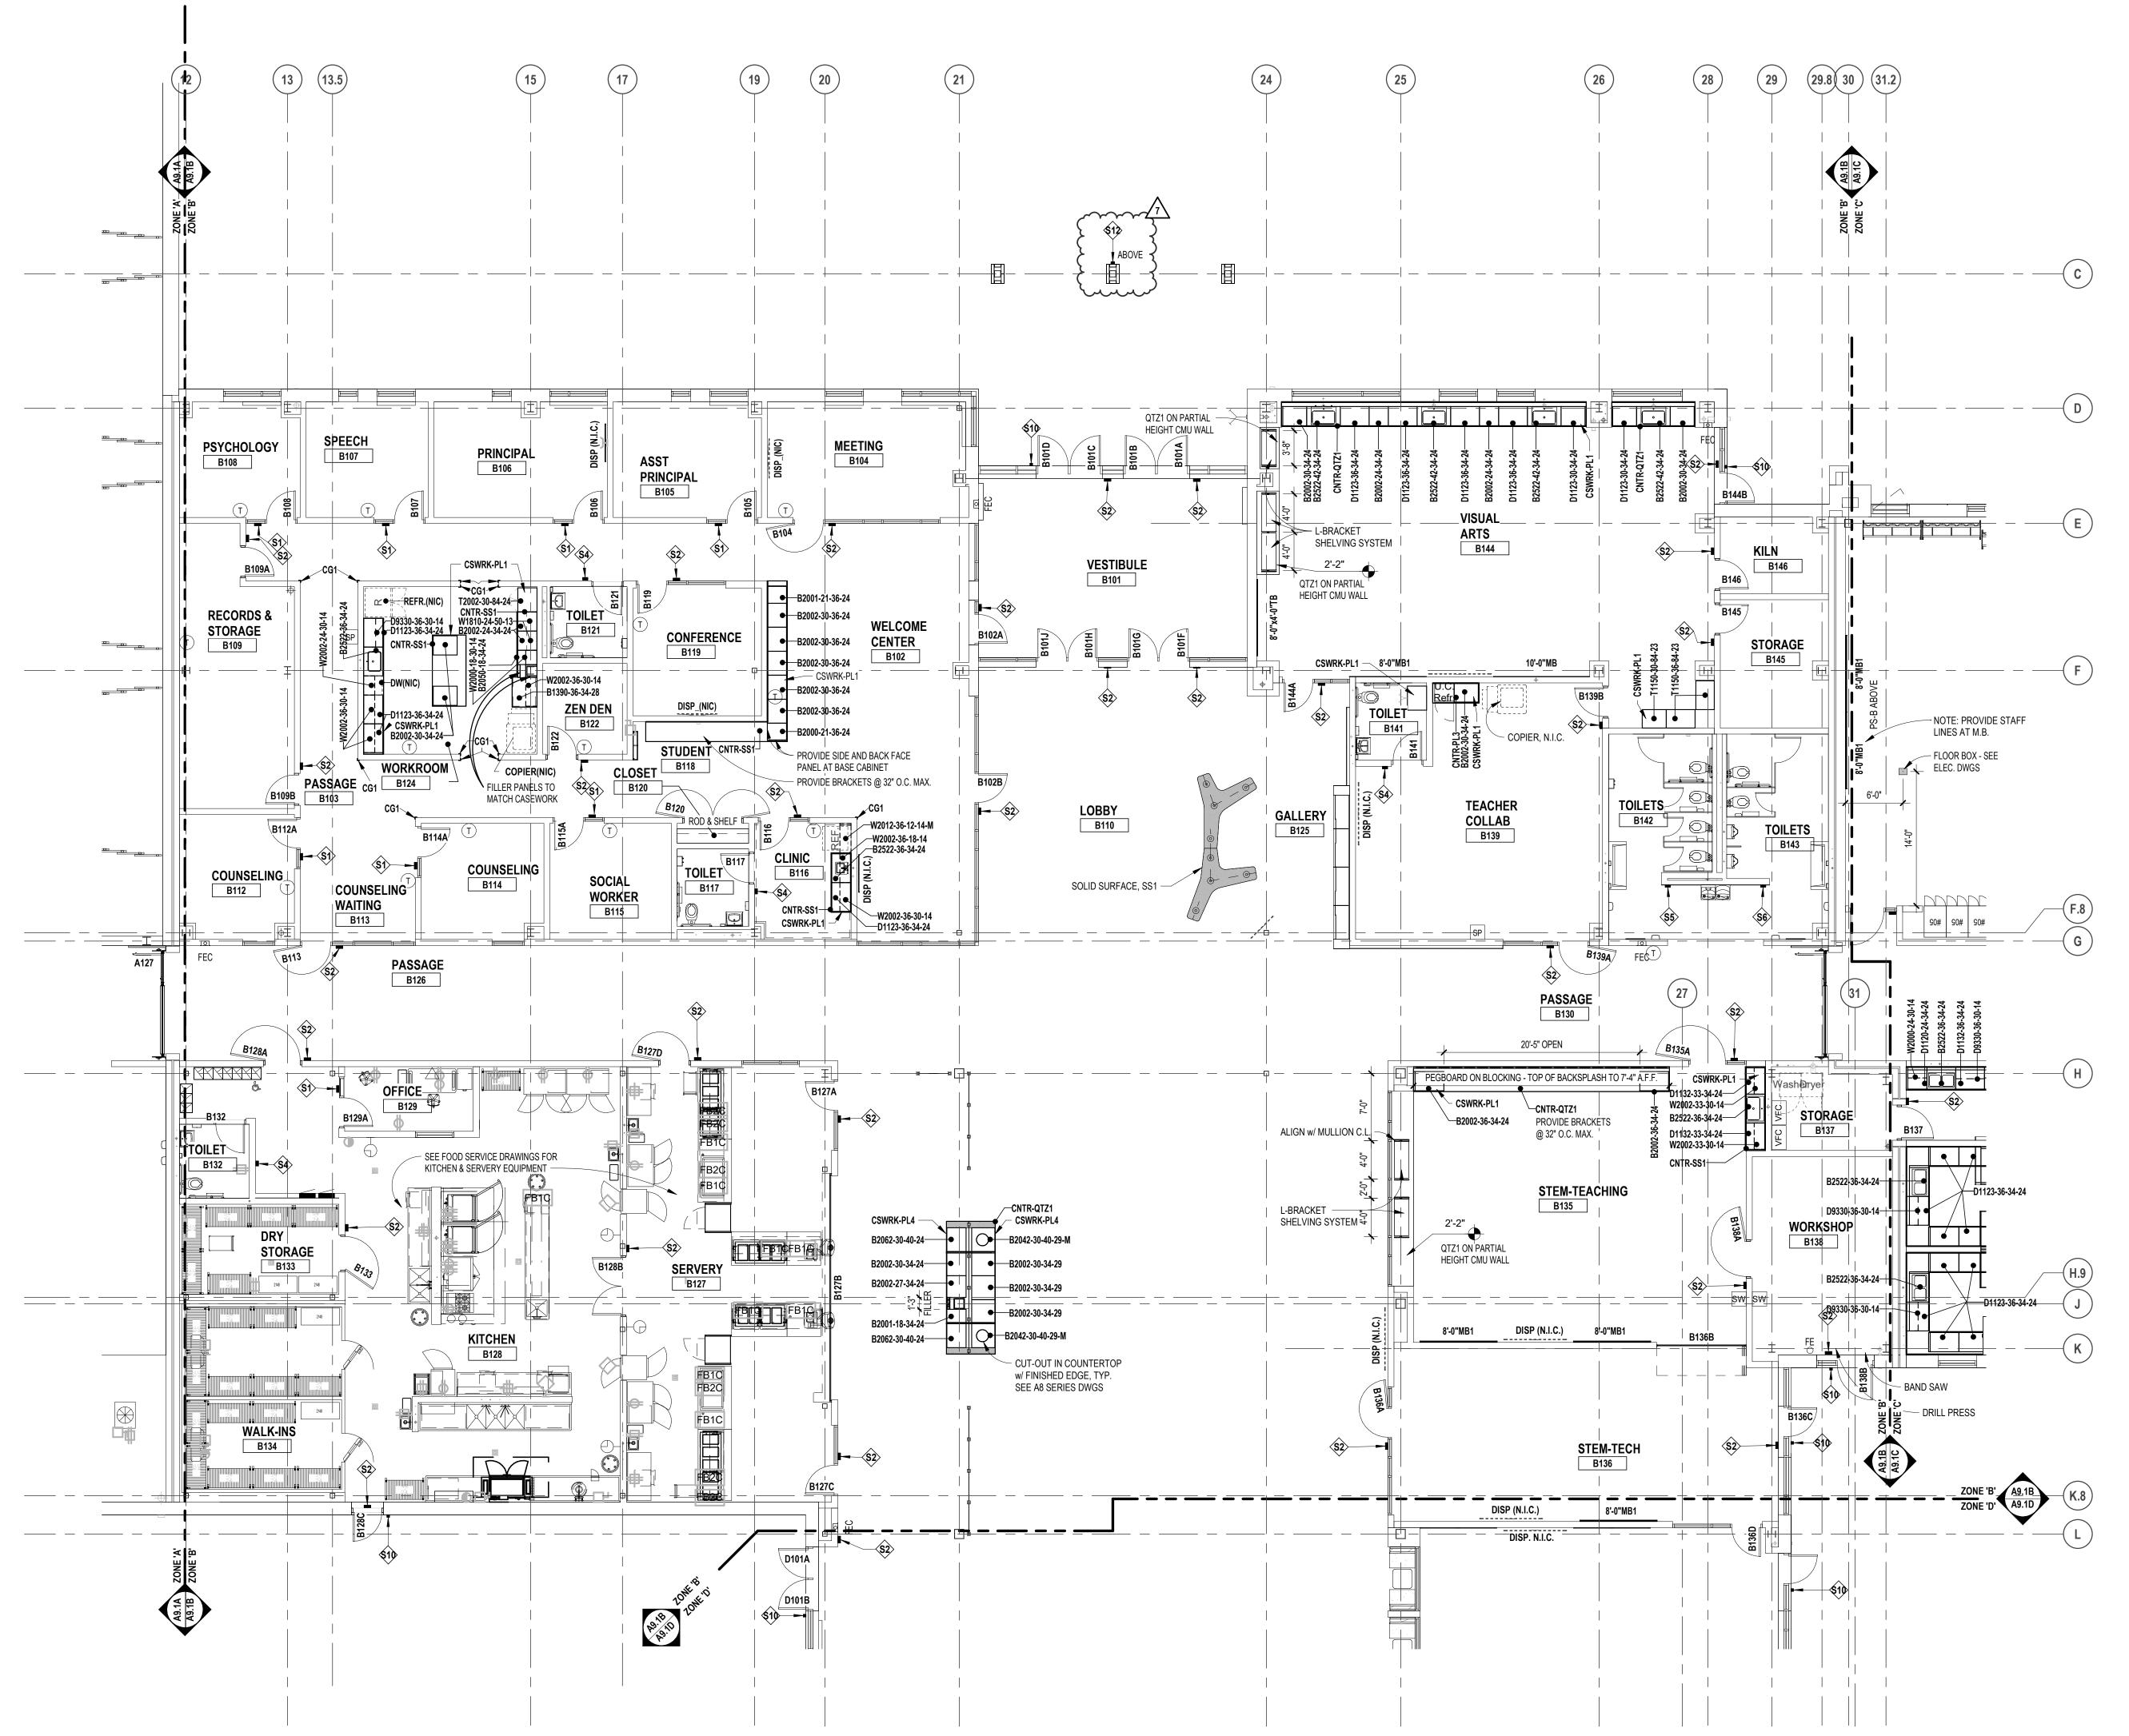
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FIRE EXTINGUISHER IN CABINET (FEC) FIRE EXTINGUISHER ON WALL BRACKET (FE) 7'-0" HIGH (UON) SURFACE MOUNT CORNER GUARD VISUAL DISPLAY BOARD NOTES TYPE OF BOARD — NOTES: 1. MB = MARKERBOARD TB = TACKBOARD TS = TACK STRIP DISP = DISPLAY (BY OTHERS) 2. MOUNTING HEIGHTS (UON): ➤ WIDTH OF MB/TB = 3'-0" AFF TO BOTTOM BOARD/STRIP 3. MAP RAILS SHALL BE CONTINUOUS OVER MARKERBOARDS. **HEIGHT OF ALL BOARDS** ARE 4'-0" (UON) 4. ALL MARKERBOARDS SHALL BE PROVIDED WITH TRAYS & MB1 = PORCELAIN ENAMEL STEEL HORIZONTAL ORIENTATION MB2 = PORCELAIN ENAMEL STEEL VERTICAL ORIENTATION MB3 = MAGNETIC GLASS CASEWORK NOTES 1. ALL PREFABRICATED CABINETS INDICATED ARE BASED ON TMI STORAGE SYSTEMS CORPORATION PRODUCTS. REFER TO TMI CATALOG FOR TYPICAL NUMBERING FORMAT. 2. ALL TMI CABINETS ARE DESIGNATED USING THE TYPICAL TMI ELEVEN (11) DIGIT NOTATION SYSTEM. THE FIRST FIVE DIGITS ARE THE MODEL NUMBER FOLLOWED BY THREE SETS OF TWO DIGIT NUMBERS FOR THE WIDTH, HEIGHT AND DEPTH. 3. WIDTH, HEIGHT AND DEPTH OF PREFABRICATED CABINETS IS INDICATED IN INCHES UNLESS NOTED OTHERWISE. MODEL DIMENSIONS ARE NOMINAL UNLESS SPECIFICALLY NOTED. "00000-00-00-00-M" INDICATES MODIFIED CASEWORK. 4. PROVIDE PLASTIC LAMINATE COUNTERTOPS (WITH BACK/END SPLASHES) AT ALL BASE CABINETS. RADIUS ALL OUTSIDE CORNERS (U.O.N.) 5. ALL EXPOSED SURFACES OF CASEWORK TO BE FINISHED, TYPICAL. 6. WALL CABINETS (OVER COUNTERS) ARE TYPICALLY MOUNTED AT 7'-4" AFF TO TOP (UON). 7. PROVIDE FINISHED END PANELS ON ALL EXPOSED CASEWORK ENDS. 8. PROVIDE RESTRAINING CHAINS ON ALL END BASE AND WALL CABINET DOORS WHICH OPEN AGAINST PERPENDICULAR WALLS. 9. WHERE CASEWORK IS HELD AWAY FROM WALLS, TO FLUSH-OUT WITH ADJACENT CABINETS, SCRIBE END/FILLER PANELS TO WALLS. 10. PROVIDE FILLER PANELS WHERE SHOWN AND/OR OTHERWISE REQUIRED FOR A COMPLETE INSTALLATION. 11. PROVIDE LOCKS AT ALL CABINET DOORS AND DRAWERS (U.O.N.) 12. MODIFY SINK BASE CABINETS AS REQUIRED TO ACCOMMODATE OVERSIZED SINKS (SEE MECHANICAL FOR OVERSIZED SINK LOCATIONS. 13. WHERE BF 34" HIGH BASE CABINETS ARE INDICATED, MODIFY CABINET CONSTRUCTION BY REDUCING THE HEIGHT OF ALL COMPARTMENTS EQUALLY (INDICATE ON SHOP DWGS.) 14. PROVIDE INTERMEDIATE PLASTIC LAMINATE CLAD SUPPORT PANELS @ 4'-0" OC MAXIMUM AT ALL UNSUPPORTED COUNTER TOPS (UON). 15. PROVIDE GROMMETS AT ALL COUNTERS WITH KNEESPACES, WHERE POWER/DATA OUTLETS ARE LOCATED BELOW (REFER TO ELECTRICAL DRAWINGS FOR LOCATIONS), UON. PROVIDE (1) ONE GROMMET PER KNEESPACE (UON). FINAL LOCATION(S) WILL BE MARKED-UP ON THE 16. PROVIDE MOISTURE RESISTANT PARTICLE BOARD AT SINK BASE, COUNTERTOP, AND SPLASH WITHIN 18" OF SINK. 17. SEE MECHANICAL DRAWINGS FOR POINT OF USE ACID NEUTRALIZATION TANKS. 18. ALL TYPICAL MUSIC WING CABINETS INDICATED ARE BASED ON WENGER CORPORATION PRODUCTS. REFER TO WENGER CATALOG FOR TYPICAL NUMBERING FORMAT. 19. ALL WENGER CABINETRY IS DESIGNATED USING THE PREFIX "W-" AND THEN THE WENGER 20. NOT USED. LOCKER LEGEND SINGLE-TIER STANDARD LOCKERS (12" X 15" X 72" HIGH) VENTILATED, ON METAL 'Z' BASE SINGLE-TIER ADA ACCESSIBLE LOCKERS (12" X 15" X 72" HIGH) VENTILATED, ON METAL 'Z' BASE DOUBLE-TIER CORRIDOR LOCKERS (12" X 15" X 60" HIGH) VENTILATED, ON METAL 'Z' BASE DOUBLE-TIER ADA ACCESSIBLE CORRIDOR LOCKERS (12" X 15" X 60" HIGH) VENTILATED, ON METAL 'Z' BASE SINGLE-TIER STANDARD LOCKERS (12" X 15" X 30" HIGH) VENTILATED, ON METAL 'Z' BASE SINGLE-TIER ADA ACCESSIBLE STANDARD LOCKERS (12" X 15" X 30" HIGH) VENTILATED, ON METAL 'Z' BASE SINGLE-TIER ATHLETIC LOCKERS (15" X 15" X 72" HIGH), VENTILATED, ON 4" TALL CMU BASE SINGLE-TIER ADA ACCESSIBLE ATHLETIC LOCKERS (15" X 15" X 72" HIGH) VENTILATED, ON 4" TALL CMU/CONCRETE BASE ( -/--- ) FIVE-TIER ATHLETIC LOCKERS (15" X 15" X 60" HIGH), VENTILATED, ON 4" TALL CMU/CONCRETE BASE FIVE-TIER ADA ACCESSIBLE ATHLETIC LOCKERS (15" X 15" X 60" HIGH) VENTILATED, ON 4" TALL CMU BASE DOUBLE-TIER ATHLETIC LOCKERS (15" X 15" X 60" HIGH), VENTILATED, ON 18" TALL CMU BASE DOUBLE-TIER ADA ACCESSIBLE ATHLETIC LOCKERS (15" X 15" X 60" HIGH) VENTILATED, ON 18" TALL CMU BASE TYPE DOUBLE-TIER ATHLETIC LOCKERS (24" X 15" X 72" HIGH), VENTILATED, ON 18" TALL CMU BASE DOUBLE-TIER ADA ACCESSIBLE ATHLETIC LOCKERS (24" X 15" X 72" HIGH) VENTILATED, ON 18" TALL CMU BASE **LOCKER NOTES:** 1. PROVIDE CONTINUOUS SLOPED TOPS AT ALL LOCKERS (UON) 2. PROVIDE FILLER PIECES AT ENDS & CORNERS AS REQUIRED 3. SIZES INDICATED ABOVE REFER TO WIDTH x DEPTH x HEIGHT 4. LOCKERS TAGGED WITH "A" ARE ACCENT COLOR LOCKERS. SEE SPECIFICATIONS. PROJECTION SCREEN SCHEDULE PS-A 23'-8"w X 14'-9"h ELECTRICALLY OPERATED, WALL MOUNTED PS-B 9'-8"w X 6'-0-1/2"h FIXED, WALL MOUNTED PC-C 16'-6"w X 10'-4"h ELECTRICALLY OPERATED, RECESSED MOUNTED NOTES: 1. REFER TO ELECTRICAL PLANS AND SPECIFICATIONS FOR ADDITIONAL INFORMATION. INTERIOR SIGNAGE THIS IS AN INTERIOR SIGNAGE IDENTIFICATION, REFER TO SPECIFICATIONS FOR INTERIOR SIGNAGE TYPE AND SCHEDULED INFORMATION

LEGEND

DISPLAY (BY OTHERS) - WALL OR SUSPSENDED MOUNT (BY OTHERS)

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PROJECT TITLE


## **NEW SMITH** MIDDLE SCHOOL

Bid Package No. 03B

**Troy School District** Troy, Michigan

**DRAWING TITLE** 

First Level Casework & Equipment Plan - Zone 'B'

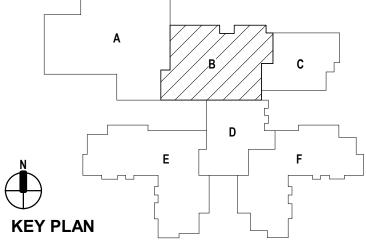

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01-13-2025	BULLETIN NO. 7
10-31-2024	CONSTRUCTION SET
07-23-2024	ADDENDUM NO. 4
07-16-2024	ADDENDUM NO. 3
06-18-2024	CONSTRUCTION DOCUMENTS
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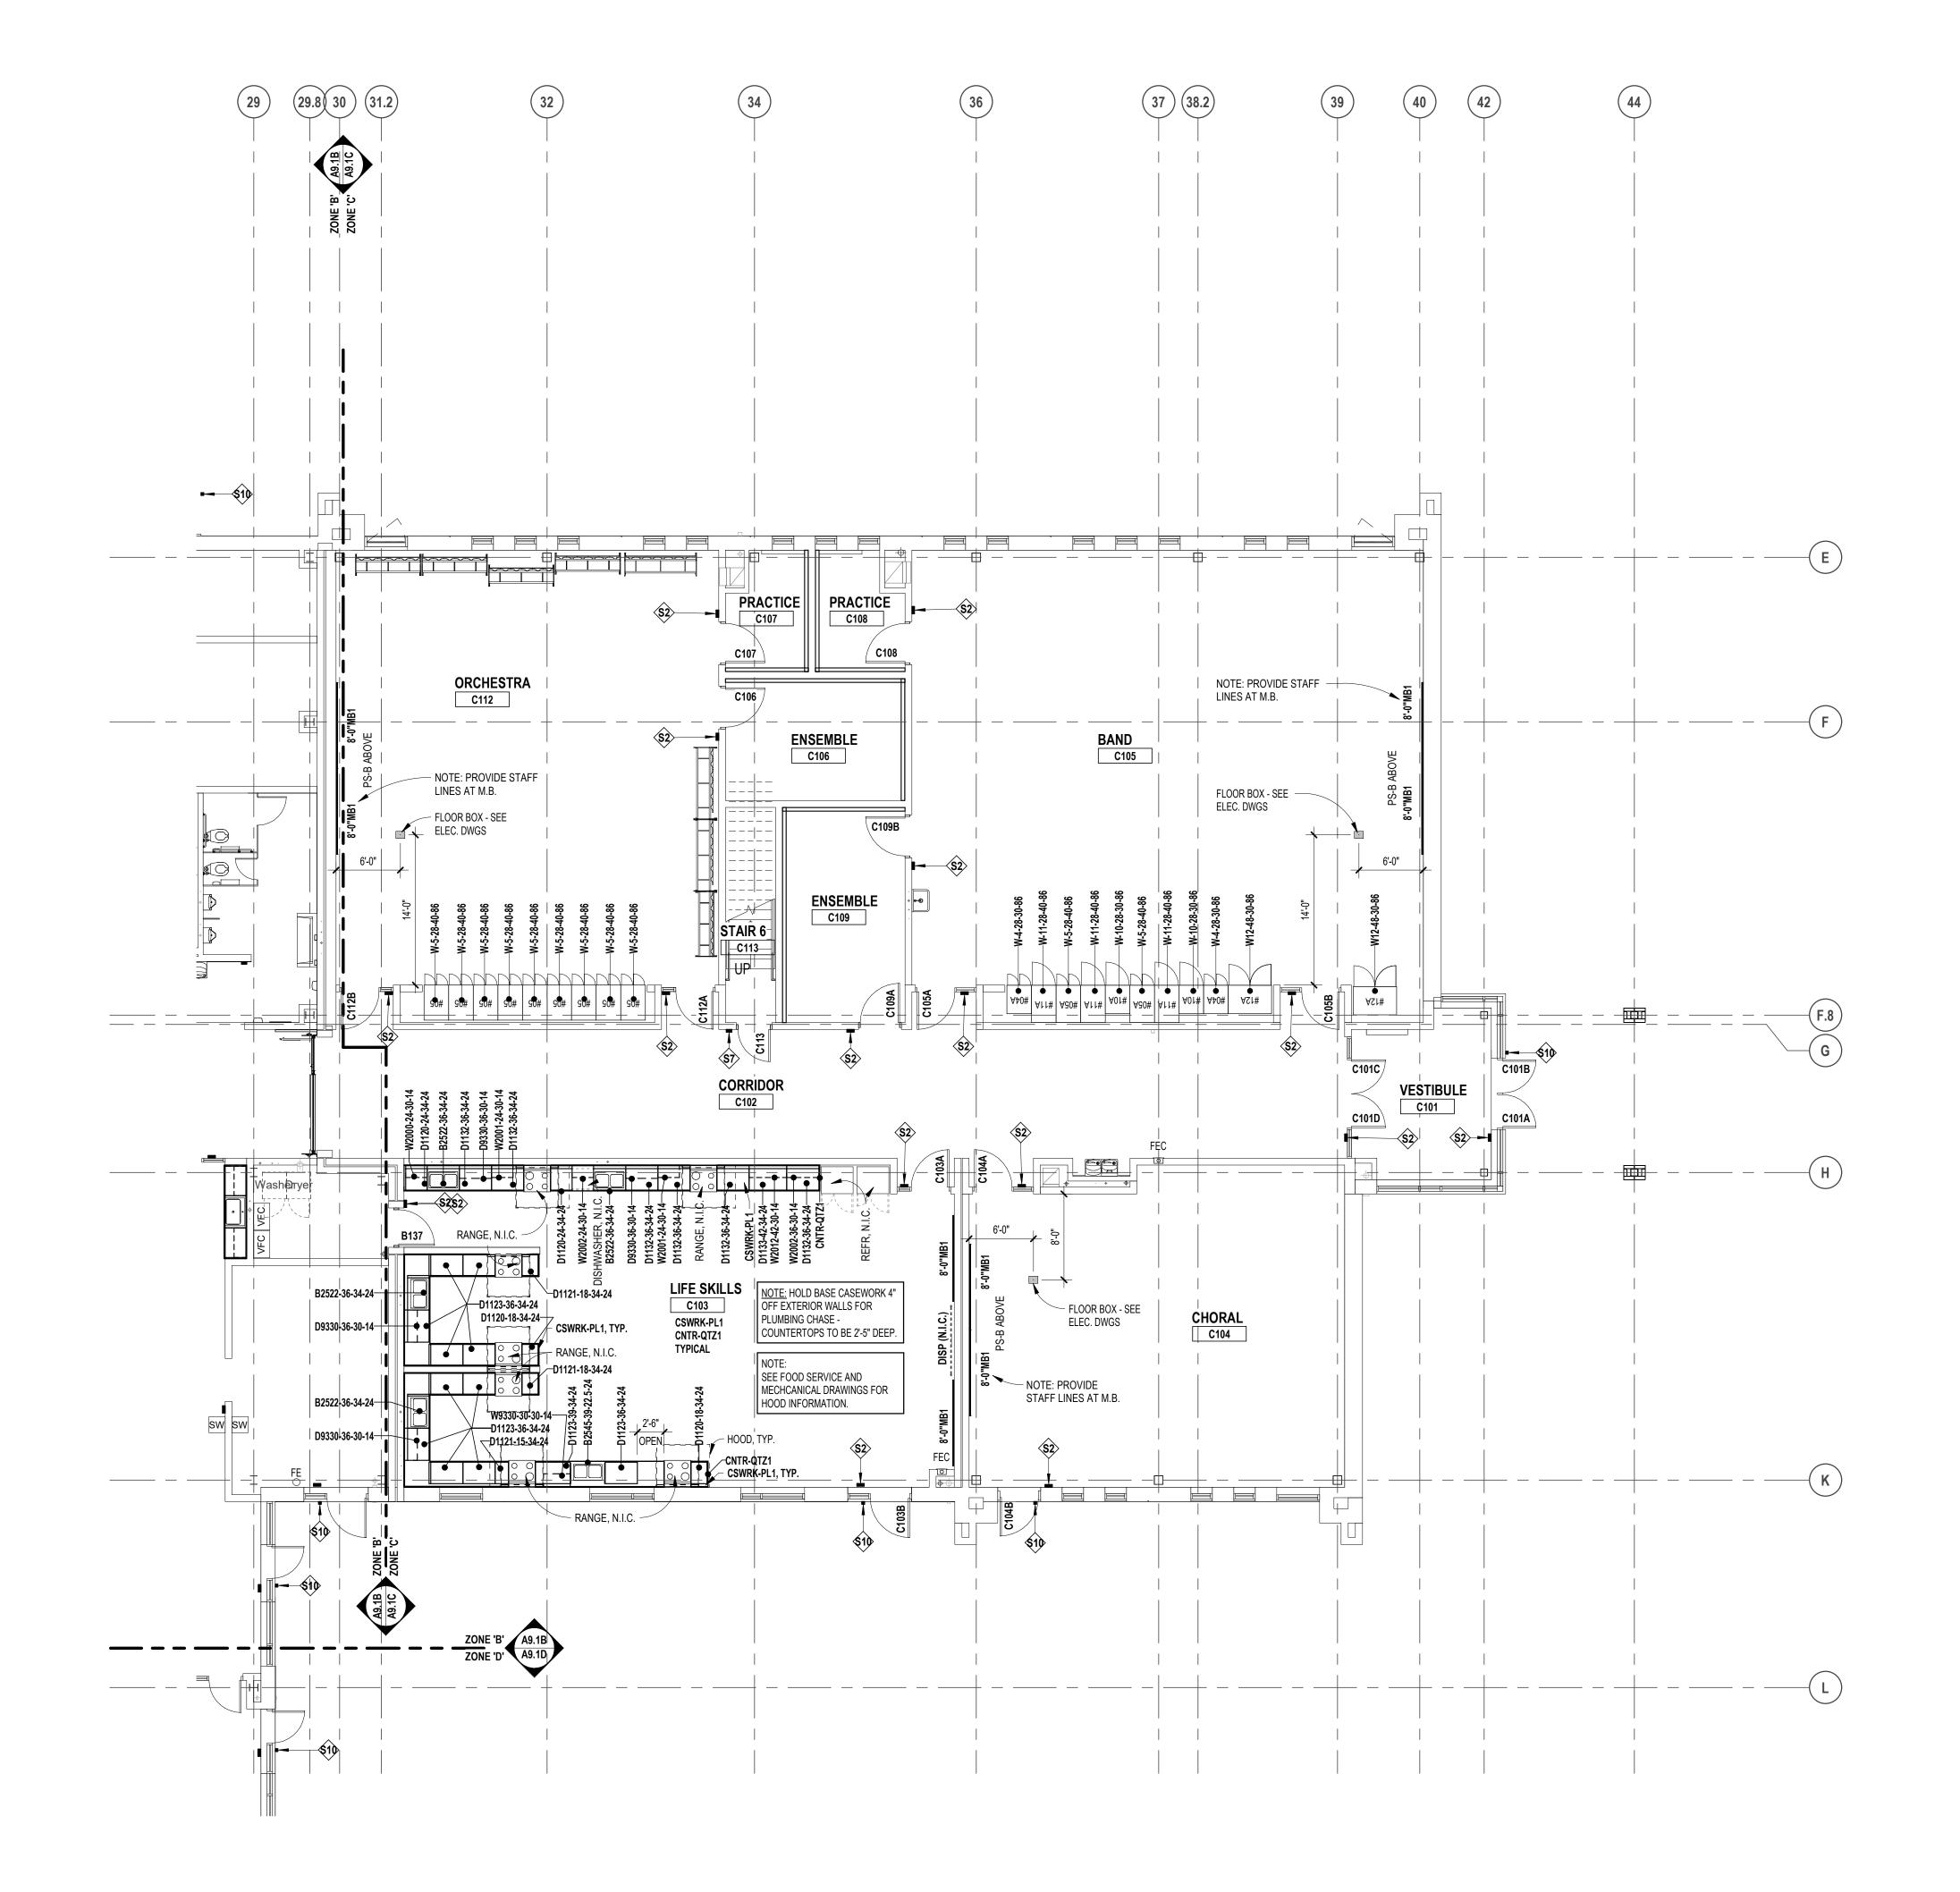
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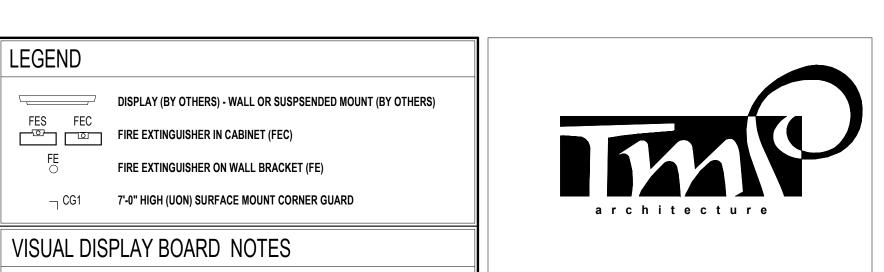
22102

drawing no. A9.1B

FIRST LEVEL CASEWORK AND EQUIPMENT PLAN - ZONE 'B' SCALE: 1/8" = 1'-0"







TYPE OF BOARD —

─ WIDTH OF

ARE 4'-0" (UON)

BOARD/STRIP

HEIGHT OF ALL BOARDS

CASEWORK NOTES

NOTES:

1. MB = MARKERBOARD

TB = TACKBOARD

TS = TACK STRIP

DISP = DISPLAY (BY OTHERS)

MB/TB = 3'-0" AFF TO BOTTOM

3. MAP RAILS SHALL BE CONTINUOUS OVER MARKERBOARDS.

4. ALL MARKERBOARDS SHALL BE PROVIDED WITH TRAYS &

MB1 = PORCELAIN ENAMEL STEEL HORIZONTAL ORIENTATION MB2 = PORCELAIN ENAMEL STEEL VERTICAL ORIENTATION

2. MOUNTING HEIGHTS (UON):

MB3 = MAGNETIC GLASS

1. ALL PREFABRICATED CABINETS INDICATED ARE BASED ON TMI STORAGE SYSTEMS CORPORATION PRODUCTS. REFER TO TMI CATALOG FOR TYPICAL NUMBERING FORMAT.

TWO DIGIT NUMBERS FOR THE WIDTH, HEIGHT AND DEPTH.

"00000-00-00-00-M" INDICATES MODIFIED CASEWORK.

CABINETS. RADIUS ALL OUTSIDE CORNERS (U.O.N.)

AGAINST PERPENDICULAR WALLS.

INSTALLATION.

SCRIBE END/FILLER PANELS TO WALLS.

MECHANICAL FOR OVERSIZED SINK LOCATIONS.

AT ALL UNSUPPORTED COUNTER TOPS (UON).

SHOP DRAWING SUBMITTAL.

SPLASH WITHIN 18" OF SINK.

NUMBER SYSTEM.

LOCKER LEGEND

20. NOT USED.

5. ALL EXPOSED SURFACES OF CASEWORK TO BE FINISHED, TYPICAL.

7. PROVIDE FINISHED END PANELS ON ALL EXPOSED CASEWORK ENDS.

11. PROVIDE LOCKS AT ALL CABINET DOORS AND DRAWERS (U.O.N.)

2. ALL TMI CABINETS ARE DESIGNATED USING THE TYPICAL TMI ELEVEN (11) DIGIT NOTATION SYSTEM. THE FIRST FIVE DIGITS ARE THE MODEL NUMBER FOLLOWED BY THREE SETS OF

3. WIDTH, HEIGHT AND DEPTH OF PREFABRICATED CABINETS IS INDICATED IN INCHES UNLESS NOTED OTHERWISE. MODEL DIMENSIONS ARE NOMINAL UNLESS SPECIFICALLY NOTED.

4. PROVIDE PLASTIC LAMINATE COUNTERTOPS (WITH BACK/END SPLASHES) AT ALLBASE

6. WALL CABINETS (OVER COUNTERS) ARE TYPICALLY MOUNTED AT 7'-4" AFF TO TOP (UON).

8. PROVIDE RESTRAINING CHAINS ON ALL END BASE AND WALL CABINET DOORS WHICH OPEN

9. WHERE CASEWORK IS HELD AWAY FROM WALLS, TO FLUSH-OUT WITH ADJACENT CABINETS,

10. PROVIDE FILLER PANELS WHERE SHOWN AND/OR OTHERWISE REQUIRED FOR A COMPLETE

12. MODIFY SINK BASE CABINETS AS REQUIRED TO ACCOMMODATE OVERSIZED SINKS (SEE

13. WHERE BF 34" HIGH BASE CABINETS ARE INDICATED, MODIFY CABINET CONSTRUCTION BY REDUCING THE HEIGHT OF ALL COMPARTMENTS EQUALLY (INDICATE ON SHOP DWGS.)

14. PROVIDE INTERMEDIATE PLASTIC LAMINATE CLAD SUPPORT PANELS @ 4'-0" OC MAXIMUM

15. PROVIDE GROMMETS AT ALL COUNTERS WITH KNEESPACES, WHERE POWER/DATA OUTLETS

ARE LOCATED BELOW (REFER TO ELECTRICAL DRAWINGS FOR LOCATIONS), UON. PROVIDE

(1) ONE GROMMET PER KNEESPACE (UON). FINAL LOCATION(S) WILL BE MARKED-UP ON THE

16. PROVIDE MOISTURE RESISTANT PARTICLE BOARD AT SINK BASE, COUNTERTOP, AND

18. ALL TYPICAL MUSIC WING CABINETS INDICATED ARE BASED ON WENGER CORPORATION PRODUCTS. REFER TO WENGER CATALOG FOR TYPICAL NUMBERING FORMAT.

19. ALL WENGER CABINETRY IS DESIGNATED USING THE PREFIX "W-" AND THEN THE WENGER

SINGLE-TIER STANDARD LOCKERS (12" X 15" X 72" HIGH)

DOUBLE-TIER CORRIDOR LOCKERS (12" X 15" X 60" HIGH)

SINGLE-TIER ADA ACCESSIBLE LOCKERS (12" X 15" X 72" HIGH) VENTILATED,

DOUBLE-TIER ADA ACCESSIBLE CORRIDOR LOCKERS (12" X 15" X 60" HIGH)

SINGLE-TIER ADA ACCESSIBLE STANDARD LOCKERS (12" X 15" X 30" HIGH)

SINGLE-TIER STANDARD LOCKERS (12" X 15" X 30" HIGH) VENTILATED,

SINGLE-TIER ATHLETIC LOCKERS (15" X 15" X 72" HIGH), VENTILATED,

SINGLE-TIER ADA ACCESSIBLE ATHLETIC LOCKERS (15" X 15" X 72" HIGH)

FIVE-TIER ATHLETIC LOCKERS (15" X 15" X 60" HIGH), VENTILATED, ON

FIVE-TIER ADA ACCESSIBLE ATHLETIC LOCKERS (15" X 15" X 60" HIGH)

DOUBLE-TIER ATHLETIC LOCKERS (15" X 15" X 60" HIGH), VENTILATED, ON

TYPE DOUBLE-TIER ATHLETIC LOCKERS (24" X 15" X 72" HIGH), VENTILATED, ON 18" TALL CMU BASE

4. LOCKERS TAGGED WITH "A" ARE ACCENT COLOR LOCKERS. SEE SPECIFICATIONS.

DOUBLE-TIER ADA ACCESSIBLE ATHLETIC LOCKERS (24" X 15" X 72" HIGH)

DOUBLE-TIER ADA ACCESSIBLE ATHLETIC LOCKERS (15" X 15" X 60" HIGH)

VENTILATED, ON 4" TALL CMU/CONCRETE BASE ( -/--- )

VENTILATED, ON METAL 'Z' BASE

VENTILATED, ON 4" TALL CMU BASE

VENTILATED, ON 18" TALL CMU BASE

**VENTILATED, ON 18" TALL CMU BASE** 

ON METAL 'Z' BASE

ON METAL 'Z' BASE

TYPE SINGLE-TIER ATHLETIC ON 4" TALL CMU BASE

TYPE FIVE-TIER ATHLETIC LOCKERS (1
4" TALL CMU/CONCRETE BASE

18" TALL CMU BASE

17. SEE MECHANICAL DRAWINGS FOR POINT OF USE ACID NEUTRALIZATION TANKS.

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PROJECT TITLE


# NEW SMITH MIDDLE SCHOOL

Bid Package No. 03B

Troy School District Troy, Michigan

DRAWING TITLE

First Level Casework & Equipment Plan - Zone 'C'

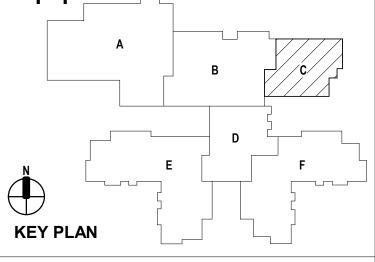

KEY PLAN	
issue dates	
·	
01-13-2025	BULLETIN NO. 7
10-31-2024	CONSTRUCTION SET
07-16-2024	ADDENDUM NO. 3 (N.R.)
06-18-2024	CONSTRUCTION DOCUMENTS
date:	issued for:

PROJECTION SCREEN SCHEDULE

1. PROVIDE CONTINUOUS SLOPED TOPS AT ALL LOCKERS (UON)
2. PROVIDE FILLER PIECES AT ENDS & CORNERS AS REQUIRED
3. SIZES INDICATED ABOVE REFER TO WIDTH x DEPTH x HEIGHT

PS-A 23'-8"w X 14'-9"h ELECTRICALLY OPERATED, WALL MOUNTED
PS-B 9'-8"w X 6'-0-1/2"h FIXED, WALL MOUNTED
PC-C 16'-6"w X 10'-4"h ELECTRICALLY OPERATED, RECESSED MOUNTED

NOTES:

LOCKER NOTES:

1. REFER TO ELECTRICAL PLANS AND SPECIFICATIONS FOR ADDITIONAL INFORMATION.

INTERIOR SIGNAGE

\$1 **-**

THIS IS AN INTERIOR SIGNAGE IDENTIFICATION, REFER TO SPECIFICATIONS FOR INTERIOR SIGNAGE TYPE AND SCHEDULED INFORMATION


drawing no. 7

checked

approved dl

project no.

22102

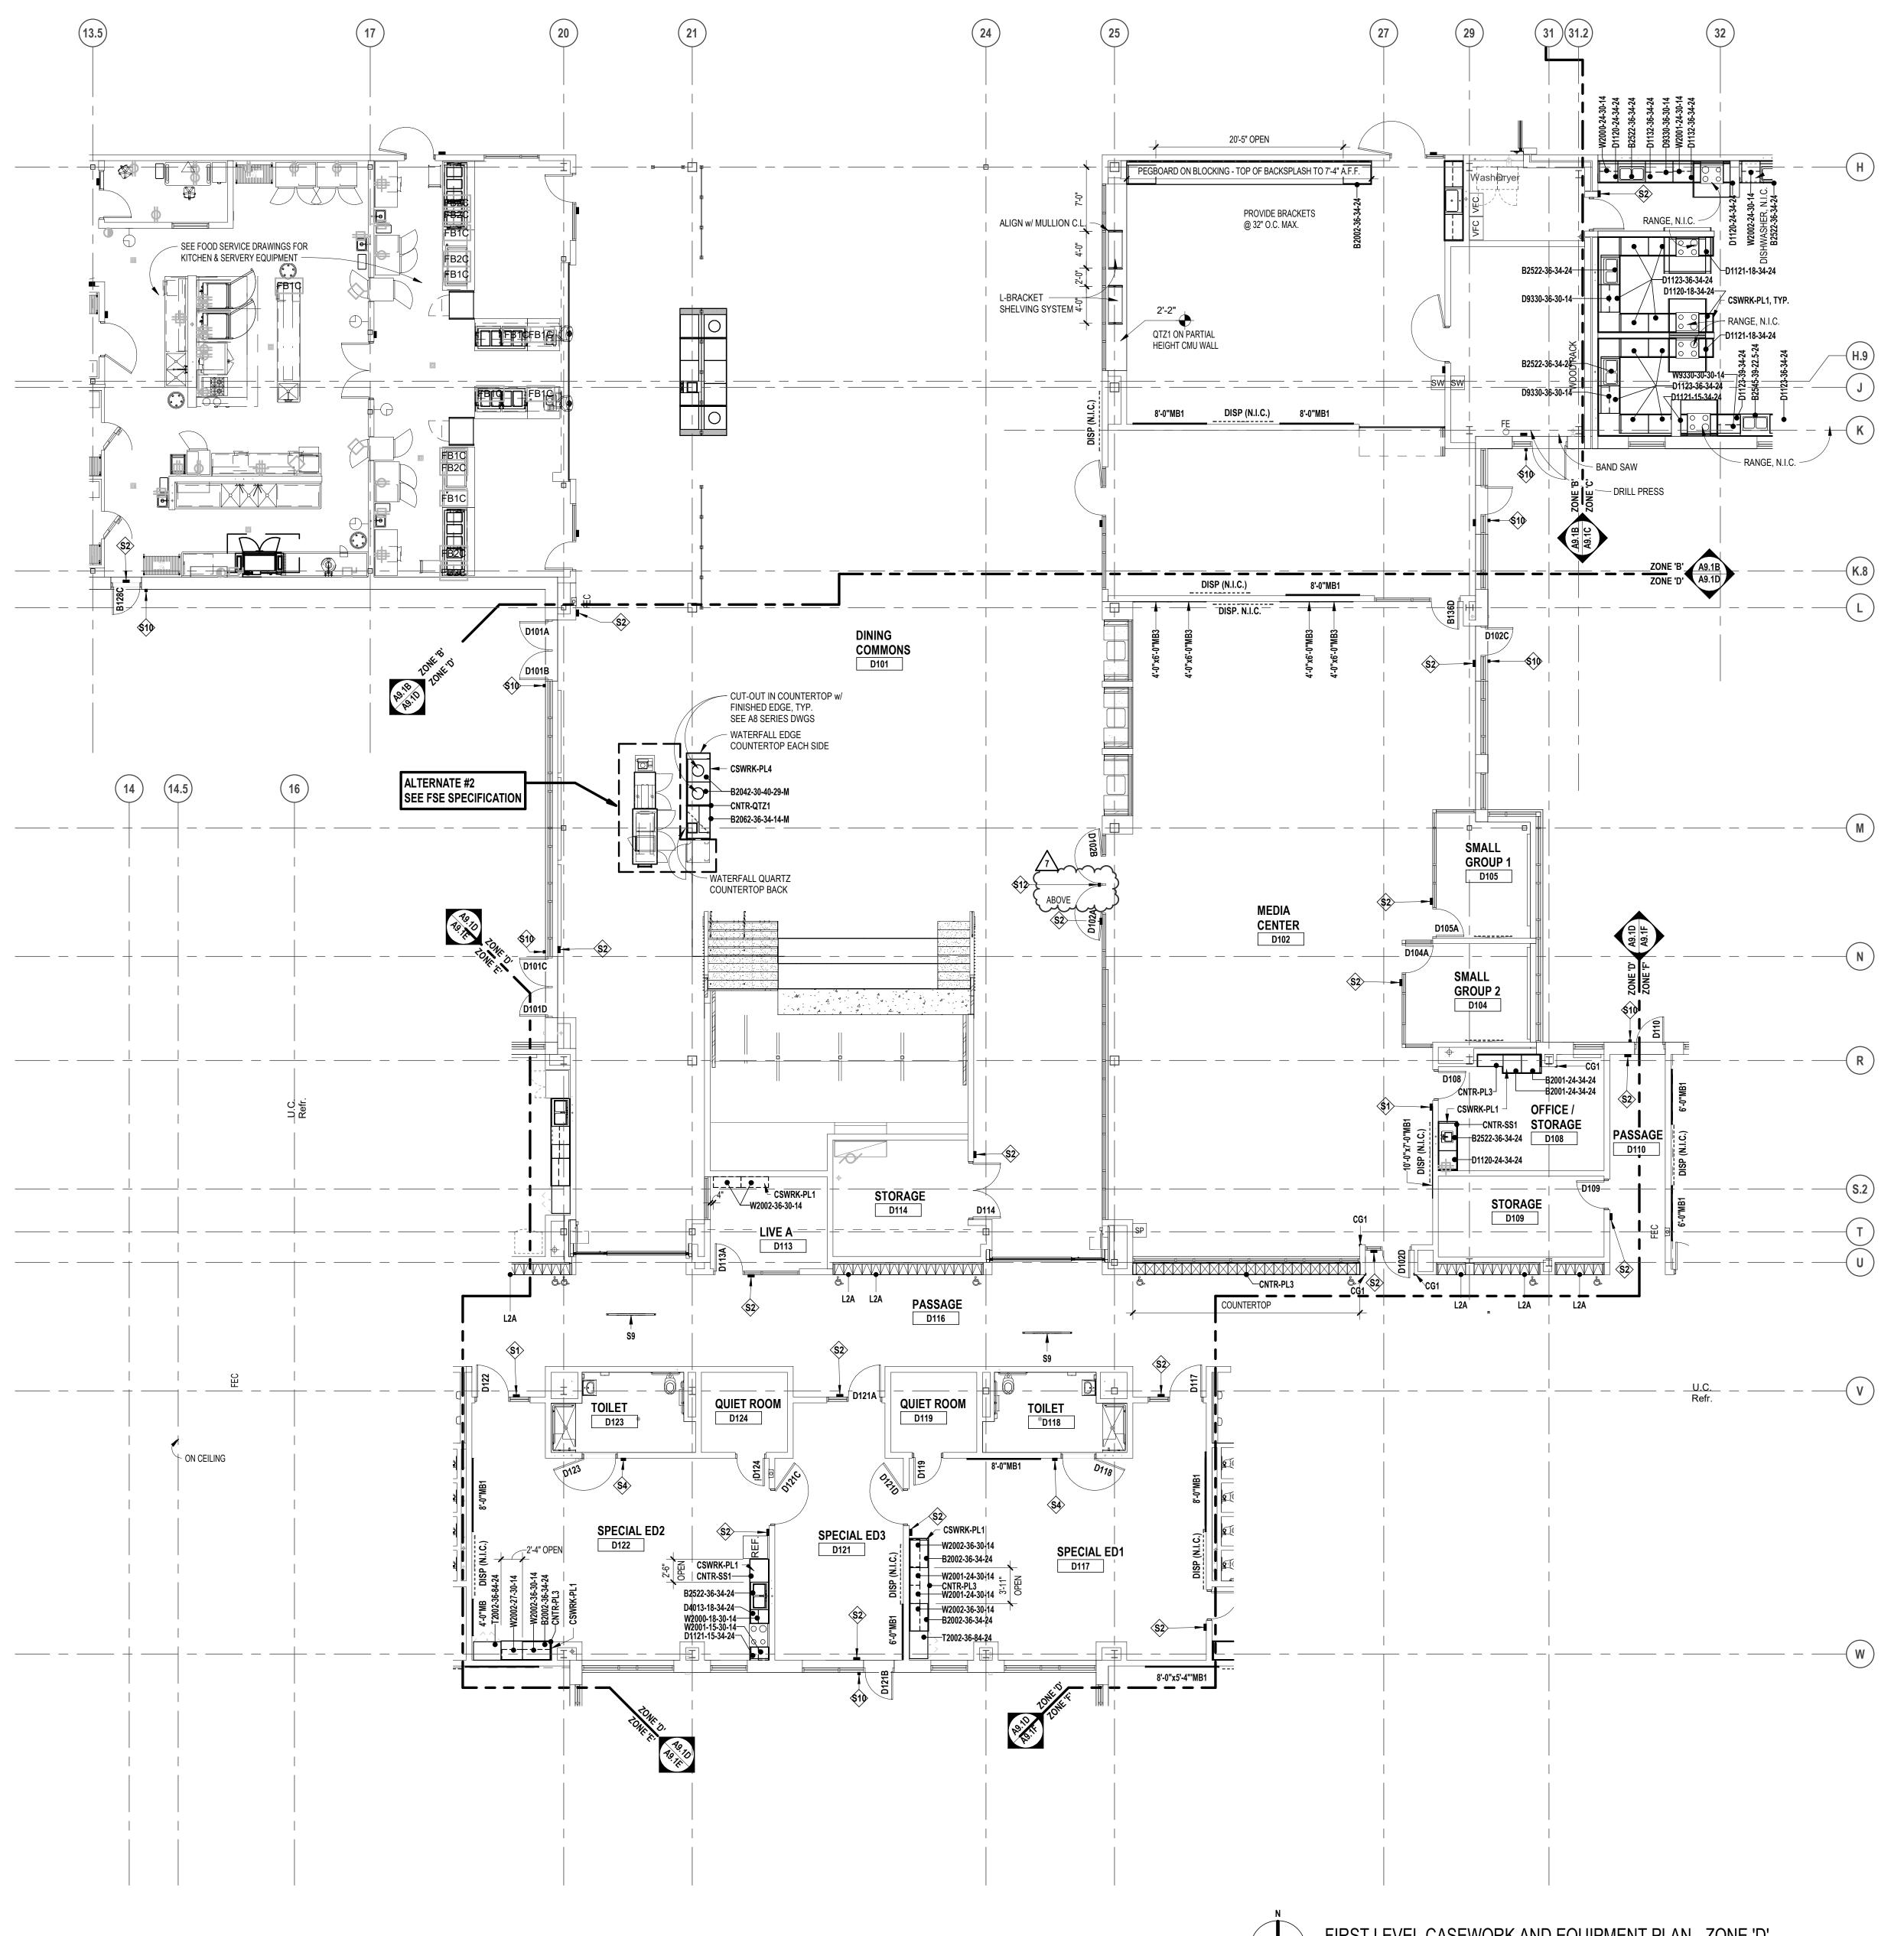

LEGEND DISPLAY (BY OTHERS) - WALL OR SUSPSENDED MOUNT (BY OTHERS) FIRE EXTINGUISHER IN CABINET (FEC) FIRE EXTINGUISHER ON WALL BRACKET (FE) 7'-0" HIGH (UON) SURFACE MOUNT CORNER GUARD

VISUAL DISPLAY BOARD NOTES

NOTES:

1. MB = MARKERBOARD

TB = TACKBOARD

TS = TACK STRIP

DISP = DISPLAY (BY OTHERS)

MB/TB = 3'-0" AFF TO BOTTOM

3. MAP RAILS SHALL BE CONTINUOUS OVER MARKERBOARDS.

4. ALL MARKERBOARDS SHALL BE PROVIDED WITH TRAYS &

MB1 = PORCELAIN ENAMEL STEEL HORIZONTAL ORIENTATION

MB2 = PORCELAIN ENAMEL STEEL VERTICAL ORIENTATION

2. MOUNTING HEIGHTS (UON):

MB3 = MAGNETIC GLASS

1. ALL PREFABRICATED CABINETS INDICATED ARE BASED ON TMI STORAGE SYSTEMS

TWO DIGIT NUMBERS FOR THE WIDTH, HEIGHT AND DEPTH.

"00000-00-00-00-M" INDICATES MODIFIED CASEWORK.

CABINETS. RADIUS ALL OUTSIDE CORNERS (U.O.N.)

AGAINST PERPENDICULAR WALLS.

SCRIBE END/FILLER PANELS TO WALLS.

5. ALL EXPOSED SURFACES OF CASEWORK TO BE FINISHED, TYPICAL.

7. PROVIDE FINISHED END PANELS ON ALL EXPOSED CASEWORK ENDS.

CORPORATION PRODUCTS. REFER TO TMI CATALOG FOR TYPICAL NUMBERING FORMAT.

2. ALL TMI CABINETS ARE DESIGNATED USING THE TYPICAL TMI ELEVEN (11) DIGIT NOTATION

SYSTEM. THE FIRST FIVE DIGITS ARE THE MODEL NUMBER FOLLOWED BY THREE SETS OF

3. WIDTH, HEIGHT AND DEPTH OF PREFABRICATED CABINETS IS INDICATED IN INCHES UNLESS

NOTED OTHERWISE. MODEL DIMENSIONS ARE NOMINAL UNLESS SPECIFICALLY NOTED.

4. PROVIDE PLASTIC LAMINATE COUNTERTOPS (WITH BACK/END SPLASHES) AT ALL BASE

6. WALL CABINETS (OVER COUNTERS) ARE TYPICALLY MOUNTED AT 7'-4" AFF TO TOP (UON).

8. PROVIDE RESTRAINING CHAINS ON ALL END BASE AND WALL CABINET DOORS WHICH OPEN

9. WHERE CASEWORK IS HELD AWAY FROM WALLS, TO FLUSH-OUT WITH ADJACENT CABINETS,

SINGLE-TIER STANDARD LOCKERS (12" X 15" X 72" HIGH) VENTILATED, ON METAL 'Z' BASE

DOUBLE-TIER CORRIDOR LOCKERS (12" X 15" X 60" HIGH)

ON METAL 'Z' BASE

ON METAL 'Z' BASE

ON 4" TALL CMU BASE

VENTILATED, ON METAL 'Z' BASE

VENTILATED, ON METAL 'Z' BASE

VENTILATED, ON METAL 'Z' BASE

4" TALL CMU/CONCRETE BASE

18" TALL CMU BASE

VENTILATED, ON 4" TALL CMU BASE

**VENTILATED, ON 18" TALL CMU BASE** 

SINGLE-TIER ADA ACCESSIBLE LOCKERS (12" X 15" X 72" HIGH) VENTILATED,

DOUBLE-TIER ADA ACCESSIBLE CORRIDOR LOCKERS (12" X 15" X 60" HIGH)

SINGLE-TIER STANDARD LOCKERS (12" X 15" X 30" HIGH) VENTILATED,

SINGLE-TIER ATHLETIC LOCKERS (15" X 15" X 72" HIGH), VENTILATED,

VENTILATED, ON 4" TALL CMU/CONCRETE BASE ( -/ --- )

SINGLE-TIER ADA ACCESSIBLE ATHLETIC LOCKERS (15" X 15" X 72" HIGH)

FIVE-TIER ATHLETIC LOCKERS (15" X 15" X 60" HIGH), VENTILATED, ON

FIVE-TIER ADA ACCESSIBLE ATHLETIC LOCKERS (15" X 15" X 60" HIGH)

DOUBLE-TIER ATHLETIC LOCKERS (15" X 15" X 60" HIGH), VENTILATED, ON

DOUBLE-TIER ADA ACCESSIBLE ATHLETIC LOCKERS (15" X 15" X 60" HIGH)

THIS IS AN INTERIOR SIGNAGE IDENTIFICATION, REFER TO SPECIFICATIONS FOR INTERIOR SIGNAGE TYPE AND

SCHEDULED INFORMATION

SINGLE-TIER ADA ACCESSIBLE STANDARD LOCKERS (12" X 15" X 30" HIGH)

TYPE OF BOARD —

─ WIDTH OF

ARE 4'-0" (UON)

BOARD/STRIP

**HEIGHT OF ALL BOARDS** 

CASEWORK NOTES

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PROJECT TITLE


## **NEW SMITH** MIDDLE SCHOOL

Bid Package No. 03B

**Troy School District** Troy, Michigan

**DRAWING TITLE** 

First Level Casework & Equipment Plan - Zone 'D'

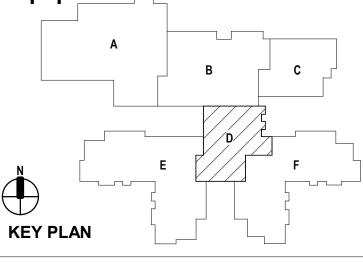

KEY PLAN	
issue dates	
01-13-2025	BULLETIN NO. 7
10-31-2024	CONSTRUCTION SET
07-16-2024	ADDENDUM NO. 3 (N.R.)
06-18-2024	CONSTRUCTION DOCUMENTS
dato:	issued for:

issued for:

checked approved dl


project no.

22102

drawing no. A9.1D

10. PROVIDE FILLER PANELS WHERE SHOWN AND/OR OTHERWISE REQUIRED FOR A COMPLETE INSTALLATION. 11. PROVIDE LOCKS AT ALL CABINET DOORS AND DRAWERS (U.O.N.) 12. MODIFY SINK BASE CABINETS AS REQUIRED TO ACCOMMODATE OVERSIZED SINKS (SEE MECHANICAL FOR OVERSIZED SINK LOCATIONS. 13. WHERE BF 34" HIGH BASE CABINETS ARE INDICATED, MODIFY CABINET CONSTRUCTION BY REDUCING THE HEIGHT OF ALL COMPARTMENTS EQUALLY (INDICATE ON SHOP DWGS.) 14. PROVIDE INTERMEDIATE PLASTIC LAMINATE CLAD SUPPORT PANELS @ 4'-0" OC MAXIMUM AT ALL UNSUPPORTED COUNTER TOPS (UON). 15. PROVIDE GROMMETS AT ALL COUNTERS WITH KNEESPACES, WHERE POWER/DATA OUTLETS ARE LOCATED BELOW (REFER TO ELECTRICAL DRAWINGS FOR LOCATIONS), UON. PROVIDE (1) ONE GROMMET PER KNEESPACE (UON). FINAL LOCATION(S) WILL BE MARKED-UP ON THE SHOP DRAWING SUBMITTAL. 16. PROVIDE MOISTURE RESISTANT PARTICLE BOARD AT SINK BASE, COUNTERTOP, AND SPLASH WITHIN 18" OF SINK. 17. SEE MECHANICAL DRAWINGS FOR POINT OF USE ACID NEUTRALIZATION TANKS. 18. ALL TYPICAL MUSIC WING CABINETS INDICATED ARE BASED ON WENGER CORPORATION PRODUCTS. REFER TO WENGER CATALOG FOR TYPICAL NUMBERING FORMAT. 19. ALL WENGER CABINETRY IS DESIGNATED USING THE PREFIX "W-" AND THEN THE WENGER 20. NOT USED. LOCKER LEGEND TYPE DOUBLE-TIER ATHLETIC LOCKERS (24" X 15" X 72" HIGH), VENTILATED, ON 18" TALL CMU BASE DOUBLE-TIER ADA ACCESSIBLE ATHLETIC LOCKERS (24" X 15" X 72" HIGH) **VENTILATED, ON 18" TALL CMU BASE** LOCKER NOTES: 1. PROVIDE CONTINUOUS SLOPED TOPS AT ALL LOCKERS (UON) 2. PROVIDE FILLER PIECES AT ENDS & CORNERS AS REQUIRED 3. SIZES INDICATED ABOVE REFER TO WIDTH x DEPTH x HEIGHT 4. LOCKERS TAGGED WITH "A" ARE ACCENT COLOR LOCKERS. SEE SPECIFICATIONS. PROJECTION SCREEN SCHEDULE PS-A 23'-8"w X 14'-9"h ELECTRICALLY OPERATED, WALL MOUNTED PS-B 9'-8"w X 6'-0-1/2"h FIXED, WALL MOUNTED PC-C 16'-6"w X 10'-4"h ELECTRICALLY OPERATED, RECESSED MOUNTED NOTES: 1. REFER TO ELECTRICAL PLANS AND SPECIFICATIONS FOR ADDITIONAL INFORMATION. INTERIOR SIGNAGE

FIRST LEVEL CASEWORK AND EQUIPMENT PLAN - ZONE 'D' SCALE: 1/8" = 1'-0"

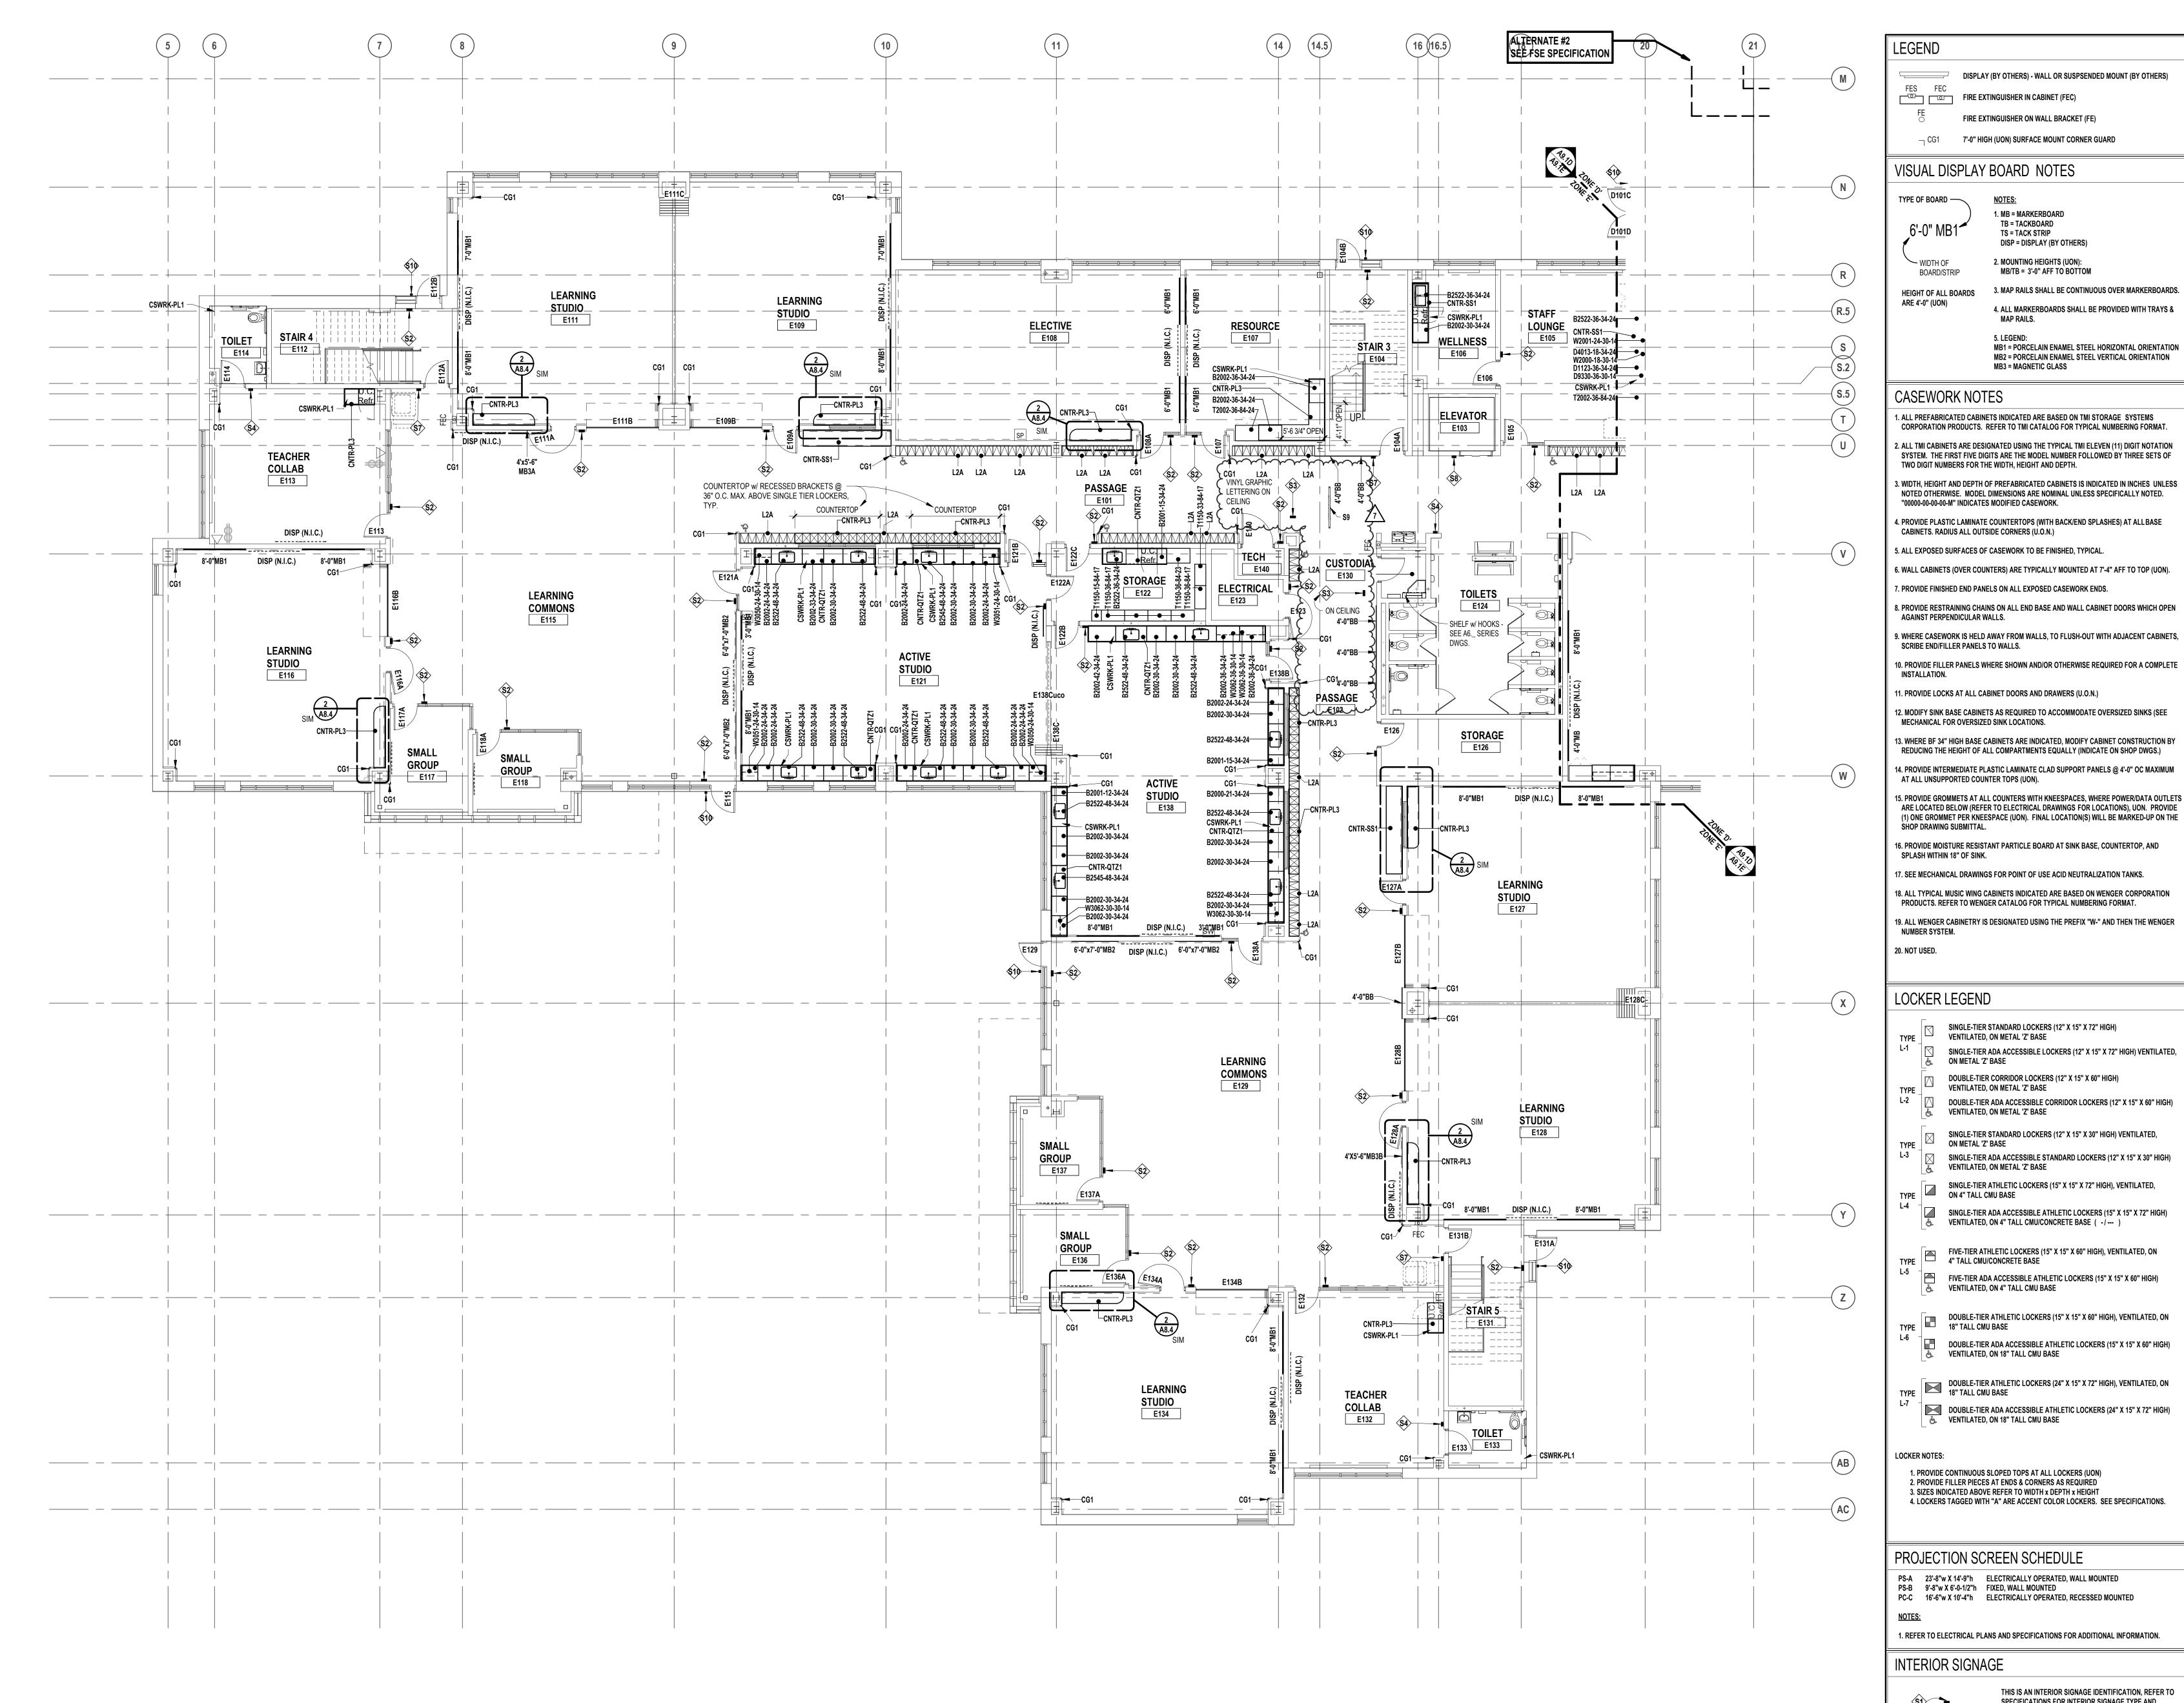

FIRST LEVEL CASEWORK AND EQUIPMENT PLAN - ZONE 'E SCALE: 1/8" = 1'-0"



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DISPLAY (BY OTHERS) - WALL OR SUSPSENDED MOUNT (BY OTHERS)

FIRE EXTINGUISHER ON WALL BRACKET (FE)

1. MB = MARKERBOARD

TB = TACKBOARD

TS = TACK STRIP

DISP = DISPLAY (BY OTHERS)

3. MAP RAILS SHALL BE CONTINUOUS OVER MARKERBOARDS.

4. ALL MARKERBOARDS SHALL BE PROVIDED WITH TRAYS &

MB1 = PORCELAIN ENAMEL STEEL HORIZONTAL ORIENTATION

MB2 = PORCELAIN ENAMEL STEEL VERTICAL ORIENTATION

2. MOUNTING HEIGHTS (UON): MB/TB = 3'-0" AFF TO BOTTOM

MB3 = MAGNETIC GLASS

SINGLE-TIER STANDARD LOCKERS (12" X 15" X 72" HIGH)

DOUBLE-TIER CORRIDOR LOCKERS (12" X 15" X 60" HIGH)

SINGLE-TIER ADA ACCESSIBLE LOCKERS (12" X 15" X 72" HIGH) VENTILATED,

DOUBLE-TIER ADA ACCESSIBLE CORRIDOR LOCKERS (12" X 15" X 60" HIGH)

SINGLE-TIER STANDARD LOCKERS (12" X 15" X 30" HIGH) VENTILATED,

SINGLE-TIER ATHLETIC LOCKERS (15" X 15" X 72" HIGH), VENTILATED,

VENTILATED, ON 4" TALL CMU/CONCRETE BASE ( -/--- )

SINGLE-TIER ADA ACCESSIBLE ATHLETIC LOCKERS (15" X 15" X 72" HIGH)

FIVE-TIER ATHLETIC LOCKERS (15" X 15" X 60" HIGH), VENTILATED, ON

FIVE-TIER ADA ACCESSIBLE ATHLETIC LOCKERS (15" X 15" X 60" HIGH)

DOUBLE-TIER ATHLETIC LOCKERS (15" X 15" X 60" HIGH), VENTILATED, ON

DOUBLE-TIER ADA ACCESSIBLE ATHLETIC LOCKERS (15" X 15" X 60" HIGH)

THIS IS AN INTERIOR SIGNAGE IDENTIFICATION, REFER TO SPECIFICATIONS FOR INTERIOR SIGNAGE TYPE AND

SCHEDULED INFORMATION

SINGLE-TIER ADA ACCESSIBLE STANDARD LOCKERS (12" X 15" X 30" HIGH)

VENTILATED, ON METAL 'Z' BASE

4" TALL CMU/CONCRETE BASE

18" TALL CMU BASE

VENTILATED, ON 4" TALL CMU BASE

ON METAL 'Z' BASE

ON METAL 'Z' BASE

ON 4" TALL CMU BASE

7'-0" HIGH (UON) SURFACE MOUNT CORNER GUARD

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PROJECT TITLE


## **NEW SMITH** MIDDLE SCHOOL

Bid Package No. 03B

**Troy School District** Troy, Michigan

**DRAWING TITLE** 

First Level Casework & Equipment Plan - Zone 'E'

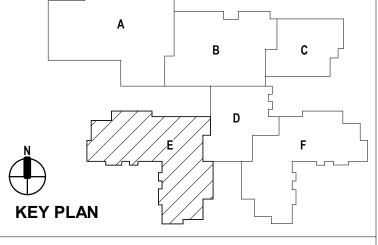

issue dates

01-13-2025 **BULLETIN NO. 7** 10-31-2024 **CONSTRUCTION SET** 07-16-2024 ADDENDUM NO. 3 (N.R.) 06-18-2024 CONSTRUCTION DOCUMENTS


drawn checked

approved dl

project no.

22102

drawing no. A9.1E

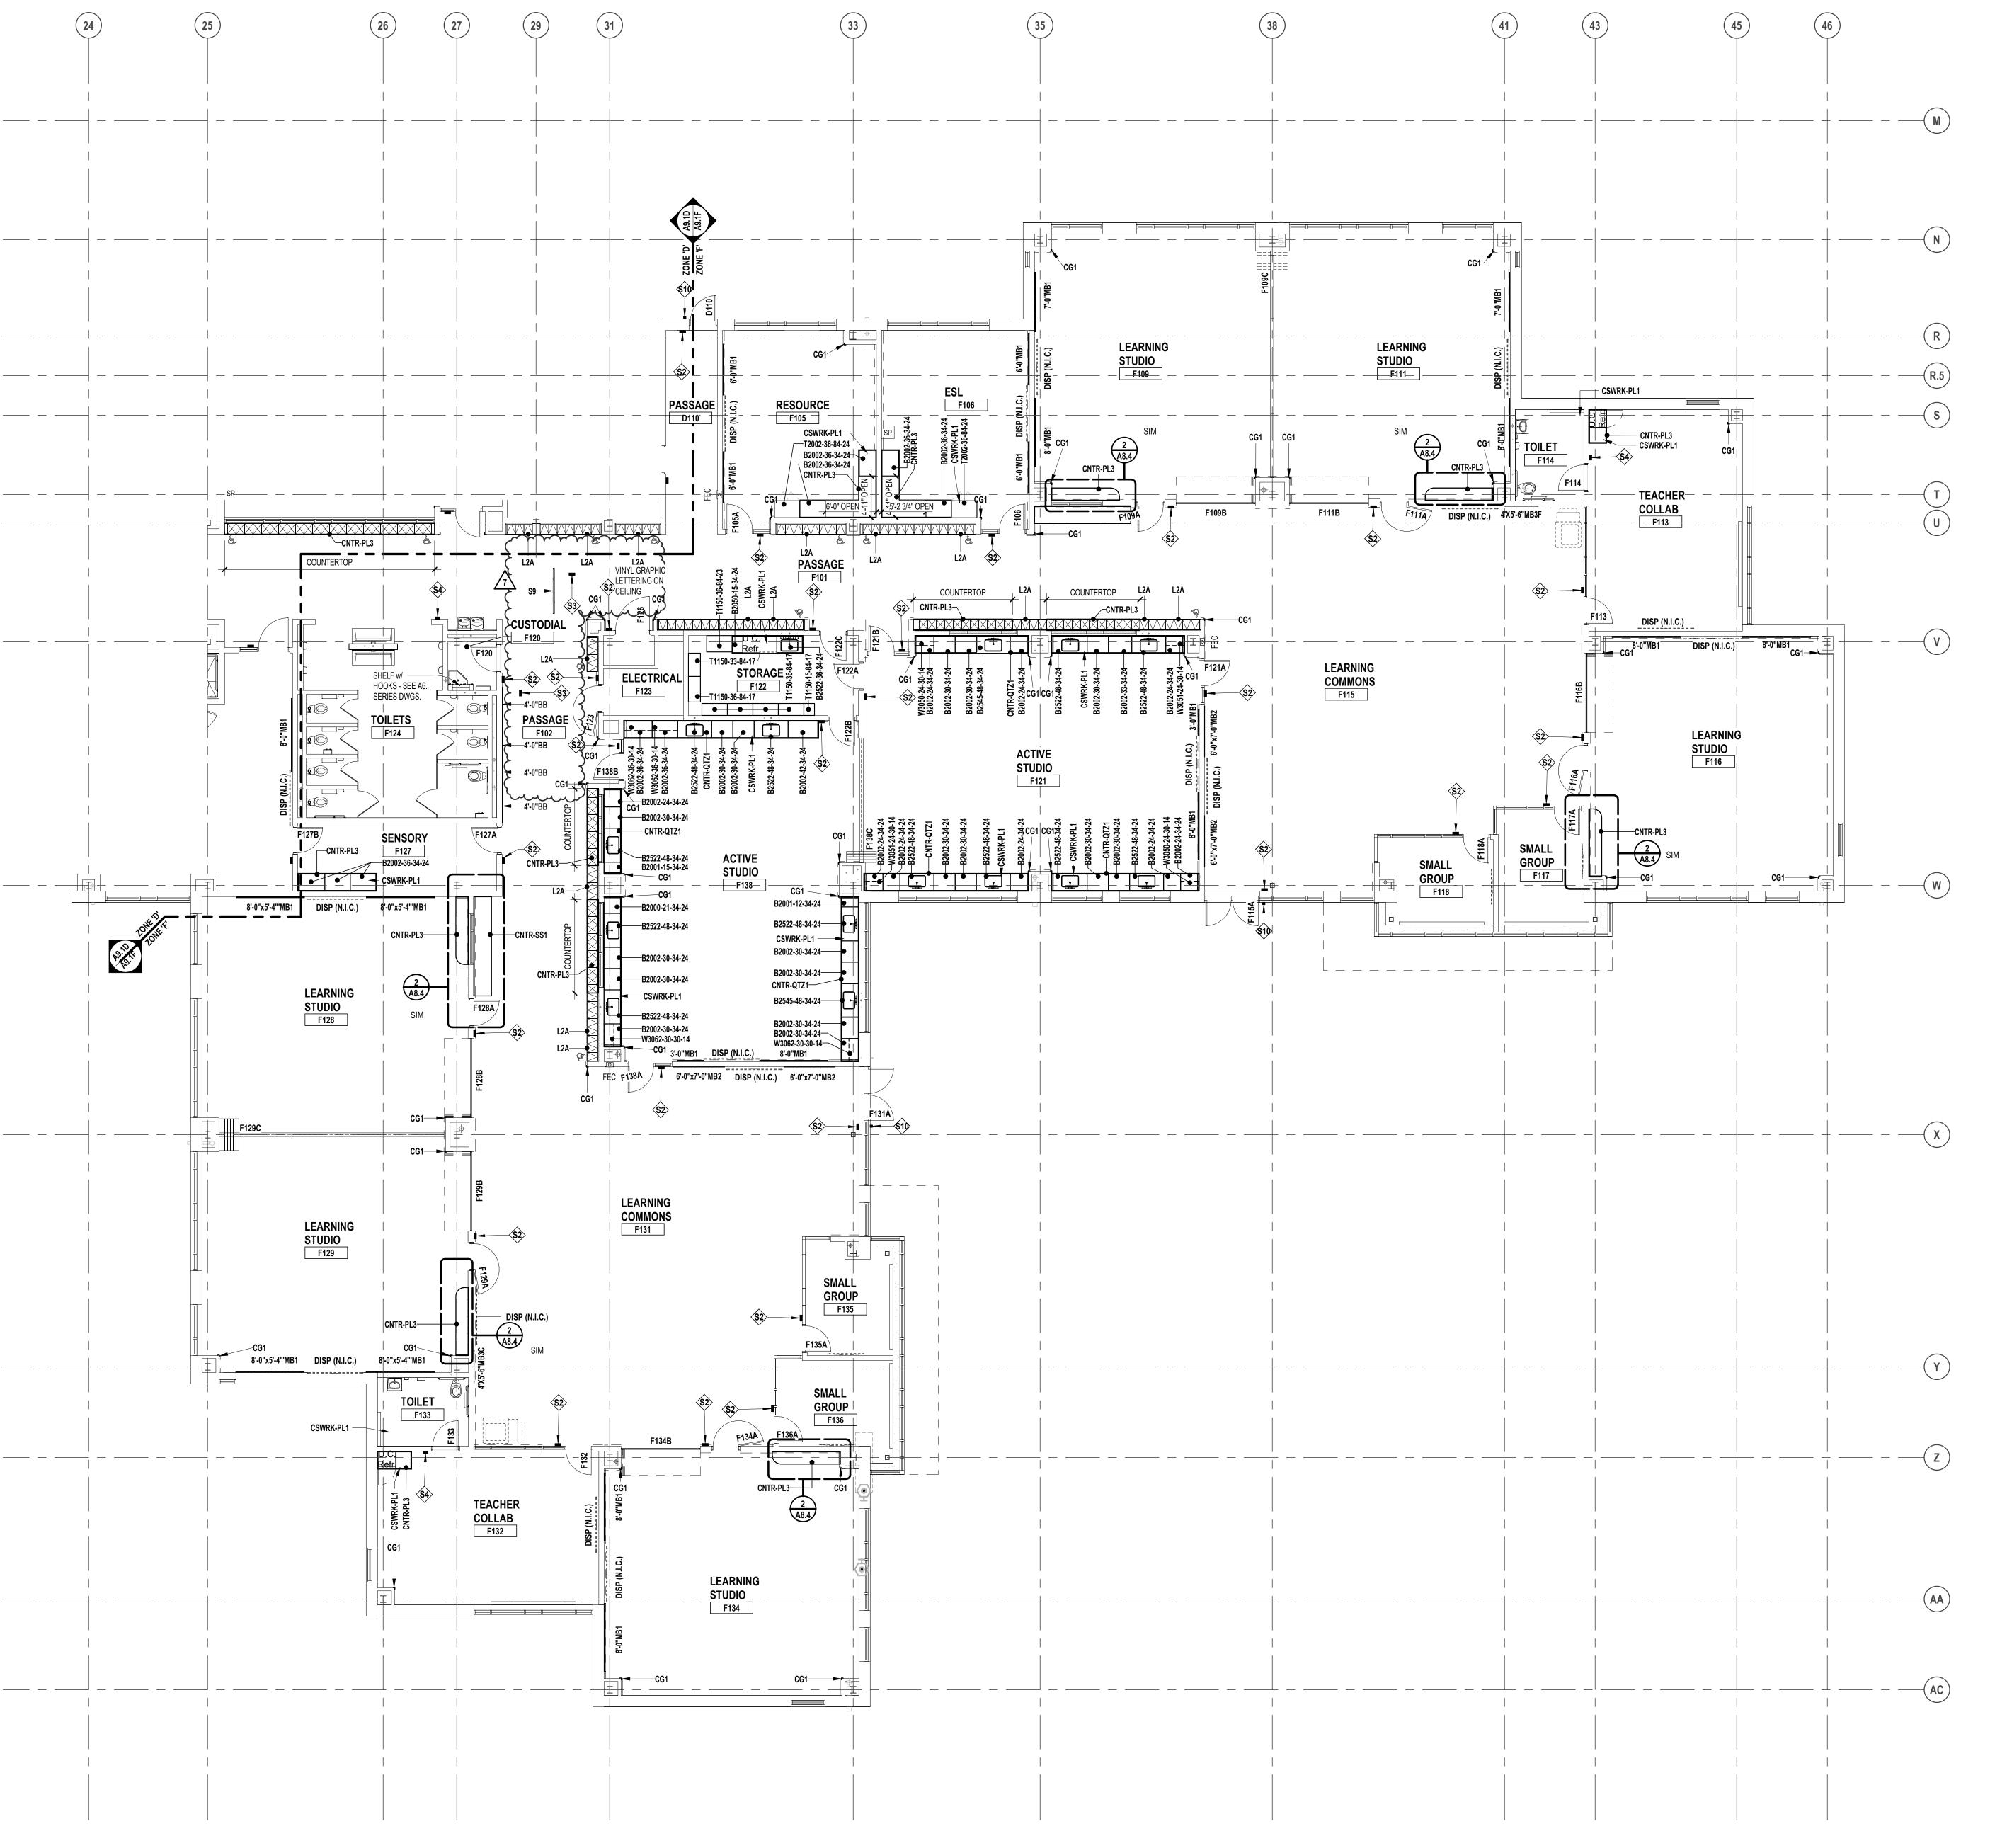

LEGEND DISPLAY (BY OTHERS) - WALL OR SUSPSENDED MOUNT (BY OTHERS) FIRE EXTINGUISHER IN CABINET (FEC) FIRE EXTINGUISHER ON WALL BRACKET (FE) 7'-0" HIGH (UON) SURFACE MOUNT CORNER GUARD VISUAL DISPLAY BOARD NOTES 1. MB = MARKERBOARD TB = TACKBOARD TS = TACK STRIP DISP = DISPLAY (BY OTHERS) 2. MOUNTING HEIGHTS (UON): ➤ WIDTH OF MB/TB = 3'-0" AFF TO BOTTOM BOARD/STRIP 3. MAP RAILS SHALL BE CONTINUOUS OVER MARKERBOARDS. **HEIGHT OF ALL BOARDS** ARE 4'-0" (UON) 4. ALL MARKERBOARDS SHALL BE PROVIDED WITH TRAYS & MB1 = PORCELAIN ENAMEL STEEL HORIZONTAL ORIENTATION MB2 = PORCELAIN ENAMEL STEEL VERTICAL ORIENTATION MB3 = MAGNETIC GLASS CASEWORK NOTES 1. ALL PREFABRICATED CABINETS INDICATED ARE BASED ON TMI STORAGE SYSTEMS CORPORATION PRODUCTS. REFER TO TMI CATALOG FOR TYPICAL NUMBERING FORMAT. 2. ALL TMI CABINETS ARE DESIGNATED USING THE TYPICAL TMI ELEVEN (11) DIGIT NOTATION SYSTEM. THE FIRST FIVE DIGITS ARE THE MODEL NUMBER FOLLOWED BY THREE SETS OF TWO DIGIT NUMBERS FOR THE WIDTH, HEIGHT AND DEPTH. 3. WIDTH, HEIGHT AND DEPTH OF PREFABRICATED CABINETS IS INDICATED IN INCHES UNLESS NOTED OTHERWISE. MODEL DIMENSIONS ARE NOMINAL UNLESS SPECIFICALLY NOTED. "00000-00-00-00-M" INDICATES MODIFIED CASEWORK. 4. PROVIDE PLASTIC LAMINATE COUNTERTOPS (WITH BACK/END SPLASHES) AT ALL BASE CABINETS. RADIUS ALL OUTSIDE CORNERS (U.O.N.) 5. ALL EXPOSED SURFACES OF CASEWORK TO BE FINISHED, TYPICAL. 6. WALL CABINETS (OVER COUNTERS) ARE TYPICALLY MOUNTED AT 7'-4" AFF TO TOP (UON). 7. PROVIDE FINISHED END PANELS ON ALL EXPOSED CASEWORK ENDS. 8. PROVIDE RESTRAINING CHAINS ON ALL END BASE AND WALL CABINET DOORS WHICH OPEN AGAINST PERPENDICULAR WALLS. 9. WHERE CASEWORK IS HELD AWAY FROM WALLS, TO FLUSH-OUT WITH ADJACENT CABINETS, SCRIBE END/FILLER PANELS TO WALLS. 10. PROVIDE FILLER PANELS WHERE SHOWN AND/OR OTHERWISE REQUIRED FOR A COMPLETE 11. PROVIDE LOCKS AT ALL CABINET DOORS AND DRAWERS (U.O.N.) 12. MODIFY SINK BASE CABINETS AS REQUIRED TO ACCOMMODATE OVERSIZED SINKS (SEE MECHANICAL FOR OVERSIZED SINK LOCATIONS. 13. WHERE BF 34" HIGH BASE CABINETS ARE INDICATED, MODIFY CABINET CONSTRUCTION BY REDUCING THE HEIGHT OF ALL COMPARTMENTS EQUALLY (INDICATE ON SHOP DWGS.) 14. PROVIDE INTERMEDIATE PLASTIC LAMINATE CLAD SUPPORT PANELS @ 4'-0" OC MAXIMUM AT ALL UNSUPPORTED COUNTER TOPS (UON). 15. PROVIDE GROMMETS AT ALL COUNTERS WITH KNEESPACES, WHERE POWER/DATA OUTLETS ARE LOCATED BELOW (REFER TO ELECTRICAL DRAWINGS FOR LOCATIONS), UON. PROVIDE (1) ONE GROMMET PER KNEESPACE (UON). FINAL LOCATION(S) WILL BE MARKED-UP ON THE SHOP DRAWING SUBMITTAL. 16. PROVIDE MOISTURE RESISTANT PARTICLE BOARD AT SINK BASE, COUNTERTOP, AND SPLASH WITHIN 18" OF SINK. 17. SEE MECHANICAL DRAWINGS FOR POINT OF USE ACID NEUTRALIZATION TANKS. 18. ALL TYPICAL MUSIC WING CABINETS INDICATED ARE BASED ON WENGER CORPORATION PRODUCTS. REFER TO WENGER CATALOG FOR TYPICAL NUMBERING FORMAT. 19. ALL WENGER CABINETRY IS DESIGNATED USING THE PREFIX "W-" AND THEN THE WENGER 20. NOT USED. LOCKER LEGEND SINGLE-TIER STANDARD LOCKERS (12" X 15" X 72" HIGH) VENTILATED, ON METAL 'Z' BASE SINGLE-TIER ADA ACCESSIBLE LOCKERS (12" X 15" X 72" HIGH) VENTILATED, ON METAL 'Z' BASE DOUBLE-TIER CORRIDOR LOCKERS (12" X 15" X 60" HIGH) VENTILATED, ON METAL 'Z' BASE DOUBLE-TIER ADA ACCESSIBLE CORRIDOR LOCKERS (12" X 15" X 60" HIGH) VENTILATED, ON METAL 'Z' BASE SINGLE-TIER STANDARD LOCKERS (12" X 15" X 30" HIGH) VENTILATED, ON METAL 'Z' BASE SINGLE-TIER ADA ACCESSIBLE STANDARD LOCKERS (12" X 15" X 30" HIGH) VENTILATED, ON METAL 'Z' BASE SINGLE-TIER ATHLETIC LOCKERS (15" X 15" X 72" HIGH), VENTILATED, ON 4" TALL CMU BASE SINGLE-TIER ADA ACCESSIBLE ATHLETIC LOCKERS (15" X 15" X 72" HIGH) VENTILATED, ON 4" TALL CMU/CONCRETE BASE ( -/ --- ) FIVE-TIER ATHLETIC LOCKERS (15" X 15" X 60" HIGH), VENTILATED, ON 4" TALL CMU/CONCRETE BASE FIVE-TIER ADA ACCESSIBLE ATHLETIC LOCKERS (15" X 15" X 60" HIGH) VENTILATED, ON 4" TALL CMU BASE DOUBLE-TIER ATHLETIC LOCKERS (15" X 15" X 60" HIGH), VENTILATED, ON 18" TALL CMU BASE DOUBLE-TIER ADA ACCESSIBLE ATHLETIC LOCKERS (15" X 15" X 60" HIGH) VENTILATED, ON 18" TALL CMU BASE TYPE DOUBLE-TIER ATHLETIC LOCKERS (24" X 15" X 72" HIGH), VENTILATED, ON 18" TALL CMU BASE

DOUBLE-TIER ADA ACCESSIBLE ATHLETIC LOCKERS (24" X 15" X 72" HIGH)

4. LOCKERS TAGGED WITH "A" ARE ACCENT COLOR LOCKERS. SEE SPECIFICATIONS.

**VENTILATED, ON 18" TALL CMU BASE** 

1. PROVIDE CONTINUOUS SLOPED TOPS AT ALL LOCKERS (UON)

2. PROVIDE FILLER PIECES AT ENDS & CORNERS AS REQUIRED

3. SIZES INDICATED ABOVE REFER TO WIDTH x DEPTH x HEIGHT

PS-A 23'-8"w X 14'-9"h ELECTRICALLY OPERATED, WALL MOUNTED

PC-C 16'-6"w X 10'-4"h ELECTRICALLY OPERATED, RECESSED MOUNTED

1. REFER TO ELECTRICAL PLANS AND SPECIFICATIONS FOR ADDITIONAL INFORMATION.

SCHEDULED INFORMATION

THIS IS AN INTERIOR SIGNAGE IDENTIFICATION, REFER TO SPECIFICATIONS FOR INTERIOR SIGNAGE TYPE AND

PROJECTION SCREEN SCHEDULE

PS-B 9'-8"w X 6'-0-1/2"h FIXED, WALL MOUNTED

INTERIOR SIGNAGE

LOCKER NOTES:

NOTES:

architecture

T M P a R C H I T E C T U R E I N C

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PROJECT TITLE


# NEW SMITH MIDDLE SCHOOL

Bid Package No. 03B

Troy School District Troy, Michigan

DRAWING TITLE

First Level Casework & Equipment Plan - Zone 'F'

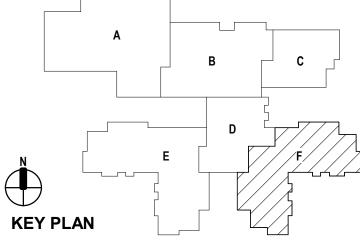

issue dates

O1-13-2025
BULLETIN NO. 7
CONSTRUCTION SET

 01-13-2025
 BULLETIN NO. 7

 10-31-2024
 CONSTRUCTION SET

 07-16-2024
 ADDENDUM NO. 3 (N.R.)

 06-18-2024
 CONSTRUCTION DOCUMENTS

 date:
 issued for:

issued for:

checked jw
approved dl


project no.

22102


A9.1F

FIRST LEVEL CASEWORK AND EQUIPMENT PLAN - ZONE 'F'

SCALE: 1/8" = 1'-0"

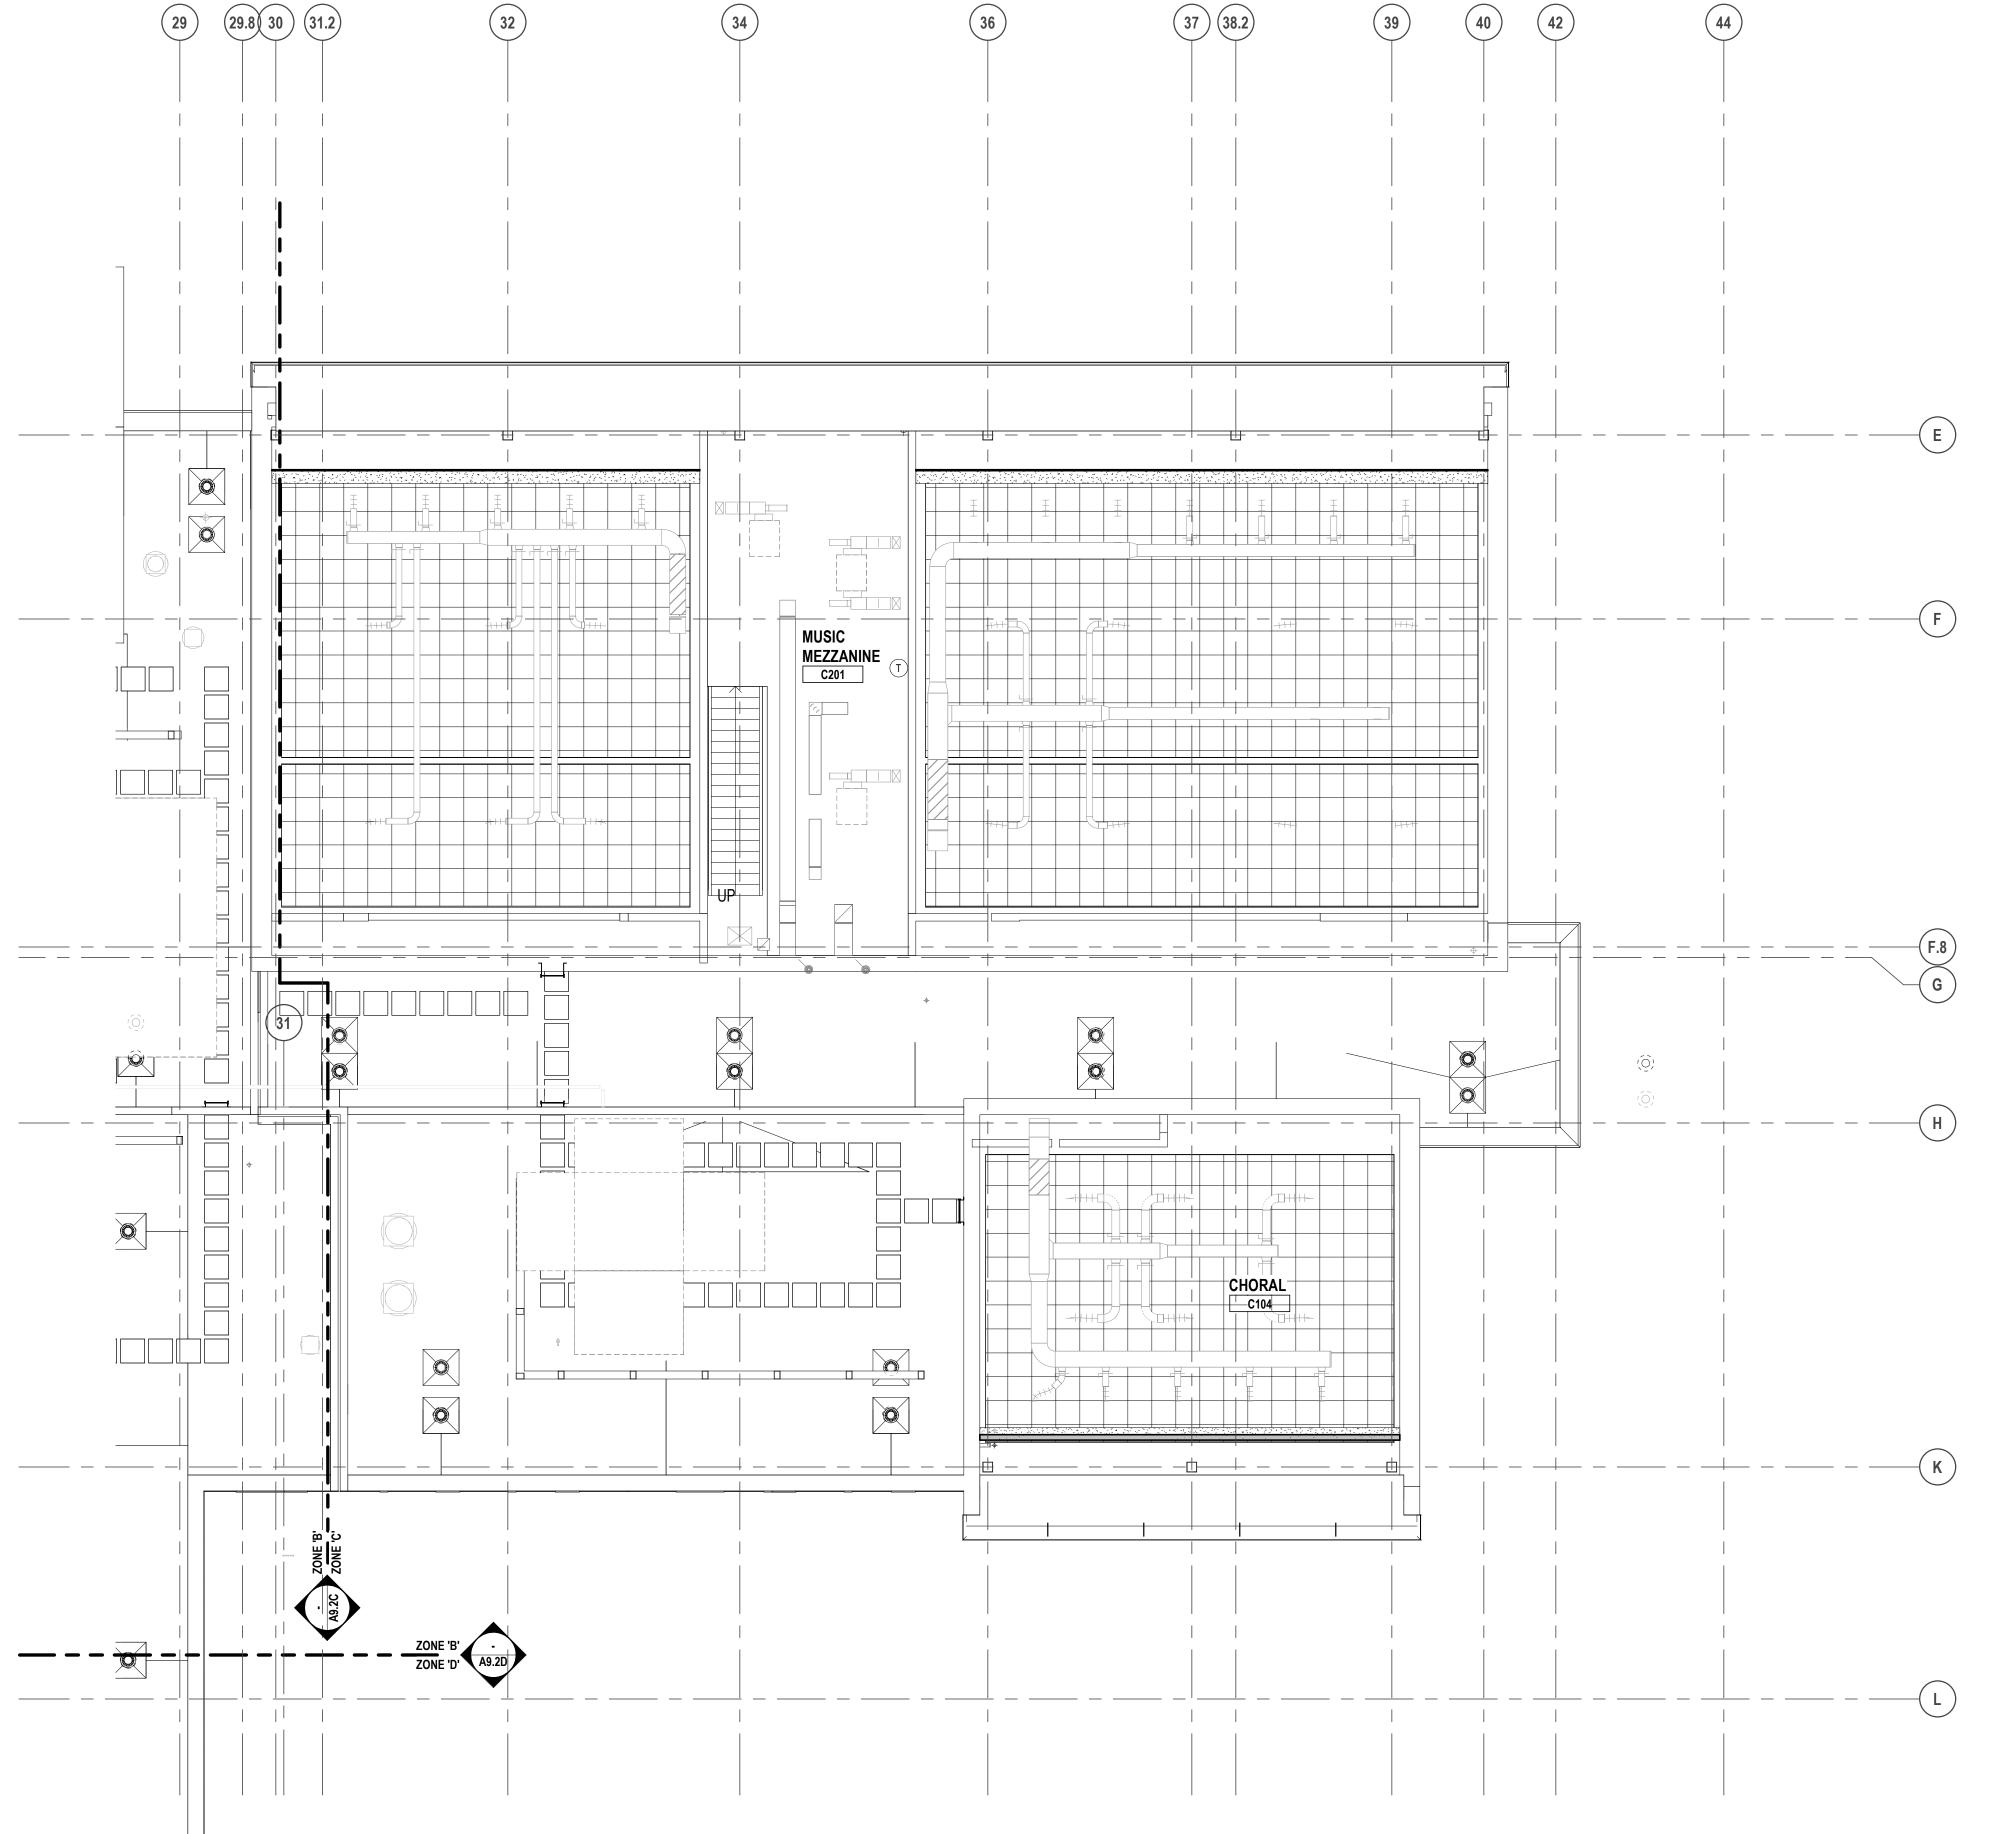

MEZZANINE LEVEL CASEWORK & EQUPMENT PLAN - ZONE 'C' SCALE: 1/8" = 1'-0"

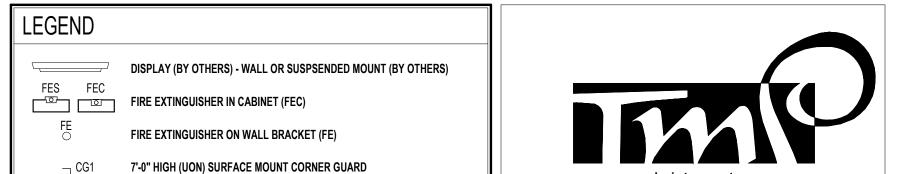

VISUAL DISPLAY BOARD NOTES

NOTES:

1. MB = MARKERBOARD

TB = TACKBOARD

TS = TACK STRIP

DISP = DISPLAY (BY OTHERS)

MB/TB = 3'-0" AFF TO BOTTOM

4. ALL MARKERBOARDS SHALL BE PROVIDED WITH TRAYS &

MB1 = PORCELAIN ENAMEL STEEL HORIZONTAL ORIENTATION MB2 = PORCELAIN ENAMEL STEEL VERTICAL ORIENTATION

HEIGHT OF ALL BOARDS 3. MAP RAILS SHALL BE CONTINUOUS OVER MARKERBOARDS.

MB3 = MAGNETIC GLASS

1. ALL PREFABRICATED CABINETS INDICATED ARE BASED ON TMI STORAGE SYSTEMS CORPORATION PRODUCTS. REFER TO TMI CATALOG FOR TYPICAL NUMBERING FORMAT.

TWO DIGIT NUMBERS FOR THE WIDTH, HEIGHT AND DEPTH.

"00000-00-00-00-M" INDICATES MODIFIED CASEWORK.

CABINETS. RADIUS ALL OUTSIDE CORNERS (U.O.N.)

AGAINST PERPENDICULAR WALLS.

INSTALLATION.

SCRIBE END/FILLER PANELS TO WALLS.

MECHANICAL FOR OVERSIZED SINK LOCATIONS.

AT ALL UNSUPPORTED COUNTER TOPS (UON).

SHOP DRAWING SUBMITTAL.

SPLASH WITHIN 18" OF SINK.

LOCKER LEGEND

20. NOT USED.

5. ALL EXPOSED SURFACES OF CASEWORK TO BE FINISHED, TYPICAL.

7. PROVIDE FINISHED END PANELS ON ALL EXPOSED CASEWORK ENDS.

11. PROVIDE LOCKS AT ALL CABINET DOORS AND DRAWERS (U.O.N.)

2. ALL TMI CABINETS ARE DESIGNATED USING THE TYPICAL TMI ELEVEN (11) DIGIT NOTATION SYSTEM. THE FIRST FIVE DIGITS ARE THE MODEL NUMBER FOLLOWED BY THREE SETS OF

3. WIDTH, HEIGHT AND DEPTH OF PREFABRICATED CABINETS IS INDICATED IN INCHES UNLESS NOTED OTHERWISE. MODEL DIMENSIONS ARE NOMINAL UNLESS SPECIFICALLY NOTED.

4. PROVIDE PLASTIC LAMINATE COUNTERTOPS (WITH BACK/END SPLASHES) AT ALLBASE

6. WALL CABINETS (OVER COUNTERS) ARE TYPICALLY MOUNTED AT 7'-4" AFF TO TOP (UON).

8. PROVIDE RESTRAINING CHAINS ON ALL END BASE AND WALL CABINET DOORS WHICH OPEN

9. WHERE CASEWORK IS HELD AWAY FROM WALLS, TO FLUSH-OUT WITH ADJACENT CABINETS,

10. PROVIDE FILLER PANELS WHERE SHOWN AND/OR OTHERWISE REQUIRED FOR A COMPLETE

12. MODIFY SINK BASE CABINETS AS REQUIRED TO ACCOMMODATE OVERSIZED SINKS (SEE

13. WHERE BF 34" HIGH BASE CABINETS ARE INDICATED, MODIFY CABINET CONSTRUCTION BY REDUCING THE HEIGHT OF ALL COMPARTMENTS EQUALLY (INDICATE ON SHOP DWGS.)

14. PROVIDE INTERMEDIATE PLASTIC LAMINATE CLAD SUPPORT PANELS @ 4'-0" OC MAXIMUM

15. PROVIDE GROMMETS AT ALL COUNTERS WITH KNEESPACES, WHERE POWER/DATA OUTLETS

ARE LOCATED BELOW (REFER TO ELECTRICAL DRAWINGS FOR LOCATIONS), UON. PROVIDE (1) ONE GROMMET PER KNEESPACE (UON). FINAL LOCATION(S) WILL BE MARKED-UP ON THE

16. PROVIDE MOISTURE RESISTANT PARTICLE BOARD AT SINK BASE, COUNTERTOP, AND

18. ALL TYPICAL MUSIC WING CABINETS INDICATED ARE BASED ON WENGER CORPORATION PRODUCTS. REFER TO WENGER CATALOG FOR TYPICAL NUMBERING FORMAT.

19. ALL WENGER CABINETRY IS DESIGNATED USING THE PREFIX "W-" AND THEN THE WENGER

SINGLE-TIER STANDARD LOCKERS (12" X 15" X 72" HIGH)

DOUBLE-TIER CORRIDOR LOCKERS (12" X 15" X 60" HIGH)

SINGLE-TIER ADA ACCESSIBLE LOCKERS (12" X 15" X 72" HIGH) VENTILATED,

DOUBLE-TIER ADA ACCESSIBLE CORRIDOR LOCKERS (12" X 15" X 60" HIGH)

SINGLE-TIER ADA ACCESSIBLE STANDARD LOCKERS (12" X 15" X 30" HIGH)

SINGLE-TIER STANDARD LOCKERS (12" X 15" X 30" HIGH) VENTILATED,

SINGLE-TIER ATHLETIC LOCKERS (15" X 15" X 72" HIGH), VENTILATED,

VENTILATED, ON 4" TALL CMU/CONCRETE BASE ( -/ --- )

SINGLE-TIER ADA ACCESSIBLE ATHLETIC LOCKERS (15" X 15" X 72" HIGH)

FIVE-TIER ATHLETIC LOCKERS (15" X 15" X 60" HIGH), VENTILATED, ON

FIVE-TIER ADA ACCESSIBLE ATHLETIC LOCKERS (15" X 15" X 60" HIGH)

DOUBLE-TIER ATHLETIC LOCKERS (15" X 15" X 60" HIGH), VENTILATED, ON

TYPE DOUBLE-TIER ATHLETIC LOCKERS (24" X 15" X 72" HIGH), VENTILATED, ON 18" TALL CMU BASE

4. LOCKERS TAGGED WITH "A" ARE ACCENT COLOR LOCKERS. SEE SPECIFICATIONS.

DOUBLE-TIER ADA ACCESSIBLE ATHLETIC LOCKERS (24" X 15" X 72" HIGH)

DOUBLE-TIER ADA ACCESSIBLE ATHLETIC LOCKERS (15" X 15" X 60" HIGH)

VENTILATED, ON METAL 'Z' BASE

ON METAL 'Z' BASE

ON METAL 'Z' BASE

TYPE ON 4" TALL CMU BASE

TYPE 18" TALL CMU BASE

LOCKER NOTES:

NOTES:

TYPE FIVE-TIER ATHLETIC LOCKERS (1
4" TALL CMU/CONCRETE BASE

**EXECUTE** VENTILATED, ON 4" TALL CMU BASE

VENTILATED, ON 18" TALL CMU BASE

**VENTILATED, ON 18" TALL CMU BASE** 

PROJECTION SCREEN SCHEDULE

PS-B 9'-8"w X 6'-0-1/2"h FIXED, WALL MOUNTED

INTERIOR SIGNAGE

1. PROVIDE CONTINUOUS SLOPED TOPS AT ALL LOCKERS (UON) 2. PROVIDE FILLER PIECES AT ENDS & CORNERS AS REQUIRED 3. SIZES INDICATED ABOVE REFER TO WIDTH x DEPTH x HEIGHT

PS-A 23'-8"w X 14'-9"h ELECTRICALLY OPERATED, WALL MOUNTED

PC-C 16'-6"w X 10'-4"h ELECTRICALLY OPERATED, RECESSED MOUNTED

1. REFER TO ELECTRICAL PLANS AND SPECIFICATIONS FOR ADDITIONAL INFORMATION.

SCHEDULED INFORMATION

THIS IS AN INTERIOR SIGNAGE IDENTIFICATION, REFER TO SPECIFICATIONS FOR INTERIOR SIGNAGE TYPE AND

17. SEE MECHANICAL DRAWINGS FOR POINT OF USE ACID NEUTRALIZATION TANKS.

2. MOUNTING HEIGHTS (UON):

TYPE OF BOARD —

─ WIDTH OF

ARE 4'-0" (UON)

BOARD/STRIP

CASEWORK NOTES

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registration seal

consultant

PROJECT TITLE


## **NEW SMITH** MIDDLE SCHOOL

Bid Package No. 03B

**Troy School District** Troy, Michigan

**DRAWING TITLE** 

Mezzanine Level Casework & **Equipment Plan - Zone 'C'** 

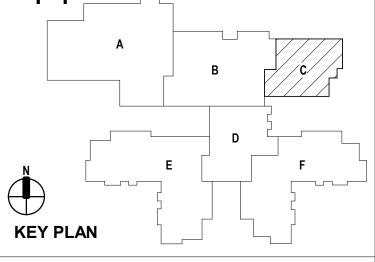


KEY PLAN	
issue dates	
01-13-2025	BULLETIN NO. 7
10-31-2024	CONSTRUCTION SET
07-16-2024	ADDENDUM NO. 3 (N.R.)
06-18-2024	CONSTRUCTION DOCUMENTS
date:	issued for:


checked approved dl

project no.

22102

drawing no.

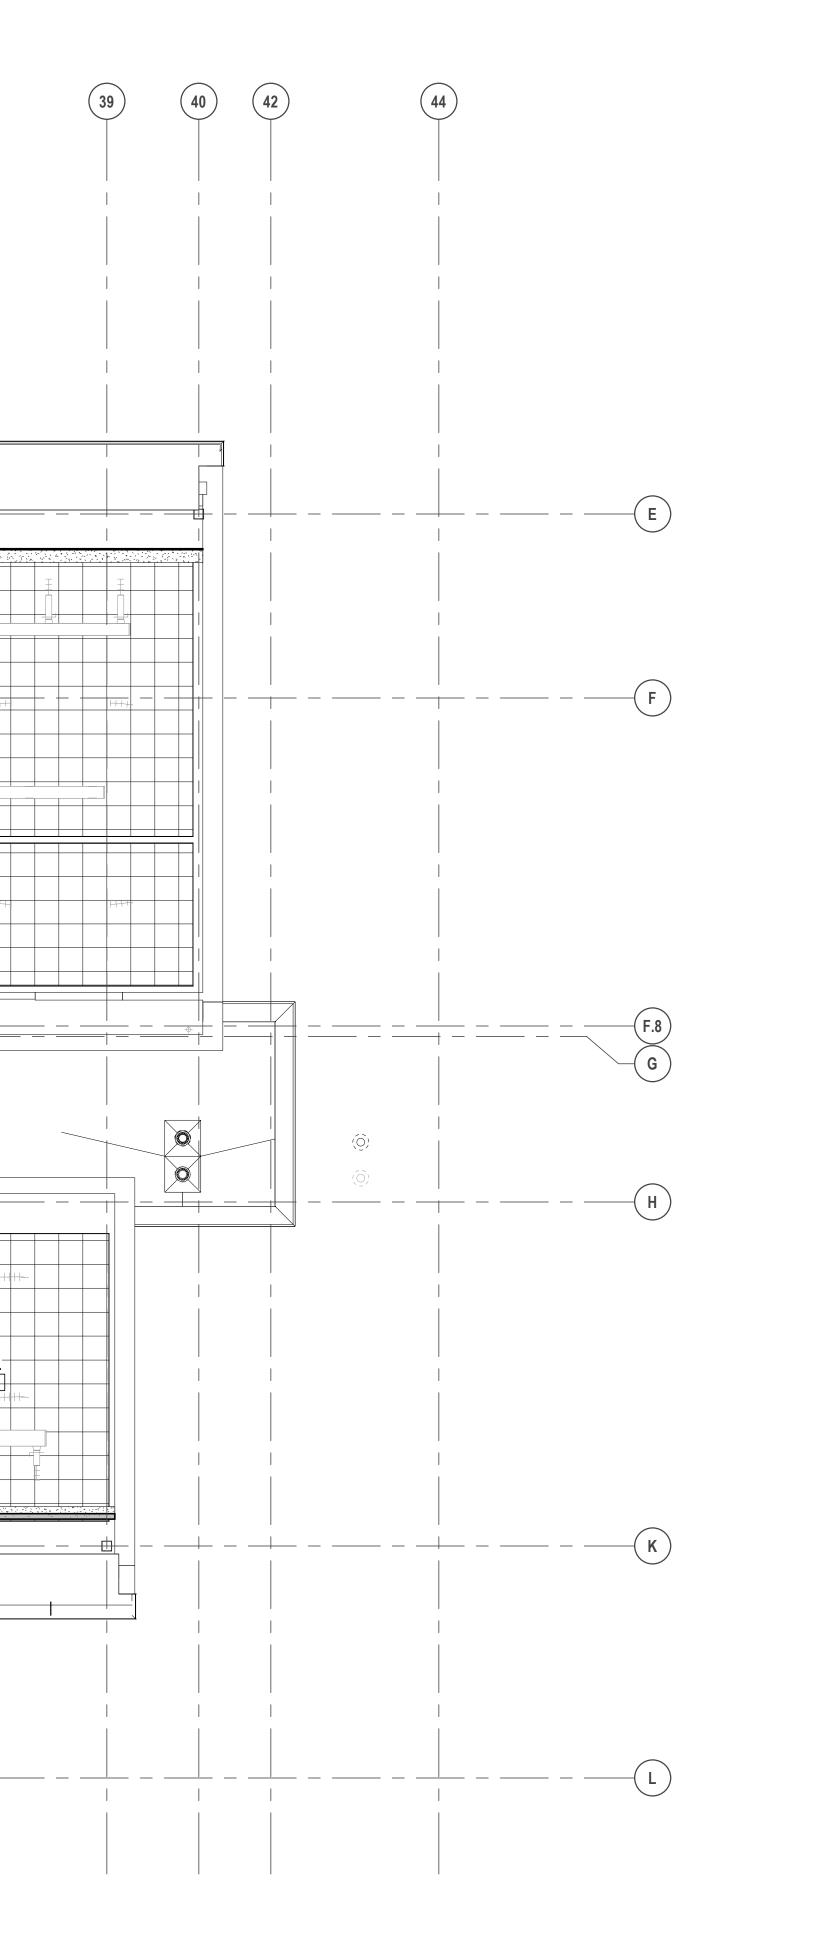

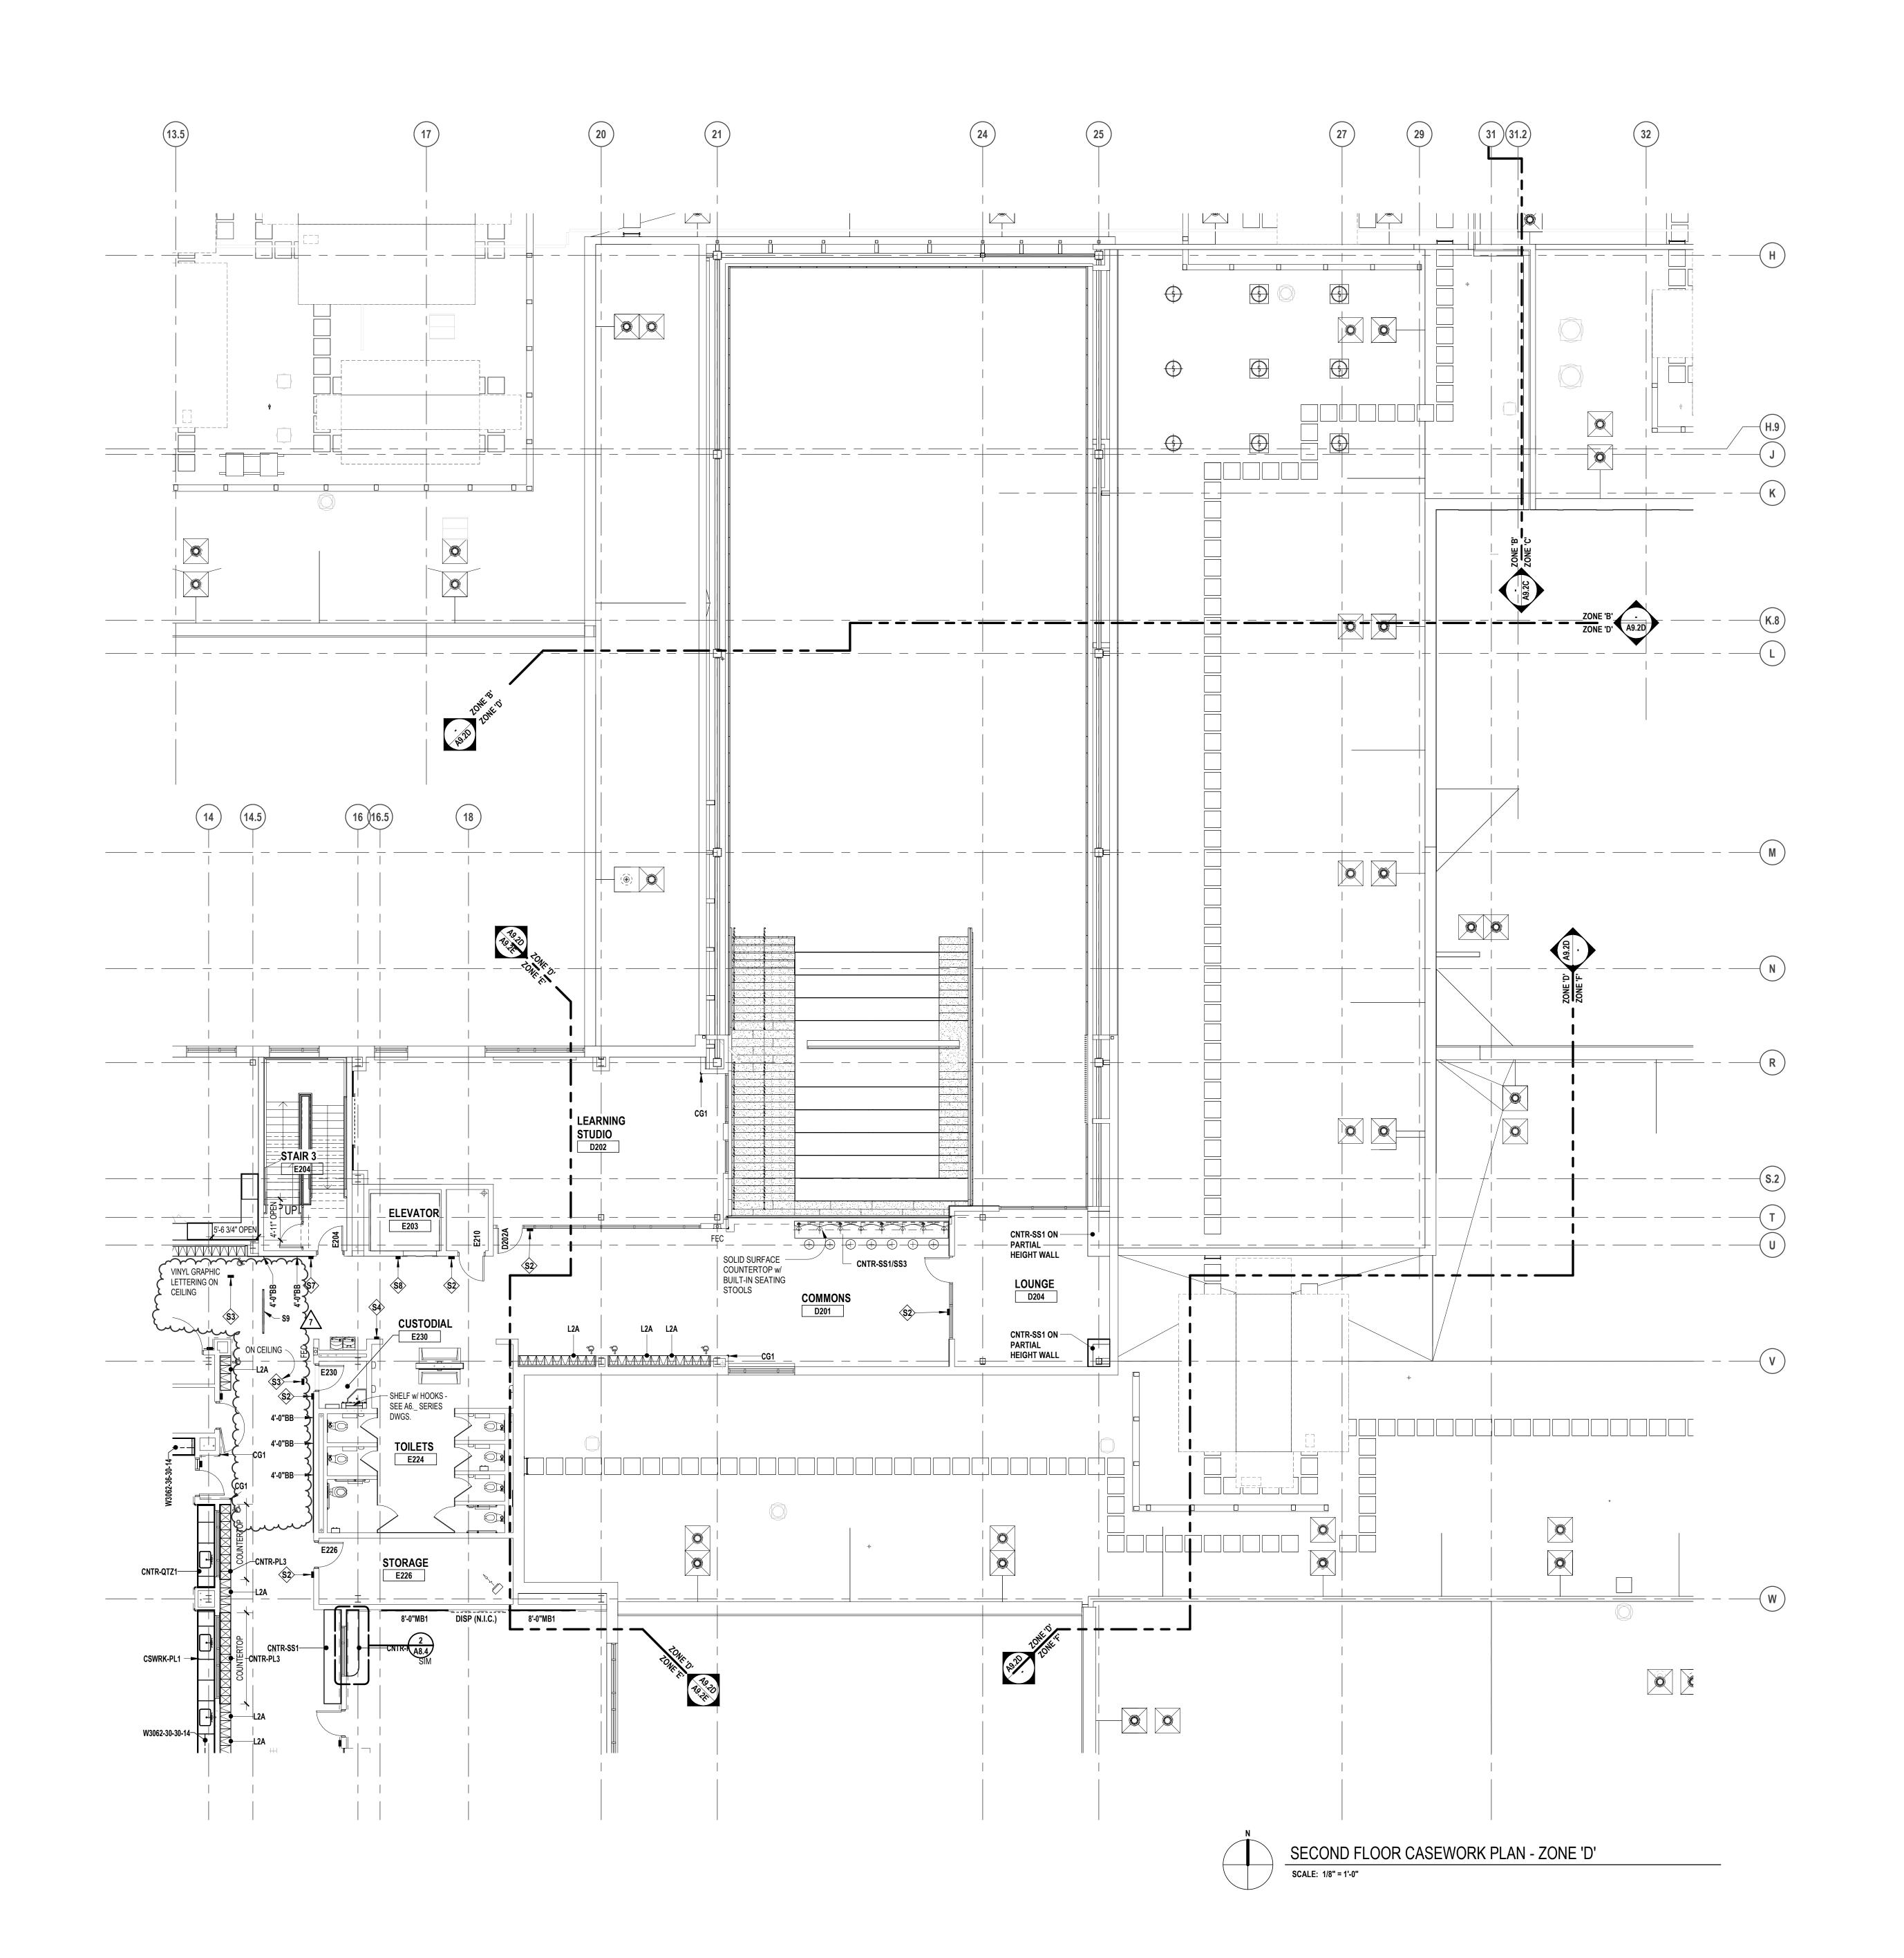

LEGEND DISPLAY (BY OTHERS) - WALL OR SUSPSENDED MOUNT (BY OTHERS) FIRE EXTINGUISHER IN CABINET (FEC) FIRE EXTINGUISHER ON WALL BRACKET (FE) 7'-0" HIGH (UON) SURFACE MOUNT CORNER GUARD

VISUAL DISPLAY BOARD NOTES

NOTES:

1. MB = MARKERBOARD

TB = TACKBOARD

TS = TACK STRIP

DISP = DISPLAY (BY OTHERS)

MB/TB = 3'-0" AFF TO BOTTOM

3. MAP RAILS SHALL BE CONTINUOUS OVER MARKERBOARDS.

4. ALL MARKERBOARDS SHALL BE PROVIDED WITH TRAYS &

MB1 = PORCELAIN ENAMEL STEEL HORIZONTAL ORIENTATION MB2 = PORCELAIN ENAMEL STEEL VERTICAL ORIENTATION

2. MOUNTING HEIGHTS (UON):

MB3 = MAGNETIC GLASS

TYPE OF BOARD —

─ WIDTH OF

ARE 4'-0" (UON)


BOARD/STRIP

HEIGHT OF ALL BOARDS

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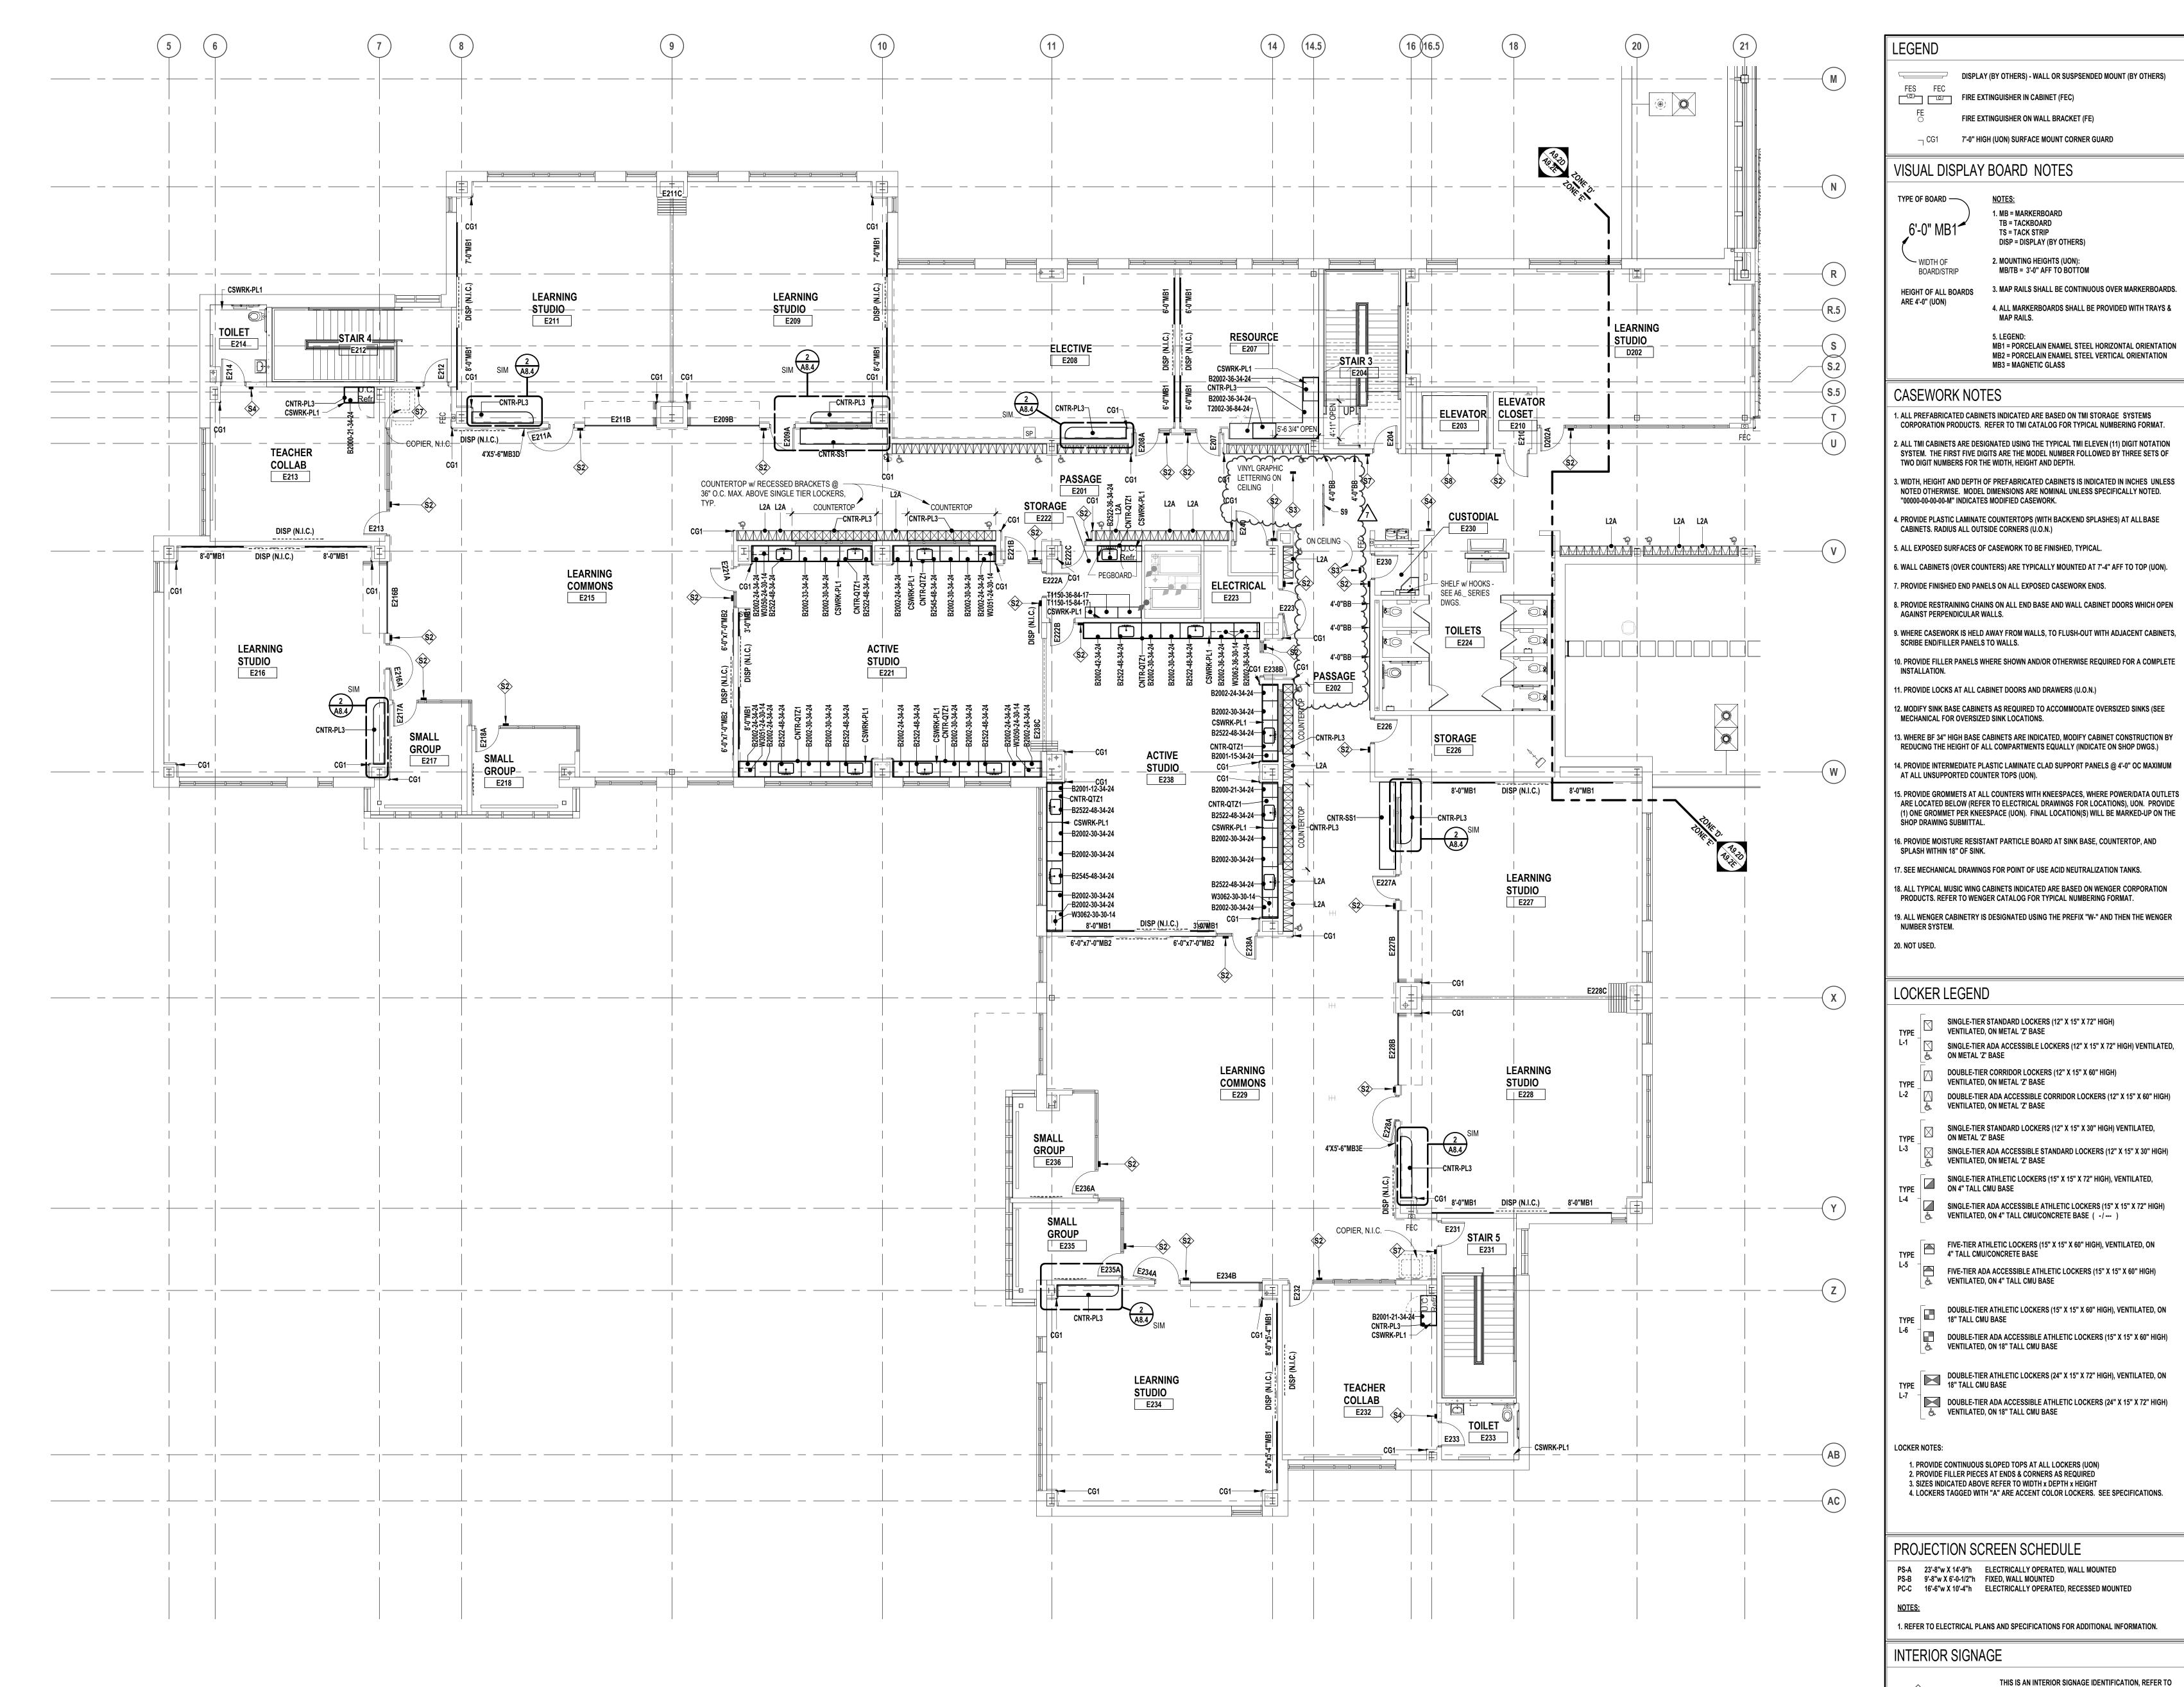
registration seal



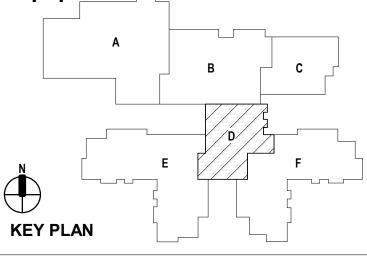


**BULLETIN NO. 7 CONSTRUCTION SET** 10-31-2024 ADDENDUM NO. 4 07-16-2024 **ADDENDUM NO. 3** 06-18-2024 CONSTRUCTION DOCUMENTS

CASEWORK NOTES 1. ALL PREFABRICATED CABINETS INDICATED ARE BASED ON TMI STORAGE SYSTEMS CORPORATION PRODUCTS. REFER TO TMI CATALOG FOR TYPICAL NUMBERING FORMAT. 2. ALL TMI CABINETS ARE DESIGNATED USING THE TYPICAL TMI ELEVEN (11) DIGIT NOTATION SYSTEM. THE FIRST FIVE DIGITS ARE THE MODEL NUMBER FOLLOWED BY THREE SETS OF TWO DIGIT NUMBERS FOR THE WIDTH, HEIGHT AND DEPTH. 3. WIDTH, HEIGHT AND DEPTH OF PREFABRICATED CABINETS IS INDICATED IN INCHES UNLESS NOTED OTHERWISE. MODEL DIMENSIONS ARE NOMINAL UNLESS SPECIFICALLY NOTED. "00000-00-00-00-M" INDICATES MODIFIED CASEWORK. 4. PROVIDE PLASTIC LAMINATE COUNTERTOPS (WITH BACK/END SPLASHES) AT ALLBASE CABINETS. RADIUS ALL OUTSIDE CORNERS (U.O.N.) 5. ALL EXPOSED SURFACES OF CASEWORK TO BE FINISHED, TYPICAL. consultant 6. WALL CABINETS (OVER COUNTERS) ARE TYPICALLY MOUNTED AT 7'-4" AFF TO TOP (UON). 7. PROVIDE FINISHED END PANELS ON ALL EXPOSED CASEWORK ENDS. 8. PROVIDE RESTRAINING CHAINS ON ALL END BASE AND WALL CABINET DOORS WHICH OPEN AGAINST PERPENDICULAR WALLS. 9. WHERE CASEWORK IS HELD AWAY FROM WALLS, TO FLUSH-OUT WITH ADJACENT CABINETS, SCRIBE END/FILLER PANELS TO WALLS. 10. PROVIDE FILLER PANELS WHERE SHOWN AND/OR OTHERWISE REQUIRED FOR A COMPLETE INSTALLATION. 11. PROVIDE LOCKS AT ALL CABINET DOORS AND DRAWERS (U.O.N.) 12. MODIFY SINK BASE CABINETS AS REQUIRED TO ACCOMMODATE OVERSIZED SINKS (SEE MECHANICAL FOR OVERSIZED SINK LOCATIONS. 13. WHERE BF 34" HIGH BASE CABINETS ARE INDICATED, MODIFY CABINET CONSTRUCTION BY REDUCING THE HEIGHT OF ALL COMPARTMENTS EQUALLY (INDICATE ON SHOP DWGS.) 14. PROVIDE INTERMEDIATE PLASTIC LAMINATE CLAD SUPPORT PANELS @ 4'-0" OC MAXIMUM AT ALL UNSUPPORTED COUNTER TOPS (UON). 15. PROVIDE GROMMETS AT ALL COUNTERS WITH KNEESPACES, WHERE POWER/DATA OUTLETS PROJECT TITLE ARE LOCATED BELOW (REFER TO ELECTRICAL DRAWINGS FOR LOCATIONS), UON. PROVIDE (1) ONE GROMMET PER KNEESPACE (UON). FINAL LOCATION(S) WILL BE MARKED-UP ON THE **NEW SMITH** SHOP DRAWING SUBMITTAL. 16. PROVIDE MOISTURE RESISTANT PARTICLE BOARD AT SINK BASE, COUNTERTOP, AND MIDDLE SCHOOL SPLASH WITHIN 18" OF SINK. 17. SEE MECHANICAL DRAWINGS FOR POINT OF USE ACID NEUTRALIZATION TANKS. 18. ALL TYPICAL MUSIC WING CABINETS INDICATED ARE BASED ON WENGER CORPORATION Bid Package No. 03B PRODUCTS. REFER TO WENGER CATALOG FOR TYPICAL NUMBERING FORMAT. 19. ALL WENGER CABINETRY IS DESIGNATED USING THE PREFIX "W-" AND THEN THE WENGER 20. NOT USED. **Troy School District** LOCKER LEGEND Troy, Michigan SINGLE-TIER STANDARD LOCKERS (12" X 15" X 72" HIGH) VENTILATED, ON METAL 'Z' BASE **DRAWING TITLE** SINGLE-TIER ADA ACCESSIBLE LOCKERS (12" X 15" X 72" HIGH) VENTILATED, ON METAL 'Z' BASE DOUBLE-TIER CORRIDOR LOCKERS (12" X 15" X 60" HIGH) VENTILATED, ON METAL 'Z' BASE DOUBLE-TIER ADA ACCESSIBLE CORRIDOR LOCKERS (12" X 15" X 60" HIGH) VENTILATED, ON METAL 'Z' BASE SINGLE-TIER STANDARD LOCKERS (12" X 15" X 30" HIGH) VENTILATED, ON METAL 'Z' BASE SINGLE-TIER ADA ACCESSIBLE STANDARD LOCKERS (12" X 15" X 30" HIGH) VENTILATED, ON METAL 'Z' BASE SINGLE-TIER ATHLETIC LOCKERS (15" X 15" X 72" HIGH), VENTILATED, ON 4" TALL CMU BASE SINGLE-TIER ADA ACCESSIBLE ATHLETIC LOCKERS (15" X 15" X 72" HIGH) VENTILATED, ON 4" TALL CMU/CONCRETE BASE ( -/--- ) FIVE-TIER ATHLETIC LOCKERS (15" X 15" X 60" HIGH), VENTILATED, ON **KEY PLAN** 4" TALL CMU/CONCRETE BASE FIVE-TIER ADA ACCESSIBLE ATHLETIC LOCKERS (15" X 15" X 60" HIGH) VENTILATED, ON 4" TALL CMU BASE issue dates DOUBLE-TIER ATHLETIC LOCKERS (15" X 15" X 60" HIGH), VENTILATED, ON 18" TALL CMU BASE DOUBLE-TIER ADA ACCESSIBLE ATHLETIC LOCKERS (15" X 15" X 60" HIGH) VENTILATED, ON 18" TALL CMU BASE TYPE DOUBLE-TIER ATHLETIC LOCKERS (24" X 15" X 72" HIGH), VENTILATED, ON 18" TALL CMU BASE DOUBLE-TIER ADA ACCESSIBLE ATHLETIC LOCKERS (24" X 15" X 72" HIGH) VENTILATED, ON 18" TALL CMU BASE LOCKER NOTES: 1. PROVIDE CONTINUOUS SLOPED TOPS AT ALL LOCKERS (UON) 2. PROVIDE FILLER PIECES AT ENDS & CORNERS AS REQUIRED 3. SIZES INDICATED ABOVE REFER TO WIDTH x DEPTH x HEIGHT 4. LOCKERS TAGGED WITH "A" ARE ACCENT COLOR LOCKERS. SEE SPECIFICATIONS. PROJECTION SCREEN SCHEDULE checked PS-A 23'-8"w X 14'-9"h ELECTRICALLY OPERATED, WALL MOUNTED approved dl PS-B 9'-8"w X 6'-0-1/2"h FIXED, WALL MOUNTED
PC-C 16'-6"w X 10'-4"h ELECTRICALLY OPERATED, RECESSED MOUNTED NOTES: project no. 1. REFER TO ELECTRICAL PLANS AND SPECIFICATIONS FOR ADDITIONAL INFORMATION. 22102 INTERIOR SIGNAGE THIS IS AN INTERIOR SIGNAGE IDENTIFICATION, REFER TO SPECIFICATIONS FOR INTERIOR SIGNAGE TYPE AND drawing no. SCHEDULED INFORMATION A9.2D



SECOND LEVEL CASEWORK PLAN - ZONE 'E' SCALE: 1/8" = 1'-0"

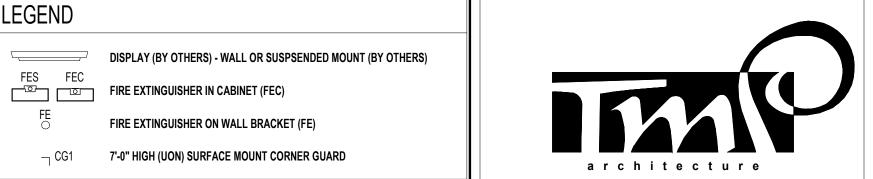

1. MB = MARKERBOARD

TB = TACKBOARD

TS = TACK STRIP

DISP = DISPLAY (BY OTHERS)

3. MAP RAILS SHALL BE CONTINUOUS OVER MARKERBOARDS.

4. ALL MARKERBOARDS SHALL BE PROVIDED WITH TRAYS &

MB1 = PORCELAIN ENAMEL STEEL HORIZONTAL ORIENTATION MB2 = PORCELAIN ENAMEL STEEL VERTICAL ORIENTATION

2. MOUNTING HEIGHTS (UON): MB/TB = 3'-0" AFF TO BOTTOM

MB3 = MAGNETIC GLASS

SINGLE-TIER STANDARD LOCKERS (12" X 15" X 72" HIGH)

DOUBLE-TIER CORRIDOR LOCKERS (12" X 15" X 60" HIGH)

SINGLE-TIER ADA ACCESSIBLE LOCKERS (12" X 15" X 72" HIGH) VENTILATED,

DOUBLE-TIER ADA ACCESSIBLE CORRIDOR LOCKERS (12" X 15" X 60" HIGH)

SINGLE-TIER ADA ACCESSIBLE STANDARD LOCKERS (12" X 15" X 30" HIGH)

SINGLE-TIER STANDARD LOCKERS (12" X 15" X 30" HIGH) VENTILATED,

SINGLE-TIER ATHLETIC LOCKERS (15" X 15" X 72" HIGH), VENTILATED,

VENTILATED, ON 4" TALL CMU/CONCRETE BASE ( -/ --- )

SINGLE-TIER ADA ACCESSIBLE ATHLETIC LOCKERS (15" X 15" X 72" HIGH)

FIVE-TIER ATHLETIC LOCKERS (15" X 15" X 60" HIGH), VENTILATED, ON

FIVE-TIER ADA ACCESSIBLE ATHLETIC LOCKERS (15" X 15" X 60" HIGH)

DOUBLE-TIER ATHLETIC LOCKERS (15" X 15" X 60" HIGH), VENTILATED, ON

DOUBLE-TIER ADA ACCESSIBLE ATHLETIC LOCKERS (15" X 15" X 60" HIGH)

THIS IS AN INTERIOR SIGNAGE IDENTIFICATION, REFER TO SPECIFICATIONS FOR INTERIOR SIGNAGE TYPE AND

SCHEDULED INFORMATION

VENTILATED, ON METAL 'Z' BASE

4" TALL CMU/CONCRETE BASE

18" TALL CMU BASE

VENTILATED, ON 4" TALL CMU BASE

VENTILATED, ON 18" TALL CMU BASE

VENTILATED, ON 18" TALL CMU BASE

ON METAL 'Z' BASE

ON METAL 'Z' BASE

ON 4" TALL CMU BASE

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PROJECT TITLE


### **NEW SMITH** MIDDLE SCHOOL

Bid Package No. 03B

**Troy School District** Troy, Michigan

**DRAWING TITLE** 

Second Level Casework & Equipment Plan - Zone 'E'

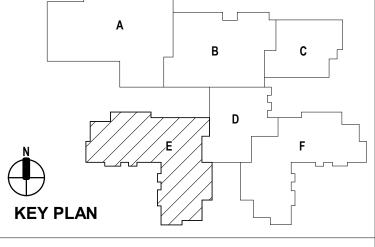

issue dates	
01-13-2025	BULLETIN NO. 7
10-31-2024	CONSTRUCTION SET
07-16-2024	ADDENDUM NO. 3 (N.R.)
06-18-2024	CONSTRUCTION DOCUMENTS

checked approved dl

project no.

22102

drawing no. A9.2E