YORK SCHOOL DISTRICT 1


EDUCATION SERVICE CENTER ROOF REPLACEMENT

16 SPRUCE STREET YORK, SC 29745

REI PROJECT NO. 024CLT-098

DATE: 10-31-24



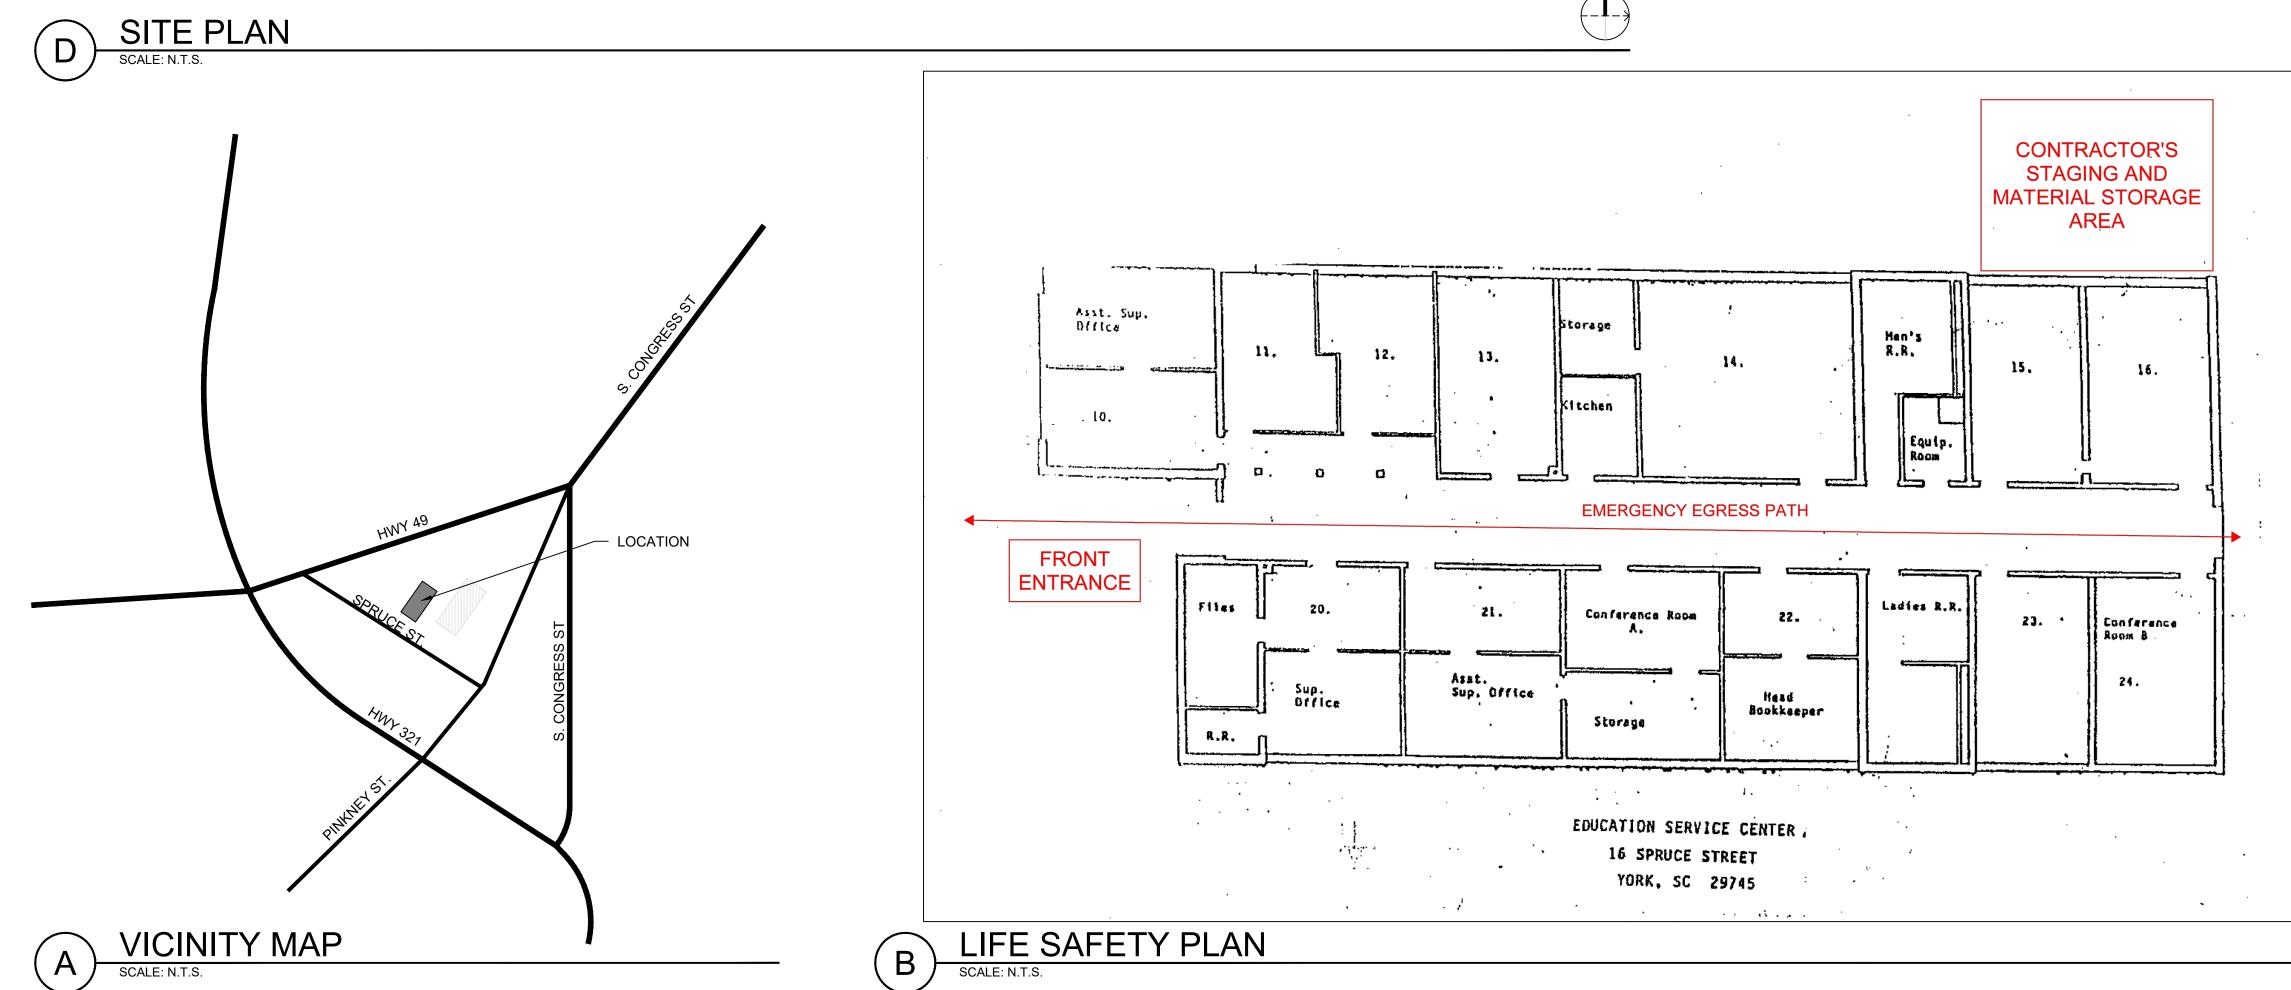

THESE DOCUMENTS ARE THE PROPERTY OF REI ENGINEERS, INC. (REI) AND REI RETAINS ALL RIGHTS THEREIN, INCLUDING COPYRIGHTS. IT MAY ONLY BE USED IN A MANNER CONSISTENT WITH REI'S RIGHTS WHILE REI IS PROVIDING SERVICE FOR THE SPECIFIC OF, AND COMPENSATION TO, REI ENGINEERS, INC. DIMENSIONS, DETAIL COMPONENTS AND EQUIPMENT PENETRATION LOCATIONS ARE FOR INFORMATION ONLY. CONTRACTOR IS RESPONSIBLE TO FIELD VERIFY ALI ONLY ONE DETAIL INDICATOR MAY BE SHOWN FOR EACH TYPE OF ROOF PENETRATION. ALL OTHER SIMILAR PENETRATIONS ARE TO BE FLASHED AS REQUIRED BY THE TYPICAL DETAIL INDICATOR, UNLESS OTHERWISE NOTED. NOTES ARE INTENDED TO PROVIDE TYPICAL LOCATIONS OF WORK. IT IS CONTRACTORS RESPONSIBILITY TO QUANTIFY ALL LOCATIONS. DETAIL NOTES

1. LIGHT LINES REPRESENT EXISTING CONSTRUCTION TO REMAIN AND DARK LINES REPRESENT NEW COMPONENTS TO BE PROVIDED. N.I.C NOT IN CONTRACT N.T.S. NOT TO SCALE CONTROL JOINT O.C. ON CENTER DOWNSPOUT OVERFLOW EXPANSION JOINT PRESSURE SENSITIVE **EXISTING** SQUARE FEET S.S. STAINLESS STEEL GALV. GALVANIZED TERM. TERMINATE/TERMINATION HEIGHT G-001 COVER XR101 ROOF PLAN XR301 ROOF SYSTEMS/RE-ROOF ANALYSIS XR501 DETAILS BUILDING CODE REFERENCE: 2021 SC BUILDING CODE 2009 IECC 2021 SC EXISTING BUILDING CODE 2021 SC FIRE CODE 2021 SC FUEL GAS CODE 2021 SC MECHANICAL CODE 2021 SC PLUMBING CODE

PROJECT NAME: YORK SCHOOL DISTRICT 1 **EDUCATION SERVICE CENTER ROOF** REPLACEMENT 16 SPRUCE STREET YORK, SC 29745 PROJ. NO: 024CLT-098 NO. DATE DESCRIPTION CD 10-21-24 CONTRACT DOCUMENTS THIS LINE IS 1 INCH ON THE ORIGINAL DRAWING IF IT IS NOT 1 INCH ON THIS PAGE, SCALE DRAWING ACCORDINGLY.

ENGINEERS

Engineering solutions for tomorrow®

1927 J.N. Pease Place | Suite 201

CHARLOTTE, NC 28262

AUTHORIZATION #1906

SRCTT ELL N.L E S

DRAWING:


G-001

COVER

GENERAL NOTES & INFORMATION

SCALE: N.T.S.

NFPA 70 WITH SC MODIFICATIONS

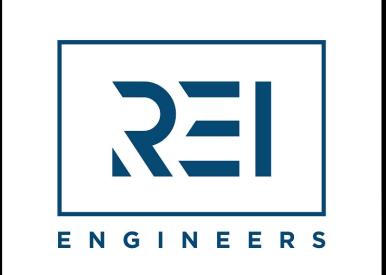

Engineering solutions for tomorrow®

1927 J.N. Pease Place | Suite 201

CHARLOTTE, NC 28262 SOUTH CAROLINA

CERTIFICATE OF

AUTHORIZATION #1906 www.reiengineers.com

SEALS:

PROJECT NAME:

PROJ. NO:

YORK SCHOOL

DISTRICT 1

EDUCATION SERVICE

CENTER ROOF

REPLACEMENT

16 SPRUCE STREET

YORK, SC 29745

024CLT-098

THIS LINE IS 1 INCH ON

THE ORIGINAL DRAWING

IF IT IS NOT 1 INCH ON THIS PAGE,


SCALE DRAWING ACCORDINGLY.

ROOF PLAN

NO. DATE DESCRIPTION

CD 10-21-24 CONTRACT DOCUMENTS



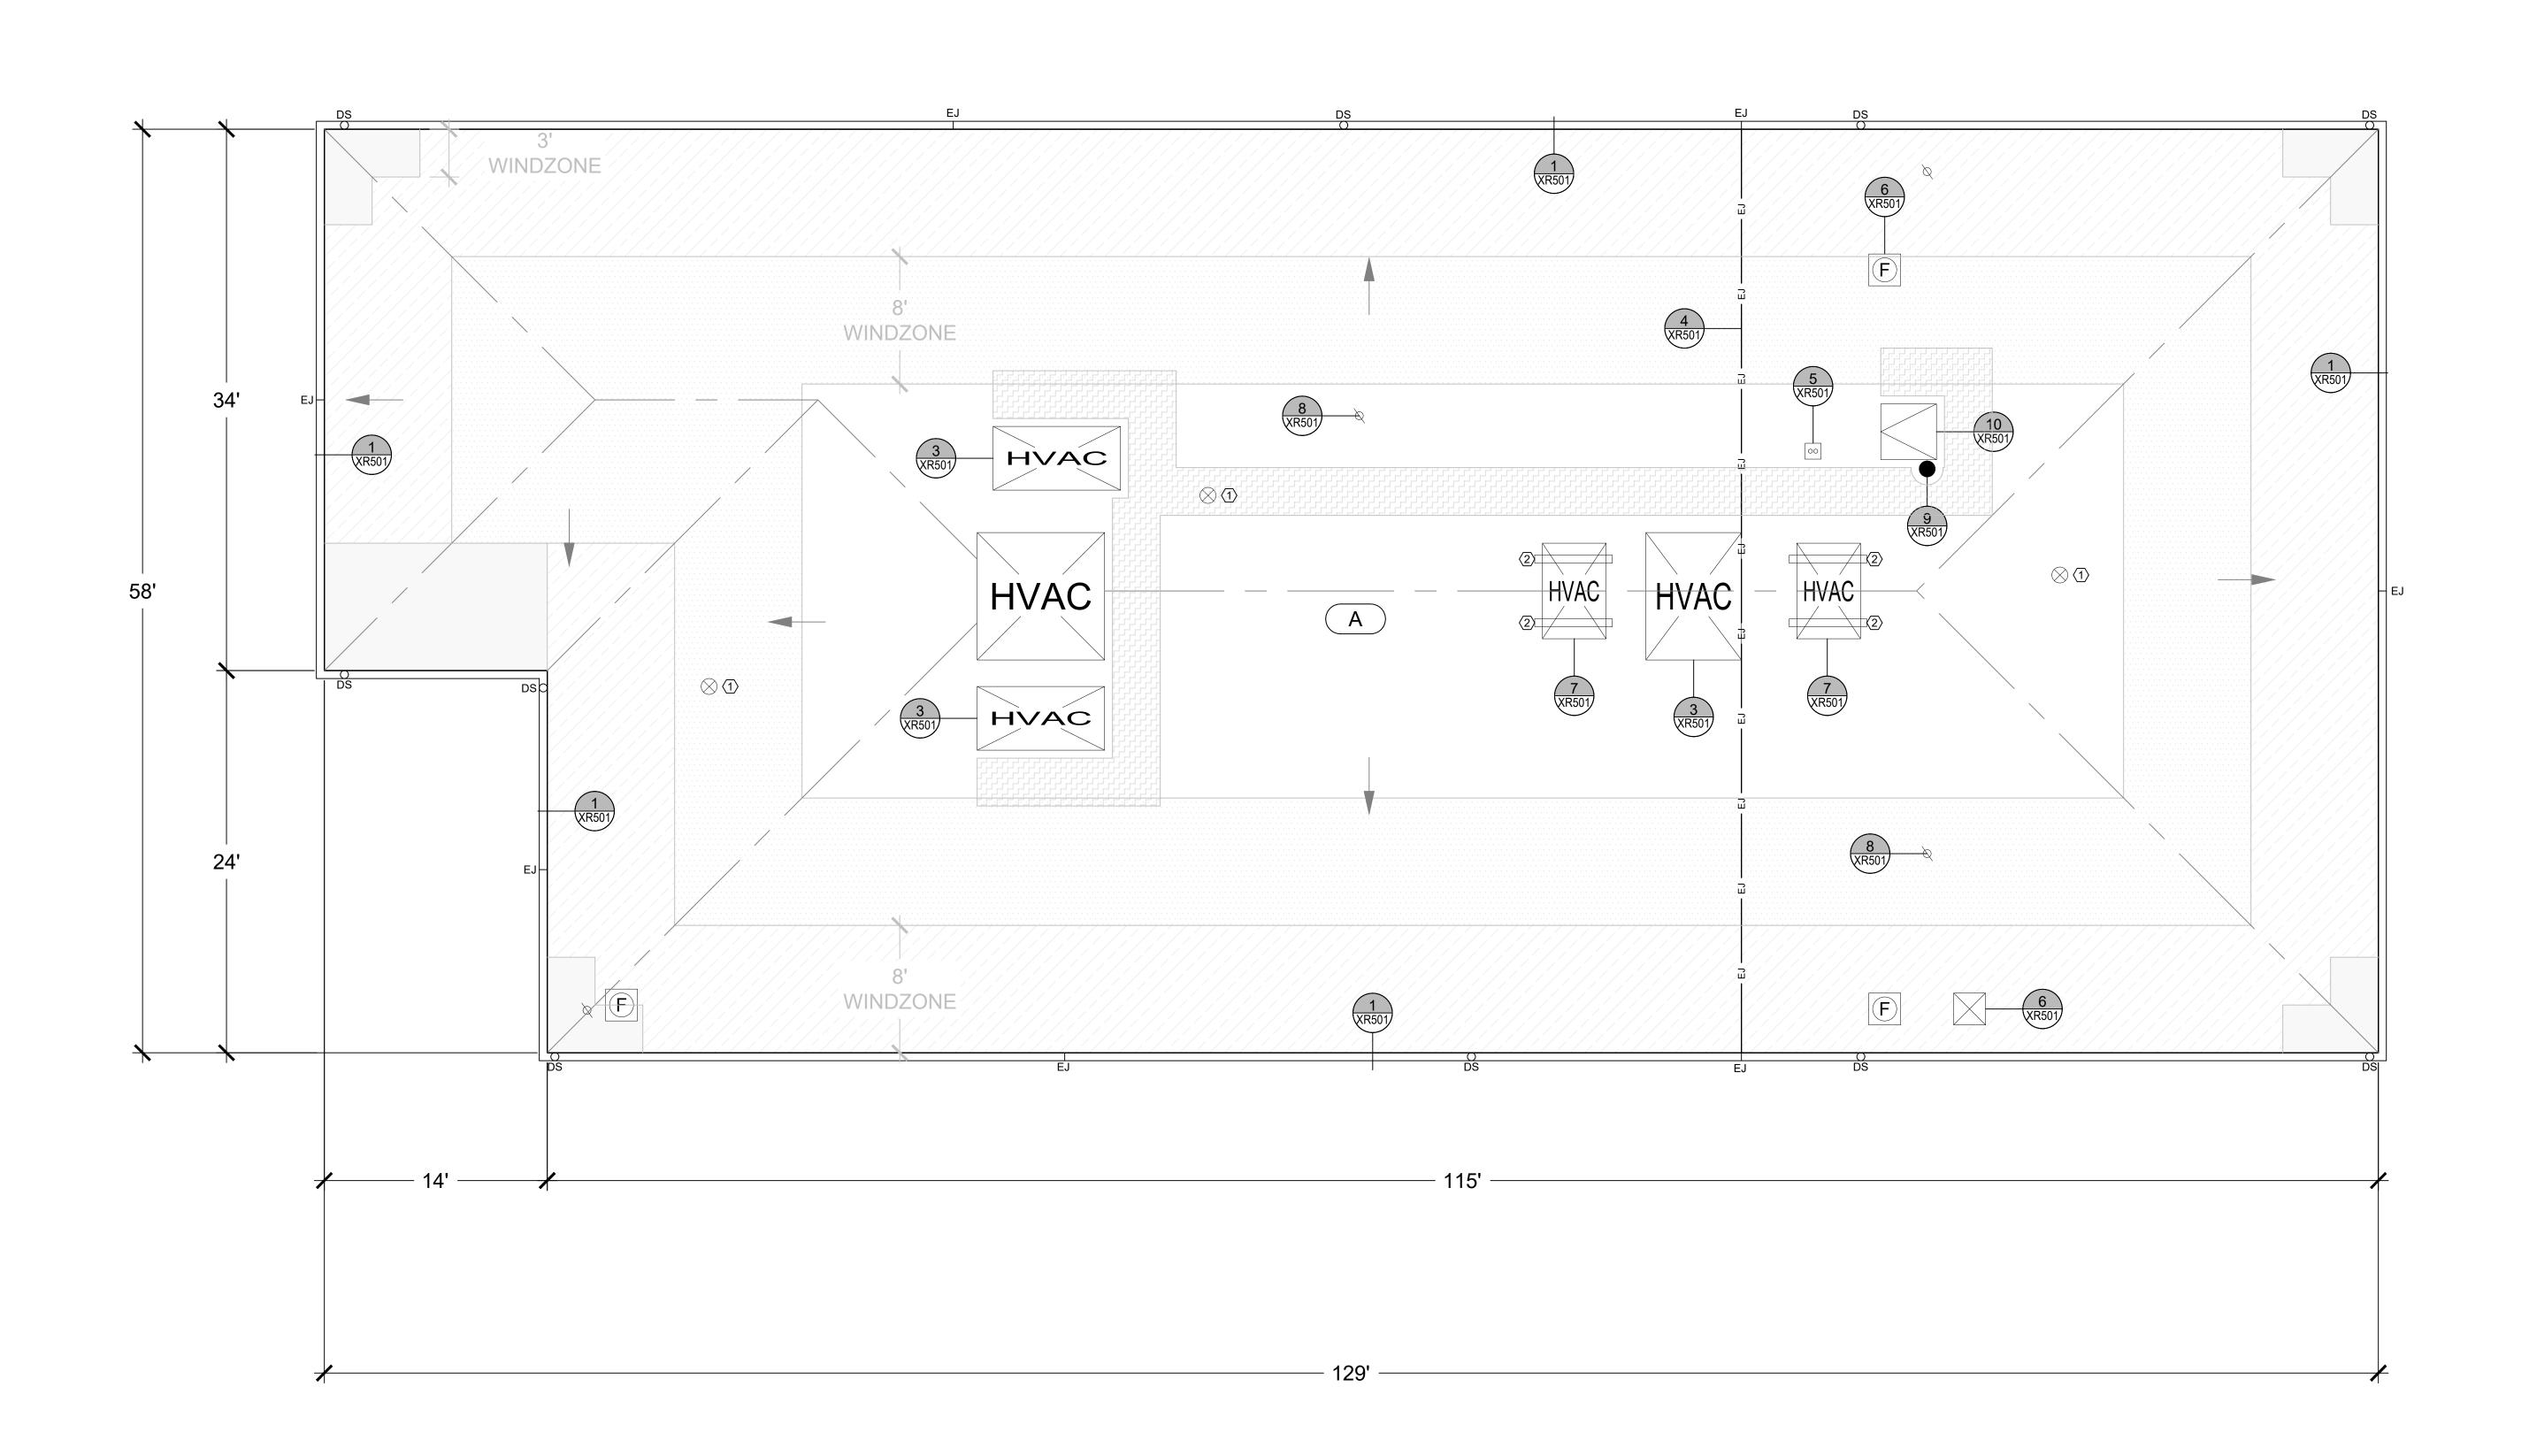

ROOF PLAN

ROOF SECTOR	AREA	HEIGHT (FT.)
А	±7,146 SQ. FT.	11.5

WIND SUMI	UPLIF MARY	Т
ASCE	E 7 - 16	
ULTIMATE DESIGN WIND SPEED	120	MPH
RISK CATEGORY	I	II
EXPOSURE	(
ENCLOSURE	ENCL	OSED
	ULTIMATE WIND UPLIFT PRESSURES (Pult)	MIN. REQUIRED WIND UPLIFT STRENGTH (Sreq = Pult X 1.25 SF)
ZONE 1' - FIELD	-29 PSF	-36 PSF
ZONE 1 - FIELD	-50 PSF	-63 PSF
ZONE 2 - PERIMETER	-66 PSF	-83 PSF
ZONE 3 - CORNER	-90 PSF	-113 PSF

WIND ZONES

ZONE 1' (INTERIOR) ZONE 1 (FIELD)

ZONE 2 (PERIMETER)
ZONE 3 (CORNER)

GENERAL NOTES:

1. THESE DOCUMENTS ARE THE PROPERTY OF REI ENGINEERS, INC. (REI) AND REI RETAINS ALL RIGHTS
THEREIN, INCLUDING COPYRIGHTS. IT
MAY ONLY BE USED IN A MANNER CONSISTENT WITH REI'S RIGHTS WHILE REI IS PROVIDING SERVICE FOR THE SPECIFIC PROJECT IDENTIFIED OR REFERRED TO HEREIN OR EXTENSIONS THERETO. IT MAY NOT BE USED FOR ANY OTHER PURPOSE EXCEPT WITH THE EXPRESS WRITTEN AGREEMENT OF, AND COMPENSATION TO, REI ENGINEERS, INC. 2. DIMENSIONS, DETAIL COMPONENTS AND EQUIPMENT PENETRATION LOCATIONS ARE FOR INFORMATION

ONLY. CONTRACTOR IS RESPONSIBLE TO FIELD VERIFY ALL INFORMATION PROVIDED. 3. ONLY ONE DETAIL INDICATOR MAY BE SHOWN FOR EACH TYPE OF ROOF PENETRATION. ALL OTHER SIMILAR PENETRATIONS ARE TO BE FLASHED AS REQUIRED BY THE TYPICAL DETAIL INDICATOR, UNLESS OTHERWISE

NOTED.

4. NOTES ARE INTENDED TO PROVIDE TYPICAL LOCATIONS OF WORK. IT IS THE CONTRACTORS RESPONSIBILITY TO QUANTIFY ALL LOCATIONS. SHEET NOTES:

1. REMOVE EXISTING ROOF DRAINS AND REPAIR ROOF DECK.

2. REMOVE SLEEPER CURBS AND REPLACE WITH MECHANICAL ROOF

— ROOF EDGE PARAPET WALL

-EJ- EXPANSION JOINT GUTTER EDGE --- TAPERED INSULATION -S→ STRUCTURAL SLOPE

→ TAPERED INSULATION SLOPE CRICKET SLOPE ⊗ ROOF DRAIN

Ø SOIL PIPE O PIPE PENETRATION HIGH HEAT PENETRATION

HVAC UNIT


MECHANICAL CURB MULTIPLE PIPE PENETRATION © EXHAUST FAN


— EQUIPMENT SUPPORT CURB WALKPAD NOT IN CONTRACT XX ROOF AREA INDICATOR ₩ NOTE NO.

SHT DETAIL INDICATOR

DRAWING: XR101

SHEET TITLE:

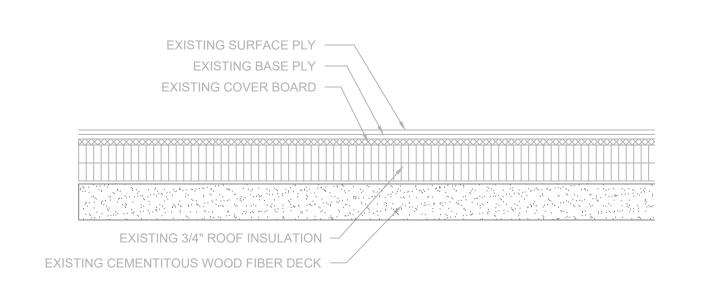


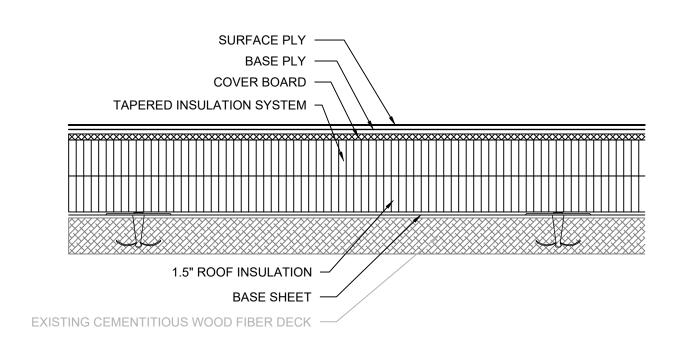

- 1. PROVIDE AN APPROVED, TESTED ROOF ASSEMBLY IN ACCORDANCE WITH FM 4474, UL 580 OR UL 1897 TO RESIST THE MINIMUM REQUIRED WIND UPLIFT STRENGTH SPECIFIED ON DRAWING XR101. PROVIDE SUBMITTAL INCLUDING DOCUMENTATION OF TESTED ASSEMBLY ALONG WITH ATTACHMENT
- REQUIREMENTS FOR THE ASSEMBLY. 2. ANY WHOLE OR PARTIAL INSULATION BOARD OR PORTION OF ANY BOARD WHICH FALLS IN THE PERIMETERS & CORNERS OUTLINED SHALL BE SUBJECT TO THE FASTENING REQUIREMENTS FOR THE HIGHEST WIND ZONE ENCOUNTERED, ACROSS THE ENTIRE BOARD.





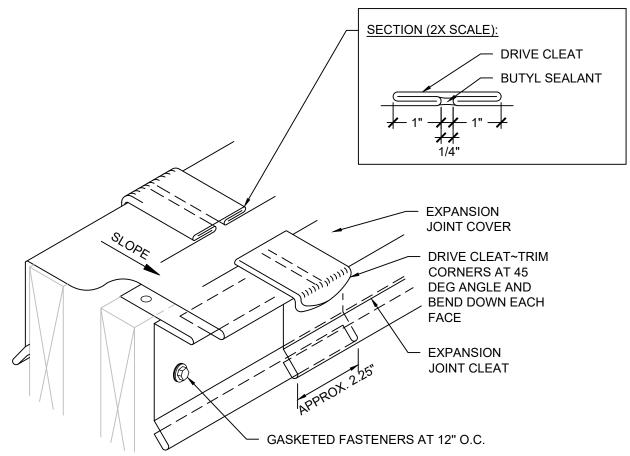




Form F3 – Re-Roofing Analysis Date: November 14, 2024 SUBMITTAL: □ Schematic □ Design Development □ Construction Document SC CODE EDITION: 2018 ICC CODE EDITION: 2018 ICC A117.1 EDITION: N/A OSF GUIDE EDITION: 2023 OTHER CODES/STANDARDS & EDITIONS: 2009 International Energy Conservation Code 2018 International Existing Building Code, Level 1 Alteration PROJECT DESCRIPTION: [Brief Scope of Work & Include project delivery method (i.e. CMR, etc.)] Single prime construction for Education Service Center Roof Replacement

	BASIC RE-RO	OFING COD	E INFORMATI	ON		
DESIGNATED AREAS OF BUILDING	Building Code	Area 1	Area 2	Area 3	Area 4	Area 5
CONSTRUCTION CLASSIFICATION TYPE	Section 602	IIB				
Roof Construction including supporting beams & joist	Table 601	-	-	-	-	-
As Required, Hrs		0 hr.				
As Designed, Hrs		0 hr.				
Testing Agency & Design No. (UL, FM, etc.)		N/A				
Wall/Partition Key Code		N/A				

1 of 2 Version May 2021

Version May 2021

STRU	ICTURAL DESIGN INFORMATION	I, BUILDING	CONSTRUCTION DOCUMENTS
WIND LOADS	Analysis Procedure (ASCE 7 or SC 1609.6)	BC ASCE 7-16	No Cinnada a saladan da data da da sanina na
	Basic design Wind Speed, MPH (3 sec gust IBC Fig 1609.3)	120 = V	\. Signed, sealed and dated drawings II. Fully coordinated within and with the Project Manual.
	Exposure Category		
	Wind Importance Factor (ASCE 7 T 1.5-2)	able1.15 = lw	PROJECT MANUAL
	Internal Pressure Coefficient (ASCE	7) -1.18 = GCpi	
	External Pressure Coefficient (ASCI	₹ 7)-1.00 = GCp	 \. Signed, sealed and dated II. Fully coordinated within and with the Construction Documents
	ONAL QUESTIONS e a site plan showing the life safety plan d	uring construction a	This information shall be part and within the drawing sheet set.
1. Prepar any a admir the bu	e a site plan showing the life safety plan d dditional details on how the contractor will nistration informed about issues that may a uilding	keep the school ffect daily operation	• This information shall be part and within the drawing sheet set. non-discluded is in
1. Prepar any a admir the bu	e a site plan showing the life safety plan d dditional details on how the contractor will nistration informed about issues that may a	keep the school ffect daily operation	• This information shall be part and within the drawing sheet set. This information shall be part and within the drawing sheet set.
1. Prepar any a admir the bu 2. Will the 3. What winsula	e a site plan showing the life safety plan d dditional details on how the contractor will histration informed about issues that may a uilding ere be additional weight added to the exist will the insulation values be in areas being tion will meet current energy codes.	keep the school ffect daily operation ing structure? reroofed? Confirm t	• This information shall be part and within the drawing sheet set. This information shall be part and within the drawing sheet set. This information shall be part and within the drawing sheet set.
1. Prepar any a admir the bu 2. Will the 3. What winsula	e a site plan showing the life safety plan d dditional details on how the contractor will histration informed about issues that may a uilding ere be additional weight added to the exist will the insulation values be in areas being tion will meet current energy codes.	keep the school ffect daily operation ing structure? reroofed? Confirm t	• This information shall be part and within the drawing sheet set. This information shall be part and within the drawing sheet set.
1. Prepar any a admir the bu 2. Will the 3. What winsula 4. Will the	e a site plan showing the life safety plan d dditional details on how the contractor will histration informed about issues that may a uilding ere be additional weight added to the exist will the insulation values be in areas being tion will meet current energy codes.	keep the school ffect daily operation ing structure? reroofed? Confirm t	• This information shall be part and within the drawing sheet set. □□□□□□□□□□□□□□□□□□□□□□□□□□□□□□□□□□□
 Preparany a admir the bute Will the sum of the bute Will the sum of the bute What winsulate What winsulate What winsulate What winsulate 	e a site plan showing the life safety plan d dditional details on how the contractor will histration informed about issues that may a uilding ere be additional weight added to the exist will the insulation values be in areas being tion will meet current energy codes.	keep the school ffect daily operation ing structure? reroofed? Confirm t	• This information shall be part and within the drawing sheet set. This information shall be part and within the drawing sheet set. This information shall be part and within the drawing sheet set.
1. Prepar any a admir the but 2. Will the standard will the standard will the standard with the standa	e a site plan showing the life safety plan didditional details on how the contractor will histration informed about issues that may a wilding ere be additional weight added to the exist will the insulation values be in areas being tion will meet current energy codes. The existing roof drainage stay the same and will the new roof assembly consist of?	keep the school ffect daily operation ing structure? reroofed? Confirm t meet current code?	This information shall be part and within the drawing sheet set. This information shall be part and within the drawing sheet set. This information shall be part and within the drawing sheet set. This information shall be part and within the drawing sheet set. This information shall be part and within the drawing sheet set. This information shall be part and within the drawing sheet set.

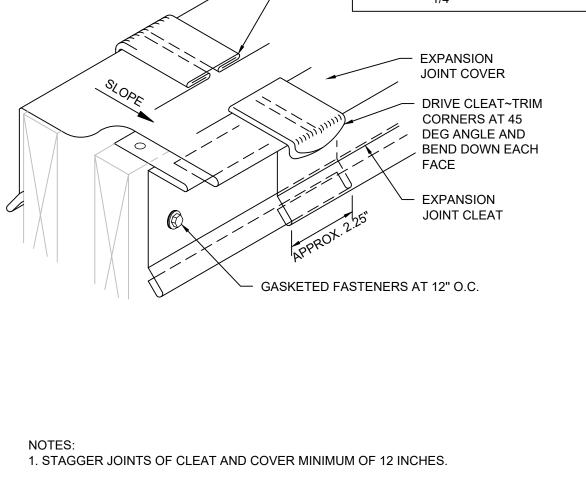

SEALS:

GENERAL NOTES:

1. THESE DOCUMENTS ARE THE PROPERTY OF REI ENGINEERS, INC. (REI) AND REI RETAINS ALL RIGHTS THEREIN, INCLUDING COPYRIGHTS. IT MAY ONLY BE USED IN A MANNER CONSISTENT WITH REI'S RIGHTS WHILE REI IS PROVIDING SERVICE FOR THE SPECIFIC PROJECT IDENTIFIED OR REFERRED TO HEREIN OR EXTENSIONS THERETO. IT MAY NOT BE USED FOR ANY OTHER PURPOSE EXCEPT WITH THE EXPRESS WRITTEN AGREEMENT OF, AND COMPENSATION TO, REI ENGINEERS, INC.

ENGINEERS

Engineering solutions for tomorrow®

1927 J.N. Pease Place | Suite 201

CHARLOTTE, NC 28262

SOUTH CAROLINA

CERTIFICATE OF

AUTHORIZATION #1906

www.reiengineers.com

2. DIMENSIONS, DETAIL COMPONENTS AND EQUIPMENT PENETRATION LOCATIONS ARE FOR INFORMATION ONLY. CONTRACTOR IS RESPONSIBLE TO FIELD VERIFY ALL INFORMATION PROVIDED. SHEET NOTES:

1. FOR DETAILS, LIGHT LINES REPRESENT EXISTING

CONSTRUCTION TO REMAIN AND DARK LINES REPRESENT NEW COMPONENTS TO BE PROVIDED.

2. ANY WHOLE OR PARTIAL INSULATION BOARD OR PORTION OF ANY BOARD WHICH FALLS IN THE PERIMETERS & CORNERS OUTLINED SHALL BE SUBJECT TO THE FASTENING REQUIREMENTS FOR THE HIGHEST WIND ZONE ENCOUNTERED, ACROSS THE ENTIRE BOARD.

PROJECT NAME:

YORK SCHOOL DISTRICT 1

EDUCATION SERVICE **CENTER ROOF** REPLACEMENT

16 SPRUCE STREET YORK, SC 29745

PROJ. NO:

024CLT-098

NO. DATE DESCRIPTION

CD 10-21-24 CONTRACT DOCUMENTS

THIS LINE IS 1 INCH ON THE ORIGINAL DRAWING

IF IT IS NOT 1 INCH ON THIS PAGE, SCALE DRAWING ACCORDINGLY.


SHEET TITLE:


ROOF SYSTEMS/ **RE-ROOF ANALYSIS**

DRAWING:


XR301



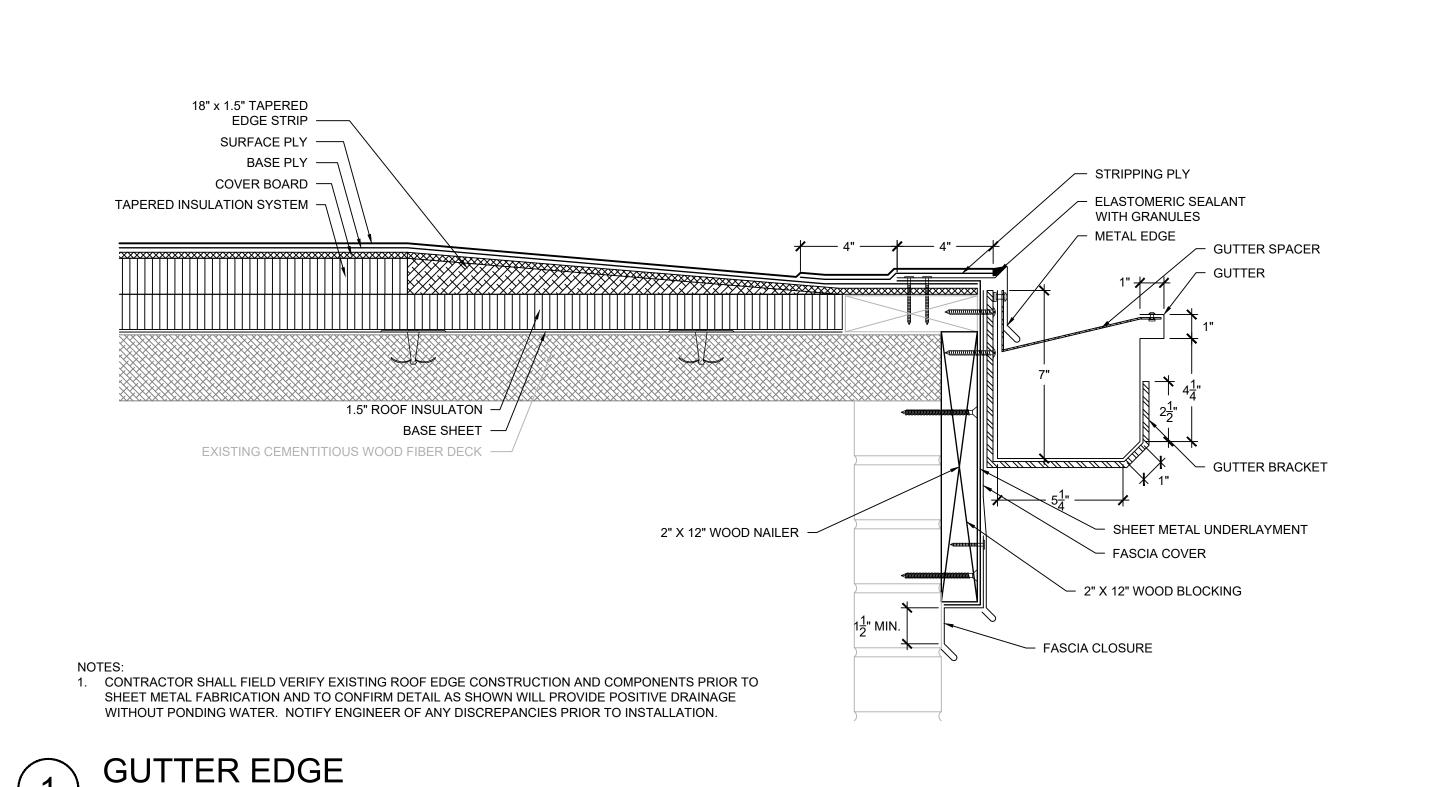

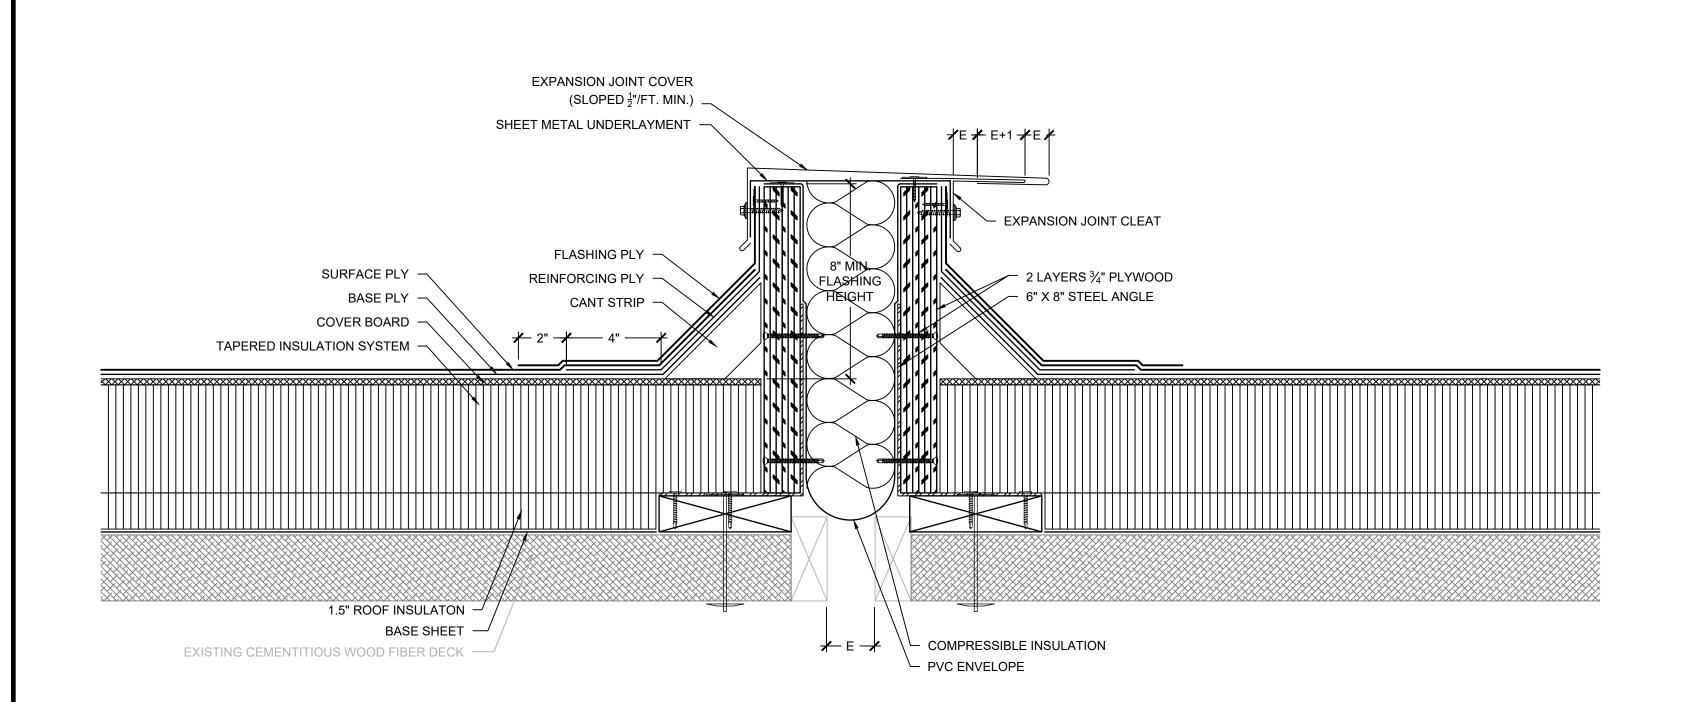


4 EXPANSION JOINT SCALE: 3" = 1'-0"

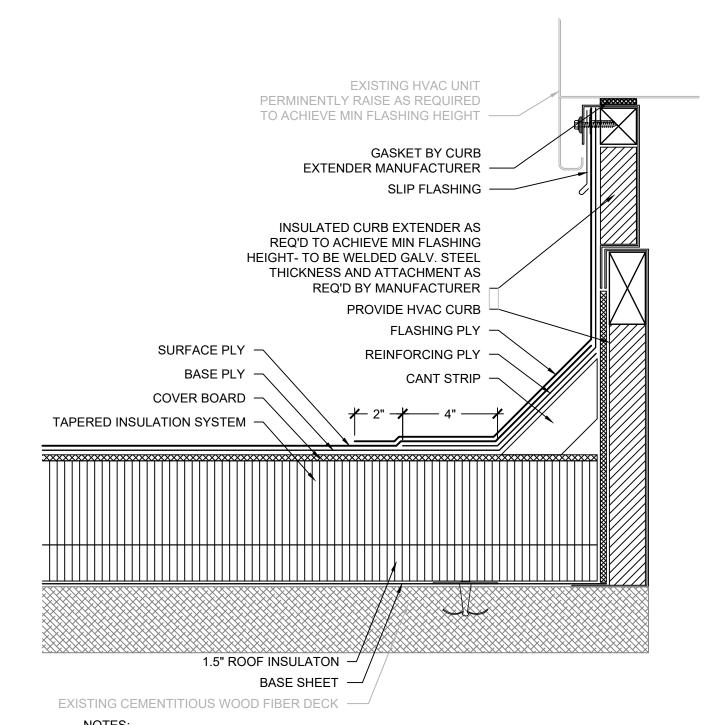


1. PROPERLY DISCONNECT UNIT, EXTEND CURB HEIGHT WITH HVAC UNIT MANUFACTURER APPROVED CURB EXTENSION TO PROVIDE MINIMUM 8" FLASHING HEIGHT, AND PROPERLY REINSTALL AND


MECHANICAL CURB

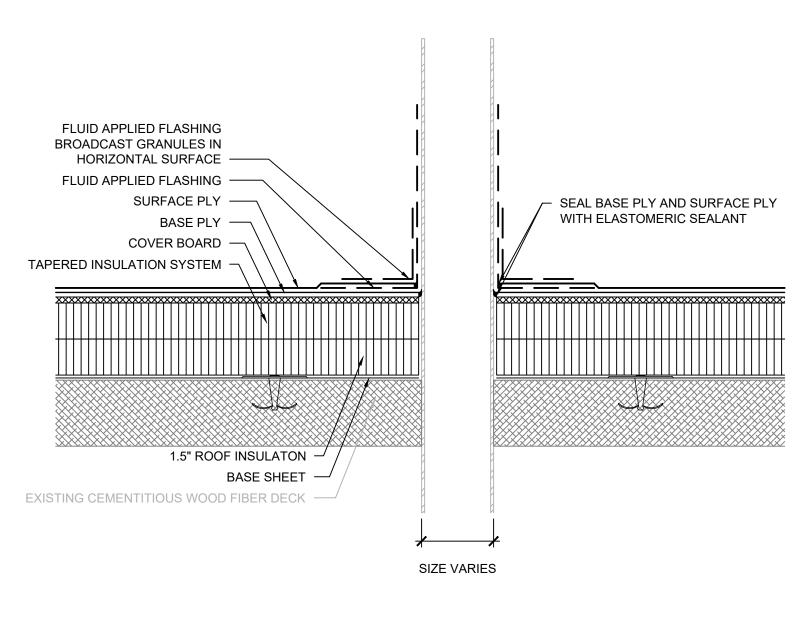


1. EXTEND PIPE PENETRATION TO PROVIDE MINIMUM 8" FLASHING HEIGHT.

PIPE PENETRATION

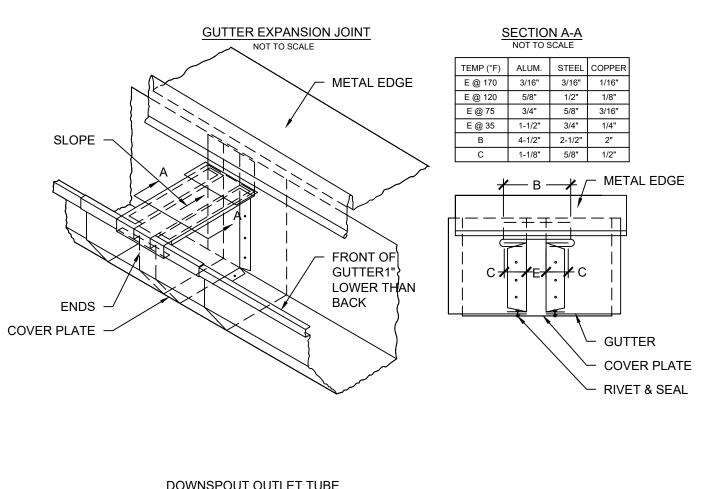

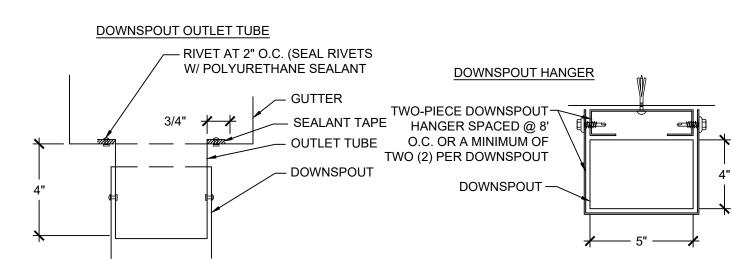


GUTTER/ DOWNSPOUT COMPONENTS

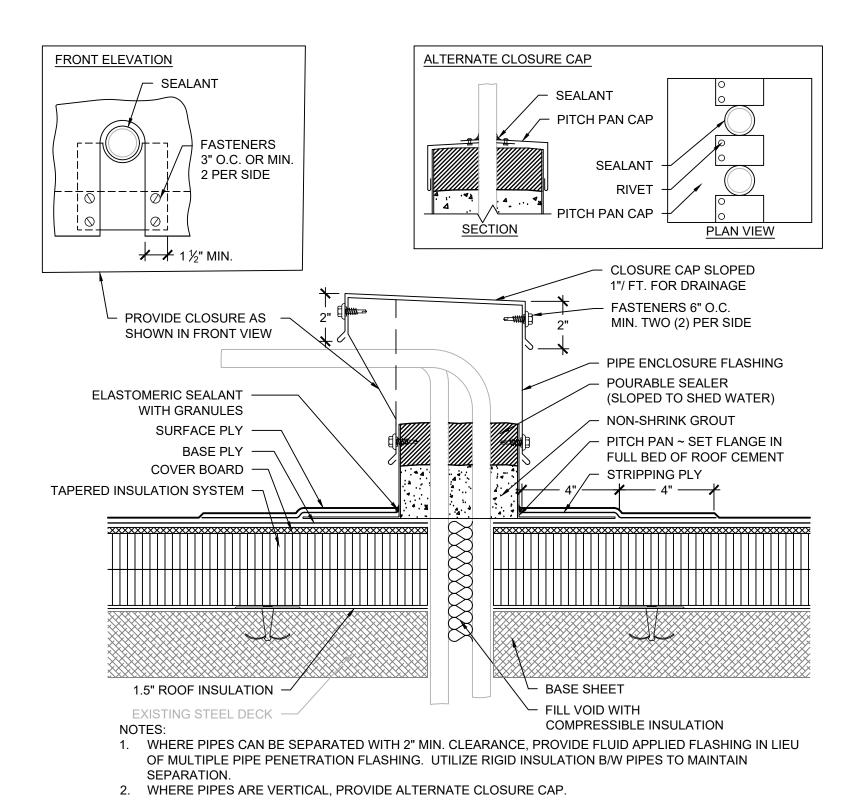


5 MULTIPLE PIPE PENETRATION

SCALE: 3" = 1'-0"

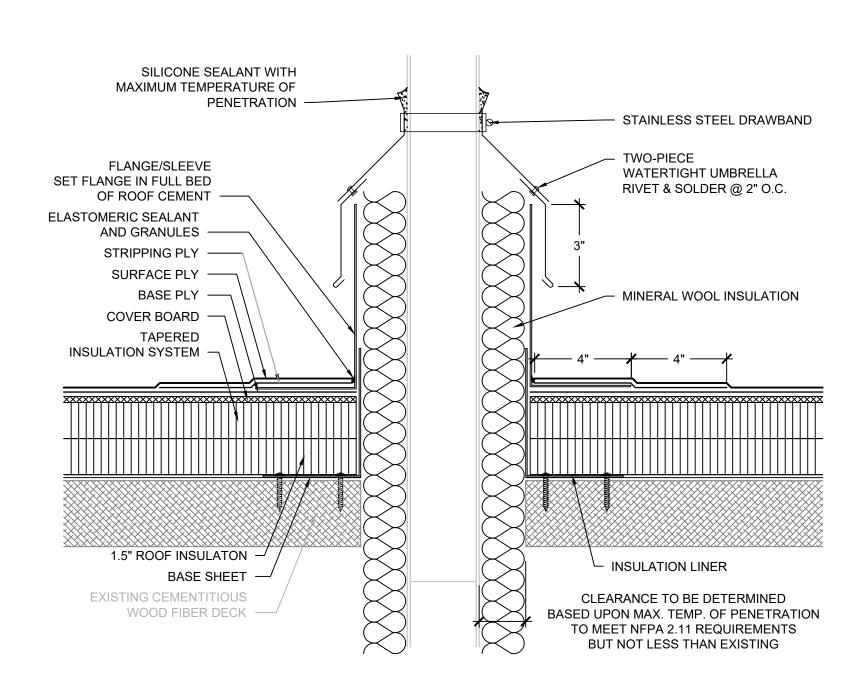


HIGH HEAT PENETRATION

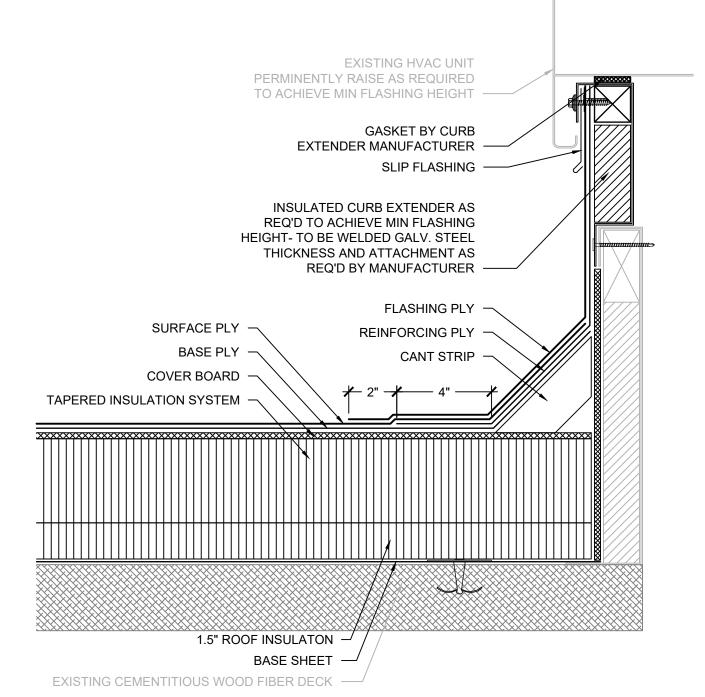

1. PROPERLY DISCONNECT UNIT, EXTEND CURB HEIGHT WITH HVAC UNIT MANUFACTURER APPROVED CURB EXTENSION TO PROVIDE MINIMUM 8" FLASHING HEIGHT, AND PROPERLY REINSTALL AND RECONNECT UNIT.


HVAC UNIT WITH CURB EXTENSION

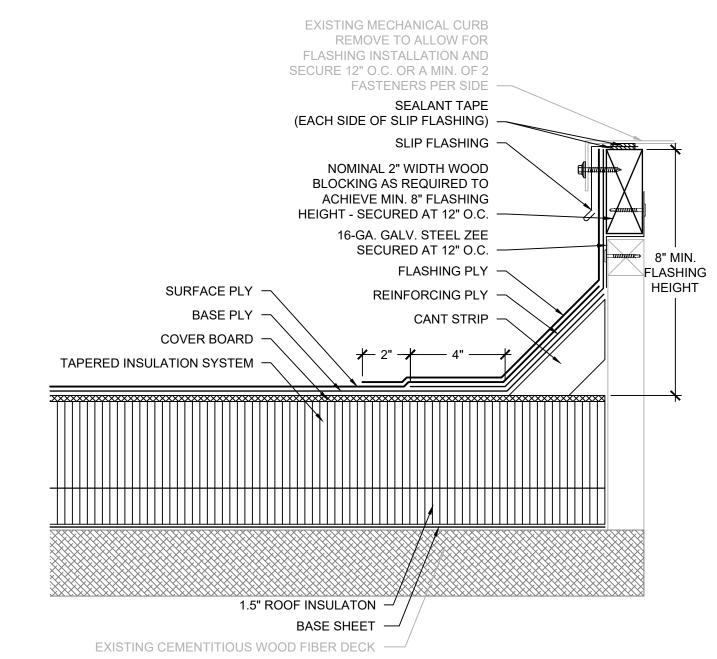

NOTES: 1. PROPERLY DISCONNECT UNIT TO RAISE AND ALLOW FLASHING INSTALLATION THEN PROPERLY REINSTALL AND 2. EXTEND CURB HEIGHT AND/OR PROVIDE WOOD NAILERS TO PROVIDE MINIMUM 8" FLASHING HEIGHT.

3. ATTACH EQUIPMENT/UNIT TO CURB WITH A MINIMUM OF TWO FASTENERS PER SIDE AND ENSURE ALL PRE-DRILLED HOLES ARE UTILIZED FOR ATTACHMENT. PROVIDE MECHANICALLY ATTACHED BASE SHEET OVER COMBUSTIBLE OR NAILABLE SUBSTRATES PRIOR TO ADHERING

MECHANICAL CURB

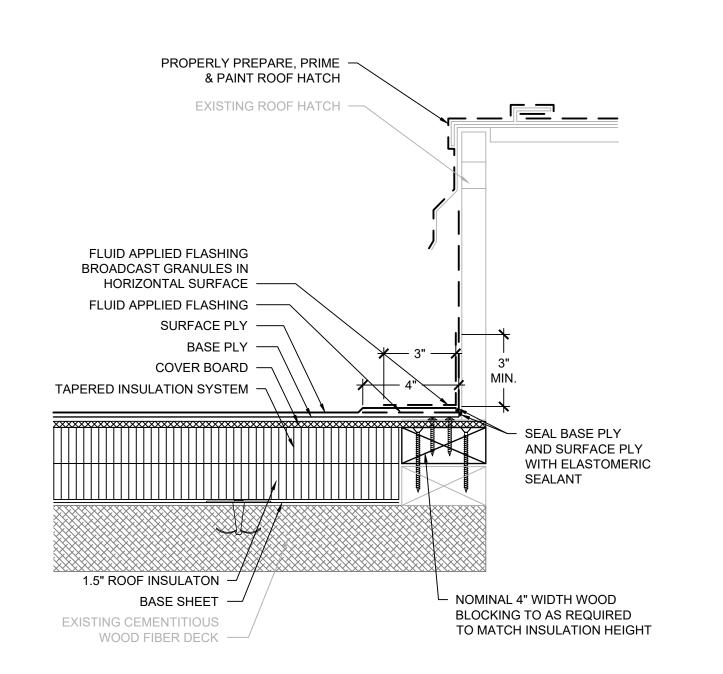

ROOF HATCH
SCALE: 3" = 1'-0"



SOUTH CAROLINA CERTIFICATE OF **AUTHORIZATION #1906** www.reiengineers.com

SEALS:



THESE DOCUMENTS ARE THE PROPERTY OF RE ENGINEERS, INC. (REI) AND REI RETAINS ALL RIGHTS THEREIN, INCLUDING COPYRIGHTS. IT MAY ONLY BE USED IN A MANNER CONSISTENT WITH REI'S RIGHTS WHILE REI IS PROVIDING SERVICE FOR THE SPECIFIC PROJECT IDENTIFIED OR REFERRED TO HEREIN OF EXTENSIONS THERETO. IT MAY NOT BE USED FOR ANY OTHER PURPOSE EXCEPT WITH THE EXPRESS WRITTEN AGREEMENT OF, AND COMPENSATION TO

REI ENGINEERS, INC. DIMENSIONS, DETAIL COMPONENTS AND EQUIPMENT PENETRATION LOCATIONS ARE FOR INFORMATION ONLY. CONTRACTOR IS RESPONSIBLE TO FIELD VERIFY ALL INFORMATION PROVIDED.

FOR DETAILS, LIGHT LINES REPRESENT EXISTING CONSTRUCTION TO REMAIN AND DARK LINES REPRESENT NEW COMPONENTS TO BE PROVIDED. ANY WHOLE OR PARTIAL INSULATION BOARD OR PORTION OF ANY BOARD WHICH FALLS IN THE PERIMETERS & CORNERS OUTLINED SHALL BE SUBJECT TO THE FASTENING REQUIREMENTS FOR THE HIGHEST WIND ZONE ENCOUNTERED, ACROSS

PROJECT NAME:

THE ENTIRE BOARD.

YORK SCHOOL DISTRICT 1

EDUCATION SERVICE CENTER ROOF REPLACEMENT

16 SPRUCE STREET YORK, SC 29745

PROJ. NO:

024CLT-098

NO. DATE DESCRIPTION

CD 10-21-24 | CONTRACT DOCUMENTS

THIS LINE IS 1 INCH ON THE ORIGINAL DRAWING

IF IT IS NOT 1 INCH ON THIS PAGE, SCALE DRAWING ACCORDINGLY.

SHEET TITLE:

DETAILS

DRAWING:

XR501