
EDGEMONT UNION FREE SCHOOL DISTRICT GREENVILLE ELEMENTARY SCHOOL WINDOW REPLACEMENT AND RELATED WORK

100 GLENDALE ROAD, SCARSDALE, NY 10583

SED PROJECT NUMBER:

66-04-06-03-0-008-023

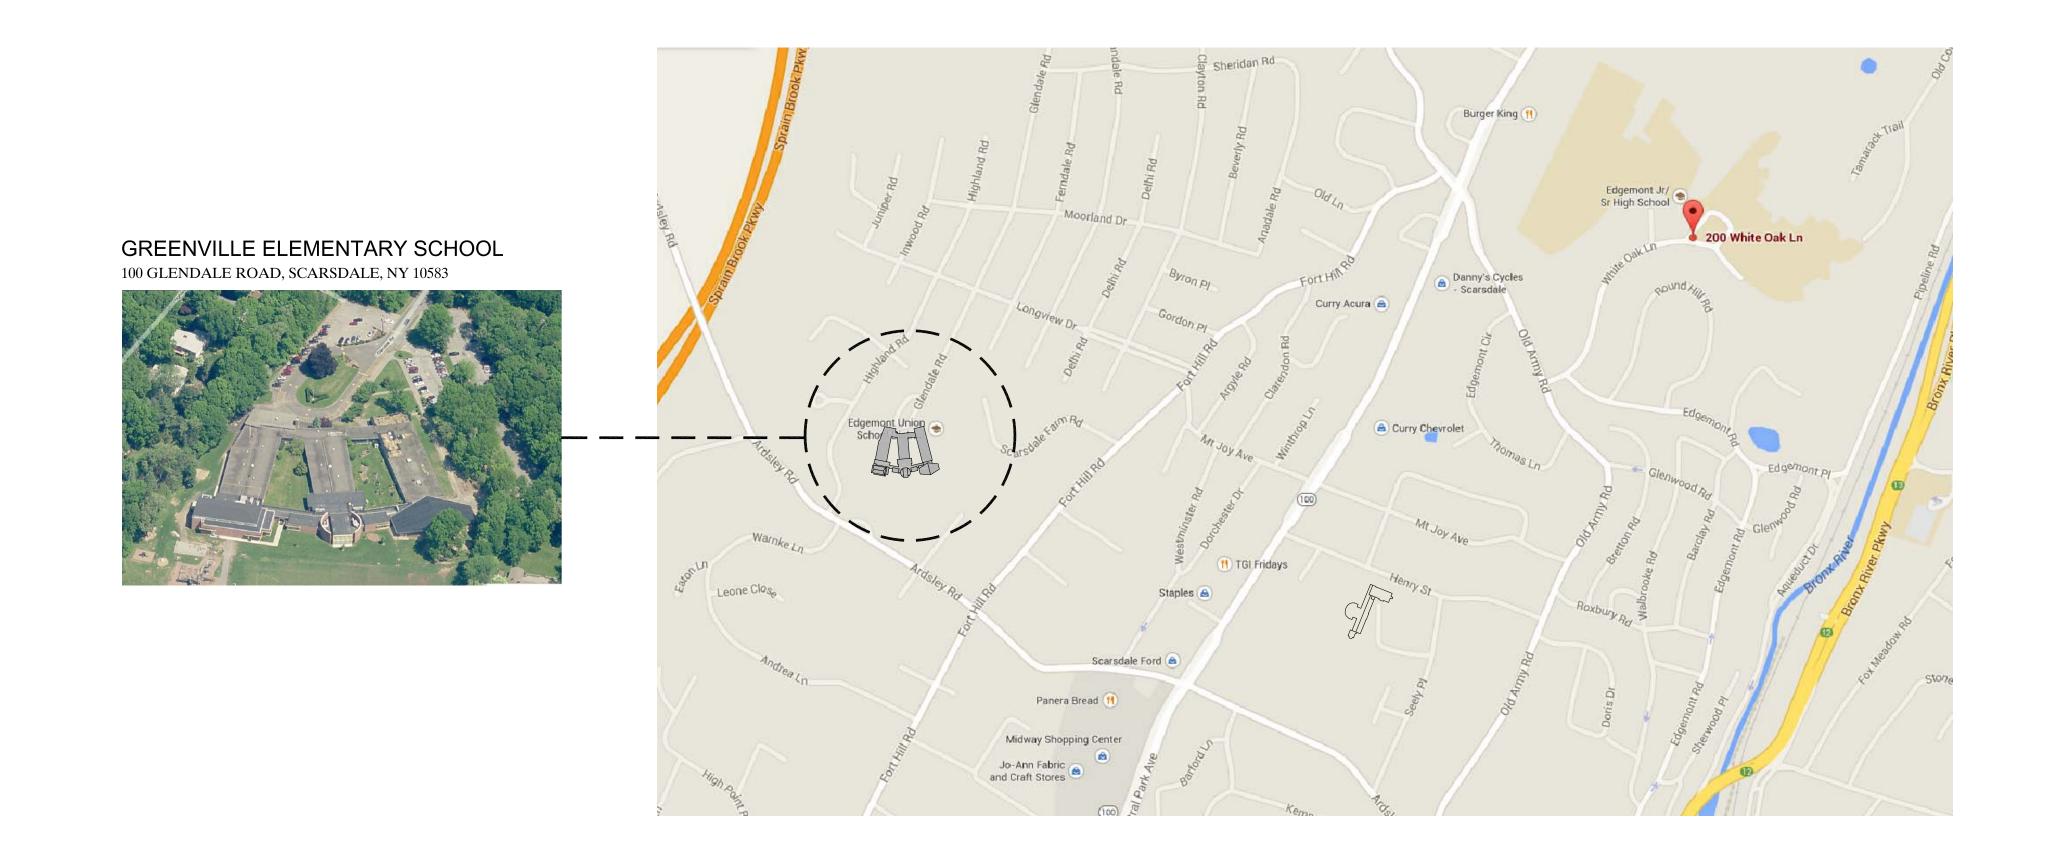



45 KNOLLWOOD ROAD ELMSFORD NEW YORK 10523
TEL 914.592.4444 FAX 914.592.1717
WWW.FULLERDANGELO.COM

Copyright 2024 All Rights Reserved by FULLER & D'ANGELO P.C.

10-23-2024
08-27-2024
11-14-2023
DATE

SHEET SIZE
30"x42"

SCALE
AS NOTED


DRAWN BY
F & D

RE-BID
SED SUBMISSION
ISSUED TO

DRAWING NO.

T-1

FILE NO.
23501.00

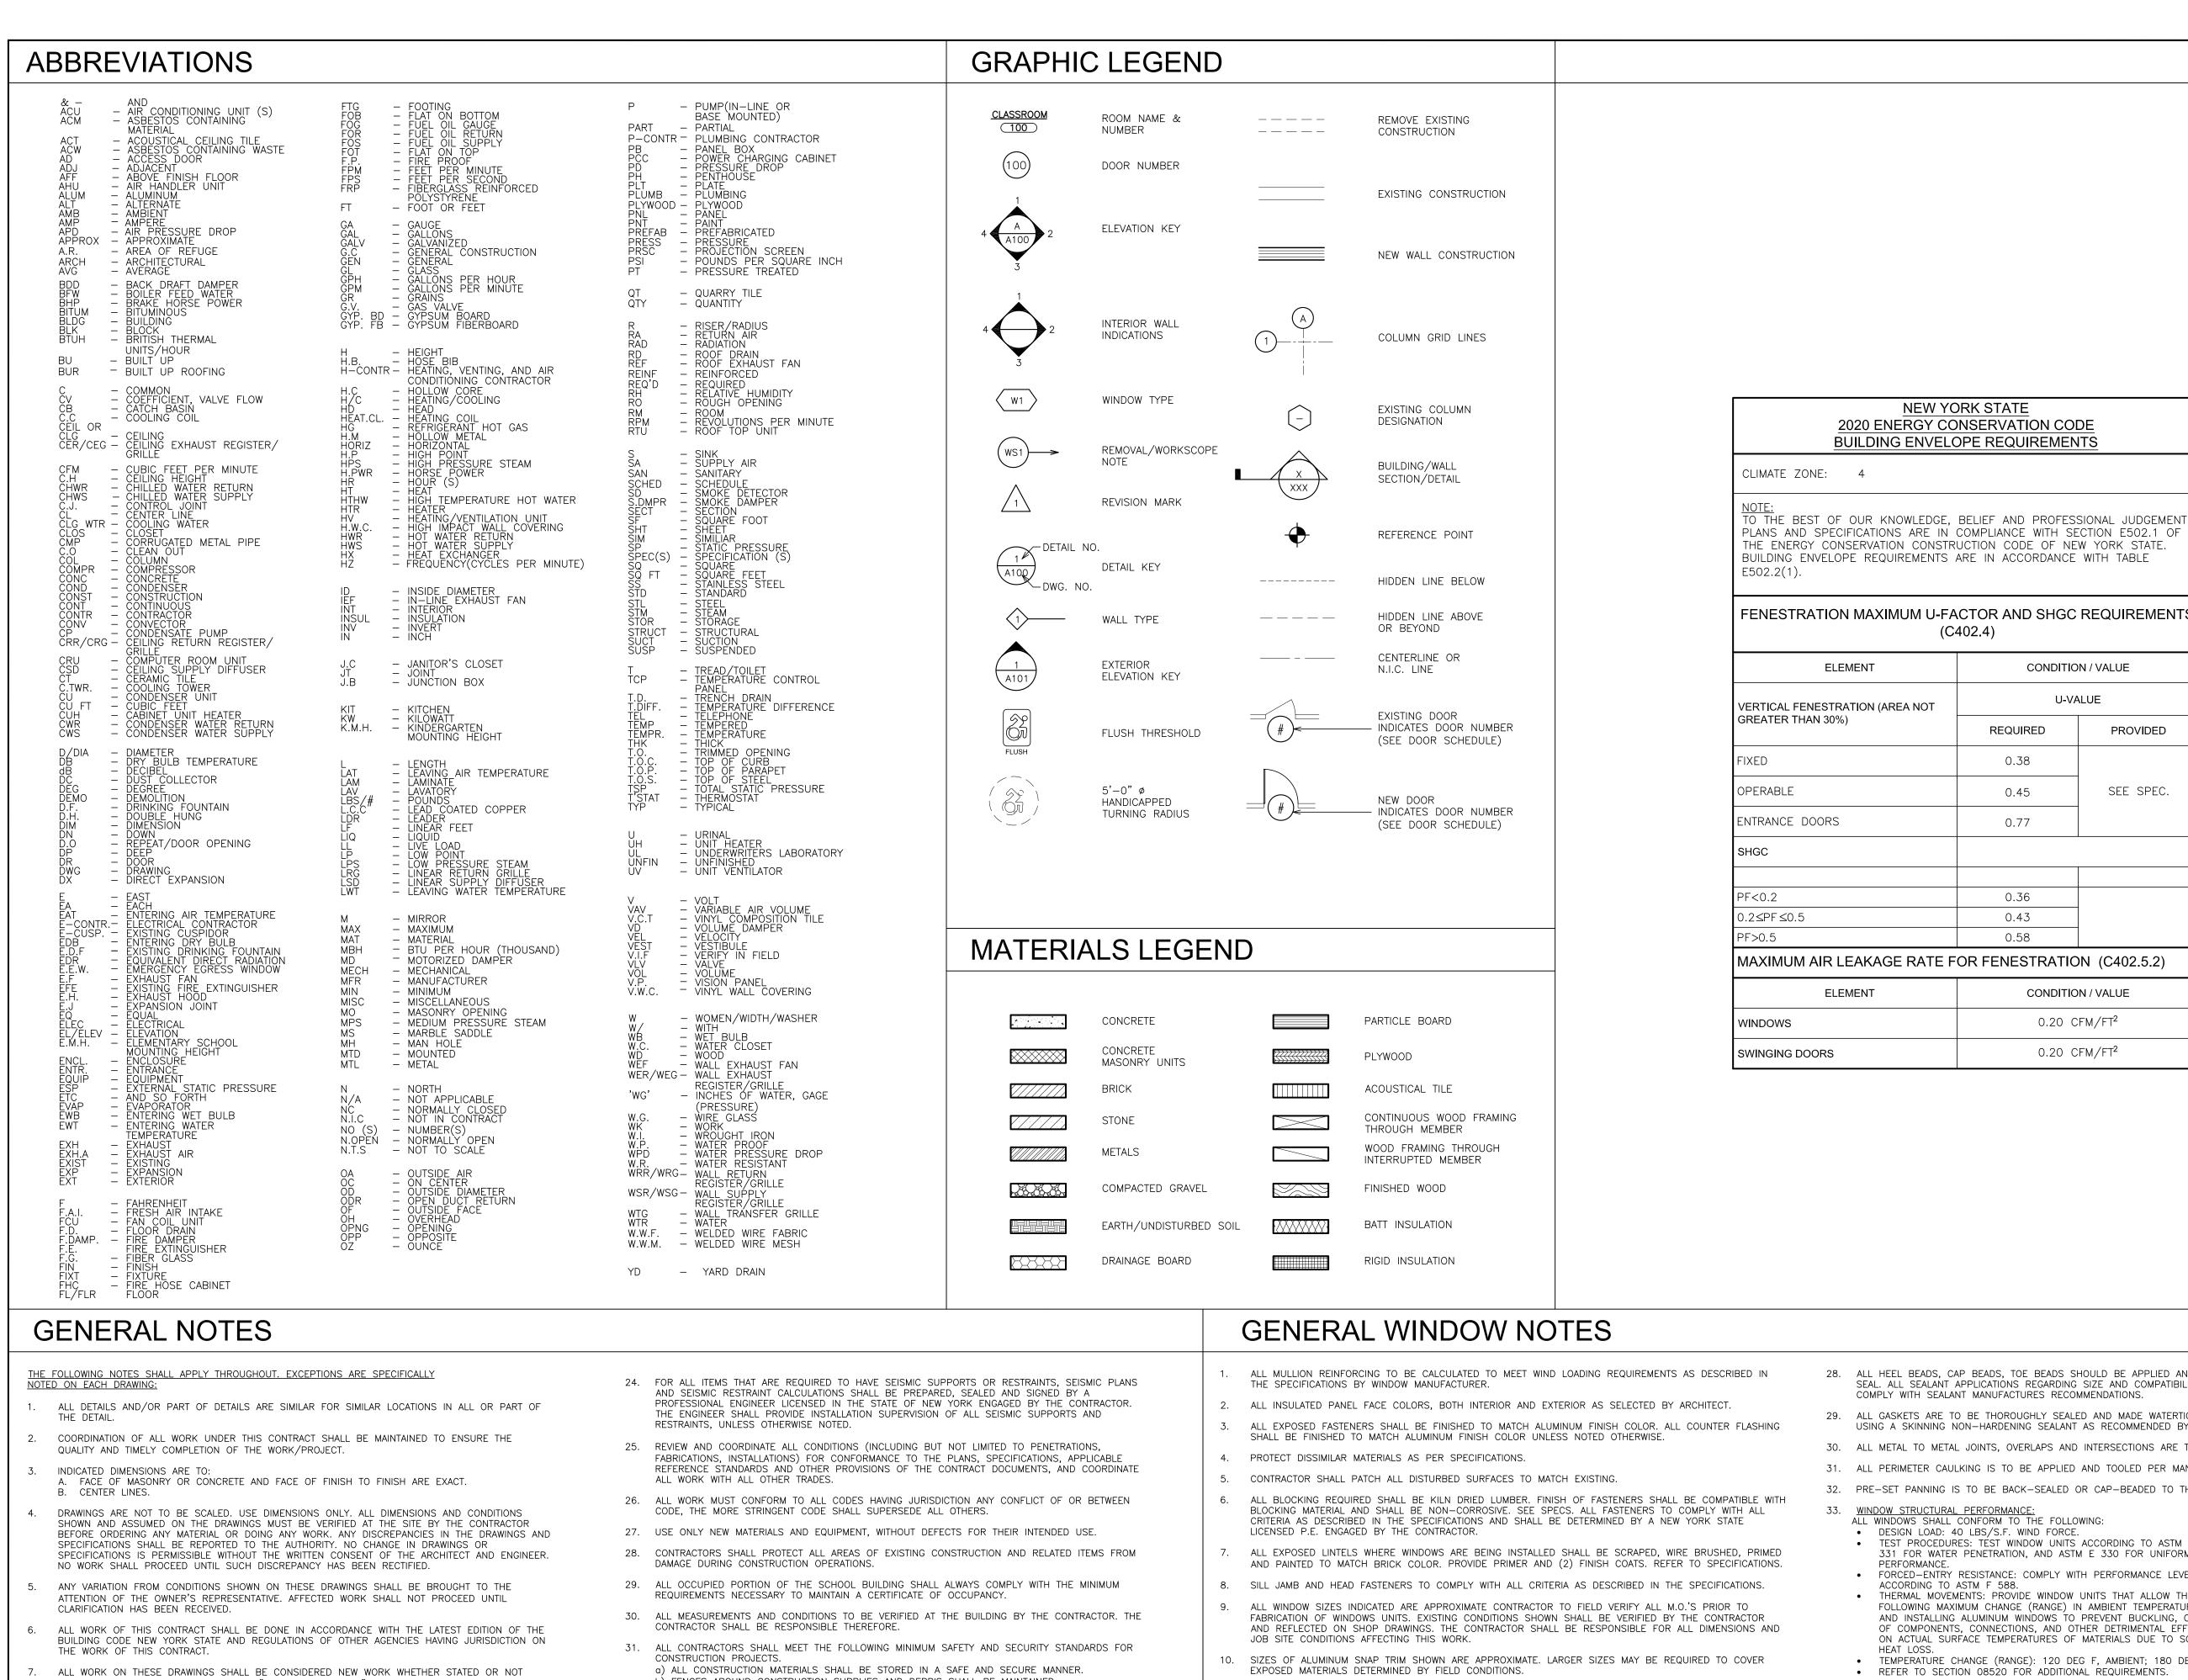

- EXCEPT WHERE SPECIFICALLY NOTED AS "EXISTING TO REMAIN"
- 8. DISCREPANCIES AND OMISSIONS ON DRAWINGS AND SPECIFICATIONS SHALL BE REPORTED TO THE OWNER'S REPRESENTATIVE IN WRITING FOR CLARIFICATION.
- 9. SET ALL WORK STRAIGHT, PLUMB AND LEVEL OR WITH INDICATED SLOPE.
- 10. THE CONTRACTOR SHALL USE THE APPROVED STANDARDS: A.I.S.C. FEDERAL, U.S., ETC. STANDARDS OF THEIR TRADES. ALL CONSTRUCTION SHALL BE PERFORMED TO THESE STANDARDS.
- 11. IF AMBIGUITIES EXIST IN THE CONTRACT DOCUMENTS, THE CONTRACTOR SHALL INCLUDE IN HIS BID THE MORE EXPENSIVE MATERIAL OR METHOD OF WORK.
- 12. THE CONTRACTOR SHALL REMOVE AND DISPOSE OF DEBRIS. THE CONTRACTOR SHALL KEEP WORK SITE FREE FROM DEBRIS AND ACCUMULATED REFUSE, AND SHALL HAVE SOLE RESPONSIBILITY FOR PROTECTING ALL DANGEROUS AREAS FROM ENTRY BY UNAUTHORIZED PARTIES. SITE SHALL BE LEFT BROOM CLEAN AT THE END OF EACH WORKING DAY.
- 13. LARGE SCALE DETAILS HAVE PRECEDENCE, HOWEVER WORK INDICATED ON SMALL SCALE DRAWINGS SHALL NOT BE OMITTED. SIMILARLY, NOTES TAKE PRECEDENCE OVER SCHEDULES, PIPING AND WIRE DIAGRAMS. HOWEVER, WORK SHOWN OR DESCRIBED BY OTHER METHODS SHALL NOT BE OMITTED. 14. THE CONTRACTOR SHALL PATCH AND REPAIR ALL DAMAGED OR EXPOSED SURFACES DUE TO

CONTRACT WORK. ALL NEWLY INSTALLED, PATCHED WORK AND ALL AFFECTED AREAS SHALL BE

- PAINTED. ALL PAINTING WORK SHALL BE PERFORMED TO COVER THE ENTIRE HORIZONTAL OR VERTICAL SURFACE TO THE CLOSEST CORNER IN ALL FOUR DIRECTIONS. COLOR TO MATCH EXISTING 15. THE CONTRACTOR SHALL FURNISH AND INSTALL NEW MATERIALS AT NO ADDITIONAL COST TO THE
- OWNER FOR THE FOLLOWING CONDITIONS: A) TO FURNISH THE WORK OF THIS CONTRACT IN WORKMANLIKE MANNER. THE CONTRACTOR SHALL BE RESPONSIBLE FOR ADEQUATELY BRACING AND PROTECTING ALL WORK
- DURING CONSTRUCTION AGAINST DAMAGE, BREAKAGE, COLLAPSE, DISTORTIONS AND OFF ALIGNMENTS ACCORDING TO CODES AND STANDARDS OF GOOD PRACTICE. 17. THE CONTRACTOR SHALL INCLUDE ALL PROPRIETARY AND ASSOCIATED SUPPLEMENTARY WORK TO PROVIDE A COMPLETE AND FINISHED INSTALLATION.
- 18. WHERE MANUFACTURER'S NAMES AND PRODUCT NUMBERS ARE INDICATED ON DRAWINGS, IT SHALL BE CONSTRUCTED TO MEAN THE ESTABLISHMENT OF QUALITY AND PERFORMANCE STANDARDS OF SUCH ITEMS. ALL OTHER PRODUCTS MUST BE SUBMITTED TO THE ARCHITECT FOR APPROVAL IN ACCORDANCE TO CONTRACT DOCUMENT REQUIREMENT BEFORE THEY SHALL BE DEEMED EQUAL.
- 19. FIRESTOPPING SHALL BE INSTALLED AT ALL PENETRATIONS OF FIRE RATED CONSTRUCTION AS PER SPECIFICATIONS. 20. PROVIDE GUARDS, RAILS, BARRICADES, FENCES, SIDEWALK SHEDS, CATCH PLATFORMS, DECKING,
- 21. THE CONTRACTOR SHALL, UNLESS OTHERWISE PROVIDED IN THE CONTRACT DOCUMENTS, SECURE AND PAY FOR REQUIRED INSPECTIONS, PERMIT(S), FEES, LICENSE AND INSPECTIONS NECESSARY FOR
- 22. ADDITIONAL NOTES WHICH ARE APPLICABLE TO THIS PROJECT MAY BE FOUND THROUGHOUT THE CONTRACT DOCUMENTS.
- 23. SEISMIC RESTRAINTS SHALL BE PROVIDED, IN ACCORDANCE TO APPLICABLE CODES.

NIGHT LIGHTING, ETC., AS REQUIRED. TO PROVIDE ADEQUATE PROTECTION.

THE PROPER EXECUTION OF THE WORK.

- b) FENCES AROUND CONSTRUCTION SUPPLIES AND DEBRIS SHALL BE MAINTAINED.) WORKERS SHALL BE REQUIRED TO WEAR PHOTO IDENTIFICATION BADGES AT ALL TIMES FOR
- 32. a) REMOVAL OF ALL DEBRIS SHALL BE THROUGH DESIGNATED, SEPARATED AND PROTECTED AREAS OF THE BUILDING. THERE SHALL BE NO MOVEMENT OF DEBRIS OR EQUIPMENT THROUGH OCCUPIED b) ALL OCCUPIED PARTS OF A BUILDING AFFECTED BY CONSTRUCTION ACTIVITY SHALL BE CLEANED
- AT THE CLOSE OF EACH WORK DAY. 33. CONTRACTOR SHALL MAKE THE BUILDING SECURE AT THE END OF EACH WORK DAY. PROVIDE TEMPORARY PLYWOOD COVERS OVER WINDOW/ DOOR OPENINGS AS REQUIRED TO SECURE BUILDING
- TO THE OWNERS SATISFACTION.
- 34. CLEANING DURING WINDOW WORK: -PRIOR TO START OF WINDOW WORK IN A SPACE, THE CONTRACTOR WILL MOVE ALL FURNITURE, EQUIPMENT AND MATERIALS TO A SPACE OPPOSITE IN THE ROOM FROM THE WINDOW. THE MATERIALS, EQUIPMENT AND FURNITURE WILL BE COVERED WITH SHEETING AT LEAST 1 MIL. THICK. THE MATERIALS ARE TO BE PROTECTED THROUGHOUT THE WORK. THROUGHOUT THE PROJECT, GARBAGE AND DEBRIS BOTH INSIDE AND OUTSIDE ARE TO BE CLEANED ON DAILY BASIS. -AT THE COMPLETION OF THE WINDOW WORK, THE MATERIALS, EQUIPMENT AND FURNITURE WILL BE MOVED BACK TO THEIR ORIGINAL LOCATION BY DISTRICT PERSONNEL -THE CONTRACTOR SHALL CLEAN MATERIALS, EQUIPMENT AND FURNITURE SURFACES AND BROOM

GENERAL REMOVAL NOTES:

CLEANED THE FLOORS.

IDENTIFICATION AND SECURITY PURPOSES WHILE WORKING ON SITE.

- REMOVAL DRAWINGS INDICATE ONLY MAJOR SCOPE OF REMOVALS. CONTRACTOR IS REQUIRED TO REMOVE ANY AND ALL ITEMS NOT SHOWN AS REQUIRED TO SUIT ALL NEW WORK. CONTRACTOR IS REQUIRED TO REMOVE, PROTECT AND STORE ANY AND ALL ITEMS SHOWN AS REQUIRED TO SUIT ALL NEW WORK, COORDINATE w/OWNER FOR STORING LOCATIONS.
- CONTRACTOR IS TO VERIFY ANY MAJOR DIMENSIONAL DEVIATIONS FROM DRAWINGS OR STRUCTURAL OBSTRUCTIONS. THESE SHALL BE BROUGHT TO THE OWNER'S REPRESENTATIVE'S ATTENTION. ALL CONTRACT DRAWINGS INDICATE APPROXIMATE DIMENSIONS AND EXISTING CONDITIONS BASED ON FIELD SURVEY AND DRAWINGS FURNISHED BY THE OWNER. VARIATIONS MAY EXIST AS TO FIELD CONDITIONS. THE COST FOR ANY SUCH VARIATIONS SHALL BE INCLUDED WITHIN THE CONTRACT BID.
- ALL SURFACES DISTURBED BY REMOVALS SHALL BE PATCHED/REPAIRED TO MATCH EXISTING ADJACENT FINISHES, COORDINATE AND PREPARE SURFACES TO ACCOMMODATE WITH NEW FINISH ACCORDING TO SPECS AND MANUFACTURER'S RECOMMENDATIONS.
- GENERAL CONTRACTOR SHALL FIRE STOP ALL TRADE RELATED EXISTING OR NEW PENETRATIONS THROUGH FLOORS, PARTITIONS AND WALLS AT ALL LOCATIONS WITH APPROVED MATERIALS AND SYSTEMS.
- ALWAYS WORK IN A MANNER WHICH PROVIDES CONTINUOUS SUPPORT TO STRUCTURE ABOVE. PROVIDE APPROPRIATE LINTEL FOR ALL OPENINGS UNLESS SPECIFIED OTHERWISE. 6. REMOVE ALL WINDOW TREATMENTS AND HARDWARE WHERE WINDOWS ARE BEING REPLACED. IF REQUESTED,
- TURNOVER TO OWNER. 7. GENERAL CONTRACTOR TO COORDINATE REMOVALS WITH NEW WORK.
- FOR ABATEMENT OF HAZARDOUS/ TOXIC MATERIALS REFER TO HAZARDOUS MATERIALS DRAWINGS AND SPECIFICATIONS.
- ABATEMENT OF HAZARDOUS MATERIAL SHALL BE COORDINATED WITH REMOVAL WORK.

- 11. CONCEALED FLASHING SHALL BE CORROSION RESISTANT, NON-STAINING AND NON-BLEEDING, COMPATIBLE WITH ADJACENT MATERIALS.
- 12. SEALANT COLOR SHALL MATCH ADJACENT ALUMINUM EXTRUSION AND FLASHING. UNLESS NOTED OTHERWISE. 13. FASTENER TYPE, LENGTH, AND SPACING SHALL BE AS REQUIRED BY DESIGN LOAD CRITERIA AND SHALL BE DETERMINED BY A NEW YORK STATE LICENSED P.E. ENGAGED BY THE CONTRACTOR.
- 14. REFER TO SPECIFICATIONS FOR SCREENS.
- 15. ALL INSULATED PANELS SHALL BE FIRE RATED. REFER TO SPECIFICATIONS.
- 16. EMERGENCY EGRESS WINDOWS (EEW) WINDOWS SHALL HAVE A MINIMUM NET CLEAR OPENING OF 6 S.F. WITH A MINIMUM DIMENSION OF 24". WINDOW OPERATING HARDWARE SHALL BE A MAXIMUM OF 54" ABOVE THE FINISHED FLOOR. PROVIDE LABEL, REFER TO DETAIL 1/A726.
- 17. PROVIDE SECURITY AND WEATHER PROTECTION OF THE WINDOW OPENINGS AND PROTECT FROM DAMAGE. MINIMUM ¼" PLYWOOD AND PLASTIC SHEETING.
- 18. ALL GLAZING 1" INSULATING TEMPERED UNLESS NOTED OTHERWISE.
- 19. CONTRACTOR TO CAREFULLY UNFASTEN EXISTING METAL PARTITION CLOSURE PLATES PRIOR TO REMOVAL OF EXISTING CURTAINWALL. TRIM CLOSURE PLATES TO ACCOMMODATE NEW WINDOW WALL SYSTEM. 20. PROVIDE AND INSTALL WINDOW TREATMENT AS INDICATED AND PER SPECIFICATIONS. PROVIDE RESCUE
- WINDOW LABEL OVER SHADE AT ALL DESIGNATED EGRESS WINDOWS. 21. CONTRACTOR TO FIELD VERIFY ALL CONDUIT, VENT, FANS, AC UNITS, AND SIMILAR ITEMS AND PROVIDE
- CONTRACTOR SHALL REMOVE ALL EXISTING WINDOWS. TRIM AND MISCELLANEOUS APPURTENANCES AS
- REQUIRED. TO INSTALL NEW WINDOW UNITS. 23. ISOLATE ALL ALUMINUM TO BE PLACED DIRECTLY IN CONTACT WITH UNCURED MASONRY OR INCOMPATIBLE
- MATERIALS. THIS ISOLATION OR COATING SHOULD BE INDICATED ON SHOP DRAWINGS. 24. WHEN USING PRESSURE TREATED WOOD BLOCKING IT HAS BECOME NECESSARY TO ISOLATE ALL ALUMINUM
- SURFACES THAT COMES INTO CONTACT WITH THIS WOOD. THE USE OF COMPATIBLE SELF ADHESIVE WINDOW AND DOOR FLASHING IS AN ACCEPTABLE MEANS OF ISOLATION.
- 25. IF CONTRACTOR INTENDS TO USE PRESSURE TREATED WOOD BLOCKING, STAINLESS STEEL FASTENERS ARE
- PROTECT MATERIALS AFTER ERECTION- PROTECT BY WRAPPING WITH KRAFT PAPER OR BY ERECTING VISQUEEN OR CANVAS SPLATTER SCREEN. CEMENT. PLASTER, TERRAZZO AND OTHER ALKALINE SOLUTIONS AND ACID BASED MATERIALS USED TO CLEAN MASONRY ARE VERY HARMFUL TO THE FINISH AND SHOULD BE REMOVED WITH WATER AND MILD SOAP IMMEDIATELY. ALL CLEANING SHOULD BE DONE IN ACCORDANCE WITH AAMA 609.93 VOLUNTARY GUIDE SPECIFICATION FOR CLEANING AND MAINTENANCE OF PAINTED ALUMINUM EXTRUSIONS AND CURTAIN WALL PANELS.
- 27. SEALANT MUST BE COMPATIBLE WITH ALL MATERIALS WITH WHICH THEY HAVE CONTACT, INCLUDING OTHER SEALANT SURFACES.

TO THE BEST OF OUR KNOWLEDGE, BELIEF AND PROFESSIONAL JUDGMENT, PLANS AND SPECIFICATIONS ARE IN COMPLIANCE WITH THE ENERGY CONSERVATION CONSTRUCTION CODE OF NEW YORK STATE.

28. ALL HEEL BEADS, CAP BEADS, TOE BEADS SHOULD BE APPLIED AND TOOLED TO ACHIEVE A WEATHER TIGHT SEAL. ALL SEALANT APPLICATIONS REGARDING SIZE AND COMPATIBILITY WITH ADJACENT MATERIALS SHOULD

CONDITION / VALUE

U-VALUE

CONDITION / VALUE

 0.20 CFM/FT^2

 0.20 CFM/FT^2

PROVIDED

SEE SPEC.

REQUIRED

0.38

0.45

0.77

0.36

0.43

0.58

- 29. ALL GASKETS ARE TO BE THOROUGHLY SEALED AND MADE WATERTIGHT AT ALL JOINTS AND INTERSECTIONS USING A SKINNING NON-HARDENING SEALANT AS RECOMMENDED BY SEALANT MANUFACTURER.
- 30. ALL METAL TO METAL JOINTS, OVERLAPS AND INTERSECTIONS ARE TO BE SEALED WATERTIGHT.
- 31. ALL PERIMETER CAULKING IS TO BE APPLIED AND TOOLED PER MANUFACTURERS RECOMMENDATIONS.
- 32. PRE-SET PANNING IS TO BE BACK-SEALED OR CAP-BEADED TO THE WINDOW FRAME.
 - DESIGN LOAD: 40 LBS/S.F. WIND FORCE. TEST PROCEDURES: TÉST WINDOW UNITS ACCORDING TO ASTM E 283 FOR AIR INFILTRATION, ASTM E
- FORCED-ENTRY RESISTANCE: COMPLY WITH PERFORMANCE LEVEL 10 REQUIREMENTS WHEN TESTED ACCORDING TO ASTM F 588. THERMAL MOVEMENTS: PROVIDE WINDOW UNITS THAT ALLOW THERMAL MOVEMENT RESULTING FROM THE FOLLOWING MAXIMUM CHANGE (RANGE) IN AMBIENT TEMPERATURE WHEN ENGINEERING, FABRICATING, AND INSTALLING ALUMINUM WINDOWS TO PREVENT BUCKLING, OPENING OF JOINTS, AND OVERSTRESSING OF COMPONENTS, CONNECTIONS, AND OTHER DETRIMENTAL EFFECTS. BASE ENGINEERING CALCULATION ON ACTUAL SURFACE TEMPERATURES OF MATERIALS DUE TO SOLAR HEAT GAIN AND NIGHTTIME SKY
- TEMPERATURE CHANGE (RANGE): 120 DEG F, AMBIENT; 180 DEG F, MATERIAL SURFACES.
- 36. <u>SAFETY GLAZING REQUIREMENTS (NYSBC CHAPTER 24)</u>
 INSTALL SAFETY GLAZING IN SPECIFIC HAZARDOUS LOCATIONS AS REQUIRED PER SECTION 2406.
- 38. AT LOCATIONS WHERE EXISTING FIN TUBE RADIATION IS TO BE TEMPORARILY SUPPORTED, WINDOW
- 39. AT LOCATIONS WHERE EXISTING FIN TUBE RADIATION IS TO BE REMOVED, THE WINDOW CONTRACTOR IS

- COMPLY WITH SEALANT MANUFACTURES RECOMMENDATIONS.

- ALL WINDOWS SHALL CONFORM TO THE FOLLOWING:
- 331 FOR WATER PENETRATION, AND ASTM E 330 FOR UNIFORM LOAD DEFLECTION AND STRUCTURAL
- REFER TO SECTION 08520 FOR ADDITIONAL REQUIREMENTS.
- REFER TO SPECIFICATION SECTIONS 084313, 084413, 085113.
- CONTRACTOR IS TO TEST THE HEATING SYSTEM UPON COMPLETION OF CONSTRUCTION AND MAKE ANY
- REQUIRED TO DRAIN THE HEATING SYSTEM, INSTALL NEW FIN TUBE, REFILL THE SYSTEM AND TEST. WINDOW CONTRACTOR TO MAKE ANY REPAIRS NECESSARY. GLYCOL MAY OR MAY NOT BE IN THE SYSTEM (V.I.F.).

LIST OF DRAWINGS

ABBREVIATIONS, LEGENDS, GENERAL NOTES, GENERAL WINDOW NOTES,

PARTIAL FIRST FLOOR PLANS & PARTIAL CLEARSTORY PLANS

WINDOW SCHEDULE, DOOR SCHEDULE, & DOOR TYPES

GENERAL REMOVAL NOTES & LIST OF DRAWINGS

EXTERIOR PARTIAL ELEVATIONS

EXTERIOR PARTIAL ELEVATIONS

EXTERIOR PARTIAL ELEVATIONS

WALL SECTIONS

WALL SECTIONS

WALL SECTIONS

WALL SECTIONS

WINDOW DETAILS

WINDOW DETAILS

WINDOW DETAILS

WALL SECTIONS

GENERAL:

ARCHITECTURAL:

G-1

A301

A302

A425

A426

A427

A428

A429


A726

A727

A728

W IAGUTOTHUGA CONCOLACI AND OA
AS PER USA CONGRESS ARCHIECIORAL W
PROTECTION ACT OF 1990 ALL IDEAS AND
DERIVATIVES THEREOF, ALL DRAWINGS AND
CONSTITUTE THE ORIGINAL COPYRIGHT WOR
D'ANGELO, P.C. (F&D). THE DRAWINGS AN
INSTRUMENTS OF SERVICE BY F&D ARE CF
THIS PROJECT ONLY AND REMAIN THE PRO
OF F&D. ANY REPRODUCTION WITHOUT THE
F&D IS PROHIBITED.


TEL 914.692,4444 WWW.FULLERDANGEL	
WWW.FULLERDANGEL	WWW.FULLERDANGEL

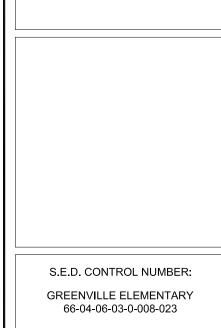



DRAWING TITLE LOCATION MAP, ABBREVIATIONS, LEGENDS, GENERAL NOTES, GENERAL WINDOW NOTES & GENERAL REMOVAL NOTES


10-23-2024	RE-BID
08-27-2024	BID
11-14-2023	S.E.D. SUBMISSION
DATE	ISSUED TO
SCALE	DRAWING NO.
AS NOTED	
DRAWN BY	G1
CHECKED BY	FILE NO.


FILE: I:\23501.00 Edgemont Greenville Window replacement\DRAWINGS\CURRENT\1-F&D\23501.00-G-1.dwg

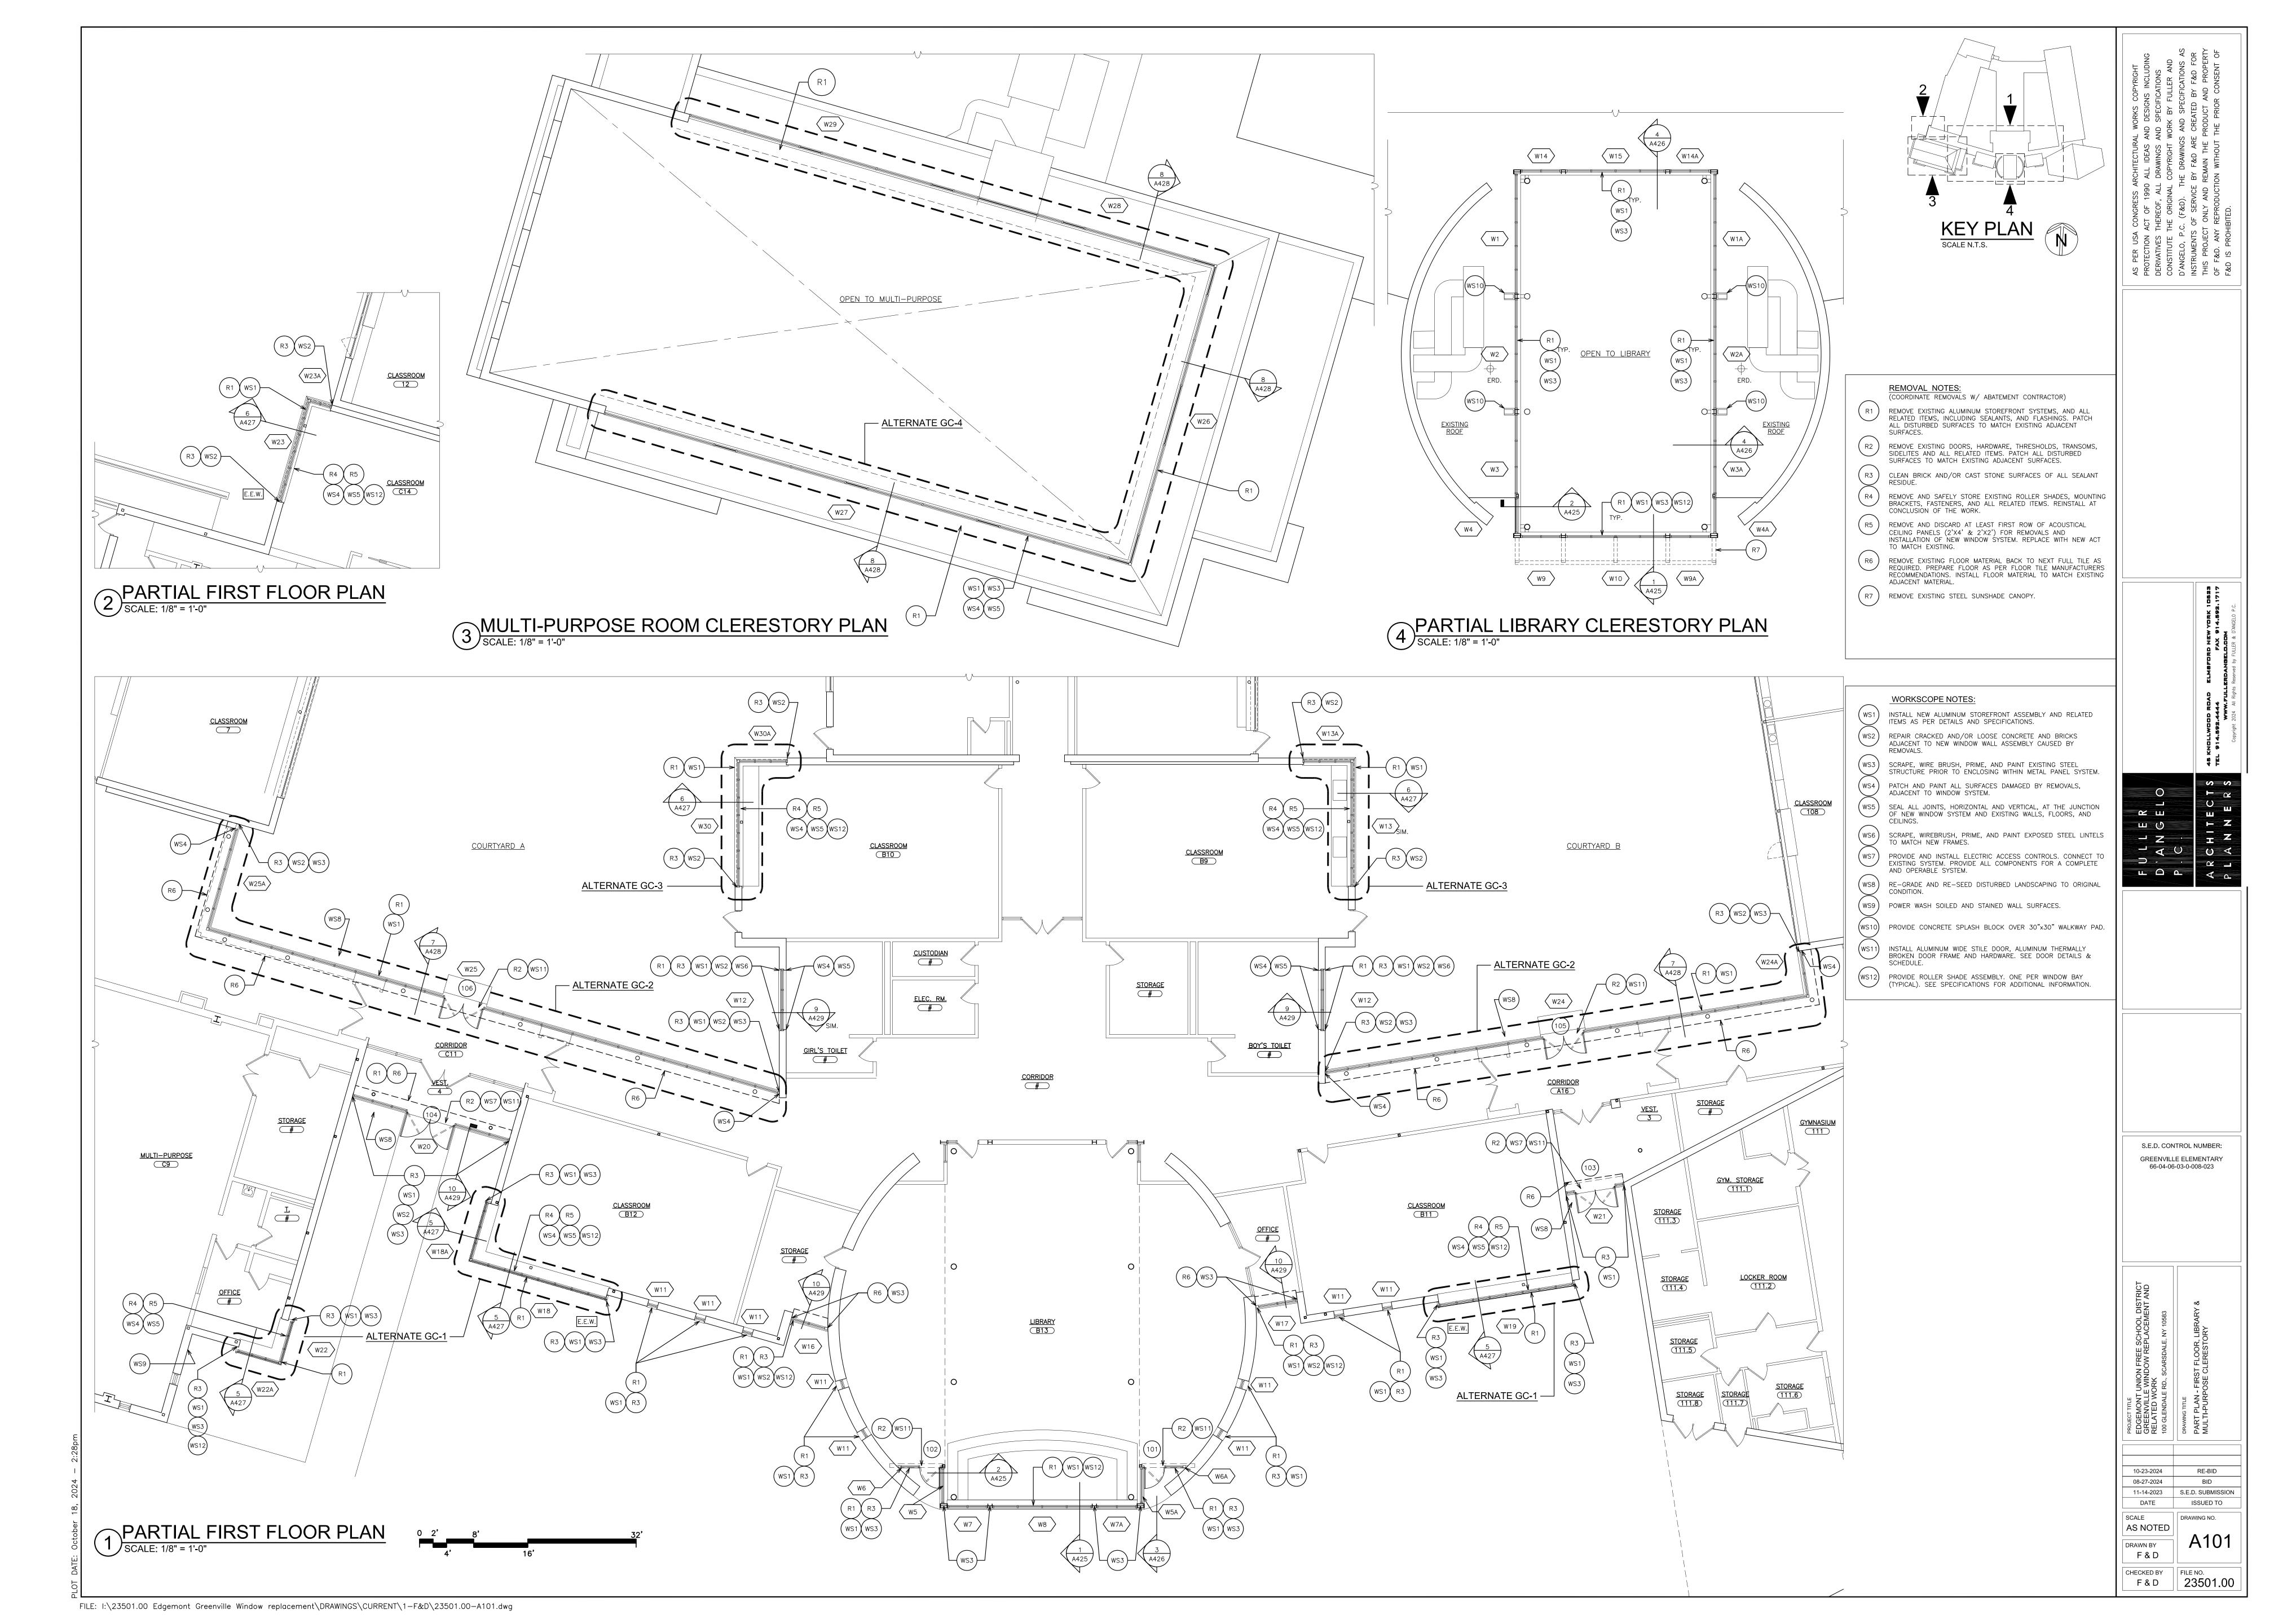


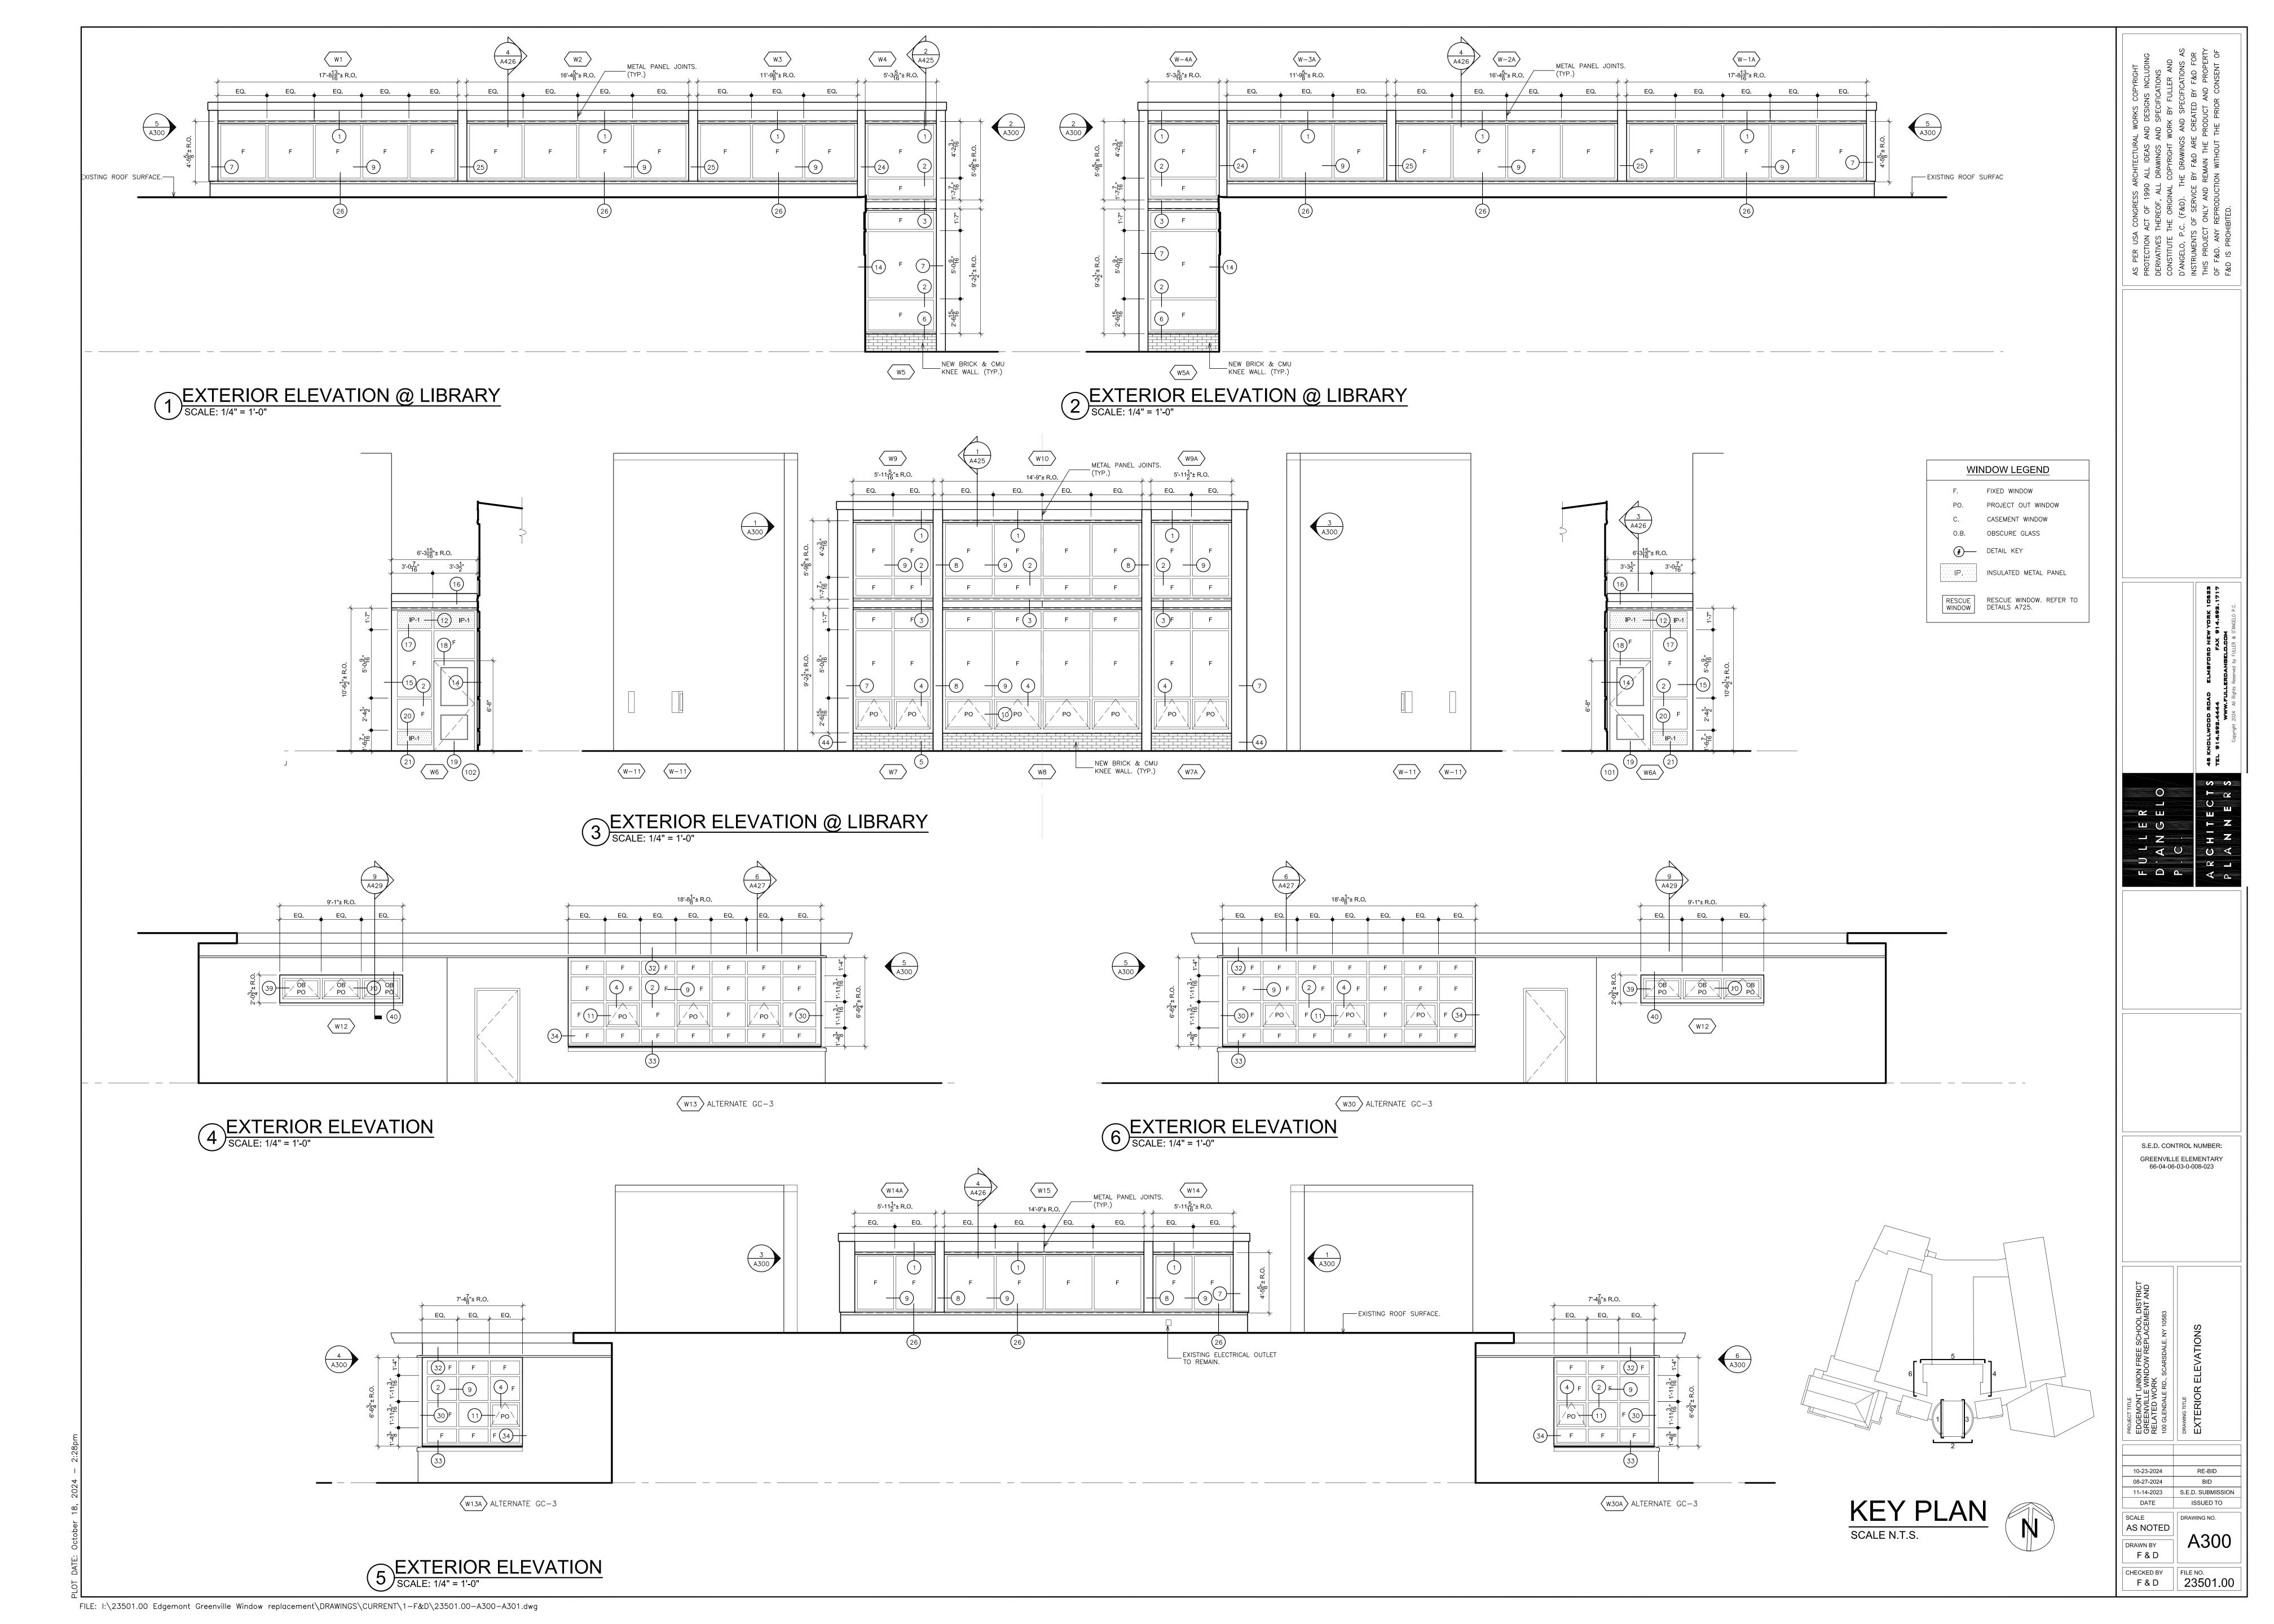


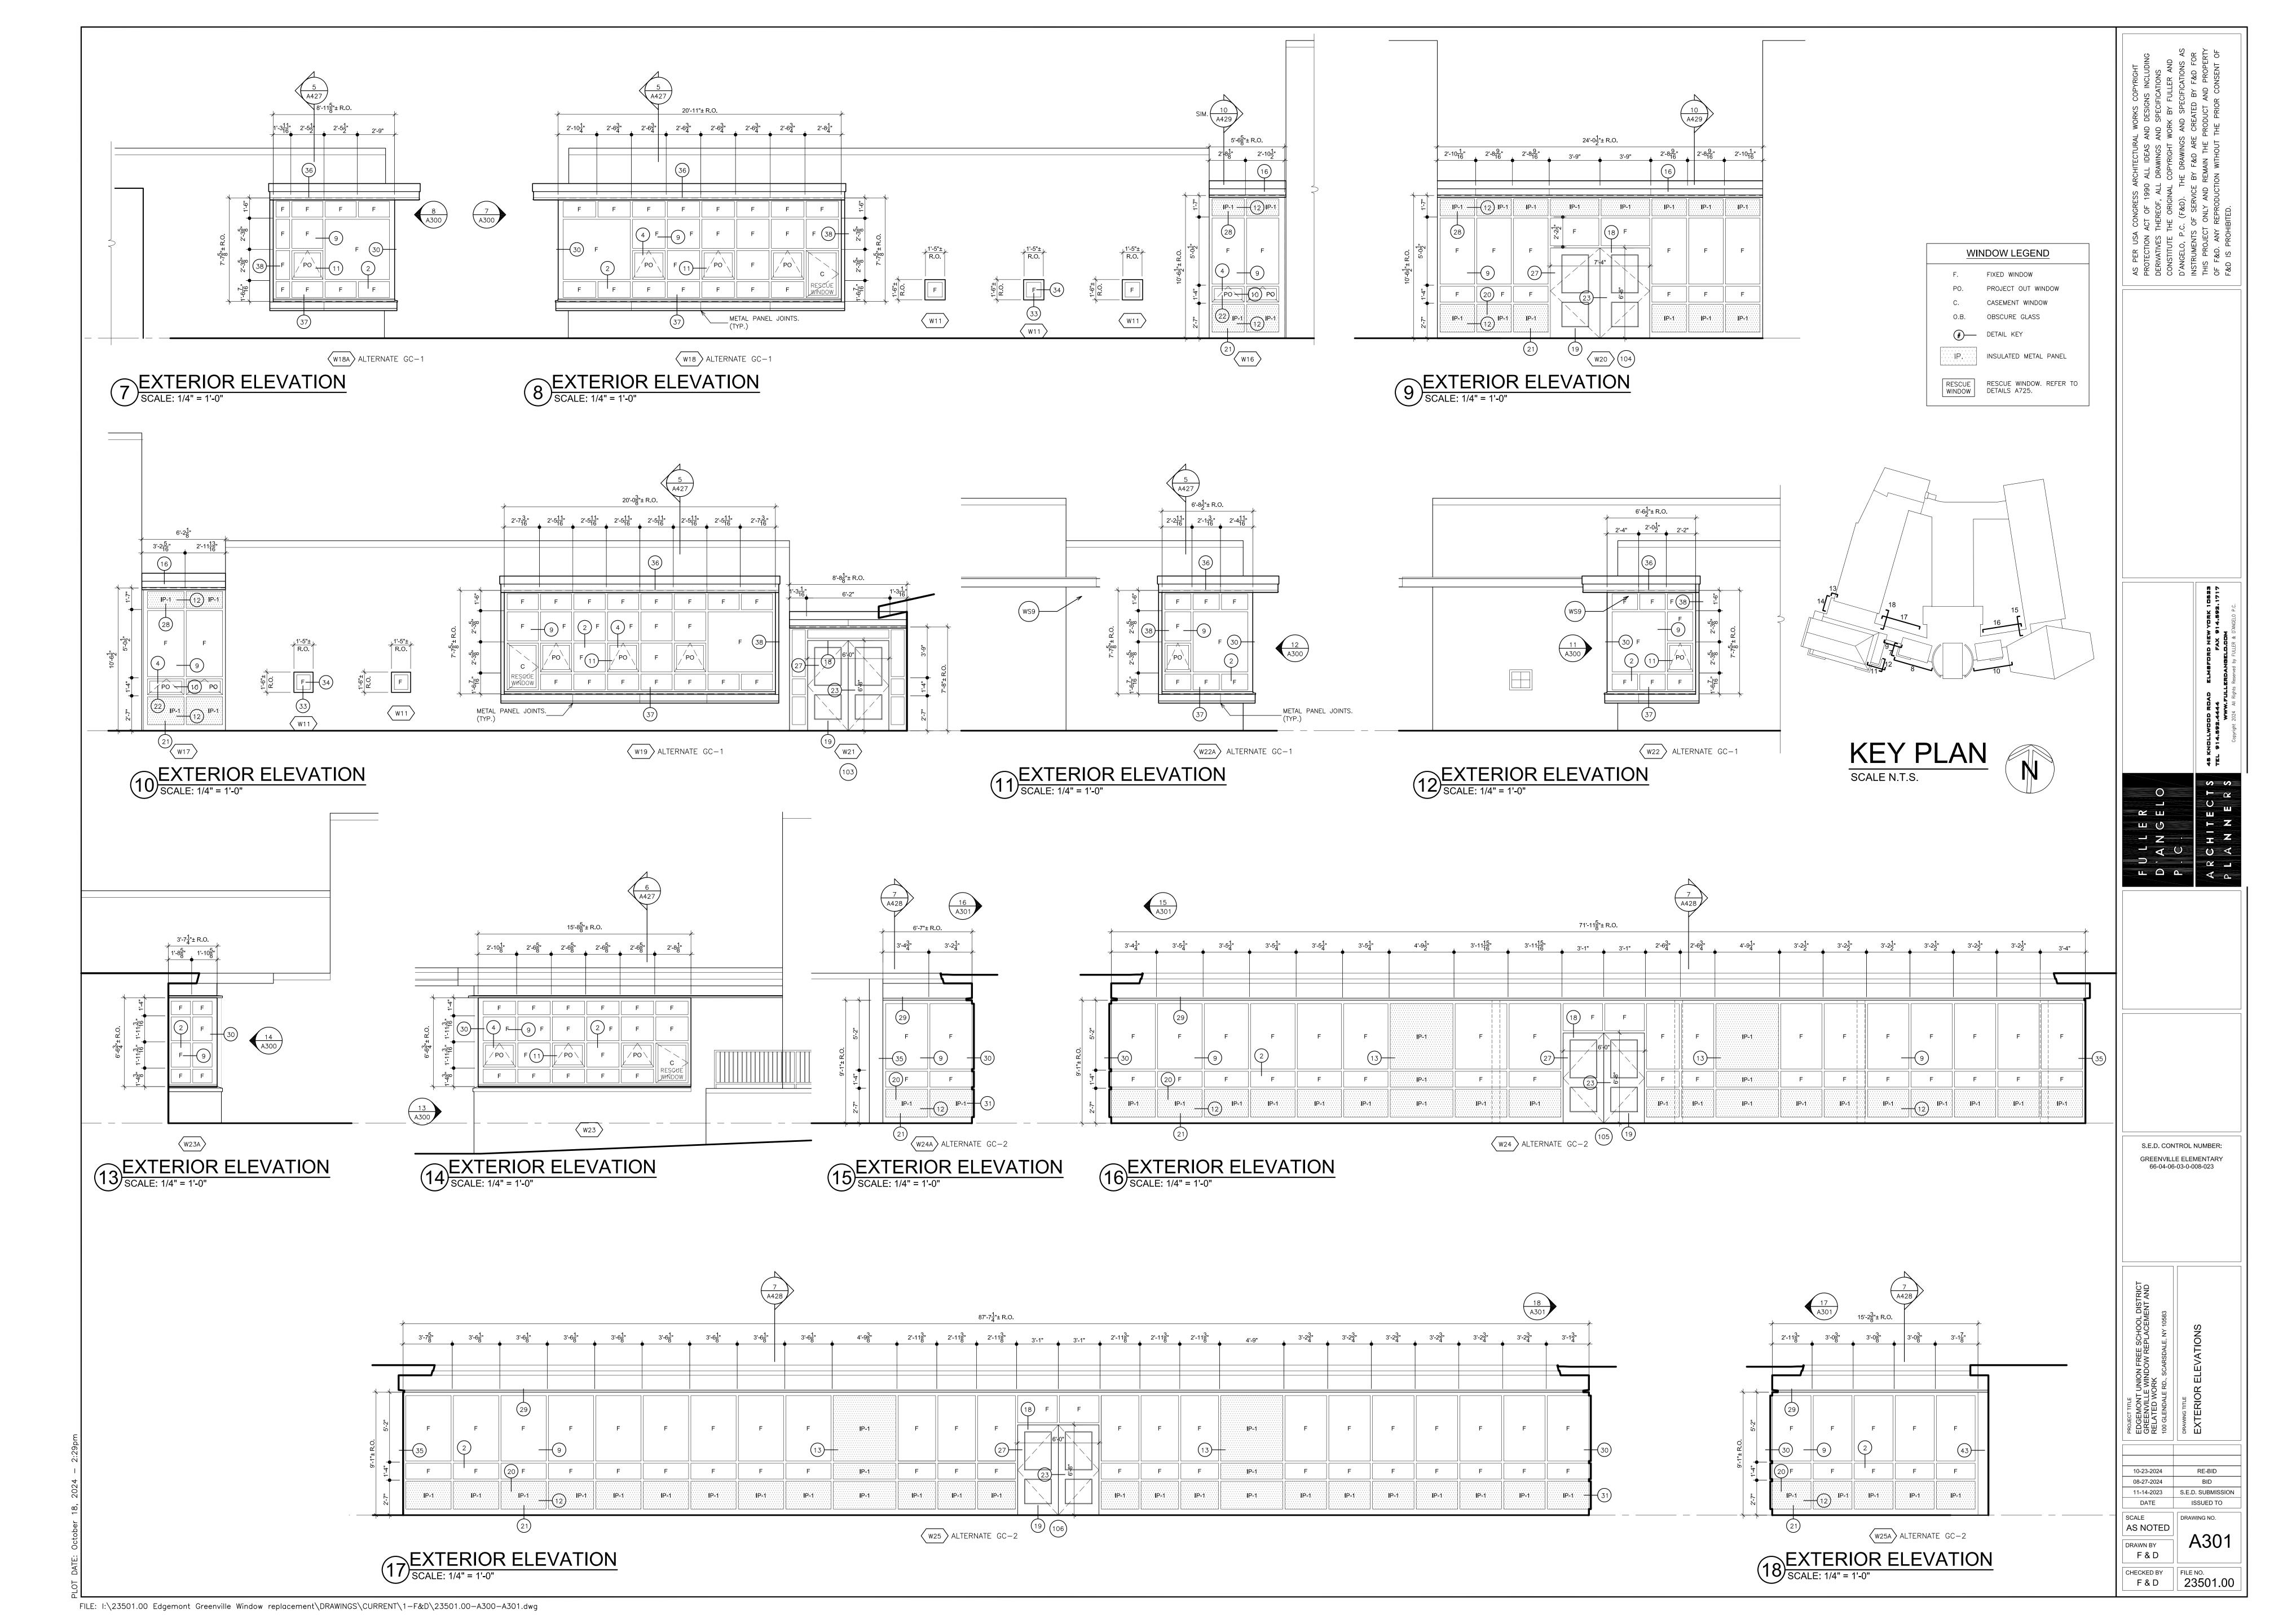


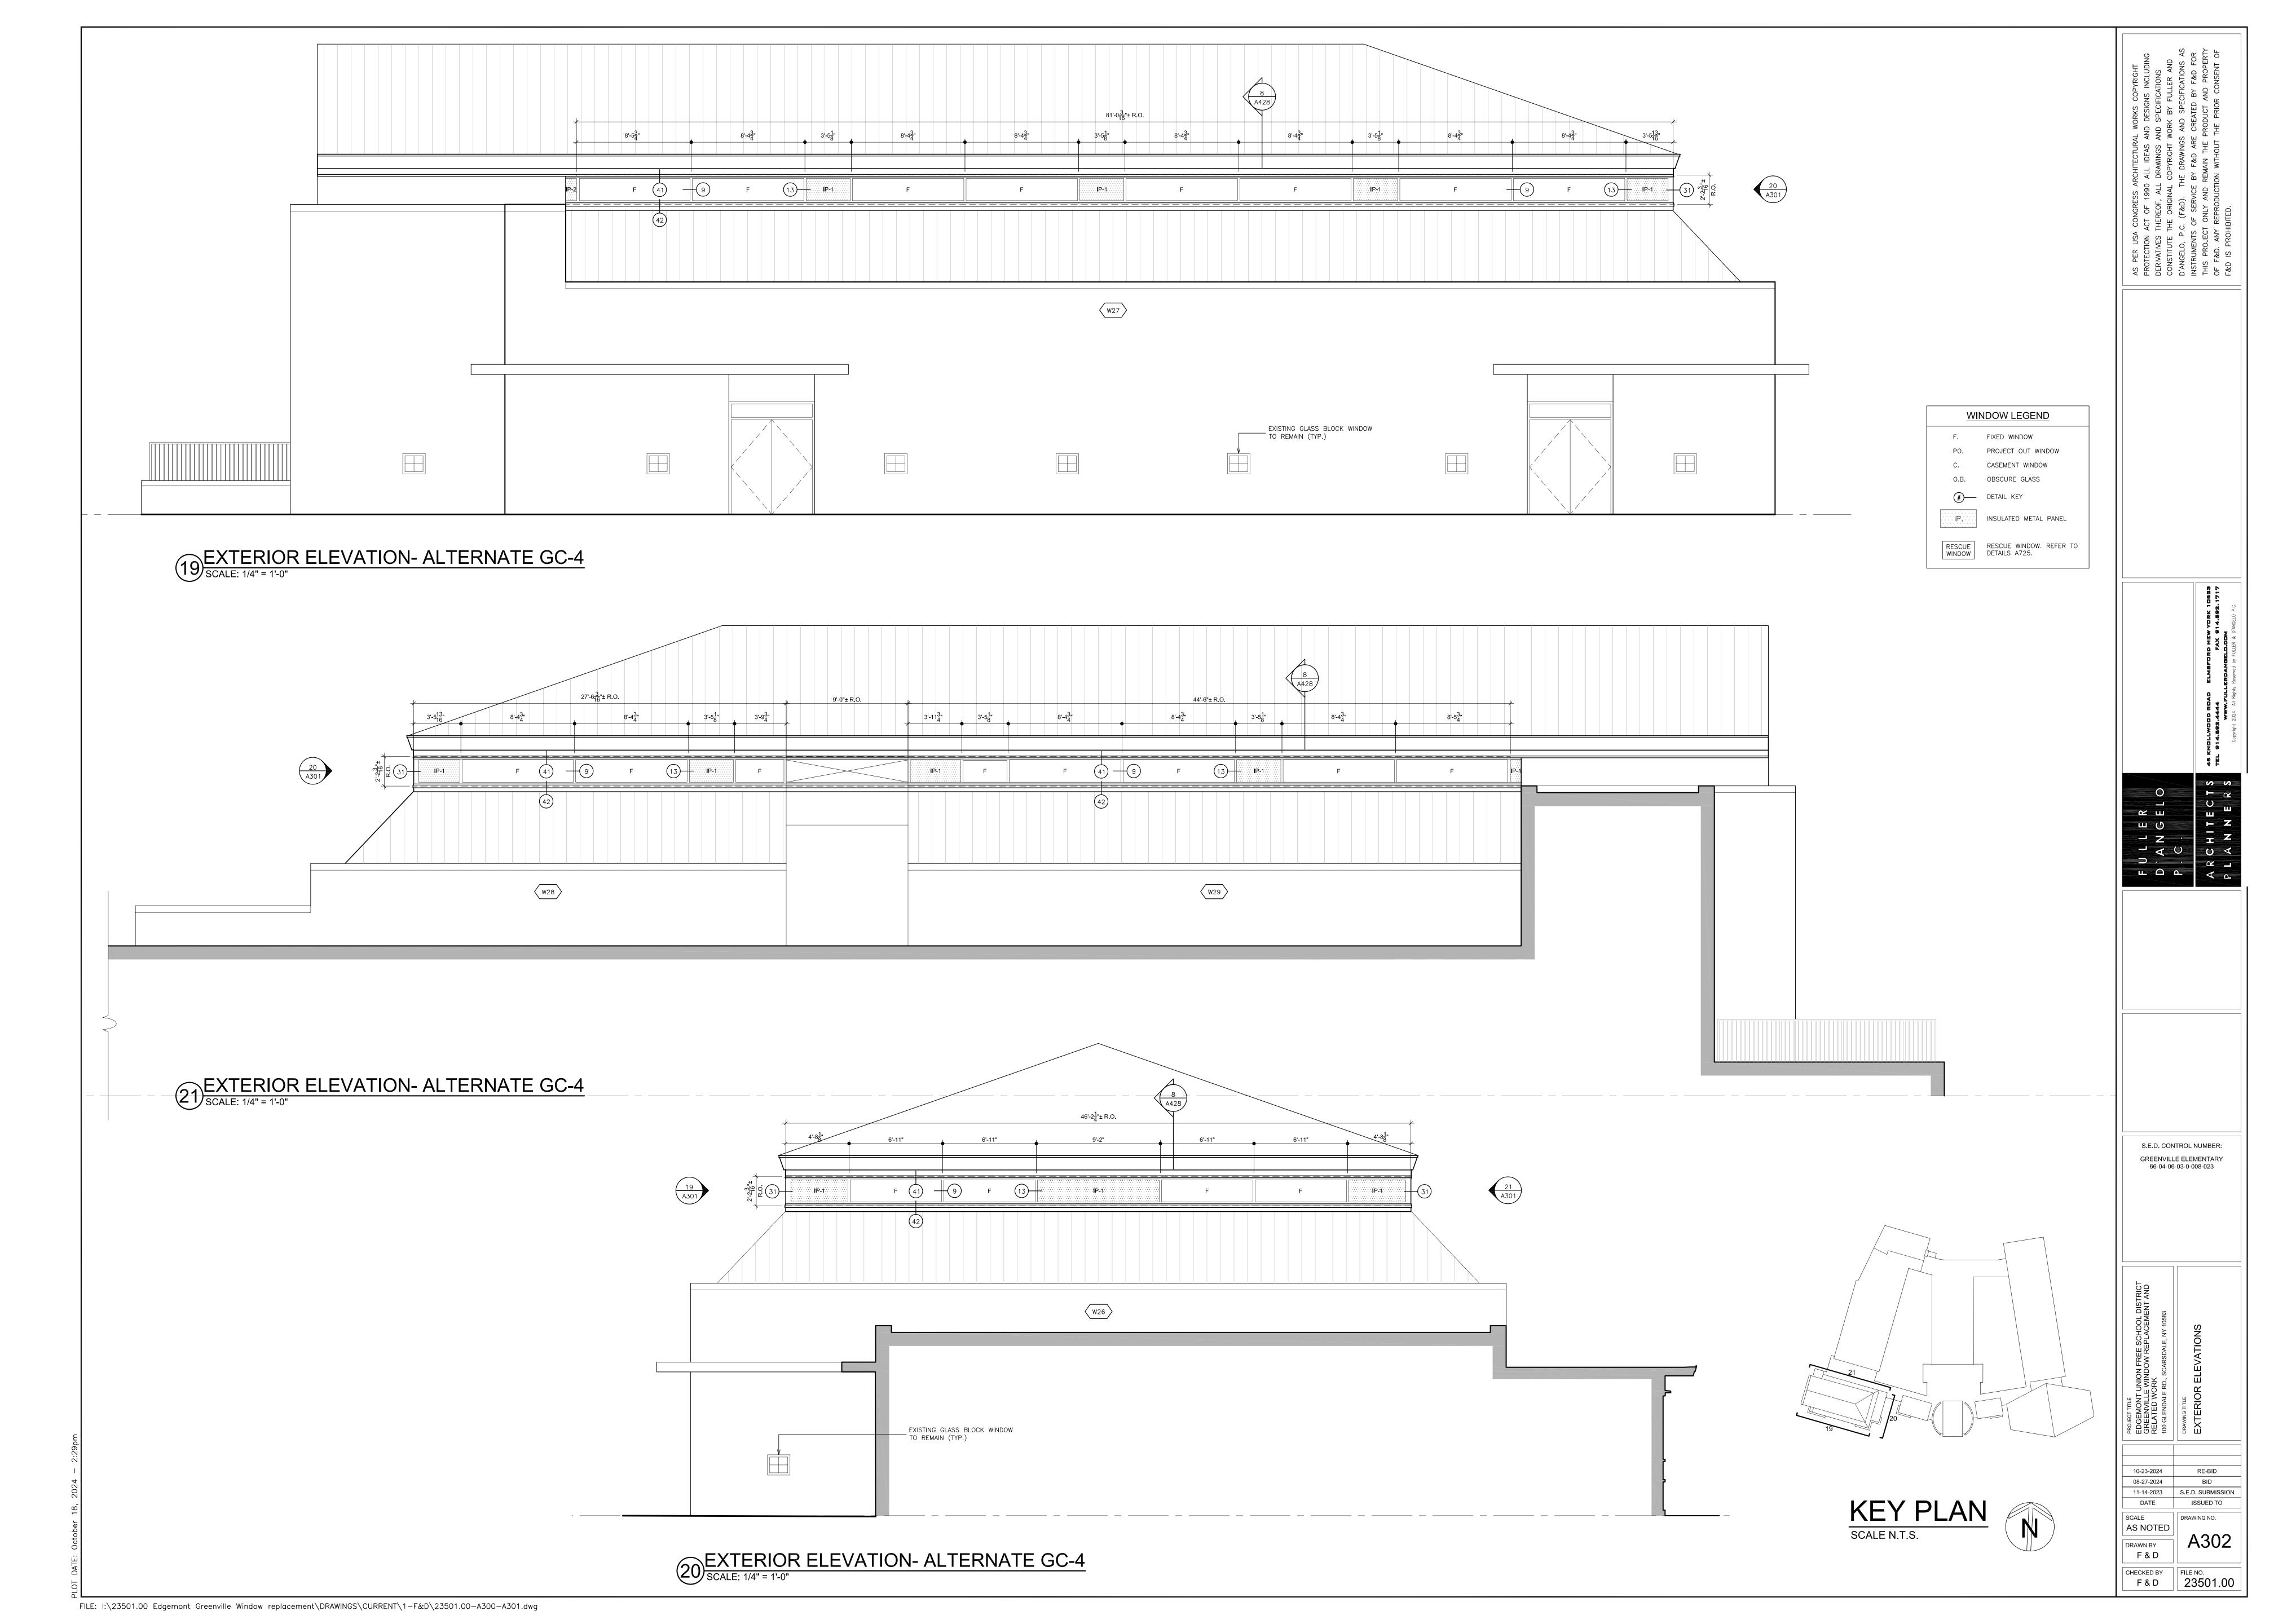


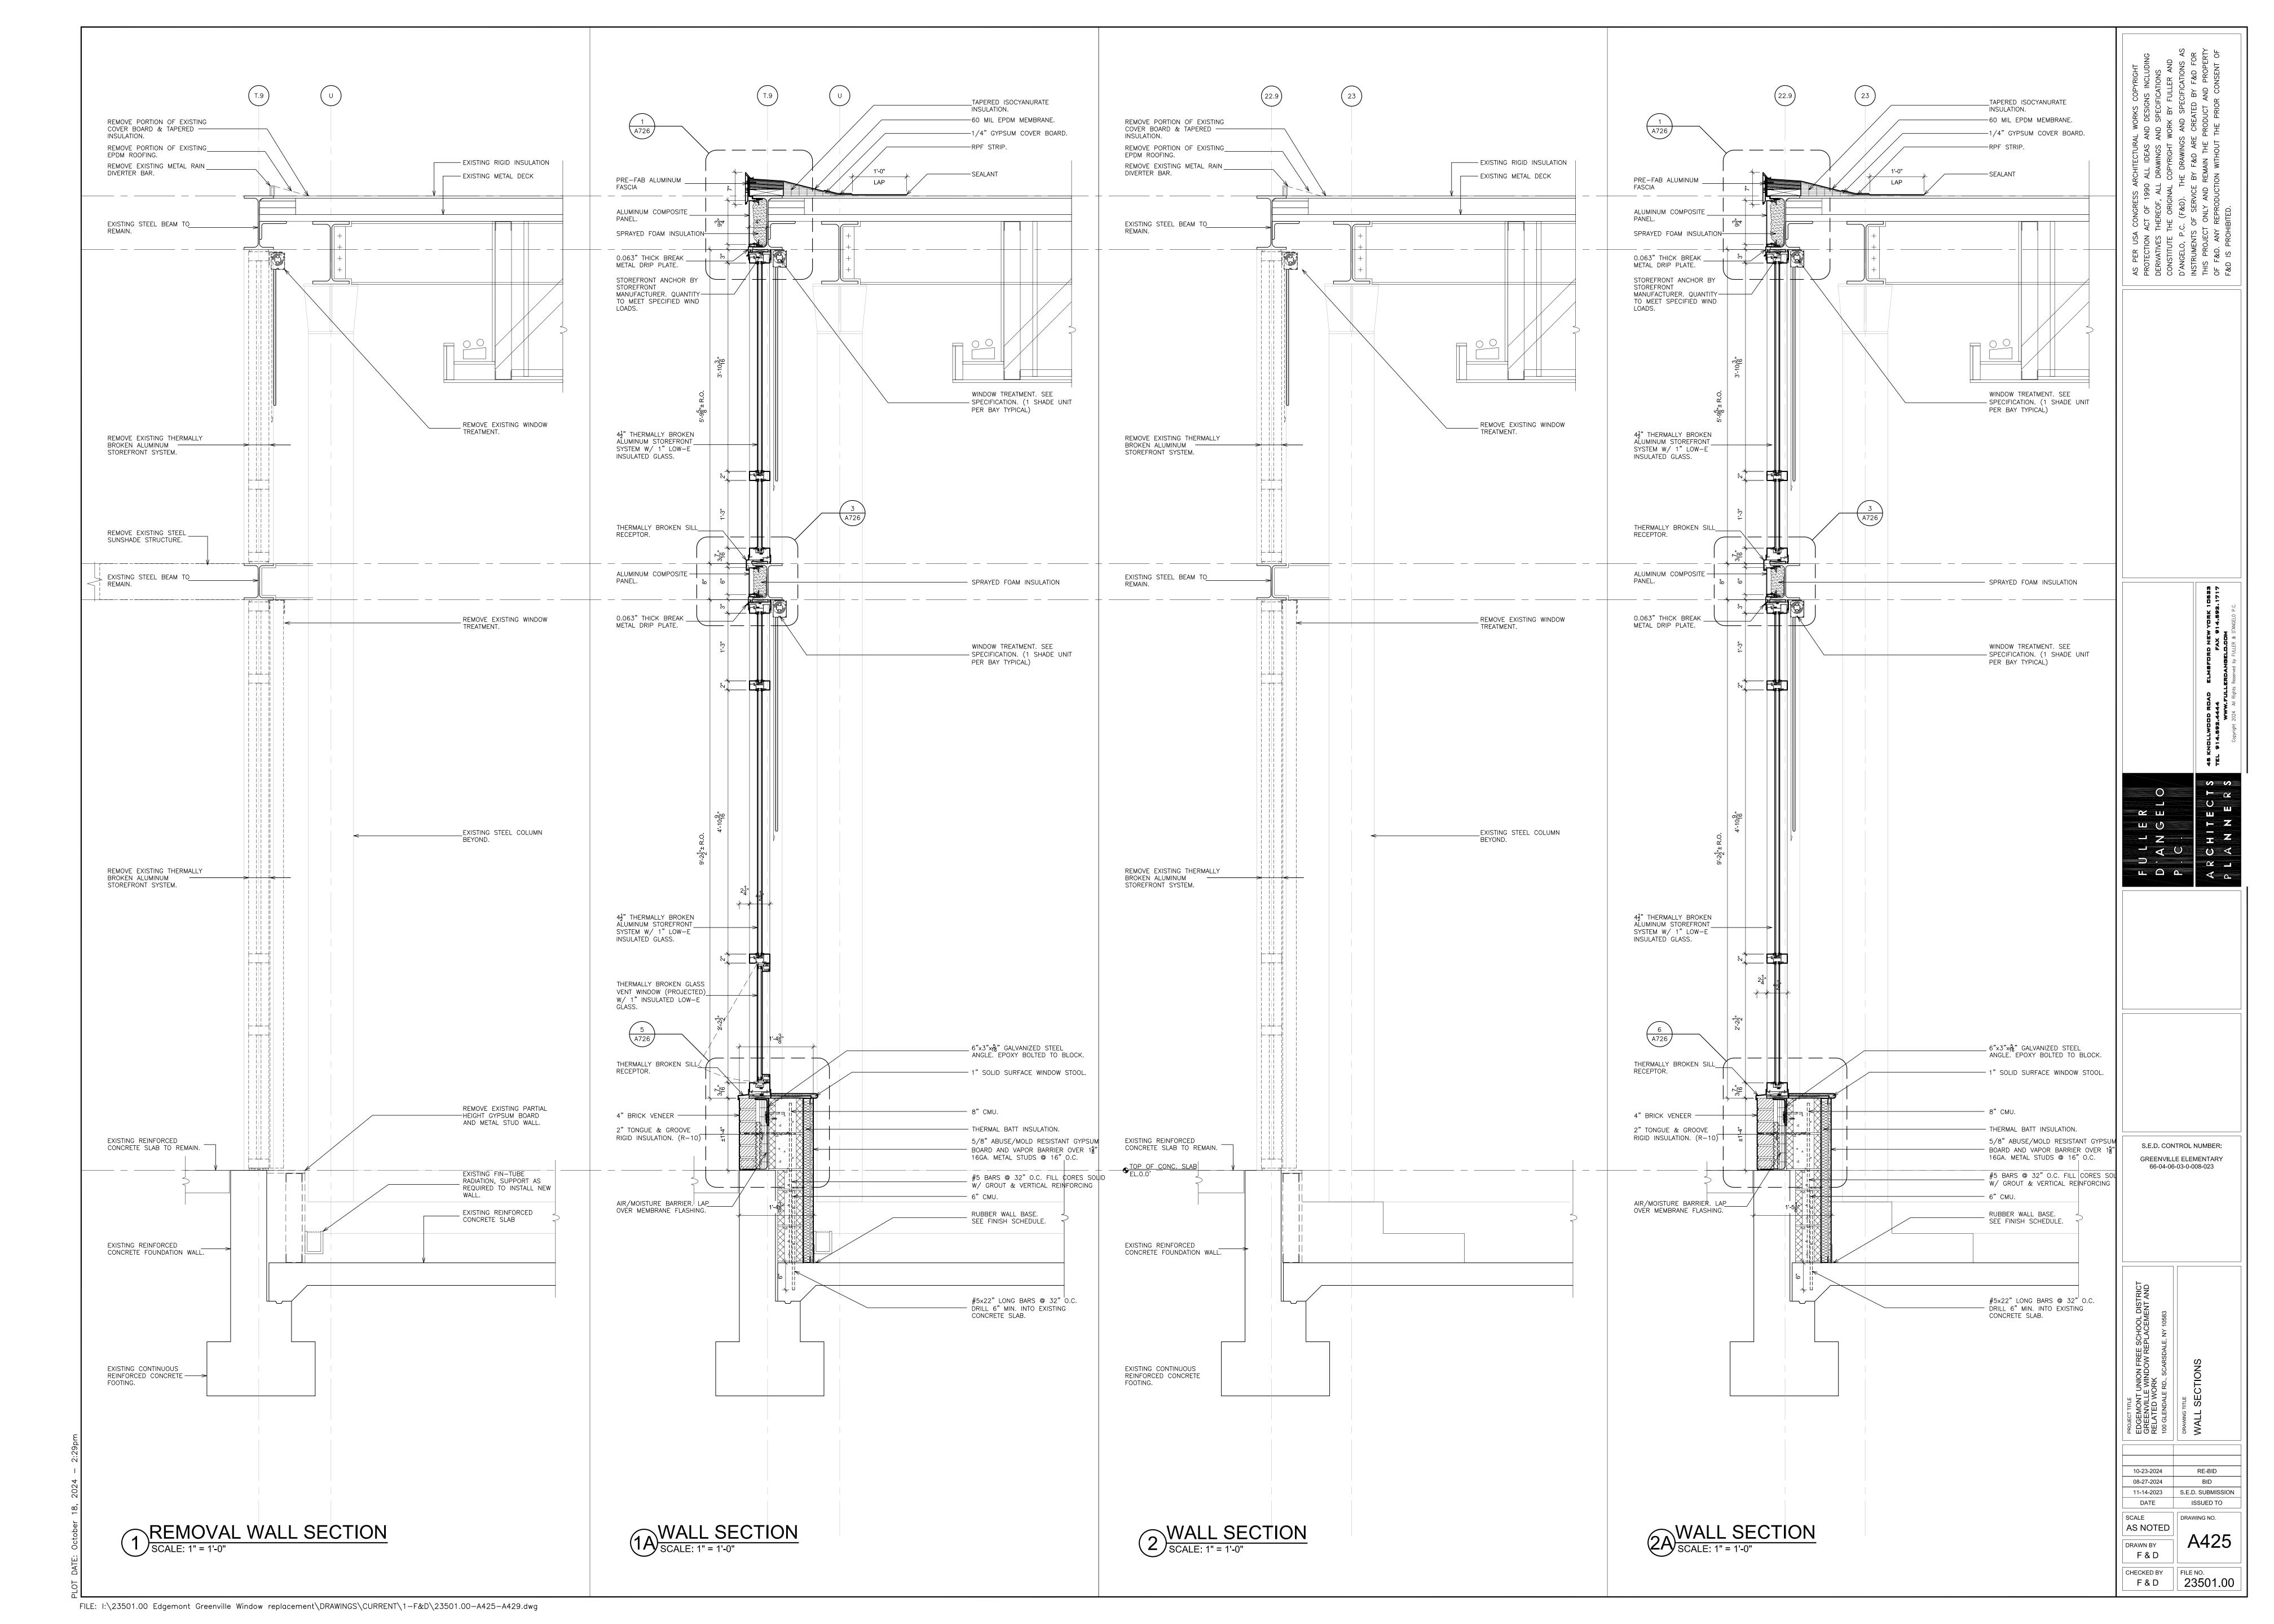


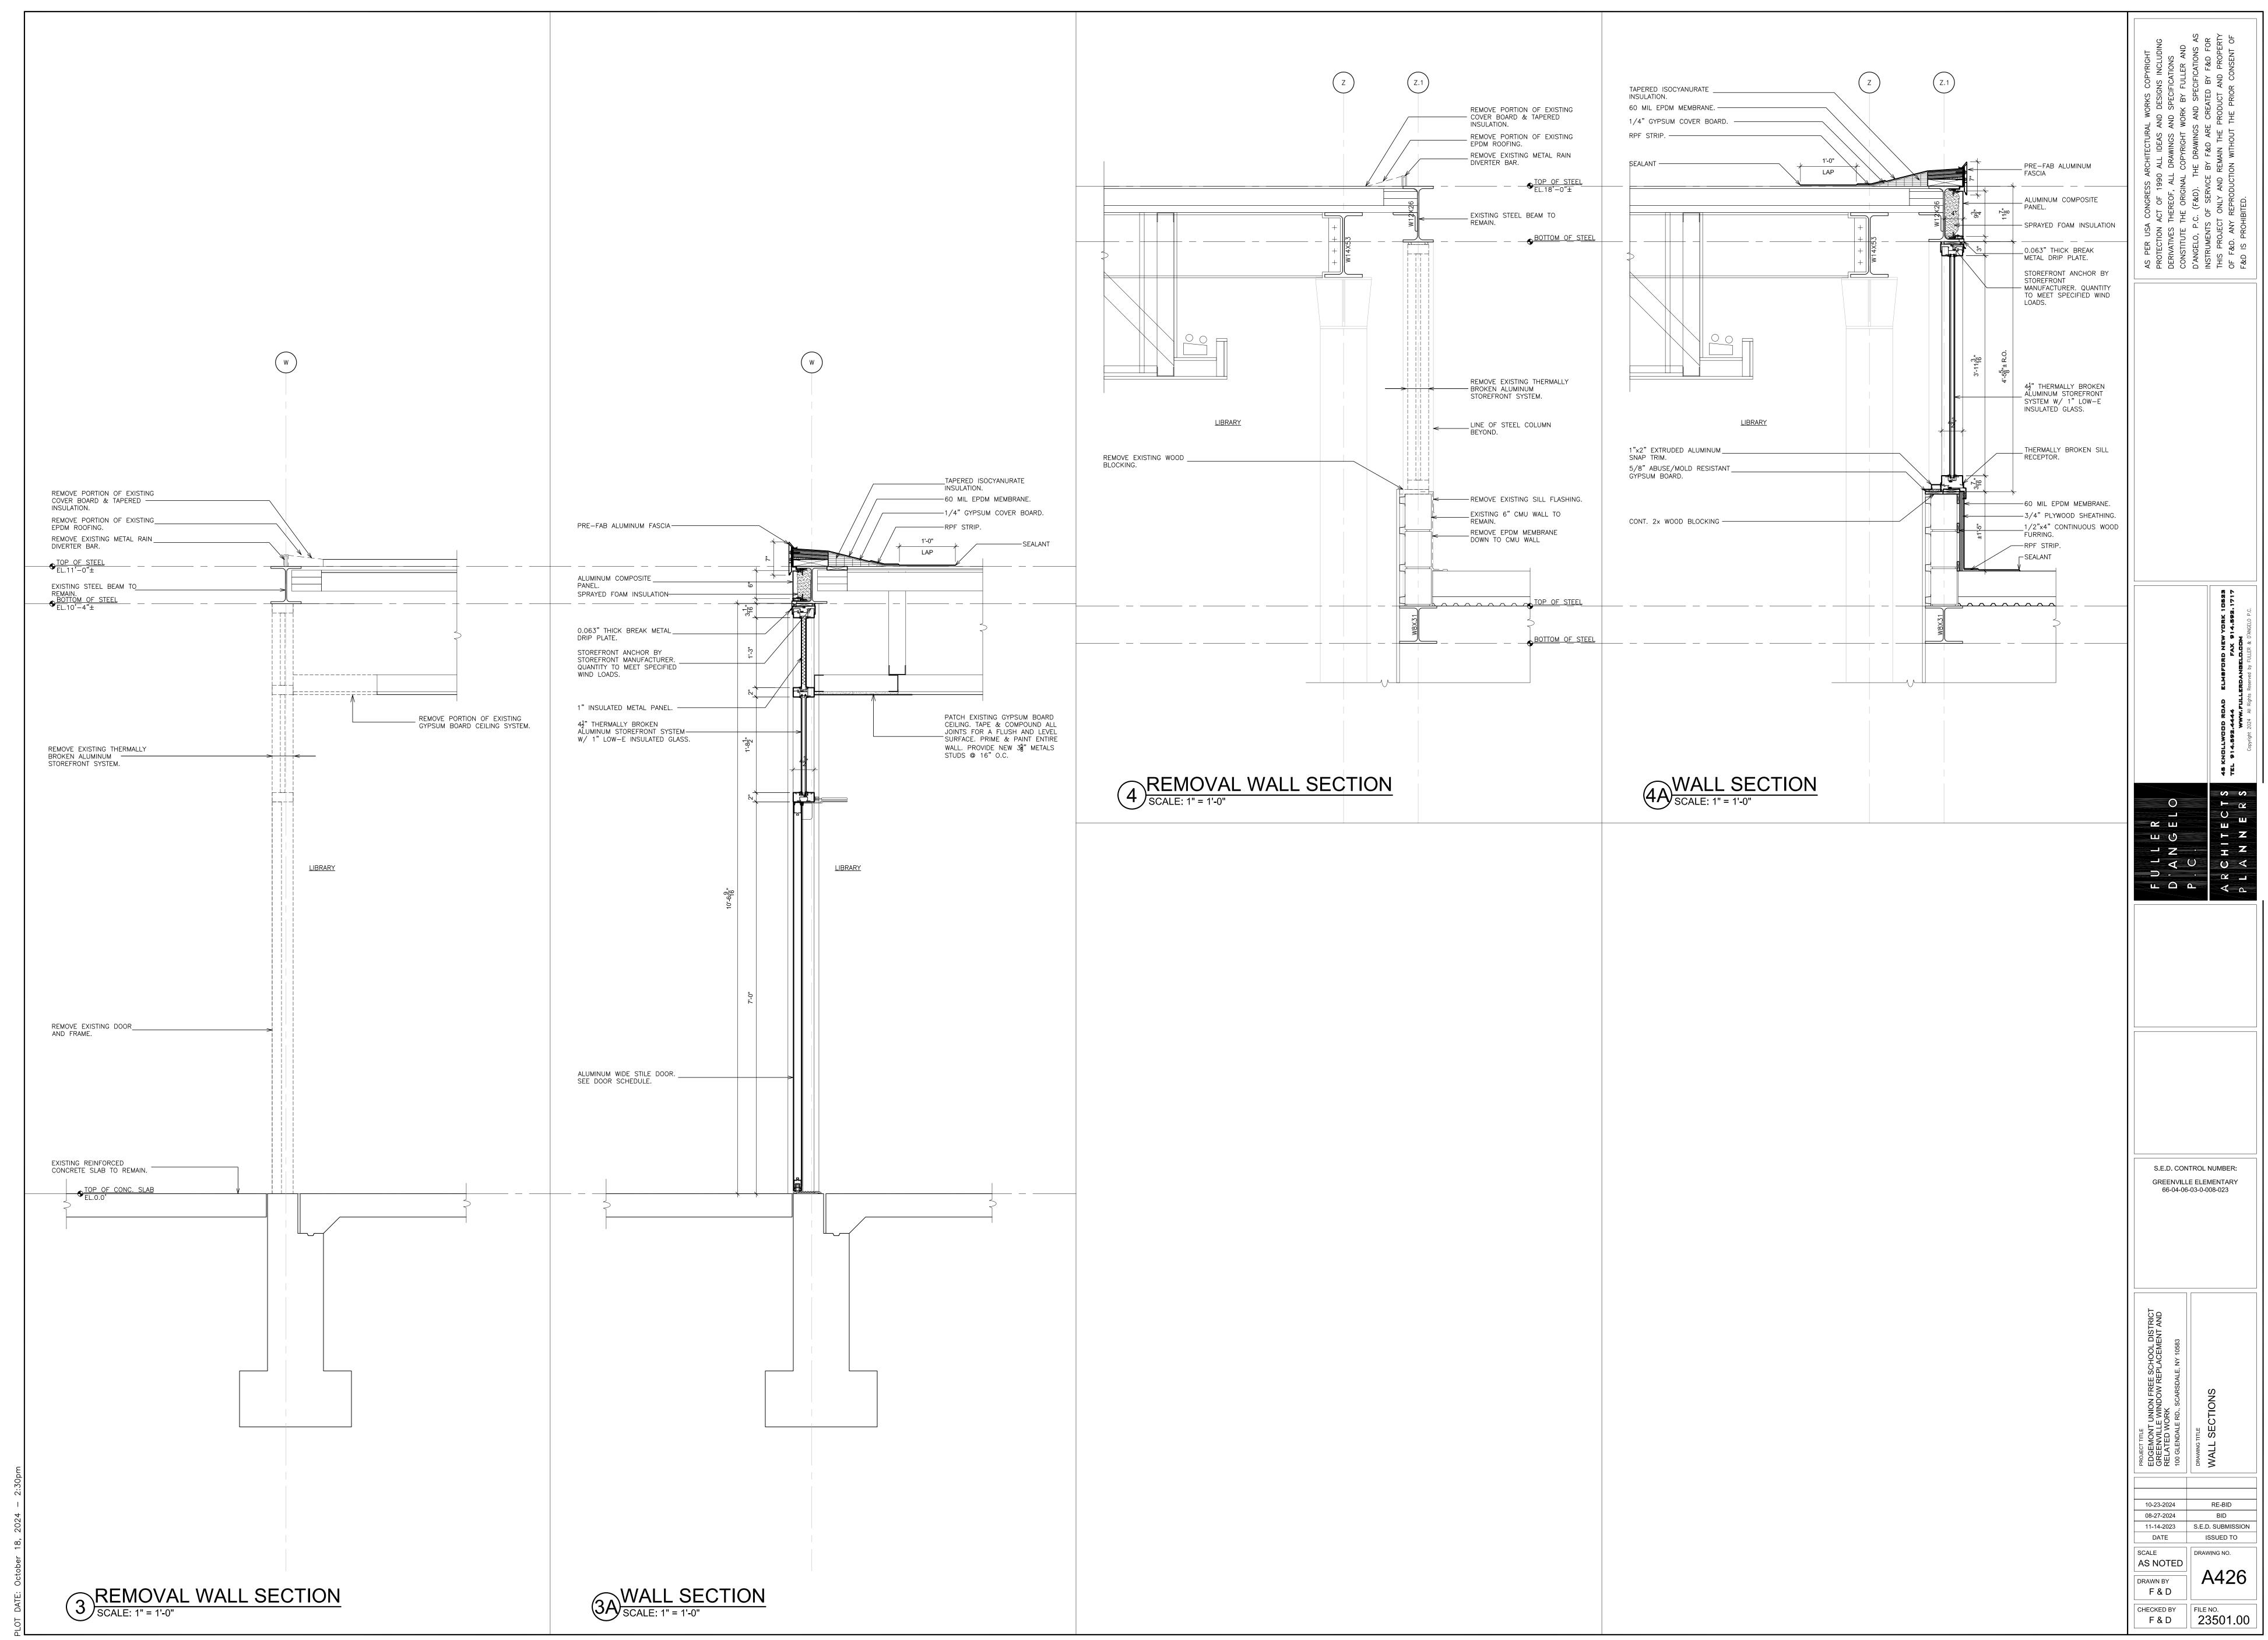

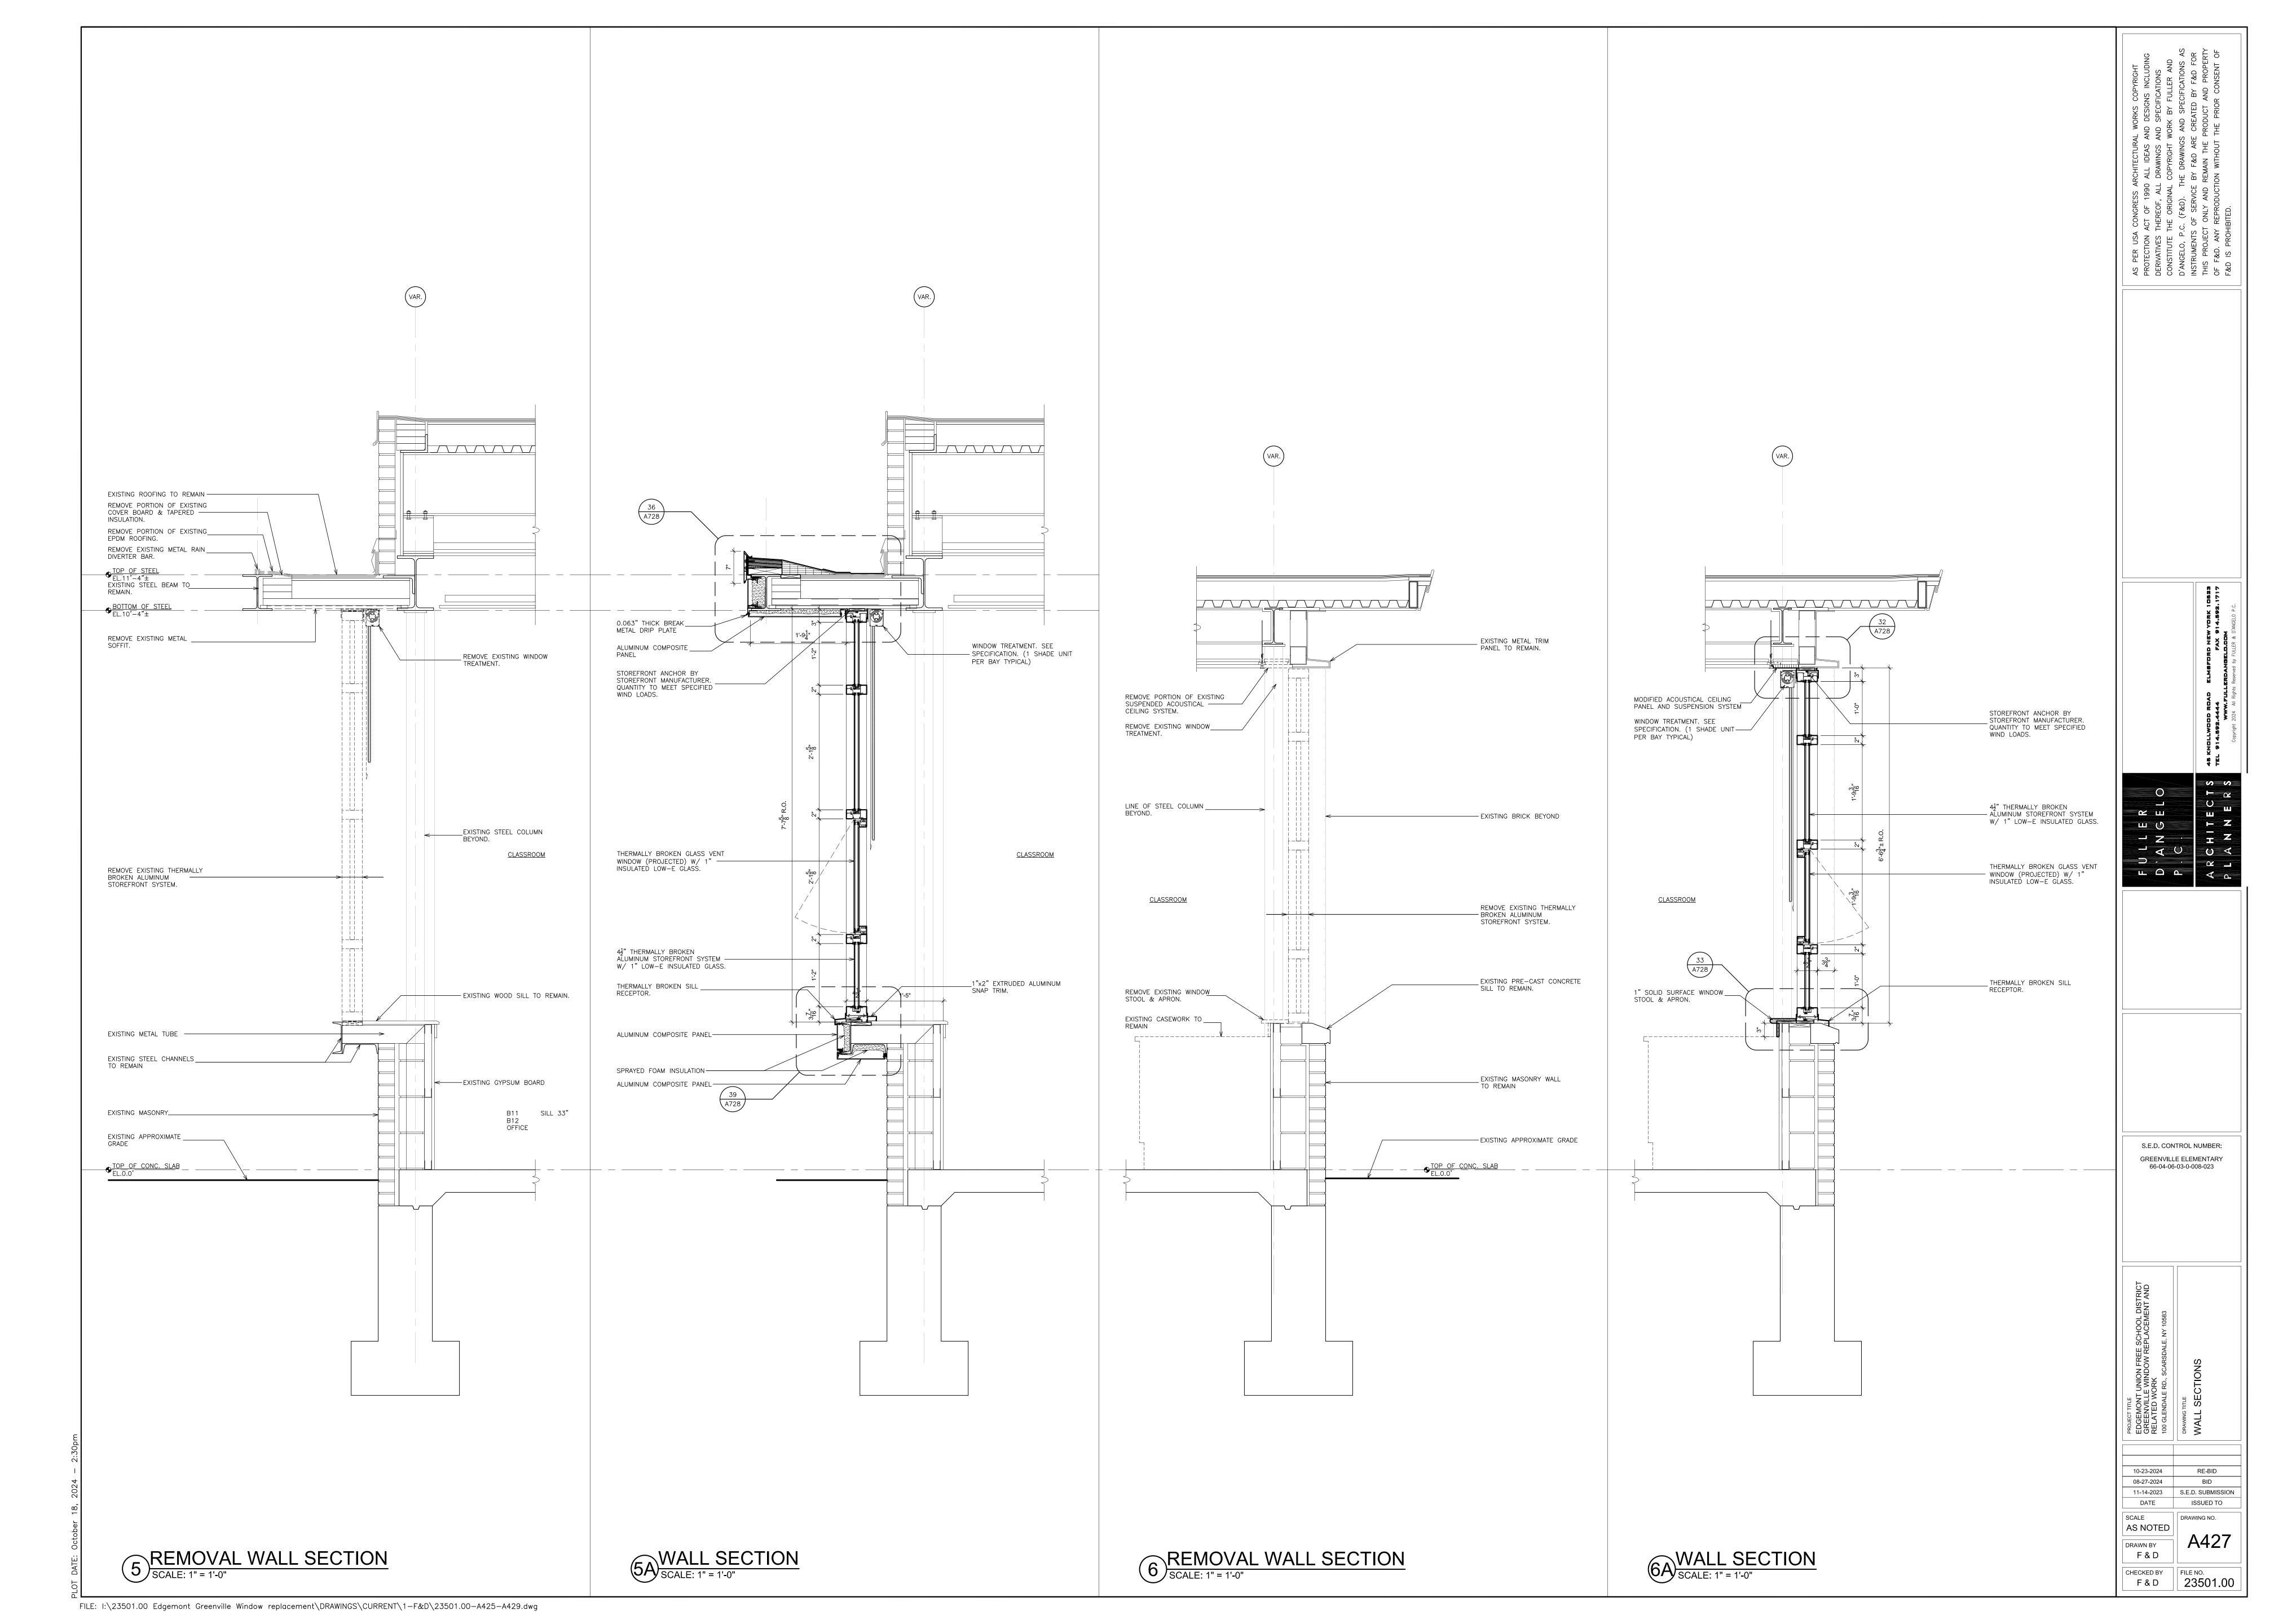


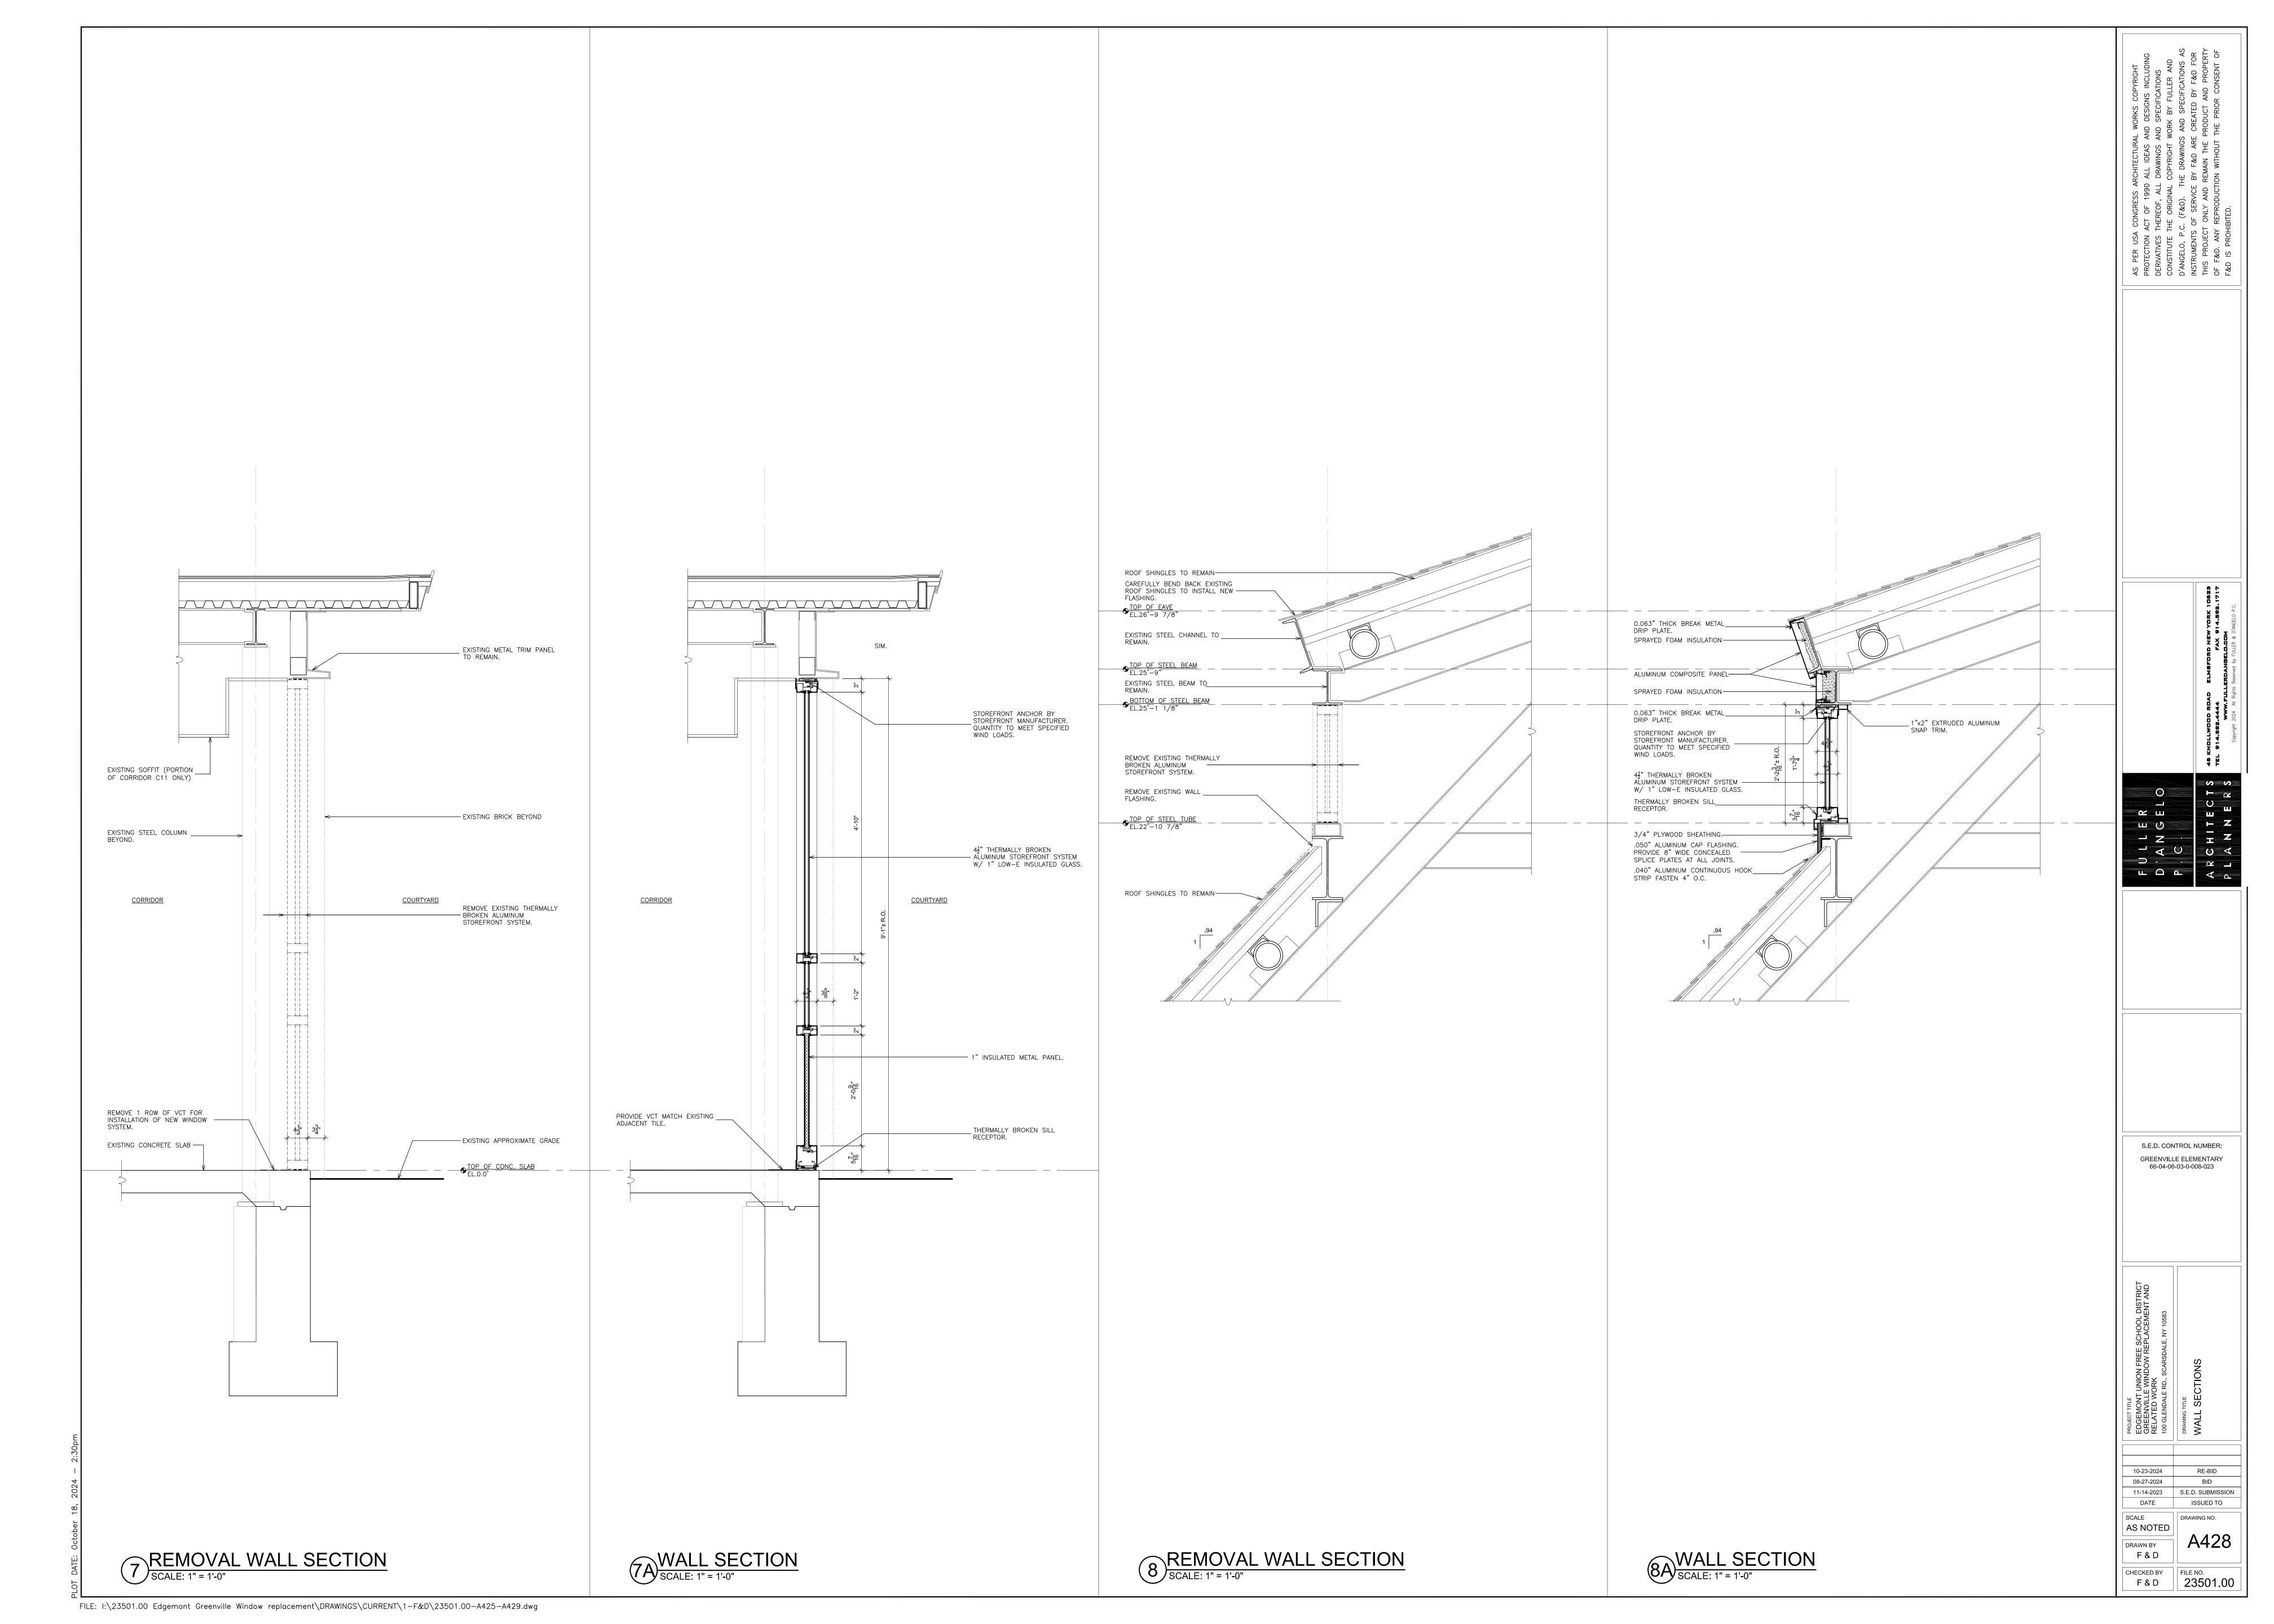

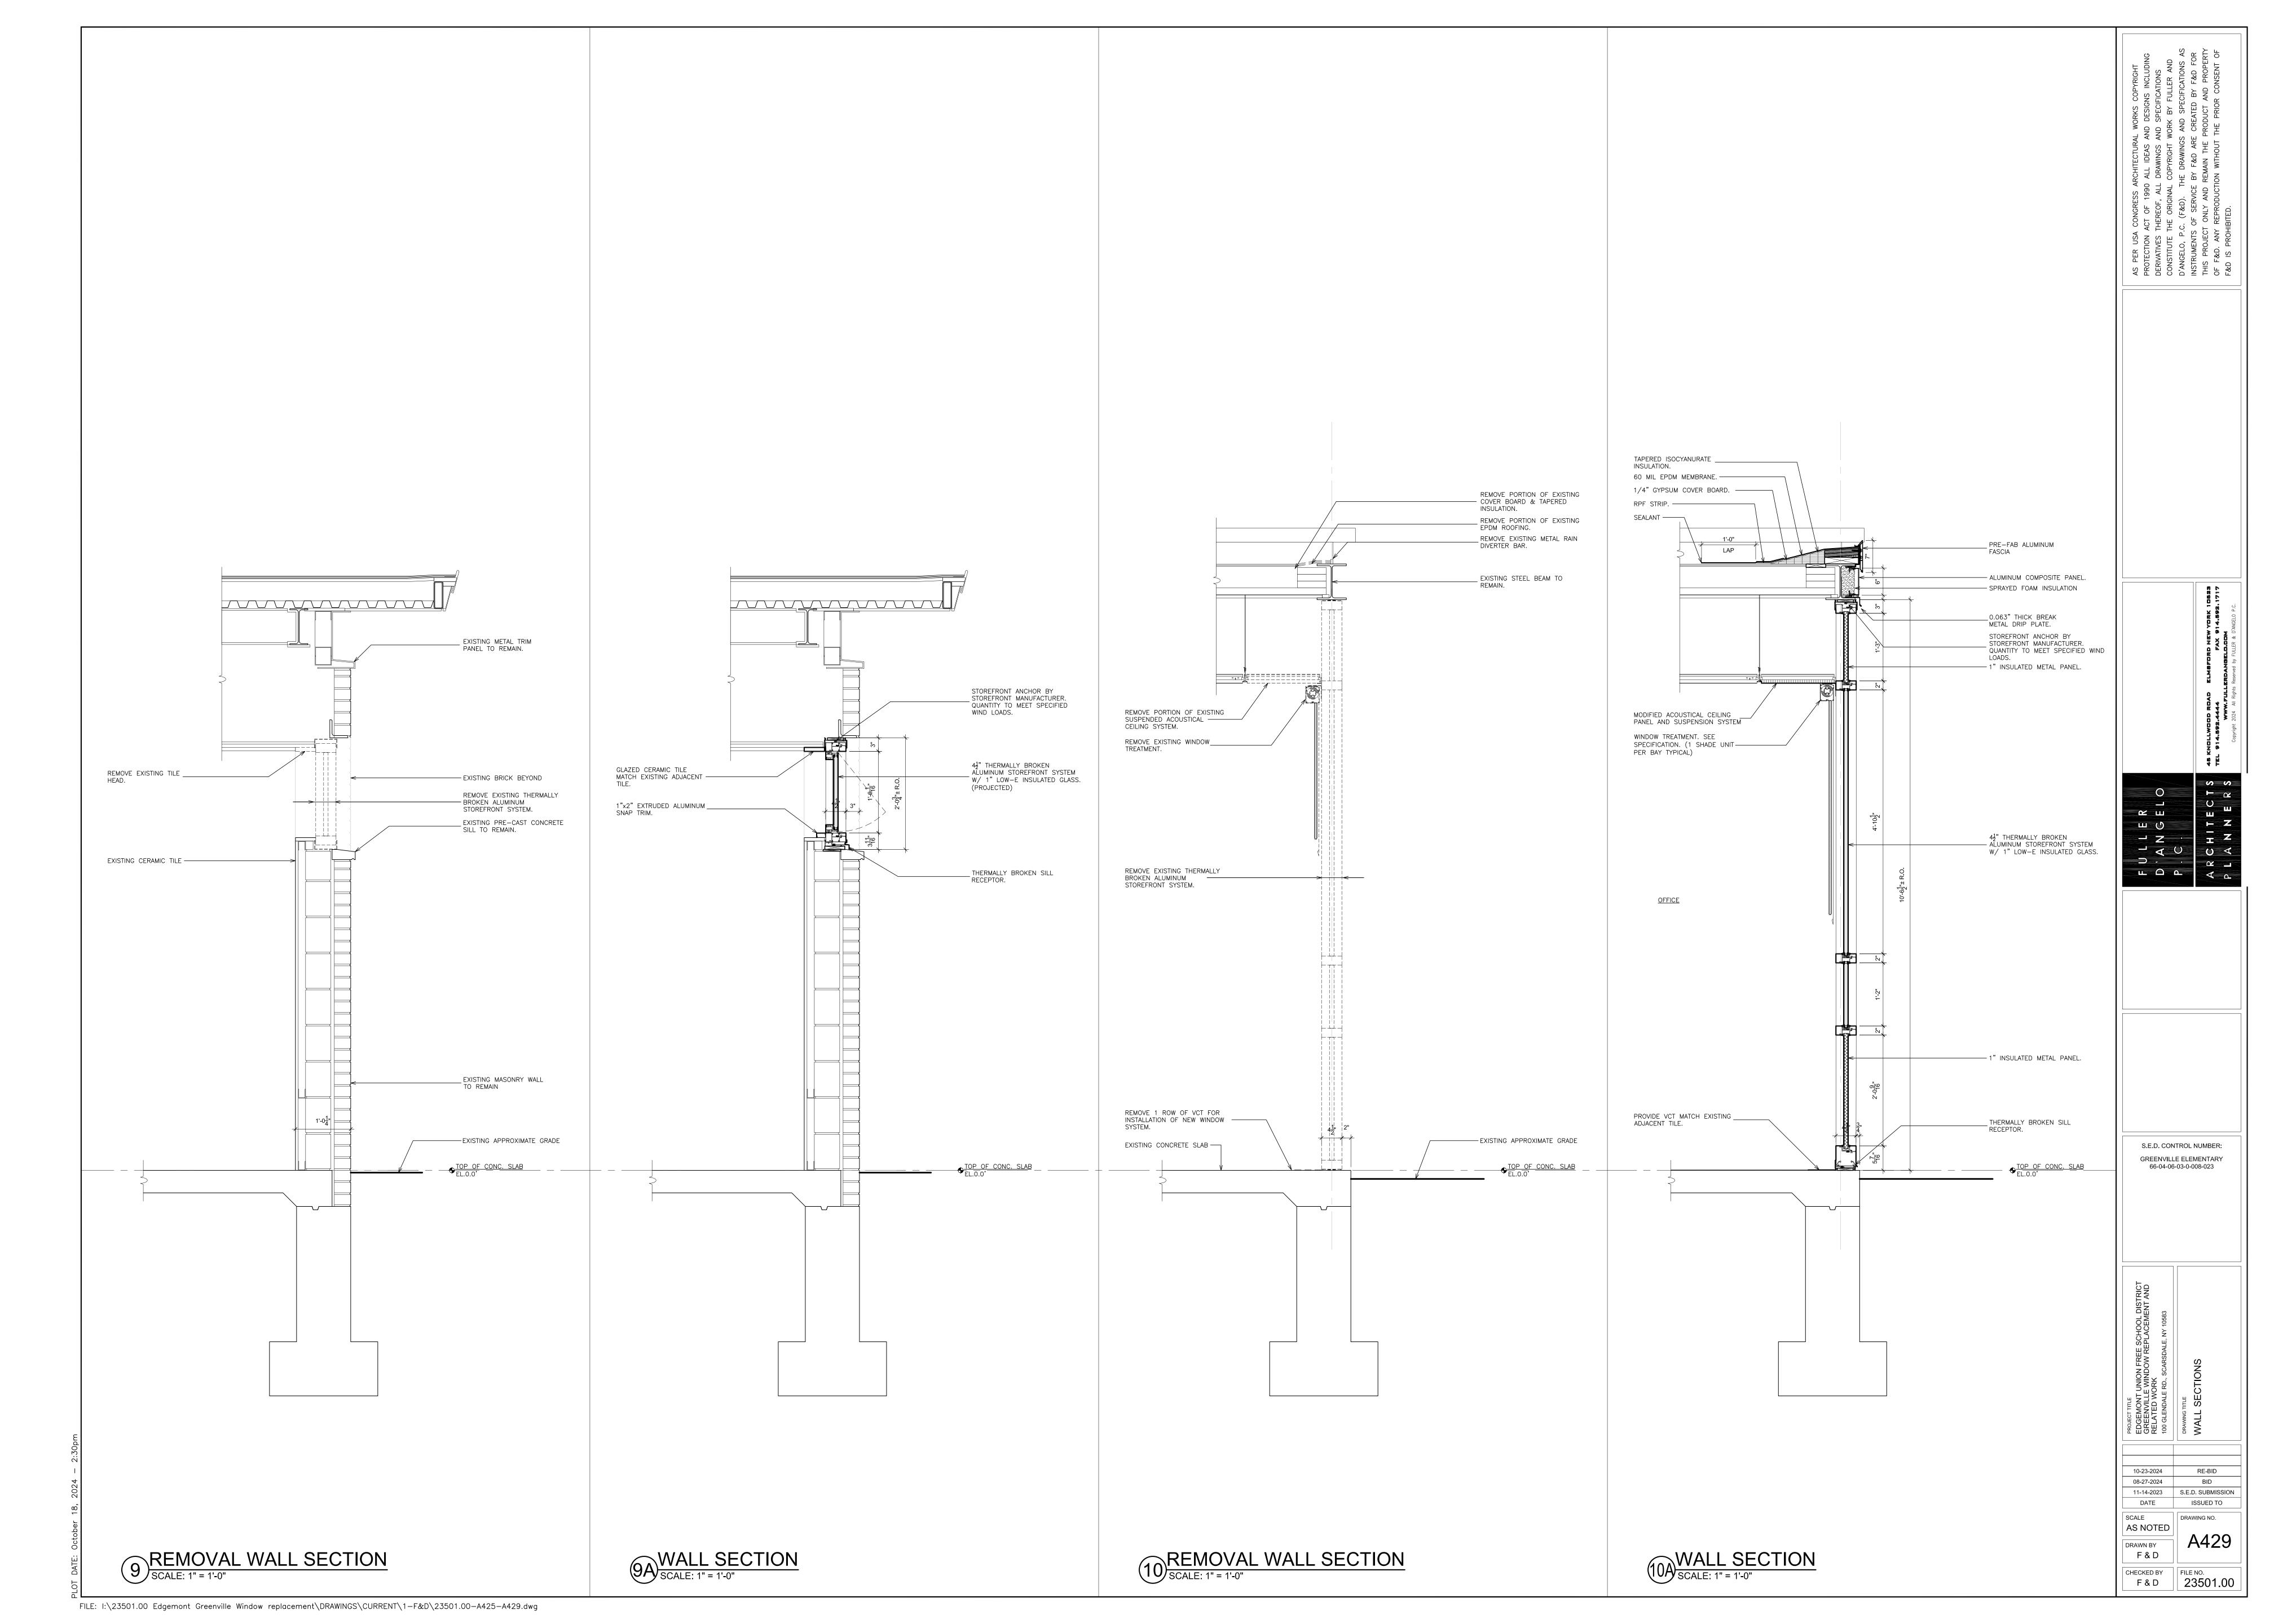

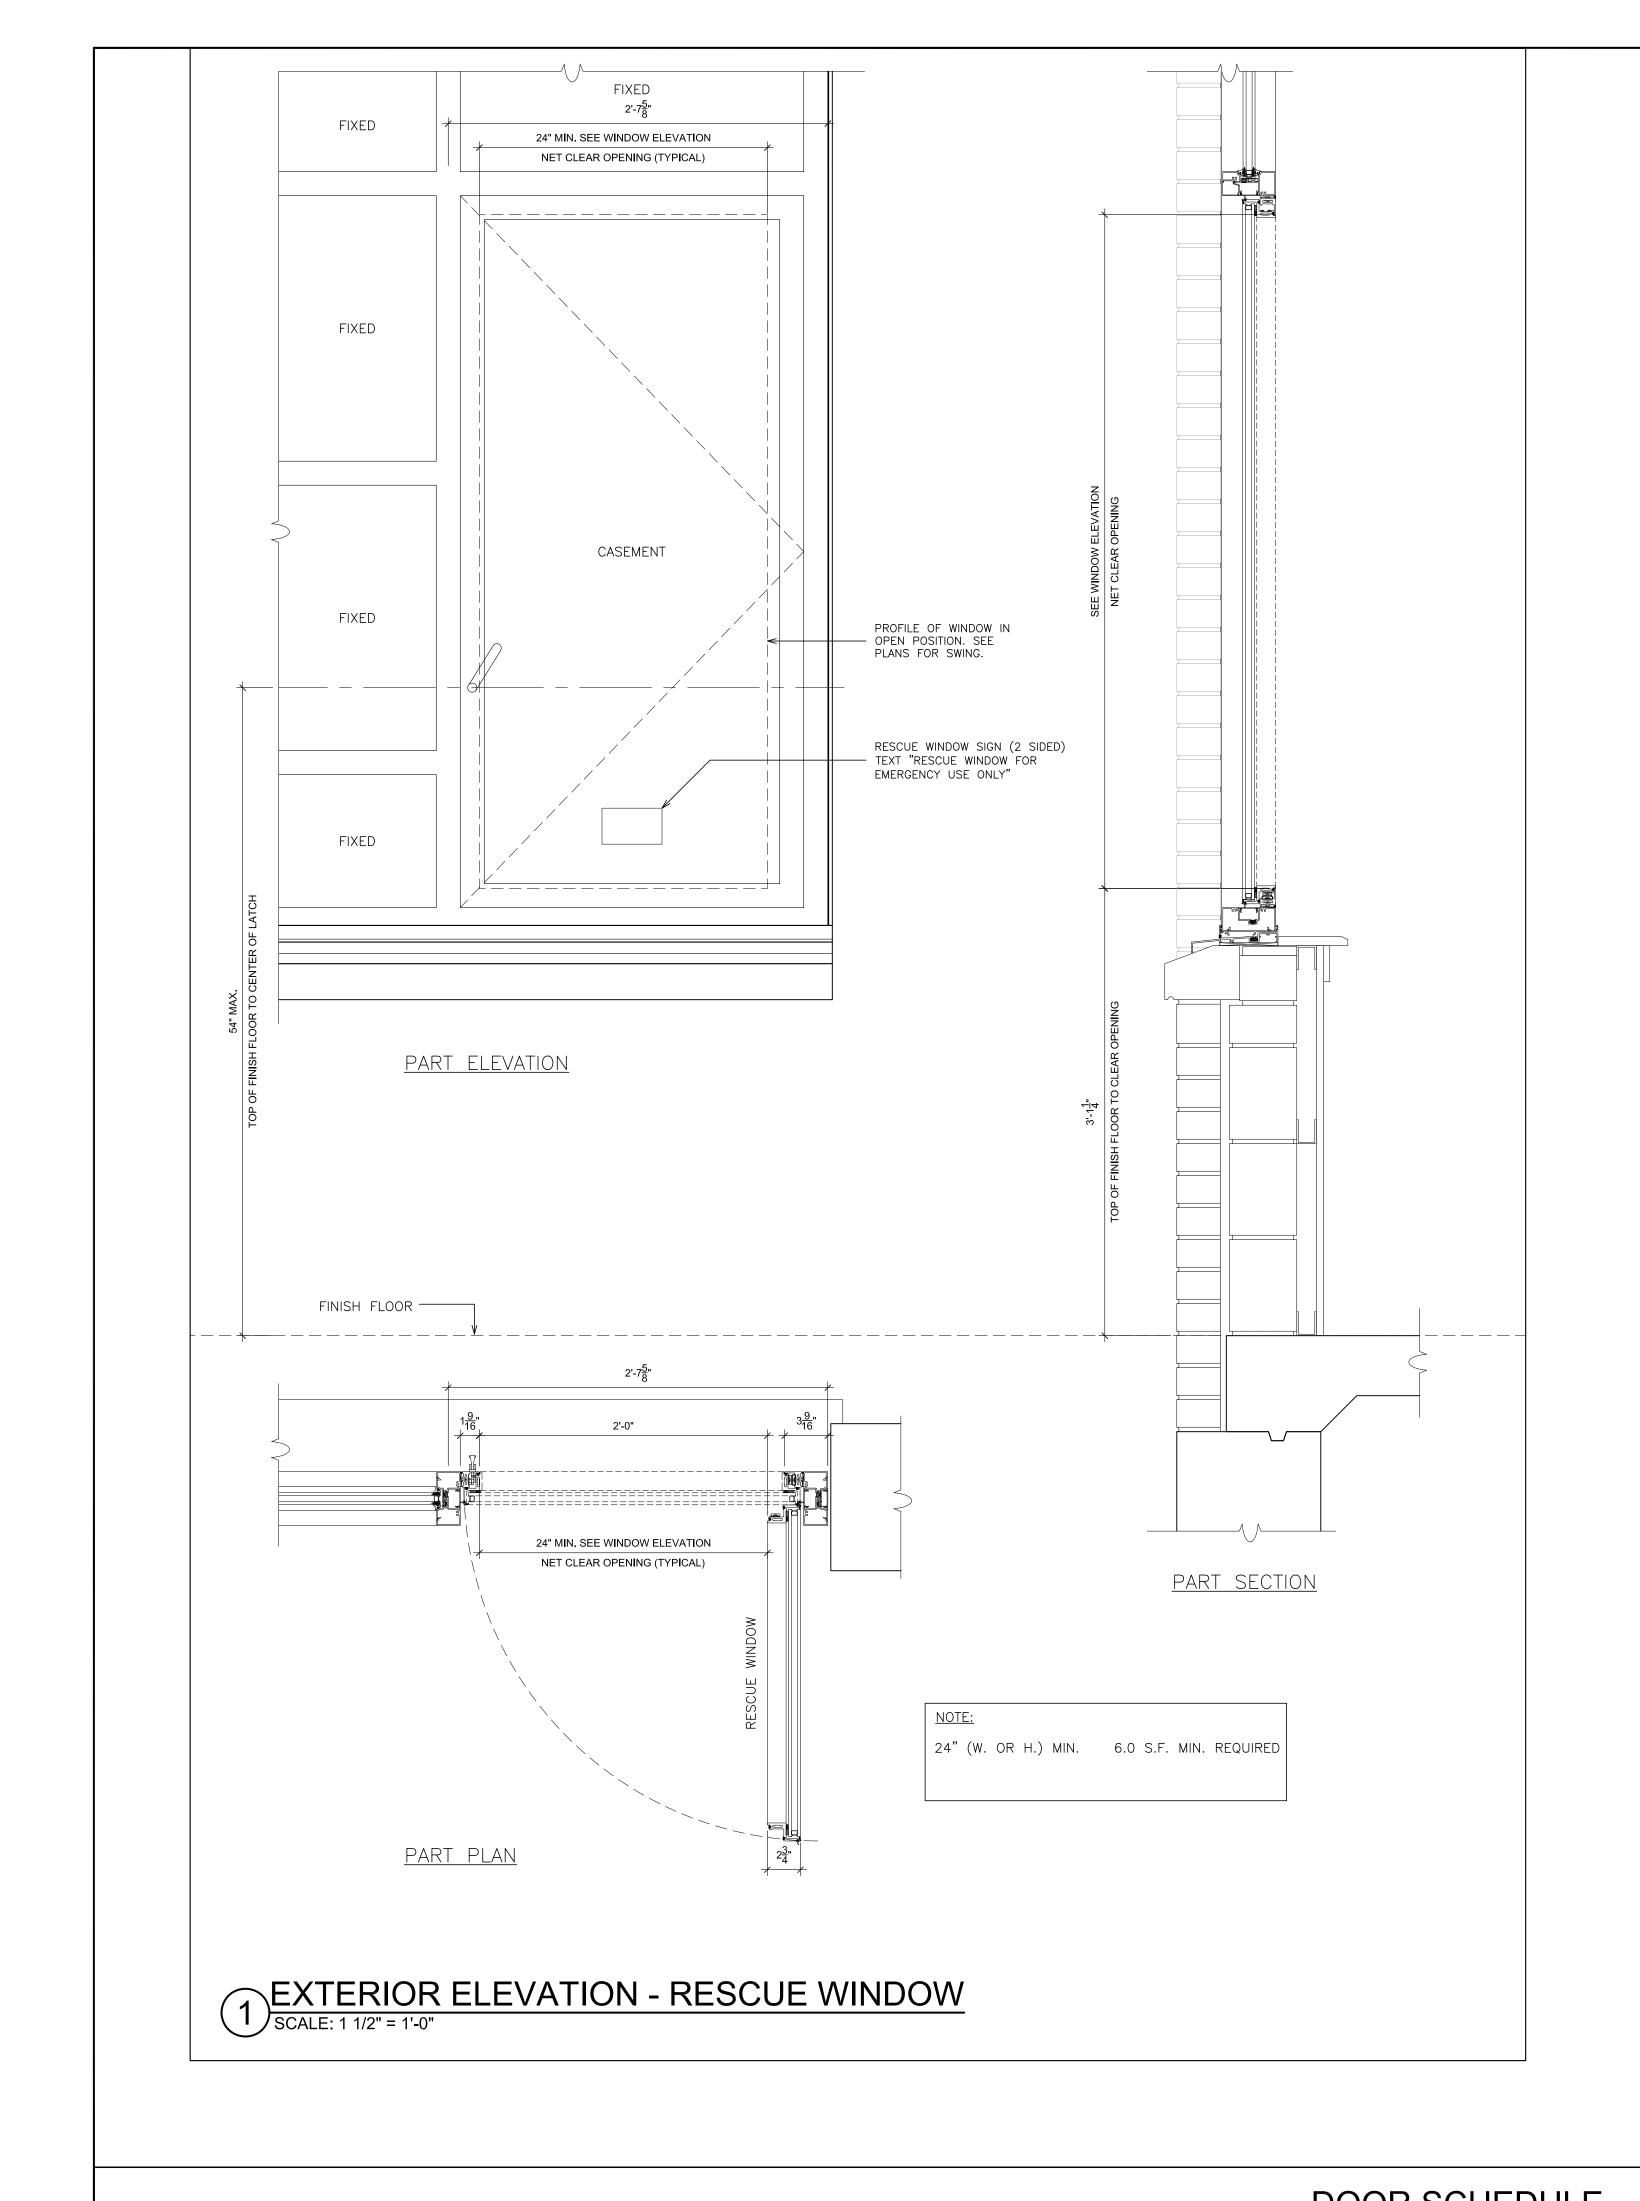




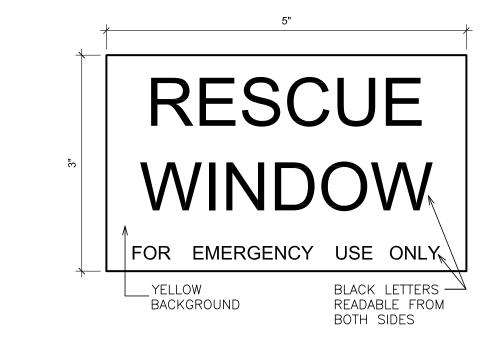

2 RESCUE WINDOW LABEL (RW)
SCALE: NTS

															000	RSC	CHE	DULE													
					DO	OR				FRAN	ИE		FIRE RATING							Н	IARD\	WARE									INDICATES REQUIRED WORK
					SIZE						DETAIL		(MIN.)	FIRE	CODE	Gl	AZING	DISA REQUIRI	BLE EMENTS	HAR	RDWARE T	YPE	FUNCTION			MISCELLANEOU:	S	(SECURITY		O INDICATES EXISTING W FRAMED WITH WINDOW SYSTEM
BUILDING	LEVEL	DOOR NUMBER	DRAWING NUMBER	ROOM / RM No.	DOUBLE LEAF DOOR HEIGH THOUSE THOUS THOUSE THOUSE THOUSE THOUSE THOUSE THOUSE THOUSE THOUSE	NEW DOOR	EXISTING DOOR DOOR TYPE	DOOR MATERIAL	FRAME TYPE	FRAME MATERIAL HEAD DETAIL	JAMB DETAIL	SADDLE DETAIL 90 MINUTES	45 MINUTES O MINUTES	PANIC RELEASE LATCH POSITIVE LATCHING	AUTOMATIC CLOSER (DELAYED ACTION) E.M. HOLD — OPEN	SMOKE SEALS FIRE RATED	LAMINATED	SAFETY FILM LEVER, U—HANDLE KICK PLATE (BEVELED 4 SIDES)	ADA CONFORMING ACCESSIBLE THRESHOLD	MORTISE LOCK SET	CYLINDER(S) CYLINDER(S)	CLASSROOM CLASSROOM CLASSROOM	CLASSROOM DEADBOLT OFFICE STORE ROOM	TOILET OCCUPANCY INDICATOR	180° SWING REMOVABLE MULLION CONTINUOUS HINGE	CYLINDER DOGGING RECESS PULL HOLD OPEN-CLOSER	FLOOR STOP OVERHEAD STOP PERIMETER WEATHERSTRIPING	DOOR CONTACTS	ACCESS CONTROL READER ELECTRIFIED HARDWARE ELECTRIC STRIKE	HARDWARE SET NO.	FRP FIBERGLASS REINFORCED POLYESTER AL ALUMINUM HM HOLLOW METAL WD WOOD GT WOOD GRAIN STEEL SLT STEEL SD SEE DRAWINGS E EXISTING REMARKS
	С	1 101	A101	LIBRARY	3'-0" x 6'-8"± V.I.F.		D- 1	1 AL	W-6	AL 18	14	19													•		•			01 0	1
щ≿ 	OOR	2 102	A101	LIBRARY	3'-0" x 6'-8"± V.I.F.		D-1	1 AL	W-6A	AL 18	14	19				•											•			01 0:	2
NVILL SNTAF	FL	3 103	A101	VESTIBULE 3	6'-0" x 6'-8"± V.I.F.		D-1	1 AL	W-21	AL 18	27	19																		02 0	3
GREENVILLE ELEMENTARY SCHOOLS	OUNE	4 104	A101	VESTIBULE 4	7'-4" x 6'-8"± V.I.F.		D-1	1 AL	W-20	AL 18	27	19																		02 04	
	GR	5 105	A101	CORRIDOR A16	6'-0" x 6'-8"± V.I.F.		D- 1	1 AL	W-24	AL 18	27	19													0 0		•		(02 0	5

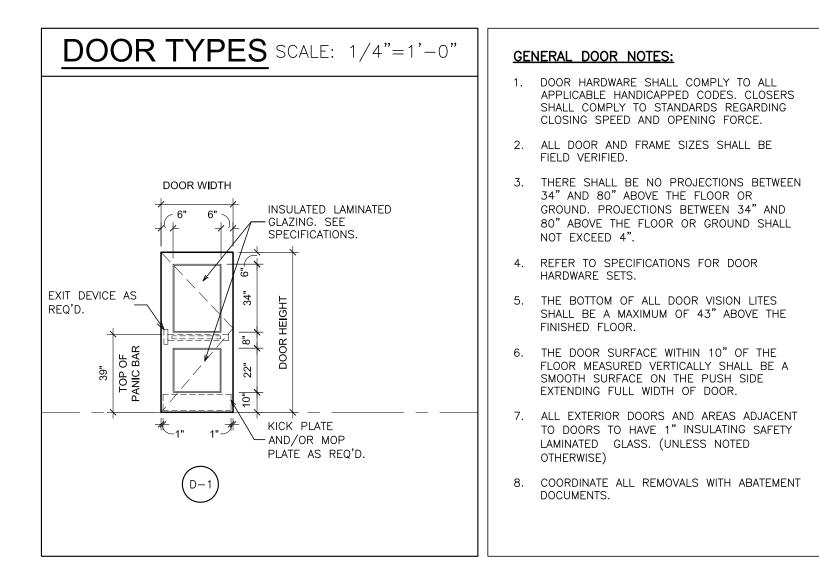

S.E.D. CONTROL NUMBER: GREENVILLE ELEMENTARY 66-04-06-03-0-008-023 DRAWING TITL WINDOW (10-23-2024 RE-BID 08-27-2024 11-14-2023 S.E.D. SUBMISSION DATE ISSUED TO SCALE AS NOTED DRAWN BY F&D CHECKED BY | FILE NO. F&D 23501.00

리 L FILE: I:\23501.00 Edgemont Greenville Window replacement\DRAWINGS\CURRENT\1-F&D\23501.00-A725.dwg

6'-0" x 6'-8"± V.I.F.

● D-1 AL W-25 AL 18 27 19

06 106 A101 CORRIDOR C11

