


EDGEMONT UNION FREE SCHOOL DISTRICT
GREENVILLE ELEMENTARY SCHOOL
WINDOW REPLACEMENT AND RELATED WORK

100 GLENDALE ROAD, SCARSDALE, NY 10583

SED PROJECT NUMBER:

66-04-06-03-0-008-023

GREENVILLE ELEMENTARY SCHOOL
100 GLENDALE ROAD, SCARSDALE, NY 10583

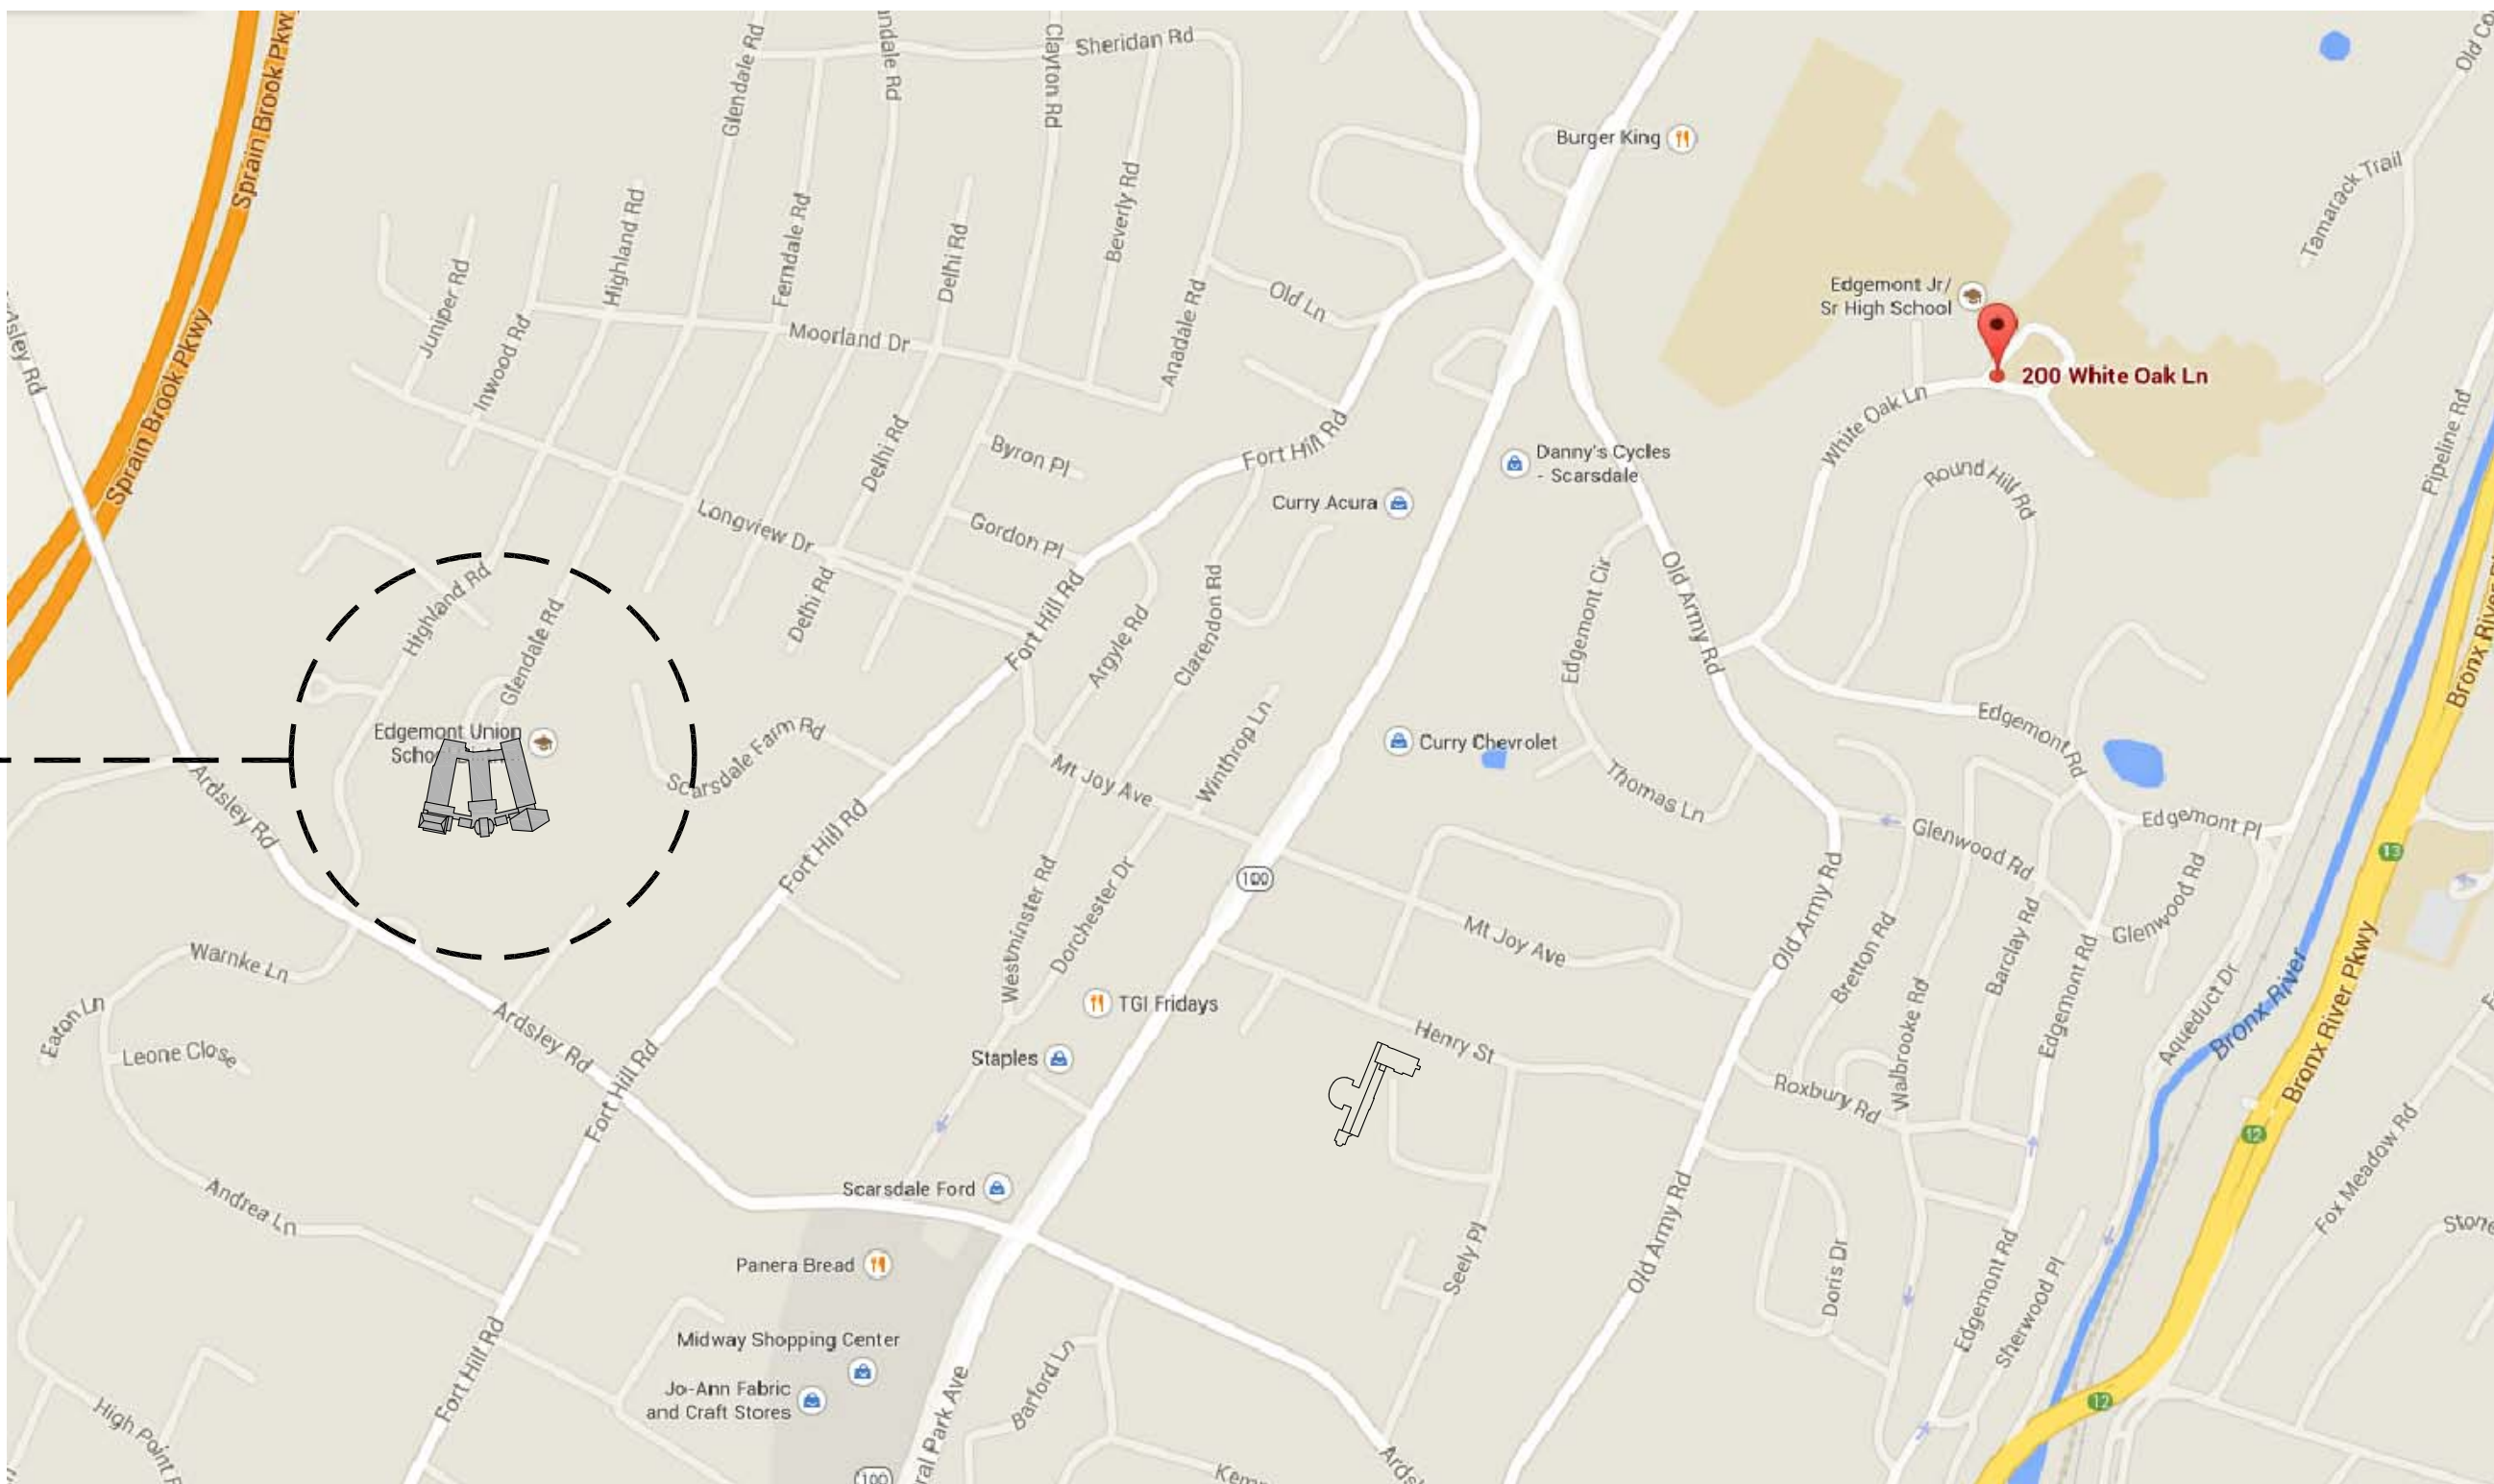

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10-23-2024	RE-BID
08-27-2024	BID
11-14-2023	SED SUBMISSION
DATE	ISSUED TO
SHEET SIZE 30"x42"	DRAWING NO. T-1
SCALE AS NOTED	FILE NO. 23501.00
DRAWN BY F & D	

ABBREVIATIONS

&-	AND	ETG	FOOTING
ACM	ASBESTOS CONTAINING	FOR	FLAT ON BOTTOM
ACT	ACUSTICAL CEILING TILE	FOR	FUEL OIL RETURN
AD	ASBESTOS CONTAINING WASTE	FOT	FLOOR FINISH
ADJ	ADJACENT	FR	FEET PER MINUTE
ALUM	ALUMINUM	FRP	FIBERGLASS REINFORCED POLYESTER
AMB	AMBIENT	FT	FOOT OR FEET
APD	AIR PRESSURE DROP	GA	GALLONS
APPROX	APPROXIMATE	GA/CALV	GALLONS PER HOUR
A.R.	AREA OF REFUGE	GEN	GENERAL CONSTRUCTION
ARCH	ARCHITECTURAL	GEN	GENERAL
AVG	AVERAGE	OPH	OPH PER HOUR
BDD	BACK DRAFT DAMPER	OR	OR PER MINUTE
BHP	BRAKE HORSE POWER	OR	OR
BILM	BUILDING MATERIALS	OR	OR
BLDG	BUILDING	OR	OR
BU	BRITISH THERMAL UNITS/HOUR	OR	OR
BUH	BUILT UP	OR	OR
BUR	BUILT UP ROOFING	OR	OR
C.V.	COMMON	OR	OR
CE	CEFFICIENT, VALVE FLOW	OR	OR
CEB	CATCH BASIN	OR	OR
CEIL OR	CEILING	OR	OR
CER/CEG	CEILING EXHAUST REGISTER/GRILLE	OR	OR
CFM	CUBIC FEET PER MINUTE	OR	OR
CHWR	CHILLED WATER RETURN	OR	OR
CHW	CHILLED WATER SUPPLY	OR	OR
CJ	CONTROL JOINT	OR	OR
CLG WTR	COOLING WATER	OR	OR
CMP	CORRUGATED METAL PIPE	OR	OR
CON	CONCRETE	OR	OR
CONCR	CONCRETE	OR	OR
CONC	CONCRETE	OR	OR
CONST	CONSTRUCTION	OR	OR
CONTR	CONTRACTOR	OR	OR
CONV	CONVEYOR	OR	OR
CRP/CRG	CONDENSATE PUMP/RETURN REGISTER/GRILLE	OR	OR
CRU	CEILING RETURN ROOM UNIT	OR	OR
CSD	CEILING SUPPLY DIFFUSER	OR	OR
C.TWR	CEILING TOWER	OR	OR
CUB	CUBIC FEET	OR	OR
CU FT	CUBIC FEET	OR	OR
CUT	CUBIC TON UNIT HEATER	OR	OR
CWS	CONDENSER WATER RETURN	OR	OR
D	DIAMETER	OR	OR
D/DIA	DIAMETER	OR	OR
DB	DRY BULB TEMPERATURE	OR	OR
DC	DUST COLLECTOR	OR	OR
DEMO	DEMOLITION	OR	OR
D.H.	DOUBLE HUNG	OR	OR
D.O.	DOWN	OR	OR
DP	DEEP	OR	OR
DWG	DRAWING	OR	OR
E	EAST	OR	OR
EAT	ENTERING AIR TEMPERATURE	OR	OR
E-CONTR	ELECTRICAL CONTRACTOR	OR	OR
E-ESP	ELECTRICAL SUPPLY	OR	OR
EOS	ENTERING DRY BULB	OR	OR
EWF	EQUIVALENT DIRECT RADIATION	OR	OR
EWF	EMERGENCY EGRESS WINDOW	OR	OR
EWF	EXHAUST FAN	OR	OR
EWF	EXTINGUISHER	OR	OR
E.H.	EXHAUST HOOD	OR	OR
E.H.	EXHAUST JOINT	OR	OR
ELEC	ELECTRICAL	OR	OR
EL/ELEV	ELEVATION	OR	OR
ENCL	ENCLOSURE	OR	OR
ENCL	ENTRANCE	OR	OR
ENTR	ENTRANCE	OR	OR
ESP	EQUIPMENT	OR	OR
ESP	EXTERNAL STATIC PRESSURE	OR	OR
EVAP	EVAPORATOR	OR	OR
EWB	ENTERING WET BULB	OR	OR
EWB	ENTERING WATER	OR	OR
EXH	EXHAUST	OR	OR
EXH	EXHAUST AIR	OR	OR
EXIST	EXISTING	OR	OR
EXT	EXTERIOR	OR	OR
F	FAHRENHEIT	OR	OR
F.A.I.	FAN INTAKE	OR	OR
FCU	FAN COIL UNIT	OR	OR
F.DAMP	FIRE DAMPER	OR	OR
F.F.	FIBER GLASS	OR	OR
FL	FLOOR	OR	OR
FL/FLR	FLOOR	OR	OR

AND	AND	ETG	FOOTING
ASBESTOS CONTAINING	ASBESTOS CONTAINING	FOR	FLAT ON BOTTOM
ACUSTICAL CEILING TILE	ACUSTICAL CEILING TILE	FOR	FUEL OIL RETURN
ASBESTOS CONTAINING WASTE	ASBESTOS CONTAINING WASTE	FOT	FLOOR FINISH
ADJACENT	ADJACENT	FR	FEET PER MINUTE
ALUMINUM	ALUMINUM	FRP	FIBERGLASS REINFORCED POLYESTER
AMBIENT	AMBIENT	FT	FOOT OR FEET
AIR PRESSURE DROP	AIR PRESSURE DROP	GA	GALLONS
APPROXIMATE	APPROXIMATE	GA/CALV	GALLONS PER HOUR
AREA OF REFUGE	AREA OF REFUGE	GEN	GENERAL CONSTRUCTION
ARCHITECTURAL	ARCHITECTURAL	GEN	GENERAL
AVERAGE	AVERAGE	OPH	OPH PER HOUR
BACK DRAFT DAMPER	BACK DRAFT DAMPER	OR	OR PER MINUTE
BRAKE HORSE POWER	BRAKE HORSE POWER	OR	OR
BUILDING MATERIALS	BUILDING MATERIALS	OR	OR
BUILDING	BUILDING	OR	OR
BRITISH THERMAL UNITS/HOUR	BRITISH THERMAL UNITS/HOUR	OR	OR
BUILT UP	BUILT UP	OR	OR
BUILT UP ROOFING	BUILT UP ROOFING	OR	OR
COMMON	COMMON	OR	OR
CEFFICIENT, VALVE FLOW	CEFFICIENT, VALVE FLOW	OR	OR
CATCH BASIN	CATCH BASIN	OR	OR
CEILING	CEILING	OR	OR
CEILING EXHAUST REGISTER/GRILLE	CEILING EXHAUST REGISTER/GRILLE	OR	OR
CUBIC FEET PER MINUTE	CUBIC FEET PER MINUTE	OR	OR
CHILLED WATER RETURN	CHILLED WATER RETURN	OR	OR
CHILLED WATER SUPPLY	CHILLED WATER SUPPLY	OR	OR
CONTROL JOINT	CONTROL JOINT	OR	OR
COOLING WATER	COOLING WATER	OR	OR
CORRUGATED METAL PIPE	CORRUGATED METAL PIPE	OR	OR
CONCRETE	CONCRETE	OR	OR
CONCRETE	CONCRETE	OR	OR
CONSTRUCTION	CONSTRUCTION	OR	OR
CONTRACTOR	CONTRACTOR	OR	OR
CONVEYOR	CONVEYOR	OR	OR
CONDENSATE PUMP/RETURN REGISTER/GRILLE	CONDENSATE PUMP/RETURN REGISTER/GRILLE	OR	OR
CEILING RETURN ROOM UNIT	CEILING RETURN ROOM UNIT	OR	OR
CEILING SUPPLY DIFFUSER	CEILING SUPPLY DIFFUSER	OR	OR
CEILING TOWER	CEILING TOWER	OR	OR
CUBIC FEET	CUBIC FEET	OR	OR
CUBIC TON UNIT HEATER	CUBIC TON UNIT HEATER	OR	OR
CONDENSER WATER RETURN	CONDENSER WATER RETURN	OR	OR
CONDENSER WATER SUPPLY	CONDENSER WATER SUPPLY	OR	OR
DIAMETER	DIAMETER	OR	OR
DRY BULB TEMPERATURE	DRY BULB TEMPERATURE	OR	OR
DUST COLLECTOR	DUST COLLECTOR	OR	OR
DEMOLITION	DEMOLITION	OR	OR
DEMOUNTABLE	DEMOUNTABLE	OR	OR
DOUBLE HUNG	DOUBLE HUNG	OR	OR
DOWN	DOWN	OR	OR
DEEP	DEEP	OR	OR
DRAWING	DRAWING	OR	OR
DIRECT EXPANSION	DIRECT EXPANSION	OR	OR
EAST	EAST	OR	OR
EACH	EACH	OR	OR
ENTERING AIR TEMPERATURE	ENTERING AIR TEMPERATURE	OR	OR
ELECTRICAL CONTRACTOR	ELECTRICAL CONTRACTOR	OR	OR
ELECTRICAL SUPPLY	ELECTRICAL SUPPLY	OR	OR
ENTERING DRY BULB	ENTERING DRY BULB	OR	OR
EXISTING DRINKING FOUNTAIN	EXISTING DRINKING FOUNTAIN	OR	OR
EQUIVALENT DIRECT RADIATION	EQUIVALENT DIRECT RADIATION	OR	OR
EMERGENCY EGRESS WINDOW	EMERGENCY EGRESS WINDOW	OR	OR
EXHAUST FAN	EXHAUST FAN	OR	OR
EXTINGUISHER	EXTINGUISHER	OR	OR
EXHAUST HOOD	EXHAUST HOOD	OR	OR
EXHAUST JOINT	EXHAUST JOINT	OR	OR
ELECTRICAL	ELECTRICAL	OR	OR
ELEVATION	ELEVATION	OR	OR
ELEMENTARY SCHOOL	ELEMENTARY SCHOOL	OR	OR
MOUNTING HEIGHT	MOUNTING HEIGHT	OR	OR
ENCLOSURE	ENCLOSURE	OR	OR
ENTRANCE	ENTRANCE	OR	OR
EQUIPMENT	EQUIPMENT	OR	OR
EXTERNAL STATIC PRESSURE	EXTERNAL STATIC PRESSURE	OR	OR
EVAPORATOR	EVAPORATOR	OR	OR
ENTERING WET BULB	ENTERING WET BULB	OR	OR
ENTERING WATER	ENTERING WATER	OR	OR
TEMPERATURE	TEMPERATURE	OR	OR
EXHAUST	EXHAUST	OR	OR
EXHAUST AIR	EXHAUST AIR	OR	OR
EXISTING	EXISTING	OR	OR
EXTENSION	EXTENSION	OR	OR
EXTERIOR	EXTERIOR	OR	OR
FAHRENHEIT	FAHRENHEIT	OR	OR
FAN INTAKE	FAN INTAKE	OR	OR
FAN COIL UNIT	FAN COIL UNIT	OR	OR
FIRE DAMPER	FIRE DAMPER	OR	OR
FIBER GLASS	FIBER GLASS	OR	OR
FIXTURE	FIXTURE	OR	OR
FIRE EXTINGUISHER	FIRE EXTINGUISHER	OR	OR
FLOOR	FLOOR	OR	OR

GENERAL NOTES

- THE FOLLOWING NOTES SHALL APPLY THROUGHOUT. EXCEPTIONS ARE SPECIFICALLY NOTED ON EACH DRAWING:
- ALL DETAILS AND/OR PART OF DETAILS ARE SIMILAR FOR SIMILAR LOCATIONS IN ALL OR PART OF THE DETAIL.
 - COORDINATION OF ALL WORK UNDER THIS CONTRACT SHALL BE MAINTAINED TO ENSURE THE QUALITY AND TIMELY COMPLETION OF THE WORK/PROJECT.
 - INDICATED DIMENSIONS ARE TO:
A. FACE OF MASONRY OR CONCRETE AND FACE OF FINISH TO FINISH ARE EXACT.
B. CENTER LINES.
 - DRAWINGS ARE NOT TO BE SCALED. USE DIMENSIONS ONLY. ALL DIMENSIONS AND CONDITIONS SHOWN AND ASSUMED ON THE DRAWINGS MUST BE VERIFIED BY THE CONTRACTOR BEFORE ORDERING ANY MATERIAL OR DOING ANY DISCREPANCIES IN THE DRAWINGS AND SPECIFICATIONS SHALL BE REPORTED TO THE AUTHORITY. NO CHANGE IN DRAWINGS OR SPECIFICATIONS IS PERMISSIBLE WITHOUT THE WRITTEN CONSENT OF THE ARCHITECT AND ENGINEER. NO WORK SHALL PROCEED UNTIL SUCH DISCREPANCY HAS BEEN RECTIFIED.
 - ANY VARIATION FROM CONDITIONS SHOWN ON THESE DRAWINGS SHALL BE BROUGHT TO THE ATTENTION OF THE OWNER'S REPRESENTATIVE. AFFECTED WORK SHALL NOT PROCEED UNTIL CLARIFICATION HAS BEEN RECEIVED.
 - ALL WORK OF THIS CONTRACT SHALL BE DONE IN ACCORDANCE WITH THE LATEST EDITION OF THE BUILDING CODE NEW YORK STATE AND REGULATIONS OF OTHER AGENCIES HAVING JURISDICTION ON THE WORK OF THIS CONTRACT.
 - ALL WORK ON THESE DRAWINGS SHALL BE CONSIDERED NEW WORK WHETHER STATED OR NOT EXCEPT WHERE SPECIFICALLY NOTED AS "EXISTING TO REMAIN".
 - DISCREPANCIES AND OMISSIONS ON DRAWINGS AND SPECIFICATIONS SHALL BE REPORTED TO THE OWNER'S REPRESENTATIVE IN WRITING FOR CLARIFICATION.
 - SET ALL WORK STRAIGHT, PLUMB AND LEVEL OR WITH INDICATED SLOPE.
 - THE CONTRACTOR SHALL USE THE APPROVED STANDARDS: A.I.S.C. FEDERAL, U.S., ETC. STANDARDS OF THEIR TRADES. ALL CONSTRUCTION SHALL BE PERFORMED TO THESE STANDARDS.
 - IF AMBIGUITIES EXIST IN THE CONTRACT DOCUMENTS, THE CONTRACTOR SHALL INCLUDE IN HIS BID THE MORE EXPENSIVE MATERIAL OR METHOD OF WORK.
 - THE CONTRACTOR SHALL REMOVE AND DISPOSE OF DEBRIS. THE CONTRACTOR SHALL KEEP WORK SITE FREE FROM DEBRIS AND ACCUMULATED REFUSE, AND SHALL HAVE SOLE RESPONSIBILITY FOR PROTECTING ALL DANGEROUS AREAS FROM ENTRY BY UNAUTHORIZED PARTIES. SITE SHALL BE LEFT BROOM CLEAN AT THE END OF EACH WORKING DAY.
 - LARGE SCALE DETAILS HAVE PRECEDENCE, HOWEVER WORK INDICATED ON SMALL SCALE DRAWINGS SHALL NOT BE OMITTED. SIMILARLY, NOTES TAKE PRECEDENCE OVER SCHEDULES, PIPING AND WIRE DIAGRAMS, HOWEVER, WORK SHOWN OR DESCRIBED BY OTHER METHODS SHALL NOT BE OMITTED.
 - THE CONTRACTOR SHALL PATCH AND REPAIR ALL DAMAGED OR EXPOSED SURFACES DUE TO CONTRACT WORK. ALL NEWLY INSTALLED, PATCHED WORK AND ALL AFFECTED AREAS SHALL BE PAINTED. ALL PAINTING WORK SHALL BE PERFORMED TO COVER THE ENTIRE HORIZONTAL OR VERTICAL SURFACE TO THE CLOSEST CORNER IN ALL FOUR DIRECTIONS. COLOR TO MATCH EXISTING CONDITIONS.
 - THE CONTRACTOR SHALL FURNISH AND INSTALL NEW MATERIALS AT NO ADDITIONAL COST TO THE OWNER FOR THE FOLLOWING CONDITIONS:
A) TO FURNISH THE WORK OF THIS CONTRACT IN WORKMANLIKE MANNER.
 - THE CONTRACTOR SHALL BE RESPONSIBLE FOR ADEQUATE BRACING AND PROTECTING ALL WORK DURING CONSTRUCTION AGAINST DAMAGE, BREAKAGE, COLLAPSE, DISTORTIONS AND OFFSETS ACCORDING TO CODES AND STANDARDS OF GOOD PRACTICE.
 - THE CONTRACTOR SHALL INCLUDE ALL PROPRIETARY AND ASSOCIATED SUPPLEMENTARY WORK TO PROVIDE A COMPLETE AND FINISHED INSTALLATION.
 - WHERE MANUFACTURER'S NAMES AND PRODUCT NUMBERS ARE INDICATED ON DRAWINGS, IT SHALL BE CONSTRUCTED TO MEAN THE ESTABLISHMENT OF QUALITY AND PERFORMANCE STANDARDS OF SUCH ITEMS. ALL OTHER PRODUCTS MUST BE SUBMITTED TO THE ARCHITECT FOR APPROVAL IN ACCORDANCE TO CONTRACT DOCUMENT REQUIREMENT BEFORE THEY SHALL BE DEEMED EQUAL.
 - FIRESTOPPING SHALL BE INSTALLED AT ALL PENETRATIONS OF FIRE RATED CONSTRUCTION AS PER SPECIFICATIONS.
 - PROVIDE GUARDS, RAILS, BARRICADES, FENCES, SIDEWALK SHEDS, CHAIR PLATFORMS, DECKING, NIGHT LIGHTING, ETC., AS REQUIRED, TO PROVIDE ADEQUATE PROTECTION.
 - THE CONTRACTOR SHALL, UNLESS OTHERWISE PROVIDED IN THE CONTRACT DOCUMENTS, SECURE AND PAY FOR REQUIRED INSPECTIONS, PERMITS(S), FEES, LICENSE AND INSPECTIONS NECESSARY FOR THE PROPER EXECUTION OF THE WORK.
 - ADDITIONAL NOTES WHICH ARE APPLICABLE TO THIS PROJECT MAY BE FOUND THROUGHOUT THE CONTRACT DOCUMENTS.
 - SEISMIC RESTRAINTS SHALL BE PROVIDED, IN ACCORDANCE TO APPLICABLE CODES.

GENERAL REMOVAL NOTES:

- REMOVAL DRAWINGS INDICATE ONLY MAJOR SCOPE OF REMOVALS. CONTRACTOR IS REQUIRED TO REMOVE ANY AND ALL ITEMS NOT SHOWN AS REQUIRED TO SUIT ALL NEW WORK. CONTRACTOR IS REQUIRED TO REMOVE, PROTECT AND STORE ANY AND ALL ITEMS SHOWN AS REQUIRED TO SUIT ALL NEW WORK, COORDINATE w/OWNER FOR STORING LOCATIONS.
- CONTRACTOR IS TO VERIFY ANY MAJOR DIMENSIONAL DEVIATIONS FROM DRAWINGS OR STRUCTURAL OBSTRUCTIONS. THESE SHALL BE BROUGHT TO THE OWNER'S REPRESENTATIVE'S ATTENTION. ALL CONTRACT DRAWINGS INDICATE APPROXIMATE DIMENSIONS AND EXISTING CONDITIONS BASED ON FIELD SURVEY AND DRAWINGS FURNISHED BY THE OWNER. VARIATIONS MAY EXIST AS TO FIELD CONDITIONS. THE COST FOR ANY SUCH VARIATIONS SHALL BE INCLUDED WITHIN THE CONTRACT BID.
- ALL SURFACES DISTURBED BY REMOVALS SHALL BE PATCHED/REPAIRED TO MATCH EXISTING ADJACENT FINISHES, COORDINATE AND PREPARE SURFACES TO ACCOMMODATE WITH NEW FINISH ACCORDING TO SPECS AND MANUFACTURER'S RECOMMENDATIONS.
- GENERAL CONTRACTOR SHALL FIRE STOP ALL TRADE RELATED EXISTING OR NEW PENETRATIONS THROUGH FLOORS, PARTITIONS AND WALLS AT ALL LOCATIONS WITH APPROVED MATERIALS AND SYSTEMS.
- ALWAYS WORK IN A MANNER WHICH PROVIDES CONTINUOUS SUPPORT TO STRUCTURE ABOVE. PROVIDE APPROPRIATE UNITS FOR ALL OPENINGS UNLESS SPECIFIED OTHERWISE.
- REMOVE ALL WINDOW TREATMENTS AND HARDWARE WHERE WINDOWS ARE BEING REPLACED. IF REQUESTED, TURNOVER TO OWNER.
- GENERAL CONTRACTOR TO COORDINATE REMOVALS WITH NEW WORK.
- FOR ABATEMENT OF HAZARDOUS/ TOXIC MATERIALS REFER TO HAZARDOUS MATERIALS DRAWINGS AND SPECIFICATIONS.
- ABATEMENT OF HAZARDOUS MATERIAL SHALL BE COORDINATED WITH REMOVAL WORK.

GRAPHIC LEGEND

	ROOM NAME & NUMBER		REMOVE EXISTING CONSTRUCTION
	DOOR NUMBER		EXISTING CONSTRUCTION
	ELEVATION KEY		NEW WALL CONSTRUCTION
	INTERIOR WALL INDICATIONS		COLUMN GRID LINES
	WINDOW TYPE		EXISTING COLUMN DESIGNATION
	REMOVAL/WORKSCOPE NOTE		BUILDING/WALL SECTION/DETAIL
	REVISION MARK		REFERENCE POINT
	DETAIL NO.		HIDDEN LINE BELOW
	DETAIL KEY		HIDDEN LINE ABOVE OR BEYOND
	EXTERIOR ELEVATION KEY		CENTERLINE OR N.I.C. LINE
	FLUSH THRESHOLD		EXISTING DOOR INDICATES DOOR NUMBER (SEE DOOR SCHEDULE)
	5'-0\"/>		NEW DOOR INDICATES DOOR NUMBER (SEE DOOR SCHEDULE)

MATERIALS LEGEND

	CONCRETE		PARTICLE BOARD
	CONCRETE MASONRY UNITS		PLYWOOD
	BRICK		ACOUSTICAL TILE
	STONE		CONTINUOUS WOOD FRAMING THROUGH MEMBER
	METALS		WOOD FRAMING THROUGH INTERRUPTED MEMBER
	COMPACTED GRAVEL		FINISHED WOOD
	EARTH/UNDISTURBED SOIL		BATT INSULATION
	DRAINAGE BOARD		RIGID INSULATION

GENERAL WINDOW NOTES

- ALL MILLION REINFORCING TO BE CALCULATED TO MEET WIND LOADING REQUIREMENTS AS DESCRIBED IN THE SPECIFICATIONS BY WINDOW MANUFACTURER.
- ALL INSULATED PANEL FACE COLORS, BOTH INTERIOR AND EXTERIOR AS SELECTED BY ARCHITECT.
- ALL EXPOSED FASTENERS SHALL BE FINISHED TO MATCH ALUMINUM FINISH COLOR. ALL COUNTER FLASHING SHALL BE FINISHED TO MATCH ALUMINUM FINISH COLOR UNLESS NOTED OTHERWISE.
- PROTECT DISSIMILAR MATERIALS AS PER SPECIFICATIONS.
- CONTRACTOR SHALL PATCH ALL DISTURBED SURFACES TO MATCH EXISTING.
- ALL BLOCKING REQUIRED SHALL BE KILN DRIED LUMBER. FINISH OF FASTENERS SHALL BE COMPATIBLE WITH BLOCKING MATERIAL AND SHALL BE NON-CORROSIVE. SEE SPECS. ALL FASTENERS TO COMPLY WITH ALL CRITERIA AS DESCRIBED IN THE SPECIFICATIONS AND SHALL BE DETERMINED BY A NEW YORK STATE LICENSED P.E. ENGAGED BY THE CONTRACTOR.
- ALL EXPOSED UNITS WHERE WINDOWS ARE BEING INSTALLED SHALL BE SCRAPED, WIRE BRUSHED, PRIMED AND PAINTED TO MATCH BRICK COLOR. PROVIDE PRIMER AND (2) FINISH COATS. REFER TO SPECIFICATIONS.
- SILL JAMB AND HEAD FASTENERS TO COMPLY WITH ALL CRITERIA AS DESCRIBED IN THE SPECIFICATIONS.
- ALL WINDOW SIZES INDICATED ARE APPROXIMATE. CONTRACTOR TO FIELD VERIFY ALL M.O.'S PRIOR TO FABRICATION OF WINDOWS UNITS. EXISTING CONDITIONS SHOWN SHALL BE VERIFIED BY THE CONTRACTOR AND REFLECTED ON SHOP DRAWINGS. THE CONTRACTOR SHALL BE RESPONSIBLE FOR ALL DIMENSIONS AND JOB SITE CONDITIONS AFFECTING THIS WORK.
- SIZES OF ALUMINUM SNAP TRIM SHOWN ARE APPROXIMATE. LARGER SIZES MAY BE REQUIRED TO COVER EXPOSED MATERIALS DETERMINED BY FIELD CONDITIONS.
- CONCEALED FLASHING SHALL BE CORROSION RESISTANT, NON-STAINING AND NON-BLEEDING, COMPATIBLE WITH ADJACENT MATERIALS.
- SEALANT COLOR SHALL MATCH ADJACENT ALUMINUM EXTRUSION AND FLASHING, UNLESS NOTED OTHERWISE.
- FASTENER TYPE, LENGTH, AND SPACING SHALL BE AS REQUIRED BY DESIGN LOAD CRITERIA AND SHALL BE DETERMINED BY A NEW YORK STATE LICENSED P.E. ENGAGED BY THE CONTRACTOR.
- REFER TO SPECIFICATIONS FOR SCREENS.
- ALL INSULATED PANELS SHALL BE FIRE RATED. REFER TO SPECIFICATIONS.
- EMERGENCY EGRESS WINDOWS (EEW) WINDOWS SHALL HAVE A MINIMUM NET CLEAR OPENING OF 6 S.F. WITH A MINIMUM DIMENSION OF 24\"/>
- PROVIDE SECURITY AND WEATHER PROTECTION OF THE WINDOW OPENINGS AND PROTECT FROM DAMAGE. MINIMUM 1/2\"/>
- ALL GLAZING 1\"/>
- CONTRACTOR TO CAREFULLY UNFASTEN EXISTING METAL PARTITION CLOSURE PLATES PRIOR TO REMOVAL OF EXISTING CURTAINWALL. TRIM CLOSURE PLATES TO ACCOMMODATE NEW WINDOW WALL SYSTEM.
- PROVIDE AND INSTALL WINDOW TREATMENT AS INDICATED AND PER SPECIFICATIONS. PROVIDE RESCUE WINDOW LABEL OVER SHADE AT ALL DESIGNATED EGRESS WINDOWS.
- CONTRACTOR TO FIELD VERIFY ALL CONDUIT, VENT, FANS, AC UNITS, AND SIMILAR ITEMS AND PROVIDE OPENINGS TO SUIT.
- CONTRACTOR SHALL REMOVE ALL EXISTING WINDOWS. TRIM AND MISCELLANEOUS APPURTENANCES AS REQUIRED, TO INSTALL NEW WINDOW UNITS.
- ISOLATE ALL ALUMINUM TO BE PLACED DIRECTLY IN CONTACT WITH UNCURD MASONRY OR INCOMPATIBLE MATERIALS. THIS ISOLATION OR COATING SHOULD BE INDICATED ON SHOP DRAWINGS.
- WHEN USING PRESSURE TREATED WOOD BLOCKING IT HAS BECOME NECESSARY TO ISOLATE ALL ALUMINUM SURFACES THAT COMES INTO CONTACT WITH THIS WOOD. THE USE OF COMPATIBLE SELF ADHESIVE WINDOW AND DOOR FLASHING IS AN ACCEPTABLE MEANS OF ISOLATION.
- IF CONTRACTOR INTENDS TO USE PRESSURE TREATED WOOD BLOCKING, STAINLESS STEEL FASTENERS ARE REQUIRED.
- PROTECT MATERIALS AFTER ERECTION— PROTECT BY WRAPPING WITH KRAFT PAPER OR BY ERECTING VISQUEEN OR CANVAS SPLATTER SCREEN. CEMENT, PLASTER, TERRAZZO AND OTHER ALKALINE SOLUTIONS AND ACID BASED MATERIALS USED TO CLEAN MASONRY ARE VERY HARMFUL TO THE FINISH AND SHOULD BE REMOVED WITH WATER AND MILD SOAP IMMEDIATELY. ALL CLEANING SHOULD BE DONE IN ACCORDANCE WITH ANMA 609.9.3 VOLUNTARY GUIDE SPECIFICATION FOR CLEANING AND MAINTENANCE OF PAINTED ALUMINUM EXTRUSIONS AND CURTAIN WALL PANELS.
- SEALANT MUST BE COMPATIBLE WITH ALL MATERIALS WITH WHICH THEY HAVE CONTACT, INCLUDING OTHER SEALANT SURFACES.

SPECIAL NOTE:
TO THE BEST OF OUR KNOWLEDGE, BELIEF AND PROFESSIONAL JUDGMENT, PLANS AND SPECIFICATIONS ARE IN COMPLIANCE WITH THE ENERGY CONSERVATION CONSTRUCTION CODE OF NEW YORK STATE.

LIST OF DRAWINGS

GENERAL:	
T-1	TITLE SHEET
G-1	ABBREVIATIONS, LEGENDS, GENERAL NOTES, GENERAL WINDOW NOTES, GENERAL REMOVAL NOTES & LIST OF DRAWINGS
ARCHITECTURAL:	
A101	PARTIAL FIRST FLOOR PLANS & PARTIAL CLEARSTORY PLANS
A300	EXTERIOR PARTIAL ELEVATIONS
A301	EXTERIOR PARTIAL ELEVATIONS
A302	EXTERIOR PARTIAL ELEVATIONS
A425	WALL SECTIONS
A426	WALL SECTIONS
A427	WALL SECTIONS
A428	WALL SECTIONS
A429	WALL SECTIONS
A725	WINDOW SCHEDULE, DOOR SCHEDULE, & DOOR TYPES
A726	WINDOW DETAILS
A727	WINDOW DETAILS
A728	WINDOW DETAILS

NEW YORK STATE 2020 ENERGY CONSERVATION CODE BUILDING ENVELOPE REQUIREMENTS		
CLIMATE ZONE: 4		
NOTE: TO THE BEST OF OUR KNOWLEDGE, BELIEF AND PROFESSIONAL JUDGEMENT, PLANS AND SPECIFICATIONS ARE IN COMPLIANCE WITH SECTION E502.1 OF THE ENERGY CONSERVATION CONSTRUCTION CODE OF NEW YORK STATE. BUILDING ENVELOPE REQUIREMENTS ARE IN ACCORDANCE WITH TABLE E502.2(1).		
FENESTRATION MAXIMUM U-FACTOR AND SHGC REQUIREMENTS (C402.4)		
ELEMENT	CONDITION / VALUE	
VERTICAL FENESTRATION (AREA NOT GREATER THAN 30%)	U-VALUE	
	REQUIRED	PROVIDED
FIXED	0.38	SEE SPEC.
OPERABLE	0.45	
ENTRANCE DOORS	0.77	
SHGC		
PF<0.2	0.36	
0.2≤PF≤0.5	0.43	
PF>0.5	0.58	
MAXIMUM AIR LEAKAGE RATE FOR FENESTRATION (C402.5.2)		
ELEMENT	CONDITION / VALUE	
WINDOWS	0.20 CFM/FT²	
SWINGING DOORS	0.20 CFM/FT²	

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ARCHITECTS
&
PLANNERS

S.E.D. CONTROL NUMBER:
GREENVILLE ELEMENTARY
66-06-034-008-023

PROJECT NAME:
EDGEMONT UNION FREE SCHOOL DISTRICT
GREENVILLE WINDOW REPLACEMENT AND
RELATED WORK

DRAWING TITLE:
GENERAL REMOVAL NOTES

10-23-2024 RE-BID

08-27-2024 BID

11-14-2023 S.E.D. SUBMISSION

DATE ISSUED TO:


SCALE AS NOTED

DRAWING NO. G1


DRAWN BY F & D

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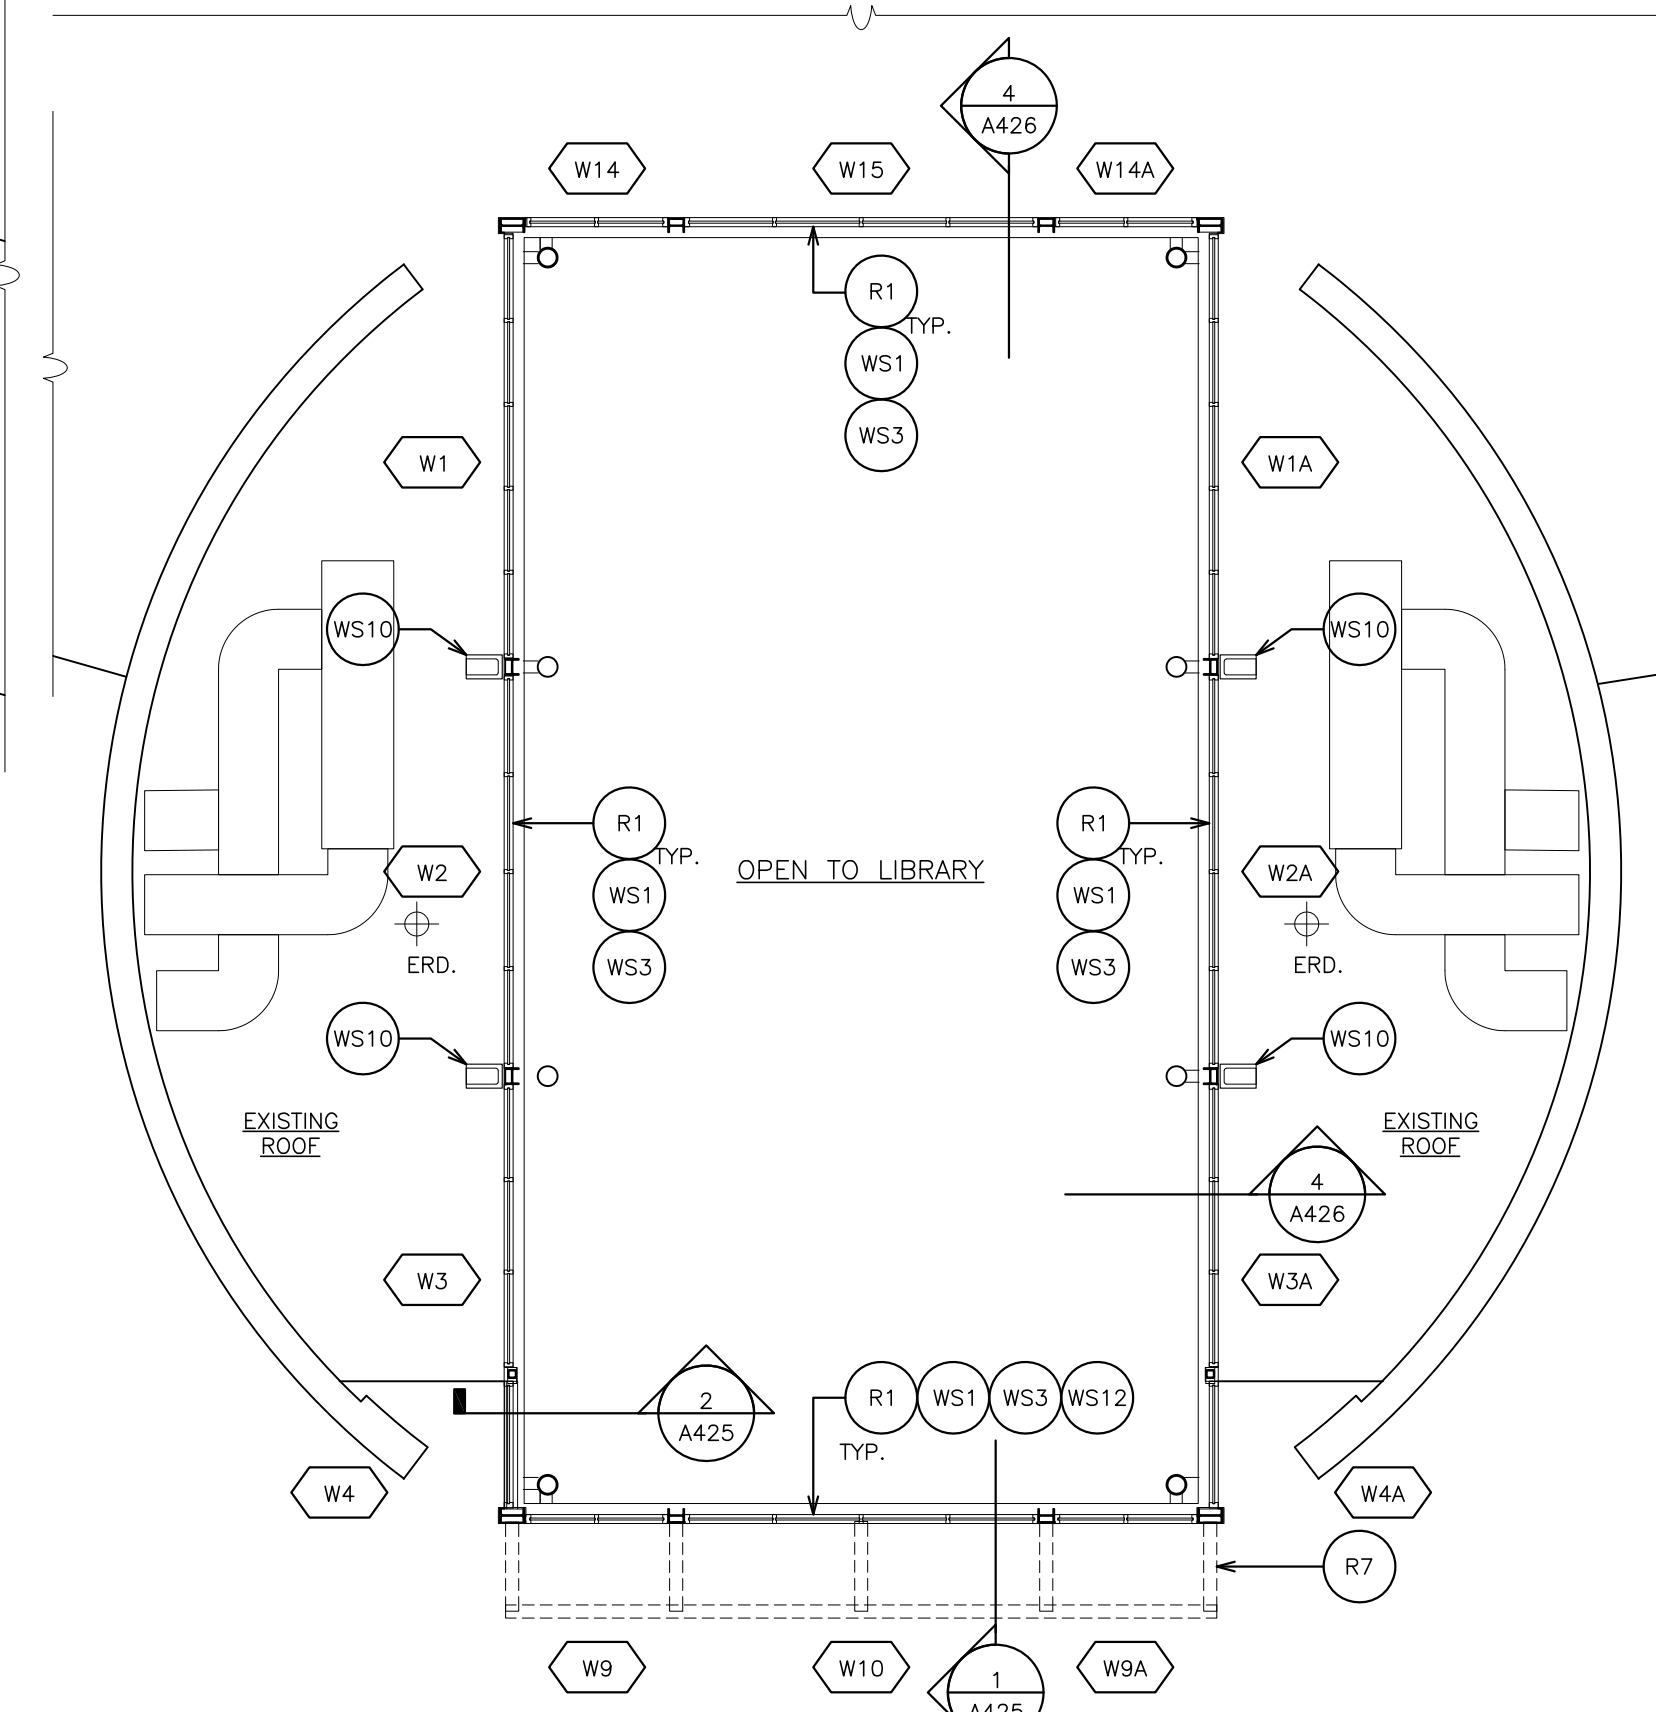
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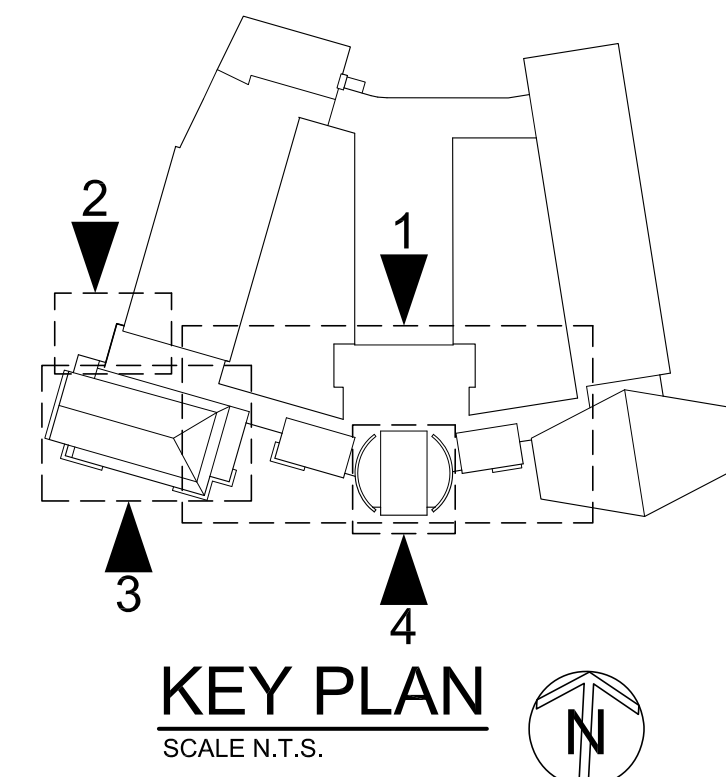
2 PARTIAL FIRST FLOOR PLAN
SCALE: 1/8" = 1'-0"

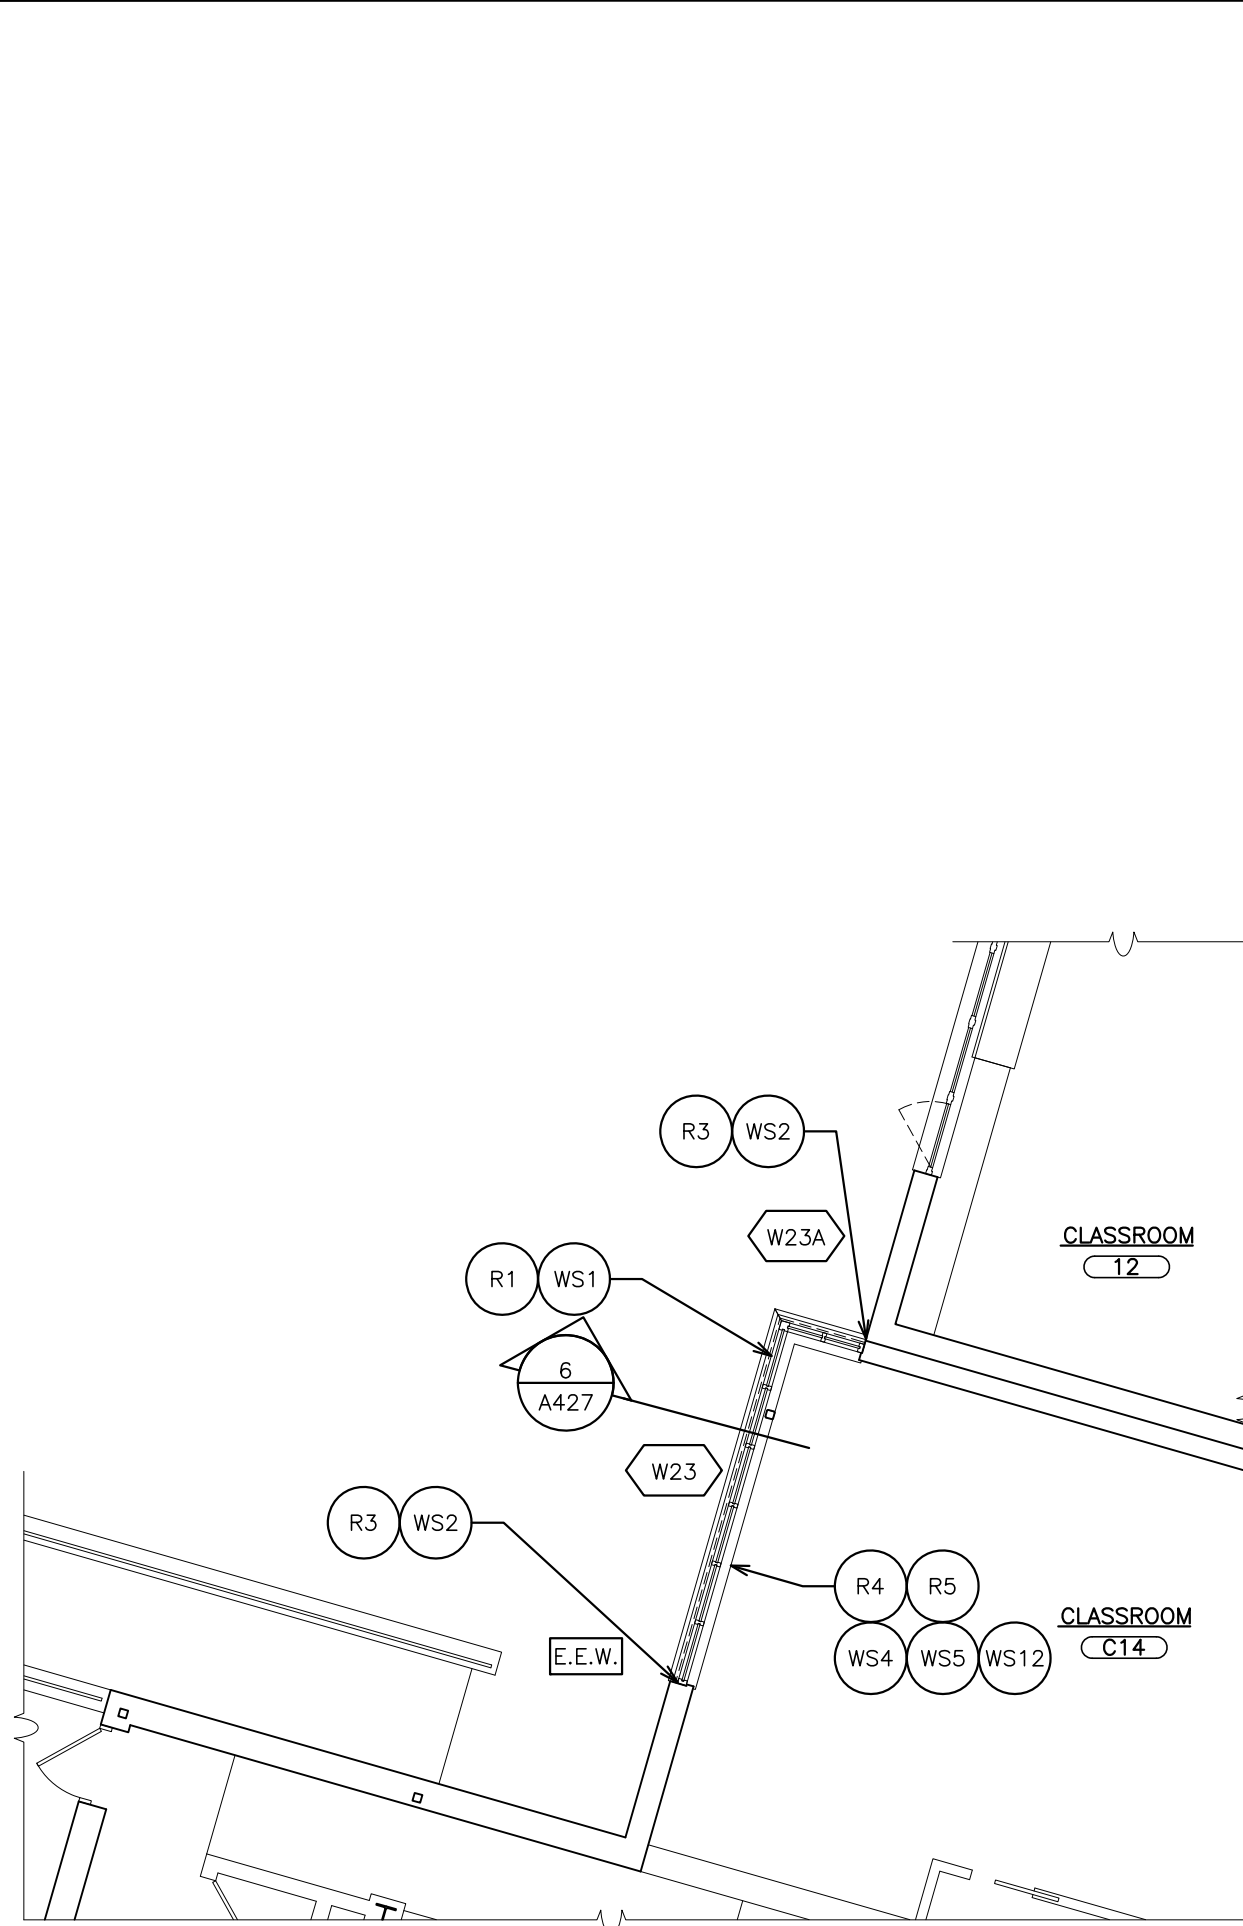

3 MULTI-PURPOSE ROOM CLERESTORY PLAN
SCALE: 1/8" = 1'-0"

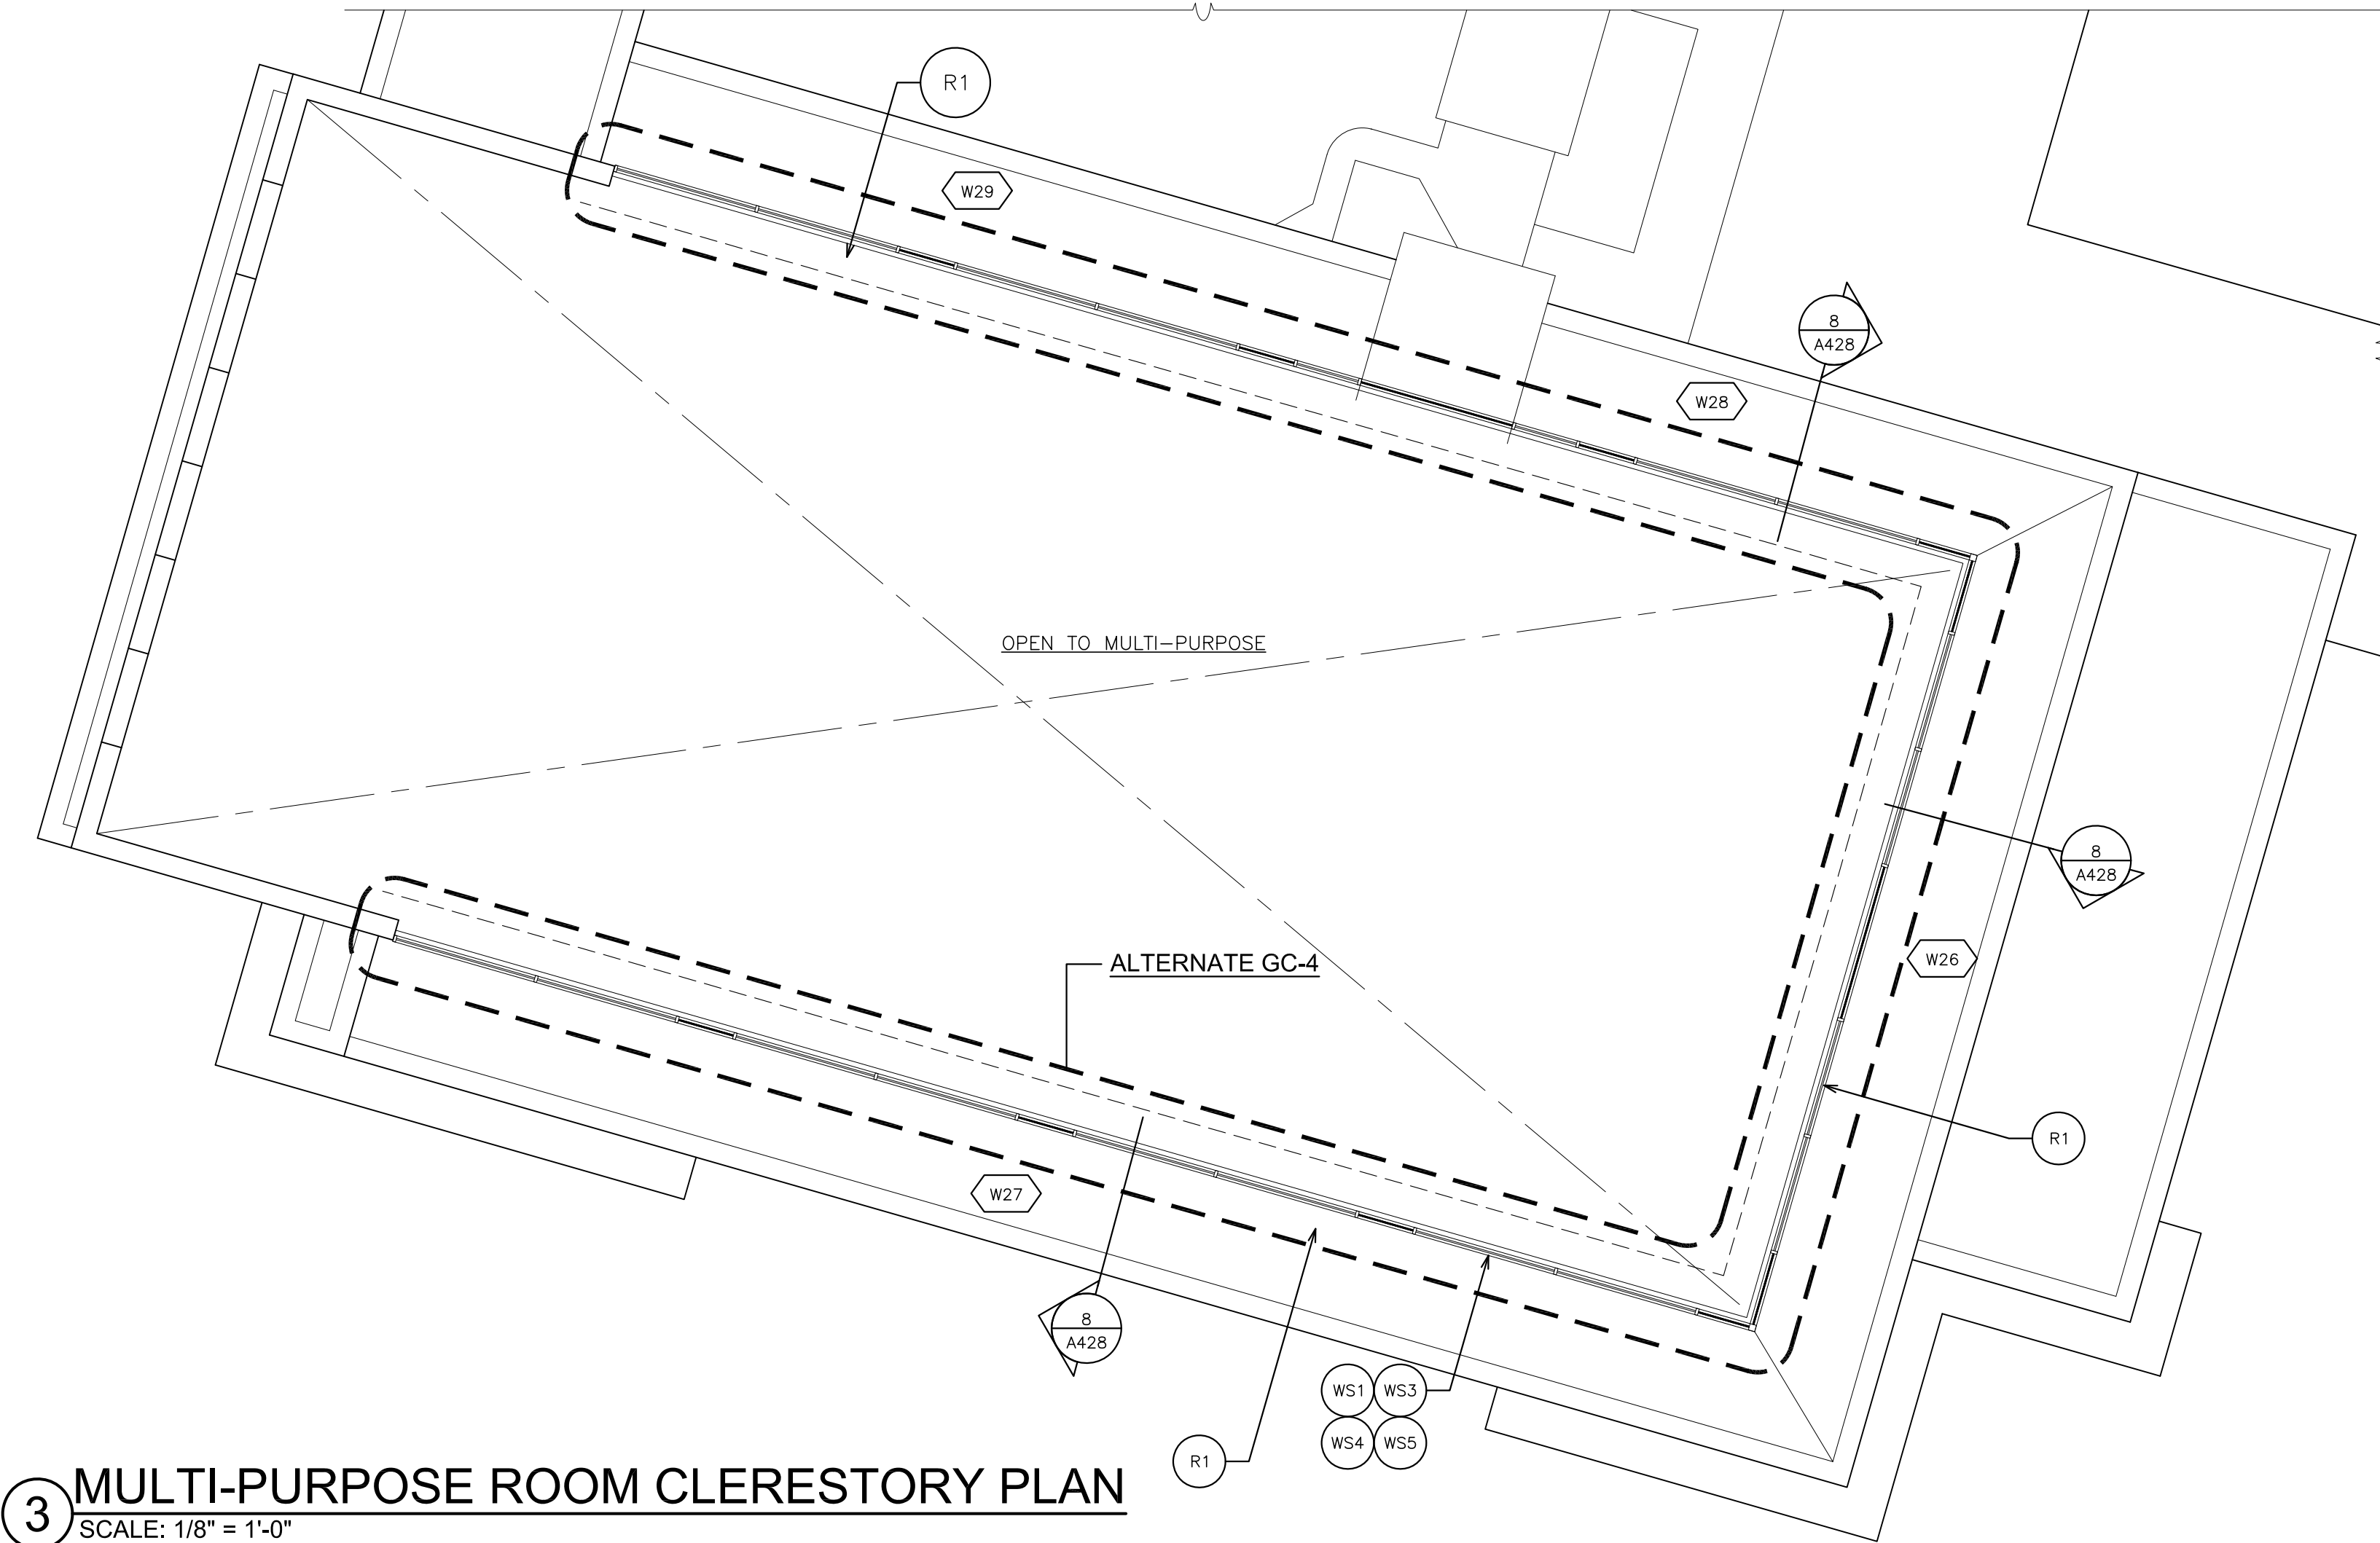


4 PARTIAL LIBRARY CLERESTORY PLAN
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KEY PLAN
SCALE: 1/8" = 1'-0"


- REMOVAL NOTES:**
(COORDINATE REMOVALS W/ ABATEMENT CONTRACTOR)
- R1 REMOVE EXISTING ALUMINUM STOREFRONT SYSTEMS, AND ALL RELATED ITEMS, INCLUDING SEALANTS, AND FLASHINGS. PATCH ALL DISTURBED SURFACES TO MATCH EXISTING ADJACENT SURFACES.
 - R2 REMOVE EXISTING DOORS, HARDWARE, THRESHOLDS, TRANSOMS, SIBELTES AND ALL RELATED ITEMS. PATCH ALL DISTURBED SURFACES TO MATCH EXISTING ADJACENT SURFACES.
 - R3 CLEAN BRICK AND/OR CAST STONE SURFACES OF ALL SEALANT RESIDUE.
 - R4 REMOVE AND SAFELY STORE EXISTING ROLLER SHADES, MOUNTING BRACKETS, FASTENERS, AND ALL RELATED ITEMS. REINSTALL AT CONCLUSION OF THE WORK.
 - R5 REMOVE AND DISCARD AT LEAST FIRST ROW OF ACOUSTICAL CEILING PANELS (2'X4' & 2'X2') FOR REMOVALS AND INSTALLATION OF NEW WINDOW SYSTEM. REPLACE WITH NEW ACT TO MATCH EXISTING.
 - R6 REMOVE EXISTING FLOOR MATERIAL BACK TO NEXT FULL TILE AS REQUIRED. PREPARE FLOOR AS PER FLOOR TILE MANUFACTURERS RECOMMENDATIONS. INSTALL FLOOR MATERIAL TO MATCH EXISTING ADJACENT MATERIAL.
 - R7 REMOVE EXISTING STEEL SUNSHADE CANOPY.

- WORKSCOPE NOTES:**
- WS1 INSTALL NEW ALUMINUM STOREFRONT ASSEMBLY AND RELATED ITEMS AS PER DETAILS AND SPECIFICATIONS.
 - WS2 REPAIR CRACKED AND/OR LOOSE CONCRETE AND BRICKS ADJACENT TO NEW WINDOW WALL ASSEMBLY CAUSED BY REMOVALS.
 - WS3 SCRAPE, WIRE BRUSH, PRIME, AND PAINT EXISTING STEEL STRUCTURE PRIOR TO ENCLOSING WITHIN METAL PANEL SYSTEM.
 - WS4 PATCH AND PAINT ALL SURFACES DAMAGED BY REMOVALS, ADJACENT TO WINDOW SYSTEM.
 - WS5 SEAL ALL JOINTS, HORIZONTAL AND VERTICAL, AT THE JUNCTION OF NEW WINDOW SYSTEM AND EXISTING WALLS, FLOORS, AND CEILINGS.
 - WS6 SCRAPE, WIREBRUSH, PRIME, AND PAINT EXPOSED STEEL LINTELS TO MATCH NEW FRAMES.
 - WS7 PROVIDE AND INSTALL ELECTRIC ACCESS CONTROLS. CONNECT TO EXISTING SYSTEM. PROVIDE ALL COMPONENTS FOR A COMPLETE AND OPERABLE SYSTEM.
 - WS8 RE-GRADE AND RE-SEED DISTURBED LANDSCAPING TO ORIGINAL CONDITION.
 - WS9 POWER WASH SOILED AND STAINED WALL SURFACES.
 - WS10 PROVIDE CONCRETE SPLASH BLOCK OVER 30"x30" WALKWAY PAD.
 - WS11 INSTALL ALUMINUM WIDE STILE DOOR, ALUMINUM THERMALLY BROKEN DOOR FRAME AND HARDWARE. SEE DOOR DETAILS & SCHEDULE.
 - WS12 PROVIDE ROLLER SHADE ASSEMBLY, ONE PER WINDOW BAY (TYPICAL). SEE SPECIFICATIONS FOR ADDITIONAL INFORMATION.




1 PARTIAL FIRST FLOOR PLAN
SCALE: 1/8" = 1'-0"

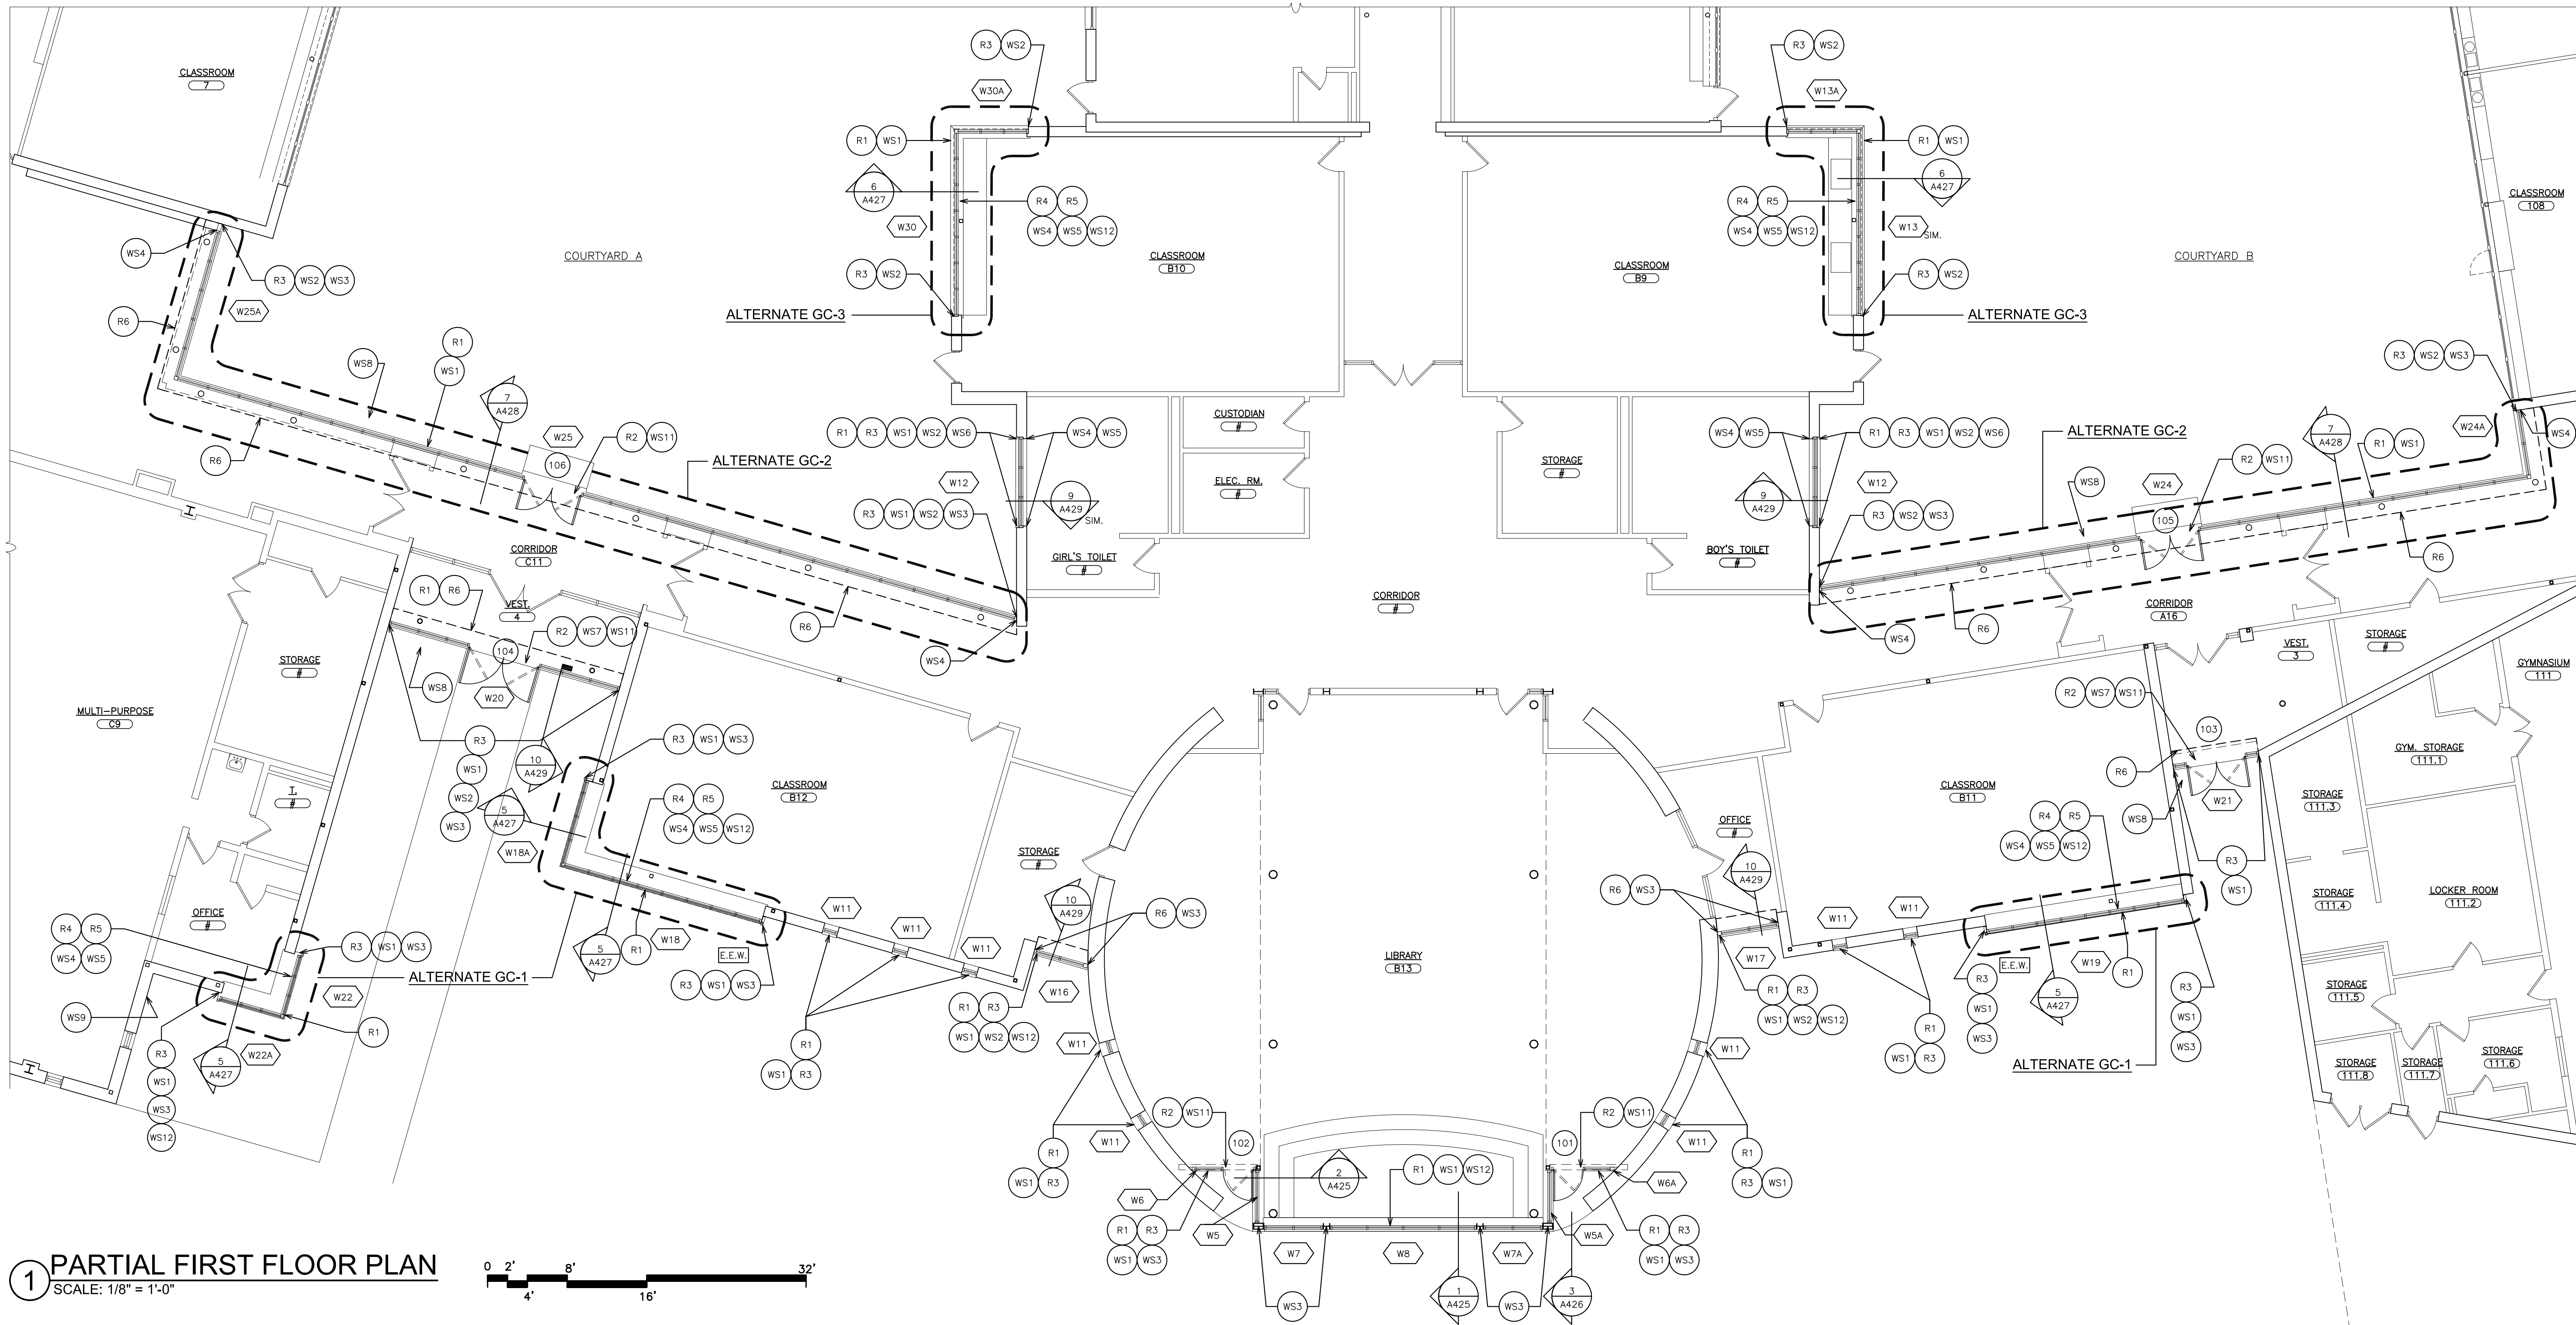

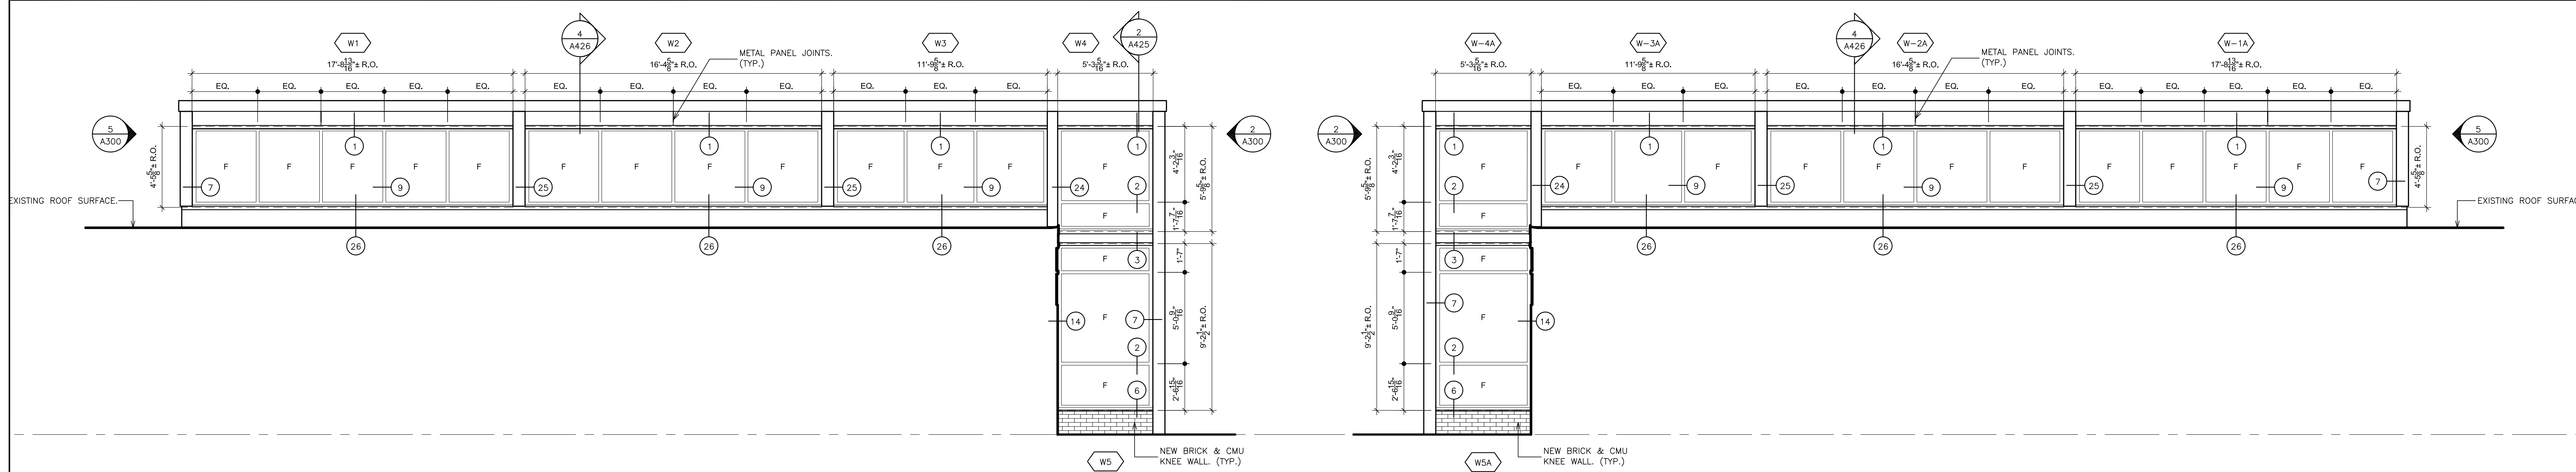


1 EXTERIOR ELEVATION @ LIBRARY
SCALE: 1/4" = 1'-0"

2 EXTERIOR ELEVATION @ LIBRARY
SCALE: 1/4" = 1'-0"

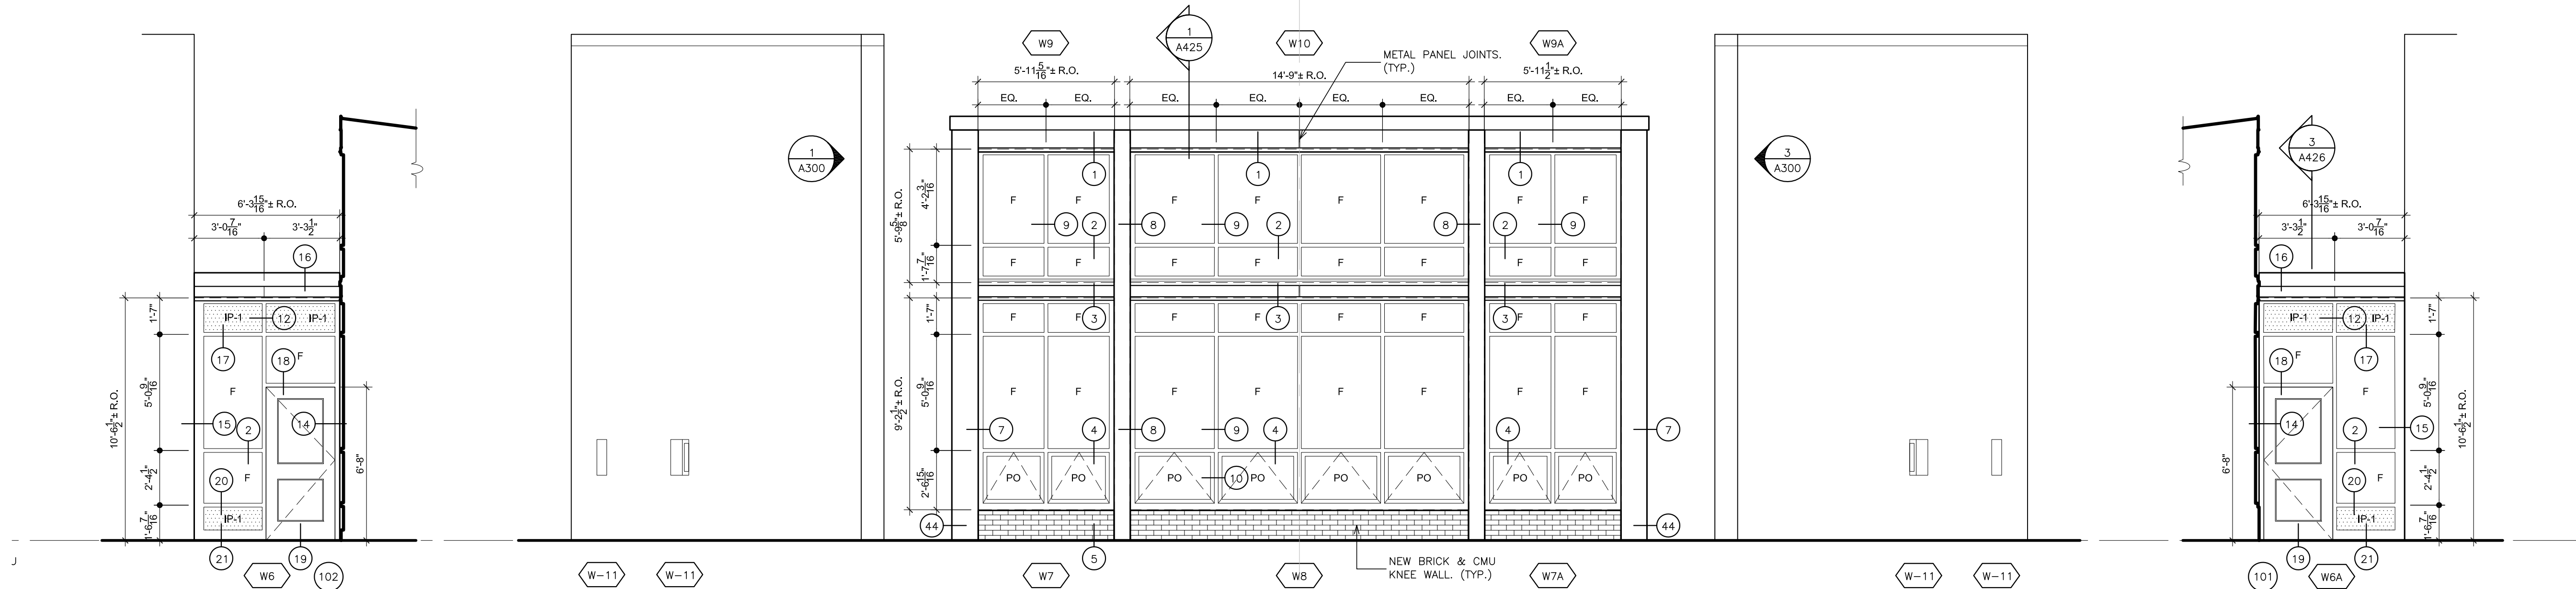


3 EXTERIOR ELEVATION @ LIBRARY
SCALE: 1/4" = 1'-0"

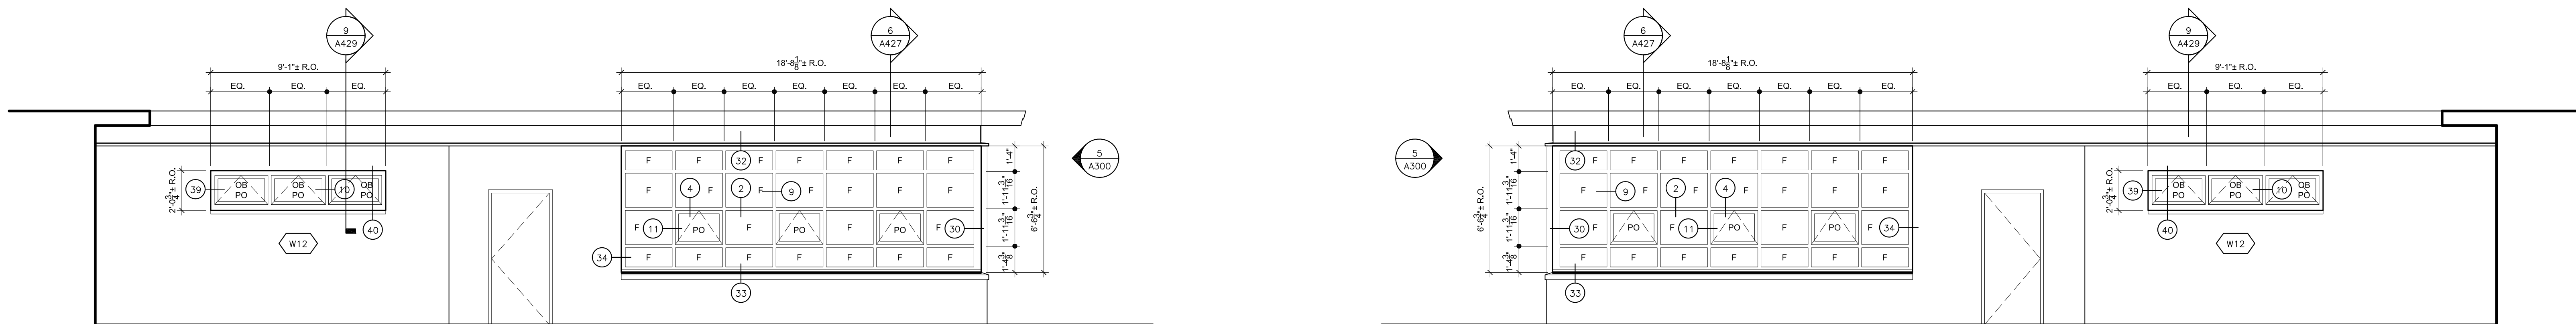


4 EXTERIOR ELEVATION
SCALE: 1/4" = 1'-0"


6 EXTERIOR ELEVATION
SCALE: 1/4" = 1'-0"

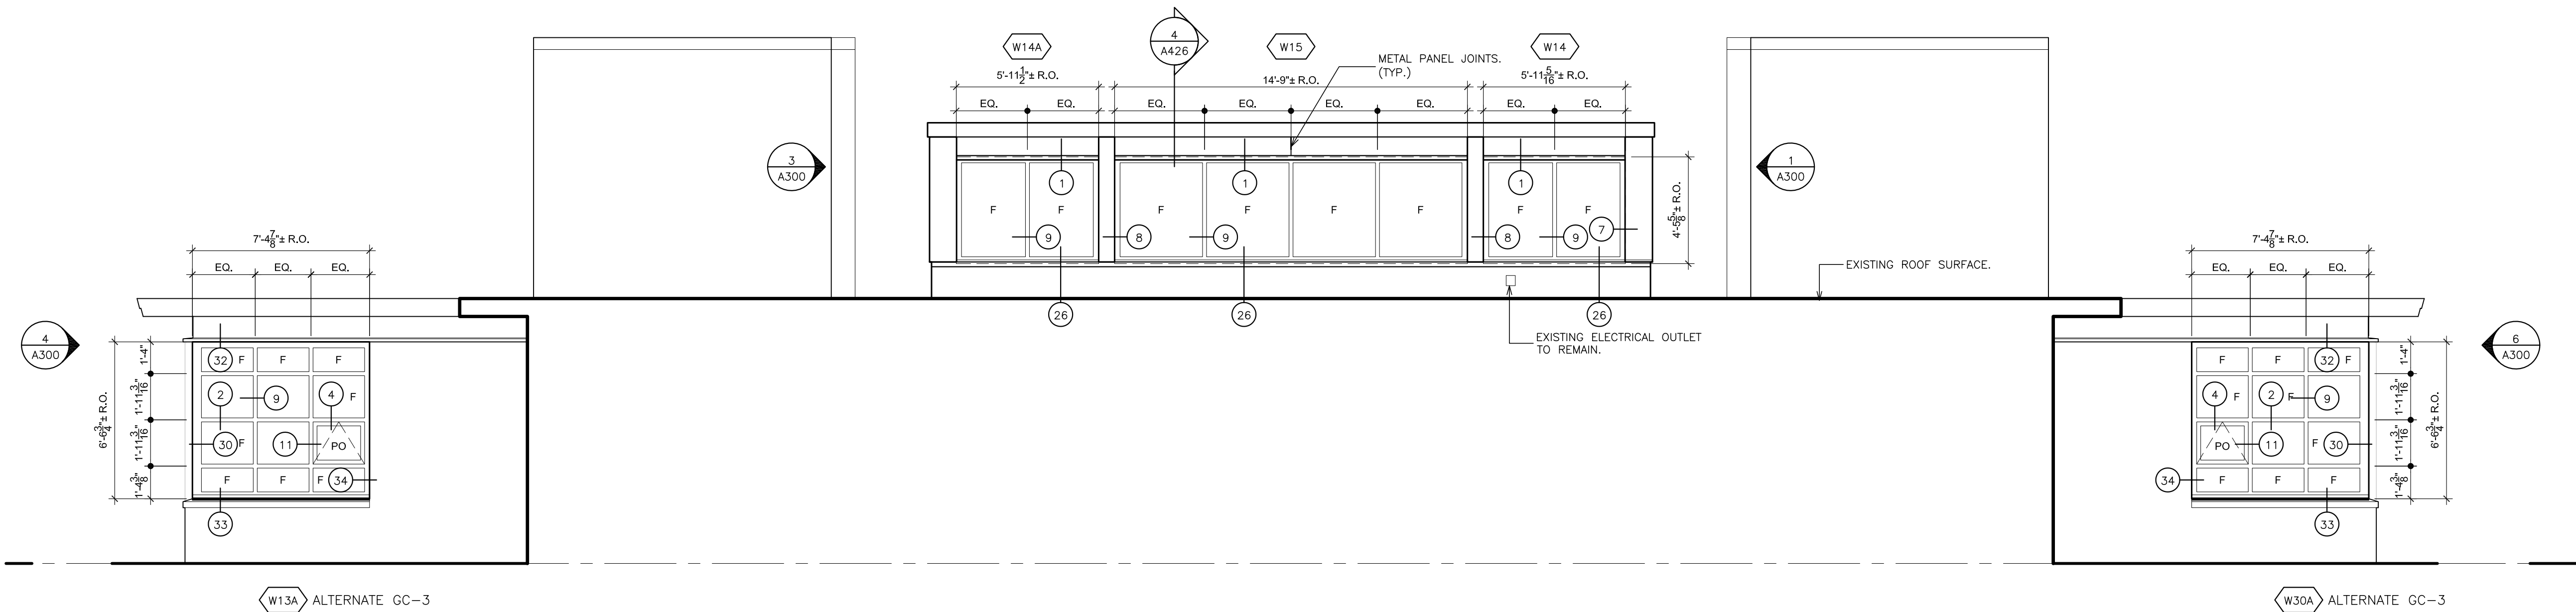

5 EXTERIOR ELEVATION
SCALE: 1/4" = 1'-0"

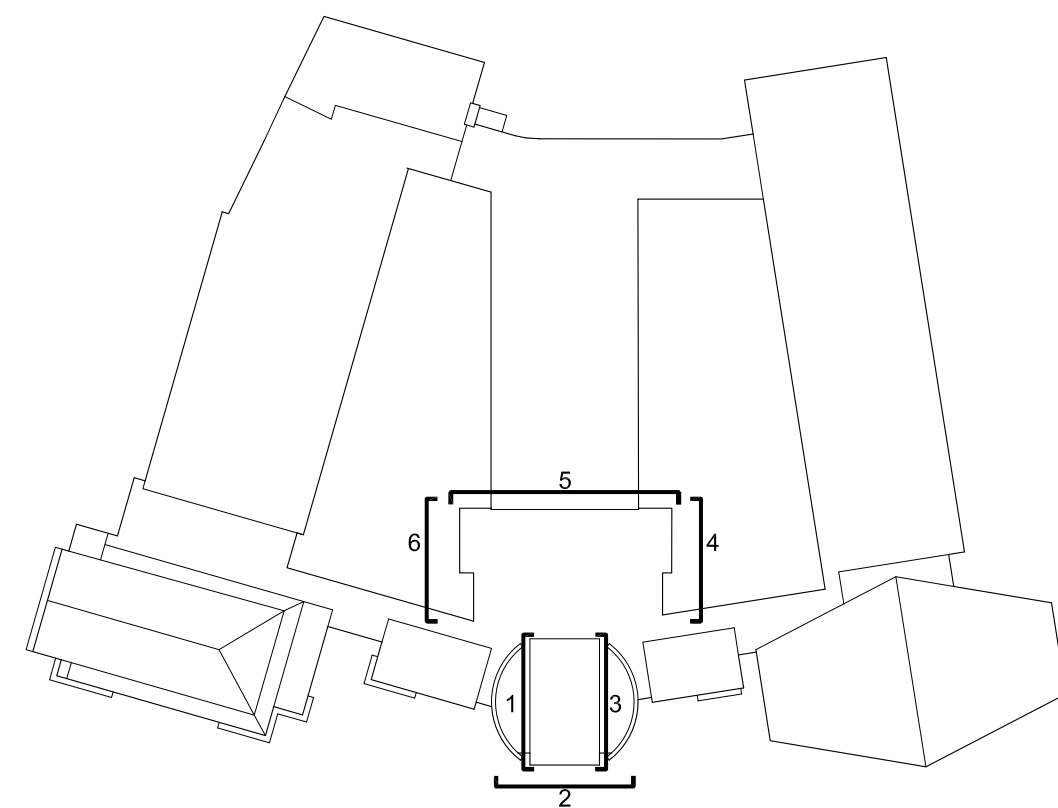

KEY PLAN
SCALE N.T.S.

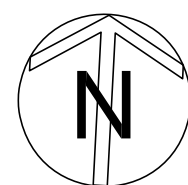

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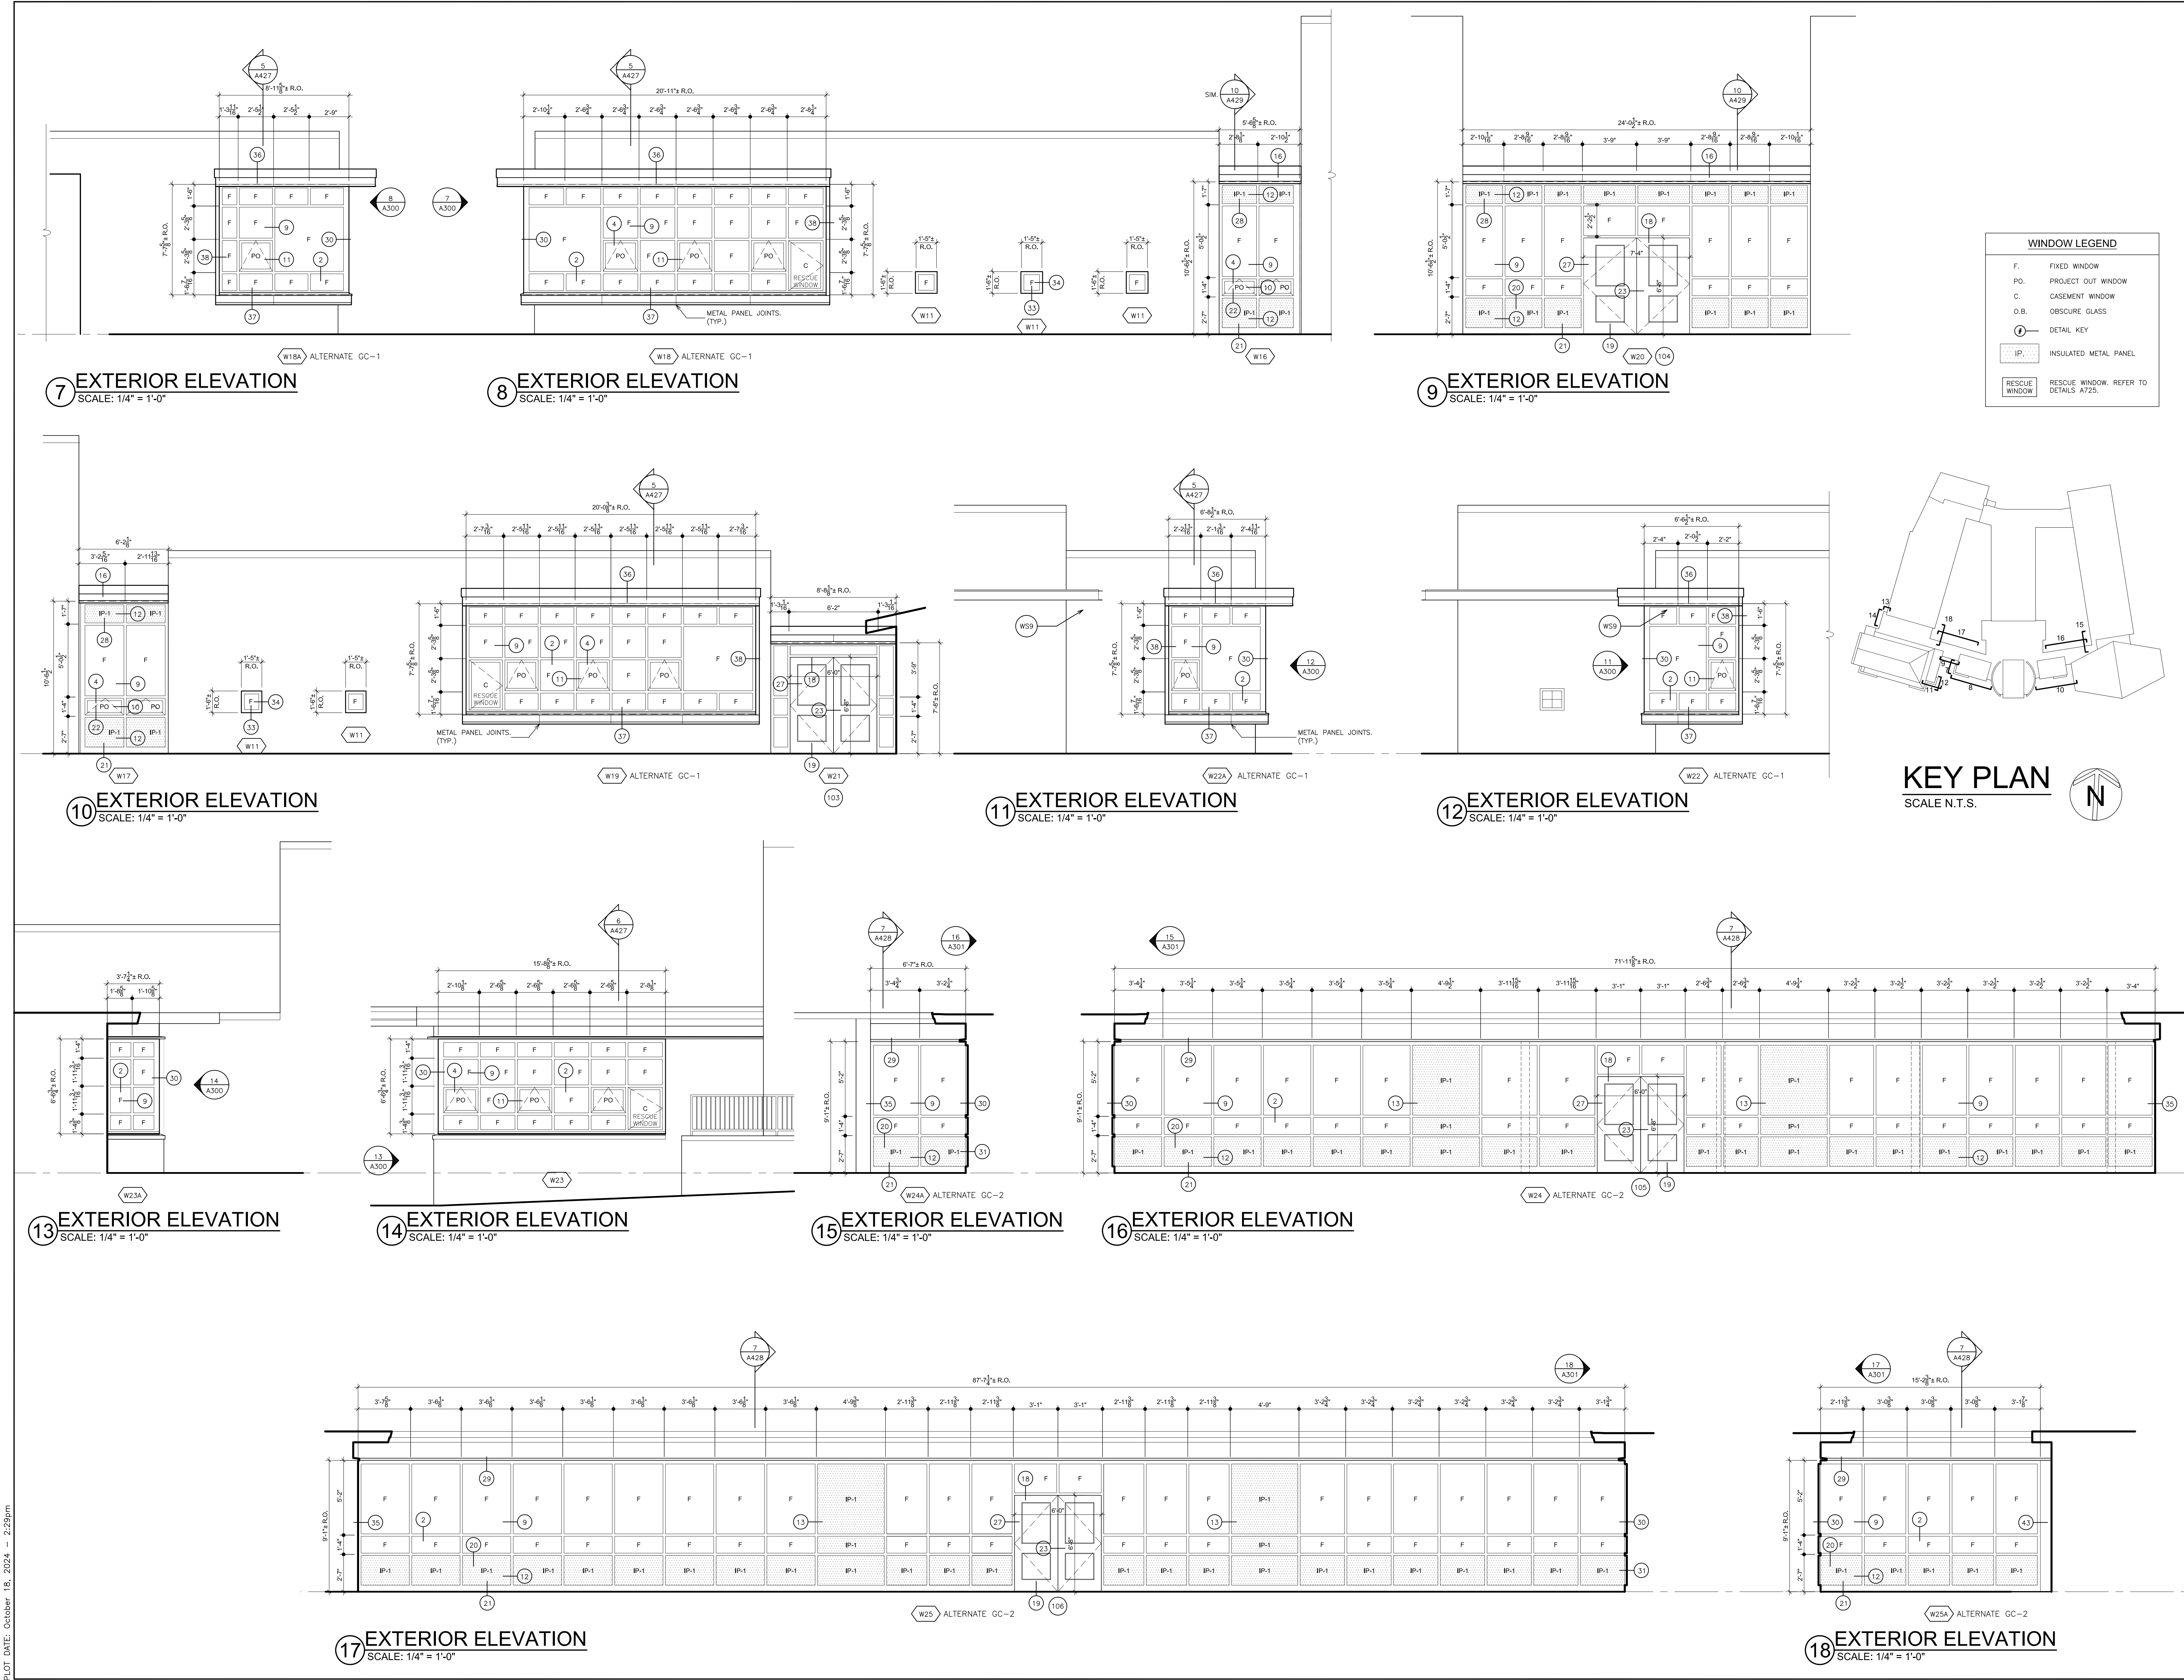
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GREENVILLE ELEMENTARY
66-04-06-03-0-008-023

PROJECT NAME
EDGEMONT UNION FREE SCHOOL DISTRICT
GREENVILLE WINDOW REPLACEMENT AND
RELATED WORK
100 GLENDALE RD., SCARSDALE, NY 10583
DRAWING TITLE
EXTERIOR ELEVATIONS

10-23-2024	RE-BID
08-27-2024	BID
11-14-2023	S.E.D. SUBMISSION
DATE	ISSUED TO
SCALE AS NOTED	DRAWING NO. A300
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FILE NO. 23501.00	



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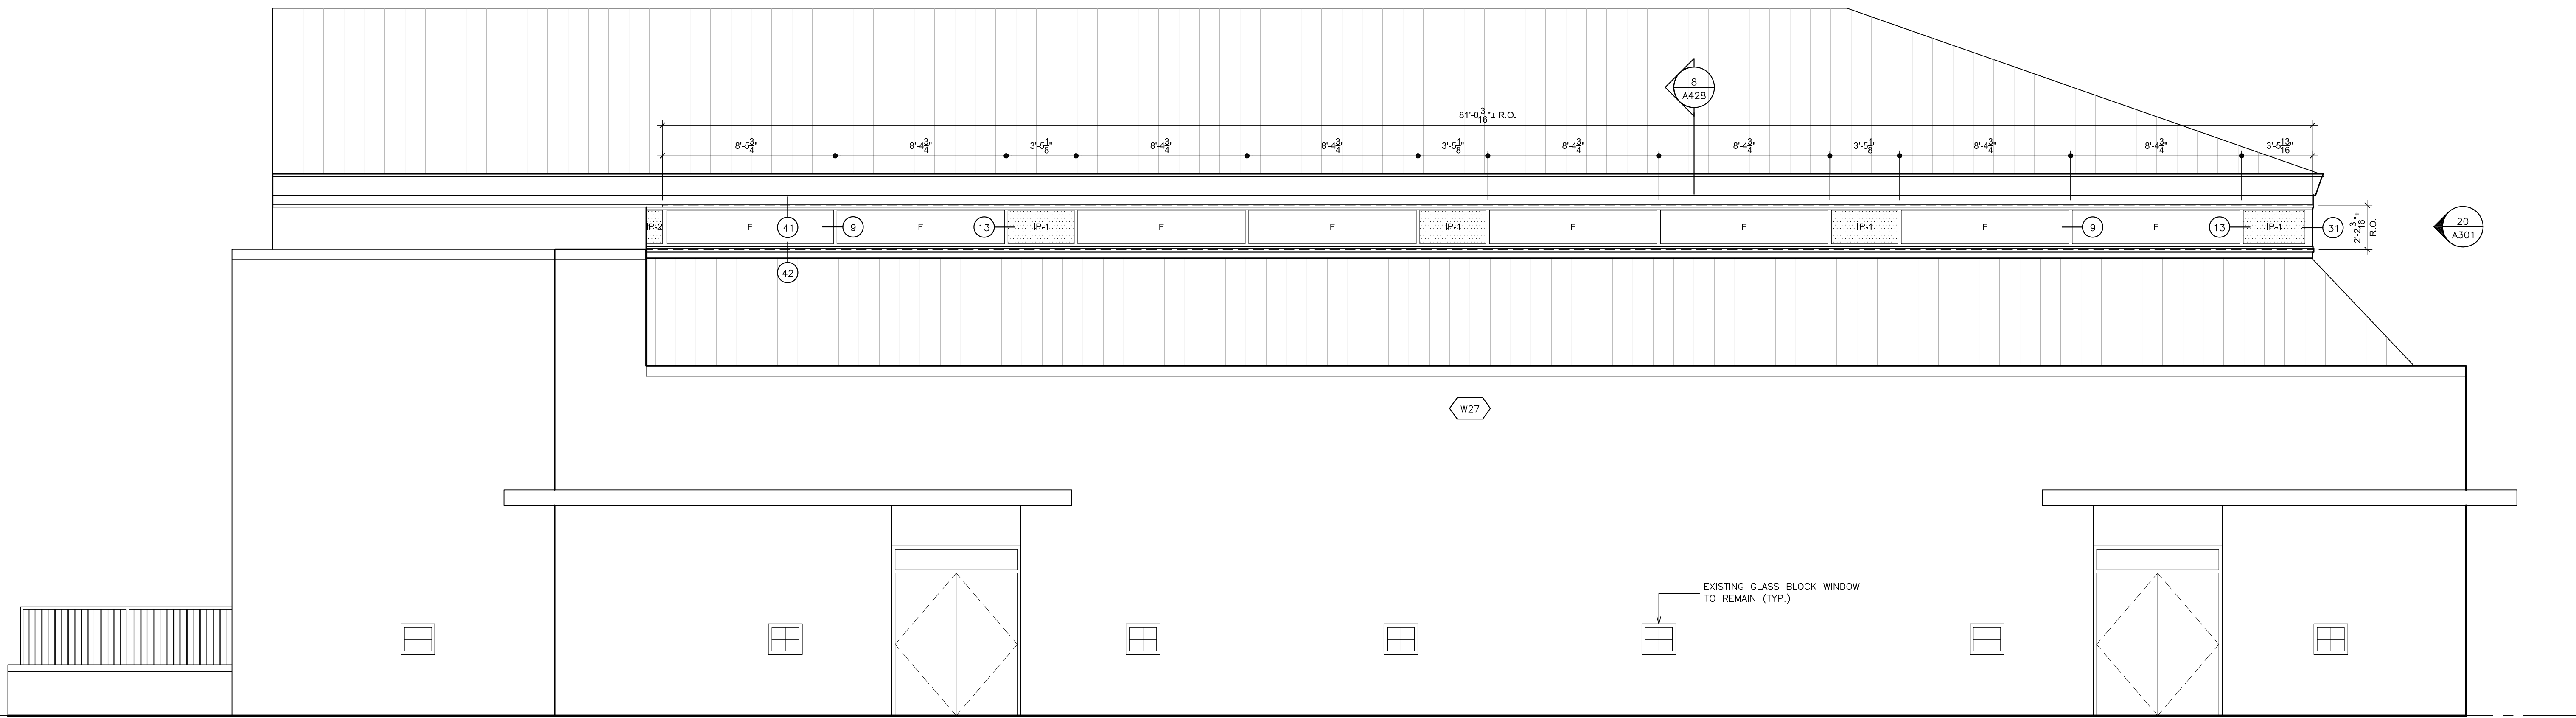
S.E.D. CONTROL NUMBER:
GREENVILLE ELEMENTARY
66-04-06-03-0-008-023

PROJECT: EDELMONT UNION FREE SCHOOL DISTRICT
GREENVILLE WINDOW REPLACEMENT AND
RELATED WORK
100 GLENDALE RD., SCARSDALE, NY 10583
DRAWING TITLE
EXTERIOR ELEVATIONS


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08-27-2024 BID
11-14-2023 S.E.D. SUBMISSION
DATE ISSUED TO
SCALE AS NOTED
DRAWN BY F & D
CHECKED BY F & D
FILE NO. 23501.00

PLOT DATE: October 18, 2024 — 2:29pm


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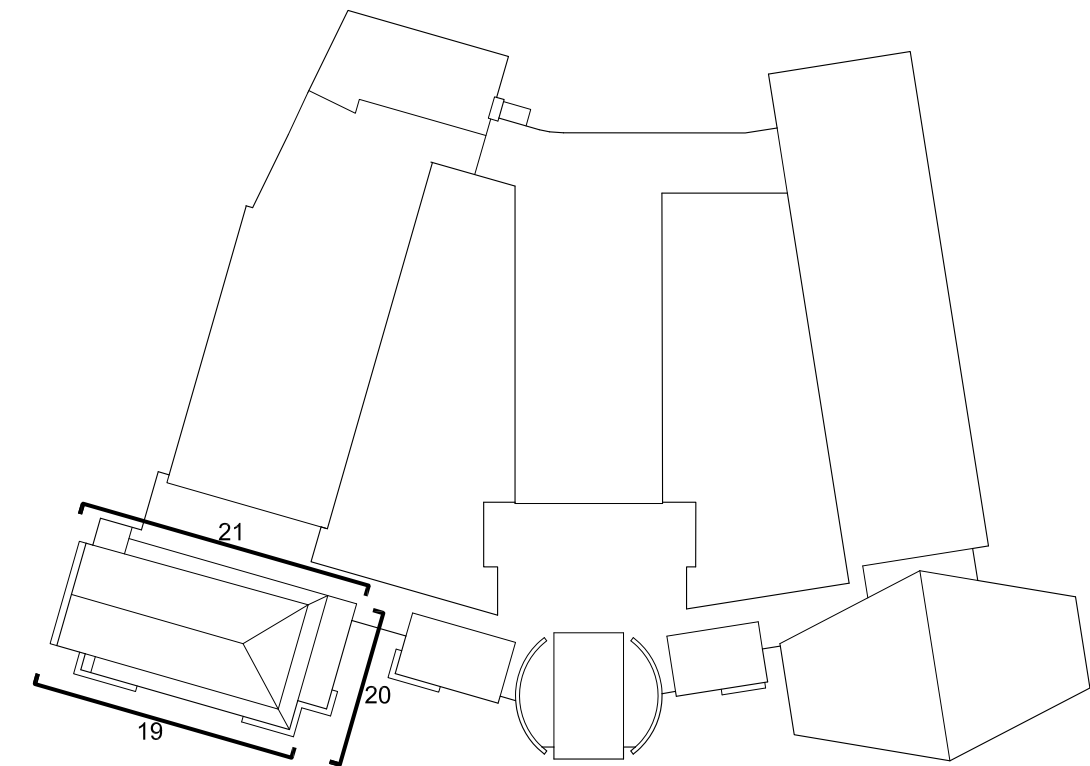
19 EXTERIOR ELEVATION- ALTERNATE GC-4
SCALE: 1/4" = 1'-0"




20 EXTERIOR ELEVATION- ALTERNATE GC-4
SCALE: 1/4" = 1'-0"

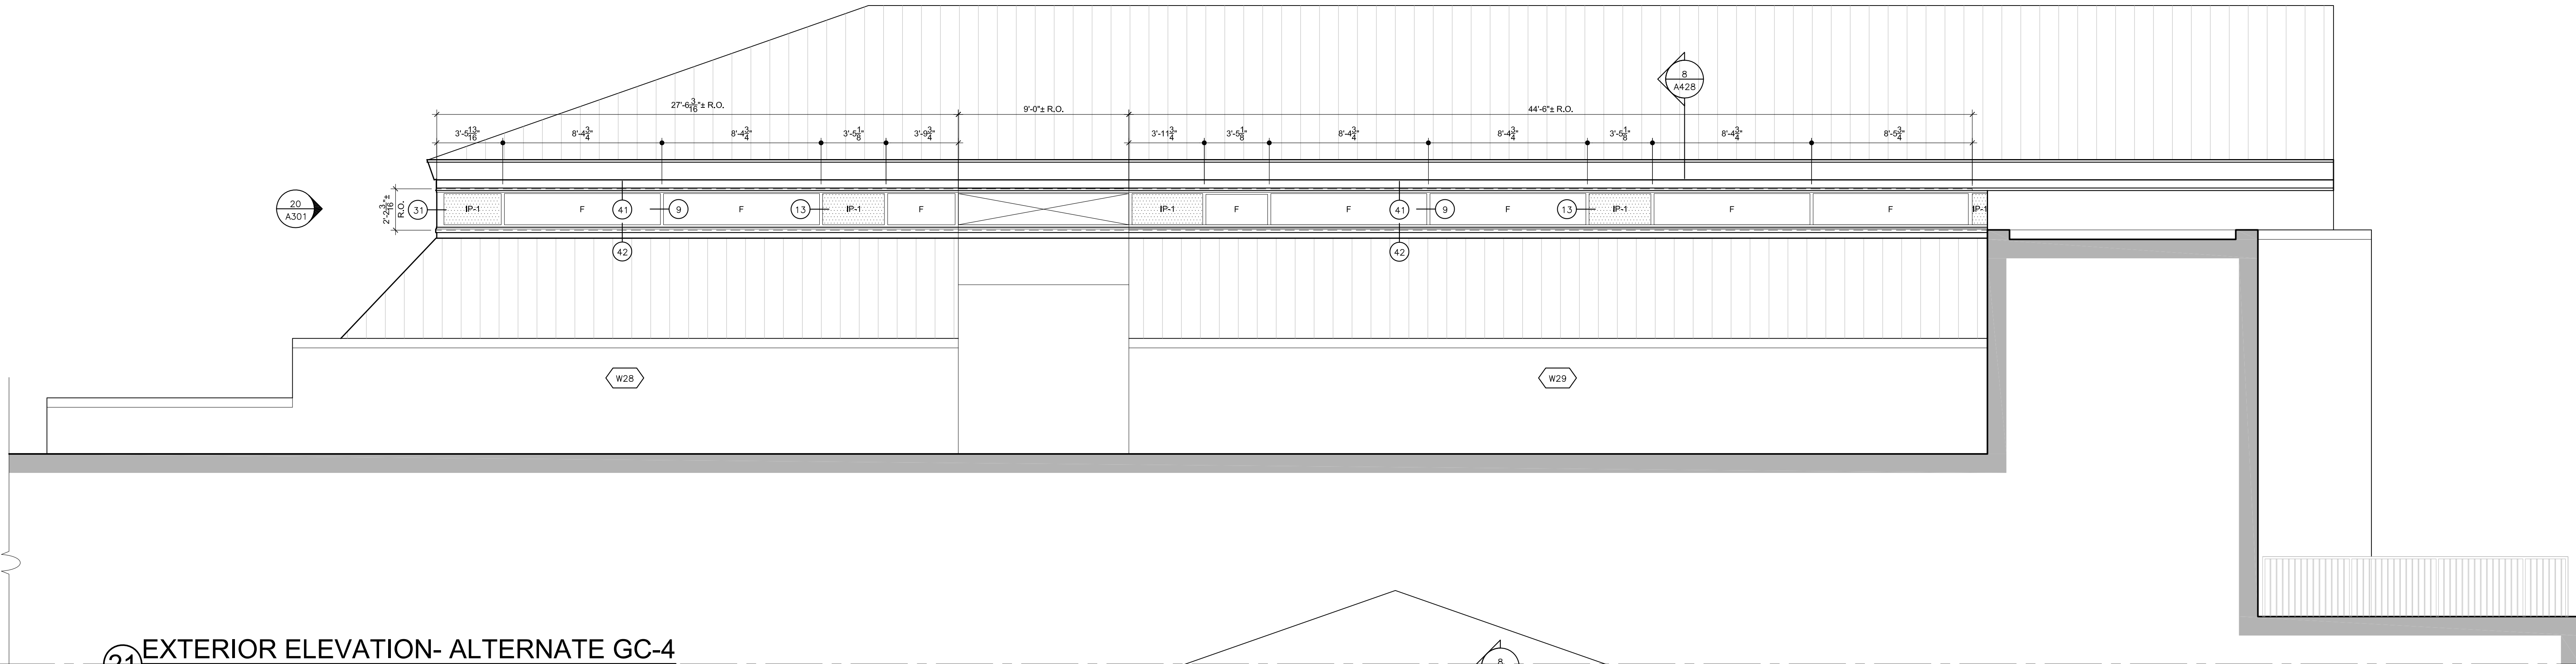

21 EXTERIOR ELEVATION- ALTERNATE GC-4
SCALE: 1/4" = 1'-0"

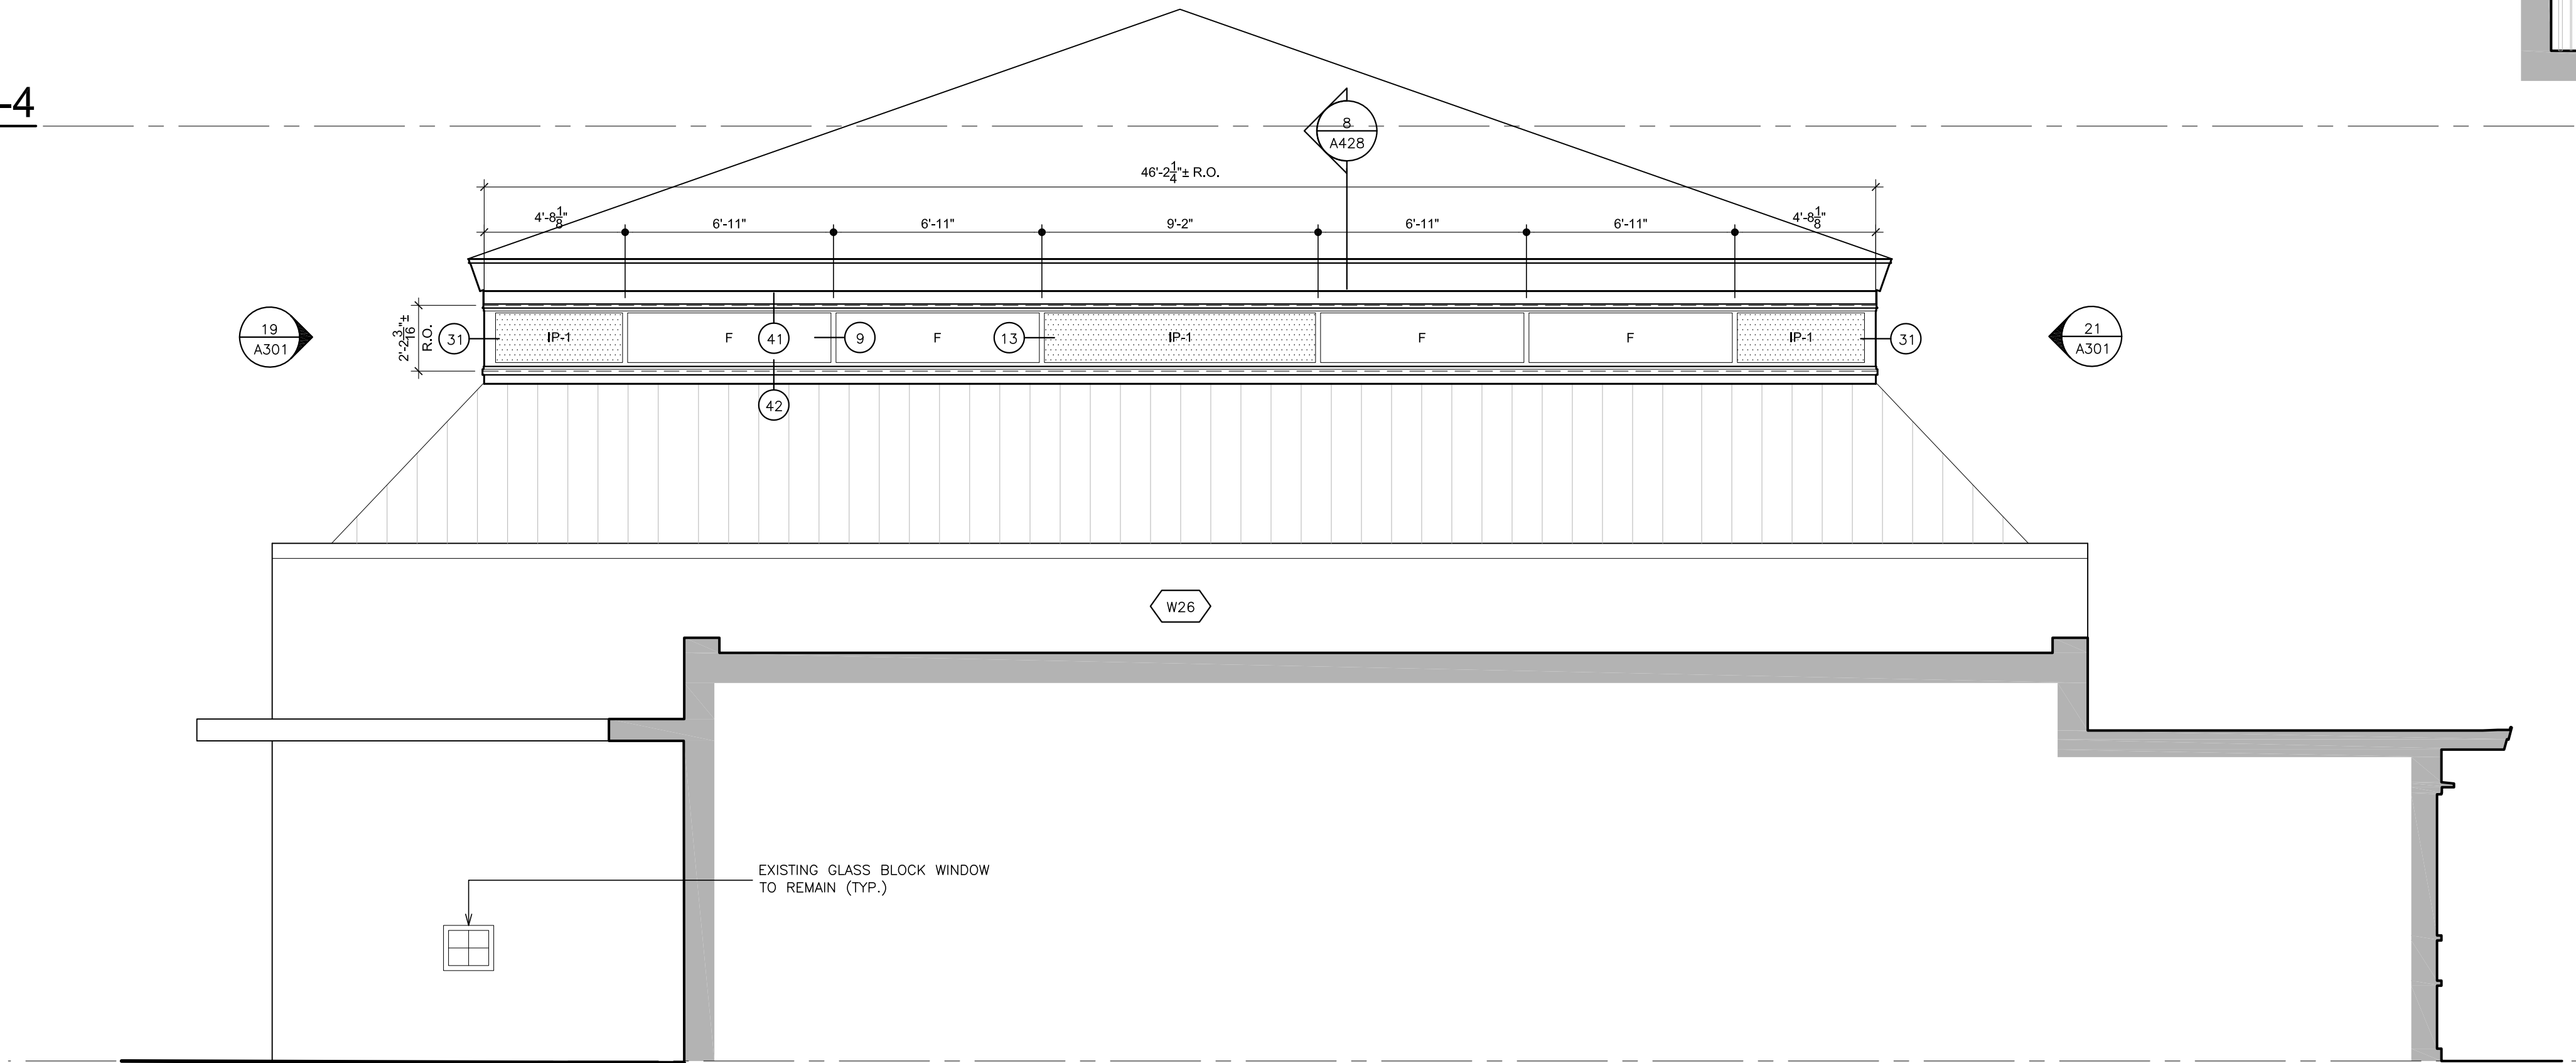

KEY PLAN
SCALE N.T.S.

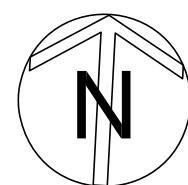

WINDOW LEGEND	
F.	FIXED WINDOW
P.O.	PROJECT OUT WINDOW
C.	CASEMENT WINDOW
O.B.	OBSCURE GLASS
Ⓢ	DETAIL KEY
IP-1	INSULATED METAL PANEL
RESCUE WINDOW	RESCUE WINDOW. REFER TO DETAILS A725.

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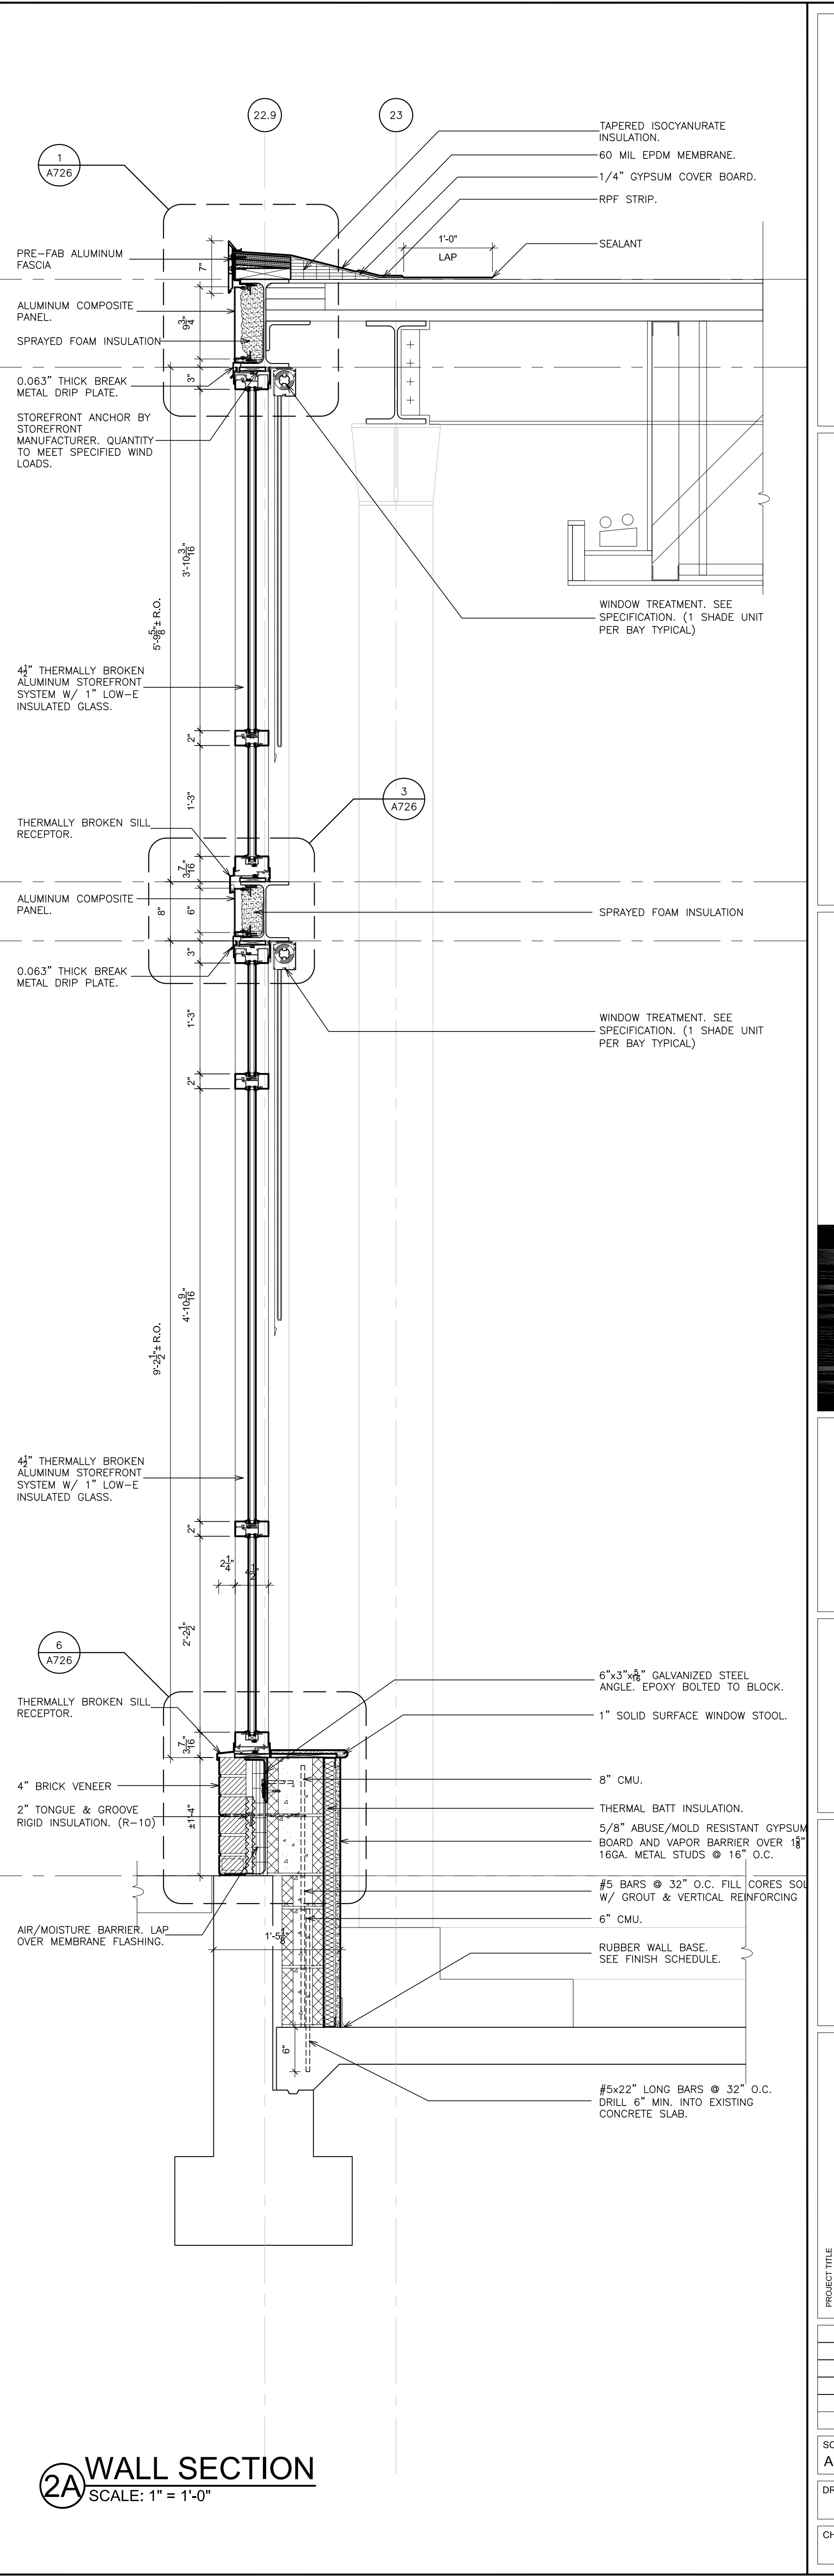
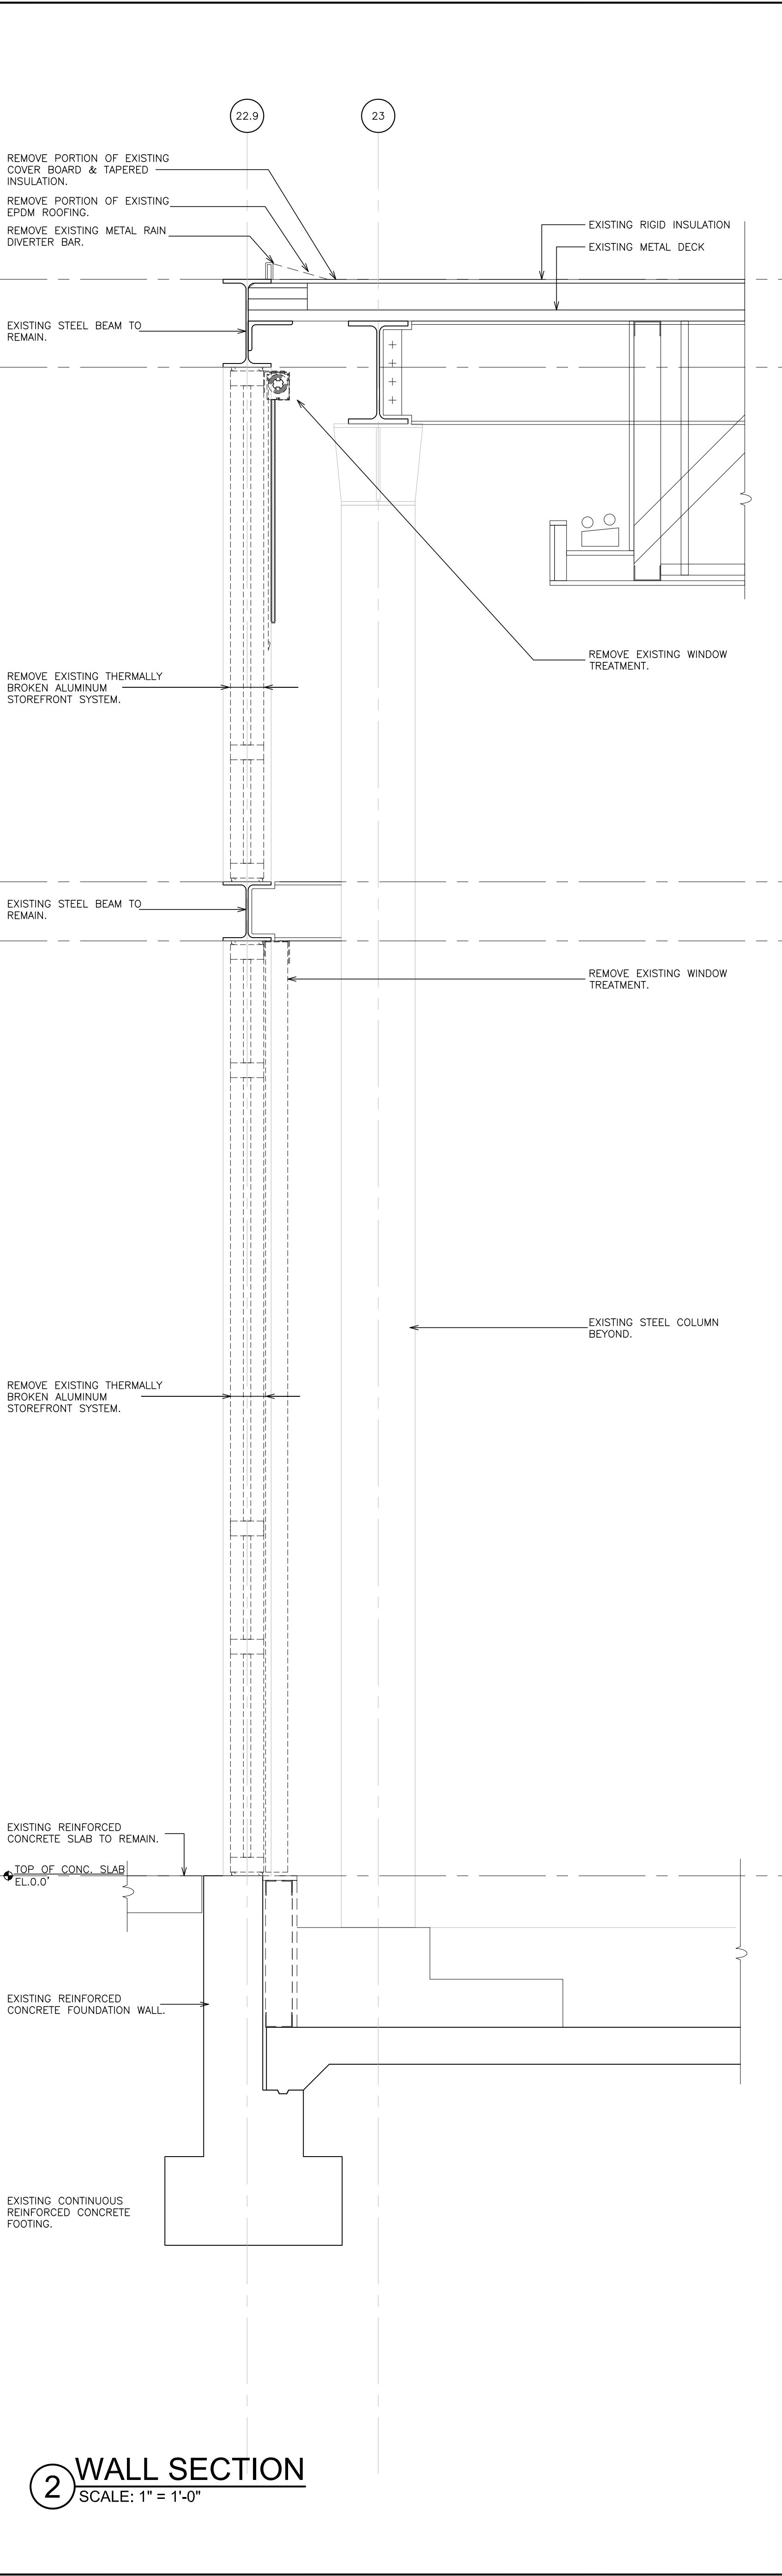
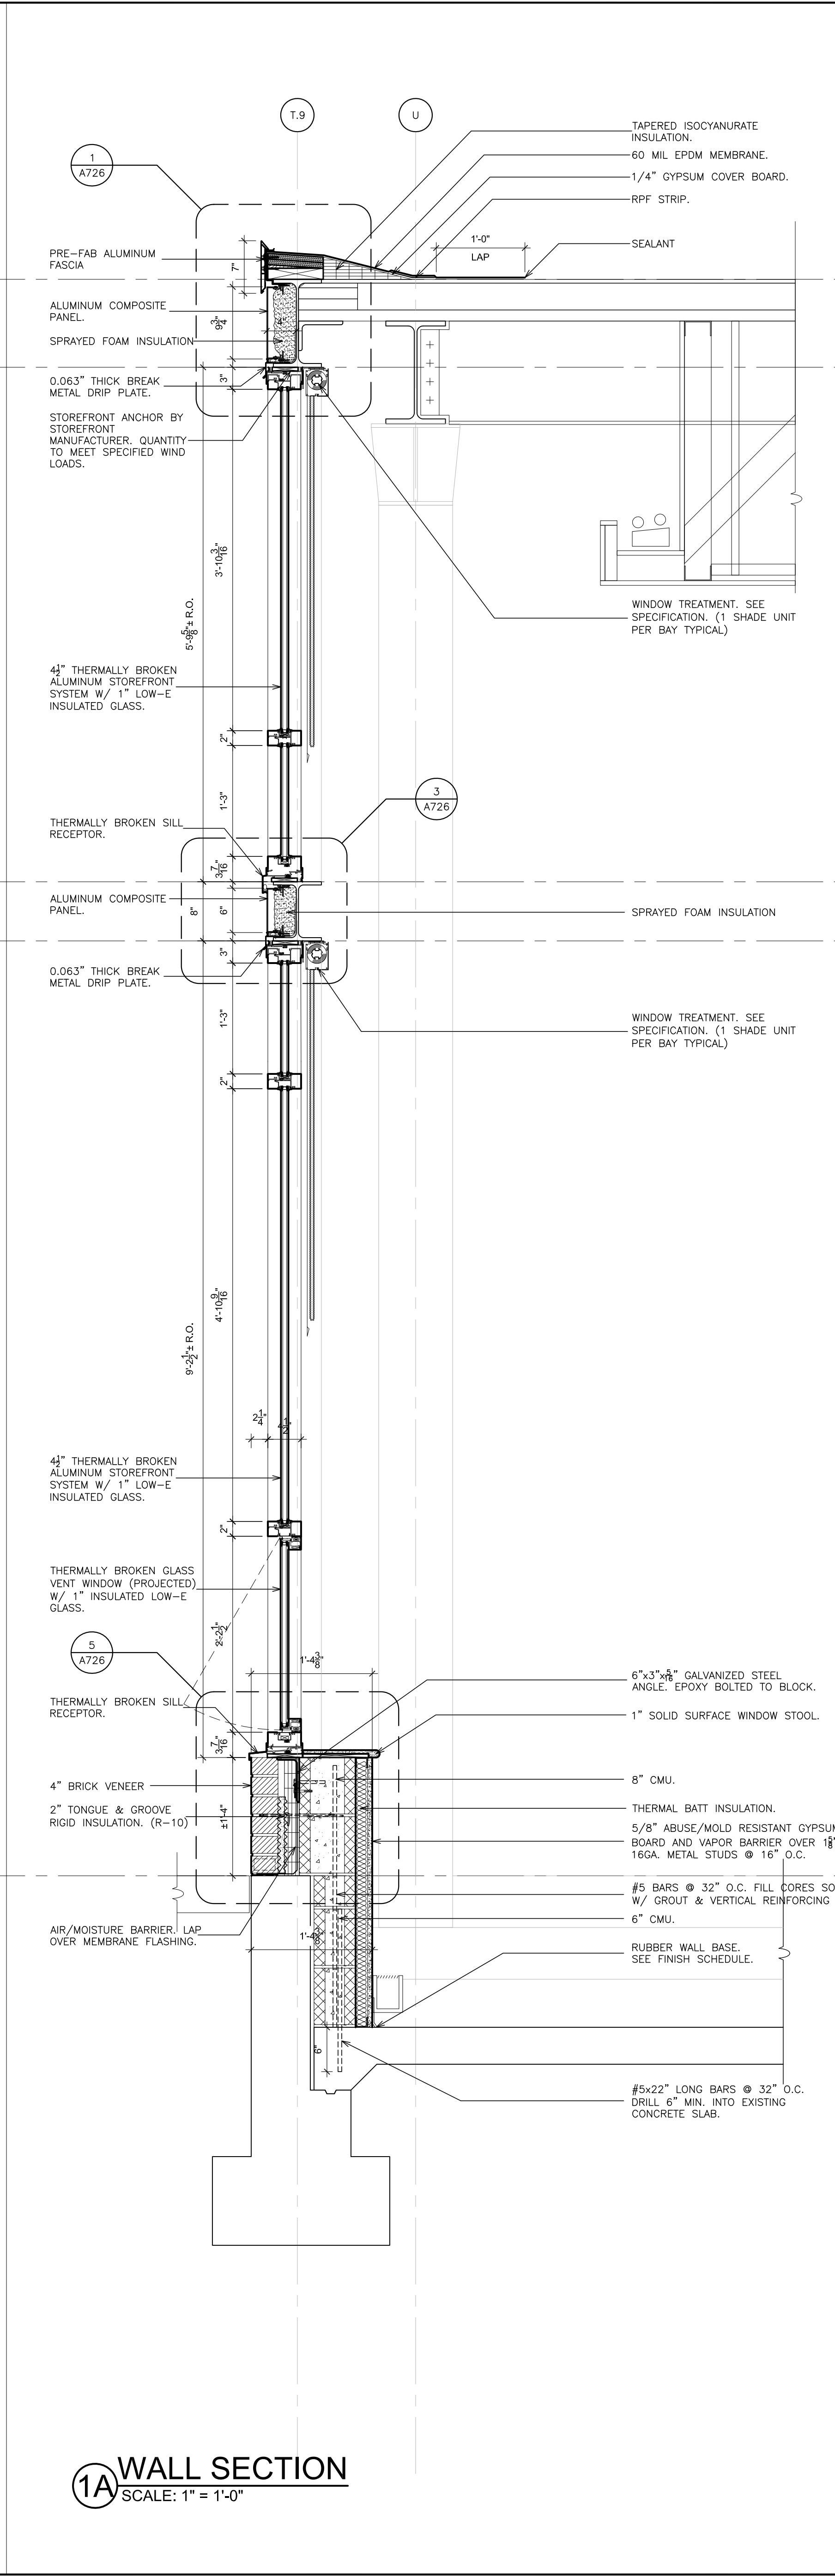
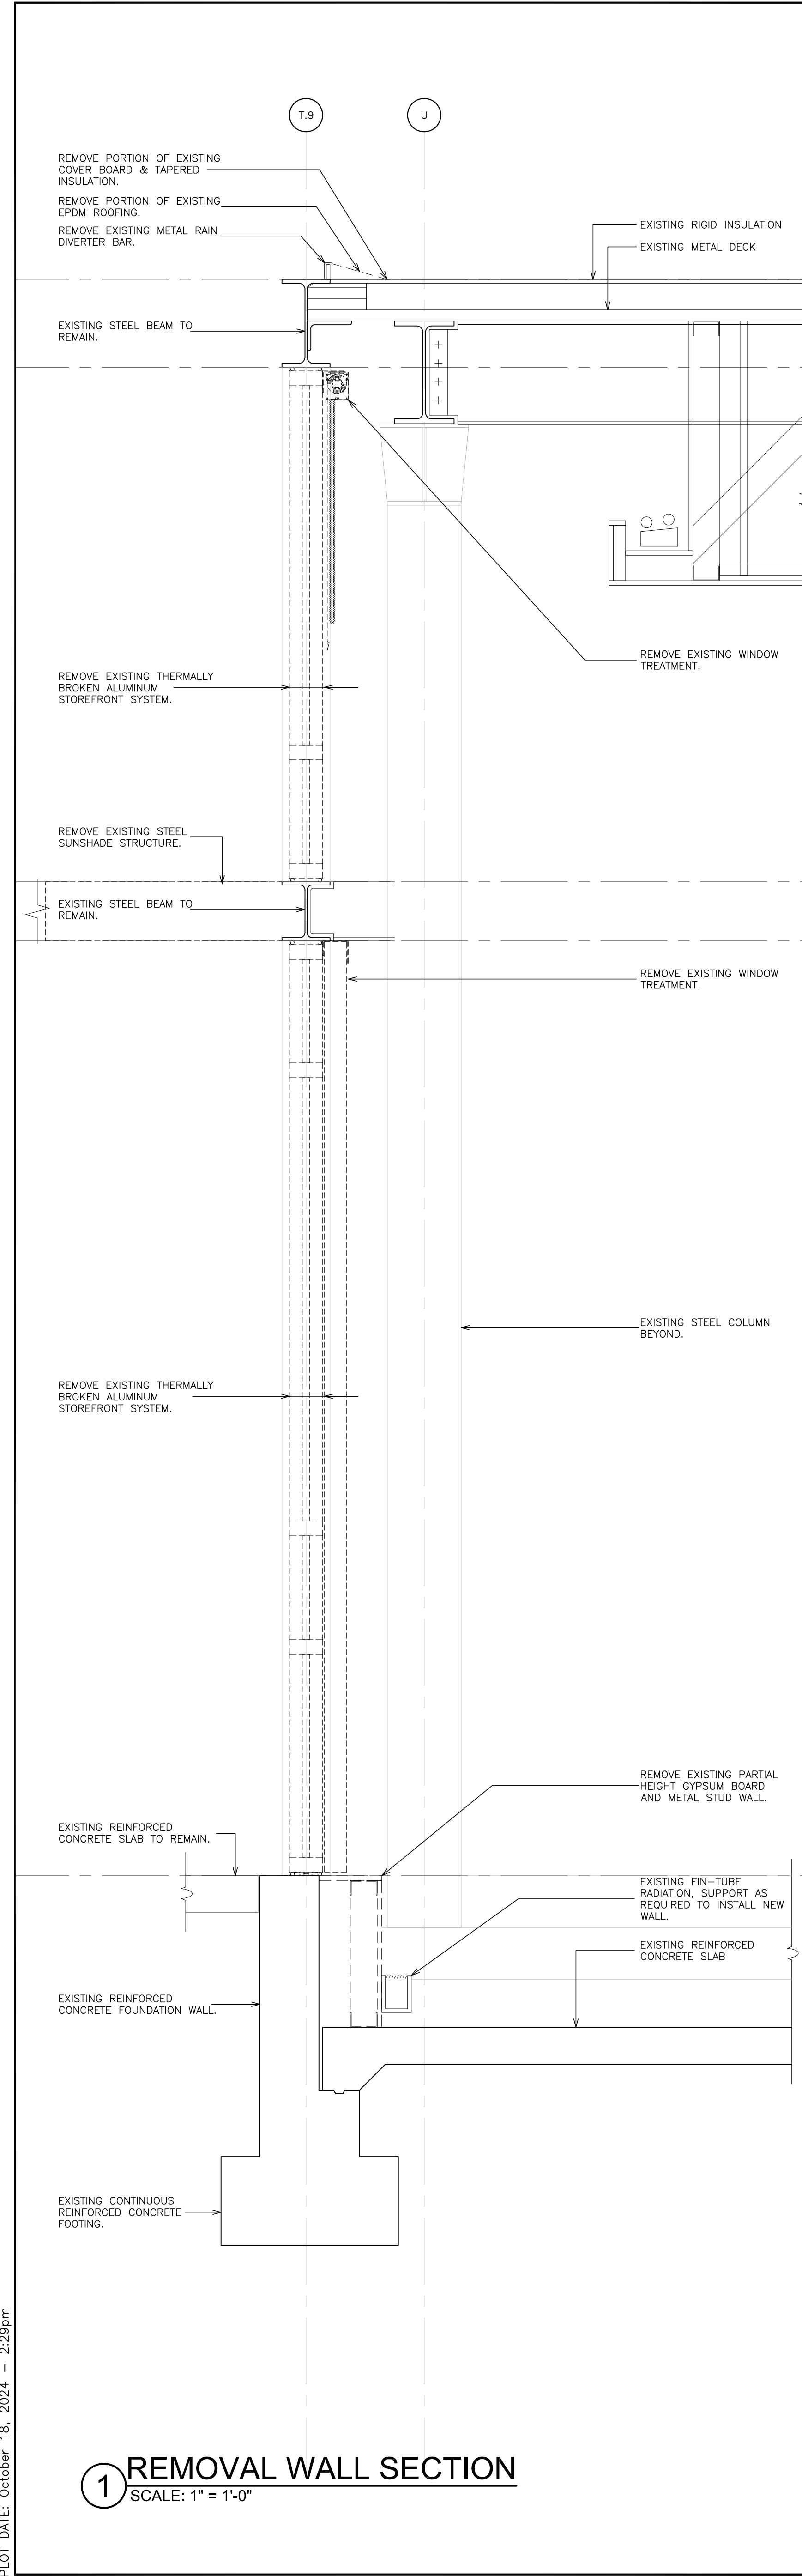
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S.E.D. CONTROL NUMBER:
GREENVILLE ELEMENTARY
66-04-06-03-0-008-023

PROJECT: EDELMONT UNION FREE SCHOOL DISTRICT
GREENVILLE WINDOW REPLACEMENT AND
RELATED WORK
100 GLENDALE RD., SCARSDALE, NY 10583
DRAWING TITLE
EXTERIOR ELEVATIONS

10-23-2024	RE-BID
08-27-2024	BID
11-14-2023	S.E.D. SUBMISSION
DATE	ISSUED TO
SCALE AS NOTED	DRAWING NO. A302
DRAWN BY F & D	CHECKED BY F & D
FILE NO. 23501.00	

PLOT DATE: October 18, 2024 — 2:29pm



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66-04-06-034-008-023

PROJECT: EDELMONT UNION FREE SCHOOL DISTRICT
GREENVILLE WINDOW REPLACEMENT AND
RELATED WORK
100 GLENDALE RD., SCARSDALE, NY 10583

DRAWING TITLE
WALL SECTIONS

10-23-2024	RE-BID
08-27-2024	BID
11-14-2023	S.E.D. SUBMISSION
DATE	ISSUED TO

SCALE: AS NOTED
DRAWN BY: F & D
CHECKED BY: F & D

DRAWING NO.: A425
FILE NO.: 23501.00

PLOT DATE: October 18, 2024 -- 2:30pm

FILE: I:\23501.00 Edgemont Greenville Window replacement\DRAWINGS\CURRENT\1-F&D\23501.00-A425-A429.dwg

3 REMOVAL WALL SECTION

SCALE: 1" = 1'-0"

3A WALL SECTION

SCALE: 1" = 1'-0"

4 REMOVAL WALL SECTION

SCALE: 1" = 1'-0"

4A WALL SECTION

SCALE: 1" = 1'-0"

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66-04-06-03-0-008-023

PROJECT: NEW
EDGEMONT UNION FREE SCHOOL DISTRICT
GREENVILLE WINDOW REPLACEMENT AND
RELATED WORK
100 GLENDALE RD., SCARSDALE, NY 10583
DRAWING TITLE
WALL SECTIONS


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08-27-2024	BID
11-14-2023	S.E.D. SUBMISSION
DATE	ISSUED TO
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DRAWN BY F & D	A426
CHECKED BY F & D	FILE NO. 23501.00

PLOT DATE: October 18, 2024 -- 2:30pm

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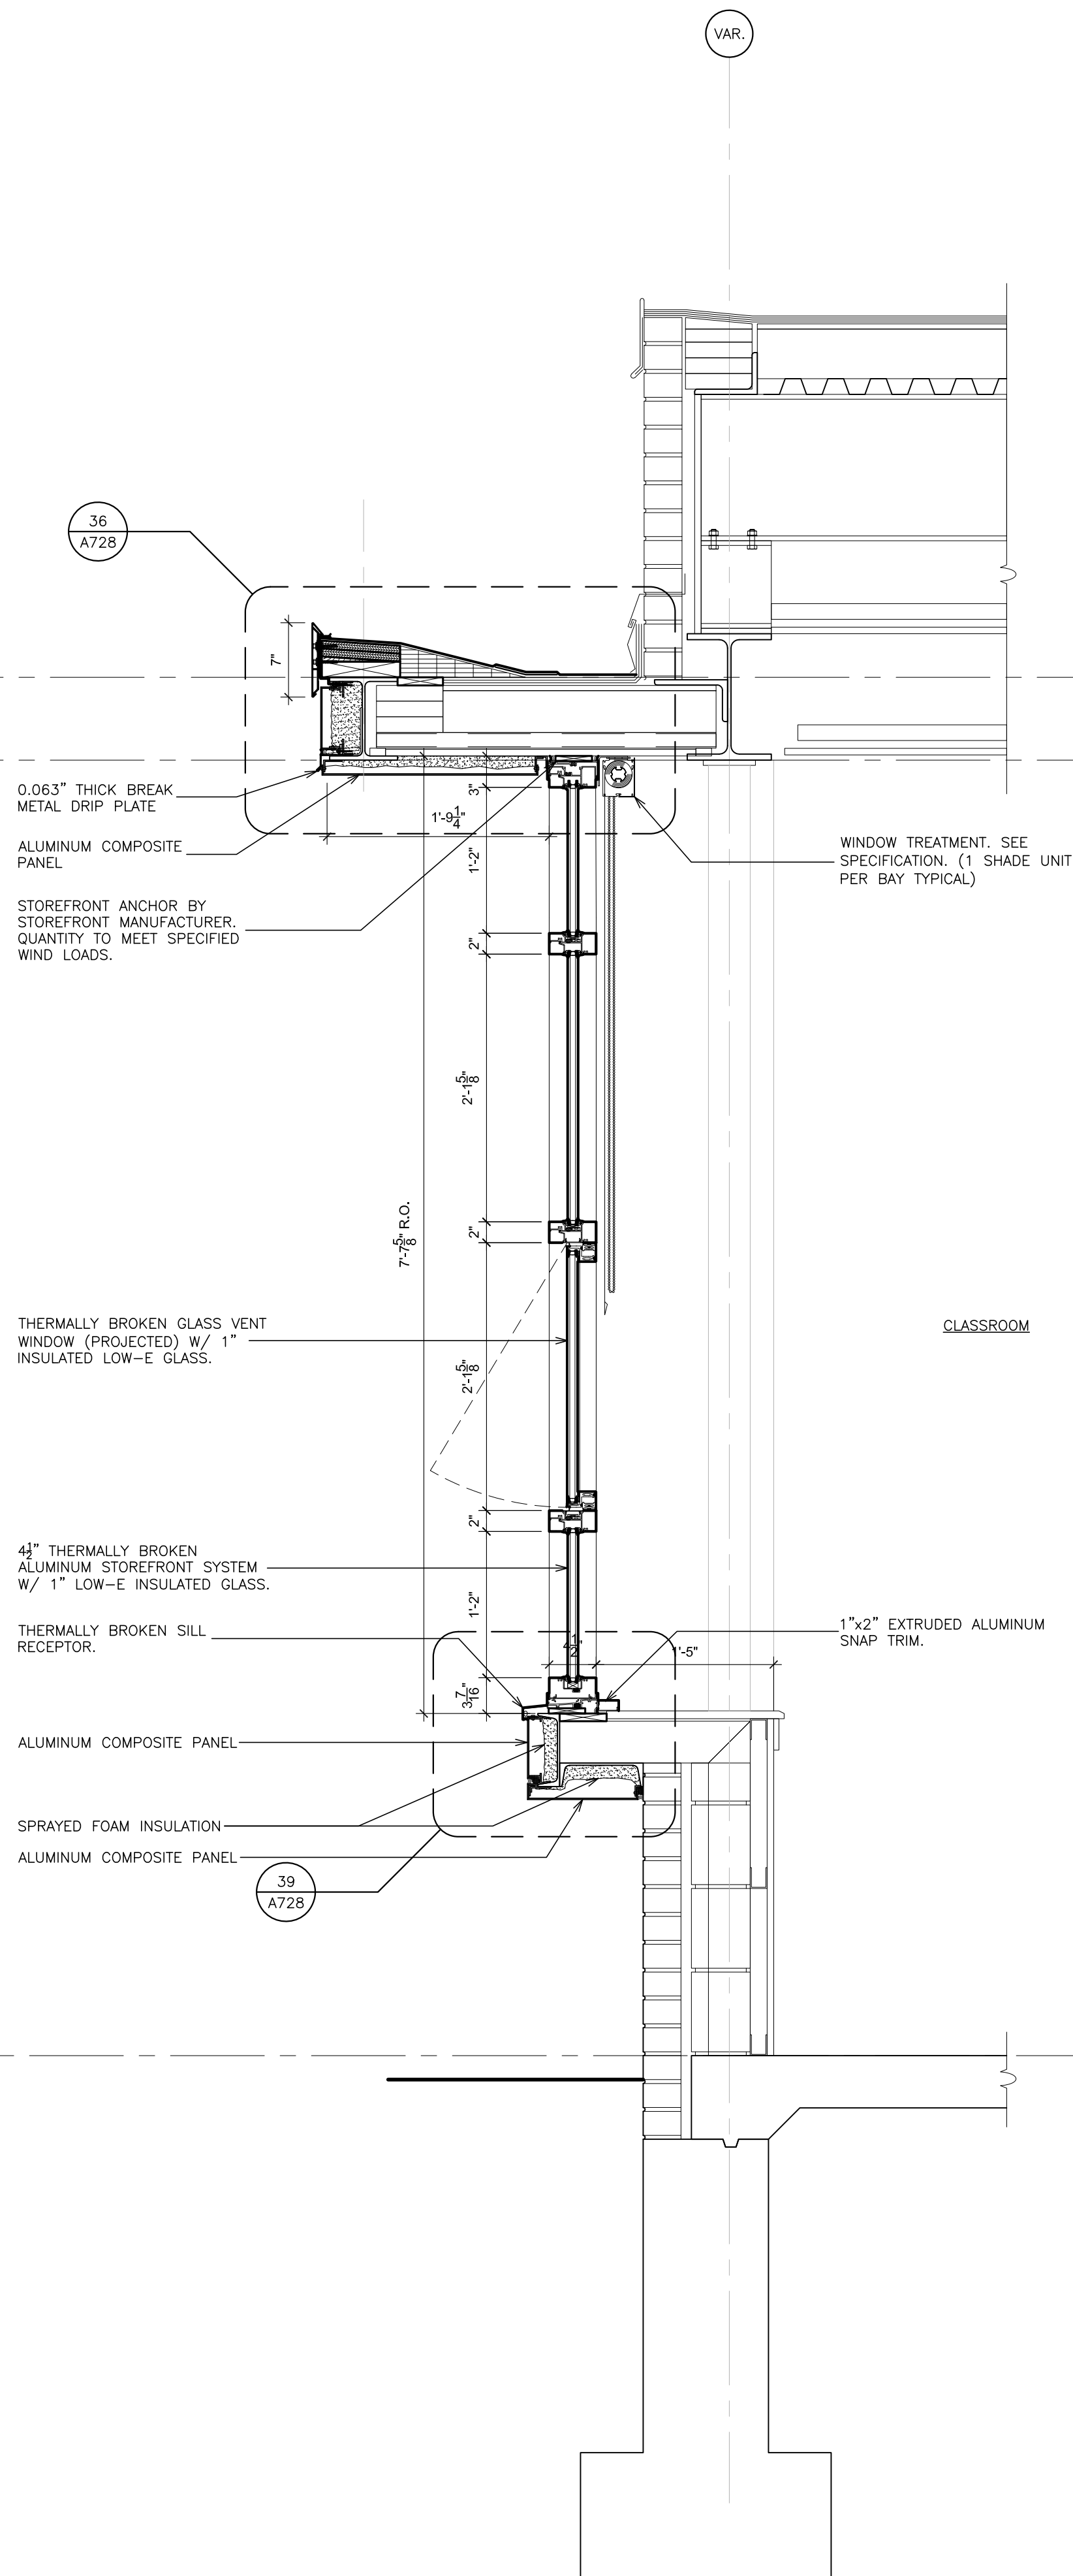
5 REMOVAL WALL SECTION

SCALE: 1" = 1'-0"

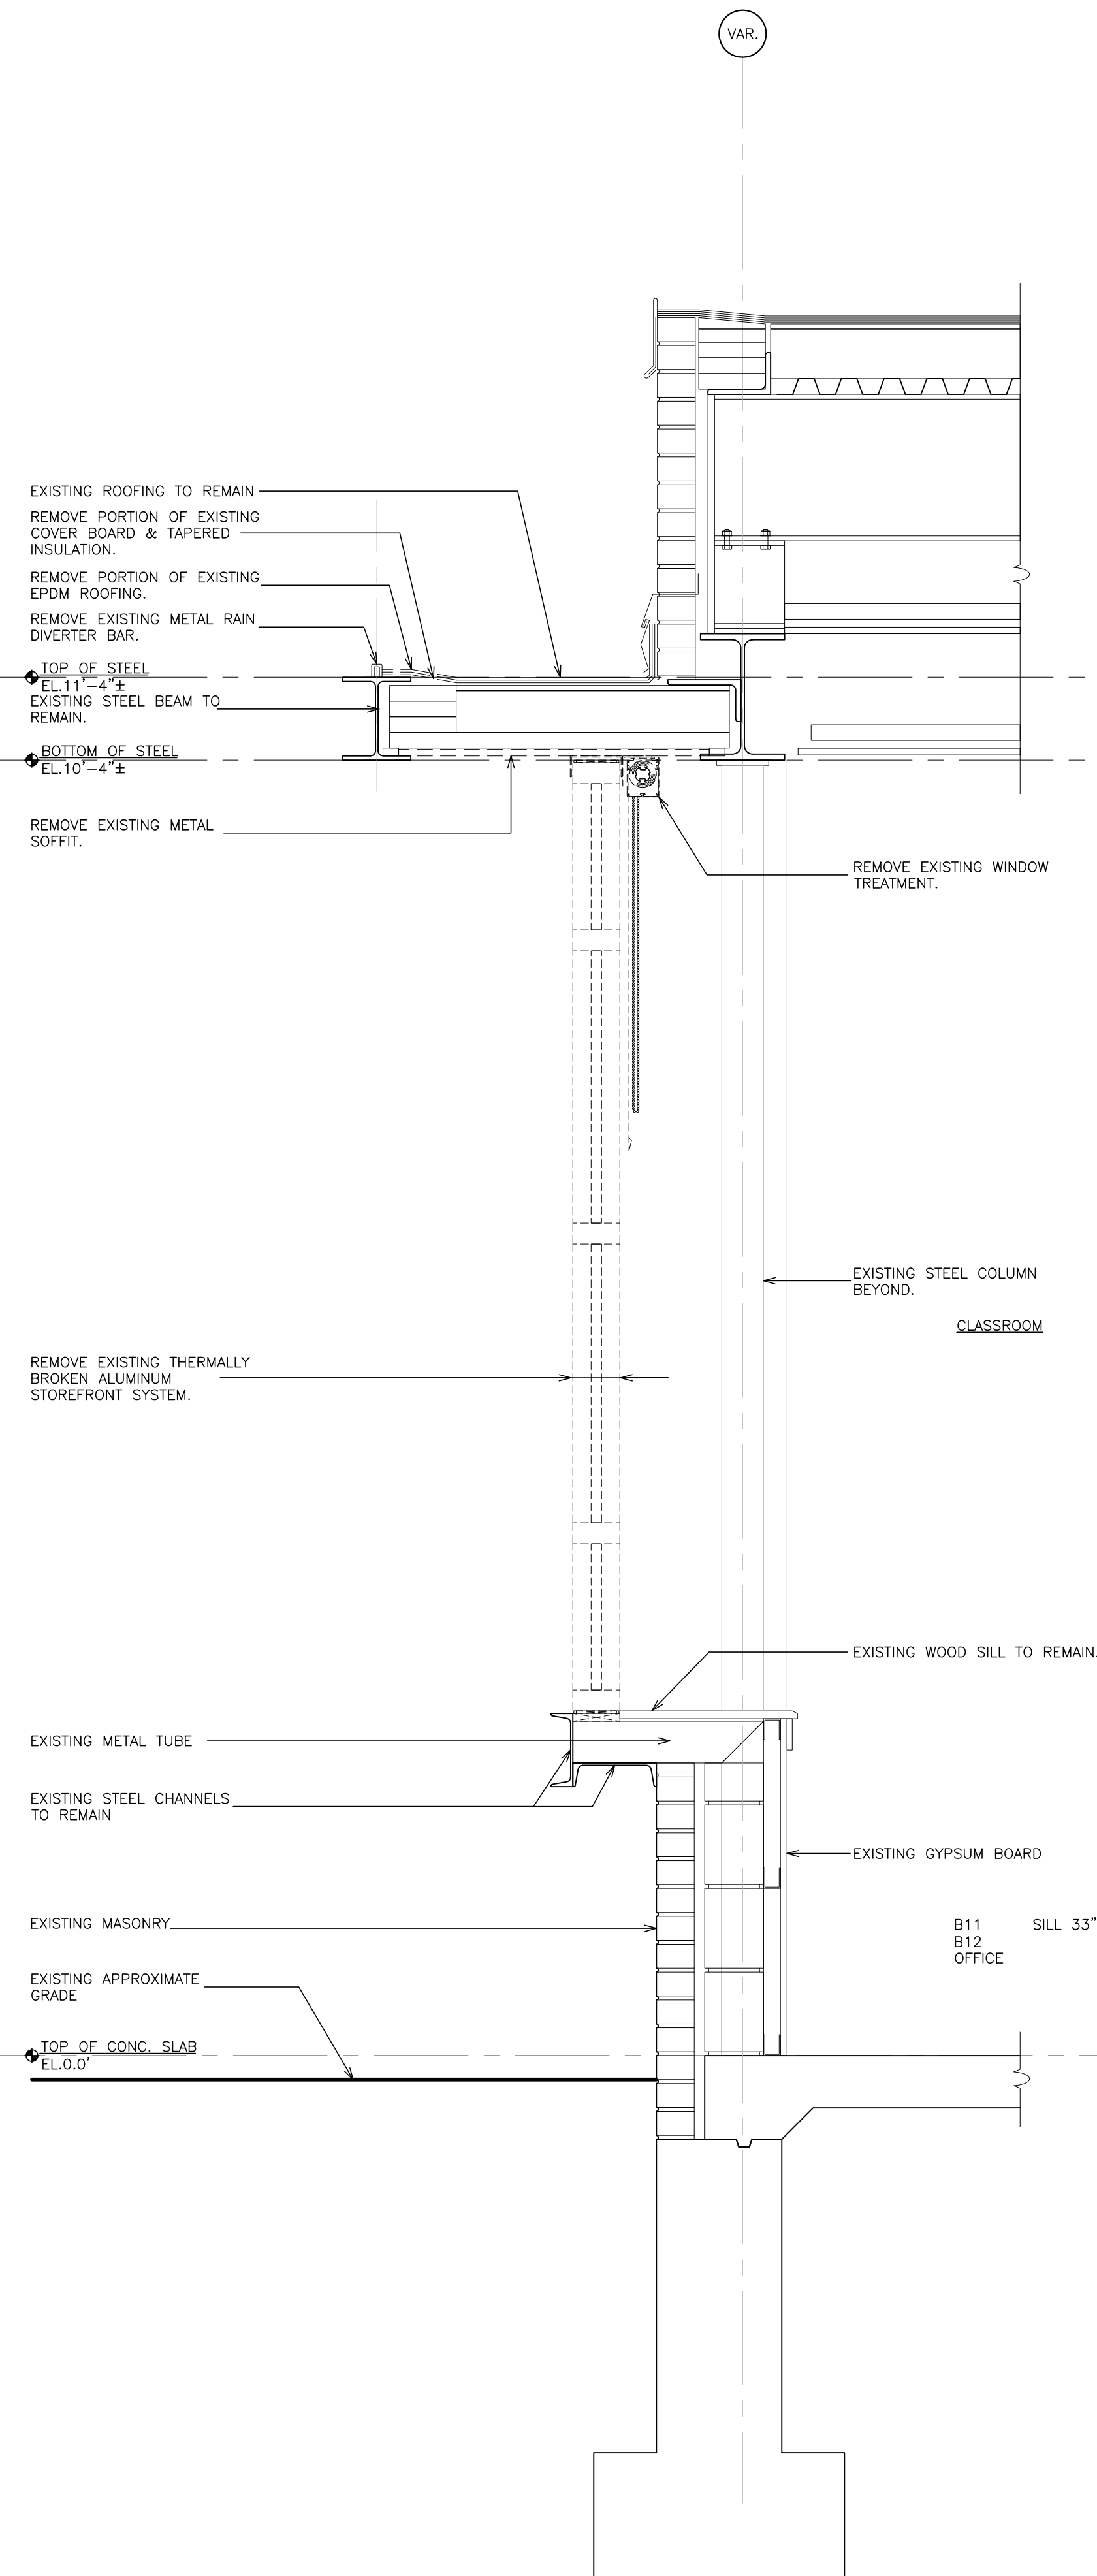


5A WALL SECTION

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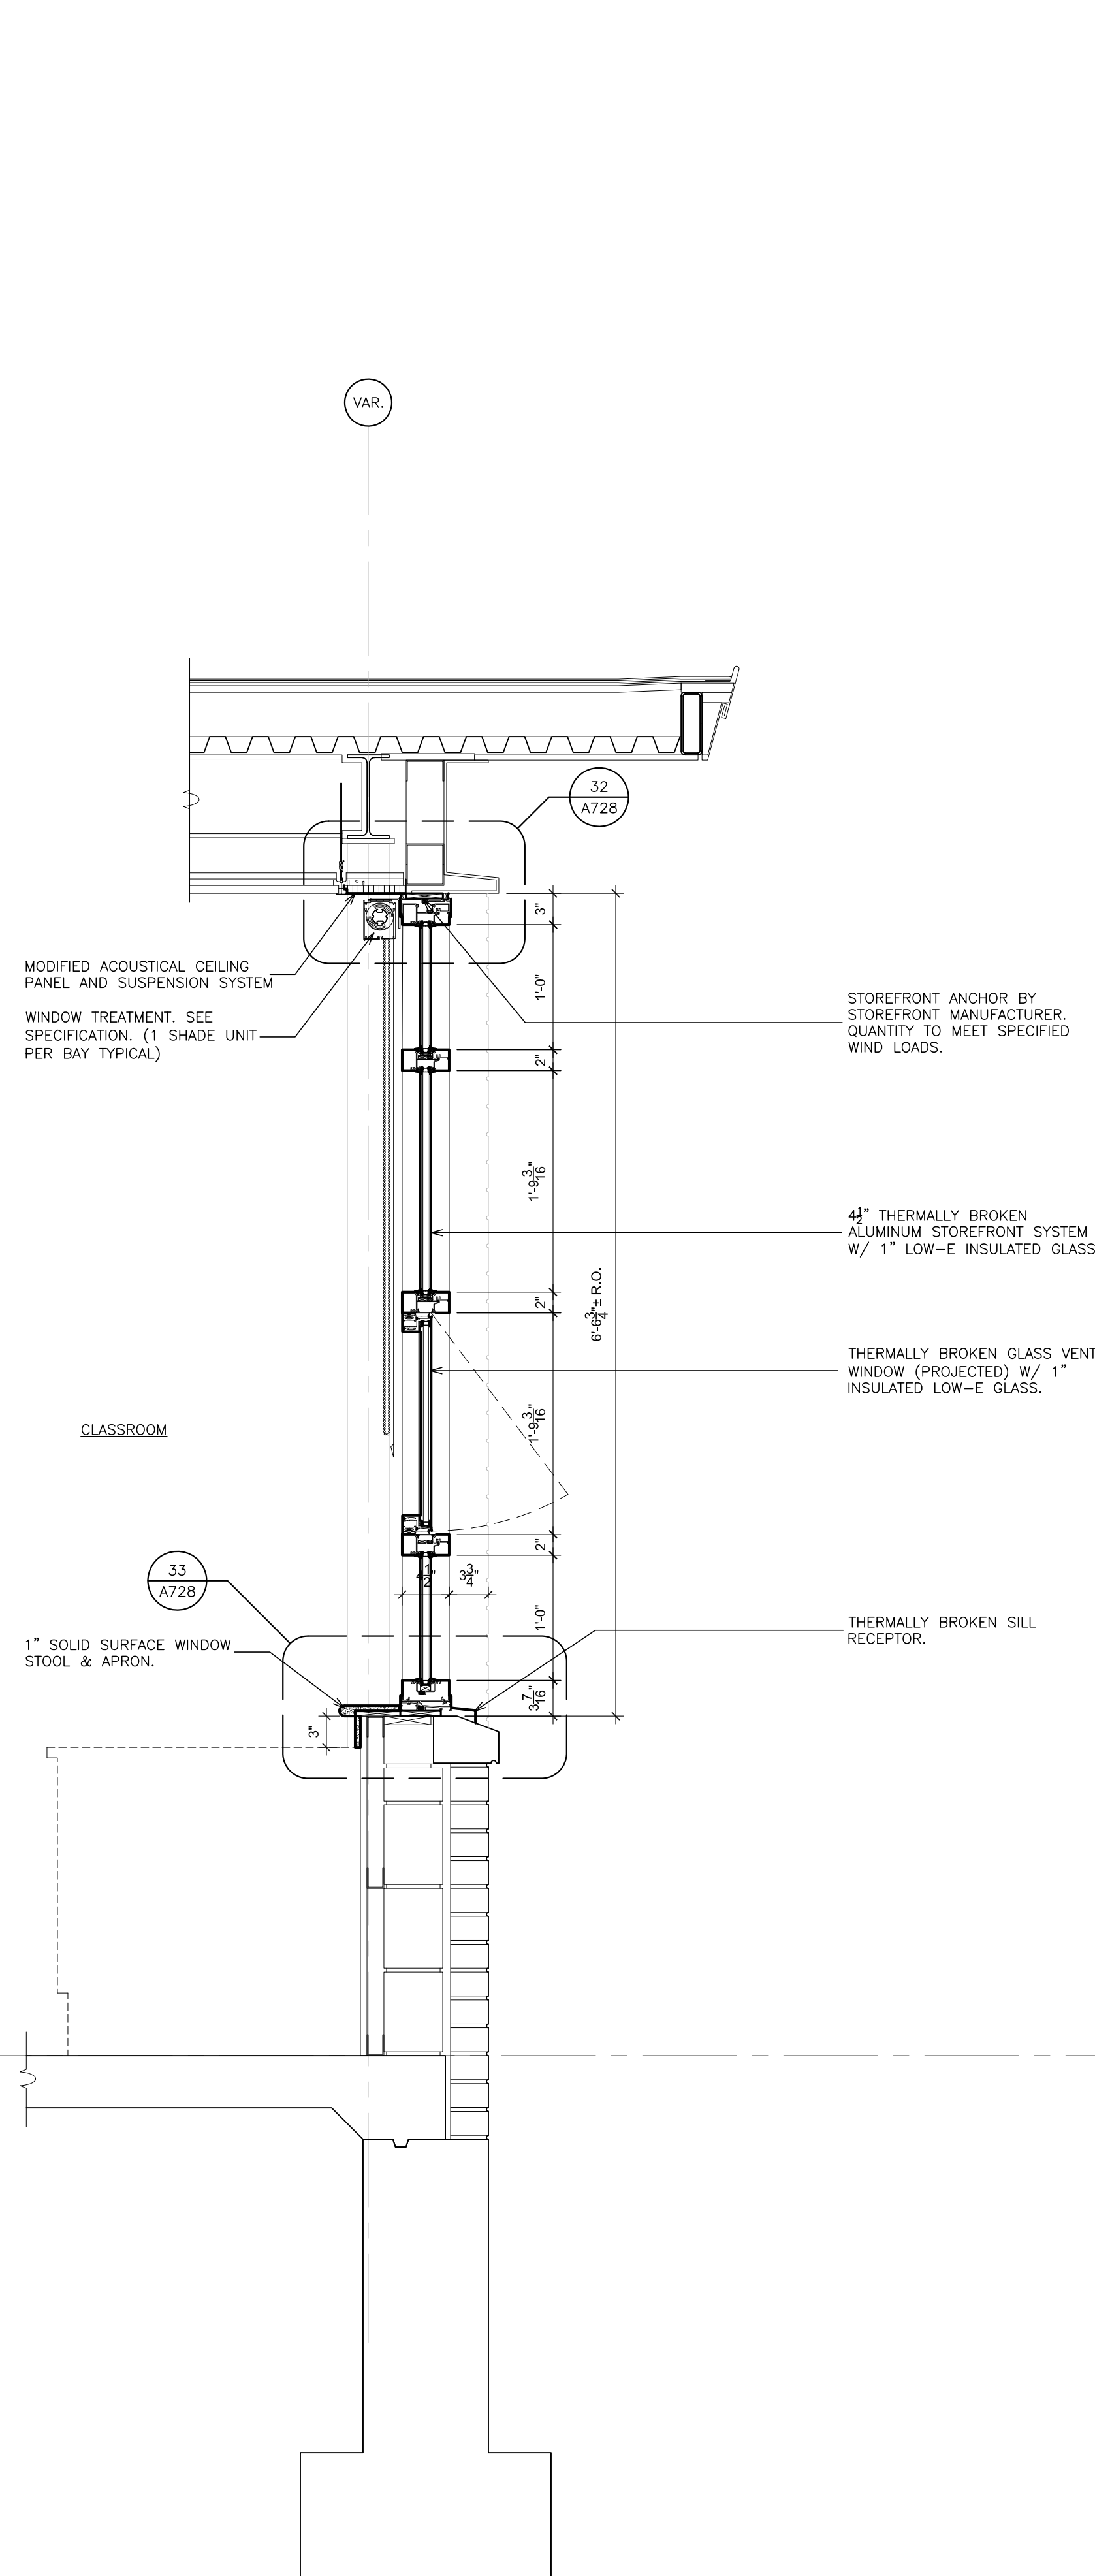
6 REMOVAL WALL SECTION

SCALE: 1" = 1'-0"



6A WALL SECTION

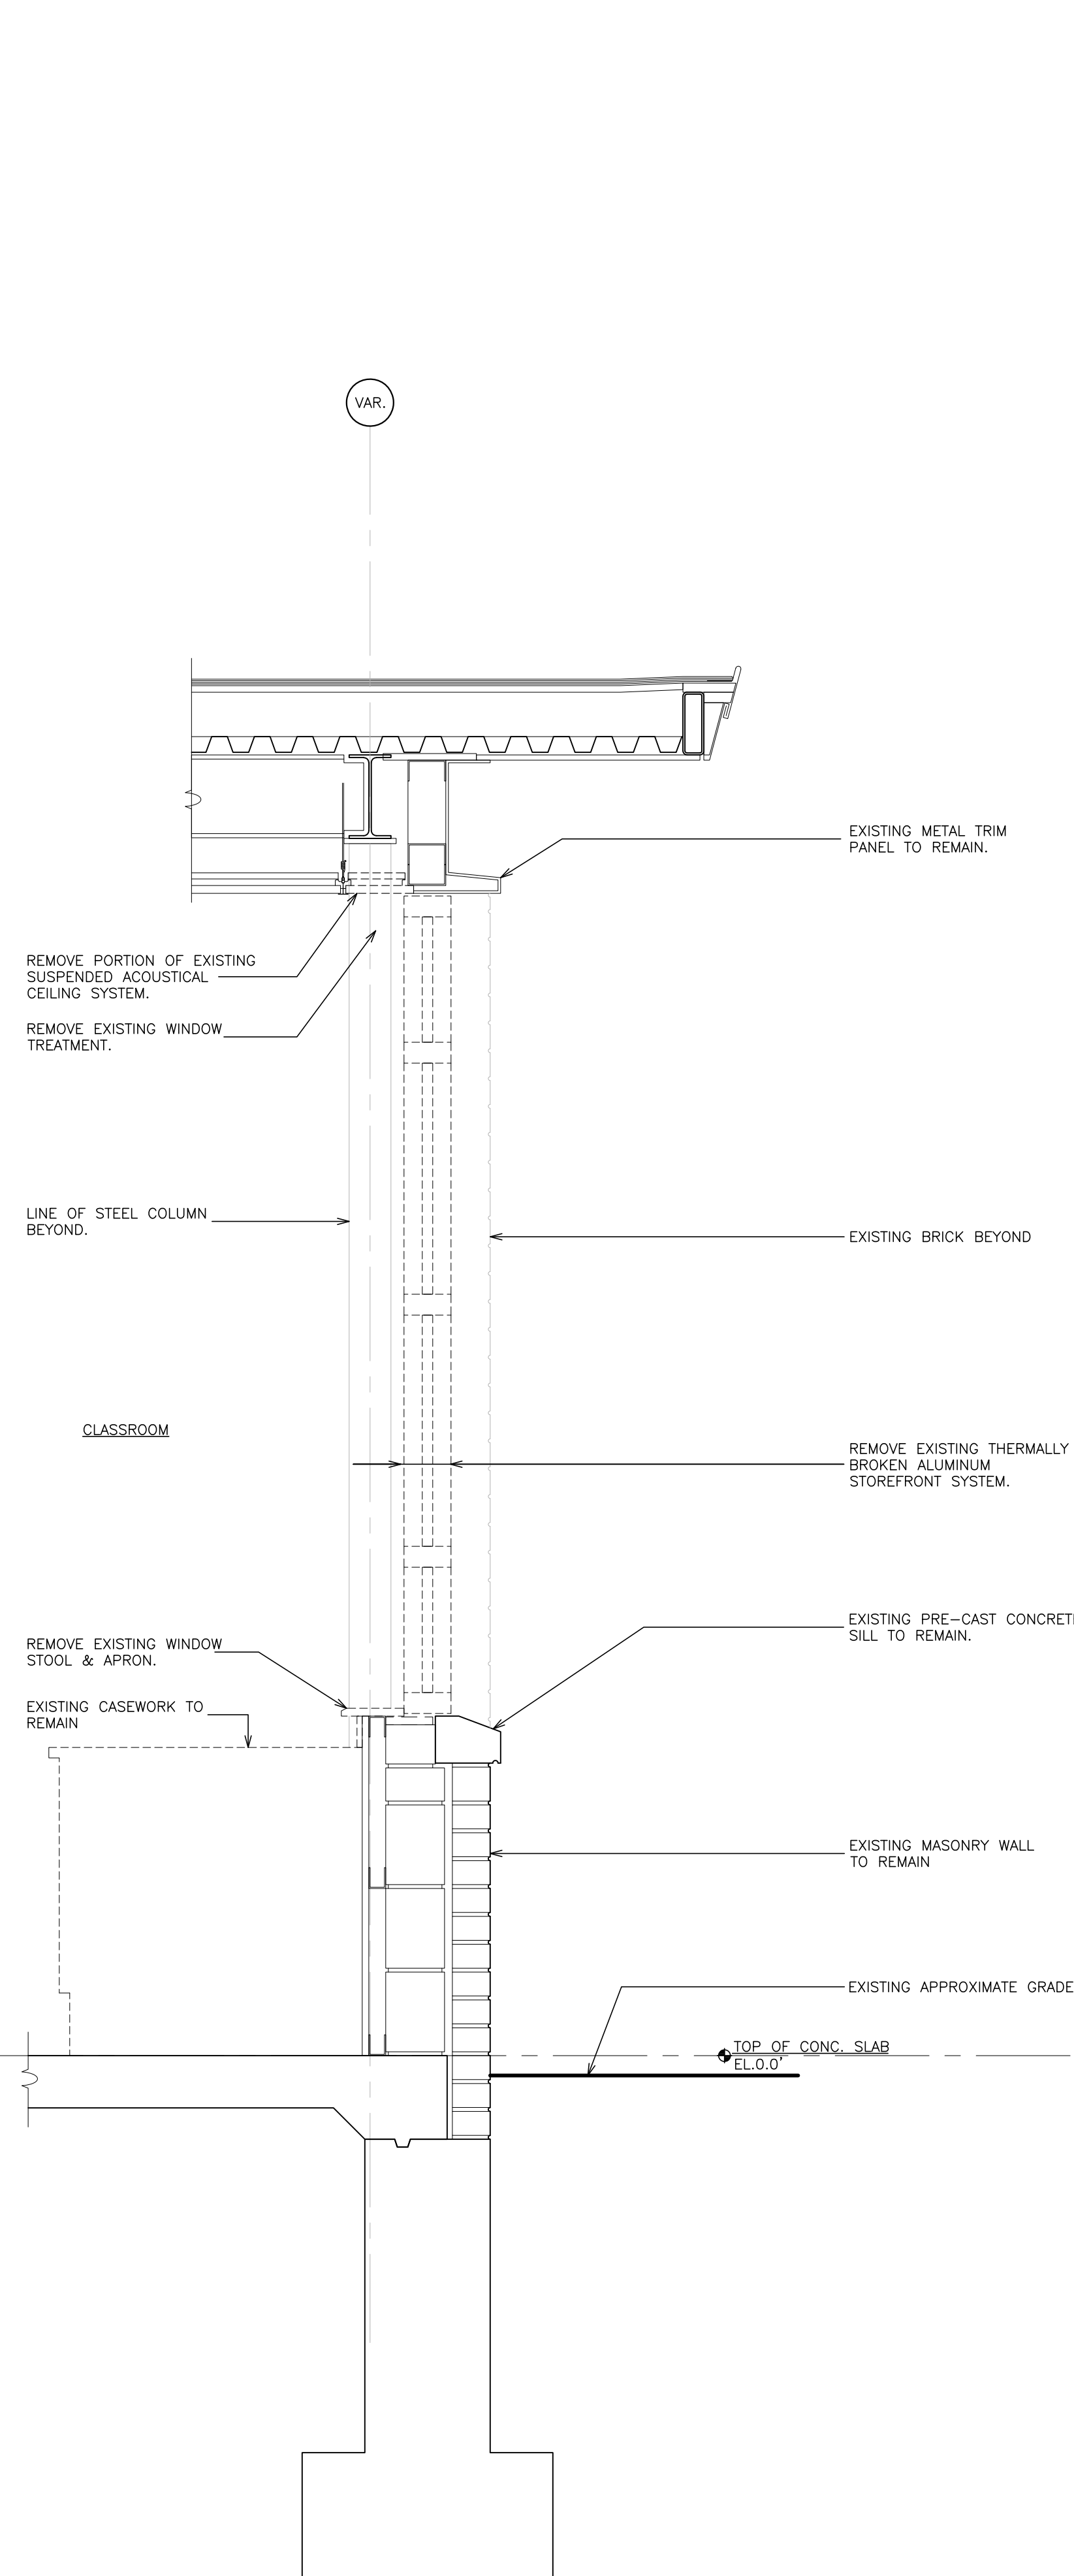SCALE: 1" = 1'-0"



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66-04-06-03-0-008-023

PROJECT: EDELMONT UNION FREE SCHOOL DISTRICT
GREENVILLE WINDOW REPLACEMENT AND
RELATED WORK
100 GLENDALE RD., SCARSDALE, NY 10583
DRAWING TITLE
WALL SECTIONS


10-23-2024	RE-BID
08-27-2024	BID
11-14-2023	S.E.D. SUBMISSION
DATE	ISSUED TO
SCALE AS NOTED	DRAWING NO.
DRAWN BY F & D	A427
CHECKED BY F & D	FILE NO. 23501.00

PLOT DATE: October 18, 2024 — 2:50pm

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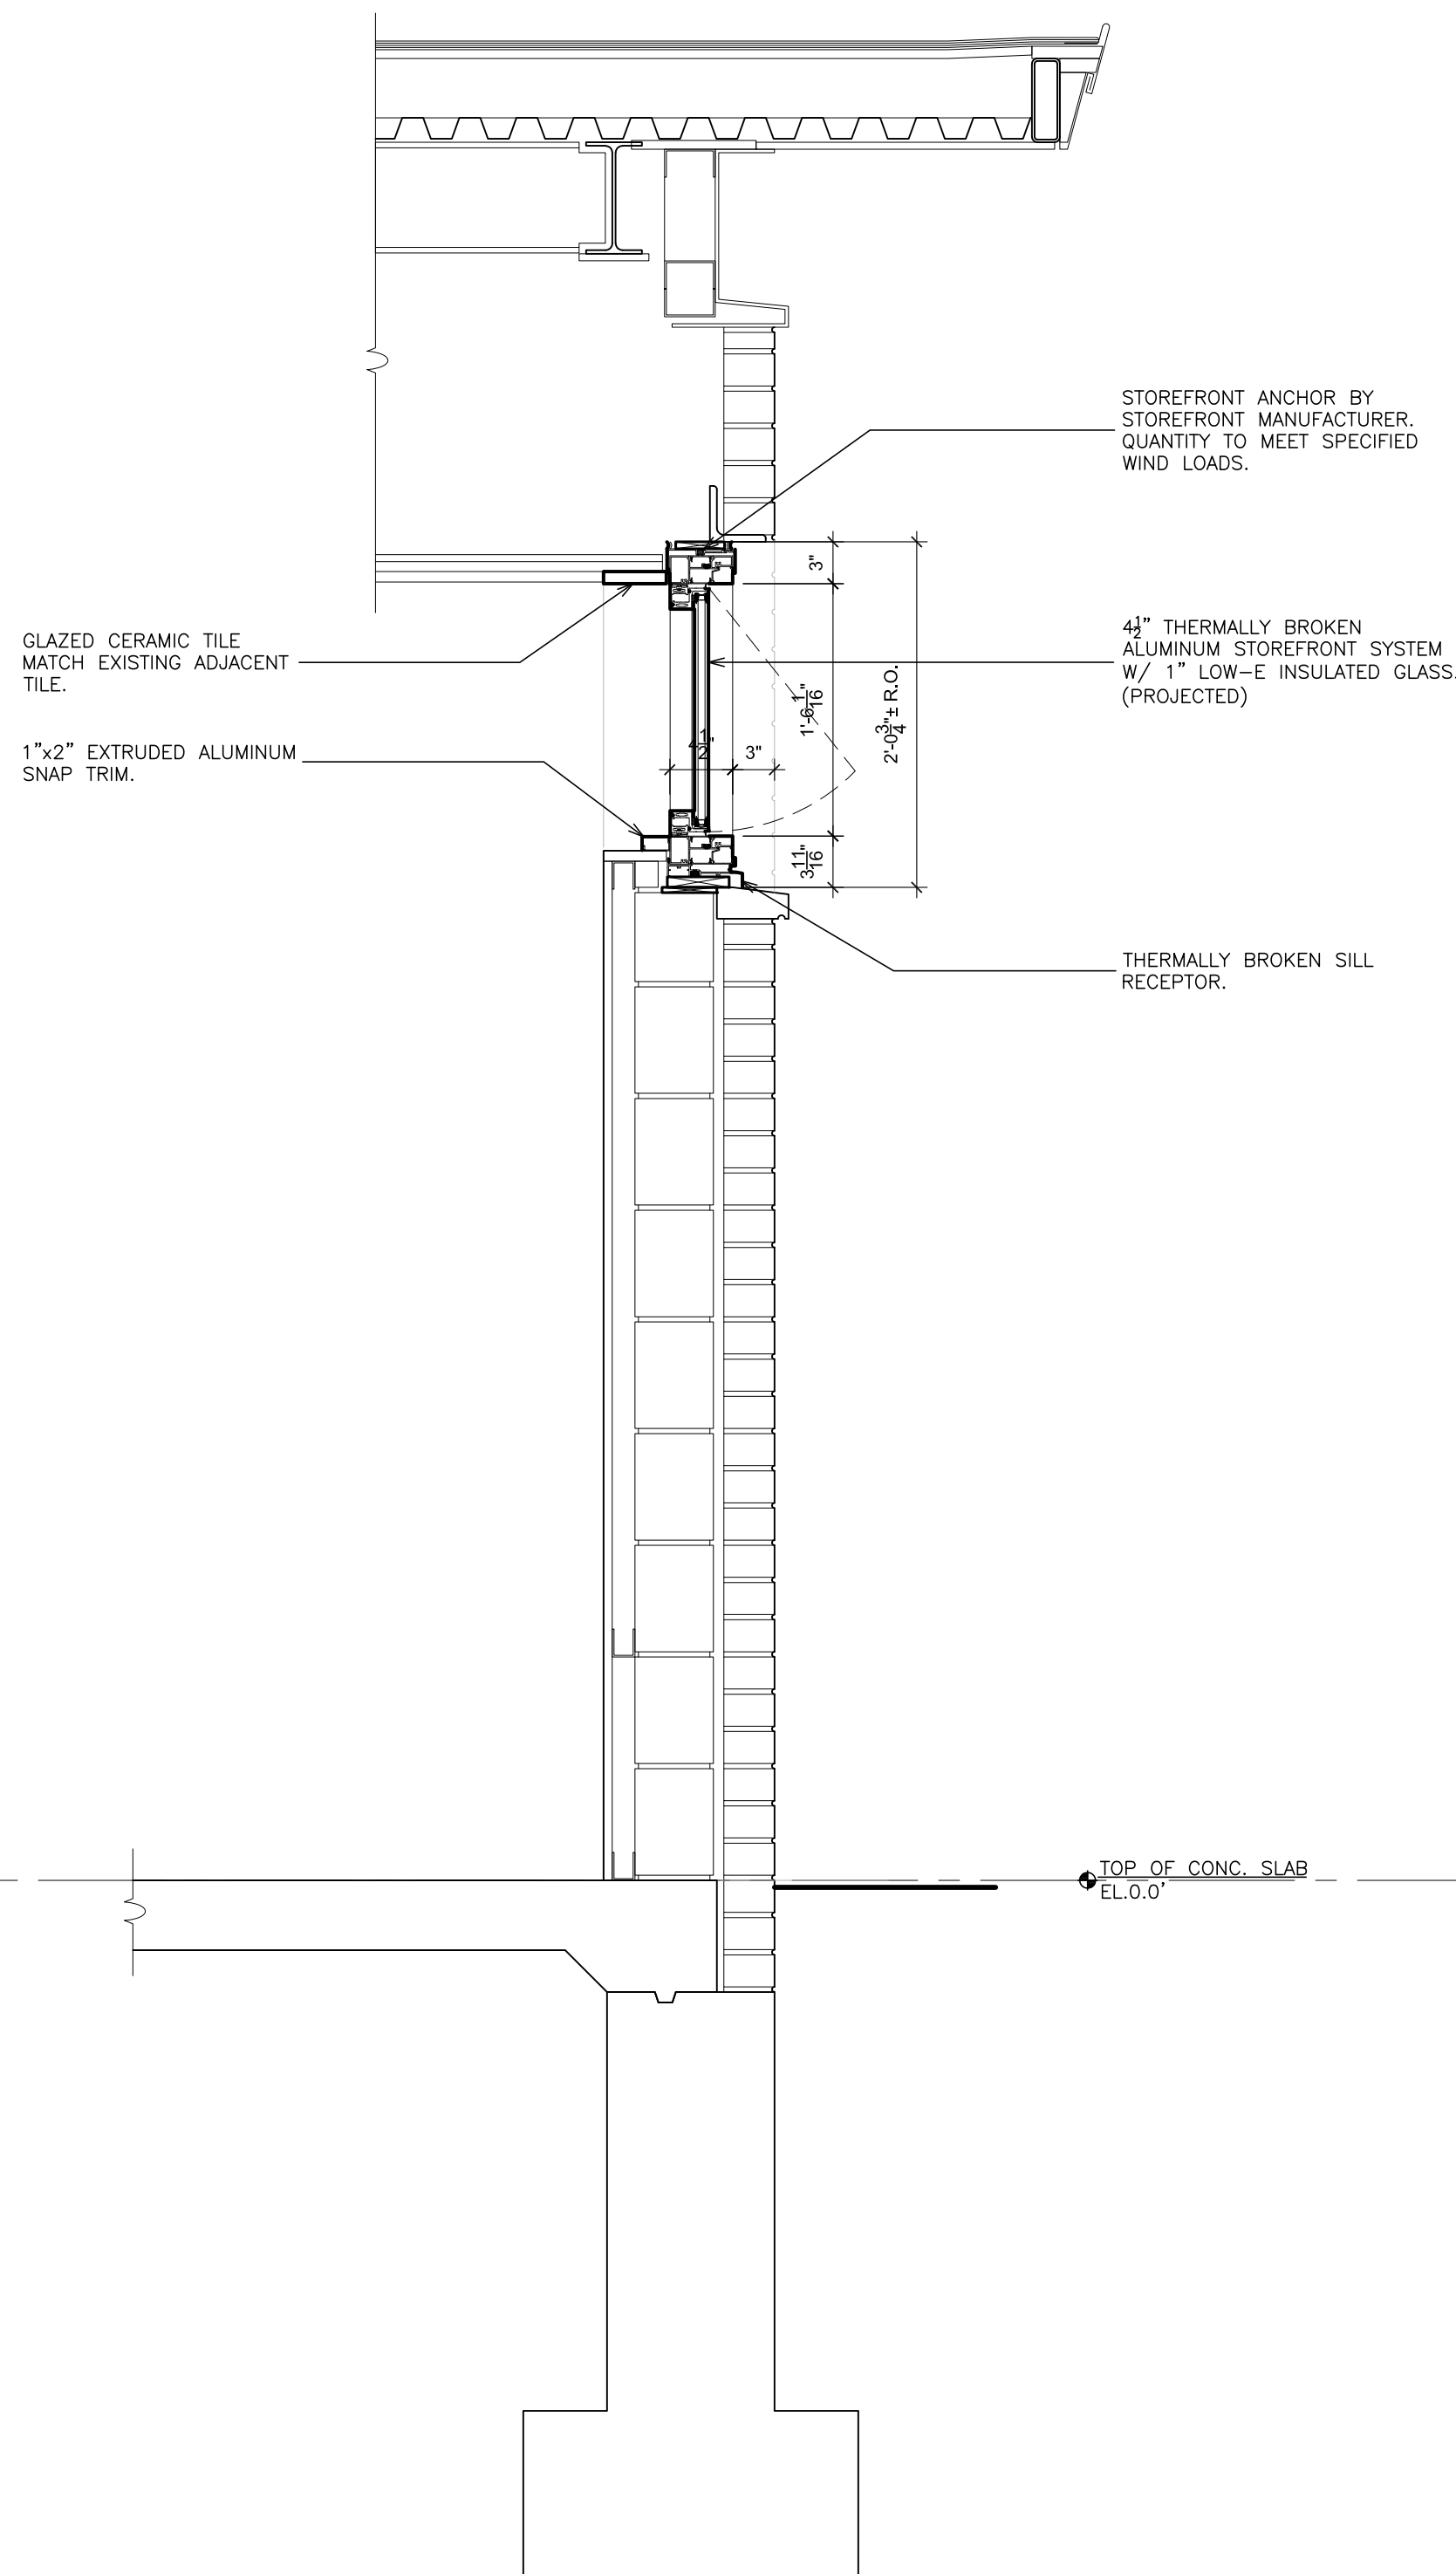
9 REMOVAL WALL SECTION

SCALE: 1" = 1'-0"

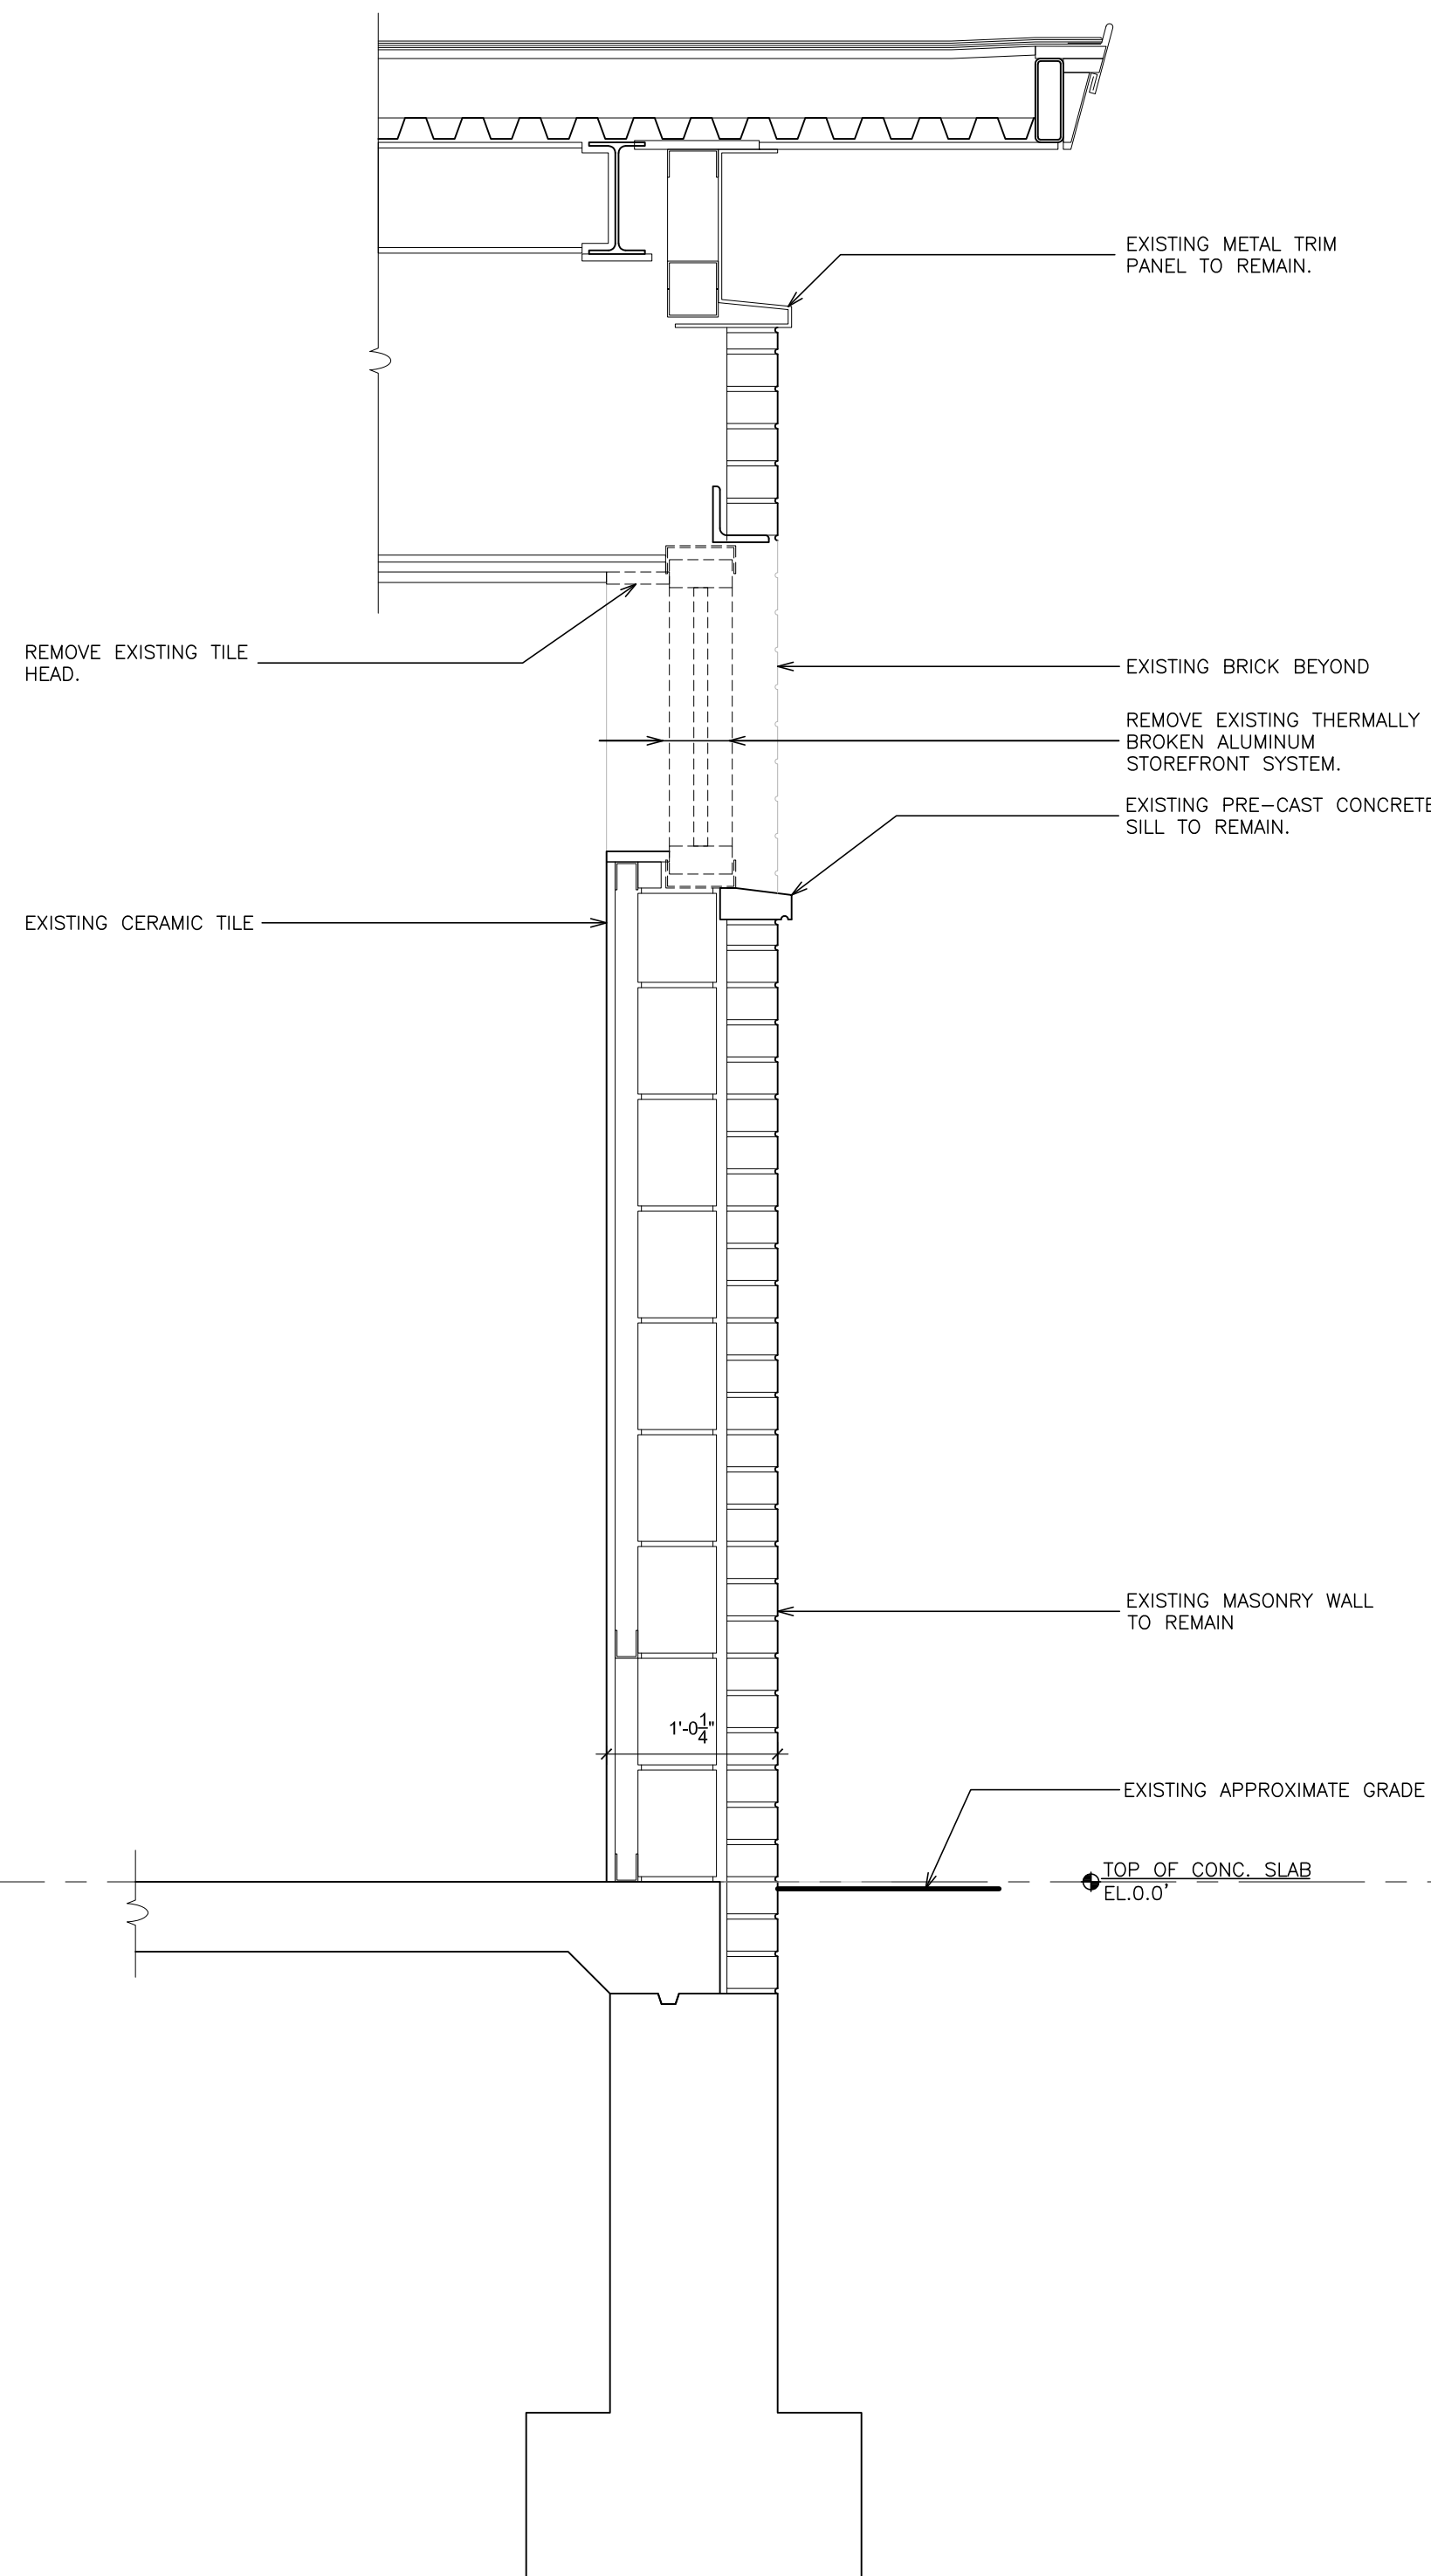


9A WALL SECTION

SCALE: 1" = 1'-0"




10 REMOVAL WALL SECTION

SCALE: 1" = 1'-0"

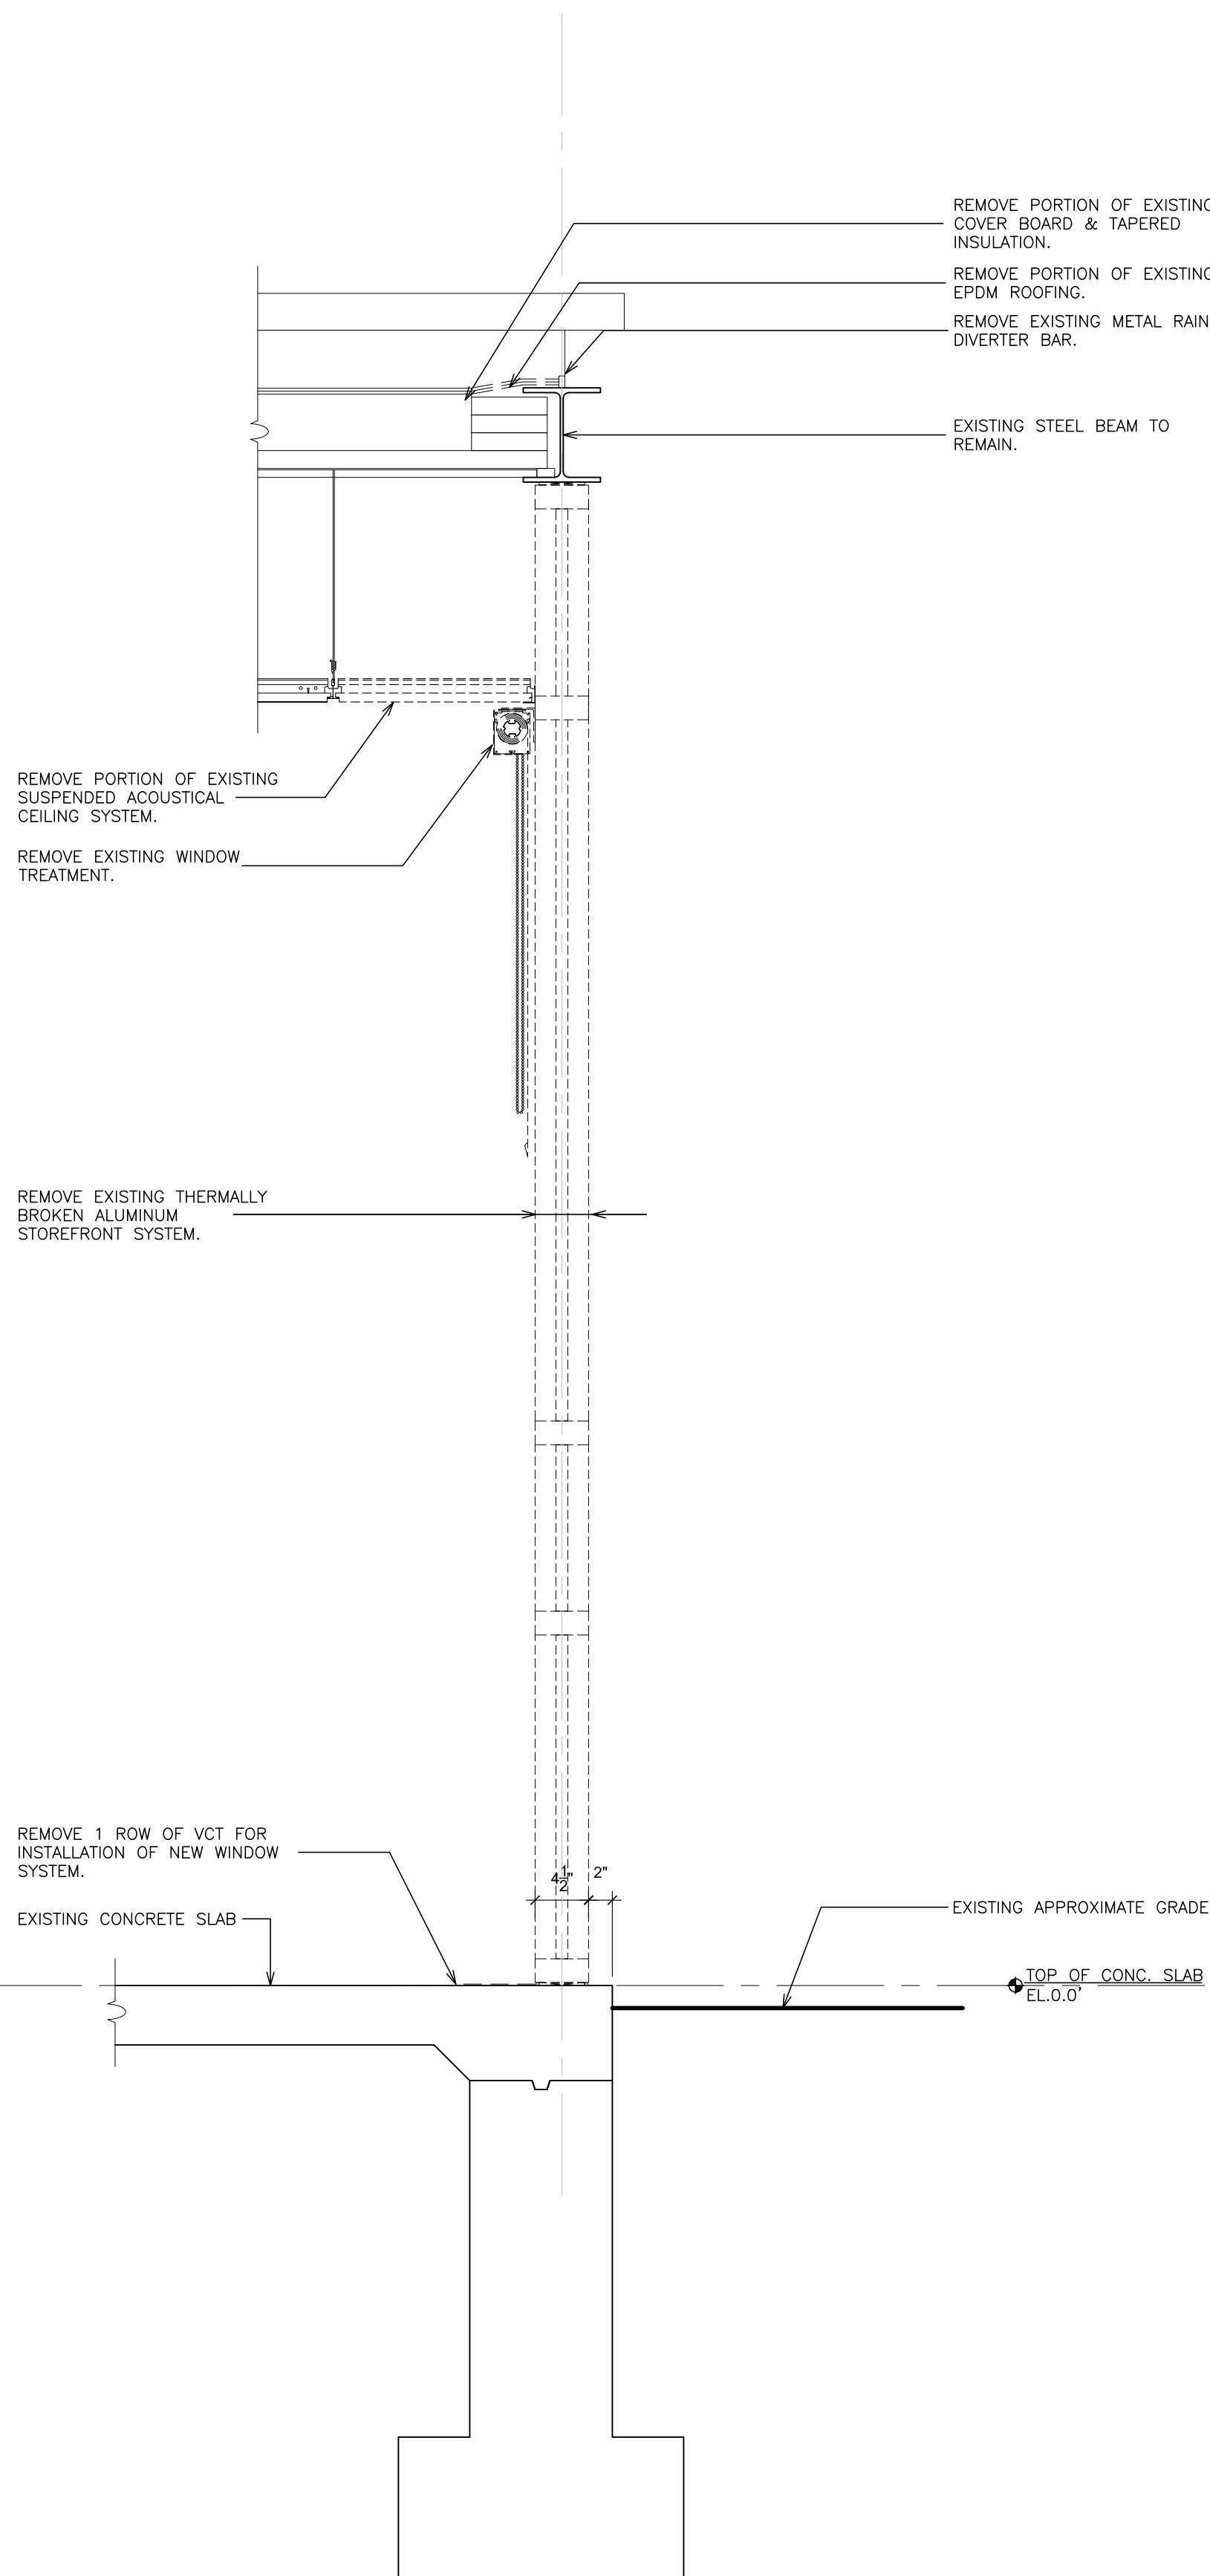

10A WALL SECTION

SCALE: 1" = 1'-0"

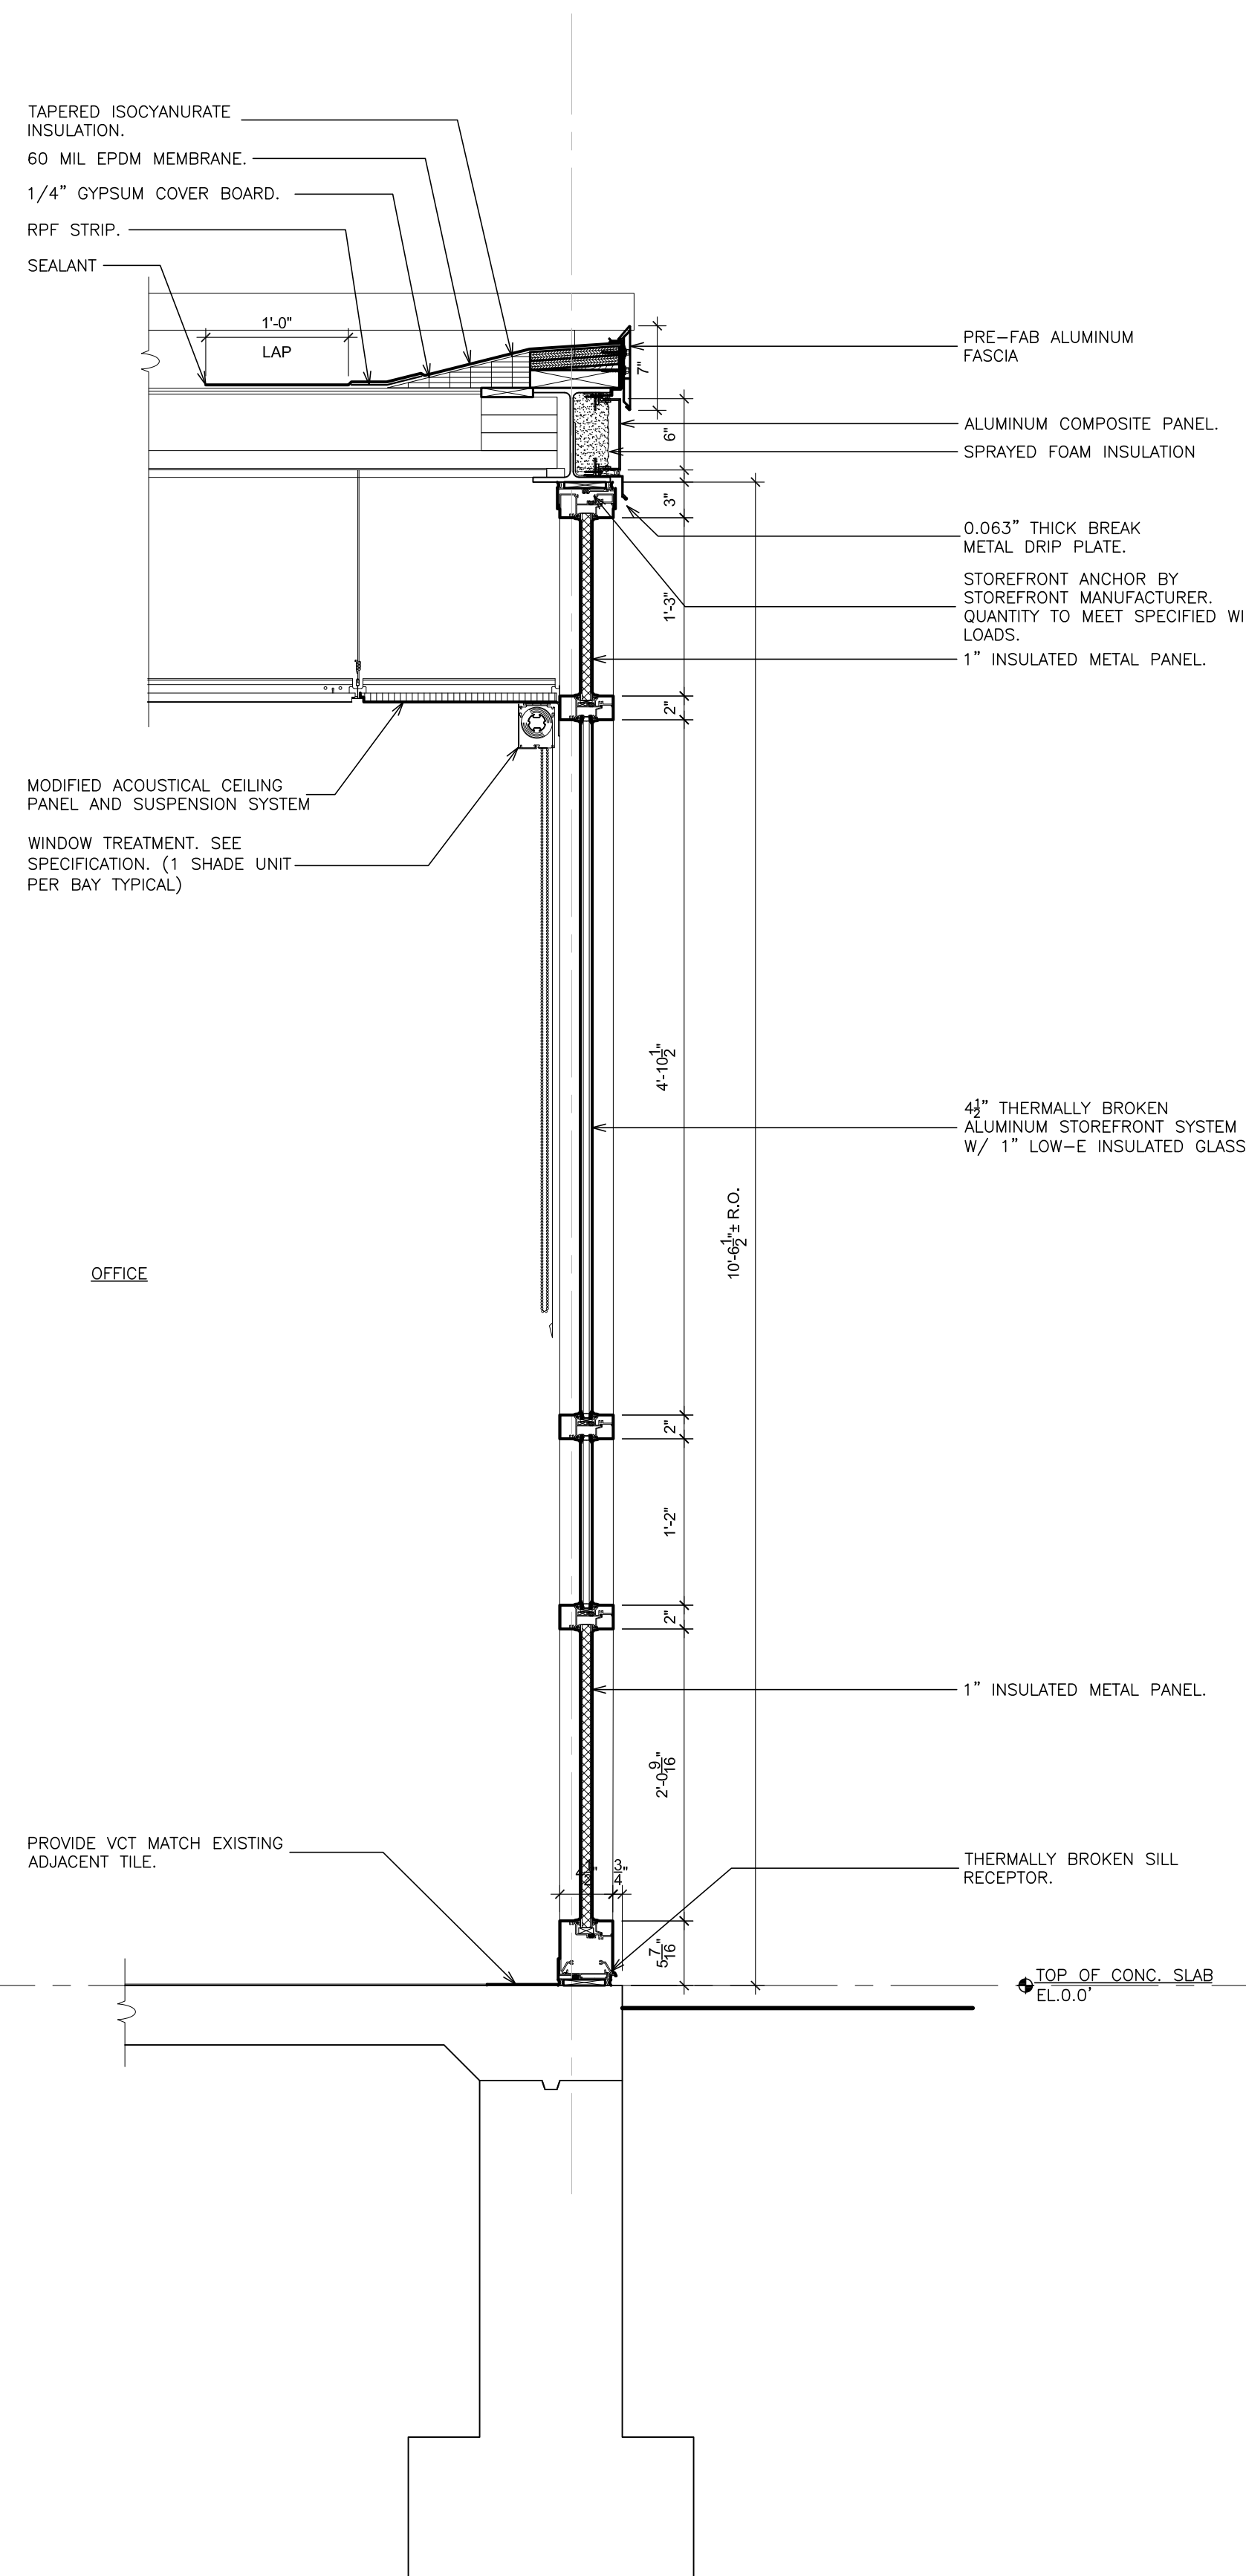

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PROJECT: NEW
EDGEMONT UNION FREE SCHOOL DISTRICT
GREENVILLE WINDOW REPLACEMENT AND
RELATED WORK
100 GLENDALE RD., SCARSDALE, NY 11583
DRAWING TITLE
WALL SECTIONS

10-23-2024	RE-BID
08-27-2024	BID
11-14-2023	S.E.D. SUBMISSION
DATE	ISSUED TO


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DRAWING NO.
A429
















FILE NO.
23501.00

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ARCHITECTS PLANNERS					
S.E.D. CONTROL NUMBER: GREENVILLE ELEMENTARY 06-04-05-03-0009-023					
PROJECT TITLE EDGE MONT UNION FREE SCHOOL DISTRICT EDGE MONT WINDOW REPLACEMENT AND RELATED WORK 100 GLENDALE RD., SCARSDALE, NY 10583		DRAWING TYPE WINDOW SCHEDULE, DOOR SCHEDULE, DOOR TYPES & RESCUE WINDOW DETAIL			
10-23-2024		RE-BID			
08-27-2024		BID			
11-14-2023		S.E.D. SUBMISSION			
DATE		ISSUED TO			
SCALE AS NOTED BY F & D		DRAWING NO. A725			
CHECKED BY F & D		FILE NO. 23501.00			

PLOT DATE: October 18, 2024 - 2:31pm

FILE: I:\23501.00 Edgemont Greenville Window replacement\DRAWINGS\CURRENT\1-F&D\23501.00-A727-729.dwg

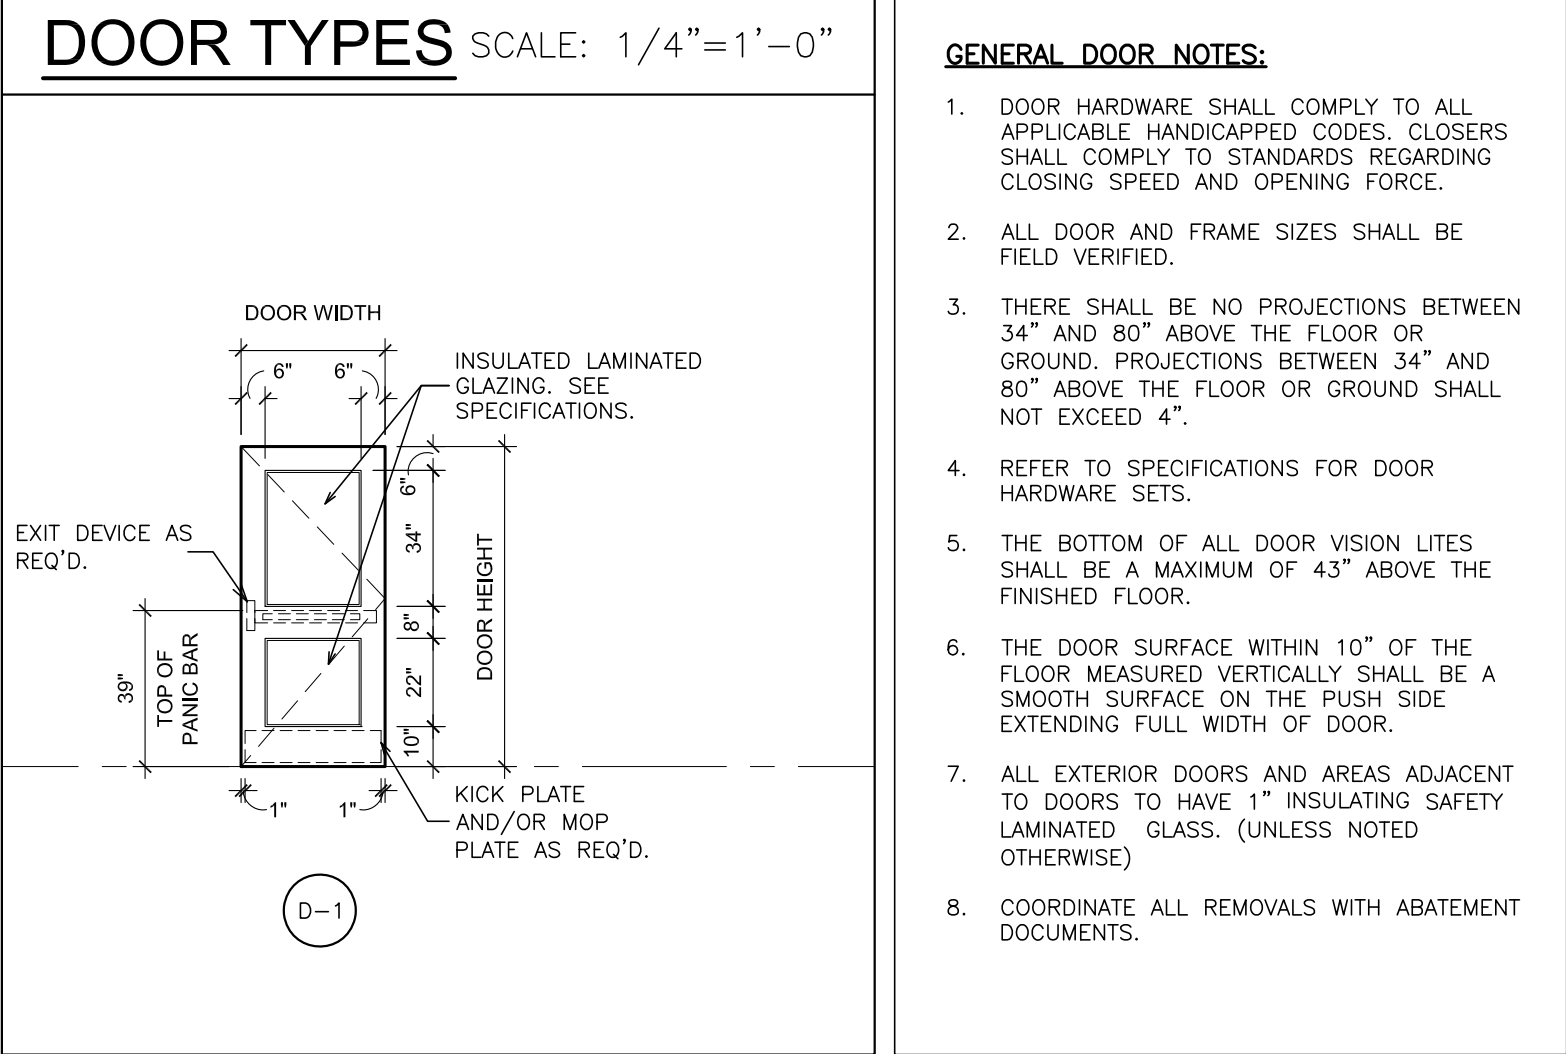
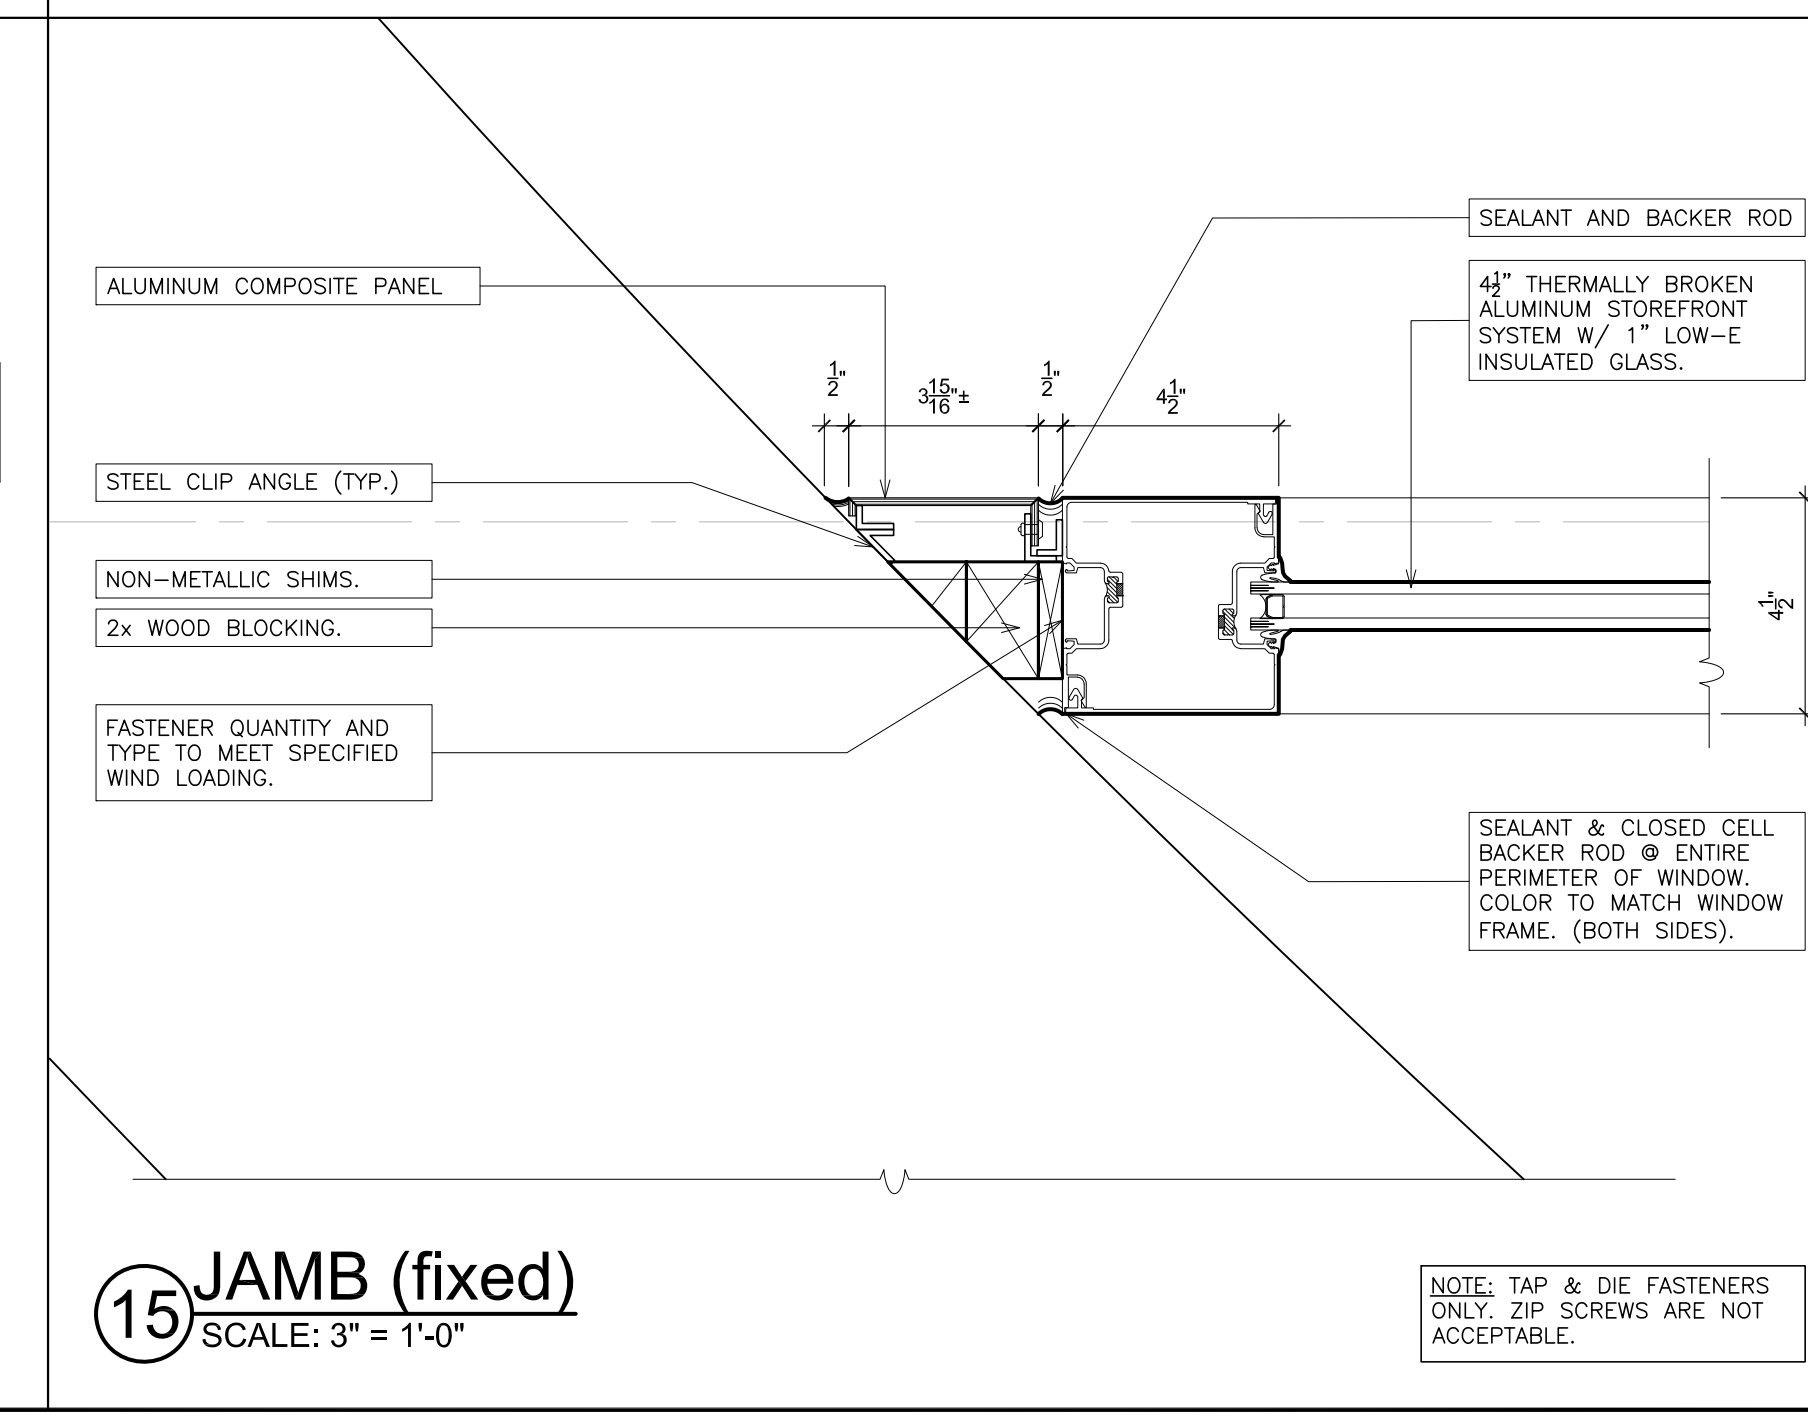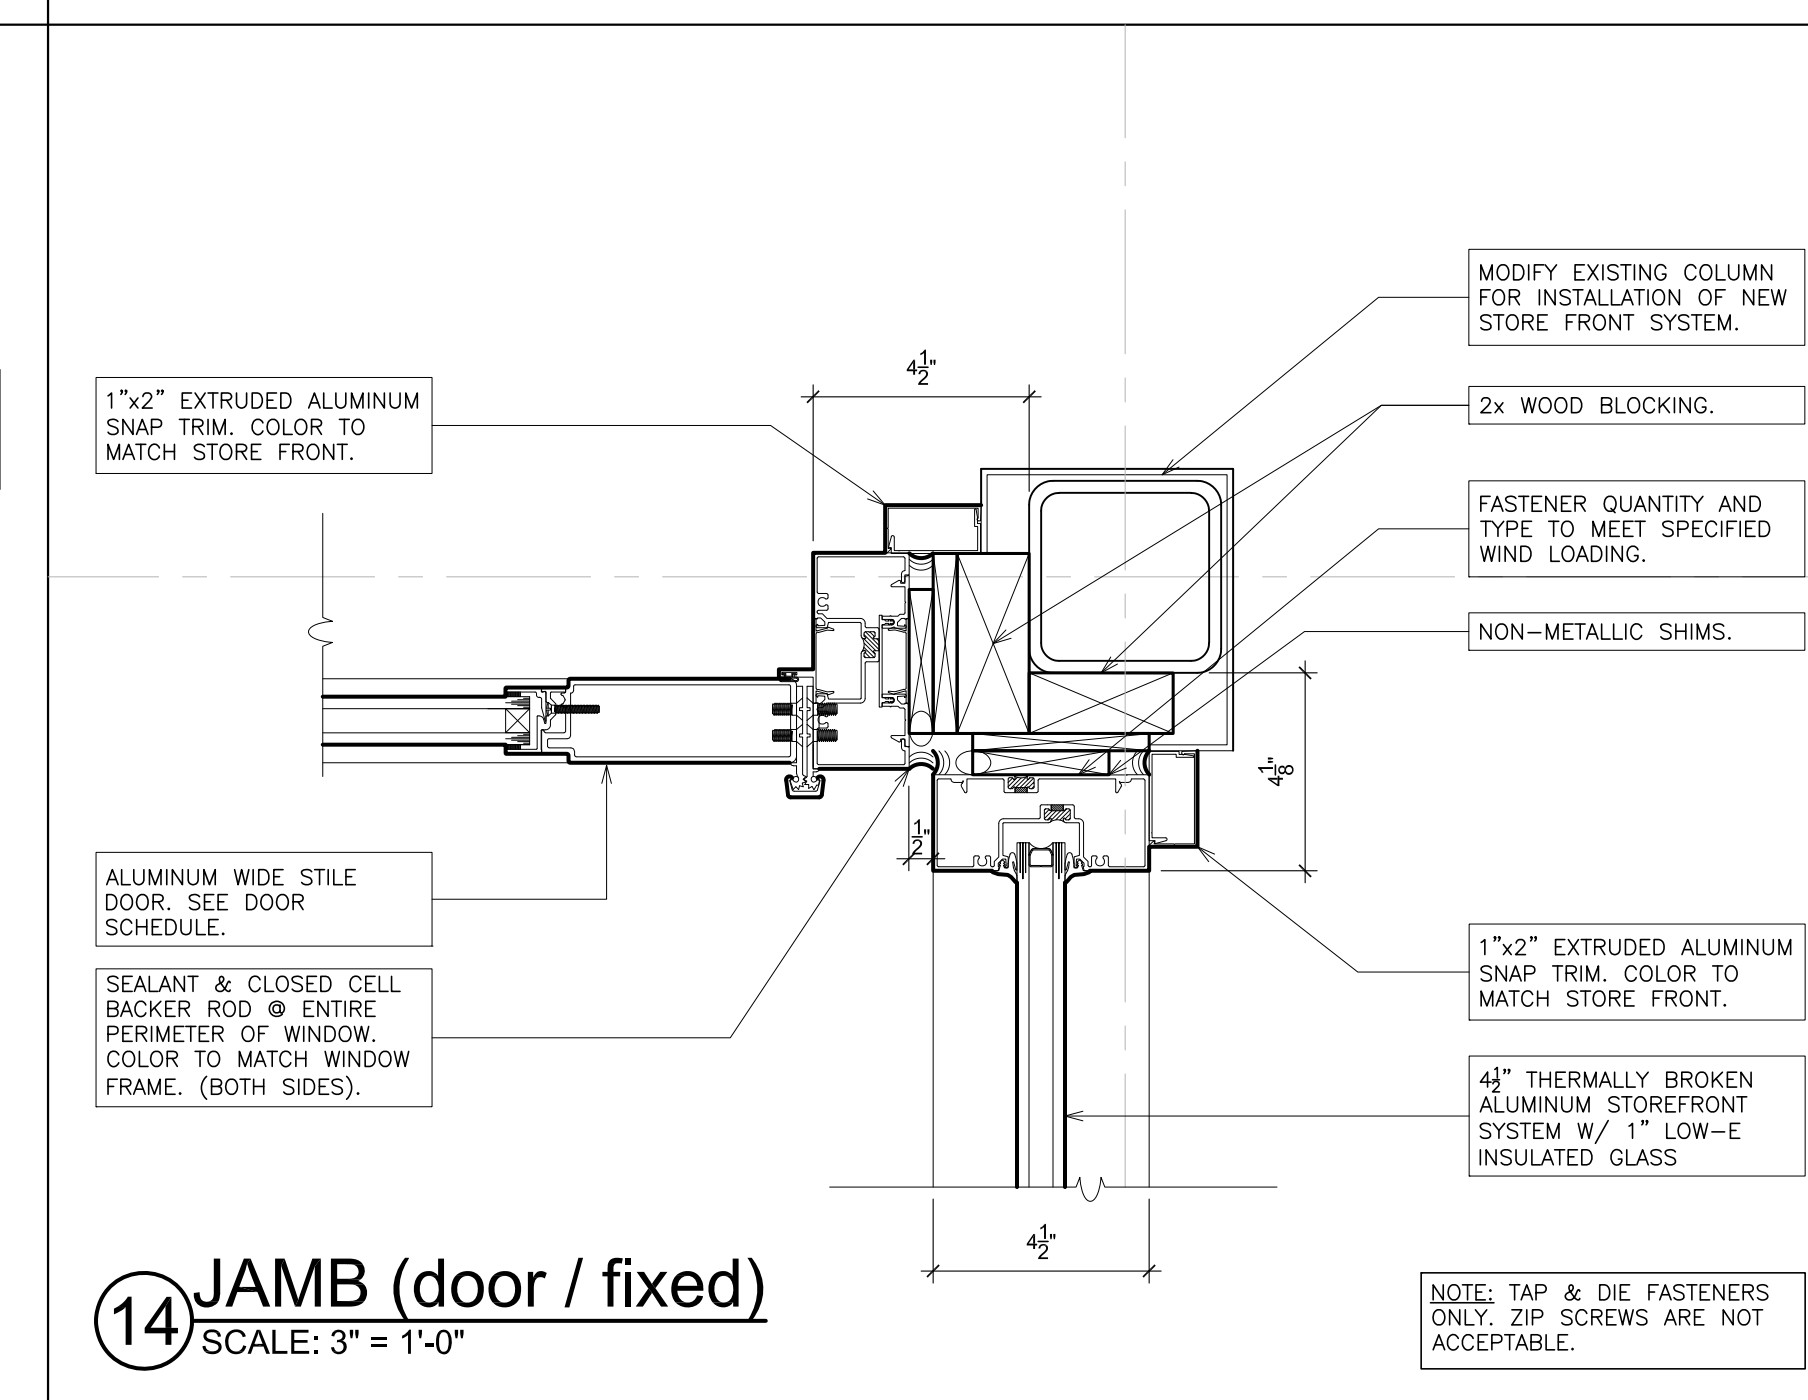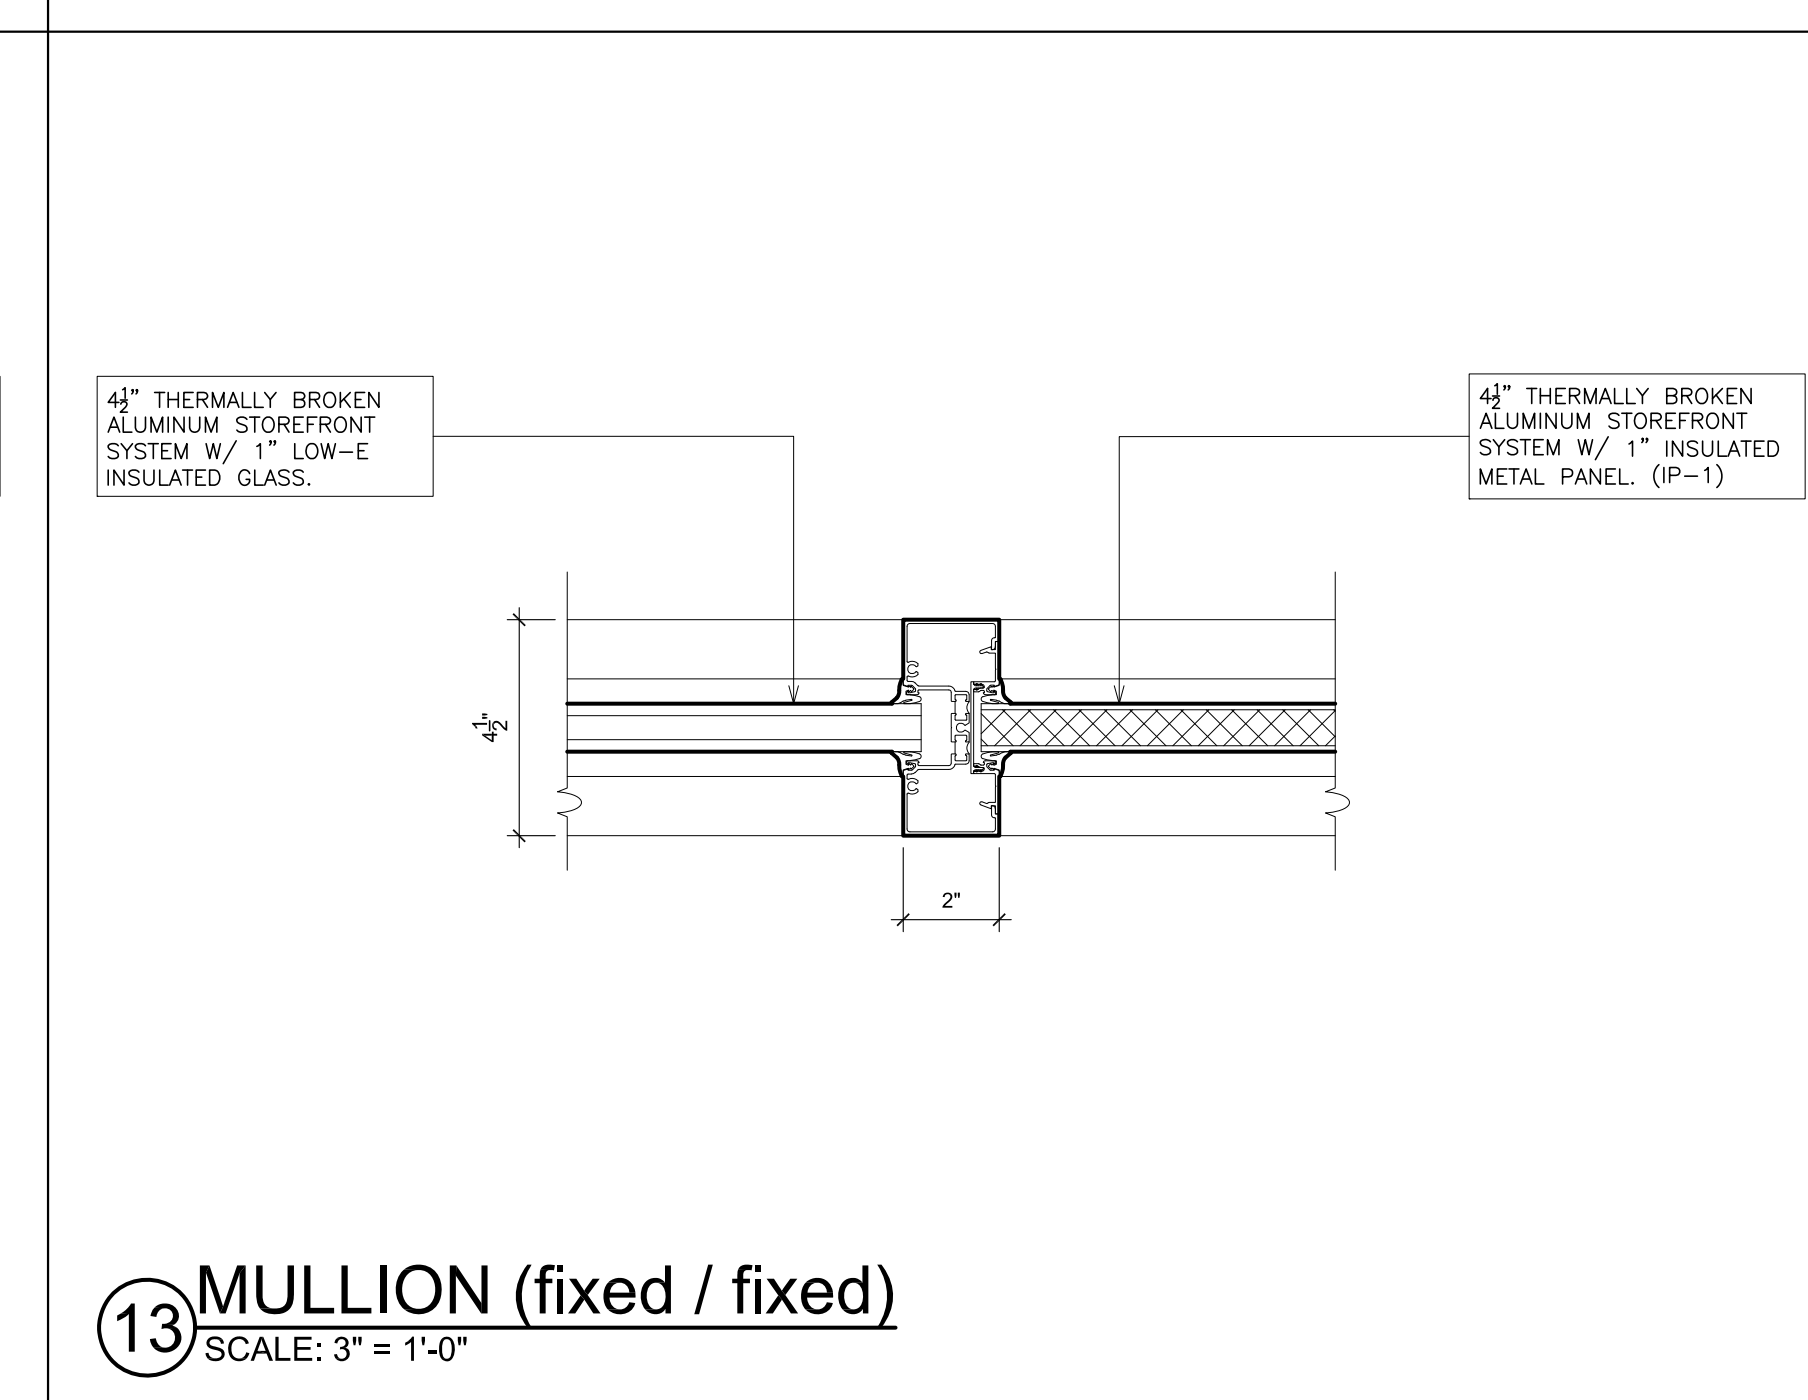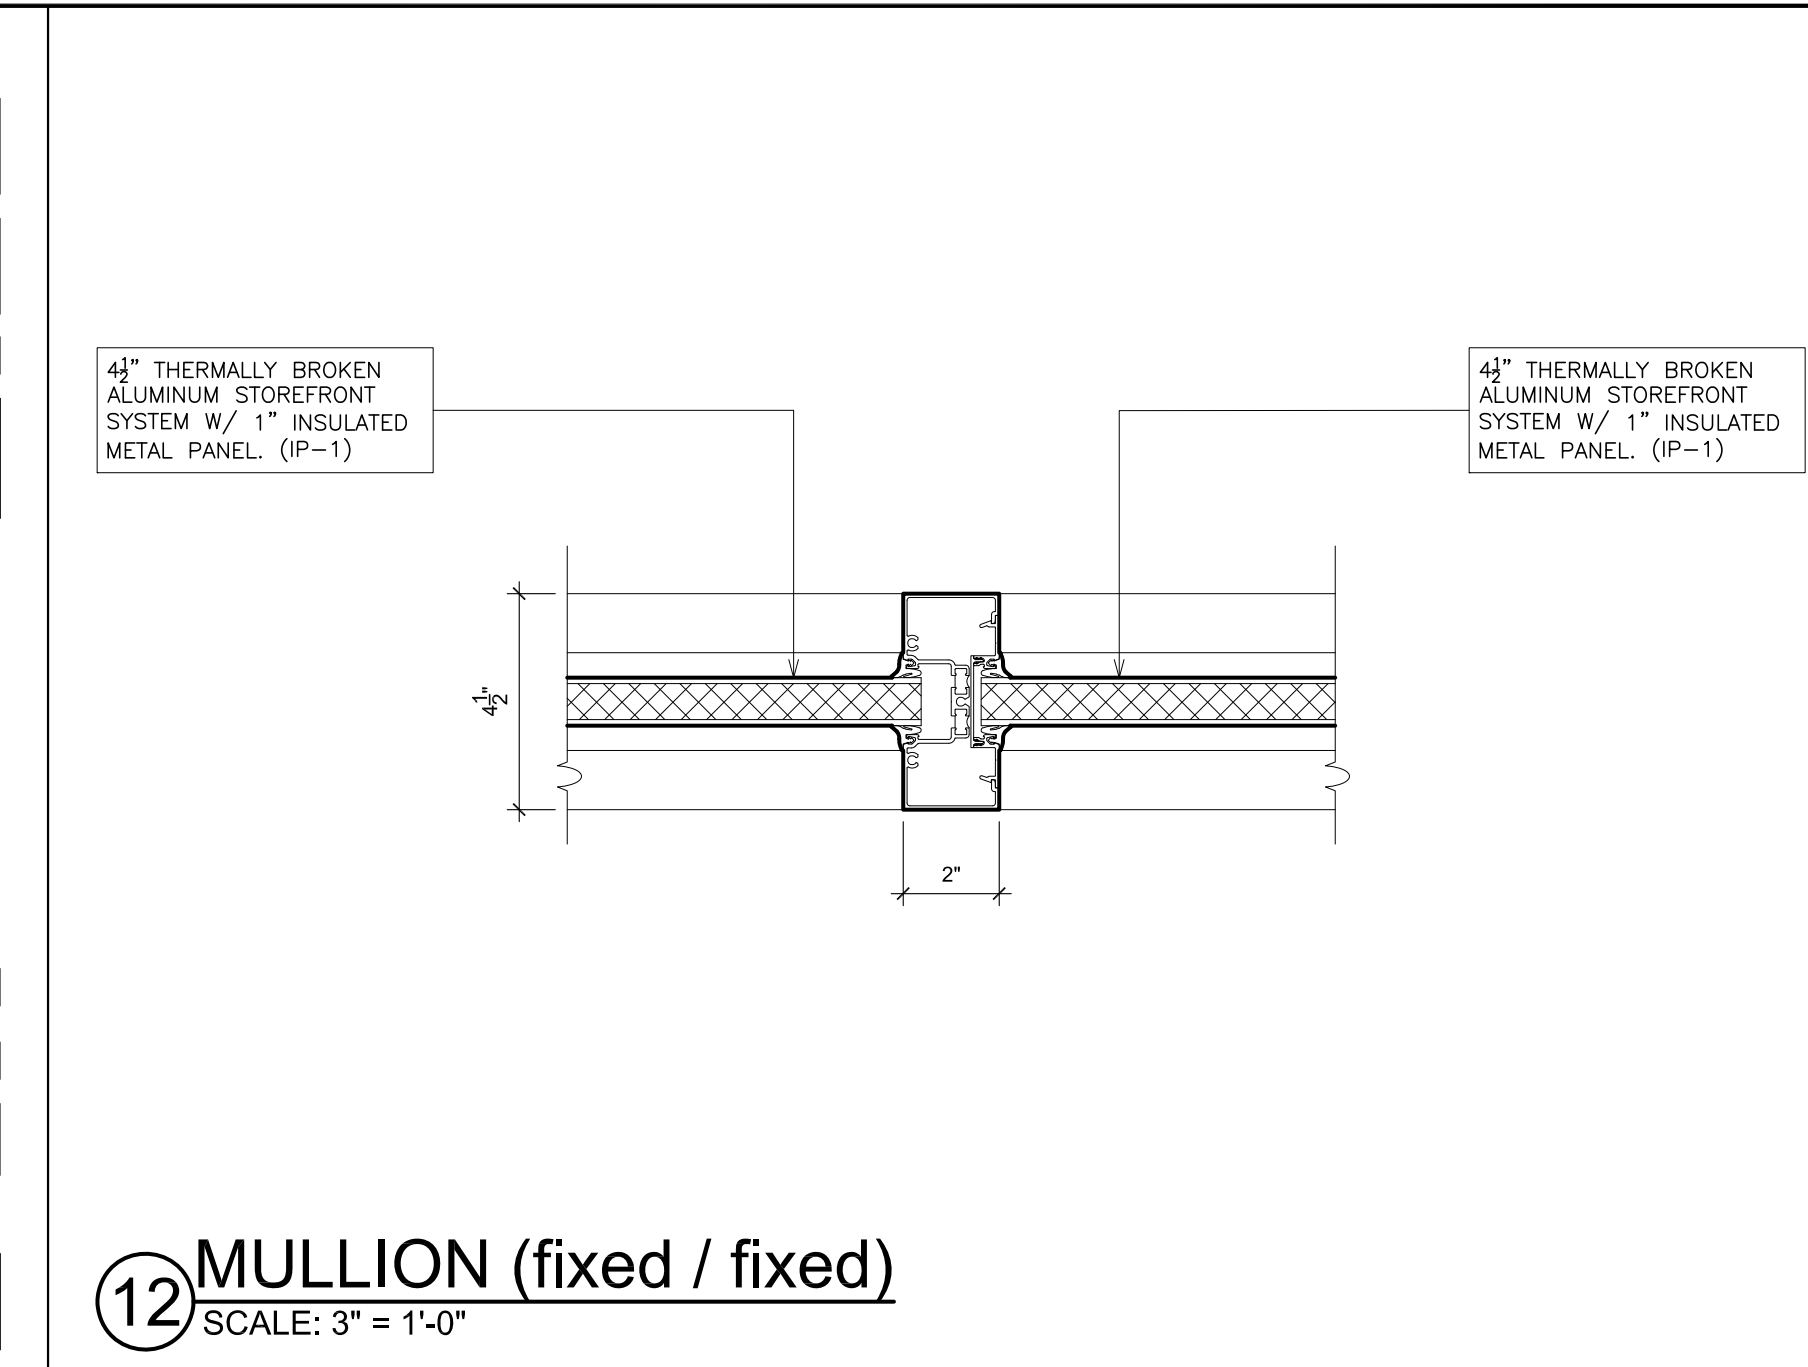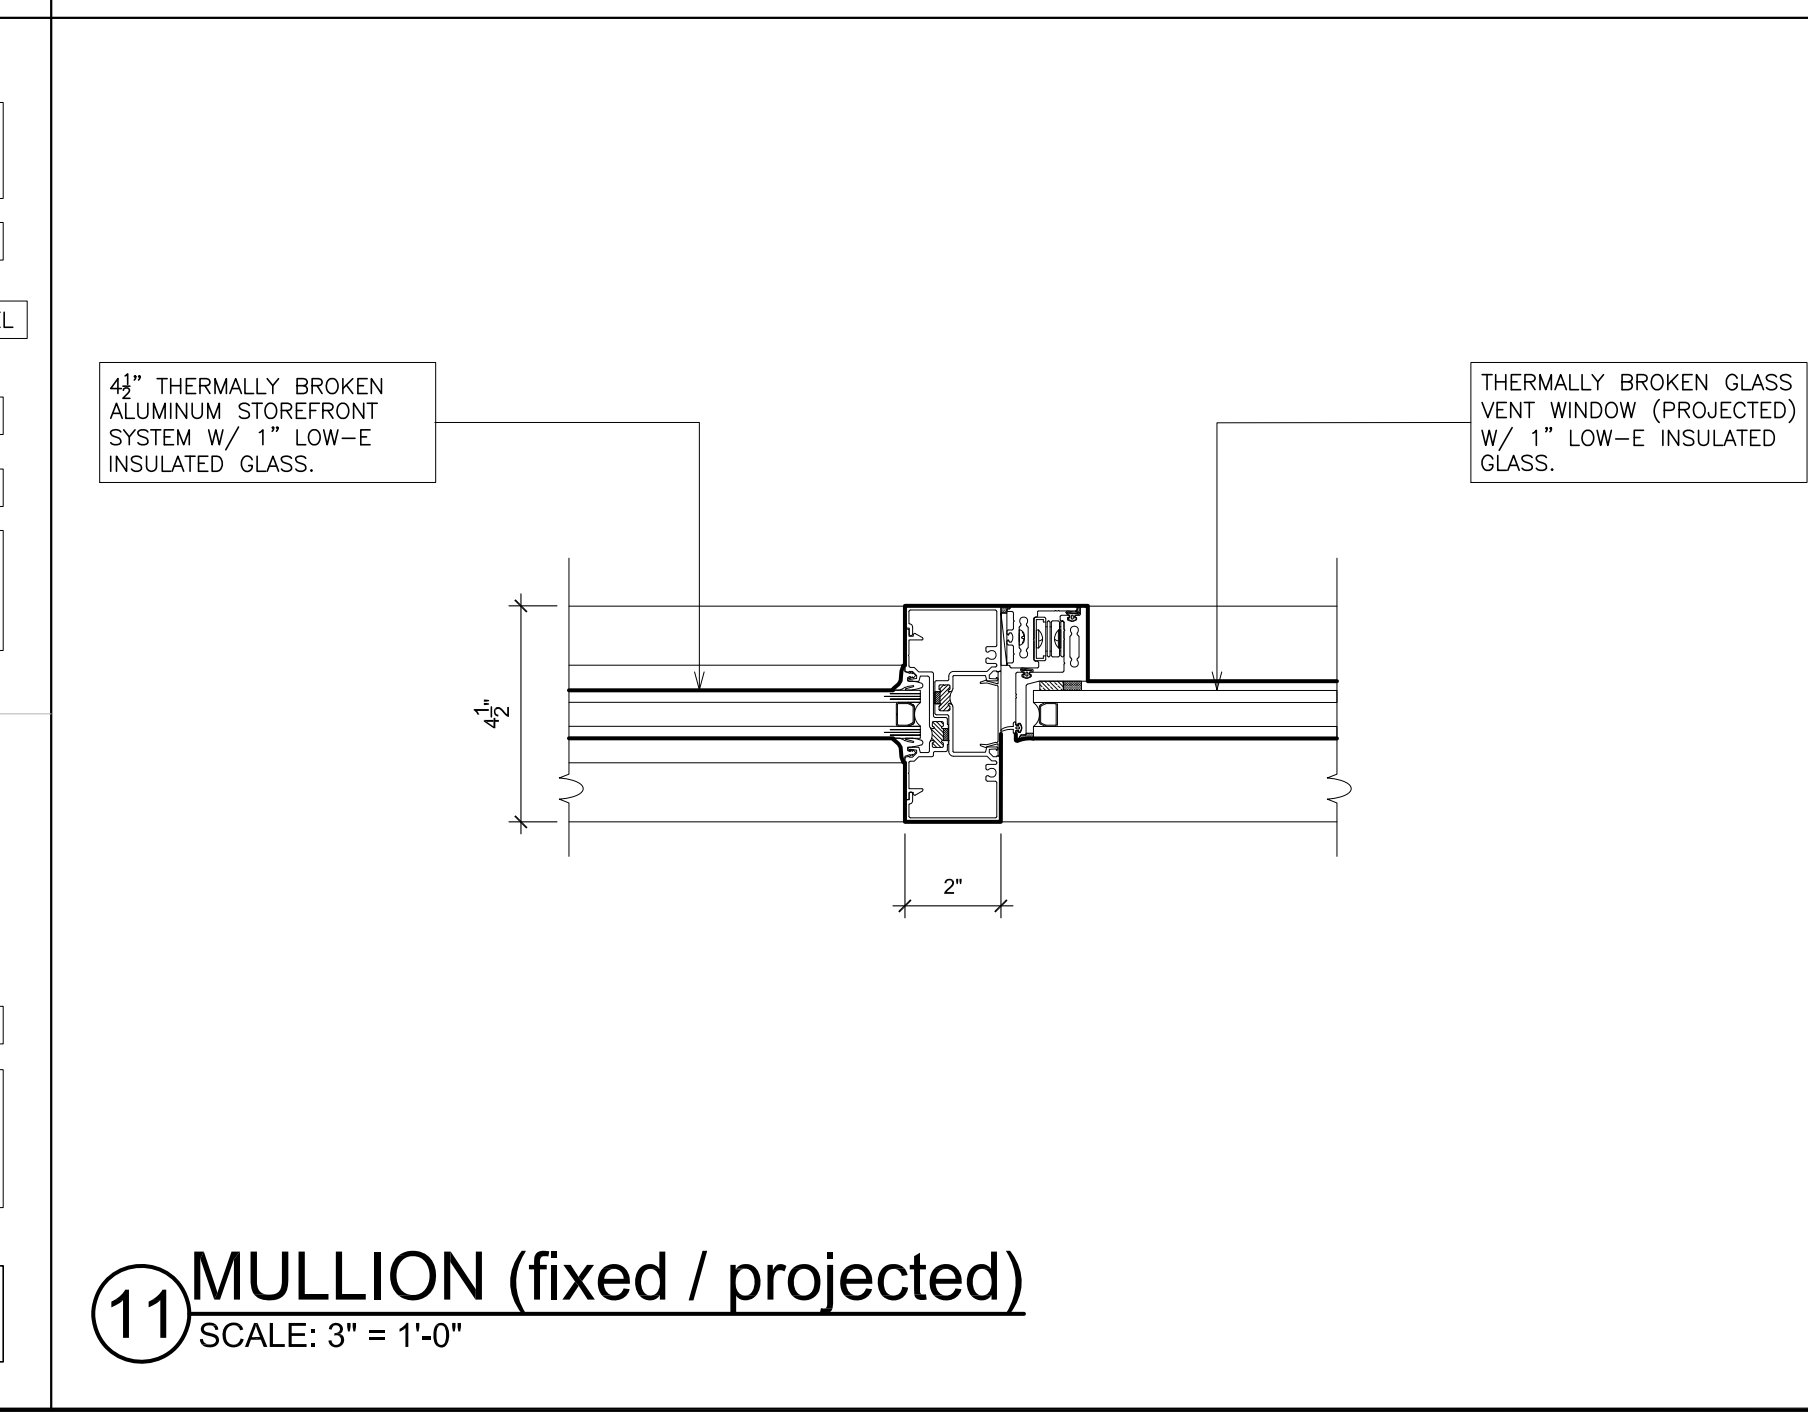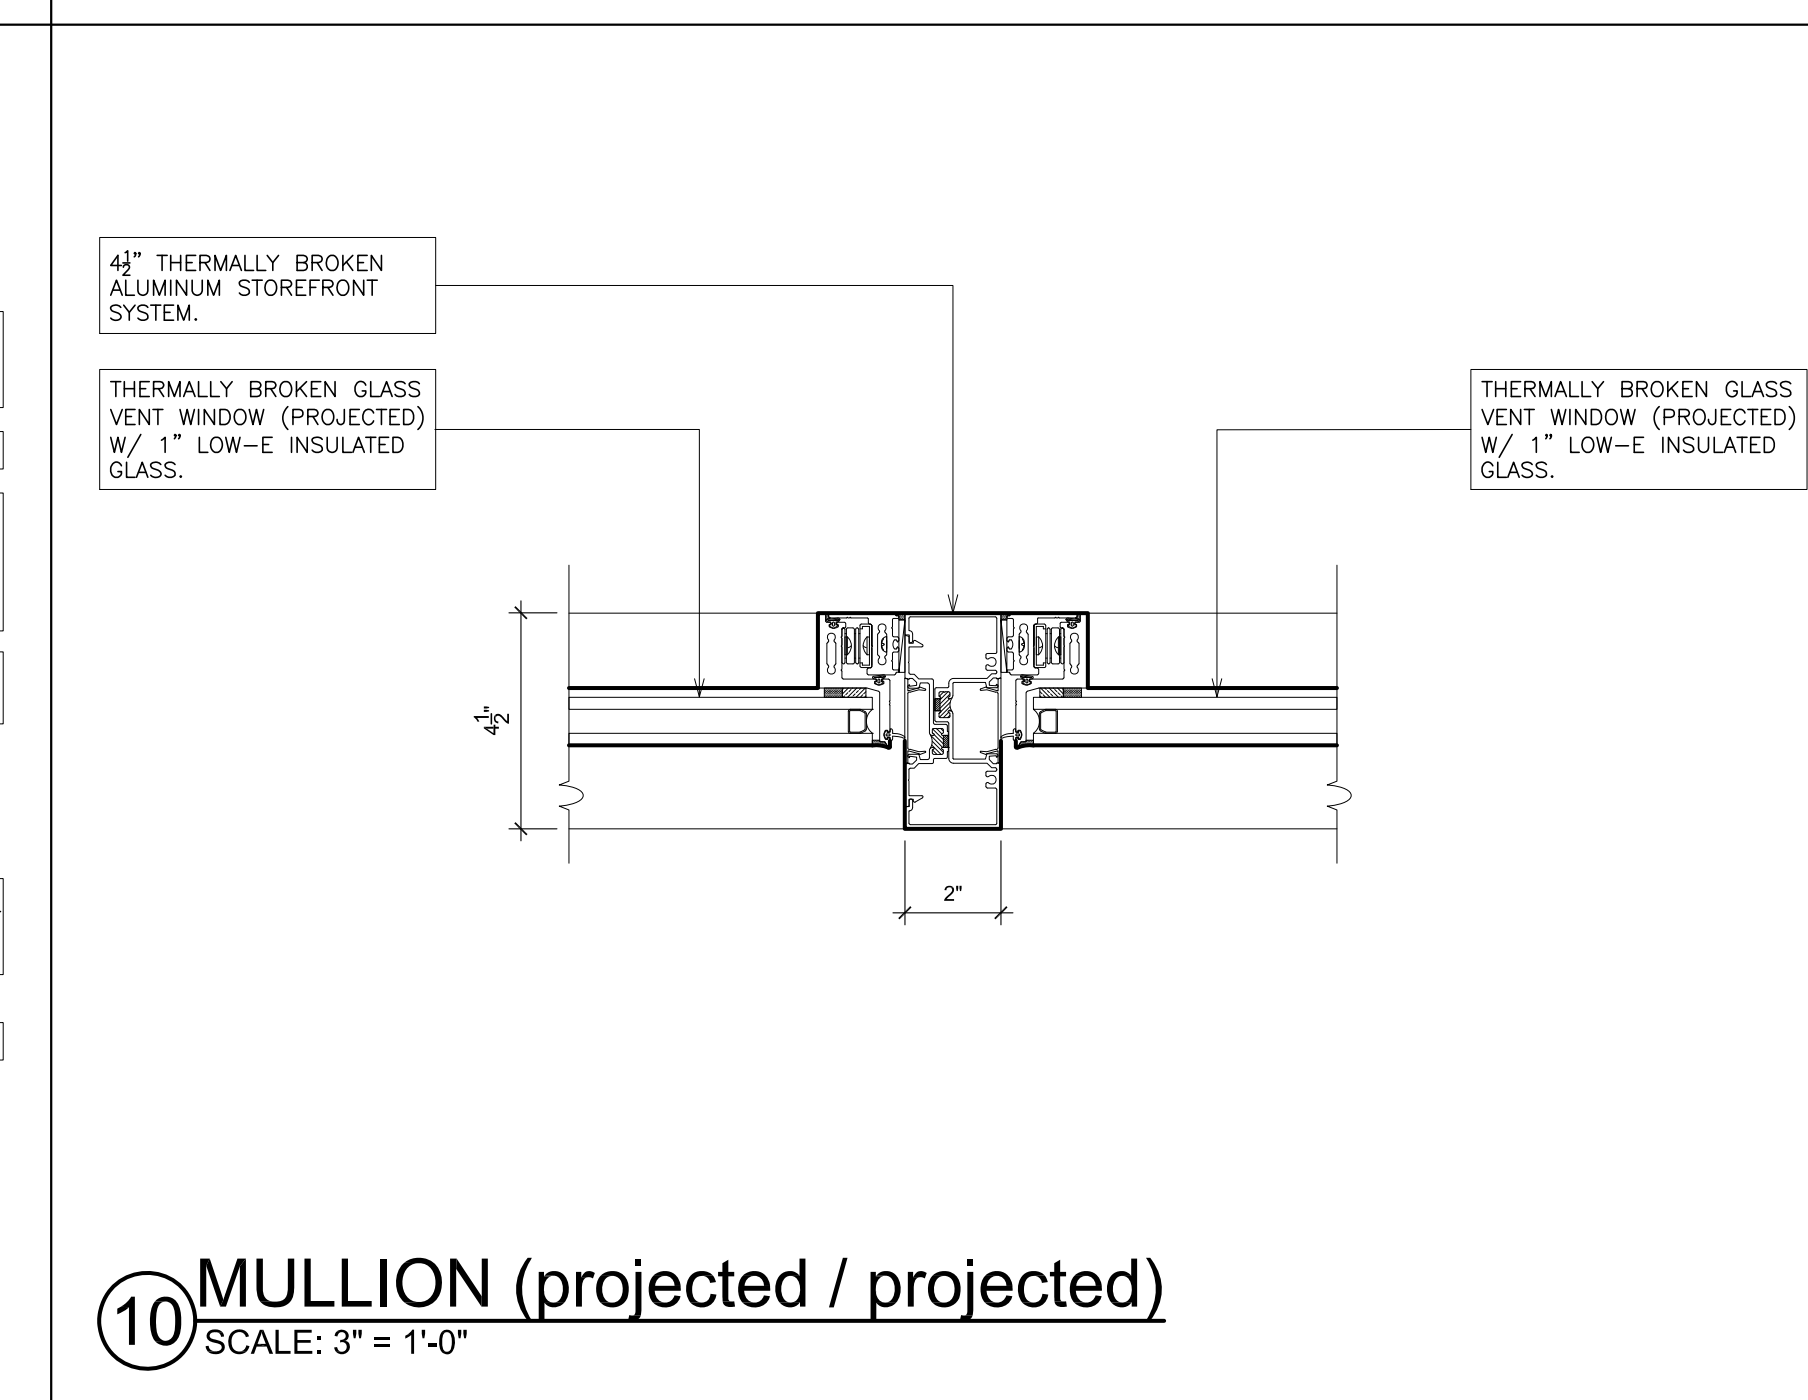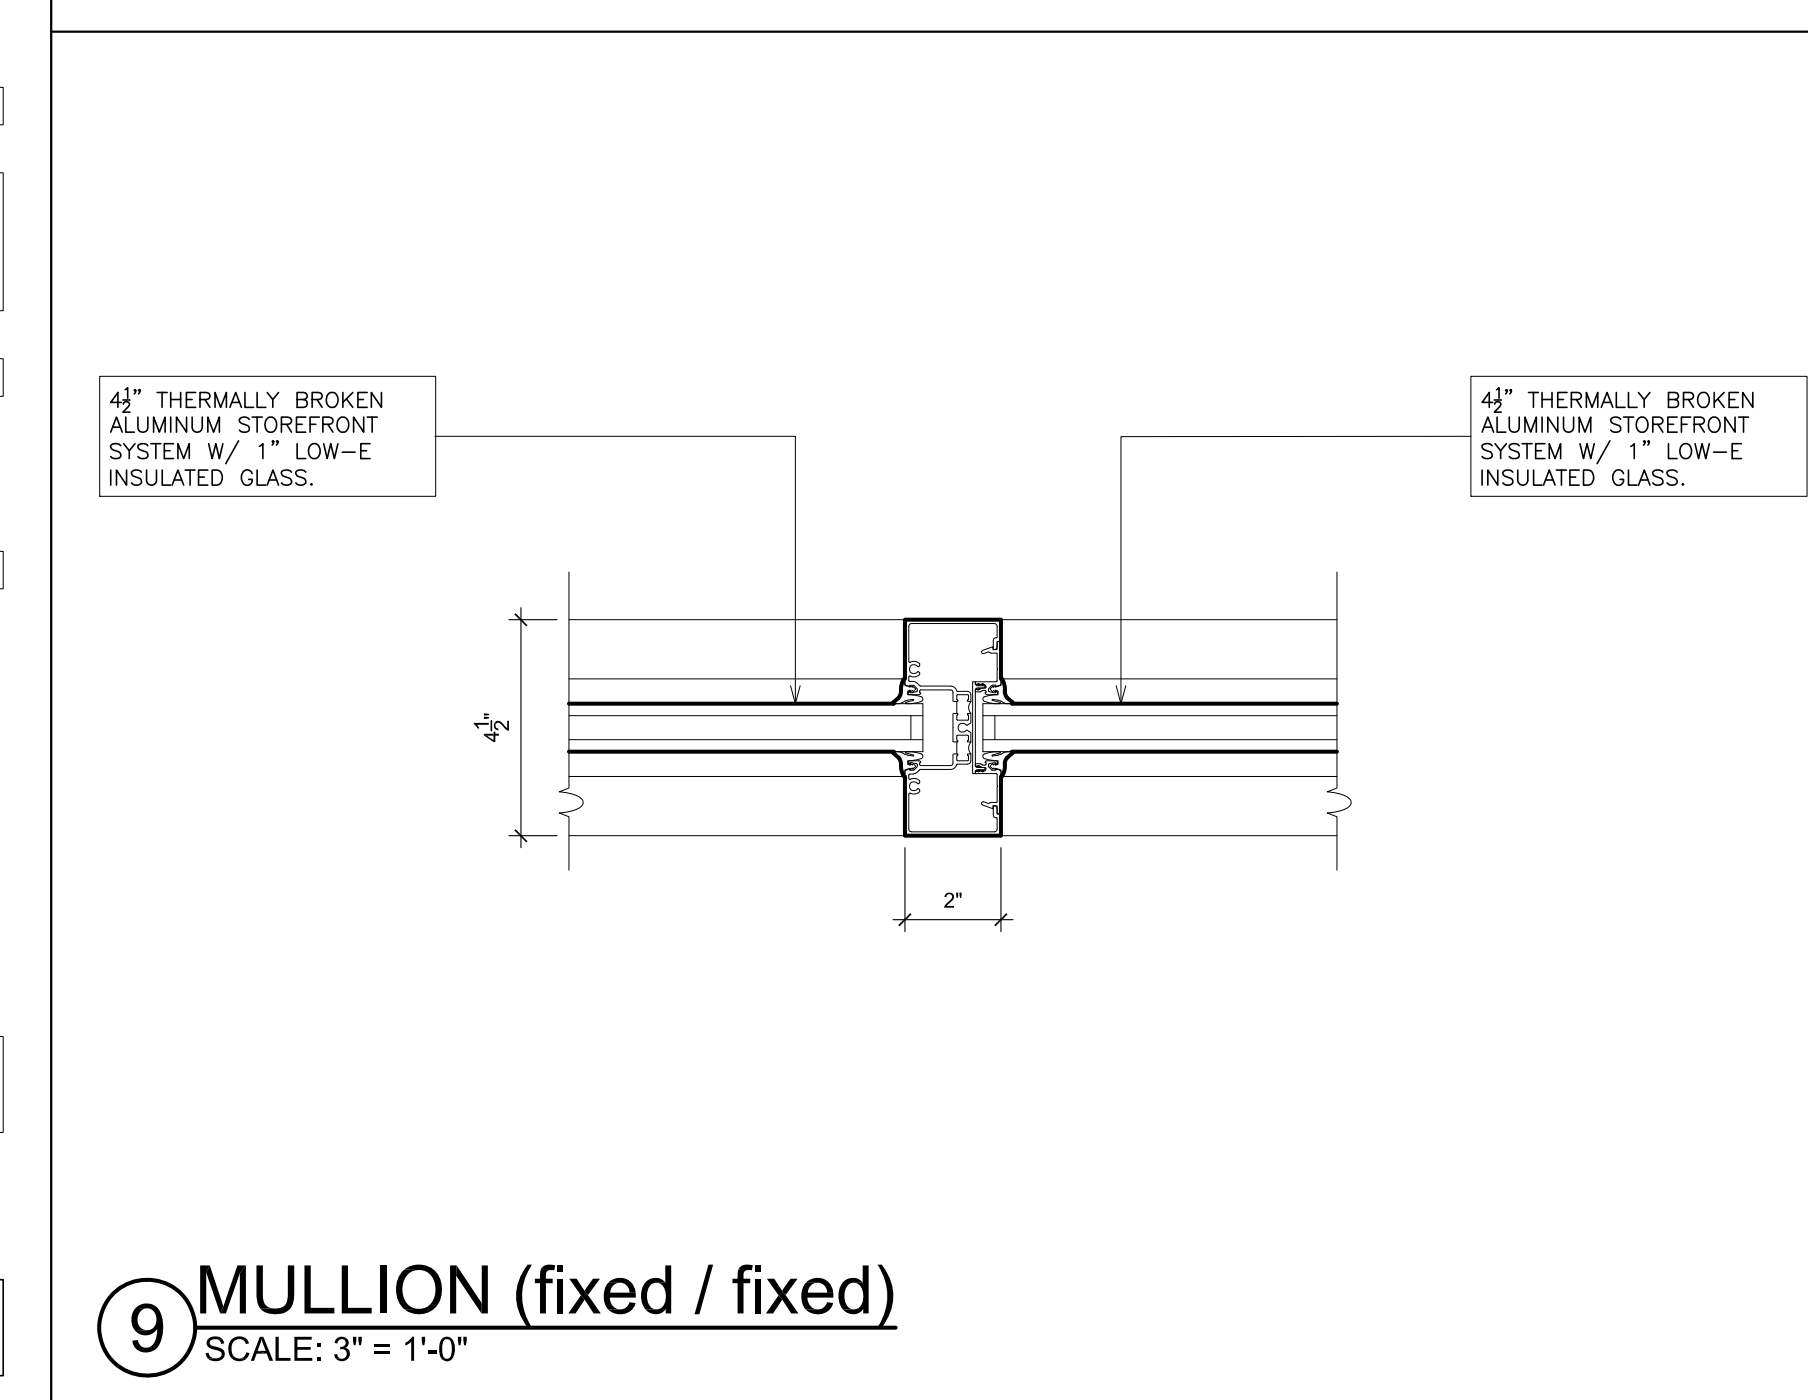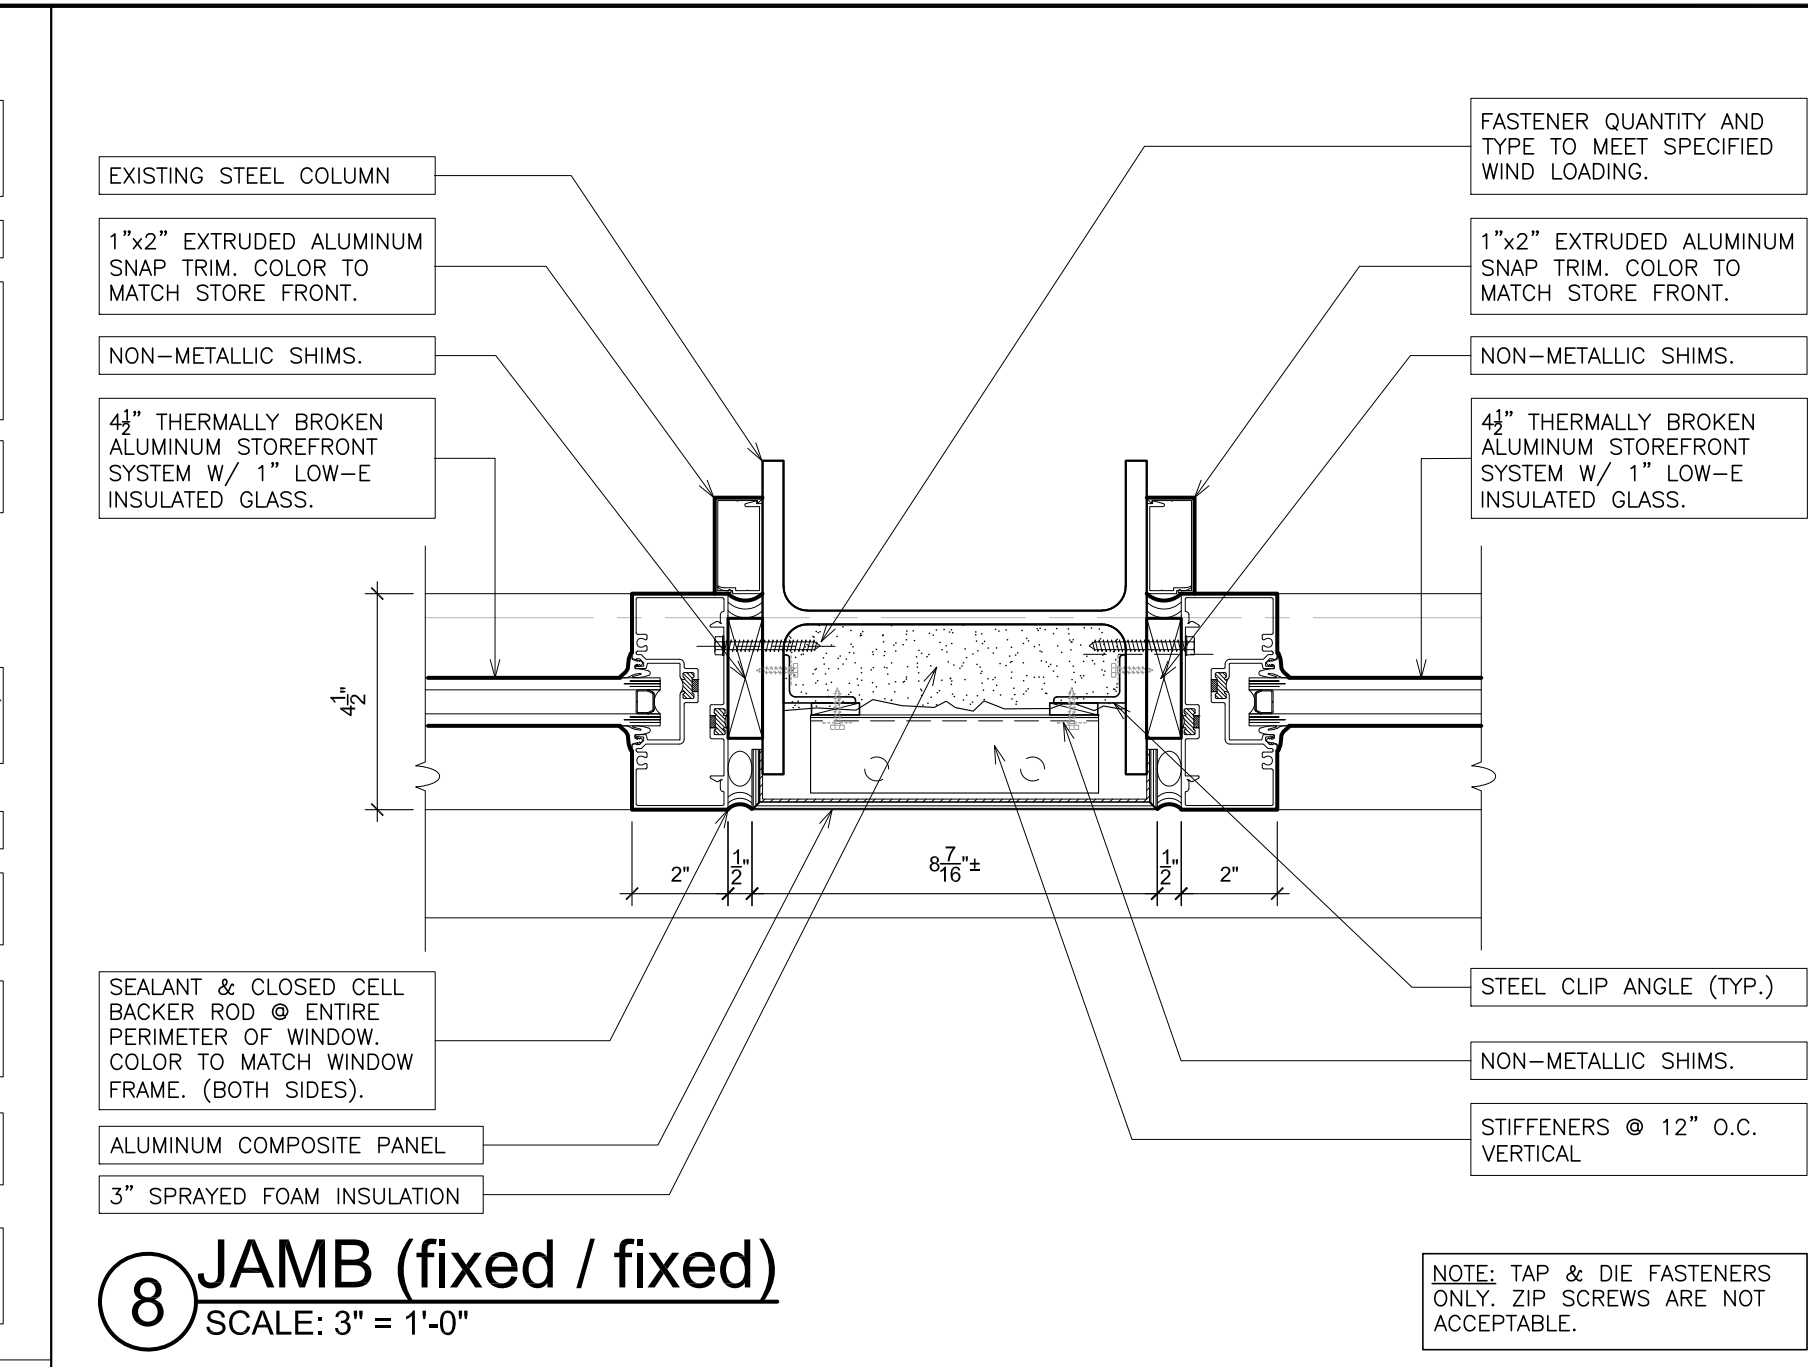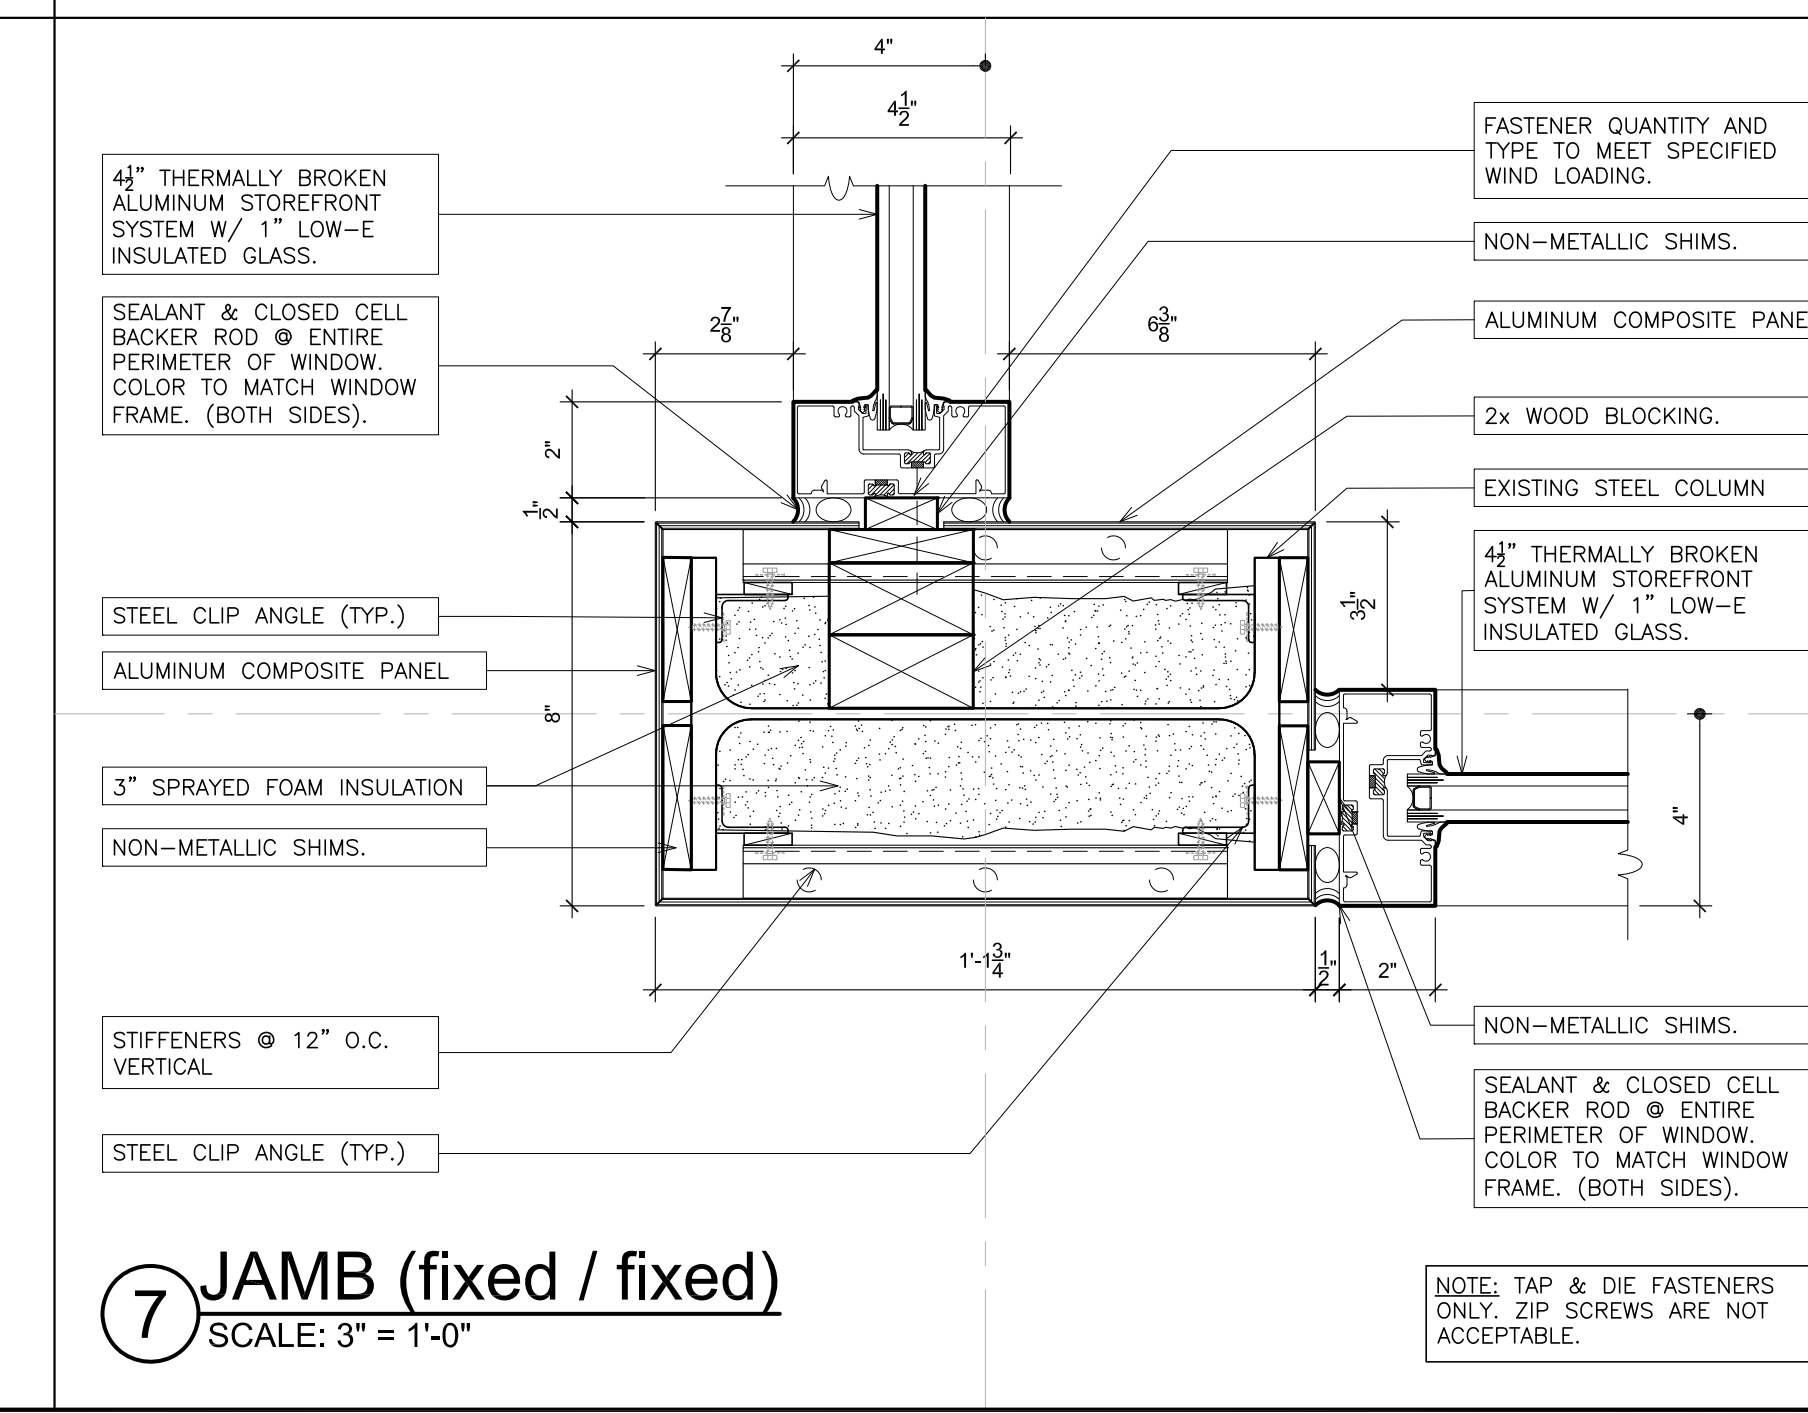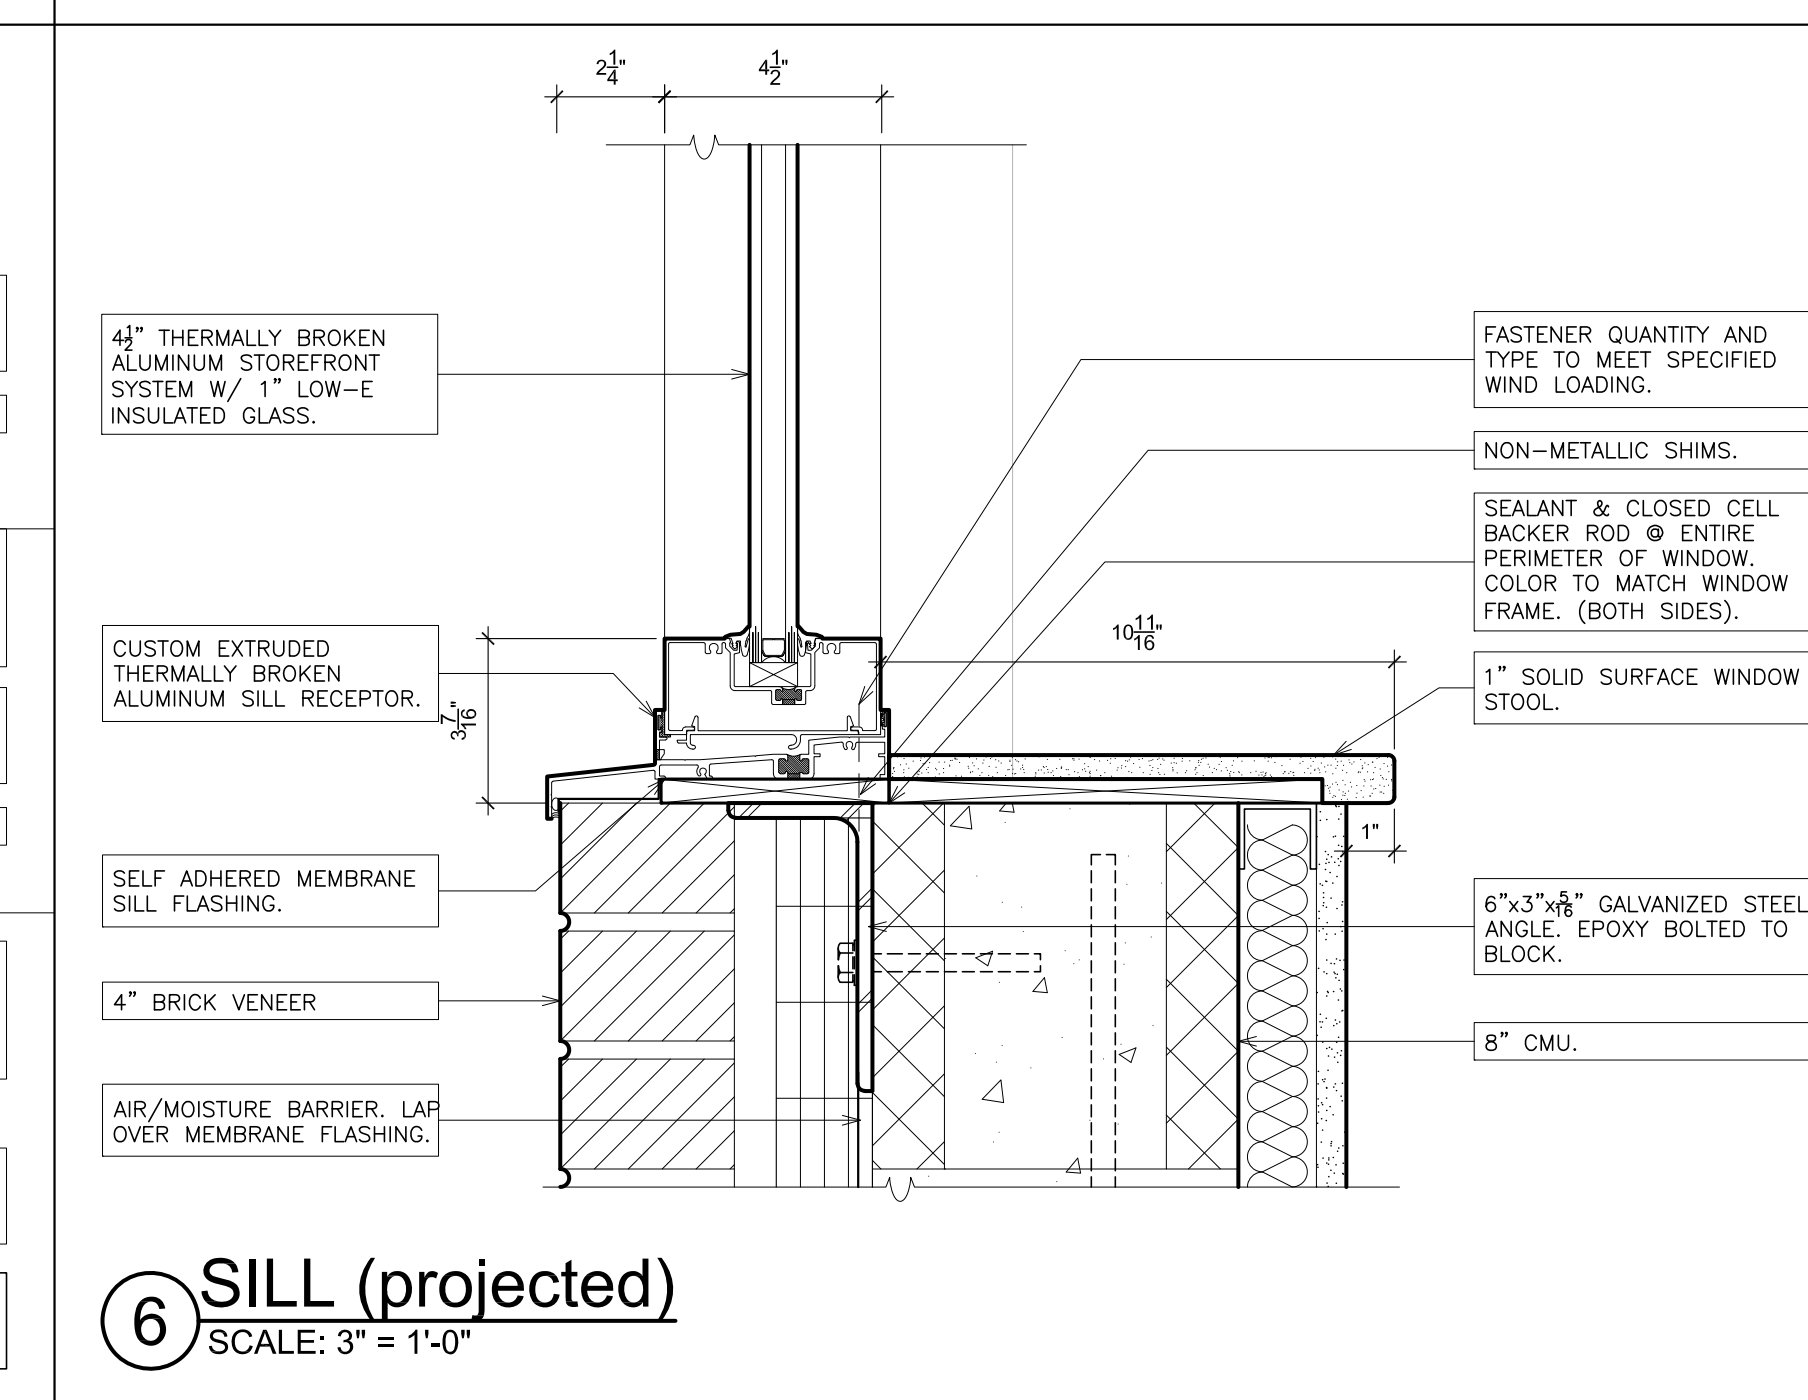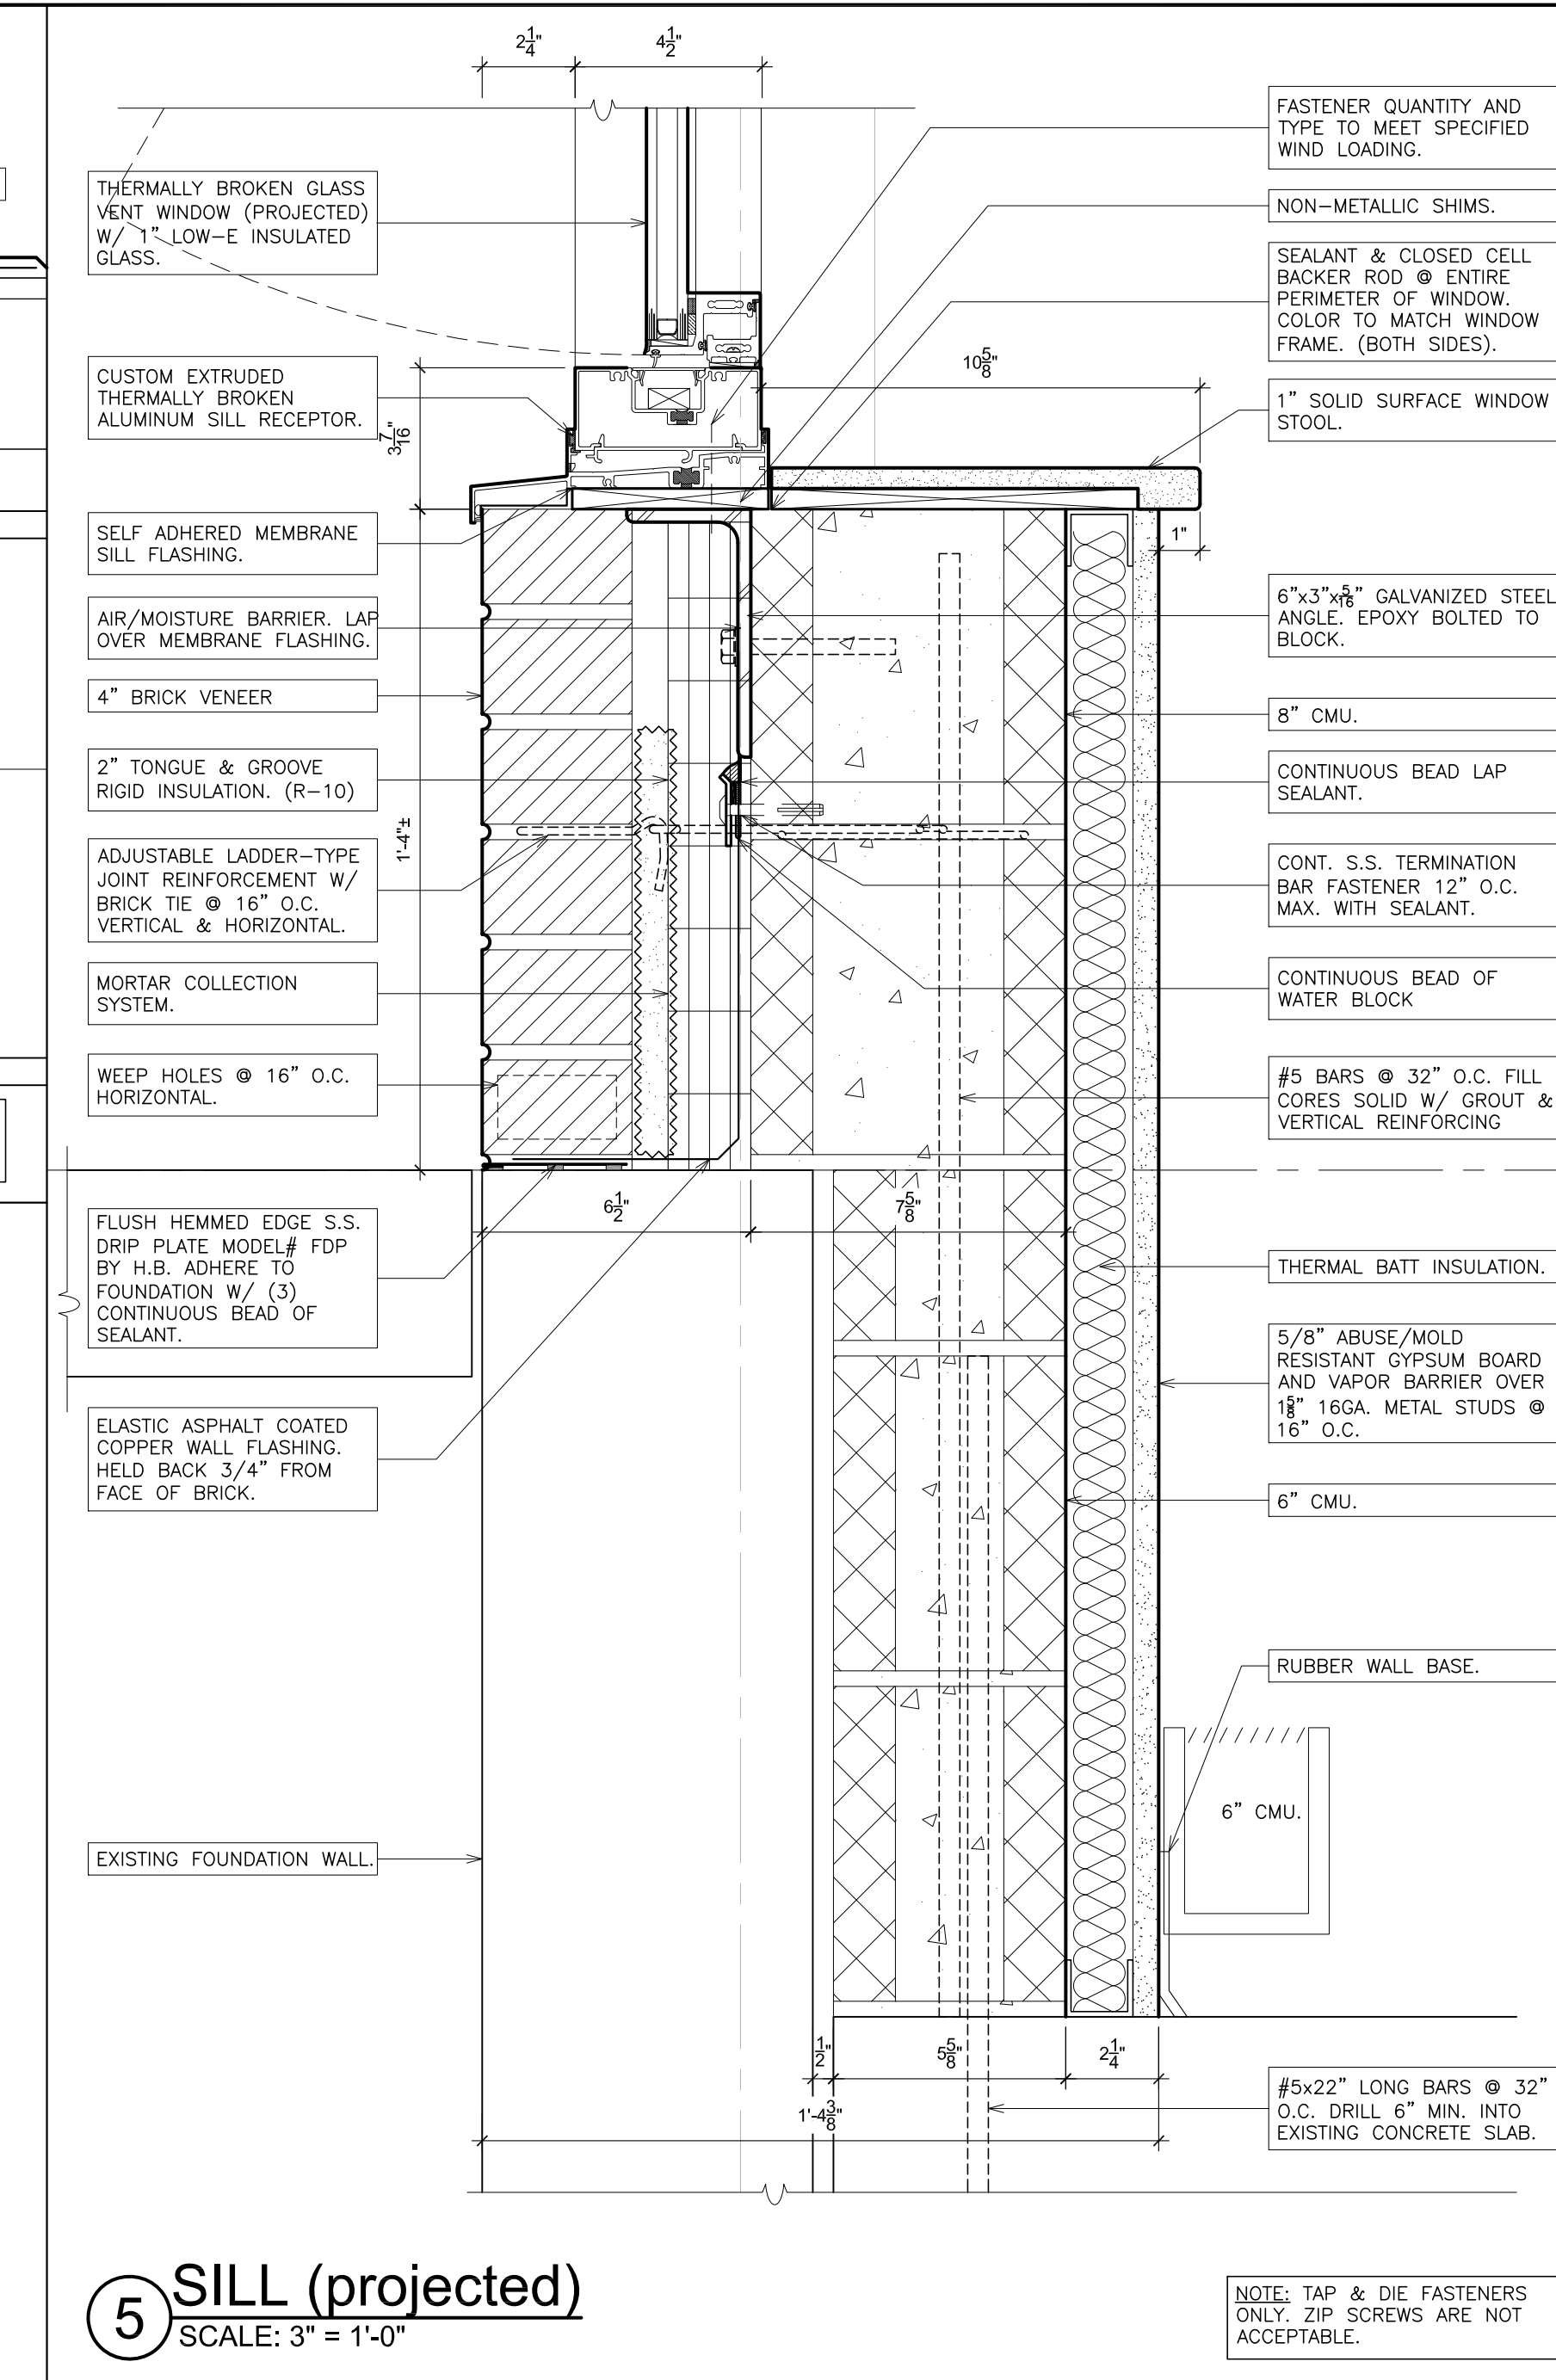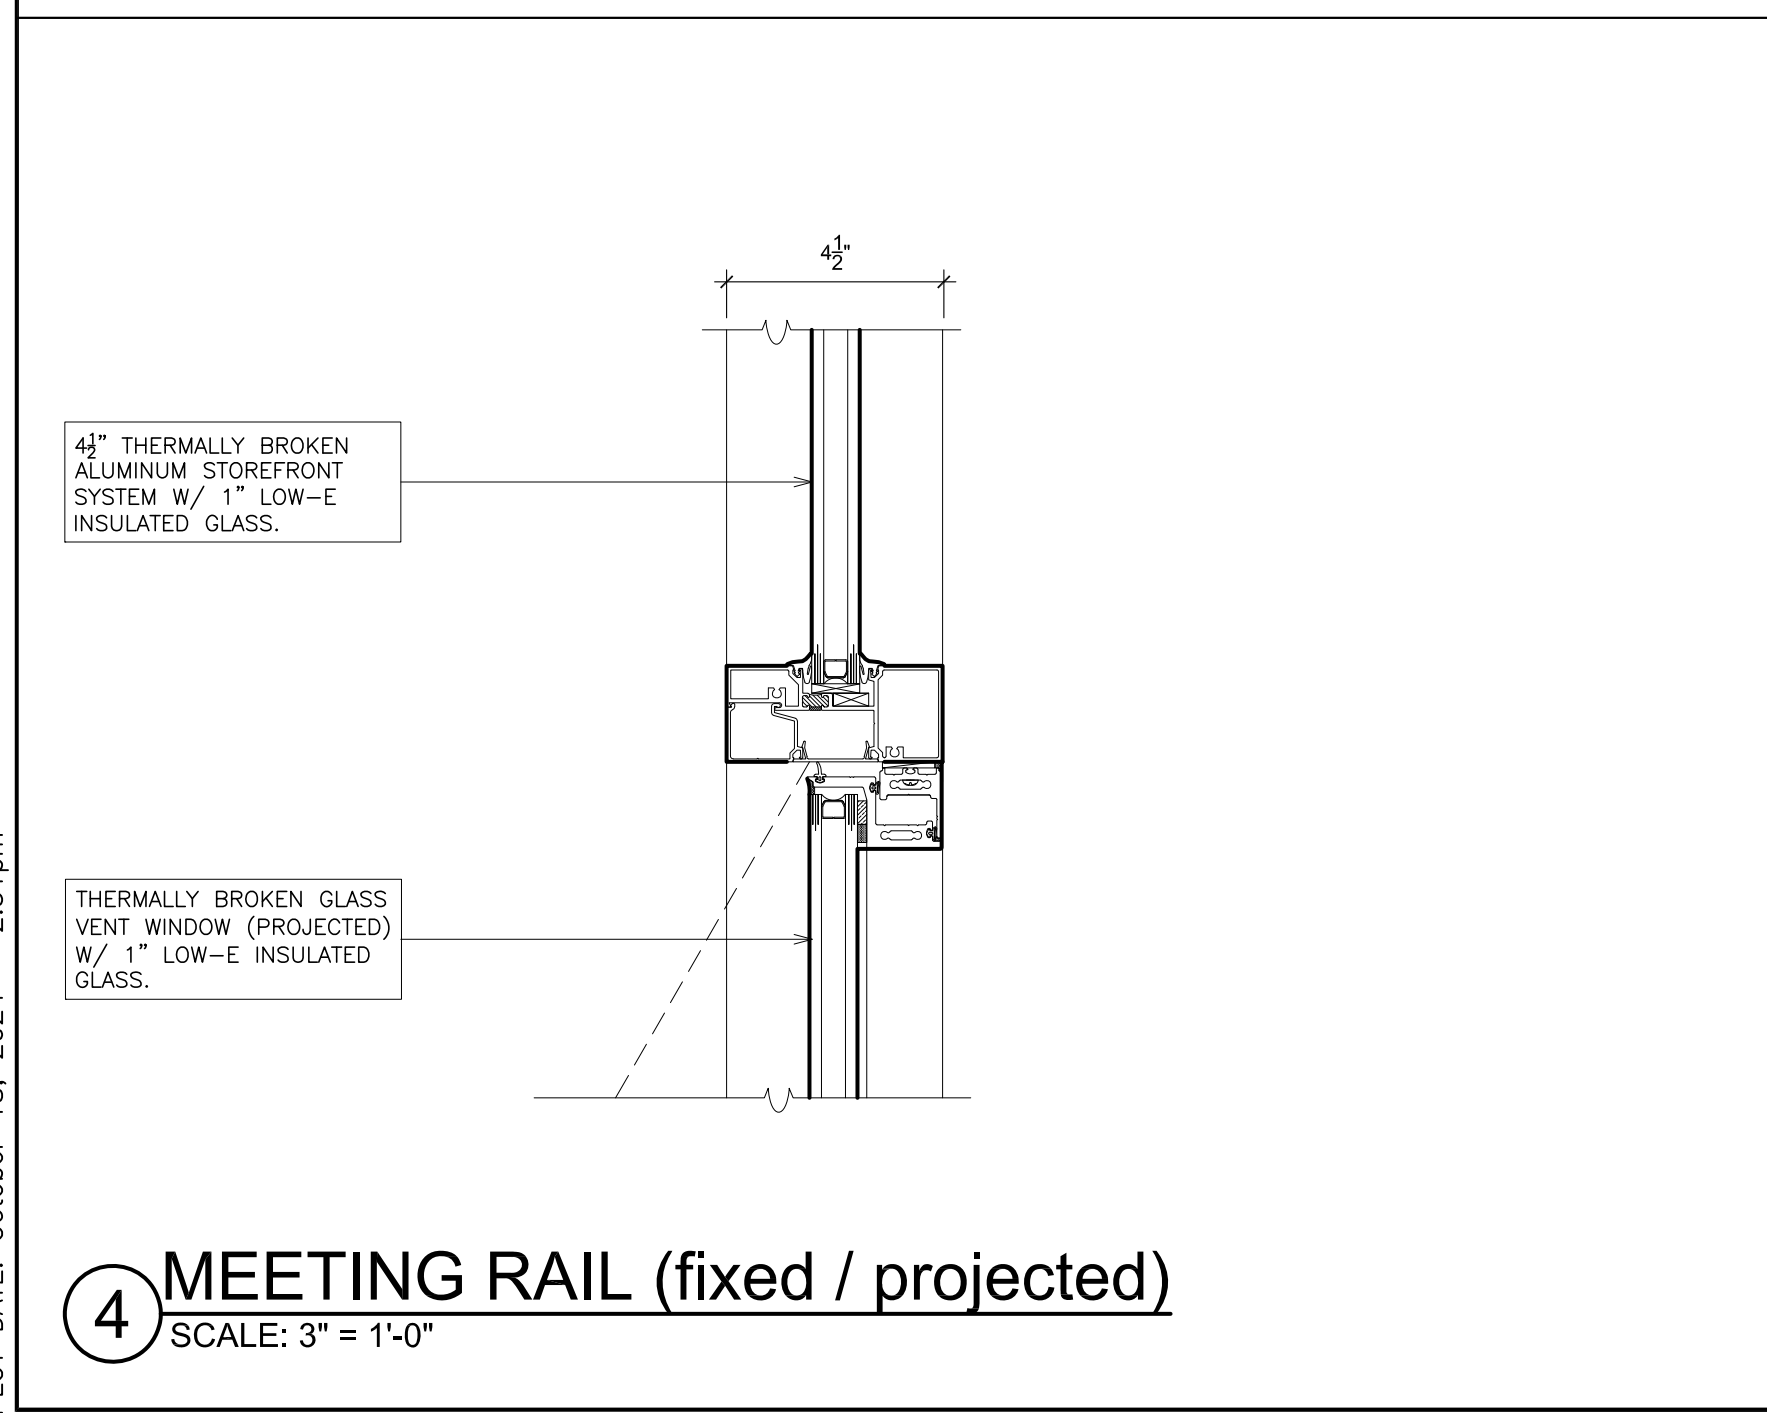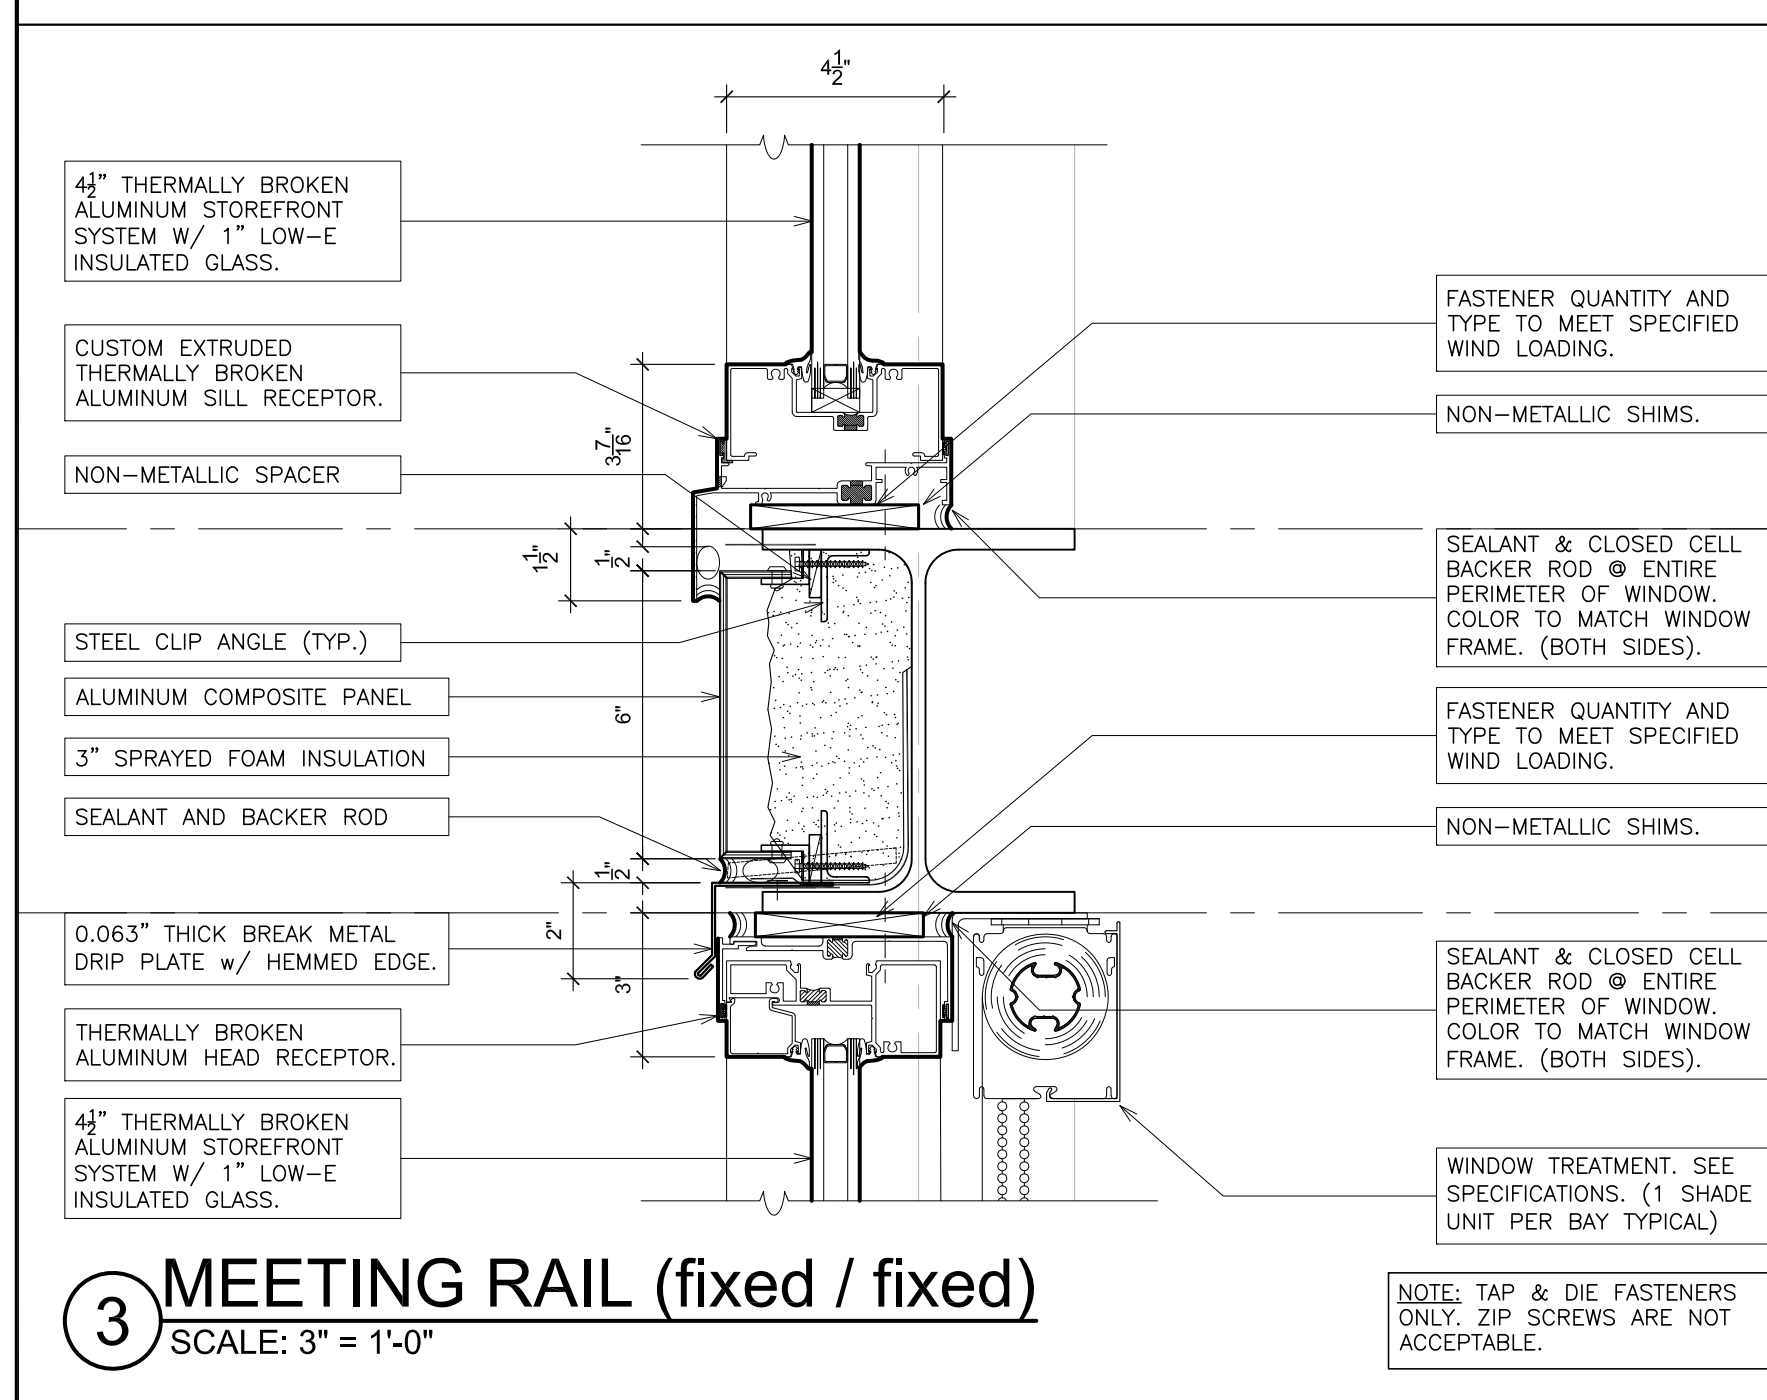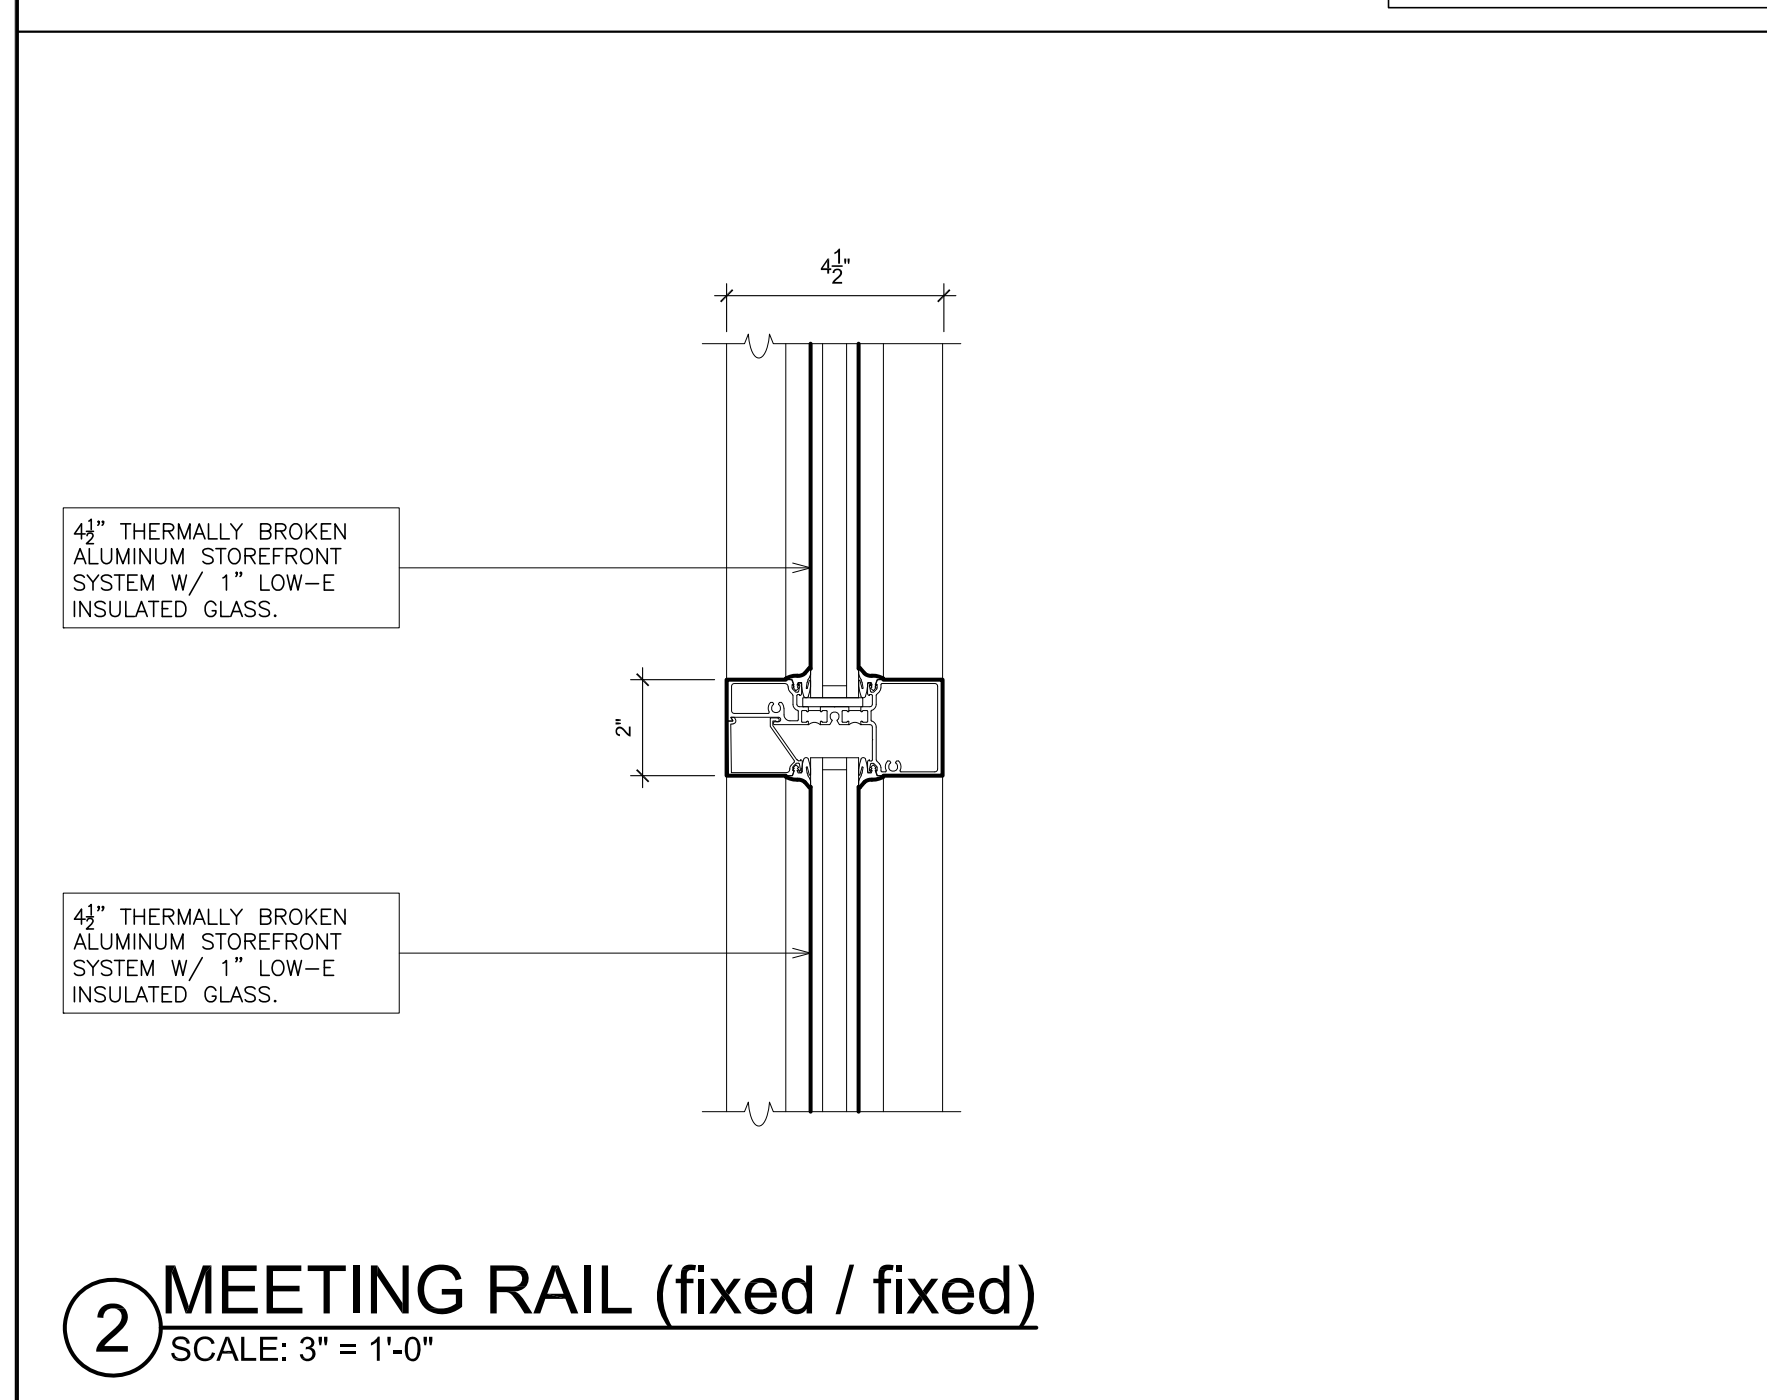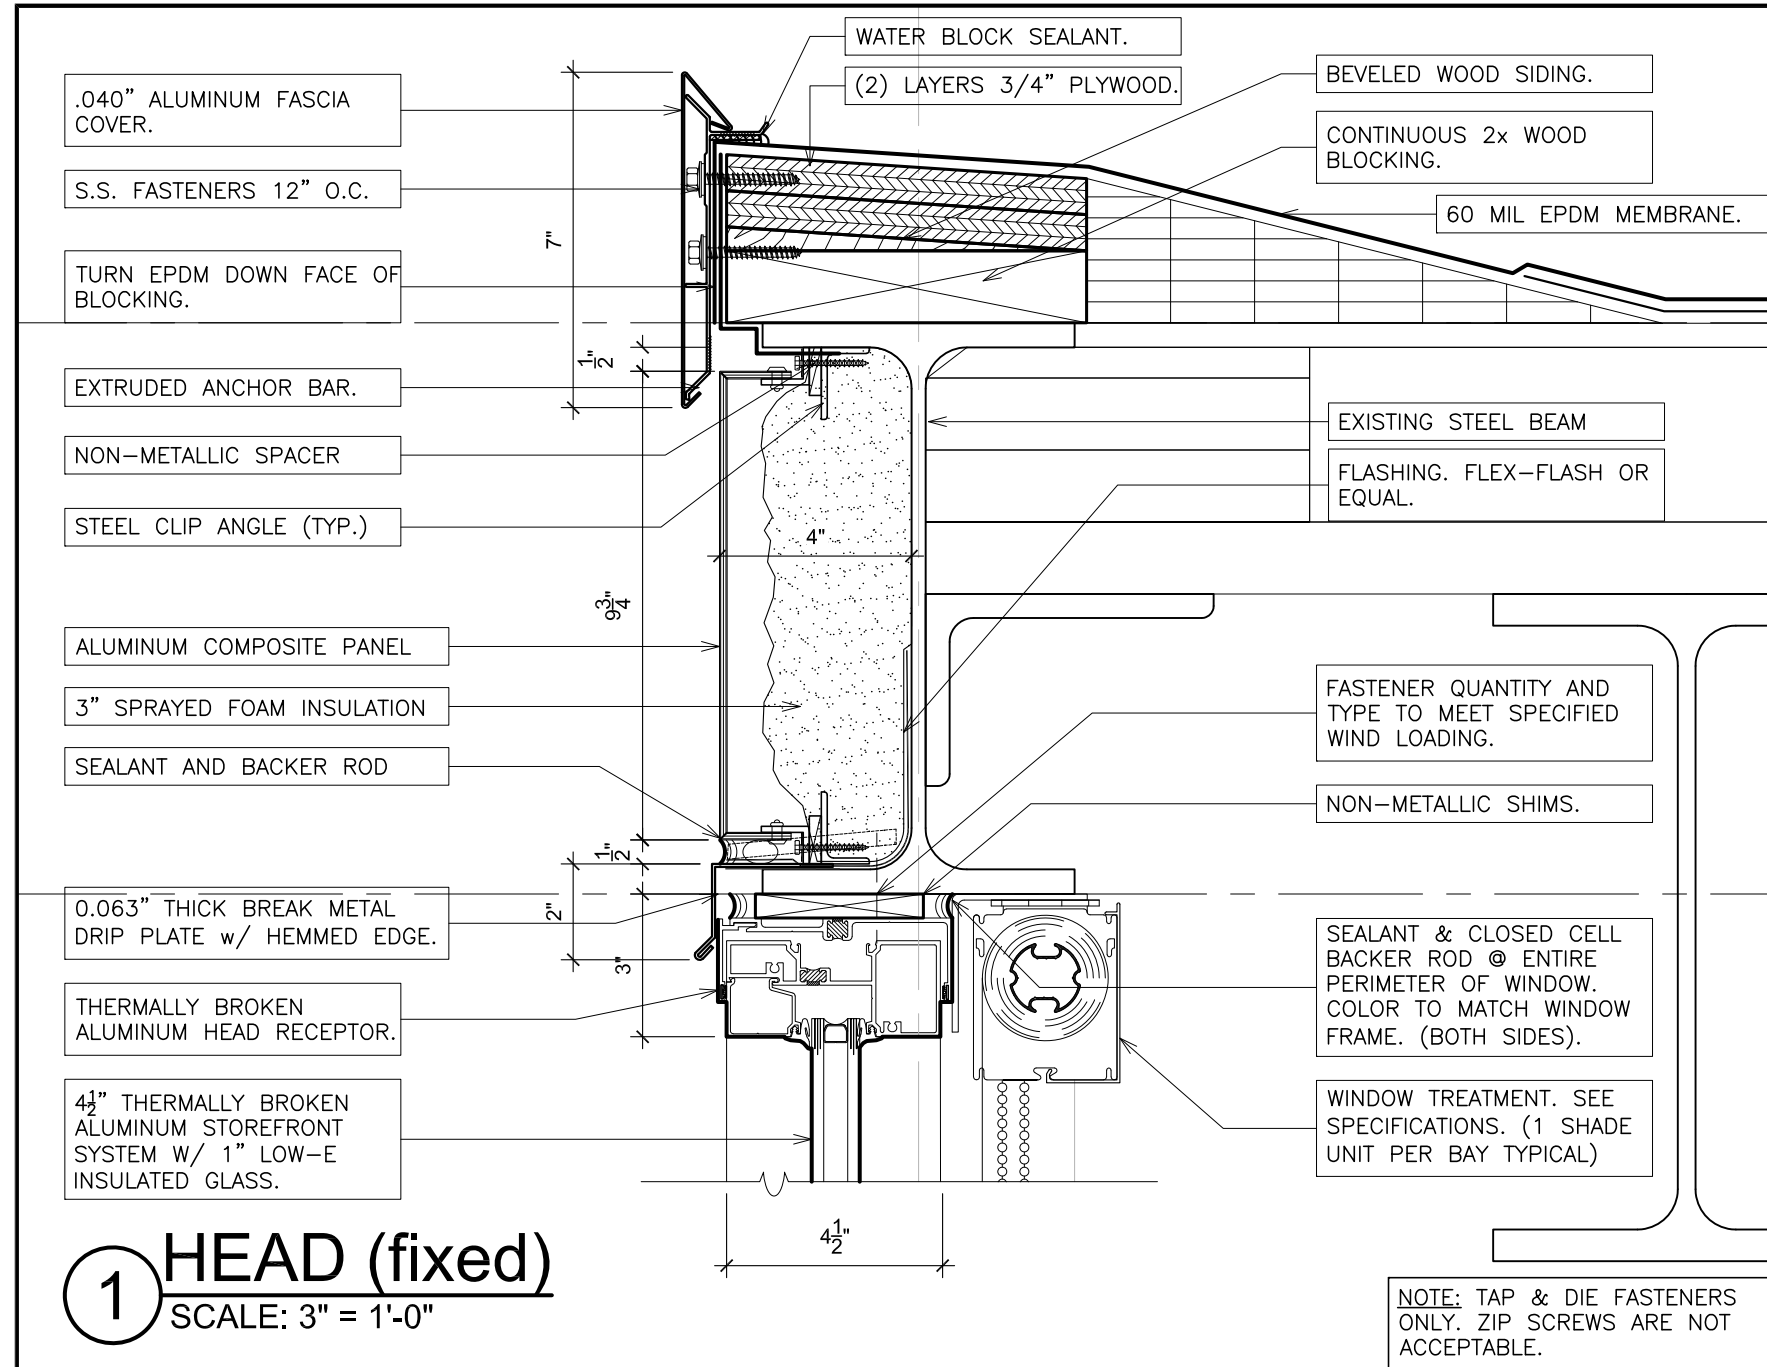
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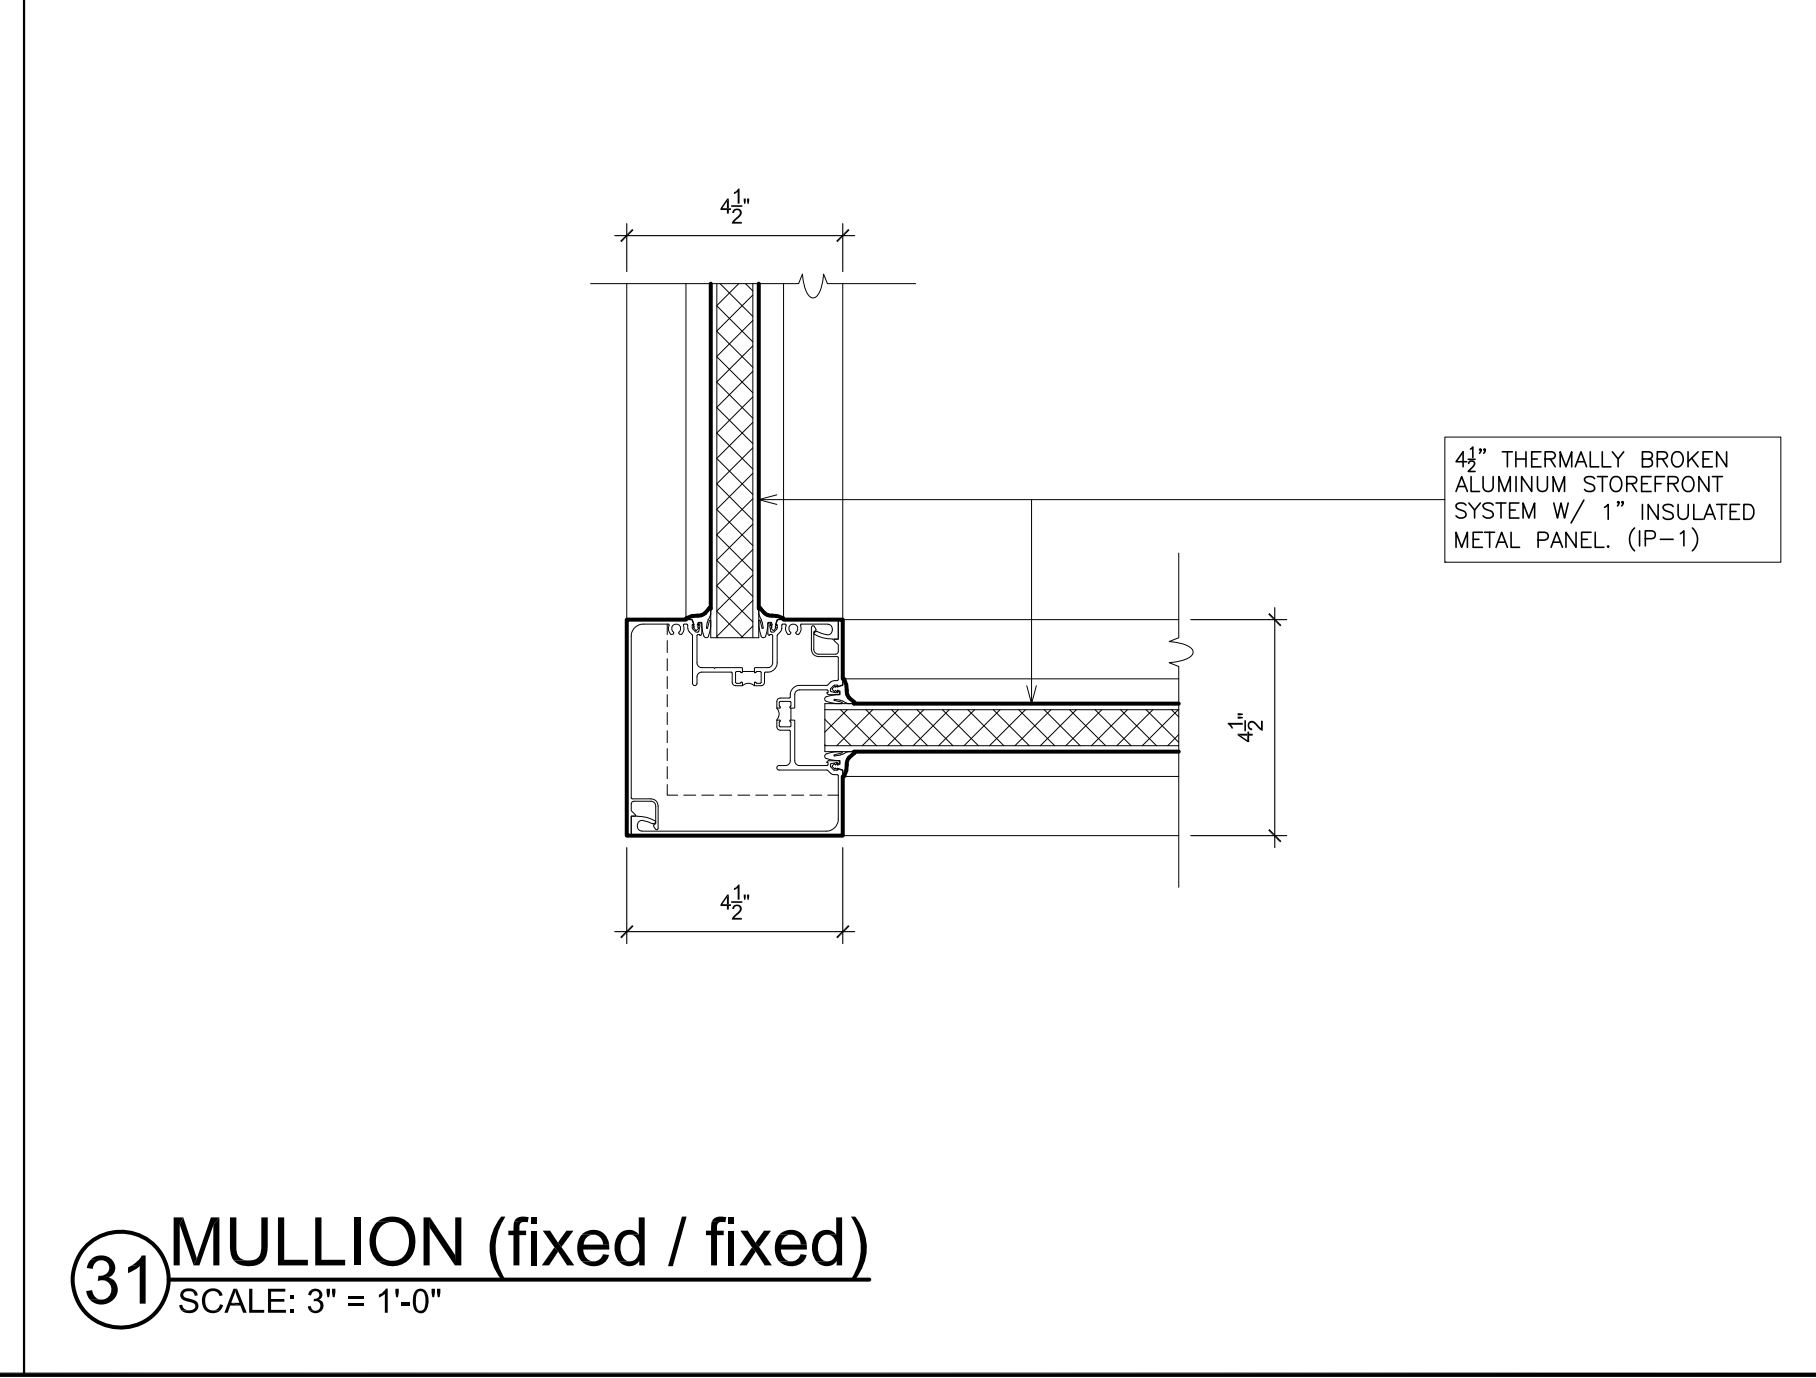
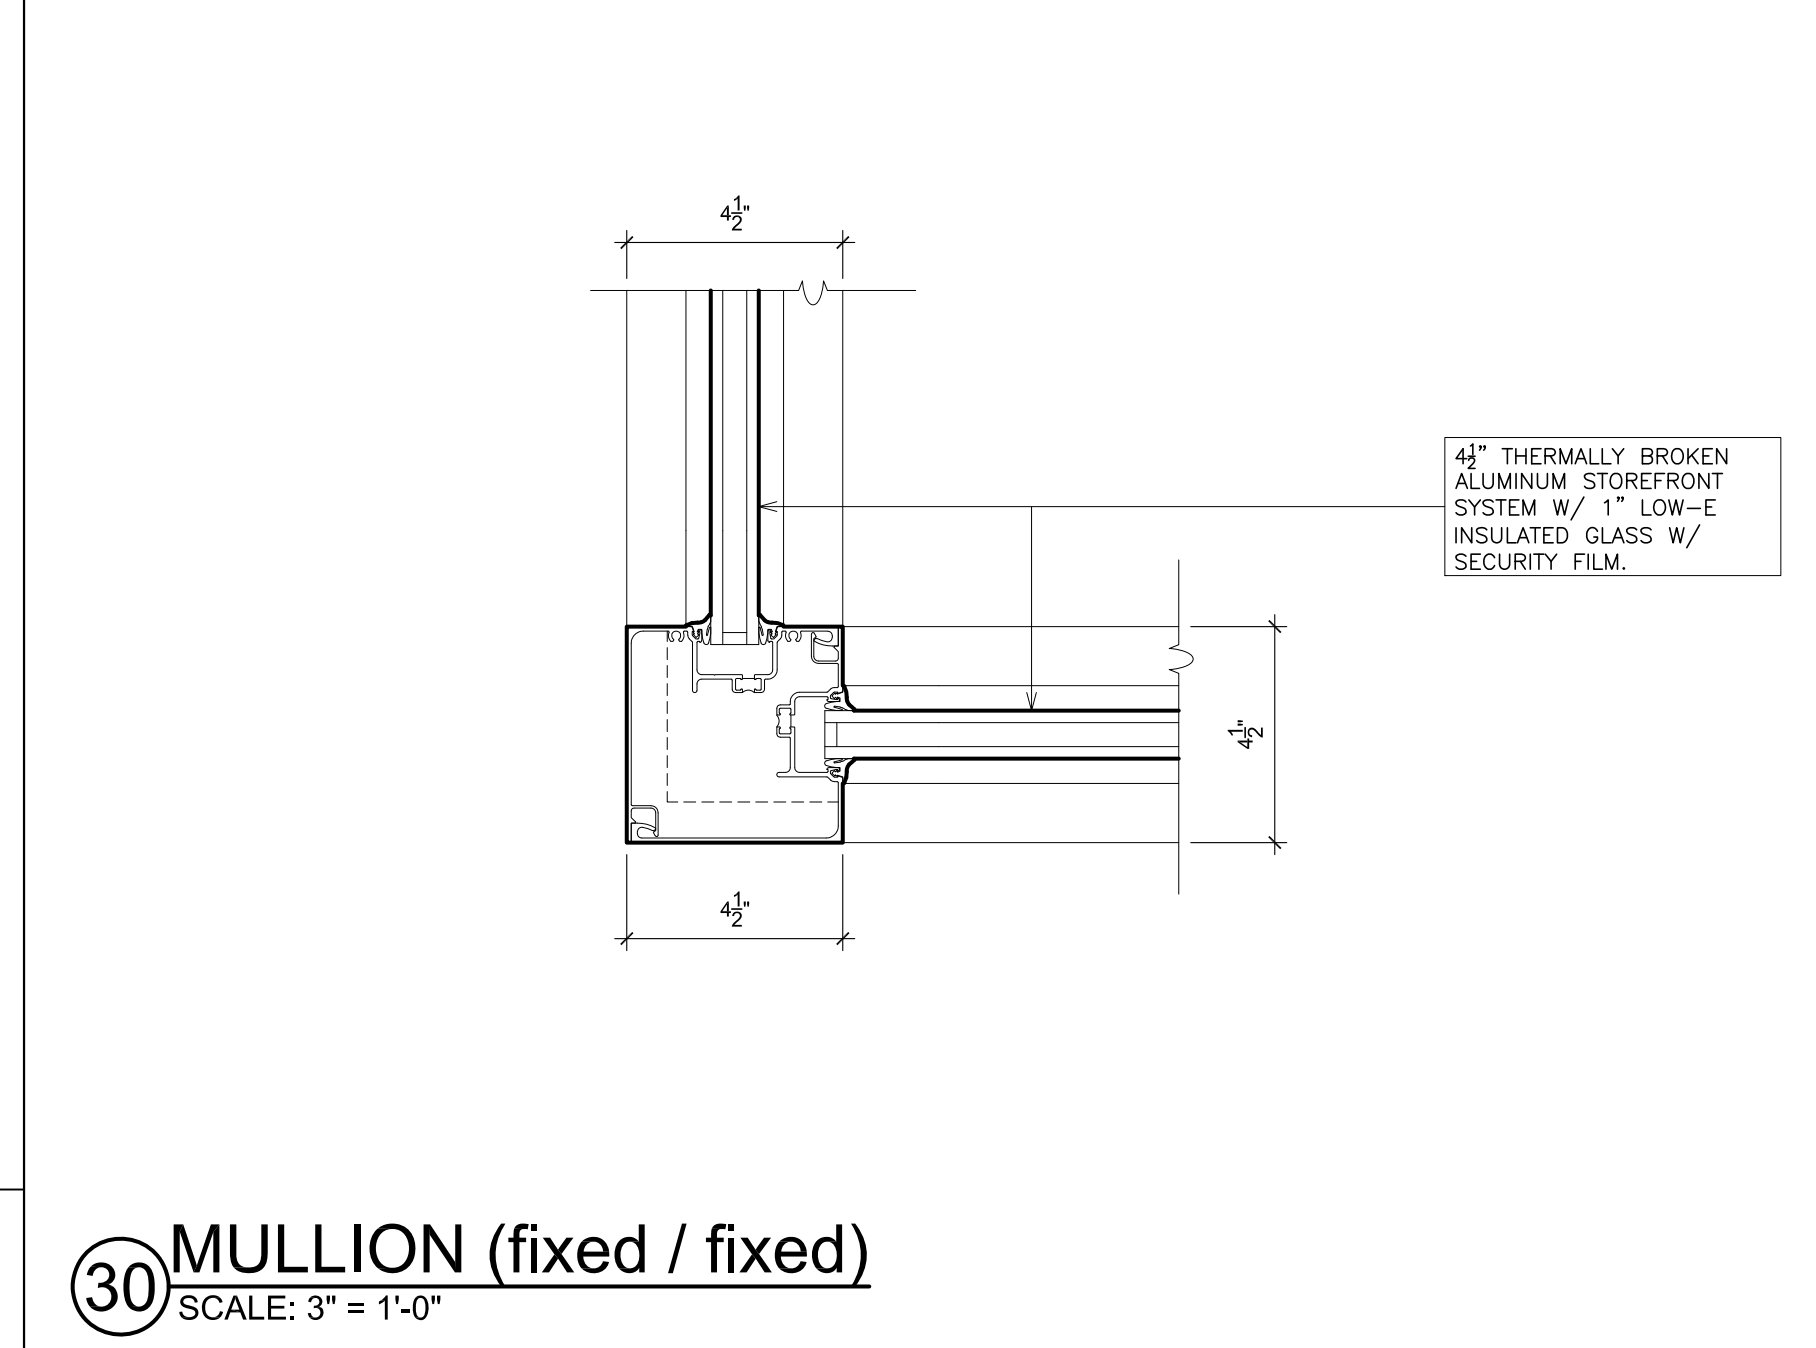
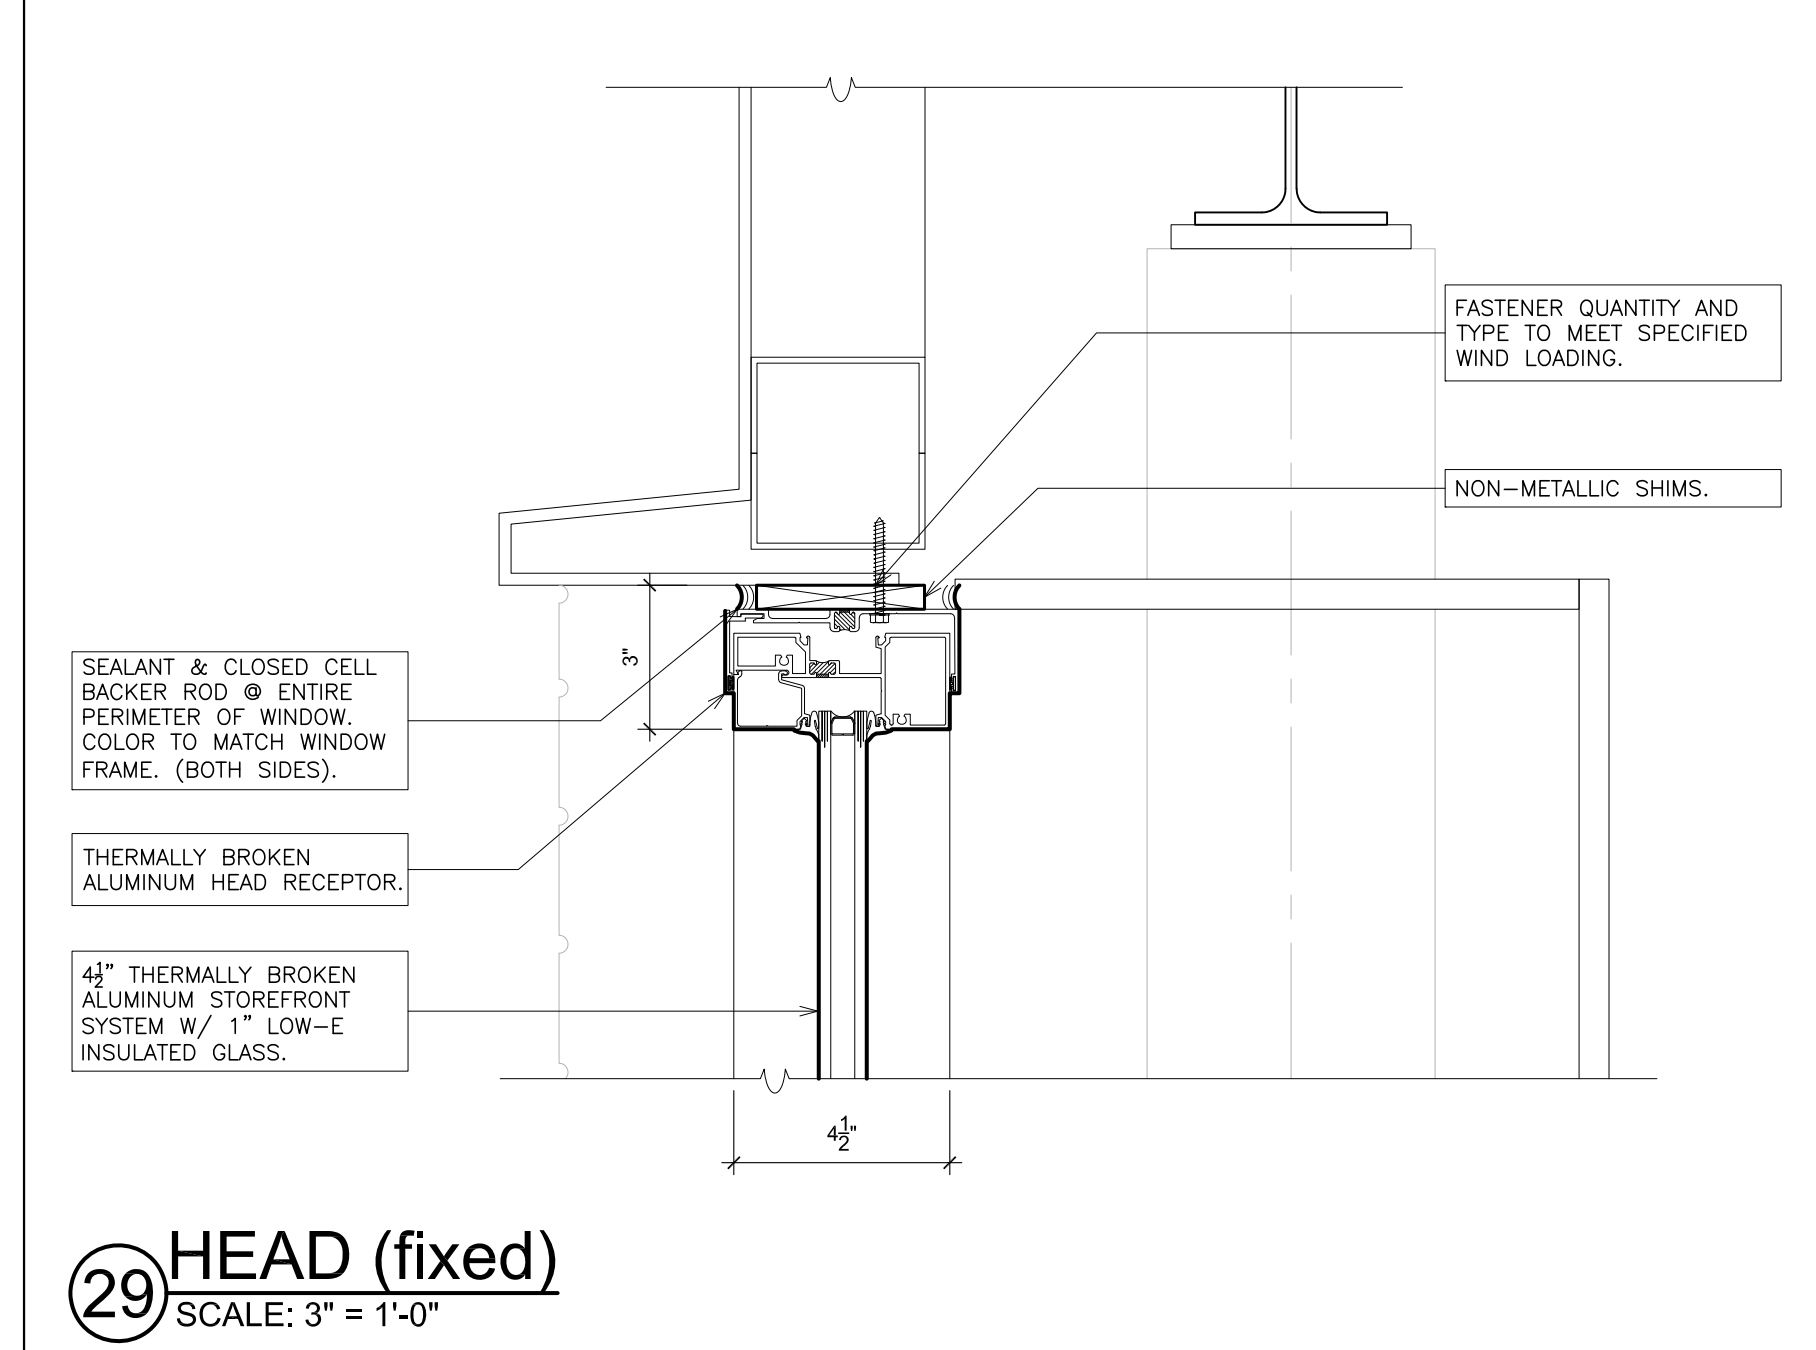
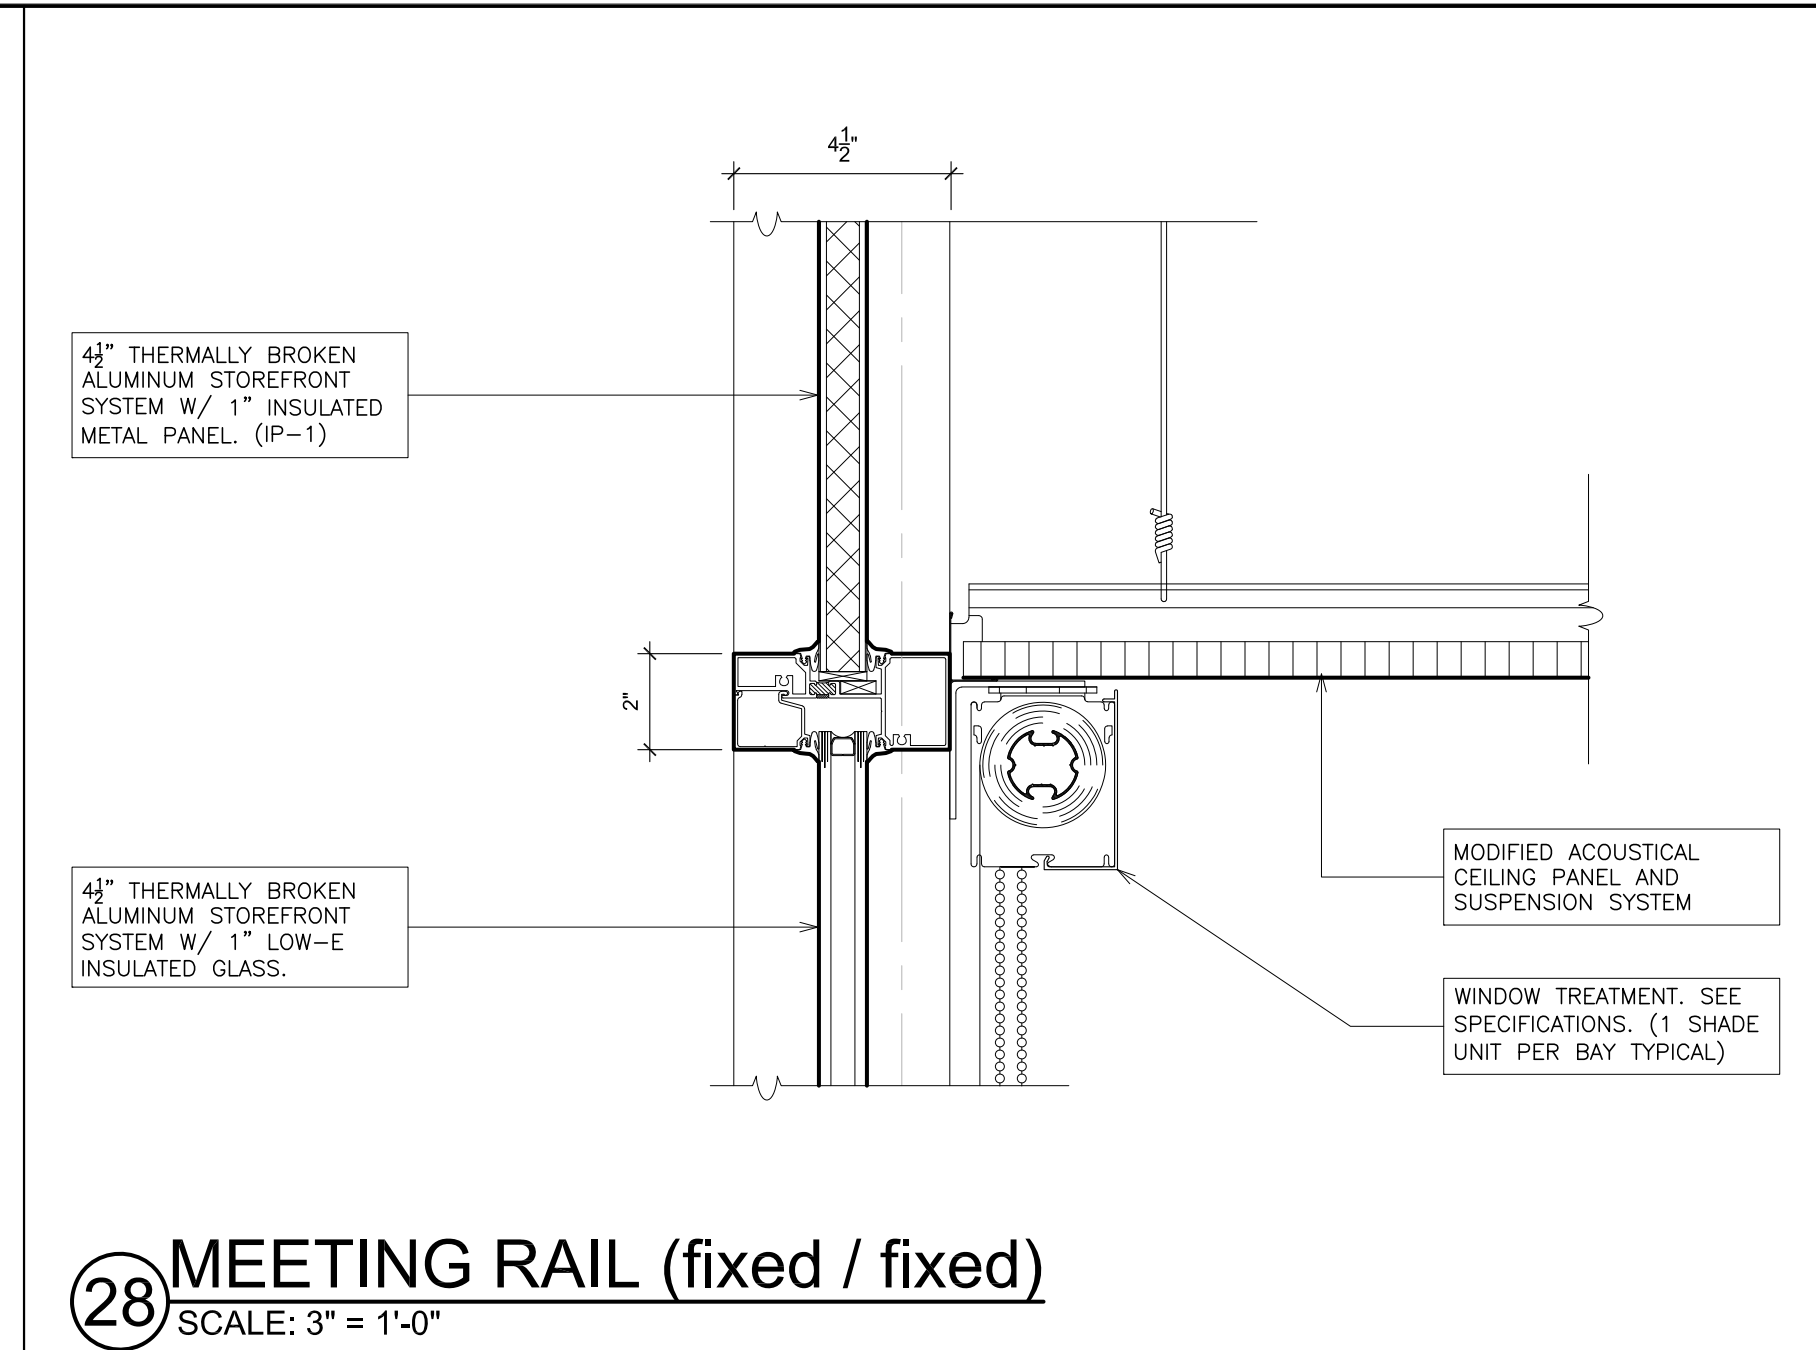
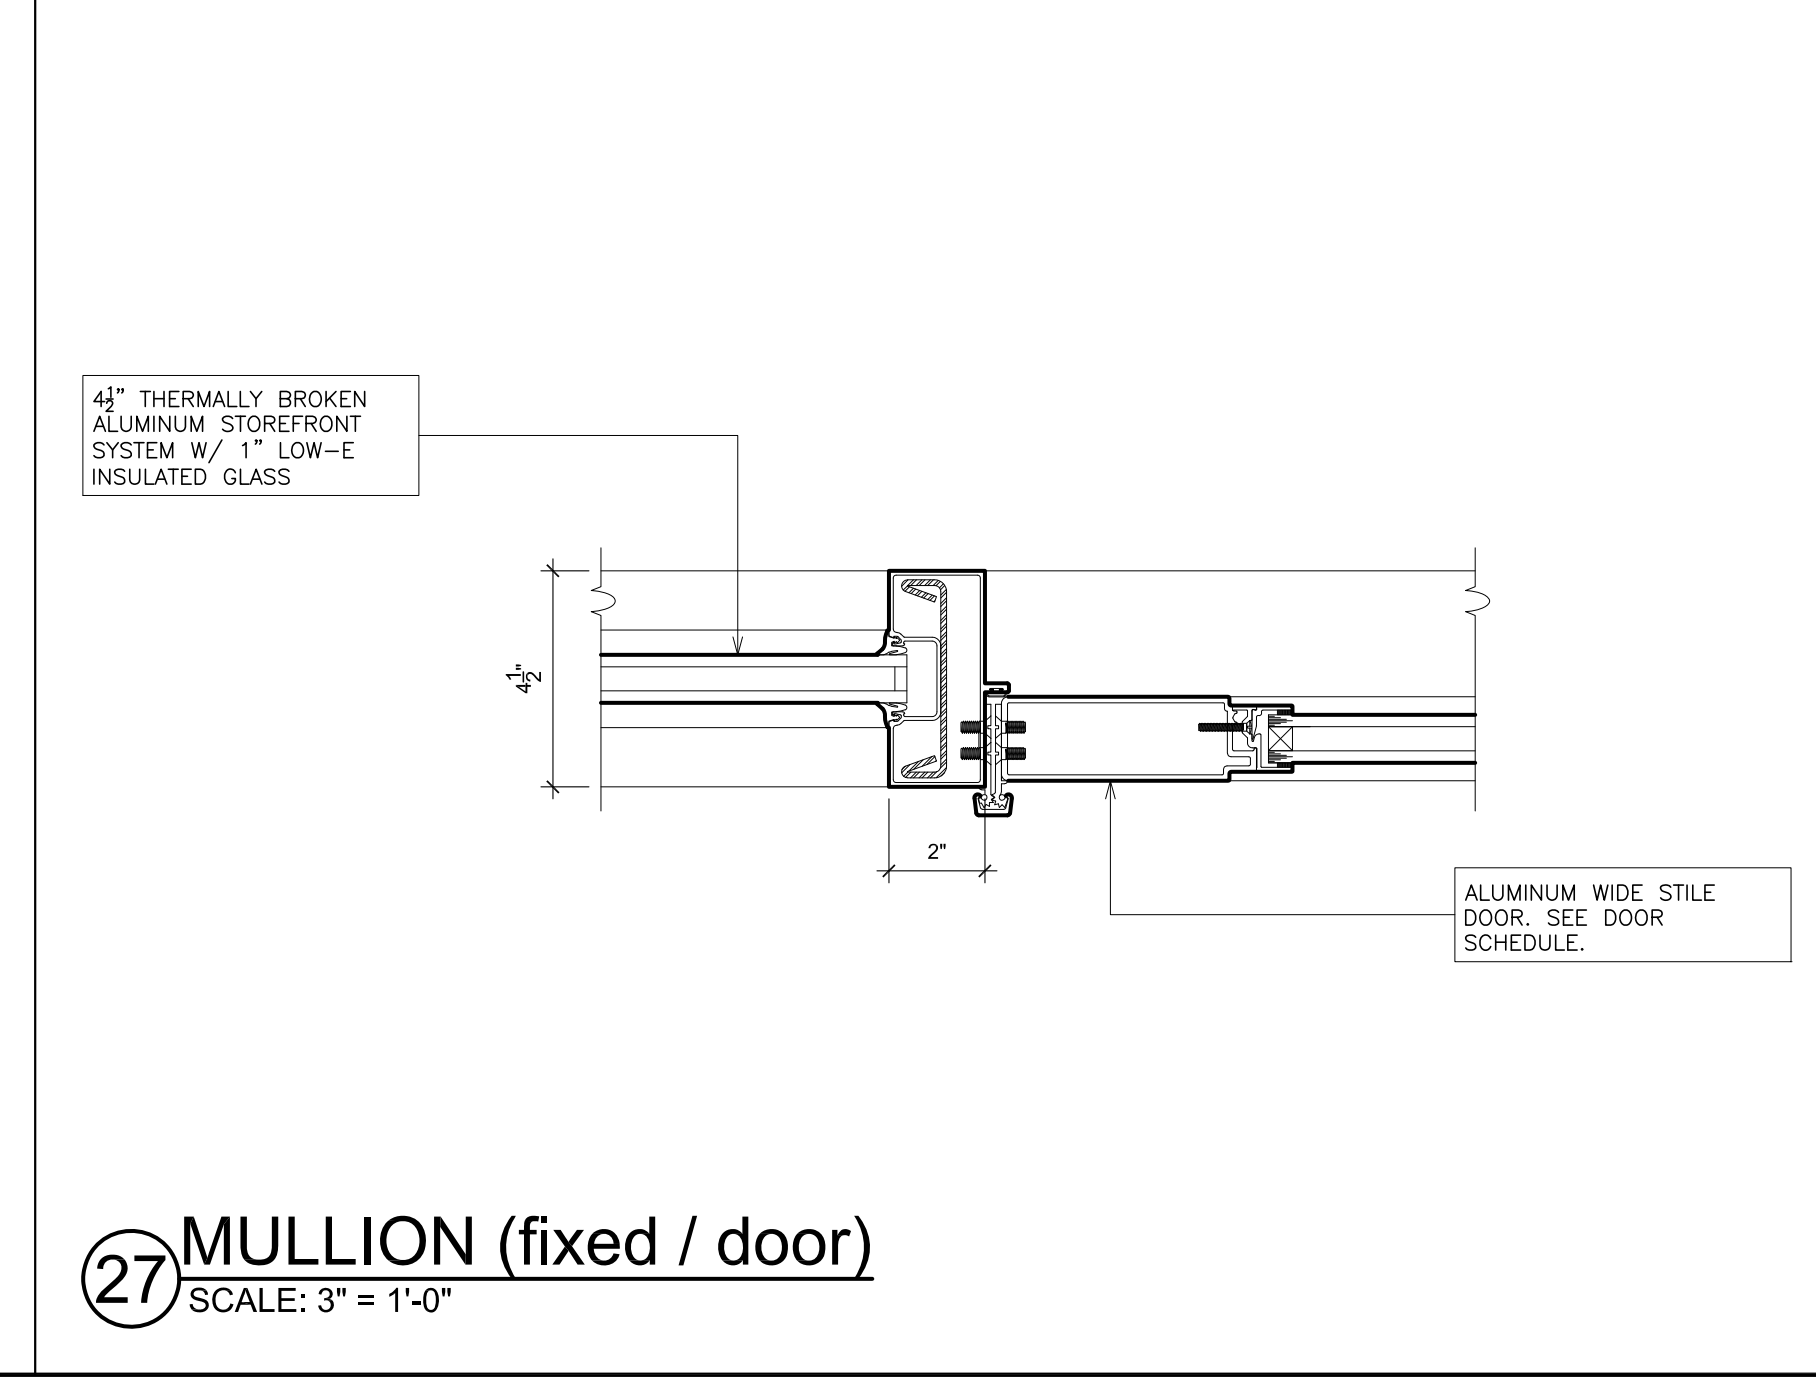
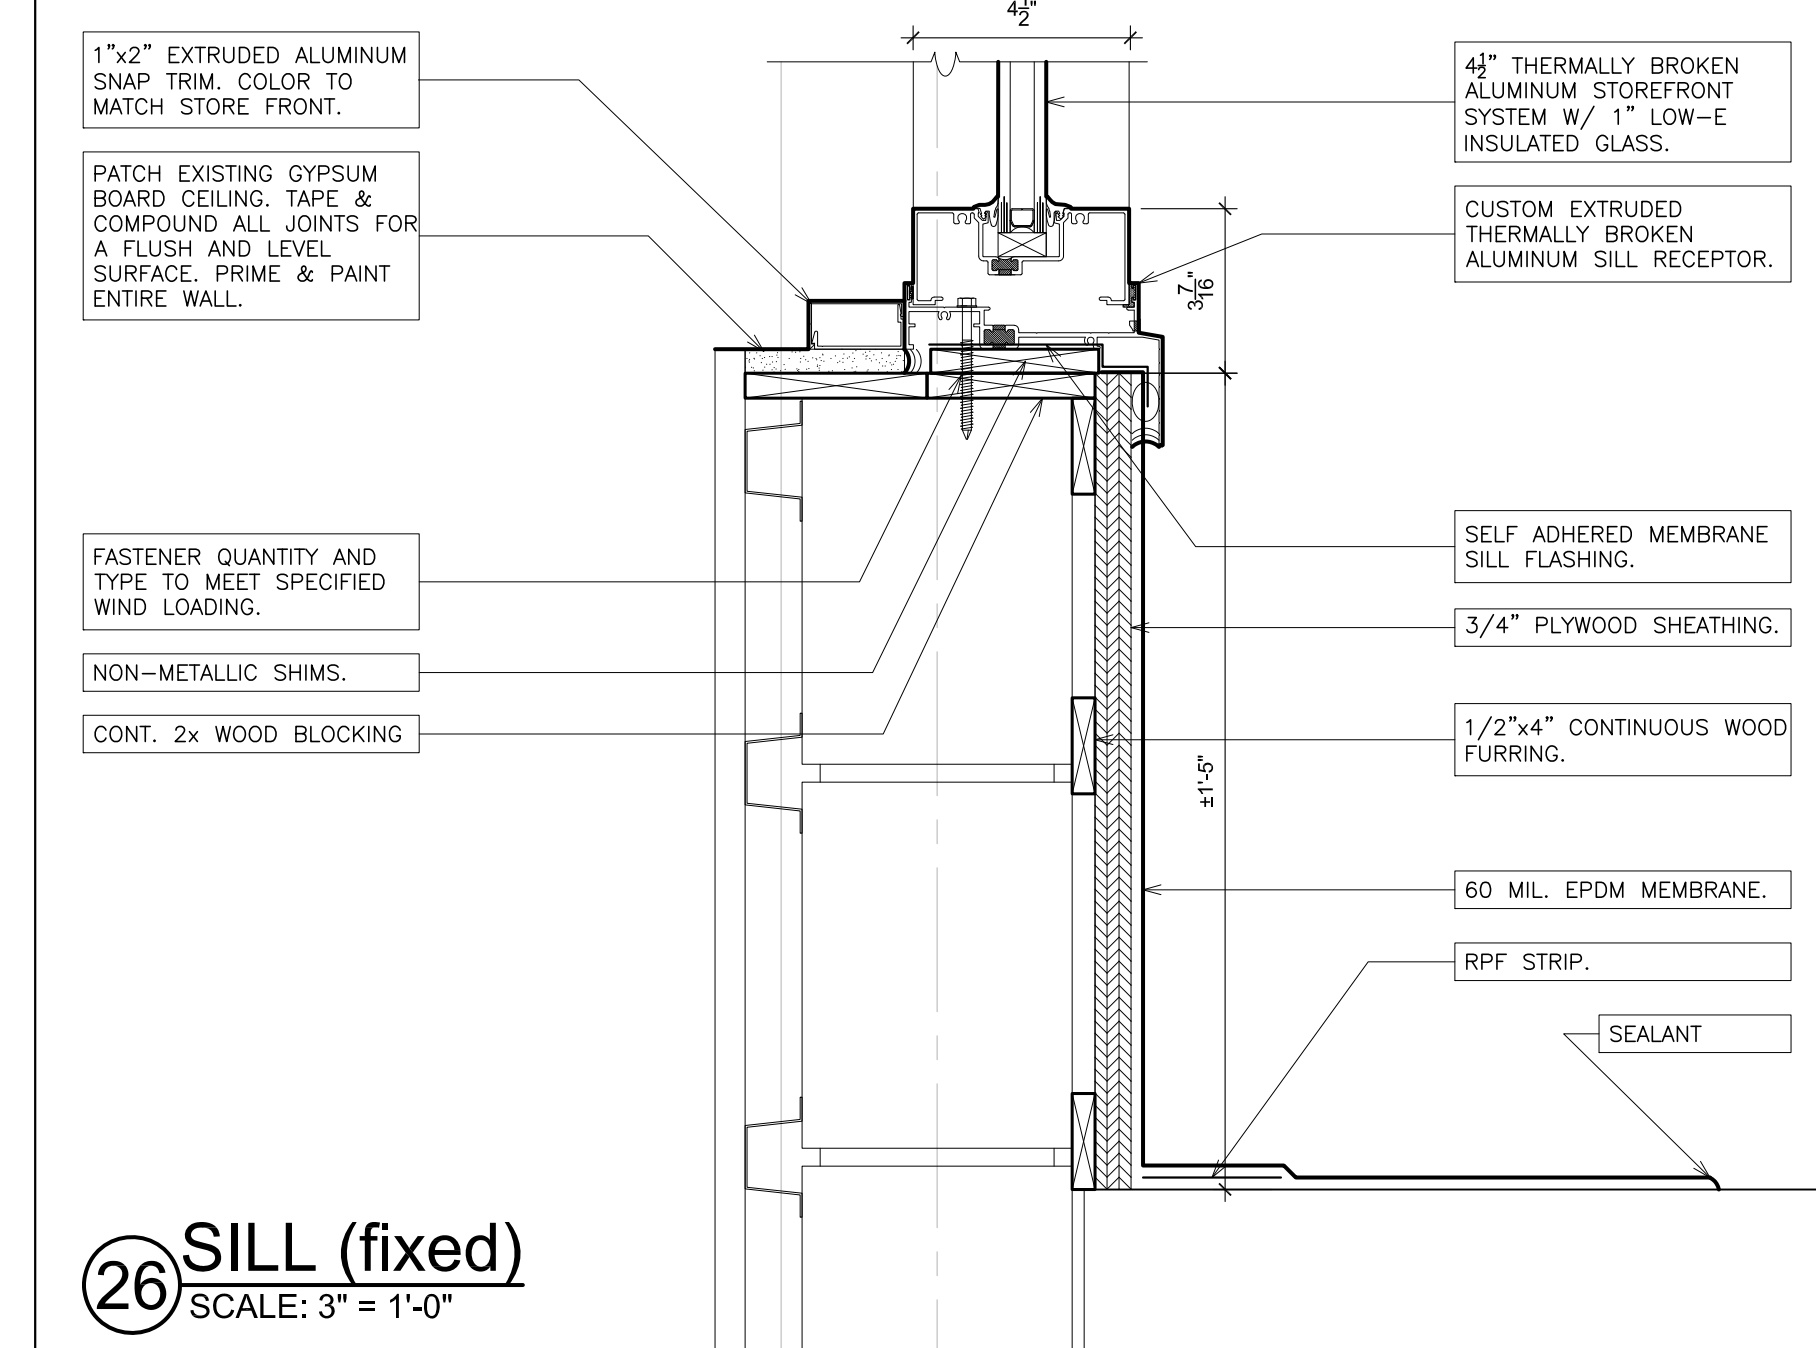
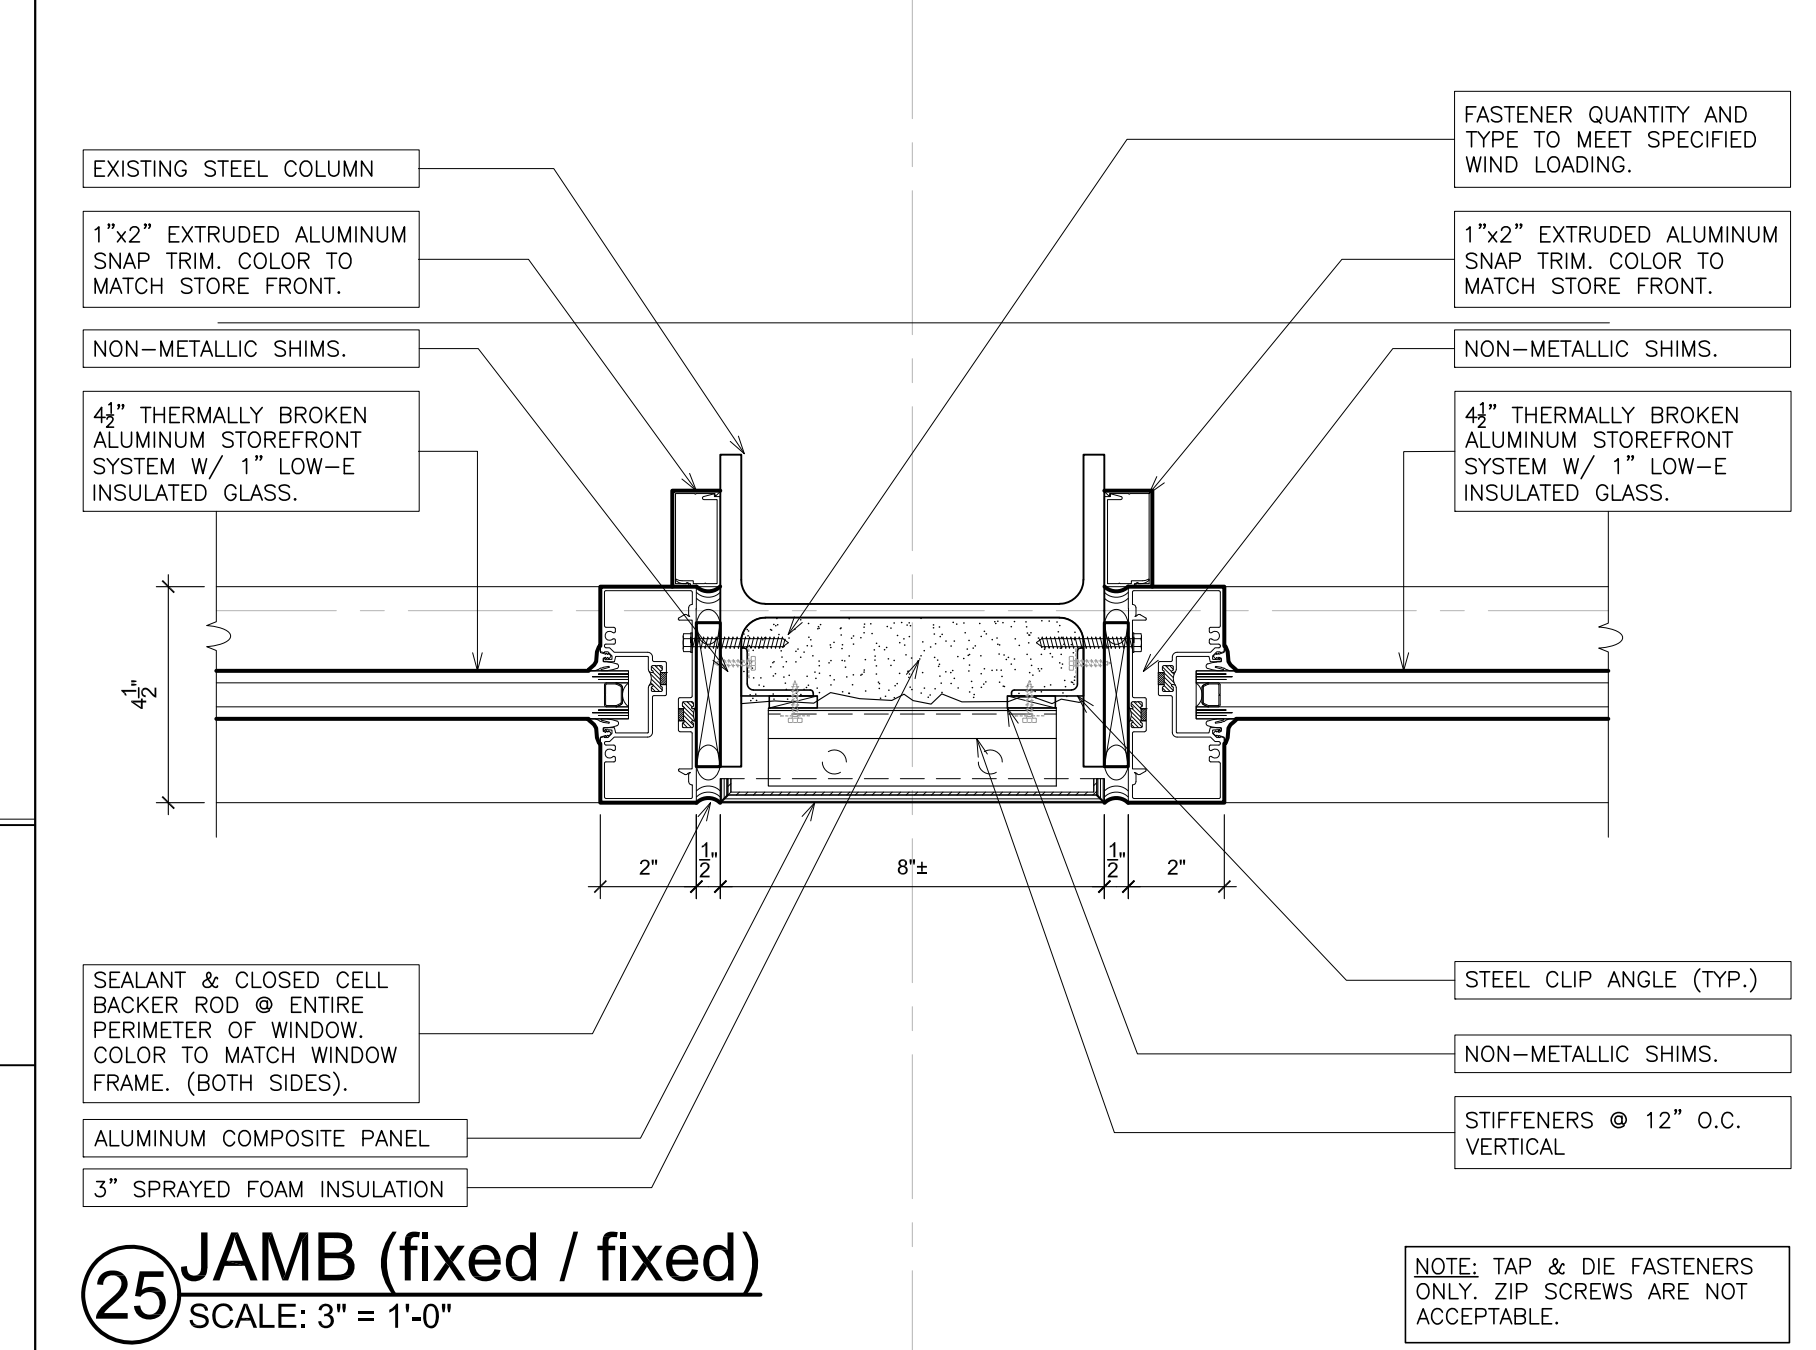
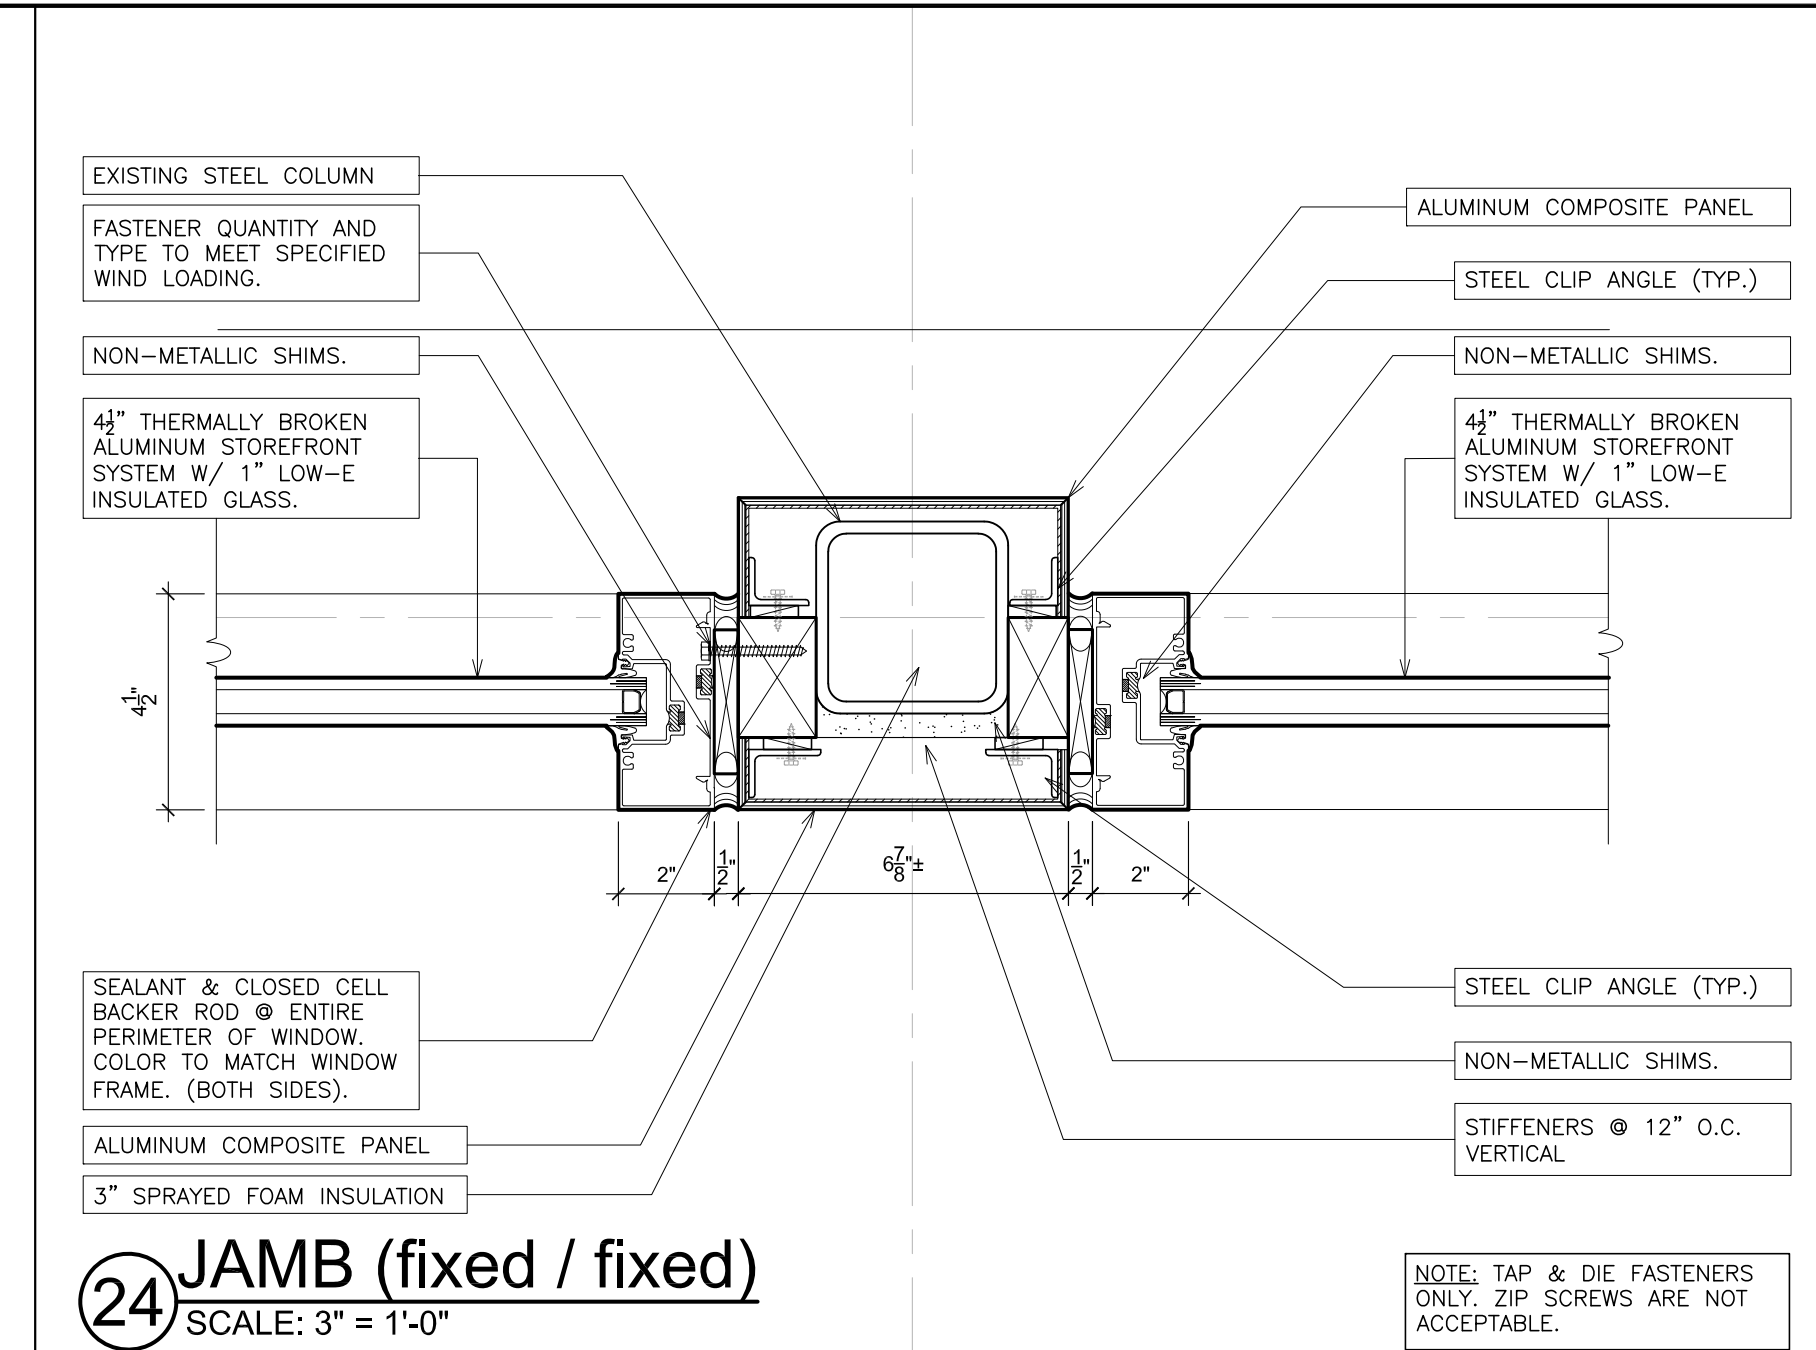
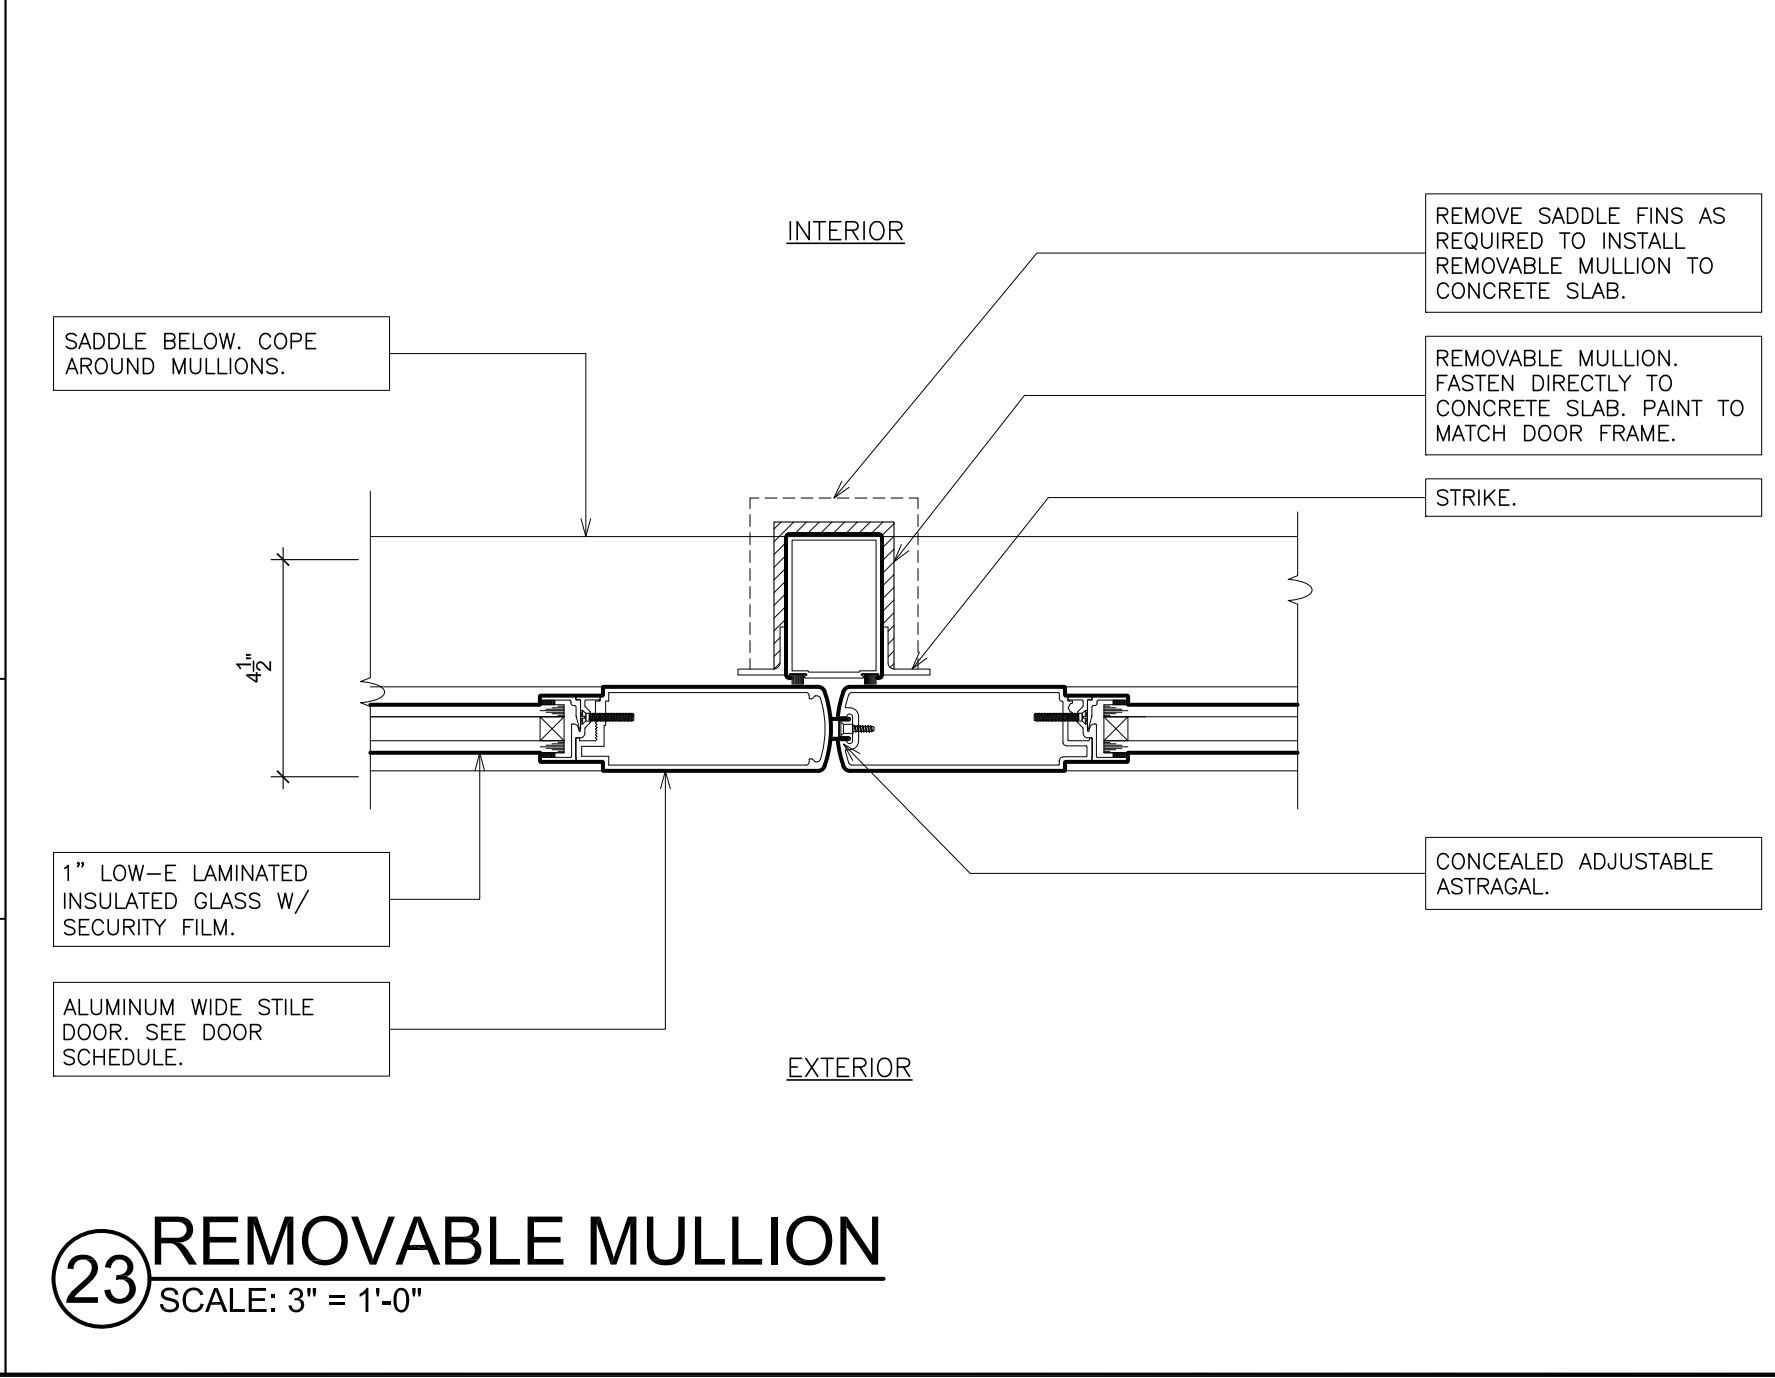
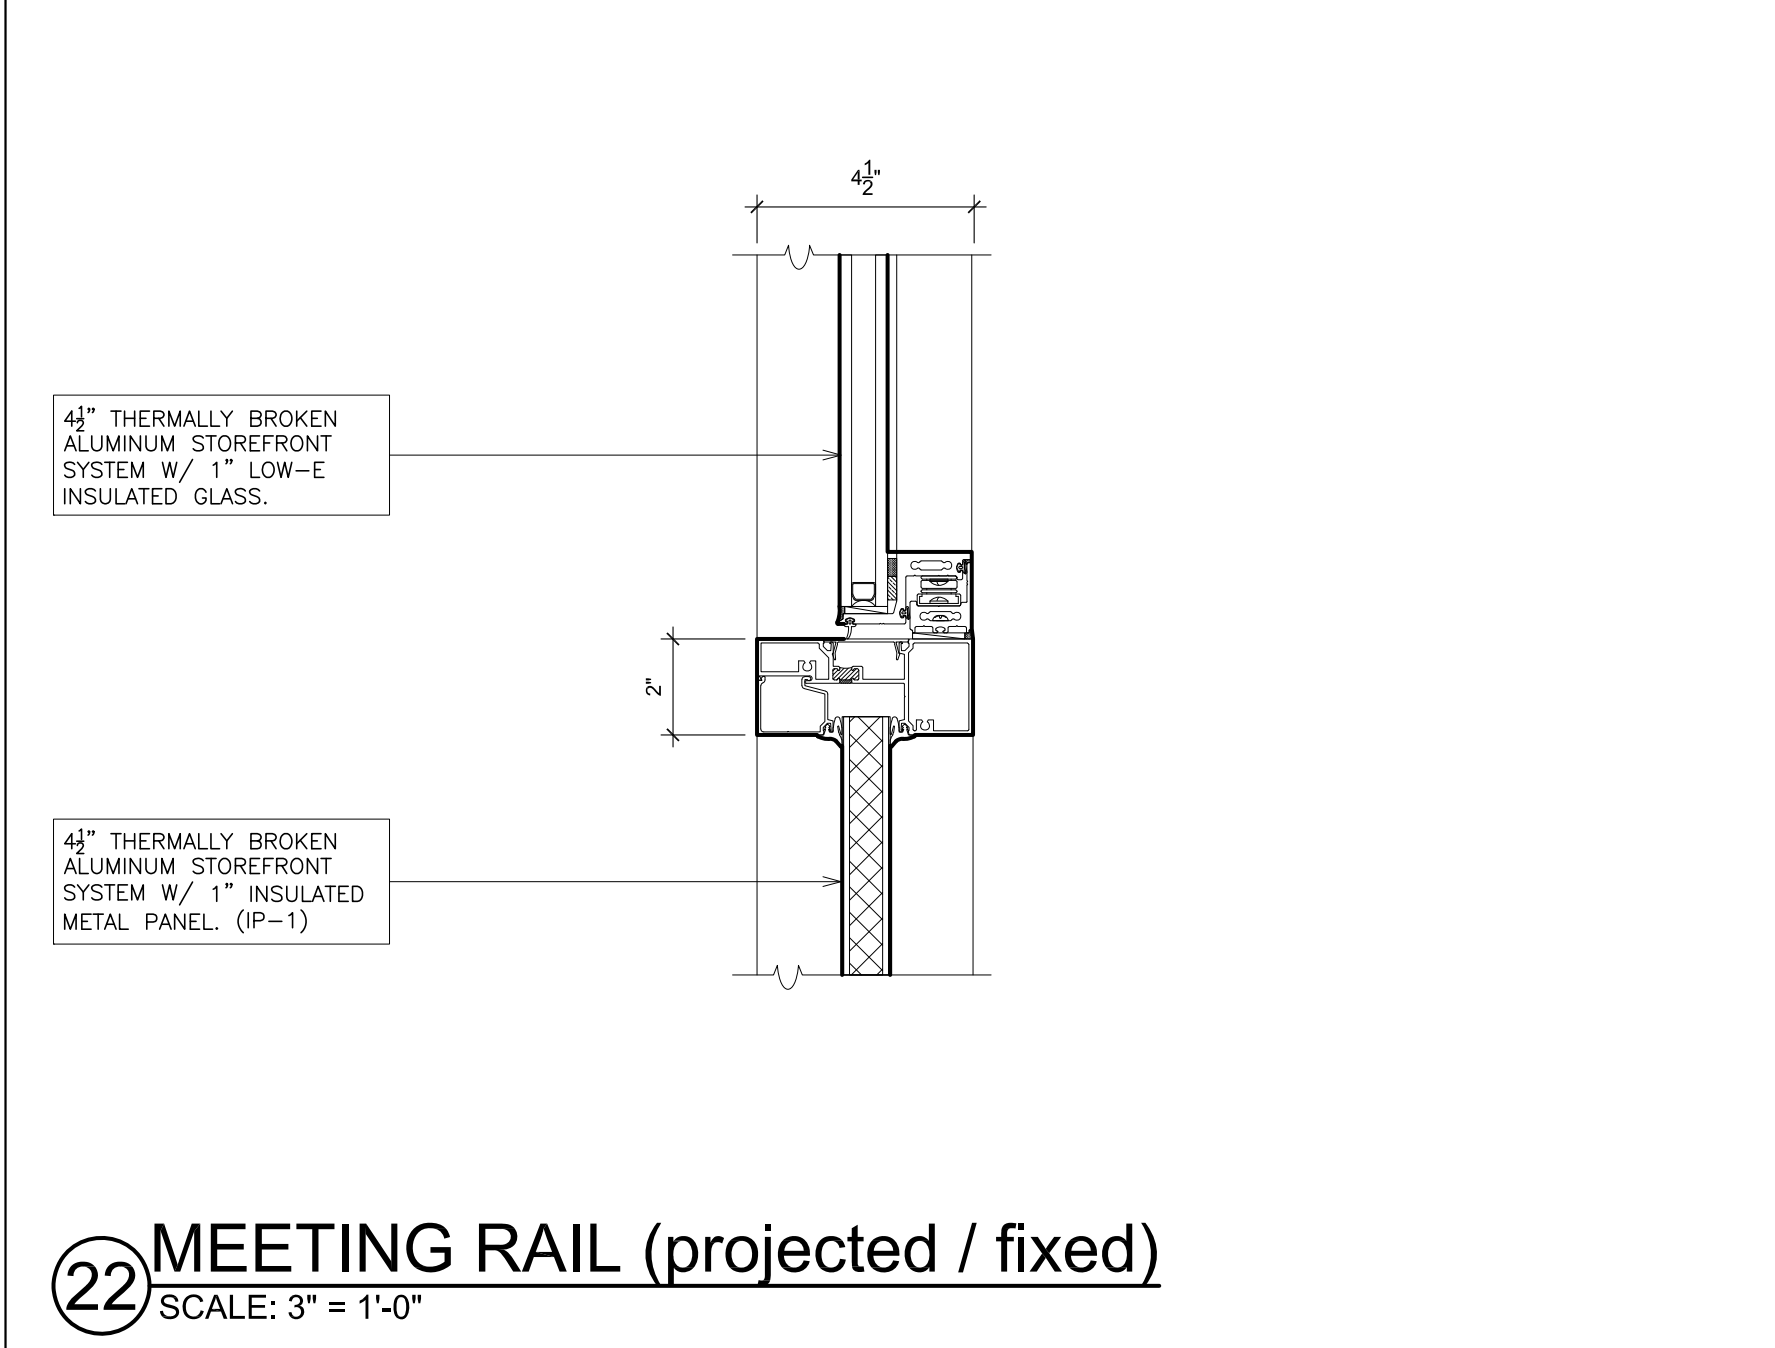
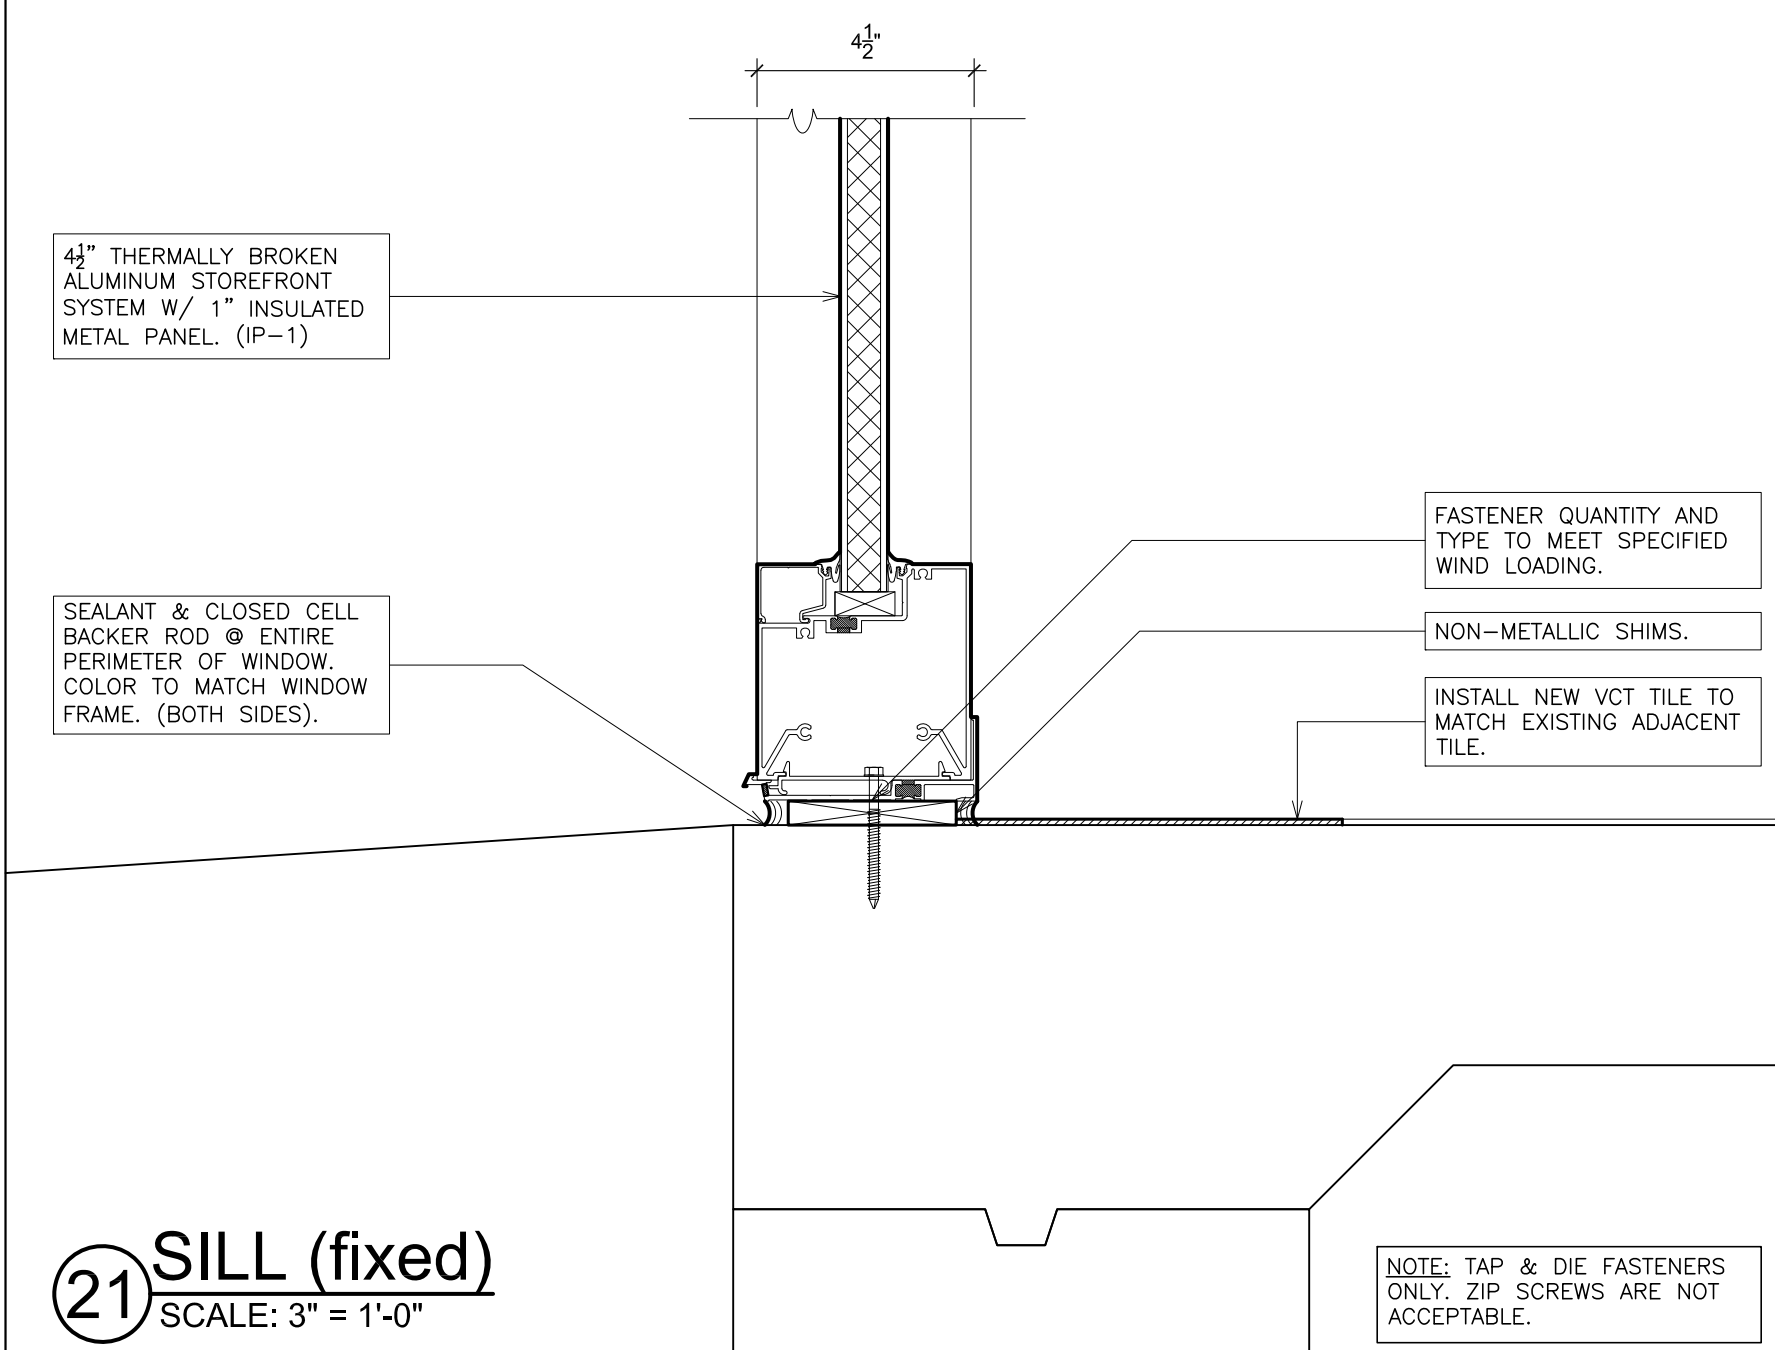
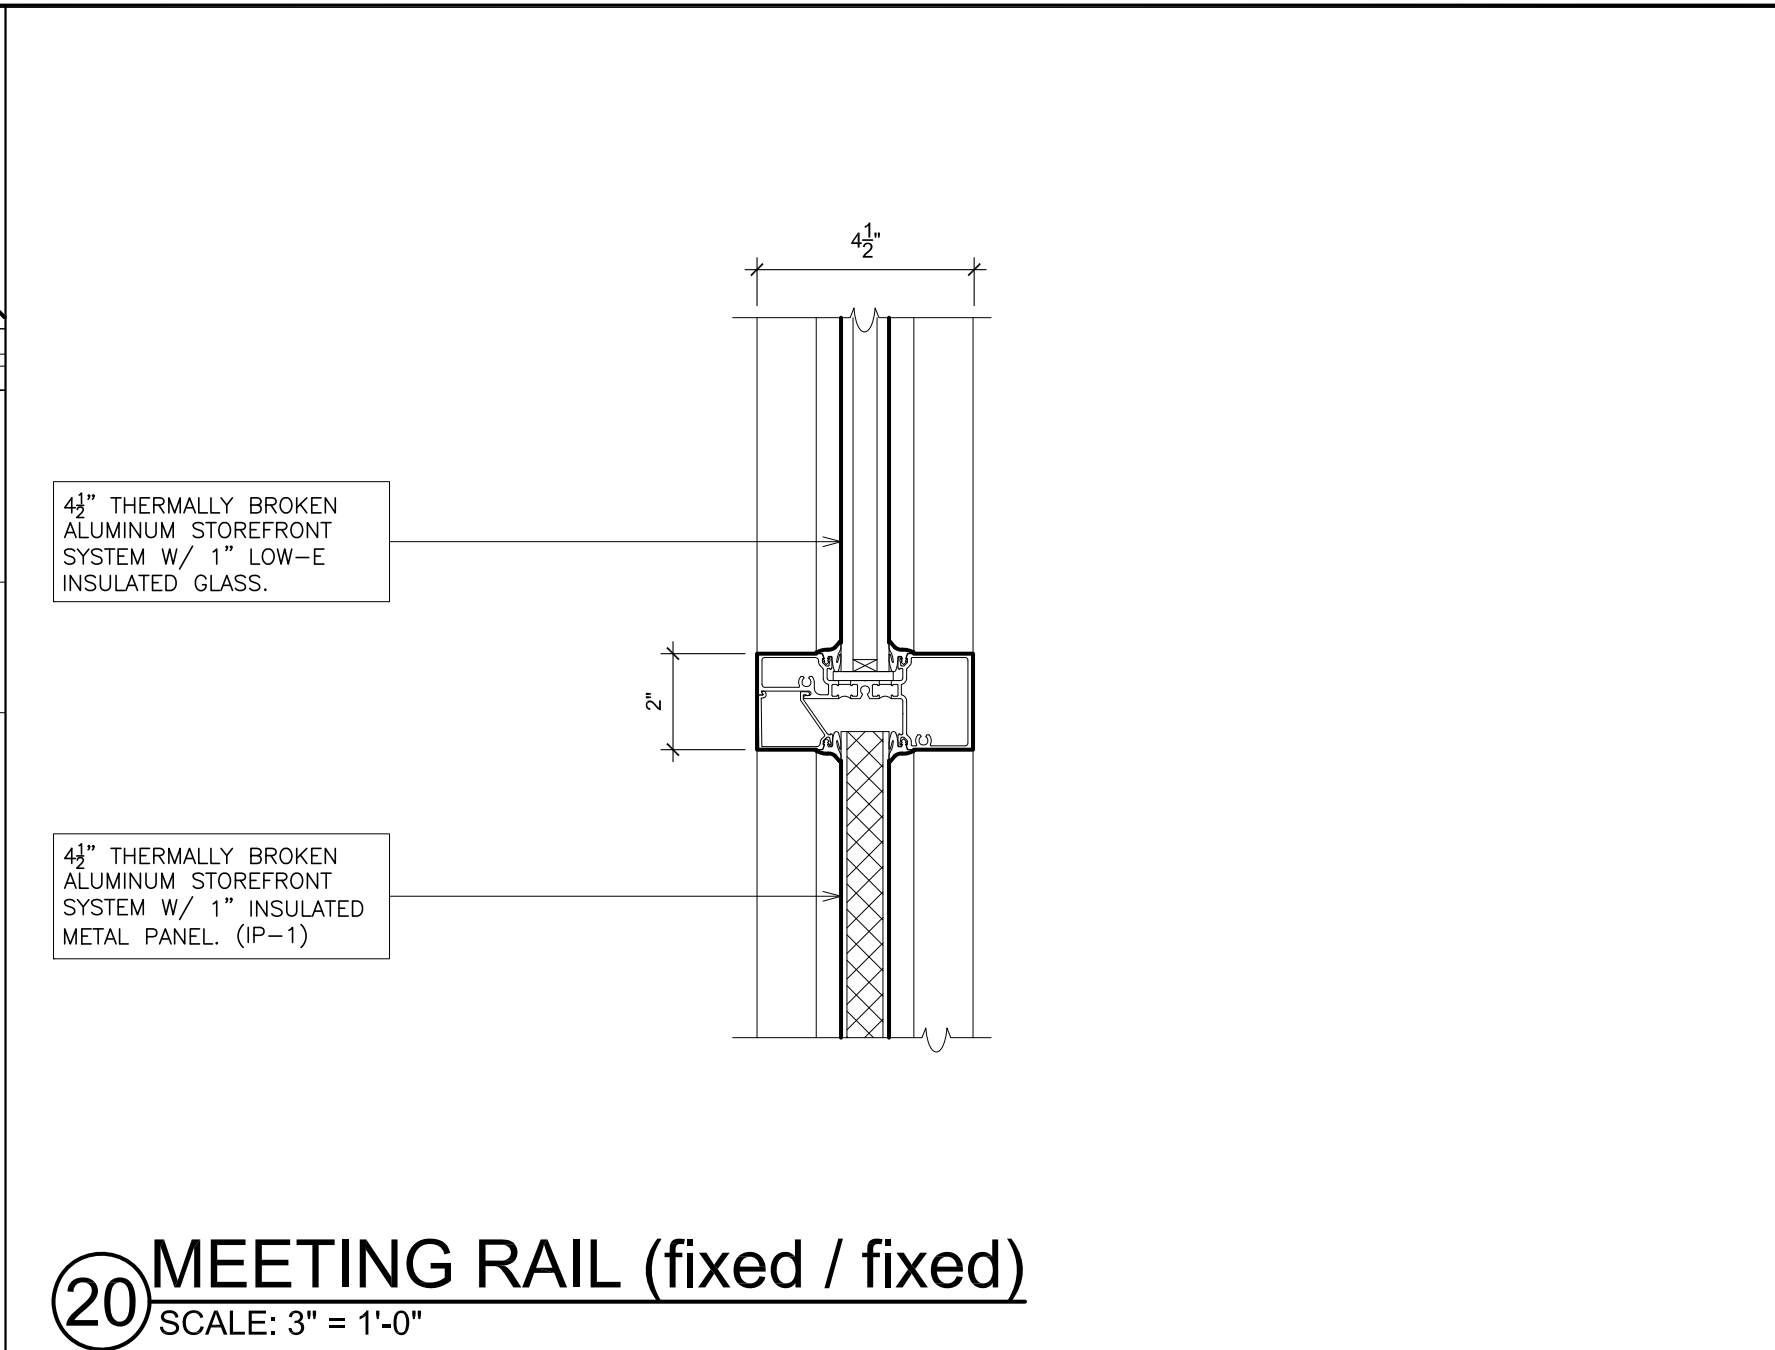
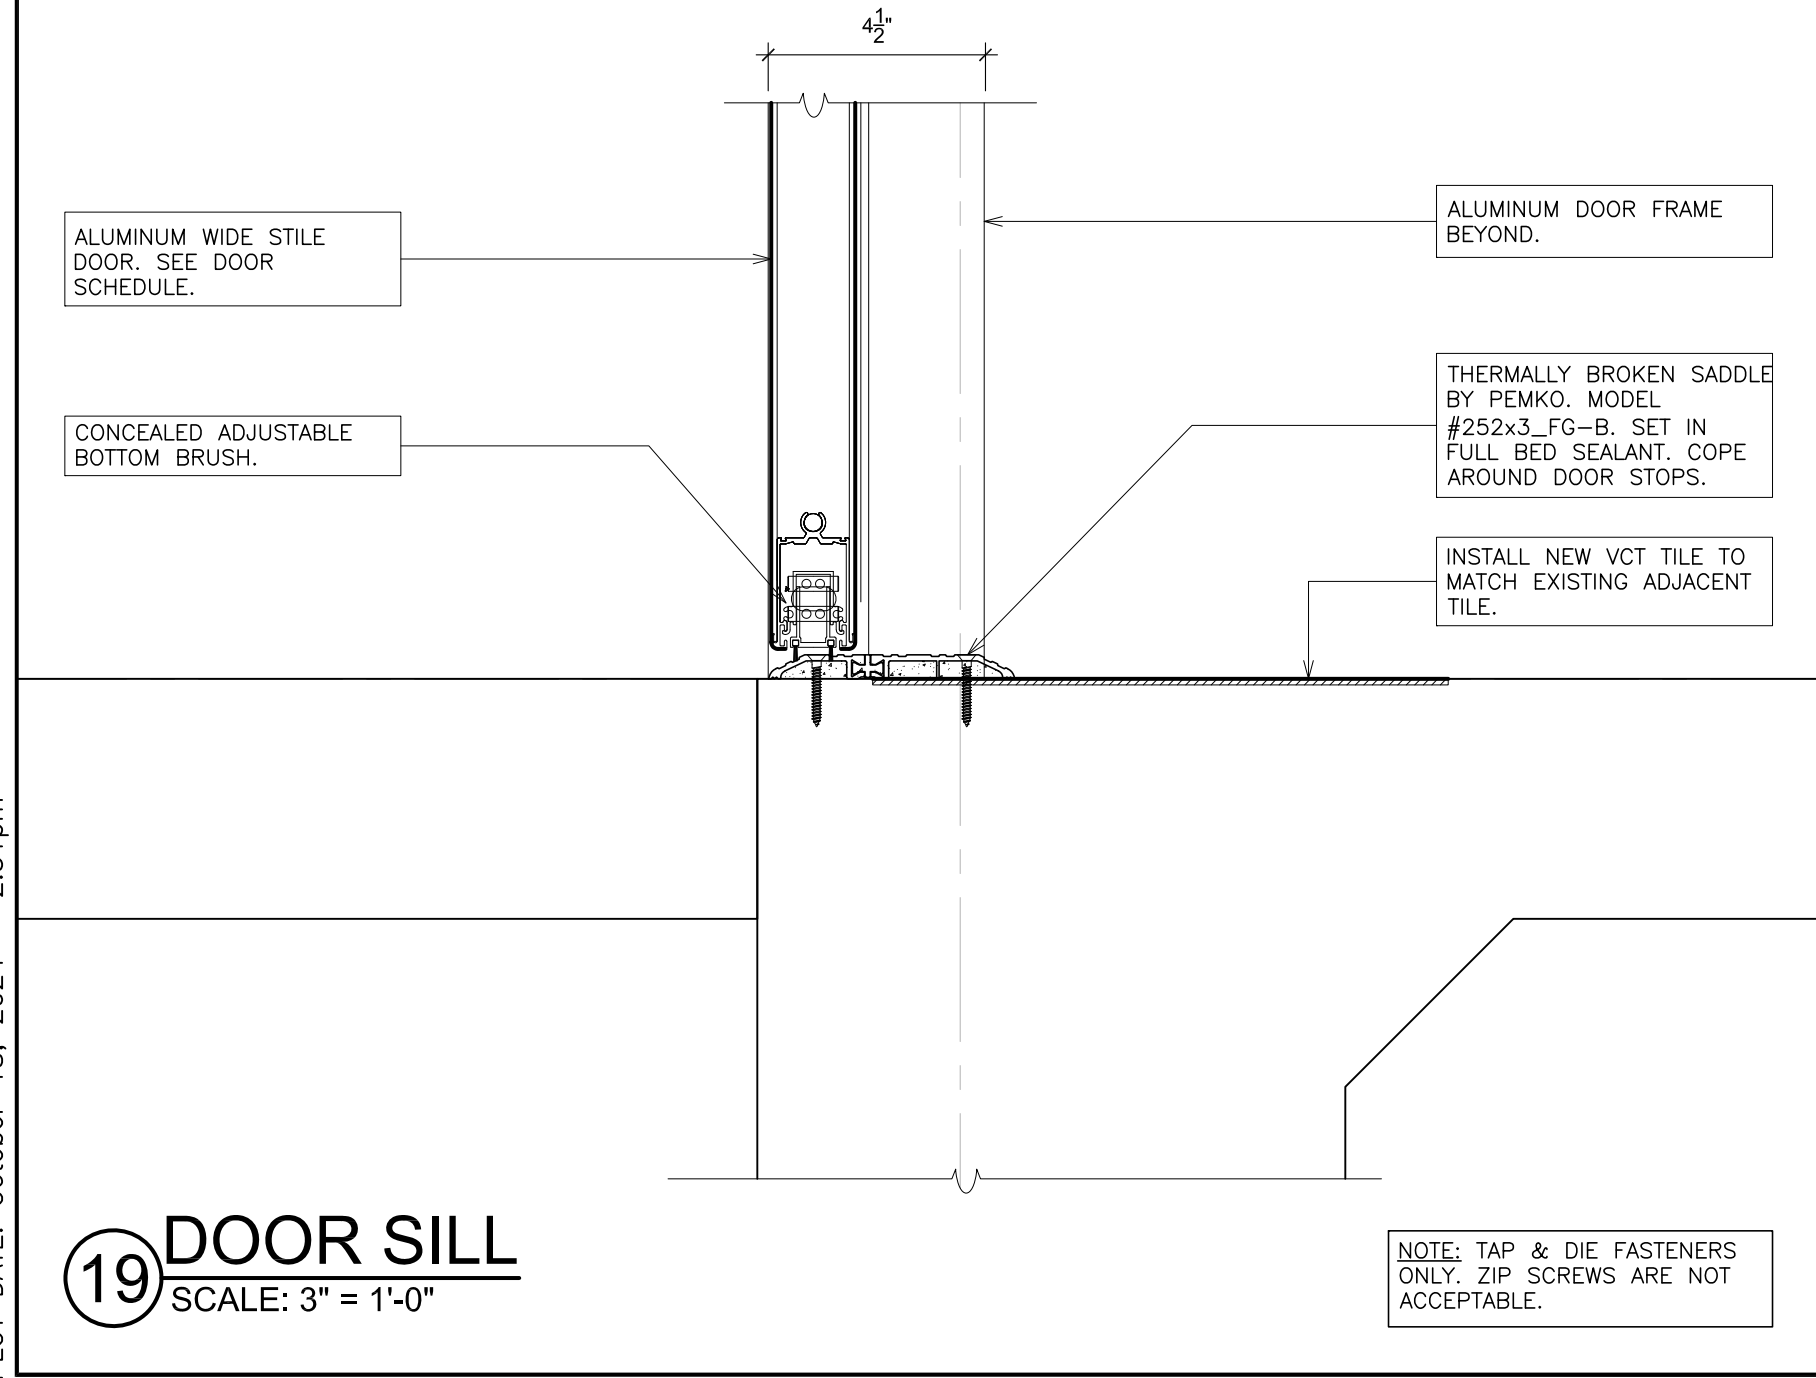
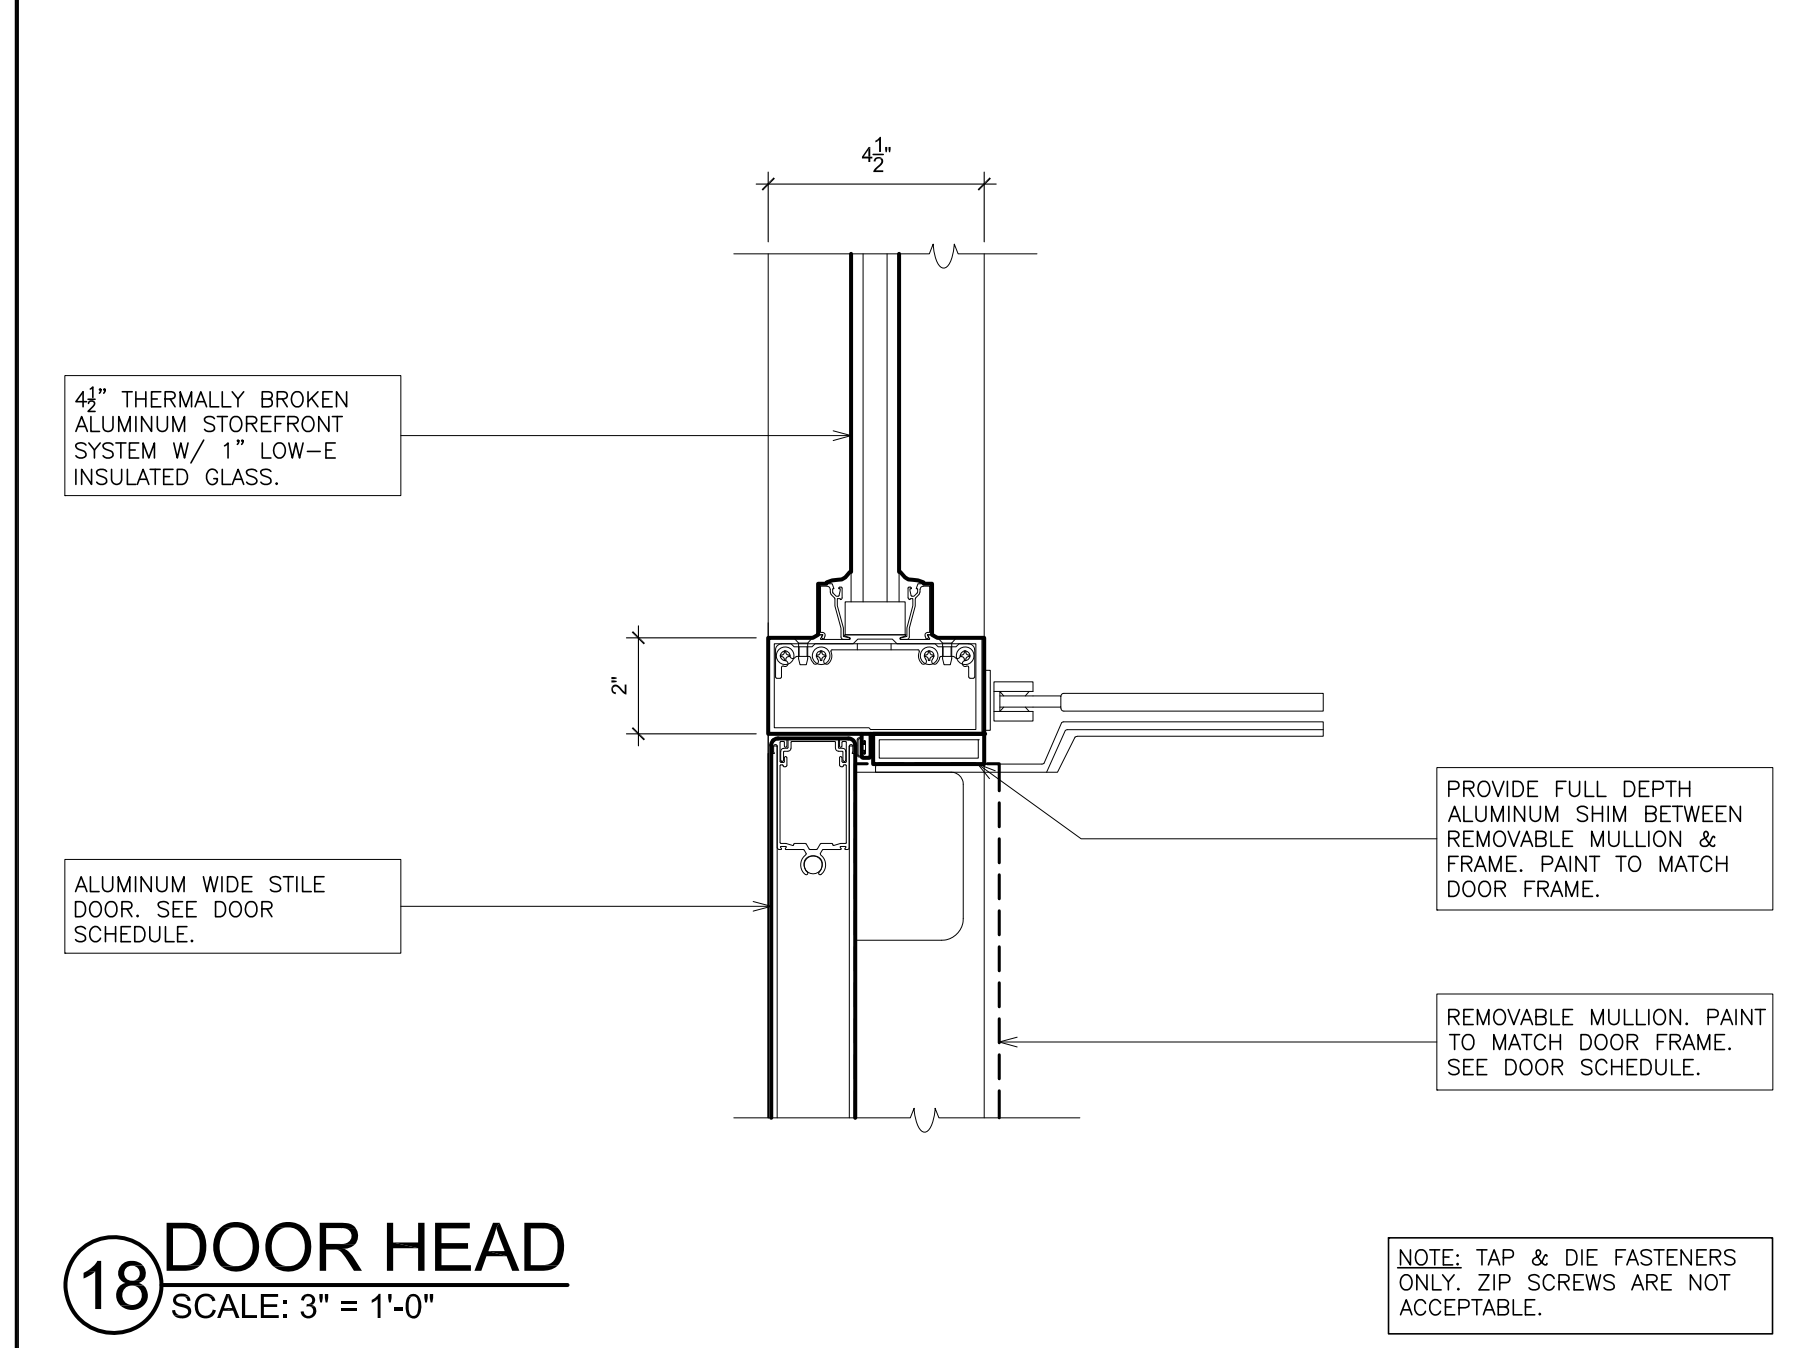
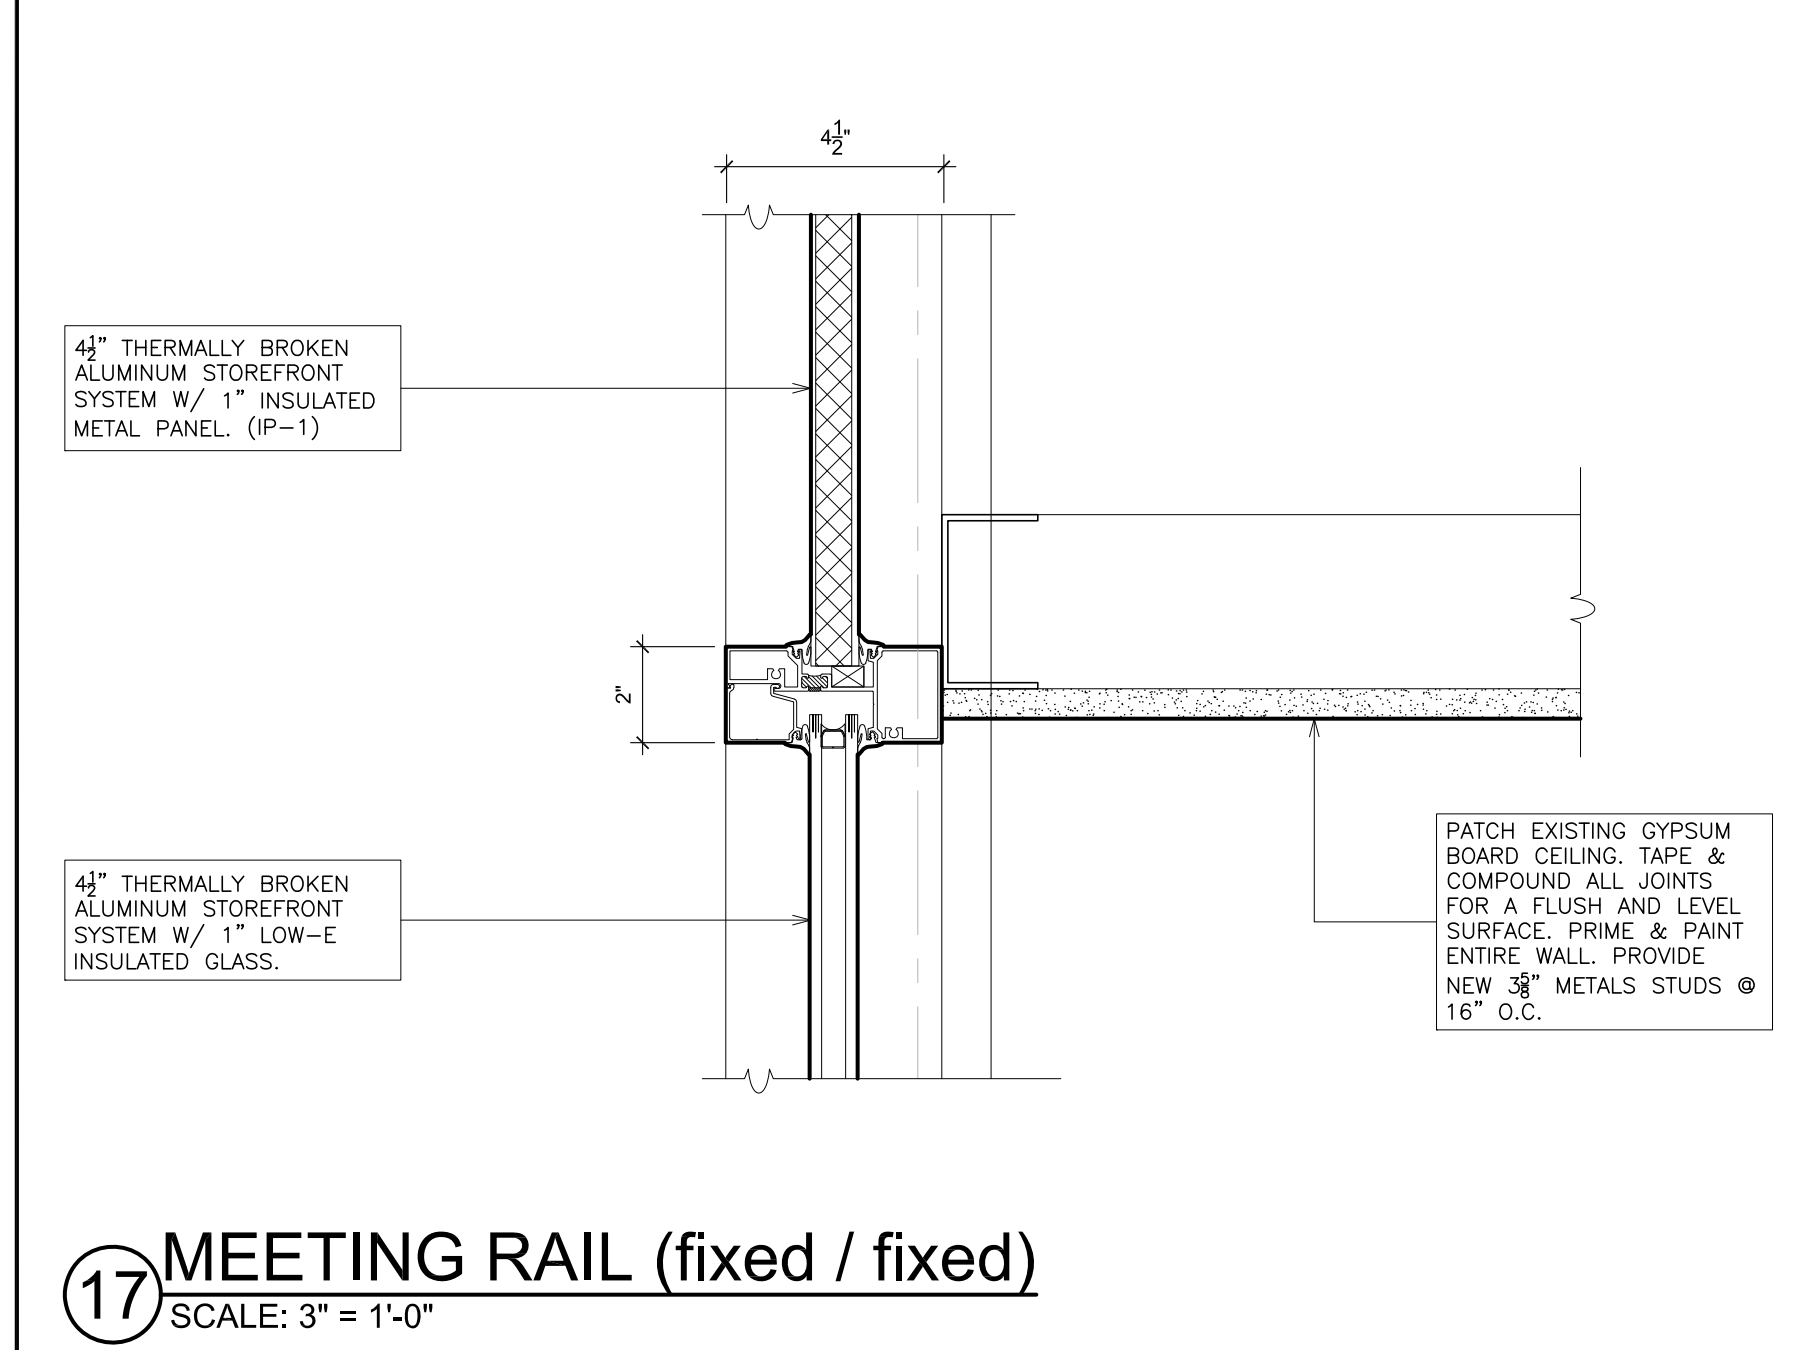
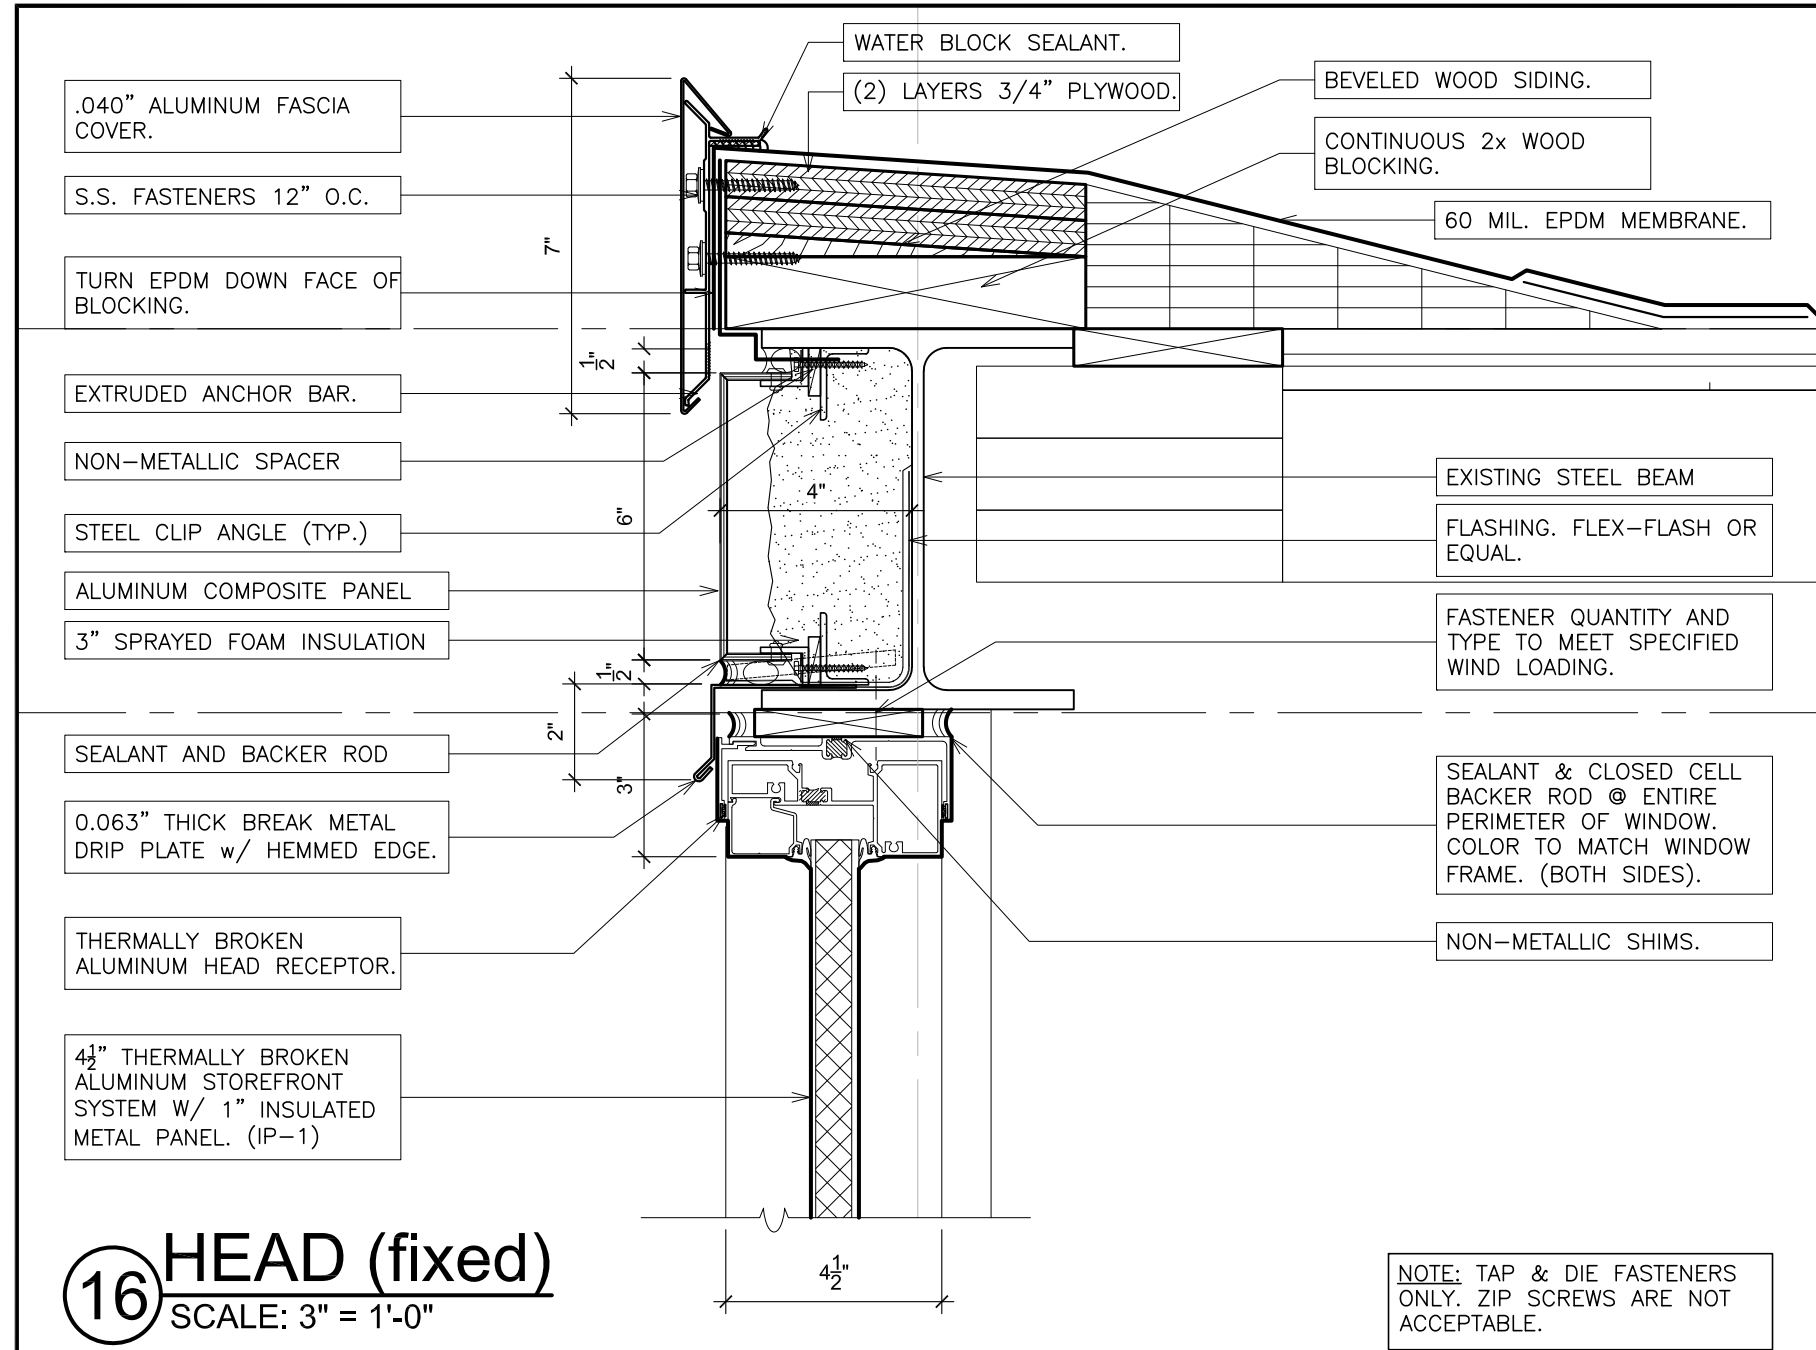
S.E.D. CONTROL NUMBER:
GREENVILLE ELEMENTARY
66-04-06-03-0-008-023

PROJECT: EDEMONT UNION FREE SCHOOL DISTRICT
GREENVILLE WINDOW REPLACEMENT AND
RELATED WORK
100 GLENDALE RD., SCARSDALE, NY 11535
DRAWING TITLE
WINDOW DETAILS

10-23-2024	RE-BID
08-27-2024	BID
11-14-2023	S.E.D. SUBMISSION
DATE	ISSUED TO
SCALE	DRAWING NO.
AS NOTED	A726
DRAWN BY F & D	CHECKED BY F & D
FILE NO. 23501.00	

PLOT DATE: October 18, 2024 — 2:31pm

FILE: I:\23501.00 Edgemont Greenville Window replacement\DRAWINGS\CURRENT\1-F&D\23501.00-A727-729.dwg



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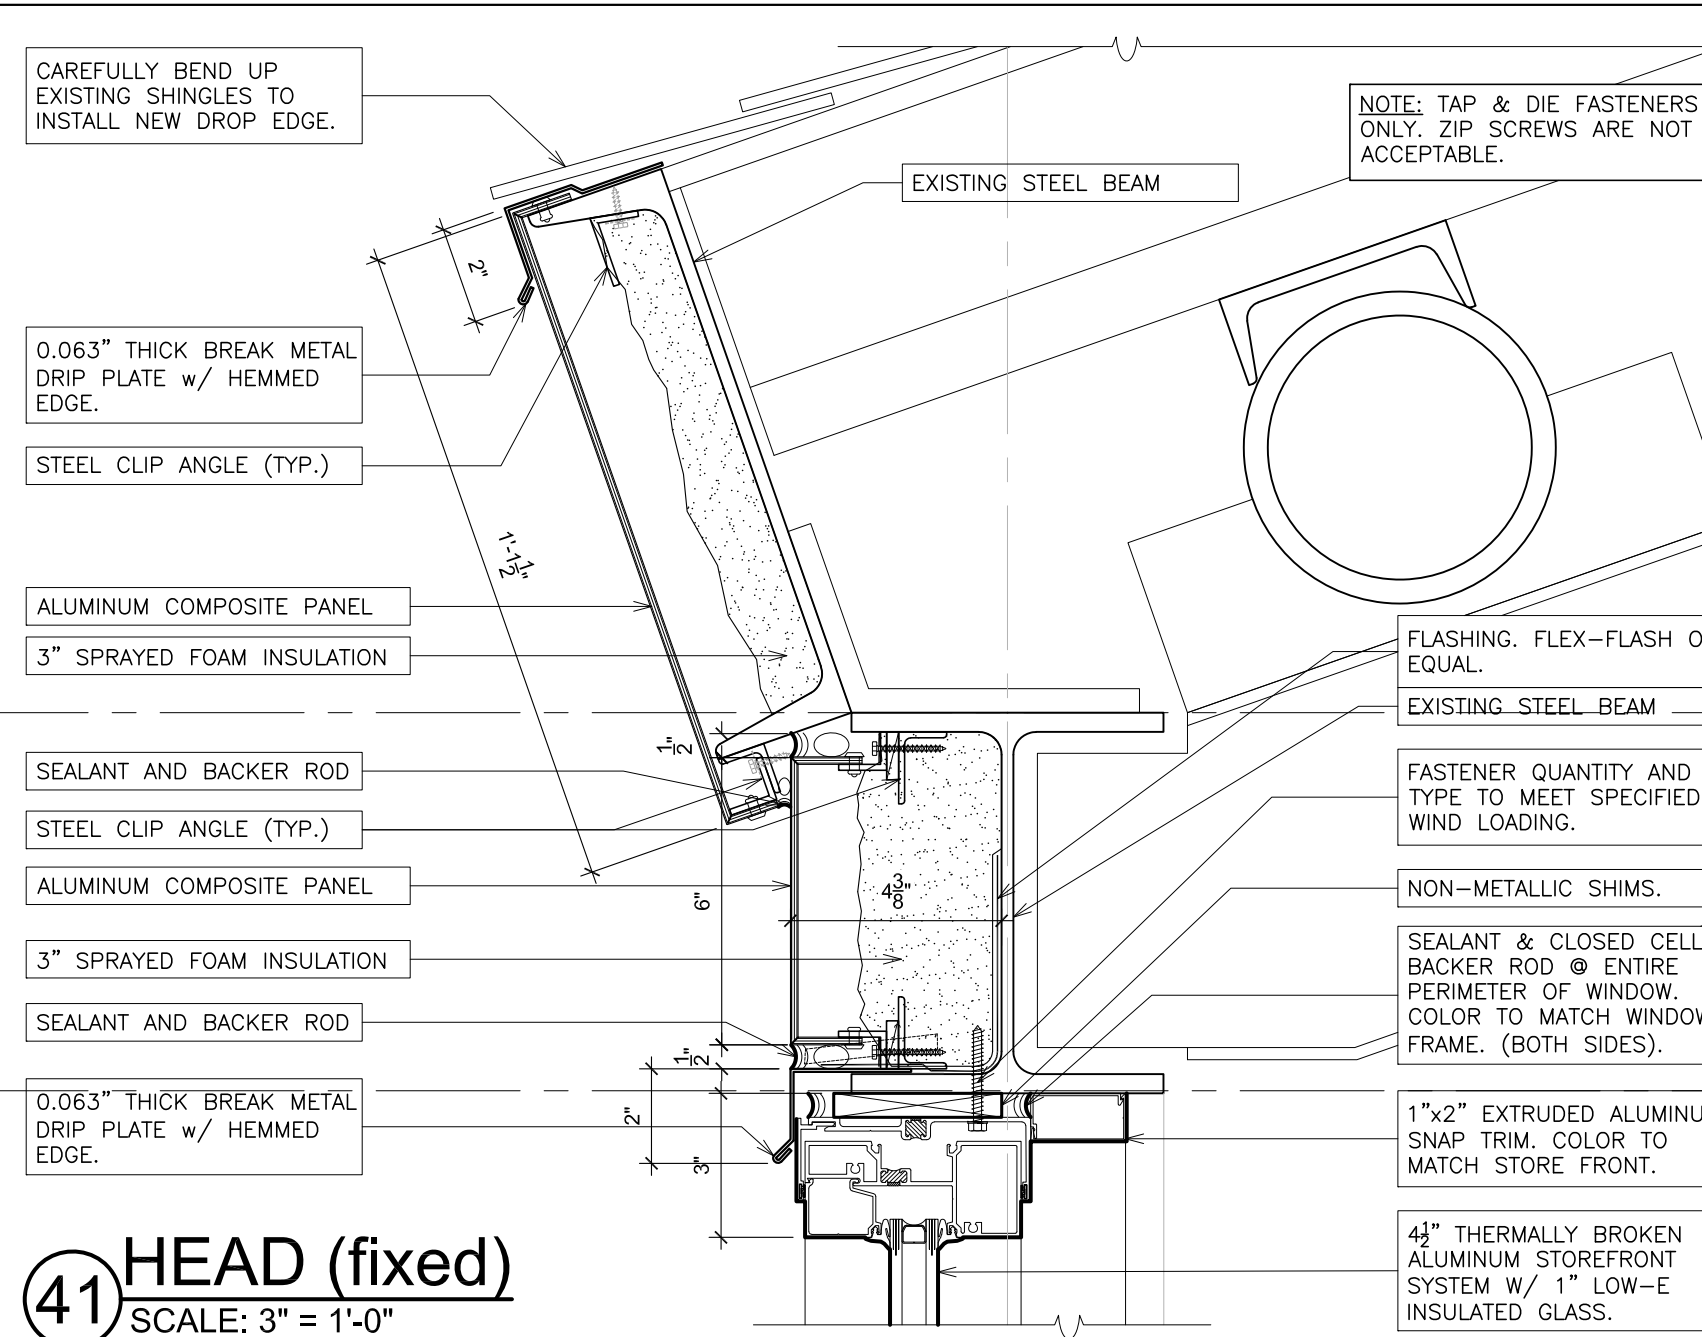
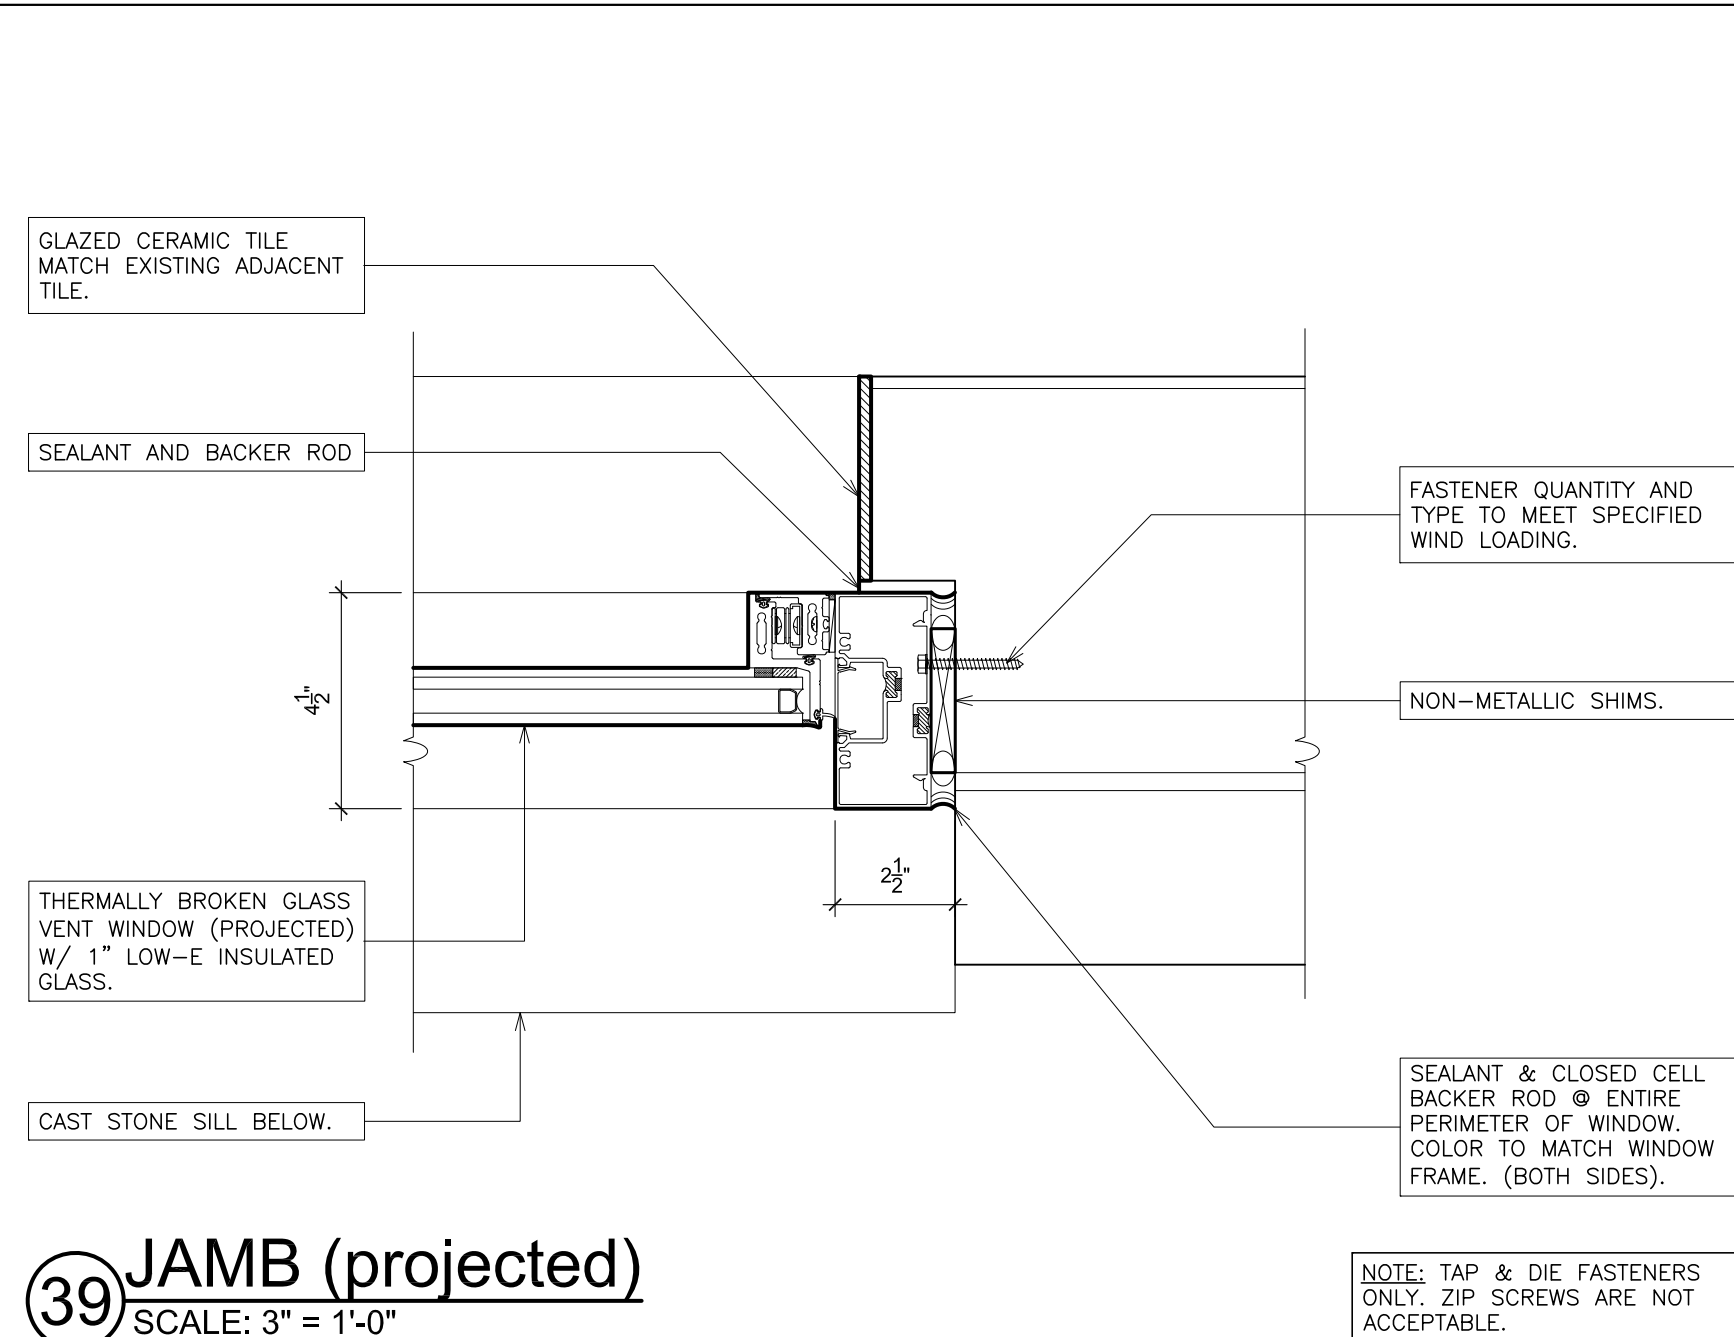
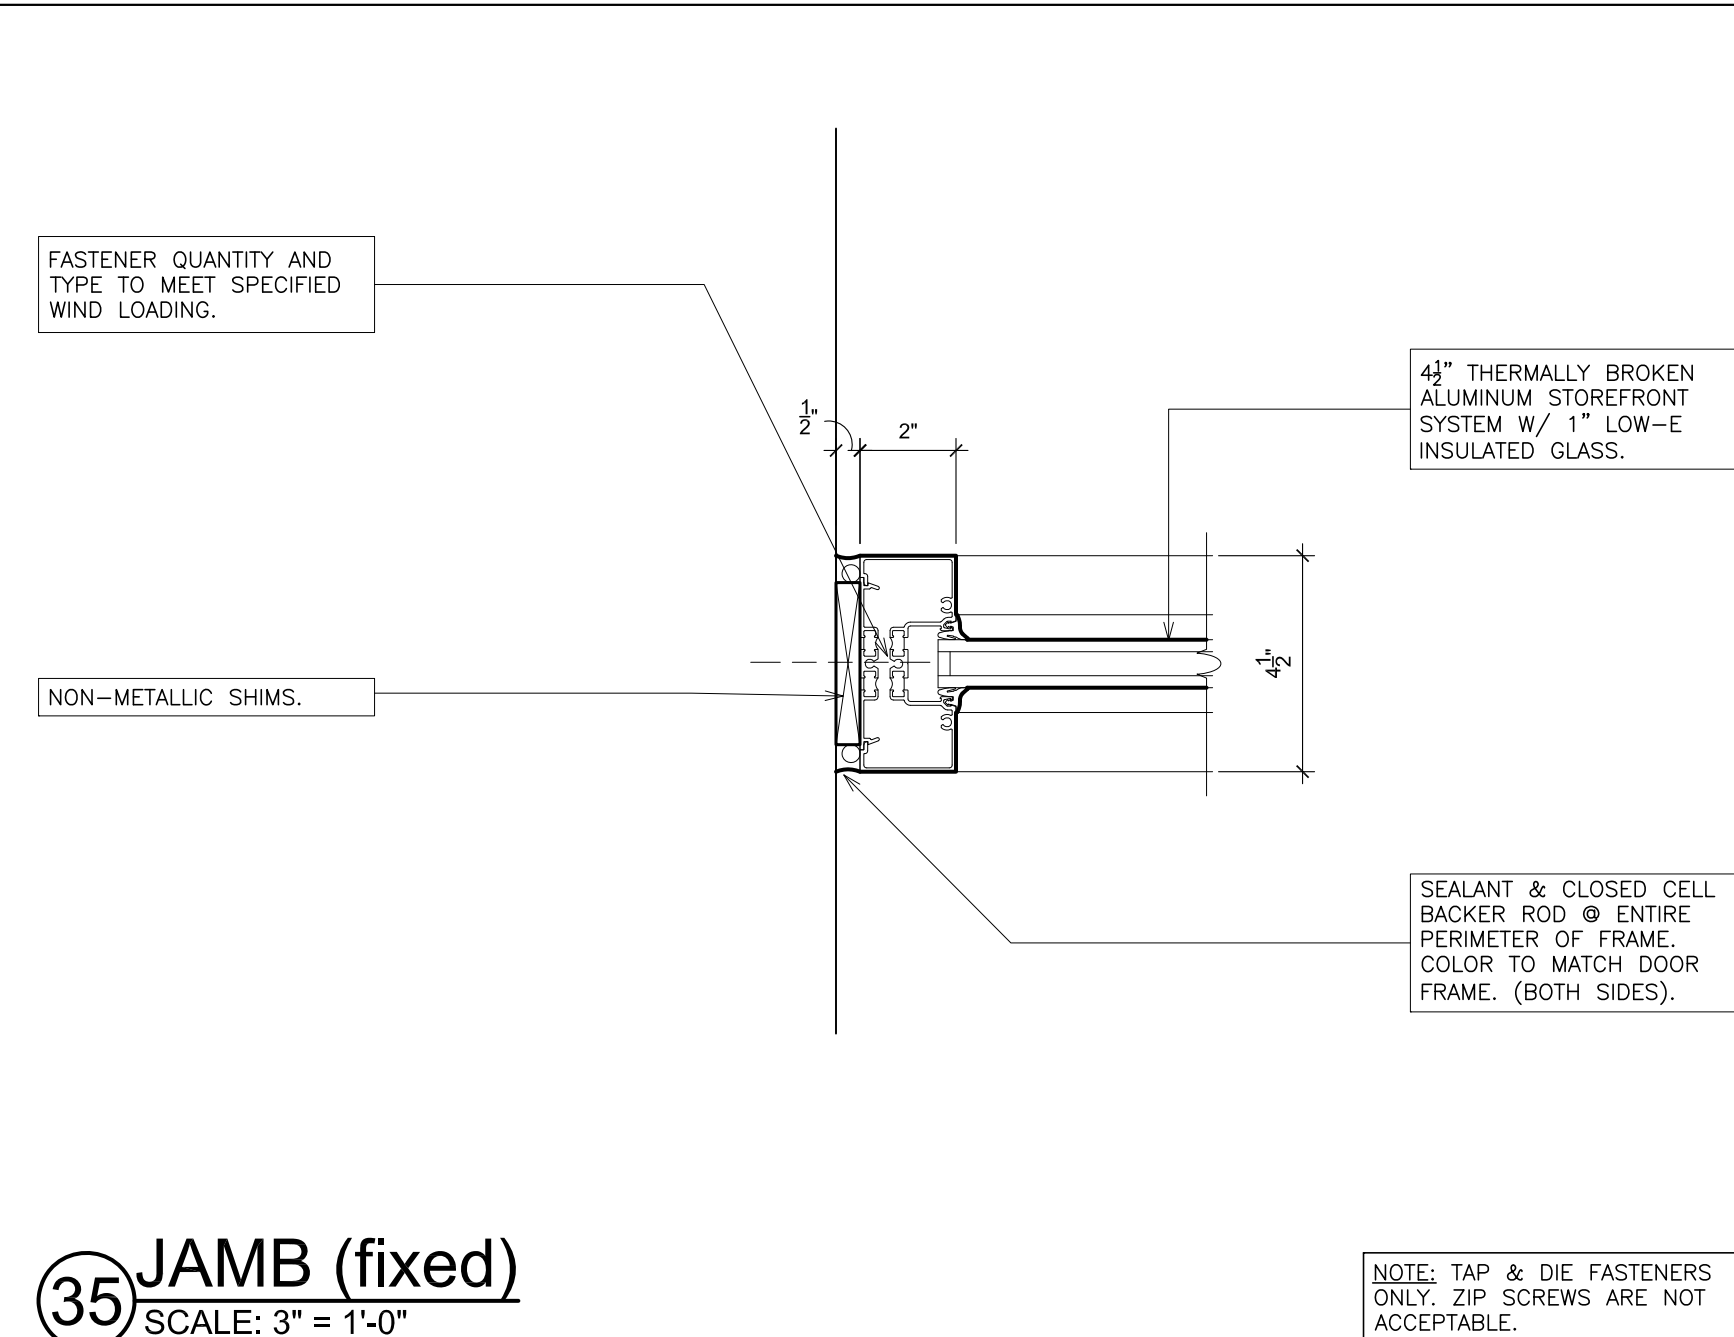
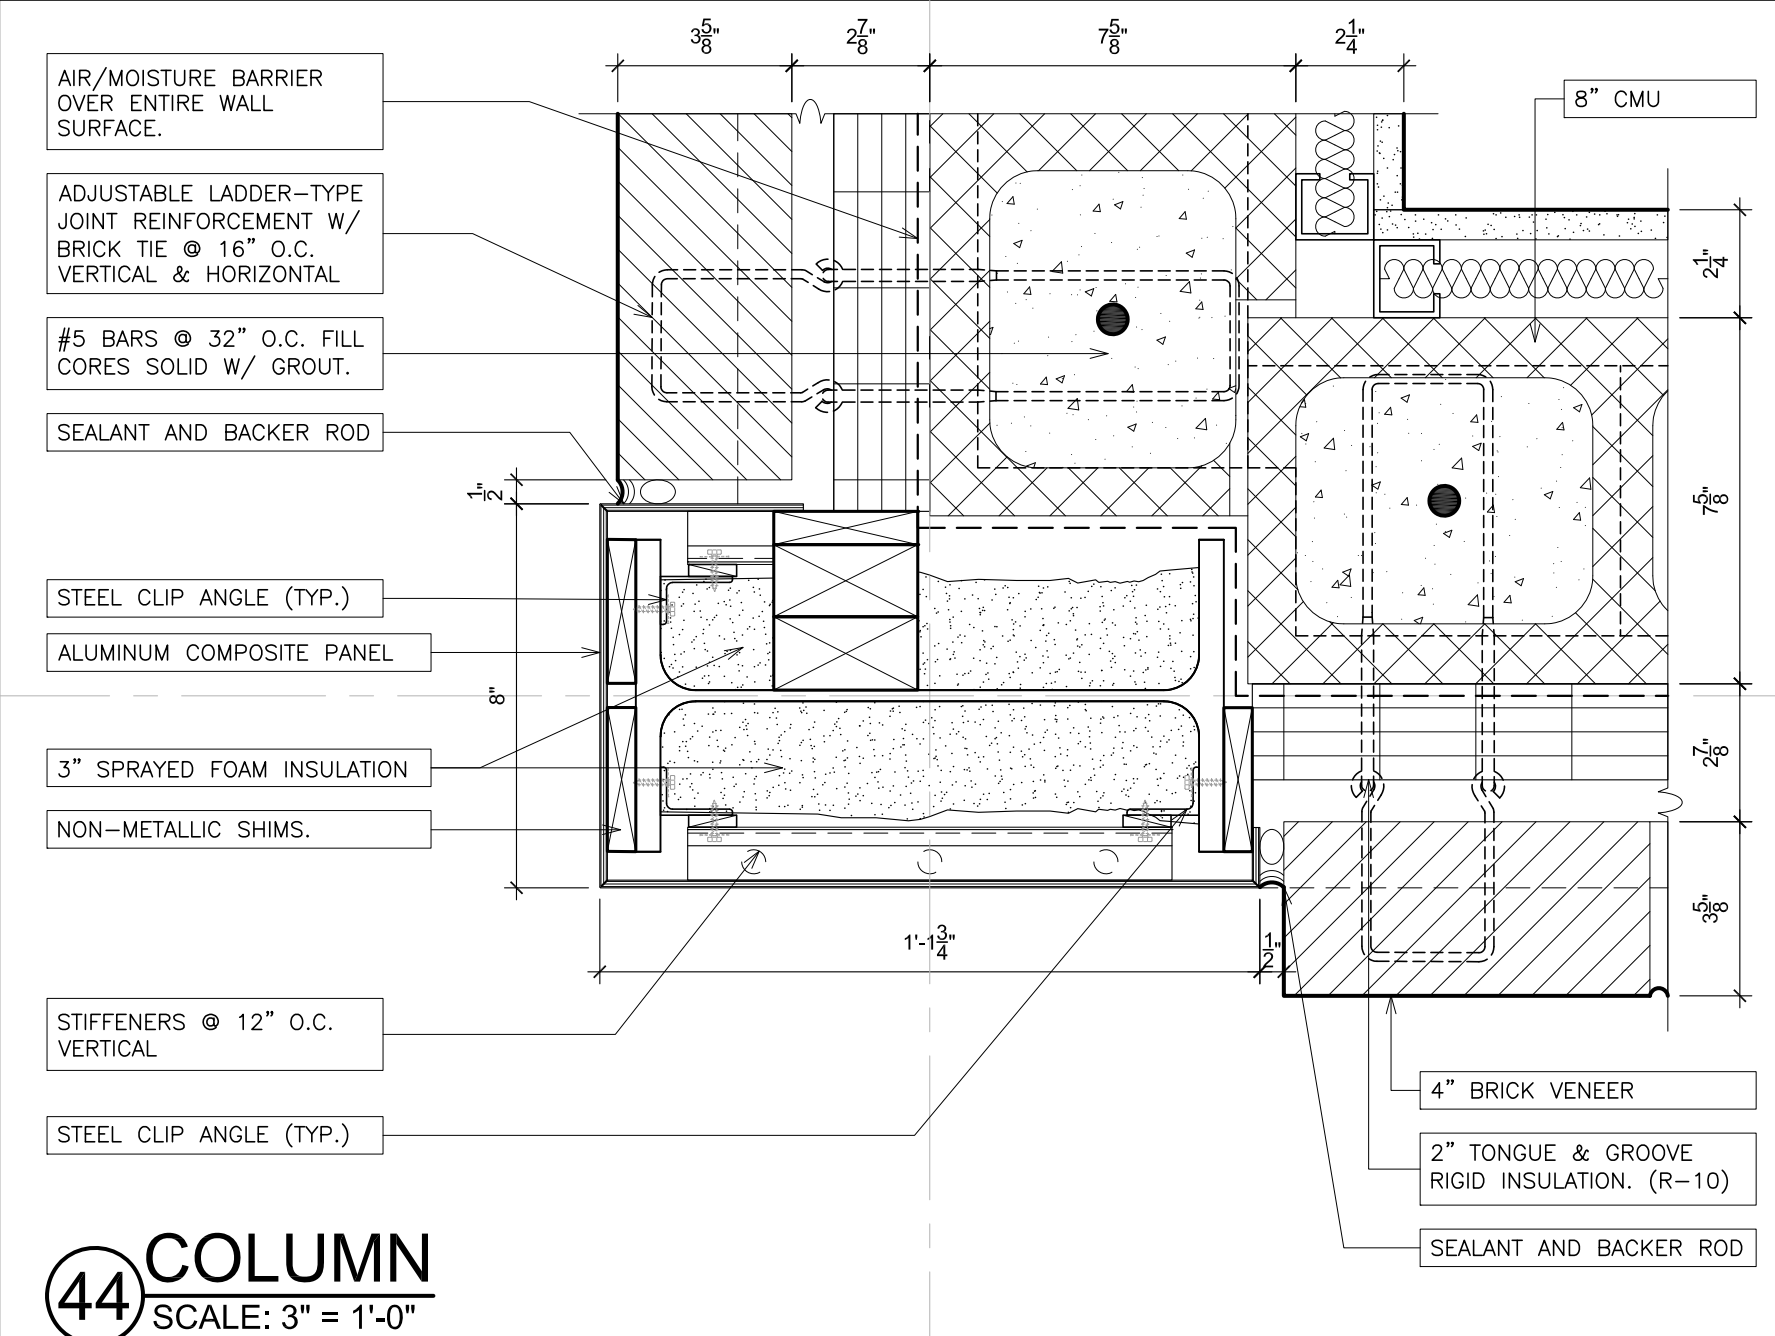
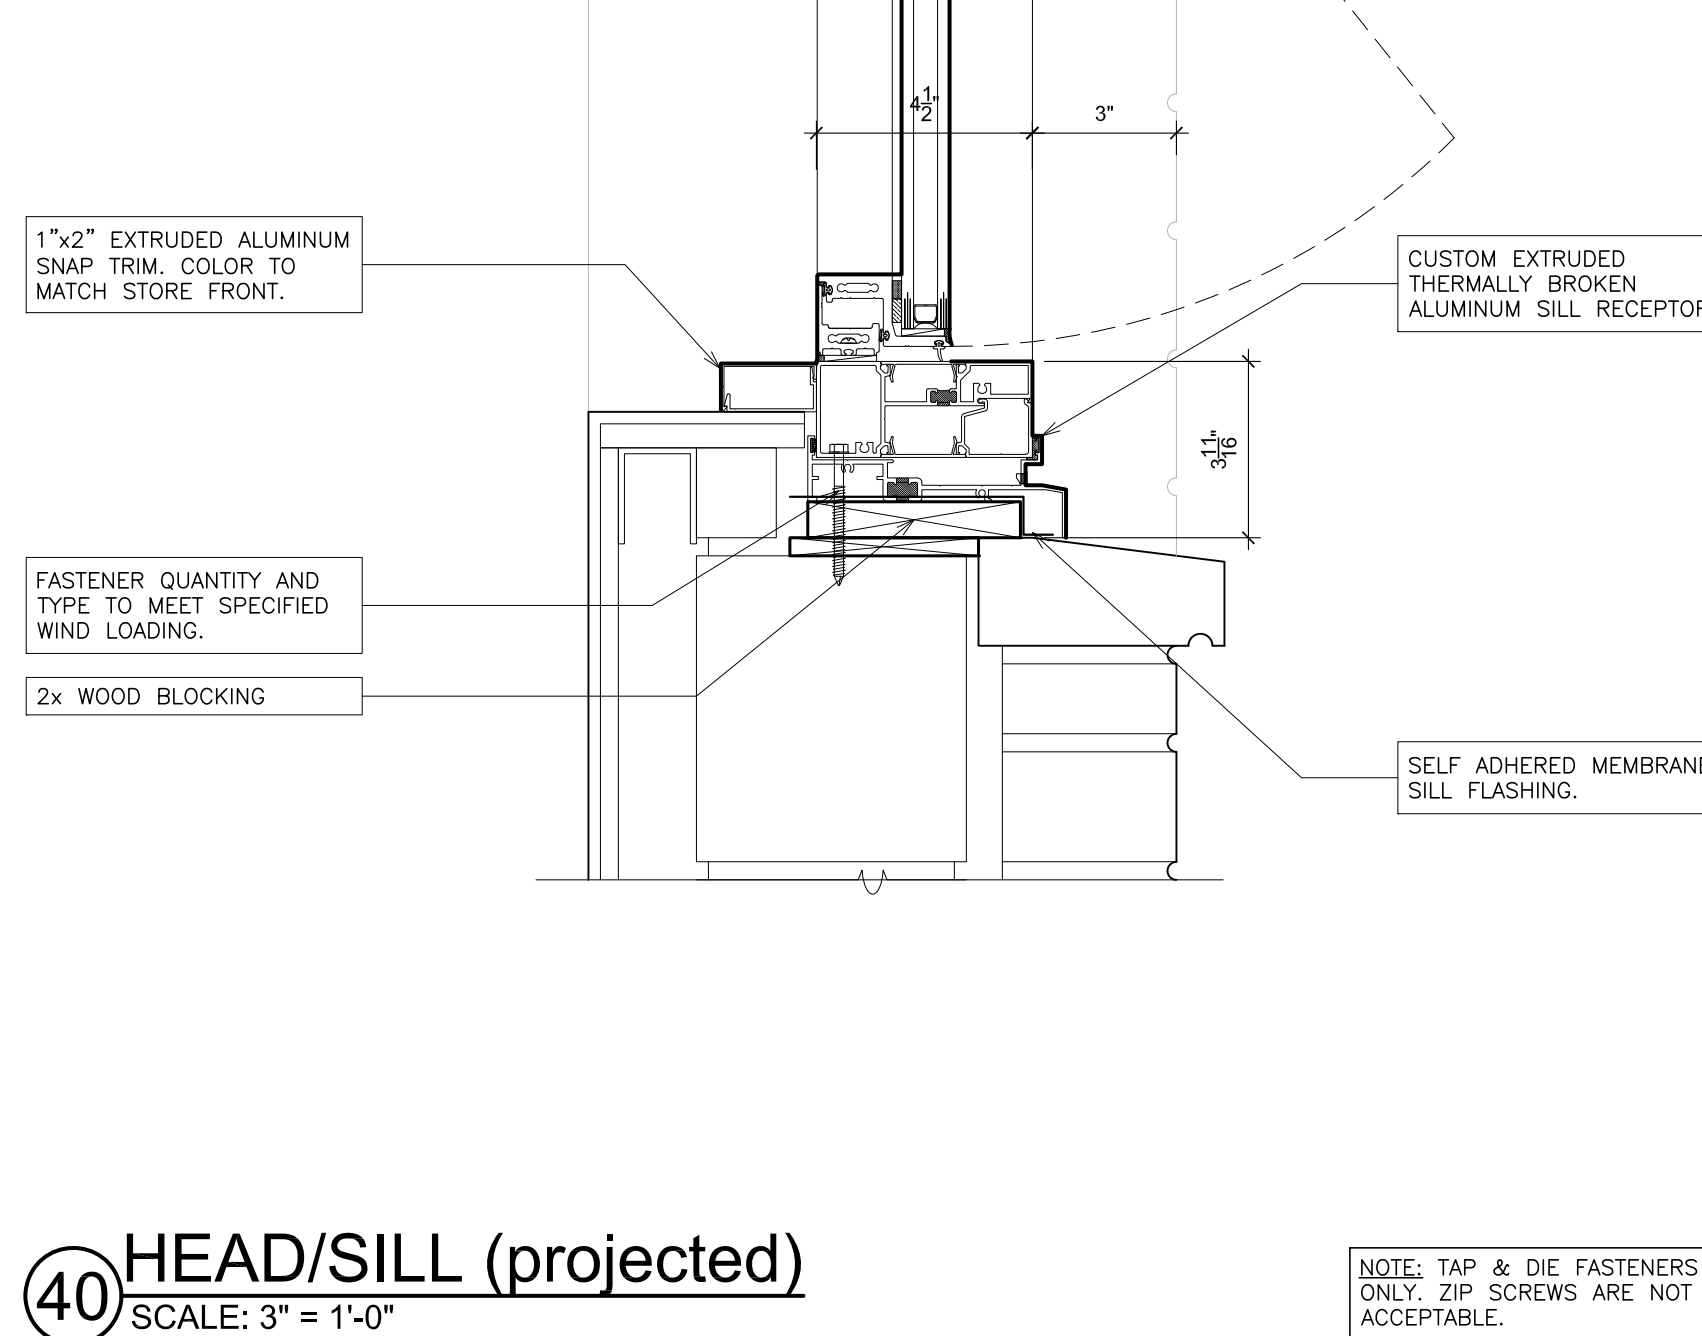
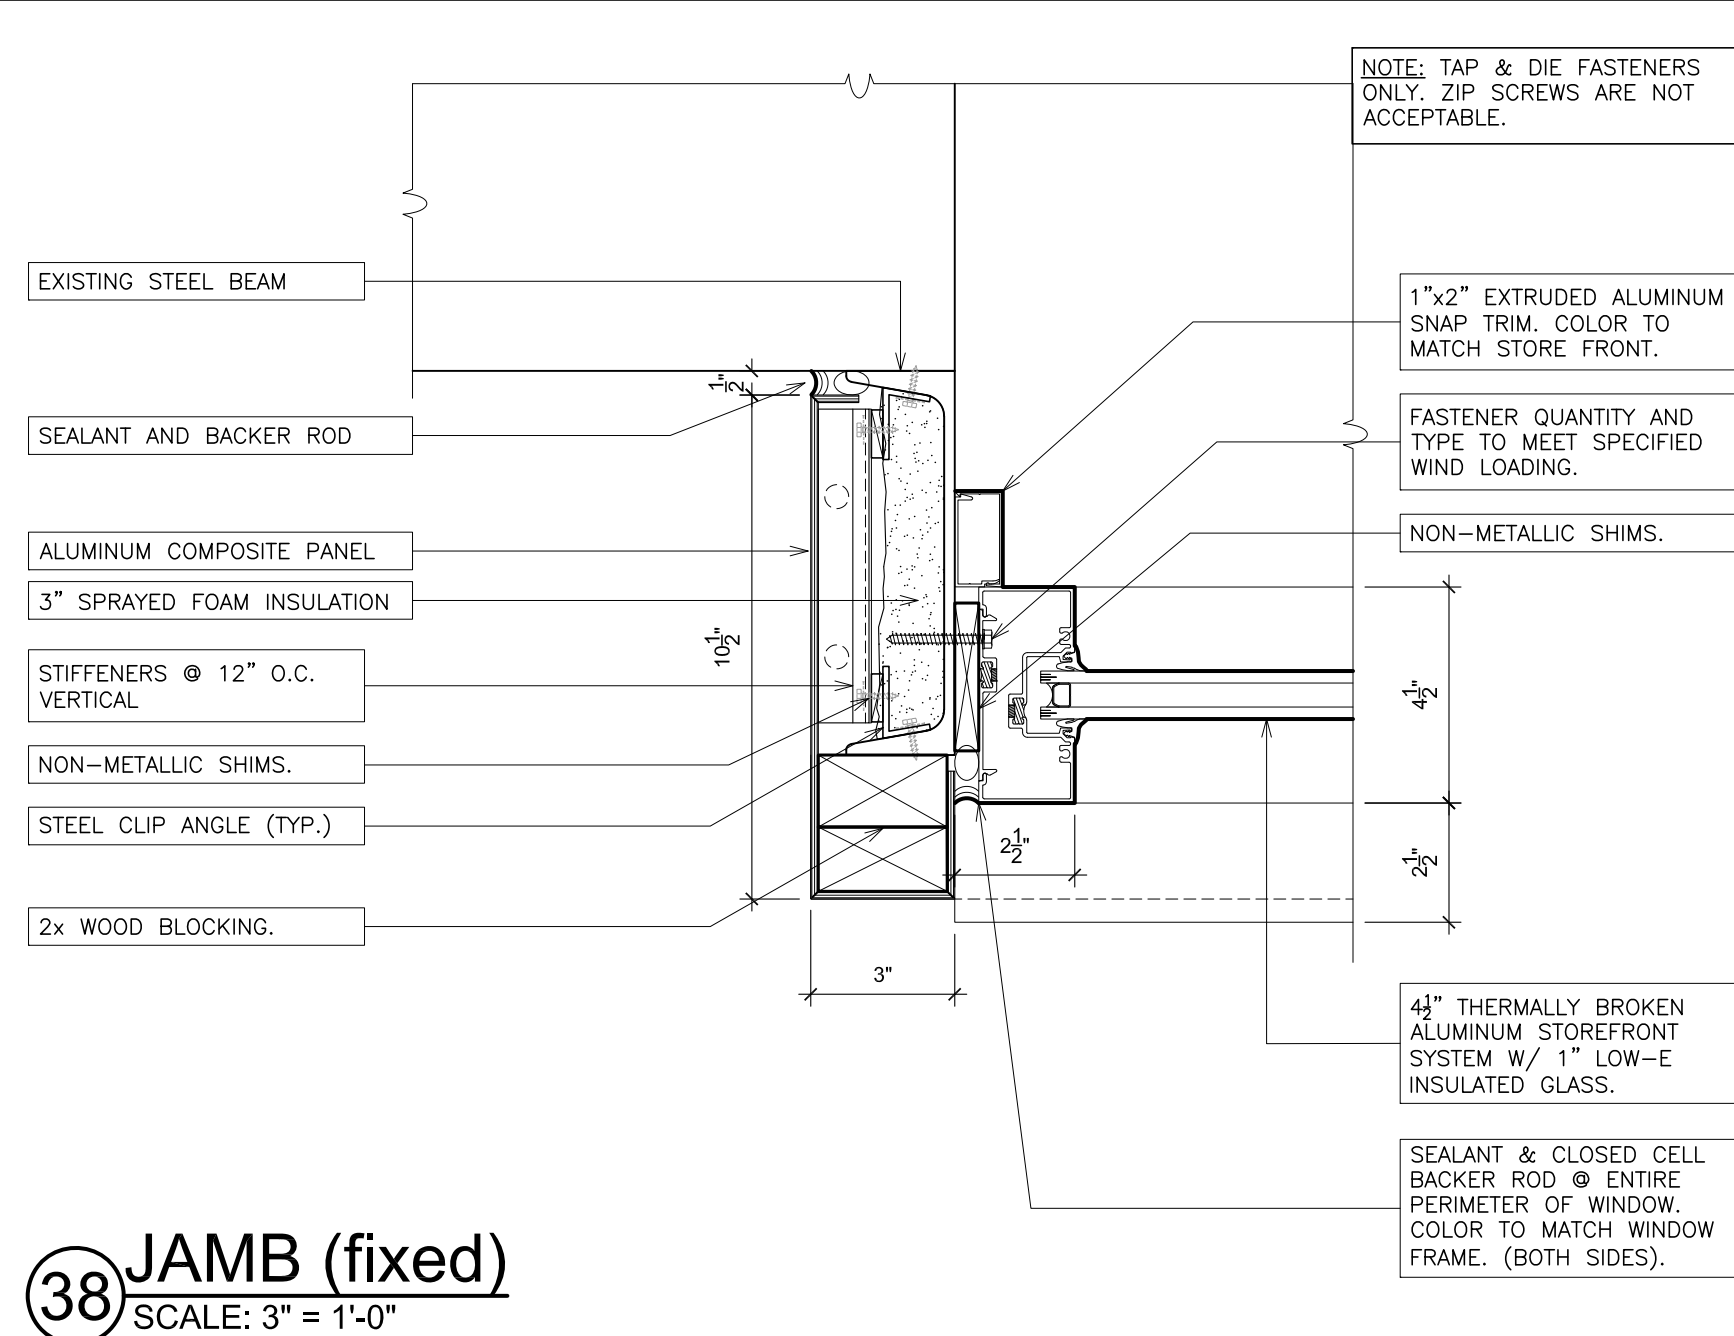
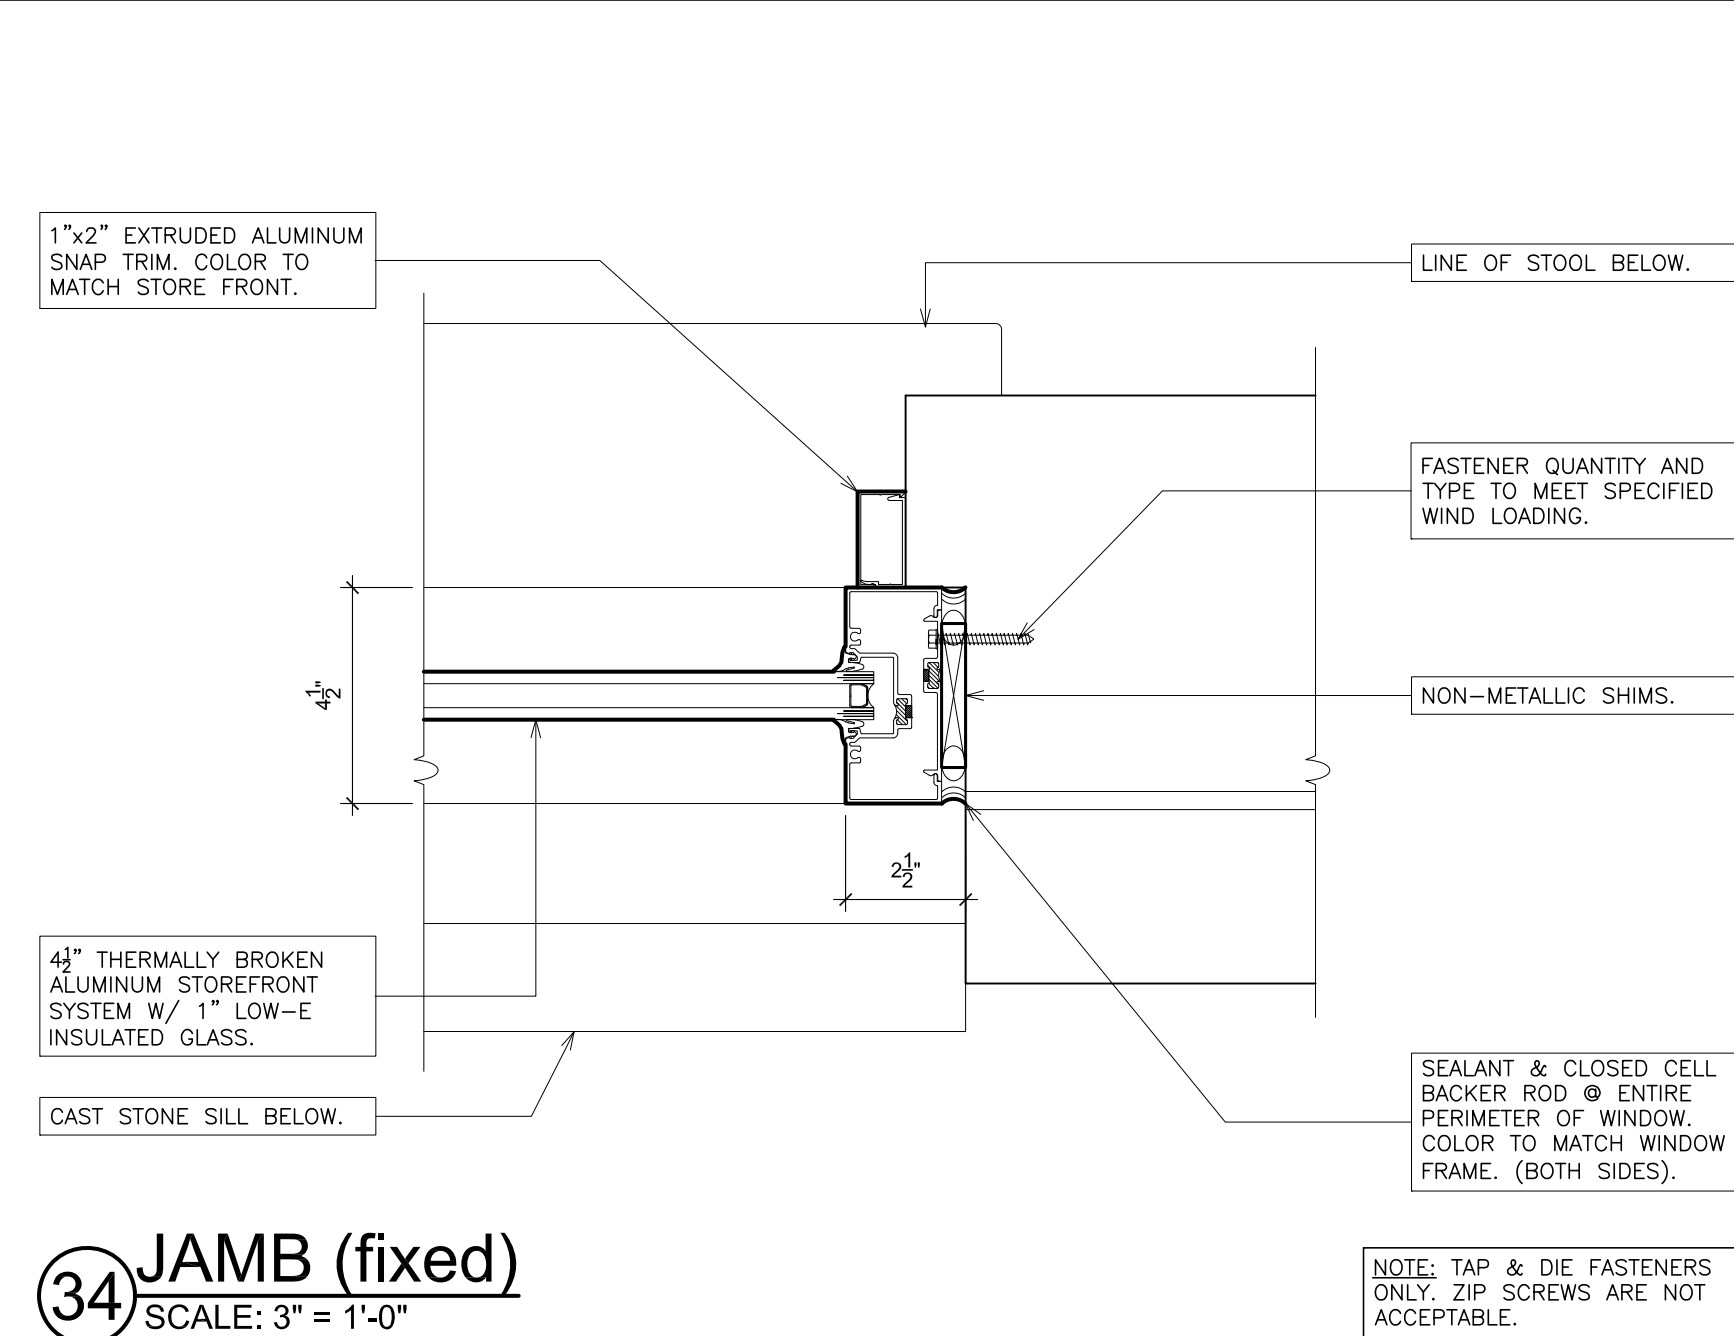
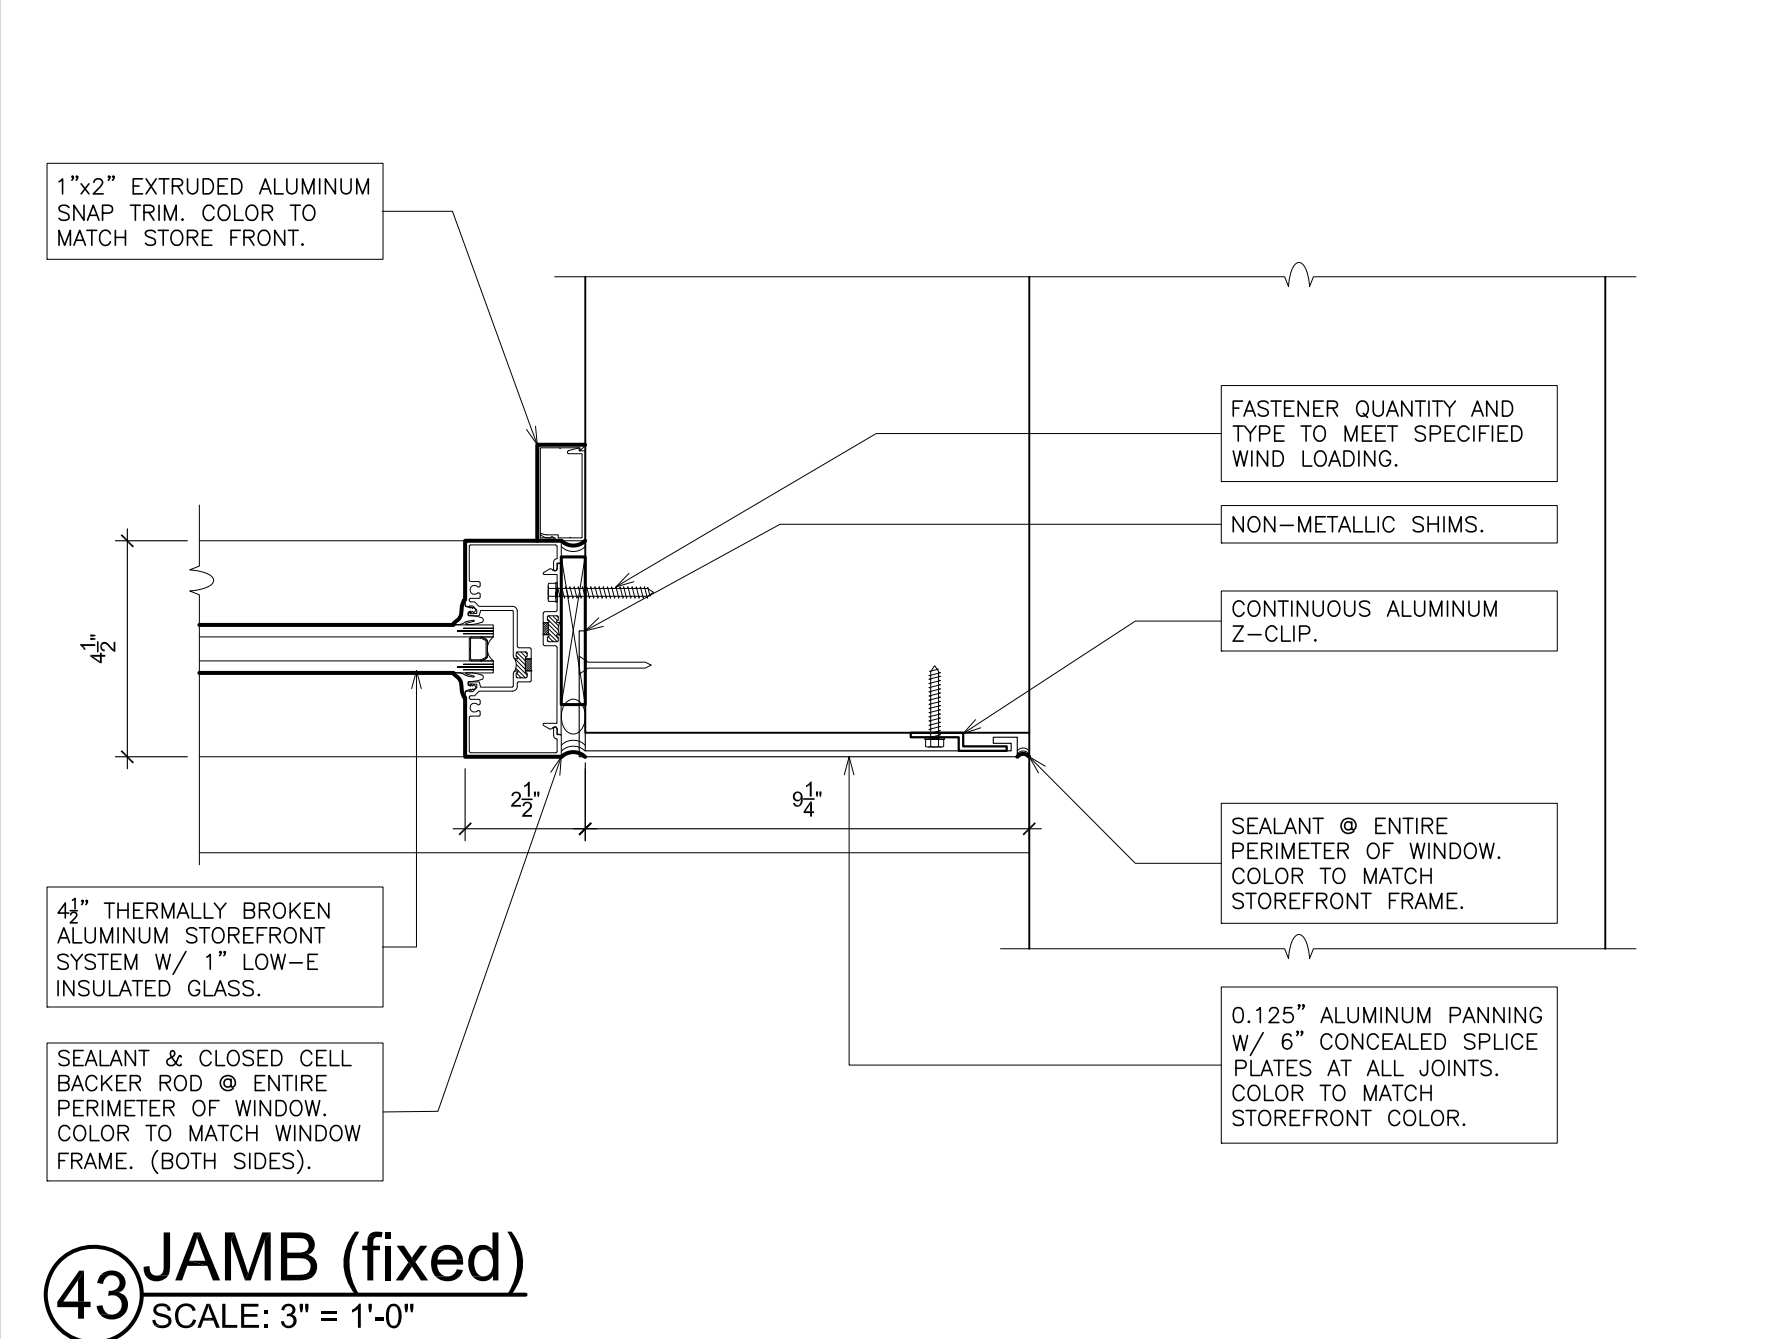
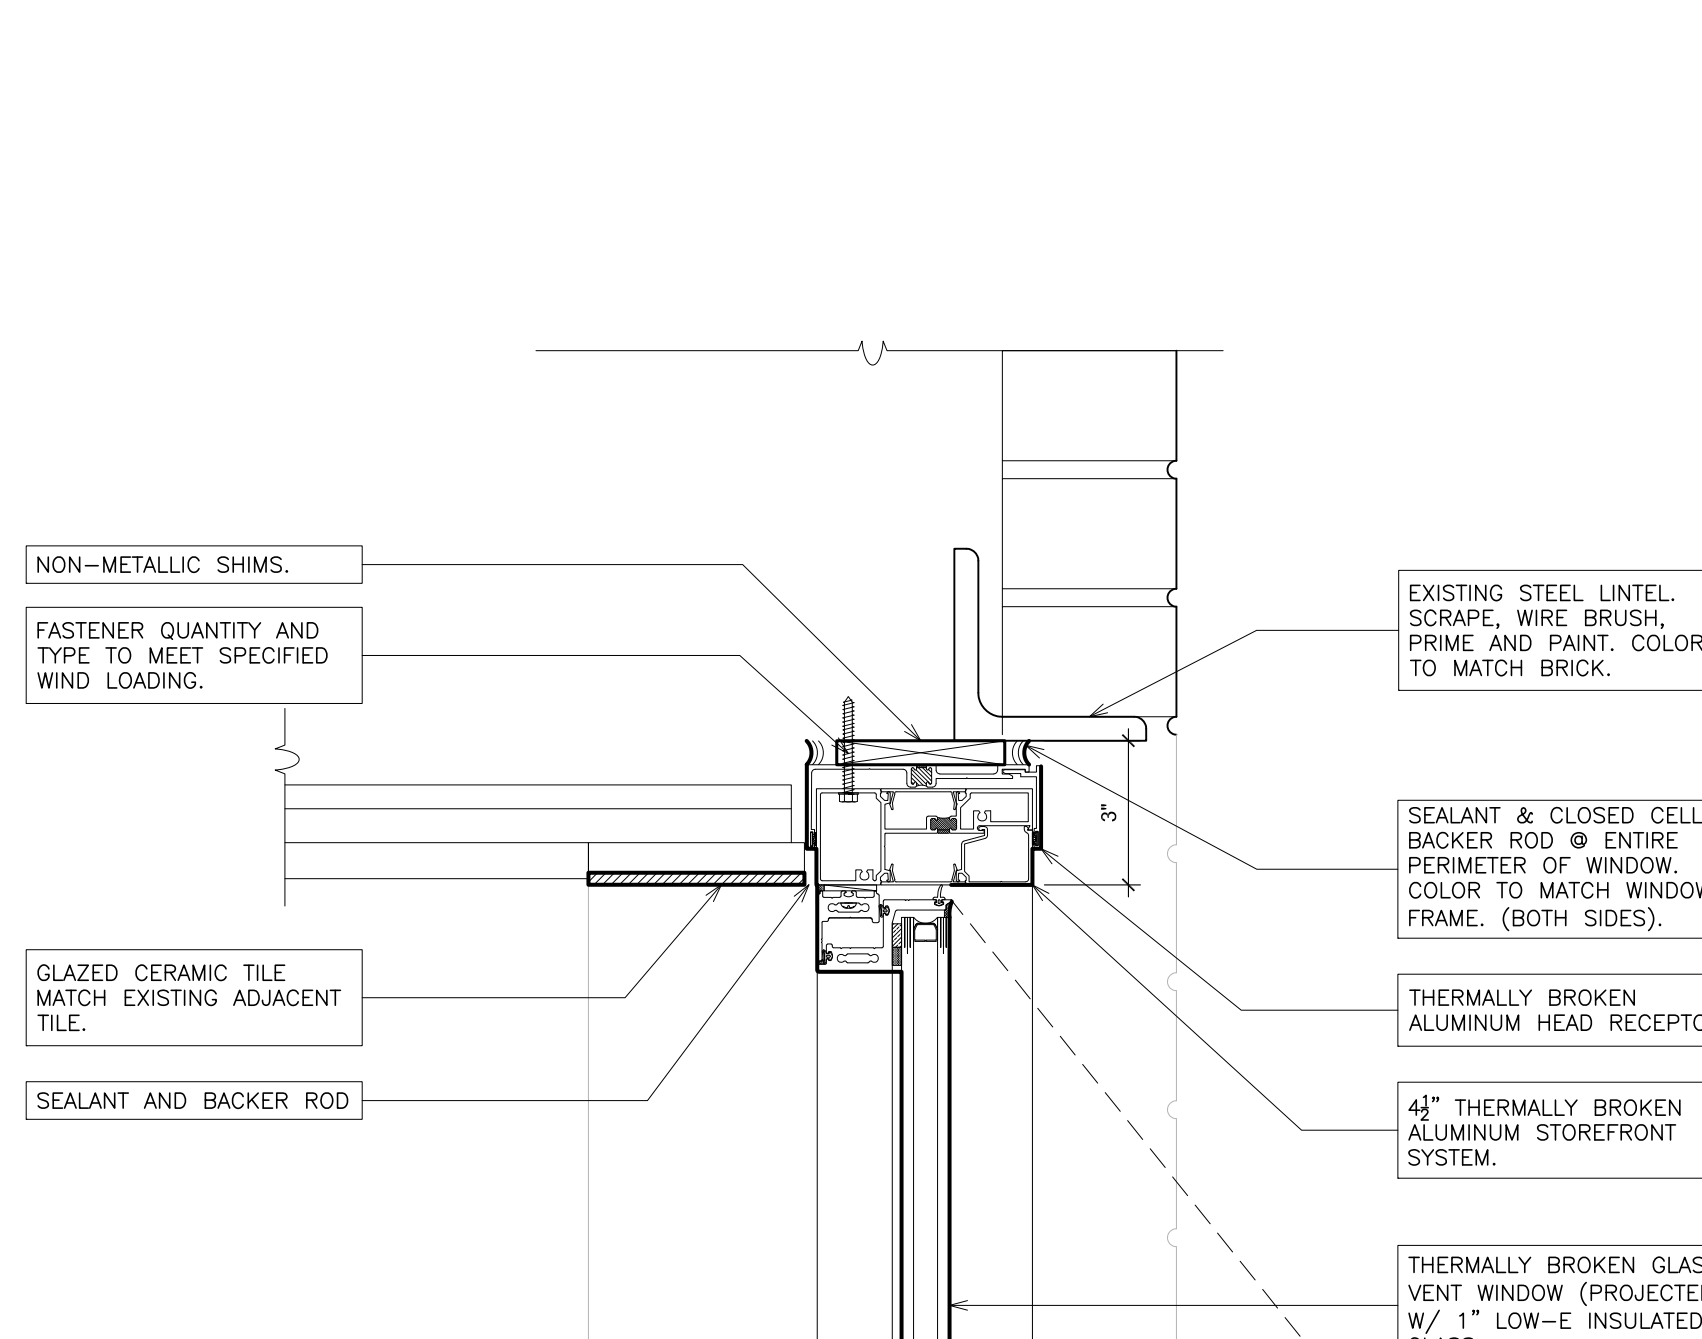
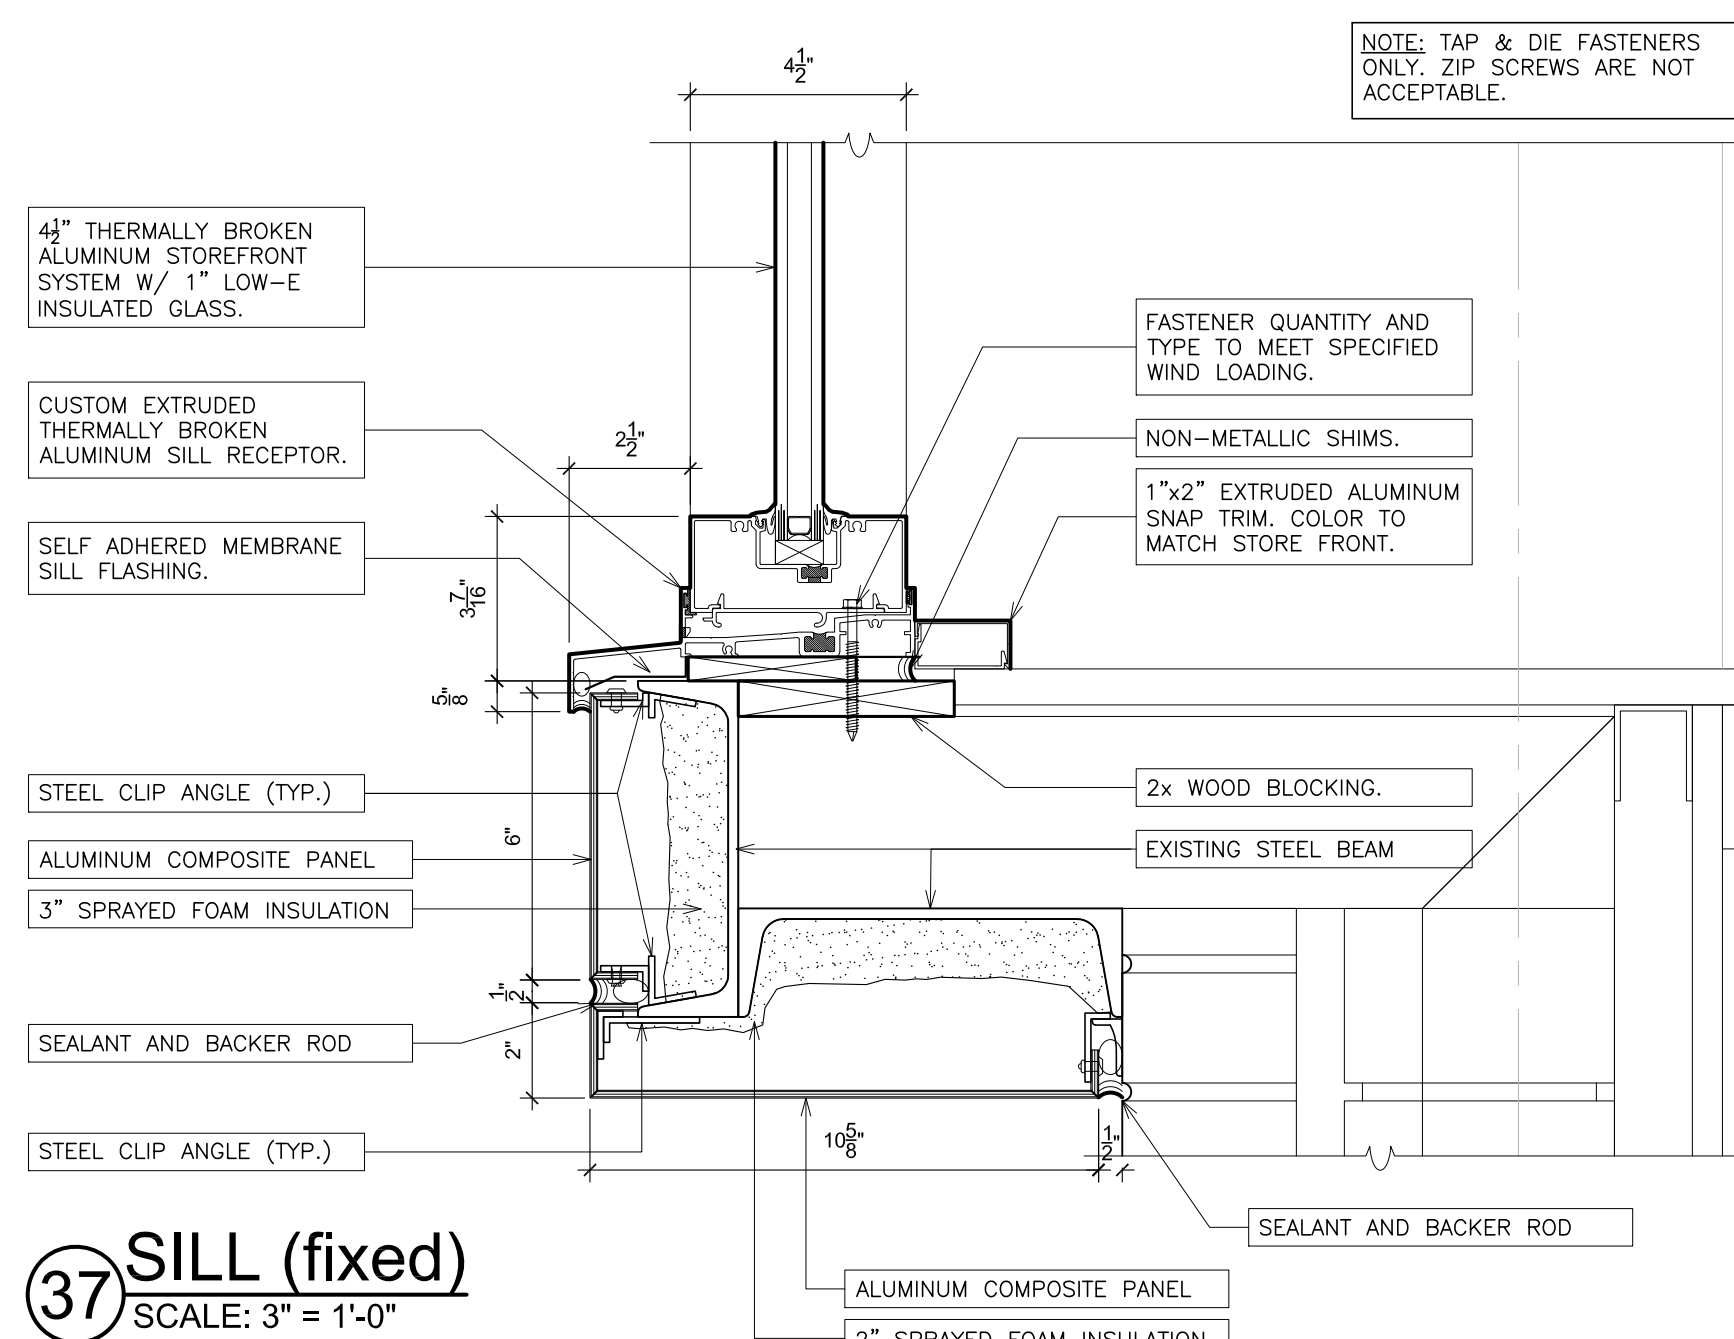
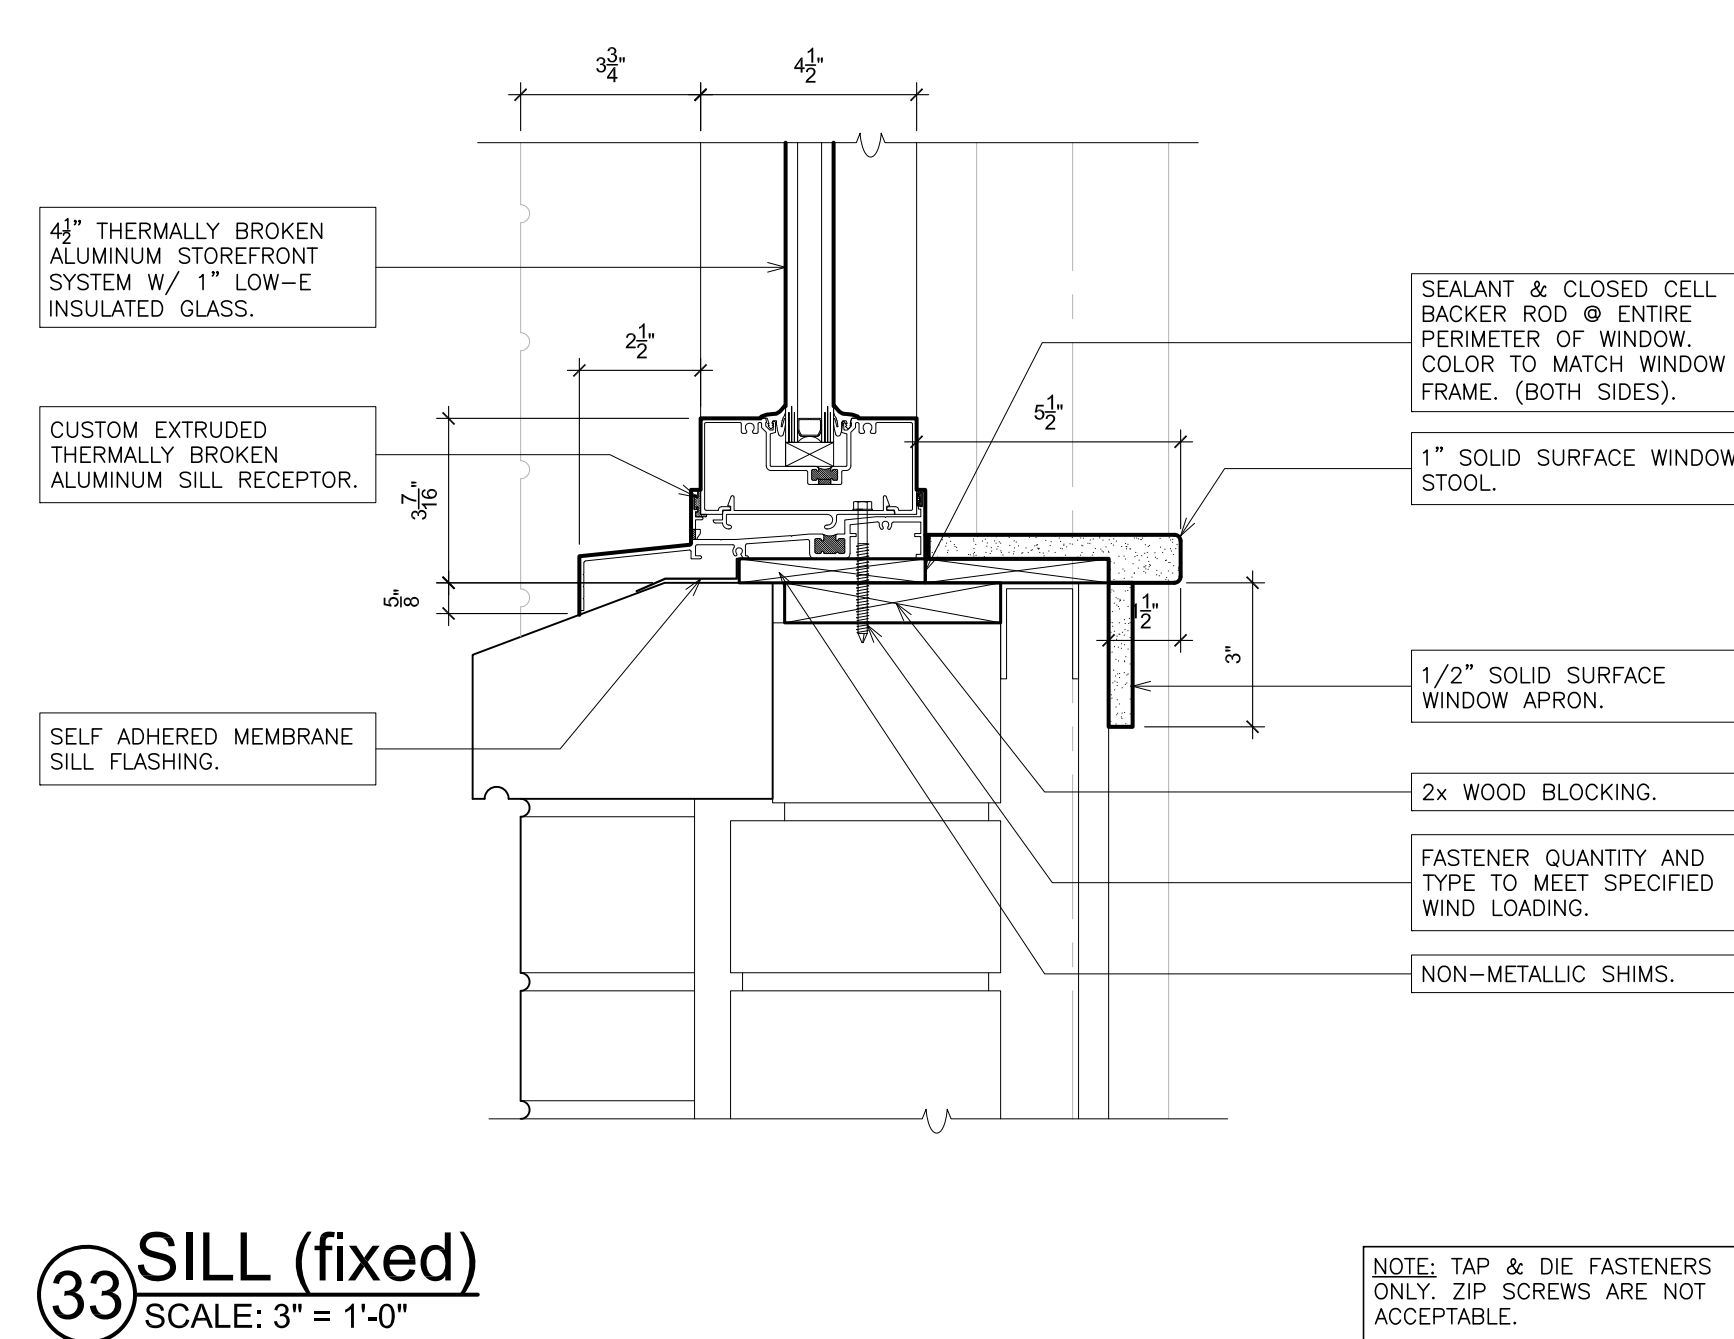
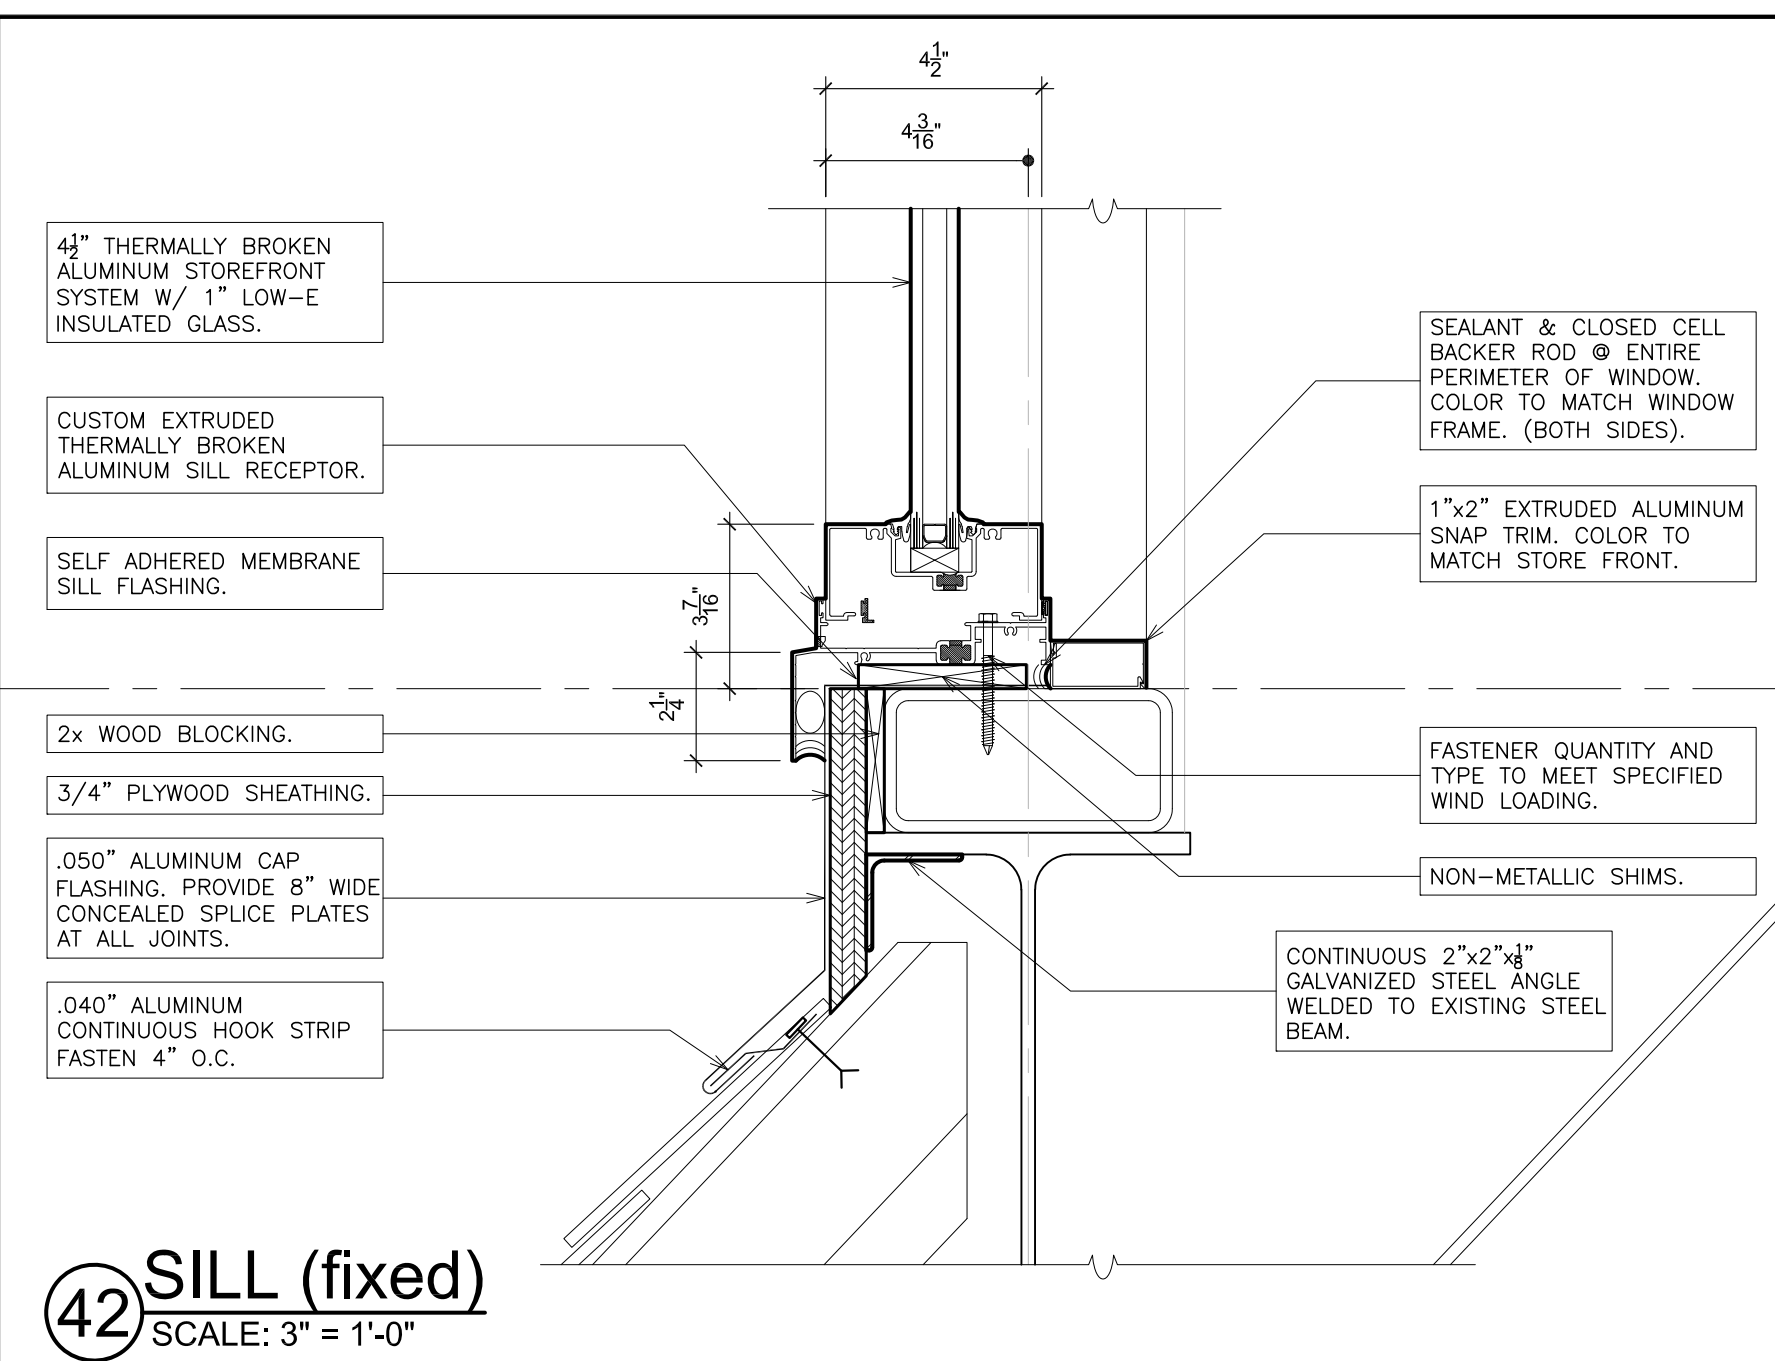
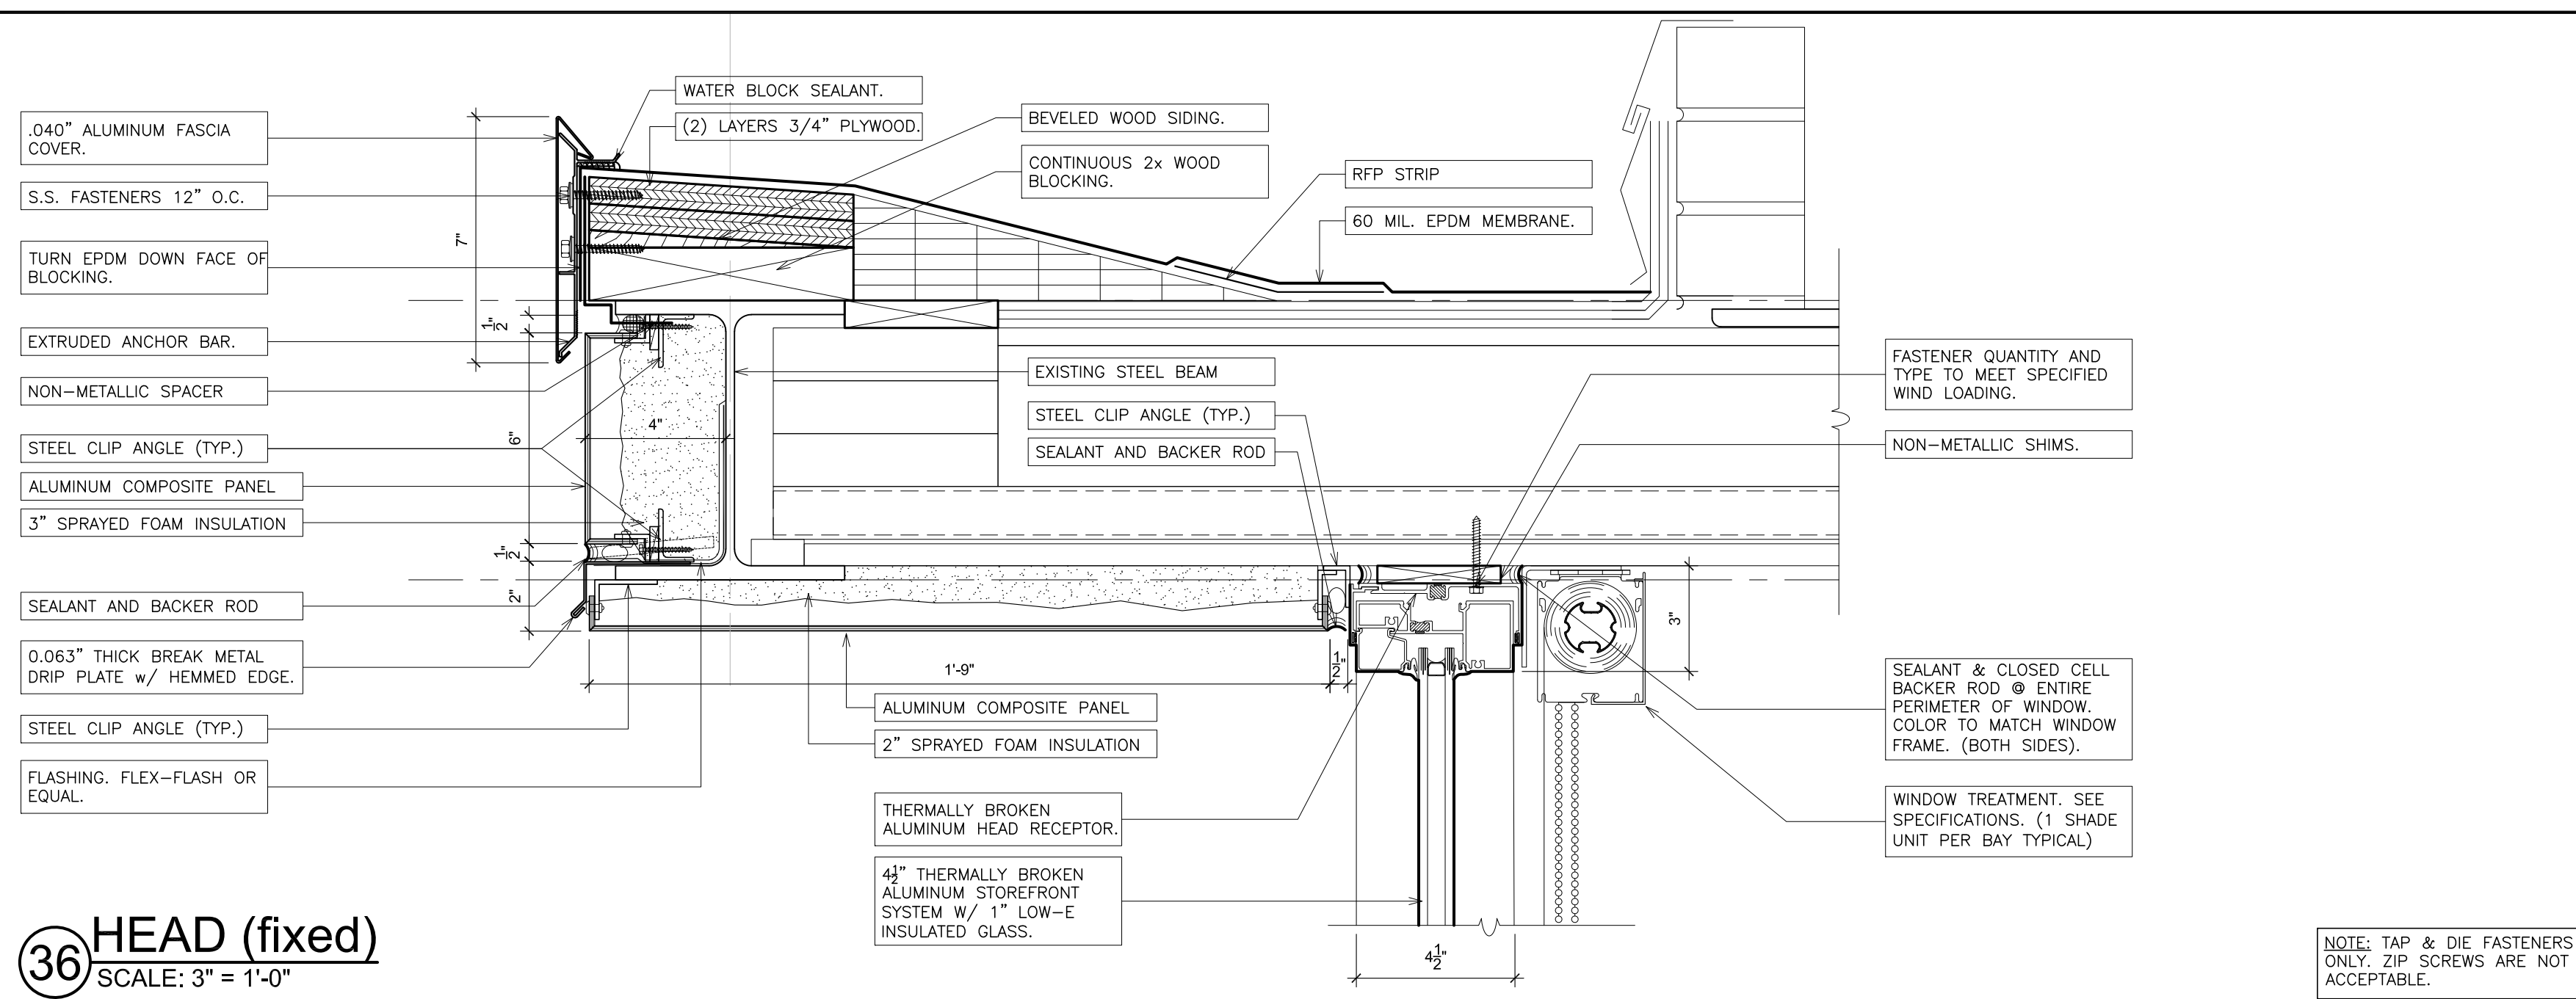
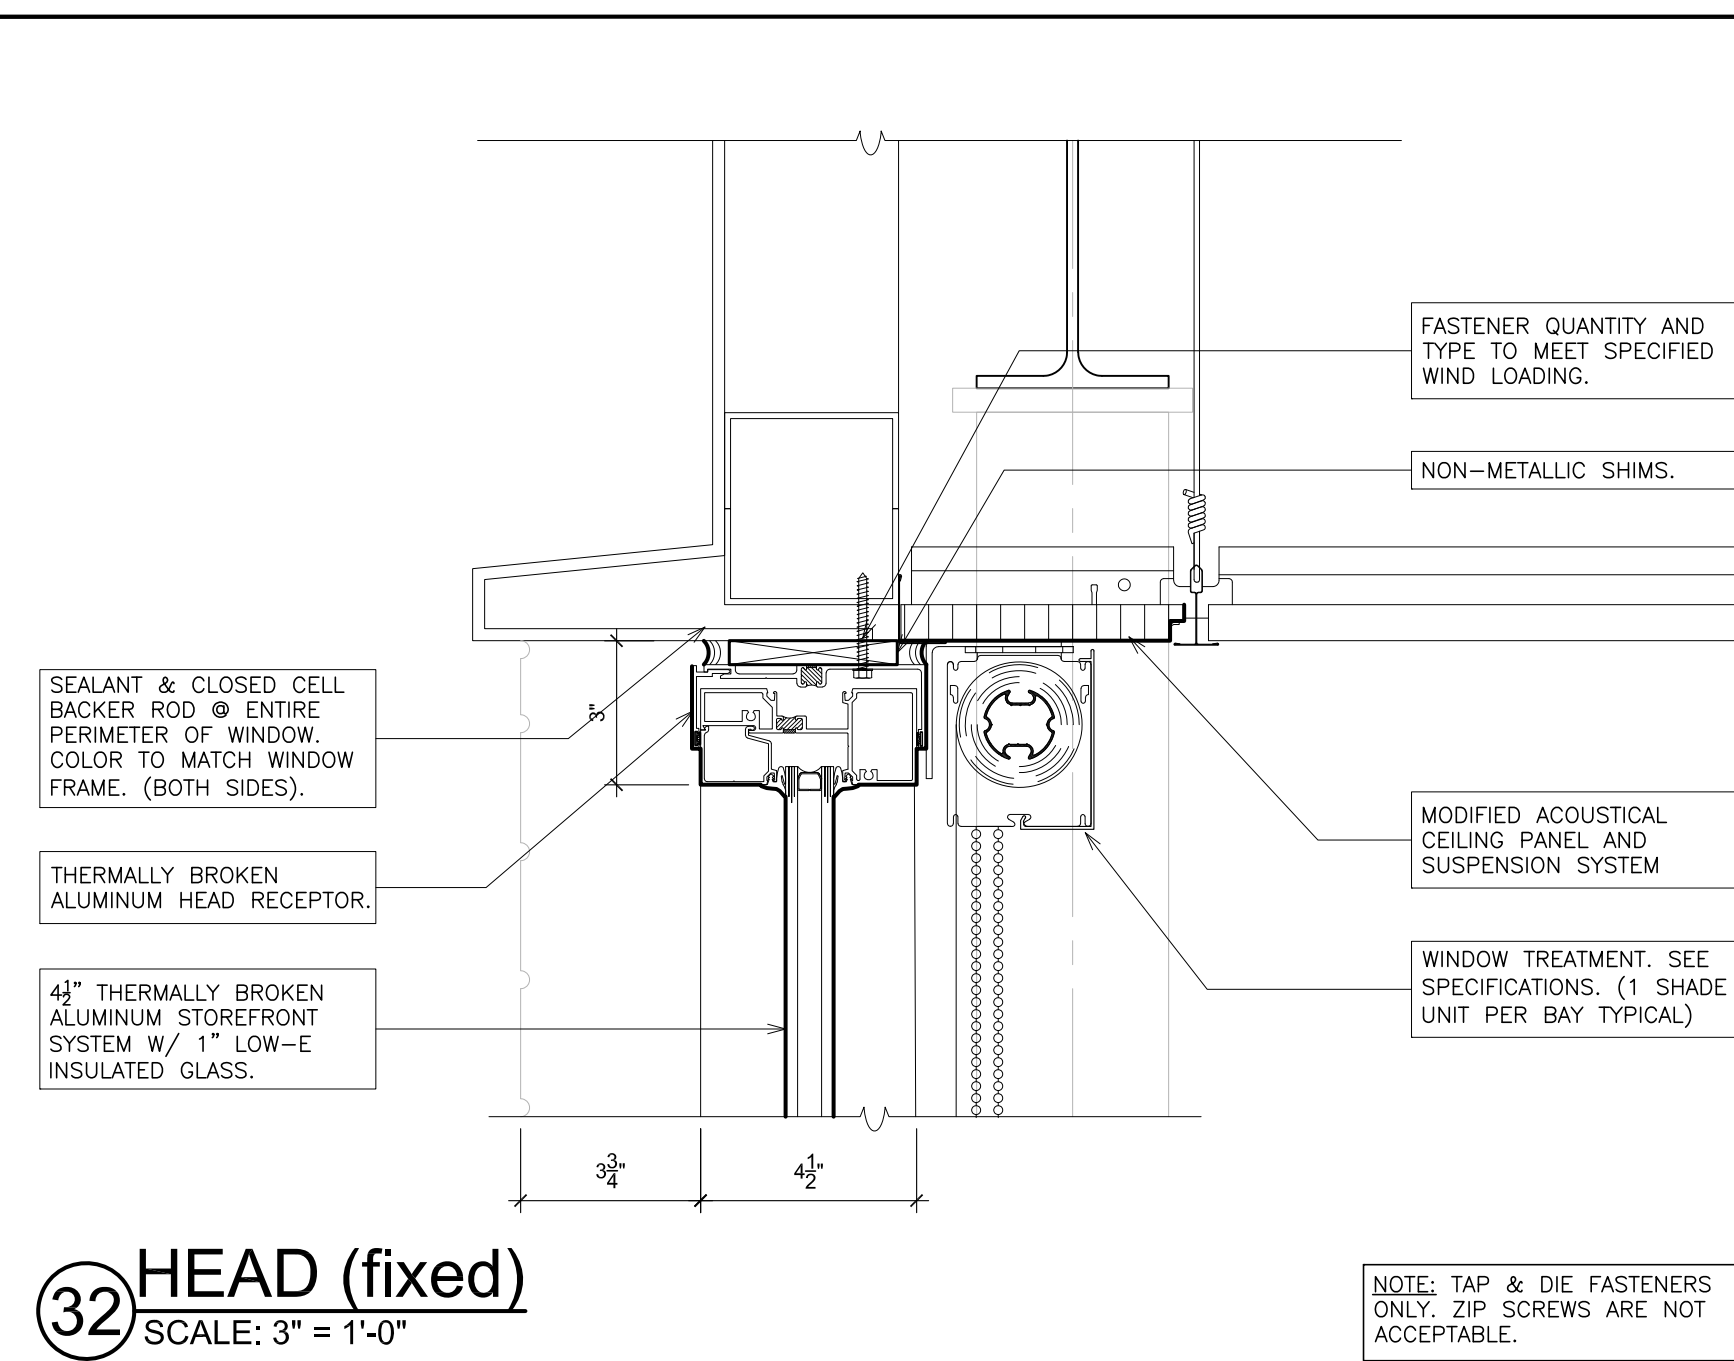
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S.E.D. CONTROL NUMBER:
GREENVILLE ELEMENTARY
66-04-06-034-008-023

PROJECT: NEW
EDGEMONT UNION FREE SCHOOL DISTRICT
GREENVILLE WINDOW REPLACEMENT AND
RELATED WORK
100 GLENDALE RD., SCARSDALE, NY 10583
DRAWING TITLE
WINDOW DETAILS

10-23-2024	RE-BID
08-27-2024	BID
11-14-2023	S.E.D. SUBMISSION
DATE	ISSUED TO
SCALE AS NOTED	DRAWING NO. A727
DRAWN BY F & D	CHECKED BY F & D
FILE NO. 23501.00	



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S.E.D. CONTROL NUMBER:
GREENVILLE ELEMENTARY
66-04-06-03-0-008-023

PROJECT TITLE	EDGEMONT UNION FREE SCHOOL, DISTRICT GREENVILLE WINDOW REPLACEMENT AND RELATED WORK
DRAWING TITLE	WINDOW DETAILS
PROJECT ADDRESS	110 GLENDALE RD., SCARSDALE, NY 10583

10-23-2024	RE-BID
08-27-2024	BID
11-14-2023	S.E.D. SUBMISSION
DATE	ISSUED TO
SCALE AS NOTED	DRAWING NO. A728
DRAWN BY F & D	
CHECKED BY F & D	FILE NO. 23501.00