



### **Troy Schools District**

# RFP #2324-04 BP#1B – Elementary School Playgrounds Phase #2 - Addendum #1 October 23<sup>rd</sup>, 2024

#### **Content Included in this Addendum:**

Cover Page (1 Page) Barton Malow Write Up (2 Pages) Pre-Bid Job Walk (1 Page) TMP Addendum #1 Write Up (25 Pages)

**TOTAL PAGES: 29 Pages** 



October 23rd, 2024

Troy Schools District – BP#1B – Elementary School Playgrounds Phase #2 – Addendum #1

#### Addendum #1 Bidder Clarifications

#### A. General Clarifications

- Clarification: Playground contractors will remove and reinstall all structures noted on drawings that are shown to be relocated
- Project Manual updates for work scopes shown below
- Pre-Bid Walk through occurred on 10/16 at Hamilton Elementary

#### B. Clarifications and Additions to Work Scopes

- ADD to Demo scope of work Sawcut and remove 2" strip of the existing asphalt where the new concrete curb will meet to edge of asphalt
- ADD to All Work scopes Contractors to provide bridging and steel plates to access land lock areas shown on drawings for all sites
- ADD to Site scope Field verify and coordinate all new fencing and relocated fencing with Barton Malow Builders before installation
- **ADD to Site scope** Refer to sheet C1.0 on the drawings for added site demo key note #9 regarding removal of light posts and concrete base.
- **REMOVE from Asphalt scope** Sawcut and remove existing asphalt and base to maintain a clean transition referencing the additional 2' strip needed at concrete curb and existing asphalt.

#### C. RFI Responses

**Q:** Is the sitework contractor in charge of building and removal of the temporary road for access? **A:** Yes, if needed.

**Q:** Does the synthetic turf have concrete underneath them, does this fall on sitework contractor or the playground contractor?

**A:** All concrete is the responsibility of the site contractor.

**Q:** Should the landscaper include an allowance for filling water bags of the trees? **A:** No, refer to specs for watering.

**Q:** Should the landscaper include an allowance for temporary irrigation to water hydro seed since there will be no access to water seed after school begins?

A: No, refer to specs for watering.

**Q:** The specs call out for lawn mowing, fertilizing, and weeding. The schools don't allow us on site during the day once kids ave access to playgrounds. How are we supposed to complete this task?

**A:** Must be coordinated with Barton Malow Builders to occur after or before recess and/or after school hours or weekends.

**Q:** How do we ensure mowing and fertilizing new lawn areas don't cross contaminate or conflict with the undisturbed lawn schedule?

**A:** See previous answer.

**Q:** 5B in the job scope for sitework says to provide and install and remove 2000 linear foot of temp chain link post driven fencing at each school. Is there a fencing detail that is more specific?

**A:** No detail provided. Field verify and coordinate with Barton Malow Builders.

**Q:** 5C in the job scope for sitework – Is there more detail regarding the communication boards and posts?

**A:** Boards are furnished by owner and posts are provided and installed by contractor.

**Q:** Does the landscape bid category have an allowance?

**A:** No.



#### **MEETING SIGN-IN SHEET**

DATE:	10/16/2024		PROJECT:	BP#1B TROY SCHOOL DISTRICT		
TIME:	4:00PM			ELEMENTARY SCHOOL PLAYGROUNDS PHASE #2		
HAMILTON ELEMENTARY – 5625 NORTHFIE TROY, MI, 48098		LD PKWY, SUBJECT:	PRE-BID MEETING			
ATTENI (Please prir		COMPANY	CATEGORY BIDDING	TELEPHONE	E-MAIL ADDRESS	
Justin Sherman		Barton Malow Builders			Justin.Sherman@bartonmalow.com	
Jon Johnson		Barton Malow Builders			Jon.Johnson@bartonmalow.com	
Adam Lewis		Barton Malow Builders			Adam.Lewis@bartonmalow.com	
Franco San	told	Suntors Servicesher	Site WOLK	586-770-5577	Franco Appetraissnau. net	
JOHN GIMM		NAGLE PAVING	Asp	248-765-3106	JoHNGEN AGLEPAVING COM	
Jechson War	wo-fl	Eciple Excavatru	Site work	810 767-7878	j Wentworth @ eagle excavation. con	
DADR VE Brenden F	TRSR 120	Santoro Services LL	Site work	<u>586-615-1956</u> <u>586-292-0943</u>	Drendan Odet oits now. Me	
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#### Addendum

October 22, 2024 **Date** 

**Project Name** Troy School District - Costello Elementary School Playground, Hamilton

Elementary School Playground, Leonard Elementary School Playground,

Schroeder Elementary School Playground, Wass Elementary School Playground,

Wattles Elementary School Playground

22088B, 22089B, 22091B, 22094B, 22096B, 22097B TMP Project No(s).

Bid Package No. 01B Addendum No. One (1)

The Bidding Documents are modified, supplemented, or augmented as follows and the Addendum is hereby made a part of the proposed Contract Documents.

The following Drawing(s) and Attachment(s) are issued with this Addendum:

Drawing No(s).: 22088B - Costello Elementary: C1.0

22089B - Hamilton Elementary: C1.0, C2.1, CE-2.2.0, CE-2.3.0

22091B - Leonard Elementary: C2.0 22094B - Schroeder Elementary: C3.2 22096B - Wass Elementary: C1.0

22097B - Wattles Elementary: C1.0

Specification Section(s): 00 0110, 10 1426, 32 1218 Attachment(s):

Item No.	Specification Changes
SC-1	Refer to Section No. 00 0110 – TABLE OF CONTENTS (reissued)  A. Added Division 10 specification section as indicated.
SC-2	Refer to Section No. 101426 – POST AND PANEL SIGNAGE (new)  A. Issued new specification section, complete.
SC-3	Refer to Section No. 32 1218 – PLAYGROUND ASPHALT PAVING MARKINGS (reissued):

A. Reduced number of painted exercises at Leonard Elementary and identified painted exercises as active or passive as indicated.

#### TMP ARCHITECTURE INC

October 22, 2024

Troy School District – Costello Elementary School Playground, Hamilton Elementary School Playground, Leonard Elementary School Playground, Schroeder Elementary School Playground, Wass Elementary School Playground

TMP Project No(s). 22088B, 22089B, 22091B, 22094B, 22096B, 22097B

Bid Package No. 01B

Addendum No. One (1) Page 2 of 3

#### 22088B - Costello Elementary School

Item No. Civil (Playground) Drawing Changes

CED-1 Refer to Drawing No. C1.0 (reissued):

A. Revised Demolition note #9 as indicated.

#### 22089B - Hamilton Elementary School

Item No. Civil (Playground) Drawing Changes

CED-1 Refer to Drawing No. C1.0 (reissued):

A. Revised Demolition note #9 as indicated.

CED-2 Refer to Drawing No. C2.1 (reissued):

A. Removed plastic edging and concrete curb along the northwest and northeast sides of the kindergarten playground as indicated. Added loose fill safety surfacing (by playground contractor) at reduced depth extending to existing fence line as indicated.

#### Item No. Civil Drawing Changes

CD-1 Refer to Drawing No. CE-2.2.0 (reissued):

A. Removed plastic edging and concrete curb along the northwest and northeast sides of the kindergarten playground as indicated.

CD-2 Refer to Drawing No. CE-2.3.0 (reissued):

A. Revised spot elevations along the northwest and northeast sides of the kindergarten playground as indicated.

#### TMP ARCHITECTURE INC

October 22, 2024

Troy School District – Costello Elementary School Playground, Hamilton Elementary School Playground, Leonard Elementary School Playground, Schroeder Elementary School Playground, Wass Elementary School Playground, Wattles Elementary School Playground

TMP Project No(s). 22088B, 22089B, 22091B, 22094B, 22096B, 22097B

Bid Package No. 01B

Addendum No. One (1) Page 3 of 3

#### 22091B - Leonard Elementary School

Item No. **Civil (Playground) Drawing Changes** 

CED-1 Refer to Drawing No. C2.0 (reissued):

> A. Reduced number of painted exercises and directionally oriented and identified painted exercises as active or passive as indicated.

#### 22094B - Schroeder Elementary School

Item No. Civil (Playground) Drawing Changes

CED-1 Refer to Drawing No.C3.2 (reissued):

A. Shifted lateral underdrain north as indicated.

#### 22096B - Wass Elementary School

Item No. Civil (Playground) Drawing Changes

CED-1 Refer to Drawing No. C1.0 (reissued):

A. Revised Demolition note #9 as indicated.

#### 22097B - Wattles Elementary School

Item No. **Civil (Playground) Drawing Changes** 

CED-1 Refer to Drawing No. C1.0 (reissued):

A. Revised Demolition note #9 as indicated.

\*\*\*END OF ADDENDUM NO. 1 - BID PACKAGE NO. 1B\*\*\*

#### **TABLE OF CONTENTS**

#### PROCUREMENT AND CONTRACTING REQUIREMENTS GROUP

#### **DIVISION 00 - PROCUREMENT AND CONTRACTING REQUIREMENTS**

Section	Title	Issued
00 0101 00 0110	Title Page Table of Contents	CD CD, ADD1
00 0115	List of Drawings	CD
00 8200	Availability of Electronic Files	CD
00 8200.02	Electronic Files Release Form (Free)	CD

#### **SPECIFICATIONS GROUP**

#### **GENERAL REQUIREMENTS SUBGROUP**

#### **DIVISION 01 - GENERAL REQUIREMENTS**

Section	Title	Issued
01 2200 01 2500 01 2500.01 01 3000 01 3000.01	Unit Prices Substitution Procedures TMP Substitution Request Form Administrative Requirements TMP Submittal and Sample Transmittal	CD CD CD CD
01 4000 01 4100 01 4216 01 4219 01 4533	Form Quality Requirements Regulatory Requirements Definitions Reference Standards Code-Required Special Inspections and	CD CD CD CD
01 5639 01 6000 01 7000 01 7329 01 7800 01 7900	Procedures Temporary Tree and Plan Protection Product Requirements Execution and Closeout Requirements Cutting and Patching Closeout Submittals Demonstration and Training	CD CD CD CD CD

#### **FACILITY CONSTRUCTION SUBGROUP**

#### **DIVISION 02 - EXISTING CONDITIONS**

Section Title Issued

02 4100 Demolition CD

**DIVISION 03 - CONCRETE** 

Not Used

**DIVISION 04 - MASONRY** 

Not Used

**DIVISION 05 - METALS** 

Not Used

**DIVISION 06 - WOOD, PLASTICS, AND COMPOSITES** 

Not Used

**DIVISION 07 - THERMAL AND MOISTURE PROTECTION** 

Not Used

**DIVISION 08 - OPENINGS** 

Not Used

**DIVISION 09 - FINISHES** 

Not Used

**DIVISION 10 - SPECIALTIES** 

Section Title Issued

10 1426 Post and Panel Signs ADD1

#### **DIVISION 11 - EQUIPMENT**

Not Used

#### **DIVISION 12 - FURNISHINGS**

Not Used

#### **DIVISION 13 - SPECIAL CONSTRUCTION**

Not Used

#### **DIVISION 14 - CONVEYING EQUIPMENT**

Not Used

#### **FACILITY SERVICES SUBGROUP**

#### **DIVISION 20 - COMMON MECHANICAL REQUIREMENTS**

Not Used

#### **DIVISION 21 - FIRE SUPPRESSION**

Not Used

#### **DIVISION 22 - PLUMBING**

Not Used

#### **DIVISION 23 – HEATING VENTILATING AND AIR CONDITIONING (HVAC)**

Not Used

#### **DIVISION 25 - INTEGRATED AUTOMATION**

Not Used

#### **DIVISION 26 - ELECTRICAL**

Not Used

#### **DIVISION 27 - COMMUNICATIONS**

Not Used

#### **DIVISION 28 - ELECTRONIC SAFETY AND SECURITY**

Not Used

#### SITE AND INFRASTRUCTURE SUBGROUP

#### **DIVISION 31 – EARTHWORK**

Section	Title	Issued
31 1000	Site Clearing	CD
31 2000	Earth Moving	CD

#### **DIVISION 32 - EXTERIOR IMPROVEMENTS**

Section	Title	Issued
32 1218	Playground Asphalt Paving	CD, ADD1
32 9200	Turf and Grasses	CD
32 9300	Plants	CD

#### **DIVISION 33 - UTILITIES**

Not Used

#### **END OF SECTION**

### SECTION 101426 - POST AND PANEL SIGNAGE \*\*ADD1\*\*

#### **PART 1 GENERAL**

#### 1.01RELATED DOCUMENTS

A. Drawings and general provisions of the Contract, including General and Supplementary Conditions and Division 01 Specification Sections, apply to this Section.

#### 1.02 SUMMARY

- A. This Section includes the following:
  - 1. Non-illuminated "Communication Board" post and panel signs.
- B. Related Sections include the following:
  - 1. Division 01 Section "Temporary Facilities and Controls" for temporary Project identification signs and for temporary informational and directional signs.
  - 2. Division 03 Section "Cast-in-Place Concrete" for concrete foundations and concrete fill.

#### 1.03 PERFORMANCE REQUIREMENTS

A. Design Criteria: Design, fabricate, and install exterior post and panel signs to withstand a wind velocity of 100 mph (160 km/h) on the total sign area, in all directions.

#### 1.04 SUBMITTALS

- A. Product Data: For each type of post and panel sign specified. Include details of construction relative to materials, dimensions of individual components, profiles, and finishes.
  - 1. Provide manufacturer's written instructions for maintaining and cleaning sign surfaces.
- B. Shop Drawings: For each type of sign indicated.
  - 1. Provide plans, elevations, and at least 3/4-inch (1:20) scale sections of typical members and other components. Show anchors, reinforcement, accessories, layout, and installation details.

#### 1.05 QUALITY ASSURANCE

- A. Installer Qualifications: Engage an experienced installer who is an authorized representative of the sign manufacturer and who has completed installation of post and panel signs similar in material, design, and extent to that indicated for this Project and with a record of successful in-service performance.
- B. Source Limitations for Signs: Obtain each sign type indicated from one source from a single manufacturer.
- C. Product Options: Drawings indicate size, profiles, and dimensional requirements of post and panel signs and are based on the specific type and model indicated. Other manufacturers' signs may be considered provided deviations are minor and do not change the design concept and are approved by the Architect.
  - Do not modify intended aesthetic effects, as judged solely by the Architect, except with Architect's approval and only to the extent needed to comply with performance requirements. Where modifications are proposed, submit comprehensive explanatory data to Architect for review.

#### 1.06 DELIVERY AND HANDLING

- A. Delivery: Provide protective covering or crating as recommended by the manufacturer to protect sign components and surfaces against damage during transportation and delivery.
  - Coordinate delivery time so signs can be installed within 24 hours of receipt at Project site.
- B. Handle signs carefully to prevent breakage, surface abrasion, denting, soiling, and other defects. Comply with the manufacturer's written handling instructions for unloading components subject to damage.
  - 1. Inspect sign components for damage on delivery.

- Do not install damaged sign components.
- 3. Repair minor damage to signs, provided the finished repair is equal in all respects to the original work and is approved by Architect; otherwise, remove and replace damaged sign components.

#### 1.07 **WARRANTY**

- A. General Warranty: The special warranty specified in this Article shall not deprive the Owner of other rights the Owner may have under other provisions of the Contract Documents and shall be in addition to, and run concurrent with, other warranties made by the Contractor under requirements of the Contract Documents.
- B. Interpretive signs must be warranted for a period of 10 years against chipping and delaminating and for five years against fading.

#### **PART 2 - PRODUCTS**

#### 2.01 **MATERIALS**

- A. Communication Board Signs: 32 Core Communication Playground Boards, as manufactured by Oakland Schools, (248) 209-2150, Printing@OSisd.org.
  - 1. Model #PS-0232, 2-sided sign
  - Frame:
    - a. (2) 2-3/8" dia. x 8'-0" length, 40WT galvanized posts
    - b. (2) 2-3/8" dome post caps
    - c. (4) 2-3/8" brace bands with nuts and bolts.
  - Contractor to provide additional installation materials as required by manufacturer.
  - 4. Sign panel art graphics must match existing communication board graphics at Troy School Districts. Owner to provide graphics files as needed.

#### 2.02 **ACCESSORIES**

- A. Fasteners: Use concealed fasteners fabricated from metals that are noncorrosive to sign material and mounting surface.
- B. Anchors and Inserts: Use nonferrous metal or hot-dip galvanized anchors and inserts. Use stainless steel for drilled-in-place anchors. Furnish inserts, as required, to be set into concrete.

#### **PART 3 - EXECUTION**

#### 3.01 **PREPARATION**

A. Furnish templates, anchor bolts, internal reinforcement, and other items required to be set in concrete post foundations at proper time for setting.

#### 3.02 **INSTALLATION**

- A. General: Locate sign units and accessories where indicated, using mounting methods of type described and complying with manufacturer's written instructions.
- B. Use anchors as indicated on drawings. Use templates, setting drawings, diagrams, instructions, and directions provided by suppliers of items to be attached.
- C. Install signs level, plumb, and at height indicated, with surfaces free from distortion or other defects in appearance.
- D. Install Communication Board signs per Drawings and manufacturer's written instructions.

#### **CLEANING AND PROTECTION** 3.03

- A. After installation, clean soiled sign surfaces according to manufacturer's written instructions. Protect signs from damage until acceptance by Owner.
- B. Protect installed sign units from damage until acceptance by Owner.

#### **END OF SECTION**

#### **SECTION 32 1218 - PLAYGROUND ASPHALT PAVING MARKINGS**

#### **PART 1 - GENERAL**

#### 1.1 RELATED DOCUMENTS

- A. Drawings and general provisions of the Contract, including General and Supplementary Conditions and Division 01 Specification Sections, apply to this Section.
- B. MDOT Standard Specifications For Construction, current edition.

#### 1.2 SUMMARY

- A. Section Includes:
  - 1. Pavement-marking paint.
  - 2. Asphalt coating sealer

#### 1.3 **DEFINITION**

- A. Hot-Mix Asphalt Paving Terminology: Refer to ASTM D 8 for definitions of terms.
- B. MDOT: Michigan Department of Transportation.

#### 1.4 SYSTEM DESCRIPTION

- A. Provide hot-mix asphalt paving according to materials, workmanship, and other applicable requirements of standard specification of MDOT.
  - 1. Standard Specification: Michigan Department of Transportation Standards, current edition.

#### 1.5 SUBMITTALS

A. Product Data: For each type of product indicated.

#### 1.6 QUALITY ASSURANCE

A. Installer Qualifications: Asphalt paint authorized installer who is trained and approved for installation of asphalt paint graphics required for this Project.

#### 1.7 DELIVERY, STORAGE, AND HANDLING

- A. Deliver pavement-marking materials to Project site in original packages with seals unbroken and bearing manufacturer's labels containing brand name and type of material, date of manufacture, and directions for storage.
- B. Store pavement-marking materials in a clean, dry, protected location within temperature range required by manufacturer. Protect stored materials from direct sunlight.

#### 1.8 PROJECT CONDITIONS

A. Pavement-Marking Paint: Proceed with pavement marking only on clean, dry surfaces and at a minimum ambient or surface temperature of 40 deg F for oil-based materials, 50 deg F for water-based materials and not exceeding 95 deg F

#### **PART 2 - PRODUCTS**

#### 2.1 AUXILIARY MATERIALS

- A. Pavement-Marking Paint: Alkyd-resin type, lead and chromate free, ready mixed, complying with AASHTO M 248, Type N; colors complying with FS TT-P-1952.
  - 1. Basketball Court Line Color: White
  - 2. Basketball Court Free Throw Box Infill Color: Blue
  - 3. Asphalt Painted Games:
    - a. Silly Track:
      - 1) Color A: Yellow
      - 2) Color B: Purple
    - b. USA Map:
      - 1) Color C (Country & State Outlines): White
      - 2) Color D (State Infills): Red, orange, yellow, green, blue & purple, colors to alternate and no one (1) color shall be adjacent to the same (1) color.
    - c. Mirror Me:

- 1) Color A: White
- 2) Color B: Red
- 3) Color C: Orange
- 4) Color D: Yellow
- 5) Color E: Green
- 6) Color F: Blue
- 7) Color G: Purple
- 8) Color H: Black
- d. Four-Square:
  - 1) Colors: Refer to construction documents for color information to match each school's colors.
- e. Fitness Agility Ladder:
  - 1) Color A: Blue
  - 2) Color B: Red
  - 3) Feet Color: White
- f. Bulls Eye Game:
  - 1) Inner Circle Color: Yellow
  - 2) Middle Circle Color: Blue
  - 3) Outer Circle Color: Red
  - 4) Text Color: White
  - 5) Throw Line: Red
- g. Robot Hopscotch, #ST 5021 as manufactured by Fit and Fun Playscapes, 200 Overocker road, Bldg. 2, Poughkeepsie, NY, 12603, (800)681-0684, info@fitandfunllc.com
  - 1) Colors to match manufacturer's written instructions.
- h. Alphabet Snake, #ST 5063 as manufactured by Fit and Fun Playscapes, 200 Overocker road, Bldg. 2, Poughkeepsie, NY, 12603, (800)681-0684, info@fitandfunllc.com
  - 1) Colors to match manufacturer's written instructions
- Skelly Board, #ST 5020 as manufactured by Fit and Fun Playscapes, 200 Overocker road, Bldg. 2, Poughkeepsie, NY, 12603, (800)681-0684, info@fitandfunllc.com
  - 1) Colors to match manufacturer's written instructions.
- 4. Exercise Stations:
  - a. Costello Elementary:
    - a) Jumping Jacks, #ST 5071, as manufactured by Fit and Fun Playscapes, 200 Overocker road, Bldg. 2, Poughkeepsie, NY, 12603, (800)681-0684, info@fitandfunllc.com, Color: Blue
    - b) Side Jump, #ST 5076 as manufactured by Fit and Fun Playscapes, 200 Overocker road, Bldg. 2, Poughkeepsie, NY, 12603, (800)681-0684, info@fitandfunllc.com, Color: Yellow
    - c) High Knees, #ST 5080 as manufactured by Fit and Fun Playscapes, 200 Overocker road, Bldg. 2, Poughkeepsie, NY, 12603, (800)681-0684, info@fitandfunllc.com, Color: Cyan
    - d) Step, #ST 5104 as manufactured by Fit and Fun Playscapes, 200 Overocker road, Bldg. 2, Poughkeepsie, NY, 12603, (800)681-0684, info@fitandfunllc.com, Color: Green

- e) Hop, #ST 5075, as manufactured by Fit and Fun Playscapes, 200 Overocker road, Bldg. 2, Poughkeepsie, NY, 12603, (800)681-0684, info@fitandfunllc.com, Color: Orange
- f) Sprint, #ST 5079, as manufactured by Fit and Fun Playscapes, 200 Overocker road, Bldg. 2, Poughkeepsie, NY, 12603, (800)681-0684, <a href="mailto:info@fitandfunllc.com">info@fitandfunllc.com</a>, Color: Magenta

#### 2) Hamilton Elementary:

- Squats, #ST 5069 as manufactured by Fit and Fun Playscapes, 200 Overocker road, Bldg. 2, Poughkeepsie, NY, 12603, (800)681-0684, info@fitandfunllc.com, Color: Green
- b) Lunges, #ST 5070, as manufactured by Fit and Fun Playscapes, 200 Overocker road, Bldg. 2, Poughkeepsie, NY, 12603, (800)681-0684, info@fitandfunllc.com, Color: Purple
- c) Jumping Jacks, #ST 5071, as manufactured by Fit and Fun Playscapes, 200 Overocker road, Bldg. 2, Poughkeepsie, NY, 12603, (800)681-0684, info@fitandfunllc.com, Color: Blue
- d) Jump Rope, ST #5065, as manufactured by Fit and Fun Playscapes, 200 Overocker road, Bldg. 2, Poughkeepsie, NY, 12603, (800)681-0684, info@fitandfunllc.com, Color: Magenta
- e) Side Jump, #ST 5076 as manufactured by Fit and Fun Playscapes, 200 Overocker road, Bldg. 2, Poughkeepsie, NY, 12603, (800)681-0684, info@fitandfunllc.com, Color: Orange
- f) High Knees, #ST 5080 as manufactured by Fit and Fun Playscapes, 200 Overocker road, Bldg. 2, Poughkeepsie, NY, 12603, (800)681-0684, info@fitandfunllc.com, Color: Cyan
- g) Dancer Pose, #ST 5108, as manufactured by Fit and Fun Playscapes, 200 Overocker road, Bldg. 2, Poughkeepsie, NY, 12603, (800)681-0684, info@fitandfunllc.com, Color: Red
- h) Star Pose, ST #5112 as manufactured by Fit and Fun Playscapes, 200 Overocker road, Bldg. 2, Poughkeepsie, NY, 12603, (800)681-0684, <a href="mailto:info@fitandfunllc.com">info@fitandfunllc.com</a>, Color: Yellow
- i) Step, #ST 5104 as manufactured by Fit and Fun Playscapes, 200 Overocker road, Bldg. 2, Poughkeepsie, NY, 12603, (800)681-0684, info@fitandfunllc.com, Color: Green
- j) Tight Rope, #ST 5105 as manufactured by Fit and Fun Playscapes, 200 Overocker road, Bldg. 2, Poughkeepsie, NY, 12603, (800)681-0684, info@fitandfunllc.com, Color: Purple
- k) Tree Pose, #ST 5106 as manufactured by Fit and Fun Playscapes, 200 Overocker road, Bldg. 2, Poughkeepsie, NY, 12603, (800)681-0684, info@fitandfunllc.com, Color: Blue
- I) Sprint, #ST 5079, as manufactured by Fit and Fun Playscapes, 200 Overocker road, Bldg. 2, Poughkeepsie, NY, 12603, (800)681-0684, info@fitandfunllc.com, Color: Magenta
- m) Hop, #ST 5075, as manufactured by Fit and Fun Playscapes, 200 Overocker road, Bldg. 2, Poughkeepsie, NY, 12603, (800)681-0684, info@fitandfunllc.com, Color: Orange

- n) Peaceful Warrior, #ST 5107, as manufactured by Fit and Fun Playscapes, 200 Overocker road, Bldg. 2, Poughkeepsie, NY, 12603, (800)681-0684, info@fitandfunllc.com, Color: Cyan
- 3) Leonard Elementary:
  - Squats, #ST 5069 as manufactured by Fit and Fun Playscapes, 200
     Overocker road, Bldg. 2, Poughkeepsie, NY, 12603, (800)681-0684, info@fitandfunllc.com, Color: Green
  - b) Lunges, #ST 5070, as manufactured by Fit and Fun Playscapes, 200 Overocker road, Bldg. 2, Poughkeepsie, NY, 12603, (800)681-0684, info@fitandfunllc.com, Color: Purple
  - c) Jumping Jacks, #ST 5071, as manufactured by Fit and Fun Playscapes, 200 Overocker road, Bldg. 2, Poughkeepsie, NY, 12603, (800)681-0684, info@fitandfunllc.com, Color: Blue
  - d) Jump Rope, ST #5065, as manufactured by Fit and Fun Playscapes, 200 Overocker road, Bldg. 2, Poughkeepsie, NY, 12603, (800)681-0684, info@fitandfunllc.com, Color: Magenta \*\*ADD1\*\*
  - e) Side Jump, #ST 5076 as manufactured by Fit and Fun Playscapes, 200 Overocker road, Bldg. 2, Poughkeepsie, NY, 12603, (800)681-0684, info@fitandfunllc.com, Color: Orange
  - f) High Knees, #ST 5080 as manufactured by Fit and Fun Playscapes, 200 Overocker road, Bldg. 2, Poughkeepsie, NY, 12603, (800)681-0684, info@fitandfunllc.com, Color: Cyan
  - g) Dancer Pose, #ST 5108, as manufactured by Fit and Fun Playscapes, 200 Overocker road, Bldg. 2, Poughkeepsie, NY, 12603, (800)681-0684, info@fitandfunllc.com, Color: Red
  - h) Star Pose, ST #5112 as manufactured by Fit and Fun Playscapes, 200 Overocker road, Bldg. 2, Poughkeepsie, NY, 12603, (800)681-0684, info@fitandfunllc.com, Color: Yellow
  - i) Step, #ST 5104 as manufactured by Fit and Fun Playscapes, 200 Overocker road, Bldg. 2, Poughkeepsie, NY, 12603, (800)681-0684, info@fitandfunllc.com, Color: Green \*\*ADD1\*\*
  - j) Tight Rope, #ST 5105 as manufactured by Fit and Fun Playscapes, 200 Overocker road, Bldg. 2, Poughkeepsie, NY, 12603, (800)681-0684, info@fitandfunllc.com, Color: Purple \*\*ADD1\*\*
  - k) Tree Pose, #ST 5106 as manufactured by Fit and Fun Playscapes, 200 Overocker road, Bldg. 2, Poughkeepsie, NY, 12603, (800)681-0684, <a href="mailto:info@fitandfunllc.com">info@fitandfunllc.com</a>, Color: Blue
  - l) Sprint, #ST 5079, as manufactured by Fit and Fun Playscapes, 200 Overocker road, Bldg. 2, Poughkeepsie, NY, 12603, (800)681-0684, info@fitandfunllc.com, Color: Magenta \*\*ADD1\*\*
  - m) Hop, #ST 5075, as manufactured by Fit and Fun Playscapes, 200 Overocker road, Bldg. 2, Poughkeepsie, NY, 12603, (800)681-0684, <a href="mailto:info@fitandfunllc.com">info@fitandfunllc.com</a>, Color: Orange
  - n) Peaceful Warrior, #ST 5107, as manufactured by Fit and Fun Playscapes, 200 Overocker road, Bldg. 2, Poughkeepsie, NY, 12603, (800)681-0684, info@fitandfunllc.com, Color: Cyan
- 4) Schroeder Elementary:

- Squats, #ST 5069 as manufactured by Fit and Fun Playscapes, 200 Overocker road, Bldg. 2, Poughkeepsie, NY, 12603, (800)681-0684, info@fitandfunllc.com, Color: Green
- b) Lunges, #ST 5070, as manufactured by Fit and Fun Playscapes, 200 Overocker road, Bldg. 2, Poughkeepsie, NY, 12603, (800)681-0684, info@fitandfunllc.com, Color: Purple
- c) Jumping Jacks, #ST 5071, as manufactured by Fit and Fun Playscapes, 200 Overocker road, Bldg. 2, Poughkeepsie, NY, 12603, (800)681-0684, info@fitandfunllc.com, Color: Blue
- d) Side Jump, #ST 5076 as manufactured by Fit and Fun Playscapes, 200 Overocker road, Bldg. 2, Poughkeepsie, NY, 12603, (800)681-0684, info@fitandfunllc.com, Color: Magenta
- e) High Knees, #ST 5080 as manufactured by Fit and Fun Playscapes, 200 Overocker road, Bldg. 2, Poughkeepsie, NY, 12603, (800)681-0684, info@fitandfunllc.com, Color: Cyan
- f) Step, #ST 5104 as manufactured by Fit and Fun Playscapes, 200 Overocker road, Bldg. 2, Poughkeepsie, NY, 12603, (800)681-0684, info@fitandfunllc.com, Color: Red
- g) Tight Rope, #ST 5105 as manufactured by Fit and Fun Playscapes, 200 Overocker road, Bldg. 2, Poughkeepsie, NY, 12603, (800)681-0684, info@fitandfunllc.com, Color: Yellow
- h) Hop, #ST 5075, as manufactured by Fit and Fun Playscapes, 200 Overocker road, Bldg. 2, Poughkeepsie, NY, 12603, (800)681-0684, info@fitandfunllc.com, Color: Orange

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- d) Jump Rope, ST #5065, as manufactured by Fit and Fun Playscapes, 200 Overocker road, Bldg. 2, Poughkeepsie, NY, 12603, (800)681-0684, info@fitandfunllc.com, Color: Magenta
- e) Side Jump, #ST 5076 as manufactured by Fit and Fun Playscapes, 200 Overocker road, Bldg. 2, Poughkeepsie, NY, 12603, (800)681-0684, <a href="mailto:info@fitandfunllc.com">info@fitandfunllc.com</a>, Color: Orange
- f) High Knees, #ST 5080 as manufactured by Fit and Fun Playscapes, 200 Overocker road, Bldg. 2, Poughkeepsie, NY, 12603, (800)681-0684, info@fitandfunllc.com, Color: Cyan
- g) Dancer Pose, #ST 5108, as manufactured by Fit and Fun Playscapes, 200 Overocker road, Bldg. 2, Poughkeepsie, NY, 12603, (800)681-0684, info@fitandfunllc.com, Color: Red

- h) Star Pose, ST #5112 as manufactured by Fit and Fun Playscapes, 200 Overocker road, Bldg. 2, Poughkeepsie, NY, 12603, (800)681-0684, <a href="mailto:info@fitandfunllc.com">info@fitandfunllc.com</a>, Color: Yellow
- i) Step, #ST 5104 as manufactured by Fit and Fun Playscapes, 200 Overocker road, Bldg. 2, Poughkeepsie, NY, 12603, (800)681-0684, info@fitandfunllc.com, Color: Green
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- c) Jumping Jacks, #ST 5071, as manufactured by Fit and Fun Playscapes, 200 Overocker road, Bldg. 2, Poughkeepsie, NY, 12603, (800)681-0684, info@fitandfunllc.com, Color: Blue
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- f) High Knees, #ST 5080 as manufactured by Fit and Fun Playscapes, 200 Overocker road, Bldg. 2, Poughkeepsie, NY, 12603, (800)681-0684, <a href="mailto:info@fitandfunllc.com">info@fitandfunllc.com</a>, Color: Cyan
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- h) Star Pose, ST #5112 as manufactured by Fit and Fun Playscapes, 200 Overocker road, Bldg. 2, Poughkeepsie, NY, 12603, (800)681-0684, info@fitandfunllc.com, Color: Yellow

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- n) Peaceful Warrior, #ST 5107, as manufactured by Fit and Fun Playscapes, 200 Overocker road, Bldg. 2, Poughkeepsie, NY, 12603, (800)681-0684, info@fitandfunllc.com, Color: Cyan
- B. Asphalt Coating Sealer: Mineral filled asphalt emulsion pavement sealer, complying with ASTM D8099.
  - 1. Product: MasterSeal, Product #S1010 as manufactured by SealMaster, https://sealmaster.net/, or approved substitute.

#### **PART 3 - EXECUTION**

#### 3.1 EXAMINATION

- A. Verify that pavement surfacing is smooth and clean, free of debris before painting.
- B. Notify Construction Manager in writing of any unsatisfactory conditions. Proceed with painting only after unsatisfactory conditions have been corrected.


#### 3.2 PAVEMENT MARKING

- A. Do not apply pavement-marking paint until layout, colors, and placement have been verified with Architect.
- B. Allow paying to age for 30 days before starting payement marking.
- C. Sweep and clean surface to eliminate loose material and dust.
- D. Apply paint with mechanical equipment to produce pavement markings, of dimensions indicated, with uniform, straight edges. Apply at manufacturer's recommended rates to provide a minimum wet film thickness of 15 mils.

#### 3.3 ASPHALT COATING SEALER

- A. Sweep and clean surface to eliminate loose material and dust.
- B. Apply sealer per manufacturer's written instructions.

#### **END OF SECTION**

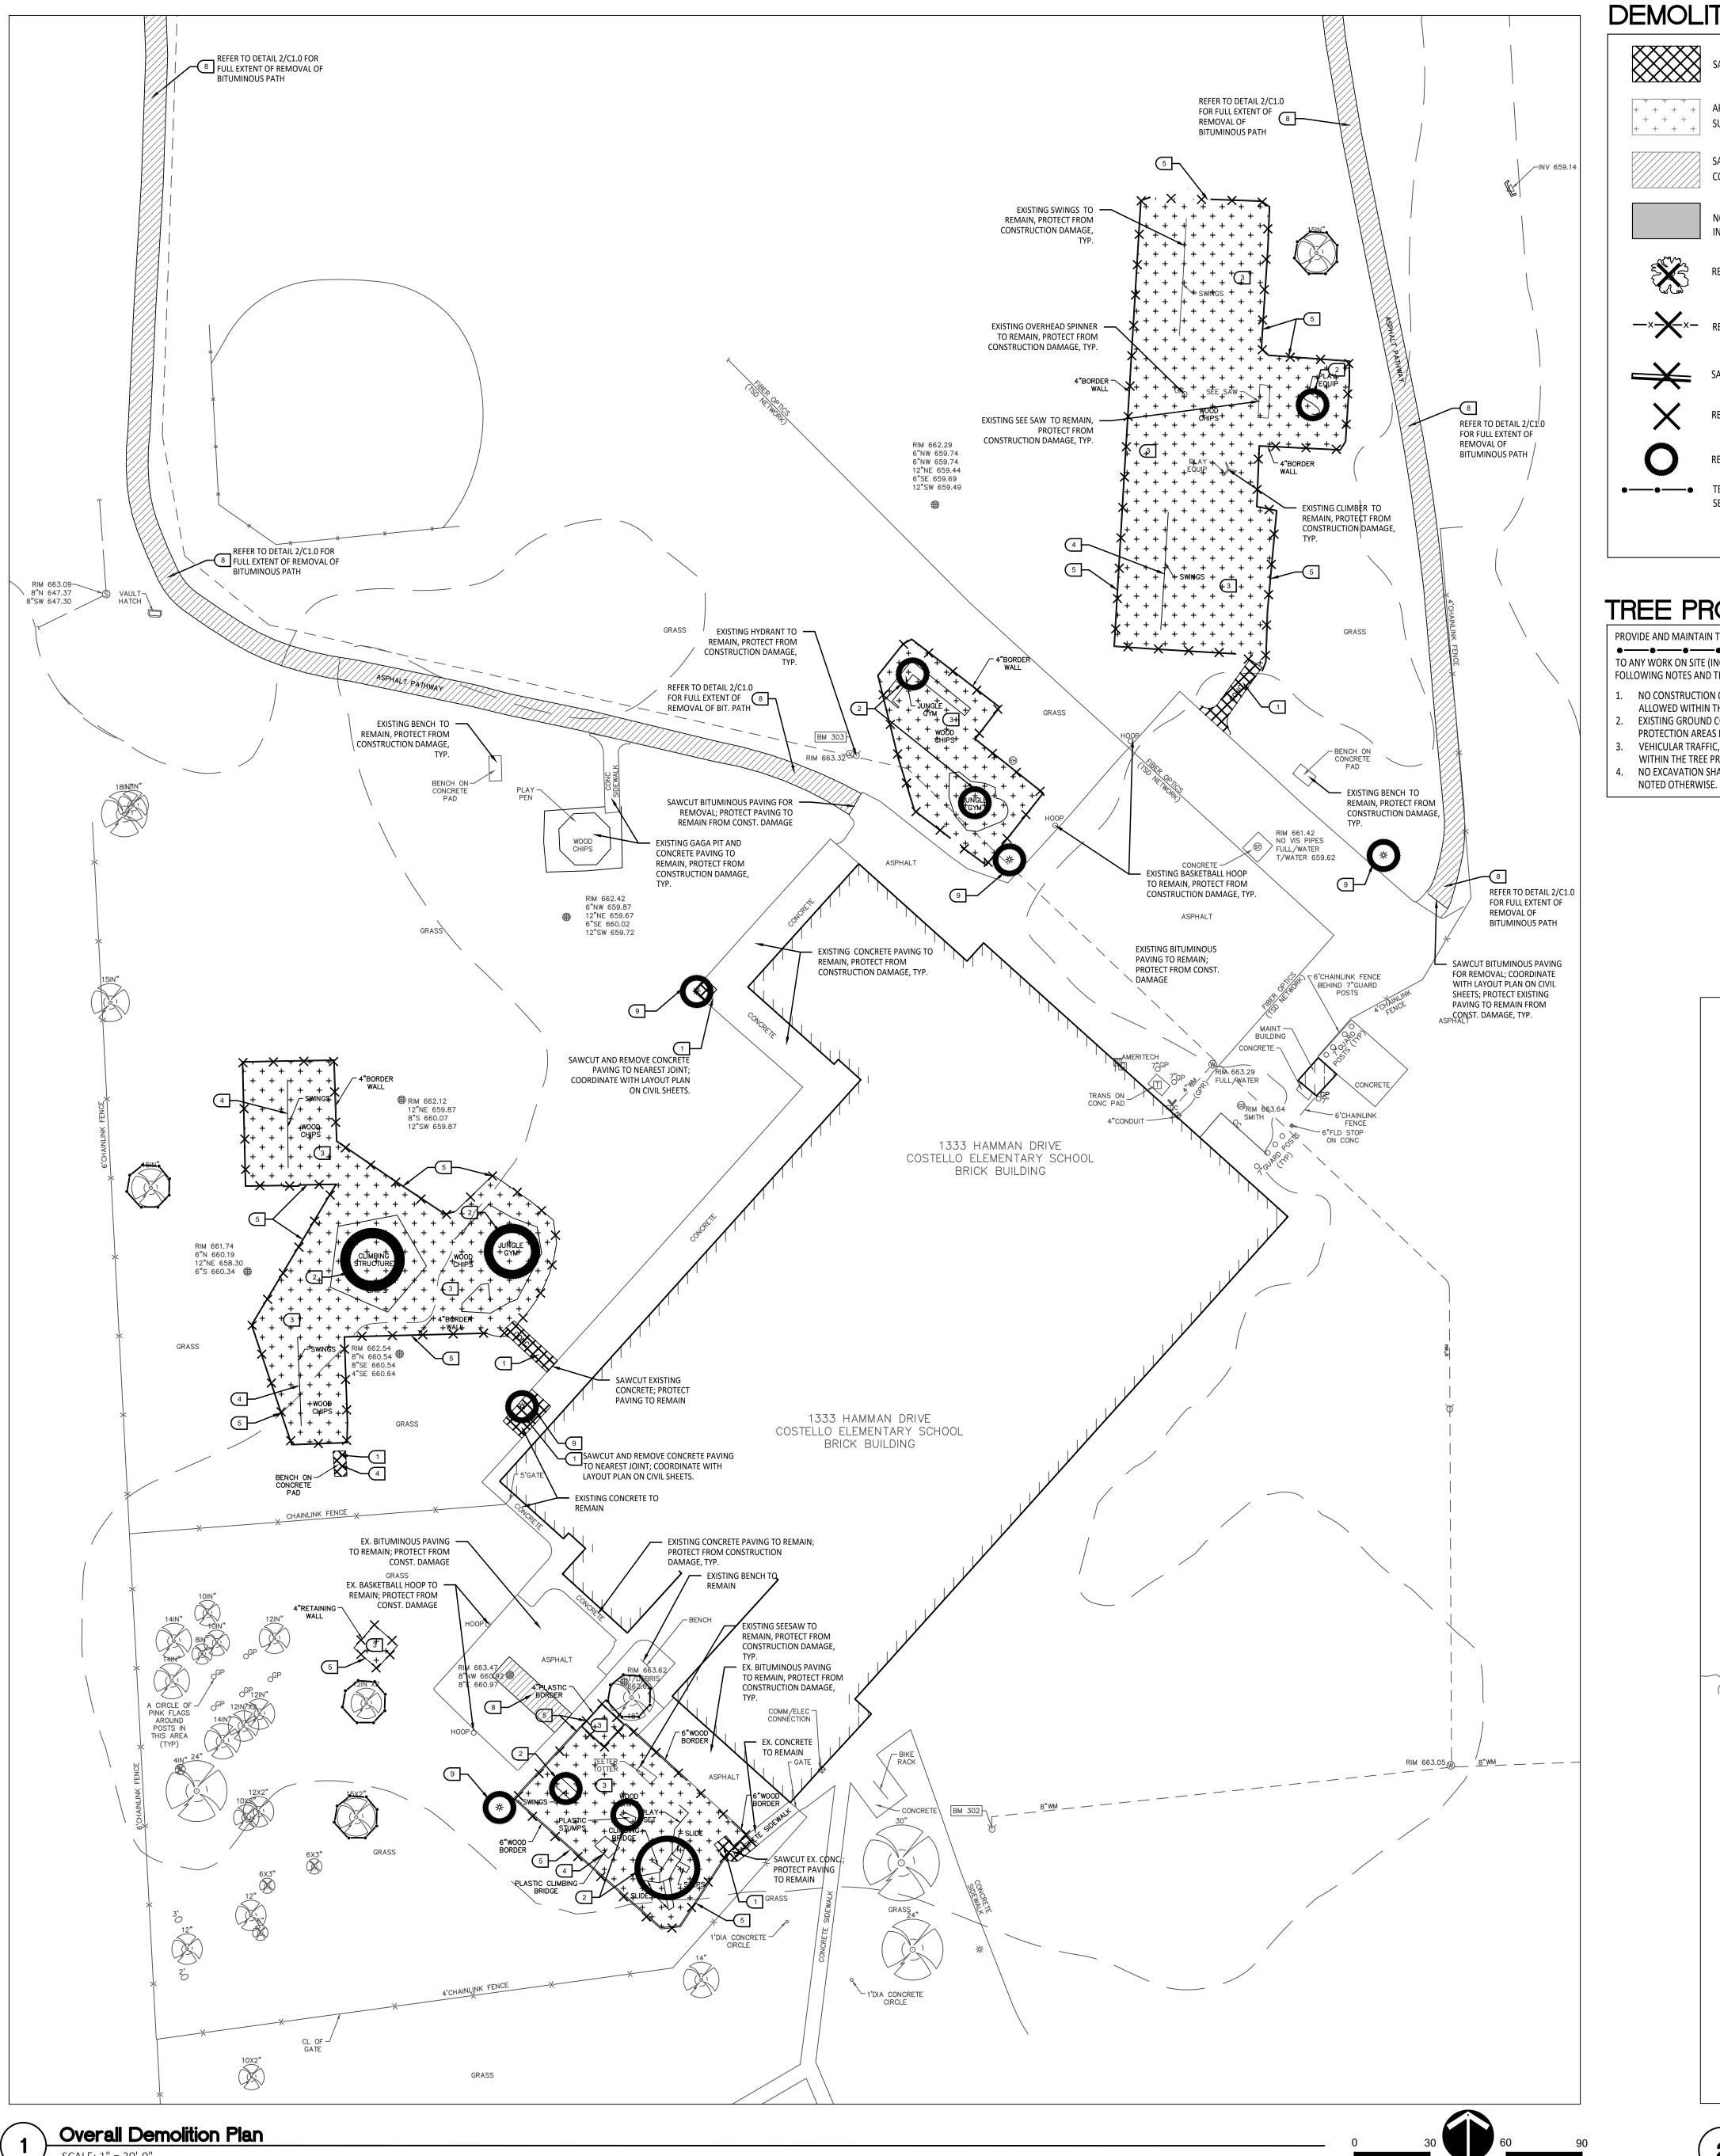



# SAWCUT AND REMOVE CONCRETE, INCLUDING SUBBASE AREA FOR EXISTING PLAY SURFACING REMOVAL SAWCUT AND REMOVE EXISTING BITUMINOUS PAVEMENT COMPLETELY. INCLUDING SUBBASE NO WORK. PARKING OR STORAGE IN THIS SHADED AREA

REMOVE MISCELLANEOUS FEATURE COMPLETELY AS NOTED

REMOVE MISCELLANEOUS FEATURE COMPLETELY AS NOTED

TEMPORARY TREE PROTECTION FENCE SEE DETAIL 1/C4.0

## TREE PROTECTION NOTES:

PROVIDE AND MAINTAIN TEMPORARY TREE PROTECTION FENCING IN ALL LOCATIONS MARKED TO ANY WORK ON SITE (INCLUDING TOPSOIL STRIPPING OPERATIONS). REFER TO THE FOLLOWING NOTES AND THE SPECIFICATIONS FOR TREE PROTECTION REQUIREMENTS.

- NO CONSTRUCTION OPERATIONS, EQUIPMENT, MATERIALS OR TOPSOIL SHALL BE ALLOWED WITHIN THE TREE PROTECTION AREAS. EXISTING GROUND COVER AND TOPSOIL SHALL NOT BE REMOVED FROM TREE PROTECTION AREAS DURING EARTHWORK PHASE.
- VEHICULAR TRAFFIC, PARKING, EQUIPMENT OR MATERIAL STORAGE MAY NOT OCCUR WITHIN THE TREE PROTECTION AREAS AT ANY TIME. NO EXCAVATION SHALL BE MADE WITHIN THE TREE PROTECTION AREAS EXCEPT AS

# SITE DEMOLITION KEY

- 1 SAWCUT AND REMOVE EXISTING CONCRETE PAVING INCLUDING SUB-BASE.
- REMOVE EXISTING PLAY EQUIPMENT INCLUDING ALL CONCRETE FOOTINGS. DESTROY ALL PLAY EQUIPMENT COMPLETELY SO IT CANNOT BE RE-ASSEMBLED.
- REMOVE EXISTING PLAY SAFETY SURFACING, INCLUDING DRAINAGE AGGREGATE.
- 4 PLAYGROUND CONTRACTOR TO SALVAGE EXISTING PLAY EQUIPMENT AND RE-INSTALL ON-SITE.
- 5 REMOVE EXISTING PLAY EDGING COMPLETELY.
- (6) REMOVE EXISTING FENCING COMPLETELY (INCLUDING FOUNDATIONS)
- REMOVE EXISTING TREE INCLUDING ALL ROOT SYSTEMS.
- 8 SAWCUT AND REMOVE EXISTING BITUMINOUS PAVEMENT INCLUDING SUB-BASE. OWNER TO DISCONNECT POWER AND REMOVE LIGHT HEAD. SITE CONTRACTOR TO CUT WIRE AT A MINIMUM OF 24" BELOW FINISHED GRADE
- AND REMOVE LIGHT POLE AND CONCRETE BASE COMPLETELY.
- (11) SALVAGE EXISTING SITE FURNISHINGS AND REINSTALL AT LOCATION TO BE DETERMINED.

# **DEMOLITION NOTES:**

- SURVEY OF EXISTING CONDITIONS PROVIDED BY PEA GROUP, 1849 POND RUN, AUBURN HILLS, MI, 48326. 248-689-9090.
- VERIFY LOCATIONS OF ALL BELOW GRADE UTILITIES PRIOR TO BEGINNING WORK. 72 HOURS BEFORE YOU DIG CALL "MISS DIG" AT 1-800-482-7171.
- PROTECT ALL TREES & EXISTING FEATURES TO REMAIN AS SPECIFIED.
- REFER TO LAYOUT PLAN FOR LIMITS OF WORK. DISCREPANCIES BETWEEN SITE AND PLANS SHOULD BE REPORTED TO THE PROJECT MANAGER IMMEDIATELY.
- ALL TOPSOIL AND EXCESS FILL MATERIAL SHALL BE STOCKPILED ON SITE SEPARATELY FOR LATER RE-USE. LOCATE STOCKPILES IN AREAS AS DIRECTED BY CONSTRUCTION MANAGER AND PROTECT FROM EFFECTS OF EROSION.
- ALL PAVEMENT DEMOLITION TO BE SAWCUT AND REMOVED COMPLETELY, INCLUDING BASE/SUBBASE MATERIALS.
- CONTRACTOR IS NOT ALLOWED TO RE-USE, DONATE, OR SELL ANY EXISTING PLAYGROUND EQUIPMENT SCHEDULED TO BE DEMOLISHED.

ALL EXISTING PLAYGROUND EQUIPMENT TO BE REMOVED MUST BE DESTROYED COMPLETELY SO THAT IT CANNOT BE RE-ASSEMBLED. THE

IN LOCATIONS WHERE PROPOSED PAVING WILL BE INSTALLED WHERE EXISTING PAVING WAS REMOVED, THE BASE MATERIAL CAN BE LEFT IN PLACE PROVIDED IT IS TESTED TO BE ADEQUATE IN BOTH DEPTH AND GRADATION. IF EITHER OF THESE IS INADEQUATE, THE BASE MATERIAL SHOULD BE REMOVED AND REPLACED.


(PER FLOOD INSURANCE RATE MAP NUMBER 26125C-0532F, REVISED DATE SEPTEMBER 29, 2006) SPECIAL FLOOD HAZARD AREAS SUBJECT TO INUNDATION BY THE 1% ANNUAL CHANCE FLOOD THE 1% ANNUAL CHANCE FLOOD (100 YEAR FLOOD), ALSO KNOWN AS THE BASE FLOOD, IS THE FLOOD THAT HAS A 1% CHANCE OF BEING EQUALED OR EXCEEDED IN ANY GIVEN YEAR. THE SPECIAL FLOOD HAZARD AREA IS THE AREA SUBJECT TO FLOODING BY THE 1% ANNUAL CHANCE FLOOD. AREAS OF SPECIAL FLOOD HAZARD INCLUDE ZONES A, AE, AH, AO, AR, A99, V AND VE. THE BASE FLOOD ELEVATION IS THE WATER-SURFACE ELEVATION OF THE 1% ANNUAL CHANCE FLOOD. ZONE AE - BASE FLOOD ELEVATIONS DETERMINED.

FLOODWAY AREAS IN ZONE AE
THE FLOODWAY IS THE CHANNEL OF STREAM PLUS ANY ADJACENT FLOODPLAIN AREAS THAT MUST BE KEPT
FREE OF ENCROACHMENT SO THAT THE 1% ANNUAL CHANCE FLOOD CAN BE CARRIED WITHOUT SUBSTANTIAL INCREASES IN FLOOD HEIGHTS.

OTHER FLOOD AREAS

ZONE X — AREA OF 0.2% ANNUAL CHANCE FLOOD; AREAS OF 1% ANNUAL CHANCE FLOOD WITH AVERAGE DEPTHS OF LESS THAN 1 FOOT OR WITH DRAINAGE AREAS LESS THAN 1 SQUARE MILE; AND AREAS PROTECTED BY LEVEES FROM 1% ANNUAL CHANCE FLOOD.

OTHER AREAS ZONE X — AREA TO BE DETERMINED OUTSIDE OF THE 0.2% ANNUAL CHANCE FLOODPLAIN.

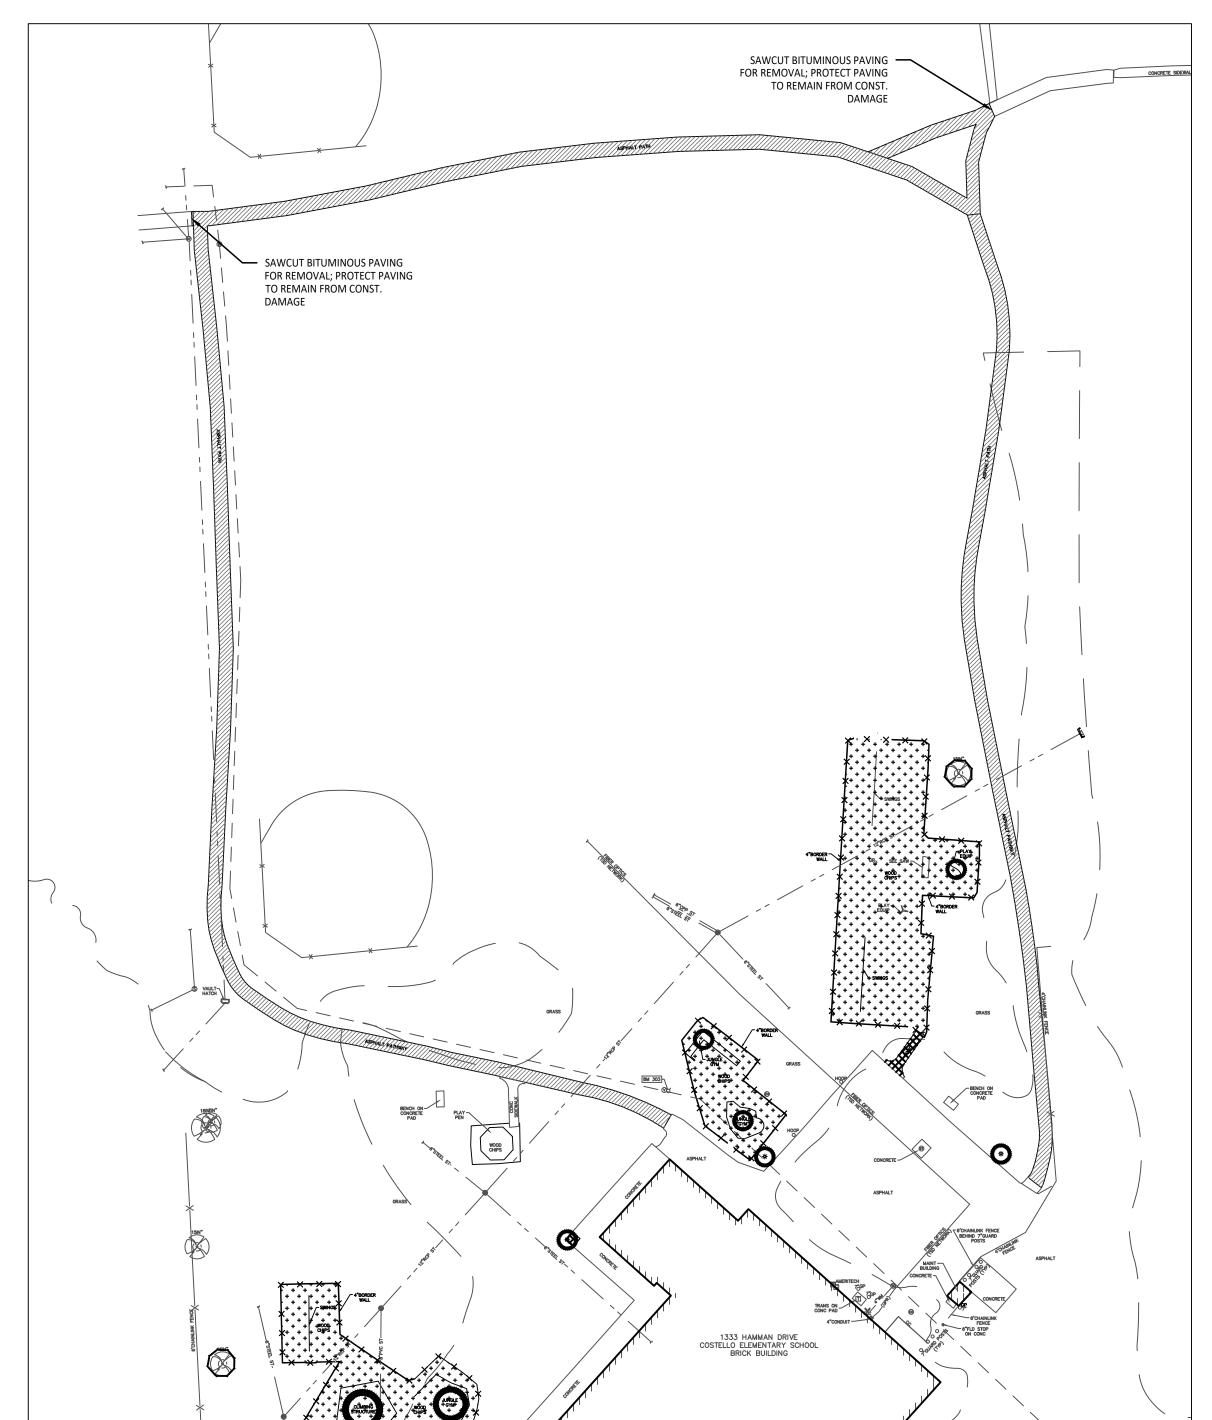





TMP ARCHITECTURE INC 1191 WEST SQUARE LAKE ROAD BLOOMFIELD HILLS • MICHIGAN • 48302 PH • 248.338.4561 FX • 248.338.0223 EM • INFO @ TMP-ARCHITECTURE.COM

**REGISTRATION SEAL** 



141 E. Michigan Avenue, Suite 500 Kalamazoo Michigan 49007 Phone (269) 381-3357 Fax (269) 381-2944

> Urban Planning Parks & Recreation Campus & Institutional Planning Camp Planning & Design

Landscape Architecture

# PROJECT TITLE Costello **Elementary School** Playground Remodel Bid Package No.01B

Troy School District Troy, Michigan

DRAWING TITLE


Demolition Plan

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10-22-2024	ADDENDUM #1	
10-03-2024	CONSTRUCTION DOCUMENTS	
DATE:	ISSUED FOR:	
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CHECKED	DID	
APPROVED	DID	

22088B

PROJECT NO.

DRAWING NO. **C1.0** 

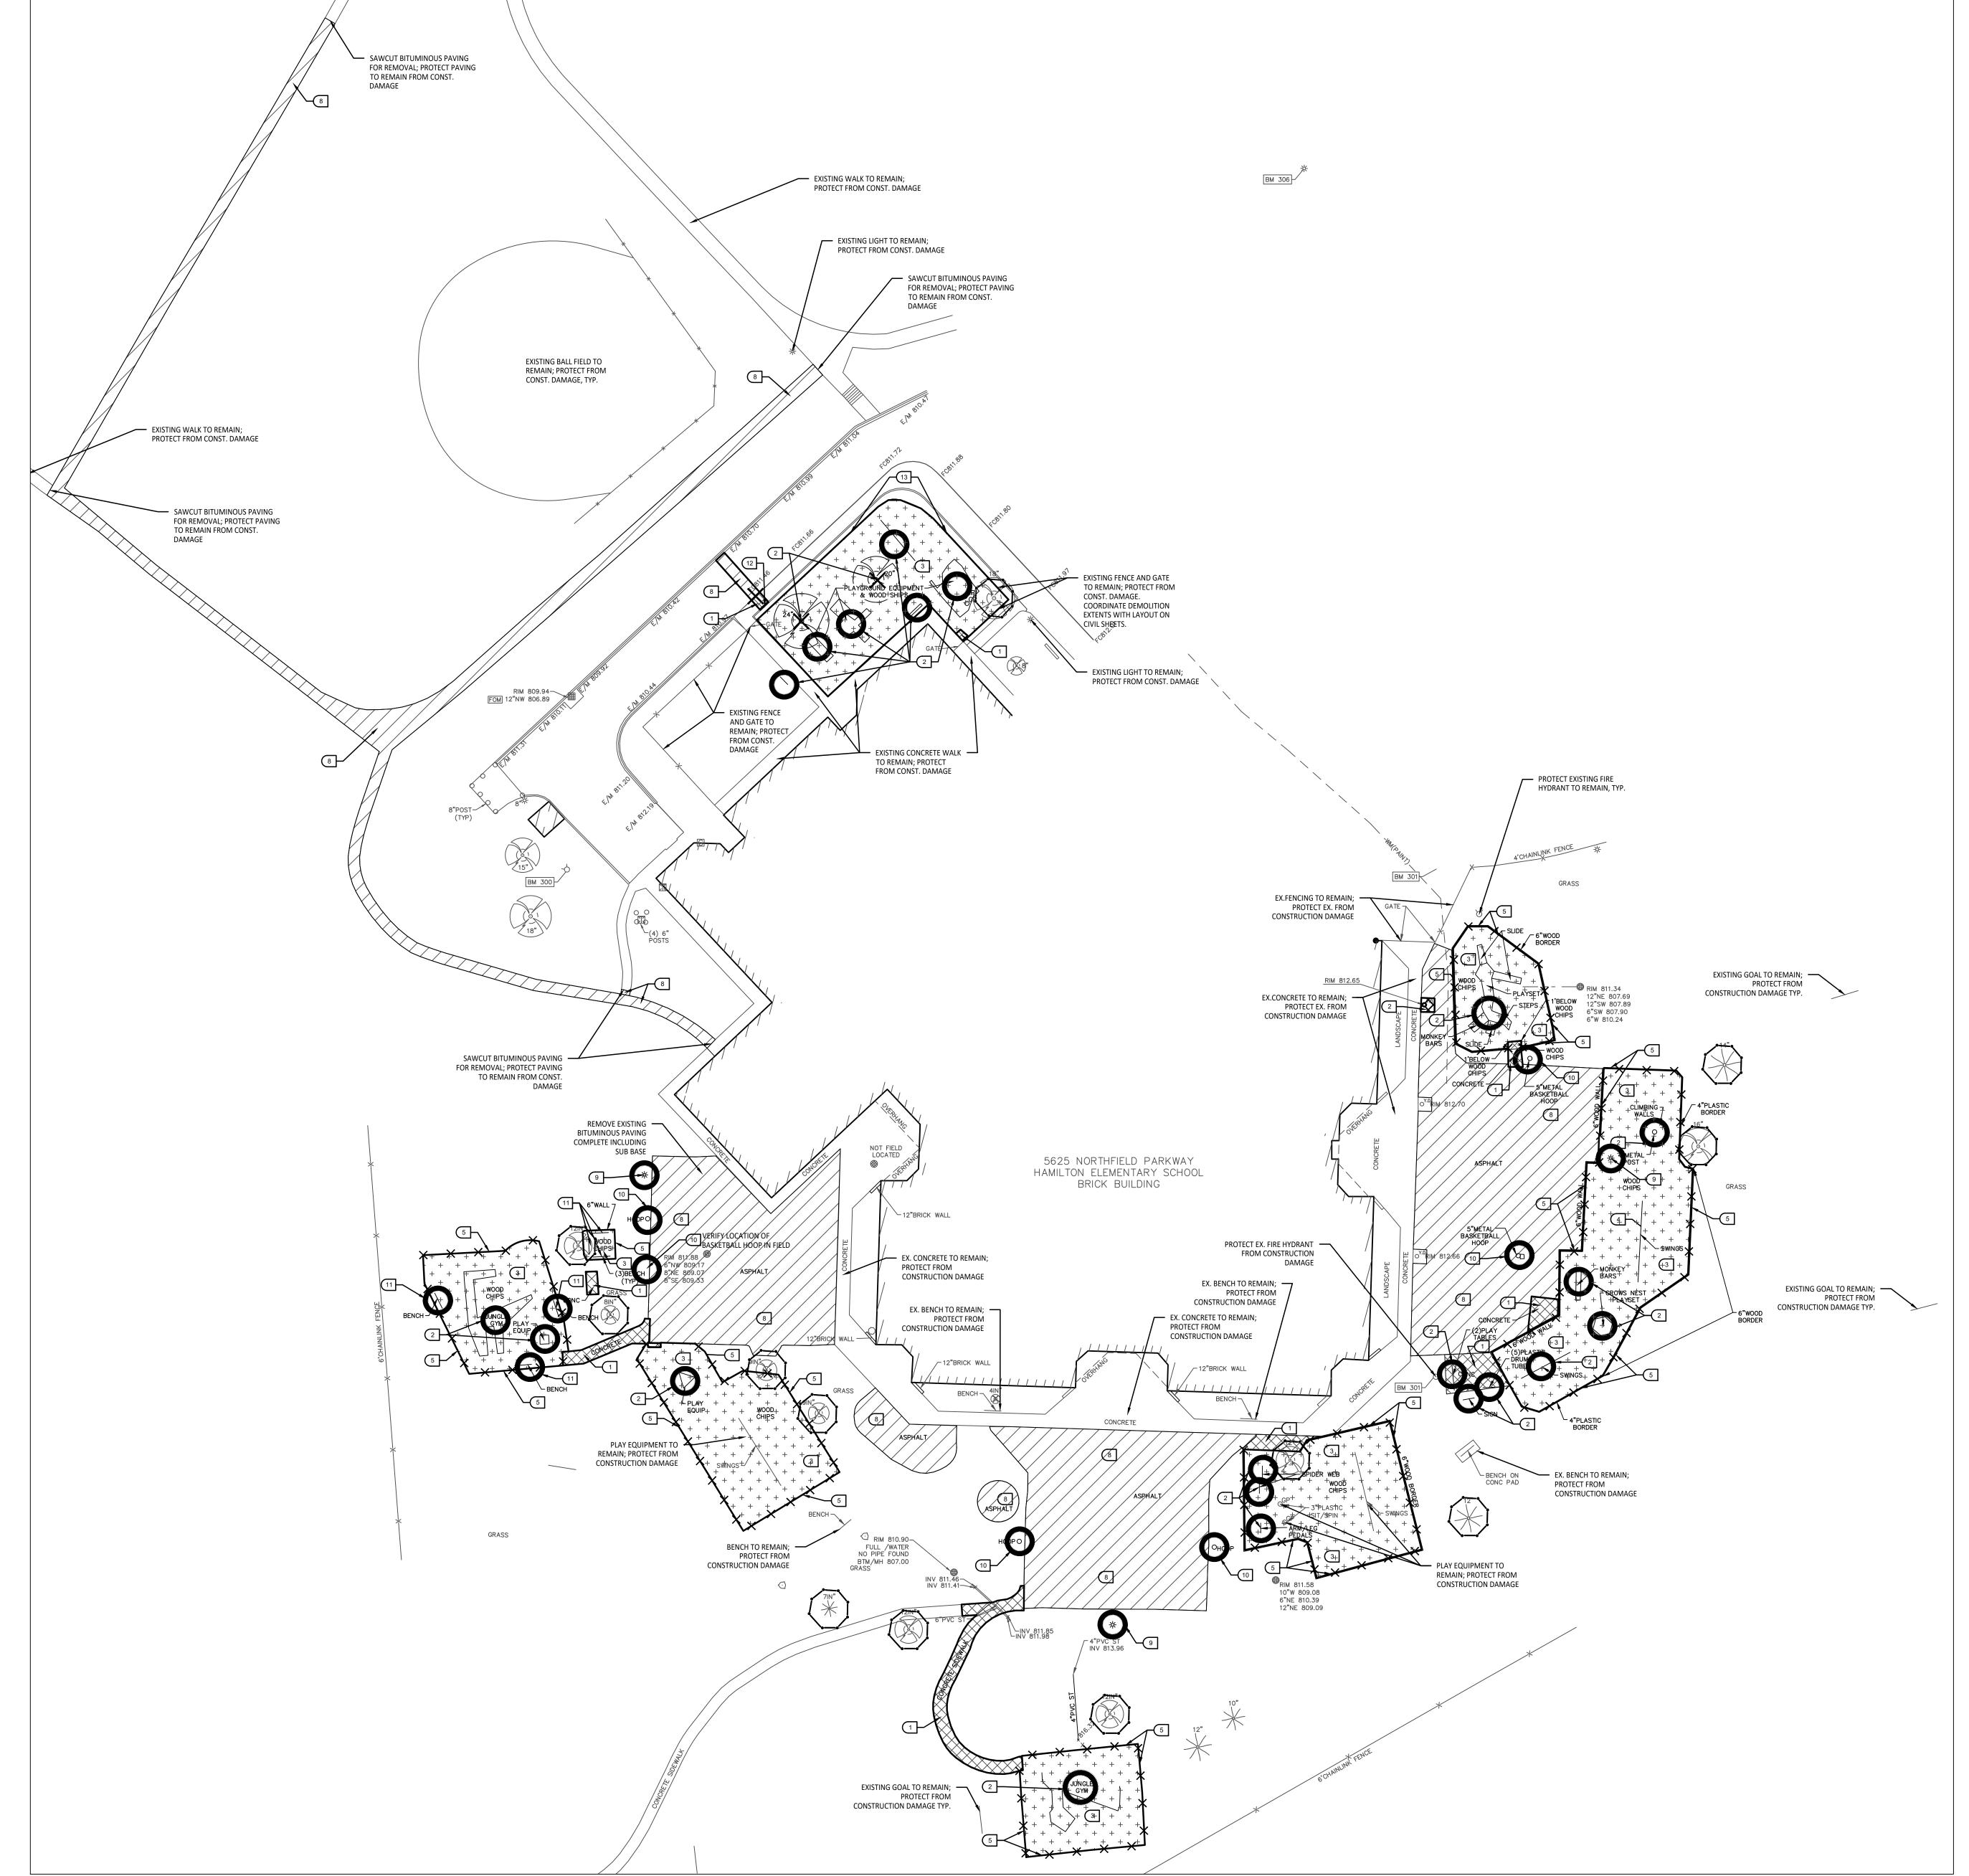


## **DEMOLITION NOTES:**

- SURVEY OF EXISTING CONDITIONS PROVIDED BY PEA GROUP, 1849 POND RUN, AUBURN HILLS, MI, 48326.
- VERIFY LOCATIONS OF ALL BELOW GRADE UTILITIES PRIOR TO BEGINNING WORK. 72 HOURS BEFORE YOU DIG
- CALL "MISS DIG" AT 1-800-482-7171. PROTECT ALL TREES & EXISTING FEATURES TO REMAIN AS SPECIFIED.
- REFER TO LAYOUT PLAN FOR LIMITS OF WORK.
- DISCREPANCIES BETWEEN SITE AND PLANS SHOULD BE REPORTED TO THE PROJECT MANAGER IMMEDIATELY.
- ALL TOPSOIL AND EXCESS FILL MATERIAL SHALL BE STOCKPILED ON SITE SEPARATELY FOR LATER RE-USE. LOCATE STOCKPILES IN AREAS AS DIRECTED BY CONSTRUCTION MANAGER AND PROTECT FROM EFFECTS OF
- ALL PAVEMENT DEMOLITION TO BE SAWCUT AND REMOVED COMPLETELY, INCLUDING BASE/SUBBASE MATERIALS. ALL EXISTING PLAYGROUND EQUIPMENT TO BE REMOVED MUST BE DESTROYED COMPLETELY SO THAT IT CANNOT BE RE-ASSEMBLED. THE CONTRACTOR IS NOT ALLOWED TO RE-USE, DONATE, OR SELL ANY EXISTING PLAYGROUND EQUIPMENT SCHEDULED TO BE DEMOLISHED.
- IN LOCATIONS WHERE PROPOSED PAVING WILL BE INSTALLED WHERE EXISTING PAVING WAS REMOVED, THE BASE MATERIAL MAY BE LEFT IN PLACE PROVIDED IT IS TESTED TO BE ADEQUATE IN BOTH DEPTH AND GRADATION. IF EITHER OF THESE IS INADEQUATE, THE BASE MATERIAL SHOULD BE REMOVED AND REPLACED.

# SITE DEMOLITION KEY

- 1 SAWCUT AND REMOVE EXISTING CONCRETE PAVING INCLUDING SUB-BASE.
- REMOVE EXISTING PLAY EQUIPMENT INCLUDING ALL CONCRETE FOOTINGS. DESTROY ALL PLAY EQUIPMENT COMPLETELY SO THAT IT CANNOT BE RE-ASSEMBLED.
- REMOVE EXISTING PLAY SAFETY SURFACING, INCLUDING DRAINAGE AGGREGATE.
- PLAYGROUND CONTRACTOR TO SALVAGE EXISTING PLAY EQUIPMENT AND RE-INSTALL ON-SITE.
- 5 REMOVE EXISTING PLAY EDGING COMPLETELY.
- 6 REMOVE EXISTING FENCING COMPLETELY (INCLUDING FOUNDATIONS)
- 7 REMOVE EXISTING TREE INCLUDING ALL ROOT SYSTEMS.
- SAWCUT AND REMOVE EXISTING BITUMINOUS PAVEMENT INCLUDING SUB-BASE. OWNER TO DISCONNECT POWER AND REMOVE LIGHT HEAD. SITE CONTRACTOR TO CUT WIRE AT A MINIMUM OF 24" BELOW FINISHED GRADE AND REMOVE LIGHT POLE AND CONCRETE BASE COMPLETELY.
- 10 SALVAGE EXISTING PLAY EQUIPMENT, PLAYGROUND CONTRACTOR TO REINSTALL ON SITE.
- (11) SALVAGE EXISTING SITE FURNISHINGS AND REINSTALL AT LOCATION TO BE DETERMINED.
- [12] SAWCUT AND REMOVE EXISTING CURB AND GUTTER.
- (13) SALVAGE EXISTING FENCE AND RE-INSTALL ON SITE PER CIVIL PLANS.

# DEMOLITION LEGEND:

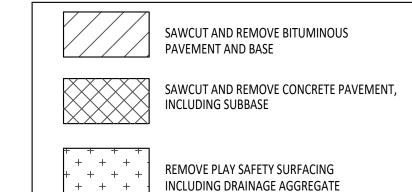

NO WORK, PARKING OR STORAGE IN THIS SHADED AREA

SAWCUT & REMOVE CONCRETE CURB & GUTTER


RELOCATE EXISTING SITE

LIGHTING PER ELEC. PLAN

• TEMPORARY TREE PROTECTION FENCE, REFER TO DETAIL 1/C4.0

# TREE PROTECTION NOTES:

- — ● — — ● . TREE FENCING SHALL BE PROVIDED AND IN PLACE PRIOF TO ANY WORK ON SITE (INCLUDING TOPSOIL STRIPPING OPERATIONS). REFER TO THE
- NO CONSTRUCTION OPERATIONS, EQUIPMENT, MATERIALS OR TOPSOIL SHALL BE
- ALLOWED WITHIN THE TREE PROTECTION AREAS. EXISTING GROUND COVER AND TOPSOIL SHALL NOT BE REMOVED FROM TREE
- PROTECTION AREAS DURING EARTHWORK PHASE. VEHICULAR TRAFFIC, PARKING, EQUIPMENT OR MATERIAL STORAGE MAY NOT OCCUR
- WITHIN THE TREE PROTECTION AREAS AT ANY TIME. NO EXCAVATION SHALL BE MADE WITHIN THE TREE PROTECTION AREAS EXCEPT AS

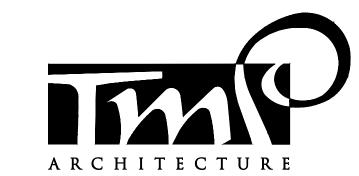

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**REGISTRATION SEAL** 

CONSULTANT



141 E. Michigan Avenue, Suite 500 Kalamazoo Michigan 49007 Phone (269) 381-3357 Fax (269) 381-2944

> Landscape Architecture Urban Planning Parks & Recreation Campus & Institutional Planning Camp Planning & Design

PROJECT TITLE

# **Hamilton** Elementary School Playground Remodel Bid Package No.01B

Troy School District Troy, Michigan

DRAWING TITLE

Demolition Plan

SSUE DATES	
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10-22-2024 ADDENDUM #1 CONSTRUCTION DOCUMENTS

DRAWN CHECKED

**APPROVED** DID


PROJECT NO.

22089B

DRAWING NO. **C1.0** 


Overall Demolition Plan

Scale: 1" = 30'-0"

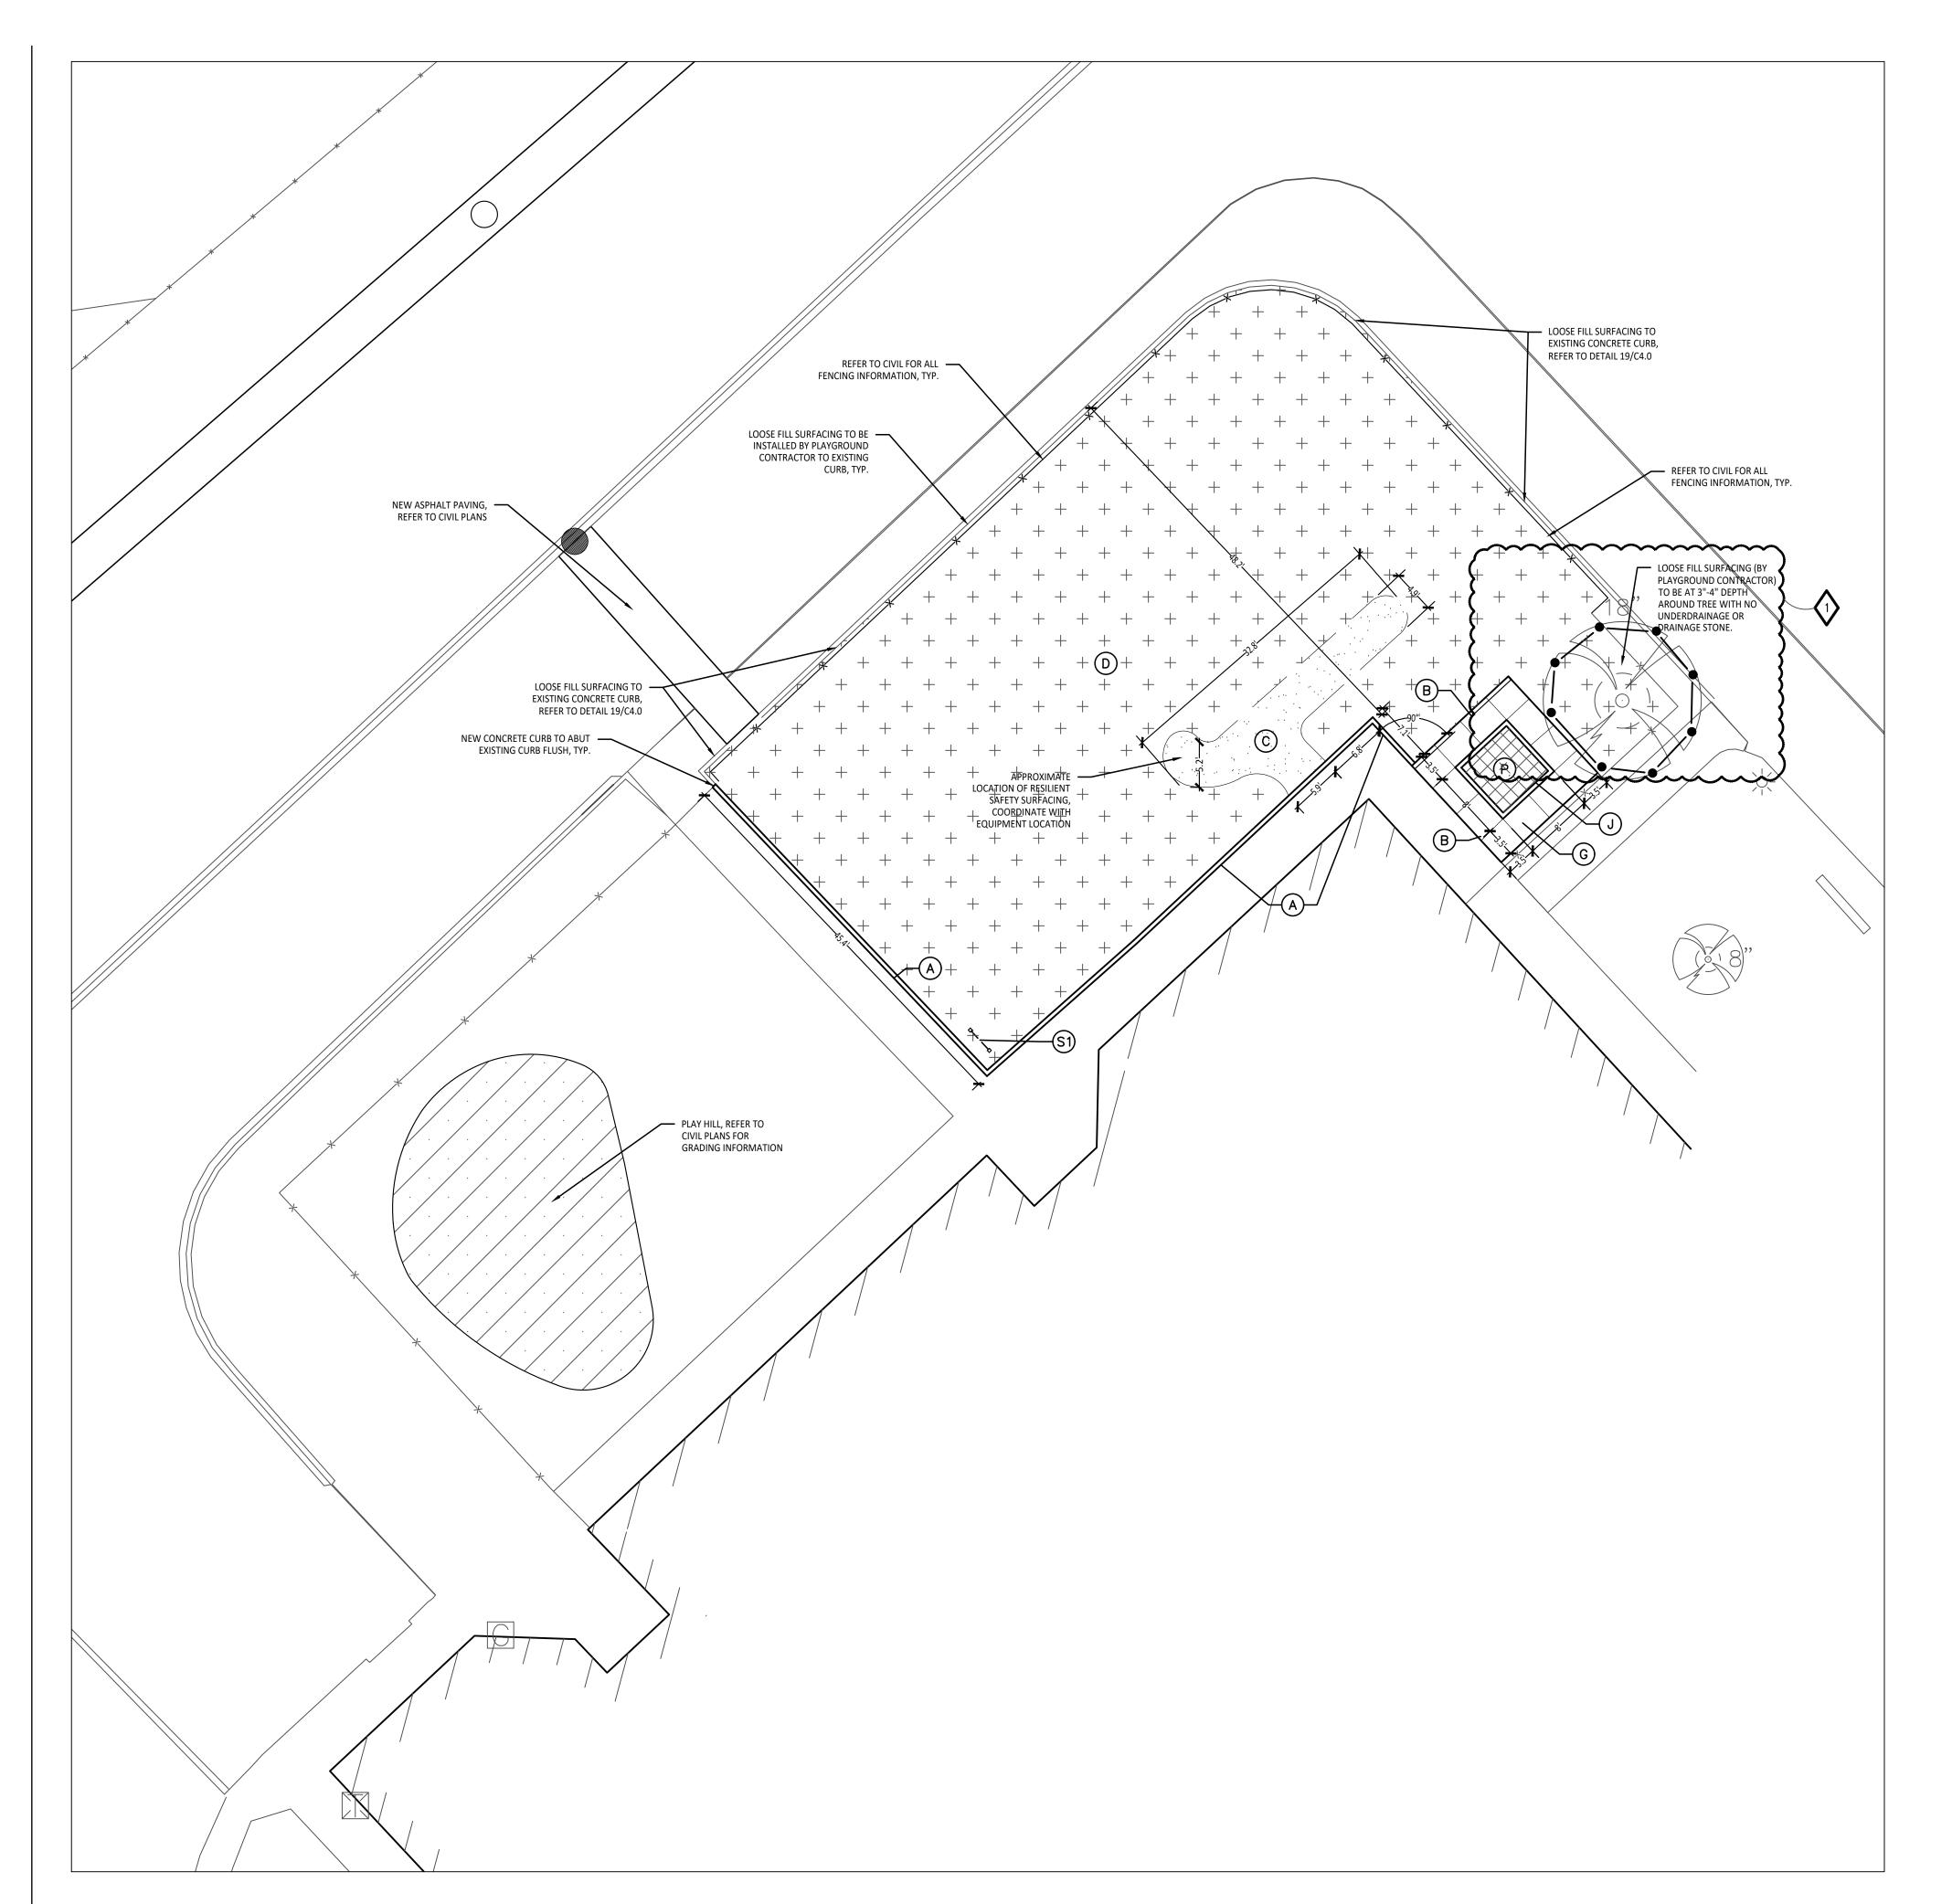

Playground Layout Enlargement Plan - Kindergarten

Scale: 1" = 10'-0"

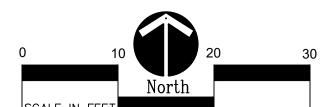

# CONTRACTOR COORDINATION NOTES:

SITE CONTRACTOR AND PLAYGROUND CONTRACTOR ARE REQUIRED TO COORDINATE BOTH WITH EACH OTHER AND WITH CONSTRUCTION MANAGER. THE INSTALLATION PROCESS FOR THE PLAYGROUND SAFETY SURFACING SHOULD BE AS

\* SITE CONTRACTOR TO EXCAVATE AREA AS SHOWN ON CONSTRUCTION DOCUMENTS. \* SITE CONTRACTOR TO INSTALL UNDERDRAINS AS SHOWN ON CONSTRUCTION DOCUMENTS. SITE CONTRACTOR TO USE LAYOUT SERVICES FROM CADD FILES FOR INSTALLATION TO ENSURE THAT THE UNDERDRAINS ARE INSTALLED IN THE CORRECT LOCATIONS.

\* THE PLAYGROUND CONTRACTOR WILL THEN INSTALL THE POSTS AND FOOTINGS FOR ALL EQUIPMENT. \* THE SITE CONTRACTOR WILL THEN INSTALL THE DRAINAGE AGGREGATE, TAKING CARE TO NOT DAMAGE THE POSTS OR POWDERCOATING OF THE PLAY EQUIPMENT. THE SITE CONTRACTOR WILL ALSO INSTALL THE ADDITIONAL ENGINEERED FILL FOR THE RESILIENT SURFACING AREAS. THE SITE CONTRACTOR MUST COORDINATE THE DEPTHS WITH THE PLAYGROUND CONTRACTOR PRIOR TO INSTALLATION AS THE DEPTHS VARY BETWEEN PLAYGROUND CONTRACTORS. \* THE PLAYGROUND CONTRACTOR WILL INSTALL THE GEOTEXTILE FABRIC, PLAYGROUND EQUIPMENT, AND SAFETY

### BARRIER-FREE NOTES

BARRIER-FREE PARKING AND ACCESSIBLE ROUTE(S) MUST COMPLY WITH THE AMERICANS WITH DISABILITIES ACT AND MICHIGAN BARRIER-FREE CODE REQUIREMENTS, INCLUDING BUT NOT LIMITED TO THE FOLLOWING: - 1:50 (2%) MAXIMUM CROSS-SLOPE ON ACCESSIBLE ROUTE.

- NO CHANGES IN LEVEL GREATER THAN 1/2" ALONG ACCESSIBLE ROUTE. - 1:20 (5%) MAXIMUM LONGITUDINAL SLOPE ON ACCESSIBLE ROUTE (EXCEPT WHERE RAMPS ARE PROVIDED). - 1:50 (2%) MAXIMUM SLOPE (IN ANY DIRECTION) IN B.F. PARKING AND ACCESS AISLES.

NOTE: VERIFY LOCATION OF NEW PLAYGROUND EQUIPMENT PRIOR TO INSTALLATION OF ANY CONCRETE CURB. CONCRETE CURB TO BE INSTALLED OUTSIDE OF FALL SAFETY ZONE OF EACH PIECE OF EQUIPMENT PER ASTM 1487-05 AND MANUFACTURER'S WRITTEN RECOMMENDATIONS.


NOTE: PLAYGROUND EQUIPMENT AND SURFACING PURCHASE AND INSTALLATION IS UNDER SEPARATE CONTRACT AND IS NOT INCLUDED IN THIS BID PACKAGE. CONTRACTOR IS REQUIRED TO COORDINATE INSTALLATION OF PLAYGROUND EQUIPMENT AND SURFACING WITH PLAYGROUND INSTALLER PRIOR TO ANY EXCAVATION AND CONCRETE CURBING OR PAVING INSTALLATION.

SURVEY OF EXISTING CONDITIONS PROVIDED BY PEA GROUP, 1849 POND RUN, AUBURN HILLS, MICHIGAN 48326, (248)689-9090.

LAYOUT NOTES:

- PAVEMENT DIMENSIONS AND RADII ARE TO EDGE OF PAVEMENT OR BACK OF
- CURB. PLASTIC EDGING IS MEASURED TO/FROM CENTER OF PIN. DISCREPANCIES BETWEEN SITE AND PLANS SHOULD BE REPORTED TO THE PROJECT
- VERIFY LOCATIONS OF ALL BELOW GRADE UTILITIES PRIOR TO BEGINNING WORK. 72 HOURS BEFORE YOU DIG CALL "MISS DIG" AT 1-800-482-7171.
- PROVIDE BARRIER FREE PARKING SIGNS FOR ALL BARRIER FREE PARKING SPACES. ALL SIGNS TO COMPLY WITH THE MDOT MICHIGAN MANUAL OF UNIFORM TRAFFIC
- SITE LAYOUT POINTS SHOULD BE ESTABLISHED AND PROTECTED FOR FUTURE SITE

PROPOSED FEATURES LEGEND:

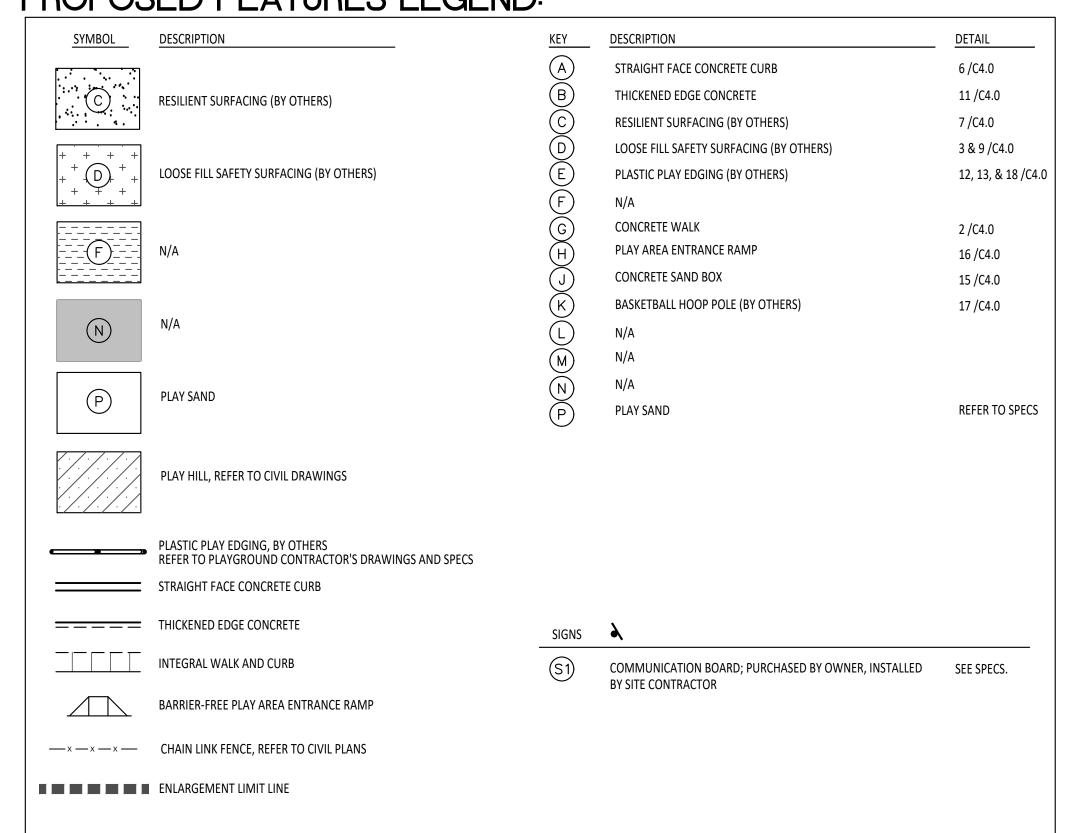



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CONSULTANT

141 E. Michigan Avenue, Suite 500 Kalamazoo Michigan 49007 Phone (269) 381-3357 Fax (269) 381-2944

Landscape Architecture Urban Planning Parks & Recreation
Campus & Institutional Planning
Camp Planning & Design

PROJECT TITLE

# **Hamilton** Elementary School Playground Remodel Bid Package No.01B

Troy School District Troy, Michigan

DRAWING TITLE
Playground Layout
Enlargement Plans

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	ADDENDUM #4
10-22-2024	ADDENDUM #1

PROJECT NO.


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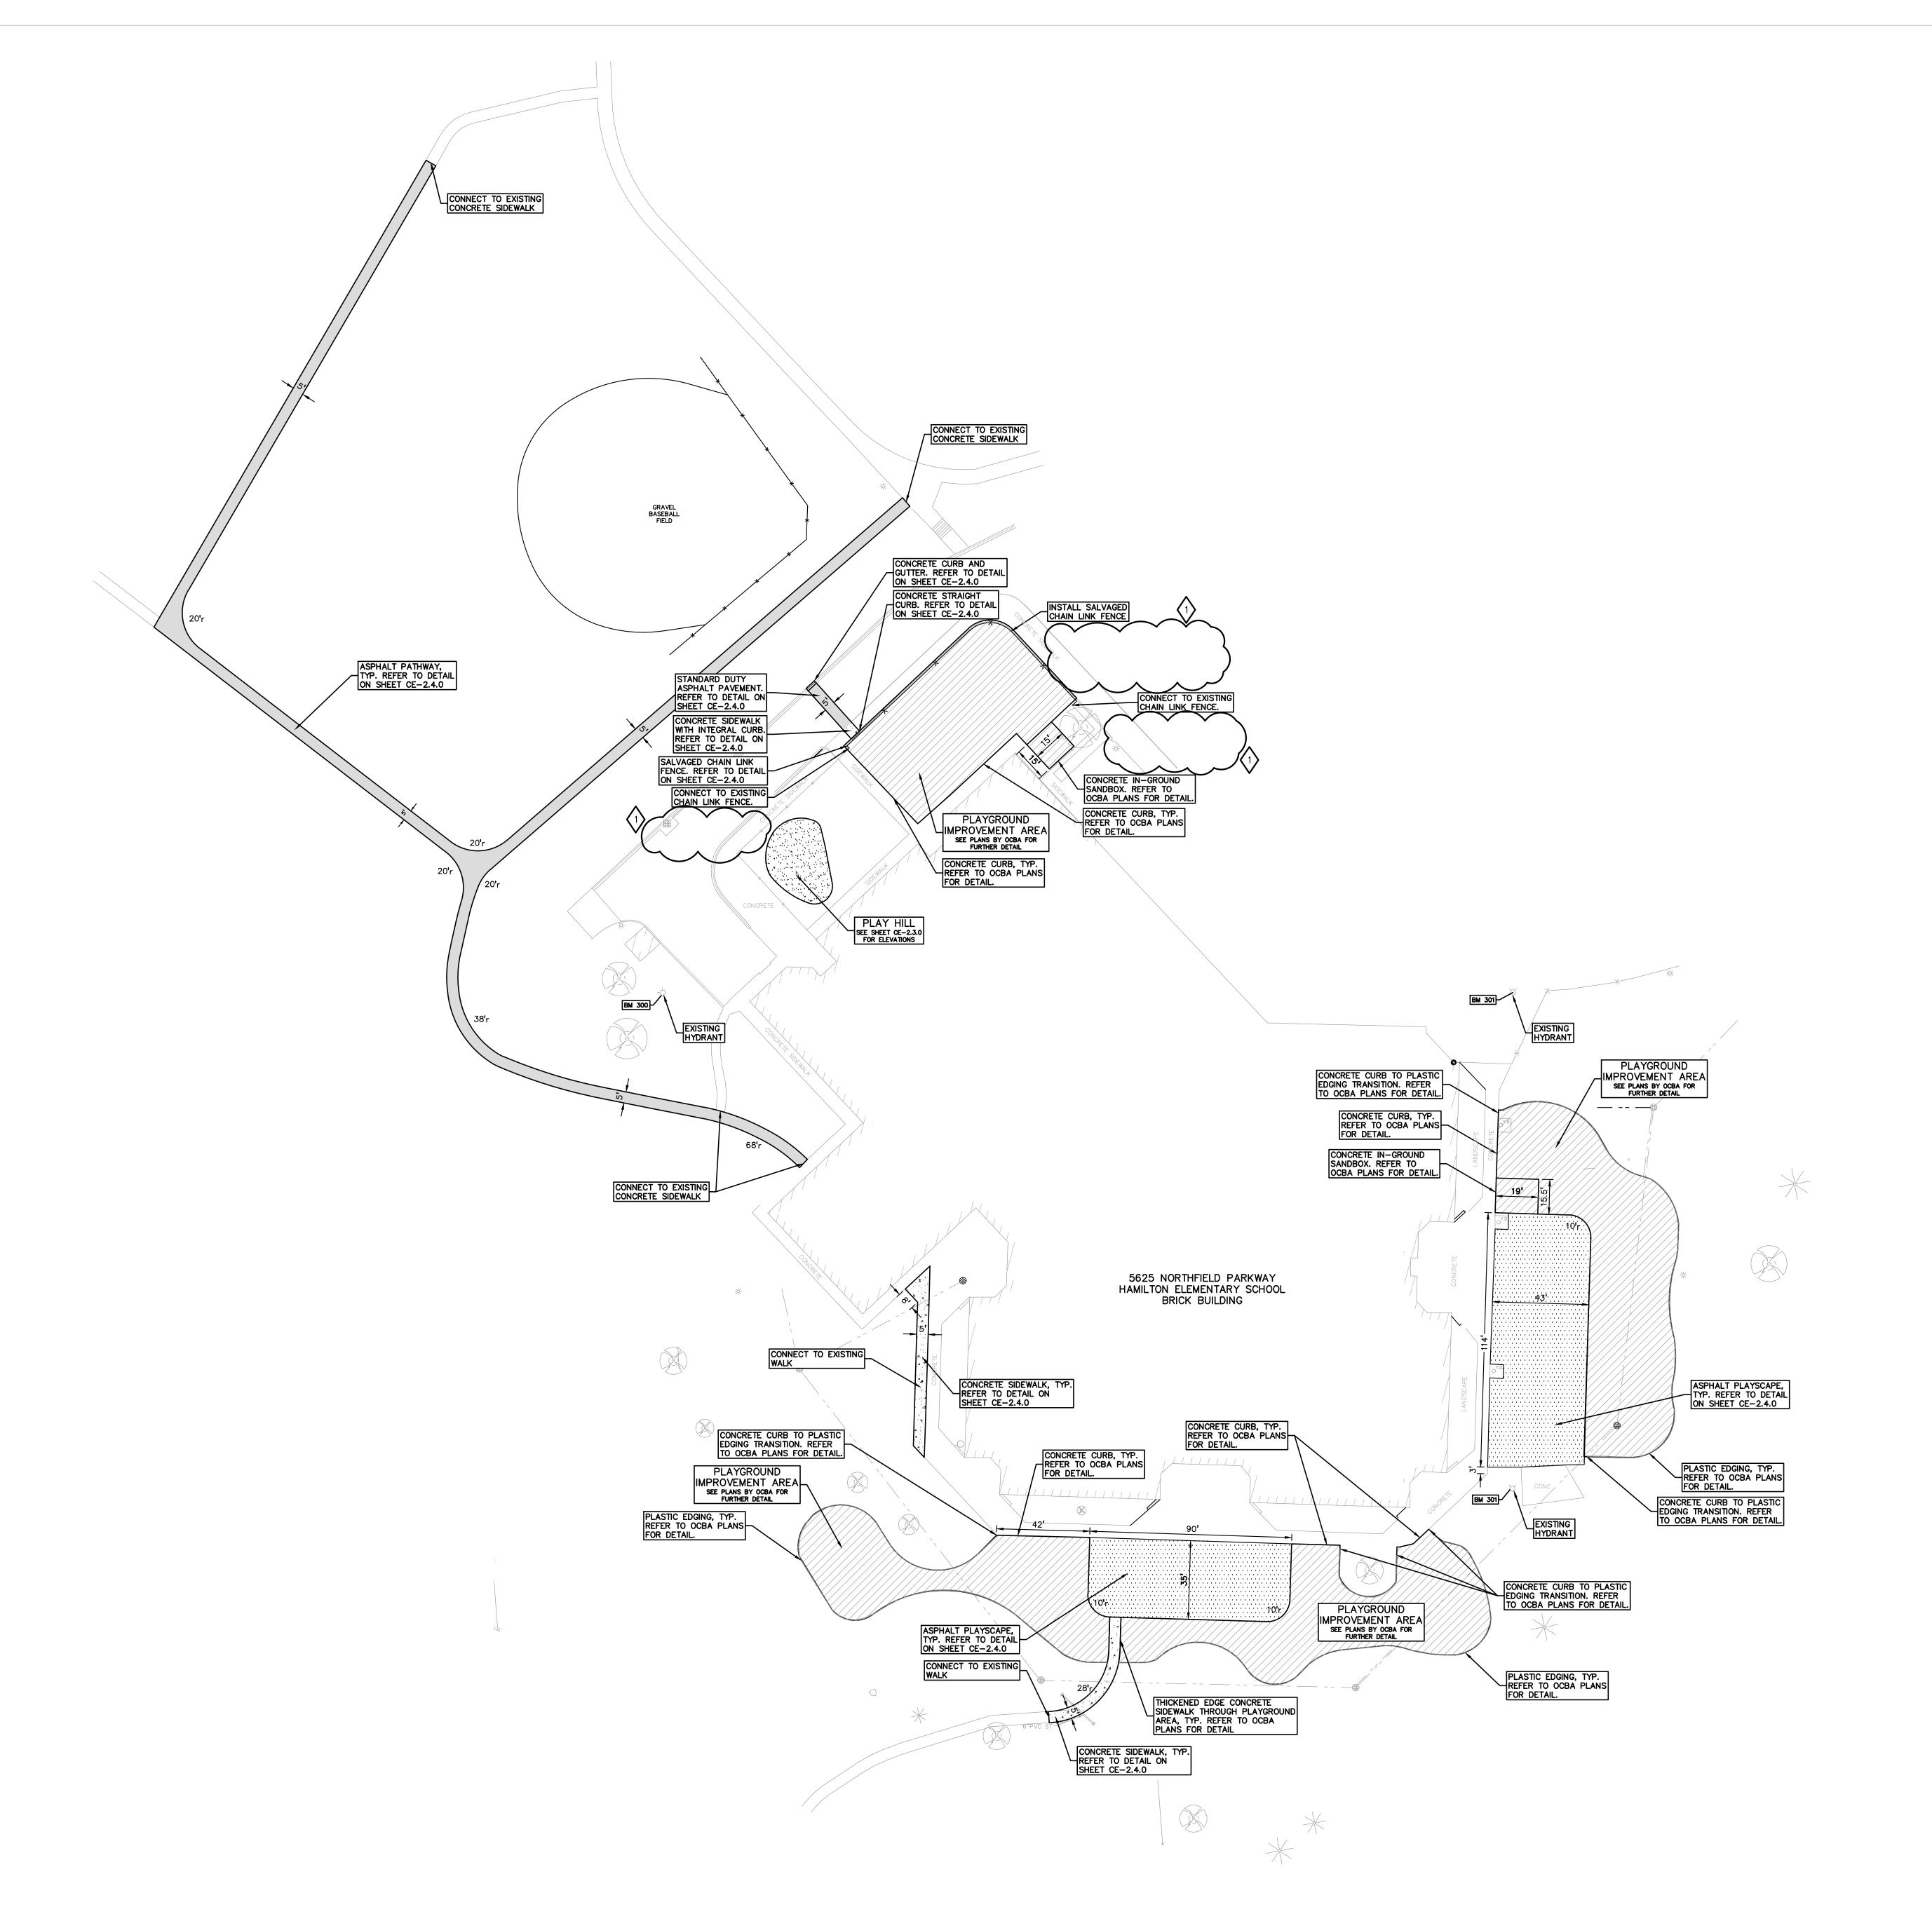
22089B


DRAWING NO.

**C2.1** 



2 4 Square Layout Detail

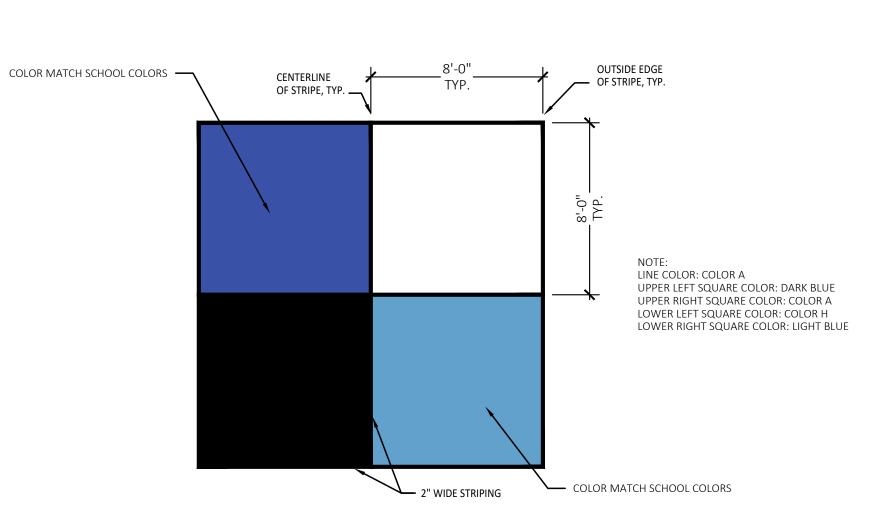

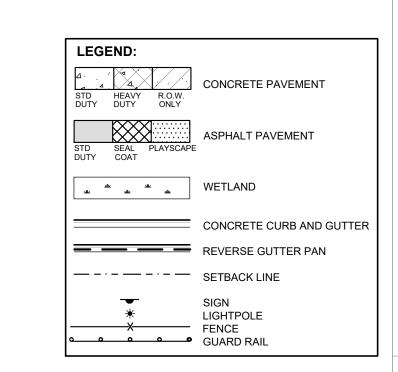



T M P A R C H I T E C T U R E I N C

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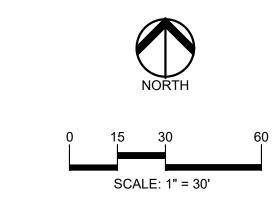
#### NOTE

- . CONTRACTOR TO VERIFY ALL QUANTITIES SHOWN ON THE PLANS. ANY DEVIATIONS TO THE PLAN QUANTITIES SHALL BE BROUGHT TO THE ATTENTION OF THE SCHOOL DISTRICT AND PEA GROUP, IN WRITING PER THE BID PACKAGE, FOR VERIFICATION PRIOR TO BIDDING.
- 2. ALL DIMENSIONS SHOWN ARE TO BACK OF CURB, FACE OF SIDEWALK, CENTER OF MANHOLE/CATCH BASIN UNLESS OTHERWISE NOTED.
- 3. DOWEL INTO EXISTING CURB AND GUTTER 9" WITH EPOXY COATED #4 BAR CONTINUOUS BETWEEN EXISTING AND
- PROPOSED CURBING.

  4. REFER TO NOTES AND DETAILS SHEET FOR PAVING DETAILS.
- 5. CONTRACTOR TO FIELD VERIFY ALL UNDERGROUND UTILITIES PRIOR TO CONSTRUCTION INCLUDING BUT NOT LIMITED TO: SITE LIGHTING, FIBER LINES, ETC.
- 6. CONTRACTOR TO REMOVE AND REPLACE SIGNS AND POSTS PER DETAILS ON SHEET C-4.0. ALL SIGNS AND ANY POSTS IN GOOD CONDITION SHALL BE RETURNED TO THE OWNER. ALL POSTS DAMAGED OR OTHERWISE NOT IN USEABLE CONDITION, SHALL BE DISPOSED OF AT NO ADDITIONAL COST TO THE OWNER.
- 7. FOR THE TWO (2) CATCH BASINS, LOCATED IN THE WORK AREA; BIDDERS ARE TO INCLUDE RECONSTRUCTION OF THESE STRUCTURES (GREATER THAN 12—INCHES IN DEPTH FROM THE RIM ELEVATION OF REPAIR WORK) IN THE BASE BID. THE SUCCESSFUL BIDDER WILL BE PAID FOR REPAIRING EACH STRUCTURE BASED ON THE ACTUAL DEPTH OF REPAIR WITH EITHER STRUCTURAL ADJUSTMENT (WITHIN TOP 12—INCHES OF RIM ELEVATION) OR STRUCTURAL RECONSTRUCTION (GREATER THAN 12—INCHES IN DEPTH) PER THE UNIT PRICES PROVIDED IN THE BID PACKAGE AND THE SCOPE OF WORK DETERMINED AND APPROVED PRIOR TO THE WORK COMMENCING. REPLASTERING OF THE ENTIRE STRUCTURE SHALL BE INCLUDED IN THE UNIT PRICE FOR BOTH STRUCTURAL ADJUSTMENT AND STRUCTURAL RECONSTRUCTION.

### SUBGRADE UNDERCUTTING NOTES:

- 1. TO MINIMIZE SUBGRADE INSTABILITY AND UNDERCUTS, THE SUBGRADE SHALL NOT BE LEFT EXPOSED TO PRECIPITATION AND CONSTRUCTION OPERATIONS AND SHOULD BE PERFORMED DURING THE SUMMER MONTHS TO ENSURE DRY, WARM, WEATHER. ADDITIONALLY, THE SUBGRADE MAY BECOME UNSTABLE UNDER REPEATED LOADING OF CONSTRUCTION TRAFFIC; THEREFORE, CONSTRUCTION EQUIPMENT SHOULD BE LIMITED ON THE EXPOSED
- 2. SUBGRADE UNDERCUT SHALL BE EVALUATED BY A QUALIFIED ENGINEERING TECHNICIAN TO DETERMINE IF SUBGRADE STABILIZATION IS NECESSARY. UNDERCUT EXCAVATIONS SHALL BE BACKFILLED WITH MDOT 21AA DENSE GRADED AGGREGATE PLACED IN AN ENGINEERED MANNER. LIFT THICKNESS SHALL NOT EXCEED 9 INCHES. THE USE OF TRI-AXIAL GEOGRID MAY BE USED TO REDUCE UNDERCUT DEPTHS, AS APPROVED BY THE DISTRICT AND PER THE UNIT PRICE PROVIDED WITH THE CONTRACTORS BID.
- . THE QUANTITY FOR "SUBGRADE UNDERCUT" FOR EACH SITE SHALL BE INCLUDED IN THE BASE BID. THIS ITEM IS CONSIDERED AN ALLOWANCE AND FINAL PAYMENT WILL BE BASED ON THE ACTUAL VOLUME OF COMPACTED IN PLACE STONE PER THE UNIT PRICE PROVIDED IN THE BID PACKAGE.
- 4. ALL ENGINEERED FILL SHALL BE COMPACTED TO A DENSITY OF AT LEAST 95 PERCENT OF THE MAXIMUM DENSITY DETERMINED BY THE MODIFIED PROCTOR (ASTM D1557) METHOD OF TESTING. ALL ENGINEERED FILL MATERIAL SHALL BE PLACED AND COMPACTED AT APPROXIMATELY THE OPTIMUM MOIUSTURE CONTENT. FROZEN MATERIAL SHALL NOT BE USED AS FILL, NOR SHOULD FILL BE PLACED ON A FROZEN SUBGRADE.
- . SUBGRADE UNDERCUT DRAIN TILE SHALL BE EVALUATED BY A QUALIFIED ENGINEERING TECHNICIAN TO DETERMINE IF SUBGRADE STABILIZATION IS NECESSARY. DRAIN TILE SHALL BE PLACED WITHIN ANY UNDERCUT AREA AND CONNECTED TO THE CLOSEST CATCH BASIN TO PREVENT GROUNDWATER FROM POOLING WITHIN THE GRANULAR SOILS IN UNDERCUTS AND CREATING "BATHTUBS" IN THE COHESIVE SOILS.
- 6. THE QUANTITY FOR "SUBGRADE UNDERCUT DRAIN TILE (4")" FOR EACH SITE SHALL BE INCLUDED IN THE BASE BID. THIS ITEM IS CONSIDERED AN ALLOWANCE AND FINAL PAYMENT WILL BE BASED ON THE ACTUAL FOOTAGE OF COMPACTED IN PLACE STONE PER THE UNIT PRICE PROVIDED IN THE BID PACKAGE.



#### CURB. FACE OF

CONSULTANT



www.peagroup.com

PROJECT TITLE

# Hamilton Elementary School 5625 NORTHFIELD PARKWAY

# Playground Remodel Bid Package No.01B

Troy School District Troy, Michigan

Dimension & Paving Plan

ISSUE DATES

10-22-2024 ADDENDUM 1
10-02-2024 CONSTRUCTION DOCUMENTS
09-10-2024 OWNER REVIEW
08-21-2024 INTERNAL COORDINATION

DATE: ISSUED FOR:
DRAWN JG

07-24-2024 DESIGN DEVELOPMENT


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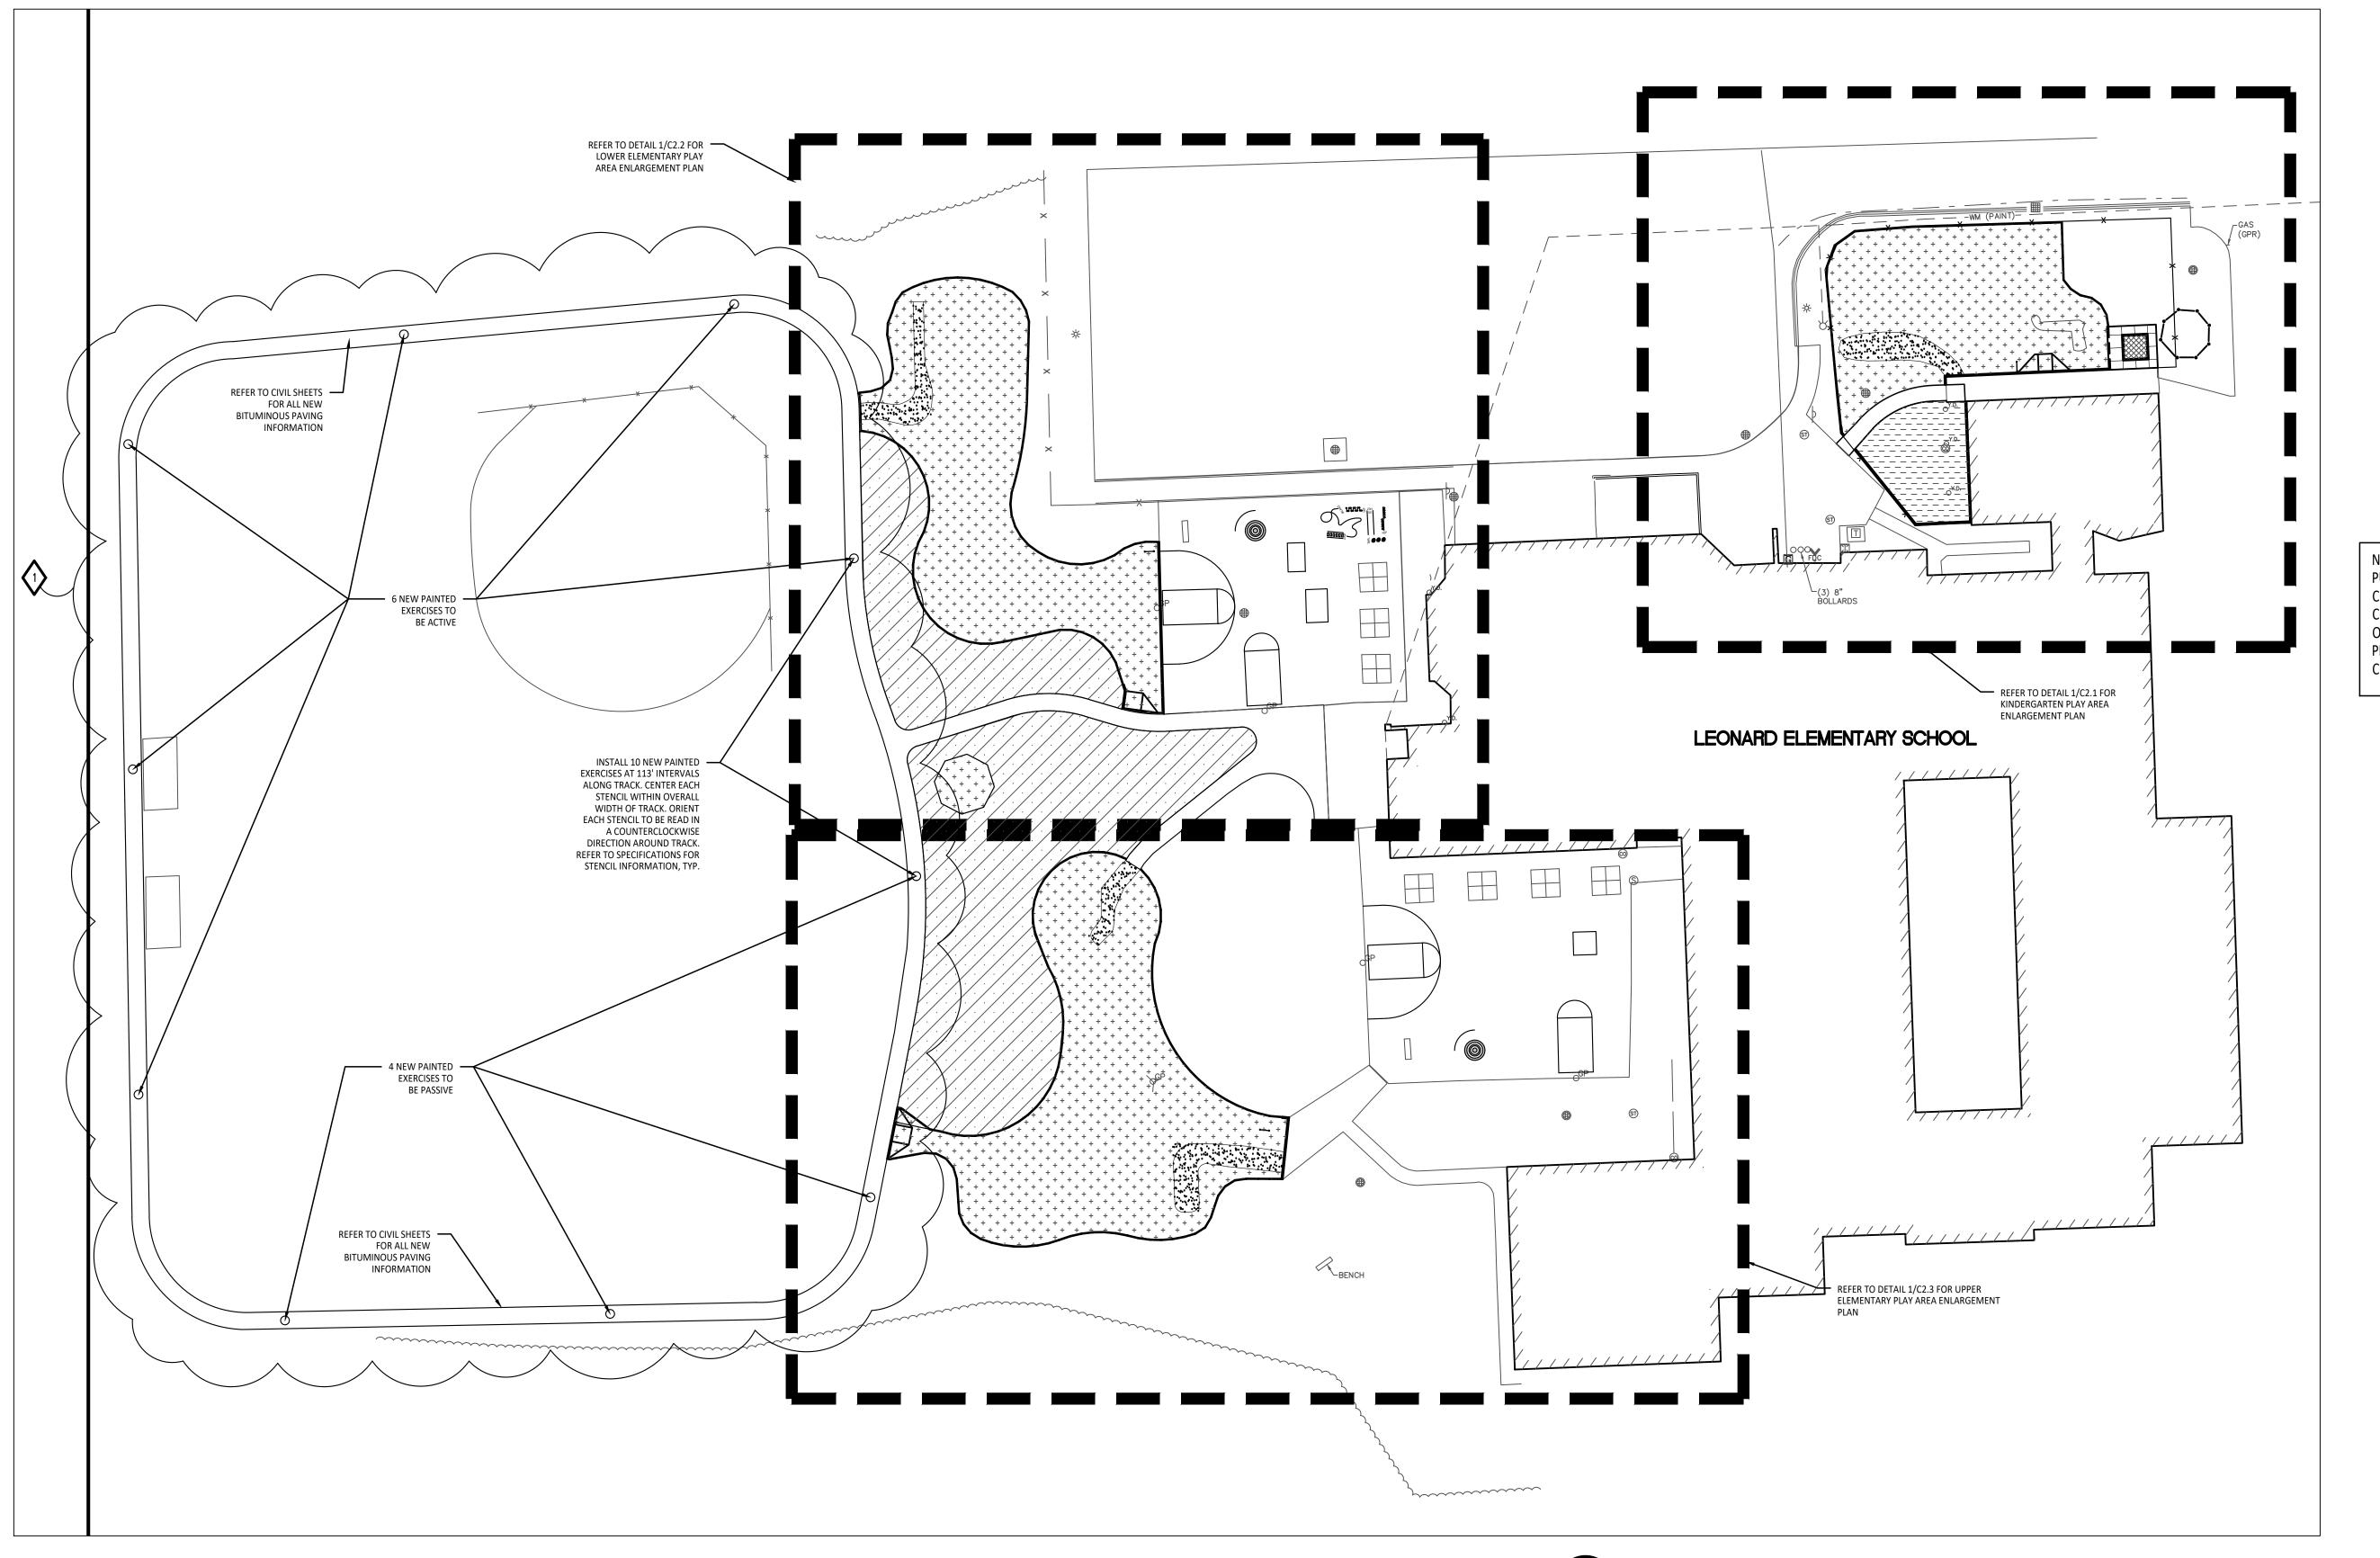
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DRAWING NO.

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## LAYOUT NOTES:

SURVEY OF EXISTING CONDITIONS PROVIDED BY PEA GROUP, 1849 POND RUN, AUBURN HILLS, MICHIGAN 48326, (248)689-9090.

PAVEMENT DIMENSIONS AND RADII ARE TO EDGE OF PAVEMENT OR BACK OF

CURB. PLASTIC EDGING MEASURED TO/FROM CENTER OF PIN.

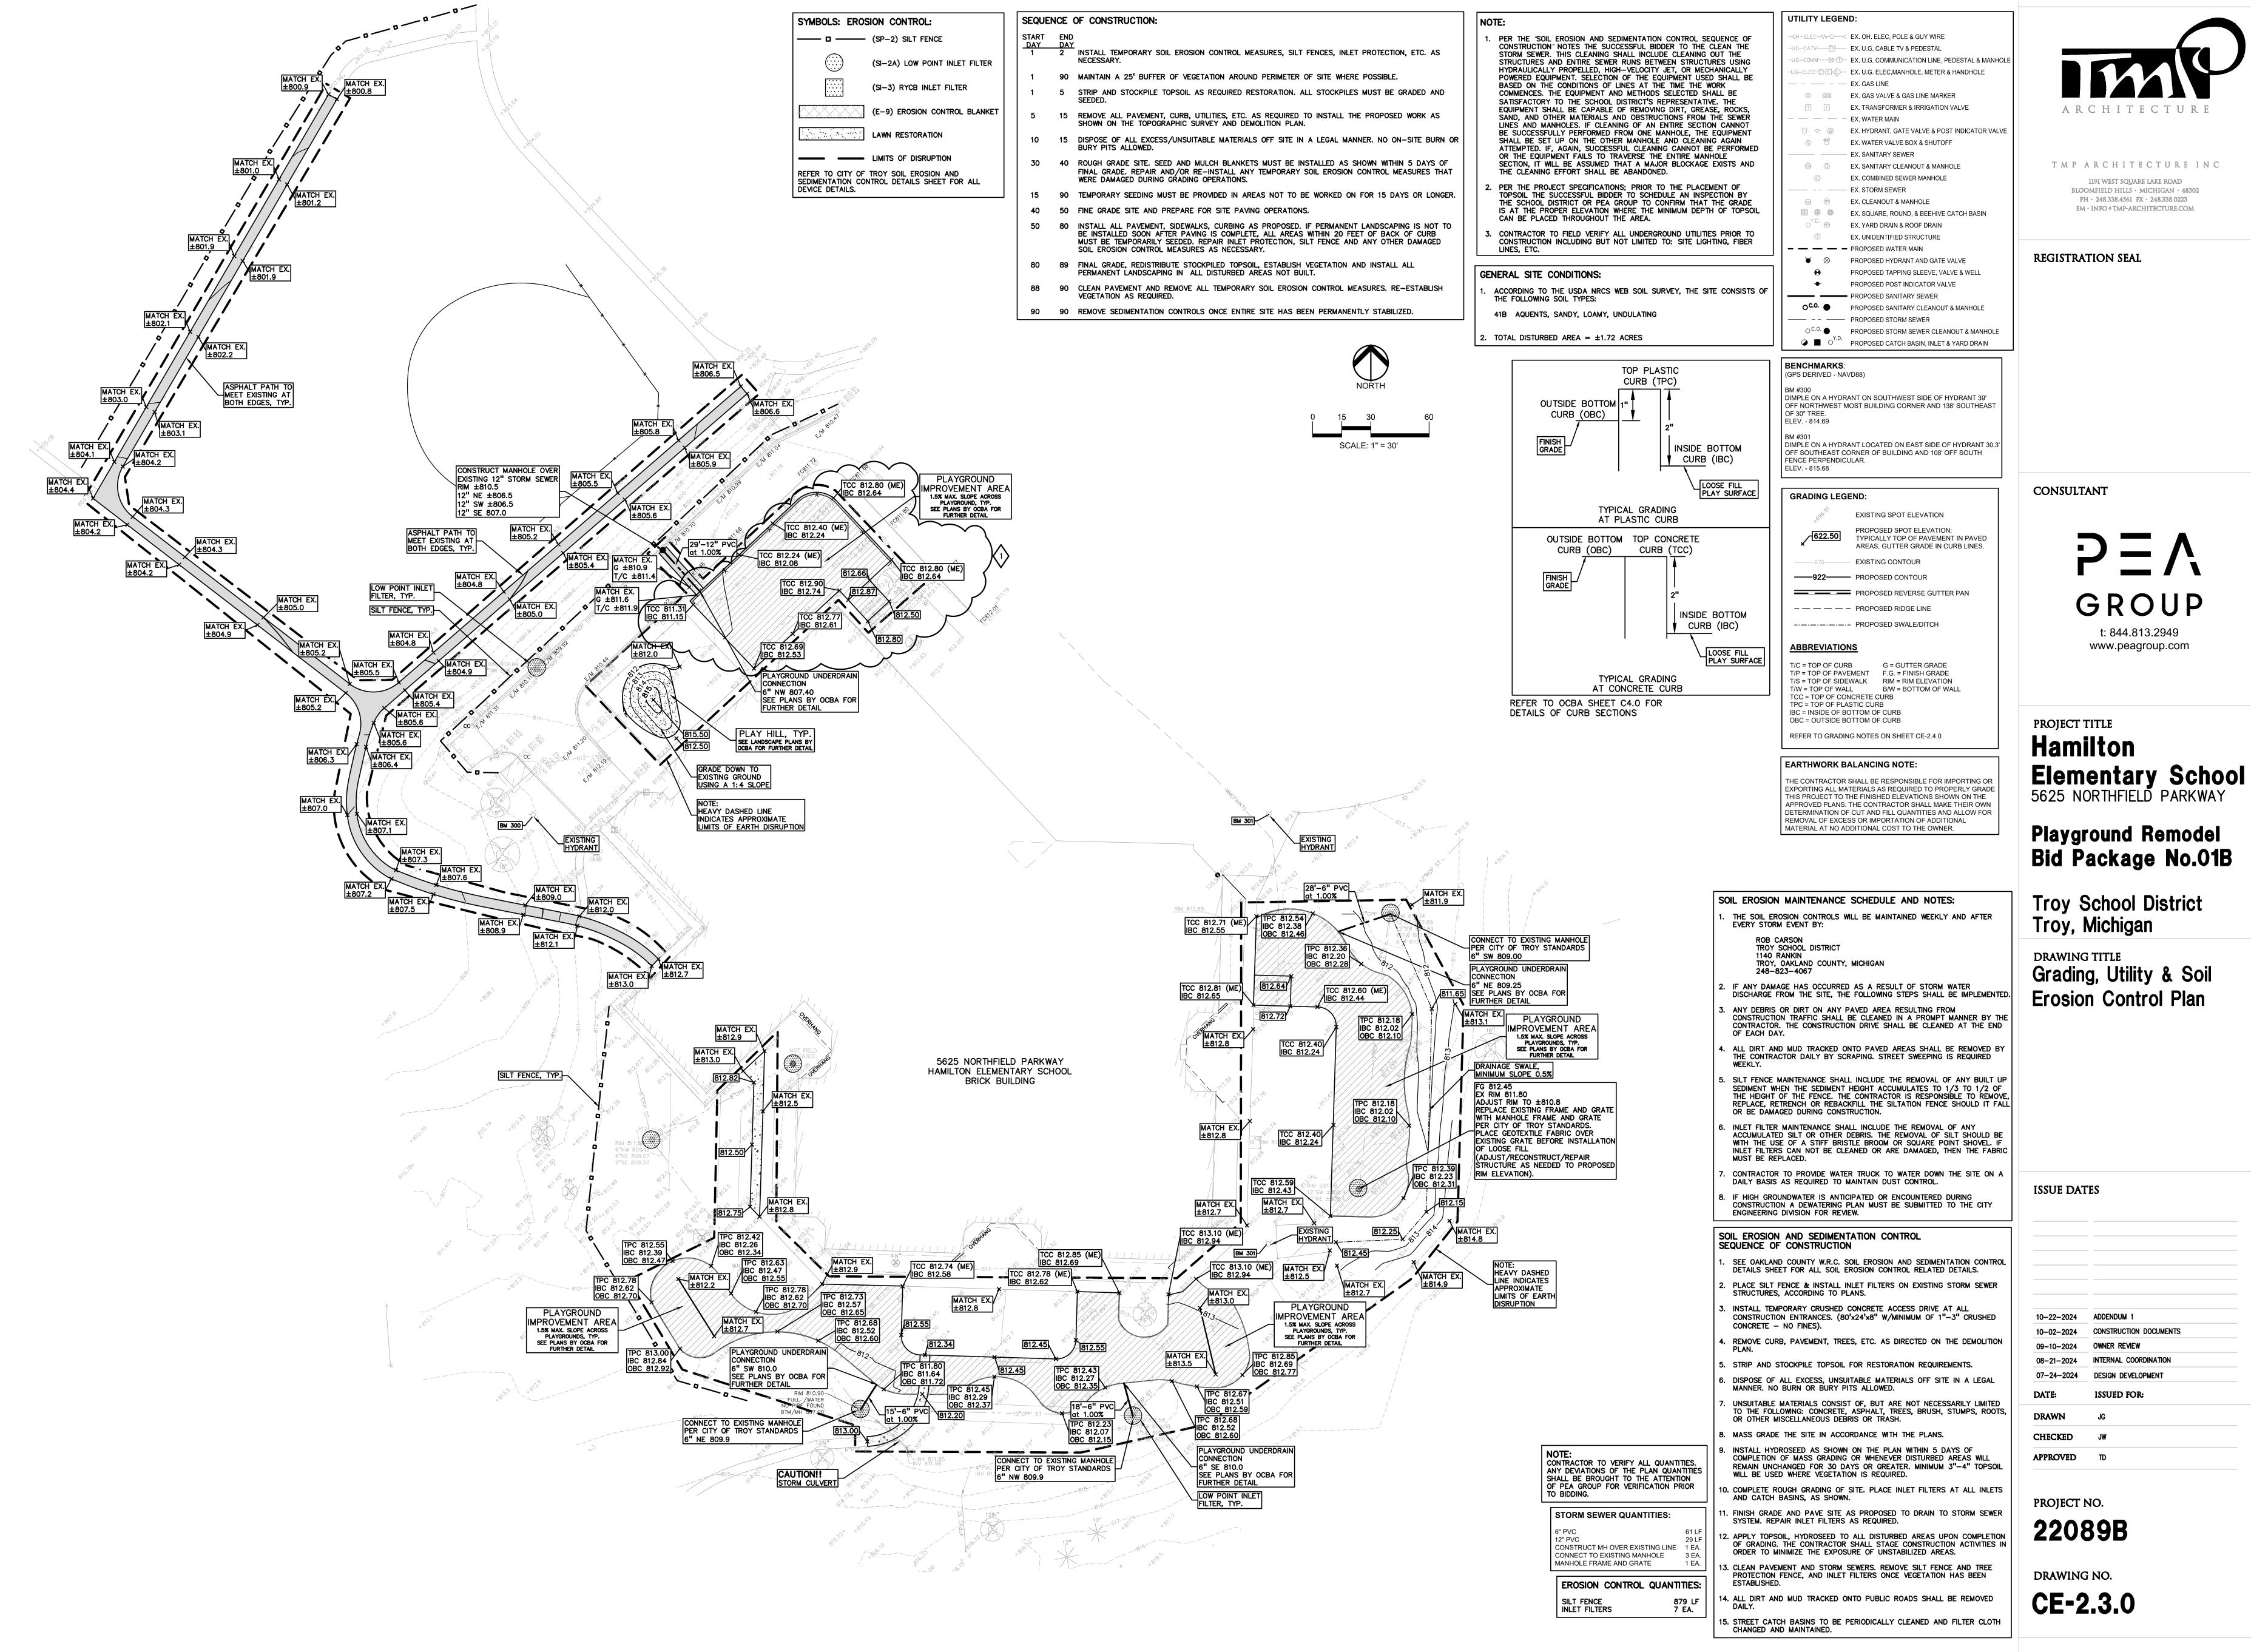DISCREPANCIES BETWEEN SITE AND PLANS SHOULD BE REPORTED TO THE PROJECT MANAGER IMMEDIATELY.

VERIFY LOCATIONS OF ALL BELOW GRADE UTILITIES PRIOR TO BEGINNING WORK. 72 HOURS BEFORE YOU DIG CALL "MISS DIG" AT 1-800-482-7171.

PROVIDE BARRIER FREE PARKING SIGNS FOR ALL BARRIER FREE PARKING SPACES. ALL SIGNS TO COMPLY WITH THE MDOT MICHIGAN MANUAL OF UNIFORM TRAFFIC

SITE LAYOUT POINTS SHOULD BE ESTABLISHED AND PROTECTED FOR FUTURE SITE

# BARRIER-FREE NOTES

BARRIER-FREE PARKING AND ACCESSIBLE ROUTE(S) MUST COMPLY WITH THE AMERICANS WITH DISABILITIES ACT AND MICHIGAN BARRIER-FREE CODE REQUIREMENTS, INCLUDING BUT NOT LIMITED TO THE FOLLOWING:

- 1:50 (2%) MAXIMUM CROSS-SLOPE ON ACCESSIBLE ROUTE. NO CHANGES IN LEVEL GREATER THAN 1/2" ALONG ACCESSIBLE ROUTE.

- 1:20 (5%) MAXIMUM LONGITUDINAL SLOPE ON ACCESSIBLE ROUTE (EXCEPT WHERE RAMPS ARE PROVIDED). - 1:50 (2%) MAXIMUM SLOPE (IN ANY DIRECTION) IN B.F. PARKING AND ACCESS AISLES.

NOTE: PLAYGROUND EQUIPMENT AND SURFACING PURCHASE AND INSTALLATION IS UNDER SEPARATE CONTRACT AND IS NOT INCLUDED IN THIS BID PACKAGE. CONTRACTOR IS REQUIRED TO COORDINATE INSTALLATION OF PLAYGROUND EQUIPMENT AND SURFACING WITH PLAYGROUND INSTALLER PRIOR TO ANY EXCAVATION AND CONCRETE CURBING OR PAVING INSTALLATION.

NOTE: VERIFY LOCATION OF NEW PLAYGROUND **EQUIPMENT PRIOR TO INSTALLATION OF ANY** CONCRETE CURB. CONCRETE CURB TO BE INSTALLED OUTSIDE OF FALL SAFETY ZONE OF EACH PIECE OF EQUIPMENT PER ASTM 1487-05 AND MANUFACTURER'S WRITTEN RECOMMENDATIONS.

# CONTRACTOR COORDINATION NOTES:

SITE CONTRACTOR AND PLAYGROUND CONTRACTOR ARE REQUIRED TO COORDINATE BOTH WITH EACH OTHER AND WITH CONSTRUCTION MANAGER. THE INSTALLATION PROCESS FOR THE PLAYGROUND SAFETY SURFACING SHOULD BE AS

\* SITE CONTRACTOR TO EXCAVATE AREA AS SHOWN ON CONSTRUCTION DOCUMENTS. \* SITE CONTRACTOR TO INSTALL UNDERDRAINS AS SHOWN ON CONSTRUCTION DOCUMENTS. SITE CONTRACTOR

\* THE PLAYGROUND CONTRACTOR WILL THEN INSTALL THE POSTS AND FOOTINGS FOR ALL EQUIPMENT. \* THE SITE CONTRACTOR WILL THEN INSTALL THE DRAINAGE AGGREGATE, TAKING CARE TO NOT DAMAGE THE POSTS OR POWDERCOATING OF THE PLAY EQUIPMENT. THE SITE CONTRACTOR WILL ALSO INSTALL THE ADDITIONAL ENGINEERED FILL FOR THE RESILIENT SURFACING AREAS. THE SITE CONTRACTOR MUST COORDINATE THE DEPTHS WITH THE PLAYGROUND CONTRACTOR PRIOR TO INSTALLATION AS THE DEPTHS VARY BETWEEN PLAYGROUND CONTRACTORS. \* THE PLAYGROUND CONTRACTOR WILL INSTALL THE GEOTEXTILE FABRIC, PLAYGROUND EQUIPMENT, AND SAFETY SURFACING.

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Landscape Architecture Urban Planning Parks & Recreation Campus & Institutional Planning Camp Planning & Design

### PROJECT TITLE


# Leonard **Elementary School** Playground Remodel Bid Package No.01B

Troy School District Troy, Michigan


Overall Playground Layout Plan


Overall Playground Layout Plan

Scale: 1" = 30'-0"

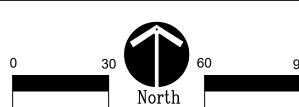

### PROPOSED FEATURES LEGEND: STRAIGHT FACE CONCRETE CURB 6 /C4.0 THICKENED EDGE CONCRETE 11 /C4.0 RESILIENT SURFACING (BY OTHERS) 7 /C4.0 3 & 9 /C4.0 LOOSE FILL SAFETY SURFACING (BY OTHERS) LOOSE FILL SAFETY SURFACING (BY OTHERS) 12, 13, & 18 /C4.0 PLASTIC PLAY EDGING (BY OTHERS) 4, 5, & 8 /C4.0 SYNTHETIC TURF (BY OTHERS) CONCRETE WALK 2 /C4.0 SYNTHETIC TURF (BY OTHERS) PLAY AREA ENTRANCE RAMP 16 /C4.0 **CONCRETE SAND BOX** 15 /C4.0 PLAY HILL, REFER TO CIVIL DRAWINGS PLASTIC PLAY EDGING, BY OTHERS REFER TO PLAYGROUND CONTRACTOR'S DRAWINGS AND SPECS STRAIGHT FACE CONCRETE CURB ===== THICKENED EDGE CONCRETE SIGNS 👗 INTEGRAL WALK AND CURB COMMUNICATION BOARD; PURCHASED BY OWNER, INSTALLED SEE SPECS. BY SITE CONTRACTOR BARRIER-FREE PLAY AREA ENTRANCE RAMP —x —x —x — CHAIN LINK FENCE, REFER TO CIVIL PLANS ■ ■ ■ ■ ■ ENLARGEMENT LIMIT LINE

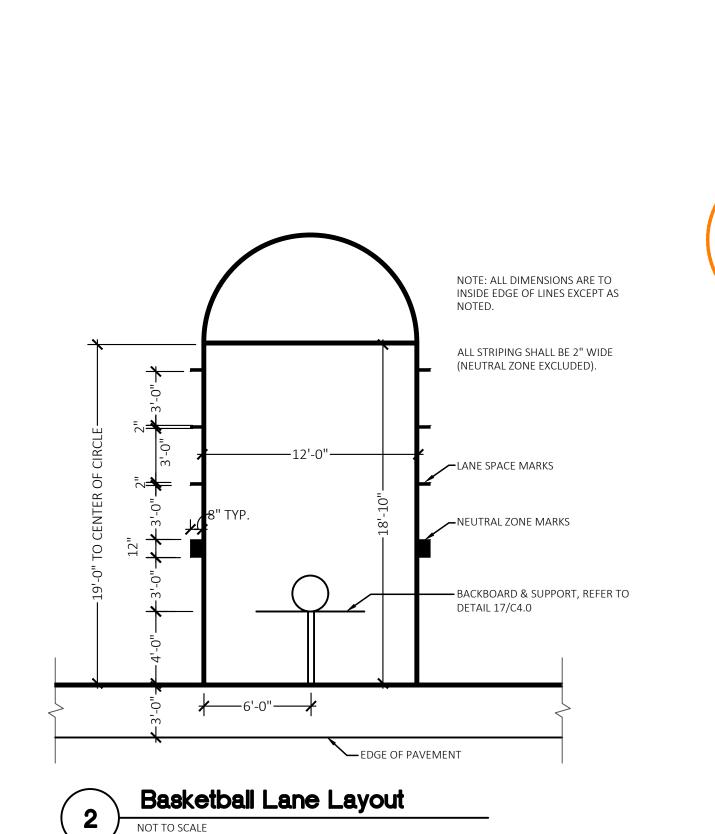

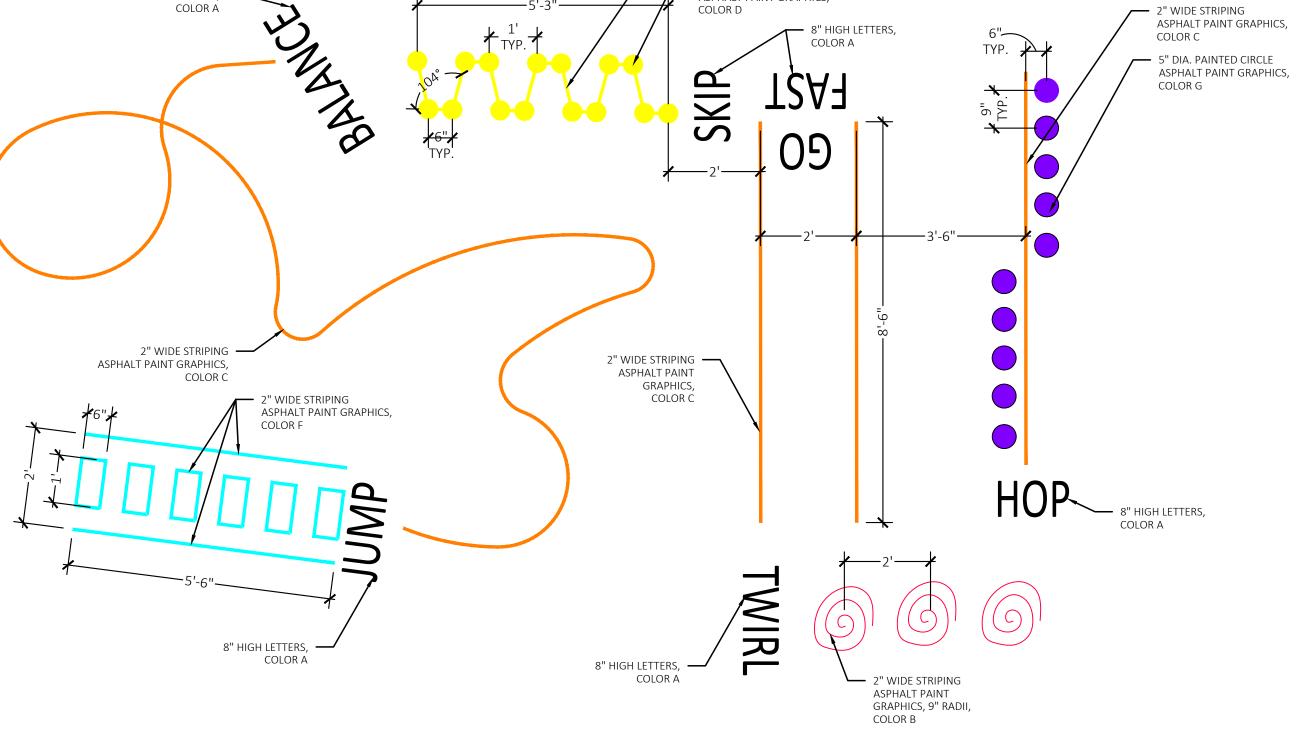

2" WIDE STRIPING ASPHALT PAINT GRAPHICS,


— 5" DIA. PAINTED CIRCLE

Silly Track Layout


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10-03-2024	CONSTRUCTION DOCUMENTS	
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APPROVED	DID	

22091B

DRAWING NO. **C2.0** 

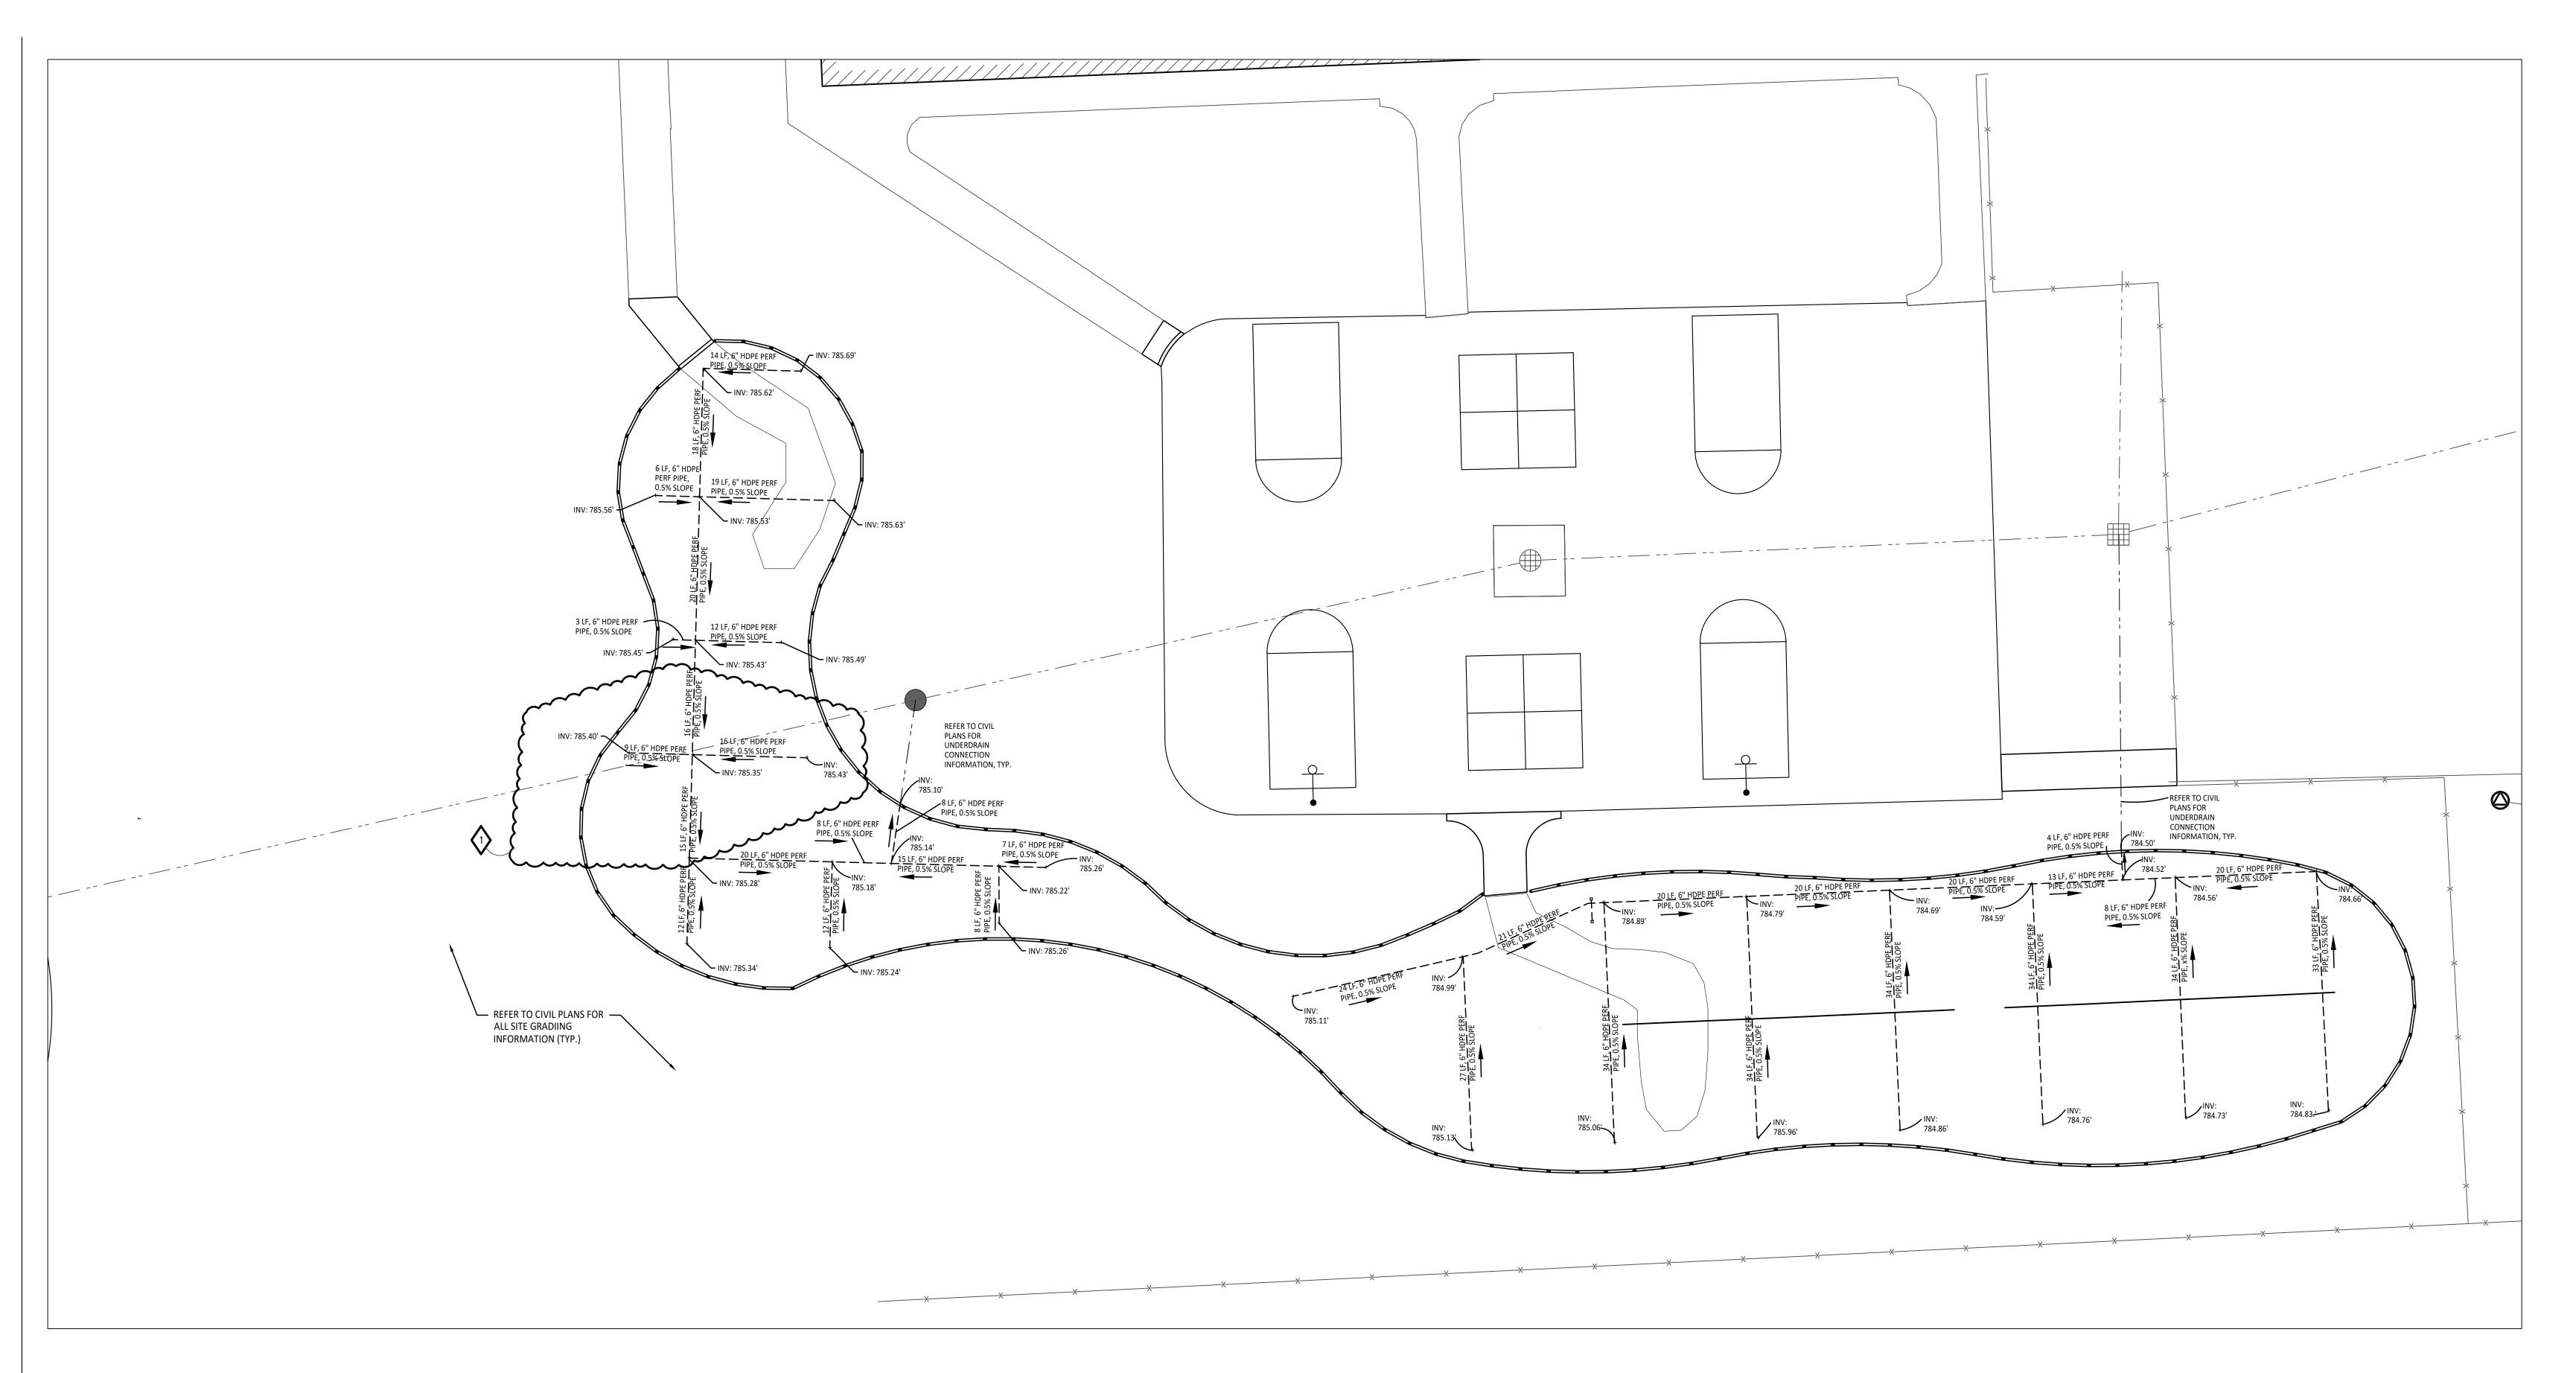

1 Playground Drainage Enlargement Plan - Upper Elementary Play Area

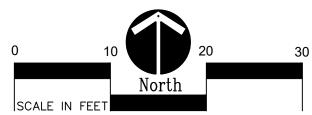

## **GRADING NOTES:**

- 1. SURVEY OF EXISTING CONDITIONS PROVIDED BY PEA GROUP, 1849 POND RUN, AUBURN HILLS, MICHIGAN, 48326, (248)689-9090.
- 1-800-482-7171.

  3. ALL NEW PAVEMENTS AND TURF AREAS ARE INTENDED TO DRAIN FREELY WITH NO PONDING. IF THIS CANNOT BE ACHIEVED USI
- 3. ALL NEW PAVEMENTS AND TURF AREAS ARE INTENDED TO DRAIN FREELY WITH NO PONDING. IF THIS CANNOT BE ACHIEVED USIN THE PROPOSED GRADES, NOTIFY THE OWNER'S REPRESENTATIVE IMMEDIATELY FOR RESOLUTION.
- 4. ALL NEW PAVEMENT ELEVATIONS AT EXTERIOR DOORS SHALL MATCH EXISTING FINISH FLOOR ELEVATIONS, TYPICAL.
- SEE SITE CIVIL PLANS FOR ALL ADDITIONAL SITE UTILITY DEMOLITION AND CONSTRUCTION.
- ALL TOPSOIL AND EXCESS FILL MATERIAL SHALL BE STOCKPILED ON SITE SEPARATELY FOR LATER RE-USE. LOCATE STOCKPILES IN AREAS AS DIRECTED BY CONSTRUCTION MANAGER AND PROTECT FROM EFFECTS OF EROSION.

### IMPORTANT NOTE

# GENERAL EARTHWORK NOTE:

CUTS AND FILLS AT THIS SITE MAY OR MAY NOT BALANCE. IT IS THE CONTRACTOR'S RESPONSIBILITY TO VERIFY THE REQUIRED EARTHWORK VOLUMES BASED ON THE GRADING PLAN SHOWN. IF FILL IS REQUIRED, THE CONTRACTOR SHALL INCLUDE THE REQUIRED VOLUME OF IMPORTED CLASS II SAND IN THE BASE BID PROPOSAL. IF EXCESS SOILS NEED TO BE SPOILED, THE CONTRACTOR SHALL INCLUDE HAULING AND SPOILING SOILS OFF SITE IN THE BASE BID PROPOSAL. NO CONTRACT COST ADJUSTMENTS WILL BE CONSIDERED FOR EARTHWORK REQUIRED TO BALANCE THE SITE.

### IMPORTANT NOTE

# BARRIER-FREE NOTES

BARRIER-FREE PARKING AND ACCESSIBLE ROUTE(S) MUST COMPLY WITH THE AMERICANS WITH DISABILITIES ACT AND MICHIGAN BARRIER-FREE CODE REQUIREMENTS, INCLUDING BUT NOT LIMITED TO THE FOLLOWING:

- 1:50 (2%) MAXIMUM CROSS-SLOPE ON ACCESSIBLE ROUTE.

NO CHANGES IN LEVEL GREATER THAN 1/2" ALONG ACCESSIBLE ROUTE.
 1:20 (5%) MAXIMUM LONGITUDINAL SLOPE ON ACCESSIBLE ROUTE (EXCEPT WHERE RAMPS ARE PROVIDED).
 1:50 (2%) MAXIMUM SLOPE (IN ANY DIRECTION) IN B.F. PARKING AND ACCESS AISLES.

# PROPOSED FEATURES LEGEND:

695	EXISTING CONTOURS
+711.55 2067 CONC.	EXISTING SPOT ELEVATIONS
710	PROPOSED CONTOURS
949.5	PROPOSED SPOT ELEVATIONS
2%	DIRECTION AND PERCENTAGE OF SLOPE
0	NEW STORMWATER STRUCTURE, REFER TO CIVIL PLANS
	PLAYGROUND UNDER DRAIN PIPE, REFER TO DETAIL 14/C4.0
INV	INVERT ELEVATION

A R C H I T E C T U R E

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Landscape Architecture
Urban Planning
Parks & Recreation
Campus & Institutional Planning
Camp Planning & Design

PROJECT TITLE

# Schroeder Elementary School Playground Remodel Bid Package No.01B

Troy School District Troy, Michigan

DRAWING TITLE
Playground Drainage
Enlargement Plan

ISSUE DATES		
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10-22-2024	ADDENDUM #1	
10-03-2024	CONSTRUCTION DOCUMENTS	
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APPROVED DID

PROJECT NO.

22094B

DRAWING NO.

# CONTRACTOR COORDINATION NOTES:

SITE CONTRACTOR AND PLAYGROUND CONTRACTOR ARE REQUIRED TO COORDINATE BOTH WITH EACH OTHER AND WITH CONSTRUCTION MANAGER. THE INSTALLATION PROCESS FOR THE PLAYGROUND SAFETY SURFACING SHOULD BE AS FOLLOWS:

\* SITE CONTRACTOR TO EXCAVATE AREA AS SHOWN ON CONSTRUCTION DOCUMENTS.


\* SITE CONTRACTOR TO INSTALL UNDERDRAINS AS SHOWN ON CONSTRUCTION DOCUMENTS. SITE CONTRACTOR

TO USE LAYOUT SERVICES FROM CADD FILES FOR INSTALLATION TO ENSURE THAT THE UNDERDRAINS ARE INSTALLED IN THE CORRECT LOCATIONS.


\* THE PLAYGROUND CONTRACTOR WILL THEN INSTALL THE POSTS AND FOOTINGS FOR ALL EQUIPMENT.

\* THE SITE CONTRACTOR WILL THEN INSTALL THE DRAINAGE AGGREGATE, TAKING CARE TO NOT DAMAGE THE POSTS OR POWDERCOATING OF THE PLAY EQUIPMENT. THE SITE CONTRACTOR WILL ALSO INSTALL THE ADDITIONAL ENGINEERED FILL FOR THE RESILIENT SURFACING AREAS. THE SITE CONTRACTOR MUST COORDINATE THE DEPTHS WITH THE PLAYGROUND CONTRACTOR PRIOR TO INSTALLATION AS THE DEPTHS VARY BETWEEN PLAYGROUND CONTRACTORS.

\* THE PLAYGROUND CONTRACTOR WILL INSTALL THE GEOTEXTILE FABRIC, PLAYGROUND EQUIPMENT, AND SAFETY

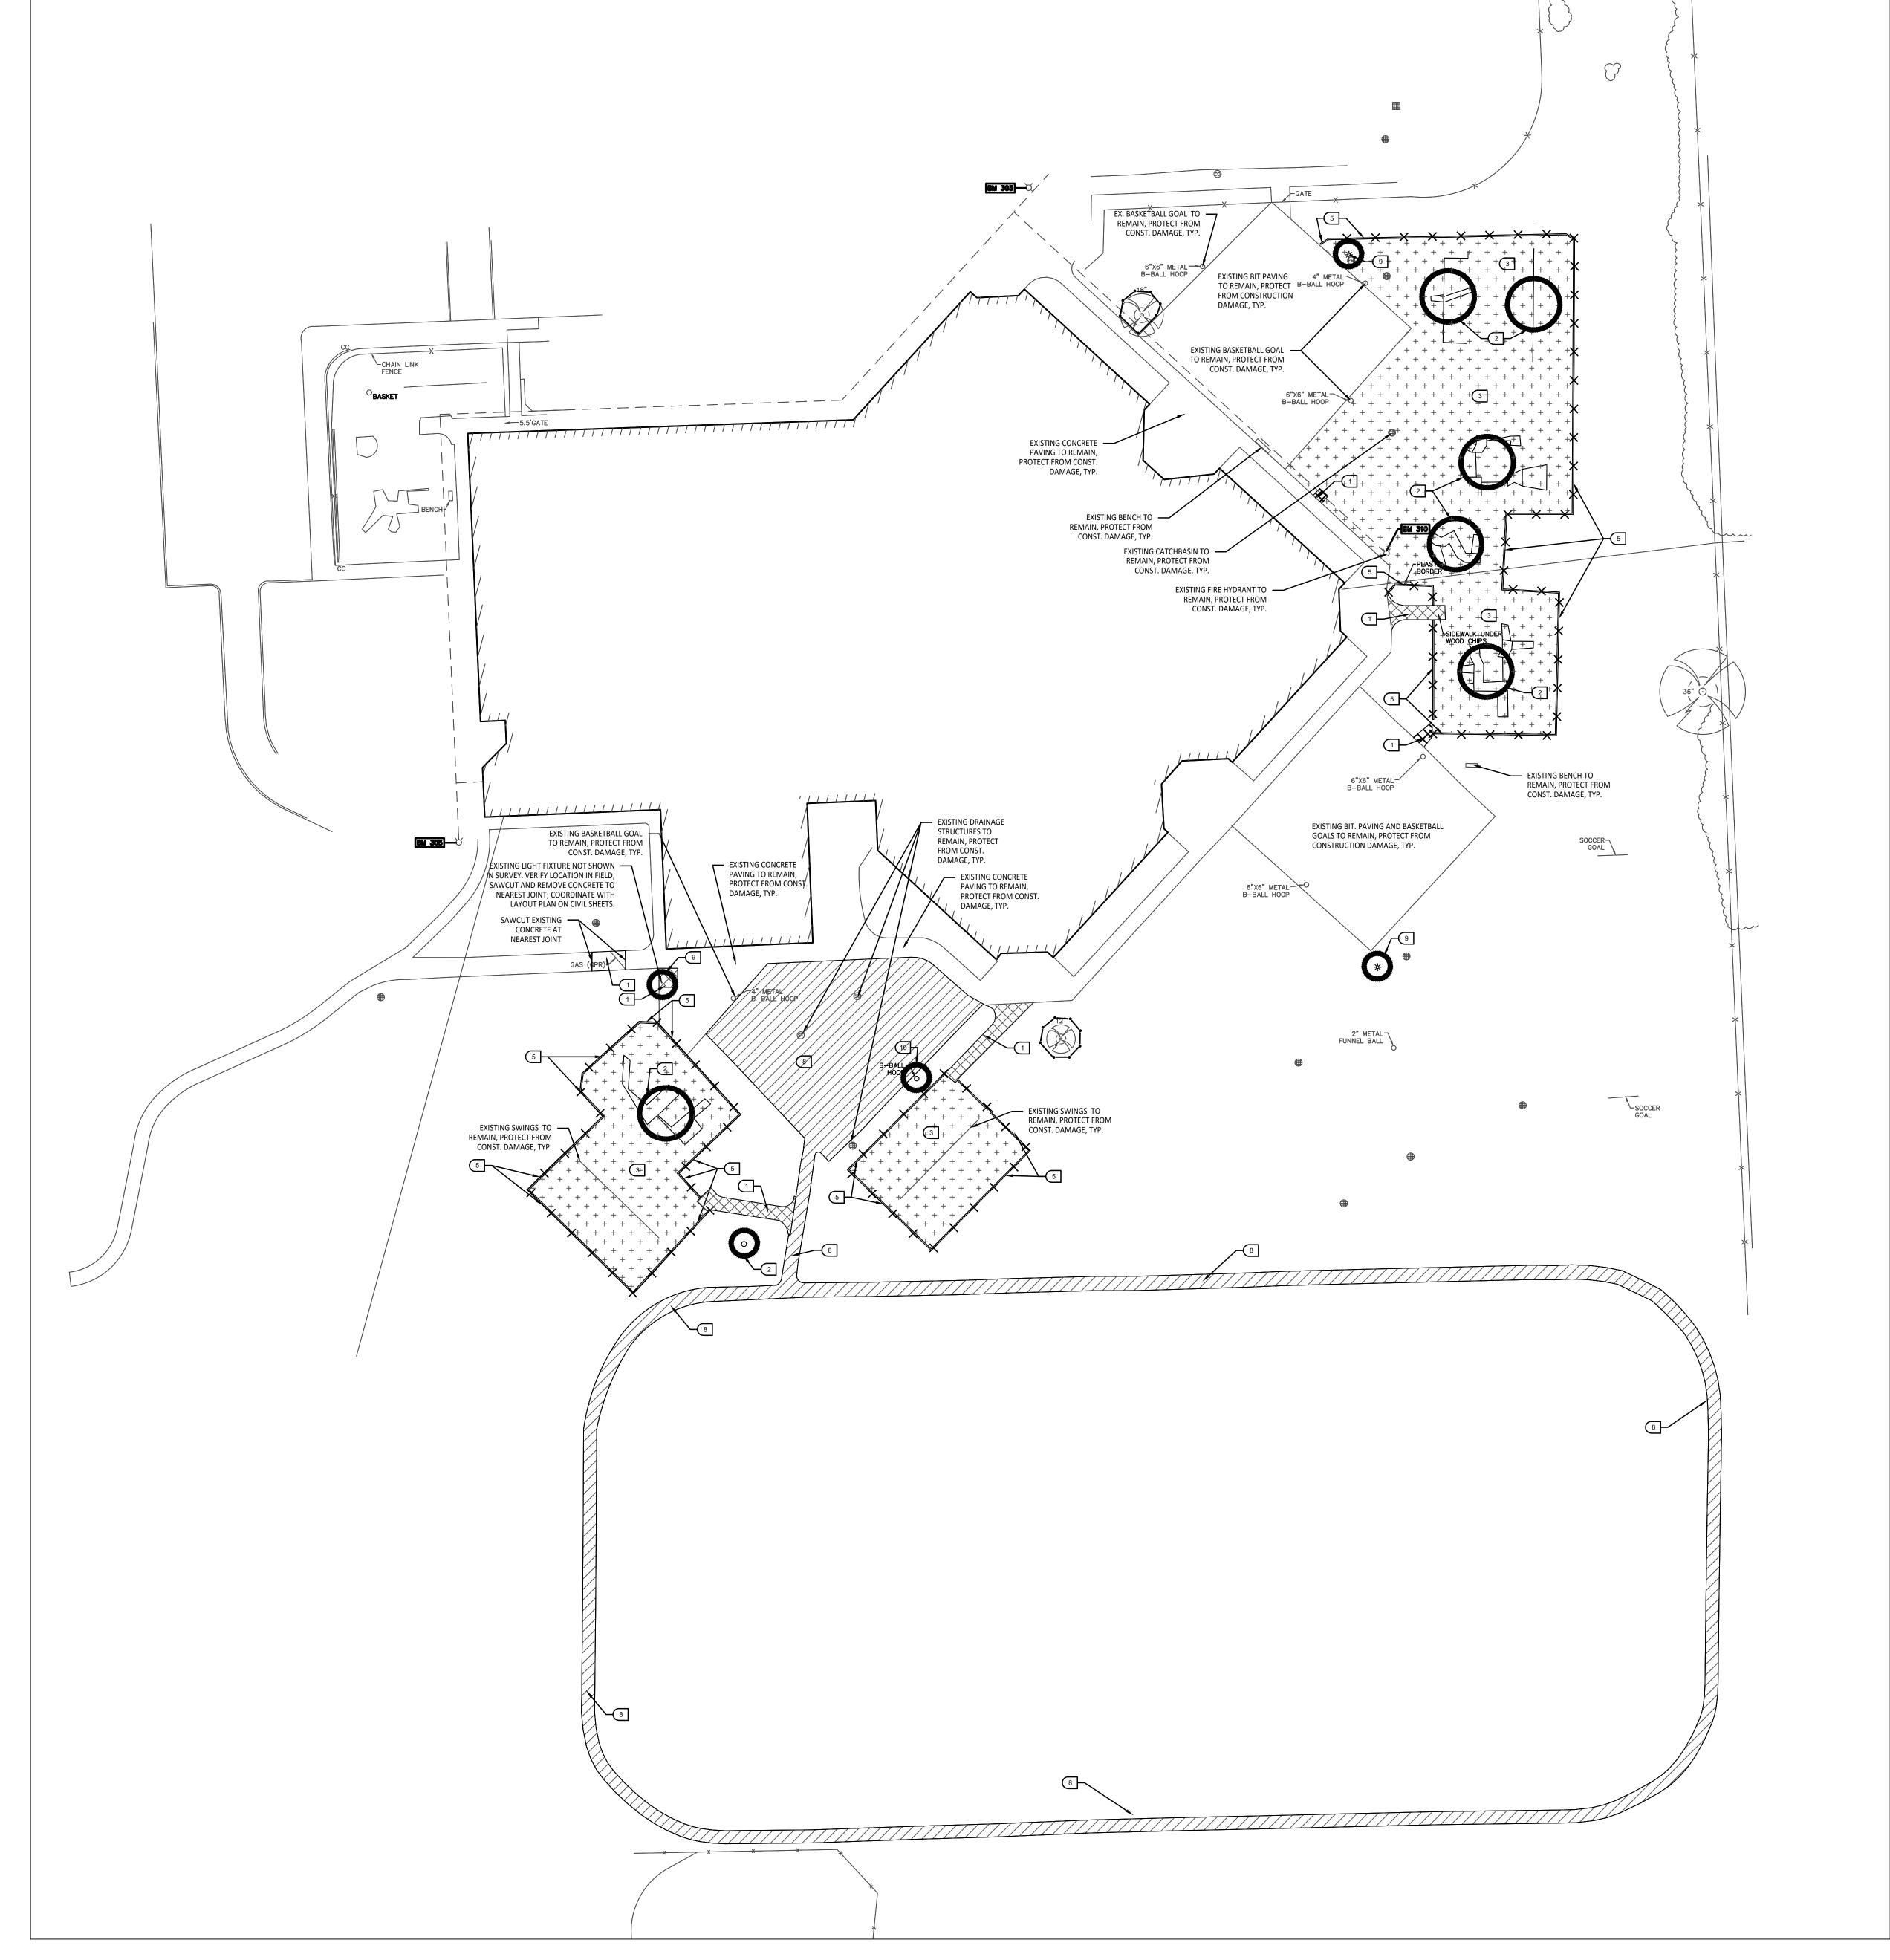



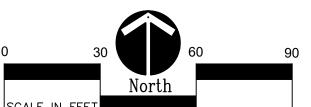

# SITE DEMOLITION KEY

- 1 SAWCUT AND REMOVE EXISTING CONCRETE PAVING INCLUDING SUB-BASE.
- 2 REMOVE EXISTING PLAY EQUIPMENT INCLUDING ALL CONCRETE FOOTINGS. DESTROY ALL PLAY EQUIPMENT COMPLETELY SO THAT IT CANNOT BE RE-ASSEMBLED.
- REMOVE EXISTING PLAY SAFETY SURFACING, INCLUDING DRAINAGE AGGREGATE.
- PLAYGROUND CONTRACTOR TO SALVAGE EXISTING PLAY EQUIPMENT AND RE-INSTALL ON-SITE.
- 5 REMOVE EXISTING PLAY EDGING COMPLETELY.

OWNER TO DISCONNECT POWER AND REMOVE LIGHT HEAD. SITE CONTRACTOR TO CUT WIRE

- AS DIRECTED BY CONSTRUCTION MANAGER AND PROTECT FROM EFFECTS OF EROSION.
- CONTRACTOR IS NOT ALLOWED TO RE-USE, DONATE, OR SELL ANY EXISTING PLAYGROUND EQUIPMENT SCHEDULED TO BE DEMOLISHED.
- PROVIDED IT IS TESTED TO BE ADEQUATE IN BOTH DEPTH AND GRADATION. IF EITHER OF THESE IS INADEQUATE, THE BASE MATERIAL SHOULD BE REMOVED AND REPLACED.

**ISSUE DATES** 

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PROJECT TITLE

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Kalamazoo Michigan 49007

Campus & Institutional Planning Camp Planning & Design

Elementary School Playground Remodel Bid Package No.01B

Troy School District Troy, Michigan

DRAWING TITLE

Demolition Plan

Phone (269) 381-3357 Fax (269) 381-2944

Landscape Architecture

Urban Planning

Parks & Recreation

10-22-2024 ADDENDUM #1


CONSTRUCTION DOCUMENTS


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PROJECT NO.


22096B

DRAWING NO. **C1.0** 



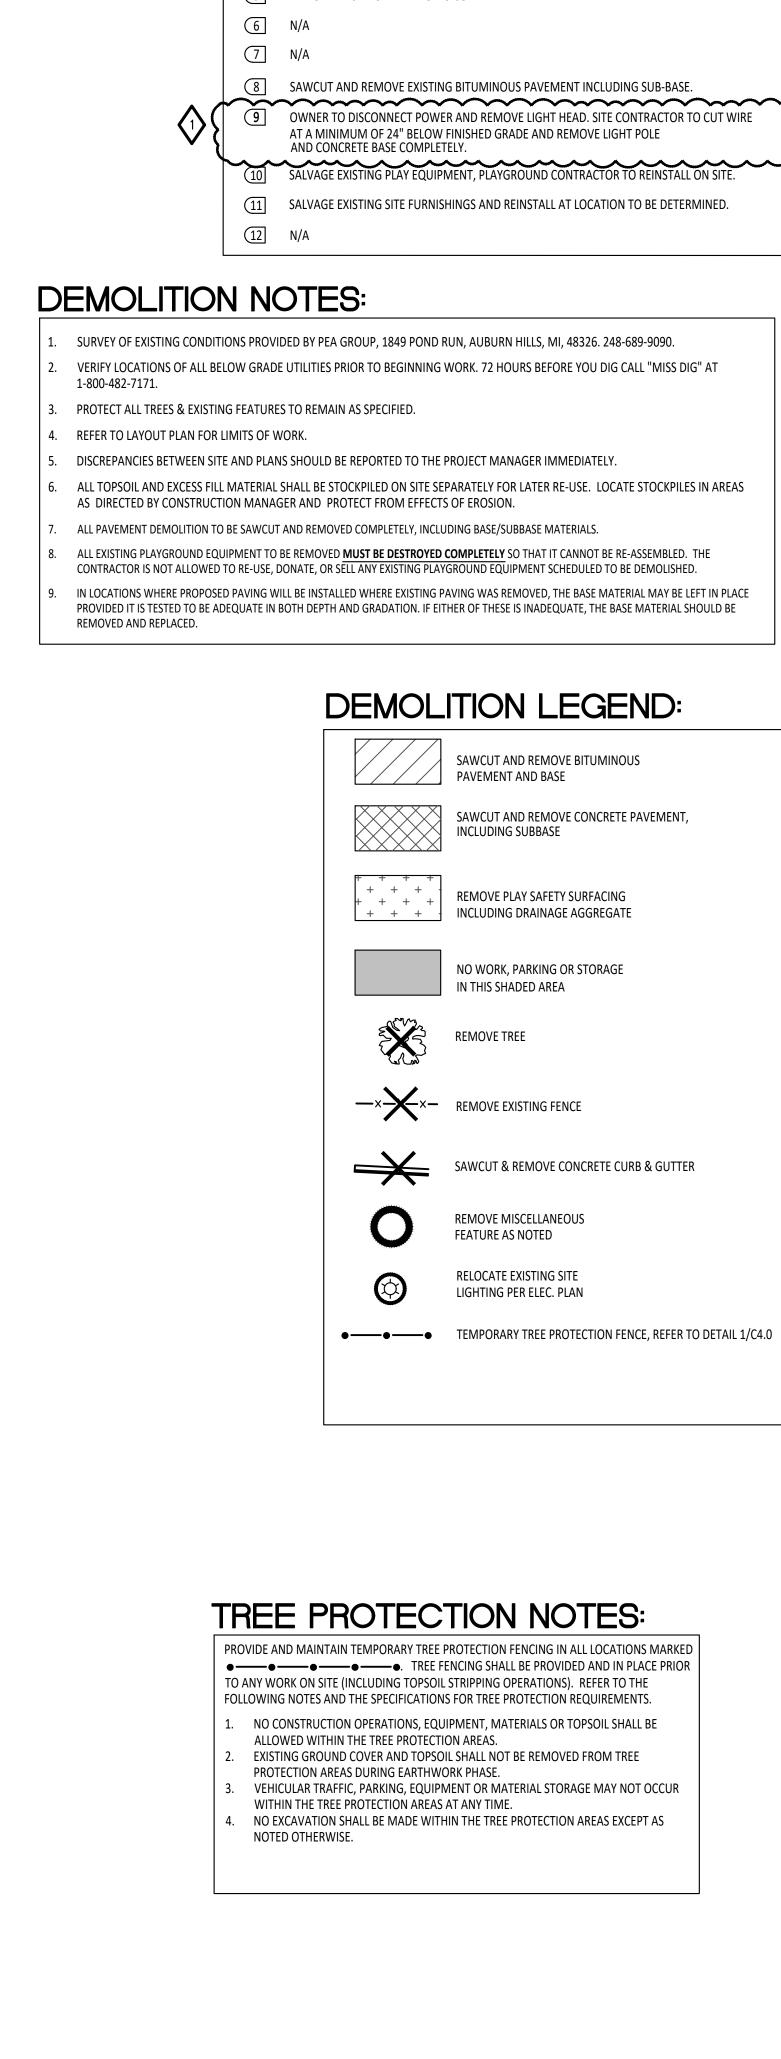

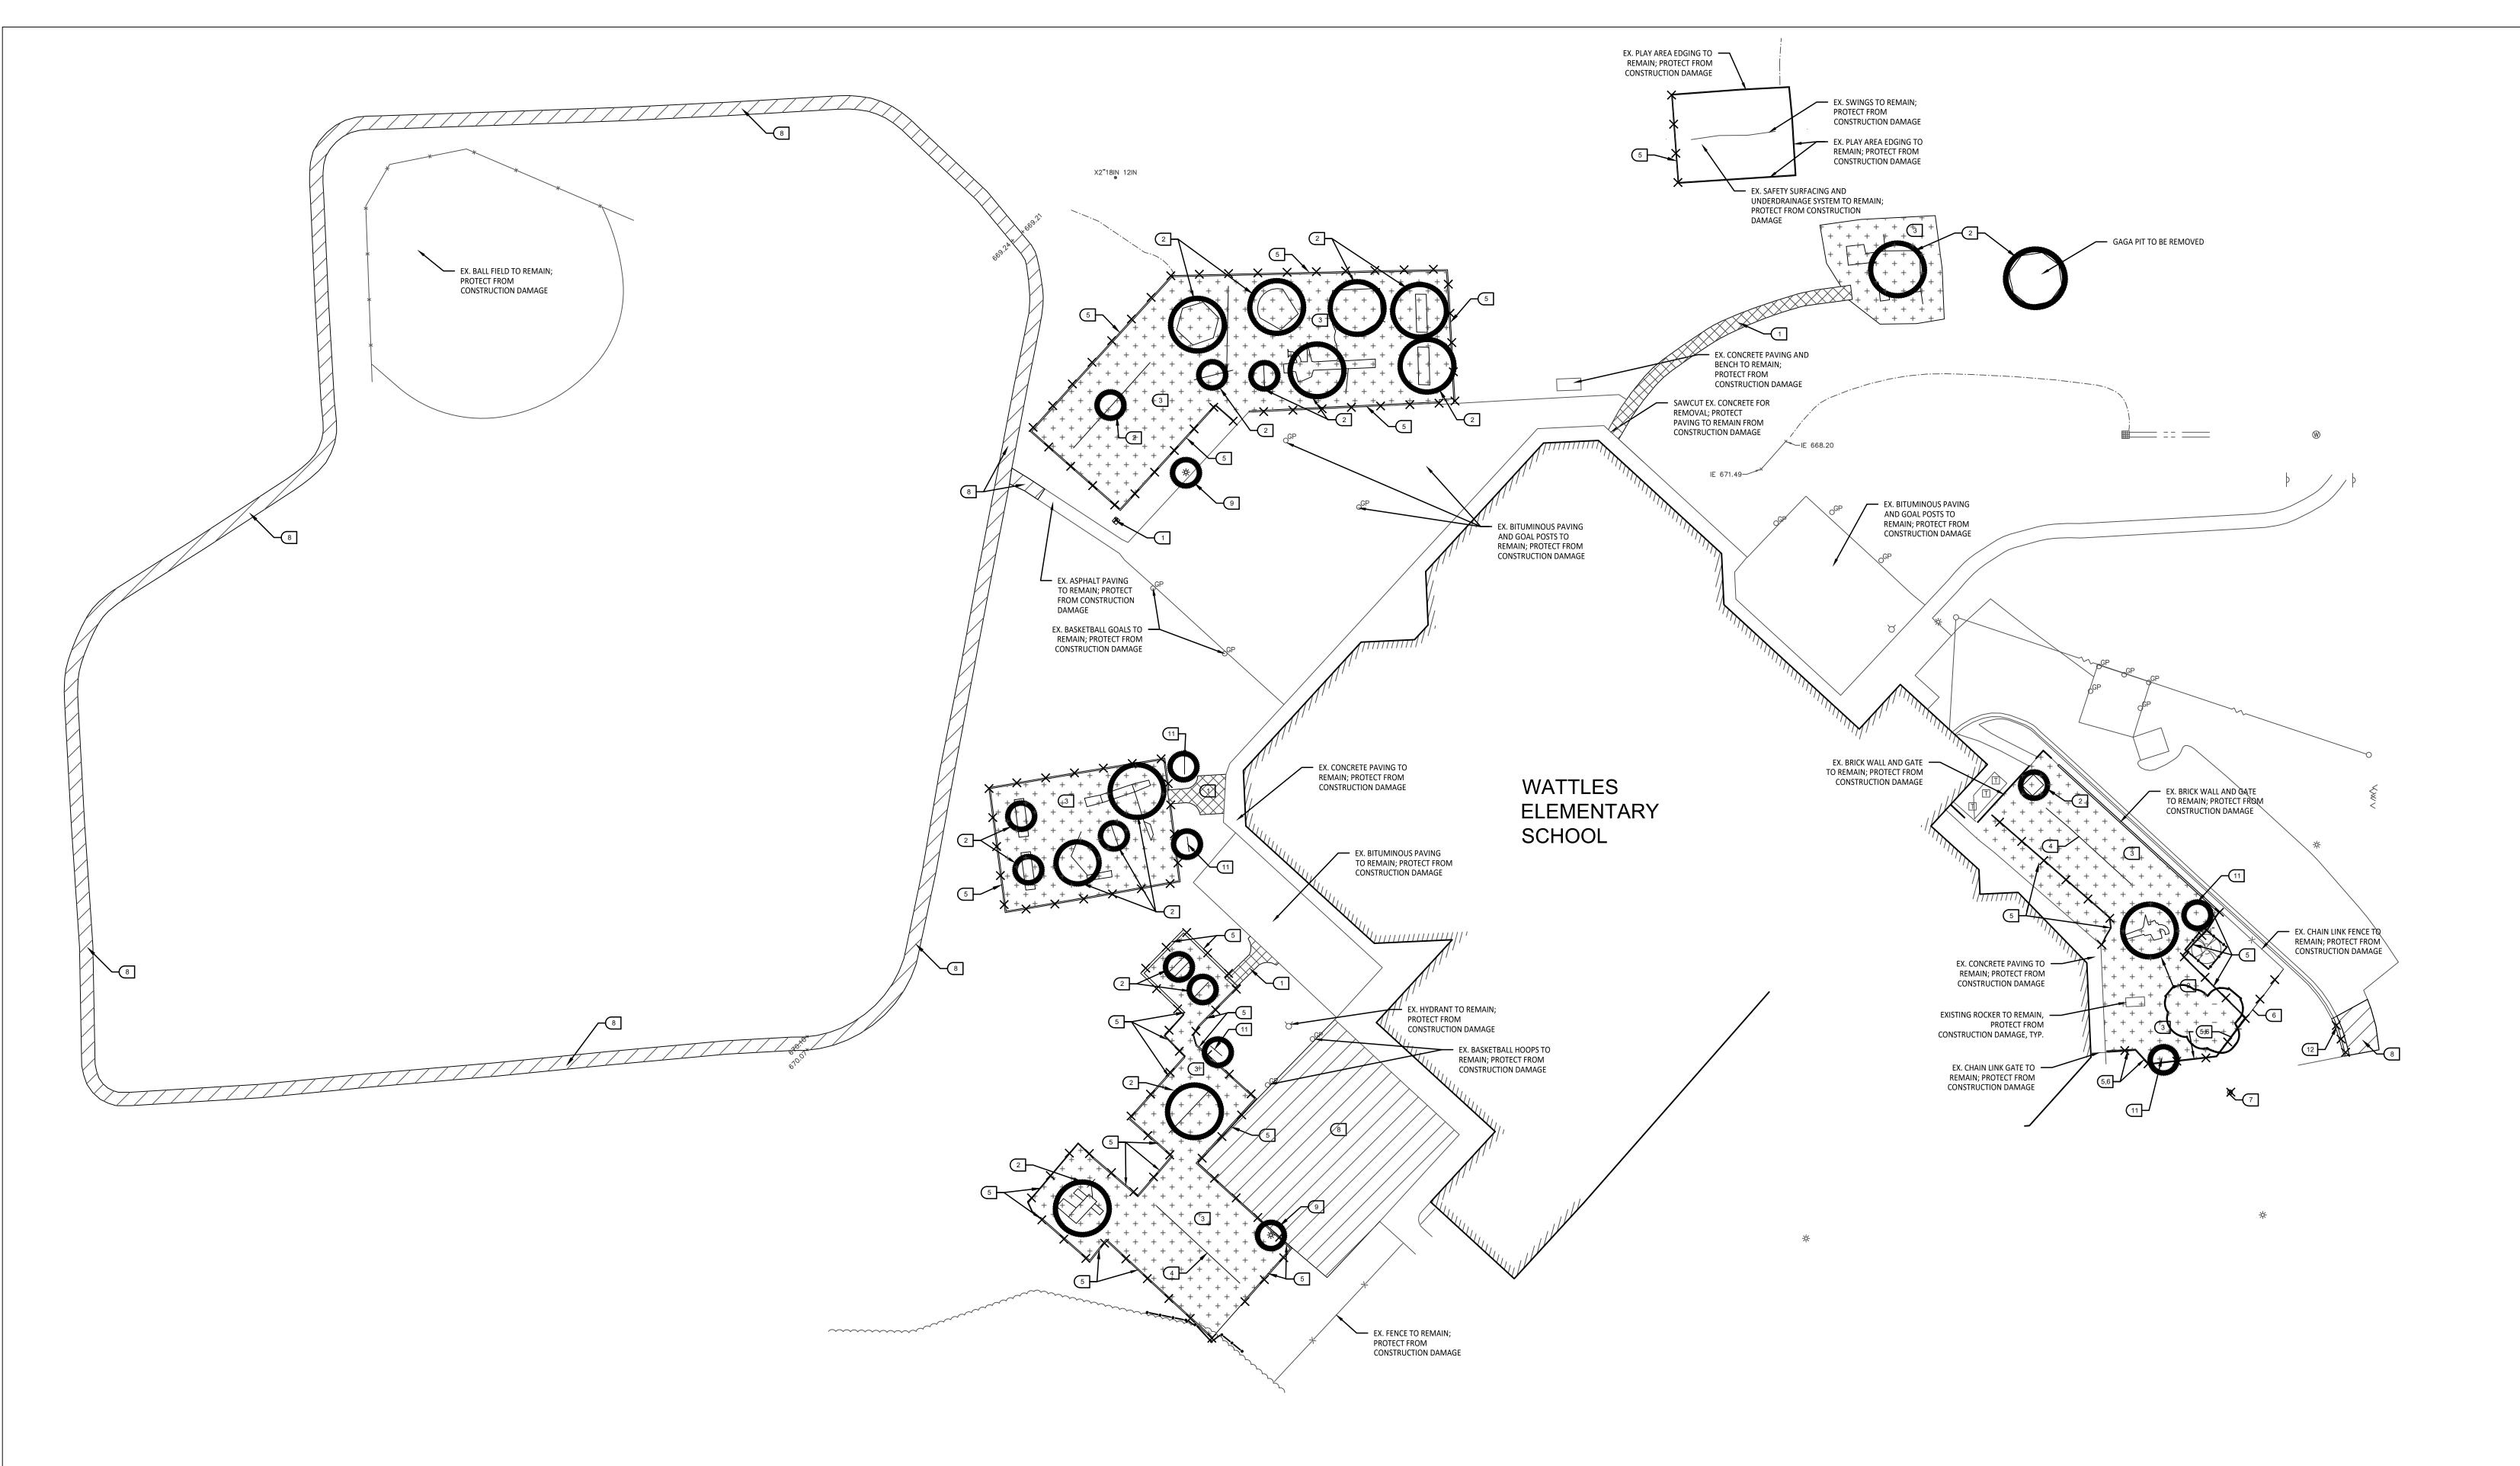Overall Demolition Plan

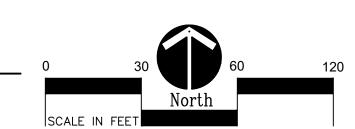

# **DEMOLITION NOTES:**

- SURVEY OF EXISTING CONDITIONS PROVIDED BY PEA GROUP, 1849 POND RUN, AUBURN HILLS, MI, 48326. 248-689-9090.
- VERIFY LOCATIONS OF ALL BELOW GRADE UTILITIES PRIOR TO BEGINNING WORK. 72 HOURS BEFORE YOU DIG CALL "MISS DIG" AT 1-800-482-7171.
- PROTECT ALL TREES & EXISTING FEATURES TO REMAIN AS SPECIFIED.
- REFER TO LAYOUT PLAN FOR LIMITS OF WORK. DISCREPANCIES BETWEEN SITE AND PLANS SHOULD BE REPORTED TO THE PROJECT
- MANAGER IMMEDIATELY.
- ALL TOPSOIL AND EXCESS FILL MATERIAL SHALL BE STOCKPILED ON SITE SEPARATELY FOR LATER RE-USE. LOCATE STOCKPILES IN AREAS AS DIRECTED BY CONSTRUCTION
- MANAGER AND PROTECT FROM EFFECTS OF EROSION. ALL PAVEMENT DEMOLITION TO BE SAWCUT AND REMOVED COMPLETELY, INCLUDING BASE/SUBBASE MATERIALS.
- ALL EXISTING PLAYGROUND EQUIPMENT TO BE REMOVED MUST BE DESTROYED COMPLETELY SO THAT IT CANNOT BE RE-ASSEMBLED. THE CONTRACTOR IS NOT ALLOWED TO RE-USE, DONATE, OR SELL ANY EXISTING PLAYGROUND EQUIPMENT SCHEDULED TO BE DEMOLISHED.
- IN LOCATIONS WHERE PROPOSED PAVING WILL BE INSTALLED WHERE EXISTING PAVING WAS REMOVED, THE BASE MATERIAL MAY BE LEFT IN PLACE PROVIDED IT IS TESTED TO BE ADEQUATE IN BOTH DEPTH AND GRADATION. IF EITHER OF THESE IS INADEQUATE, THE BASE MATERIAL SHOULD BE REMOVED AND REPLACED.

# TREE PROTECTION NOTES:

• — • • • TREE FENCING SHALL BE PROVIDED AND IN PLACE PRIOR FOLLOWING NOTES AND THE SPECIFICATIONS FOR TREE PROTECTION REQUIREMENTS.

- NO CONSTRUCTION OPERATIONS, EQUIPMENT, MATERIALS OR TOPSOIL SHALL BE
- ALLOWED WITHIN THE TREE PROTECTION AREAS. EXISTING GROUND COVER AND TOPSOIL SHALL NOT BE REMOVED FROM TREE
- PROTECTION AREAS DURING EARTHWORK PHASE. VEHICULAR TRAFFIC, PARKING, EQUIPMENT OR MATERIAL STORAGE MAY NOT OCCUR WITHIN THE TREE PROTECTION AREAS AT ANY TIME.
- NO EXCAVATION SHALL BE MADE WITHIN THE TREE PROTECTION AREAS EXCEPT AS NOTED OTHERWISE.

# 7 REMOVE EXISTING TREE INCLUDING ALL ROOT SYSTEMS.

# SITE DEMOLITION KEY

1 SAWCUT AND REMOVE EXISTING CONCRETE PAVING INCLUDING SUB-BASE.

DEMOLITION LEGEND:

PAVEMENT AND BASE

+ + + + INCLUDING DRAINAGE AGGREGATE

IN THIS SHADED AREA

REMOVE TREE

SAWCUT AND REMOVE BITUMINOUS

SAWCUT AND REMOVE CONCRETE

PAVEMENT, INCLUDING SUBBASE

REMOVE PLAY SAFETY SURFACING

NO WORK, PARKING OR STORAGE

SAWCUT & REMOVE CONCRETE CURB & GUTTER

REMOVE MISCELLANEOUS

RELOCATE EXISTING SITE

LIGHTING PER ELEC. PLAN

REFER TO DETAIL 1/C4.0

FEATURE AS NOTED

• — • TEMPORARY TREE PROTECTION FENCE,

- REMOVE EXISTING PLAY EQUIPMENT INCLUDING ALL CONCRETE FOOTINGS. <u>DESTROY ALL PLAY</u> EQUIPMENT COMPLETELY SO THAT IT CANNOT BE RE-ASSEMBLED.
- REMOVE EXISTING PLAY SAFETY SURFACING, INCLUDING DRAINAGE AGGREGATE.
- PLAYGROUND CONTRACTOR TO SALVAGE EXISTING PLAY EQUIPMENT AND RE-INSTALL ON-SITE.
- 5 REMOVE EXISTING PLAY EDGING COMPLETELY. 6 REMOVE EXISTING FENCING COMPLETELY (INCLUDING FOUNDATIONS)
- 8 SAWCUT AND REMOVE EXISTING BITUMINOUS PAVEMENT INCLUDING SUB-BASE. 9 OWNER TO DISCONNECT POWER AND REMOVE HEAD. SITE CONTRACTOR TO CUT WIRE AT A MINIMUM OF 24" BELOW FINISHED GRADE AND REMOVE LIGHT POLE AND CONCRETE BASE COMPLETELY.
- (10) SALVAGE EXISTING PLAY EQUIPMENT, PLAYGROUND CONTRACTOR TO REINSTALL ON SITE. (11) SALVAGE EXISTING SITE FURNISHINGS AND REINSTALL AT LOCATION TO BE DETERMINED.
- 12 SAWCUT AND REMOVE EXISTING CURB AND GUTTER.



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Landscape Architecture Urban Planning Parks & Recreation Campus & Institutional Planning Camp Planning & Design

Fax (269) 381-2944

# PROJECT TITLE Wattles Elementary School Playground Remodel Bid Package No.01B

Troy School District Troy, Michigan

DRAWING TITLE

Demolition Plan

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**APPROVED** DID

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