
BRIGHTON AREA SCHOOLS HILTON ELEMENTARY TOILET ROOMS RENOVATION

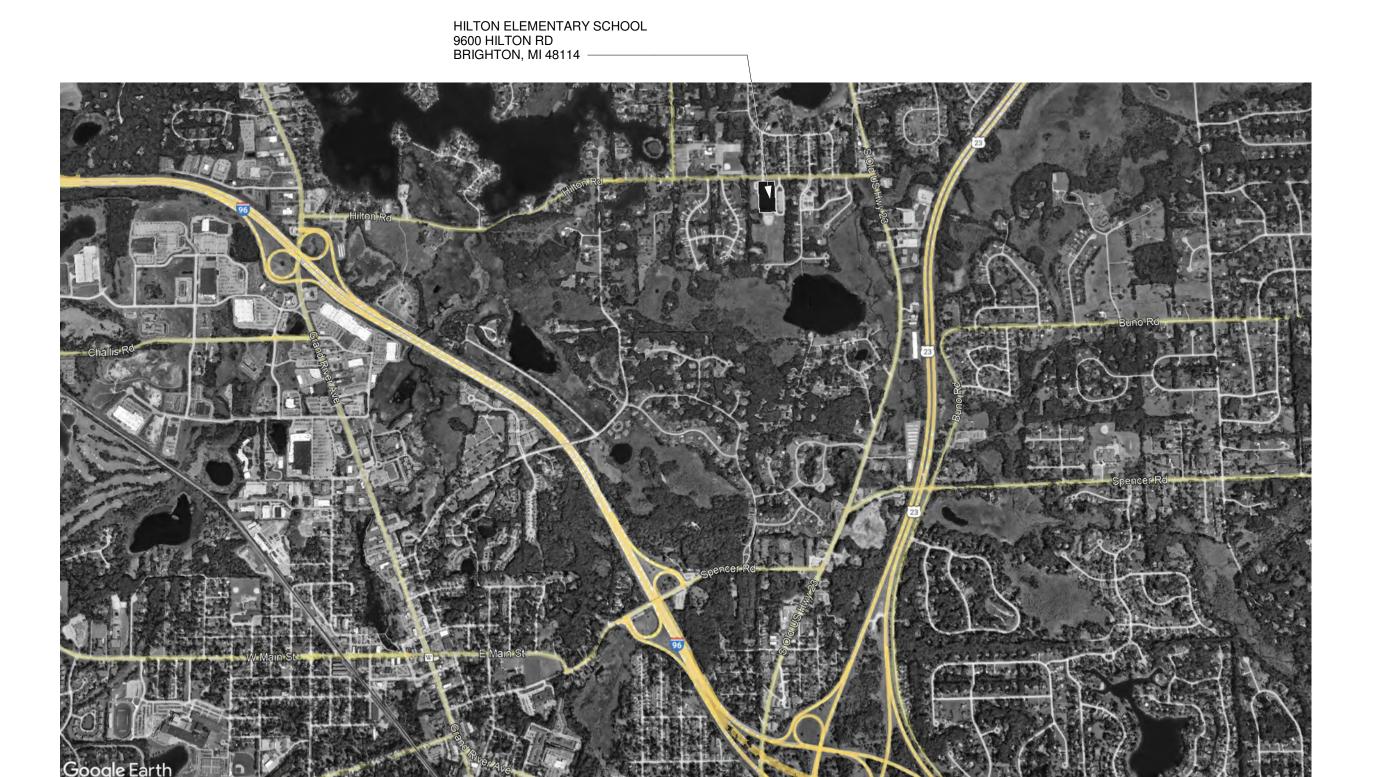

DRAWING INDEX

ALL DEMOLITION DRAWINGS ARE IN COLOR, WITH DEMOLITION SHOWN IN RED (TYP.) REFER TO SHEET INDEX FOR LIST OF SHEETS IN COLOR.

	ARCHITECTURAL	
SHEET NUMBER	SHEET NAME	BIDS & PERMITS
A0.0	COVER	Х
A0.1	COMPOSITE PLAN	X
A2.0	ENLGD TOILET RM DEMO & NEW WORK PLNS	Х
A3.0	INTERIOR ELEVATIONS & DETAILS	X
ID200	OVERALL FINISH FLOOR PLAN & KEY	Х

	MECHANICAL	
SHEET NUMBER	SHEET NAME	BIDS & PERMITS
MP1.0	MECHANICAL & PLUMBING COMPOSITE PLAN	X
MP1.1	MECHANICAL & PLUMBING PLANS	X
MP1.2	MECHANICAL & PLUMBING PLANS	X

	<u>ELECTRICAL</u>	
SHEET NUMBER	SHEET NAME	BIDS & PERMITS
EO.1	GENERAL ELECTRICAL INFORMATION	X
E1.0	ELECTRICAL NEW WORK PLANS	X
E2.0	ELECTRICAL RISER AND SCHEDULES	X
E3.0	ELECTRICAL SPECIFICATIONS	X





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Giad	11-08-23	BIDS & PERMITS
	DATE:	ISSUED FOR

N TOILET RM RENOVATION
N RD., BRIGHTON, MI 48114

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architects aid pc

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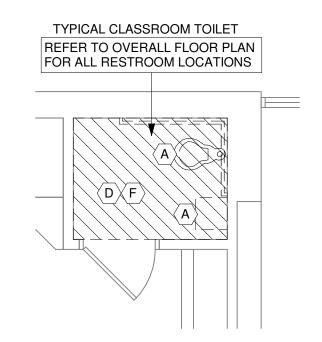
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A0.1

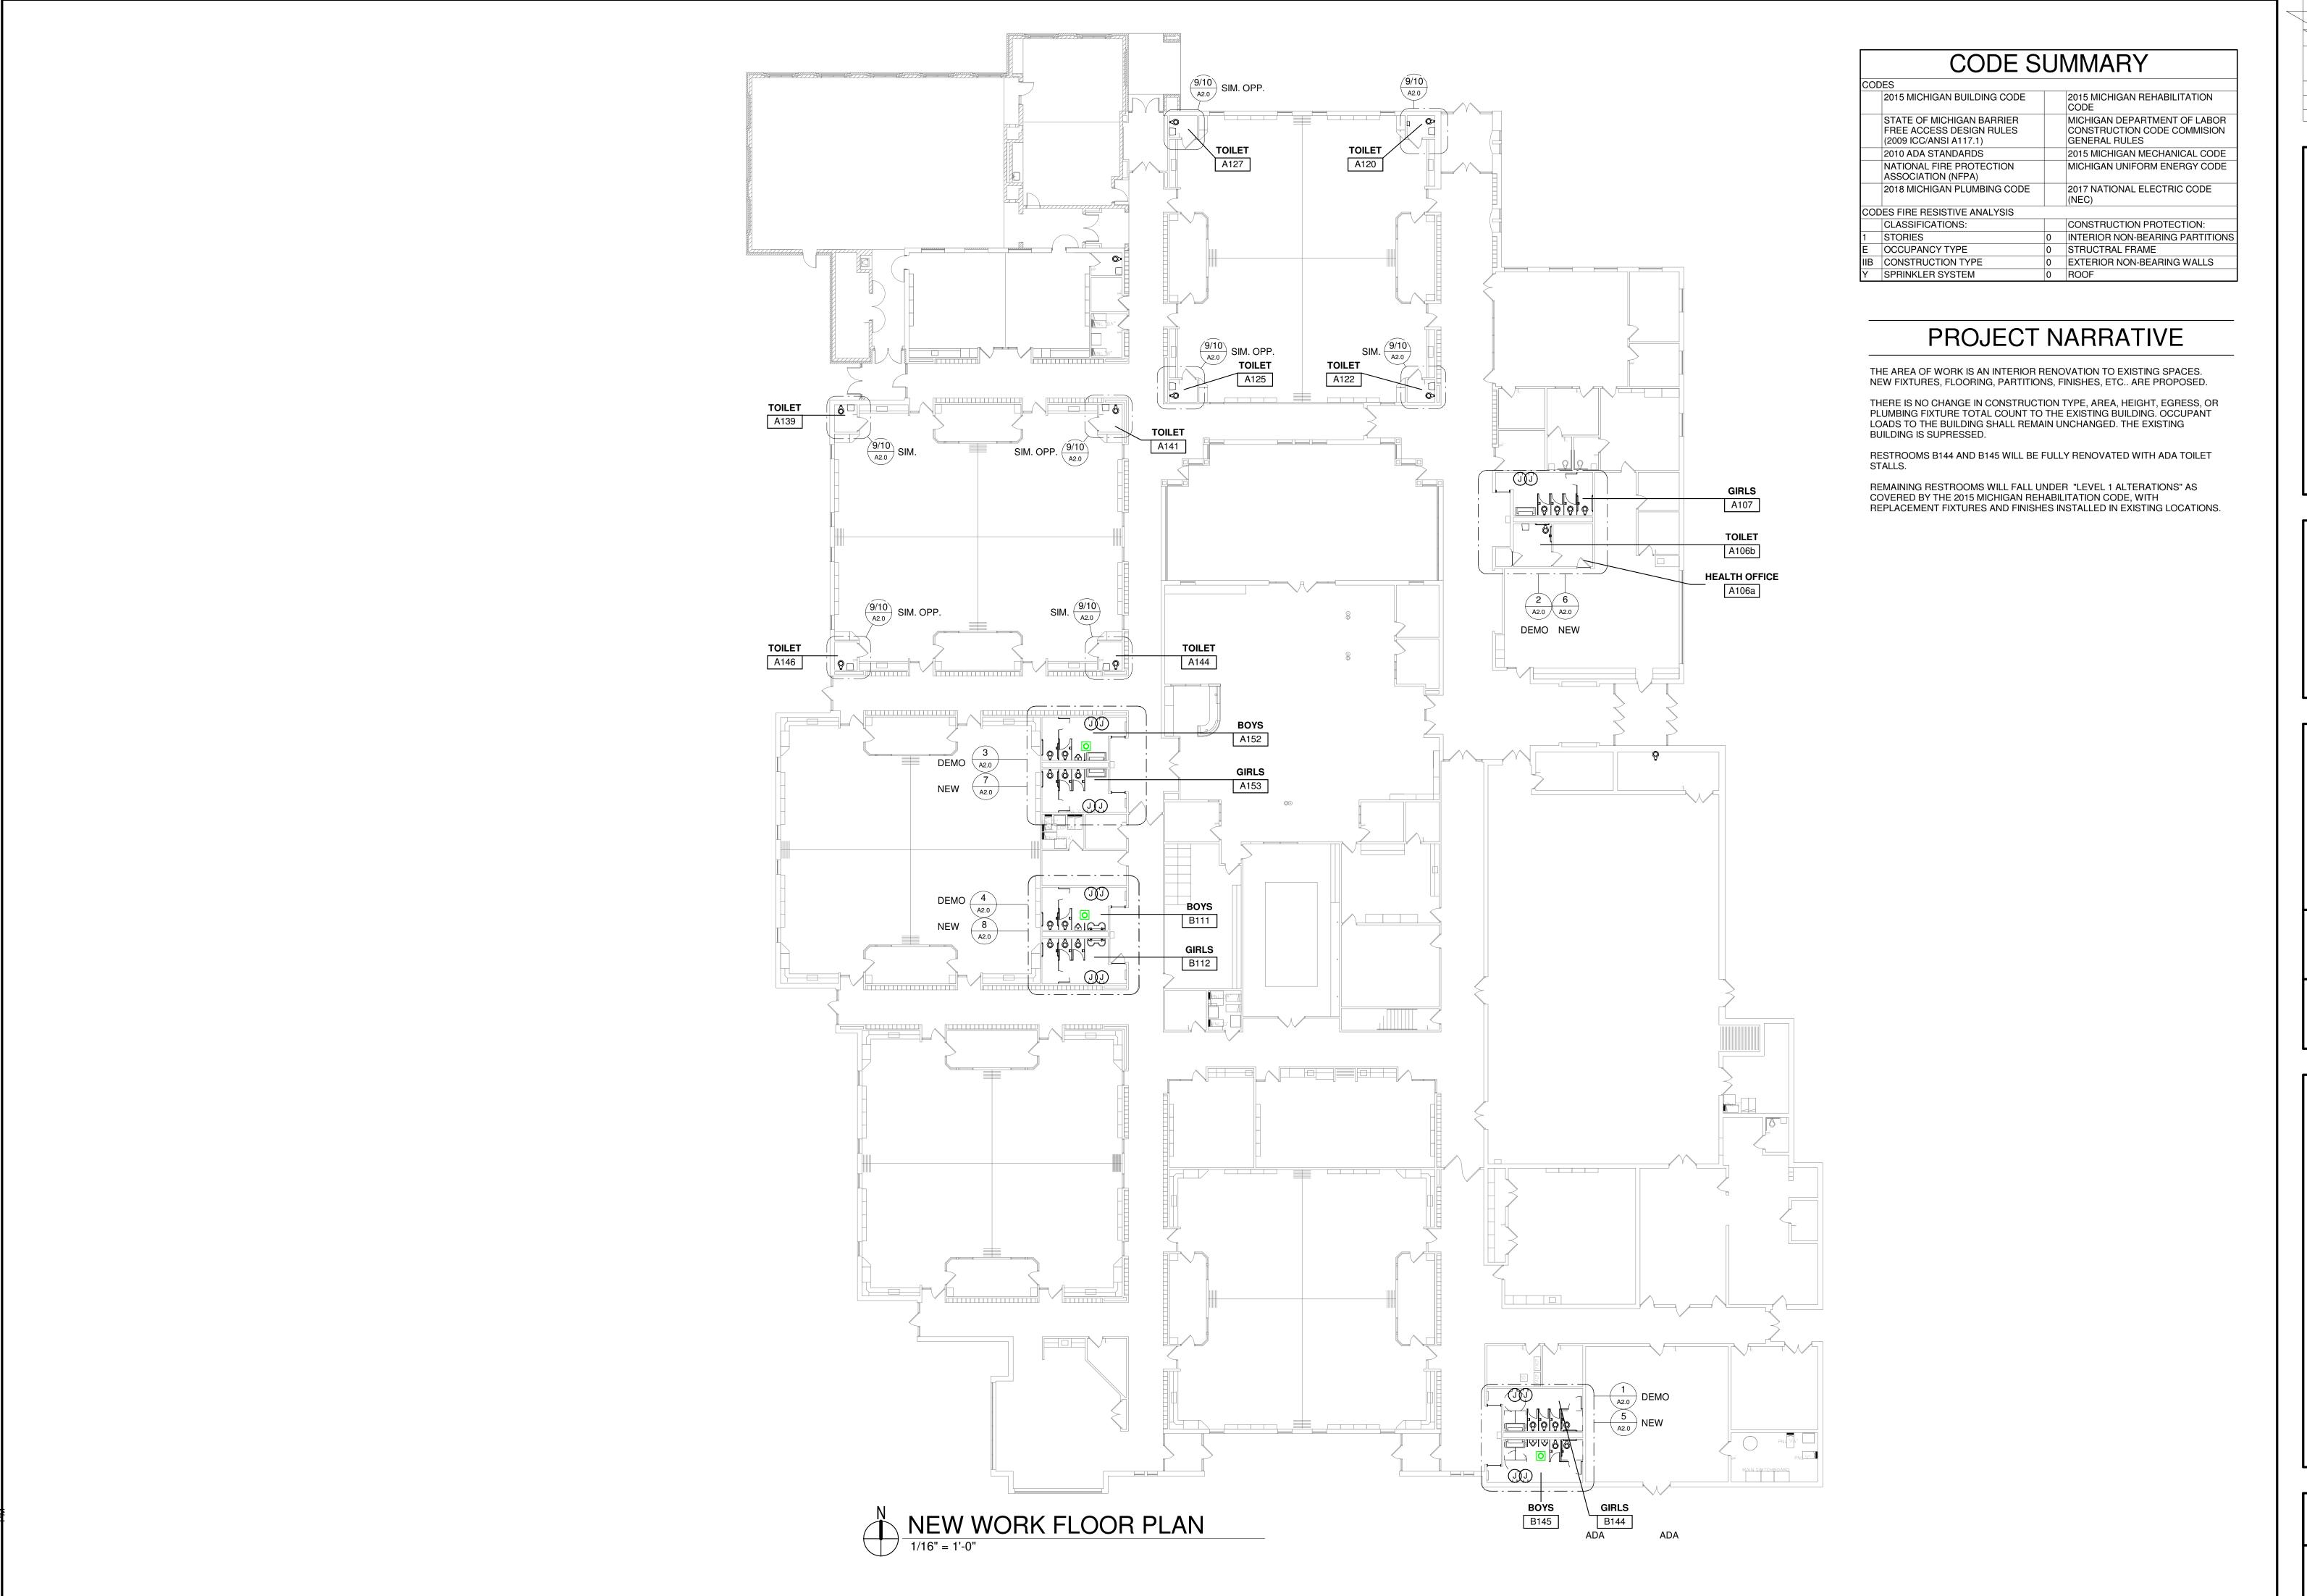
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TYPICAL CLASSROOM TOILET ROOM PLAN

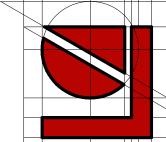
1/4" = 1'-0"




TYPICAL CLASSROOM **TOILET ROOM DEMOLITION PLAN**

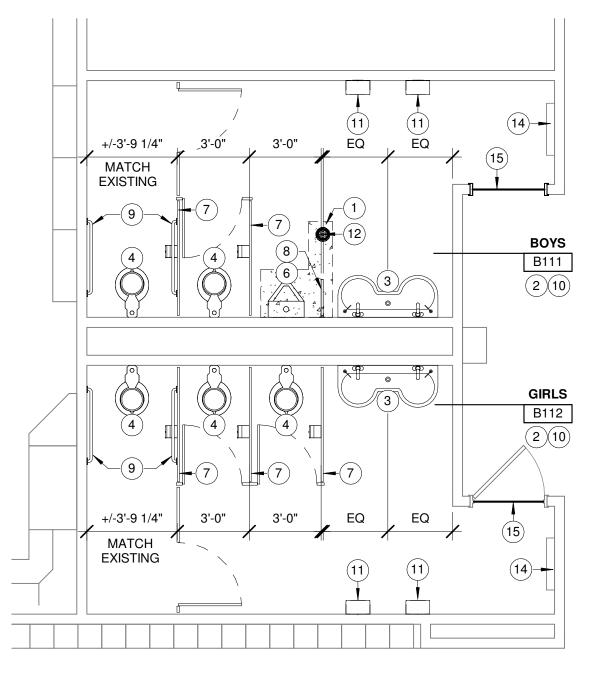


8 NEW WORK PLAN (B111, B112)

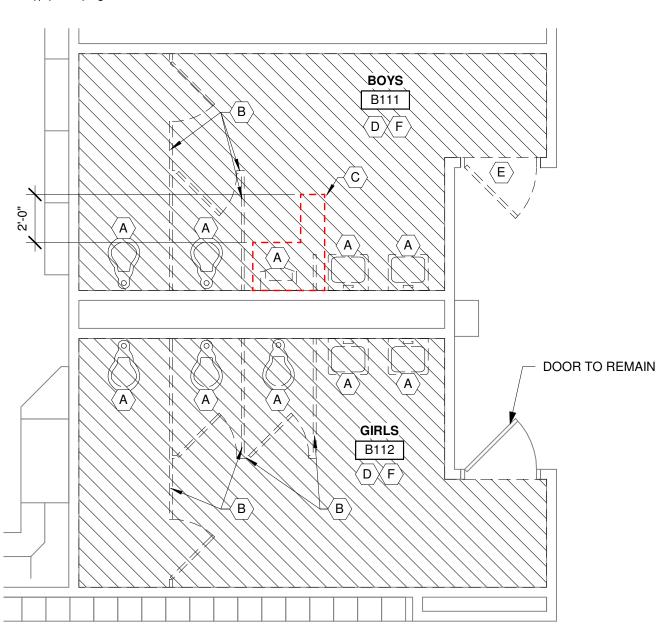

ENLARGED DEMO PLAN (B111, B112)1/4" = 1'-0"

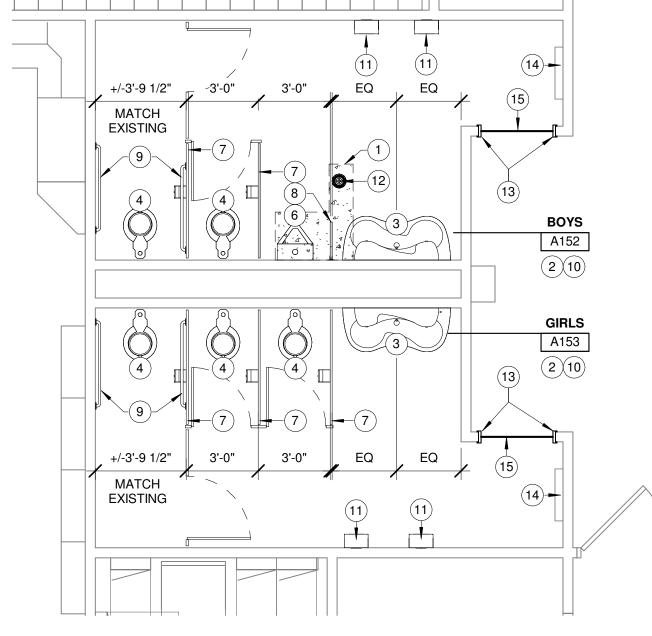

NEW WORK PLAN (A152, A153)

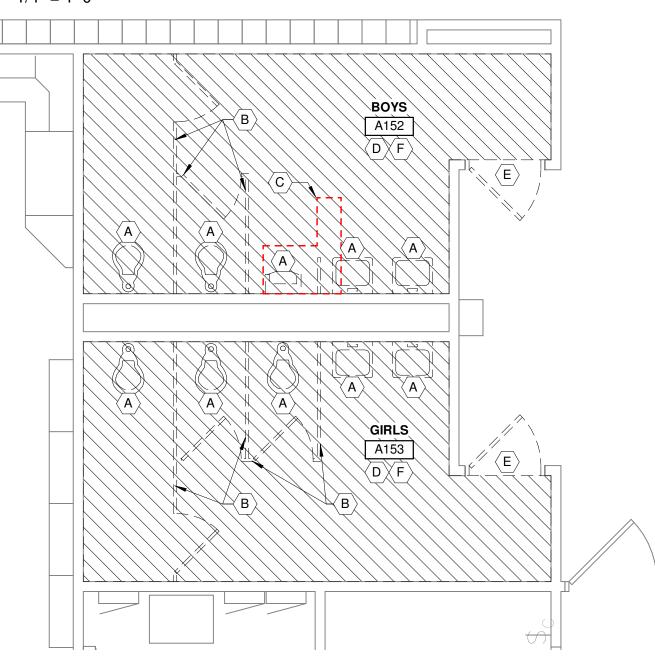

3 ENLARGED DEMO PLAN (A152, A153)

GENERAL NOTES

- CONTRACTOR SHALL BE RESPONSIBLE TO FIELD VERIFY EXISTING CONDITIONS REGARDING DEMOLITION AND NEW WORK BEFORE SUBMITTING A BID FOR THIS PROJECT. CONTRACTOR SHALL REPORT ANY DISCREPENCIES TO ARCHITECT.
- ANY EXISTING CONDITIONS TO REMAIN THAT ARE DISTURBED ARE TO BE PATCHED/REPAIRED TO MATCH ADJACENT
- WORK SHALL BE IN ACCORDANCE WITH ALL FEDERAL, STATE, AND LOCAL CODES, LAWS, AND REGULATIONS.
- REFER TO ELECTRICAL AND MECHANICAL DRAWINGS AS
- APPLICABLE FOR ADDITIONAL SCOPE OF WORK.
- INTERIOR DIMENSIONS ARE FROM FINISH FACE.
- ALL FINISH MATERIALS SHALL ACCOMODATE ALL M/E ITEMS (CLEANOUTS, FACEPLATES, ETC.)

A107 2 10

CL A106c

A106b
2 10

ENLARGED DEMO (A106A, A106B, A107)2 1/4" = 1'-0"

- VERIFY FINAL FINISH MATERIALS AND LOCATIONS WITH FLOOR
- FINISH PLANS AND FINISH SCHEDULE SHEETS.
- REFER TO SHEET A3.0 FOR ACCESSIBLE MOUNTING HEIGHTS.

NEW WORK KEYNOTES

- INFILL REMOVED CONCRETE SLAB. MATCH EXISTING THICKNESS. PROVIDE SMOOTH TRANSITION TO ADJACENT MATERIALS. SLOPE TO DRAIN AS REQUIRED. SLOPE NOT TO EXCEED 2%.
- PATCH/REPAIR SURFACES AND PROVIDE NEW FLOOR TILE, WALL TILE, AND/OR PAINT AS SPECIFIED. REFER TO FINISH SCHEDULE.
- 2-STATION, WALL-HUNG HANDWASHING SYSTEM AS SCHEDULED. REFER TO PLUMBING DRAWINGS.
- FLOOR-MOUNTED WATER CLOSET AS SCHEDULED (COORDINATE FIXTURE PLACEMENT WITH MINIMUM PARTITION CLEARANCES AS
- FLOOR-MOUNTED ADA WATER CLOSET. ENSURE FLUSH VALVE IS ON OPEN SIDE. REFER TO PLUMBING DRAWINGS. (COORDINATE FIXTURE PLACEMENT WITH MINIMUM PARTITION CLEARANCES AS NOTED).
- WALL-HUNG URINAL AS SCHEDULED. REFER TO PLUMBING DRAWINGS. (COORDINATE FIXTURE PLACEMENT WITH MINIMUM PARTITION CLEARANCES AS NOTED).
- TOILET PARTITION. REFER TO ELEVATIONS AND SPECIFICATIONS, MAINTAIN PROPER CLEARANCES (MINIMUM CLEARANCES ARE NOTED, COORDINATE WITH PLUMBING FIXTURE PLACEMENT).
- SPECIFICATIONS. ADA GRAB BARS. REFER TO STANDARD ELEVATIONS AND
- SPECIFICATIONS FOR SIZE AND PLACEMENT.

20" DEEP URINAL SCREEN. REFER TO ELEVATIONS AND

- PROVIDE RESTROOM ACCESSORIES AS SPECIFIED.
- WALL MOUNTED ELECTRIC HAND DRYER. REFER TO STANDARD ELEVATIONS AND ELECTRICAL DRAWINGS.
- FLOOR DRAIN. REFER TO PLUMBING DRAWINGS.
- PROVIDE NEW HOLLOW METAL FRAME AT DOOR OPENING.
- PROVIDE FIN TUBE COVER, REFER TO MECHANICAL
- PROVIDE ADA COMPLIANT THRESHOLD. REFER TO FINISH PLANS.

+/-3'-7 1/2"

MATCH **EXISTING**

HEALTH OFFICE

DEMOLITION KEYNOTES

A. REMOVE EXISTING PLUMBING FIXTURES.

OF OWNERS REPRESENTATIVE.


MOUNTING HEIGHTS AND LOCATIONS).

- REMOVE TOILET PARTITIONS.
- SAWCUT AND REMOVE PORTION OF CONCRETE SLAB. VERIFY EXTENTS IN FIELD. REFER TO PLUMBING DRAWINGS.
- REMOVE TOILET ROOM ACCESSORIES (MIRRORS, GRAB BARS,
- DISPENSERS, WASTE RECEPTACLES, ETC.) THROUGHOUT.

REMOVE WOOD DOORS AND H.M. FRAMES. STORE AT DIRECTION

DEMOLISH PORTION OF PARTITIONS AS REQUIRED FOR IN WALL PLUMBING/ELECTRICAL MODIFICATIONS. (COORDINATE WITH

LEGEND

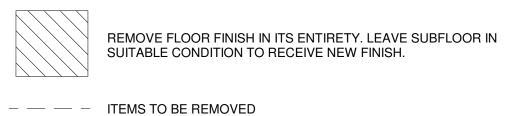

———— EXISTING ITEMS TO REMAIN


Room name ROOM NAME KEYNOTES LOCATED WITH ROOM TAG ARE 101 ROOM NUMBER 'TYPICAL' TO ENTIRE ROOM

KEYNOTE (DEMO)

KEYNOTE (NEW)

MIN 2'-6" **GIRLS** B144 2 (10) B145

5 NEW WORK PLAN (B144 & B145)

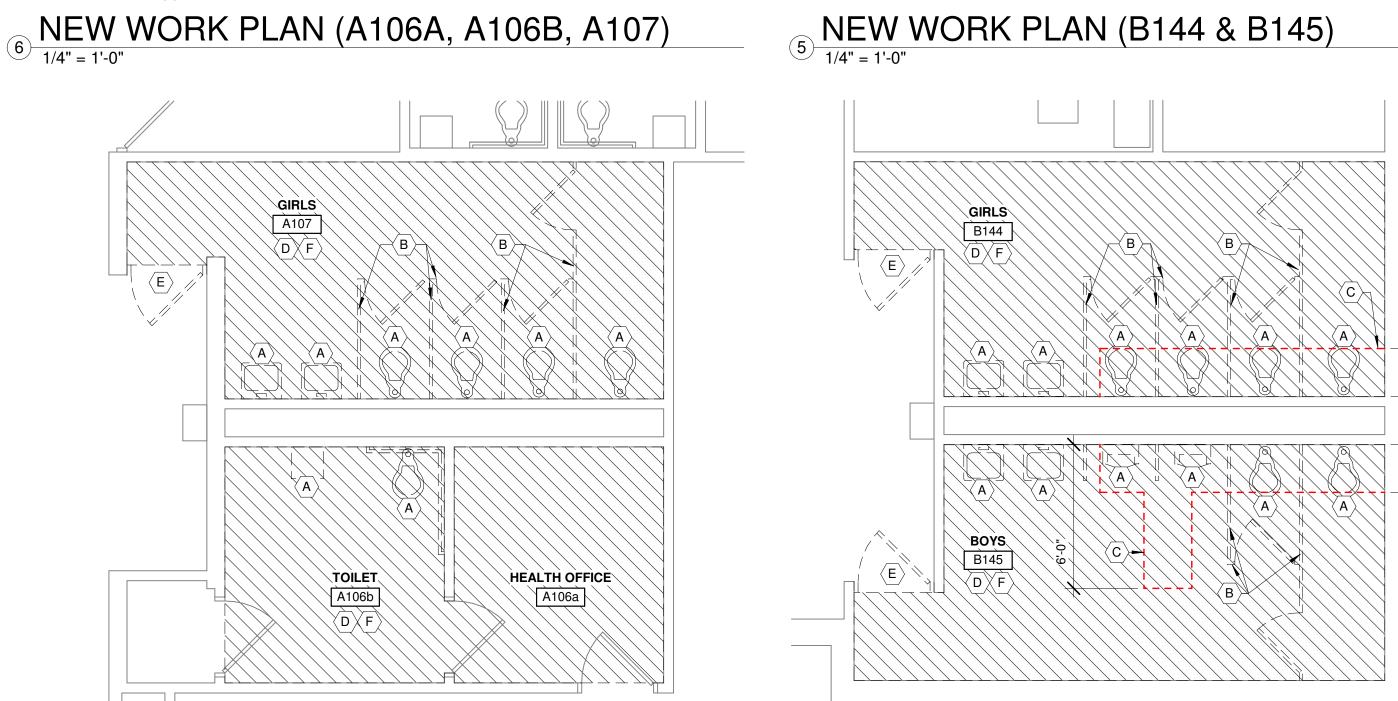


ENLARGED DEMO PLAN (B144 & B145)


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RM RENOVATION

A2.0



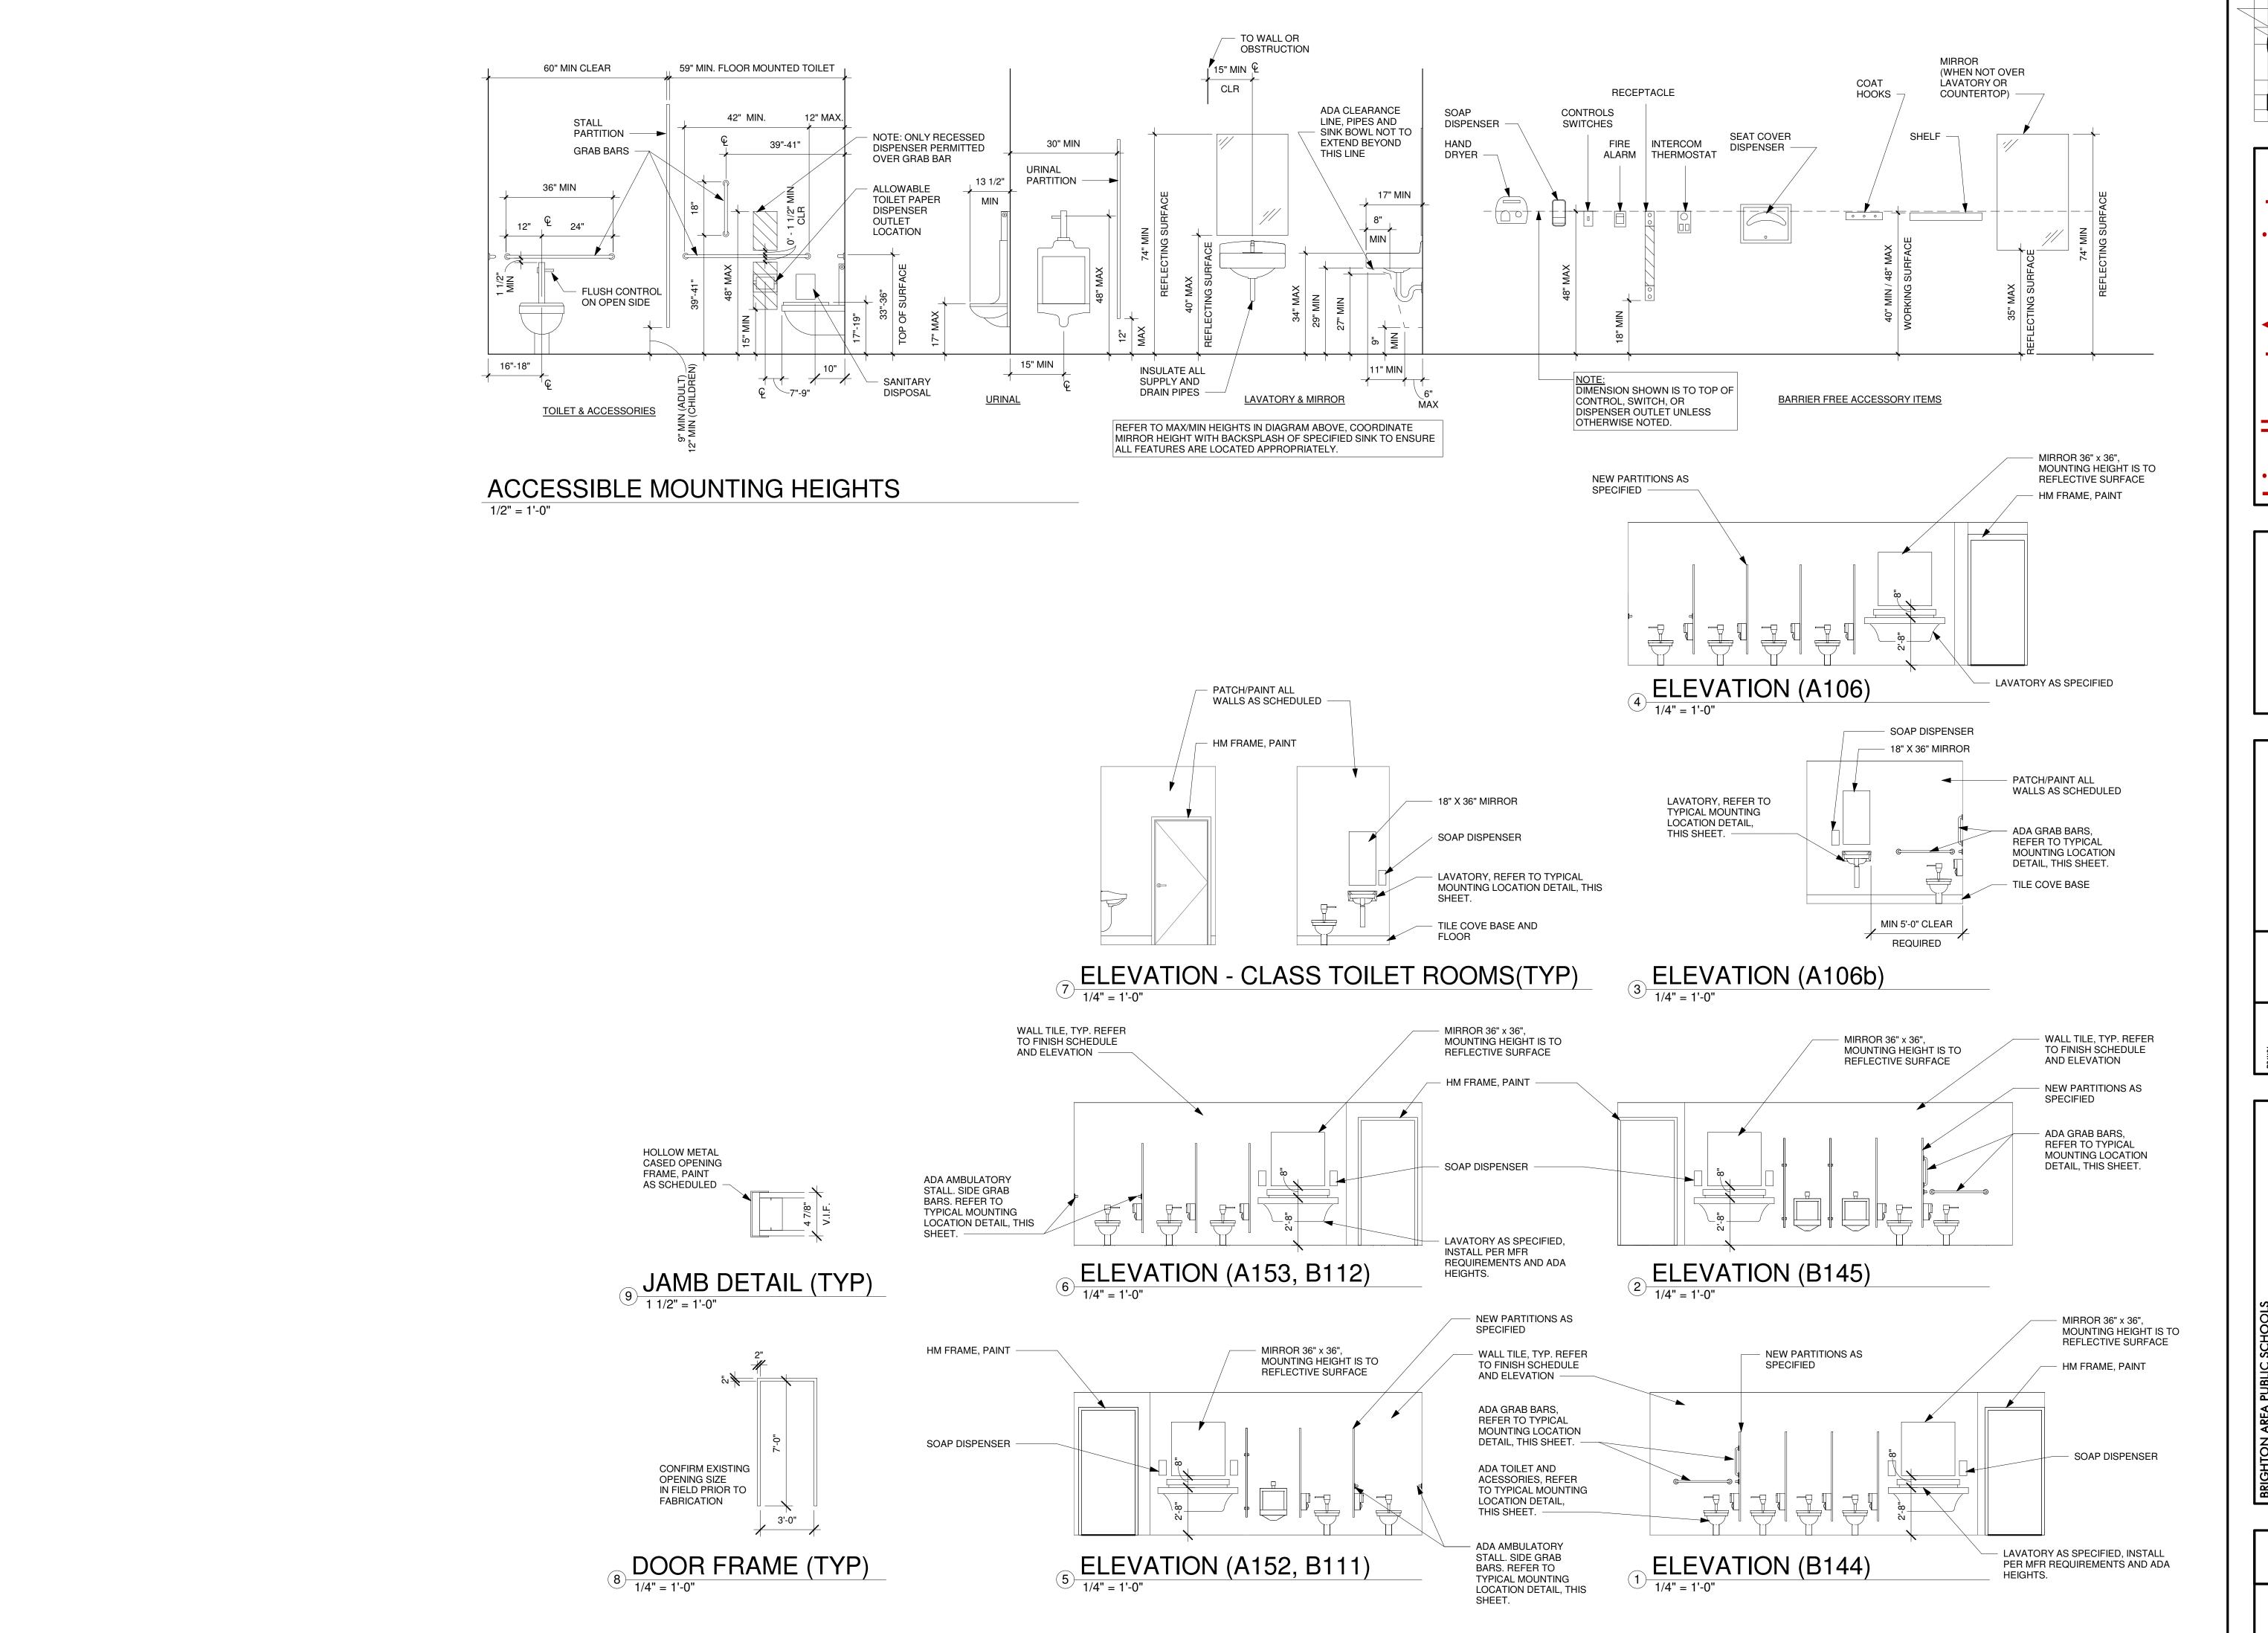


RENOVATION

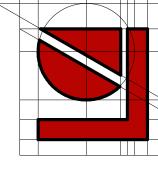
RM MI 481 INTERIOR


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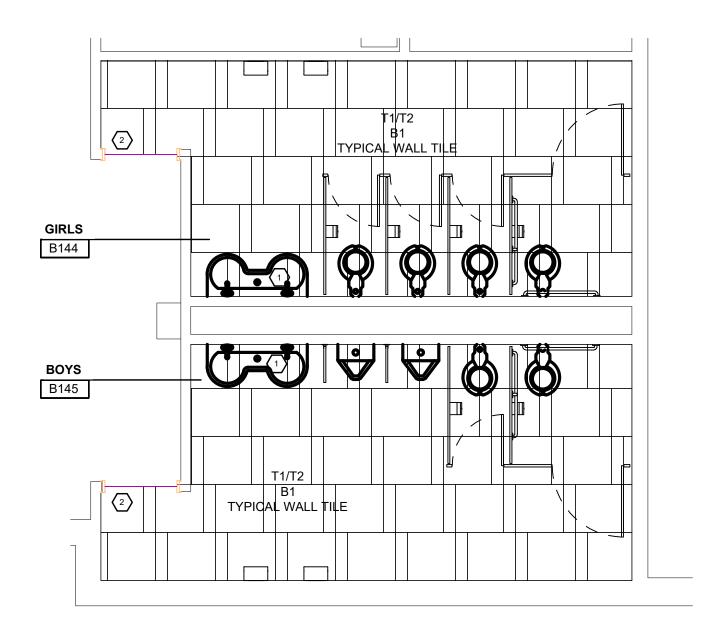




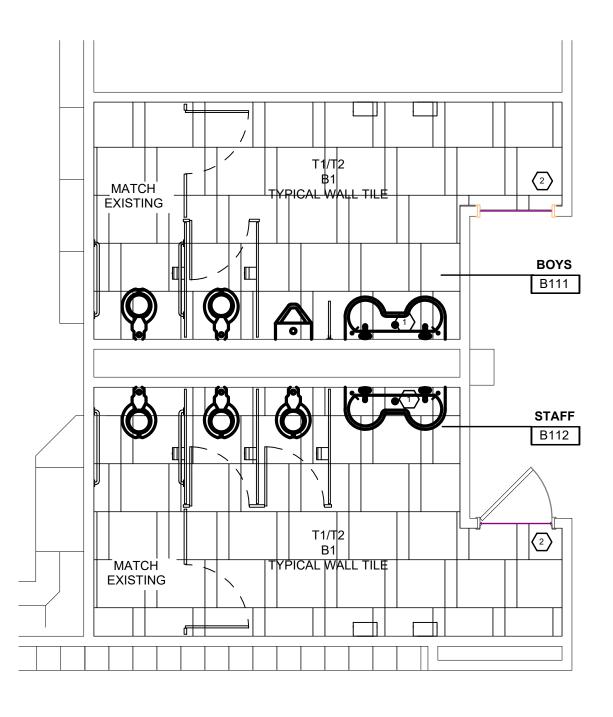



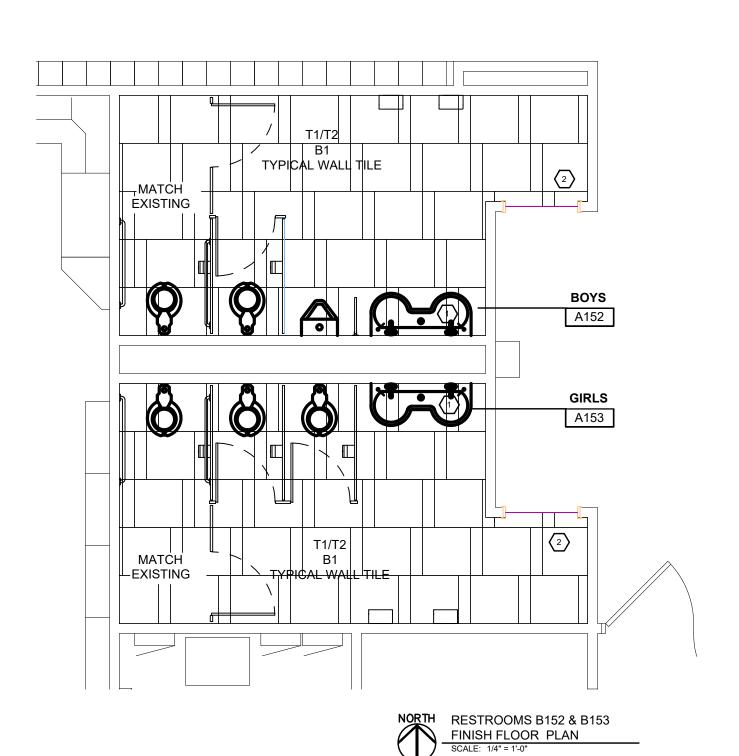


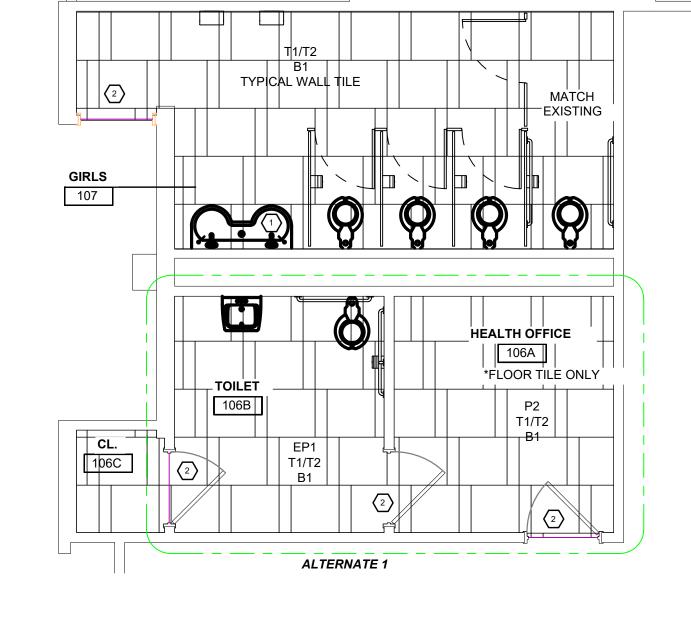




			FINISH KEY	
CODE	MATERIAL	MANUFACTURER	DESCRIPTION	REMARKS
SS1	SOLID SURFACE	TERREON/BRADLEY	COLOR: EMPIRE GRAY	BRADLEY EXPRESS MG SERIES 2 WASH STATION
EP1	EPOXY PAINT	BENJAMIN MOORE	COLOR: BERBER WHITE 955	FIELD (ALL WALLS, UNLESS NOTED OTHERWISE)
P1	PAINT	BENJAMIN MOORE	COLOR: WHITE DOVE OC-17	GENERAL CEILING COLOR, EXPOSED DECK/BEAMS
P2	PAINT	BENJAMIN MOORE	COLOR: BERBER WHITE 955	OFFICE FIELD WALL COLOR
B1	BASE TILE	CROSSVILLE	COLLECTION/STYLE: PORTUGAL COLOR: VELHO WHITE SIZE: 6X12 COVE BASE TILE GROUT: TBD	
T1	TILE	CROSSVILLE	COLLECTION/STYLE: PORTUGAL COLOR: VELHO WHITE SIZE: 24"X24" TILE GROUT: TBD	
T2	TILE	CROSSVILLE	COLLECTION/STYLE: PORTUGAL COLOR: VELHO VERDE SIZE: 6"X24" GROUT: TBD	
Т3	TILE	CROSSVILLE	COLLECTION/STYLE: GLASS BLOX COLOR: MOONBEAM SIZE: 2"X4" BRICK MOSAIC	
T4	TILE	CROSSVILLE	COLLECTION/STYLE: GLASS BLOX COLOR: ORANGE SIZZLE SIZE: 2"X4" BRICK MOSAIC	
P1	PARTITIONS	TBD	COLLECTION/STYLE: TBD COLOR: BLACK	



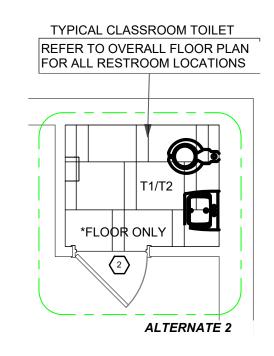



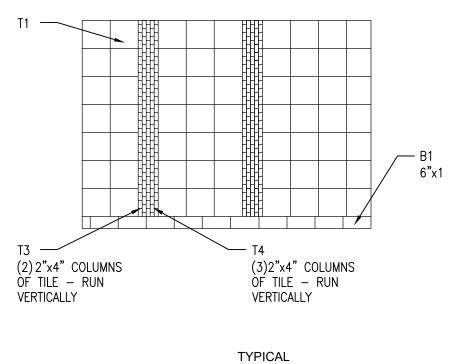

TYPICAL WALL TILE PATTERN SCALE: 1/16" = 1'-0"

FINISH PLAN GENERAL NOTES:

- ALL WALLS TO BE PAINTED EP1 UNLESS OTHERWISE NOTED ON PLAN.
- 2. REFER TO FINISH KEY FOR SPECIFIC FINISH TYPES.
- 3. CONTACT DESIGNER SHOULD ANY FINISH DISCREPANCIES OCCUR.
- 4. THIS SHEET IS INTENDED TO BE PRINTED IN COLOR TO CONVEY NECESSARY DESIGN INFORMATION.
- 5. PATCH ALL HOLES, ETC. LEFT BY ALL TRADES (INCLUDING ELECTRICAL AND MECHANICAL) PRIOR TO PAINTING. PAINT WALL(S) OR CEILING(S) NOT SCHEDULED TO BE PAINTED, WHICH HAVE HAD PATCHING, FROM INSIDE CORNER TO INSIDE CORNER ACROSS ENTIRE SURF1ACE.
- 6. FLOORING CONTRACTOR SHALL INCLUDE FLOOR PREPARATION IN THEIR BASE BID SCOPE OF WORK. ANTICIPATE AN APPLICATION OF FLOOR STONE OVER THE ENTIRE SURF1ACE TO BRING LIKE-PRODUCTS TO A LEVEL CONDITION THAT MEETS OR EXCEEDS THE SUBFLOOR TOLERANCES ESTABLISHED BY PRODUCT MANUFACTURER. WHERE MATERIAL IS TO BE INSTALLED AT SLAB ON GRADE CONDITIONS, MOISTURE TESTS SHALL BE CONDUCTED OF THE EXISTING SLAB TO ENSURE THE SUBFLOOR MEETS PRODUCT REQUIREMENTS. AT FLOOR TILE INSTALLATIONS, THE MOVEMENT GUIDELINES ESTABLISHED IN EJ171-05 SHALL BE FOLLOWED, INCLUDING THE USE OF BOND BREAKER TAPES AS RECOMMENDED.

FINISH PLAN KEY NOTES:

(TYPICAL THIS SHEET ONLY)

SOLID SURFACE (SS1) COUNTERTOP

2 PAINTED DOOR/WINDOW FRAMES (P4)

DISCLAIMER

DATE

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03/30/23 OWNER REVIEW

11/08/23 BIDS & PERMITS


DRAWN BY JL

PROJECT NO.

OVERALL FINISH FLOOR PLAN & KEY

SHEET NO.

ID200

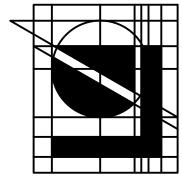





THIS DRAWING IS DIAGRAMMATIC AND SHOULD BE USED TO DETERMINE THE DESIGN INTENT. THE CONTRACTOR SHALL FIELD VERIFY ALL WORK AND SHALL NOTIFY THE ARCHITECT

ONTRACTOR TAKING FULL RESPONSIBILITY AND LIABILITY FOR AID DISCREPANCIES. NOTICE: THIS DRAWING AND THE DESIGN ARE THE PROPERTY OF MECHANICAL ELECTRICAL ENGINEERING

ONSULTANTS, PC AND NO ALTERATIONS AND/OR TRANSFERS OF WORK ARE PERMITTED UNLESS WRITTEN APPROVAL IS GRANTED BY MECHANICAL ELECTRICAL ENGINEERING CONSULTANTS, PC.

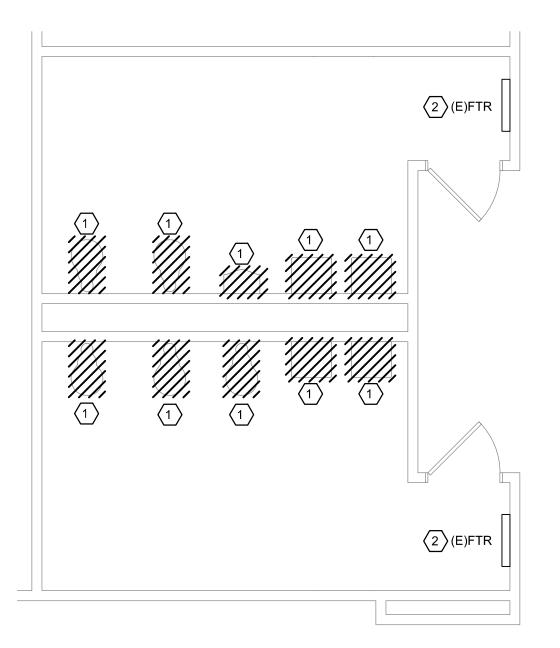


S.W. TOILET ROOM MECHANICAL & PLUMBING DEMOLITION PLAN 1/4" = 1'-0"

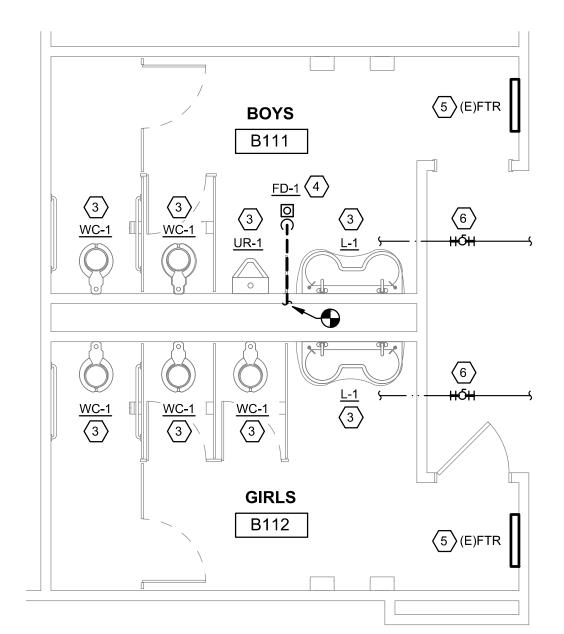


S.W. TOILET ROOM
MECHANICAL & PLUMBING
NEW WORK PLAN

1/4" = 1'-0"

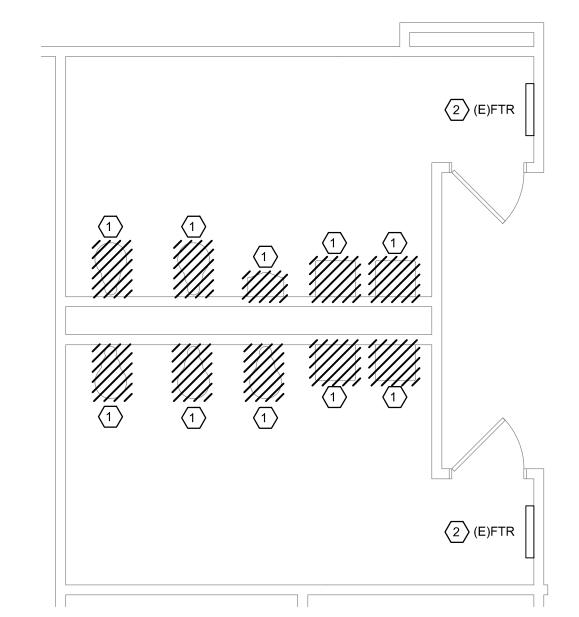


N.W. TOILET ROOM
MECHANICAL & PLUMBING
DEMOLITION PLAN

1/4" = 1'-0"

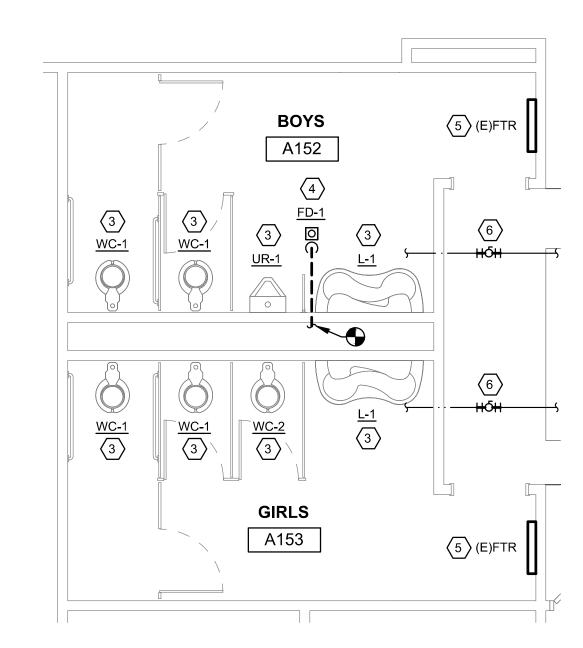


N.W. TOILET ROOM
MECHANICAL & PLUMBING
NEW WORK PLAN

					Р	LUM	IBING FIXTI	JRE SCHEDULE					
UNIT ID	BARRIER	ITEM	PI	PE CONNE	CTION SIZE	ES	MANUFACTURER/	DEMARKS					
UNITID	FREE	HEW	WASTE	VENT	CW	HW	MODEL NO.	REMARKS					
FD-1	-	FLOOR DRAIN	4"	-	-	-	ZURN: Z415B	DURA-COATED CAST IRON BODY WITH BOTTOM NO HUB OUTLET, COMBINATION INVERTIBLE MEMBRANE CLAMP AND ADJUSTABLE COLLAR WITH SEEPAGE SLOTS AND 5"Ø POLISHED NICKEL BRONZE, LIGHT-DUTY STRAINER. PROVIDE SURESEAL OR EQUIVALENT WATERLESS INLINE TRAP SEAL.					
L-1	Y	LAVATORY	2"	1 1/2"	1/2"		BRADLEY: MG-2	SOLID SURFACE MATERIAL LAVATORY SYSTEM, DUAL STATION, CONTINUOUS BOWL, WITH PEDESTAL AND STAINLESS STEEL MOUNTING FRAME. FAUCET: INFRARED SENSOR OPERATED BY LAVATORY MANUFACTURER, 0.5 GPM, SLOW-CLOSING SOLENOID VALVE. WITH ASSE 1070 COMPLIANT MIXING VALVE PER STATION.					
UR-1	Υ	URINAL (WALL MOUNTED)	2"	1 1/2"	3/4"	-	KOHLER: BARDON K-4991-ET	WASHOUT URINAL, VITREOUS CHINA, TOP SPUD, EXTENDED RIM, 0.125 - 1.0 GPF. FLUSH VALVE: SLOAN REGAL 186 SMO - 1.0, SIDE MOUNT SENSOR OPERATED. MOUNT AT ADA HEIGHT.					
WC-1	Y	WATER CLOSET (FLOOR MOUNTED)	4"	2"	1 1/2"	-	KOHLER: HIGHCLIFF K-96057	VITREOUS CHINA, ELONGATED BOWL, TOP SPUD, 1.0 - 1.6 GPF. FLUSH VALVE: SLOAN REGAL 111 SMO - 1.6, SIDE MOUNT SENSOR OPERATED.					

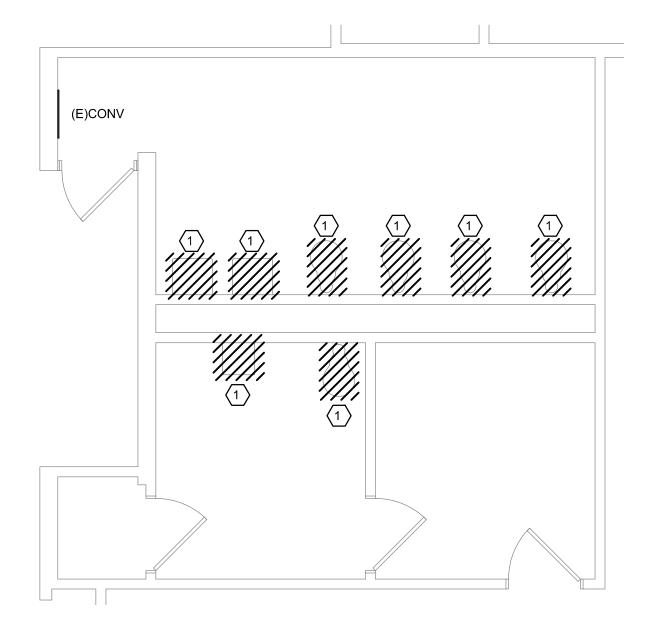


N.E. TOILET ROOM
MECHANICAL & PLUMBING
DEMOLITION PLAN

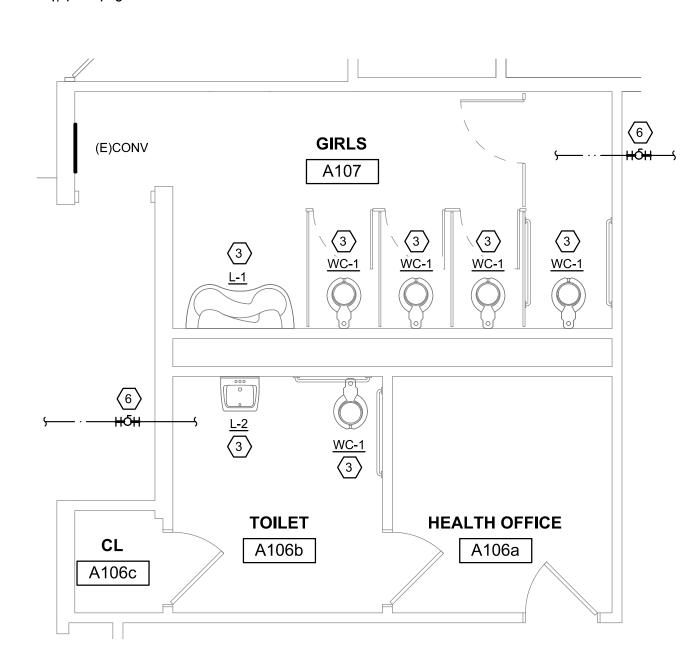


N.E. TOILET ROOM MECHANICAL & PLUMBING NEW WORK PLAN

PROVIDE NEW SHUT-OFF ON EXISTING DOMESTIC HOT AND COLD WATER.

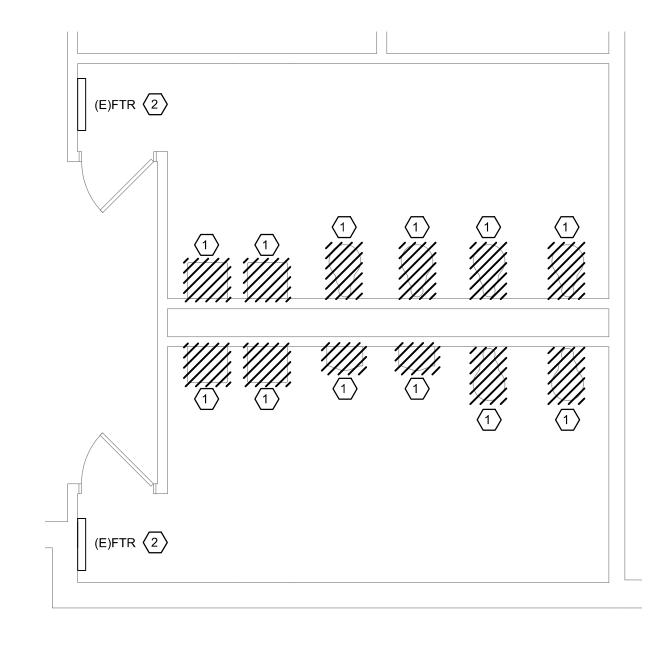

S.E. TOILET ROOM
MECHANICAL & PLUMBING
DEMOLITION PLAN

1/4" = 1'-0"

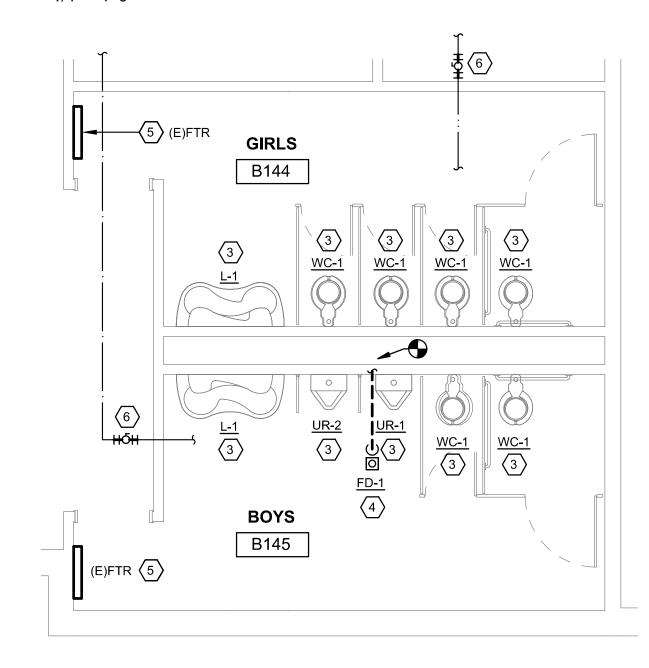


S.E. TOILET ROOM MECHANICAL & PLUMBING NEW WORK PLAN

○ KEYNOTES ○	GENERAL NOTES
 REMOVE PLUMBING FIXTURE. PLUMBING PIPING SHALL REMAIN TO BE REUSED. REMOVE FINNED TUBE RADIATOR COVER. INSTALL NEW PLUMBING FIXTURE AND CONNECT TO EXISTING PLUMBING PIPING. EXTEND/REWORK PIPING AS NECESSARY BASED ON NEW LOCATION. FURNISH AND INSTALL NEW WALL CARRIERS/SUPPORTS AS REQUIRED. COORDINATE FLOOR SLAB CUTTING WITH GENERAL TRADES. TIE NEW 4" SANITARY PIPE INTO EXISTING SANITARY LINES IN AREA. INSTALL NEW FINNED TUBE ELEMENT ENCLOSURE, MODINE MODEL #S012 OR EQUIVALENT, SLOPED TOP WITH STAMPED GRILLE. PROVIDE ALL HANGER STRIPS, ENCLOSURE WALL STRIPS, SUPPORT BRACKETS, ELEMENT CRADLES, AND END CAPS. APPROXIMATELY 26" LONG, 12" TALL, 5-1/4" DEEP COVER. FIELD VERIFY FOR EXACT DIMENSIONS AND FINNED TUBE PIPE CONDITIONS. COORDINATE INSTALLATION WITH FINISHED WALL MATERIAL. 	 THESE DRAWINGS ARE DIAGRAMMATIC AND INDICATE THE GENERAL EXTENT OF THE WORK. MECHANICAL DEMOLITION WORK REQUIRED TO COMPLETE THE INSTALLATION OF NEW SYSTEMS SHALL BE PERFORMED AS PART OF THE PROJECT BASE BID. CONTRACTOR SHALL VISIT SITE PRIOR TO SUBMITTING BID AND VERIFY LOCATIONS OF EXISTING EQUIPMENT, PIPING, AND SYSTEM COMPONENTS TO FAMILIARIZE THEMSELVES WITH THE SCOPE OF WORK. PRIOR TO DEMOLITION THE CONTRACTOR SHALL NOTE DIFFERENCES IN THE FIELD CONDITIONS AND WHAT IS SHOWN ON THE CONTRACT DOCUMENTS AND NOTIFY THE ARCHITECT PRIOR TO PROCEEDING WITH WORK. THE CONTRACTOR SHALL PERFORM ALL DEMOLITION WORK NECESSARY TO PROPERLY COMPLETE THE NEW WORK SHOWN ELSEWHERE. PATCH AND REPAIR ALL EXISTING SURFACES TO REMAIN THAT MAY BE DAMAGED BY THE PERFORMANCE OF THE DEMOLITION WORK. PROTECT PIPING FROM ENETRANCE OF FOREIGN MATERIALS. VERIFY AND PROTECT ANY EQUIPMENT, PIPING, COMPONENTS, TO REMAIN OR BE REUSED PRIOR TO DEMOLITION. ANY SUCH ITEMS THAT ARE DAMAGED DURING DEMOLITION SHALL BE THE RESPONSIBILITY OF THE CONTRACTOR AND SHALL BE REPAIRED OR REPLACED AT NO ADDITIONAL COST TO THE CONTRACT. OWNER SHALL HAVE THE FIRST RIGHT OF REFUSAL OF ANY EQUIPMENT NOTED TO BE REMOVED. PROVIDE PLUMBING SYSTEMS COMPLETE AND PER APPLICABLE CODES INCLUDING REQUIRED COMPONENTS, OFFSETS REQUIRED TO AVOID STRUCTURE, ETC. CONTRACTOR SHALL COORDINATE THE INSTALLATION OF PLUMBING AND PIPING WITH THE WORK OF ALL OTHER TRADES. PIPING SHALL NOT BE INSTALLED IN A LOCATION THAT RESTRICTS THE ACCESS TO MECHANICAL DEVICES REQUIRING ACCESS. REFER TO ARCHITECTURAL PLANS FOR SPECIFICATIONS OF AND EXACT LOCATIONS OF FIXTURES (STANDARD AND BARRIER FREE), SINKS, ETC. REFER TO PLUMBING FIXTURE SCHEDULES FOR CONNECTION SIZES, ACCESSORIES, AND ADDITIONAL INFORMATION.




THIS DRAWING IS DIAGRAMMATIC AND SHOULD BE USED TO DETERMINE THE DESIGN INTENT. THE CONTRACTOR SHALL FIELD VERIFY ALL WORK AND SHALL NOTIFY THE ARCHITECT IMMEDIATELY OF ANY DISCREPANCIES IN THE DOCUMENTS BEFORE PROCEEDING. FAILURE TO DO SO WILL RESULT IN THE CONTRACTOR TAKING FULL RESPONSIBILITY AND LIABILITY FOR SAID DISCREPANCIES. NOTICE: THIS DRAWING AND THE DESIGN ARE THE PROPERTY OF MECHANICAL ELECTRICAL ENGINEERING CONSULTANTS, PC AND NO ALTERATIONS AND/OR TRANSFERS OF WORK ARE PERMITTED UNLESS WRITTEN APPROVAL IS GRANTED BY MECHANICAL ELECTRICAL ENGINEERING CONSULTANTS, PC.

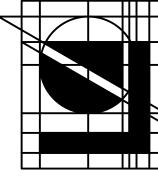

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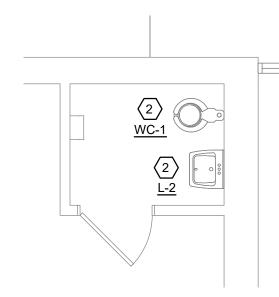
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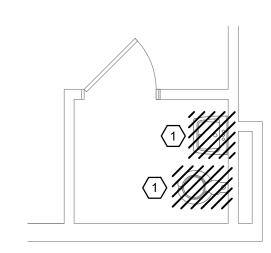
TOIET ROOM RENOVATIONS for:
HILTON ELEMENTARY SCHOOL
9600 HILTON RD., BRIGHTON, MI 48114

MP1.1 18-785

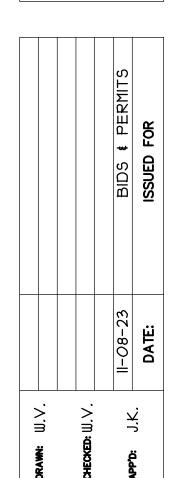


1/4" = 1'-0"


TOILET ROOM A120 PLUMBING NEW WORK PLAN 1/4" = 1'-0"




TOILET ROOM A122 PLUMBING DEMOLITION PLAN

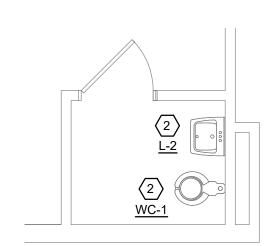


TOILET ROOM A122 PLUMBING NEW WORK PLAN 1/4" = 1'-0"

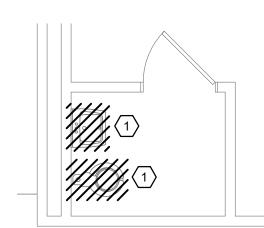


TOILET ROOM A125 PLUMBING DEMOLITION PLAN

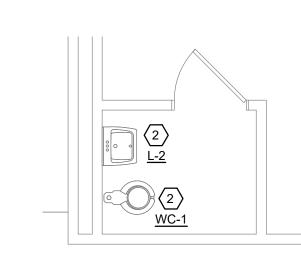


TOILET ROOM A125 PLUMBING NEW WORK PLAN

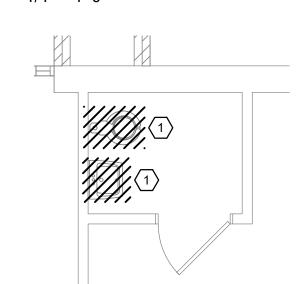


TOILET ROOM A127 PLUMBING DEMOLITION PLAN 1/4" = 1'-0"

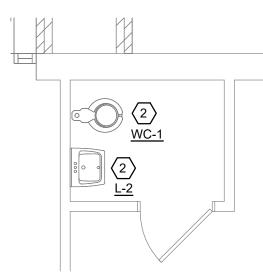


TOILET ROOM A127 PLUMBING NEW WORK PLAN 1/4" = 1'-0"

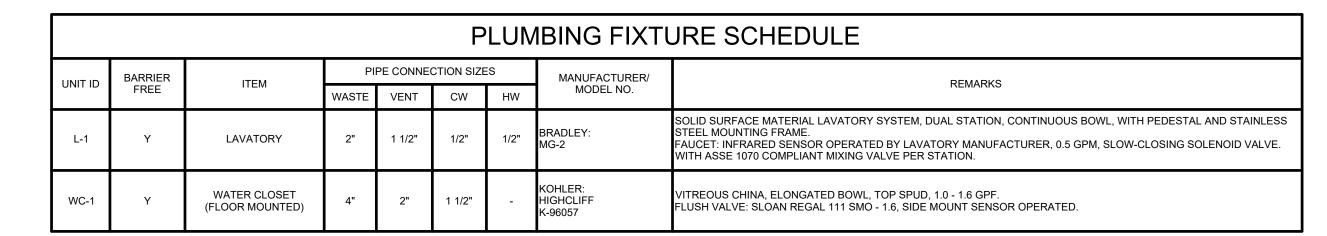


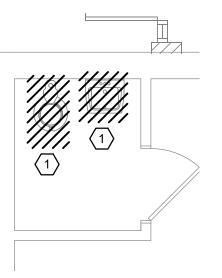


TOILET ROOM A139 PLUMBING DEMOLITION PLAN

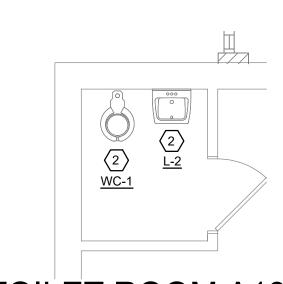


TOILET ROOM A139 PLUMBING NEW WORK PLAN 1/4" = 1'-0"

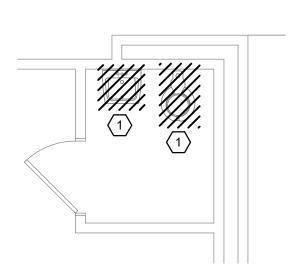


TOILET ROOM A141 PLUMBING DEMOLITION PLAN

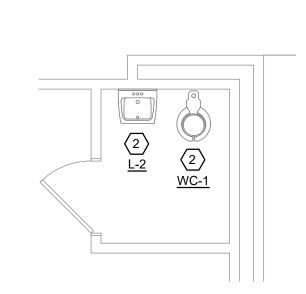


TOILET ROOM A141 PLUMBING NEW WORK PLAN 1/4" = 1'-0"

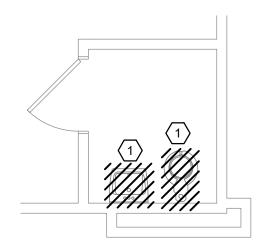


TOILET ROOM A144 PLUMBING DEMOLITION PLAN 1/4" = 1'-0"

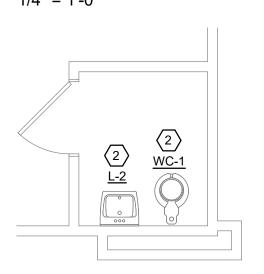

TOILET ROOM A144 PLUMBING NEW WORK PLAN 1/4" = 1'-0"

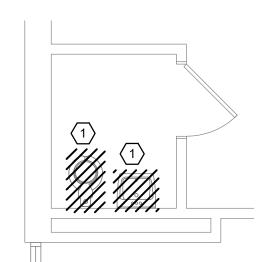

TOILET ROOM A146 PLUMBING DEMOLITION PLAN

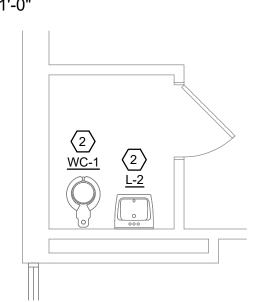

TOILET ROOM A146 PLUMBING NEW WORK PLAN 1/4" = 1'-0"

○ KEYNOTES	GENERAL NOTES
REMOVE PLUMBING FIXTURE. PLUMBING PIPING SHALL REMAIN TO BE REUSED. INSTALL NEW PLUMBING FIXTURE AND CONNECT TO EXISTING PLUMBING PIPING. EXTEND/REWORK PIPING AS NECESSARY BASED	 THESE DRAWINGS ARE DIAGRAMMATIC AND INDICATE THE GENERAL EXTENT OF THE WORK. MECHANICAL DEMOLITION WORK REQUIRED TO COMPLETE THE INSTALLATION OF NEW SYSTEMS SHALL BE PERFORMED AS PART OF THE PROJECT BASE BID. CONTRACTOR SHALL VISIT SITE PRIOR TO SUBMITTING BID AND VERIFY LOCATIONS OF EXISTING EQUIPMENT, PIPING, AND SYSTEM COMPONENTS TO FAMILIARIZE THEMSELVES WITH THE SCOPE OF WORK.
ON NEW LOCATION. FURNISH AND INSTALL NEW WALL CARRIERS/SUPPORTS AS REQUIRED.	4. PRIOR TO DEMOLITION THE CONTRACTOR SHALL NOTE DIFFERENCES IN THE FIELD CONDITIONS AND WHAT IS SHOWN ON THE CONTRACT DOCUMENTS AND NOTIFY THE ARCHITECT PRIOR TO PROCEEDING WITH WORK. 5. THE CONTRACTOR SHALL PERFORM ALL DEMOLITION WORK NECESSARY TO PROPERLY COMPLETE THE NEW WORK SHOWN ELSEWHERE.
	 PATCH AND REPAIR ALL EXISTING SURFACES TO REMAIN THAT MAY BE DAMAGED BY THE PERFORMANCE OF THE DEMOLITION WORK. PROTECT PIPING FROM ENETRANCE OF FOREIGN MATERIALS. VERIFY AND PROTECT ANY EQUIPMENT, PIPING, COMPONENTS, TO REMAIN OR BE REUSED PRIOR TO DEMOLITION. ANY SUCH ITEMS THAT ARE DAMAGED DURING DEMOLITION SHALL BE THE RESPONSIBILITY OF THE CONTRACTOR AND SHALL BE REPAIRED OR REPLACED AT NO


ADDITIONAL COST TO THE CONTRACT. OWNER SHALL HAVE THE FIRST RIGHT OF REFUSAL OF ANY EQUIPMENT NOTED TO BE REMOVED. PROVIDE PLUMBING SYSTEMS COMPLETE AND PER APPLICABLE CODES INCLUDING REQUIRED COMPONENTS, OFFSETS REQUIRED TO AVOID STRUCTURE, ETC. PIPING SHALL NOT BE INSTALLED IN A LOCATION THAT RESTRICTS THE ACCESS TO MECHANICAL DEVICES REQUIRING ACCESS. REFER TO ARCHITECTURAL PLANS FOR SPECIFICATIONS OF AND EXACT LOCATIONS OF FIXTURES (STANDARD AND BARRIER FREE), SINKS,

ETC. REFER TO PLUMBING FIXTURE SCHEDULES FOR CONNECTION SIZES, ACCESSORIES, AND ADDITIONAL INFORMATION.



THIS DRAWING IS DIAGRAMMATIC AND SHOULD BE USED TO VERIFY ALL WORK AND SHALL NOTIFY THE ARCHITECT BEFORE PROCEEDING. FAILURE TO DO SO WILL RESULT IN THE ONTRACTOR TAKING FULL RESPONSIBILITY AND LIABILITY FOR AID DISCREPANCIES. NOTICE: THIS DRAWING AND THE DESIGN RE THE PROPERTY OF MECHANICAL ELECTRICAL ENGINEERING ONSULTANTS, PC AND NO ALTERATIONS AND/OR TRANSFERS OF VORK ARE PERMITTED UNLESS WRITTEN APPROVAL IS GRANTED

Y MECHANICAL ELECTRICAL ENGINEERING CONSULTANTS, PC

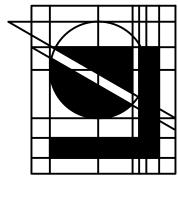

Lindhout Associates
architects aia pc
10465 citation drive, brighton, michigan 48116-951

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KEYED NOTE IDENTIFIER

ELECTDICAL SYMBOLLIST

	ELECTRIC	CAL SYMBOL LI	SI
	POWER SYMBOLS		ONE-LINE DIAGRAM SYMBOLS
SYMBOL	DESCRIPTION	SYMBOL	DESCRIPTION
J	JUNCTION BOX - CEILING MOUNTED	200AF (° 175AT (°)	CIRCUIT BREAKER - UPPER NUMERAL DENOTES AMPERAGE FRAME RATING AND LOWER NUMERAL
\bigcirc_{F}	JUNCTION BOX - FLOOR MOUNTED	1,	INDICATES TRIP RATING
\bigcirc_{HD}	JUNCTION BOX - WALL MOUNTED, FOR HAND DRYER HEIGHT AS INDICATED ON ARCHITECTURAL PLANS	200 110	FUSIBLE DISCONNECT SWITCH - UPPER NUMERAL DENOTES SWITCH SIZE, LOWER NUMERAL DENOTES FUSE SIZE
M	KWH METER	(G)	GENERATOR
	WALL MOUNTED SURFACE RACE WAY		
\Box $\frac{30}{10}$	FUSIBLE DISCONNECT SWITCH - UPPER NUMERAL DENOTES SWITCH SIZE, LOWER NUMERAL DENOTES	⊣ ⊩	GROUND
	FUSE SIZE	®	KIRK-KEY INTERLOCK
□ 30	NON-FUSED DISCONNECT SWITCH - NUMERAL DENOTES SWITCH SIZE	14,874 A. SYM. 3Ø	INDICATES AVAILABLE FAULT CURRENT IN 3-PHASE SYMMETRICAL AMPERES
\boxtimes	MAGNETIC MOTOR STARTER	m	TRANSFORMER
\boxtimes	COMBINATION MOTOR STARTER	6 9	AUTOMATIC TRANSFER SWITCH
Ф	DUPLEX RECEPTACLE OUTLET +18" A.F.F.	_ d	
₼	DUPLEX RECEPTACLE OUTLET +48" A.F.F.		
\nearrow	MOTOR CONNECTION		WIRING & CONDUIT SYMBOLS
	LOAD CENTER	SYMBOL	DESCRIPTION
	LIGHTING PANELBOARD		CONDUIT RUN IN WALL OR ABOVE CEILING
	POWER PANELBOARD		CONDUIT RUN BELOW GRADE OR CONCRETE SLAB
	DISTRIBUTION PANELBOARD		BRANCH CIRCUIT HOMERUN
	MAIN SWITCHBOARD	NOTE:	ANY CIRCUIT WITHOUT FURTHER IDENTIFICATION IS 2-WIRE PLUS GROUND
T	TRANSFORMER		WIRE. A GREATER NUMBER OF WIRES IS INDICATED BY HASH MARKS.
	CONTROL PANEL	' /////// /	EXISTING TO BE REMOVED OR ABANDONED
Ø	UTILITY POLE		

PROJECT SPECIFIC NOTES

- 1. APPLICABLE CODES INCLUDE, BUT ARE NOT NECESSARILY LIMITED TO, THE FOLLOWING:
- 1.1. 2015 MICHIGAN BUILDING CODE
- 1.2. 2017 NEC WITH MICHIGAN PART 8 AMENDMENTS (INCLUDING NEC
- 1.3. 2017 MICHIGAN ENERGY CODE (IECC 2015 / ASHRAE 90.1 2013) 1.4. 2009 ICC ANSI STANDARD A117.1-2009
- 1.5. 2015 INTERNATIONAL FIRE CODE.
- 2. CONTRACTOR SHALL PROVIDE NAMEPLATES FOR ALL ELECTRICAL EQUIPMENT AND ARC-FLASH LABELS INDICATING REQUIRED PPE
- 3. ALL WIRING AND BUSSING SHALL BE COPPER, UNLESS OTHERWISE
- 4. SURGE PROTECTION DEVICES SHALL BE PROVIDED WHERE INDICATED

5. A SEPARATE EQUIPMENT GROUNDING CONDUCTORS, SIZED PER NEC,

- ON THE DRAWINGS AND/OR SPECIFICATIONS.
- 6. PROVIDE A THERMAL-ADHESIVE LABEL ON EACH DEVICE (LIGHT SWITCH, RECEPTACLE, ETC.) INDICATING THE SOURCE PANEL AND CIRCUIT

SHALL BE INSTALLED WITH ALL CIRCUIT CONDUCTORS.

GENERAL NOTES

- 1. THE CONTRACTOR SHALL ABIDE BY ALL FEDERAL, STATE, AND/OR LOCAL CODES. IF A DISCREPANCY BETWEEN CODES OCCURS, THE MOST STRINGENT SHALL PREVAIL.
- 2. THE CONTRACTOR SHALL FIELD VERIFY EXISTING CONDITIONS PRIOR TO THE COMMENCEMENT OF ANY WORK. SHOULD DISCREPANCIES BE DISCOVERED, THE CONTRACTOR SHALL VERIFY INTENT WITH THE ENGINEER/OWNER BEFORE PROCEEDING.
- 3. COORDINATE LOCATIONS OF ALL CEILING MOUNTED DEVICES WITH OTHER TRADES PRIOR TO INSTALLATION.
- 4. COORDINATE ALL ROUGH-IN REQUIREMENTS FOR OWNER FURNISHED EQUIPMENT WITH THE OWNER PRIOR TO BEGINNING WORK. THESE DRAWINGS ARE BASED ON THE BEST INFORMATION AVAILABLE DURING THE DESIGN PHASE OF THE PROJECT.
- 5. COORDINATE WITH MILLWORK CONTRACTOR TO DETERMINE THE EXACT LOCATION OF OUTLETS BEING PLACED IN MILLWORK.
- 6. ALL DEVICES ARE TO BE FLUSH MOUNTED UNLESS NOTED OTHERWISE.
- 7. DEVICES NOTED "GFI" SHALL INCLUDE GROUND FAULT INTERRUPTING
- 8. DEVICES NOTED "WP" SHALL BE WEATHERPROOF, "WHILE-IN-USE" TYPE WHERE APPLICABLE.
- 9. MULTI-WIRE BRANCH CIRCUITS SHALL BE PROVIDED WITH THE MEANS TO SIMULTANEOUSLY DISCONNECT ALL UNDERGROUND CONDUCTORS AT THE POINT WHERE THE BRANCH CIRCUIT ORIGINATES. REFER TO 2017 NEC 210.4 (B). THIS APPLIES TO ALL MULTI-WIRE BRANCH CIRCUITS SUPPLYING ANY LOAD.
- 10. DEDICATED NEUTRAL CONDUCTORS SHALL BE CONSIDERED CURRENT-CARRYING CONDUCTORS. HOMERUNS CONTAINING MORE THAN THREE CURRENT-CARRYING CONDUCTORS SHALL BE DERATED IN ACCORDANCE WITH THE 2017 NEC.
- 11. BRANCH CIRCUIT HOMERUN CONDUCTORS SHALL BE SIZED IN ACCORDANCE WITH THE 2017 NEC. THE MAXIMUM ALLOWABLE VOLTAGE DROP ON A FEEDER IS 2% AND THE MAXIMUM ALLOWABLE VOLTAGE DROP ON A BRANCH CIRCUIT IS 3%. PROVIDE BRANCH CIRCUIT CONDUCTORS SIZED TO ENSURE THE TOTAL VOLTAGE DROP FROM THE SOURCE TO THE POINT OF UTILIZATION IS LESS THAN OR EQUAL TO 5%.
- 12. DEDICATED NEUTRALS SHALL BE PROVIDED FOR ALL BRANCH CIRCUITS, EXCEPT WHERE A MULTI-WIRE CIRCUIT IS REQUIRED TO SERVE THE LOAD (I.E. SYSTEMS FURNITURE). WHEN SHARING THE NEUTRAL CONDUCTOR IN A MULTI-WIRE CIRCUIT, THE NEUTRAL SIZE SHALL BE INCREASED 17790.
- 13. ALL MOUNTING HEIGHTS PROVIDED ARE TO CENTER OF DEVICE, UNLESS OTHERWISE INDICATED.

GENERAL NOTES - DEMOLITION

- 1. CERTAIN AREAS IN THE EXISTING BUILDING SHALL BE MODIFIED TO SUIT THE NEW REQUIREMENTS. THESE DRAWINGS ARE DIAGRAMMATIC AND ARE INTENDED TO INDICATE THE SCOPE OF WORK REQUIRED TO COMPLETE A SAFE REMOVAL OF THE ELECTRICAL SYSTEMS AS INDICATED BY THE NOTES ON THIS DRAWING.
- 2. WORK IN THE AREA SHALL INCLUDE THE DISCONNECTION, REMOVAL, RELOCATION, AND RECONNECTION COMPLETE IN ALL RESPECTS OF ALL ITEMS REQUIRED TO SUIT THE DESIGN INTENT. IT SHALL BE THE RESPONSIBILITY OF THE CONTRACTOR TO VISIT THE PROJECT SITE TO CORRECTLY ASCERTAIN THE SCOPE OF SERVICES AND TO INCLUDE ALL PERTINENT COSTS IN HIS BID. NO EXTRAS WILL BE ALLOWED.
- 3. ALL ELECTRICAL WORK INTERFERING WITH AND REQUIRING MODIFICATION FOR THE NEW REQUIREMENTS SHALL BE RELOCATED AS DIRECTED BY BUILDING MANAGEMENT PERSONNEL AND REINSTALLED AND REWIRED AS NECESSARY TO THE SATISFACTION OF THE BUILDING
- 4. PROVIDE ALL EQUIPMENT, MATERIALS, LABOR AND SUPERVISION NECESSARY TO PROVIDE A SAFE ELECTRICAL INSTALLATION. ALL ELECTRICAL DEVICES AND SYSTEMS THAT ARE INDICATED AS EXISTING TO REMAIN SHALL BE IN SAFE WORKING ORDER.
- 5. OBTAIN NECESSARY PERMITS FROM THE LOCAL AUTHORITY HAVING JURISDICTION BEFORE PROCEEDING WITH ANY WORK IN THE FIELD.
- 6. ALL WORK SHALL BE PERFORMED IN ACCORDANCE WITH THE NATIONAL ELECTRICAL CODE, OSHA AND OTHER ELECTRICAL SAFETY STANDARDS AND GUIDELINES. CONFORM TO ALL STATE AND LOCAL CODES AND STANDARDS.
- 7. ALL EQUIPMENT AND WIRING NOT IN RENOVATION AREAS BUT AFFECTED BY WORK IN RENOVATION AREAS SHALL BE RECONNECTED AS REQUIRED FOR A COMPLETE WORKING SYSTEM.
- 8. ABANDONED AND INACTIVE CONDUITS, WIRE, DEVICES, EQUIPMENT, ETC., SHALL BE REMOVED IN THEIR ENTIRETY. IN ADDITION TO THESE ITEMS, THIS CONTRACTOR SHALL REMOVE ALL ITEMS AS INDICATED ON THE PLANS, OR AS REQUIRED TO CLEAN UP THE ENTIRE AREA OF UNUSED, ABANDONED, OR INACTIVE MATERIALS. CONDUIT AND WIRING FEEDING DEVICES AND EQUIPMENT TO BE REMOVED SHALL ALSO BE REMOVED UP TO THE NEXT ACTIVE PULLBOX, JUNCTION BOX, OR PANELBOARD. HANGERS, MESSENGER CABLE, BRACKETS, ETC, SUPPORTING ITEMS TO BE REMOVED SHALL ALSO BE UNFASTENED AND REMOVED. OPEN HOLES IN DUCTS, BOXES, PANELBOARDS, AND KNOCKOUTS SHALL BE CLOSED WITH SUITABLE SNAP PLUGS OR FILLER
- 9. THE CONTRACTOR SHALL REMOVE AND DELIVER TO A PLACE DESIGNATED BY THE OWNER ALL EXISTING ELECTRICAL EQUIPMENT NO LONGER INTENDED FOR USE. THIS EQUIPMENT REMAINS THE PROPERTY OF THE OWNER.
- 10. ANY EQUIPMENT, DEVICES, MATERIALS, ETC., THE OWNER ELECTS NOT TO RETAIN SHALL BE LEGALLY DISPOSED OF BY THE CONTRACTOR OFF THE OWNER'S PREMISES.
- 11. AT COMPLETION OF ALL ELECTRICAL WORK, UPDATE CIRCUIT DIRECTORIES IN PANELS AFFECTED BY NEW WORK WITH NEW TYPEWRITTEN CIRCUIT DESCRIPTIONS. CIRCUIT DIRECTORIES SHALI BE MOUNTED ON INSIDE OF FRONT PANEL COVER IN A CLEAR PLASTIC
- 12. EQUIPMENT SHALL BE INSTALLED IN ACCORDANCE WITH MANUFACTURER'S RECOMMENDATIONS, AND IN ACCORDANCE WITH THEIR LISTING OR LABELING REQUIREMENTS. ANY PENETRATIONS THROUGH FIRE RATED ASSEMBLIES THAT ARE CREATED BY THE ELECTRICAL DEMOLITION, SHALL BE SEALED AND RESTORED IN ACCORDANCE WITH THE UL FIRE RESISTANCE DIRECTORY.
- 13. WHERE CONDUIT AND/OR OUTLET BOXES INDICATED FOR DEMOLITION ARE EMBEDDED IN CONCRETE OR BELOW CONCRETE SLAB, ABANDON IN PLACE. CUT BACK AND SEAL EXPOSED CONDUIT. PROVIDE BLANK COVERS FOR ABANDONED BOXES. REMOVE ALL ASSOCIATED WIRING BACK TO SOURCE.

ELECTRICAL ABBREVIATIONS

- ALTERNATING CURRENT
- ABOVE COUNTERTOP
- ARC FAULT CIRCUIT INTERRUPTER
- ABOVE FINISHED FLOOR TO CENTERLINE
- ABOVE FINISHED GRADE TO CENTERLINE
- BLANK COVER PLATE
- BOLTED PRESSURE SWITCH CONDUIT
- CKT/CIRC CIRCUIT **CURRENT TRANSFORMER CABINET**
- DISTRIBUTION PANEL
- **EXISTING**
- ELECTRICAL CONTRACTOR EC
- EXHAUST FAN
- ELECTRIC WATER HEATER


ELECTRIC WATER COOLER


- FIRE ALARM ANNUNCIATOR PANEL
- FIRE ALARM CONTROL PANEL
- FURNACE
- GROUND FAULT CIRCUIT INTERRUPTER
- GROUNDED ISOLATED GROUND
- MAIN DISTRIBUTION PANEL
- NIGHT LIGHT
- POWER PANEL
- POWER POLE
- ROUGHED-IN ONLY
- ROOFTOP UNIT
- RELOCATED
- SURFACE MOUNTED
- UNDER COUNTER
- UNLESS OTHERWISE NOTED
- WATER HEATER WEATHERPROOF

	SHEET INDEX										
SHEET NUMBER	SHEET TITLE										
E0.1	GENERAL ELECTRICAL INFORMATION										
E1.0	ELECTRICAL NEW WORK PLANS										
E2.0	ELECTRICAL POWER ONE-LINE AND SCHEDULES										
E3.0	ELECTRICAL SPECIFICATIONS										




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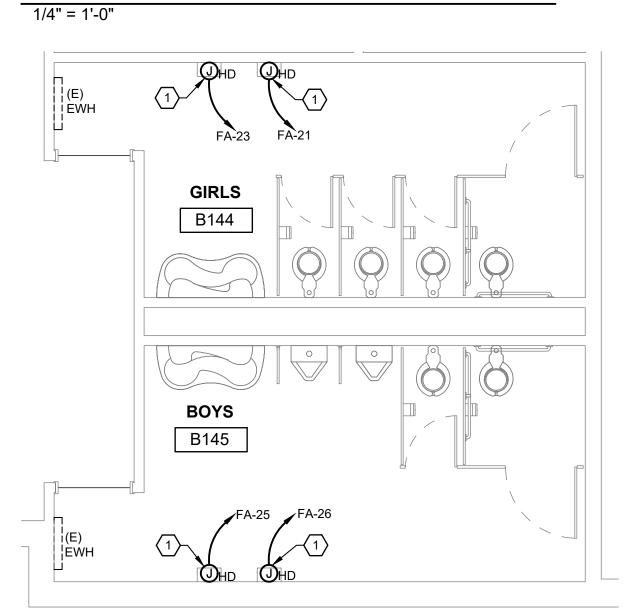


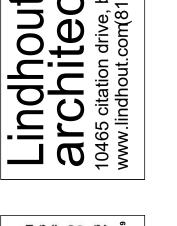

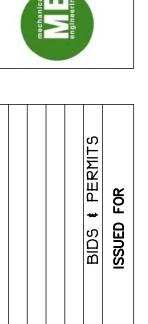
N.W. TOILET ROOM

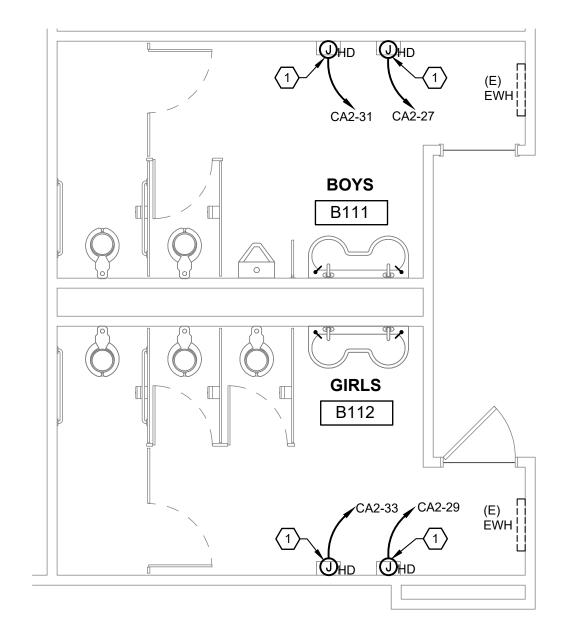

ELECTRICAL NEW WORK PLAN -S.W. TOILET ROOM



ELECTRICAL NEW WORK PLAN -S.E. TOILET ROOM

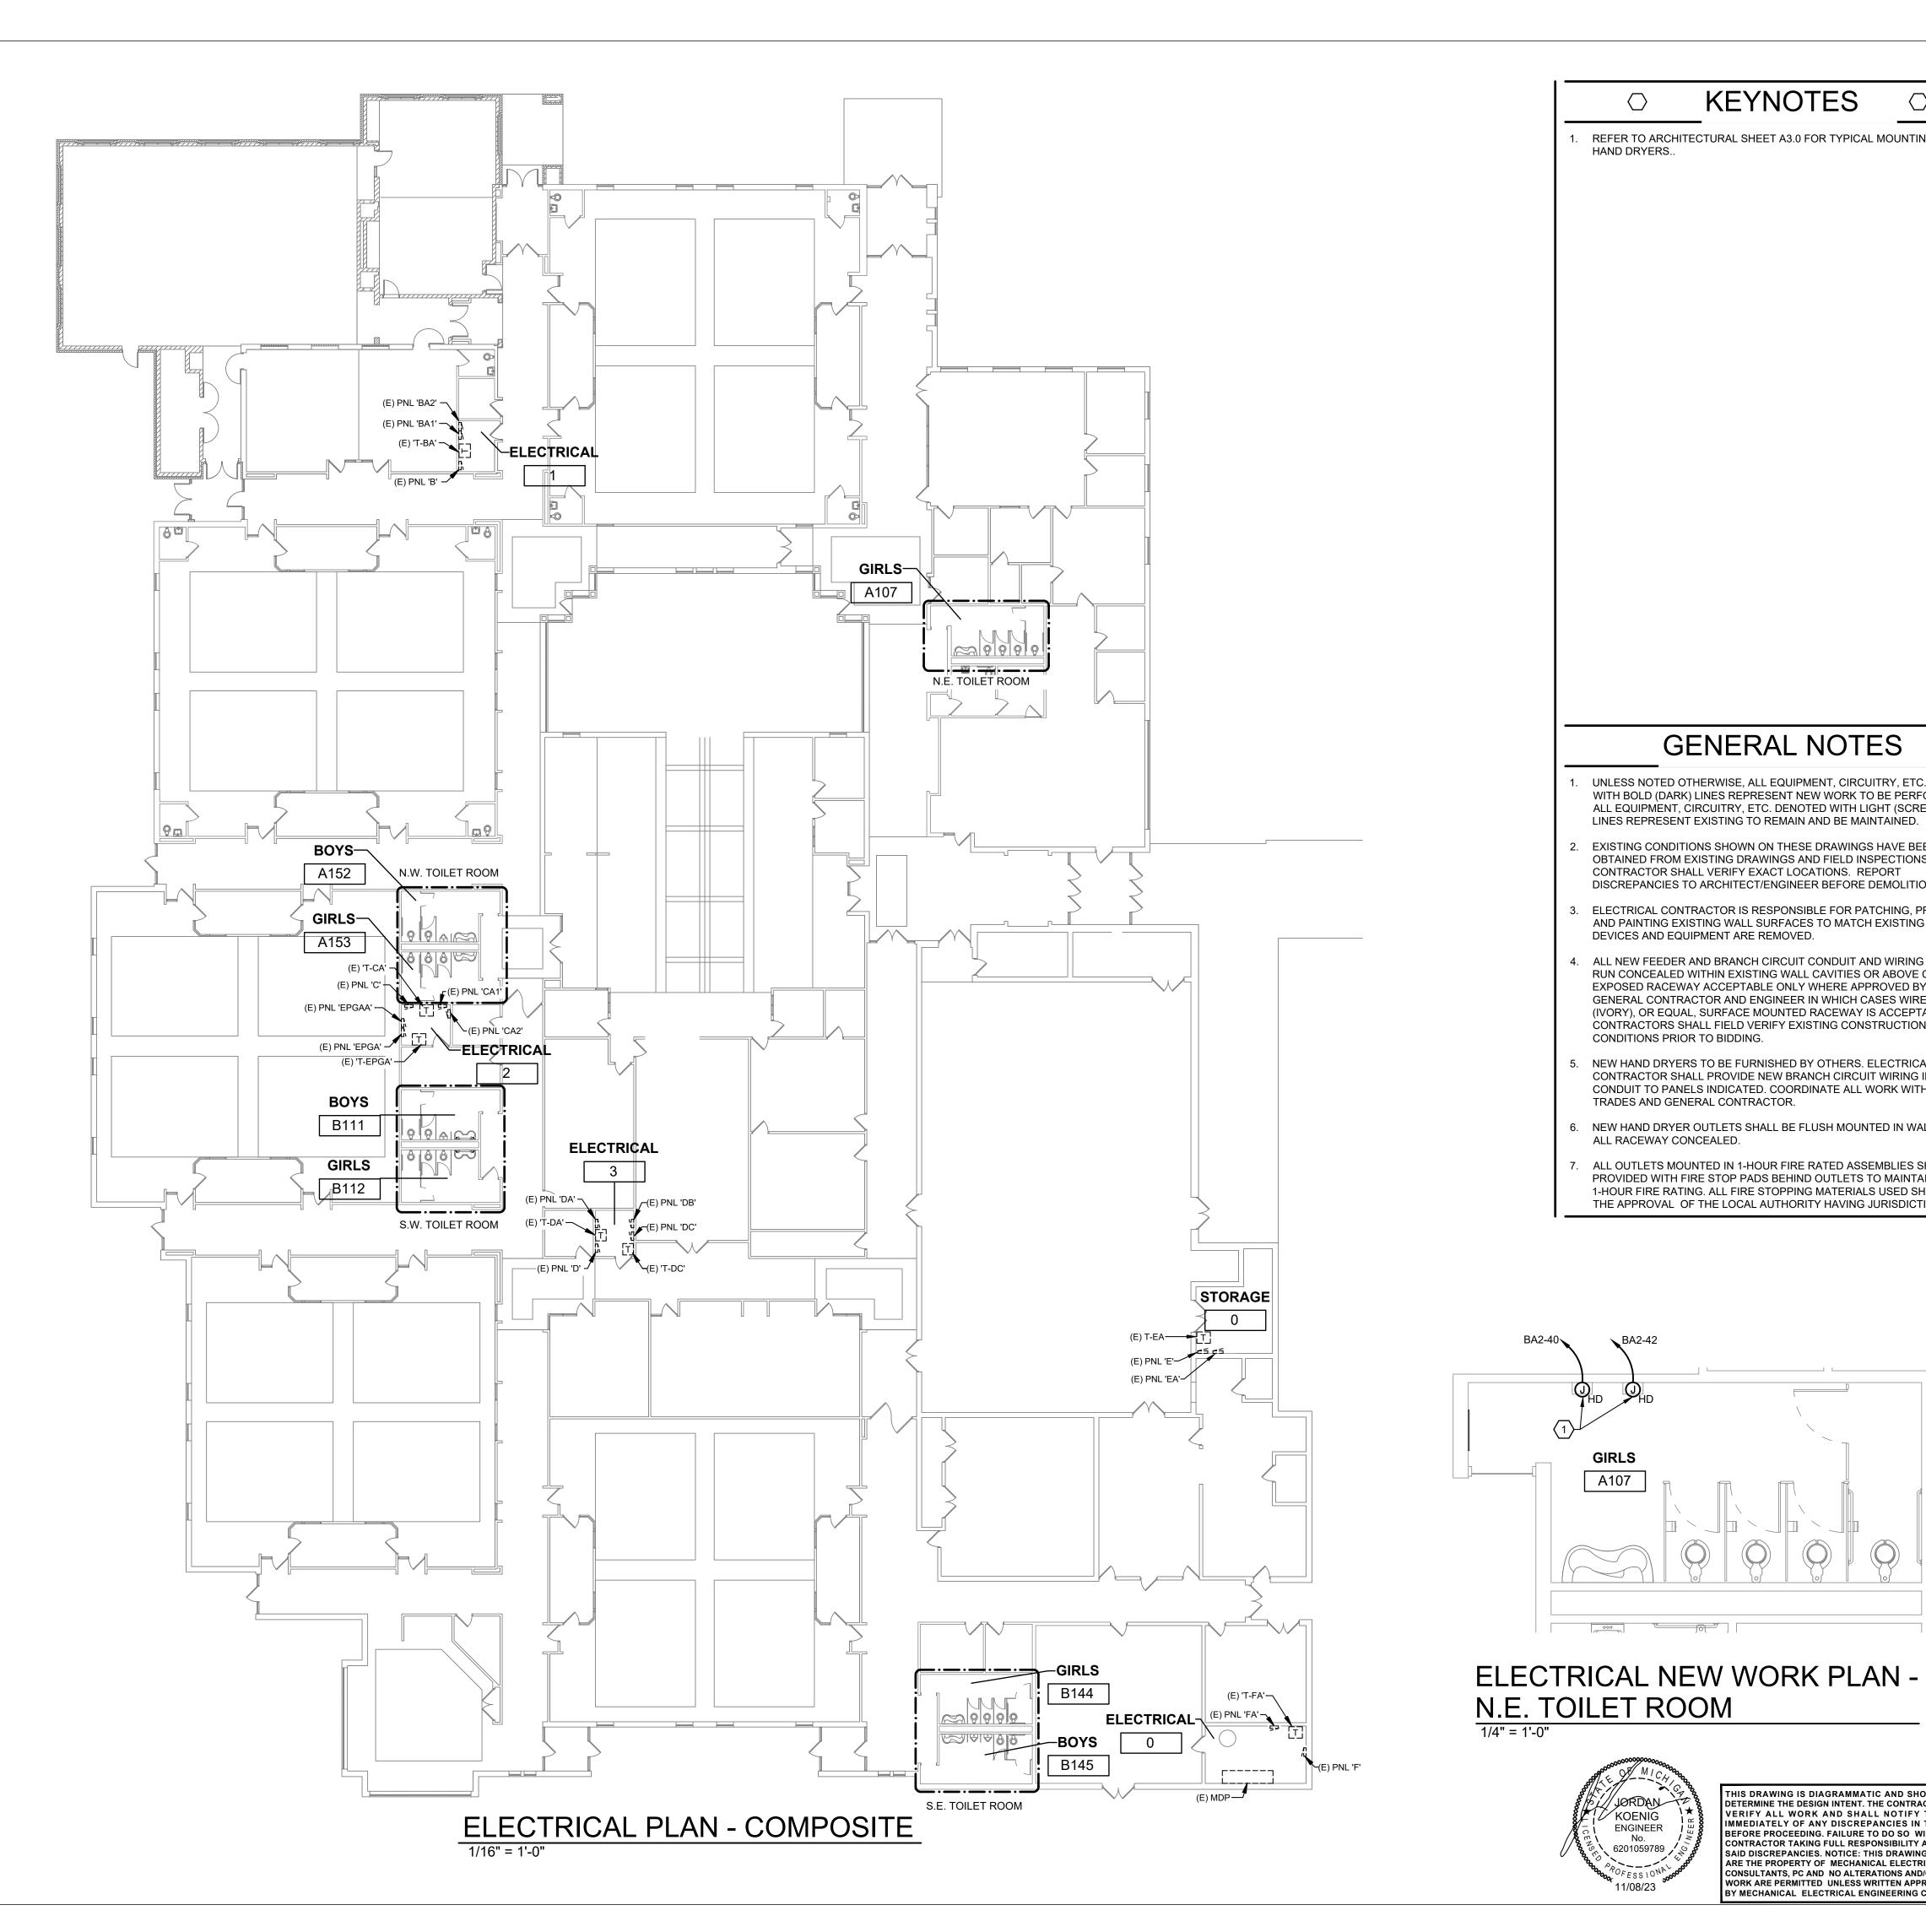

KEYNOTES

GENERAL NOTES

UNLESS NOTED OTHERWISE, ALL EQUIPMENT, CIRCUITRY, ETC. DENOTED WITH BOLD (DARK) LINES REPRESENT NEW WORK TO BE PERFORMED. ALL EQUIPMENT, CIRCUITRY, ETC. DENOTED WITH LIGHT (SCREENED)

AND PAINTING EXISTING WALL SURFACES TO MATCH EXISTING WHERE

ALL NEW FEEDER AND BRANCH CIRCUIT CONDUIT AND WIRING SHALL BE RUN CONCEALED WITHIN EXISTING WALL CAVITIES OR ABOVE CEILINGS. EXPOSED RACEWAY ACCEPTABLE ONLY WHERE APPROVED BY OWNER, GENERAL CONTRACTOR AND ENGINEER IN WHICH CASES WIREMOLD 700

LINES REPRESENT EXISTING TO REMAIN AND BE MAINTAINED.

OBTAINED FROM EXISTING DRAWINGS AND FIELD INSPECTIONS.

CONTRACTORS SHALL FIELD VERIFY EXISTING CONSTRUCTION

NEW HAND DRYERS TO BE FURNISHED BY OTHERS. ELECTRICAL

CONTRACTOR SHALL PROVIDE NEW BRANCH CIRCUIT WIRING IN METAL CONDUIT TO PANELS INDICATED. COORDINATE ALL WORK WITH OTHER

NEW HAND DRYER OUTLETS SHALL BE FLUSH MOUNTED IN WALL WITH

ALL OUTLETS MOUNTED IN 1-HOUR FIRE RATED ASSEMBLIES SHALL BE PROVIDED WITH FIRE STOP PADS BEHIND OUTLETS TO MAINTAIN THE 1-HOUR FIRE RATING. ALL FIRE STOPPING MATERIALS USED SHALL MEET THE APPROVAL OF THE LOCAL AUTHORITY HAVING JURISDICTION

CONTRACTOR SHALL VERIFY EXACT LOCATIONS. REPORT

DEVICES AND EQUIPMENT ARE REMOVED.

CONDITIONS PRIOR TO BIDDING.

ALL RACEWAY CONCEALED.


A107

JORDAN KOENIG

ENGINEER No.

TRADES AND GENERAL CONTRACTOR.

. REFER TO ARCHITECTURAL SHEET A3.0 FOR TYPICAL MOUNTING OF HAND DRYERS.

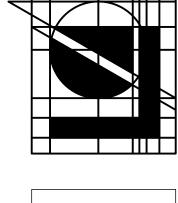



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THIS DRAWING IS DIAGRAMMATIC AND SHOULD BE USED TO DETERMINE THE DESIGN INTENT. THE CONTRACTOR SHALL FIELD VERIFY ALL WORK AND SHALL NOTIFY THE ARCHITECT

DNSULTANTS, PC AND NO ALTERATIONS AND/OR TRANSFERS OF ORK ARE PERMITTED UNLESS WRITTEN APPROVAL IS GRANTED Y MECHANICAL ELECTRICAL ENGINEERING CONSULTANTS, PC.

(E) DTE ENERGY PAD し人人人 MOUNT TRANSFORMER (Υ¥Υ) 500KVA × 480/277VOLT, 3-PHASE, 4-WIRE

стᡛ—М

BUILDING DEMAND CALCULATION EXISTING BUILDING DEMAND LOAD NEW HAND DRYER TOTAL LOAD NEW BUILDING DEMAND (TOTAL)

= 435KVA = 14KVA = 449KVA

MAIN DISTRIBUT 0/277VOLT, 3-PH/ 0A. BUS	TION PANEL (ASE, 4-WIRE	(MDP)				 1200A 1200A BPS 							
-	300/3	225/3) 125/3	125/3	400/3	225/3) 50 /3	100/3	100 /3	100/3	100 /3	100/3	60/3
 - MC	. — . —	 	 	 	 - 			'INL		NL	\\\\\\\\\\\\\\\\\\\\\\\\\\\\\\\\\\\\\\		
 		'E' 	'F' 	'A'		P' PUM	Р		JMP	Г	PUMP	100/3 100/3	
		(YXY) <u>T-EA</u> % 	(((② (Y X Y) <u>T-DA</u> ※ 	(Y	ΥΥ <u>Τ-CA</u> ※ 	(Y ,	YY 1 <u>T-BA</u> ※ 	(Y	
		 PNL 'EA' 	PNL 'FA' 	PNL 'AA' 		 PNL 'DA' 	 P 'C	PNL PNL CA1' 'CA2'	 P 'B _		 - -	PNL EGPA'	RTU RTU
						 PNL 'DB' 					 E	PNL EGPAA'	
					EXISTING N.T.S.	POWER C	NE-LIN	IE DIAGR	<u>AM</u>			- -	

VOLTAGE AND PHASE 120/208V.3Ø 4W

CKT CKT CKT CKT

20 3 4 20

20 7 8 20

20 9 10 20

20 | 15 | 16 | 20

20 17 18 20

360 | 20 | 5 | 6 | 20

360 | 20 | 11 | 12 | 20

C | BRKR | # | # | BRKR | A | B |

20 | 1 | 2 | 20 | 360

20 | 13 | 14 | 20 | 360

SYM. A.I.C. MIN.

LOAD - VA.

360

MOUNTING <u>SURFACE</u>

LOAD SERVED

PLUGS - BATHROOMS

PLUGS - CONF. RM. 18

COUNTER PLUGS - RM. 18

COUNTER PLUGS - C.R. 15

PLUGS - CONF. RM. 14 COUNTER PLUGS - C.R. 14

HAND DRYER - BOYS A152 HAND DRYER - GIRLS A153 HAND DRYER - STAFF A153

17,420 TOTAL DEMAND LOAD

-- 25% LIGHTING LOAD

12,000 SPARE

29,420 DESIGN LOAD 82 DESIGN AMPS

COPY MACHINE

500 WATER COOLER

360 PLUGS - C.R. 18

PLUGS - C.R. 15

360 PLUGS - CONF. RM. 15

PLUGS - C.R. 14

SPACE

SPACE SPACE SPACE SPACE SPACE

EXISTING PANEL BOARD MAINS	<u>'BA2'</u> 150A MCB			VOLTA	GE AND PHASE	120/208	V.3Ø 4W	SY	M. A.I.C. I 22,000	MIN.	MOUNTING SURFACE		
	L	_OAD - V	4	CKT	СКТ	CKT	СКТ	l	OAD - VA	۹.			
LOAD SERVED	Α	В	С	BRKR	#	#	BRKR	Α	В	С		LOAD SERVED	
FLOOR BOX - C.R. 8	360			20	1	2	20				PLUGS - C	.R. 6	
FLOOR BOX - C.R. 8		360		20	3	4	20				PLUGS - C	.R. 5	
FLOOR BOX - C.R. 9			360	20	5	6	20				PLUGS - C	.R. 5	
FLOOR BOX - C.R. 9	360			20	7	8	20				COUNTER PLUGS - C.R. 6		
FLOOR BOX - C.R. 9		360		20	9	10	20				PLUGS - C.R. 6		
FLOOR BOX - C.R. 9			360	20	11	12	20				COUNTER PLUGS - C.R. 8		
FLOOR BOX - C.R. 7	360			20	13	14	20				PLUGS - C.R. 8		
FLOOR BOX - C.R. 7		360		20	15	16	20				COUNTER PLUGS - C.R. 8		
FLOOR BOX - C.R. 7			360	20	17	18	20				PLUGS - CONF. RM. 8		
FLOOR BOX - C.R. 7	360			20	19	20	20				DOSING PUMP CONTROL		
FLOOR BOX - C.R. 7		360		20	21	22	20				PLUG - ELECTRIC ROOM		
FLOOR BOX - C.R. 7			360	20	23	24	20				FLOOR BOX - C.R. 8		
FLOOR BOX - C.R. 7	360			20	25	26	20				FLOOR BOX - C.R. 8		
		500		30	27	28	20				CP1 / CP2 - STORAGE REC. PROJECTOR SCREEN		
VACUUM SYSTEM-ADD			500	1 /	29	30	20						
	500			3	31	32	20				FREEZE TAPE - NORTH		
TRACK LIGHTS - FLOOR BOX		500		20	33	34	20				REC - MULTI-PURPOSE		
EF-1 - CUH-1			500	20	35	36	20				REC - RM. A165		
SPACE					37	38	20				REC - RM.	A166	
SPACE					39	40	20		1000		HAND DRY	'ER - GIRLS A107	
SPACE					41	42	20			1000	HAND DRY	'ER - GIRLS A107	
LOAD DESCRIPTION	DEM	IAND FAC	CTOR		VOLT-AMPS								
EGAB BEGGINI TIGHT		D.F.		C	ONNECTE	ĒD		DEM	MAND		17,580	TOTAL DEMAND LOAD	
LIGHTING		1.0			500			5	00		125	25% LIGHTING LOAD	
RECEPTACLES		NEC			10,080			10,	080		3,000	SPARE	
SMALL MOTORS		1.0			200			2	00				
MISC. EQUIPMENT		1.0			3,000			3,0	000		20,705	DESIGN LOAD	
HAND DRYERS		1.0			2,000			2,0	000		58	DESIGN AMPS	
		TOTAL			17,580			17,	580				

	PLUGS - CONF. RM. 13	360			20	19	20	20	360				
	COUNTER PLUGS - C.R. 13		360		20	21	22	20		360			
	PLUGS - C.R. 13			360	20	23	24	20			360		
*	HAND DRYER - BOYS A152	1000			20	25	26	20	1000				
*	HAND DRYER - BOYS B111		1000		20	27	28	20		1000			
*	HAND DRYER - STAFF B111			1000	20	29	30	20			1000		
*	HAND DRYER - BOYS B111	1000			20	31	32	20					
*	HAND DRYER - GIRLS B111		1000		20	33	34	20					
	SPACE					35	36	20			-		
	SPACE					37	38	20					
	SPACE					39	40	20					
	SPACE					41	42	20			-		
	LOAD DESCRIPTION	DEM	AND FAC	TOR	VOLT-AMPS								
	EOAD BEOOM! HON		D.F.			CONNECTED			DEMAND				
	LIGHTING		1.0										
	RECEPTACLES		NEC		7,920			7,920					
	SMALL MOTORS		1.0										
	MISC. EQUIPMENT		1.0		1,500			1,500					
	HAND DRYERS		1.0		8,000			8,000					
			TOTAL		17,420			17,420					
	* ASTERISK DENOTES NEW CIRCUIT BREAKER												

360

EXISTING PANEL BOARD 'CA2'
MAINS 150A MCB

LOAD SERVED

COUNTER PLUGS - C.R. 12

COUNTER PLUGS - C.R. 11

COUNTER PLUGS - C.R. 16

PLUGS - CONF. RM. 16

PLUGS - CONF. RM. 12

PLUGS CONF. RM. 11

PLUGS C.R. 12

PLUGS C.R. 11

PLUGS C.R. 16

LOAD - VA

360

360


A | B |

360

360

EXISTING PANEL BOARD MAINS				VOLTAGE AND PHASE 120/208V.3Ø 4W			SYM. A.I.C. MIN. 22,000			MOUNTING SURFACE		
	LOAD - VA		СКТ	CKT	CKT	CKT CKT	LOAD - VA.					
LOAD SERVED	Α	В	С	BRKR	#	#	BRKR	Α	В	С	LOAD SERVED	
PLUGS - MUSIC ROOM	360			20	1	2	15	100			FIRE ALARM PANEL	
CONTROL CONSOLE / MUSIC RM.		360		20	3	4	20		250		SOFTNER	
PLUGS - MUSIC ROOM			360	20	5	6	20			500	ELECTRICAL LOAD	
IGHTING CONTROL PANEL	100			15	7	8	20	250			IRON FILTERS	
GUARDIAN ALARM PLUGS/CUSTODIAL		360		20	9	10	15		1000		PUMP PP-1, JCI CONTROLS	
WATER COOLER			600	20	11	12	15			1000	PUMP PP-2	
PLUGS RESTROOM	360			20	13	14	15	1000			EXHAUST FAN #7	
PLUGS RECEIVING ROOM		360		20	15	16	15		500		BOILER #2	
PLUGS MECHANICAL ROOM/CARD READER			360	20	17	18	15			500	BOILER #1	
HOT WATER BOILER	500			20	19	20	15	100			FIRE HORN	
HAND DRYER - GIRLS B144		1000		20	21	22					SPACE	
HAND DRYER - GIRLS B144			1000	20	23	24					SPACE	
HAND DRYER - BOYS B145	1000			20	25	26	20	1000			HAND DRYER - BOYS B145	
SPACE					27	28					SPACE	
SPACE					29	30					SPACE	
SPACE					31	32					SPACE	
SPACE		-			33	34					SPACE	
SPACE					35	36					SPACE	
SPACE					37	38					SPACE	
SPACE					39	40					SPACE	
SPACE					41	42					SPACE	
	DEMAND FACTOR D.F.		VOLT-AMPS									
LOAD DESCRIPTION			CONNECTED				DEMAND			12,920	TOTAL DEMAND LOAD	
LIGHTING	1.0									25% LIGHTING LOAD		
RECEPTACLES	NEC		2,520			2,520				16,000	SPARE	
SMALL MOTORS	1.0		3,600			3,600						
MISC. EQUIPMENT	1.0		2,800			2,800				28,920	DESIGN LOAD	
HAND DRYERS	1.0		4,000			4,000				80	DESIGN AMPS	
		TOTAL			12,920			12,	920			

* ASTERISK DENOTES NEW CIRCUIT BREAKER

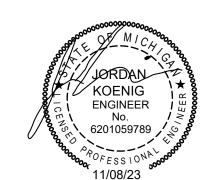

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ROOM RENOVATIONS for:
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HILTON RD., BRIGHTON, MI 48114

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architects aia pc

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ELECTRICAL SPECIFICATIONS

1. WORK INCLUDED

- A. These specifications and accompanying drawings contemplate the provisions by the electrical contractor of all labor and materials required to install a complete system of electrical work as indicated on the drawings and/or herein specified.
- B. Without restricting the generality of the foregoing, the following shall be included:
- New branch circuit wiring, raceway, and connection complete. Grounding of complete electrical system per article 250 of NEC and
- specifications. 3) Modifications of existing electrical distribution system equipment as required, and final connections complete.

2. STANDARDS OF MATERIAL AND WORKMANSHIP

Fire Underwriter's Laboratories.

- A. All equipment shall be new and shall conform in all respects to the latest approved standards of the I.E.E.E., ANSI
- B. All work shall be done at such times and in such a manner as will least interfere with
- the maintenance and operation of all related or affected systems. C. All materials and equipment shall bear the label of approval of the National Board of
- D. The electrical contractor shall effectively protect, at his own expense, such of his work, materials or equipment as is liable to injury during the construction period.
- E. All openings into any part of the conduit system as well as associated fixtures, equipment, etc., both before and after being set in place, must be securely covered or otherwise protected to prevent obstruction of the conduit, or injury due to carelessness or maliciously dropped tools or materials, grit, dirt or any foreign matter. The electrical contractor shall be held responsible for all damage done until his work is fully and finally accepted. Conduit ends shall be covered with capped bushings. All electrical equipment shall be grounded.
- F. It is not intended that the drawings or this specification indicate or specify each piece of conduit, fittings, etc., required for the installation. Where items are required for the satisfactory operation of the installation and are not indicated on the drawings, they shall be considered to be both specified and indicated.
- G. General requirements and details of equipment are shown. Dimensions or scales shown are approximate and must be checked at job prior to installation of equipment or any order given for fabrication.
- H. Electrical contractors shall have competent foreman on the premises at all times to superintend and check and lay out all work, give information to general contractor regarding chases and openings, and be responsible for such locations. This contractor shall cooperate with other contractors where chases, openings, pipes, foundations, etc., are in proximity to the work of other trades and arrange the work to fit. This contractor shall study where other trades leave connections and outlets to be connected, so that all work and appliances shall be properly arranged for and connected ready for use.

3. COMPLIANCE WITH CODES AND ORDINANCES

All electrical work shall comply with the 2017 National Electrical Code, 2015 Michigan Building Code, 2017 Michigan electrical code, Michigan construction code Part 8 Electrical Code, all local ordinances and regulations and the Occupational Safety and Health Act

4. PERMITS AND FEES

The electrical contractor shall obtain all permits, pay all fees, and arrange for all inspections for his work. At the completion of electrical work, the electrical contractor shall furnish the owner with all certificates of final inspection and approvals.

5. SITE VISITS BY THE CONTRACTOR

- A. The contractor shall visit the site and verify the conditions under which his work must be conducted before submitting his proposal.
- B. The submitting of a proposal implies that the contractor has visited the site, is conversant with all site conditions, including existing services and equipment, obstructions and all conditions, which will be encountered in the removal and/or relocation of present materials and equipment, installation of new materials and cutting and patching, etc., for a complete electrical installation.

6. CONFLICTS WITH STRUCTURE

Should any structural difficulties prevent setting of cabinets, running conductors, etc., at points shown on plans, the necessary minor deviations therefrom, as determined by architect, may be permitted and must be made without additional cost.

. SUBSTITUTIONS

- A. Any equipment proposed as equal to that specified shall be so proven by the contractor who shall, prior to bidding, submit via us mail or email, the manufacturer's
- 1) The engineer shall review and approve or disapprove, in writing, such proposed substitutions prior to bidding time.

name, model numbers, verification data sheets and applicable working drawings.

- 2) If this procedure is not followed by the contractor prior to bidding, the contractor shall bid equipment of make and model number as specified herein, or on the
- 3) All equipment submittals which have been substituted by the contractor without prior written approval by the engineer will be rejected by the engineer and returned to the contractor who shall then submit equipment as specified.

B. Contractor s agreement to pay for review of substitutions:

- 1) In the event equipment substitutions are proposed to the engineer after the contract has been awarded, the engineer will record all time used by him in
- evaluation of each proposed substitution. 2) Whether or not the engineer approves the proposed substitution, the contractor agrees to promptly upon receipt of the engineer's billing, reimburse the engineer at the rate of two and three quarter times the direct cost to the engineer for all time spent by him in evaluation of the proposed substitution.

8. COOPERATION WITH OTHER CONTRACTORS

- A. Electrical contractor shall arrange all parts of his work in proper relation to the work of others and to the architectural finish. Where interferences occur, the electrical contractor shall, before installing the work involved, consult with the architect as to the exact location and level of his work. The architect's decision shall be final.
- B. The electrical contractor shall be responsible for the arrangement of his work, and equipment and maintenance of proper headroom under this work. Should work installed by him require modification to avoid interference with other work, as determined by the architect, such changes shall be made without additional cost.

10. OWNER TESTS AND INSPECTIONS

- A. The Owner reserves the right to inspect and test any portion of the equipment during the progress of its erection. The contractor shall afford the Owner's representative every facility for evaluating the skill and competence of the mechanics and to examine the materials and installation. Concealed work shall be reopened when so directed during his periodic visits.
- B. The contractor shall notify the Owner's representative or engineer before any electrical work is concealed by a concrete pour, covering of a trench, a wall or installation of a ceiling. This notification shall be received from the contractor at least 72 hours prior to concealment.
- C. The electrical contractor shall test the entire system in the presence of the Owner's representative when the work is finally completed to insure that all portions are free from short circuits and grounds, are in good and intended working condition. Power for final tests after all erections are completed will be furnished by the owner. All equipment necessary to conduct the above tests shall be furnished at the expense of the electrical contractor.

11. CUTTING AND PATCHING

Cutting and patching of walls, floors, ceilings, roofs, etc., shall be done at the expense of the contractor installing equipment and appurtenances, subject to the approval of the Owner/ architect. Structural members shall not be cut without obtaining written permission

12. FLASHING

Conduits passing through roofs or outside walls exposed to weather shall be carefully flashed. Fire proofing of holes shall be provided and shall be of a UL listed material, and approved by authority having jurisdiction (AHJ).

13. FIRE AND SMOKE BARRIERS

- A. All conduit penetrations in fire_rated walls and floors and designated smoke barriers shall be sealed with an approved fire barrier material.
- B. System shall pass fire test exposure per ASTM E_814 (U. L. 1479) and will provide a 3_hour fire rating.
- C. Barrier material shall be equal to 3M fire barrier composite sheet CS 195. All seams and edges shall be sealed with 3M CP_25 fire barrier caulk or 303 putty, or equal.

14. CLEAN UP

The electrical contractor and his sub_contractors shall keep the premises free of debris and unusable materials resulting from their work and immediately upon completion of this work, he shall remove such debris and materials from the Hospital property and he shall leave all floors broom clean in areas affected by their work.

15. MANUFACTURER'S DRAWING

- A. The electrical contractor shall submit to the engineer manufacturer's drawings of receptacles, switches and misc. electrical devices equipment to be installed on this job, for the approval before ordering same for installation.
- B. Failure of the electrical contractor to submit shop drawings in ample time for checking shall not entitle him to an extension of contract time, and no claim for extension by reason of such default will be allowed.

16. AS_BUILT DRAWINGS

- A. A set of the construction drawings shall be marked up with red pen during construction to indicate the true and accurate "as built" condition. At the completion of the project, they shall serve as final "as_built" drawings. Submit to the Owner and architect the original revised "as built" drawings and one set of color copies.
- B. Final payment will not be made to the electrical contractor until the completed as_built drawings have been submitted.

18. SPECIFICATIONS AND DRAWINGS

Any item appearing on the drawings and not in the specification or vice versa, and any items appearing in neither but necessary to accomplish the intent of these specifications, shall be furnished by the electrical contractor.

19. **GROUNDING**

- A. Furnish and install a complete grounding system in accordance with the National Electrical Code and Michigan Building Code.
- B. The grounding electrode system shall be in compliance with 2017 NEC, Articles 250.66 and 250.122.
- C. Grounding path from circuits, equipment, and conductor enclosures shall be permanent and continuous; and shall have a resistance to ground of less than 5
- D. All cabinets, motor frames, motor starters, transfer switches, conduit systems, panelboards, transformers, etc., shall be thoroughly grounded in accordance with the NEC Sections 250.24; 250.50; 250.52; and tables 250.66 and 250.122.

20. CONDUCTORS

All conductors shall be installed in approved raceway. All branch circuit conductors shall be copper, with type XHHW, THHN or THW, 75 deg.C., 600 volt insulation, All feeders shall be copper, with type XHHW or RHW, 75 deg C. 600 volt insulation.

21. RACEWAYS

- A. Raceway installed below ground and exterior to the building may be schedule 40 heavy wall PVC plastic type.
- B. All conduit installed exposed at exterior of building shall be galvanized rigid steel.
- C. Raceway installed indoor may be galvanized rigid steel or thin_wall type electrical metallic tubing ("EMT").

Fuses 0 to 600 ampere shall be current limiting dual_element type, with separate elements for overloads and short circuits, 200,000 A.I.C. R.M.S. symmetrical. UL Class RK1. Bussmann or approved equal.

23. GUARANTEE

A. Electrical contractor shall guarantee all work installed by his workmen under this contract to be free from all defective workmanship and materials for a period of one year after the acceptance of the generator installation by the Owner/Architect. Should defects occur within this period, the electrical contractor shall repair and/or replace defective items, at no expense to the Owner.

24. NAMEPLATES


Control panels, disconnect switches, panelboards, etc., shall be identified with manufacturer's nameplates, shop orders, where applicable on composite assemblies, and designations used on the drawings. Nameplates for this purpose shall be laminated phenolic plastic, beveled edge, black with engraved white letters. Except where impractical, letters and numerals shall be a minimum of 1/4" high. Nameplates shall be mechanically secured. Dymo labels shall not be used for this purpose. Panel directories shall be neatly typed showing equipment served and location for each breaker or switch.

25. **TESTING**

A All circuits and equipment shall be tested upon completion of work and final tests, when requested, shall be done in the presence of the Owner/Architect. Any circuits or equipment found to be defective shall be replaced or repaired, as necessary, and then retested without additional expense to the Owner.

26. CLEANING

Upon completion of the project, all enclosures shall be left free of refuse and the exterior free of dirt and paint splatters.

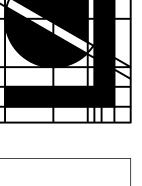



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IMMEDIATELY OF ANY DISCREPANCIES IN THE DOCUMENTS

BEFORE PROCEEDING. FAILURE TO DO SO WILL RESULT IN THE

CONTRACTOR TAKING FULL RESPONSIBILITY AND LIABILITY FOR

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KOENIG

No.

6201059789

ENGINEER