
TOWN OF PUTNAM, CONNECTICUT **ROUTE 44 SIDEWALK RECONSTRUCTION PROJECT NO. L115-0003** OCTOBER 25, 2022, REVISED THROUGH APRIL 3, 2024

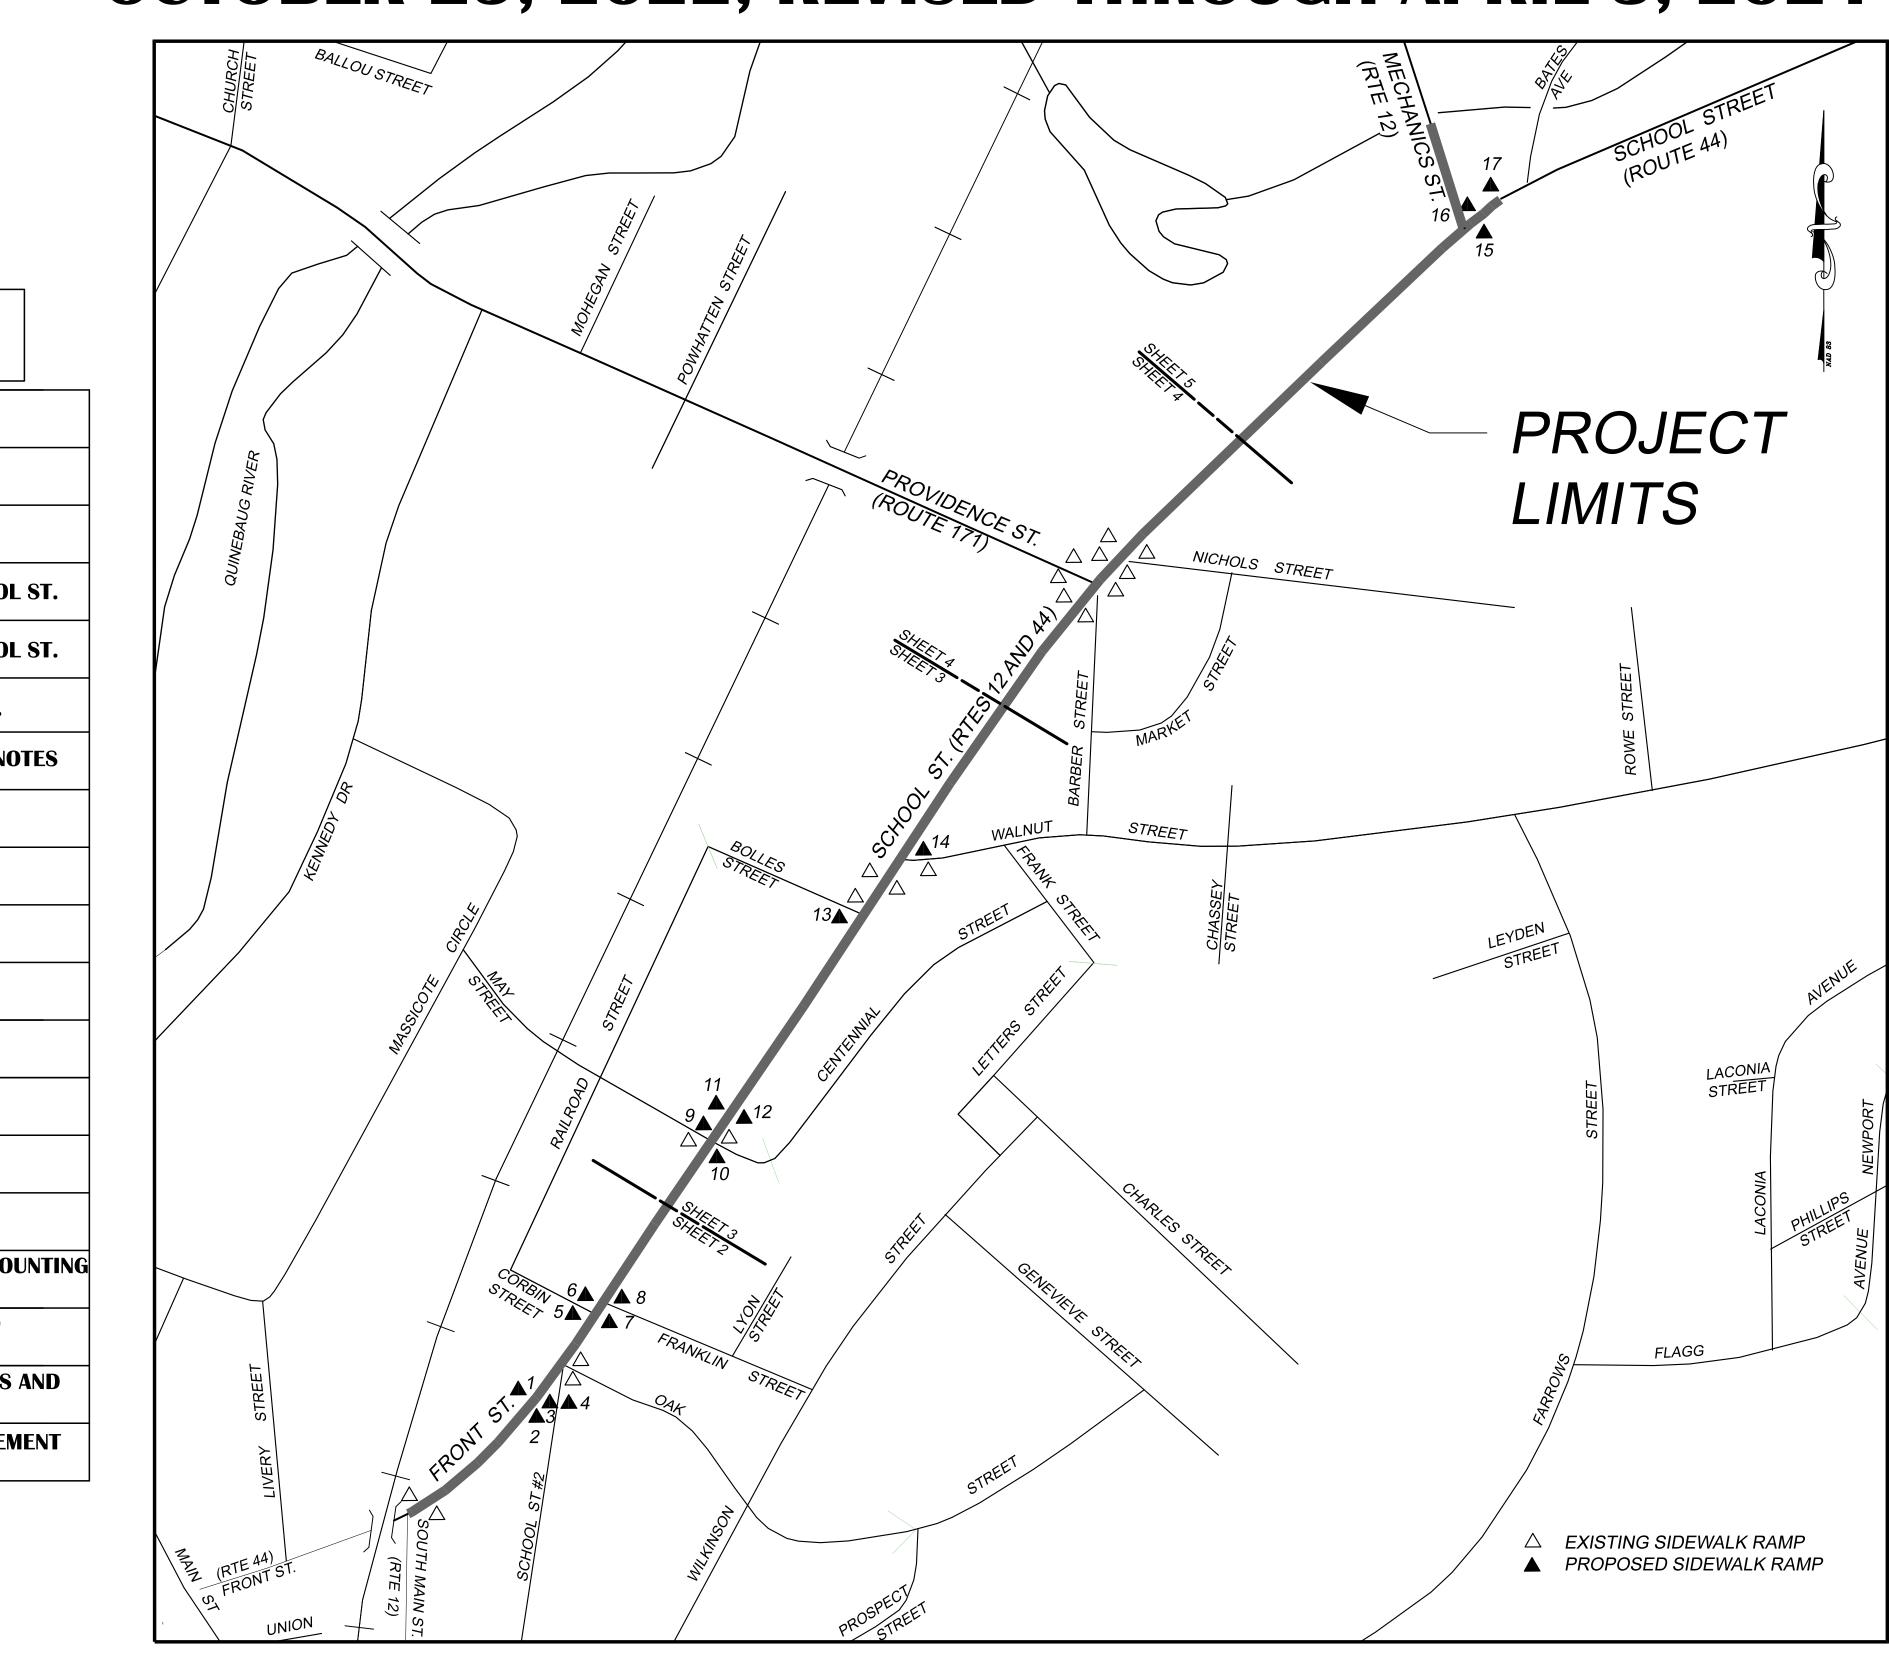

INDEX OF DRAWINGS

NO.	DESCRIPTION
1	LOCATION MAP, INDEX, LEGEND
2	PLAN VIEW FRONT ST 142 SCHOOL ST.
3	PLAN VIEW 142 SCHOOL ST 231 SCHOOL ST.
4	PLAN VIEW 231 SCHOOL ST 296 SCHOOL ST.
5	PLAN VIEW 296 SCHOOL ST BATES AVE.
6	SIDEWALK DETAILS AND CONSTRUCTION NOTES
UNNUMBERED	CONNDOT, SIDEWALK RAMPS, SHEET 1
UNNUMBERED	CONNDOT, SIDEWALK RAMPS, SHEET 2
UNNUMBERED	CONNDOT, SIDEWALK RAMPS, SHEET 3
UNNUMBERED	CONNDOT, SIDEWALK RAMPS, SHEET 4
UNNUMBERED	CONNDOT, SIDEWALK RAMPS, SHEET 6
HW-921_01	CONNDOT, CONCRETE SIDEWALKS
HW-924_01	CONNDOT, CONCRETE DRIVEWAY RAMPS
TR-1208_01	CONNDOT, SIGN PLACEMENT AND RETROFELFECTIVE STRIP DETAILS
TR-1208_02	CONNDOT, METAL SIGNPOSTS AND SIGN MOUNTING DETAILS
TR-1220_01	CONNDOT, SIGNS FOR CONSTRUCTION AND PERMIT OPERATIONS
TR-1220_02	CONNDOT, CONSTRUCTION SIGN SUPPORTS AND CHANNELIZING DEVICES
UNNUMBERED	CONNDOT, ENCROACHMENT PERMIT - PAVEMENT REPAIR

TOWN ADMINISTRATOR: ELAINE SISTARE MAYOR: BARNEY SENEY

LOCATION MAP WITH SIDEWALK RAMP LOCATIONS

J & D CIVIL ENGINEERS, LLC

401 RAVENELLE ROAD THOMPSON, CT 06255

PHONE: 860-923-2920 JDCIVILENGINEERS.COM


LEGEND


	EXISTING CONTOUR
•	STONE WALL
СВ	CATCHBASIN
🔿 ДМН	DRAINAGE MANHOLE
_o GG	GAS GATE
ж	HYDRANT
° WG	WATER GATE
🔾 ЅМН	SANITARY MANHOLE
¢ LP	LIGHT POLE
<0>SNET 1470	UTILITY POLE
O TEL MH	TELEPHONE MANHOLE
<u> </u>	BRASS PIN
	MONUMENT
── STOP	SIGN
DWS	DETECTABLE WARNING STRI
\bigtriangleup	EXISTING SIDEWALK RAMP
14	PROPOSED SIDEWALK RAMP


CONNDOT STANDARD SPECS FOR ROADS, BRIDGES, FACILITIES & INCIDENTAL CONSTRUCTION, FORM 818, DATED 2020 WITH SUPPLEMENTS THROUGH JULY 2022 SHALL GOVERN

BEGINNING AT SOUTH MAIN STREET, ENDING AT BATES AVENUE PROJECT LENGTH = 3700' ±

22235

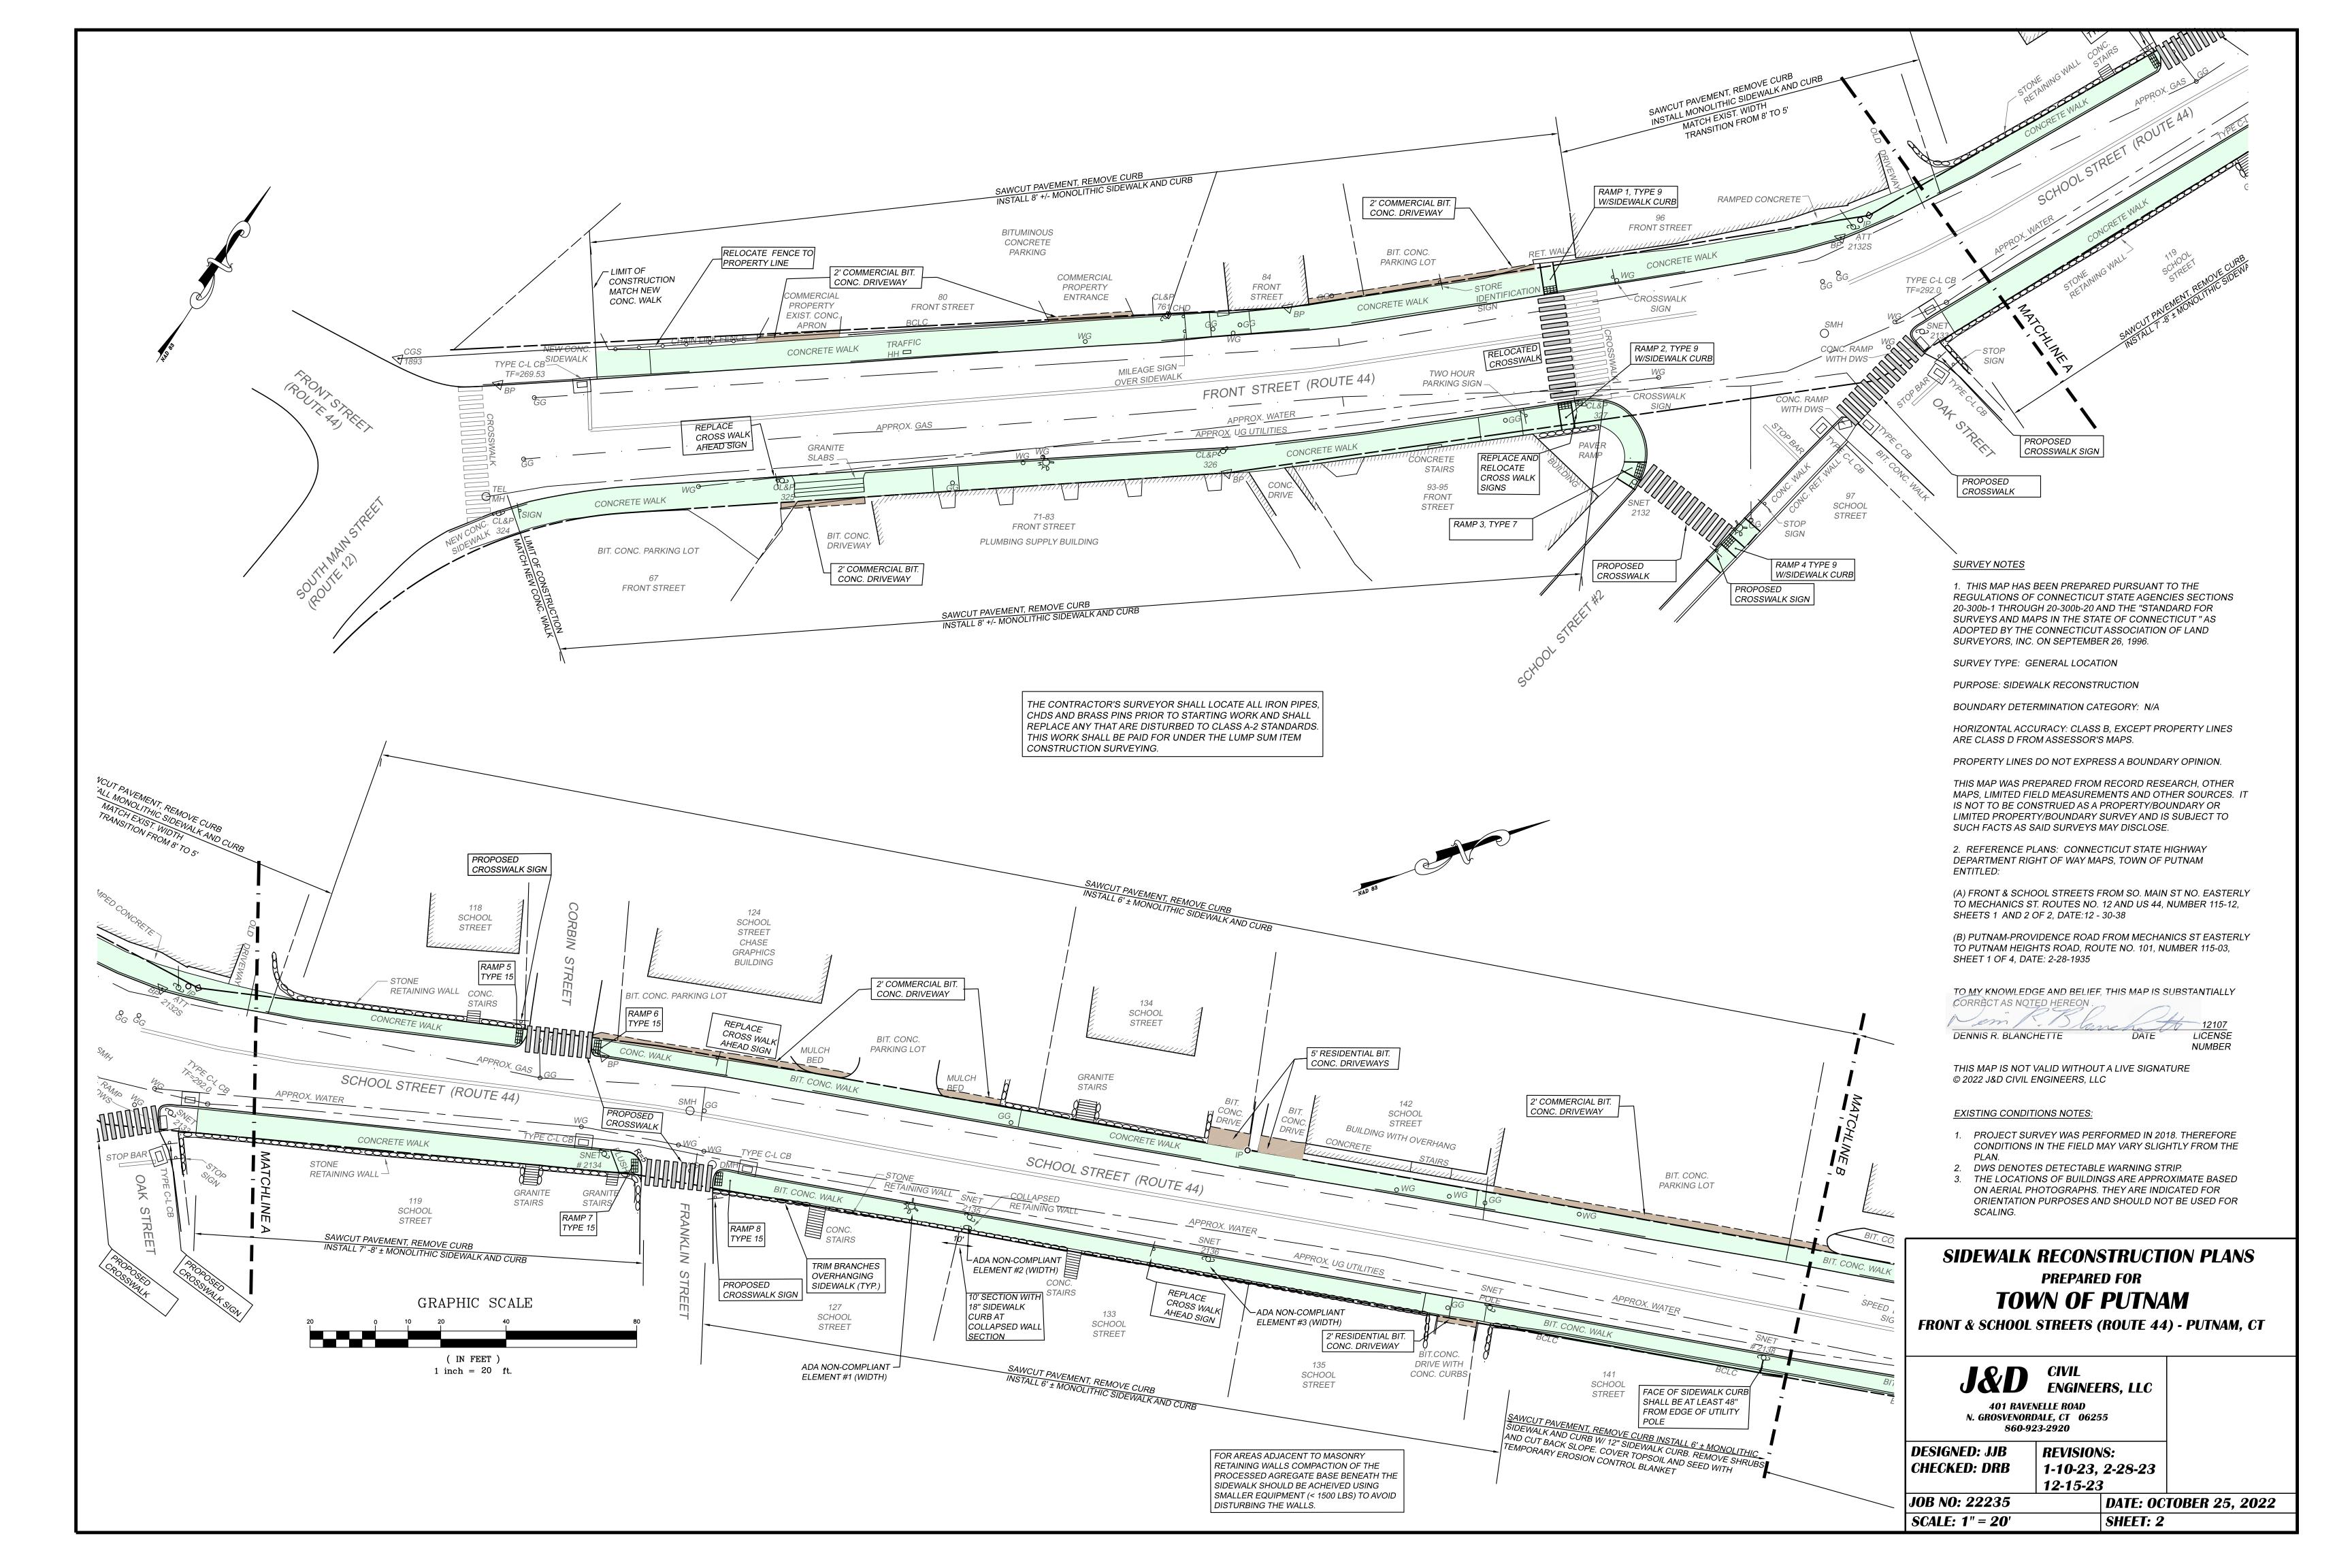

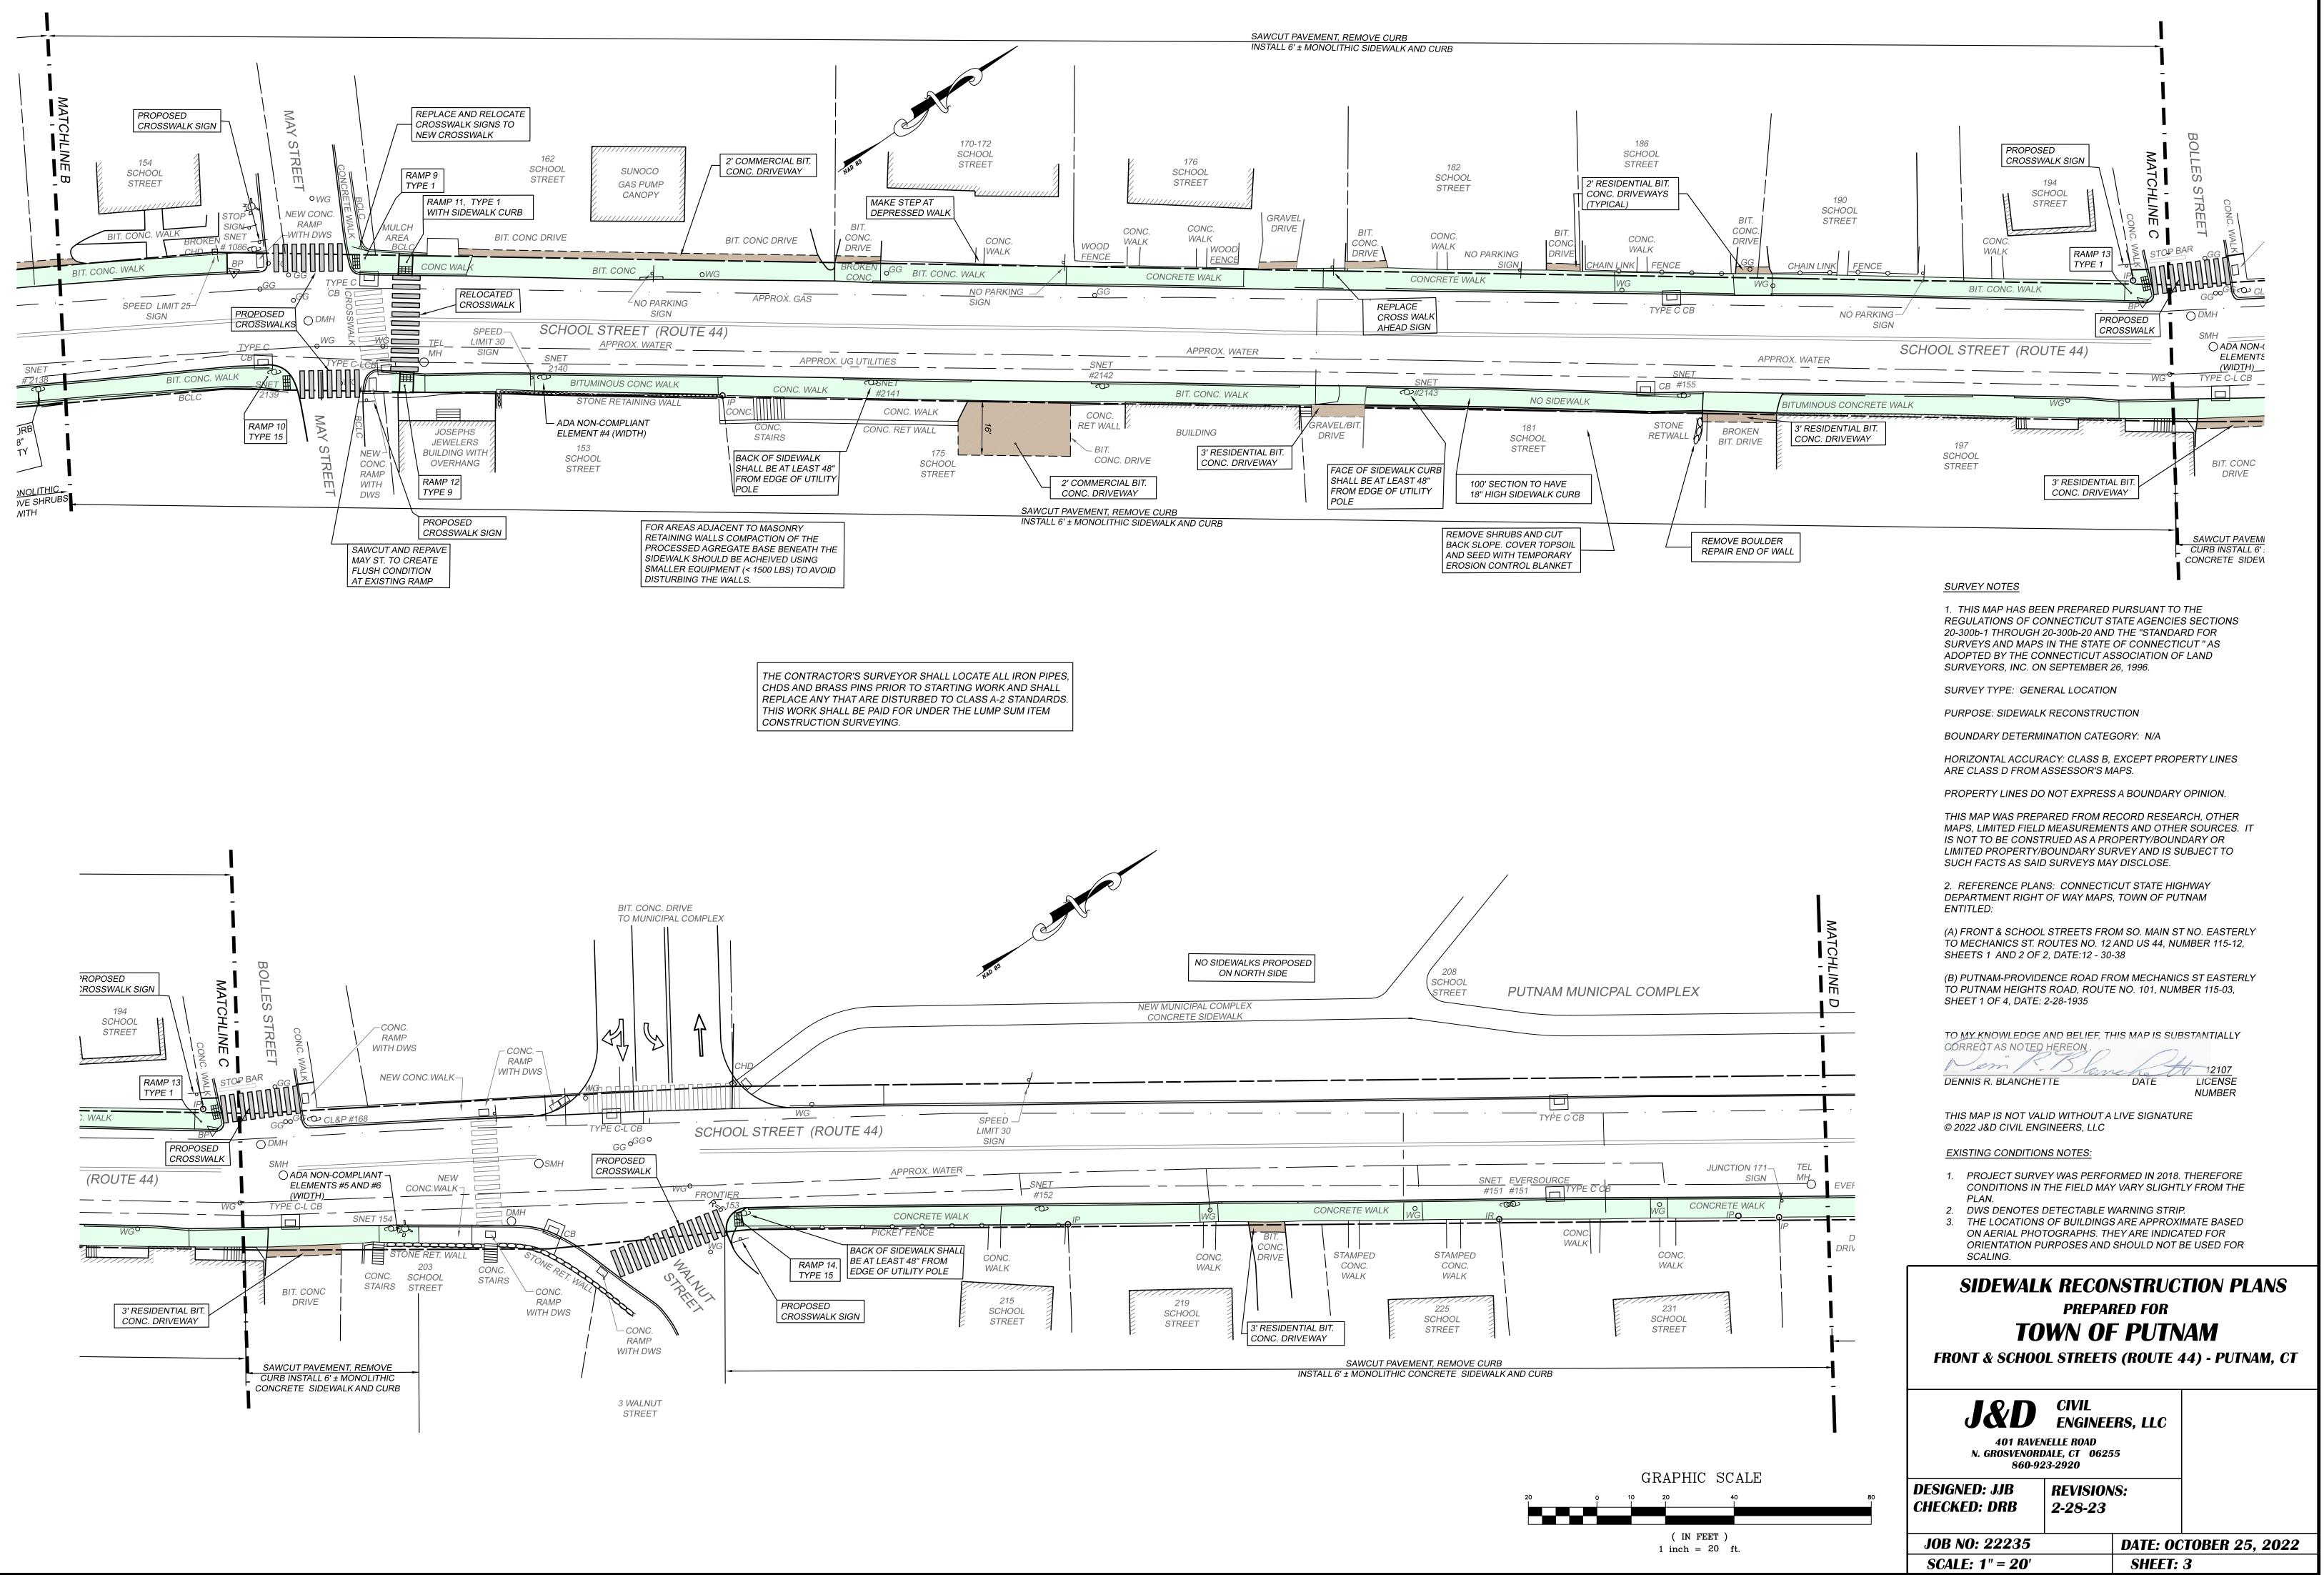

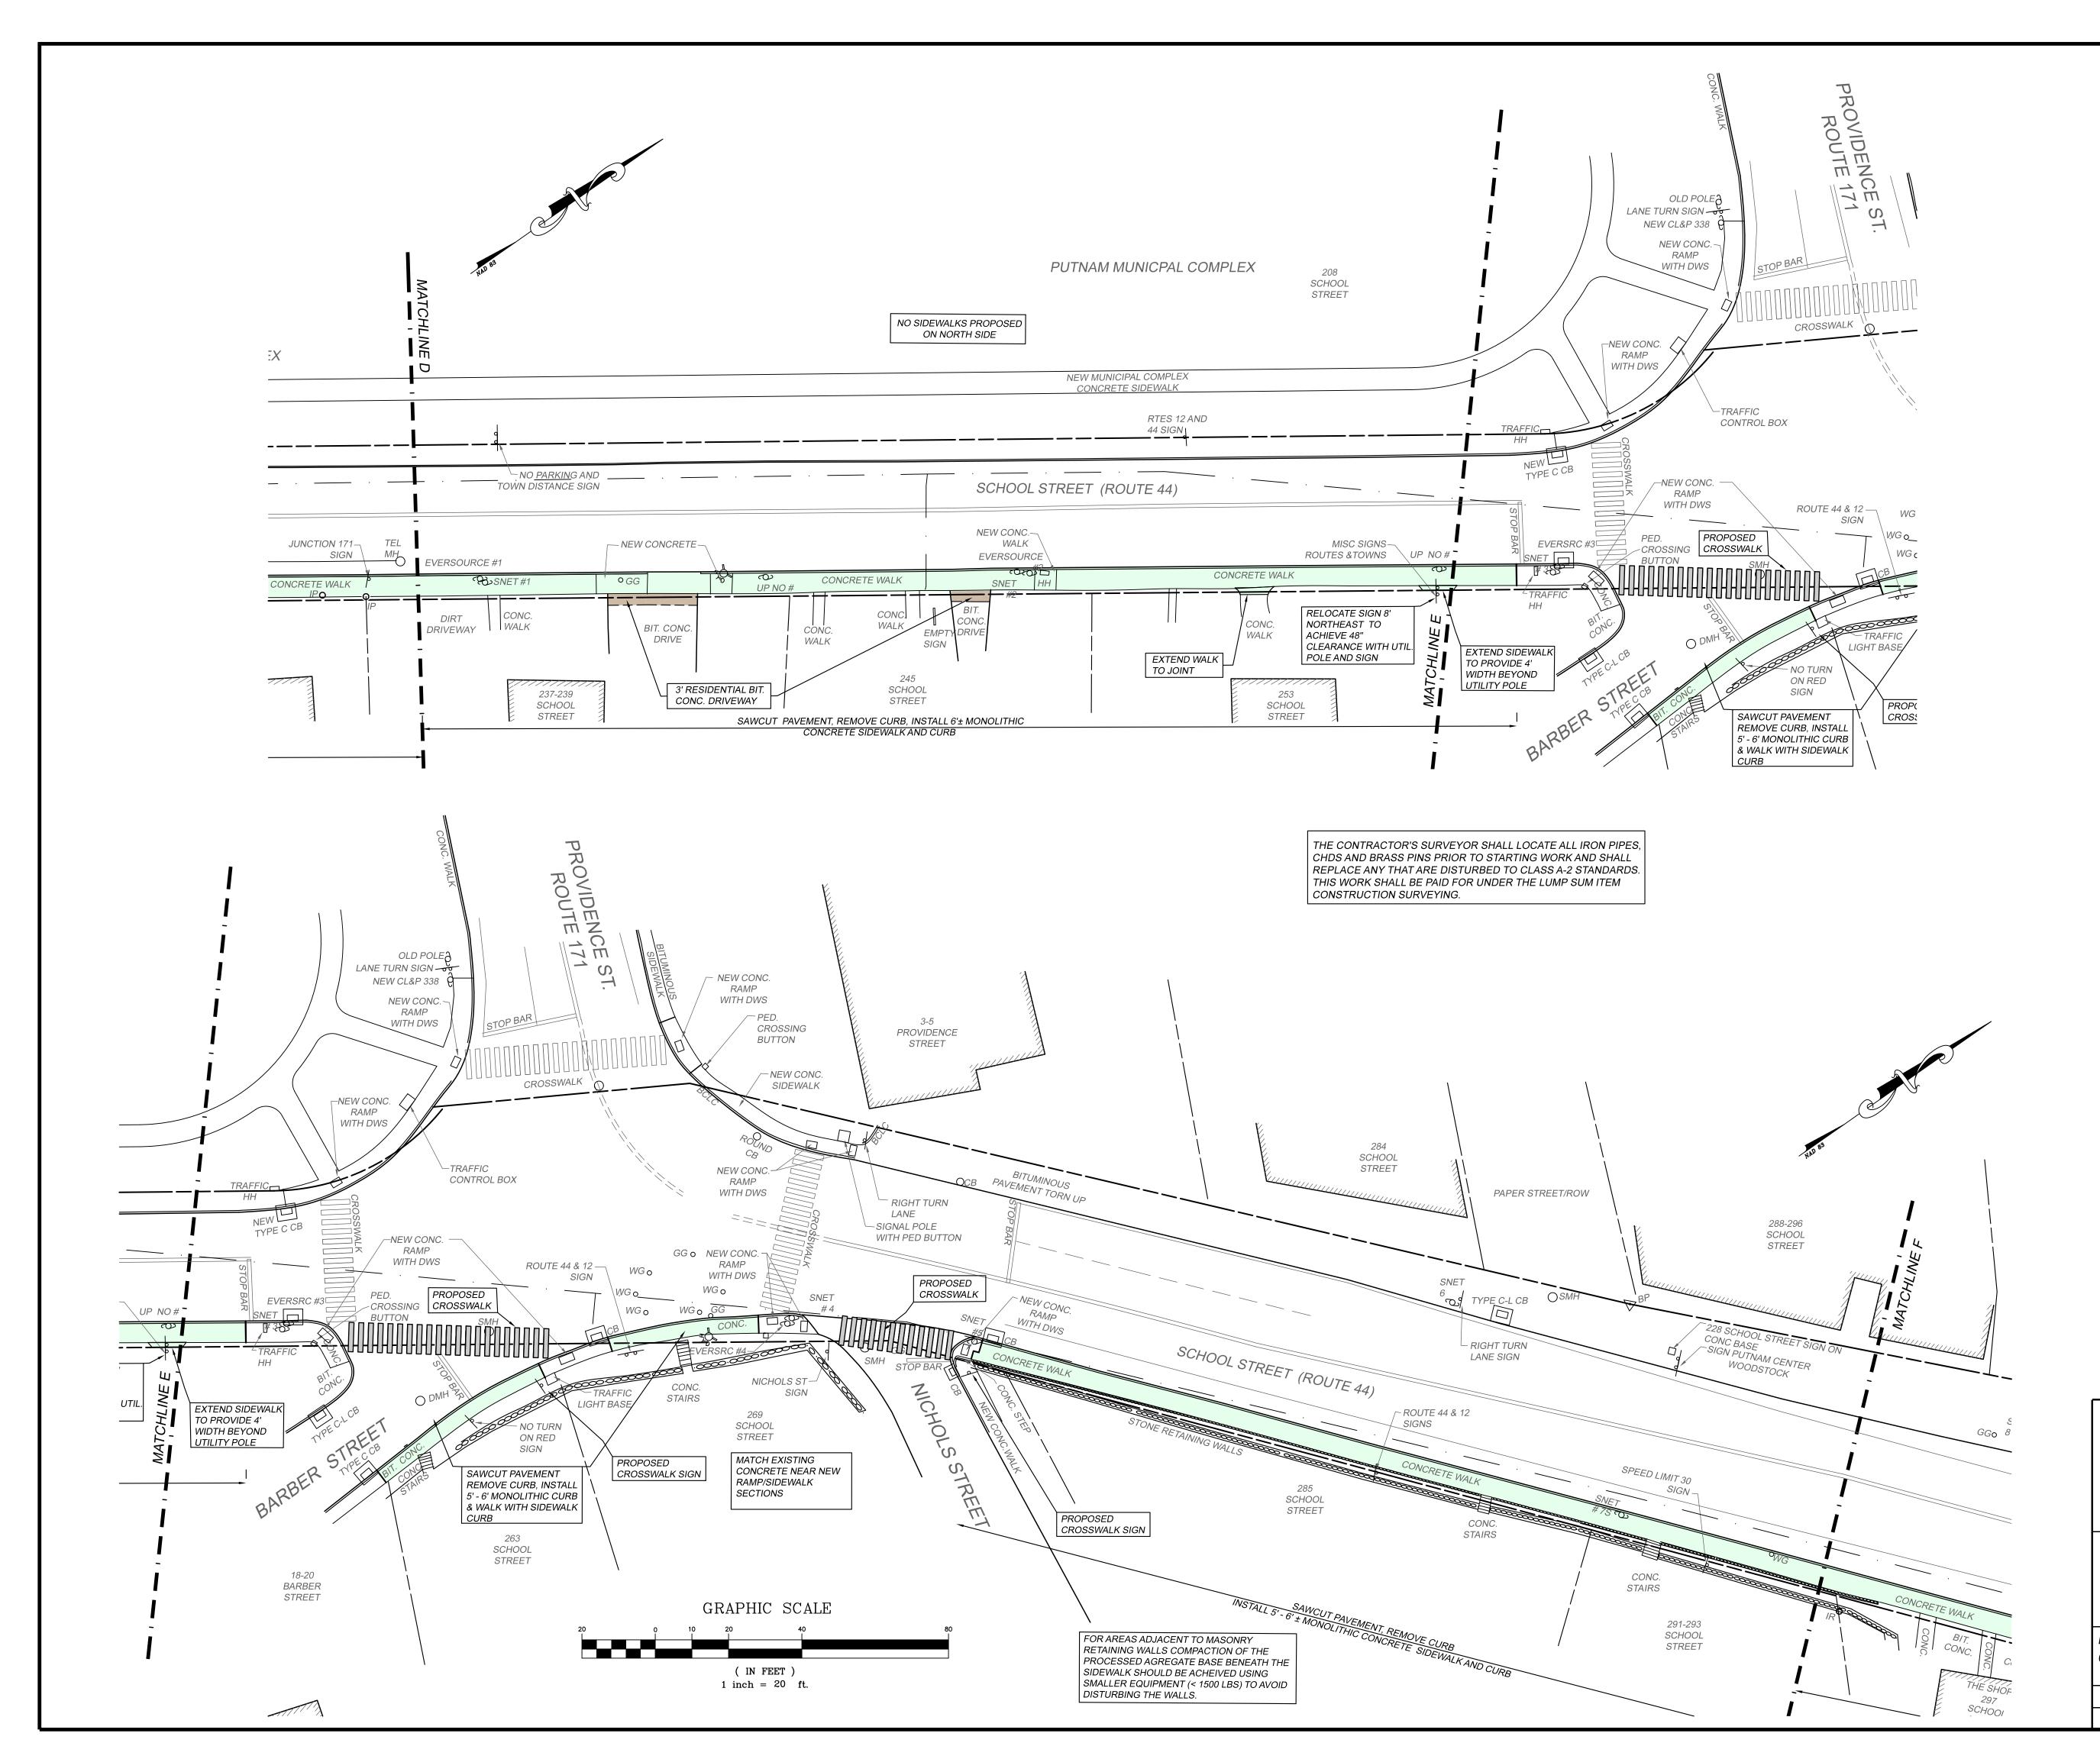

SURVEY NOTES

1. THIS MAP HAS BEEN PREPARED PURSUANT TO THE REGULATIONS OF CONNECTICUT STATE AGENCIES SECTIONS 20-300b-1 THROUGH 20-300b-20 AND THE "STANDARD FOR SURVEYS AND MAPS IN THE STATE OF CONNECTICUT "AS ADOPTED BY THE CONNECTICUT ASSOCIATION OF LAND SURVEYORS, INC. ON SEPTEMBER 26, 1996.

SURVEY TYPE: GENERAL LOCATION

PURPOSE: SIDEWALK RECONSTRUCTION

BOUNDARY DETERMINATION CATEGORY: N/A

HORIZONTAL ACCURACY: CLASS B, EXCEPT PROPERTY LINES ARE CLASS D FROM ASSESSOR'S MAPS.

PROPERTY LINES DO NOT EXPRESS A BOUNDARY OPINION.

THIS MAP WAS PREPARED FROM RECORD RESEARCH, OTHER MAPS, LIMITED FIELD MEASUREMENTS AND OTHER SOURCES. IT IS NOT TO BE CONSTRUED AS A PROPERTY/BOUNDARY OR LIMITED PROPERTY/BOUNDARY SURVEY AND IS SUBJECT TO SUCH FACTS AS SAID SURVEYS MAY DISCLOSE.

2. REFERENCE PLANS: CONNECTICUT STATE HIGHWAY DEPARTMENT RIGHT OF WAY MAPS, TOWN OF PUTNAM ENTITLED:

(A) FRONT & SCHOOL STREETS FROM SO. MAIN ST NO. EASTERLY TO MECHANICS ST. ROUTES NO. 12 AND US 44, NUMBER 115-12, SHEETS 1 AND 2 OF 2, DATE:12 - 30-38

(B) PUTNAM-PROVIDENCE ROAD FROM MECHANICS ST EASTERLY TO PUTNAM HEIGHTS ROAD, ROUTE NO. 101, NUMBER 115-03, SHEET 1 OF 4, DATE: 2-28-1935


TO MY KNOWLEDGE AND BELIEF, THIS MAP IS SUBSTANTIALLY CORRECT AS NOTED HEREON.

DENNIS R. BLANCHETTE DATE LICENSE NUMBER

THIS MAP IS NOT VALID WITHOUT A LIVE SIGNATURE © 2022 J&D CIVIL ENGINEERS, LLC

EXISTING CONDITIONS NOTES:


- 1. PROJECT SURVEY WAS PERFORMED IN 2018. THEREFORE CONDITIONS IN THE FIELD MAY VARY SLIGHTLY FROM THE PLAN.
- DWS DENOTES DETECTABLE WARNING STRIP.
 THE LOCATIONS OF BUILDINGS ARE APPROXIMATE BASED ON AERIAL PHOTOGRAPHS. THEY ARE INDICATED FOR ORIENTATION PURPOSES AND SHOULD NOT BE USED FOR SCALING.

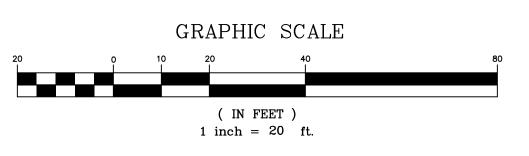


SIDEWALK RECONSTRUCTION PLANS PREPARED FOR TOWN OF PUTNAM FRONT & SCHOOL STREETS (ROUTE 44) - PUTNAM, CT J&D CIVIL ENGINEERS, LLC 401 RAVENELLE ROAD N. GROSVENORDALE, CT 06255 860-923-2920 DESIGNED: JJB REVISIONS:


SCALE: 1" = 20'

DATE: OCTOBER 25, 2022 SHEET: 4

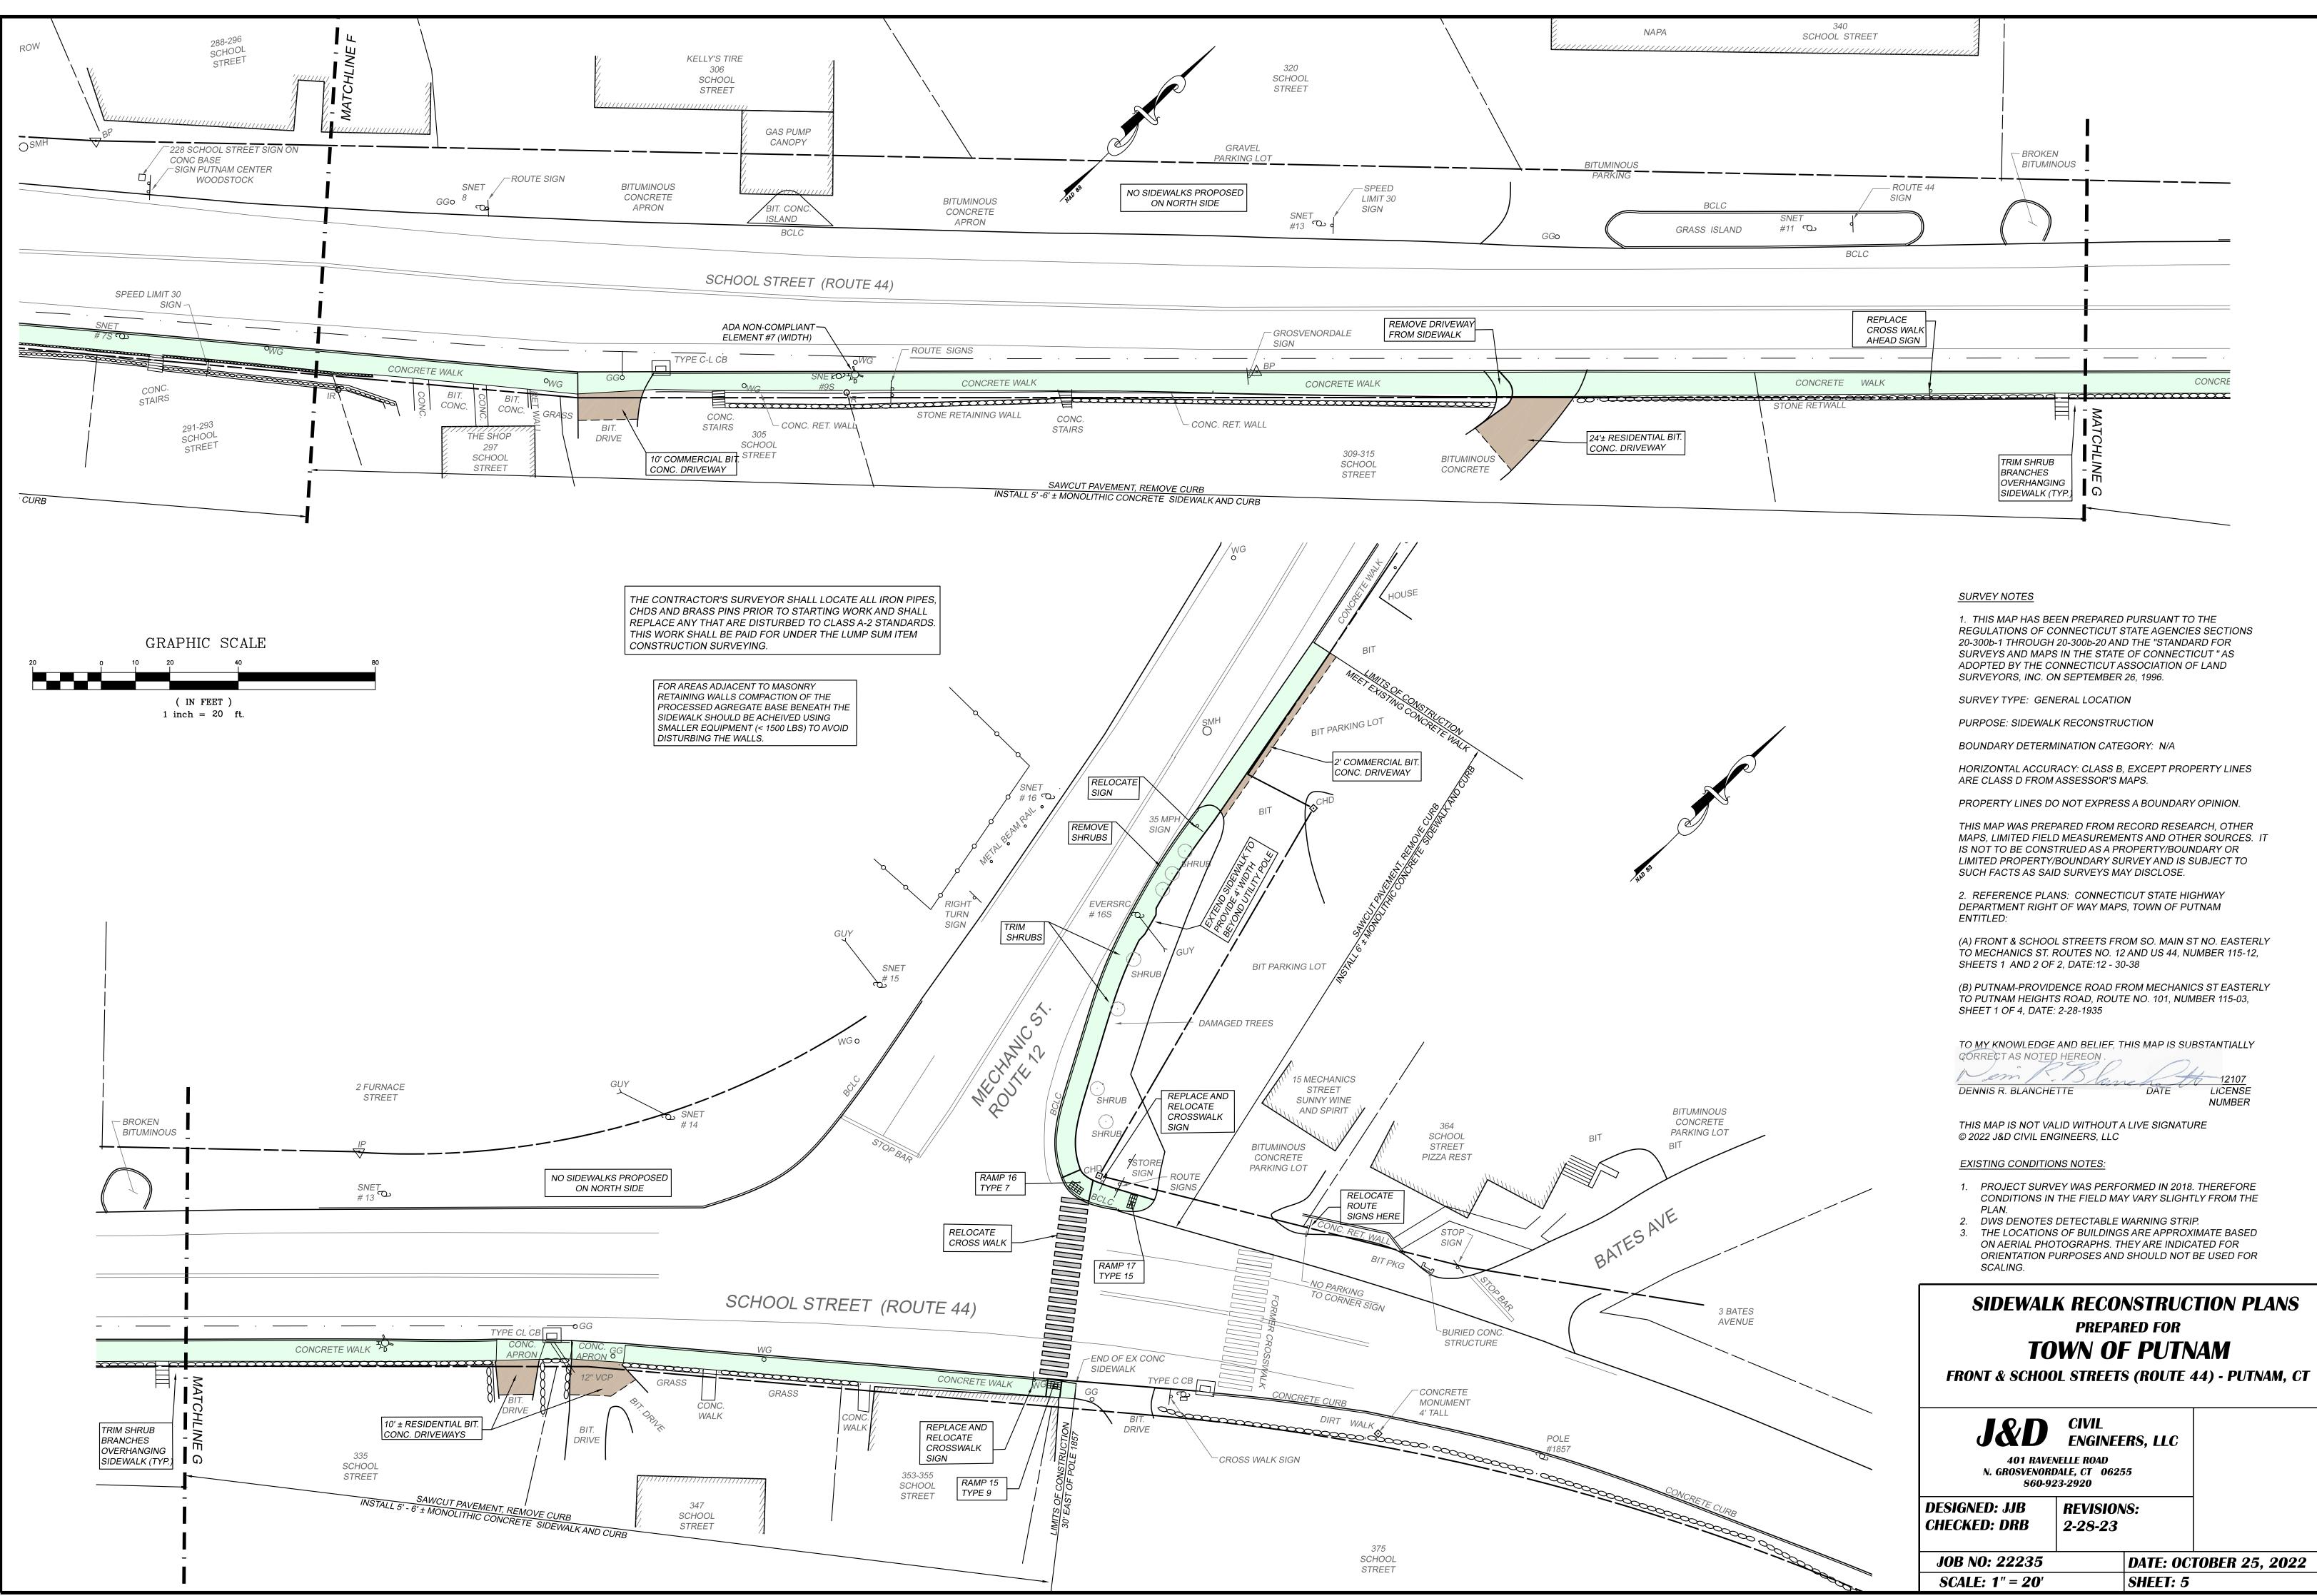


J&D	CIVIL ENGINEERS, LLC	
N. GROSVENOI	ENELLE ROAD RDALE, CT 06255 923-2920	
ESIGNED: JJB IECKED: DRB	REVISIONS: 2-28-23	

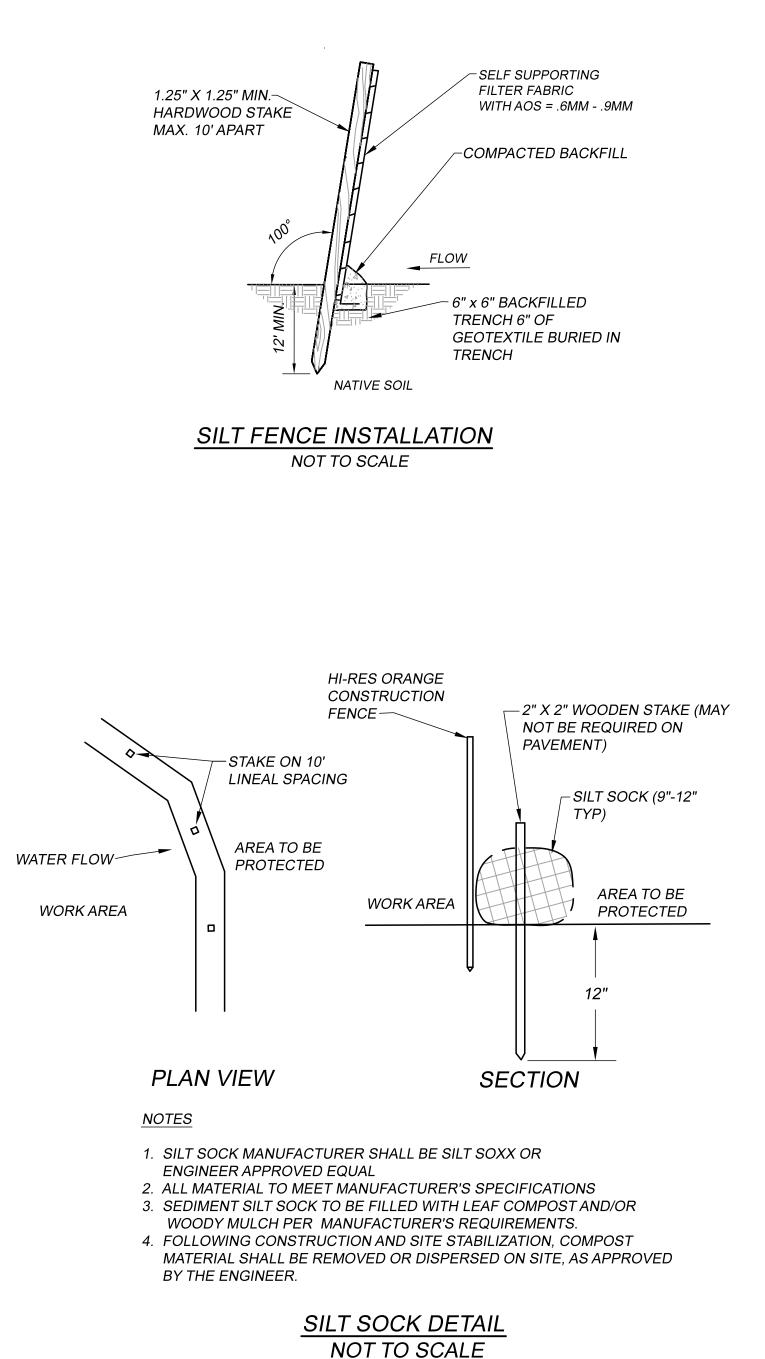


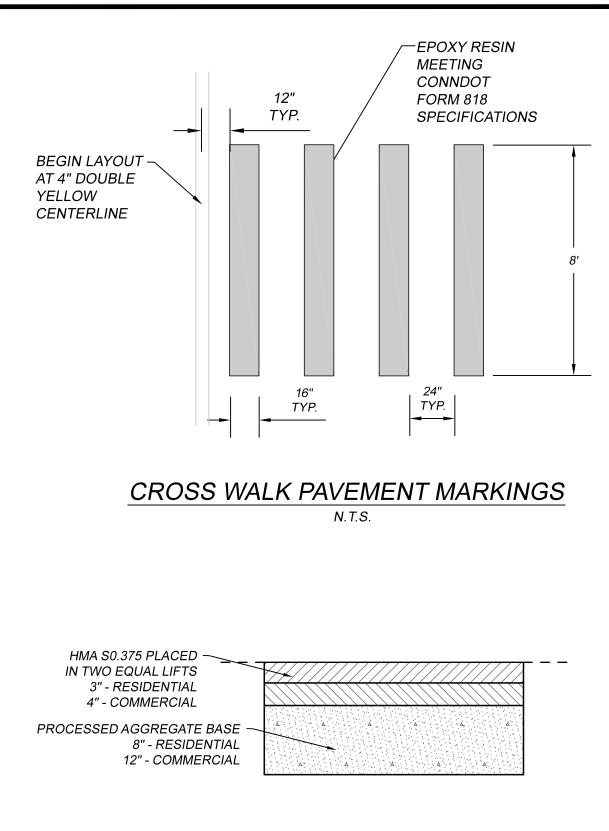



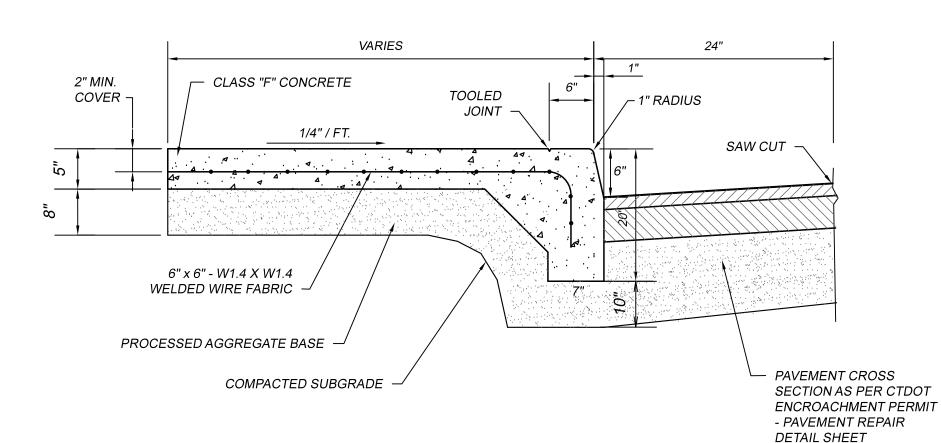

CROSS SECTION

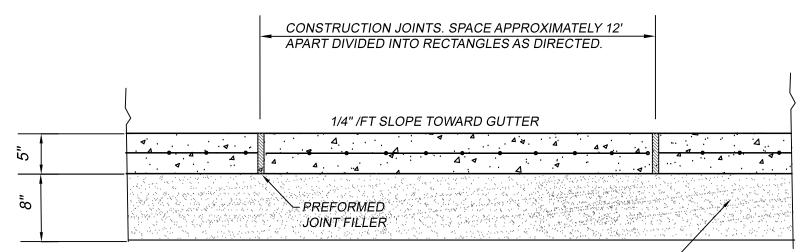

PROCESSED AGGREGATE BASE

LONGITUDINAL SECTION

TOWN OF PUTNAM STANDARD MONOLITHIC CONCRETE SIDEWALK AND CURB SECTION NOT TO SCALE

CONSTRUCTION NOTES:

- 1. EXISTING SIDEWALKS AND CURB TO BE REMOVED AND DISPOSED OF IN A APPROPRIATE MANNER. NEW MONOLITHIC SIDEWALKS AND CURBING ARE TO BE CONSTRUCTED PER THE DETAIL ON THIS SHEET.
- 2. ALL DISTURBED AREAS NOT SCHEDULED FOR PAVEMENT OR CONCRETE WALKS SHALL BE PERMANENTLY ESTABLISHED AS TURF, UNLESS OTHERWISE NOTED ON THE PLANS.
- 3. THE LOCATIONS OF EXISTING UTILITIES ARE SHOWN FOR INFORMATIONAL PURPOSES ONLY. IT IS THE RESPONSIBILITY OF THE CONTRACTOR TO VERIFY THE LOCATION AND ELEVATION OF ALL UTILITIES AND CONTACT "CALL BEFORE YOU DIG" AT (860) 922-4455 AND OBTAIN ALL APPLICABLE PERMITS, PRIOR TO ANY EXCAVATION.
- 4. THE CONTRACTOR IS RESPONSIBLE FOR ADJUSTING TO GRADE ALL GATE BOXES, CURB STEP BOXES. MANHOLE FRAME AND CATCH BASIN FRAMES THAT ARE DIRECTLY AFFECTED BY CONSTRUCTION.
- 5. THE CONTRACTOR SHALL NOTIFY UTILITY COMPANIES AT LEAST 24-HOURS PRIOR TO COMMENCEMENT OF CONSTRUCTION. CONTACT INFORMATION IS AS FOLLOWS: WATER CAR

WAILN	GAG
PUTNAM WATER POLLUTION CONTROL AUTHORITY 200 SCHOOL STREET PUTNAM, CT 06260 (860) 963 - 6800 X252	EVERSOURCE ENERGY 1 COMMERCE AVE DANIELSON, CT 06239 (888) 544 - 4826
ELECTRIC	TELEPHONE
EVERSOURCE ENERGY (888) 544 - 4826	FRONTIER COMMUNICATIONS 134 CLUB ROAD NO. WINDHAM , CT 06256 (860) 450 -2793

- 6. THE CONTRACTOR SHALL VERIFY AND FIELD FIT THE ELEVATIONS OF ALL CURBS, SIDEWALKS AND STORM DRAINAGE STRUCTURES.
- 7. THE CONTRACTOR SHALL BE RESPONSIBLE FOR DISPOSING OF ALL CURBING, INCLUDING GRANITE, THAT IS REMOVED.

EROSION & SEDIMENTATION NOTES AND SEQUENCE OF OPERATIONS


- 1. THE PROPOSED ACTIVITY CONSISTS OF THE REPLACEMENT/ADDITION OF CONCRETE MONOLITHIC SIDEWALK WITH CURB.
- 2. PRIOR TO ANY CONSTRUCTION, EXCAVATION OR FILLING, ALL IMPROVEMENTS SHALL BE ACCURATELY STAKED IN THE FIELD BY A LAND SURVEYOR WHO IS REGISTERED IN THE STATE OF CONNECTICUT.
- 3. ALL TREES AND BRUSH WITHIN THE AREAS OF DISTURBANCE SHALL BE REMOVED. STUMPS SHALL BE EXCAVATED FROM THE DISTURBED AREAS AND, ALONG WITH BRUSH, LIMBS AND SAPLINGS, SHALL BE REMOVED FROM THE SITE AND DISPOSED OF IN A MANNER CONSISTENT WITH ALL APPLICABLE LAWS.
- 4. FINAL GRADES SHALL BE ACHIEVED AS QUICKLY AS POSSIBLE AND, IMMEDIATELY THEREAFTER, SIDESLOPES SHALL BE STABILIZED WITH 4" OF TOPSOIL. THE AREA SHALL BE SEEDED AND PROTECTED WITH STRAW MULCH IN ACCORDANCE WITH THE SPECIFICATIONS CONTAINED HEREIN.
- 5. ALL EROSION AND SEDIMENTATION CONTROL MEASURES SHALL BE CONSTRUCTED IN ACCORDANCE WITH STANDARDS AND SPECIFICATIONS OF THE "2002 CONNECTICUT EROSION & SEDIMENTATION GUIDELINES", CT DEP BULLETIN NO.34.
- 6. ANY EROSION CONTROL DEVICES DAMAGED AS A RESULT OF A STORM EVENT OR CONSTRUCTION ACTIVITIES SHALL BE IMMEDIATELY REPAIRED.
- 7. THE TOWN OF PUTNAM SHALL BE NOTIFIED PRIOR TO COMMENCEMENT OF CONSTRUCTION AND AT KEY POINTS DURING CONSTRUCTION SO THAT INSPECTIONS OF EROSION AND SEDIMENTATION CONTROL MEASURES CAN BE SCHEDULED.
- 8. THE RESPONSIBILITY FOR IMPLEMENTATION OF THE PLAN SHALL REST WITH THE CONTRACTOR AWARDED THE PROJECT.
- 9. THE SEED MIXTURE TO BE USED ON THIS PROJECT IS THE FOLLOWING:


SEED	LB/1,000 S
KENTUCKY BLUEGRASS	.45
CREEPING RED FESCURE (PENNLAWN, WINTERGREEN	.45
PERENNIAL RYEGRASS (NORLEAS, MANHATTEN)	.10
Т	OTAL = 1.00




TRAFFIC SIGN NOTES:

- 1. ALL CROSSWALK AND CROSSWALK AHEAD SIGNS SHALL BE NEW. EXISTING SIGNS SHAL BE REPLACED EXCEPT FOR THE NEW SIGNS ASSOCIATED WITH THE NEW CROSSWALK AT THE ENTRANCE TO THE MUNICIPAL COMPLEX AT 200 SCHOOL STREET.
- 2. ALL NEW CROSSWALK AND CROSSWALK AHEAD SIGNS SHALL HAVE FLUORESCENT YELLOW GREEN RETROREFLECTIVE STRIPS ON THE POSTS.
- 3. CROSS WALK SIGNS PEDESTRIAN SYMBOL SHALL BE CT DOT CATALOG SIGN NUMBER 41-4829.
- 4. DIAGONAL ARROWS BELOW PEDESTRIAN SYMBOLS SHALL BE CT DOT CATALOG SIGN NUMBER 41-2617 OR 41-2619.
- 5. AHEAD PLAQUE FOR CROSSWALK AHEAD SIGNS SHALL BE CT DOT CATALOG SIGN NUMBER 41-6126.

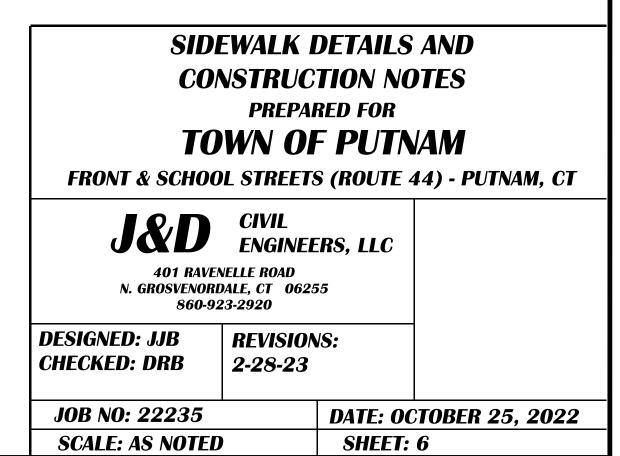


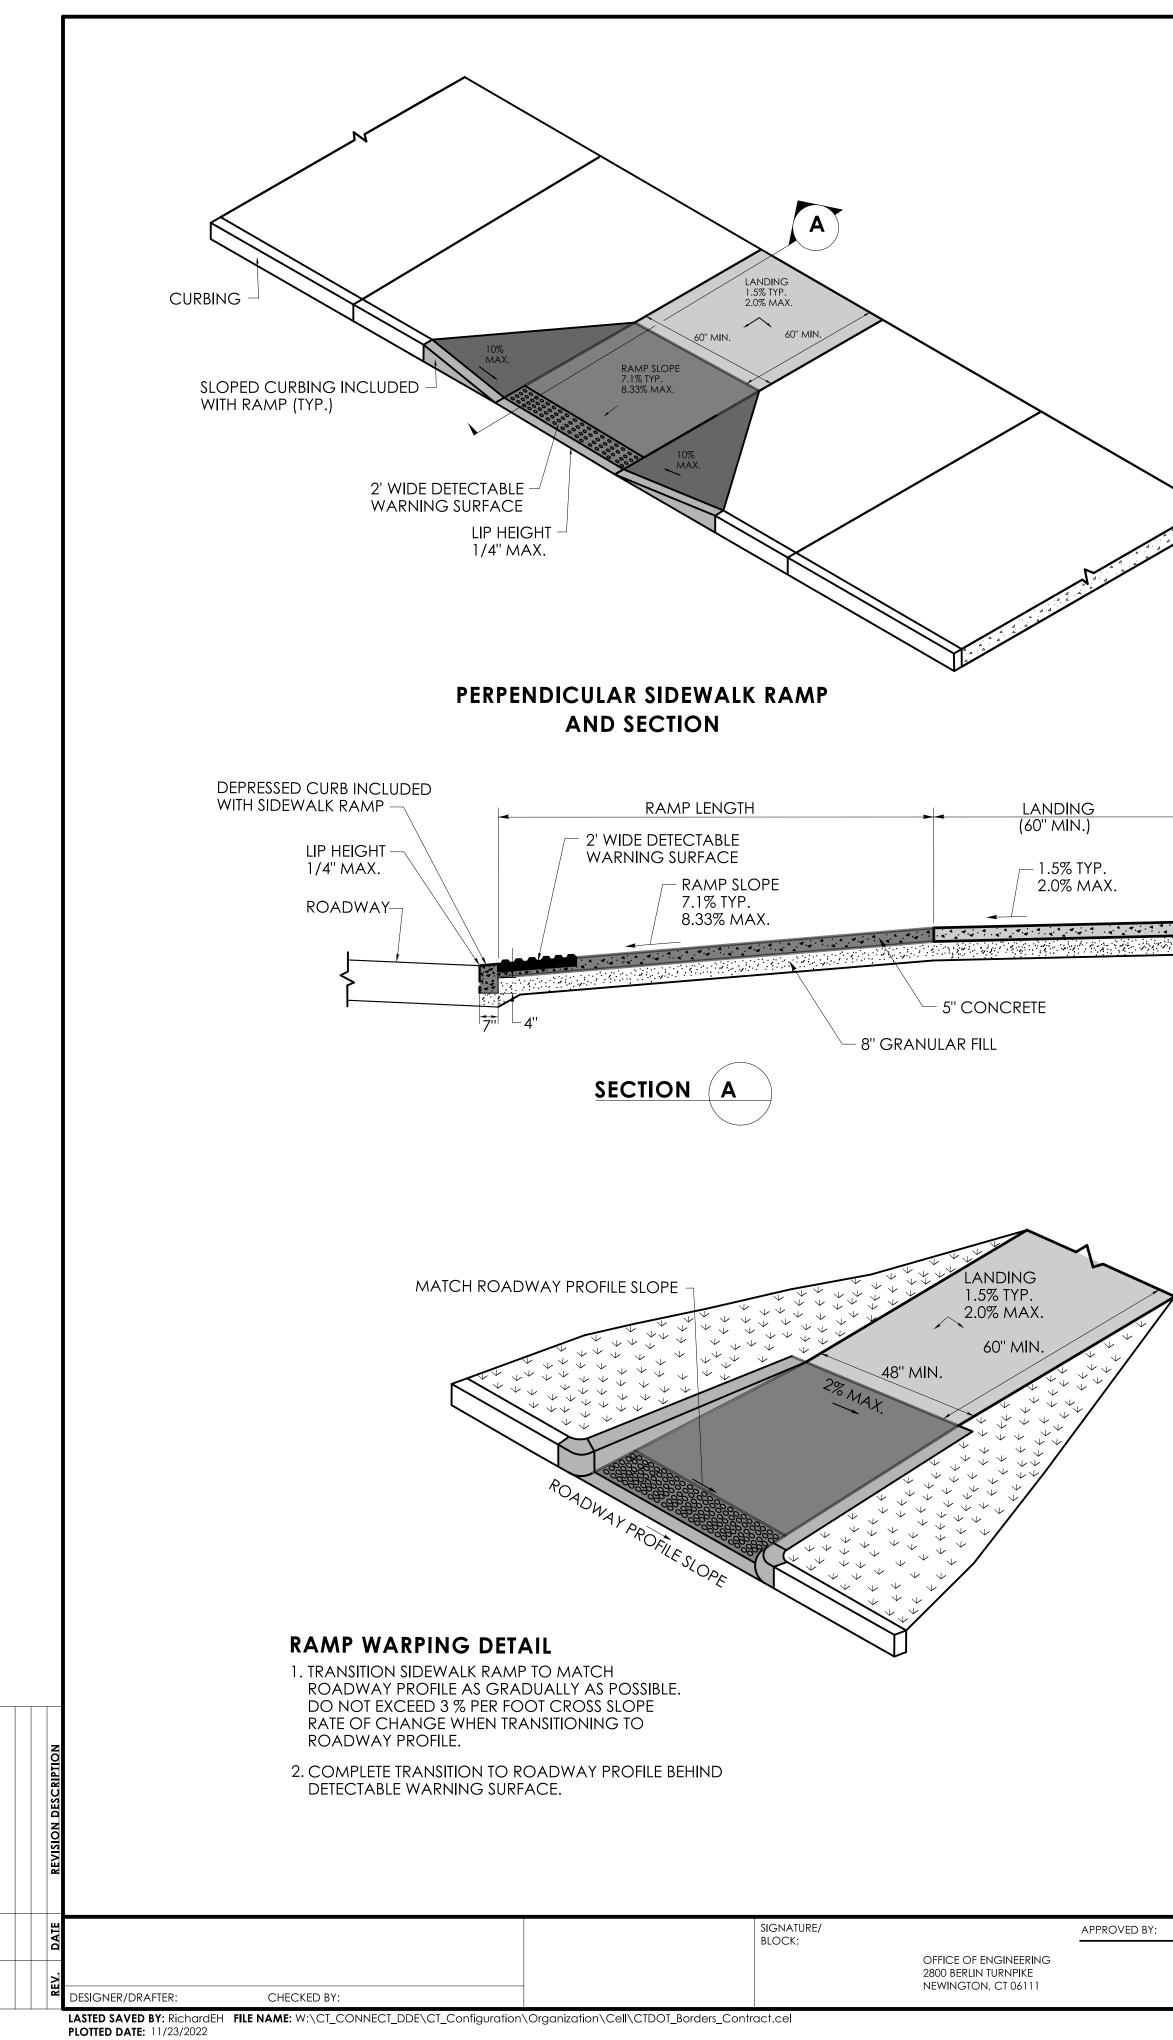

GENERAL NOTES:

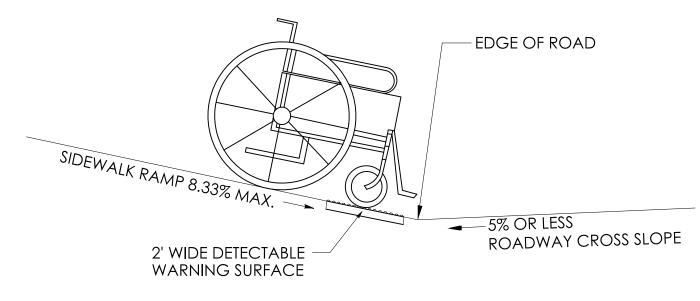

SIDEWALK RAMP GRADE AT ROADWAY CROSS SLOPE OF 5% OR LESS GUTTER COUNTER SLOPE

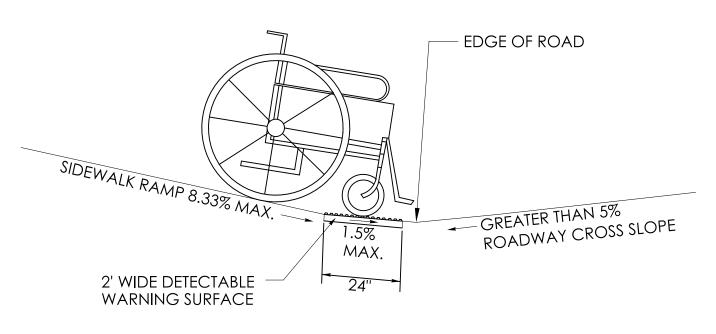

SIDEWALK RAMP GRADE AT **ROADWAY CROSS SLOPE OF GREATER THAN 5% GUTTER COUNTER SLOPE**









1. SIDEWALK RAMPS SHALL HAVE A COARSE BROOM FINISH TRANSVERSE TO THE SLOPE OF THE RAMP. 2. VERTICAL SURFACE DISCONTINUITIES AT JOINTS SHALL NOT EXCEED $\frac{1}{4}$ INCH.

3. REMOVAL OF EXISTING SIDEWALK FOR NEW RAMP INSTALLATIONS SHALL BE TO THE NEAREST EXPANSION OR CONTRACTION JOINT.


4. THE RUNNING SLOPE OF THE CURB RAMP SHALL BE 8.33 PERCENT MAXIMUM BUT SHALL NOT REQUIRE THE RAMP LENGTH TO EXCEED 15 FEET.

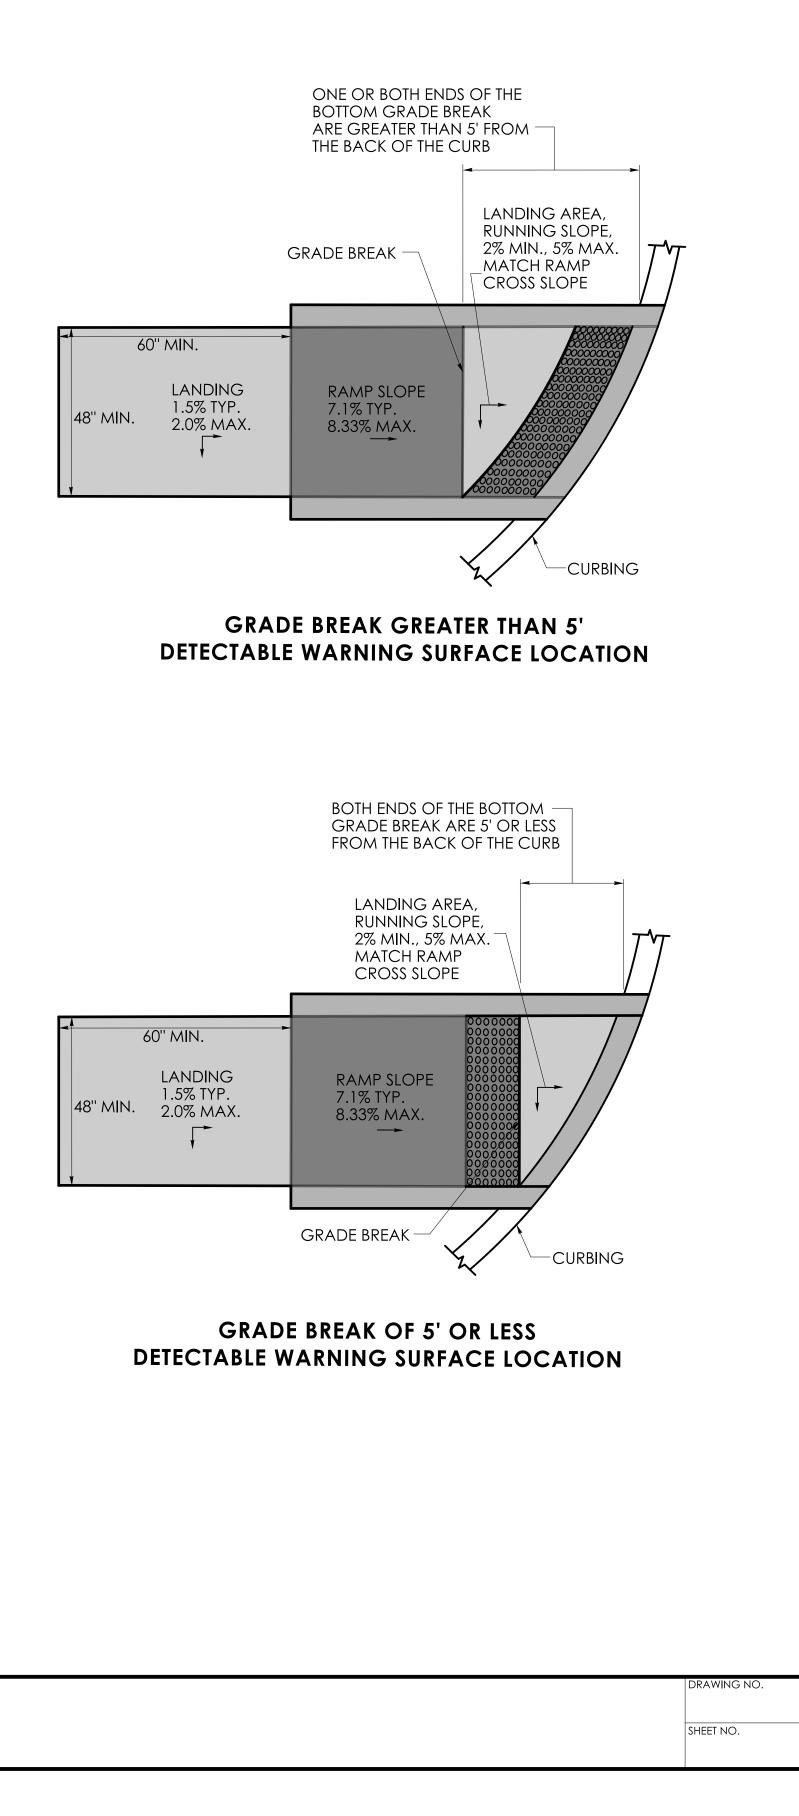

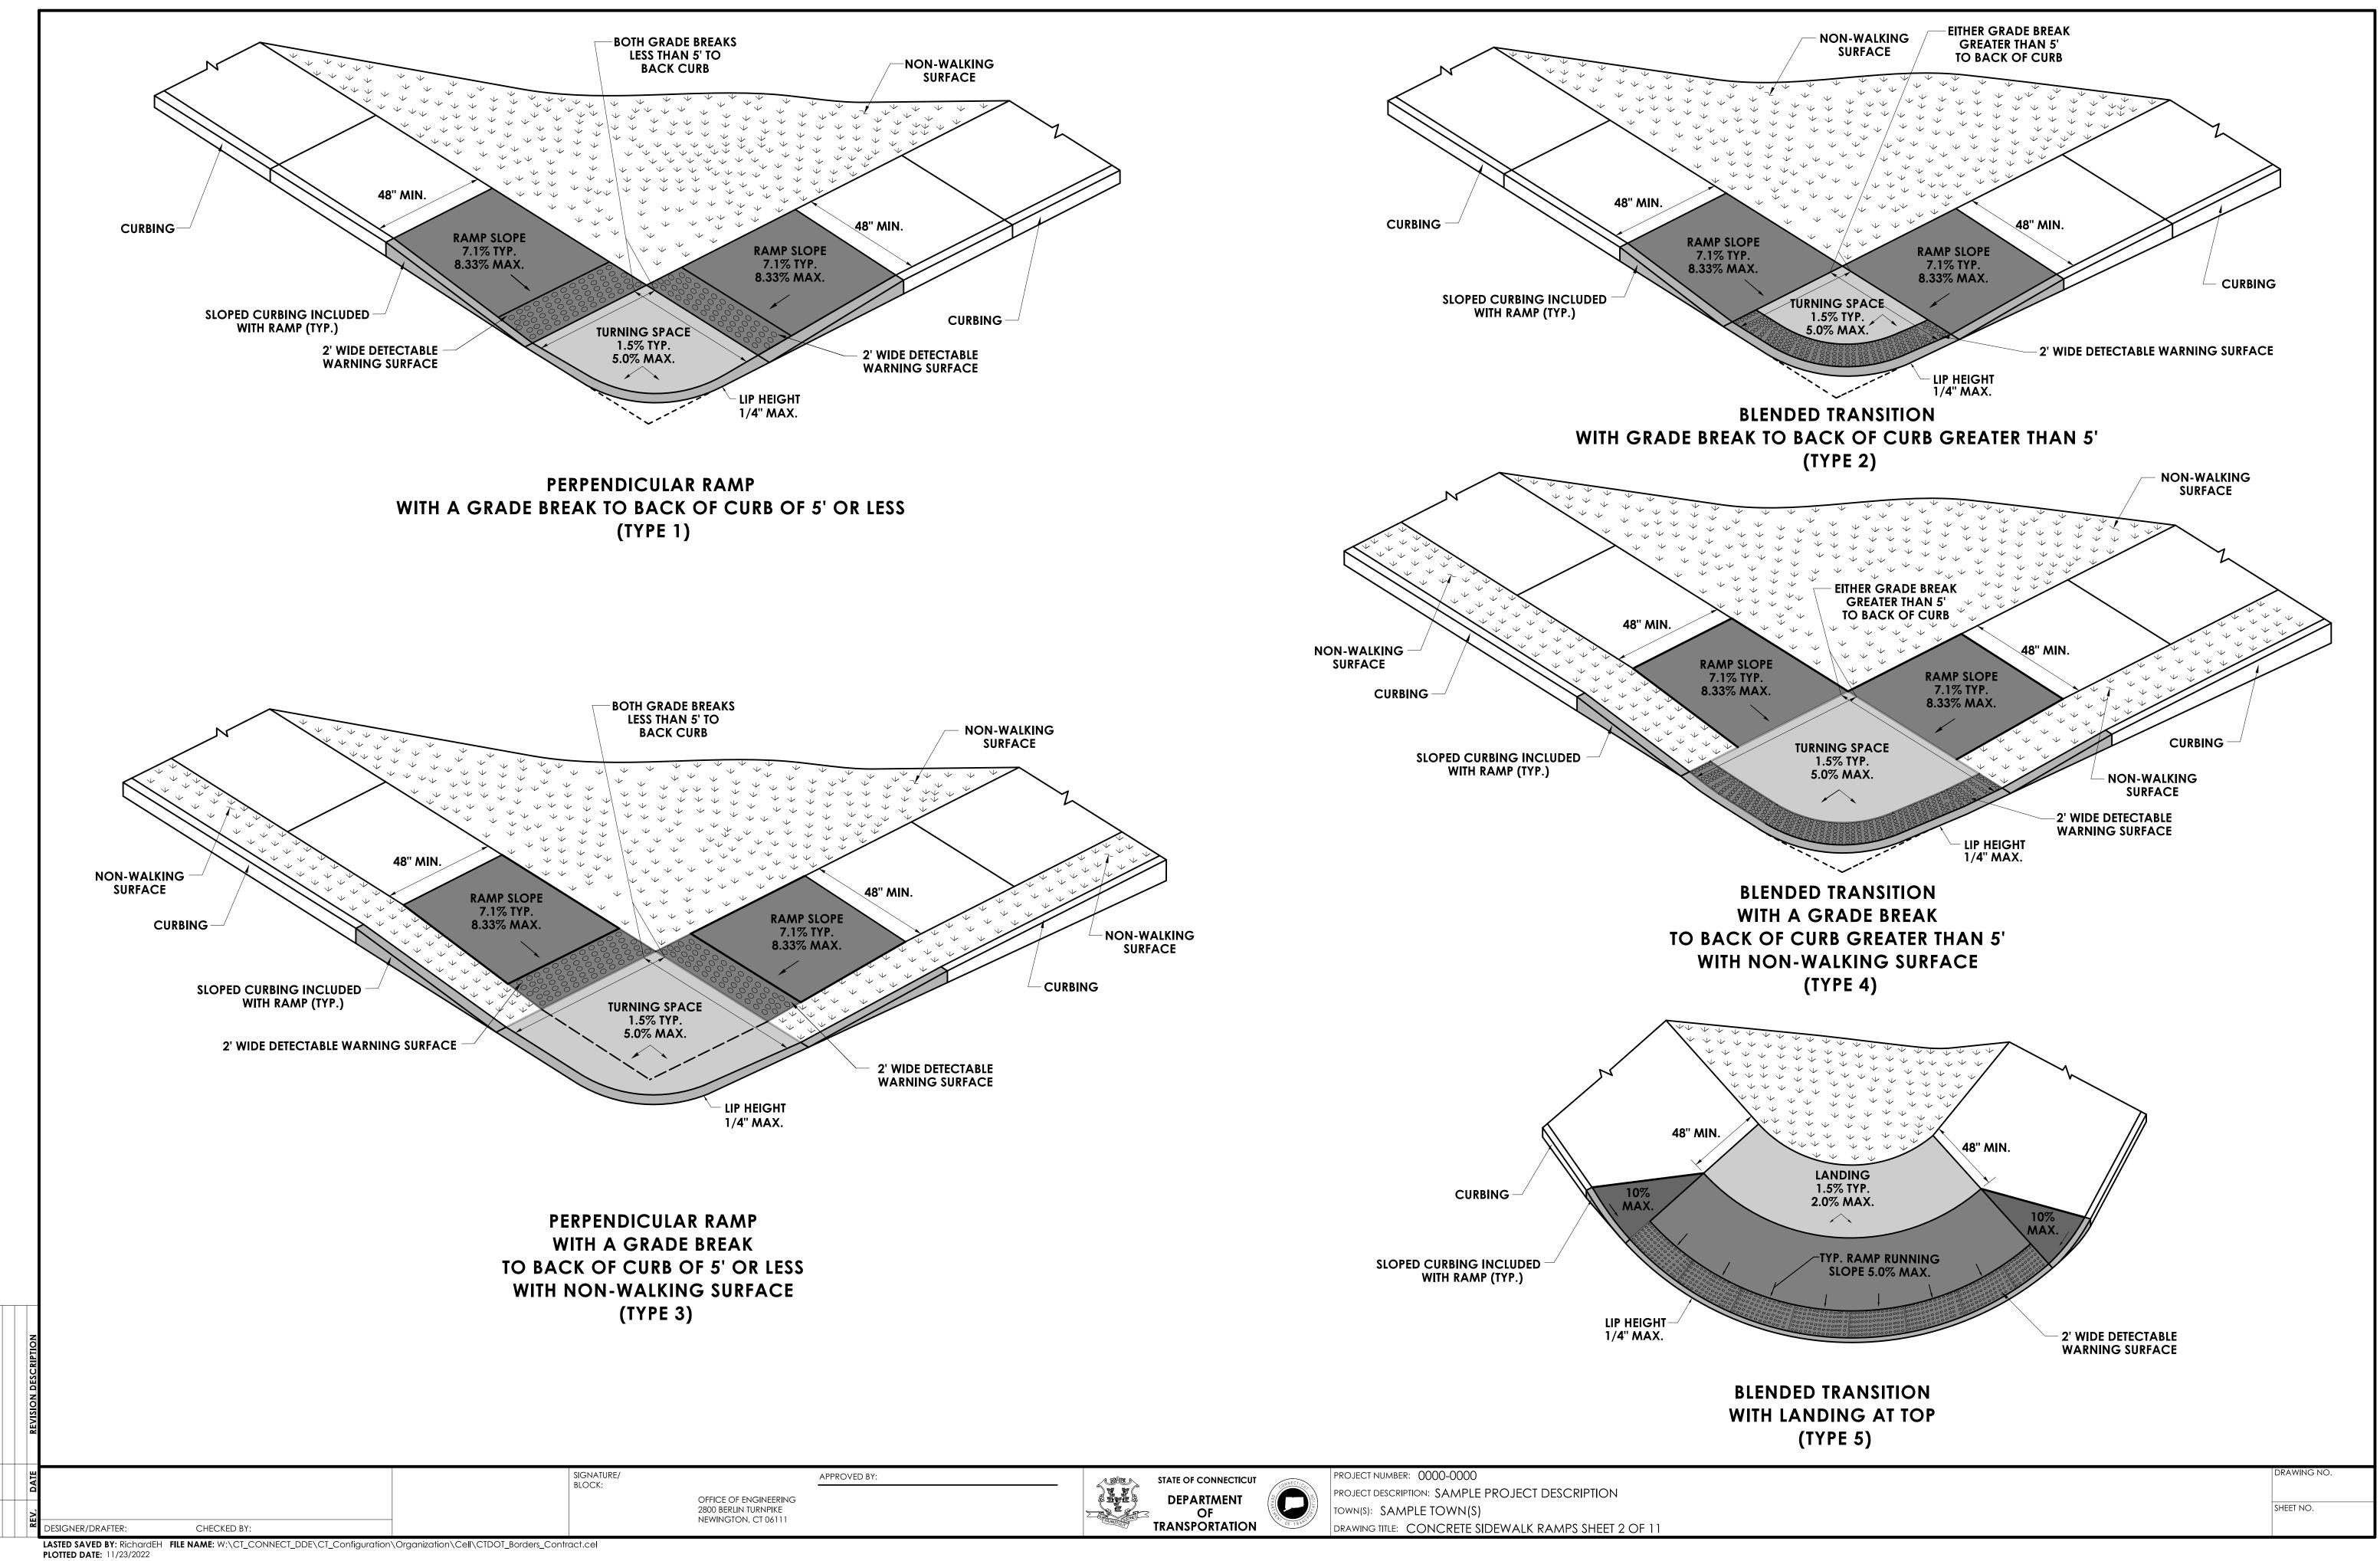


DNNECTICUT	ONNECT/O	
IMENT	DED XOL	PROJECT DESCRIPTION: SAMPLE PROJECT DESCRIPTION
F		TOWN(S): SAMPLE TOWN(S)
RTATION	OF TRANS	DRAWING TITLE: CONCRETE SIDEWALK RAMPS SHEET 2 OF

	CROS
	CROS
SIGNATURE/ BLOCK:	

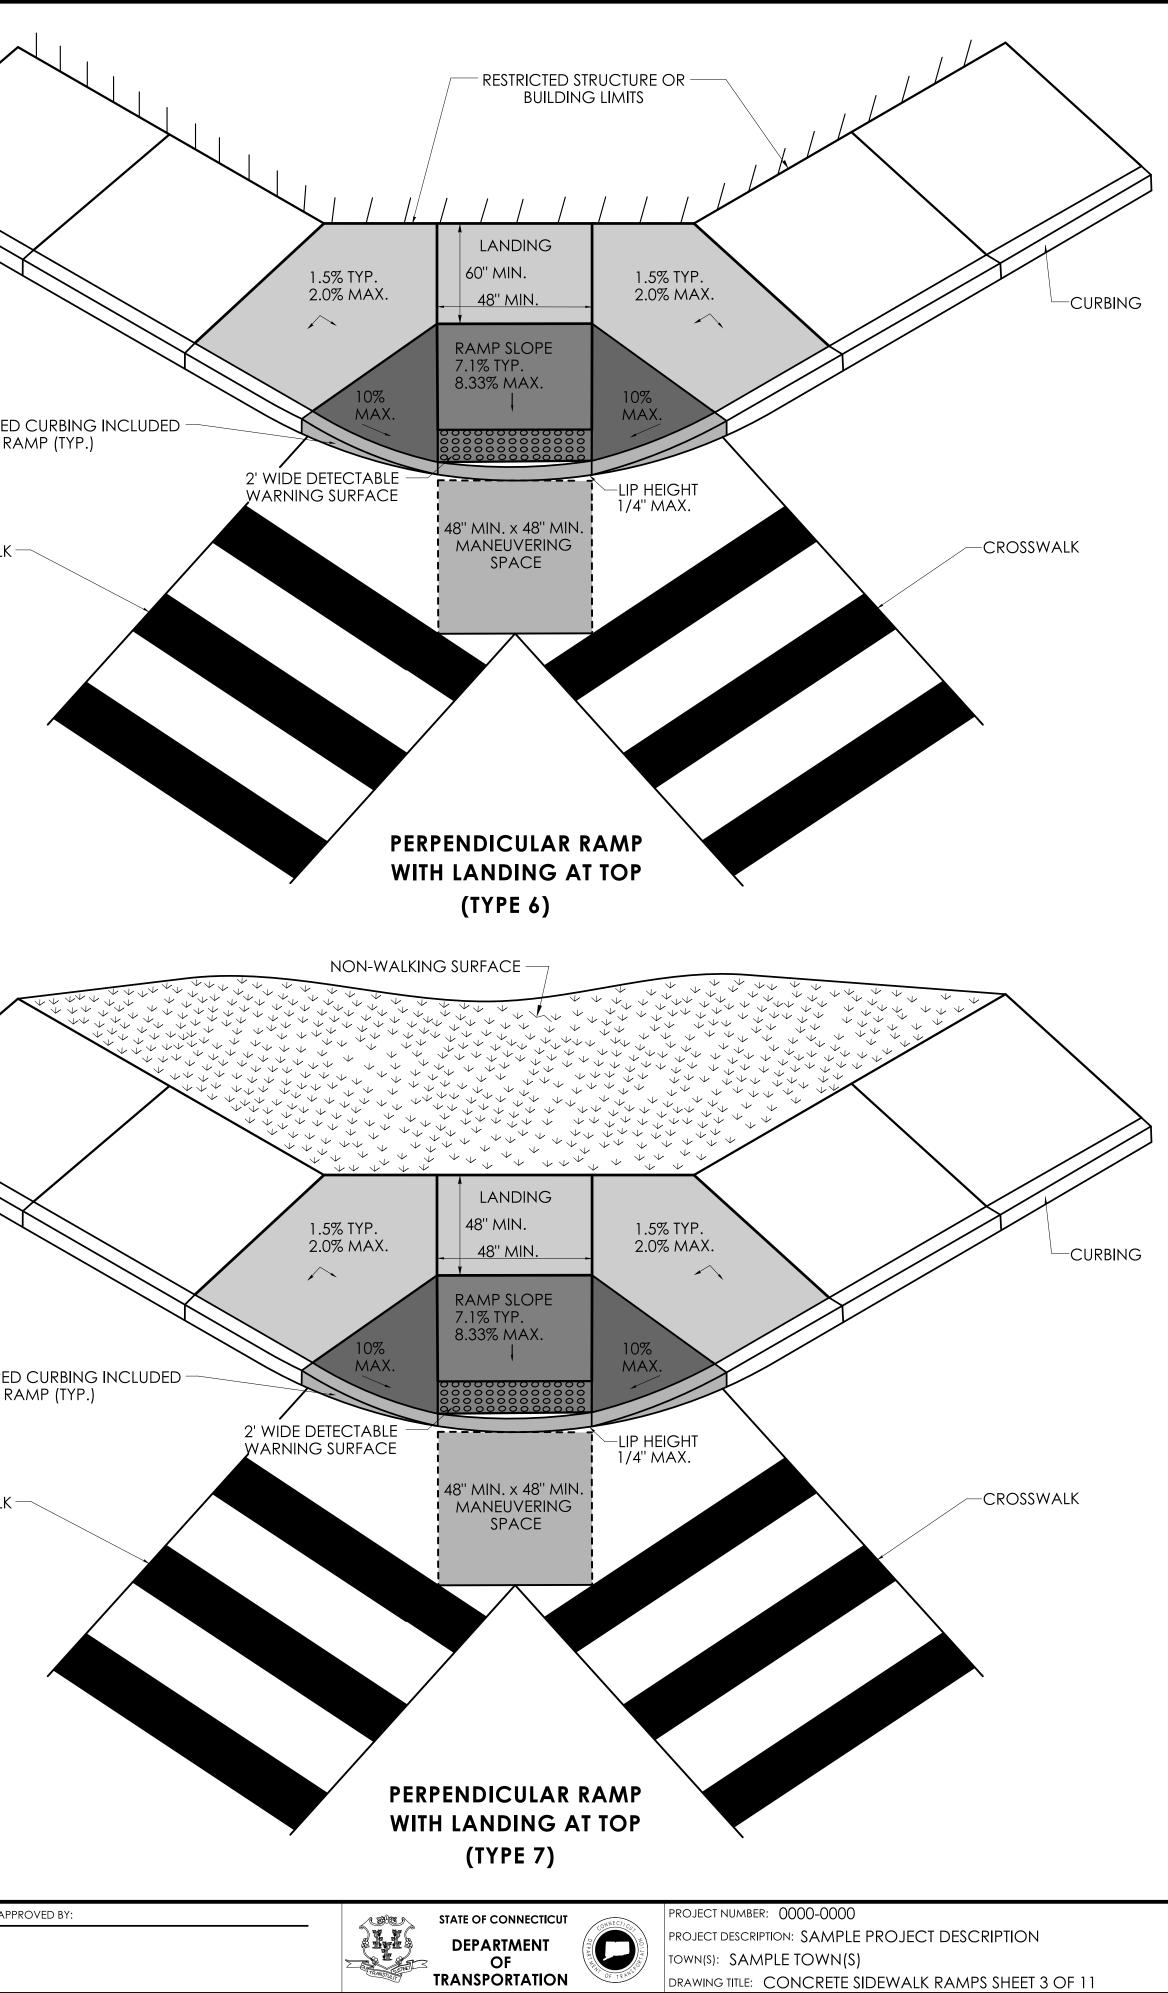


		DRA	WING NO.

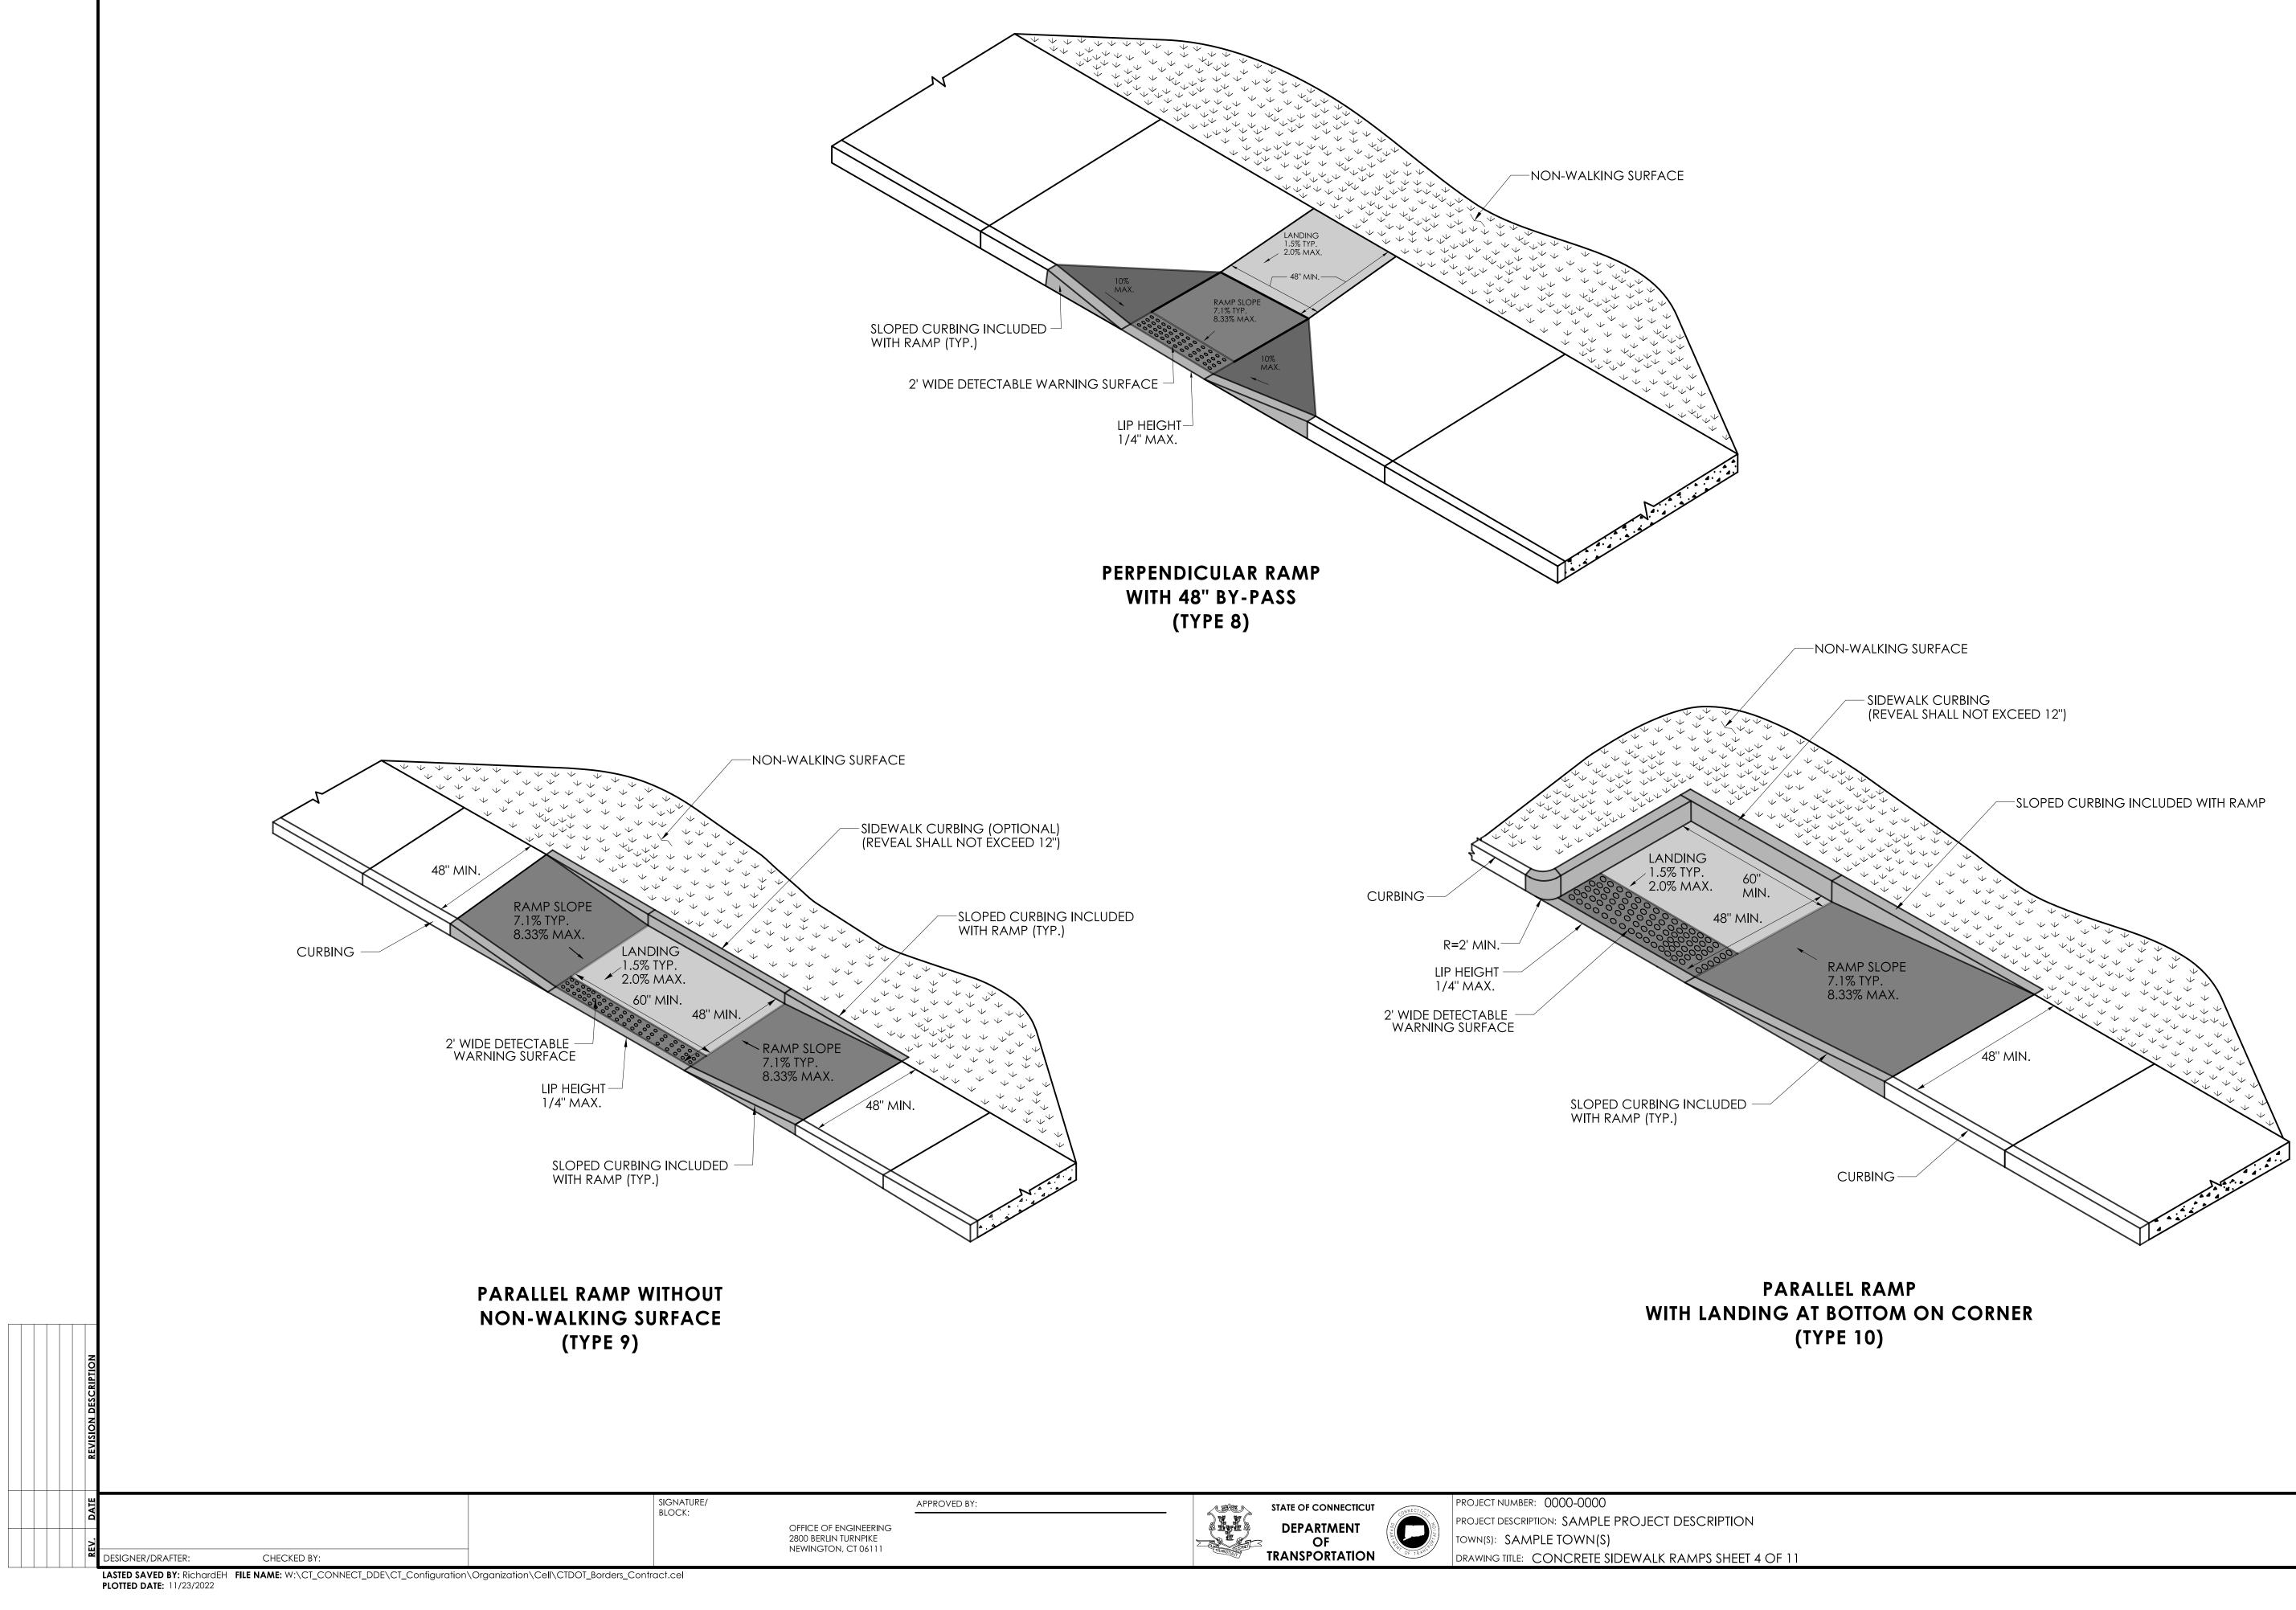

		NECL	PROJECT NUMBER: 0000-0000
-	DEPARTMENT		PROJECT DESCRIPTION: SAMPLE PROJECT DESCRIPTION
	OF	AR INTER	TOWN(S): SAMPLE TOWN(S)
	TRANSPORTATION	OF TRAMS	DRAWING TITLE: CONCRETE SIDEWALK RAMPS SHEET 4 OF 1

ROVED	DV.
	ы.


RAWING NO. SHEET NO.

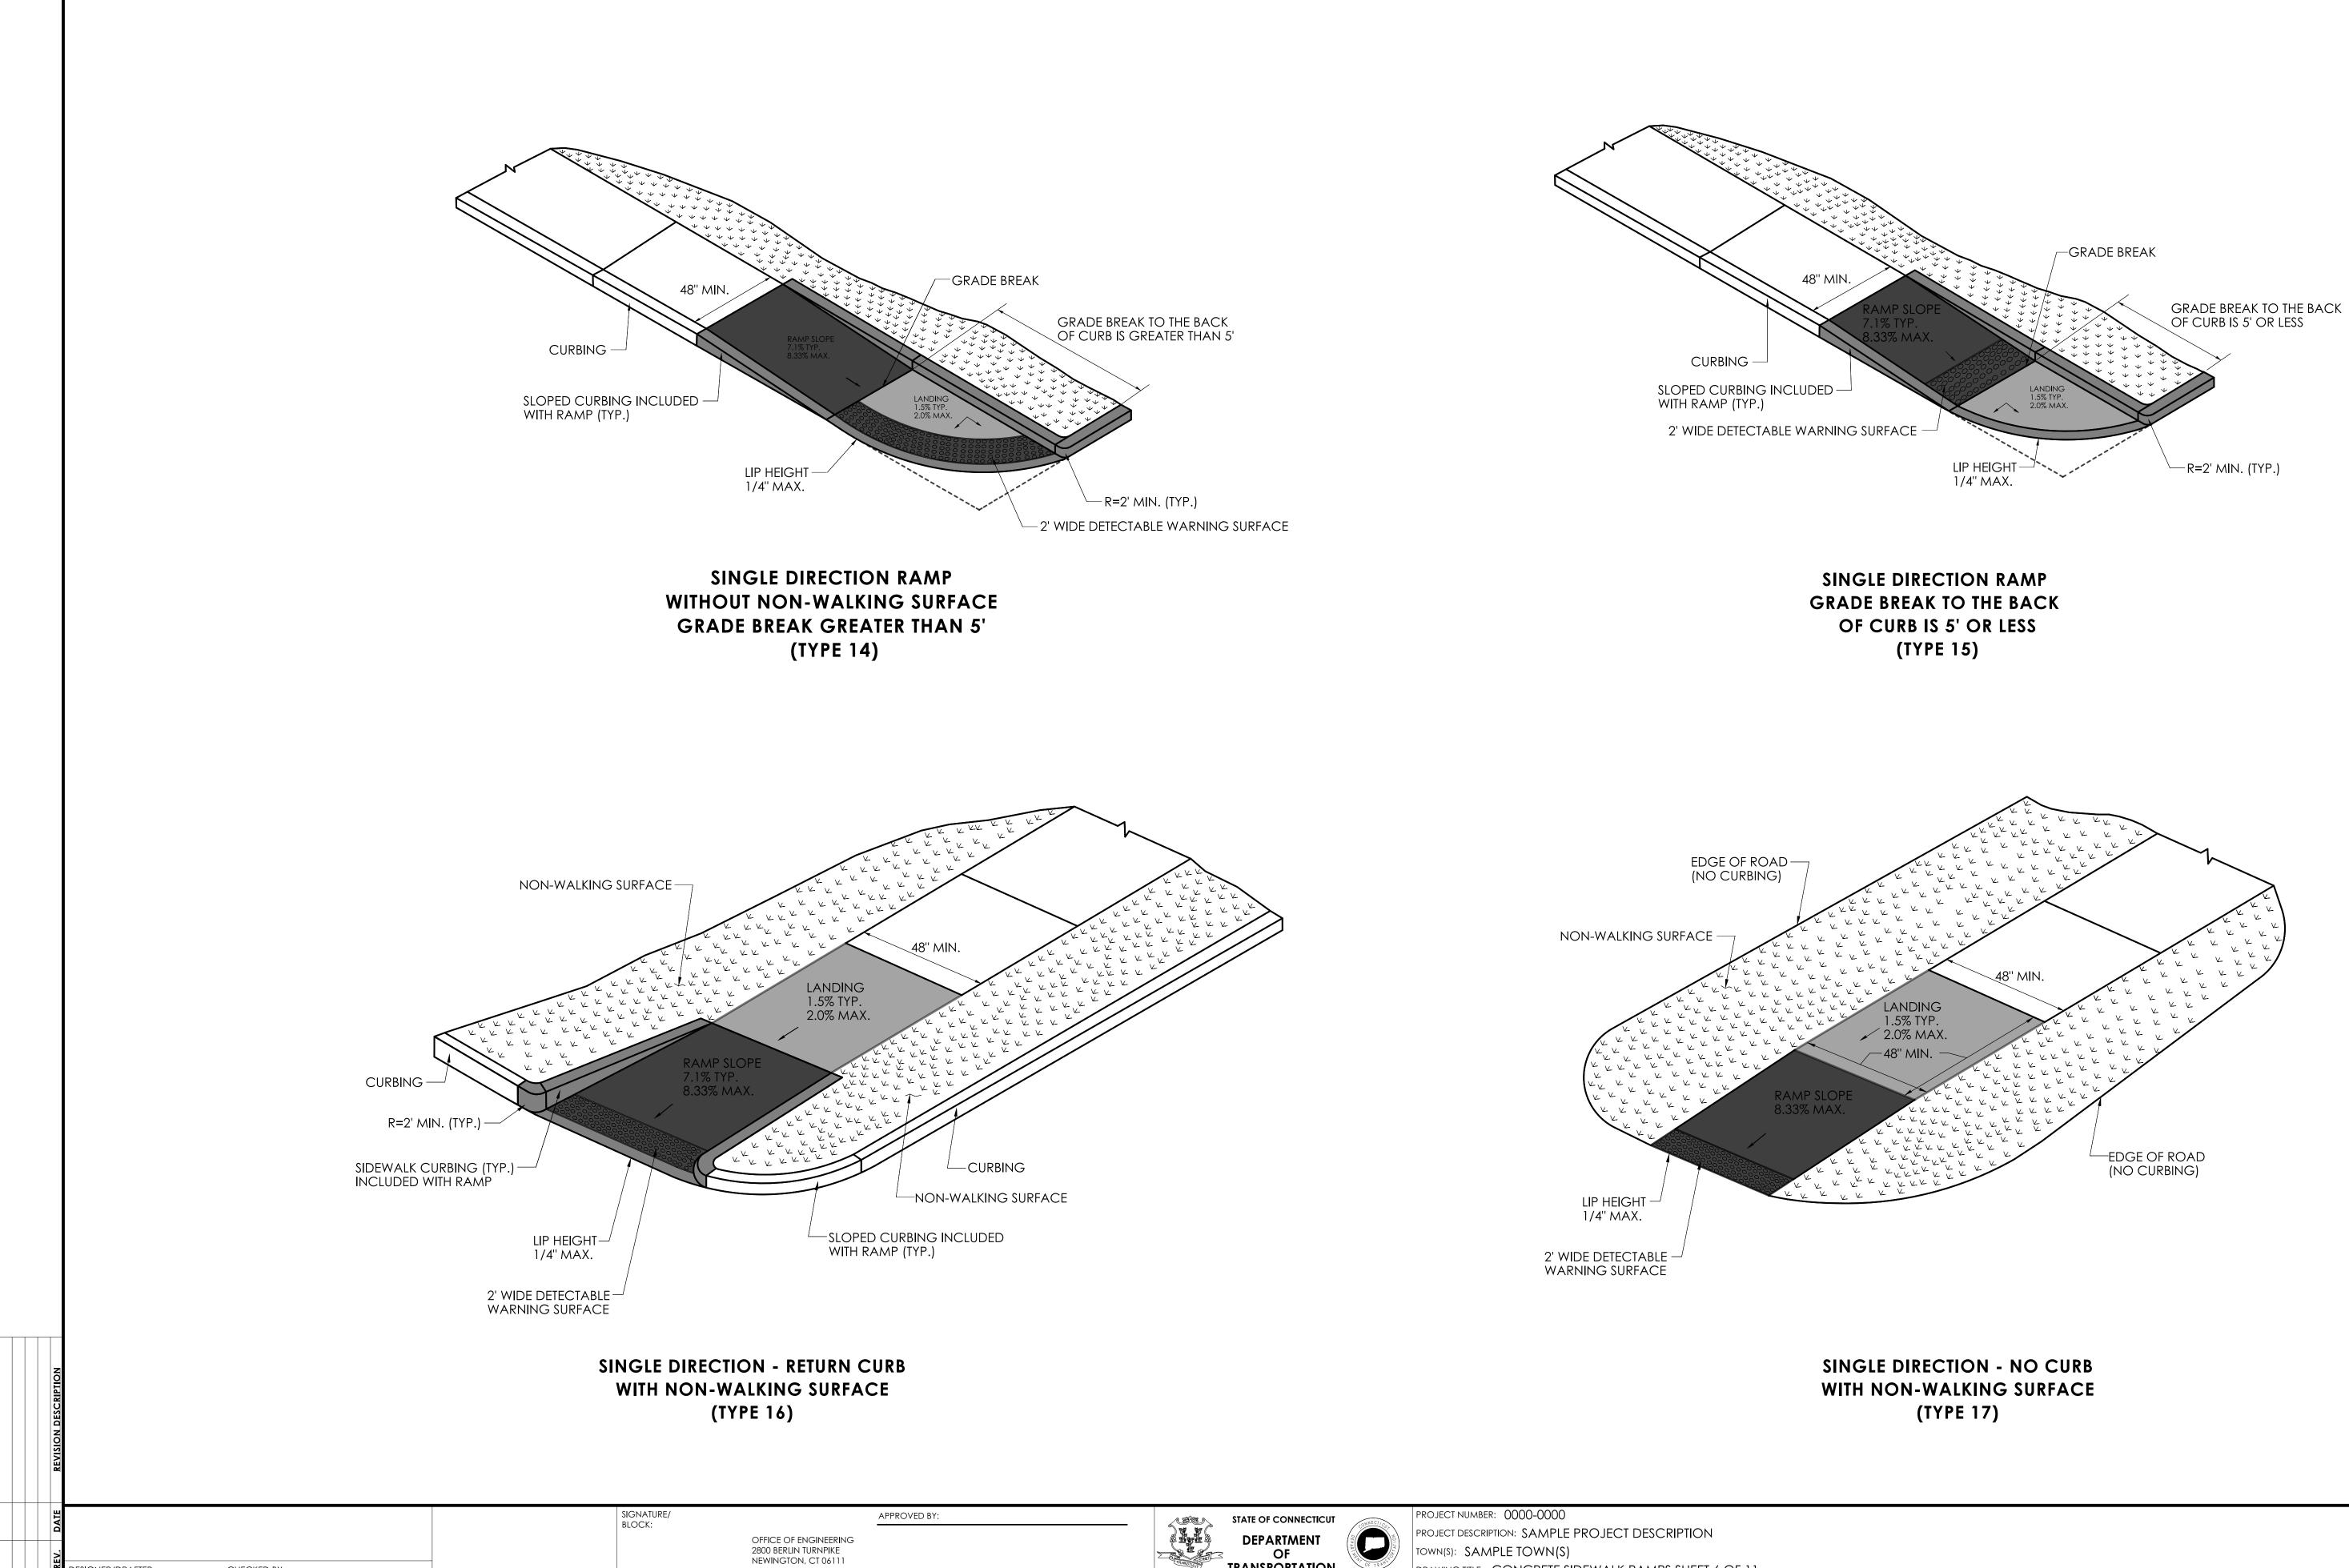

DESIGNER/DRAFTER:

LASTED SAVED BY: RichardEH FILE NAME: W:\CT_CONNECT_DDE\CT_Configuration\Organization\Cell\CTDOT_Borders_Contract.cel PLOTTED DATE: 11/23/2022


CHECKED BY:

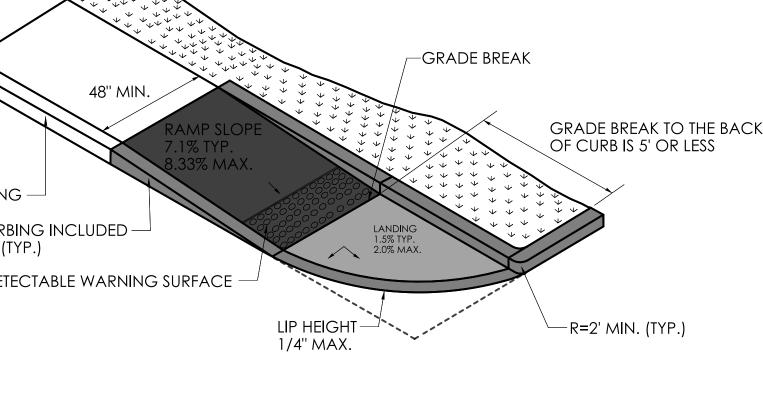

PROVED BY:			PROJECT NUMBER: 0000-0000
	DEPARTMENT	CONNECT/CUT	PROJECT DESCRIPTION: SAMPLE PROJECT DESCRIPTION
	OF	ARINE V	TOWN(S): SAMPLE TOWN(S)
	TRANSPORTATION	OF TRANS	DRAWING TITLE: CONCRETE SIDEWALK RAMPS SHEET 6 OF 11

RAWING NO.

SHEET NO.

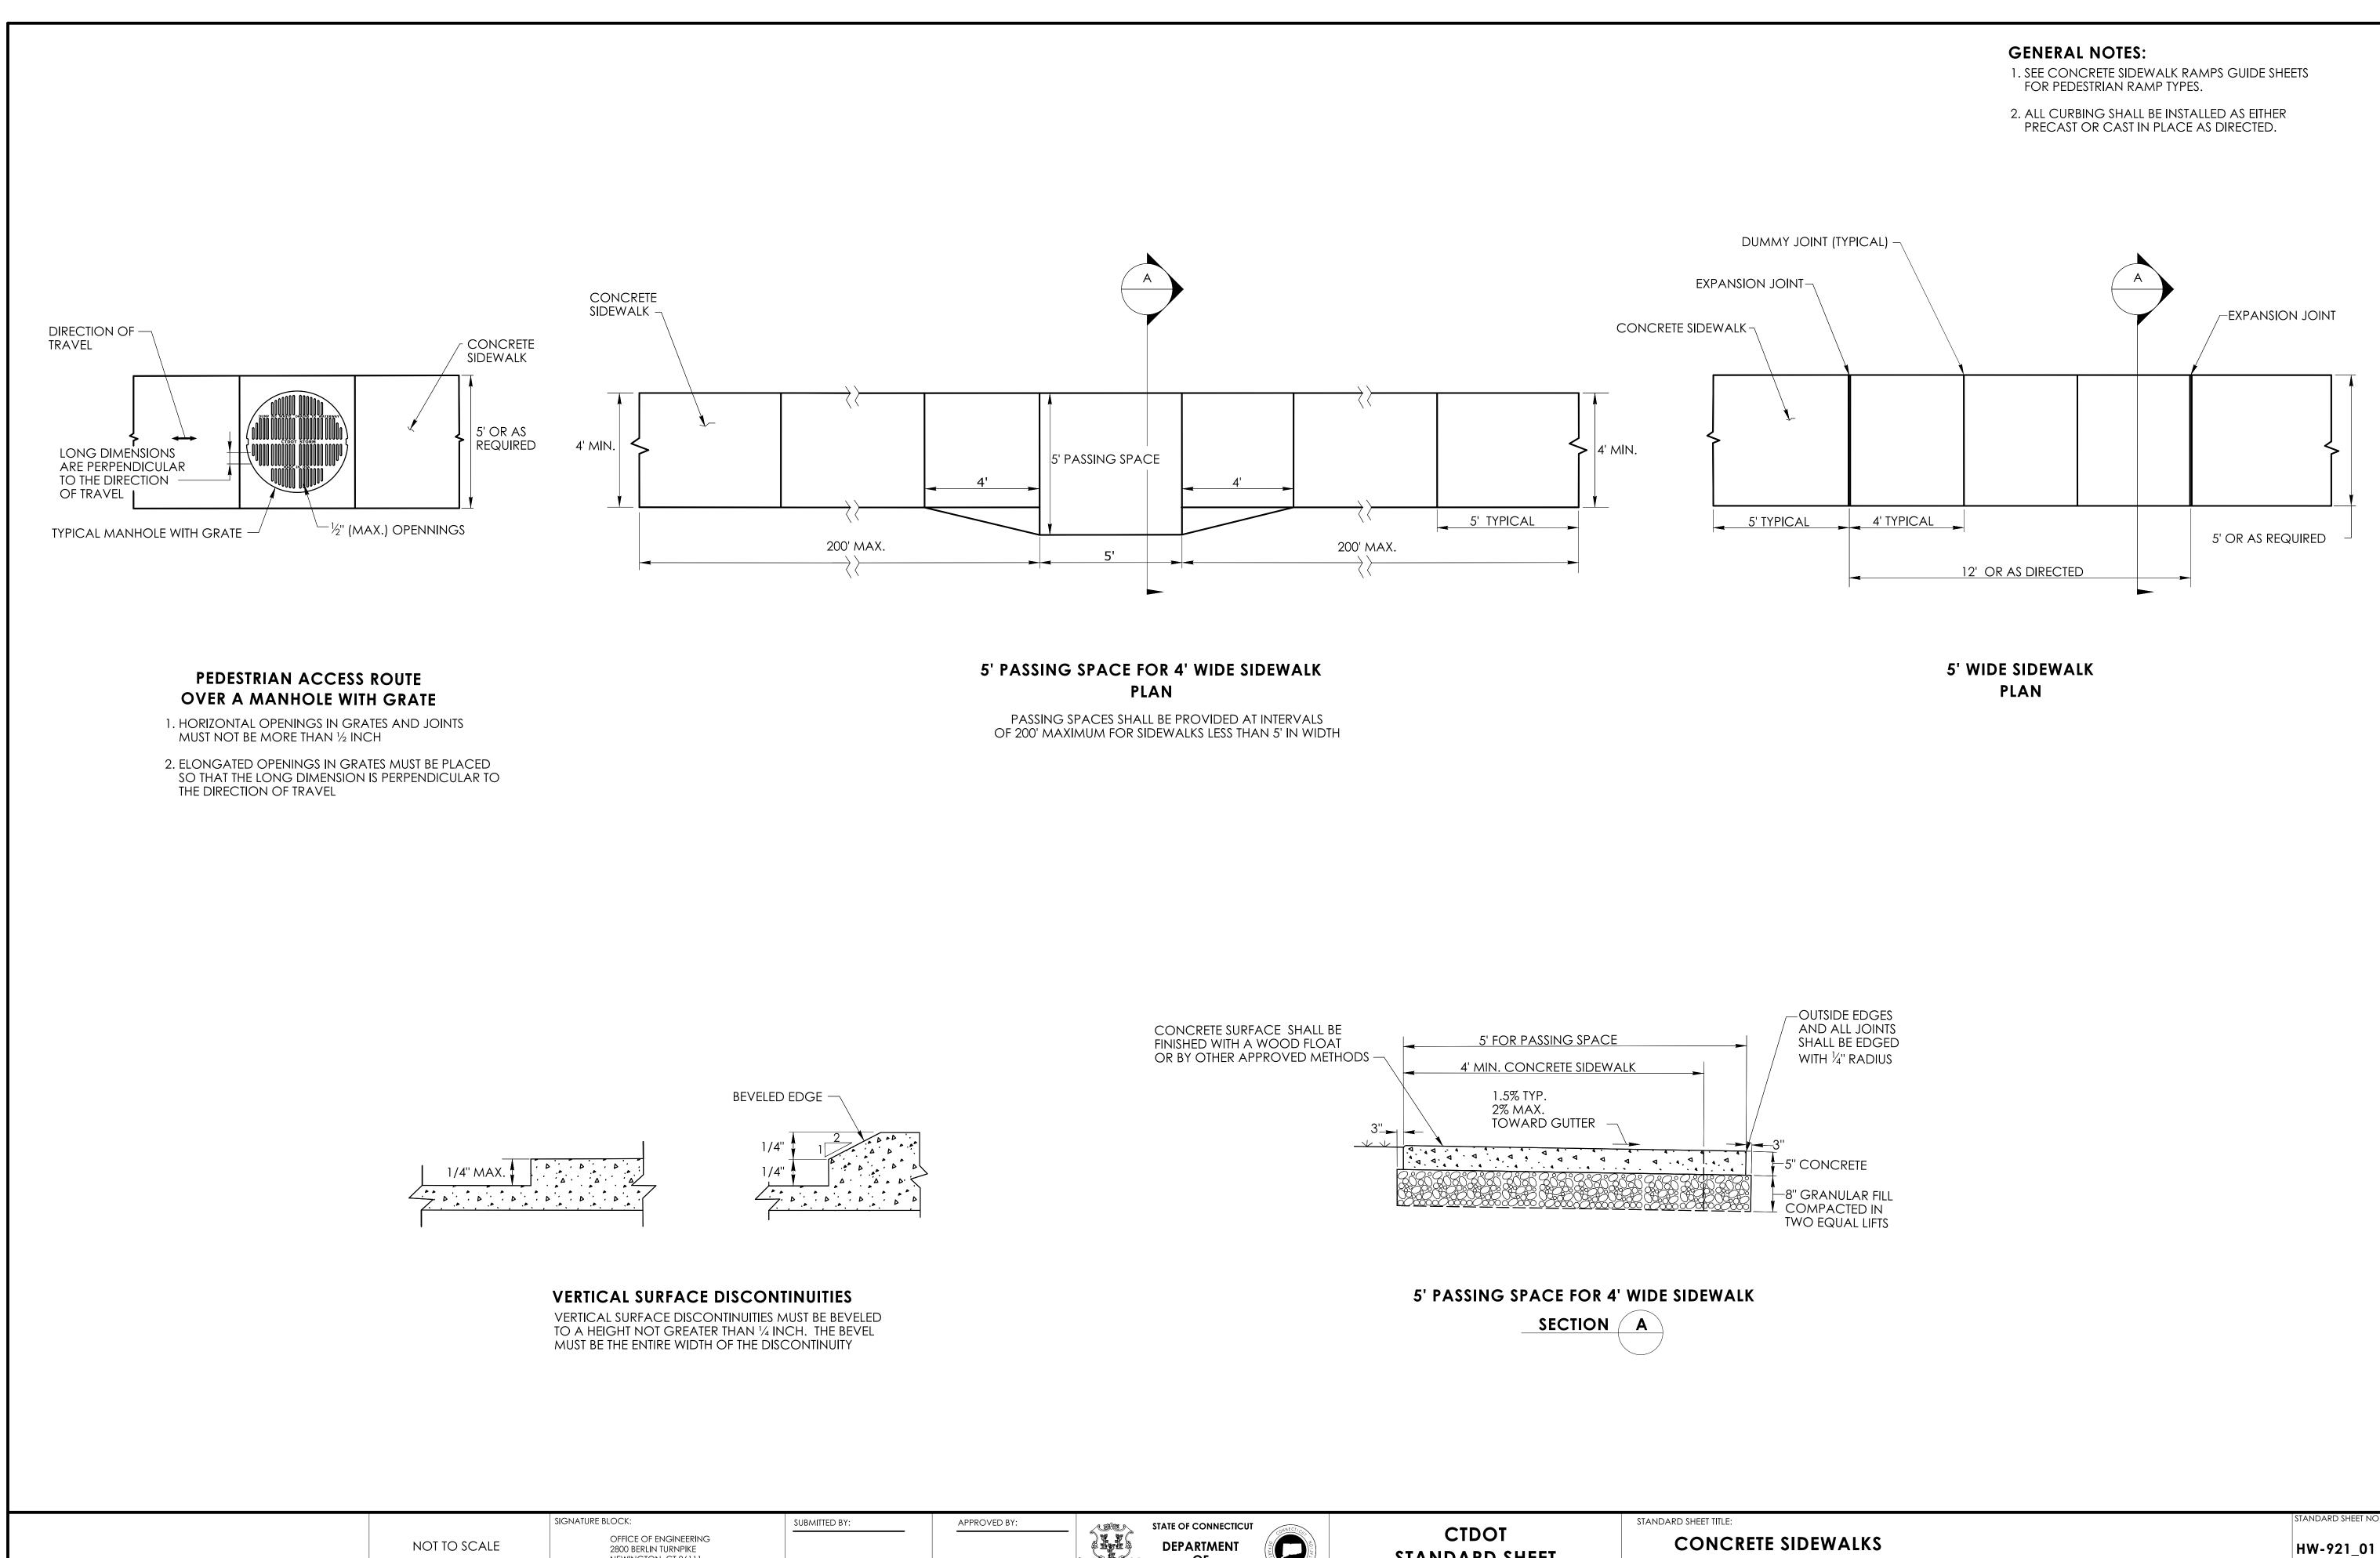


PLOTTED DATE: 9/23/2022


NEWINGTON, CT 06111


STANDARD SHEET OF TRANSPORTATION

andard sheet no.

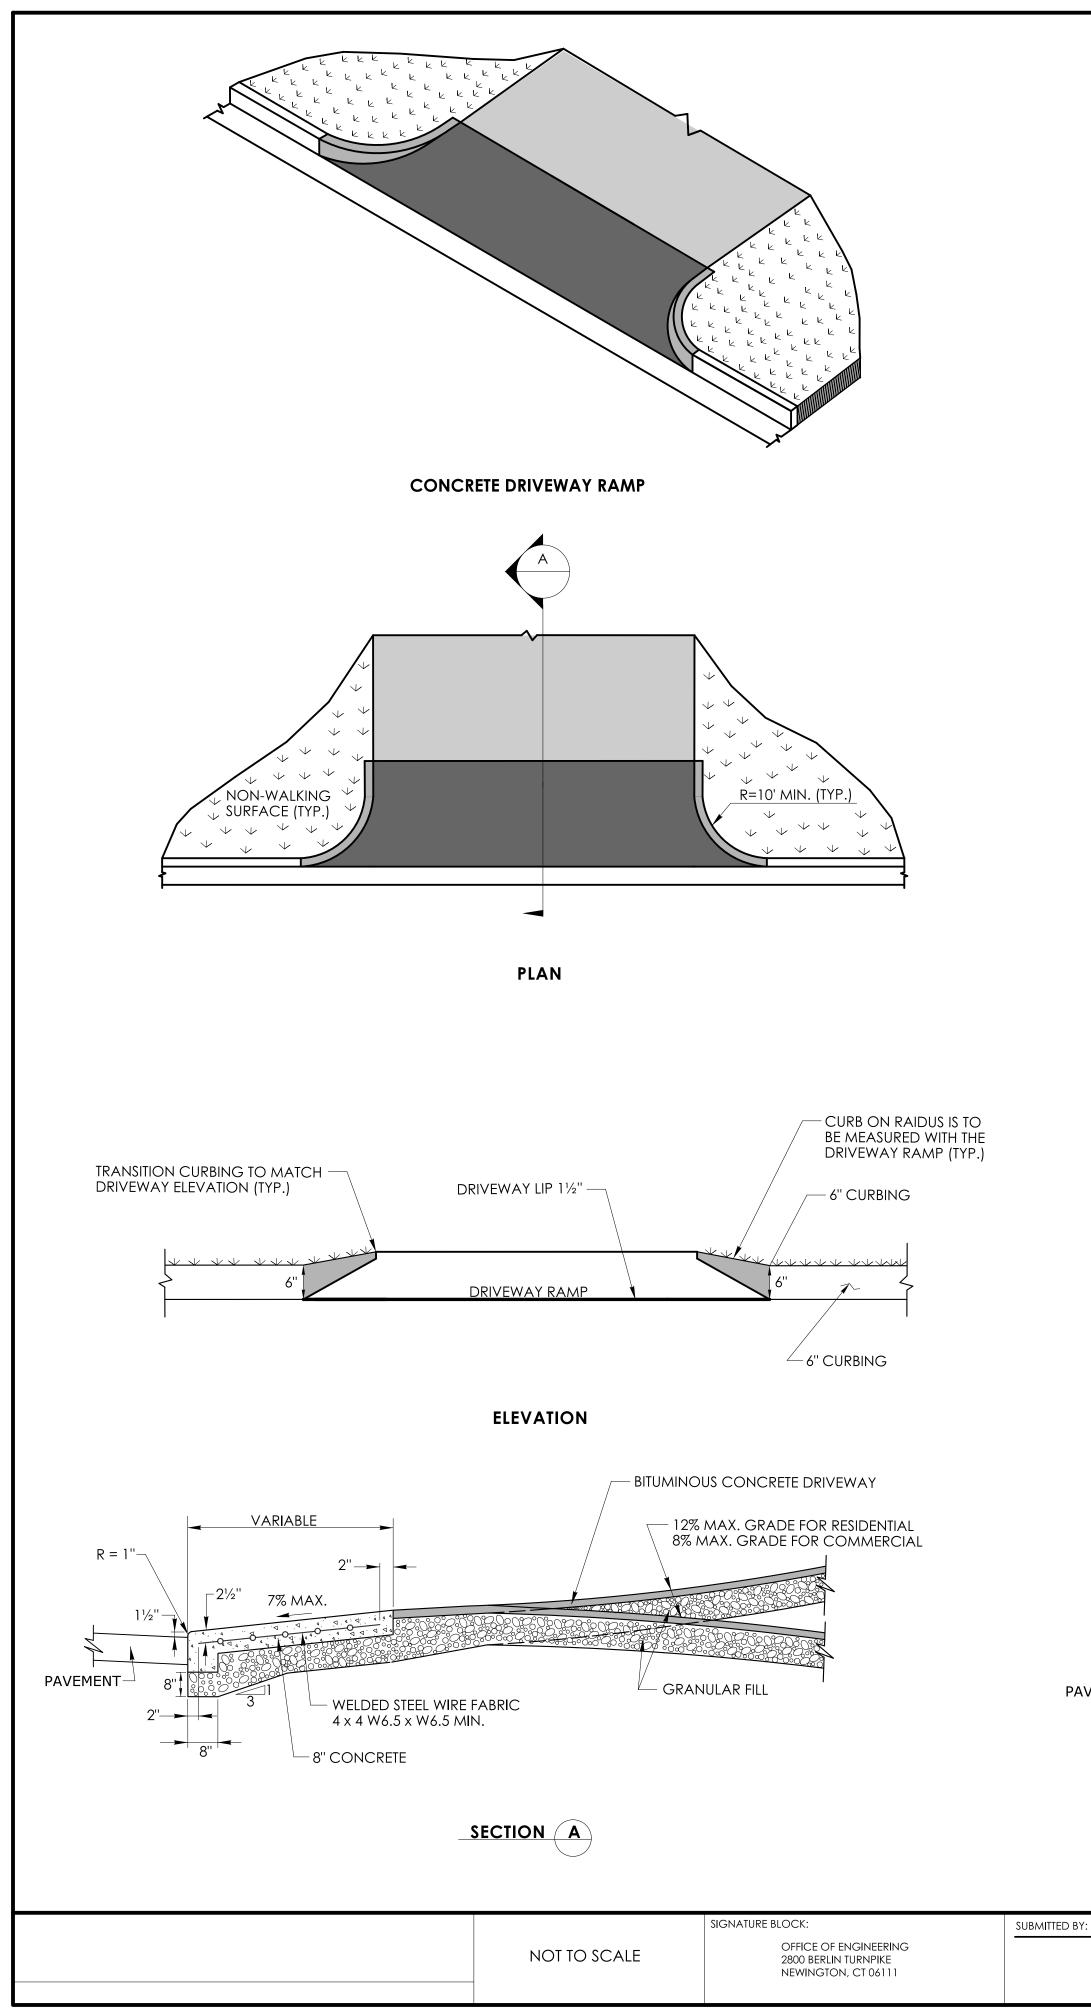


PLOTTED DATE: 10/5/2022

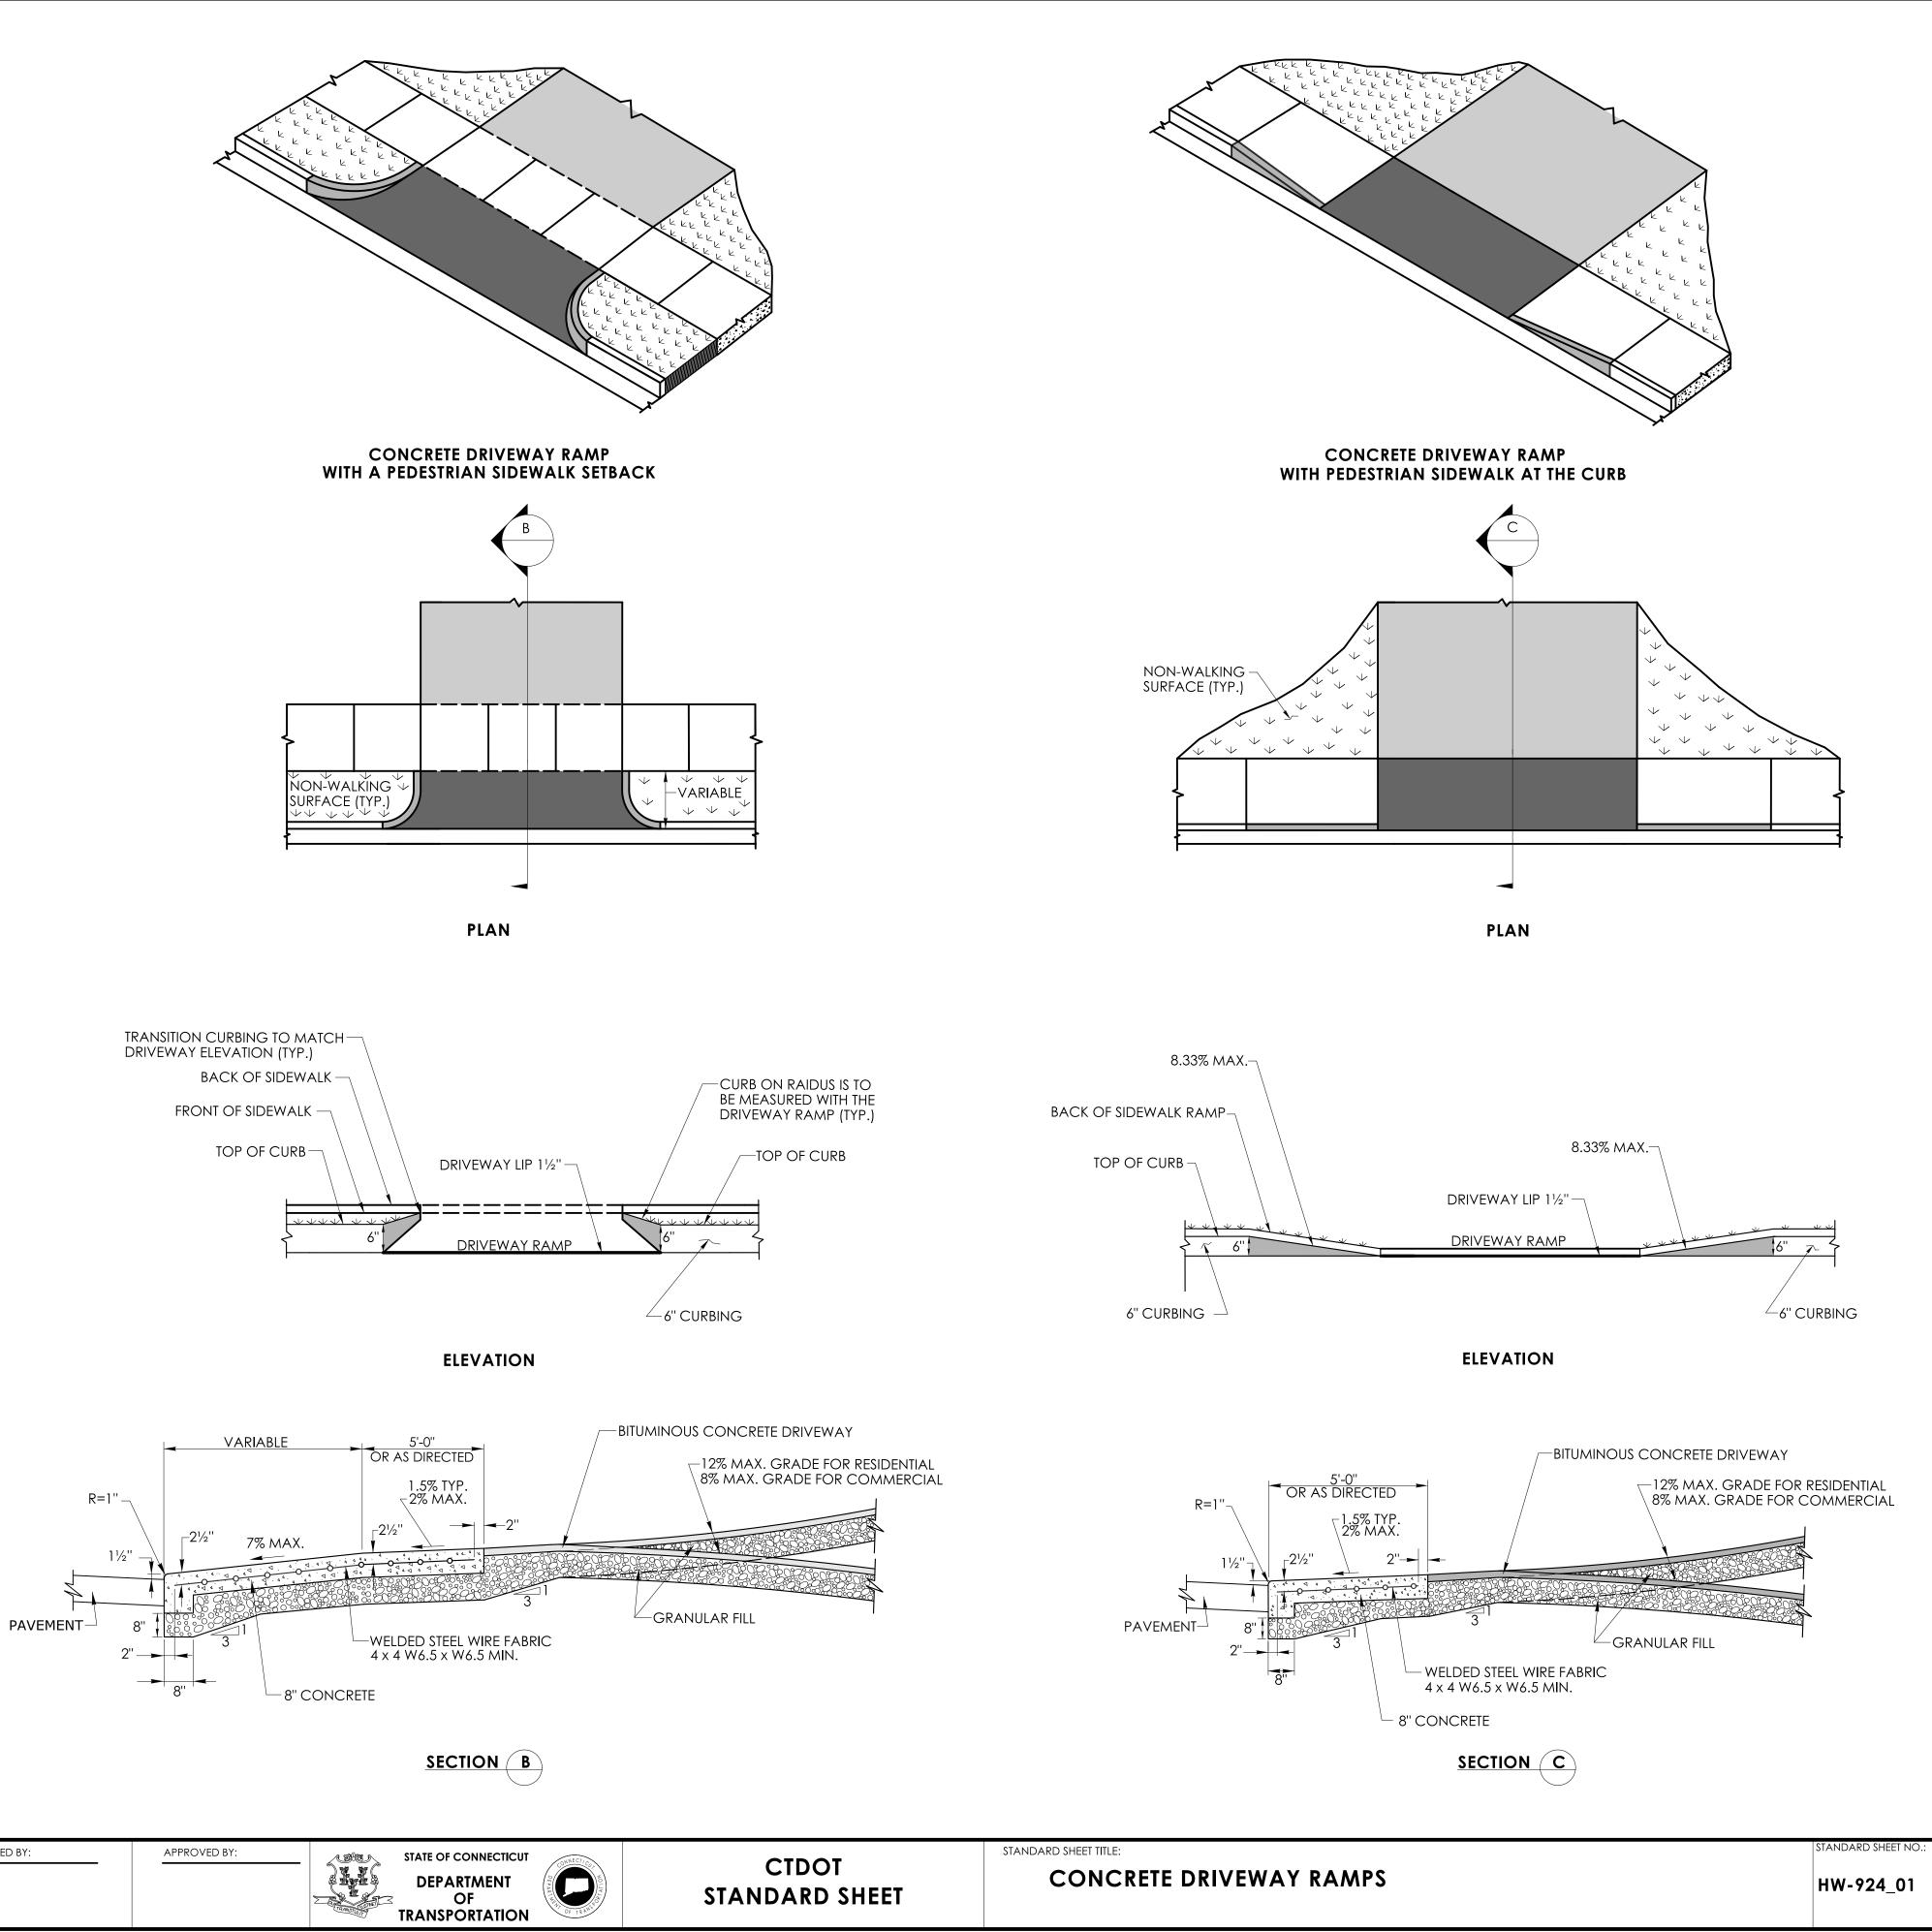

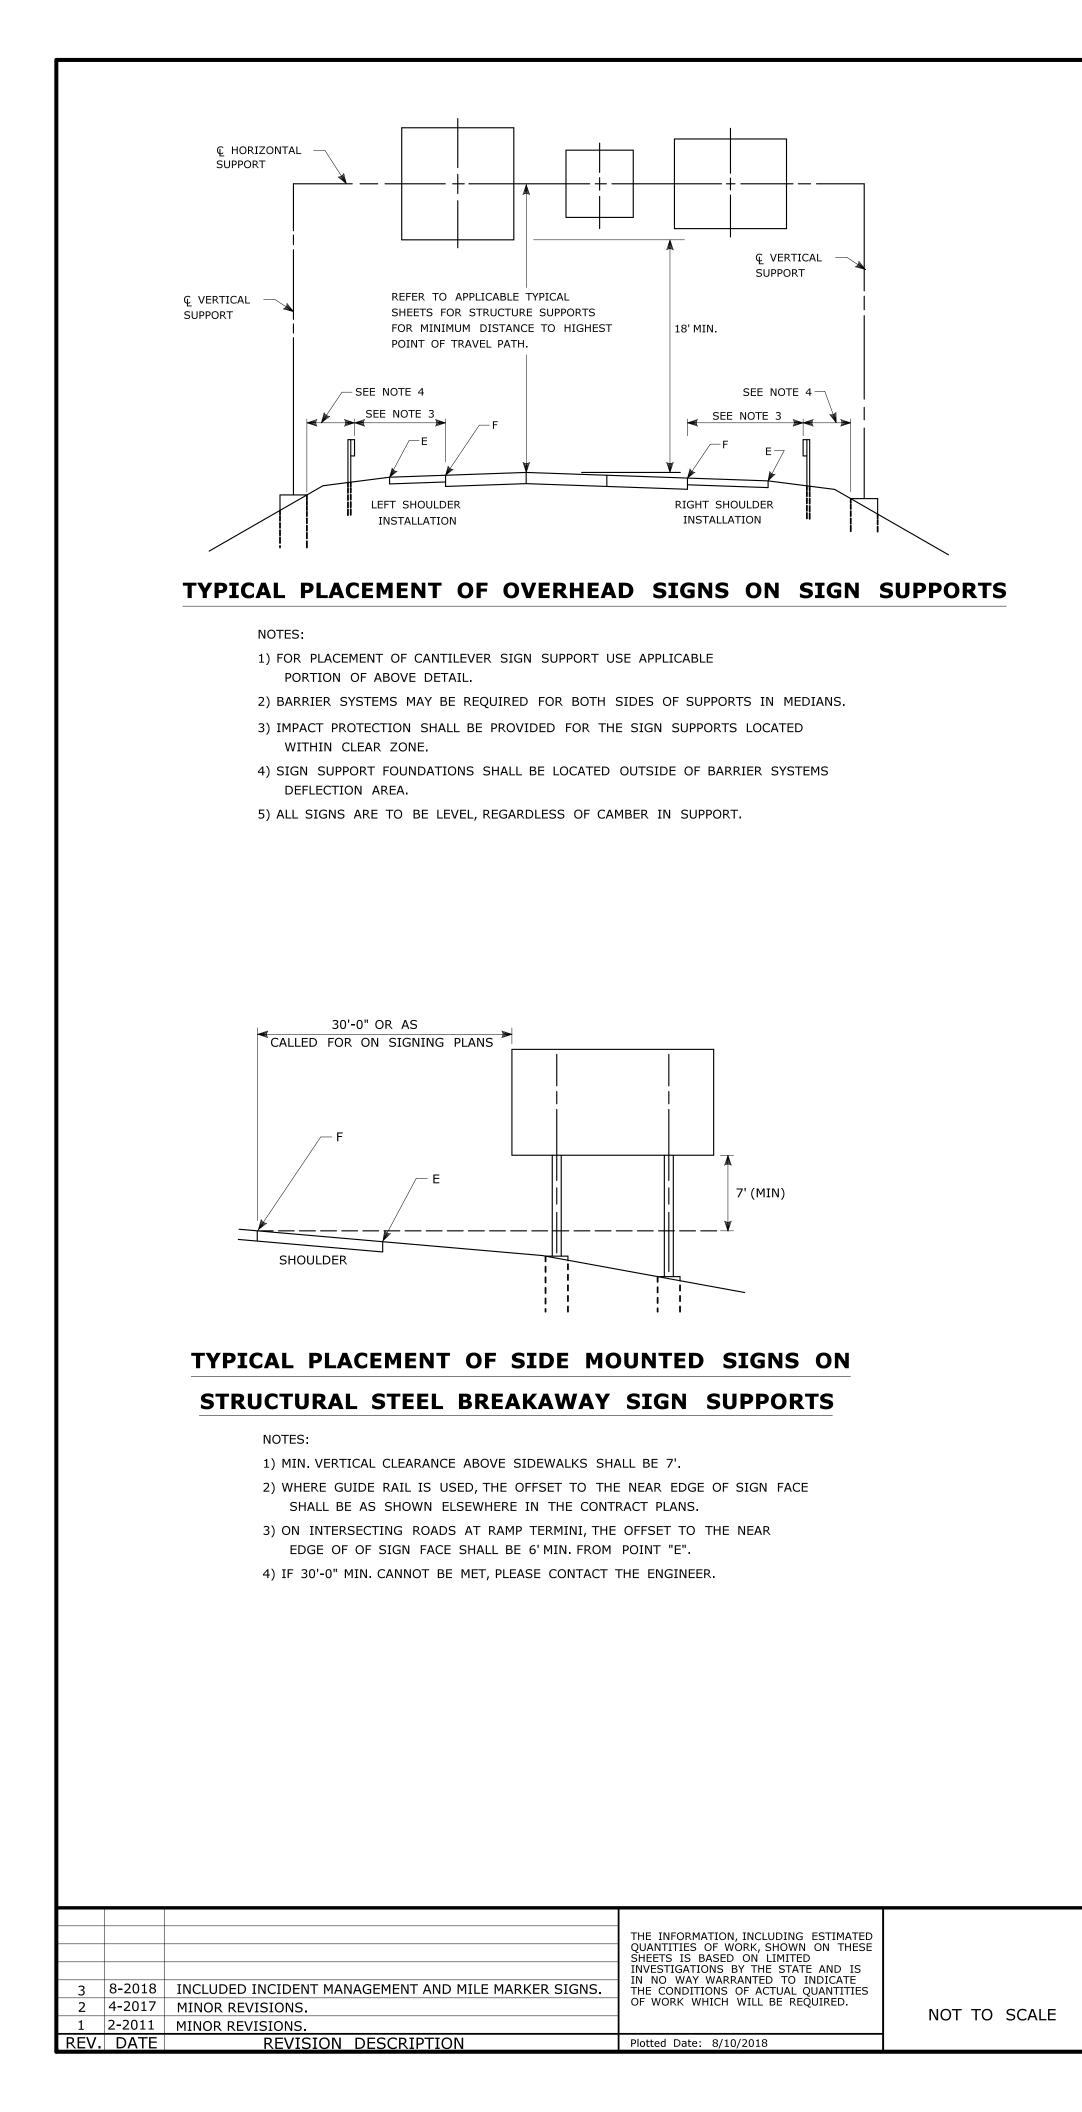

(MIECICO)	SUBMITTED BY:	NAME/DATE/TIME:	
STATE OF CONNECTICUT DEPARTMENT OF TRANSPORTATION	APPROVED BY:	NAME/DATE/TIME:	CTDOT STANDARD SHEET
		Г	

					СТДОТ	
A BOA	OWNECTIC	SUBMITTED BY:	NAME/DATE/TIME:			
				5	A CLEAR PATH OF NOT	LESS TH
				(4)	IS LIMITED OR WHERE	

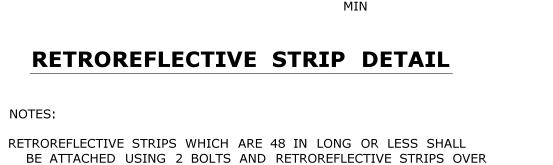

48 IN LONG SHALL BE ATTACHED USING 3 BOLTS AS SHOWN ON


REFER TO STANDARD SHEET No. TR-1208_02 "METAL SIGN POSTS

RETROREFLECTIVE STRIP COLOR SHALL MATCH THE BACKGROUND COLOR OF THE SIGN, EXCEPT THAT THE COLOR OF THE STRIP FOR "YIELD" AND

AND SIGN MOUNTING DETAILS" FOR MOUNTING DETAILS.

Model: TR-1208_01


"DO NOT ENTER" SIGNS SHALL BE RED.

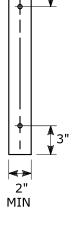

NOTES:

Filename: TR_1208_01_1_2018.dgn


THE DETAILS ABOVE.

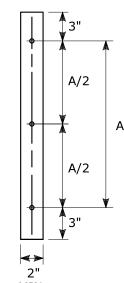


RETROREFLECTIVE STRIPS 48" LONG OR LESS:


RETROREFLECTIVE STRIPS OVER 48" LONG:

SIGN ORIENTATION DETAILS FOR SIDE MOUNTED SIGNS ON STRUCTURAL STEEL BREAKAWAY SIGN SUPPORTS

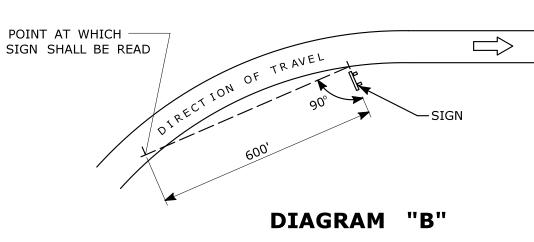

ON A HORIZONTAL CURVE SECTION, POSITION THE SIGN SO THE VERTICAL AXIS IS PLUMB AND THE HORIZONTAL AXIS IS AT AN ANGLE OF 90° WITH A STRAIGHT LINE BETWEEN THE SIGN AND THE POINT AT WHICH THE SIGN SHALL BE READ.

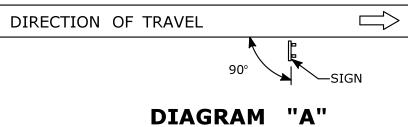

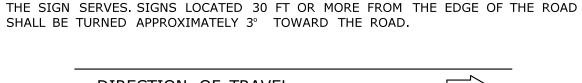

THE HORIZONTAL AXIS IS AT AN ANGLE OF 90° WITH THE TRAFFIC LANE WHICH

FOR MAXIMUM EFFECTIVENESS, POSITION SIDE MOUNTED SIGNS ON STRUCTURAL STEEL BREAKAWAY SIGN SUPPORTS AS FOLLOWS:

ON A TANGENT SECTION, POSITION THE SIGN SO THE VERTICAL AXIS IS PLUMB AND

OFFICE	OF	ENGINEERING
OFFICE	OF	ENGINEERING

ALL SIGNS AN	D SHIELDS ON	ASSEMBLIES SH				
		NDARD SHEET No. TR-1208_02 AND SIGN MOUNTING.				
			SIGN SUPPORT, E SIGN TO WIT			
PARKING SIGN	IS TYPICALLY U	SE 45° MOUNT	TING BRACKET.			
DIM."A" MIN SIGN HEIGHT	DIM."B" MIN LATERAL OFFSET (1)	DIM."C" MIN PLAQUE HEIGHT	ASSEMBLY LOO			
7' (2)	" ② ^{6'} 3 ^{5'}		SIGNS ON FRI ONE-DIRECTIO AND WRONG			
5'	5' 2' 4'		 SIGNS IN RU DO NOT ENT DO NOT ENT 			
5'	2'	N/A	CHEVRON ALL FREEWAYS, EX ONE-DIRECTION			

12' ③

2' 🕢

2' 🕢

2'

TYPICAL SIGN PLACEMENT DETAIL


NOTES:

4'

4'

7'

 $\langle 3 \rangle$

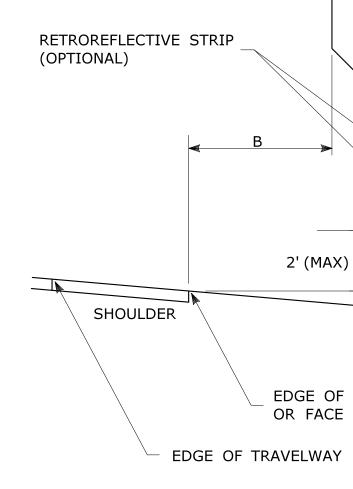

SIGN PLACEMENT AND **RETROREFLECTIVE STRIP DETAILS**

ANDARD SHEET TITLE

THAN 4 FT SHALL BE PROVIDED IN SIDEWALK AREAS.

(4) A LATERAL OFFSET OF AT LEAST 1 FT FROM THE FACE OF THE CURB MAY BE USED WHERE SIDEWALK WIDTH ING UTILITY POLES ARE CLOSE TO THE CURB.

6 FT FROM EDGE OF SHOULDER, WHEN SHOULDER IS OVER 6 FT WIDE 12 FT FROM EDGE OF TRAVELWAY, WHEN SHOULDER IS LESS THAN 6 FT WIDE.

 $\langle 2 \rangle$ 8 FT MINIMUM HEIGHT REQUIRED IF A SUPPLEMENTAL PLAQUE IS SUBMOUNTED BELOW THE MAJOR SIGN.

(1) OR AS DIRECTED BY THE ENGINEER

N/A

4'

6'


7'

UE	ASSEMBLY LOCATION
	SIGNS ON FREEWAYS AND EXPRESSWAYS EXCEPT CHEVRON ALIGNMENT SIGNS, ONE-DIRECTION LARGE ARROW SIGNS, DO NOT ENTER SIGNS, AND WRONG WAY SIGNS
	 SIGNS IN RURAL AREAS DO NOT ENTER AND WRONG WAY SIGNS ALONG EXIT RAMPS DO NOT ENTER AND WRONG WAY SIGNS ON LIMITED ACCESS HIGHWAYS
	 CHEVRON ALIGNMENT SIGNS LOCATED ON FREEWAYS, EXPRESSWAYS, RAMPS, AND IN RURAL AREAS ONE-DIRECTION LARGE ARROW SIGNS LOCATED ON FREEWAYS, EXPRESSWAYS, RAMPS, AND IN RURAL AREAS
	INCIDENT MANAGEMENT SIGNS AND MILE POST MARKER ASSEMBLIES LOCATED ON FREEWAYS AND EXPRESSWAYS
	CENTRAL ISLANDS OF ROUNDABOUTS
	BUSINESS & RESIDENTIAL AREAS WHERE PARKING OR OTHER OBSTRUCTIONS LIMIT VISIBILITY
	SIDEWALKS 5

OF THE SIGN TO WITHIN 2 FT ABOVE THE EDGE OF THE ROADWAY.

1208_02 "METAL SIGN POSTS AND SIGN MOUNTING DETAILS" FOR D ON SIGN SUPPORT, IT SHALL BE PLACED FOR THE FULL LENGTH OF

TIONAL ASSEMBLIES SHALL ABUT VERTICALLY.

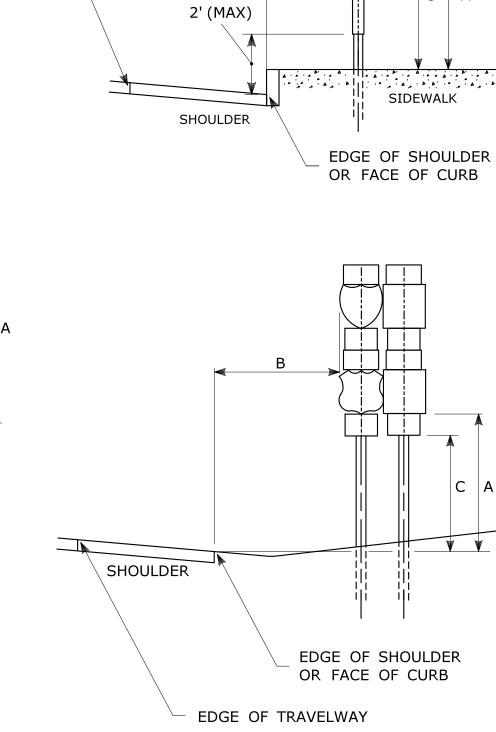

RETROREFLECTIVE STRIP

- EDGE OF TRAVELWAY

B


C

(OPTIONAL)


С EDGE OF SHOULDER OR FACE OF CURB

TR-1208_01

TANDARD SHEET NO.:

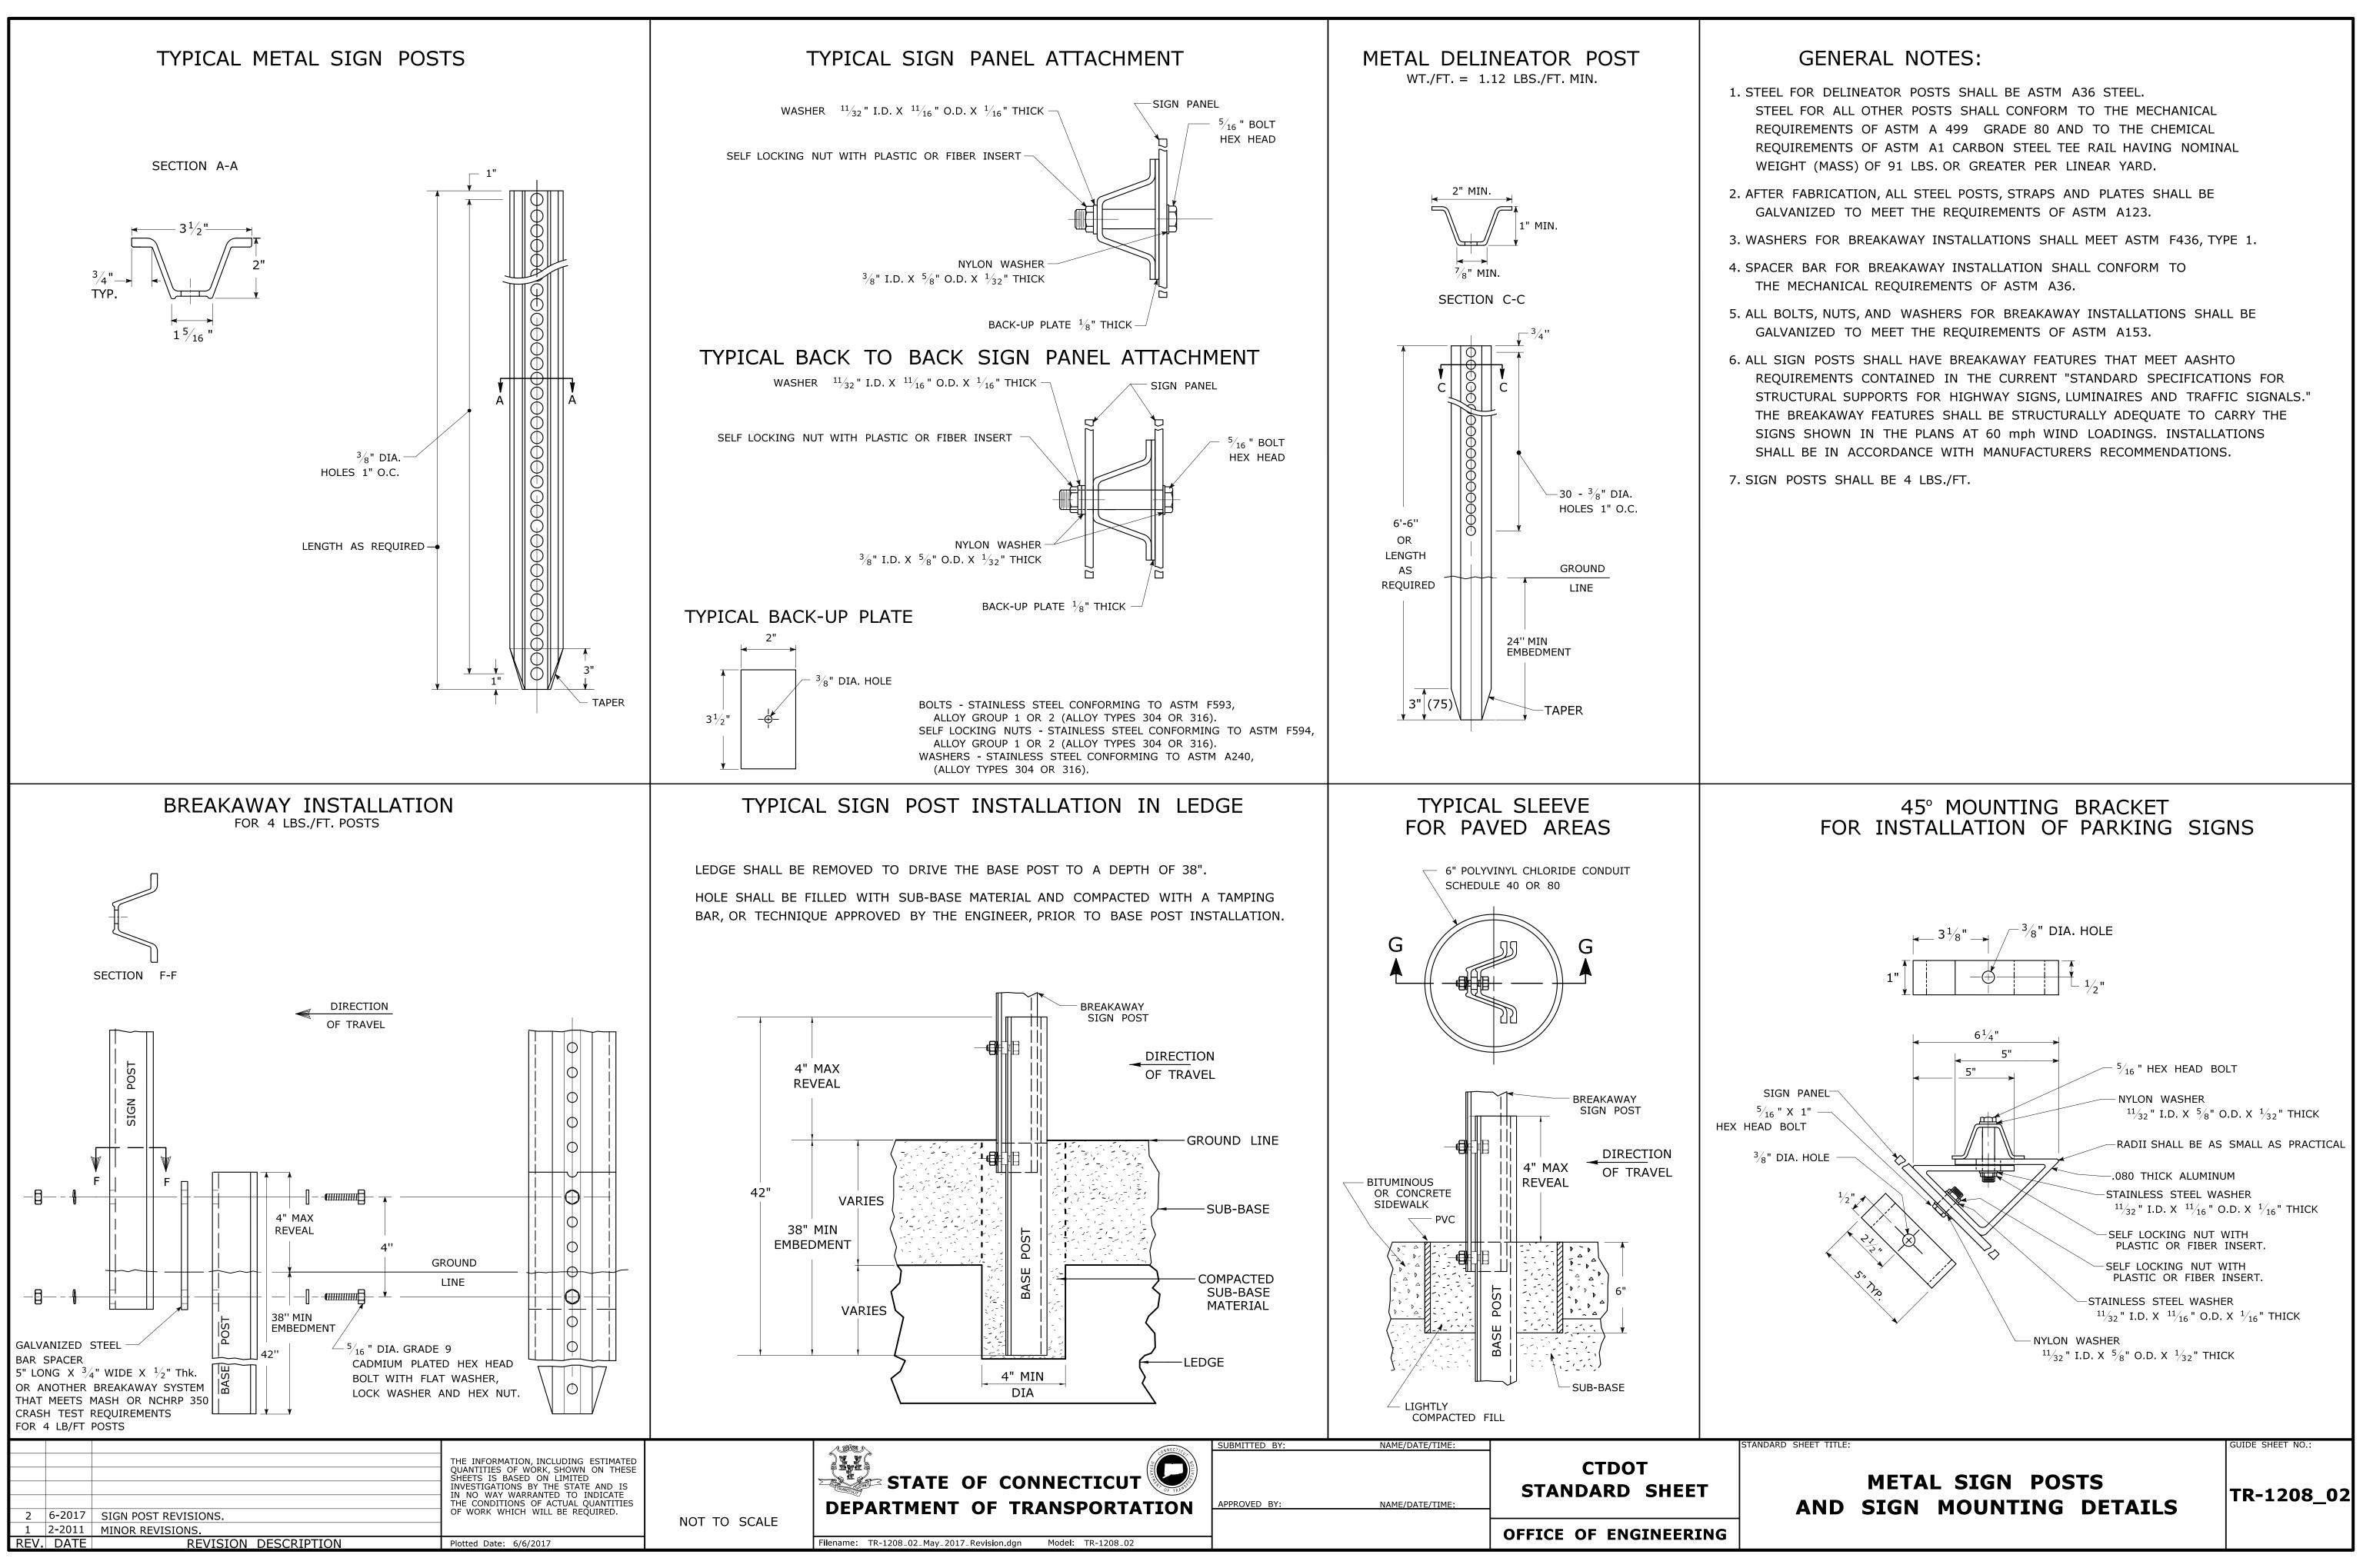



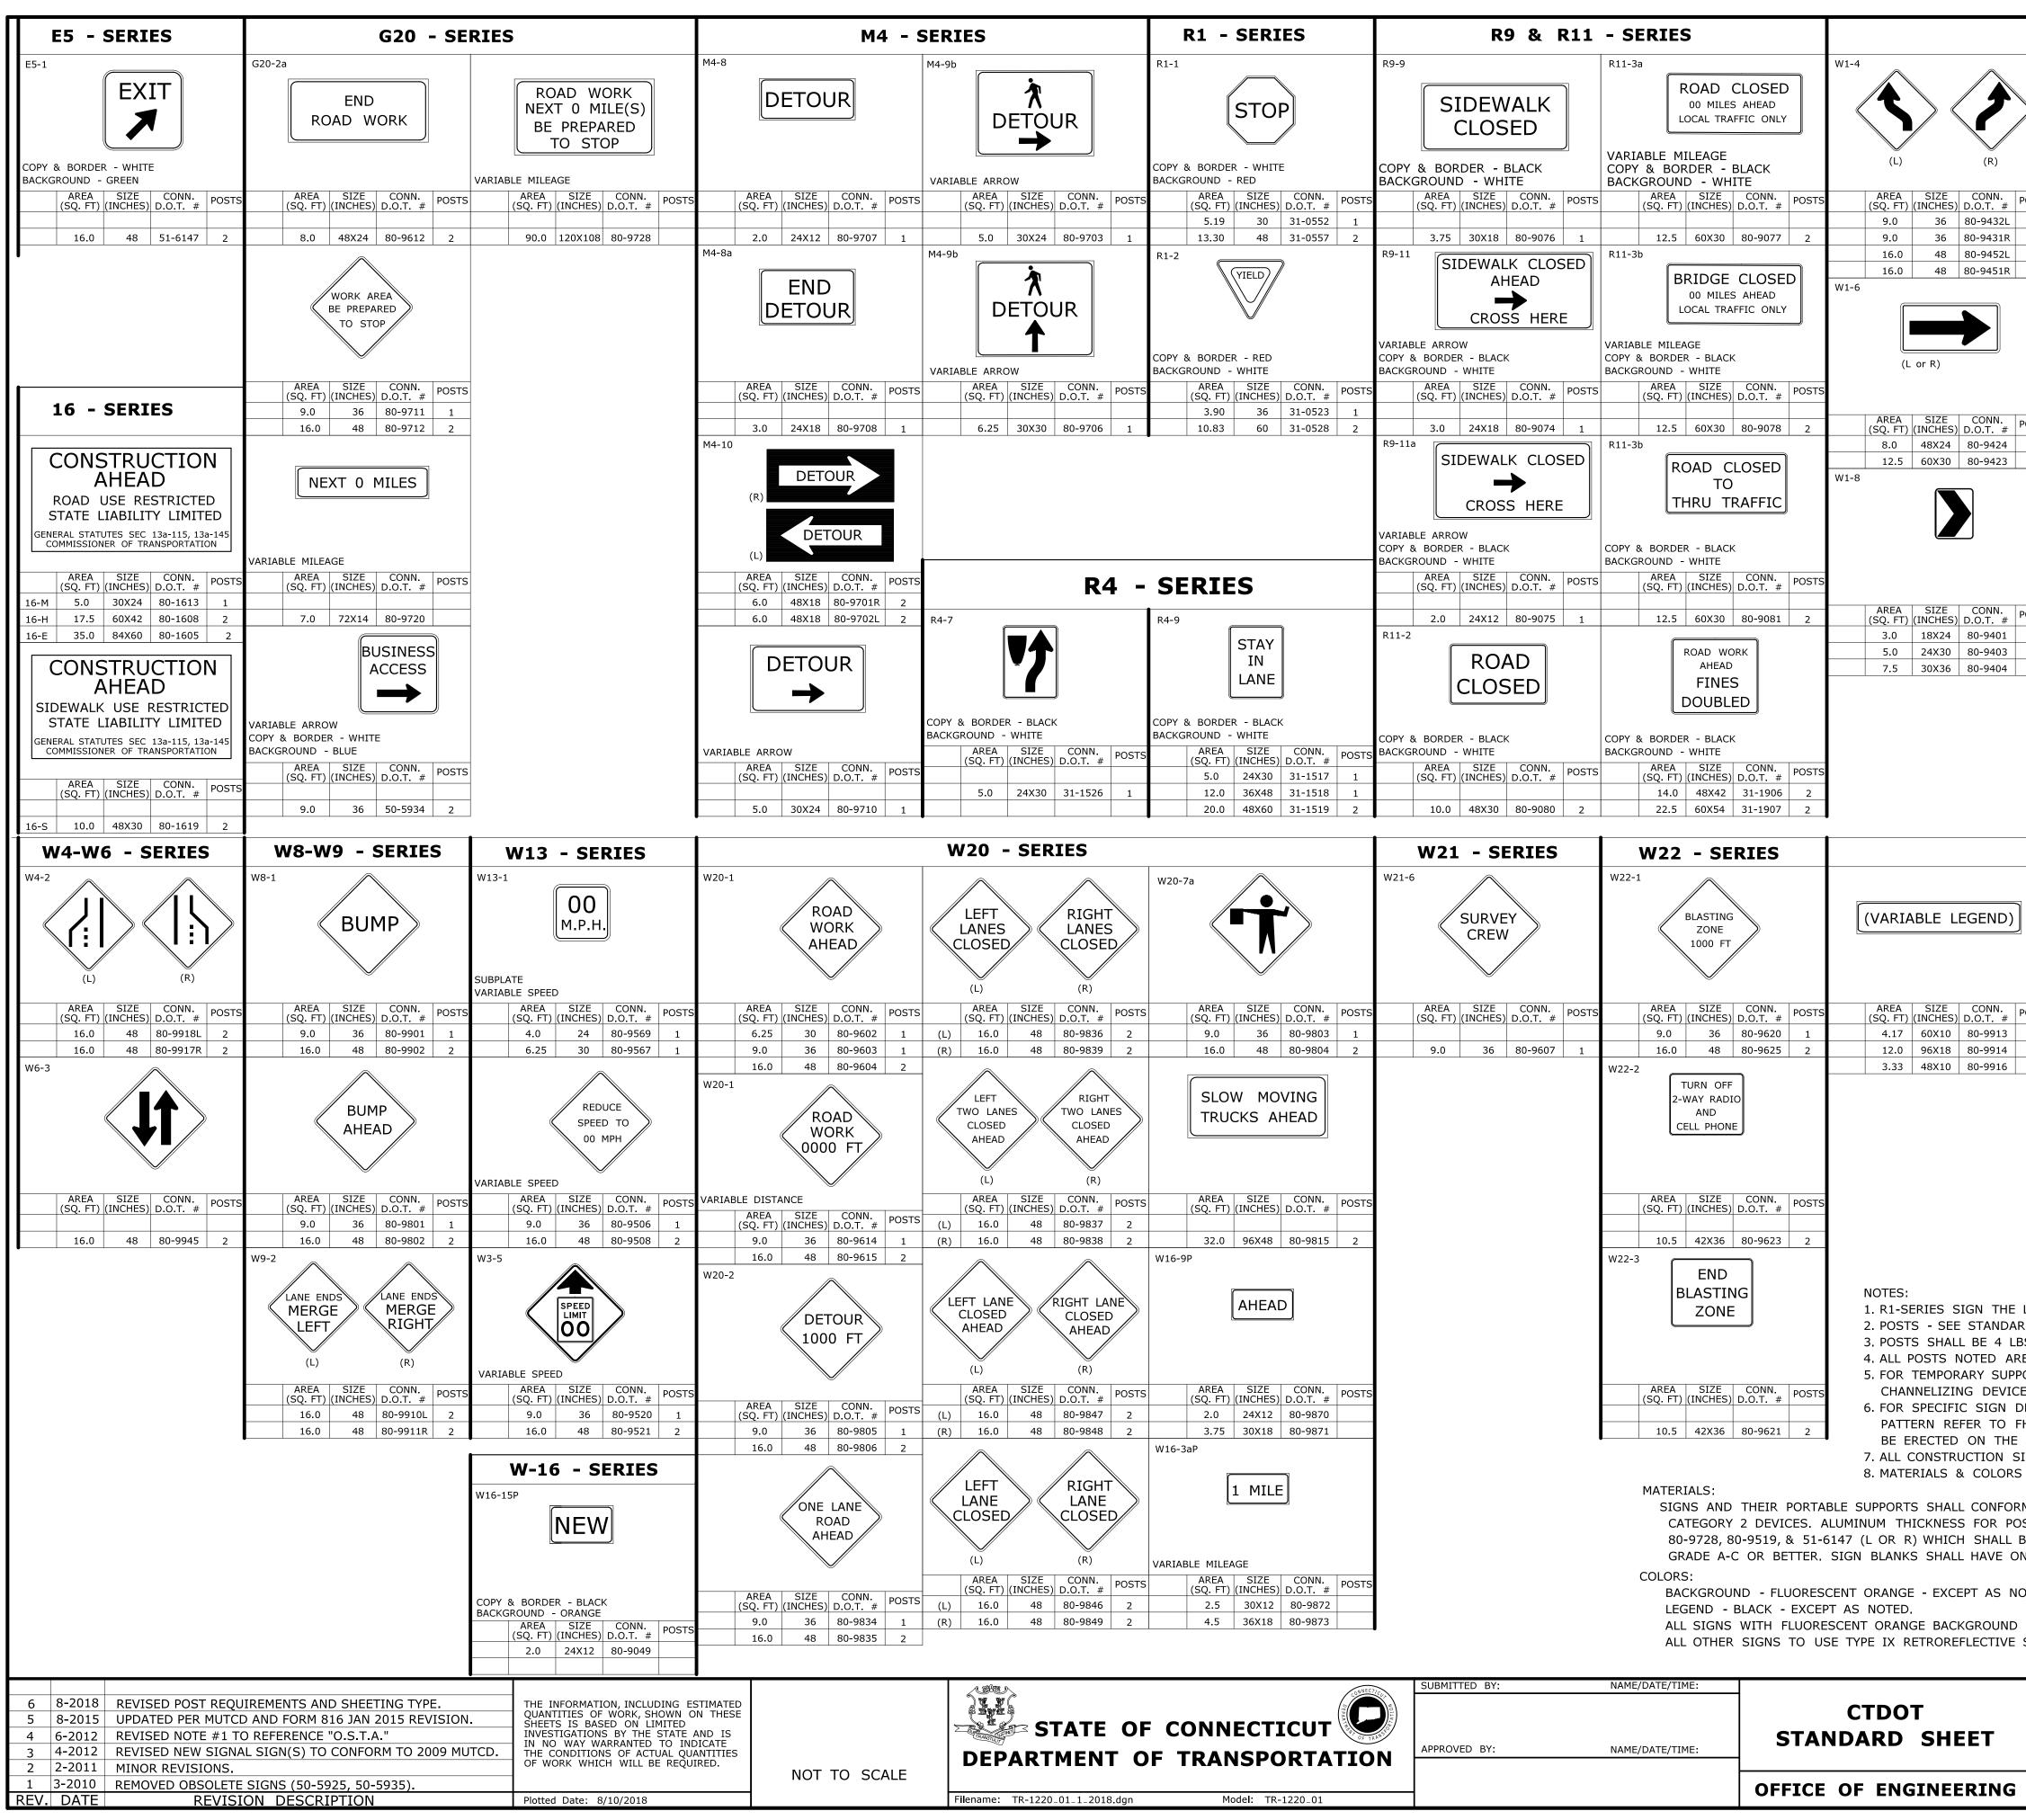


TD 1220 01	1 2010 1	Madal.	TD 1000 01

		BOTH LANES SHIFT RIGHT		>		K	
POSTS	(L)	(R)	AREA	(L)	(R)	ARROW & BORE BACKGROUND - AREA	FLUORESCENT ORANGE
1		80-9433L 2	25.0	(INCHES) D.O.T. 7 60 80-9483	≠ L 2	9.0	36 80-9050 1
1 2		80-9435R 2 V	25.0 V1-4c	60 80-9485	R 2	W3-2	48 80-9051 2
2		BOTH LANES SHIFT RIGHT					
		22	TTT	. 77		No. Contraction of the second se	∇
		■ ■ (R)			■(R)		W/ WHITE BORDER
	AREA SIZE	CONN. POSTS	AREA	SIZE CONN.	POSTS	AREA	FLUORESCENT ORANGE
		80-9434L 2	25.0	(INCHES) D.O.T. ; 60 80-9484	≠ L 2	9.0	36 80-9054 1
2		30-9436R 2	25.0	60 80-9486	R 2	W3-3	48 80-9055 2
2							
						TOP CIRCLE - RE	
		AHEAD				MIDDLE CIRCLE BOTTOM CIRCLE	- YELLOW ❤ - GREEN
	AREA SIZE	CONN. POSTS				AREA	FLUORESCENT ORANGE
		80-9443L 2				9.0	36 80-9052 1
	25.0 60 8	30-9445R 2				16.0	48 80-9053 2
1							
		77					
		(R)					
	AREA SIZE	CONN. DOSTS					
		80-9444L 2					
	25.0 60 8	30-9446R 2					
						STOP-SL	OW PADDLE
	\land					SIDE A	SIDE B
				ARIABLE)		STOP	SLOW
						SIDE A BACKGROUND - COPY & BORDE	
	ANK OR					SIDE B BACKGROUND -	
POSTS	AREA SIZE (SQ. FT) (INCHES) [CONN. D.O.T. # POSTS	AREA (SQ. FT)	SIZE CONN. (INCHES) D.O.T. ;		AREA	SIZE CONN. INCHES) D.O.T. # POSTS
2	9.0 36	80-9933 1	12.5	60X30 80-9928	3 2	2.25	18 80-9950 PADDLE
2	16.0 48	80-9934 2	24.0	72X48 80-9929	9 2		
	USE		SHOULDER				
	SHOULDE		CLOSED AHEAD				
	AREA	CONN. POSTS	(1)	(2)	DOSTS		
	(SQ. FT) (INCHES) I 16.0 48	80-9956 2	(1) 16.0	(INCHES) D.O.T. 4 48 80-995	72		
			(2)9.0(2)16.0	36 80-9958 48 80-9959	_		
LEGEND) "O.S.T.A." SHALL /	APPEAR.					
D SHE S./FT.	ET TR-1208_02 - "M	1ETAL SIGN POS	STS AND SI	GN MOUNTING	G DETAI	LS".	
	LONG TERM INSTA SEE STANDARD SHE					TS AND	
ES". ESIGN,	CONTACT CONN. D	.O.T., DIVISION	OF TRAFFIC		G. FOR	BOLT HOLE	
HWA P	JBLICATION "STAND POSTS, OR SPAN/MA	DARD HIGHWAY	SIGNS". SI	GNS OF DIFFE	RENT D	IMENSIONS TO	
IGNS T	O BE PAID FOR UN CONFORM TO STA	NDER THE CONS	STRUCTION S	-			
	THE REQUIREMENTS			1-3) OR THE	ΔΔΩΗΤΟ	MASH FOR	
ST ΜΟΙ	JNTED SIGNS SHAL	L BE .100" EXC	EPT SIGN #	s 80-1605,80	-9914, 8	80-9815,	
	", PLYWOOD THICKN T OF PRIMER PAINT				=		COPY.
DTED.							
	E TYPE VIII RETROF	REFLECTIVE SHE	ETING.				
SHEETI	NG.						
STAND	ARD SHEET TITLE:						STANDARD SHEET NO.:
	STGN	S FOR	CONS	TRUCT		J	
		D PERM				-	TR-1220_01


W3 - SERIES

W1 - SERIES

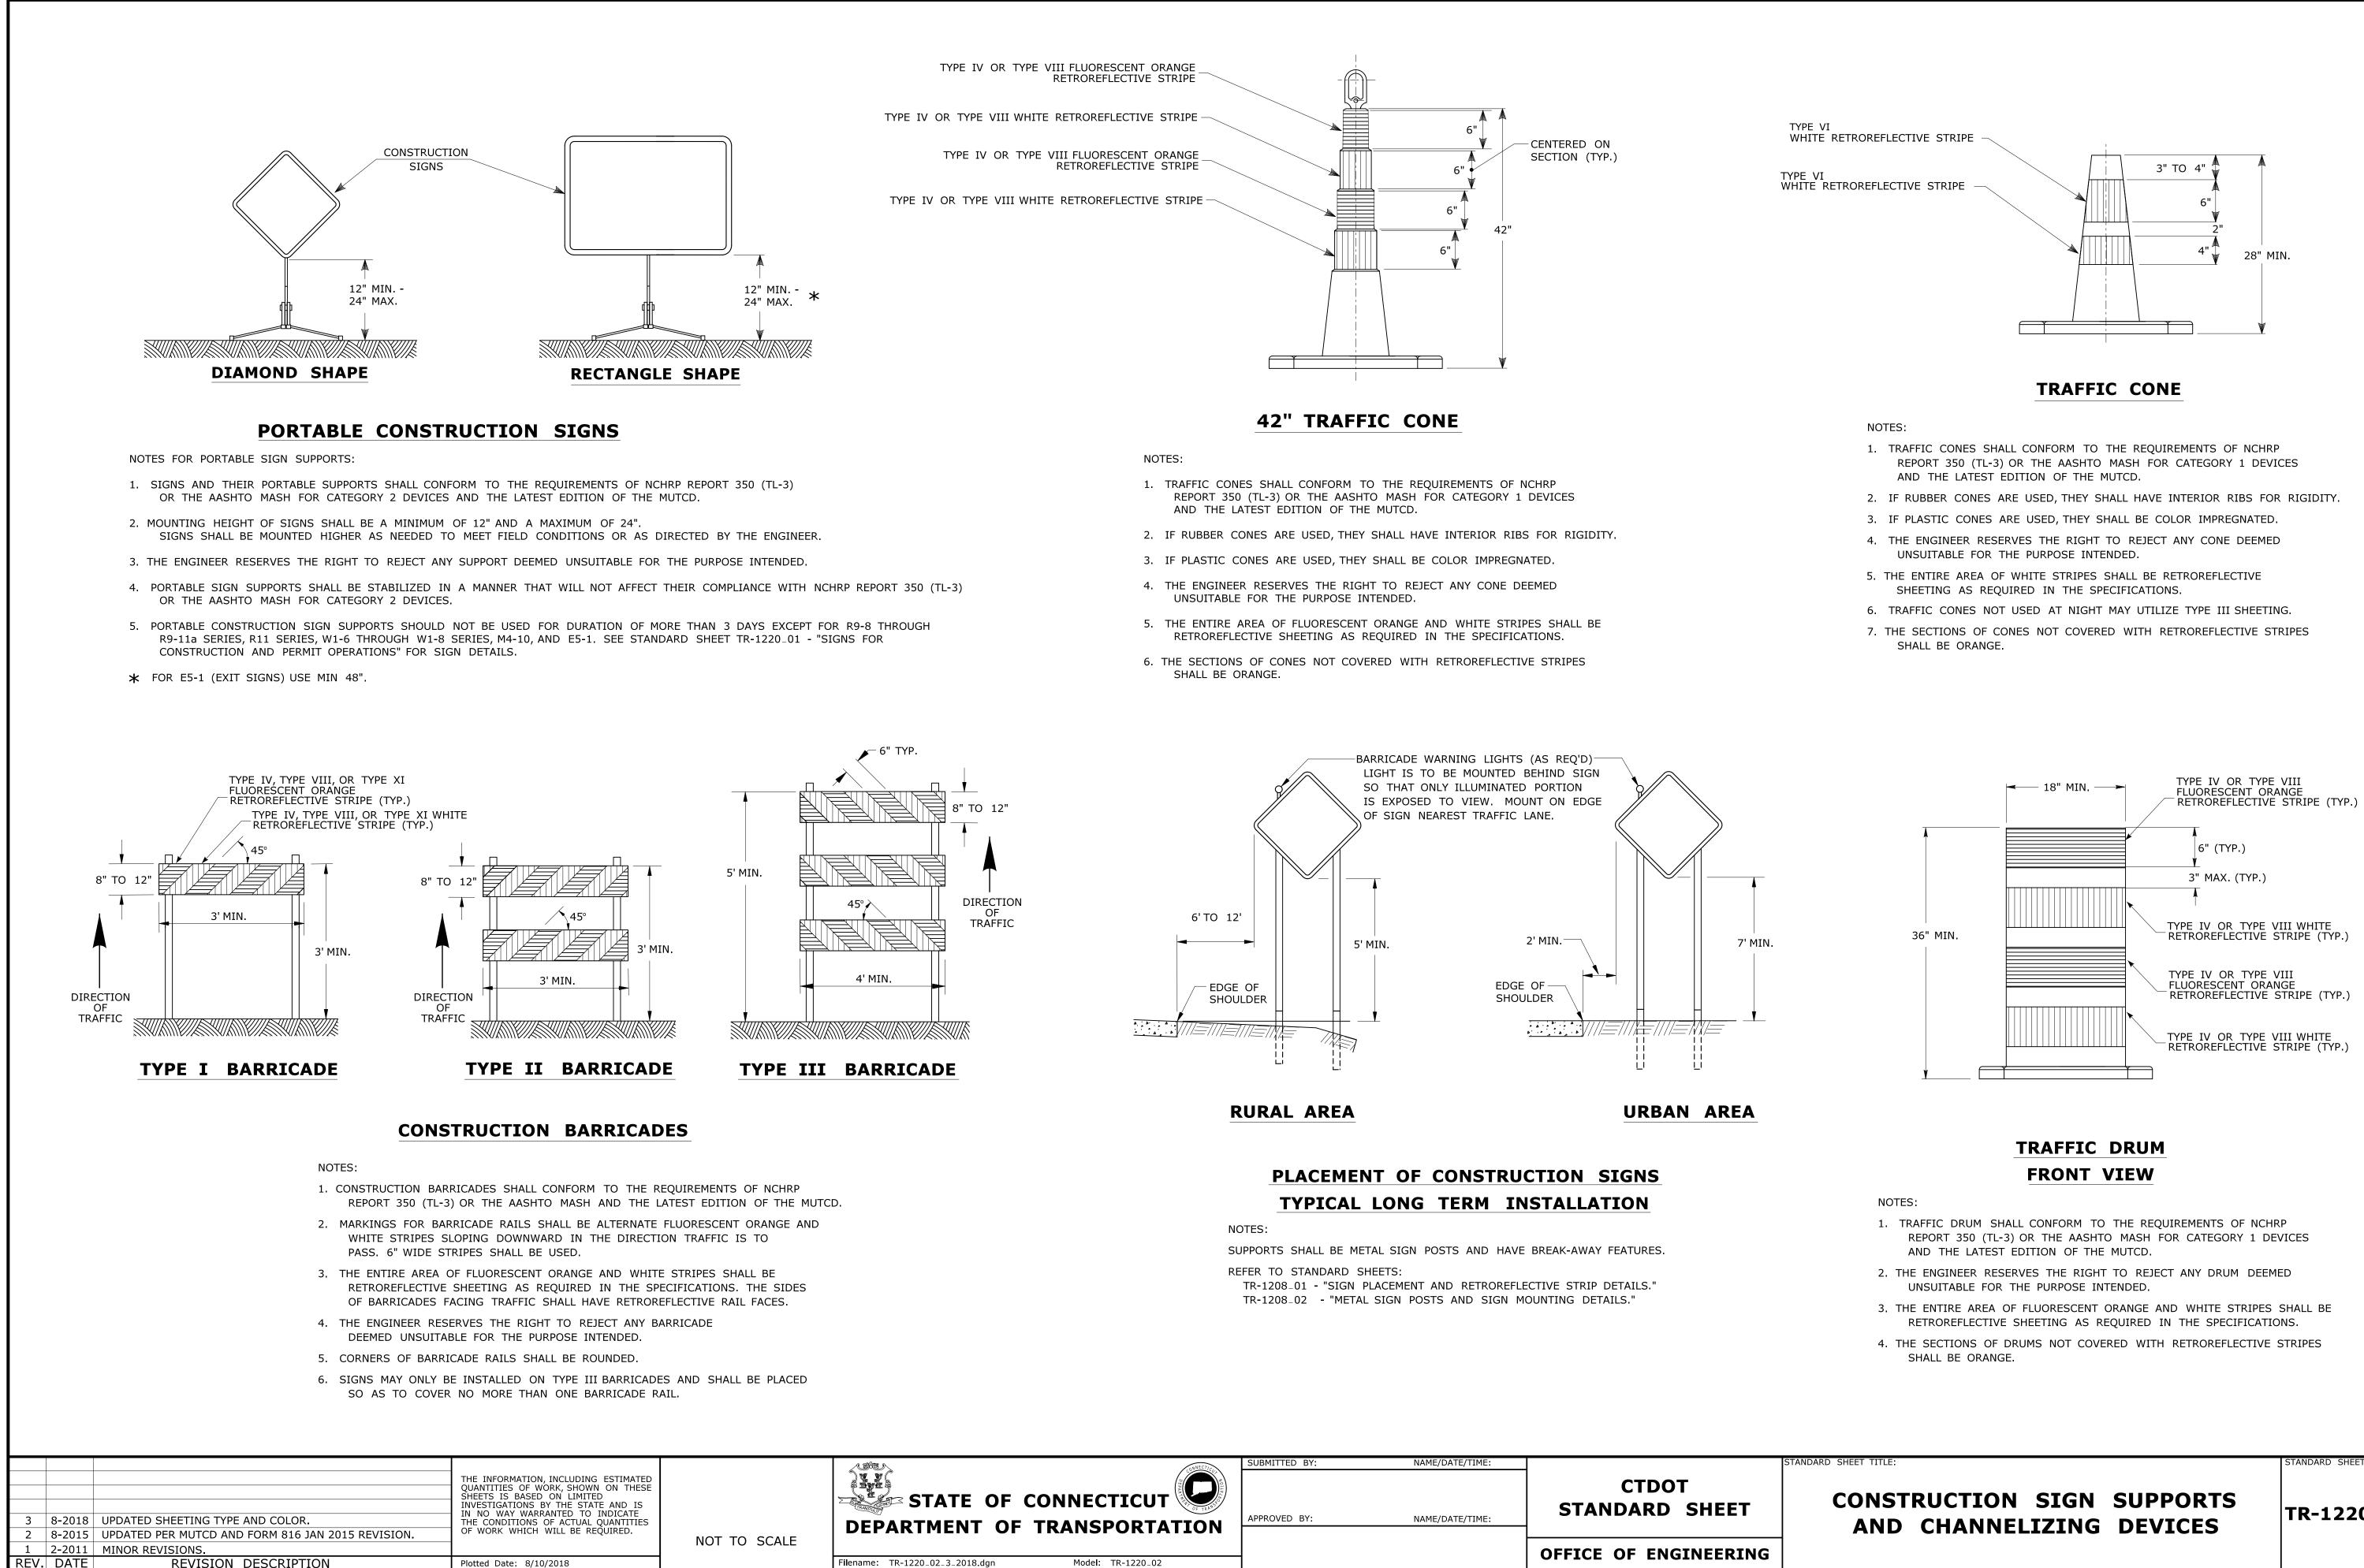

FANDARD SHEET NO.:

TR-1220_02

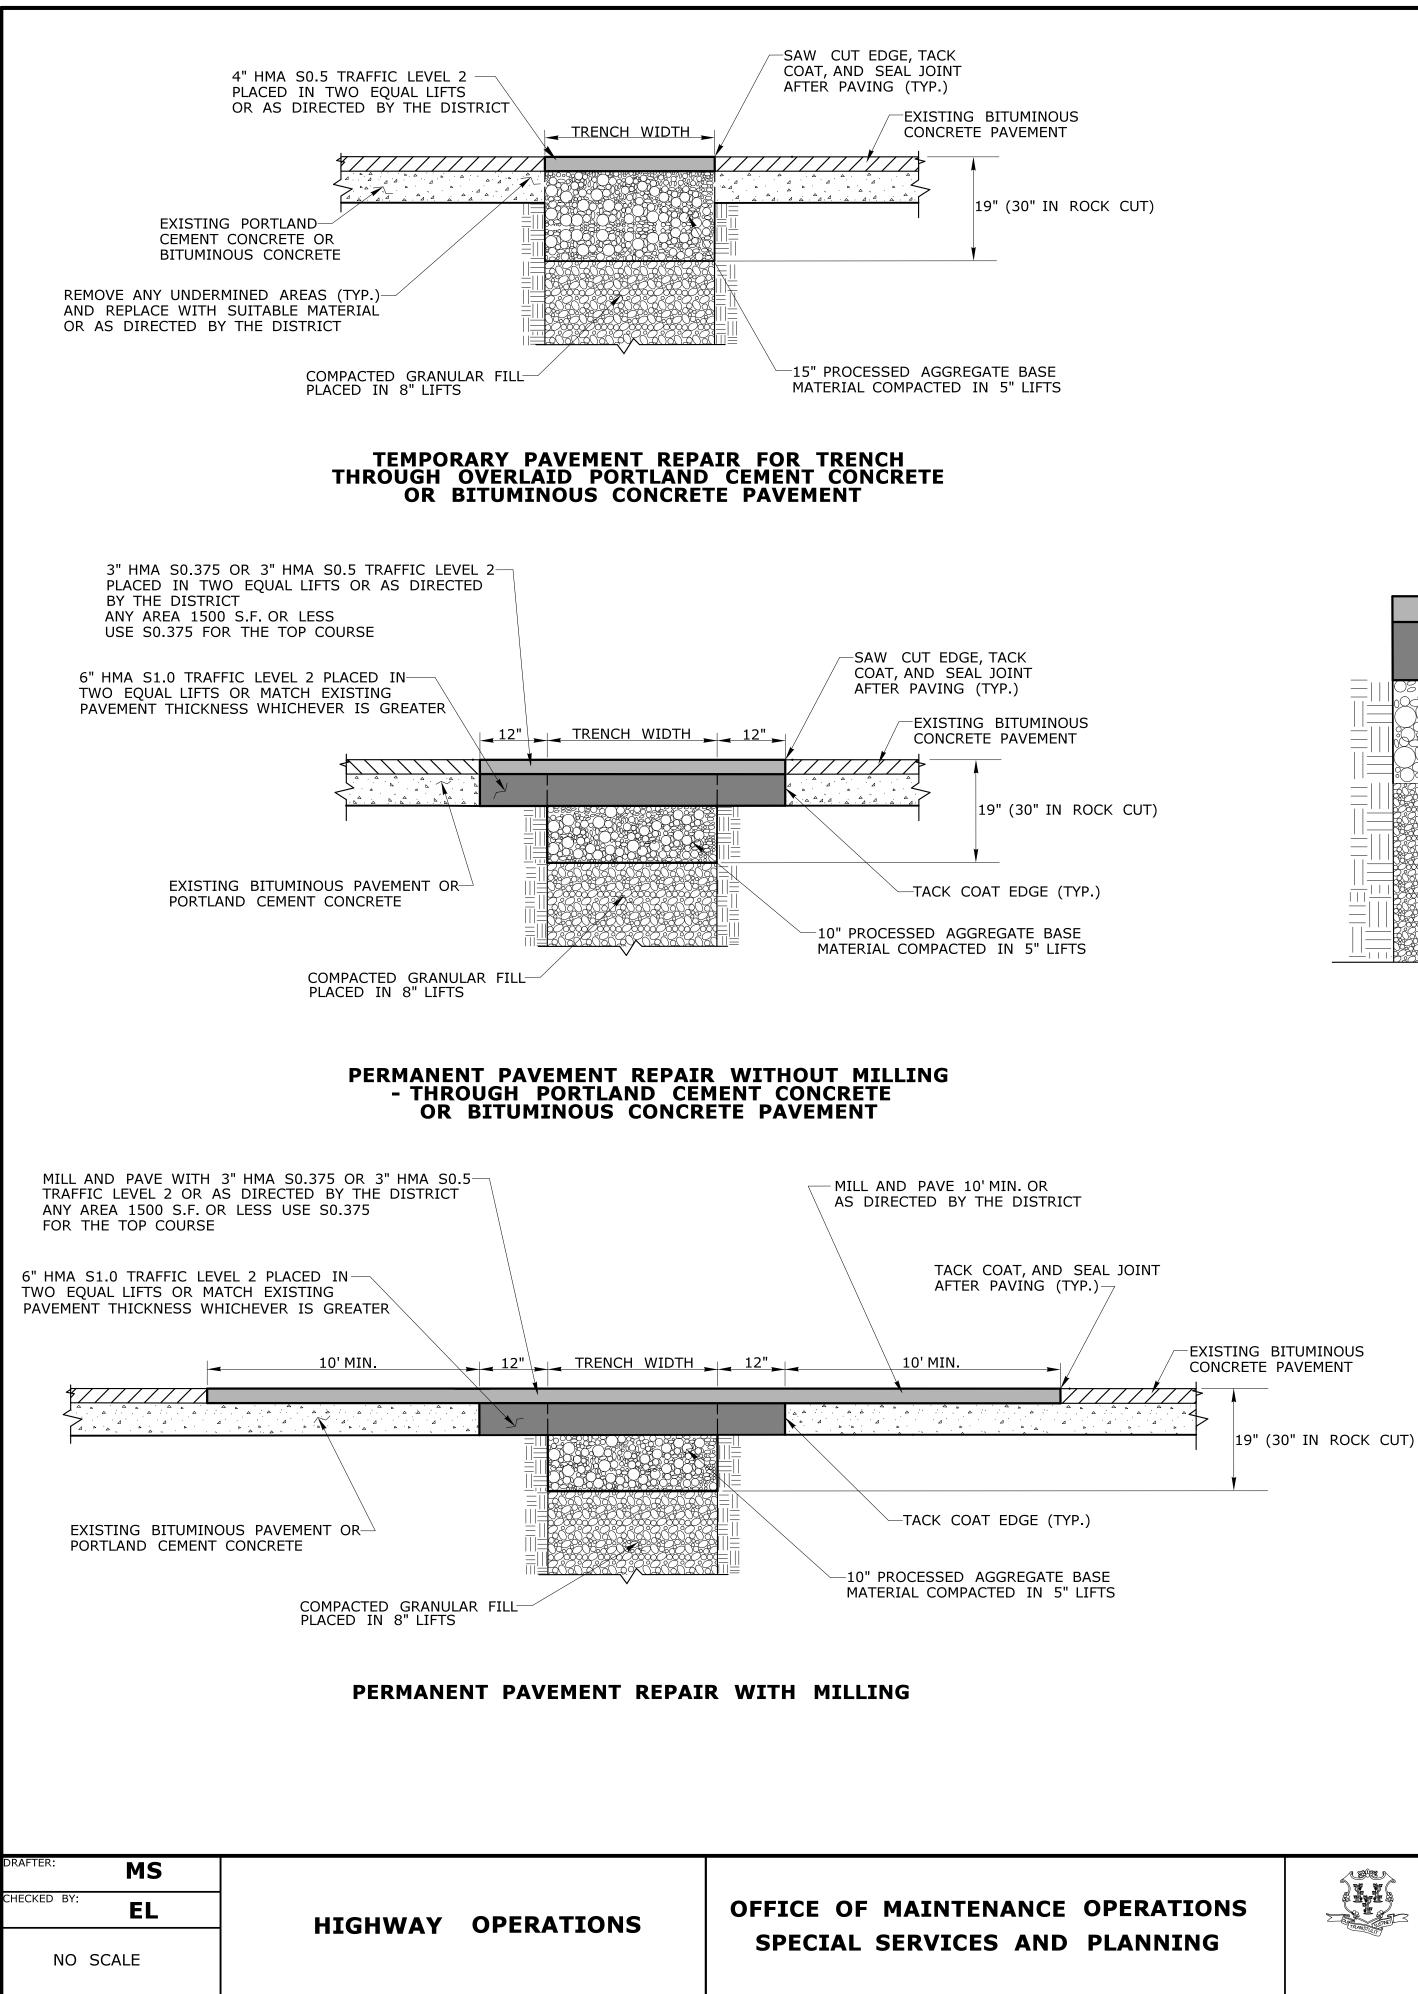








WITH THE FINAL LIFT BEING 2" 2. TRANSVERSE TRENCHING FOR JOINTED CONCRETE PAVEMENT: TABLE 1 TOTAL SLAB LENGTH (L) MIN. LENGTH REMAINING 40' OR LONGER 15' - 40' 15' OR SHORTER

GENERAL NOTES:

WITH THE FINAL LIFT BEING 2"

1/4 L

10'

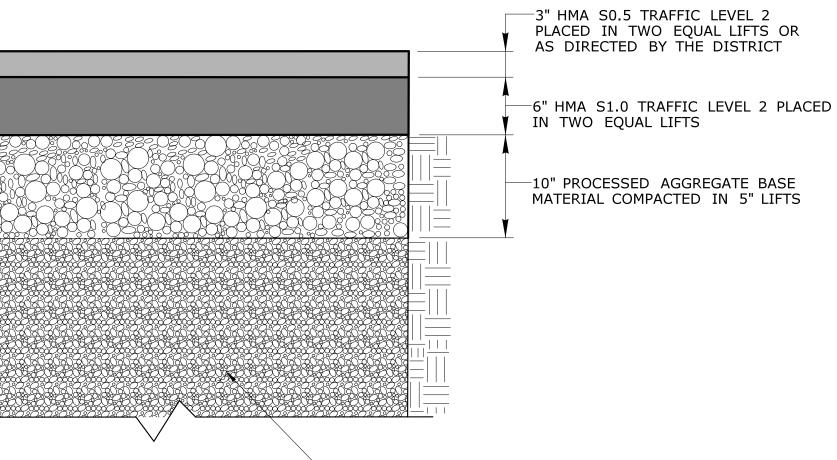

ROADWAY PROFILE

-COMPACTED GRANULAR FILL PLACED IN 8" LIFTS



