


July 23, 2024



12222 Merit Dr.
Suite 400
Dallas, TX 75251
(972) 788-4222
www.rwb.net
TBPE Registered Firm# 2176

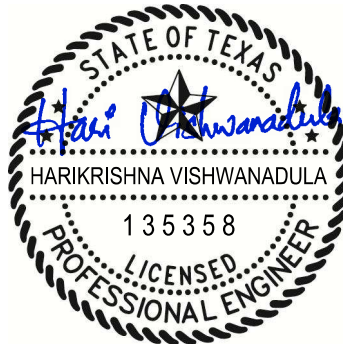

07.23.2024

MECHANICAL ENGINEER OF RECORD

**RWB CONSULTING ENGINEERS
MECHANICAL, PLUMBING & ELECTRICAL ADDENDUM 2 ITEMS FOR
WALNUT GROVE MIDDLE SCHOOL CHILLER REPLACEMENT
MIDLOTHIAN I.S.D.**

Questions from the Pre-Bid meeting and after:

- i. Is the refrigerant monitoring system intended to be furnished and installed under division 23 09 00?

Response: Yes, shall be furnished under mechanical 23 09 00

- ii. On drawing MP1.01, should the note at the air separator be Note 2?

Response: Yes, it should be note 2. Will correct in the Addendum.

- iii. On drawing MP1.01, Note 3 reads "to be installed under alternate scope". This is to be included in the base bid correct?

Response: Yes, it should be part of base bid. Will correct it in the Addendum.

- iv. Is there an alternate manufacturer allowed for the SCBA? It appears International Safety Instruments (ISI) is no longer in business.

Response: MSA or approved equal can be submitted as an alternate manufacturer for the SCBA that meet/exceed the specifications.

- v. Is there a possibility that a second job walk could be scheduled and the bid date extended by a week or so?

Response: Yes, please reach out to Chris Johnson from the district to schedule a site visit. His contact number is # 469 901 8323. Bid date will not be extended and will remain the same.

- vi. Is there a bid bond required for this project?

Response: Yes, refer to specifications.

The following items modify the Specifications and Drawings and shall become part of the Contract Documents.

REVISIONS TO THE PROJECT MANUAL

The following specifications have been revised in this addendum. These revisions shall replace previously issued specifications as noted below.

1. SECTION 00 30 00 – Proposal Form

- a. Added 20 HP and 30 HP VFDs to the VFD unit pricing list. See attached for revised proposal form.

2. SECTION 23 64 16 – Centrifugal Water Chillers

- a. Refer to Article 2.3, Note 'H', revise item 5 to read as follows
 - 5. Acceptable Manufacturer: International Safety Instruments (ISI) "Vanguard", MSA or approved equal.

REVISED & REISSUED DRAWINGS

The following list of drawings notes drawings revised and re-issued in this addendum. Previous versions of these drawings shall be removed and replaced with these revised drawings.

1. REVISED & REISSUED DRAWINGS:

- 1. COVER SHEET
- 2. M1.00 – ORIENTATION FLOOR PLAN – LEVEL 1 - MECHANICAL
- 3. M2.00 - ORIENTATION FLOOR PLAN – LEVEL 2 - MECHANICAL
- 4. DMP1.01 – DEMOLITION FLOOR PLAN – CENTRAL UTILITY PLANT – MECHANICAL AND PLUMBING
- 5. DM1.02 – ENLARGED DEMOLITION FLOOR PLANS – LEVEL 1 - MECHANICAL
- 6. DM2.01 – ENLARGED DEMOLITIONS FLOOR PLANS – LEVEL 1 - MECHANICAL
- 7. DM3.01 – HYDRONIC FLOW DIAGRAMS DEMOLITION - MECHANICAL
- 8. MP1.01 – FLOOR PLAN – CENTRAL UTILITY PLANT – MECHANICAL
- 9. M1.02 – ENLARGED FLOOR PLANS – LEVEL 1 - MECHANICAL
- 10. M2.01 – ENLARGED FLOOR PLANS – LEVEL 2 - MECHANICAL
- 11. M3.01 – HYDRONIC FLOW DIAGRAMS - HVAC
- 12. M4.01 – DETAILS, SCHEDULES, & LEGEND – MECHANICAL

END OF RWB CONSULTING ENGINEERS' ADDENDUM ITEMS

SECTION 00 30 00**PROPOSAL FORM**

SUBMITTED BY:

(Name of Proposer)

(Address)

Dear Sir:

The undersigned, having examined the drawings, specifications, related documents, and the site of the proposed work, and being familiar with all of the conditions surrounding the work, including the availability of materials and labor, hereby proposes to furnish all labor, materials, and equipment required for the Chiller Replacement at Walnut Grove Middle School, in accordance with the drawings and project manual prepared by RWB Consulting Engineers for the lump sum of:

BASE PROPOSAL amount of:

Dollars (\$_____).

Under ALTERNATE NO. 1, Provide the added cost to provide replacement Variable Frequency Drives (VFDs) for all VFDs noted in the contract documents. This cost shall include the equipment cost only and shall NOT include any associated cost to remove and install the new VFDs or any associated labor or other cost.

ALTERNATE NO. 1 amount of:

Dollars (\$_____).

Under ALTERNATE NO. 2, Provide the added cost to provide an extended four (4) year compressor warranty for the centrifugal chiller, which will result in a total of five (5) years from the date of substantial completion.

ALTERNATE NO. 2 amount of:

Dollars (\$_____).

Under ALTERNATE NO. 3, Provide the added cost to provide a five (5) year maintenance contract on the entire Central Plant, to include all associated mechanical and plumbing equipment in the central plant. This will include all annual inspections required to be conducted on all equipment as well. Refer to Section 01 01 01 Annual Maintenance Service Scope, for scope of work to be included in this maintenance contract. This maintenance contract shall start at the conclusion of the required one (1) year warranty for the scope of work for the base proposal work.

ALTERNATE NO. 3 amount of:

Dollars (\$_____).

Provide Unit Pricing to install the following Variable Frequency Drives (VFD), which are all located indoors in mechanical rooms and serve either pumps or air handlers:

VFD Size	Unit Pricing to Install One (1) VFD of this associated HP at either an indoor AHU or Pump (\$)
1 HP	
2 HP	
3 HP	
5 HP	
10 HP	
20 HP	
30 HP	

Provide the associated equipment lead time of the equipment below and which manufacturer was included in the base bid proposal:

Equipment Type	Manufacturer	Equipment Lead Time (Months)
Centrifugal Chiller		
Variable Frequency Drive		

Notes:

1. Amount shall be shown in both words and figures. In case of discrepancy, the amount shown in words shall govern.
2. Prices listed on Bid Form acknowledge that work for Walnut Grove Middle School cannot begin until Thanksgiving or Winter Break of 2024.
3. The above amount does not include State of Texas Sales Tax.
4. The above amounts do include allowances as stated in Section 01 02 00.
5. The Base Proposal Work is intended to be performed during normal working hours, except for activities that create excessive noise or causes a disruption in building services. In these instances, work shall be performed only when scheduled by the Owner, after hours, or on weekends.
6. Building will not be available to contractors until Thanksgiving or Winter Break. Thanksgiving Break starts Tuesday November 26, 2024 at noon and ends December 1, 2024 at 11:59PM. Phased work will need to be coordinated with the district. Winter Break starts 5:00PM on December 20, 2024 and ends January 5, 2025 at 11:59PM.
7. All Base and Alternate Proposal work shall be substantially completed by 11:00PM January 5, 2025, unless the VFD lead time does not allow for work to be done over Winter Break. If VFD lead time is extended, then ONLY work for VFD replacement scope can be extended to be completed during Spring Break. Spring Break is from Friday March 7, 2025 at 5:00PM until Sunday March 16 at 11:59PM.
8. Contractor shall include cost to work double shifts and/or weekends as required to complete project by required substantial completion date.
9. Contractor shall include any required equipment expediting cost and charges to complete the work within the timeline established based on the associated notice to proceed listed, site availability, and substantial completion date.

10. The following is the associated proposal and award schedule for the project:

- a. Pre-Bid Meeting: July 16, 2024 @ 11am CST @ WGMS.
- b. Questions Due: July 19, 2024 by 12:00pm CST.
- c. Final Addenda: July 23, 2024, posted by 4pm CST.
- d. Proposals Due: August 1, 2024 by 2pm CST.
- e. Board Meeting: August 19, 2024
- f. Notice to Proceed: August 20, 2024.

The undersigned affirms that the above stipulated base Proposal sum represents the entire cost per drawings, specifications, and addenda and that no claim will be made on account of any increase in wage scales, material prices, taxes, insurance, cost indexes, or any other rates affecting the construction industry and/or this project.

The undersigned Proposer agrees that this Proposal shall be good and may not be withdrawn for a period of 45 calendar days after the scheduled closing time for receiving Proposals.

The undersigned Proposer understands that the Owner reserves the right to reject any or all Proposals and to waive any informalities in the Proposal.

The Owner reserves the right to require Bonds of the successful Proposer. If written notice of acceptance of this Proposal is received within 45 days after date designated for opening of Proposals, the undersigned, within 10 days of receipt of the Contract, will sign and deliver to the Owner the contract and any required Performance Bond, Labor and Material Payment Bond and properly executed Insurance Verification Form required by the Owner.

Should the undersigned fail to deliver the signed Contract or the required Bonds or Insurance Form within the 10 day period, the Owner reserves the right to terminate the relationship.

TIME OF COMPLETION AND LIQUIDATED DAMAGES

1. The contract date will be established as the number of consecutive calendar days as set out on the proposal form from the "Notice-to-proceed" date issued by the Owner.
2. Failure of the Contractor to complete the Work by the contract date will result in damages being sustained by the Owner. Such damages are, and will continue to be, impracticable and extremely difficult to determine. Due consideration will be given to delays falling within agreed terms of the contract.
3. The Contractor will pay the Owner Five Hundred Dollars (\$500.00) for each calendar day of delay in finishing the Work in excess of time specified for completion, plus authorized time extensions. Execution of the Contract under these specifications shall constitute agreement by the Owner and Contractor that the amount indicated is the minimum value of the costs and actual damage caused by failure of the Contractor to Substantially Complete the Work within the allotted time, that such sum is Liquidated Damages and shall not be construed as a penalty, and that such sum may be deducted from payments due the Contractor if such delay occurs.

Addenda: The undersigned hereby acknowledges receipt of the following addenda to the Drawings and Specifications, all of the provisions and requirements of which addenda have been taken into consideration in the preparation of this Proposal.

Addendum No. _____ dated _____ Addendum No. _____ dated _____

Addendum No. _____ dated _____ Addendum No. _____ dated _____

Addendum No. _____ dated _____ Addendum No. _____ dated _____

Date: _____

Signed _____

Title _____

Name of Firm _____

Organized as a: (Mark one)

Proprietorship _____

Partnership _____

Corporation _____

Under the law of the State Of:

(Date)

Legal Address:

Telephone No. _____

Fax No. _____

E-mail _____

If Proposal is by a corporation, affix seal above address.

END OF PROPOSAL FORM

MIDLOTHIAN ISD

INSPIRING EXCELLENCE

CSP 2425-01 WGMS CHILLER PROJECT

07/16/24	WGMS Chiller Project	Pre-Bid Date:	July 16, 2024 @ 11 am
Pre-Bid	MISD	Place/Room:	WGMS

Name	Company	Phone	E-Mail
Scott Moore	Infinity	469-5784679	scott.moore@infinitycontractors.com
Sohn Keller	NTD Mechanical	469-333-0454	skeller@ntdmechanical.com
Roger Bauer	DMF Corp	214-412-8247	rbauer@deckamechanical.com
Mark Mikes	Burger Engineering	817 817-890-1974	mmikes@burger-engr.com
Marlon Hort	RCR	972-284-9224	mhart@rcr.net
Hari Vishwanadula	RWB	972-788-4222	hari@rwb.net
Chris Johnson	MISD	469-901-8323	Chris.Johnson@Midlothianisd.org
Sam Deere	Compass	214-454-1580	sdeere@compassdallas.com
Jose Martinez	MFS D	817-6009-2051	jose.martinez@Midlothianisd.org
Shana Venture	MISD	469-856-5032	shana.venture@midlothianisd.org

MIDLOTHIAN INDEPENDENT SCHOOL DISTRICT WALNUT GROVE MIDDLE SCHOOL

990 Walnut Grove Rd, Midlothian TX 76065

CHILLER REPLACEMENT JULY 03, 2024



SHEET INDEX

SHEET NO. DESCRIPTION


M1.00	ORIENTATION FLOOR PLAN - LEVEL 1 - MECHANICAL
M2.00	ORIENTATION FLOOR PLAN - LEVEL 2 - MECHANICAL
DMP1.01	DEMOLITION FLOOR PLAN - CENTRAL UTILITY PLANT - MECHANICAL & PLUMBING
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M4.01	DETAILS, SCHEDULES, & LEGEND - MECHANICAL
DE1.01	DEMOLITION FLOOR PLAN - CENTRAL UTILITY PLANT - ELECTRICAL
DE1.02	ENLARGED DEMOLITION FLOOR PLANS - LEVEL 1 - ELECTRICAL
DE2.01	ENLARGED DEMOLITION FLOOR PLANS - LEVEL 2 - ELECTRICAL
E1.00	ORIENTATION FLOOR PLAN - LEVEL 1 - ELECTRICAL
E1.01	FLOOR PLAN - CENTRAL UTILITY PLANT - ELECTRICAL
E1.02	ENLARGED FLOOR PLANS - LEVEL 1 - ELECTRICAL
E2.00	ORIENTATION FLOOR PLAN - LEVEL 2 - ELECTRICAL
E2.01	ENLARGED FLOOR PLANS - LEVEL 2 - ELECTRICAL



Reed, Wells, Benson & Company
Consulting Engineers #F-2176

MERIT TOWER, 12222 MERIT DRIVE, SUITE 400 DALLAS, TX 75251
PHONE: (972) 788-4222 FAX: (972) 788-0002 WWW.RWB.NET

RWB PROJECT # 24040.00

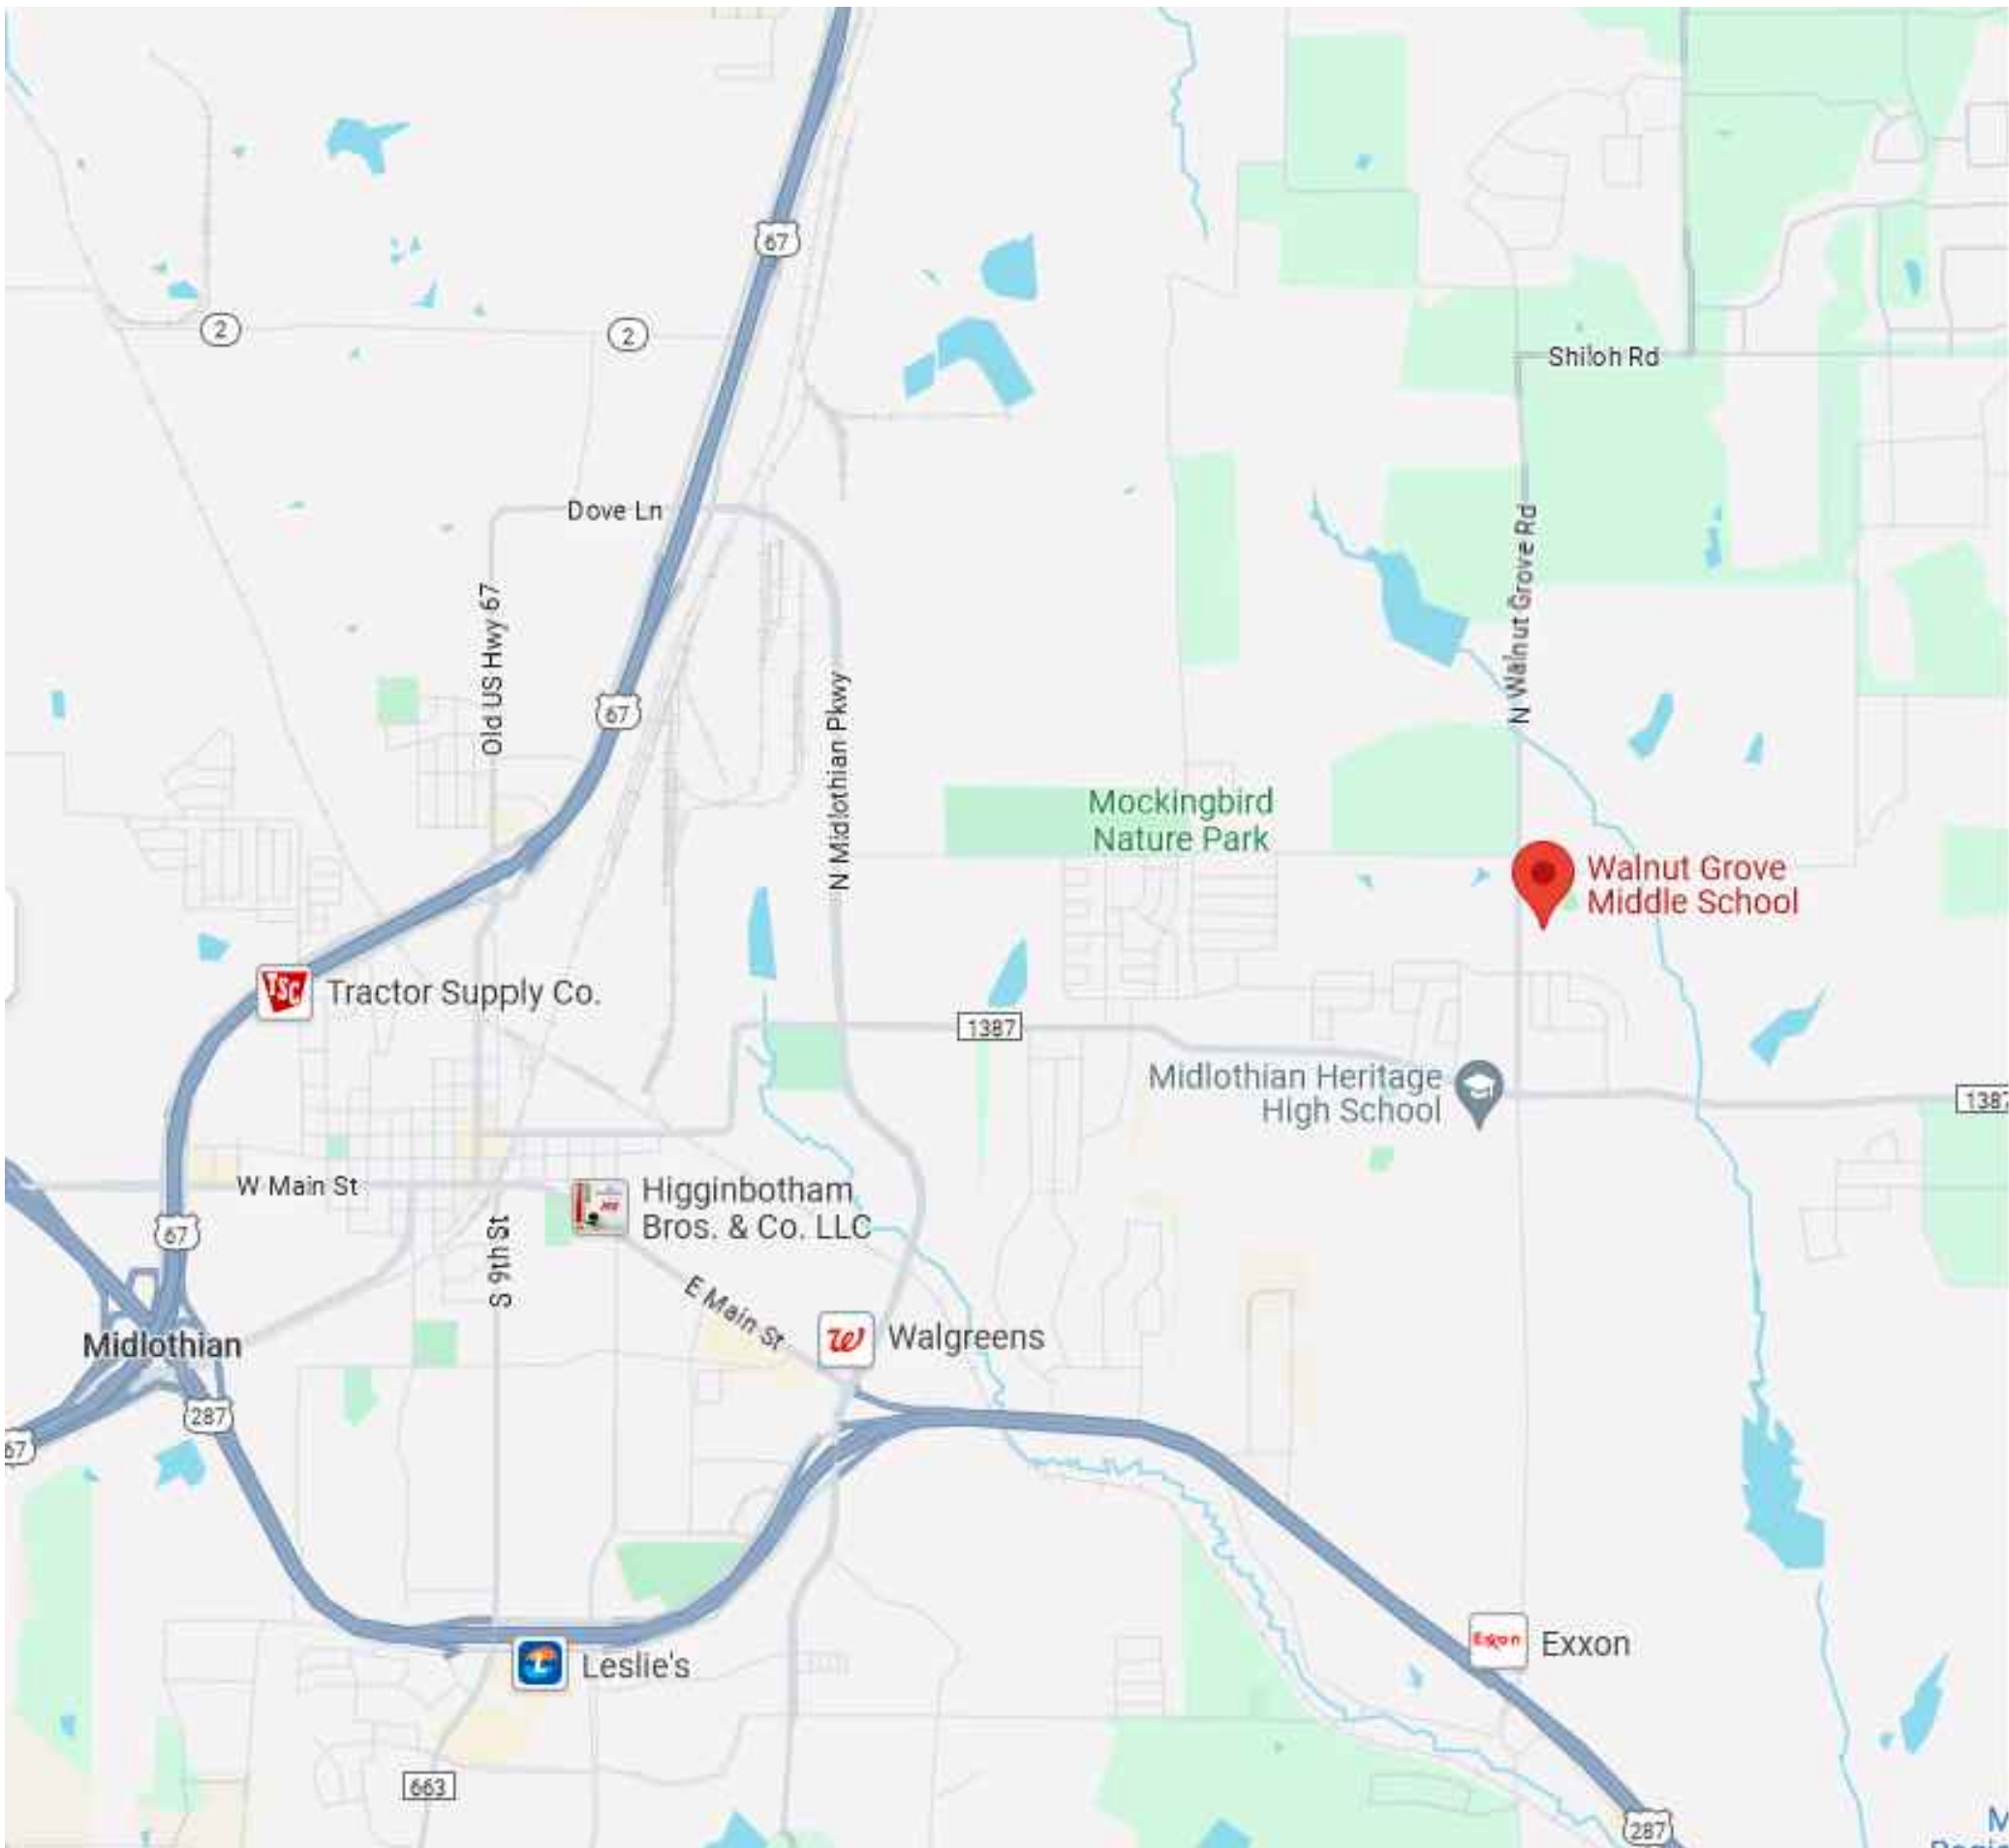

Location Map

ISSUES		
1	ISSUE FOR CONSTRUCTION	2024.07.03

1	ADDENDUM #2	2024.07.23
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ORIENTATION FLOOR PLAN - LEVEL 1 - HVAC

EET NO.

11.00





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ORIE
SCALE: 1/16

ORIENTATION FLOOR PLAN - LEVEL 1 - HVAC

SCALE: 1/16" = 1'-0"

Drawing: 24040 - MIDLOTHIAN I.S.D. WALNUT GROVE MS CHILLER REPLACEMENT; File: 24040.dwg; Plot Date: 7/23/2024 5:23 PM; Plot Scale: 1/16" = 1'-0"; Page: Sheet 01 of 01

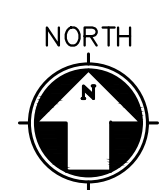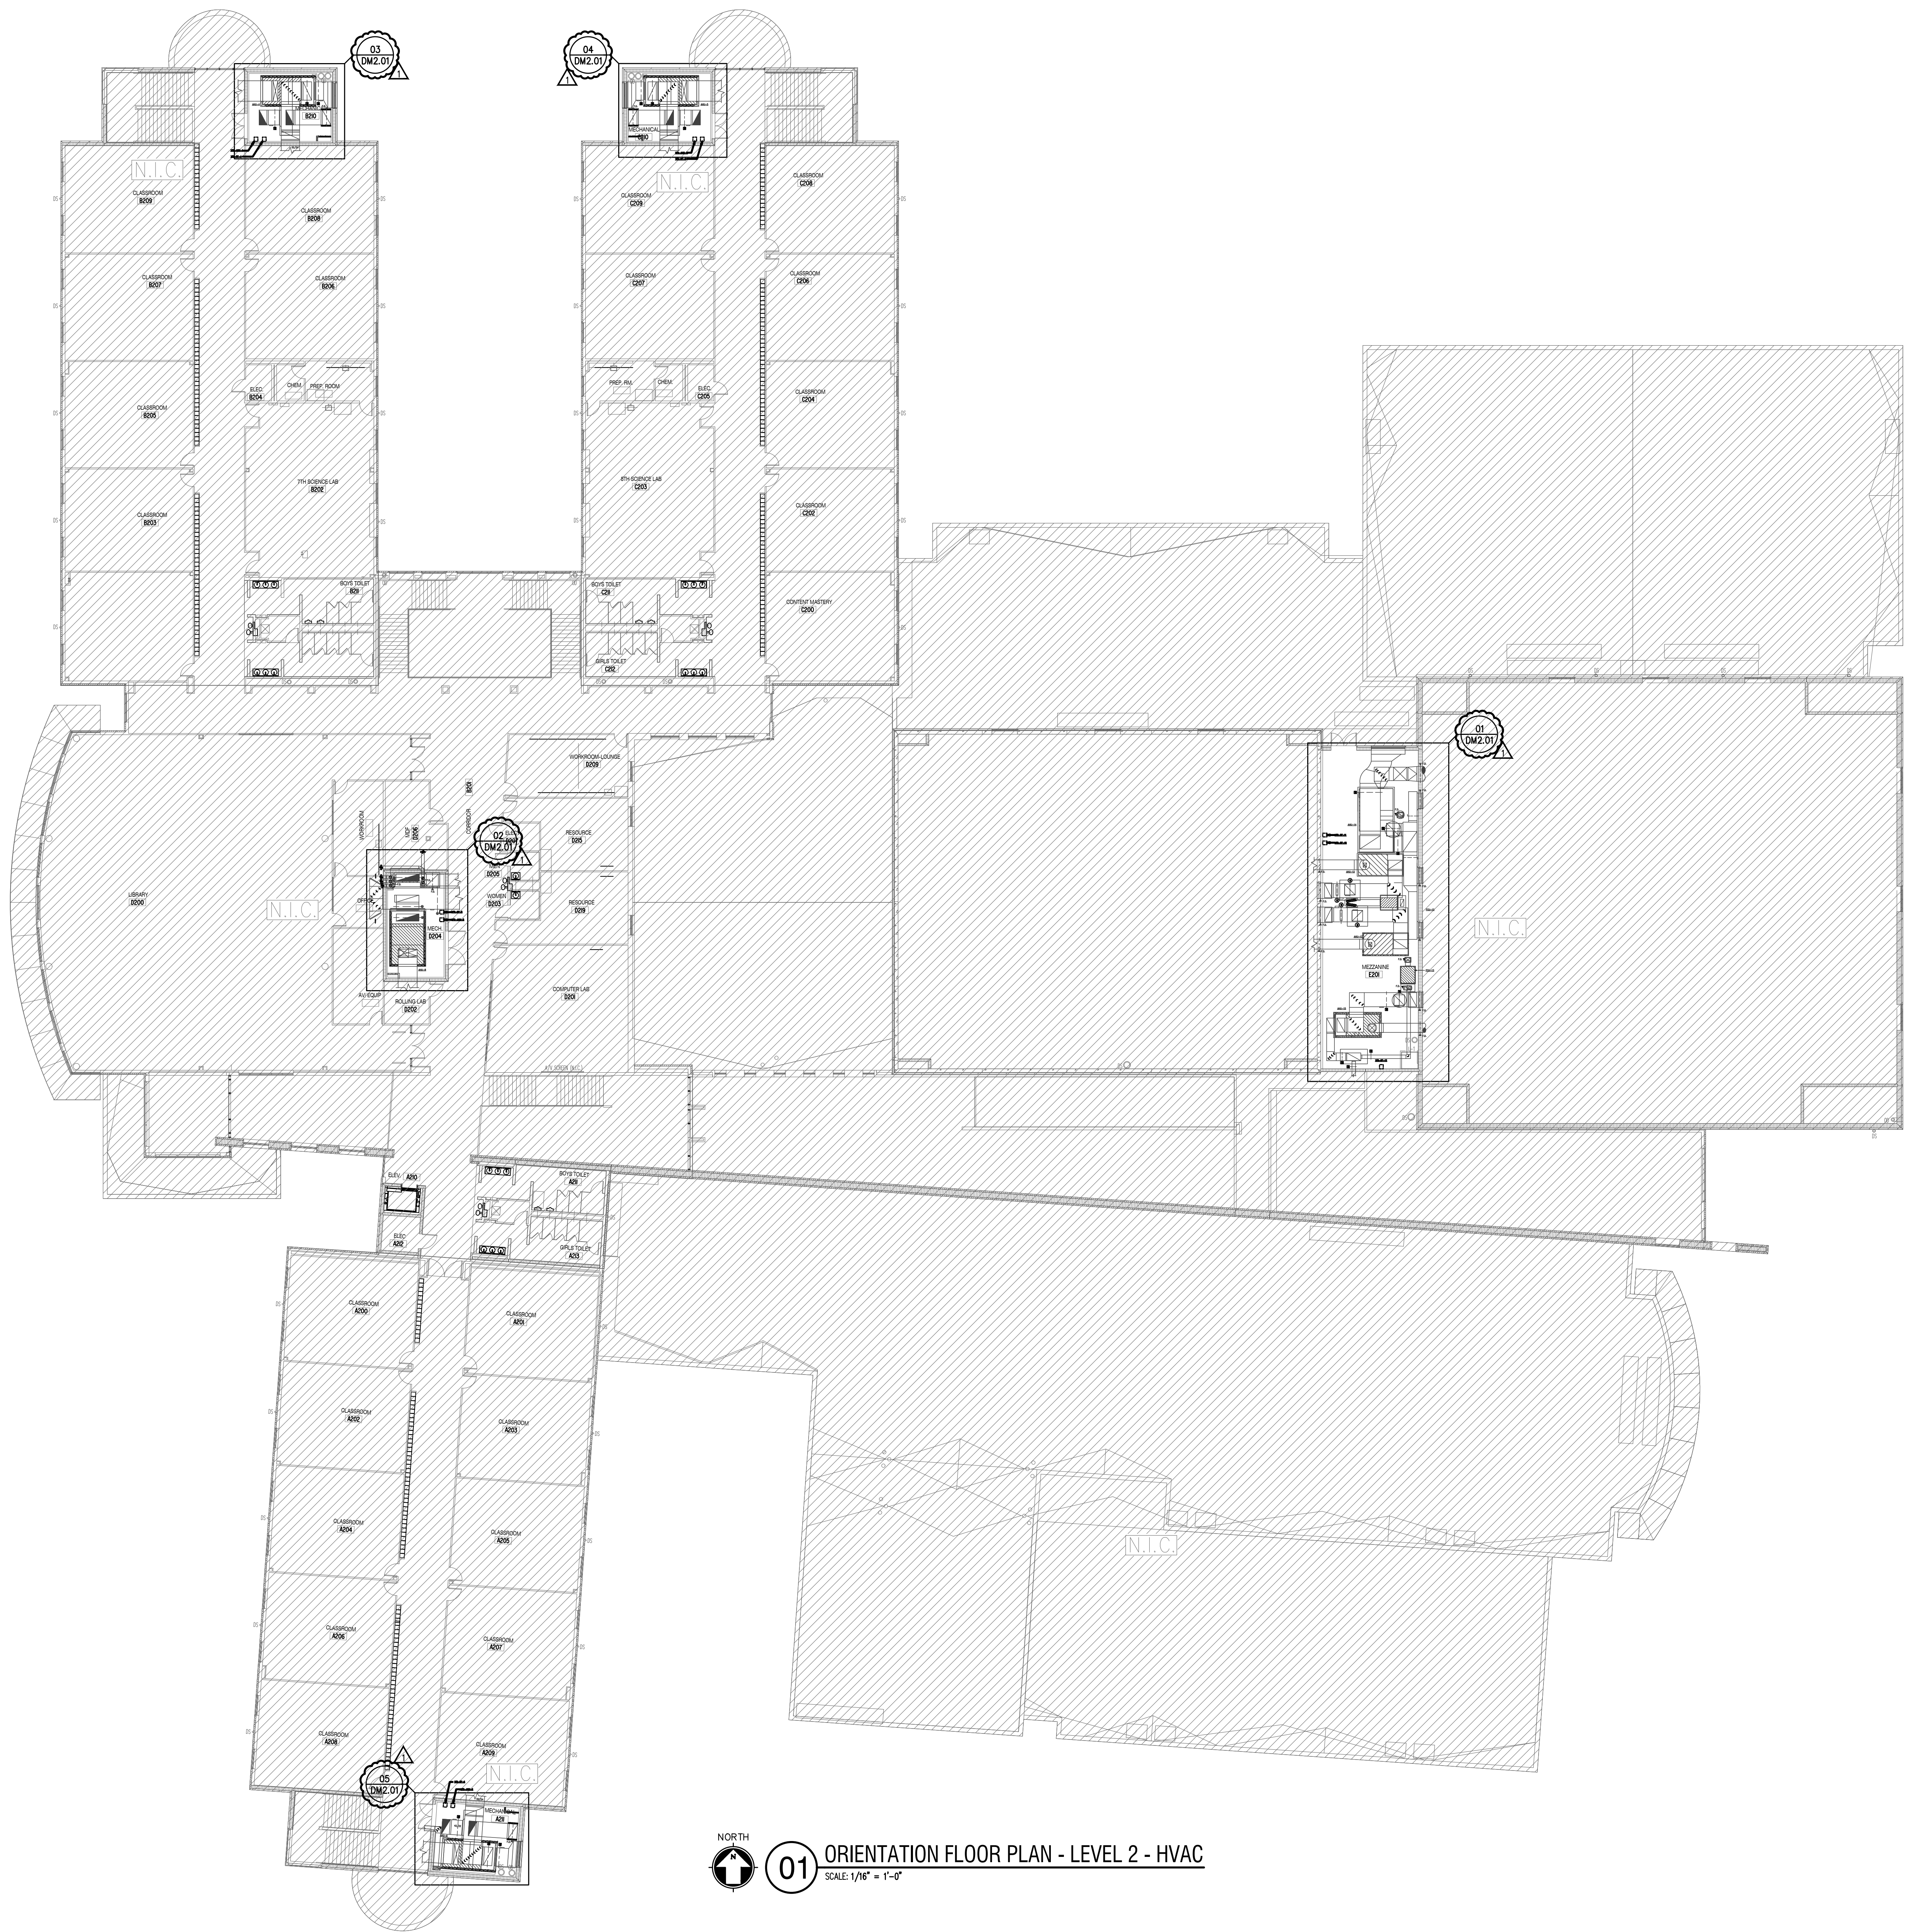

01

ORIENTATION FLOOR PLAN - LEVEL 2 - HVAC
SCALE: 1/16" = 1'-0"

2024.07.03

ISSUES

01 ISSUE FOR CONSTRUCTION 2024.07.03

REVISIONS

01 ADDENDUM #2 2024.07.23



**WALNUT GROVE MS
CHILLER REPLACEMENT**
MIDLOTHIAN I.S.D.
990 Walnut Grove Rd, Midlothian, TX 76065


ORIENTATION FLOOR
PLAN - LEVEL 2 - HVAC

JOB NO.: 24040-00
DRAWN BY: BM
CHECKED BY: HV

SHEET NO.

M2.00

Drawing: 24040 - MIDLOTHIAN I&D WALNUT GROVE MS CHILLER/UTILITY PLANT (01.DWG) Plot Date: 7/23/2024 5:22 PM Plot Scale: 1/4" = 1'-0" Paper Size: 30" x 42" IN

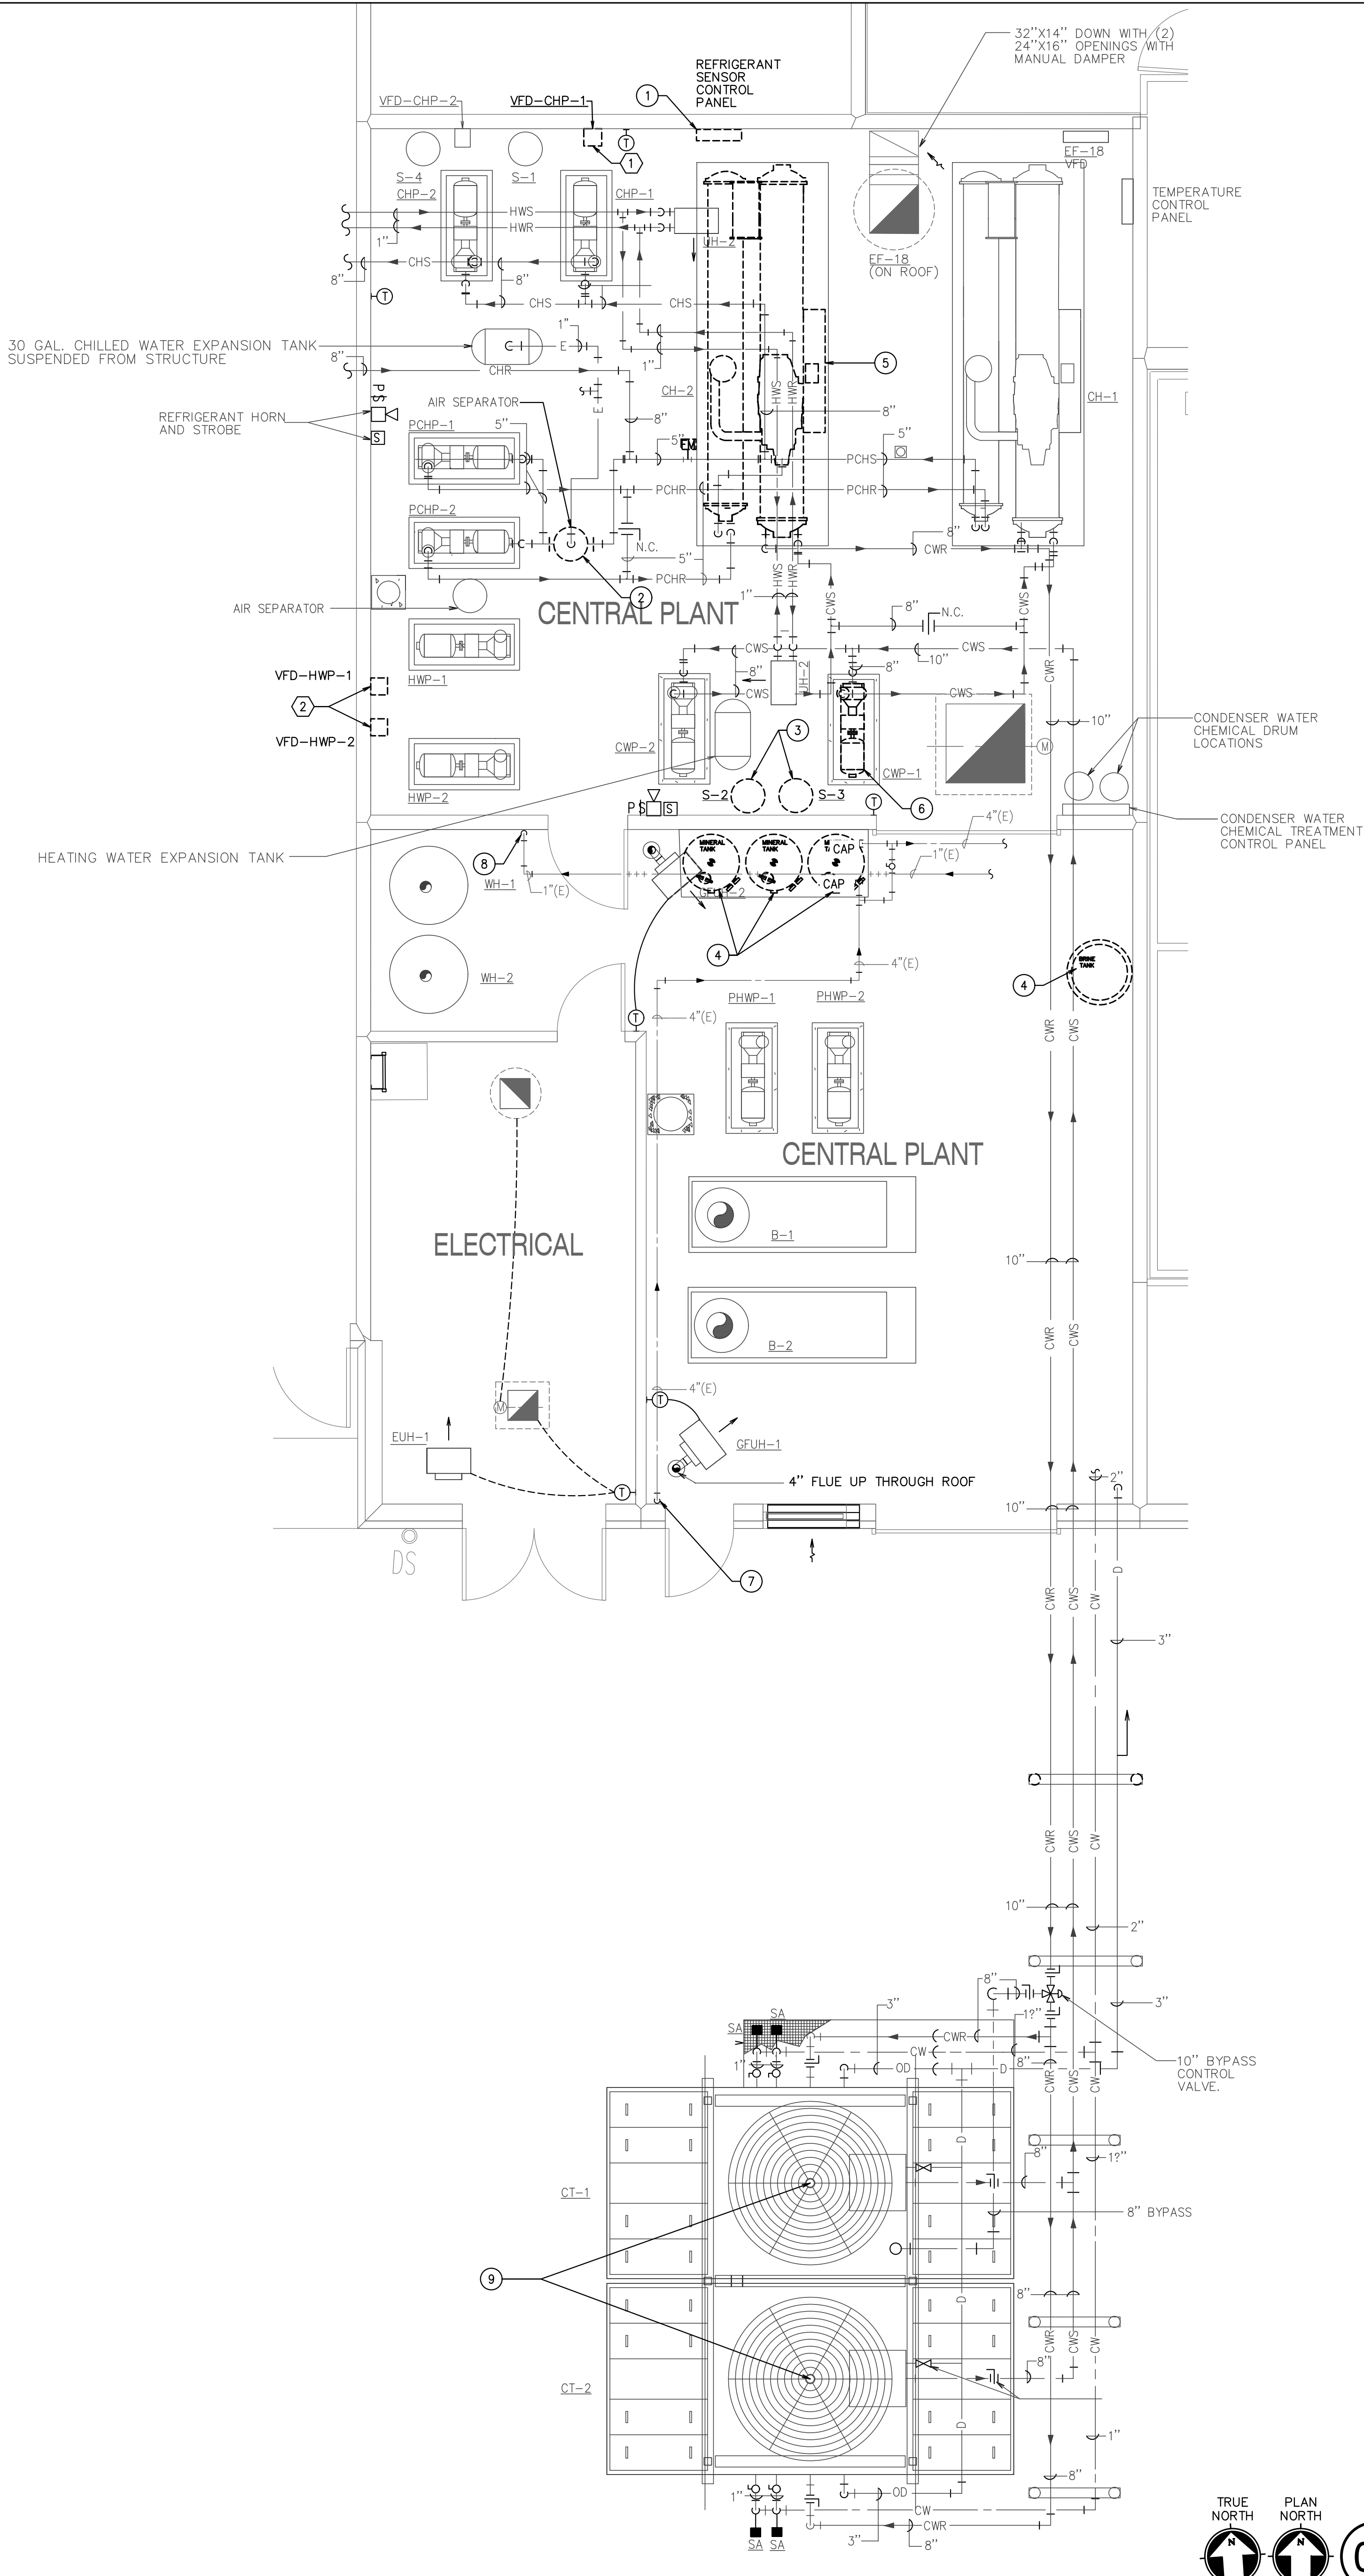

GENERAL DEMOLITION NOTES:

1. THE INFORMATION ON THE DEMOLITION DRAWINGS ARE NOT FROM "AS-BUILT" DRAWINGS BUT FROM ORIGINAL DRAWINGS. THIS INFORMATION IS INCLUDED FOR REFERENCE ONLY. CONTRACTOR WILL BE RESPONSIBLE FOR VISITING THE SITE PRIOR TO SUBMITTING A BID TO DETERMINE THE AMOUNT OF WORK THAT WILL BE REQUIRED. CONTRACTOR SHALL EXAMINE THE EXISTING BUILDING AND GENERALLY VERIFY THE LOCATION OF ALL EXISTING WORK AND BECOME INFORMED AS TO THE RELATION TO, AND EFFECT ON, THE WORK REQUIRED BEFORE SUBMITTING A BID. SUBMISSION OF A BID WILL CONSTITUTE EVIDENCE THAT THE CONTRACTOR HAS INSPECTED THE SITE OF THE PROPOSED WORK.
2. EXISTING MPE ITEMS TO BE REMOVED SHALL BE RETURNED TO THE OWNER OR DISPOSED OF AS DIRECTED BY THE DESIGNATED OWNER'S REPRESENTATIVE.
3. COORDINATE DEMOLITION WORK WITH THE BUILDING MAINTENANCE PERSONNEL AND OTHER TRADES PERFORMING WORK IN THE BUILDING PRIOR TO THE REMOVAL OF ANY ITEMS OF EQUIPMENT OR SYSTEMS THAT WILL EFFECT OTHER SYSTEMS WITHIN THE LIMIT OF NEW CONSTRUCTION OR OTHER AREAS OF THE BUILDING. THE BUILDING WILL BE OCCUPIED DURING CONSTRUCTION; AND, THEREFORE, UTILITIES MUST REMAIN IN OPERATION AT ALL TIMES. ANY REQUIRED OUTAGES MUST BE COORDINATED WITH THE OWNER.
4. PRIOR TO THE REMOVAL OF ANY MPE ITEMS OR EQUIPMENT, CONTRACTOR MUST VERIFY THE ORIGIN AND TERMINATION OF THOSE SYSTEMS AND CONFIRM THAT THE ITEMS BEING REMOVED DO NOT SERVE ANY ITEMS THAT ARE TO REMAIN (INCLUDING THOSE IN AREAS OUTSIDE THE CONTRACT LIMITS).
5. CONTRACTOR SHALL CONTACT CONTROLS SYSTEM INSTALLER BEFORE ANY DEMOLITION WORK IS STARTED TO ALLOW THEM TO TAG & IDENTIFY ITEMS TO REMAIN AND BE PROTECTED AND ITEMS TO BE REMOVED. THE CONTROLS SYSTEM INSTALLER SHALL COORDINATE WITH THE OWNER FOR ELEMENTS OF THE EXISTING CONTROLS SYSTEM THAT SHALL BE CAREFULLY REMOVED AND GIVEN TO THE OWNER SUCH AS EXISTING TEMPERATURE SENSORS THAT WILL NOT BE RE-USED. ALL EXISTING TEMPERATURE ONLY SENSORS SERVING EXISTING RTUS SHALL BE CAREFULLY REMOVED, SHRINK WRAPPED, PALLETIZED, AND PROVIDED TO OWNER FOR THEIR USE.
6. DO NOT ABANDON ANY ITEMS IN PLACE. REMOVE ALL COMPONENTS ASSOCIATED WITH EACH ITEM CALLED OUT TO BE REMOVED. WHERE ITEMS ARE REMOVED PATCH/REPLACE ROOF, WALLS, CEILING OR FLOOR, AS APPLICABLE, TO MATCH EXISTING FINISHES, WHERE NEW FINISHES ARE CALLED FOR PATCHING SHALL MATCH THE NEW FINISH.
7. ALL EXISTING FIRE ALARM, SECURITY AND OTHER CEILING MOUNTED DEVICES TO REMAIN IN OPERATION DURING CONSTRUCTION AND BE RE-INSTALLED AS NEEDED. TEMPORARILY SUPPORT AS NEEDED.
8. ALL EXISTING LIGHTS ARE TO BE REUSED AND REMAIN IN PLACE, UNLESS NOTED OTHERWISE. CONTRACTOR TO SUPPORT LIGHTS ABOVE CEILING DURING ANY CEILING DEMOLITION.
9. THE MECHANICAL CONTRACTOR / DEMOLITION CONTRACTOR SHALL COORDINATE WITH ELECTRICAL CONTRACTOR REGARDING THE SCOPE OF DEMOLITION FOR ELECTRICAL CONNECTIONS. THOSE UNITS BEING REMOVED SHALL BE SAFELY DISCONNECTED FROM EXISTING POWER.
10. CONTRACTOR SHALL COORDINATE REMOVAL OF EXISTING UNITS WITH DISTRICT, ALLOWING THE DISTRICT TO REMOVE ANY EXISTING UNIT COMPONENTS FOR SPARE STOCK.
11. PROVIDE FLOOR PROTECTION IN ALL AREAS OF DEMOLITION AND NEW WORK THROUGH OUT THE BUILDING FROM WORK AREA TO EXTERIOR. FLOORING PROTECTION TO BE FULL WIDTH OF CORRIDOR AND BE RAM BOARD OR EQUAL TYPE FLOOR PROTECTION.

GENERAL PHASING NOTES:


1. ISOLATE CHILLED WATER PORTION OF CENTRAL PLANT AT EXISTING CENTRAL PLANT ISOLATION VALVES PRIOR TO ANY WORK.
2. STRICTLY COORDINATE REMOVAL OF DOMESTIC WATER SYSTEM WATER SOFTENER TO BE DURING PERIOD WHEN BUILDING IS UNOCCUPIED.

NOTES BY SYMBOL 'O':

1. EXISTING REFRIGERANT MONITORING STATION TO BE DEMOLISHED AND REPLACED WITH NEW. REMOVE EXISTING LODESTONE TYPE REFRIGERANT SENSORS AND REPLACE WITH ALL NEW. RE-USE EXISTING POWER TO PANEL.
2. EXISTING AIR SEPARATOR TO BE REMOVED AND REPLACED WITH NEW. DISCONNECT EXISTING MAKE UP WATER LINE AND DRAIN LINE AS NEEDED TO ACCOMMODATE NEW SEPARATOR.
3. EXISTING CONDENSER WATER CENTRIFUGAL SEPARATOR TO BE REMOVED AND REPLACED WITH NEW. REPLACE EXISTING SEPARATOR, BAG FILTER, INTERCONNECTING PIPING BETWEEN THE TWO AND PIPING TO SEPARATOR FROM CONDENSER WATER MAIN. DISCONNECT AND RE-CONNECT POWER AND CONTROLS.
4. EXISTING WATER SOFTENER SYSTEM AND ASSOCIATED INTERCONNECTED PIPING TO BE DEMOLISHED. CAP PIPING DOWNSTREAM OF THE SYSTEM BY-PASS AND OPEN BY-PASS.
5. EXISTING SCREW CHILLER TO BE DEMOLISHED AND REPLACED WITH A NEW CENTRIFUGAL CHILLER. REMOVE EXISTING CHILLED AND CONDENSER WATER PIPING IN VERTICAL UP TO EXISTING ISOLATION VALVES OR AS FAR BACK AS NEEDED TO ALLOW FOR CHILLER TO BE REMOVED AND RE-INSTALLED. REMOVE EXISTING REFRIGERANT PURGE SYSTEM PIPING UP AT EXISTING CH-1 PURGE PIPING. REMOVE EXISTING CONTROLS BACK TO SOURCE. REMOVE AND RE-INSTALL EXISTING ELECTRICAL.
6. EXISTING CWP-1 TO BE REMOVED AND RE-INSTALLED TO ALLOW FOR THE REMOVAL OF THE EXISTING CHILLER AND THE INSTALLATION OF THE NEW CHILLER. CAREFULLY STORE AND PROTECT THROUGHOUT NEW CHILLER INSTALLATION. RE-MOUNT AND RE-ALIGN EXISTING PUMP, LUBE AND SERVICE PRIOR TO RE-INSTALLATION.
7. EXISTING 4" DOMESTIC COLD WATER RISER WITH SHUT-OFF VALVE IN RISER.
8. EXISTING 1" DOMESTIC HOT WATER DN. TO CIRCULATION PUMP.
9. REMOVE EXISTING 10HP COOLING TOWER FAN MOTORS AND REPLACE WITH NEW MOTOR. MATCH EXISTING TYPE OF MOTOR. EXISTING MOTOR IS WEATHERPROOF TOTALLY ENCLOSED TYPE.

ALTERNATE NOTES BY SYMBOL 'O':

1. EXISTING CH-1 VFD TO BE REMOVED AND REPLACED WITH NEW. EXISTING CONTROLS TO BE REMOVED AND RE-INSTALLED. EXISTING ELECTRICAL TO BE REMOVED AND RE-INSTALLED. VFD EQUIPMENT TO BE PRICED AS ALTERNATE. UNIT INSTALLATION TO BE PROCEED AS UNIT PRICE. REFER TO SCHEDULES FOR VFD SIZE.
2. EXISTING HWP-1 & HWP-2 VFDs TO BE REMOVED AND REPLACED WITH NEW. EXISTING CONTROLS TO BE REMOVED AND RE-INSTALLED. EXISTING ELECTRICAL TO BE REMOVED AND RE-INSTALLED. VFD EQUIPMENT TO BE PRICED AS ALTERNATE. UNIT INSTALLATION TO BE PROCEED AS UNIT PRICE. REFER TO SCHEDULES FOR VFD SIZE.

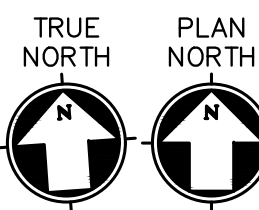

01

DEMOLITION FLOOR PLAN - CENTRAL UTILITY PLANT - MECHANICAL

SCALE: 1/4" = 1'-0"



2024.07.03

ISSUES

01 ISSUE FOR CONSTRUCTION 2024.07.03

REVISIONS

01 ADDENDUM #2 2024.07.23




WALNUT GROVE MS
CHILLER REPLACEMENT
MIDLOTHIAN I.S.D.
990 Walnut Grove Rd, Midlothian, TX 76065

DEMOLITION FLOOR
PLAN - CENTRAL
UTILITY PLANT -
MECHANICAL &
PLUMBING


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SHEET NO.


DMP1.01

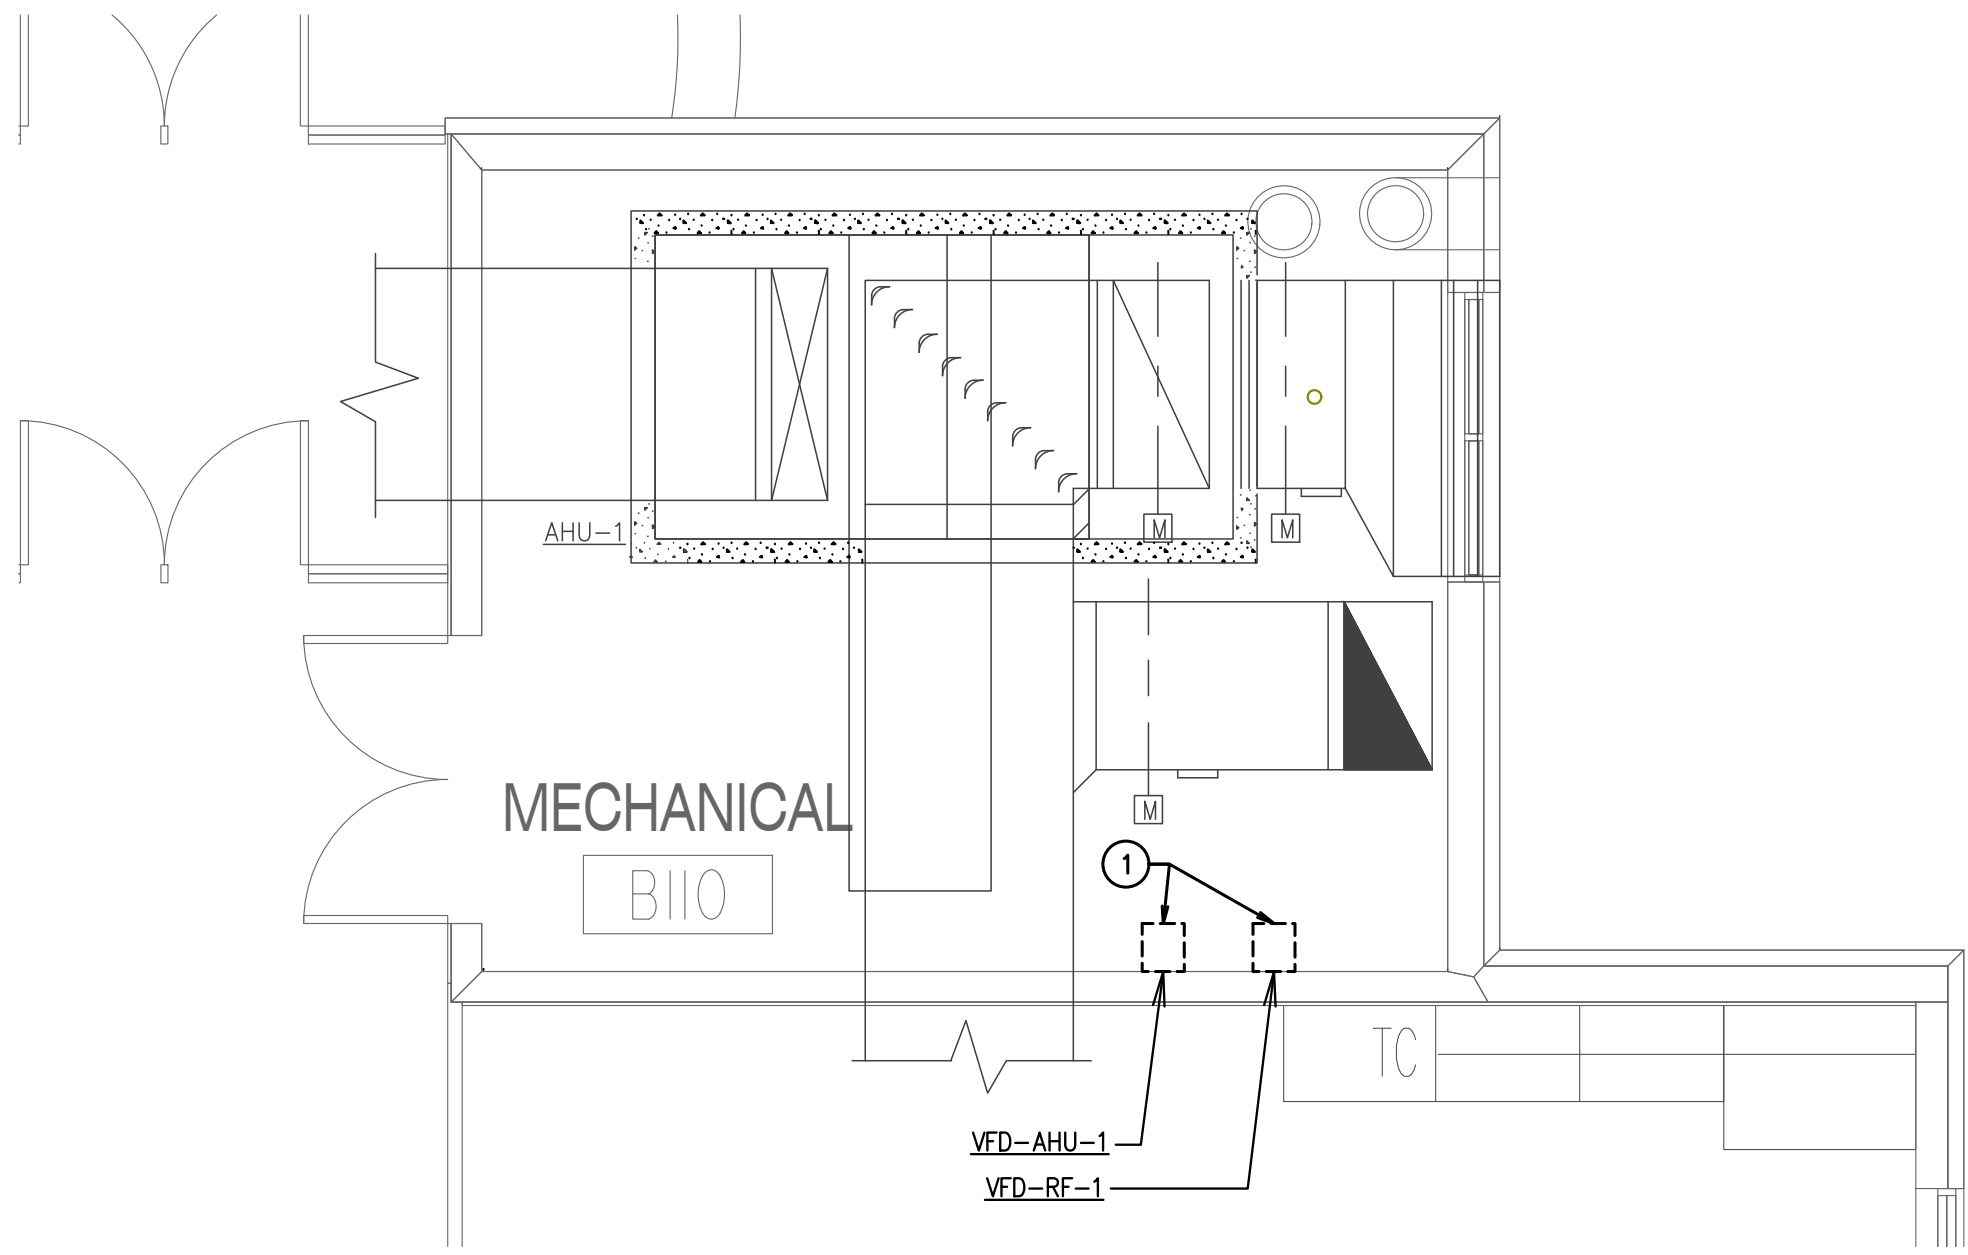


TRUE NORTH PLAN NORTH
01 ENLARGED MECHANICAL ROOM PLAN - LEVEL 1 - AHU-1
SCALE: 1/4" = 1'-0"

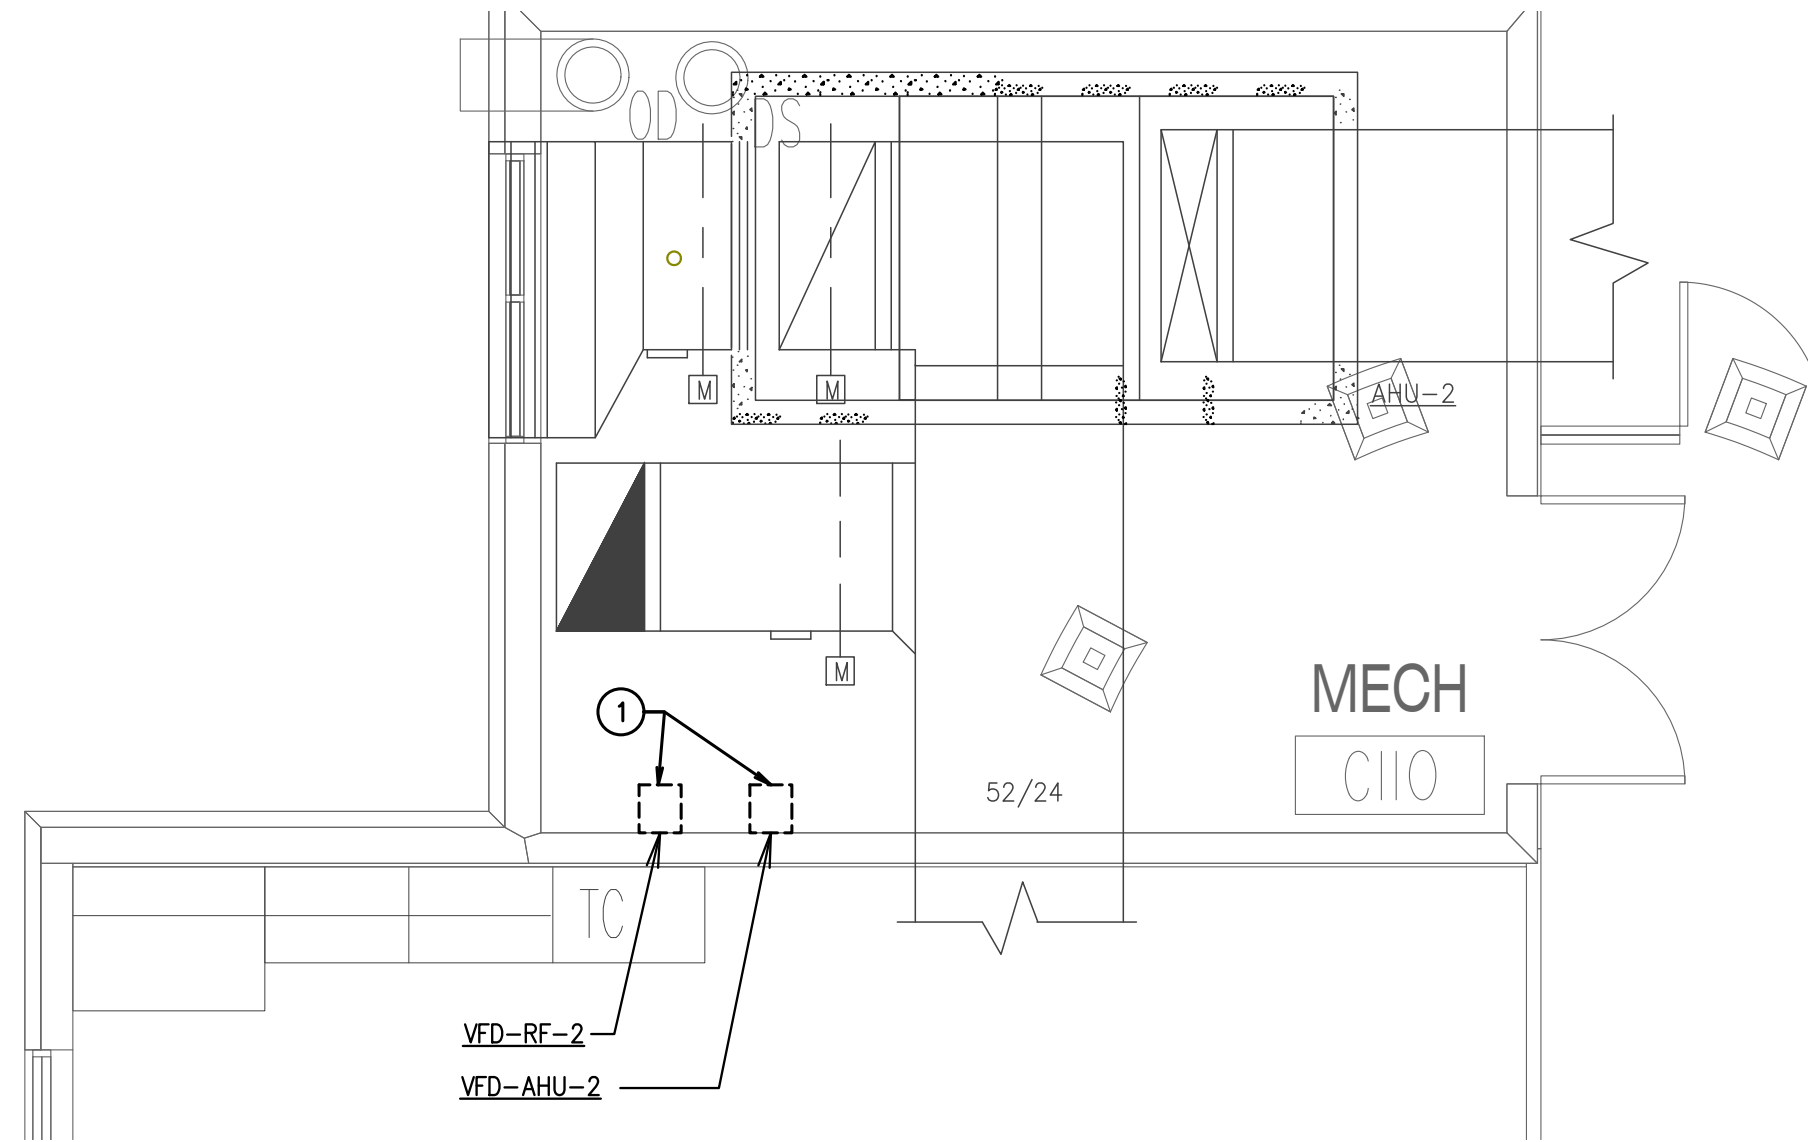


TRUE NORTH PLAN NORTH
02 ENLARGED MECHANICAL ROOM PLAN - LEVEL 1 - AHU-2
SCALE: 1/4" = 1'-0"

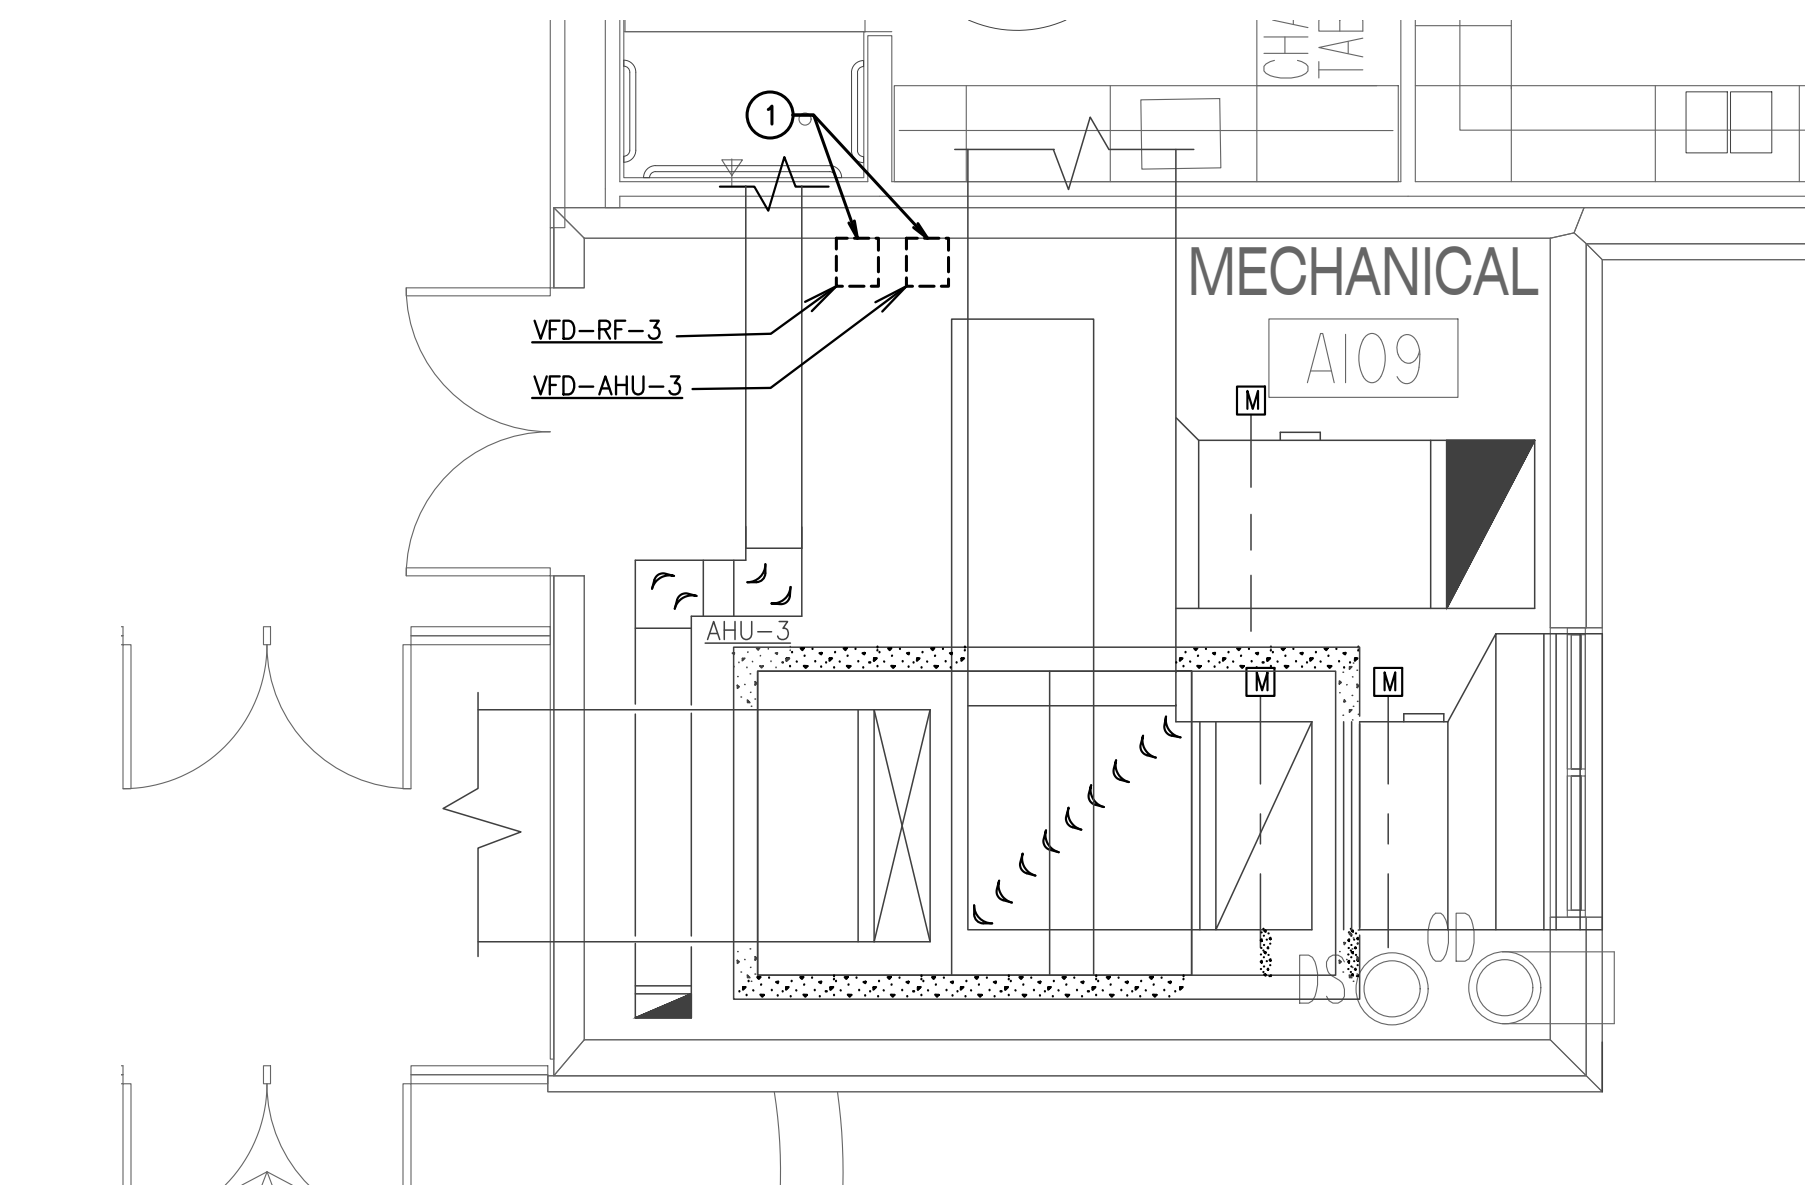

TRUE NORTH PLAN NORTH
03 ENLARGED MECHANICAL ROOM PLAN - LEVEL 1 - AHU-3
SCALE: 1/4" = 1'-0"

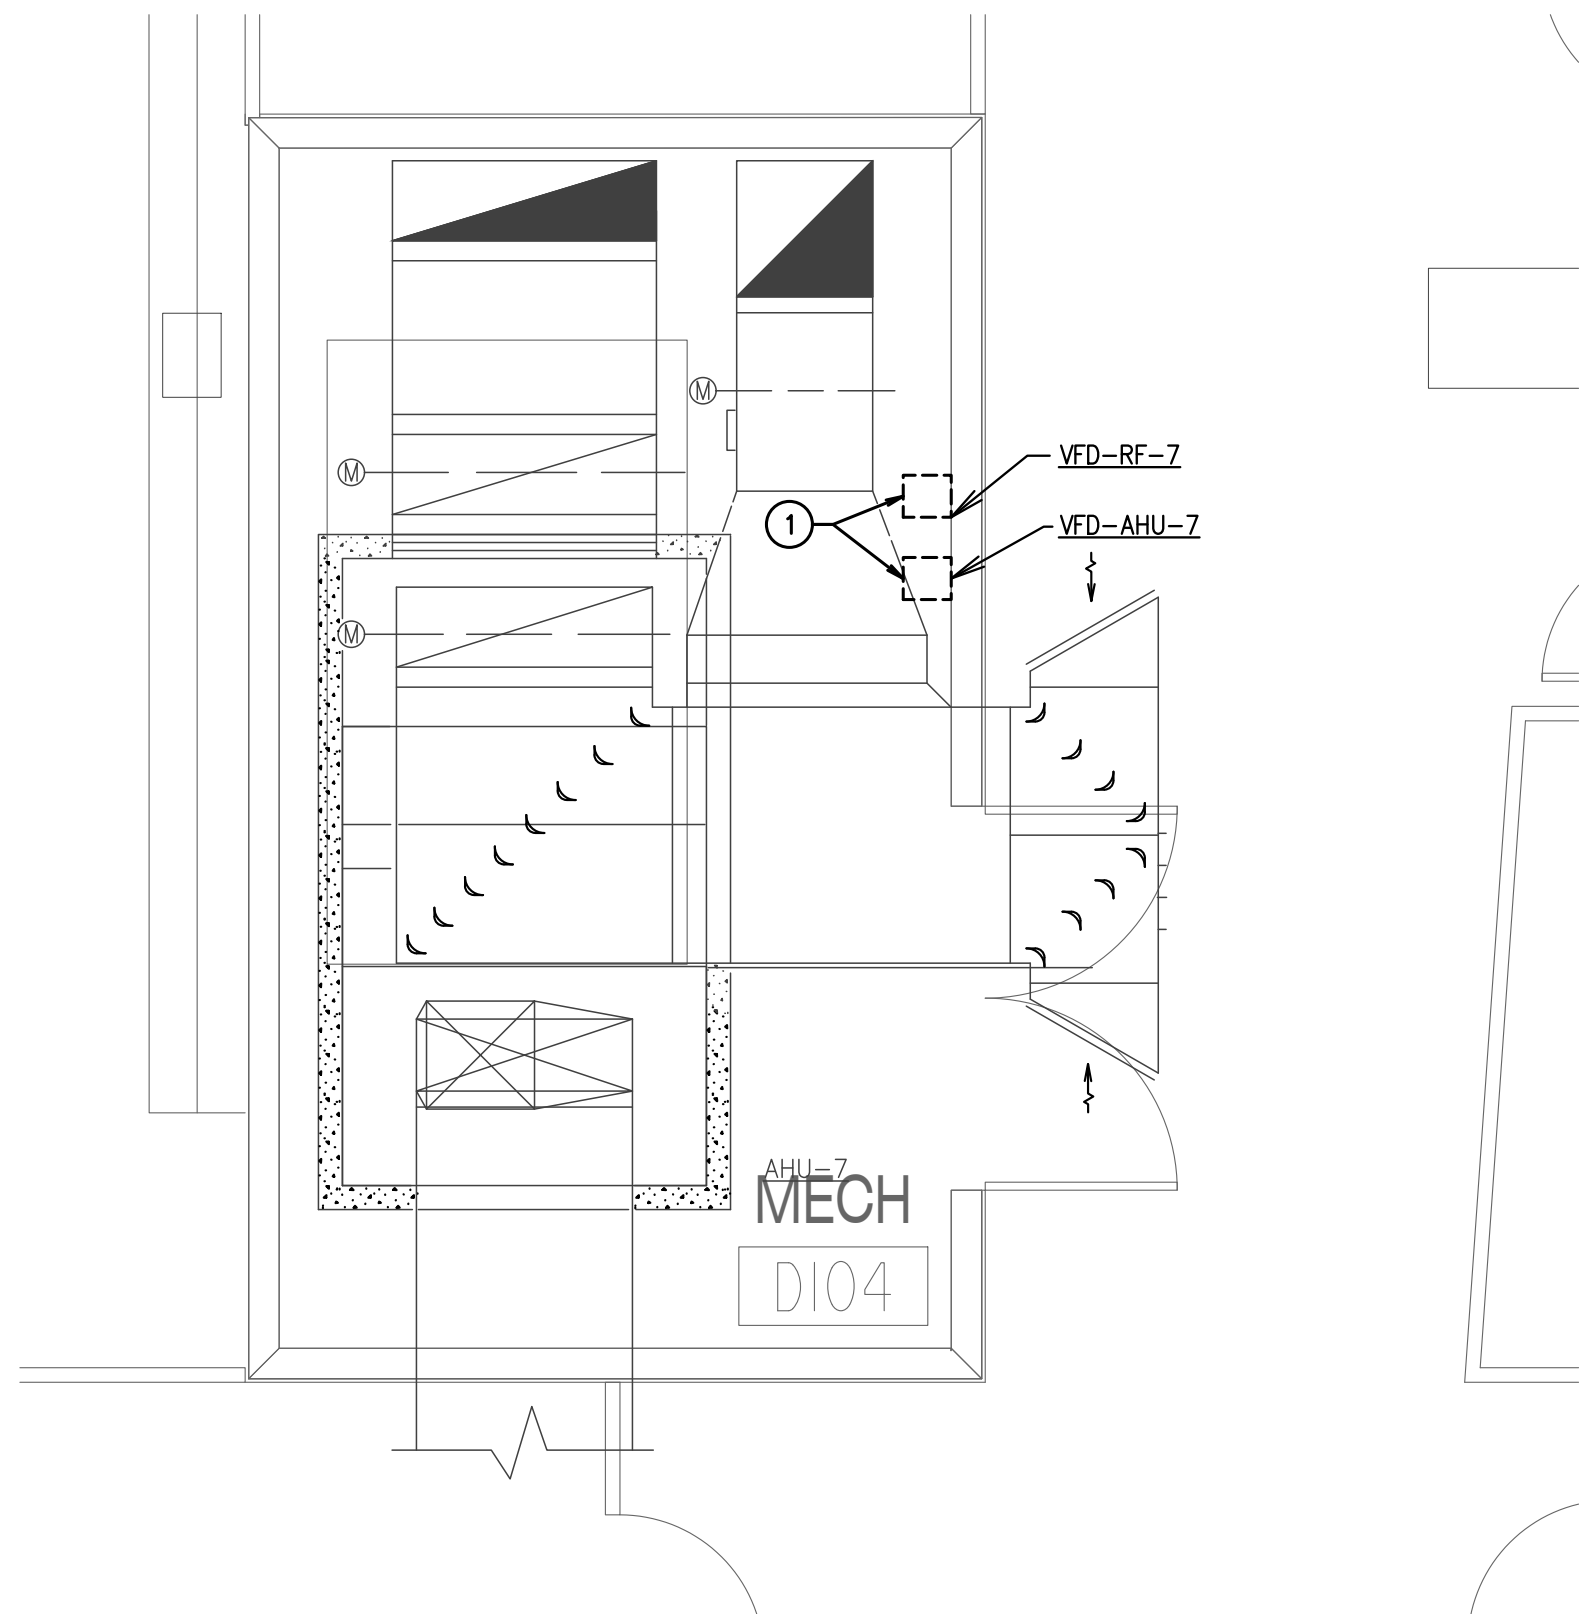

TRUE NORTH PLAN NORTH
04 ENLARGED MECHANICAL ROOM PLAN - LEVEL 1 - AHU-7
SCALE: 1/4" = 1'-0"

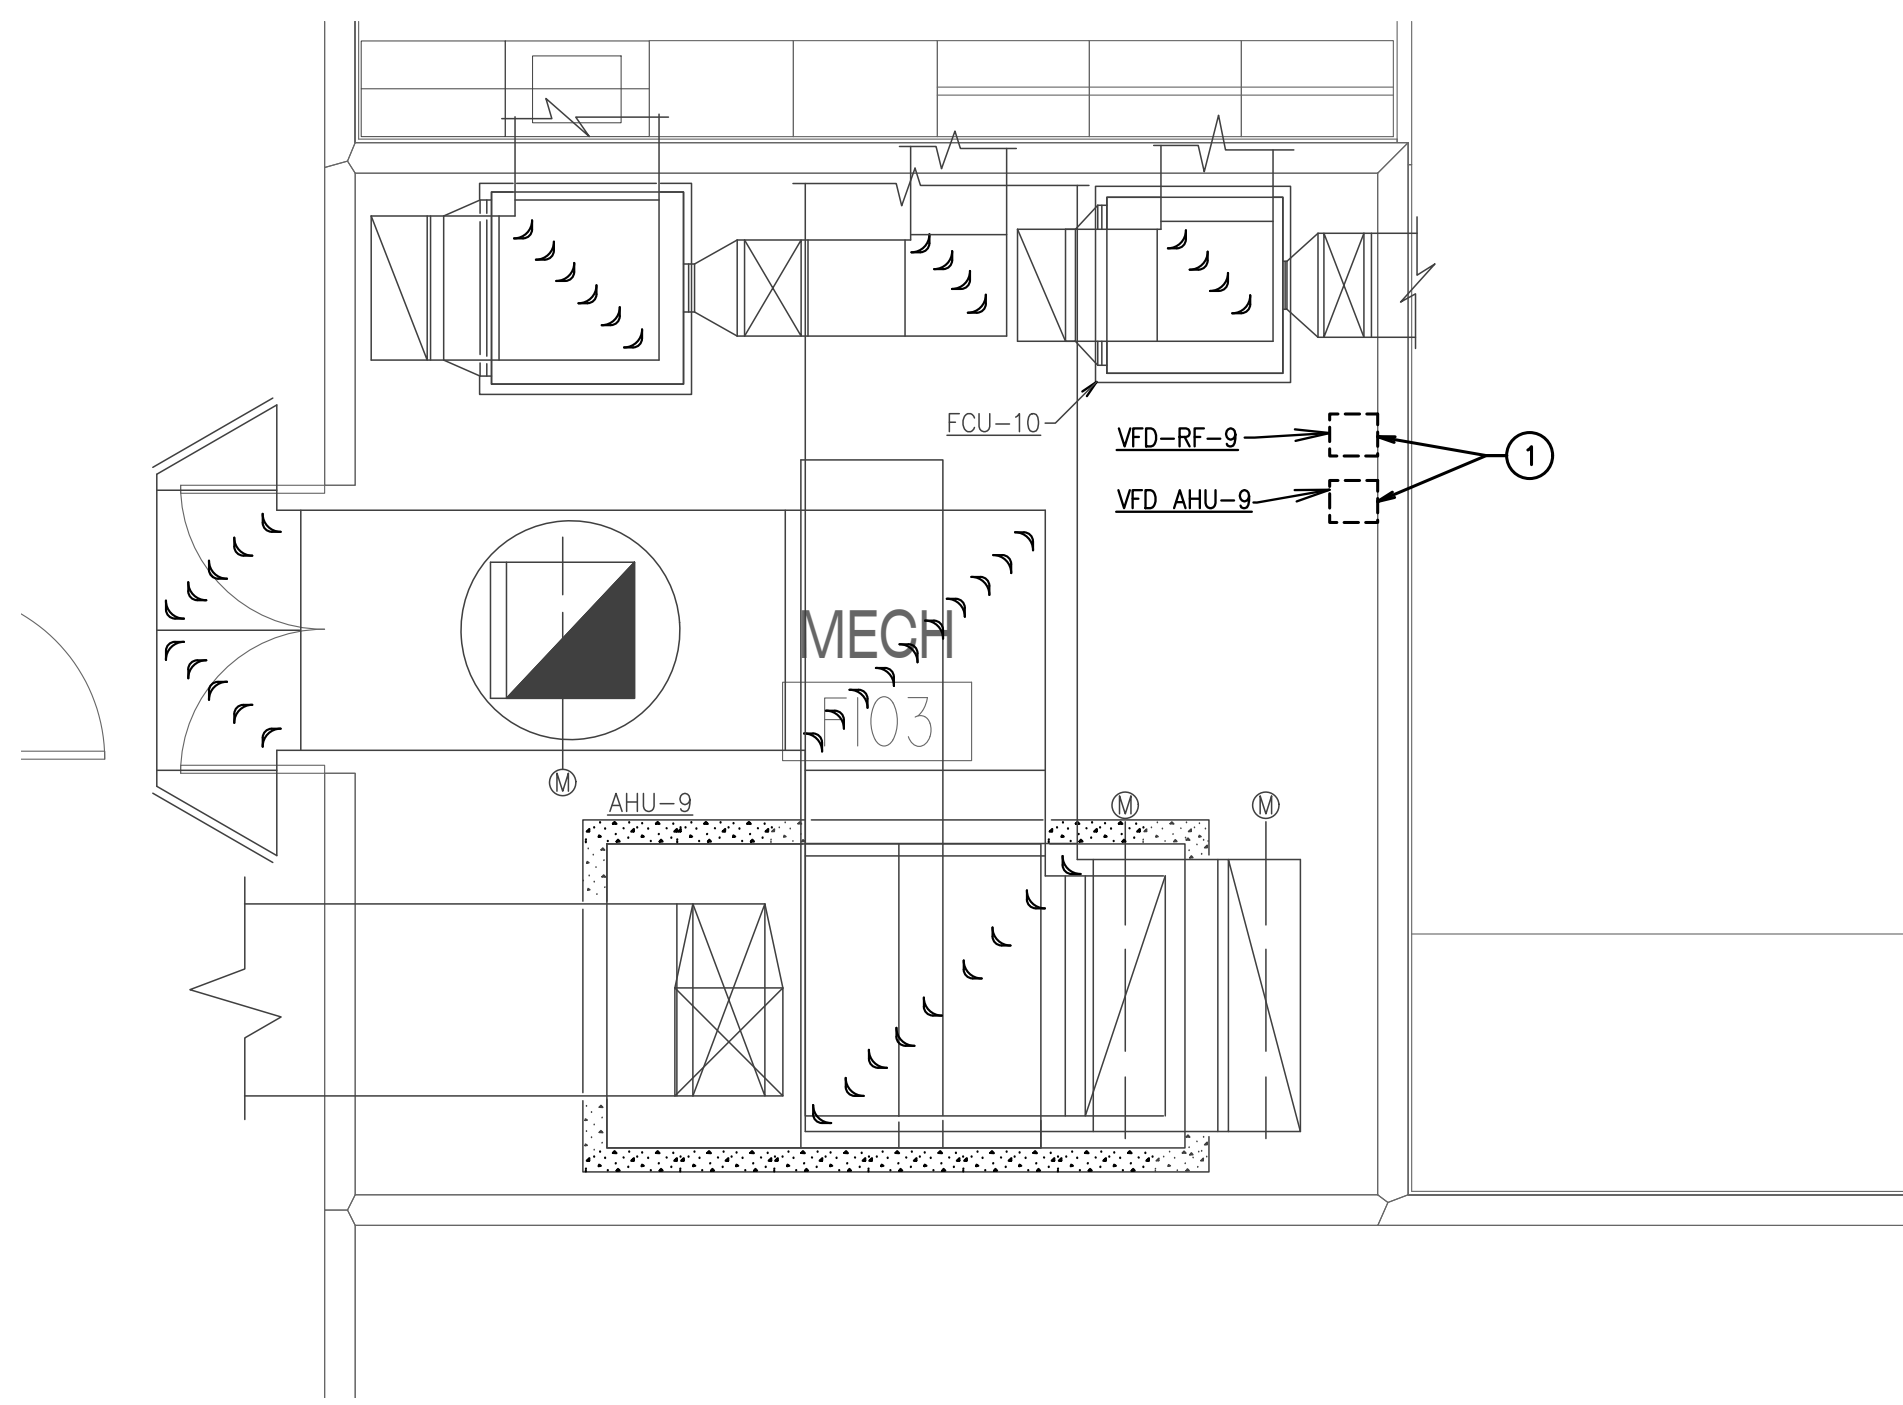

TRUE NORTH PLAN NORTH
05 ENLARGED MECHANICAL ROOM PLAN - LEVEL 1 - AHU-9
SCALE: 1/4" = 1'-0"

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- EXISTING MPE ITEMS TO BE REMOVED SHALL BE RETURNED TO THE OWNER OR DISPOSED OF AS DIRECTED BY THE DESIGNATED OWNER'S REPRESENTATIVE.
- COORDINATE DEMOLITION WORK WITH THE BUILDING MAINTENANCE PERSONNEL AND OTHER TRADES PERFORMING WORK IN THE BUILDING PRIOR TO THE REMOVAL OF ANY ITEMS OF EQUIPMENT OR SYSTEMS THAT WILL EFFECT OTHER SYSTEMS WITHIN THE LIMIT OF NEW CONSTRUCTION OR OTHER AREAS OF THE BUILDING. THE BUILDING WILL BE OCCUPIED DURING CONSTRUCTION; AND, THEREFORE, UTILITIES MUST REMAIN IN OPERATION AT ALL TIMES. ANY REQUIRED OUTAGES MUST BE COORDINATED WITH THE OWNER.
- PRIOR TO THE REMOVAL OF ANY MPE ITEMS OR EQUIPMENT, CONTRACTOR MUST VERIFY THE ORIGIN AND TERMINATION OF THOSE SYSTEMS AND CONFIRM THAT THE ITEMS BEING REMOVED DO NOT SERVE ANY ITEMS THAT ARE TO REMAIN (INCLUDING THOSE IN AREAS OUTSIDE THE CONTRACT LIMITS).
- CONTRACTOR SHALL CONTACT CONTROLS SYSTEM INSTALLER BEFORE ANY DEMOLITION WORK IS STARTED TO ALLOW THEM TO TAG & IDENTIFY ITEMS TO REMAIN AND BE PROTECTED AND ITEMS TO BE REMOVED. THE CONTROLS SYSTEM INSTALLER SHALL COORDINATE WITH THE OWNER FOR ELEMENTS OF THE EXISTING CONTROLS SYSTEM THAT SHALL BE CAREFULLY REMOVED AND GIVEN TO THE OWNER SUCH AS EXISTING TEMPERATURE SENSORS THAT WILL NOT BE RE-USED. ALL EXISTING TEMPERATURE ONLY SENSORS SERVING EXISTING RTUS SHALL BE CAREFULLY REMOVED, SHRINK WRAPPED, PALLETIZED, AND PROVIDED TO OWNER FOR THEIR USE.
- DO NOT ABANDON ANY ITEMS IN PLACE. REMOVE ALL COMPONENTS ASSOCIATED WITH EACH ITEM CALLED OUT TO BE REMOVED. WHERE ITEMS ARE REMOVED PATCH/REPLACE ROOF, WALLS, CEILING OR FLOOR. AS APPLICABLE, TO MATCH EXISTING FINISHES, WHERE NEW FINISHES ARE CALLED FOR PATCHING SHALL MATCH THE NEW FINISH.
- ALL EXISTING FIRE ALARM, SECURITY AND OTHER CEILING MOUNTED DEVICES TO REMAIN IN OPERATION DURING CONSTRUCTION AND BE RE-INSTALLED AS NEEDED. TEMPORARILY SUPPORT AS NEEDED.
- ALL EXISTING LIGHTS ARE TO BE REUSED AND REMAIN IN PLACE, UNLESS NOTED OTHERWISE. CONTRACTOR TO SUPPORT LIGHTS ABOVE CEILING DURING ANY CEILING DEMOLITION.
- THE MECHANICAL CONTRACTOR / DEMOLITION CONTRACTOR SHALL COORDINATE WITH ELECTRICAL CONTRACTOR REGARDING THE SCOPE OF DEMOLITION FOR ELECTRICAL CONNECTIONS. THOSE UNITS BEING REMOVED SHALL BE SAFELY DISCONNECTED FROM EXISTING POWER.
- CONTRACTOR SHALL COORDINATE REMOVAL OF EXISTING UNITS WITH DISTRICT, ALLOWING THE DISTRICT TO REMOVE ANY EXISTING UNIT COMPONENTS FOR SPARE STOCK.
- PROVIDE FLOOR PROTECTION IN ALL AREAS OF DEMOLITION AND NEW WORK THROUGH OUT THE BUILDING FROM WORK AREA TO EXTERIOR. FLOORING PROTECTION TO BE FULL WIDTH OF CORRIDOR AND BE RAM BOARD OR EQUAL TYPE FLOOR PROTECTION.

ALTERNATE NOTES BY SYMBOL '1':

- 1 EXISTING VFD TO BE REMOVED AND REPLACED WITH NEW. PROVIDE COST FOR EQUIPMENT UNDER ALTERNATE AND COST FOR INSTALLATION AS UNIT PRICING PER HP. SIZE. EXISTING CONTROLS TO BE REMOVED AND RE-INSTALLED. EXISTING ELECTRICAL TO BE REMOVED AND RE-INSTALLED. REFER TO SCHEDULE FOR VFD SIZE.

2024.07.03

ISSUES

01 ISSUE FOR CONSTRUCTION 2024.07.03

REVISIONS

01 ADDENDUM #2 2024.07.23



WALNUT GROVE MS
CHILLER REPLACEMENT
MIDLOTHIAN I.S.D.
990 Walnut Grove Rd, Midlothian, TX 76065


ENLARGED
DEMOLITION FLOOR
PLANS - LEVEL 1 -
HVAC

JOB NO.: 24040-00
DRAWN BY: BM
CHECKED BY: HV


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DM1.02


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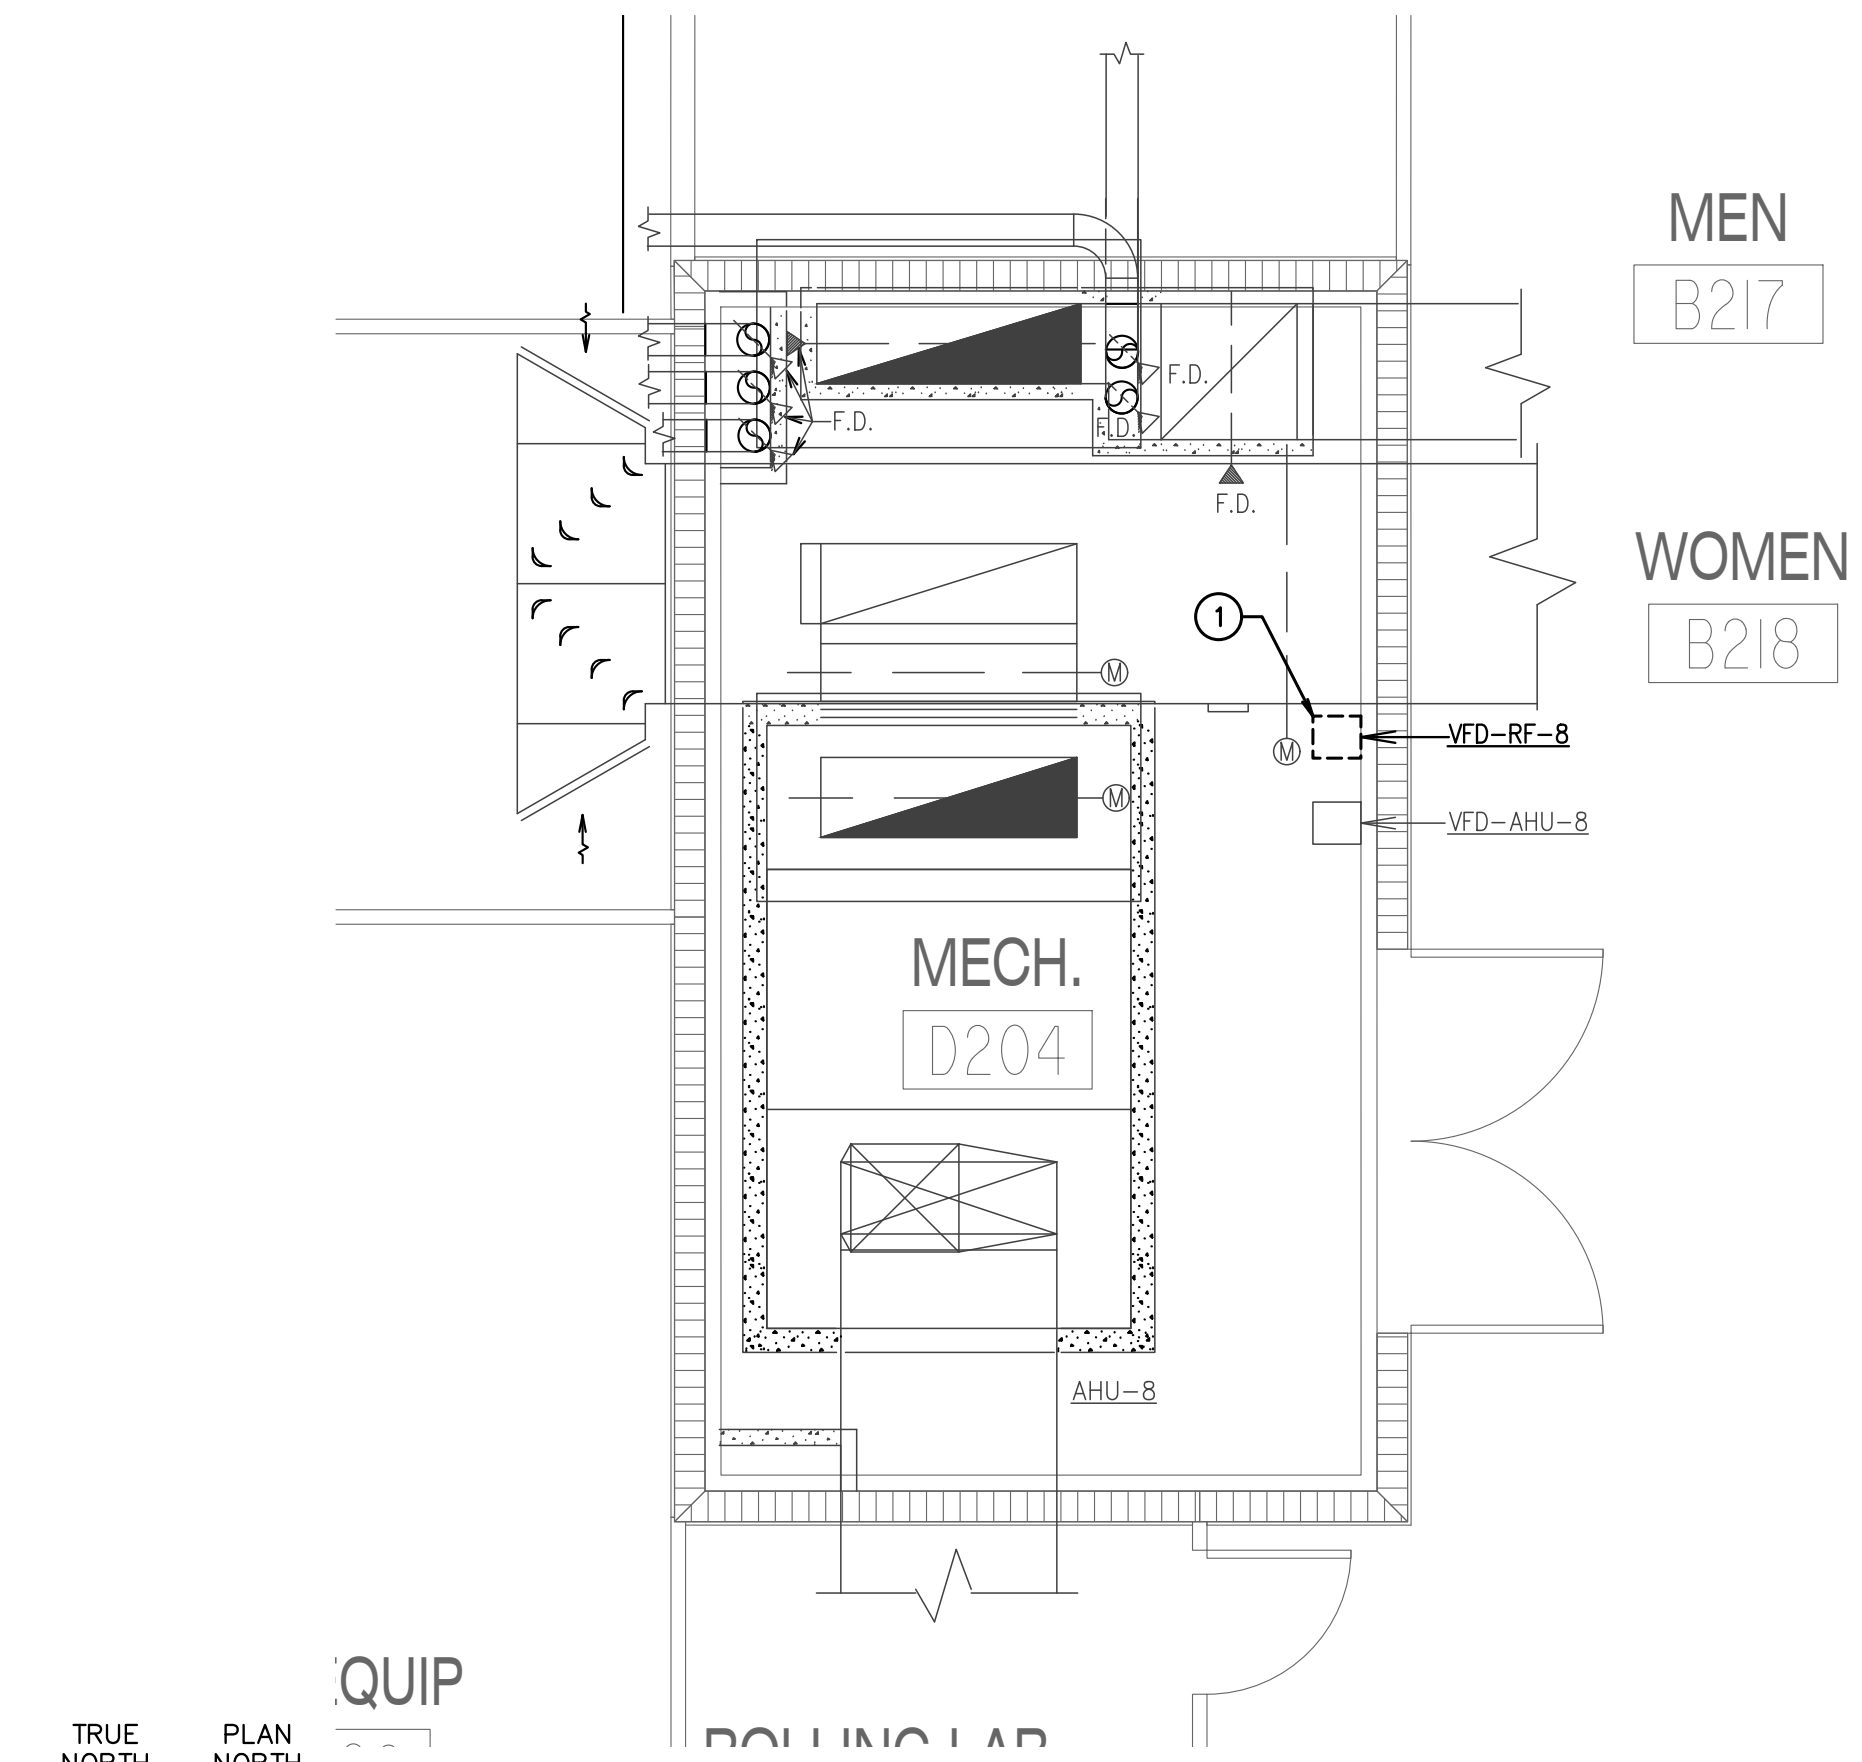
TRUE NORTH PLAN NORTH
01 ENLARGED MECHANICAL ROOM PLAN - LEVEL 2 - AHU-4
SCALE: 1/4" = 1'-0"

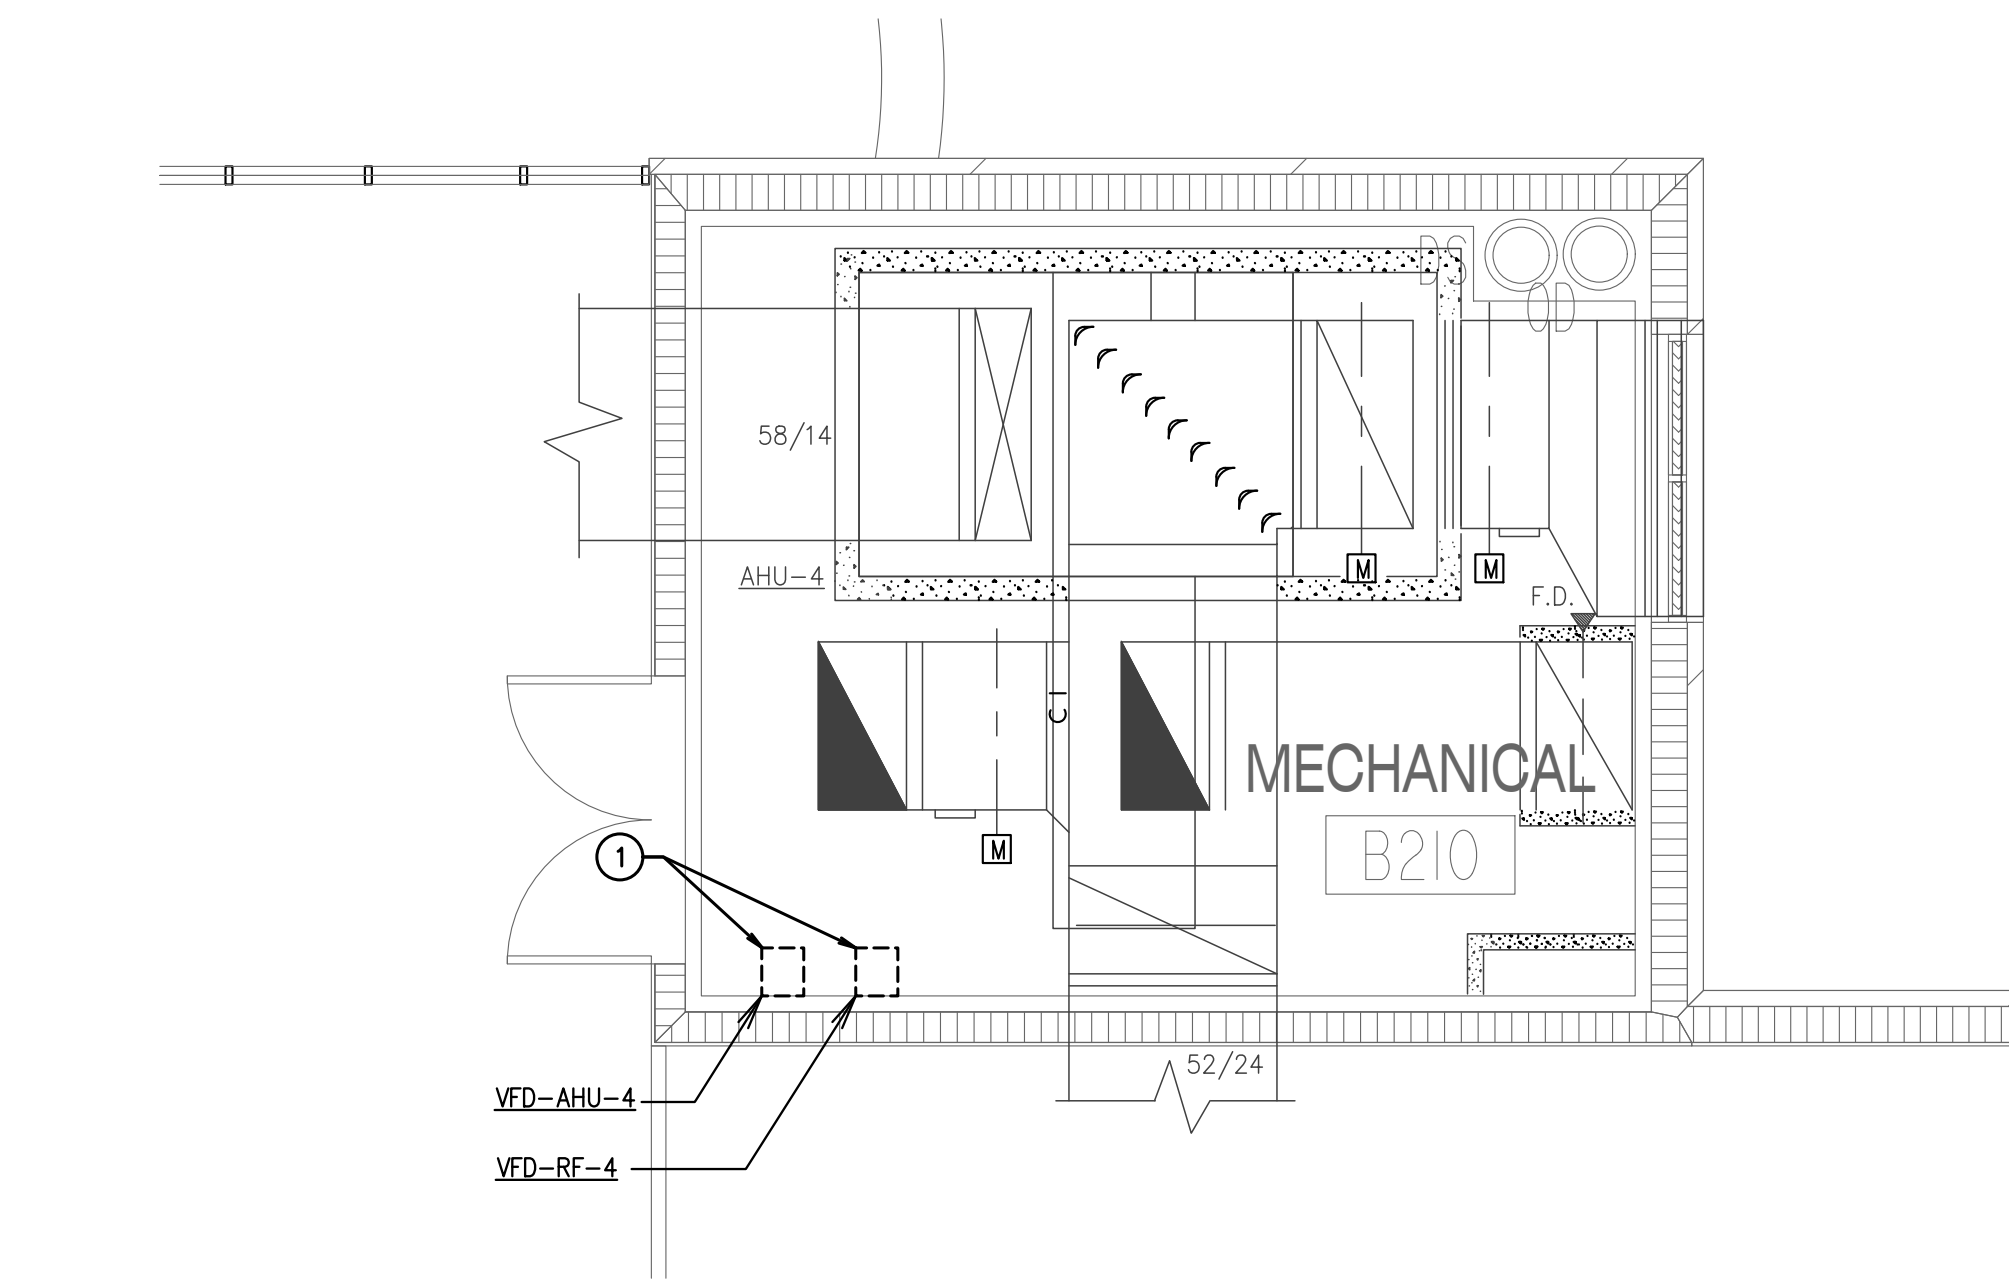

TRUE NORTH PLAN NORTH
02 ENLARGED MECHANICAL ROOM PLAN - LEVEL 2 - AHU-5
SCALE: 1/4" = 1'-0"

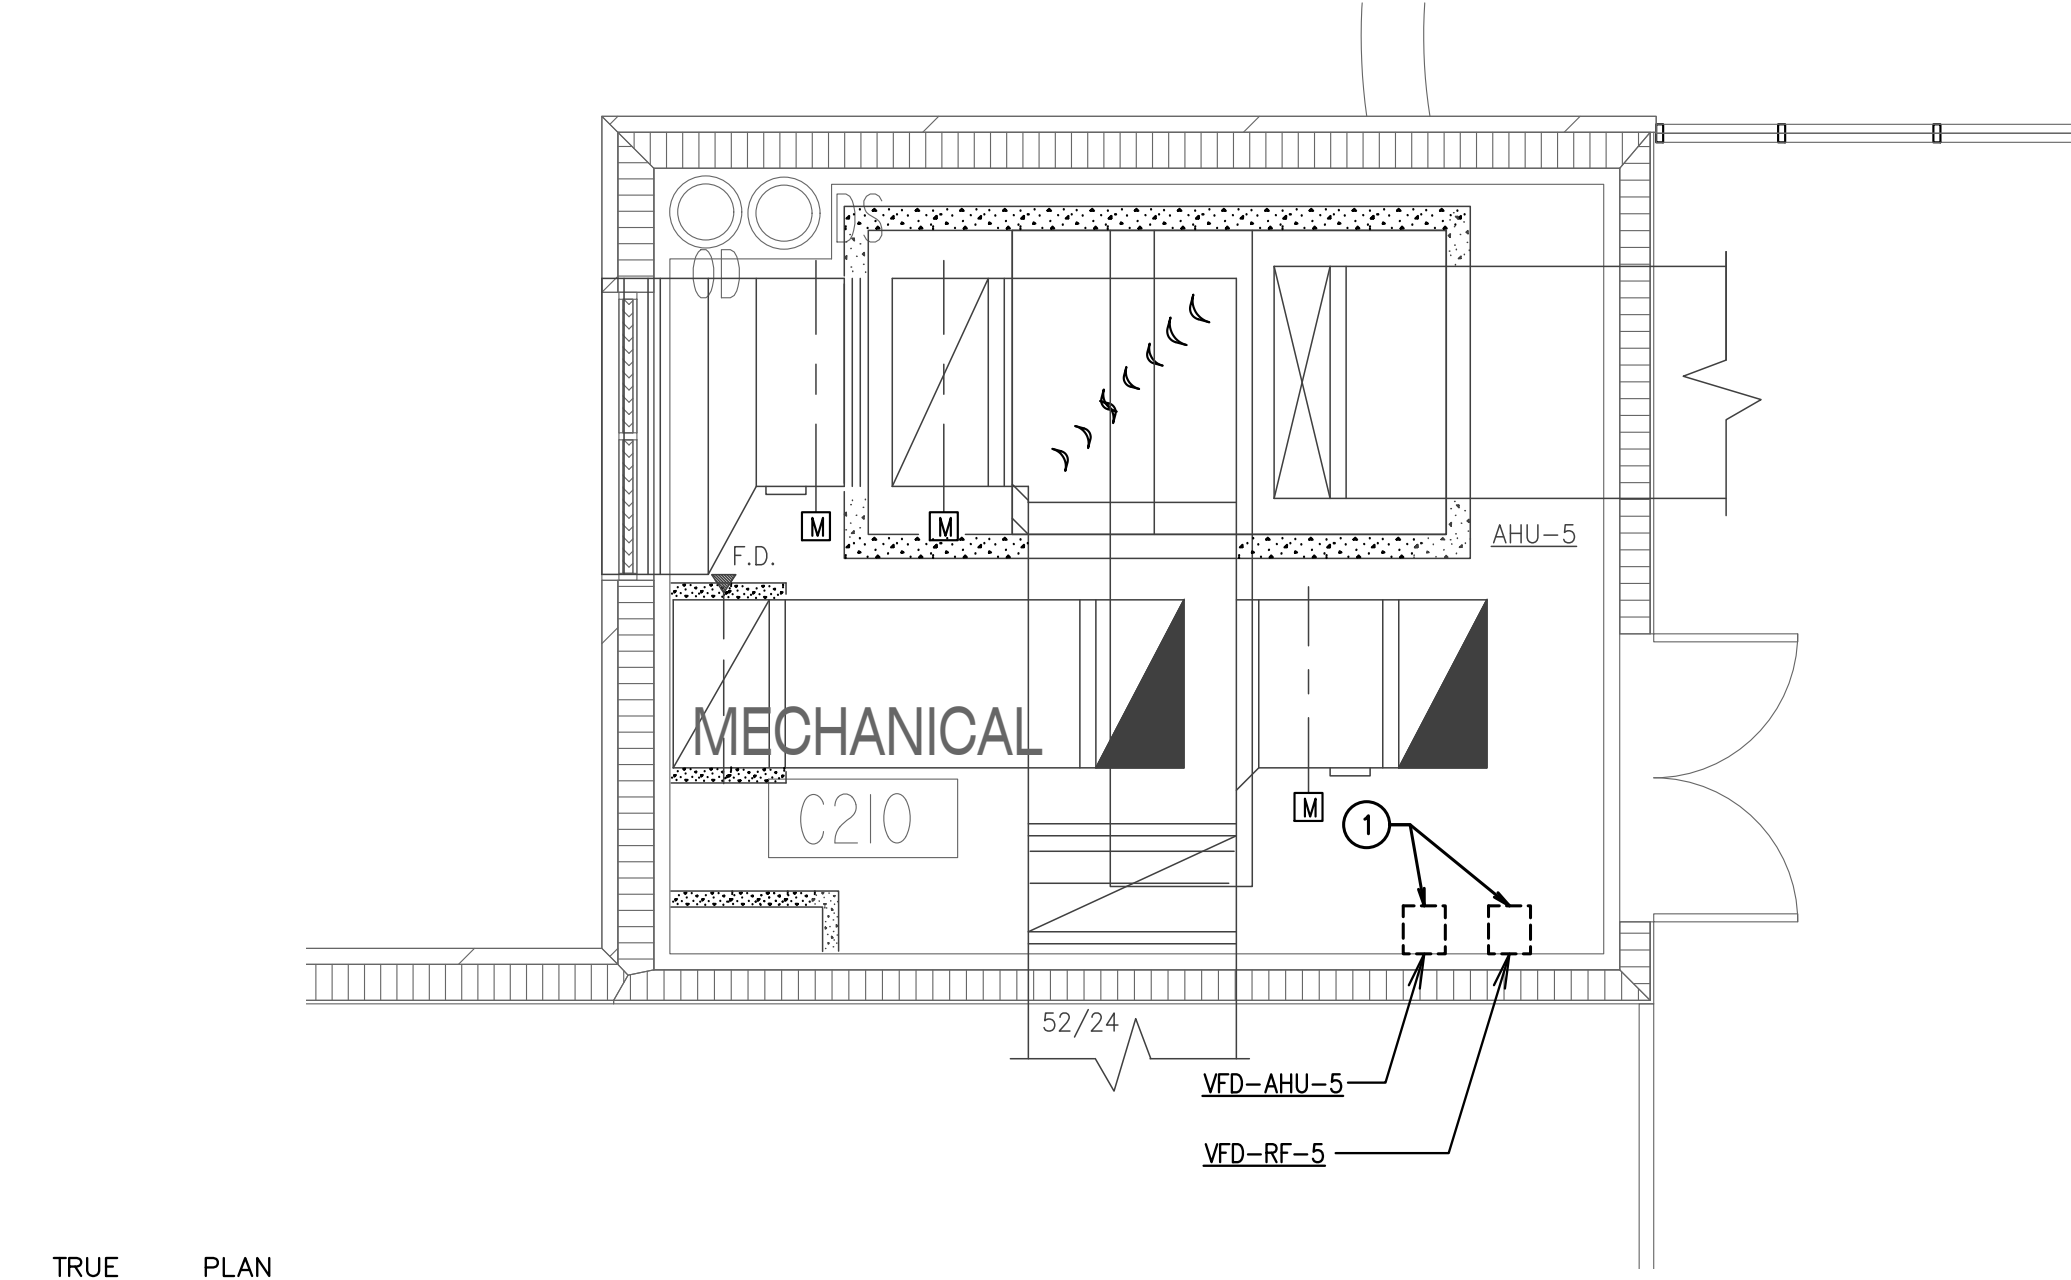

TRUE NORTH PLAN NORTH
03 ENLARGED MECHANICAL ROOM PLAN - LEVEL 2 - AHU-6
SCALE: 1/4" = 1'-0"

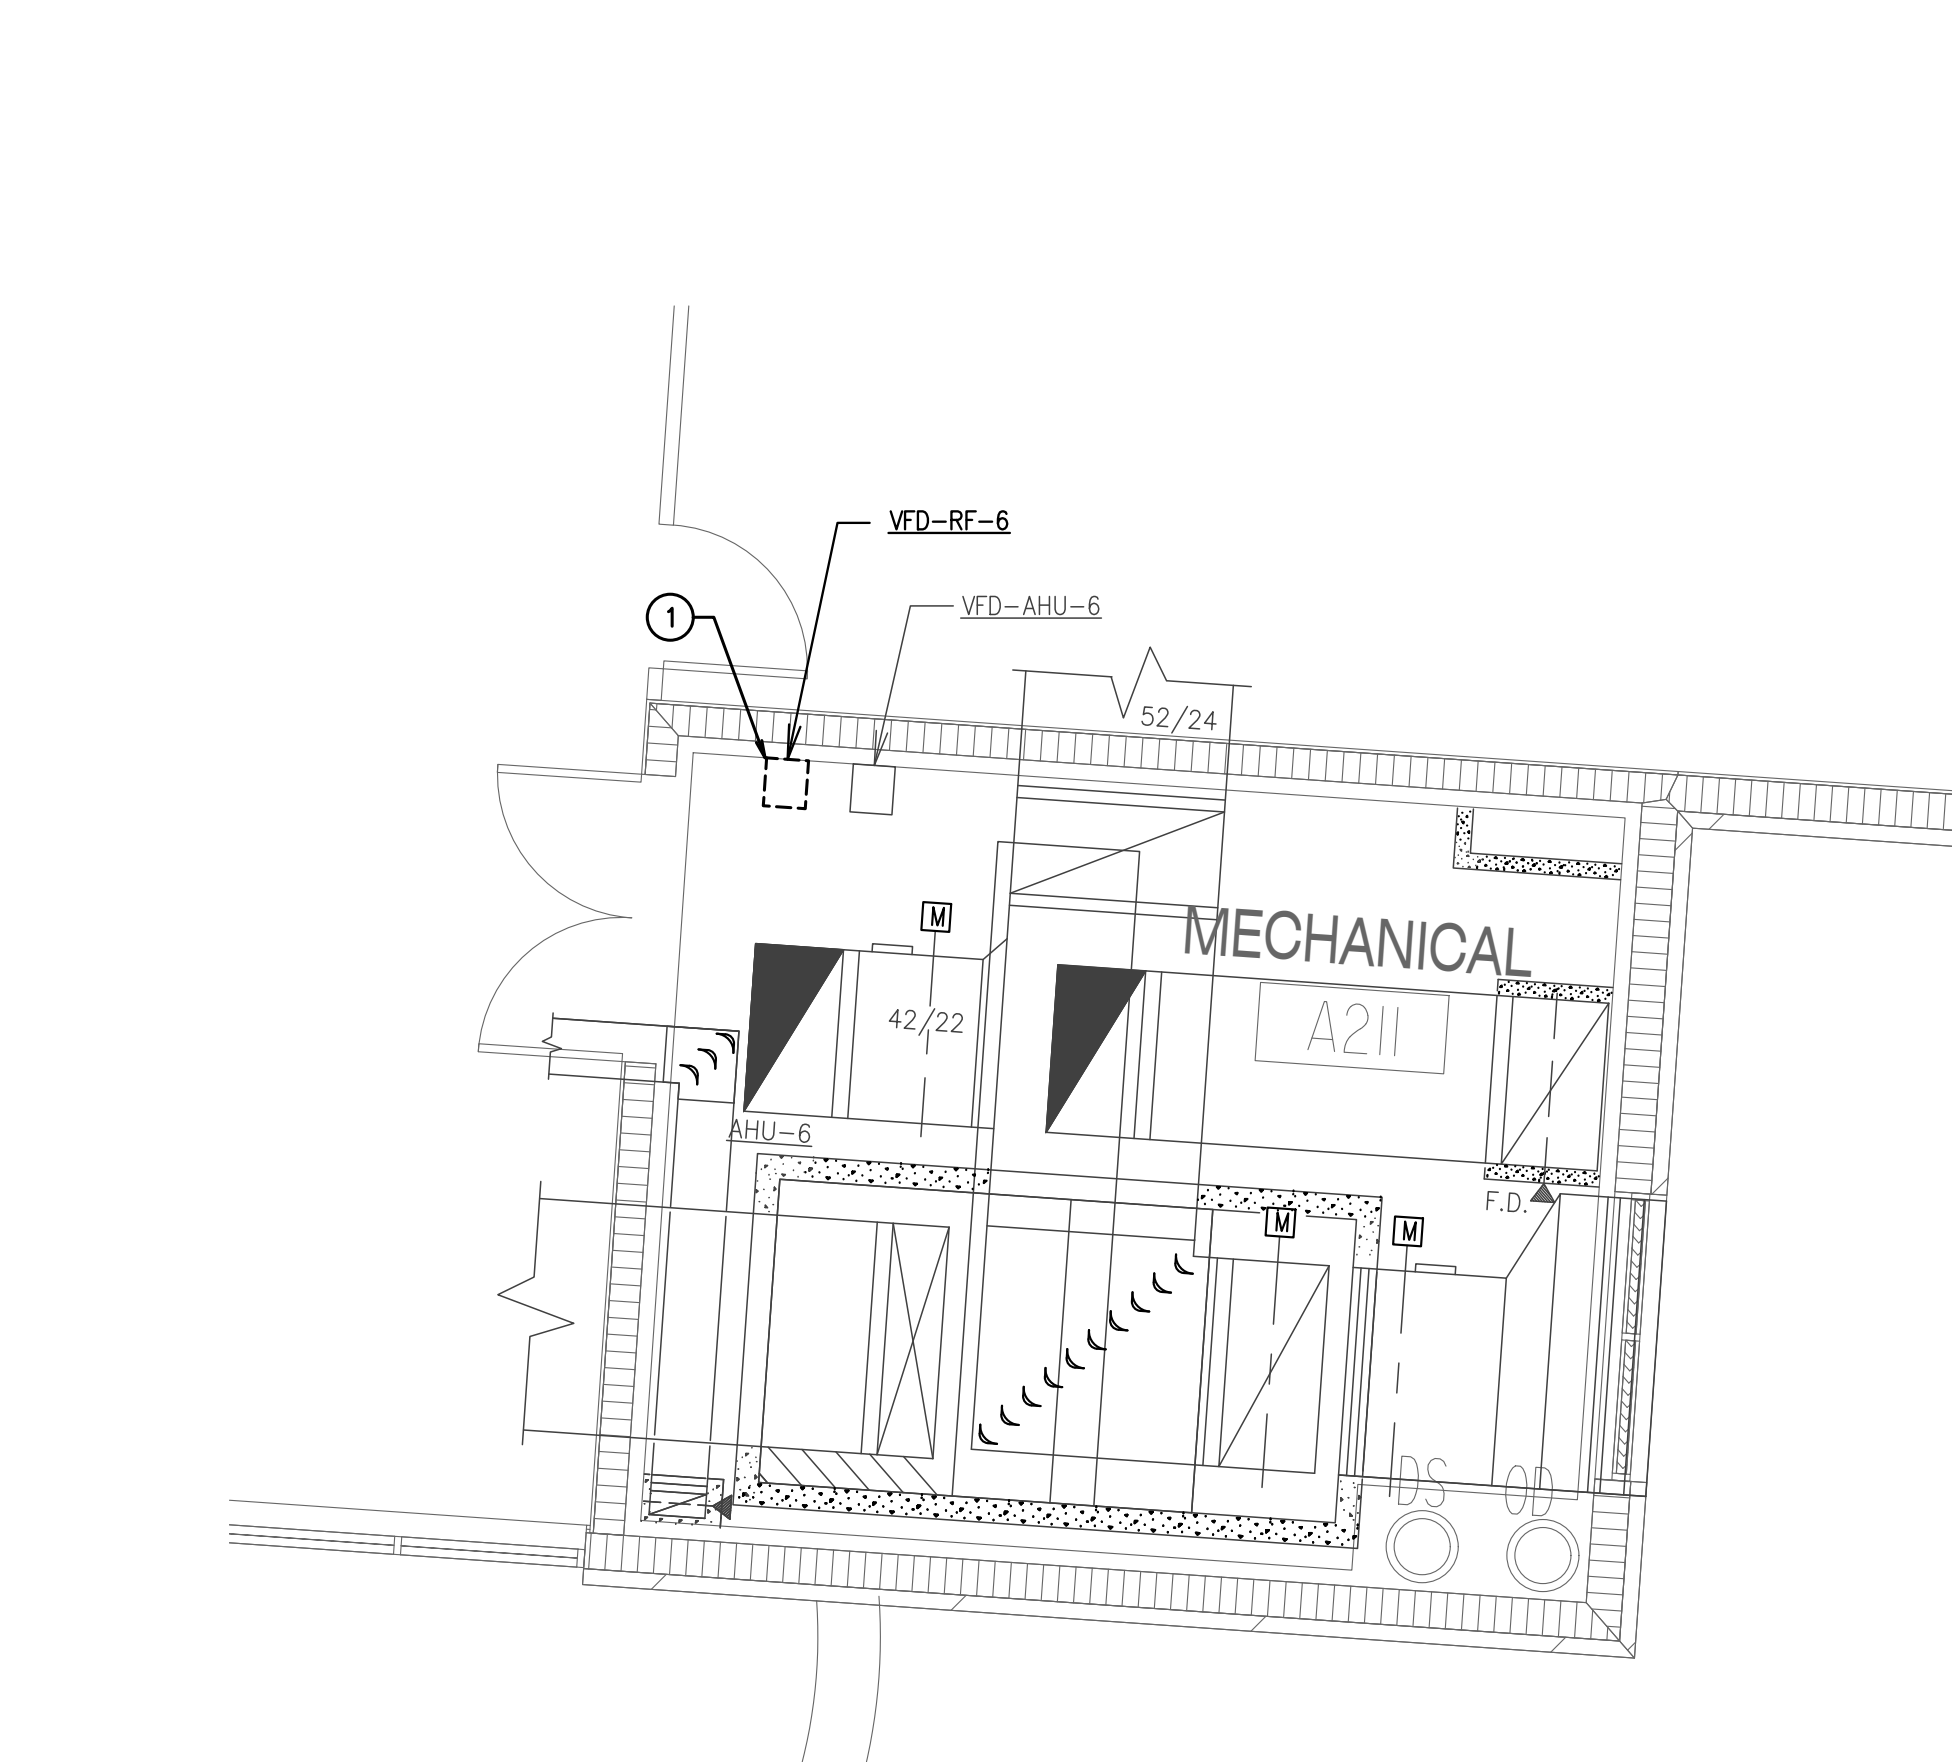


TRUE NORTH PLAN NORTH
04 ENLARGED MECHANICAL ROOM PLAN - LEVEL 2 - AHU-8
SCALE: 1/4" = 1'-0"

GENERAL DEMOLITION NOTES:

1. THE INFORMATION ON THE DEMOLITION DRAWINGS ARE NOT FROM "AS-BUILT" DRAWINGS BUT FROM ORIGINAL DRAWINGS. THIS INFORMATION IS INCLUDED FOR REFERENCE ONLY. CONTRACTOR WILL BE RESPONSIBLE FOR VISITING THE SITE PRIOR TO SUBMITTING A BID TO DETERMINE THE AMOUNT OF WORK THAT WILL BE REQUIRED. CONTRACTOR SHALL EXAMINE THE EXISTING BUILDING AND GENERALLY VERIFY THE LOCATION OF ALL EXISTING WORK AND BECOME INFORMED AS TO THE RELATION TO, AND EFFECT ON, THE WORK REQUIRED BEFORE SUBMITTING A BID. SUBMISSION OF A BID WILL CONSTITUTE EVIDENCE THAT THE CONTRACTOR HAS INSPECTED THE SITE OF THE PROPOSED WORK.
2. EXISTING MPE ITEMS TO BE REMOVED SHALL BE RETURNED TO THE OWNER OR DISPOSED OF AS DIRECTED BY THE DESIGNATED OWNER'S REPRESENTATIVE.
3. COORDINATE DEMOLITION WORK WITH THE BUILDING MAINTENANCE PERSONNEL AND OTHER TRADES PERFORMING WORK IN THE BUILDING PRIOR TO THE REMOVAL OF ANY ITEMS OF EQUIPMENT OR SYSTEMS THAT WILL AFFECT OTHER SYSTEMS WITHIN THE LIMIT OF NEW CONSTRUCTION OR OTHER AREAS OF THE BUILDING. THE BUILDING WILL BE OCCUPIED DURING CONSTRUCTION; AND, THEREFORE, UTILITIES MUST REMAIN IN OPERATION AT ALL TIMES. ANY REQUIRED OUTAGES MUST BE COORDINATED WITH THE OWNER.
4. PRIOR TO THE REMOVAL OF ANY MPE ITEMS OR EQUIPMENT, CONTRACTOR MUST VERIFY THE ORIGIN AND TERMINATION OF THOSE SYSTEMS AND CONFIRM THAT THE ITEMS BEING REMOVED DO NOT SERVE ANY ITEMS THAT ARE TO REMAIN (INCLUDING THOSE IN AREAS OUTSIDE THE CONTRACT LIMITS).
5. CONTRACTOR SHALL CONTACT CONTROLS SYSTEM INSTALLER BEFORE ANY DEMOLITION WORK IS STARTED TO ALLOW THEM TO TAG & IDENTIFY ITEMS TO REMAIN AND BE PROTECTED AND ITEMS TO BE REMOVED. THE CONTROLS SYSTEM INSTALLER SHALL COORDINATE WITH THE OWNER FOR ELEMENTS OF THE EXISTING CONTROLS SYSTEM THAT SHALL BE CAREFULLY REMOVED AND GIVEN TO THE OWNER SUCH AS EXISTING TEMPERATURE SENSORS THAT WILL NOT BE RE-USED. ALL EXISTING TEMPERATURE ONLY SENSORS SERVING EXISTING RTUS SHALL BE CAREFULLY REMOVED, SHRINK WRAPPED, PALLETIZED, AND PROVIDED TO OWNER FOR THEIR USE.
6. DO NOT ABANDON ANY ITEMS IN PLACE. REMOVE ALL COMPONENTS ASSOCIATED WITH EACH ITEM CALLED OUT TO BE REMOVED. WHERE ITEMS ARE REMOVED PATCH/REPLACE ROOF, WALLS, CEILING OR FLOOR, AS APPLICABLE, TO MATCH EXISTING FINISHES. WHERE NEW FINISHES ARE CALLED FOR PATCHING SHALL MATCH THE NEW FINISH.
7. ALL EXISTING FIRE ALARM, SECURITY AND OTHER CEILING MOUNTED DEVICES TO REMAIN IN OPERATION DURING CONSTRUCTION AND BE RE-INSTALLED AS NEEDED, TEMPORARILY SUPPORT AS NEEDED.
8. ALL EXISTING LIGHTS ARE TO BE REUSED AND REMAIN IN PLACE, UNLESS NOTED OTHERWISE. CONTRACTOR TO SUPPORT LIGHTS ABOVE CEILING DURING ANY CEILING DEMOLITION.
9. THE MECHANICAL CONTRACTOR / DEMOLITION CONTRACTOR SHALL COORDINATE WITH ELECTRICAL CONTRACTOR REGARDING THE SCOPE OF DEMOLITION FOR ELECTRICAL CONNECTIONS. THOSE UNITS BEING REMOVED SHALL BE SAFELY DISCONNECTED FROM EXISTING POWER.
10. CONTRACTOR SHALL COORDINATE REMOVAL OF EXISTING UNITS WITH DISTRICT, ALLOWING THE DISTRICT TO REMOVE ANY EXISTING UNIT COMPONENTS FOR SPARE STOCK.
11. PROVIDE FLOOR PROTECTION IN ALL AREAS OF DEMOLITION AND NEW WORK THROUGH OUT THE BUILDING FROM WORK AREA TO EXTERIOR. FLOORING PROTECTION TO BE FULL WIDTH OF CORRIDOR AND BE RAM BOARD OR EQUAL TYPE FLOOR PROTECTION.

ALTERNATE NOTES BY SYMBOL (○):

1. EXISTING VED TO BE REMOVED AND REPLACED WITH NEW. PROVIDE COST FOR EQUIPMENT UNDER ALTERNATE AND COST FOR INSTALLATION AS UNIT PRICING PER HP. SIZE. EXISTING CONTROLS TO BE REMOVED AND RE-INSTALLED. EXISTING ELECTRICAL TO BE REMOVED AND RE-INSTALLED. REFER TO SCHEDULE FOR VED SIZE.

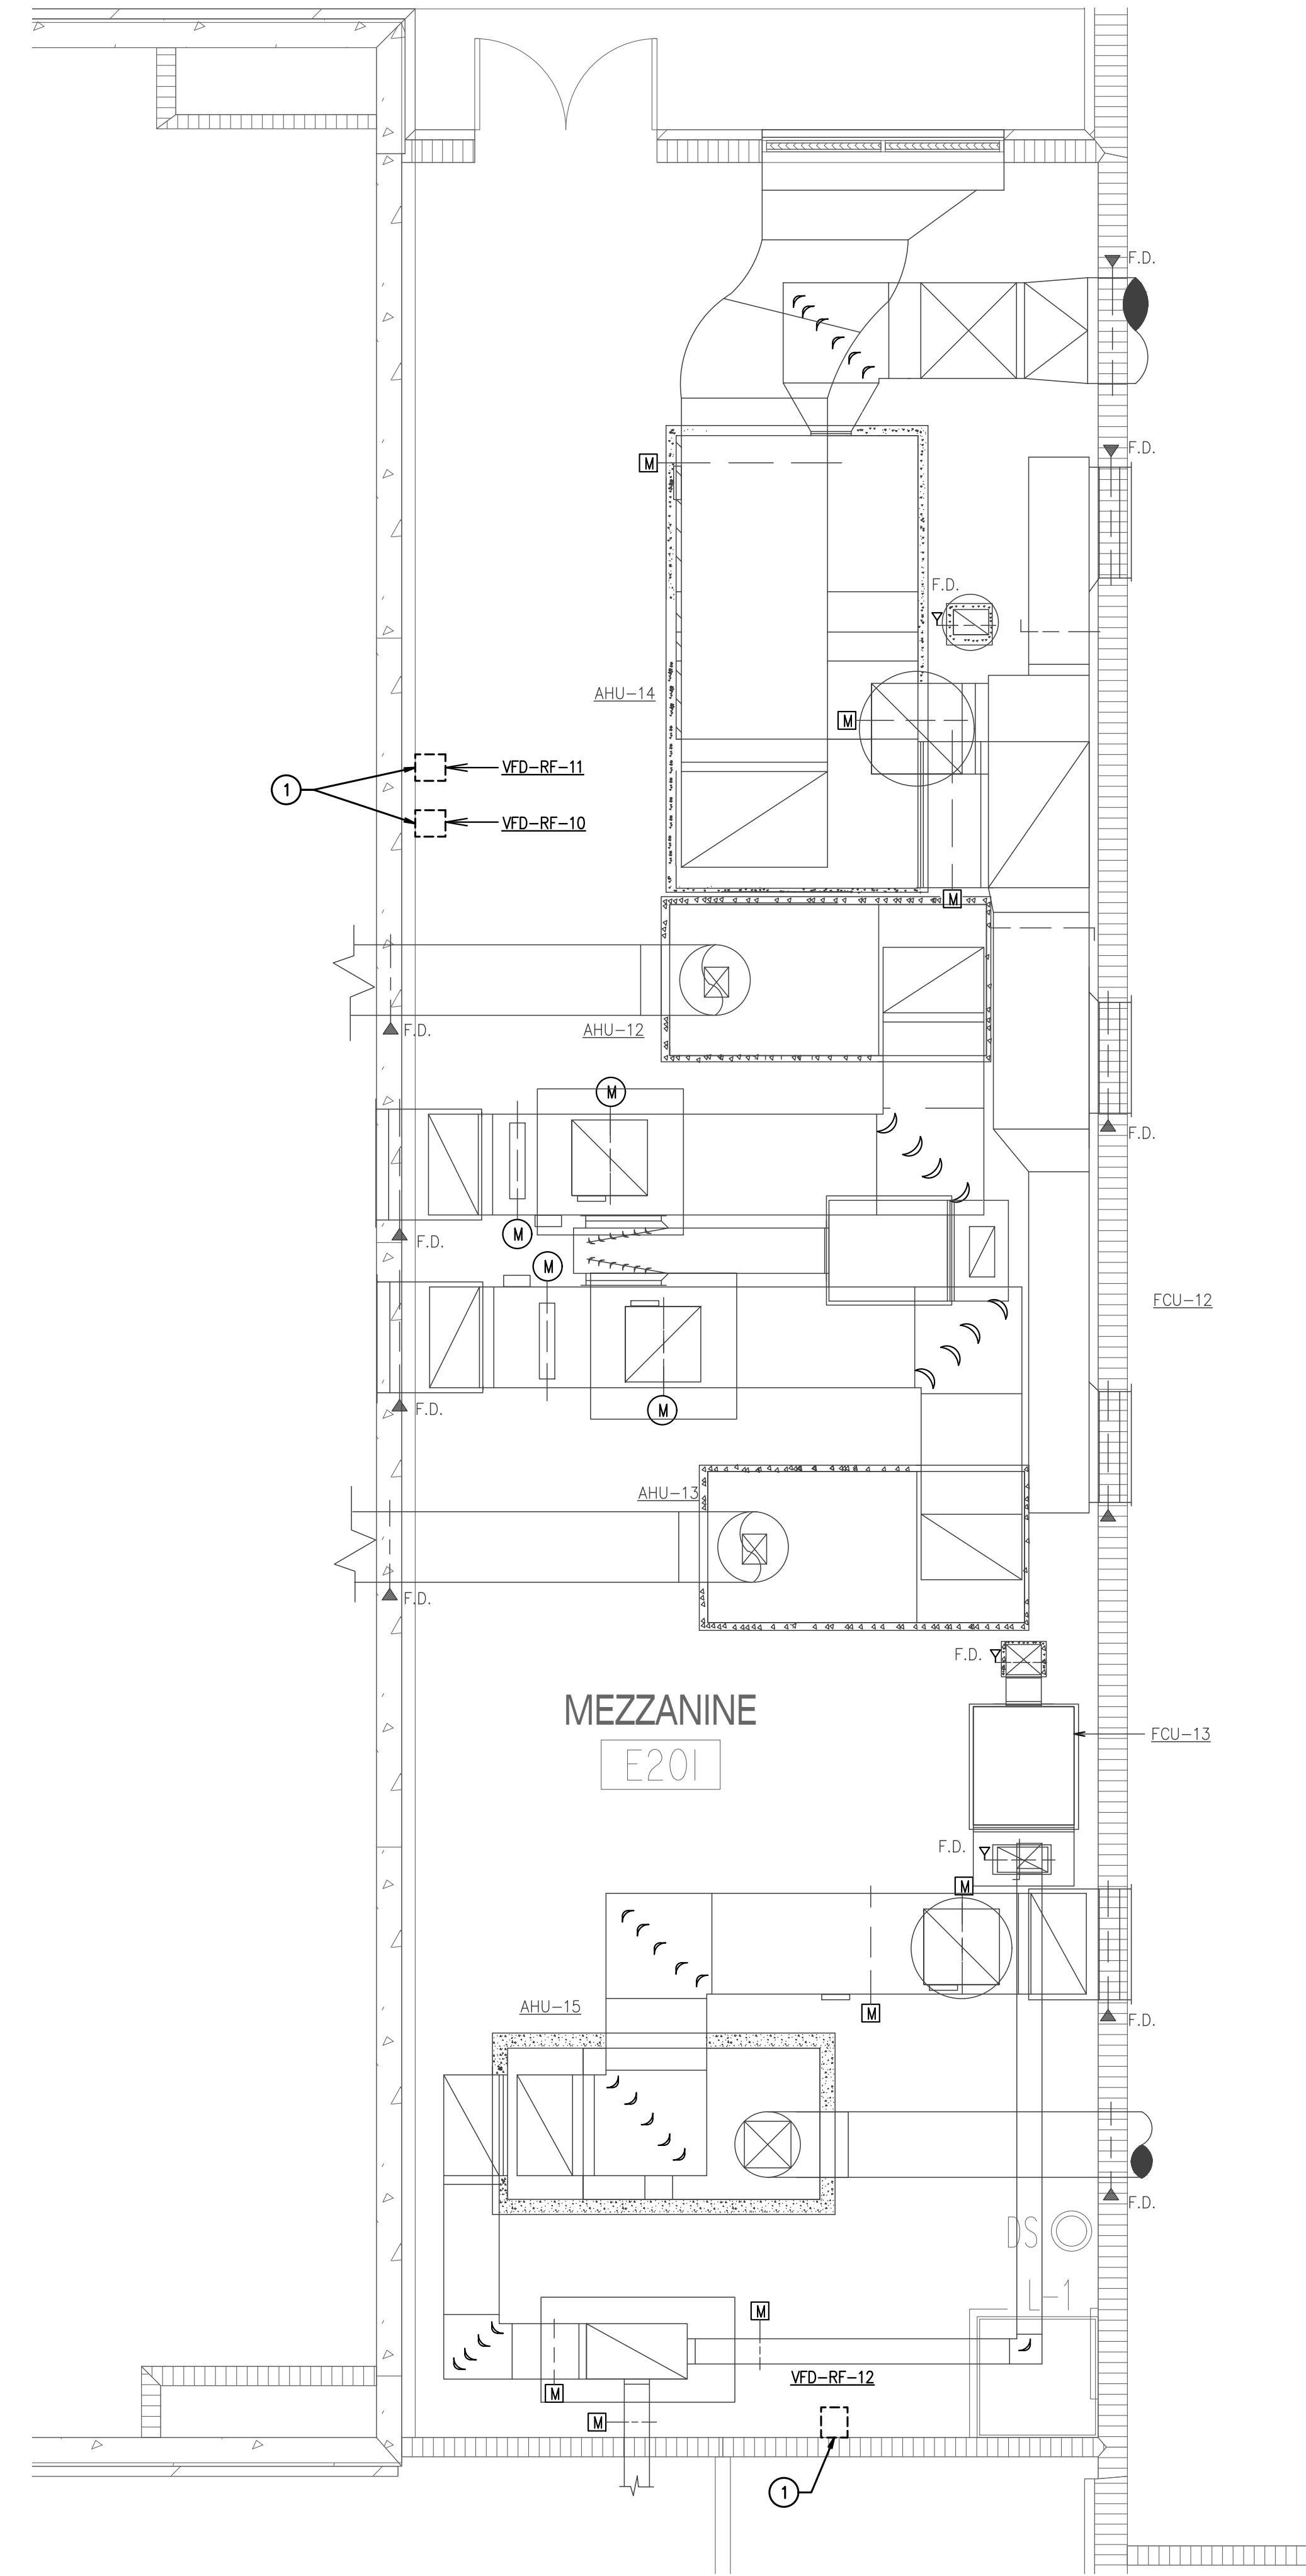

TRUE NORTH PLAN NORTH
05 ENLARGED MECHANICAL ROOM PLAN - LEVEL 2 - AHU 12-15
SCALE: 1/4" = 1'-0"

2024.07.03

ISSUES

01 ISSUE FOR CONSTRUCTION 2024.07.03

REVISIONS

01 ADDENDUM #2 2024.07.23



WALNUT GROVE MS
CHILLER REPLACEMENT
MIDLOTHIAN I.S.D.
990 Walnut Grove Rd, Midlothian, TX 76065


ENLARGED
DEMOLITION FLOOR
PLANS - LEVEL 2 -
HVAC

JOB NO.: 24040-00
DRAWN BY: BM
CHECKED BY: HV


SHEET NO.

DM2.01

Drawing: 34040 - MIDLOTHIAN I&D WALNUT GROVE MS CHILLER/PAVING/COOLING TOWER/CHAS. Rev. By: BAKER, MARK; Rev. Date: 7/23/2024 5:23 PM; Ref. Scale: 1:1; Paper: Standard 30" X36" X2 N

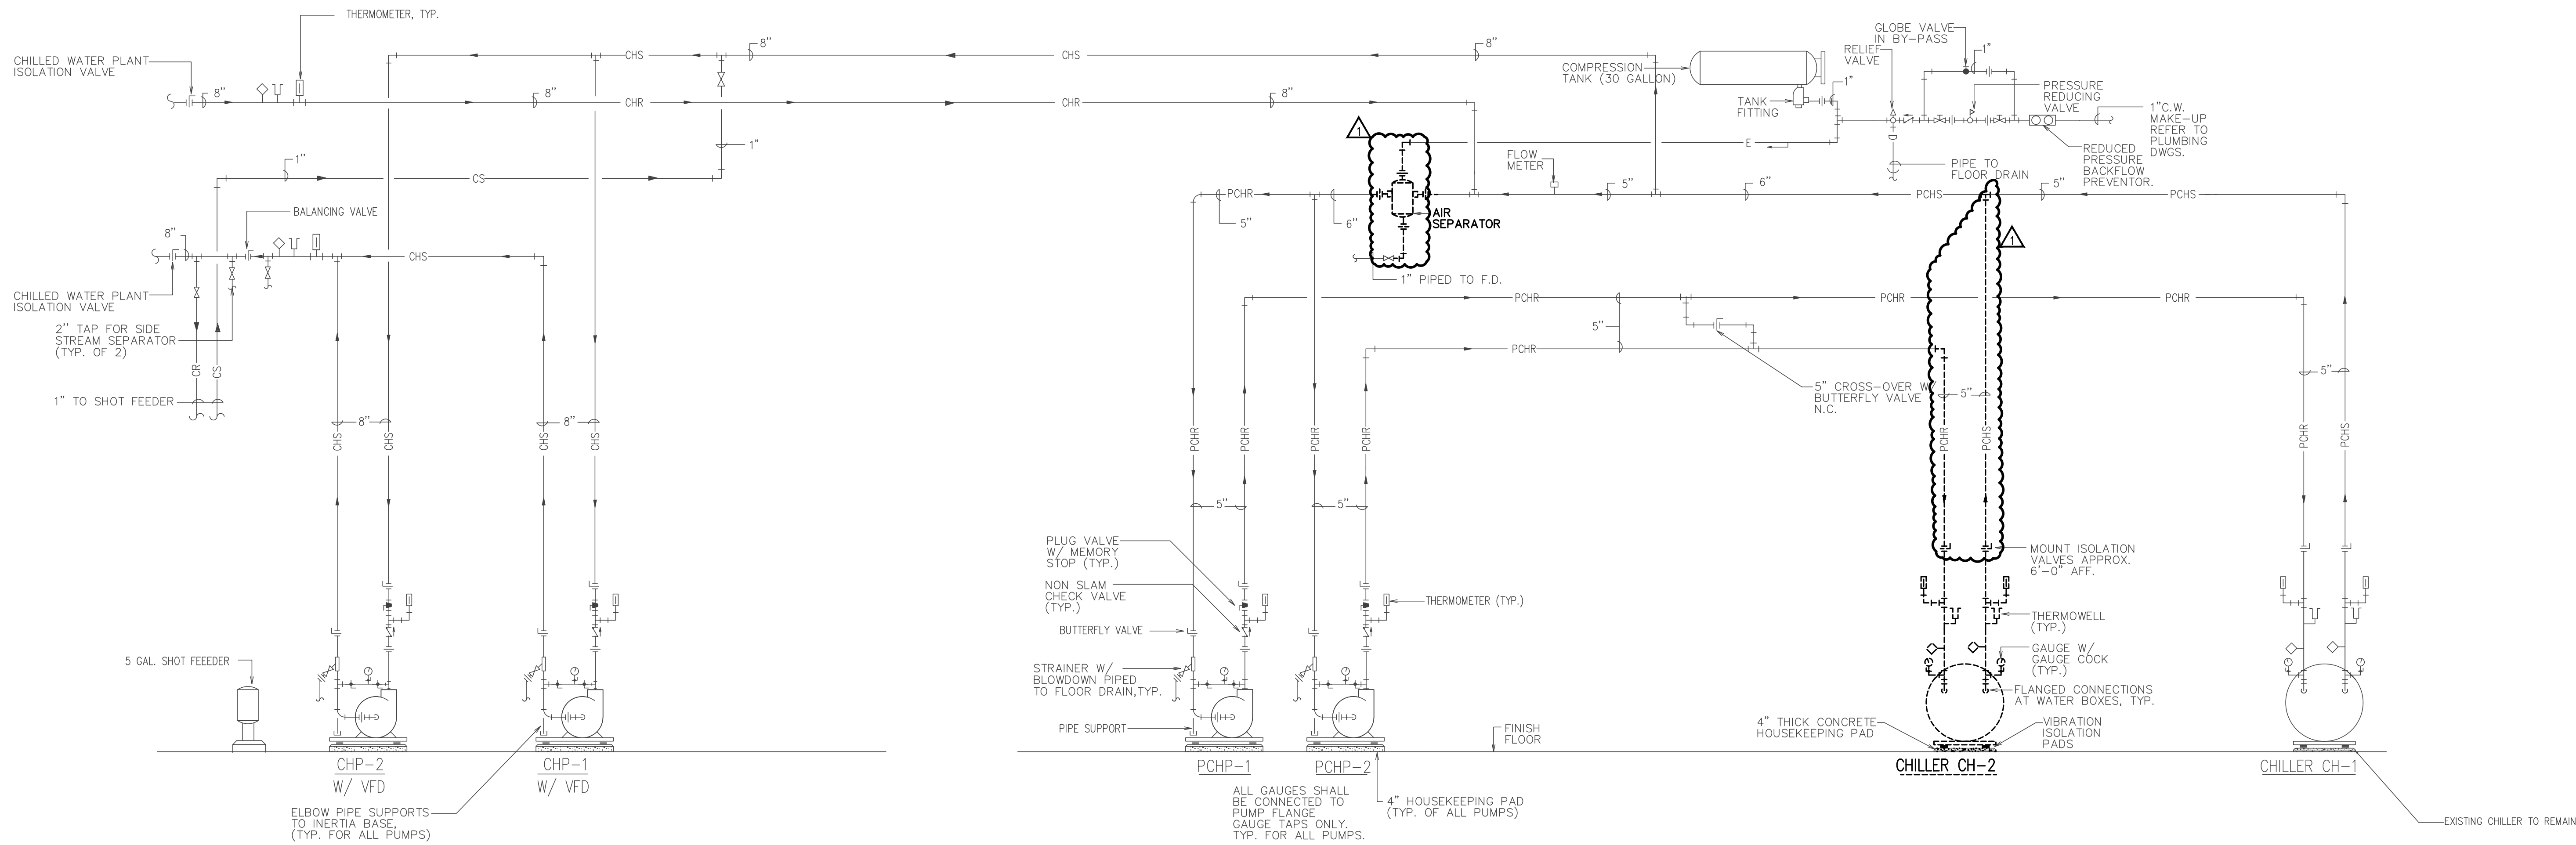

01 CHILLED WATER FLOW DIAGRAM
SCALE: SCHEMATIC ONLY

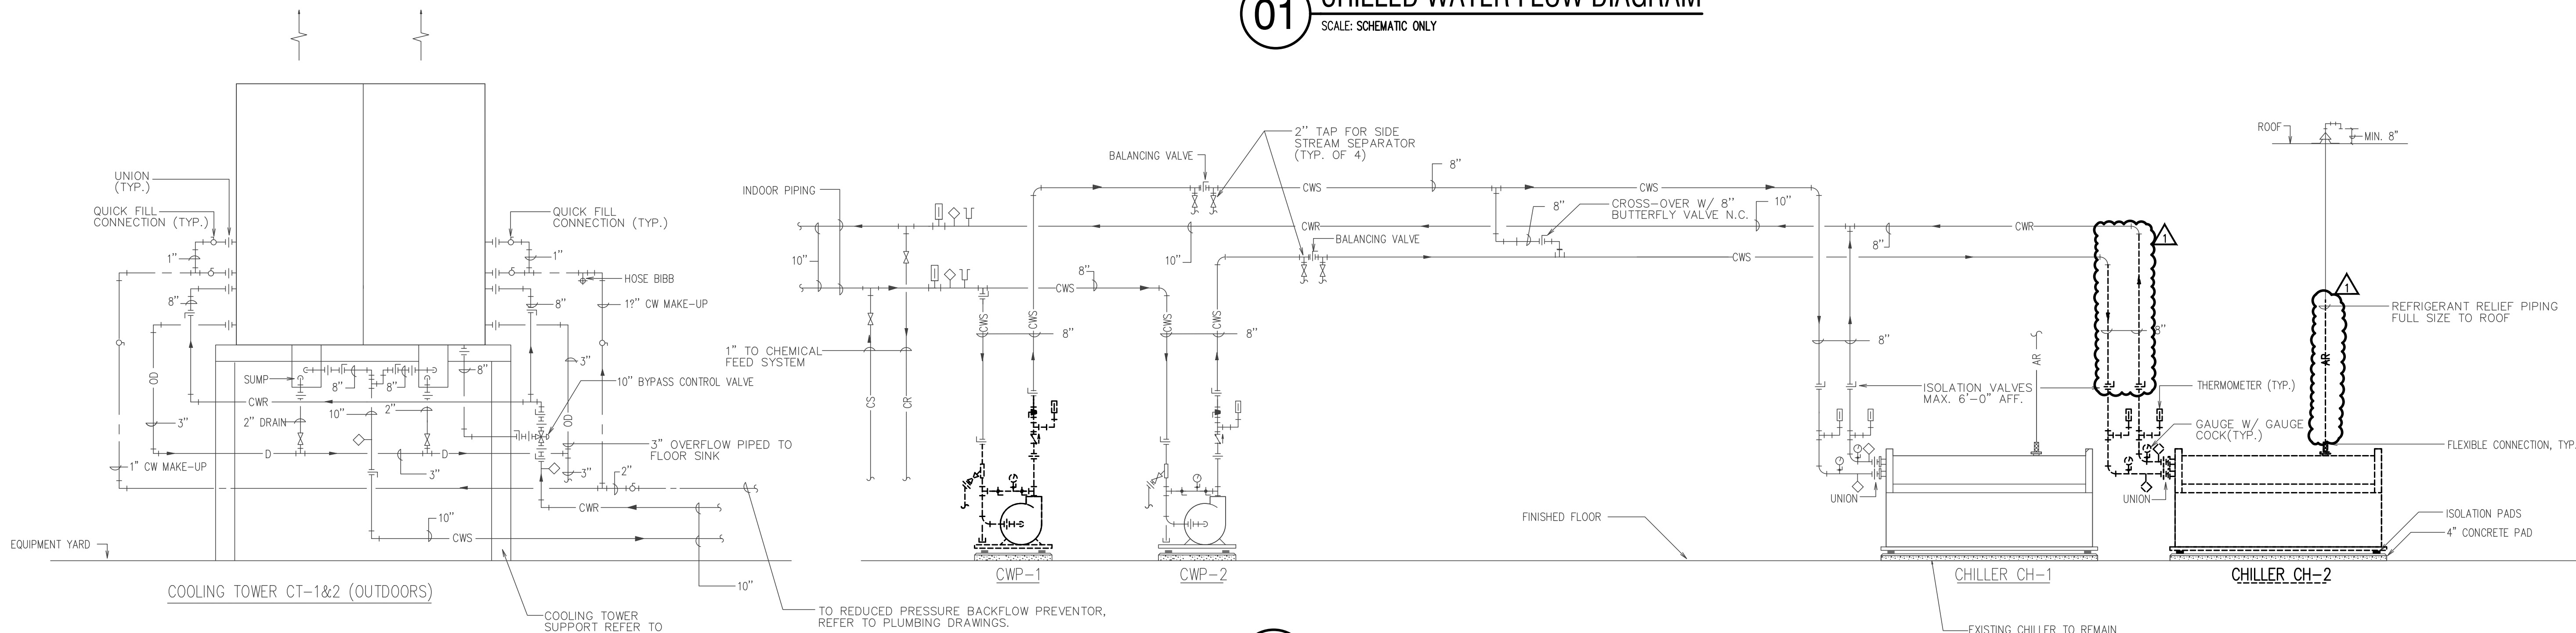

02 CONDENSER WATER FLOW DIAGRAM
SCALE: SCHEMATIC ONLY

2024.07.03

ISSUES

01 ISSUE FOR CONSTRUCTION 2024.07.03

REVISIONS

01 ADDENDUM #2 2024.07.23



WALNUT GROVE MS
CHILLER REPLACEMENT
MIDLOTHIAN I.S.D.
990 Walnut Grove Rd, Midlothian, TX 76065

HYDRONIC FLOW
DIAGRAMS
DEMOLITION - HVAC


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DRAWN BY: BM

CHECKED BY: HV

SHEET NO.

DM3.01

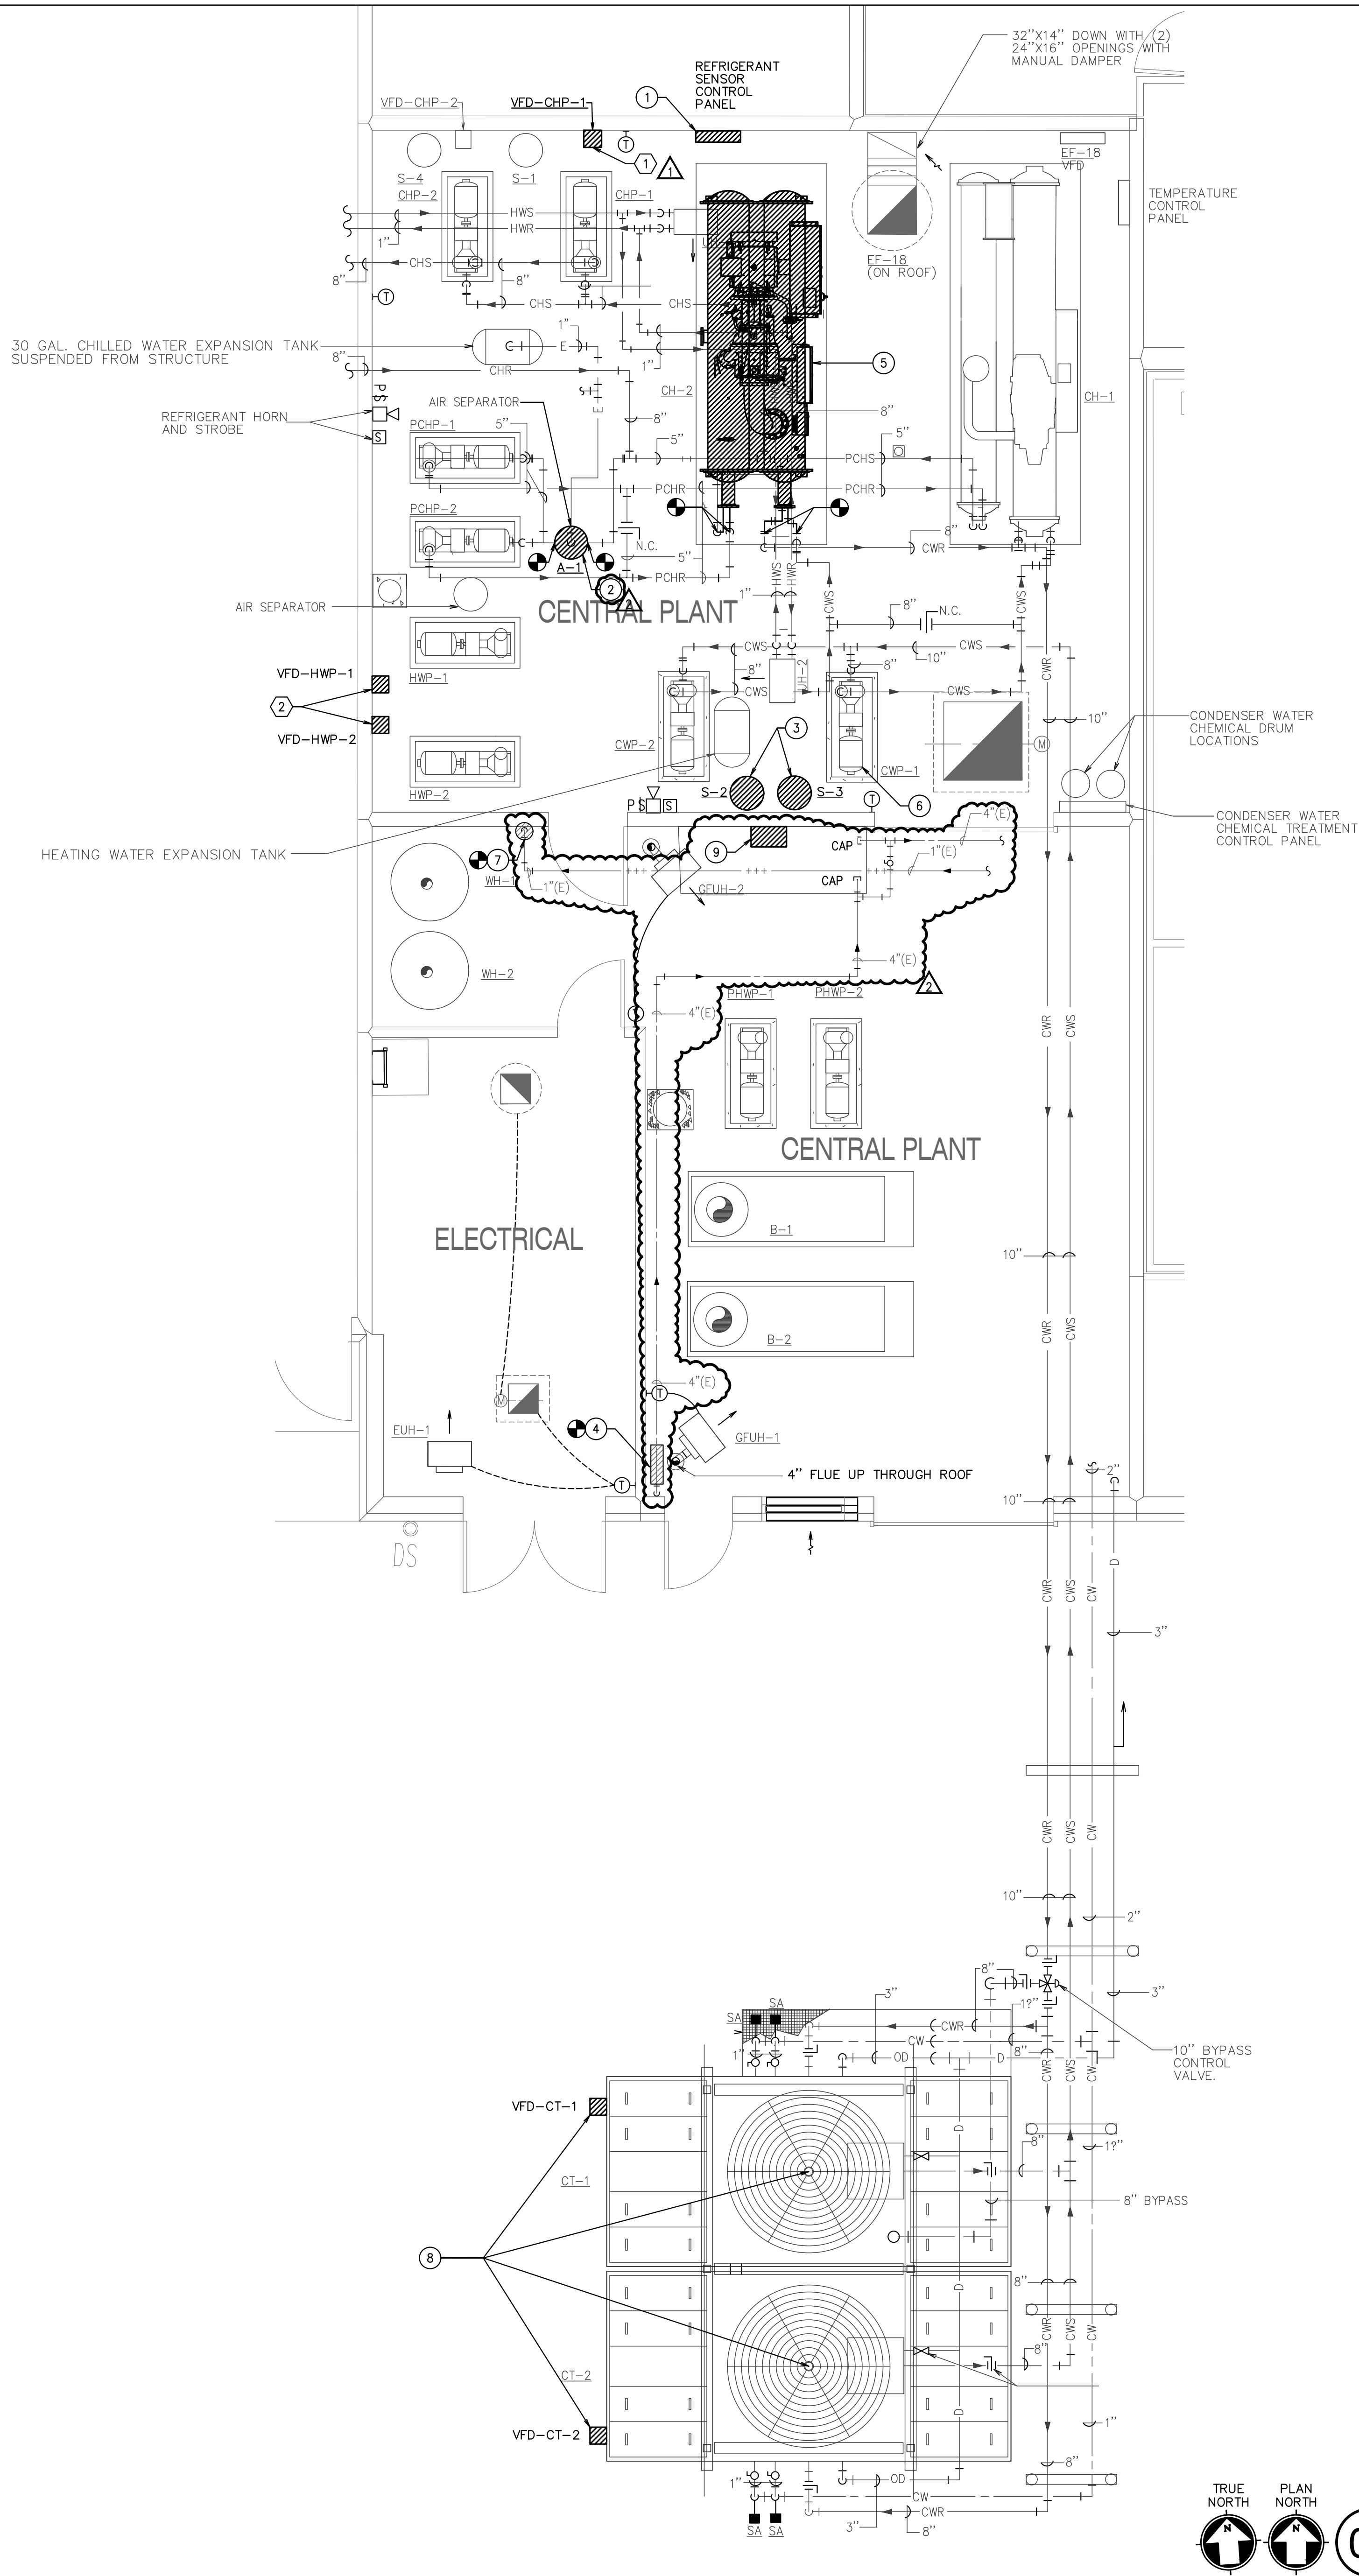

GENERAL MECHANICAL NOTES:

1. RECTANGULAR SUPPLY AIR DUCTWORK IS TO BE LINED WITH 1½" THICK ACOUSTICAL AND THERMAL LINER FOR THE FIRST 10'-0" FROM THE UNIT AND EXTERNALLY WRAPPED WITH 1" INSULATION. TRANSFER AIR DUCTWORK IS TO MEET THE 2018 IECC REQUIREMENT. RECTANGULAR RETURN DUCT SHALL BE LINED WITH 1" LINER FOR THE FIRST 10'-0" FROM THE UNIT AND EXTERNALLY WRAPPED WITH MINIMUM 2" INSULATION AFTER THE FIRST TRANSFER. TRANSFER AIR DUCTWORK IS TO BE LINED WITH 1" LINER. DUCTWORK SECTIONS SHOWN ARE NET INTERNAL AIR STREAM DIMENSIONS. SHEET METAL SIZES ARE TO BE DETERMINED IN SIZE TO ACCOMMODATE CLEAR DIMENSIONS. EXISTING DUCTWORK IS TO BE EXTERNALLY WRAPPED, FLEXIBLE ROUNDED DUCT SHALL HAVE A MINIMUM R-VALUE OF 6.0.
2. BRANCH RUN-OUTS TO CEILING MOUNTED AIR DEVICES SHALL BE SAME SIZE AS NECK, UNLESS NOTED OTHERWISE. PROVIDE A TWIST-IN FLARED TAP WITH MANUAL VALVE. DANGEROUS PRESSURE. BRANCH RUN-OUTS TO SHOWN IN SCHEDULE SHALL BE 1" UNLESS A MAXIMUM OF 8'-0" FROM DIFFUSERS, INSTALL STRAIGHT AS POSSIBLE WITH LONG RADII BENDS WITH CLAMPS TO BE USED AT BOTH ENDS.
3. ALL DUCTWORK AND PIPING SHALL BE RUN CONCEALED ABOVE CEILINGS AS HIGH AS POSSIBLE, CONCEALED IN CHASES, OR FURROWS IN GENERAL LOCATIONS SHOWN, UNLESS NOTED OTHERWISE.
4. LOCATE CEILING MOUNTED AIR DEVICES APPROXIMATELY WHERE SHOWN. VERIFY EXISTING CEILING TYPES TO CONFIRM FAN MOUNTING TYPES REQUIRED. ALL CEILING DIFFUSERS TO BE FOUR-WAY TYPE UNLESS NOTED OTHERWISE BY AIR FLOW ARROWS ON FLOOR PLAN.
5. EXISTING AND NEW DIFFUSERS FOR ALL DUCTWORK CONNECTED TO UNITS REPLACED OR ADDED TO BE BALANCED TO NEW AIRFLOW VALUES SHOWN. TAB FIRM CONTRACTOR DIRECTLY WITH OWNER.
6. WHERE EXISTING DUCTWORK IS REMOVED AND NOT REUSED, INSTALL INSULATED CAPS AND SEAL AIR TIGHT.
7. REMOVE EXISTING CEILING GRID AND LINES AS NEEDED TO REMOVE EXISTING AND INSTALL NEW CEILING, PIPING, AND DUCTWORK. REMOVE EXISTING CEILING GRID WHERE POSSIBLE. STORE AND STACK EXISTING TILE FOR REUSE AND PROTECT. WHERE NEW CEILING TILE IS REQUIRED, IT SHALL BE ALL NEW THROUGH THE ROOM. DO NOT MIX NEW AND EXISTING CEILING TILE IN THE SAME SPACE. ALL NEW CEILING TILE TO MATCH EXISTING CEILING HEIGHTS. ANY CEILINGS TO REMAIN THAT ARE DAMAGED DURING CONSTRUCTION SHALL BE REPLACED BY THE CONTRACTOR WITH PRODUCTS AND FINISHES THAT MATCH EXISTING.
8. EXISTING LIGHTS TO BE REUSED AND REMAIN IN PLACE. CONTRACTOR TO SUPPORT LIGHTS ABOVE CEILING DURING ANY CEILING REMOVAL.
9. WHERE ITEMS ARE REMOVED PATCH WALLS, CEILING, OR FLOOR AS APPLICABLE TO MATCH EXISTING FINISHES.
10. EXISTING SECURITY SYSTEM AND DEVICES TO REMAIN IN PLACE AND ACTIVE DURING CONSTRUCTION. ANY DEVICES IN CEILINGS TO BE REMOVED AND REPLACED TO BE TEMPORARILY SUPPORTED. ALL SECURITY SCHEME OF WORK TO BE CONTRACTED WITH SAS.
11. CLEAN ALL EXISTING REUSED SUPPLY, RETURN, AND EXHAUST AIR GRILLES FREE OF ALL DIRT AND GROSS PARTICLES. PAINT GRILLES TO MATCH EXISTING COLOR. REMOVE SIGNS OF RUST ARE NOTED ON EXISTING GRILLES TO MATCH EXISTING COLOR OF GRILLE.
12. NEW TEMPERATURE SENSOR TO BE INSTALLED WHERE OLD SENSOR WAS REMOVED, WHEN IN COMPLIANCE WITH A4A HEIGHT REQUIREMENTS. WHEN NOT IN COMPLIANCE PROVIDE NEW SENSOR AT A4A HEIGHT AND PROVIDE STAINLESS STEEL COVER PLATE OVER NEW SENSOR. RE-USE EXISTING WIRING PATHWAY TO ACCESSIBLE CEILING, UP TO ROOF. PATCH, REPAIR AND PAINT WALL AS NEEDED.
13. PROVIDE FLOOR PROTECTION IN ALL AREAS OF THE DEMOLITION AND NEW WORK THROUGHOUT BUILDING FROM WORK AREA TO EXTERIOR. FLOORING PROTECTION TO BE FULL WIDTH OF CORRIDOR AND STAIRWELL TO BE RAM BOARD OR EQUIVALENT FLOOR PROTECTION.

GENERAL PLUMBING NOTE:

1. CONTRACTOR SHALL PROVIDE AN EASY WATER SYSTEM AND CONTROLLER ON ALL DOMESTIC HOT WATER RETURN PIPING DOWNSTREAM OF THE CIRCULATION PUMP AND INSTALLED PER THE MANUFACTURER'S INSTALLATION INSTRUCTIONS.

NOTES BY SYMBOL '○':

- 1 NEW REFRIGERANT MONITORING STATION TO BE INSTALLED. PATCH, REPAIR, AND PAINT WALL AS NEEDED AFTER INSTALLATION. PROVIDE ALL NEW REFRIGERANT MONITOR SENSING PIPING AND CONTROLS AND THE INTO EXISTING EMS SYSTEM.
- 2 NEW AIR SEPARATOR TO BE INSTALLED. RE-CONNECT EXISTING DRAIN LINE, MAKE-UP/EXPANSION WATER LINE AND PROVIDE NEW UNIONS AND PIPING IN MAIN CHILLED-WATER LINE AS NEEDED.
- 3 NEW CENTRIFUGAL SEPARATOR TO BE INSTALLED. REFER TO DETAIL #02 ON SHEET M-4.01 FOR ADDITIONAL DETAILS. COORDINATE LOCATION OF NEW EQUIPMENT WITH EXISTING INSTALLATION.
- 4 NEW EASY WATER SYSTEM, EF-50-N / W-4S-4 AND CONTROLLER. PROVIDE 4" PIPE (OR MATCH EXISTING) SIZE WITH FLANGES. PROVIDE FLANGES ON EXISTING COOPER PIPING AND REMOVE SECTION OF DOMESTIC WATER PIPING AS NEEDED TO INSTALL WATER CONDENSER. PROVIDE INSULATION ON PIPE SECTION REMOVED AND REPLACED WITH FLANGED CONDITIONER PIPE SECTION. PATCH AND SEAL INSULATION.
- 5 NEW CENTRIFUGAL CHILLER TO BE INSTALLED. OFFSET CHILLER AND CONDENSER WATER PIPING AS NEEDED TO ACCOMMODATE NEW CHILLER CONNECTIONS. RE-UNION, AND RE-INSULATE PIPING AS NEEDED IN VERTICAL. REPLACE AND RE-WORK EXISTING WATER-INSULATED PURGE PIPING AS WELL.
- 6 EXISTING CWP-1 TO BE RE-INSTALLED AFTER THE INSTALLATION OF THE NEW CENTRIFUGAL CHILLER. RE-MOUNT PUMP BASE. RE-ALIGN PUMP AND MOTORS. RE-CONNECT ALL PIPING AND REPLACE EXISTING STRAINER BASKET.
- 7 NEW EASY WATER NO-SALT WATER CONDITIONING SYSTEM, CS500 W / TW-1 AND CONTROLLER. PROVIDE 1" PIPE (OR MATCH EXISTING) SIZE WITH FLANGES. PROVIDE FLANGES ON EXISTING COOPER PIPING AND REMOVE SECTION OF DOMESTIC WATER PIPING AS NEEDED TO INSTALL WATER CONDENSER. PROVIDE INSULATION ON PIPE SECTION REMOVED AND REPLACED WITH FLANGED CONDITIONER PIPE SECTION. PATCH AND SEAL INSULATION.
- 8 REPLACE EXISTING FAN MOTORS WITH NEW 10HP FAN MOTORS. CONFIRM NEW FAN MOTOR POWER TO BE THE SAME AS EXISTING MOTORS TO BE VFD COMPATIBLE. VFDs TO BE OF NEMA 3R CONSTRUCTION, WITH SUN SHIELDS AND TO BE MOUNTED IN PLACE OF EXISTING FAN MOTOR STARTERS. CONTRACTOR TO REMOVE EXISTING 2-SPEED VFDs AND REPLACE WITH VFD ELECTRICAL CONTRACTOR SHALL PROVIDE PUMP FROM EXISTING 480V/3PH, 40A/3P CIRCUIT BREAKER IN EXISTING PANEL "H4" TO NEW VFDs FOR COOLING TOWER FAN MOTORS. IT IS THE ELECTRICAL CONTRACTOR'S RESPONSIBILITY TO FIELD ALL TRACES ALL EXISTING FEEDERS AND BRANCH CIRCUITS WIRING FOR COOLING TOWERS FROM EXISTING ELECTRICAL DISTRIBUTION EQUIPMENT. ANY ABANDONED EQUIPMENT, RACEWAYS, AND CONDUITS SHALL BE REMOVED IN THEIR ENTIRETY AS REQUIRED BY CODE. CONTRACTOR TO PROVIDE NEW FULCRUMS, BRACKETS, AND CONDUITS TO SUPPORT NEW VFDs AND RACEWAYS TO SUPPORT NEW VFD EQUIPMENT, INCLUDING THEIR RESPECTIVE ACCESSORIES, TO EXISTING ELECTRICAL CIRCUITS MADE AVAILABLE BY DEMOLITION OF OLD HVAC EQUIPMENT. REFER TO VFD SCHEDULE FOR VFD SIZE. VFDs TO BE 1PH TO ACCOMMODATE THE DE-RATING FOR VFD INSTALLED OUTDOOR. RE-PULL WIRING AND CONDUIT AS NEEDED FOR LARGER VFD SIZE.
- 9 NEW SELF CONTAINED BREATHING APPARATUS TO BE INSTALLED OUTSIDE THE CHILLER ROOM. COORDINATE WITH OWNER FOR THE EXACT MOUNTING LOCATION.

ALTERNATE NOTES BY SYMBOL '⬡':

- ① PROVIDE COST FOR NEW CHP-1 VFD UNDER ALTERNATE. PROVIDE INSTALLATION PRICING PER VFD HP SIZE. ANS NOTED ON BID FORM. REFER TO EQUIPMENT SCHEDULE FOR VFD HP SIZE.
- ② PROVIDE COST FOR NEW HWP-1 & HWP-2 VFDs UNDER ALTERNATE. PROVIDE INSTALLATION PRICING PER VFD HP SIZE. ANS NOTED ON BID FORM. REFER TO EQUIPMENT SCHEDULE FOR VFD HP SIZE.



2024.07.03

ISSUES

01	ISSUE FOR CONSTRUCTION	2024.07.03
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REVISIONS	
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01	ADDENDUM #1	2024.07.12
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**WALNUT GROVE MS
CHILLER REPLACEMENT**
MIDLOTHIAN I.S.D.
990 Walnut Grove Rd, Midlothian, TX 76065






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CENTRAL UTILITY
PLANT - MECHANICAL
& PLUMBING

JOB NO.: 24040-00

SHEET 1

MP1.01

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GENERAL MECHANICAL NOTES:

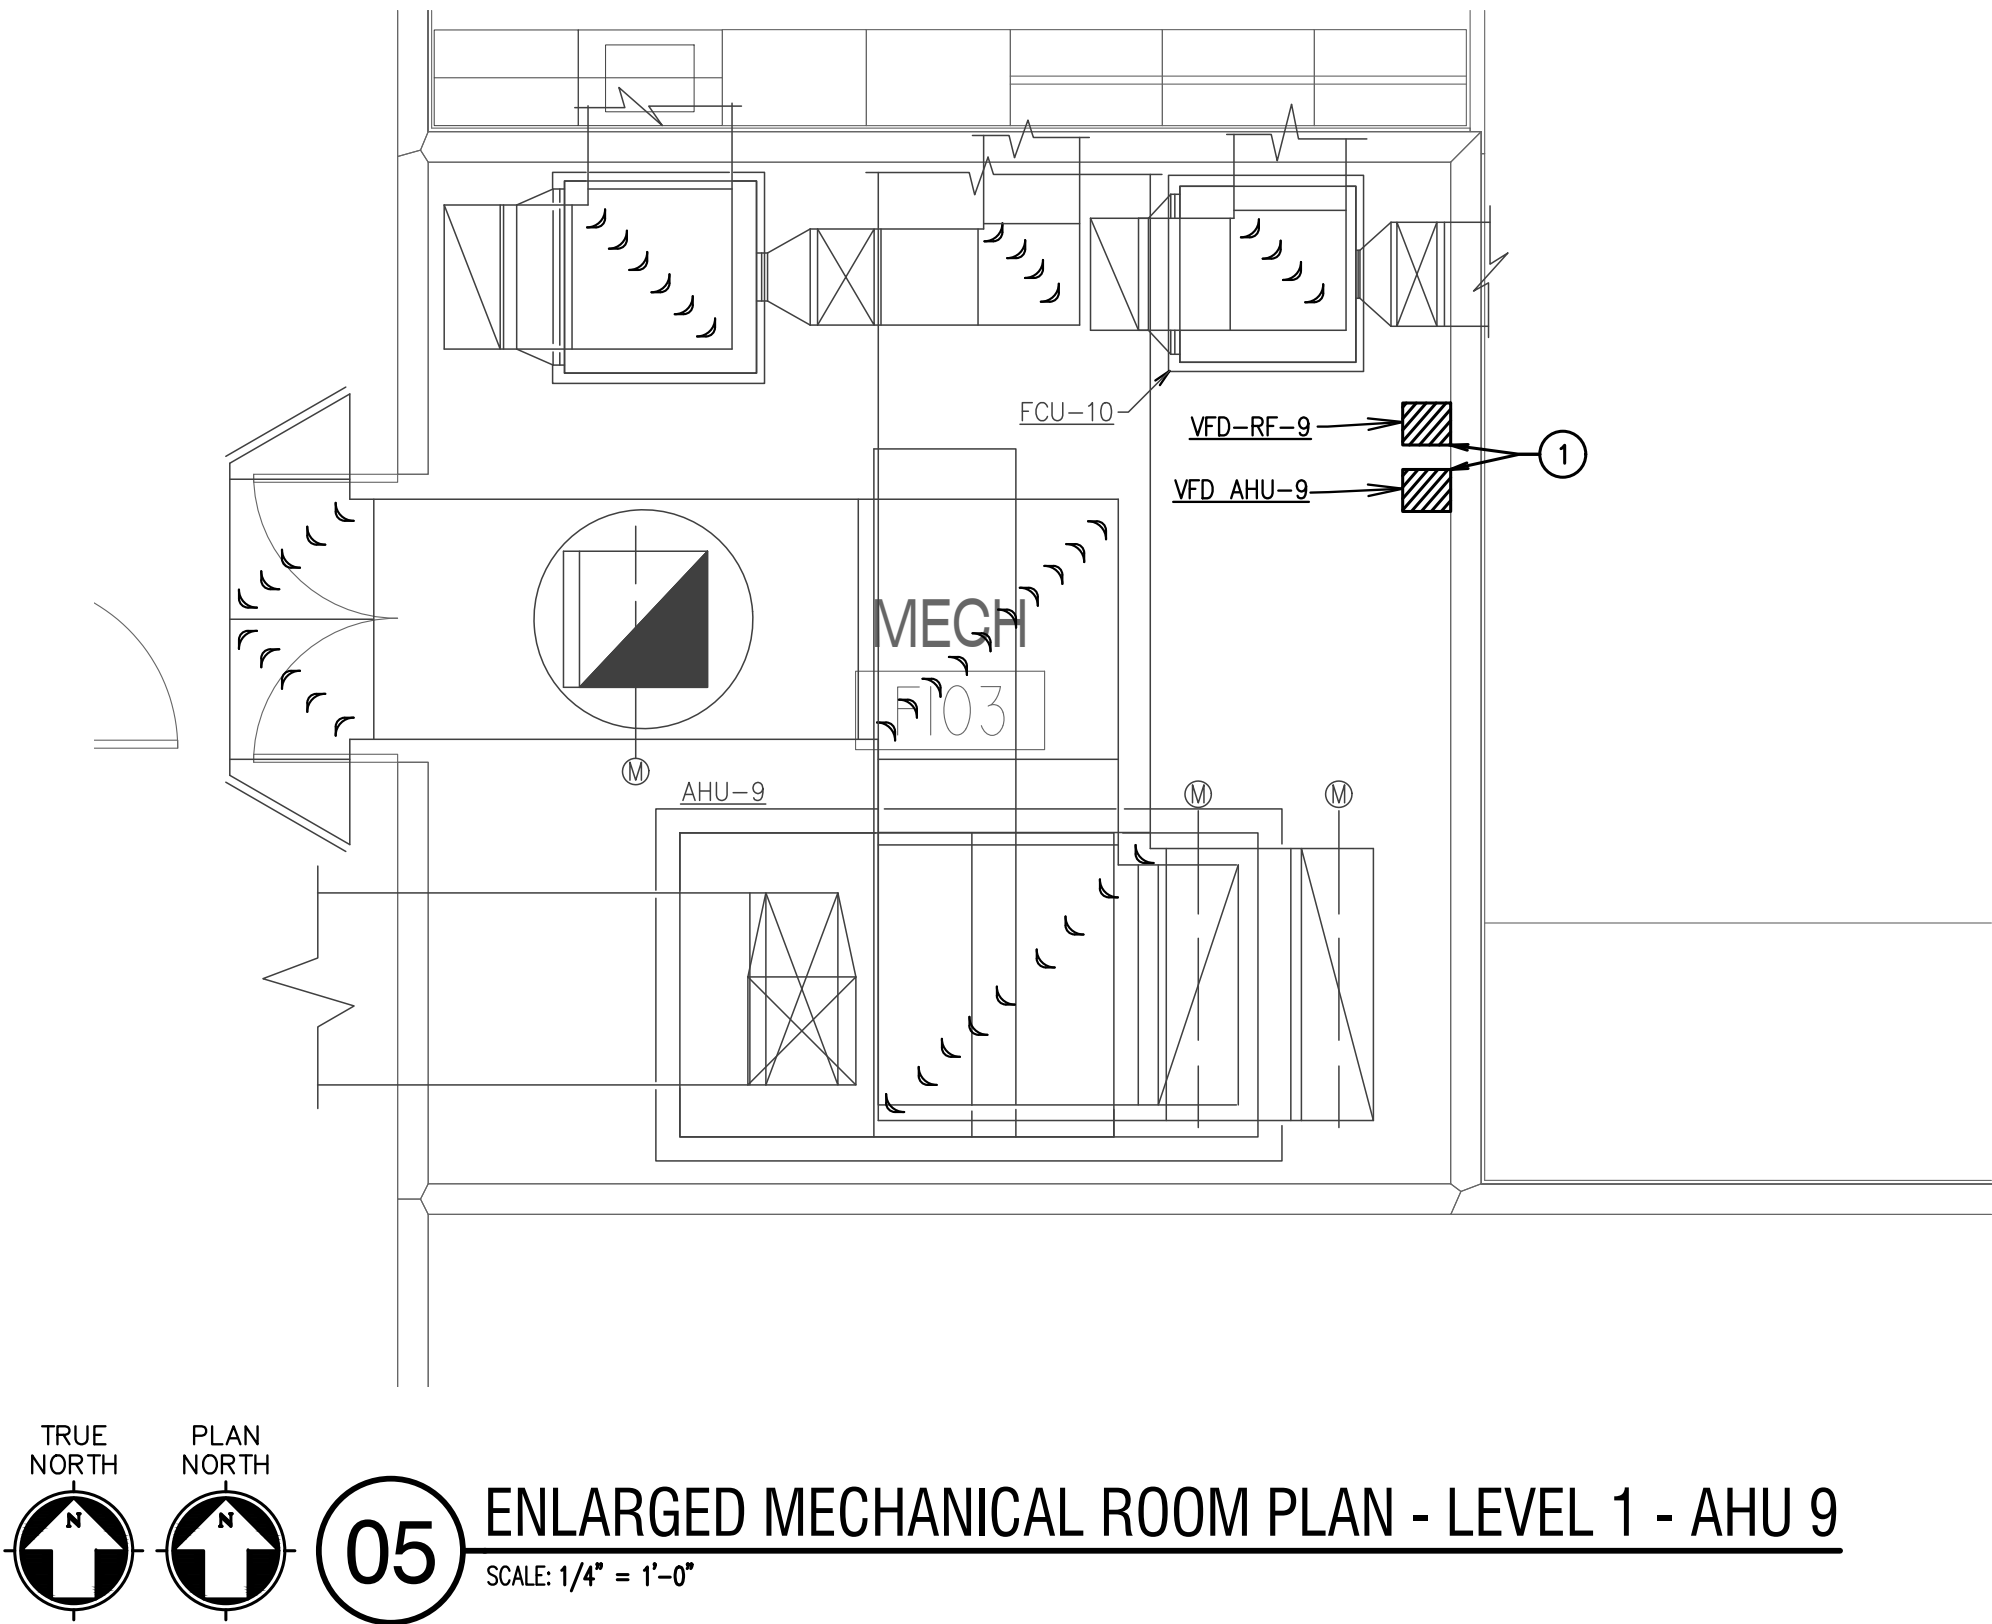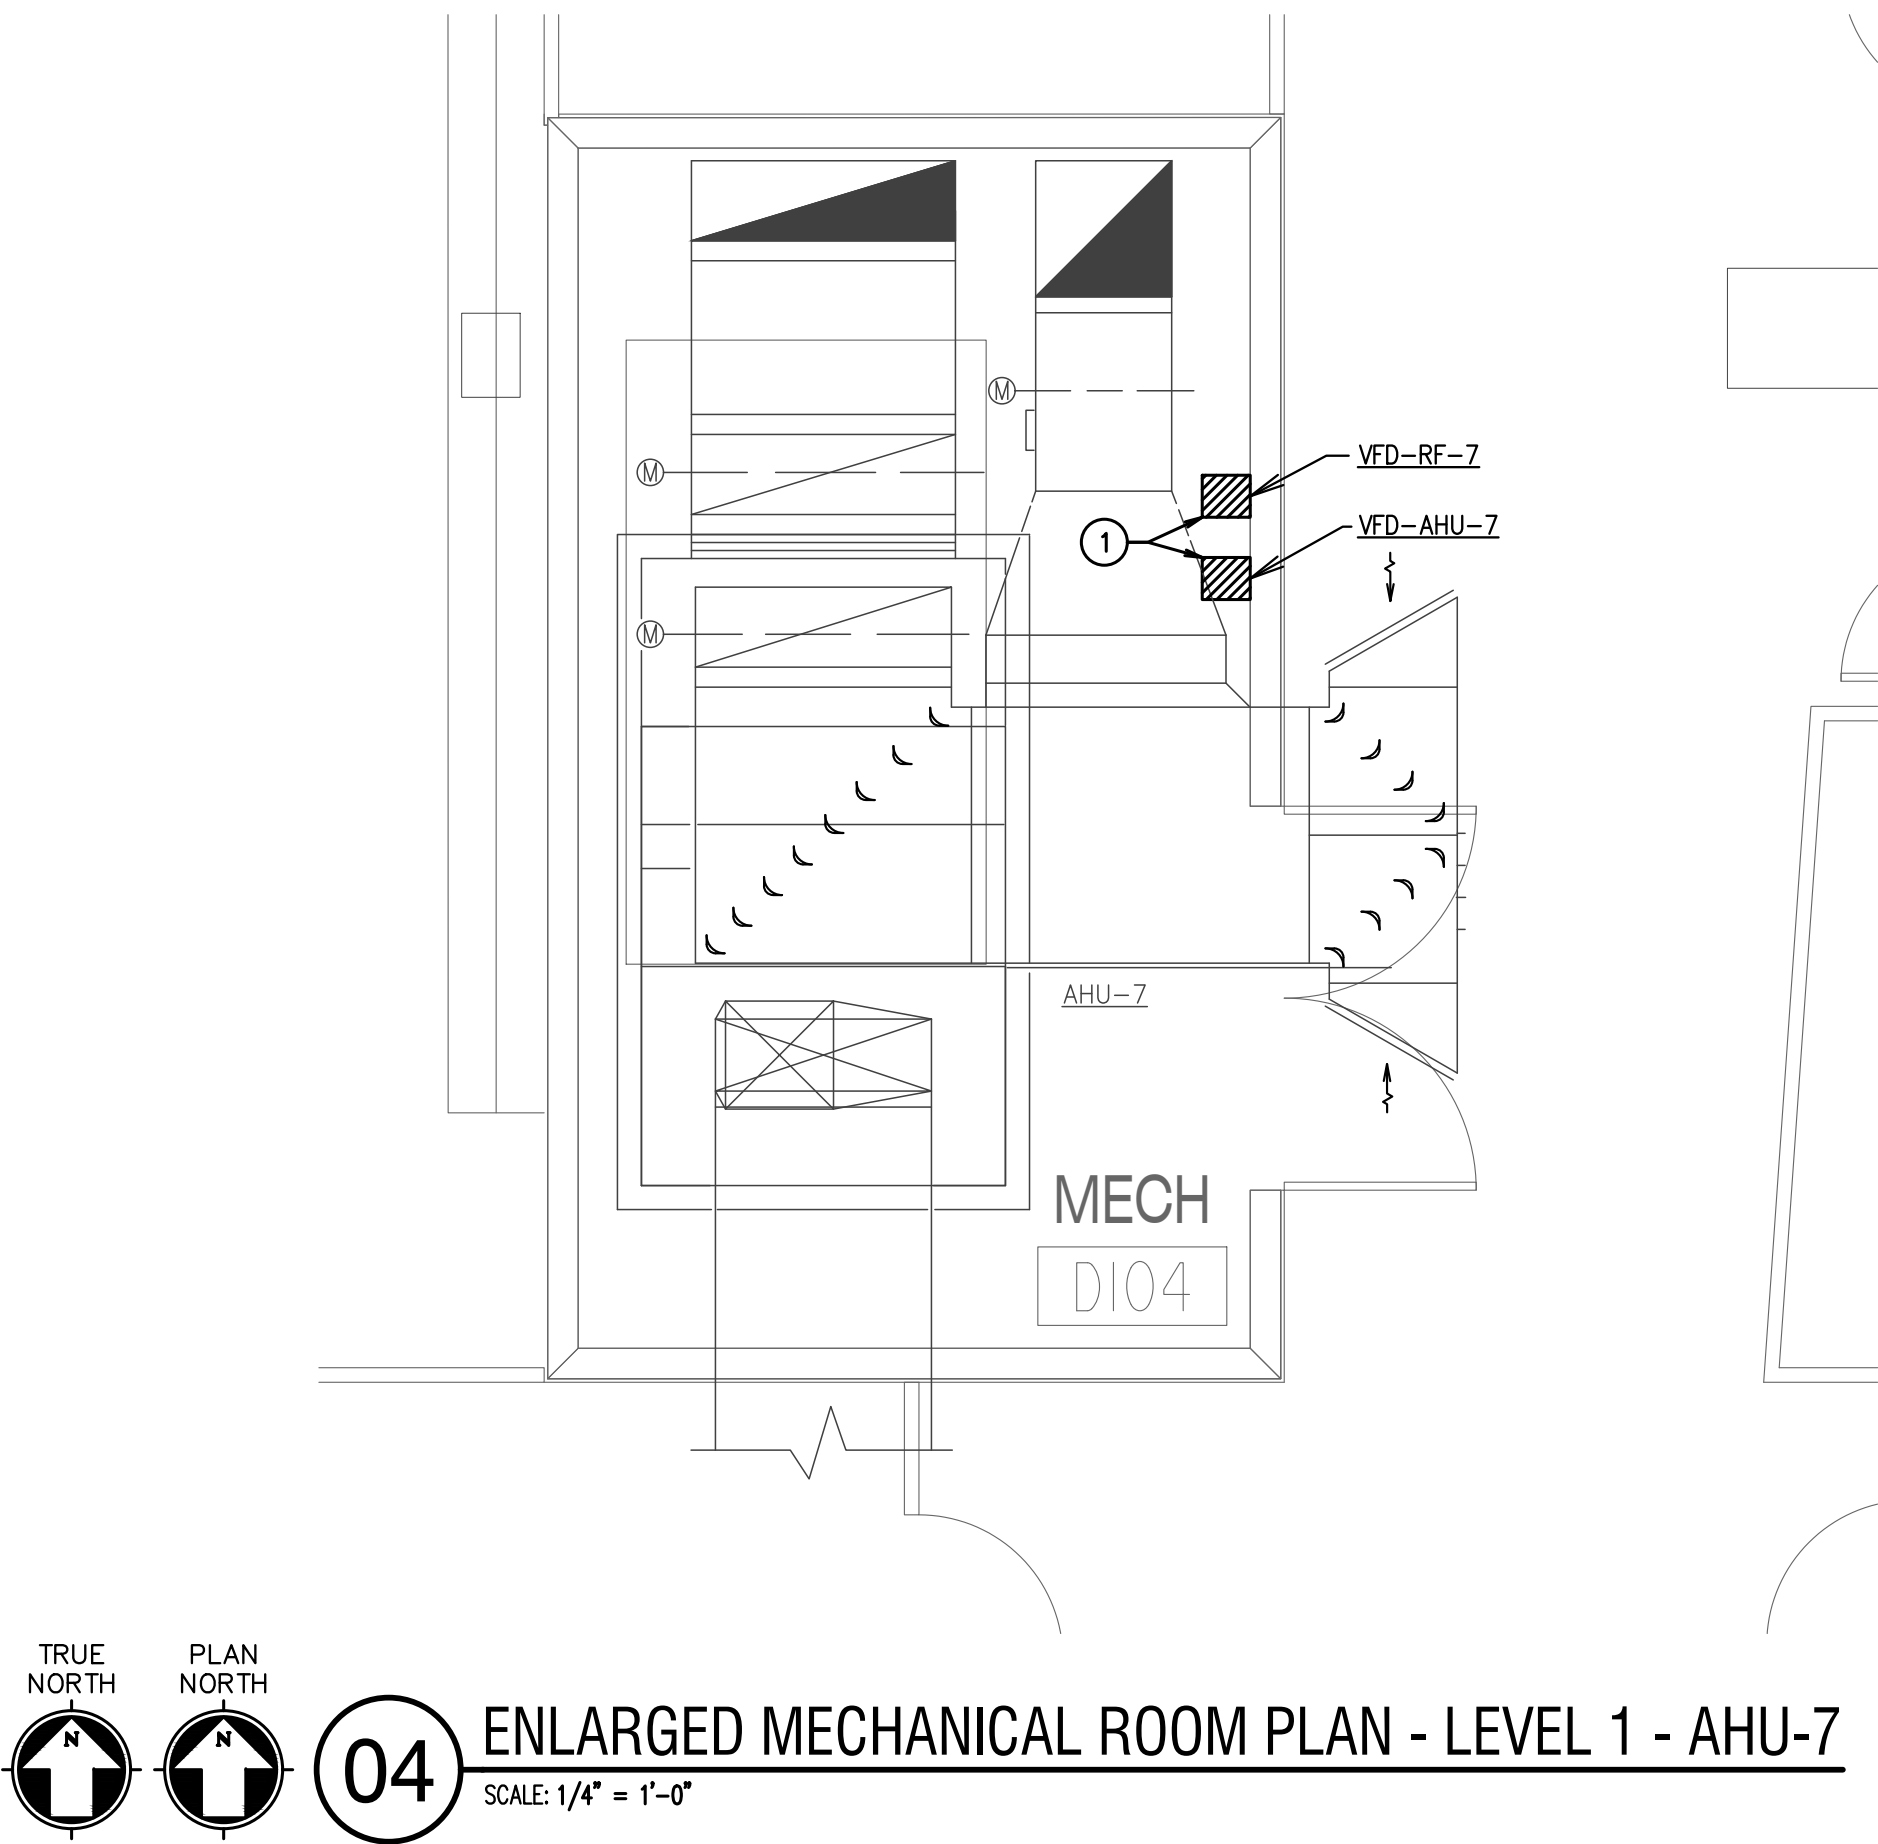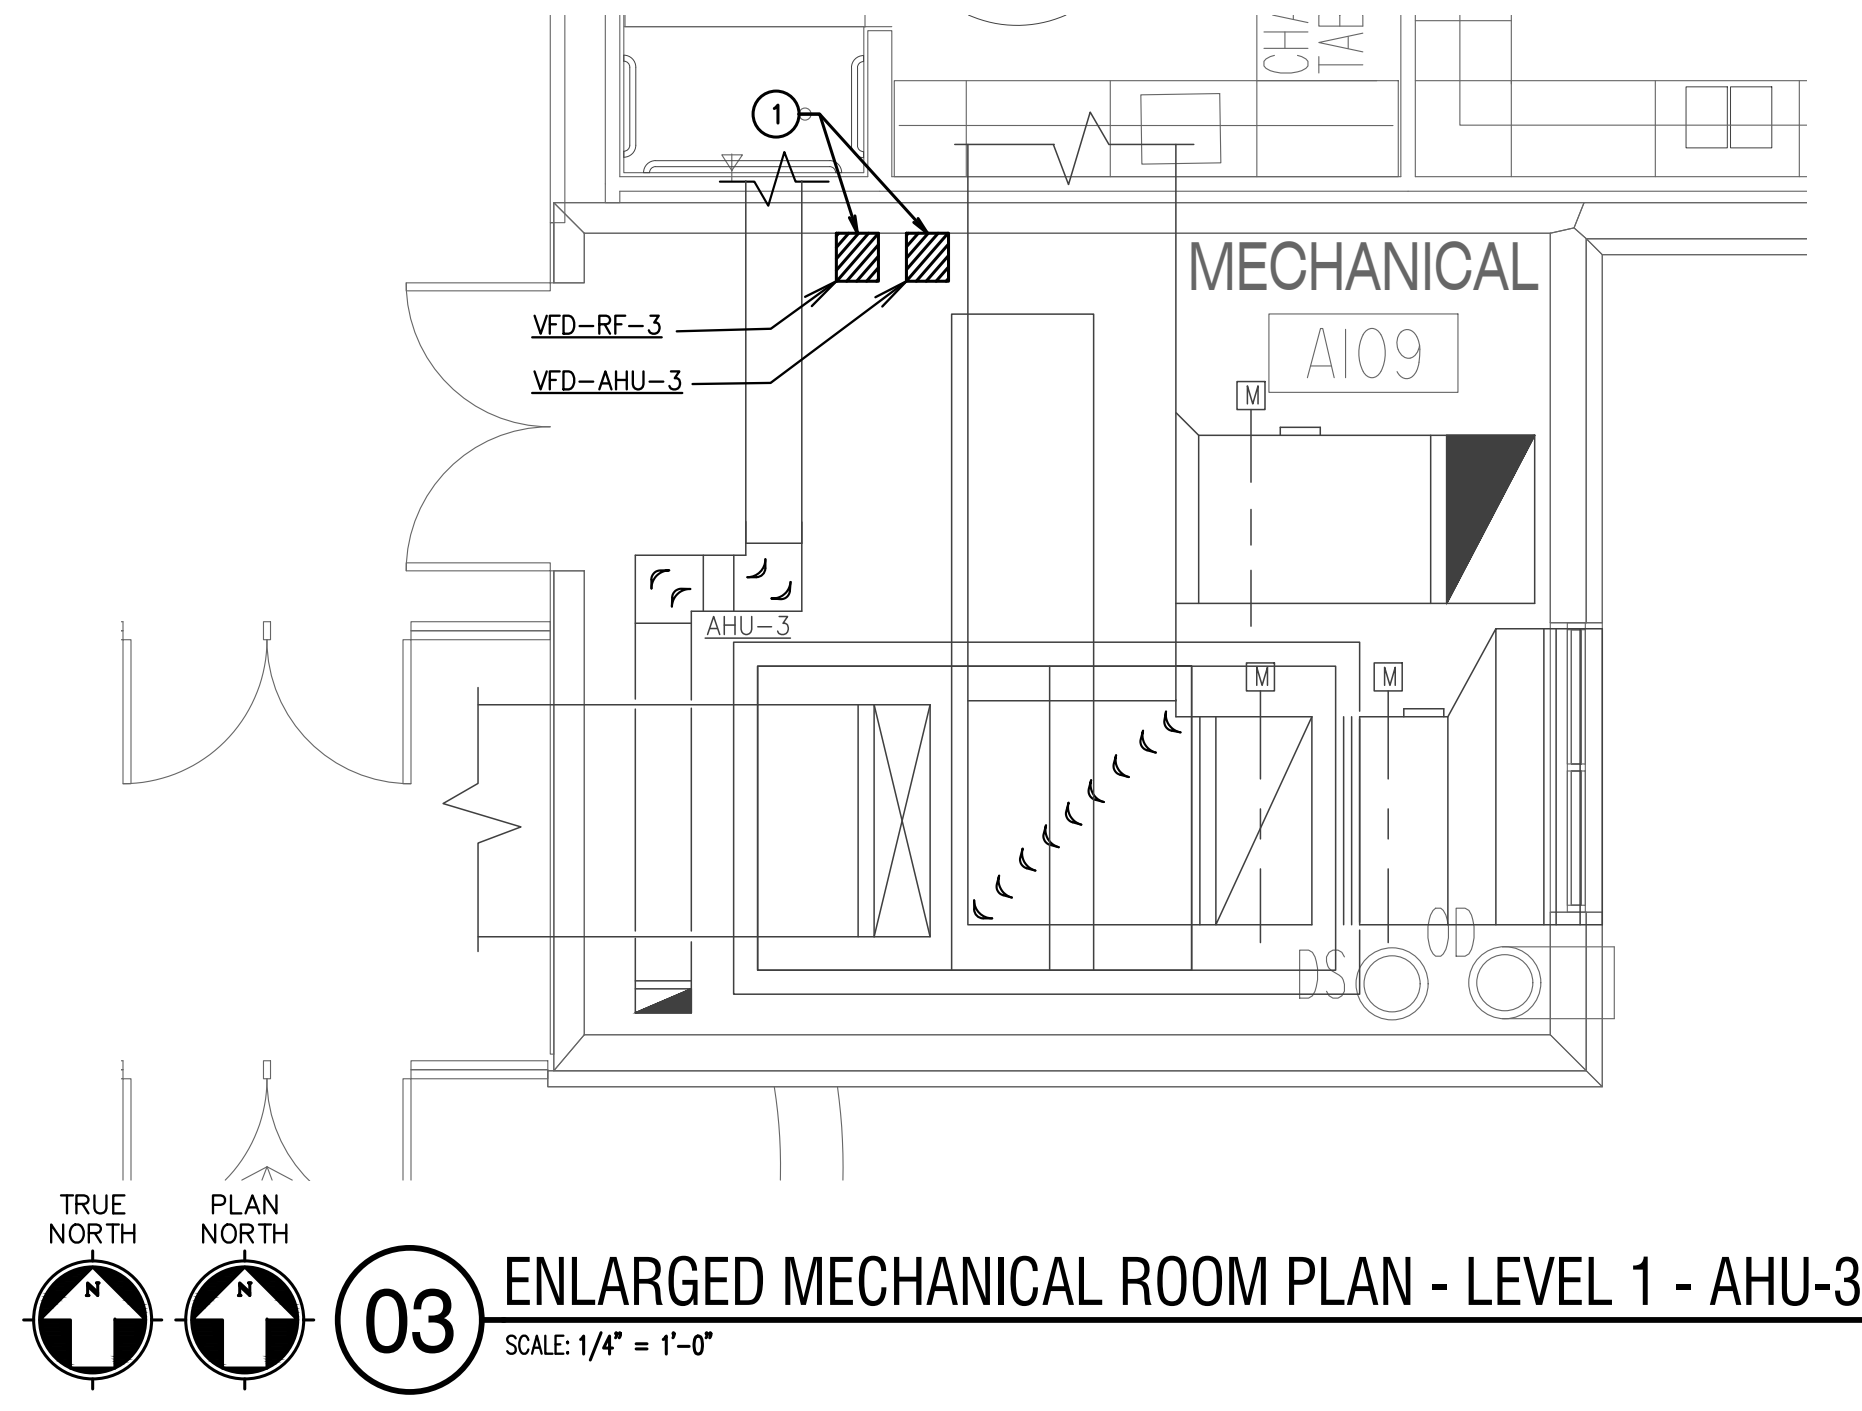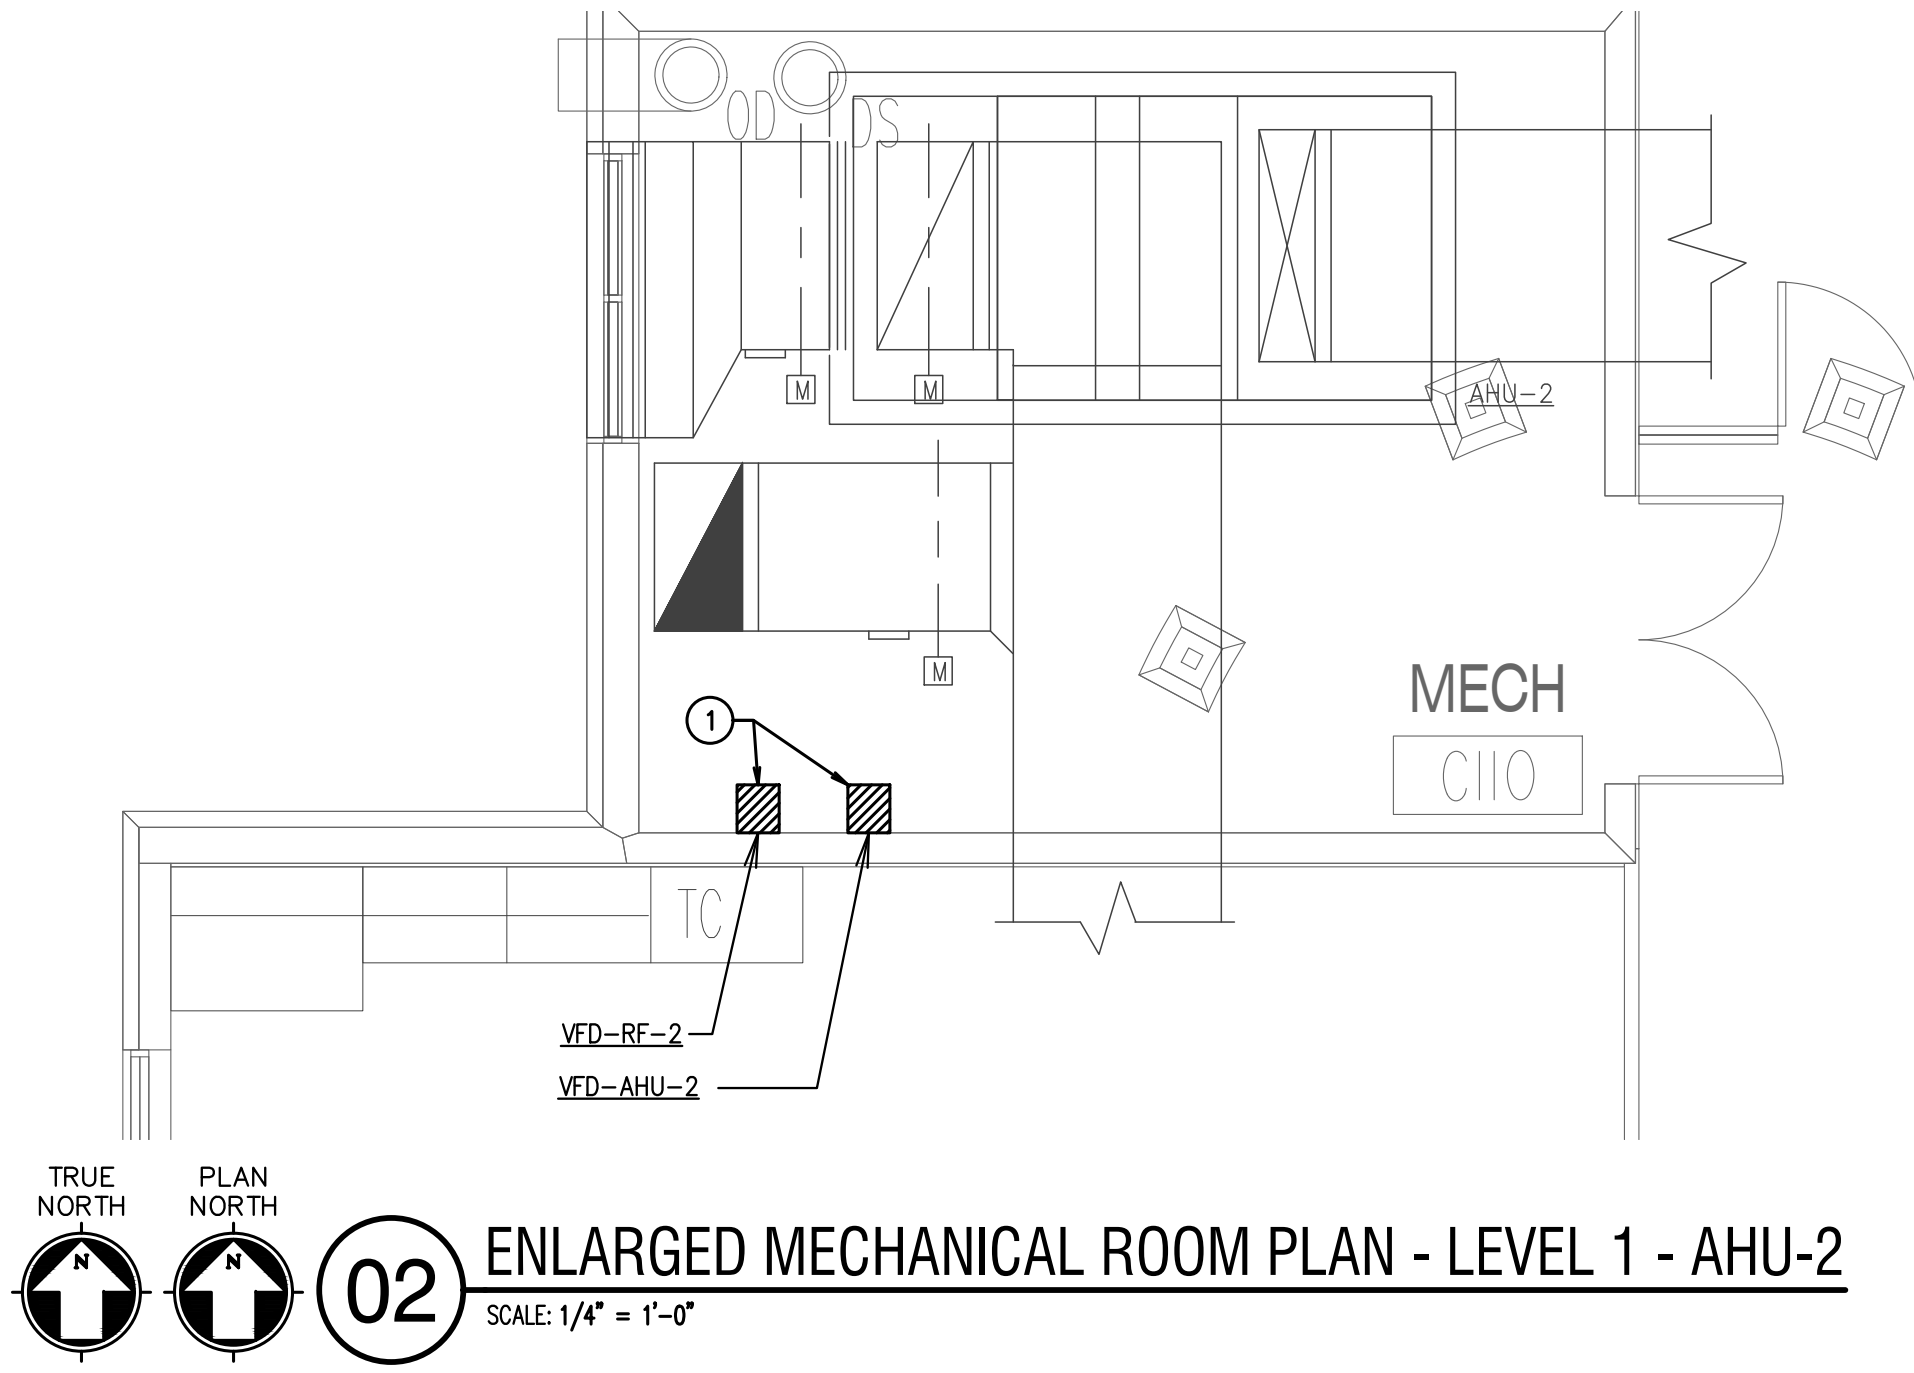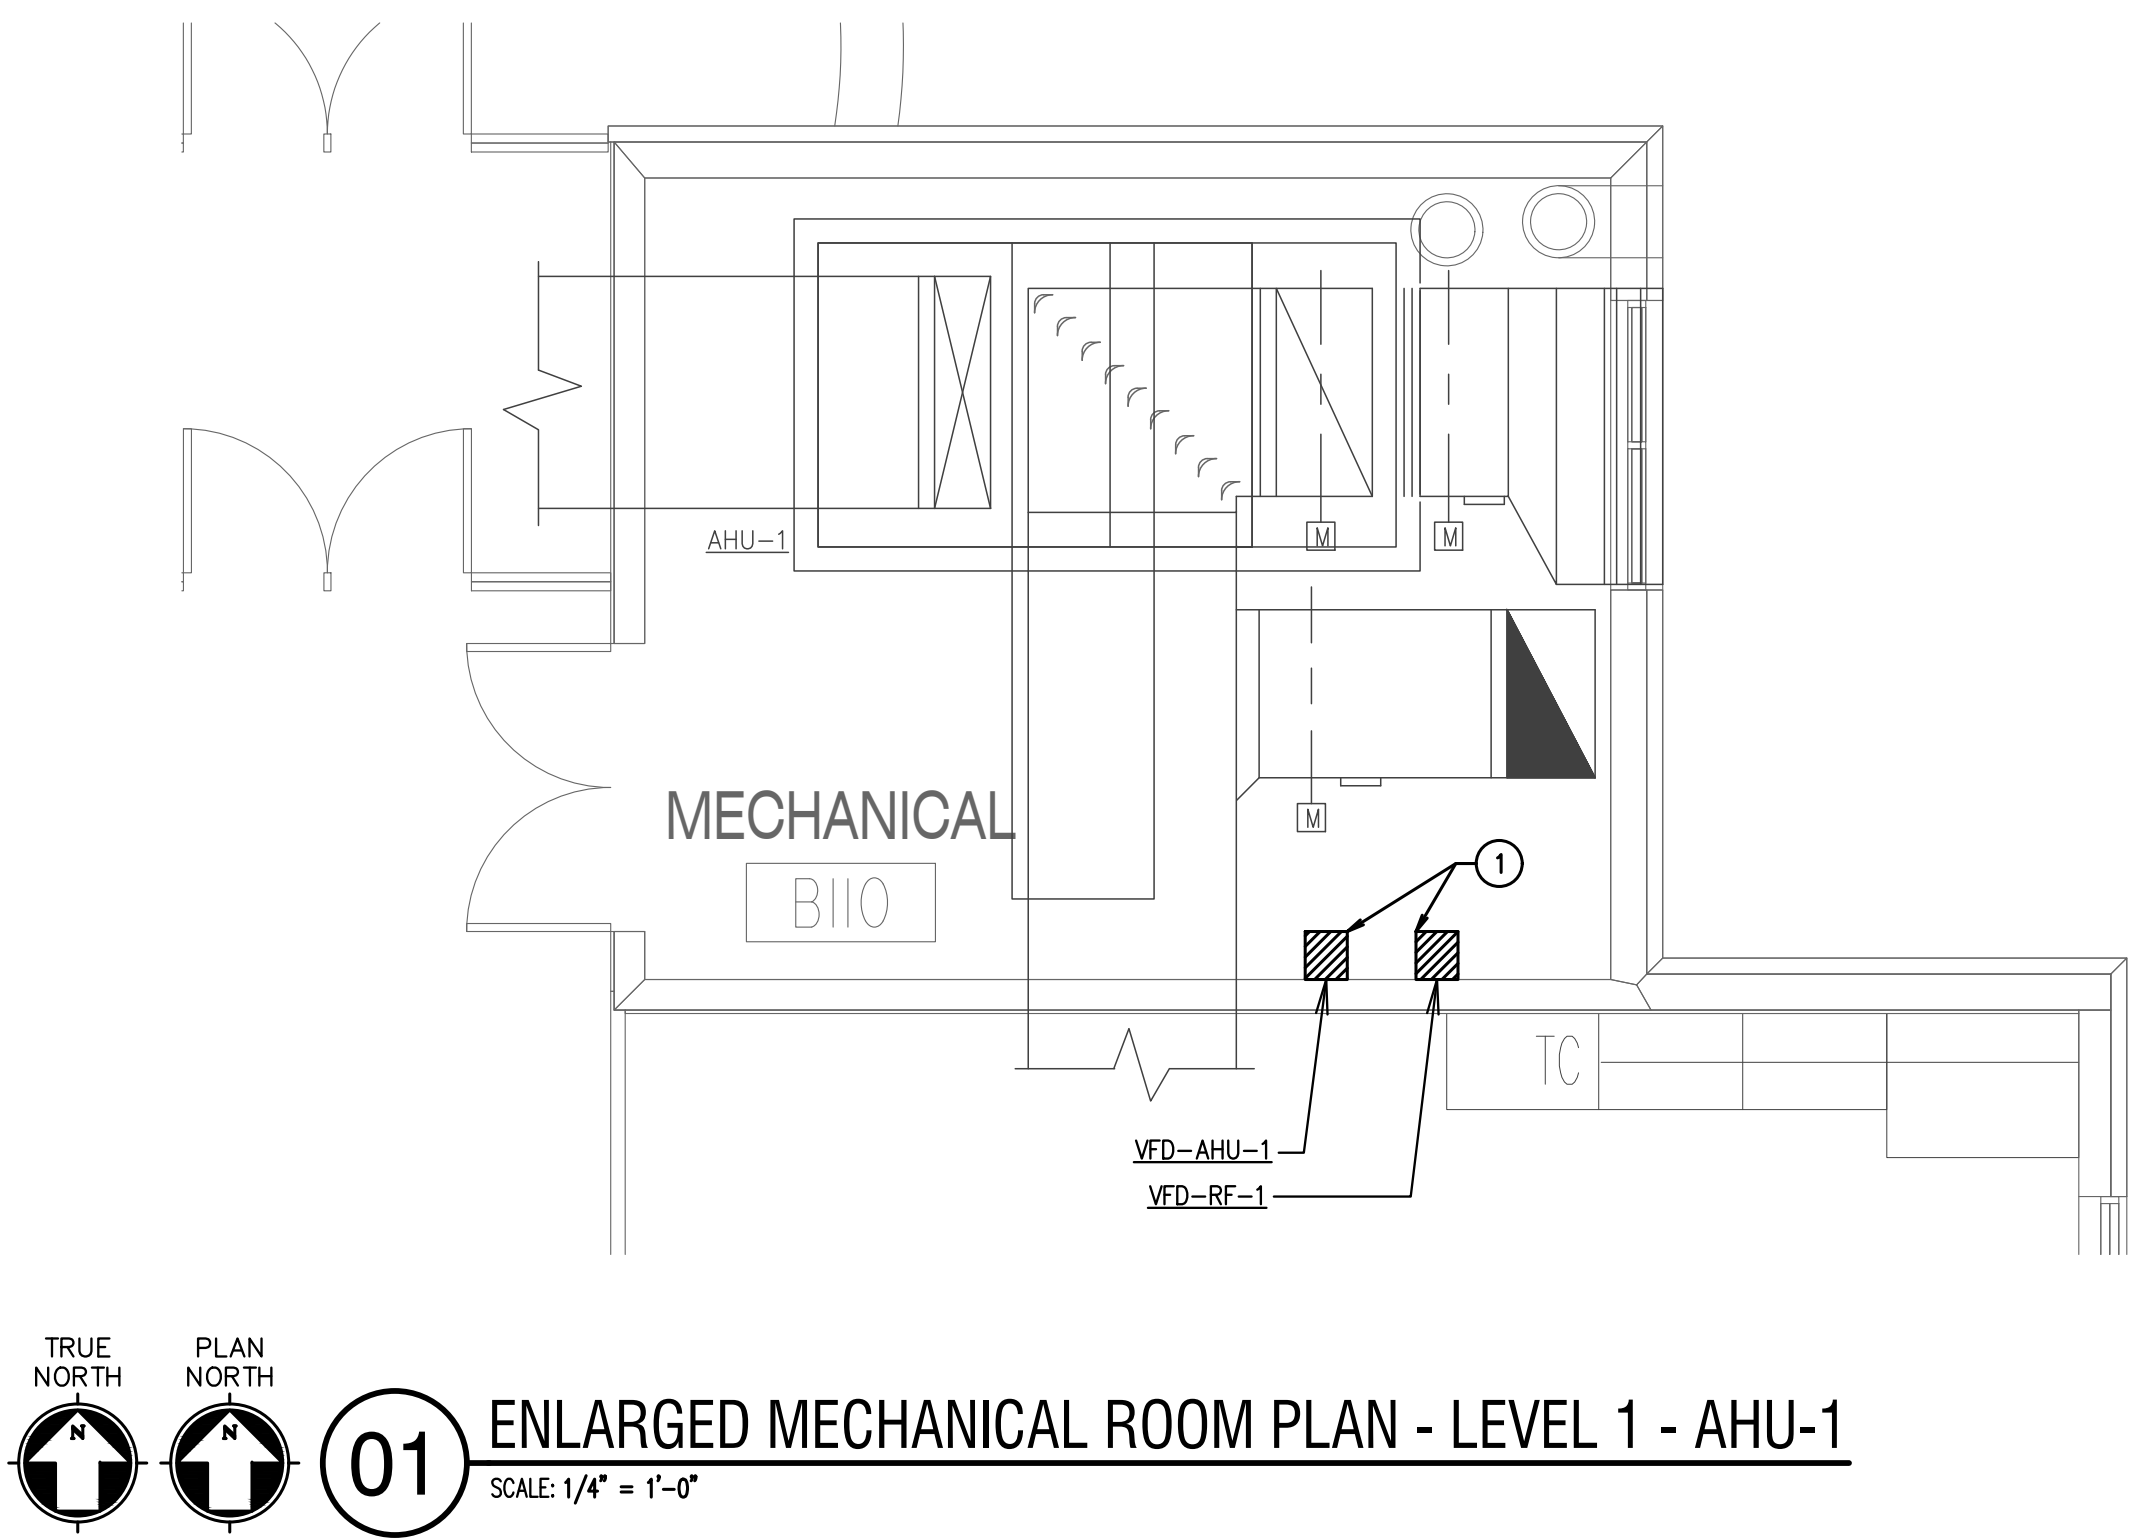- RECTANGULAR SUPPLY AIR DUCTWORK IS TO BE LINED WITH 1/2" THICK ACOUSTICAL AND THERMAL LINER FOR THE FIRST 10'-0" FROM THE UNIT AND EXTERNALLY WRAPPED WITH MINIMUM 2" INSULATION AFTER THE FIRST 10'-0" TO MEET THE 2018 IECC REQUIREMENTS. RECTANGULAR RETURN DUCT SHALL BE LINED WITH 1" LINER FOR THE FIRST 10'-0" FROM THE UNIT AND EXTERNALLY WRAPPED WITH MINIMUM 2" INSULATION AFTER THE FIRST 10'-0". ALL TRANSFER AIR DUCTS TO BE INTERNALLY LINED WITH 1" LINER. DUCTWORK SIZES SHOWN ARE NET INTERNAL AIR STREAM DIMENSIONS. SHEET METAL SIZES ARE TO BE INCREASED IN SIZE TO MAINTAIN THESE INTERNAL CLEAR DIMENSIONS. ROUND DUCTWORK IS TO BE EXTERNALLY WRAPPED. FLEXIBLE ROUND DUCT SHALL HAVE A MINIMUM R-VALUE OF 6.0.
- BRANCH RUN-OUTS TO CEILING MOUNTED AIR DEVICES SHALL BE SAME SIZE AS NECK, UNLESS NOTED OTHERWISE. PROVIDE A TWIST-IN FLARED TAP WITH MANUAL VOLUME DAMPER AT MAIN DUCT TAP, AND EXTEND AS SHOWN. EXTEND FLEXIBLE DUCTWORK A MAXIMUM OF 5'-0" FROM DIFFUSERS, INSTALL STRAIGHT AS POSSIBLE WITH LONG RADIUS BENDS WITH CLAMPS TO BE USED AT BOTH ENDS.
- ALL DUCTWORK AND PIPING SHALL BE RUN CONCEALED ABOVE CEILINGS AS HIGH AS POSSIBLE & CONCEALED IN WALLS, CHASES, OR FURROUTS IN GENERAL LOCATIONS SHOWN, UNLESS NOTED OTHERWISE.
- LOCATE CEILING MOUNTED AIR DEVICES APPROXIMATELY WHERE SHOWN. VERIFY EXISTING CEILING TYPES TO CONFIRM FRAME MOUNTING TYPES REQUIRED. ALL CEILING DIFFUSERS TO BE FOUR-WAY TYPE UNLESS NOTED OTHERWISE BY AIR FLOW ARROWS ON FLOOR PLAN.
- EXISTING AND NEW DIFFUSERS FOR ALL DUCTWORK CONNECTED TO UNITS REPLACED OR ADDED TO BE BALANCED TO NEW AIRFLOW VALUES SHOWN. TAB FIRM CONTRACTED DIRECTLY WITH OWNER.
- WHERE EXISTING DUCTWORK IS REMOVED AND NOT REUSED, INSTALL INSULATED CAPS AND SEAL AIR TIGHT.
- REMOVE EXISTING CEILING GRID AND TILE AS NEEDED TO REMOVE EXISTING AND INSTALL NEW DUCTWORK, PIPING, AND UNITS. REUSE EXISTING CEILING TILE AND GRID WHERE POSSIBLE. STORE AND STACK EXISTING TILE FOR REUSE AND PROTECT. WHERE NEW CEILING TILE IS REQUIRED, IT SHALL BE ALL NEW THROUGH THE ROOM. DO NOT MIX NEW AND EXISTING CEILING TILE IN THE SAME SPACE. ALL NEW CEILING HEIGHTS TO MATCH EXISTING CEILING HEIGHTS. ANY CEILINGS TO REMAIN THAT ARE DAMAGED DURING CONSTRUCTION SHALL BE REPLACED BY THE CONTRACTOR WITH PRODUCTS AND MATERIALS THAT MATCH EXISTING.
- EXISTING LIGHTS TO BE REUSED AND REMAIN IN PLACE. CONTRACTOR TO SUPPORT LIGHTS ABOVE CEILING DURING ANY CEILING REMOVAL.
- WHERE ITEMS ARE REMOVED PATCH WALLS, CEILING, OR FLOOR AS APPLICABLE TO MATCH EXISTING FINISHES.
- EXISTING SECURITY SYSTEM AND DEVICES TO REMAIN IN PLACE AND ACTIVE DURING CONSTRUCTION. ANY DEVICES IN CEILINGS TO BE REMOVED AND REPLACED TO BE TEMPORARILY SUPPORTED. ALL SECURITY SCOPE OF WORK TO BE CONTRACTED WITH SAS.
- CLEAN ALL EXISTING REUSED SUPPLY, RETURN, AND EXHAUST AIR GRILLES FREE OF ALL DUST AND DEBRIS. PAINT ALL EXISTING SUPPLY AND RETURN AIR GRILLES WHERE SIGNS OF RUST ARE NOTED ON EXISTING GRILLES TO MATCH EXISTING COLOR OF GRILLE.
- NEW TEMPERATURE SENSOR TO BE INSTALLED WHERE OLD SENSOR WAS REMOVED, WHEN IN COMPLIANCE WITH ADA HEIGHT REQUIREMENTS. WHEN NOT IN COMPLIANCE PROVIDE NEW SENSOR AT ADA HEIGHT AND PROVIDE STAINLESS STEEL COVER PLATE OVER EXISTING WALL OPENING. RE-USE EXISTING WIRING PATHWAY TO ACCESSIBLE CEILING, UP TO ROOF. PATCH, REPAIR AND PAINT WALL AS NEEDED.
- PROVIDE FLOOR PROTECTION IN ALL AREAS OF THE DEMOLITION AND NEW WORK THROUGHOUT BUILDING FROM WORK AREA TO EXTERIOR. FLOORING PROTECTION TO BE FULL WIDTH OF CORRIDOR AND STAIRWELL TO BE RAM BOARD OR EQUAL TYPE FLOOR PROTECTION.

ALTERNATE NOTES BY SYMBOL 'O':

- 1 NEW VFD IN PLACE OF EXISTING. PATCH, REPAIR, AND PAINT WALL TO MATCH EXISTING AS NEEDED AFTER NEW VFD INSTALLATION. EQUIPMENT COST TO BE PRICED AS ALTERNATE AND INSTALLATION COST TO BE PROVIDED AS UNIT PRICING PER HP SIZE. REFER TO VFD SCHEDULES FOR SIZES. RE-CONNECT EXISTING CONTROLS AND POWER.

2024.07.03

ISSUES

01 ISSUE FOR CONSTRUCTION 2024.07.03

REVISIONS

01 ADDENDUM #2 2024.07.23




WALNUT GROVE MS
CHILLER REPLACEMENT
MIDLOTHIAN I.S.D.
990 Walnut Grove Rd, Midlothian, TX 76065

ENLARGED FLOOR
PLANS - LEVEL 1 -
HVAC

JOB NO.: 24040-00
DRAWN BY: BM
CHECKED BY: HV

SHEET NO.

M1.02

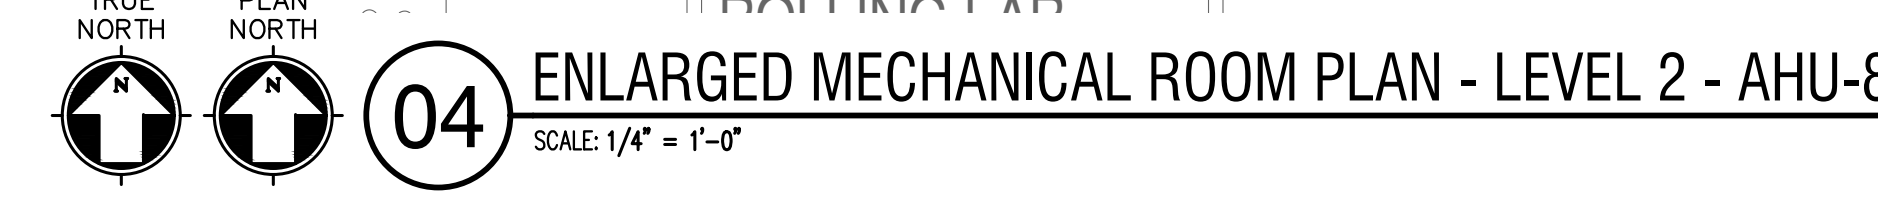

1. RECTANGULAR SUPPLY AIR DUCTWORK IS TO BE LINED WITH 1/2" THICK ACoustICAL AND THERMAL LINER FOR THE FIRST 10'-0" FROM THE UNIT AND EXTERNALLY WRAPPED WITH MINIMUM 2" INSULATION AFTER THE FIRST 10'-0" TO MEET THE 2018 IECC REQUIREMENTS. RECTANGULAR RETURN DUCT SHALL BE LINED WITH 1" LINER FOR THE FIRST 10'-0" FROM THE UNIT AND EXTERNALLY WRAPPED WITH MINIMUM 2" INSULATION AFTER THE FIRST 10'-0". ALL TRANSFER AIR DUCTS TO BE INTERNALLY LINED WITH 1" LINER. DUCTWORK SECTIONS SHOWN ARE NET INTERNAL AIR STREAM DIMENSIONS. SHEET METAL SIZES ARE TO BE INCREASED IN SIZE TO MAINTAIN THESE INTERNAL CLEAR DIMENSIONS. ROUND DUCTWORK IS TO BE EXTERNALLY WRAPPED. FLEXIBLE ROUND DUCT SHALL HAVE A MINIMUM R-VALUE OF 6.0.
2. BRANCH RUN-OUTS TO CEILING MOUNTED AIR DEVICES SHALL BE SAME SIZE AS NECK, UNLESS NOTED OTHERWISE. PROVIDE 1/2" MIN. INSULATION WRAPPED WITH MINIMUM 2" INSULATION AT MAIN DUCT TAB, AND EXTEND AS SHOWN. EXTEND FLEXIBLE DUCTWORK A MAXIMUM OF 5'-0" FROM DIFFUSERS, INSTALL STRAIGHT AS POSSIBLE WITH LONG RADII BENDS WITH CLAMPS TO BE USED AT BOTH ENDS.
3. ALL DUCTWORK AND PIPING SHALL BE RUN CONCEALED ABOVE CEILINGS AS HIGH AS POSSIBLE & CONCEALED IN WALLS, CHASES, OR FURRUTS IN GENERAL LOCATIONS SHOWN, UNLESS NOTED OTHERWISE.
4. LOCATE CEILING MOUNTED AIR DEVICES APPROXIMATELY WHERE SHOWN. VERIFY EXISTING CEILING TYPES TO CONFIRM FRAME MOUNTING TYPES REQUIRED. ALL CEILING DIFFUSERS TO BE FOUR-WAY TYPE UNLESS NOTED OTHERWISE BY AIR FLOW ARROWS ON FLOOR PLAN.
5. EXISTING AND NEW DIFFUSERS FOR ALL DUCTWORK CONNECTED TO UNITS REPLACED OR ADDED TO BE BALANCED TO NEW AIRFLOW VOLUMES SHOWN. TAB FIRM CONTRACTED DIRECTLY WITH OWNER.
6. WHERE EXISTING DUCTWORK IS REMOVED AND NOT REUSED, INSTALL INSULATED CAPS AND SEAL AIR TIGHT.
7. REMOVE EXISTING CEILING GRID AND TILE AS NEEDED TO REMOVE EXISTING AND INSTALL NEW DUCTWORK, PIPING, AND WIRING. EXISTING CEILING TILE AND GRID WHERE POSSIBLE. STORE AND STACK EXISTING TILE FOR REUSE AND REINSTALL WHERE NEW TILE IS REQUIRED. IT SHALL BE ALL NEW THROUGH THE ROOM. DO NOT MIX NEW AND EXISTING CEILING TILE IN THE SAME SPACE. ALL NEW CEILING HEIGHTS TO MATCH EXISTING CEILING HEIGHTS. ANY CEILINGS TO REMAIN THAT ARE DAMAGED DURING CONSTRUCTION SHALL BE REPLACED BY THE CONTRACTOR WITH PRODUCTS AND MATERIALS THAT MATCH EXISTING.
8. EXISTING LIGHTS TO BE REMOVED AND REMAIN IN PLACE. CONTRACTOR TO SUPPORT LIGHTS ABOVE CEILING DURING ANY CEILING REMOVAL.
9. WHERE ITEMS ARE REMOVED PATCH WALLS, CEILING, OR FLOOR AS APPLICABLE TO MATCH EXISTING FINISHES.
10. EXISTING SECURITY SYSTEM AND DEVICES TO REMAIN IN PLACE AND ACTIVE DURING CONSTRUCTION. ANY DEVICES IN CEILINGS TO BE REMOVED AND REPLACED TO BE TEMPORARILY SUPPORTED. ALL SECURITY SCOPE OF WORK TO BE CONTRACTED WITH SAS.
11. EXISTING ALL EXISTING RETURN SUPPLY, RETURN, AND EXHAUST AIR GRILLES FREE OF ALL DUST AND DEBRIS. PATCH ALL EXISTING SUPPLY AND RETURN AIR GRILLES WHERE SIGNS OF RUST ARE NOTED ON EXISTING GRILLES TO MATCH EXISTING COLOR OF GRILLE.
12. NEW TEMPERATURE SENSOR TO BE INSTALLED WHERE OLD SENSOR WAS REMOVED, WHEN IN COMPLIANCE WITH ADA HEIGHT REQUIREMENTS, WHEN NOT IN COMPLIANCE PROVIDE NEW SENSOR AT ADA HEIGHT AND PROVIDE STAINLESS STEEL COVER PLATE OVER EXISTING WALL OPENING. RE-USE EXISTING WIRING PATHWAY TO ACCESSIBLE CEILING, UP TO ROOF. PATCH, REPAIR AND PATCH WALL AS NEEDED.
13. PROVIDE FLOOR PROTECTION IN ALL AREAS OF THE DEMOLITION AND NEW WORK THROUGHTOUT BUILDING FROM WORK AREA TO EXTERIOR. CONSTRUCTION TO BE FULL WIDTH OF CORRIDOR AND STAIRWELL TO BE RAIN BOARD OR EQUIV. TYPE FLOOR PROTECTION.

① NEW VFD IN PLACE OF EXISTING. PATCH, REPAIR, AND PAINT WALL TO MATCH EXISTING AS NEEDED AFTER NEW VFD INSTALLATION. EQUIPMENT COST TO BE PRICED AS ALTERNATE AND INSTALLATION COST TO BE PROVIDED AS UNIT PRICING PER HP SIZE. REFER TO VFD SCHEDULES FOR SIZES. RE-CONNECT EXISTING CONTROLS AND POWER.

ISSUES		
01	ISSUE FOR CONSTRUCTION	2024.07.03

REVISIONS		
01	ADDENDUM #1	2024.07.12
02	ADDENDUM #2	2024.07.23

[illegible]

**WALNUT GROVE MS
CHILLER REPLACEMENT**

MIDLOTHIAN I.S.D.
990 Walnut Grove Rd, Midlothian, TX 76065

HYDRONIC FLOW
DIAGRAMS - HVAC

JOB NO.: 24040-00
DRAWN BY: BM
CHECKED BY: HV

M3.01

- ① NEW AIR SEPARATOR TO BE INSTALLED.
- ② NEW CENTRIFUGAL CHILLER TO BE INSTALLED.



