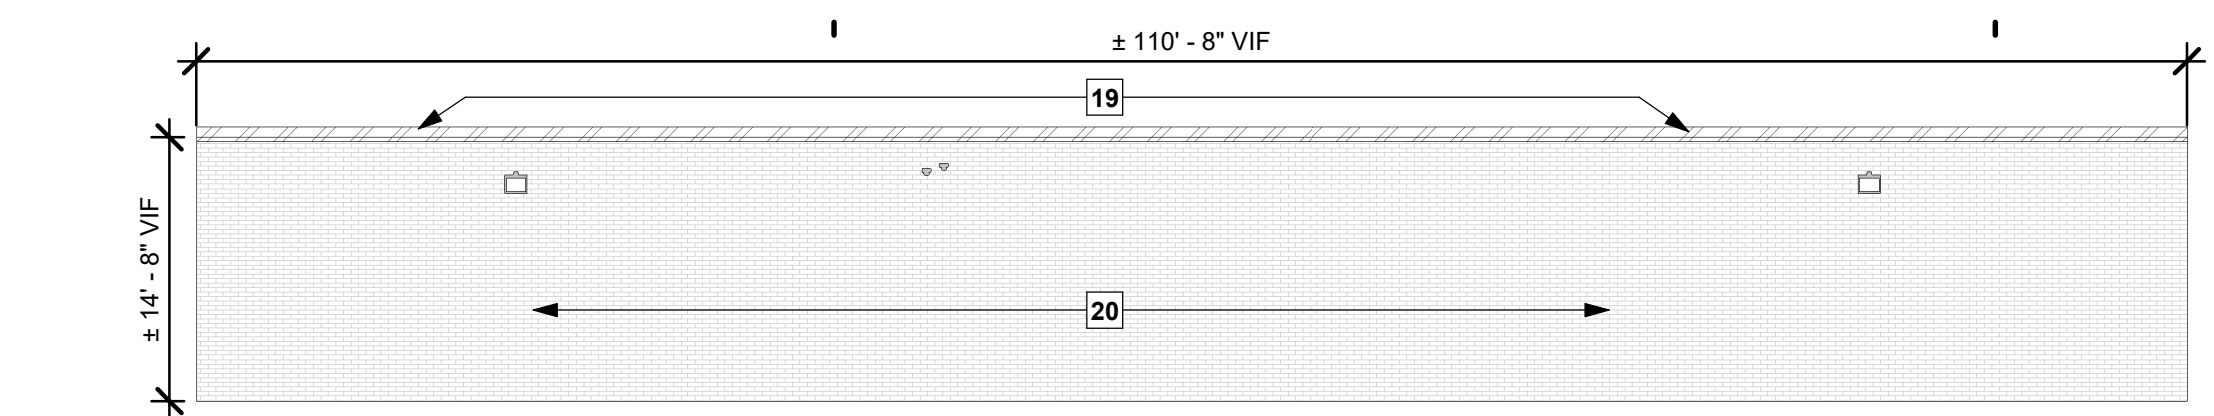
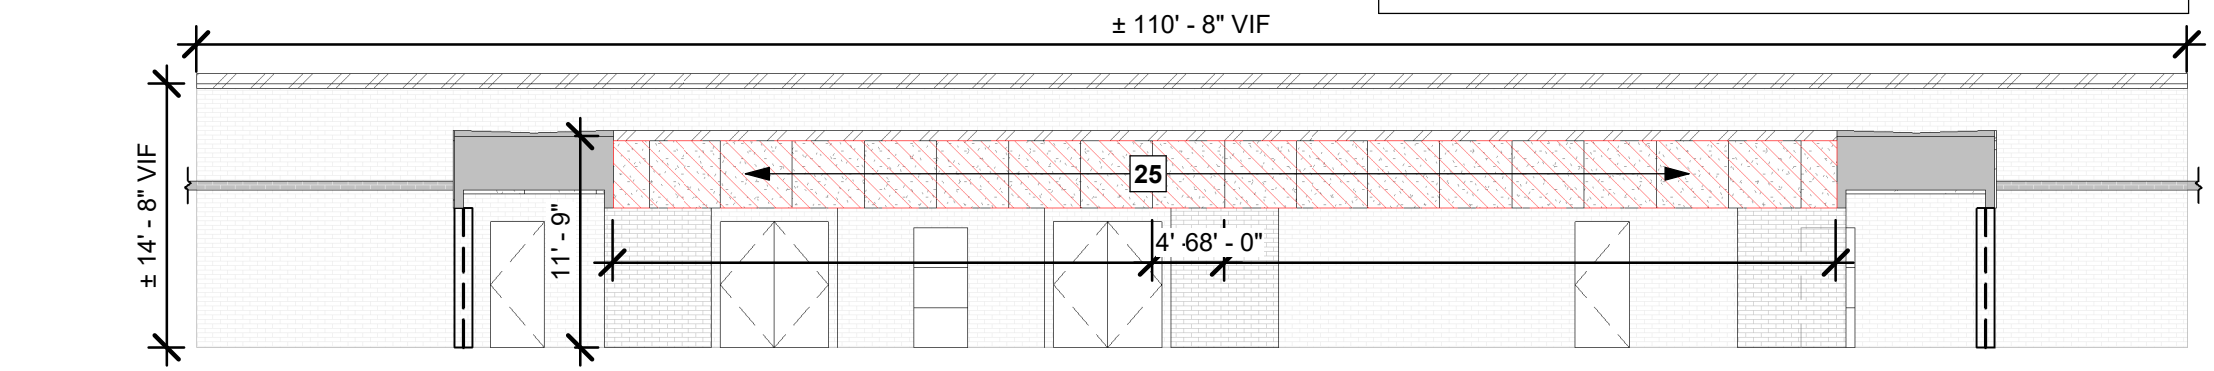


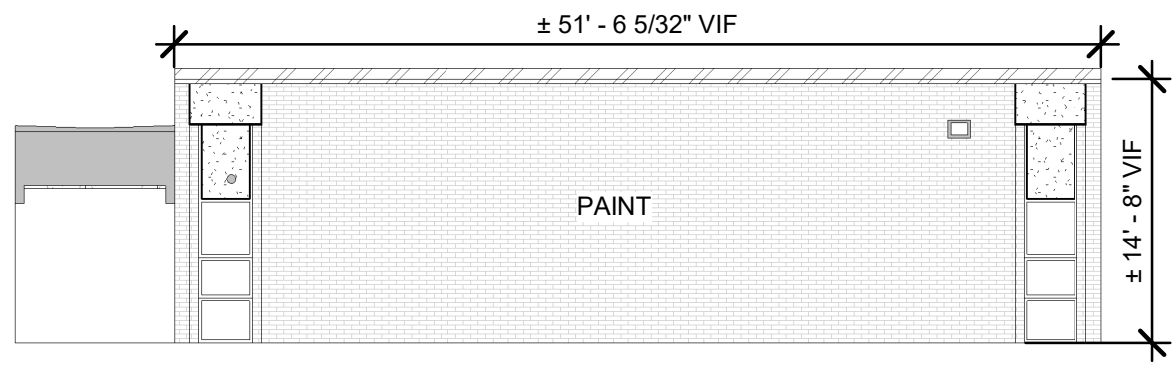
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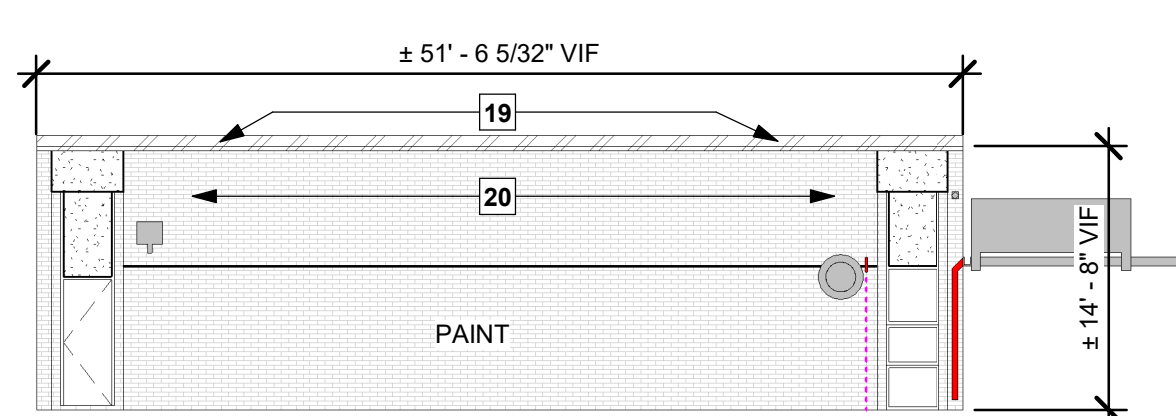
2A WEST EXTERIOR ELEVATION - BUILDING K
3/32" = 1'-0"



2B EAST EXTERIOR ELEVATION - BUILDING K
3/32" = 1'-0"



8A NORTH EXTERIOR ELEVATION - BUILDING K
3/32" = 1'-0"



8B SOUTH EXTERIOR ELEVATION - BUILDING K
3/32" = 1'-0"

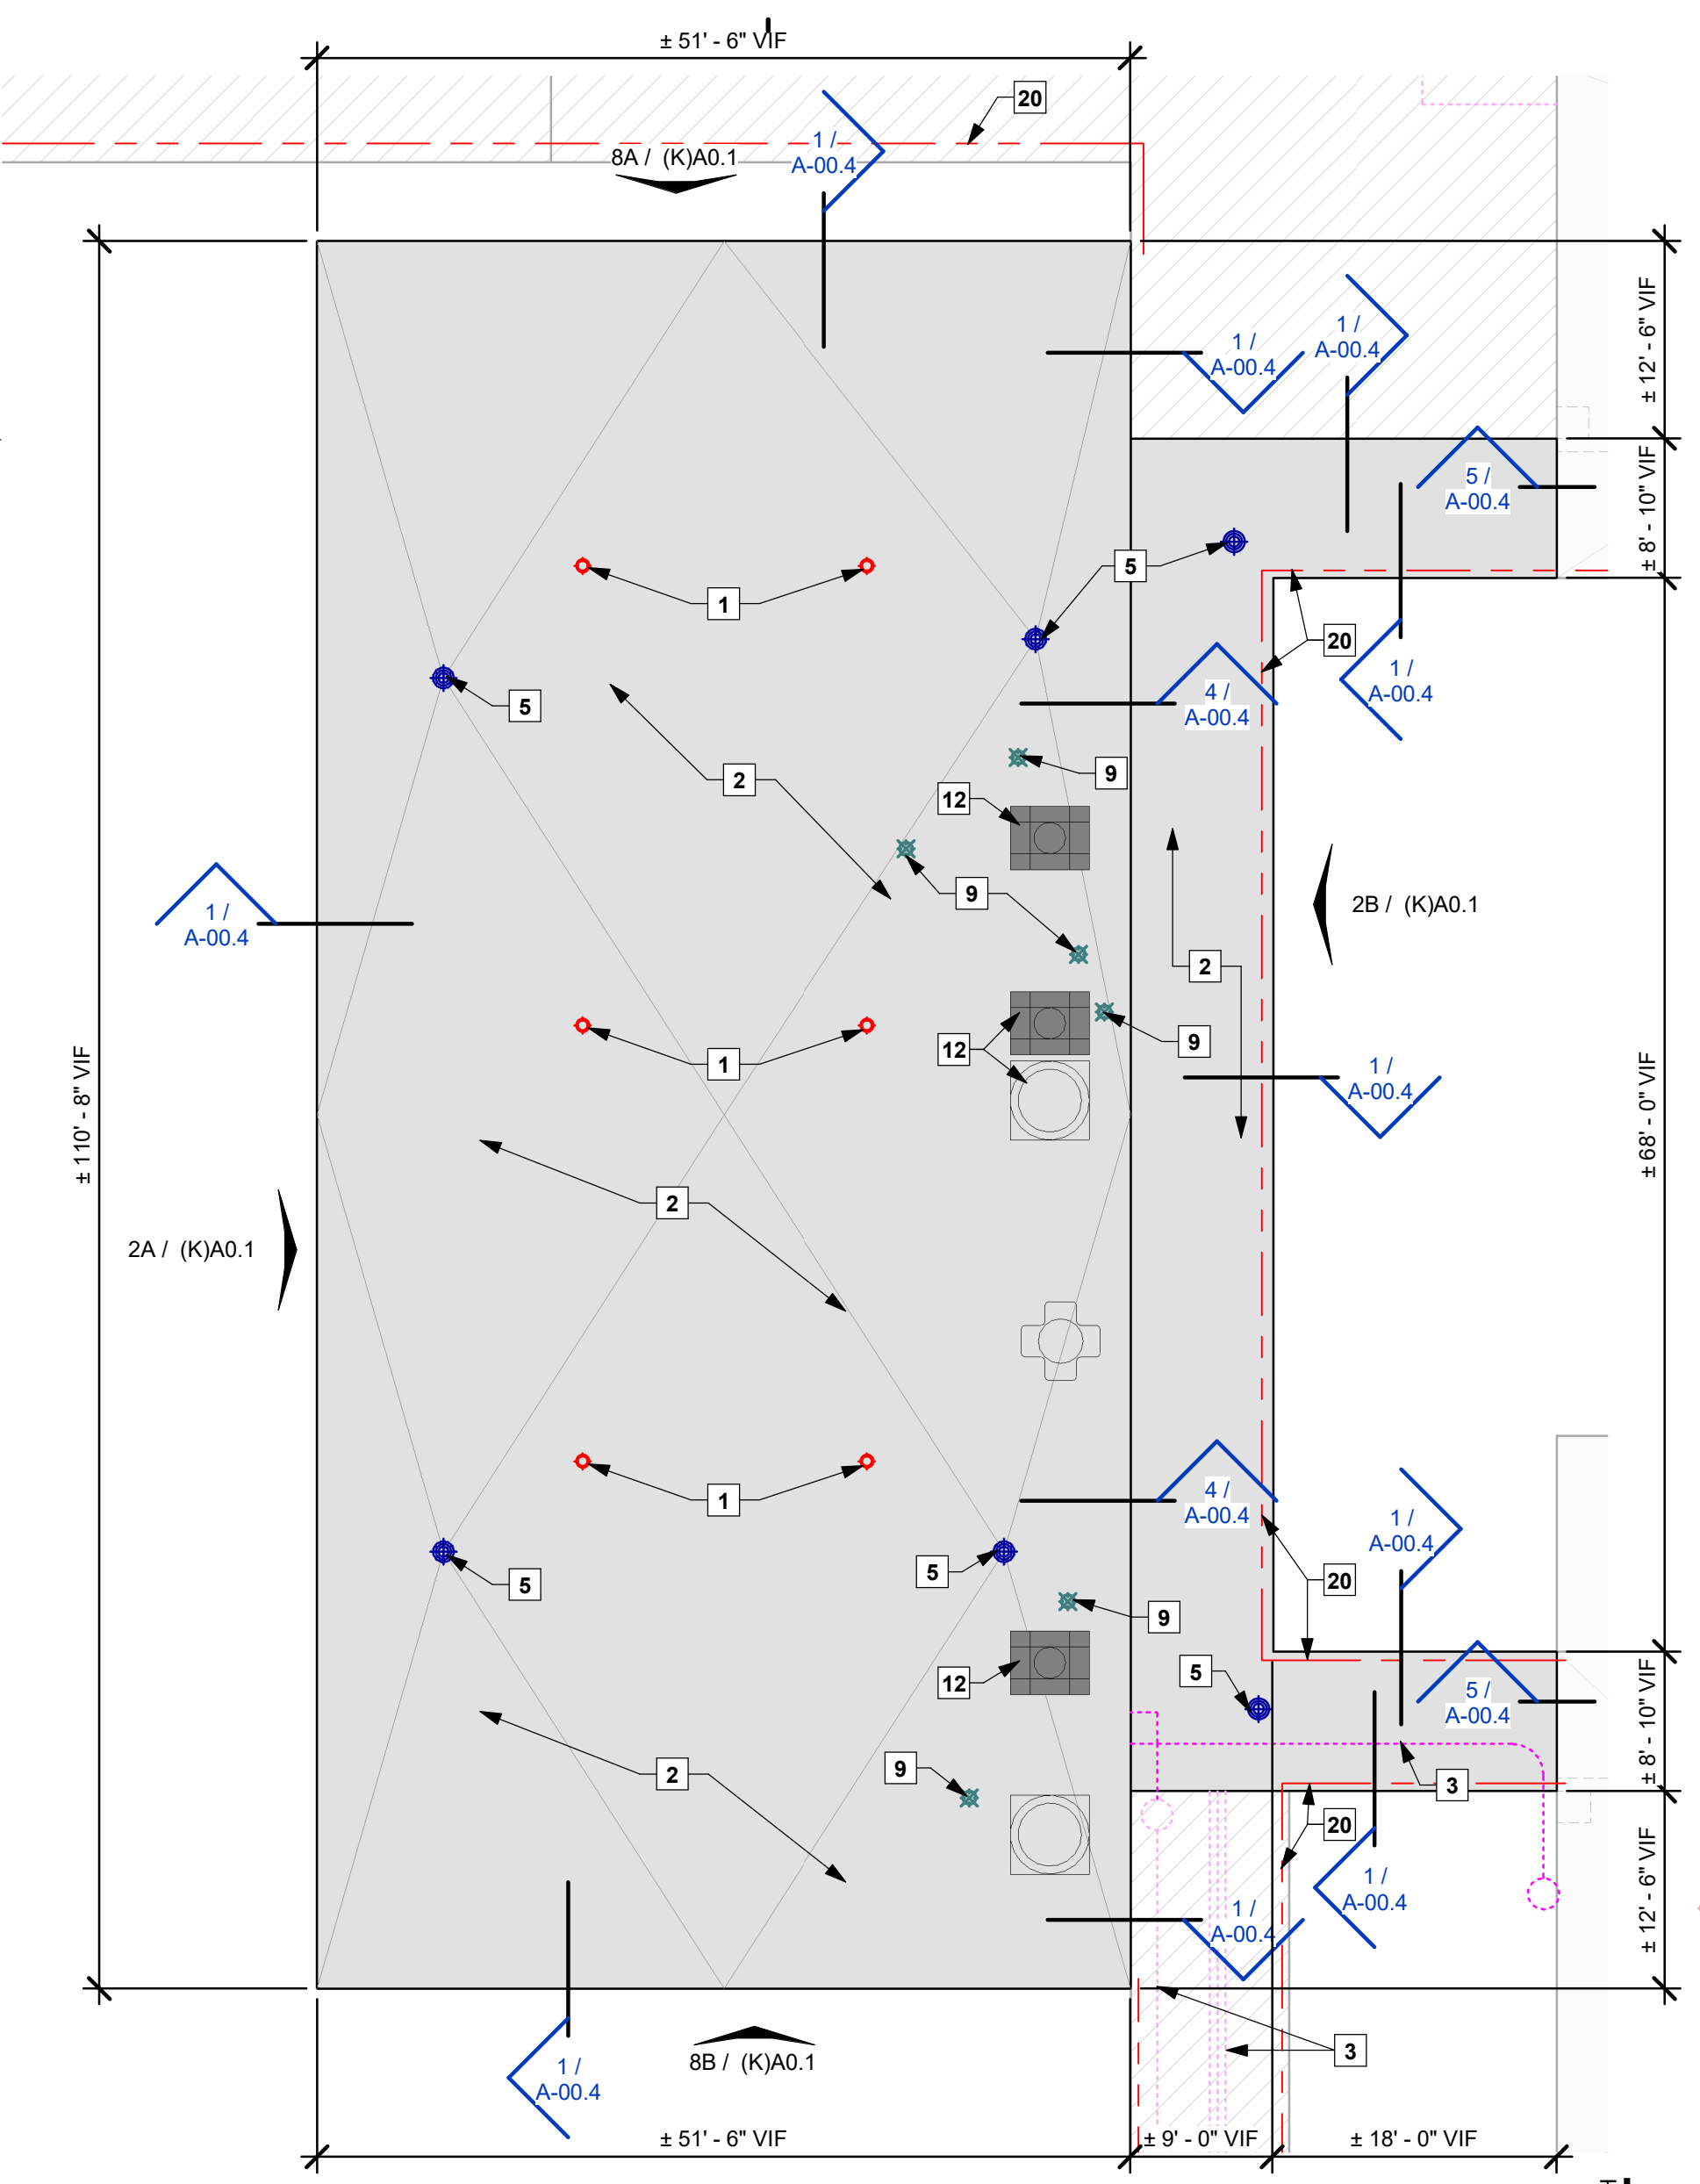
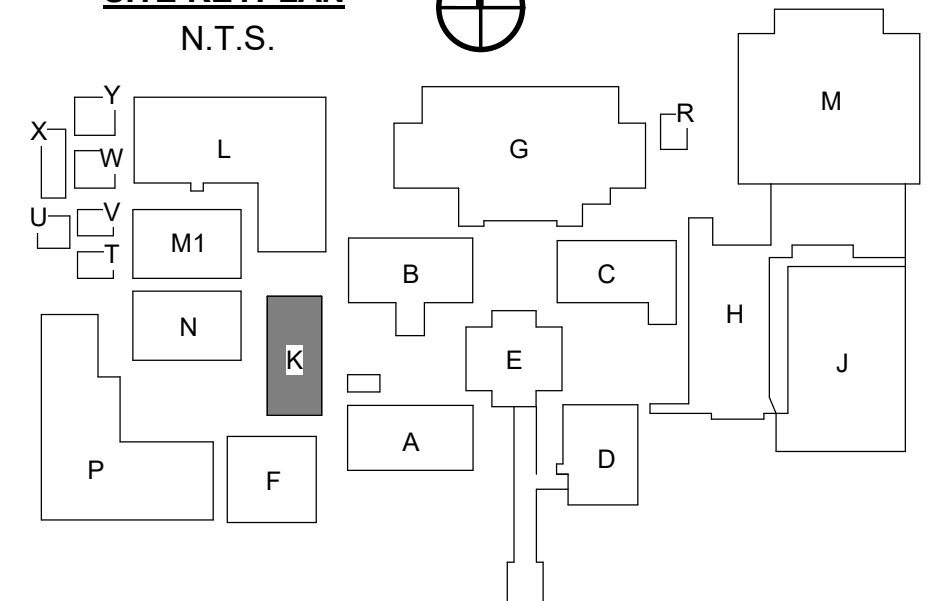
HAZARDOUS MATERIAL GENERAL NOTES

- ALL WORK INDICATED AS HAZARDOUS MATERIALS SHALL BE REMOVED BY ABATEMENT CONTRACTOR. CONTRACTOR IS TO COORDINATE WITH ABATEMENT CONTRACTOR FOR ABATEMENT WORK TO BE PERFORMED IN CONJUNCTION WITH THIS CONTRACT.
- COORDINATE SCHEDULED WORK WITH ABATEMENT CONTRACTOR AS TO NOT EXPOSE ANY EXTERIOR COMPONENTS TO THE WEATHER MORE THAN REQUIRED FOR REPAIRS.
- ABATEMENT OF INTERIOR COMPONENTS WILL NEED TO BE COORDINATED WITH CONTRACTOR'S PHASING PLAN FOR INTERIOR REPAIRS. CONTRACTOR IS RESPONSIBLE FOR PROTECTING BUILDING STRUCTURE AND INTERIOR FINISHES FROM ANY INCLIMATIC WEATHER AT ALL TIMES.

ROOFING SYMBOL LEGEND

- EXISTING SKYLIGHT SEE KEYNOTE 11 SEE DETAIL 19 / A-00.4
- ROOF DRAIN LOCATION SEE KEYNOTE 5 SEE DETAIL 16 / A-00.4
- ROOF PIPING PENETRATION SEE KEYNOTE 9
- ROOF FAN / VENT SEE KEYNOTE 12
- ROOF FAN / VENT SEE KEYNOTE 12
- DOWNSPOUT SEE KEYNOTE 30
- MISC MEP SEE KEYNOTE 12
- TURBINE VENT SEE KEYNOTE 12
- EXPANSION JOINT SEE KEYNOTE 8 SEE DETAIL 3 / A-00.4
- SCUPPER/OPENING FOR DRAINAGE SEE KEYNOTE 28 SEE DETAIL 15 / A-00.4
- ONE-WAY ROOF VENT TO BE REMOVED W/ ROOFING
- CONDUIT/PIPING RUNS SEE KEYNOTE 3

SITE KEYPLAN
N.T.S.




14 ROOF PLAN - BUILDING K
3/32" = 1'-0"

KEYNOTES

- PASSIVE AIR ROOF VENT REPLACEMENT:** EXISTING PASSIVE AIR ROOF VENT TO BE REMOVED.
- ROOF ASSEMBLY REPLACEMENT:** SHADED REGION INDICATES EXISTING ROOFING ASSEMBLY TO BE REMOVED TO EXISTING METAL ROOF DECKING SUBSTRATE BELOW, AND NEW ROOFING INSTALLED. ALL DEBRIS IS TO BE REMOVED FROM THE SITE. SEE SPECIFICATIONS FOR EXTENT OF DEMOLITION AND SITE CONSTRAINTS.
- RIGID CONDUIT REPAIR (VIF):** INDICATES EXISTING RIGID CONDUIT RUNS EXPOSED ON EXISTING ROOF. CONTRACTOR SHALL MAKE VISUAL INSPECTIONS ON SITE TO VERIFY THE EXTENT OF WORK WHICH BE REQUIRED TO MOVE AND RELOCATE THESE CONDUIT RUNS DURING THE PROCESS OF RE-ROOFING AND TO ENSURE THAT THE NEW ROOF SLOPES ARE INTEGRATED AND ACCOUNTED FOR WHERE EXTENSIONS OF THESE CONDUITS AND WIRING IS REQUIRED.
- ROOF CURB REPLACEMENT:** ALL EXISTING ROOF CURBS TO BE REMOVED AND REPLACED IN AREAS BEING RE-ROOFED.
- ROOF DRAIN REPAIR (VIF):** APPROXIMATE LOCATION OF EXISTING ROOF DRAIN. CONTRACTOR SHALL VISUALLY INSPECT ALL CONDITIONS REPLACE DAMAGED COMPONENTS AND ADJUST TO NEW ROOF SLOPE.
- FLASHING VIF:** SEE DETAILS FOR FLASHING AND COUNTERFLASHING WHICH IS TO TIE INTO THE EXISTING BUILDING ENVELOPE. VERIFY CLEARANCES AND LOCATIONS FOR INSTALLATION OF ALL FLASHING AND TERMINATION BARS AS DETAILED.
- RUNNER CURB INSTALLMENT:** PROVIDE NEW "RUNNER CURBS" FOR SUPPORT OF ALL HARD PIPING WHICH IS TO REMAIN ON ROOF AFTER NEW INSTALLATION. SPACE CURBS AS REQUIRED SO CONDUIT AND PIPING DOES NOT SAG BETWEEN THESE LOCATIONS. INSTALL AS DETAILED.
- ROOF EXPANSION JOINT REPAIR (VIF):** INDICATES APPROXIMATE AREA AND LOCATION OF ROOF EXPANSION JOINT. CONTRACTOR SHALL VISUALLY INSPECT THE EXISTING CONDITIONS AT THE SITE AND PROVIDE A NEW EXPANSION JOINT AS DETAILED WITHIN THESE DOCUMENTS. THE INSTALLER SHOULD ASSUME THAT ALL EXISTING WOOD BLOCKING SHALL BE REPLACED WITH NEW TREATED WOOD BLOCKING AS PER DETAILS. PROVIDE NEW CANT STRIP, FLASHING, PRE-FINISHED EXPANSION JOINT COVER, VINYL BELOWS, AND BASE FLASHING AS DETAILED. VERIFY EXACT ROUTING AND AREA WHERE THIS EJ IS TO BE REMOVED AND REPLACED. VERIFY ALL EXISTING CONDITIONS, ESPECIALLY ANY PIPING, AND CONDUIT WHICH MIGHT INTERSECT OR CROSS OVER THIS JOINT.
- PLUMBING VENT REPLACEMENT (VIF):** CONTRACTOR SHALL VISUALLY INSPECT ALL EXISTING ROOFING PLUMBING VENTS WHICH ARE TO REMAIN. CONFIRM HEIGHTS OF VENT PIPING AND EXTEND WHERE REQUIRED DUE TO INSTALLATION OF NEW TAPERED INSULATION. EXTEND ALL VENTS AS REQUIRED TO MAINTAIN VERTICAL CLEARANCES CALLED FOR ON EACH RELATED CONSTRUCTION DETAIL. REPLACE ALL LEAD VENT & PIPE FLASHING. TYPICAL ALL LOCATIONS.
- FLASHING REPLACEMENT:** REMOVE AND REPLACE FLASHING, COUNTERFLASHING AND PRE-FINISHED METAL FASCIA FLASHING AS DETAILED.
- SKYLIGHT REPLACEMENT:** INSTALL NEW ALUMINUM SKYLIGHT GUARD TO MATCH EXISTING.
- HVAC REPAIR (VIF):** INDICATES EXISTING HVAC EQUIPMENT AT EXISTING ROOF WHICH IS TO REMAIN. COORDINATE WORK INVOLVED WITH THIS EQUIPMENT AND NEW ROOFING ASSEMBLY SO AS TO NOT DISRUPT SERVICE TO THE EXISTING BUILDING. IF SERVICE IS REQUIRED TO BE TEMPORARILY SUSPENDED WHILE NEW WORK IS TAKING PLACE, THE CONTRACTOR SHALL COORDINATE ANY AND ALL OUTAGES WITH THE OWNER AND WILL BE REQUIRED TO ONLY PERFORM THIS WORK AT TIMES WHEN SUSPENSION OF THIS SERVICE MINIMALLY AFFECTS THE OWNERS USE OF THE BUILDING. IF THE SERVICE CANNOT BE SUSPENDED DURING OWNER'S OPERATING HOURS, WORK MAY HAVE TO BE PERFORMED AFTER HOURS, OR ON WEEKENDS.
- SATELLITE INSTALLATION:** SEE DETAILS FOR SATELLITE MOUNTING UNIT.
- "A" METAL PANEL REPLACEMENT:** METAL WALL PANEL "E" - REMOVE AND REPLACE DAMAGED/MISSING METAL WALL PANEL AS SPECIFIED. SEE BUILDING ELEVATIONS.
- SIGNAGE INSTALLATION:** INSTALL MISSING LETTERING TO MATCH EXISTING.
- ROOF ACCESSORY REPLACEMENT:** REPLACE DAMAGED ROOF ACCESSORIES. MATCH EXISTING TYPE, MATERIAL, AND STYLE.
- DOWNSPOUT AND GUTTER CLEANING:** DOWNSPOUT/COLLECTOR LOCATIONS. SEE ELEVATIONS. CONTRACTOR IS TO REMOVE ALL DEBRIS FROM GUTTERS AND DOWN SPOUTS.
- SATELLITE REMOVAL:** REMOVE ALL SATELLITE COMPONENTS. THESE ARE NO LONGER IN USE.
- COPING:** SEE ROOFING SHEETS FOR COPING, OVERHANG & ROOFING SCOPES. TYP.
- TEMPORARY CHAIN LINK FENCING -** PROVIDE 6" TEMPORARY CHAIN LINK FENCING TO PROTECT STUDENT TRAFFIC DURING CONSTRUCTION. PROVIDE ACCESS TO THE GREATEST EXTENT POSSIBLE. COORDINATE WITH PHASING AND SCHOOL PRINCIPAL.
- WIND TURBINE REPLACEMENT:** REMOVE AND REPLACE WIND TURBINE TO MATCH EXISTING.
- PAINTING EXTERIOR:** CLEAN, PREP & RE-PAINT WALLS AND ARTWORK TO COVER SCUFFS AND DAMAGE FROM STORM DEBRIS. COLOR TO MATCH EXISTING AS APPROVED BY ARCHITECT.
- GLASS REPLACEMENT:** REMOVE AND REPLACE DAMAGED GLASS (OR PLYWOOD WHERE APPLICABLE) TO MATCH EXISTING. PROVIDE CAULKING AND GASKETING.
- STUCCO SOFFIT REPLACEMENT:** SOFFIT REMOVED BY OTHERS (HAZARDOUS MATERIAL). COORDINATE AND INSTALL NEW STUCCO SOFFIT.
- COORDINATE REMOVAL OF **AGGREGATE PANELS (HAZARDOUS MATERIAL)** WITH ABATEMENT CONTRACTOR. COORDINATE WITH ABATEMENT CONTRACTOR AND INSTALL NEW GFRG FACADE PANELS AS SPECIFIED. REMOVE AND REPLACE DAMAGED WALL FRAMING - SEE STRUCTURAL AND WALL SECTIONS. SALVAGE AND REINSTALL MEP COMPONENTS AT SAME LOCATIONS - COORDINATE WITH MEP.
- DOWNSPOUT AND GUTTER REPLACEMENT:** REMOVE REMAINING ATTACHMENTS AND COMPONENTS OF DOWNSPOUT, GUTTER AND CONDUCTOR HEADS AND INSTALL NEW TO MATCH EXISTING COLOR, DIMENSION, GAUGE, AND MATERIAL. GROUT HOLES AT OLD STRAPS PRIOR TO NEW INSTALLATION & ATTACH AT INTERVALS EQUAL TO EXISTING SPACING. SALVAGE AND PREP REMAINING COMPONENTS FOR NEW INSTALLATION. CONTRACTOR IS TO REMOVE ALL DEBRIS FROM GUTTERS AND DOWN SPOUTS.
- BRICK REPAIR:** REMOVE AND REPLACE BRICK FACADE AS INDICATED. DISPOSE OF OLD BRICK. MATCH NEW BRICK AND MORTAR TO EXISTING AS APPROVED BY ARCHITECT. PRESERVE SUBSTRATE. REMOVE OLD BRICK TIES AND WATER PROOFING. INSTALL NEW WATERPROOFING AND BRICK TIES AT A MIN. OF 24" O.C. VERTICAL AND HORIZONTAL.
- PLASTER SOFFIT REPLACEMENT:** REMOVE REMAINING VINYL SOFFIT AND REPLACE TO MATCH EXISTING - PRESERVE LIGHT & REINSTALL AS NECESSARY.

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FAX: 337.466.3779

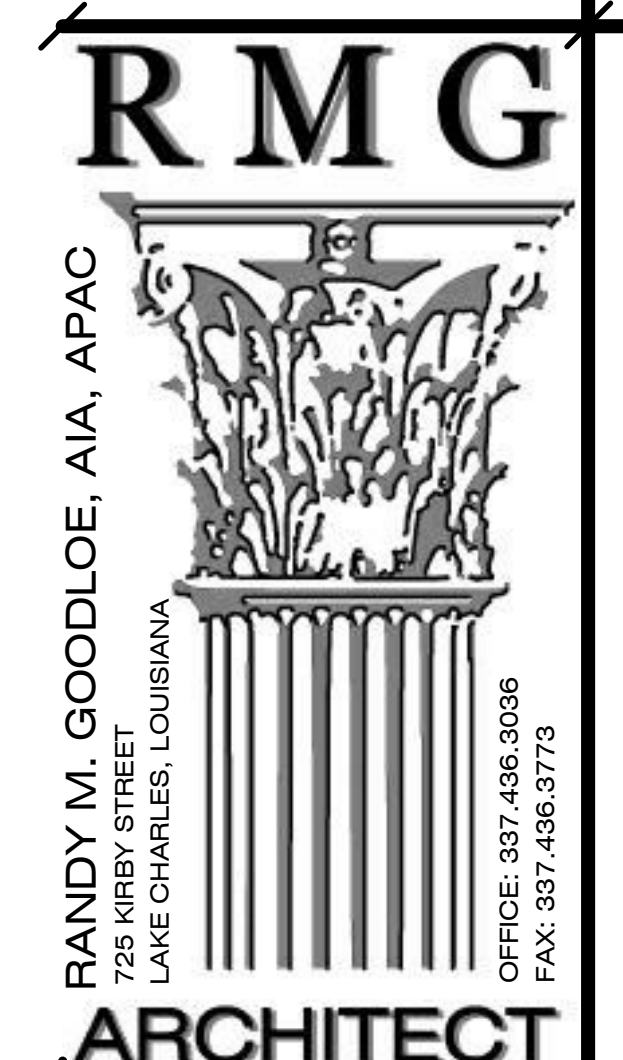

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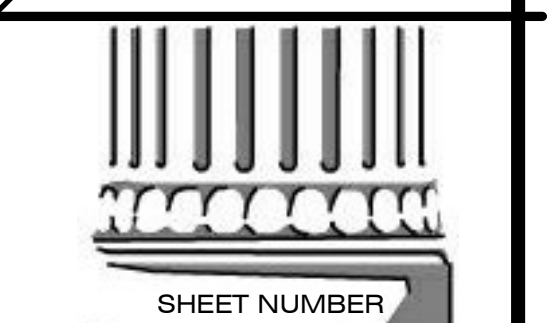
HURRICANE LAURA REPAIRS TO
A.M. BARBE HIGH SCHOOL
2200 W. McNEESE ST.
FOR
CALCASIEU PARISH SCHOOL BOARD
LAKE CHARLES, LA 70605
HL-003-01.03.04.05.06.07

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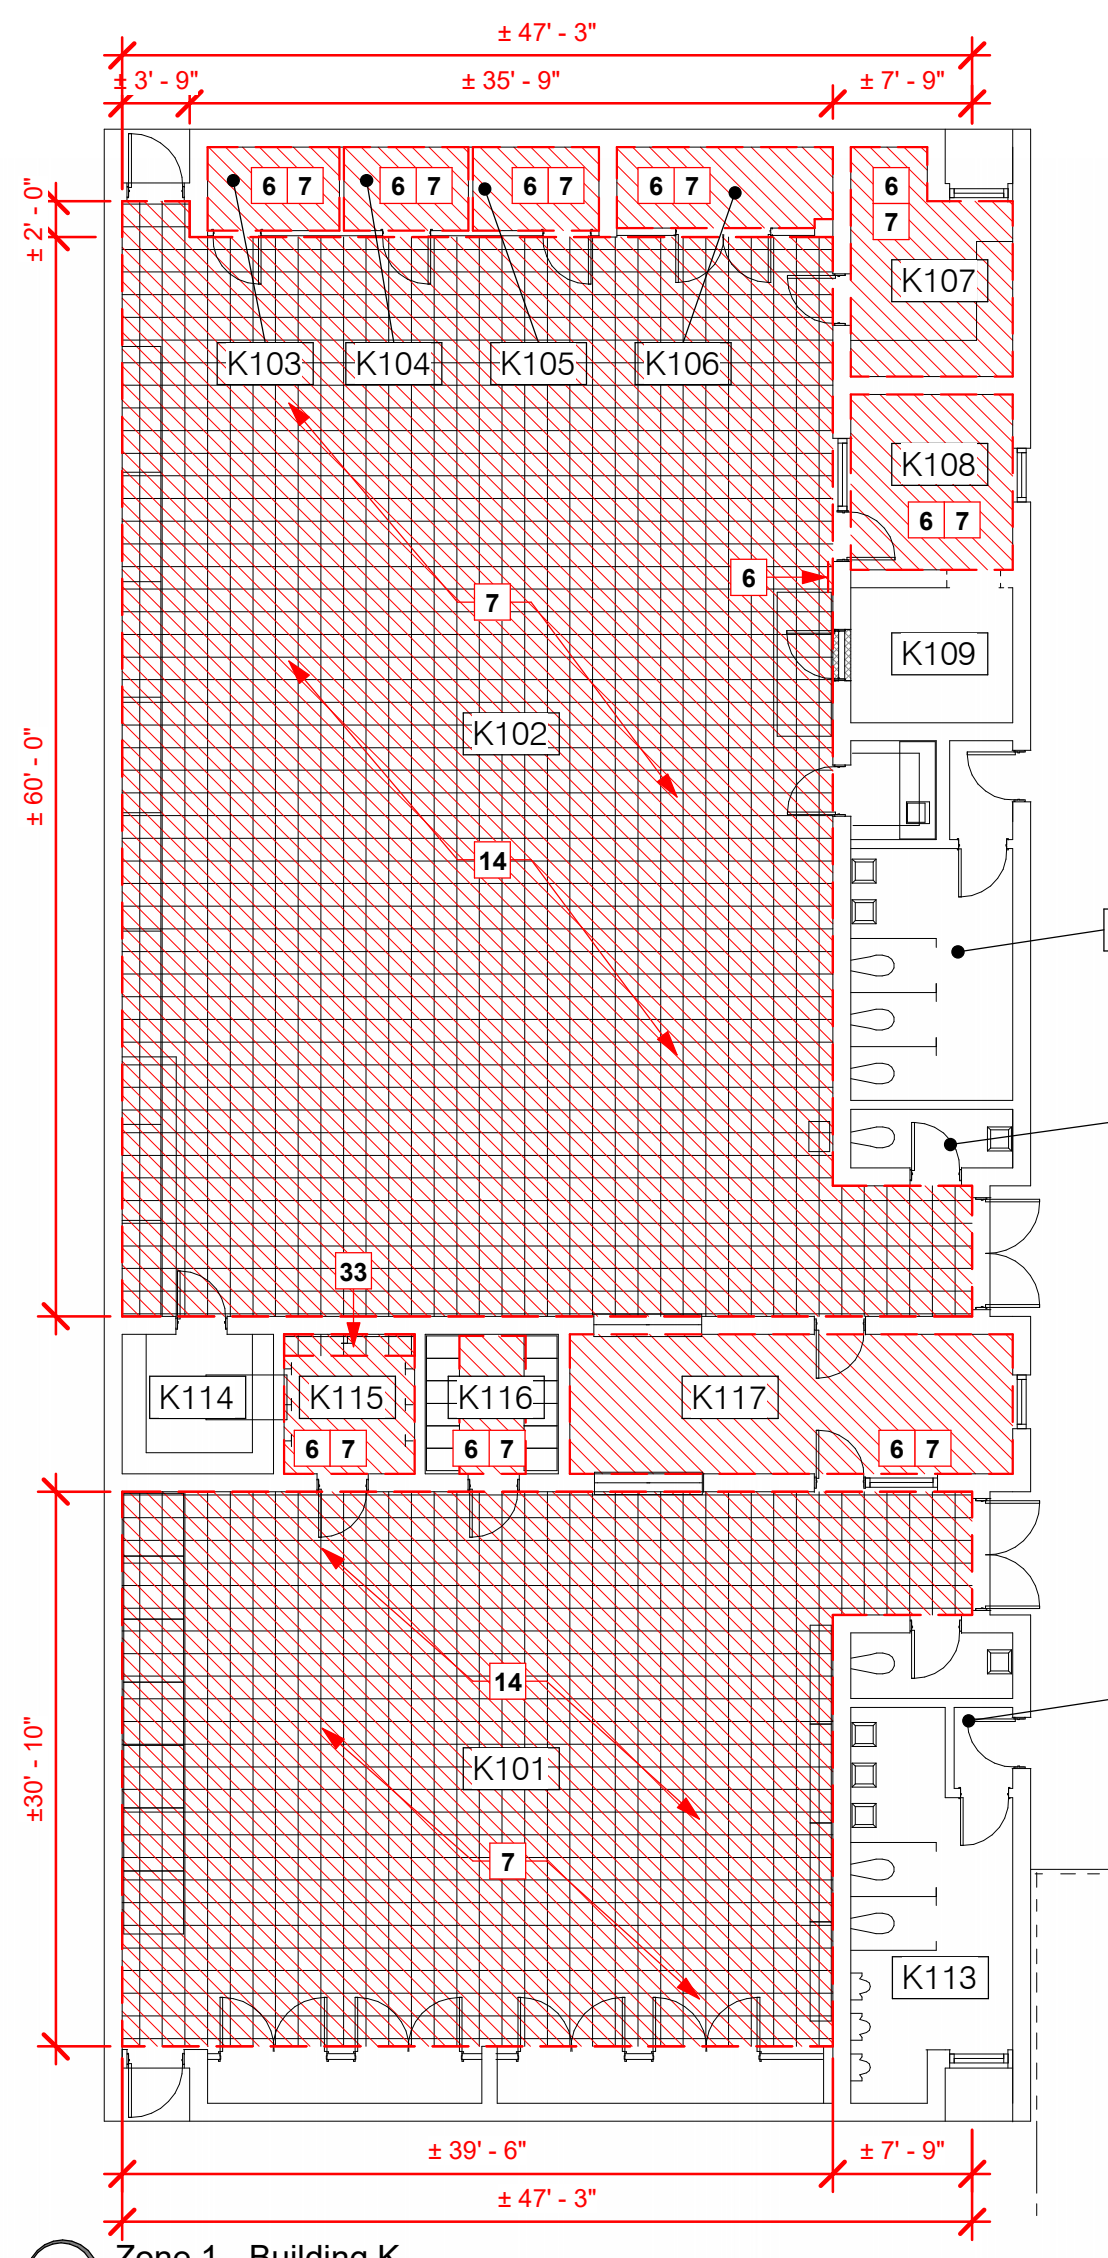
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OWNER PROJECT NO.
HL-003-01.03.04.05.06.07

PROJECT MANAGER
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DATE ISSUED
06/28/2024

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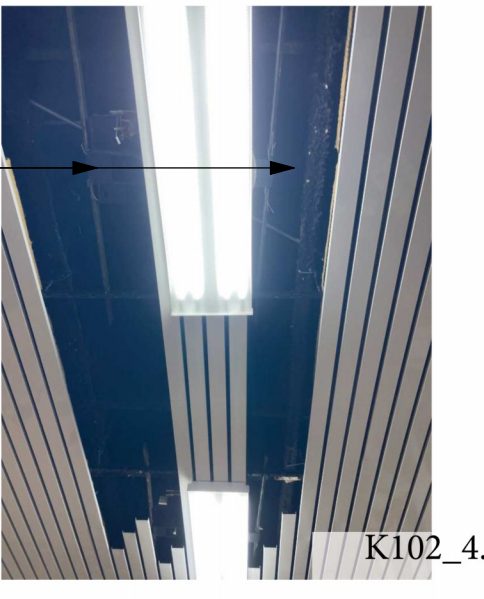
SHEET NUMBER
(K)A0.1
BLDG K ROOF



Zone 1 - Building K
3/32" = 1'-0"



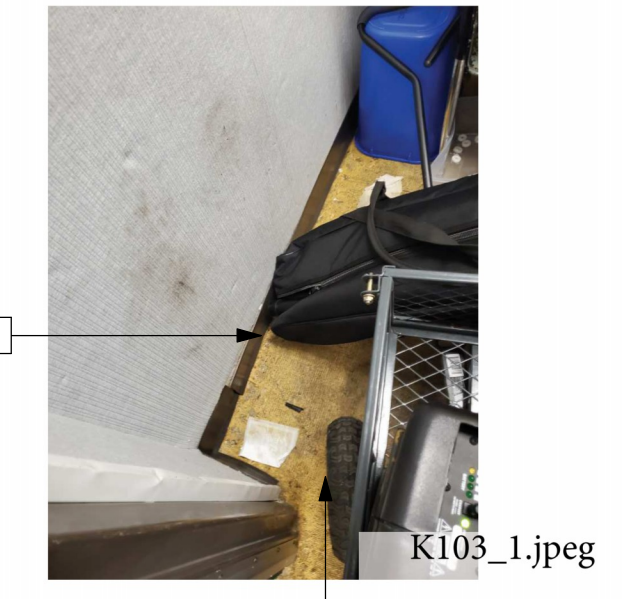
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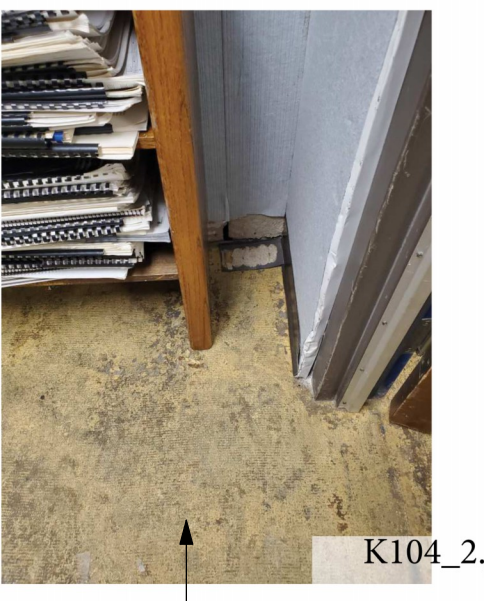
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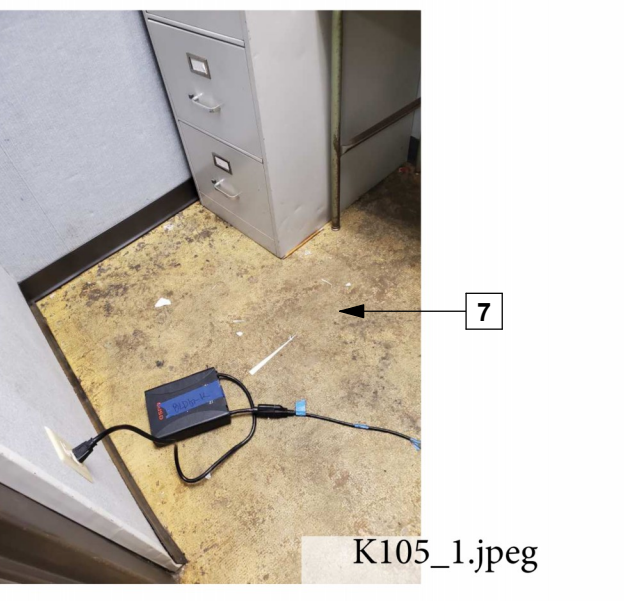
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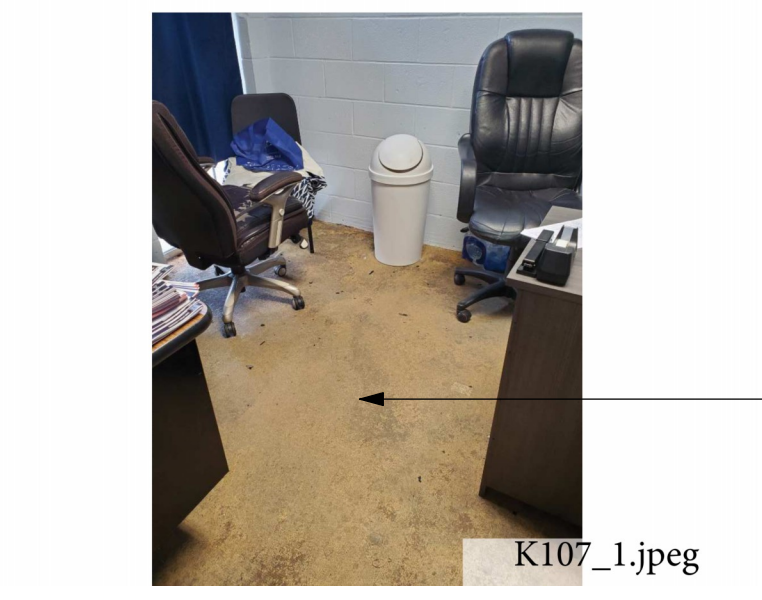
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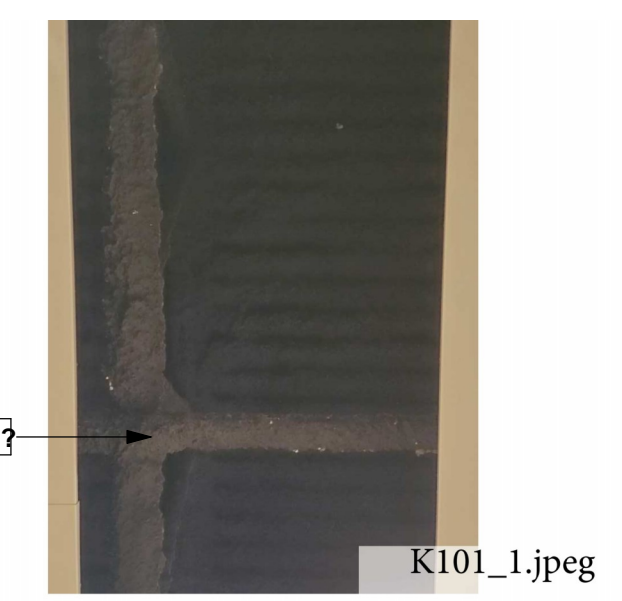
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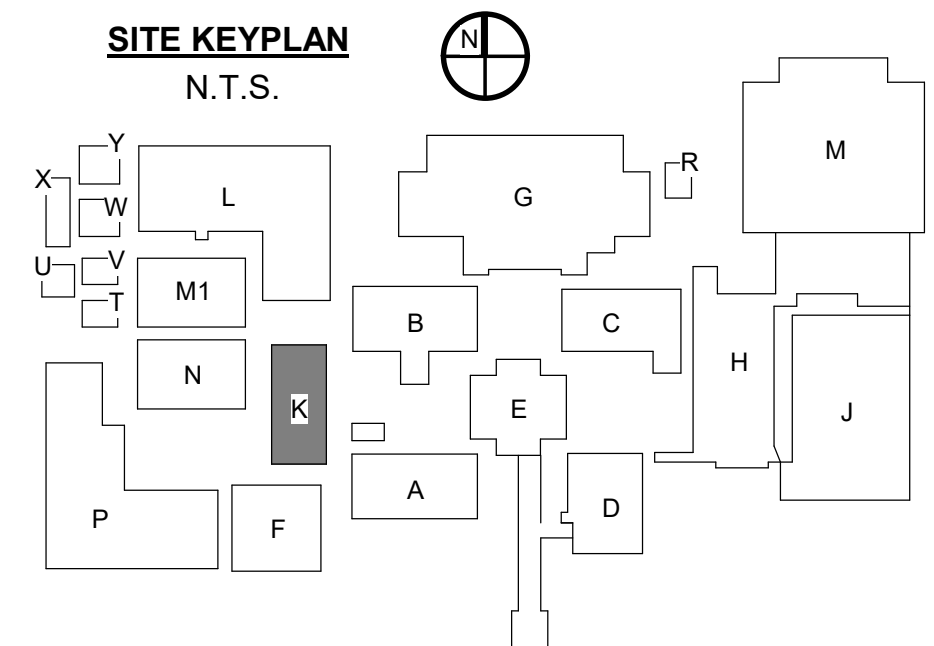
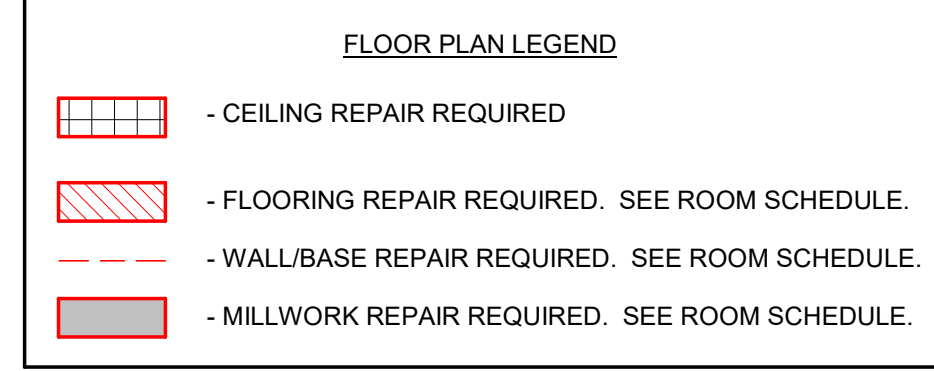
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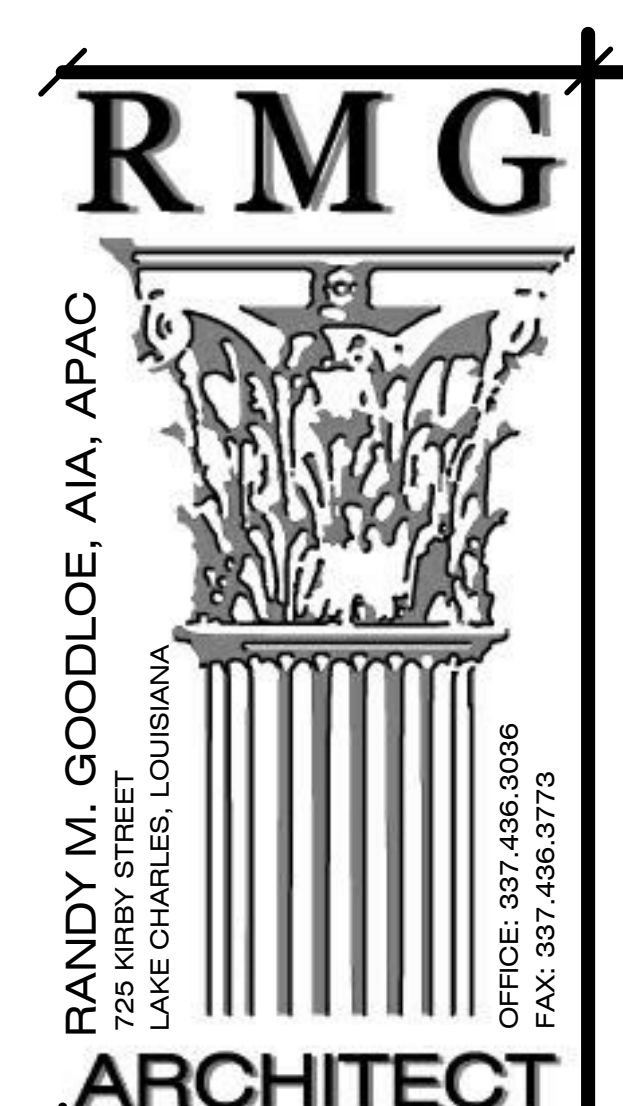
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ROOMS - BUILDING K		
ROOM NUMBER	Area	Perimeter
K101	1393 SF	170' - 11"
K102	2497 SF	225' - 8"
K103	33 SF	23' - 9"
K104	31 SF	22' - 11"
K105	32 SF	23' - 1"
K106	58 SF	34' - 6"
K107	94 SF	42' - 7"
K108	83 SF	36' - 6"
K115	57 SF	30' - 3"
K116	55 SF	29' - 9"
K117	190 SF	64' - 4"

*THESE MEASUREMENTS ARE APPROXIMATE TO BE USED AS GUIDELINES ONLY. CONTRACTOR IS RESPONSIBLE FOR ALL FINAL MEASUREMENTS.



- KEYNOTES**
- SUSPENDED ACOUSTIC CEILING REPLACEMENT:** REMOVE AND REPLACE DAMAGED CEILING GRID AND CEILING TILE AS SPECIFIED.
 - CEILING GRID:** REMOVE AND REPLACE DAMAGED CEILING GRID. MATCH EXISTING. SEE UNIT PRICE NO. 5
 - VCT FLOORING REPAIRS:** REMOVE AND REPLACE VCT FLOORING AS SPECIFIED IN AREAS WHERE INDICATED. SEE UNIT PRICE NO. 3.
 - WINDOW REPAIRS:** REPLACE BROKEN WINDOW PANES, BLOCKS, AND GASKETS TO MATCH EXISTING. ALL SEALANTS SHALL BE REMOVED AND REPLACED AS SPECIFIED TO ENSURE WEATHER TIGHT SEAL. SEE ELEVATIONS.
 - STRUCTURAL CLAY BLOCK:** GLAZED STRUCTURAL CLAY BLOCK TO BE REMOVED AND REPLACED AS SPECIFIED TO MATCH EXISTING. CLEAN ALL CHALKING RESIDUE FROM EFFERVESCENCE.
 - VINYL BASE REPLACEMENT:** REPLACE DAMAGED OR MISSING BASE AS SPECIFIED TO MATCH EXISTING. SEE UNIT PRICE NO. 4
 - CARPET REPAIRS:** DAMAGED CARPET HAS BEEN REMOVED. CLEAN FLOOR AND INSTALL NEW CARPET TILE AS SPECIFIED.
 - PAINTING:** WALL SURFACE IS TO BE SANDED, PREPARED, AND REPAINT TO MATCH EXISTING CORNER TO CORNER. WATER STAINED WALL FROM ROOF LOSS.
 - PAINTED CEILING STRUCTURE:** CEILING INCLUDING METAL TRUSSES ARE TO BE CLEANED, PREPPED, AND REPAINTED END TO END TO MATCH EXISTING COLOR.
 - VCT FLOORING CLEANING:** CLEAN WATER STAINS FROM VCT FLOORING TO REMOVE ANY DISCOLORATION WHERE INDICATED. MOP AND WAX ALL VCT FLOORING AT THE END OF CONSTRUCTION.
 - SKYLIGHT REPAIRS:** REMOVE AND REPLACE SKYLIGHT TO MATCH EXISTING.
 - TERRAZZO FLOORING CLEANING:** CLEAN AND POLISH EXISTING TERRAZZO FLOORING. REFER TO ROOM SCHEDULE FOR CLARITY.
 - CEILING TILE REPLACEMENT:** REMOVE AND REPLACE DAMAGED OR MISSING ACOUSTIC CEILING TILE WITH NEW CEILING TILE AS SPECIFIED IN AREAS INDICATED. MATCH EXISTING TYPE AND SIZE. SEE UNIT PRICE NO. 1. INSTALL R-30 BATT INSULATION OVER TILE. SEE UNIT PRICE NO. 2
 - NOT USED.**
 - EXTERIOR WINDOWS AND DOORS:** CAULK AND RESEAL PERIMETER OF EXISTING WINDOWS AND DOORS.
 - CMU REPAIR:** RE-POINT DAMAGED CMU JOINTS AS SHOWN. PAINT WALL FROM END TO END IN COLOR TO MATCH EXISTING AS SPECIFIED. SEE PHOTOS.
 - BRICK REPAIR:** CAULK CRACKED AREAS AND REPAINT.
 - LOCKERS:** REPLACE DAMAGED UNITS AS SHOWN. MATCH EXISTING STYLE, SIZE AND COLORS.
 - BRICK WALLS:** CLEAN ALL WATER STAINS FROM ENTIRE BRICK WALL.
 - SHELVING REPLACEMENT:** REMOVE AND REPLACE DAMAGED SHELVING UNITS WITH **GLASS DOORS**. MATCH EXISTING MATERIALS, FINISHES AND CONSTRUCTION STYLE.
 - BASE CABINET:** REMOVE AND REPLACE DAMAGED BASE CABINET. MATCH EXISTING STYLE, SIZE, AND CONSTRUCTION. SALVAGE AND REINSTALL COUNTERTOP.
 - SECTIONAL DOOR:** REMOVE AND REPLACE OVERHEAD SECTIONAL DOOR AS SPECIFIED. CONTRACTOR TO PROVIDE ANY ADDITIONAL SUPPORT REQUIRED BY THE MANUFACTURER.
 - GYPSON BOARD:** REMOVE AND REPLACE DAMAGED GYPSON BOARD TO NEAREST FRAMING MEMBER. FINISH AND RE-PAINT WALL CORNER TO CORNER.
 - PREFINISHED GYPSON BOARD WITH VINYL WALL COVER AND CORNER TRIM:** REMOVE AND REPLACE DAMAGED VINYL COVERED GYPSON BOARD FROM FLOOR TO CEILING WHERE INDICATED ON FLOOR PLAN.
 - STOREFRONT WINDOW:** REMOVE AND REPLACE STOREFRONT WINDOW AS SPECIFIED.
 - STUCCO SOFFIT:** REMOVE & REPLACE STUCCO SOFFIT. COORDINATE WITH ABATEMENT SCOPE & ABATEMENT CONTRACTOR TO ENSURE WEATHER-TIGHTNESS AND PHASING COORDINATION. SEE WALL SECTIONS & DETAILS.
 - GYPSON CEILING REPAIRS:** REMOVE AND REPLACE DAMAGED GYPSON CEILING BOARD TO NEAREST FRAMING MEMBER WHERE INDICATED. FINISH TO MATCH EXISTING AS SPECIFIED.
 - METAL ROOF PANEL REPAIRS:** REMOVE AND REPLACE DEFORMED OR MISSING METAL ROOF PANELS TO MATCH EXISTING.
 - CONCRETE FLOOR CLEANING:** CLEAN AND RESEAL FLOOR AS SPECIFIED.
 - BASE CABINET:** REMOVE AND REPLACE DAMAGED BASE CABINET. MATCH EXISTING STYLE, SIZE, AND CONSTRUCTION. SALVAGE AND REINSTALL COUNTERTOP.
 - TILE CLEANING:** CLEAN STAINS FROM WALL TILE TO REMOVE ANY DISCOLORATION WHERE INDICATED.
 - CLEAN/REPAINT MASONRY WALL:** MECHANICALLY REMOVE ALL LOOSE OR PEELING PAINT AND ALL GYR RESIDUE FROM EFFERVESCENCE FROM CORNER TO CORNER. PERFORM REQUIRED MOISTURE TESTING PRIOR TO REPAIRING WALL AS SPECIFIED.
 - PLASTER CEILING REPAIRS:** REMOVED AND REPLACE DAMAGED PLASTER CEILING WHERE INDICATED AS SPECIFIED, PAINT IN COLOR TO MATCH EXISTING.
 - MEP DAMAGES:** SEE MECHANICAL, PLUMBING AND ELECTRICAL PLANS.
 - FURNITURE SETTING AND RESETTING:** RELOCATE ALL EXISTING FURNITURE TO TEMPORARY ROOM IN MODULAR BUILDINGS WHILE EXISTING SPACE IS BEING REPAIRED. REINSTALL AND RESET FURNITURE ONCE REPAIRS ARE COMPLETE. SEE PHASING PLAN.
 - SUSPENDED CEILING INSULATION:** INSTALL R-19 BATT INSULATION AS SPECIFIED ABOVE PREVIOUSLY INSTALLED SUSPENDED CEILING TILE. SEE UNIT PRICE NO. 2.
 - BRICK WALL REPLACEMENT:** REMOVE AND REPLACE BRICK WALL AS INDICATED. DISPOSE OF OLD BRICK. MATCH NEW BRICK AND MORTAR TO EXISTING AS APPROVED BY ARCHITECT. SEE STRUCTURAL. BUILDING TO REMAIN WEATHERPROOF AND CONDITIONED DURING REPAIRS.
 - DOOR REPAIR:** CLEAN, PREP AND RE-PAINT DOOR FRAME - SEE DOOR SCHEDULE.
 - CORRIDOR WALL REPAIR:** REMOVE DAMAGED STOREFRONT WINDOW AND EXISTING 3/4" PLYWOOD SHEATHING BELOW WINDOW. INSTALL NEW WINDOW PER SCHEDULE AND NEW 3/4" PLYWOOD SHEATHING. PAINT AS SPECIFIED, IN COLOR AS SELECTED. SEE DETAILS.
 - GLAZING REPAIR:** REMOVE AND REPLACE BROKEN GLASS. MATCH EXISTING TINT. PROVIDE SAFETY GLASS AS REQUIRED.
 - DOOR REPAIR:** REMOVE AND REPLACE EXISTING LEFT DOOR LEAF. PROVIDE AN INSULATED HOLLOW METAL DOOR WITH VISION PANEL TO MATCH RIGHT DOOR LEAF. REINSTALL EXISTING DOOR HARDWARE. PAINT AS DIRECTED.



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A.M. BARBE HIGH SCHOOL
2200 W. McNEESE ST.
FOR
CALCASIEU PARISH SCHOOL BOARD
LAKE CHARLES, LA 70605
HL-003-01.03.04.05.06.07

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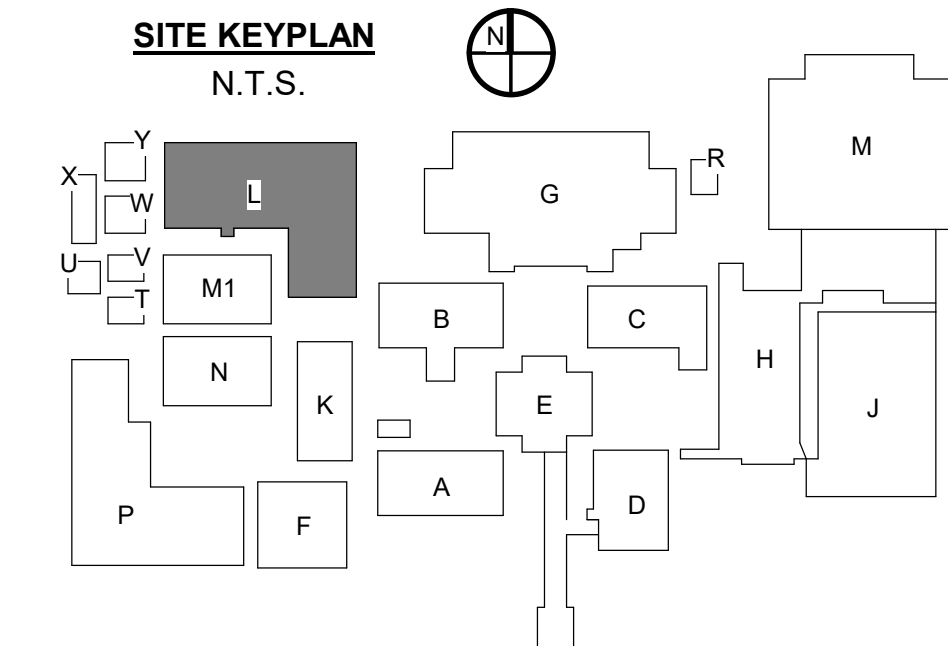
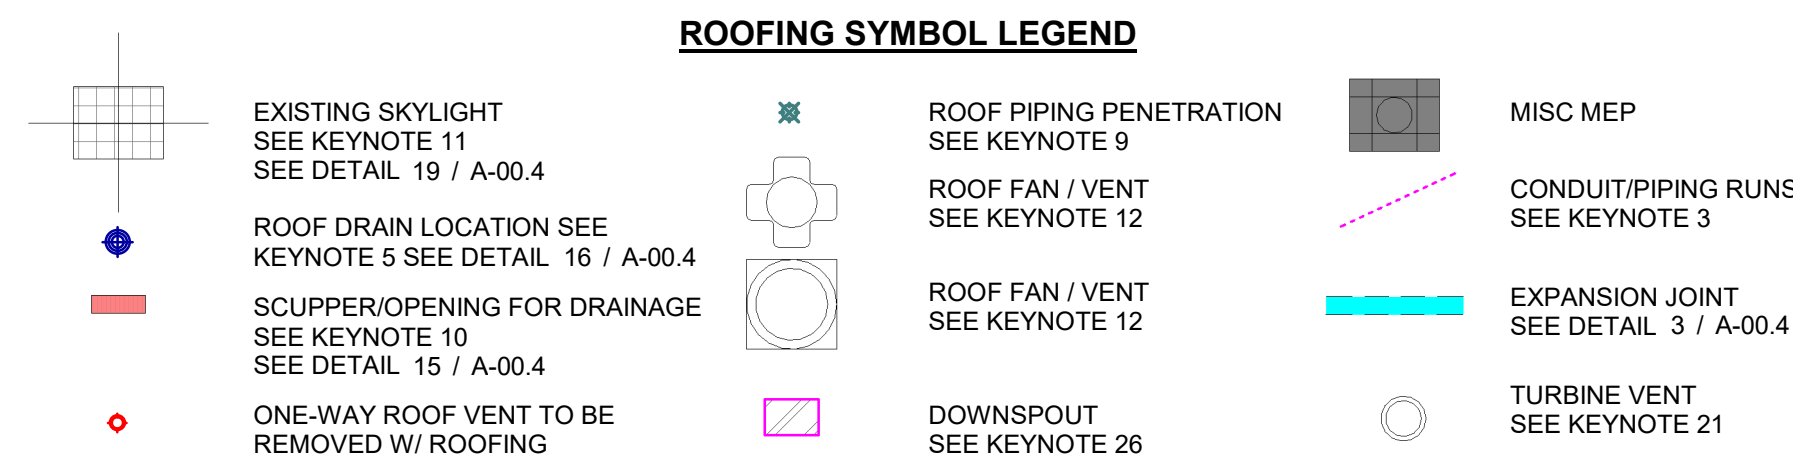
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DATE ISSUED
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SHEET NUMBER
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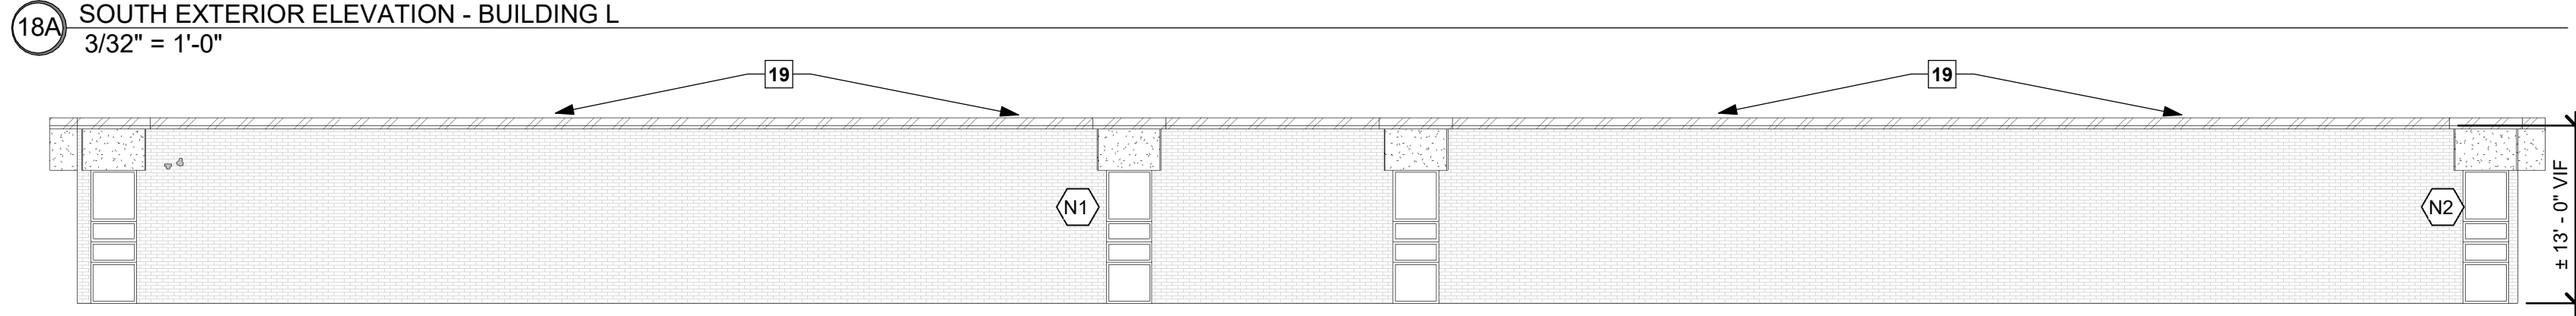
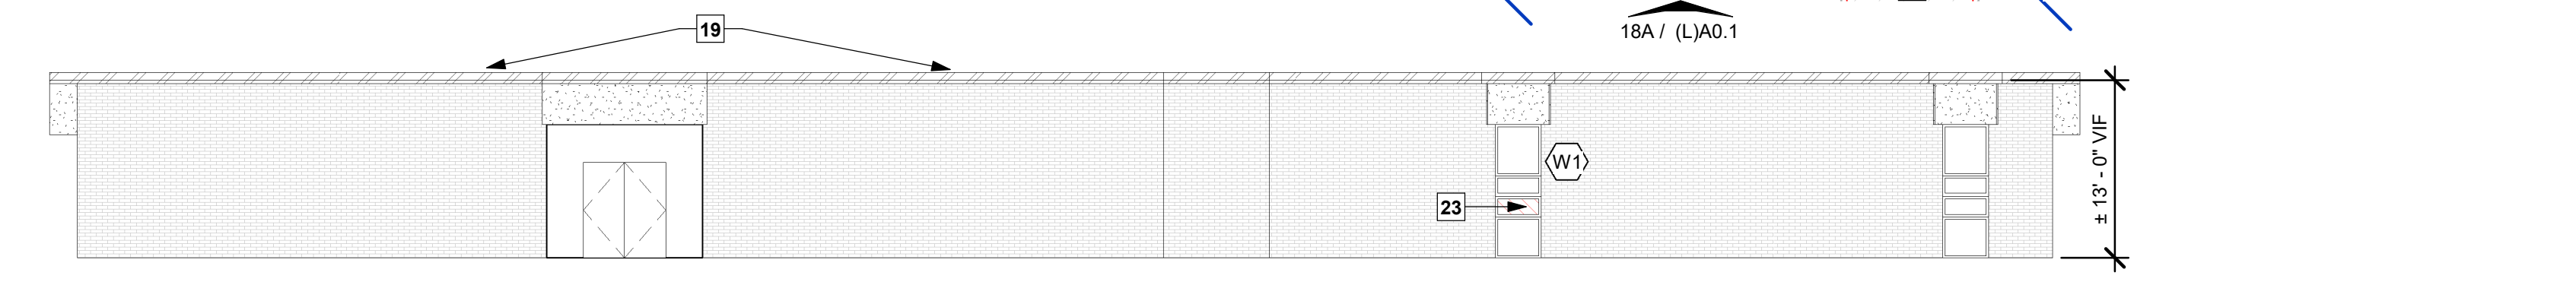
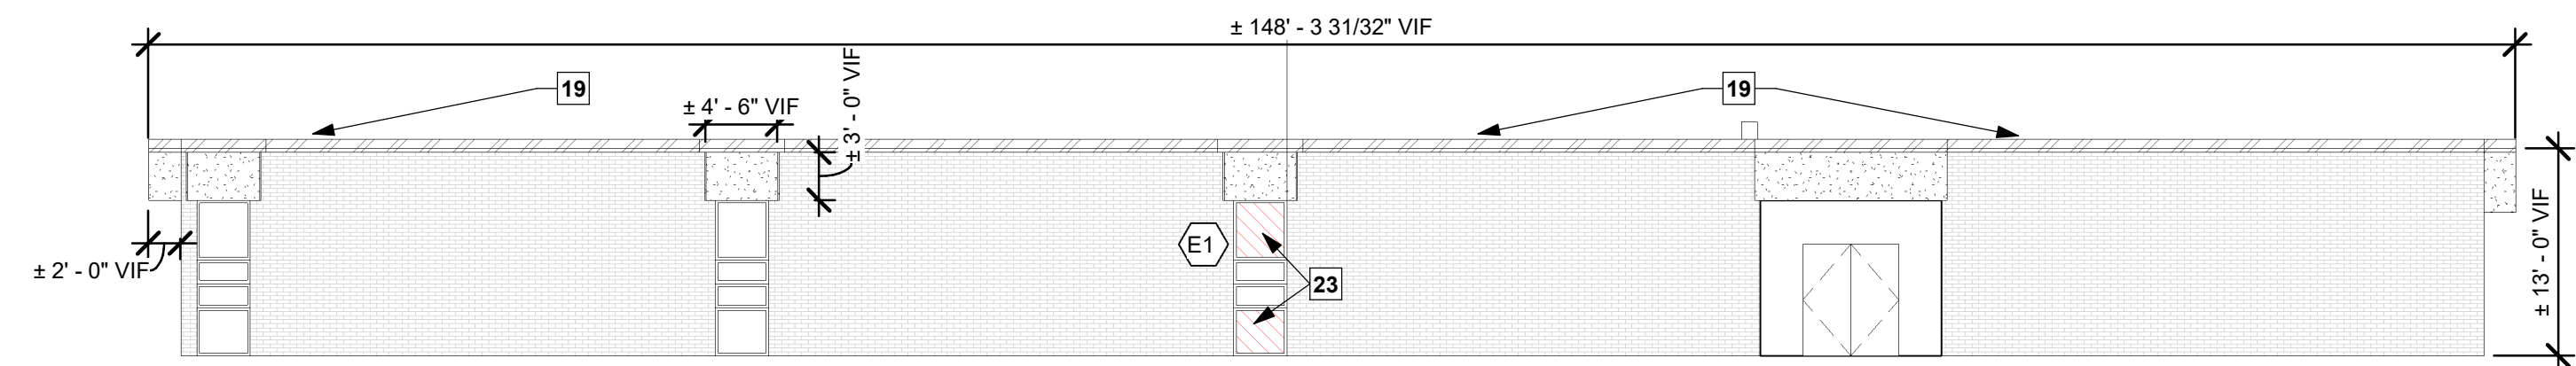
NOTE: IMAGES ARE FOR VISUAL REFERENCES TO HELP UNDERSTAND DAMAGES. THEY DO NOT REPRESENT THE ENTIRE SCOPE OF WORK AND SHOULD BE USED IN CONJUNCTION WITH THE DRAWINGS AND CURRENT CONDITIONS IN THE FIELD. CONTRACTOR SHALL CONFIRM CURRENT CONDITIONS IN THE FIELD PRIOR TO BIDDING - TYPICAL.



HAZARDOUS MATERIAL GENERAL NOTES


- ALL WORK INDICATED AS HAZARDOUS MATERIALS SHALL BE REMOVED BY ABATEMENT CONTRACTOR. CONTRACTOR IS TO COORDINATE WITH ABATEMENT CONTRACTOR FOR ABATEMENT WORK TO BE PERFORMED IN CONJUNCTION WITH THIS CONTRACT.
- COORDINATE SCHEDULED WORK WITH ABATEMENT CONTRACTOR AS TO NOT EXPOSE ANY EXTERIOR COMPONENTS TO THE WEATHER MORE THAN REQUIRED FOR REPAIRS.
- ABATEMENT OF INTERIOR COMPONENTS WILL NEED TO BE COORDINATED WITH CONTRACTOR'S PHASING PLAN FOR INTERIOR REPAIRS. CONTRACTOR IS RESPONSIBLE FOR PROTECTING BUILDING STRUCTURE AND INTERIOR FINISHES FROM ANY INCLIMATIC WEATHER AT ALL TIMES.

8 ROOF PLAN - BUILDING L
3/32" = 1'-0"



KEYNOTES

- PASSIVE AIR ROOF VENT REPLACEMENT:** EXISTING PASSIVE AIR ROOF VENT TO BE REMOVED.
- ROOF ASSEMBLY REPLACEMENT:** SHADDED REGION INDICATES EXISTING ROOFING ASSEMBLY TO BE REMOVED TO EXISTING METAL ROOF DECKING SUBSTRATE BELOW, AND NEW ROOFING INSTALLED. ALL DEBRIS IS TO BE REMOVED FROM THE SITE. SEE SPECIFICATIONS FOR EXTENT OF DEMOLITION AND SITE CONSTRAINTS.
- RIGID CONDUIT REPAIR (VIF):** INDICATES EXISTING RIGID CONDUIT RUNS EXPOSED ON EXISTING ROOF. CONTRACTOR SHALL MAKE VISUAL INSPECTIONS ON SITE TO VERIFY THE EXTENT OF WORK WHICH BE REQUIRED TO MOVE AND RELOCATE THESE CONDUIT RUNS DURING THE PROCESS OF RE-ROOFING AND TO ENSURE THAT THE NEW ROOF SLOPES ARE INTEGRATED AND ACCOUNTED FOR WHERE EXTENSIONS OF THESE CONDUITS AND WIRING IS REQUIRED.
- ROOF CURB REPLACEMENT:** ALL EXISTING ROOF CURBS TO BE REMOVED AND REPLACED IN AREAS BEING RE-ROOFED.
- ROOF DRAIN REPAIR (VIF):** APPROXIMATE LOCATION OF EXISTING ROOF DRAIN. CONTRACTOR SHALL VISUALLY INSPECT ALL CONDITIONS REPLACE DAMAGED COMPONENTS AND ADJUST TO NEW ROOF SLOPE.
- FLASHING VIF:** SEE DETAILS FOR FLASHING AND COUNTERFLASHING WHICH IS TO TIE INTO THE EXISTING BUILDING ENVELOPE. VERIFY CLEARANCES AND LOCATIONS FOR INSTALLATION OF ALL FLASHING AND TERMINATION BARS AS DETAILED.
- RUNNER CURB INSTALLMENT:** PROVIDE NEW "RUNNER CURBS" FOR SUPPORT OF ALL HARD PIPING WHICH IS TO REMAIN ON ROOF AFTER NEW INSTALLATION. SPACE CURBS AS REQUIRED SO CONDUIT AND PIPING DOES NOT SAG BETWEEN THESE LOCATIONS. INSTALL AS DETAILED.
- ROOF EXPANSION JOINT REPAIR (VIF):** INDICATES APPROXIMATE AREA AND LOCATION OF ROOF EXPANSION JOINT. CONTRACTOR SHALL VISUALLY INSPECT THE EXISTING CONDITIONS AT THE SITE AND PROVIDE A NEW EXPANSION JOINT AS DETAILED WITHIN THESE DOCUMENTS. THE INSTALLER SHOULD ASSUME THAT ALL EXISTING WOOD BLOCKING SHALL BE REPLACED WITH NEW TREATED WOOD BLOCKING AS PER DETAILS. PROVIDE NEW CANT STRIP, FLASHING, PRE-FINISHED EXPANSION JOINT COVER, VINYL BELLOWS, AND BASE FLASHING AS DETAILED. VERIFY EXACT ROUTING AND AREA WHERE THIS EJ IS TO BE REMOVED AND REPLACED. VERIFY ALL EXISTING CONDITIONS, ESPECIALLY ANY PIPING, AND CONDUIT WHICH MIGHT INTERSECT OR CROSS OVER THIS JOINT.
- PLUMBING VENT REPLACEMENT (VIF):** CONTRACTOR SHALL VISUALLY INSPECT ALL EXISTING ROOFING PLUMBING VENTS WHICH ARE TO REMAIN. CONFIRM HEIGHTS OF VENT PIPING AND EXTEND WHERE REQUIRED DUE TO INSTALLATION OF NEW TAPERED INSULATION. EXTEND ALL VENTS AS REQUIRED TO MAINTAIN VERTICAL CLEARANCES CALLED FOR ON EACH RELATED CONSTRUCTION DETAIL. REPLACE ALL LEAD VENT & PIPE FLASHING. TYPICAL ALL LOCATIONS.
- FLASHING REPLACEMENT:** REMOVE AND REPLACE FLASHING, COUNTER-FLASHING AND PRE-FINISHED METAL FASCIA FLASHING AS DETAILED.
- SKYLIGHT REPLACEMENT:** INSTALL NEW ALUMINUM SKYLIGHT GUARD TO MATCH EXISTING.
- HVAC REPAIR (VIF):** INDICATES EXISTING HVAC EQUIPMENT AT EXISTING ROOF WHICH IS TO REMAIN. COORDINATE WORK INVOLVED WITH THIS EQUIPMENT AND NEW ROOFING ASSEMBLY SO AS TO NOT DISRUPT SERVICE TO THE EXISTING BUILDING. IF SERVICE IS REQUIRED TO BE TEMPORARILY SUSPENDED WHILE NEW WORK IS TAKING PLACE. THE CONTRACTOR SHALL COORDINATE ANY AND ALL OUTAGES WITH THE OWNER AND WILL BE REQUIRED TO ONLY PERFORM THIS WORK AT TIMES WHEN SUSPENSION OF THIS SERVICE MINIMALLY AFFECTS THE OWNERS USE OF THE BUILDING. IF THE SERVICE CANNOT BE SUSPENDED DURING OWNER'S OPERATING HOURS, WORK MAY HAVE TO BE PERFORMED AFTER HOURS, OR ON WEEKENDS.
- SATELLITE INSTALLATION:** SEE DETAILS FOR SATELLITE MOUNTING UNIT.
- "A" METAL PANEL REPLACEMENT:** METAL WALL PANEL "E" - REMOVE AND REPLACE DAMAGED/MISSING METAL WALL PANEL AS SPECIFIED. SEE BUILDING ELEVATIONS.
- SIGNAGE INSTALLATION:** INSTALL MISSING LETTERING TO MATCH EXISTING.
- ROOF ACCESSORY REPLACEMENT:** REPLACE DAMAGED ROOF ACCESSORIES. MATCH EXISTING TYPE, MATERIAL, AND STYLE.
- DOWNSPOUT AND GUTTER CLEANING:** DOWNSPOUT/COLLECTOR LOCATIONS. SEE ELEVATIONS. CONTRACTOR IS TO REMOVE ALL DEBRIS FROM GUTTERS AND DOWN SPOUTS.
- SATELLITE REMOVAL:** REMOVE ALL SATELLITE COMPONENTS. THESE ARE NO LONGER IN USE.
- COPING:** SEE ROOFING SHEETS FOR COPING, OVERHANG & ROOFING SCOPES - TYPE.
- TEMPORARY CHAIN LINK FENCING** - PROVIDE 6' TEMPORARY CHAIN LINK FENCING TO PROTECT STUDENT TRAFFIC DURING CONSTRUCTION. PROVIDE ACCESS TO THE GREATEST EXTENT POSSIBLE. COORDINATE WITH PHASING AND SCHOOL PRINCIPAL.
- WIND TURBINE REPLACEMENT:** REMOVE AND REPLACE WIND TURBINE TO MATCH EXISTING.
- PAINTING EXTERIOR:** CLEAN, PREP & RE-PAINT WALLS AND ARTWORK TO COVER SCUFFS AND DAMAGE FROM STORM DEBRIS. COLOR TO MATCH EXISTING AS APPROVED BY ARCHITECT.
- GLASS REPLACEMENT:** REMOVE AND REPLACE DAMAGED GLASS (OR PLYWOOD WHERE APPLICABLE) TO MATCH EXISTING. PROVIDE CAULKING AND GASKETING.
- STUCCO SOFFIT REPLACEMENT:** SOFFIT REMOVED BY OTHERS (HAZARDOUS MATERIAL). COORDINATE AND INSTALL NEW STUCCO SOFFIT.
- COORDINATE REMOVAL OF AGGREGATE PANELS (HAZARDOUS MATERIAL)** WITH ABATEMENT SCOPE AND ABATEMENT CONTRACTOR. COORDINATE AND INSTALL NEW GFRC FACADE PANELS AS SPECIFIED. REMOVE AND REPLACE DAMAGED WALL FRAMING - SEE STRUCTURAL AND WALL SECTIONS. SALVAGE AND REINSTALL MEP COMPONENTS AT SAME LOCATIONS - COORDINATE WITH MEP.
- DOWNSPOUT AND GUTTER REPLACEMENT:** REMOVE REMAINING ATTACHMENTS AND COMPONENTS OF DOWNSPOUT, GUTTER AND CONDUCTOR HEADS AND INSTALL NEW TO MATCH EXISTING COLOR, DIMENSION, GAUGE, AND MATERIAL. GROUT HOLES AT OLD STRAPS PRIOR TO NEW INSTALLATION & ATTACH AT INTERVALS EQUAL TO EXISTING SPACING. SALVAGE AND PREP REMAINING COMPONENTS FOR NEW INSTALLATION. CONTRACTOR IS TO REMOVE ALL DEBRIS FROM GUTTERS AND DOWN SPOUTS.
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- PLASTER SOFFIT REPLACEMENT:** REMOVE REMAINING VINYL SOFFIT AND REPLACE TO MATCH EXISTING - PRESERVE LIGHT & REINSTALL AS NECESSARY.

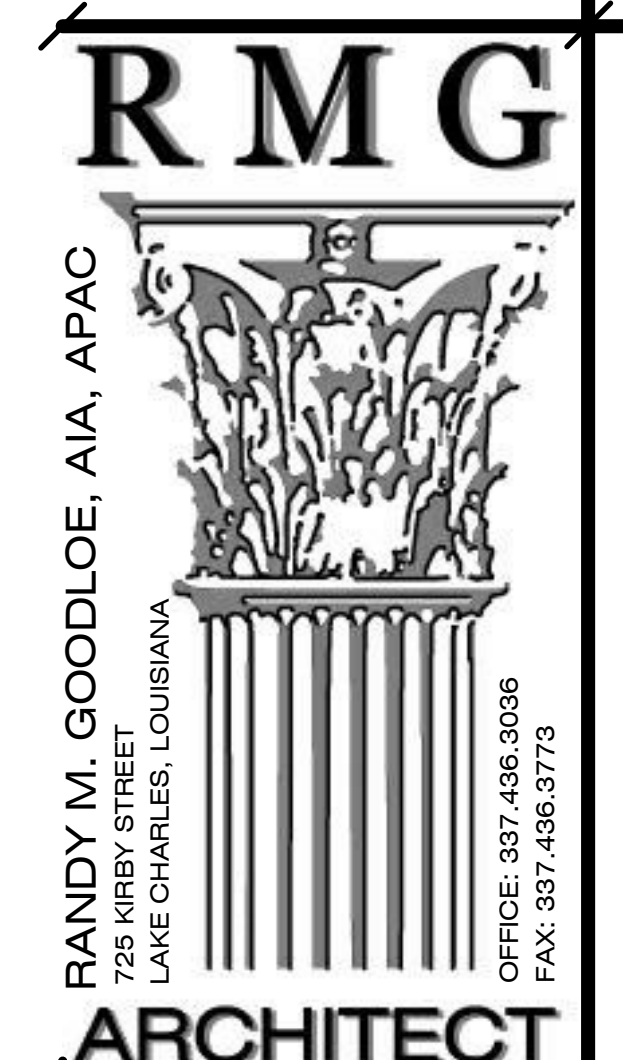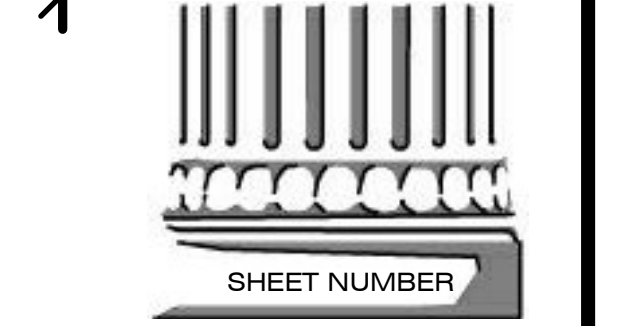


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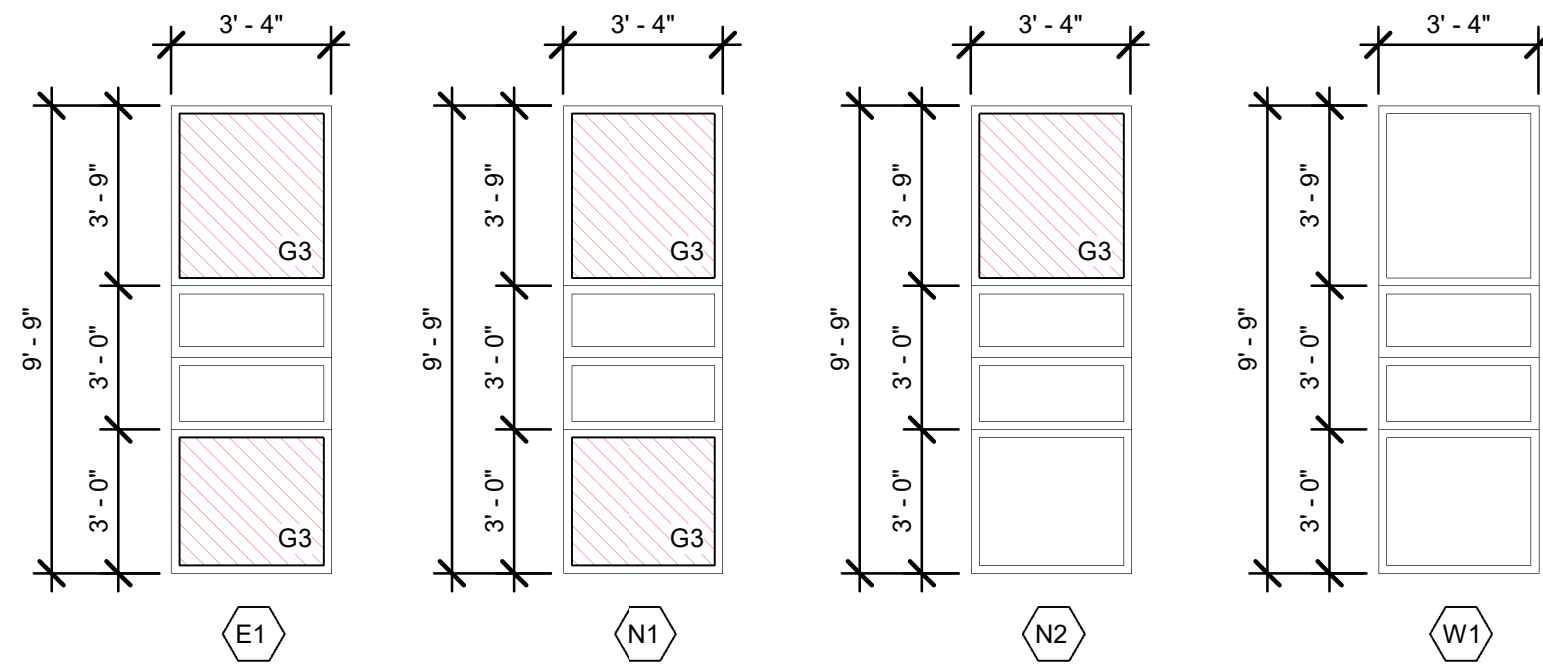
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SHEET NUMBER
(L)A0.1
BLOG L ROOF



*SIZES ARE APPROXIMATE. VERIFY IN FIELD.

GLAZING SCHEDULE

- G1 - CLEAR, INSULATED GLASS AS SPECIFIED.
- G2 - SPANDRAL GLASS AS SPECIFIED.
- G3 - TINTED, INSULATED GLASS AS SPECIFIED.
- G4 - ALUMINUM WINDOW PANEL AS SPECIFIED.

*GLAZING OF NEW STOREFRONT UNITS ARE TO BE LARGE MISSLE IMPACT AS SPECIFIED. REPLACEMENT GLAZING IS TO MATCH EXISTING.



MARK	SIZE	FRAME		COMMENTS
		TYPE	MATERIAL	
E1	SEE ELEVATION	STOREFRONT	EXISTING	REPLACE DAMAGED GLASS AS INDICATED
N1	SEE ELEVATION	STOREFRONT	EXISTING	REPLACE DAMAGED GLASS AS INDICATED
N2	SEE ELEVATION	STOREFRONT	EXISTING	REPLACE DAMAGED GLASS AS INDICATED
W1	SEE ELEVATION	STOREFRONT	EXISTING	REPLACE DAMAGED GLASS AS INDICATED

KEYNOTES TO SHEET

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19. **COPING:** SEE ROOFING SHEETS FOR COPING, OVERHANG & ROOFING SCOPES -TYP.
20. **EXTERIOR CLEANING:** PRESSURE WASH WALLS TO REMOVE SCUFFS FROM STORM DEBRIS.
21. **WIND TURBINE REPLACEMENT:** REMOVE AND REPLACE WIND TURBINE TO MATCH EXISTING.
22. **PAINTING EXTERIOR:** CLEAN, PREP & RE-PAINT WALLS AND ARTWORK TO COVER SCUFFS AND DAMAGE FROM STORM DEBRIS. COLOR TO MATCH EXISTING AS APPROVED BY ARCHITECT.
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26. **DOWNSPOUT AND GUTTER REPLACEMENT:** REMOVE REMAINING ATTACHMENTS AND COMPONENTS OF DOWNSPOUT, GUTTER AND CONDUCTOR HEADS AND INSTALL NEW TO MATCH EXISTING COLOR, DIMENSION, GAUGE, AND MATERIAL. GROU HOLES AT OLD STRAPS PRIOR TO NEW INSTALLATION & ATTACH AT INTERVALS EQUAL TO EXISTING SPACING. SALVAGE AND PREP REMAINING COMPONENTS FOR NEW INSTALLATION. CONTRACTOR IS TO REMOVE ALL DEBRIS FROM GUTTERS AND DOWN SPOUTS.
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28. **PLASTER SOFFIT REPLACEMENT:** REMOVE REMAINING VINYL SOFFIT AND REPLACE TO MATCH EXISTING - PRESERVE LIGHT & REINSTALL AS NECESSARY.

SITE KEYPLAN

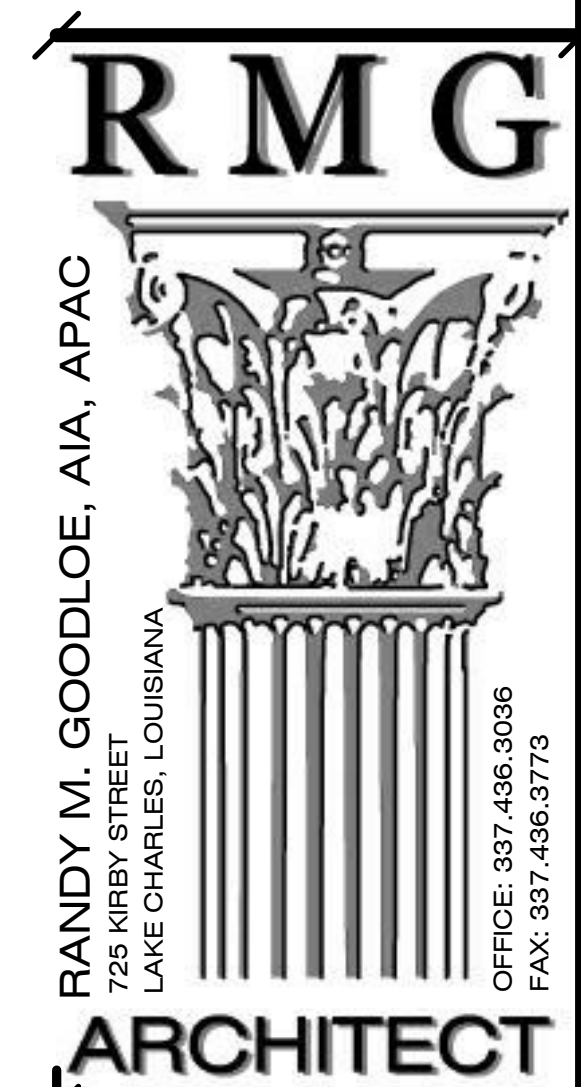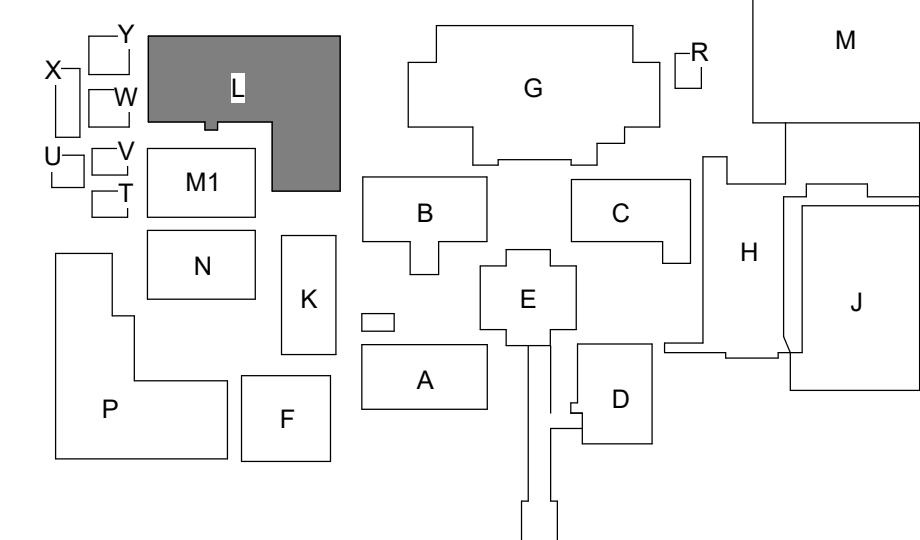N.T.S.



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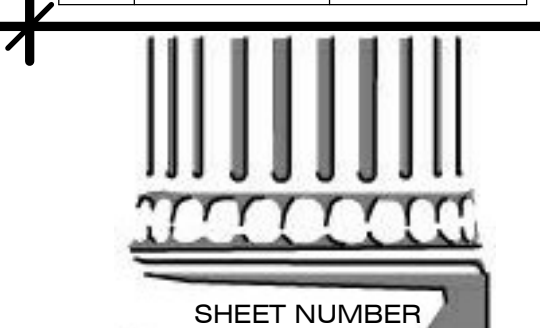
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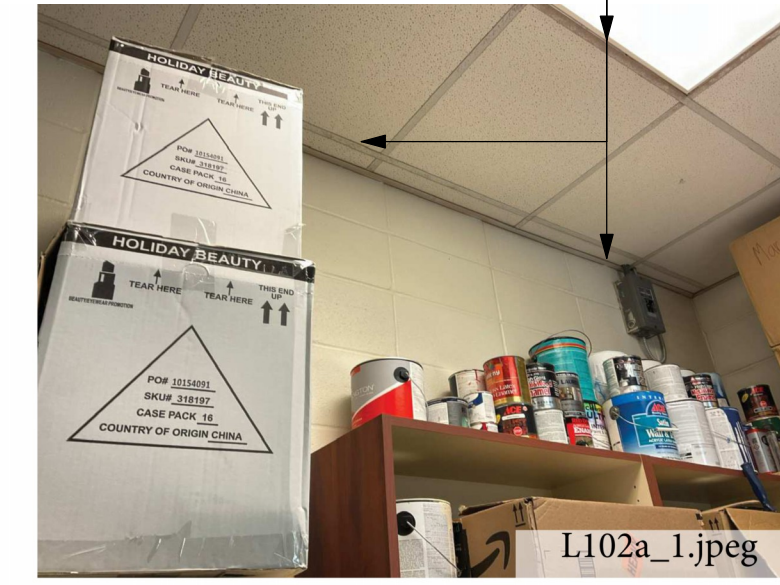
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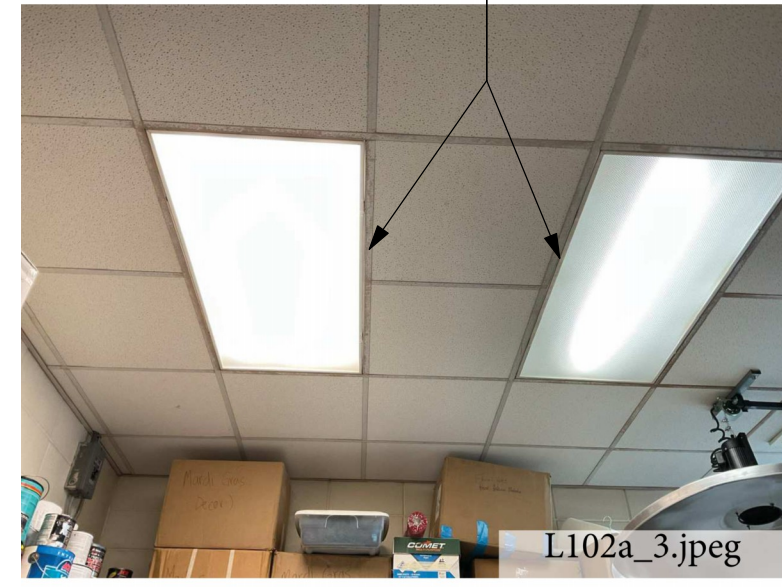
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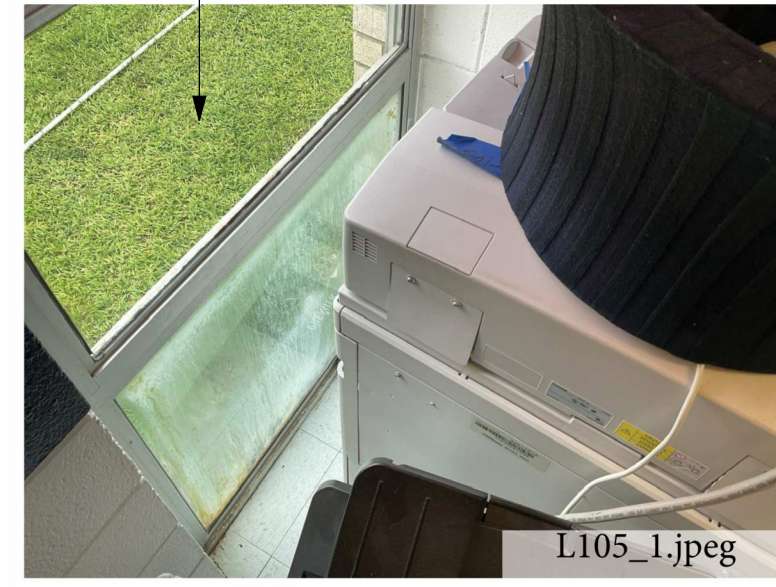
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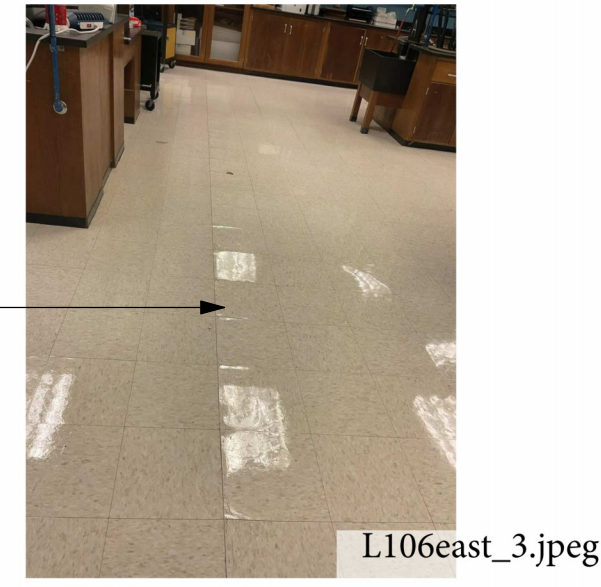
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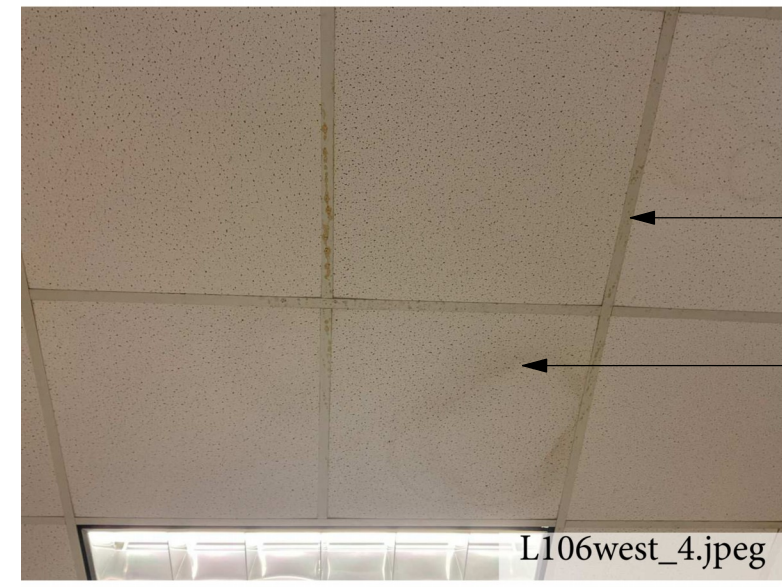
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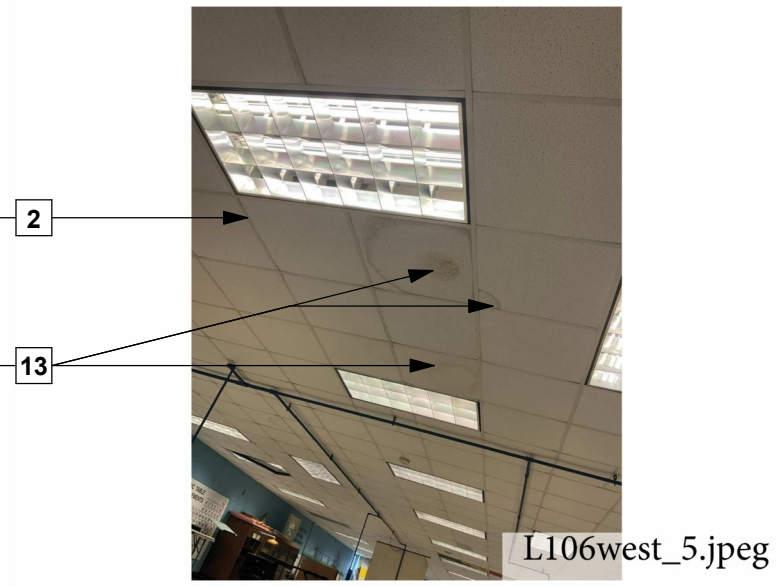
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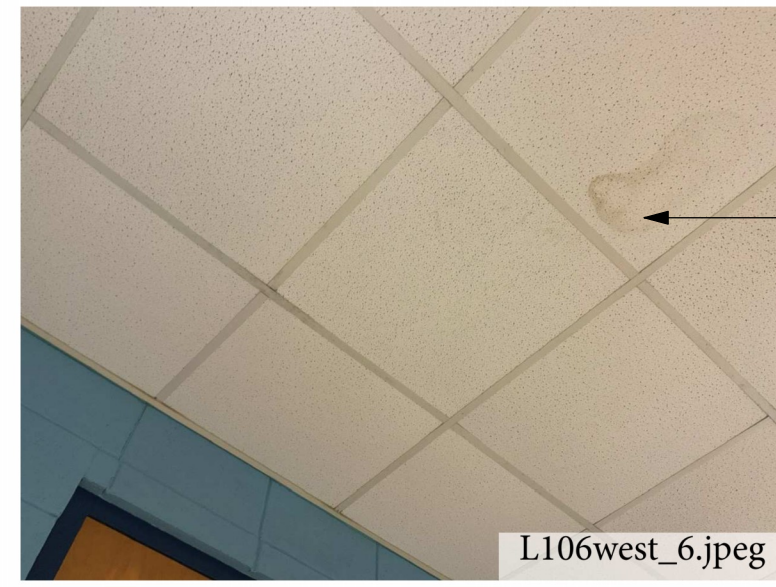
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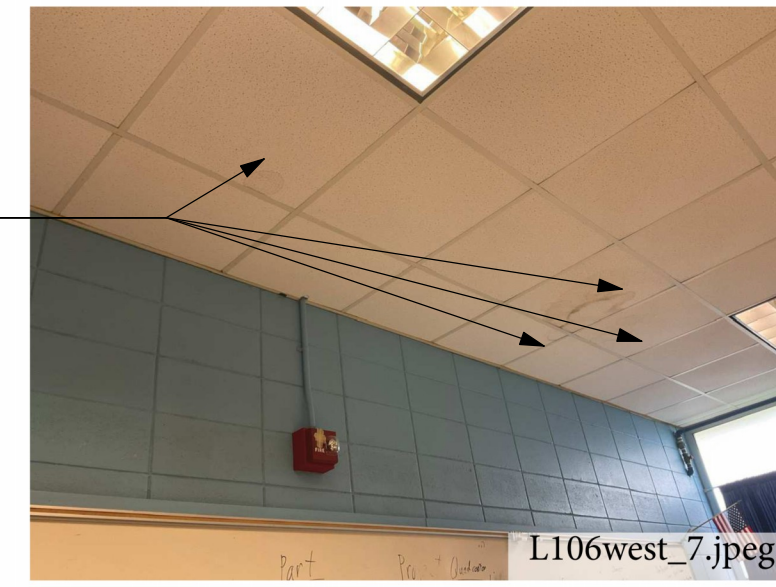
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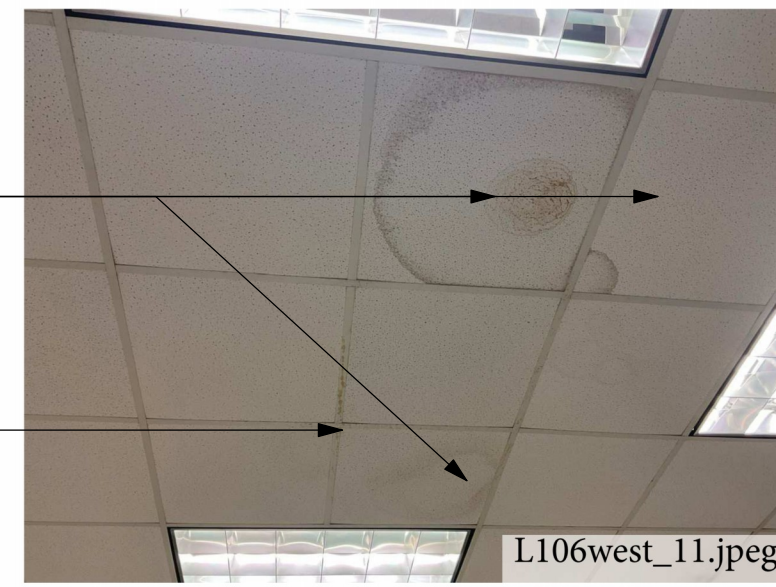
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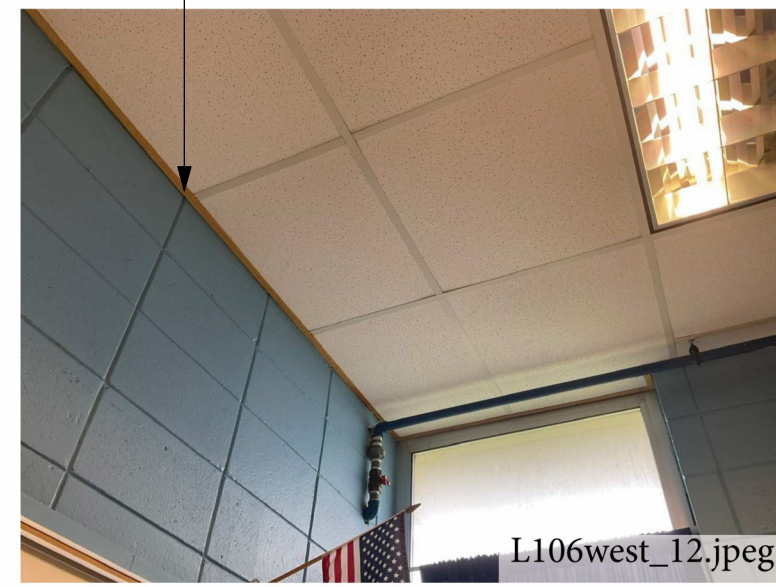
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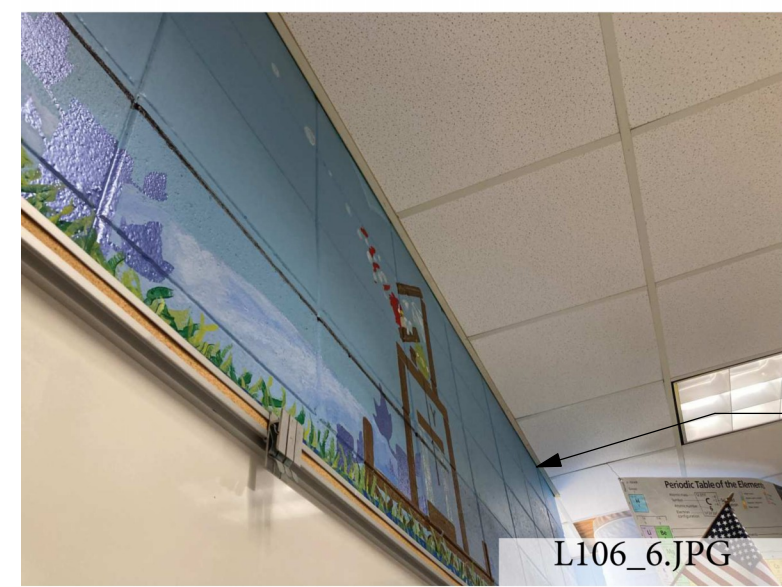
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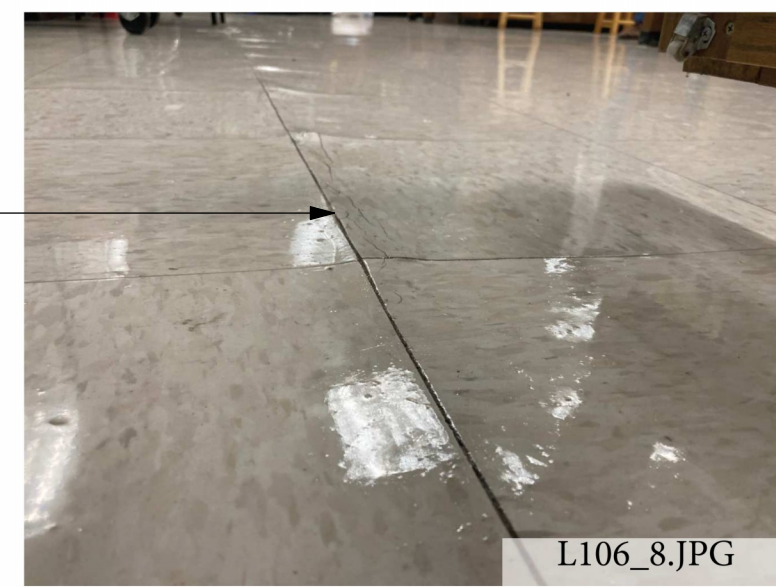
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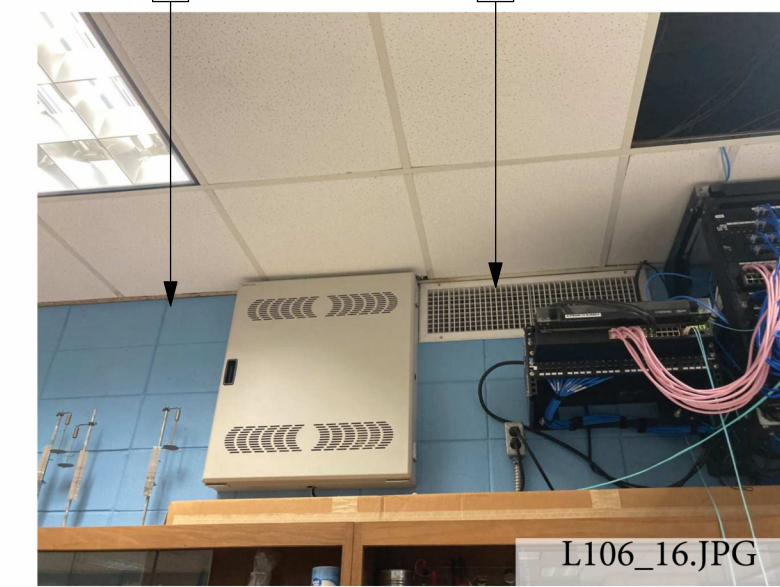
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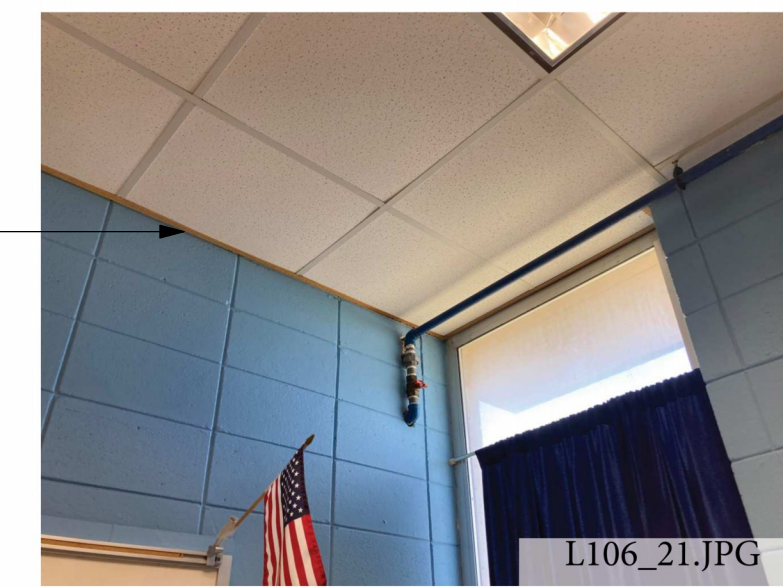
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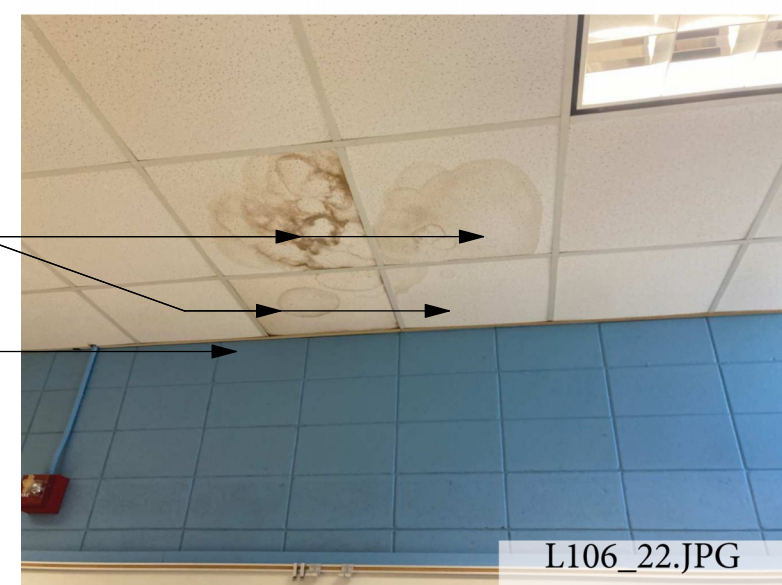
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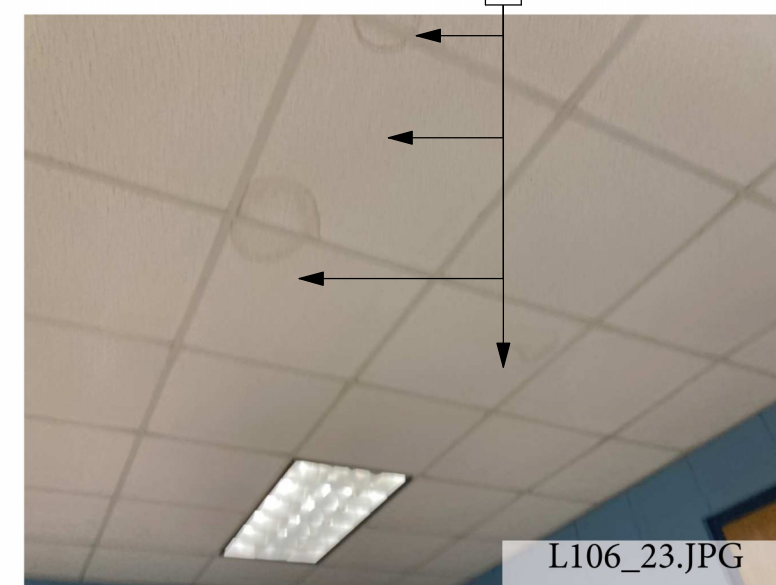
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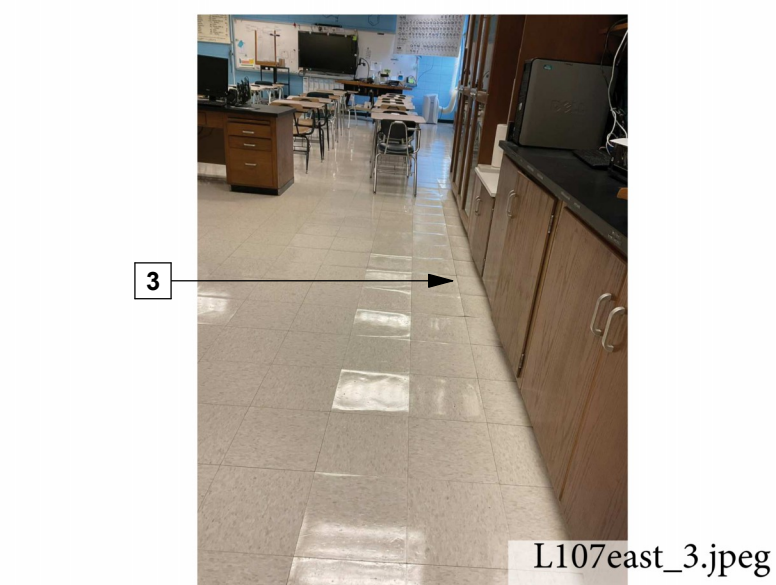
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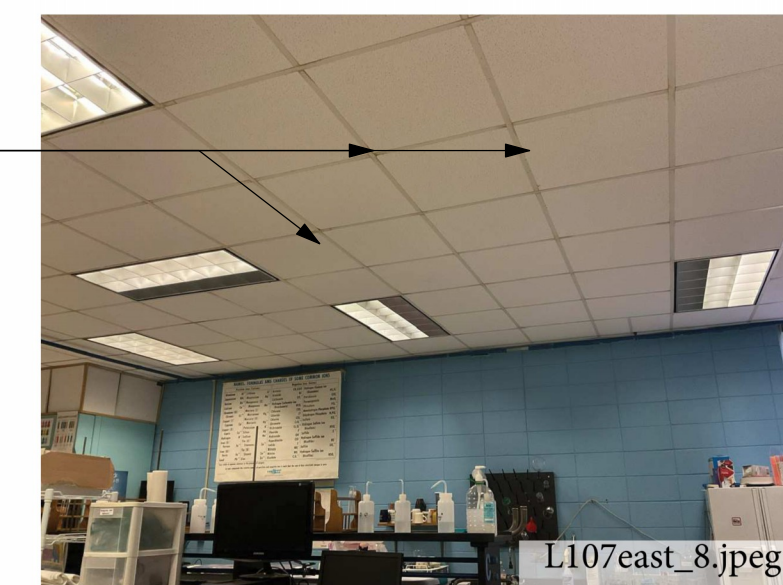
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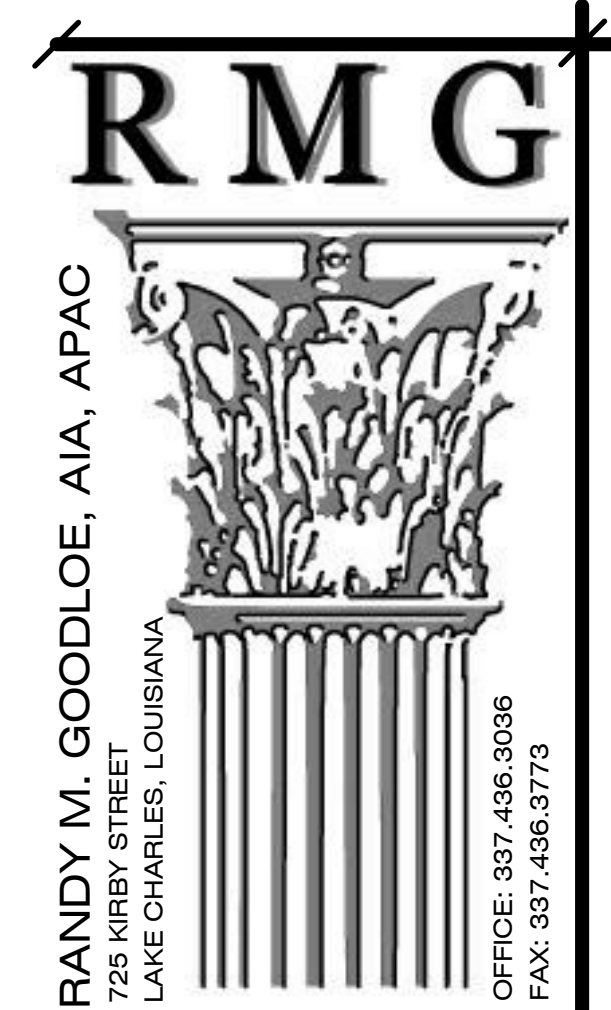
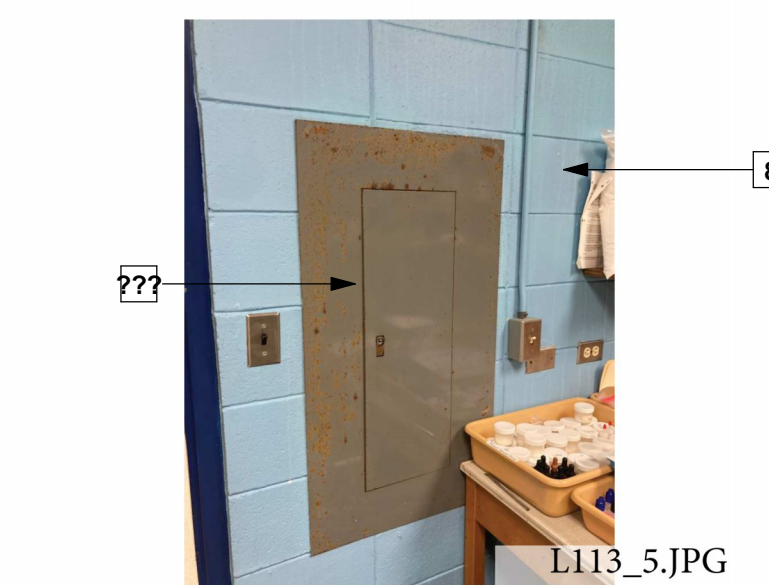
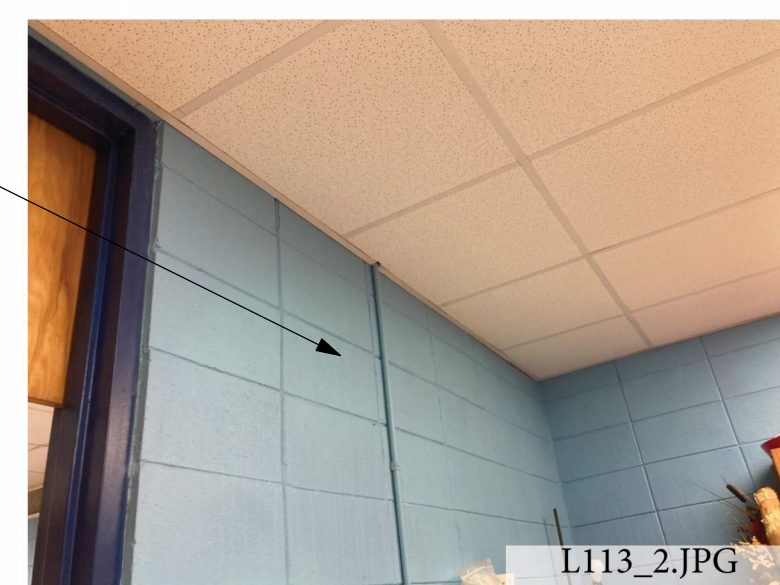
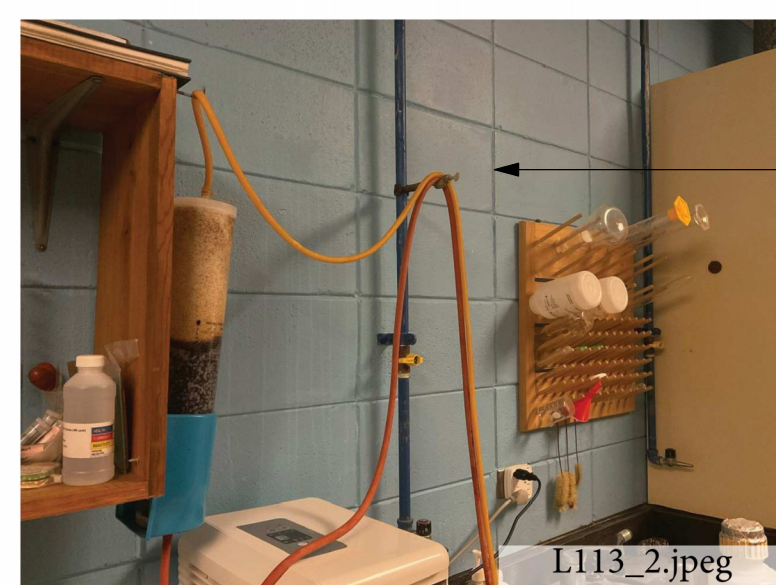
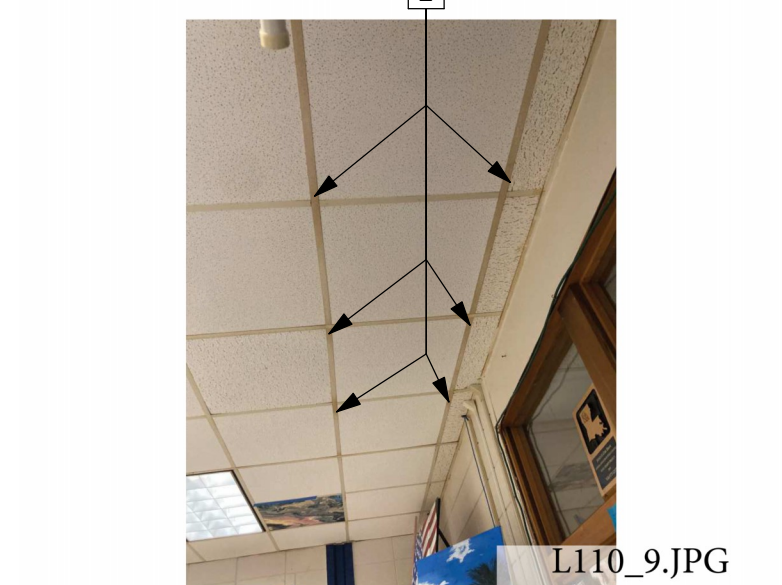
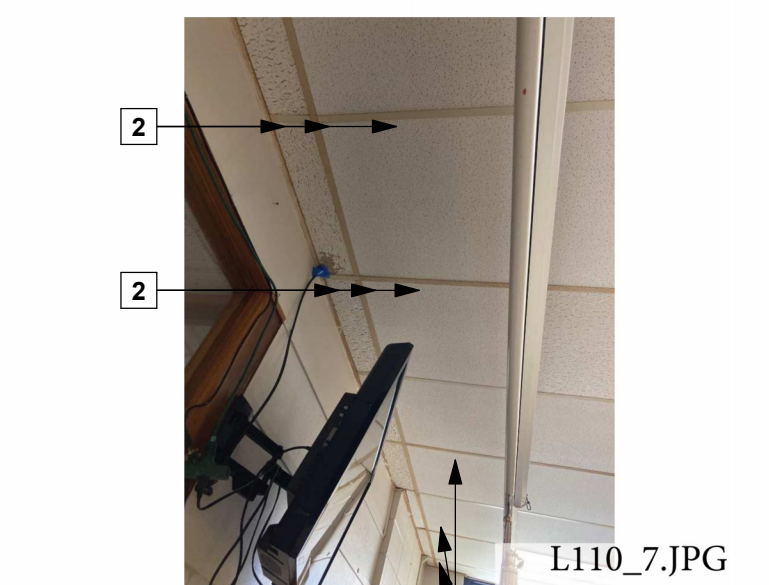
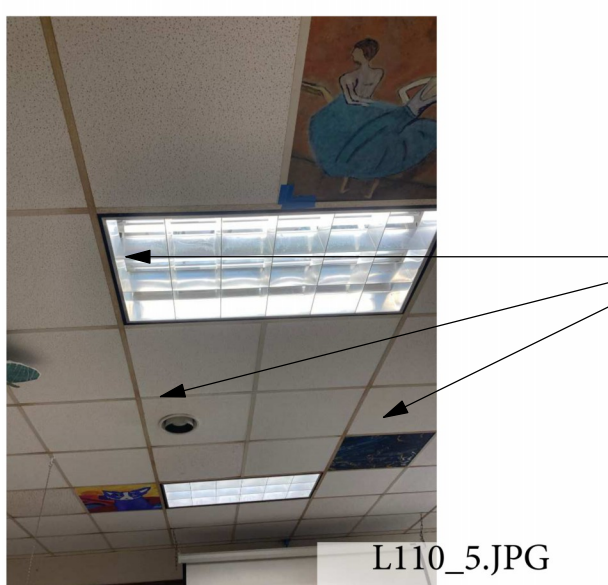
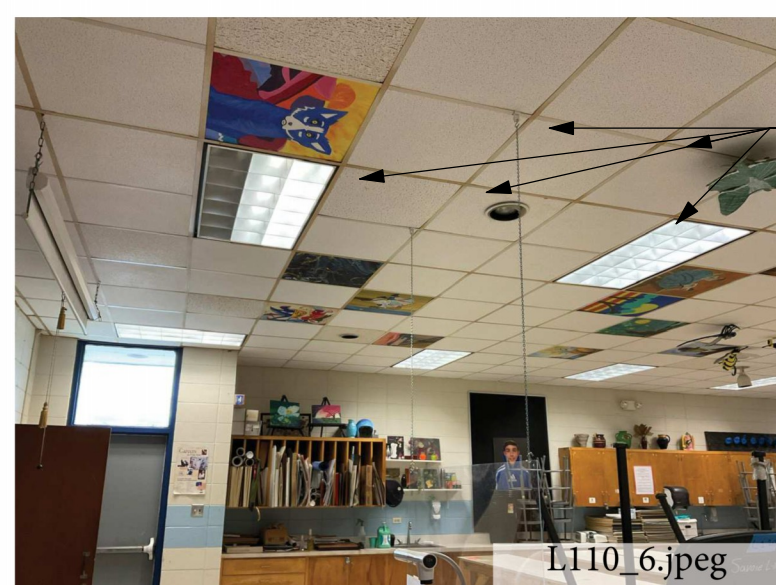
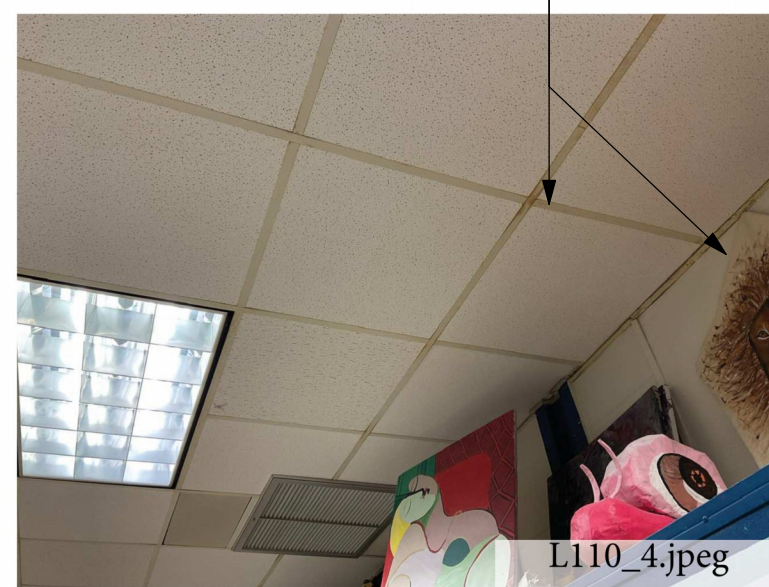
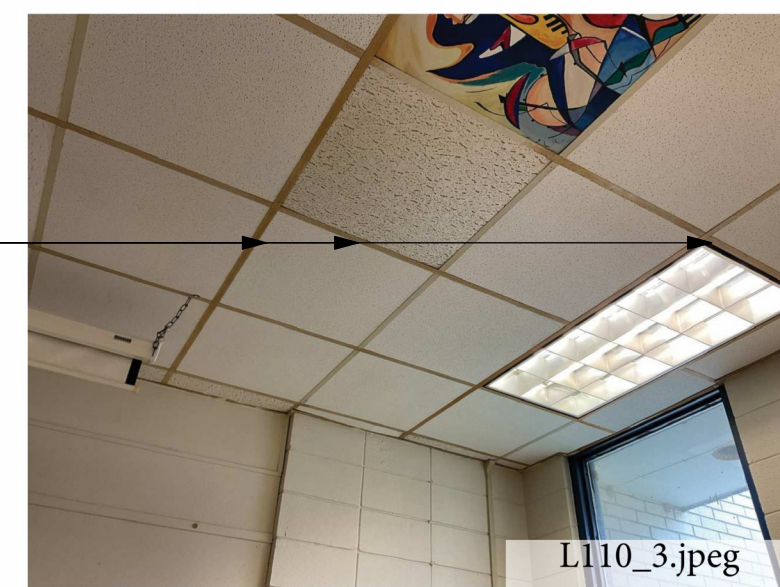
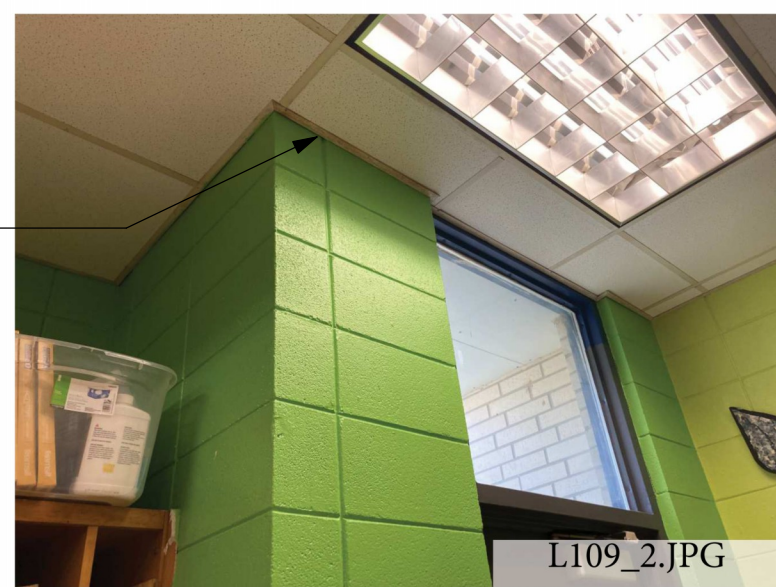
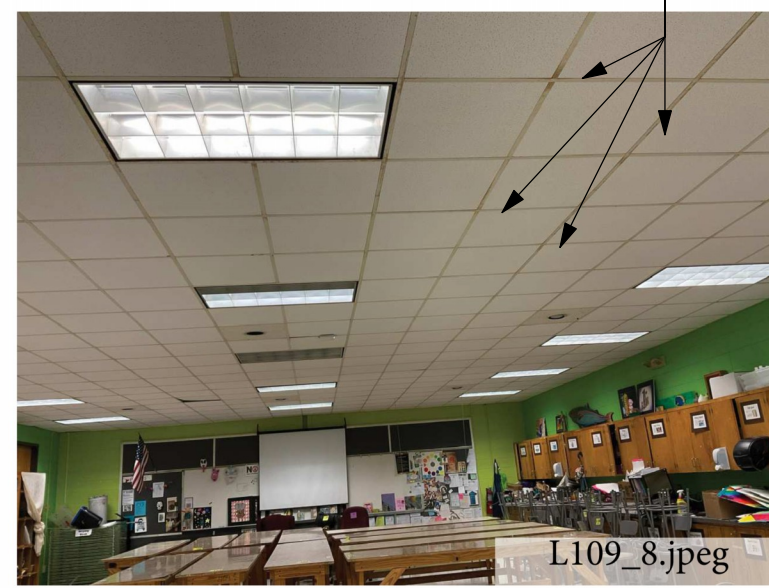
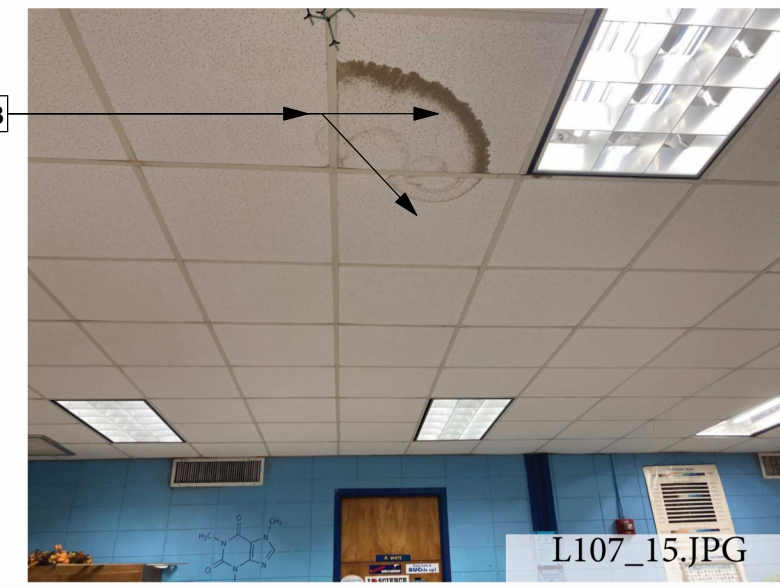
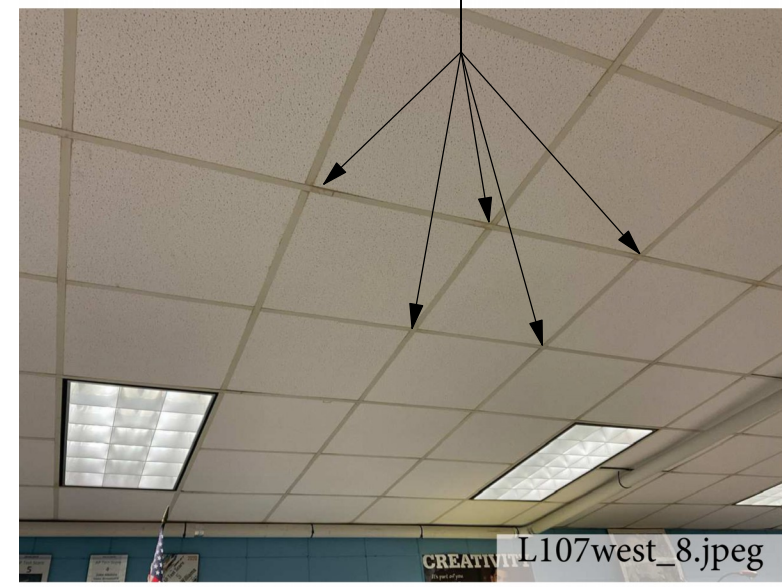
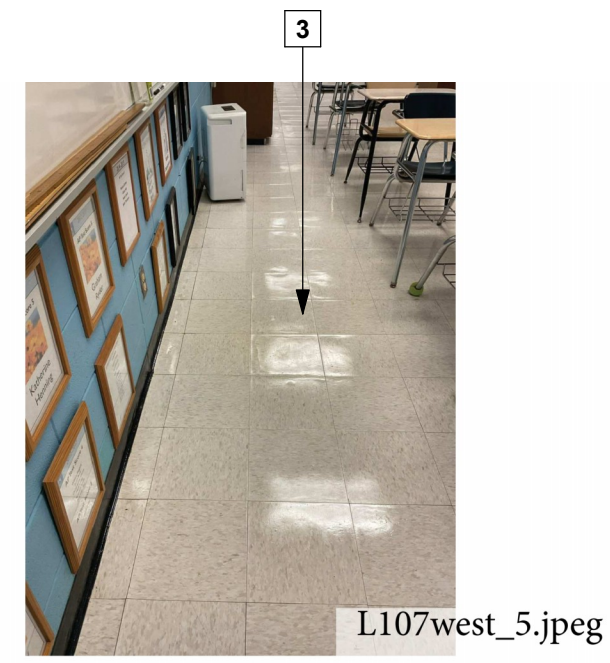
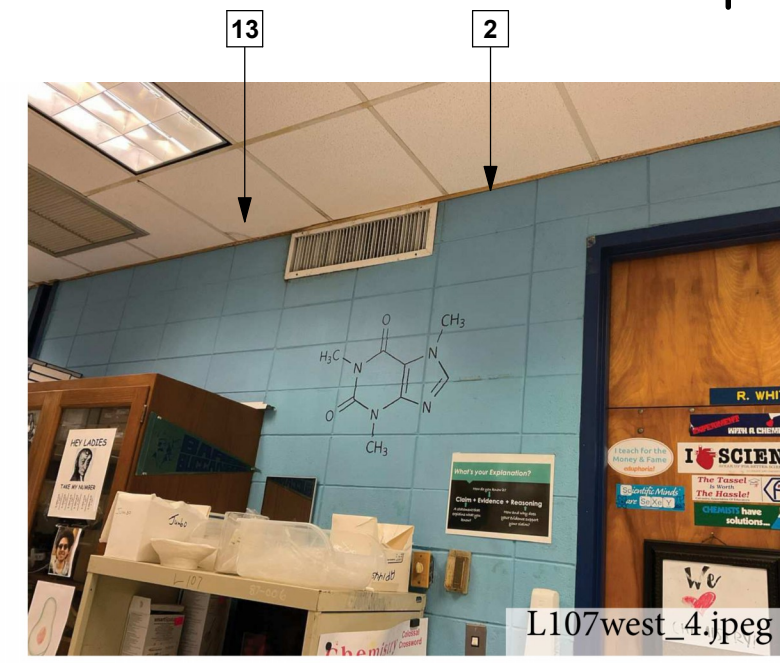
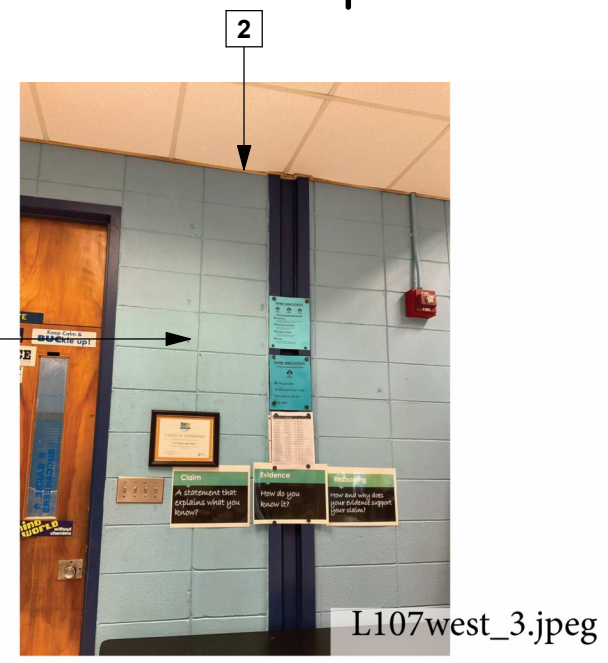
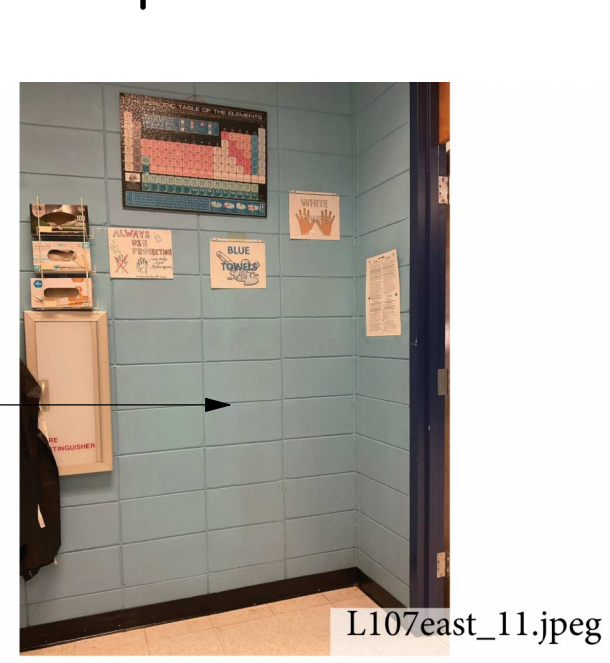
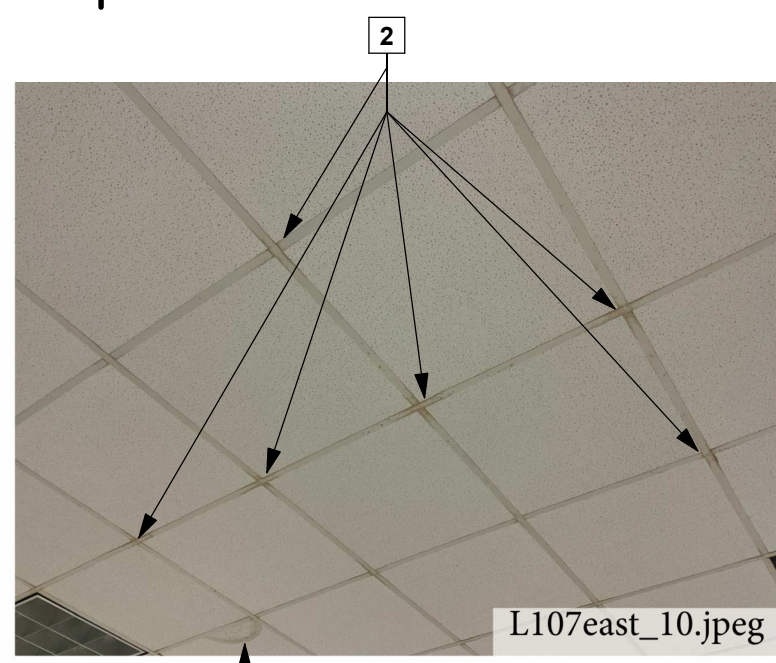
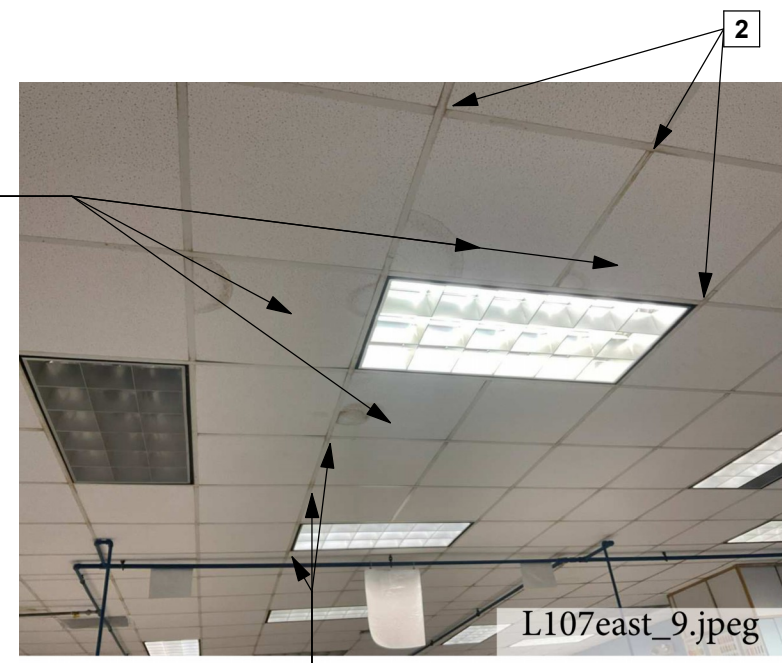
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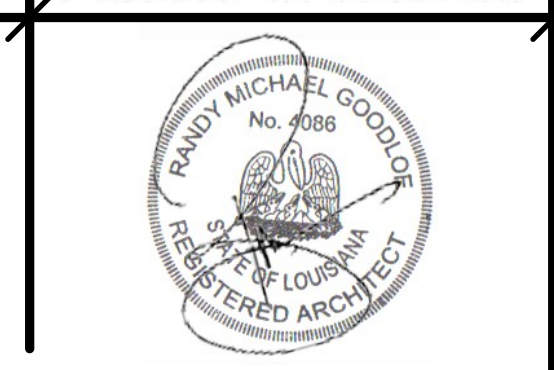
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SHEET NUMBER
(L)A1.2
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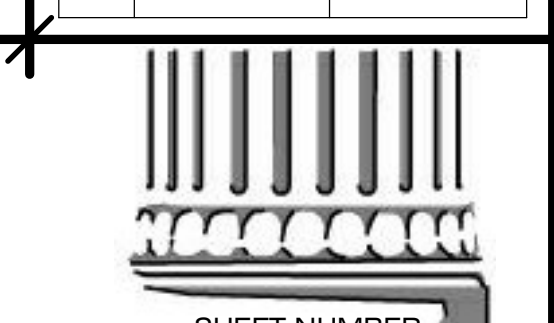
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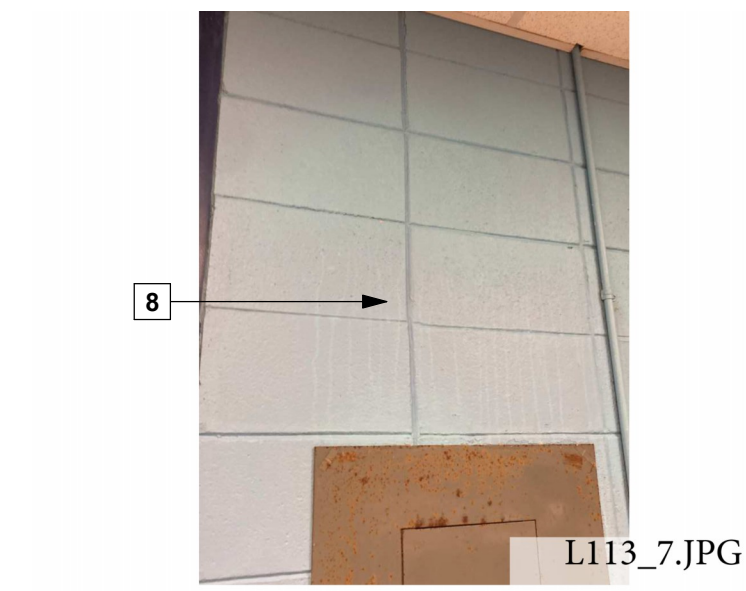
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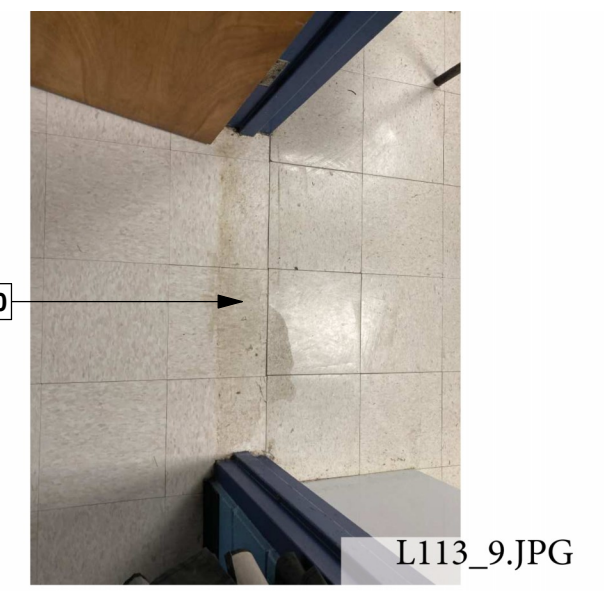


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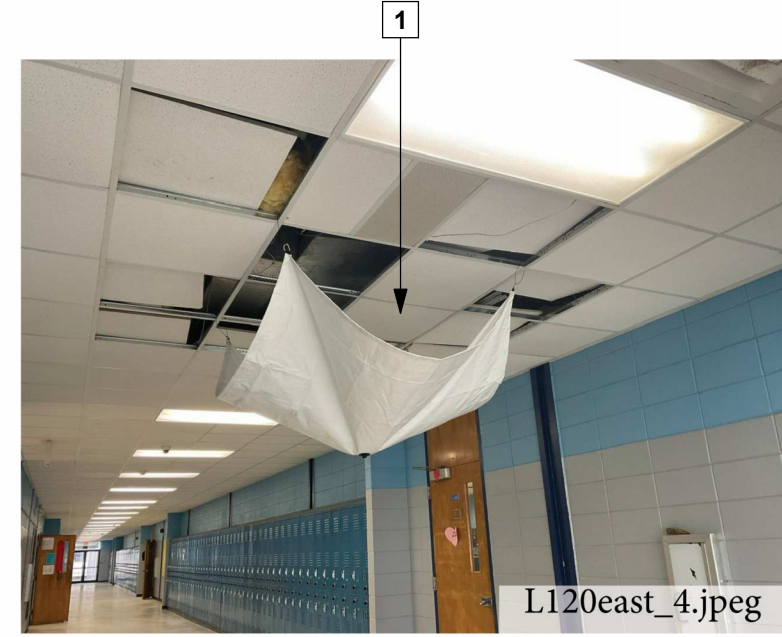
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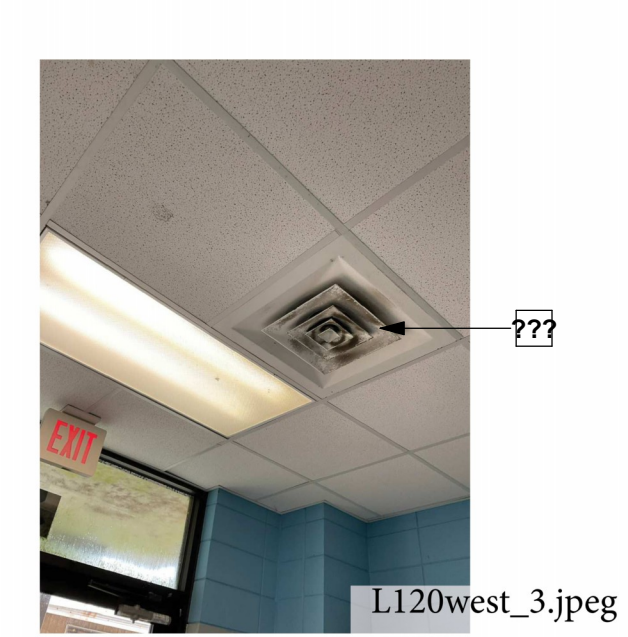
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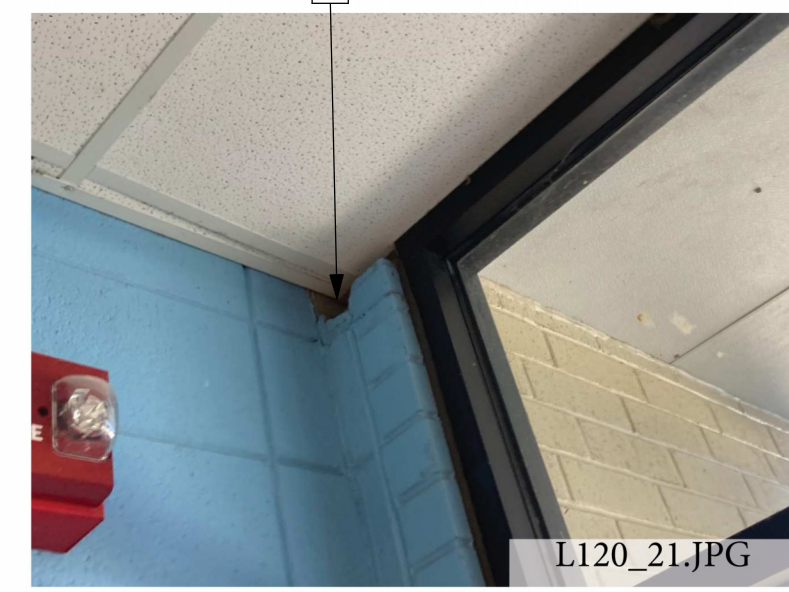
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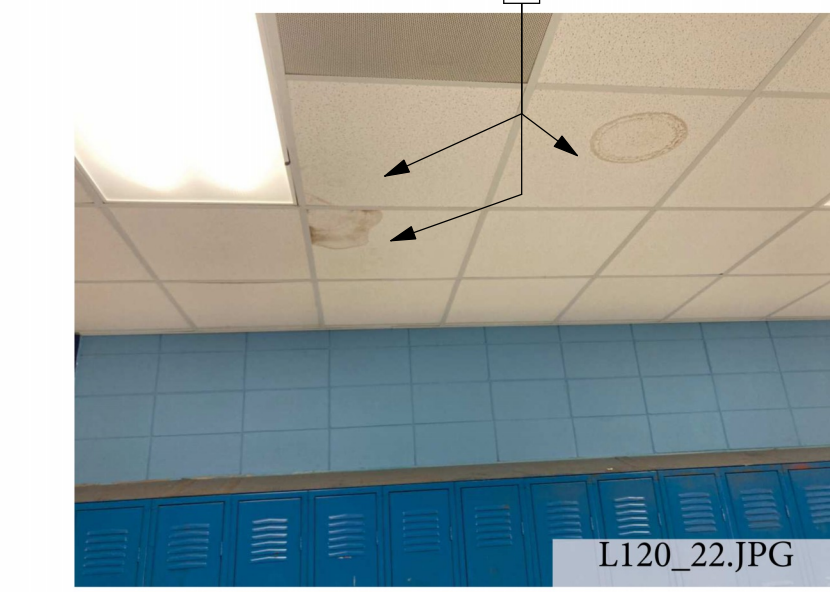
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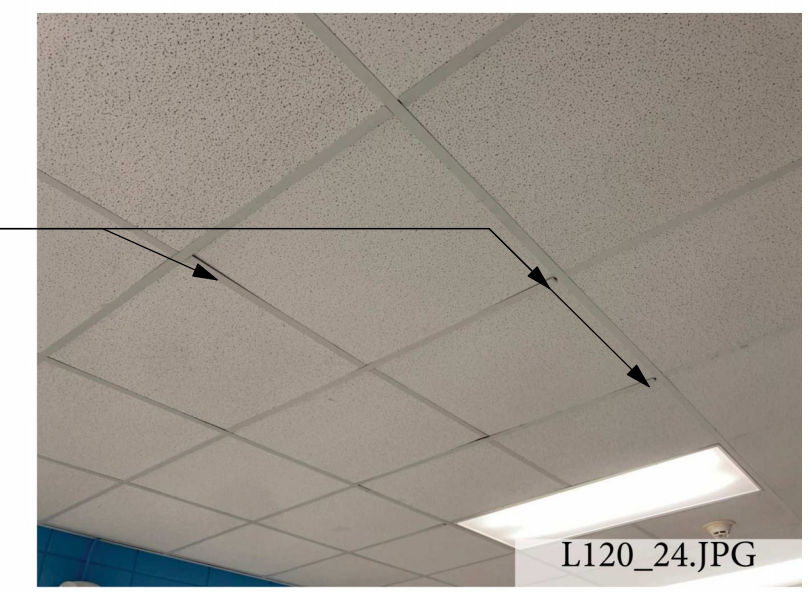
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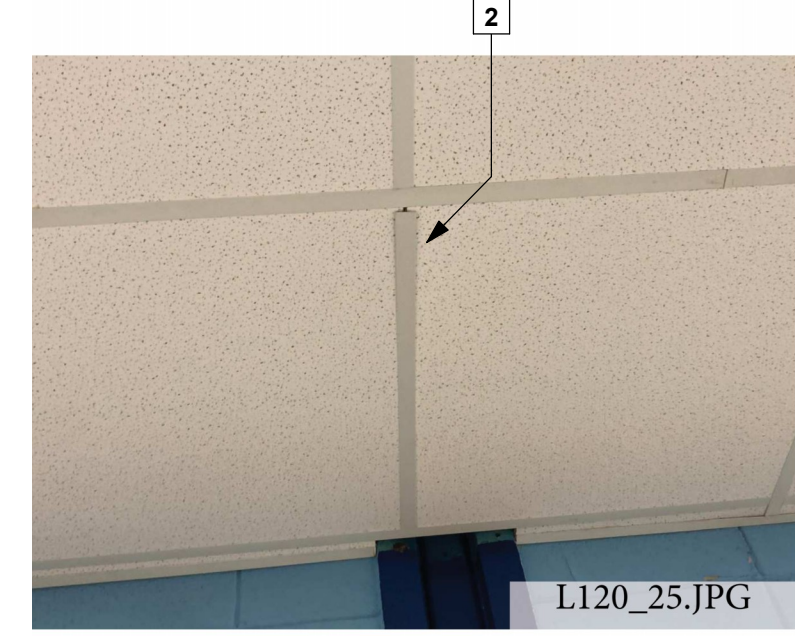
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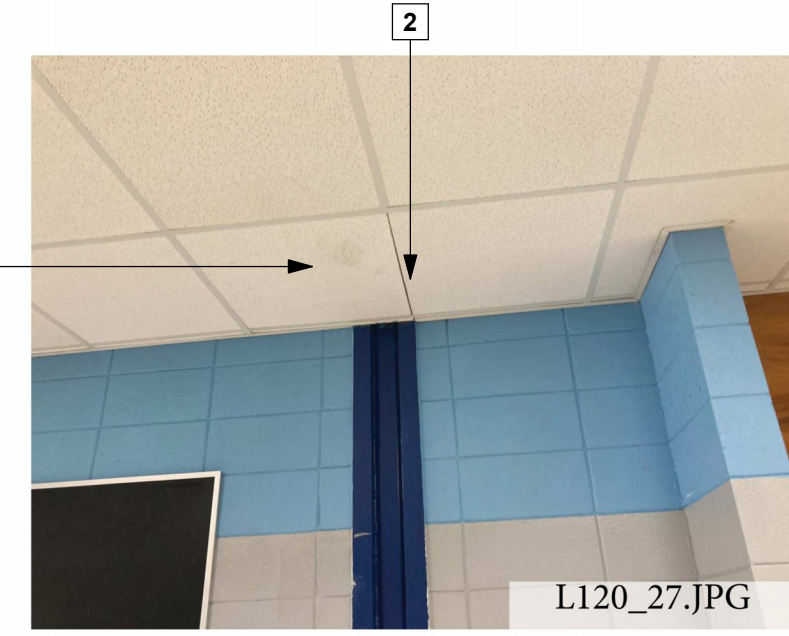
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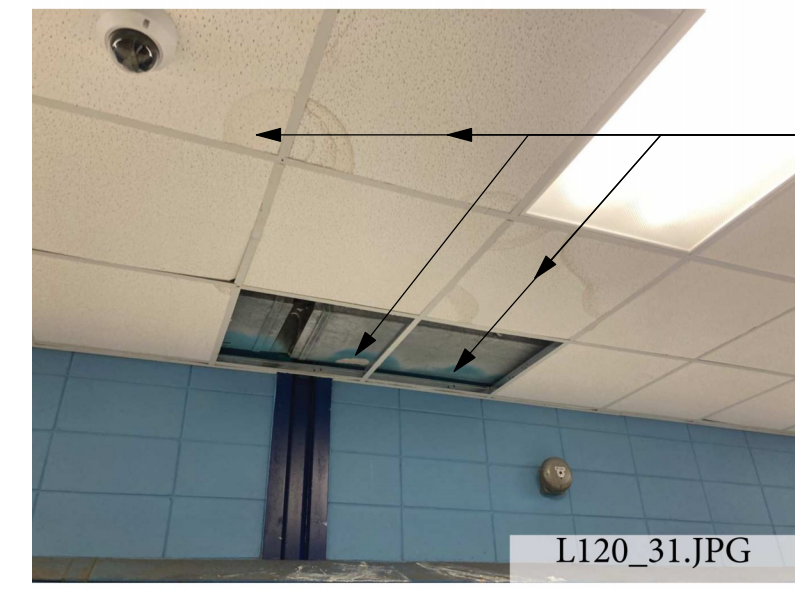
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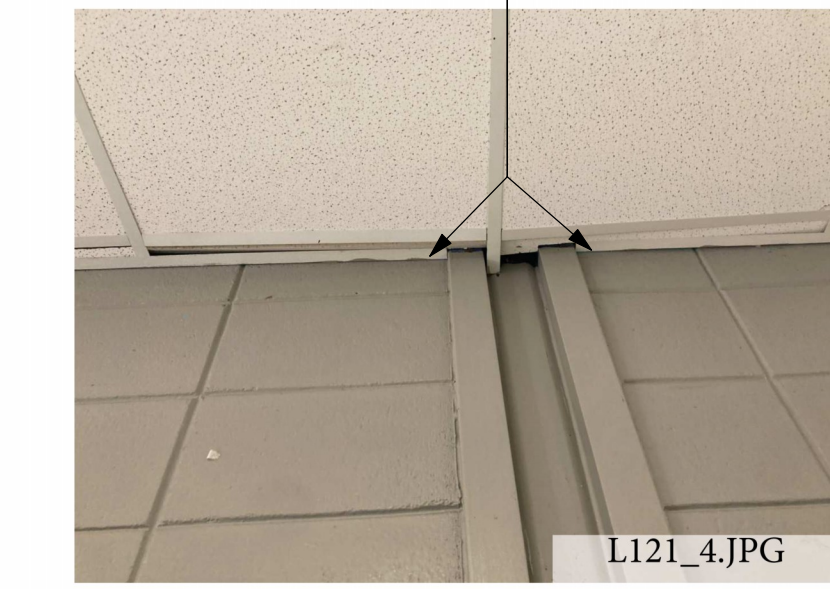
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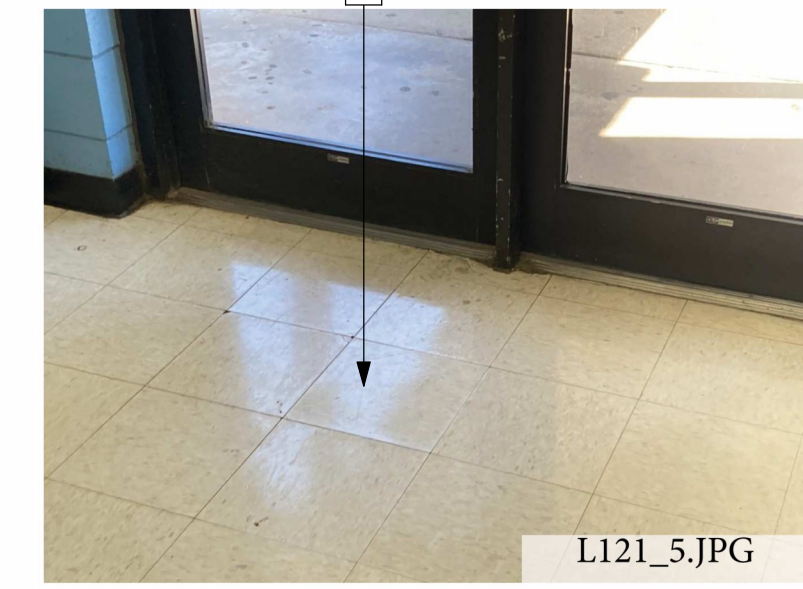
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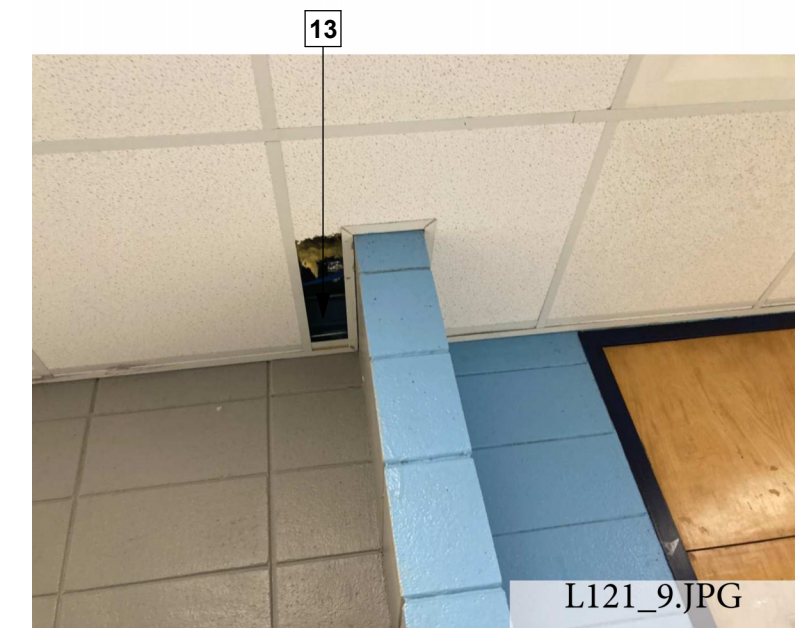
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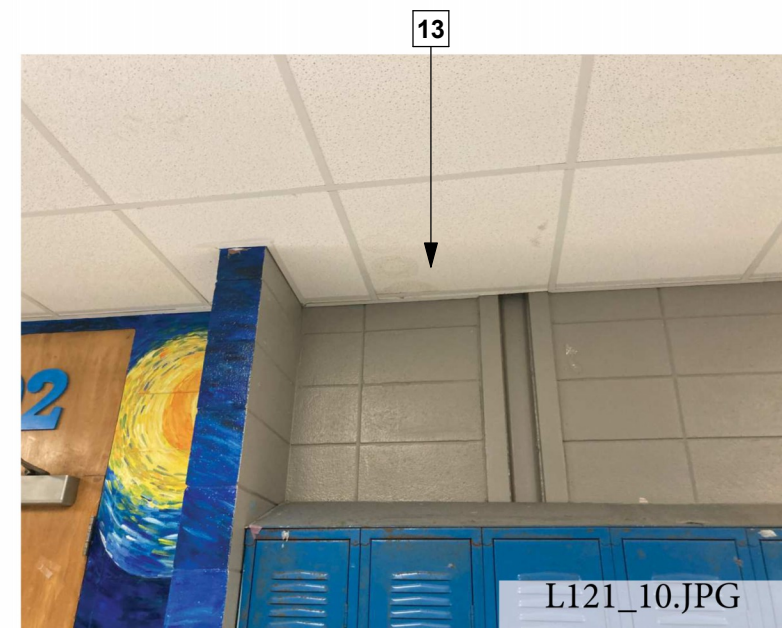
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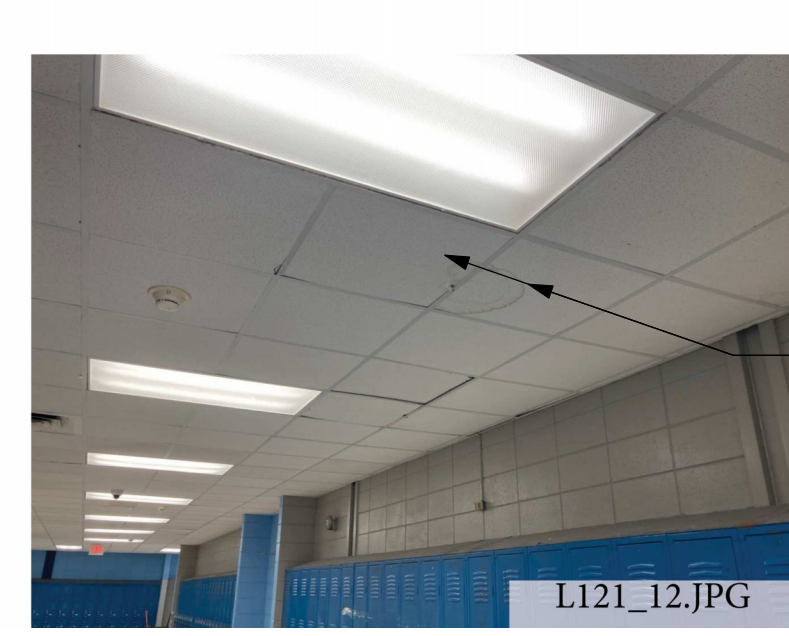
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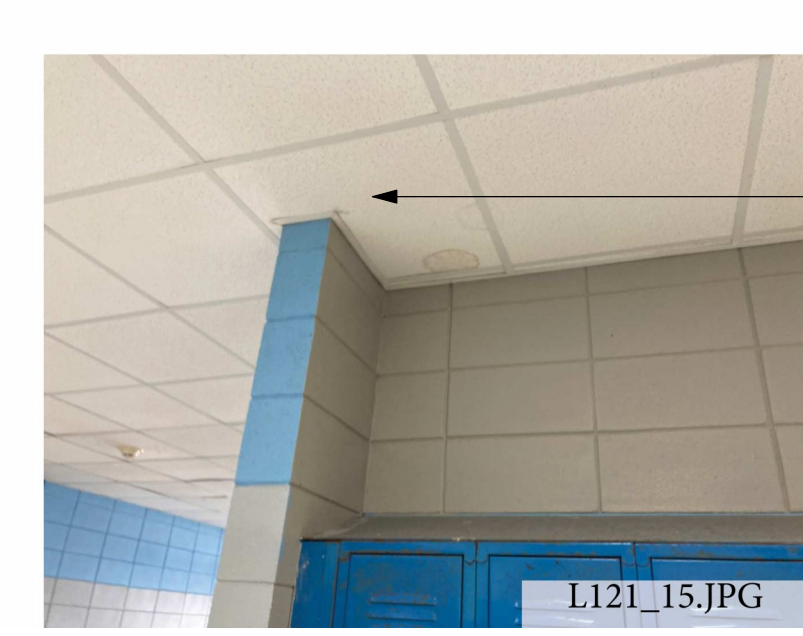
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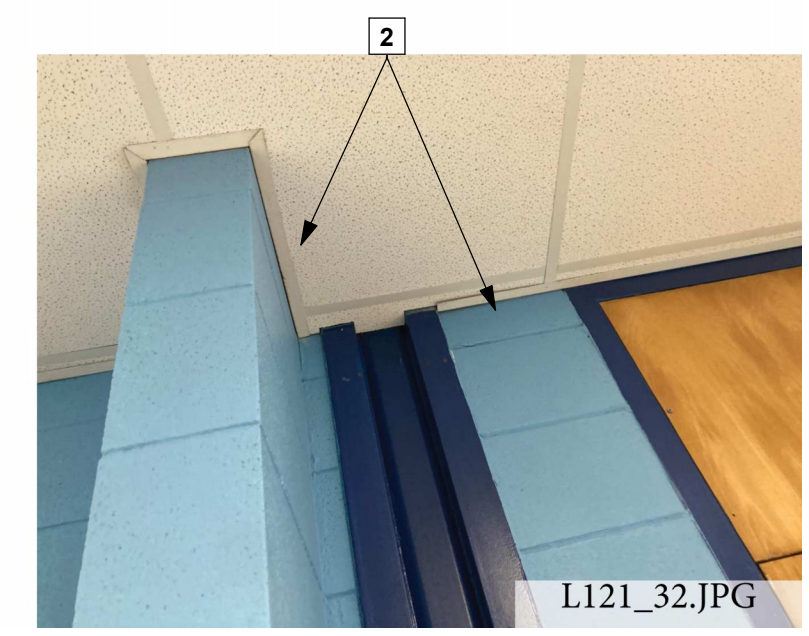
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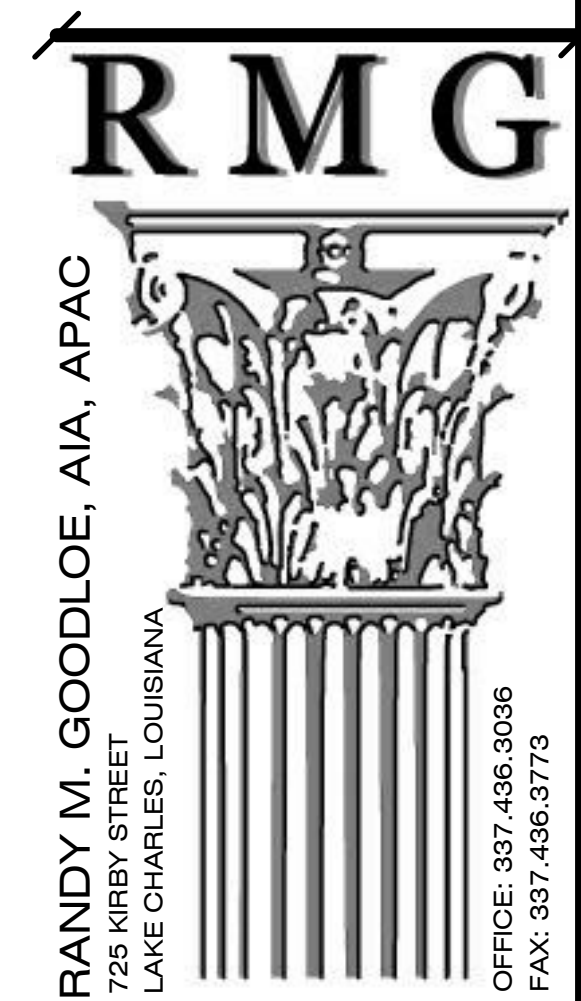
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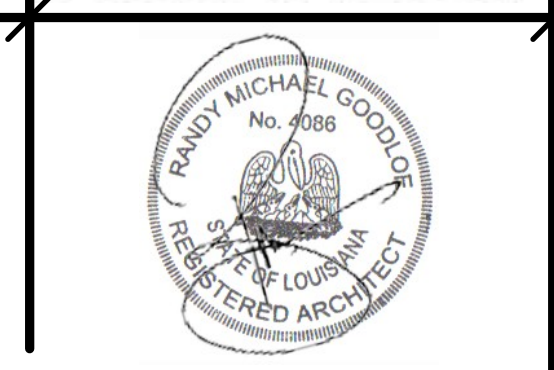


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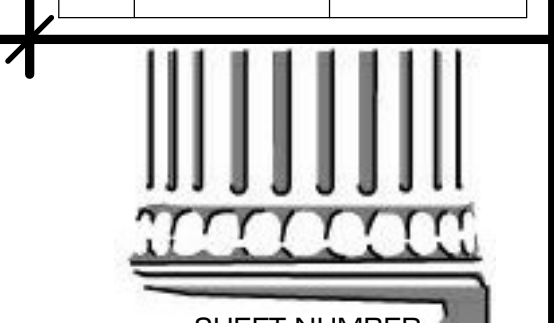
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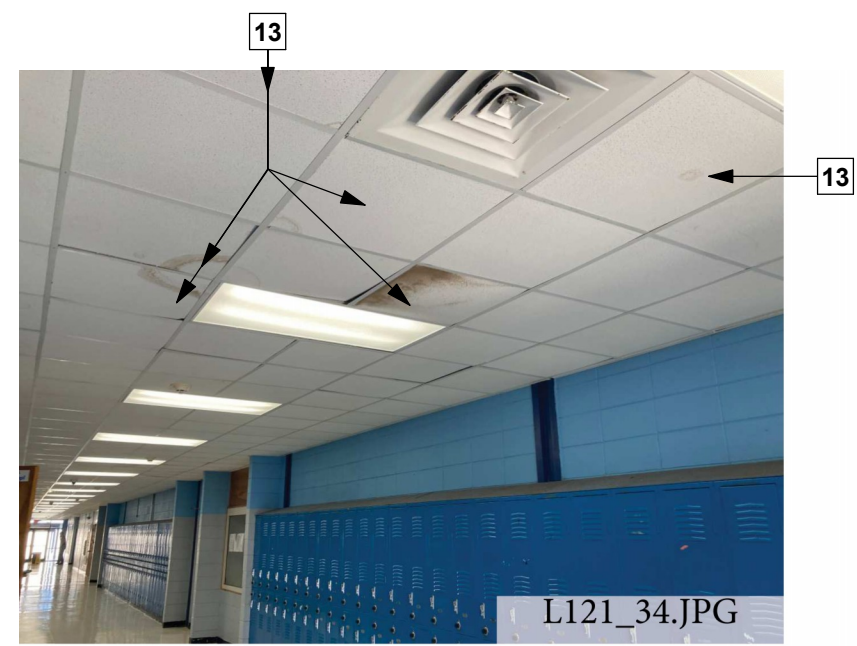
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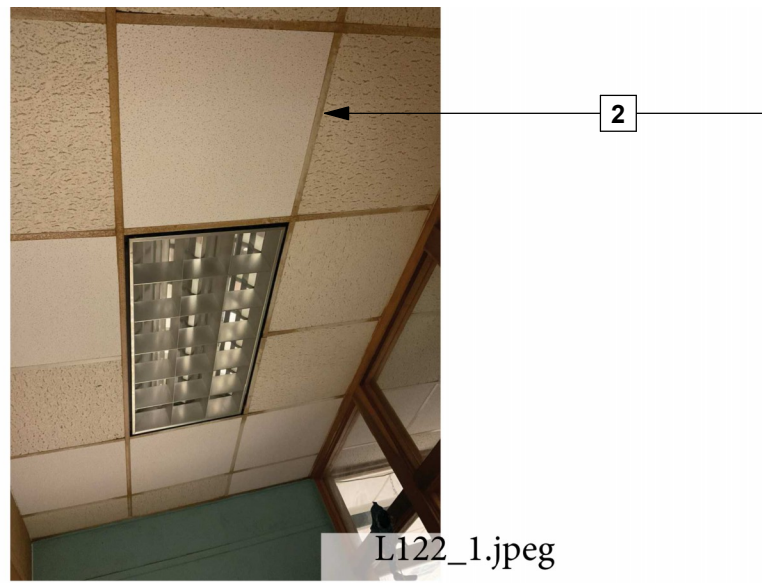
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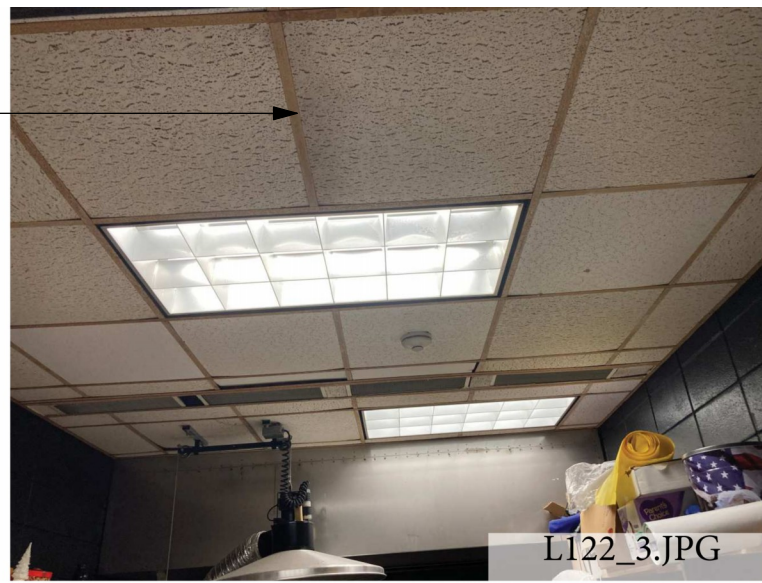
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(L)A1.4
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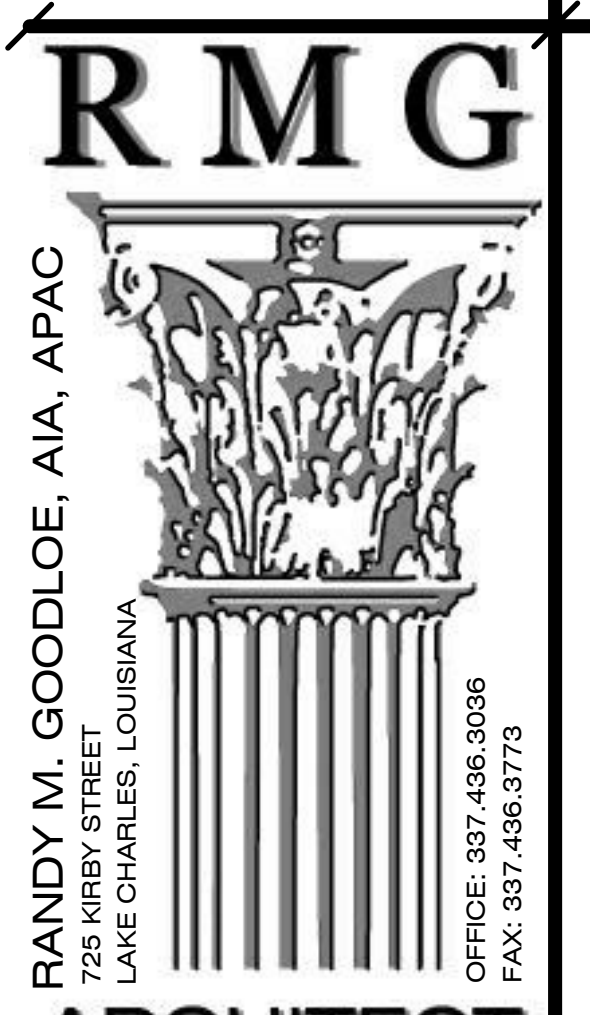
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Lwalkway_1.jpeg



Lwalkway_2.jpeg



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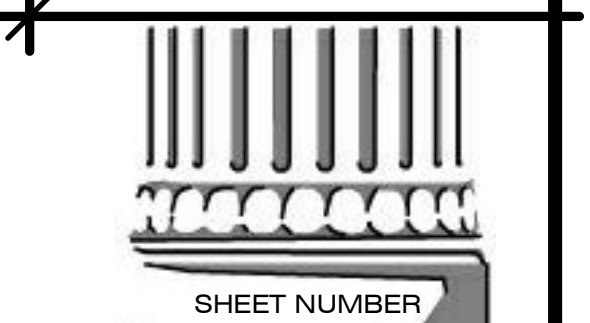
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INTERIOR REPAIR LEGEND - BUILDING M							
ROOM NUMBER	Approx. Area (SF)	Approx. Perimeter (LF)	Floor	Wall	Ceiling	Other	Fire Safety
M101	746.61 SF	110.19 LF	-	-	-	-	-
M102	746.58 SF	110.19 LF	-	-	-	-	-
M103	754.27 SF	110.83 LF	-	-	-	-	-
M104	754.24 SF	110.82 LF	F1	-	C1,C2, C3, C4	-	-
M105	746.58 SF	110.19 LF	-	-	-	-	-
M106	746.55 SF	110.19 LF	-	-	-	-	-
M107	704.99 SF	191.63 LF	-	-	-	-	-

SCHEDULE FLOOR NOTES

- F1 - CLEAN ENTIRE VCT FLOOR, BUFF AND WAX.
- F2 - HATCHED AREA INDICATES VCT FLOORING TO BE REMOVED AND REPLACED TO MATCH EXISTING. SEE UNIT PRICE NO. 3
- F3 - HATCHED AREA INDICATED REPLACE MISSING VCT TO MATCH EXISTING. SEE UNIT PRICE NO. 3
- F4 - REMOVE ALL WALL BASE AND REPLACE TO MATCH EXISTING.

SCHEDULE CEILING NOTES

- C1 - REMOVE AND REPLACE DAMAGED CEILING TILES TO MATCH EXISTING. SEE UNIT PRICE NO. 1
- C2 - REMOVE AND REPLACE DAMAGED CEILING GRID TO MATCH EXISTING. SEE UNIT PRICE NO. 5
- C3 - HATCHED AREA INDICATES DAMAGED INSULATION TO BE REMOVED AND REPLACED TO MATCH EXISTING. SEE UNIT PRICE NO. 2
- C4 - HATCHED AREA INDICATES DAMAGED GYPSUM CEILING TO BE REMOVED AND REPLACED.
- C5 - HATCHED AREA INDICATES DAMAGED "X" GYPSUM CEILING TO BE REMOVED AND REPLACED ABOVE AND BELOW TRUSS CHORD, TAPE, FLOAT AND FIRESTOP CAULK.

SCHEDULE WALL NOTES

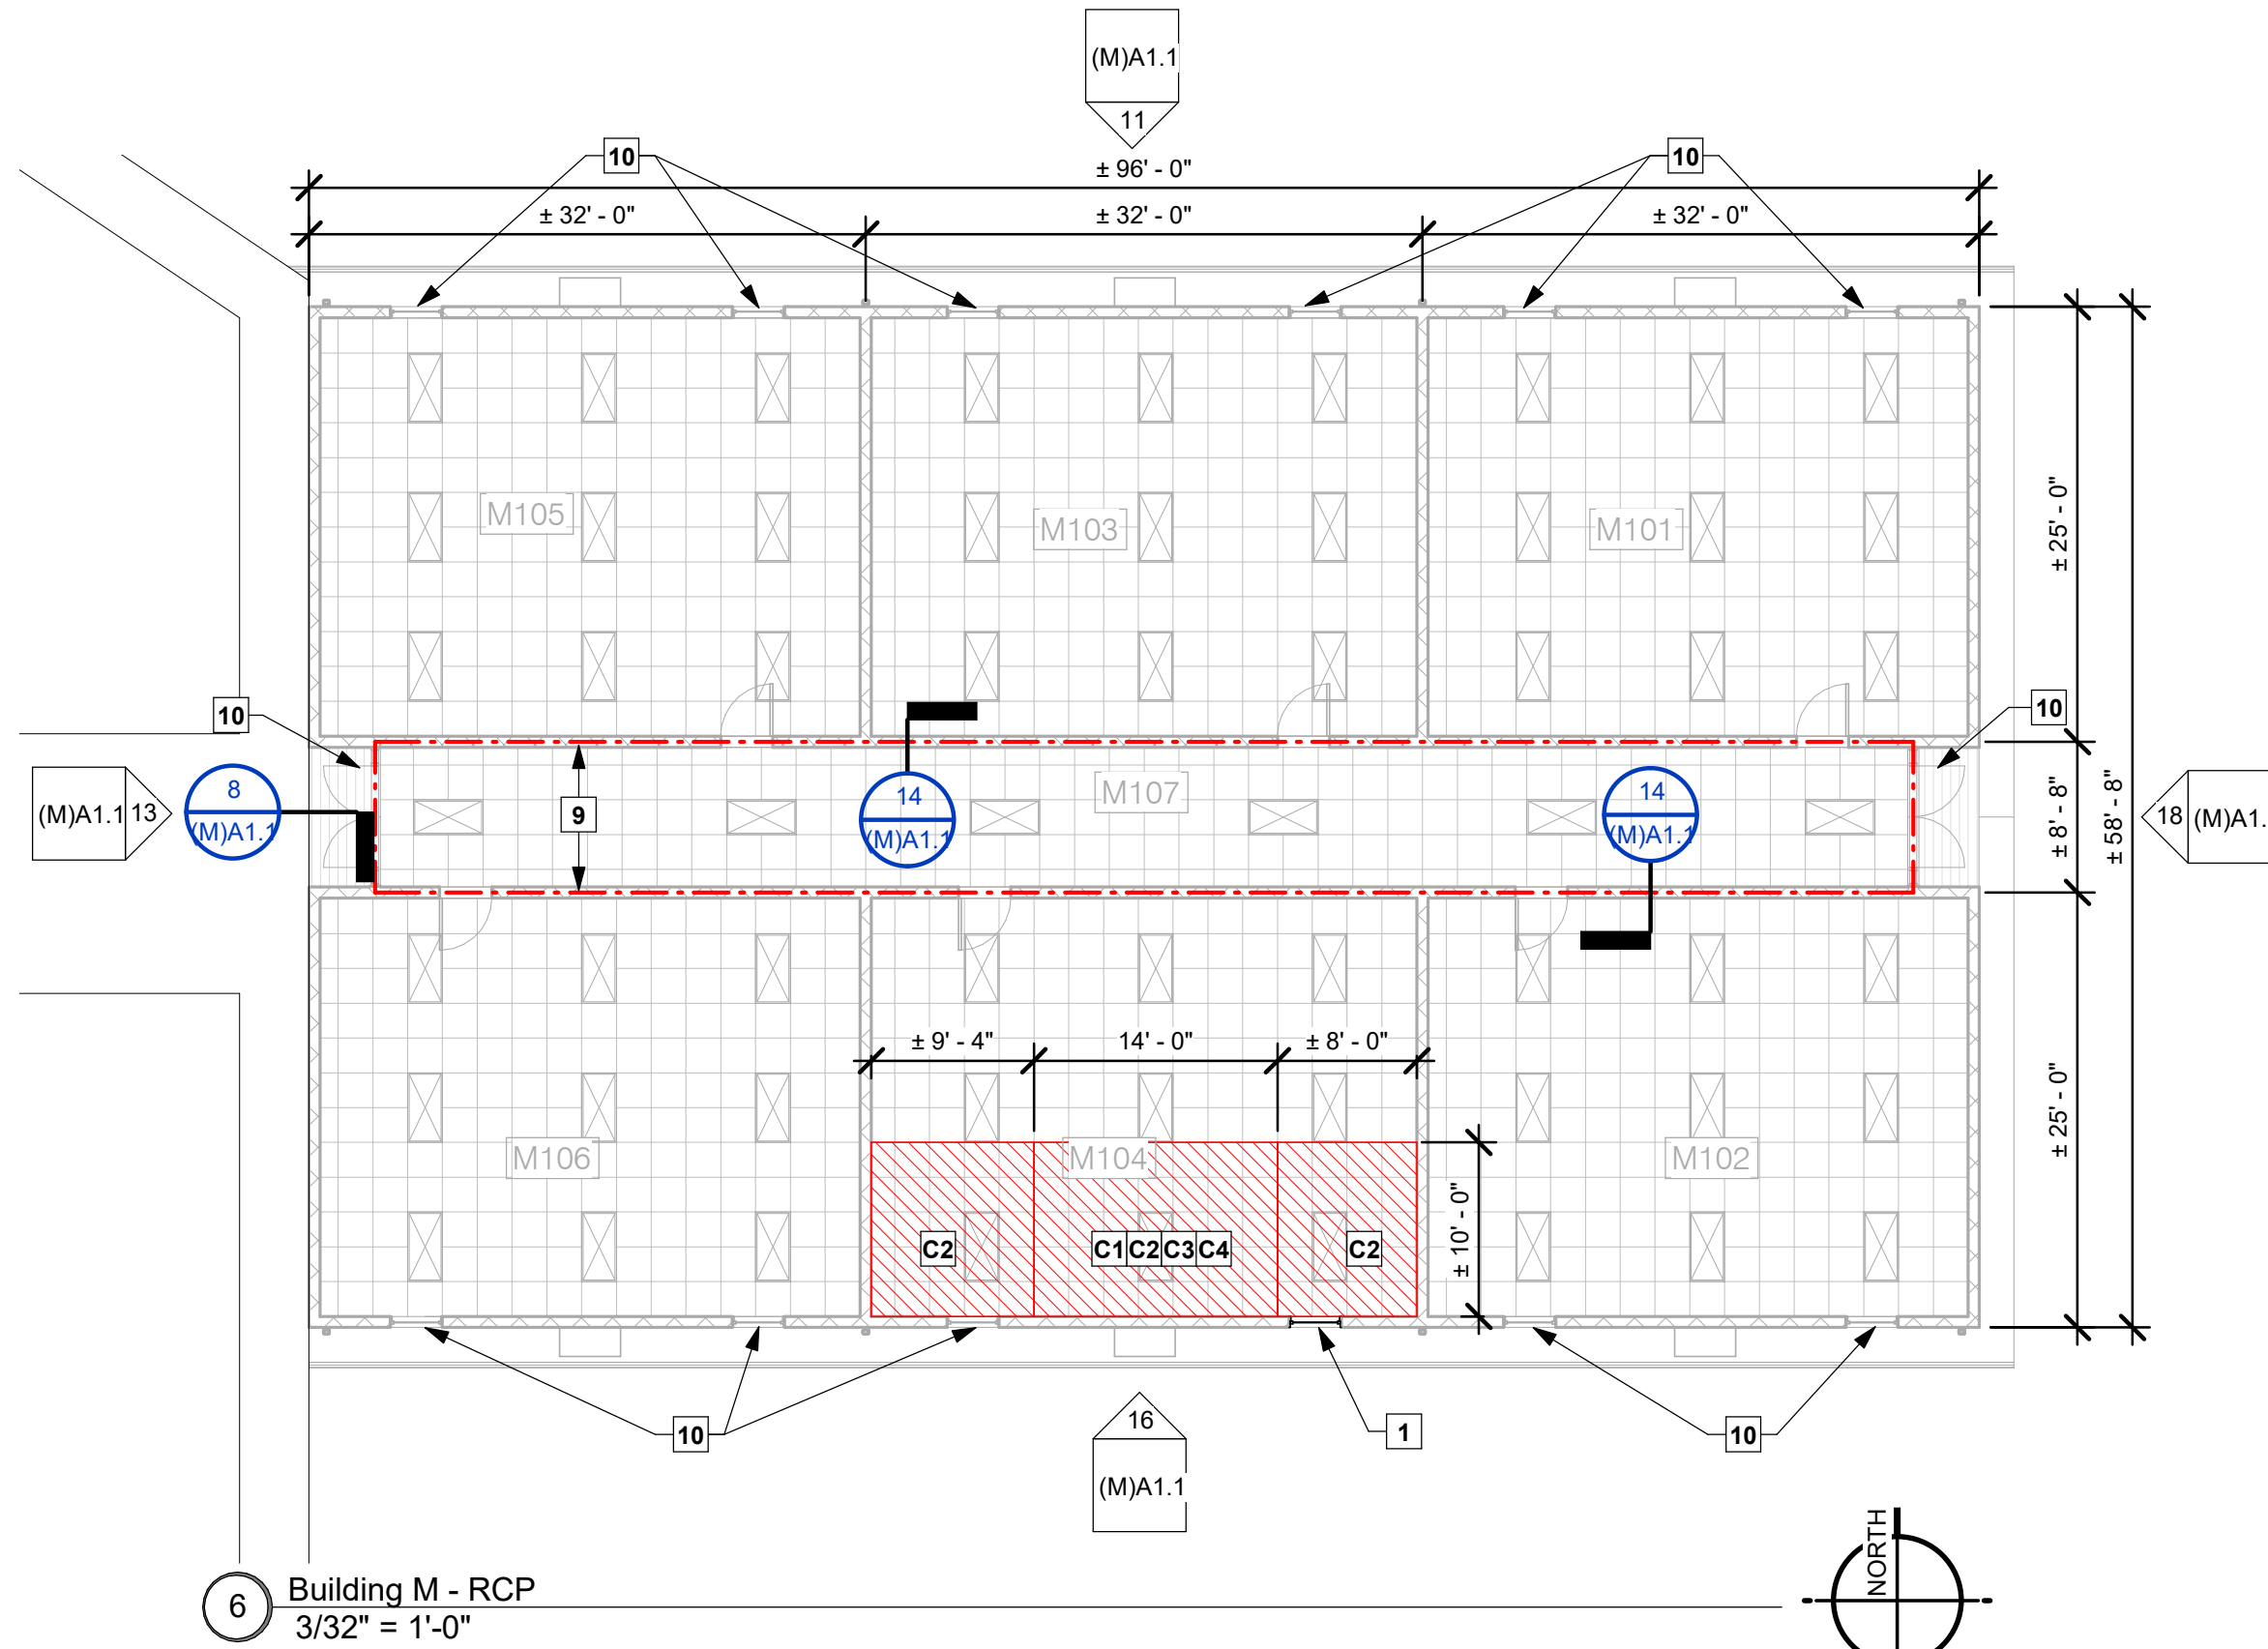
- W1 - CLEAN ALL WALLS AND BASE.
- W2 - REMOVE INTERIOR WALL FINISH AND INSULATION FROM CORNER TO CORNER. REPLACE INSULATION, WALL FINISH AND PAINT TO MATCH EXISTING.

SCHEDULE ARCHITECTURAL NOTES


- A1 - REMOVE DAMAGED EXPANSION JOINT SEALANT AND BACKER ROD. PROVIDE CONTINUOUS NEW BACKER ROD AND SEALANT AT CMU EXPANSION JOINTS FROM SLAB TO TOP PLATE. PAINT TO MATCH EXISTING.

KEYNOTES TO SET


- REMOVE AND REPLACE BROKEN PANES AND GASKETING TO MATCH EXISTING AND CAULK AND RESEAL WINDOW PERIMETER.
- DASHED LINE INDICATES DAMAGED CMU EXPANSION JOINTS. SEE SCHEDULE A1 FOR REPAIRS.
- REMOVE AND REPLACE METAL WALL PANEL TO MATCH EXISTING.
- INSTALL NEW SPLASH GUARD AT ENTRY OPENING ABOVE CANOPY TO MATCH EXISTING. SPLASH GUARD TO BE ATTACHED UNDERNEATH VINYL SIDING AND FASTEN TO NAILER. BOTTOM OF FLASHING TO BE FASTENED TO CANOPY WITH FASTENER #12A 12X1" WITH WASHER @ 2'-0" O.C. AS DETAILED. SEE SHEET A-A1.7.
- REMOVE AND REPLACE WINDOW SCREENS TO MATCH EXISTING.
- NOT USED.
- NOT USED.
- REMOVE AND REPLACE MISSING METAL ROOF PANEL TO MATCH EXISTING PROFILE, GAUGE AND FINISH. INSTALL AS DETAILED. SEE SHEET A-A1.9.
- INDICATES EXISTING 1-HR FIRE RATED WALLS AND CEILING ASSEMBLY THROUGHOUT CORRIDOR AS DETAILED. SEE SHEET A-A1.7.
- CAULK AND RESEAL PERIMETER OF ALL EXISTING WINDOWS AND DOORS.



BUILDING M WINDOW SCHEDULE			
MARK	SIZE	FRAME	GLASS
		TYPE & MATERIAL	
A	36"X60"	ALUMINUM SINGLE HUNG	CLEAR, SINGLE PANE

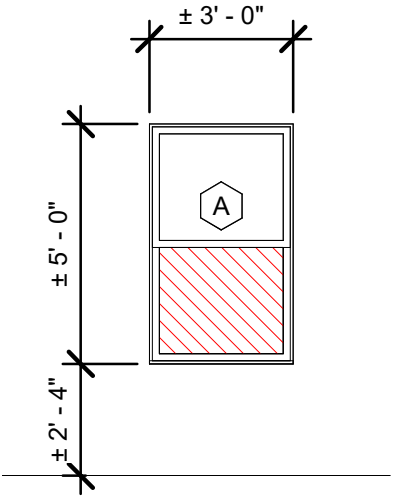


7 WINDOW ELEVATION
1/4" = 1'-0"

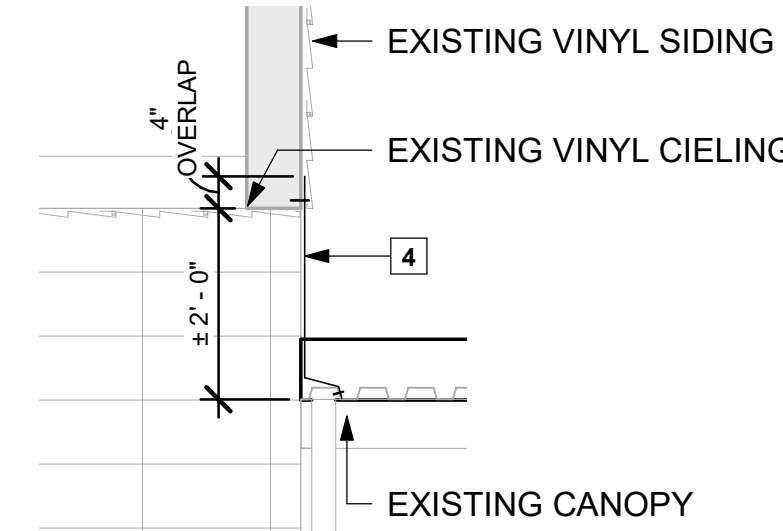


8 CANOPY FLASHING
1/2" = 1'-0"
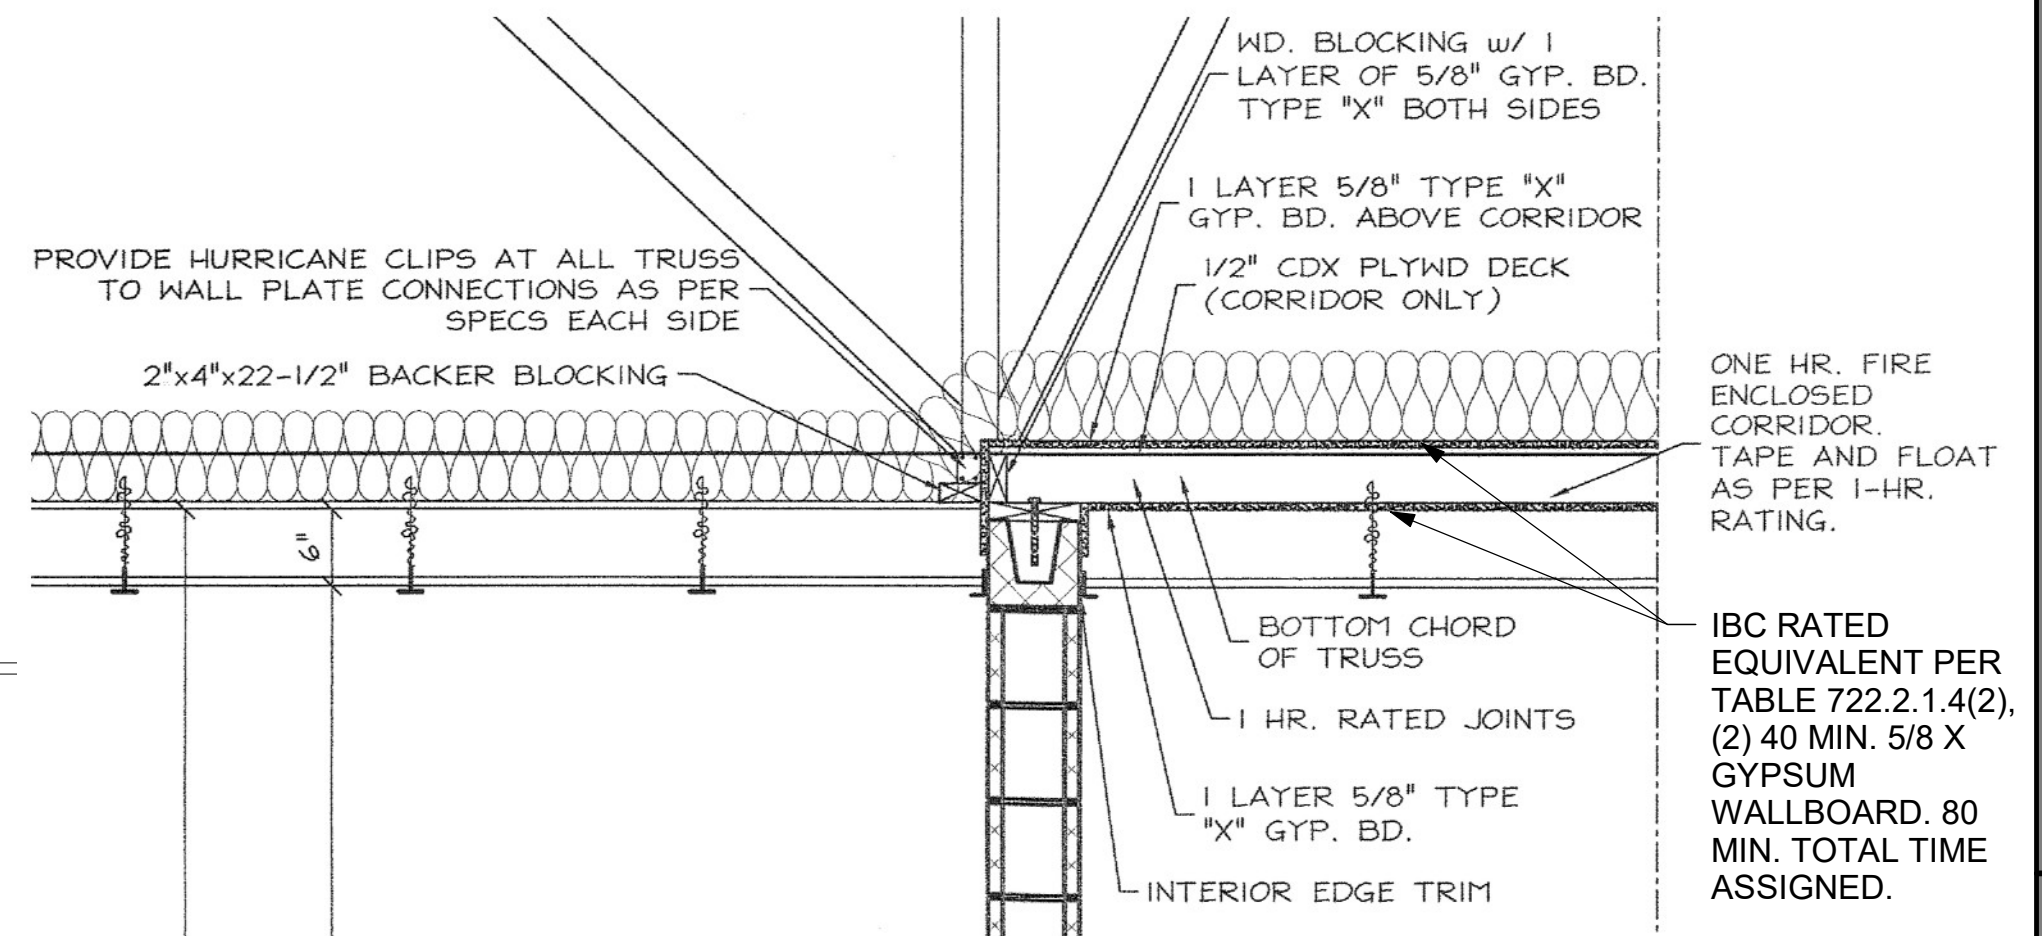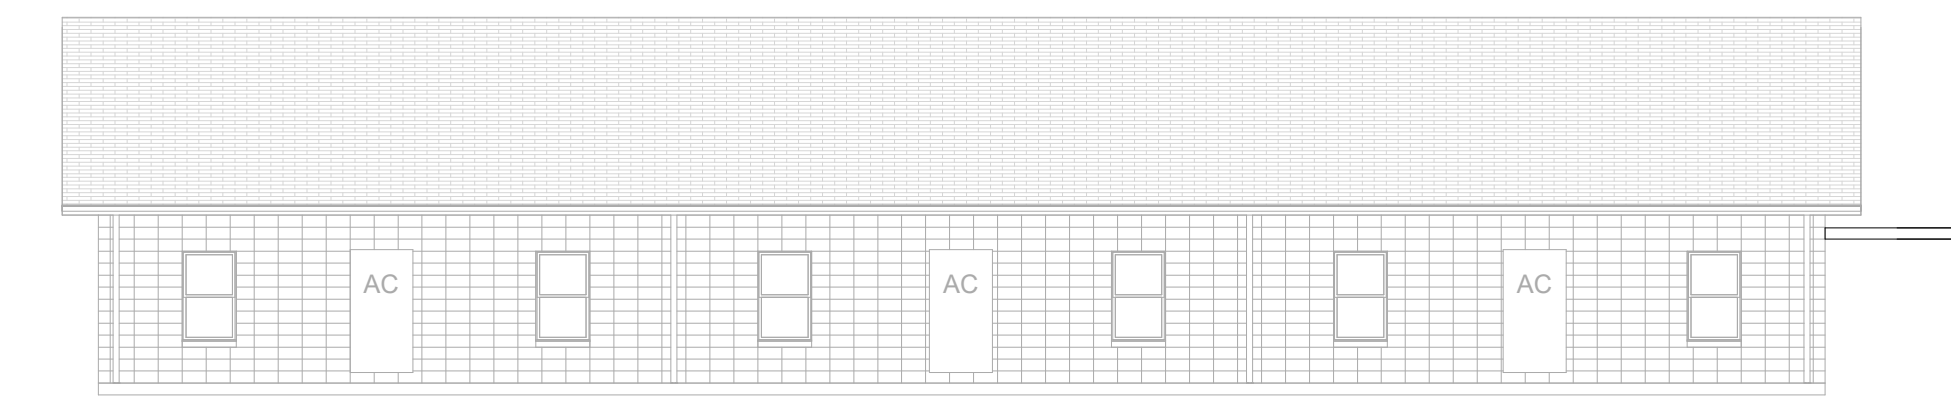
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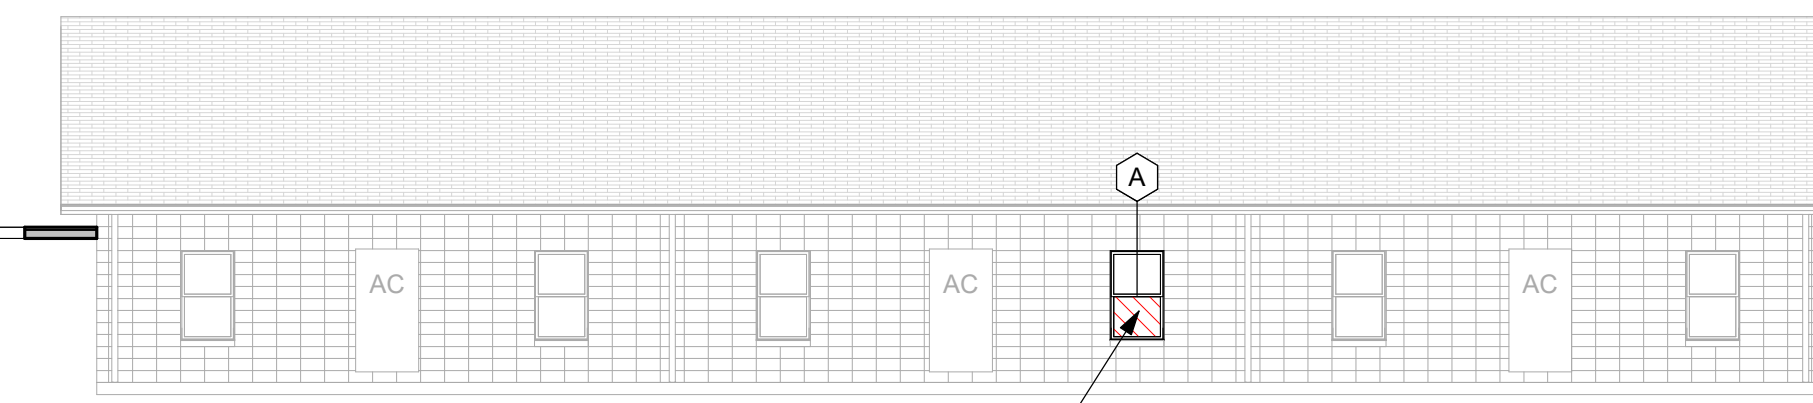


14 Fire Rated Corridor and Ceiling Structure - Scan
1/4" = 1'-0"

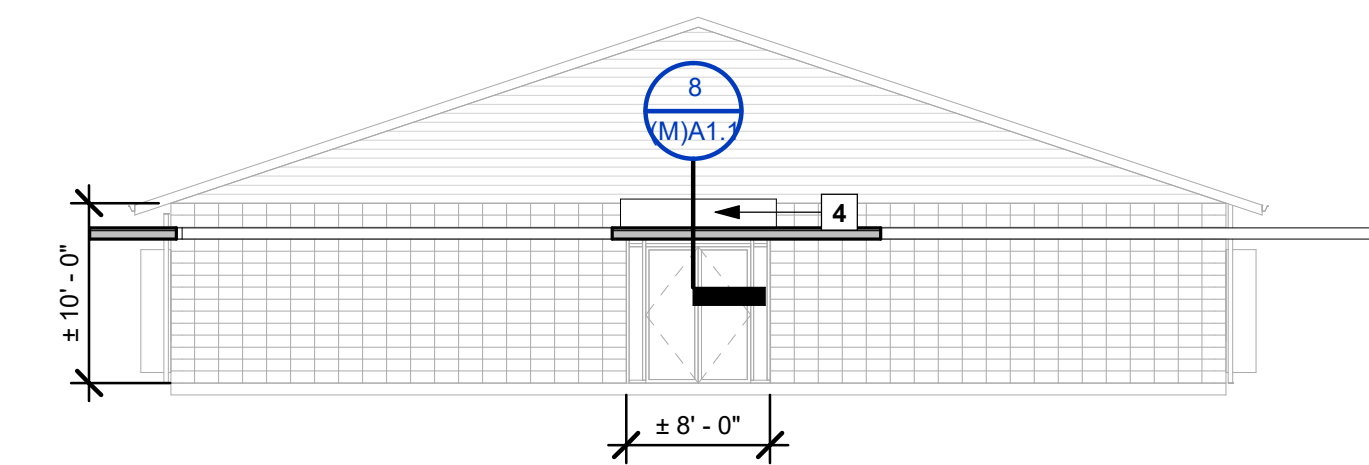
* NOTE: ALL ROOFING, SOFFITS, EAVES AND VINYL SIDING ABOVE TOP PLATE ARE NOT IN CONTRACT. CONTRACTOR TO TAKE CARE NOT TO DAMAGE NEW WORK DONE BY OTHERS AND ARE RESPONSIBLE FOR REPAIRING ANY DAMAGES CAUSED TO ITEMS OUT OF SCOPE OF WORK




11 BLDG M - NORTH ELEVATION
3/32" = 1'-0"




16 BLDG M - SOUTH ELEVATION
3/32" = 1'-0"



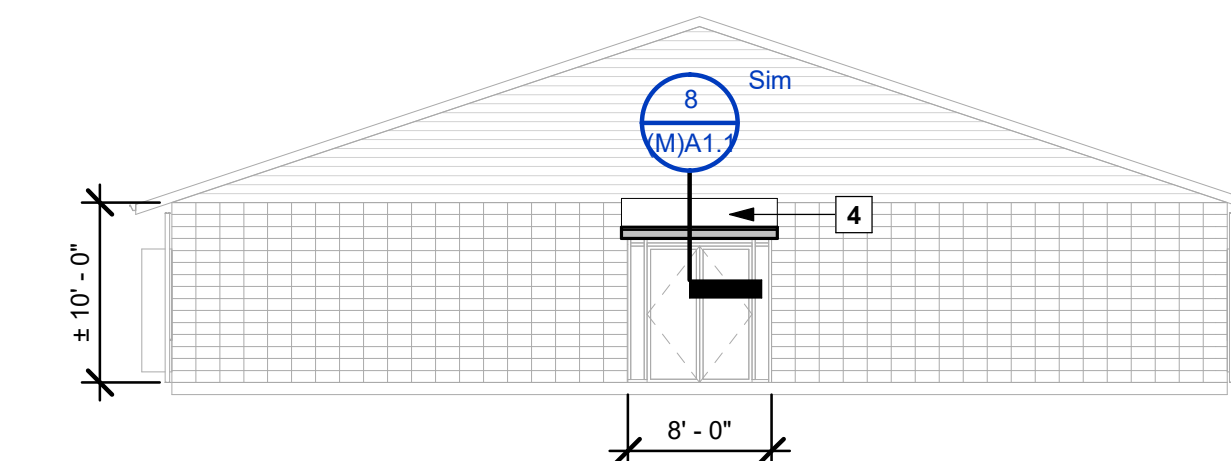13 BLDG M - WEST ELEVATION
3/32" = 1'-0"



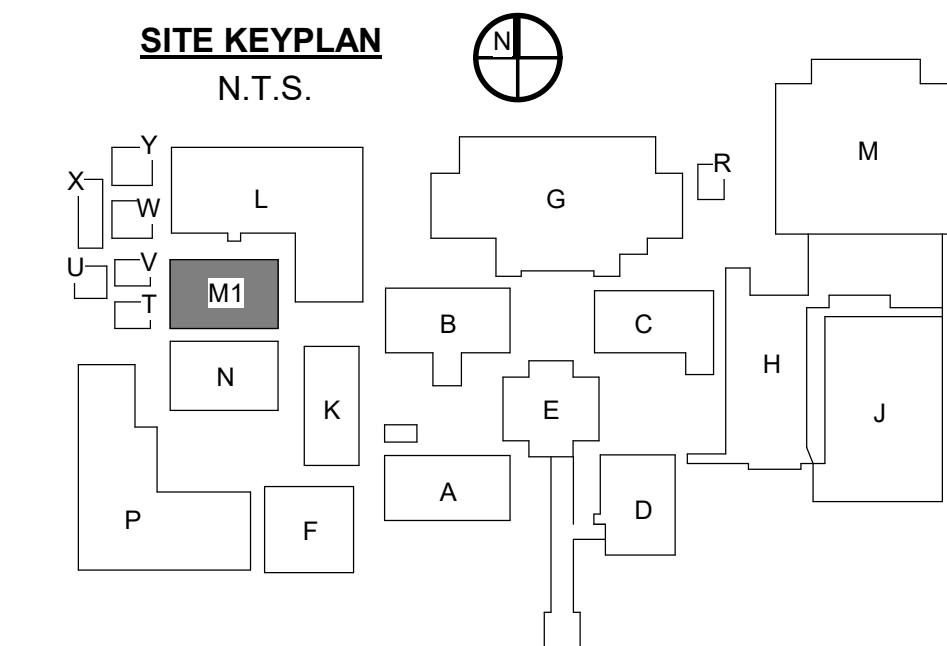18 BLDG M - EAST ELEVATION
3/32" = 1'-0"



SITE KEYPLAN
N.T.S.

RMG
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A.M. BARBE HIGH SCHOOL
 2200 W. McNEESE ST.
 FOR
CALCASIEU PARISH SCHOOL BOARD
 LAKE CHARLES, LA 70605
 HL-003-01.03.04.05.06.07

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RMG PROJECT NO.
20042-01-G
 OWNER PROJECT NO.
HL-003-01.03.04.05.06.07
 PROJECT MANAGER
TM

DATE ISSUED
06/28/2024

REVISED

SHEET NUMBER

(M)A1.1
 POD BLDG M

INTERIOR REPAIR LEGEND - BUILDING N							
ROOM NUMBER	Approx. Area (SF)	Approx. Perimeter (LF)	Floor	Wall	Ceiling	Other	Fire Safety
N101	746.61 SF	110.19 LF	F1	-	C1,C2, C3, C4	-	-
N102	746.58 SF	110.19 LF	F1	-	C3	-	-
N103	754.27 SF	110.83 LF	-	-	-	-	-
N104	754.24 SF	110.82 LF	F1	-	C3	-	-
N105	746.58 SF	110.19 LF	-	-	-	-	-
N106	746.55 SF	110.19 LF	F1	-	C3	-	-
N107	704.99 SF	191.63 LF	F1	-	C3, C5	-	-

SCHEDULE FLOOR NOTES

- F1 - CLEAN ENTIRE VCT FLOOR, BUFF AND WAX.
- F2 - HATCHED AREA INDICATES VCT FLOORING TO BE REMOVED AND REPLACED TO MATCH EXISTING. SEE UNIT PRICE NO. 3
- F3 - HATCHED AREA INDICATED REPLACE MISSING VCT TO MATCH EXISTING. SEE UNIT PRICE NO. 3
- F4 - REMOVE ALL WALL BASE AND REPLACE TO MATCH EXISTING.

SCHEDULE CEILING NOTES

- C1 - REMOVE AND REPLACE DAMAGED CEILING TILES TO MATCH EXISTING. SEE UNIT PRICE NO. 1
- C2 - REMOVE AND REPLACE DAMAGED CEILING GRID TO MATCH EXISTING. SEE UNIT PRICE NO. 5
- C3 - HATCHED AREA INDICATES DAMAGED INSULATION TO BE REMOVED AND REPLACED TO MATCH EXISTING. SEE UNIT PRICE NO. 2
- C4 - HATCHED AREA INDICATES DAMAGED GYPSUM CEILING TO BE REMOVED AND REPLACED.
- C5 - HATCHED AREA INDICATES DAMAGED "X" GYPSUM CEILING TO BE REMOVED AND REPLACED ABOVE AND BELOW TRUSS CHORD, TAPE, FLOAT AND FIRESTOP CAULK.

SCHEDULE WALL NOTES

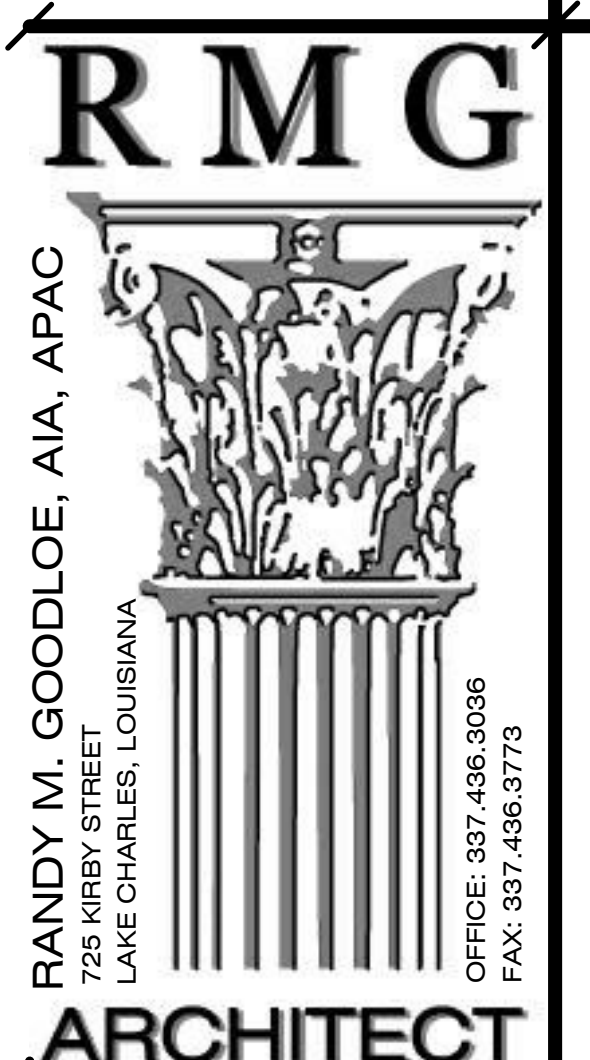
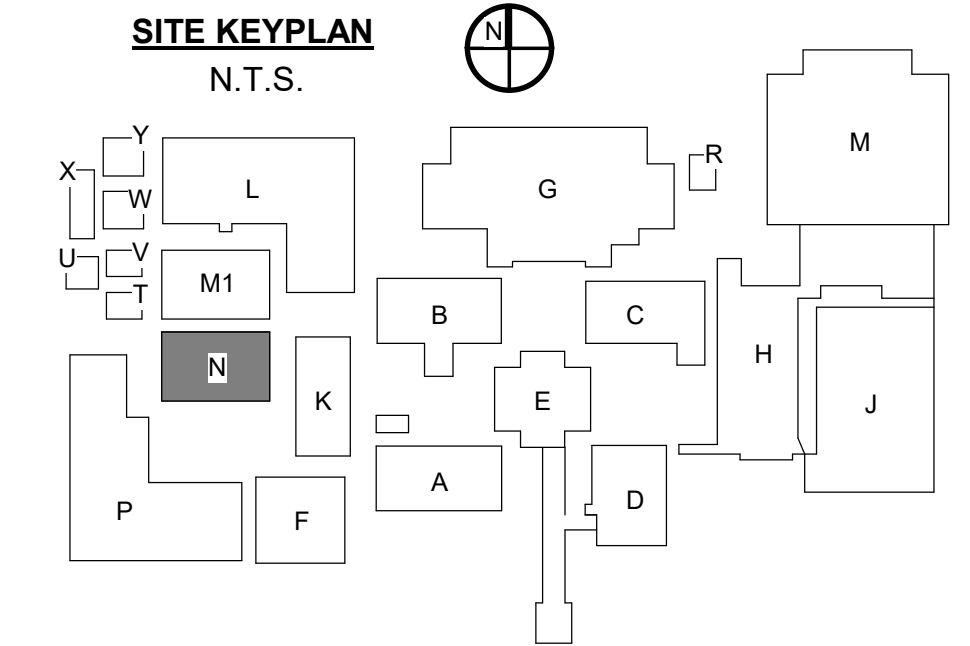
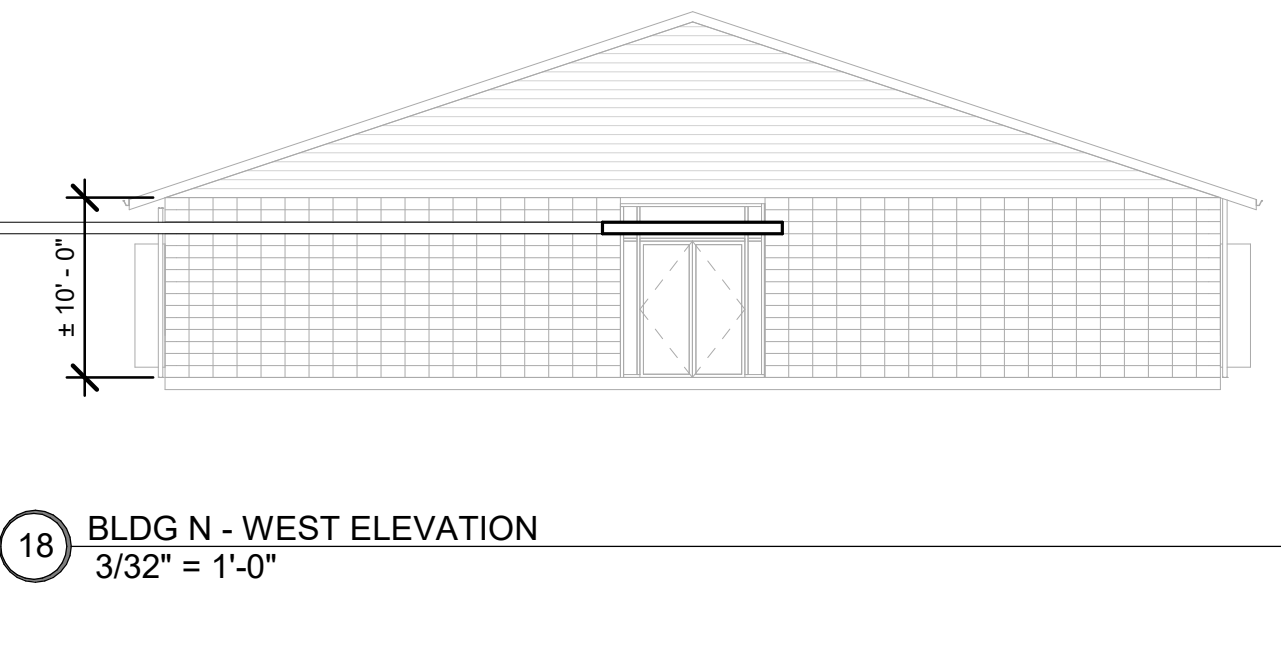
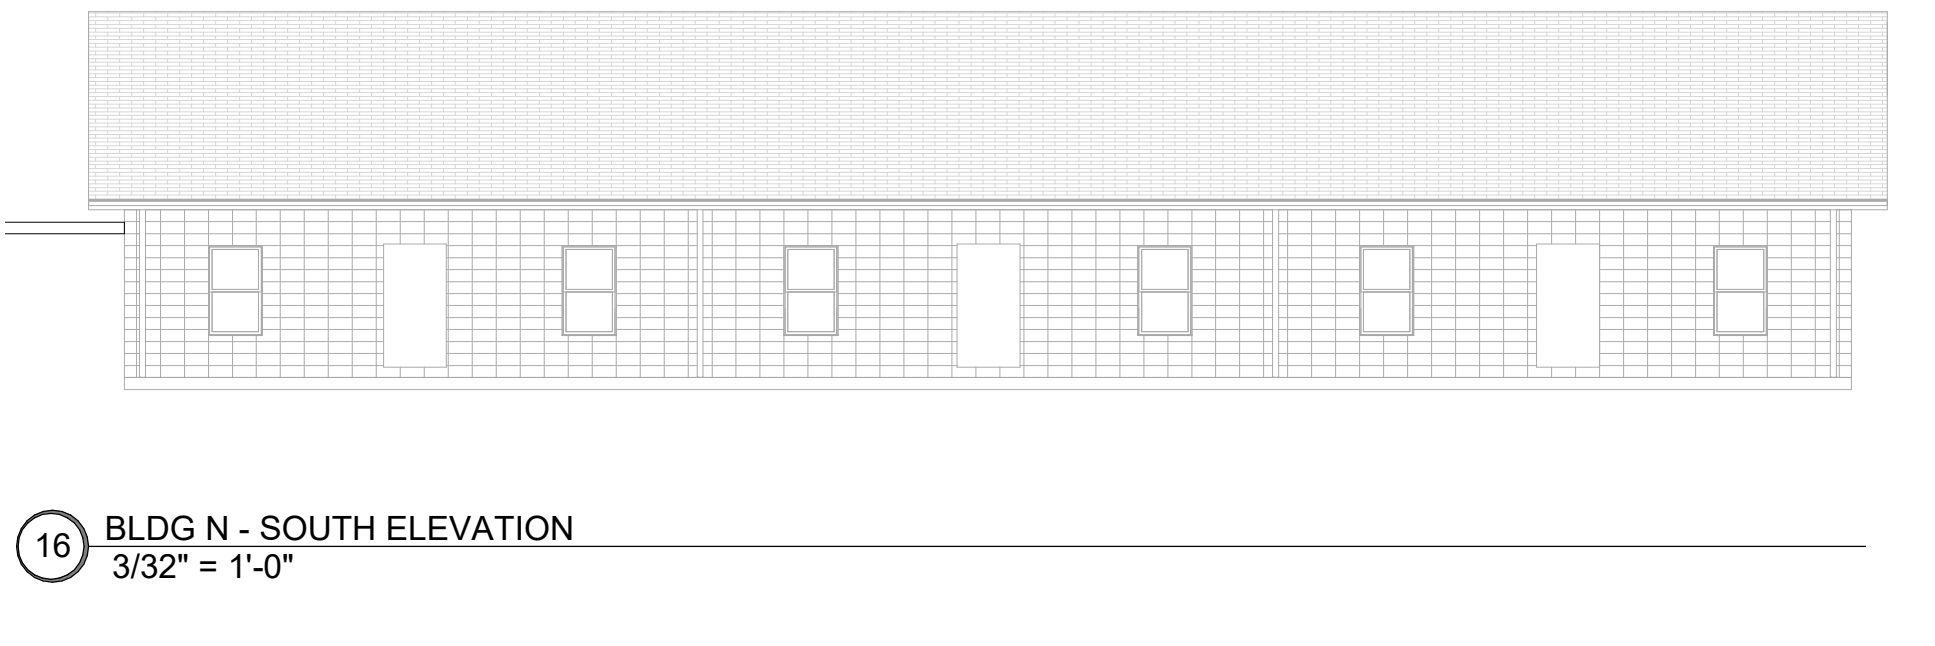
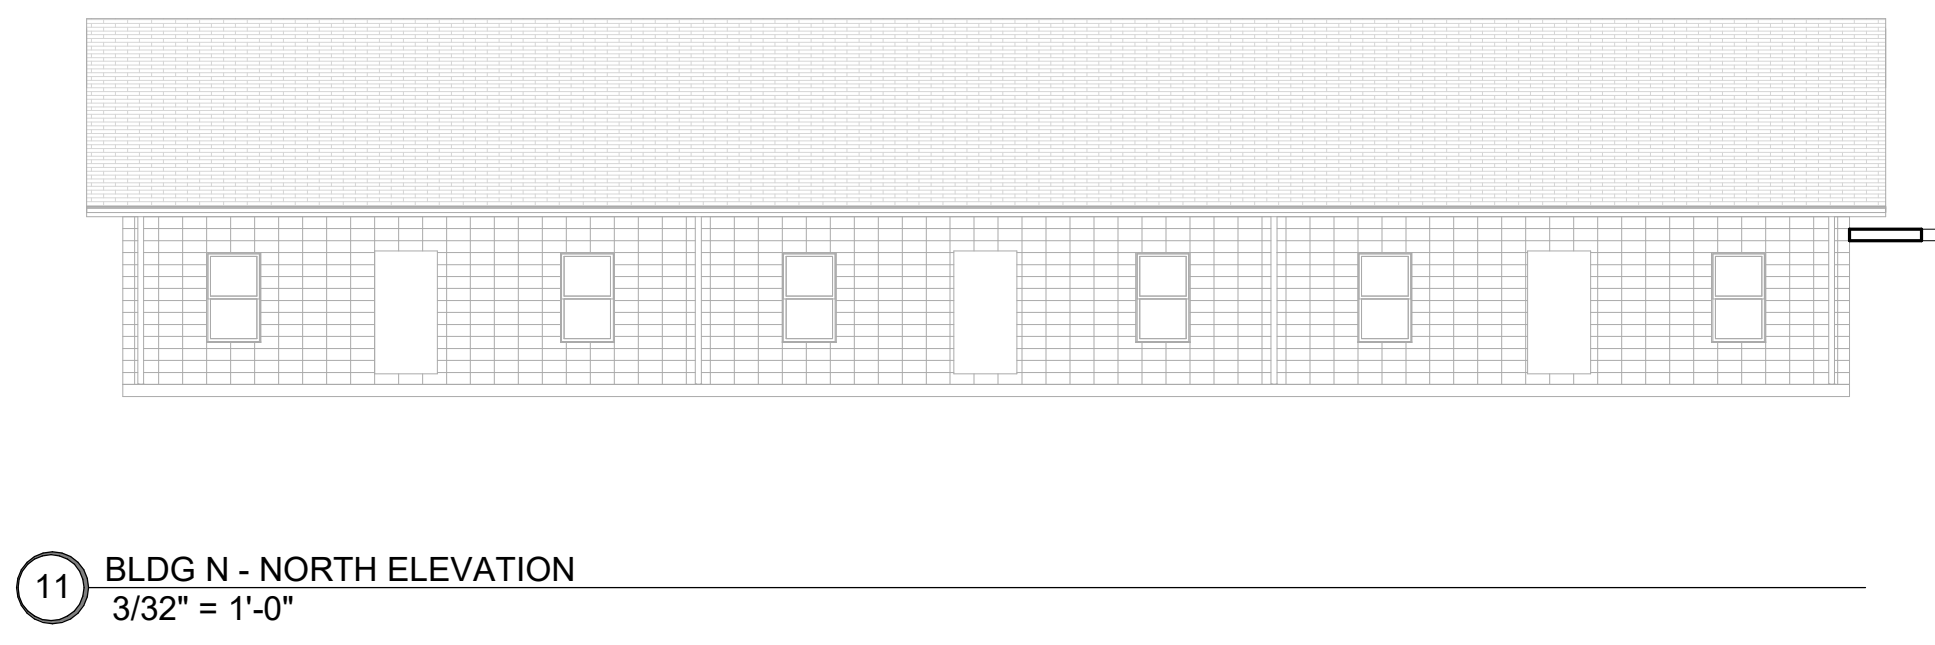
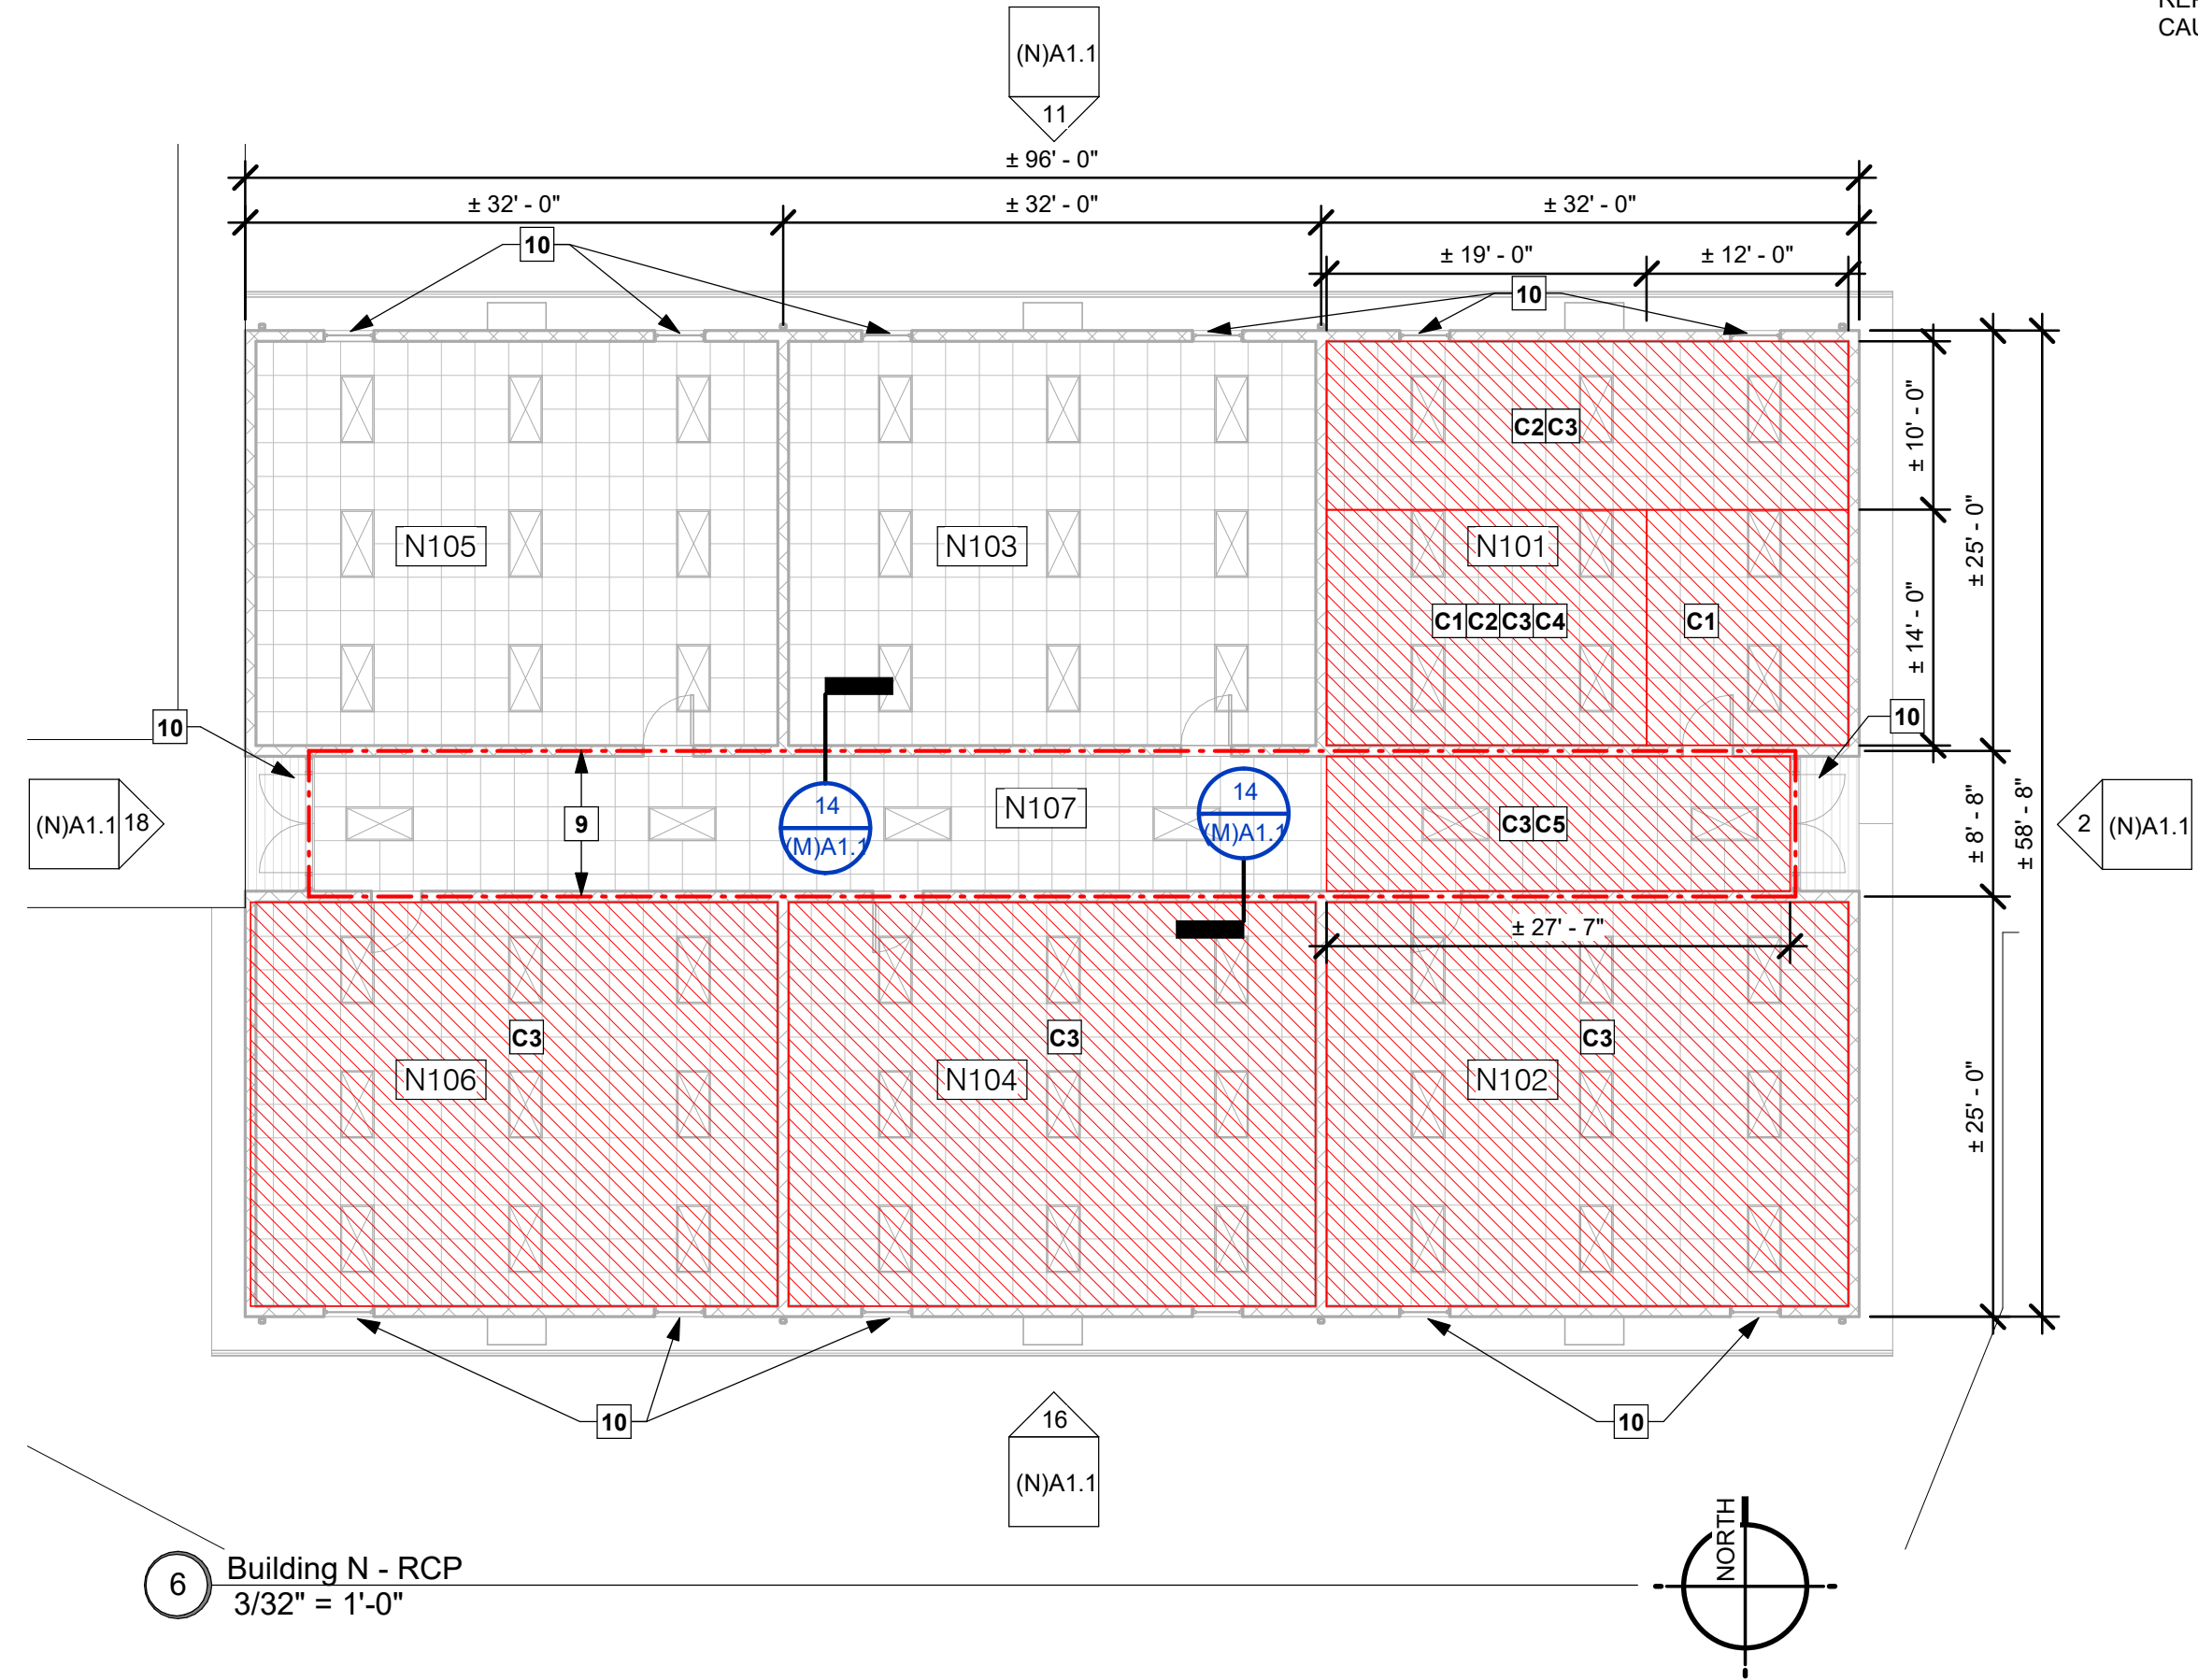
- W1 - CLEAN ALL WALLS AND BASE.
- W2 - REMOVE INTERIOR WALL FINISH AND INSULATION FROM CORNER TO CORNER. REPLACE INSULATION, WALL FINISH AND PAINT TO MATCH EXISTING.

SCHEDULE ARCHITECTURAL NOTES

- A1 - REMOVE DAMAGED EXPANSION JOINT SEALANT AND BACKER ROD. PROVIDE CONTINUOUS NEW BACKER ROD AND SEALANT AT CMU EXPANSION JOINTS FROM SLAB TO TOP PLATE. PAINT TO MATCH EXISTING.

KEYNOTES TO SET

- REMOVE AND REPLACE BROKEN PANES AND GASKETING TO MATCH EXISTING AND CAULK AND RESEAL WINDOW PERIMETER.
- DASHED LINE INDICATES DAMAGED CMU EXPANSION JOINTS. SEE SCHEDULE A1 FOR REPAIRS.
- REMOVE AND REPLACE METAL WALL PANEL TO MATCH EXISTING.
- INSTALL NEW SPLASH GUARD AT ENTRY OPENING ABOVE CANOPY TO MATCH EXISTING. SPLASH GUARD TO BE ATTACHED UNDERNEATH VINYL SIDING AND FASTEN TO NAILER. BOTTOM OF FLASHING TO BE FASTENED TO CANOPY WITH FASTENER #12A 12X1" WITH WASHER @ 2'-0" O.C. AS DETAILED. SEE SHEET A-A1.7.
- REMOVE AND REPLACE WINDOW SCREENS TO MATCH EXISTING.
- NOT USED.
- NOT USED.
- REMOVE AND REPLACE MISSING METAL ROOF PANEL TO MATCH EXISTING PROFILE, GAUGE AND FINISH. INSTALL AS DETAILED. SEE SHEET A-A1.9.
- INDICATES EXISTING 1-HR FIRE RATED WALLS AND CEILING ASSEMBLY THROUGHOUT CORRIDOR AS DETAILED. SEE SHEET A-A1.7.
- CAULK AND RESEAL PERIMETER OF ALL EXISTING WINDOWS AND DOORS.



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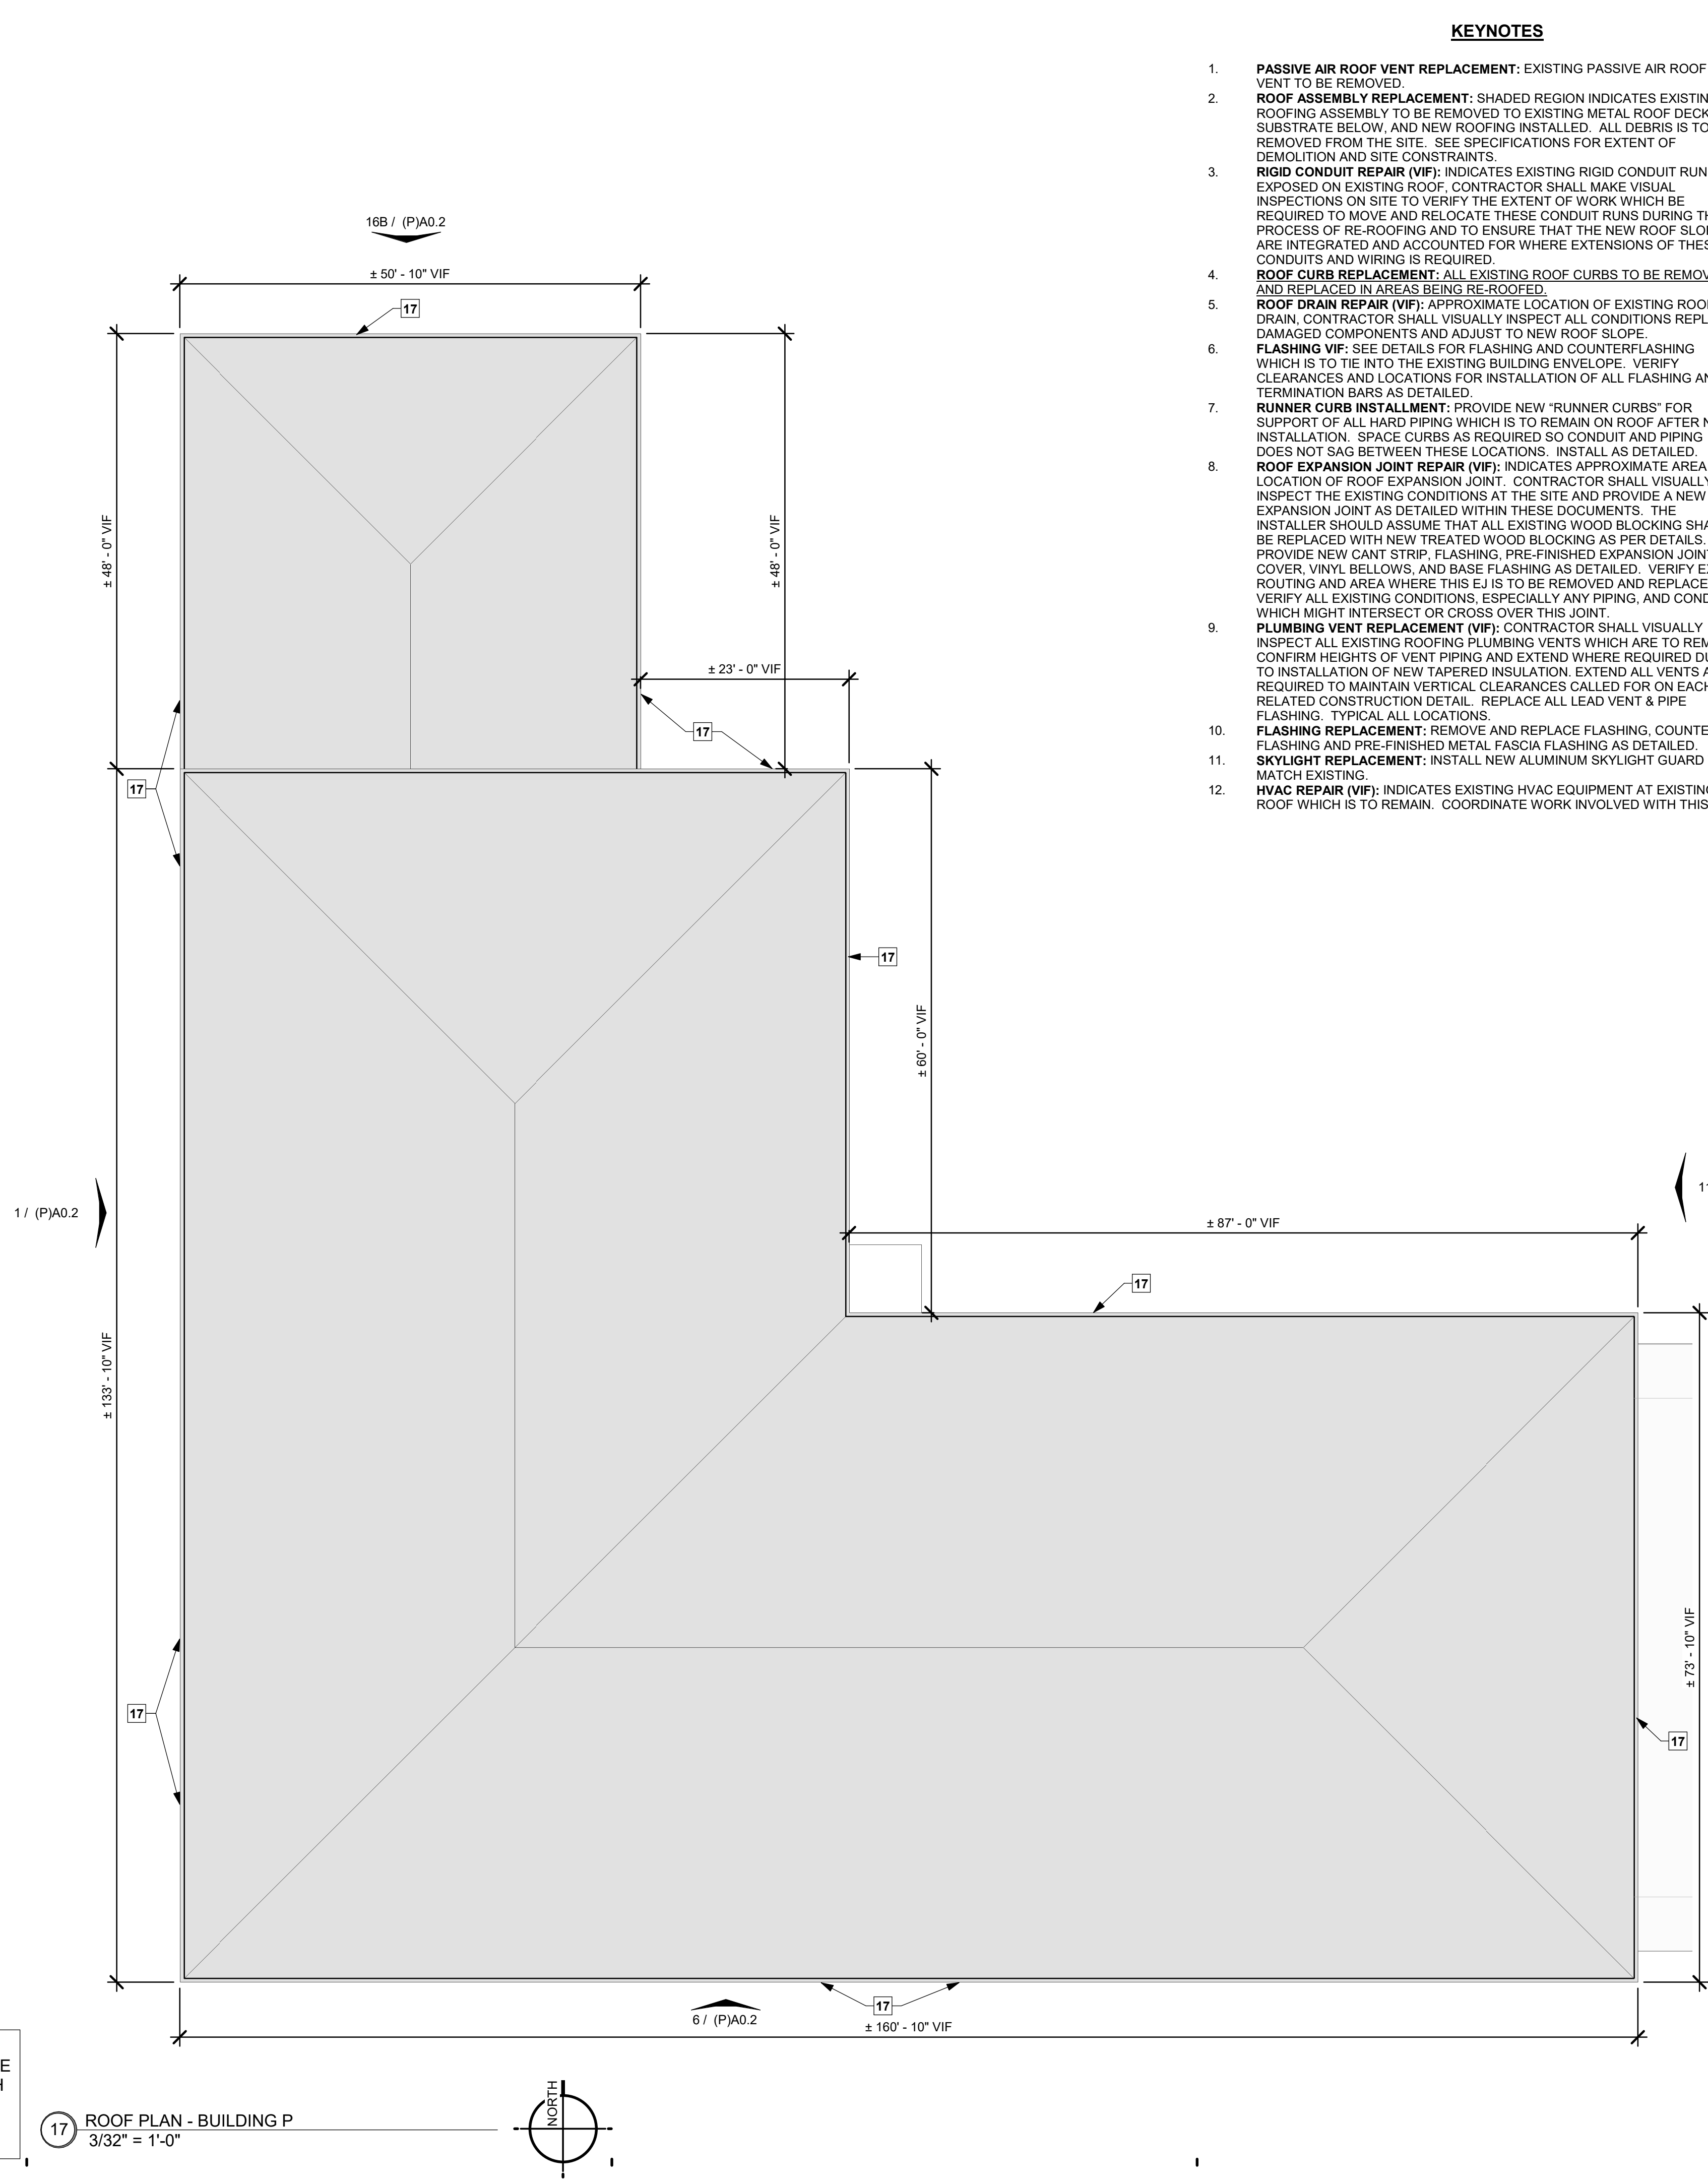
RMG PROJECT NO. 20042-01-G
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SHEET NUMBER
(N)A1.1
POD BLDG N


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NOTE: IMAGES ARE FOR VISUAL REFERENCES TO HELP UNDERSTAND DAMAGES. THEY DO NOT REPRESENT THE ENTIRE SCOPE OF WORK AND SHOULD BE USED IN CONJUNCTION WITH THE DRAWINGS AND CURRENT CONDITIONS IN THE FIELD. CONTRACTOR SHALL CONFIRM CURRENT CONDITIONS IN THE FIELD PRIOR TO BIDDING - TYPICAL.



17 ROOF PLAN - BUILDING P 3/32" = 1'-0"



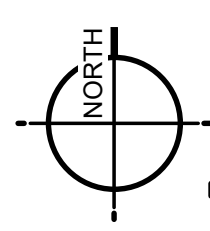
KEYNOTES

- 1. PASSIVE AIR ROOF VENT REPLACEMENT: EXISTING PASSIVE AIR ROOF VENT TO BE REMOVED.
2. ROOF ASSEMBLY REPLACEMENT: SHADED REGION INDICATES EXISTING ROOFING ASSEMBLY TO BE REMOVED TO EXISTING METAL ROOF DECKING SUBSTRATE BELOW, AND NEW ROOFING INSTALLED. ALL DEBRIS IS TO BE REMOVED FROM THE SITE. SEE SPECIFICATIONS FOR EXTENT OF DEMOLITION AND SITE CONSTRAINTS.
3. RIGID CONDUIT REPAIR (VIF): INDICATES EXISTING RIGID CONDUIT RUNS EXPOSED ON EXISTING ROOF. CONTRACTOR SHALL MAKE VISUAL INSPECTIONS ON SITE TO VERIFY THE EXTENT OF WORK WHICH BE REQUIRED TO MOVE AND RELOCATE THESE CONDUIT RUNS DURING THE PROCESS OF RE-ROOFING AND TO ENSURE THAT THE NEW ROOF SLOPES ARE INTEGRATED AND ACCOUNTED FOR WHERE EXTENSIONS OF THESE CONDUITS AND WIRING IS REQUIRED.
4. ROOF CURB REPLACEMENT: ALL EXISTING ROOF CURBS TO BE REMOVED AND REPLACED IN AREAS BEING RE-ROOFED.
5. ROOF DRAIN REPAIR (VIF): APPROXIMATE LOCATION OF EXISTING ROOF DRAIN. CONTRACTOR SHALL VISUALLY INSPECT ALL CONDITIONS REPLACE DAMAGED COMPONENTS AND ADJUST TO NEW ROOF SLOPE.
6. FLASHING VIF: SEE DETAILS FOR FLASHING AND COUNTERFLASHING WHICH IS TO TIE INTO THE EXISTING BUILDING ENVELOPE. VERIFY EXACT CLEARANCES AND LOCATIONS FOR INSTALLATION OF ALL FLASHING AND TERMINATION BARS AS DETAILED.
7. RUNNER CURB INSTALLMENT: PROVIDE NEW "RUNNER CURBS" FOR SUPPORT OF ALL HARD PIPING WHICH IS TO REMAIN ON ROOF AFTER NEW INSTALLATION. SPACE CURBS AS REQUIRED SO CONDUIT AND PIPING DOES NOT SAG BETWEEN THESE LOCATIONS. INSTALL AS DETAILED.
8. ROOF EXPANSION JOINT REPAIR (VIF): INDICATES APPROXIMATE AREA AND LOCATION OF ROOF EXPANSION JOINT. CONTRACTOR SHALL VISUALLY INSPECT THE EXISTING CONDITIONS AT THE SITE AND PROVIDE A NEW EXPANSION JOINT AS DETAILED WITHIN THESE DOCUMENTS. THE INSTALLER SHOULD ASSUME THAT ALL EXISTING WOOD BLOCKING SHALL BE REPLACED WITH NEW TREATED WOOD BLOCKING AS PER DETAILS. PROVIDE NEW CANT STRIP, FLASHING, PRE-FINISHED EXPANSION JOINT COVER, VINYL BELLOW, AND BASE FLASHING AS DETAILED. VERIFY EXACT ROUTING AND AREA WHERE THIS EJ IS TO BE REMOVED AND REPLACED, VERIFY ALL EXISTING CONDITIONS, ESPECIALLY ANY PIPING, AND CONDUIT WHICH MIGHT INTERSECT OR CROSS OVER THIS JOINT.
9. PLUMBING VENT REPLACEMENT (VIF): CONTRACTOR SHALL VISUALLY INSPECT ALL EXISTING ROOFING PLUMBING VENTS WHICH ARE TO REMAIN. CONFIRM HEIGHTS OF VENT PIPING AND EXTEND WHERE REQUIRED DUE TO INSTALLATION OF NEW TAPERED INSULATION. EXTEND ALL VENTS AS REQUIRED TO MAINTAIN VERTICAL CLEARANCES CALLED FOR ON EACH RELATED CONSTRUCTION DETAIL. REPLACE ALL LEAD VENT & PIPE FLASHING. TYPICAL ALL LOCATIONS.
10. FLASHING REPLACEMENT: REMOVE AND REPLACE FLASHING, COUNTERFLASHING AND PRE-FINISHED METAL FASCIA FLASHING AS DETAILED.
11. SKYLIGHT REPLACEMENT: INSTALL NEW ALUMINUM SKYLIGHT GUARD TO MATCH EXISTING.
12. HVAC REPAIR (VIF): INDICATES EXISTING HVAC EQUIPMENT AT EXISTING ROOF WHICH IS TO REMAIN. COORDINATE WORK INVOLVED WITH THIS

- 13. EQUIPMENT AND NEW ROOFING ASSEMBLY SO AS TO NOT DISRUPT SERVICE TO THE EXISTING BUILDING. IF SERVICE IS REQUIRED TO BE TEMPORARILY SUSPENDED WHILE NEW WORK IS TAKING PLACE, THE CONTRACTOR SHALL COORDINATE ANY AND ALL OUTAGES WITH THE OWNER AND WILL BE REQUIRED TO ONLY PERFORM THIS WORK AT TIMES WHEN SUSPENSION OF THIS SERVICE MINIMALLY AFFECTS THE OWNERS USE OF THE BUILDING. IF THE SERVICE CANNOT BE SUSPENDED DURING OWNERS OPERATING HOURS, WORK MAY HAVE TO BE PERFORMED AFTER HOURS, OR ON WEEKENDS.
14. SATellite INSTALLATION: SEE DETAILS FOR SATellite MOUNTING UNIT.
15. "A" METAL PANEL REPLACEMENT: METAL WALL PANEL "E" - REMOVE AND REPLACE DAMAGED/MISSING METAL WALL PANEL AS SPECIFIED. SEE BUILDING ELEVATIONS.
16. SIGNAGE INSTALLATION: INSTALL MISSING LETTERING TO MATCH EXISTING.
17. ROOF ACCESSORY REPLACEMENT: REPLACE DAMAGED ROOF ACCESSORIES. MATCH EXISTING TYPE, MATERIAL, AND STYLE.
18. DOWNSPOUT AND GUTTER CLEANING: DOWNSPOUT/COLLECTOR LOCATIONS, SEE ELEVATIONS. CONTRACTOR IS TO REMOVE ALL DEBRIS FROM GUTTERS AND DOWNSPOUTS.
19. SATellite REMOVAL: REMOVE ALL SATellite COMPONENTS. THESE ARE NO LONGER IN USE.
20. COPING: SEE ROOFING SHEETS FOR COPING, OVERHANG & ROOFING SCOPES - TYP.
21. TEMPORARY CHAIN LINK FENCING - PROVIDE 6" TEMPORARY CHAIN LINK FENCING TO PROTECT STUDENT TRAFFIC DURING CONSTRUCTION. PROVIDE ACCESS TO THE GREATEST EXTENT POSSIBLE. COORDINATE WITH PHASING AND SCHOOL PRINCIPAL.
22. WIND TURBINE REPLACEMENT: REMOVE AND REPLACE WIND TURBINE TO MATCH EXISTING.
23. PAINTING EXTERIOR: CLEAN, PREP & RE-PAINT WALLS AND ARTWORK TO COVER SCUFFS AND DAMAGE FROM STORM DEBRIS. COLOR TO MATCH EXISTING AS APPROVED BY ARCHITECT.
24. GLASS REPLACEMENT: REMOVE AND REPLACE DAMAGED GLASS (OR PLYWOOD WHERE APPLICABLE) TO MATCH EXISTING. PROVIDE CAULKING AND GASKETING.
25. STUCCO SOFFIT REPLACEMENT: SOFFIT REMOVED BY OTHERS (HAZARDOUS MATERIAL). COORDINATE AND INSTALL NEW STUCCO SOFFIT.
26. COORDINATE REMOVAL OF AGGREGATE PANELS (HAZARDOUS MATERIAL) WITH ABATEMENT SCOPE AND ABATEMENT CONTRACTOR. COORDINATE AND INSTALL NEW GFRC FACADE PANELS AS SPECIFIED. REMOVE AND REPLACE DAMAGED WALL FRAMING - SEE STRUCTURAL AND WALL SECTIONS. SALVAGE AND REINSTALL MEP COMPONENTS AT SAME LOCATIONS - COORDINATE WITH MEP.
27. DOWNSPOUT AND GUTTER REPLACEMENT: REMOVE REMAINING ATTACHMENTS AND COMPONENTS OF DOWNSPOUT, GUTTER AND CONDUCTOR HEADS AND INSTALL NEW TO MATCH EXISTING COLOR, DIMENSION, GAUGE, AND MATERIAL. GROUT HOLES AT OLD STRAPS PRIOR TO NEW INSTALLATION & ATTACH AT INTERVALS EQUAL TO EXISTING SPACING. SALVAGE AND PREP REMAINING COMPONENTS FOR NEW INSTALLATION. CONTRACTOR IS TO REMOVE ALL DEBRIS FROM GUTTERS AND DOWNSPOUTS.
28. BRICK REPAIR: REMOVE AND REPLACE BRICK FACADE AS INDICATED. DISPOSE OF OLD BRICK. MATCH NEW BRICK AND MORTAR TO EXISTING AS APPROVED BY ARCHITECT. PRESERVE SUBSTRATE. REMOVE OLD BRICK TIES AND WATER PROOFING. INSTALL NEW WATERPROOFING AND BRICK TIES AT A MIN. OF 24" O.C. VERTICAL AND HORIZONTAL.
29. PLASTER SOFFIT REPLACEMENT: REMOVE REMAINING VINYL SOFFIT AND REPLACE TO MATCH EXISTING - PRESERVE LIGHT & REINSTALL AS NECESSARY.

ROOFING SYMBOL LEGEND

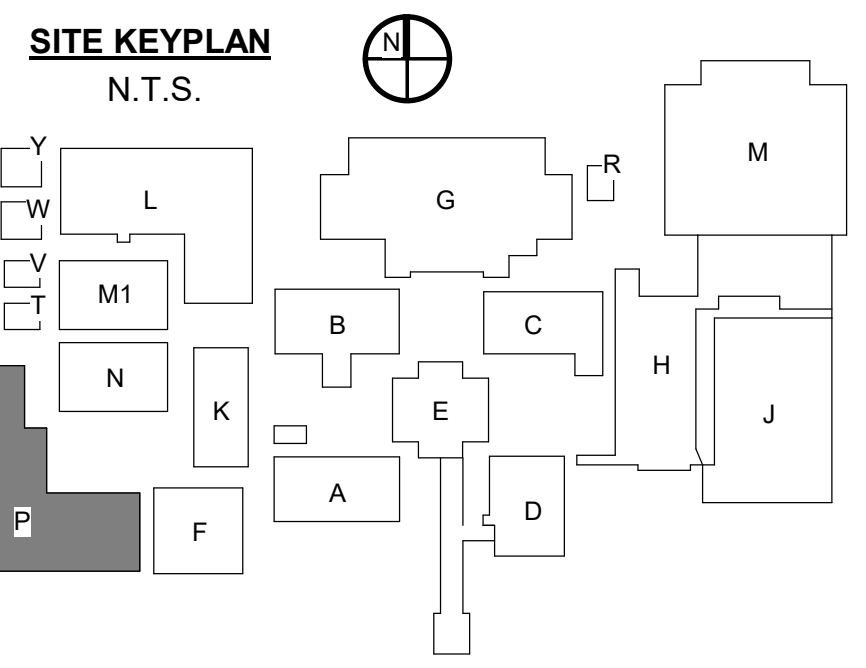- EXISTING SKYLIGHT SEE KEYNOTE 11 SEE DETAIL 19 / A-00.4
ROOF DRAIN LOCATION SEE KEYNOTE 5 SEE DETAIL 16 / A-00.4
ROOF PIPING PENETRATION SEE KEYNOTE 9
ROOF FAN / VENT SEE KEYNOTE 12
ROOF FAN / VENT SEE KEYNOTE 12
DOWNSPOUT SEE KEYNOTE 30
MISC MEP SEE KEYNOTE 12
TURBINE VENT SEE KEYNOTE 12
EXPANSION JOINT SEE KEYNOTE 8 SEE DETAIL 3 / A-00.4
SCUPPER/OPENING FOR DRAINAGE SEE KEYNOTE 28 SEE DETAIL 15 / A-00.4
ONE-WAY ROOF VENT TO BE REMOVED W/ ROOFING
CONDUIT/PIPING RUNS SEE KEYNOTE 3



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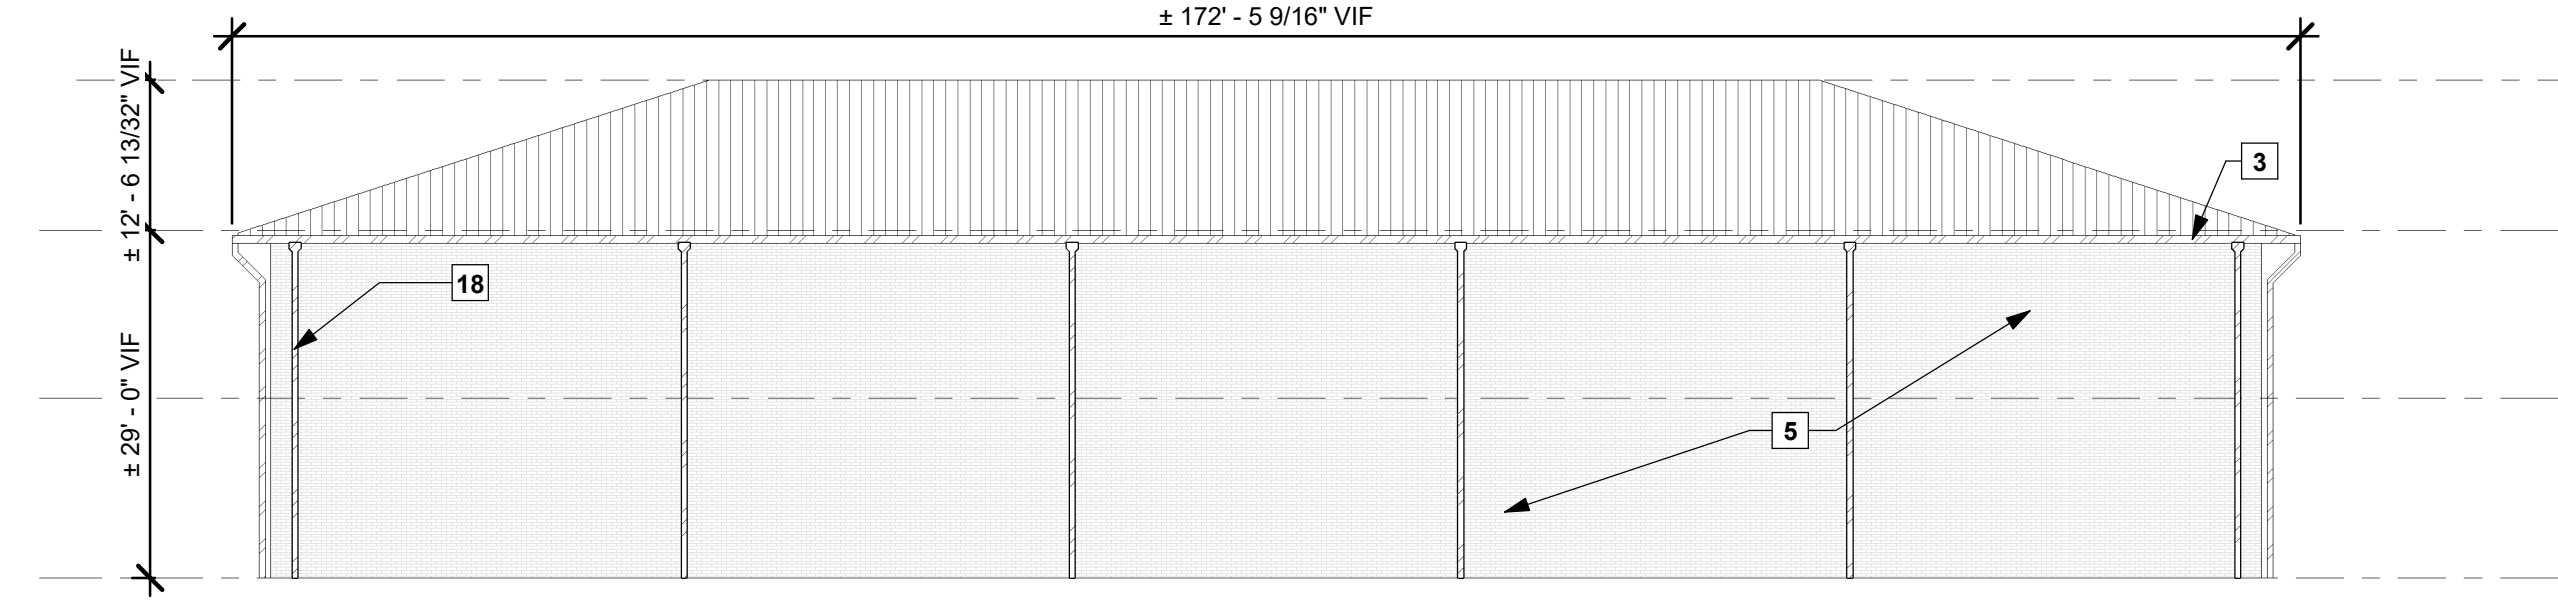
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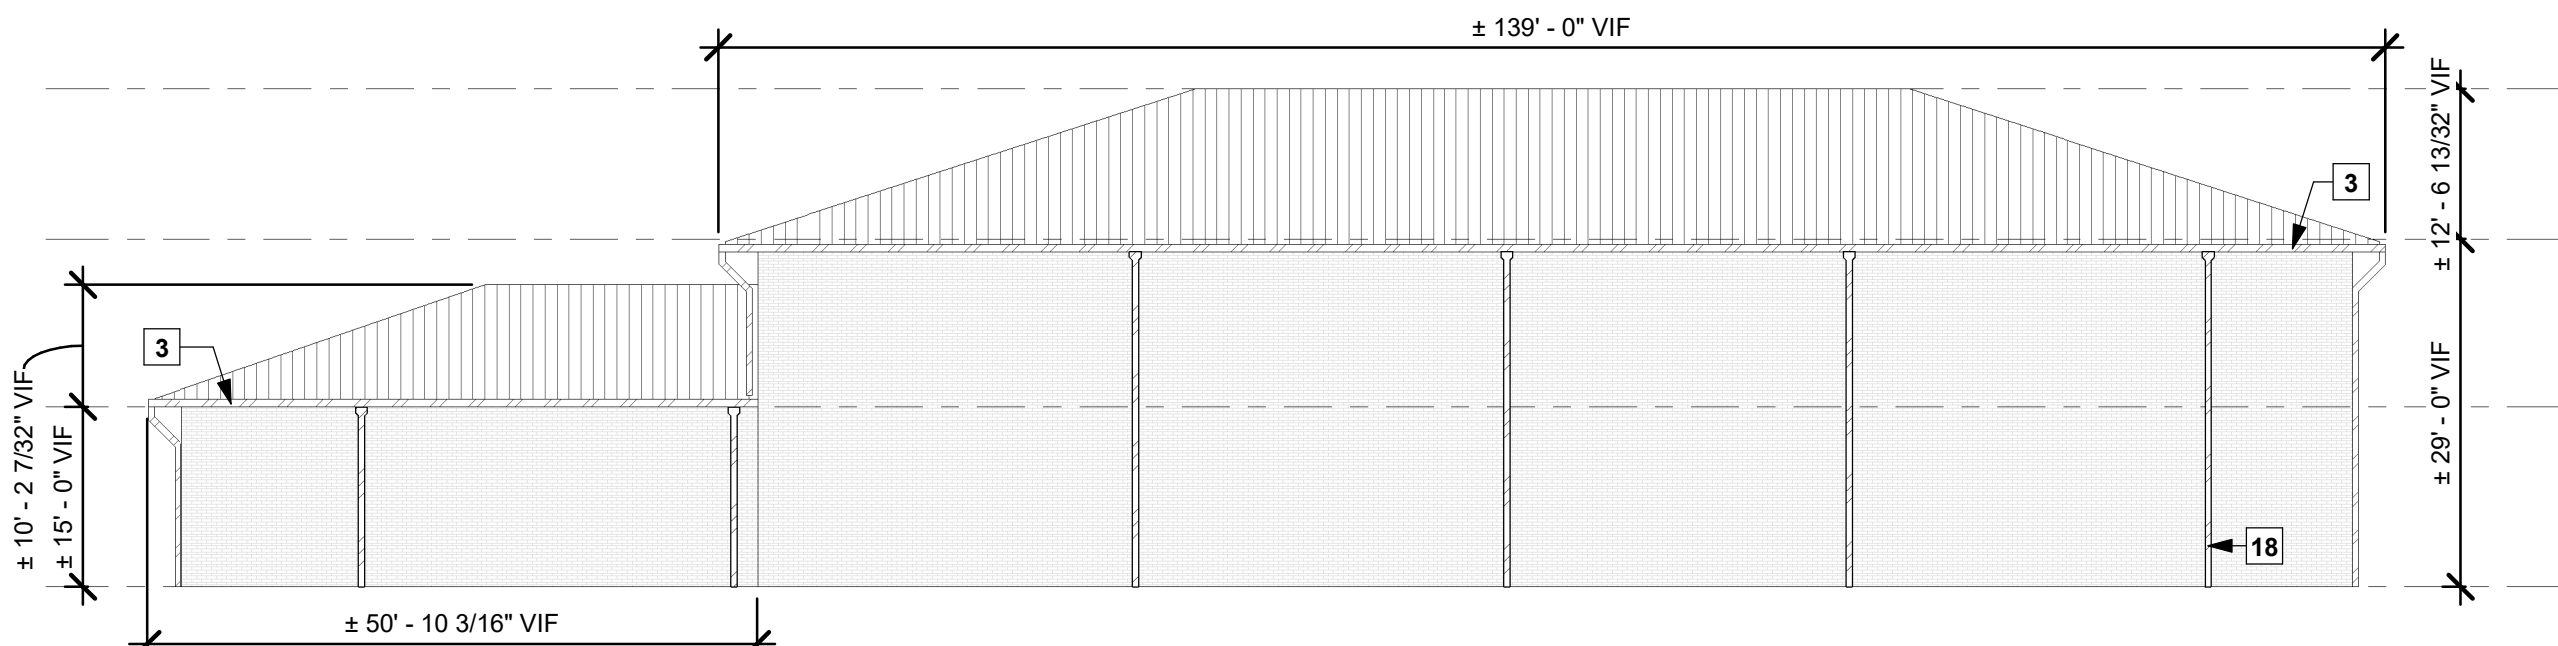
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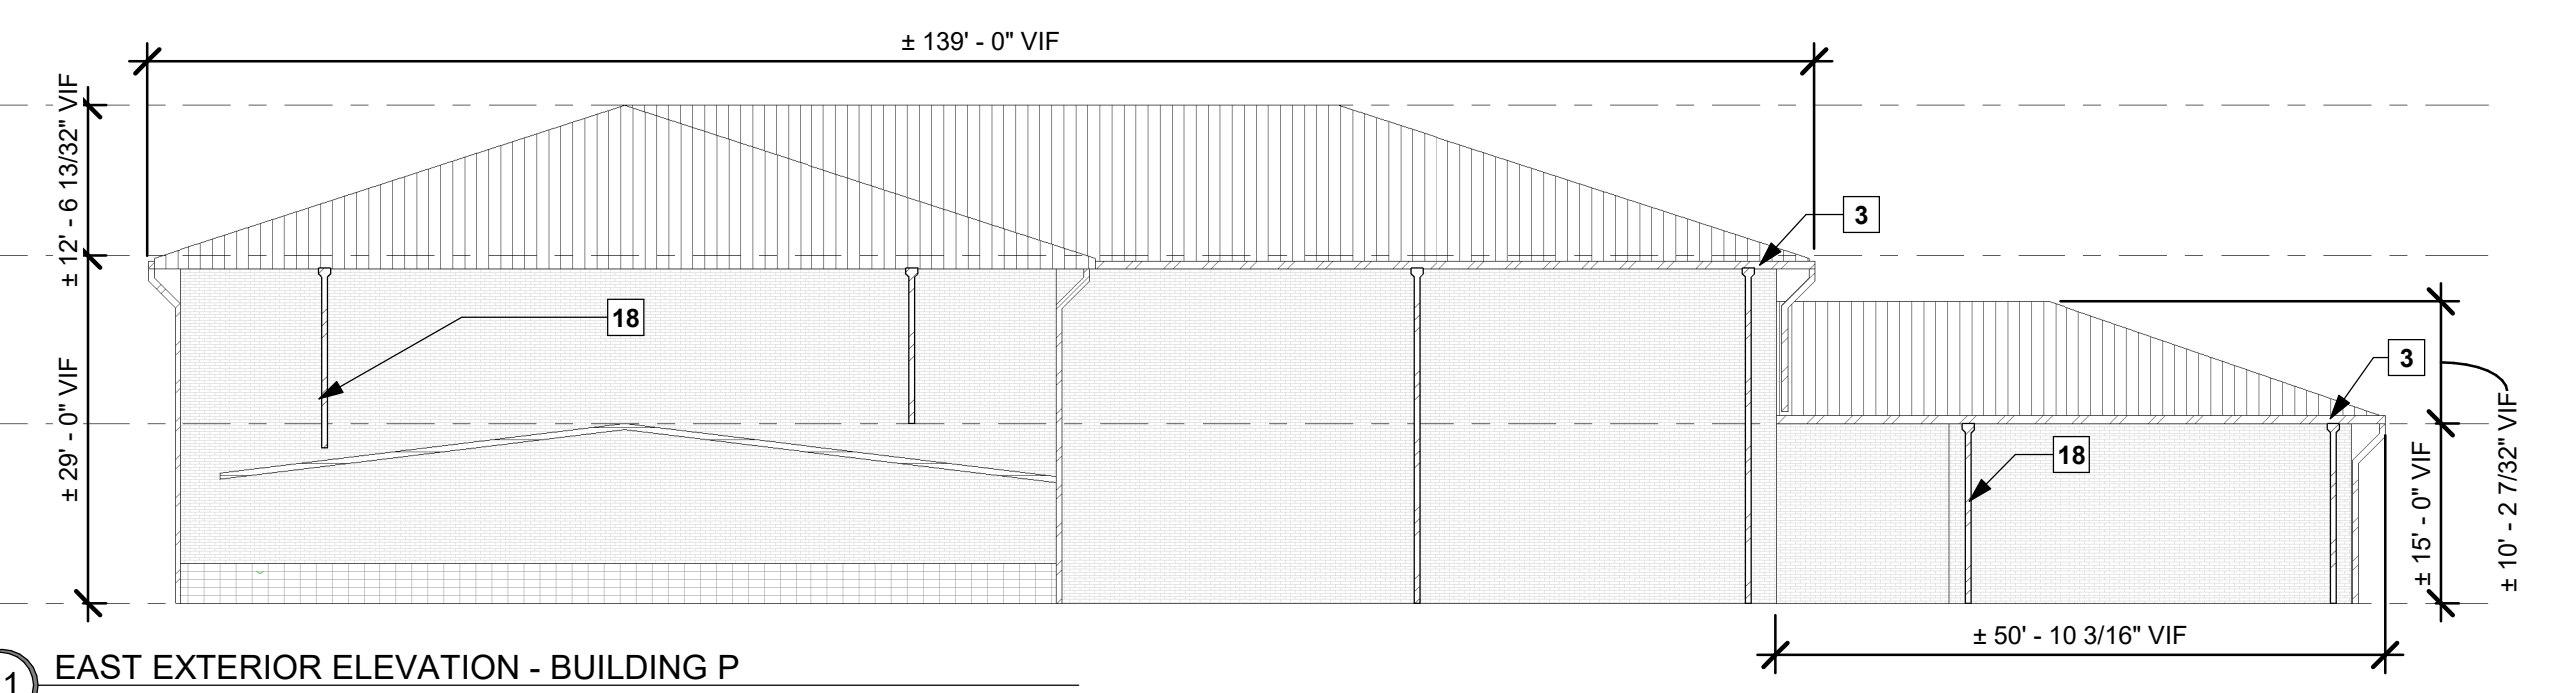
SHEET NUMBER (P)A0.1 BLDG P ROOF




1 SOUTH EXTERIOR ELEVATION - BUILDING P
1/16" = 1'-0"










6 WEST EXTERIOR ELEVATION - BUILDING P
1/16" = 1'-0"



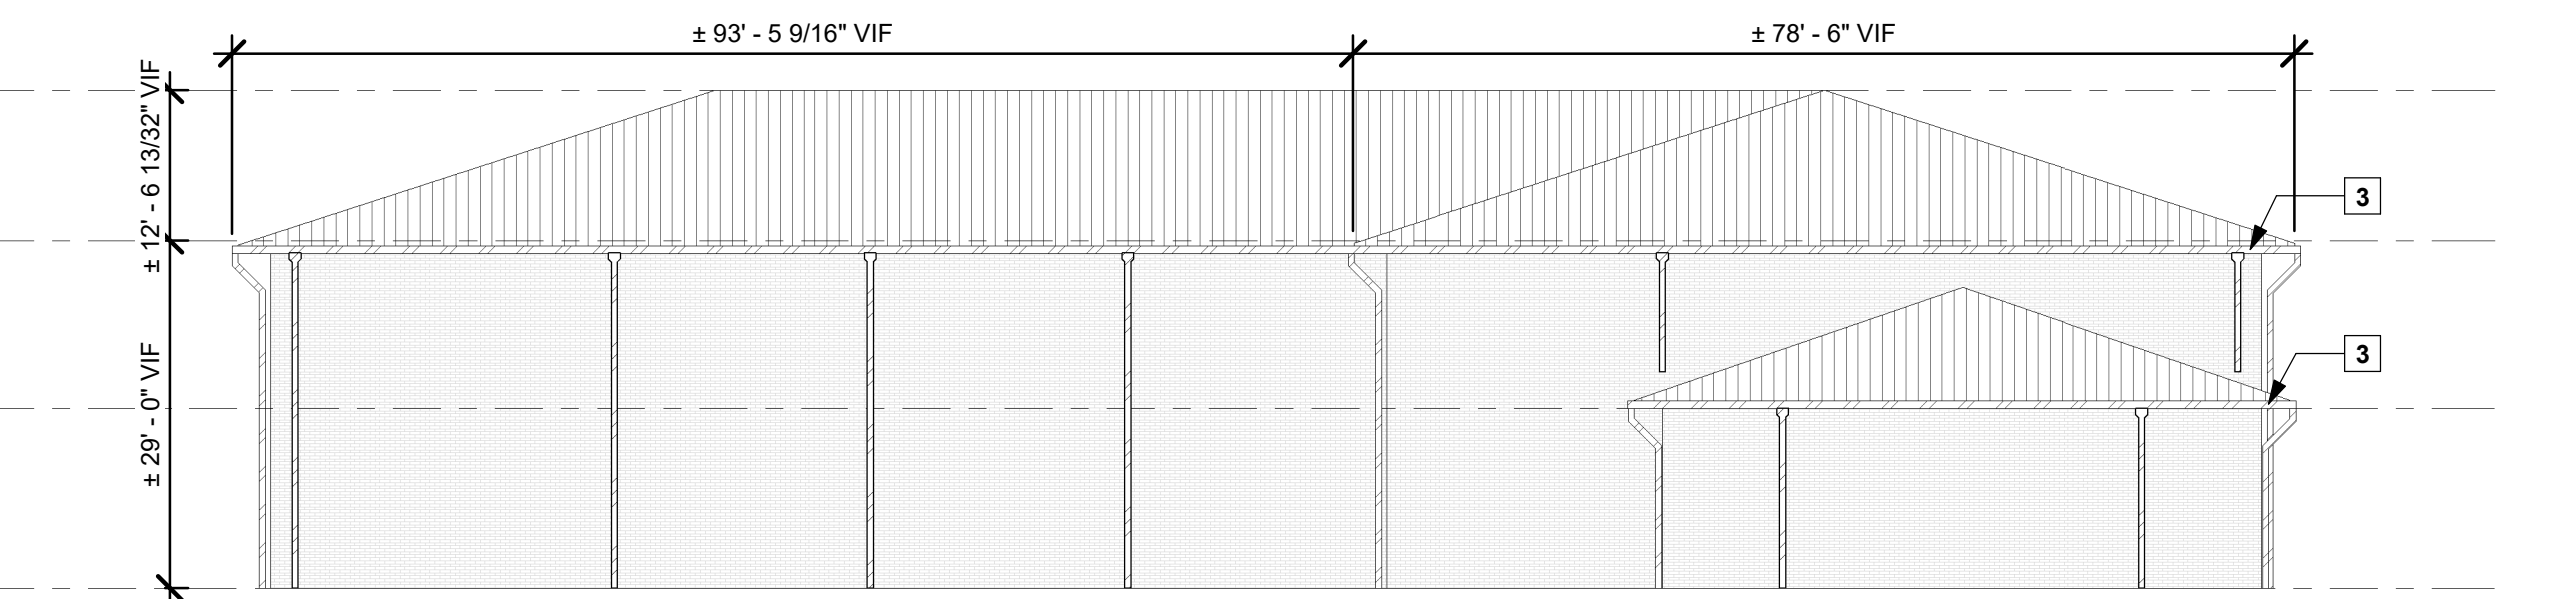11 EAST EXTERIOR ELEVATION - BUILDING P
1/16" = 1'-0"



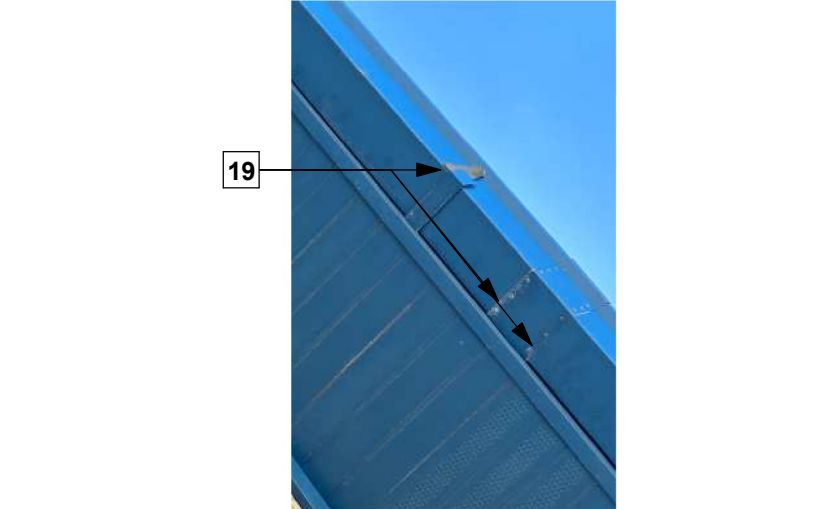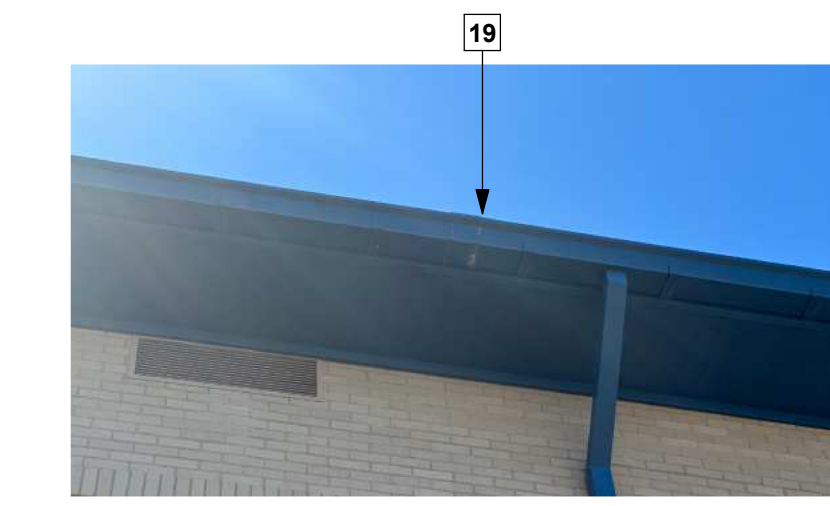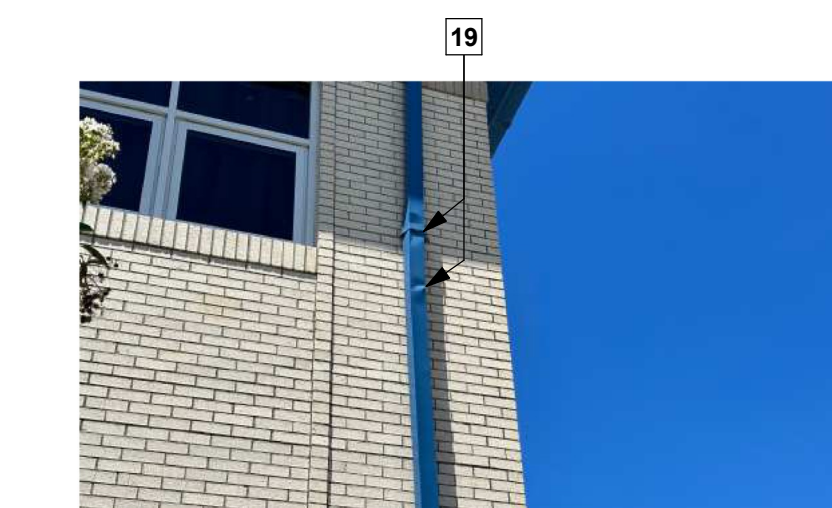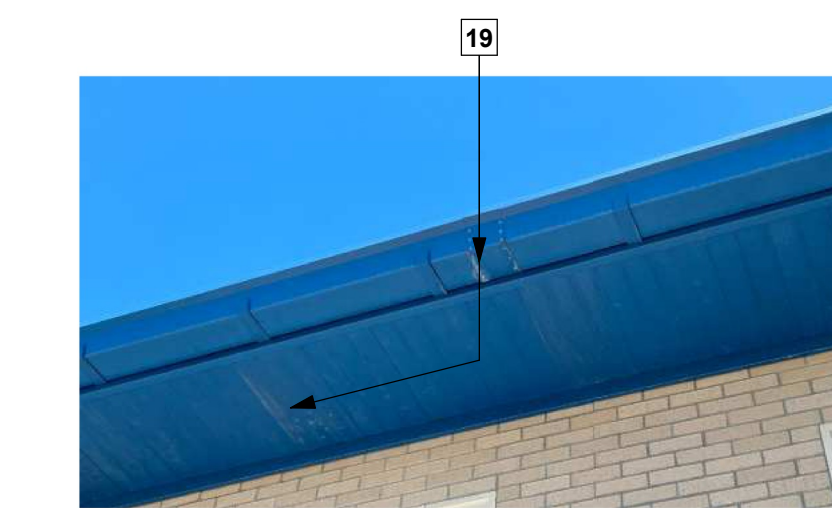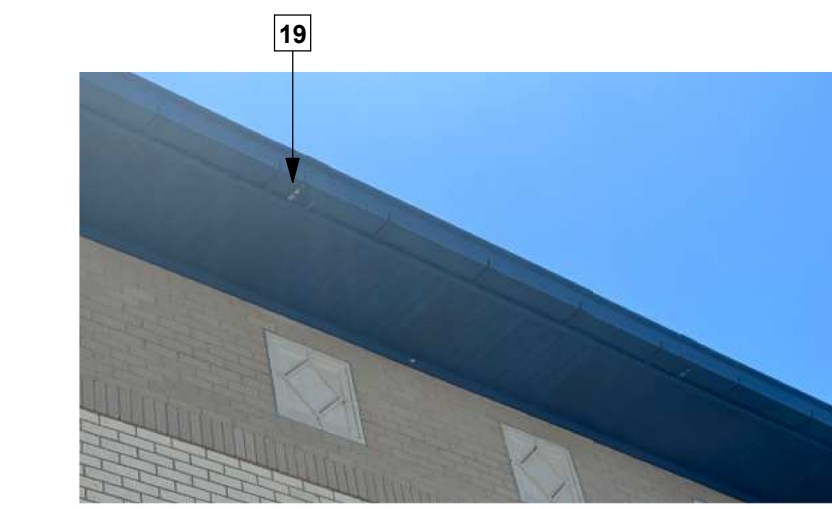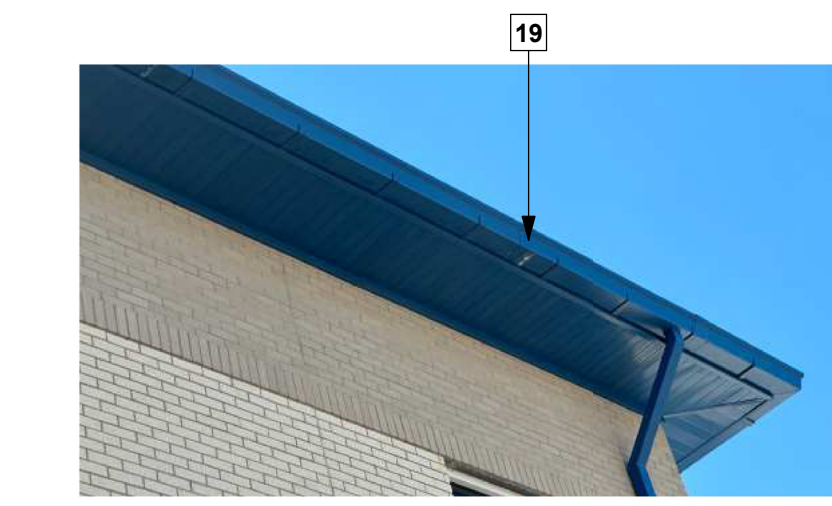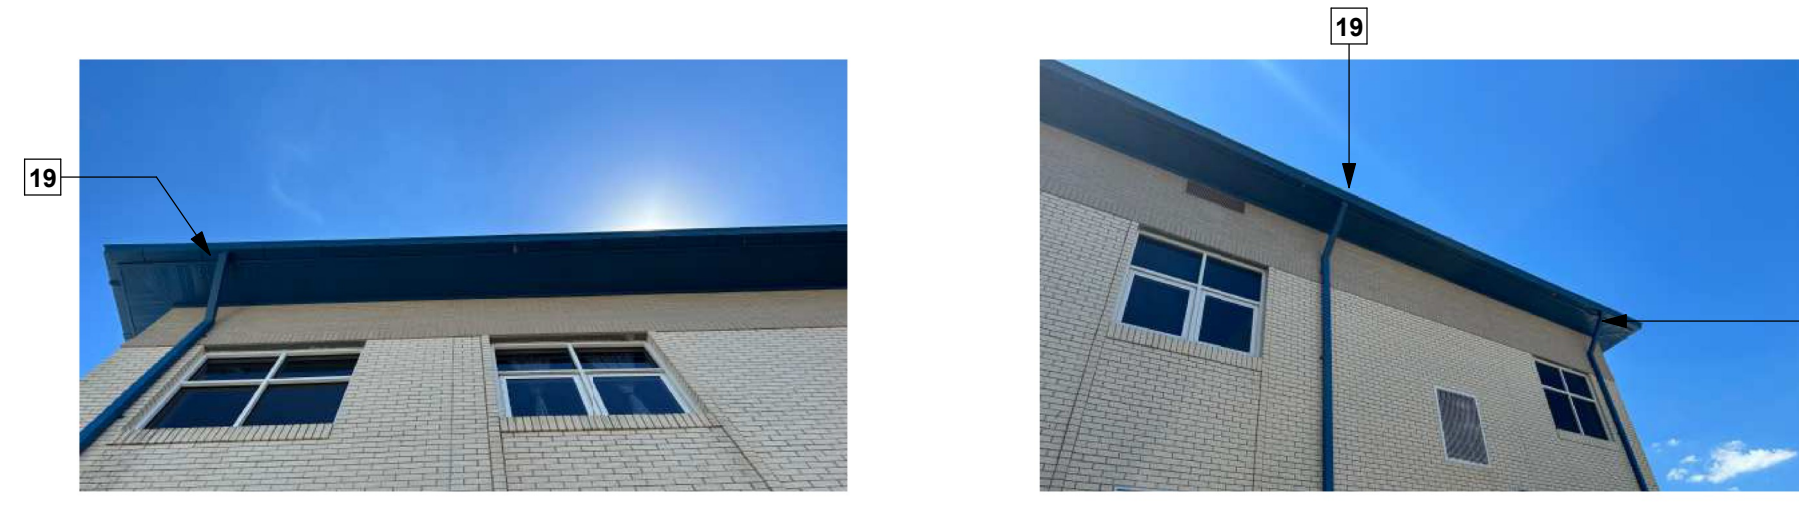
16B NORTH EXTERIOR ELEVATION - BUILDING P
1/16" = 1'-0"




- KEYNOTES**
- "A" METAL PANEL REPLACEMENT: METAL WALL PANEL "A" - REMOVE AND REPLACE DAMAGED/MISSING METAL WALL PANEL AS SPECIFIED. SEE BUILDING ELEVATIONS.
 - SIGNAGE INSTALLATION: INSTALL MISSING LETTERING TO MATCH EXISTING.
 - DOWNSPOUT AND GUTTER REPLACEMENT: REMOVE REMAINING ATTACHMENTS AND COMPONENTS OF DOWNSPOUT, GUTTER AND CONDUCTOR HEADS AND INSTALL NEW TO MATCH EXISTING COLOR, DIMENSION, GAUGE, AND MATERIAL. GROUT HOLES AT OLD STRAPS PRIOR TO NEW INSTALLATION & ATTACH AT INTERVALS EQUAL TO EXISTING SPACING. SALVAGE AND PREP REMAINING COMPONENTS FOR NEW INSTALLATION. CONTRACTOR IS TO REMOVE ALL DEBRIS FROM GUTTERS AND DOWN SPOUTS.
 - COPING: SEE ROOFING SHEETS FOR COPING, OVERHANG & ROOFING SCOPES - TYP.
 - EXISTING LIGHT FIXTURE - CONTRACTOR IS TO WEATHER SEAL FIXTURE AT METAL WALL PANEL.
 - NOT USED.
 - BRICK REPAIR: REMOVE AND REPLACE BRICK FACADE AS INDICATED. DISPOSE OF OLD BRICK. MATCH NEW BRICK AND MORTAR TO EXISTING AS APPROVED BY ARCHITECT. PRESERVE SUBSTRATE. REMOVE OLD BRICK TIES AND WATER PROOFING. INSTALL NEW WATERPROOFING AND BRICK TIES AT A MIN. OF 24" O.C. VERTICAL AND HORIZONTAL.
 - PAINTING EXTERIOR: CLEAN, PREP & RE-PAIN WALLS AND ARTWORK TO COVER SCUFFS AND DAMAGE FROM STORM DEBRIS. COLOR TO MATCH EXISTING AS APPROVED BY ARCHITECT.
 - GLASS REPLACEMENT: REMOVE AND REPLACE DAMAGED GLASS (OR PLYWOOD WHERE APPLICABLE) TO MATCH EXISTING. PROVIDE CAULKING AND GASKETING.
 - STUCCO SOFFIT REPLACEMENT: SOFFIT REMOVED BY OTHERS (HAZARDOUS MATERIAL). COORDINATE AND INSTALL NEW STUCCO SOFFIT.
 - AGGREGATE PANEL REPLACEMENT: DELAMINATED & DAMAGED AGGREGATE PANELS REMOVED BY OTHERS (HAZARDOUS MATERIAL). COORDINATE AND INSTALL NEW FACADE PANEL AS SPECIFIED. REINSTALL MEP COMPONENTS AT SAME LOCATIONS.
 - CONDUIT REPAIR: REPAIR CONDUIT AND MEP EQUIPMENT TO WORKING ORDER PER MEP DOCUMENTS.
 - GLAZING REPLACEMENT: REMOVE DAMAGED GLAZING SYSTEM AND REPLACE WITH NEW TO MATCH EXISTING AS SPECIFIED. PROVIDE NEW CONTINUOUS 4X4 STEEL ANGLE WELDED TO STRUCTURE FOR SUPPORT.
 - DOOR REPLACEMENT: REMOVE REMAINING DOOR DEBRIS AND COVERINGS AND REPLACE TO MATCH EXISTING, INCLUDING FRAMES, HARDWARE, AND GASKETING. SEE DOOR SCHEDULE.
 - METAL PANEL REPLACEMENT: REMOVE REMAINING DAMAGED METAL PANEL ASSEMBLY AND REPLACE WITH NEW SYSTEM TO MATCH EXISTING. COORDINATE REMOVAL AND INSTALLATION TO PREVENT WEATHER INTRUSION.
 - SOFFIT PANEL REPLACEMENT: REMOVE AND REPLACE SOFFIT PANELS TO MATCH EXISTING - APPROX. 3'X3' PANELS.
 - GLASS AND GLAZING REPLACEMENT: REMOVE AND DISPOSE OF MESH, BROKEN & REMAINING GLASS AND GLAZING - REPLACE WITH SOLID PANELS AS SPECIFIED.
 - DOWNSPOUT AND GUTTER CLEANING: DOWNSPOUT/COLLECTOR LOCATIONS. CONTRACTOR IS TO REMOVE ALL DEBRIS FROM GUTTERS AND DOWN SPOUTS.
 - GUTTER REPAIR - RESEAL ALL JOINTS; PROVIDE ALL RIVETS

ROOFING SYMBOL LEGEND

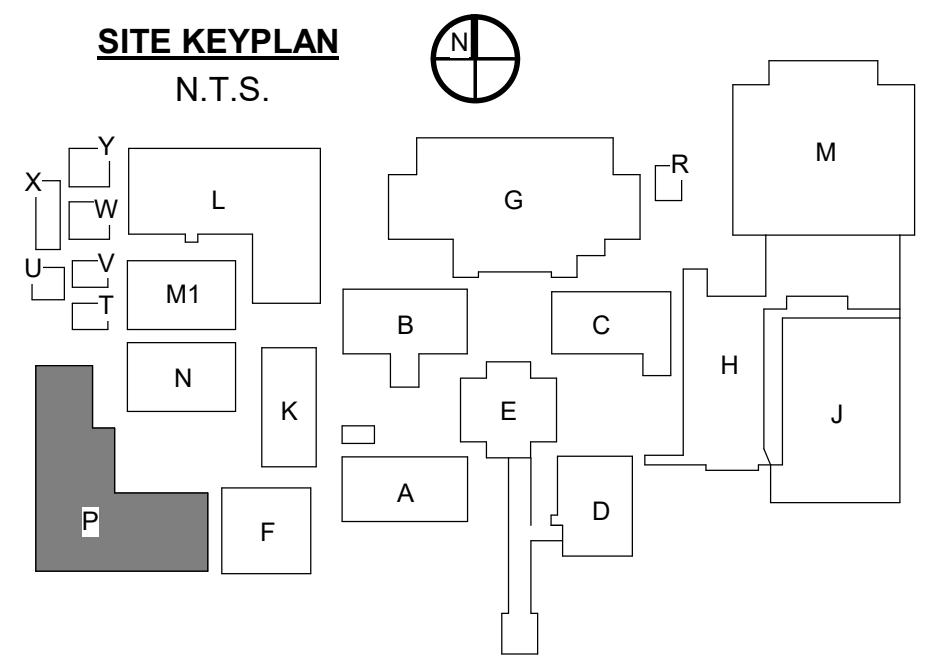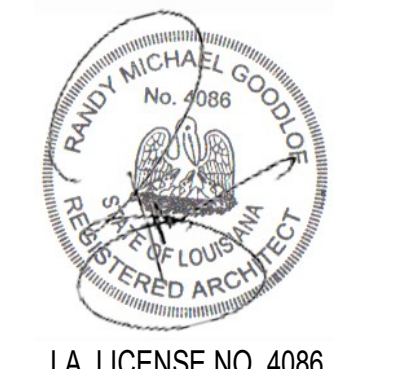- EXISTING SKYLIGHT SEE KEYNOTE 11 SEE DETAIL 19 / A-00.4
- ROOF DRAIN LOCATION SEE KEYNOTE 5 SEE DETAIL 16 / A-00.4
- ROOF PIPING PENETRATION SEE KEYNOTE 9
- ROOF FAN / VENT SEE KEYNOTE 12
- ROOF FAN / VENT SEE KEYNOTE 12
- DOWNSPOUT SEE KEYNOTE 30
- MISC MEP SEE KEYNOTE 12
- TURBINE VENT SEE KEYNOTE 12
- EXPANSION JOINT SEE DETAIL 3 / A-00.4
- SCUPPER/OPENING FOR DRAINAGE SEE KEYNOTE 28 SEE DETAIL 15 / A-00.4
- ONE-WAY ROOF VENT TO BE REMOVED W/ ROOFING
- CONDUIT/PIPING RUNS SEE KEYNOTE 3



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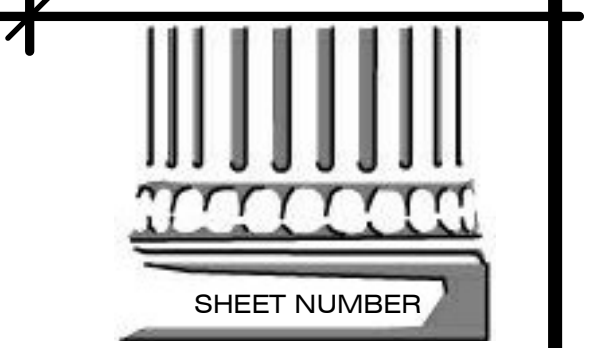
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 2200 W. McNEESE ST.
 FOR
CALCASIEU PARISH SCHOOL BOARD
 LAKE CHARLES, LA 70605
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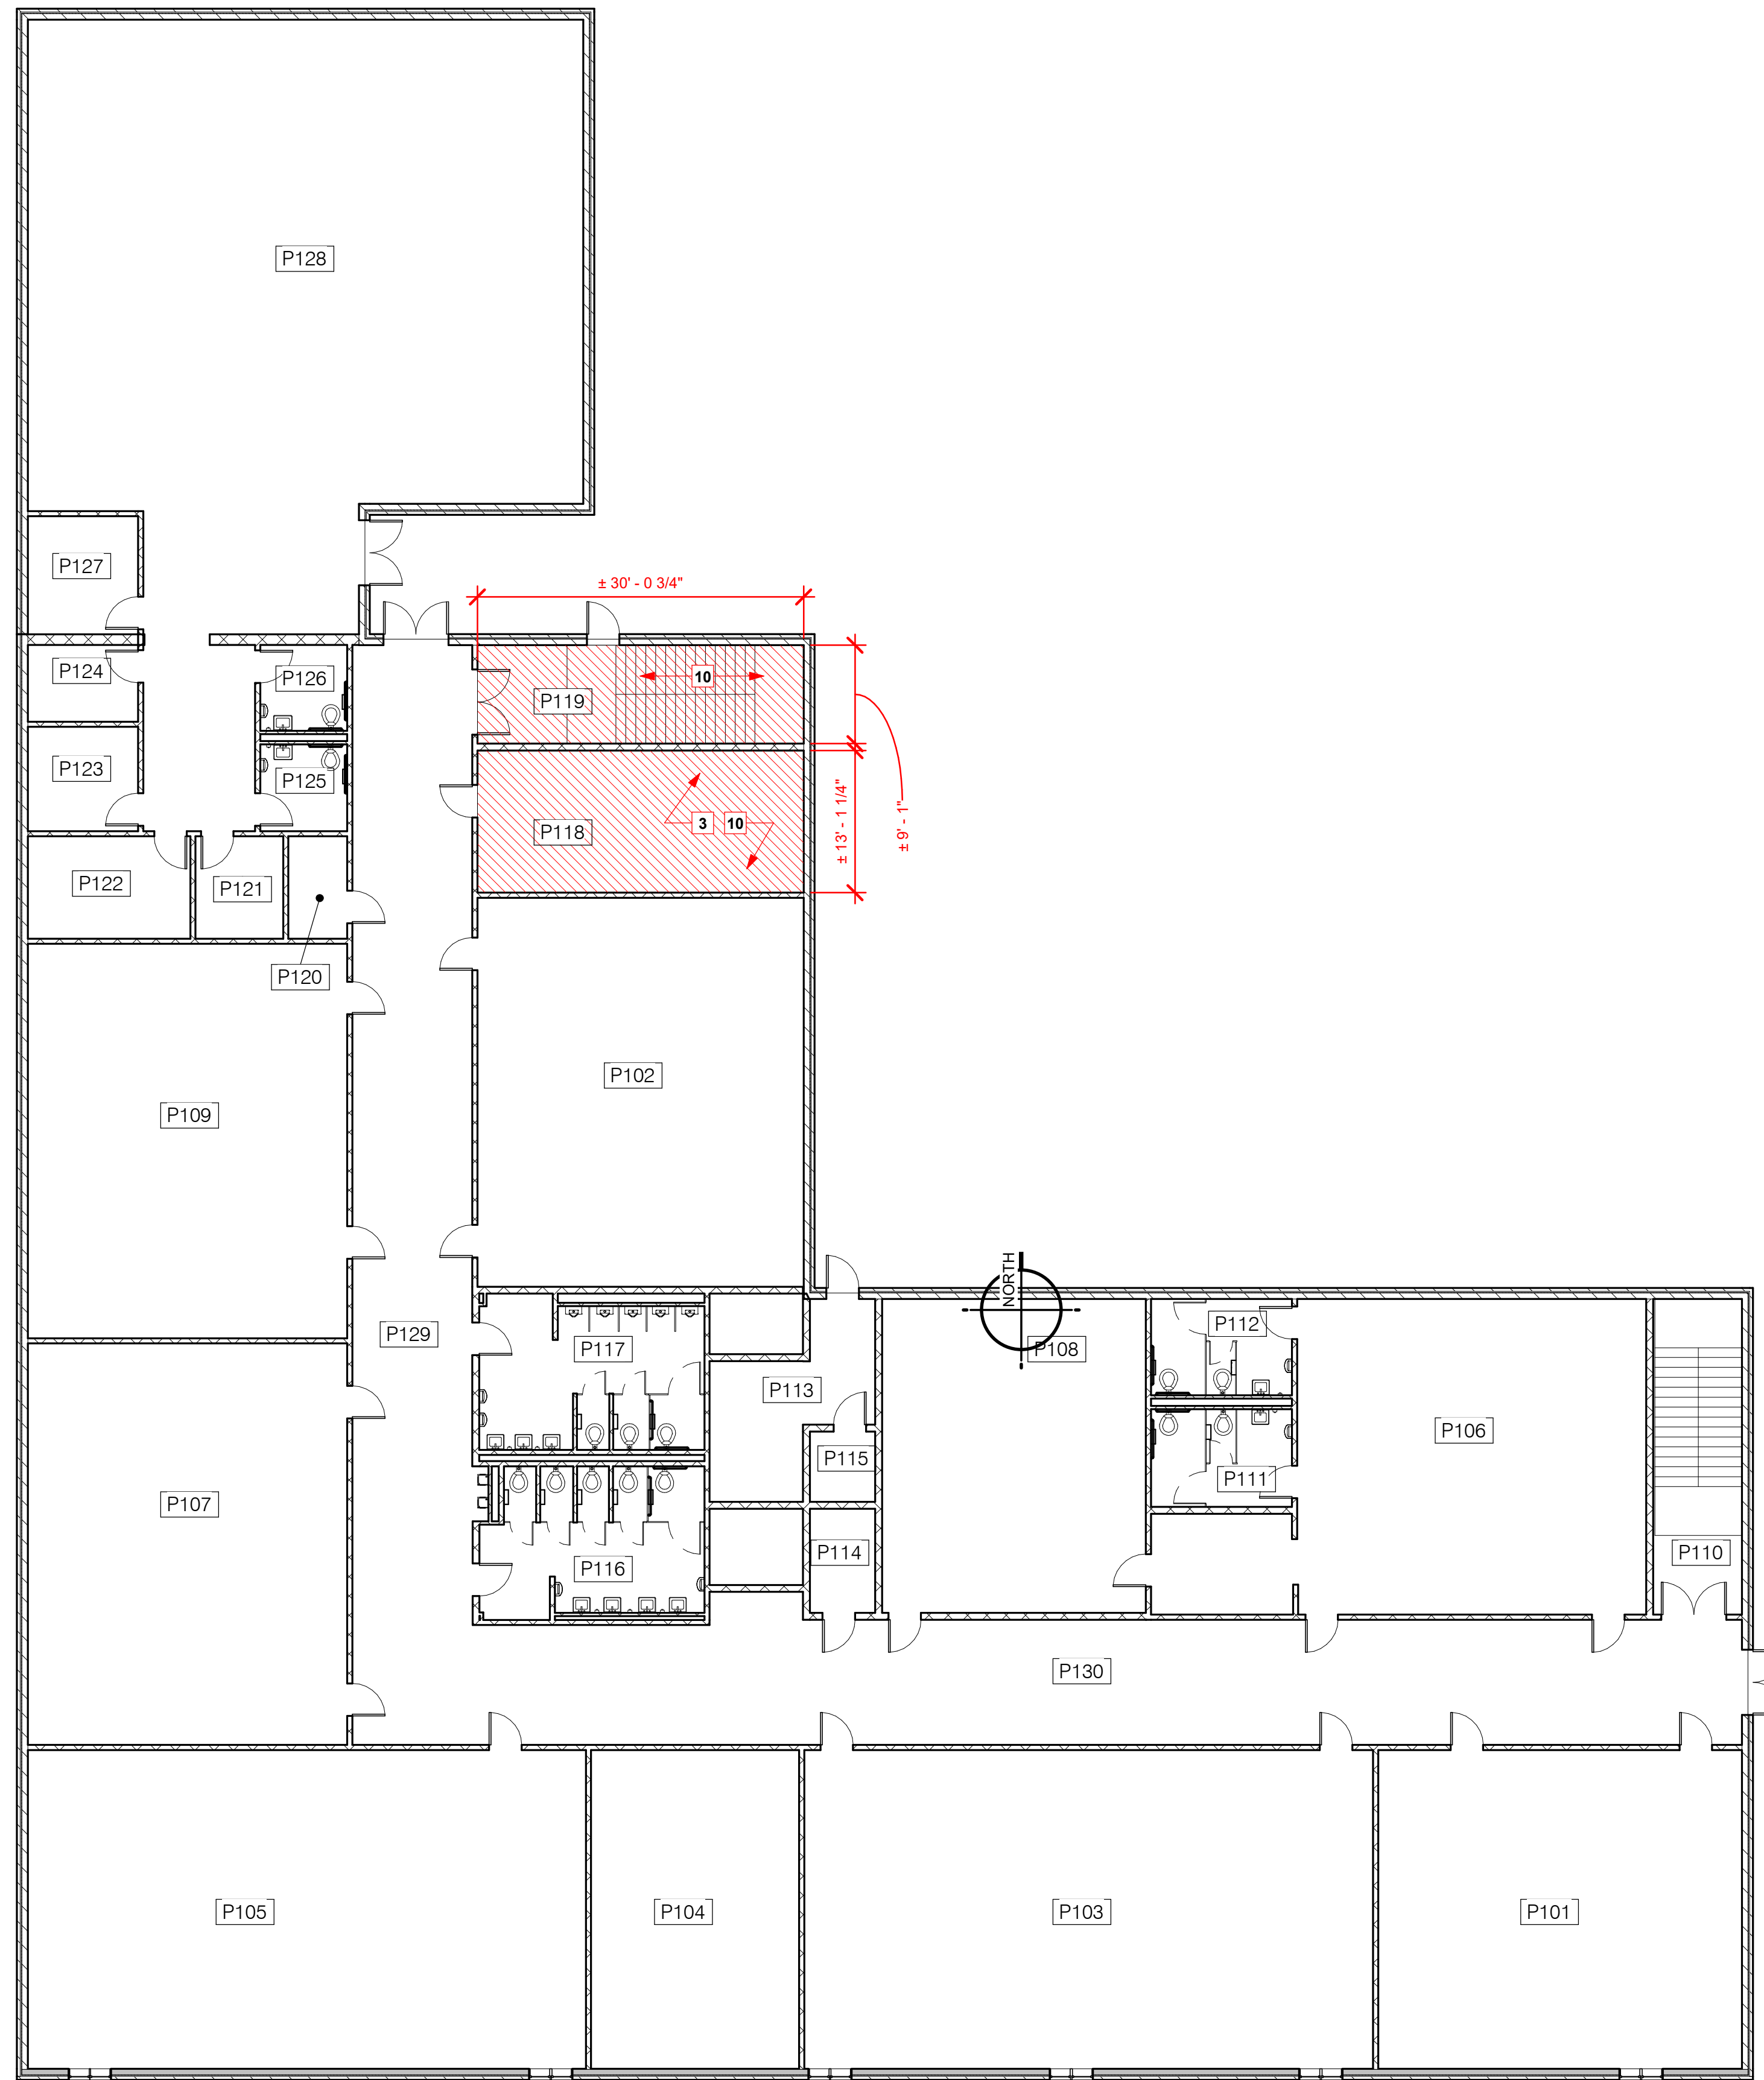
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SHEET NUMBER
(P)A0.2
 BLDG P ELEVATIONS


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16 Zone 1 - Building P First Floor
3/32" = 1'-0"



FLOOR PLAN LEGEND	
	- CEILING REPAIR REQUIRED
	- FLOORING REPAIR REQUIRED. SEE ROOM SCHEDULE.
	- WALL/BASE REPAIR REQUIRED. SEE ROOM SCHEDULE.
	- MILLWORK REPAIR REQUIRED. SEE ROOM SCHEDULE.

ROOMS - BUILDING P		
ROOM NUMBER	Area	Perimeter
P118	394 SF	86'- 4"
P119	273 SF	78'- 3"

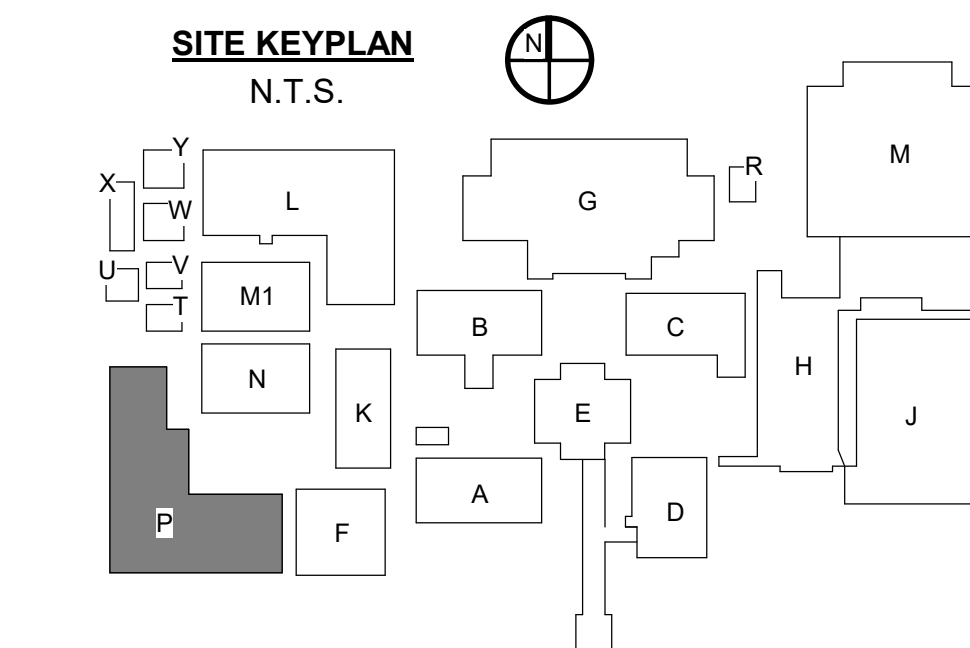

KEYNOTES

- SUSPENDED ACOUSTIC CEILING REPLACEMENT:** REMOVE AND REPLACE DAMAGED CEILING GRID AND CEILING TILE AS SPECIFIED.
- CEILING GRID:** REMOVE AND REPLACE DAMAGED CEILING GRID. MATCH EXISTING. SEE UNIT PRICE NO. 5.
- VCT FLOORING REPAIRS:** REMOVE AND REPLACE VCT FLOORING AS SPECIFIED IN AREAS WHERE INDICATED. SEE UNIT PRICE NO. 3.
- WINDOW REPAIRS:** REPLACE BROKEN WINDOW PANES, BLOCKS, AND GASKETS TO MATCH EXISTING. ALL SEALANTS SHALL BE REMOVED AND REPLACED AS SPECIFIED TO ENSURE WEATHER TIGHT SEAL. SEE ELEVATIONS.
- STRUCTURAL CLAY BLOCK:** GLAZED STRUCTURAL CLAY BLOCK TO BE REMOVED AND REPLACED AS SPECIFIED TO MATCH EXISTING. CLEAN ALL CHALKING RESIDUE FROM EFFERVESCENCE.
- VINYL BASE REPLACEMENT:** REPLACE DAMAGED OR MISSING BASE AS SPECIFIED TO MATCH EXISTING. SEE UNIT PRICE NO. 4.
- CARPET REPAIRS:** DAMAGED CARPET HAS BEEN REMOVED. CLEAN FLOOR AND INSTALL NEW CARPET TILE AS SPECIFIED.
- PAINTING:** WALL SURFACE IS TO BE SANDED, PREPARED, AND REPAINT TO MATCH EXISTING CORNER TO CORNER. WATER STAINED WALL FROM ROOF LOSS.
- PAINTED CEILING STRUCTURE:** CEILING INCLUDING METAL TRUSSES ARE TO BE CLEANED, PREPPED, AND REPAINTED END TO END TO MATCH EXISTING COLOR.
- VCT FLOORING CLEANING:** CLEAN WATER STAINS FROM VCT FLOORING TO REMOVE ANY DISCOLORATION WHERE INDICATED. MOP AND WAX ALL VCT FLOORING AT THE END OF CONSTRUCTION.
- SKYLIGHT REPAIRS:** REMOVE AND REPLACE SKYLIGHT TO MATCH EXISTING.
- TERRAZZO FLOORING CLEANING:** CLEAN AND POLISH EXISTING TERRAZZO FLOORING. REFER TO ROOM SCHEDULE FOR CLARITY.
- CEILING TILE REPLACEMENT:** REMOVE AND REPLACE DAMAGED OR MISSING ACOUSTIC CEILING TILE WITH NEW CEILING TILE AS SPECIFIED IN AREAS INDICATED. MATCH EXISTING TYPE AND SIZE. SEE UNIT PRICE NO. 1. INSTALL R-30 BATT INSULATION OVER TILE. SEE UNIT PRICE NO. 2.
- NOT USED.**
- EXTERIOR WINDOWS AND DOORS:** CAULK AND RESEAL PERIMETER OF EXISTING WINDOWS AND DOORS.
- CMU REPAIR:** RE-POINT DAMAGED CMU JOINTS AS SHOWN. PAINT WALL FROM END TO END IN COLOR TO MATCH EXISTING AS SPECIFIED. SEE PHOTOS.
- BRICK REPAIR:** CAULK CRACKED AREAS AND REPAINT.
- LOCKERS:** REPLACE DAMAGED UNITS AS SHOWN. MATCH EXISTING STYLE, SIZE AND COLORS.
- BRICK WALLS:** CLEAN ALL WATER STAINS FROM ENTIRE BRICK WALL.
- SHELVING REPLACEMENT:** REMOVE AND REPLACE DAMAGED SHELVING UNITS WITH **GLASS DOORS**. MATCH EXISTING MATERIALS, FINISHES AND CONSTRUCTION STYLE.
- BASE CABINET:** REMOVE AND REPLACE DAMAGED BASE CABINET. MATCH EXISTING STYLE, SIZE, AND CONSTRUCTION. SALVAGE AND REINSTALL COUNTERTOP.
- SECTIONAL DOOR:** REMOVE AND REPLACE OVERHEAD SECTIONAL DOOR AS SPECIFIED. CONTRACTOR TO PROVIDE ANY ADDITIONAL SUPPORT REQUIRED BY THE MANUFACTURER.
- GYPSON BOARD:** REMOVE AND REPLACE DAMAGED GYPSON BOARD TO NEAREST FRAMING MEMBER. FINISH AND RE-PAINT WALL CORNER TO CORNER.
- PREFINISHED GYPSON BOARD WITH VINYL WALL COVER AND CORNER TRIM:** REMOVE AND REPLACE DAMAGED VINYL COVERED GYPSON BOARD FROM FLOOR TO CEILING WHERE INDICATED ON FLOOR PLAN.
- STOREFRONT WINDOW:** REMOVE AND REPLACE STOREFRONT WINDOW AS SPECIFIED.
- NOT USED.**
- GYPSON CEILING REPAIRS:** REMOVE AND REPLACE DAMAGED GYPSON CEILING BOARD TO NEAREST FRAMING MEMBER WHERE INDICATED, FINISH TO MATCH EXISTING AS SPECIFIED.
- METAL ROOF PANEL REPAIRS:** REMOVE AND REPLACE DEFORMED OR MISSING METAL ROOF PANELS TO MATCH EXISTING.
- CONCRETE FLOOR CLEANING:** CLEAN AND RESEAL FLOOR AS SPECIFIED.
- BASE CABINET:** REMOVE AND REPLACE DAMAGED BASE CABINET. MATCH EXISTING STYLE, SIZE, AND CONSTRUCTION. SALVAGE AND REINSTALL COUNTERTOP. PROTECT ALL MECHANICAL CONNECTIONS.
- TILE CLEANING:** CLEAN STAINS FROM WALL TILE TO REMOVE ANY DISCOLORATION WHERE INDICATED.
- CLEAN/REPAINT MASONRY WALL:** MECHANICALLY REMOVE ALL LOOSE OR PEELING PAINT AND ALL CHALKING RESIDUE FROM EFFERVESCENCE FROM CORNER TO CORNER. PERFORM REQUIRED MOISTURE TESTING PRIOR TO REPAINTING WALL AS SPECIFIED.
- PLASTER CEILING REPAIRS:** REMOVE AND REPLACE DAMAGED PLASTER CEILING WHERE INDICATED AS SPECIFIED, PAINT IN COLOR TO MATCH EXISTING.
- MEP DAMAGES:** SEE MECHANICAL, PLUMBING AND ELECTRICAL PLANS.
- FURNITURE SETTING AND RESETTING:** RELOCATE ALL EXISTING FURNITURE TO TEMPORARY ROOM IN MODULAR BUILDINGS WHILE EXISTING SPACE IS BEING REPAIRED. REINSTALL AND RESET FURNITURE ONCE REPAIRS ARE COMPLETE. SEE PHASING PLAN.
- SUSPENDED CEILING INSULATION:** INSTALL R-19 BATT INSULATION AS SPECIFIED ABOVE PREVIOUSLY INSTALLED SUSPENDED CEILING TILE. SEE UNIT PRICE NO. 2.
- BRICK WALL REPLACEMENT:** REMOVE AND REPLACE BRICK WALL AS INDICATED. DISPOSE OF OLD BRICK. MATCH NEW BRICK AND MORTAR TO EXISTING AS APPROVED BY ARCHITECT. SEE STRUCTURAL BUILDING TO REMAIN WEATHERPROOF AND CONDITIONED DURING REPAIRS.
- DOOR REPAIR:** CLEAN, PREP AND RE-PAINT DOOR FRAME - SEE DOOR SCHEDULE.
- CORRIDOR WALL REPAIR:** REMOVE DAMAGED STOREFRONT WINDOW AND EXISTING 3/4" PLYWOOD SHEATHING BELOW WINDOW. INSTALL NEW WINDOW PER SCHEDULE AND NEW 3/4" PLYWOOD SHEATHING. PAINT AS SPECIFIED, IN COLOR AS SELECTED. SEE DETAILS.
- GLAZING REPAIR:** REMOVE AND REPLACE BROKEN GLASS. MATCH EXISTING TINT. PROVIDE SAFETY GLASS AS REQUIRED.
- DOOR REPAIR:** REMOVE AND REPLACE EXISTING LEFT DOOR LEAF. PROVIDE AN INSULATED HOLLOW METAL DOOR WITH VISION PANEL TO MATCH RIGHT DOOR LEAF. REINSTALL EXISTING DOOR HARDWARE. PAINT AS DIRECTED.



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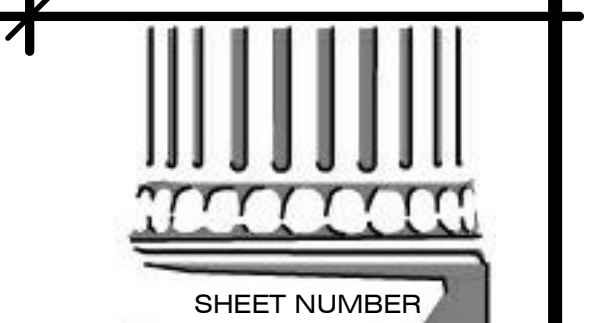
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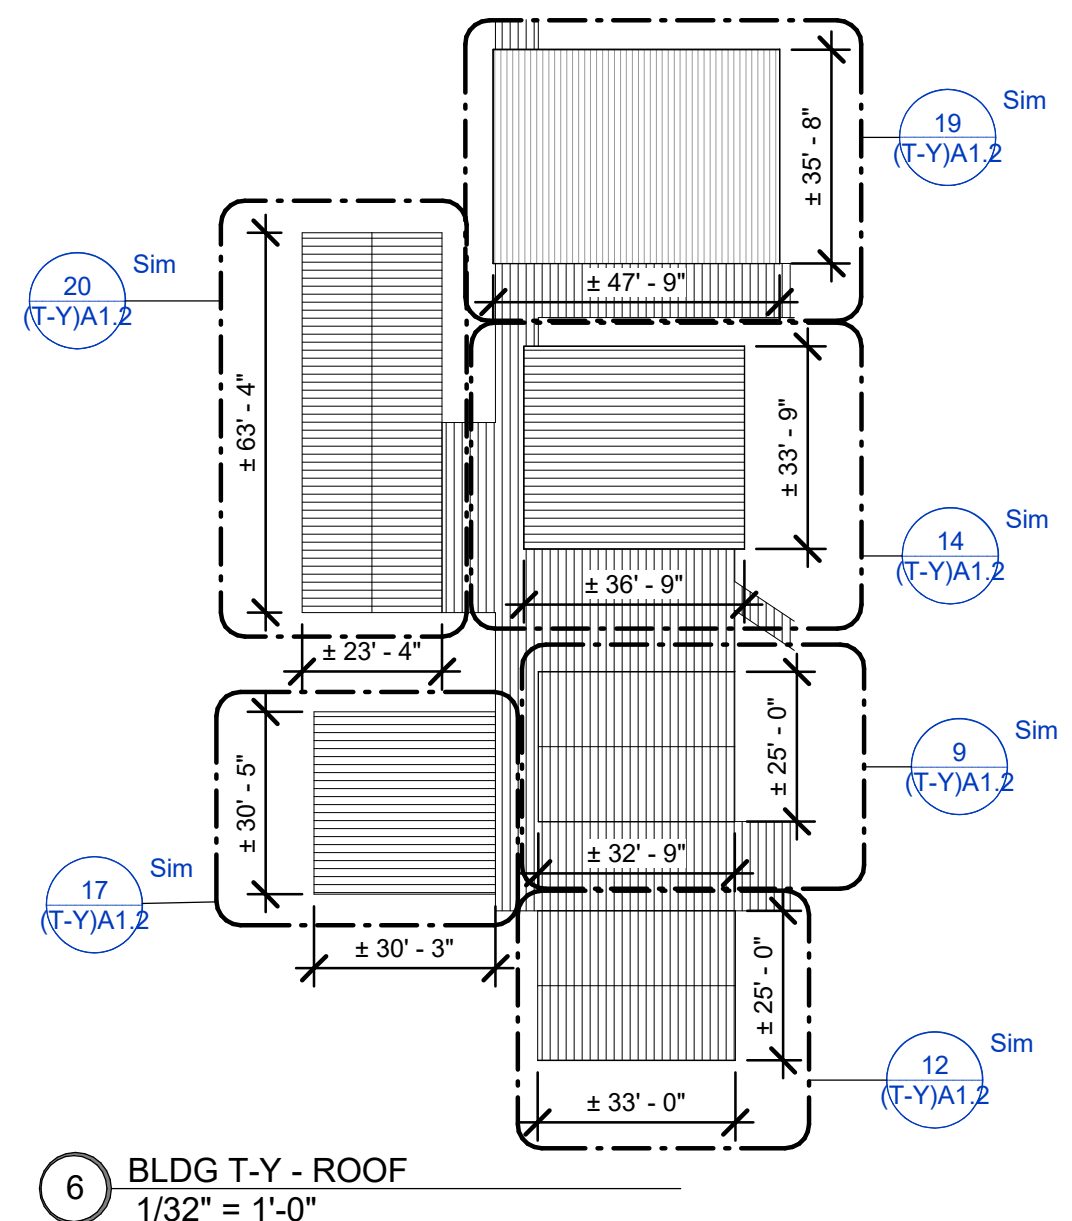
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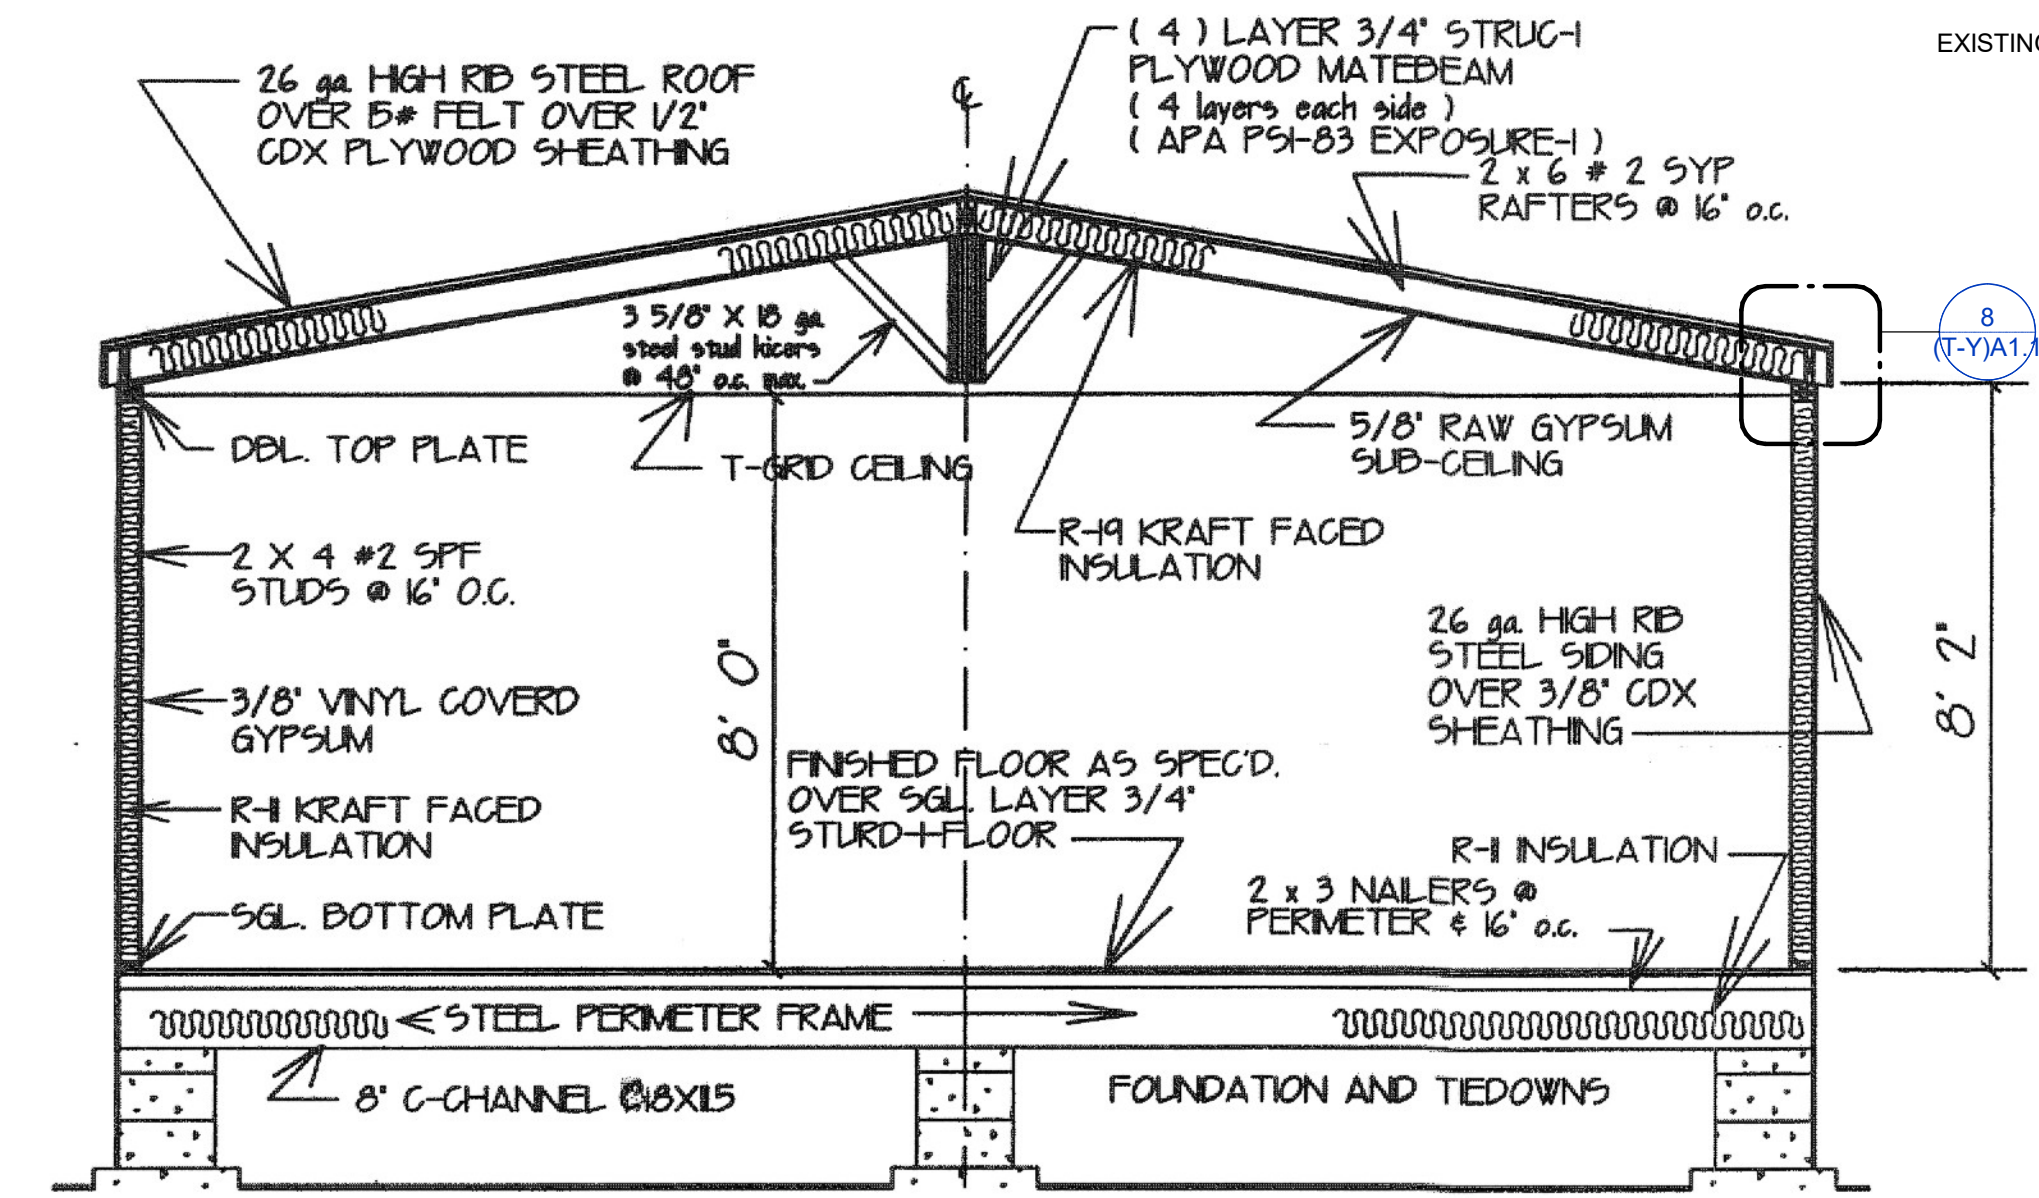
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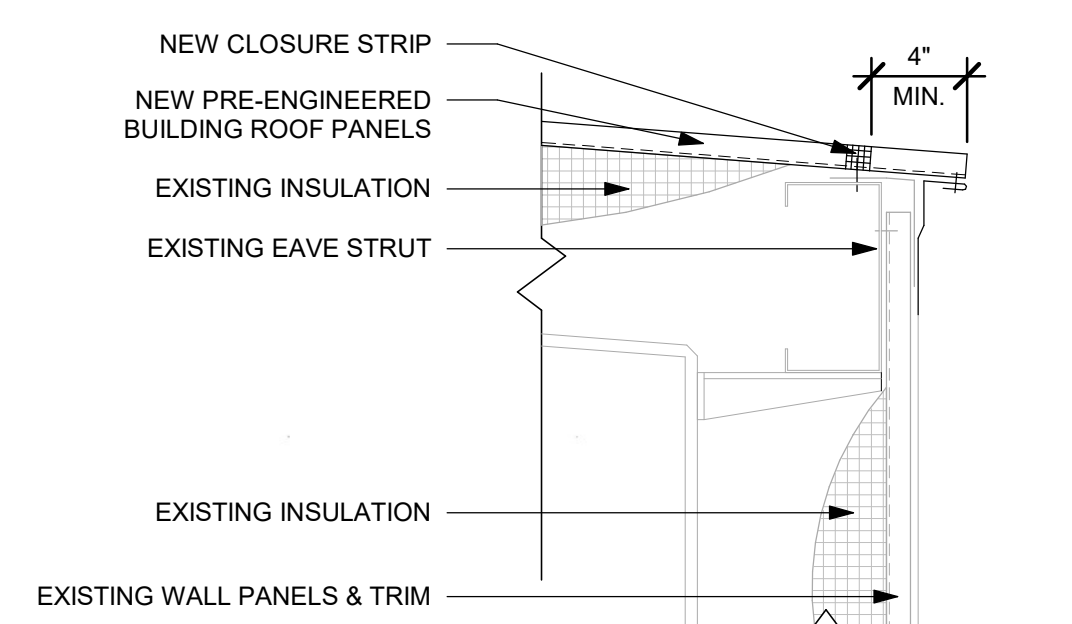
2 BLDG R - ROOF
1/32" = 1'-0"

6 BLDG T-Y - ROOF
1/32" = 1'-0"

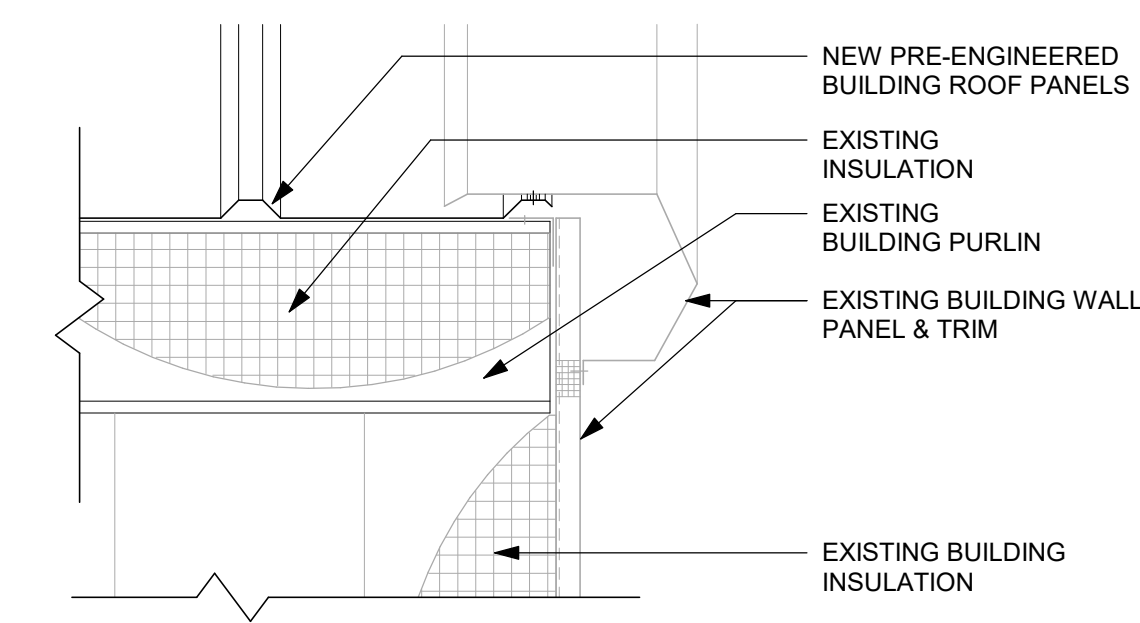
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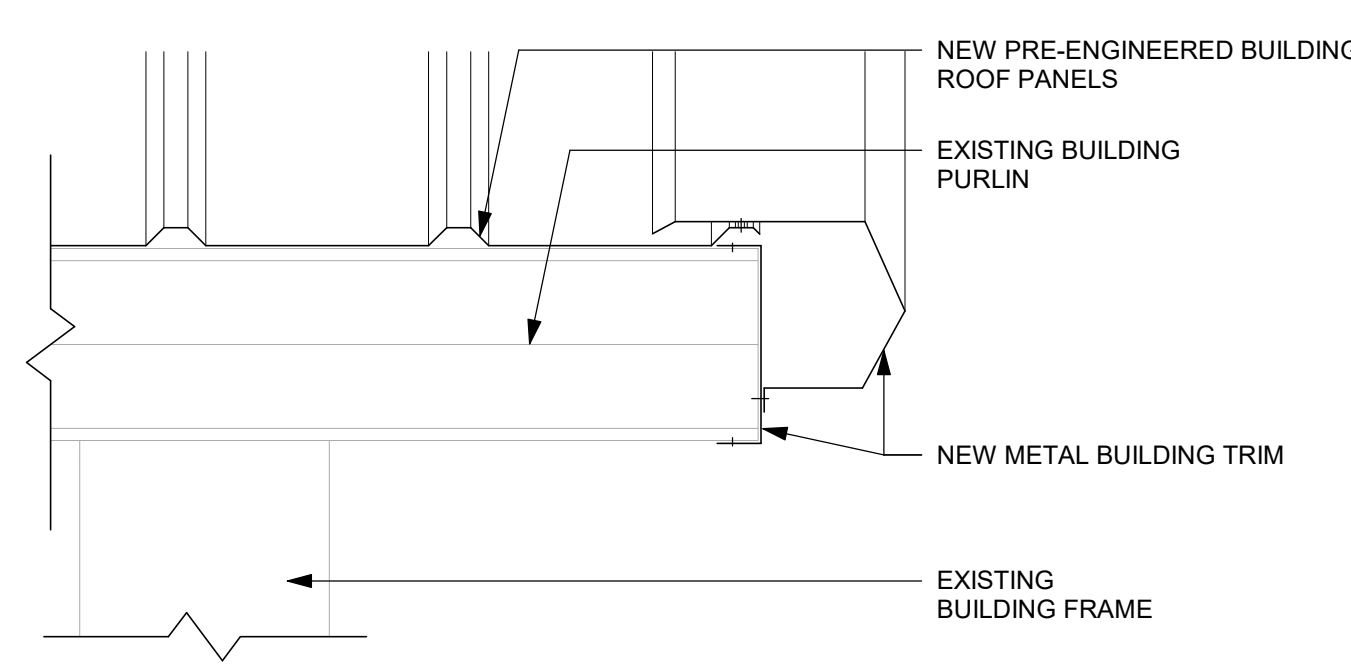
CROSS SECTION
SCALE: N/A




8 DETAIL SIDEWALL
1 1/2" = 1'-0"



9 DETAIL ENDWALL 1
1 1/2" = 1'-0"




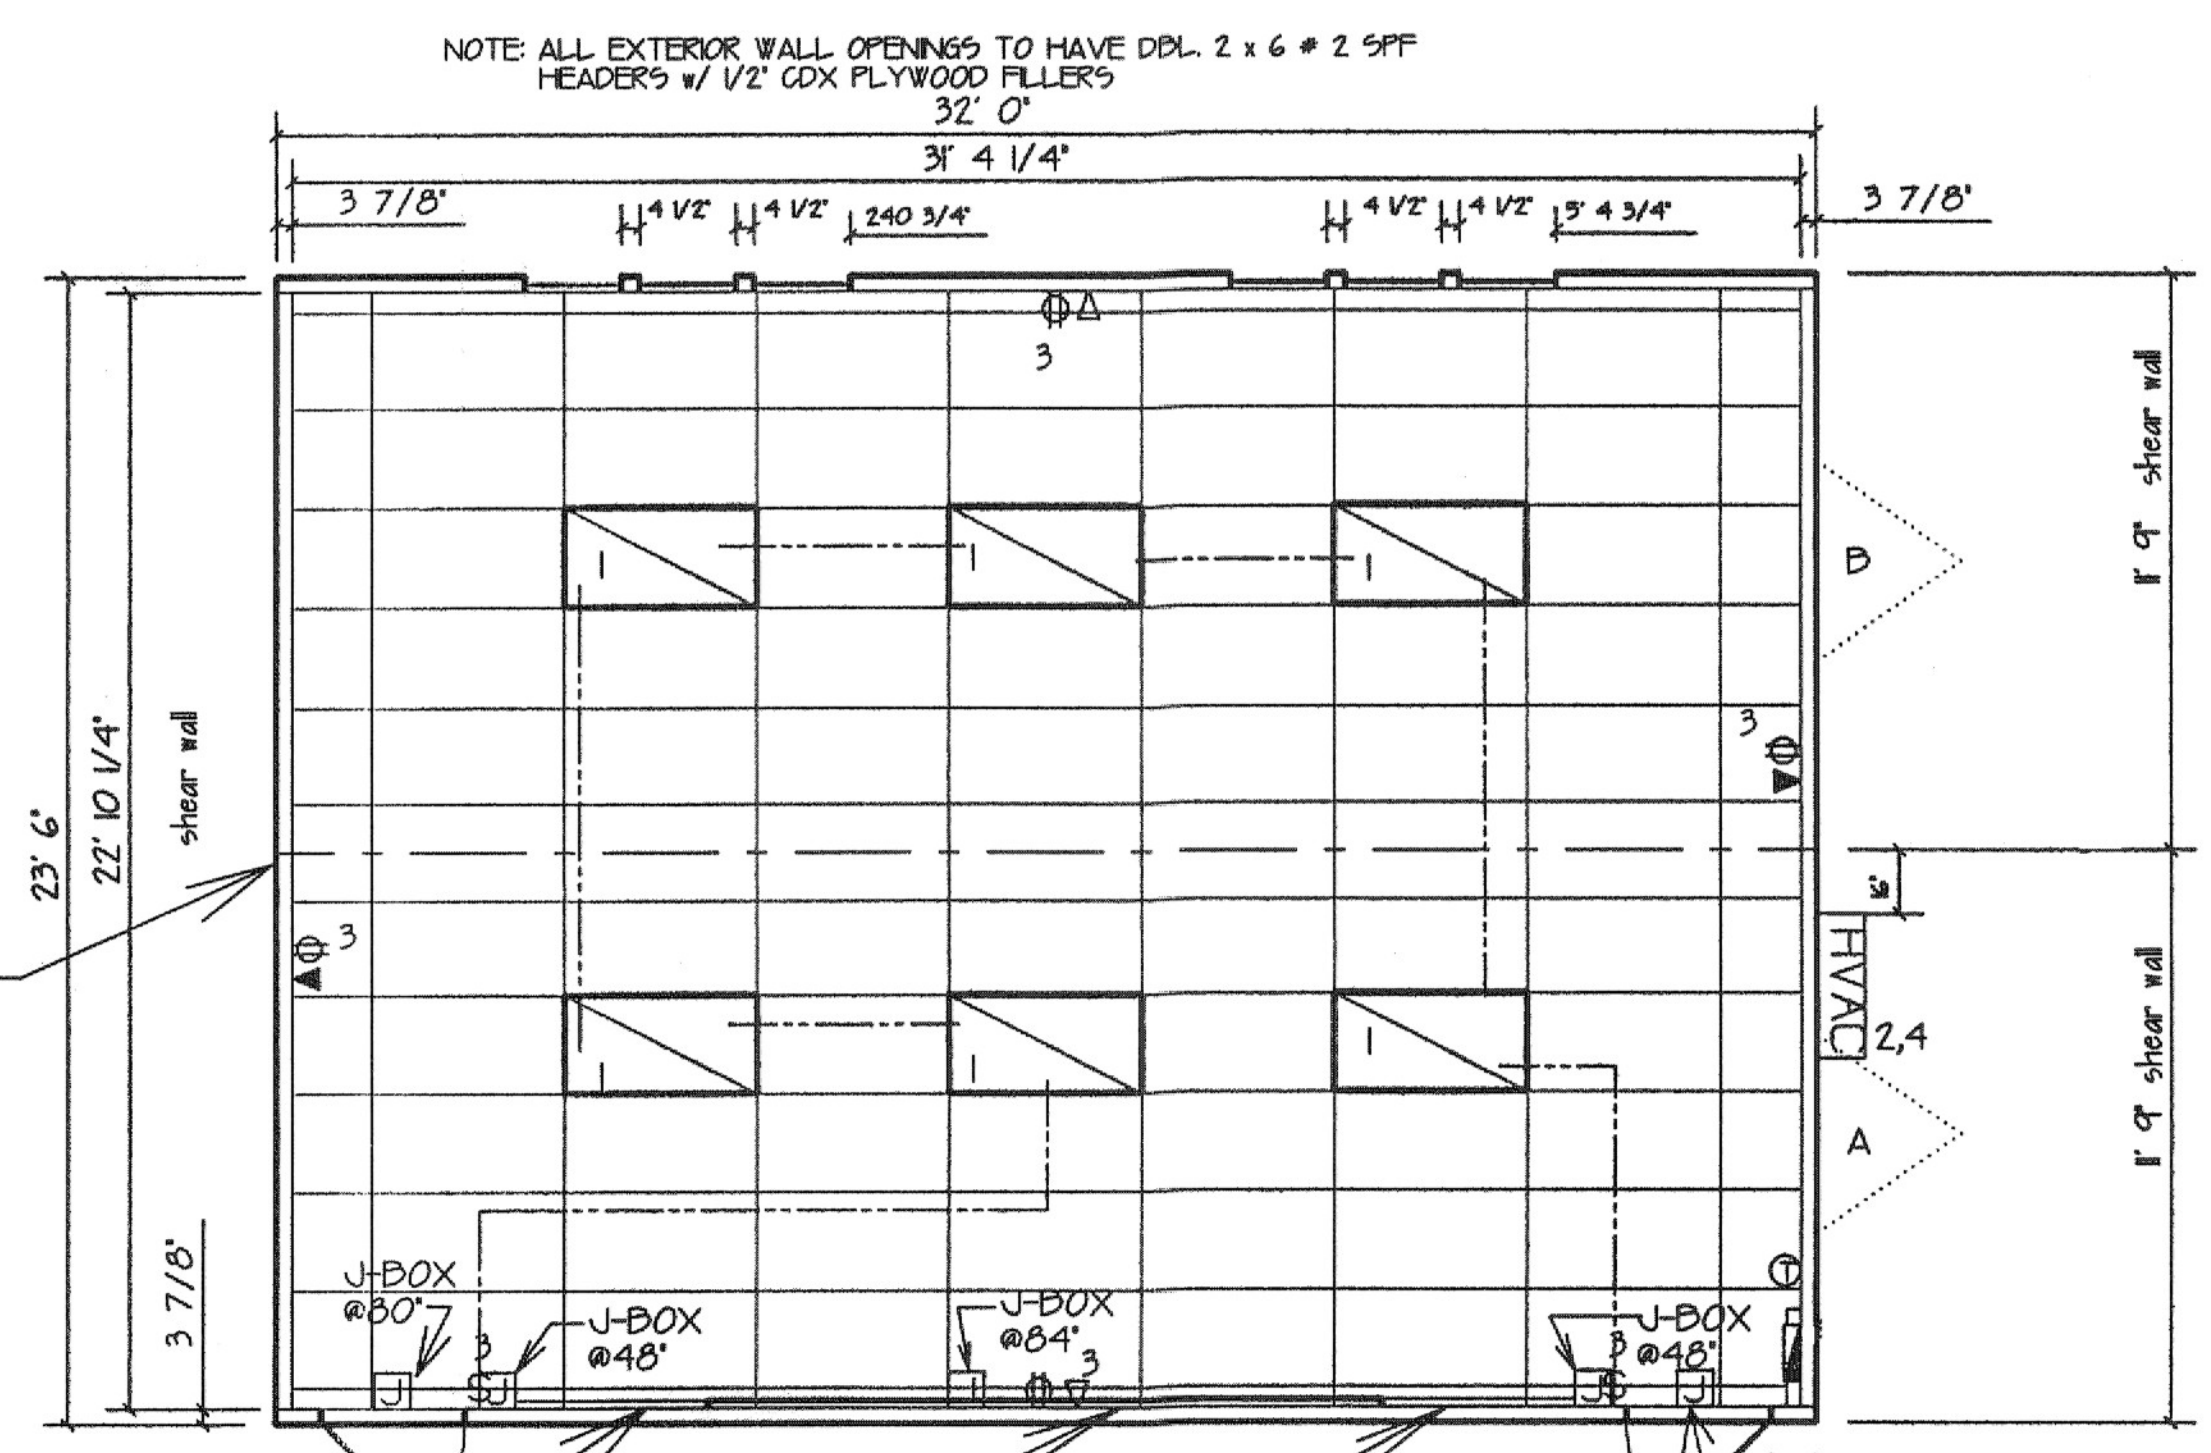10 ENDWALL OVERHAND DETAIL
1 1/2" = 1'-0"



FLOOR PLAN
SCALE: 1/4" = 1'-0"

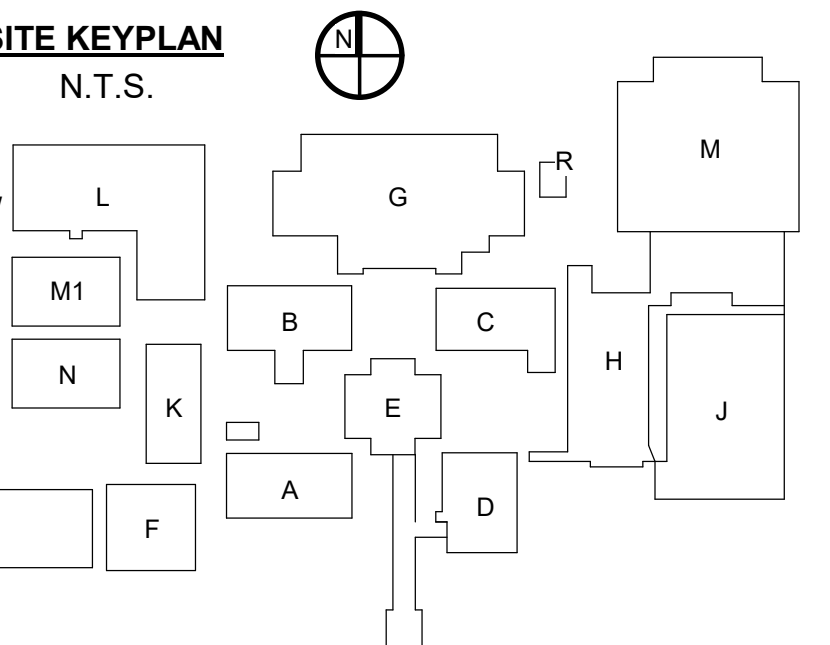NOTE: ALL EXTERIOR WALL OPENINGS TO HAVE DEL. 2 x 6 # 2 SYP HEADERS w/ 1/2" CDX PLYWOOD FILLERS



SITE KEYPLAN
N.T.S.

16 TEMPORARY BUILDING TYPICAL DETAILS - SCANS
12" = 1'-0"

KEYNOTES TO SET

1. REMOVE AND REPLACE BROKEN PANES AND GASKETING TO MATCH EXISTING AND CAULK AND RESEAL WINDOW PERIMETER.
2. DASHED LINE INDICATES DAMAGED CMU EXPANSION JOINTS. SEE SCHEDULE A1 FOR REPAIRS.
3. REMOVE AND REPLACE METAL WALL PANEL TO MATCH EXISTING.
4. INSTALL NEW SPLASH GUARD AT ENTRY OPENING ABOVE CANOPY TO MATCH EXISTING. SPLASH GUARD TO BE ATTACHED UNDERNEATH VINYL SIDING AND FASTEN TO NAILER. BOTTOM OF FLASHING TO BE FASTENED TO CANOPY WITH FASTENER #12A 12X1" WITH WASHER @ 2'-0" O.C. AS DETAILED. SEE SHEET A-A1.7.
5. REMOVE AND REPLACE WINDOW SCREENS TO MATCH EXISTING.
6. NOT USED.
7. NOT USED.
8. REMOVE AND REPLACE MISSING METAL ROOF PANEL TO MATCH EXISTING PROFILE, GAUGE AND FINISH. INSTALL AS DETAILED. SEE SHEET A-A1.9.
9. INDICATES EXISTING 1-HR FIRE RATED WALLS AND CEILING ASSEMBLY THROUGHOUT CORRIDOR AS DETAILED. SEE SHEET A-A1.7.
10. CAULK AND RESEAL PERIMETER OF ALL EXISTING WINDOWS AND DOORS.



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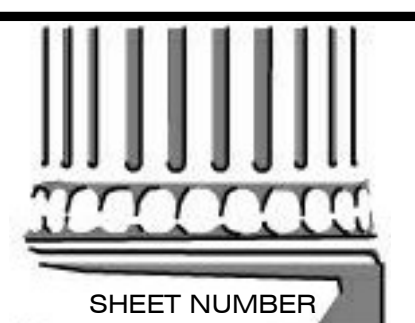
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SHEET NUMBER

(T-Y)A1.1
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INTERIOR REPAIR LEGEND - BUILDING R-Y							
ROOM NUMBER	Area (SF)	Perimeter (LF)	Floor	Wall	Ceiling	Other	Fire Safety
T101	768 SF	112 LF	-	-	-	-	-
U101	865.33 SF	117.67 LF	F2	W3	C1, C2, C3, C4	-	-
V101	764 SF	111.67 LF	-	-	-	-	-
W101	1176.53 SF	137.33 LF	-	-	-	-	-
X101	1227.41 SF	191.77 LF	-	-	C1	-	-
Y101	1279.96 SF	143.17 LF	-	W3	C1, C2, C3, C4	-	-

SCHEDULE FLOOR NOTES

- F1 - CLEAN ENTIRE VCT FLOOR, BUFF AND WAX.
- F2 - HATCHED AREA INDICATES VCT FLOORING TO BE REMOVED AND REPLACED TO MATCH EXISTING. SEE UNIT PRICE NO. 3
- F3 - HATCHED AREA INDICATED REPLACE MISSING VCT TO MATCH EXISTING. SEE UNIT PRICE NO. 3
- F4 - REMOVE ALL WALL BASE AND REPLACE TO MATCH EXISTING.

SCHEDULE CEILING NOTES

- C1 - REMOVE AND REPLACE DAMAGED CEILING TILES TO MATCH EXISTING. SEE UNIT PRICE NO. 1
- C2 - REMOVE AND REPLACE DAMAGED CEILING GRID TO MATCH EXISTING. SEE UNIT PRICE NO. 5
- C3 - HATCHED AREA INDICATES DAMAGED INSULATION TO BE REMOVED AND REPLACED TO MATCH EXISTING. SEE UNIT PRICE NO. 2
- C4 - HATCHED AREA INDICATES DAMAGED GYPSUM CEILING TO BE REMOVED AND REPLACED.
- C5 - HATCHED AREA INDICATES DAMAGED "X" GYPSUM CEILING TO BE REMOVED AND REPLACED ABOVE AND BELOW TRUSS CHORD, TAPE, FLOAT AND FIRESTOP CAULK.


SCHEDULE WALL NOTES

- W1 - CLEAN ALL WALLS AND BASE
- W2 - REMOVE INTERIOR WALL FINISH AND INSULATION FROM CORNER TO CORNER. REPLACE INSULATION, WALL FINISH AND PAINT TO MATCH EXISTING.

SCHEDULE ARCHITECTURAL NOTES

- A1 - REMOVE DAMAGED EXPANSION JOINT SEALANT AND BACKER ROD. PROVIDE CONTINUOUS NEW BACKER ROD AND SEALANT AT CMU EXPANSION JOINTS FROM SLAB TO TOP PLATE. PAINT TO MATCH EXISTING.

TEMPORARY BUILDING WINDOW SCHEDULE			
MARK	SIZE	FRAME	GLASS
		TYPE & MATERIAL	
C	36"x60"	ALUMINUM SINGLE HUNG	CLEAR, SINGLE PANE
G	18"x96"	ALUMINUM MULTI-LITE SLIDING	CLEAR, SINGLE PANE
H	48"x144"	ALUMINUM PICTURE	--
J	48"x36"	ALUMINUM SLIDING	--

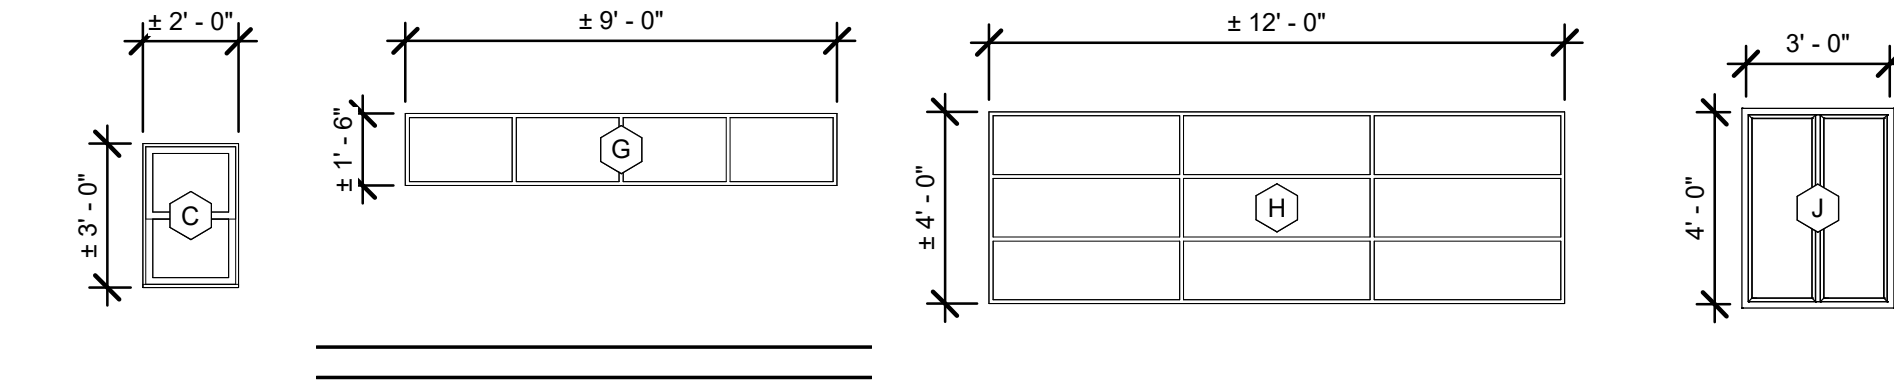


4 WINDOW ELEVATION
1/4" = 1'-0"

KEYNOTES TO SET


- REMOVE AND REPLACE BROKEN PANES AND GASKETING TO MATCH EXISTING AND CAULK AND RESEAL WINDOW PERIMETER.
- DASHED LINE INDICATES DAMAGED CMU EXPANSION JOINTS. SEE SCHEDULE A1 FOR REPAIRS.
- REMOVE AND REPLACE METAL WALL PANEL TO MATCH EXISTING.
- INSTALL NEW SPLASH GUARD AT ENTRY OPENING ABOVE CANOPY TO MATCH EXISTING. SPLASH GUARD TO BE ATTACHED UNDERNEATH VINYL SIDING AND FASTEN TO NAILER. BOTTOM OF FLASHING TO BE FASTENED TO CANOPY WITH FASTENER #12A 12X1" WITH WASHER @ 2'-0" O.C. AS DETAILED. SEE SHEET A-A1.7.
- REMOVE AND REPLACE WINDOW SCREENS TO MATCH EXISTING.
- NOT USED.
- REMOVE AND REPLACE MISSING METAL ROOF PANEL TO MATCH EXISTING PROFILE, GAUGE AND FINISH. INSTALL AS DETAILED. SEE SHEET A-A1.9.
- INDICATES EXISTING 1-HR FIRE RATED WALLS AND CEILING ASSEMBLY THROUGHOUT CORRIDOR AS DETAILED. SEE SHEET A-A1.7.
- CAULK AND RESEAL PERIMETER OF ALL EXISTING WINDOWS AND DOORS.



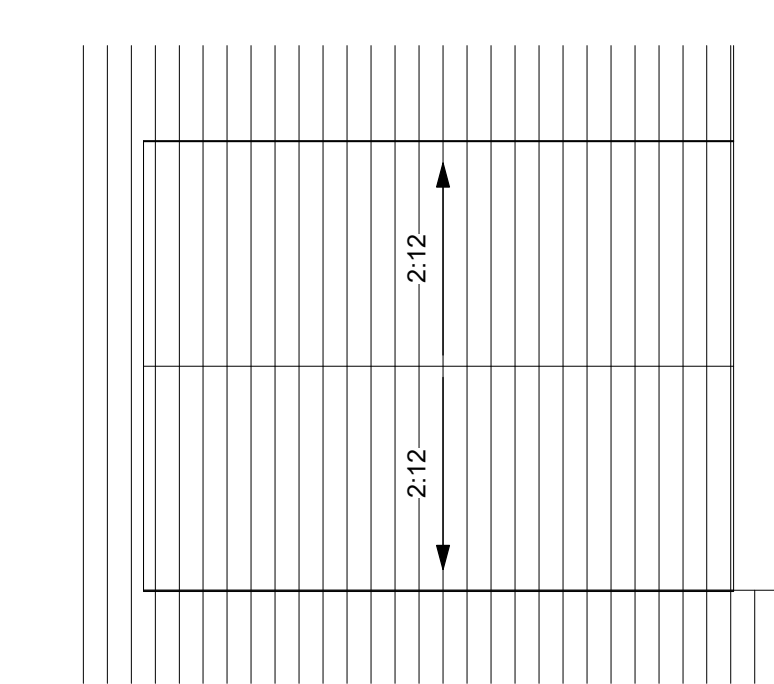
8 Building V Floor Plan
3/32" = 1'-0"




9 Building V Roof Plan
3/32" = 1'-0"

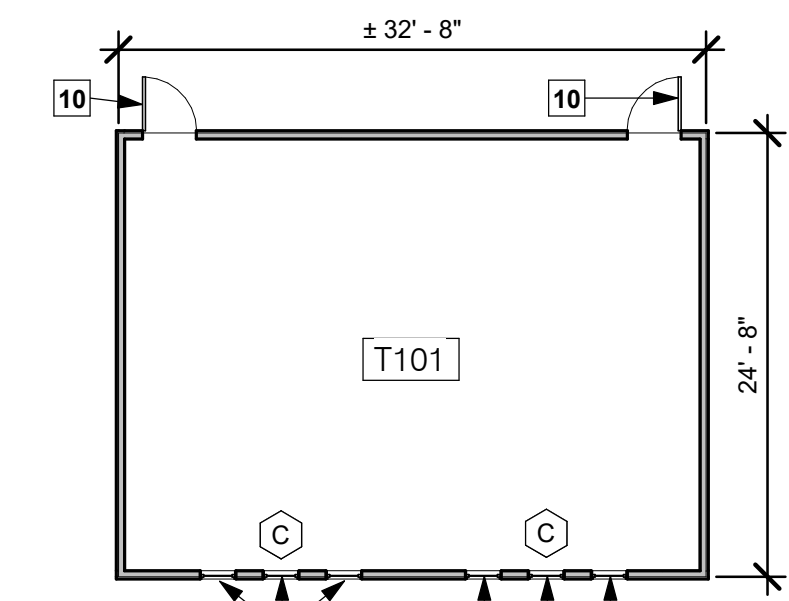


11 Building T Floor Plan
3/32" = 1'-0"

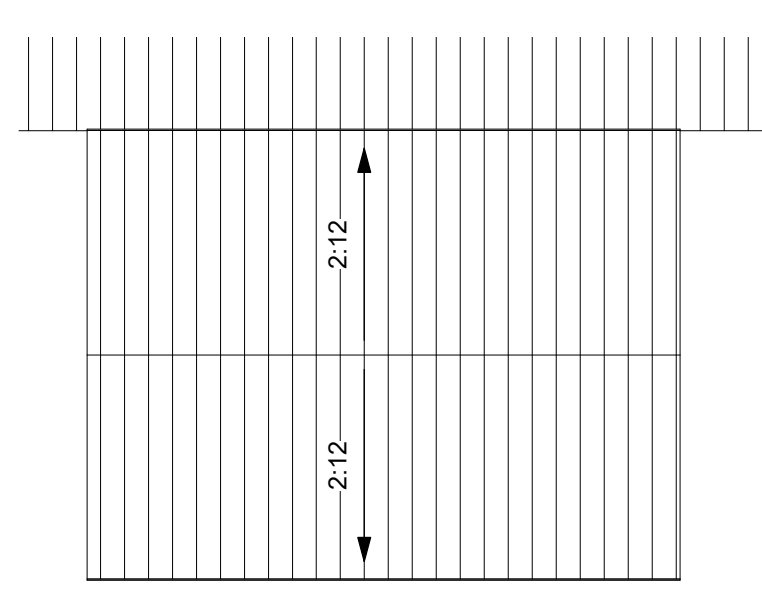


12 Building T Roof Plan
3/32" = 1'-0"

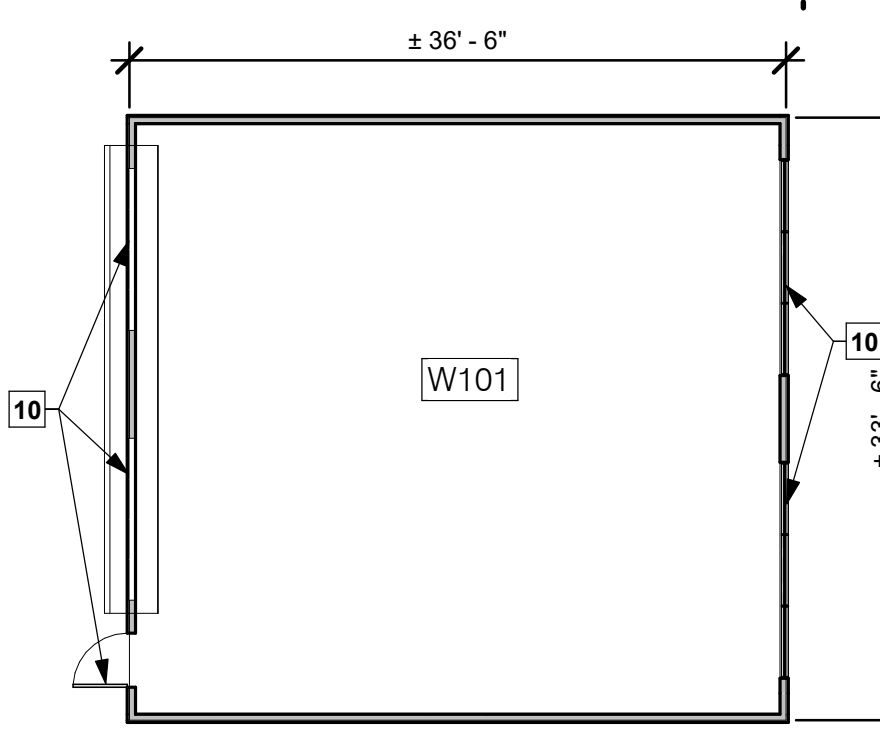


13 Building W Floor Plan
3/32" = 1'-0"

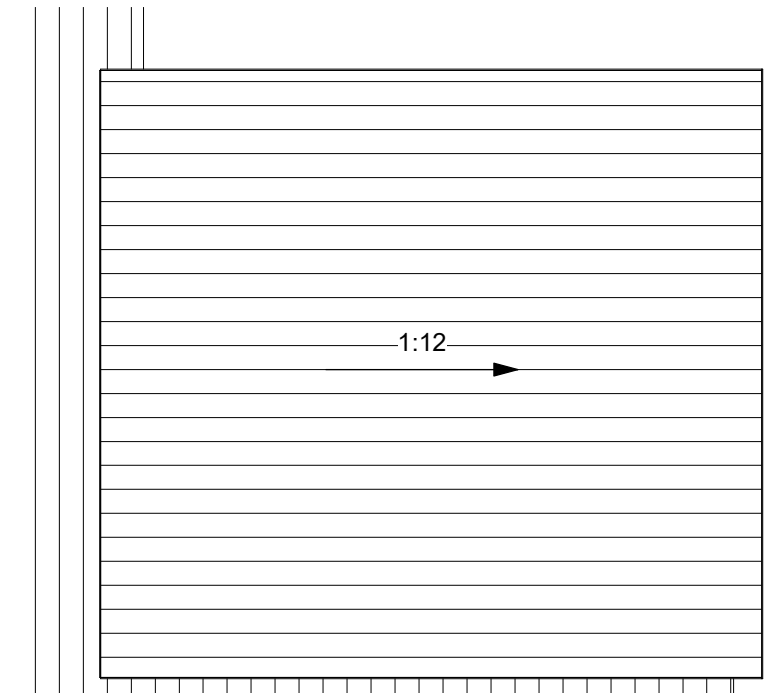


14 Building W Roof Plan
3/32" = 1'-0"

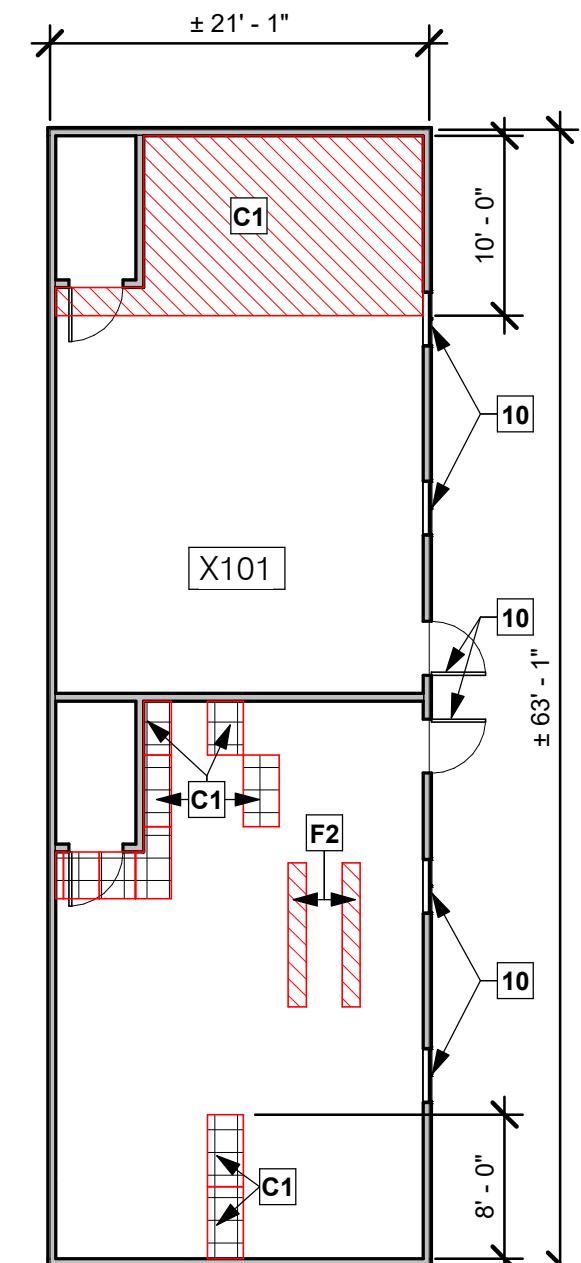


15 Building X Floor Plan
3/32" = 1'-0"

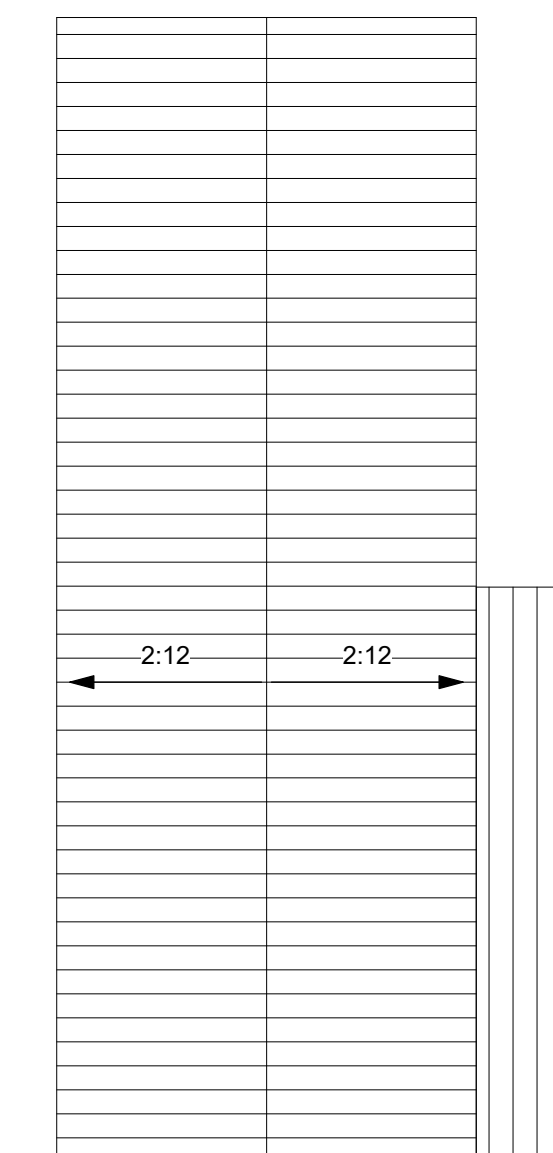


20 Building X Roof Plan
3/32" = 1'-0"

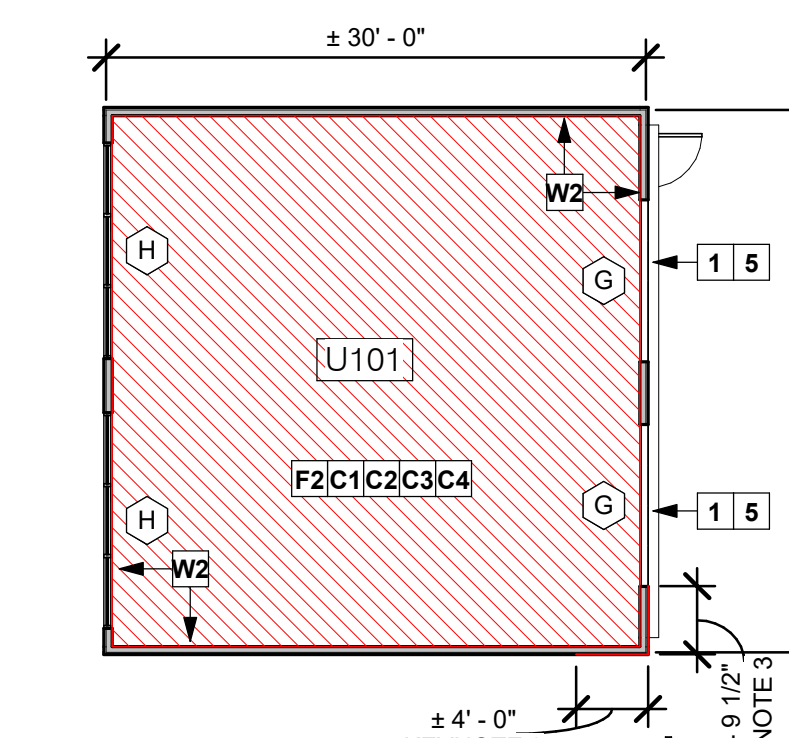


16 Building U Floor Plan
3/32" = 1'-0"

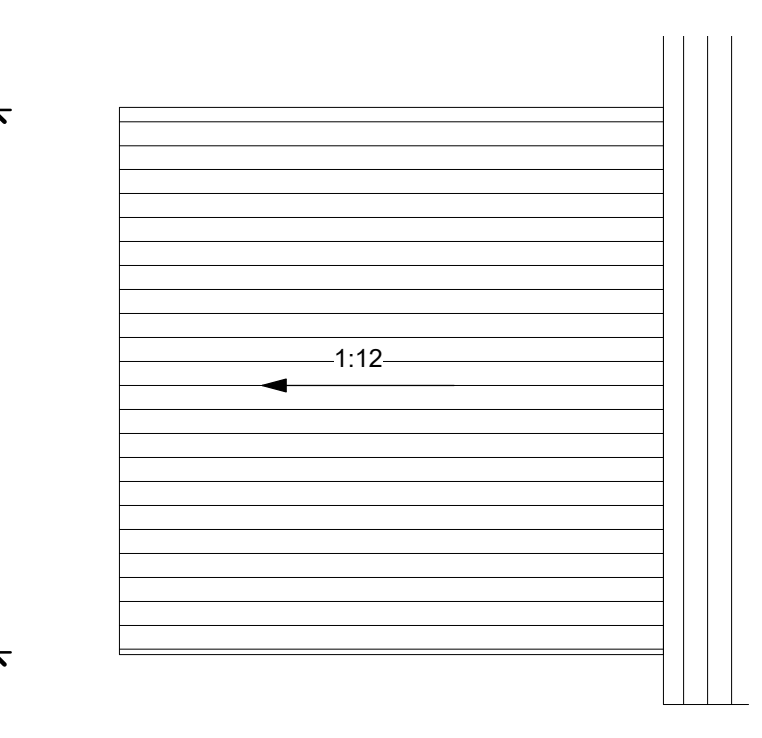


17 Building U Roof Plan
3/32" = 1'-0"

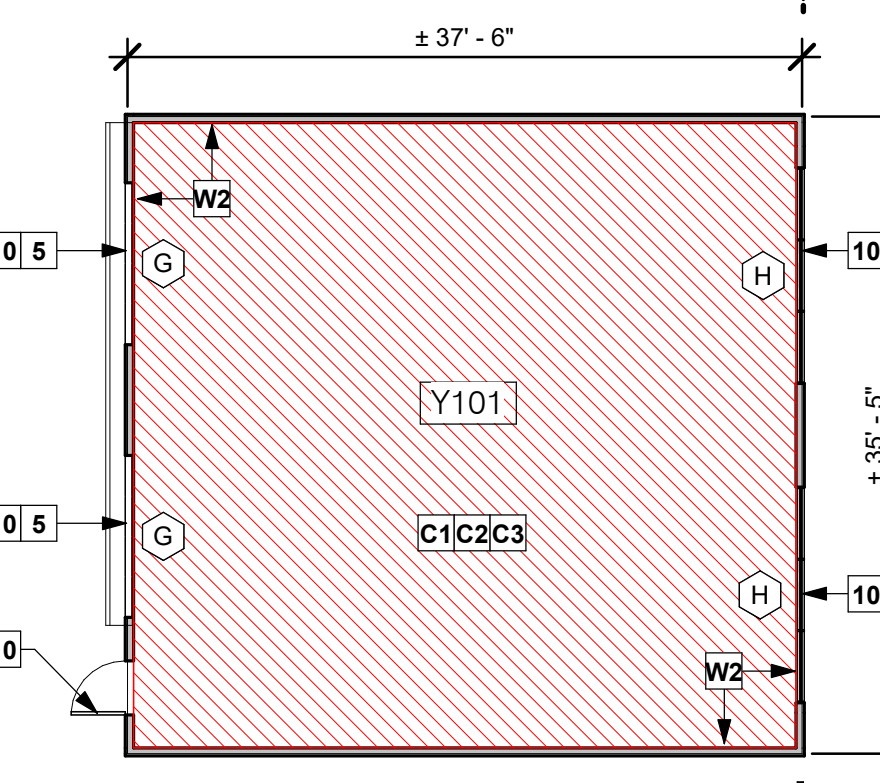

18 Building Y Floor Plan
3/32" = 1'-0"

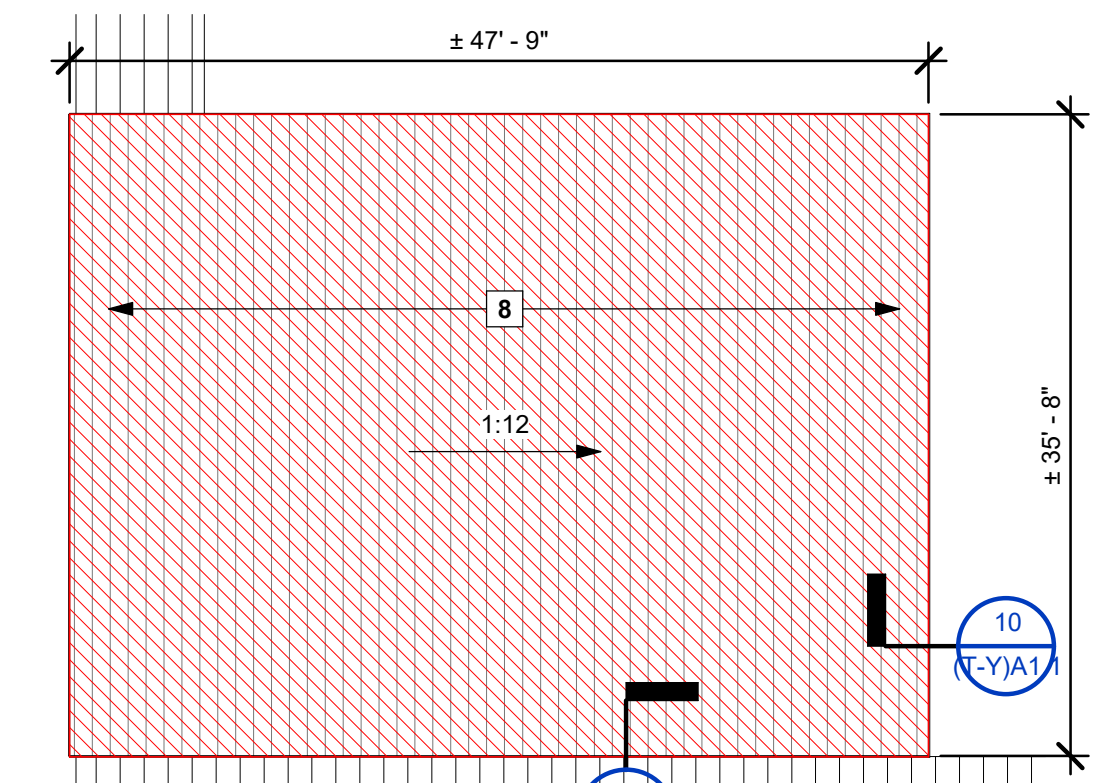

19 Building Y Roof Plan
3/32" = 1'-0"

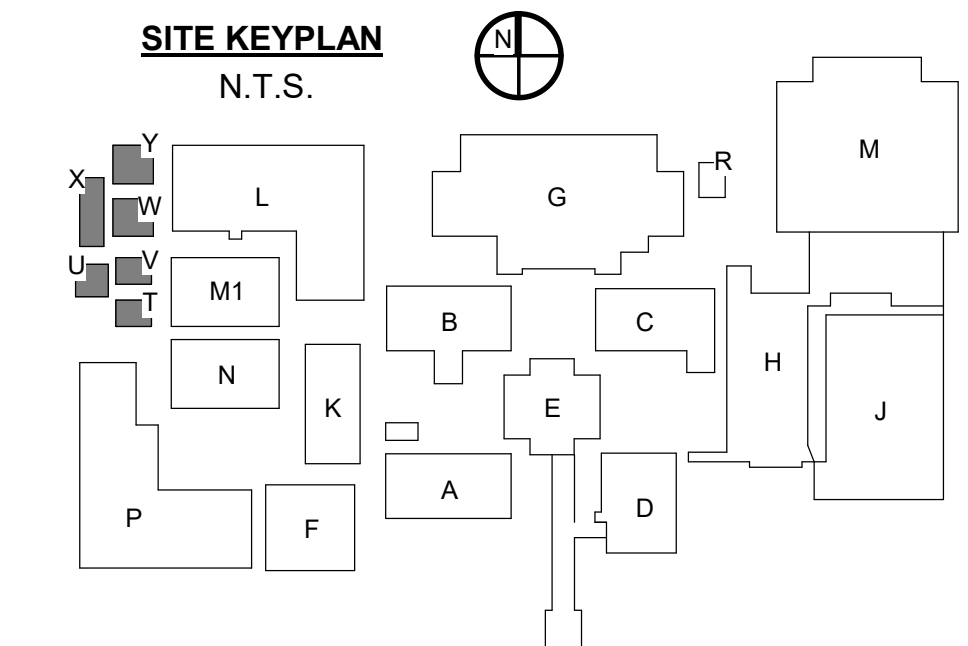

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RANDY MICHAEL GOODLOE
 No. 888
 ARCHITECT
 REGISTERED ARCHITECT
 LA. LICENSE NO. 4086

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 2200 W. McNEESE ST.
 FOR
CALCASIEU PARISH SCHOOL BOARD
 LAKE CHARLES, LA 70605
 HL-003-01.03.04.05.06.07

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20042-01-G
 OWNER PROJECT NO.
HL-003-01.03.04.05.06.07
 PROJECT MANAGER
TM
 DATE ISSUED
06/28/2024
 REVISED

SHEET NUMBER

(T-Y)A1.2
 TEMP BLDG T-Y

DESIGN LOADS

- LIVE LOADS
ROOF: 20 PSF
- WIND
WIND SPEED: 142 MPH
BUILDING RISK CATEGORY: III
IMPORTANCE FACTOR: 1.0
EXPOSURE: B
ANALYSIS PROCEDURE: PER ASCE 7-16/IBC 2021

GENERAL STRUCTURAL NOTES

- THE FOLLOWING NOTES APPLY TO ALL STRUCTURAL DRAWINGS.
- ALL DESIGN AND CONSTRUCTION IS BASED ON AND SHALL BE IN ACCORDANCE WITH THE INTERNATIONAL BUILDING CODE 2021 EDITION AND APPLICABLE LOCAL CODES.
- THE GENERAL CONTRACTOR SHALL VERIFY ALL DIMENSIONS AND SITE CONDITIONS AND NOTIFY ARCHITECT OF ANY DISCREPANCIES PRIOR TO PROCEEDING WITH WORK. FOR DIMENSIONS NOT SHOWN ON STRUCTURAL DRAWINGS, REFER TO ARCHITECTURAL DRAWINGS.
- THE STRUCTURE SHOWN ON THESE DRAWINGS IS SELF-SUPPORTING ONLY IN ITS COMPLETED FORM. THE CONTRACTOR SHALL BE RESPONSIBLE FOR PROVIDING THE DESIGN, ADEQUACY, SAFETY, AND STABILITY OF TEMPORARY ERECTION BRACING AND SHORING.
- UNLESS NOTED, ELEVATIONS SHOWN ARE TO TOP OF FOUNDATIONS, SLABS OR STEEL BEAMS.
- THE CONTRACTOR SHALL BE RESPONSIBLE FOR MEANS, METHODS, TECHNIQUES, SEQUENCES, AND PROCEDURES IN ORDER TO COMPLY WITH THE CONTRACT DRAWINGS AND SPECIFICATIONS.
- DO NOT SCALE DRAWINGS. USE ANNOTATED DIMENSIONS AS PROVIDED. NOTIFY ARCHITECT OF ANY DISCREPANCIES FOR CLARIFICATION.

STRUCTURAL STEEL NOTES

- ALL MATERIALS AND WORKMANSHIP SHALL BE IN ACCORDANCE WITH THE LATEST EDITION OF THE AISC MANUAL OF STEEL CONSTRUCTION WHICH INCLUDES THE SPECIFICATION FOR STRUCTURAL STEEL BUILDINGS, THE CODE OF STANDARD PRACTICE, AND THE AWS STRUCTURAL WELDING CODE (LATEST EDITIONS). SHOP DRAWINGS SHALL BE SUBMITTED TO ARCHITECT FOR APPROVAL PRIOR TO FABRICATION.
- VERIFY BOS/TOS ELEVATIONS AND CLEAR DIMENSIONS OF MEMBERS AT ROUGH OPENINGS WITH ARCHITECTURAL DRAWINGS.
- WELDING ELECTRODES SHALL BE E70XX LOW HYDROGEN.
- ALL EXPOSED WELDS TO BE GROUND SMOOTH TO RECEIVE PAINT OR GALVANIZING PER ARCHITECT'S FINISHES. ALL FIELD WELDS SHALL BE GROUND SMOOTH AND GALVANIZING AND/OR PRIMER SHALL BE REPAIRED PER SPECS.

NOTE: CONTRACTOR TO COORDINATE ALL ROOF TOP MECHANICAL EQUIPMENT DEMOLITION, REINSTALLATION, QUANTITIES, AND LOCATIONS WITH MEP/ARCH.

CONTRACTOR TO COORDINATE ALL MECHANICAL UNIT SUPPORT FRAMING LOCATIONS W/MECH. & HVAC SUBMITTAL.

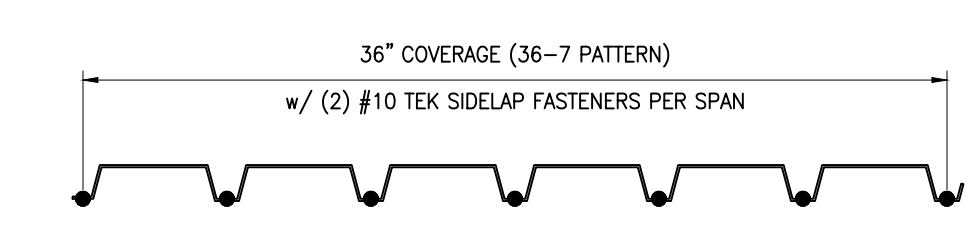
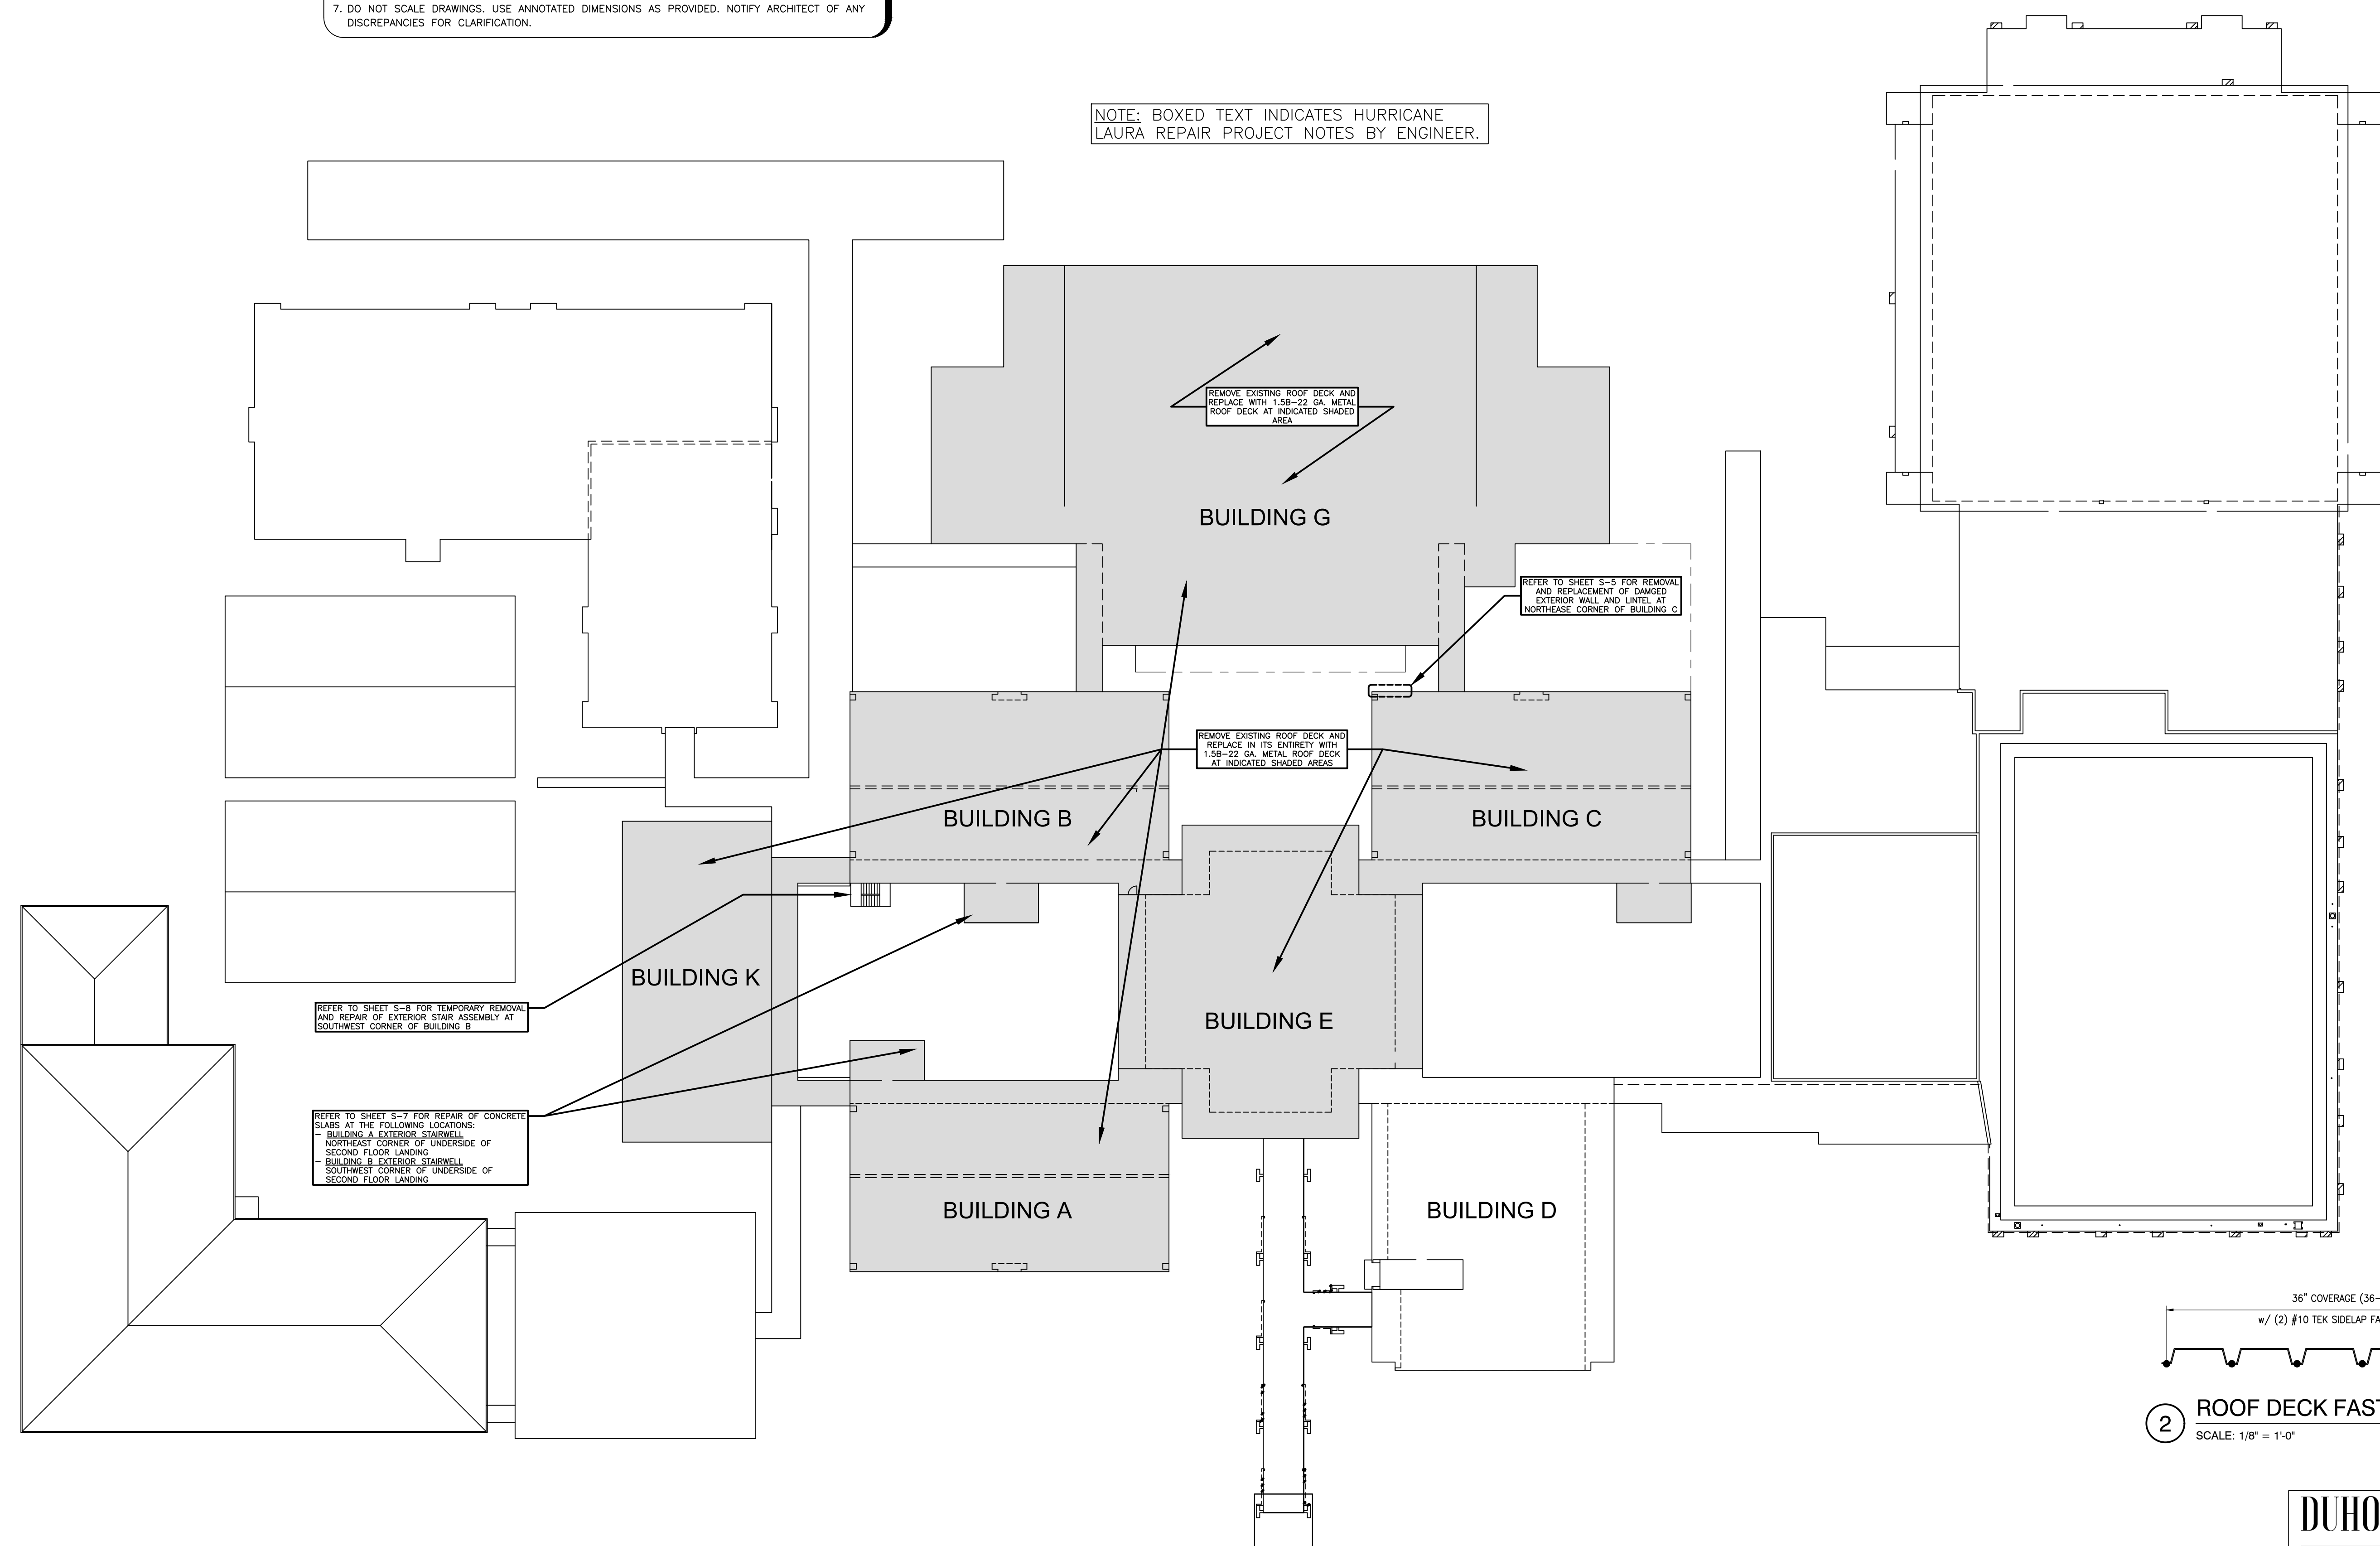
NOTE: REFER TO ARCHITECT FOR ROOFING LAYOUT, PENETRATION LOCATIONS, DETAILS, ETC. NOTIFY ARCHITECT/ENGINEER IMMEDIATELY UPON INSUFFICIENT SUPPORT CONDITIONS.

NOTE: CONTRACTOR TO VERIFY EXISTING JOIST SPACING AND SPAN DIRECTIONS PRIOR TO ANY SHOP DRAWING SUBMITTAL TO DUHON & PLEASANT FOR REVIEW.

NOTE: CONTRACTOR RESPONSIBLE FOR PROVIDING DOUBLE DECK EDGE ANGLES AT ALL TRANSITIONS OF DECK DIRECTION (AT CHANGES IN JOISTS DIRECTION).

NOTE: CONTRACTOR TO VERIFY EXISTING CONDITIONS PRIOR TO ANY SHOP DRAWING SUBMITTAL TO DUHON & PLEASANT FOR REVIEW.

NOTE: BOXED TEXT INDICATES HURRICANE LAURA REPAIR PROJECT NOTES BY ENGINEER.



2 ROOF DECK FASTENER LAYOUT
SCALE: 1/8" = 1'-0"



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JASON DUHON
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07/01/2024

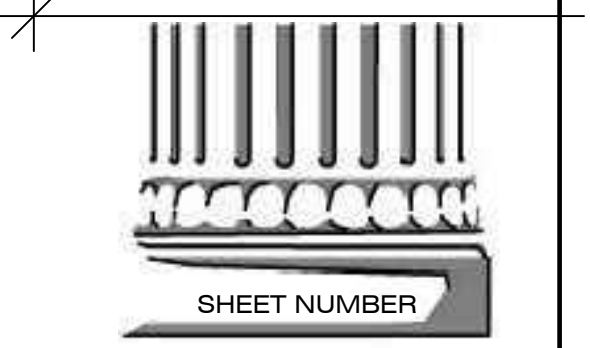
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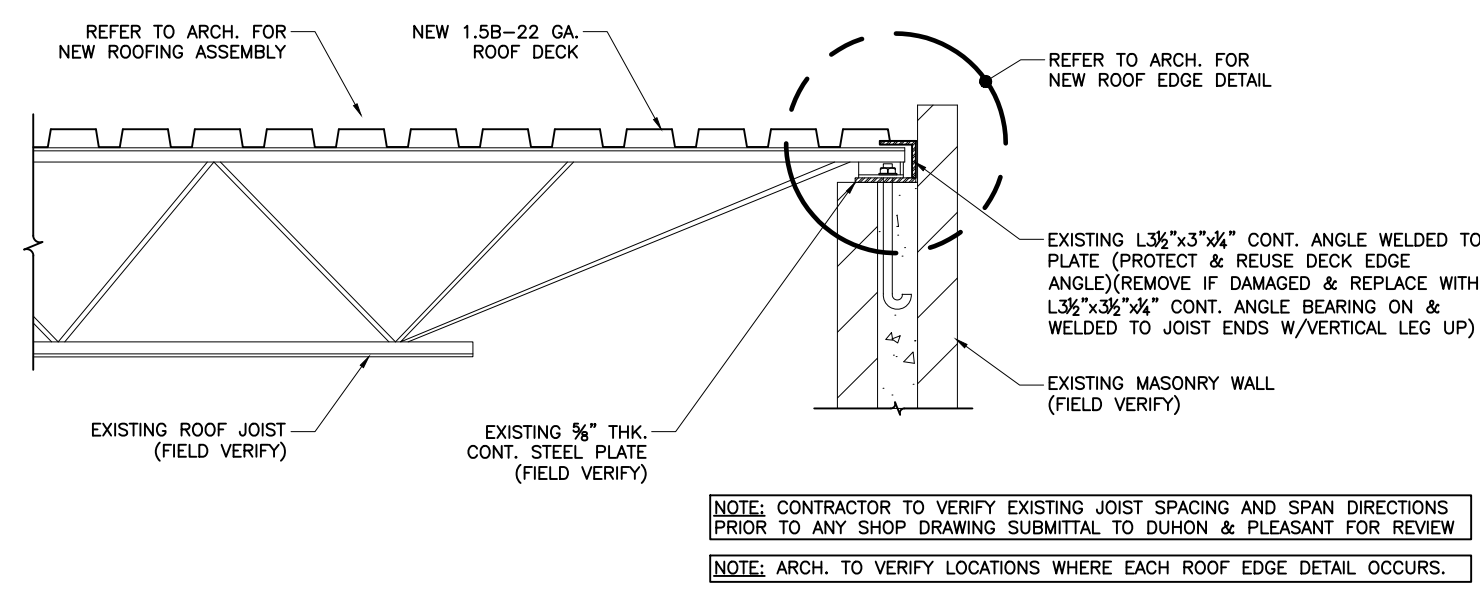


SHEET NUMBER
S-1
ROOF REPAIR PLAN


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1 CAMPUS ROOF REPAIR PLAN
SCALE: NOT TO SCALE

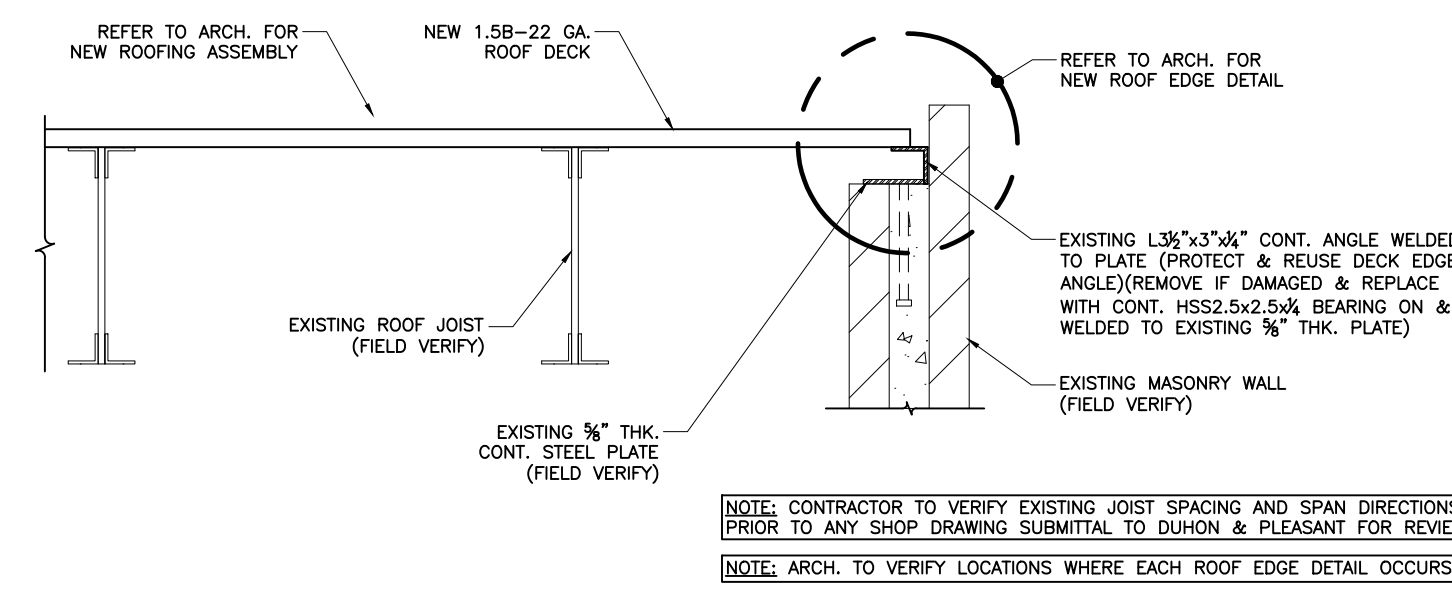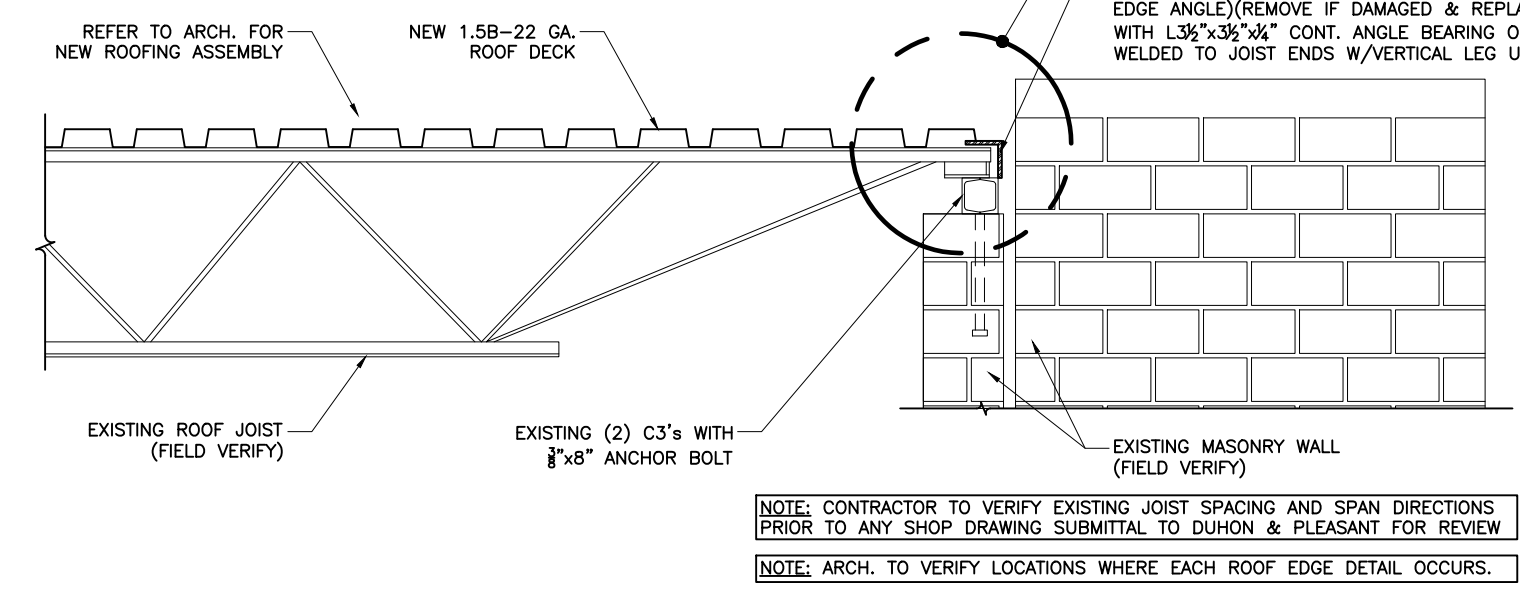
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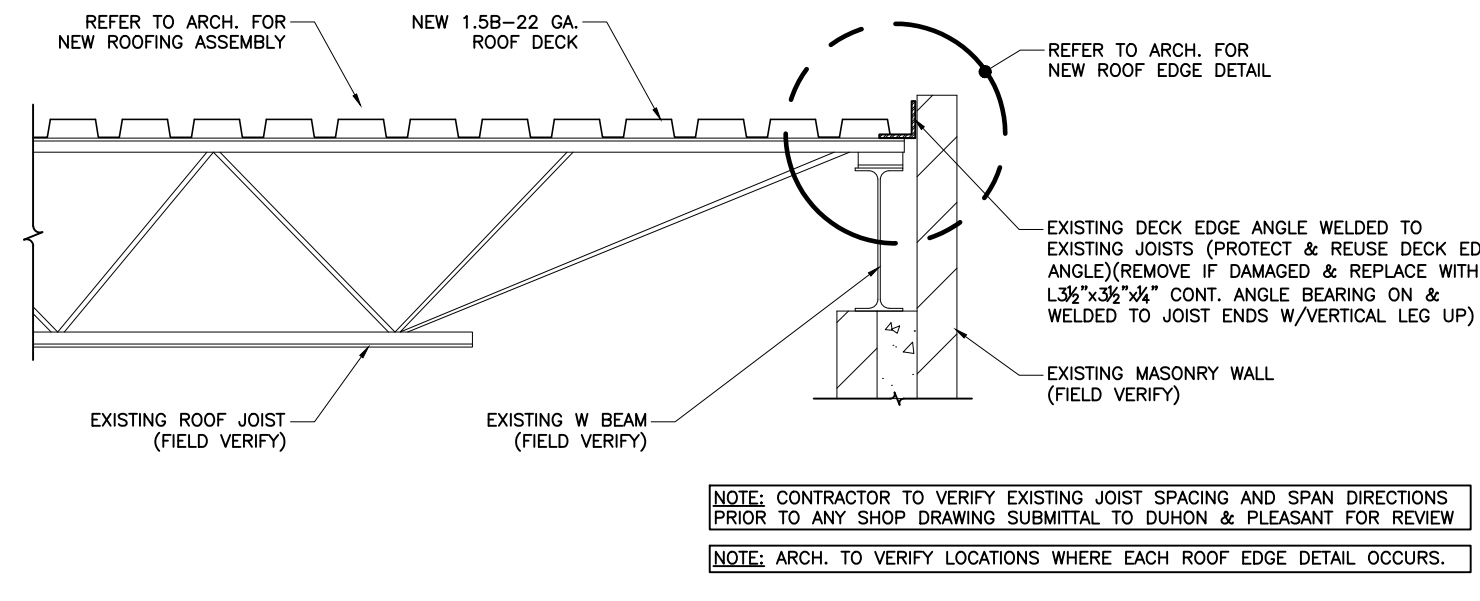
1 ROOF EDGE DETAIL - BUILDING A, B, & C
SCALE: 3/4" = 1'-0"




2 ROOF EDGE DETAIL - BUILDING A, B, & C
SCALE: 3/4" = 1'-0"




3 ROOF EDGE DETAIL - BUILDING A, B, & C
SCALE: 3/4" = 1'-0"



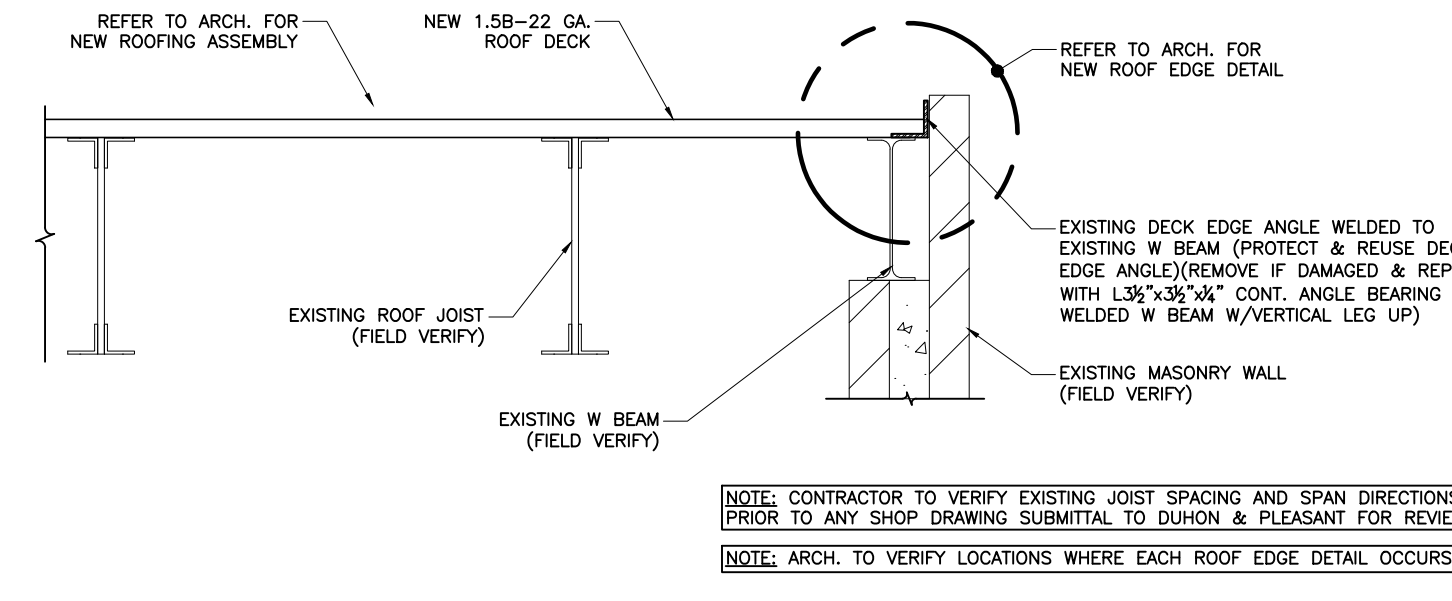
4 ROOF EDGE DETAIL - BUILDING E
SCALE: 3/4" = 1'-0"



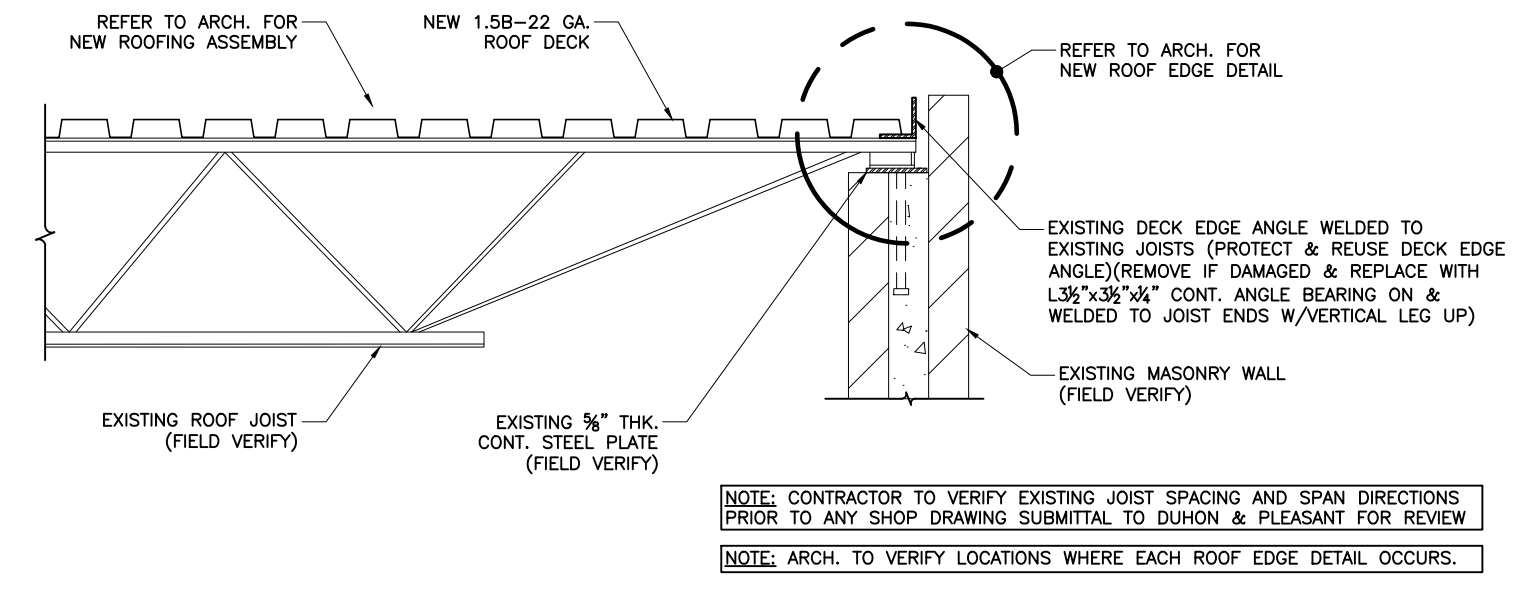5 ROOF EDGE DETAIL - BUILDING E
SCALE: 3/4" = 1'-0"



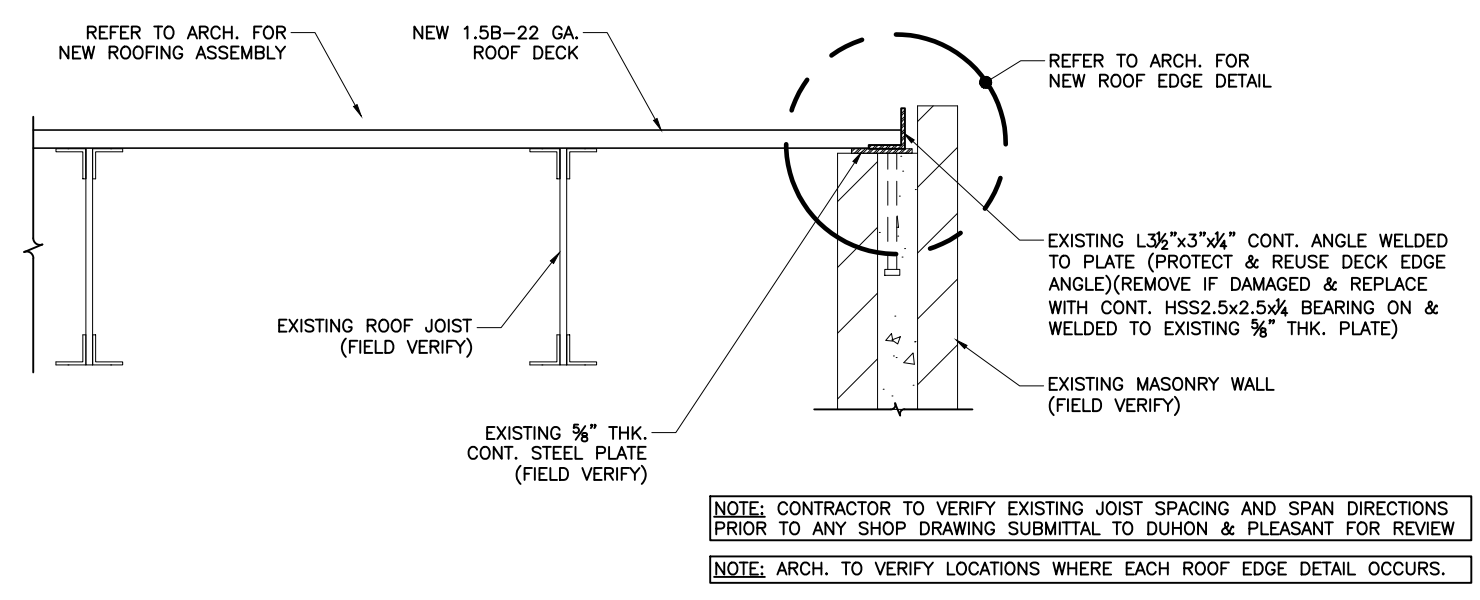6 ROOF EDGE DETAIL - BUILDING G & K
SCALE: 3/4" = 1'-0"




7 ROOF EDGE DETAIL - BUILDING G & K
SCALE: 3/4" = 1'-0"


NOTE: ALL NEW STRUCTURAL AND MISCELLANEOUS STEEL SHALL BE HOT-DIP GALVANIZED AFTER FABRICATION

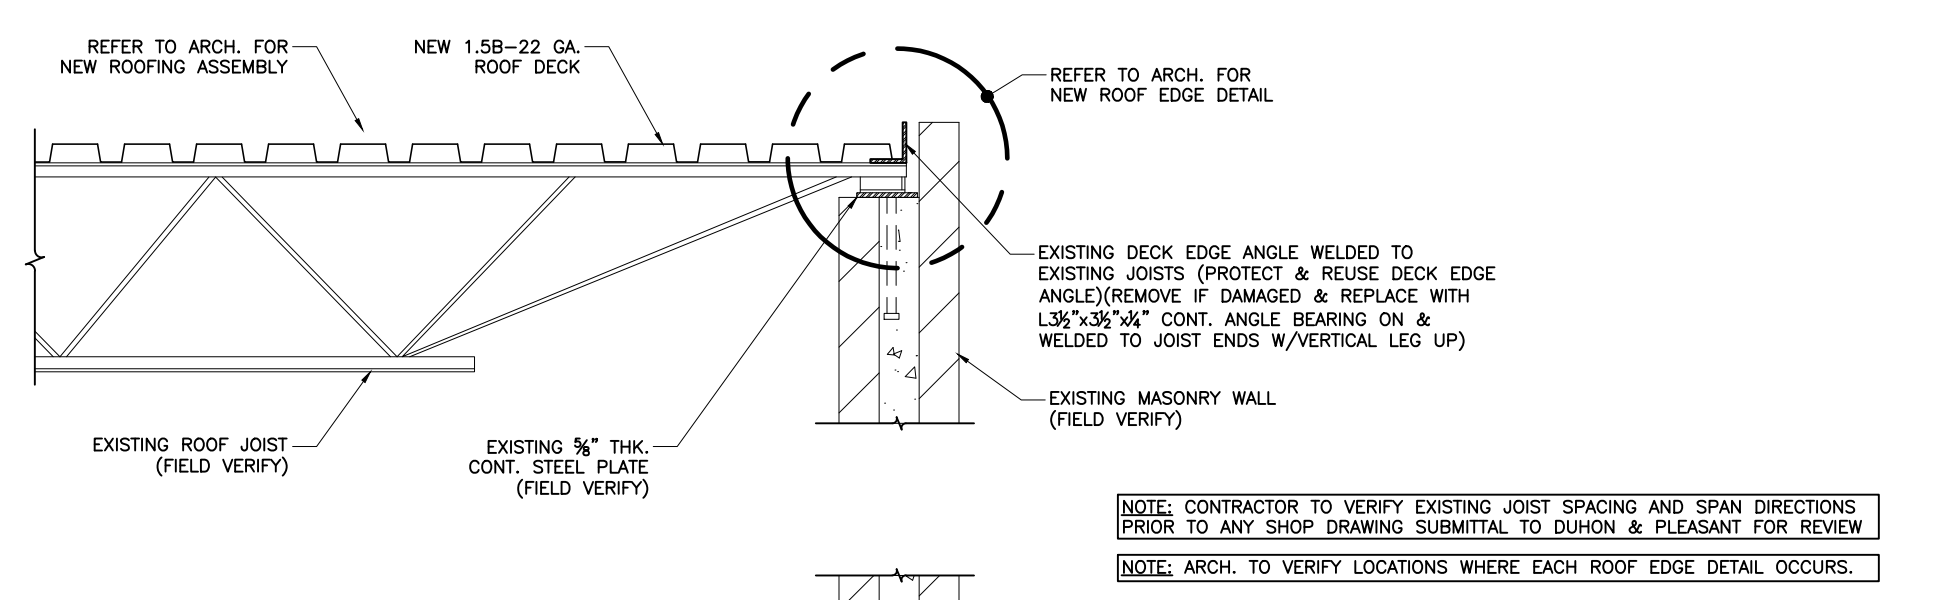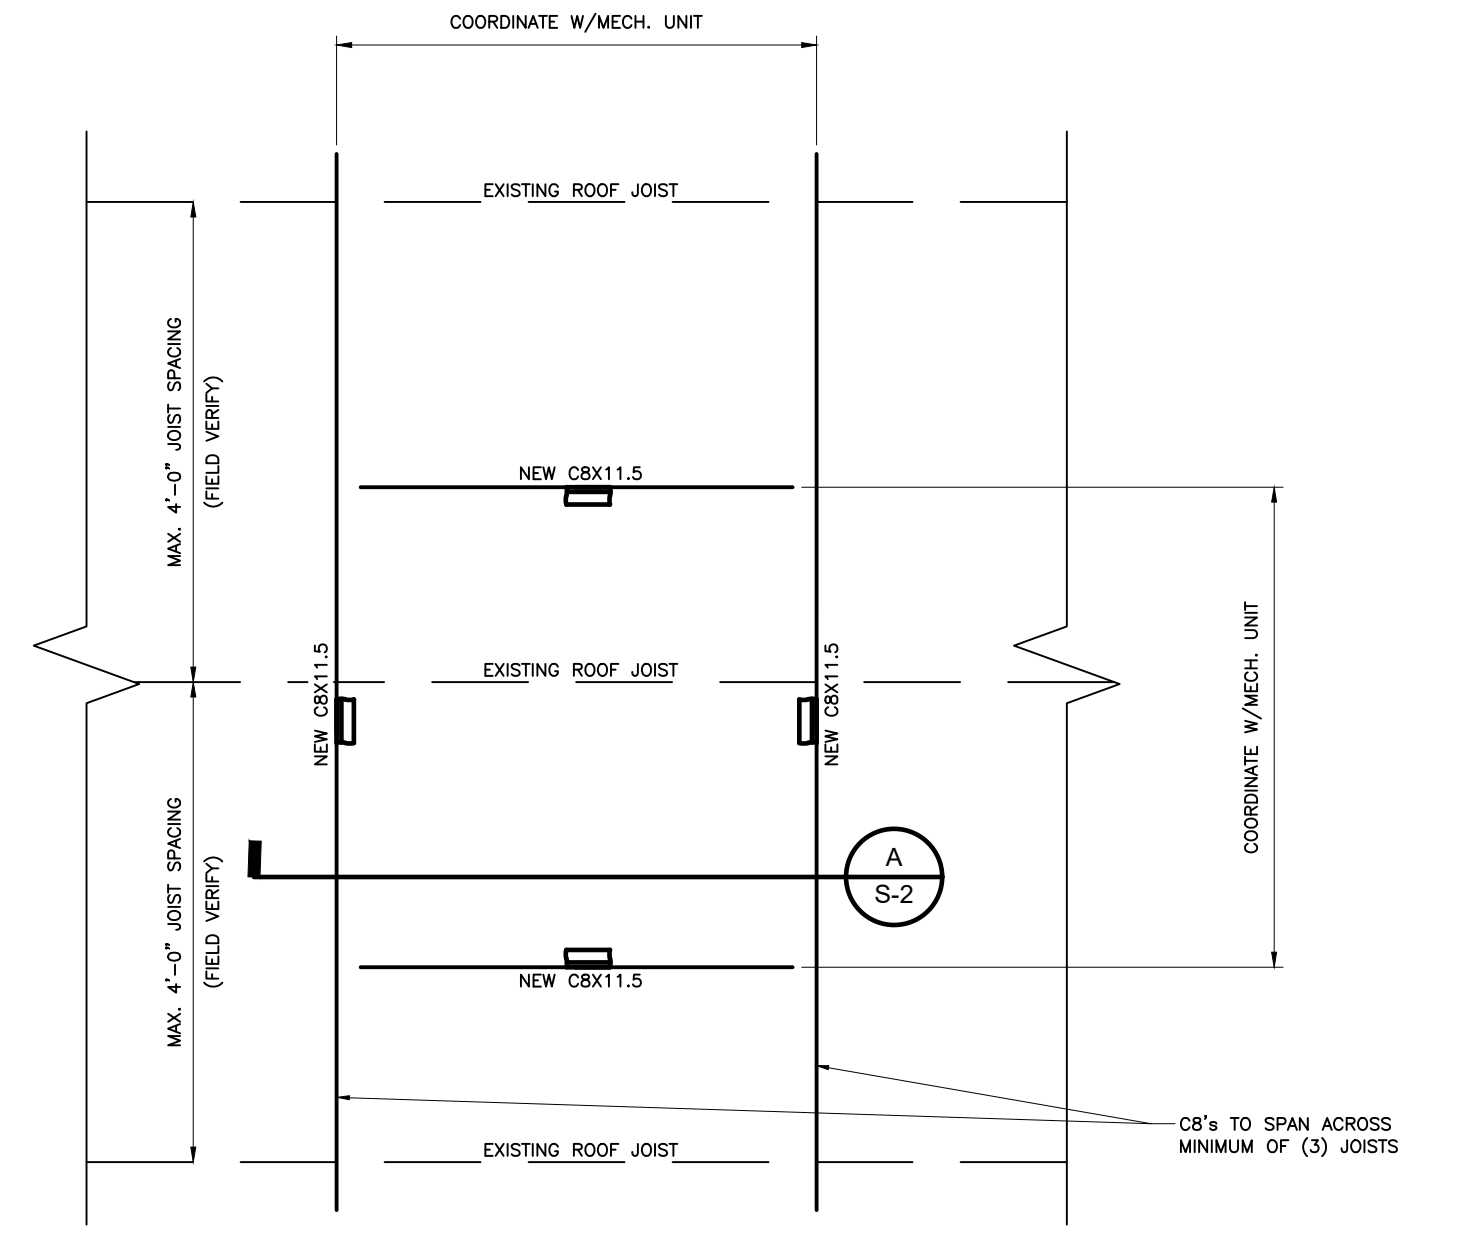NOTE: CONTRACTOR TO COORDINATE ALL ROOF TOP MECHANICAL EQUIPMENT DEMOLITION, REINSTALLATION, QUANTITIES, AND LOCATIONS WITH MEP/ARCH.

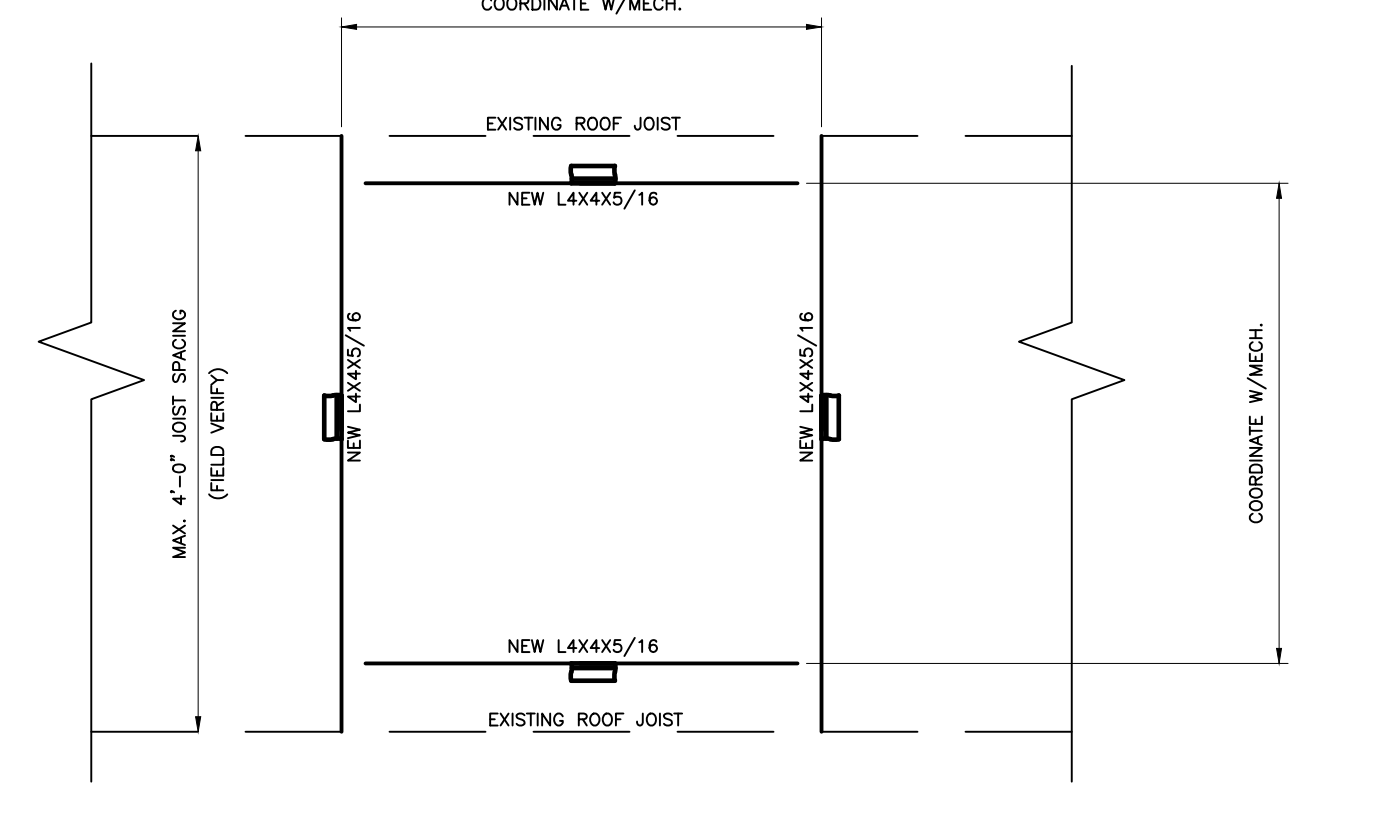
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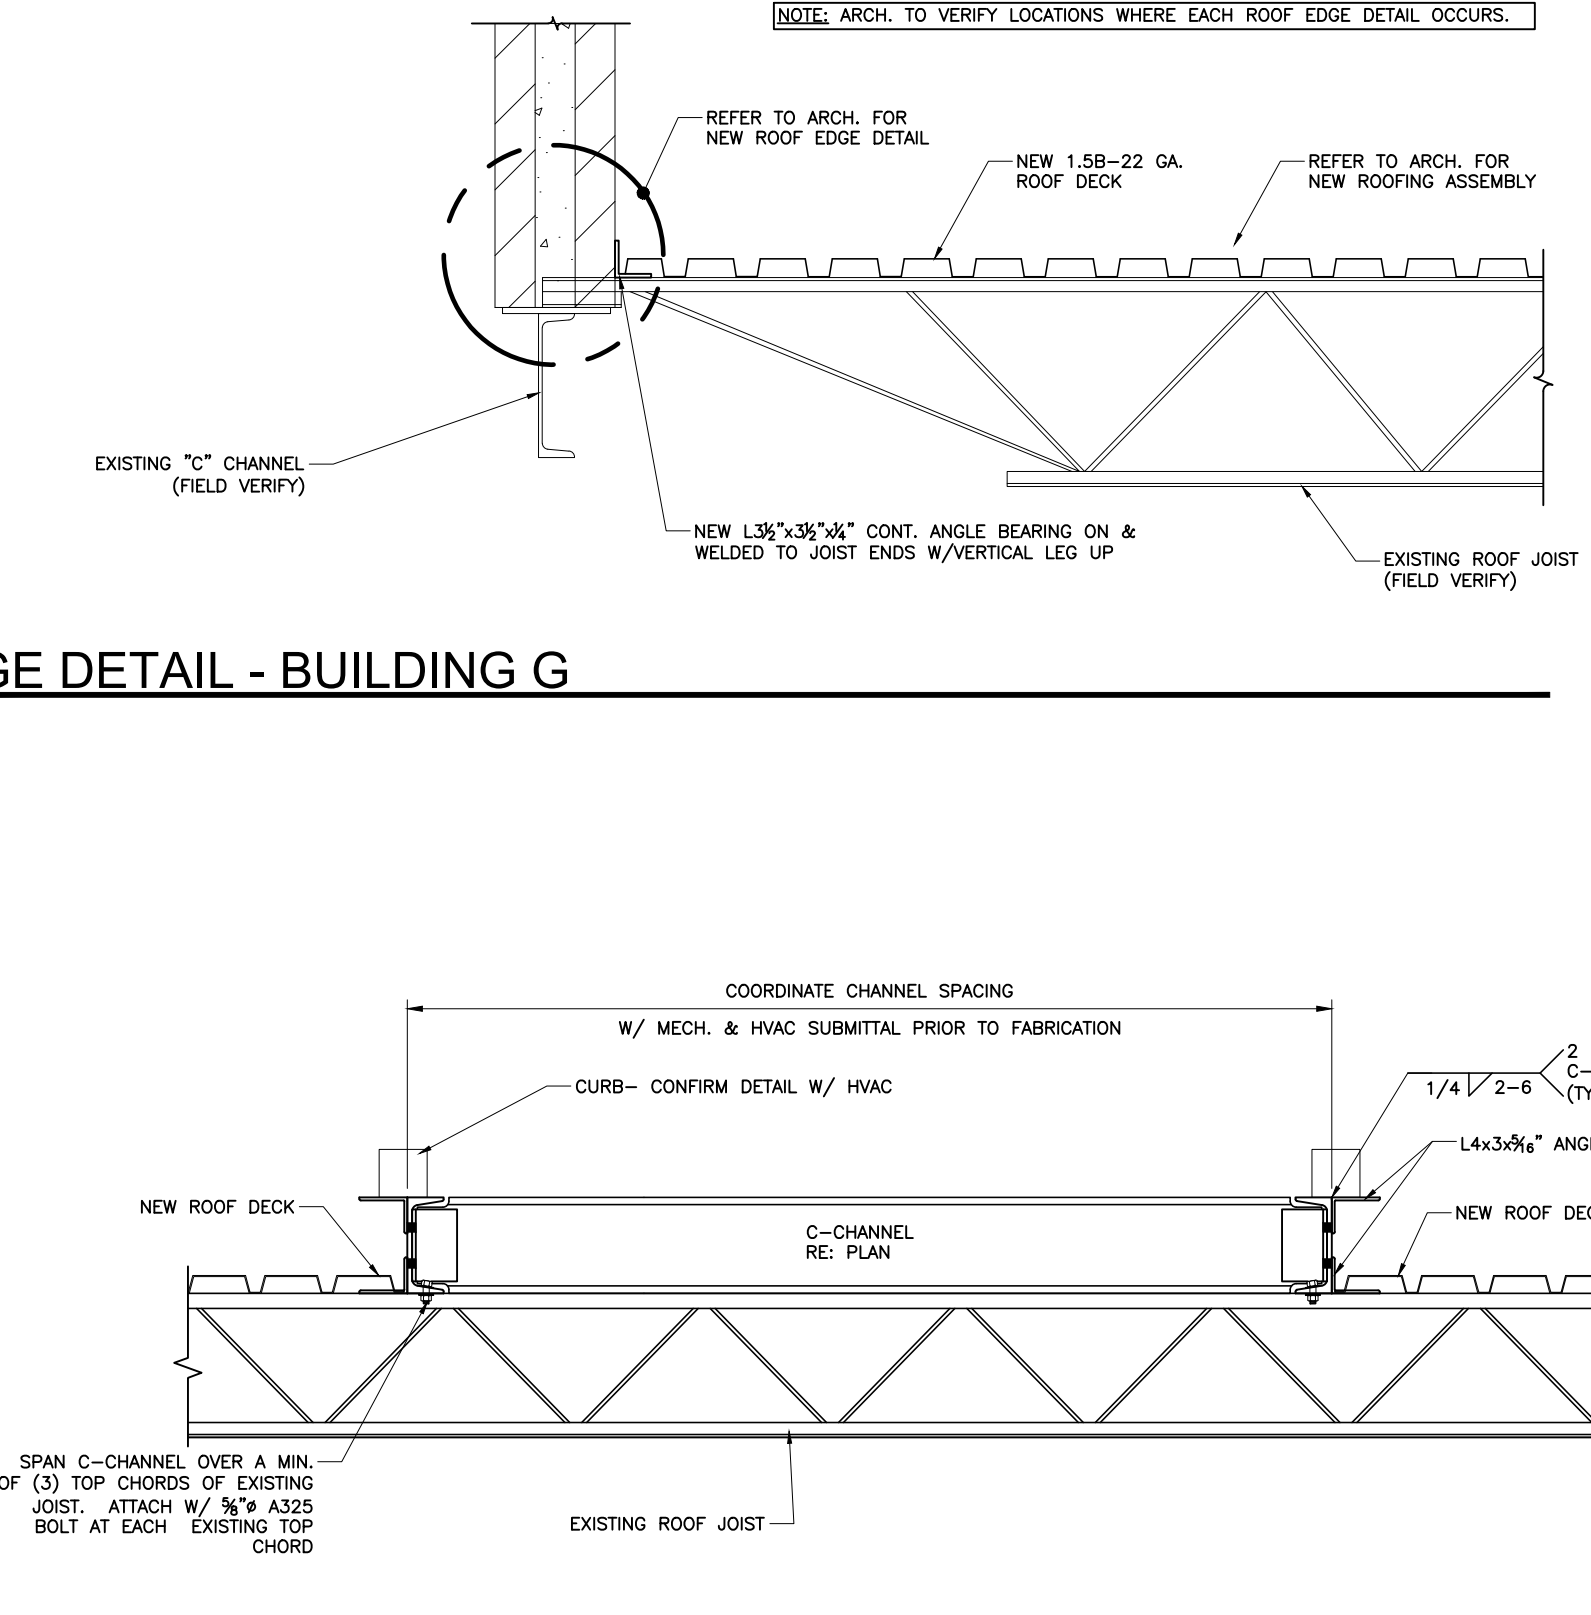
8 ROOF EDGE DETAIL - BUILDING G
SCALE: 3/4" = 1'-0"



9 CONDENSER UNIT/ AIR HANDLING UNIT FRAMING PLAN DETAIL (TYPICAL)
SCALE: 3/4" = 1'-0"



10 EXHAUST FAN/ COMBUSTION VENT/ MISC. MECH. EQUIP. FRAMING PLAN DETAIL (TYPICAL)
SCALE: 3/4" = 1'-0"



A CONDENSER UNIT/ AIR HANDLING UNIT FRAMING SECTION (TYPICAL)
SCALE: 3/4" = 1'-0"

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EXPIRES 07/01/2024

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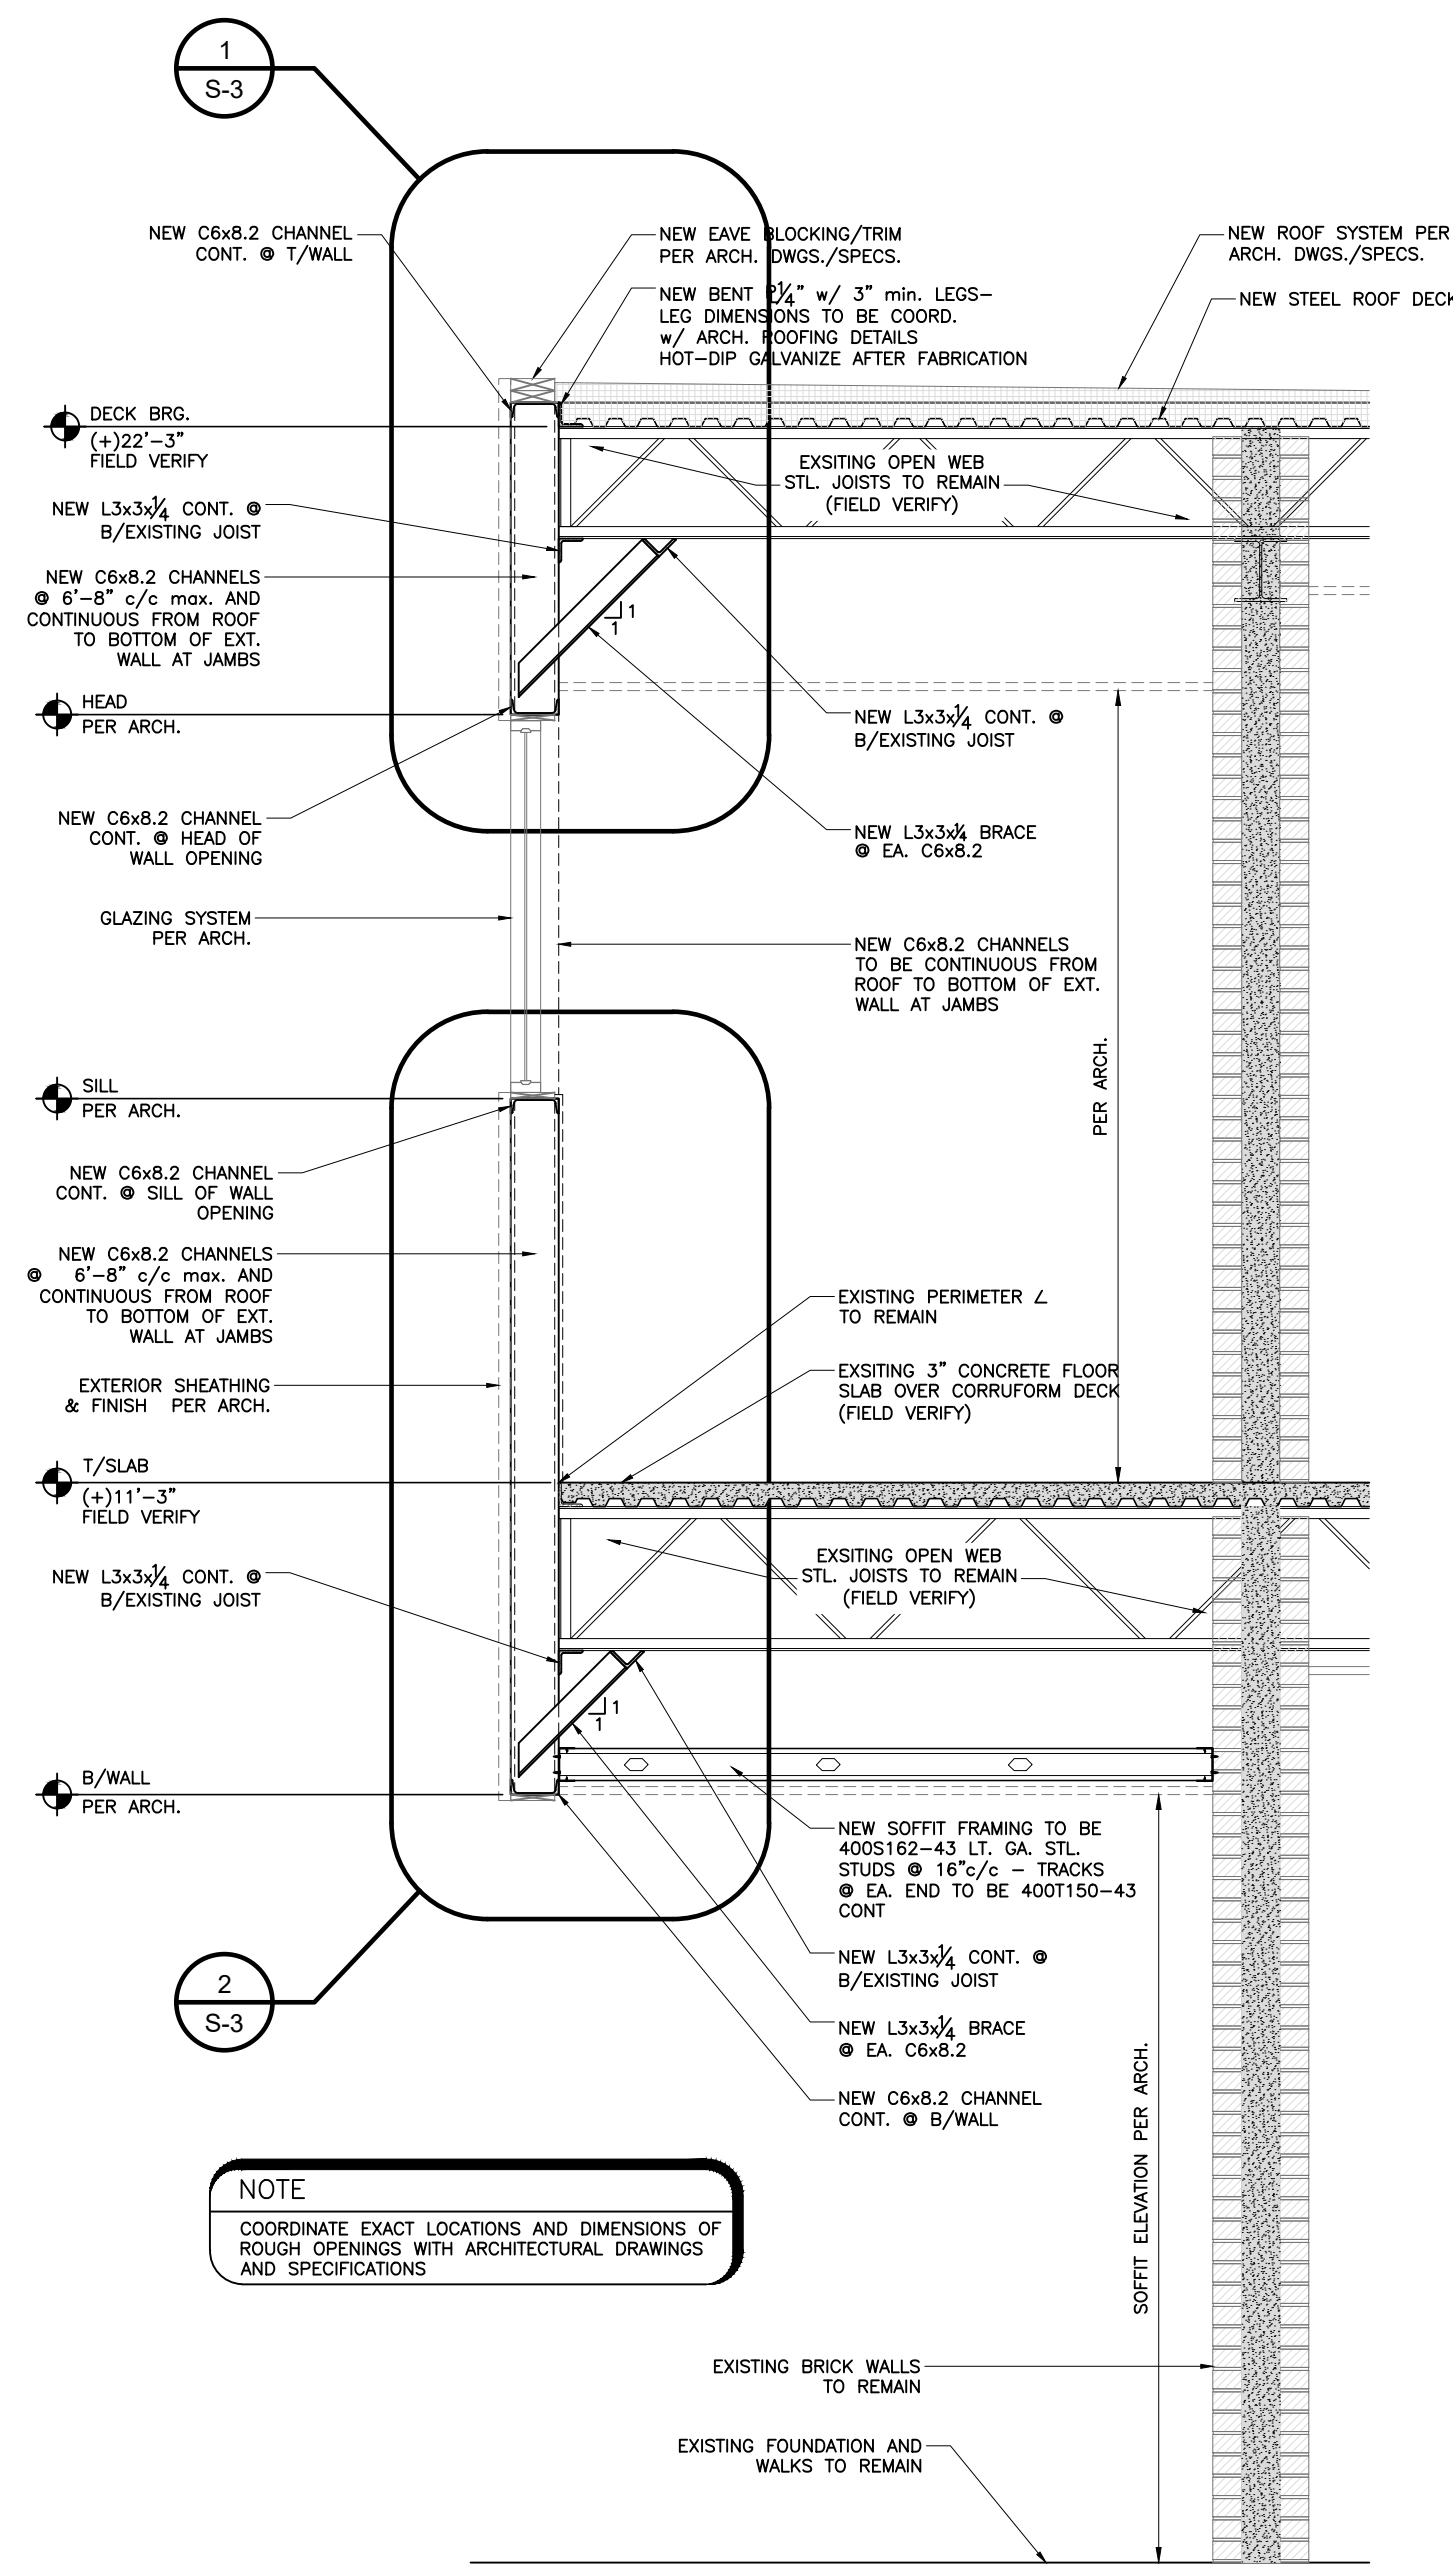
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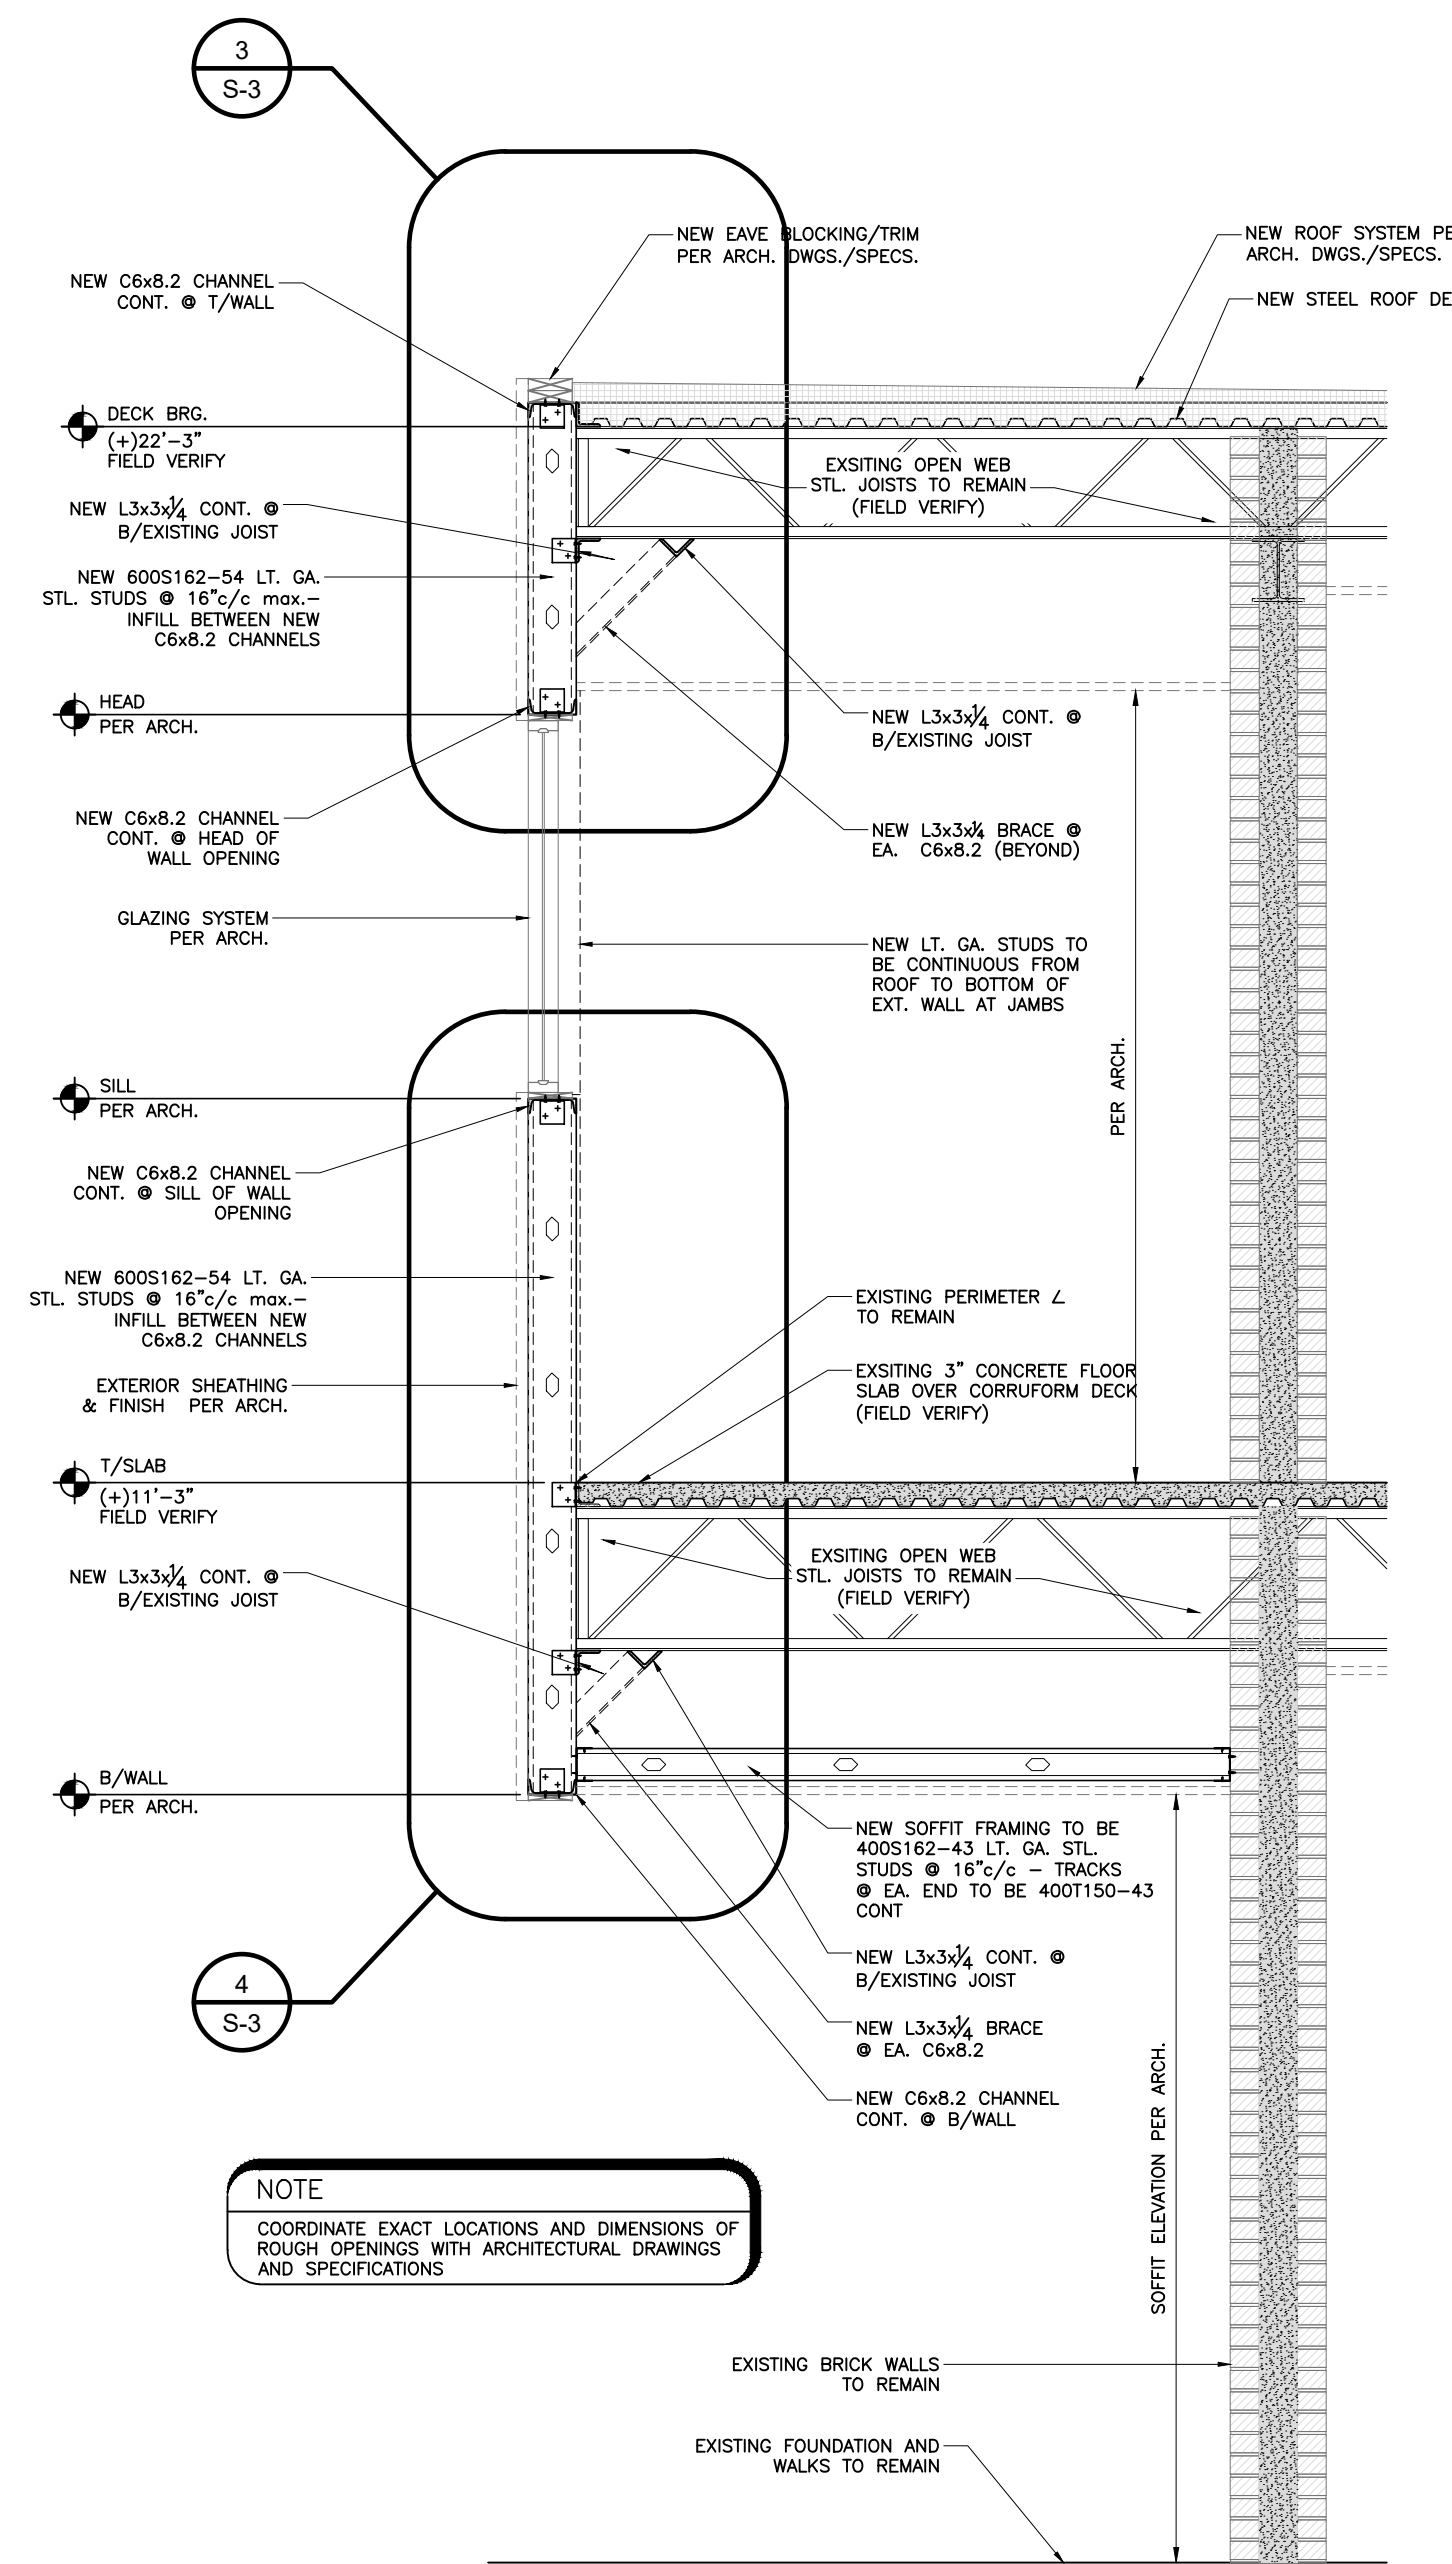
REVISED

SHEET NUMBER
S-2

**ROOF REPAIR
DETAILS**



SECTION (AT C6x8.2 FRAMES) THRU ENCLOSED BALCONY BUILDINGS A, B, & C
SCALE: 1/2" = 1'-0"



SECTION (AT LT. GA. STUD INFILL) THRU ENCLOSED BALCONY -- BUILDINGS A, B, & C
SCALE: 1/2" = 1'-0"

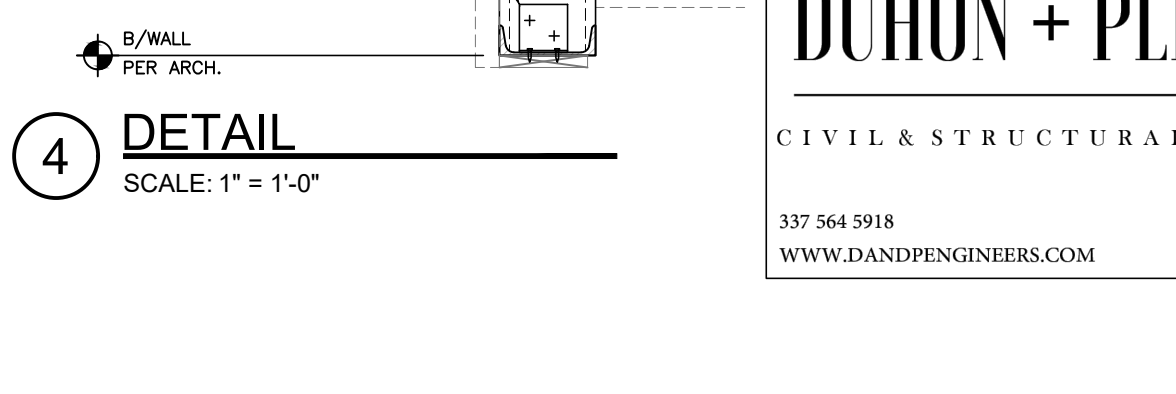
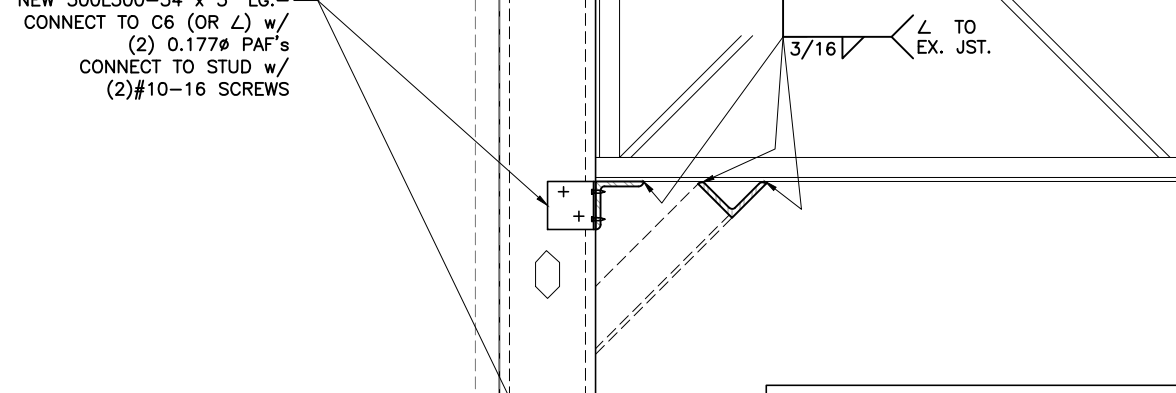
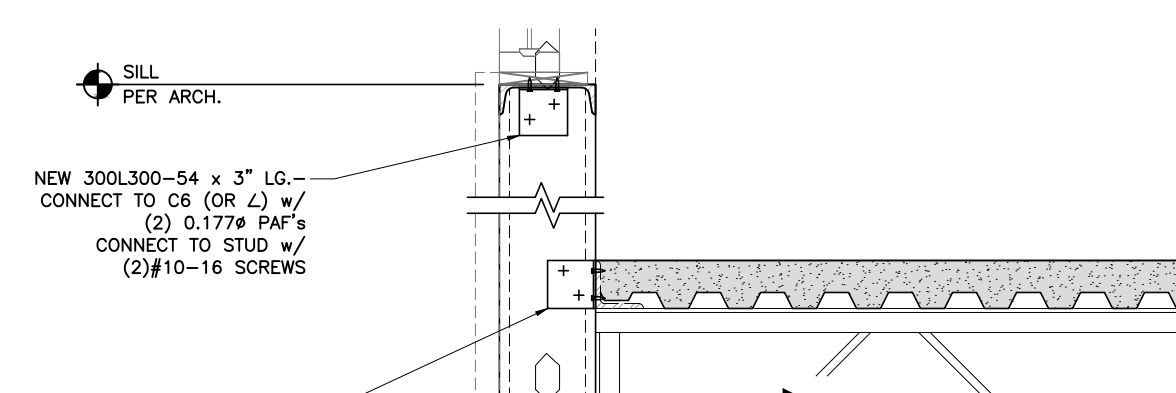
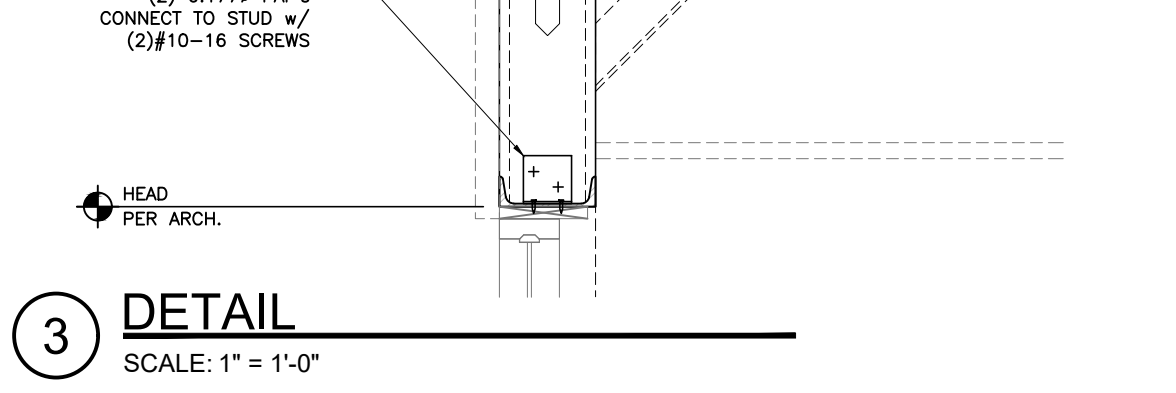
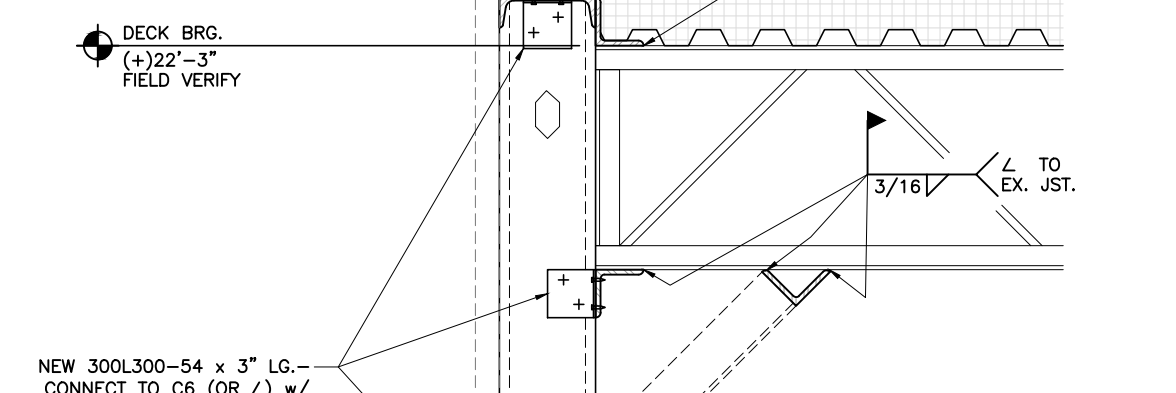
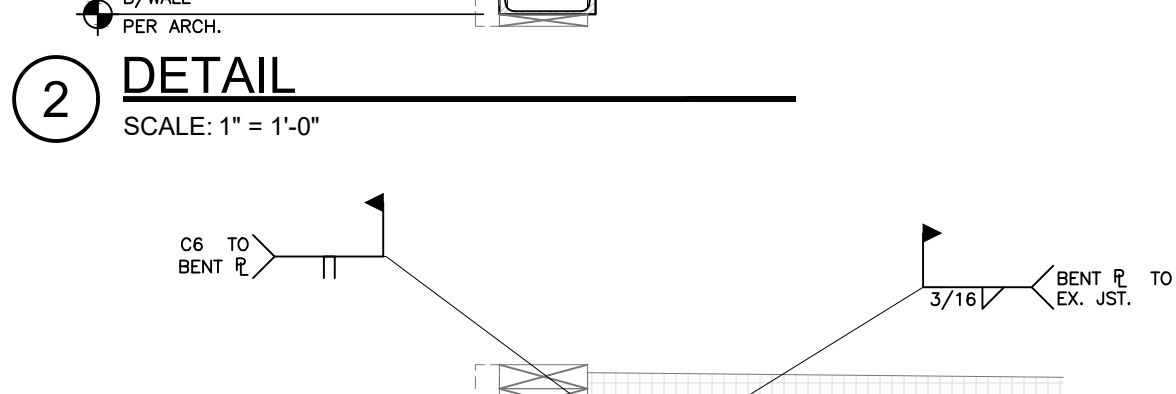
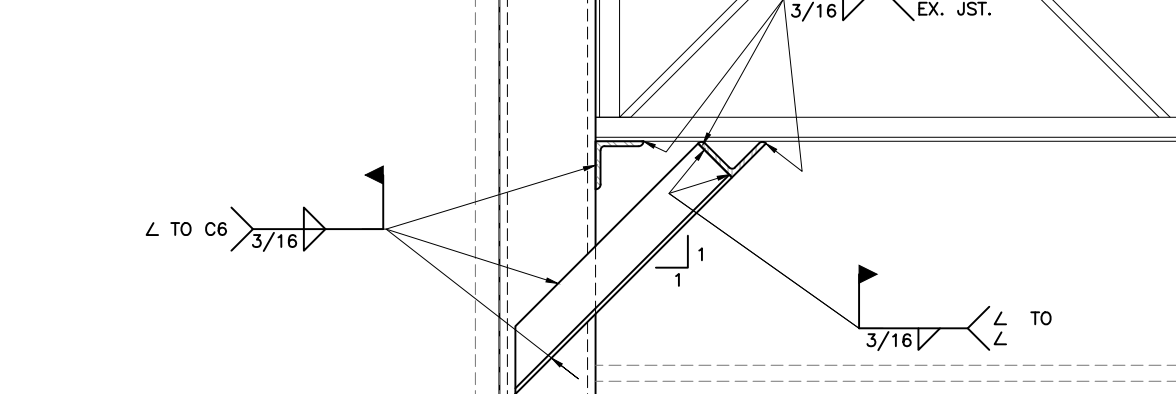
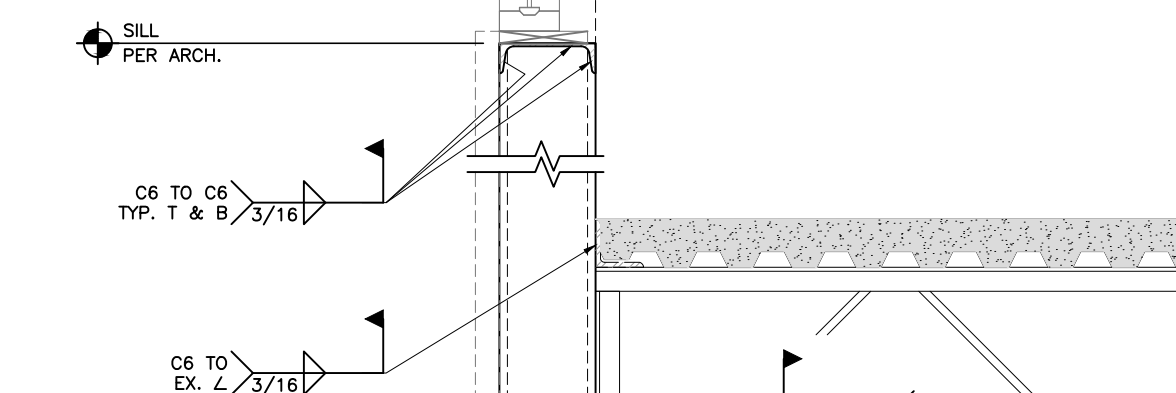
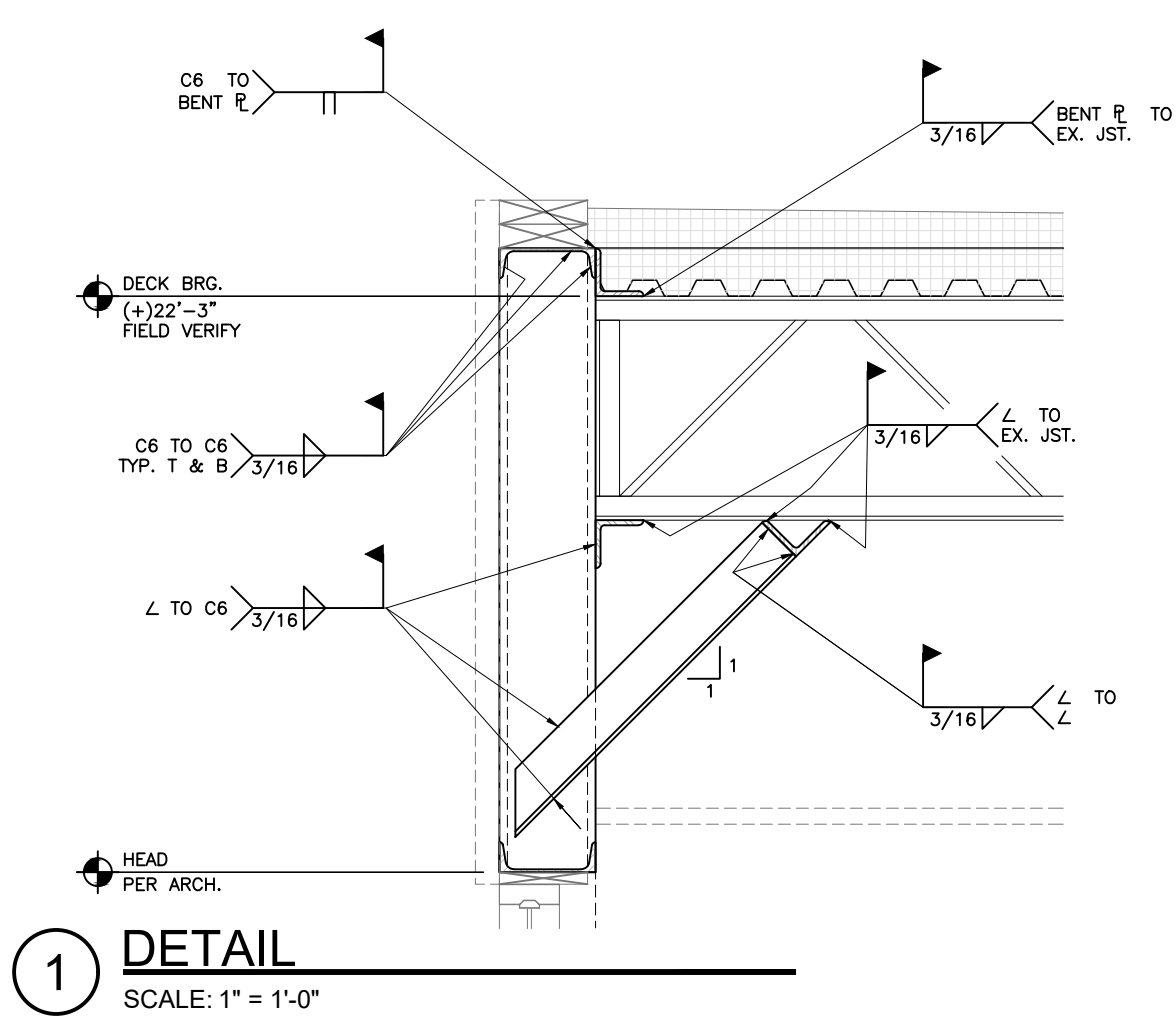


ENCLOSED BALCONY (w/ ALCOVE) AT BUILDING A
SCALE: NOT TO SCALE



ENCLOSED BALCONY (w/ ALCOVE) AT BUILDING C
SCALE: NOT TO SCALE

NOTE: ALL NEW STRUCTURAL AND MISCELLANEOUS STEEL SHALL BE HOT-DIP GALVANIZED AFTER FABRICATION



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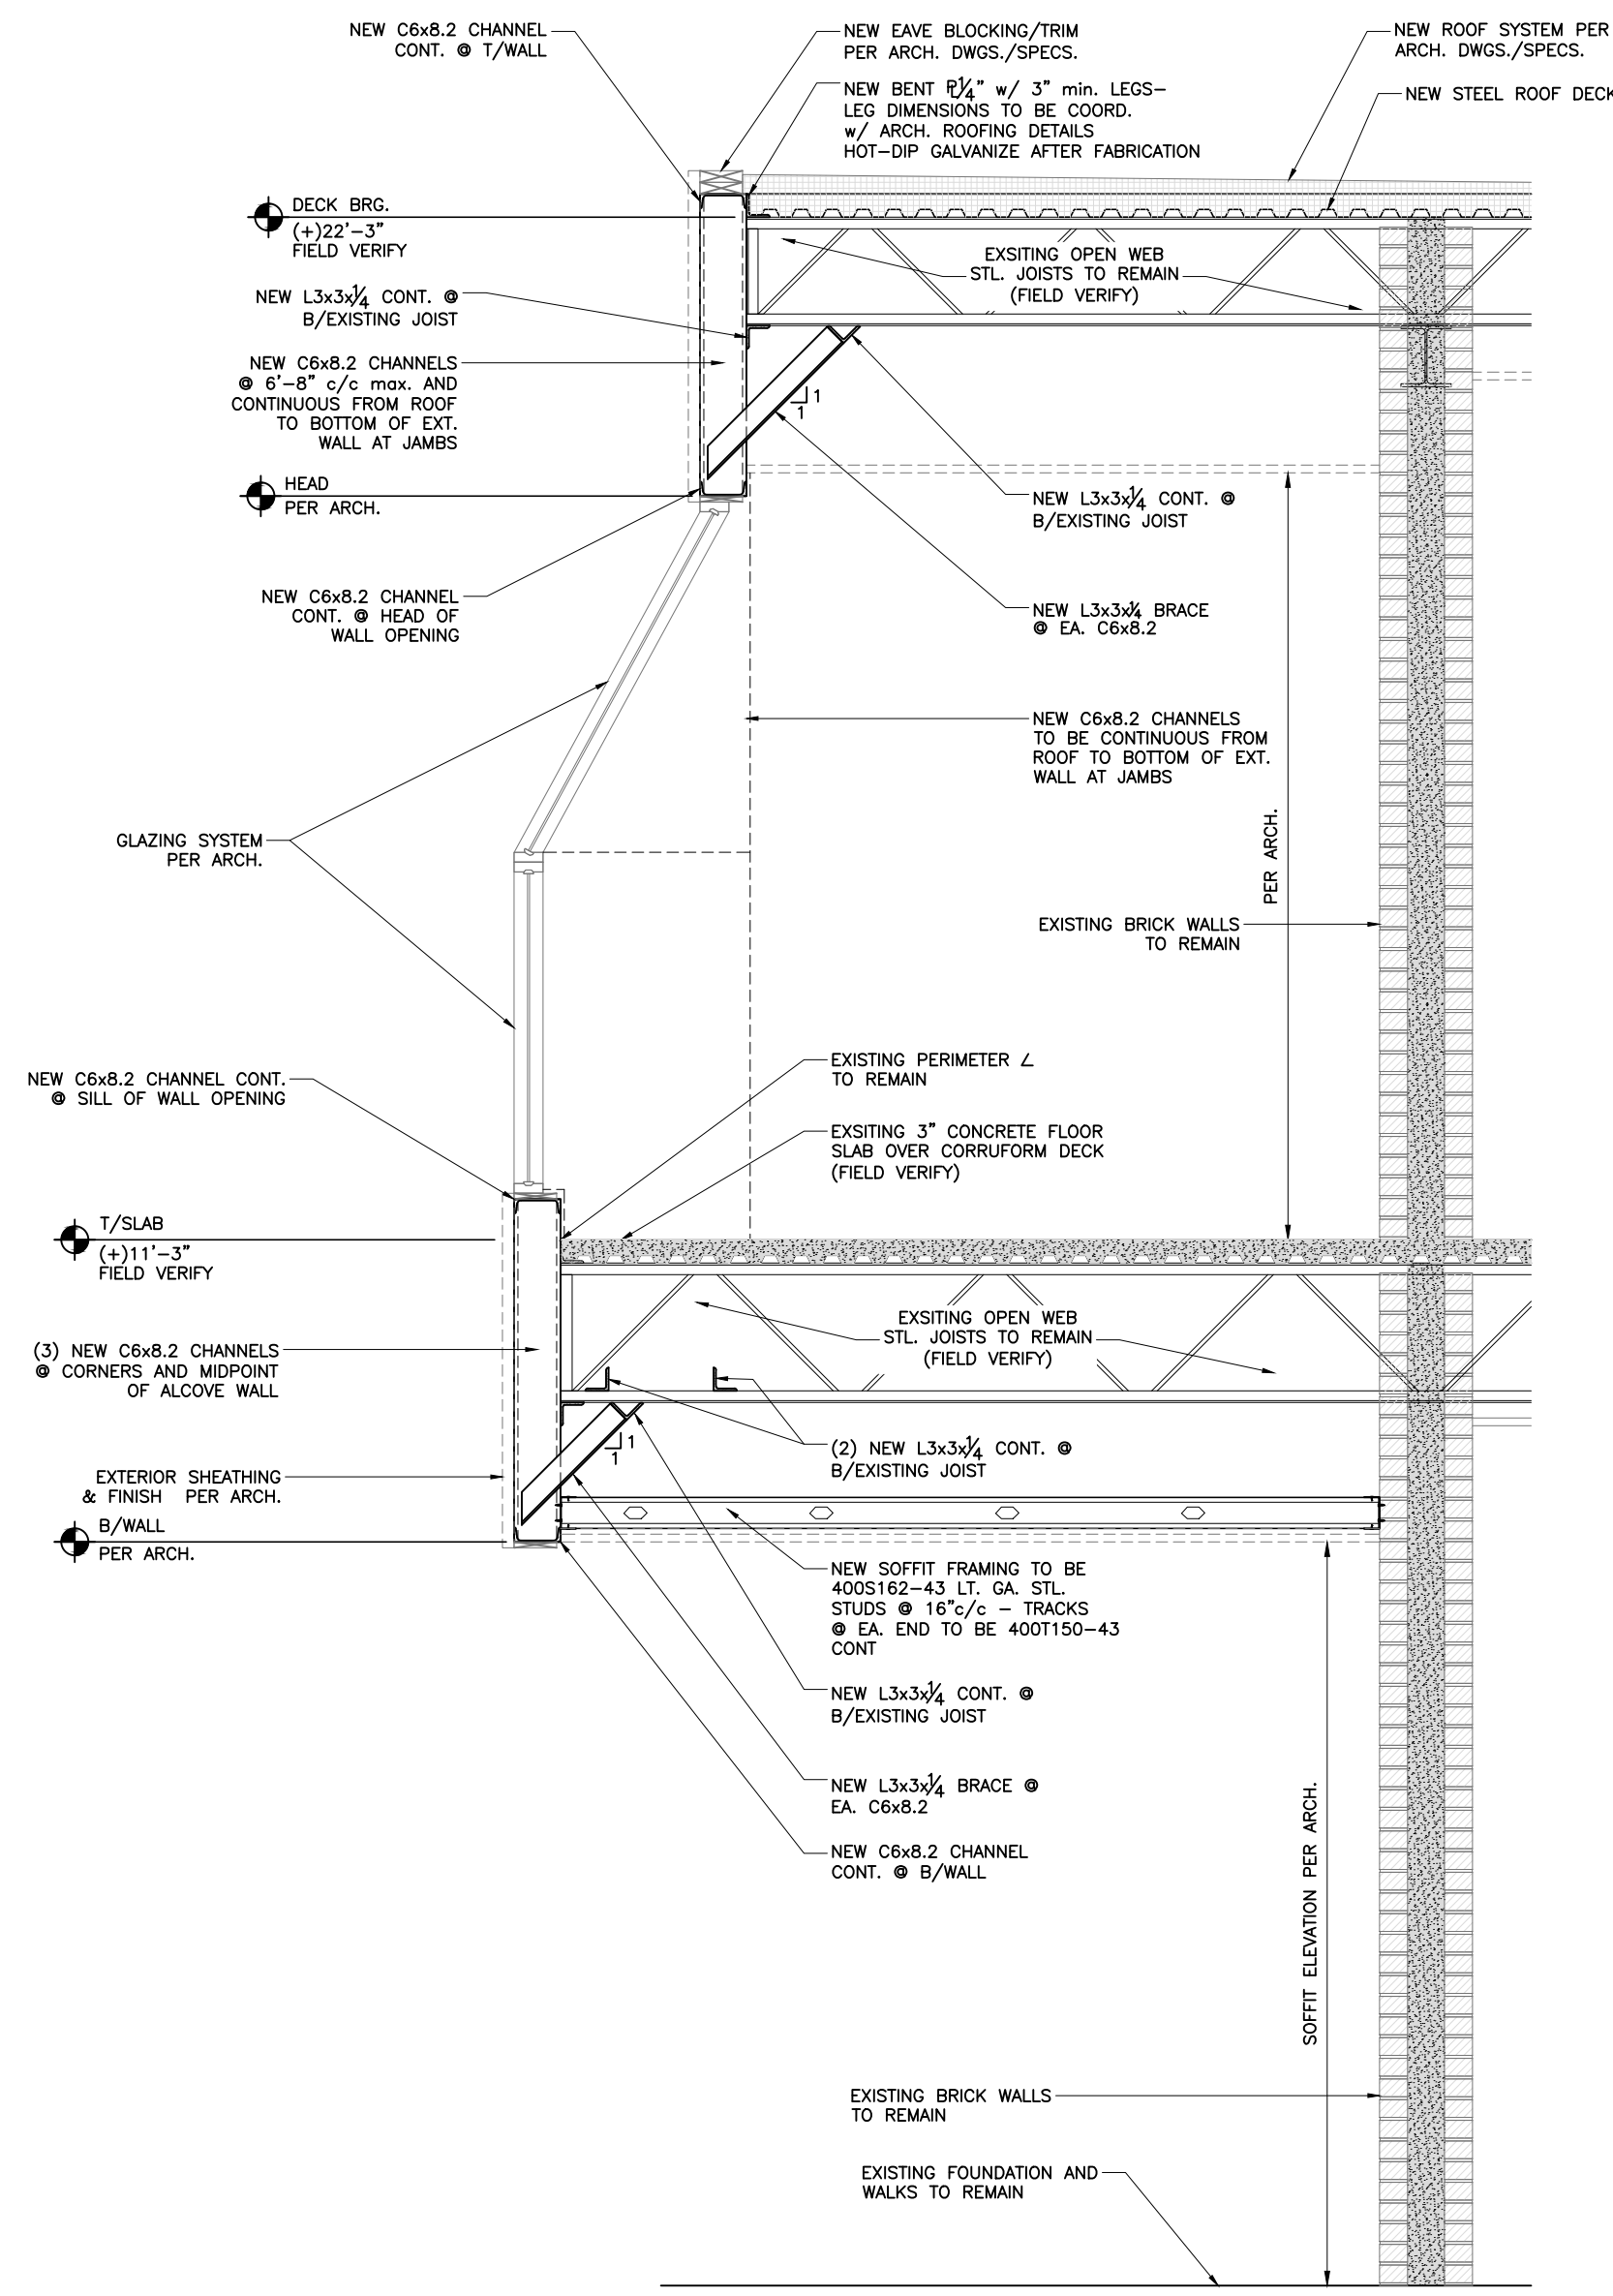
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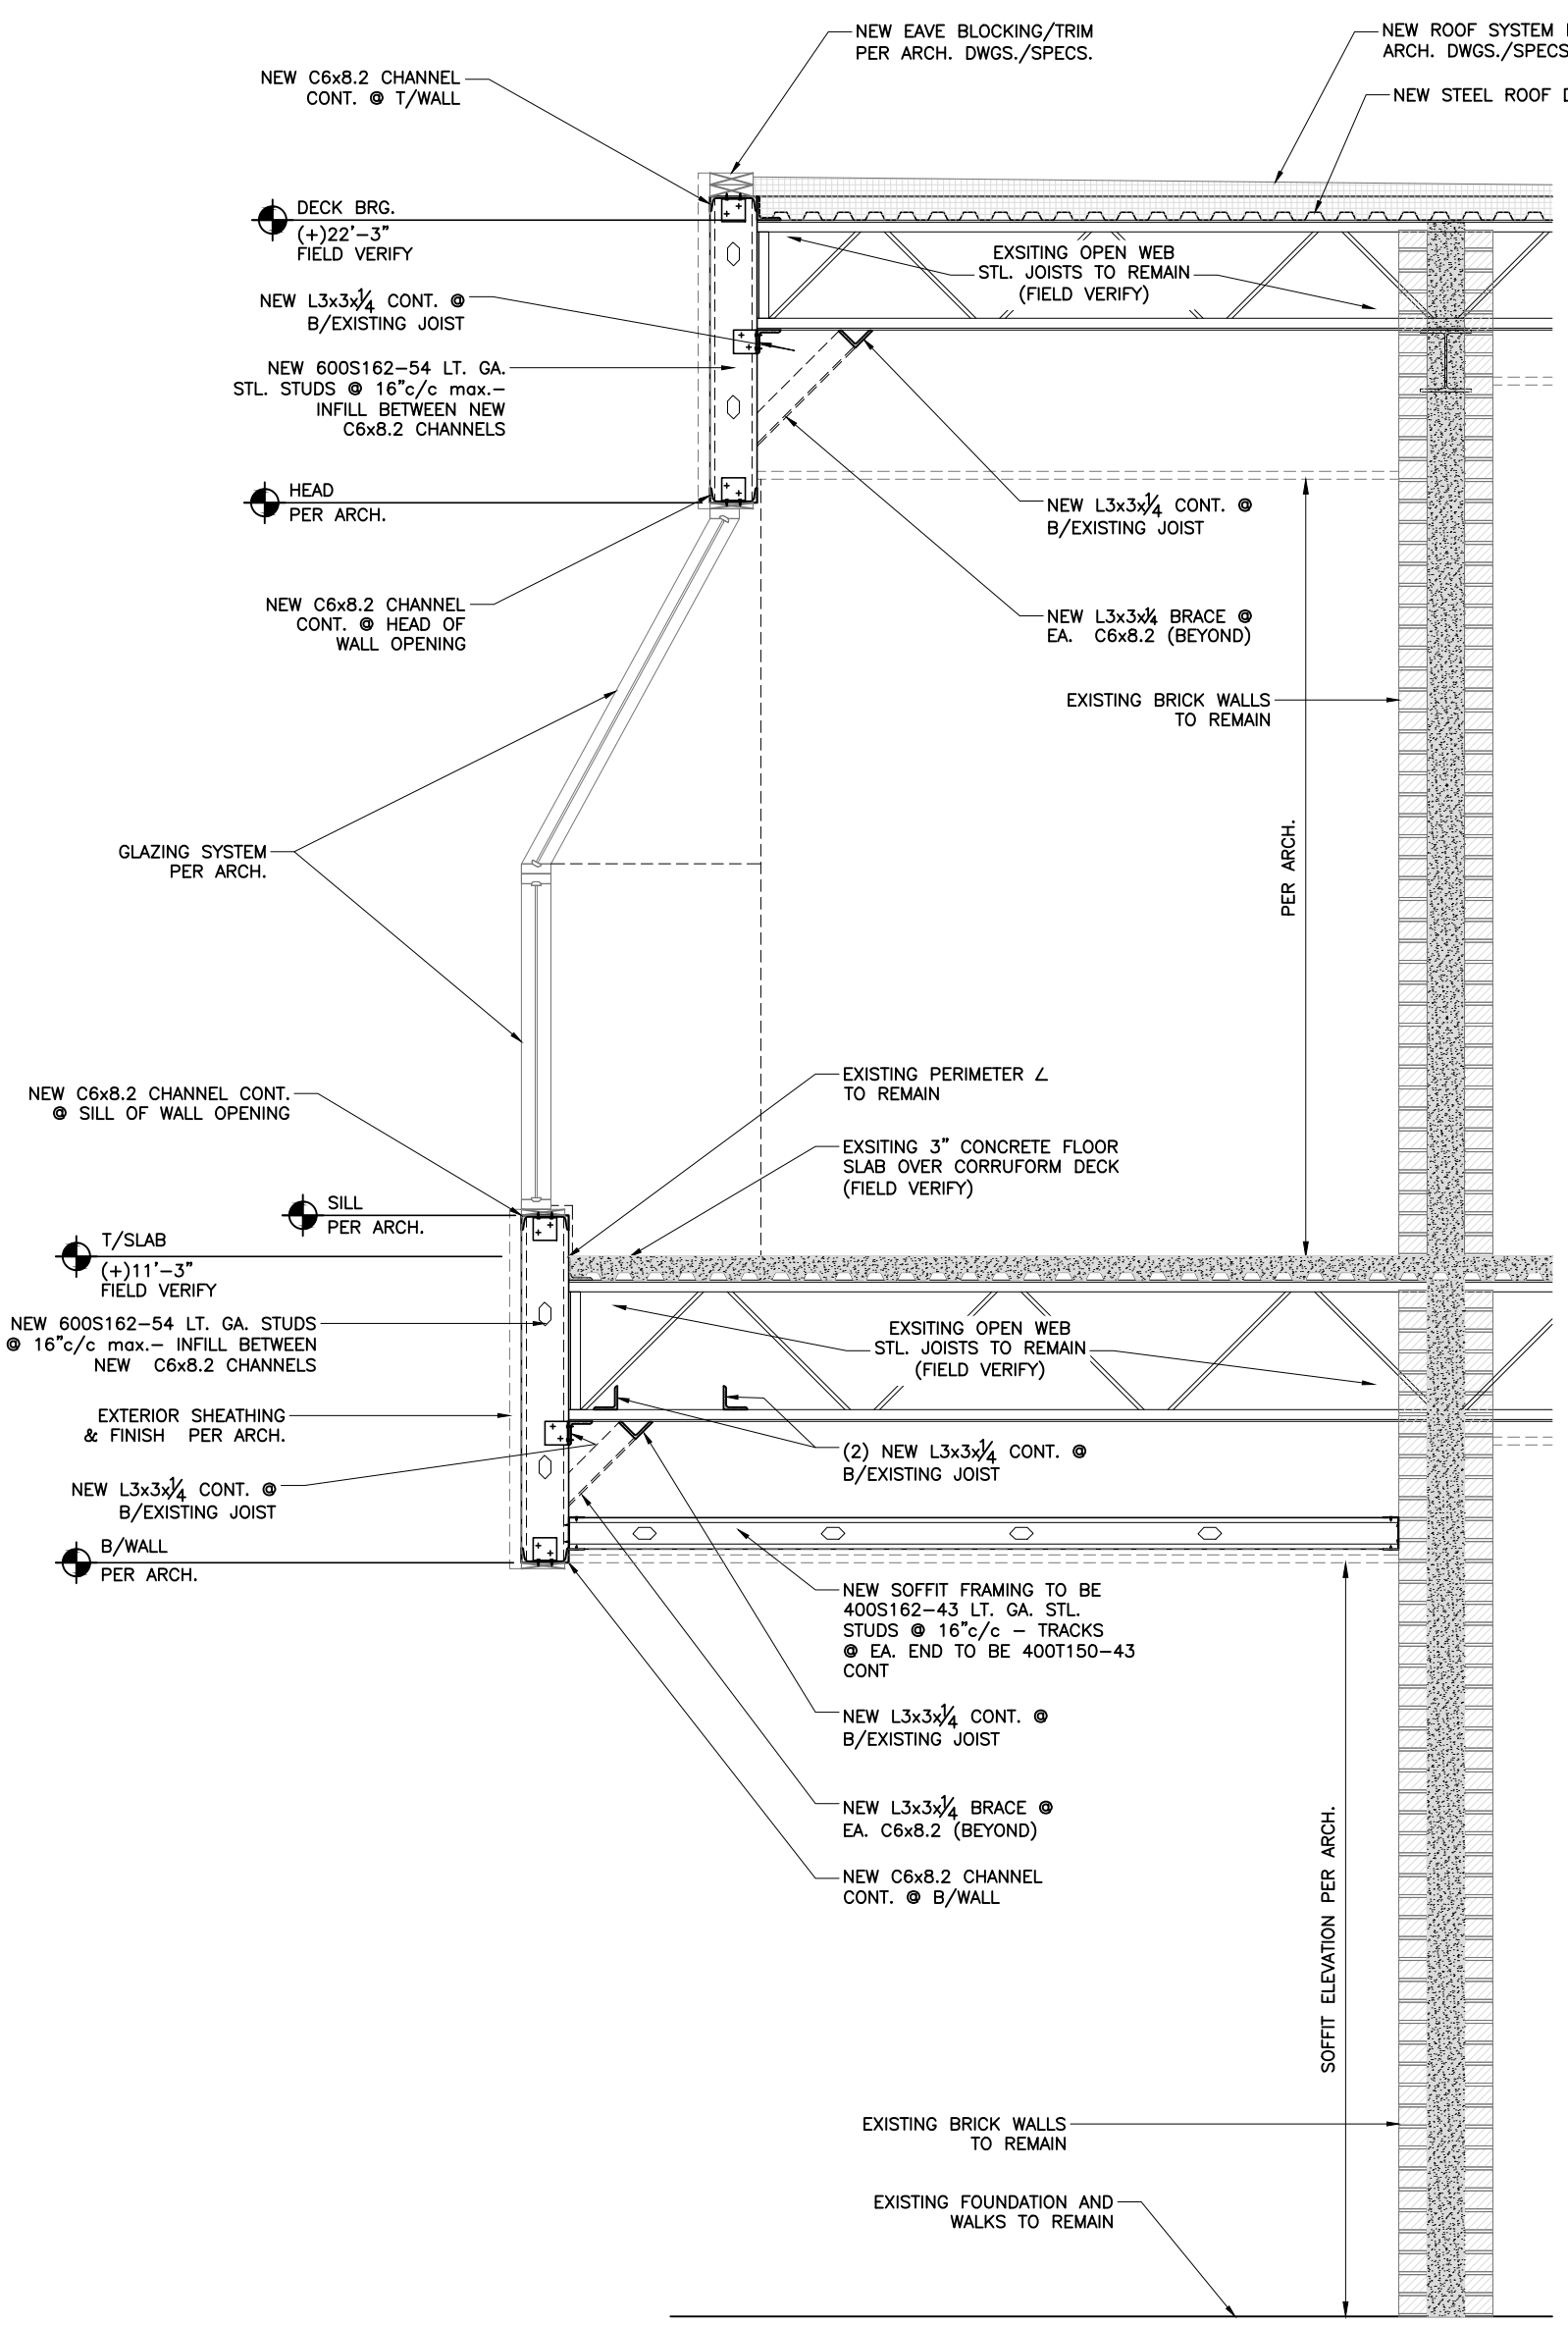
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337.564.5918 WWW.DANDPENGINEERS.COM 5393 BIG LAKE ROAD LAKE CHARLES LA 70605


S-3
ENCLOSED BALCONY WALL REPAIRS



B SECTION (AT C6x8.2 FRAMES) THRU ALCOVE OF ENCLOSED BALCONY -- BUILDINGS A & C
SCALE: 1/2" = 1'-0"



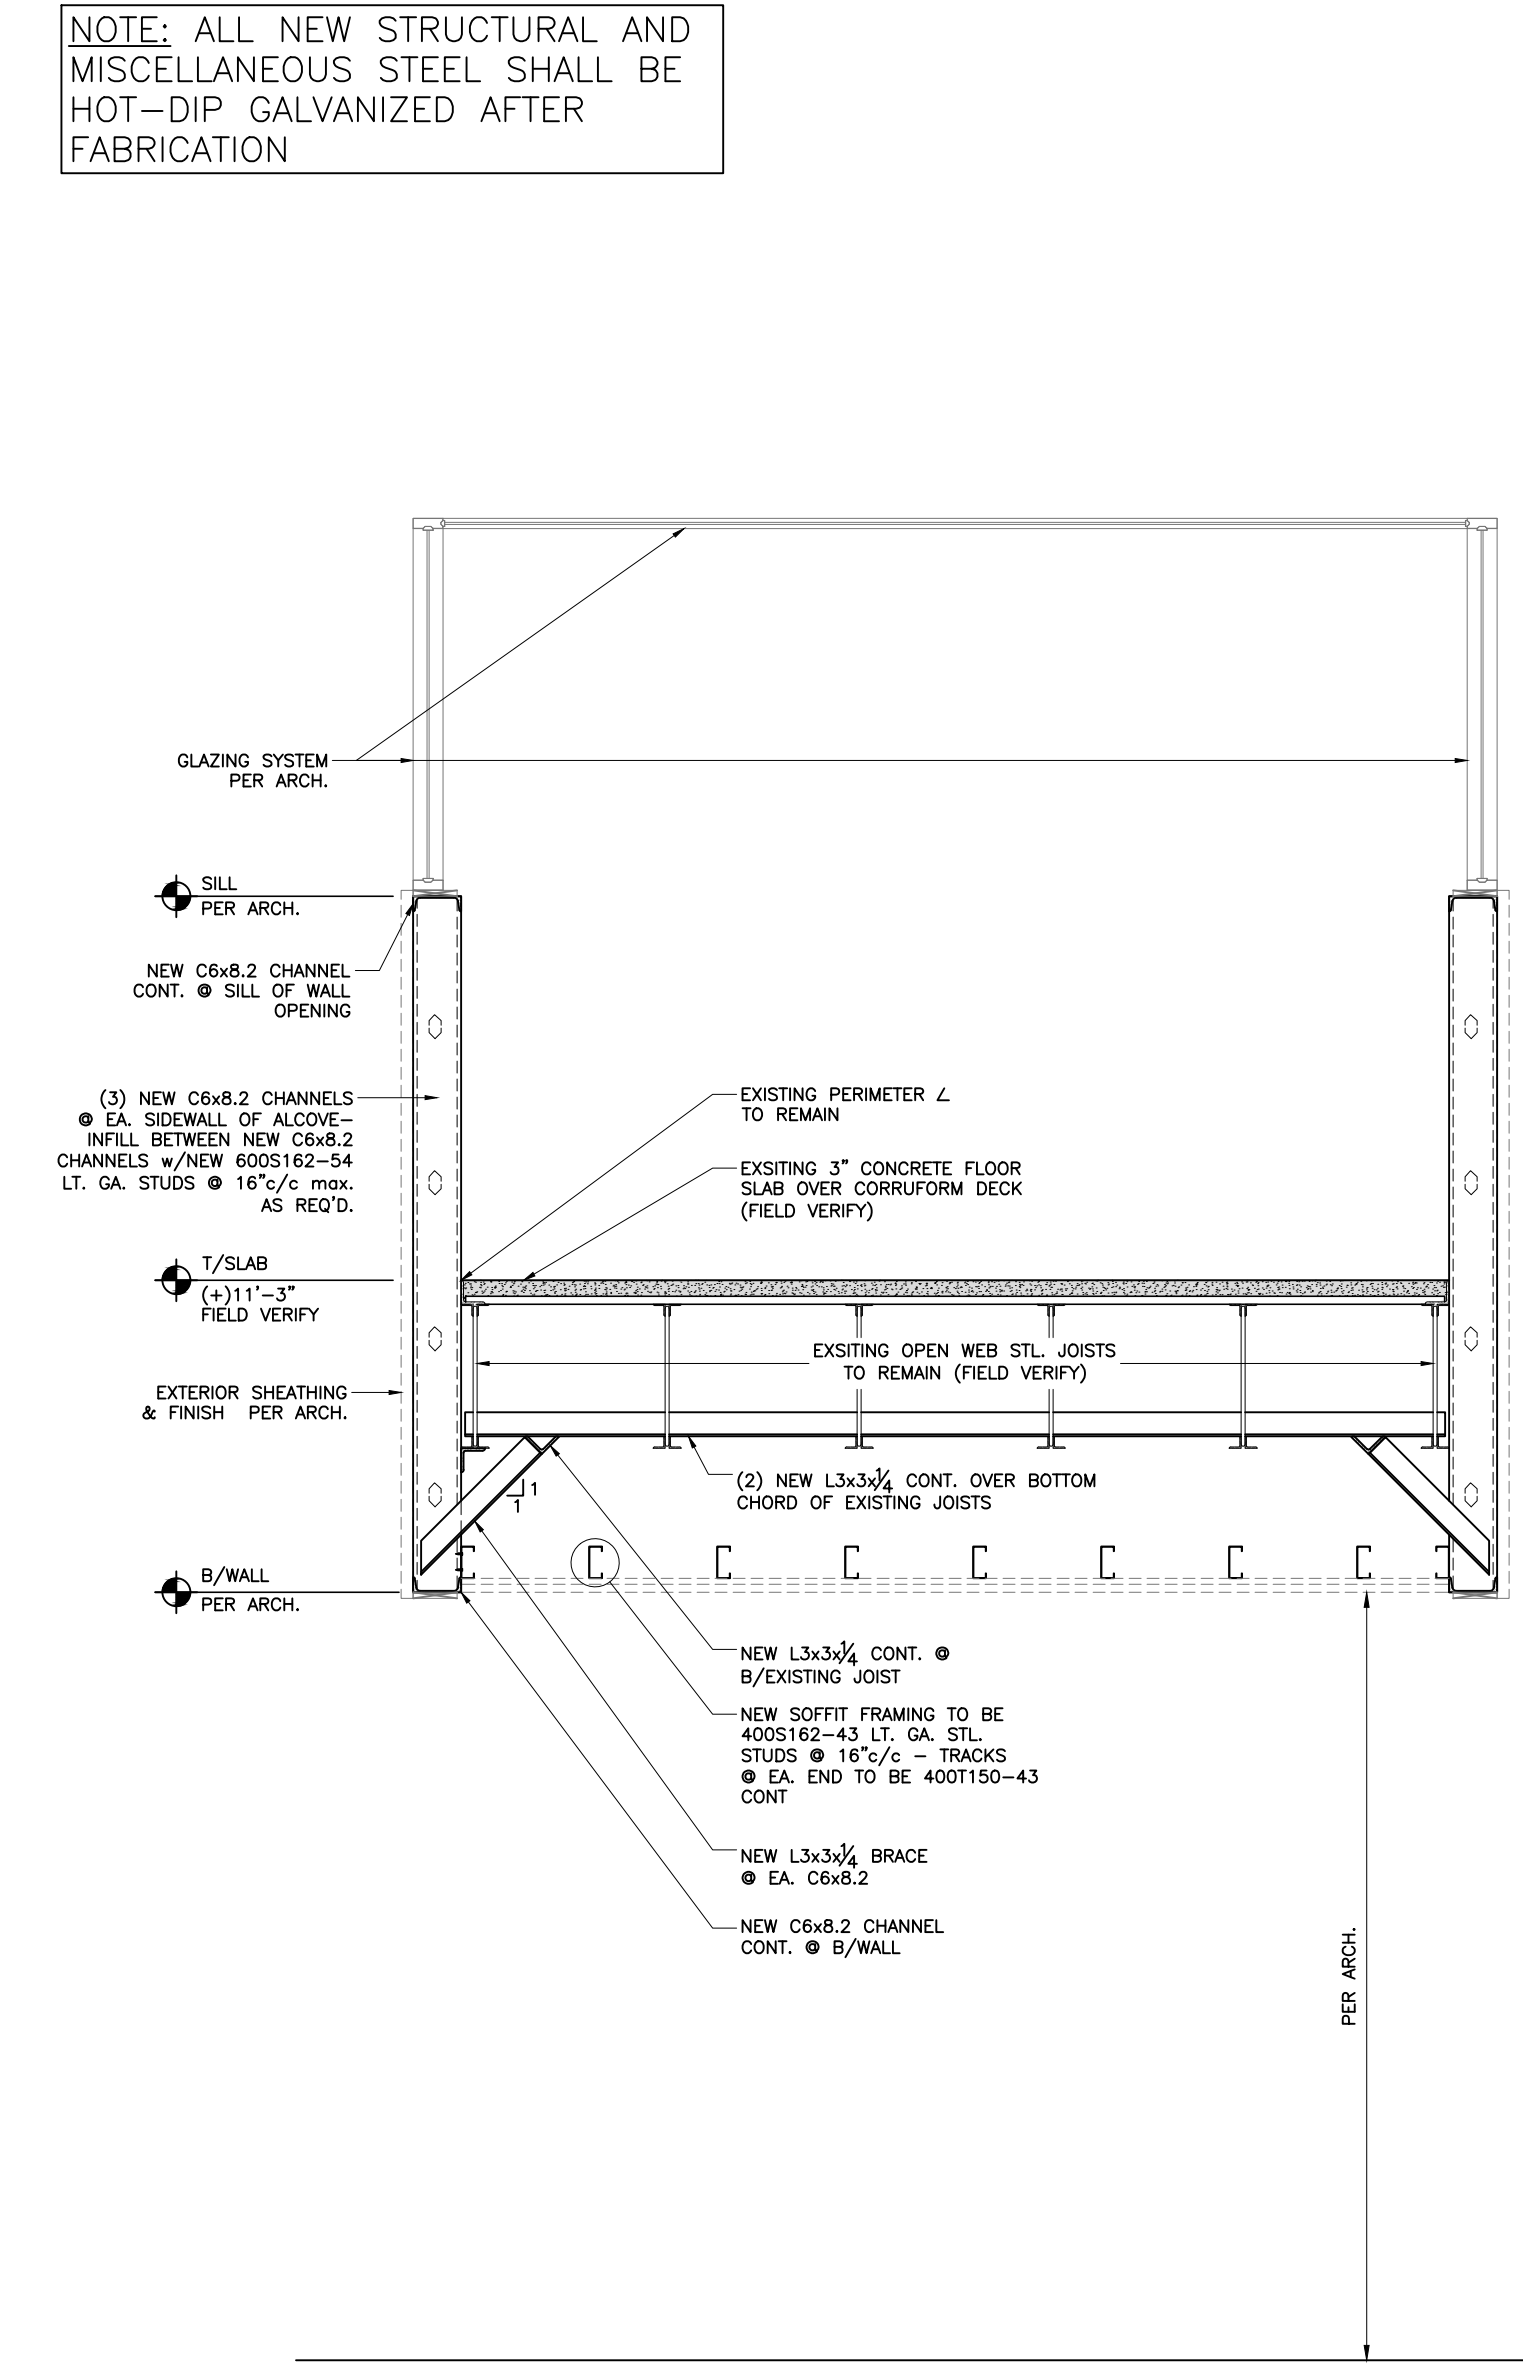B' SECTION (AT LT. GA. STUD INFILL) THRU ALCOVE OF ENCLOSED BALCONY -- BUILDINGS A & C
SCALE: 1/2" = 1'-0"




C SECTION THRU ALCOVE OF ENCLOSED BALCONY BUILDINGS A & C
SCALE: 1/2" = 1'-0"

NOTE: ALL NEW STRUCTURAL AND MISCELLANEOUS STEEL SHALL BE HOT-DIP GALVANIZED AFTER FABRICATION



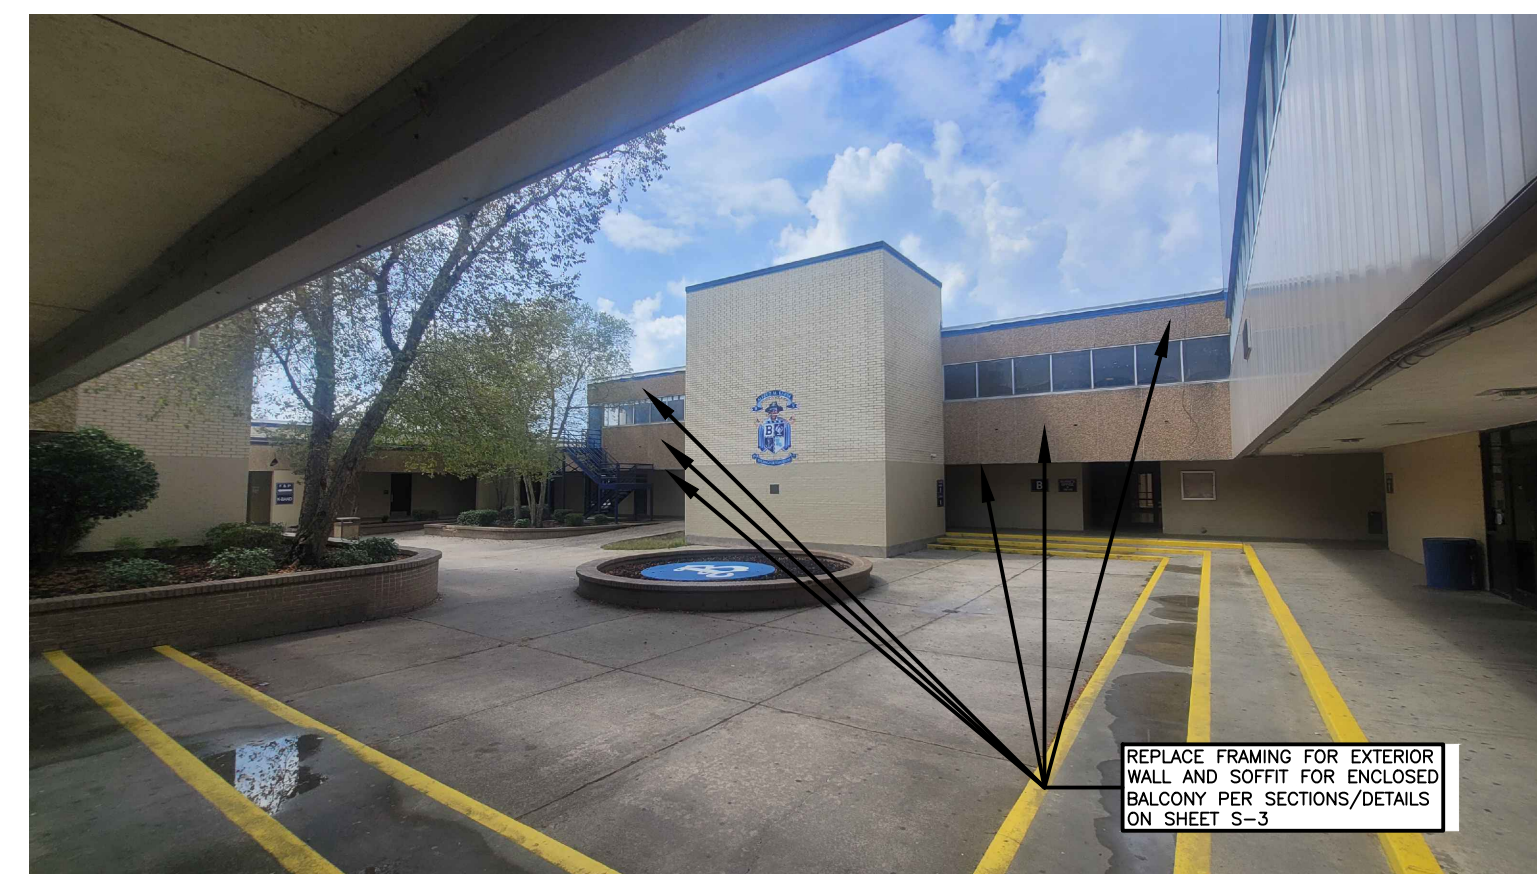A ENCLOSED BALCONY (w/ ALCOVE) AT BUILDING A
SCALE: NOT TO SCALE



B ENCLOSED BALCONY AT BUILDING B
SCALE: NOT TO SCALE



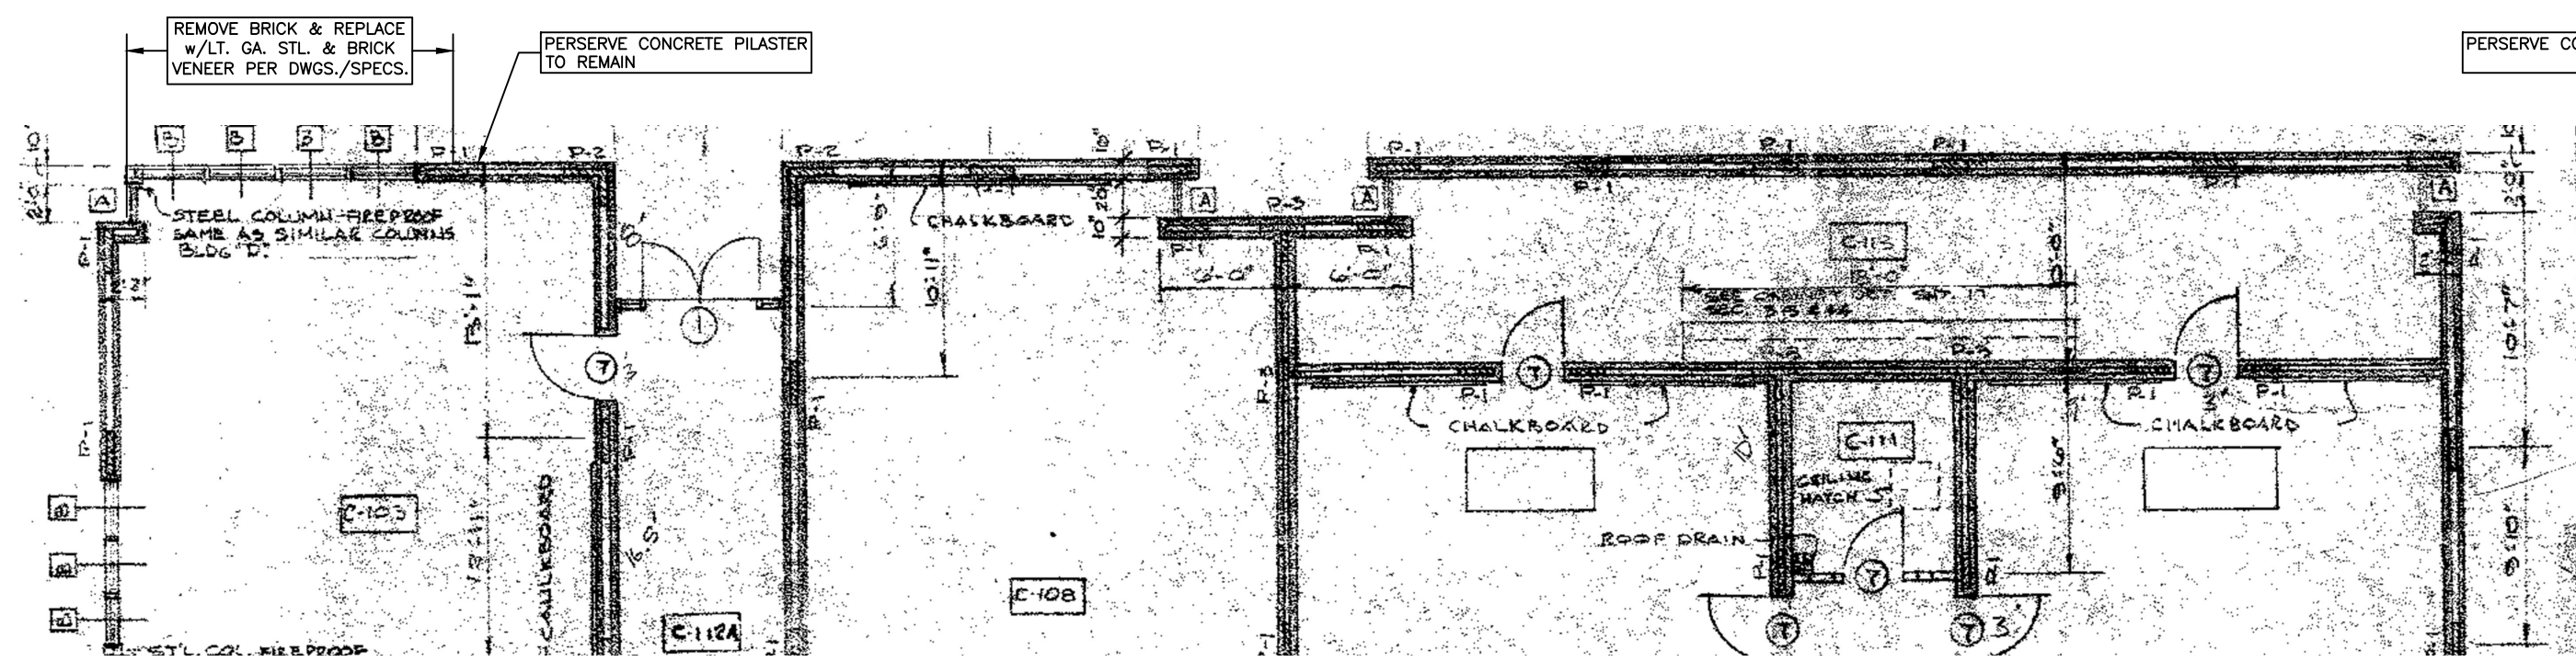
C ENCLOSED BALCONY (w/ ALCOVE) AT BUILDING C
SCALE: NOT TO SCALE

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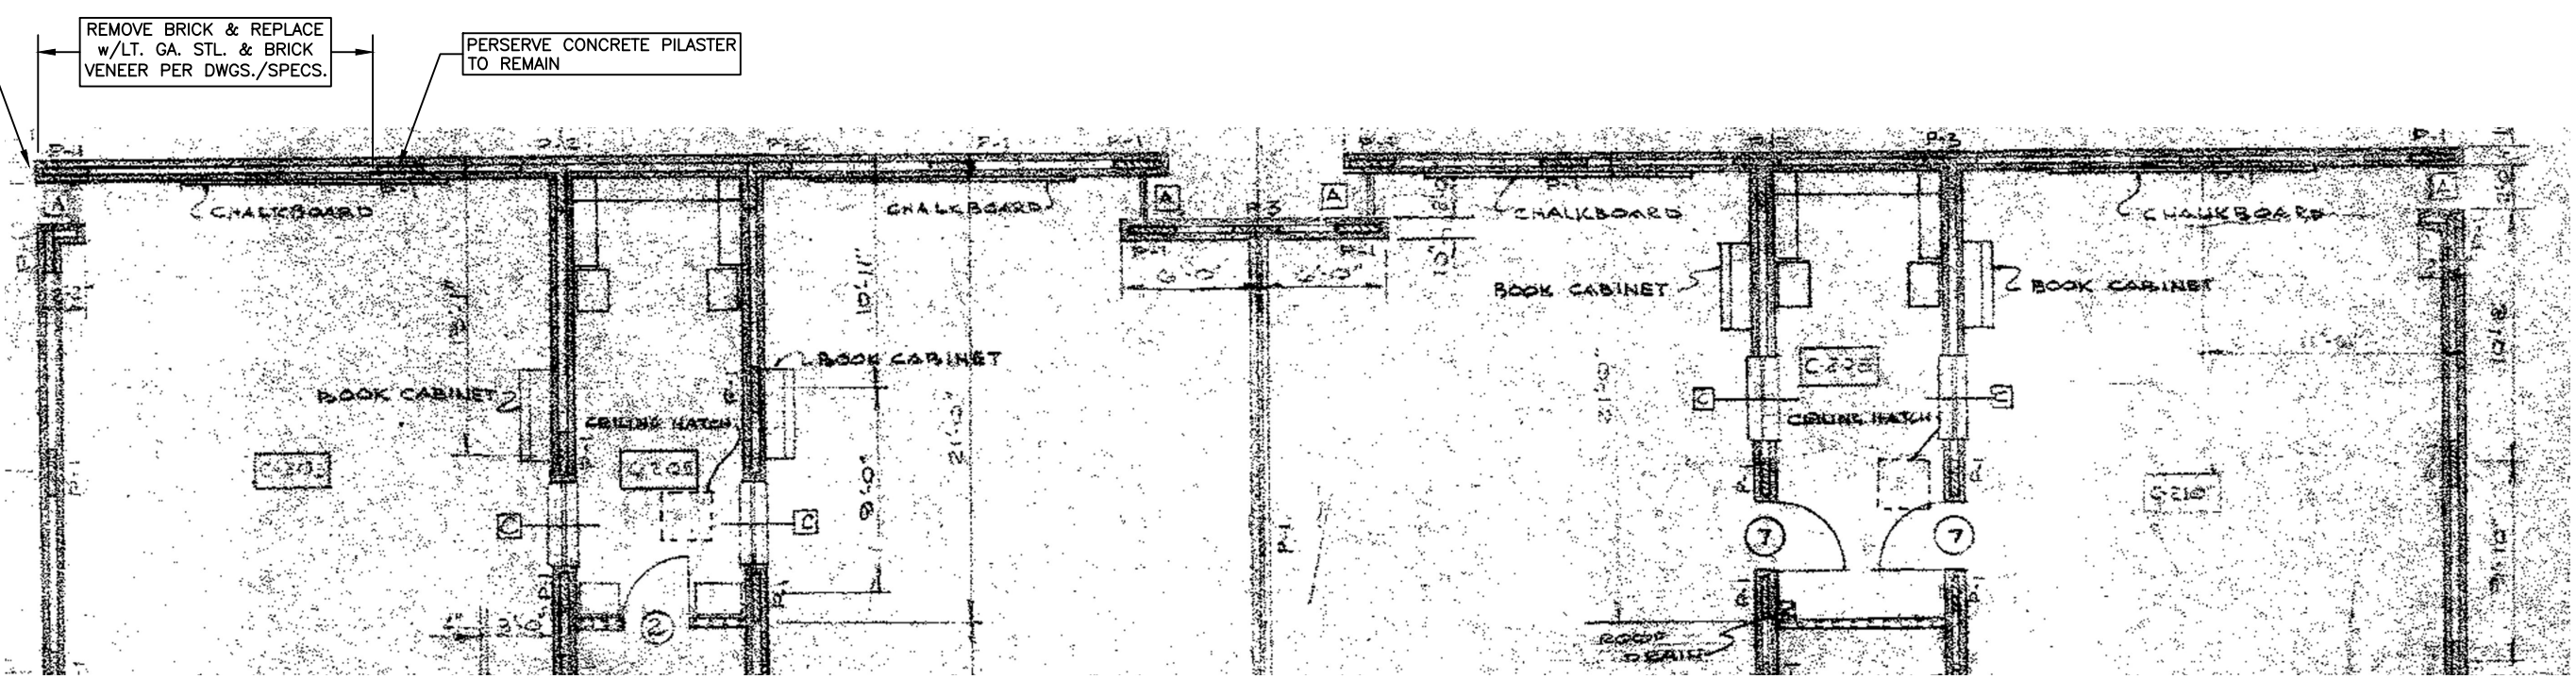
SHEET NUMBER

S-4
ENCLOSED BALCONY
WALL REPAIRS




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(ALL CONDITIONS TO BE FIELD VERIFIED)
SCALE: 1/8" = 1'-0"

NORTH




2 PARTIAL EXISTING SECOND FLOOR PLAN -- BUILDING C
(ALL CONDITIONS TO BE FIELD VERIFIED)
SCALE: 1/8" = 1'-0"

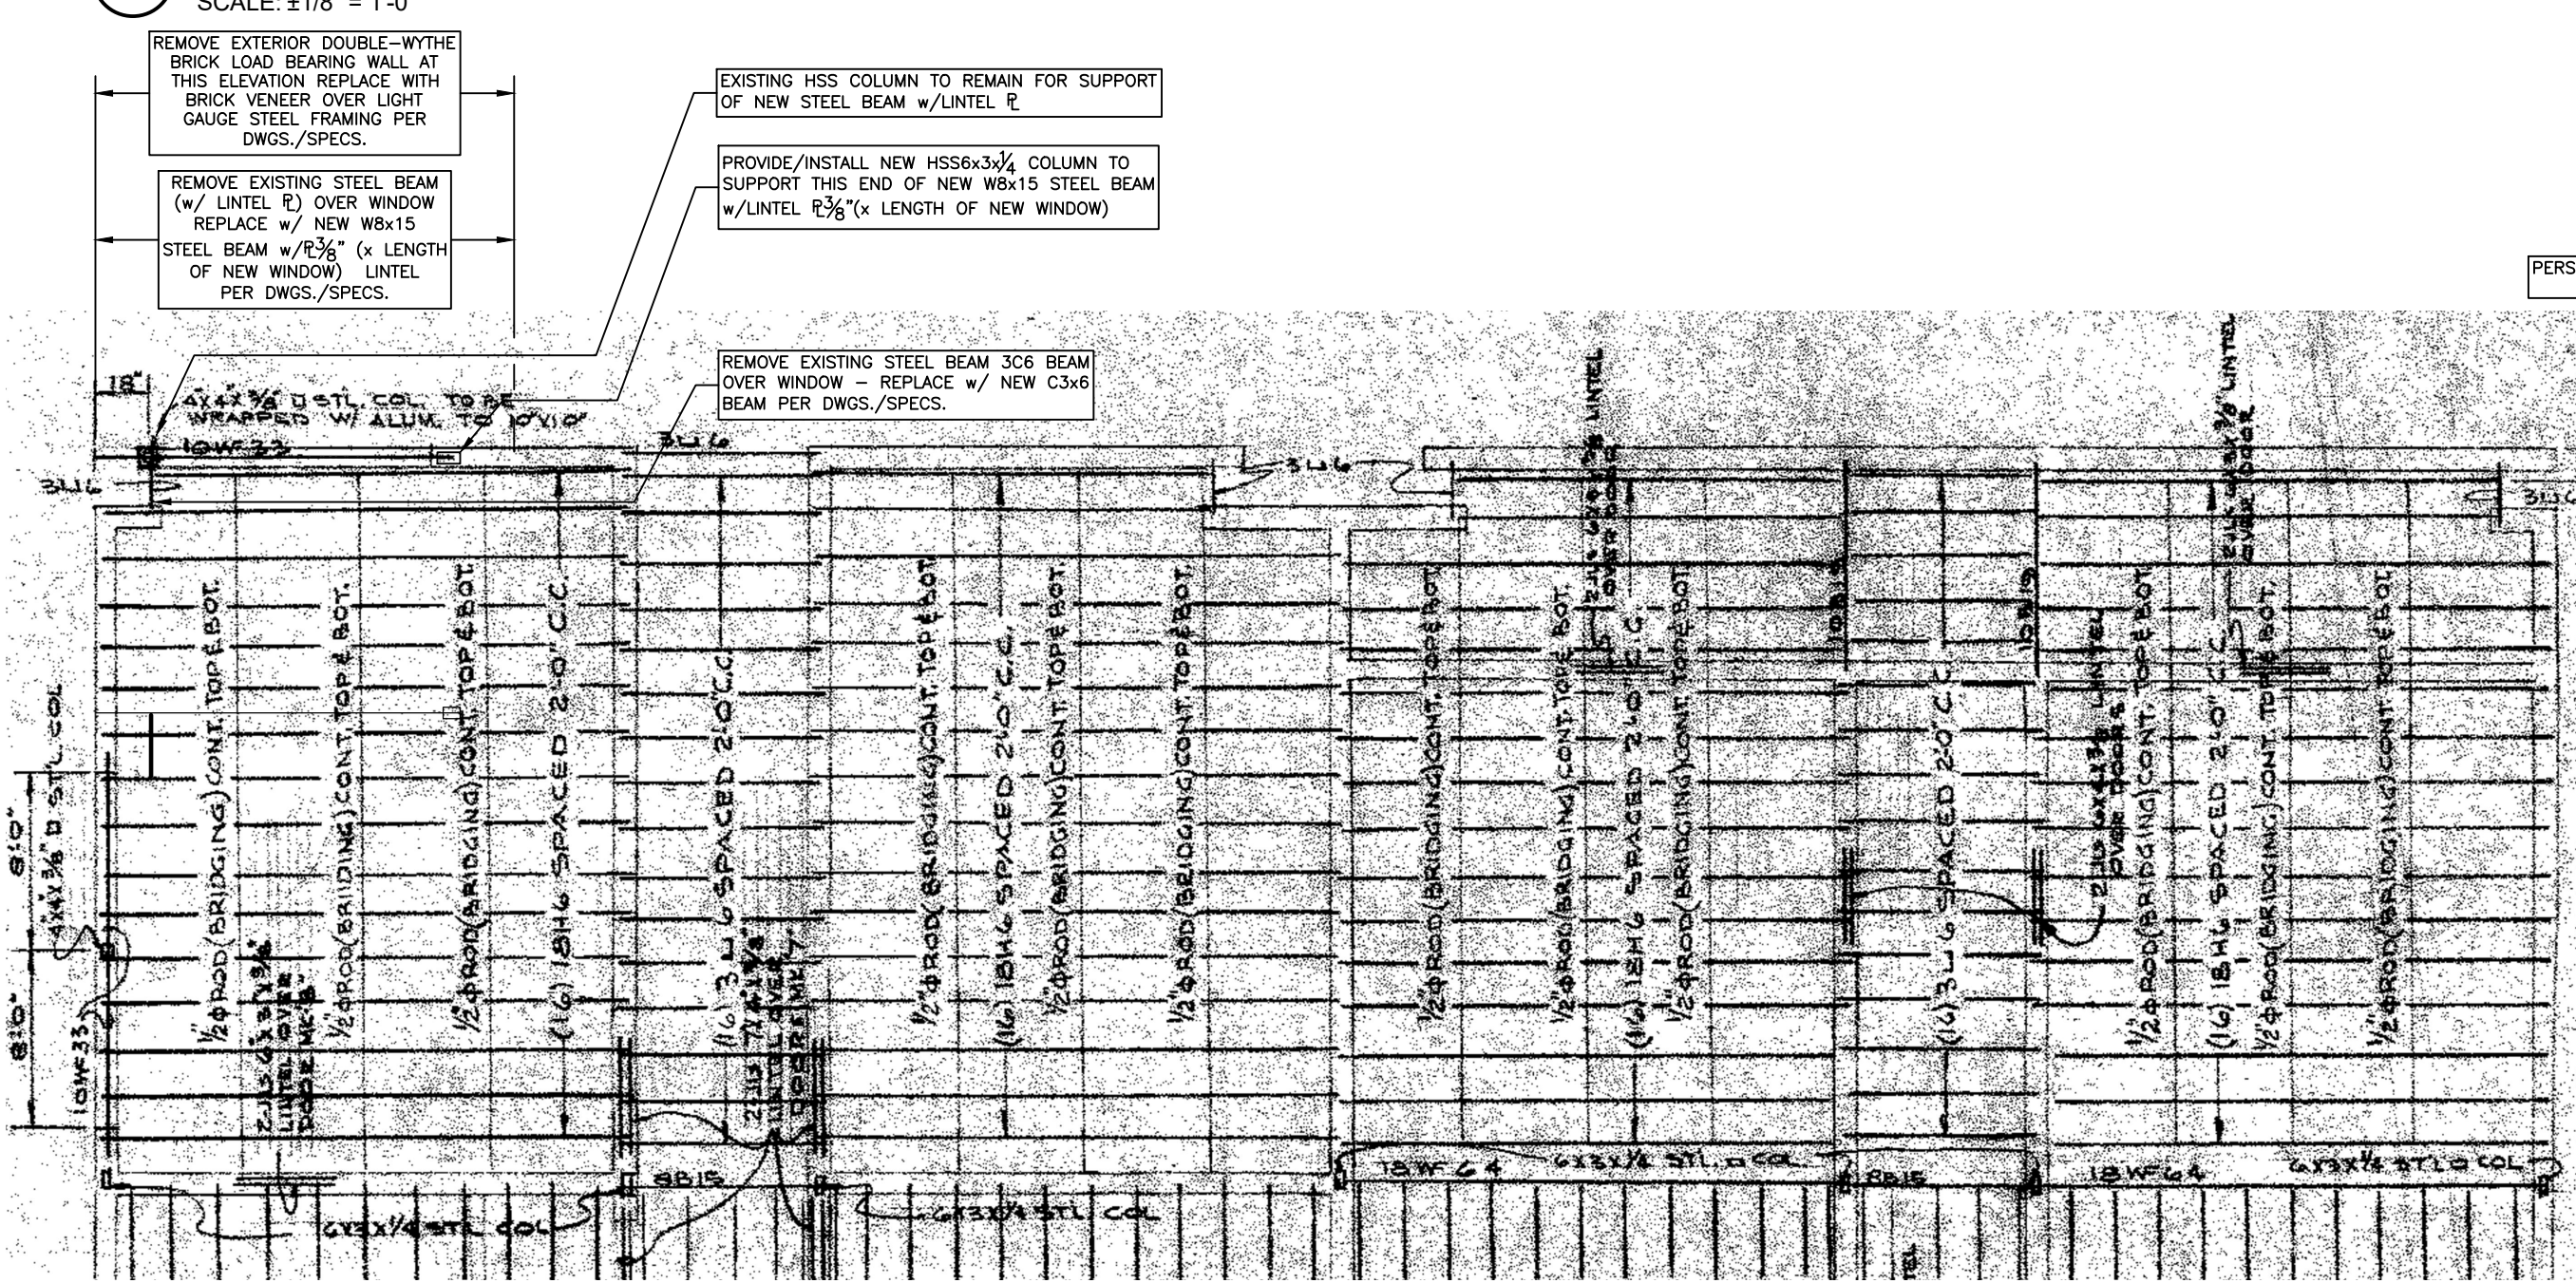NORTH




3 PARTIAL EXISTING SECOND FLOOR FRAMING PLAN -- BUILDING C
(ALL CONDITIONS TO BE FIELD VERIFIED)
SCALE: 1/8" = 1'-0"

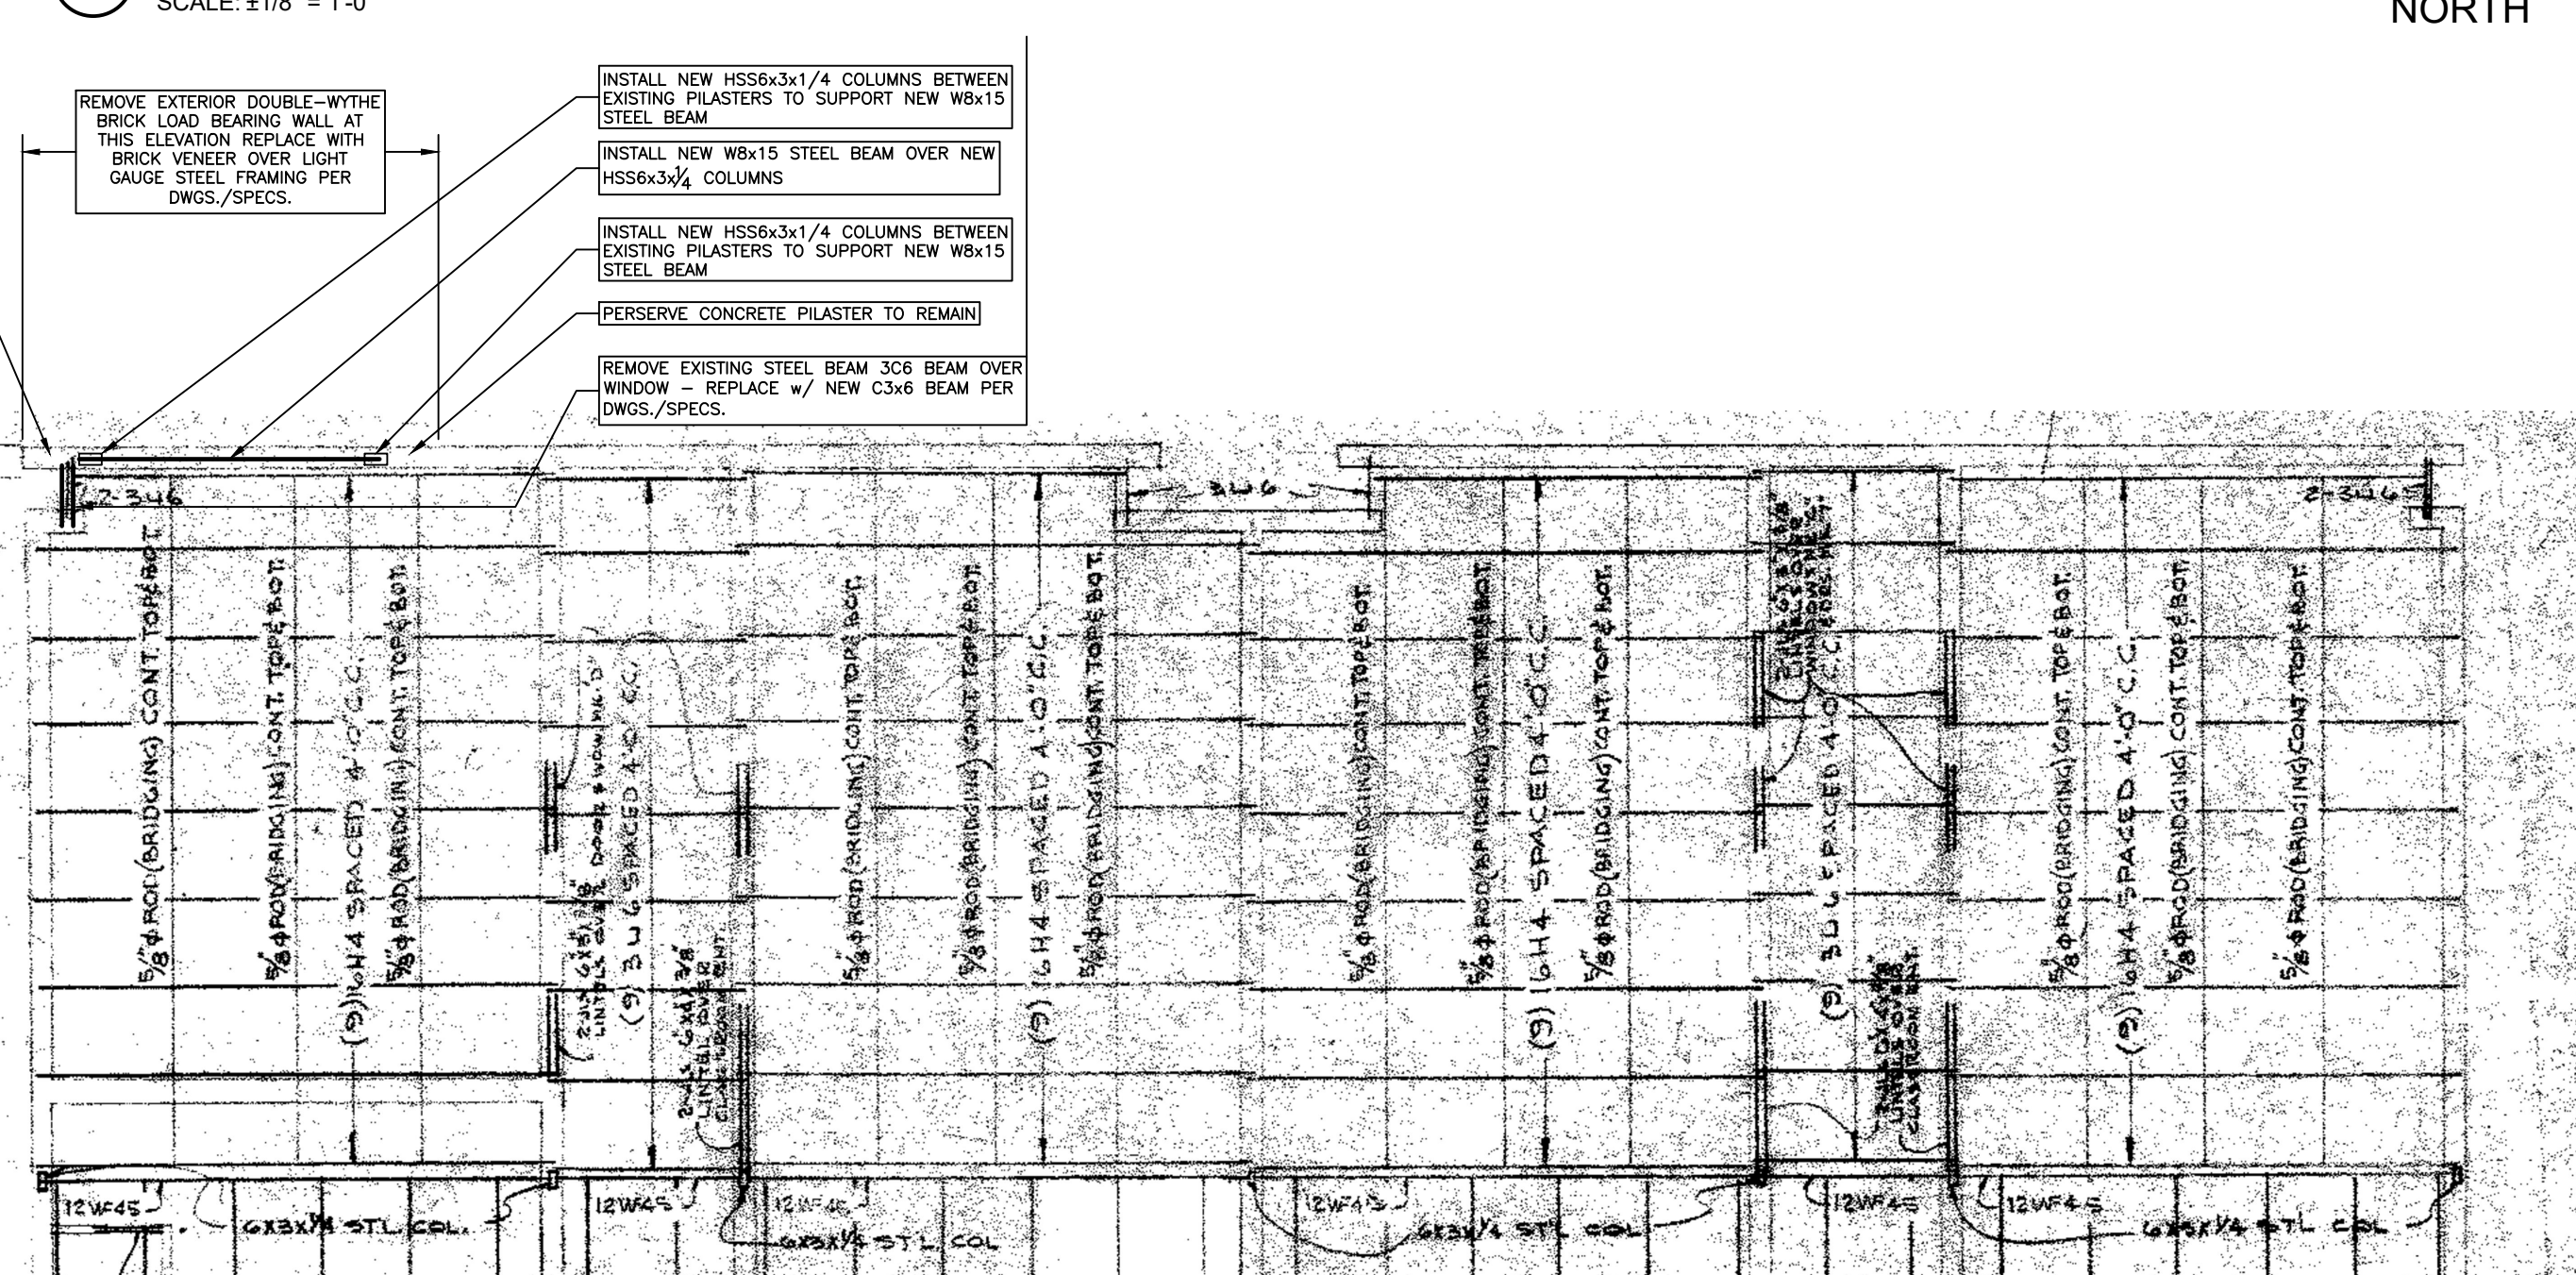NORTH






4 PARTIAL EXISTING ROOF FRAMING PLAN -- BUILDING C
(ALL CONDITIONS TO BE FIELD VERIFIED)
SCALE: 1/8" = 1'-0"

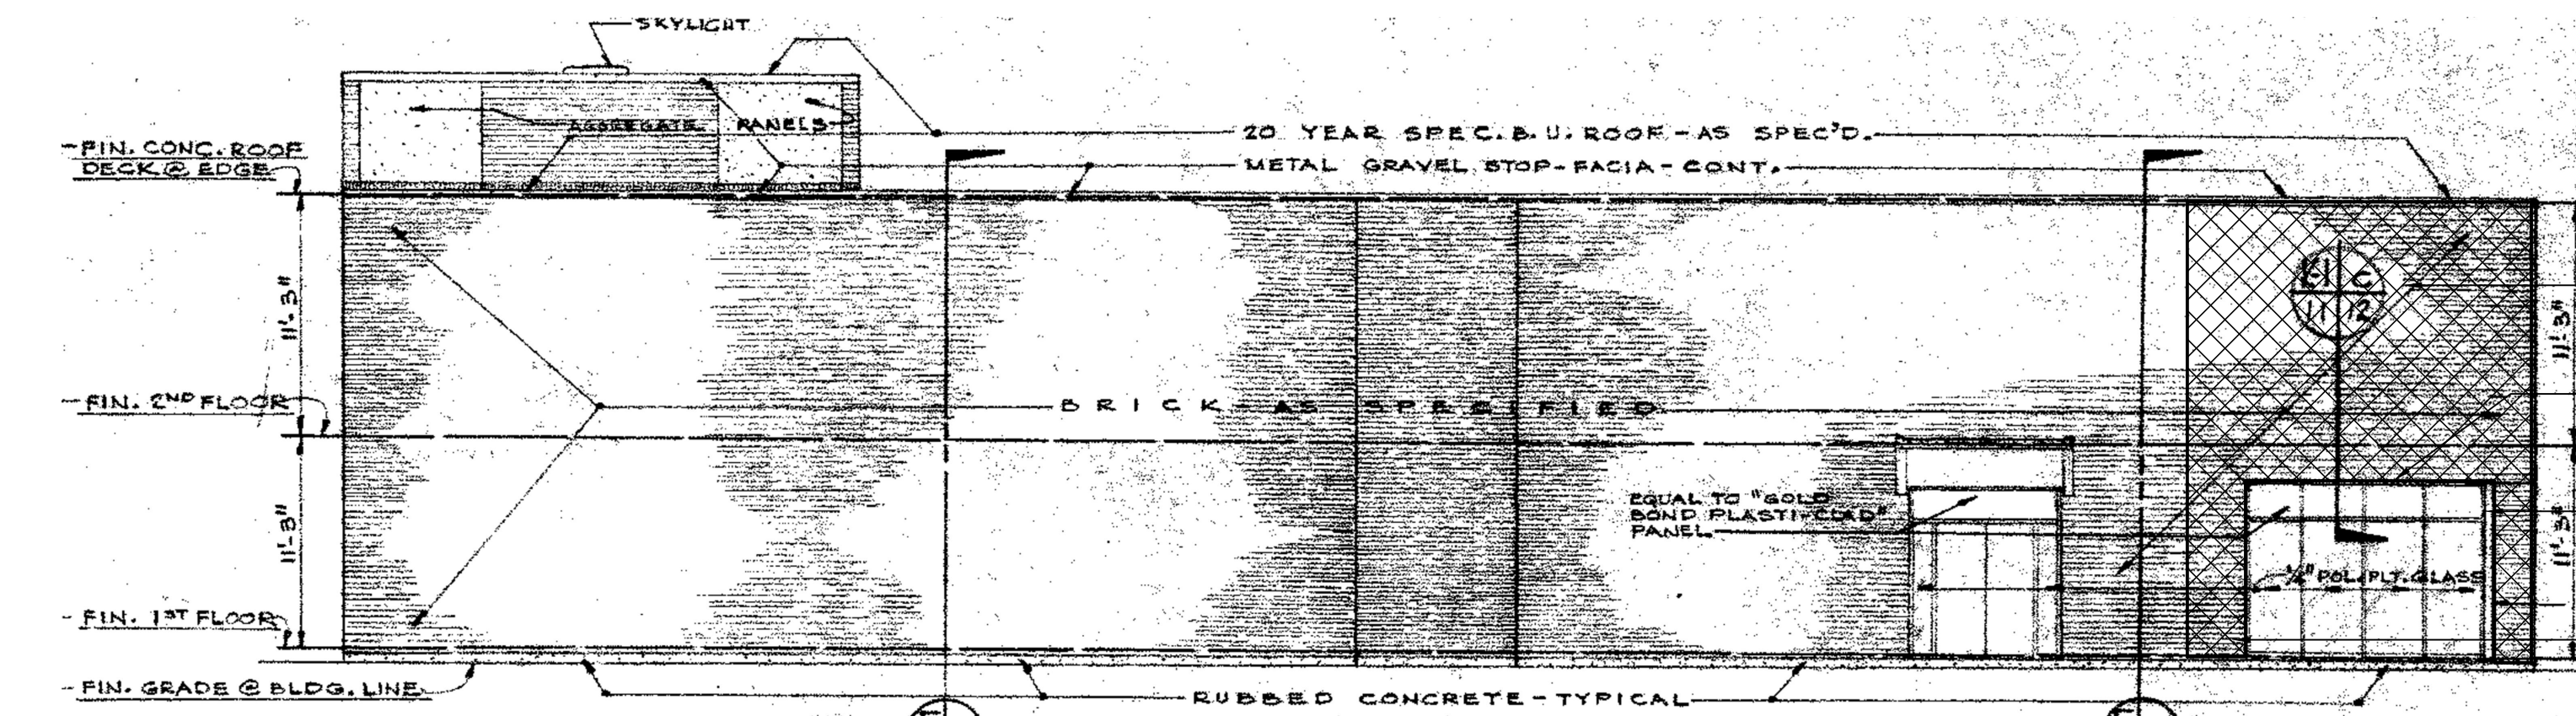NORTH



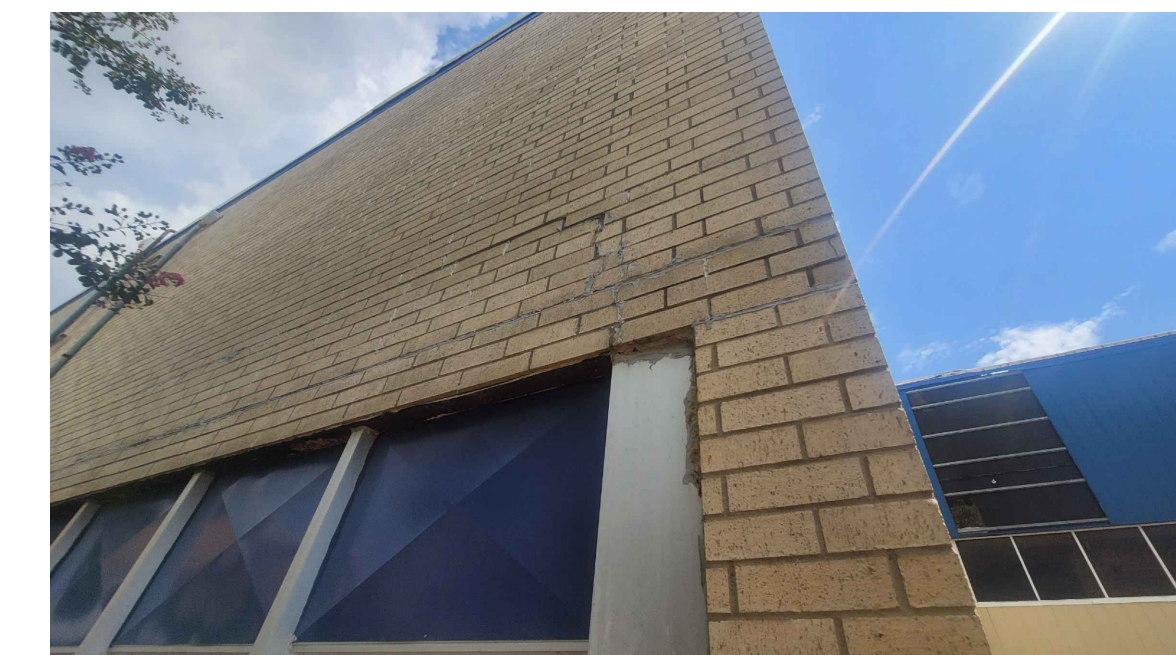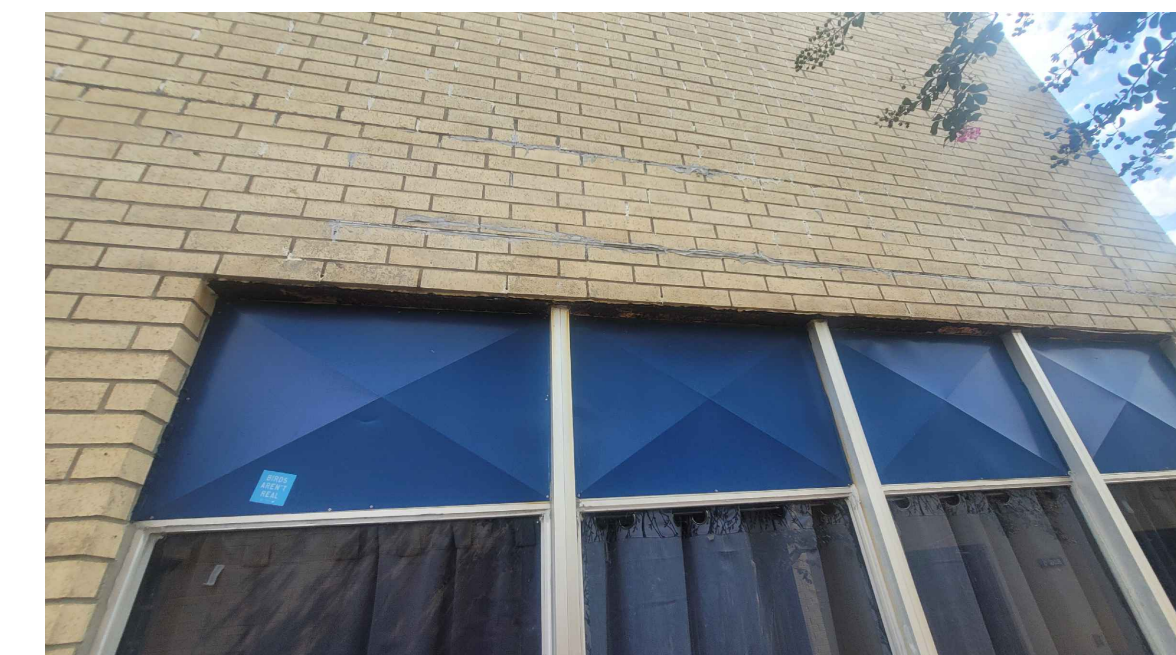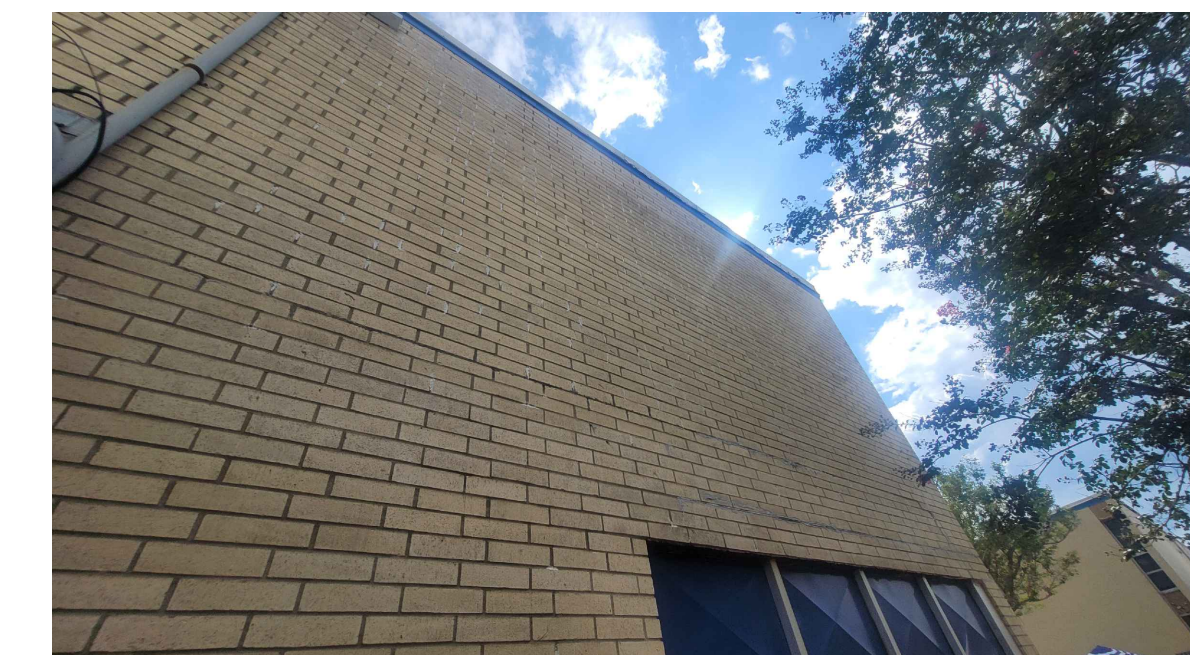5 EXISTING NORTH ELEVATION -- BUILDING C (ALL CONDITIONS TO BE FIELD VERIFIED)
SCALE: 1/8" = 1'-0"



PHOTOS OF EXISTING WINDOW AND LINTEL AT NW CORNER OF BUILDING D
SCALE: NOT TO SCALE

NOTE: ALL NEW STRUCTURAL AND MISCELLANEOUS STEEL SHALL BE HOT-DIP GALVANIZED AFTER FABRICATION

NOTE: THE EXISTING EXTERIOR DOUBLE-WYTHE BRICK WALLS ARE LOAD-BEARING ELEMENTS OF THE BUILDING !!!

THE CONTRACTOR IS RESPONSIBLE FOR THE STRUCTURAL STABILITY OF THIS BUILDING FOR THE DURATION OF THIS PROJECT. CONTRACTOR'S BID TO INCLUDE ALL COSTS FOR ANY AND ALL TEMPORARY SHORING ELEMENTS NECESSARY TO COMPLETE THIS PROJECT.

NOTE: CONTRACTOR TO VERIFY EXISTING CONDITIONS PRIOR TO ANY SHOP DRAWING SUBMITTAL TO DUHON & PLEASANT FOR REVIEW.

REMOVE EXTERIOR DOUBLE-WYTHE BRICK LOAD BEARING WALL AT THIS ELEVATION. REPLACE WITH BRICK VENEER OVER LIGHT GAUGE STEEL FRAMING PER DWGS./SPECS.

REMOVE EXISTING STEEL BEAM (w/ LINTEL) OVER WINDOW. REPLACE W/ NEW W8x15 STEEL BEAM W/ LINTEL PER DWGS./SPECS.

EXISTING HSS COLUMN TO REMAIN FOR SUPPORT OF NEW STEEL BEAM W/ LINTEL.

PROVIDE/INSTALL NEW HSS6x3x1/4 COLUMN TO SUPPORT THIS END OF NEW W8x15 STEEL BEAM W/ LINTEL PER DWGS./SPECS.

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725 KIRBY STREET
LAKE CHARLES, LOUISIANA
OFFICE: 337.436.3036
FAX: 337.436.3773
ARCHITECT

STATE OF LOUISIANA
JASON DUHON
LICENSE NO. 36051
PROFESSIONAL
07/01/2024

HURRICANE LAURA REPAIRS
A.M. BARBE HIGH SCHOOL
2200 W. McNEESE ST.
FOR
CALCASIEU PARISH SCHOOL BOARD
LAKE CHARLES, LA
HL-003-01.03.04.05.06.07

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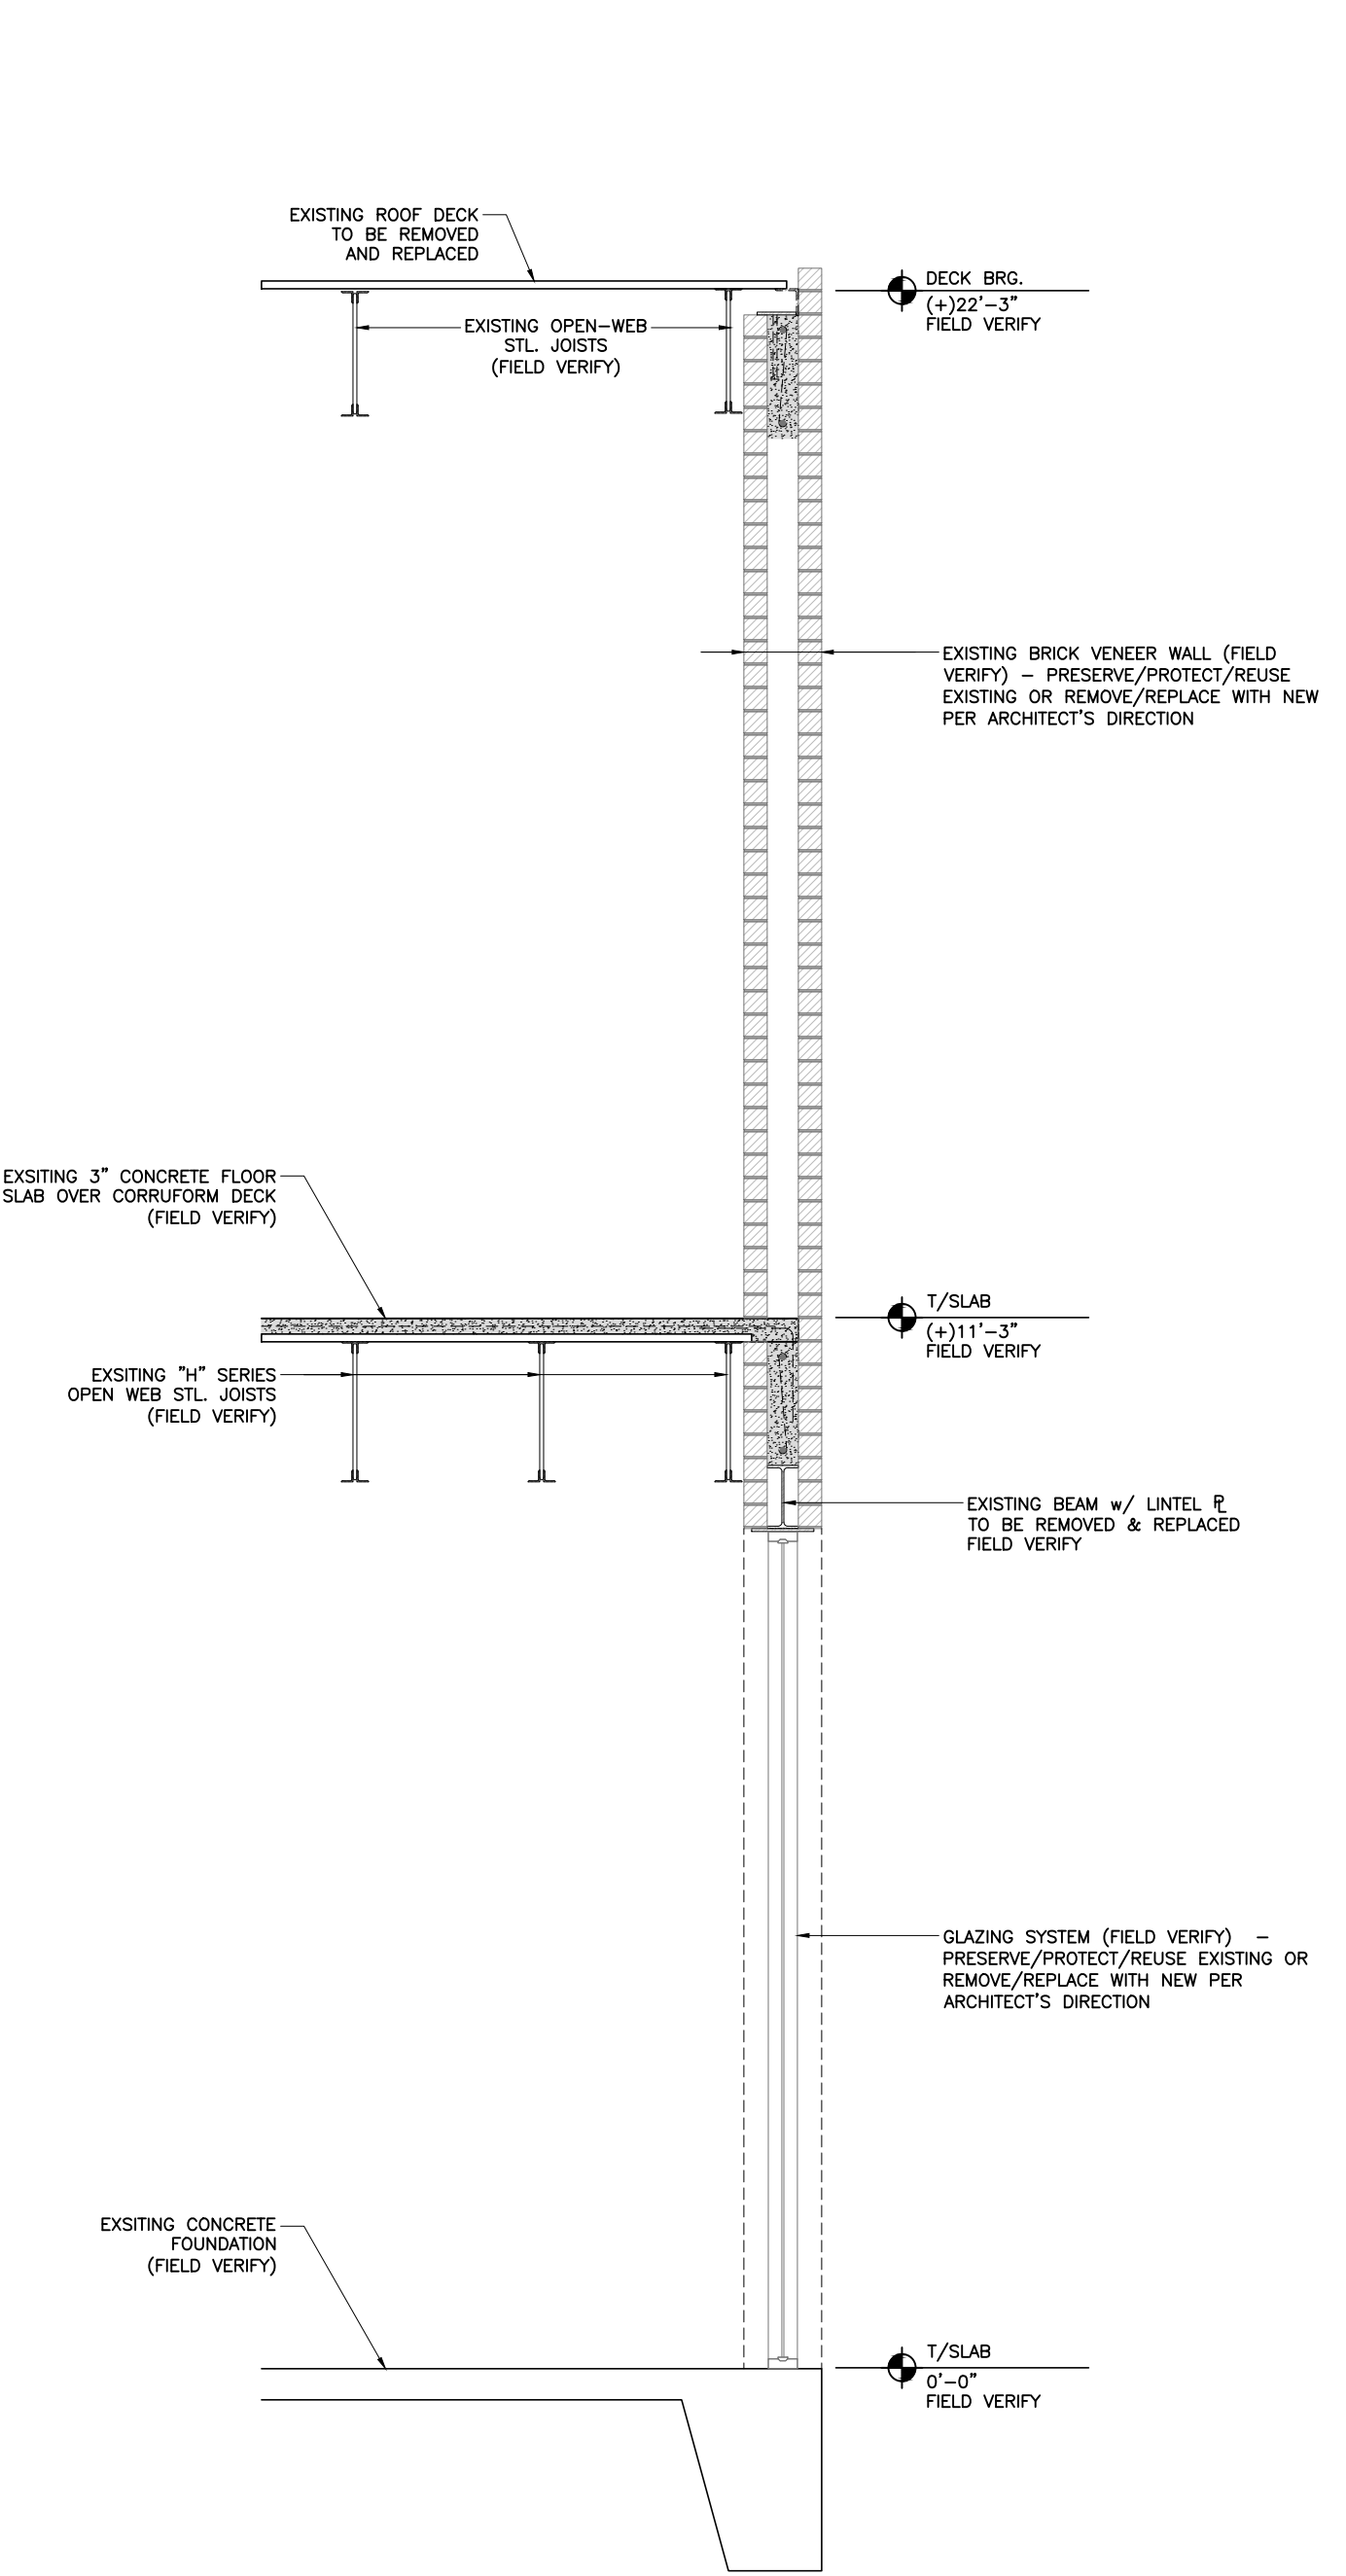
RMG PROJECT NO. 20042-01-G
OWNER PROJECT NO. HL-003-01.03.04.05.06.07
PROJECT MANAGER TM

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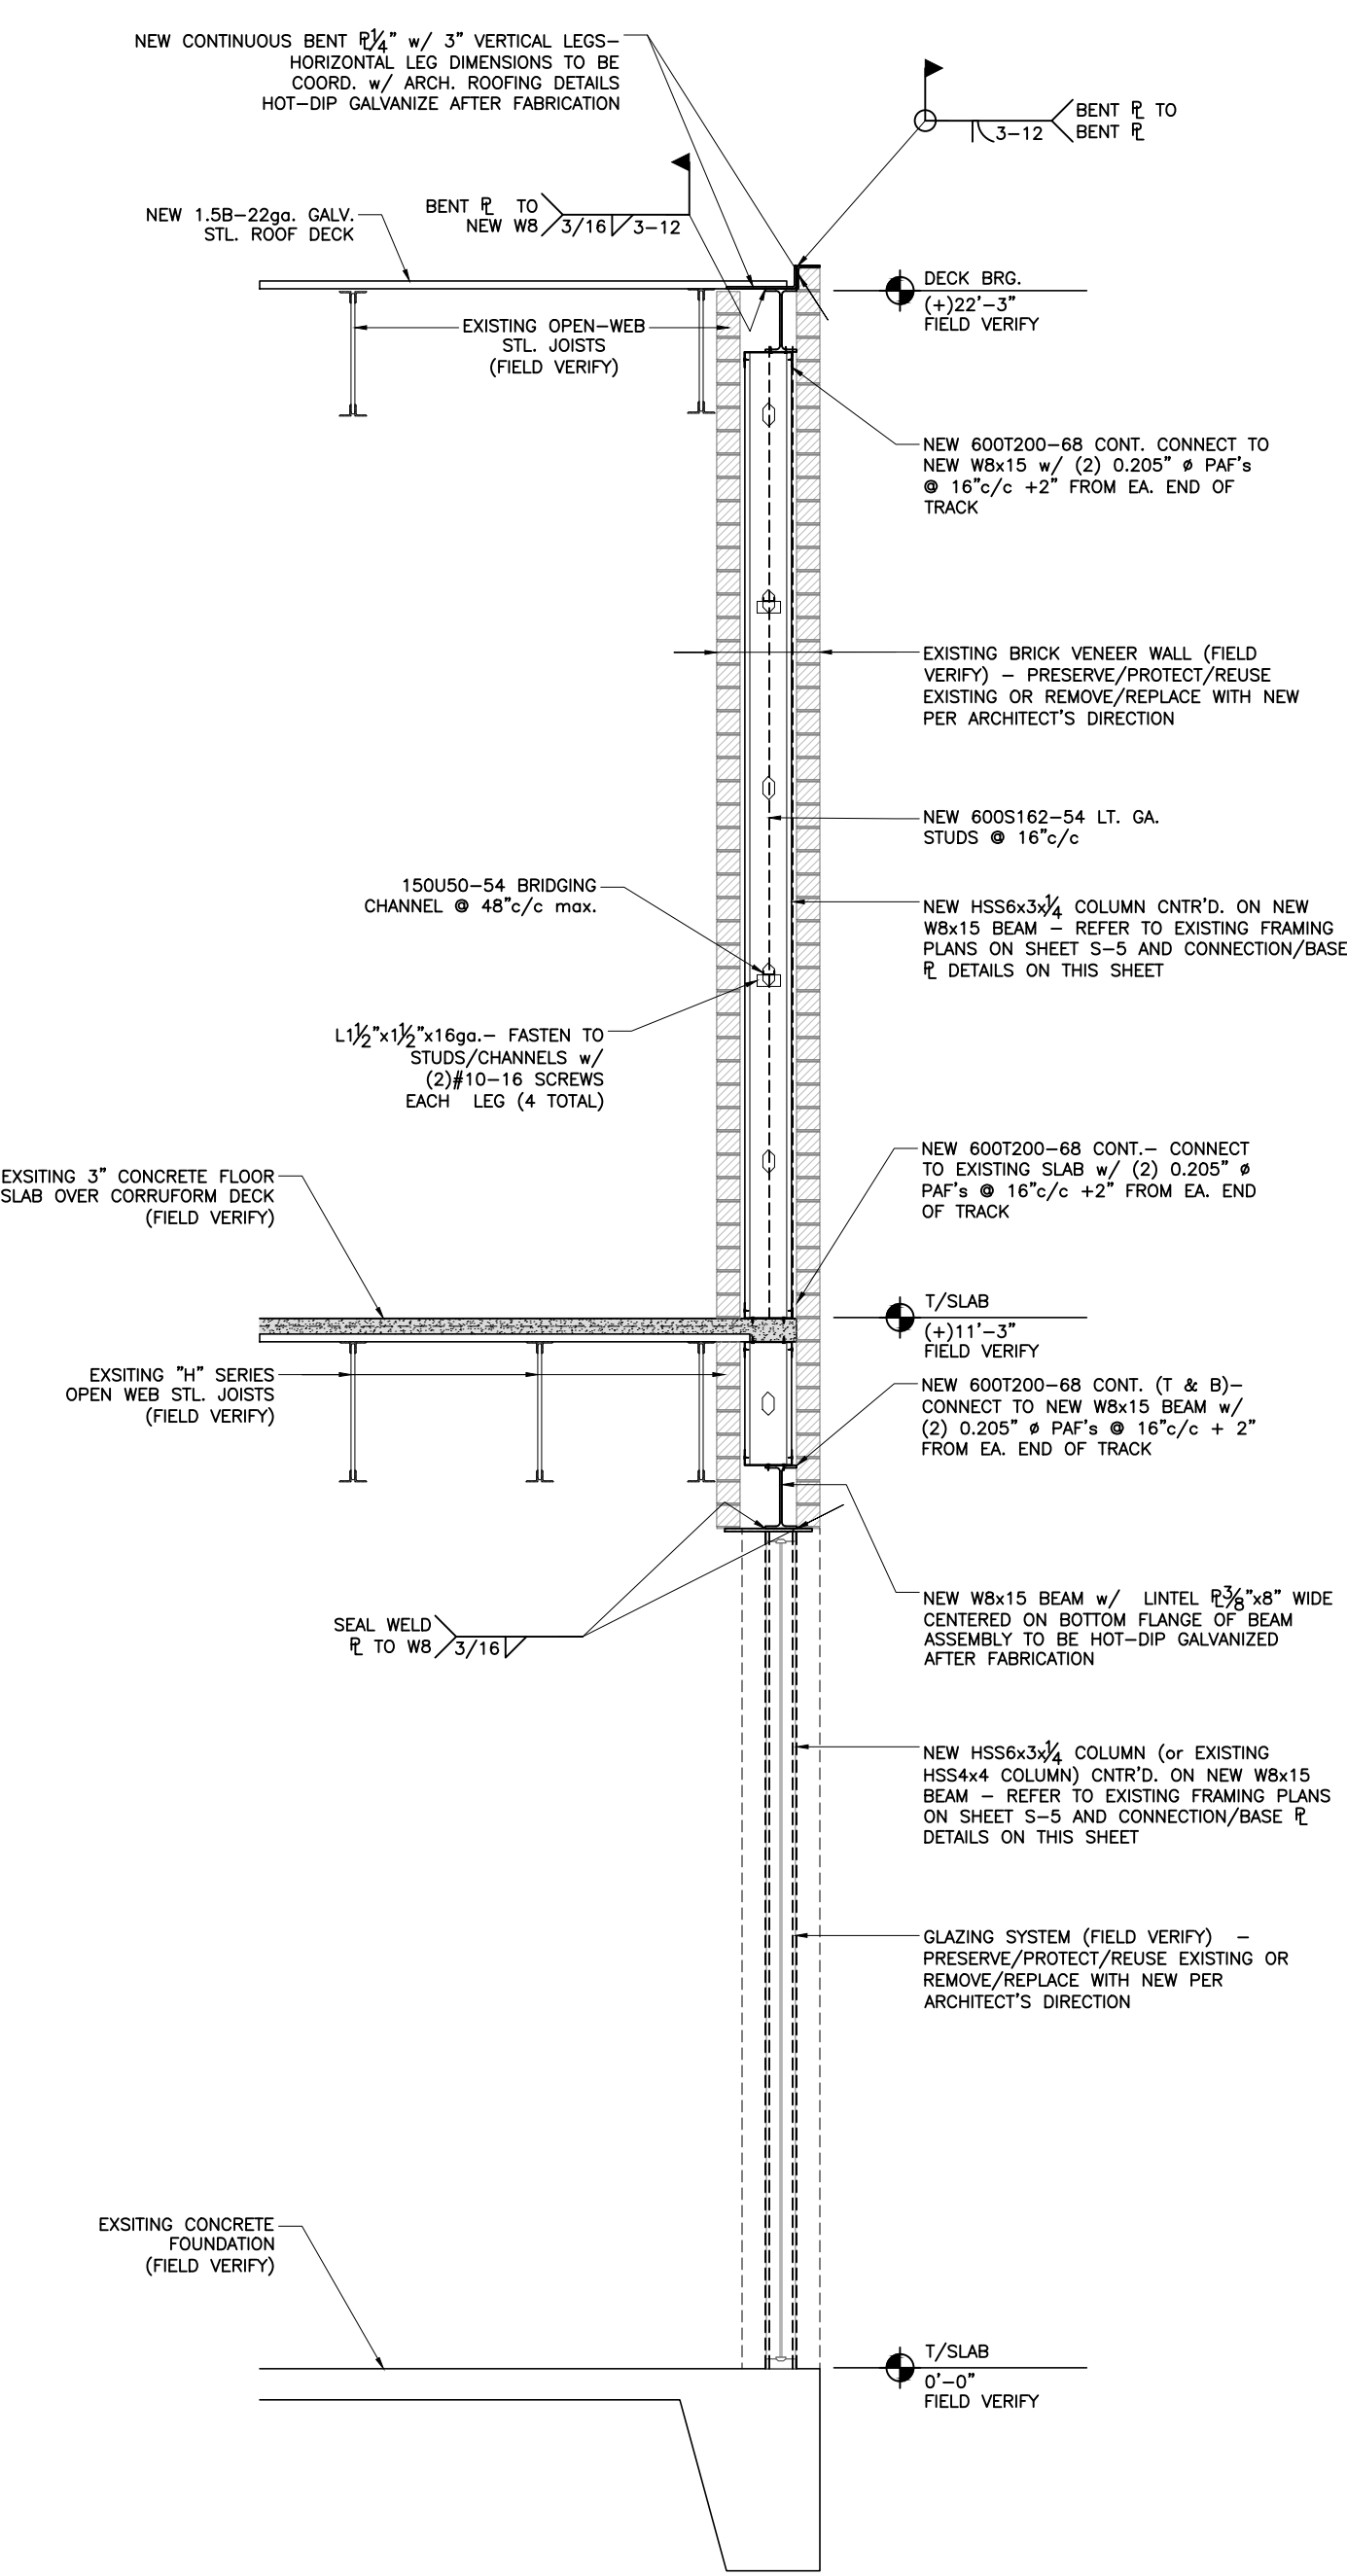
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DUHON + PLEASANT
CIVIL & STRUCTURAL ENGINEERS
337.564.5918
WWW.DANDPENGINEERS.COM
5399 BIG LAKE ROAD
LAKE CHARLES LA 70605
SHEET NUMBER
S-5
NE CORNER WALL REPAIR - BLDG "C"

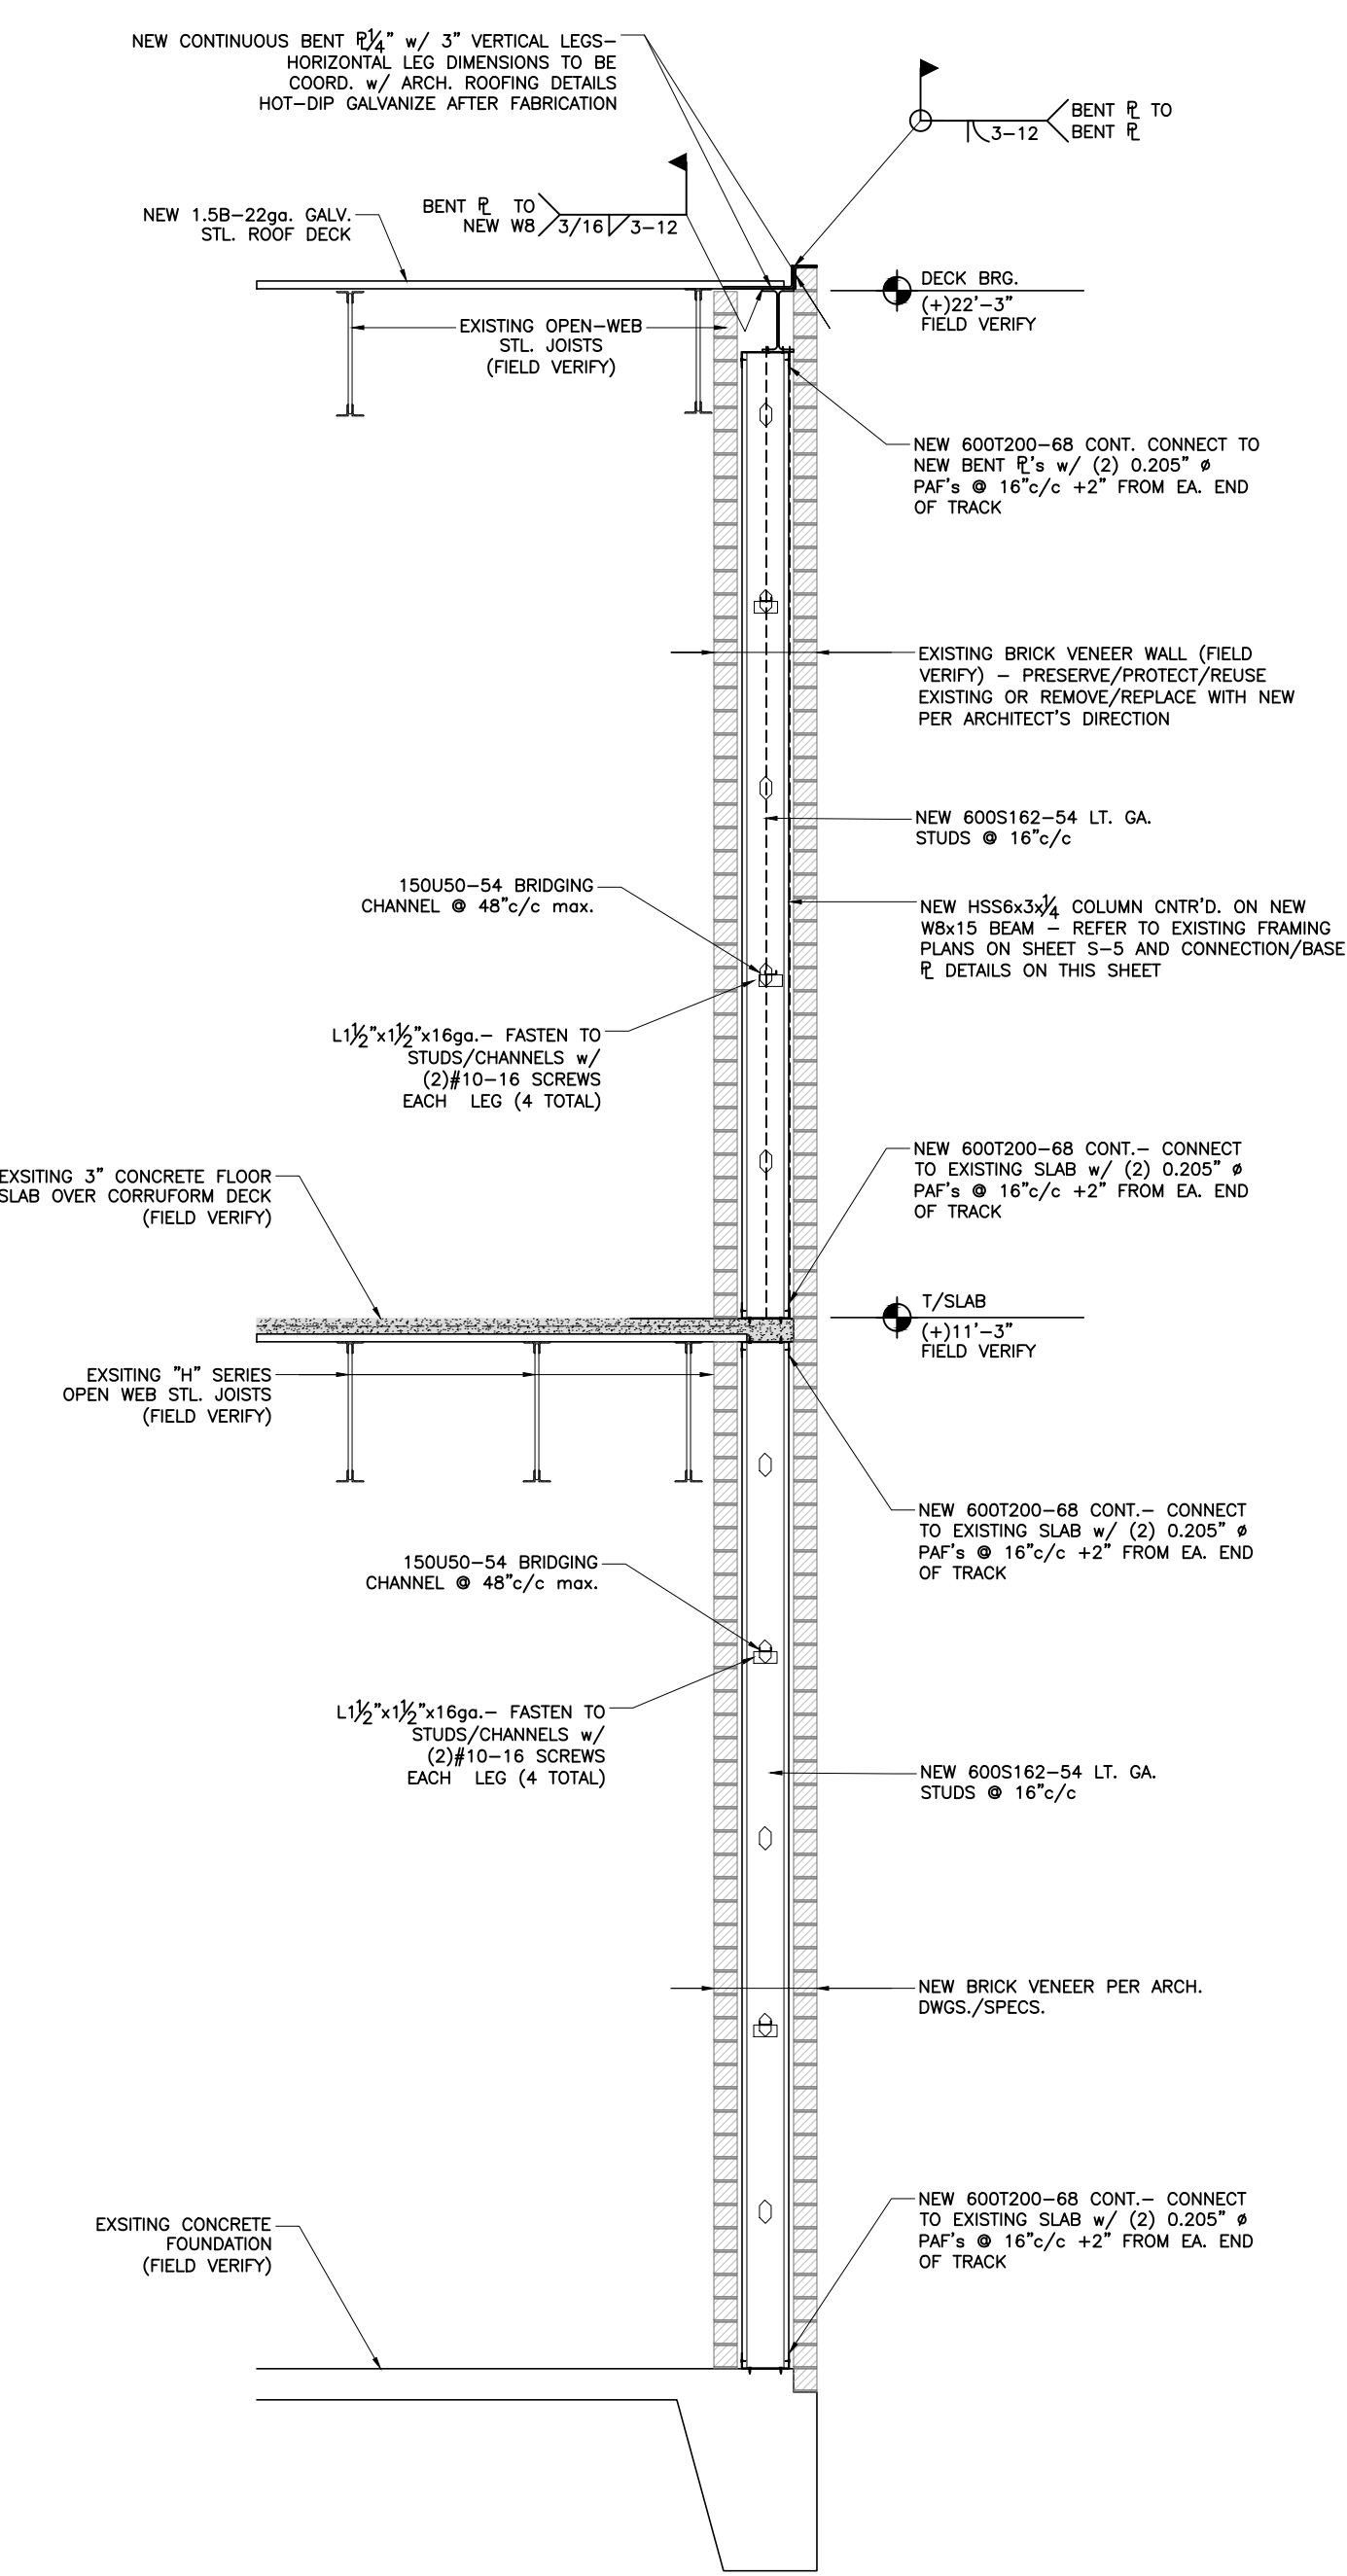
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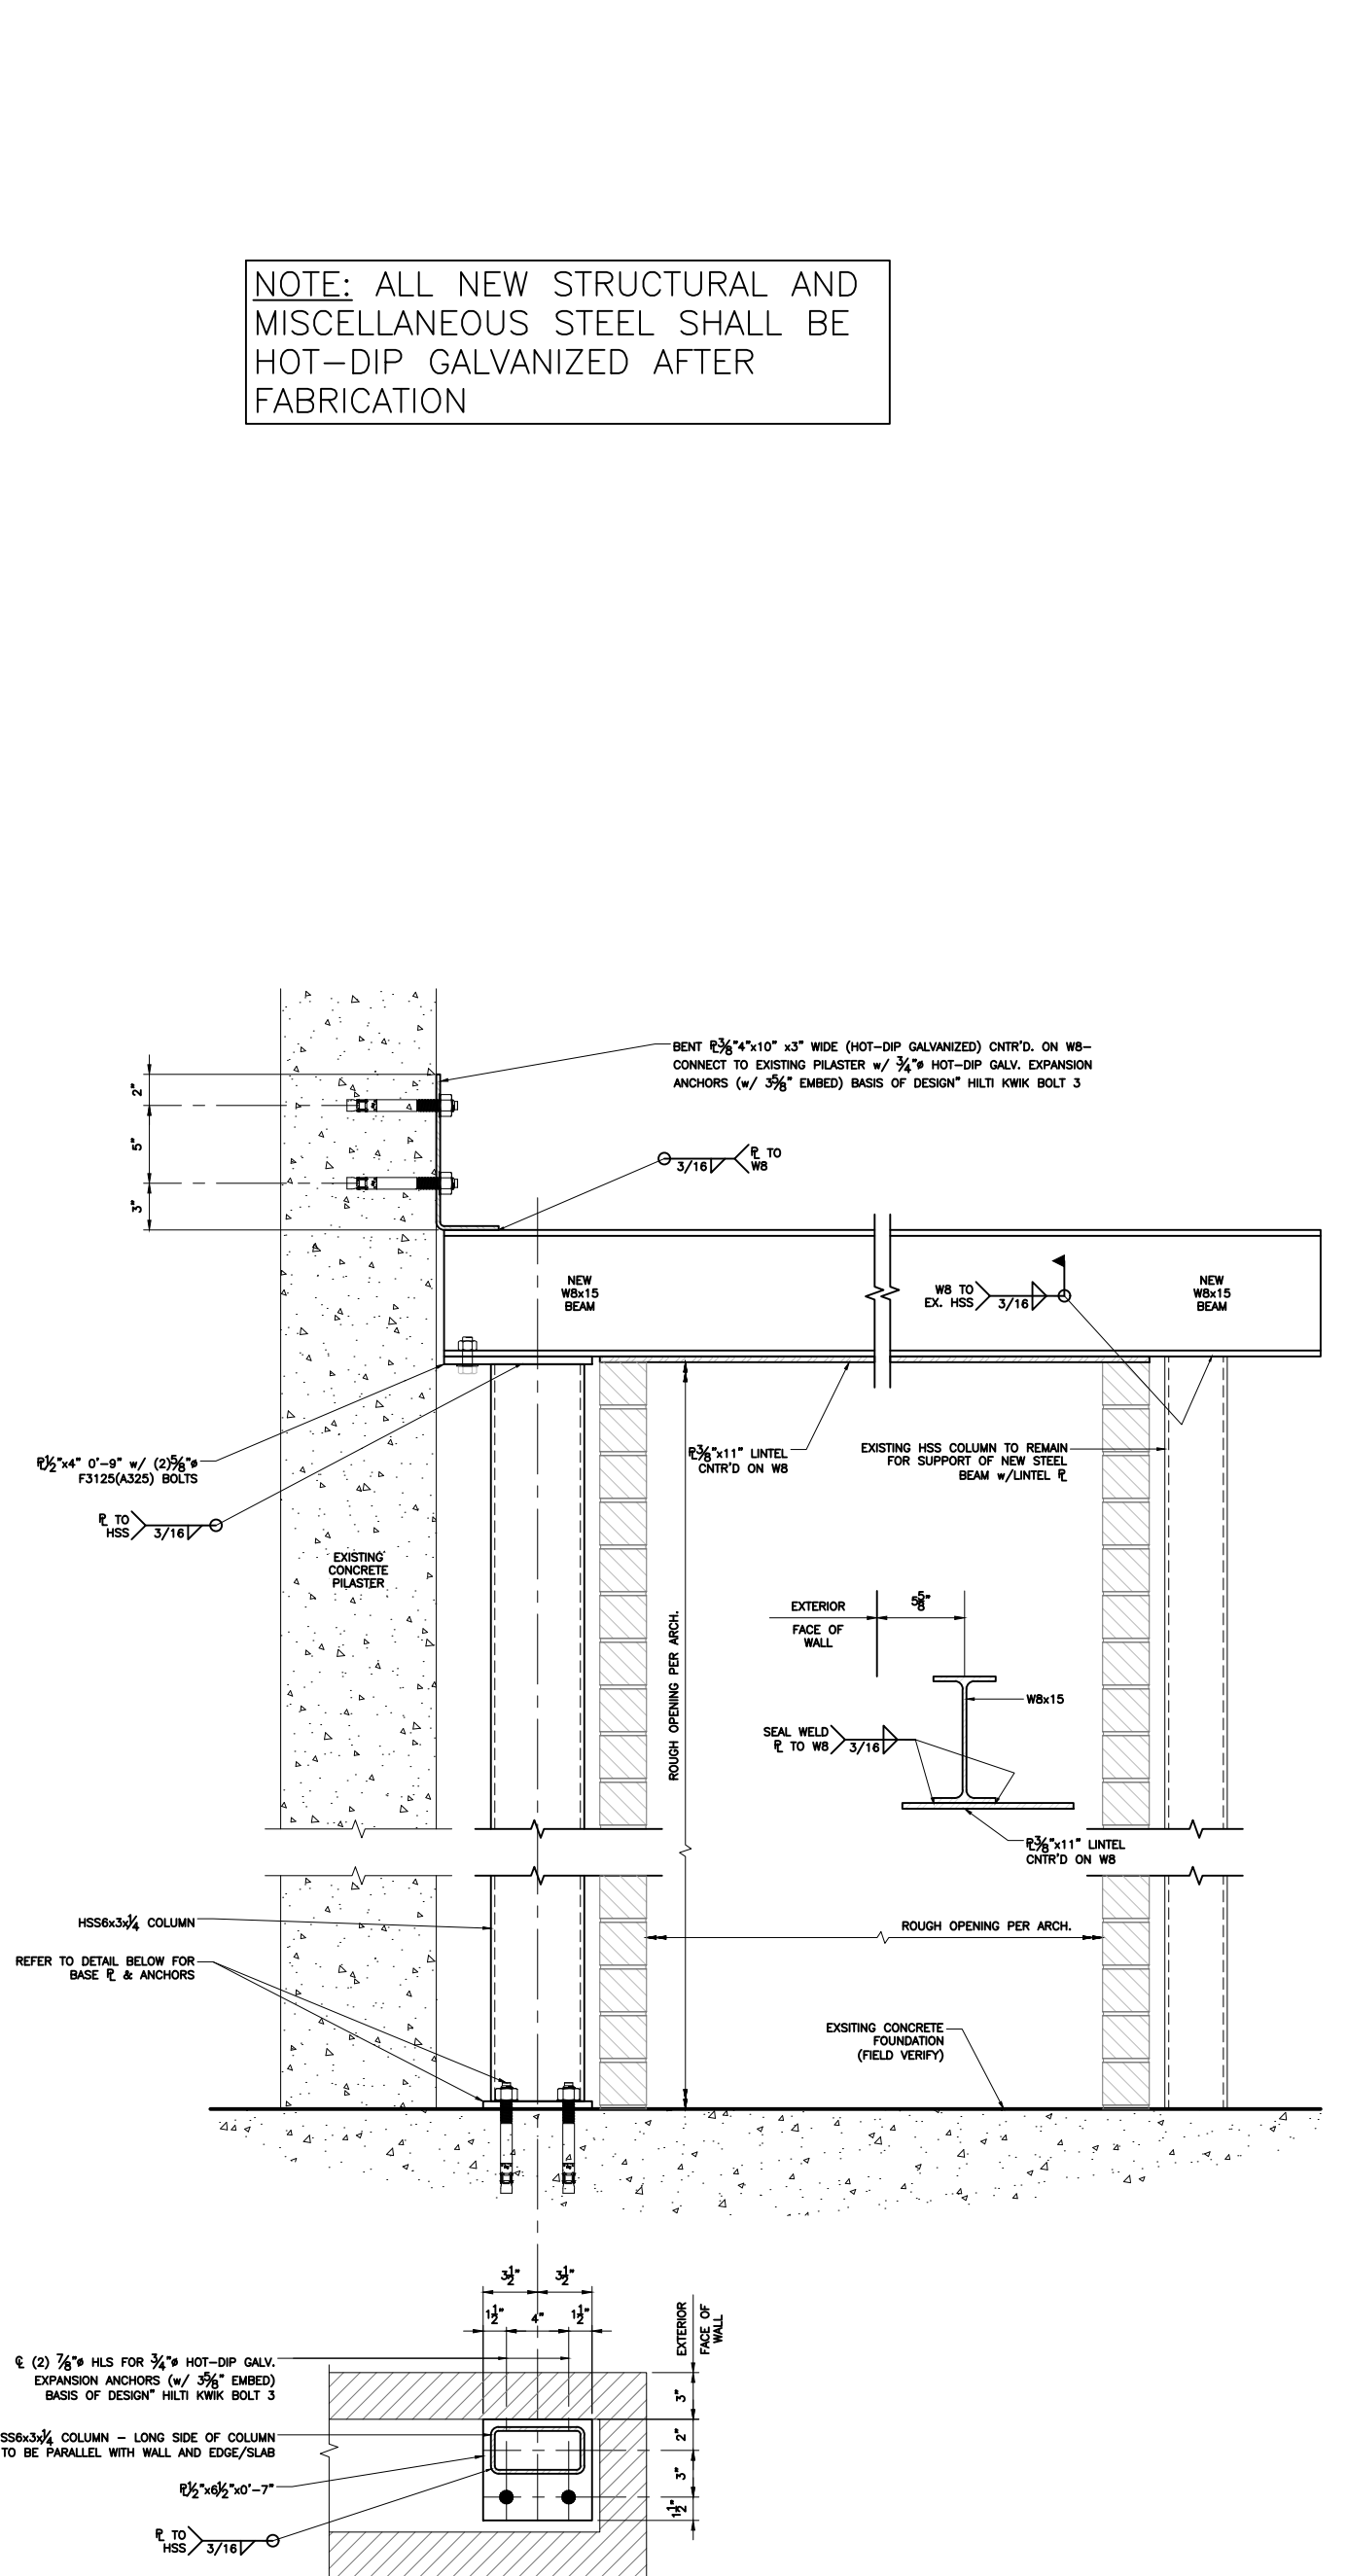
(X) SCHEMATIC SECTION THRU EXISTING WALL
FIELD VERIFY CONDITIONS
 SCALE: 1/2" = 1'-0"




(A) SECTION THRU NEW WALL AT BEAM w/ LINTEL PLATE OVER WINDOW
 SCALE: 1/2" = 1'-0"




(B) SECTION THRU NEW WALL AT FULL HT. STUDS
 SCALE: 1/2" = 1'-0"



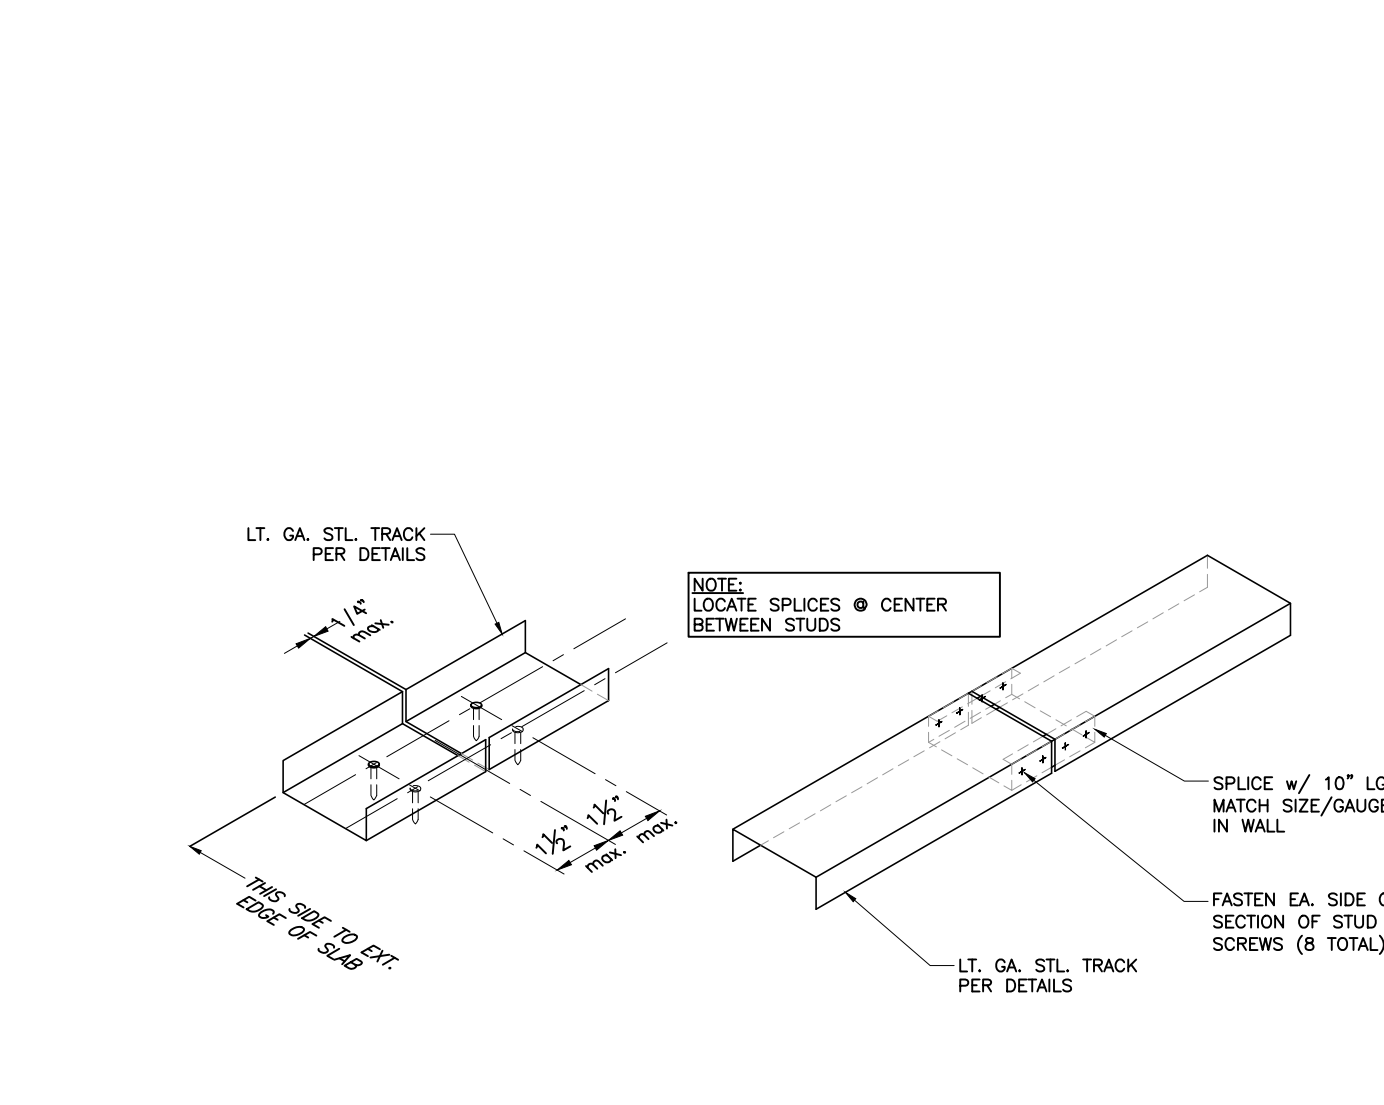
(1) CONNECTION DETAILS AT NEW W8x15 LINTEL BEAM
 SCALE: 1 1/2" = 1'-0"



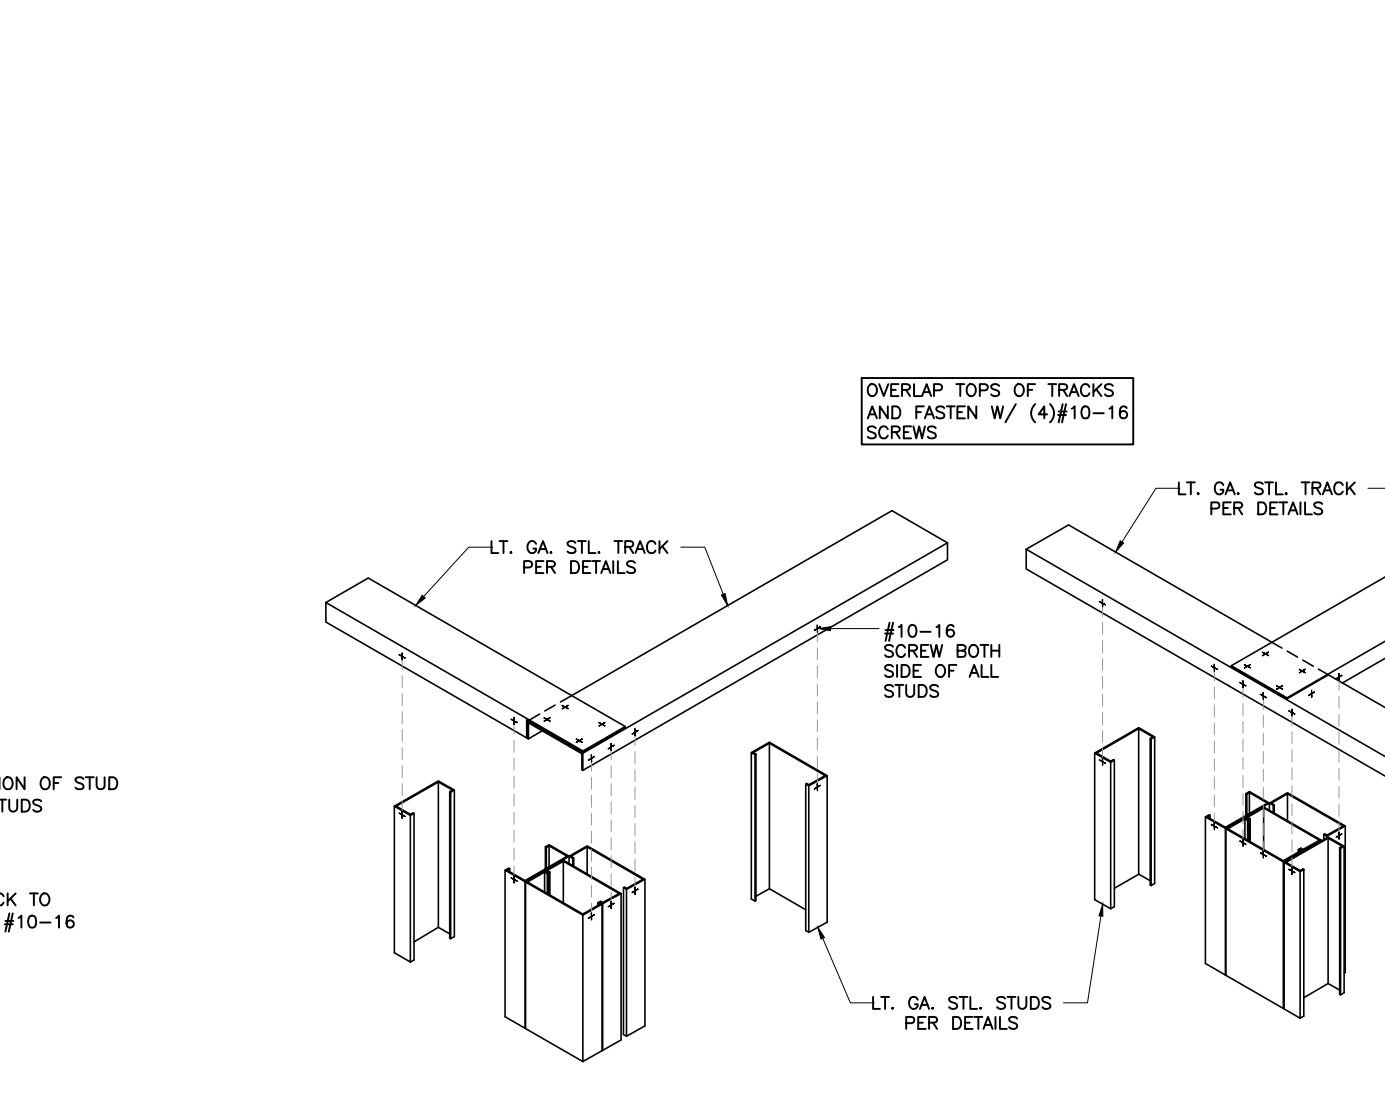
(2) LIGHT GAUGE STEEL TRACK SPLICE DETAILS
 SCALE: NO TO SCALE



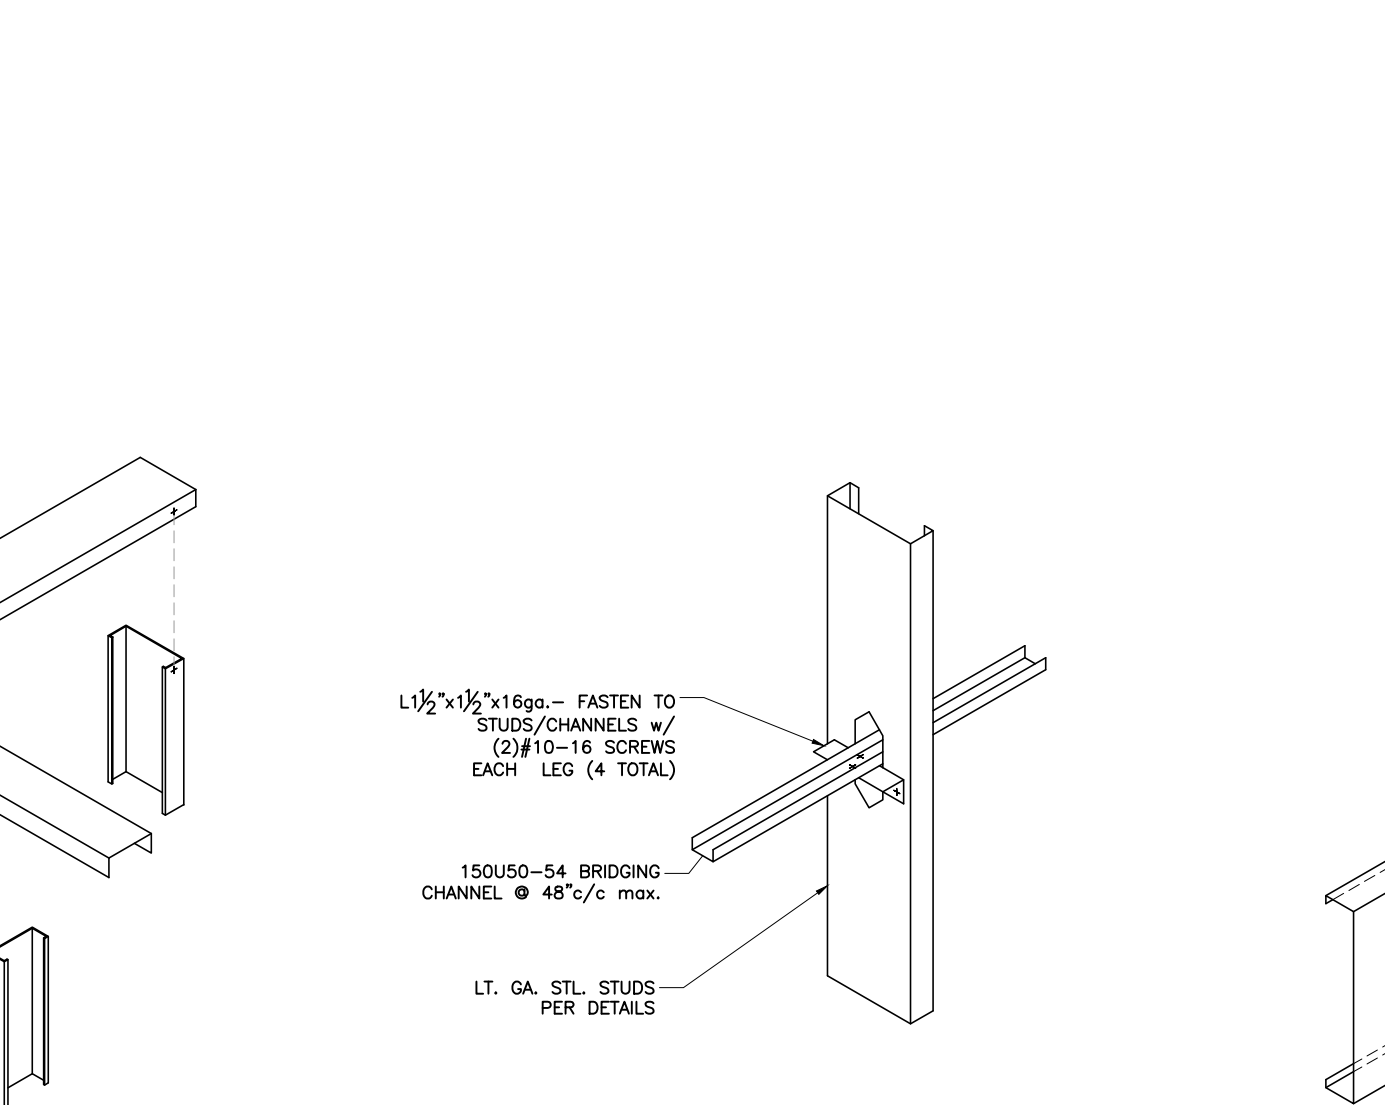(3) LIGHT GAUGE STEEL WALL INTERSECTION DETAILS
 SCALE: NO TO SCALE



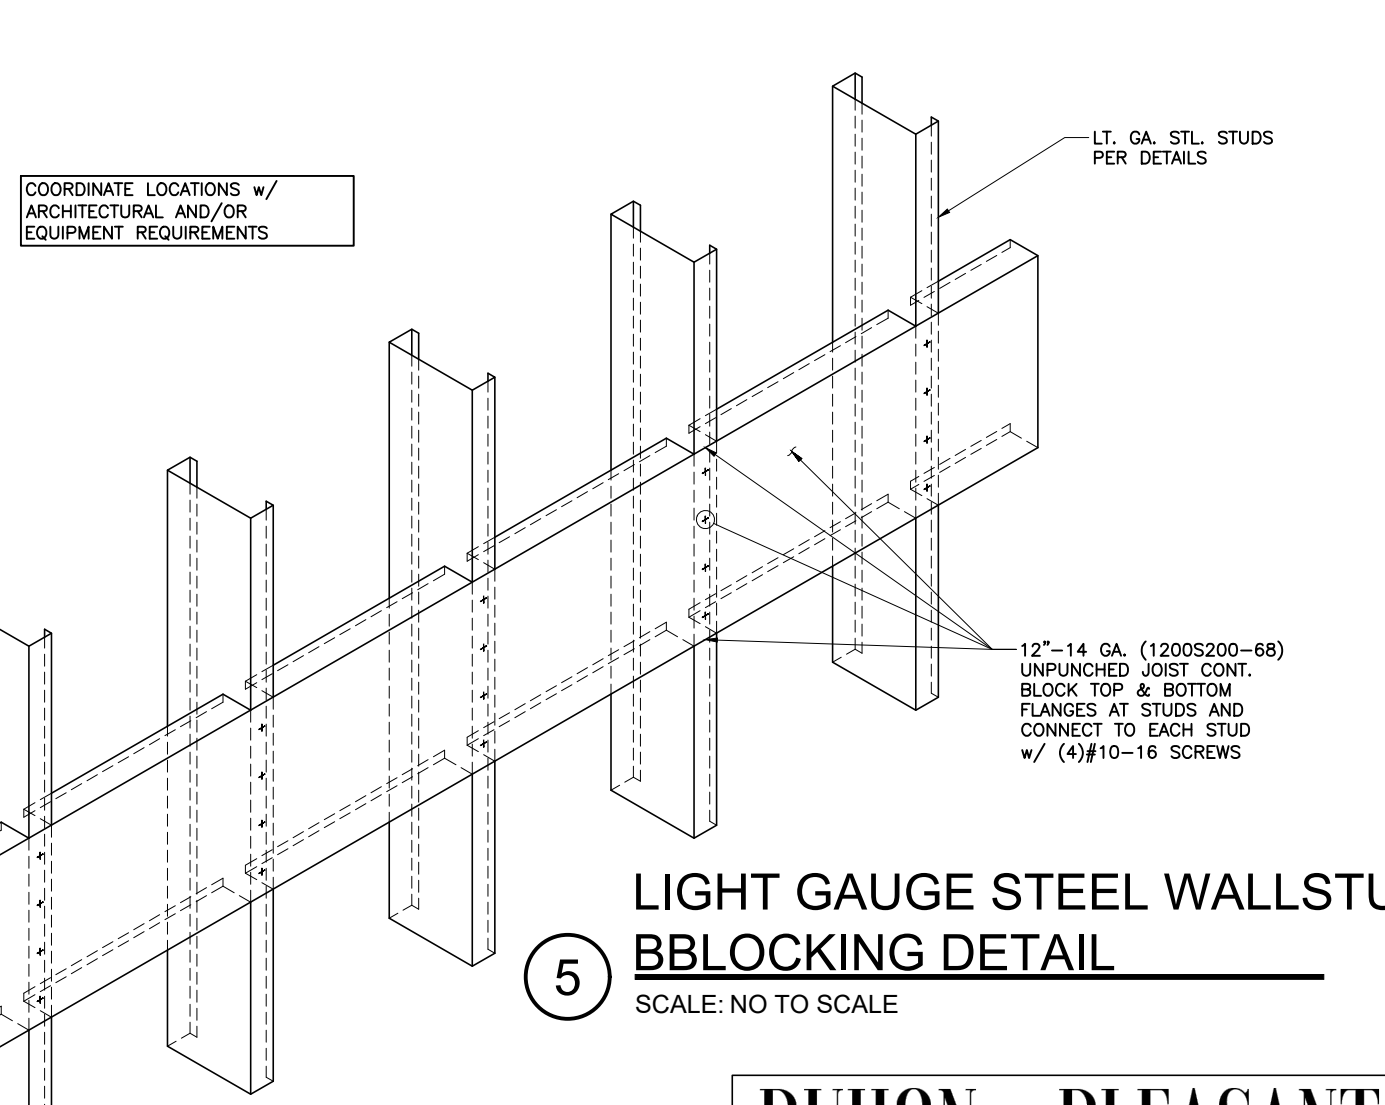(4) LIGHT GAUGE STEEL STUD BRIDGING DETAIL
 SCALE: NO TO SCALE



(5) LIGHT GAUGE STEEL WALL STUD BLOCKING DETAIL
 SCALE: NO TO SCALE

NOTE: ALL NEW STRUCTURAL AND MISCELLANEOUS STEEL SHALL BE HOT-DIP GALVANIZED AFTER FABRICATION



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20042-01-G
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 CIVIL & STRUCTURAL ENGINEERS
 337.564.5918 5393 BIG LAKE ROAD
 WWW.DANDPENGINERS.COM LAKE CHARLES LA 70605

S-6
 NE CORNER WALL REPAIR - BLDG "C"



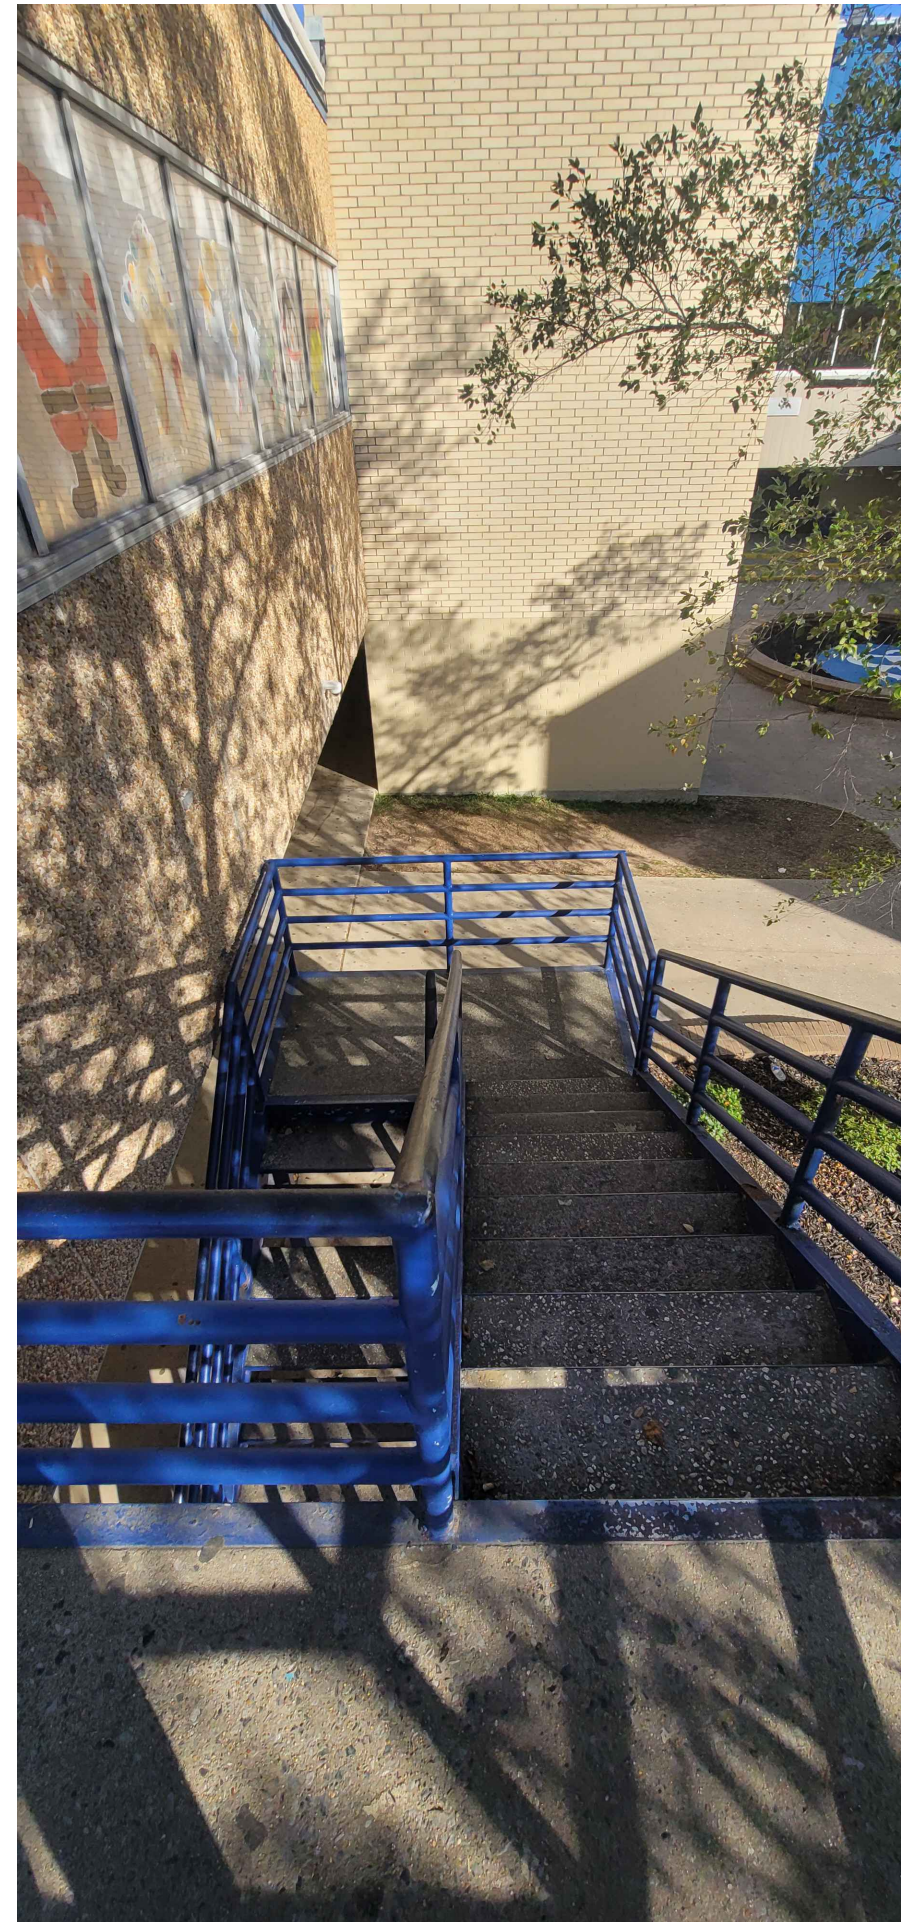
BUILDING B -- EXTERIOR STAIR
SCALE: NO SCALE



BUILDING B -- EXTERIOR STAIR
SCALE: NO SCALE



BUILDING B -- EXTERIOR STAIR
SCALE: NO SCALE



BUILDING B -- EXTERIOR STAIR
SCALE: NO SCALE



BUILDING B -- EXTERIOR STAIR
SCALE: NO SCALE



BUILDING B -- EXTERIOR STAIR
SCALE: NO SCALE



BUILDING B -- EXTERIOR STAIR
SCALE: NO SCALE

- NOTE:
1. CONTRACTOR TO DISCONNECT STAIR ASSEMBLY FROM ANCHORAGE. PROTECT ANCHORAGE COMPONENTS FROM DAMAGE FOR REINSTALLATION OF STAIR ASSEMBLY.
 2. RELOCATE STAIR ASSEMBLY TO ALLOW REPAIR/REPLACEMENT OF EXTERIOR CLADDING SYSTEM AT BUILDING B. BOLTED COMPONENTS OF STAIR ASSEMBLY MAY BE UNBOLTED TO FACILITATE RELOCATION. CONTRACTOR TO PROTECT STAIR ASSEMBLY FROM DAMAGE AS THE ASSEMBLY WILL BE REINSTALLED AFTER RELOCATION/REPAIRS ARE COMPLETED.
 3. SANDBLAST ENTIRE ASSEMBLY TO "WHITE METAL" CONDITION (SSPC-SP5/NACE 1) FOR INSPECTION BY STRUCTURAL ENGINEER. CONTRACTOR TO PROVIDE A MINIMUM NOTICE PERIOD OF (TWO) BUSINESS DAYS PRIOR TO READINESS FOR INSPECTION.
 4. CONTRACTOR TO MAKE REPAIRS TO STAIR ASSEMBLY AS DIRECTED, IN WRITING, BY STRUCTURAL ENGINEER.
 5. IMMEDIATELY AFTER REPAIRS HAVE BEEN MADE, CONTRACTOR IS TO APPLY A PRIMER COMPATIBLE WITH TOP COAT(S) AS DIRECTED IN SPECIFICATIONS.
 6. REFER TO ARCHITECTURAL DRAWINGS AND SPECIFICATIONS FOR ADDITIONAL COATING REQUIREMENTS.



BUILDING B -- EXTERIOR STAIR
SCALE: NO SCALE



BUILDING B -- EXTERIOR STAIR
SCALE: NO SCALE

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07/01/2024


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S-8
STAIR REMOVAL &
REPAIRS AT BLDG B





1 Zone 1 - Electrical Site Plan
N.T.S.

GENERAL NOTES:

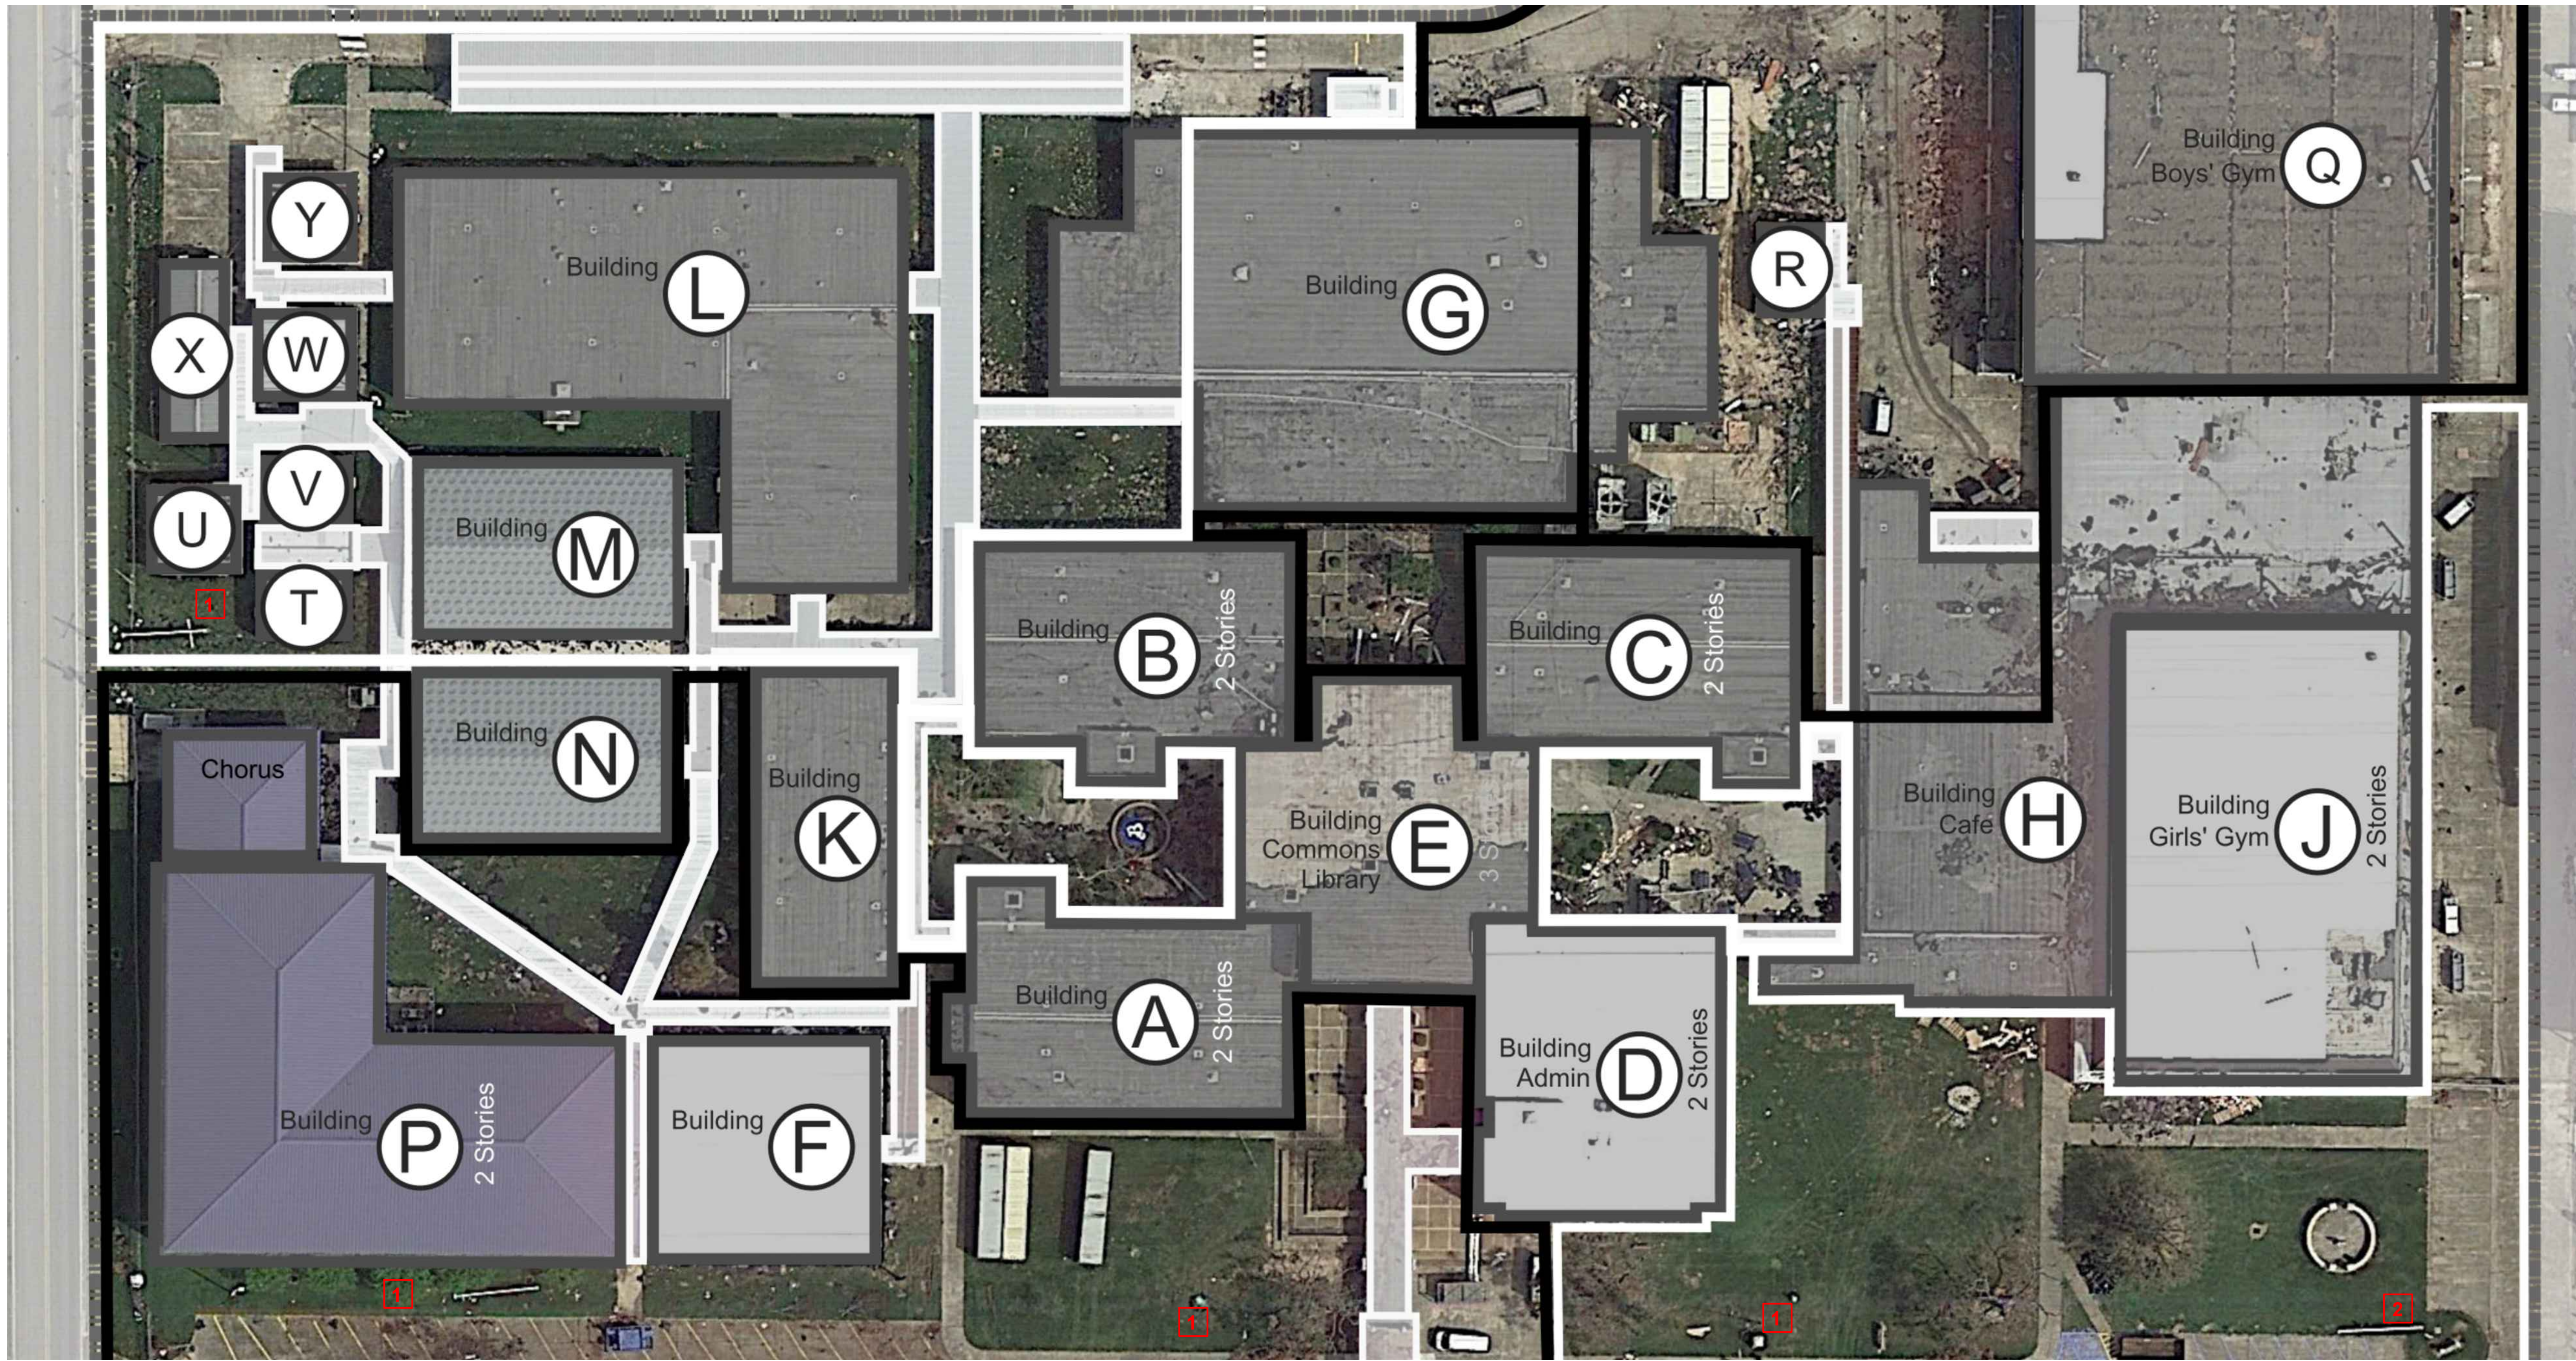- A. CONTRACTOR SHALL FIELD VERIFY EXISTING LIGHTING MOUNTING LOCATIONS IN FIELD PRIOR TO DEMOLITION. COORDINATE ALL SITE VISITS, THROUGH GENERAL CONTRACTOR AND C.P.S.B. CONTRACTOR WEAR REQUIRED PERSONAL PROTECTIVE GEAR (PPE) SPECIFICALLY REQUIRED FOR EACH BUILDING.
- B. CONTRACTOR SHALL NOTIFY ARCHITECT/ENGINEER OF ANY DISCREPANCIES IDENTIFIED IN THE FIELD PRIOR TO ORDERING LIGHT FIXTURES.
- C. THE INTENT OF THE PLAN IS FOR EXISTING CIRCUITING TO REMAIN AND EACH EXISTING LIGHT POLE TO BE REPLACED WITH THE NEW FIXTURE TYPE SPECIFIED.
- D. ALL WORK SHALL COMPLY WITH LOCAL, STATE, AND FEDERAL CODES TO THE SATISFACTION OF CODE AUTHORITIES HAVING JURISDICTION.
- E. ALL WORK SHALL COMPLY WITH THE REQUIREMENTS OF THE 2020 EDITION OF THE NEC.
- F. PRIOR TO DISCONNECTING, AND REMOVING OF ANY ELECTRICAL SERVICES IN THE DESIGNATED AREAS SHOWN, THE CONTRACTOR MUST ENSURE THAT THE SERVICES REMOVED DO NOT AFFECT THE NORMAL OPERATION OF AREAS OUTSIDE THE CONSTRUCTION AREA. COORDINATE WITH OWNER FOR ALL ELECTRICAL SHUT DOWNS AT LEAST 2 WORKING DAYS PRIOR TO WORK.

KEYNOTES:

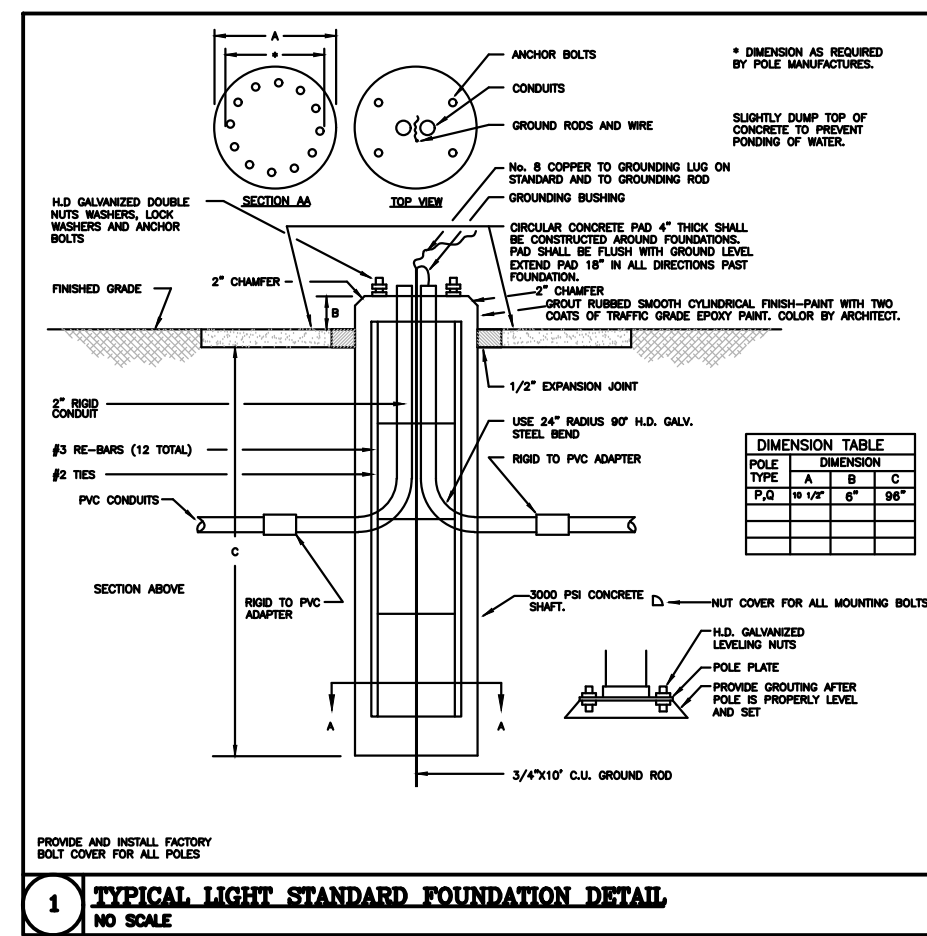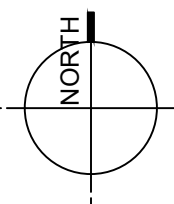- 1. CONTRACTOR SHALL DISCONNECT AND REMOVE EXISTING LIGHT POLE AND FOUNDATION. PROTECT EXISTING CIRCUIT WIRING FOR RE-USE. PROVIDE NEW POLE FIXTURE TYPE 'P' AND NEW POLE FOUNDATION. FIXTURE TYPE P SHALL BE MCGRAW-EDISON OR EQUAL GLEON-SA4C-740-U-14W-WH WITH A 25 FT SQUARE STRAIGHT STEEL POLE MCGRAW-EDISON OR EQUAL SSS-G-A-25-S-W-N-1. SWITCH THROUGH EXISTING PHOTOCELL. IF PHOTOCELL IS MISSING OR NOT WORKING PROVIDE NEW UNIT. SEE POLE FOUNDATION DETAIL THIS SHEET.
- 2. CONTRACTOR SHALL DISCONNECT AND REMOVE EXISTING LIGHT POLE AND FOUNDATION. PROTECT EXISTING CIRCUIT WIRING FOR RE-USE. PROVIDE NEW POLE FIXTURE TYPE 'Q' AND NEW POLE FOUNDATION. FIXTURE TYPE Q SHALL BE MCGRAW-EDISON OR EQUAL GLEON-SA4C-740-U-14W-WH-MA1194-QA WITH A 25 FT SQUARE STRAIGHT STEEL POLE MCGRAW-EDISON OR EQUAL SSS-G-A-25-S-W-3-5. SWITCH THROUGH EXISTING PHOTOCELL. IF PHOTOCELL IS MISSING OR NOT WORKING PROVIDE NEW UNIT. SEE POLE FOUNDATION DETAIL THIS SHEET.



NOTE: CONTRACTOR SHALL REVIEW C.P.S.B MANAGEMENT PLANS PRIOR TO ANY DEMOLITION WORK. REPORT ANY SUSPICIOUS ASBESTOS MATERIALS TO ARCHITECT / ENGINEER PRIOR TO DISTURBING SUSPECT MATERIALS


NOTE: THESE DRAWINGS ARE COPIES OF THE ORIGINAL CONSTRUCTION DOCUMENTS WITH NOTES ADDED TO DESCRIBE THE SCOPE OF WORK FOR THE HURRICANE LAURA REPAIR PROJECT. CONTRACTOR SHALL NOTIFY ARCHITECT/ENGINEER OF ANY DISCREPANCIES IDENTIFIED IN FIELD PRIOR TO ORDERING EQUIPMENT OR INSTALLATION.

NOTE: THE ELECTRICAL SCOPE OF WORK IS LIMITED TO REPLACING OR REPAIRING THE ELECTRICAL SYSTEM BACK TO ITS ORIGINAL CONDITION (LIKE FOR LIKE). THIS PROJECT'S SCOPE OF WORK DOES NOT INCLUDE BRINGING THE EXISTING ELECTRICAL SYSTEMS UP TO CODE OR ADDRESSING EXISTING CONDITIONS.



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Project No. 20300

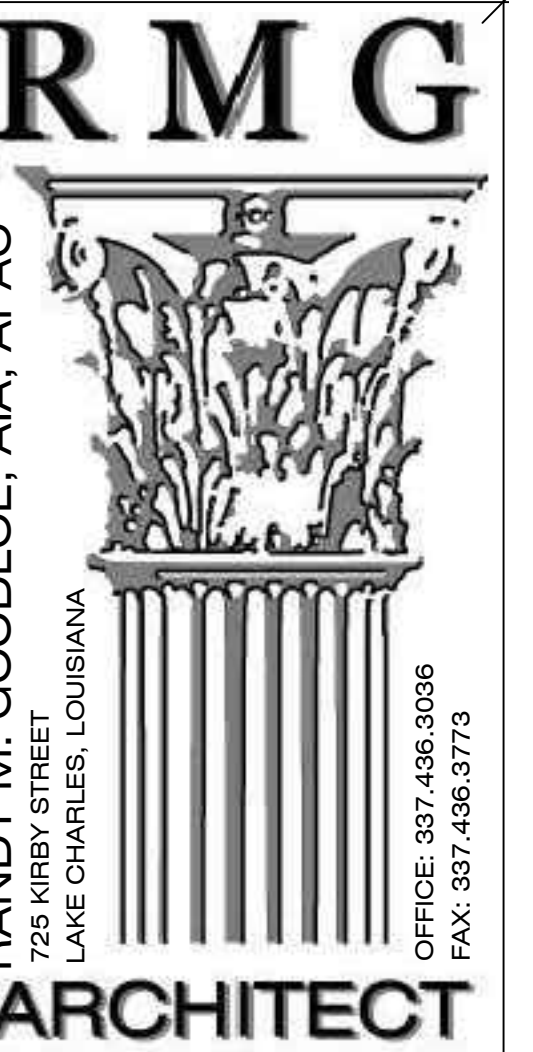

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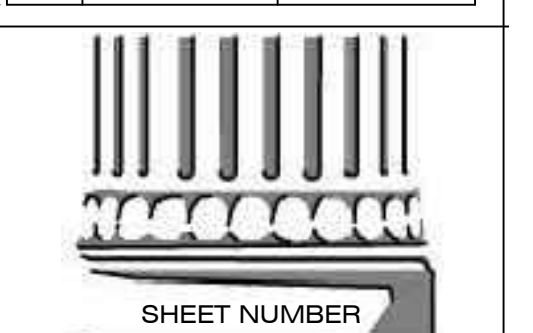
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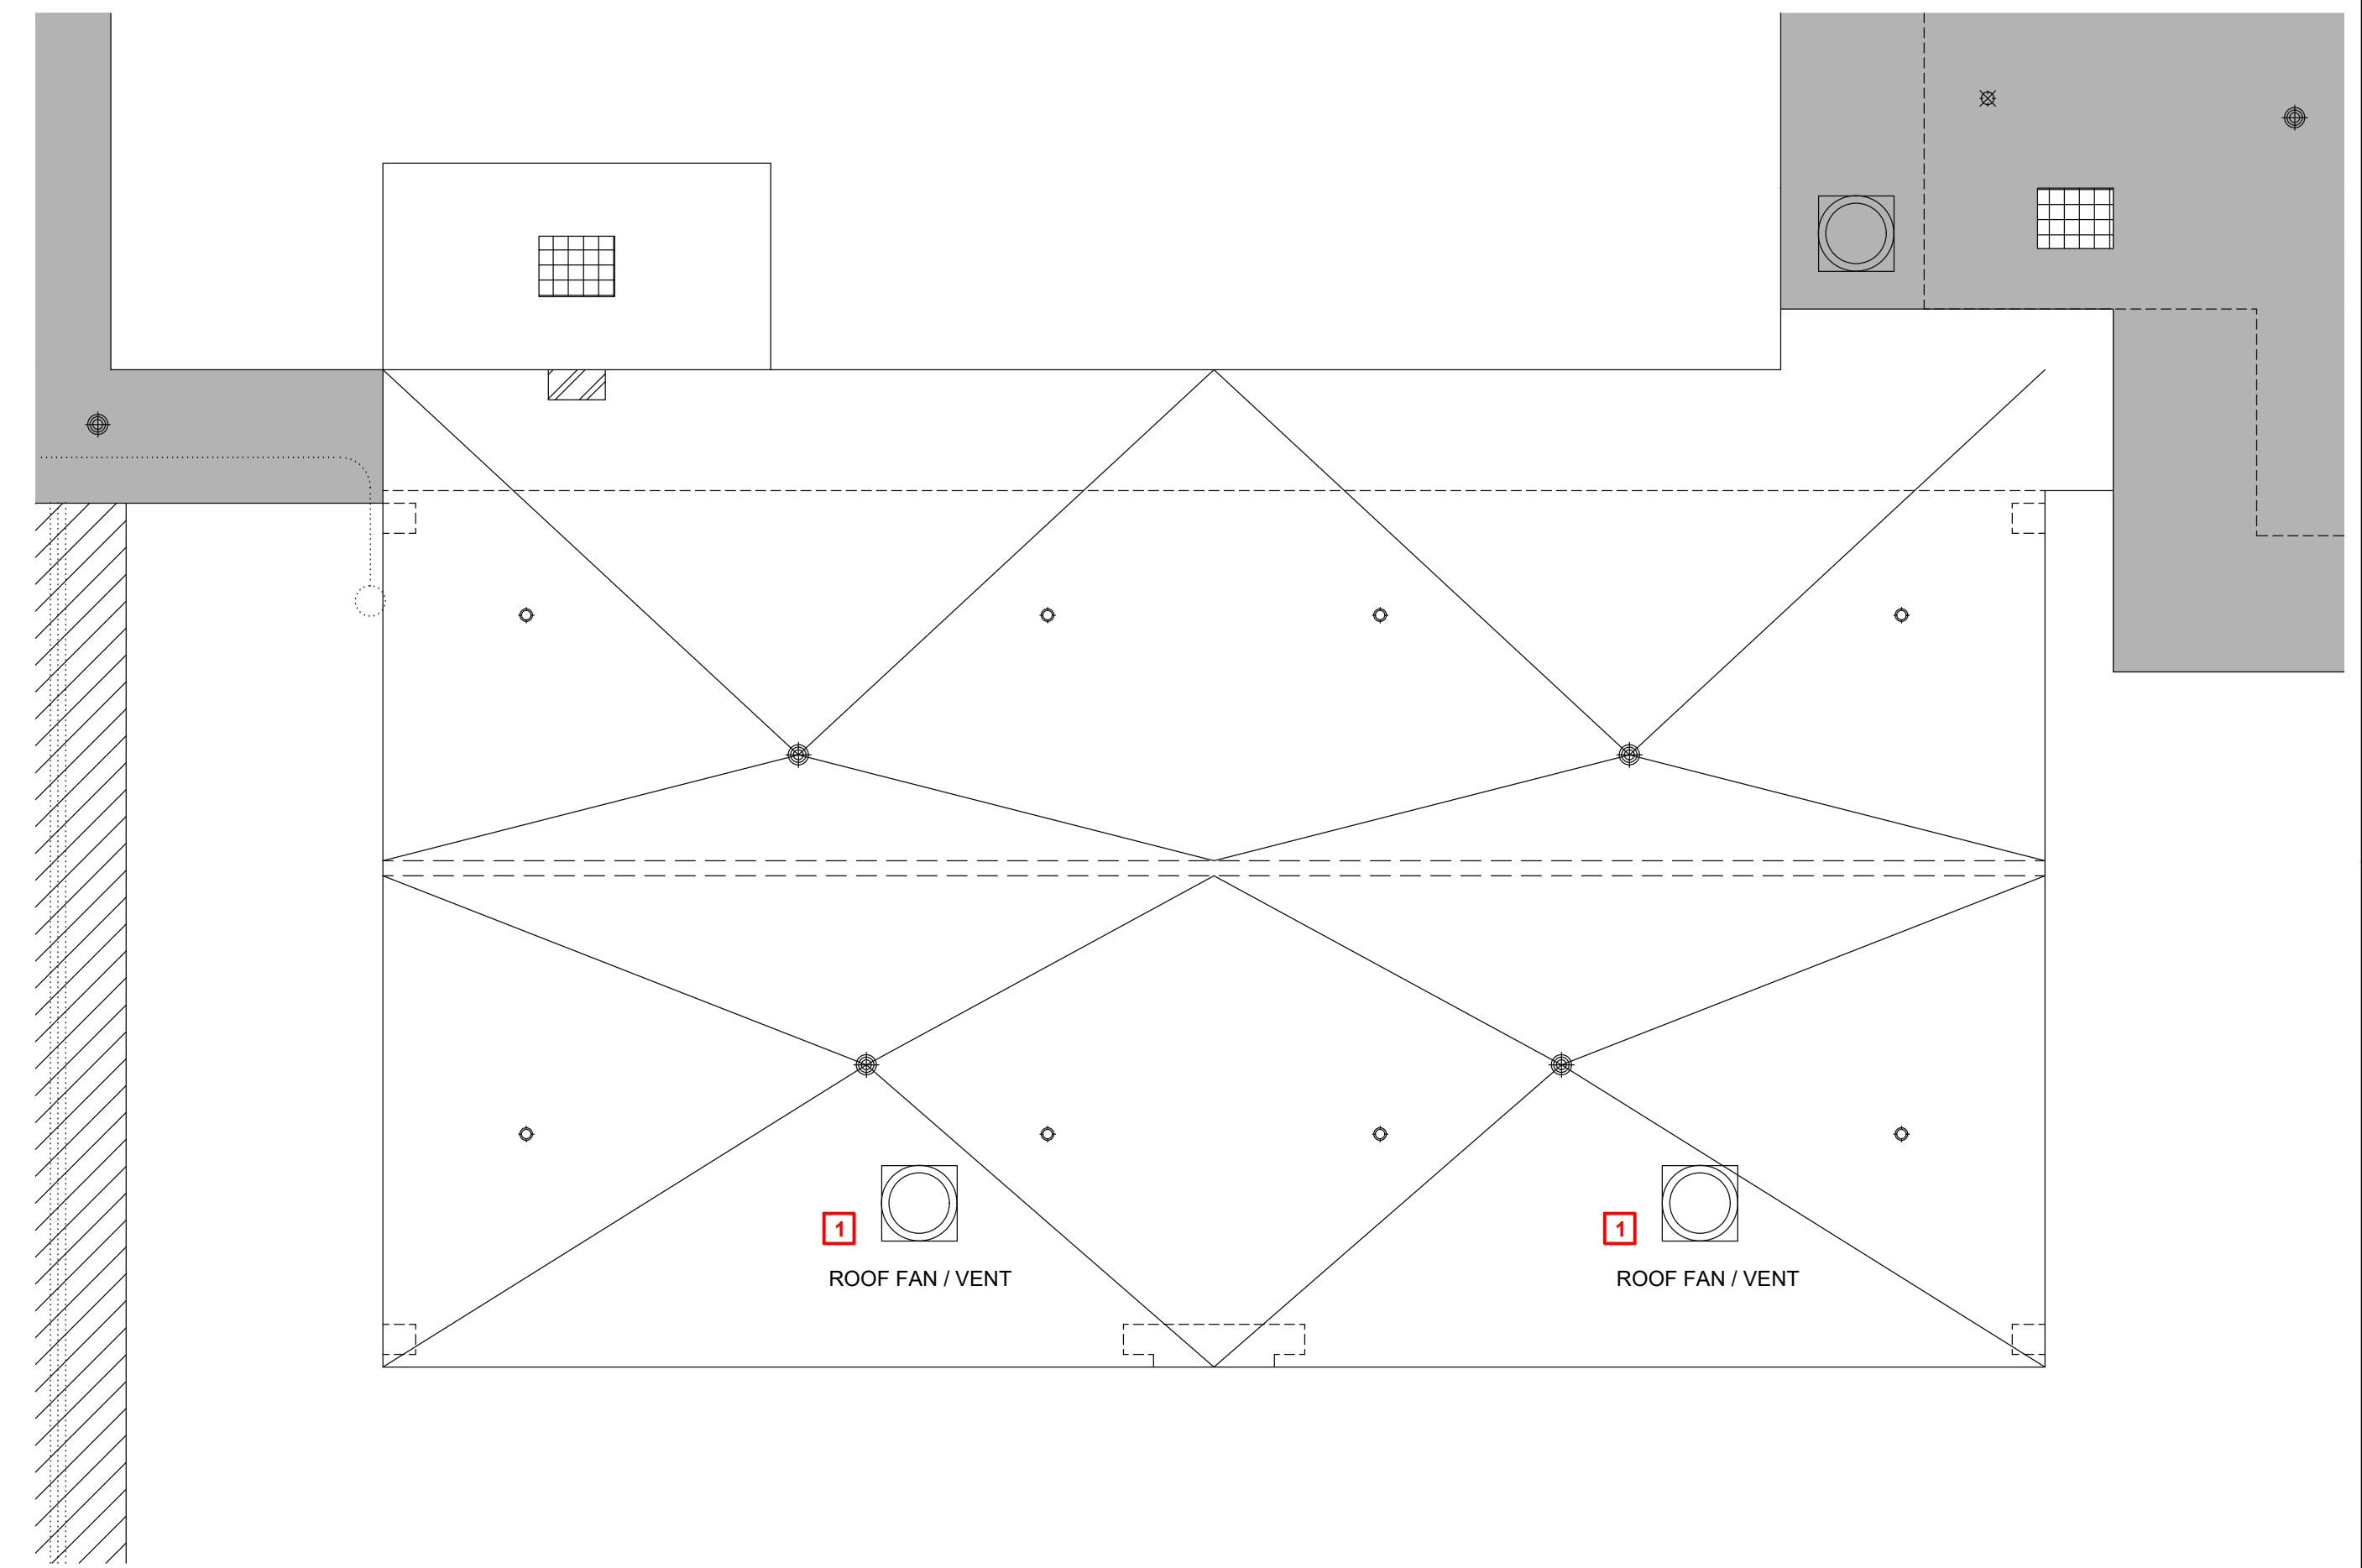
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PROJECT MANAGER DP/TV

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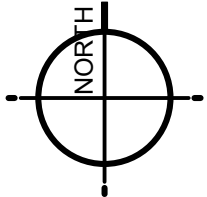
REVISED



(1)E1.0
ZONE 1 - ELECTRICAL
SITE PLAN



1 Electrical Roof Plan - Building A
3/32" = 1'-0"



GENERAL NOTES:

- A. CONTRACTOR SHALL FIELD VERIFY EXISTING ELECTRICAL EQUIPMENT SIZES IN FIELD PRIOR TO DEMOLITION. COORDINATE ALL SITE VISITS THROUGH GENERAL CONTRACTOR AND C.P.S.B.. CONTRACTOR WEAR REQUIRED PERSONAL PROTECTIVE GEAR (PPE) SPECIFICALLY REQUIRED FOR EACH BUILDING.
- B. CONTRACTOR SHALL NOTIFY ARCHITECT/ENGINEER OF ANY DISCREPANCIES IDENTIFIED IN THE FIELD PRIOR ORDERING NEW EQUIPMENT.
- C. ALL WORK SHALL COMPLY WITH LOCAL, STATE, AND FEDERAL CODES TO THE SATISFACTION OF CODE AUTHORITIES HAVING JURISDICTION.
- E. PRIOR TO DISCONNECTING AND REMOVING OF ANY ELECTRICAL SERVICES IN THE DESIGNATED AREAS SHOWN, THE CONTRACTOR MUST ENSURE THAT THE SERVICES REMOVED DO NOT AFFECT THE NORMAL OPERATION OF AREAS OUTSIDE THE CONSTRUCTION AREA. COORDINATE WITH OWNER FOR ALL ELECTRICAL SHUT DOWNS AT LEAST 2 WORKING DAYS PRIOR TO WORK.

KEYNOTES TO SHEET:

- 1. CONTRACTOR SHALL REMOVE EXISTING ROOF MOUNTED HOOD/FAN AND AND INSTALL ON NEW CURB. RECONNECT EXISTING ELECTRICAL AFTER ROOF WORK IS COMPLETE.

ROOFING SYMBOL LEGEND

- EXISTING SKYLIGHT
- ONE-WAY ROOF VENT
- ROOF DRAIN
- ROOF PIPING PENETRATION
- ROOF FAN / VENT
- ROOF FAN / VENT
- DOWNSPOUT
- MISC MEP
- CONDUIT/PIPING RUNS
- EXPANSION JOINT

NOTE:
REFER TO ARCHITECTURAL PLANS FOR ALL DIMENSIONS.

NOTE: THE ELECTRICAL SCOPE OF WORK IS LIMITED TO REPLACING OR REPAIRING THE ELECTRICAL SYSTEM BACK TO ITS ORIGINAL CONDITION (LIKE FOR LIKE). THIS PROJECT'S SCOPE OF WORK DOES NOT INCLUDE BRINGING THE EXISTING ELECTRICAL SYSTEMS UP TO CODE OR ADDRESSING EXISTING CONDITIONS.

NOTE:
CONTRACTOR SHALL REVIEW C.P.S.B MANAGEMENT PLANS PRIOR TO ANY DEMOLITION WORK. REPORT ANY SUSPICIOUS ASBESTOS MATERIALS TO ARCHITECT / ENGINEER PRIOR TO DISTURBING SUSPECT MATERIALS



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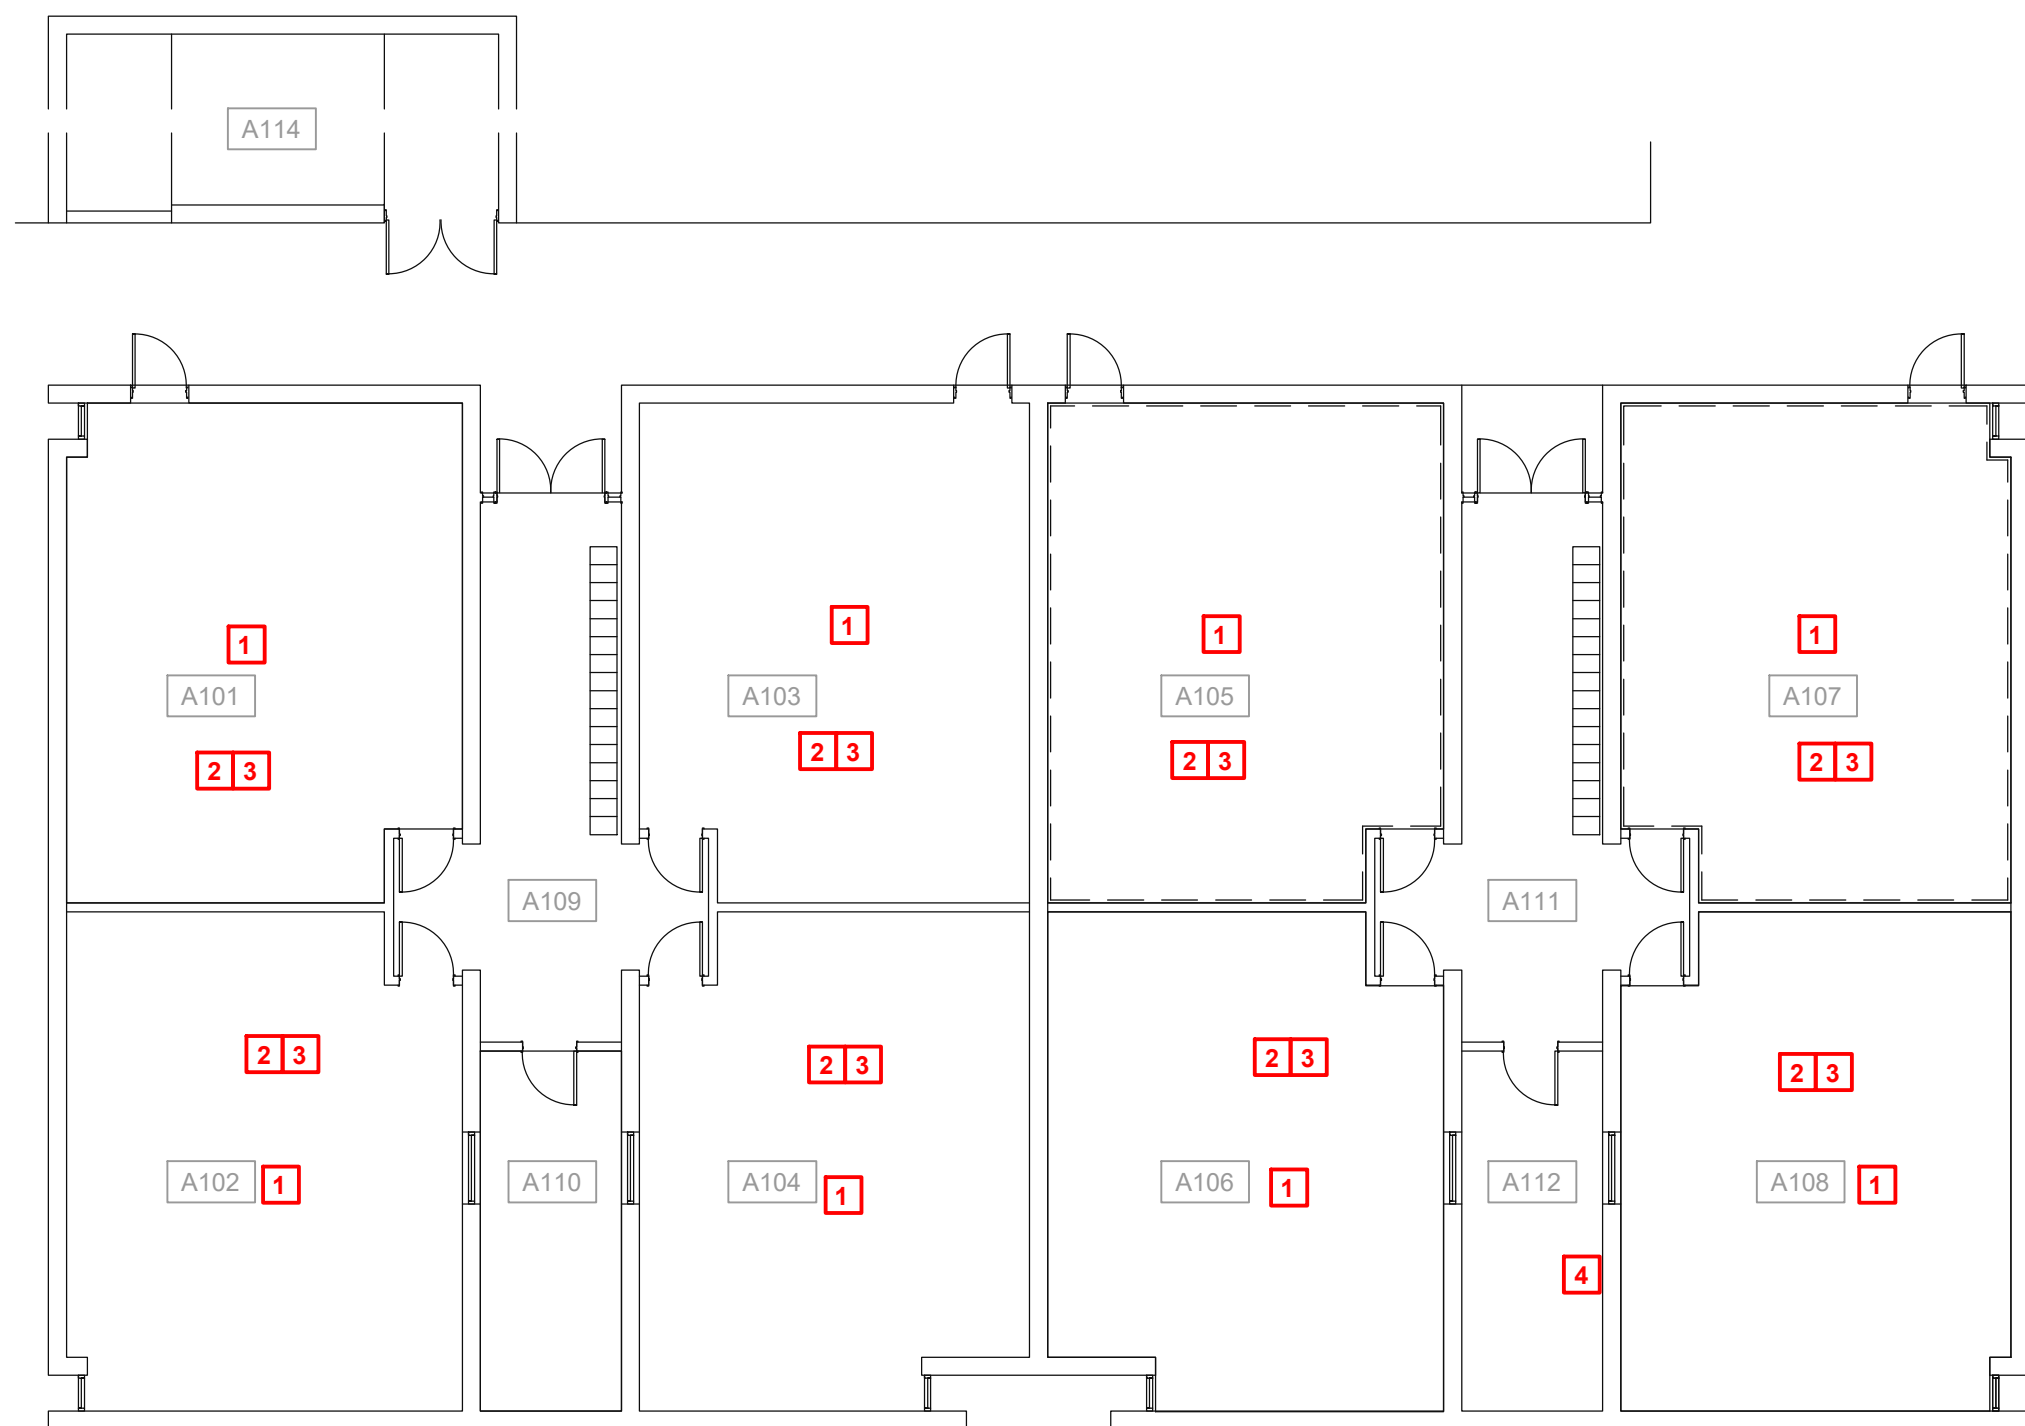
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PROJECT MANAGER
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06.28.2024

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SHEET NUMBER
(A)E0.1
BUILDING A
ROOF PLAN



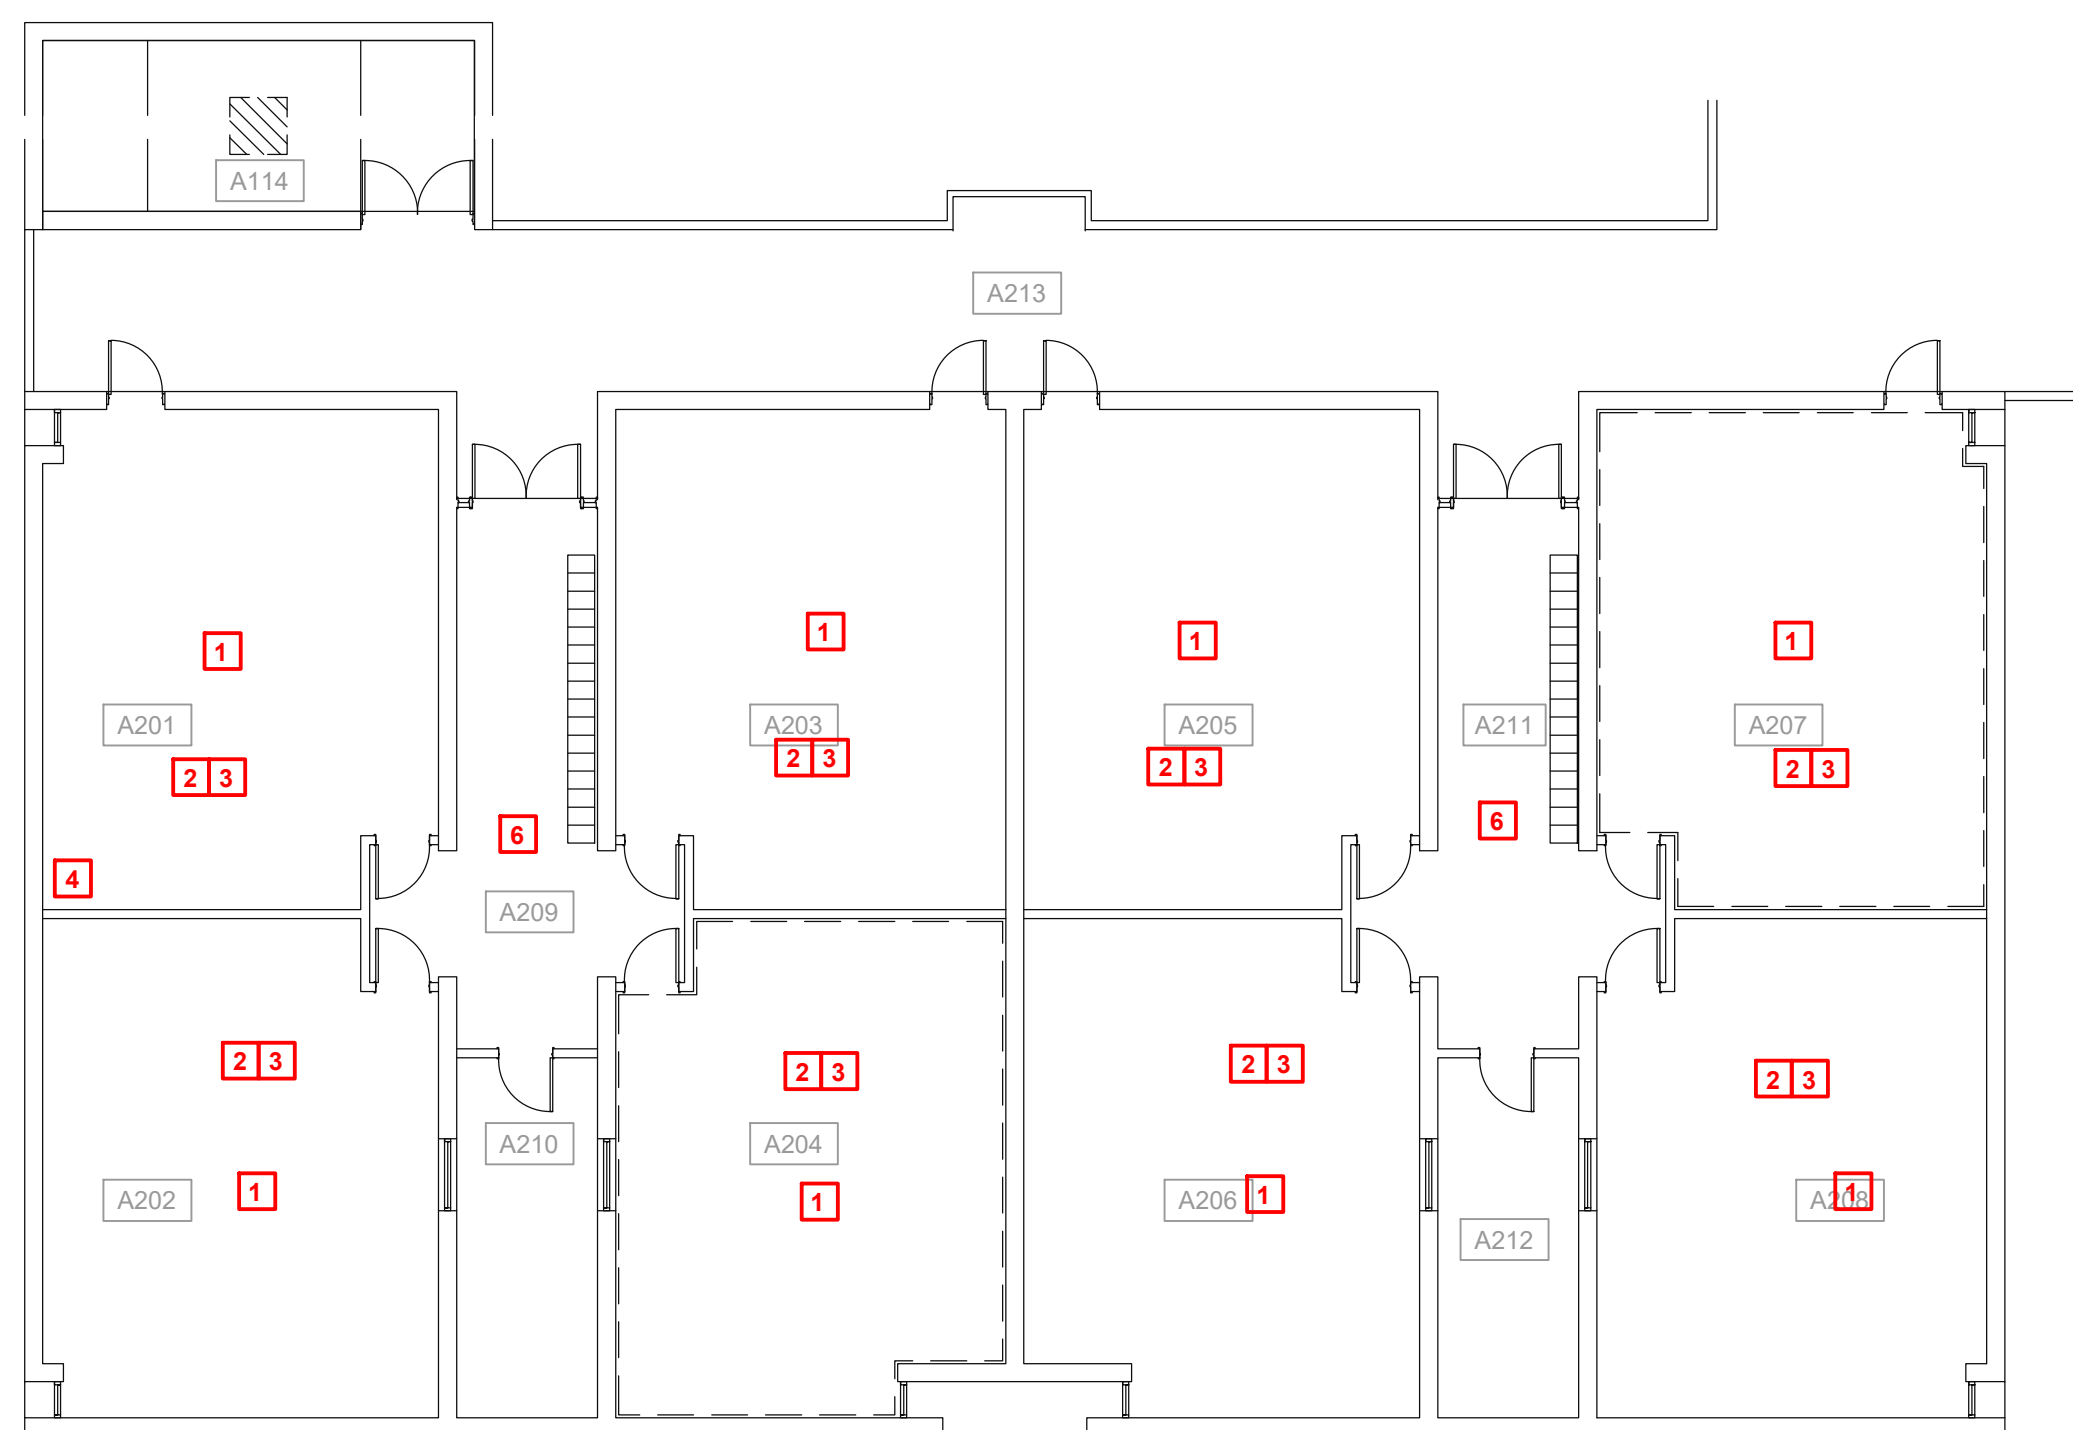
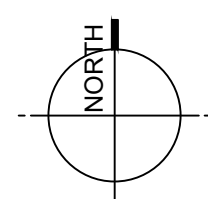
GENERAL NOTES:

- A. CONTRACTOR SHALL NOTIFY ARCHITECT/ENGINEER OF ANY DISCREPANCIES IDENTIFIED IN THE FIELD PRIOR TO ORDERING LIGHT FIXTURES.
- B. THE INTENT OF THE PLAN IS FOR EXISTING CIRCUITING TO REMAIN AND BE RE-USED. ALL EXISTING POWER WIRING SHALL BE PROTECTED DURING DEMOLITION AND AVAILABLE FOR RE-USE. ANY WIRING REMOVED OR DAMAGED DURING CONSTRUCTION SHALL BE REPLACED AT CONTRACTOR'S EXPENSE.
- C. ALL WORK SHALL COMPLY WITH LOCAL, STATE, AND FEDERAL CODES TO THE SATISFACTION OF CODE AUTHORITIES HAVING JURISDICTION.
- D. ALL WORK SHALL COMPLY WITH THE REQUIREMENTS OF THE 2020 EDITION OF NEC.
- E. PRIOR TO DISCONNECTING, AND REMOVING OF ANY ELECTRICAL SERVICES IN THE DESIGNATED AREAS SHOWN, THE CONTRACTOR MUST ENSURE THAT THE SERVICES REMOVED DO NOT AFFECT THE NORMAL OPERATION OF AREAS OUTSIDE THE CONSTRUCTION AREA. COORDINATE WITH OWNER FOR ALL ELECTRICAL SHUT DOWNS AT LEAST 2 WORKING DAYS PRIOR TO WORK.
- F. EXISTING LIGHTING THROUGHOUT THE BUILDING HAS BEEN REPLACED BY THE OWNER IN A PREVIOUS PROJECT. IF THERE ARE SPACES WHERE THE DRAWINGS REQUIRE CEILING REPLACEMENT, THE CONTRACTOR WILL BE REQUIRED TO REMOVE THE EXISTING FIXTURES, PROPERLY STORE THEM ONSITE (CONTAINER OR OTHER OWNER APPROVED AREA), THEN RE-INSTALL FOLLOWING REPLACEMENT OF CEILINGS WITHIN A GIVEN SPACE.
- G. ALL EXISTING LOW VOLTAGE WIRING SHALL BE PROTECTED DURING DEMOLITION AND AVAILABLE FOR RE-USE. ANY WIRING REMOVED OR DAMAGED DURING CONSTRUCTION SHALL BE REPLACED AT CONTRACTOR'S EXPENSE.


KEYNOTES:

- 1. ANY EXISTING CAMERAS OR WIRELESS ACCESS POINTS TO BE REMOVED DURING CONSTRUCTION SHALL BE COORDINATED WITH CPSB IT DEPARTMENT. DEVICES SHALL BE LABELED AND STORED FOR RE-INSTALLATION. CONTRACTOR IS RESPONSIBLE FOR ANY CUT OR REMOVED COMMUNICATIONS CABLING.
- 2. ANY EXISTING FIRE ALARM DEVICES TO BE REMOVED DURING CONSTRUCTION SHALL BE COORDINATED WITH SYLVAN SOUND. DEVICES SHALL BE LABELED AND STORED FOR RE-INSTALLATION. CONTRACTOR IS RESPONSIBLE FOR ANY CUT OR REMOVED FIRE ALARM WIRING.
- 3. ANY EXISTING INTERCOM DEVICES TO BE REMOVED DURING CONSTRUCTION SHALL BE COORDINATED WITH SYLVAN SOUND. DEVICES SHALL BE LABELED AND STORED FOR RE-INSTALLATION. CONTRACTOR IS RESPONSIBLE FOR ANY CUT OR REMOVED INTERCOM WIRING.
- 4. EXISTING LOCATION OF IT RACK. CONTRACTOR IS RESPONSIBLE FOR PROTECTING IT RACK, EQUIPMENT, AND WIRING DURING CONSTRUCTION. IT RACK SHALL REMAIN OPERATIONAL THROUGHOUT CONSTRUCTION UNLESS APPROVED BY CPSB IT FOR IT TO BE POWERED DOWN. PROVIDE COVER FOR RACK TO MINIMIZE DUST AND DEBRIS WHILE AT THE SAME TIME ALLOWING COOLING AND PROPER AIRFLOW.

1 Zone 1 - Building A First Floor - Electrical Plan
1/12" = 1'-0"



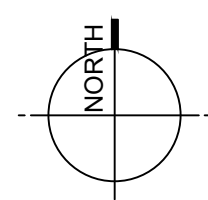2 Zone 1 - Building A Second Floor - Electrical Plan
1/12" = 1'-0"




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NOTE: THE ELECTRICAL SCOPE OF WORK IS LIMITED TO REPLACING OR REPAIRING THE ELECTRICAL SYSTEM BACK TO ITS ORIGINAL CONDITION (LIKE FOR LIKE). THIS PROJECT'S SCOPE OF WORK DOES NOT INCLUDE BRINGING THE EXISTING ELECTRICAL SYSTEMS UP TO CODE OR ADDRESSING EXISTING CONDITIONS.

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Project No. 20300



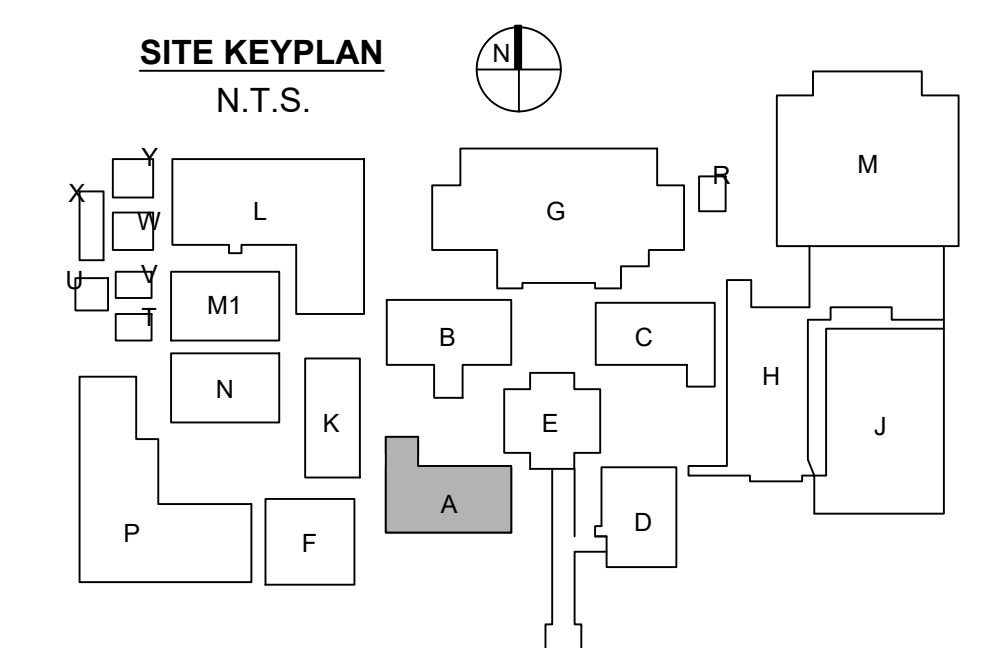NOTE:
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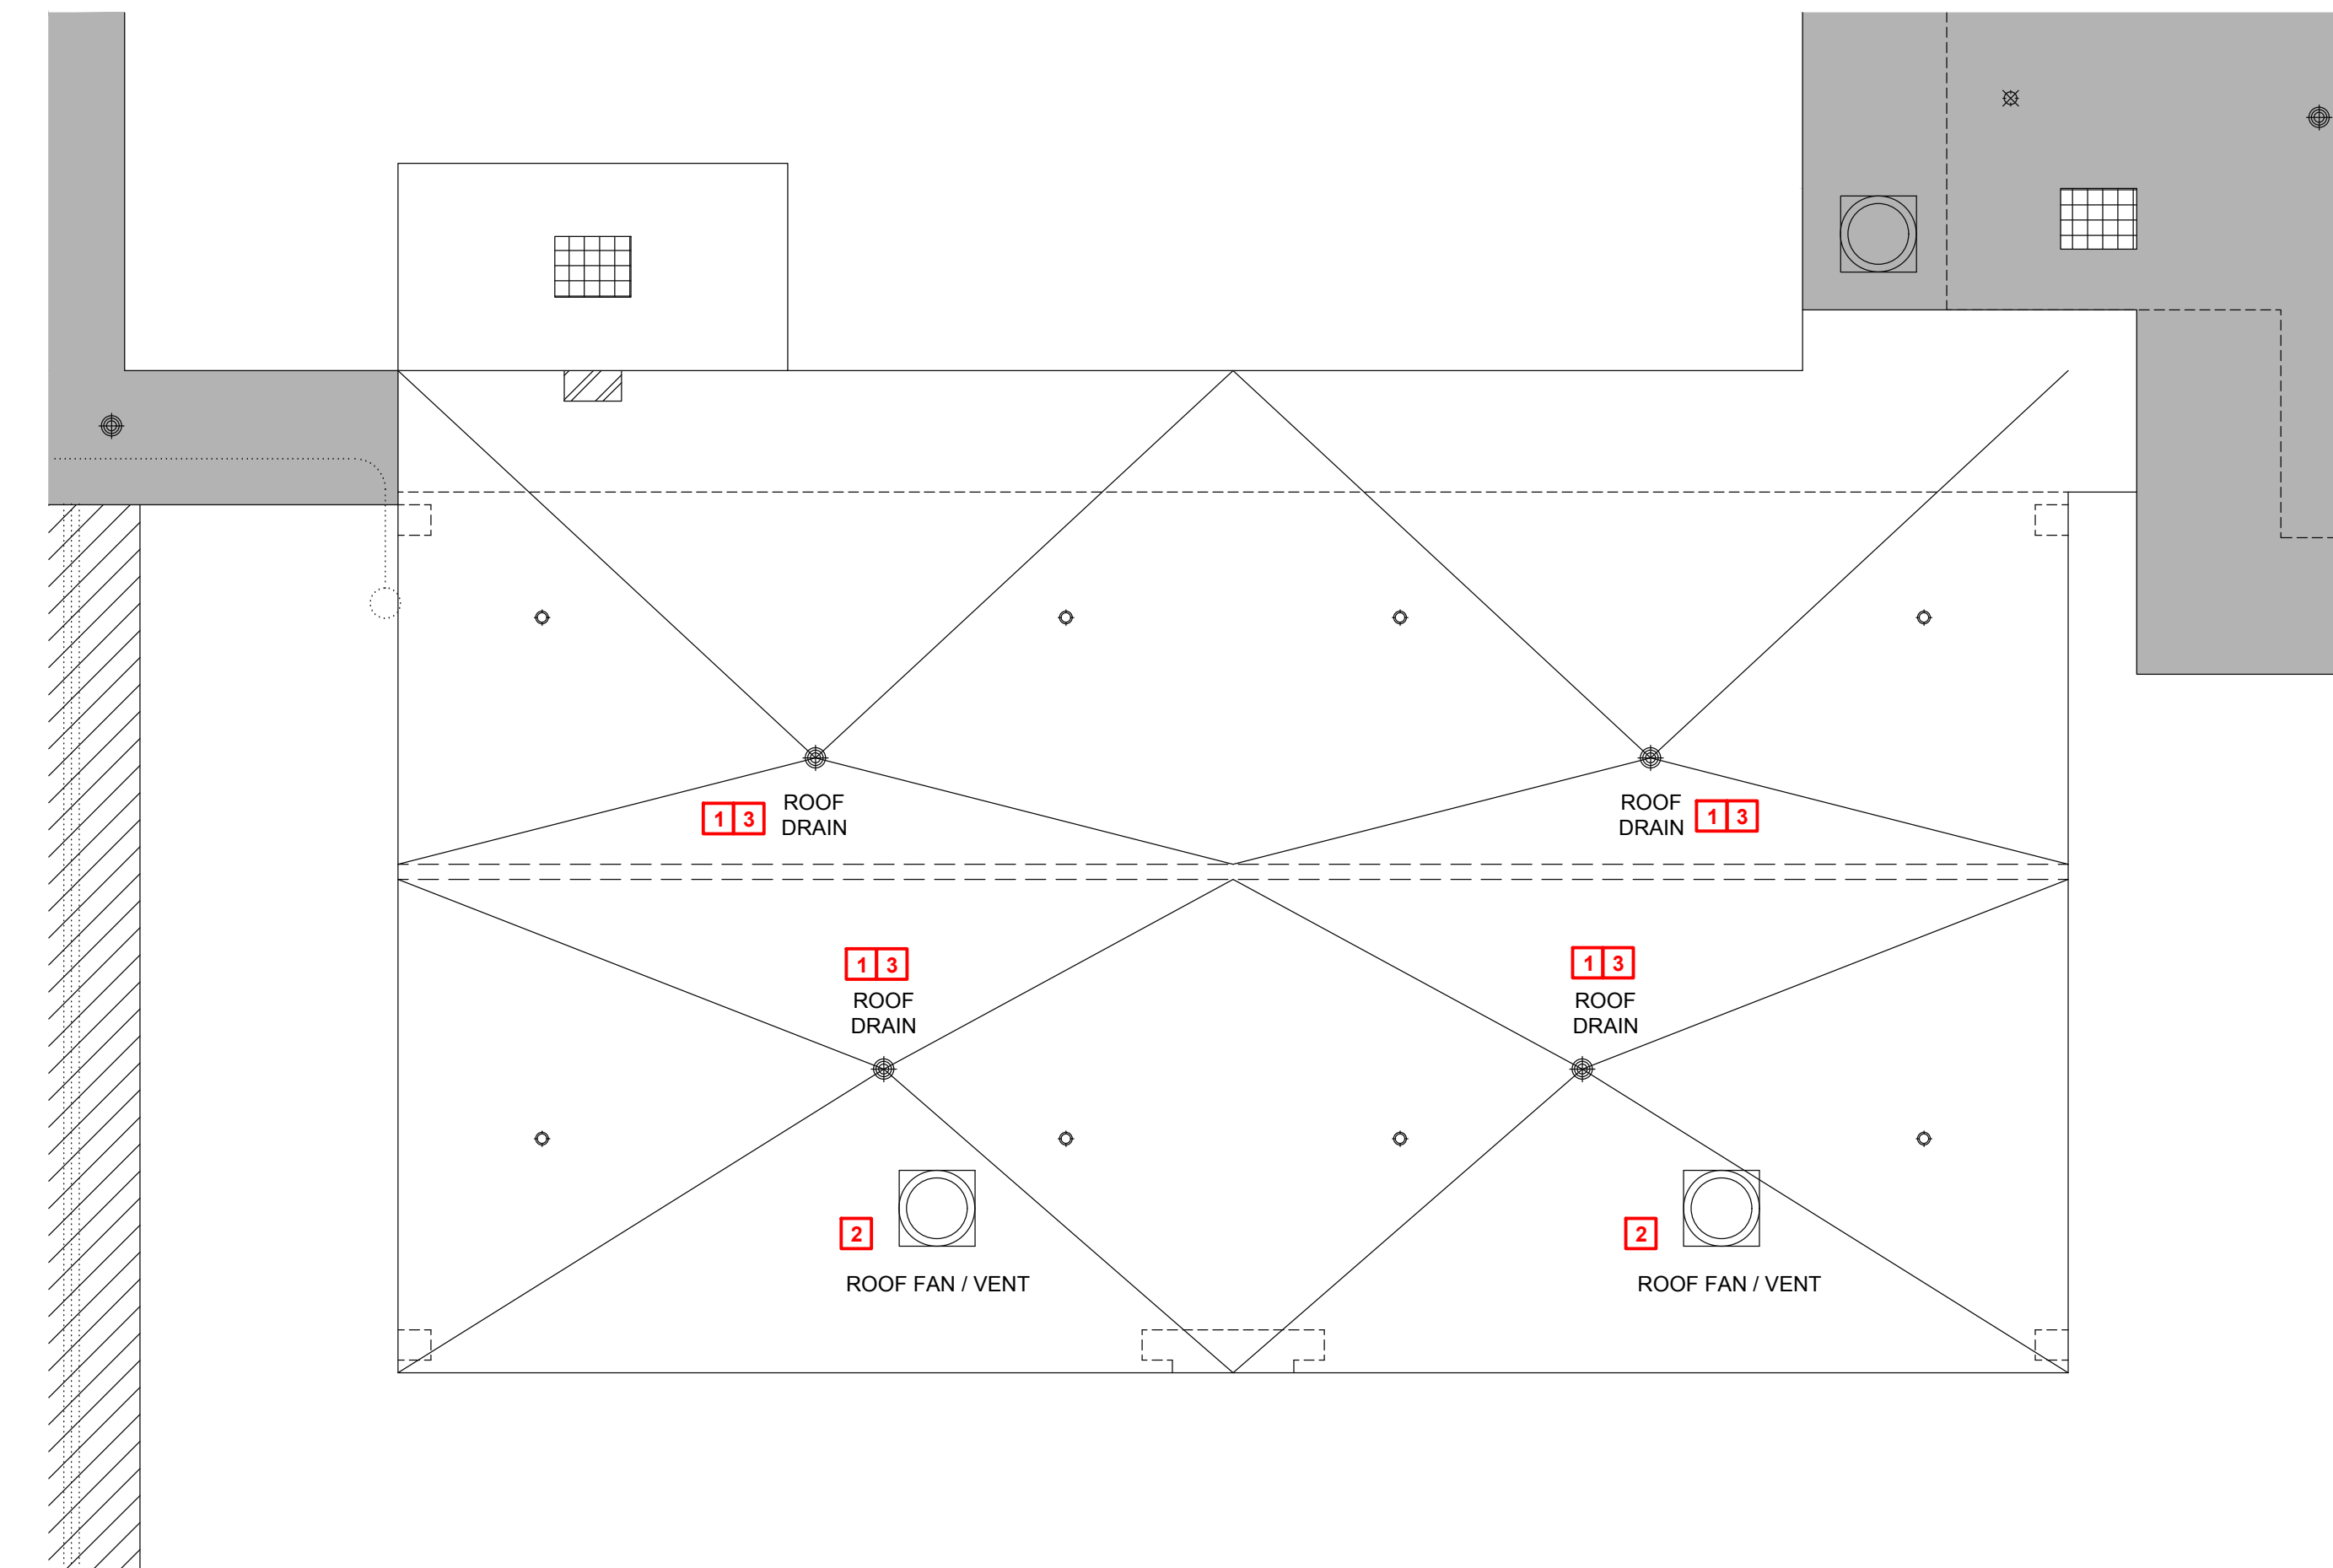
HURRICANE LAURA REPAIRS
A.M. BARBE HIGH SCHOOL
2200 W. McNEESE ST.
FOR
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20042-01-G
OWNER PROJECT NO.
HL-003-01.03.04.05.06.07
PROJECT MANAGER
DP/TV
DATE ISSUED
06.28.2024

REVISED

SHEET NUMBER
(A)E1.1
ZONE 1 - BUILDING A
ELECTRICAL PLANS



1 Mechanical Roof Plan - Building A
3/32" = 1'-0"

NOTE:
REFER TO ARCHITECTURAL PLANS
FOR ALL DIMENSIONS.

GENERAL NOTES:

- A. CONTRACTOR SHALL FIELD VERIFY EXISTING EQUIPMENT TAGS (WHERE POSSIBLE) IN FIELD PRIOR TO DEMOLITION. COORDINATE ALL SITE VISITS, THROUGH GENERAL CONTRACTOR AND C.P.S.B. CONTRACTOR WEAR REQUIRED PERSONAL PROTECTIVE GEAR (PPE) SPECIFICALLY REQUIRED FOR EACH BUILDING.
- B. CONTRACTOR SHALL NOTIFY ARCHITECT/ENGINEER OF ANY DISCREPANCIES IDENTIFIED IN THE FIELD PRIOR TO FABRICATING DUCTWORK OR ORDERING EQUIPMENT.
- C. CONTRACTOR SHALL PROVIDE TESTING AND BALANCING OF ALL HVAC SYSTEMS WHICH WERE REPLACED, MODIFIED AND/OR CLEANED.
- D. ALL WORK SHALL COMPLY WITH LOCAL, STATE, AND FEDERAL CODES TO THE SATISFACTION OF CODE AUTHORITIES HAVING JURISDICTION.
- E. ALL WORK SHALL COMPLY WITH THE REQUIREMENTS OF NFPA 90A & 101, THE CLEAN AIR ACT AND THE AMERICANS WITH DISABILITIES ACT.
- F. PRIOR TO DRAINING, DISCONNECTING, AND REMOVING OF ANY SERVICES IN THE DESIGNATED AREAS SHOWN, THE CONTRACTOR MUST ENSURE THAT THE SERVICES REMOVED DO NOT AFFECT THE NORMAL OPERATION OF AREAS OUTSIDE THE CONSTRUCTION AREA.
- G. VERIFY ADEQUATE SPACE AVAILABLE PER MANUFACTURER'S RECOMMENDATIONS, COORDINATE CLEARANCE REQUIREMENTS OF ALL MECHANICAL EQUIPMENT.

KEYNOTES TO SHEET:

1. CONTRACTOR SHALL REMOVE EXISTING ROOF DRAIN AN INSTALLED NEW ROOF DRAIN WITH DOME STRAINER IN SAME LOCATION. THE NEW ROOF DRAIN W/DOME STRAINER SHALL MATCH THE EXISTING SIZE, STYLE, ETC. OF THE EXISTING THAT IS BEING REPLACED AS PART OF THE RE-ROOFING PROJECT.
2. CONTRACTOR SHALL REMOVE EXISTING ROOF MOUNTED HOOD/FAN AND AND INSTALL ON NEW CURB. NEW CURB SHALL MATCH THE EXISTING SIZE, STYLE, ETC. OF EXISTING CURB. COORDINATE CURB HEIGHT WITH ARCHITECT & GENERAL CONTRACTOR PRIOR ORDERING.
3. ALL EXISTING ROOF DRAIN PIPING SHALL BE FLUSHED TO REMOVE LEAVES, DEBRIS, ETC. ONCE THE NEW ROOF DRAINS ARE INSTALLED.

ROOFING SYMBOL LEGEND

- EXISTING SKYLIGHT
- ONE-WAY ROOF VENT
- ROOF DRAIN
- ROOF PIPING PENETRATION
- ROOF FAN / VENT
- ROOF FAN / VENT
- DOWNSPOUT
- MISC MEP
- CONDUIT/PIPING RUNS
- EXPANSION JOINT



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NOTE:
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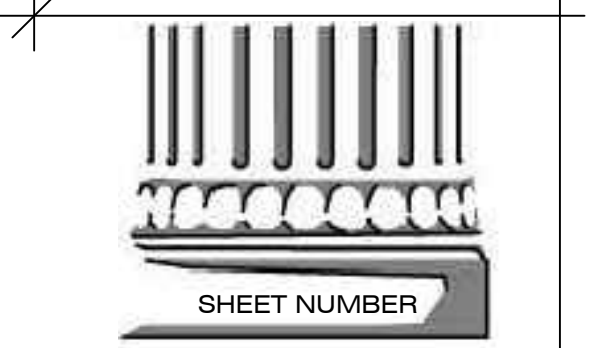


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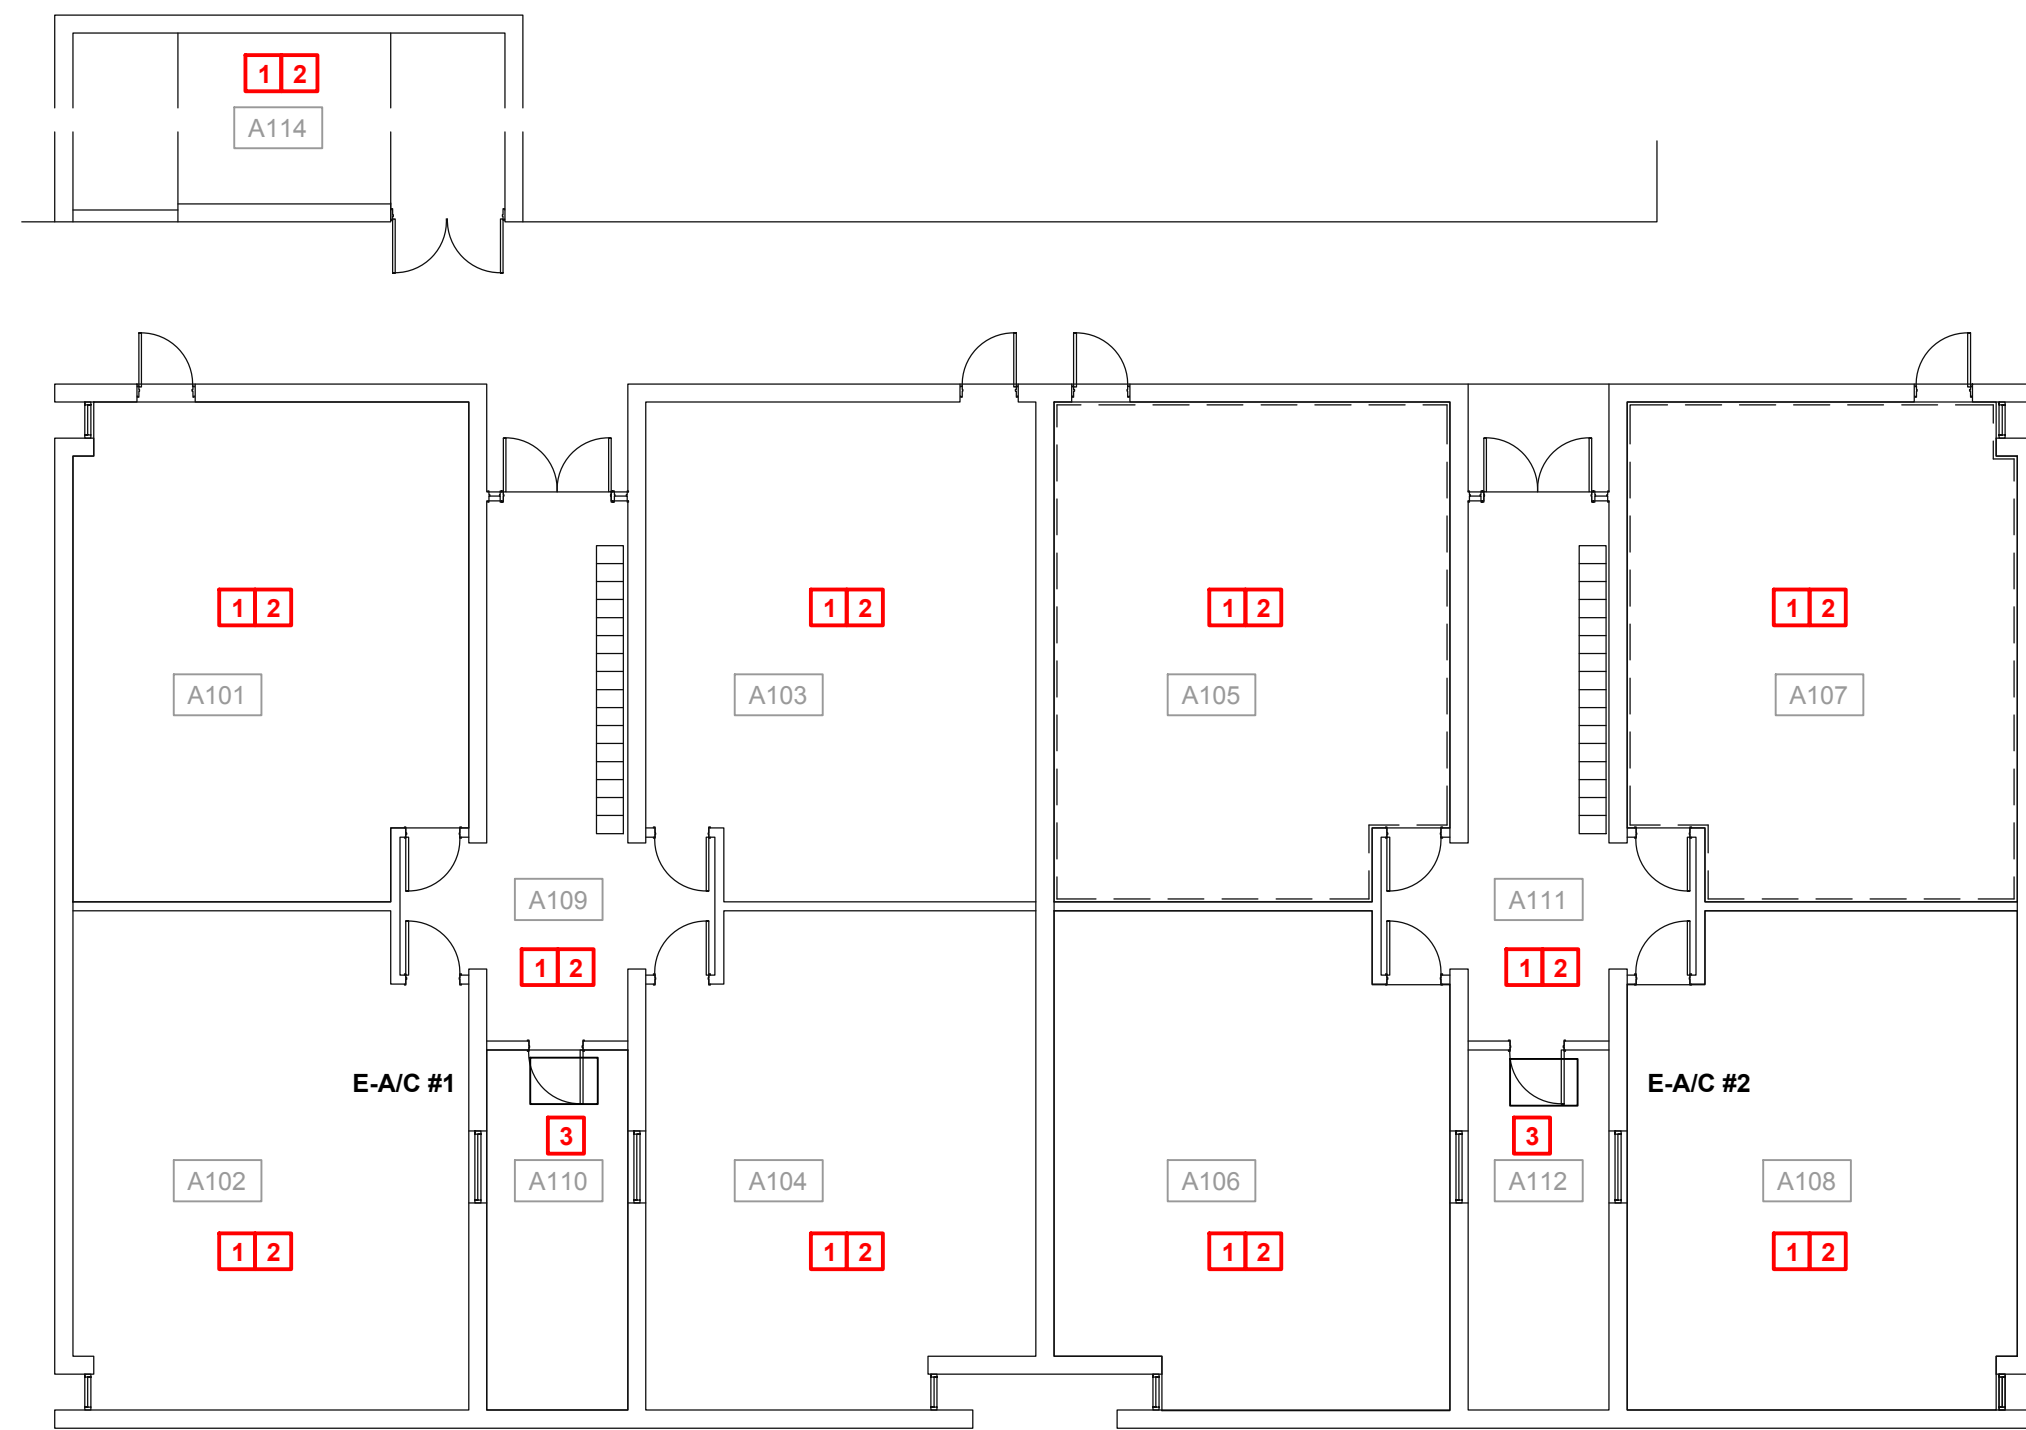
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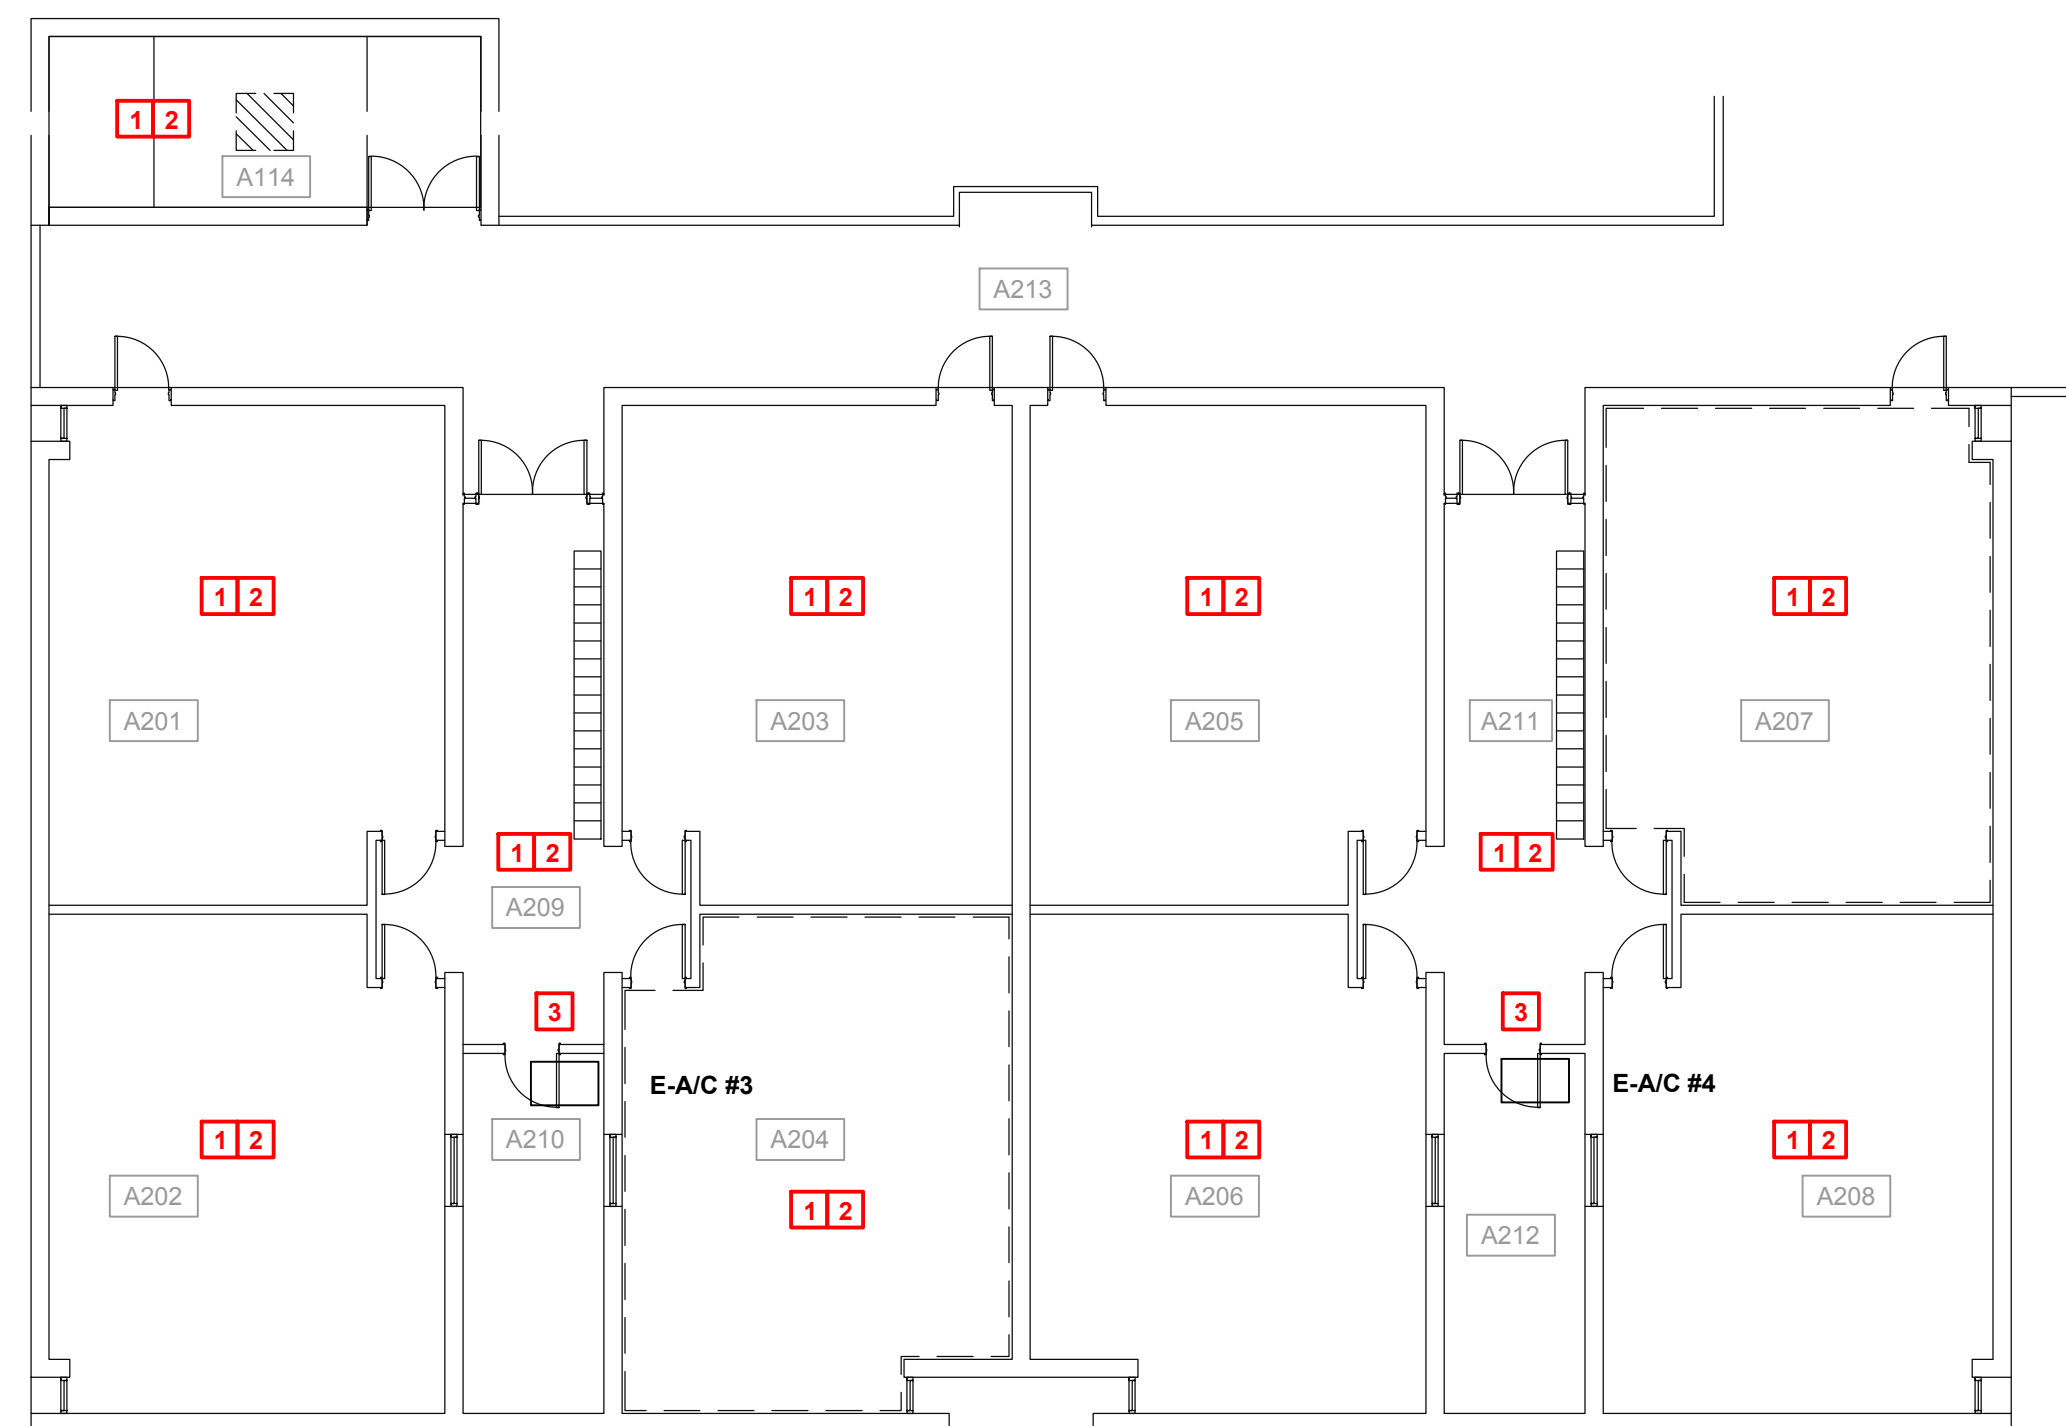


(A)M0.1
BUILDING A
ROOF PLAN



6 Zone 1 - Building A First Floor - Mechanical Plan
3/32" = 1'-0"

NOTE:
REFER TO ARCHITECTURAL DRAWINGS
FOR ALL DIMENSIONS.



16 Zone 1 - Building A Second Floor - Mechanical Plan
3/32" = 1'-0"

NOTE:
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GENERAL NOTES:

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- CONTRACTOR SHALL NOTIFY ARCHITECT/ENGINEER OF ANY DISCREPANCIES IDENTIFIED IN THE FIELD PRIOR TO FABRICATING DUCTWORK OR ORDERING EQUIPMENT.
- CONTRACTOR SHALL PROVIDE TESTING AND BALANCING OF ALL HVAC SYSTEMS WHICH WERE REPLACED, MODIFIED AND/OR CLEANED.
- ALL WORK SHALL COMPLY WITH LOCAL, STATE, AND FEDERAL CODES TO THE SATISFACTION OF CODE AUTHORITIES HAVING JURISDICTION.
- ALL WORK SHALL COMPLY WITH THE REQUIREMENTS OF NFPA 90A & 101, THE CLEAN AIR ACT AND THE AMERICANS WITH DISABILITIES ACT.
- PRIOR TO DRAINING, DISCONNECTING, AND REMOVING OF ANY SERVICES IN THE DESIGNATED AREAS SHOWN, THE CONTRACTOR MUST ENSURE THAT THE SERVICES REMOVED DO NOT AFFECT THE NORMAL OPERATION OF AREAS OUTSIDE THE CONSTRUCTION AREA.
- VERIFY ADEQUATE SPACE AVAILABLE PER MANUFACTURER'S RECOMMENDATIONS, COORDINATE CLEARANCE REQUIREMENTS OF ALL MECHANICAL EQUIPMENT.

KEYNOTES TO SHEET:

- NO INTERIOR MECHANICAL (PLUMBING & HVAC) WORK ASSOCIATED WITH THESE SPACES WITHIN THE BUILDING.
- CONTRACTOR SHALL TEMPORARILY SUPPORT AND PROTECT ANY EQUIPMENT, DIFFUSERS, GRILLES, ETC. IN OR ABOVE CEILINGS OF THESE SPACES DURING THE REMOVAL AND INSTALLATION OF NEW CEILINGS. REFER TO ARCHITECTURAL PLANS FOR THOSE LOCATIONS.
- EXISTING FAN COIL UNIT TO REMAIN AND CLEANED PER THE SPECIFICATIONS. REMOVE AND REPLACE EXISTING AIR HANDLING UNIT INTERIOR LINER AND CLEAN INTERIOR OF UNIT INCLUDING COILS.

NOTE:
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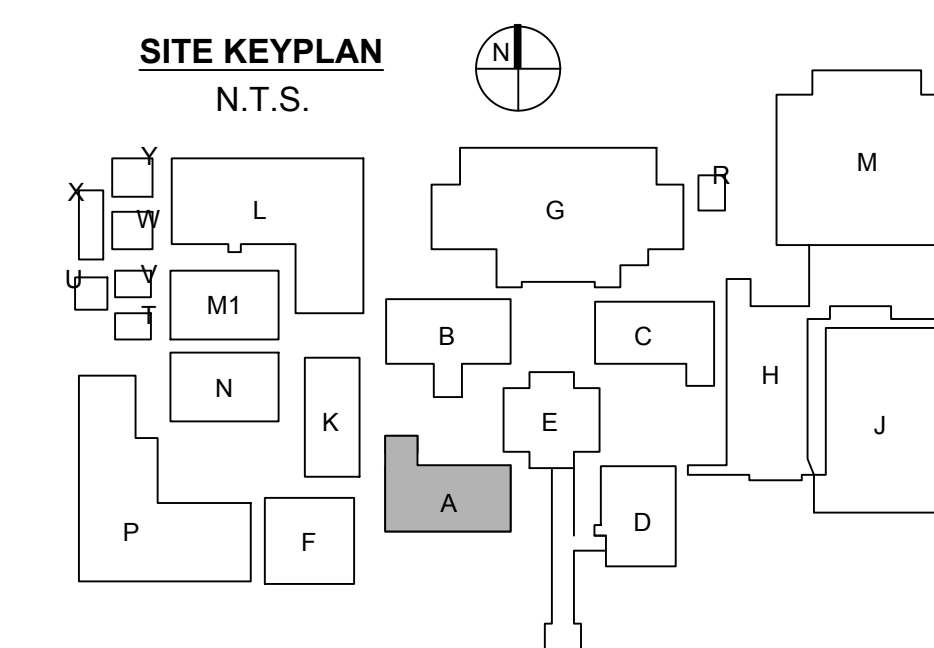
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SITE KEYPLAN N.T.S.

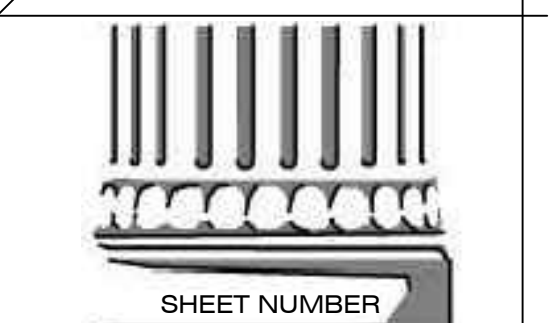


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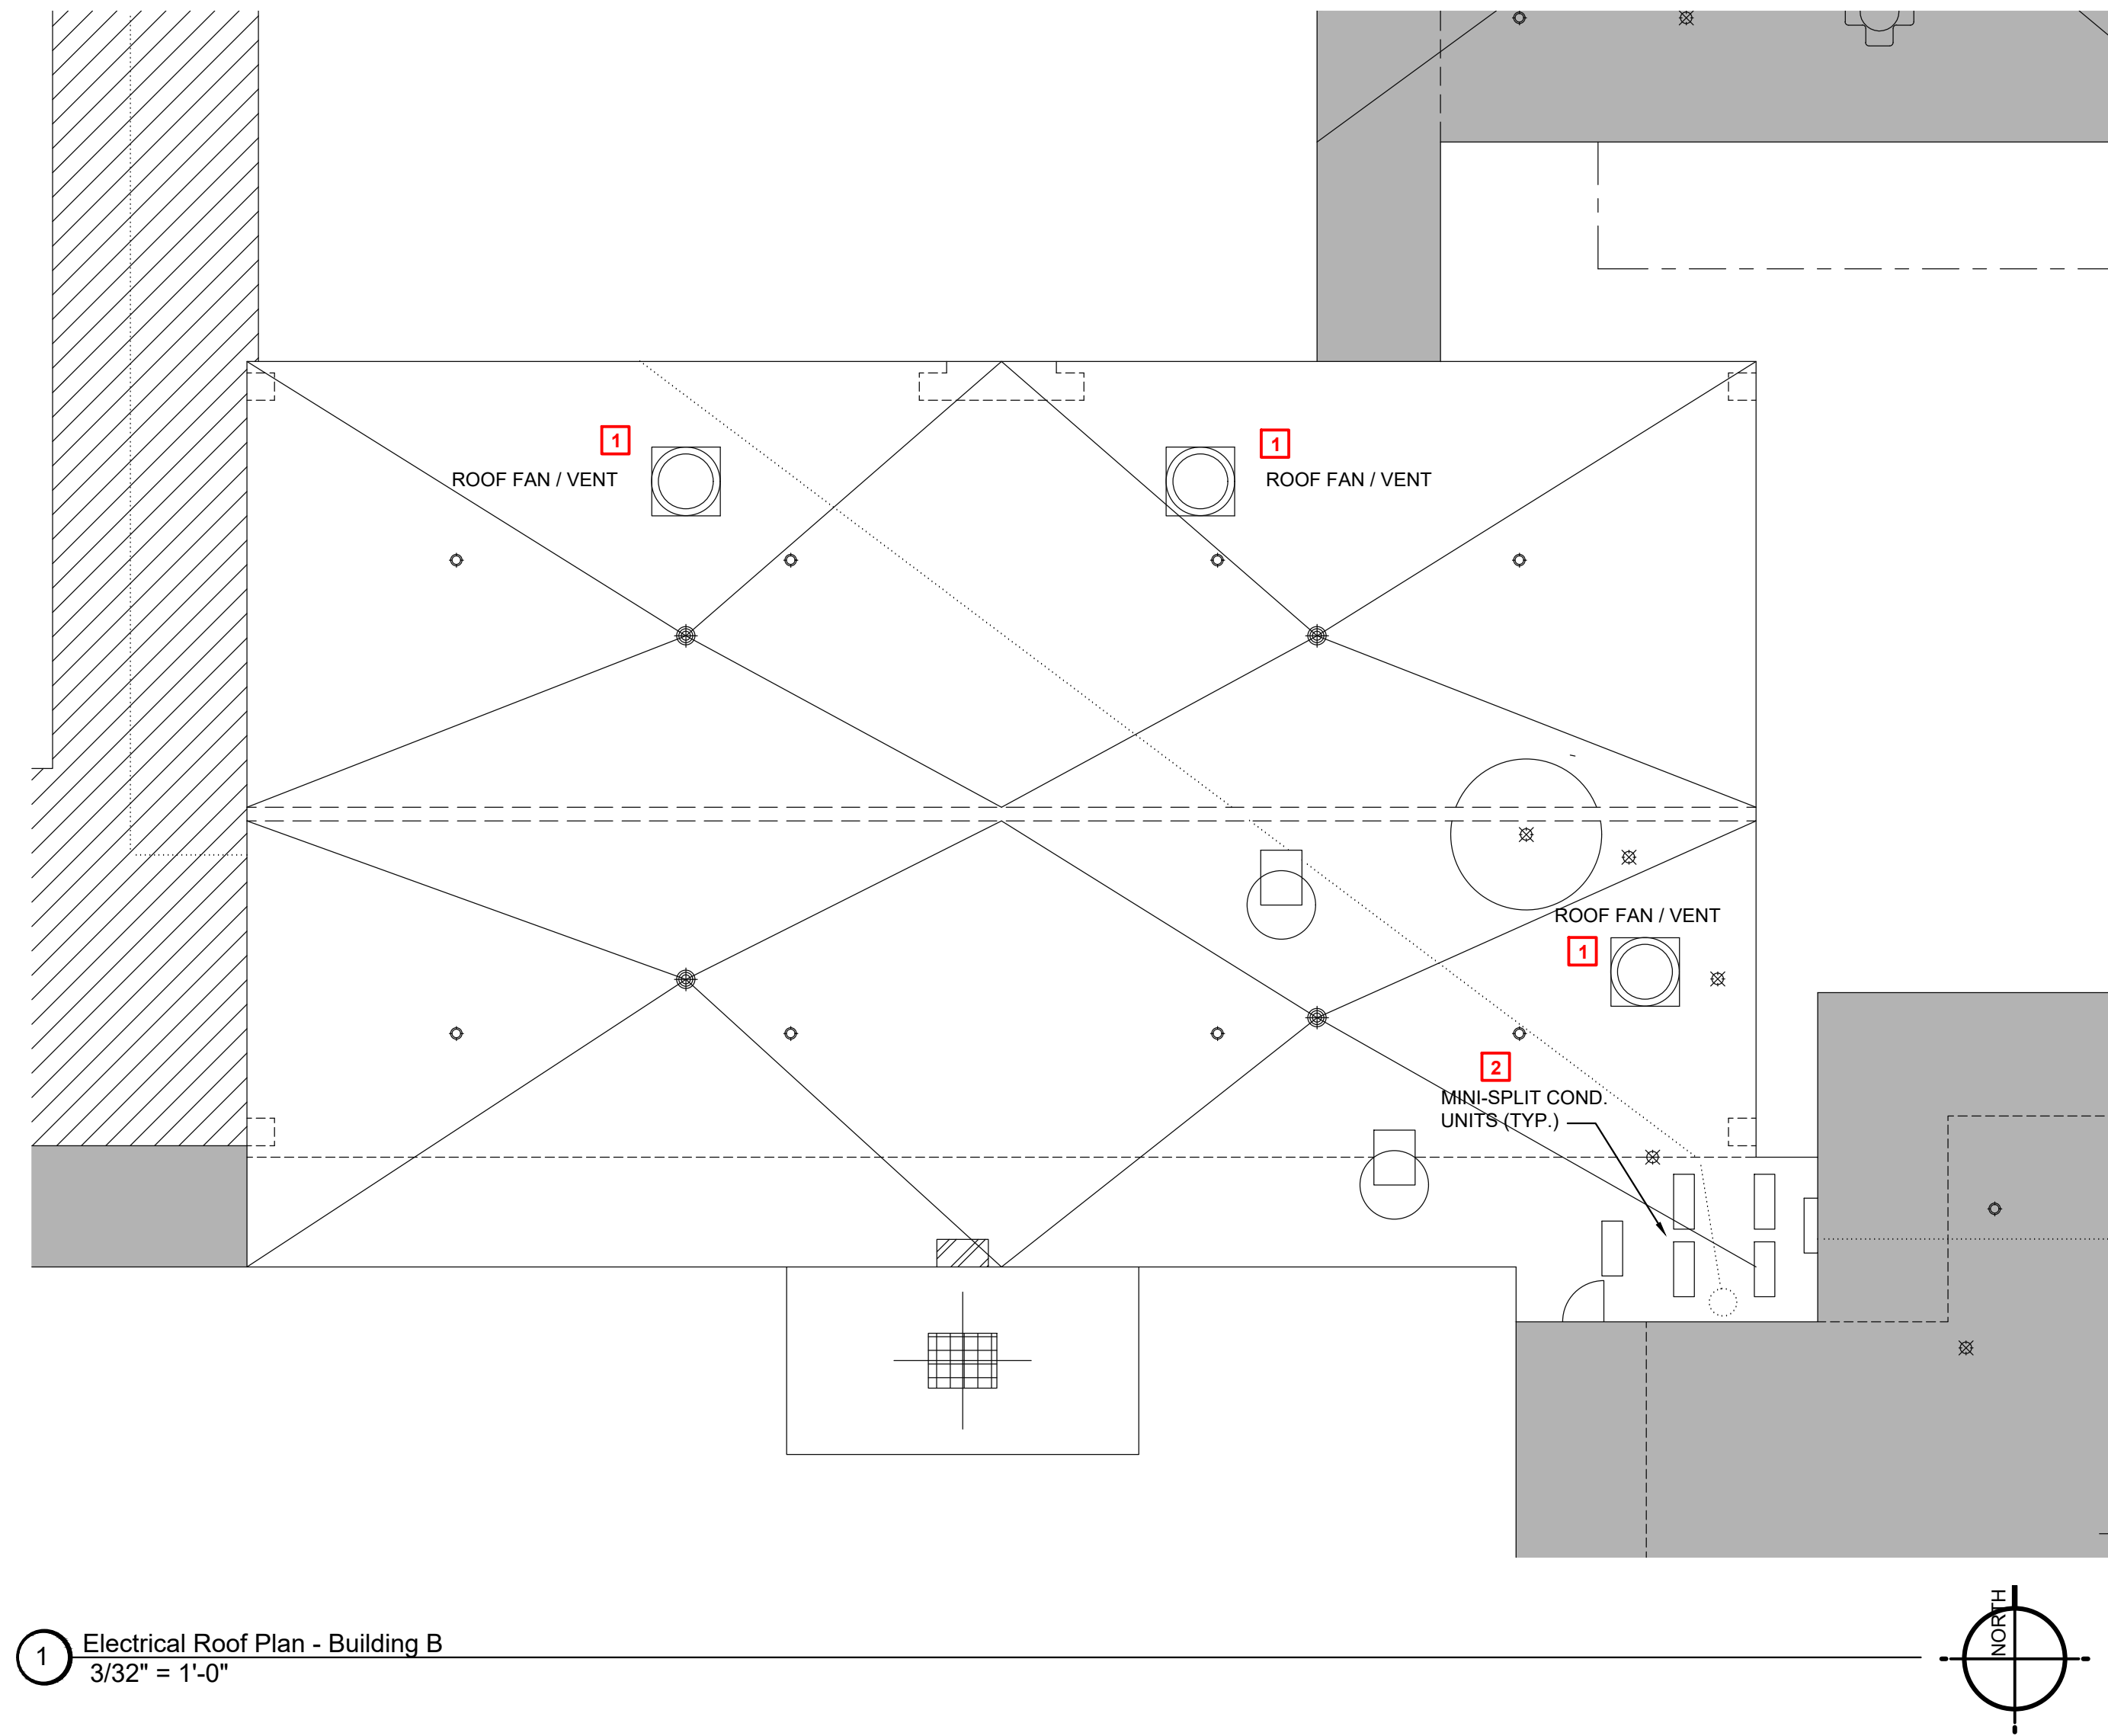
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(A)M1.1
ZONE 1 - BUILDING A
MECHANICAL PLANS

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1 Electrical Roof Plan - Building B
3/32" = 1'-0"

GENERAL NOTES:

- A. CONTRACTOR SHALL FIELD VERIFY EXISTING ELECTRICAL EQUIPMENT SIZES IN FIELD PRIOR TO DEMOLITION. COORDINATE ALL SITE VISITS, THROUGH GENERAL CONTRACTOR AND C.P.S.B. CONTRACTOR WEAR REQUIRED PERSONAL PROTECTIVE GEAR (PPE) SPECIFICALLY REQUIRED FOR EACH BUILDING.
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- C. ALL WORK SHALL COMPLY WITH LOCAL, STATE, AND FEDERAL CODES TO THE SATISFACTION OF CODE AUTHORITIES HAVING JURISDICTION.
- E. PRIOR TO DISCONNECTING, AND REMOVING OF ANY ELECTRICAL SERVICES IN THE DESIGNATED AREAS SHOWN, THE CONTRACTOR MUST ENSURE THAT THE SERVICES REMOVED DO NOT AFFECT THE NORMAL OPERATION OF AREAS OUTSIDE THE CONSTRUCTION AREA. COORDINATE WITH OWNER FOR ALL ELECTRICAL SHUT DOWNS AT LEAST 2 WORKING DAYS PRIOR TO WORK.

KEYNOTES TO SHEET:

- 1. CONTRACTOR SHALL REMOVE EXISTING ROOF MOUNTED HOOD/FAN AND AND INSTALL ON NEW CURB. RECONNECT EXISTING ELECTRICAL AFTER ROOFING IS COMPLETE.
- 2. EXISTING CONDENSING UNIT SHALL BE TEMPORARILY SUPPORTED AND PROTECTED DURING THE RE-ROOFING PROJECT. PROTECT ELECTRICAL AND VERIFY PROPER OPERATION AFTER ROOFING COMPLETE.

ROOFING SYMBOL LEGEND

- EXISTING SKYLIGHT
- ONE-WAY ROOF VENT
- ROOF DRAIN
- ROOF PIPING PENETRATION
- ROOF FAN / VENT
- ROOF FAN / VENT
- DOWNSPOUT
- MISC MEP
- CONDUIT/PIPING RUNS
- EXPANSION JOINT

NOTE:
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STATE OF LOUISIANA
DAVID B. STELLY
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06/28/2024
PROFESSIONAL
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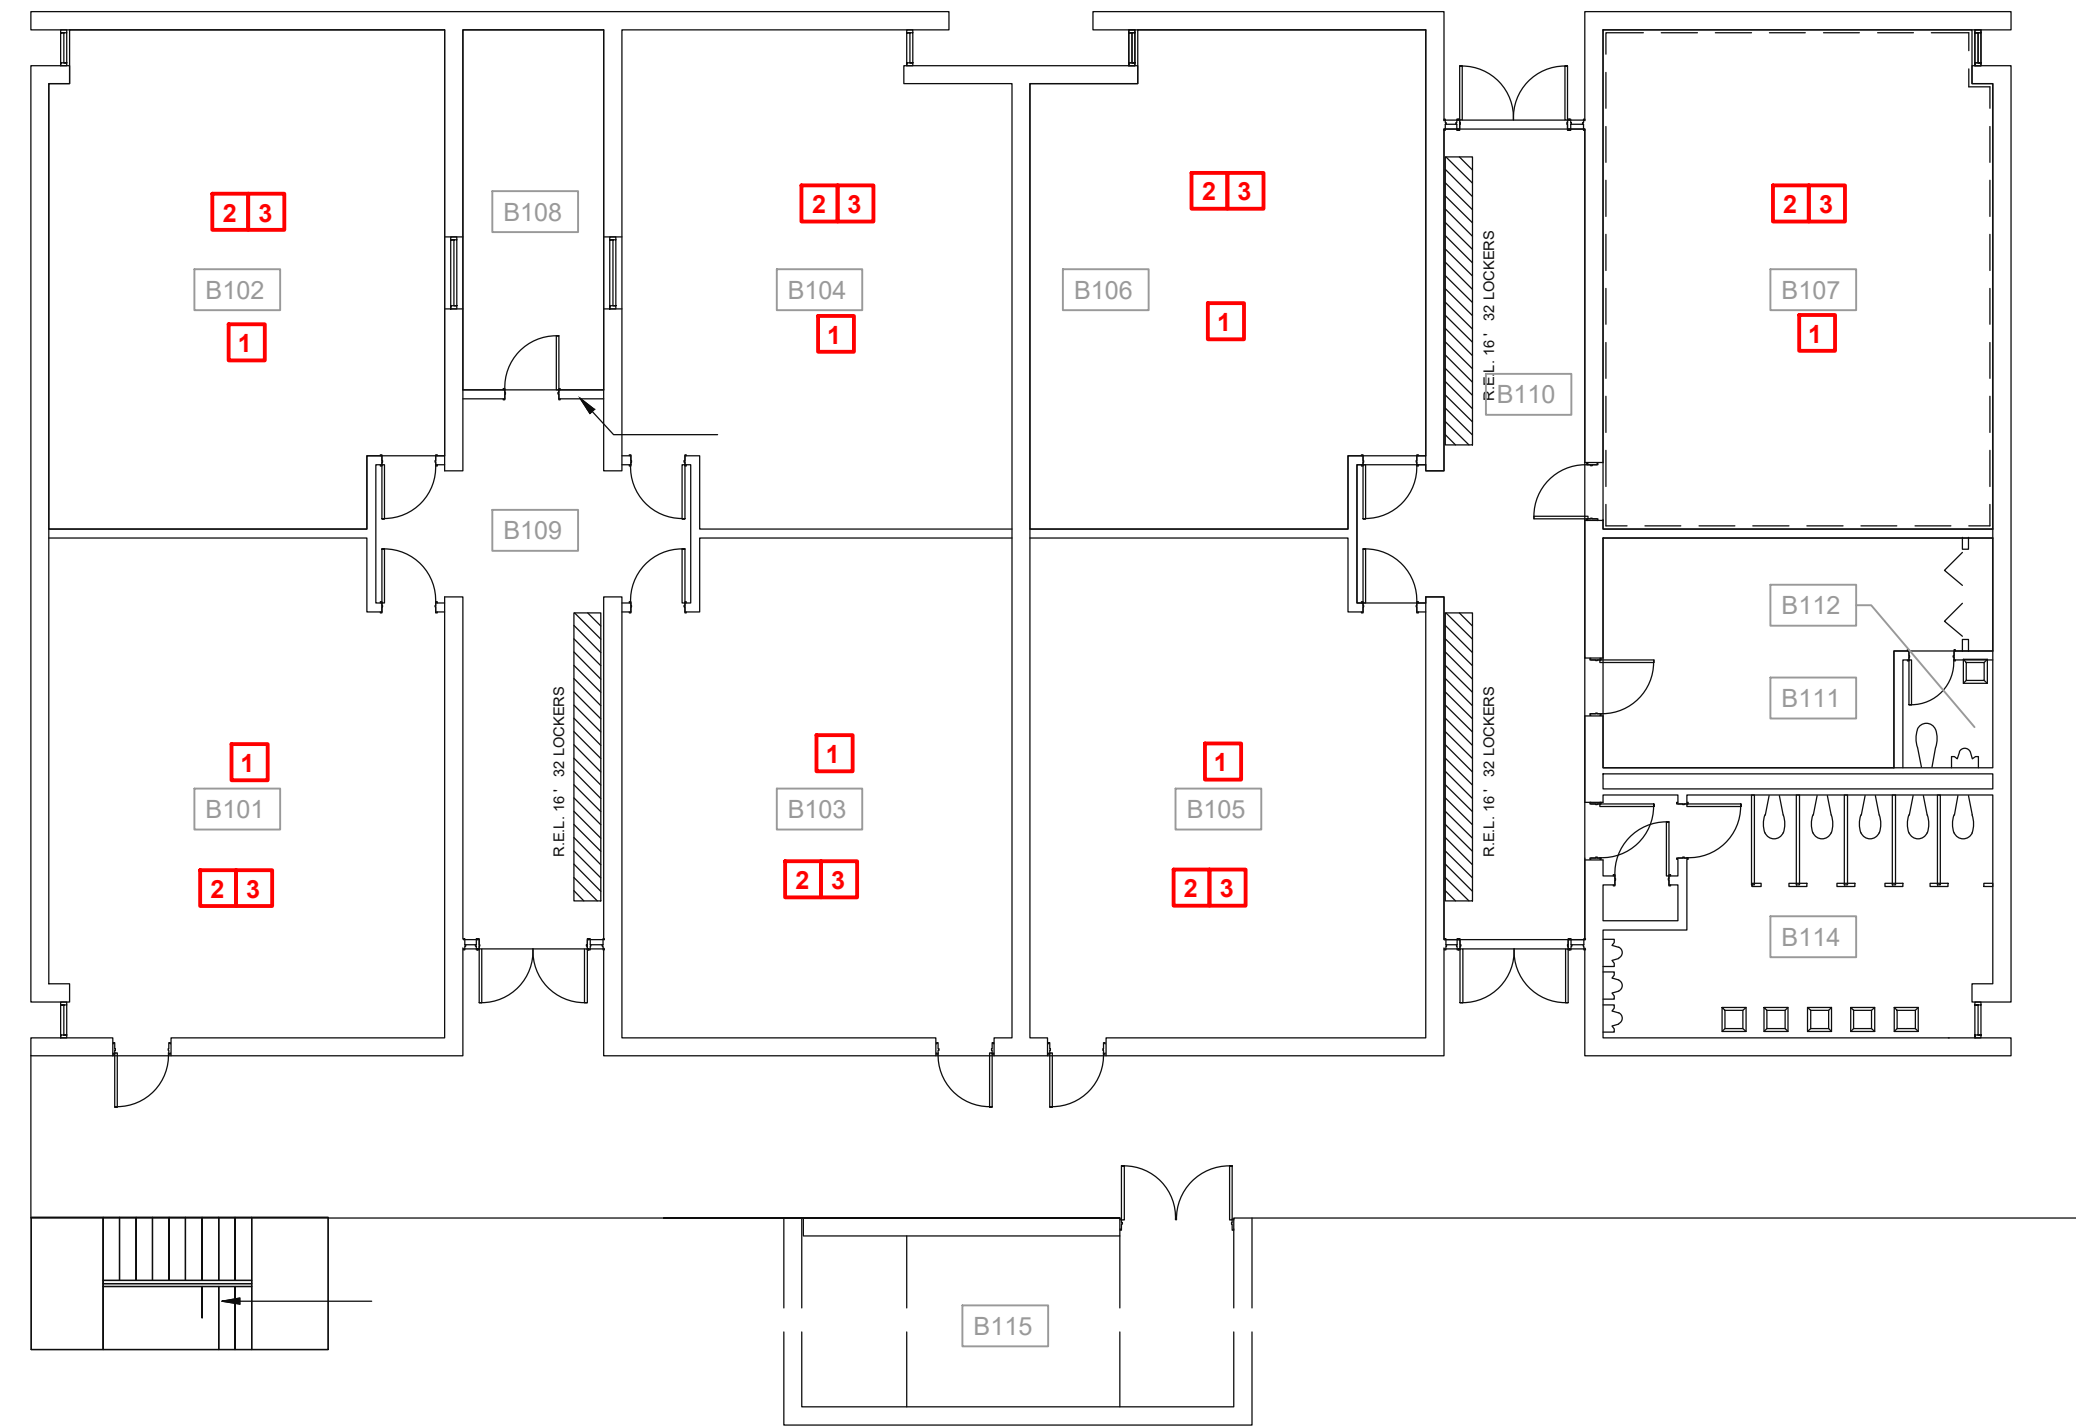
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SHEET NUMBER
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BUILDING B
ROOF PLAN




1 Zone 1 - Building B First Floor - Electrical Plan
1/12" = 1'-0"

GENERAL NOTES:

- A. CONTRACTOR SHALL NOTIFY ARCHITECT/ENGINEER OF ANY DISCREPANCIES IDENTIFIED IN THE FIELD PRIOR TO ORDERING LIGHT FIXTURES.
- B. THE INTENT OF THE PLAN IS FOR EXISTING CIRCUITING TO REMAIN AND BE RE-USED. ALL EXISTING POWER WIRING SHALL BE PROTECTED DURING DEMOLITION AND AVAILABLE FOR RE-USE. ANY WIRING REMOVED OR DAMAGED DURING CONSTRUCTION SHALL BE REPLACED AT CONTRACTOR'S EXPENSE.
- C. ALL WORK SHALL COMPLY WITH LOCAL, STATE, AND FEDERAL CODES TO THE SATISFACTION OF CODE AUTHORITIES HAVING JURISDICTION.
- D. ALL WORK SHALL COMPLY WITH THE REQUIREMENTS OF THE 2020 EDITION OF NEC.
- E. PRIOR TO DISCONNECTING AND REMOVING OF ANY ELECTRICAL SERVICES IN THE DESIGNATED AREAS SHOWN, THE CONTRACTOR MUST ENSURE THAT THE SERVICES REMOVED DO NOT AFFECT THE NORMAL OPERATION OF AREAS OUTSIDE THE CONSTRUCTION AREA. COORDINATE WITH OWNER FOR ALL ELECTRICAL SHUT DOWNS AT LEAST 2 WORKING DAYS PRIOR TO WORK.
- F. EXISTING LIGHTING THROUGHOUT THE BUILDING HAS BEEN REPLACED BY THE OWNER IN A PREVIOUS PROJECT. IF THERE ARE SPACES WHERE THE DRAWINGS REQUIRE CEILING REPLACEMENT, THE CONTRACTOR WILL BE REQUIRED TO REMOVE THE EXISTING FIXTURES, PROPERLY STORE THEM ONSITE (CONTAINER OR OTHER OWNER APPROVED AREA), THEN RE-INSTALL FOLLOWING REPLACEMENT OF CEILINGS WITHIN A GIVEN SPACE.
- G. ALL EXISTING LOW VOLTAGE WIRING SHALL BE PROTECTED DURING DEMOLITION AND AVAILABLE FOR RE-USE. ANY WIRING REMOVED OR DAMAGED DURING CONSTRUCTION SHALL BE REPLACED AT CONTRACTOR'S EXPENSE.

KEYNOTES:

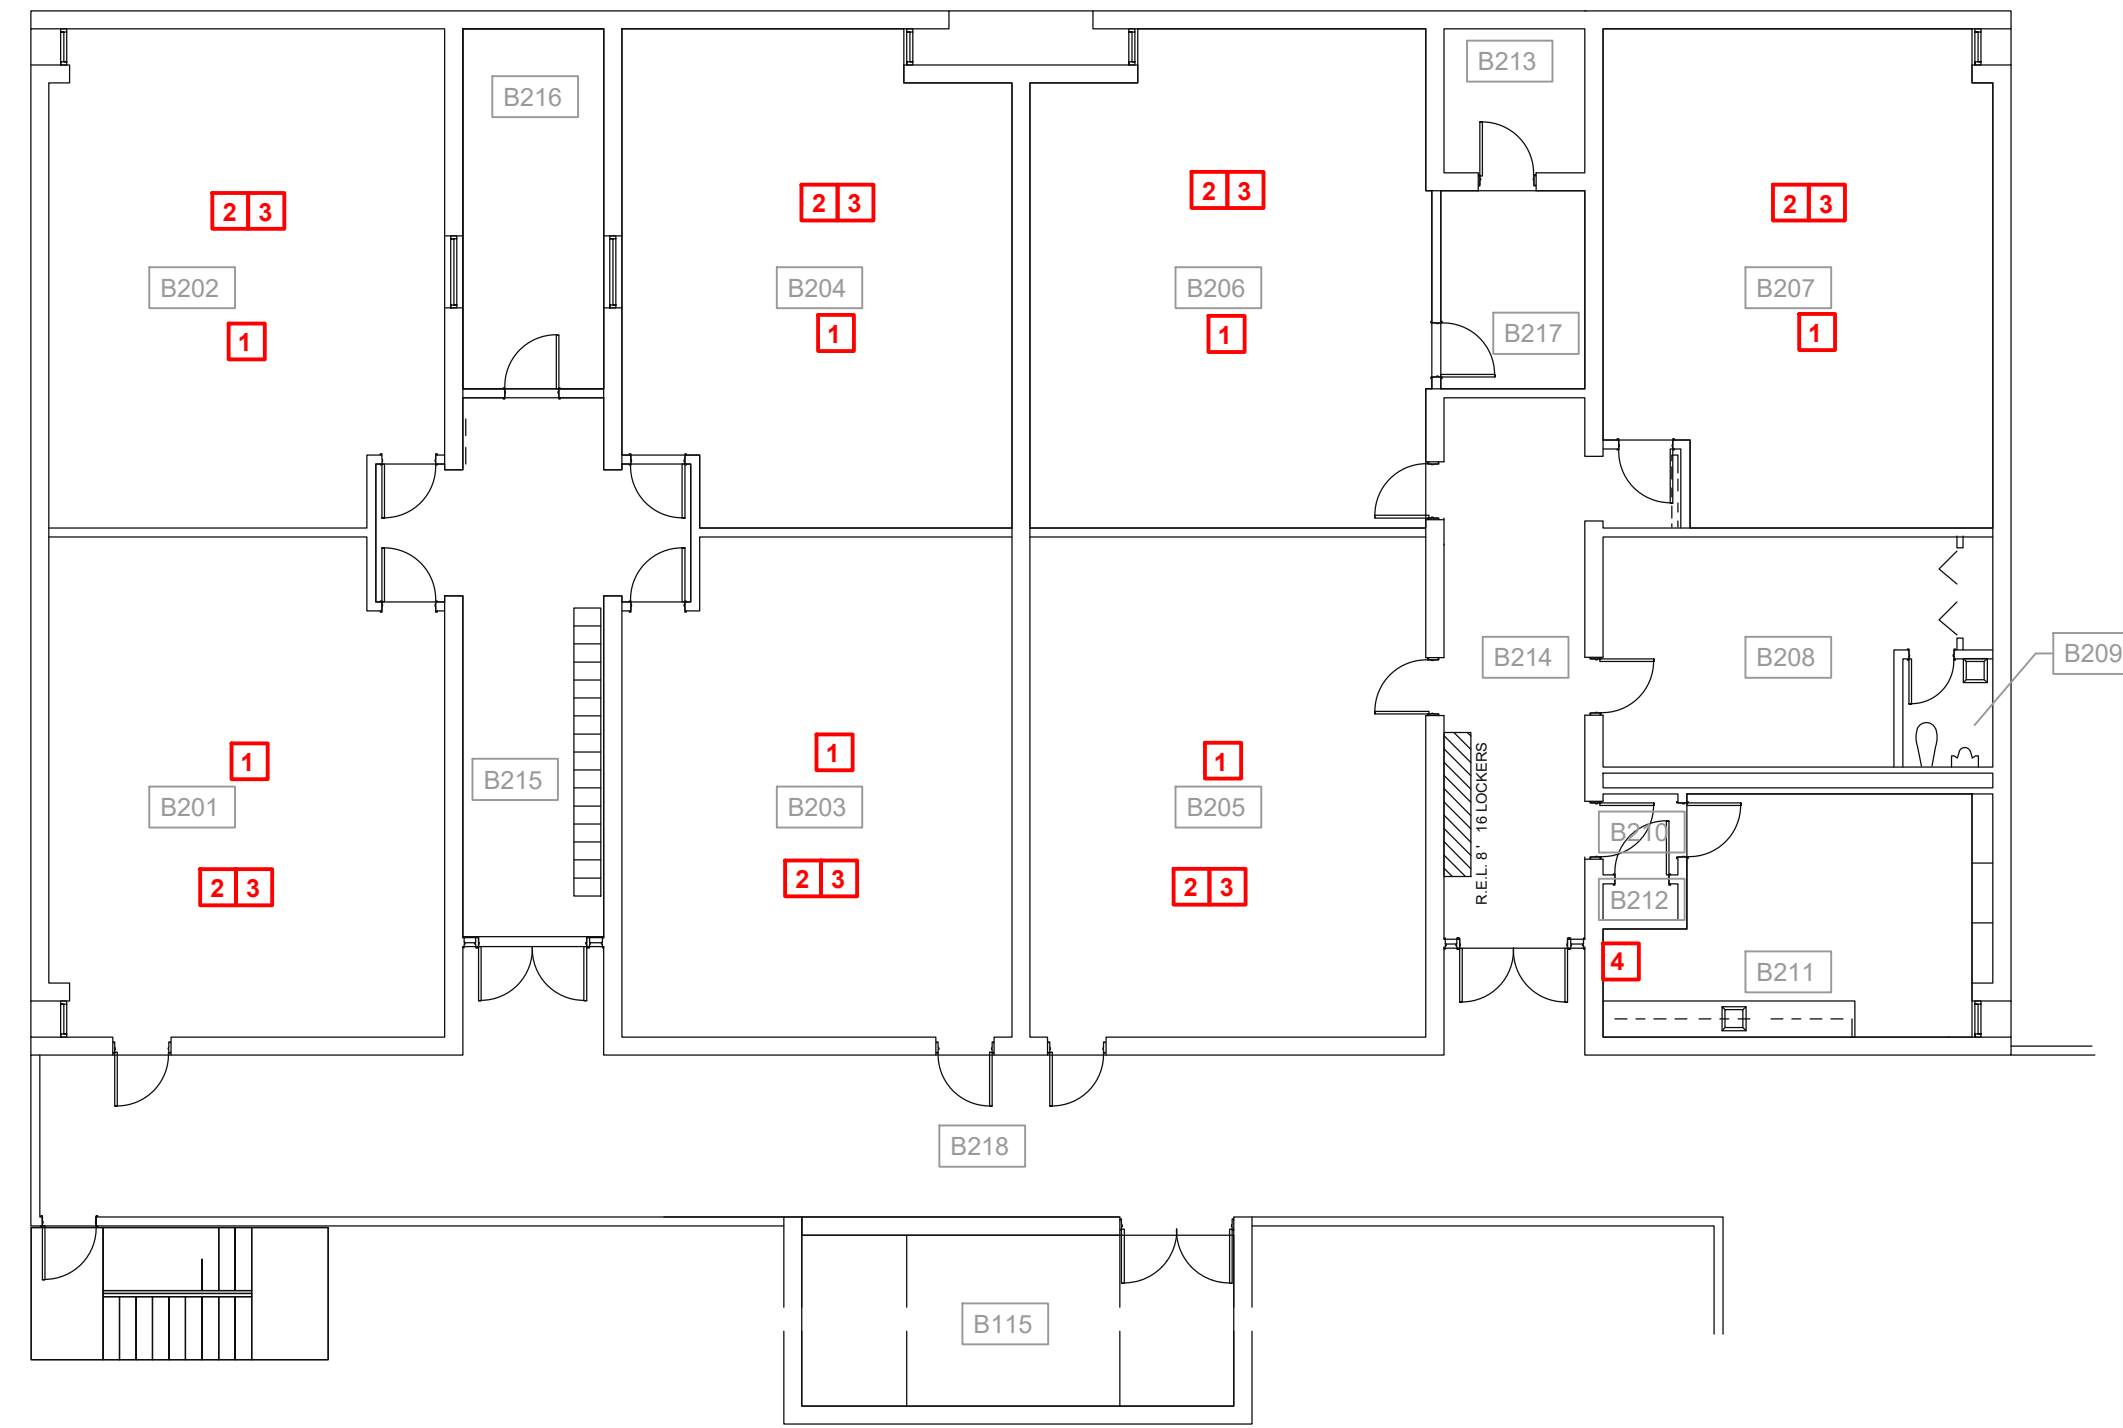- 1. ANY EXISTING CAMERAS OR WIRELESS ACCESS POINTS TO BE REMOVED DURING CONSTRUCTION SHALL BE COORDINATED WITH CPSB IT DEPARTMENT. DEVICES SHALL BE LABELED AND STORED FOR RE-INSTALLATION. CONTRACTOR IS RESPONSIBLE FOR ANY CUT OR REMOVED COMMUNICATIONS CABLING.
- 2. ANY EXISTING FIRE ALARM DEVICES TO BE REMOVED DURING CONSTRUCTION SHALL BE COORDINATED WITH SYLVAN SOUND. DEVICES SHALL BE LABELED AND STORED FOR RE-INSTALLATION. CONTRACTOR IS RESPONSIBLE FOR ANY CUT OR REMOVED FIRE ALARM WIRING.
- 3. ANY EXISTING INTERCOM DEVICES TO BE REMOVED DURING CONSTRUCTION SHALL BE COORDINATED WITH SYLVAN SOUND. DEVICES SHALL BE LABELED AND STORED FOR RE-INSTALLATION. CONTRACTOR IS RESPONSIBLE FOR ANY CUT OR REMOVED INTERCOM WIRING.
- 4. EXISTING LOCATION OF IT RACK. CONTRACTOR IS RESPONSIBLE FOR PROTECTING IT RACK, EQUIPMENT, AND WIRING DURING CONSTRUCTION. IT RACK SHALL REMAIN OPERATIONAL THROUGHOUT CONSTRUCTION UNLESS APPROVED BY CPSB IT FOR IT TO BE POWERED DOWN. PROVIDE COVER FOR RACK TO MINIMIZE DUST AND DEBRIS WHILE AT THE SAME TIME ALLOWING COOLING AND PROPER AIRFLOW.




2 Zone 1 - Building B Second Floor - Mechanical Plan
1/12" = 1'-0"

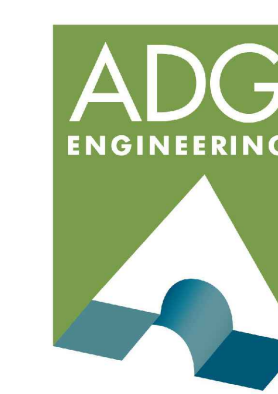TYPICAL EXISTING CLASSROOM LIGHTING

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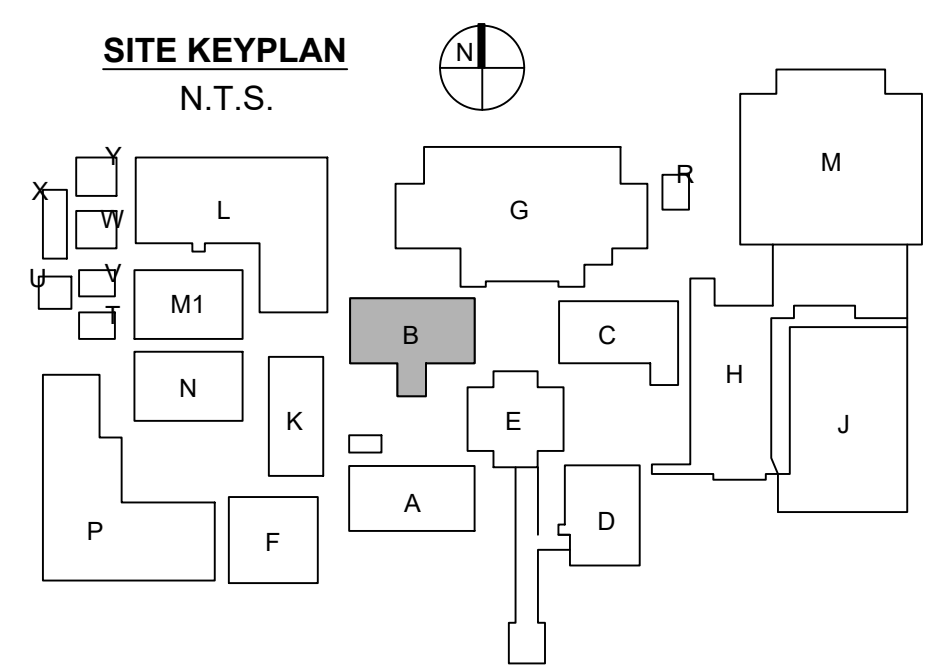
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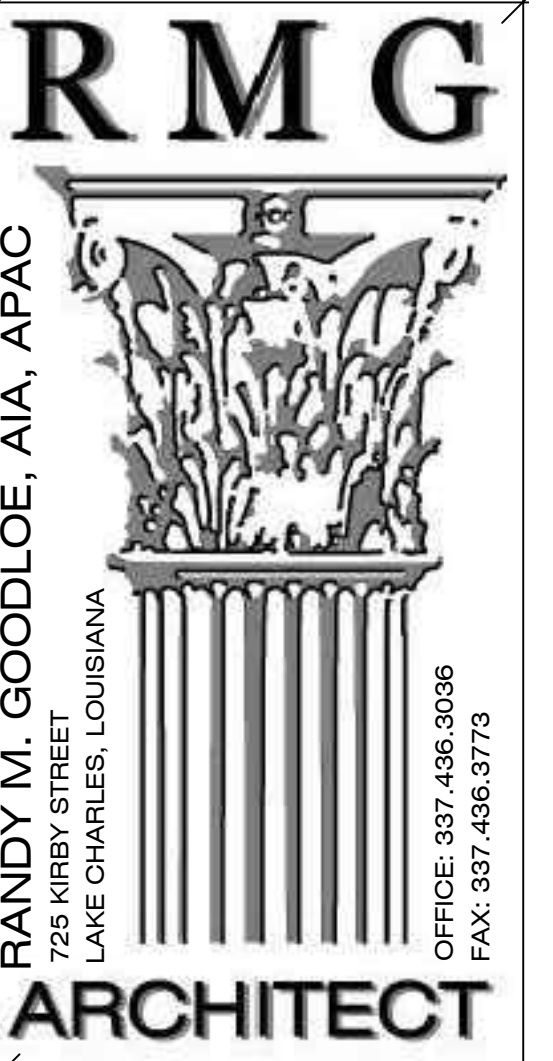


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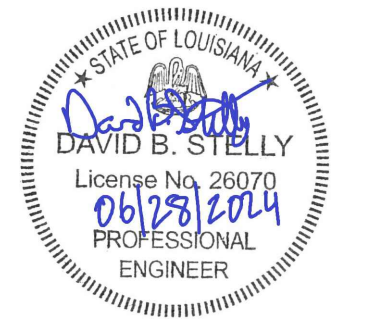
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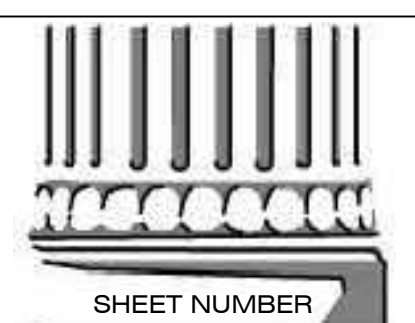


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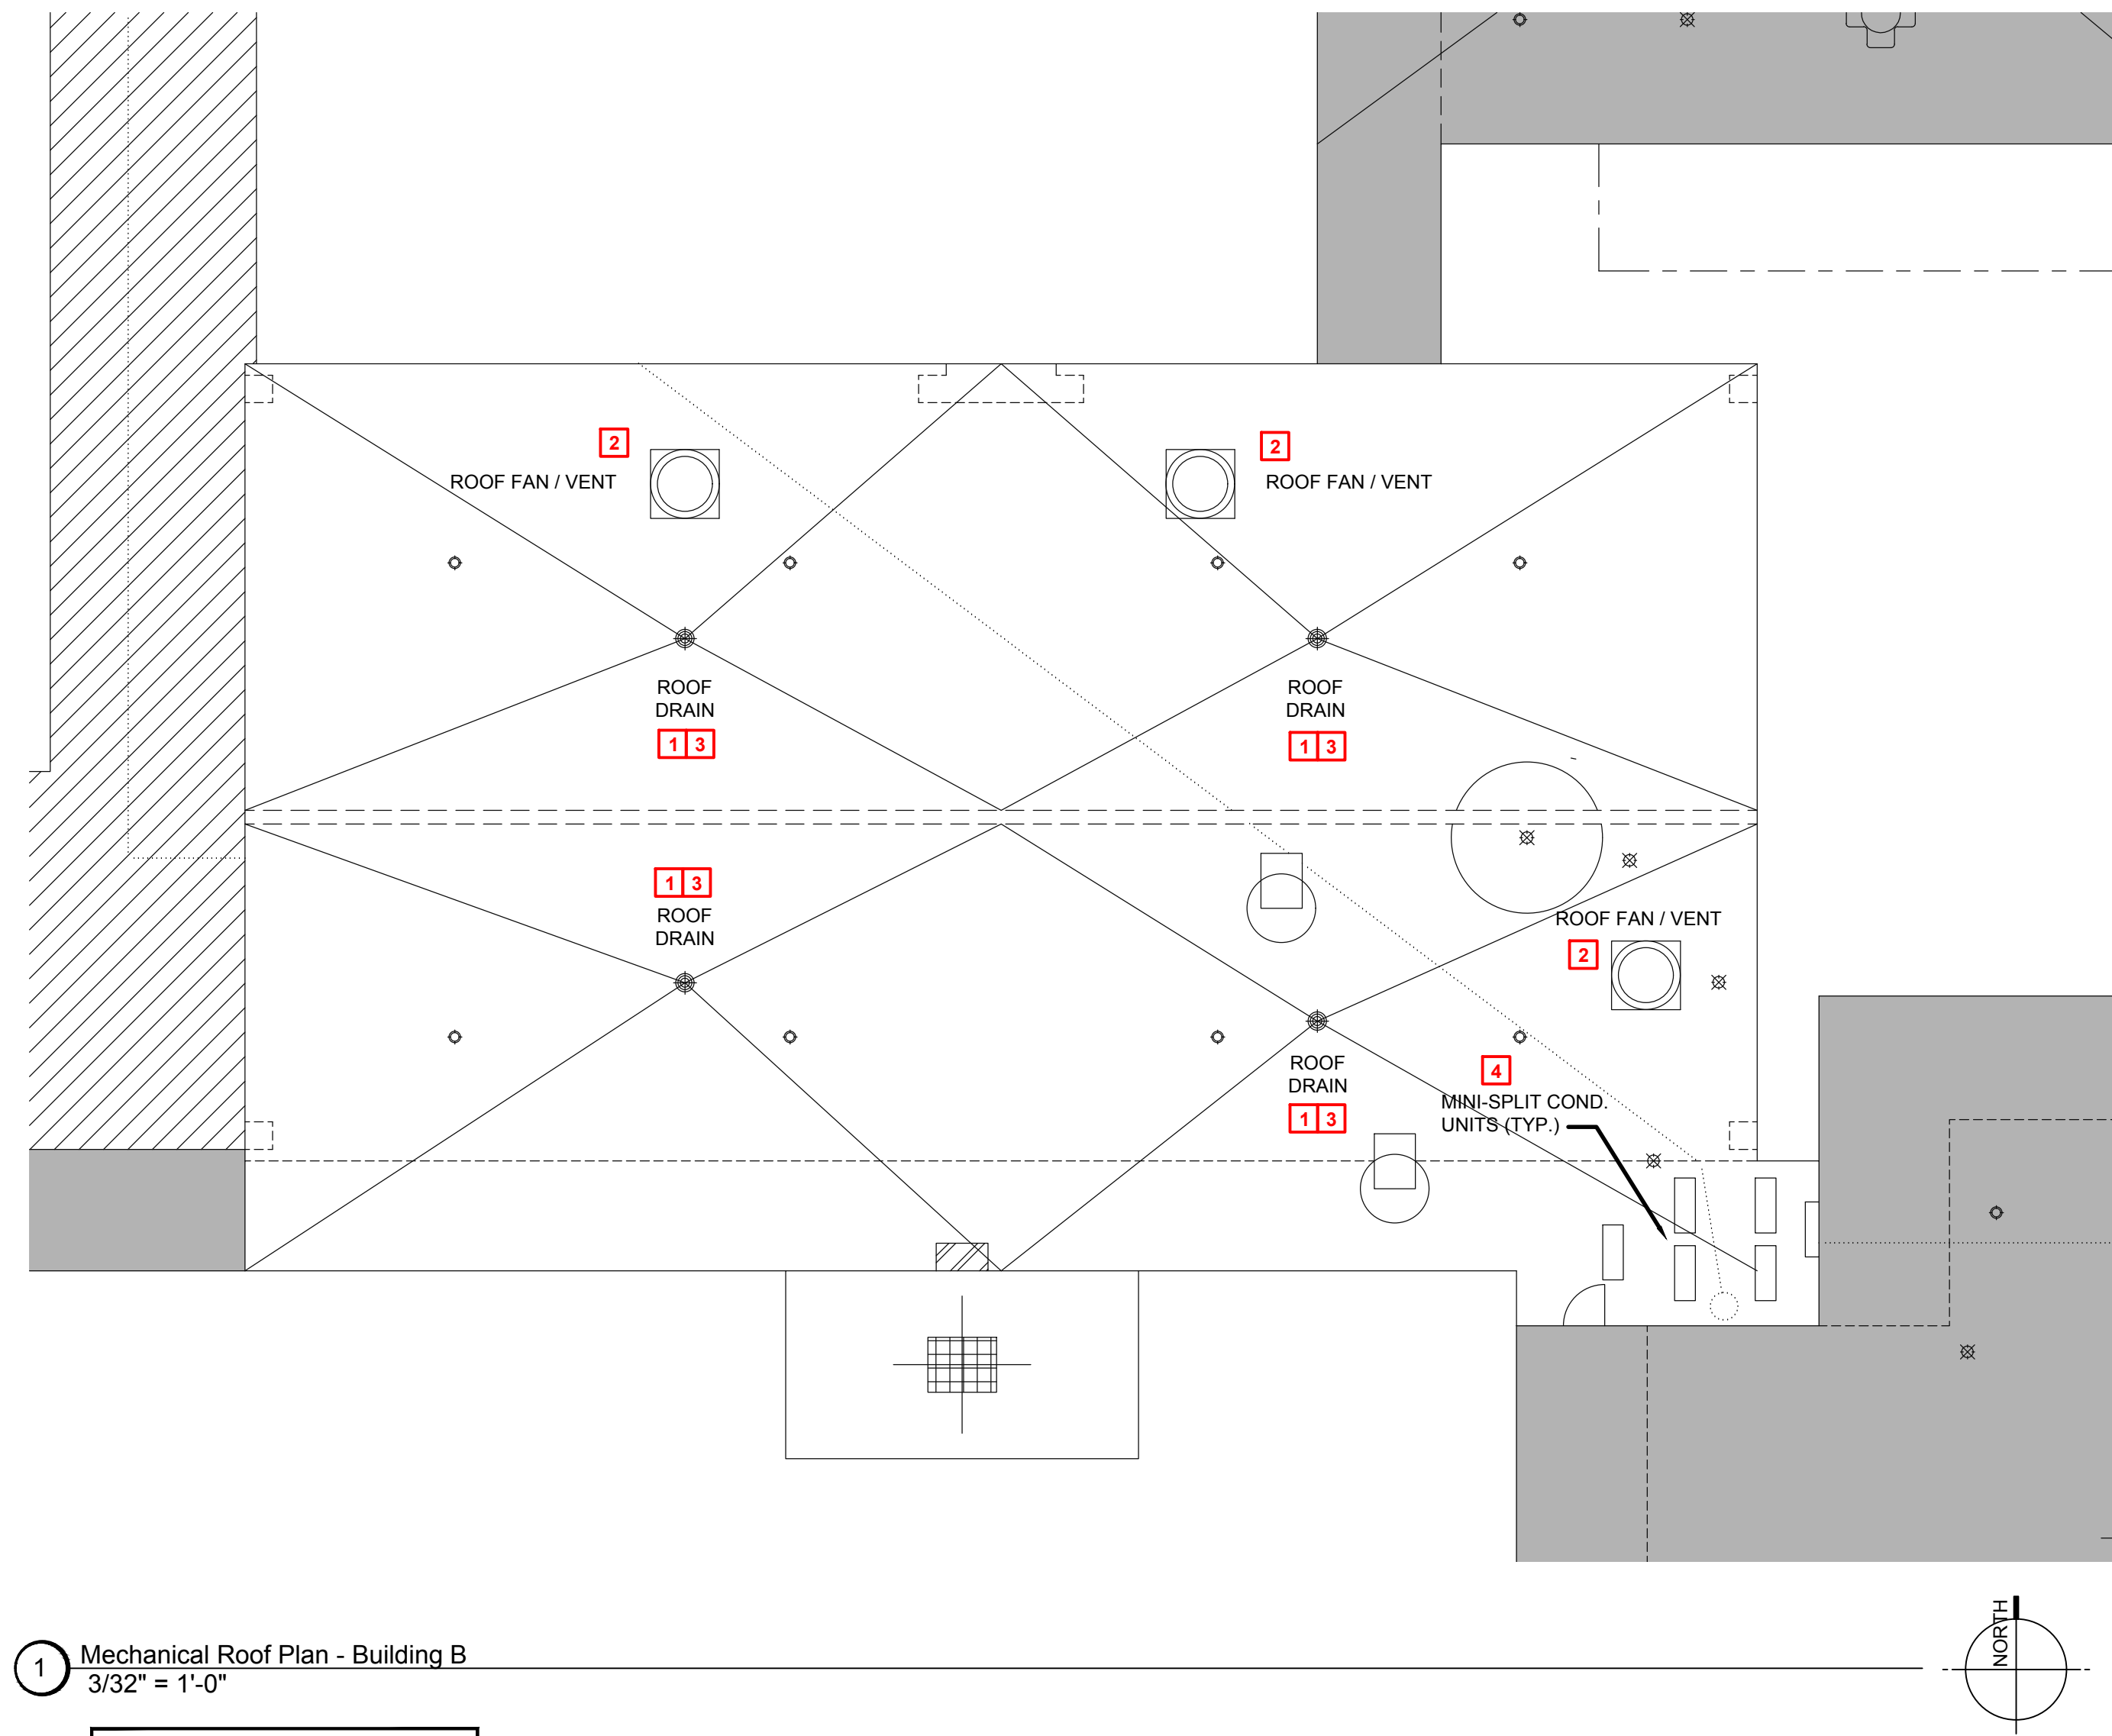
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FOR ALL DIMENSIONS.

GENERAL NOTES:

- A. CONTRACTOR SHALL FIELD VERIFY EXISTING EQUIPMENT TAGS (WHERE POSSIBLE) IN FIELD PRIOR TO DEMOLITION. COORDINATE ALL SITE VISITS, THROUGH GENERAL CONTRACTOR AND C.P.S.B.. CONTRACTOR WEAR REQUIRED PERSONAL PROTECTIVE GEAR (PPE) SPECIFICALLY REQUIRED FOR EACH BUILDING.
- B. CONTRACTOR SHALL NOTIFY ARCHITECT/ENGINEER OF ANY DISCREPANCIES IDENTIFIED IN THE FIELD PRIOR TO FABRICATING DUCTWORK OR ORDERING EQUIPMENT.
- C. CONTRACTOR SHALL PROVIDE TESTING AND BALANCING OF ALL HVAC SYSTEMS WHICH WERE REPLACED, MODIFIED AND/OR CLEANED.
- D. ALL WORK SHALL COMPLY WITH LOCAL, STATE, AND FEDERAL CODES TO THE SATISFACTION OF CODE AUTHORITIES HAVING JURISDICTION.
- E. ALL WORK SHALL COMPLY WITH THE REQUIREMENTS OF NFPA 90A & 101, THE CLEAN AIR ACT AND THE AMERICANS WITH DISABILITIES ACT.
- F. PRIOR TO DRAINING, DISCONNECTING, AND REMOVING OF ANY SERVICES IN THE DESIGNATED AREAS SHOWN, THE CONTRACTOR MUST ENSURE THAT THE SERVICES REMOVED DO NOT AFFECT THE NORMAL OPERATION OF AREAS OUTSIDE THE CONSTRUCTION AREA.
- G. VERIFY ADEQUATE SPACE AVAILABLE PER MANUFACTURER'S RECOMMENDATIONS, COORDINATE CLEARANCE REQUIREMENTS OF ALL MECHANICAL EQUIPMENT.

KEYNOTES TO SHEET:

1. CONTRACTOR SHALL REMOVE EXISTING ROOF DRAIN AN INSTALLED NEW ROOF DRAIN WITH DOME STRAINER IN SAME LOCATION. THE NEW ROOF DRAIN W/ DOME STRAINER SHALL MATCH THE EXISTING SIZE, STYLE, ETC. OF THE EXISTING THAT IS BEING REPLACED AS PART OF THE RE-ROOFING PROJECT.
2. CONTRACTOR SHALL REMOVE EXISTING ROOF MOUNTED HOOD/FAN AND AND INSTALL ON NEW CURB. NEW CURB SHALL MATCH THE EXISTING SIZE, STYLE, ETC. OF EXISTING CURB. COORDINATE CURB HEIGHT WITH ARCHITECT & GENERAL CONTRACTOR PRIOR ORDERING.
3. ALL EXISTING ROOF DRAIN PIPING SHALL BE FLUSHED TO REMOVE LEAVES, DEBRIS, ETC. ONCE THE NEW ROOF DRAINS ARE INSTALLED.
4. EXISTING CONDENSING UNIT SHALL BE TEMPORARILY SUPPORTED AND PROTECTED DURING THE RE-ROOFING PROJECT. ONCE NEW ROOF IS COMPLETED PERMANENT SUPPORTS/SLEEPERS SHALL BE PROVIDED AS REQUIRED.

ROOFING SYMBOL LEGEND

- EXISTING SKYLIGHT
- ONE-WAY ROOF VENT
- ROOF DRAIN
- ROOF PIPING PENETRATION
- ROOF FAN / VENT
- ROOF FAN / VENT
- DOWNSPOUT
- MISC MEP
- CONDUIT/PIPING RUNS
- EXPANSION JOINT



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Project No. 20300

NOTE:
CONTRACTOR SHALL REVIEW C.P.S.B MANAGEMENT PLANS PRIOR TO ANY DEMOLITION WORK. REPORT ANY SUSPICIOUS ASBESTOS MATERIALS TO ARCHITECT / ENGINEER PRIOR TO DISTURBING SUSPECT MATERIALS

NOTE:
THE HVAC SCOPE OF WORK IS LIMITED TO REPLACING OR REPAIRING THE HVAC SYSTEM BACK TO ITS ORIGINAL CONDITION (LIKE FOR LIKE). THIS PROJECT'S SCOPE OF WORK DOES NOT INCLUDE BRINGING THE EXISTING HVAC SYSTEMS UP TO CODE OR ADDRESSING EXISTING CONDITIONS.

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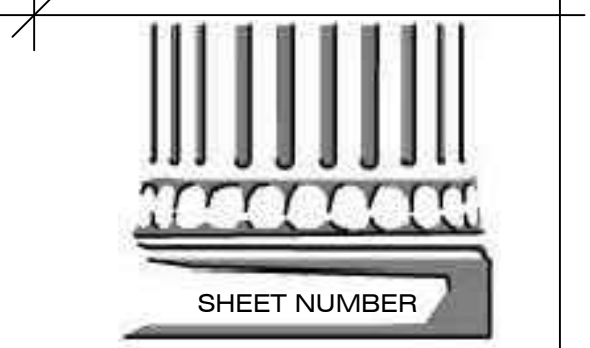


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2200 W. McNEESE ST.
FOR
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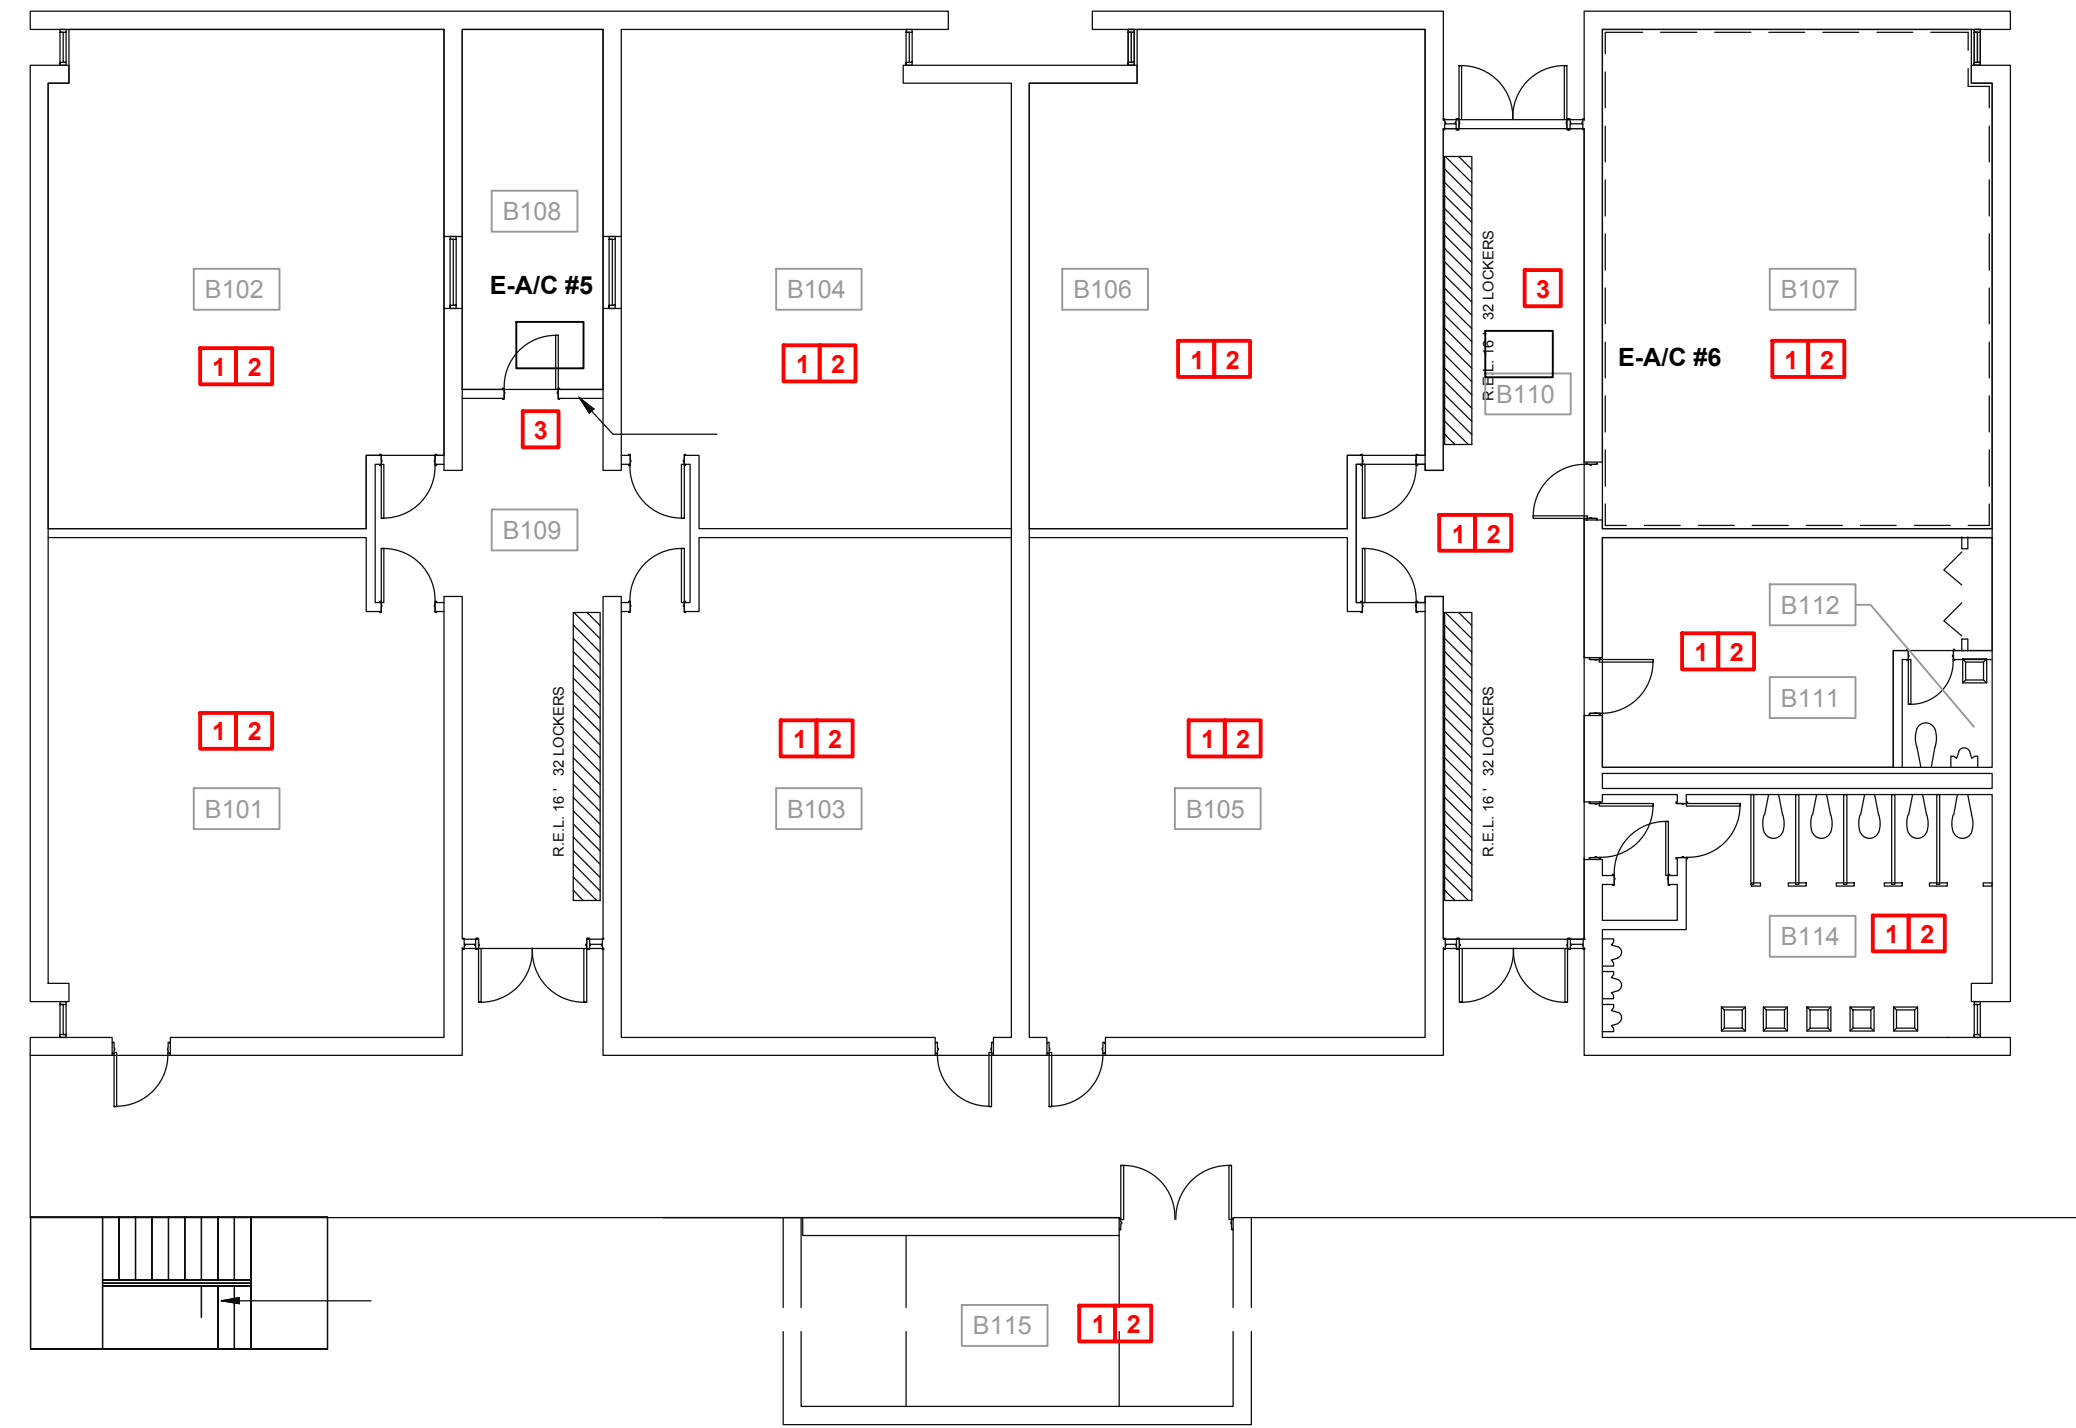
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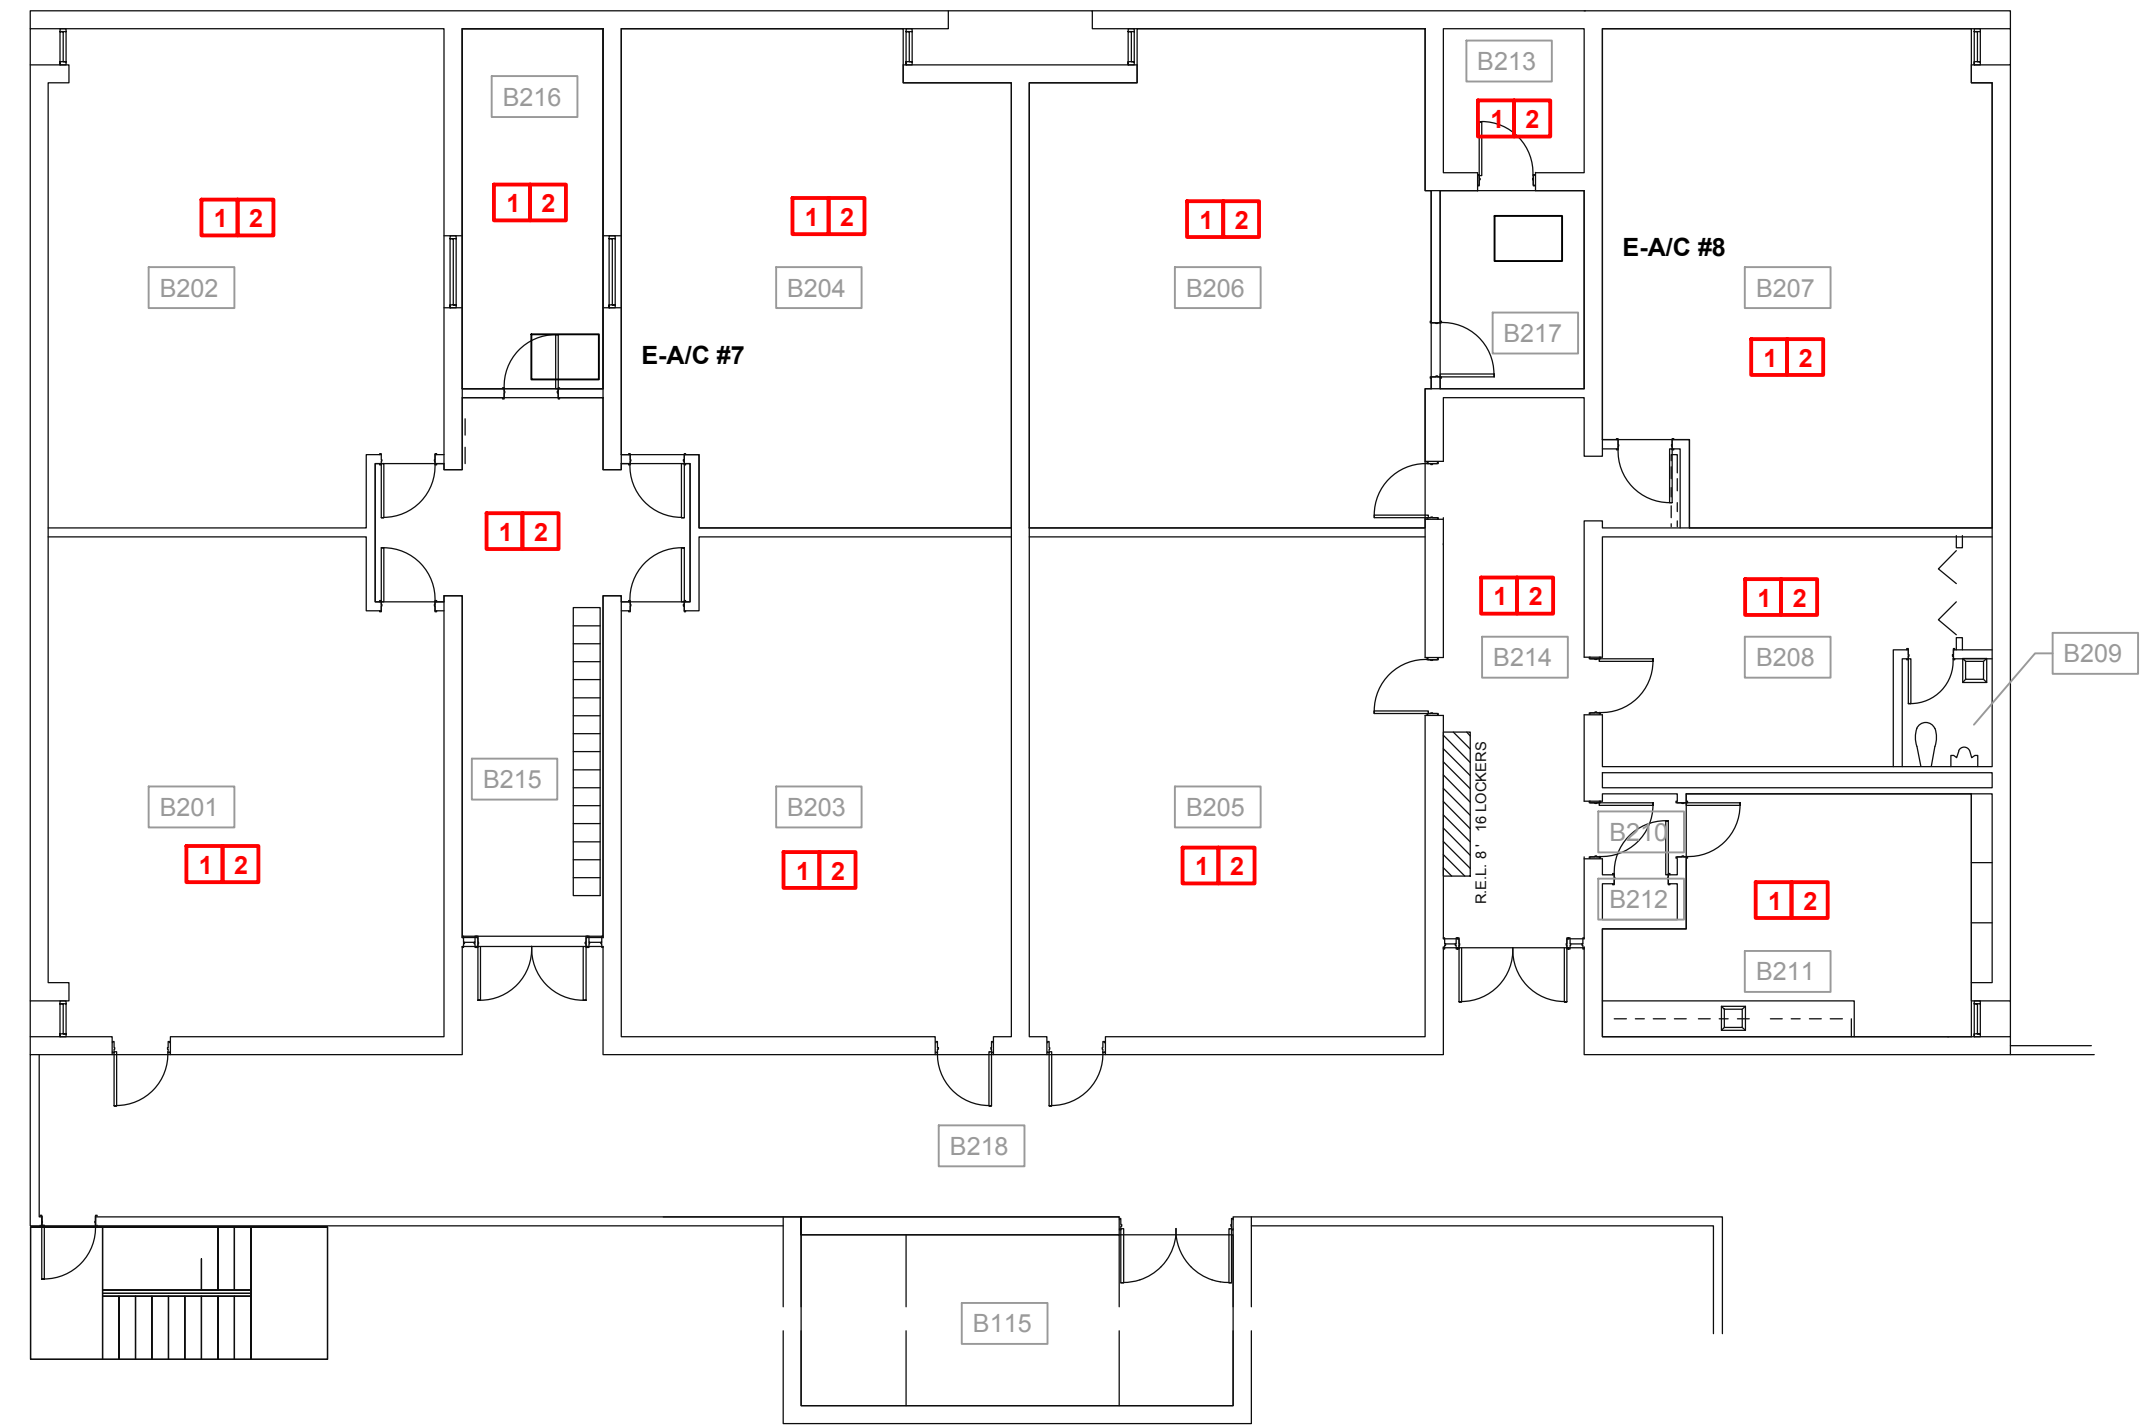


SHEET NUMBER
(B)M0.1
BUILDING B
ROOF PLAN



6 Zone 1 - Building B First Floor - Mechanical Plan
3/32" = 1'-0"

NOTE:
REFER TO ARCHITECTURAL DRAWINGS
FOR ALL DIMENSIONS.



16 Zone 1 - Building B Second Floor - Mechanical Plan
3/32" = 1'-0"

NOTE:
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FOR ALL DIMENSIONS.

GENERAL NOTES:

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- B. CONTRACTOR SHALL NOTIFY ARCHITECT/ENGINEER OF ANY DISCREPANCIES IDENTIFIED IN THE FIELD PRIOR TO FABRICATING DUCTWORK OR ORDERING EQUIPMENT.
- C. CONTRACTOR SHALL PROVIDE TESTING AND BALANCING OF ALL HVAC SYSTEMS WHICH WERE REPLACED, MODIFIED AND/OR CLEANED.
- D. ALL WORK SHALL COMPLY WITH LOCAL, STATE, AND FEDERAL CODES TO THE SATISFACTION OF CODE AUTHORITIES HAVING JURISDICTION.
- E. ALL WORK SHALL COMPLY WITH THE REQUIREMENTS OF NFPA 90A & 101, THE CLEAN AIR ACT AND THE AMERICANS WITH DISABILITIES ACT.
- F. PRIOR TO DRAINING, DISCONNECTING, AND REMOVING OF ANY SERVICES IN THE DESIGNATED AREAS SHOWN, THE CONTRACTOR MUST ENSURE THAT THE SERVICES REMOVED DO NOT AFFECT THE NORMAL OPERATION OF AREAS OUTSIDE THE CONSTRUCTION AREA.
- G. VERIFY ADEQUATE SPACE AVAILABLE PER MANUFACTURER'S RECOMMENDATIONS. COORDINATE CLEARANCE REQUIREMENTS OF ALL MECHANICAL EQUIPMENT.

KEYNOTES TO SHEET:

- 1. NO INTERIOR MECHANICAL (PLUMBING & HVAC) WORK ASSOCIATED WITH THESE SPACES WITHIN THE BUILDING.
- 2. CONTRACTOR SHALL TEMPORARILY SUPPORT AND PROTECT ANY EQUIPMENT, DIFFUSERS, GRILLES, ETC. IN OR ABOVE CEILINGS OF THESE SPACES DURING THE REMOVAL AND INSTALLATION OF NEW CEILINGS. REFER TO ARCHITECTURAL PLANS FOR THOSE LOCATIONS.
- 3. EXISTING FAN COIL UNIT TO REMAIN AND CLEANED PER THE SPECIFICATIONS. REMOVE AND REPLACE EXISTING AIR HANDLING UNIT INTERIOR LINER AND CLEAN INTERIOR OF UNIT INCLUDING COILS.

NOTE:
CONTRACTOR SHALL REVIEW C.P.S.B MANAGEMENT PLANS PRIOR TO ANY DEMOLITION WORK. REPORT ANY SUSPICIOUS ASBESTOS MATERIALS TO ARCHITECT / ENGINEER PRIOR TO DISTURBING SUSPECT MATERIALS

NOTE: THESE DRAWINGS ARE COPIES OF THE ORIGINAL CONSTRUCTION DOCUMENTS WITH NOTES ADDED TO DESCRIBE THE SCOPE OF WORK FOR THE HURRICANE LAURA REPAIR PROJECT. CONTRACTOR SHALL NOTIFY ARCHITECT/ENGINEER OF ANY DISCREPANCIES IDENTIFIED IN FIELD PRIOR TO ORDERING EQUIPMENT OR INSTALLATION.


NOTE: THE HVAC SCOPE OF WORK IS LIMITED TO REPLACING OR REPAIRING THE HVAC SYSTEM BACK TO ITS ORIGINAL CONDITION (LIKE FOR LIKE) IN MOST CIRCUMSTANCES. THIS PROJECT'S SCOPE OF WORK DOES NOT INCLUDE BRINGING ALL THE EXISTING HVAC SYSTEMS UP TO CODE OR ADDRESSING EXISTING CONDITIONS. ALTHOUGH ALL WORK MUST COMPLY WITH FEMA CONSENSUS-BASED, "LATEST PUBLISHED EDITIONS" OF CODES NOT NECESSARILY THOSE CODES ADOPTED BY THE LOCAL MUNICIPALITY.



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SITE KEYPLAN
N.T.S.



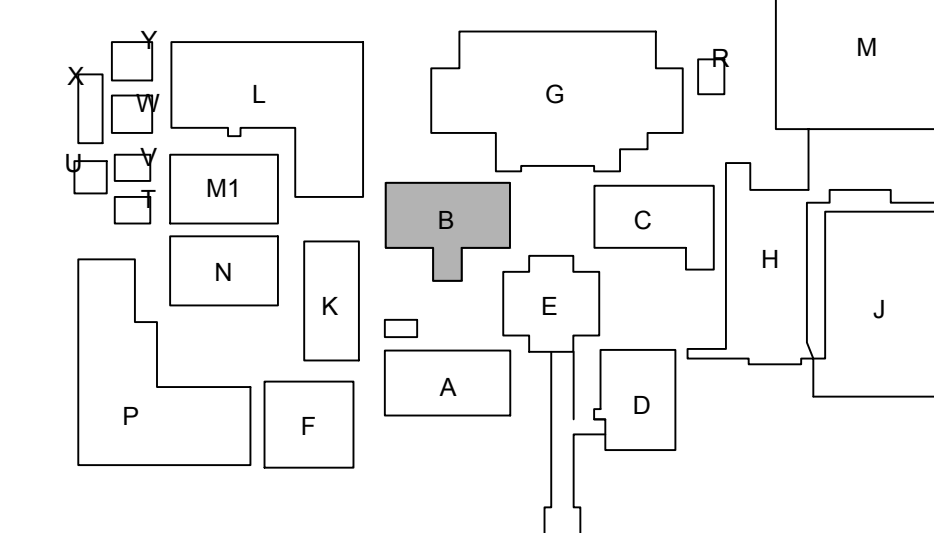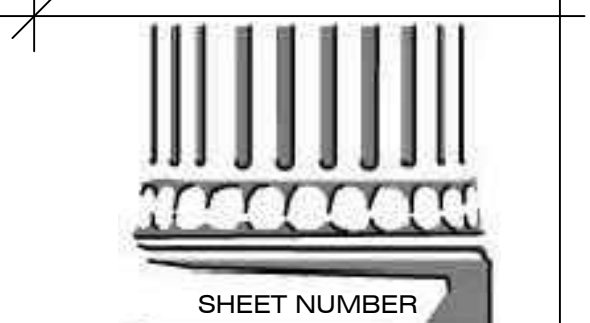
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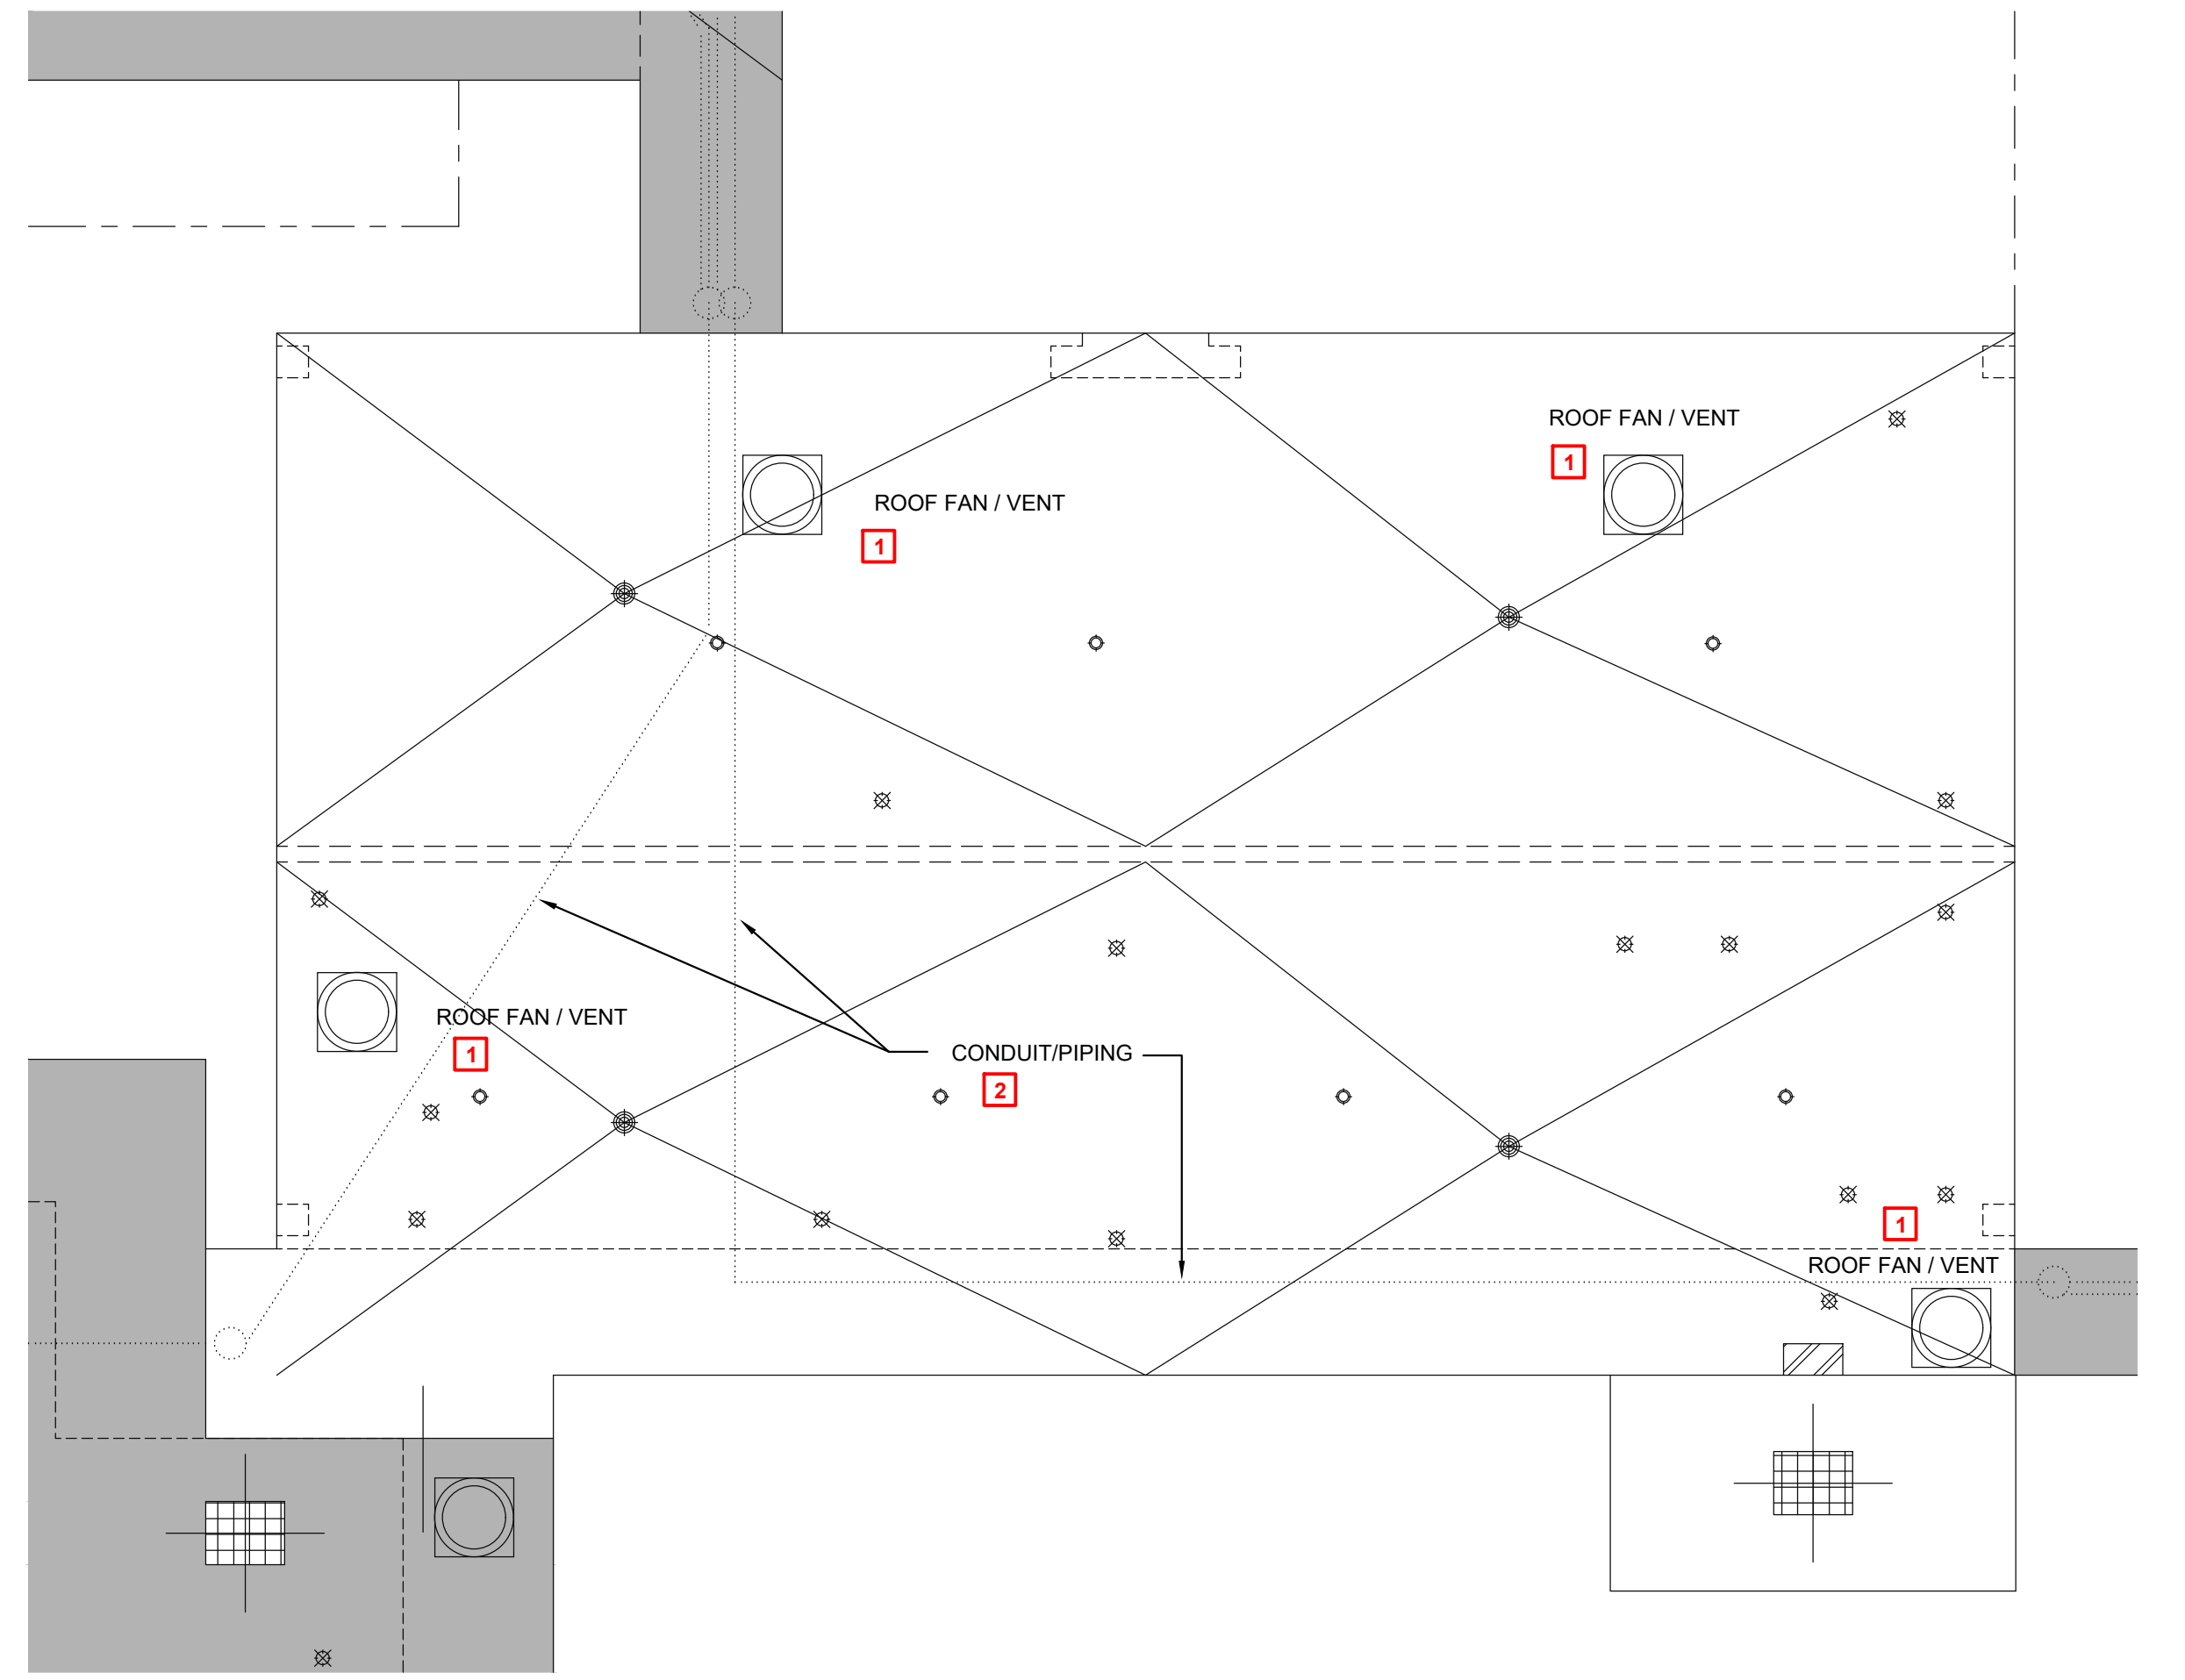
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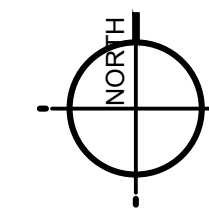


(B)M1.1

ZONE 1 - BUILDING B
MECHANICAL PLANS



1 Electrical Roof Plan - Building C
3/32" = 1'-0"



GENERAL NOTES:

- A. CONTRACTOR SHALL FIELD VERIFY EXISTING ELECTRICAL EQUIPMENT SIZES IN FIELD PRIOR TO DEMOLITION. COORDINATE ALL SITE VISITS, THROUGH GENERAL CONTRACTOR AND C.P.S.B.. CONTRACTOR WEAR REQUIRED PERSONAL PROTECTIVE GEAR (PPE) SPECIFICALLY REQUIRED FOR EACH BUILDING.
- B. CONTRACTOR SHALL NOTIFY ARCHITECT/ENGINEER OF ANY DISCREPANCIES IDENTIFIED IN THE FIELD PRIOR ORDERING NEW EQUIPMENT.
- C. ALL WORK SHALL COMPLY WITH LOCAL, STATE, AND FEDERAL CODES TO THE SATISFACTION OF CODE AUTHORITIES HAVING JURISDICTION.
- E. PRIOR TO DISCONNECTING, AND REMOVING OF ANY ELECTRICAL SERVICES IN THE DESIGNATED AREAS SHOWN, THE CONTRACTOR MUST ENSURE THAT THE SERVICES REMOVED DO NOT AFFECT THE NORMAL OPERATION OF AREAS OUTSIDE THE CONSTRUCTION AREA. COORDINATE WITH OWNER FOR ALL ELECTRICAL SHUT DOWNS AT LEAST 2 WORKING DAYS PRIOR TO WORK.

KEYNOTES TO SHEET:

- 1. CONTRACTOR SHALL REMOVE EXISTING ROOF MOUNTED HOOD/FAN AND AND INSTALL ON NEW CURB. RECONNECT EXISTING ELECTRICAL AFTER ROOFING IS COMPLETE.
- 2. EXISTING CONDUIT SHALL BE TEMPORARILY SUPPORTED AND PROTECTED DURING THE RE-ROOFING PROJECT. ONCE NEW ROOF IS COMPLETED PERMANENT CONDUIT SUPPORTS SHALL BE PROVIDED AS REQUIRED. REFER TO CODE REQUIREMENTS FOR SPACING OF SUPPORTS. SECURE CONDUITS TO SUPPORTS WITH CLAMPS AS NECESSARY.

ROOFING SYMBOL LEGEND

- EXISTING SKYLIGHT
- ONE-WAY ROOF VENT
- ROOF DRAIN
- ROOF PIPING PENETRATION
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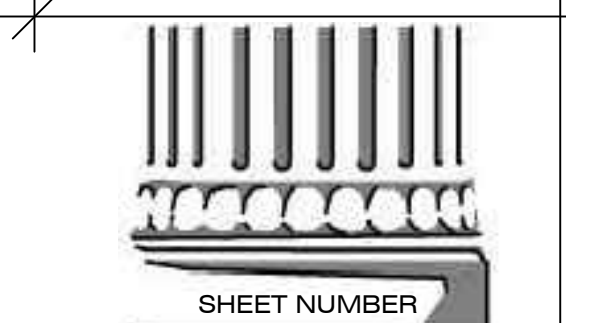


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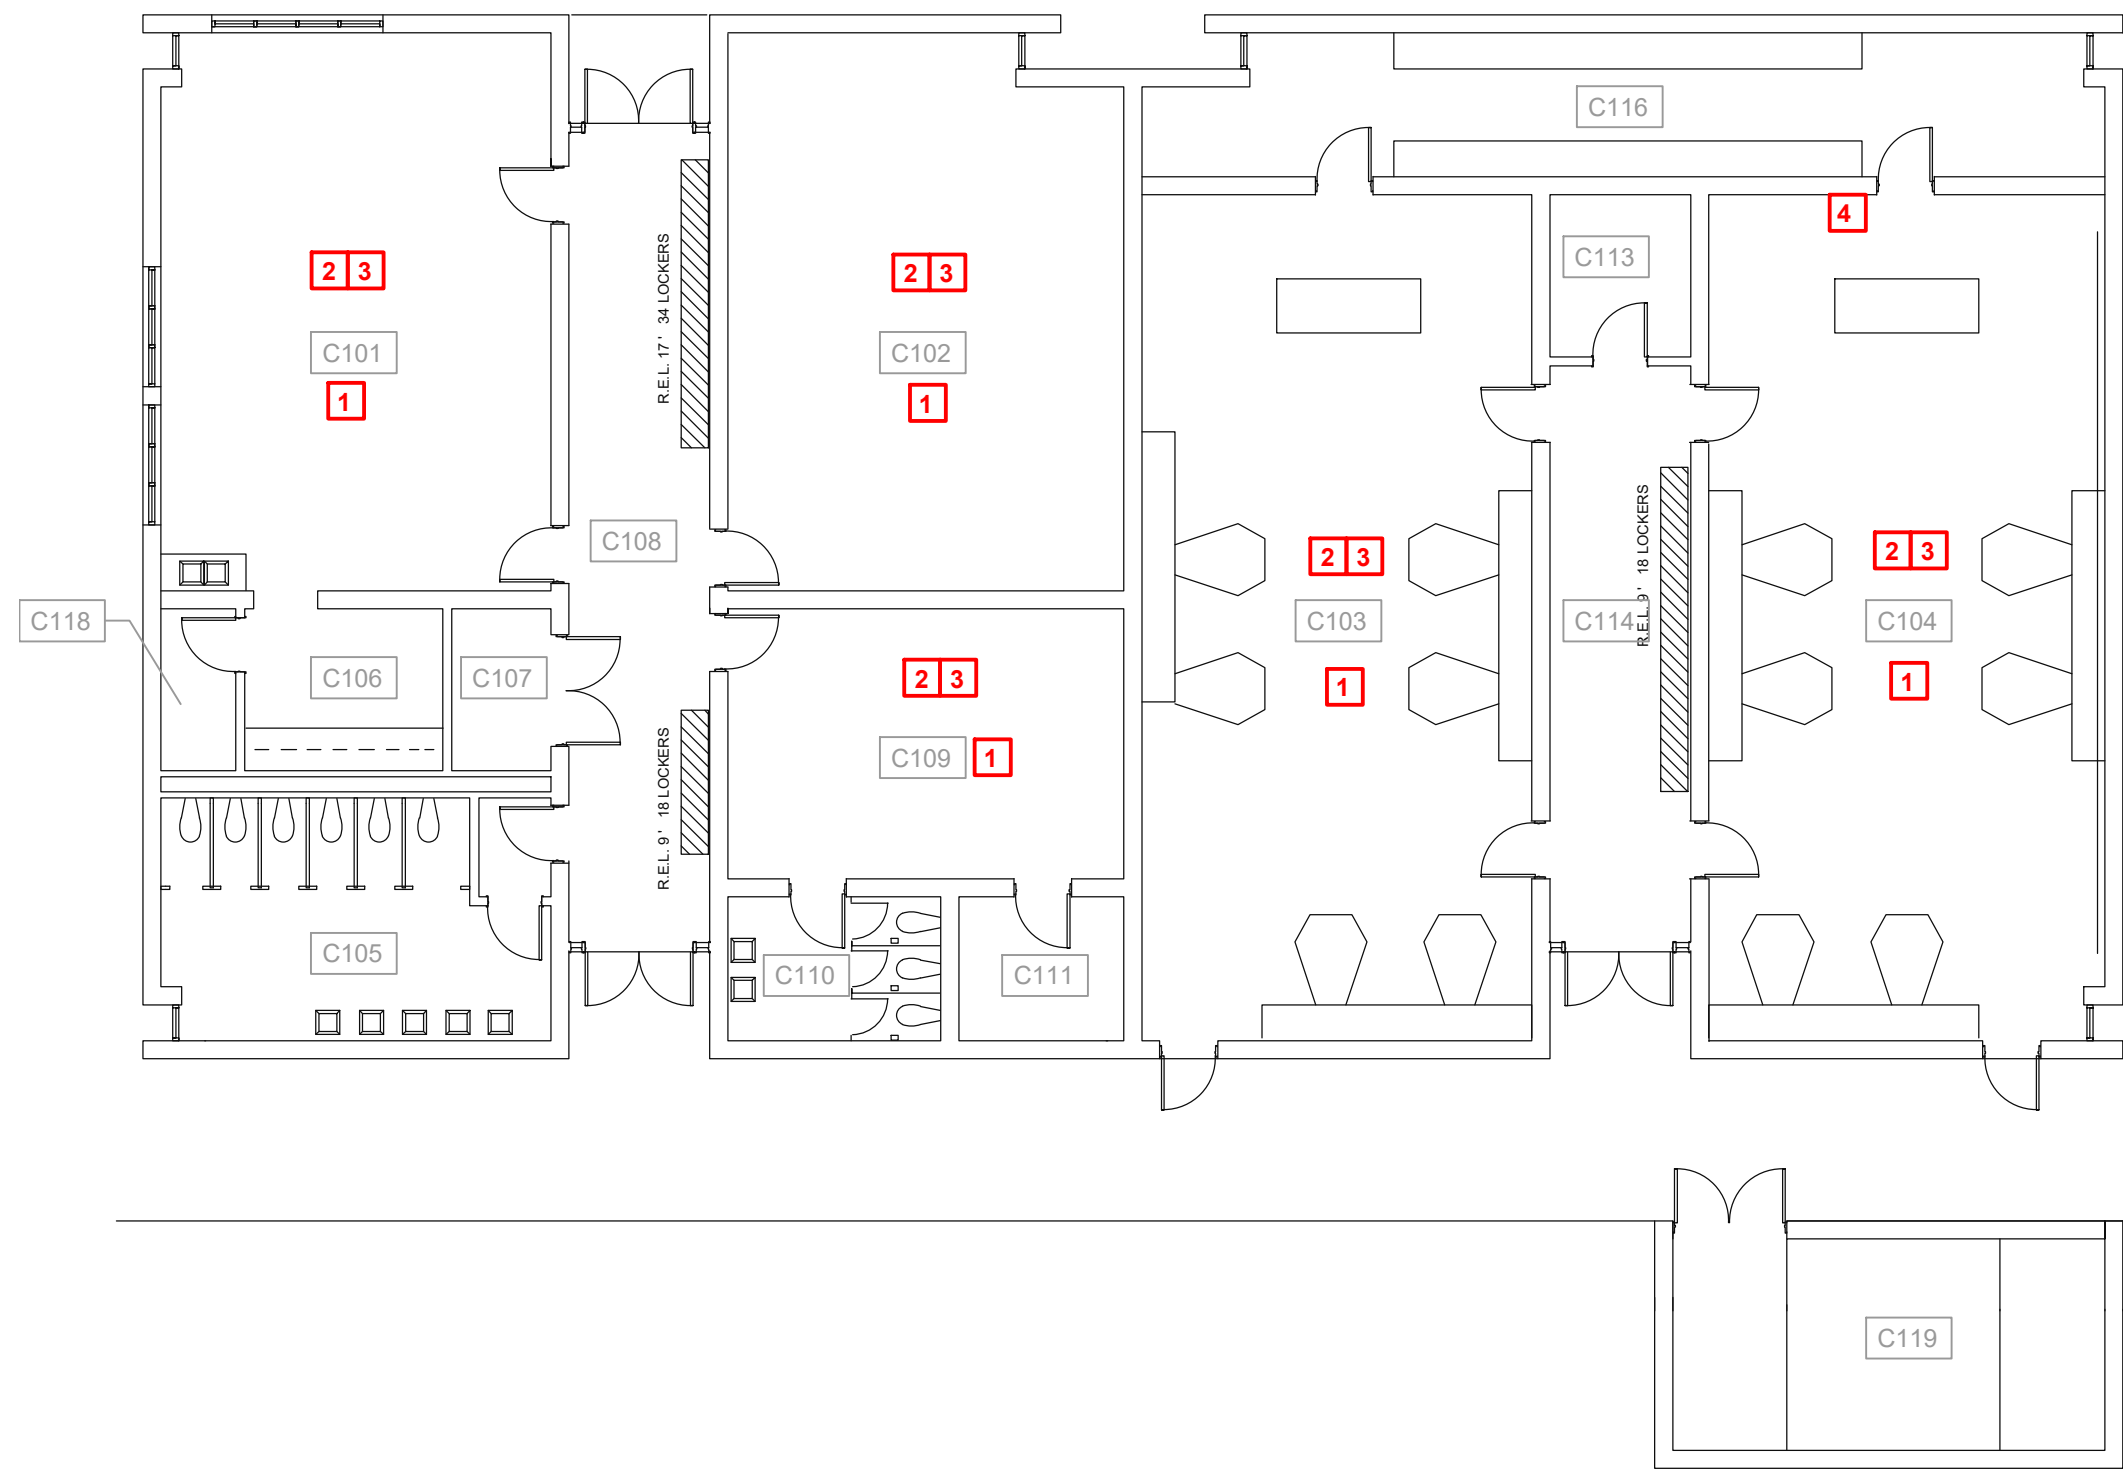
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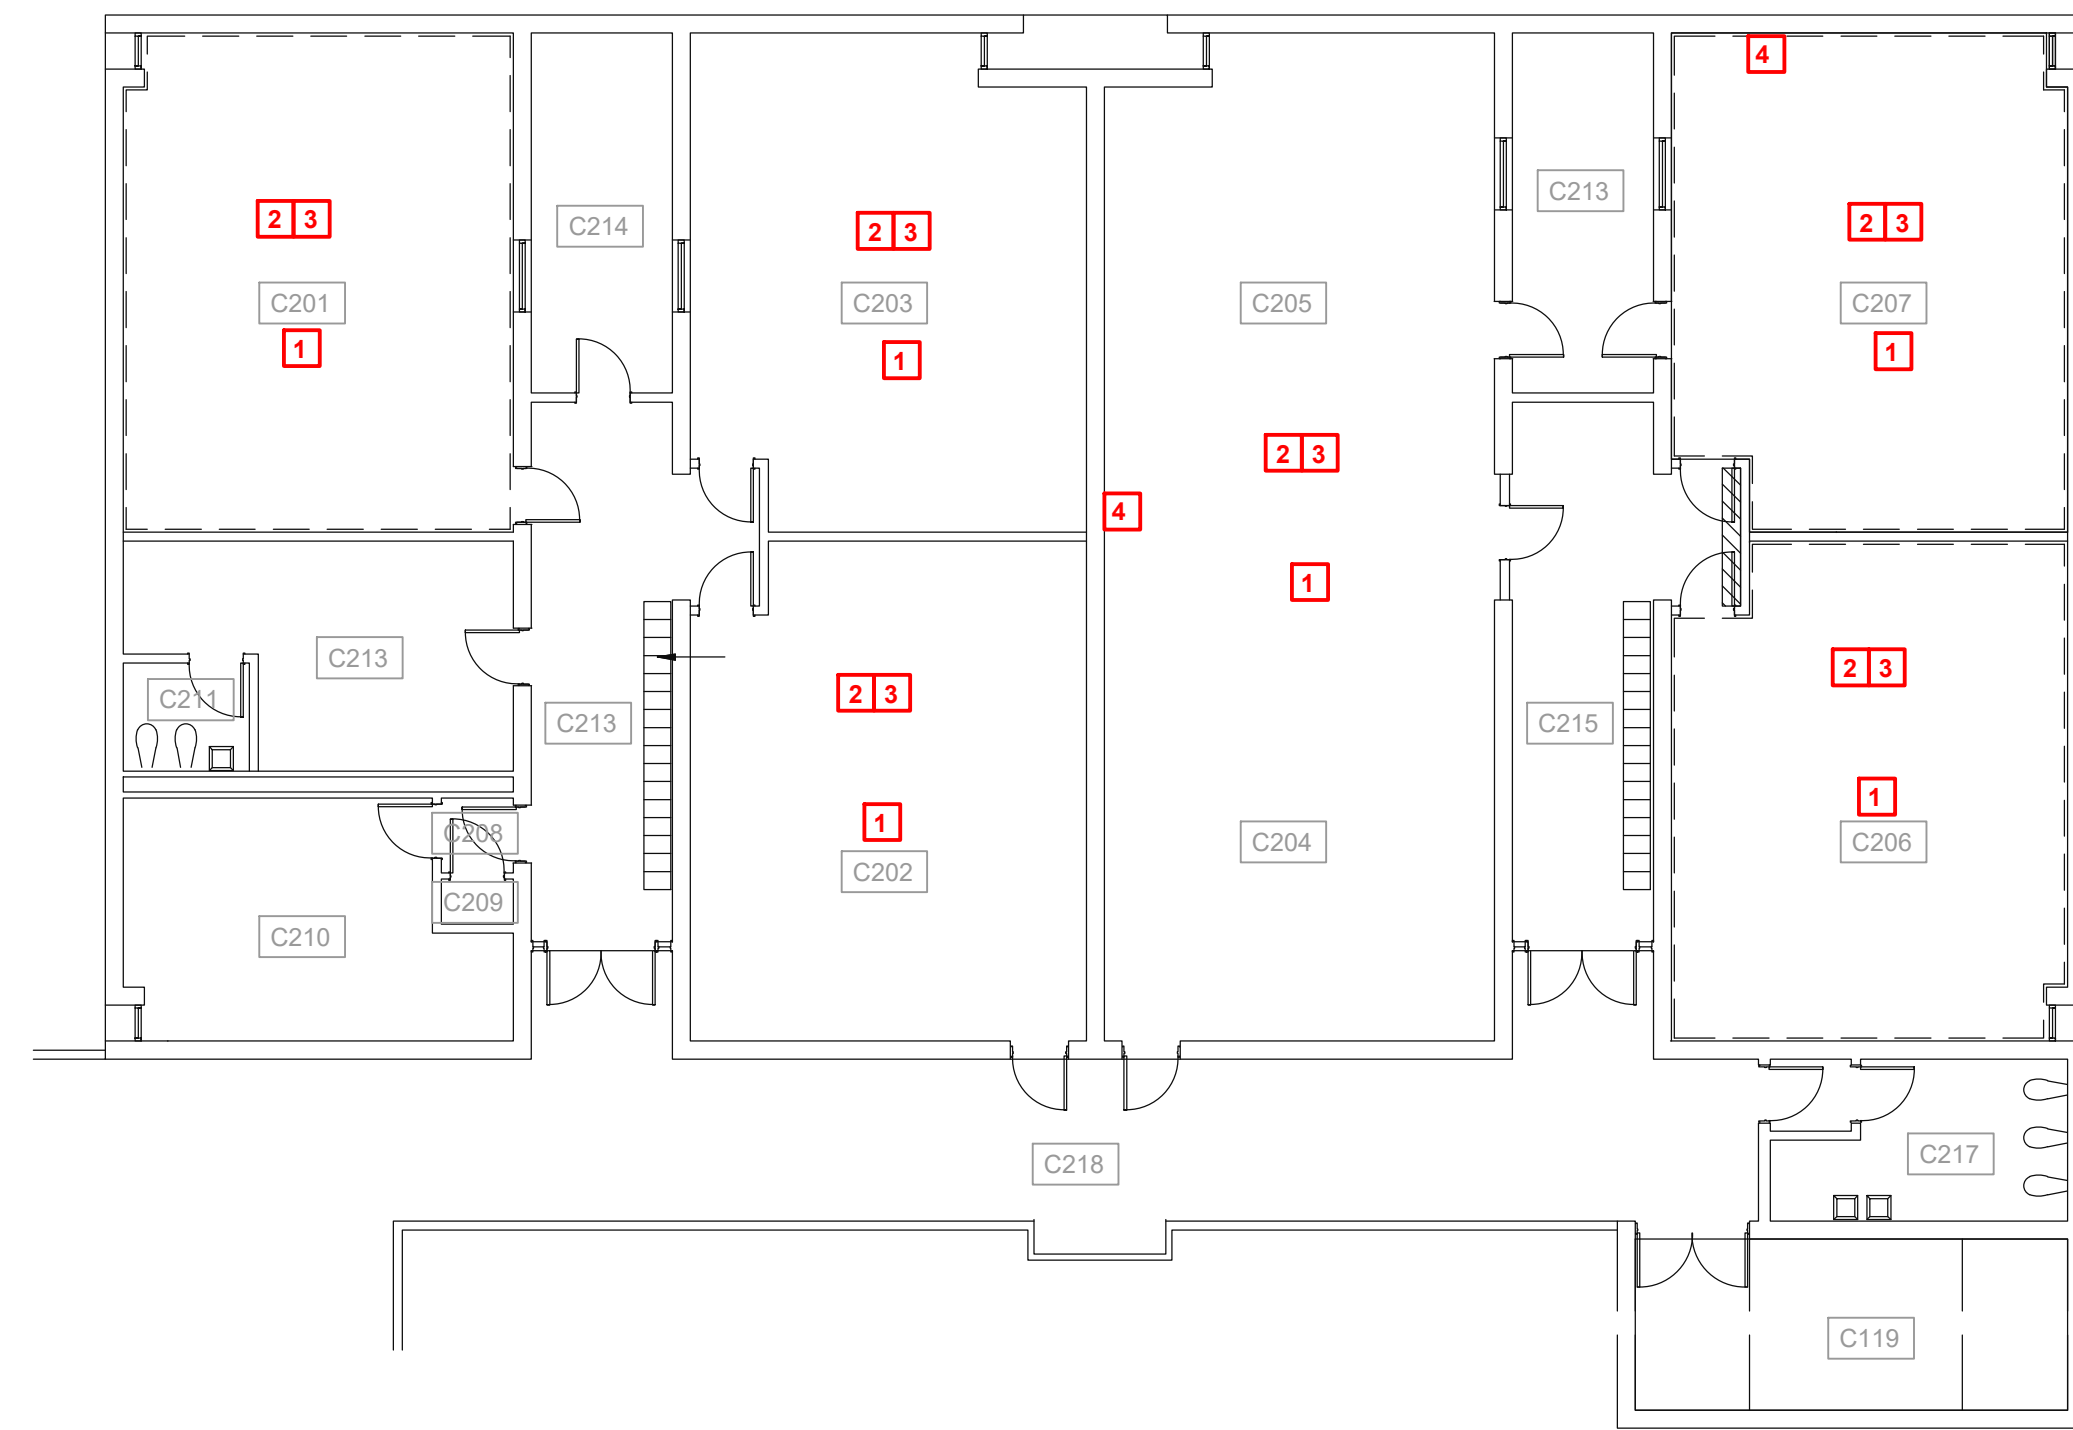
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SHEET NUMBER
(C)E0.1
 BUILDING C
 ROOF PLAN



1 Zone 1 - Building C First Floor - Electrical Plan
1/12" = 1'-0"



2 Zone 1 - Building C Second Floor - Electrical Plan
1/12" = 1'-0"

GENERAL NOTES:

- A. CONTRACTOR SHALL NOTIFY ARCHITECT/ENGINEER OF ANY DISCREPANCIES IDENTIFIED IN THE FIELD PRIOR TO ORDERING LIGHT FIXTURES.
- B. THE INTENT OF THE PLAN IS FOR EXISTING CIRCUITING TO REMAIN AND BE RE-USED. ALL EXISTING POWER WIRING SHALL BE PROTECTED DURING DEMOLITION AND AVAILABLE FOR RE-USE. ANY WIRING REMOVED OR DAMAGED DURING CONSTRUCTION SHALL BE REPLACED AT CONTRACTOR'S EXPENSE.
- C. ALL WORK SHALL COMPLY WITH LOCAL, STATE, AND FEDERAL CODES TO THE SATISFACTION OF CODE AUTHORITIES HAVING JURISDICTION.
- D. ALL WORK SHALL COMPLY WITH THE REQUIREMENTS OF THE 2020 EDITION OF NEC.
- E. PRIOR TO DISCONNECTING, AND REMOVING OF ANY ELECTRICAL SERVICES IN THE DESIGNATED AREAS SHOWN, THE CONTRACTOR MUST ENSURE THAT THE SERVICES REMOVED DO NOT AFFECT THE NORMAL OPERATION OF AREAS OUTSIDE THE CONSTRUCTION AREA. COORDINATE WITH OWNER FOR ALL ELECTRICAL SHUT DOWNS AT LEAST 2 WORKING DAYS PRIOR TO WORK.
- F. EXISTING LIGHTING THROUGHOUT THE BUILDING HAS BEEN REPLACED BY THE OWNER IN A PREVIOUS PROJECT. IF THERE ARE SPACES WHERE THE DRAWINGS REQUIRE CEILING REPLACEMENT, THE CONTRACTOR WILL BE REQUIRED TO REMOVE THE EXISTING FIXTURES, PROPERLY STORE THEM ONSITE (CONTAINER OR OTHER OWNER APPROVED AREA), THEN RE-INSTALL FOLLOWING REPLACEMENT OF CEILINGS WITHIN A GIVEN SPACE.
- G. ALL EXISTING LOW VOLTAGE WIRING SHALL BE PROTECTED DURING DEMOLITION AND AVAILABLE FOR RE-USE. ANY WIRING REMOVED OR DAMAGED DURING CONSTRUCTION SHALL BE REPLACED AT CONTRACTOR'S EXPENSE.

KEYNOTES:

- 1. ANY EXISTING CAMERAS OR WIRELESS ACCESS POINTS TO BE REMOVED DURING CONSTRUCTION SHALL BE COORDINATED WITH CPSB IT DEPARTMENT. DEVICES SHALL BE LABELED AND STORED FOR RE-INSTALLATION. CONTRACTOR IS RESPONSIBLE FOR ANY CUT OR REMOVED COMMUNICATIONS CABLING.
- 2. ANY EXISTING FIRE ALARM DEVICES TO BE REMOVED DURING CONSTRUCTION SHALL BE COORDINATED WITH SYLVAN SOUND. DEVICES SHALL BE LABELED AND STORED FOR RE-INSTALLATION. CONTRACTOR IS RESPONSIBLE FOR ANY CUT OR REMOVED FIRE ALARM WIRING.
- 3. ANY EXISTING INTERCOM DEVICES TO BE REMOVED DURING CONSTRUCTION SHALL BE COORDINATED WITH SYLVAN SOUND. DEVICES SHALL BE LABELED AND STORED FOR RE-INSTALLATION. CONTRACTOR IS RESPONSIBLE FOR ANY CUT OR REMOVED INTERCOM WIRING.
- 4. EXISTING LOCATION OF IT RACK. CONTRACTOR IS RESPONSIBLE FOR PROTECTING IT RACK, EQUIPMENT, AND WIRING DURING CONSTRUCTION. IT RACK SHALL REMAIN OPERATIONAL THROUGHOUT CONSTRUCTION UNLESS APPROVED BY CPSB IT FOR IT TO BE POWERED DOWN. PROVIDE COVER FOR RACK TO MINIMIZE DUST AND DEBRIS WHILE AT THE SAME TIME ALLOWING COOLING AND PROPER AIRFLOW.

NOTE:
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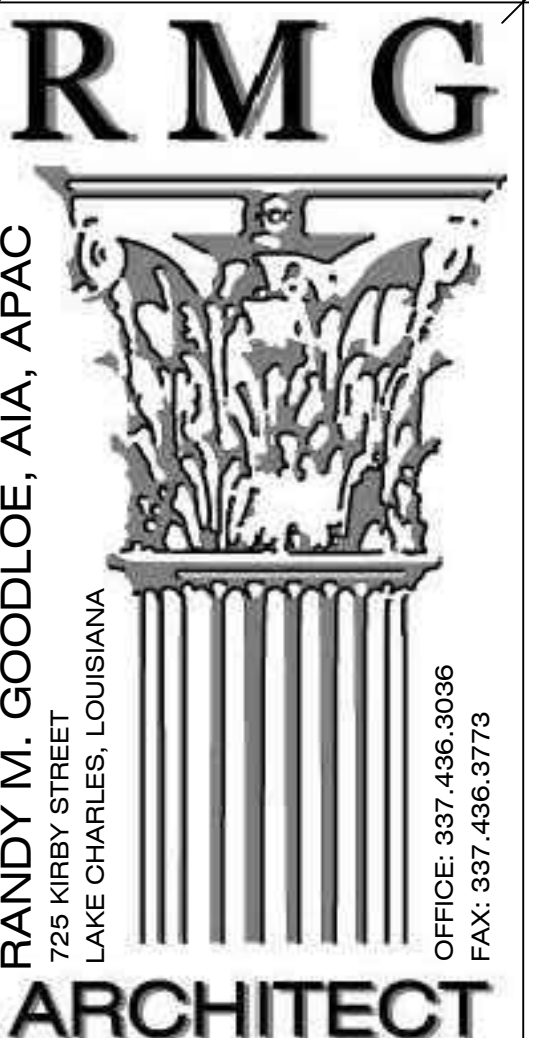
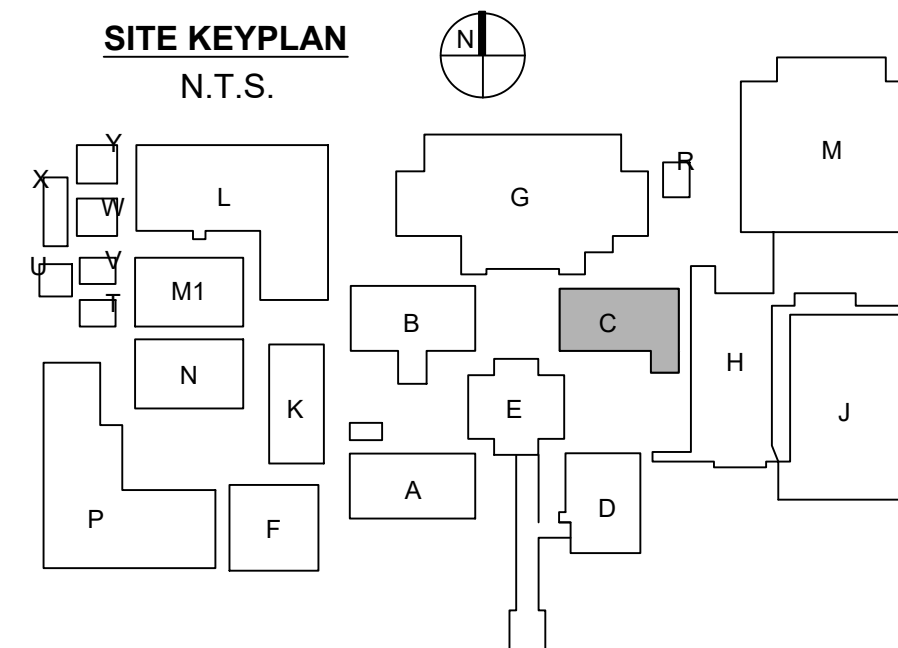
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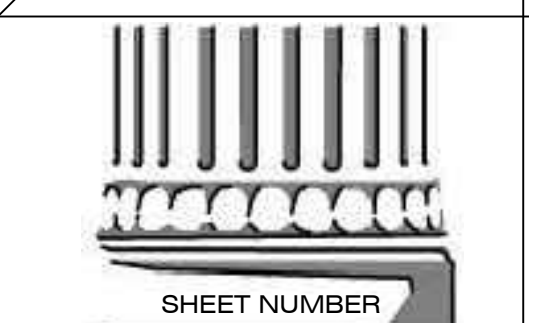


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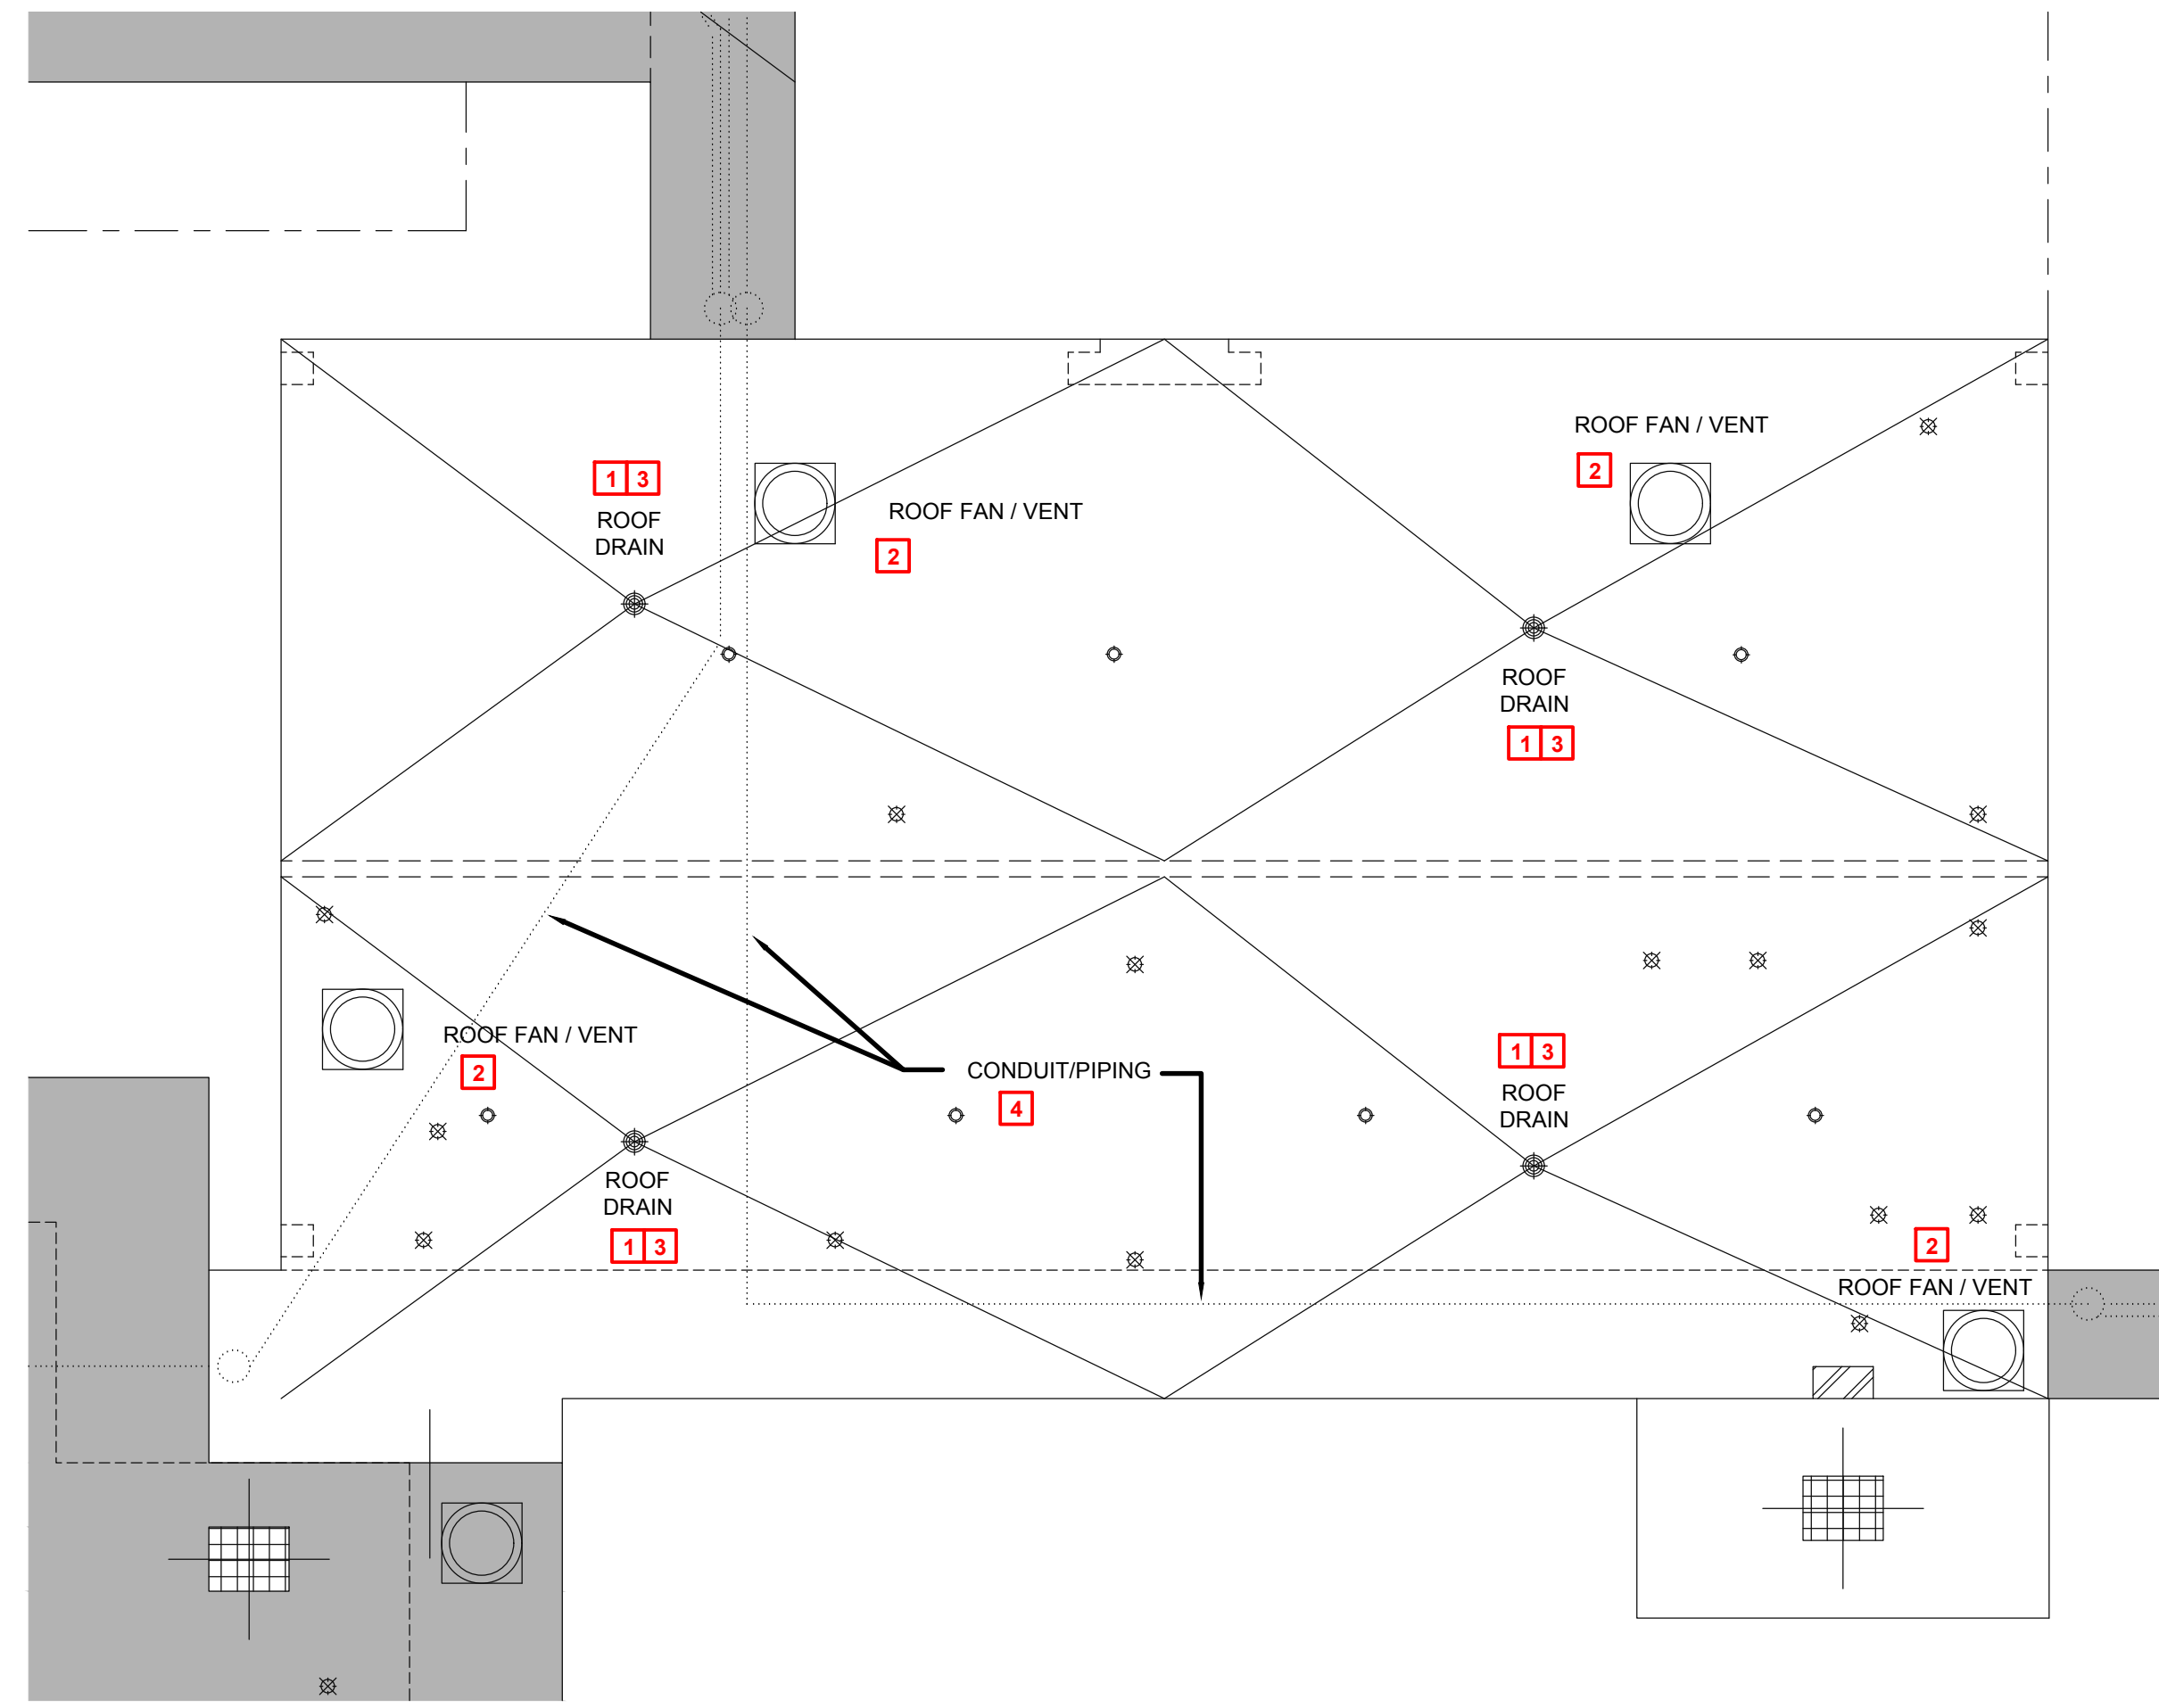
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(C)E1.1
ZONE 1 - BUILDING C
ELECTRICAL PLANS



1 Mechanical Roof Plan - Building C
3/32" = 1'-0"

NOTE:
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FOR ALL DIMENSIONS.

GENERAL NOTES:

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- G. VERIFY ADEQUATE SPACE AVAILABLE PER MANUFACTURER'S RECOMMENDATIONS, COORDINATE CLEARANCE REQUIREMENTS OF ALL MECHANICAL EQUIPMENT.

KEYNOTES TO SHEET:

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2. CONTRACTOR SHALL REMOVE EXISTING ROOF MOUNTED HOOD/FAN AND AND INSTALL ON NEW CURB. NEW CURB SHALL MATCH THE EXISTING SIZE, STYLE, ETC. OF EXISTING CURB. COORDINATE CURB HEIGHT WITH ARCHITECT & GENERAL CONTRACTOR PRIOR ORDERING.
3. ALL EXISTING ROOF DRAIN PIPING SHALL BE FLUSHED TO REMOVE LEAVES, DEBRIS, ETC. ONCE THE NEW ROOF DRAINS ARE INSTALLED.
4. EXISTING PIPING (GAS, CHILLED WATER, ETC.) SHALL BE TEMPORARILY SUPPORTED AND PROTECTED DURING THE RE-ROOFING PROJECT. ONCE NEW ROOF IS COMPLETED PERMANENT PIPING SUPPORT SHALL BE PROVIDED AS REQUIRED. REFER TO CODE REQUIREMENTS FOR SPACING OF SUPPORTS. SHIELDS SHALL BE PLACED BETWEEN CHILLED WATER PIPING SUPPORTS AND PIPING INSULATION. SECURE PIPING TO SUPPORTS WITH CLAMPS AS NECESSARY.

ROOFING SYMBOL LEGEND

- EXISTING SKYLIGHT
- ONE-WAY ROOF VENT
- ROOF DRAIN
- ROOF PIPING PENETRATION
- ROOF FAN / VENT
- ROOF FAN / VENT
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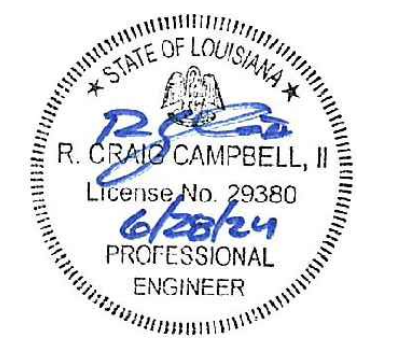


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Phone: (337) 234-5710
Email: adginc@adginc.org
Project No. 20300

NOTE:
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NOTE:
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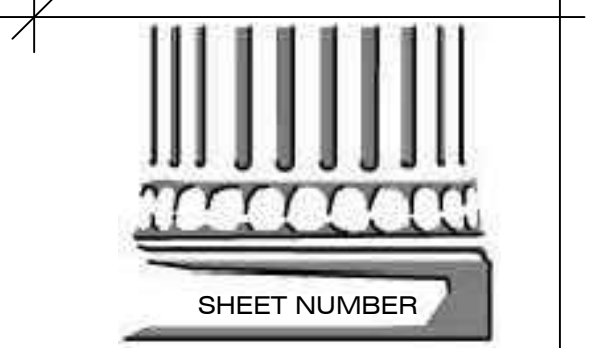


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A.M. BARBE HIGH SCHOOL
2200 W. McNEESE ST.
FOR
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LAKE CHARLES, LA
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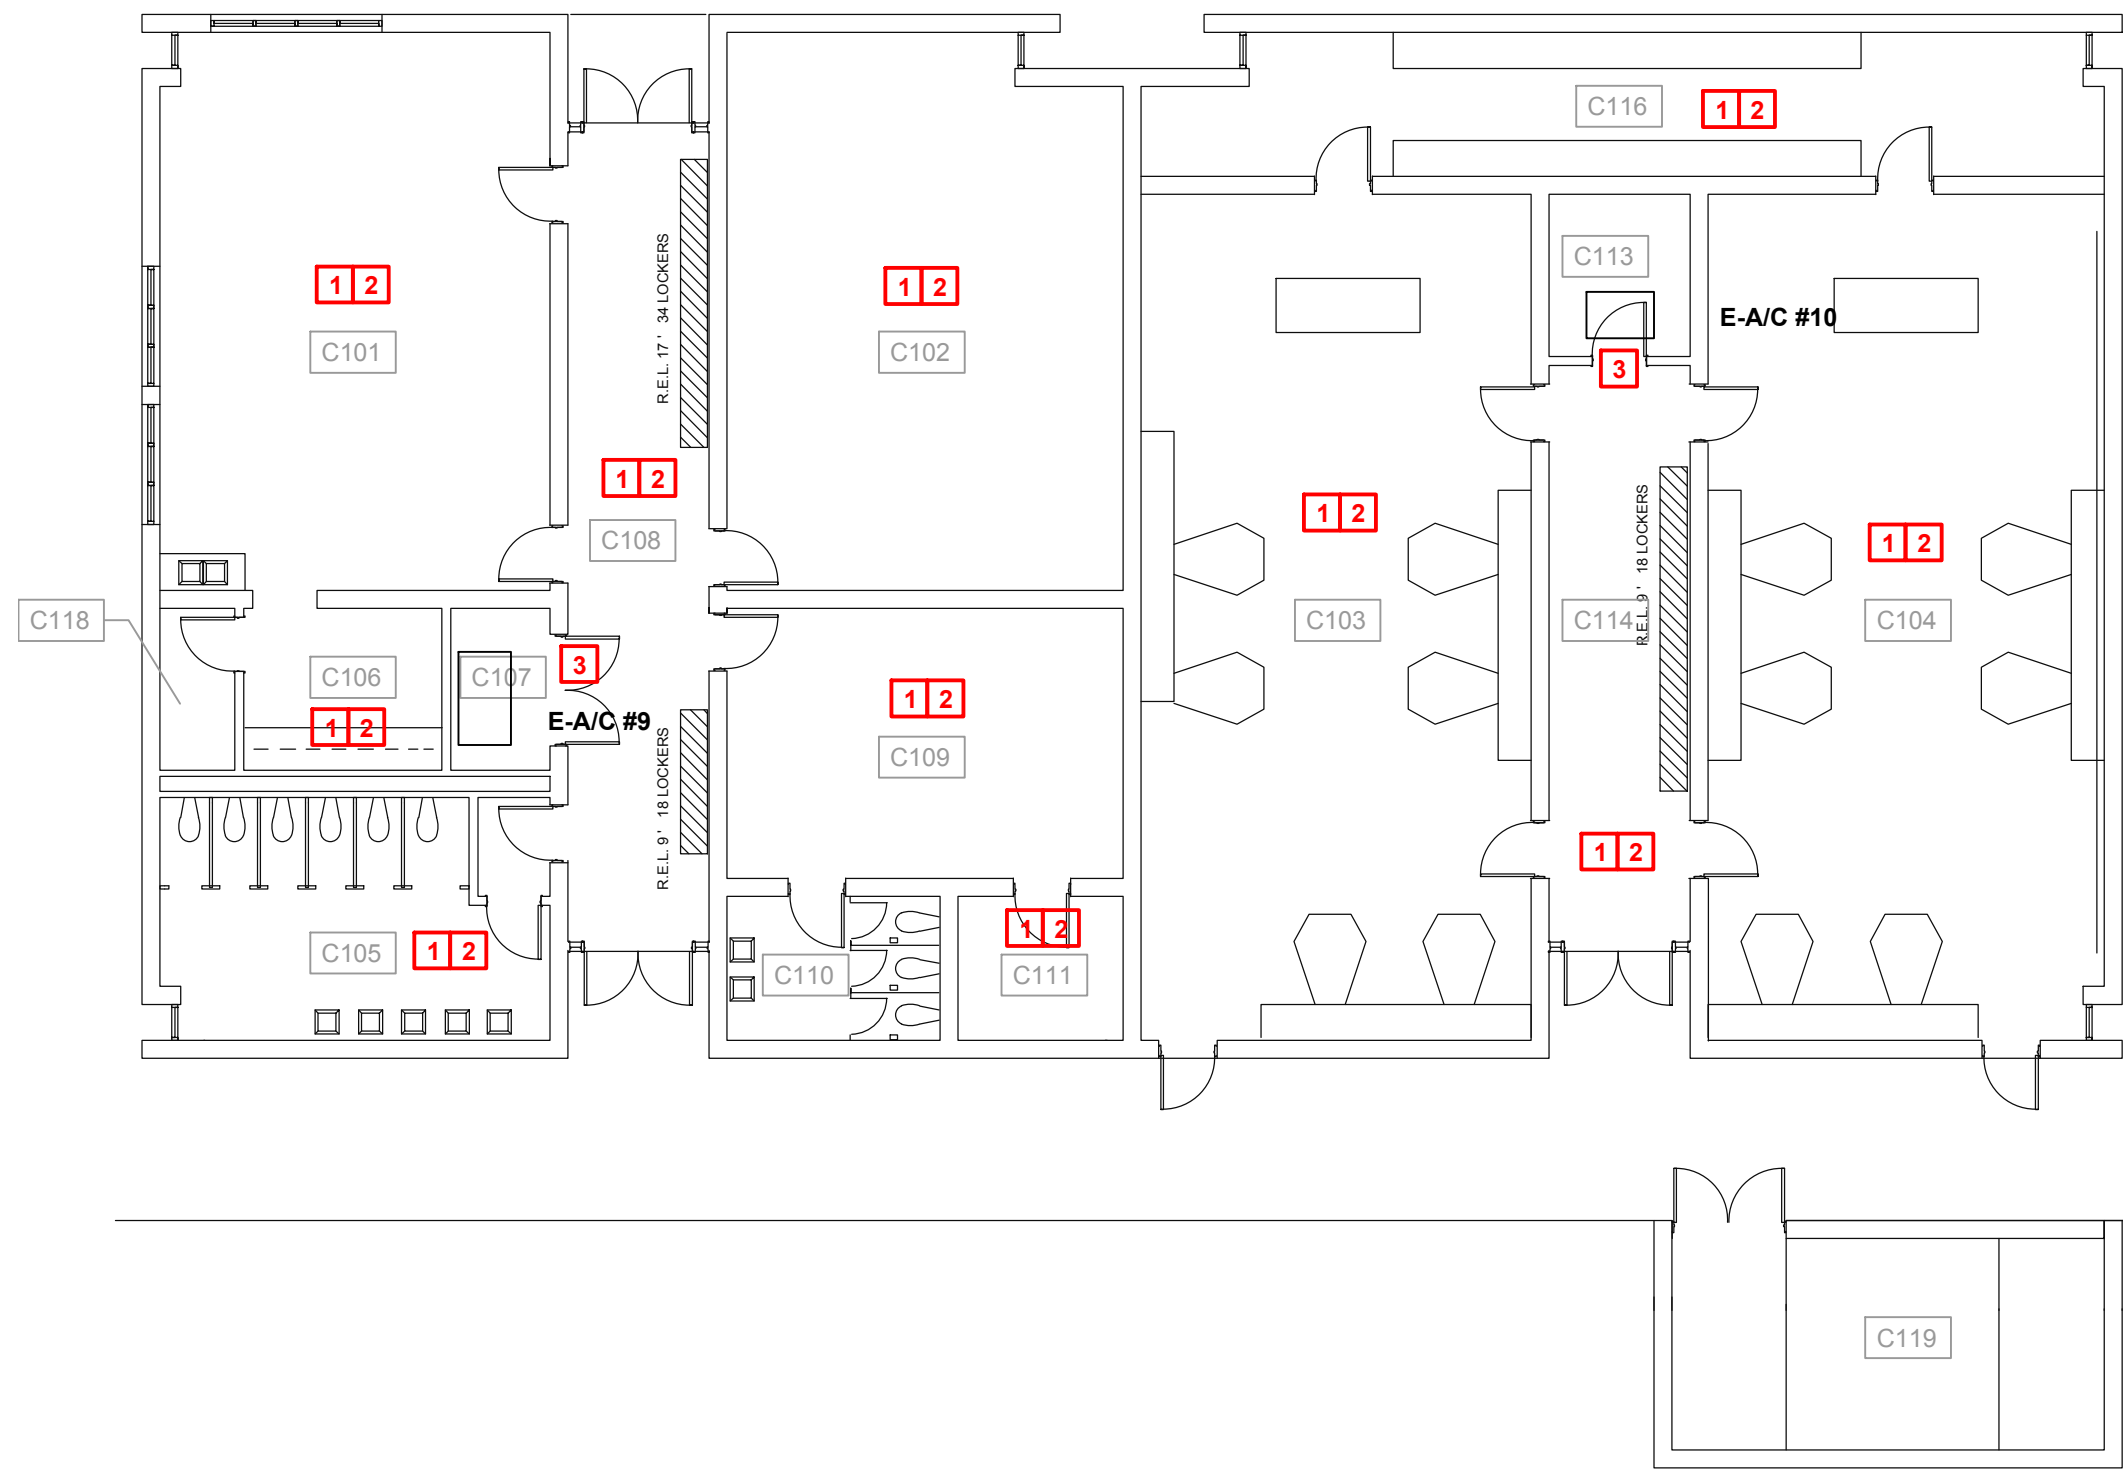
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PROJECT MANAGER
DP/TV
DATE ISSUED
06.28.2024

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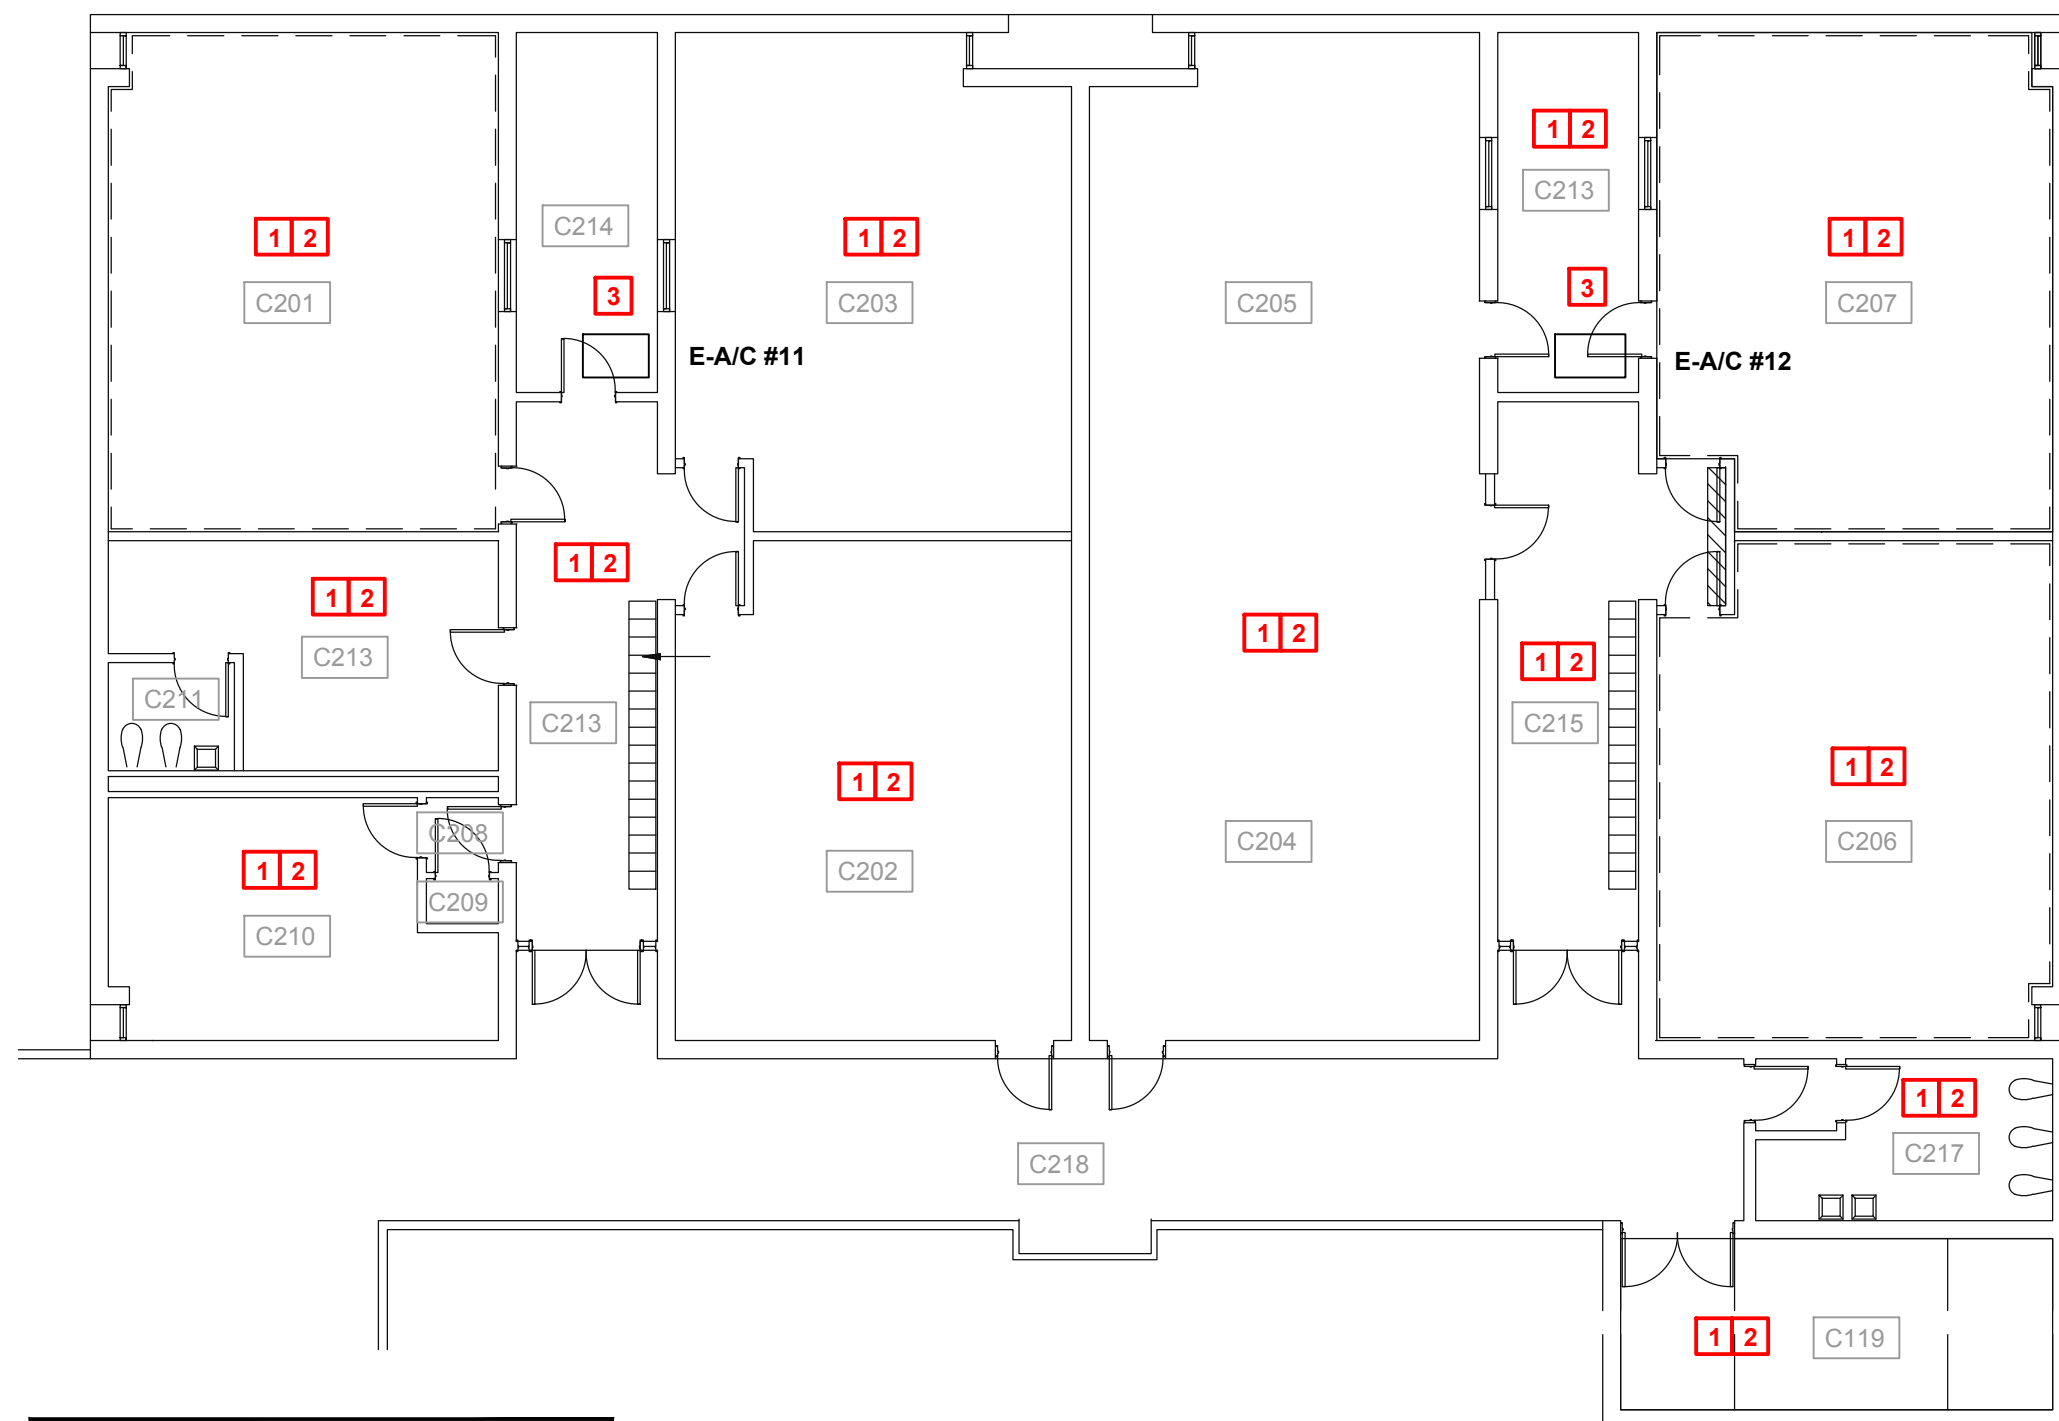
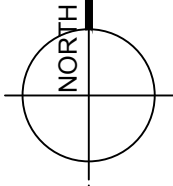


(C)M0.1
BUILDING C
ROOF PLAN



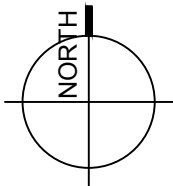
6 Zone 1 - Building C First Floor - Mechanical Plan
3/32" = 1'-0"

NOTE:
REFER TO ARCHITECTURAL DRAWINGS
FOR ALL DIMENSIONS.



16 Zone 1 - Building C Second Floor - Mechanical Plan
3/32" = 1'-0"

NOTE:
REFER TO ARCHITECTURAL DRAWINGS
FOR ALL DIMENSIONS.



GENERAL NOTES:

- A. CONTRACTOR SHALL FIELD VERIFY EXISTING EQUIPMENT TAGS (WHERE POSSIBLE) IN FIELD PRIOR TO DEMOLITION. COORDINATE ALL SITE VISITS, THROUGH GENERAL CONTRACTOR AND C.P.S.B. CONTRACTOR WEAR REQUIRED PERSONAL PROTECTIVE GEAR (PPE) SPECIFICALLY REQUIRED FOR EACH BUILDING.
- B. CONTRACTOR SHALL NOTIFY ARCHITECT/ENGINEER OF ANY DISCREPANCIES IDENTIFIED IN THE FIELD PRIOR TO FABRICATING DUCTWORK OR ORDERING EQUIPMENT.
- C. CONTRACTOR SHALL PROVIDE TESTING AND BALANCING OF ALL HVAC SYSTEMS WHICH WERE REPLACED, MODIFIED AND/OR CLEANED.
- D. ALL WORK SHALL COMPLY WITH LOCAL, STATE, AND FEDERAL CODES TO THE SATISFACTION OF CODE AUTHORITIES HAVING JURISDICTION.
- E. ALL WORK SHALL COMPLY WITH THE REQUIREMENTS OF NFPA 90A & 101, THE CLEAN AIR ACT AND THE AMERICANS WITH DISABILITIES ACT.
- F. PRIOR TO DRAINING, DISCONNECTING, AND REMOVING OF ANY SERVICES IN THE DESIGNATED AREAS SHOWN, THE CONTRACTOR MUST ENSURE THAT THE SERVICES REMOVED DO NOT AFFECT THE NORMAL OPERATION OF AREAS OUTSIDE THE CONSTRUCTION AREA.
- G. VERIFY ADEQUATE SPACE AVAILABLE PER MANUFACTURER'S RECOMMENDATIONS. COORDINATE CLEARANCE REQUIREMENTS OF ALL MECHANICAL EQUIPMENT.

KEYNOTES TO SHEET:

- 1. NO INTERIOR MECHANICAL (PLUMBING & HVAC) WORK ASSOCIATED WITH THESE SPACES WITHIN THE BUILDING.
- 2. CONTRACTOR SHALL TEMPORARILY SUPPORT AND PROTECT ANY EQUIPMENT, DIFFUSERS, GRILLES, ETC. IN OR ABOVE CEILINGS OF THESE SPACES DURING THE REMOVAL AND INSTALLATION OF NEW CEILINGS. REFER TO ARCHITECTURAL PLANS FOR THOSE LOCATIONS.
- 3. EXISTING FAN COIL UNIT TO REMAIN AND CLEANED PER THE SPECIFICATIONS. REMOVE AND REPLACE EXISTING AIR HANDLING UNIT INTERIOR LINER AND CLEAN INTERIOR OF UNIT INCLUDING COILS.



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NOTE: THESE DRAWINGS ARE COPIES OF THE ORIGINAL CONSTRUCTION DOCUMENTS WITH NOTES ADDED TO DESCRIBE THE SCOPE OF WORK FOR THE HURRICANE LAURA REPAIR PROJECT. CONTRACTOR SHALL NOTIFY ARCHITECT/ENGINEER OF ANY DISCREPANCIES IDENTIFIED IN FIELD PRIOR TO ORDERING EQUIPMENT OR INSTALLATION.

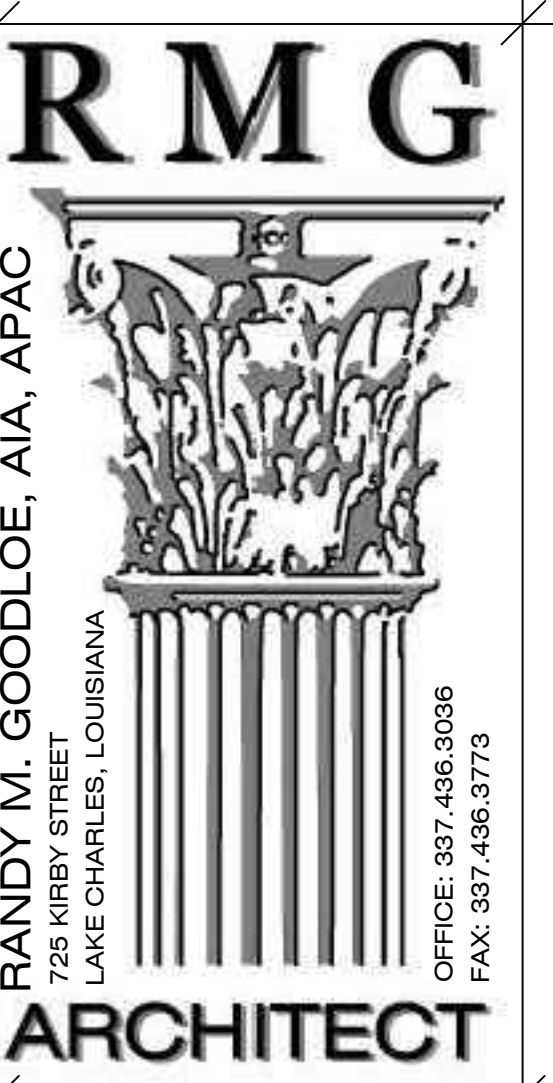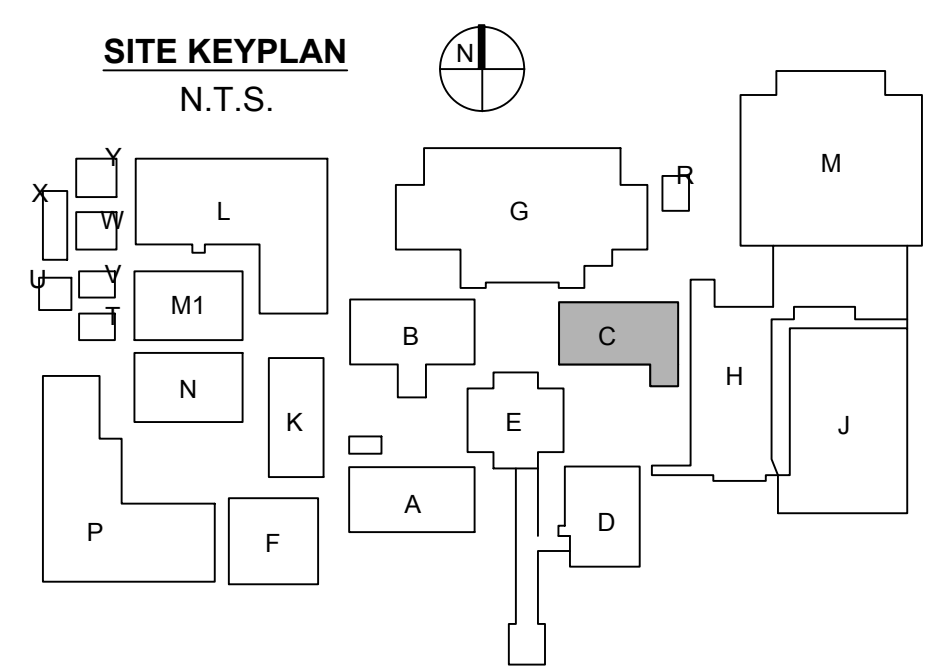NOTE: THE HVAC SCOPE OF WORK IS LIMITED TO REPLACING OR REPAIRING THE HVAC SYSTEM BACK TO ITS ORIGINAL CONDITION (LIKE FOR LIKE) IN MOST CIRCUMSTANCES. THIS PROJECT'S SCOPE OF WORK DOES NOT INCLUDE BRINGING ALL THE EXISTING HVAC SYSTEMS UP TO CODE OR ADDRESSING EXISTING CONDITIONS. ALTHOUGH ALL WORK MUST COMPLY WITH FEMA CONSENSUS-BASED, "LATEST PUBLISHED EDITIONS" OF CODES NOT NECESSARILY THOSE CODES ADOPTED BY THE LOCAL MUNICIPALITY.



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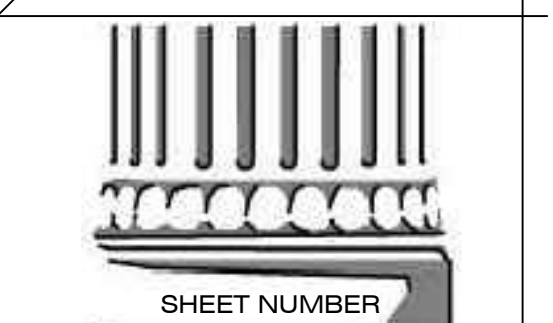


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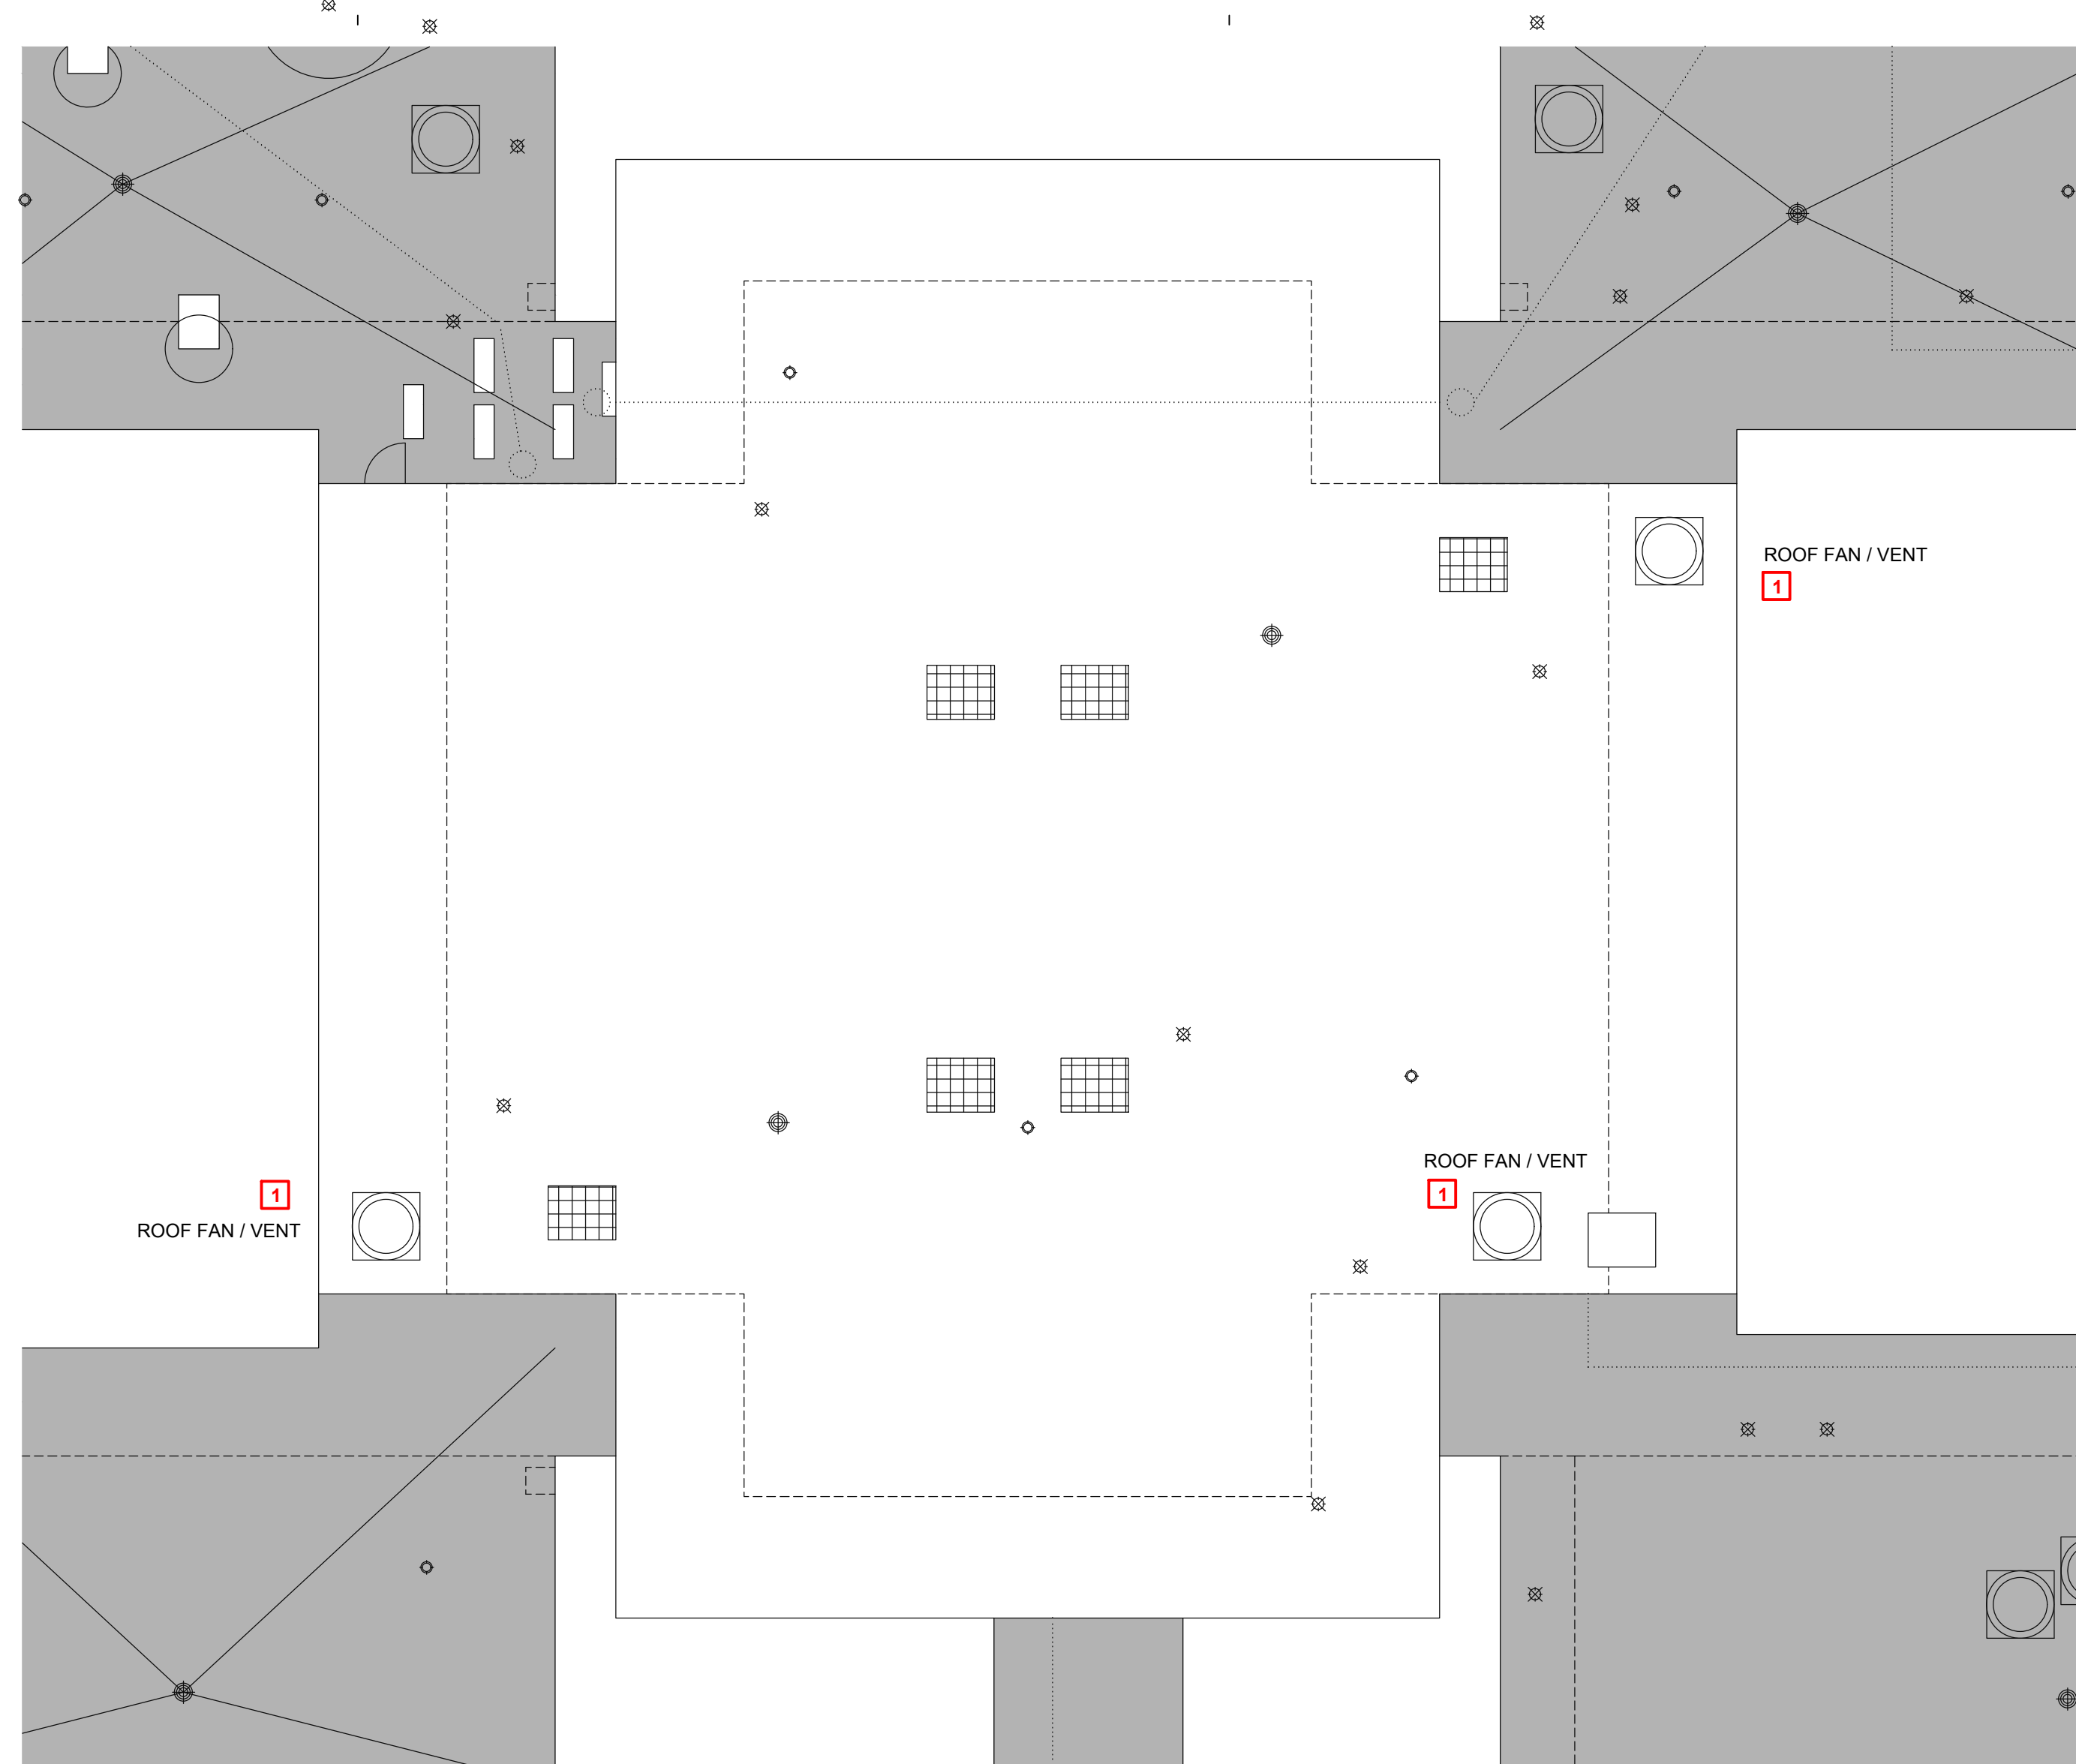
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06.28.2024

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SHEET NUMBER
(C)M1.1
ZONE 1 - BUILDING C
MECHANICAL PLANS

3/10/2022 3:12:03 PM



1 Electrical Roof Plan - Building E
3/32" = 1'-0"

GENERAL NOTES:

- A. CONTRACTOR SHALL FIELD VERIFY EXISTING ELECTRICAL EQUIPMENT SIZES IN FIELD PRIOR TO DEMOLITION. COORDINATE ALL SITE VISITS, THROUGH GENERAL CONTRACTOR AND C.P.S.B.. CONTRACTOR WEAR REQUIRED PERSONAL PROTECTIVE GEAR (PPE) SPECIFICALLY REQUIRED FOR EACH BUILDING.
- B. CONTRACTOR SHALL NOTIFY ARCHITECT/ENGINEER OF ANY DISCREPANCIES IDENTIFIED IN THE FIELD PRIOR ORDERING NEW EQUIPMENT.
- C. ALL WORK SHALL COMPLY WITH LOCAL, STATE, AND FEDERAL CODES TO THE SATISFACTION OF CODE AUTHORITIES HAVING JURISDICTION.
- E. PRIOR TO DISCONNECTING, AND REMOVING OF ANY ELECTRICAL SERVICES IN THE DESIGNATED AREAS SHOWN, THE CONTRACTOR MUST ENSURE THAT THE SERVICES REMOVED DO NOT AFFECT THE NORMAL OPERATION OF AREAS OUTSIDE THE CONSTRUCTION AREA. COORDINATE WITH OWNER FOR ALL ELECTRICAL SHUT DOWNS AT LEAST 2 WORKING DAYS PRIOR TO WORK.

KEYNOTES TO SHEET:

- 1. CONTRACTOR SHALL REMOVE EXISTING ROOF MOUNTED HOOD/FAN AND AND INSTALL ON NEW CURB. RECONNECT EXISTING ELECTRICAL ONCE ROOFING IS COMPLETE.

ROOFING SYMBOL LEGEND

- EXISTING SKYLIGHT, TO BE REMOVED AND REPLACED
- ONE-WAY ROOF VENT
- ROOF DRAIN
- ROOF PIPING PENETRATION
- ROOF FAN / VENT
- ROOF FAN / VENT
- DOWNSPOUT
- MISC MEP
- CONDUIT/PIPING RUNS
- EXPANSION JOINT



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ENGINEER

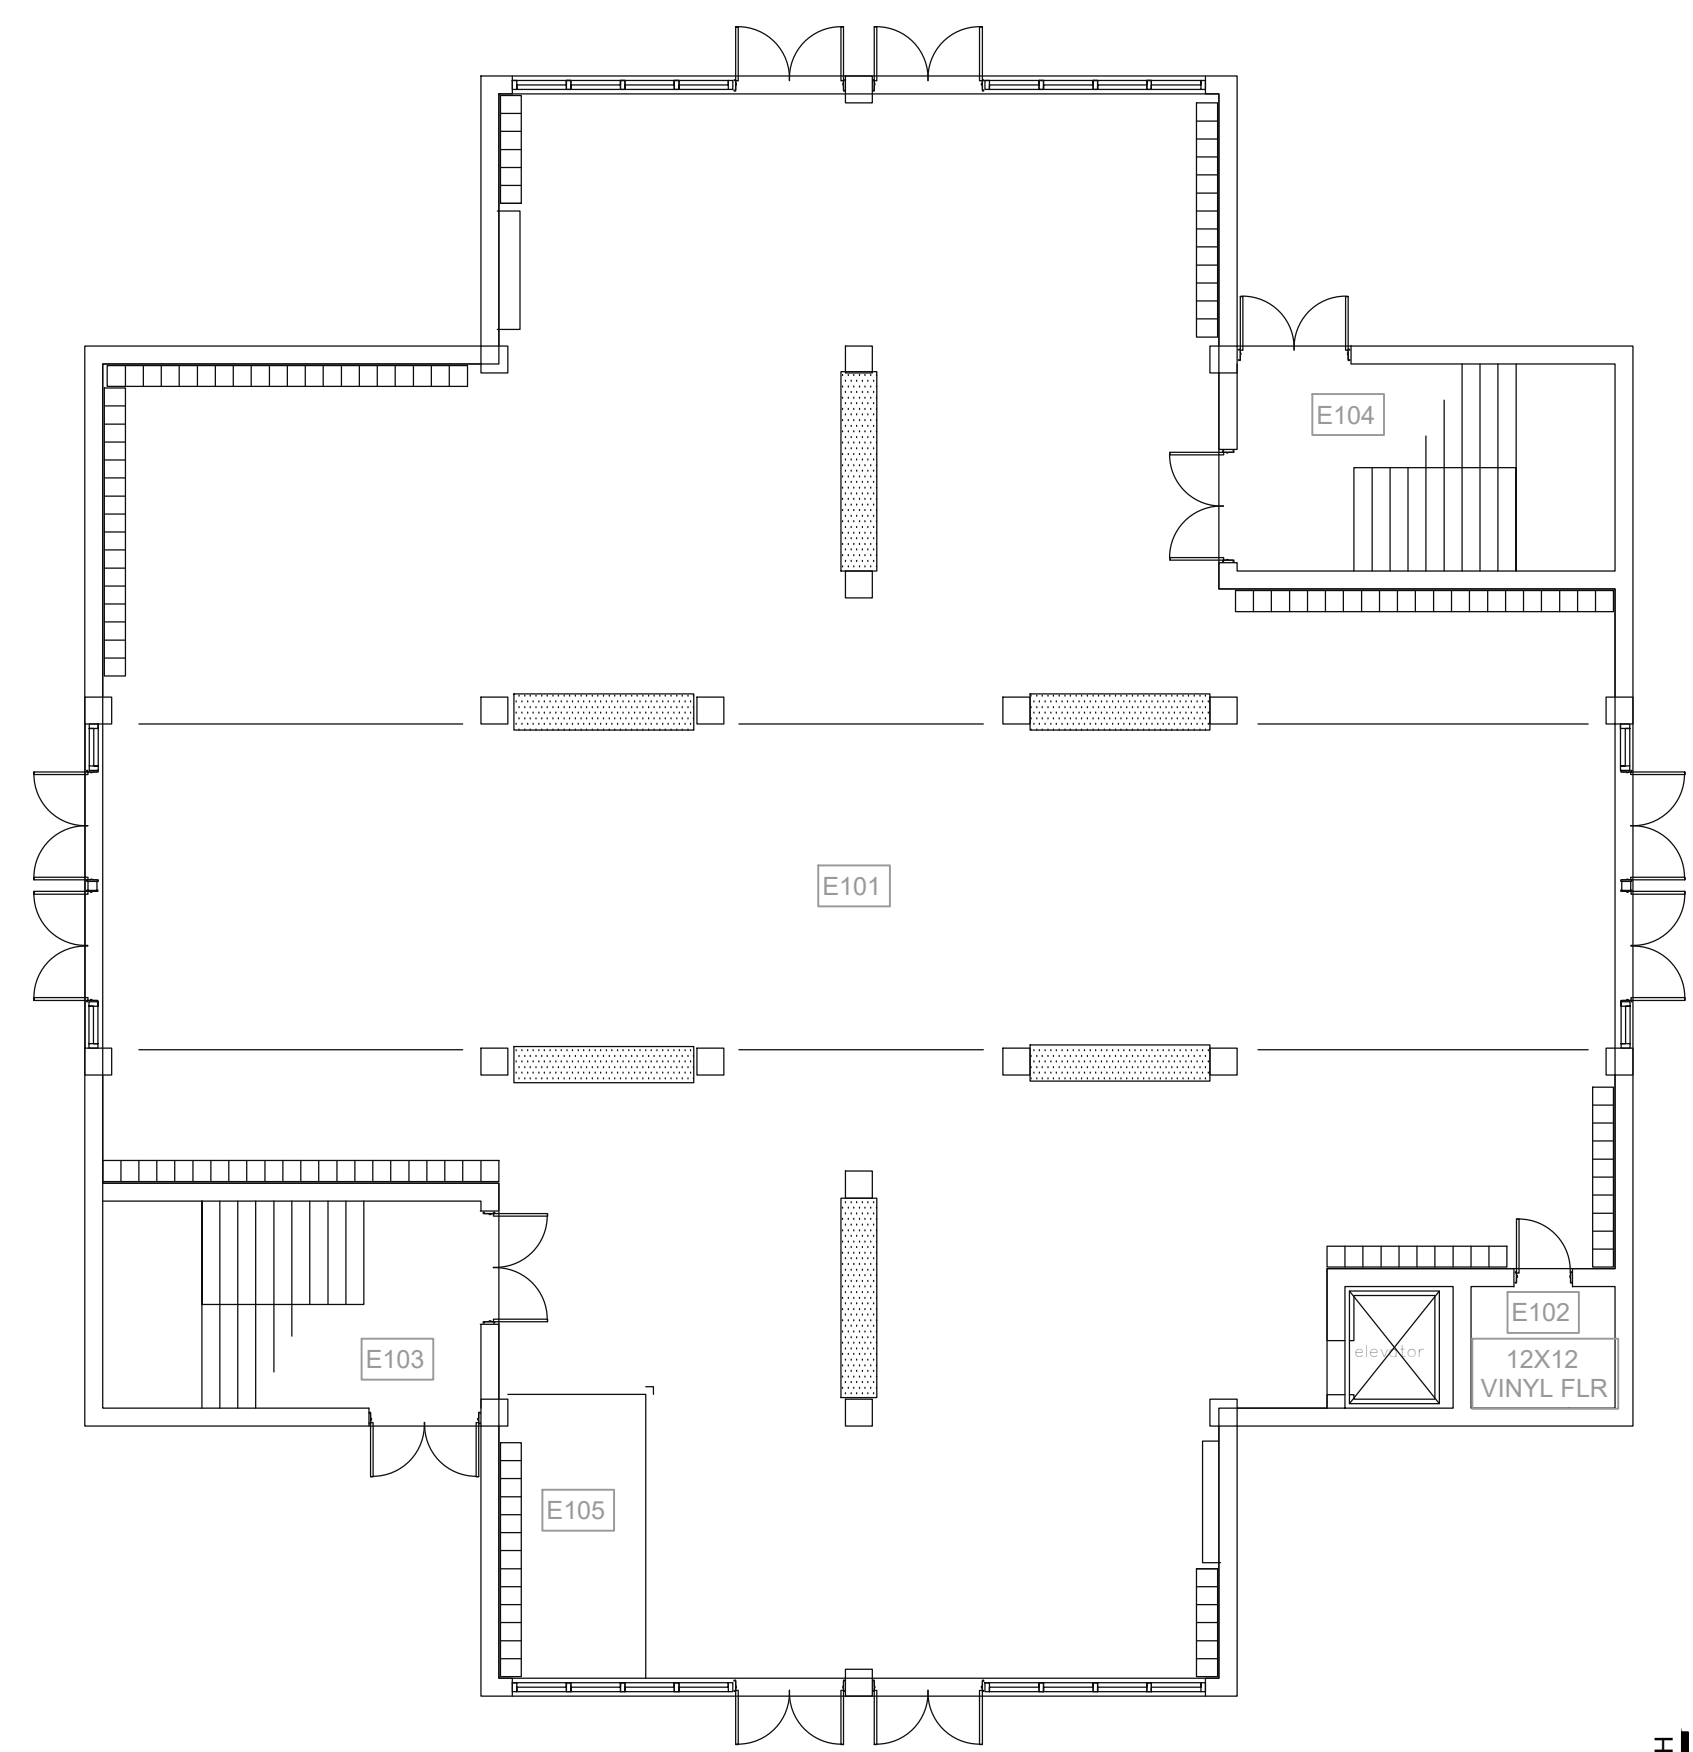
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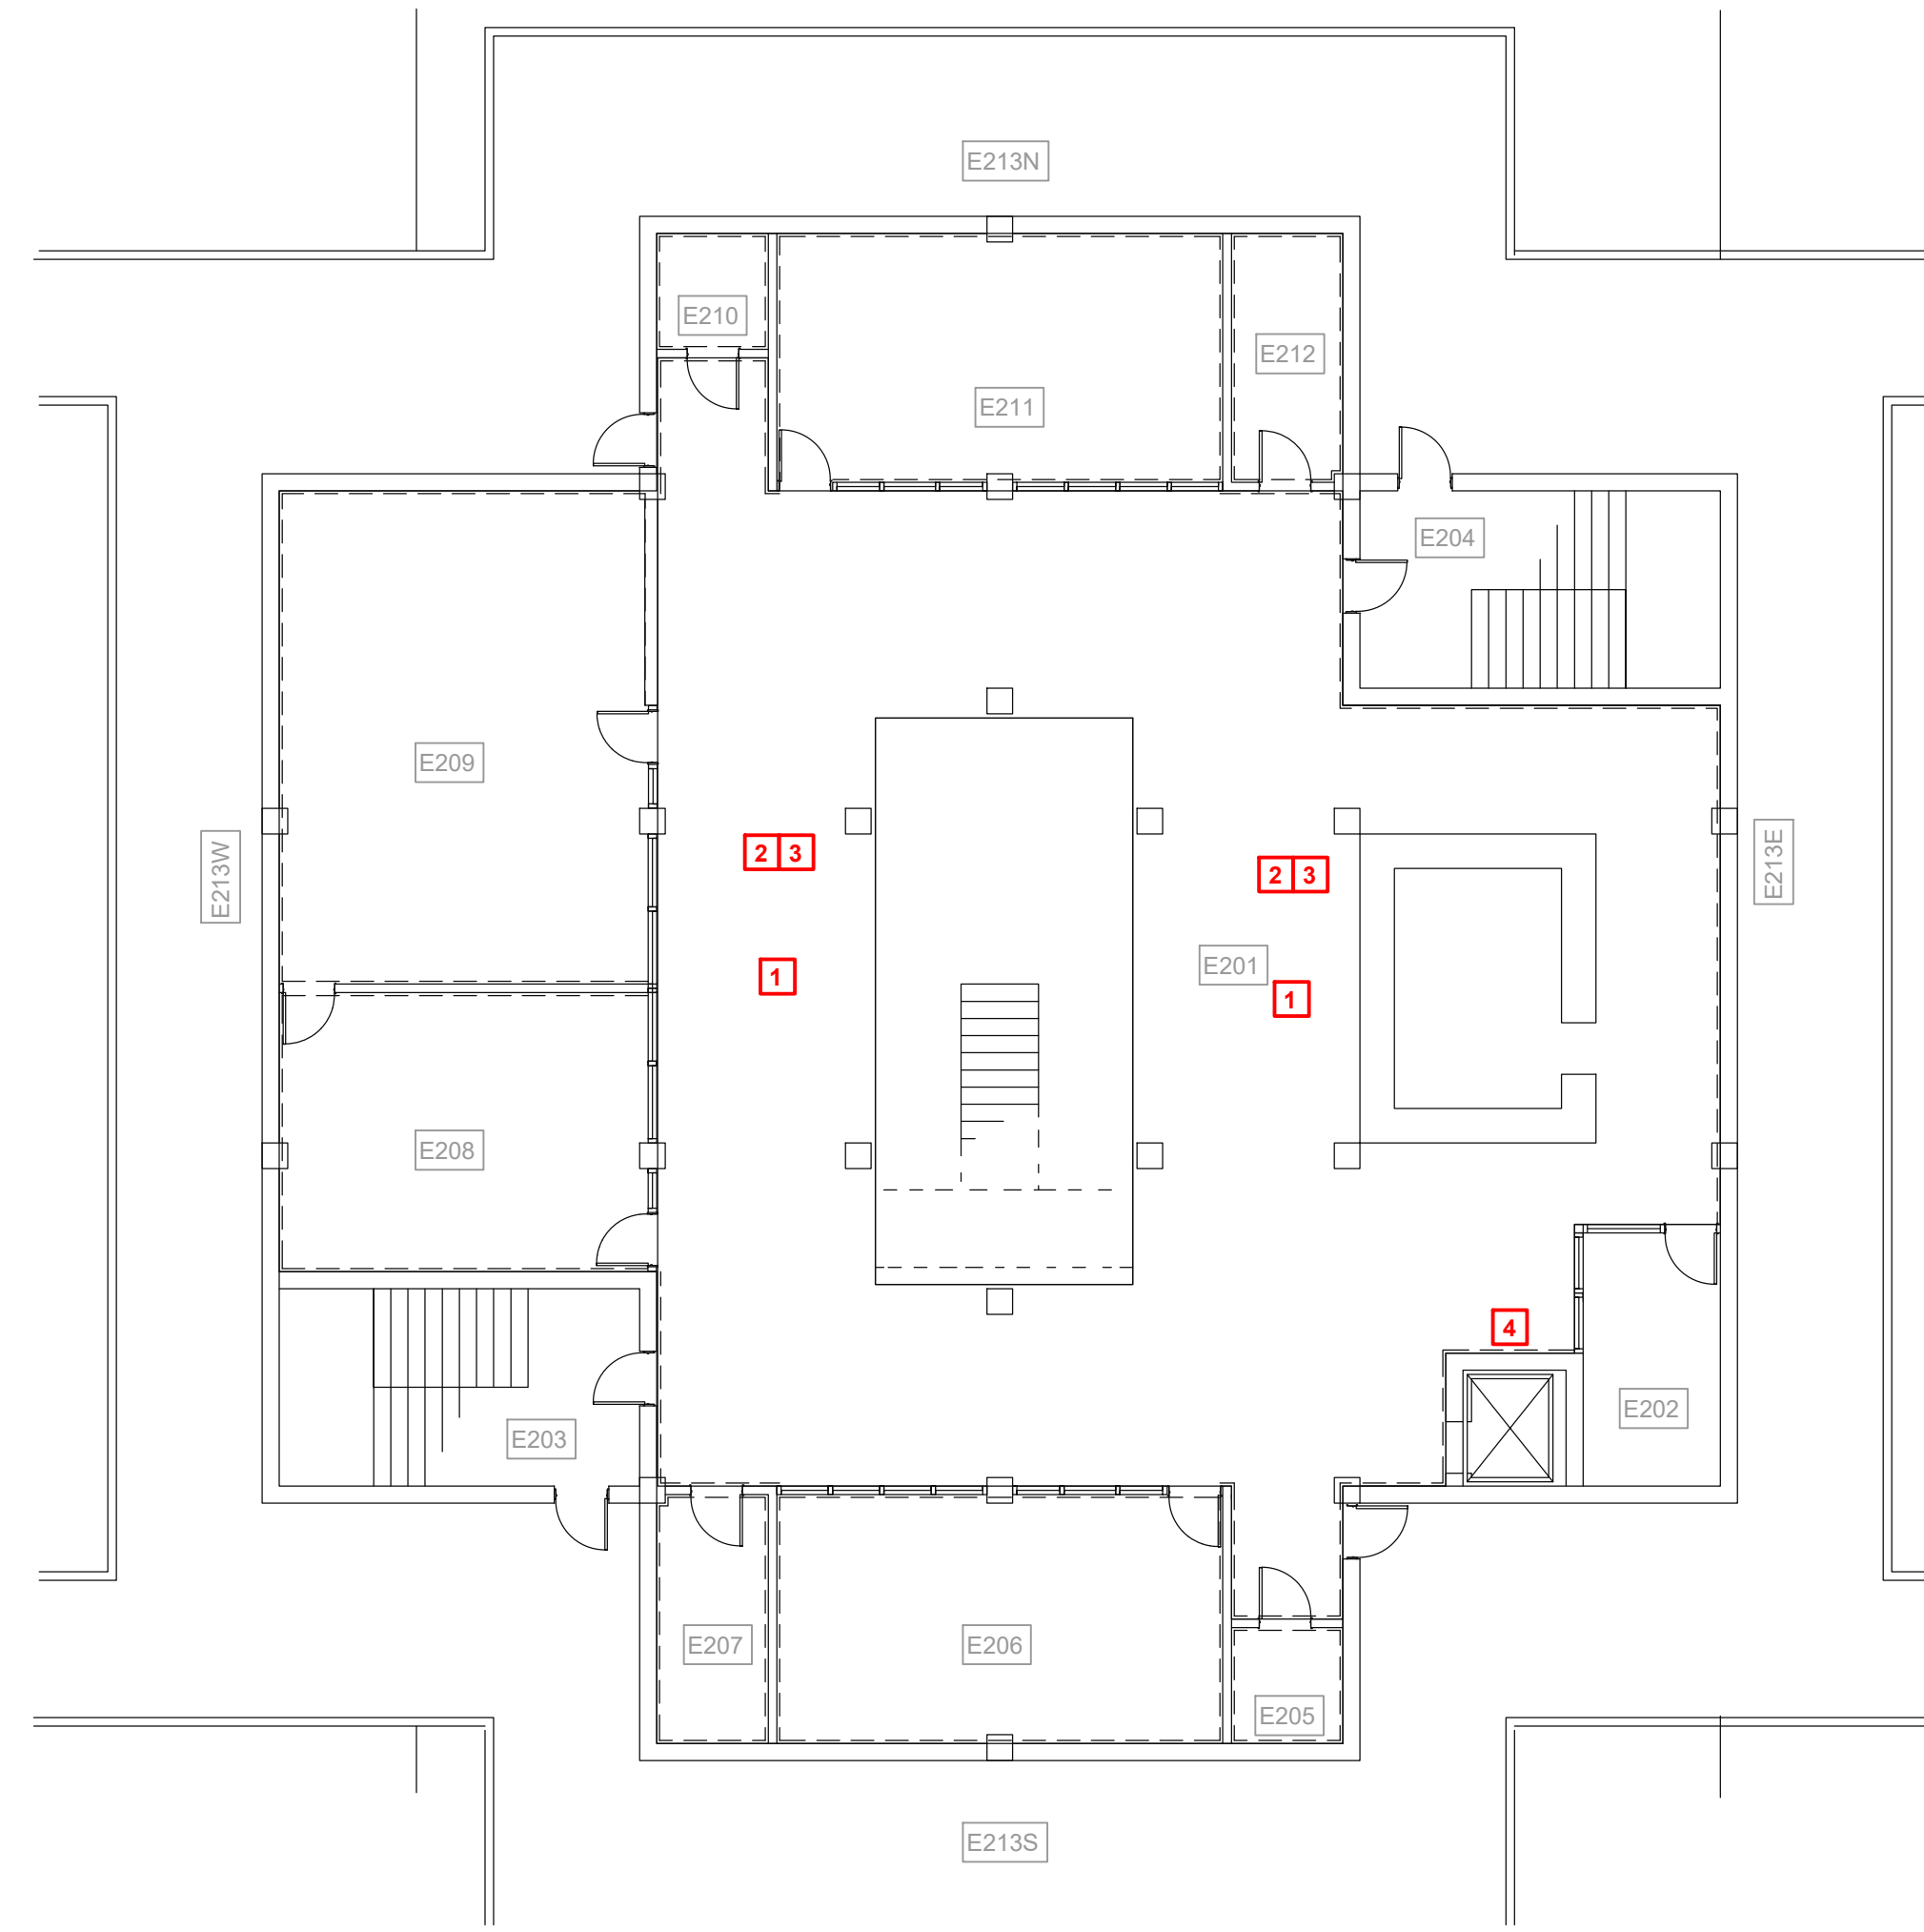
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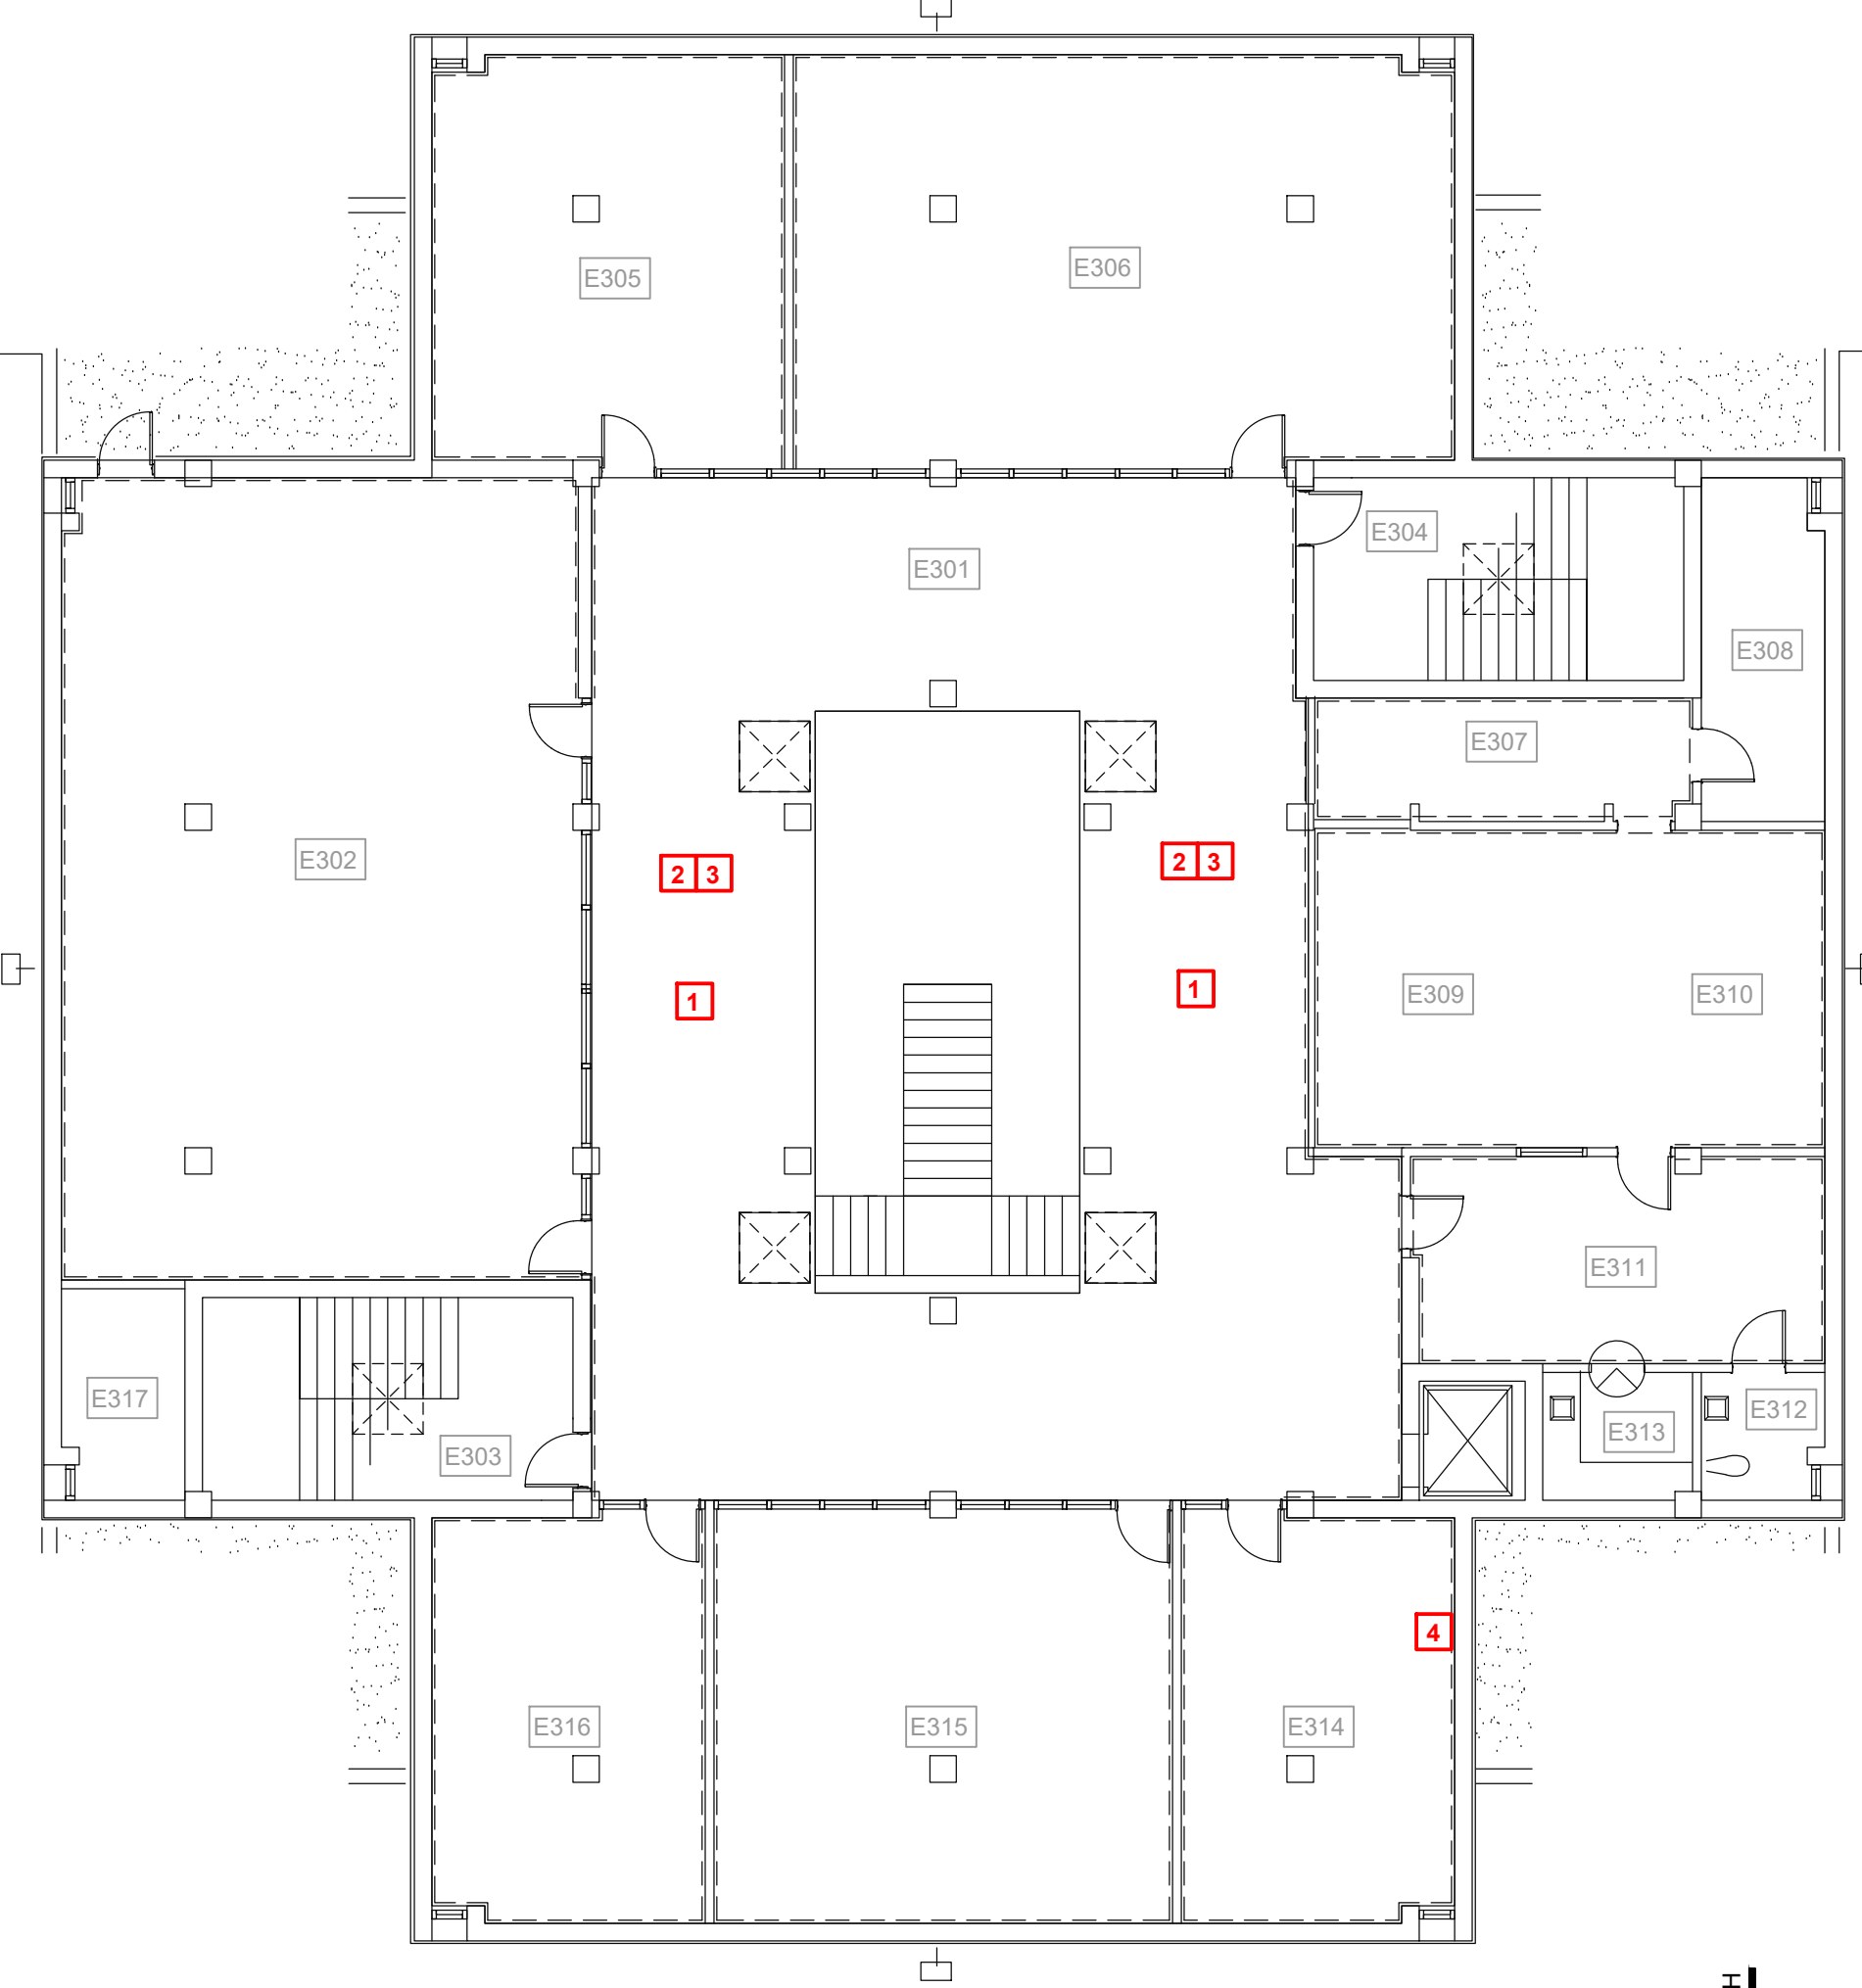
SHEET NUMBER
(E)E0.1
BUILDING E
ROOF PLAN



1 Zone 1 - Building E First Floor - Electrical Plan
1/12" = 1'-0"



2 Zone 1 - Building E Second Floor - Electrical Plan
1/12" = 1'-0"



1 Zone 1 - Building E Third Floor - Electrical Plan
1/12" = 1'-0"

GENERAL NOTES:

- A. CONTRACTOR SHALL NOTIFY ARCHITECT/ENGINEER OF ANY DISCREPANCIES IDENTIFIED IN THE FIELD PRIOR TO ORDERING LIGHT FIXTURES.
- B. THE INTENT OF THE PLAN IS FOR EXISTING CIRCUITING TO REMAIN AND BE RE-USED. ALL EXISTING POWER WIRING SHALL BE PROTECTED DURING DEMOLITION AND AVAILABLE FOR RE-USE. ANY WIRING REMOVED OR DAMAGED DURING CONSTRUCTION SHALL BE REPLACED AT CONTRACTOR'S EXPENSE.
- C. ALL WORK SHALL COMPLY WITH LOCAL, STATE, AND FEDERAL CODES TO THE SATISFACTION OF CODE AUTHORITIES HAVING JURISDICTION.
- D. ALL WORK SHALL COMPLY WITH THE REQUIREMENTS OF THE 2020 EDITION OF NEC.
- E. PRIOR TO DISCONNECTING, AND REMOVING OF ANY ELECTRICAL SERVICES IN THE DESIGNATED AREAS SHOWN, THE CONTRACTOR MUST ENSURE THAT THE SERVICES REMOVED DO NOT AFFECT THE NORMAL OPERATION OF AREAS OUTSIDE THE CONSTRUCTION AREA. COORDINATE WITH OWNER FOR ALL ELECTRICAL SHUT DOWNS AT LEAST 2 WORKING DAYS PRIOR TO WORK.
- F. EXISTING LIGHTING THROUGHOUT THE BUILDING HAS BEEN REPLACED BY THE OWNER IN A PREVIOUS PROJECT. IF THERE ARE SPACES WHERE THE DRAWINGS REQUIRE CEILING REPLACEMENT, THE CONTRACTOR WILL BE REQUIRED TO REMOVE THE EXISTING FIXTURES, PROPERLY STORE THEM ON-SITE (CONTAINER OR OTHER OWNER APPROVED AREA), THEN RE-INSTALL FOLLOWING REPLACEMENT OF CEILINGS WITHIN A GIVEN SPACE.
- G. ALL EXISTING LOW VOLTAGE WIRING SHALL BE PROTECTED DURING DEMOLITION AND AVAILABLE FOR RE-USE. ANY WIRING REMOVED OR DAMAGED DURING CONSTRUCTION SHALL BE REPLACED AT CONTRACTOR'S EXPENSE.

KEYNOTES:

- 1. ANY EXISTING CAMERAS OR WIRELESS ACCESS POINTS TO BE REMOVED DURING CONSTRUCTION SHALL BE COORDINATED WITH CP&B IT DEPARTMENT. DEVICES SHALL BE LABELED AND STORED FOR RE-INSTALLATION. CONTRACTOR IS RESPONSIBLE FOR ANY CUT OR REMOVED COMMUNICATIONS CABLING.
- 2. ANY EXISTING FIRE ALARM DEVICES TO BE REMOVED DURING CONSTRUCTION SHALL BE COORDINATED WITH SYLVAN SOUND. DEVICES SHALL BE LABELED AND STORED FOR RE-INSTALLATION. CONTRACTOR IS RESPONSIBLE FOR ANY CUT OR REMOVED FIRE ALARM WIRING.
- 3. ANY EXISTING INTERCOM DEVICES TO BE REMOVED DURING CONSTRUCTION SHALL BE COORDINATED WITH SYLVAN SOUND. DEVICES SHALL BE LABELED AND STORED FOR RE-INSTALLATION. CONTRACTOR IS RESPONSIBLE FOR ANY CUT OR REMOVED INTERCOM WIRING.
- 4. EXISTING LOCATION OF IT RACK. CONTRACTOR IS RESPONSIBLE FOR PROTECTING IT RACK, EQUIPMENT, AND WIRING DURING CONSTRUCTION. IT RACK SHALL REMAIN OPERATIONAL THROUGHOUT CONSTRUCTION UNLESS APPROVED BY CP&B IT FOR IT TO BE POWERED DOWN. PROVIDE COVER FOR RACK TO MINIMIZE DUST AND DEBRIS WHILE AT THE SAME TIME ALLOWING COOLING AND PROPER AIRFLOW.

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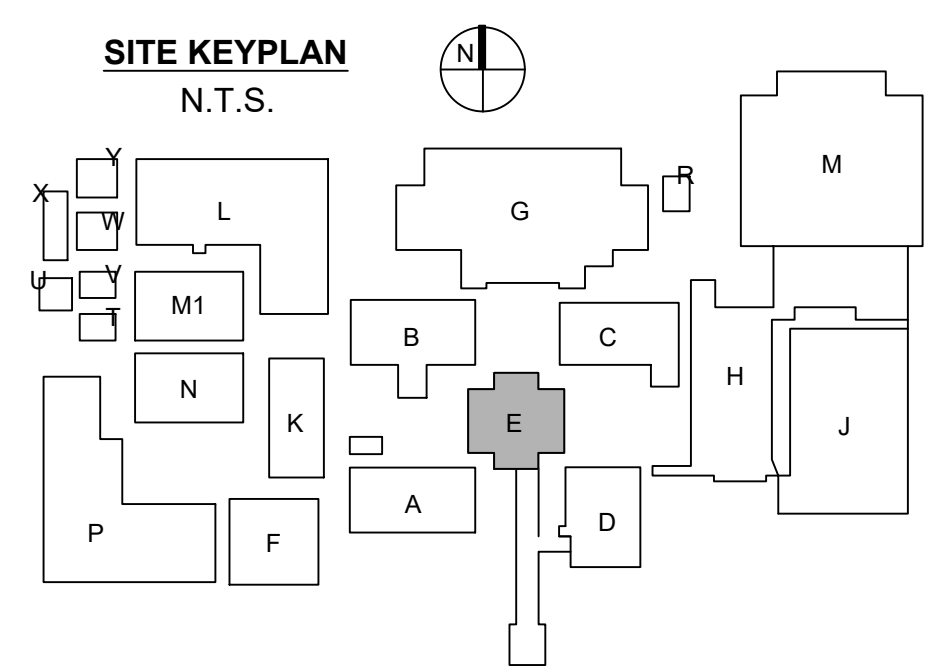
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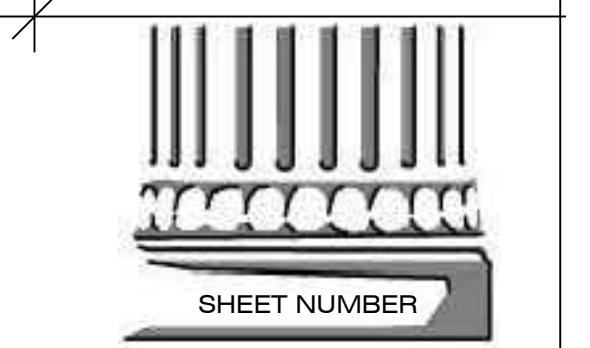


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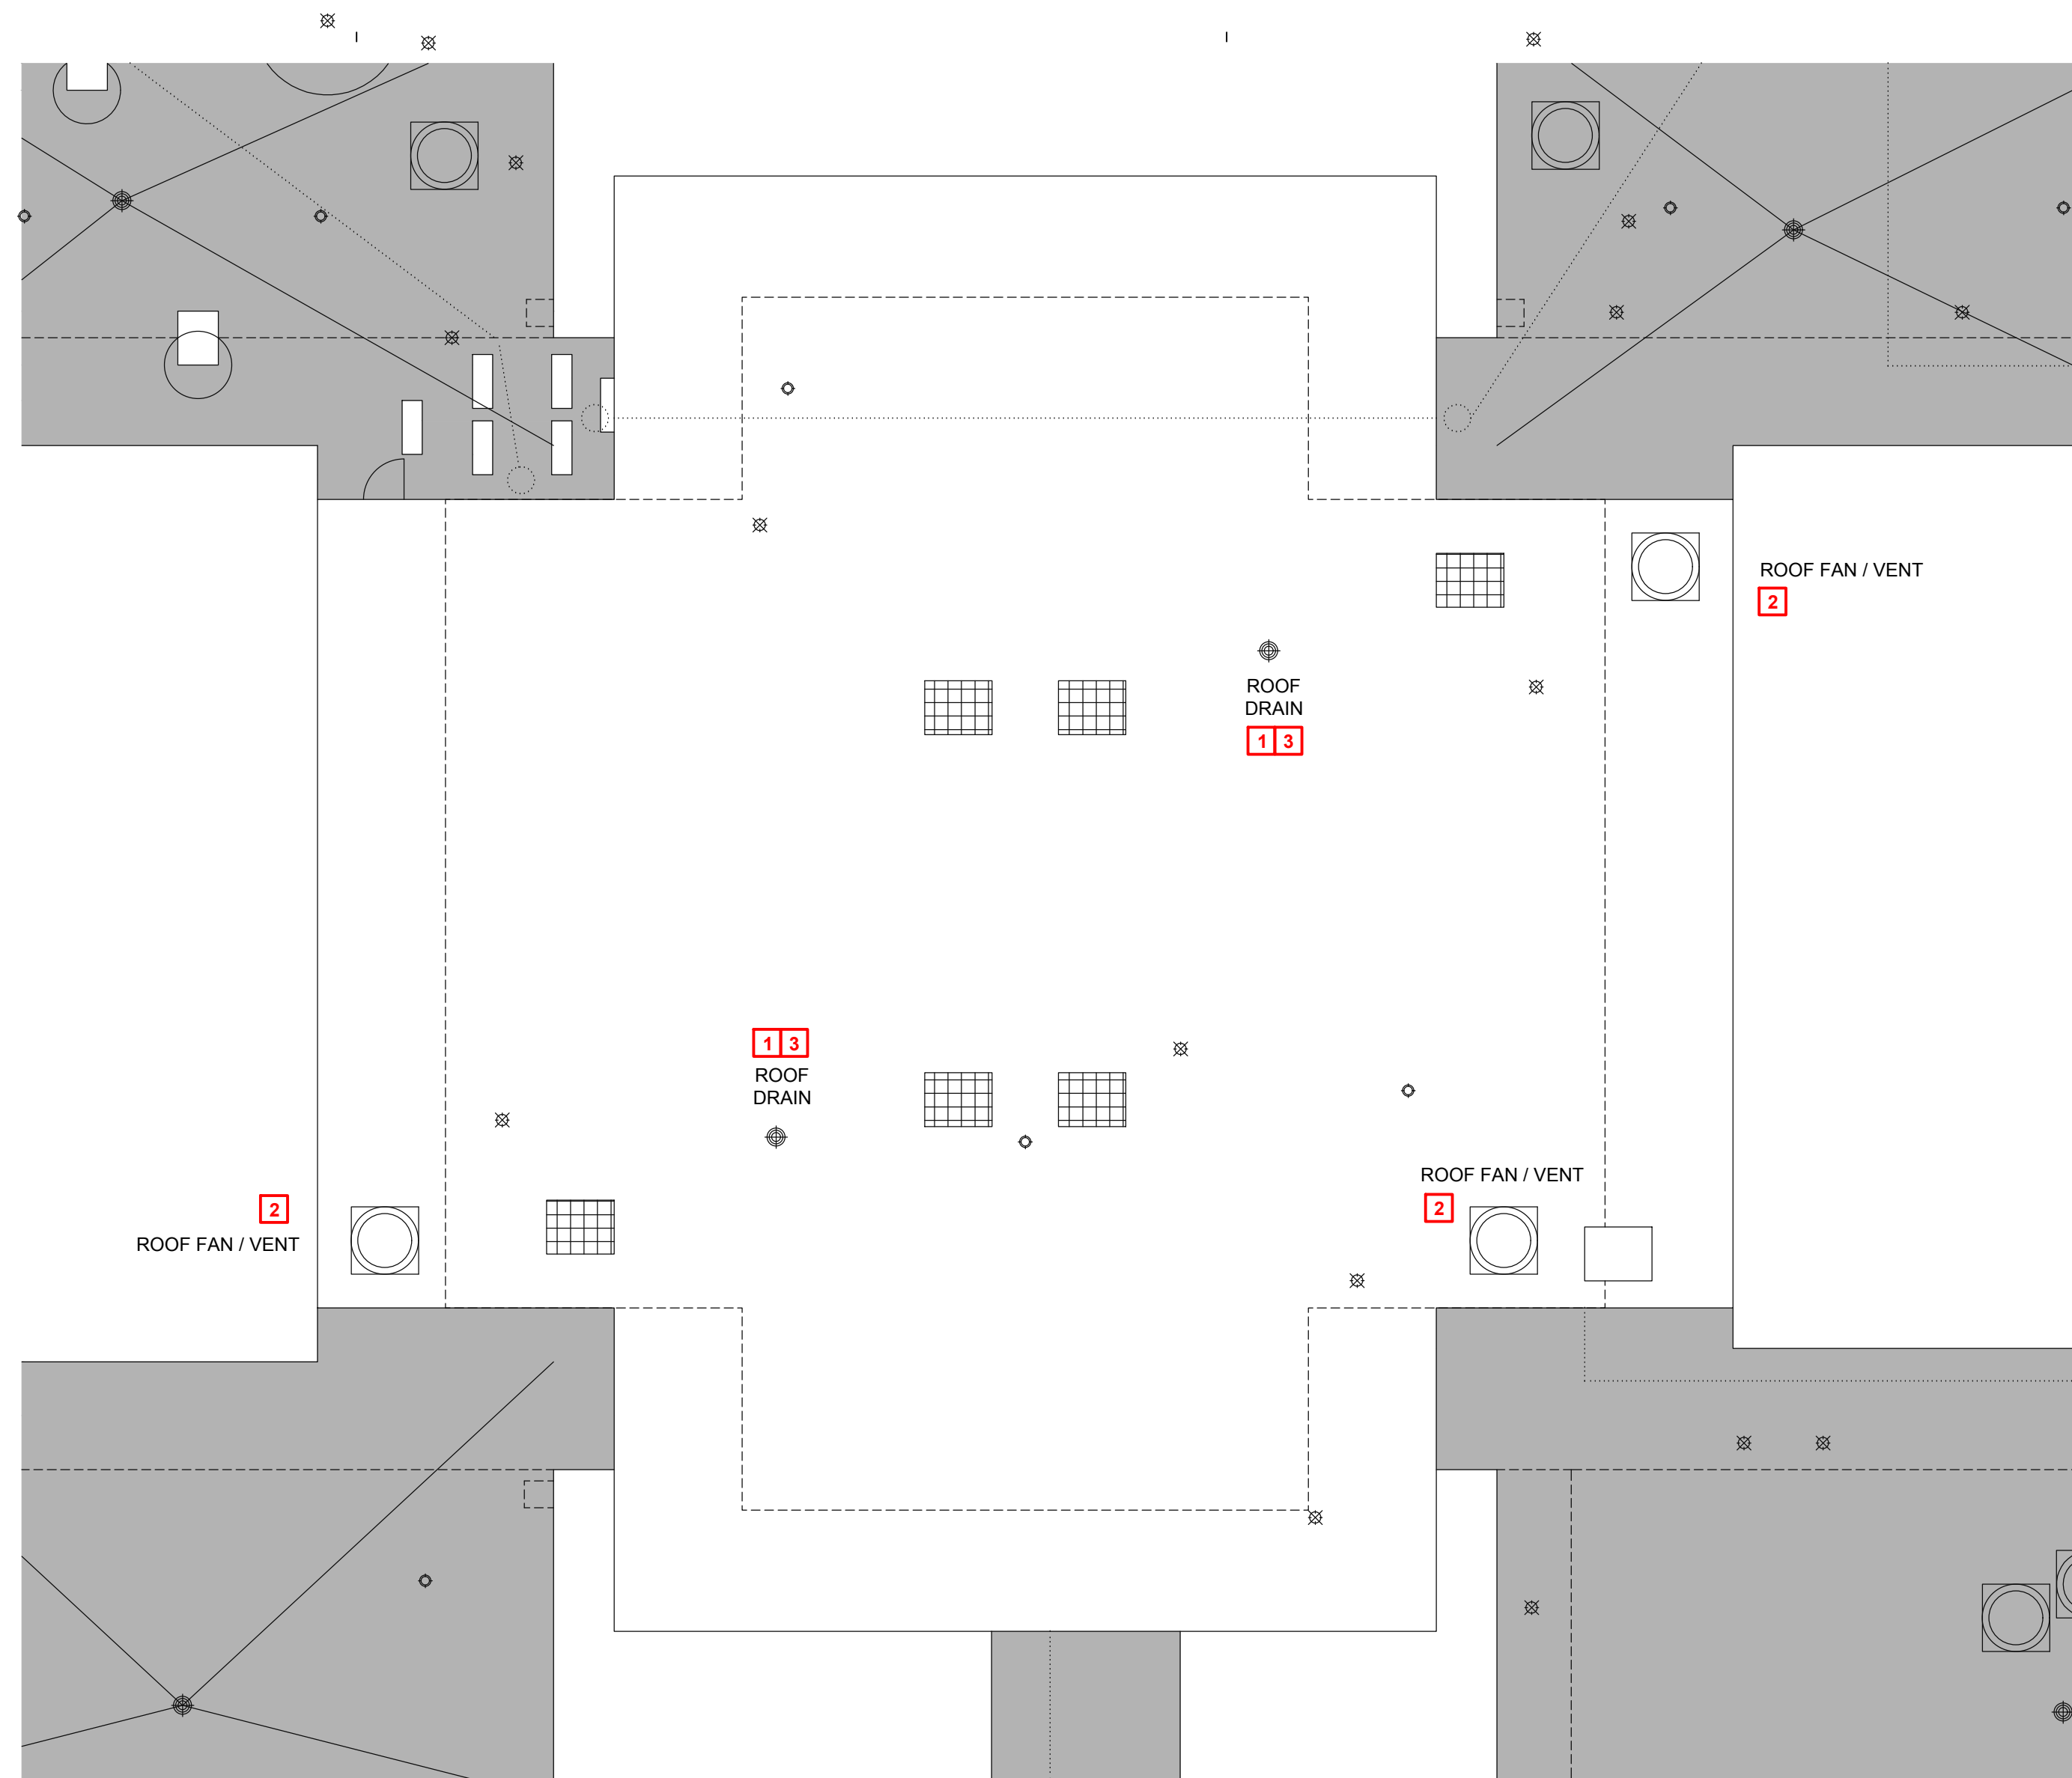
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PROJECT MANAGER DP/TV
DATE ISSUED 06.28.2024

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SHEET NUMBER
(E)E1.1
ZONE 1 - BUILDING E
ELECTRICAL PLANS



1 Mechanical Roof Plan - Building E
3/32" = 1'-0"

NOTE:
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- G. VERIFY ADEQUATE SPACE AVAILABLE PER MANUFACTURER'S RECOMMENDATIONS, COORDINATE CLEARANCE REQUIREMENTS OF ALL MECHANICAL EQUIPMENT.

KEYNOTES TO SHEET:

1. CONTRACTOR SHALL REMOVE EXISTING ROOF DRAIN AN INSTALLED NEW ROOF DRAIN WITH DOME STRAINER IN SAME LOCATION. THE NEW ROOF DRAIN W/ DOME STRAINER SHALL MATCH THE EXISTING SIZE, STYLE, ETC. OF THE EXISTING THAT IS BEING REPLACED AS PART OF THE RE-ROOFING PROJECT.
2. CONTRACTOR SHALL REMOVE EXISTING ROOF MOUNTED HOOD/FAN AND AND INSTALL ON NEW CURB. NEW CURB SHALL MATCH THE EXISTING SIZE, STYLE, ETC. OF EXISTING CURB. COORDINATE CURB HEIGHT WITH ARCHITECT & GENERAL CONTRACTOR PRIOR ORDERING.
3. ALL EXISTING ROOF DRAIN PIPING SHALL BE FLUSHED TO REMOVE LEAVES, DEBRIS, ETC. ONCE THE NEW ROOF DRAINS ARE INSTALLED.

ROOFING SYMBOL LEGEND

- EXISTING SKYLIGHT, TO BE REMOVED AND REPLACED
- ONE-WAY ROOF VENT
- ROOF DRAIN
- ROOF PIPING PENETRATION
- ROOF FAN / VENT
- ROOF FAN / VENT
- DOWNSPOUT
- MISC MEP
- CONDUIT/PIPING RUNS
- EXPANSION JOINT



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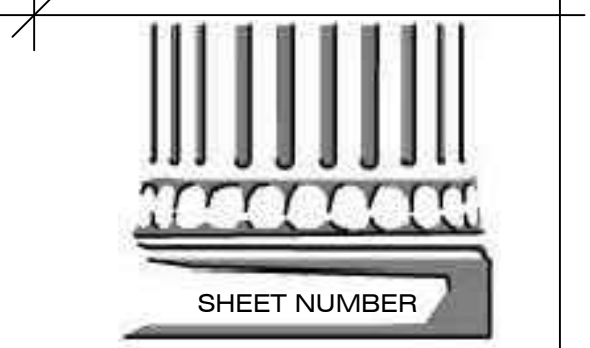
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Lic. No. 29380
6/23/21
PROFESSIONAL
ENGINEER

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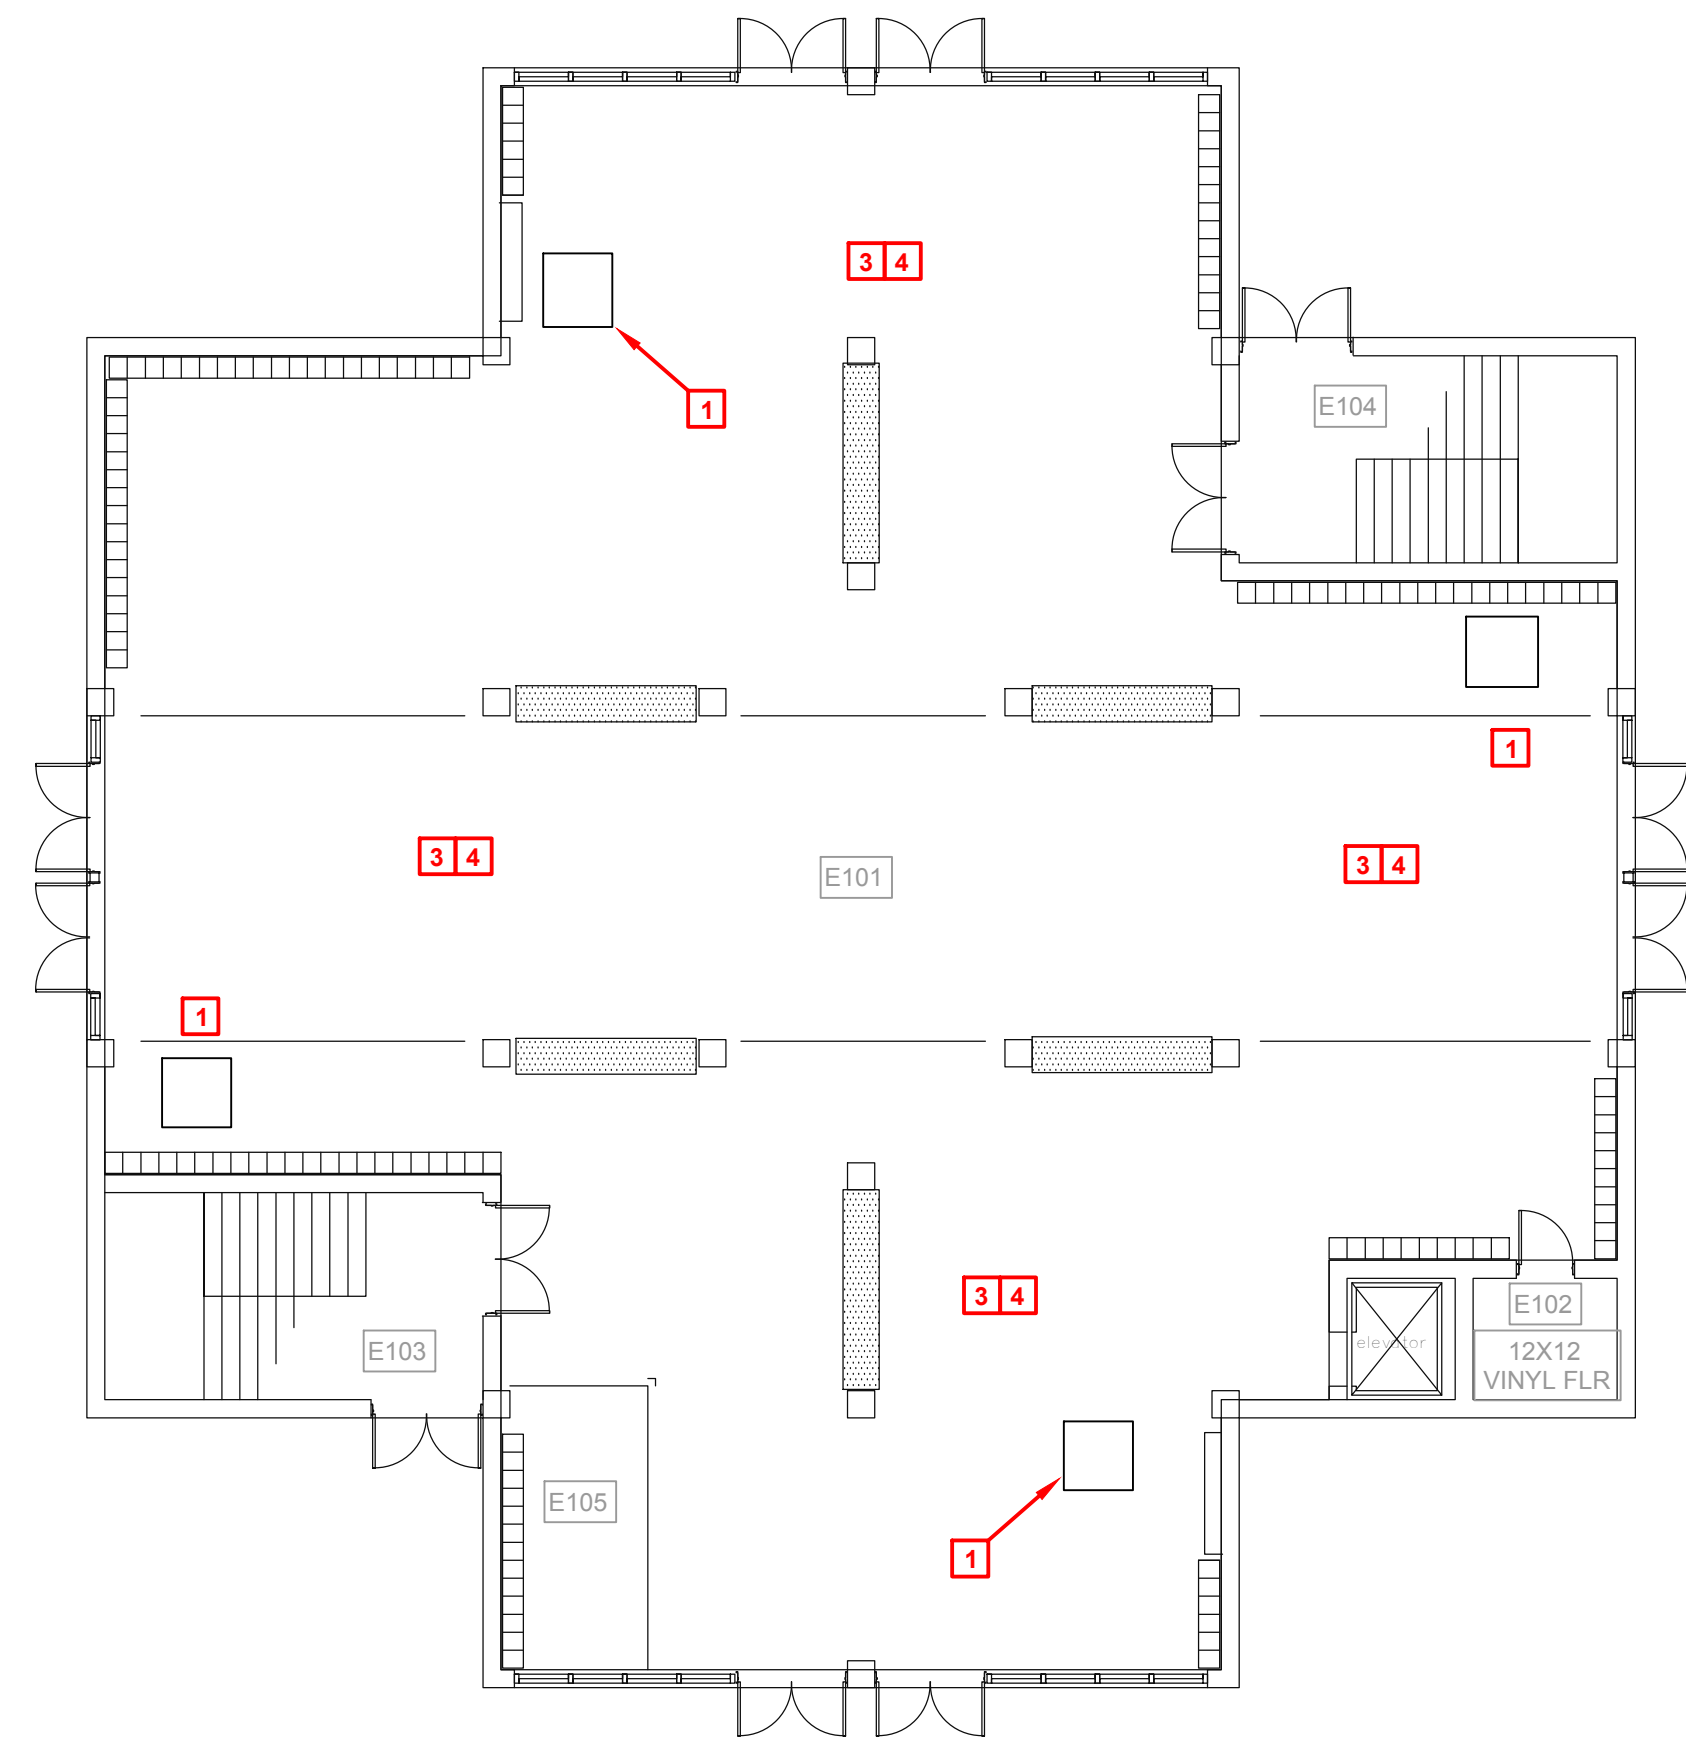
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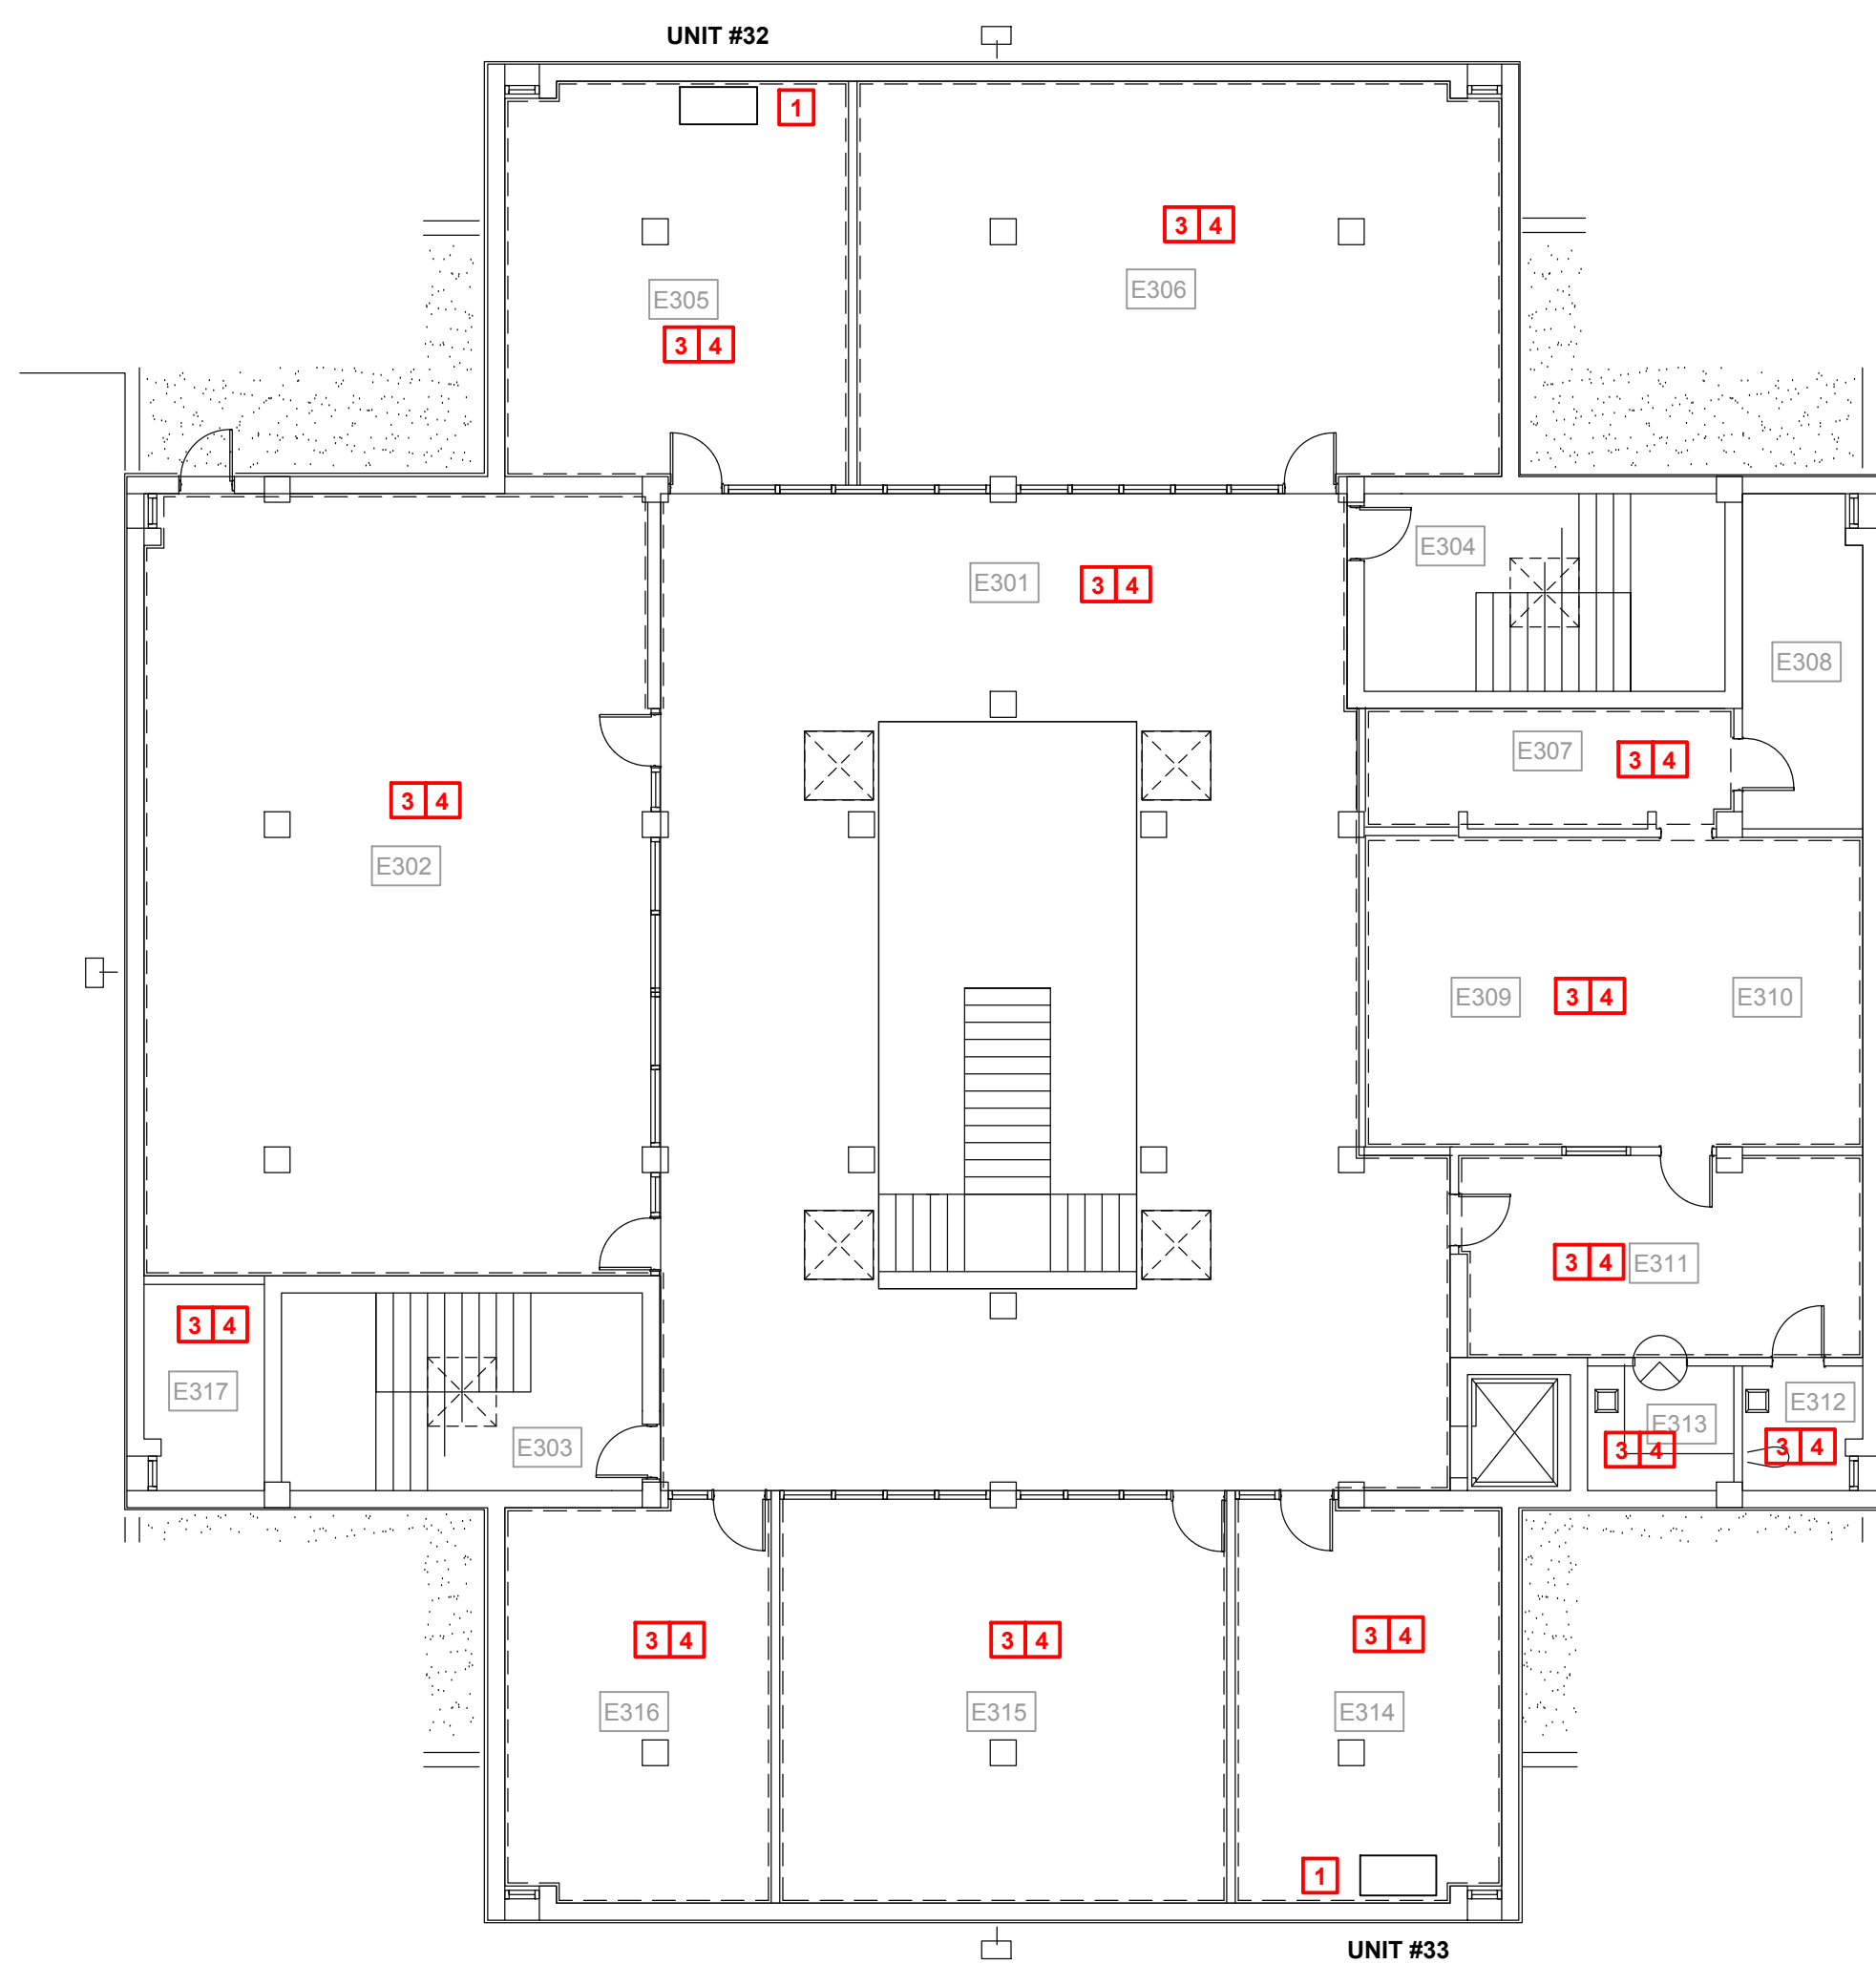
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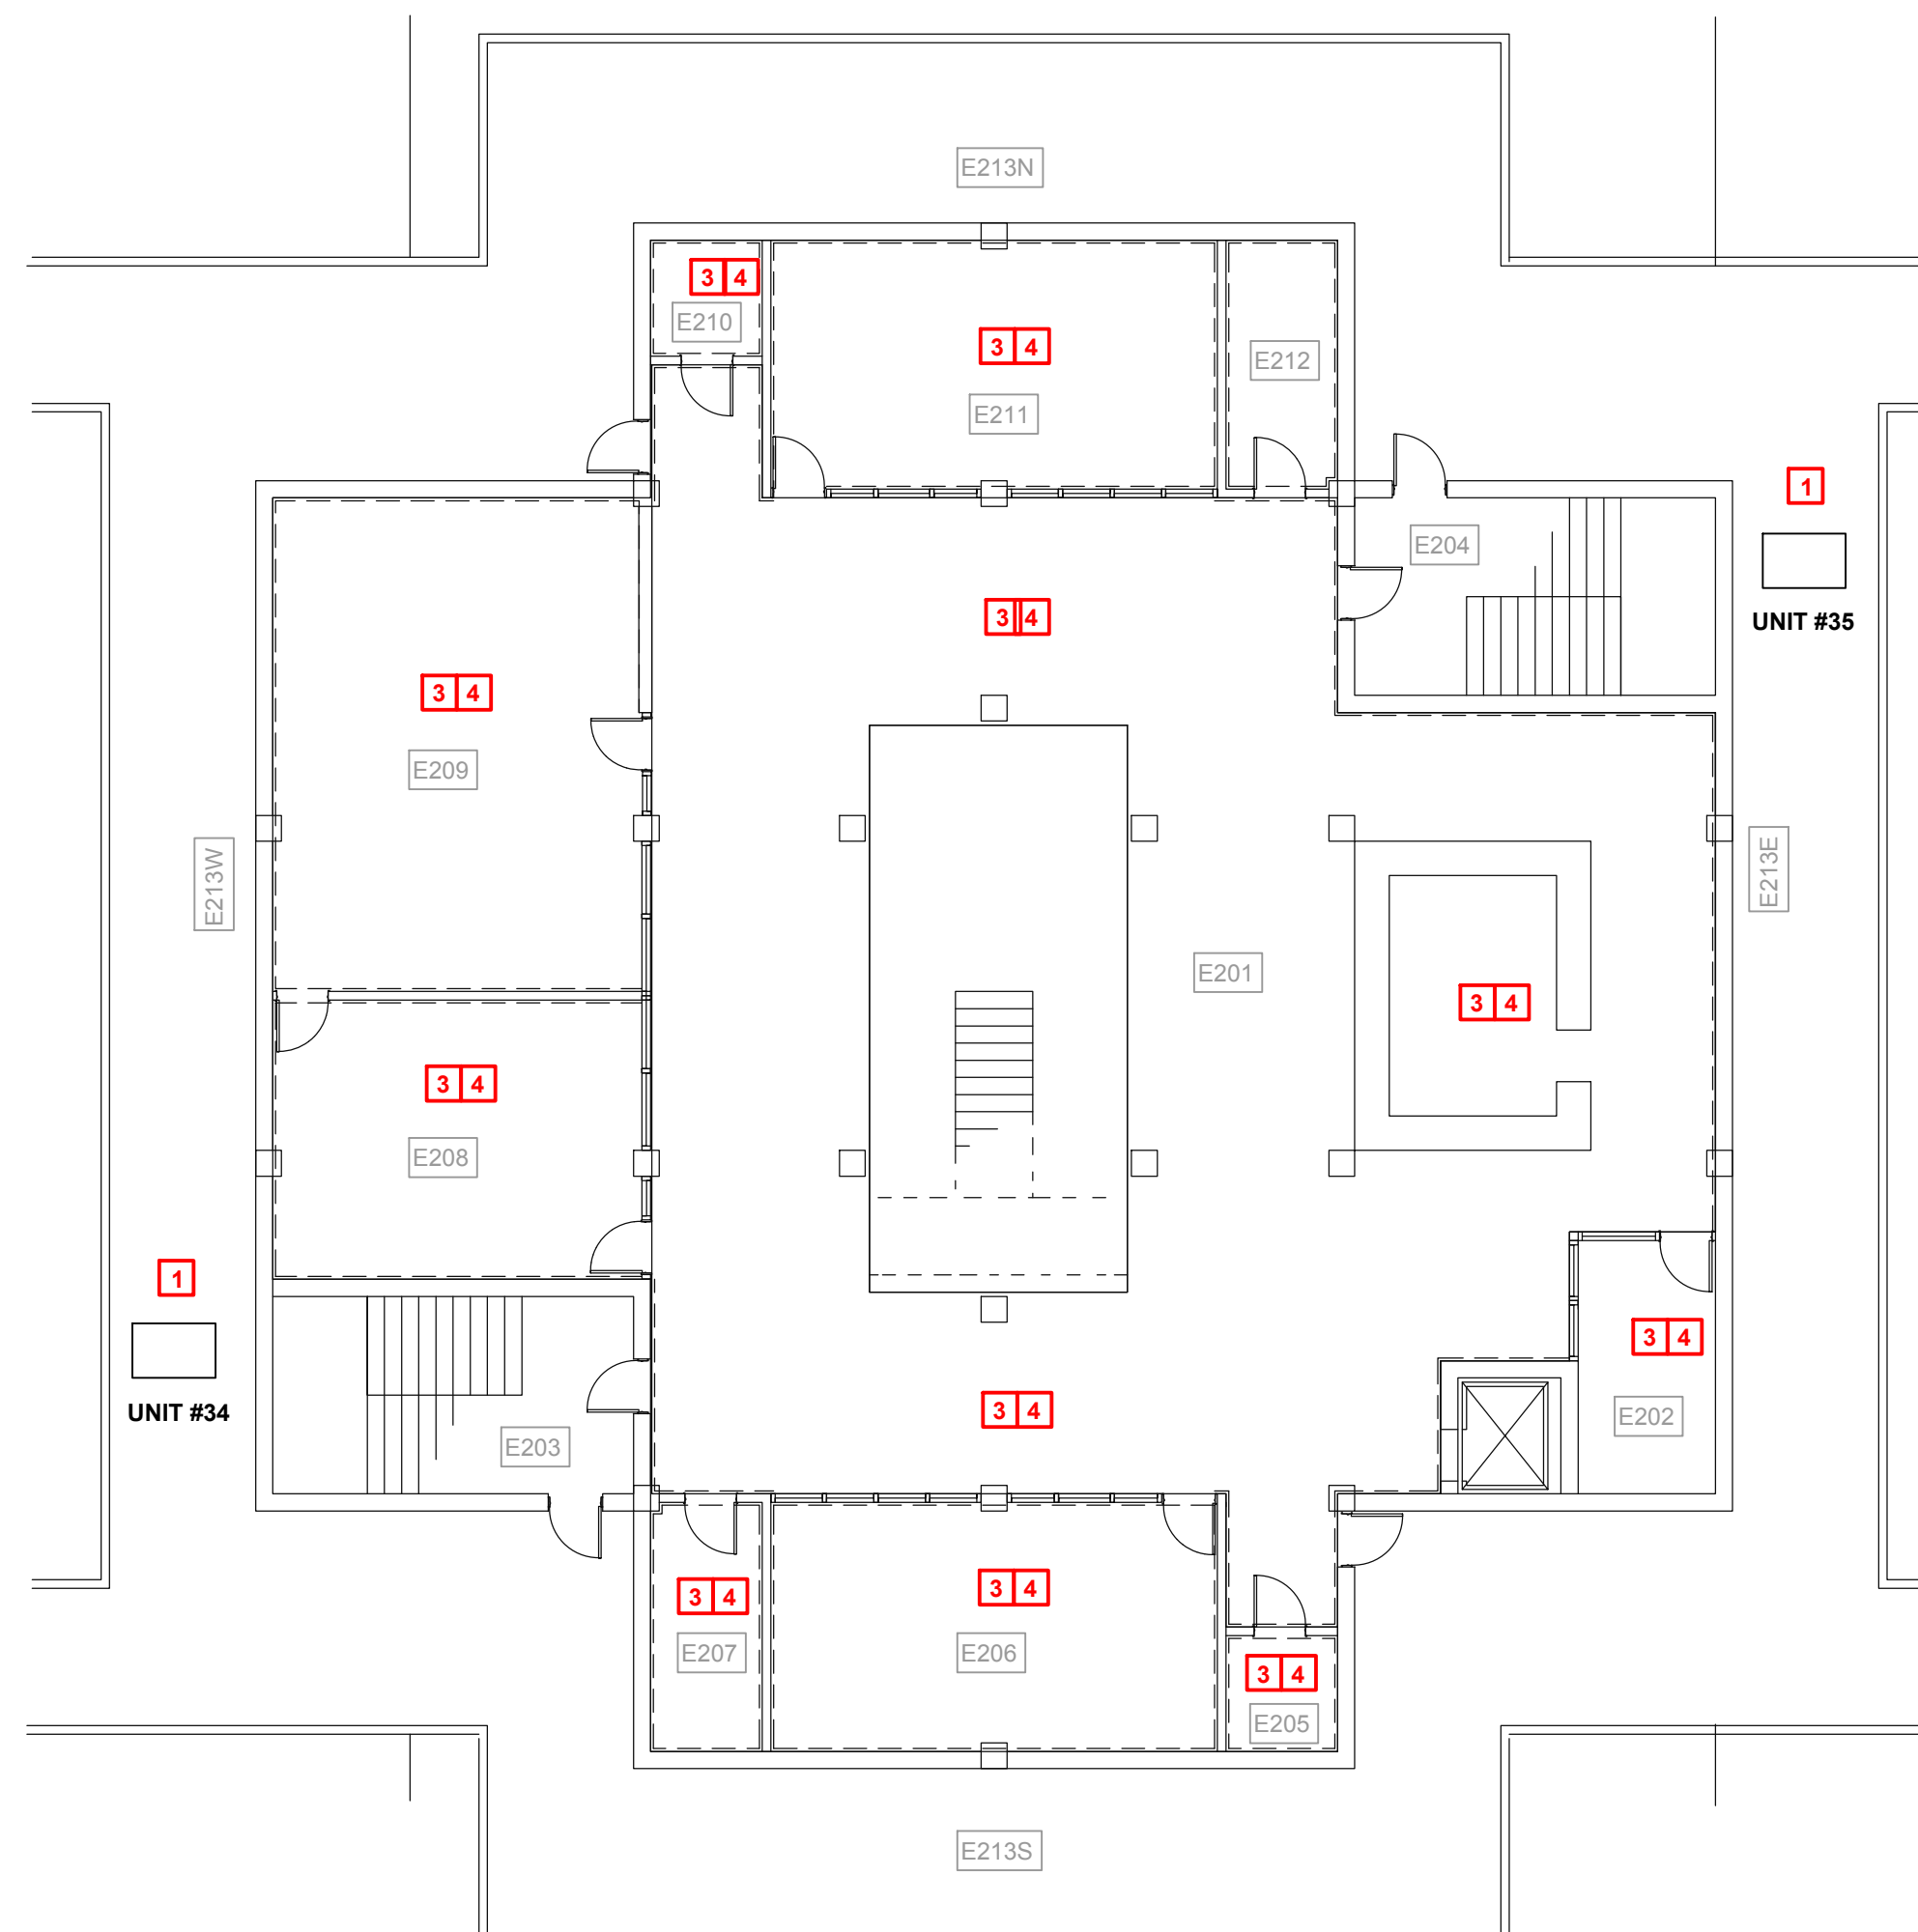
SHEET NUMBER
(E)M0.1
BUILDING E
ROOF PLAN



6 Zone 1 - Building E First Floor - Mechanical Plan
3/32" = 1'-0"



8 Zone 1 - Building E Second Floor - Mechanical Plan
3/32" = 1'-0"



16 Zone 1 - Building E Third Floor - Mechanical Plan
3/32" = 1'-0"

GENERAL NOTES:

- A. CONTRACTOR SHALL FIELD VERIFY EXISTING EQUIPMENT TAGS (WHERE POSSIBLE) IN FIELD PRIOR TO DEMOLITION. COORDINATE ALL SITE VISITS, THROUGH GENERAL CONTRACTOR AND C.P.S.B. CONTRACTOR WEAR REQUIRED PERSONAL PROTECTIVE GEAR (PPE) SPECIFICALLY REQUIRED FOR EACH BUILDING.
- B. CONTRACTOR SHALL NOTIFY ARCHITECT/ENGINEER OF ANY DISCREPANCIES IDENTIFIED IN THE FIELD PRIOR TO FABRICATING DUCTWORK OR ORDERING EQUIPMENT.
- C. CONTRACTOR SHALL PROVIDE TESTING AND BALANCING OF ALL HVAC SYSTEMS WHICH WERE REPLACED, MODIFIED AND/OR CLEANED.
- D. ALL WORK SHALL COMPLY WITH LOCAL, STATE, AND FEDERAL CODES TO THE SATISFACTION OF CODE AUTHORITIES HAVING JURISDICTION.
- E. ALL WORK SHALL COMPLY WITH THE REQUIREMENTS OF NFPA 90A & 101, THE CLEAN AIR ACT AND THE AMERICANS WITH DISABILITIES ACT.
- F. PRIOR TO DRAINING, DISCONNECTING, AND REMOVING OF ANY SERVICES IN THE DESIGNATED AREAS SHOWN, THE CONTRACTOR MUST ENSURE THAT THE SERVICES REMOVED DO NOT AFFECT THE NORMAL OPERATION OF AREAS OUTSIDE THE CONSTRUCTION AREA.
- G. VERIFY ADEQUATE SPACE AVAILABLE PER MANUFACTURER'S RECOMMENDATIONS. COORDINATE CLEARANCE REQUIREMENTS OF ALL MECHANICAL EQUIPMENT.

KEYNOTES TO SHEET:

1. EXISTING FAN COIL UNIT TO REMAIN AND CLEANED PER THE SPECIFICATIONS. REMOVE AND REPLACE EXISTING AIR HANDLING UNIT INTERIOR LINER AND CLEAN INTERIOR OF UNIT INCLUDING COILS.
2. EXISTING AIR HANDLING UNIT TO REMAIN AND CLEANED PER THE SPECIFICATIONS. REMOVE AND REPLACE EXISTING AIR HANDLING UNIT INTERIOR LINER AND CLEAN INTERIOR OF UNIT INCLUDING COILS.
3. NO INTERIOR MECHANICAL (PLUMBING & HVAC) WORK ASSOCIATED WITH THESE SPACES WITHIN THE BUILDING.
4. CONTRACTOR SHALL TEMPORARILY SUPPORT AND PROTECT ANY EQUIPMENT, DIFFUSERS, GRILLES, ETC. IN OR ABOVE CEILING OF THESE SPACES DURING THE REMOVAL AND INSTALLATION OF NEW CEILING. REFER TO ARCHITECTURAL PLANS FOR THOSE LOCATIONS.

NOTE: CONTRACTOR SHALL REVIEW C.P.S.B. MANAGEMENT PLANS PRIOR TO ANY DEMOLITION WORK. REPORT ANY SUSPICIOUS ASBESTOS MATERIALS TO ARCHITECT / ENGINEER PRIOR TO DISTURBING SUSPECT MATERIALS



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NOTE: THE HVAC SCOPE OF WORK IS LIMITED TO REPLACING OR REPAIRING THE HVAC SYSTEM BACK TO ITS ORIGINAL CONDITION (LIKE FOR LIKE) IN MOST CIRCUMSTANCES. THIS PROJECT'S SCOPE OF WORK DOES NOT INCLUDE BRINGING ALL THE EXISTING HVAC SYSTEMS UP TO CODE OR ADDRESSING EXISTING CONDITIONS. ALTHOUGH ALL WORK MUST COMPLY WITH FEMA CONSENSUS-BASED, "LATEST PUBLISHED EDITIONS" OF CODES NOT NECESSARILY THOSE CODES ADOPTED BY THE LOCAL MUNICIPALITY.

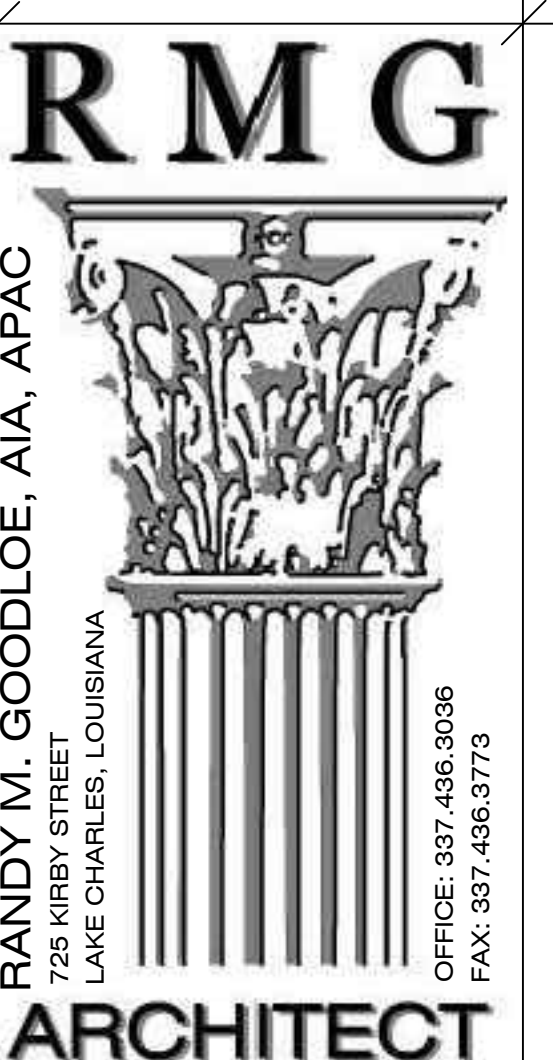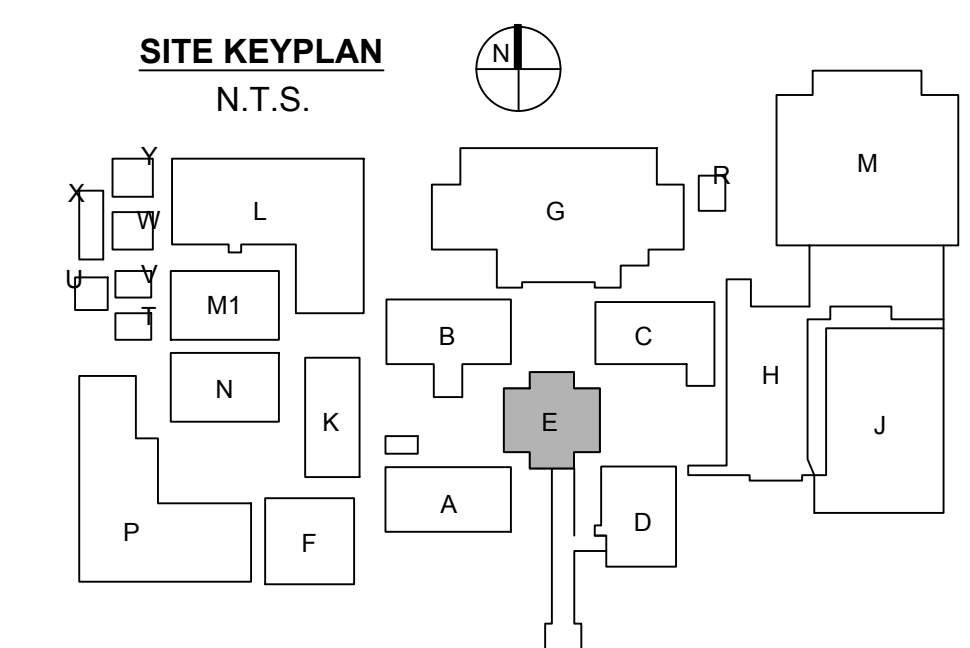NOTE: REFER TO ARCHITECTURAL DRAWINGS FOR ALL DIMENSIONS.



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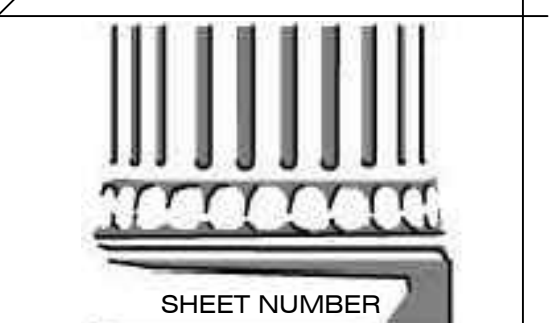


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FOR
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HL-003-01.03.04.05.06.07

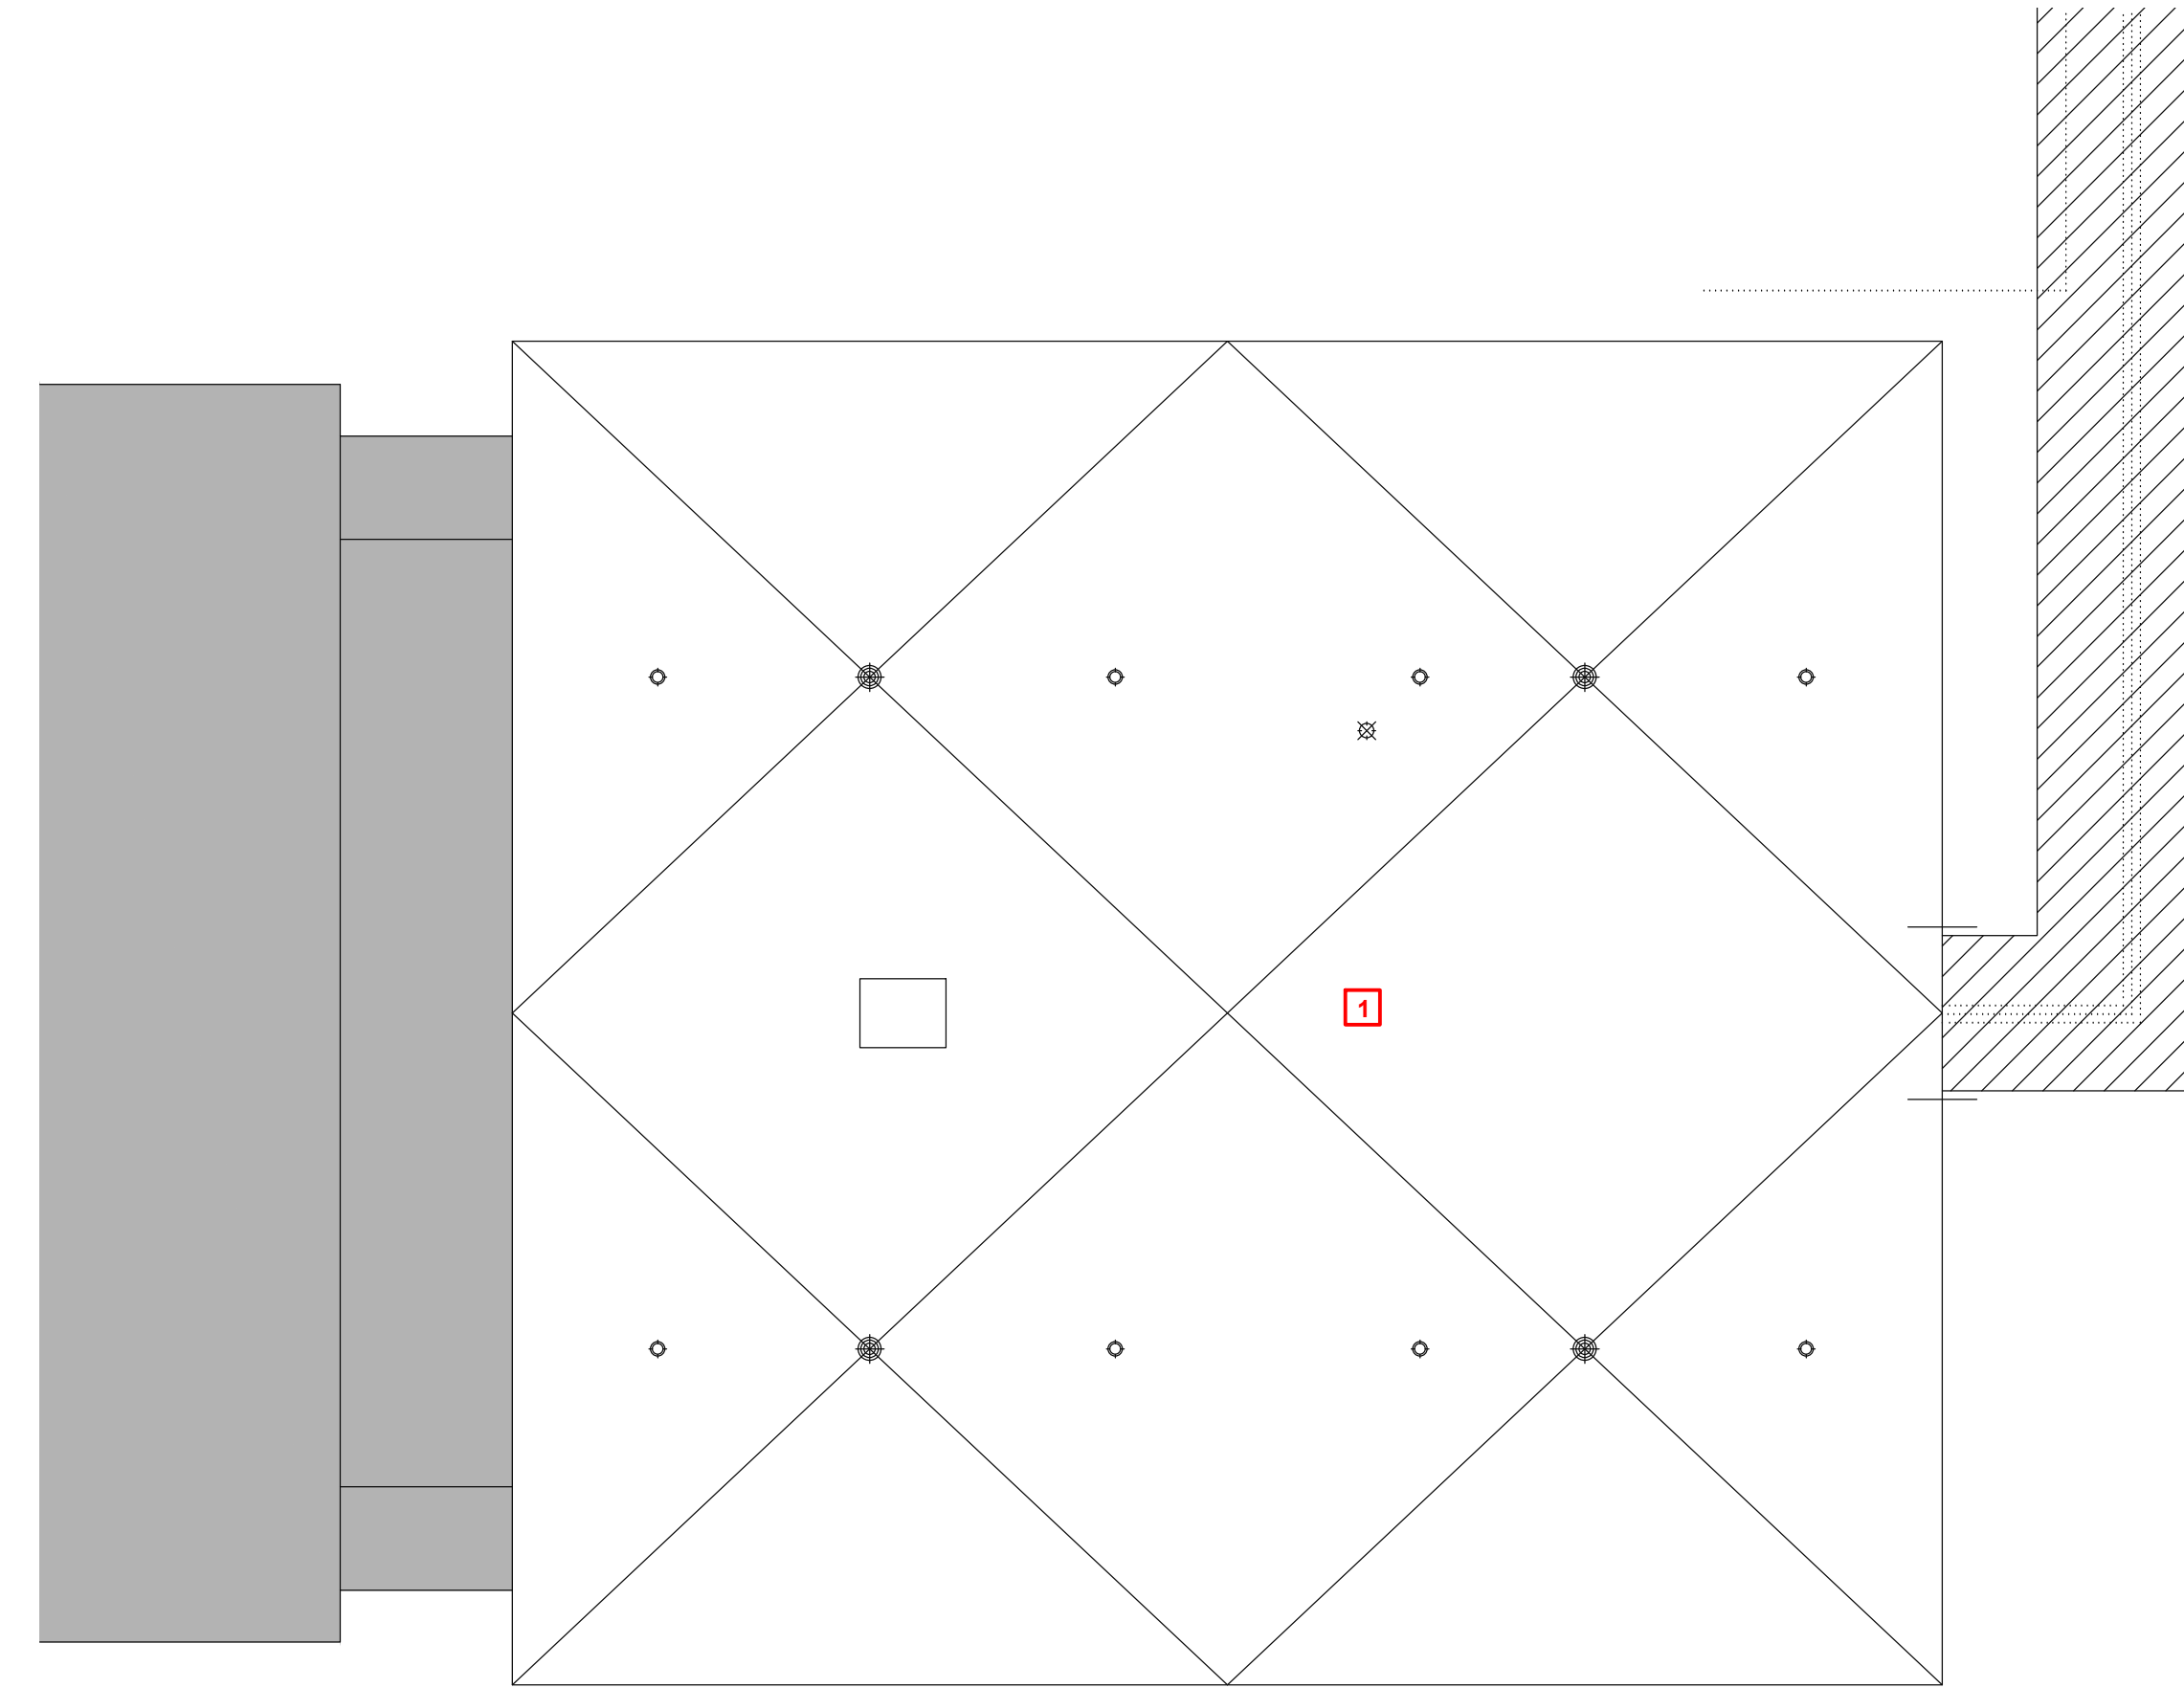
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OWNER PROJECT NO. HL-003-01.03.04.05.06.07
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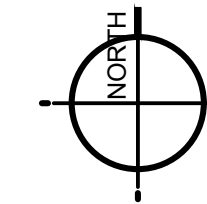
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(E)M1.1
ZONE 1 - BUILDING E
MECHANICAL PLANS



1 Electrical Roof Plan - Building F
3/32" = 1'-0"



GENERAL NOTES:

- A. CONTRACTOR SHALL FIELD VERIFY EXISTING ELECTRICAL EQUIPMENT SIZES IN FIELD PRIOR TO DEMOLITION. COORDINATE ALL SITE VISITS, THROUGH GENERAL CONTRACTOR AND C.P.S.B.. CONTRACTOR WEAR REQUIRED PERSONAL PROTECTIVE GEAR (PPE) SPECIFICALLY REQUIRED FOR EACH BUILDING.
- B. CONTRACTOR SHALL NOTIFY ARCHITECT/ENGINEER OF ANY DISCREPANCIES IDENTIFIED IN THE FIELD PRIOR ORDERING NEW EQUIPMENT.
- C. ALL WORK SHALL COMPLY WITH LOCAL, STATE, AND FEDERAL CODES TO THE SATISFACTION OF CODE AUTHORITIES HAVING JURISDICTION.
- E. PRIOR TO DISCONNECTING, AND REMOVING OF ANY ELECTRICAL SERVICES IN THE DESIGNATED AREAS SHOWN, THE CONTRACTOR MUST ENSURE THAT THE SERVICES REMOVED DO NOT AFFECT THE NORMAL OPERATION OF AREAS OUTSIDE THE CONSTRUCTION AREA. COORDINATE WITH OWNER FOR ALL ELECTRICAL SHUT DOWNS AT LEAST 2 WORKING DAYS PRIOR TO WORK.

KEYNOTES TO SHEET:

- 1. NO ELECTRICAL WORK ASSOCIATED WITH THIS ROOF.

ROOFING SYMBOL LEGEND

- EXISTING SKYLIGHT
- ONE-WAY ROOF VENT
- ROOF DRAIN
- ROOF PIPING PENETRATION
- ROOF FAN / VENT
- ROOF FAN / VENT
- DOWNSPOUT
- MISC MEP
- CONDUIT/PIPING RUNS
- EXPANSION JOINT



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NOTE:
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NOTE: THE ELECTRICAL SCOPE OF WORK IS LIMITED TO REPLACING OR REPAIRING THE ELECTRICAL SYSTEM BACK TO ITS ORIGINAL CONDITION (LIKE FOR LIKE). THIS PROJECT'S SCOPE OF WORK DOES NOT INCLUDE BRINGING THE EXISTING ELECTRICAL SYSTEMS UP TO CODE OR ADDRESSING EXISTING CONDITIONS.

NOTE:
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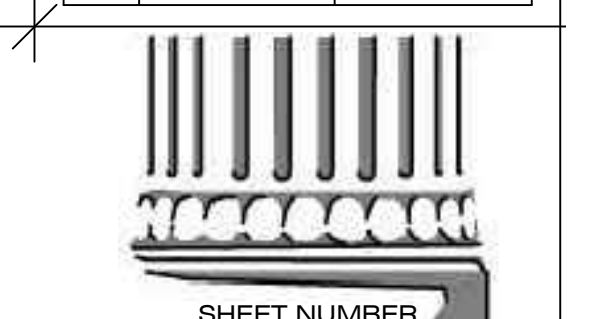
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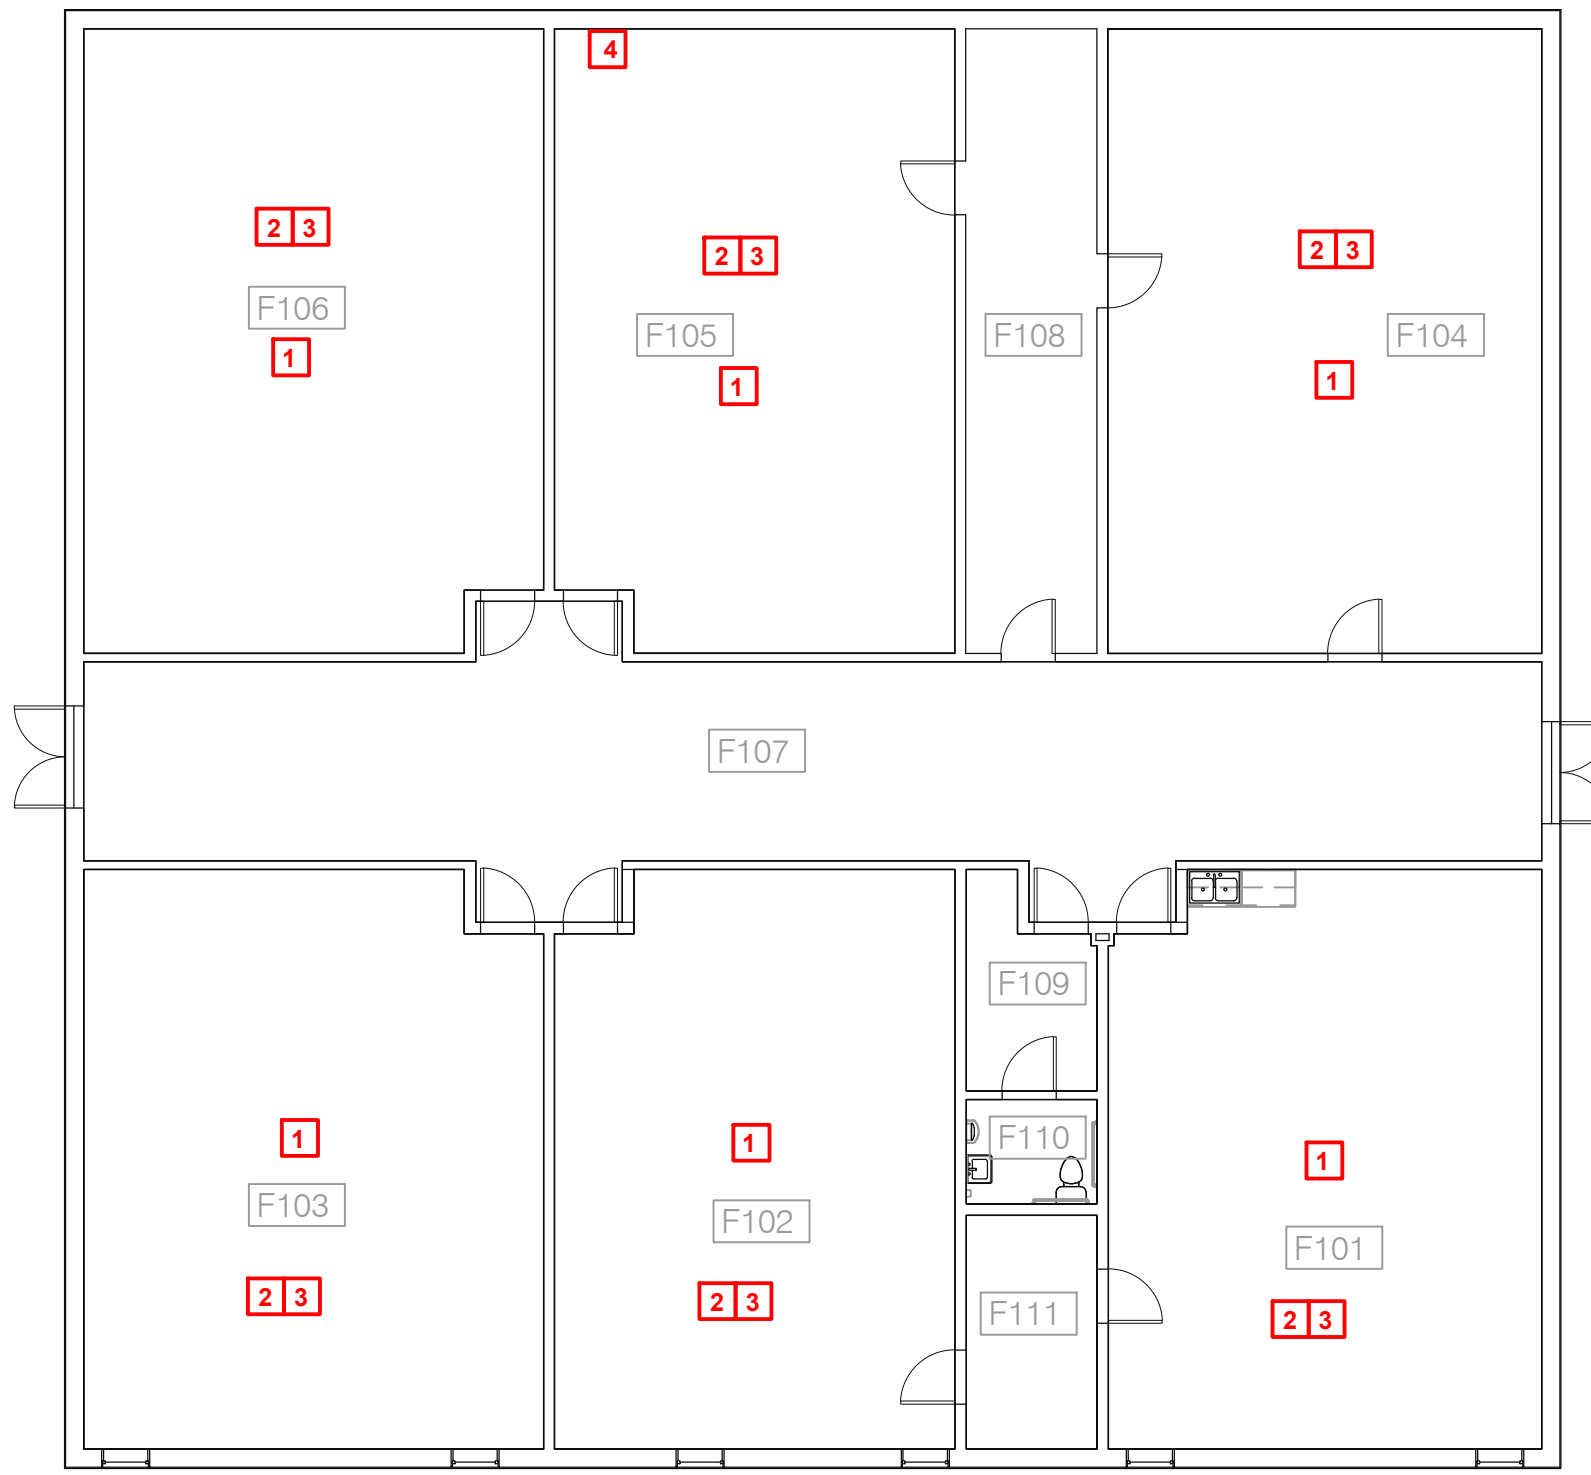
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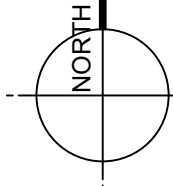
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SHEET NUMBER
(F)E0.1
BUILDING F
ROOF PLAN



1 Zone 1 - Building F - Electrical Plan
1/12" = 1'-0"



GENERAL NOTES:

- A. CONTRACTOR SHALL NOTIFY ARCHITECT/ENGINEER OF ANY DISCREPANCIES IDENTIFIED IN THE FIELD PRIOR TO ORDERING LIGHT FIXTURES.
- B. THE INTENT OF THE PLAN IS FOR EXISTING CIRCUITING TO REMAIN AND BE RE-USED. ALL EXISTING POWER WIRING SHALL BE PROTECTED DURING DEMOLITION AND AVAILABLE FOR RE-USE. ANY WIRING REMOVED OR DAMAGED DURING CONSTRUCTION SHALL BE REPLACED AT CONTRACTOR'S EXPENSE.
- C. ALL WORK SHALL COMPLY WITH LOCAL, STATE, AND FEDERAL CODES TO THE SATISFACTION OF CODE AUTHORITIES HAVING JURISDICTION.
- D. ALL WORK SHALL COMPLY WITH THE REQUIREMENTS OF THE 2020 EDITION OF NEC.
- E. PRIOR TO DISCONNECTING, AND REMOVING OF ANY ELECTRICAL SERVICES IN THE DESIGNATED AREAS SHOWN, THE CONTRACTOR MUST ENSURE THAT THE SERVICES REMOVED DO NOT AFFECT THE NORMAL OPERATION OF AREAS OUTSIDE THE CONSTRUCTION AREA. COORDINATE WITH OWNER FOR ALL ELECTRICAL SHUT DOWNS AT LEAST 2 WORKING DAYS PRIOR TO WORK.
- F. EXISTING LIGHTING THROUGHOUT THE BUILDING HAS BEEN REPLACED BY THE OWNER IN A PREVIOUS PROJECT. IF THERE ARE SPACES WHERE THE DRAWINGS REQUIRE CEILING REPLACEMENT, THE CONTRACTOR WILL BE REQUIRED TO REMOVE THE EXISTING FIXTURES, PROPERLY STORE THEM ON-SITE (CONTAINER OR OTHER OWNER APPROVED AREA), THEN RE-INSTALL FOLLOWING REPLACEMENT OF CEILING WITHIN A GIVEN SPACE.
- G. ALL EXISTING LOW VOLTAGE WIRING SHALL BE PROTECTED DURING DEMOLITION AND AVAILABLE FOR RE-USE. ANY WIRING REMOVED OR DAMAGED DURING CONSTRUCTION SHALL BE REPLACED AT CONTRACTOR'S EXPENSE.

KEYNOTES:

- 1. ANY EXISTING CAMERAS OR WIRELESS ACCESS POINTS TO BE REMOVED DURING CONSTRUCTION SHALL BE COORDINATED WITH CPSB IT DEPARTMENT. DEVICES SHALL BE LABELED AND STORED FOR RE-INSTALLATION. CONTRACTOR IS RESPONSIBLE FOR ANY CUT OR REMOVED COMMUNICATIONS CABLING.
- 2. ANY EXISTING FIRE ALARM DEVICES TO BE REMOVED DURING CONSTRUCTION SHALL BE COORDINATED WITH SYLVAN SOUND. DEVICES SHALL BE LABELED AND STORED FOR RE-INSTALLATION. CONTRACTOR IS RESPONSIBLE FOR ANY CUT OR REMOVED FIRE ALARM WIRING.
- 3. ANY EXISTING INTERCOM DEVICES TO BE REMOVED DURING CONSTRUCTION SHALL BE COORDINATED WITH SYLVAN SOUND. DEVICES SHALL BE LABELED AND STORED FOR RE-INSTALLATION. CONTRACTOR IS RESPONSIBLE FOR ANY CUT OR REMOVED INTERCOM WIRING.
- 4. EXISTING LOCATION OF IT RACK. CONTRACTOR IS RESPONSIBLE FOR PROTECTING IT RACK, EQUIPMENT, AND WIRING DURING CONSTRUCTION. IT RACK SHALL REMAIN OPERATIONAL THROUGHOUT CONSTRUCTION UNLESS APPROVED BY CPSB IT FOR IT TO BE POWERED DOWN. PROVIDE COVER FOR RACK TO MINIMIZE DUST AND DEBRIS WHILE AT THE SAME TIME ALLOWING COOLING AND PROPER AIRFLOW.


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NOTE: REFER TO ARCHITECTURAL DRAWINGS FOR ALL DIMENSIONS.

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ARCHITECT


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DAVID B. STELLY
License No. 28070
06/28/2024
PROFESSIONAL ENGINEER
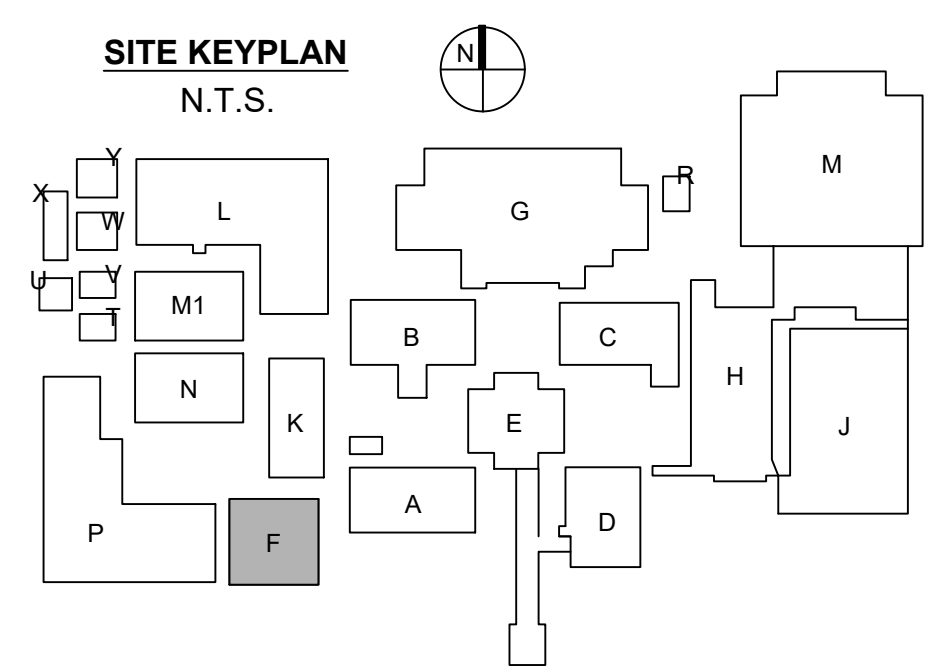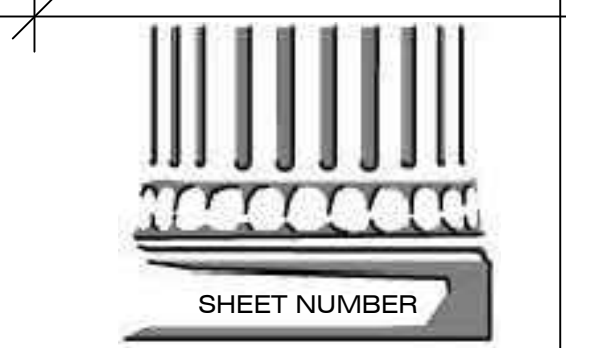
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FOR
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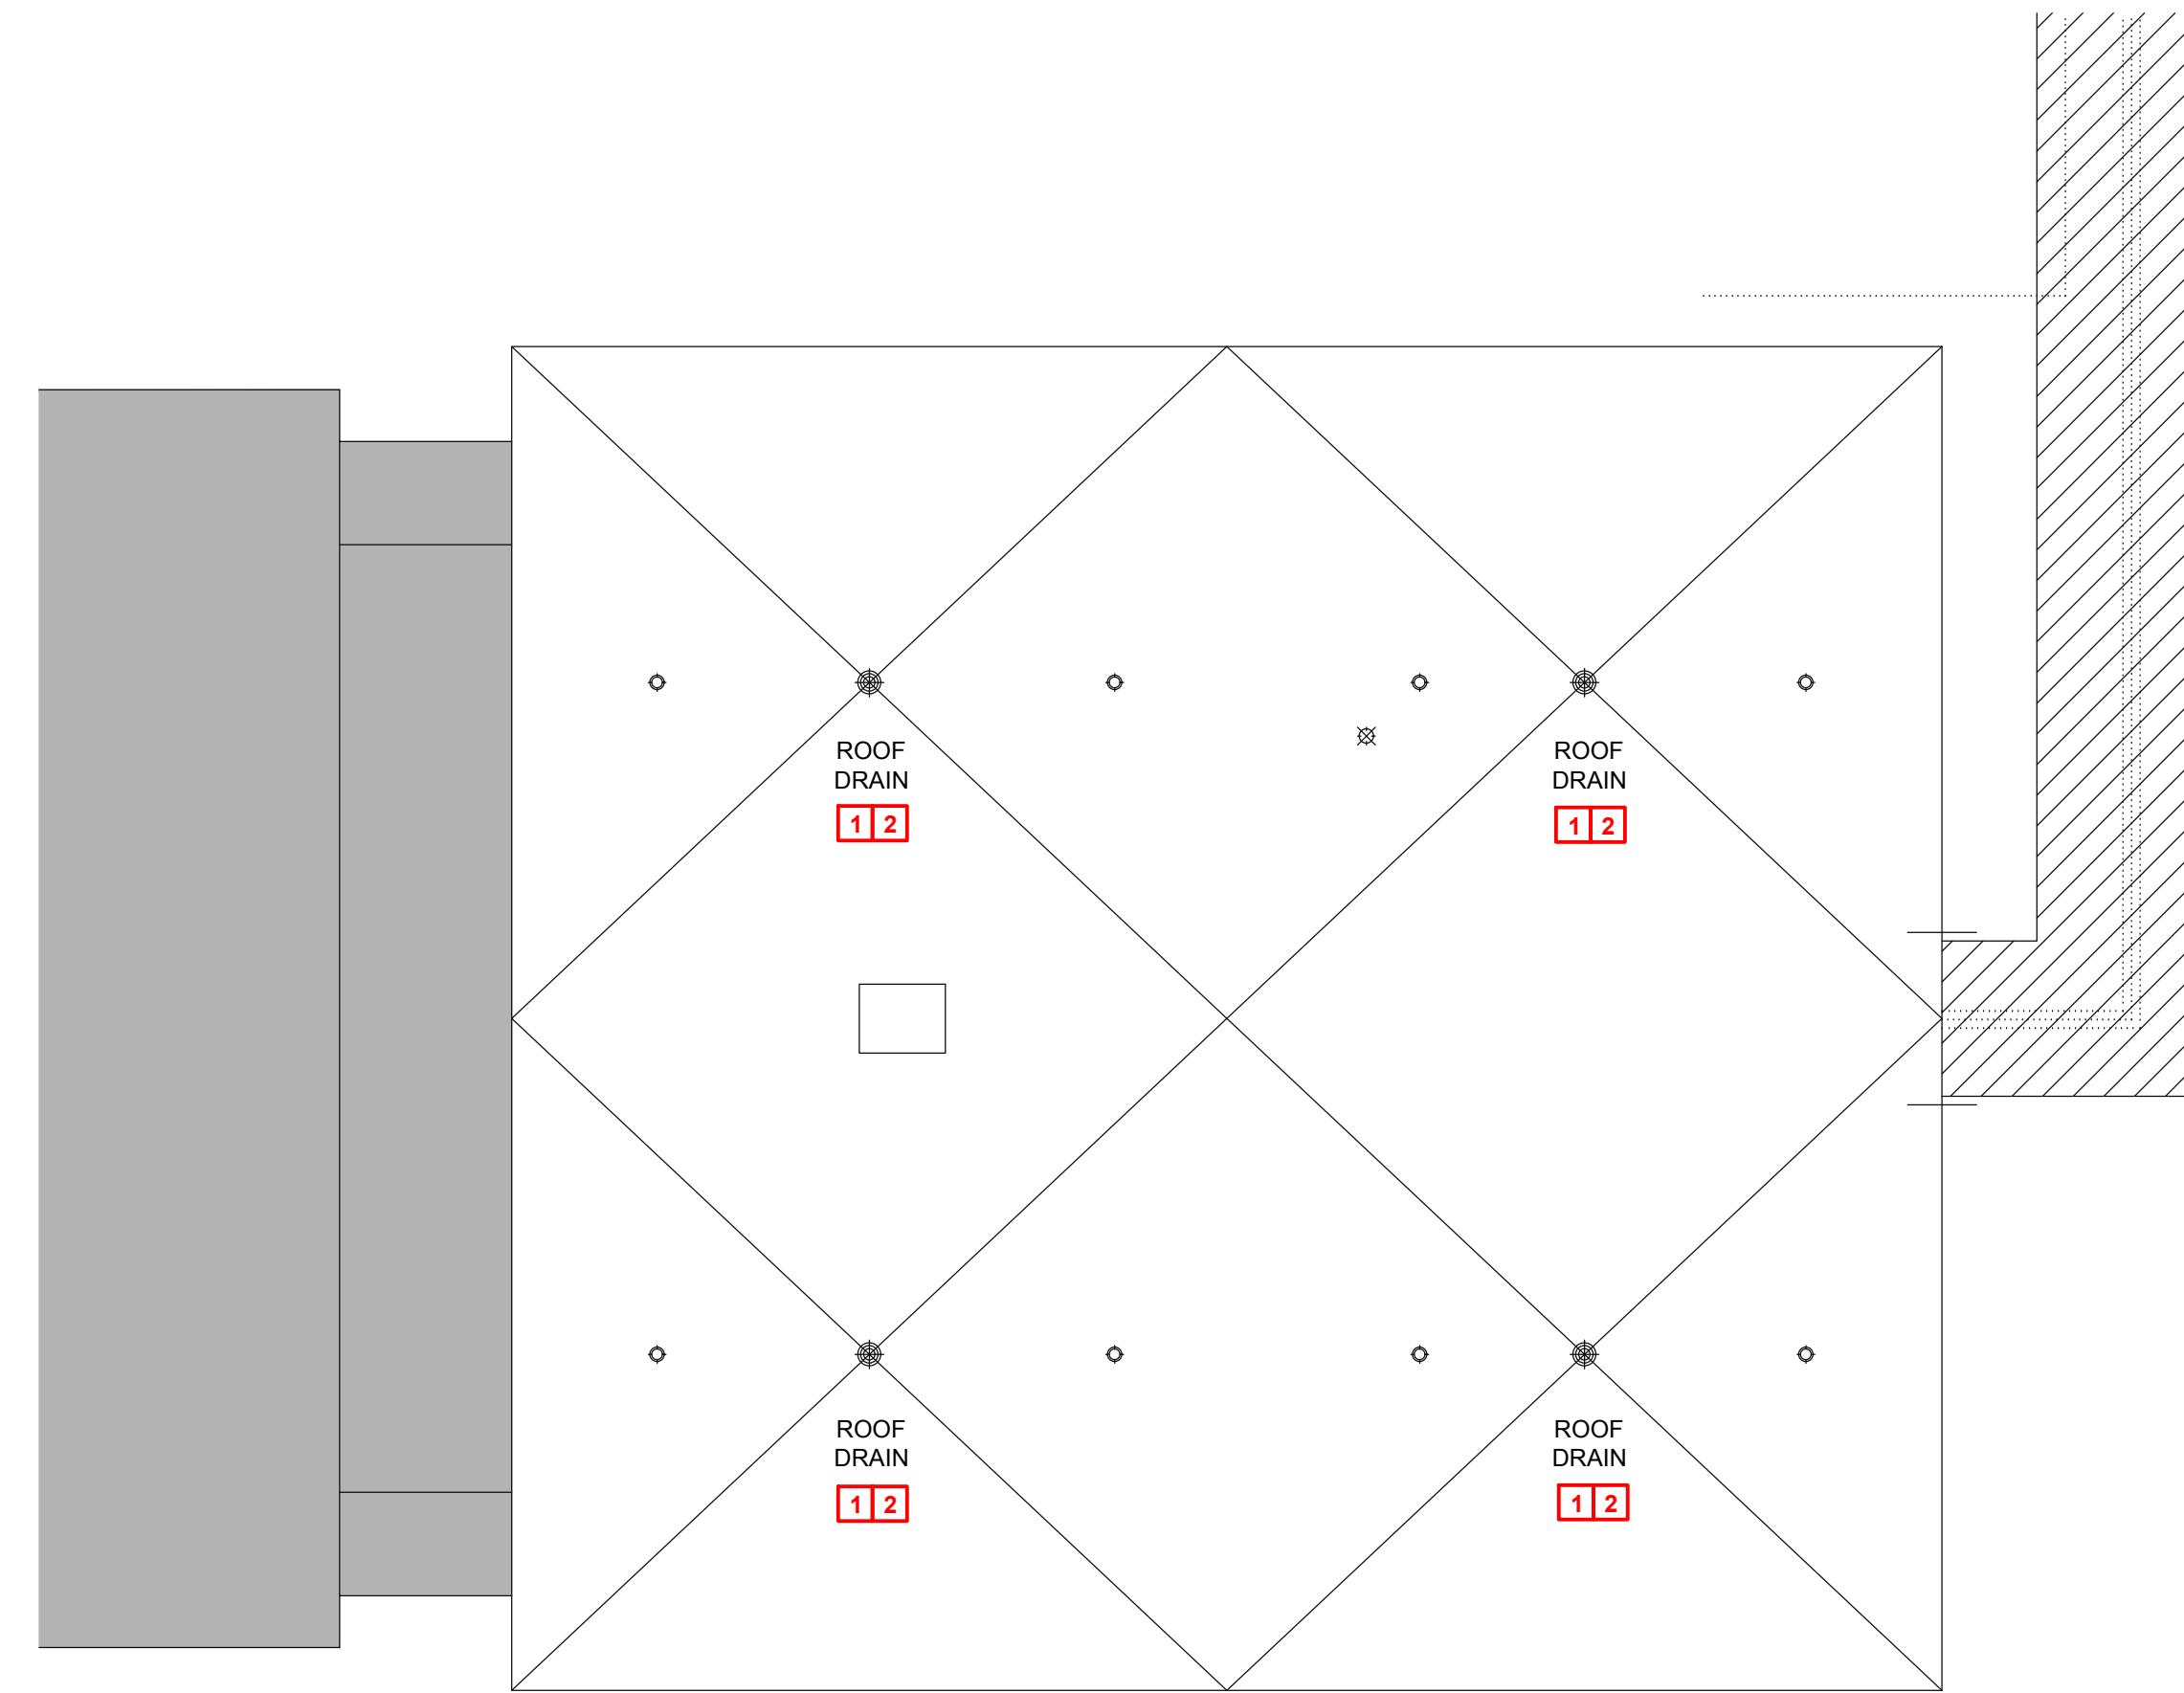
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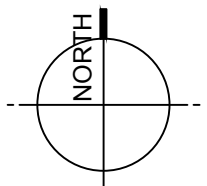


(F)E1.1
ZONE 1 - BUILDING F
ELECTRICAL PLANS



1 Mechanical Roof Plan - Building F
3/32" = 1'-0"

NOTE:
REFER TO ARCHITECTURAL PLANS
FOR ALL DIMENSIONS.



GENERAL NOTES:

- A. CONTRACTOR SHALL FIELD VERIFY EXISTING EQUIPMENT TAGS (WHERE POSSIBLE) IN FIELD PRIOR TO DEMOLITION. COORDINATE ALL SITE VISITS, THROUGH GENERAL CONTRACTOR AND C.P.S.B. CONTRACTOR WEAR REQUIRED PERSONAL PROTECTIVE GEAR (PPE) SPECIFICALLY REQUIRED FOR EACH BUILDING.
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- C. CONTRACTOR SHALL PROVIDE TESTING AND BALANCING OF ALL HVAC SYSTEMS WHICH WERE REPLACED, MODIFIED AND/OR CLEANED.
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- F. PRIOR TO DRAINING, DISCONNECTING, AND REMOVING OF ANY SERVICES IN THE DESIGNATED AREAS SHOWN, THE CONTRACTOR MUST ENSURE THAT THE SERVICES REMOVED DO NOT AFFECT THE NORMAL OPERATION OF AREAS OUTSIDE THE CONSTRUCTION AREA.
- G. VERIFY ADEQUATE SPACE AVAILABLE PER MANUFACTURER'S RECOMMENDATIONS, COORDINATE CLEARANCE REQUIREMENTS OF ALL MECHANICAL EQUIPMENT.

KEYNOTES TO SHEET:

1. CONTRACTOR SHALL REMOVE EXISTING ROOF DRAIN AN INSTALLED NEW ROOF DRAIN WITH DOME STRAINER IN SAME LOCATION. THE NEW ROOF DRAIN W/ DOME STRAINER SHALL MATCH THE EXISTING SIZE, STYLE, ETC. OF THE EXISTING THAT IS BEING REPLACED AS PART OF THE RE-ROOFING PROJECT.
2. ALL EXISTING ROOF DRAIN PIPING SHALL BE FLUSHED TO REMOVE LEAVES, DEBRIS, ETC. ONCE THE NEW ROOF DRAINS ARE INSTALLED.
3. CONTRACTOR SHALL REMOVE THE EXISTING CONDENSING UNIT THAT WAS DAMAGED DURING HURRICANE LAURA. CONTRACTOR SHALL PROVIDE AND INSTALL NEW CONDENSING UNIT WITH ONE OF EQUAL SIZE, CAPACITY, ELEC, ETC. CONTRACTOR SHALL FIELD VERIFY PRIOR TO BID, ORDERING EQUIPMENT, AND RESPECTIVE ROUGH-IN. MAKE ALL FINAL CONNECTIONS AND VERIFY EQUIPMENT IS WORKING PROPERLY.

ROOFING SYMBOL LEGEND

- EXISTING SKYLIGHT
- ONE-WAY ROOF VENT
- ROOF DRAIN
- ROOF PIPING PENETRATION
- ROOF FAN / VENT
- ROOF FAN / VENT
- DOWNSPOUT
- MISC MEP
- CONDUIT/PIPING RUNS
- EXPANSION JOINT

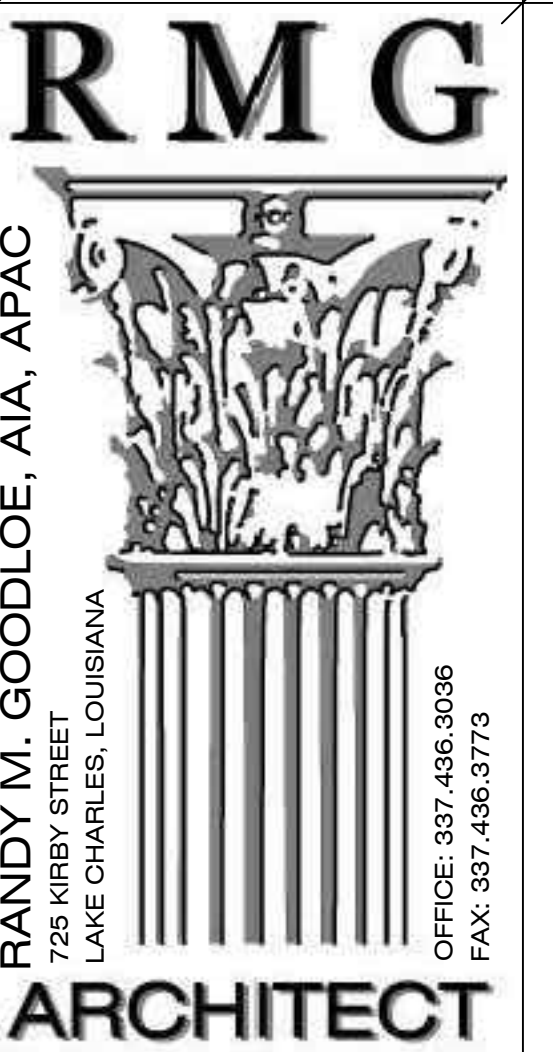


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NOTE:
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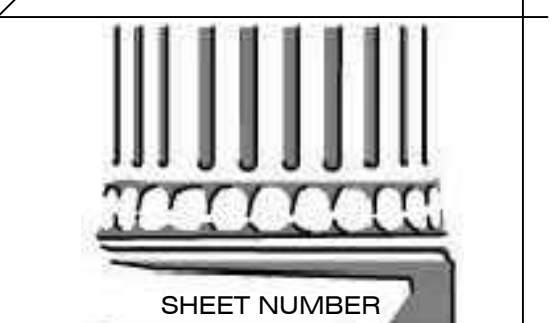


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(F)M0.1

BUILDING F
ROOF PLAN

GENERAL NOTES:

- A. CONTRACTOR SHALL FIELD VERIFY EXISTING EQUIPMENT TAGS (WHERE POSSIBLE) IN FIELD PRIOR TO DEMOLITION. COORDINATE ALL SITE VISITS, THROUGH GENERAL CONTRACTOR AND C.P.S.B. CONTRACTOR WEAR REQUIRED PERSONAL PROTECTIVE GEAR (PPE) SPECIFICALLY REQUIRED FOR EACH BUILDING.
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- G. VERIFY ADEQUATE SPACE AVAILABLE PER MANUFACTURER'S RECOMMENDATIONS. COORDINATE CLEARANCE REQUIREMENTS OF ALL MECHANICAL EQUIPMENT.

KEYNOTES TO SHEET:

- 1. EXISTING AIR HANDLING UNIT TO REMAIN AND CLEANED PER THE SPECIFICATIONS. REMOVE AND REPLACE EXISTING AIR HANDLING UNIT INTERIOR LINER AND CLEAN INTERIOR OF UNIT INCLUDING COILS.
- 2. NO INTERIOR MECHANICAL (PLUMBING & HVAC) WORK ASSOCIATED WITH THESE SPACES WITHIN THE BUILDING.
- 3. CONTRACTOR SHALL TEMPORARILY SUPPORT AND PROTECT ANY EQUIPMENT, DIFFUSERS, GRILLES, ETC. IN OR ABOVE CEILINGS OF THESE SPACES DURING THE REMOVAL AND INSTALLATION OF NEW CEILINGS. REFER TO ARCHITECTURAL PLANS FOR THOSE LOCATIONS.



6 Zone 1 - Building F - Mechanical Plan
3/32" = 1'-0"

NOTE:
REFER TO ARCHITECTURAL DRAWINGS
FOR ALL DIMENSIONS.

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FIELD PRIOR TO ORDERING EQUIPMENT OR INSTALLATION.

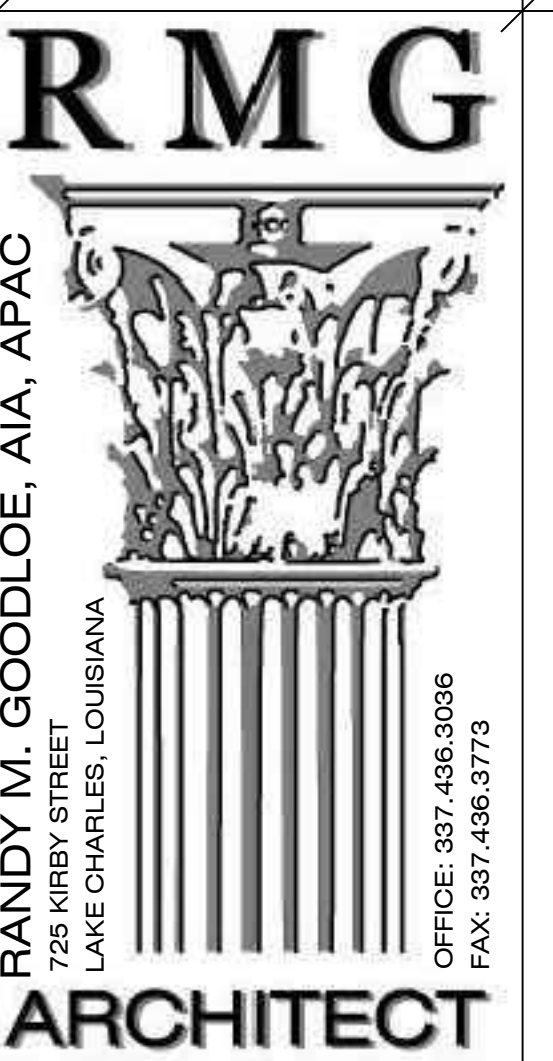
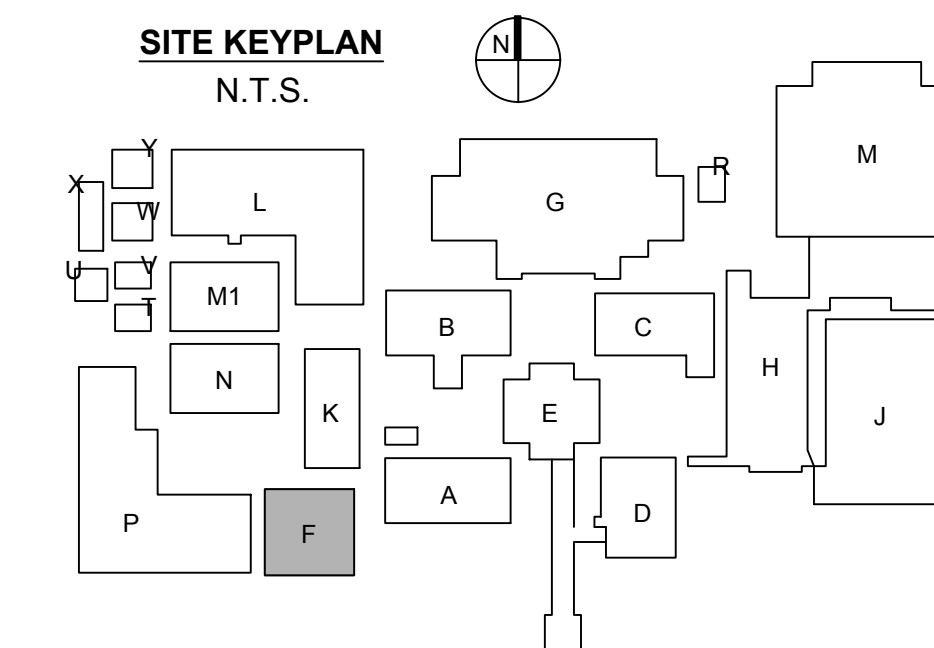
NOTE: THE HVAC SCOPE OF WORK IS LIMITED TO REPLACING OR
REPAIRING THE HVAC SYSTEM BACK TO ITS ORIGINAL CONDITION (LIKE
FOR LIKE) IN MOST CIRCUMSTANCES. THIS PROJECT'S SCOPE OF WORK
DOES NOT INCLUDE BRINGING ALL THE EXISTING HVAC SYSTEMS UP TO
CODE OR ADDRESSING EXISTING CONDITIONS. ALTHOUGH ALL WORK
MUST COMPLY WITH FEMA CONSENSUS-BASED, "LATEST PUBLISHED
EDITIONS" OF CODES NOT NECESSARILY THOSE CODES ADOPTED BY THE
LOCAL MUNICIPALITY.



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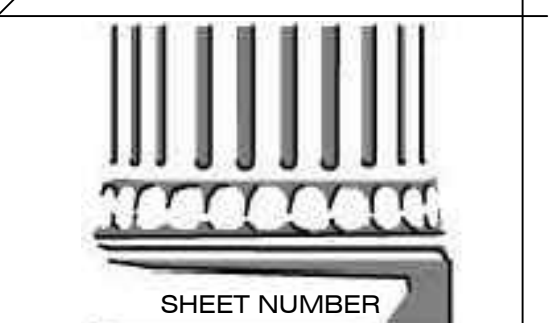


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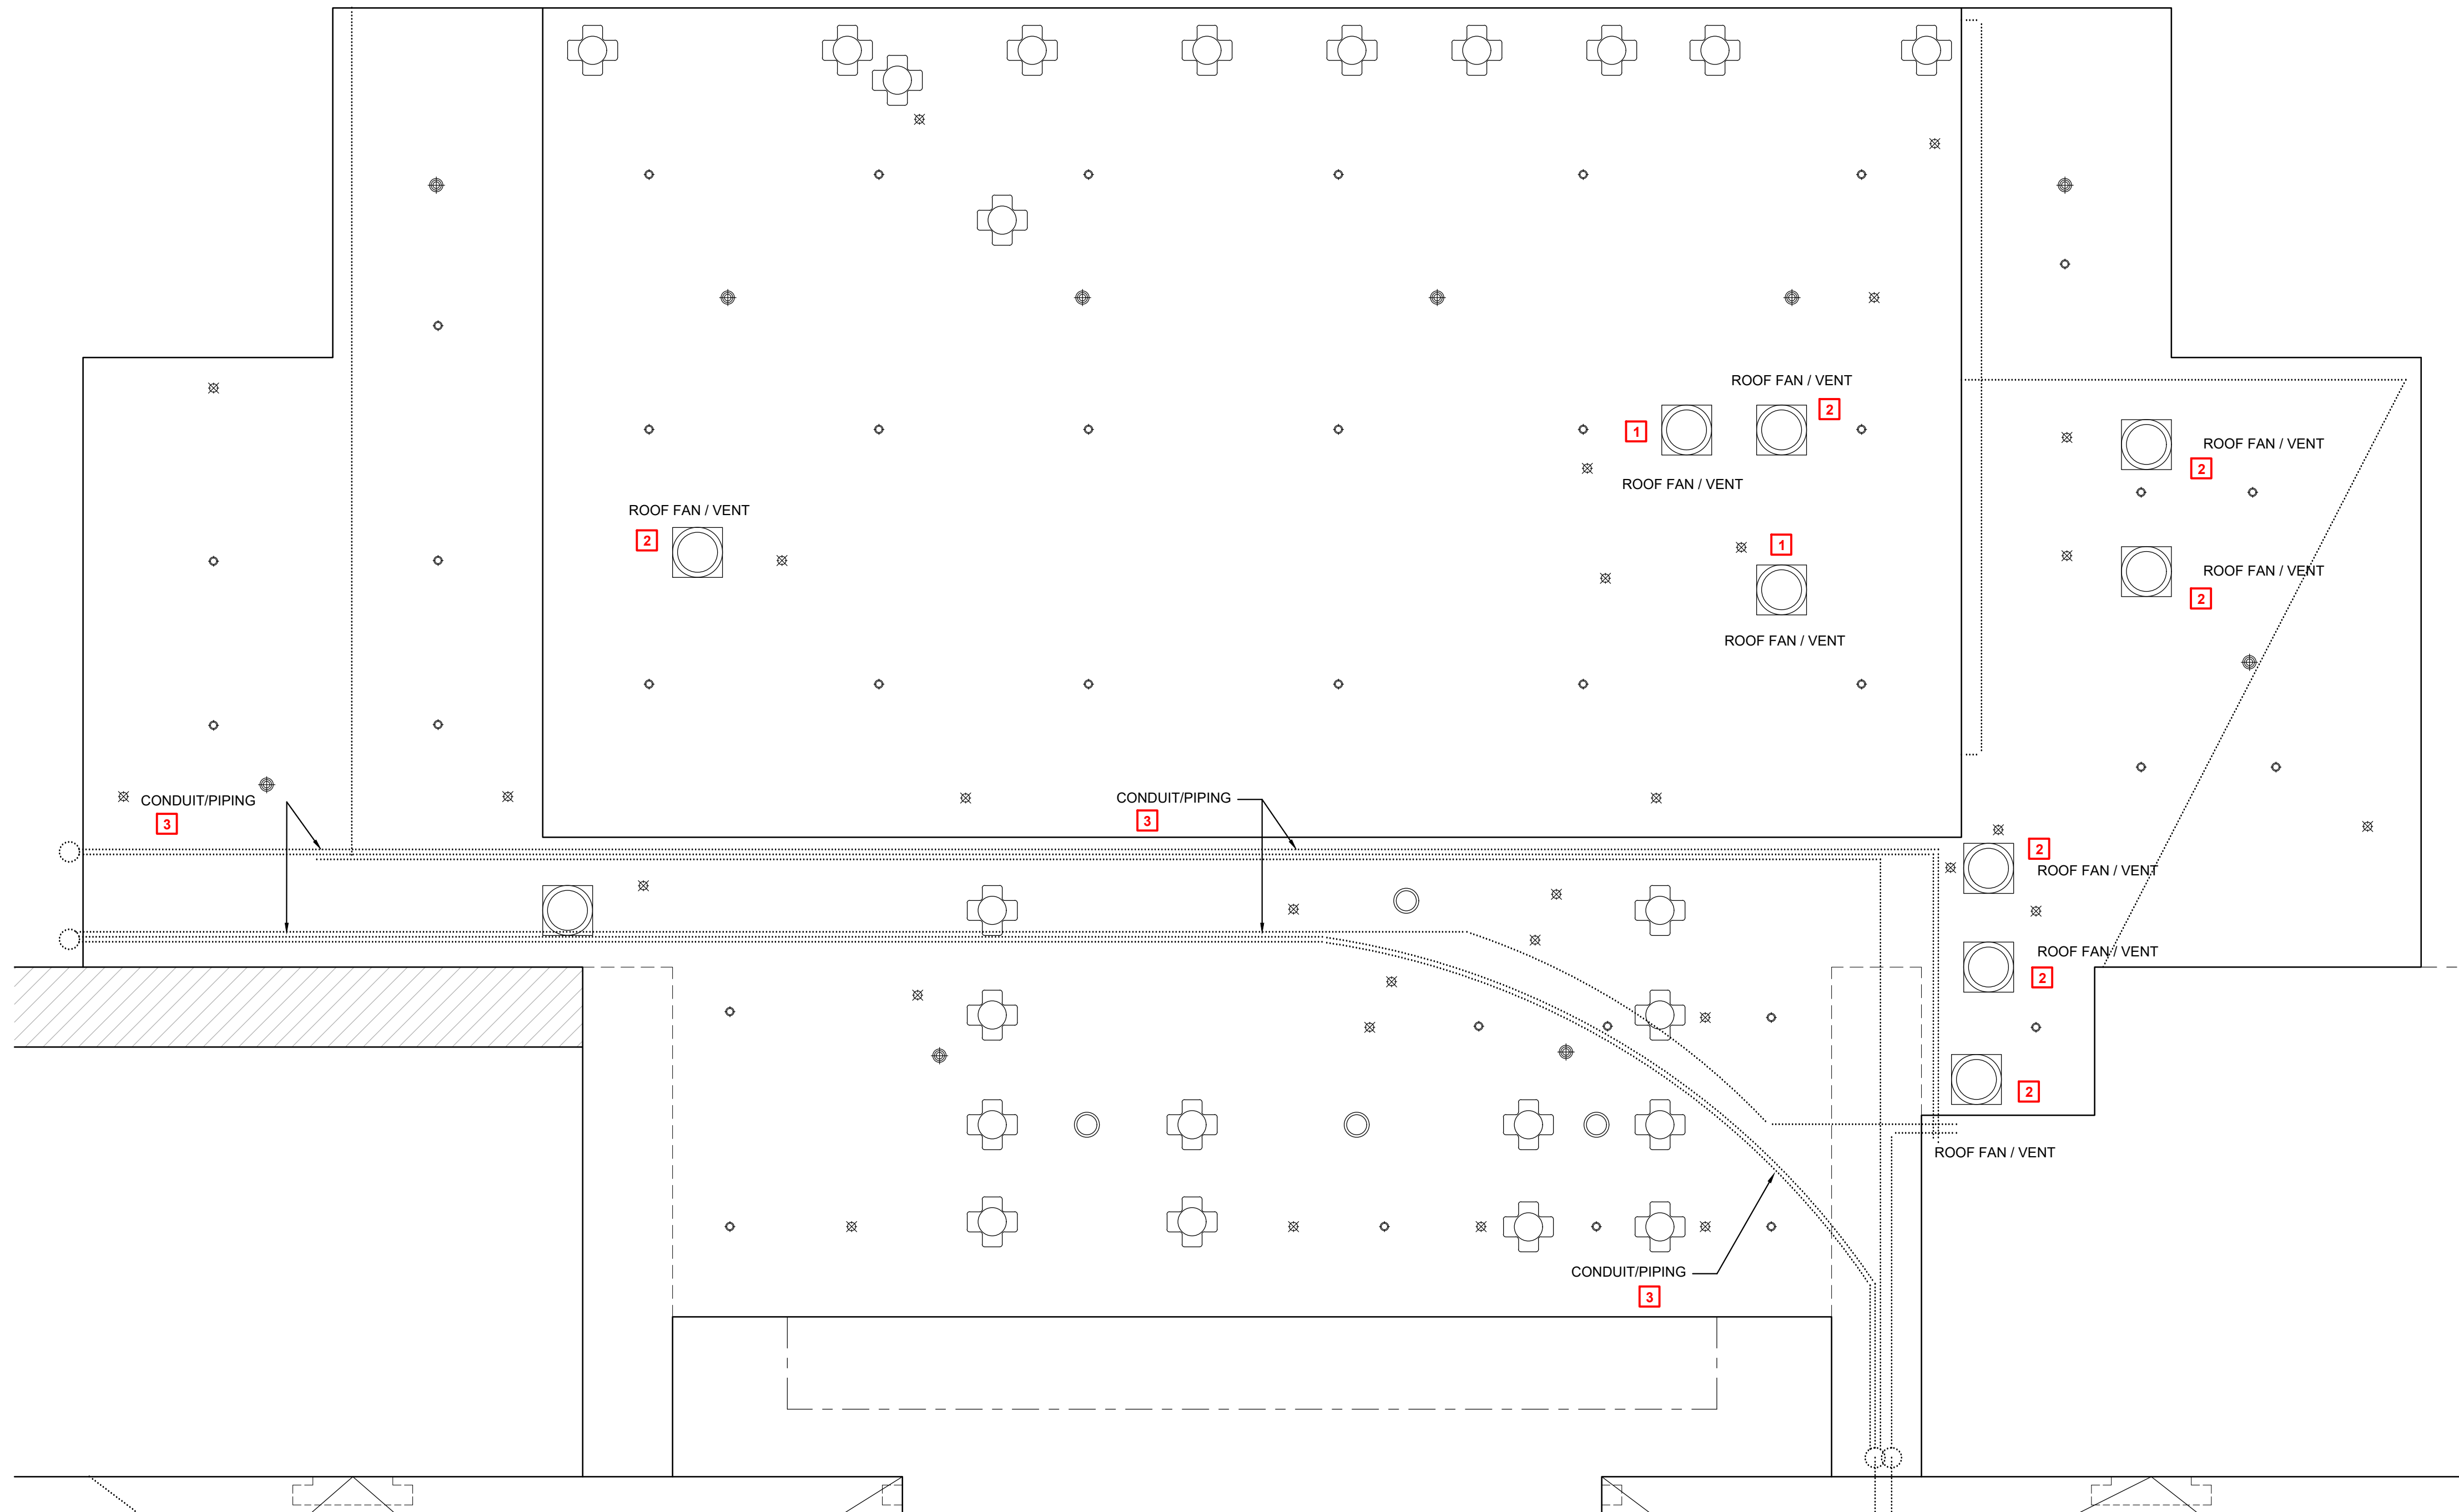
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06.28.2024

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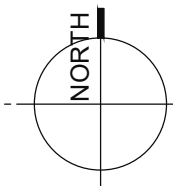


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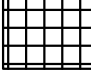



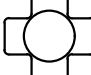





ZONE 1 - BUILDING F
MECHANICAL PLANS



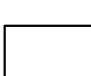1 Electrical Roof Plan - Building G
3/32" = 1'-0"



ROOFING SYMBOL LEGEND

-  EXISTING SKYLIGHT
-  ONE-WAY ROOF VENT
-  ROOF DRAIN
-  ROOF PIPING PENETRATION
-  ROOF FAN / VENT
-  ROOF FAN / VENT
-  DOWNSPOUT
-  MISC MEP
-  CONDUIT/PIPING RUNS
-  EXPANSION JOINT

GENERAL NOTES:

- A. CONTRACTOR SHALL FIELD VERIFY EXISTING ELECTRICAL EQUIPMENT SIZES IN FIELD PRIOR TO DEMOLITION. COORDINATE ALL SITE VISITS THROUGH GENERAL CONTRACTOR AND C.P.S.B. CONTRACTOR WEAR REQUIRED PERSONAL PROTECTIVE GEAR (PPE) SPECIFICALLY REQUIRED FOR EACH BUILDING.
- B. CONTRACTOR SHALL NOTIFY ARCHITECT/ENGINEER OF ANY DISCREPANCIES IDENTIFIED IN THE FIELD PRIOR ORDERING NEW EQUIPMENT.
- C. ALL WORK SHALL COMPLY WITH LOCAL, STATE, AND FEDERAL CODES TO THE SATISFACTION OF CODE AUTHORITIES HAVING JURISDICTION.
- E. PRIOR TO DISCONNECTING, AND REMOVING OF ANY ELECTRICAL SERVICES IN THE DESIGNATED AREAS SHOWN, THE CONTRACTOR MUST ENSURE THAT THE SERVICES REMOVED DO NOT AFFECT THE NORMAL OPERATION OF AREAS OUTSIDE THE CONSTRUCTION AREA. COORDINATE WITH OWNER FOR ALL ELECTRICAL SHUT DOWNS AT LEAST 2 WORKING DAYS PRIOR TO WORK.

KEYNOTES TO SHEET:

1. CONTRACTOR SHALL REMOVE THE EXISTING EXHAUST FAN. CONTRACTOR SHALL PROVIDE AND INSTALL NEW EXHAUST FAN WITH ONE OF EQUAL SIZE, CAPACITY, ELEC. ETC. PROVIDE NEW WEATHERPROOF MOTOR RATED SWITCH AND RECONNECT EXISTING CIRCUIT TO NEW FAN. MAKE ALL FINAL CONNECTIONS AND VERIFY EQUIPMENT IS WORKING PROPERLY.
2. CONTRACTOR SHALL REMOVE EXISTING ROOF MOUNTED HOOD/FAN AND AND INSTALL ON NEW CURB. RECONNECT EXISTING ELECTRICAL AFTER ROOFING IS COMPLETE.
3. EXISTING CONDUIT SHALL BE TEMPORARILY SUPPORTED AND PROTECTED DURING THE RE-ROOFING PROJECT. ONCE NEW ROOF IS COMPLETED PERMANENT CONDUIT SUPPORTS SHALL BE PROVIDED AS REQUIRED. REFER TO CODE REQUIREMENTS FOR SPACING OF SUPPORTS. SECURE CONDUIT TO SUPPORTS WITH CLAMPS AS NECESSARY.




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NOTE:
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NOTE:
CONTRACTOR SHALL REVIEW C.P.S.B MANAGEMENT PLANS PRIOR TO ANY DEMOLITION WORK. REPORT ANY SUSPICIOUS ASBESTOS MATERIALS TO ARCHITECT / ENGINEER PRIOR TO DISTURBING SUSPECT MATERIALS


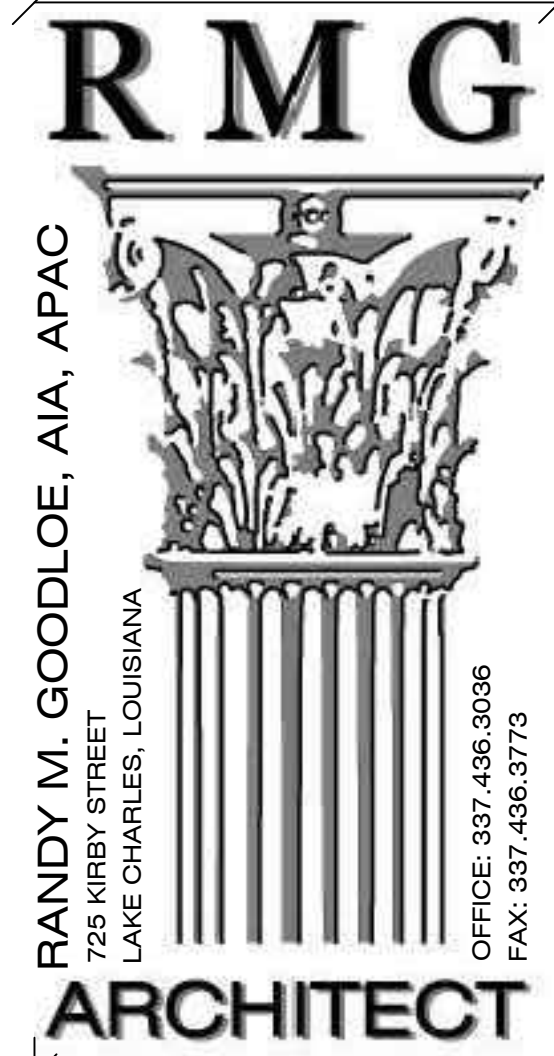
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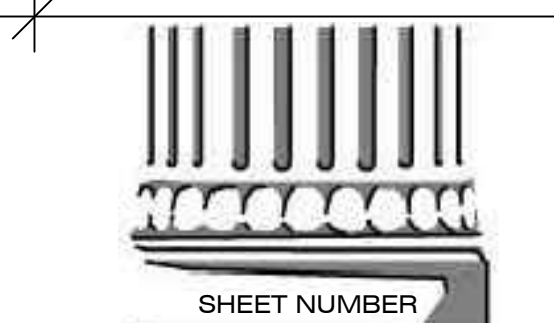


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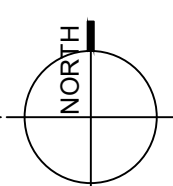
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(G)E0.1
BUILDING G
ROOF PLAN



11 Zone 1 - Building G - Electrical Plan
1/12" = 1'-0"



GENERAL NOTES:

- A. CONTRACTOR SHALL NOTIFY ARCHITECT/ENGINEER OF ANY DISCREPANCIES IDENTIFIED IN THE FIELD PRIOR TO ORDERING LIGHT FIXTURES.
- B. THE INTENT OF THE PLAN IS FOR EXISTING CIRCUITRY TO REMAIN AND BE RE-USED. ALL EXISTING POWER WIRING SHALL BE PROTECTED DURING DEMOLITION AND AVAILABLE FOR RE-USE. ANY WIRING REMOVED OR DAMAGED DURING CONSTRUCTION SHALL BE REPLACED AT CONTRACTOR'S EXPENSE.
- C. ALL WORK SHALL COMPLY WITH LOCAL, STATE, AND FEDERAL CODES TO THE SATISFACTION OF CODE AUTHORITIES HAVING JURISDICTION.
- D. ALL WORK SHALL COMPLY WITH THE REQUIREMENTS OF THE 2020 EDITION OF NEC.
- E. PRIOR TO DISCONNECTING, AND REMOVING OF ANY ELECTRICAL SERVICES IN THE DESIGNATED AREAS SHOWN, THE CONTRACTOR MUST ENSURE THAT THE SERVICES REMOVED DO NOT AFFECT THE NORMAL OPERATION OF AREAS OUTSIDE THE CONSTRUCTION AREA. COORDINATE WITH OWNER FOR ALL ELECTRICAL SHUT DOWNS AT LEAST 2 WORKING DAYS PRIOR TO WORK.
- F. EXISTING LIGHTING THROUGHOUT THE BUILDING HAS BEEN REPLACED BY THE OWNER IN A PREVIOUS PROJECT. IF THERE ARE SPACES WHERE THE DRAWINGS REQUIRE CEILING REPLACEMENT, THE CONTRACTOR WILL BE REQUIRED TO REMOVE THE EXISTING FIXTURES, PROPERLY STORE THEM ONSITE (CONTAINER OR OTHER OWNER APPROVED AREA), THEN RE-INSTALL FOLLOWING REPLACEMENT OF CEILINGS WITHIN A GIVEN SPACE.
- G. ALL EXISTING LOW VOLTAGE WIRING SHALL BE PROTECTED DURING DEMOLITION AND AVAILABLE FOR RE-USE. ANY WIRING REMOVED OR DAMAGED DURING CONSTRUCTION SHALL BE REPLACED AT CONTRACTOR'S EXPENSE.

KEYNOTES:

- 1. ANY EXISTING CAMERAS OR WIRELESS ACCESS POINTS TO BE REMOVED DURING CONSTRUCTION SHALL BE COORDINATED WITH CPSSB IT DEPARTMENT. DEVICES SHALL BE LABELED AND STORED FOR RE-INSTALLATION. CONTRACTOR IS RESPONSIBLE FOR ANY CUT OR REMOVED COMMUNICATIONS CABLING.
- 2. ANY EXISTING FIRE ALARM DEVICES TO BE REMOVED DURING CONSTRUCTION SHALL BE COORDINATED WITH SYLVAN SOUND. DEVICES SHALL BE LABELED AND STORED FOR RE-INSTALLATION. CONTRACTOR IS RESPONSIBLE FOR ANY CUT OR REMOVED FIRE ALARM WIRING.
- 3. ANY EXISTING INTERCOM DEVICES TO BE REMOVED DURING CONSTRUCTION SHALL BE COORDINATED WITH SYLVAN SOUND. DEVICES SHALL BE LABELED AND STORED FOR RE-INSTALLATION. CONTRACTOR IS RESPONSIBLE FOR ANY CUT OR REMOVED INTERCOM WIRING.
- 4. EXISTING LOCATION OF IT RACK, CONTRACTOR IS RESPONSIBLE FOR PROTECTING IT RACK, EQUIPMENT, AND WIRING DURING CONSTRUCTION. IT RACK SHALL REMAIN OPERATIONAL THROUGHOUT CONSTRUCTION UNLESS APPROVED BY CPSSB IT FOR IT TO BE POWERED DOWN. PROVIDE COVER FOR RACK TO MINIMIZE DUST AND DEBRIS WHILE AT THE SAME TIME ALLOWING COOLING AND PROPER AIRFLOW.

NOTE: CONTRACTOR SHALL REVIEW C.P.S.B MANAGEMENT PLANS PRIOR TO ANY DEMOLITION WORK. REPORT ANY SUSPICIOUS ASBESTOS MATERIALS TO ARCHITECT / ENGINEER PRIOR TO DISTURBING SUSPECT MATERIALS

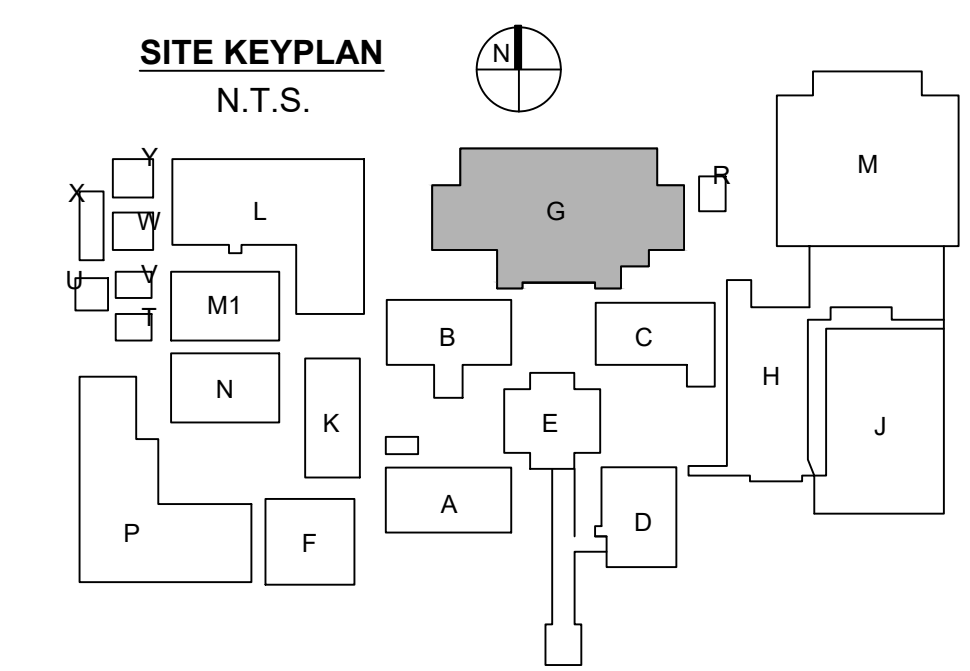
NOTE: THESE DRAWINGS ARE COPIES OF THE ORIGINAL CONSTRUCTION DOCUMENTS WITH NOTES ADDED TO DESCRIBE THE SCOPE OF WORK FOR THE HURRICANE LAURA REPAIR PROJECT. CONTRACTOR SHALL NOTIFY ARCHITECT/ENGINEER OF ANY DISCREPANCIES IDENTIFIED IN FIELD PRIOR TO ORDERING EQUIPMENT OR INSTALLATION.

NOTE: THE ELECTRICAL SCOPE OF WORK IS LIMITED TO REPLACING OR REPAIRING THE ELECTRICAL SYSTEM BACK TO ITS ORIGINAL CONDITION (LIKE FOR LIKE). THIS PROJECT'S SCOPE OF WORK DOES NOT INCLUDE BRINGING THE EXISTING ELECTRICAL SYSTEMS UP TO CODE OR ADDRESSING EXISTING CONDITIONS.

NOTE: REFER TO ARCHITECTURAL DRAWINGS FOR ALL DIMENSIONS.



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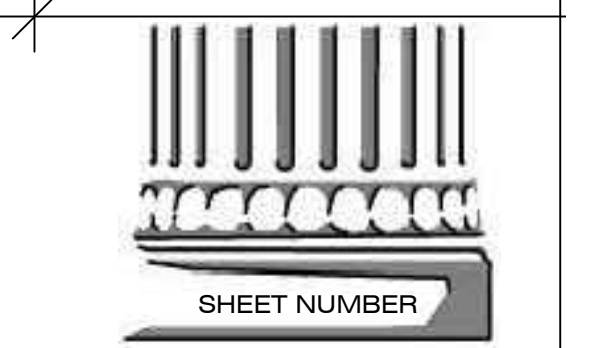


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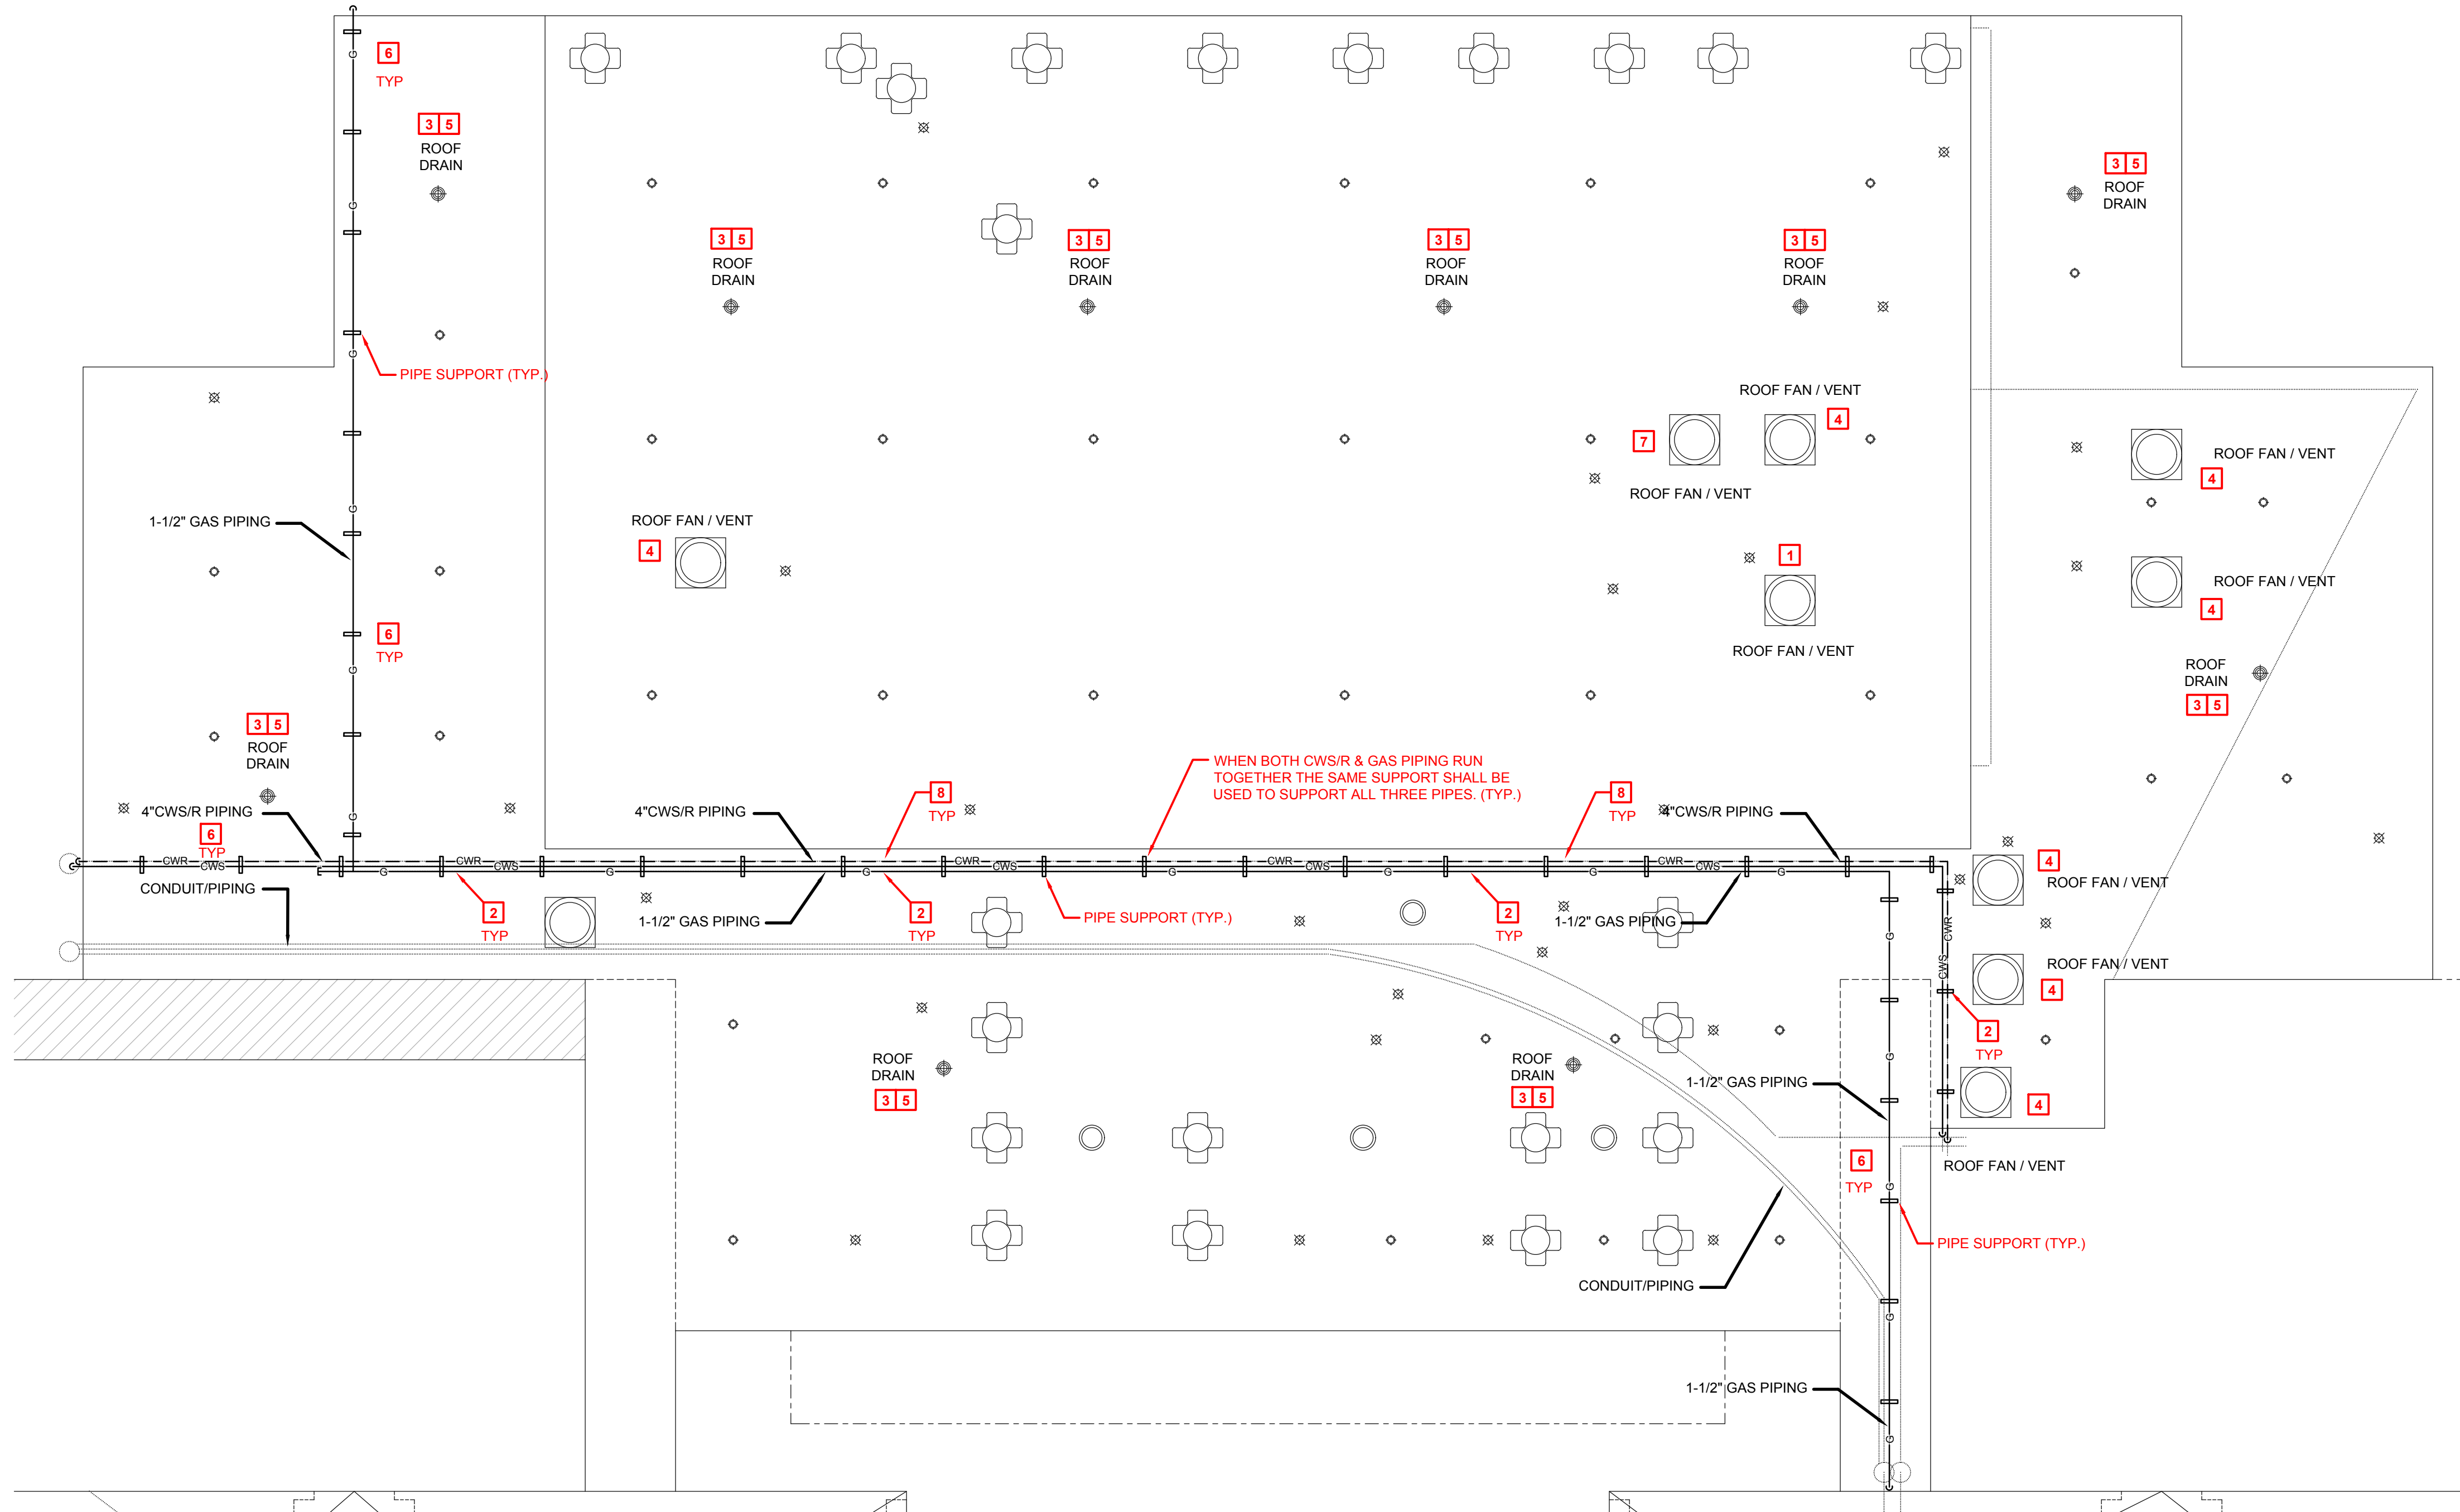
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SHEET NUMBER
(G)E1.1
ZONE 1 - BUILDING G
ELECTRICAL PLANS



1 Mechanical Roof Plan - Building G
3/32" = 1'-0"

NOTE:
REFER TO ARCHITECTURAL PLANS
FOR ALL DIMENSIONS.

FAN SCHEDULE												
No.	SERVICE	MIN. CFM	EXT. SP.	RPM	SONES	FAN HP	TYPE	DRIVE	ELECTRIC SERVICE	CONTROL	REMARKS	NOTES
EF-5	CHILLER ROOM	1,350	.25	1200	-	1/2	CENT.	BELT	120/160	THERMOSTAT	REFER TO SPECIFICATIONS	1

NOTES:
1) SHALL BE PROVIDED WITH NEW FACTORY PROVIDED CURB. COORDINATE CURB HEIGHT WITH ARCHITECT AND GENERAL CONTRACTOR PRIOR TO ORDERING.

ROOFING SYMBOL LEGEND

- EXISTING SKYLIGHT
- ONE-WAY ROOF VENT
- ROOF DRAIN
- ROOF PIPING PENETRATION
- ROOF FAN / VENT
- ROOF FAN / VENT
- DOWNSPOUT
- MISC MEP
- CONDUIT/PIPING RUNS
- EXPANSION JOINT

GENERAL NOTES:

- A. CONTRACTOR SHALL FIELD VERIFY EXISTING EQUIPMENT TAGS (WHERE POSSIBLE) IN FIELD PRIOR TO DEMOLITION. COORDINATE ALL SITE VISITS THROUGH GENERAL CONTRACTOR AND C.P.S.B. CONTRACTOR WEAR REQUIRED PERSONAL PROTECTIVE GEAR (PPE) SPECIFICALLY REQUIRED FOR EACH BUILDING.
- B. CONTRACTOR SHALL NOTIFY ARCHITECT/ENGINEER OF ANY DISCREPANCIES IDENTIFIED IN THE FIELD PRIOR TO FABRICATING DUCTWORK OR ORDERING EQUIPMENT.
- C. CONTRACTOR SHALL PROVIDE TESTING AND BALANCING OF ALL HVAC SYSTEMS WHICH WERE REPLACED, MODIFIED AND/OR CLEANED.
- D. ALL WORK SHALL COMPLY WITH LOCAL, STATE, AND FEDERAL CODES TO THE SATISFACTION OF CODE AUTHORITIES HAVING JURISDICTION.
- E. ALL WORK SHALL COMPLY WITH THE REQUIREMENTS OF NFPA 90A & 101, THE CLEAN AIR ACT AND THE AMERICANS WITH DISABILITIES ACT.
- F. PRIOR TO DRAINING, DISCONNECTING, AND REMOVING OF ANY SERVICES IN THE DESIGNATED AREAS SHOWN, THE CONTRACTOR MUST ENSURE THAT THE SERVICES REMOVED DO NOT AFFECT THE NORMAL OPERATION OF AREAS OUTSIDE THE CONSTRUCTION AREA.
- G. VERIFY ADEQUATE SPACE AVAILABLE PER MANUFACTURER'S RECOMMENDATIONS, COORDINATE CLEARANCE REQUIREMENTS OF ALL MECHANICAL EQUIPMENT.

KEYNOTES TO SHEET:

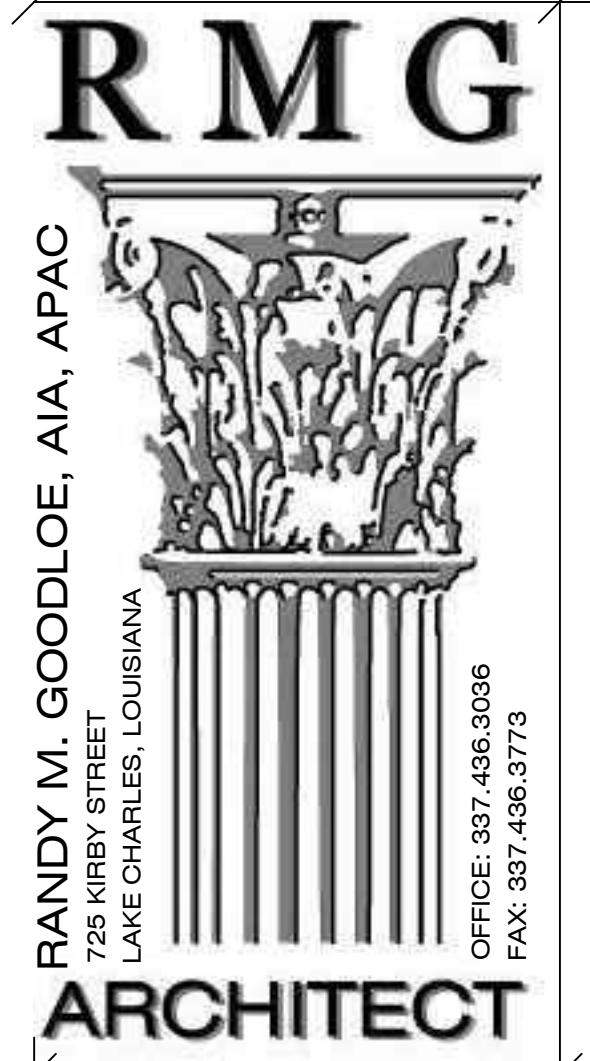
1. CONTRACTOR SHALL REMOVE THE EXISTING EXHAUST FAN. CONTRACTOR SHALL PROVIDE AND INSTALL NEW EXHAUST FAN WITH ONE OF EQUAL SIZE, CAPACITY, ELEC, ETC. CONTRACTOR SHALL FIELD VERIFY PRIOR TO BID, ORDERING EQUIPMENT, AND RESPECTIVE ROUGH-IN. MAKE ALL FINAL CONNECTIONS AND VERIFY EQUIPMENT IS WORKING PROPERLY.
2. CONTRACTOR SHALL REMOVE AND REPLACE ALL CHILLED WATER INSULATION AND JACKETING ON CHILLED WATER LINES LOCATED ON ROOF.
3. CONTRACTOR SHALL REMOVE EXISTING ROOF DRAIN AN INSTALLED NEW ROOF DRAIN WITH DOME STRAINER IN SAME LOCATION. THE NEW ROOF DRAIN W/ DOME STRAINER SHALL MATCH THE EXISTING SIZE, STYLE, ETC. OF THE EXISTING THAT IS BEING REPLACED AS PART OF THE RE-ROOFING PROJECT.
4. CONTRACTOR SHALL REMOVE EXISTING ROOF MOUNTED HOOD/FAN AND AND INSTALL ON NEW CURB. NEW CURB SHALL MATCH THE EXISTING SIZE, STYLE, HEIGHT, ETC. OF EXISTING CURB.
5. ALL EXISTING ROOF DRAIN PIPING SHALL BE FLUSHED TO REMOVE LEAVES, DEBRIS, ETC. ONCE THE NEW ROOF DRAINS ARE INSTALLED.
6. EXISTING PIPING (GAS) SHALL BE TEMPORARILY SUPPORTED AND PROTECTED DURING THE RE-ROOFING PROJECT. ONCE NEW ROOF IS COMPLETED PERMANENT PIPING SUPPORT (MIRO MODEL 8-BASE STRUT-5) SHALL BE PROVIDED AS REQUIRED. REFER TO CODE REQUIREMENTS FOR SPACING OF SUPPORTS. SHIELDS SHALL BE PLACED BETWEEN CHILLED WATER PIPING SUPPORTS AND PIPING INSULATION. SECURE PIPING TO SUPPORTS WITH CLAMPS AS NECESSARY.
7. PROVIDE AND INSTALL NEW 20"x20" THROAT DIMENSION INTAKE HOOD ON ROOF. HOOD SHALL BE ACME MODEL IV OR APPROVED EQUAL. PROVIDE 24"x24" DUCT AS NECESSARY TO CONNECT TO EXISTING DUCT/CEILING GRILLE. HOOD SHALL BE PROVIDED WITH NEW MANUFACTURER PROVIDED CURB. COORDINATE CURB HEIGHT WITH ARCHITECT AND GENERAL CONTRACTOR PRIOR TO ORDERING.
8. EXISTING CWS/R PIPING SHALL BE TEMPORARILY SUPPORTED AND PROTECTED DURING THE RE-ROOFING PROJECT. ONCE NEW ROOF AND RE-INSULATING OF PIPING IS COMPLETED A PIPE PERMANENT PIPING SUPPORT (MIRO MODEL 24-BASE STRUT-5) SHALL BE PROVIDED AS REQUIRED. REFER TO CODE REQUIREMENTS FOR SPACING OF SUPPORTS. SHIELDS SHALL BE PLACED BETWEEN CHILLED WATER PIPING SUPPORTS AND PIPING INSULATION. SECURE PIPING TO SUPPORTS WITH CLAMPS AS NECESSARY.



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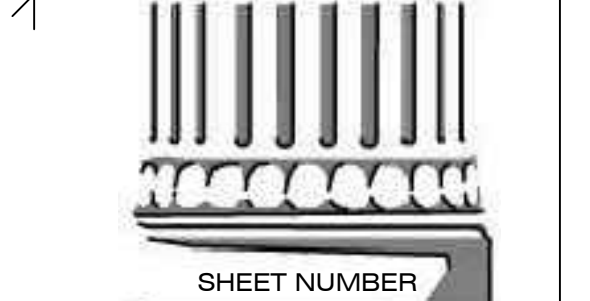
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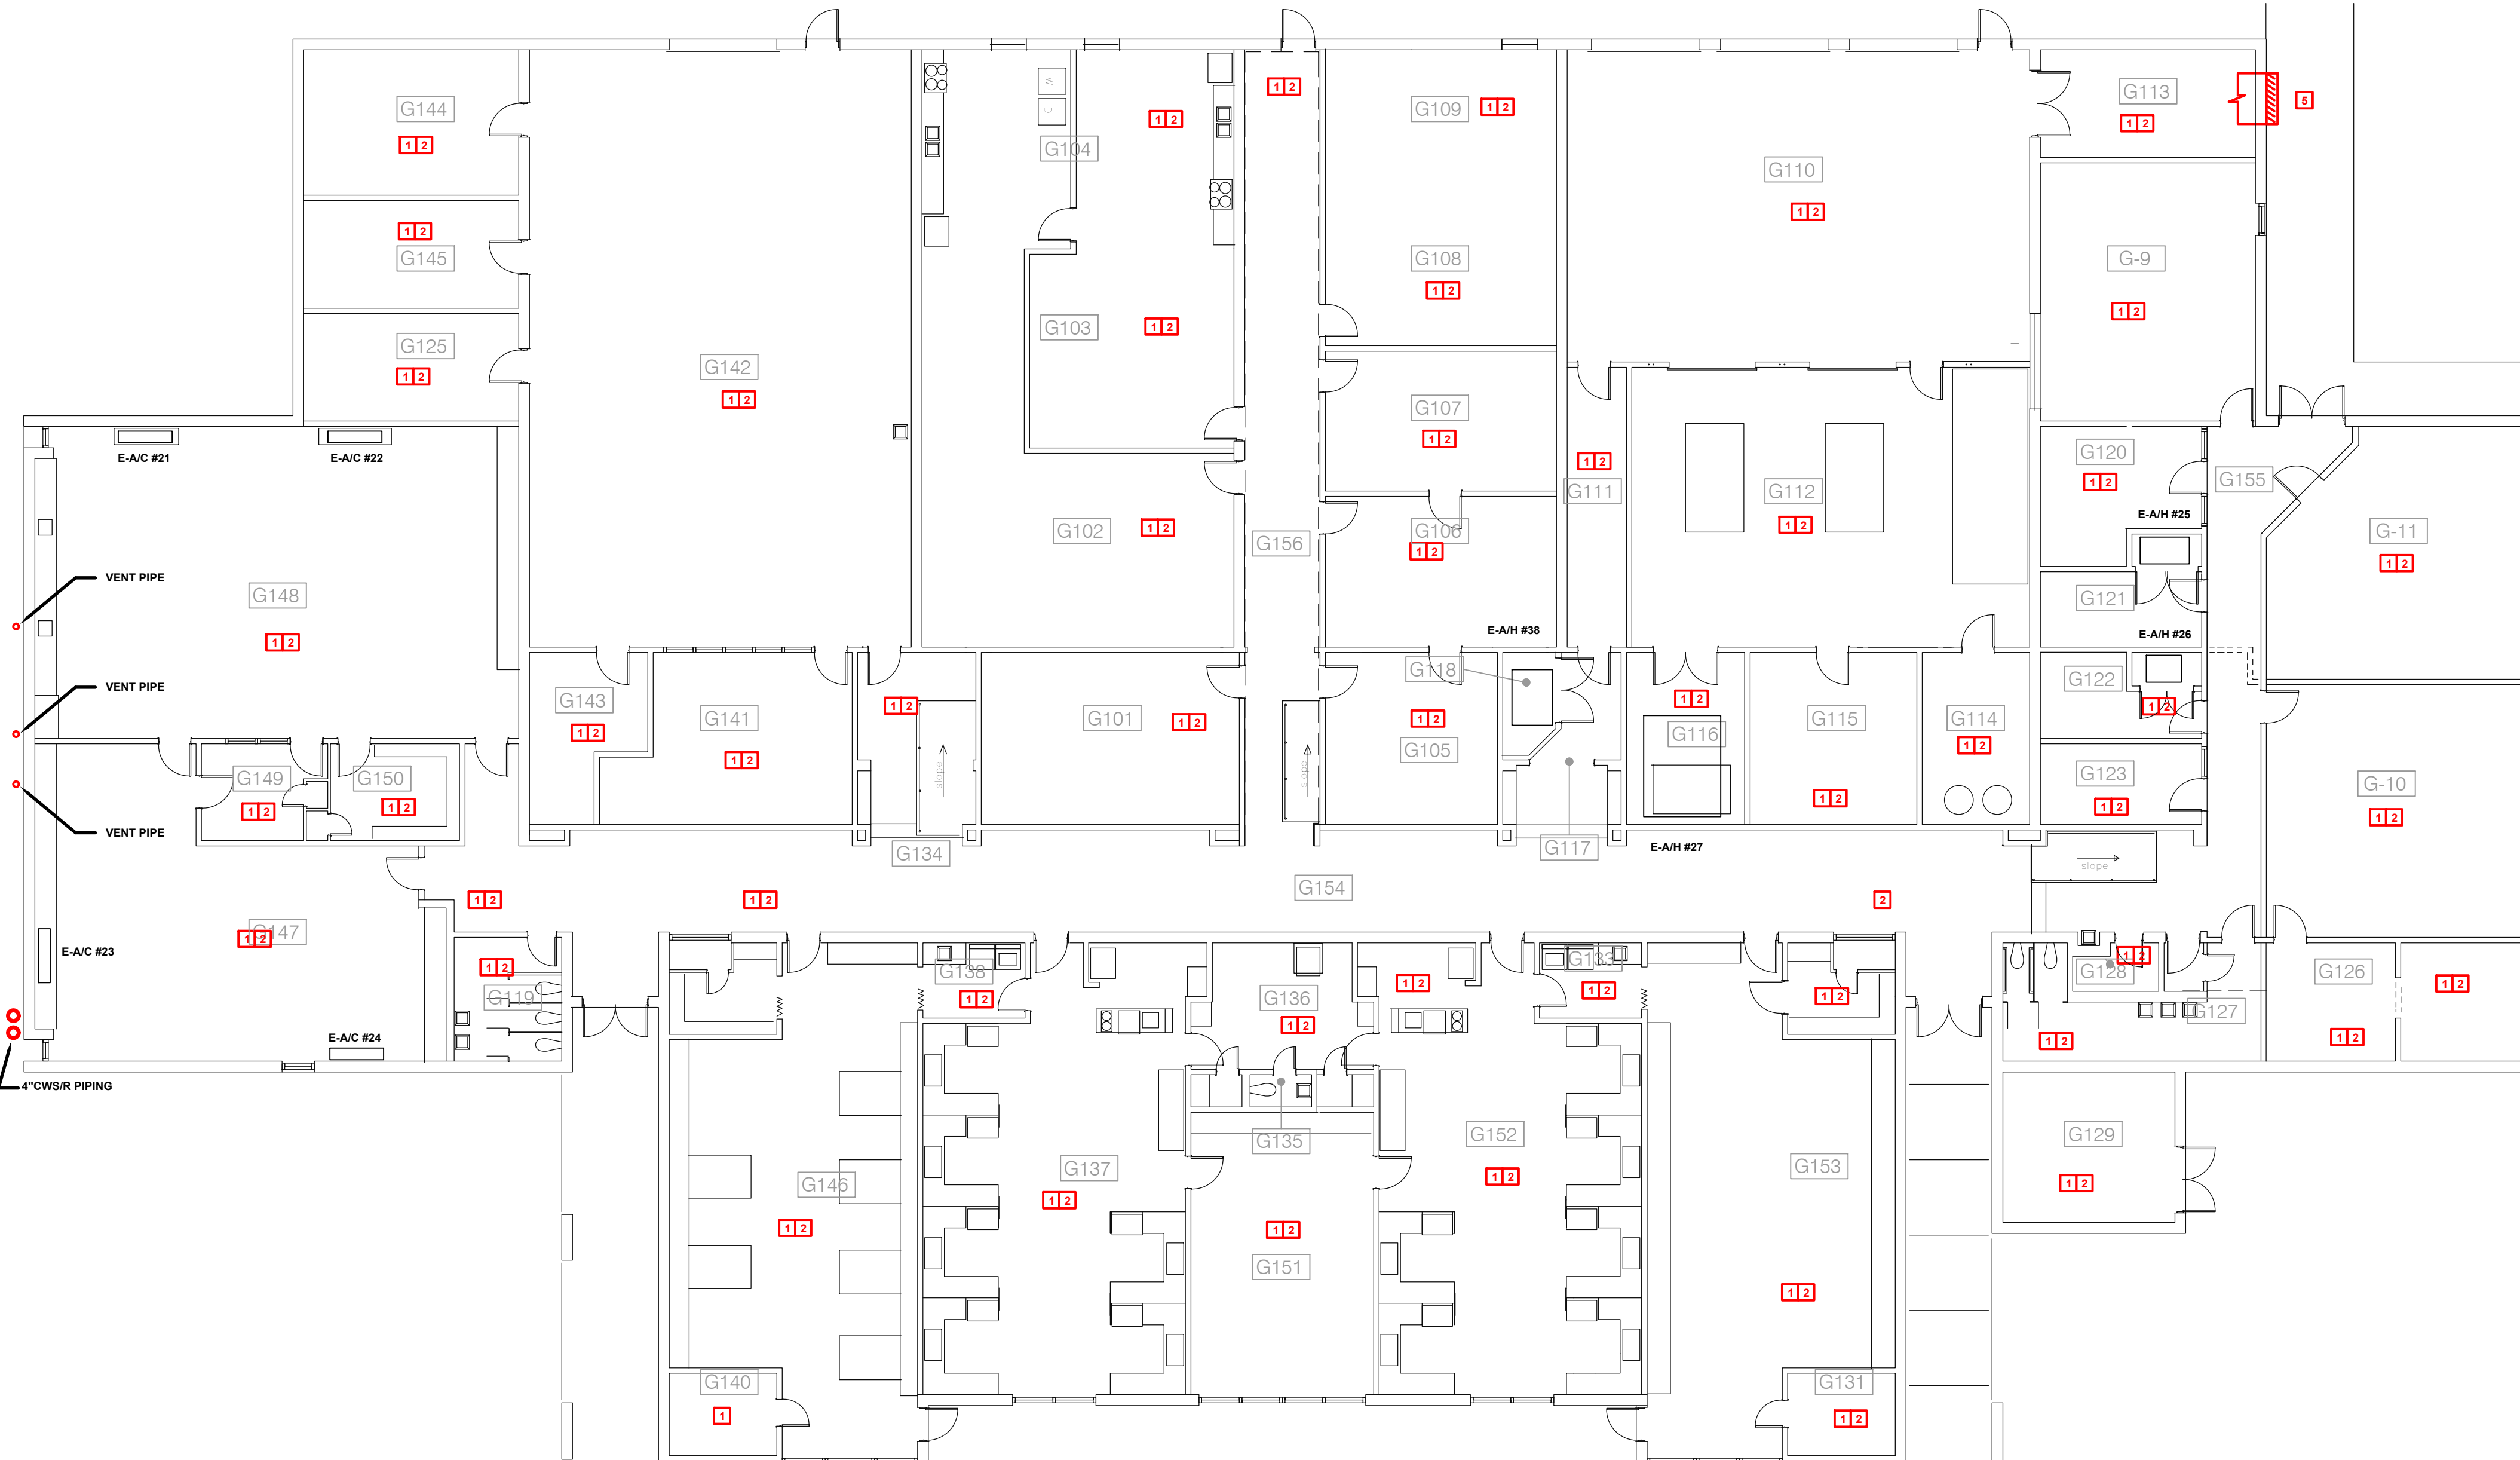
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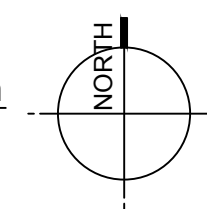


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BUILDING G
ROOF PLAN




NOTE:
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FOR ALL DIMENSIONS.

11 Zone 1 - Building G - Mechanical Plan
3/32" = 1'-0"



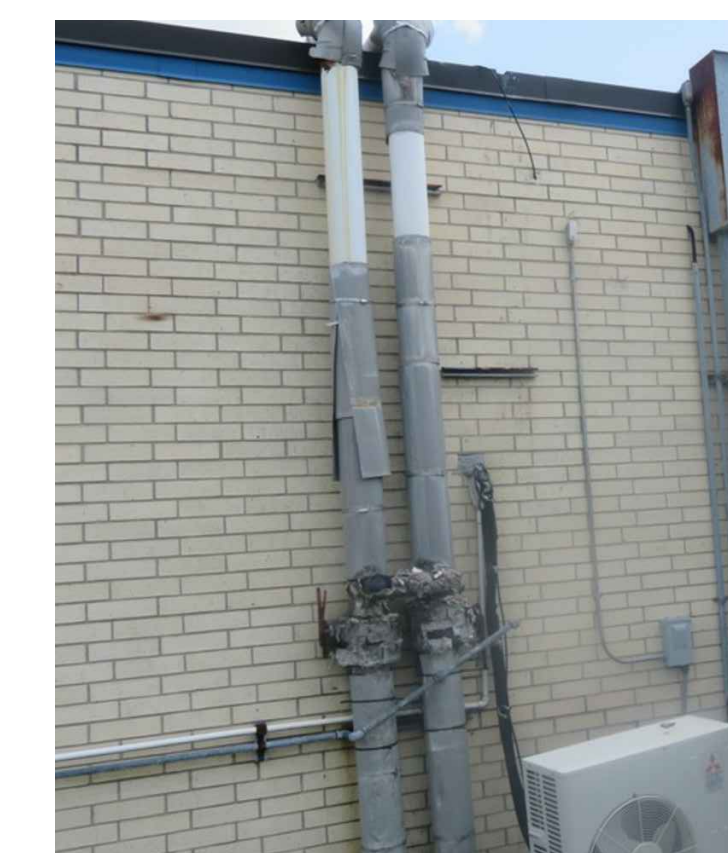16 Zone 1 - Building G - Picture #1
N.T.S.



17 Zone 1 - Building G - Picture #2
N.T.S.



18 Zone 1 - Building G - Picture #3
N.T.S.



19 Zone 1 - Building G - Picture #4
N.T.S.

GENERAL NOTES:

- A. CONTRACTOR SHALL FIELD VERIFY EXISTING EQUIPMENT TAGS (WHERE POSSIBLE) IN FIELD PRIOR TO DEMOLITION. COORDINATE ALL SITE VISITS, THROUGH GENERAL CONTRACTOR AND C.P.S.B. CONTRACTOR WEAR REQUIRED PERSONAL PROTECTIVE GEAR (PPE) SPECIFICALLY REQUIRED FOR EACH BUILDING.
- B. CONTRACTOR SHALL NOTIFY ARCHITECT/ENGINEER OF ANY DISCREPANCIES IDENTIFIED IN THE FIELD PRIOR TO FABRICATING DUCTWORK OR ORDERING EQUIPMENT.
- C. CONTRACTOR SHALL PROVIDE TESTING AND BALANCING OF ALL HVAC SYSTEMS WHICH WERE REPLACED, MODIFIED AND/OR CLEANED.
- D. ALL WORK SHALL COMPLY WITH LOCAL, STATE, AND FEDERAL CODES TO THE SATISFACTION OF CODE AUTHORITIES HAVING JURISDICTION.
- E. ALL WORK SHALL COMPLY WITH THE REQUIREMENTS OF NFPA 90A & 101, THE CLEAN AIR ACT AND THE AMERICANS WITH DISABILITIES ACT.
- F. PRIOR TO DRAINING, DISCONNECTING, AND REMOVING OF ANY SERVICES IN THE DESIGNATED AREAS SHOWN, THE CONTRACTOR MUST ENSURE THAT THE SERVICES REMOVED DO NOT AFFECT THE NORMAL OPERATION OF AREAS OUTSIDE THE CONSTRUCTION AREA.
- G. VERIFY ADEQUATE SPACE AVAILABLE PER MANUFACTURER'S RECOMMENDATIONS. COORDINATE CLEARANCE REQUIREMENTS OF ALL MECHANICAL EQUIPMENT.

KEYNOTES TO SHEET:

1. NO INTERIOR MECHANICAL (PLUMBING & HVAC) WORK ASSOCIATED WITH THESE SPACE WITHIN THE BUILDING.
2. CONTRACTOR SHALL TEMPORARILY SUPPORT AND PROTECT ANY EQUIPMENT, DIFFUSERS, GRILLES, ETC. IN OR ABOVE CEILINGS OF THESE SPACES DURING THE REMOVAL AND INSTALLATION OF NEW CEILINGS. REFER TO ARCHITECTURAL PLAN G01 BLDG. G.
3. CONTRACTOR SHALL REPLACE INSULATION THAT WAS DAMAGED ON EXTERIOR 4" CHILLED WATER PIPING (CWS/CWR) AND VALVES. EACH PIPE IS APPROXIMATELY 15FT IN LENGTH. REFER TO SPECIFICATIONS FOR EXACT REQUIREMENTS. REFER TO PICTURES #1 & #2 ON THIS SHEET.
4. CONTRACTOR SHALL REPLACE SANITARY SEWER WASTE & VENT PIPING ON EXTERIOR WALL THAT WAS DAMAGED. NEW PIPING SHALL MATCH EXISTING SIZE AND MATERIAL. APPROXIMATELY EACH DROP IS 15FT IN LENGTH. REFER TO PICTURE # 3 ON THIS SHEET.
5. CONTRACTOR SHALL REMOVE THE EXISTING WALL EXHAUST FAN. CONTRACTOR SHALL PROVIDE AND INSTALL NEW EXHAUST FAN WITH ONE OF EQUAL SIZE, CAPACITY, ELEC., ETC. CONTRACTOR SHALL FIELD VERIFY PRIOR TO BID, ORDERING EQUIPMENT, AND RESPECTIVE ROUGH-IN. MAKE ALL FINAL CONNECTIONS AND VERIFY EQUIPMENT IS WORKING PROPERLY. REFER TO PICTURE #4 ON THIS SHEET.

NOTE:
CONTRACTOR SHALL REVIEW C.P.S.B MANAGEMENT PLANS PRIOR TO ANY DEMOLITION WORK. REPORT ANY SUSPICIOUS ASBESTOS MATERIALS TO ARCHITECT / ENGINEER PRIOR TO DISTURBING SUSPECT MATERIALS


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NOTE: THE HVAC SCOPE OF WORK IS LIMITED TO REPLACING OR REPAIRING THE HVAC SYSTEM BACK TO ITS ORIGINAL CONDITION (LIKE FOR LIKE) IN MOST CIRCUMSTANCES. THIS PROJECT'S SCOPE OF WORK DOES NOT INCLUDE BRINGING ALL THE EXISTING HVAC SYSTEMS UP TO CODE OR ADDRESSING EXISTING CONDITIONS. ALTHOUGH ALL WORK MUST COMPLY WITH FEMA CONSENSUS-BASED, "LATEST PUBLISHED EDITIONS" OF CODES NOT NECESSARILY THOSE CODES ADOPTED BY THE LOCAL MUNICIPALITY.


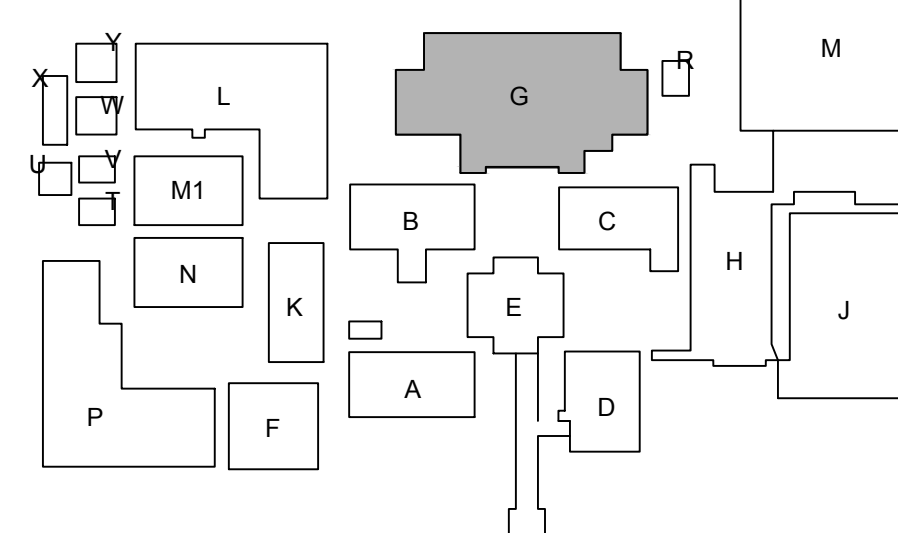
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SITE KEYPLAN
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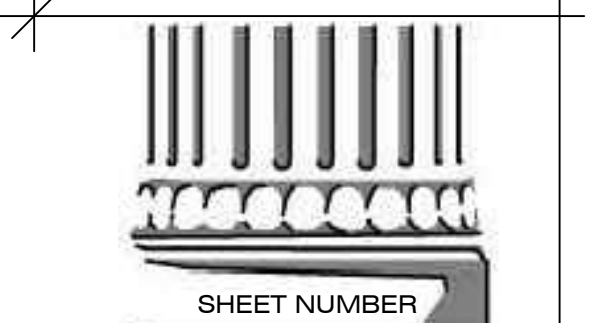
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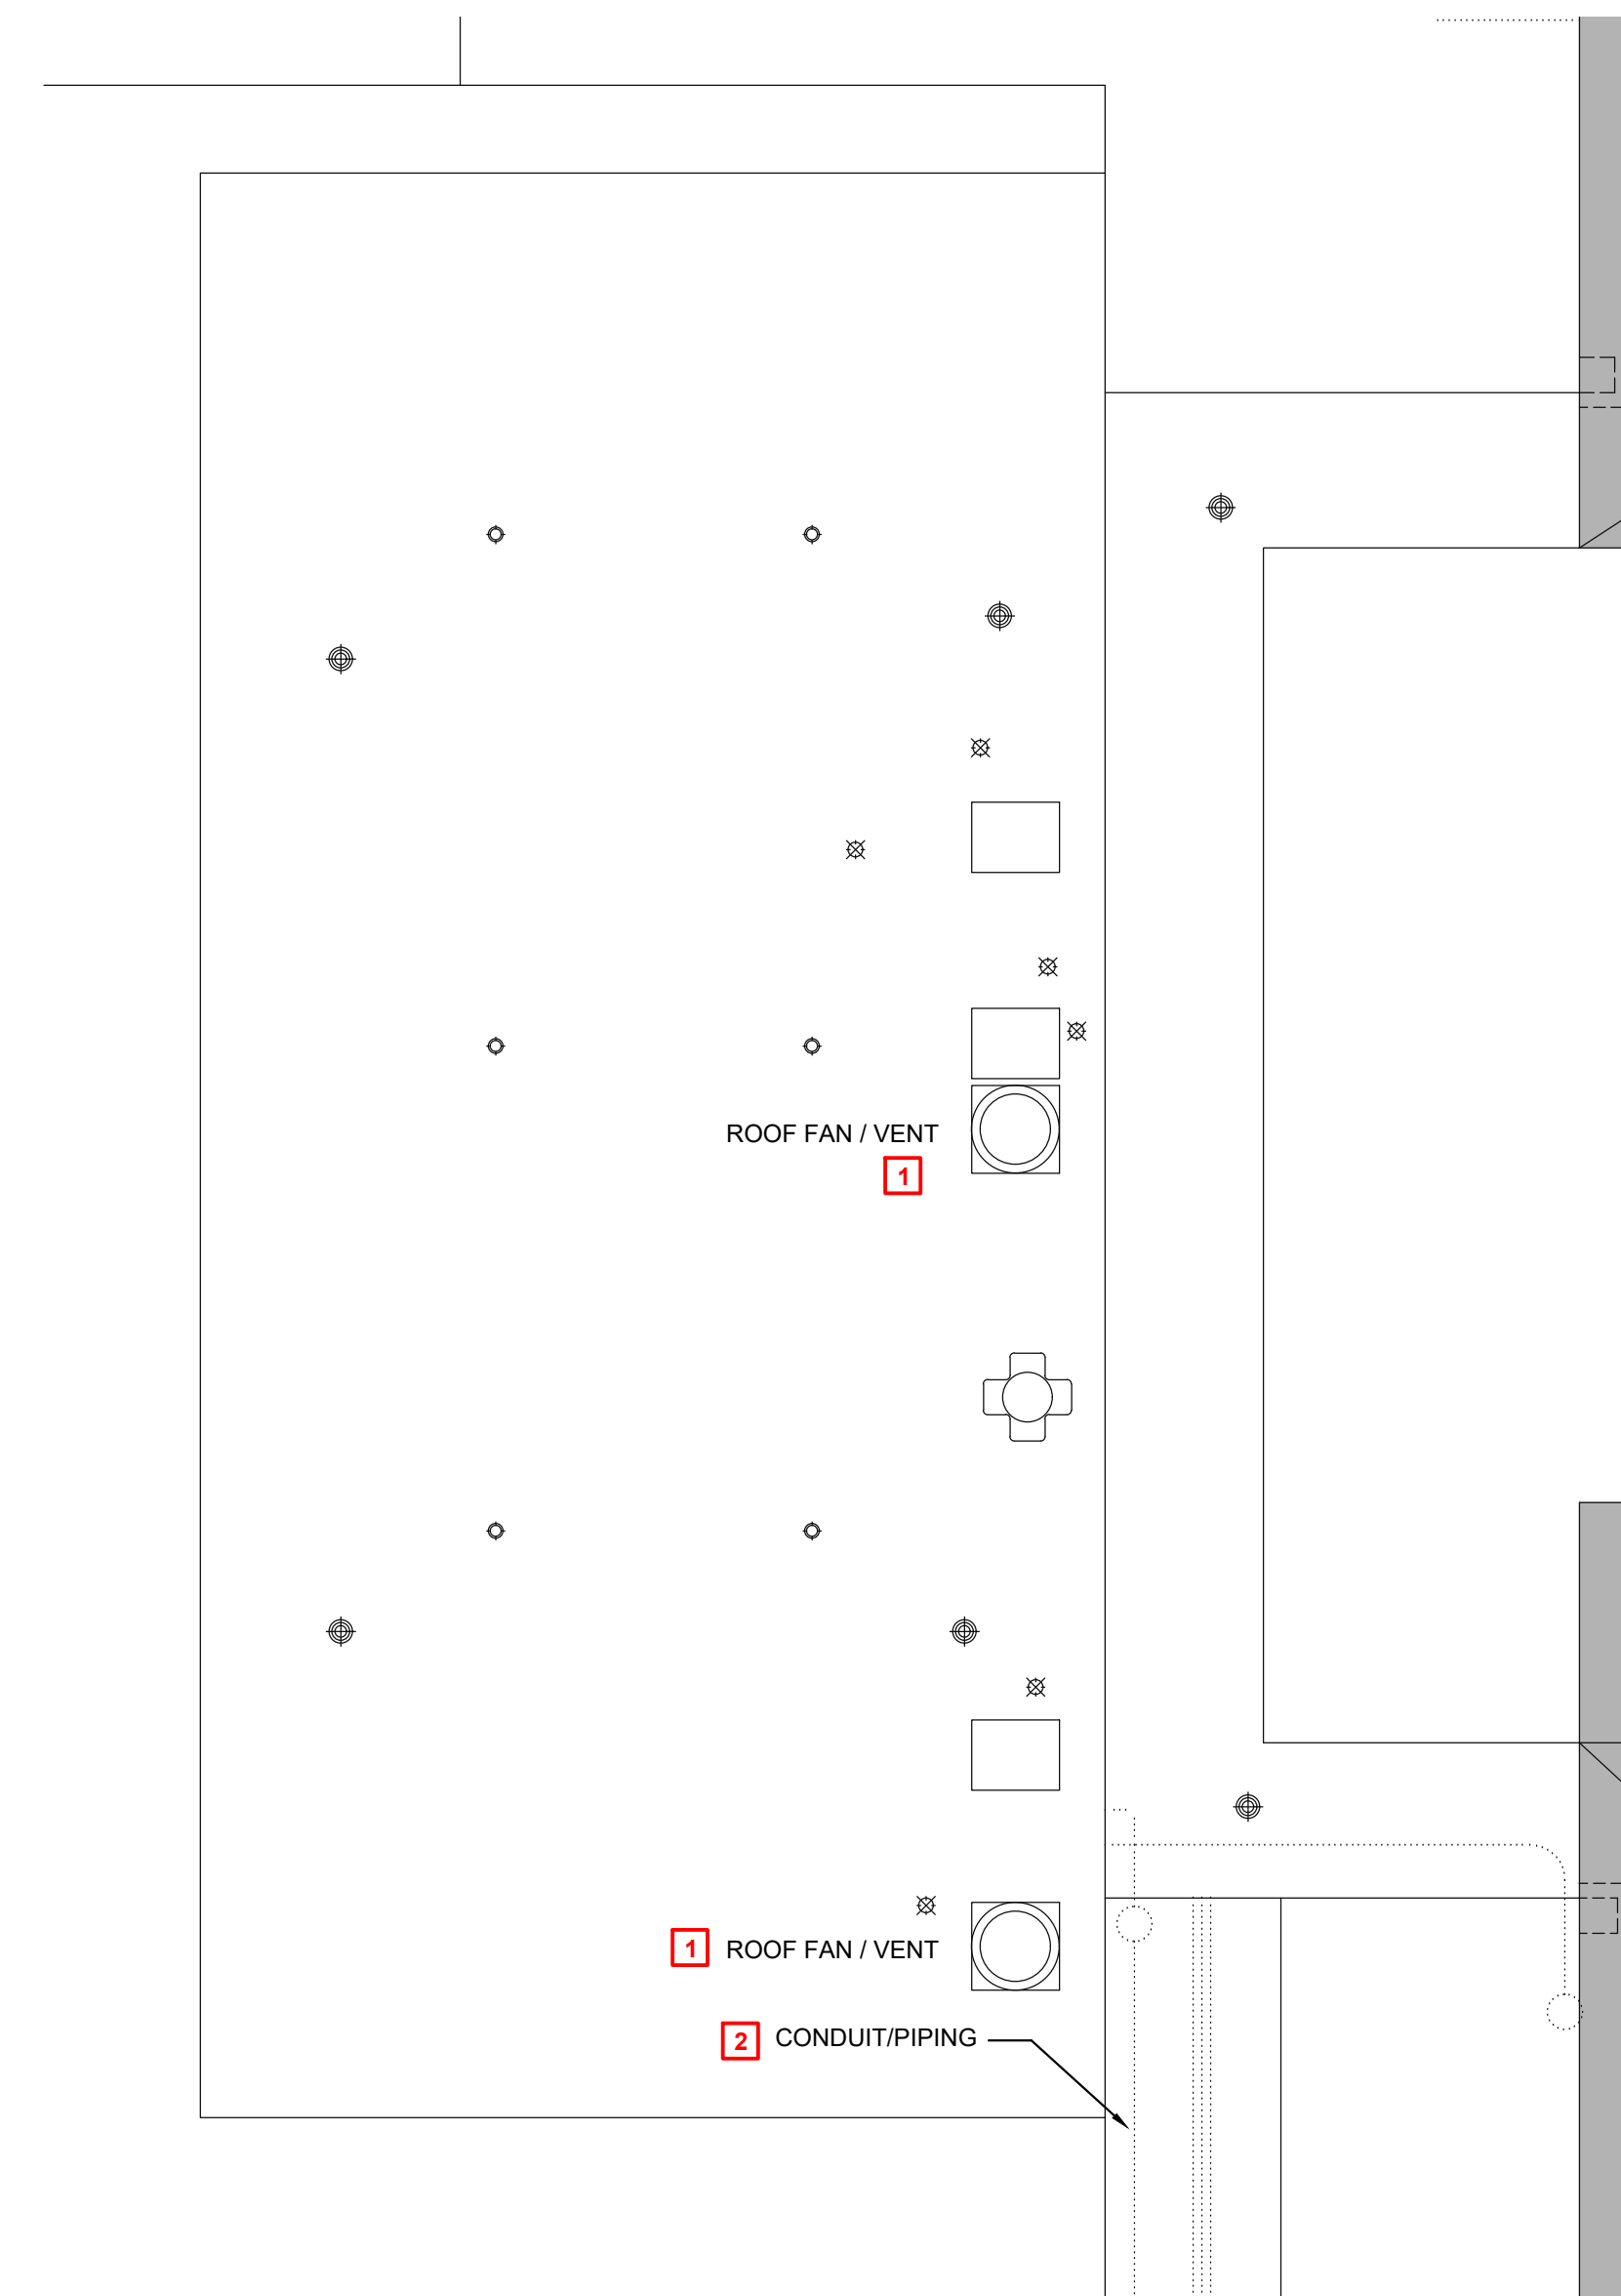
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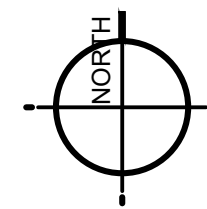
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(G)M1.1
ZONE 1 - BUILDING G
MECHANICAL PLANS



1 Electrical Roof Plan - Building K
3/32" = 1'-0"



GENERAL NOTES:

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- E. PRIOR TO DISCONNECTING, AND REMOVING OF ANY ELECTRICAL SERVICES IN THE DESIGNATED AREAS SHOWN, THE CONTRACTOR MUST ENSURE THAT THE SERVICES REMOVED DO NOT AFFECT THE NORMAL OPERATION OF AREAS OUTSIDE THE CONSTRUCTION AREA. COORDINATE WITH OWNER FOR ALL ELECTRICAL SHUT DOWNS AT LEAST 2 WORKING DAYS PRIOR TO WORK.

KEYNOTES TO SHEET:

1. CONTRACTOR SHALL REMOVE EXISTING ROOF MOUNTED HOOD/FAN AND AND INSTALL ON NEW CURB. RECONNECT EXISTING ELECTRICAL ONCE ROOF IS COMPLETED.
2. EXISTING CONDUIT SHALL BE TEMPORARILY SUPPORTED AND PROTECTED DURING THE RE-ROOFING PROJECT. ONCE NEW ROOF IS COMPLETED PERMANENT CONDUIT SUPPORTS SHALL BE PROVIDED AS REQUIRED. REFER TO CODE REQUIREMENTS FOR SPACING OF SUPPORTS. SECURE CONDUIT TO SUPPORTS WITH CLAMPS AS NECESSARY.

ROOFING SYMBOL LEGEND

- EXISTING SKYLIGHT
- ONE-WAY ROOF VENT
- ROOF DRAIN
- ROOF PIPING PENETRATION
- ROOF FAN / VENT
- ROOF FAN / VENT
- DOWNSPOUT
- MISC MEP
- CONDUIT/PIPING RUNS
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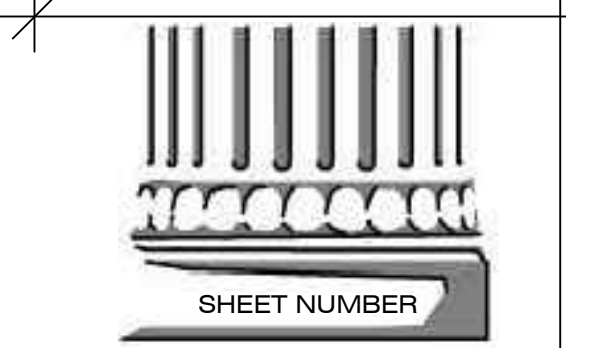
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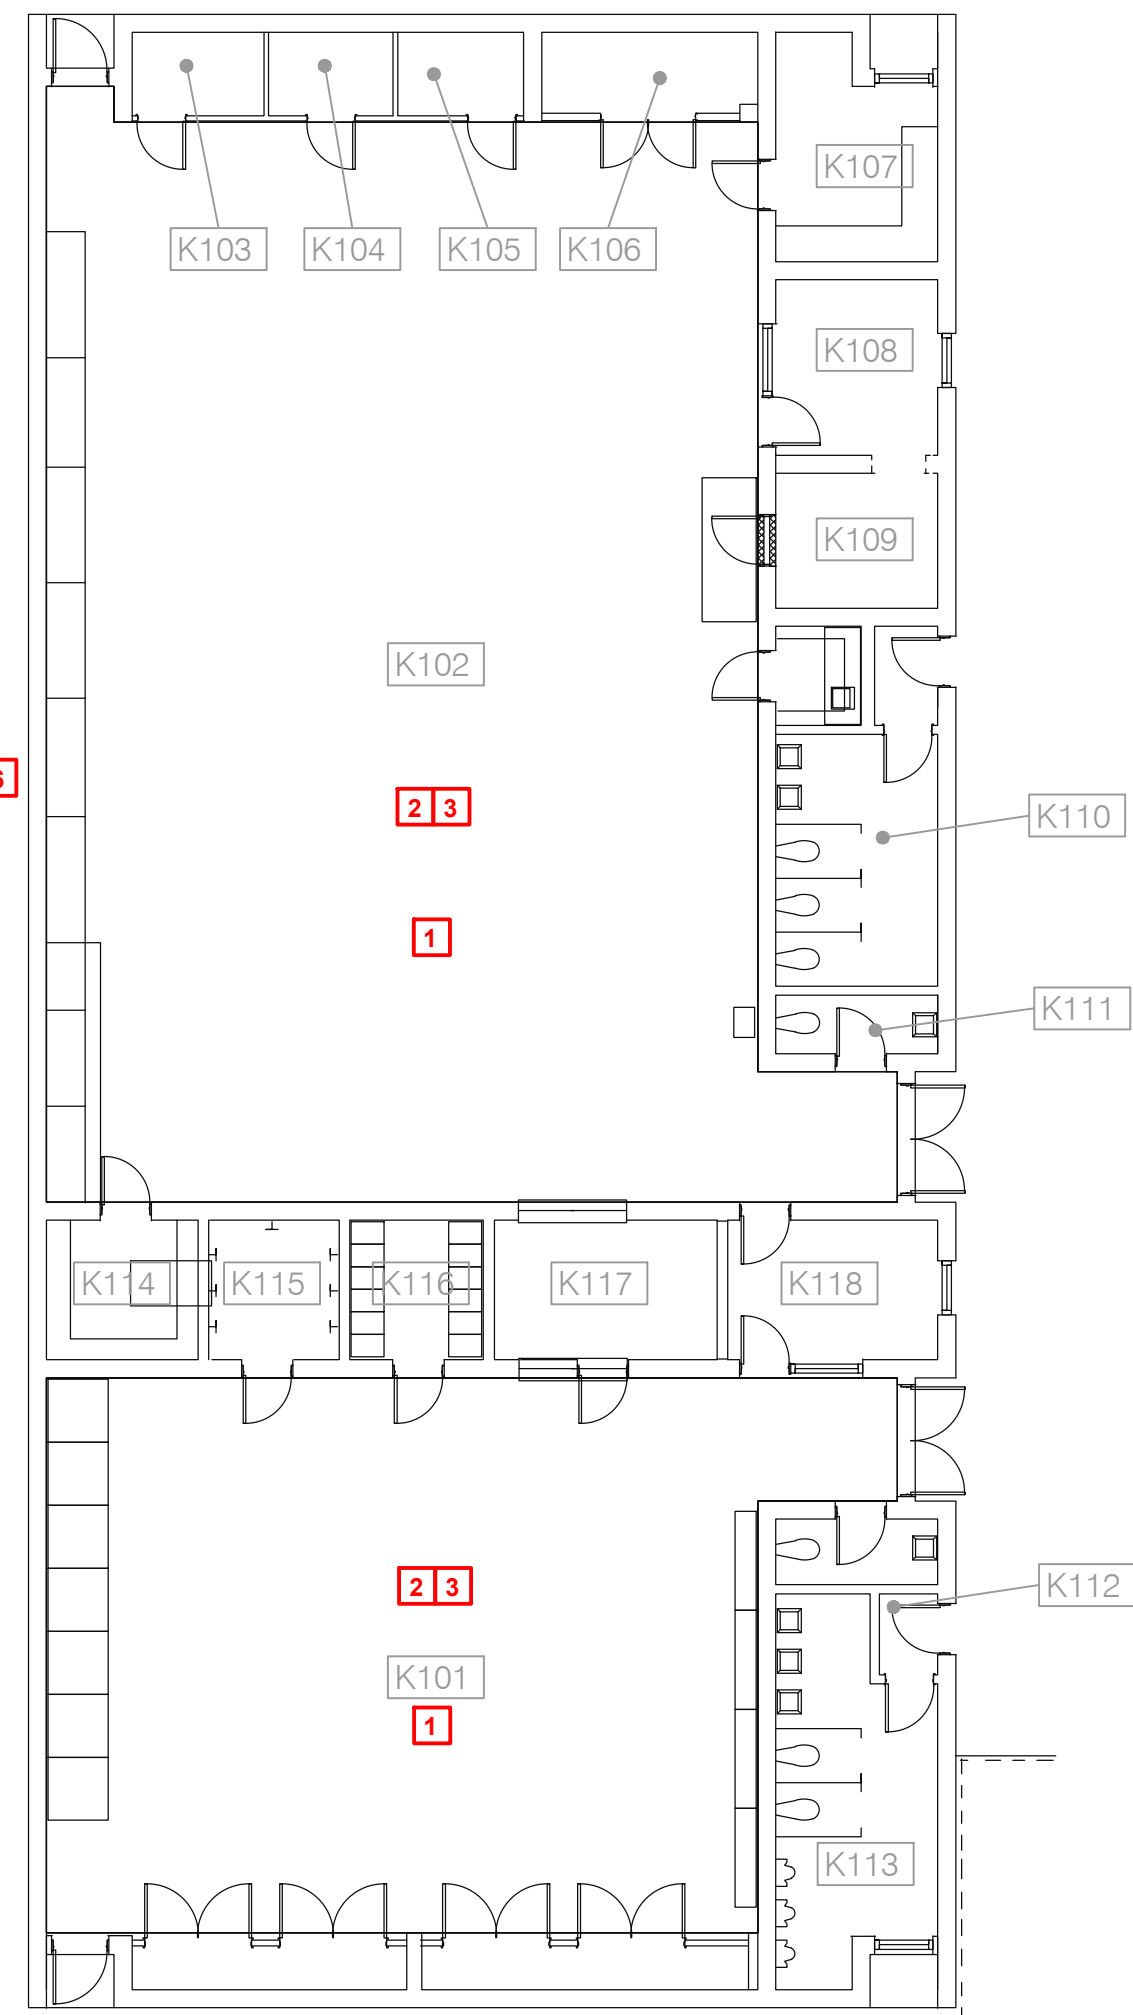
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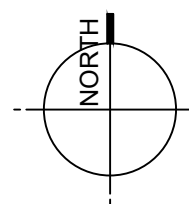
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(K)E0.1
BUILDING K
ROOF PLAN



1 Zone 1 - Building K - Electrical Plan
1/12" = 1'-0"



GENERAL NOTES:

- A. CONTRACTOR SHALL NOTIFY ARCHITECT/ENGINEER OF ANY DISCREPANCIES IDENTIFIED IN THE FIELD PRIOR TO ORDERING LIGHT FIXTURES.
- B. THE INTENT OF THE PLAN IS FOR EXISTING CIRCUITING TO REMAIN AND BE RE-USED. ALL EXISTING POWER WIRING SHALL BE PROTECTED DURING DEMOLITION AND AVAILABLE FOR RE-USE. ANY WIRING REMOVED OR DAMAGED DURING CONSTRUCTION SHALL BE REPLACED AT CONTRACTOR'S EXPENSE.
- C. ALL WORK SHALL COMPLY WITH LOCAL, STATE, AND FEDERAL CODES TO THE SATISFACTION OF CODE AUTHORITIES HAVING JURISDICTION.
- D. ALL WORK SHALL COMPLY WITH THE REQUIREMENTS OF THE 2020 EDITION OF NEC.
- E. PRIOR TO DISCONNECTING, AND REMOVING OF ANY ELECTRICAL SERVICES IN THE DESIGNATED AREAS SHOWN, THE CONTRACTOR MUST ENSURE THAT THE SERVICES REMOVED DO NOT AFFECT THE NORMAL OPERATION OF AREAS OUTSIDE THE CONSTRUCTION AREA. COORDINATE WITH OWNER FOR ALL ELECTRICAL SHUT DOWNS AT LEAST 2 WORKING DAYS PRIOR TO WORK.
- F. EXISTING LIGHTING THROUGHOUT THE BUILDING HAS BEEN REPLACED BY THE OWNER IN A PREVIOUS PROJECT. IF THERE ARE SPACES WHERE THE DRAWINGS REQUIRE CEILING REPLACEMENT, THE CONTRACTOR WILL BE REQUIRED TO REMOVE THE EXISTING FIXTURES, PROPERLY STORE THEM ON-SITE (CONTAINER OR OTHER OWNER APPROVED AREA), THEN RE-INSTALL FOLLOWING REPLACEMENT OF CEILINGS WITHIN A GIVEN SPACE.
- G. ALL EXISTING LOW VOLTAGE WIRING SHALL BE PROTECTED DURING DEMOLITION AND AVAILABLE FOR RE-USE. ANY WIRING REMOVED OR DAMAGED DURING CONSTRUCTION SHALL BE REPLACED AT CONTRACTOR'S EXPENSE.

KEYNOTES:

- 1. ANY EXISTING CAMERAS OR WIRELESS ACCESS POINTS TO BE REMOVED DURING CONSTRUCTION SHALL BE COORDINATED WITH CP&B IT DEPARTMENT. DEVICES SHALL BE LABELED AND STORED FOR RE-INSTALLATION. CONTRACTOR IS RESPONSIBLE FOR ANY CUT OR REMOVED COMMUNICATIONS CABLING.
- 2. ANY EXISTING FIRE ALARM DEVICES TO BE REMOVED DURING CONSTRUCTION SHALL BE COORDINATED WITH SYLVAN SOUND. DEVICES SHALL BE LABELED AND STORED FOR RE-INSTALLATION. CONTRACTOR IS RESPONSIBLE FOR ANY CUT OR REMOVED FIRE ALARM WIRING.
- 3. ANY EXISTING INTERCOM DEVICES TO BE REMOVED DURING CONSTRUCTION SHALL BE COORDINATED WITH SYLVAN SOUND. DEVICES SHALL BE LABELED AND STORED FOR RE-INSTALLATION. CONTRACTOR IS RESPONSIBLE FOR ANY CUT OR REMOVED INTERCOM WIRING.
- 4. CONTRACTOR SHALL DISCONNECT AND REMOVE EXISTING WALL PACKS ON THIS SIDE OF THE BUILDING (2 TOTAL) AND PROVIDE NEW FIXTURES TYPE 'W'. FIXTURES TYPE 'W' SHALL BE LUMARK OR EQUAL. FIXTURES TYPE 'W' . MOUNT NEW FIXTURES IN THE SAME LOCATIONS AND CONNECT TO EXISTING LIGHTING CIRCUIT. SWITCH THROUGH EXISTING PHOTOCELL. IF PHOTOCELL IS MISSING OR NOT WORKING PROVIDE NEW UNIT.

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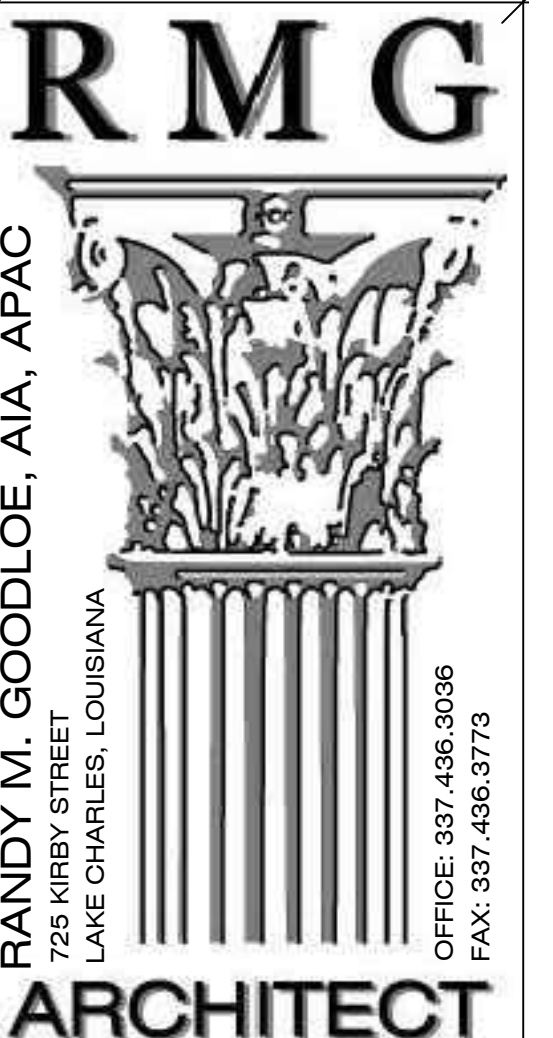
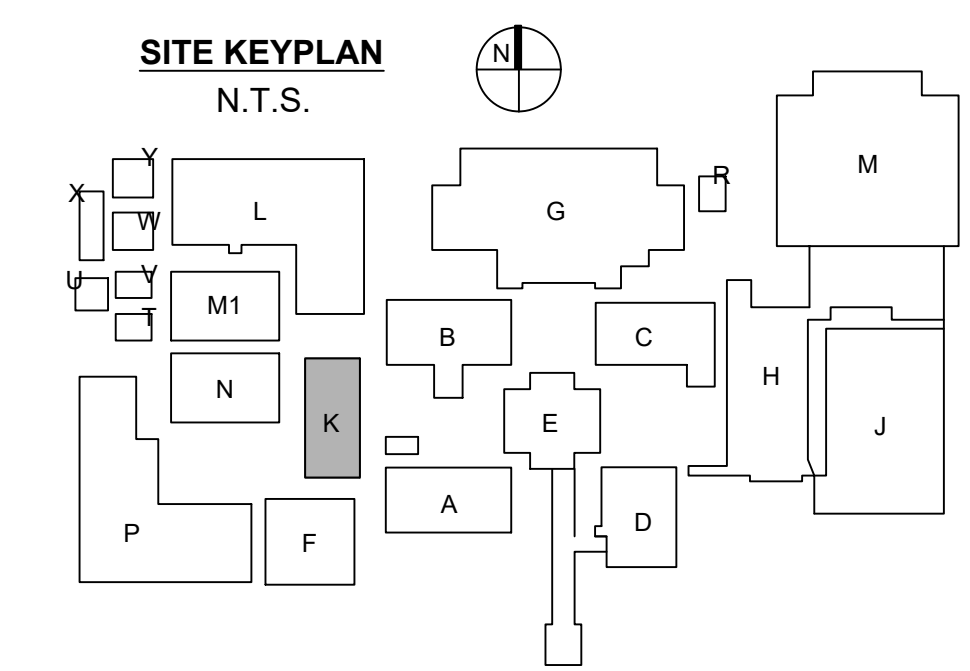
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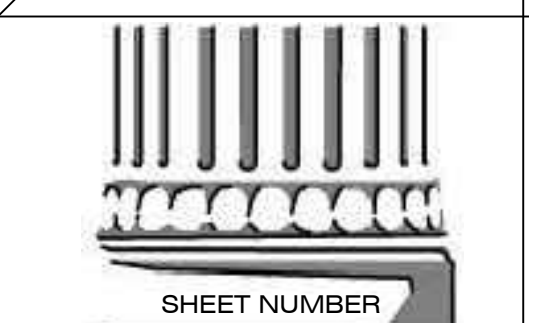
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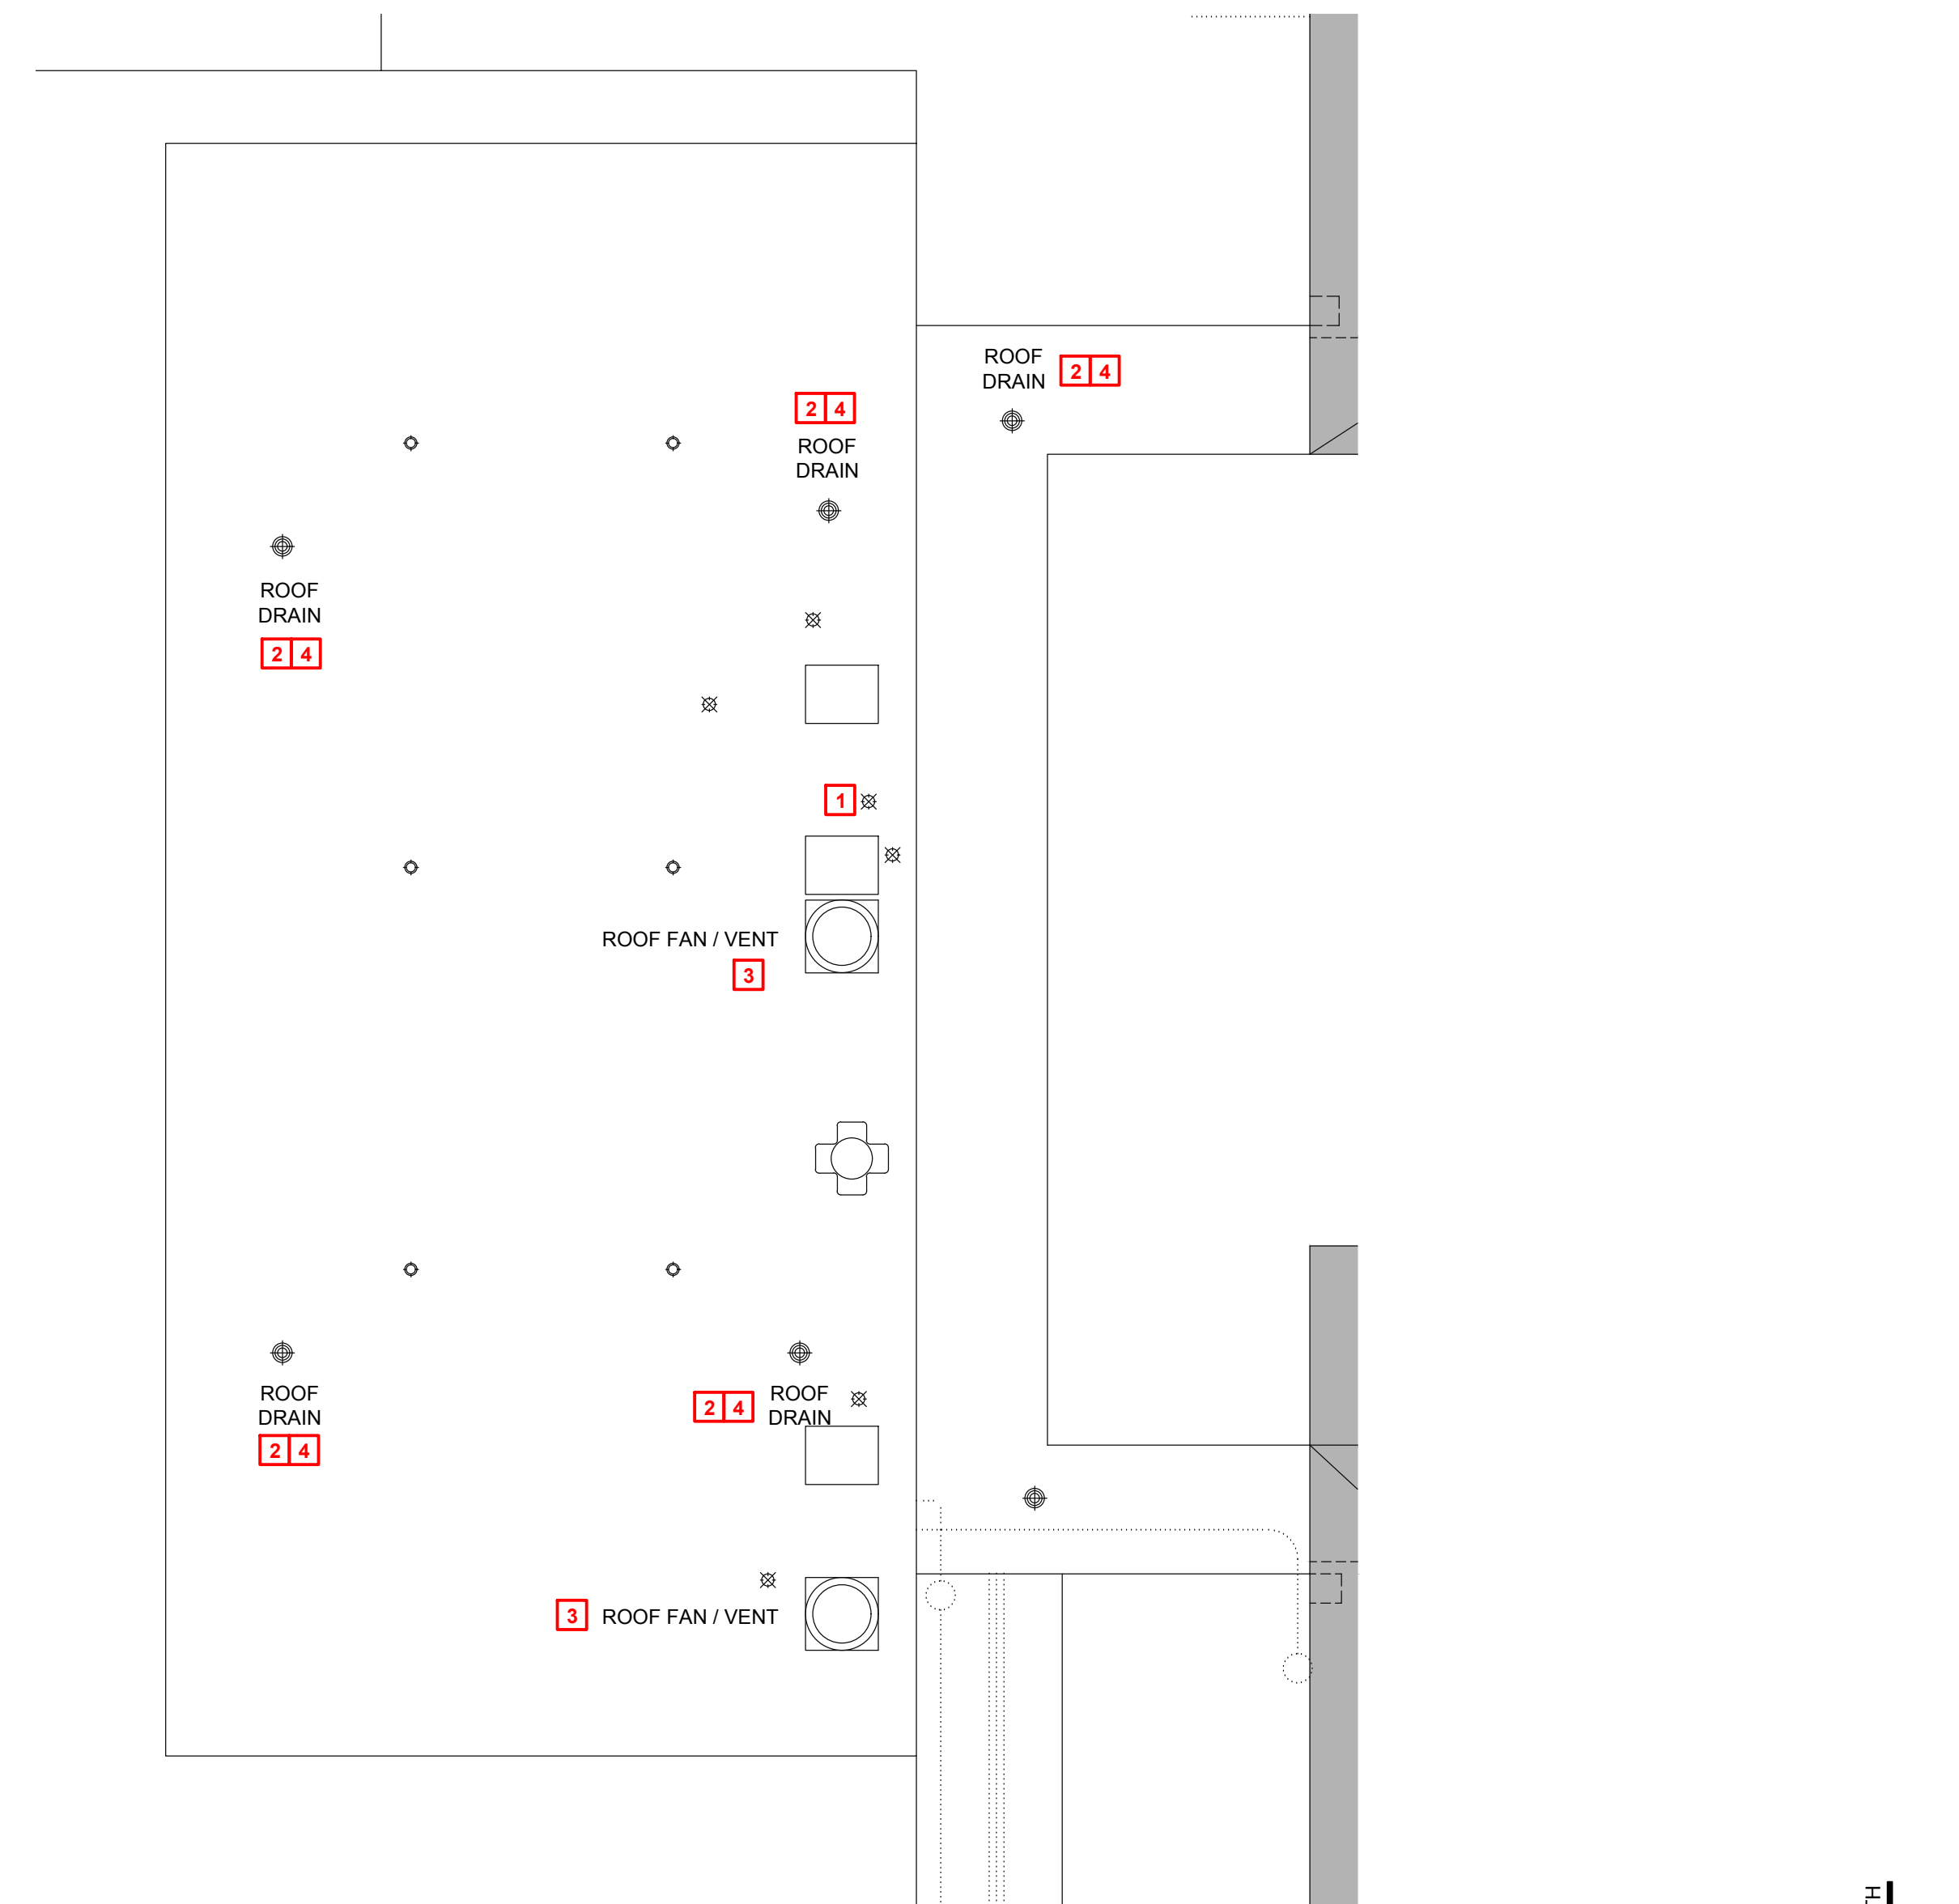
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(K)E1.1
ZONE 1 - BUILDING K
ELECTRICAL PLANS



1 Mechanical Roof Plan - Building K
3/32" = 1'-0"

NOTE:
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FOR ALL DIMENSIONS.

GENERAL NOTES:

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- G. VERIFY ADEQUATE SPACE AVAILABLE PER MANUFACTURER'S RECOMMENDATIONS. COORDINATE CLEARANCE REQUIREMENTS OF ALL MECHANICAL EQUIPMENT.

KEYNOTES TO SHEET:

- 1. CONTRACTOR SHALL REMOVE AND REPLACE EXISTING VENT THAT WAS DAMAGED DURING HURRICANE LAURA. REPLACE WITH ONE OF EQUAL SIZE.
- 2. CONTRACTOR SHALL REMOVE EXISTING ROOF DRAIN AN INSTALLED NEW ROOF DRAIN WITH DOME STRAINER IN SAME LOCATION. THE NEW ROOF DRAIN W/ DOME STRAINER SHALL MATCH THE EXISTING SIZE, STYLE, ETC. OF THE EXISTING THAT IS BEING REPLACED AS PART OF THE RE-ROOFING PROJECT.
- 2. CONTRACTOR SHALL REMOVE EXISTING ROOF MOUNTED HOOD/FAN AND AND INSTALL ON NEW CURB. NEW CURB SHALL MATCH THE EXISTING SIZE, STYLE, ETC. OF EXISTING CURB. COORDINATE CURB HEIGHT WITH ARCHITECT & GENERAL CONTRACTOR PRIOR ORDERING.
- 3. ALL EXISTING ROOF DRAIN PIPING SHALL BE FLUSHED TO REMOVE LEAVES, DEBRIS, ETC. ONCE THE NEW ROOF DRAINS ARE INSTALLED.
- 4. EXISTING PIPING (GAS, CHILLED WATER, ETC.) SHALL BE TEMPORARILY SUPPORTED AND PROTECTED DURING THE RE-ROOFING PROJECT. ONCE NEW ROOF IS COMPLETED PERMANENT PIPING SUPPORT SHALL BE PROVIDED AS REQUIRED. REFER TO CODE REQUIREMENTS FOR SPACING OF SUPPORTS. SHIELDS SHALL BE PLACED BETWEEN CHILLED WATER PIPING SUPPORTS AND PIPING INSULATION. SECURE PIPING TO SUPPORTS WITH CLAMPS AS NECESSARY.

ROOFING SYMBOL LEGEND

- EXISTING SKYLIGHT
- ONE-WAY ROOF VENT
- ROOF DRAIN
- ROOF PIPING PENETRATION
- ROOF FAN / VENT
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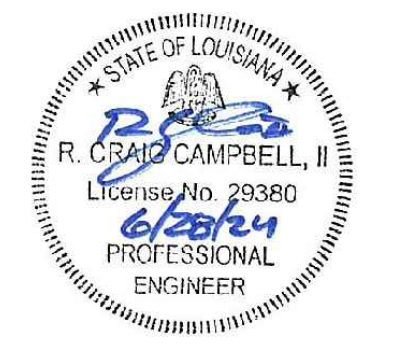
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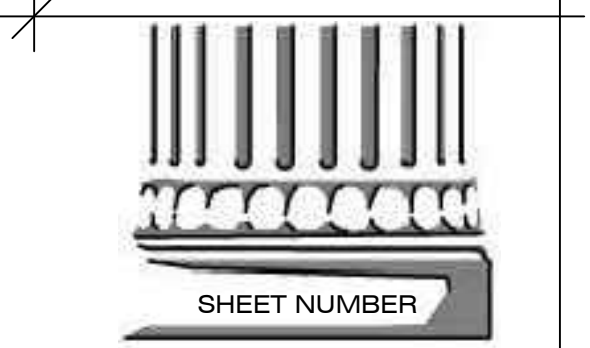
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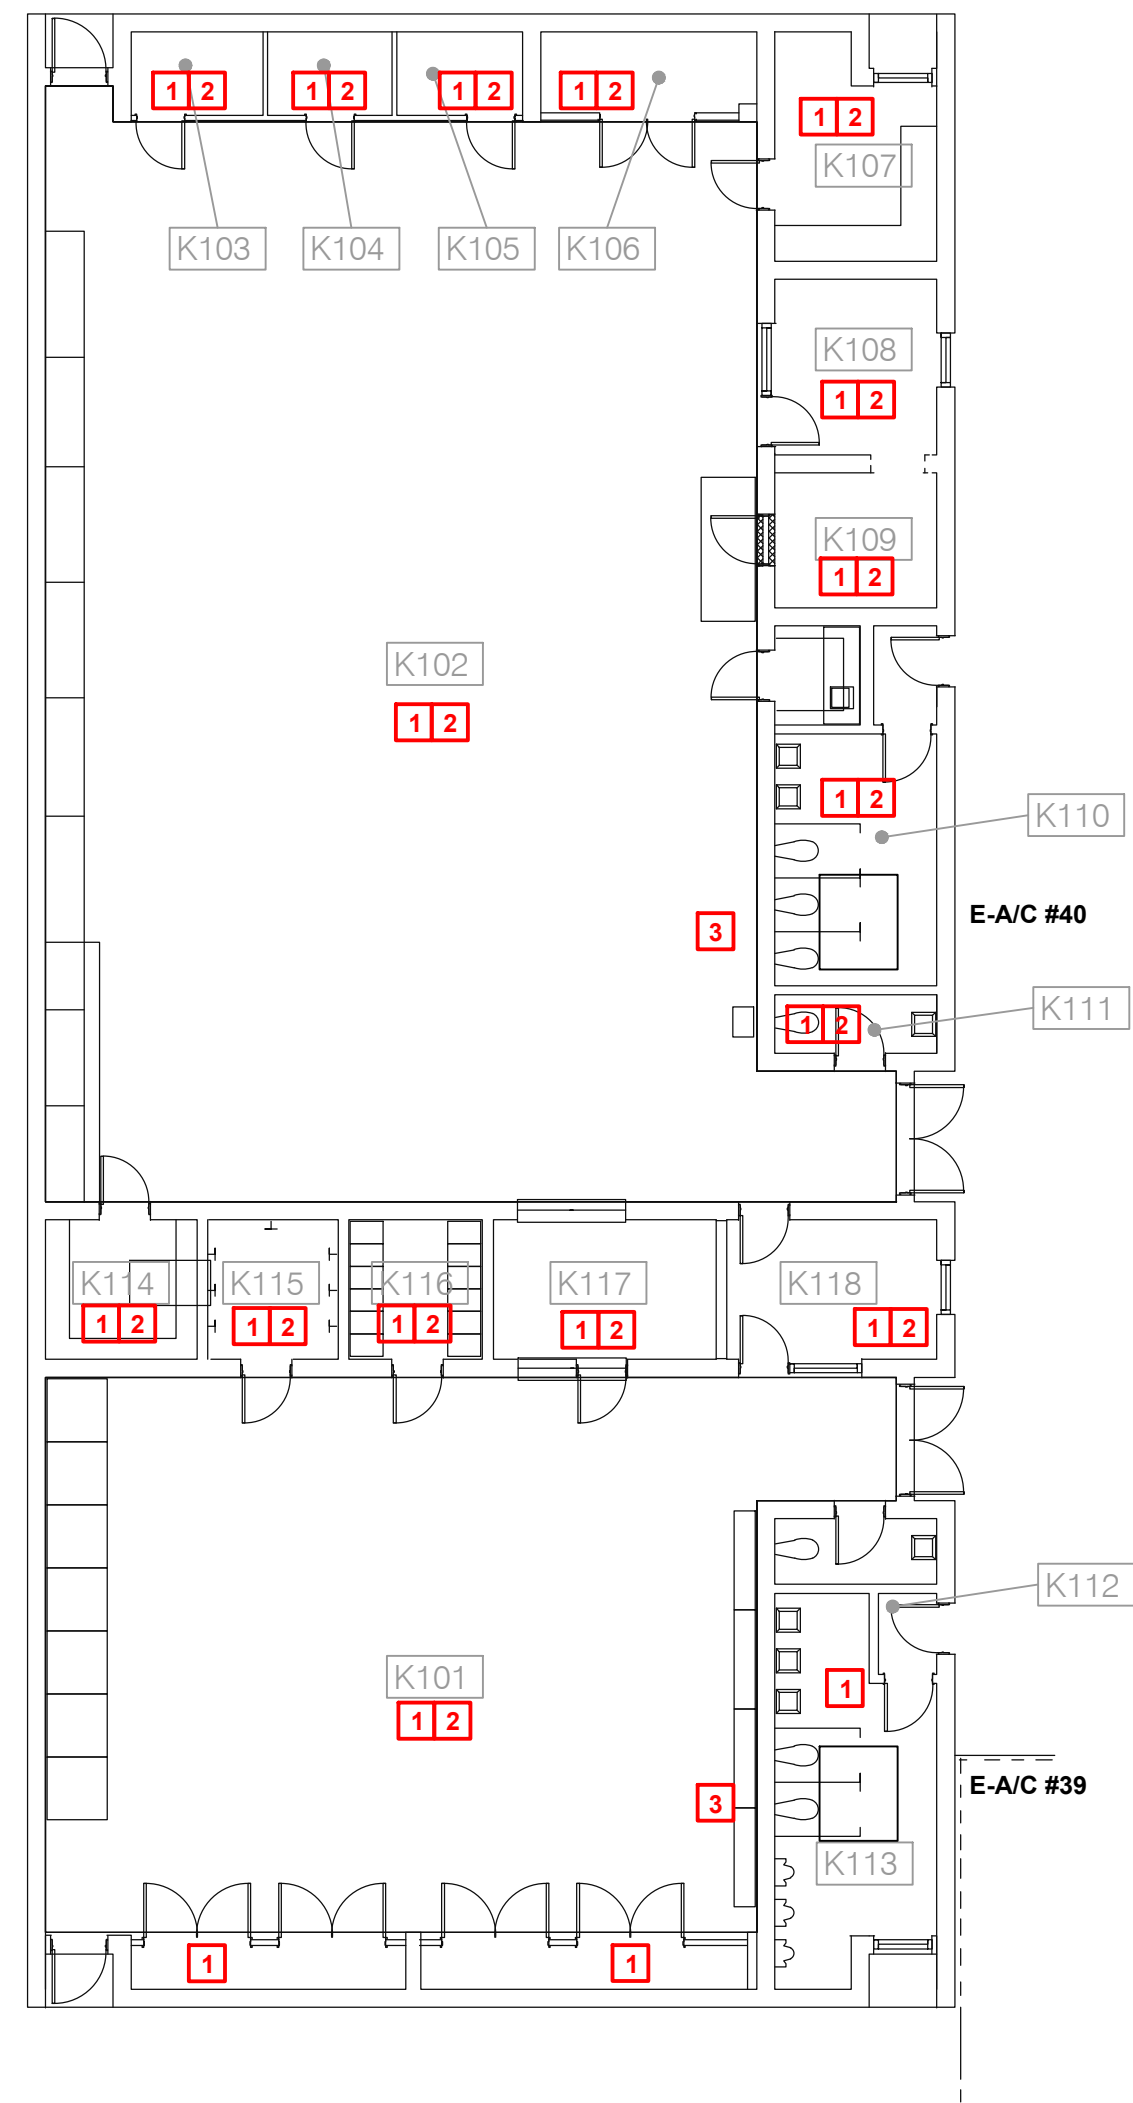
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(K)M0.1
BUILDING K
ROOF PLAN



11 Zone 1 - Building K - Mechanical Plan
3/32" = 1'-0"

NOTE:
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- CONTRACTOR SHALL TEMPORARILY SUPPORT AND PROTECT ANY EQUIPMENT, DIFFUSERS, GRILLES, ETC. IN OR ABOVE CEILINGS OF THESE SPACES DURING THE REMOVAL AND INSTALLATION OF NEW CEILINGS. REFER TO ARCHITECTURAL PLAN K01 BLDG K.

NOTE:
CONTRACTOR SHALL REVIEW C.P.S.B MANAGEMENT PLANS PRIOR TO ANY DEMOLITION WORK. REPORT ANY SUSPICIOUS ASBESTOS MATERIALS TO ARCHITECT / ENGINEER PRIOR TO DISTURBING SUSPECT MATERIALS

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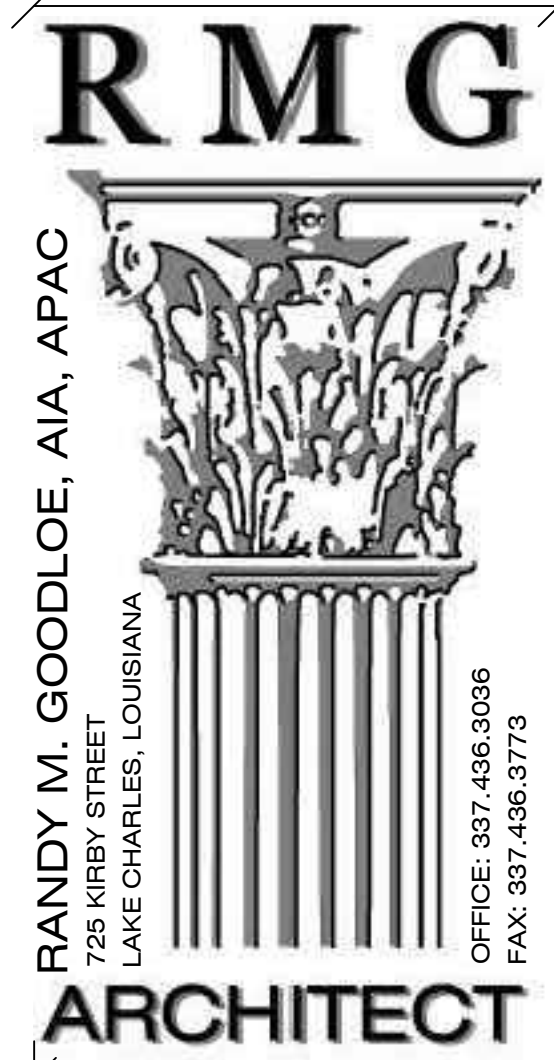
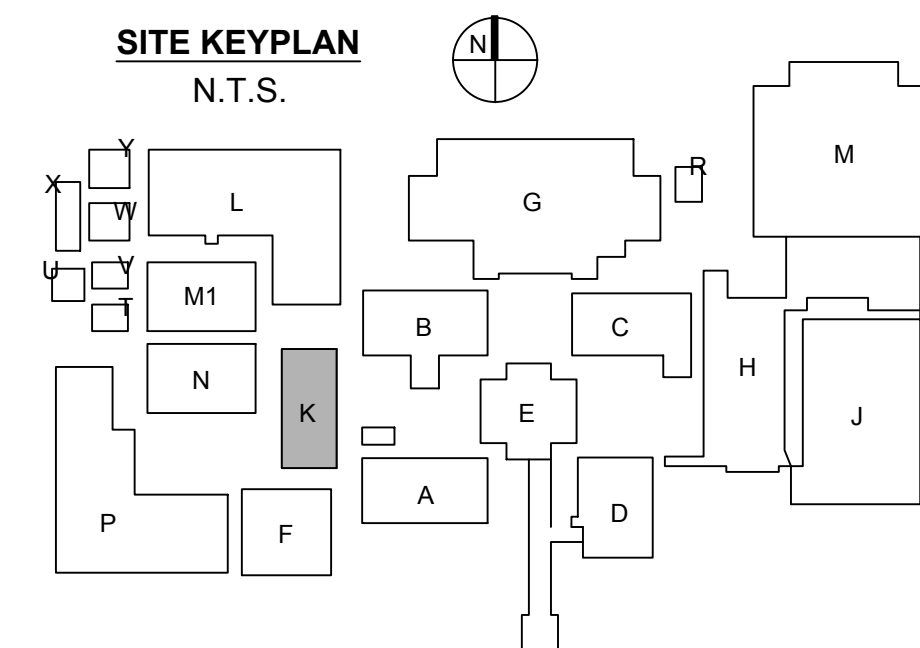
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SITE KEYPLAN
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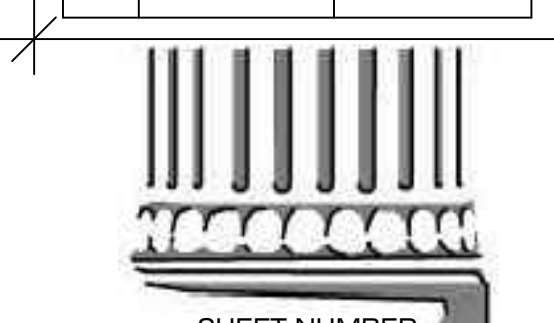


HURRICANE LAURA REPAIRS
A.M. BARBE HIGH SCHOOL
2200 W. McNEESE ST.
FOR
CALCASIEU PARISH SCHOOL BOARD
LAKE CHARLES, LA
HL-003-01.03.04.05.06.07


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PROJECT MANAGER
DP/TV
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REVISED



SHEET NUMBER
(K)M1.1
ZONE 1 - BUILDING K
MECHANICAL PLANS



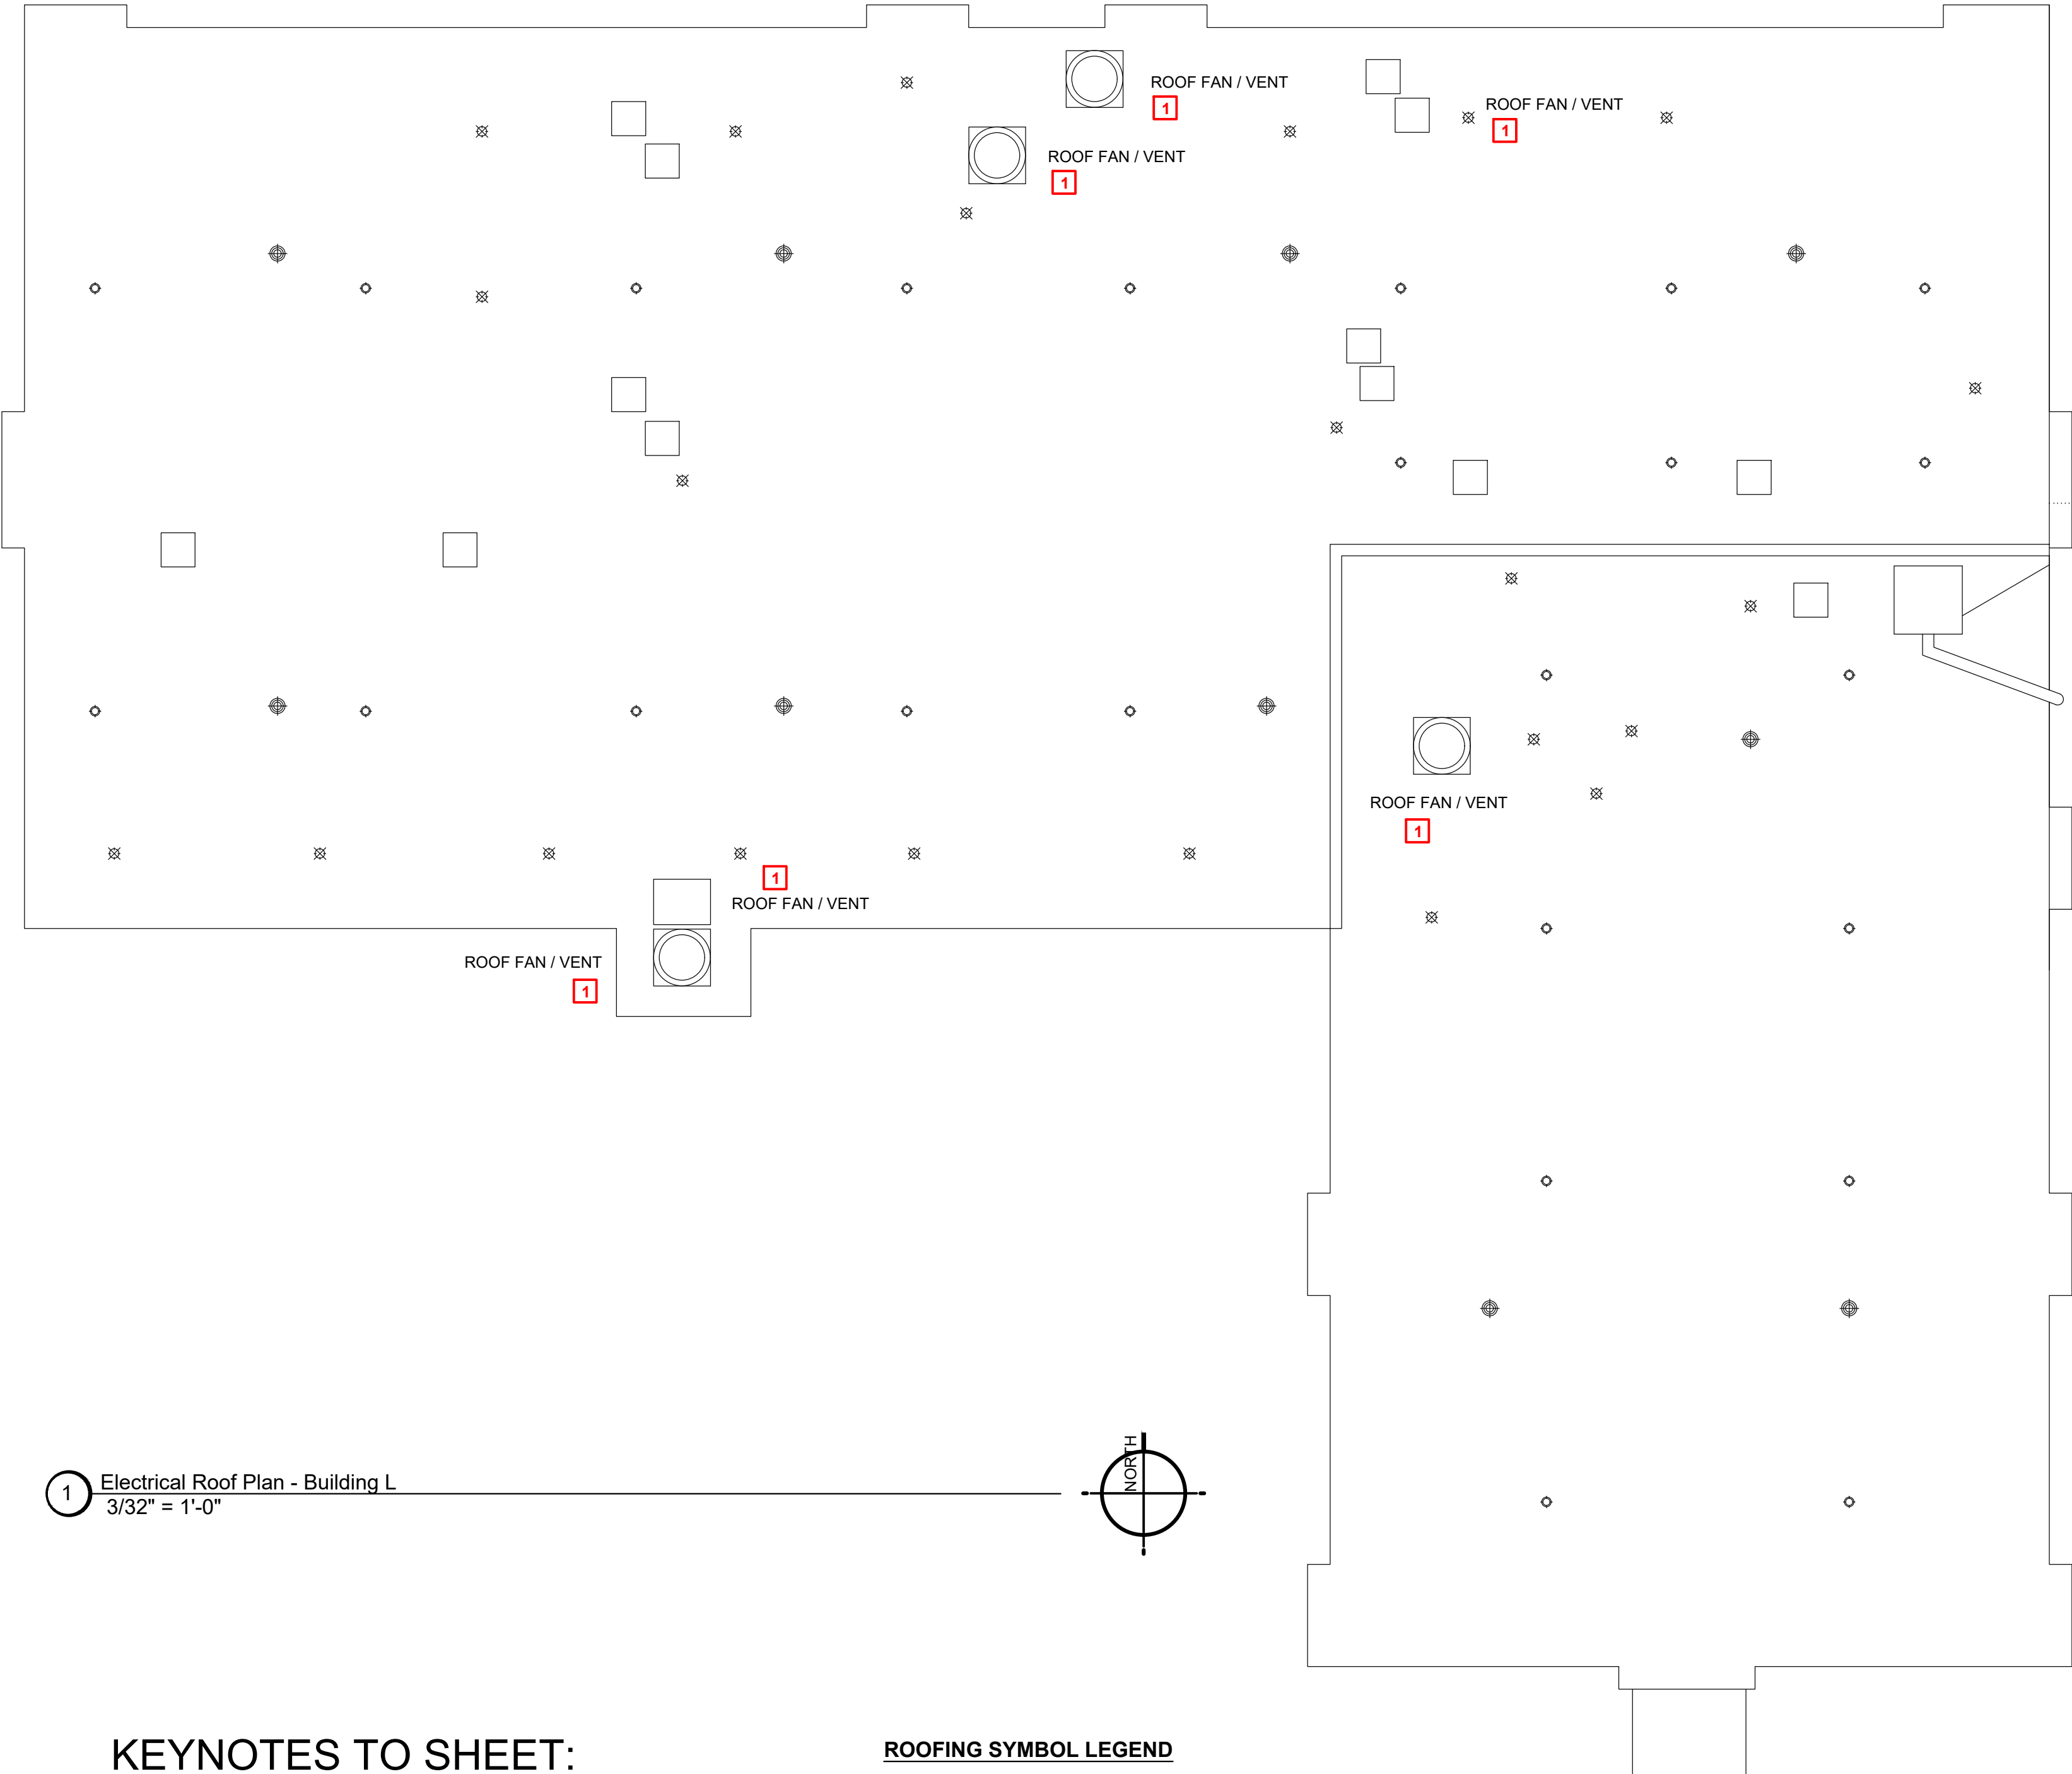1 Electrical Roof Plan - Building L
3/32" = 1'-0"

GENERAL NOTES:

- A. CONTRACTOR SHALL FIELD VERIFY EXISTING ELECTRICAL EQUIPMENT SIZES IN FIELD PRIOR TO DEMOLITION. COORDINATE ALL SITE VISITS THROUGH GENERAL CONTRACTOR AND C.P.S.B. CONTRACTOR WEAR REQUIRED PERSONAL PROTECTIVE GEAR (PPE) SPECIFICALLY REQUIRED FOR EACH BUILDING.
- B. CONTRACTOR SHALL NOTIFY ARCHITECT/ENGINEER OF ANY DISCREPANCIES IDENTIFIED IN THE FIELD PRIOR ORDERING NEW EQUIPMENT.
- C. ALL WORK SHALL COMPLY WITH LOCAL, STATE, AND FEDERAL CODES TO THE SATISFACTION OF CODE AUTHORITIES HAVING JURISDICTION.
- E. PRIOR TO DISCONNECTING, AND REMOVING OF ANY ELECTRICAL SERVICES IN THE DESIGNATED AREAS SHOWN, THE CONTRACTOR MUST ENSURE THAT THE SERVICES REMOVED DO NOT AFFECT THE NORMAL OPERATION OF AREAS OUTSIDE THE CONSTRUCTION AREA. COORDINATE WITH OWNER FOR ALL ELECTRICAL SHUT DOWNS AT LEAST 2 WORKING DAYS PRIOR TO WORK.

KEYNOTES TO SHEET:

- 1. CONTRACTOR SHALL REMOVE EXISTING ROOF MOUNTED HOOD/FAN AND AND INSTALL ON NEW CURB. RECONNECT EXISTING ELECTRICAL ONCE ROOF IS COMPLETED.

ROOFING SYMBOL LEGEND

- EXISTING SKYLIGHT
- ONE-WAY ROOF VENT
- ROOF DRAIN
- ROOF PIPING PENETRATION
- ROOF FAN / VENT
- ROOF FAN / VENT
- DOWNSPOUT
- MISC MEP
- CONDUIT/PIPING RUNS
- EXPANSION JOINT



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NOTE:
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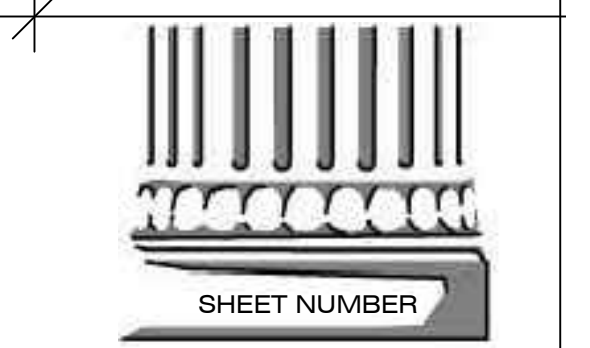
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DAVID B. STELLY
License No. 28070
06/28/2024
PROFESSIONAL
ENGINEER

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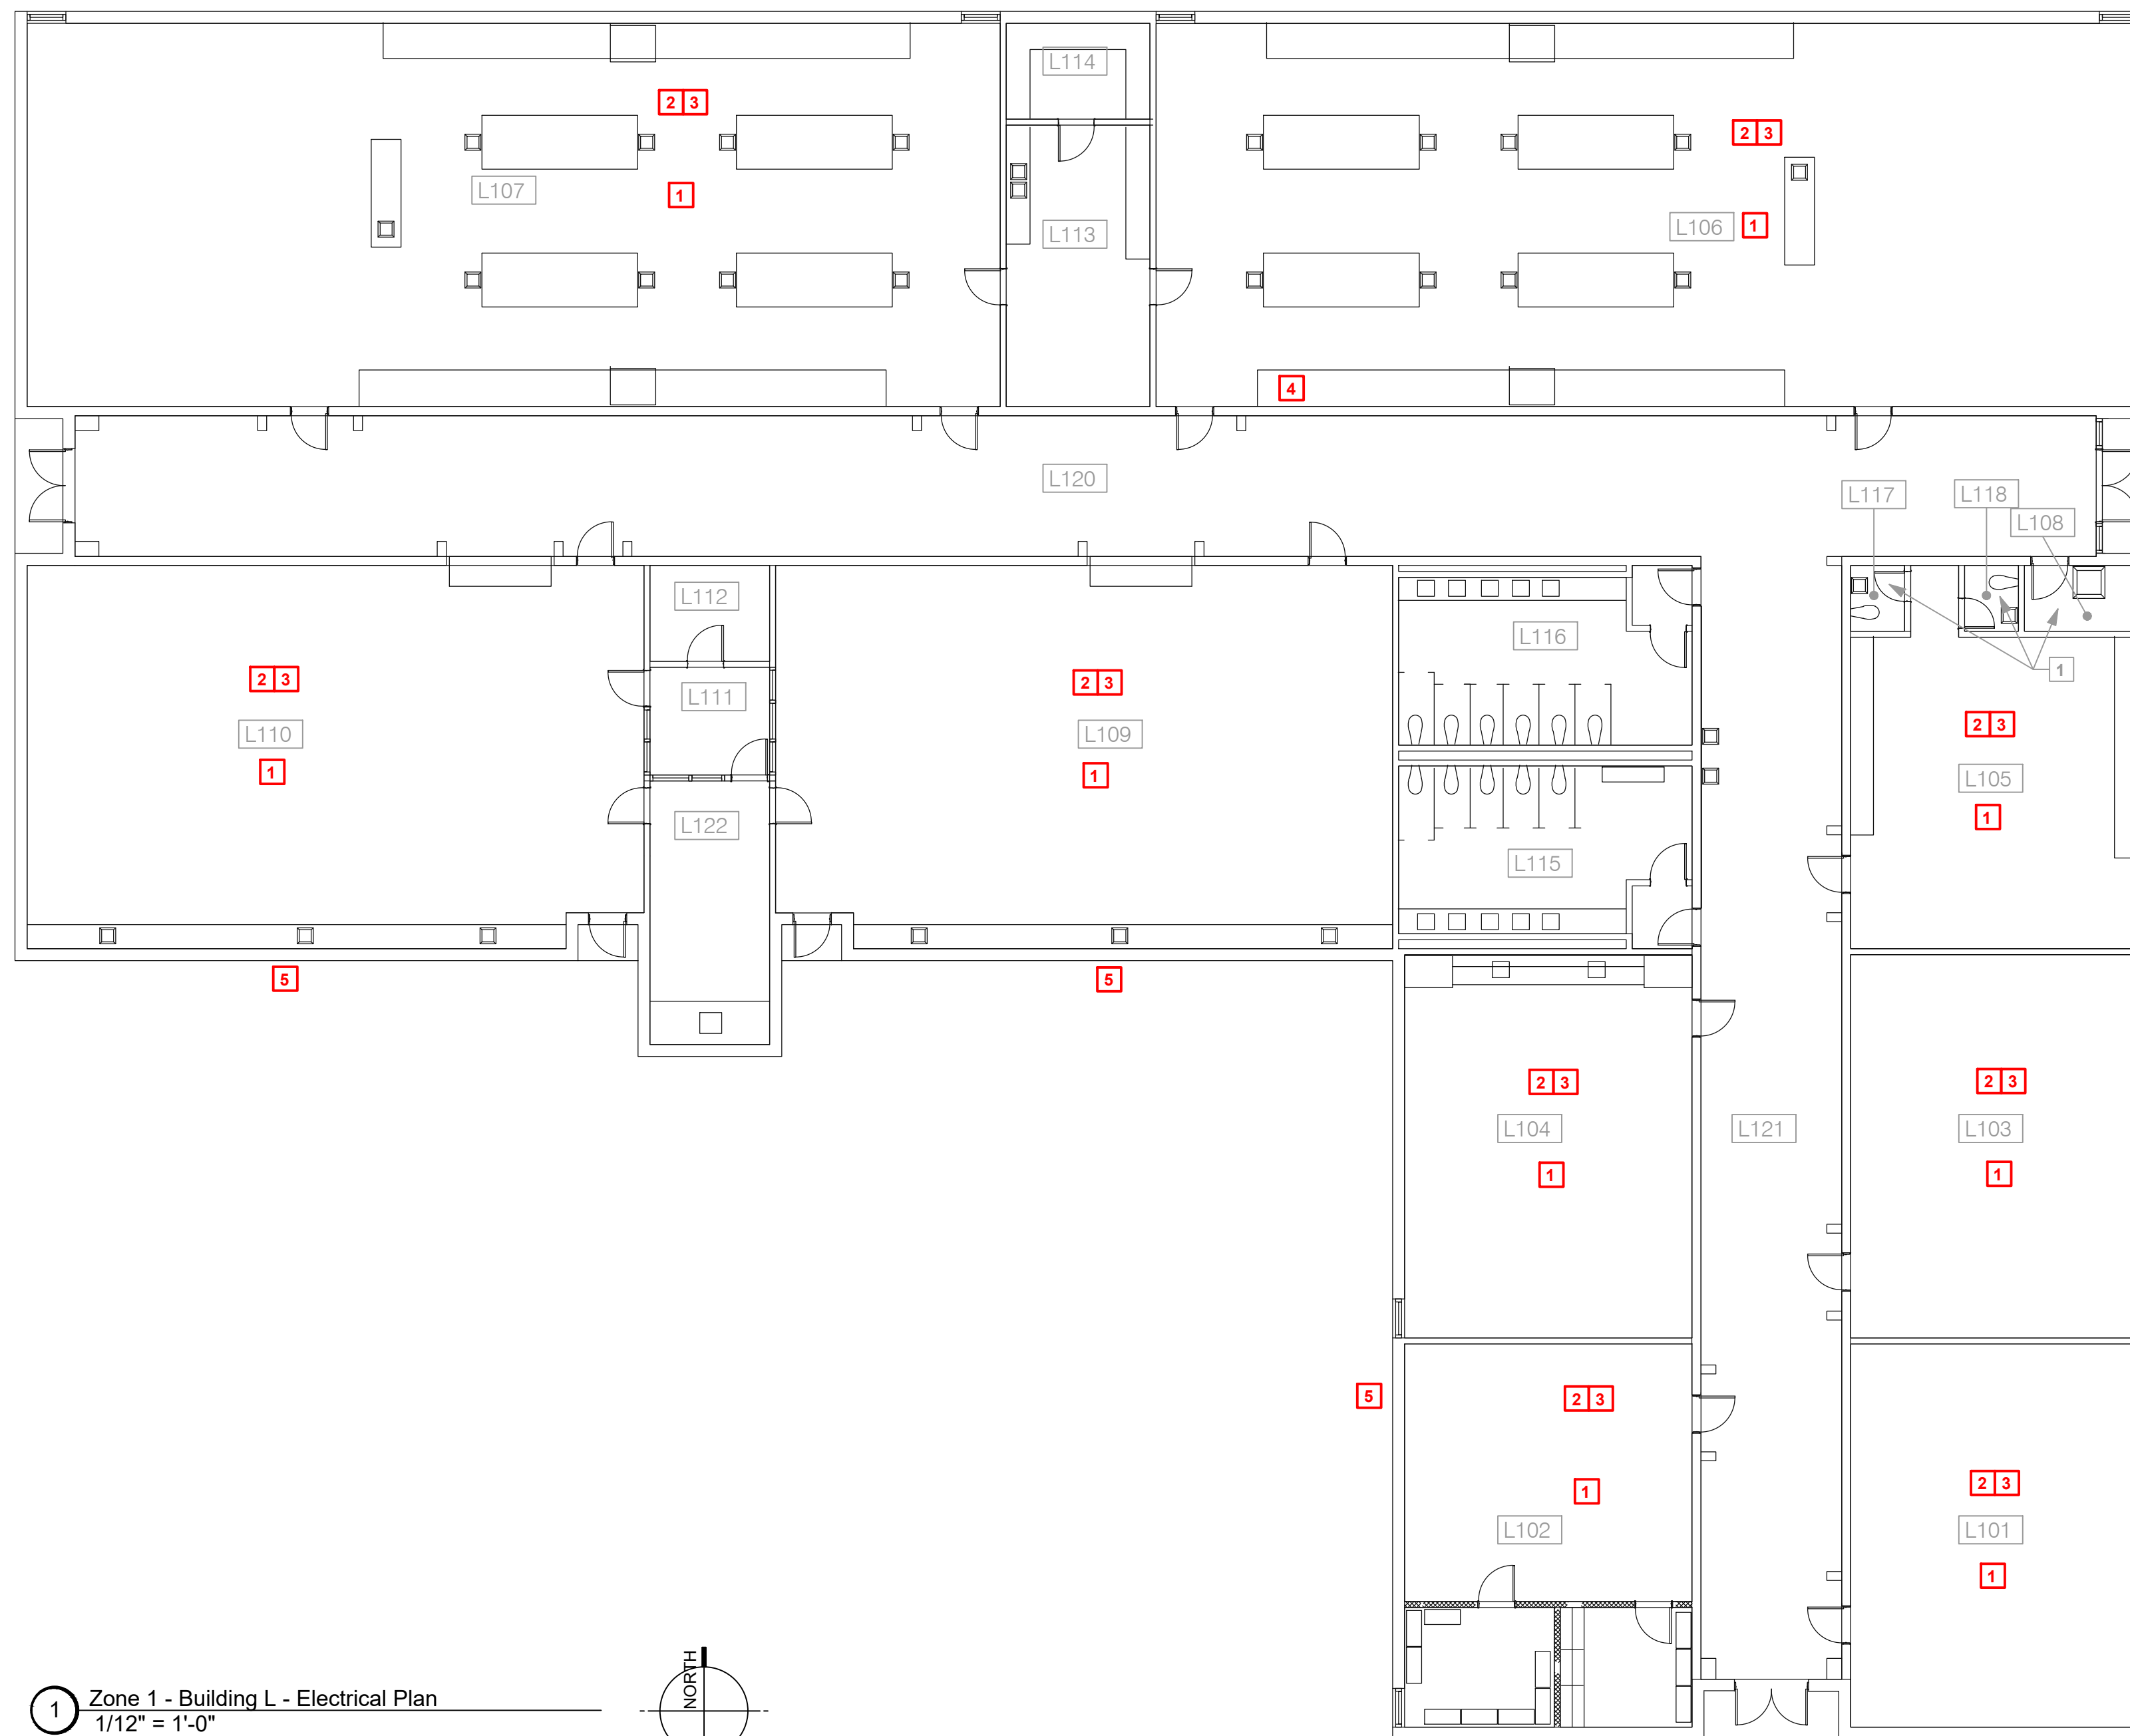
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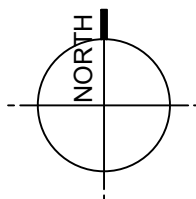
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(L)E0.1
BUILDING L
ROOF PLAN



1 Zone 1 - Building L - Electrical Plan
1/12" = 1'-0"



GENERAL NOTES:

- A. CONTRACTOR SHALL NOTIFY ARCHITECT/ENGINEER OF ANY DISCREPANCIES IDENTIFIED IN THE FIELD PRIOR TO ORDERING LIGHT FIXTURES.
- B. THE INTENT OF THE PLAN IS FOR EXISTING CIRCUITING TO REMAIN AND BE RE-USED. ALL EXISTING POWER WIRING SHALL BE PROTECTED DURING DEMOLITION AND AVAILABLE FOR RE-USE. ANY WIRING REMOVED OR DAMAGED DURING CONSTRUCTION SHALL BE REPLACED AT CONTRACTOR'S EXPENSE.
- C. ALL WORK SHALL COMPLY WITH LOCAL, STATE, AND FEDERAL CODES TO THE SATISFACTION OF CODE AUTHORITIES HAVING JURISDICTION.
- D. ALL WORK SHALL COMPLY WITH THE REQUIREMENTS OF THE 2020 EDITION OF NEC.
- E. PRIOR TO DISCONNECTING, AND REMOVING OF ANY ELECTRICAL SERVICES IN THE DESIGNATED AREAS SHOWN, THE CONTRACTOR MUST ENSURE THAT THE SERVICES REMOVED DO NOT AFFECT THE NORMAL OPERATION OF AREAS OUTSIDE THE CONSTRUCTION AREA. COORDINATE WITH OWNER FOR ALL ELECTRICAL SHUT DOWNS AT LEAST 2 WORKING DAYS PRIOR TO WORK.
- F. EXISTING LIGHTING THROUGHOUT THE BUILDING HAS BEEN REPLACED BY THE OWNER IN A PREVIOUS PROJECT. IF THERE ARE SPACES WHERE THE DRAWINGS REQUIRE CEILING REPLACEMENT, THE CONTRACTOR WILL BE REQUIRED TO REMOVE THE EXISTING FIXTURES, PROPERLY STORE THEM ONSITE (CONTAINER OR OTHER OWNER APPROVED AREA), THEN RE-INSTALL FOLLOWING REPLACEMENT OF CEILINGS WITHIN A GIVEN SPACE.
- G. ALL EXISTING LOW VOLTAGE WIRING SHALL BE PROTECTED DURING DEMOLITION AND AVAILABLE FOR RE-USE. ANY WIRING REMOVED OR DAMAGED DURING CONSTRUCTION SHALL BE REPLACED AT CONTRACTOR'S EXPENSE.

KEYNOTES:

- 1. ANY EXISTING CAMERAS OR WIRELESS ACCESS POINTS TO BE REMOVED DURING CONSTRUCTION SHALL BE COORDINATED WITH CPSB IT DEPARTMENT. DEVICES SHALL BE LABELED AND STORED FOR RE-INSTALLATION. CONTRACTOR IS RESPONSIBLE FOR ANY CUT OR REMOVED COMMUNICATIONS CABLING.
- 2. ANY EXISTING FIRE ALARM DEVICES TO BE REMOVED DURING CONSTRUCTION SHALL BE COORDINATED WITH SYLVAN SOUND. DEVICES SHALL BE LABELED AND STORED FOR RE-INSTALLATION. CONTRACTOR IS RESPONSIBLE FOR ANY CUT OR REMOVED FIRE ALARM WIRING.
- 3. ANY EXISTING INTERCOM DEVICES TO BE REMOVED DURING CONSTRUCTION SHALL BE COORDINATED WITH SYLVAN SOUND. DEVICES SHALL BE LABELED AND STORED FOR RE-INSTALLATION. CONTRACTOR IS RESPONSIBLE FOR ANY CUT OR REMOVED INTERCOM WIRING.
- 4. EXISTING LOCATION OF IT RACK. CONTRACTOR IS RESPONSIBLE FOR PROTECTING IT RACK, EQUIPMENT, AND WIRING DURING CONSTRUCTION. IT RACK SHALL REMAIN OPERATIONAL THROUGHOUT CONSTRUCTION UNLESS APPROVED BY CPSB IT FOR IT TO BE POWERED DOWN. PROVIDE COVER FOR RACK TO MINIMIZE DUST AND DEBRIS WHILE AT THE SAME TIME ALLOWING COOLING AND PROPER AIRFLOW.
- 5. CONTRACTOR SHALL DISCONNECT AND REMOVE EXISTING WALL PACKS ON THE SIDES OF THE BUILDING (1 TOTAL) AND PROVIDE NEW FIXTURES TYPE "W". FIXTURE TYPE "W" SHALL BE LUMARK OR EQUAL WPMLED208-120V. MOUNT NEW FIXTURES IN THE SAME LOCATIONS AND CONNECT TO EXISTING LIGHTING CIRCUIT. SWITCH THROUGH EXISTING PHOTOCELL. IF PHOTOCELL IS MISSING OR NOT WORKING PROVIDE NEW UNIT.

NOTE:
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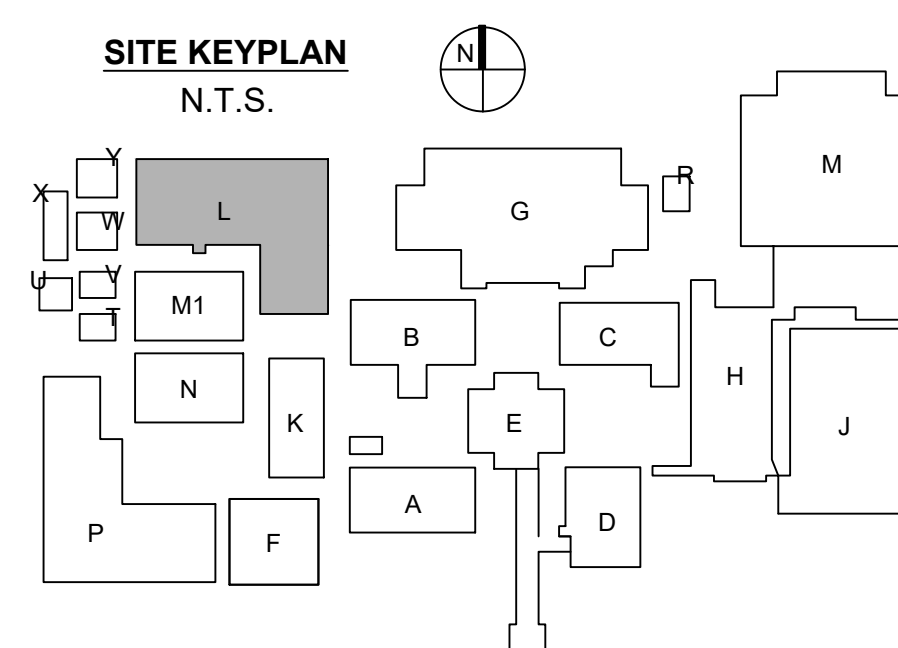
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NOTE:
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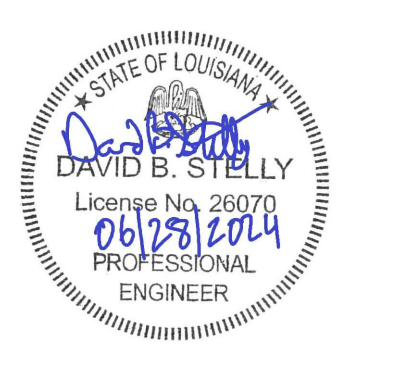


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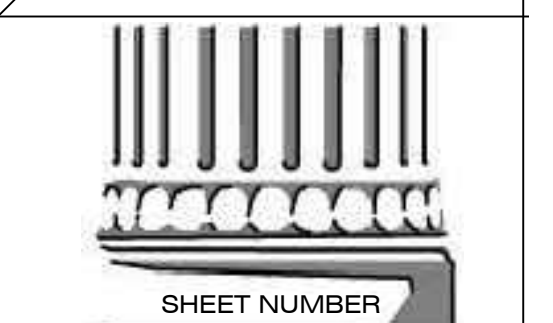


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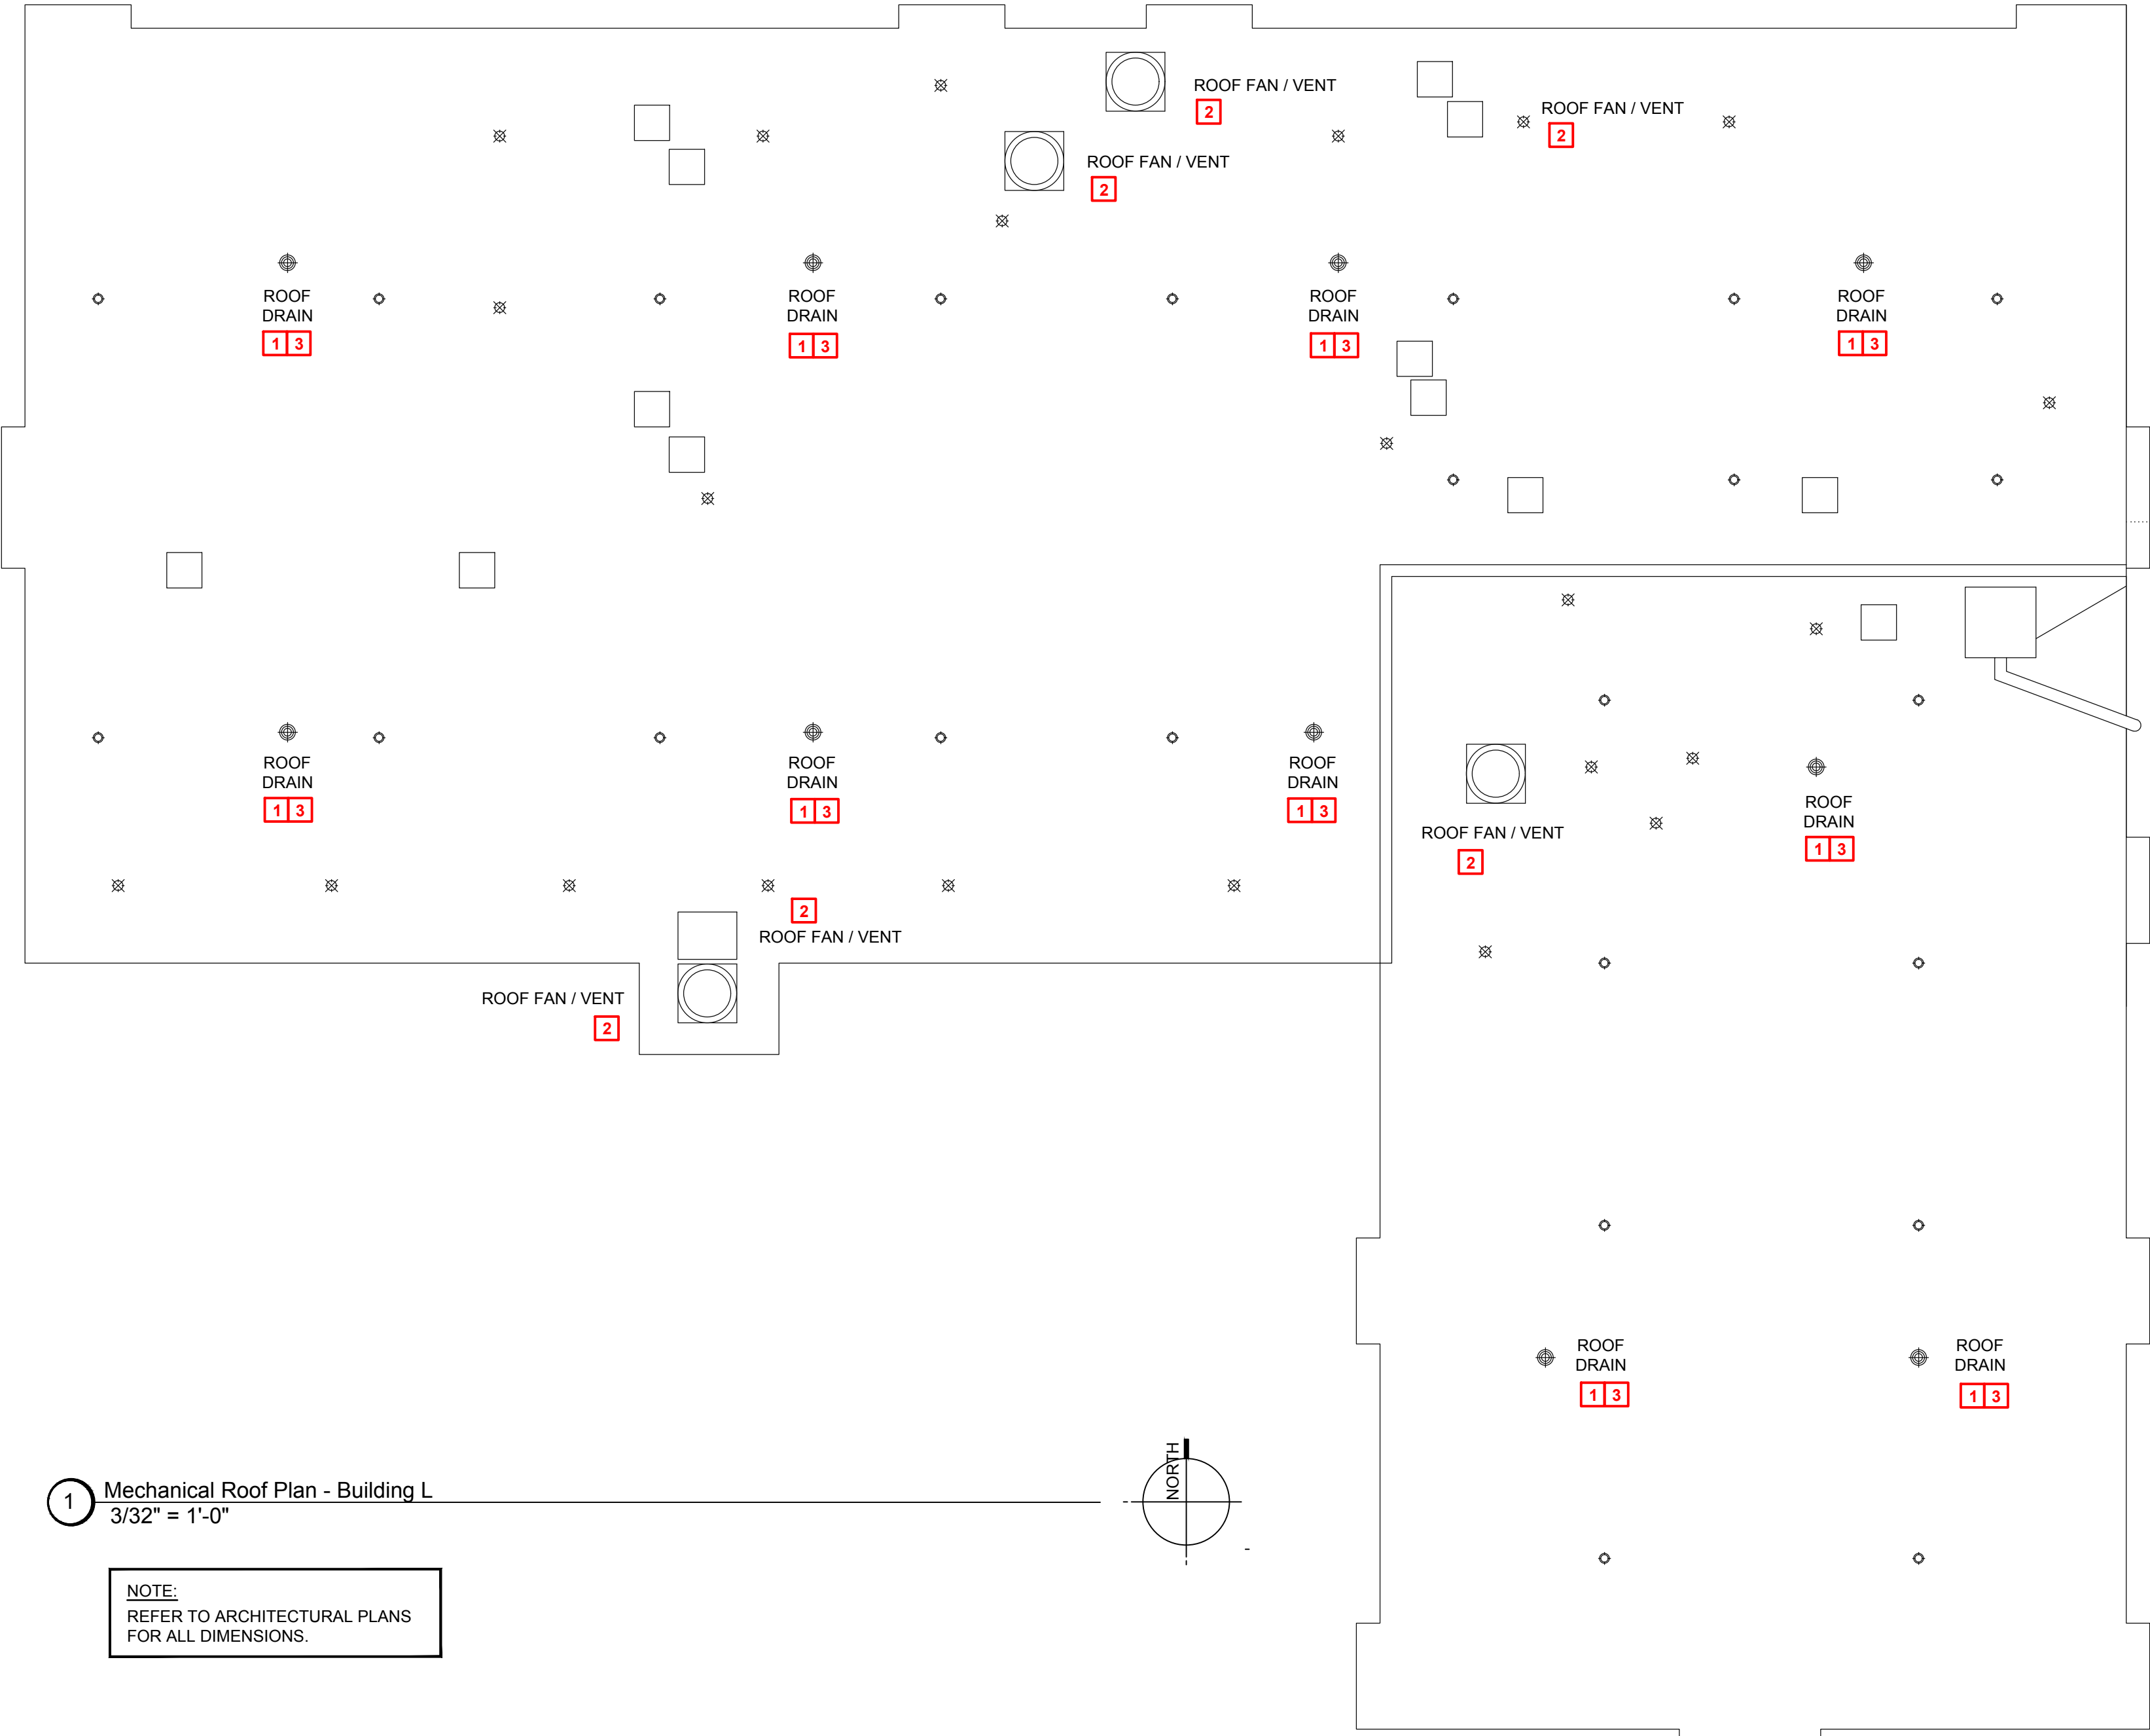
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SHEET NUMBER
(L)E1.1
ZONE 1 - BUILDING L
ELECTRICAL PLANS



1 Mechanical Roof Plan - Building L
3/32" = 1'-0"


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 - VERIFY ADEQUATE SPACE AVAILABLE PER MANUFACTURER'S RECOMMENDATIONS. COORDINATE CLEARANCE REQUIREMENTS OF ALL MECHANICAL EQUIPMENT.

- KEYNOTES TO SHEET:**
- CONTRACTOR SHALL REMOVE EXISTING ROOF DRAIN AN INSTALLED NEW ROOF DRAIN WITH DOME STRAINER IN SAME LOCATION. THE NEW ROOF DRAIN W/ DOME STRAINER SHALL MATCH THE EXISTING SIZE, STYLE, ETC. OF THE EXISTING THAT IS BEING REPLACED AS PART OF THE RE-ROOFING PROJECT.
 - CONTRACTOR SHALL REMOVE EXISTING ROOF MOUNTED HOOD/FAN AND INSTALL ON NEW CURB. NEW CURB SHALL MATCH THE EXISTING SIZE, STYLE, ETC. OF EXISTING CURB. COORDINATE CURB HEIGHT WITH ARCHITECT & GENERAL CONTRACTOR PRIOR ORDERING.
 - ALL EXISTING ROOF DRAIN PIPING SHALL BE FLUSHED TO REMOVE LEAVES, DEBRIS, ETC. ONCE THE NEW ROOF DRAINS ARE INSTALLED.

ROOFING SYMBOL LEGEND

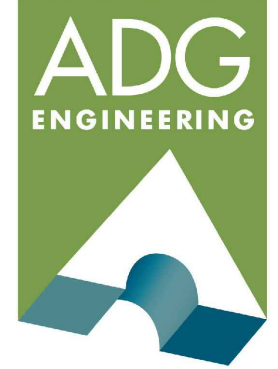- EXISTING SKYLIGHT
- ONE-WAY ROOF VENT
- ROOF DRAIN
- ROOF PIPING PENETRATION
- ROOF FAN / VENT
- ROOF FAN / VENT
- DOWNSPOUT
- MISC MEP
- CONDUIT/PIPING RUNS
- EXPANSION JOINT



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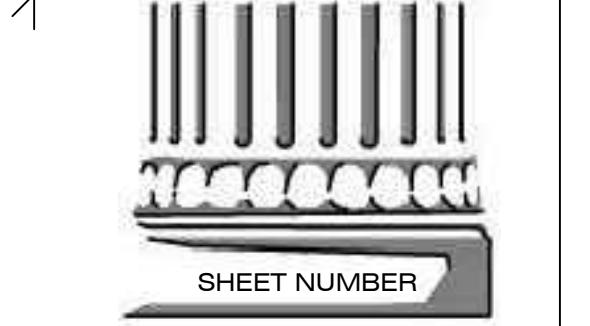


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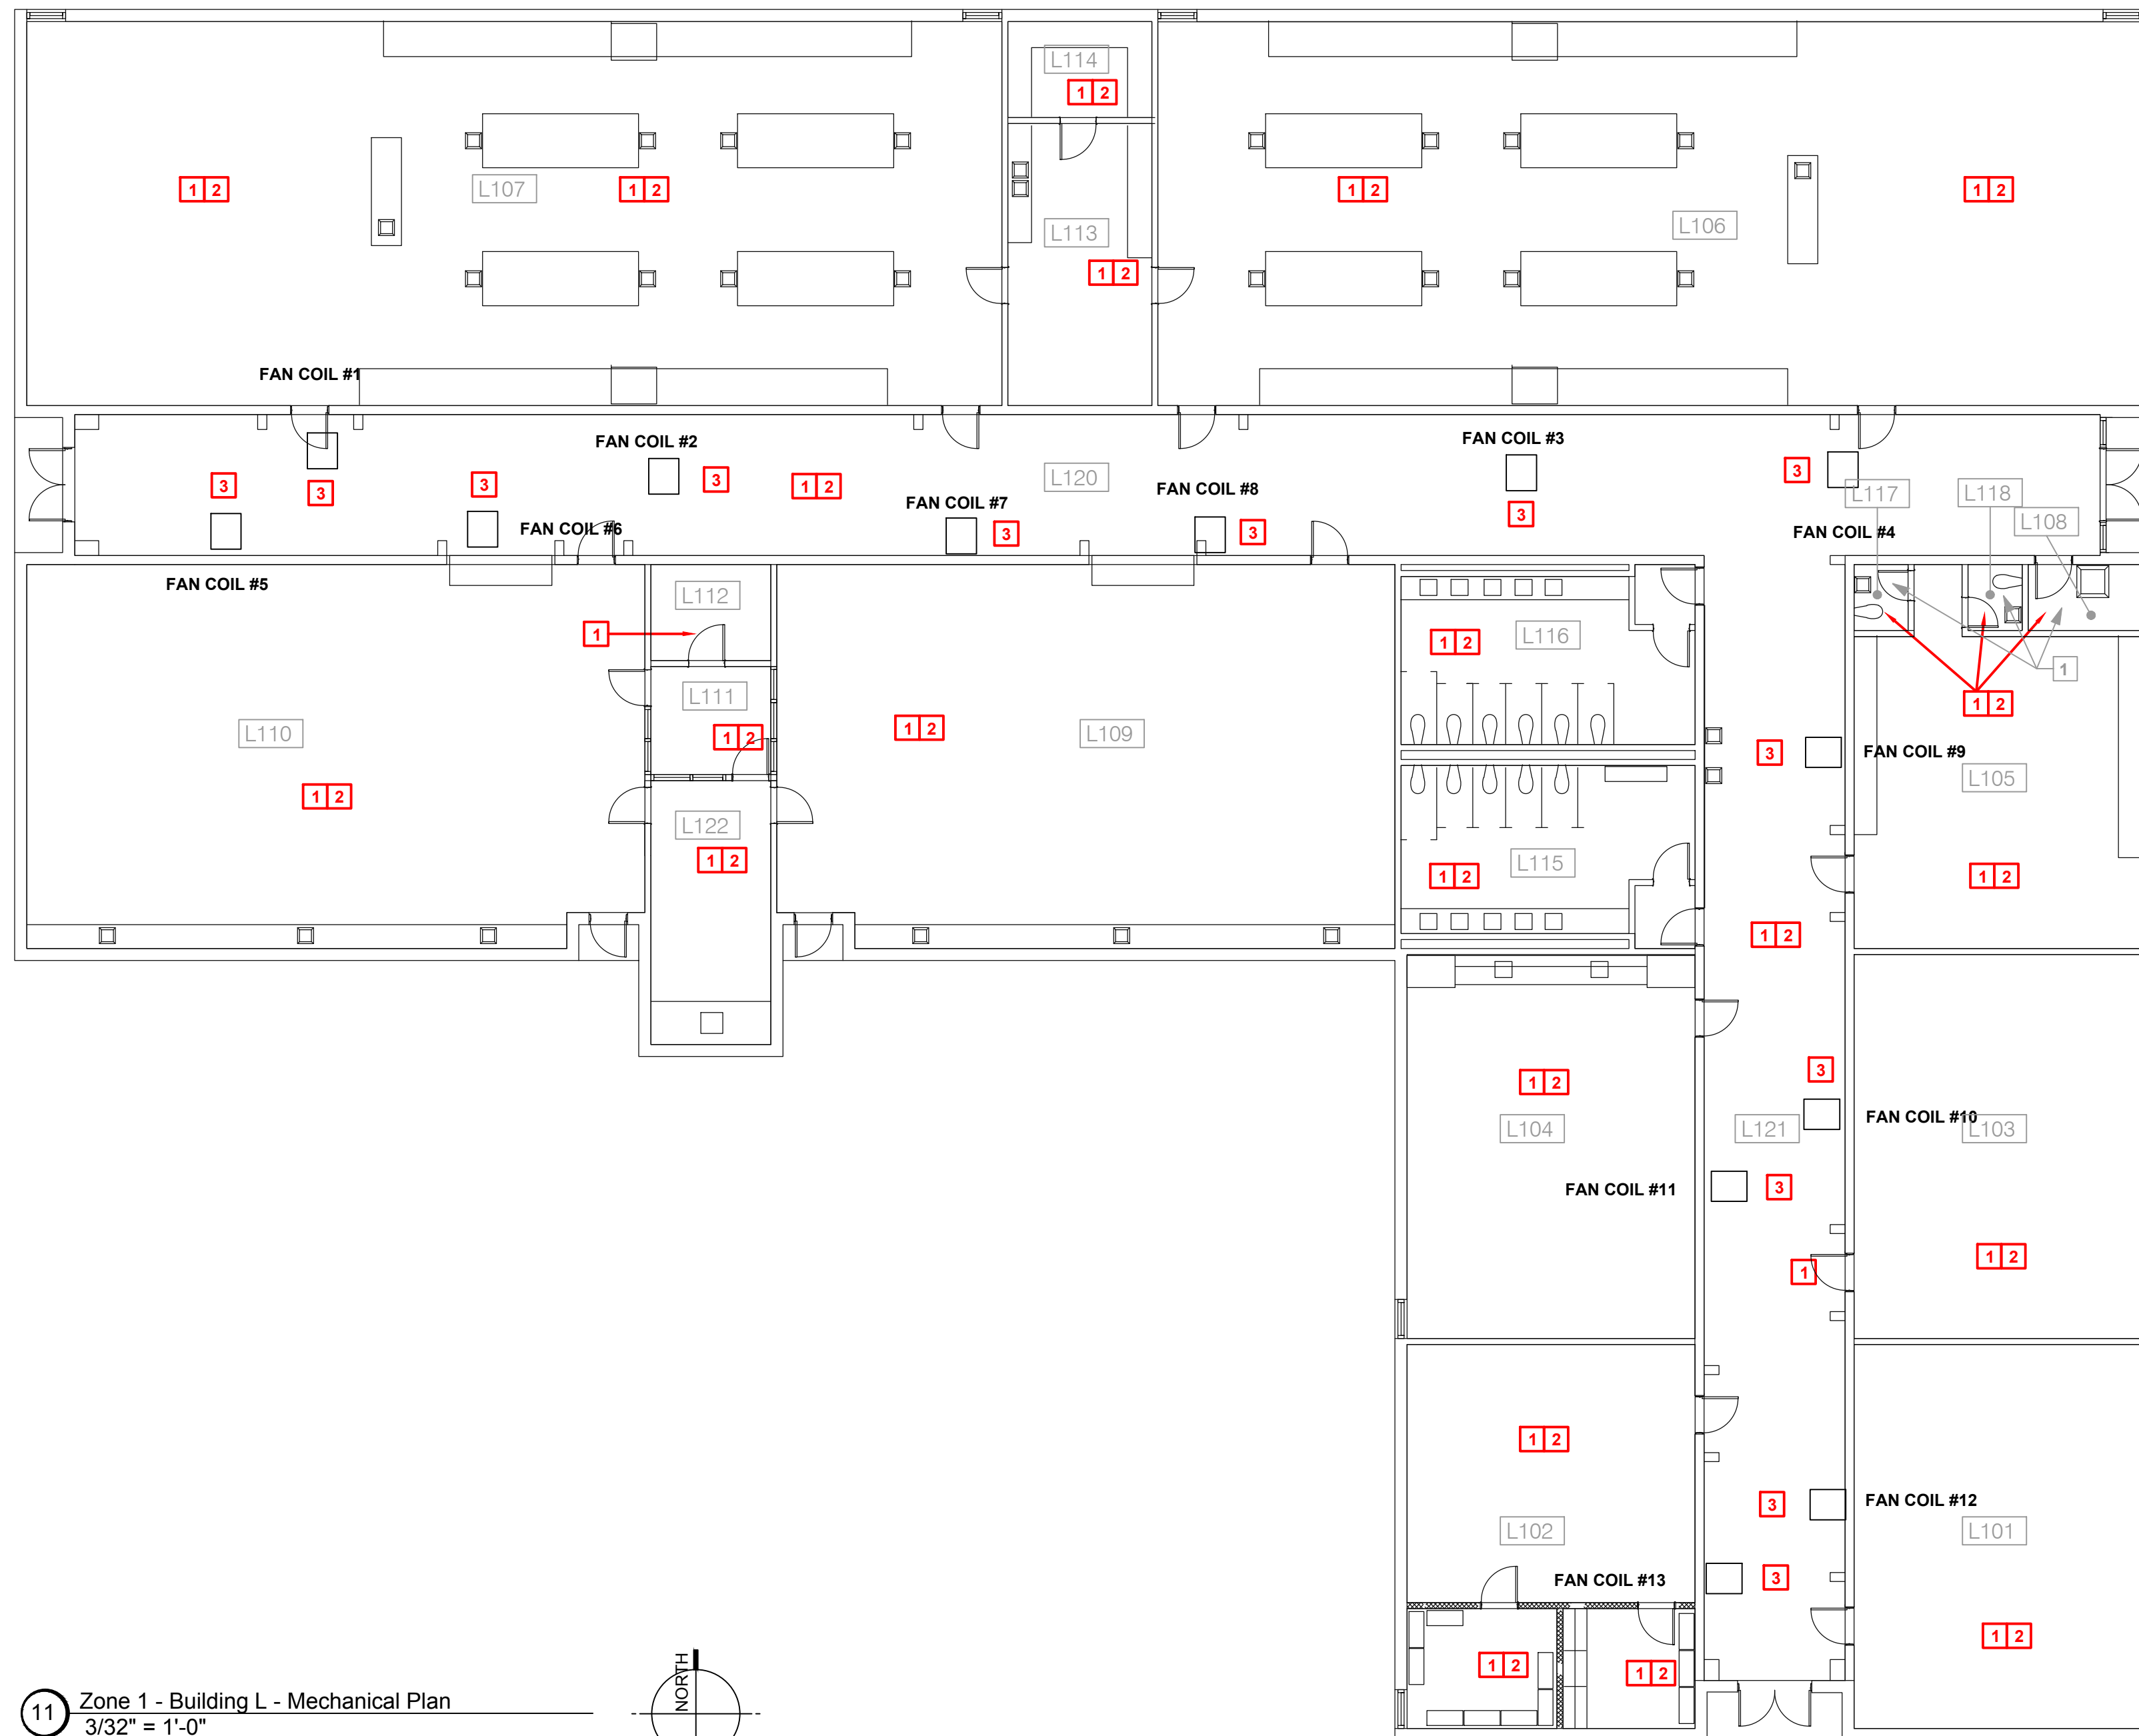
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(L)M0.1
BUILDING L
ROOF PLAN



11 Zone 1 - Building L - Mechanical Plan
3/32" = 1'-0"

NOTE:
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FOR ALL DIMENSIONS.

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- 3. EXISTING FAN COIL UNIT TO REMAIN AND CLEANED PER THE SPECIFICATIONS. REMOVE AND REPLACE EXISTING AIR HANDLING UNIT INTERIOR LINER AND CLEAN INTERIOR OF UNIT INCLUDING COILS.

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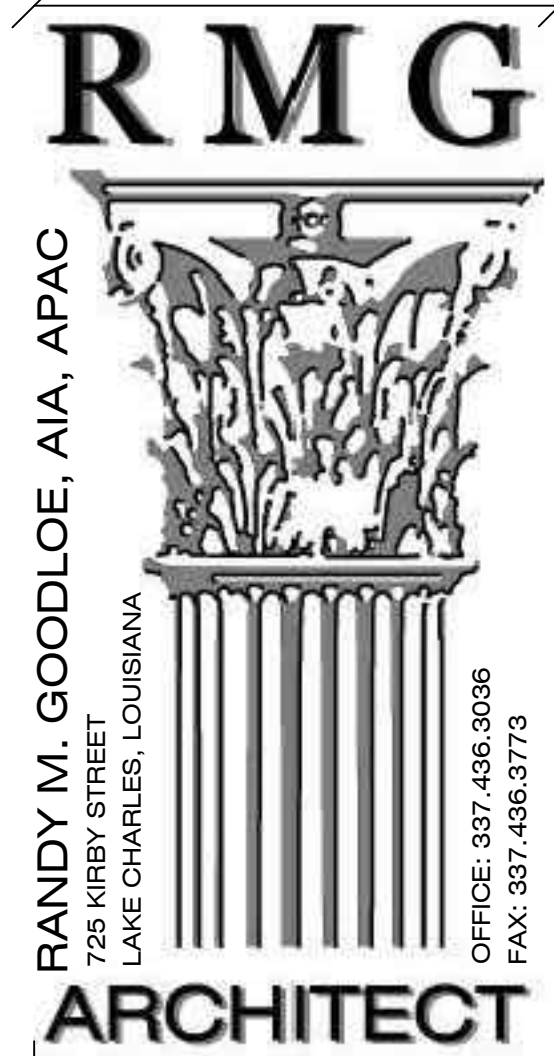
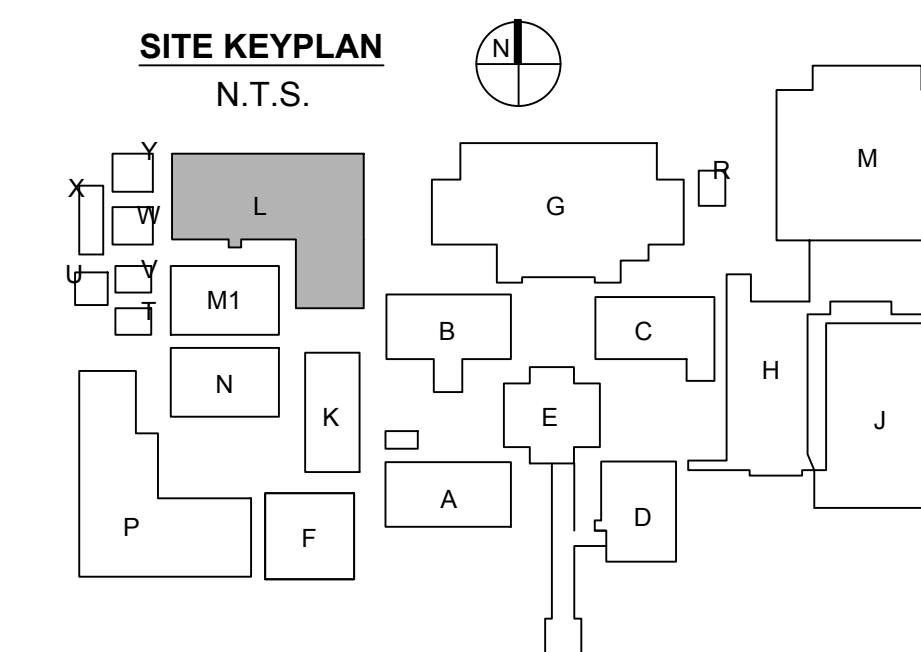
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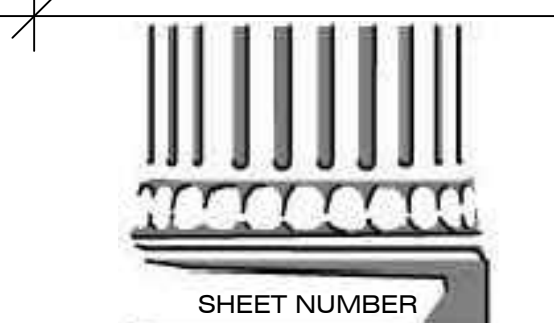


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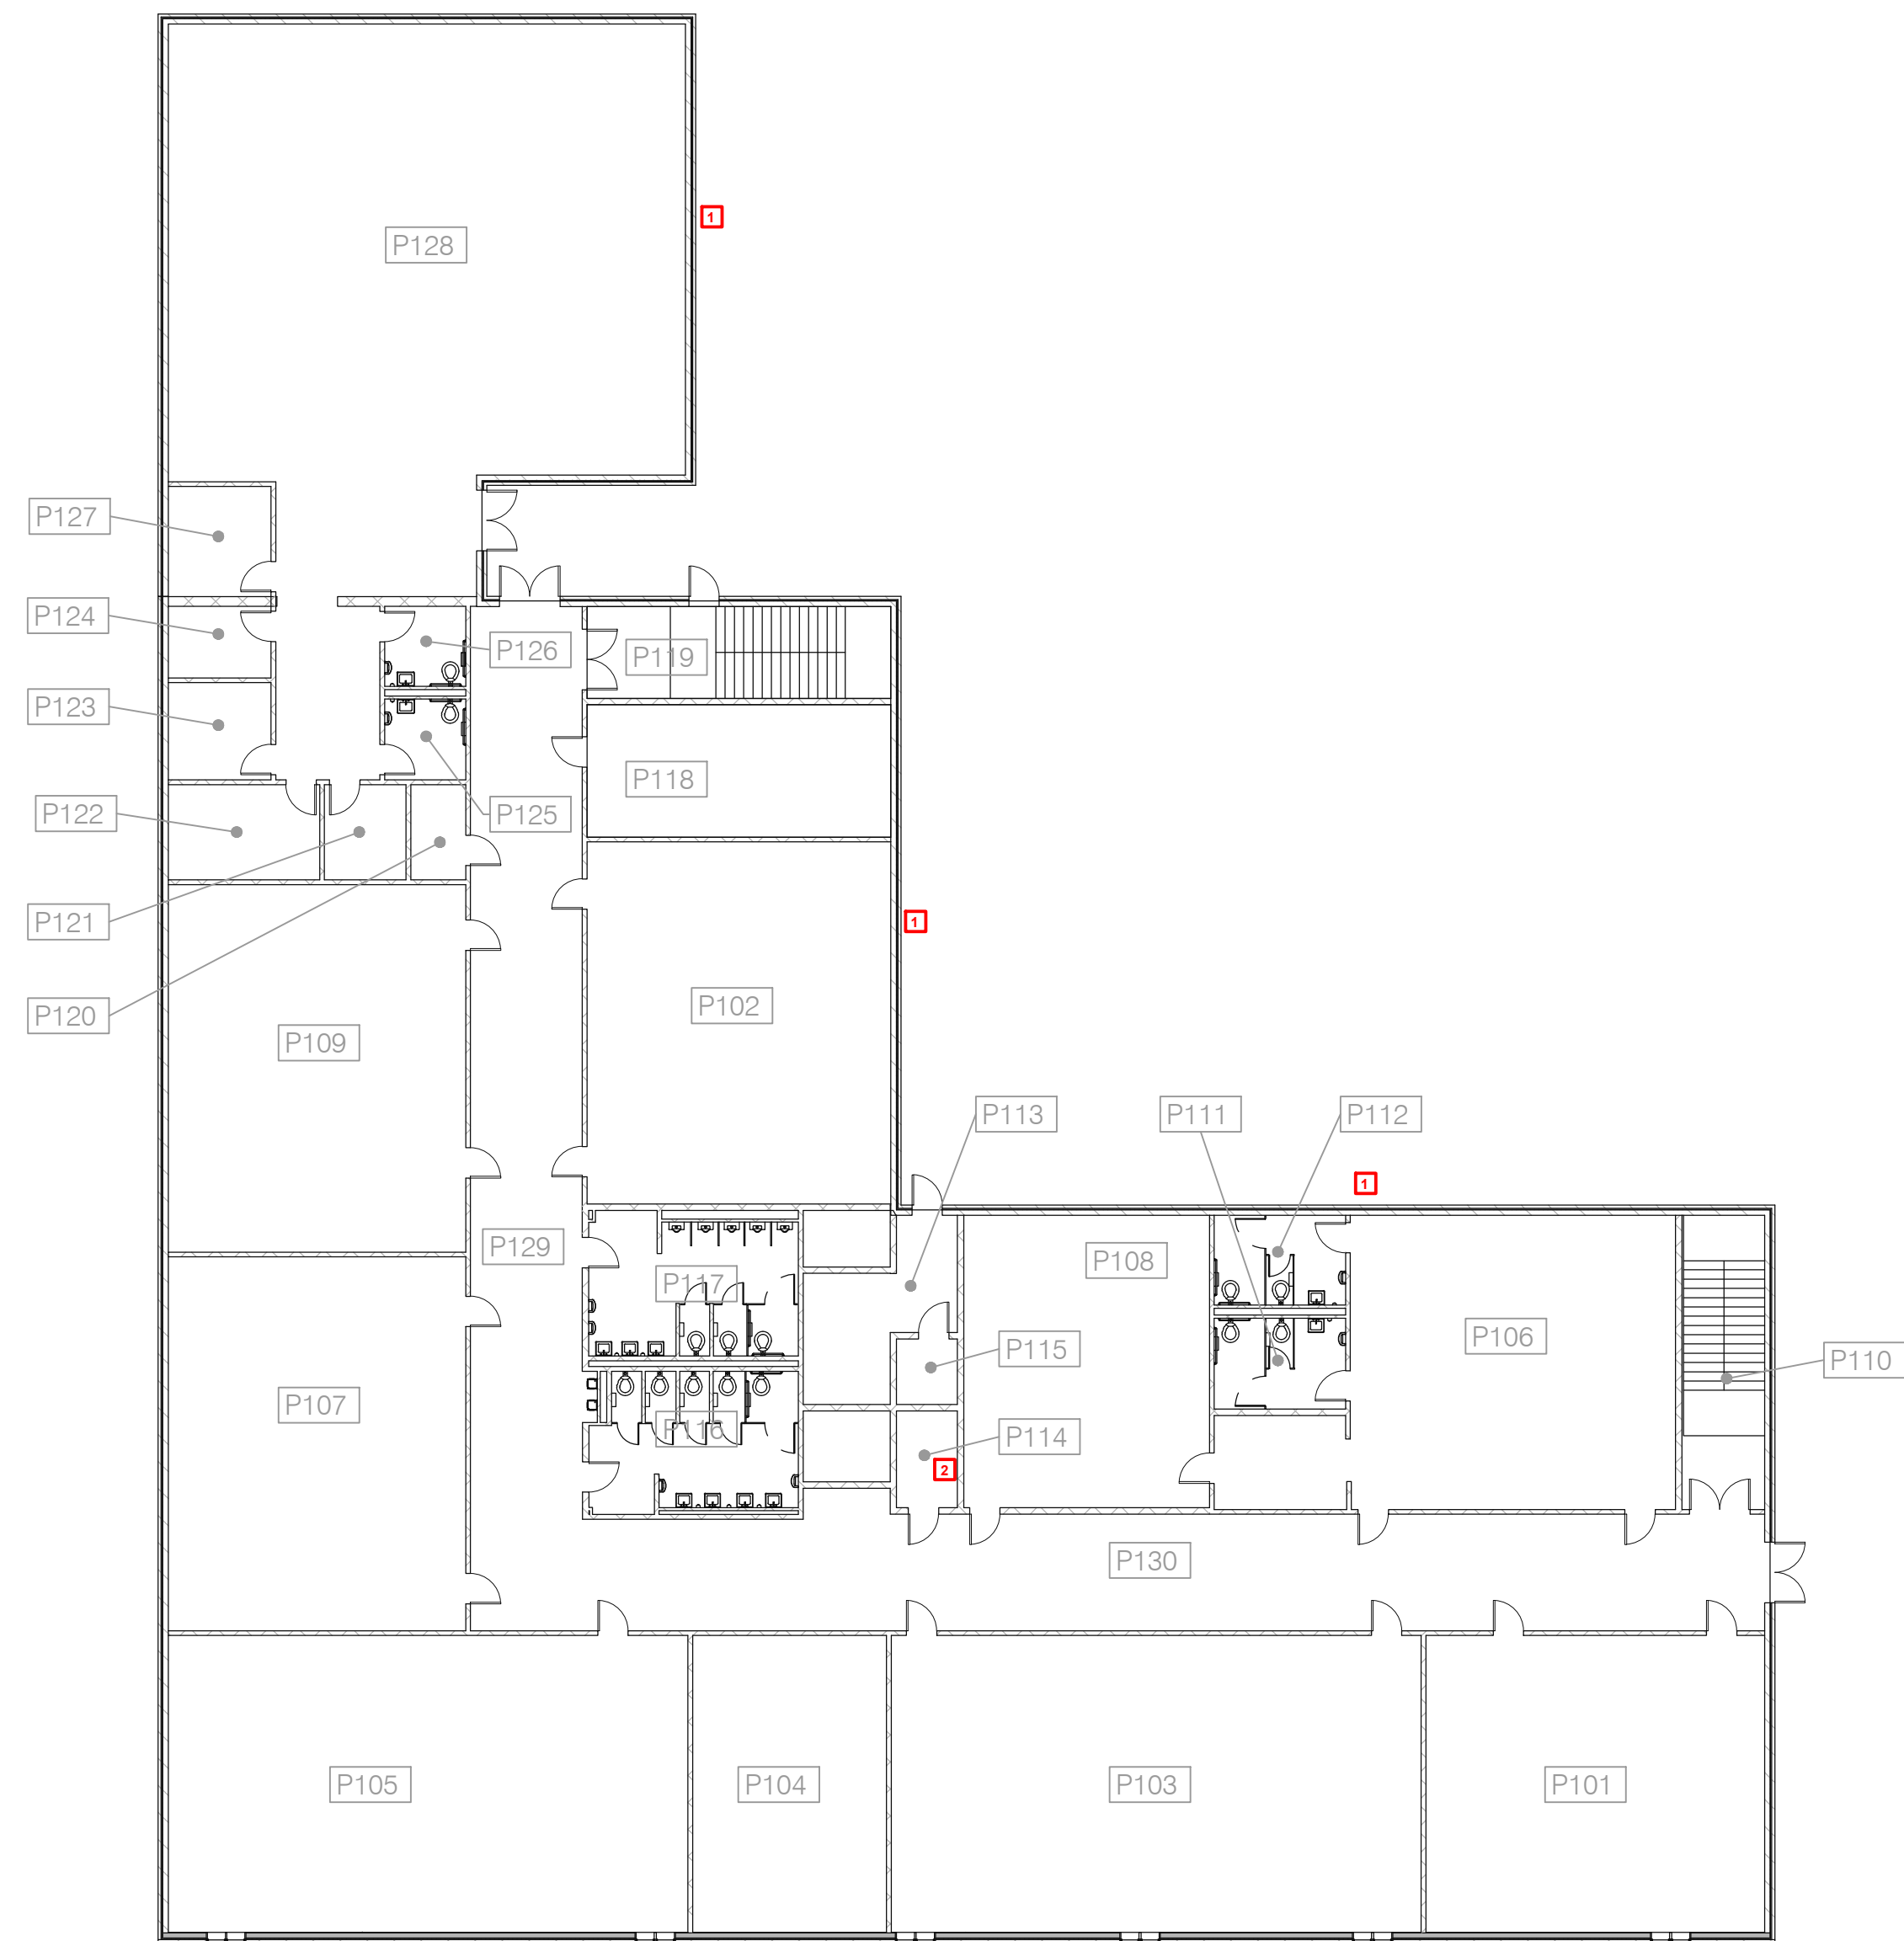
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RMG PROJECT NO.
20042-01-G
OWNER PROJECT NO.
HL-003-01.03.04.05.06.07
PROJECT MANAGER
DP/TV
DATE ISSUED
06.28.2024

REVISED



(L)M1.1
ZONE 1 - BUILDING L
MECHANICAL PLANS



1 Zone 1 - Building P First Floor - Electrical Plan
1/16" = 1'-0"



EXISTING EXTERIOR WALL PACKS

GENERAL NOTES:

- A. CONTRACTOR SHALL NOTIFY ARCHITECT/ENGINEER OF ANY DISCREPANCIES IDENTIFIED IN THE FIELD PRIOR TO ORDERING LIGHT FIXTURES.
- B. THE INTENT OF THE PLAN IS FOR EXISTING CIRCUITING TO REMAIN AND BE RE-USED. ALL EXISTING POWER WIRING SHALL BE PROTECTED DURING DEMOLITION AND AVAILABLE FOR RE-USE. ANY WIRING REMOVED OR DAMAGED DURING CONSTRUCTION SHALL BE REPLACED AT CONTRACTOR'S EXPENSE.
- C. ALL WORK SHALL COMPLY WITH LOCAL, STATE, AND FEDERAL CODES TO THE SATISFACTION OF CODE AUTHORITIES HAVING JURISDICTION.
- D. ALL WORK SHALL COMPLY WITH THE REQUIREMENTS OF THE 2020 EDITION OF NEC.
- E. PRIOR TO DISCONNECTING, AND REMOVING OF ANY ELECTRICAL SERVICES IN THE DESIGNATED AREAS SHOWN, THE CONTRACTOR MUST ENSURE THAT THE SERVICES REMOVED DO NOT AFFECT THE NORMAL OPERATION OF AREAS OUTSIDE THE CONSTRUCTION AREA. COORDINATE WITH OWNER FOR ALL ELECTRICAL SHUT DOWNS AT LEAST 2 WORKING DAYS PRIOR TO WORK.
- F. EXISTING LIGHTING THROUGHOUT THE BUILDING HAS BEEN REPLACED BY THE OWNER IN A PREVIOUS PROJECT. IF THERE ARE SPACES WHERE THE DRAWINGS REQUIRE CEILING REPLACEMENT, THE CONTRACTOR WILL BE REQUIRED TO REMOVE THE EXISTING FIXTURES, PROPERLY STORE THEM ONSITE (CONTAINER OR OTHER OWNER APPROVED AREA), THEN RE-INSTALL FOLLOWING REPLACEMENT OF CEILINGS WITHIN A GIVEN SPACE.
- G. ALL EXISTING LOW VOLTAGE WIRING SHALL BE PROTECTED DURING DEMOLITION AND AVAILABLE FOR RE-USE. ANY WIRING REMOVED OR DAMAGED DURING CONSTRUCTION SHALL BE REPLACED AT CONTRACTOR'S EXPENSE.

KEYNOTES:

- 1. CONTRACTOR SHALL DISCONNECT AND REMOVE EXISTING WALL PACKS ON THE SIDES OF THE BUILDING (3 TOTAL) AND PROVIDE NEW FIXTURES TYPE 'W'. FIXTURE TYPE 'W' SHALL BE LUMARK OR EQUAL WPMLED208-120V. MOUNT NEW FIXTURES IN THE SAME LOCATIONS AND CONNECT TO EXISTING LIGHTING CIRCUIT. SWITCH THROUGH EXISTING PHOTOCELL. IF PHOTOCELL IS MISSING OR NOT WORKING PROVIDE NEW UNIT.
- 2. EXISTING LOCATION OF IT RACK, CONTRACTOR IS RESPONSIBLE FOR PROTECTING IT RACK, EQUIPMENT, AND WIRING DURING CONSTRUCTION. IT RACK SHALL REMAIN OPERATIONAL THROUGHOUT CONSTRUCTION UNLESS APPROVED BY CPSB IT FOR IT TO BE POWERED DOWN. PROVIDE COVER FOR RACK TO MINIMIZE DUST AND DEBRIS WHILE AT THE SAME TIME ALLOWING COOLING AND PROPER AIRFLOW.

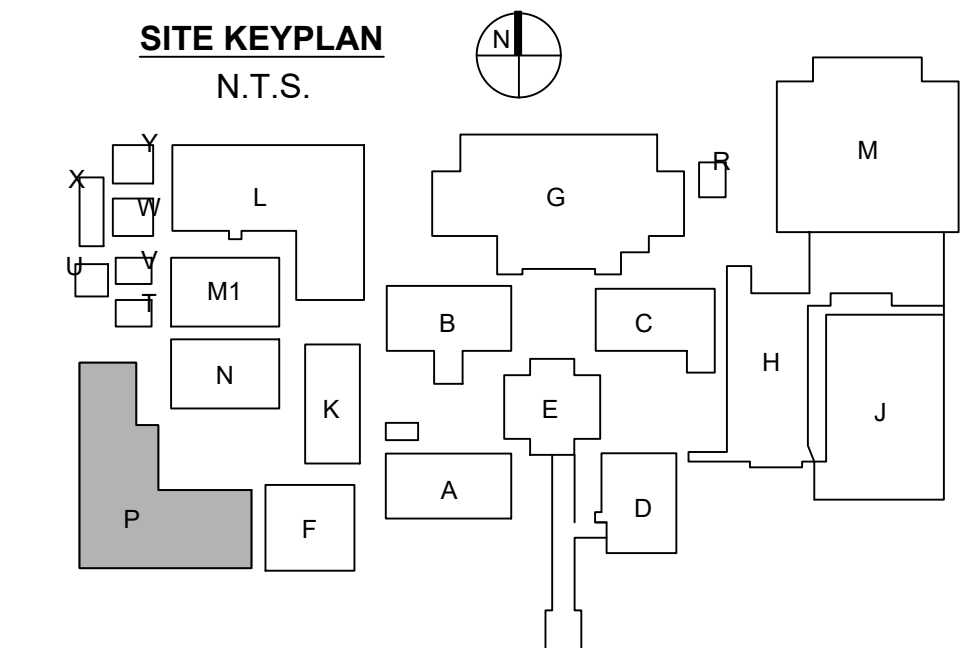
NOTE:
CONTRACTOR SHALL REVIEW C.P.S.B MANAGEMENT PLANS PRIOR TO ANY DEMOLITION WORK. REPORT ANY SUSPICIOUS ASBESTOS MATERIALS TO ARCHITECT / ENGINEER PRIOR TO DISTURBING SUSPECT MATERIALS

NOTE: THESE DRAWINGS ARE COPIES OF THE ORIGINAL CONSTRUCTION DOCUMENTS WITH NOTES ADDED TO DESCRIBE THE SCOPE OF WORK FOR THE HURRICANE LAURA REPAIR PROJECT. CONTRACTOR SHALL NOTIFY ARCHITECT/ENGINEER OF ANY DISCREPANCIES IDENTIFIED IN FIELD PRIOR TO ORDERING EQUIPMENT OR INSTALLATION.

NOTE: THE ELECTRICAL SCOPE OF WORK IS LIMITED TO REPLACING OR REPAIRING THE ELECTRICAL SYSTEM BACK TO ITS ORIGINAL CONDITION (LIKE FOR LIKE). THIS PROJECT'S SCOPE OF WORK DOES NOT INCLUDE BRINGING THE EXISTING ELECTRICAL SYSTEMS UP TO CODE OR ADDRESSING EXISTING CONDITIONS.

NOTE:
REFER TO ARCHITECTURAL DRAWINGS FOR ALL DIMENSIONS.

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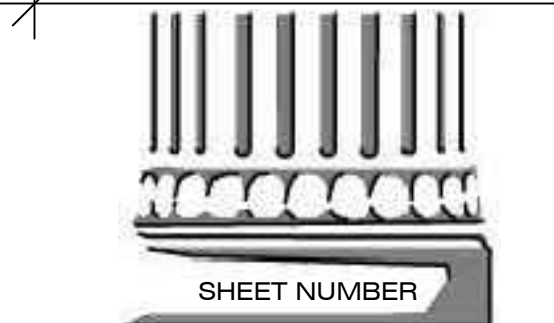
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 LAKE CHARLES, LA
 HL-003-01.03.04.05.06.07


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SHEET NUMBER
(P)E1.1
 ZONE 1 - BUILDING P
 ELECTRICAL PLANS



11 Zone 1 - Building P First Floor - Mechanical Plan
1/16" = 1'-0"

NOTE:
REFER TO ARCHITECTURAL DRAWINGS
FOR ALL DIMENSIONS.

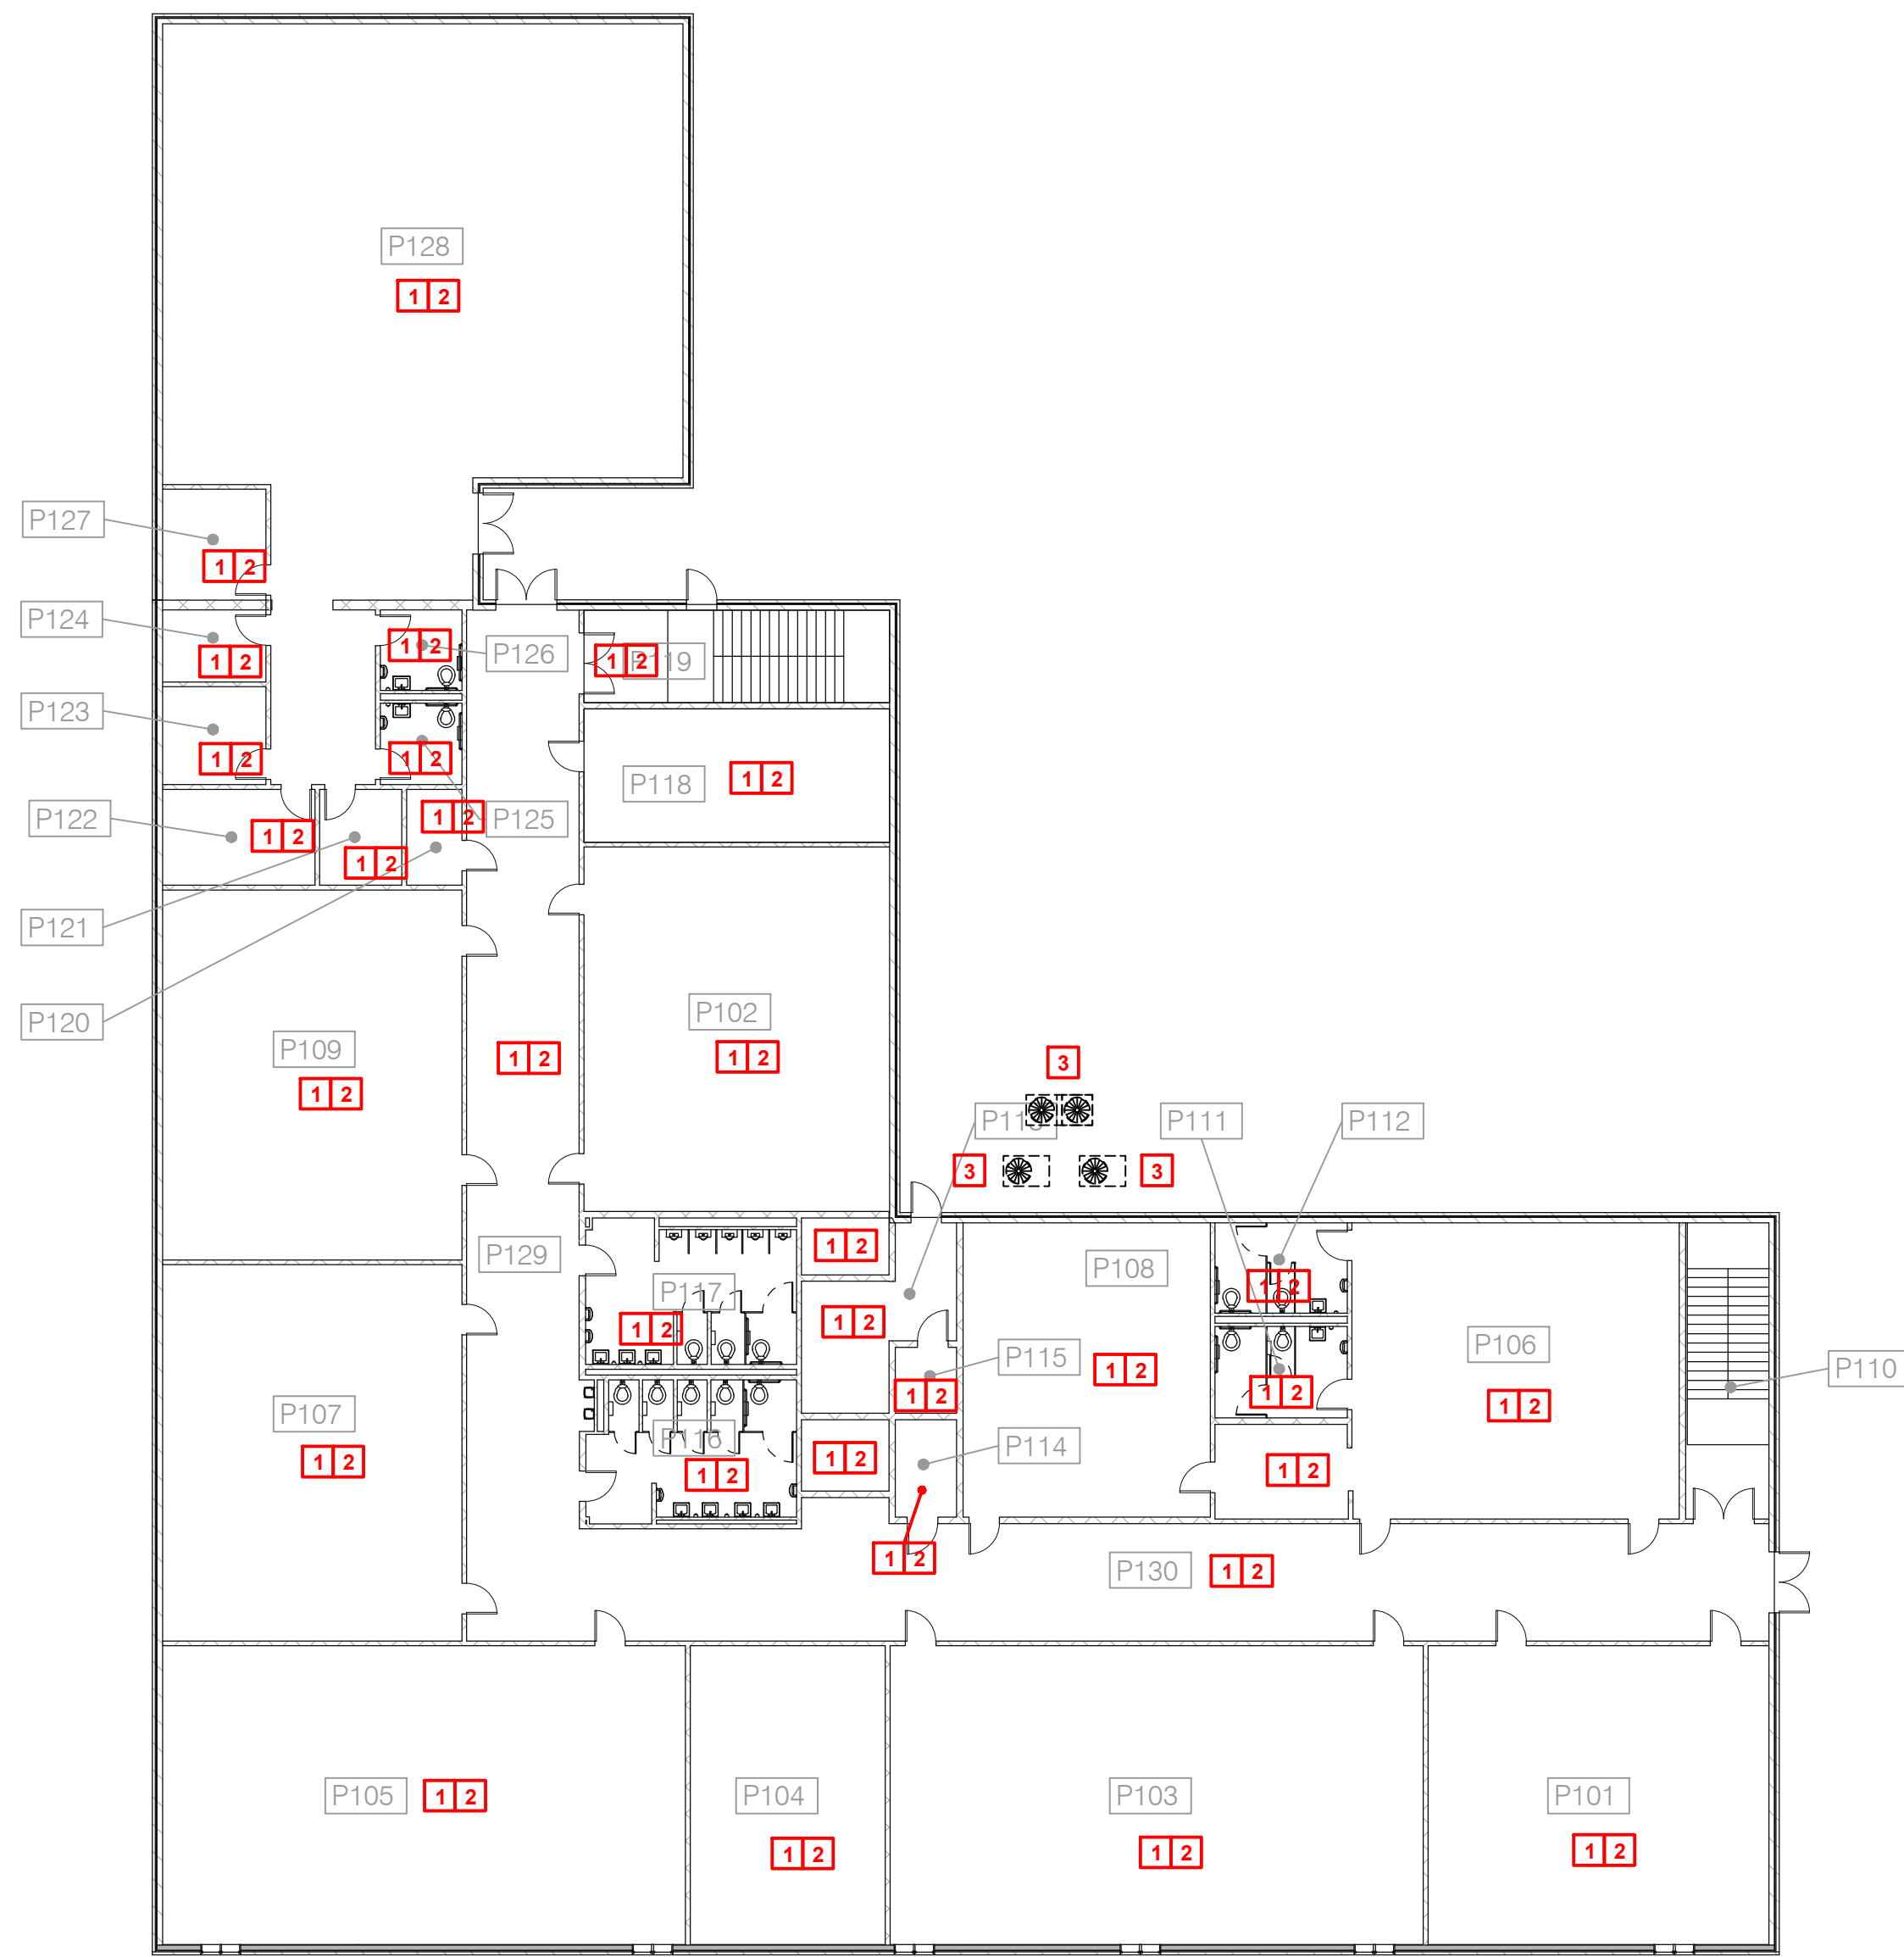GENERAL NOTES:

- A. CONTRACTOR SHALL FIELD VERIFY EXISTING EQUIPMENT TAGS (WHERE POSSIBLE) IN FIELD PRIOR TO DEMOLITION. COORDINATE ALL SITE VISITS, THROUGH GENERAL CONTRACTOR AND C.P.S.B. CONTRACTOR WEAR REQUIRED PERSONAL PROTECTIVE GEAR (PPE) SPECIFICALLY REQUIRED FOR EACH BUILDING.
- B. CONTRACTOR SHALL NOTIFY ARCHITECT/ENGINEER OF ANY DISCREPANCIES IDENTIFIED IN THE FIELD PRIOR TO FABRICATING DUCTWORK OR ORDERING EQUIPMENT.
- C. CONTRACTOR SHALL PROVIDE TESTING AND BALANCING OF ALL HVAC SYSTEMS WHICH WERE REPLACED, MODIFIED AND/OR CLEANED.
- D. ALL WORK SHALL COMPLY WITH LOCAL, STATE, AND FEDERAL CODES TO THE SATISFACTION OF CODE AUTHORITIES HAVING JURISDICTION.
- E. ALL WORK SHALL COMPLY WITH THE REQUIREMENTS OF NFPA 90A & 101, THE CLEAN AIR ACT AND THE AMERICANS WITH DISABILITIES ACT.
- F. PRIOR TO DRAINING, DISCONNECTING, AND REMOVING OF ANY SERVICES IN THE DESIGNATED AREAS SHOWN, THE CONTRACTOR MUST ENSURE THAT THE SERVICES REMOVED DO NOT AFFECT THE NORMAL OPERATION OF AREAS OUTSIDE THE CONSTRUCTION AREA.
- G. VERIFY ADEQUATE SPACE AVAILABLE PER MANUFACTURER'S RECOMMENDATIONS. COORDINATE CLEARANCE REQUIREMENTS OF ALL MECHANICAL EQUIPMENT.

KEYNOTES TO SHEET:

- 1. NO INTERIOR MECHANICAL (PLUMBING & HVAC) WORK ASSOCIATED WITH THESE SPACE WITHIN THE BUILDING.
- 2. CONTRACTOR SHALL TEMPORARILY SUPPORT AND PROTECT ANY EQUIPMENT, DIFFUSERS, GRILLES, ETC. IN OR ABOVE CEILINGS OF THESE SPACES DURING THE REMOVAL AND INSTALLATION OF NEW CEILINGS. REFER TO ARCHITECTURAL PLAN P01 BLDG P.
- 3. THE COILS OF THE EXISTING CONDENSING UNIT APPEARED TO BE DAMAGED FROM FLYING DEBRIS. CONTRACTOR SHALL COMB OUT COILS AND VERIFY PROPER OPERATION OF UNIT.



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NOTE: THE HVAC SCOPE OF WORK IS LIMITED TO REPLACING OR REPAIRING THE HVAC SYSTEM BACK TO ITS ORIGINAL CONDITION (LIKE FOR LIKE) IN MOST CIRCUMSTANCES. THIS PROJECT'S SCOPE OF WORK DOES NOT INCLUDE BRINGING ALL THE EXISTING HVAC SYSTEMS UP TO CODE OR ADDRESSING EXISTING CONDITIONS. ALTHOUGH ALL WORK MUST COMPLY WITH FEMA CONSENSUS-BASED, "LATEST PUBLISHED EDITIONS" OF CODES NOT NECESSARILY THOSE CODES ADOPTED BY THE LOCAL MUNICIPALITY.


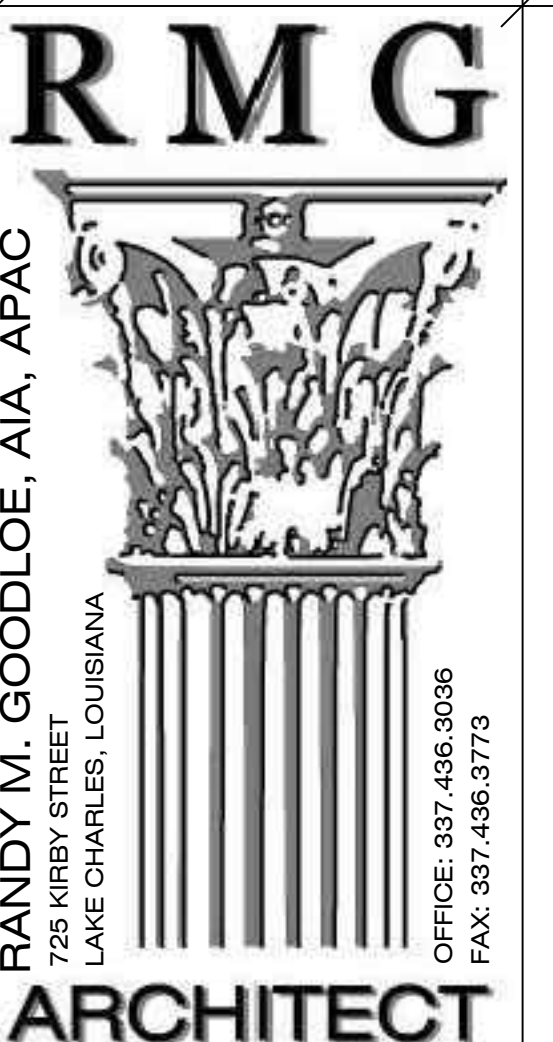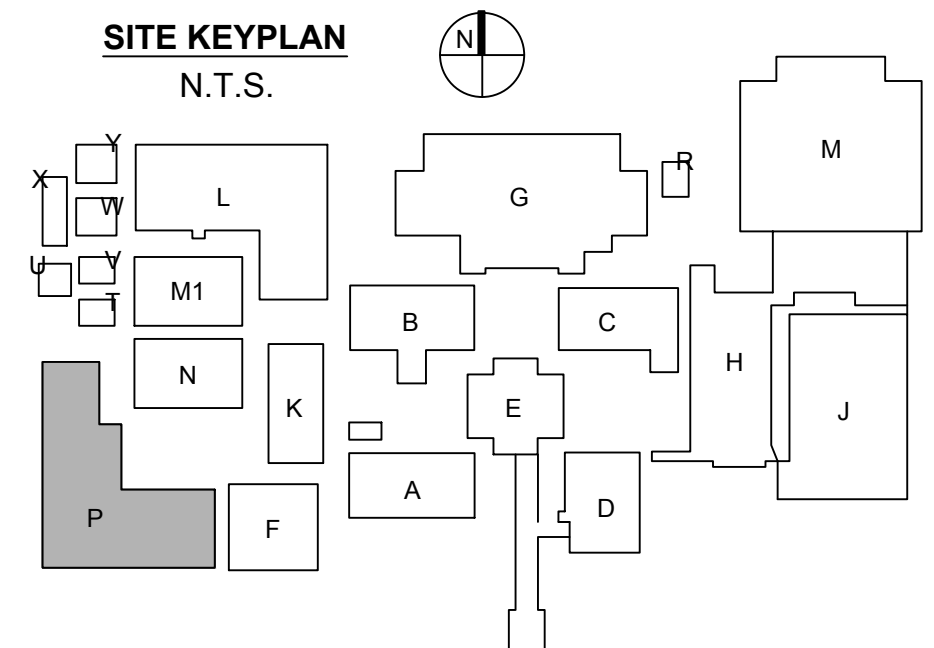
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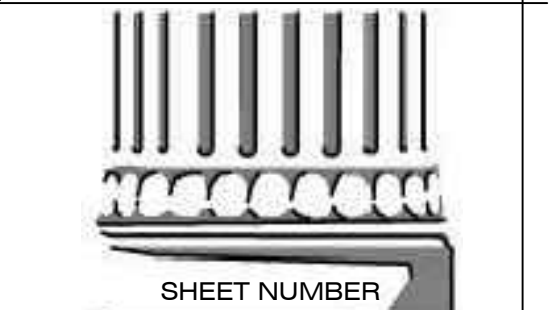


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