


SYMBOLS LEGEND

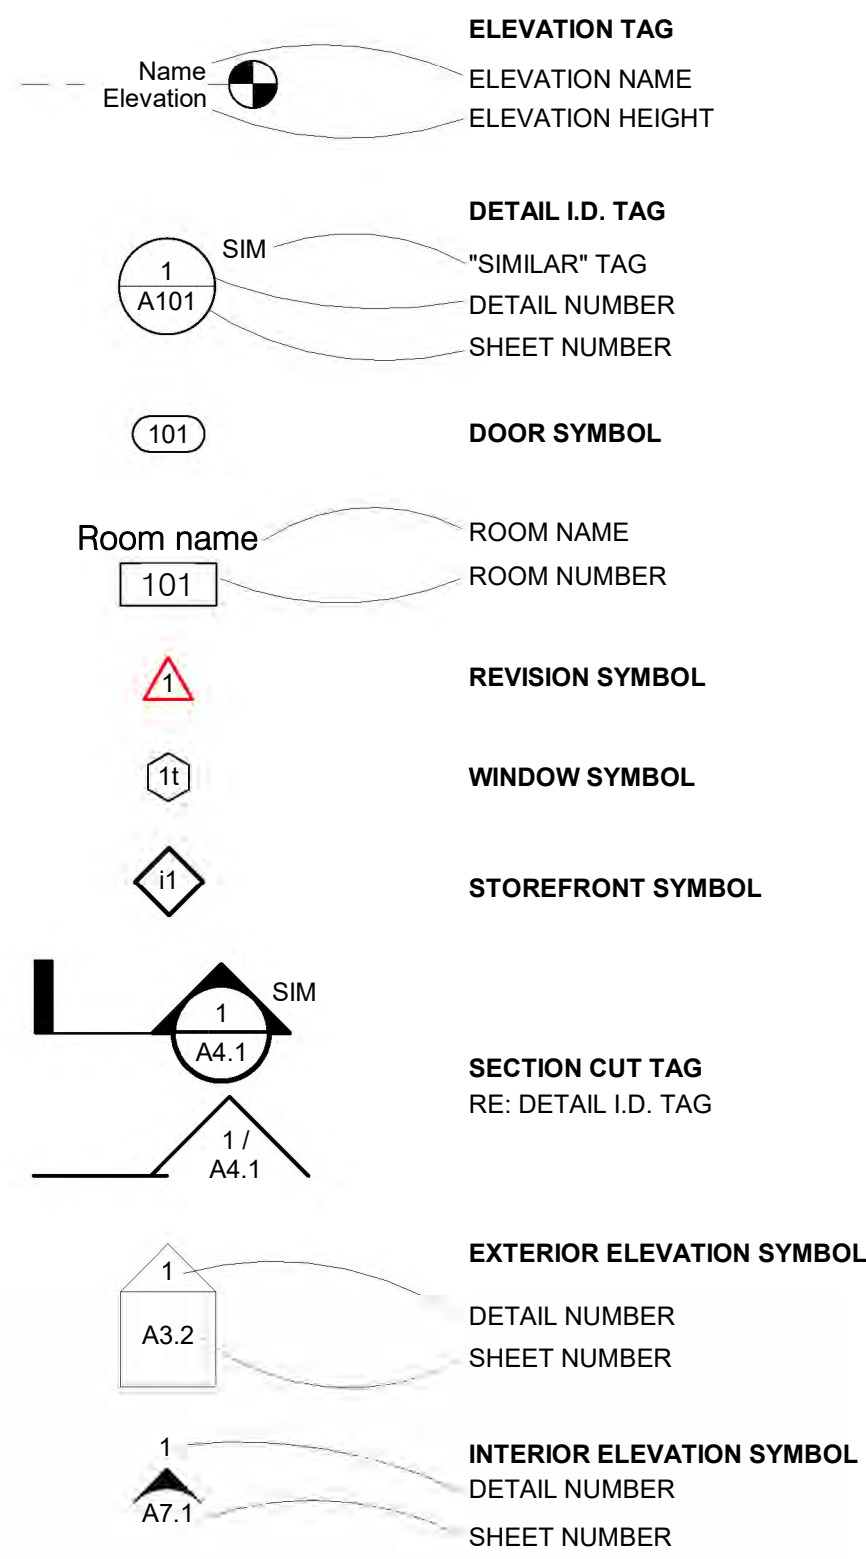

HURRICANE LAURA REPAIRS TO
A.M. BARBE HIGH SCHOOL
 FOR
CALCASIEU PARISH SCHOOL BOARD

2200 W. McNEESE ST., LAKE CHARLES, LA 70605

A.M. BARBE HIGH SCHOOL
CPSB PROJECT #HL-003-01,03,04,05,06,07

RMG PROJECT #20042-01-G

06/28/2024

SHANNON LAFARGUE
SUPERINTENDENT

DEAN ROBERTS - BOARD MEMBER

PATRICK FONTENOT - PRINCIPAL

JEROME GOODLY - ASSISTANT PRINCIPAL

GENERAL NOTES

- DO NOT SCALE DRAWINGS. USE WRITTEN DIMENSIONS ONLY. NOTIFY ARCHITECT/OWNER OF ANY DISCREPANCIES FOR CLARIFICATION.
- ALL WORK IS TO BE ACCOMPLISHED TO MEET ALL LOCAL, STATE, AND FEDERAL CODES AND ALL AUTHORITIES HAVING JURISDICTION.
- THE CONTRACTOR SHALL VISIT THE SITE AND VERIFY EXISTING CONDITION AND NOTIFY THE ARCHITECT/OWNER OF ANY DISCREPANCIES PRIOR TO BIDDING.
- THE CONTRACTOR WILL PROVIDE ALL NECESSARY BARRICADES, SIGNAGE, REFLECTORS, LIGHTS, ETC. DURING CONSTRUCTION AND PROPERLY IDENTIFY ANY AREAS CLOSED TO THE PUBLIC.
- CONTRACTOR'S PARKING OF CARS, TRUCKS, EQUIPMENT, AND MATERIAL WILL BE ALLOWED WITHIN DESIGNATED AREAS ONLY.
- THE CONTRACTOR IS RESPONSIBLE FOR THE LOCATION AND COORDINATION OF ALL CONDUIT, PIPING, AND DUCTWORK WITH THE VARIOUS TRADES.
- THE CONTRACTOR SHALL OBTAIN AND PAY FOR ALL NECESSARY PERMITS.
- THE CONTRACTOR SHALL VERIFY LOCATION OF ALL TRENCHING AND EXCAVATION WITH ARCHITECT, OWNER AND/OR RESPECTIVE ENGINEER PRIOR TO WORK.
- THE CONTRACTOR SHALL VERIFY DIMENSIONS OF EXISTING CONDITIONS, LAYOUT, AND OBTAIN APPROVAL OF ARCHITECT/OWNER PRIOR TO BEGINNING CONSTRUCTION.
- COORDINATE WORK WITH THE OWNER, INCLUDING SCHEDULING TIME AND LOCATIONS FOR DELIVERIES, BUILDING ACCESS, USE OF BUILDING SERVICES AND FACILITIES, AND USE OF ELEVATORS. MINIMIZE DISTURBANCE OF BUILDING FUNCTIONS AND OCCUPANTS.
- OWNER WILL PROVIDE WORK NOTED "BY OTHERS" OR "NIC" UNDER SEPARATE CONTRACT. INCLUDE SCHEDULE REQUIREMENTS IN CONSTRUCTION PROGRESS SCHEDULE AND COORDINATE TO ASSURE ORDERLY SEQUENCE OF INSTALLATION.
- MAINTAIN WORK AREAS SECURE AND LOCKABLE DURING CONSTRUCTION. COORDINATE WITH OWNER AND/OR PROPERTY MANAGER TO ENSURE SECURITY.
- MAINTAIN EXITS, EXIT LIGHTING, FIRE PROTECTIVE DEVICES, AND ALARMS IN CONFORMANCE WITH APPLICABLE CODES AND ORDINANCES.



LA. LICENSE NO. 4086

HURRICANE LAURA REPAIRS TO
A.M. BARBE HIGH SCHOOL
 2200 W. McNEESE ST.
 FOR
CALCASIEU PARISH SCHOOL BOARD
 LAKE CHARLES, LA 70605
 HL-003-01,03,04,05,06,07

261 - TYPICAL ABBREVIATIONS-		EPDM ETHYLENE PROPYLENE DIENE M-CLASS		J JANITOR		PSF POUNDS PER SQUARE FOOT		SPKR SPEAKER		WD WOOD	
A & @	AND AT	EQ	EQUAL EQUIPMENT	JT	JANITOR	PT	PRESSURE TREATED PAINTED	SQ	SQUARE	WIN	WINDOW
AC	AIR CONDITIONING	EXH	EXHAUST	LAM	LAMINATE	PTD	PARTITION	SS	STAINLESS STEEL	WM	WIRE MESH
ACT	ACOUSTIC CEILING TILE	EXIST	EXISTING	LAV	LAVATORY	PPV	POLYVINYL CHLORIDE	STA	STATION	WP	WATERPROOF/WATERPROOFING
ADJ	ADJACENT	EXP	EXPANSION	LB	POUNDS	PVC	POLYVINYL CHLORIDE	STC	SOUND TRANSMISSION COEFFICIENT	WPM	WATERPROOF MEMBRANE
AFF	ABOVE FINISHED FLOOR	EXT	EXTERIOR	LT	LIGHT	Q	QUANTITY	STL	STEEL	WS	WEATHER-STRIPPING
AGGR	AGGREGATE	F	FACE BRICK	M	MAXIMUM	QTY	QUANTITY	STR	STRINGER	WSCOT	WAINSCOT
ALT	ALTERNATE	FD	FLOOR DRAIN OR FIRE DEPARTMENT	MFR	MANUFACTURER	R	RADIUS/RISER	STRG	STRINGER	WT	WEIGHT
ALUM	ALUMINUM	MIN	MINIMUM	MN	MISCELLANEOUS	RA	RADIUS/RISER	STRUCT	STRUCTURAL	WV	WATER VALVE
ANOD	ANODIZED	FDC	FIRE DEPARTMENT CONNECTION	MISC	MISCELLANEOUS	RB	RUBBER	STRUCT	STRUCTURE OR STRUCTURAL	WWF	WELDED WIRE FABRIC
APPROX	APPROXIMATE	MO	MASONRY OPENING	RCP	REFLECTED CEILING PLAN	RUB	RUBBER	SUBCAT	SUBCATEGORY	WWW	WELDED WIRE MESH
ARCH	ARCHITECTURAL	MR	MOISTURE RESISTANT	SUSP	SUSPENDED	SY	SYMMETRICAL	SUSP	SUSPENDED		
ASPH	ASPHALT	MTD	MOUNTED	SYM	SYMMETRICAL	SY	SYSTEM				
AUTO	AUTOMATIC	MTG	MOUNTING								
AV	AUDIOVISUAL	MTL	METAL								
B	BUILDING	MULL	MULLION								
BLDG	BUILDING	N	NORTH								
BM	BEAM	NA	NOT APPLICABLE								
BO	BOTTOM OF	NC	NOISE CRITERIA								
BOT	BOTTOM	NIC	NOT IN CONTRACT								
BRK	BRICK	NOM	NOMINAL								
C	CATCH BASIN	NON	NON COMBUSTIBLE								
CB	CATCH BASIN	NTS	NOT TO SCALE								
CJ	CONTROL JOINT	O	ON CENTER								
CL	CENTERLINE	OC	ON CENTER								
CLG	CEILING	OD	OUTSIDE DIAMETER								
CLR	CLEAR	OF	OWNER FURNISHED, CONTRACTOR INSTALLED								
CMU	CONCRETE MASONRY UNIT	OFI	OWNER FURNISHED, OWNER INSTALLED								
CO	CLEANOUT	OPNG	OPENING								
CONC	CONCRETE	P	PAINT								
CONST	CONSTRUCTION	PAV	PAVING								
CONT	CONTINUOUS	PBD	PARTICLE BOARD								
CPT	CARPET	PC	PRECAST								
CTR	CENTER	PERIM	PERIMETER								
D	DOUBLE	PERP	PERPENDICULAR								
DBL	DOUBLE	PI	PLATE								
DEG	DEGREE	PLAM	PLASTIC LAMINATE								
DEMO	DEMOLISH OR DEMOLITION	PLBG	PLUMBING								
DF	DRINKING FOUNTAIN	PLF	POUNDS PER LINEAR FOOT								
DIA	DIAMETER	PLYWD	PLYWOOD								
DIM(S)	DIMENSION(S)	PNL	PANEL								
DISP	DISPENSER	PNT	PAINT OR PAINTED								
DN	DOWN	POL	POLISHED								
DTL	DETAIL	PREFAB	PREFABRICATED								
DWG	DRAWING	PROJ	PROJECT								
E	EACH										
EJ	EXPANSION JOINT										
ELEC	ELECTRICAL										
ELEV	ELEVATOR										
ENG	ENGINEER										

INDEX OF DRAWINGS		INDEX OF DRAWINGS	
SHEET NUMBER	SHEET NAME	SHEET NUMBER	SHEET NAME
C-1	EXISTING DRAINAGE SITE PLAN	(LA)1.1	BLDG L 1ST FLOOR PLAN
A-000	COVER SHEET	(LA)1.2	BLDG L 1ST FLOOR PLAN
A-00.0	DECOMMISSIONING PLAN	(LA)1.3	BLDG L 1ST FLOOR PLAN
A-00.1	ROOF & SOFFIT PLANS	(LA)1.4	BLDG L 1ST FLOOR PLAN
A-00.2	WALL SECTIONS & DETAILS	(LA)1.5	BLDG L 1ST FLOOR PLAN
A-00.3	WALL SECTIONS & DETAILS	(M)A1.1	POD BLDG M
A-00.4	ROOF DETAILS	(N)A1.1	POD BLDG N
A-00.5	ENTRY CANOPY	(P)A0.1	BLDG P ROOF
A-00.6	ALTERNATE 2 - COURTYARD WALL PHASING PLAN	(P)A0.2	BLDG P ELEVATIONS
(A)A0.1	BUILDING A ROOF & ELEVATIONS	(P)A1.1	BLDG P 1ST FLOOR PLAN
(A)A0.2	BUILDING A REFERENCE IMAGES	(T-Y)A1.1	TEMP BLDG DRAWINGS
(A)A1.1	BLDG A 1ST FLOOR	(T-Y)A1.2	TEMP BLDG T-Y
(A)A1.2	BLDG A 1ST FLOOR		
(A)A2.1	BLDG A 2ND FLOOR		
(A)A2.2	BLDG A 2ND FLOOR		
(B)A0.1	BUILDING B ROOF & ELEVATIONS		
(B)A0.2	BUILDING B REFERENCE IMAGES		
(B)A1.1	BLDG B 1ST FLOOR		
(B)A1.2	BLDG B 1ST FLOOR		
(B)A2.1	BLDG B 2ND FLOOR		
(B)A2.2	BLDG B 2ND FLOOR		
(C)A0.1	BUILDING C ROOF & ELEVATIONS		
(C)A0.2	BUILDING C REFERENCE IMAGES		
(C)A0.3	BLDG C SCHEDULES		
(C)A1.1	BLDG C 1ST FLOOR PLAN		
(C)A1.2	BLDG C 1ST FLOOR PLAN		
(C)A2.1	BLDG C 2ND FLOOR		
(E)A0.1	BLDG E ROOF		
(E)A0.2	BLDG E ELEVATIONS		
(E)A0.3	BUILDING E REFERENCE IMAGES		
(E)A1.1	BLDG E 1ST FLOOR PLAN		
(E)A1.2	BLDG E 1ST FLOOR PLAN		
(E)A2.1	BLDG E 2ND FLOOR PLAN		
(E)A2.2	BLDG E 2ND FLOOR PLAN		
(E)A3.1	BLDG E 3RD FLOOR PLAN		
(E)A3.2	BLDG E 3RD FLOOR PLAN		
(E)A3.3	BLDG E 3RD FLOOR PLAN		
(F)A0.1	BLDG F ELEVATIONS		
(F)A1.1	BLDG F 1ST FLOOR PLAN		
(F)A1.2	BLDG F 1ST FLOOR PLAN		
(G)A0.1	BLDG G ROOF		
(G)A0.2	BLDG G ELEVATIONS		
(G)A0.3	BLDG G REFERENCE IMAGES		
(G)A0.4	BLDG G REFERENCE IMAGES		
(G)A1.1	BLDG G 1ST FLOOR PLAN		
(G)A1.2	BLDG G 1ST FLOOR PLAN		
(G)A1.3	BLDG G 1ST FLOOR PLAN		
(G)A1.4	BLDG G 1ST FLOOR PLAN		
(G)A1.5	BLDG G 1ST FLOOR PLAN		
(G)A1.6	BLDG G 1ST FLOOR PLAN		
(G)A1.7	BLDG G 1ST FLOOR PLAN		
(K)A0.1	BLDG K ROOF		
(K)A1.1	BLDG K 1ST FLOOR PLAN		
(K)A1.2	BLDG K 1ST FLOOR PLAN		
(L)A0.1	BLDG L ROOF		
(L)A0.2	BLDG L REFERENCE IMAGES		


BUILDING TOTAL AREA

BUILDING CODES:	INTERNATIONAL EXISTING BUILDING CODE:	2021 EDITION
	INTERNATIONAL BUILDING CODE:	2021 EDITION
	NFPA 101 LIFE SAFETY:	2015 EDITION
RISK SPEED:		ASCE 7-16 (142MPH)
WIND CATEGORY:		3
CONSTRUCTION TYPE:		II-B
OCCUPANCY:		EDUCATION

BUILDING A - 14,768 SF	BUILDING N - 6,100 SF
BUILDING B - 14,768 SF	BUILDING P - 18,400 SF
BUILDING C - 14,768 SF	BUILDING R - 750 SF
BUILDING E - 27,684 SF	BUILDING T - 770 SF
BUILDING F - 6,474 SF	BUILDING U - 880 SF
BUILDING G - 25,949 SF	BUILDING V - 780 SF
BUILDING K - 5,700 SF	BUILDING X - 1120 SF
BUILDING L - 18,590 SF	BUILDING Y - 1300 SF
BUILDING M1 - 6,100 SF	

DUHON & PLEASANT
 ENGINEERING
 STRUCTURAL
 5393 BIG LAKE RD.
 LAKE CHARLES, LA 70605
 TEL: 337.564.5918

ASSOCIATED DESIGN GROUP, INC.
 ENGINEERING
 MECHANICAL - ELECTRICAL - PLUMBING
 3903 WEST CONGRESS STREET, SUITE 201
 LAFAYETTE, LA 70501
 TEL: 337.234.5710

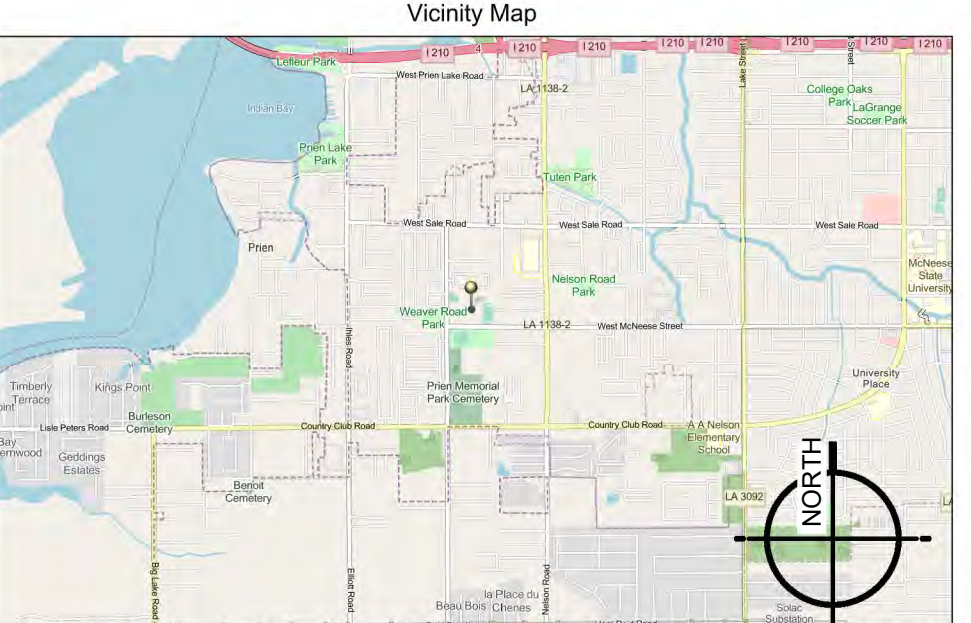

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RMG PROJECT NO.
20042-01-G
 OWNER PROJECT NO.
HL-003-01,03,04,05,06,07
 PROJECT MANAGER

DATE ISSUED
06/28/2024

REVISED	

SHEET NUMBER
A-000
 COVER SHEET


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1 SITE PLAN - BARBE CAMPUS
1" = 50'-0"



KEYNOTES TO SHEET

1. EXISTING TEMPORARY MODULAR BUILDINGS, SEE MEP SHEET FOR UTILITY DECOMMISSION PLAN. REMOVE ALL ASSOCIATED WALKS, RAMPS, CANOPIES AND STEPS IN THEIR ENTIRETY AS INDICATED. MODULAR BUILDING UNITS AND BLOCKING WILL BE REMOVED BY OTHERS - COORDINATE WITH OWNERS REP. ONCE REMOVED, REGRADE ALL EFFECTED GROUNDS TO PROVIDE POSITIVE DRAINAGE, FILL AND COMPACT ANY VOIDS. HYDROSEED ALL DISTURBED GRASS AREAS, MATCH EXISTING SPECIES.
2. REMOVE CHAINLINK FENCE SURROUND FOR ELECTRICAL SERVICE DURING DECOMMISSION OF MODULAR BUILDING.
3. THIS SECTION OF EXISTING CANOPY TO BE REMOVED AS REQUIRED FOR REMOVAL OF THE MODULAR BUILDING UNITS. REINSTALL ONCE REMOVAL IS COMPLETE.

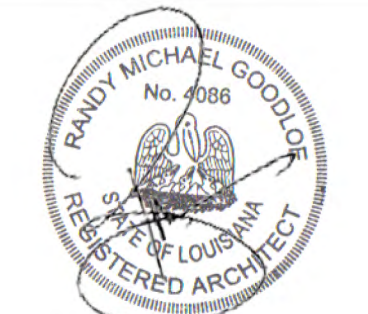

L.A. LICENSE NO. 4086


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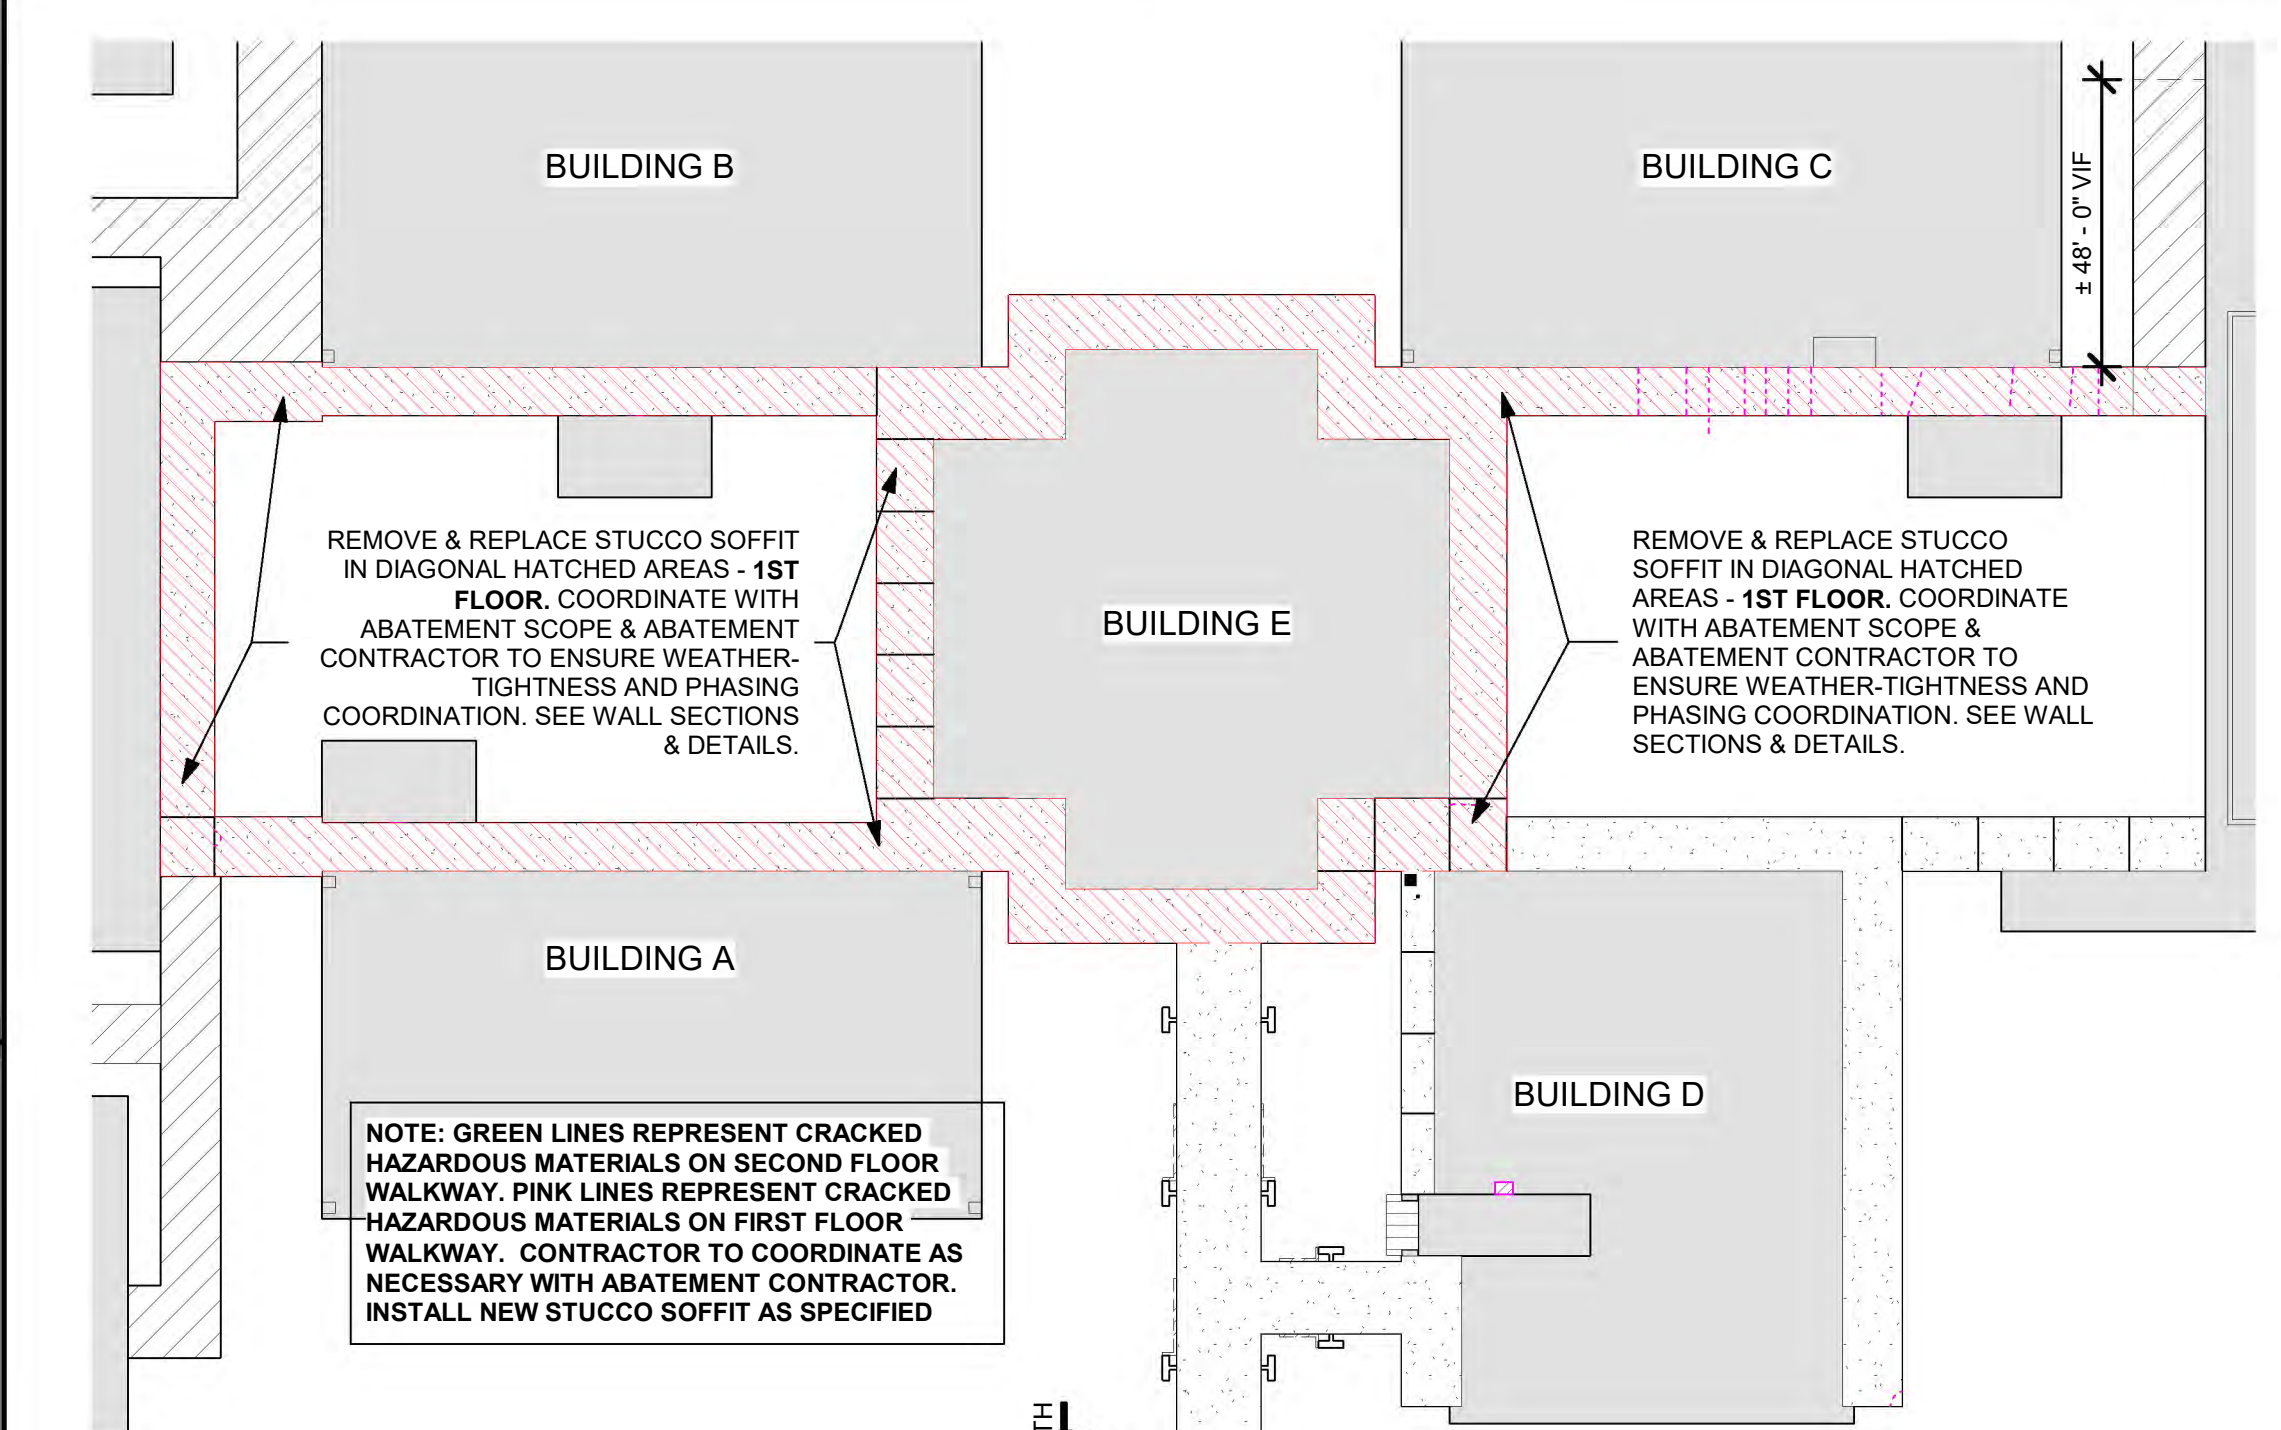
RMG PROJECT NO.
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 PROJECT MANAGER
 TM

DATE ISSUED
06/28/2024


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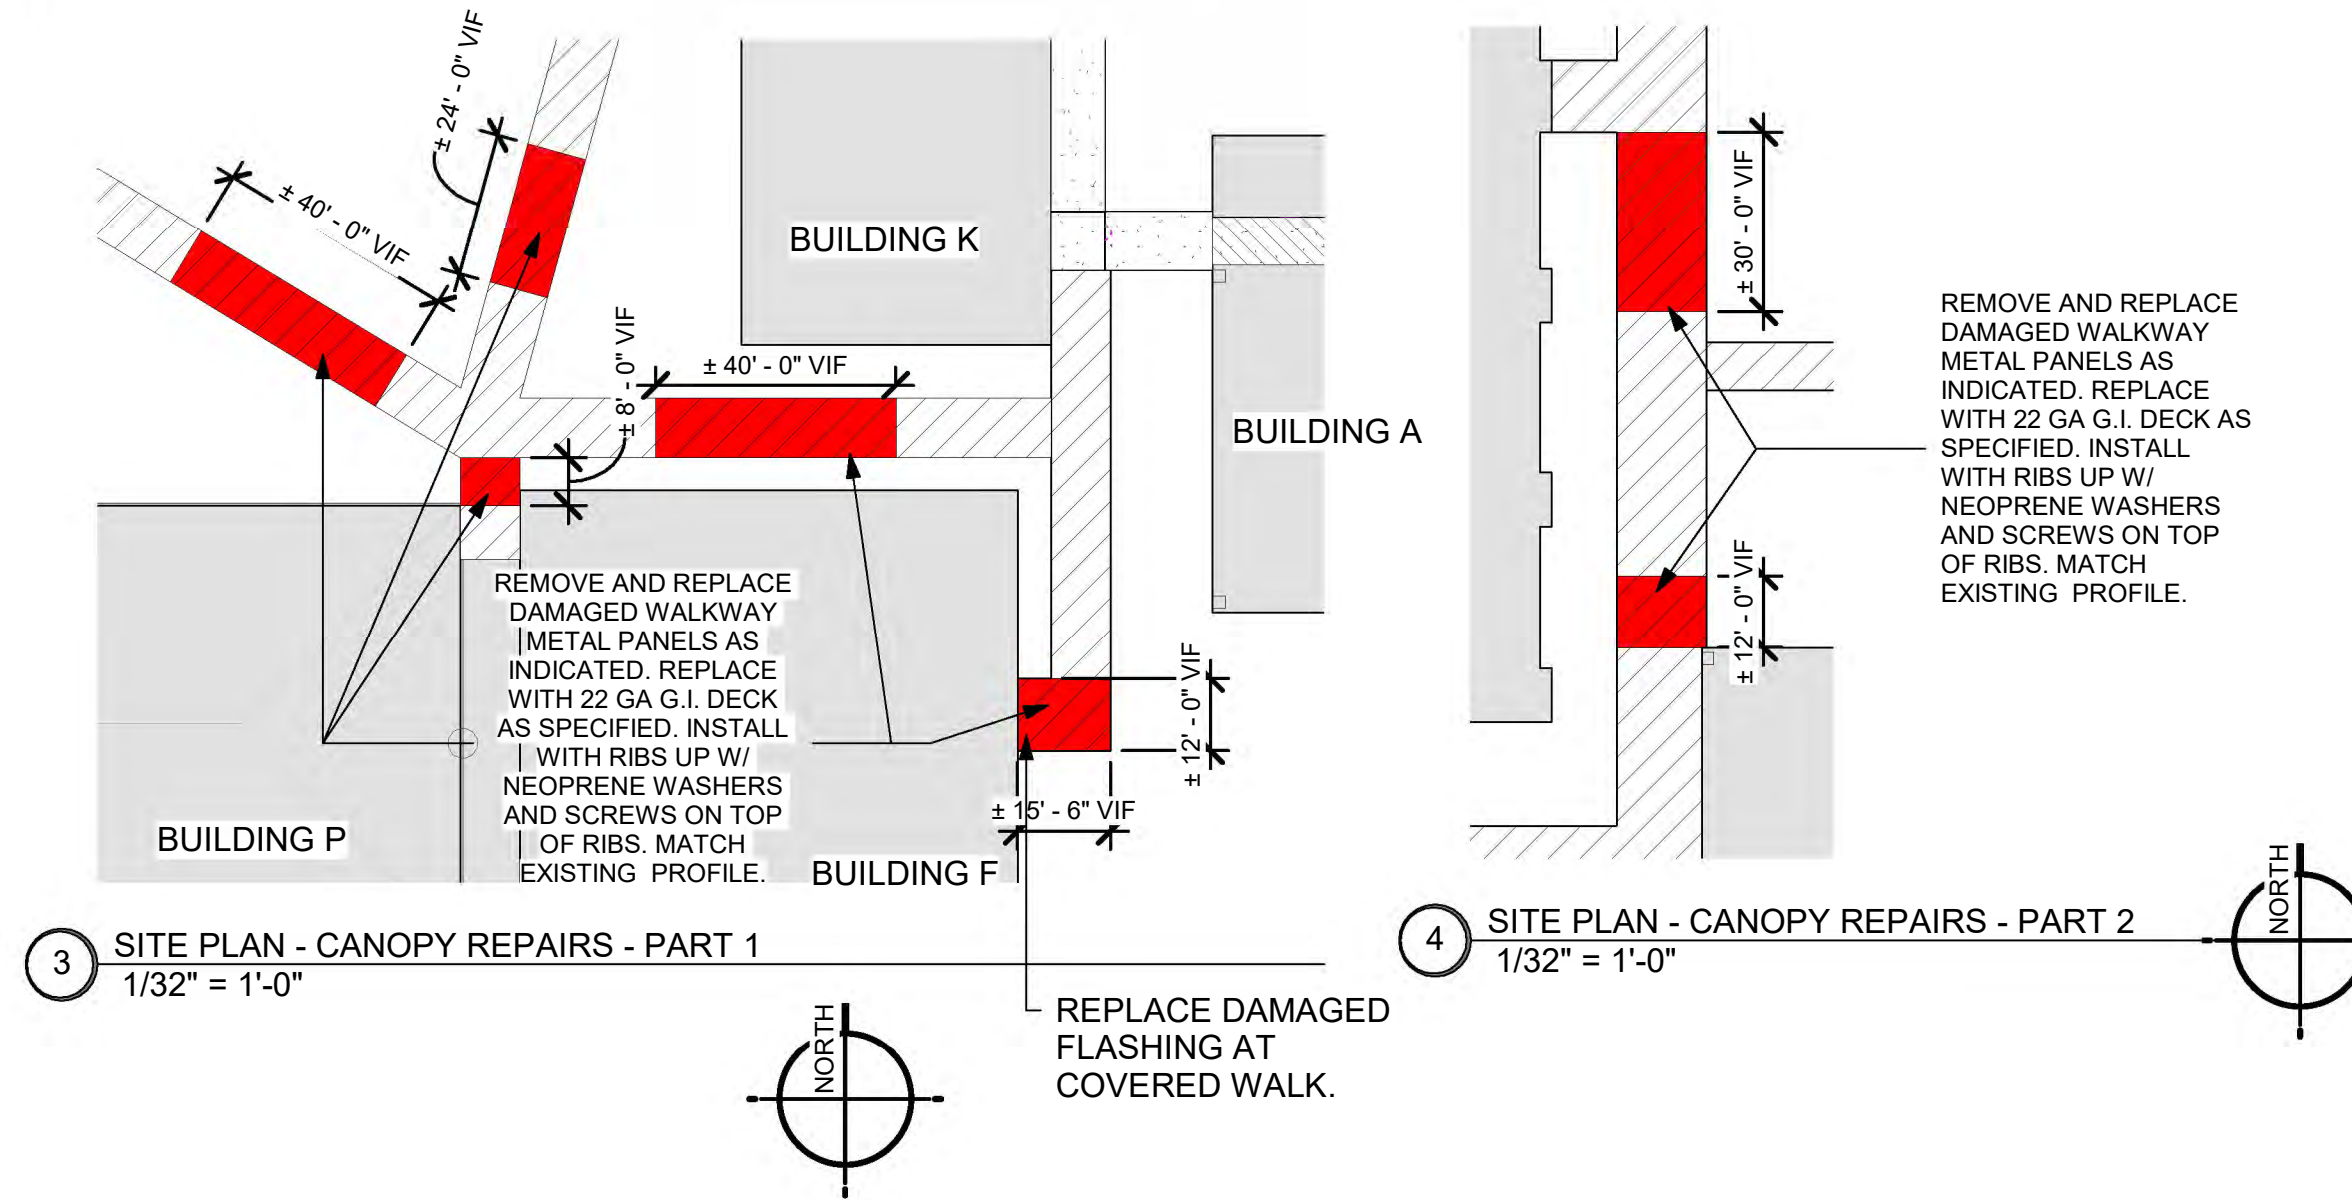
SHEET NUMBER
A-00.0
 DECOMMISSIONING
 PLAN



6 SITE PLAN - FIRST FLOOR SOFFIT REPAIRS
1/32" = 1'-0"

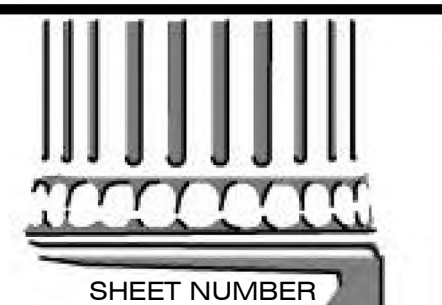


11 SITE PLAN - SECOND FLOOR SOFFIT REPAIRS
1/32" = 1'-0"

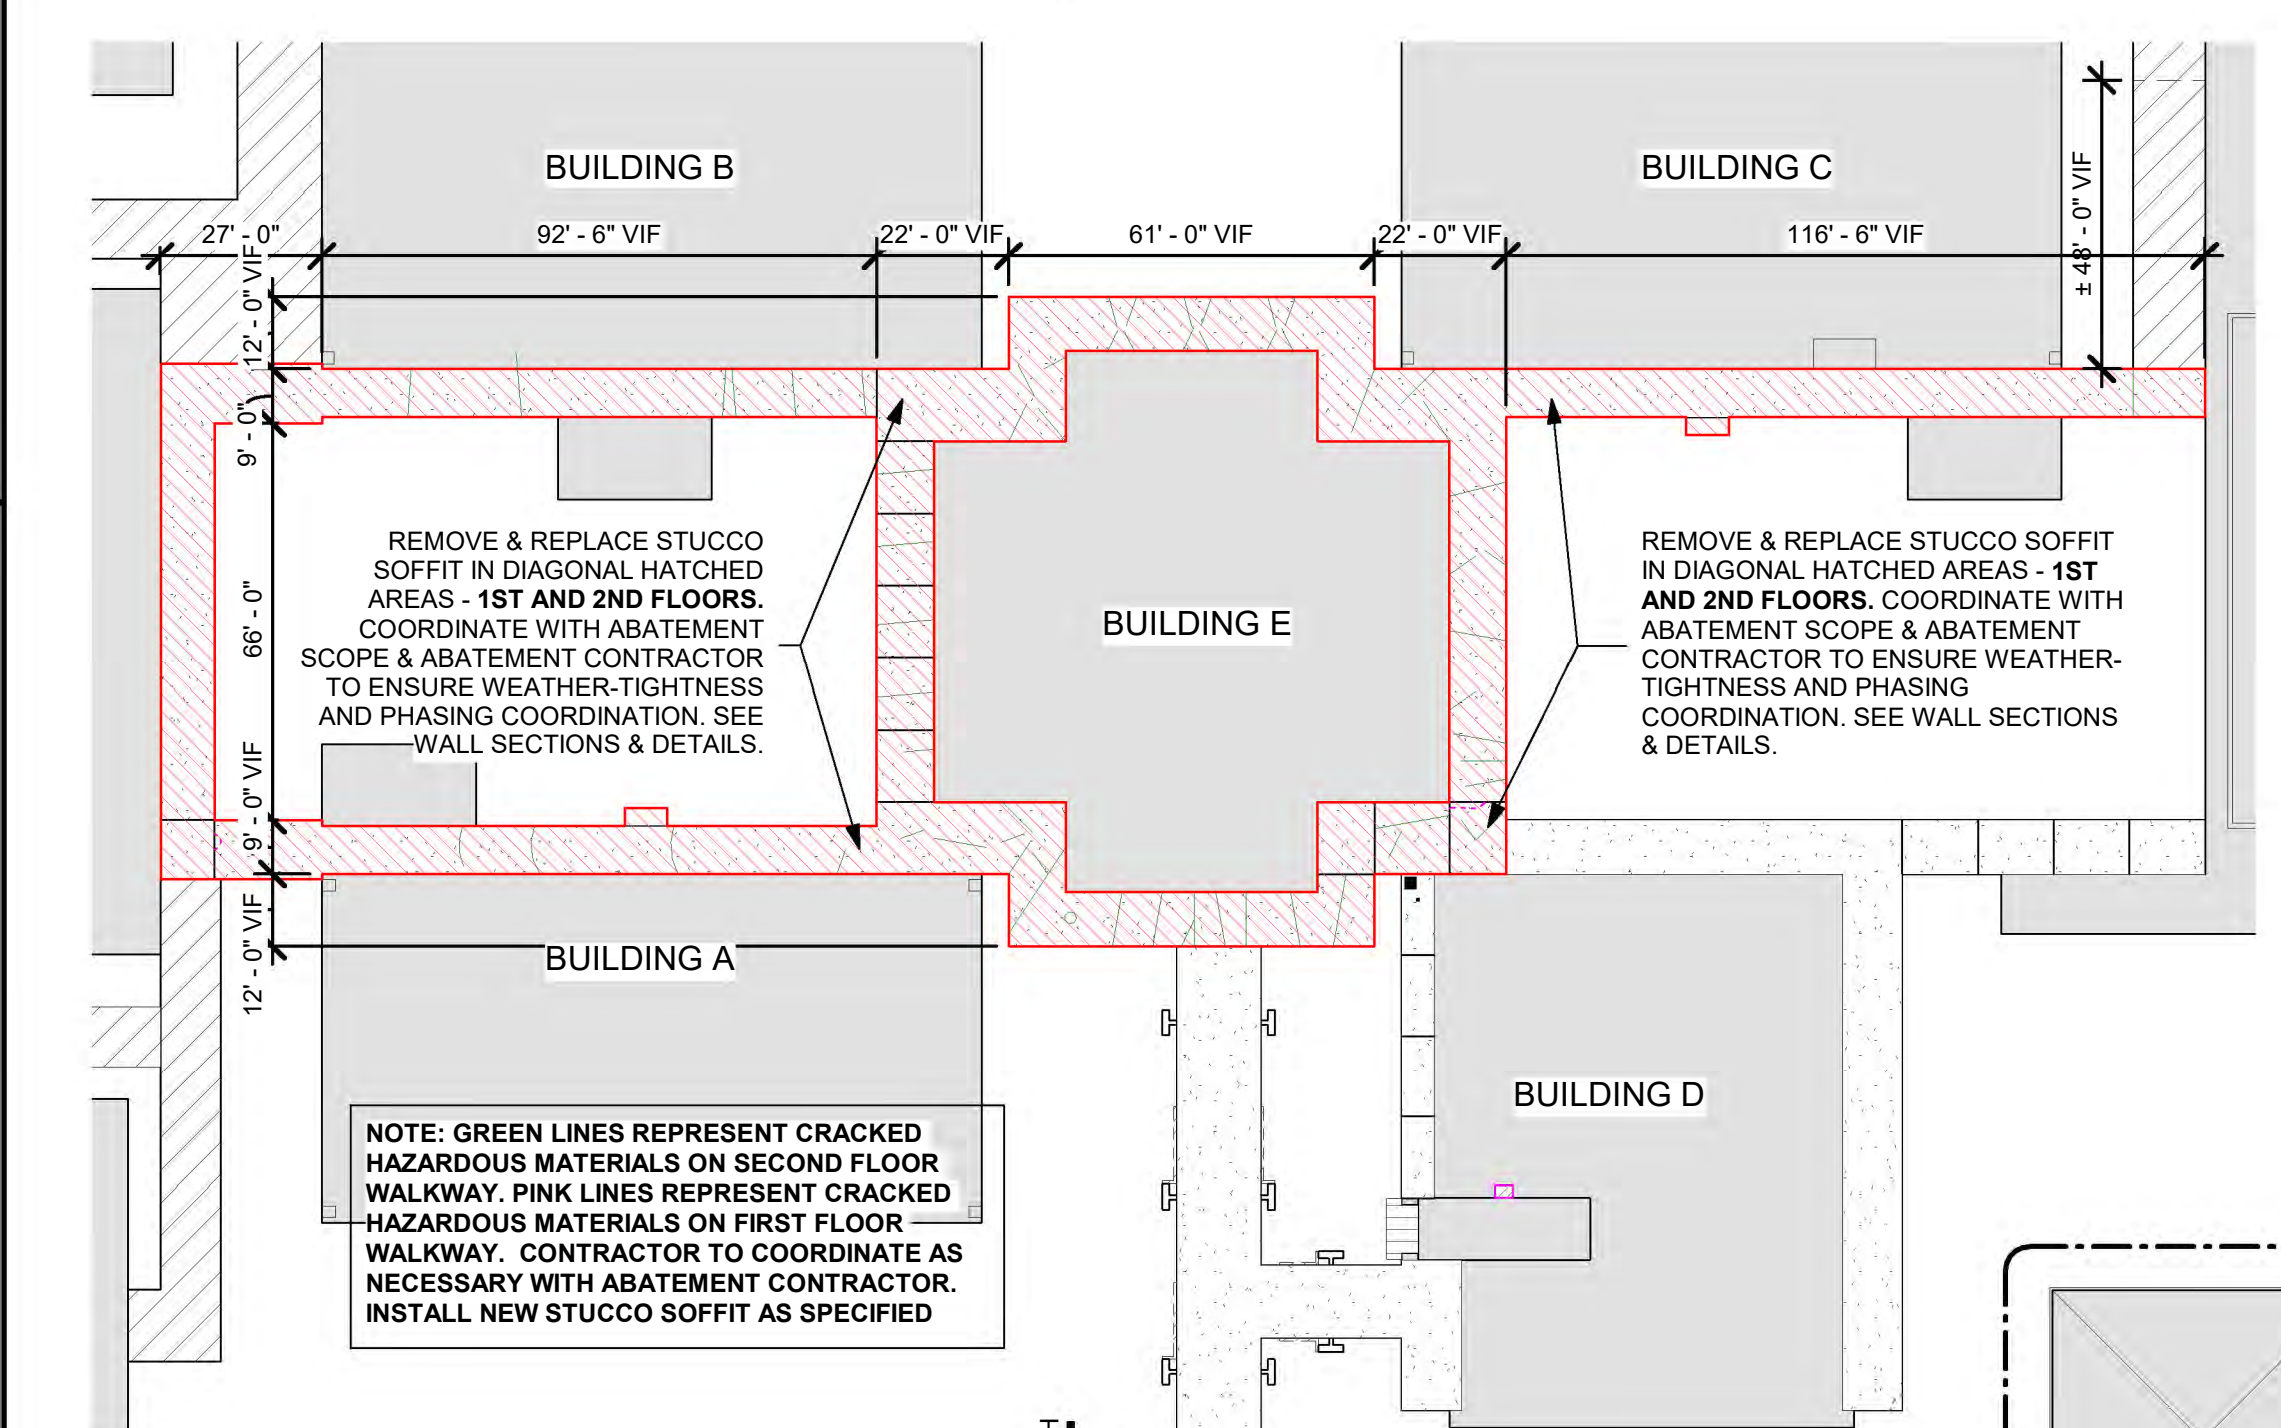

3 SITE PLAN - CANOPY REPAIRS - PART 1
1/32" = 1'-0"

4 SITE PLAN - CANOPY REPAIRS - PART 2
1/32" = 1'-0"

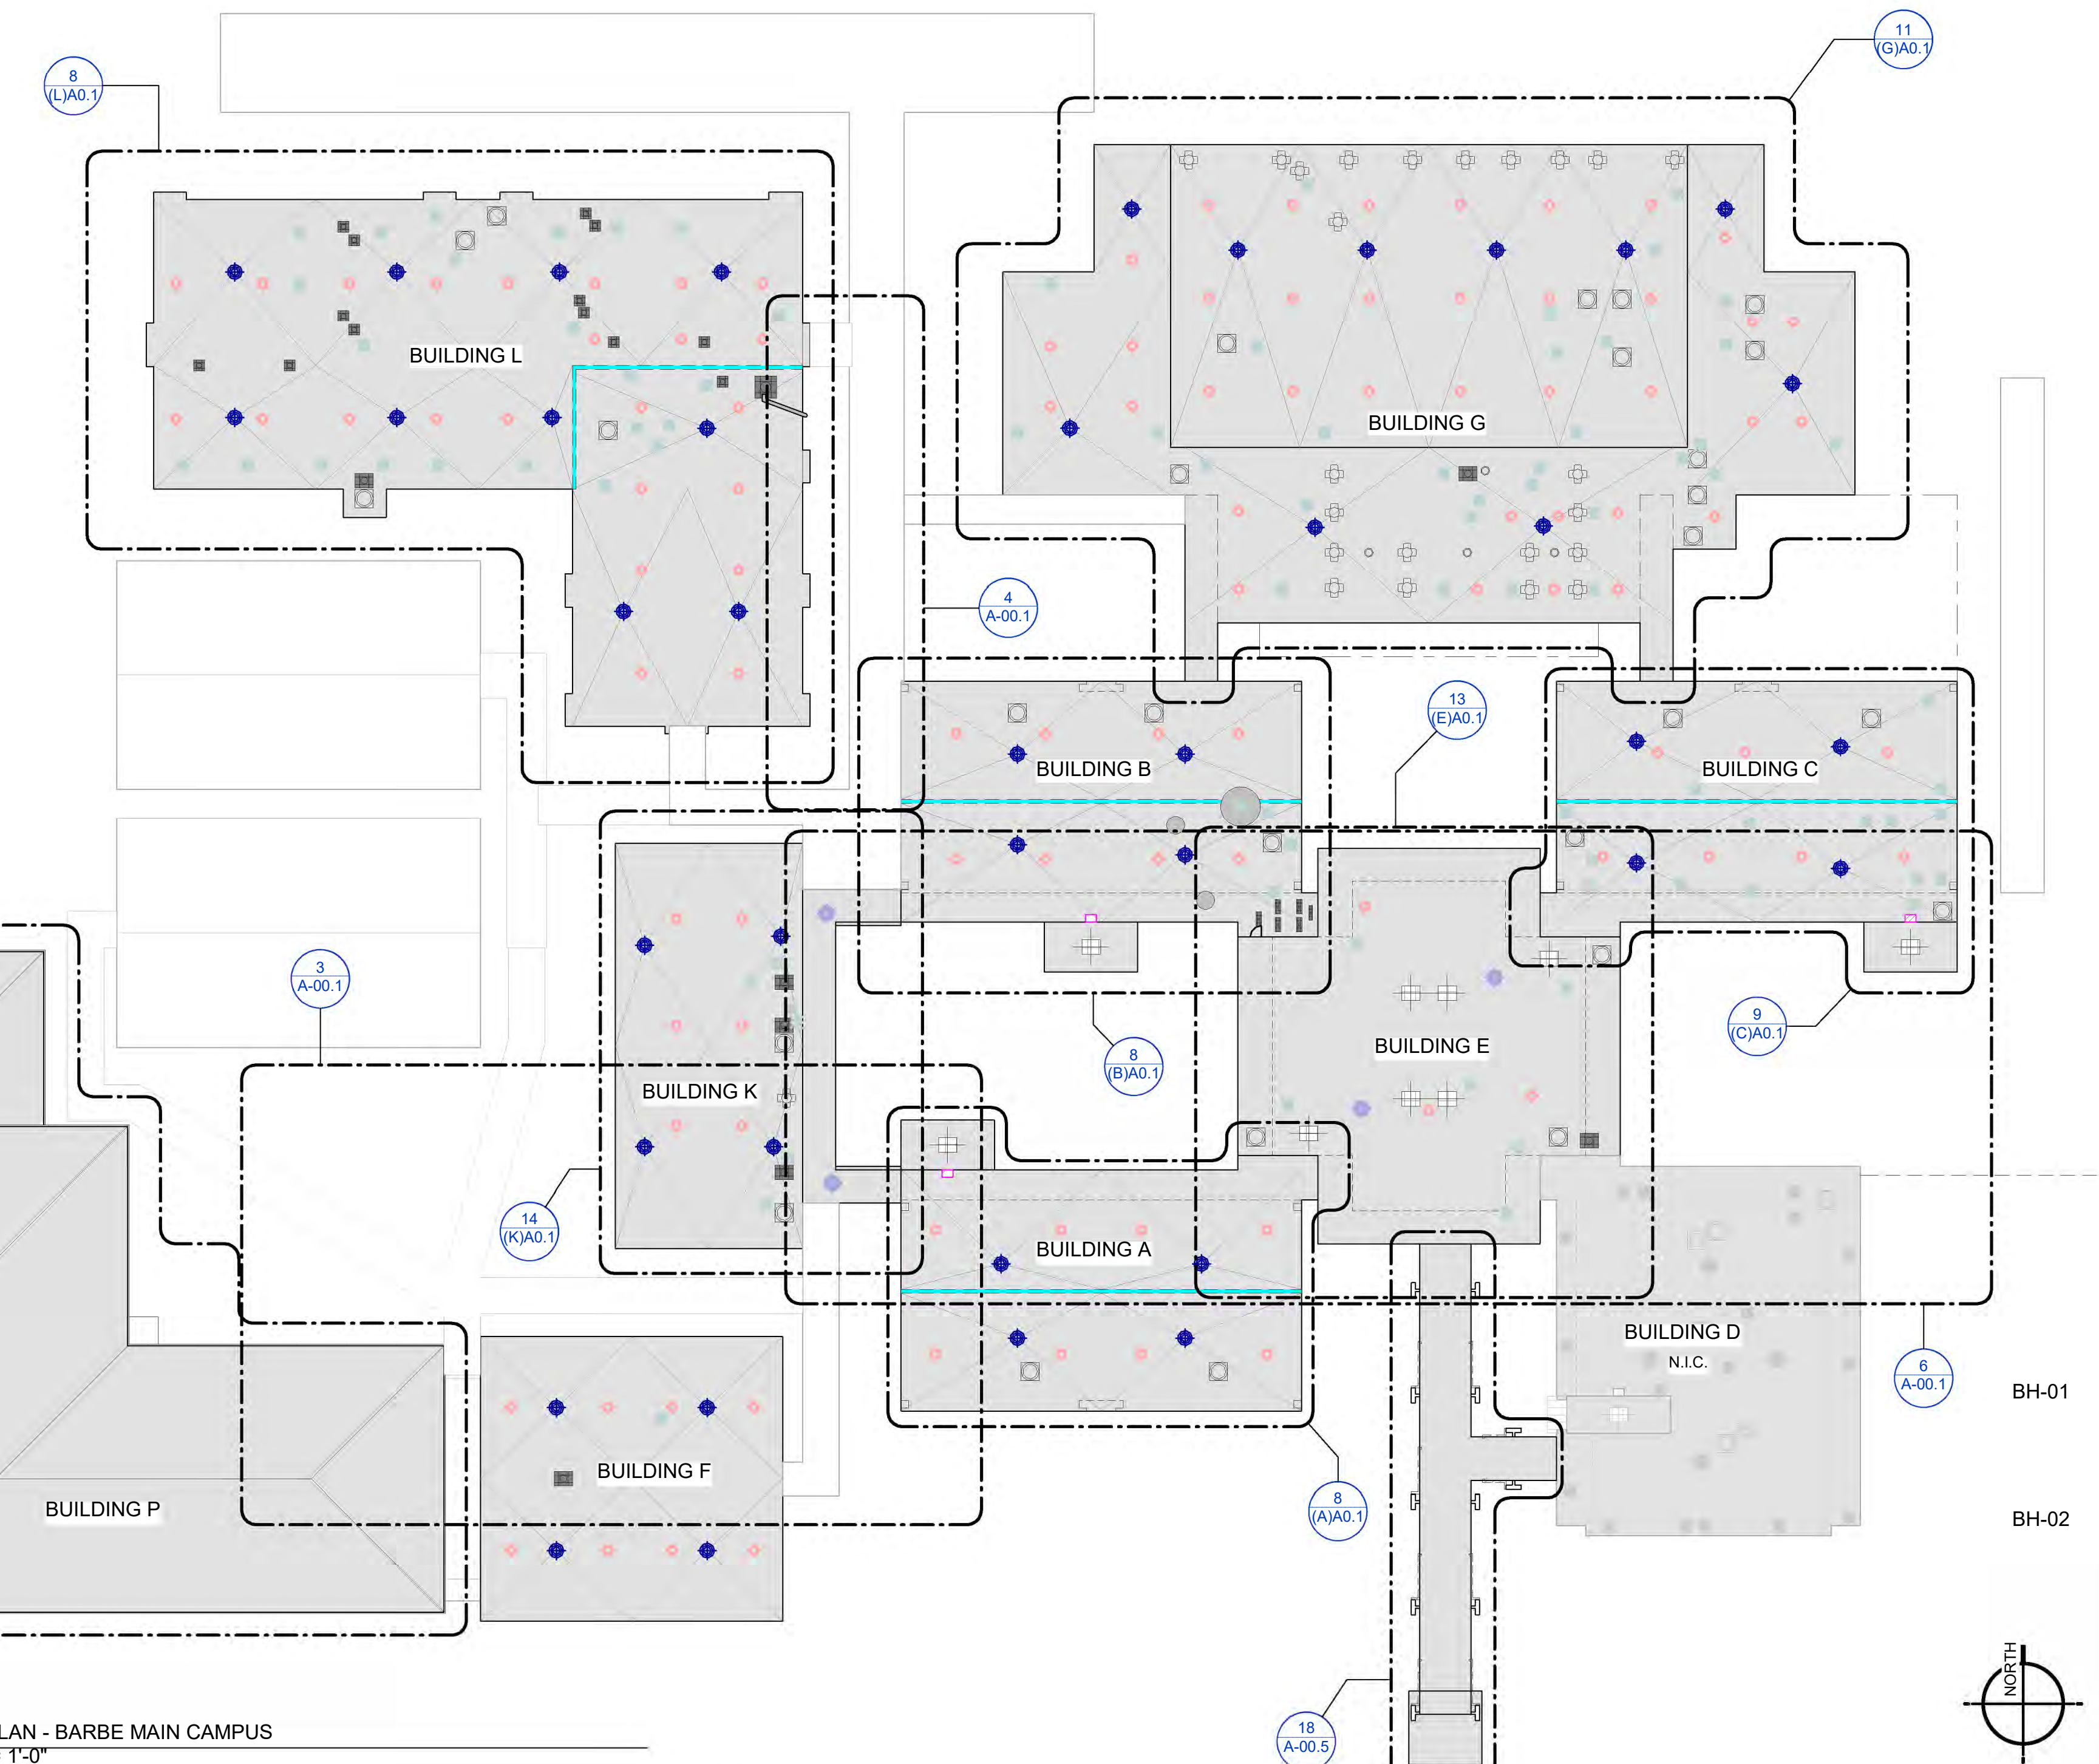

19 SITE PLAN - BARBE MAIN CAMPUS
1/32" = 1'-0"

- GENERAL NOTES
- GENERAL CONTRACTOR SHALL BE ALLOWED TO DEMOLISH SIDEWALK CANOPIES TO CREATE ACCESS POINTS FOR EQUIPMENT AND MATERIALS AS NEEDED FOR ROOF AND EXTERIOR REPAIRS. CONTRACTOR MUST COORDINATE PLANNED LOCATIONS WITH ARCHITECT AND SCHOOL PRINCIPAL PRIOR TO ANY DEMOLITION. PHOTO DOCUMENT SIDEWALK AND CANOPY THAT IS REMOVED OR DAMAGED DURING CONSTRUCTION. REPLACEMENT OF WALKS AND CANOPIES SHALL BE REPLACED TO MATCH THE EXISTING MATERIAL WHICH WAS REMOVED FOR THIS ACCESS. PROVIDE UNDERWALK DRAINAGE AT ANY NEW WALKS AND VERIFY EXISTING DRAINAGE IS NOT ADVERSELY IMPACTED.
 - UPON COMPLETION OF THE WORK THE CONTRACTOR SHALL RE-GRADE, PROVIDE POSITIVE DRAINAGE, AND HYDROSEED ALL GRASS AREAS IMPACTED OR DAMAGED BY CONSTRUCTION ACTIVITY.
 - STUDENT ACCESS PATHS MUST BE PROVIDED TO ALL BUILDINGS NOT UNDER CONSTRUCTION AT ALL TIMES. PROVIDE SAFETY FENCING ALONG ACCESS PATH TO PROTECT STUDENTS FROM CONSTRUCTION ACTIVITIES. COORDINATE WITH ARCHITECT AND SCHOOL PRINCIPAL AT EACH PHASE OF CONSTRUCTION AND AS EACH BUILDING IS REPAIRED.



725 KIRBY STREET
LAKE CHARLES, LOUISIANA
OFFICE: 337.436.3036
FAX: 337.466.3779
LA. LICENSE NO. 4086


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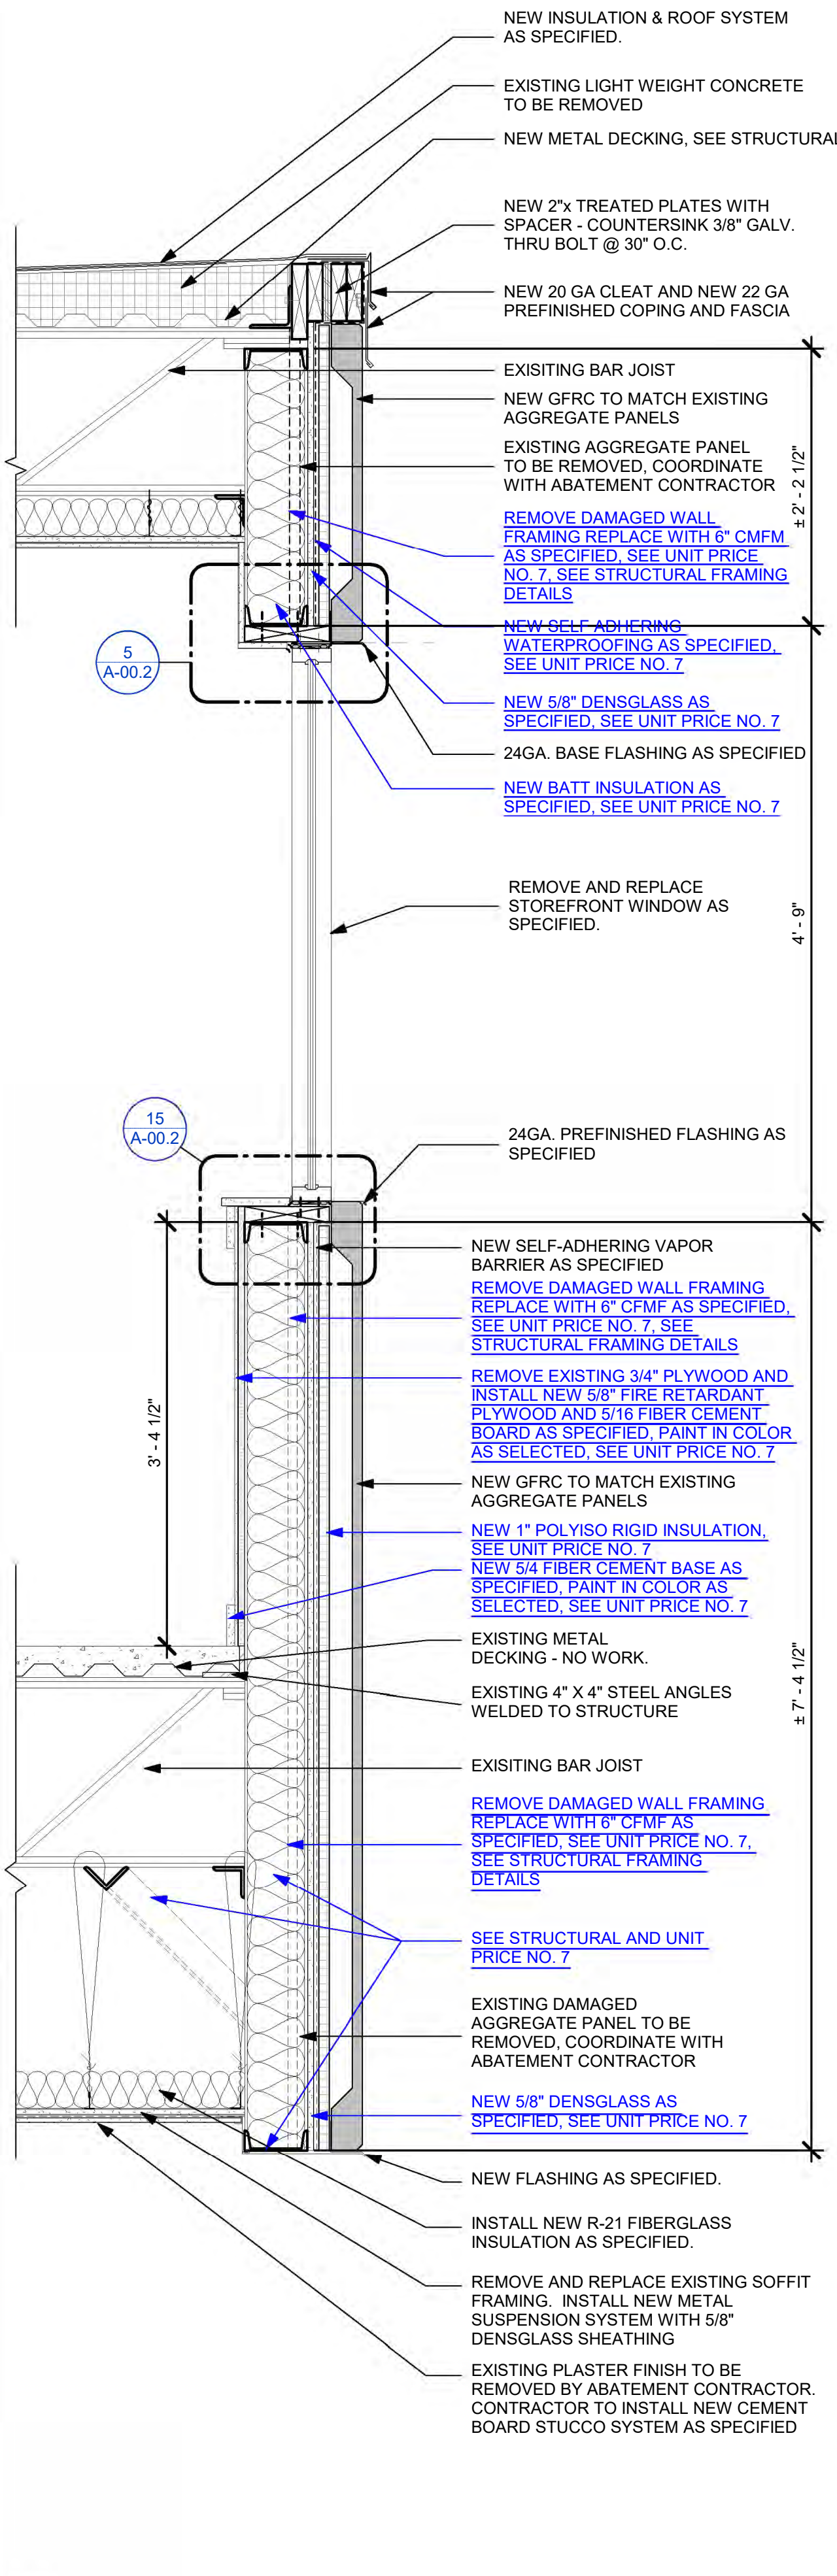
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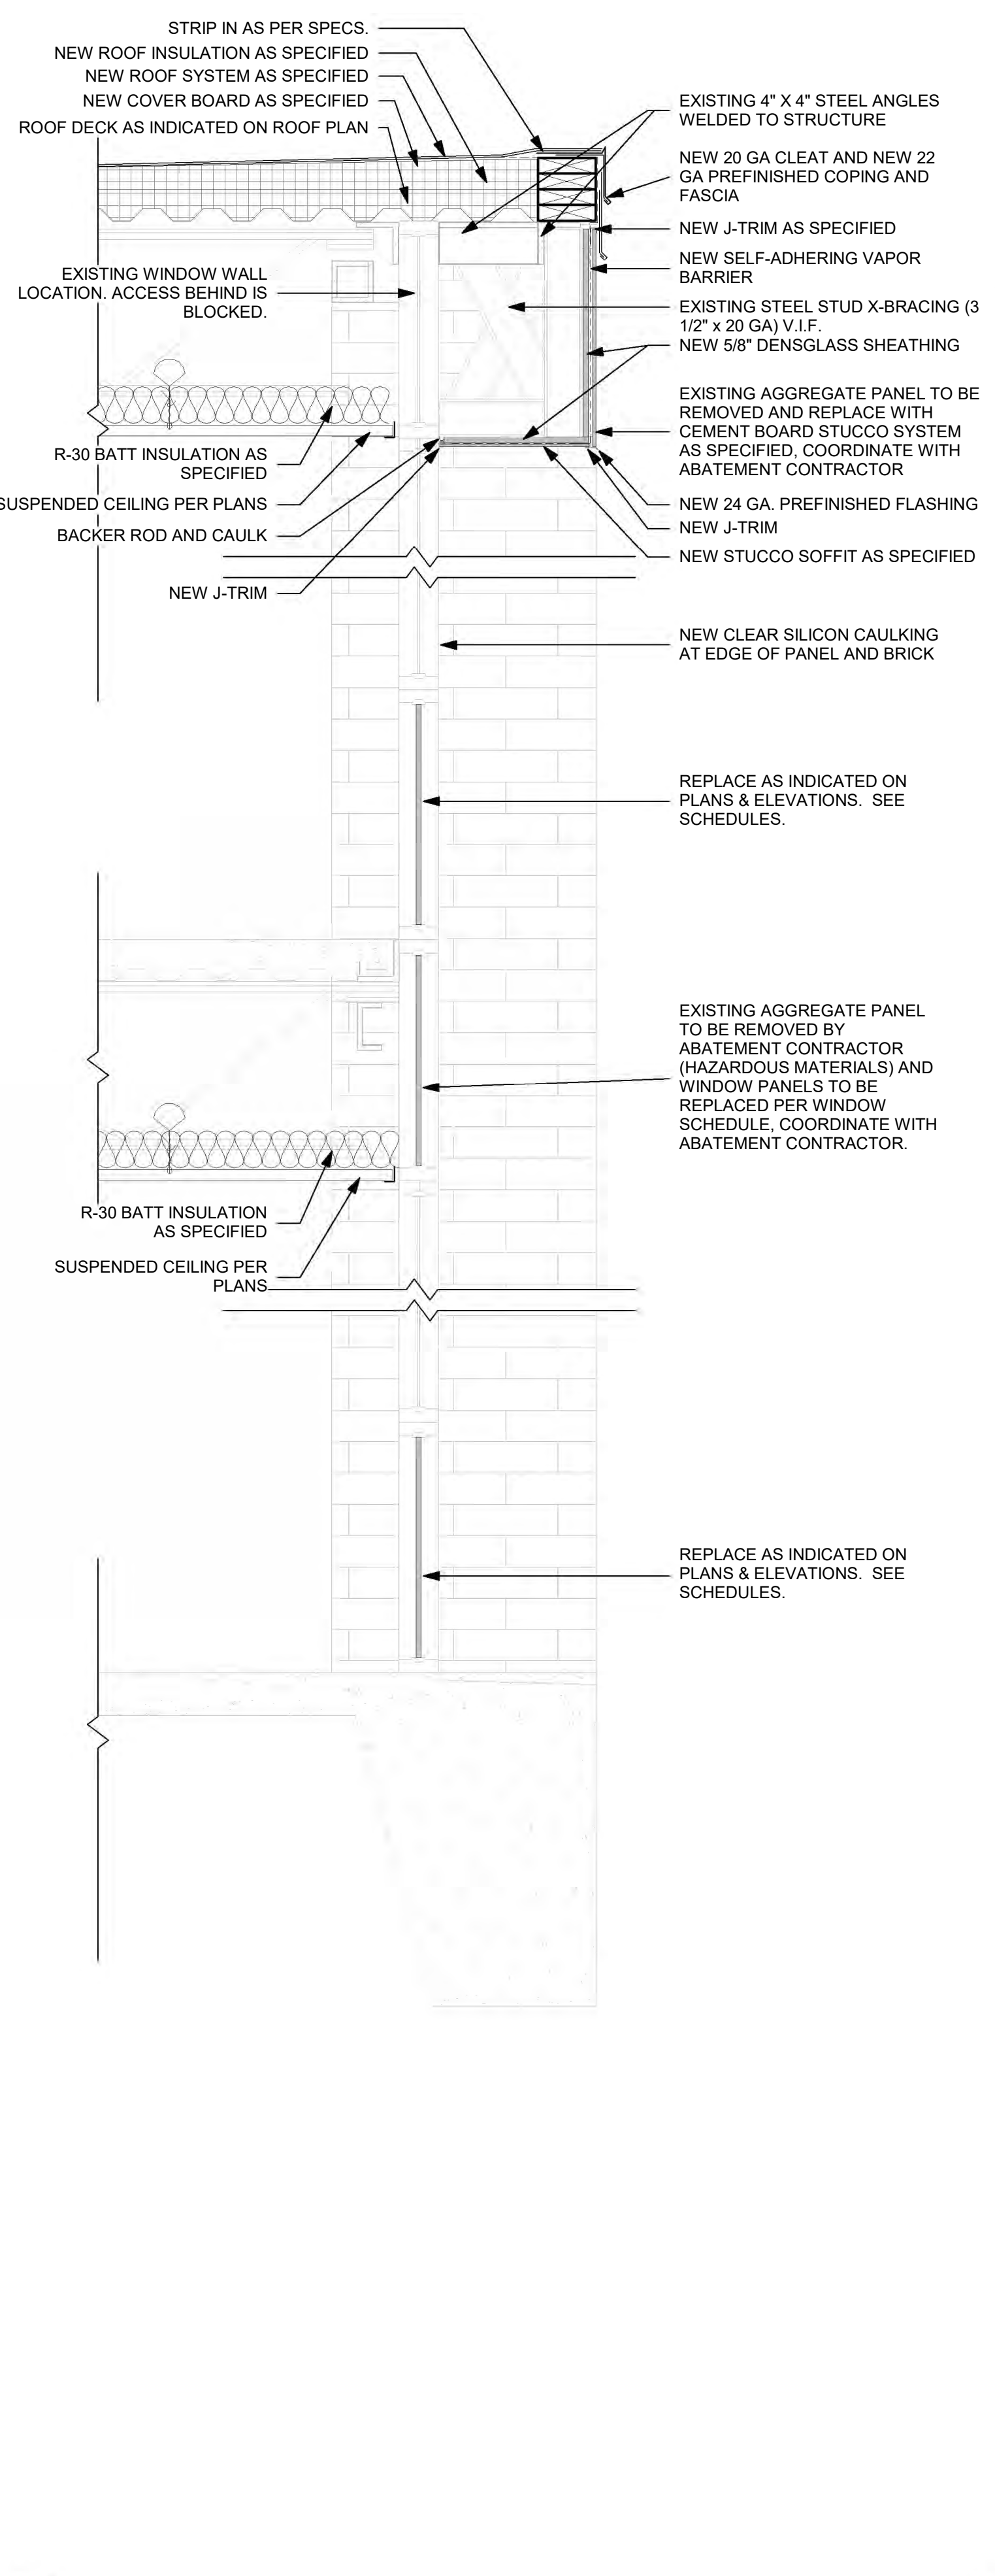
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A-00.1
ROOF & SOFFIT PLANS

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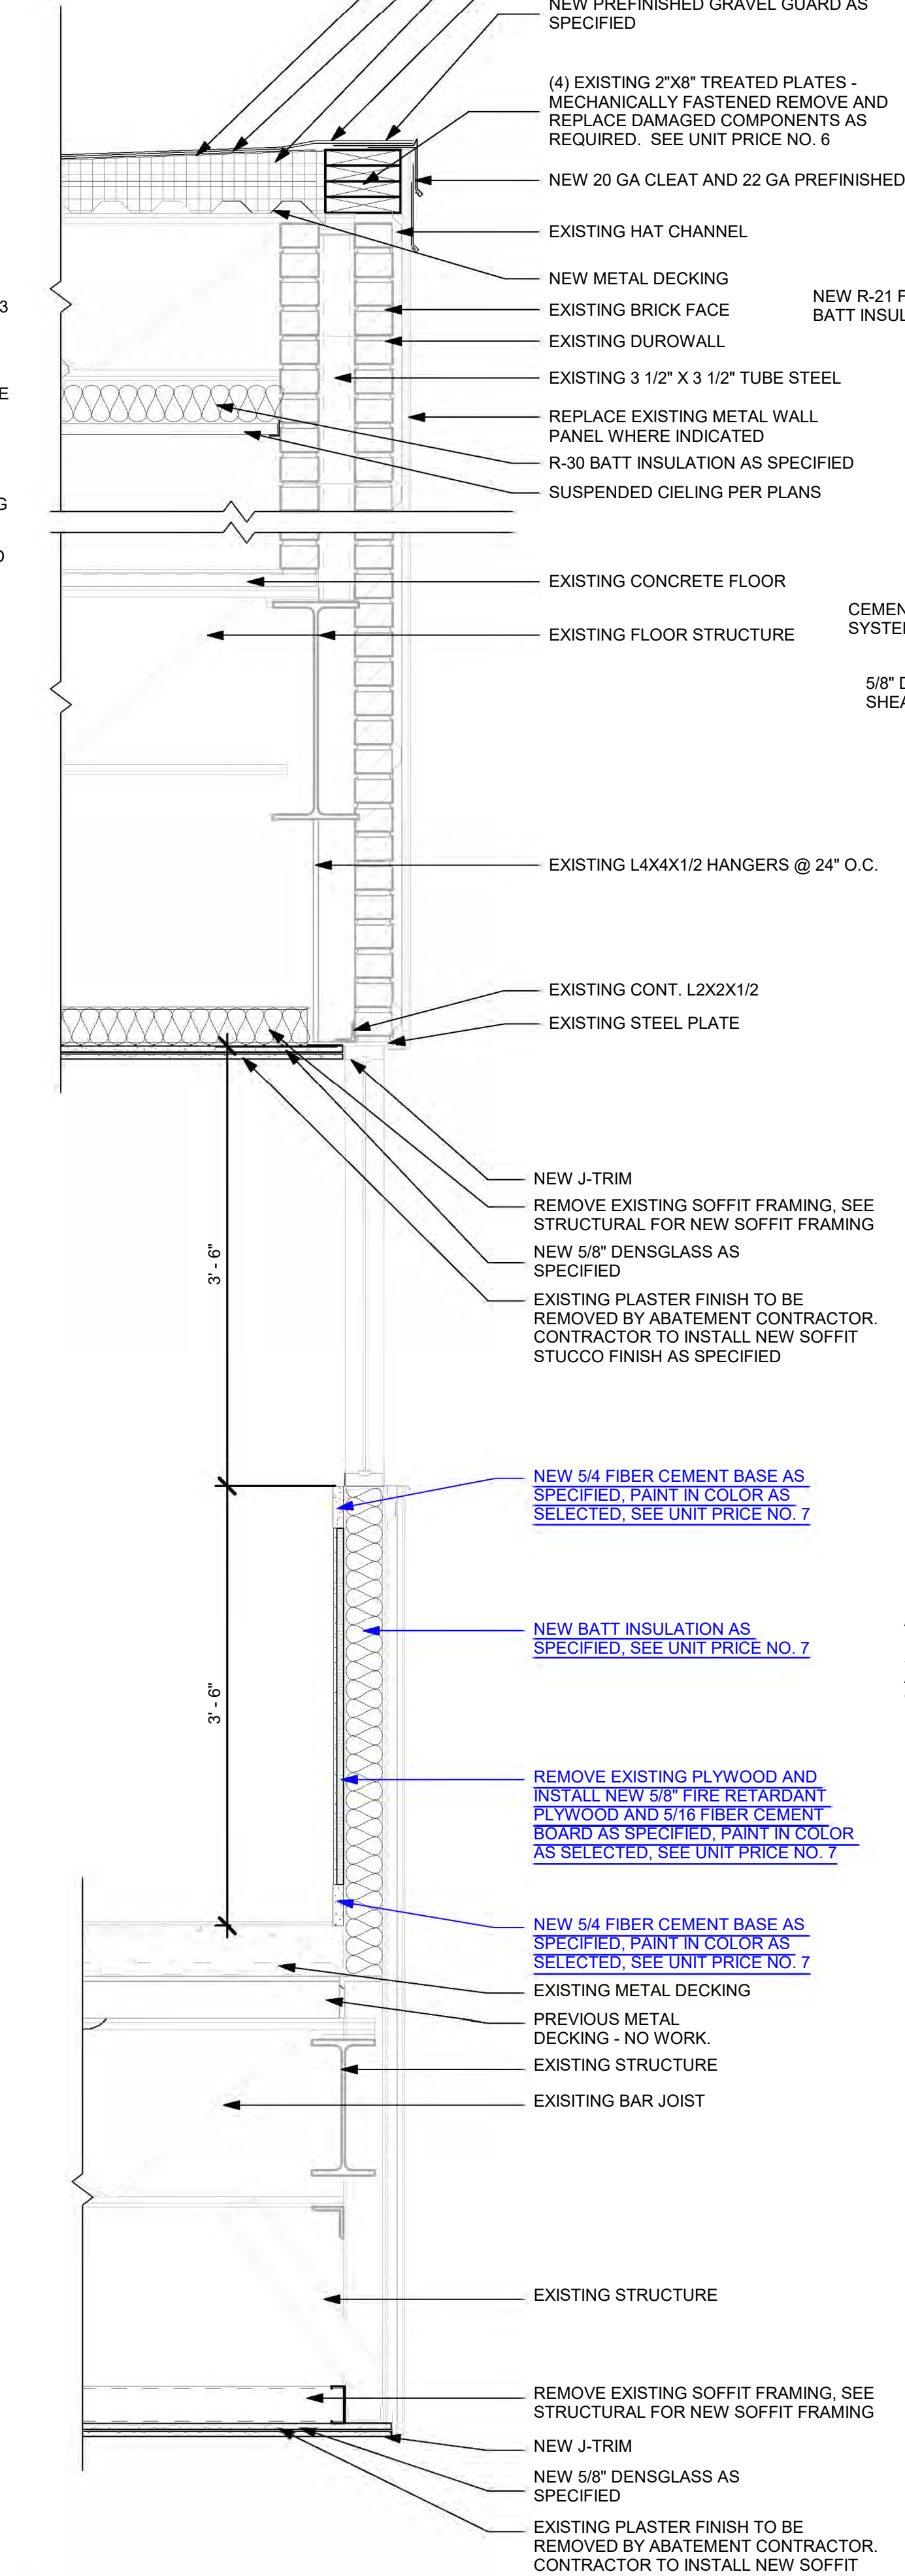
16 WALL SECTION - COURTYARD AGGREGATE WALL TYP.
1" = 1'-0"




17 WALL SECTION - BUILDING WINDOW WALL TYP.
1" = 1'-0"

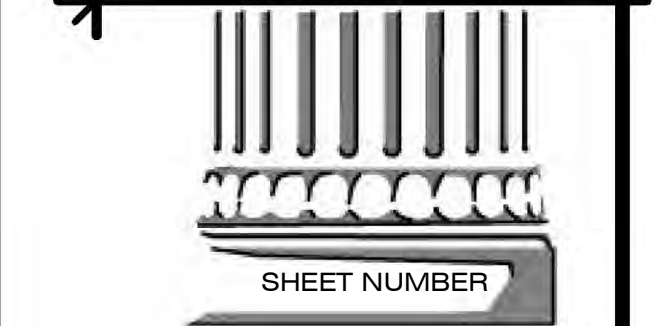


18 WALL SECTION - BUILDING E WALL TYP.
1" = 1'-0"



5 HEAD DETAIL - EXTERIOR CORRIDOR
3\"/>

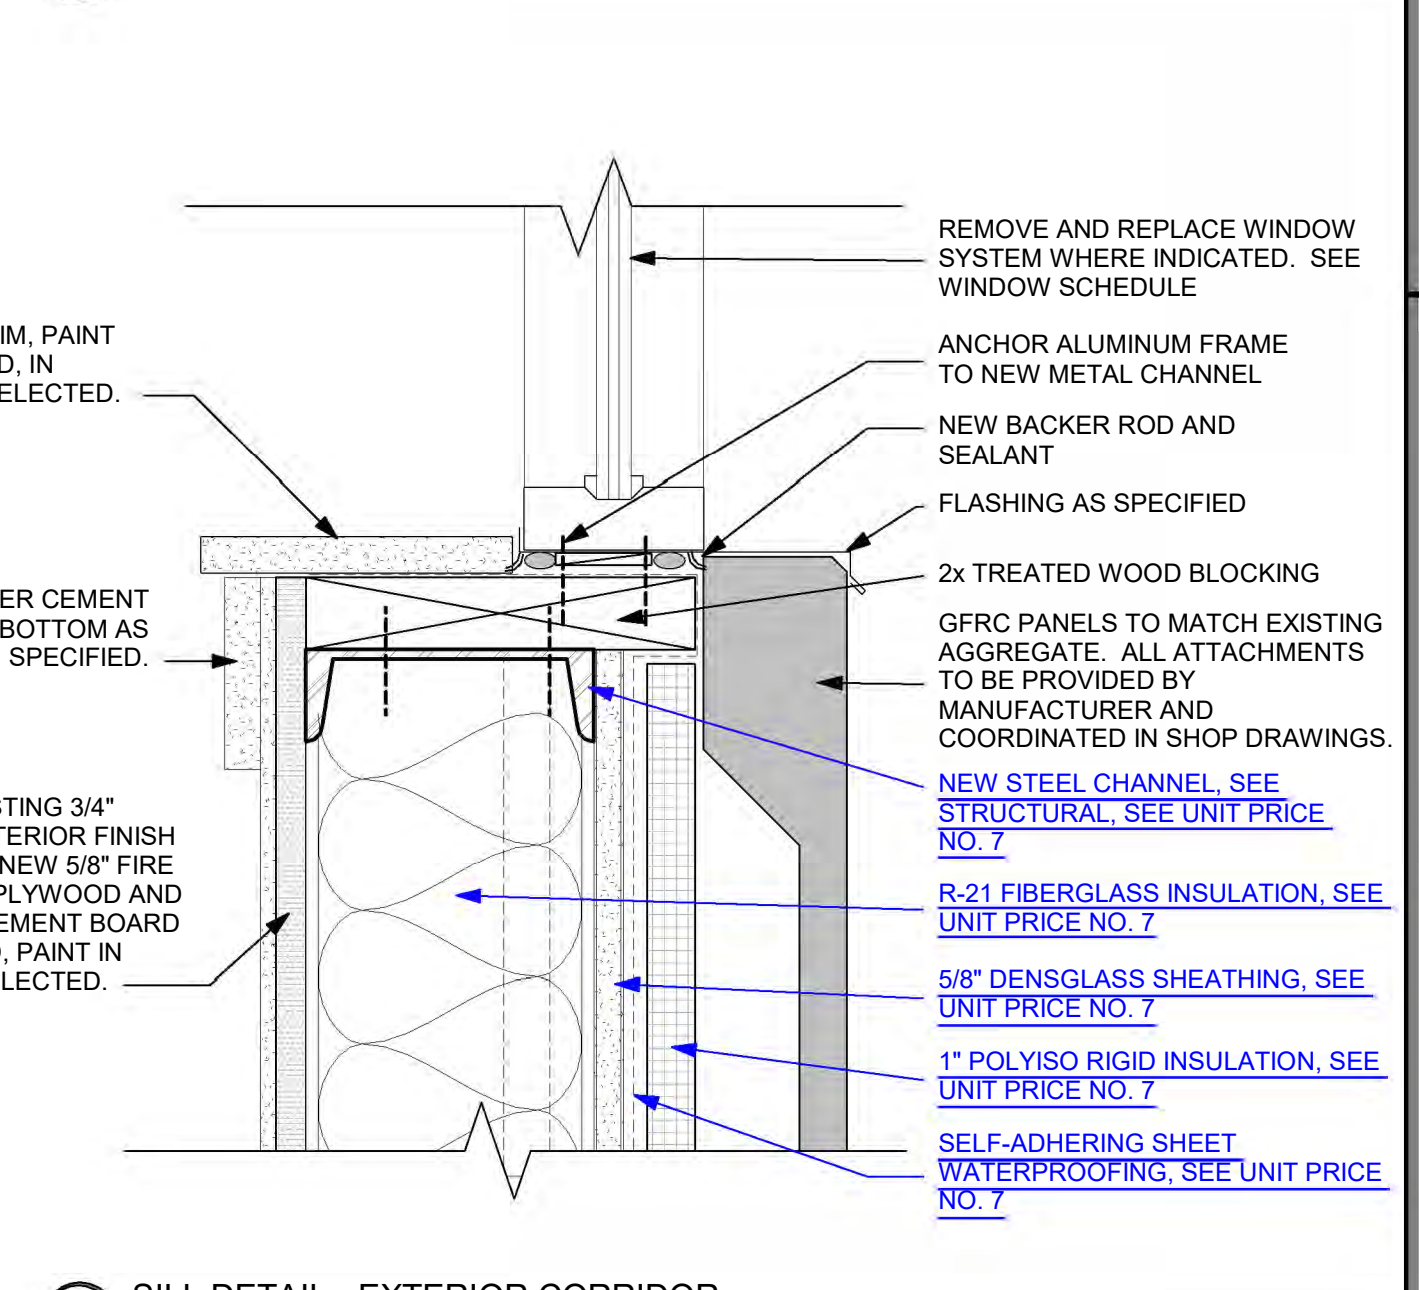

15 SILL DETAIL - EXTERIOR CORRIDOR
3\"/>

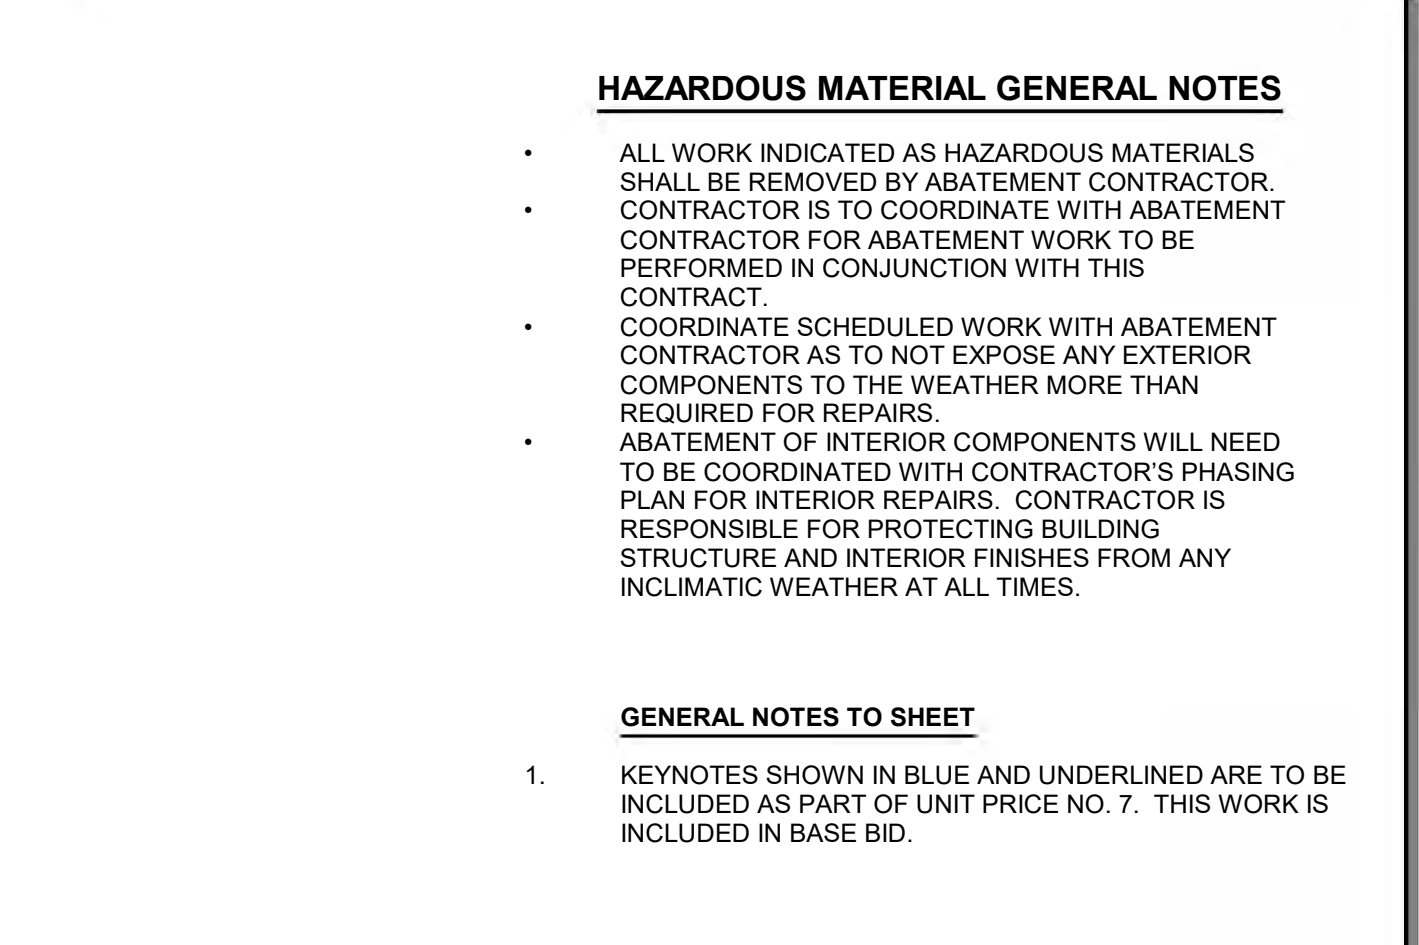


HAZARDOUS MATERIAL GENERAL NOTES

- ALL WORK INDICATED AS HAZARDOUS MATERIALS SHALL BE REMOVED BY ABATEMENT CONTRACTOR. CONTRACTOR IS TO COORDINATE WITH ABATEMENT CONTRACTOR FOR ABATEMENT WORK TO BE PERFORMED IN CONJUNCTION WITH THIS CONTRACT.
- COORDINATE SCHEDULED WORK WITH ABATEMENT CONTRACTOR AS TO NOT EXPOSE ANY EXTERIOR COMPONENTS TO THE WEATHER MORE THAN REQUIRED FOR REPAIRS.
- ABATEMENT OF INTERIOR COMPONENTS WILL NEED TO BE COORDINATED WITH CONTRACTOR'S PHASING PLAN FOR INTERIOR REPAIRS. CONTRACTOR IS RESPONSIBLE FOR PROTECTING BUILDING STRUCTURE AND INTERIOR FINISHES FROM ANY INCLIMATIC WEATHER AT ALL TIMES.

GENERAL NOTES TO SHEET

- KEYNOTES SHOWN IN BLUE AND UNDERLINED ARE TO BE INCLUDED AS PART OF UNIT PRICE NO. 7. THIS WORK IS INCLUDED IN BASE BID.

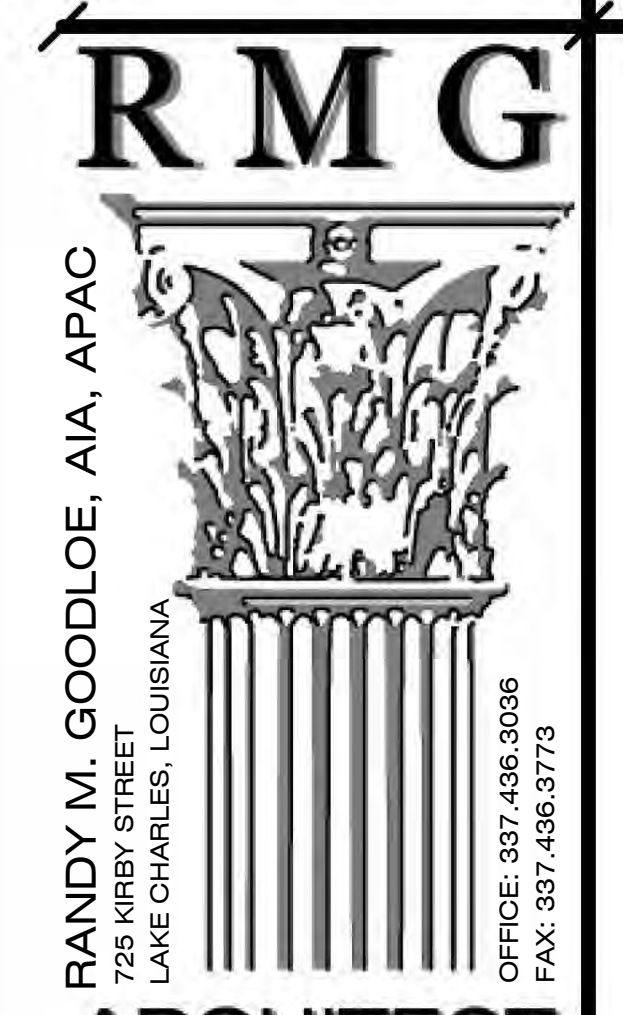

RANDY M. GOODLOE, AIA, APAC
725 KIRBY STREET
LAKE CHARLES, LOUISIANA
OFFICE: 337.436.3036
FAX: 337.466.3779



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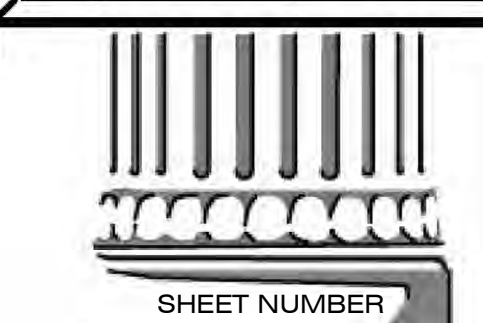
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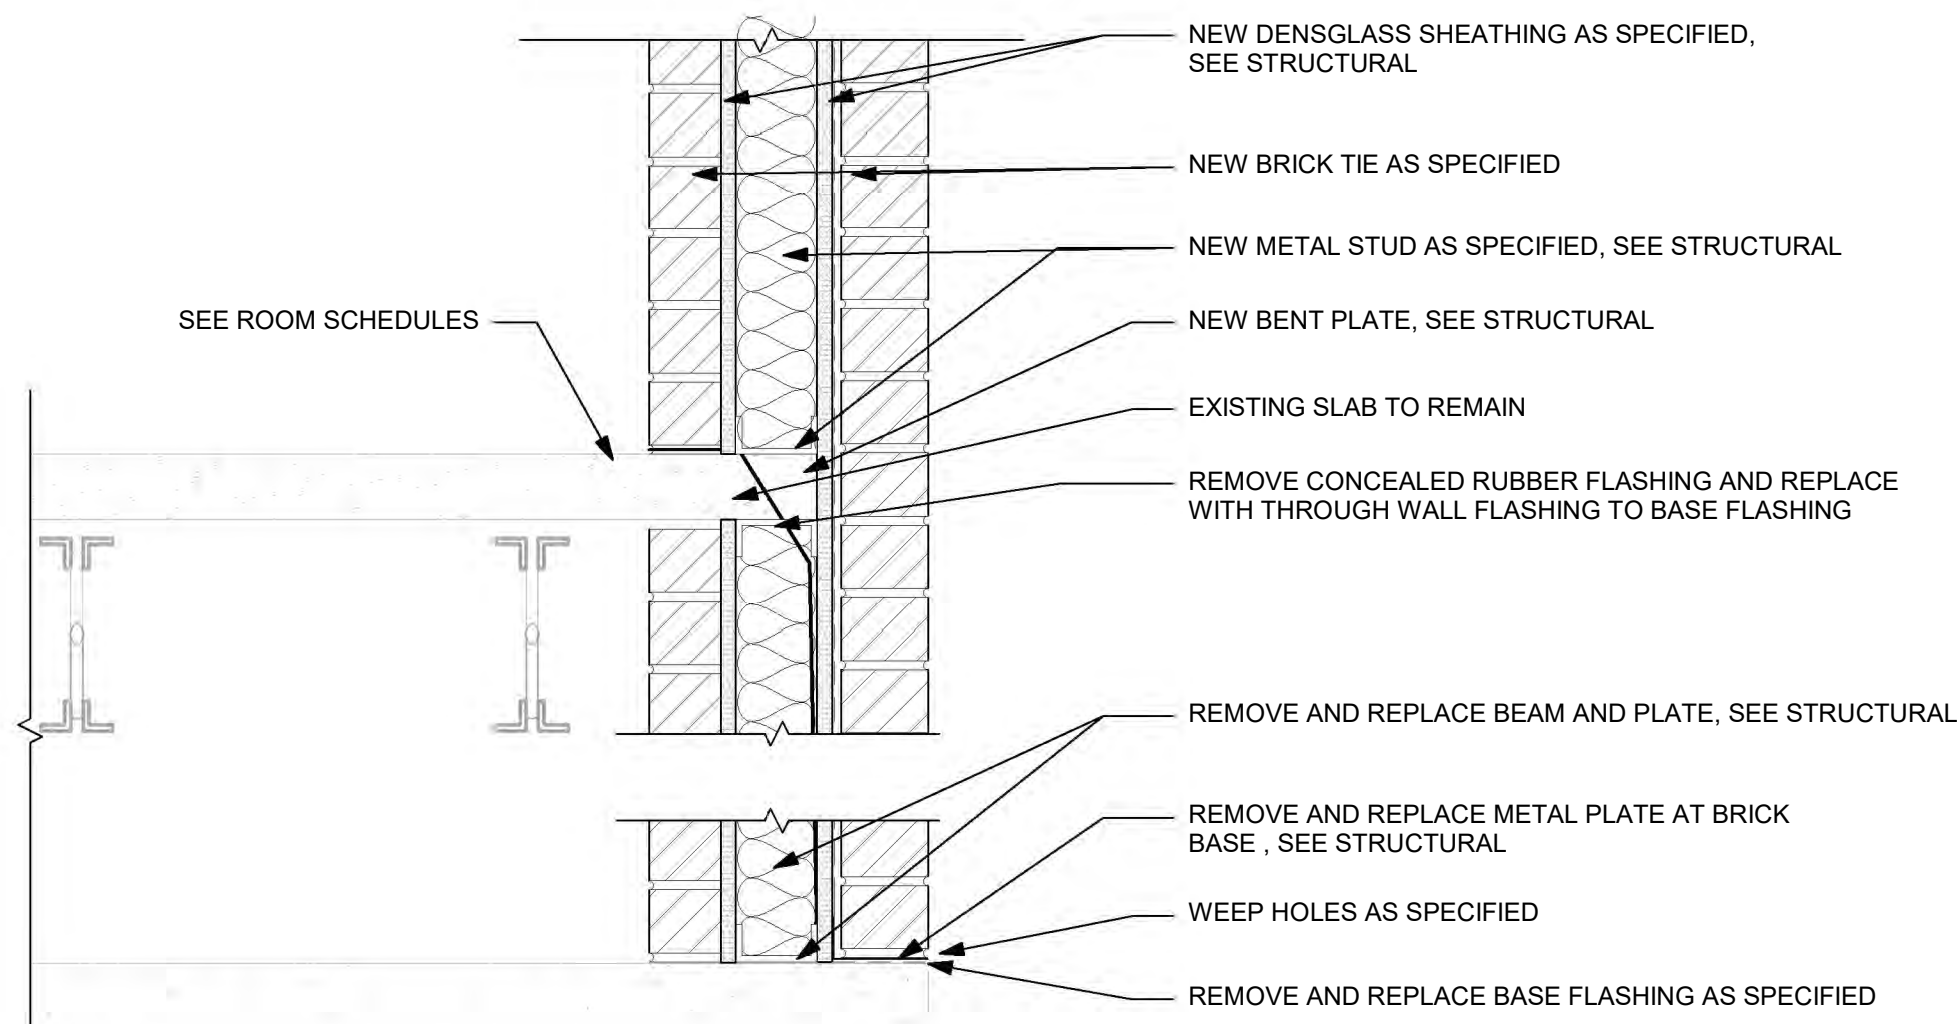
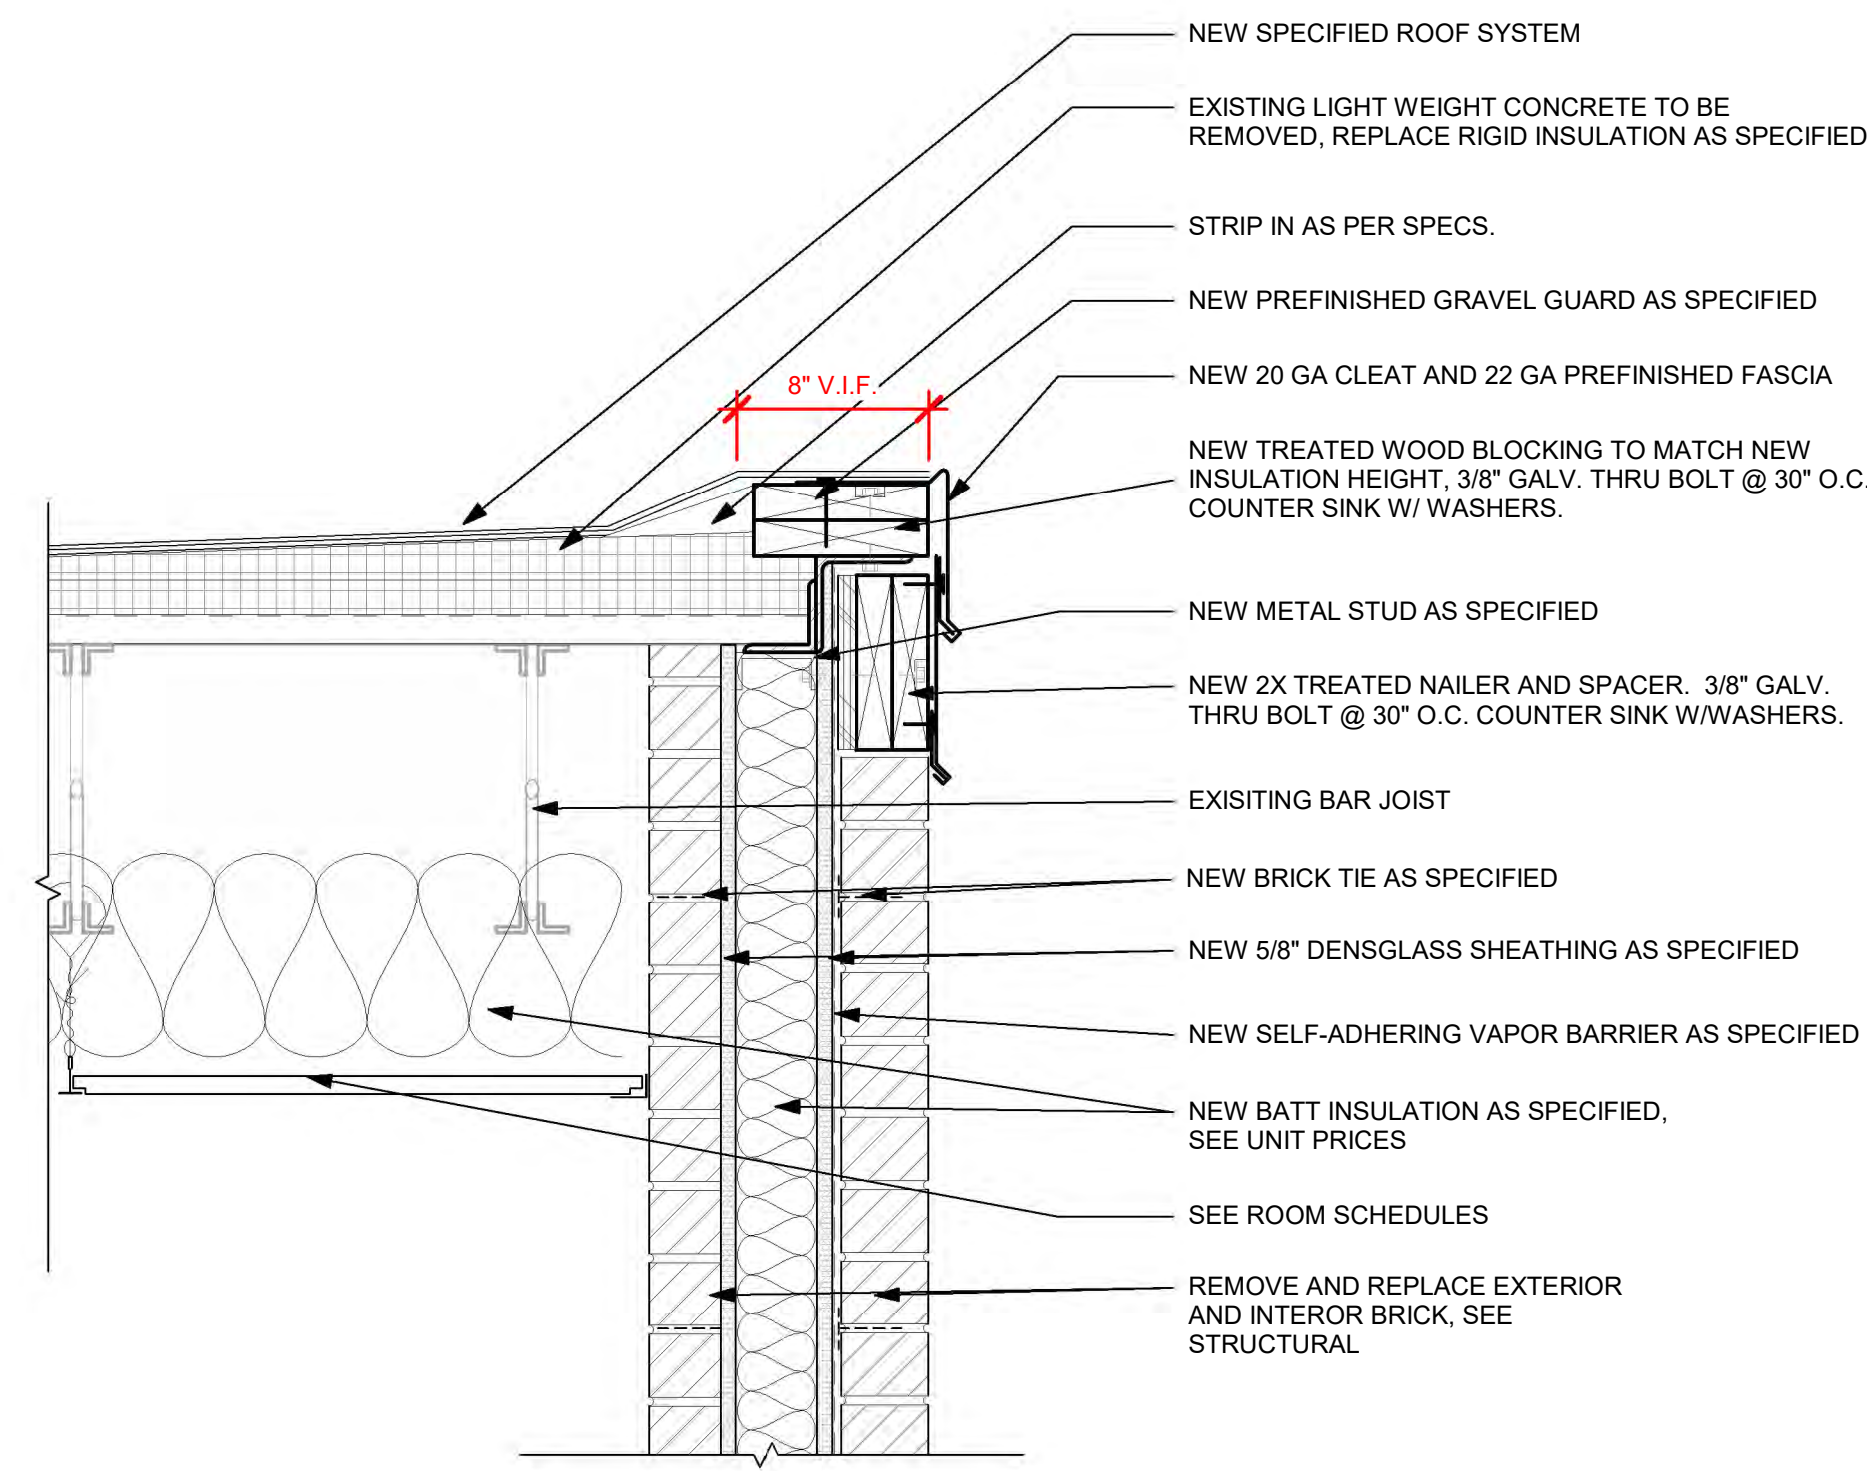
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06/28/2024



REVISED



SHEET NUMBER
A-00.2
WALL SECTIONS &
DETAILS



11 WALL SECTION - BUILDING C WALL
1 1/2" = 1'-0"

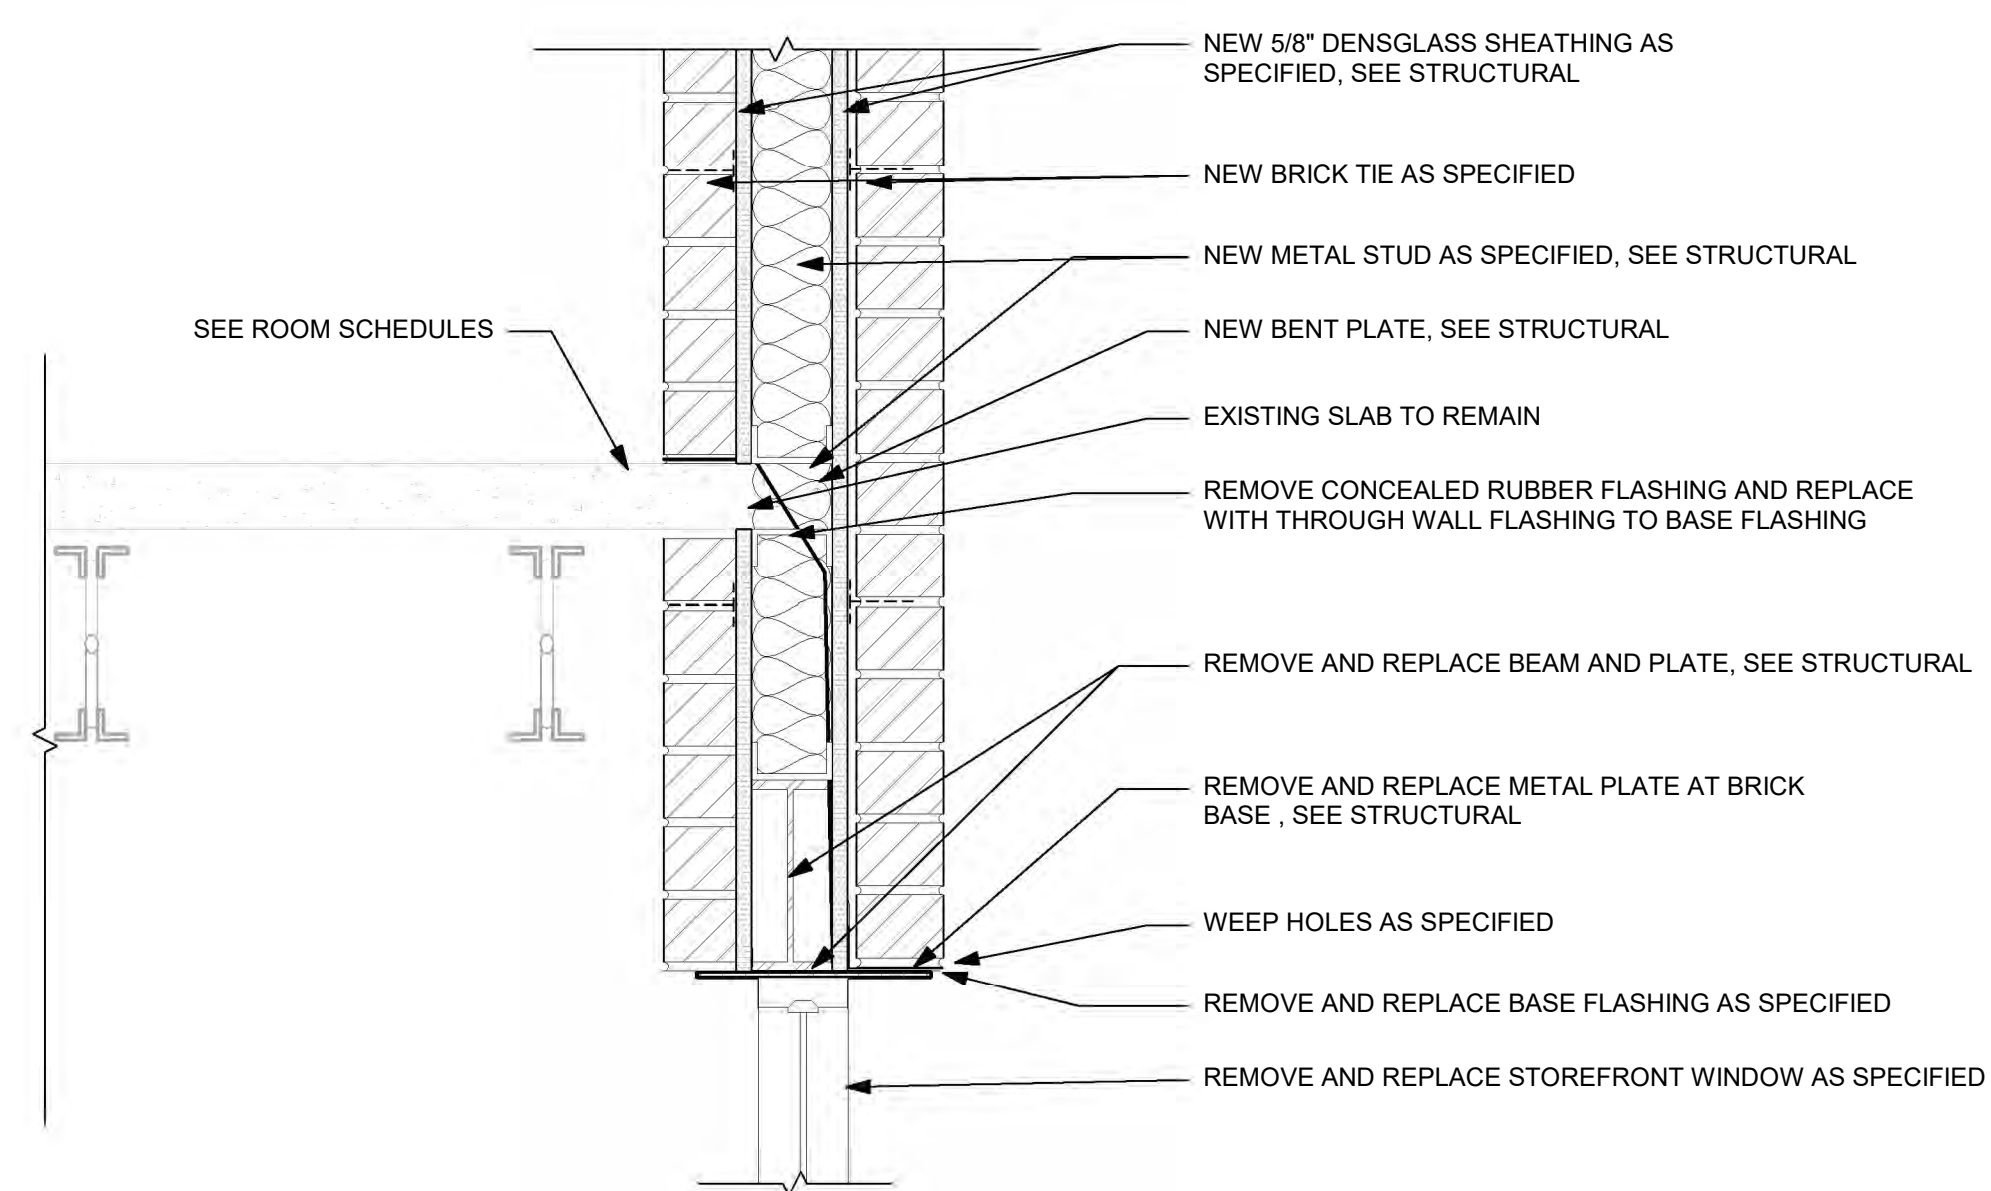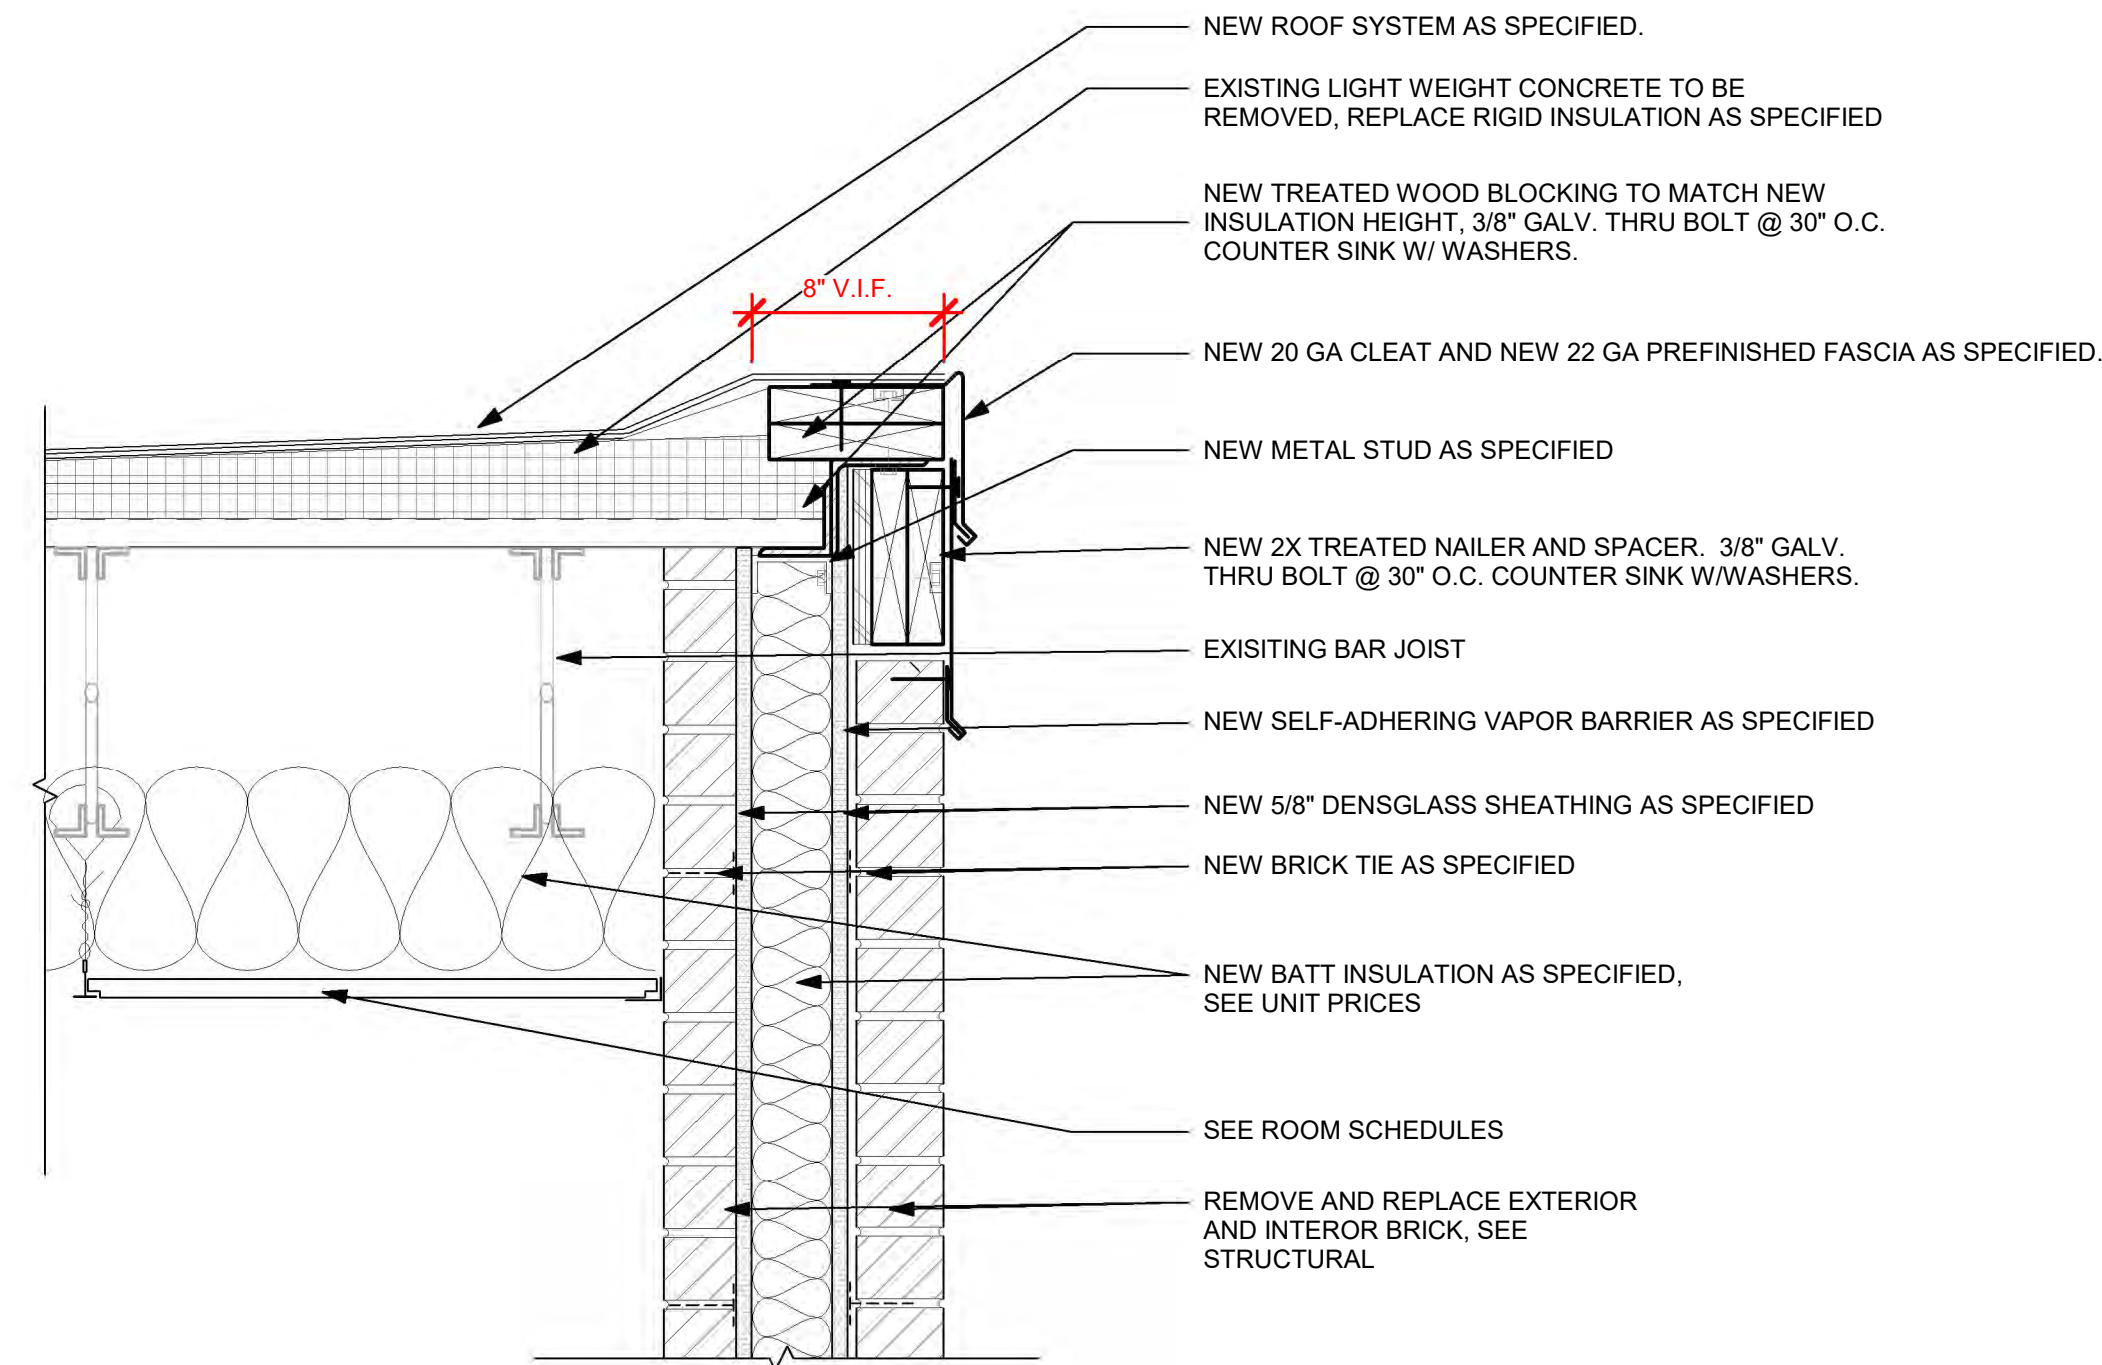

13 WALL SECTION - BUILDING C WALL @ WINDOW
1 1/2" = 1'-0"

6/27/2024 1:02:00 PM



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LA. LICENSE NO. 4086


HURRICANE LAURA REPAIRS TO
A.M. BARBE HIGH SCHOOL
2200 W. McNEESE ST.
FOR
CALCASIEU PARISH SCHOOL BOARD
LAKE CHARLES, LA 70605
HL-003-01.03.04.05.06.07

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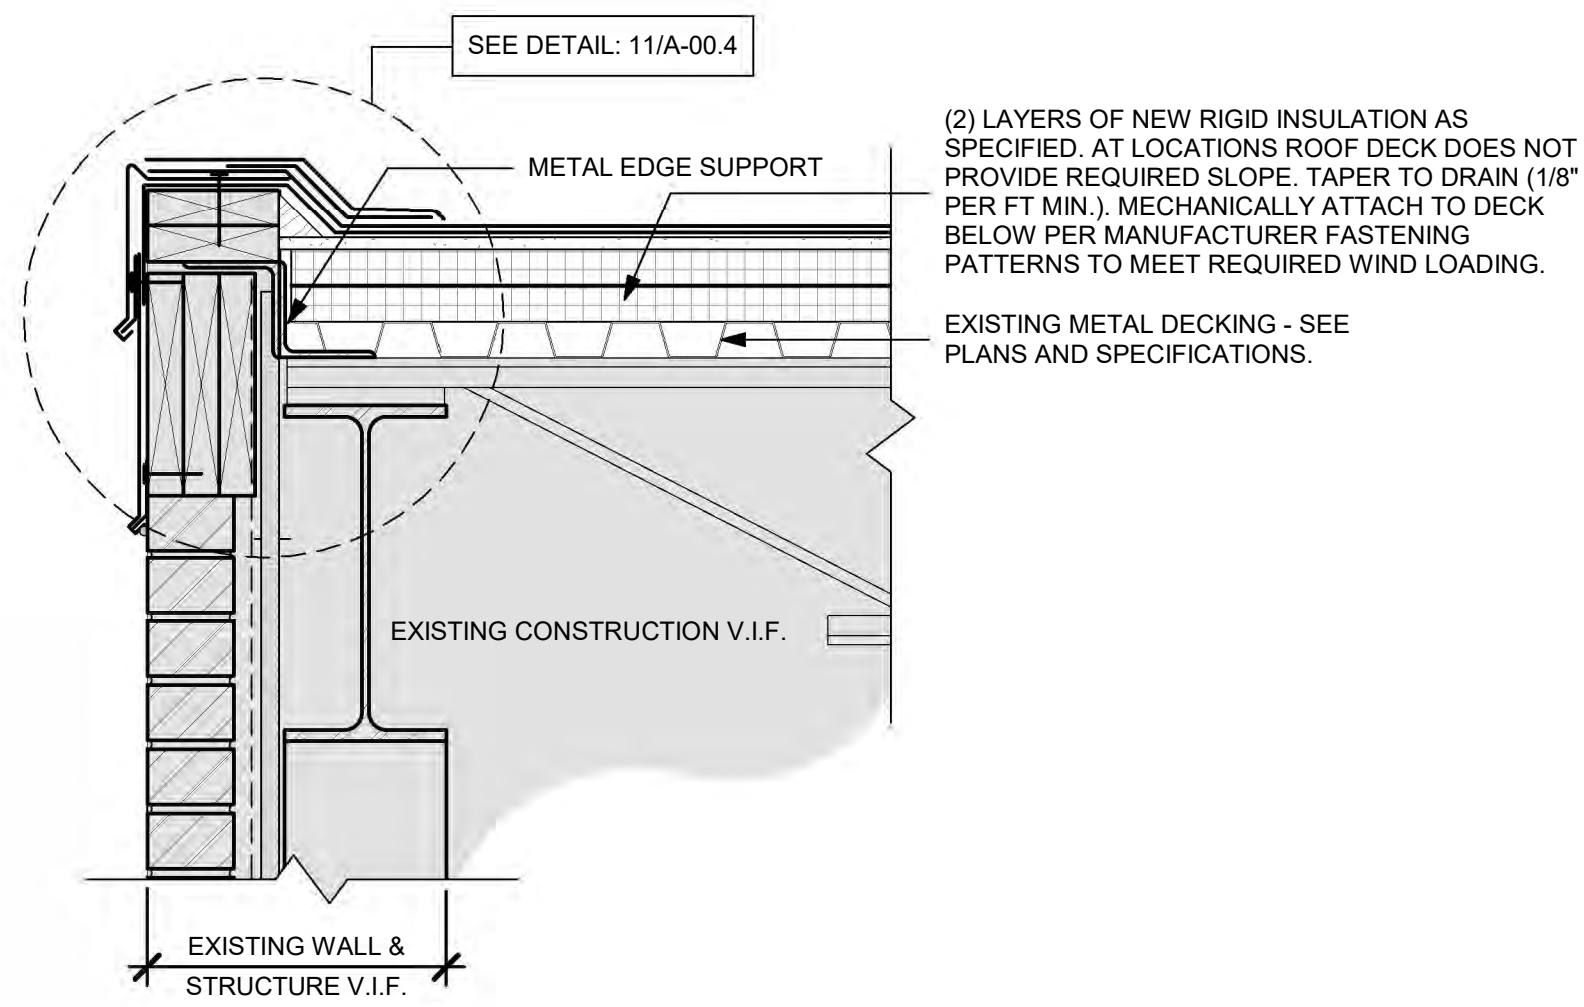
RMG PROJECT NO.
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PROJECT MANAGER
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DATE ISSUED
06/28/2024


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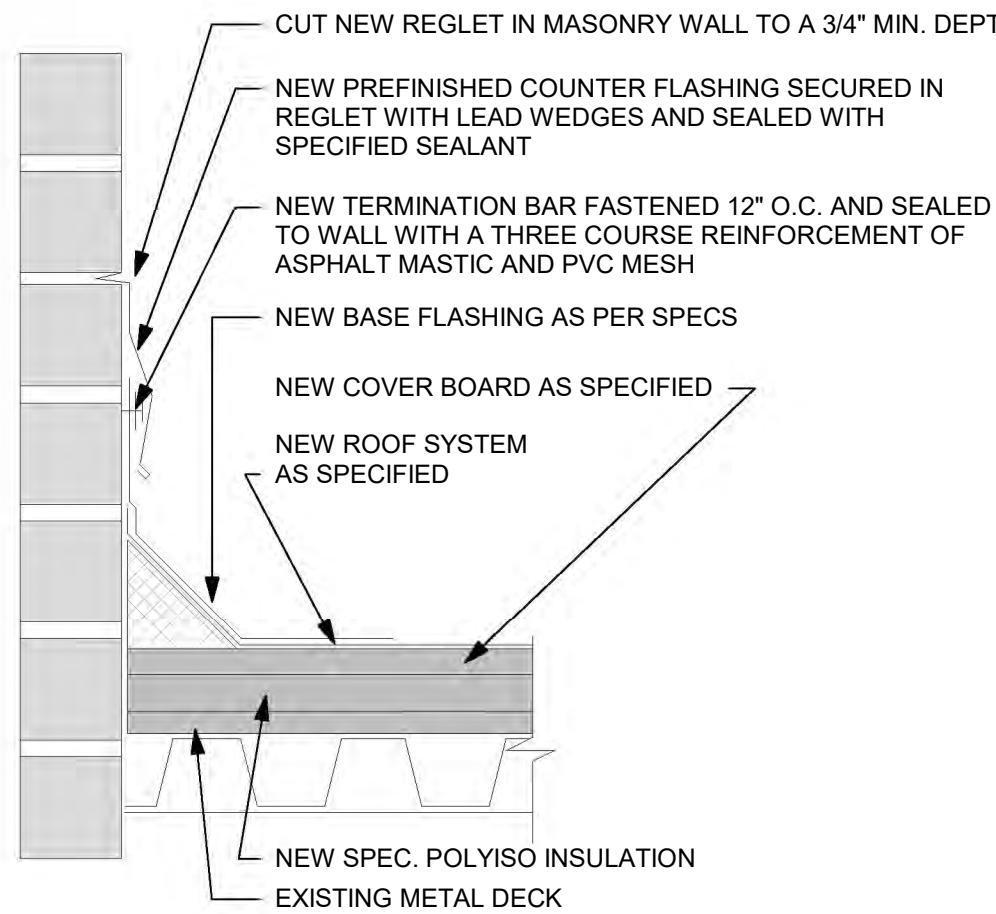
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A-00.3
WALL SECTIONS &
DETAILS




1 BARBE STANDARD ROOF EDGE - SBS ROOFING
1 1/2" = 1'-0"

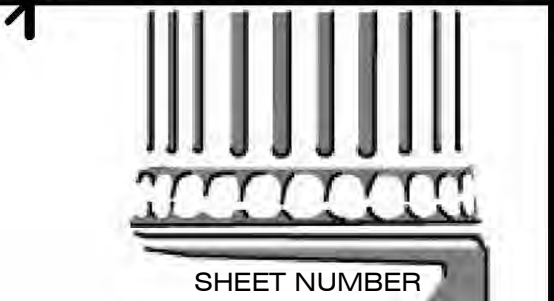


3 EXPANSION JOINT
1 1/2" = 1'-0"

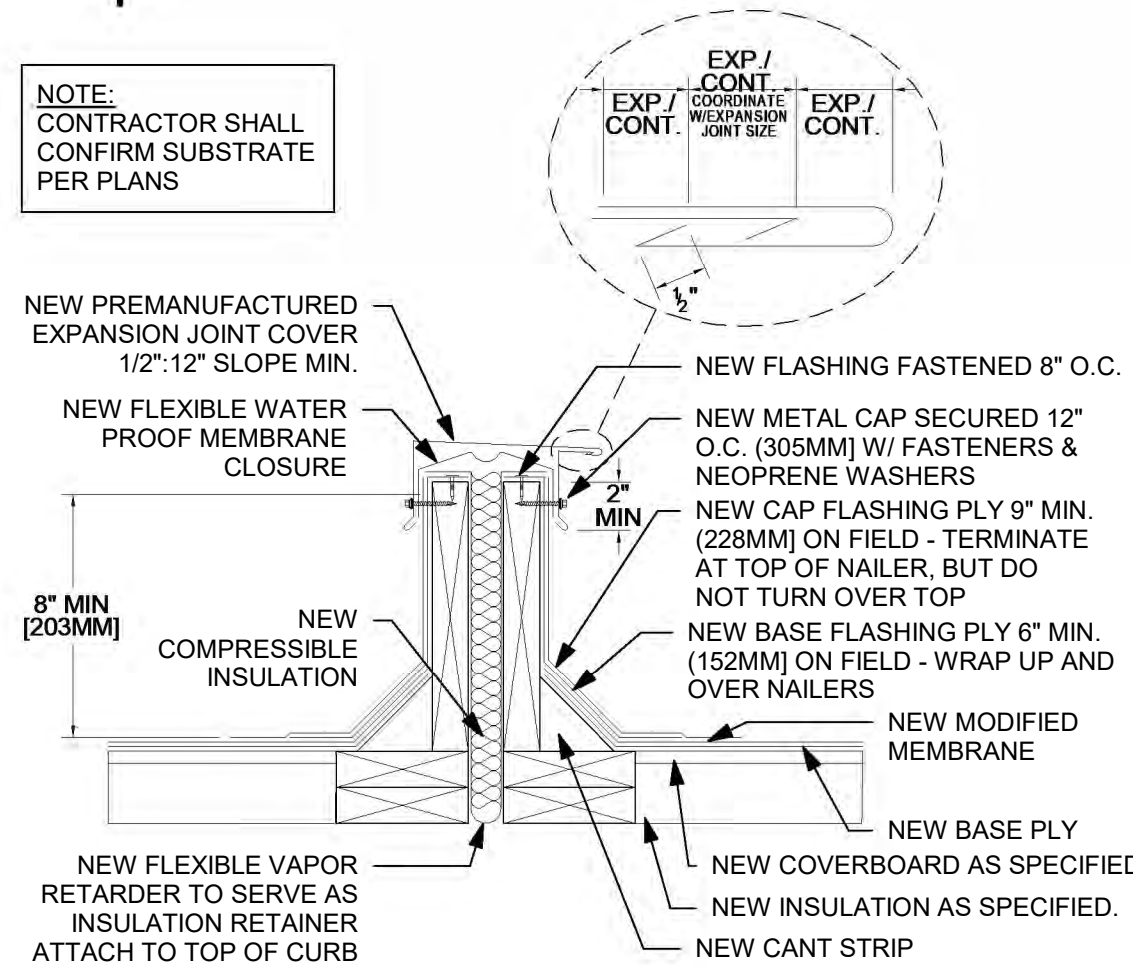


4 BARBE REGLET MOUNTED C/F
1 1/2" = 1'-0"

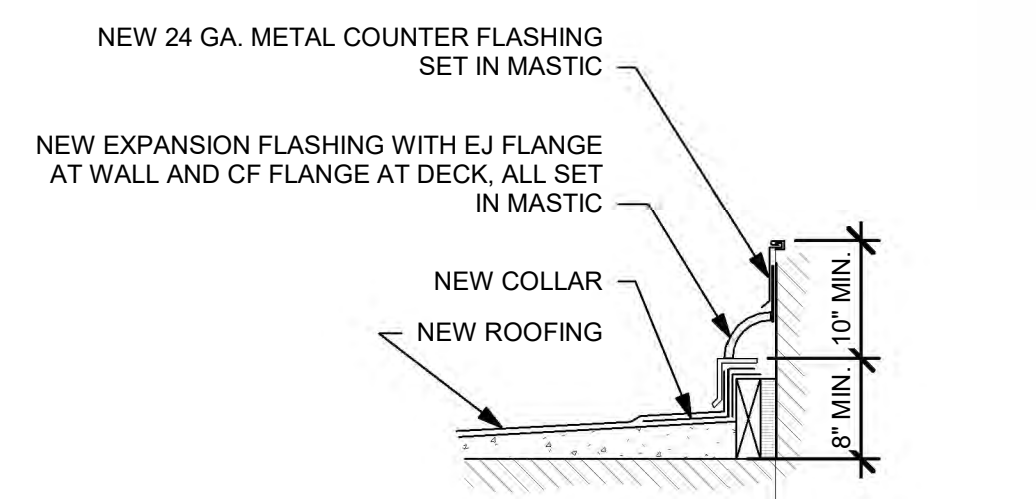


5 BARBE Roof Section RE-4
1" = 1'-0"

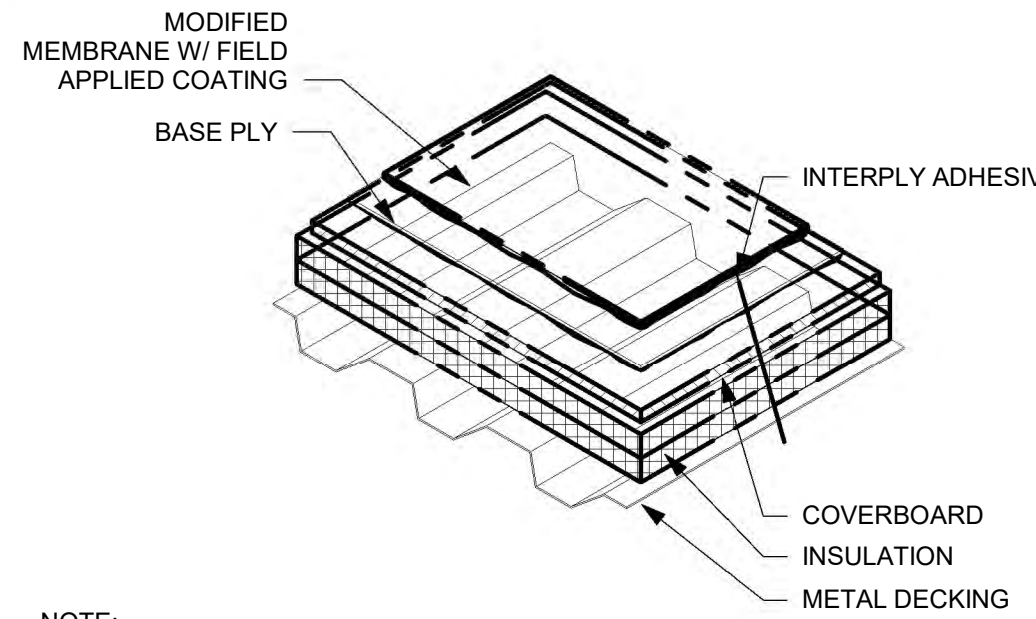


10 ROOF SYSTEM COATED SURFACE
1 1/2" = 1'-0"

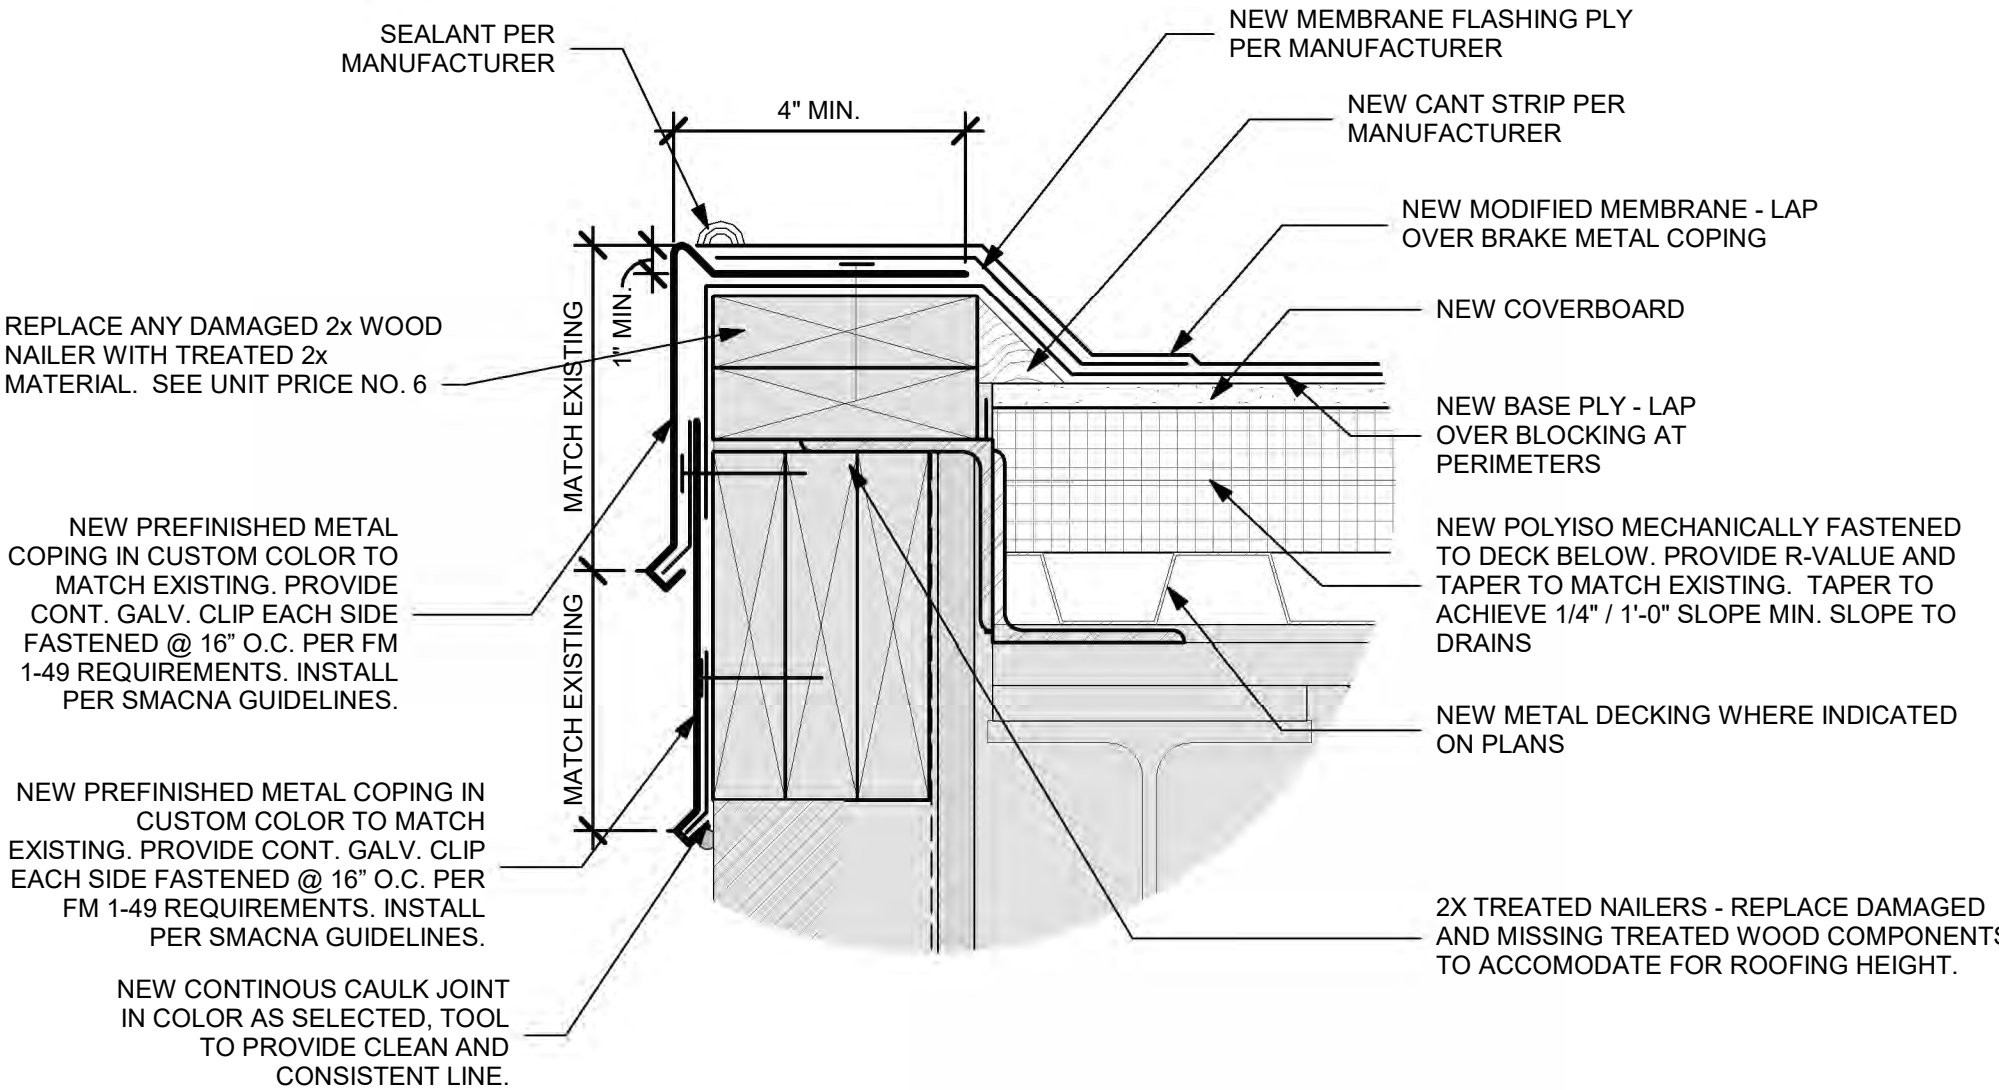


11 BARBE - GRAVEL STOP DETAIL - NEW METAL DECK
3" = 1'-0"

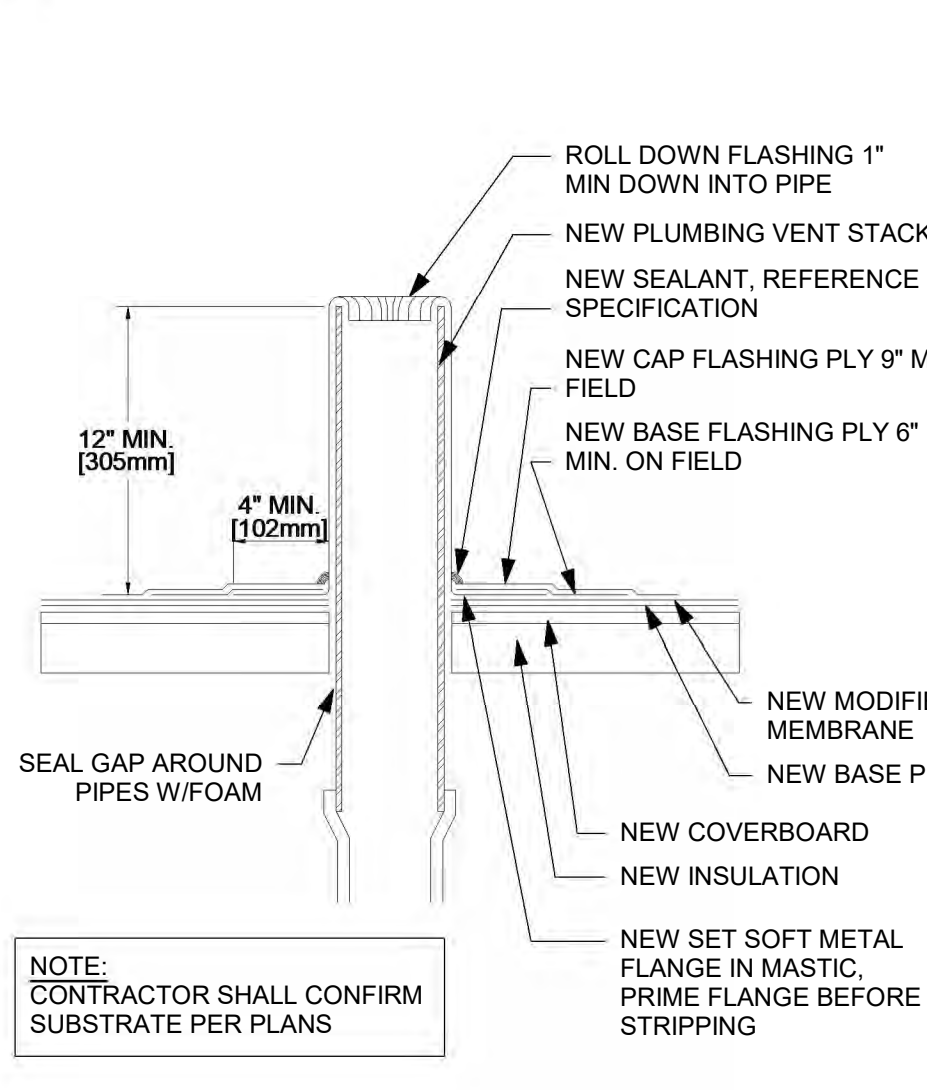


12 ROOF VENT PENETRATION DETAIL
1 1/2" = 1'-0"

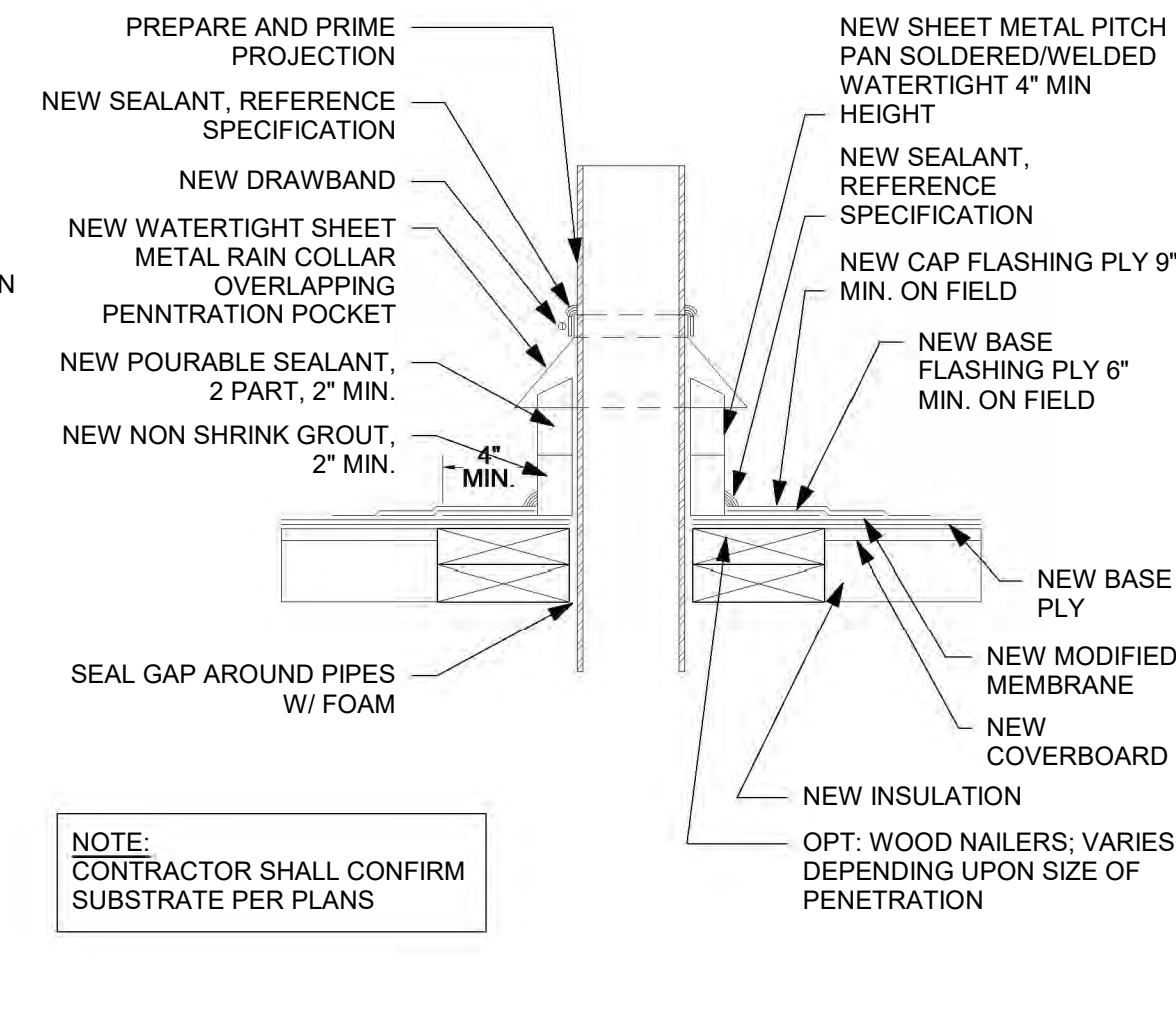


13 PITCH POCKET DETAIL
1 1/2" = 1'-0"

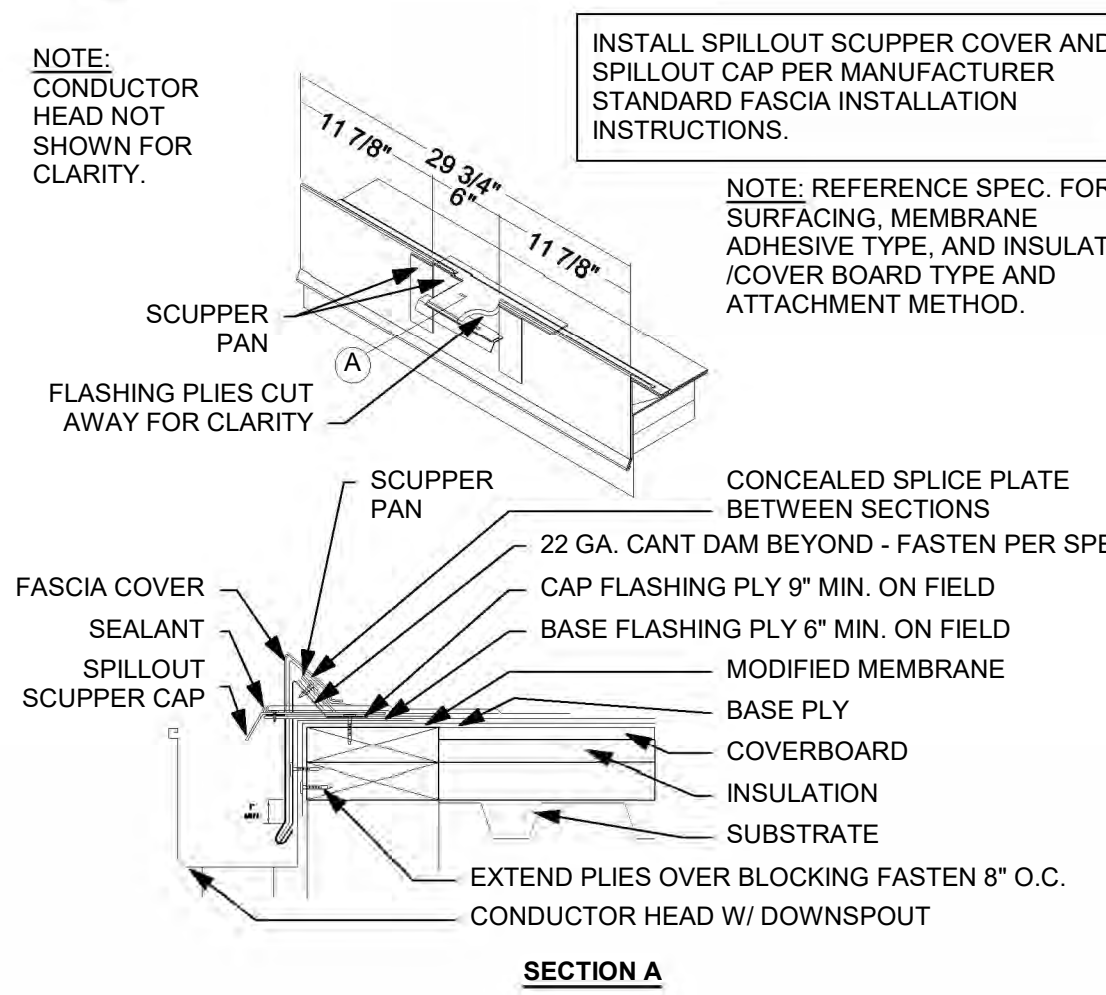


15 ROOF SCUPPER DETAIL
1 1/2" = 1'-0"

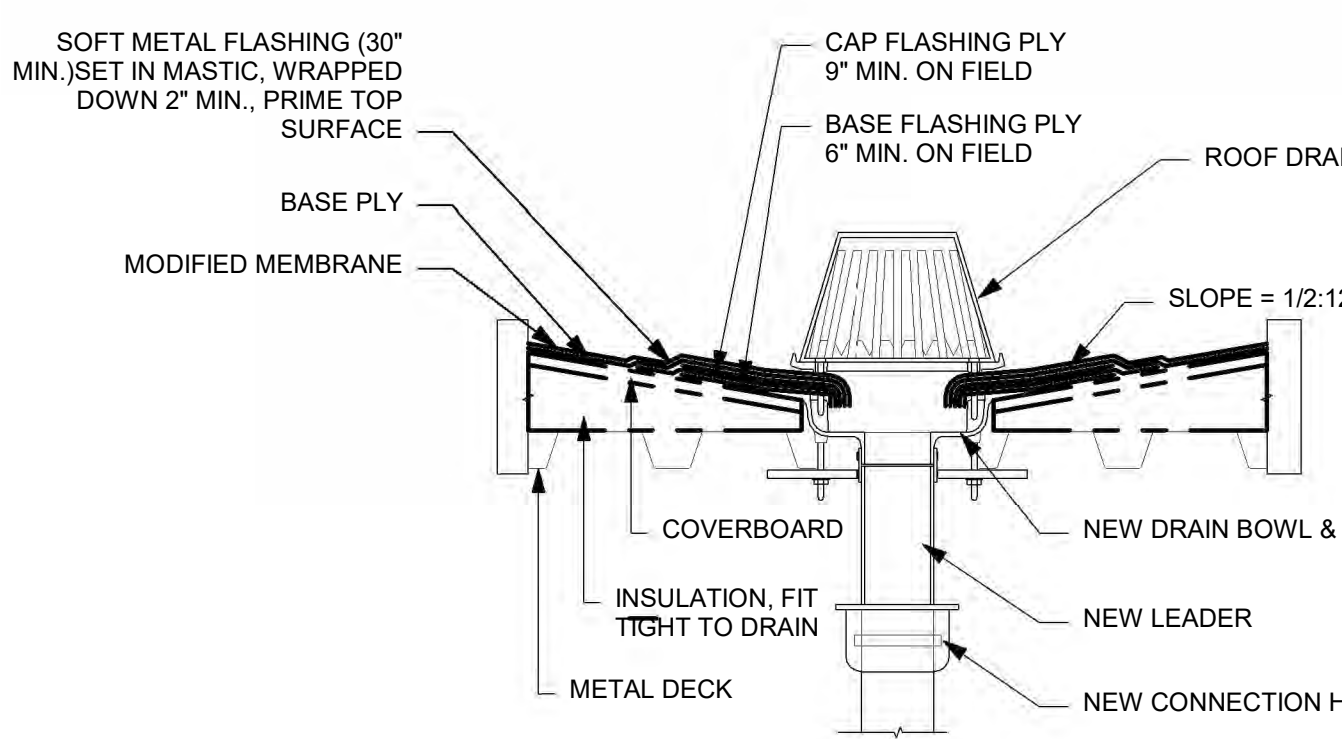


16 ROOF DRAIN DETAIL
1 1/2" = 1'-0"

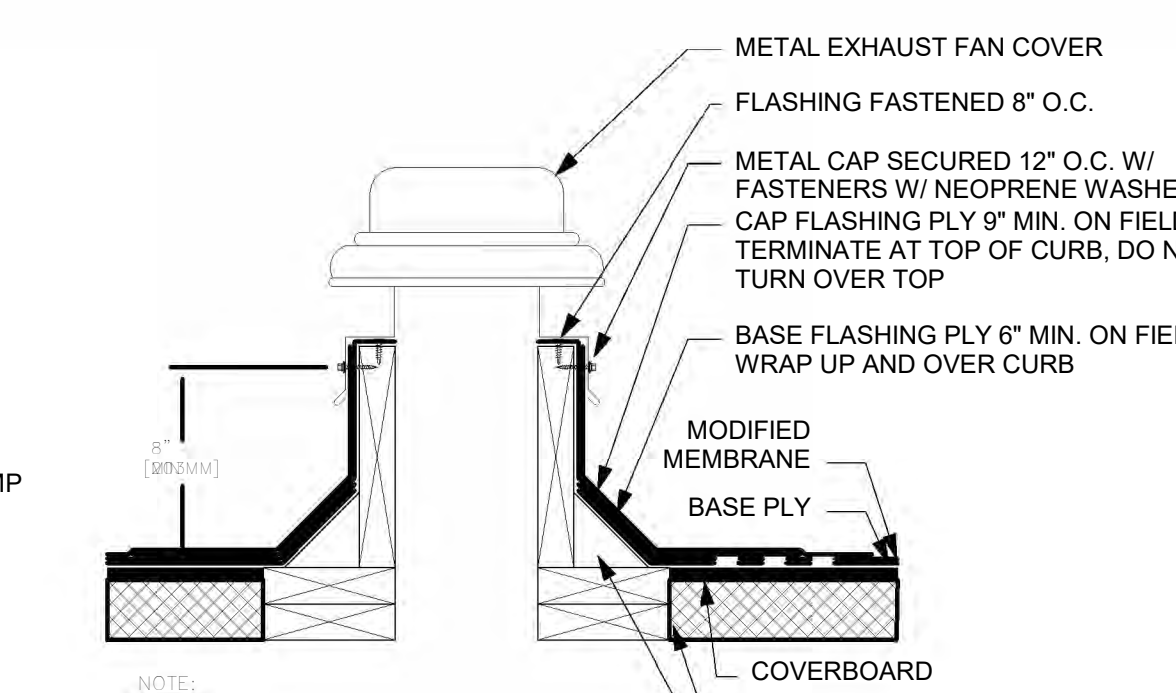


17 ROOF EXHAUST DETAIL
1 1/2" = 1'-0"

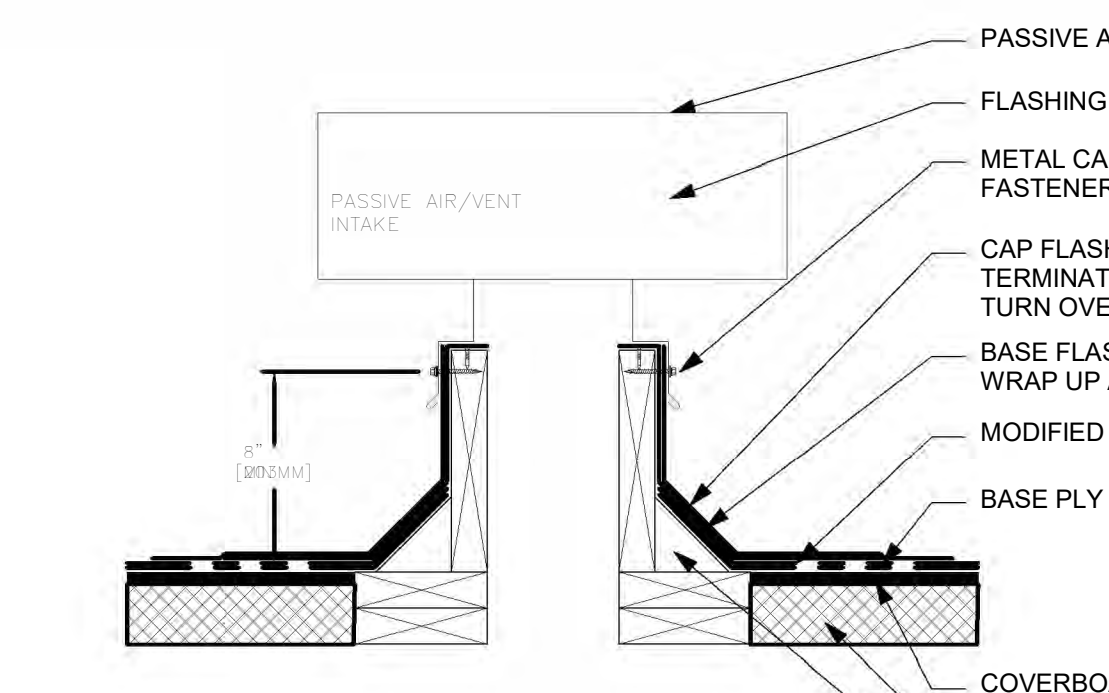

18 ROOF INTAKE DETAIL
1 1/2" = 1'-0"

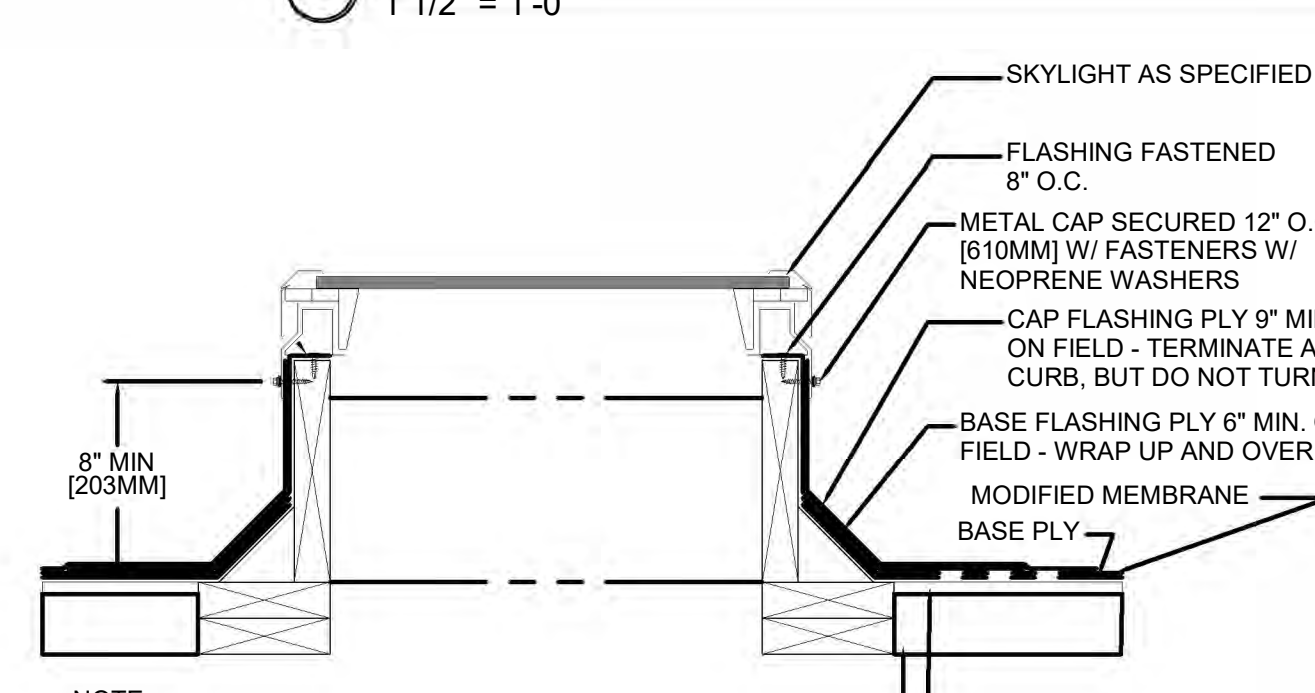

19 ROOF SKYLIGHT DETAIL
1 1/2" = 1'-0"

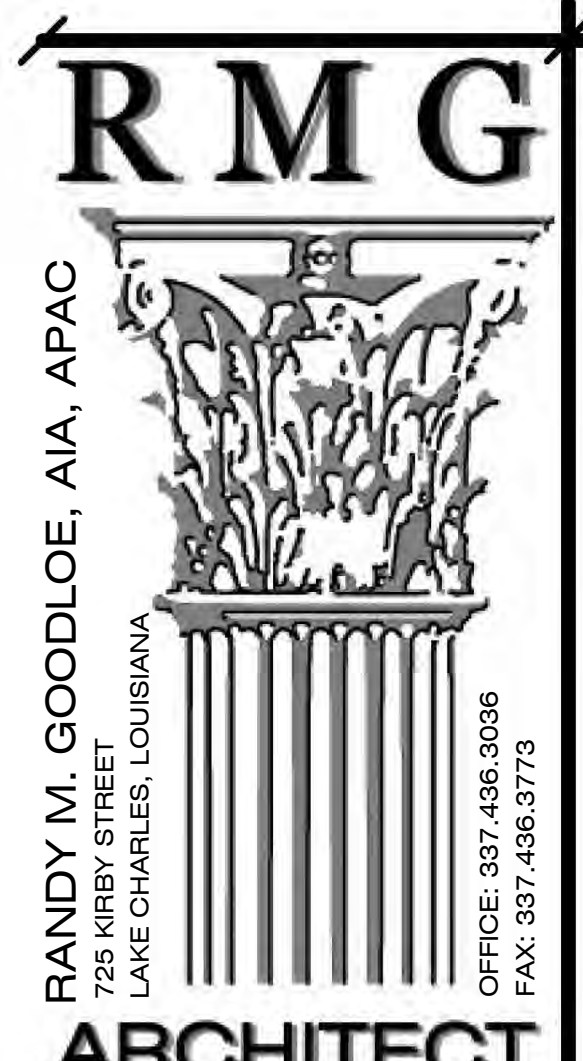

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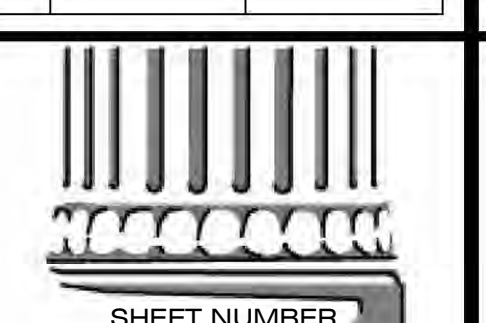
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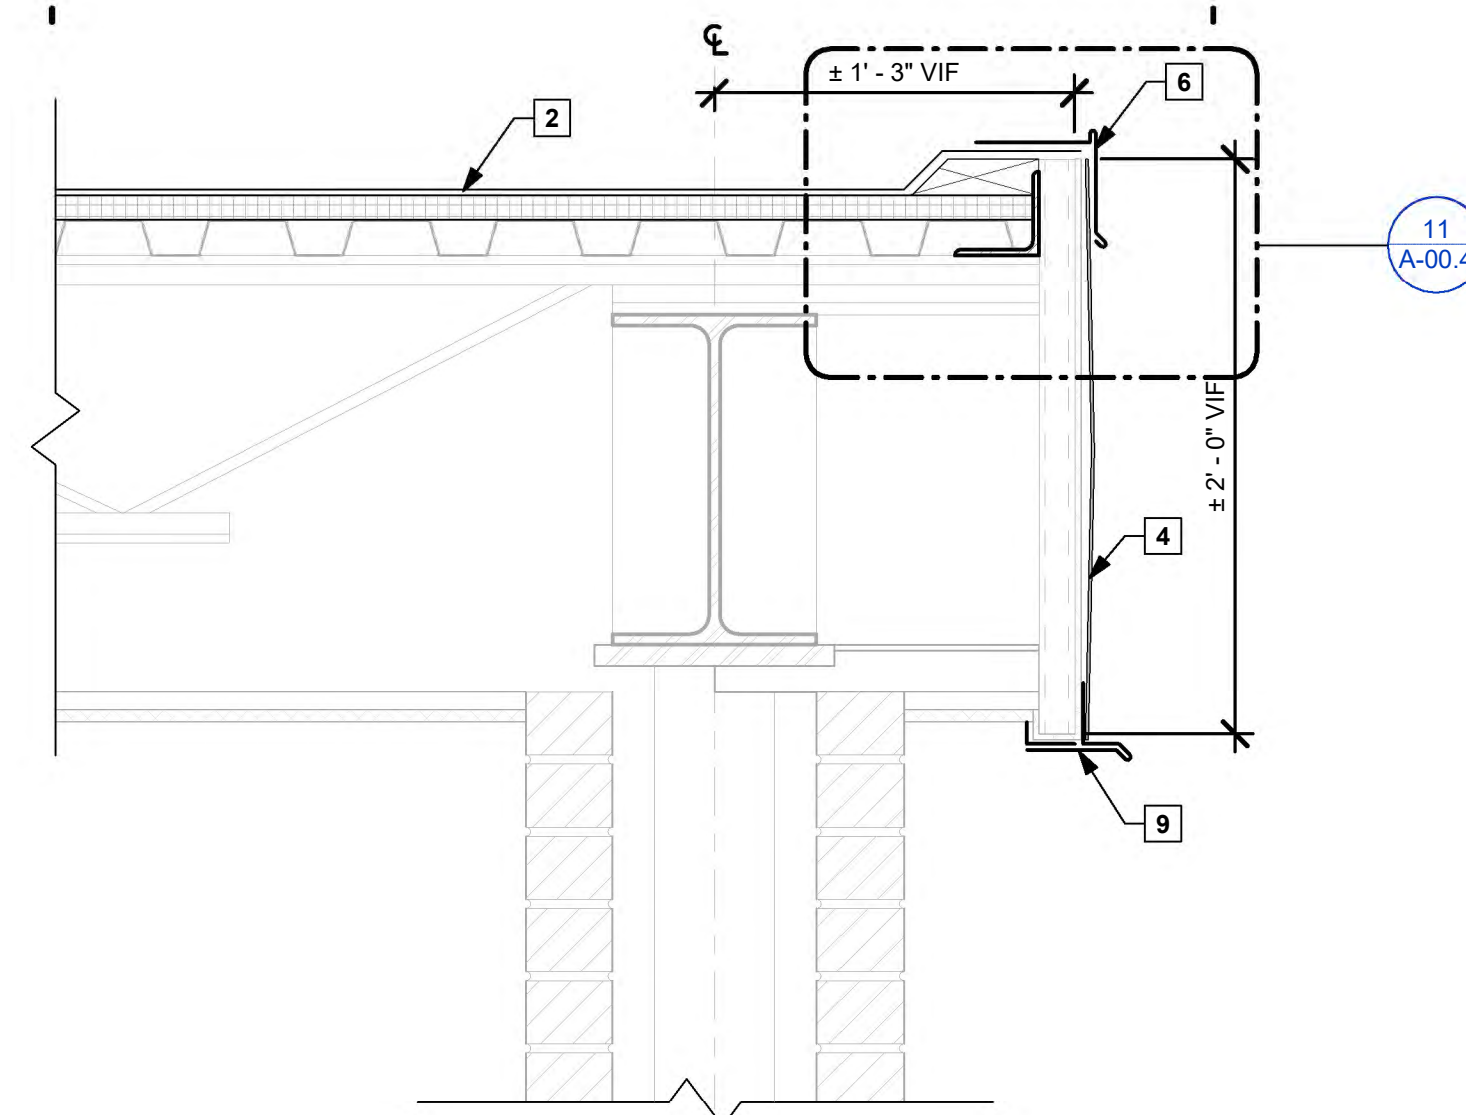
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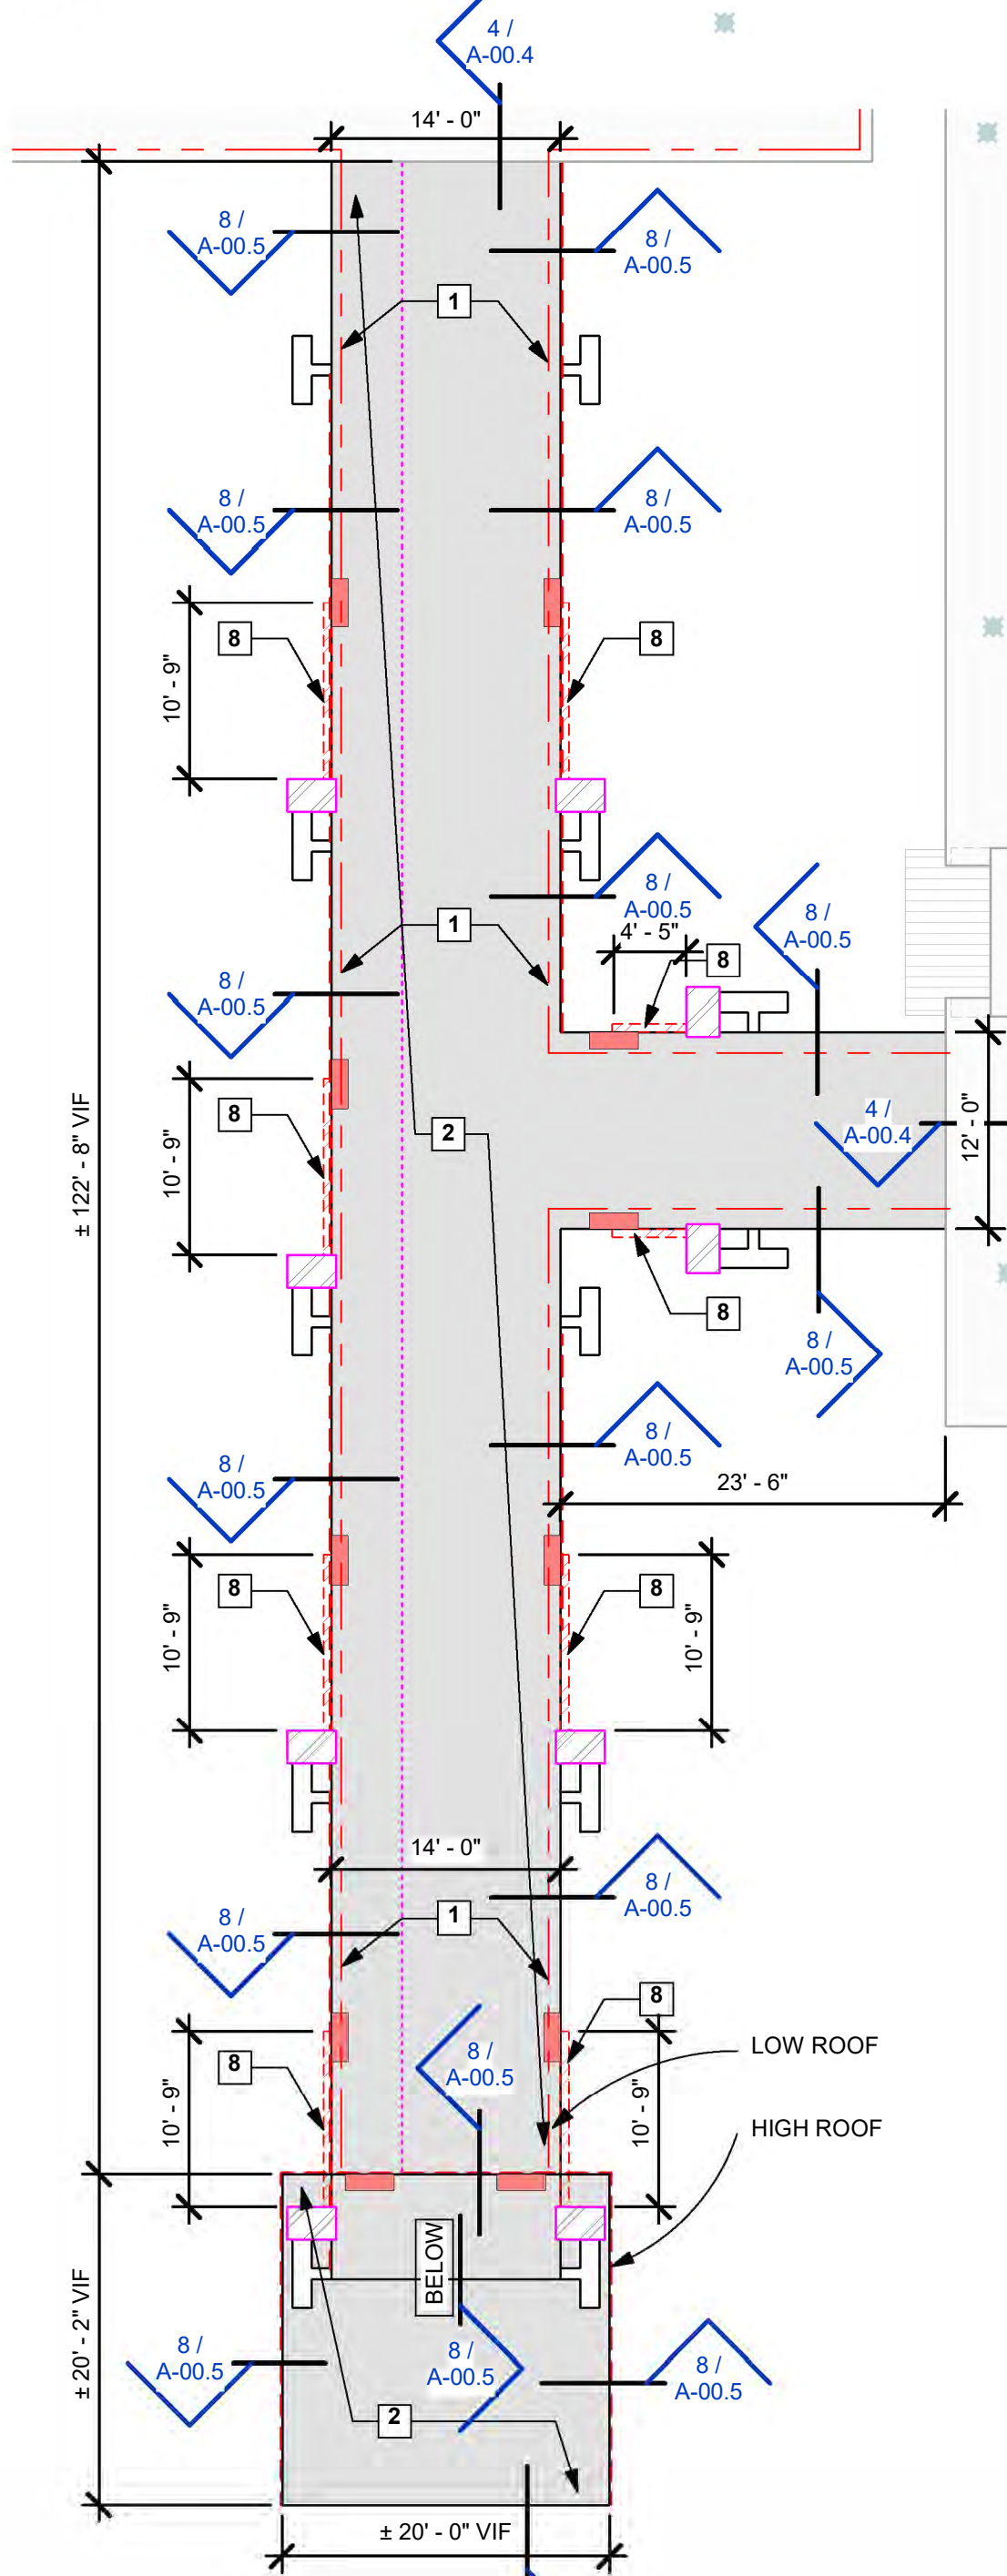
A-00.4
ROOF DETAILS



NOTE: IMAGES ARE FOR VISUAL REFERENCES TO HELP UNDERSTAND DAMAGES. THEY DO NOT REPRESENT THE ENTIRE SCOPE OF WORK AND SHOULD BE USED IN CONJUNCTION WITH THE DRAWINGS AND CURRENT CONDITIONS IN THE FIELD. CONTRACTOR SHALL CONFIRM CURRENT CONDITIONS IN THE FIELD PRIOR TO BIDDING - TYPICAL.



8 ENTRY CANOPY FASCIA DETAIL
1 1/2" = 1'-0"




18 ROOF PLAN - ENTRY CANOPY
3/32" = 1'-0"

- ROOFING SYMBOL LEGEND**
- DOWNSPOUT
SEE KEYNOTE 13
 - SCUPPER/OPENING FOR DRAINAGE
SEE KEYNOTE 10
SEE DETAIL 15/A00.4
 - CONDUIT/PIPING RUNS
SEE KEYNOTE 3

KEYNOTES TO SHEET

1. **TEMPORARY CHAIN LINK FENCING** - PROVIDE 6' TEMPORARY CHAIN LINK FENCING AT SOFFIT EDGE TO PROTECT STUDENT TRAFFIC DURING CONSTRUCTION. PROVIDE ACCESS TO THE GREATEST EXTENT POSSIBLE. COORDINATE WITH PHASING AND SCHOOL PRINCIPAL.
2. SHADED REGION INDICATES EXISTING ROOFING ASSEMBLY TO BE **REMOVED TO EXISTING ROOF DECKING** SUBSTRATE BELOW, AND NEW ROOFING INSTALLED. ALL DEBRIS IS TO BE REMOVED FROM THE SITE. SEE SPECIFICATIONS. ROOFTOP PENETRATIONS AND EQUIPMENT TO BE VERIFIED BY CONTRACTOR IN THE FIELD.
3. INDICATES **EXISTING RIGID CONDUIT/PIPING RUNS** EXPOSED ON EXISTING ROOF. CONTRACTOR SHALL MAKE VISUAL INSPECTIONS ON SITE TO VERIFY THE EXTENT OF WORK WHICH IS REQUIRED TO MOVE AND RELOCATE THESE CONDUIT RUNS DURING THE PROCESS OF RE-ROOFING AND TO ENSURE THAT THE NEW ROOF SLOPES ARE INTEGRATED AND ACCOUNTED FOR WHERE EXTENSIONS OF THESE CONDUITS AND WIRING IS REQUIRED. PROVIDE NEW "RUNNER CURBS" FOR SUPPORT OF ALL HARD PIPING WHICH IS TO REMAIN ON ROOF AFTER NEW INSTALLATION. SPACE CURBS AS REQUIRED SO CONDUIT AND PIPING DOES NOT SAG BETWEEN THESE LOCATIONS. INSTALL AS DETAILED.
4. COORDINATE **REMOVAL OF METAL PANELS AND AGGREGATE PANELS** BEHIND WITH ABATEMENT SCOPE AND ABATEMENT CONTRACTOR. PROVIDE **NEW METAL PANEL "B"** AS SPECIFIED. PROVIDE 3/4" PLYWOOD WITH ICE AND WATER SHIELD LAPPED FOR DRAINAGE. AS DETAILED.
5. **REMOVE AND REPLACE PRE-FINISHED METAL DOWNSPOUT** WITH NEW TO MATCH EXISTING COLOR, GAUGE, SIZE, & PROFILE. REMOVE PREVIOUS ATTACHMENTS AND FASTENERS & REPLACE WITH NEW. GROUT FILL ALL HOLES.
6. **REMOVE AND REPLACE FLASHING**. COUNTER-FLASHING AND PRE-FINISHED METAL FASCIA FLASHING AS DETAILED.
7. INDICATES APPROXIMATE AREA AND LOCATION OF **ROOF EXPANSION JOINT**. CONTRACTOR SHALL VISUALLY INSPECT THE EXISTING CONDITIONS AT THE SITE AND PROVIDE A NEW EXPANSION JOINT AS DETAILED. THE INSTALLER SHOULD ASSUME THAT ALL EXISTING WOOD BLOCKING SHALL BE REPLACED WITH NEW TREATED WOOD BLOCKING AS PER DETAILS. PROVIDE NEW CANT STRIP, FLASHING, PRE-FINISHED EXPANSION JOINT COVER, VINYL BELLOW, AND BASE FLASHING AS DETAILED. VERIFY EXACT ROUTING AND AREA WHERE THIS EJ IS TO BE REMOVED AND REPLACED. VERIFY ALL EXISTING CONDITIONS, ESPECIALLY ANY PIPING, AND CONDUIT WHICH MIGHT INTERSECT OR CROSS OVER THIS JOINT.
8. **REMOVE AND REPLACE PRE-FINISHED METAL GUTTER** WITH NEW TO MATCH EXISTING COLOR, GAUGE, SIZE, & PROFILE. REMOVE PREVIOUS ATTACHMENTS AND FASTENERS & REPLACE WITH NEW. GROUT FILL ALL HOLES.
9. METAL PANEL MANUFACTURER TO PROVIDE BOTTOM TRACK AND FLASHING AS REQUIRED FOR WEATHER TIGHTNESS.
10. **PROVIDE SCUPPER** THROUGH ROOF EDGE. SLOPE ROOFING AT 1/4" PER 1'-0" MIN. TO ENSURE POSITIVE DRAINAGE. COORDINATE LOCATIONS AND SIZES WITH EXISTING. NEW SCUPPERS TO BE PROVIDED AS DETAILED AND ROOF TAPER PROVIDED ACCORDINGLY.

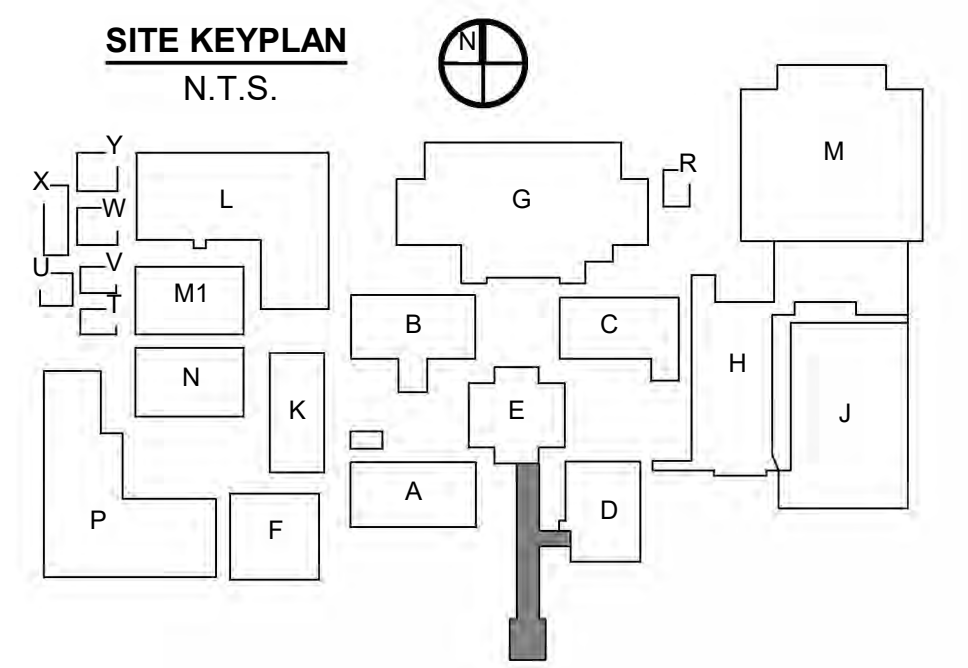

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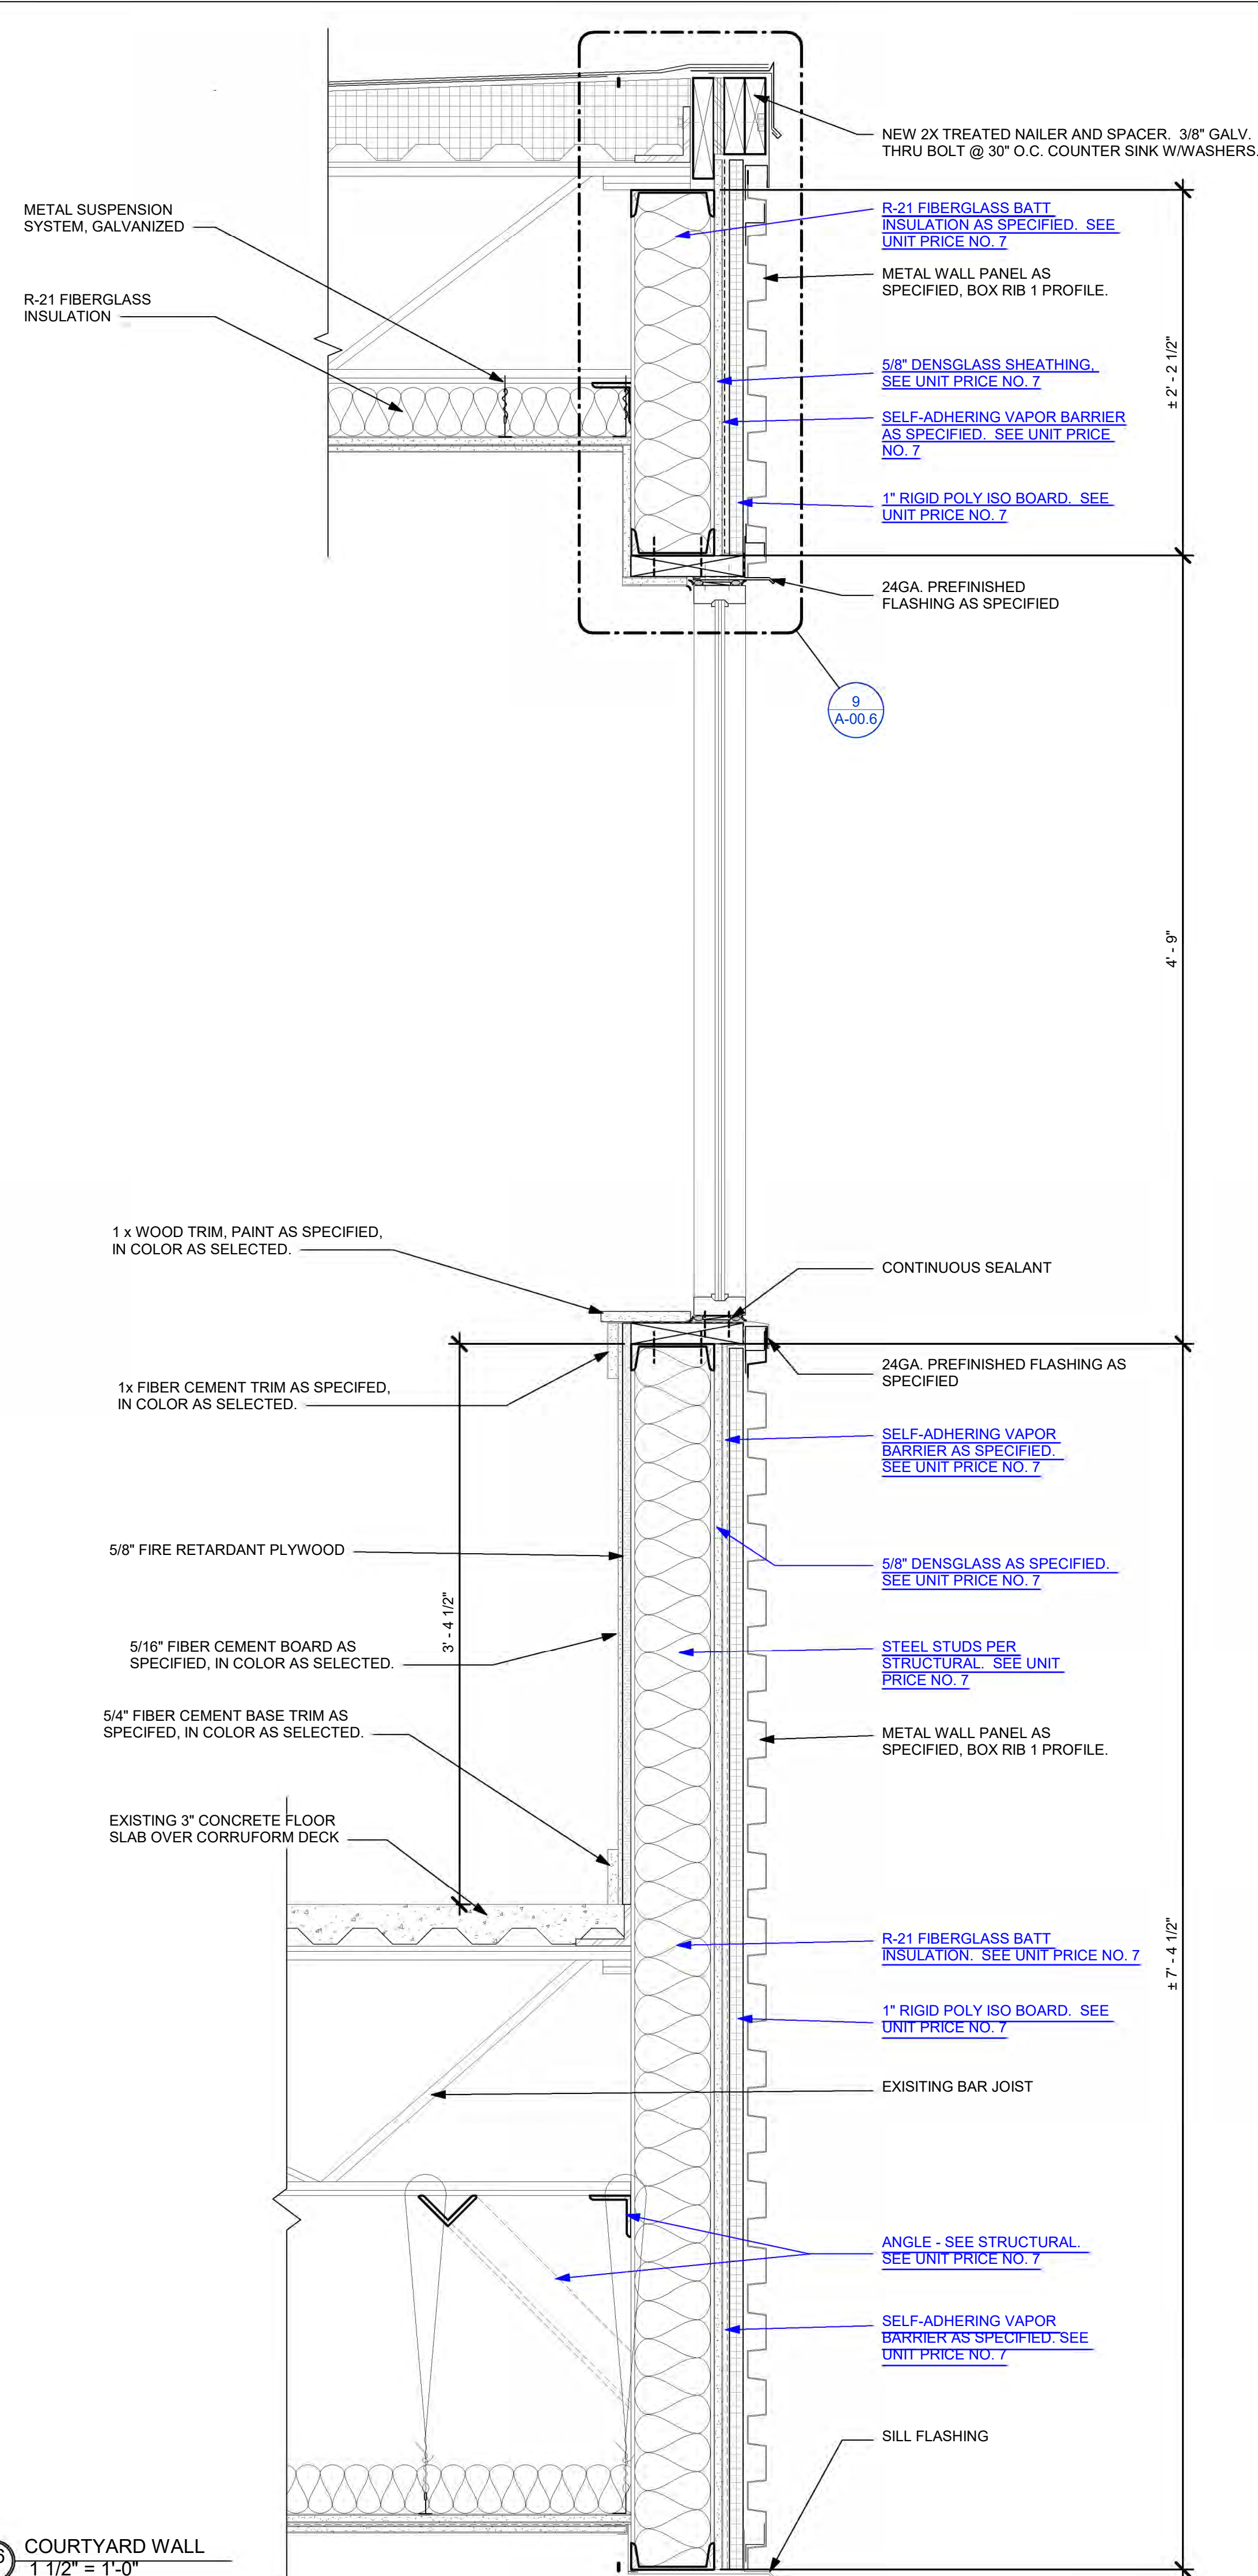
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DATE ISSUED
06/28/2024

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B	Date 2

SHEET NUMBER
A-00.5
ENTRY CANOPY


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16 COURTYARD WALL
1 1/2" = 1'-0"




GENERAL NOTE TO SHEET


- ALTERNATE NO. 2 IS TO INSTALL METAL PANELS IN LIEU OF GFRC PANELS.

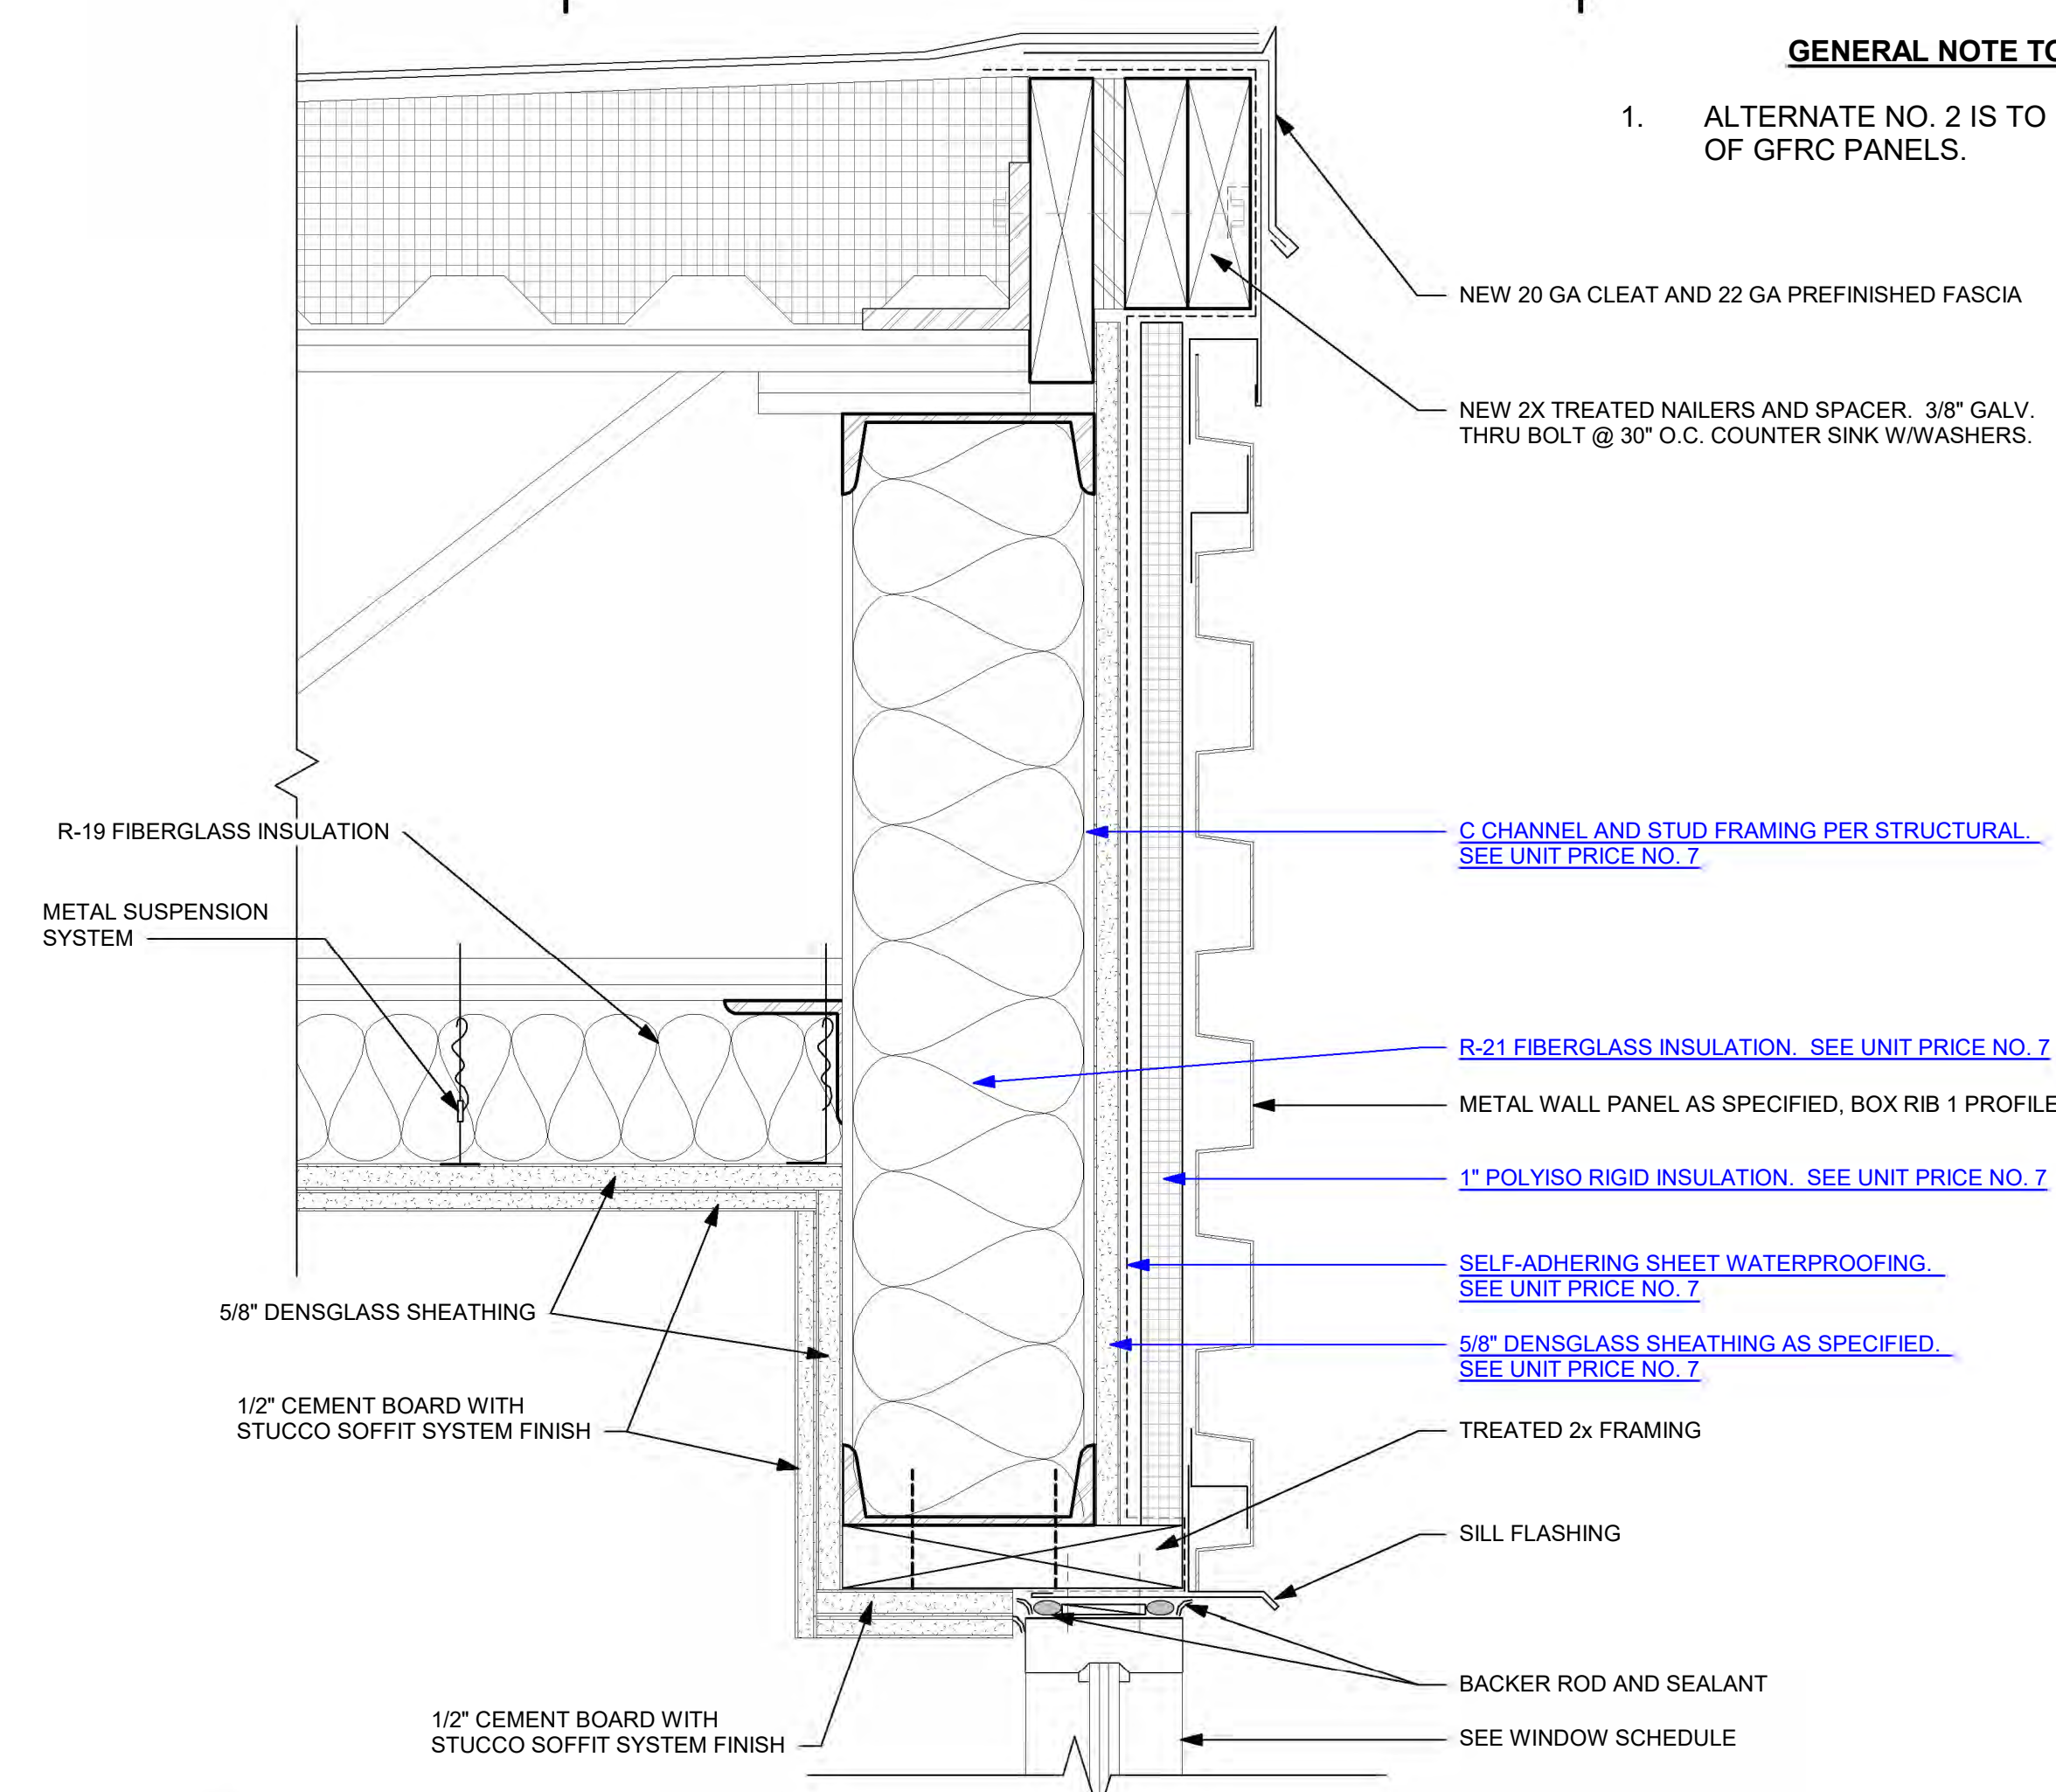


9 COURTYARD WINDOW HEAD
3" = 1'-0"

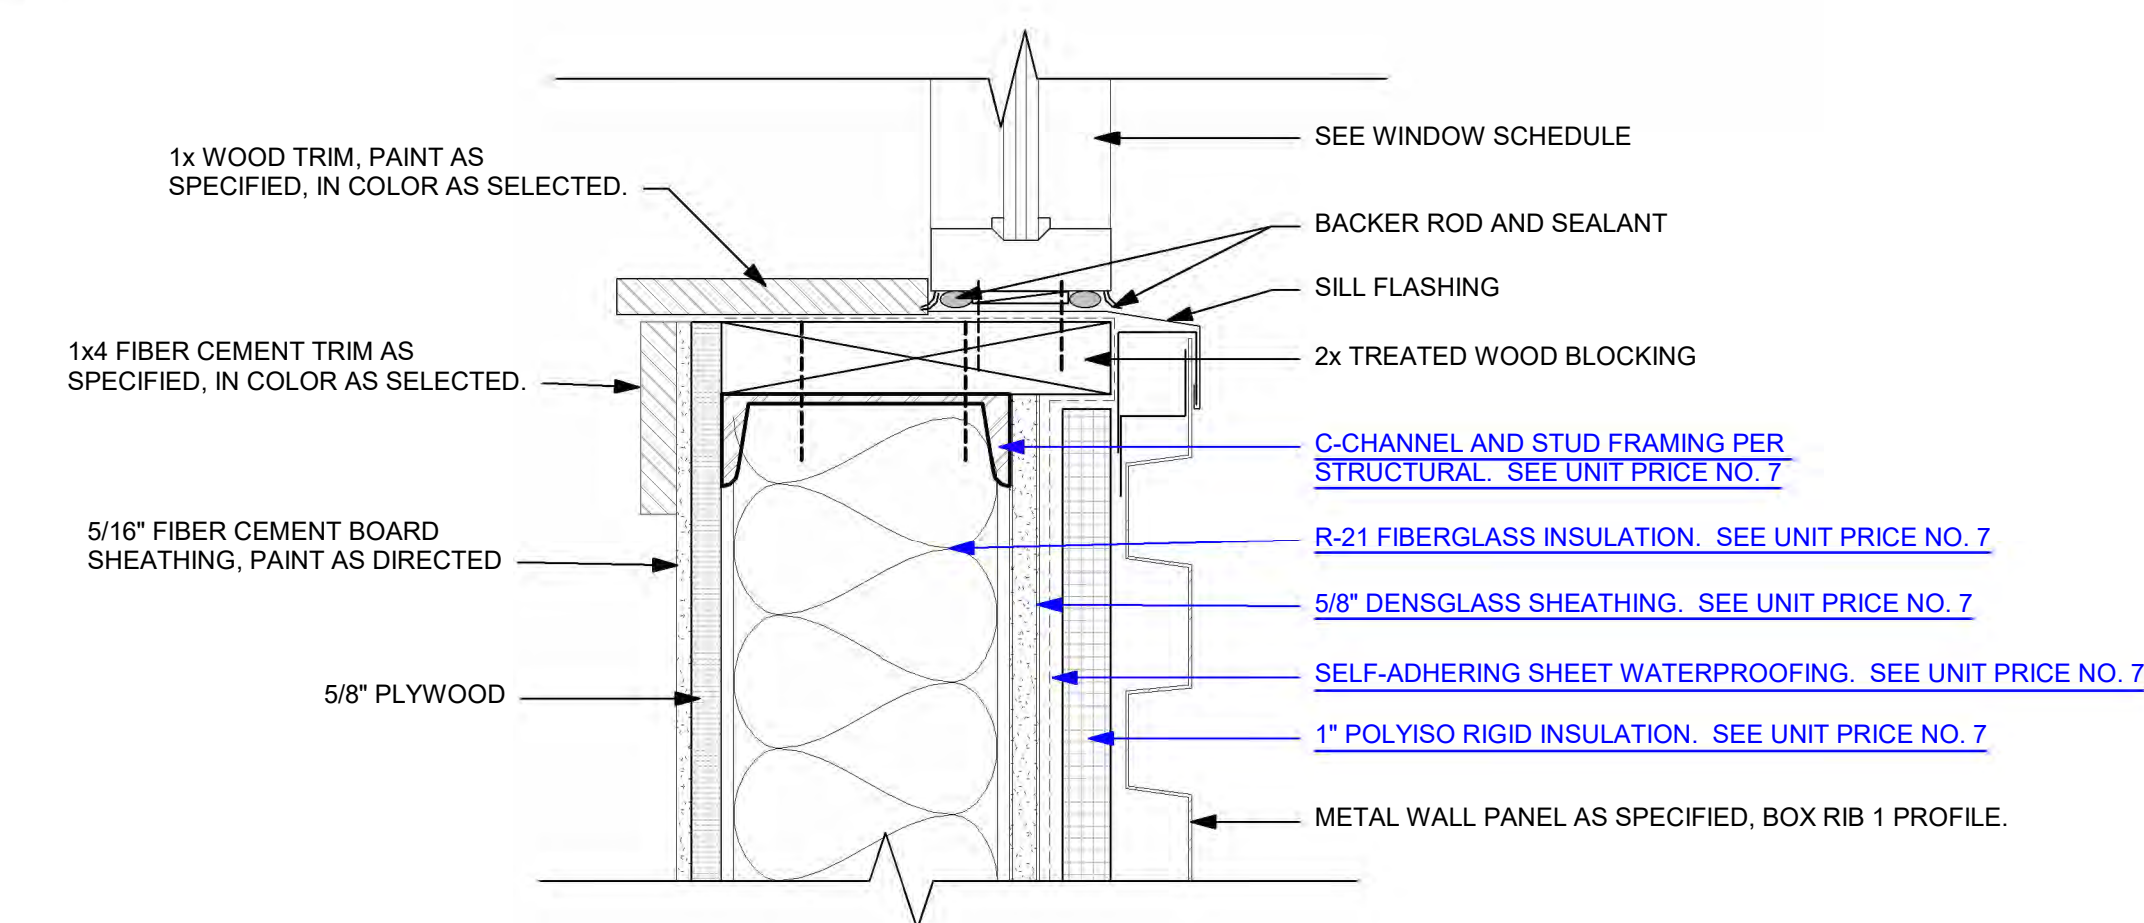

14 COURTYARD WINDOW SILL
3" = 1'-0"

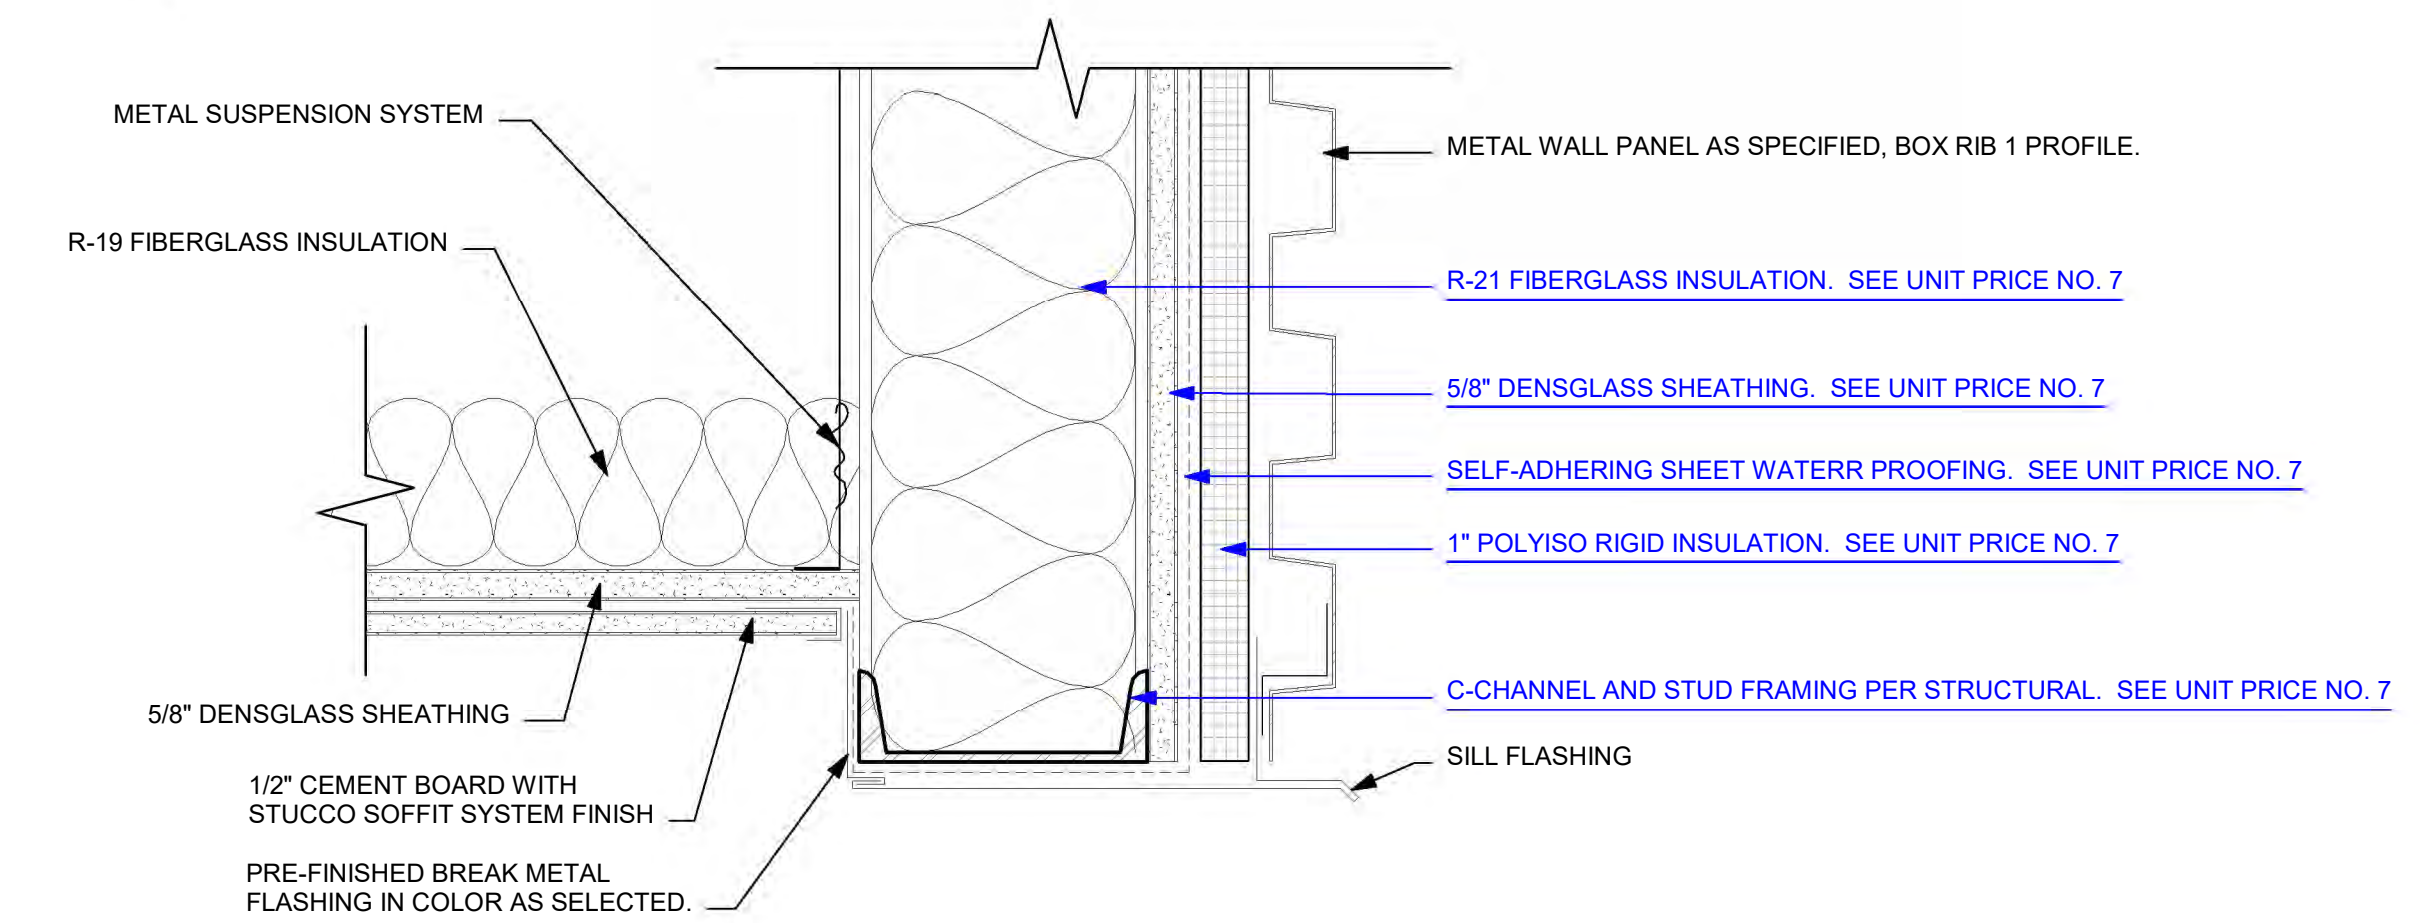

19 SOFFIT FLASHING DETAIL
3" = 1'-0"

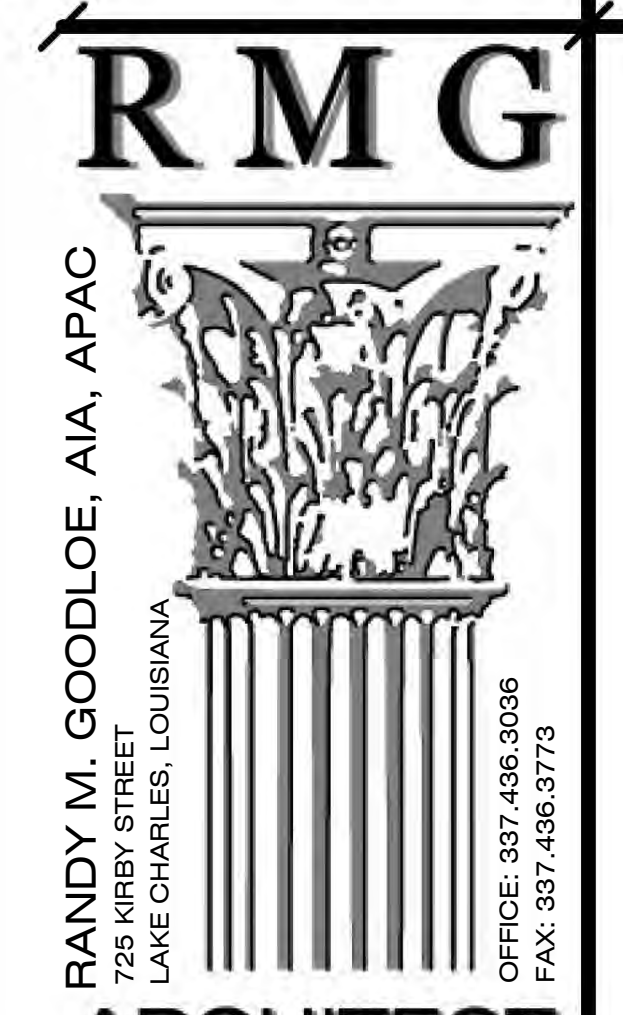

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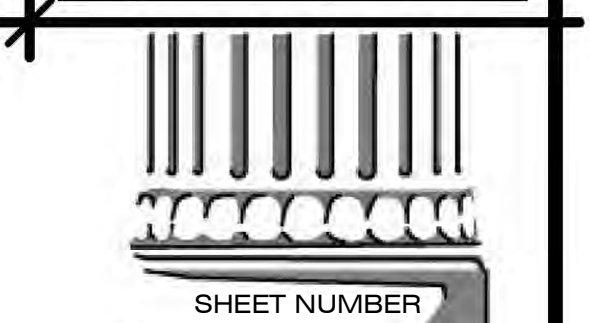
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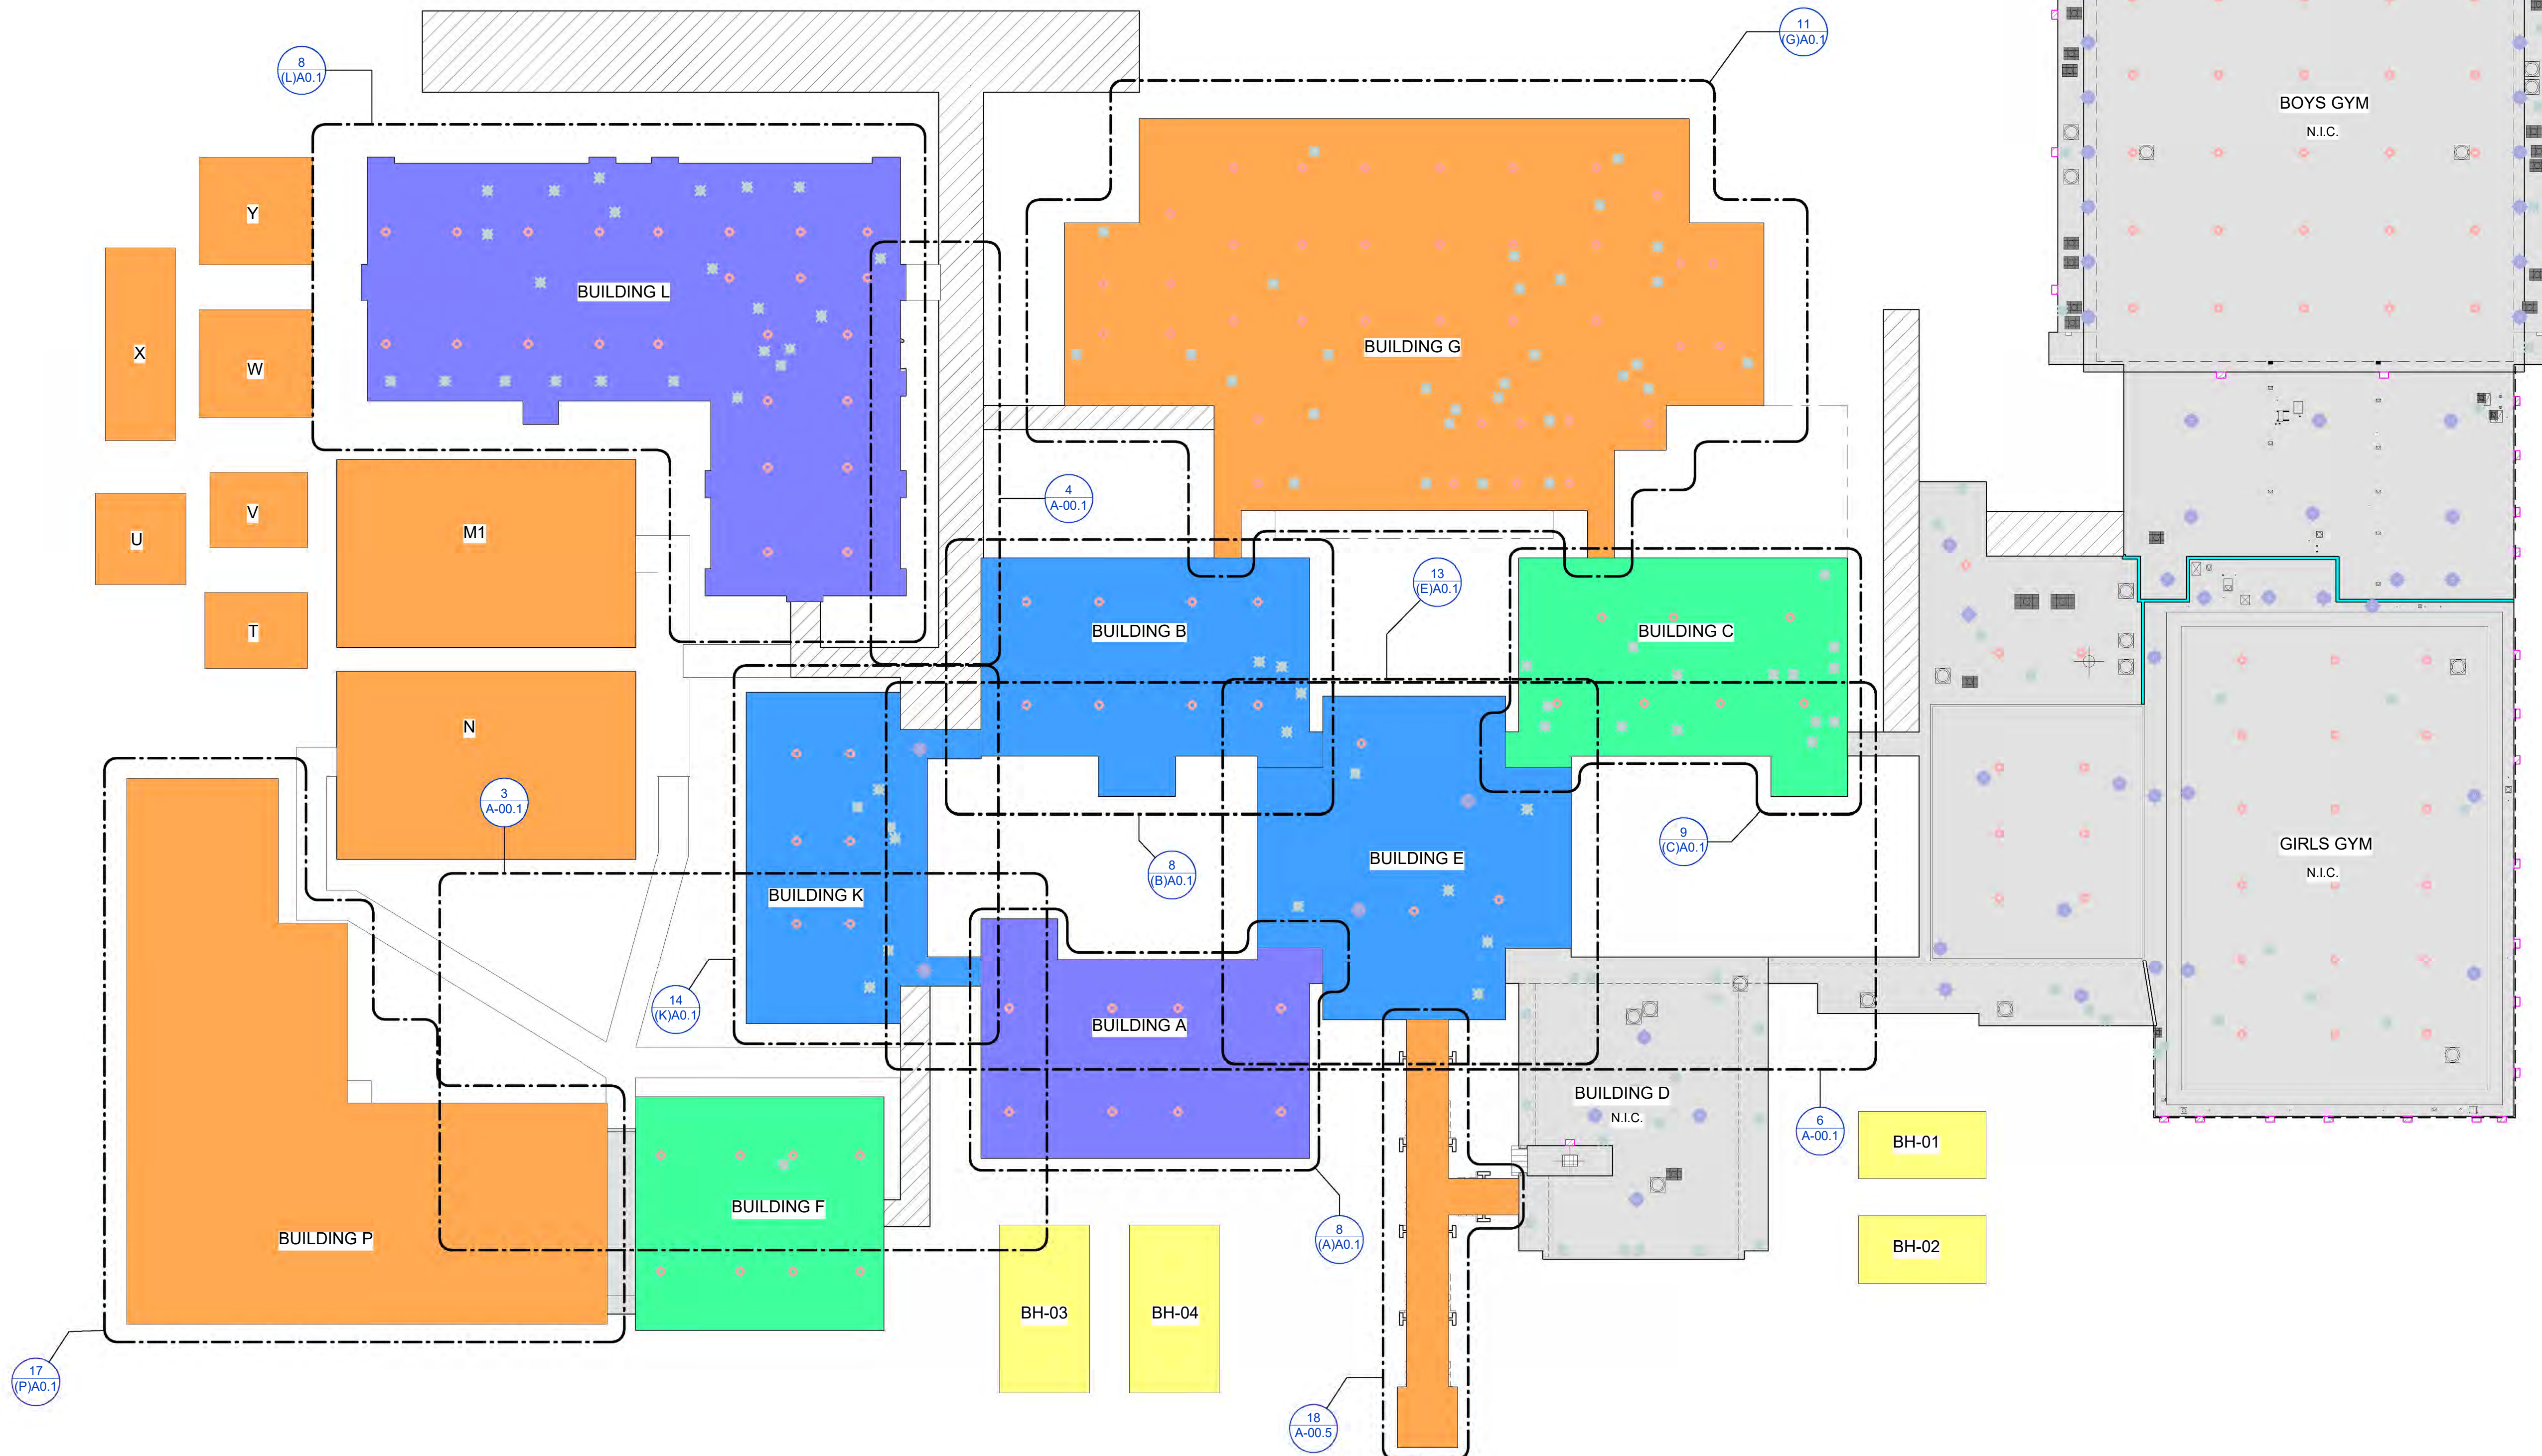
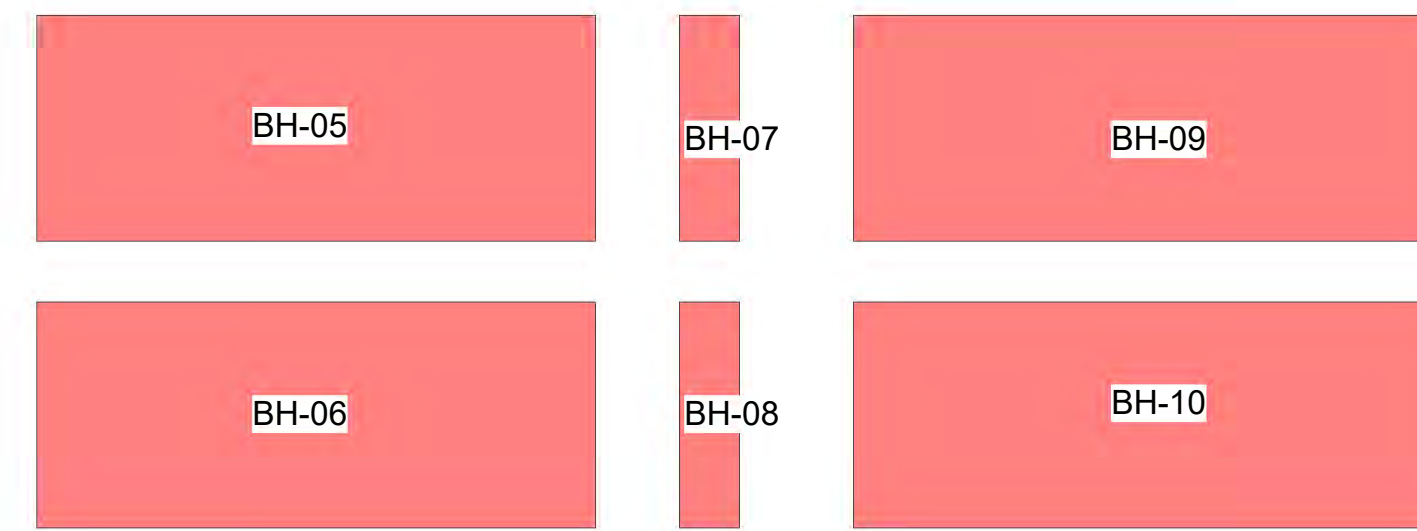
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SHEET NUMBER
A-00.6
ALTERNATE 2 -
COURTYARD WALL

PHASING LEGEND

- PHASE I
- PHASE II
- PHASE III
- PHASE IV
- PHASE V
- PHASE IV



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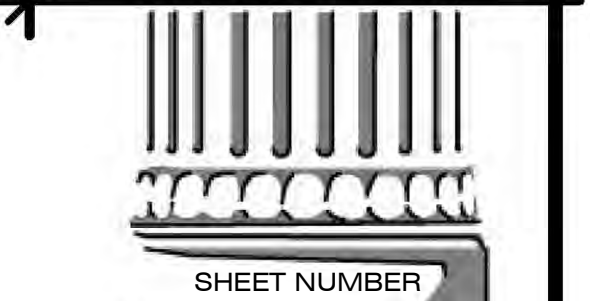
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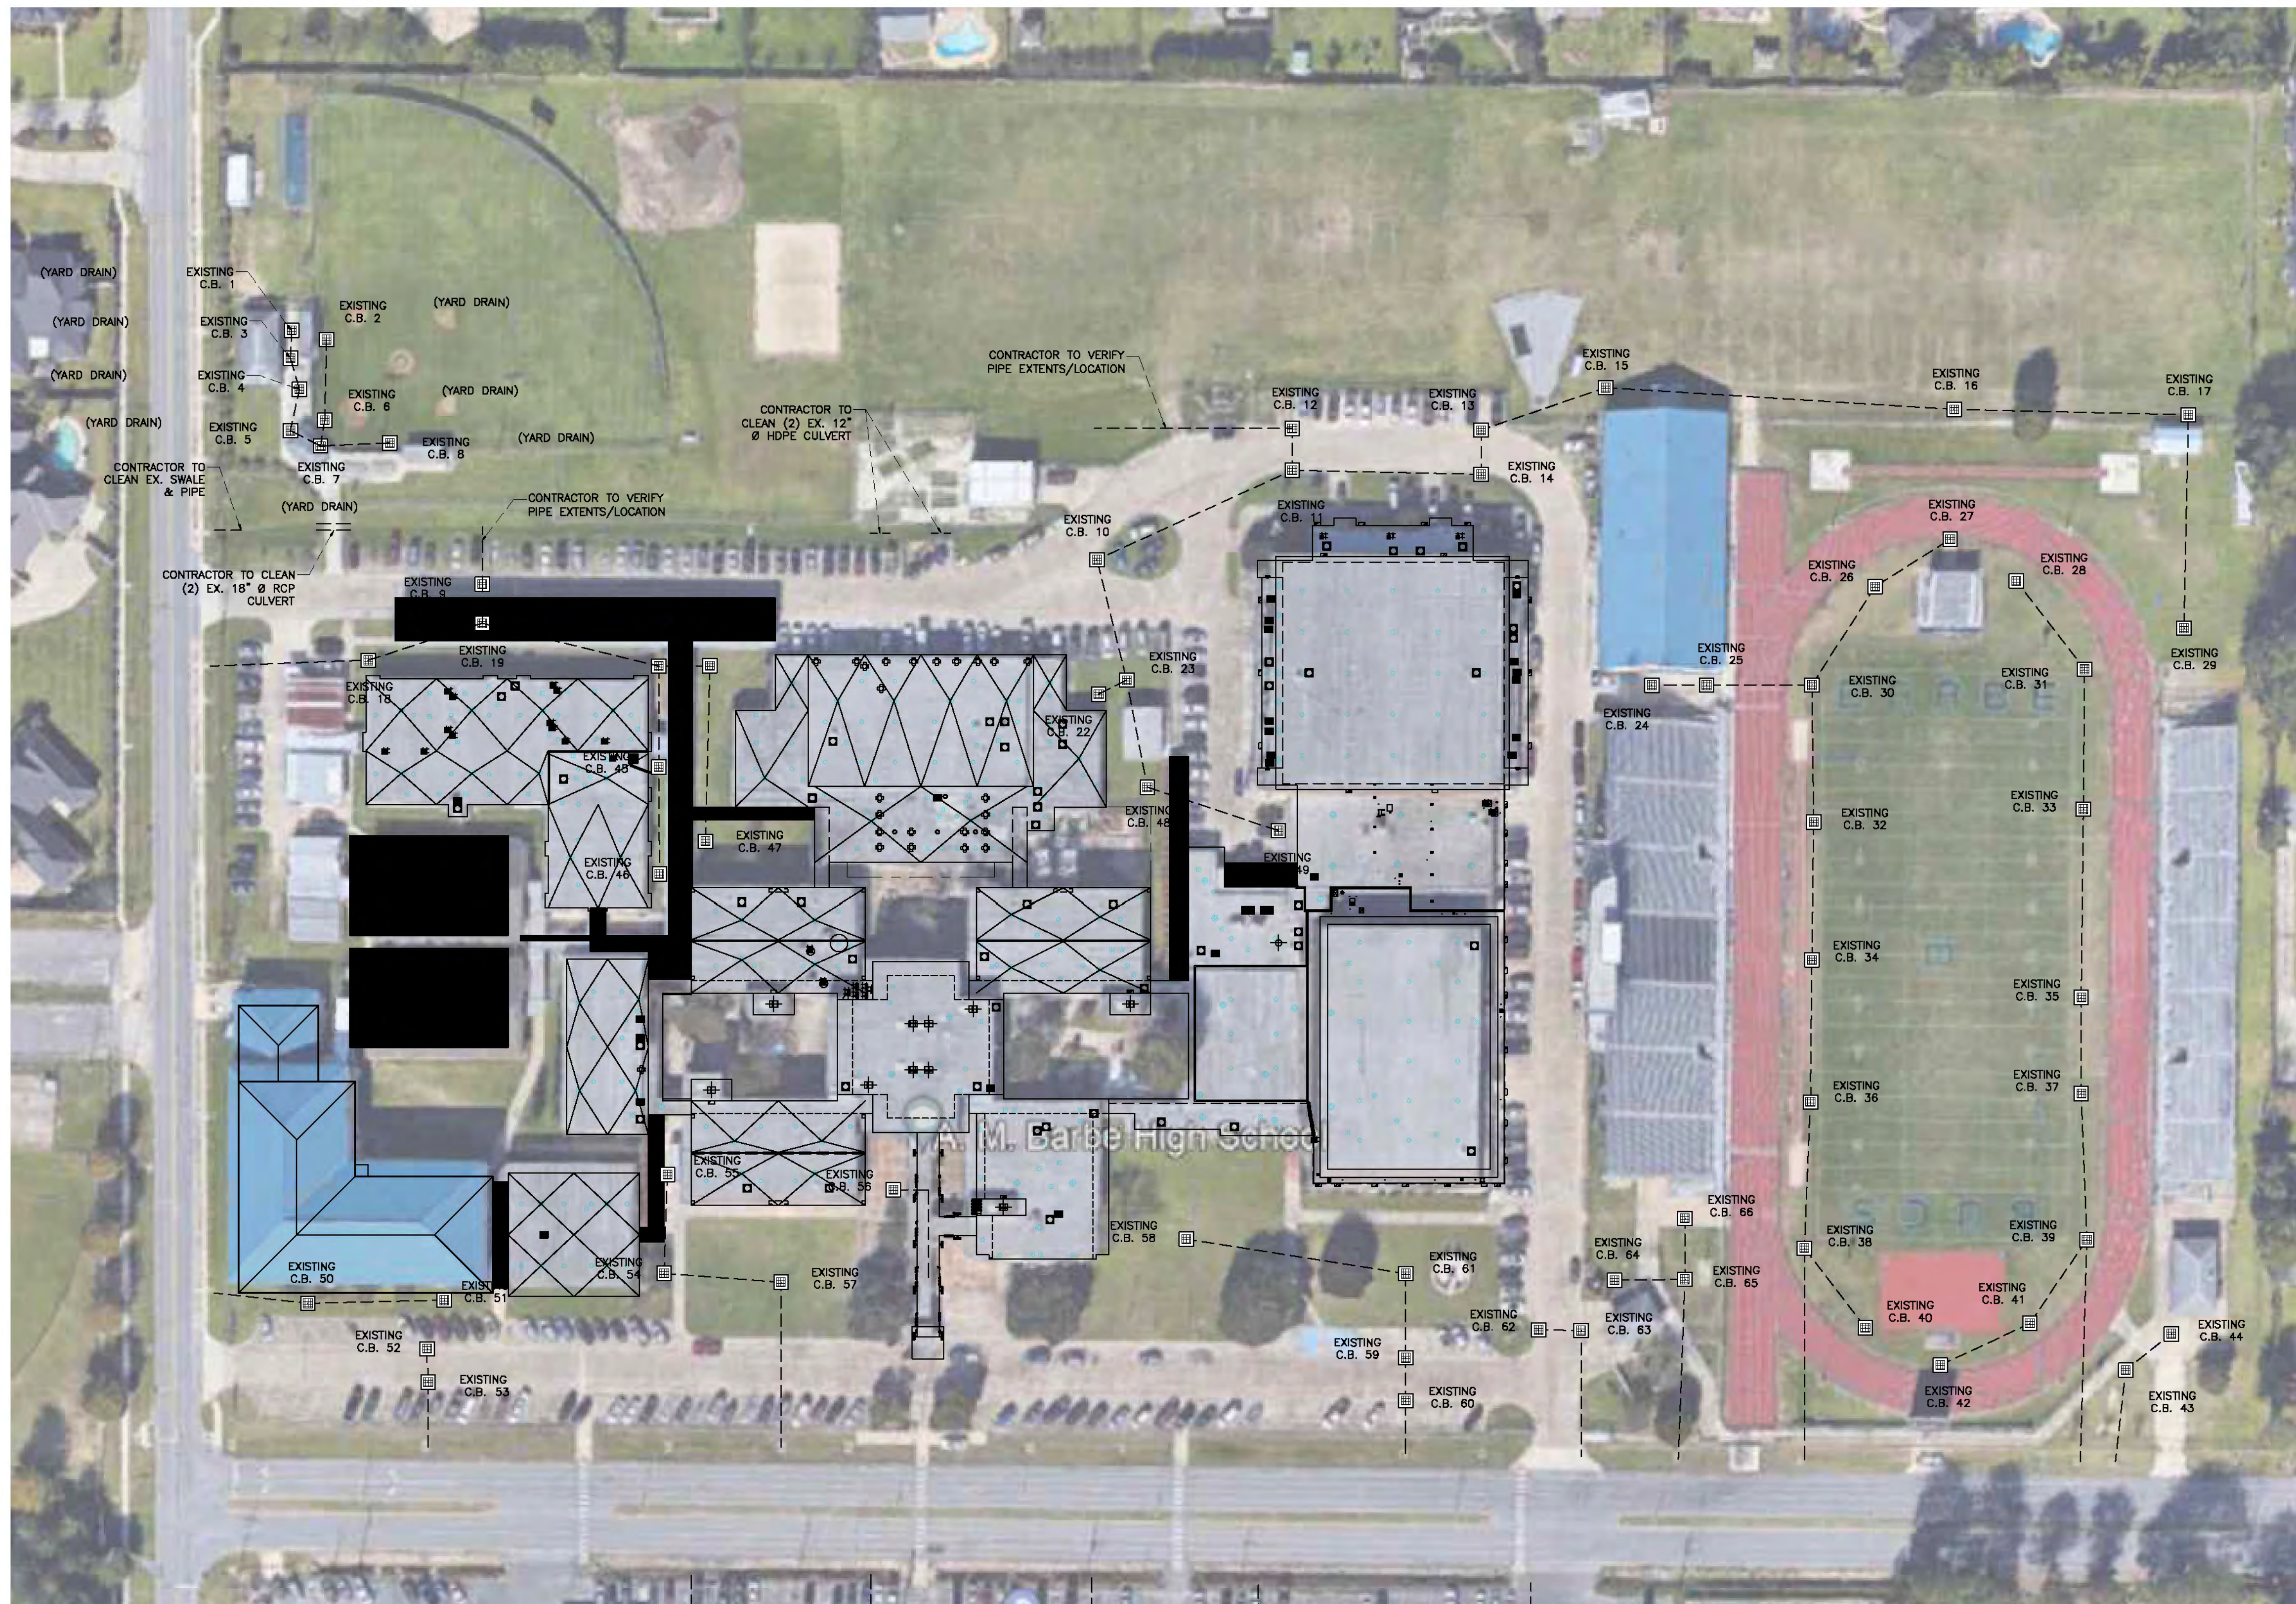
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SHEET NUMBER
A-00.7
 PHASING PLAN



LEGEND

EXISTING CONCRETE

EXISTING CATCH BASIN

RMG

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ARCHITECT

STATE OF LOUISIANA
JASON D. DUHON
Professional No. 10051
07/01/2024

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CIVIL & STRUCTURAL ENGINEERS
337.564.5918 WWW.DANDPEENGINEERS.COM 5393 HIG LAKE ROAD LAKE CHARLES LA 70605

SHEET NUMBER
C1.0
EXISTING DRAINAGE PLAN


1 SITE PLAN -- EXISTING SUBSURFACE DRAINAGE
SCALE: 1" = 60'-0"

- GENERAL CIVIL NOTES**
- WHERE PHYSICAL JOB SITE MEASUREMENTS ARE REQUIRED BEFORE FABRICATION, IT IS THE SOLE DUTY OF THE CONTRACTOR TO DETERMINE ACTUAL CONSTRUCTION DETAILS PRIOR TO FABRICATION.
 - ANY DISCREPANCIES OR CONFLICTS IN THE CONSTRUCTION DOCUMENTS SHALL BE REPORTED TO THE ARCHITECT. ALL DIMENSIONS ARE TO BE VERIFIED BY THE CONTRACTOR BEFORE CONSTRUCTION BEGINS.
 - ANY MODIFICATIONS MADE IN THE CONSTRUCTION DOCUMENTS TO ACCOMPLISH THE REQUIRED WORK SHALL BE REPORTED TO THE ARCHITECT BEFORE WORK IS DONE.
 - CONTRACTOR IS RESPONSIBLE FOR NOTIFYING LA AUTHORITIES TO IDENTIFY ALL UTILITIES PRIOR TO BEGINNING ANY WORK AT THE SITE. (LA ONE CALL 811). CAP OFF AND SEAL DISCONTINUED UTILITY SERVICES AND REMOVE PORTIONS OF LINES WITHIN EXCAVATED AREAS.
 - CONTRACTOR TO LOCATE ALL UTILITIES AND VERIFY NO CONFLICTS EXIST WITH ANY PROPOSED STORMWATER AND/OR UTILITY ROUTING PRIOR TO COMMENCEMENT OF CONSTRUCTION ACTIVITIES. IF ANY CONFLICTS ARE IDENTIFIED THE CONTRACTOR SHALL NOTIFY THE ARCHITECT FOR RESOLUTION PRIOR TO COMMENCEMENT OF CONSTRUCTION.
 - THE CONTRACTOR SHALL EMPLOY A LA. LICENSED SURVEYOR TO PROVIDE THE CONSTRUCTION LAYOUT BOUNDARIES AND/OR BASE LINES. SURVEYOR TO SET PROJECT T.B.M. FOR USE DURING CONSTRUCTION.
 - CONTRACTOR SHALL PROVIDE OWNER WITH AS-BUILT DRAWINGS OF THE SITE AND UTILITIES INSTALLED AND UNCOVERED AT THE END OF THE PROJECT.
 - CONTRACTOR SHALL PROTECT ALL EXISTING STRUCTURES, EQUIPMENT, UTILITIES, PAVING, ETC THAT ARE TO REMAIN FROM DAMAGE DURING CONSTRUCTION OPERATIONS. REPAIR / REPLACE DAMAGED ITEMS WITH NEW AT NO ADDITIONAL COST TO OWNER.
 - CONTRACTOR SHALL DISPOSE OF ALL EXCESS CONSTRUCTION MATERIALS, DEBRIS, AND/OR SOIL FROM JOB SITE IN ACCORDANCE WITH ALL LOCAL, STATE, AND FEDERAL REQUIREMENTS.


NOTE:
CONTRACTOR MUST THOROUGHLY CLEAN, VACUUM, AND HYDROFLUSH THE EXISTING CATCH BASINS/DRAINAGE PIPING AS LISTED BELOW WITHIN THE BARBE HIGH SCHOOL FACILITY/CAMPUS (MINIMUM 58 BASINS AND 4,000 LINEAR FEET OF SUBSURFACE PIPING)
EXCLUDING BASIN #s: 54, 56, 57, 58, 59, 60, & 61
DRAINAGE SYSTEMS MUST BE FREE OF ALL DEBRIS, SOILS, TRASH, ETC. AND HAVE FREE FLOWING CONDITIONS. CONTRACTOR TO PERFORM INSPECTIONS USING PRIOR APPROVED CAMERA DEVICES (CCTV ROBOTIC CRAWLER, PUSH CAMERAS, ETC.) AND PROVIDE VIDEO DOCUMENTATION OF ALL DRAINAGE STRUCTURES IN ELECTRONIC FORMAT TO THE ARCHITECT/ENGINEER.

NOTE:
CONTRACTOR TO VERIFY LOCATION OF EXISTING CATCH BASINS AND SIZE, MATERIAL, AND ROUTING OF EXISTING SUBSURFACE PIPING.

NOTE:
ALL COSTS TO HYDROFLUSH, CLEAN, AND VACUUM THE EXISTING CATCH BASINS/DRAINAGE PIPING AS REFERENCED ON THIS SHEET AND ELSEWHERE WITHIN THE CONSTRUCTION DOCUMENTS SHALL BE INCLUDED IN ADDITIVE ALTERNATE #1




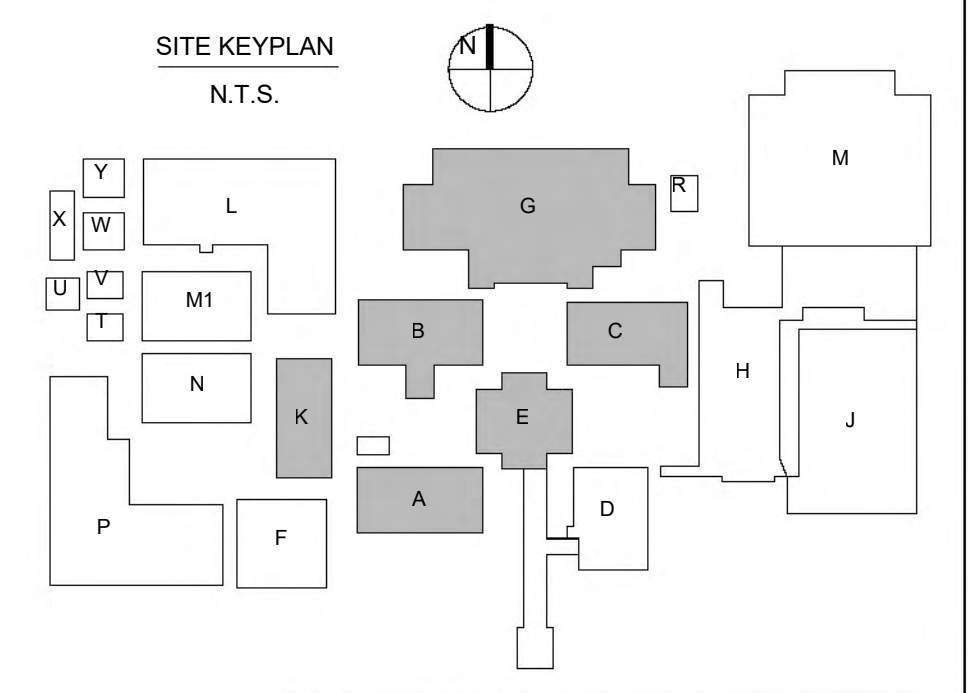


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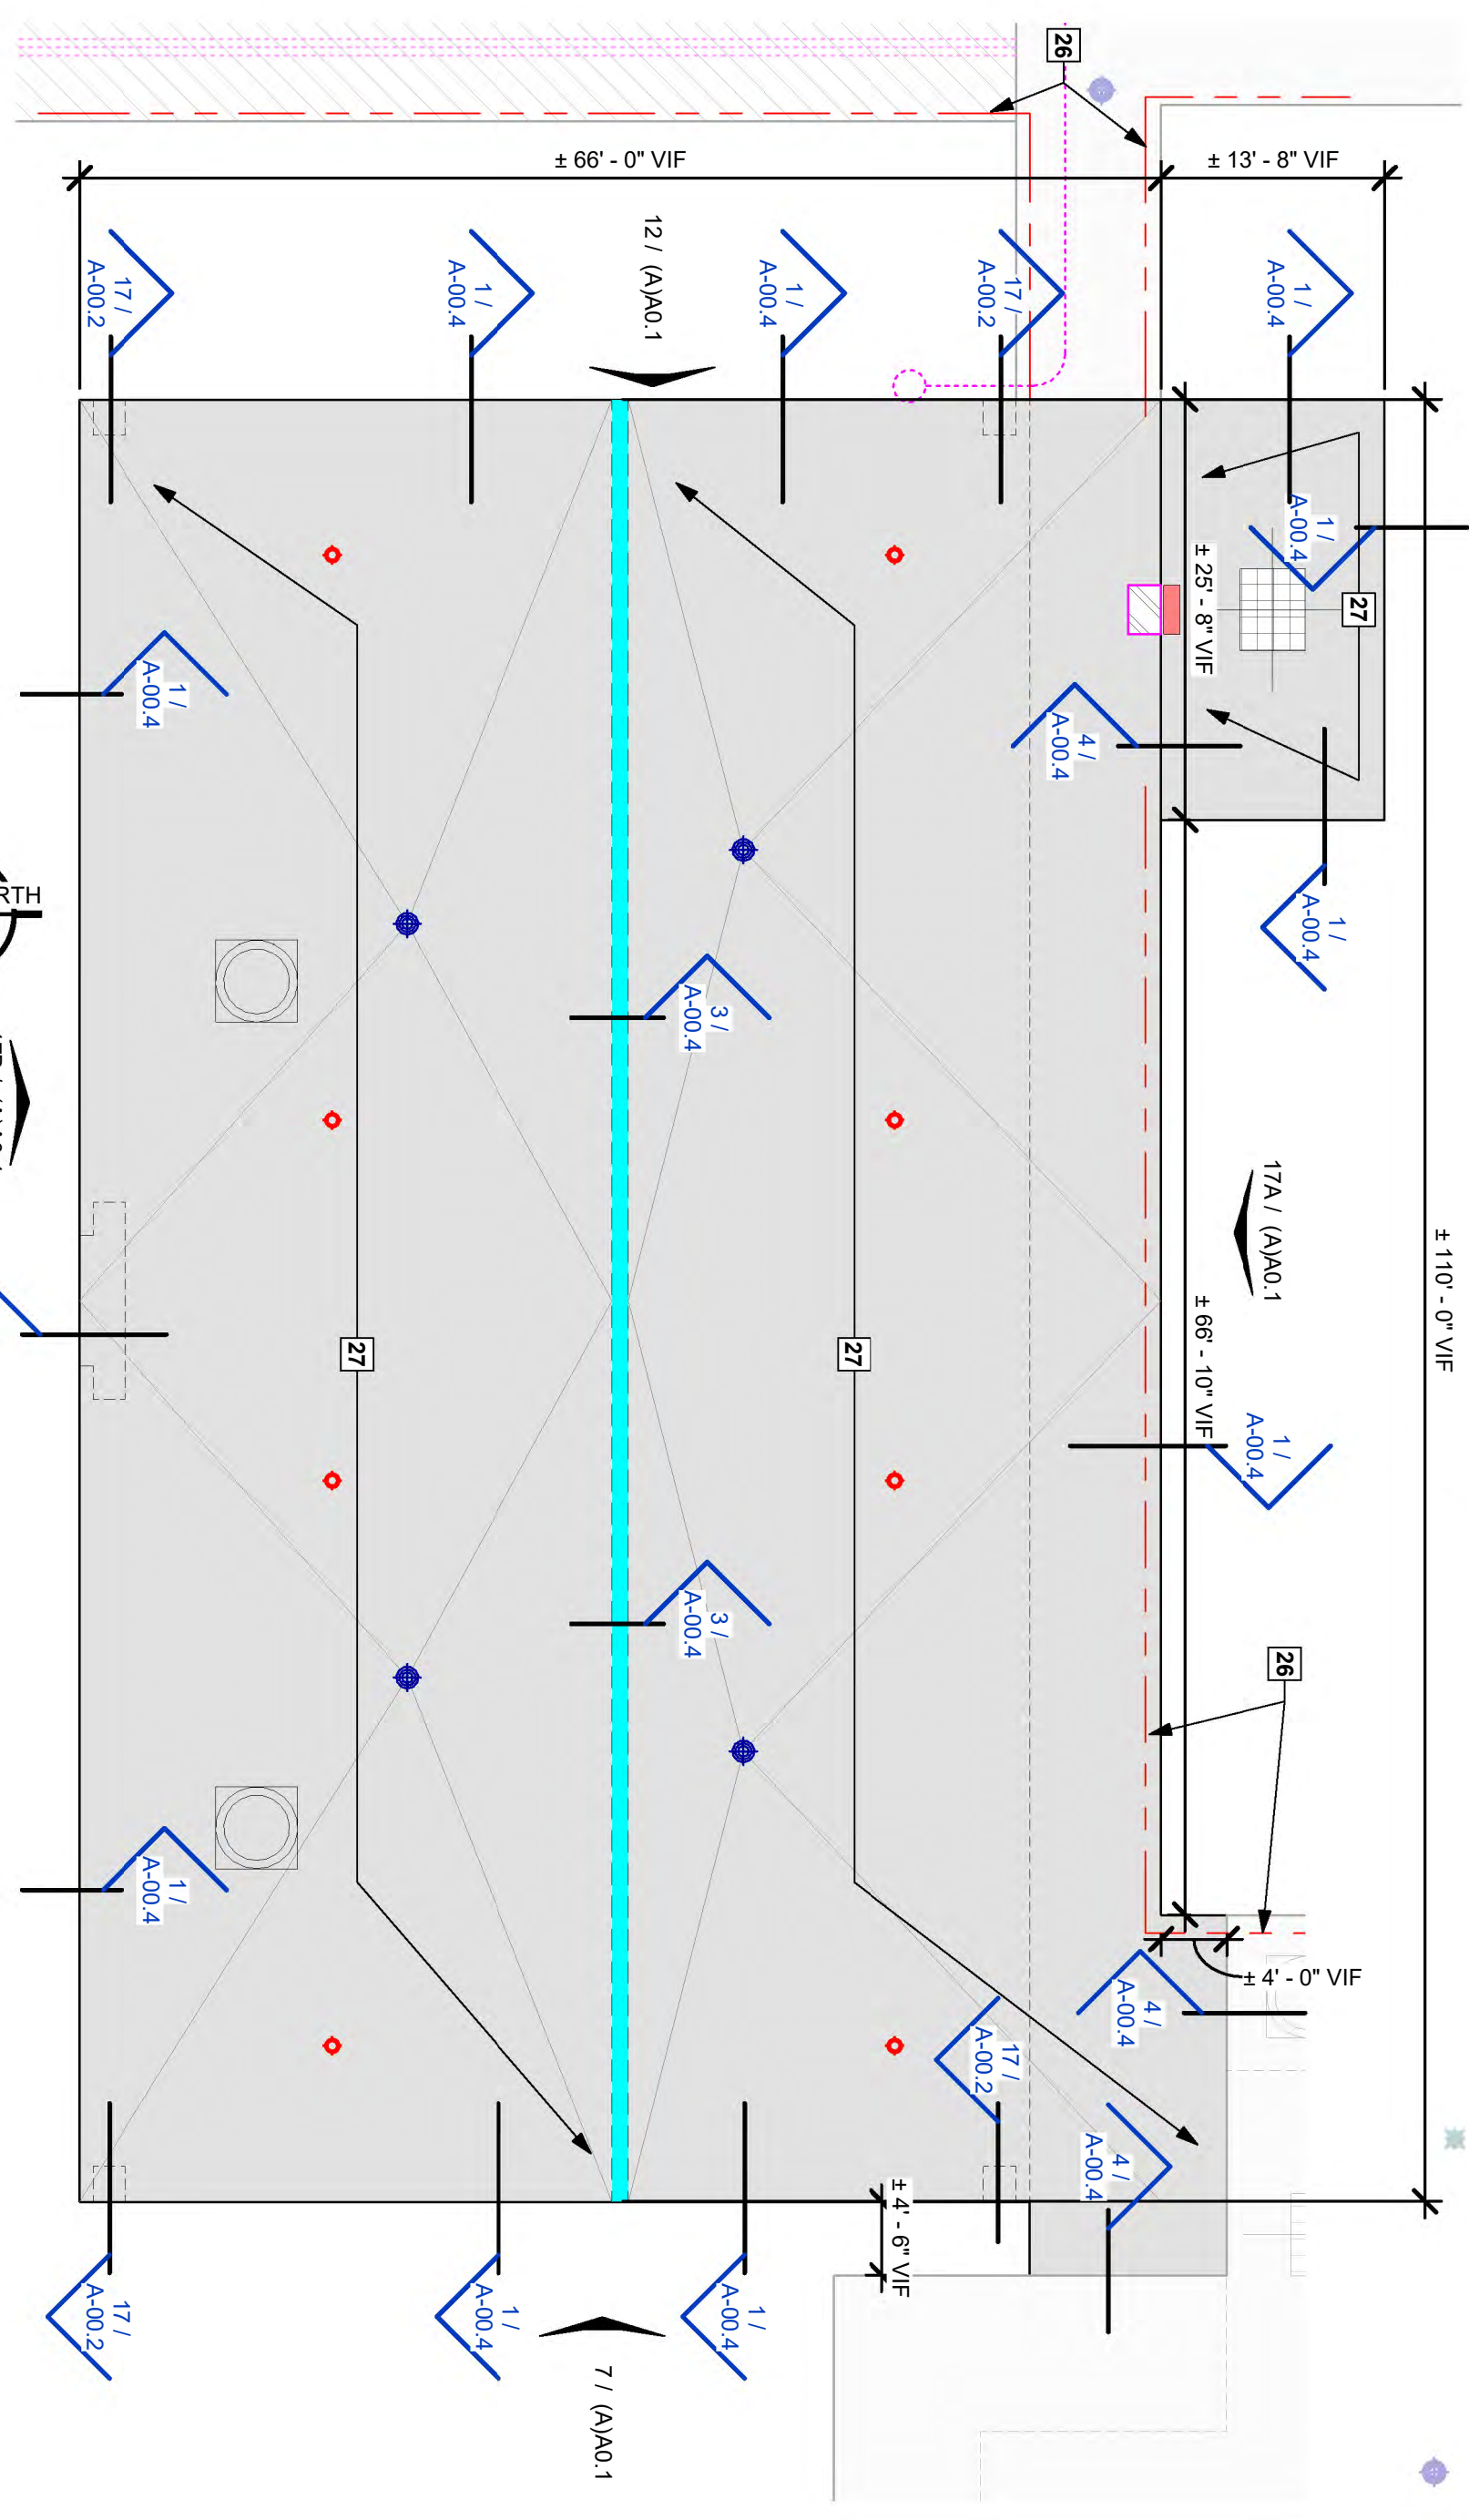
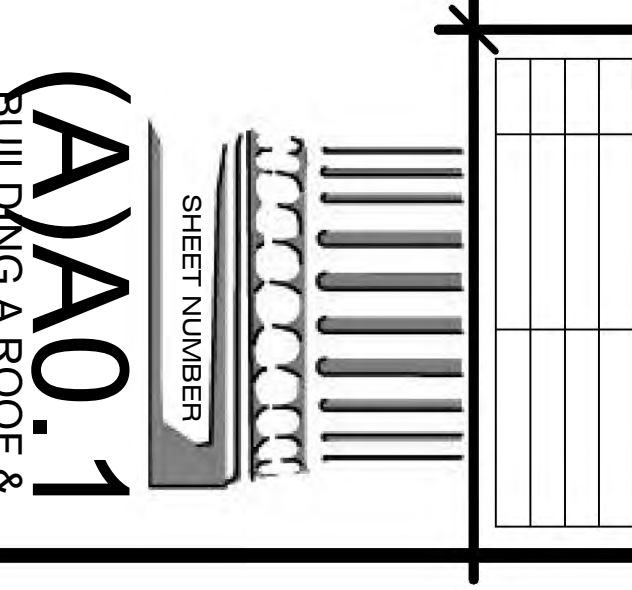
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ROOFING SYMBOL LEGEND table with 10 rows and 2 columns: Symbol and Description.

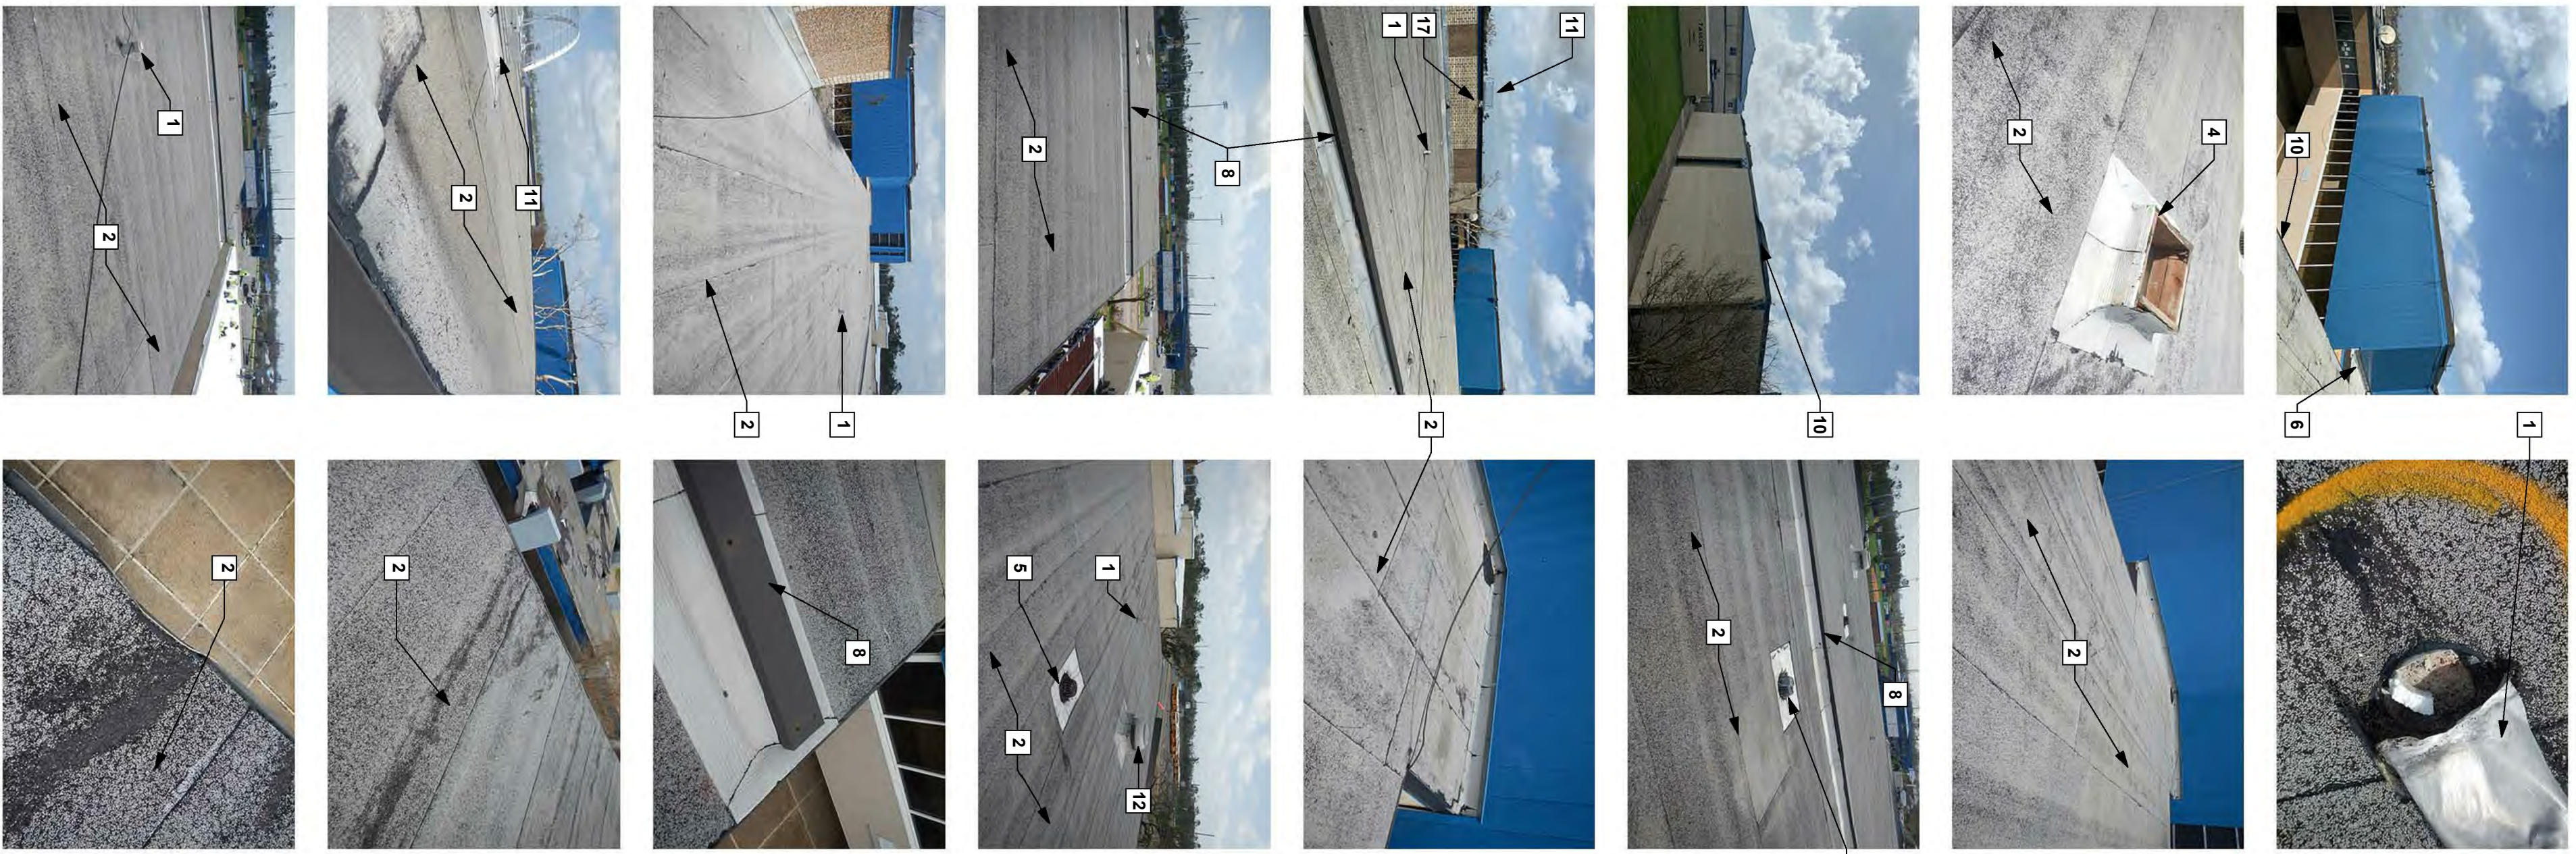

- HAZARDOUS MATERIAL GENERAL NOTES
1. ALL WORK INDICATED AS HAZARDOUS MATERIALS SHALL BE REMOVED BY APARTMENT CONTRACTOR...

- EXISTING PASSIVE AIR ROOF VENT TO BE REMOVED TYPICAL AT RE-ROOFED AREAS...
21. EXISTING PASSIVE AIR ROOF VENT TO BE REMOVED TYPICAL AT RE-ROOFED AREAS...

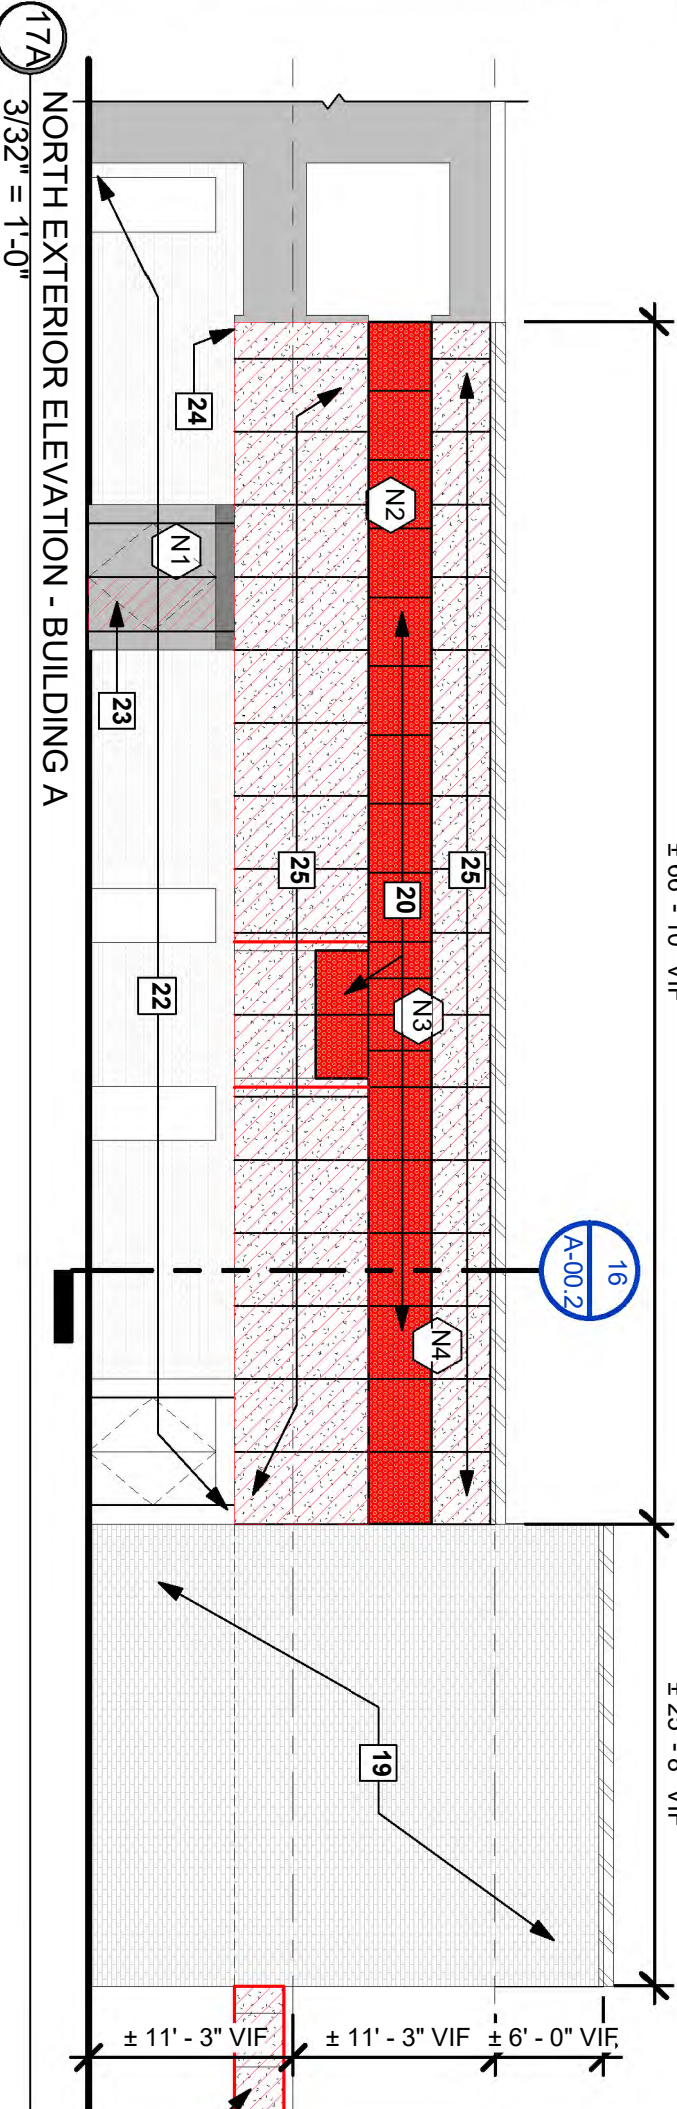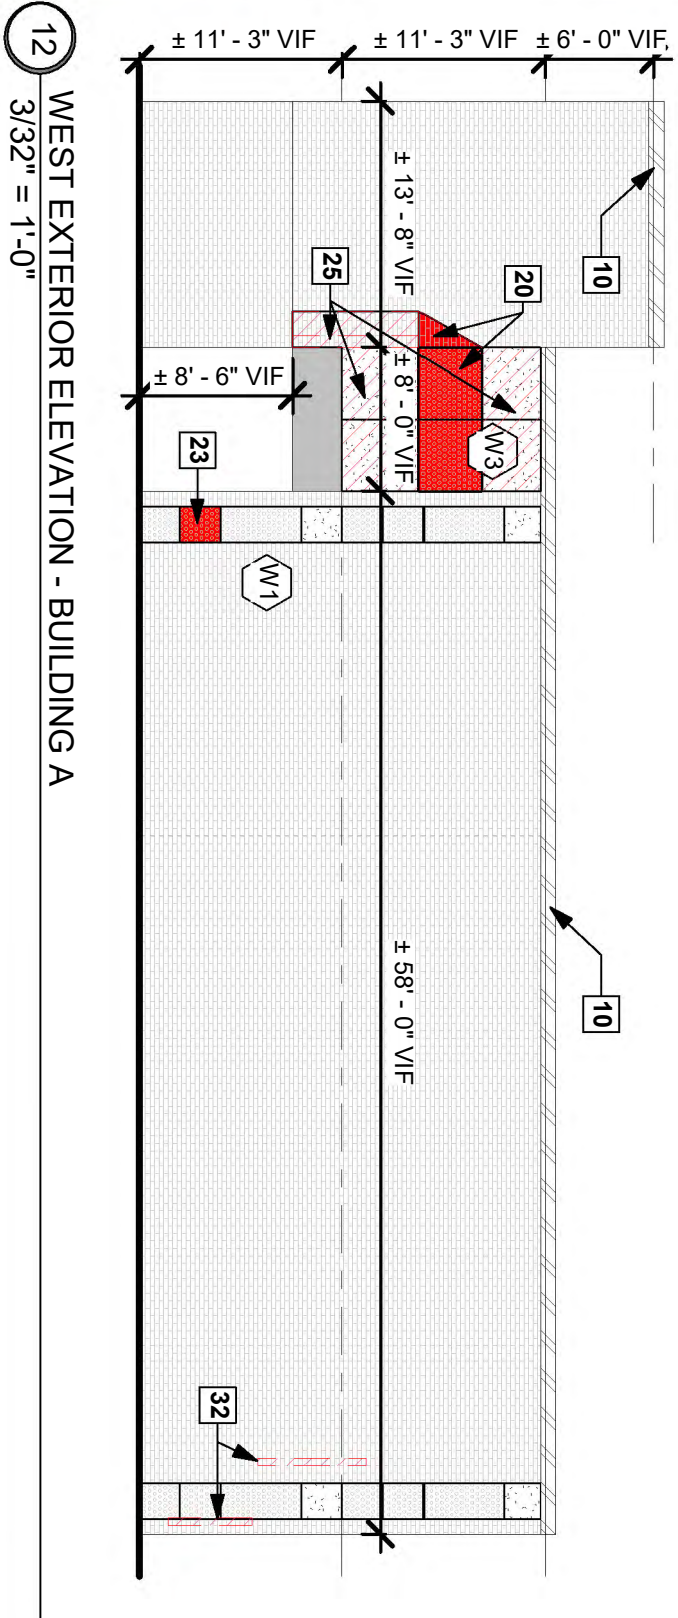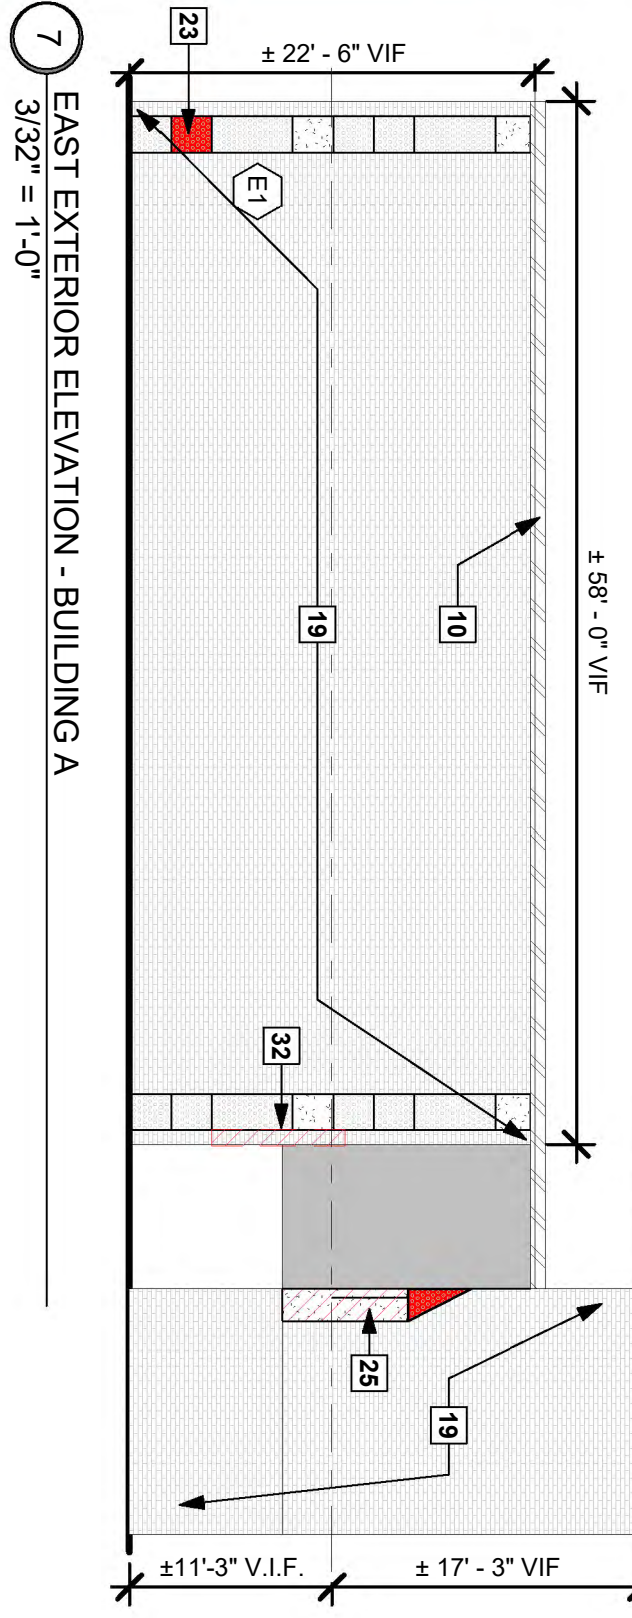
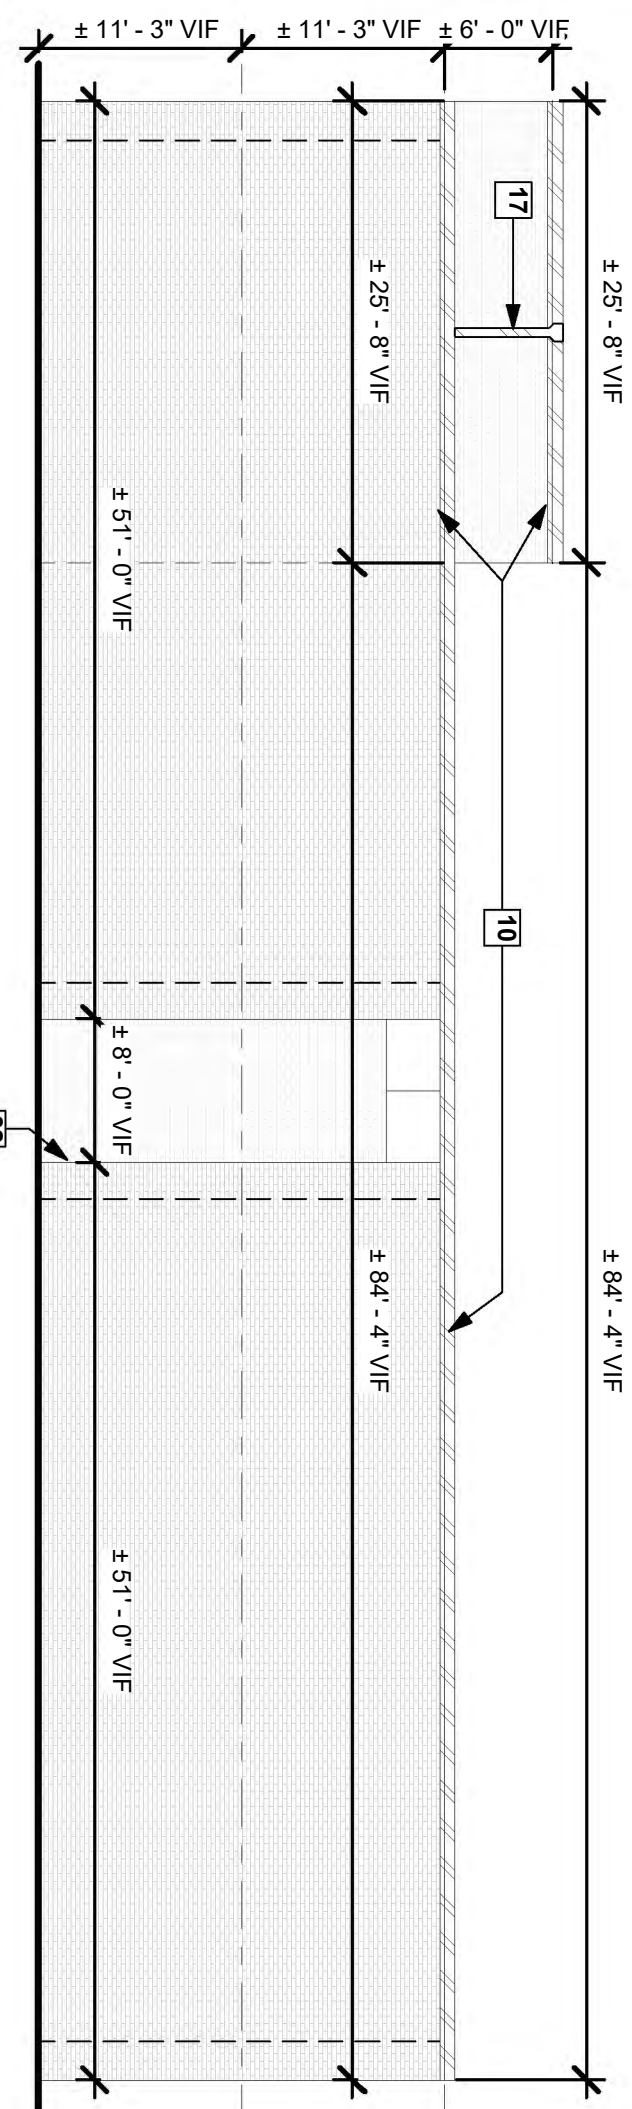


Professional seal and contact information for Randy M. Goodloe, AIA, APAC Architect, including license number and address.

Project title block: HURRICANE LAURA REPAIRS TO A.M. BARBE HIGH SCHOOL FOR CALCASIEU PARISH SCHOOL BOARD, LAKE CHARLES, LA 70605.


Revision table with columns for revision number, date, and description.

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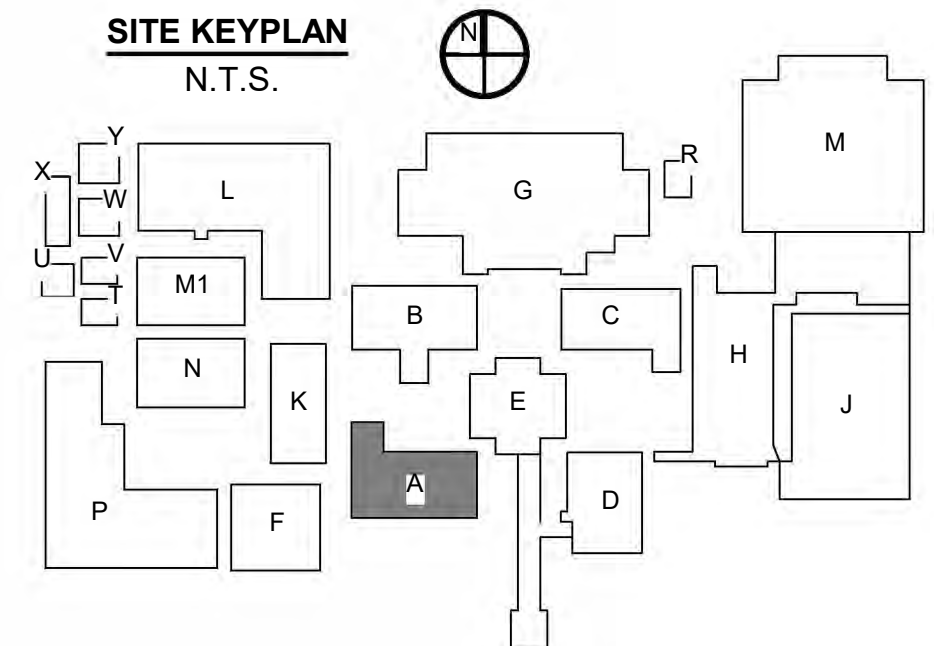
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WINDOW SCHEDULE				
MARK	SIZE	FRAME		COMMENTS
		TYPE	MATERIAL	
W1	SEE ELEVATION	STOREFRONT	EXISTING	REPLACE DAMAGED GLASS AS INDICATED
W3	SEE ELEVATION	STOREFRONT	ALUMINUM, CLEAR ANOD.	REPLACE ENTIRE UNIT
E1	SEE ELEVATION	STOREFRONT	EXISTING	REPLACE DAMAGED GLASS AS INDICATED
N1	SEE ELEVATION	STOREFRONT	EXISTING	REPLACE DAMAGED GLASS AS INDICATED
N2	SEE ELEVATION	STOREFRONT	ALUMINUM, CLEAR ANOD.	REPLACE ENTIRE UNIT
N3	SEE ELEVATION	STOREFRONT	ALUMINUM, CLEAR ANOD.	REPLACE ENTIRE UNIT
N4	SEE ELEVATION	STOREFRONT	ALUMINUM, CLEAR ANOD.	REPLACE ENTIRE UNIT

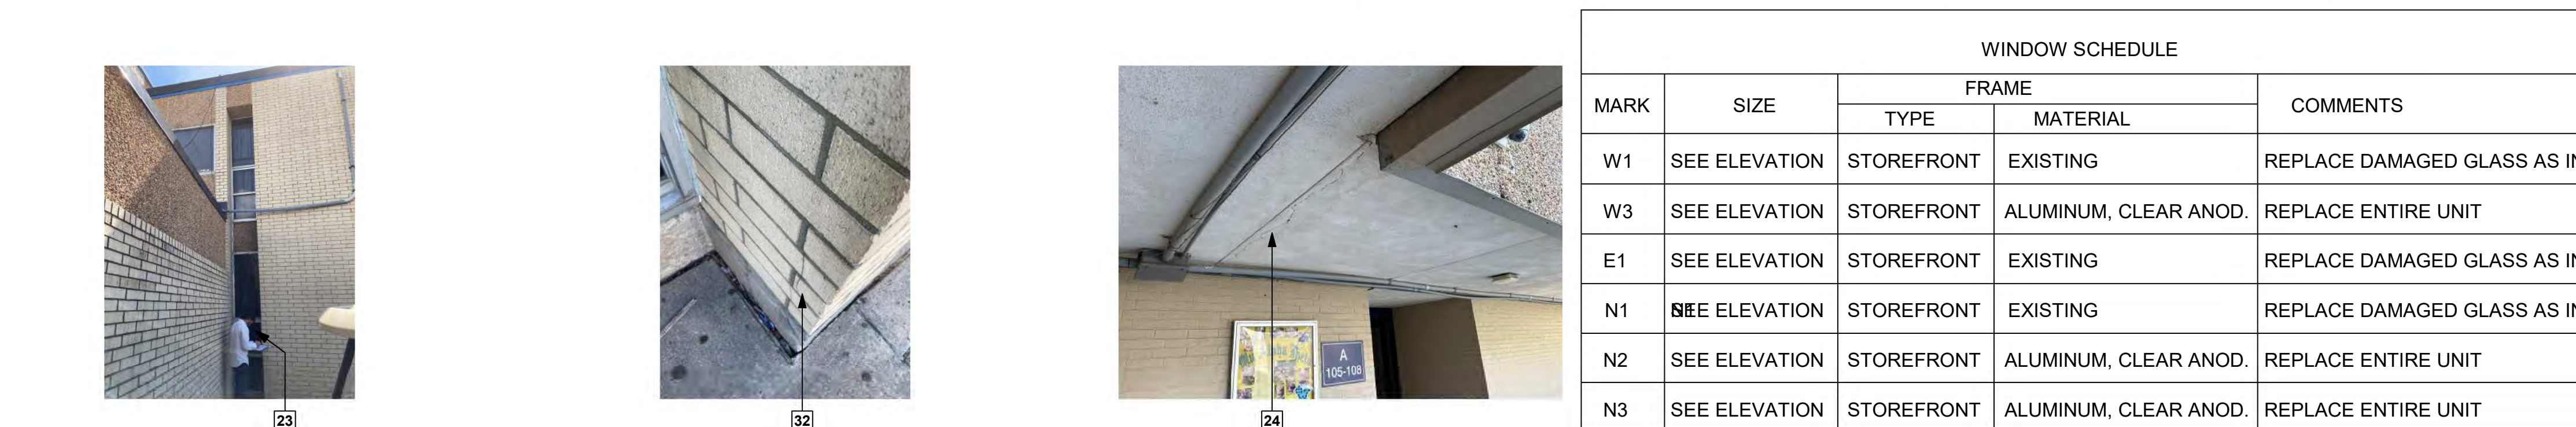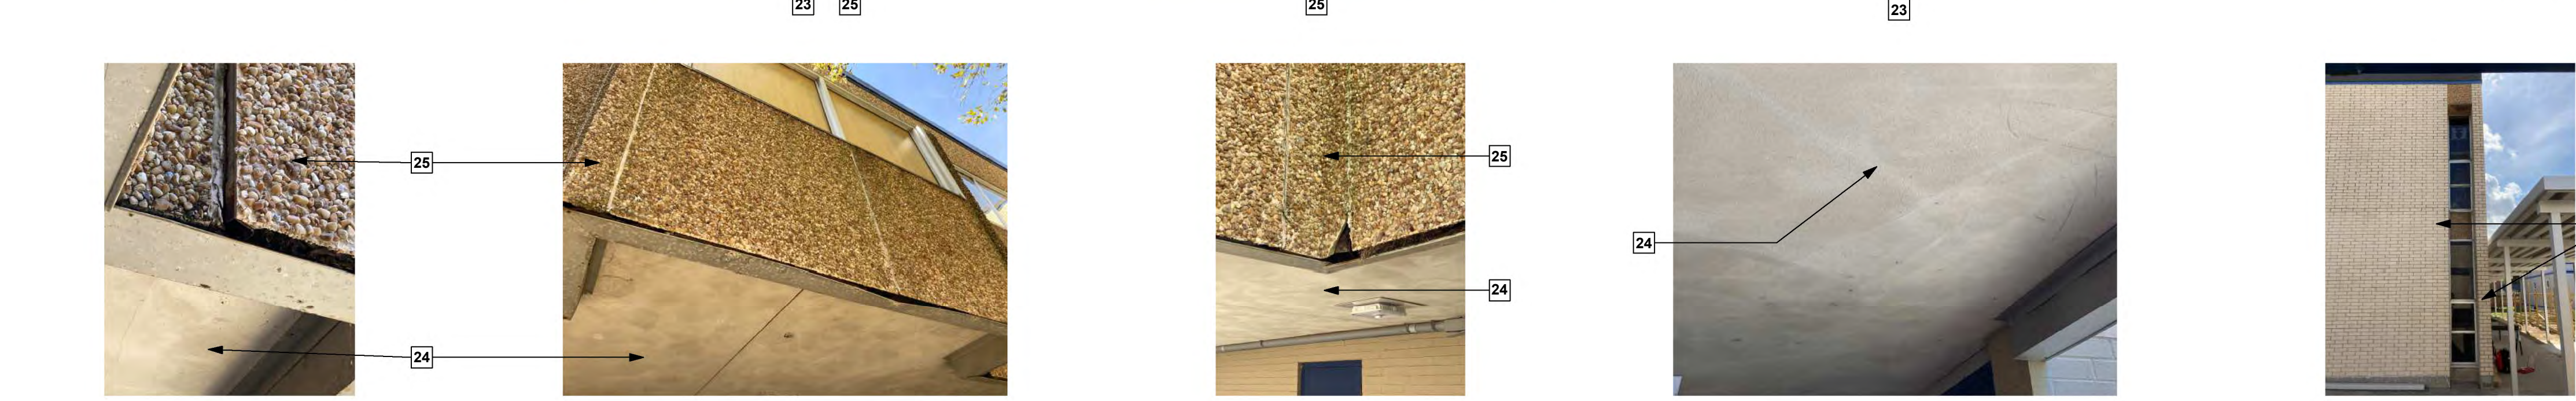

GLAZING SCHEDULE	
G1	CLEAR, INSULATED GLASS AS SPECIFIED.
G2	SPANDRAL GLASS AS SPECIFIED.
G3	TINTED, INSULATED GLASS AS SPECIFIED.
G4	ALUMINUM WINDOW PANEL AS SPECIFIED.

*GLAZING OF NEW STOREFRONT UNITS ARE TO BE LARGE MISSILE IMPACT AS SPECIFIED. REPLACEMENT GLAZING IS TO MATCH EXISTING.

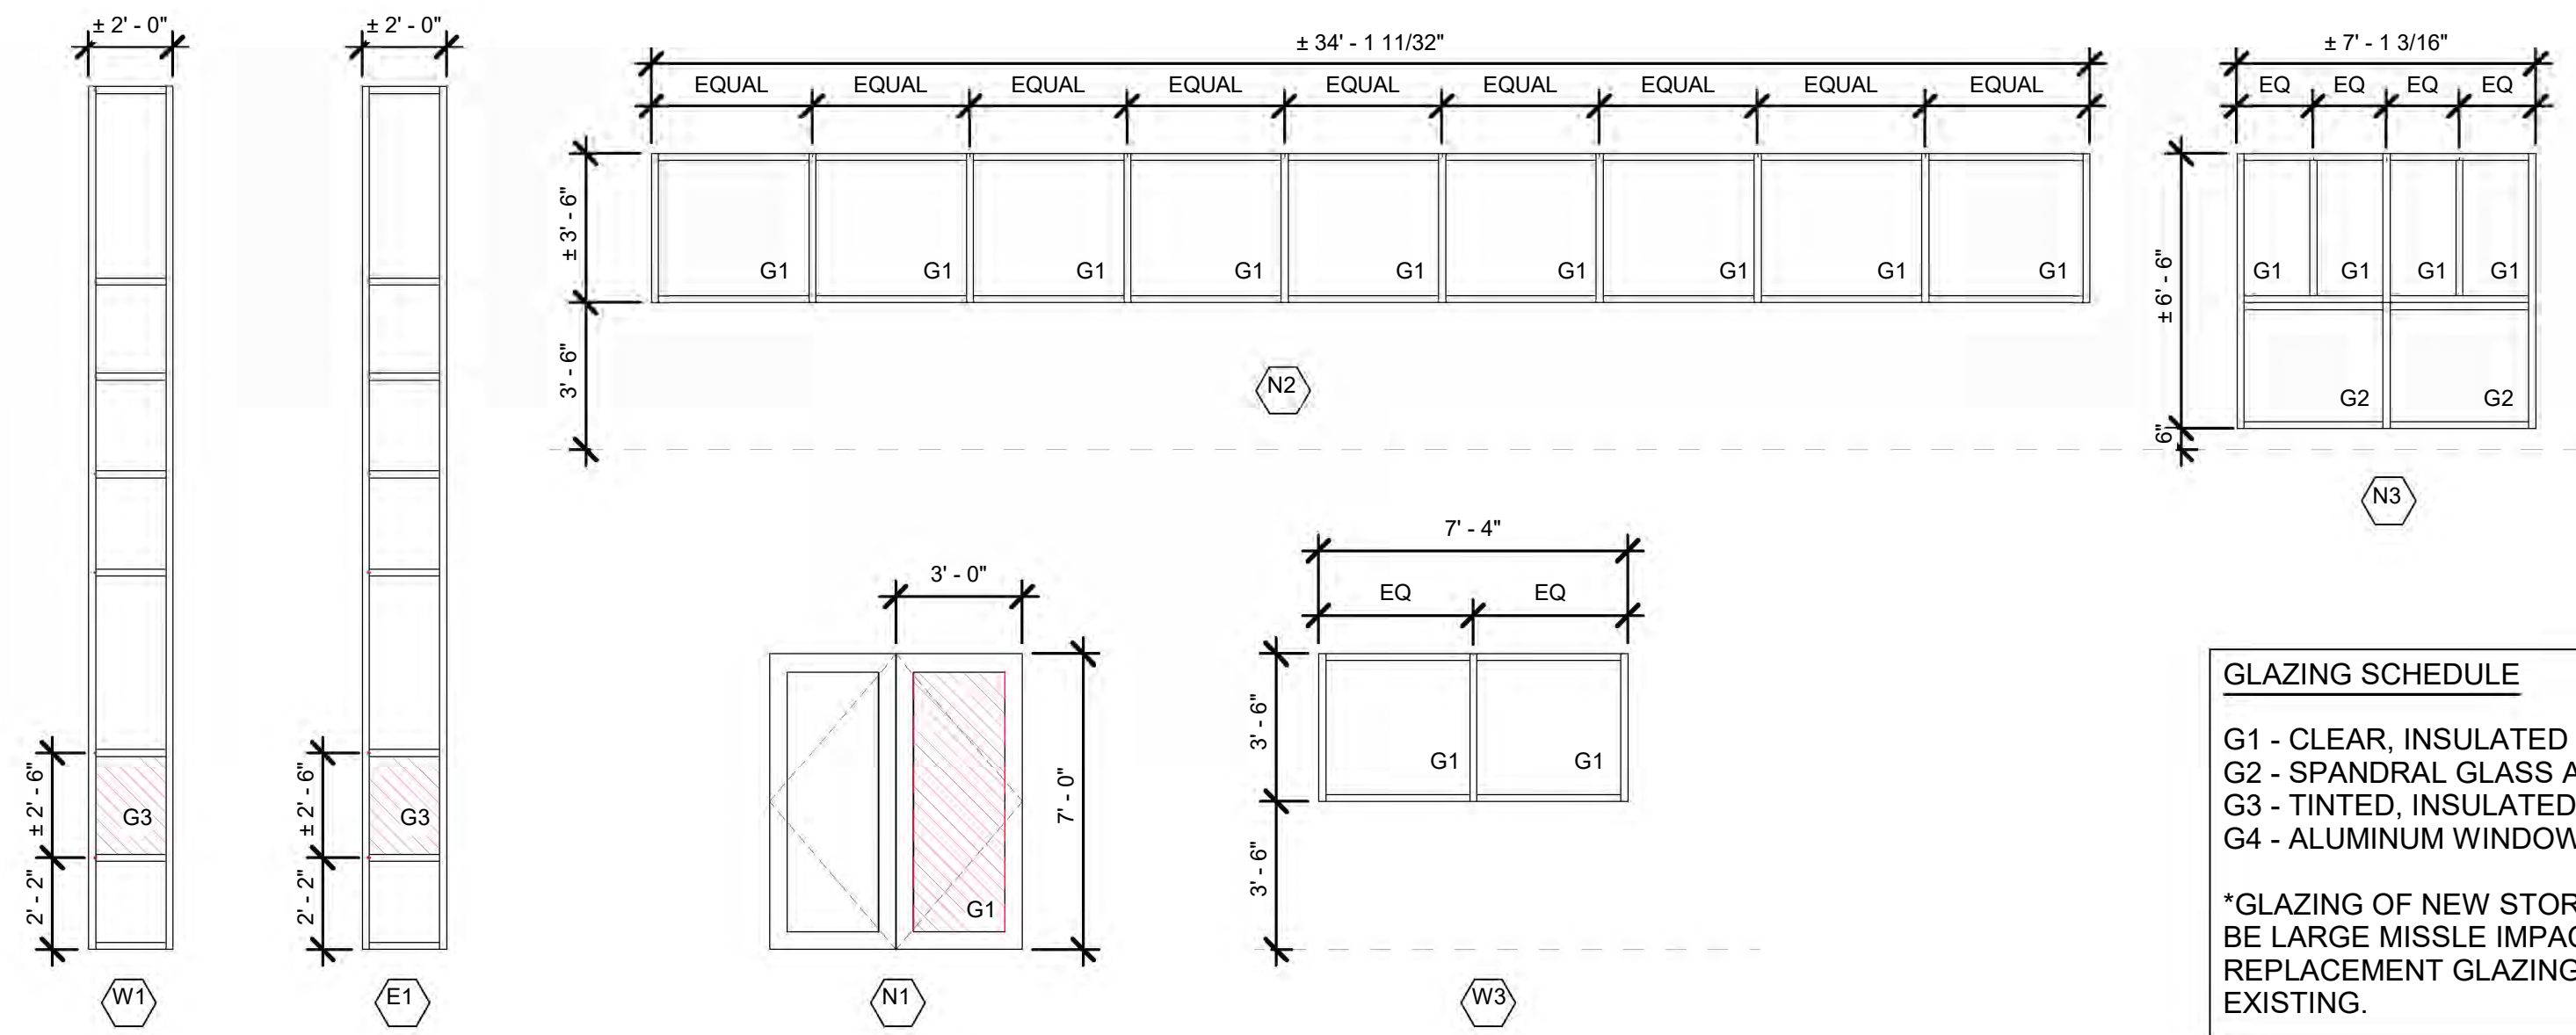

- KEYNOTES**
- EXISTING **PASSIVE AIR ROOF VENT TO BE REMOVED**. TYPICAL AT RE-ROOFED AREAS.
 - SHADED REGION INDICATES EXISTING ROOFING ASSEMBLY TO BE REMOVED TO EXISTING ROOF DECKING SUBSTRATE BELOW, AND NEW ROOFING INSTALLED. ALL DEBRIS IS TO BE REMOVED FROM THE SITE. SEE SPECIFICATIONS. ROOFTOP PENETRATIONS AND EQUIPMENT TO BE VERIFIED BY CONTRACTOR IN THE FIELD.
 - INDICATES **EXISTING RIGID CONDUIT/PIPING RUNS** EXPOSED ON EXISTING ROOF. CONTRACTOR SHALL MAKE VISUAL INSPECTIONS ON SITE TO VERIFY THE EXTENT OF WORK WHICH BE REQUIRED TO MOVE, REPAIR, AND RELOCATE THESE CONDUIT/PIPING RUNS DURING THE PROCESS OF RE-ROOFING AND TO ENSURE THAT THE NEW ROOF SLOPES ARE INTEGRATED AND ACCOUNTED FOR WHERE EXTENSIONS OF THESE CONDUITS AND WIRING IS REQUIRED. PROVIDE NEW "RUNNER CURBS" FOR SUPPORT OF ALL HARD PIPING WHICH IS TO REMAIN ON ROOF AFTER NEW INSTALLATION. SPACE CURBS AS REQUIRED SO CONDUIT AND PIPING DOES NOT SAG BETWEEN THESE LOCATIONS. INSTALL AS DETAILED. SEE KEYNOTE 12.
 - APPROXIMATE LOCATION OF **EXISTING ROOF DRAIN**. CONTRACTOR SHALL VERIFY EXISTING DRAINS AND LOCATIONS, REPLACE CLAMPS AND COVERS TO MATCH EXISTING - PATCH ROOFING AROUND DRAINS. SLOPE ROOF TO DRAIN AT 1/4" PER 1'-0" MIN. TYPICAL AT LOCATIONS OF RE-ROOFING. CONTRACTOR SHALL VERIFY LOCATION OF EXISTING OVERFLOW DRAINS AND SHALL MAINTAIN ALL OVERFLOWS IN FINAL ROOFING ASSEMBLY.
 - SEE DETAILS FOR **FLASHING AND COUNTERFLASHING** WHICH IS TO TIE INTO THE EXISTING BUILDING ENVELOPE. VERIFY CLEARANCES AND LOCATIONS FOR INSTALLATION OF ALL FLASHING AND TERMINATING BARS AS DETAILED. SEE KEYNOTE 3.
 - INDICATES APPROXIMATE AREA AND LOCATION OF **ROOF EXPANSION JOINT**. CONTRACTOR SHALL VISUALLY INSPECT THE EXISTING CONDITIONS AT THE SITE AND PROVIDE A NEW EXPANSION JOINT AS DETAILED. THE INSTALLER SHOULD ASSURE THAT ALL EXISTING WOOD BLOCKING SHALL BE REPLACED WITH NEW TREATED WOOD BLOCKING AS PER DETAILS. PROVIDE NEW CANT STRIP, FLASHING, PRE-FINISHED EXPANSION JOINT COVER, VINYL BELLOWS, AND BASE FLASHING AS DETAILED. VERIFY EXACT ROUTING AND AREA WHERE THIS EJ IS TO BE REMOVED AND REPLACED. VERIFY ALL EXISTING CONDITIONS, ESPECIALLY ANY PIPING, AND CONDUIT WHICH MIGHT INTERSECT OR CROSS OVER THIS JOINT.
 - CONTRACTOR SHALL INSPECT ALL EXISTING **ROOF PENETRATIONS**. EXTEND VENT PIPING AND OTHER PENETRATIONS WHERE REQUIRED. REPLACE ALL LEAD VENT & PIPE FLASHING. TYPICAL ALL LOCATIONS OF RE-ROOFING.
 - REMOVE AND REPLACE **FLASHING, COUNTER-FLASHING** AND PRE-FINISHED METAL FASCIA FLASHING AS DETAILED.
 - APPROXIMATE LOCATION OF **SKYLIGHT** - CONTRACTOR TO VERIFY IN FIELD. REMOVE AND REPLACE SKYLIGHT WITH NEW, TO MATCH EXISTING SIZE, SHAPE, AND FINISH. FLASH AND INSTALL PER MANUFACTURER'S INSTRUCTIONS. TYPICAL ALL LOCATIONS OF RE-ROOFING.
 - INDICATES **EXISTING ROOFTOP EQUIPMENT**. COORDINATE WITH MEP - PROVIDE NEW CURBS AS NECESSARY TO ENSURE PROPER CURB HEIGHT AND ATTACHMENT AT NEW ROOFS. PROTECT UNDAMAGED EQUIPMENT.
 - SATELLITE DISHES**, MOUNTS AND WEIGHTS TO BE REMOVED AND DISPOSED OF. PATCH ALL HOLES CAUSED BY STRUCTURE PER ROOFING MANUFACTURER RECOMMENDATIONS.
 - REMOVE AND REPLACE DAMAGED AND MISSING **METAL WALL PANEL** "E" AS SPECIFIED. SEE BUILDING ELEVATIONS.
 - INSTALL DAMAGED AND MISSING LETTERING AND **SIGNAGE** TO MATCH EXISTING.
 - ROOF ACCESSORY REPLACEMENT**: REPLACE DAMAGED ROOF ACCESSORIES. MATCH EXISTING TYPE, MATERIAL, AND STYLE.
 - REMOVE AND REPLACE PRE-FINISHED METAL DOWNSPOUT WITH NEW TO MATCH EXISTING COLOR, GAUGE, SIZE, & PROFILE. REMOVE PREVIOUS ATTACHMENTS AND FASTENERS & REPLACE WITH NEW. GROUT FILL ALL HOLES.
 - SEE KEYNOTE 13
 - EXTERIOR METAL STAIR**: SEE STRUCTURAL SHEETS. REMOVE STAIRS AS REQUIRED TO REPAIR SOFFIT OF 1ST FLOOR. REINSTALL STAIR UNIT. PROVIDE NEW THRESHOLD AS REQUIRED TO ABUT EXISTING FLOOR.
 - REMOVE PLYWOOD AND INSTALL NEW CLEAR **PLEXIGLASS PANEL** TO MATCH ADJACENT PANELS. REMOVE AND REPLACE ACCOMPANYING HORIZONTAL AND VERTICAL MULLIONS WHERE PLYWOOD IS INSTALLED.
 - REMOVE AND REPLACE **DAMAGED BRICK FACADE** AND MORTAR AS INDICATED. DISPOSE OF DAMAGED BRICK, MATCH NEW BRICK AND MORTAR TO EXISTING AS APPROVED BY ARCHITECT. PRESERVE SUBSTRATE, REMOVE OLD BRICK TIES AND WATER PROOFING. INSTALL NEW WATERPROOFING AND BRICK TIES AT A MIN. OF 24" O.C. VERTICAL AND HORIZONTAL. WATERPROOFING TO BE TAPED WITH MANUFACTURER APPROVED TAPE AND LAPPED TO PREVENT MOISTURE PENETRATION INTO THE BUILDING ENVELOPE.
 - CLEAN, PREP & RE-PAINT WALLS AND ARTWORK TO COVER SCUFFS AND DAMAGE FROM STORM DEBRIS. COLOR AND PAINT DESIGNS TO MATCH EXISTING AS APPROVED BY ARCHITECT.
 - REMOVE AND REPLACE **DAMAGED AND MISSING GLASS** TO MATCH EXISTING. PROVIDE CAULKING AND GASKETING FOR WATER-TIGHT SEAL. WHERE PLYWOOD HAS BEEN INSTALLED, REMOVE & DISPOSE OF PLYWOOD WHEN NEW GLASS IS INSTALLED.
 - EXISTING STUCCO SOFFIT TO BE REMOVED** BY ABATEMENT CONTRACTOR. INSTALL NEW 5/8" GLASS-MAT GYPSUM BOARD ON NEW METAL SUSPENSION SYSTEM AS SPECIFIED. INSTALL NEW CEMENT BOARD STUCCO SYSTEM FINISH AS SPECIFIED. COORDINATE WITH ABATEMENT SCOPE & ABATEMENT CONTRACTOR TO ENSURE WEATHER-TIGHTNESS AND PHASING COORDINATION.
 - COORDINATE REMOVAL OF (METAL PANELS WHERE APPLICABLE AND) **AGGREGATE PANELS (HAZARDOUS MATERIAL)** WITH ABATEMENT SCOPE AND ABATEMENT CONTRACTOR. COORDINATE AND INSTALL NEW FACADE PANELS AS SPECIFIED. SALVAGE AND REINSTALL MEP COMPONENTS AT SAME LOCATIONS - COORDINATE WITH MEP.
 - SEE KEYNOTE 3
 - SHADED REGION INDICATES EXISTING ROOFING ASSEMBLY TO BE REMOVED INCLUDING ROOF DECKING SUBSTRATE TO STRUCTURE BELOW, AND NEW ROOFING AND DECKING INSTALLED. ALL DEBRIS IS TO BE REMOVED FROM THE SITE. SEE SPECIFICATIONS. ROOFTOP PENETRATIONS AND EQUIPMENT TO BE VERIFIED BY CONTRACTOR IN THE FIELD.
 - PROVIDE **SCUPPER** THROUGH ROOF EDGE. SLOPE ROOFING AT 1/4" PER 1'-0" MIN. TO ENSURE POSITIVE DRAINAGE. COORDINATE LOCATIONS AND SIZES WITH EXISTING. NEW SCUPPERS TO BE PROVIDED AS DETAILED AND ROOF TAPER PROVIDED ACCORDINGLY.
 - REMOVE AND REPLACE PRE-FINISHED METAL GUTTER WITH NEW TO MATCH EXISTING COLOR, GAUGE, SIZE, & PROFILE. REMOVE PREVIOUS ATTACHMENTS AND FASTENERS & REPLACE WITH NEW. GROUT FILL ALL HOLES.
 - APPROX **DOWNSPOUT/COLLECTOR LOCATIONS**. SALVAGE UNDAMAGED DOWNSPOUTS FOR REINSTALLATION. REMOVE AND REPLACE DAMAGED DOWNSPOUTS TO MATCH EXISTING. MAINTAIN EXISTING DRAINAGE METHODOLOGY AND REINSTALL SALVAGED AND NEW MATERIALS WITH NEW ROOF AND FACADE TO MATCH EXISTING. TYPICAL AT ALL LOCATIONS OF RE-ROOFING.
 - REMOVE AND REPLACE **BRICK WALL** AS INDICATED. DISPOSE OF OLD BRICK, MATCH NEW BRICK AND MORTAR TO EXISTING AS APPROVED BY ARCHITECT. SEE STRUCTURAL BUILDING TO REMAIN.
 - WEATHERPROOF AND CONDITIONED DURING REPAIRS.
 - REPORT EXTERIOR AND INTERIOR **BRICK** AS SPECIFIED WHERE INDICATED. REPAINT IN COLOR TO MATCH EXISTING FROM END TO END.
 - REMOVE AND REPLACE **STOREFRONT WINDOW** AS SPECIFIED.

RMG ARCHITECT

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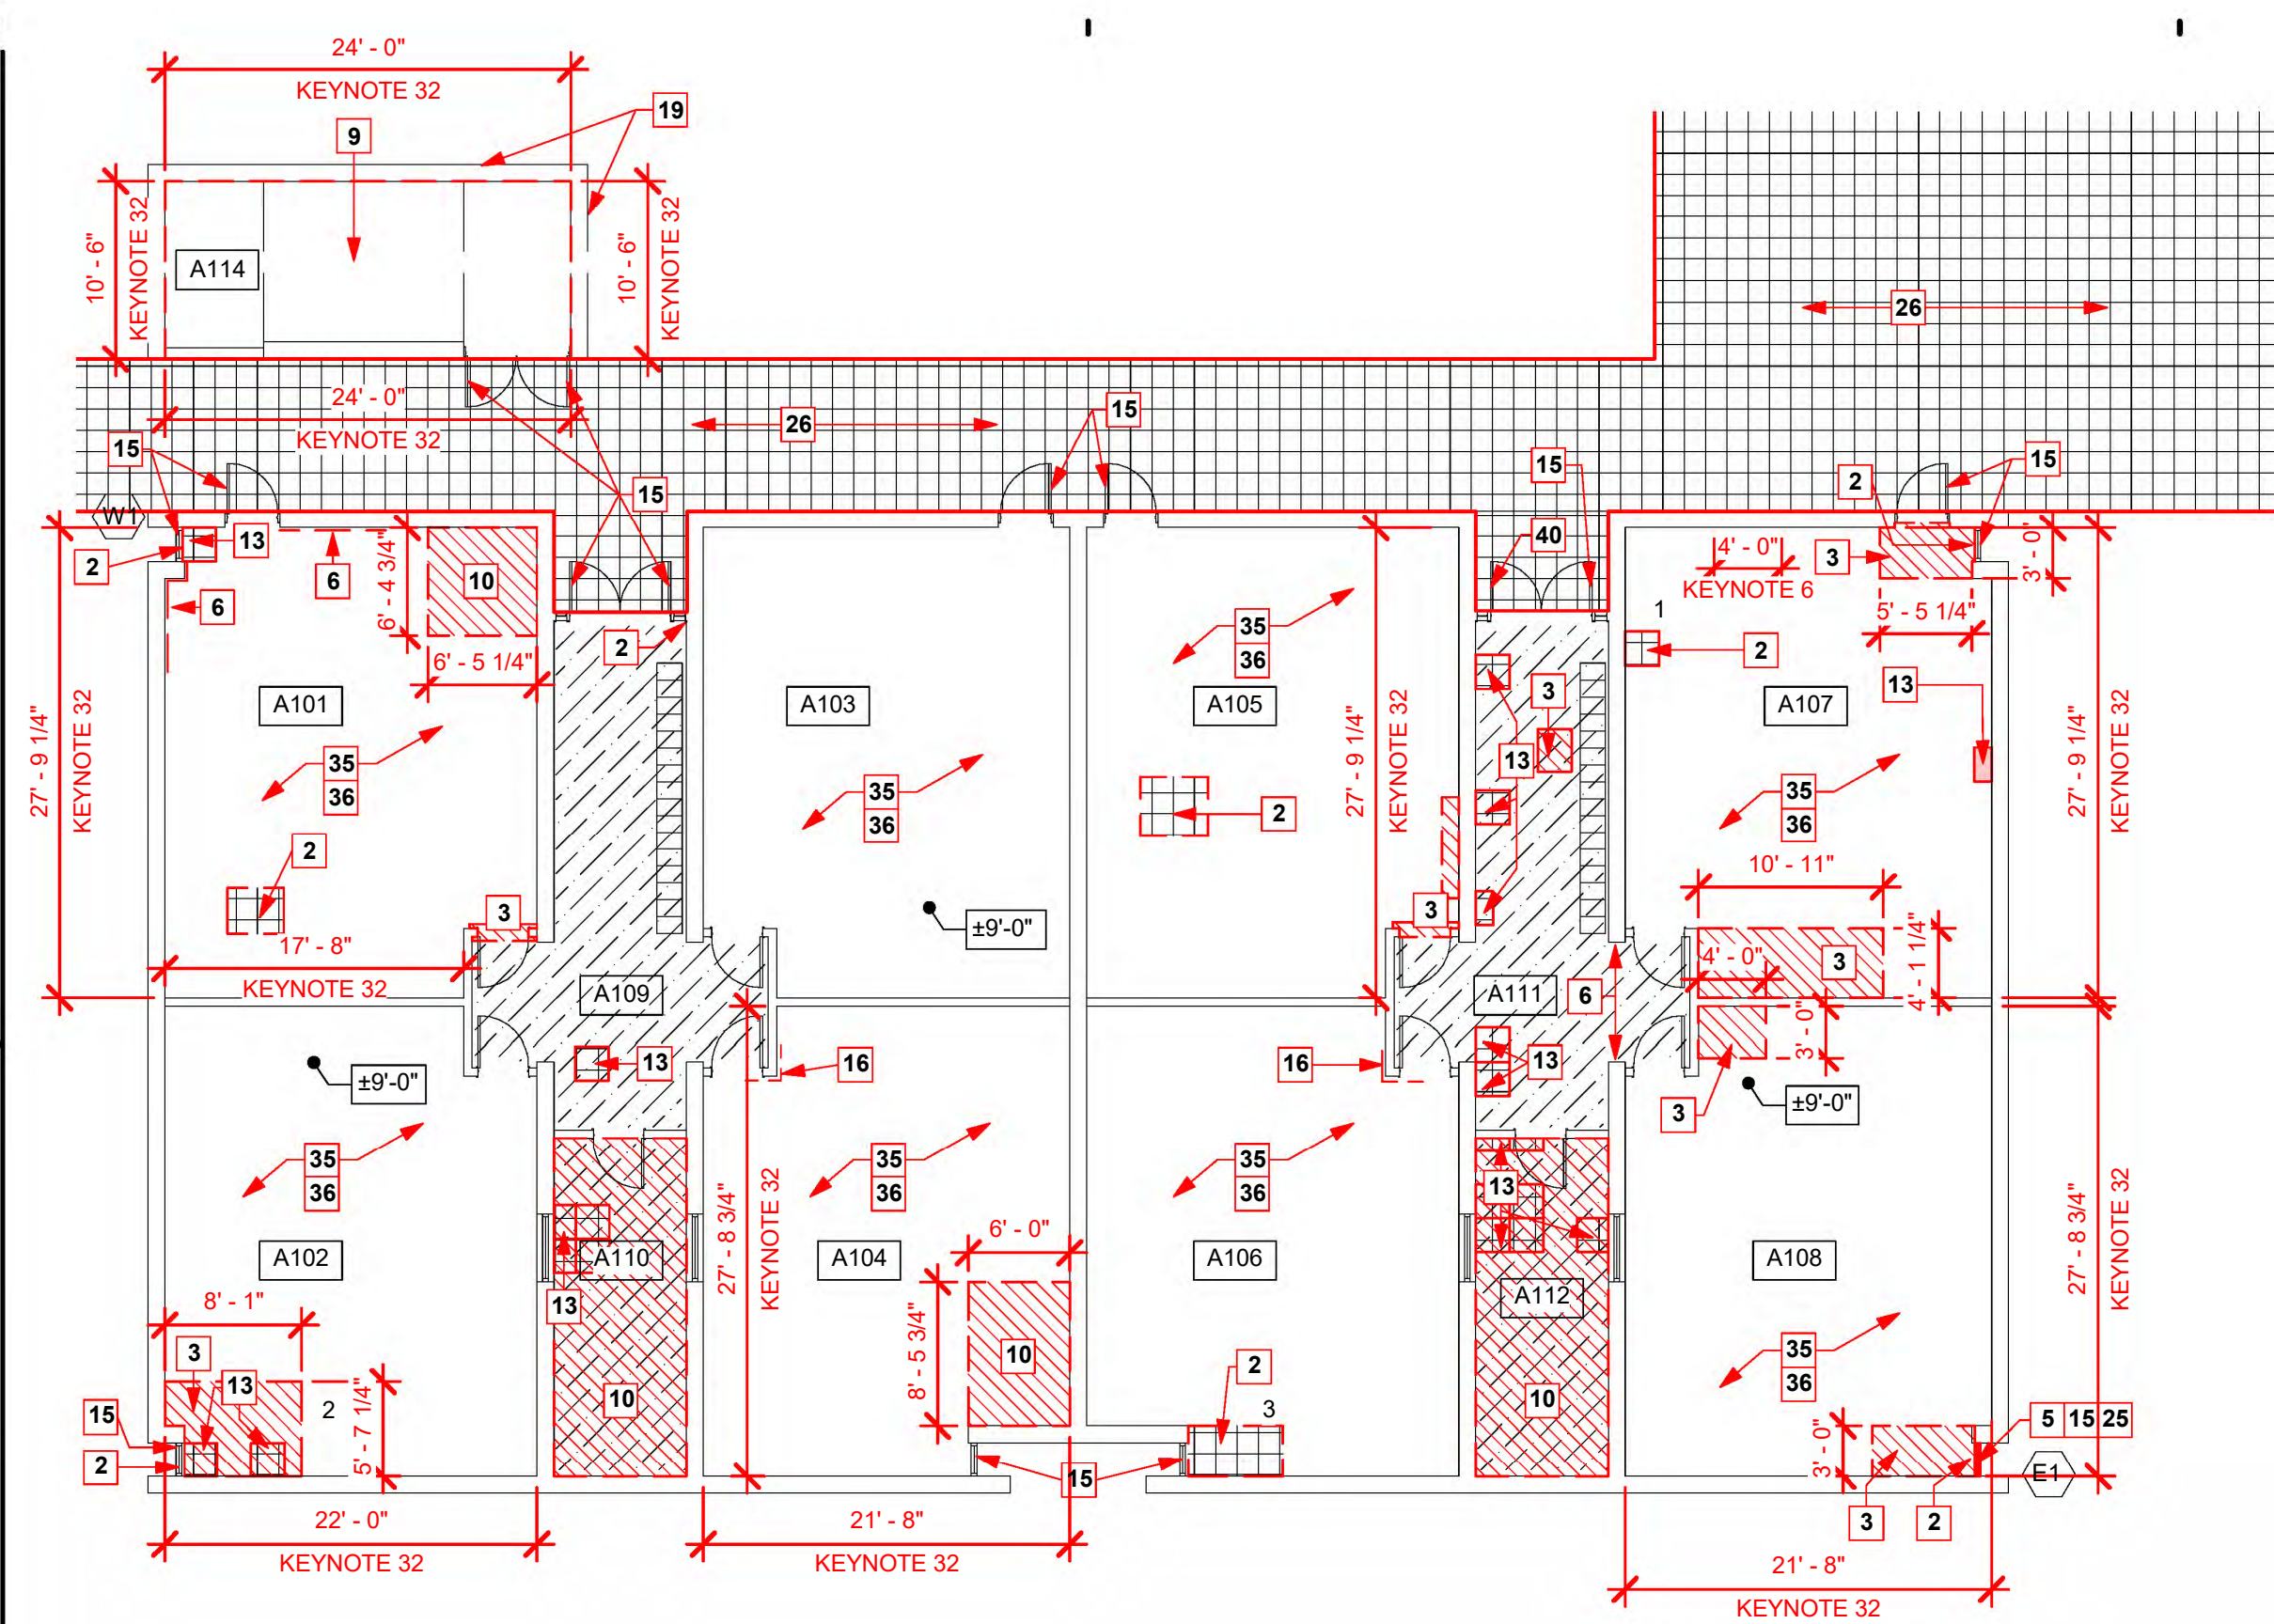
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2200 W. McNEESE ST.
FOR
CALCASIEU PARISH SCHOOL BOARD
LAKE CHARLES, LA 70605
HL-003-01.03.04.05.06.07

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RMG PROJECT NO.
20042-01-G
OWNER PROJECT NO.
HL-003-01.03.04.05.06.07
PROJECT MANAGER
TM
DATE ISSUED
06/28/2024

REVISIONS

SHEET NUMBER
(A)A0.2
BUILDING A
REFERENCE IMAGES






6 Zone 1 - Building A First Floor
3/32" = 1'-0"



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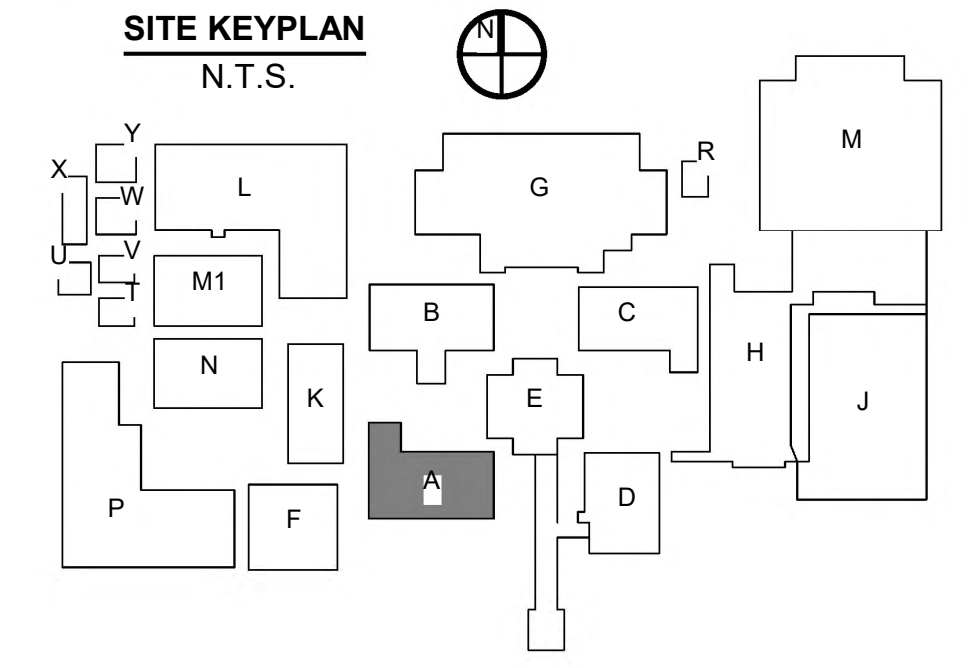
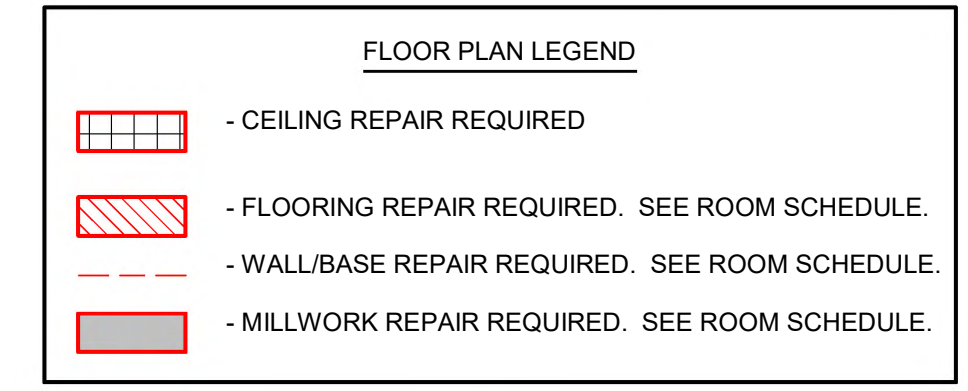
- KEYNOTES**
- SUSPENDED ACOUSTIC CEILING REPLACEMENT: REMOVE AND REPLACE DAMAGED ACOUSTIC GRID AND CEILING TILE AS SPECIFIED.
 - CEILING GRID: REMOVE AND REPLACE DAMAGED CEILING GRID. MATCH EXISTING. SEE UNIT PRICE NO. 5
 - VCT FLOORING REPAIRS: REMOVE AND REPLACE VCT FLOORING AS SPECIFIED IN AREAS WHERE INDICATED. SEE UNIT PRICE NO. 3
 - WINDOW REPAIRS: REPLACE BROKEN WINDOW PANE, BLOCKS, AND GASKETS TO MATCH EXISTING. ALL SEALANTS SHALL BE REMOVED AND REPLACED AS SPECIFIED TO ENSURE WEATHER TIGHT SEAL. SEE ELEVATIONS.
 - STRUCTURAL CLAY BLOCK: GLAZED STRUCTURAL CLAY BLOCK TO BE REMOVED AND REPLACED AS SPECIFIED TO MATCH EXISTING. CLEAN ALL CHALKING RESIDUE FROM EFFERVESCENCE.
 - VINYL BASE REPLACEMENT: REPLACE DAMAGED OR MISSING BASE AS SPECIFIED TO MATCH EXISTING. SEE UNIT PRICE NO. 4
 - CARPET REPAIRS: DAMAGED CARPET HAS BEEN REMOVED. CLEAN FLOOR AND INSTALL NEW CARPET TILE AS SPECIFIED.
 - PAINTING: WALL SURFACE IS TO BE SANDED, PREPARED, AND REPAINT TO MATCH EXISTING CORNER TO CORNER. WATER STAINED WALL FROM ROOF LOSS.
 - PAINTED CEILING STRUCTURE: CEILING INCLUDING METAL TRUSSES ARE TO BE CLEANED, PREPPED, AND REPAINTED END TO END TO MATCH EXISTING COLOR.
 - VCT FLOORING CLEANING: CLEAN WATER STAINS FROM VCT FLOORING TO REMOVE ANY DISCOLORATION WHERE INDICATED. MOP AND WAX ALL VCT FLOORING AT THE END OF CONSTRUCTION.
 - SKYLIGHT REPAIRS: REMOVE AND REPLACE SKYLIGHT TO MATCH EXISTING.
 - TERRAZZO FLOORING CLEANING: CLEAN AND POLISH EXISTING TERRAZZO FLOORING REFER TO ROOM SCHEDULE FOR CLARITY.
 - CEILING TILE REPLACEMENT: REMOVE AND REPLACE DAMAGED OR MISSING ACOUSTIC CEILING TILE WITH NEW CEILING TILE AS SPECIFIED IN AREAS INDICATED. MATCH EXISTING TYPE AND SIZE. SEE UNIT PRICE NO. 1. INSTALL R-30 BATT INSULATION OVER TILE. SEE UNIT PRICE NO. 2
 - NOT USED.
 - EXTERIOR WINDOWS AND DOORS: CAULK AND RESEAL PERIMETER OF EXISTING WINDOWS AND DOORS.
 - CMU REPAIR: RE-POINT DAMAGED CMU JOINTS AS SHOWN. PAINT WALL FROM END TO END IN COLOR TO MATCH EXISTING AS SPECIFIED. SEE PHOTOS.
 - BRICK REPAIR: CAULK CRACKED AREAS AND REPAINT.
 - LOCKERS: REPAIR DAMAGED UNITS AS SHOWN. MATCH EXISTING STYLE, SIZE AND COLORS.
 - BRICK WALLS: CLEAN ALL WATER STAINS FROM ENTIRE BRICK WALL.
 - SHELVING REPLACEMENT: REMOVE AND REPLACE DAMAGED SHELVING UNITS WITH GLASS DOORS. MATCH EXISTING MATERIALS, FINISHES AND CONSTRUCTION STYLE.
 - BASE CABINET: REMOVE AND REPLACE DAMAGED BASE CABINET. MATCH EXISTING STYLE, SIZE, AND CONSTRUCTION. SALVAGE AND REINSTALL COUNTERTOP.
 - SECTIONAL DOOR: REMOVE AND REPLACE OVERHEAD SECTIONAL DOOR AS SPECIFIED. CONTRACTOR TO PROVIDE ANY ADDITIONAL SUPPORT REQUIRED BY THE MANUFACTURER.
 - GYPSUM BOARD: REMOVE AND REPLACE DAMAGED GYPSUM BOARD TO NEAREST FRAMING MEMBER. FINISH AND RE-PAIN WALL CORNER TO CORNER.
 - PREFINISHED GYPSUM BOARD WITH VINYL WALL COVER AND CORNER TRIM: REMOVE AND REPLACE DAMAGED VINYL COVERED GYPSUM BOARD FROM FLOOR TO CEILING WHERE INDICATED ON FLOOR PLAN.
 - STOREFRONT WINDOW: REMOVE AND REPLACE STOREFRONT WINDOW AS SPECIFIED.
 - STUCCO SOFFIT: REMOVE & REPLACE STUCCO SOFFIT. COORDINATE WITH ABATEMENT SCOPE & ABATEMENT CONTRACTOR TO ENSURE WEATHER-TIGHTNESS AND PHASING COORDINATION. SEE WALL SECTIONS & DETAILS.
 - GYPSUM CEILING REPAIRS: REMOVE AND REPLACE DAMAGED GYPSUM CEILING BOARD TO NEAREST FRAMING MEMBER WHERE INDICATED, FINISH TO MATCH EXISTING AS SPECIFIED.
 - METAL ROOF PANEL REPAIRS: REMOVE AND REPLACE DEFORMED OR MISSING METAL ROOF PANELS TO MATCH EXISTING.
 - CONCRETE FLOOR CLEANING: CLEAN AND RESEAL FLOOR AS SPECIFIED.
 - BASE CABINET: REMOVE AND REPLACE DAMAGED BASE CABINET. MATCH EXISTING STYLE, SIZE, AND CONSTRUCTION. SALVAGE AND REINSTALL COUNTERTOP. PROTECT ALL MECHANICAL CONNECTIONS.
 - TILE CLEANING: CLEAN STAINS FROM WALL TILE TO REMOVE ANY DISCOLORATION WHERE INDICATED.
 - CLEAN/REPAINT MASONRY WALL: MECHANICALLY REMOVE ALL LOOSE OR PEELING PAINT AND ALL CHALKING RESIDUE FROM EFFERVESCENCE FROM CORNER TO CORNER. PERFORM REQUIRED MOISTURE TESTING PRIOR TO REPAINTING WALL AS SPECIFIED.
 - PLASTER CEILING REPAIRS: REMOVE AND REPLACE DAMAGED PLASTER CEILING WHERE INDICATED AS SPECIFIED, PAINT IN COLOR TO MATCH EXISTING.
 - MEP DAMAGES: SEE MECHANICAL, PLUMBING AND ELECTRICAL PLANS.
 - FURNITURE SETTING AND RESETTING: RELOCATE ALL EXISTING FURNITURE TO TEMPORARY ROOM IN MODULAR BUILDINGS WHILE EXISTING SPACE IS BEING REPAIRED. REINSTALL AND RESET FURNITURE ONCE REPAIRS ARE COMPLETE. SEE PHASING PLAN.
 - SUSPENDED CEILING INSULATION: INSTALL R-19 BATT INSULATION AS SPECIFIED ABOVE PREVIOUSLY INSTALLED SUSPENDED CEILING TILE. SEE UNIT PRICE NO. 2
 - BRICK WALL REPLACEMENT: REMOVE AND REPLACE BRICK WALL AS INDICATED. DISPOSE OF OLD BRICK. MATCH NEW BRICK AND MORTAR TO EXISTING AS APPROVED BY ARCHITECT, SEE STRUCTURAL. BUILDING TO REMAIN WEATHERPROOF AND CONDITIONED DURING REPAIRS.
 - DOOR REPAIR: CLEAN, PREP AND RE-PAIN DOOR FRAME - SEE DOOR SCHEDULE.
 - CORRIDOR WALL REPAIR: REMOVE DAMAGED STOREFRONT WINDOW AND EXISTING 3/4" PLYWOOD SHEATHING BELOW WINDOW. INSTALL NEW WINDOW PER SCHEDULE AND NEW 3/4" PLYWOOD SHEATHING. PAINT AS SPECIFIED, IN COLOR AS SELECTED. SEE DETAILS.
 - GLAZING REPAIR: REMOVE AND REPLACE BROKEN GLASS. MATCH EXISTING TINT. PROVIDE SAFETY GLASS AS REQUIRED.
 - DOOR REPAIR: REMOVE AND REPLACE EXISTING LEFT DOOR LEAF. PROVIDE AN INSULATED HOLLOW METAL DOOR WITH VISION PANEL TO MATCH RIGHT DOOR LEAF. REINSTALL EXISTING DOOR HARDWARE. PAINT AS DIRECTED.

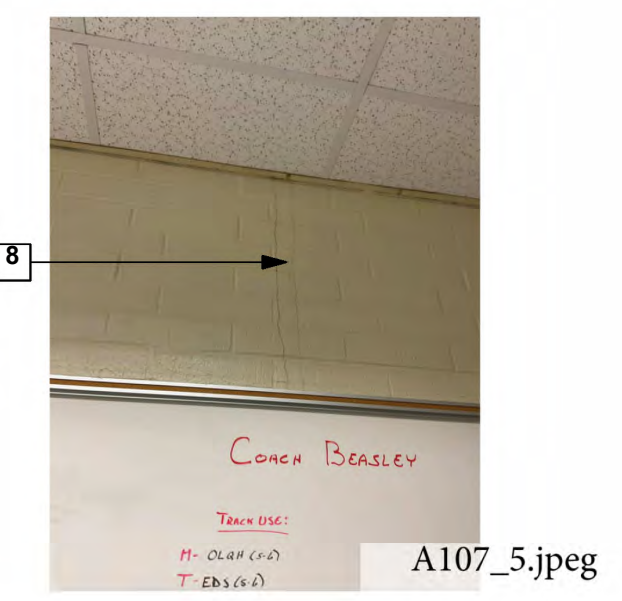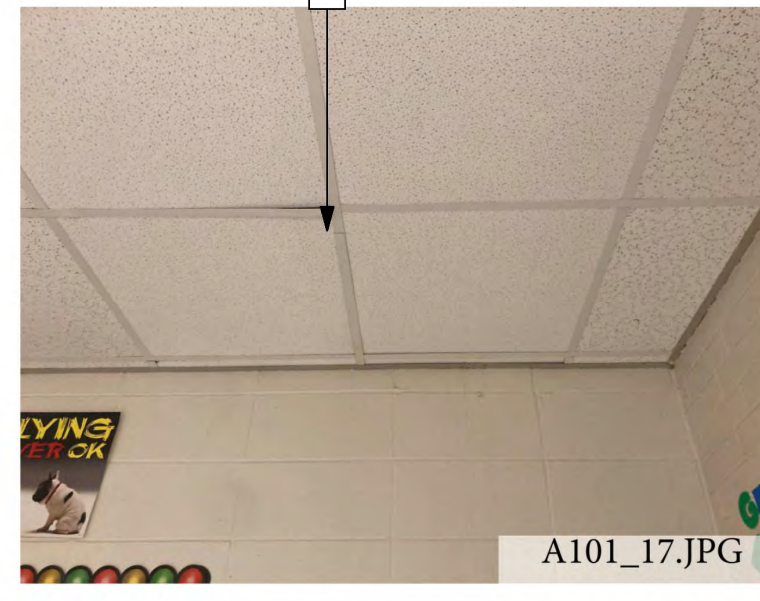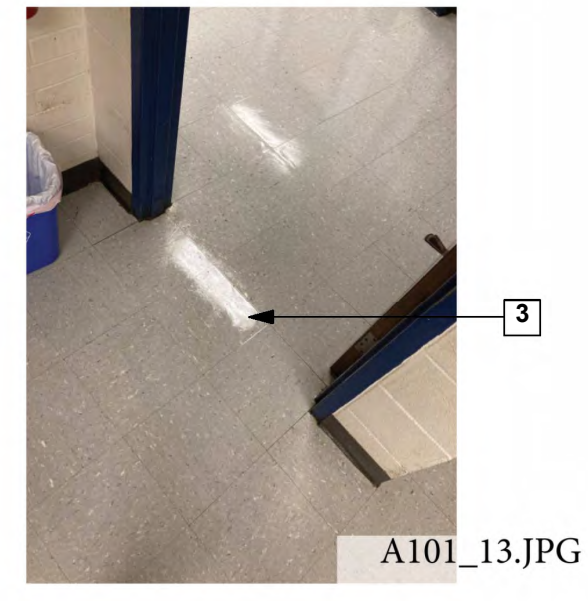

ROOMS - BUILDING A1

ROOM NUMBER	Area	Perimeter
A101	656 SF	105' - 9"
A102	666 SF	106' - 7"
A103	680 SF	106' - 5"
A104	673 SF	108' - 10"
A105	657 SF	104' - 10"
A106	650 SF	107' - 4"
A107	656 SF	105' - 0"
A108	665 SF	105' - 10"
A109	331 SF	102' - 3"
A110	181 SF	61' - 1"
A111	339 SF	104' - 3"
A112	173 SF	59' - 1"
A114	416 SF	86' - 6"

*THESE MEASUREMENTS ARE APPROXIMATE TO BE USED AS GUIDELINES ONLY. CONTRACTOR IS RESPONSIBLE FOR ALL FINAL MEASUREMENTS.



HURRICANE LAURA REPAIRS TO
A.M. BARBE HIGH SCHOOL
2200 W. McNEESE ST.
FOR
CALCASIEU PARISH SCHOOL BOARD
LAKE CHARLES, LA 70605
HL-003-01.03.04.05.06.07

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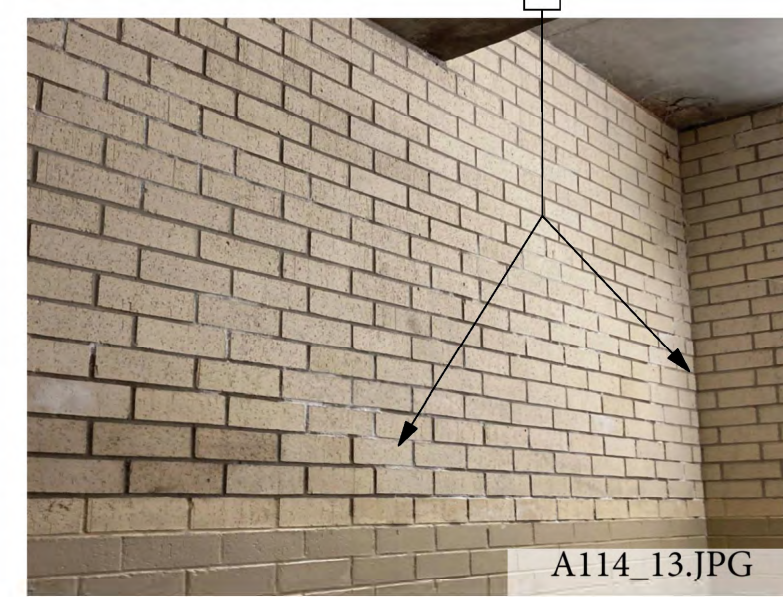
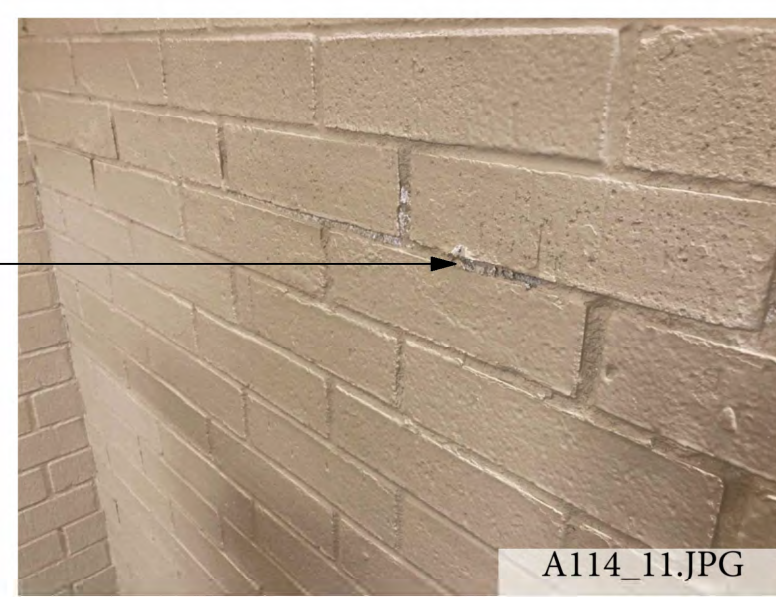
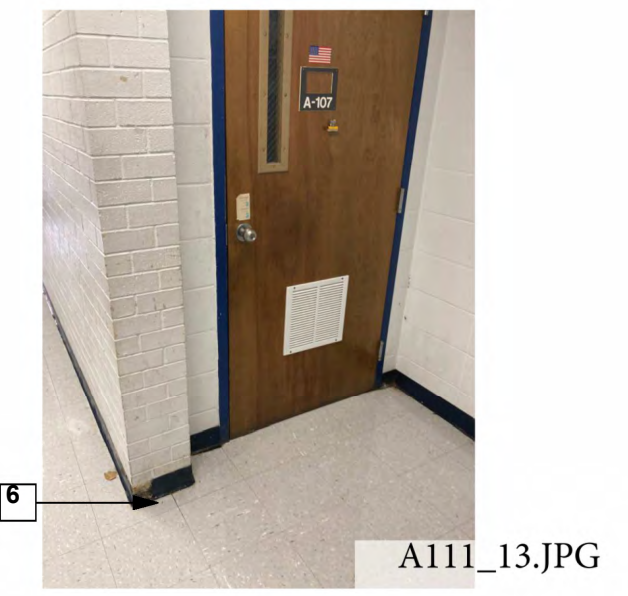
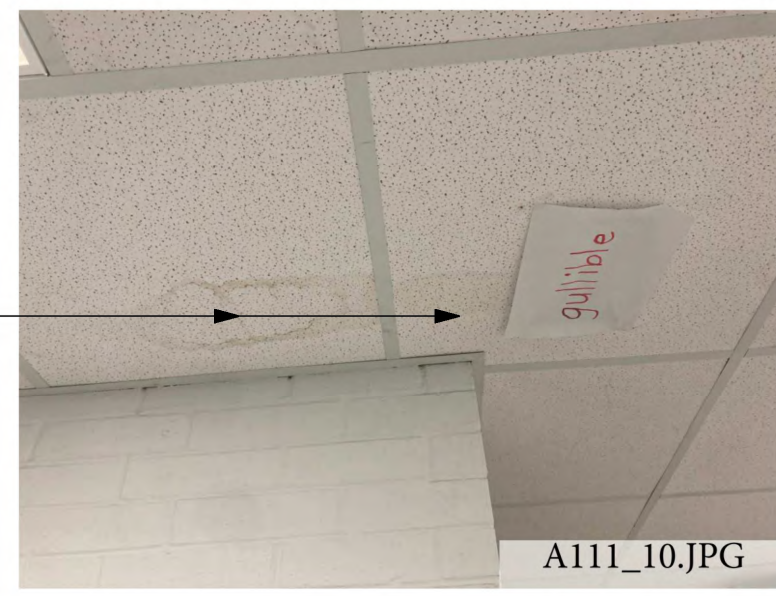
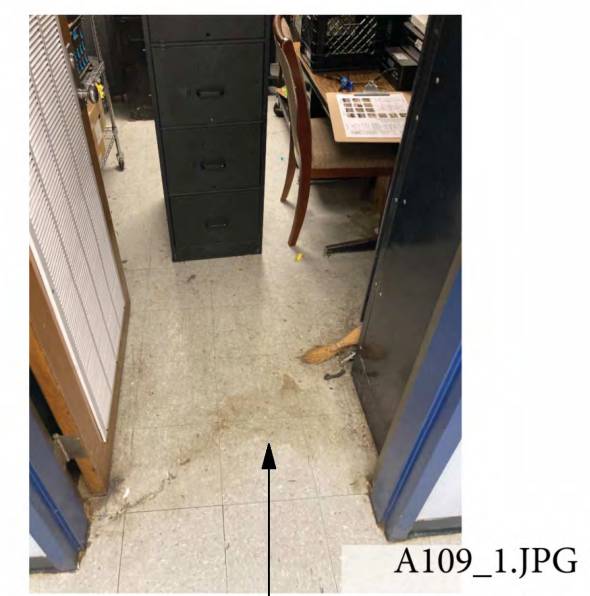
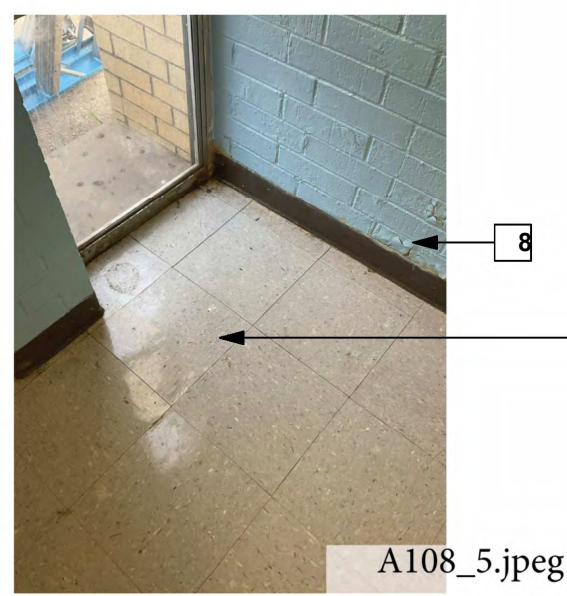
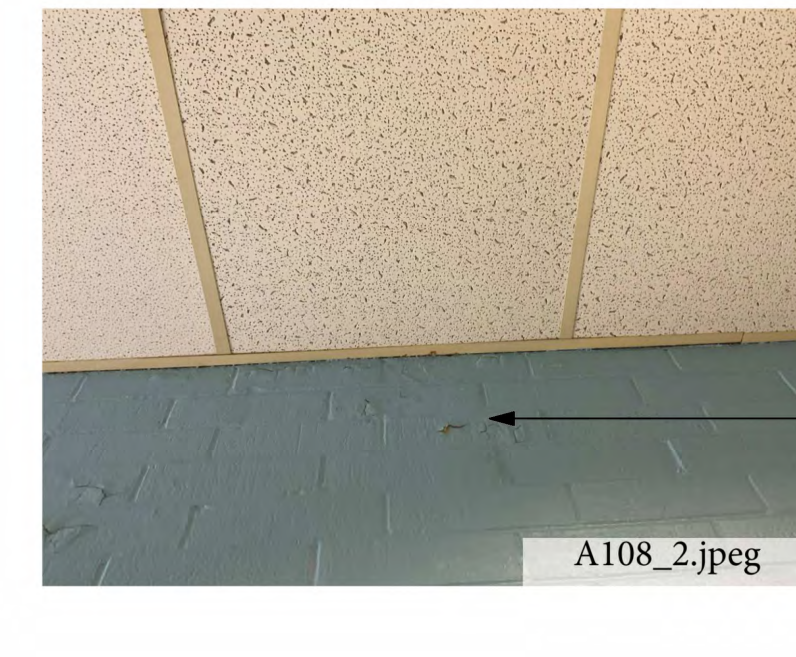
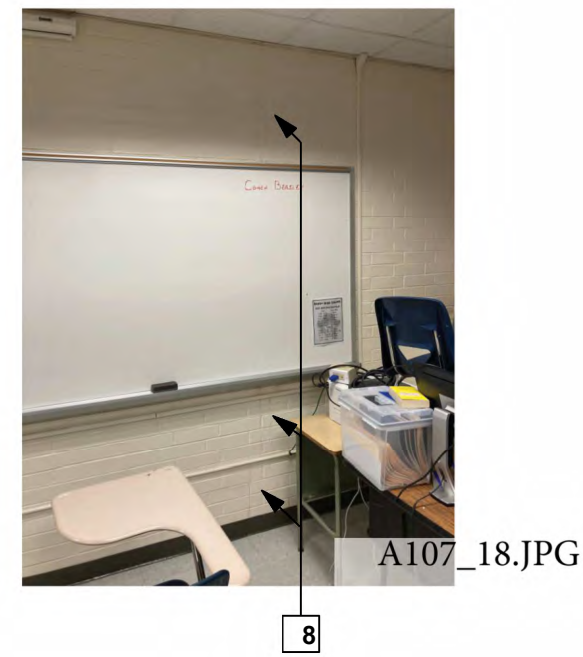
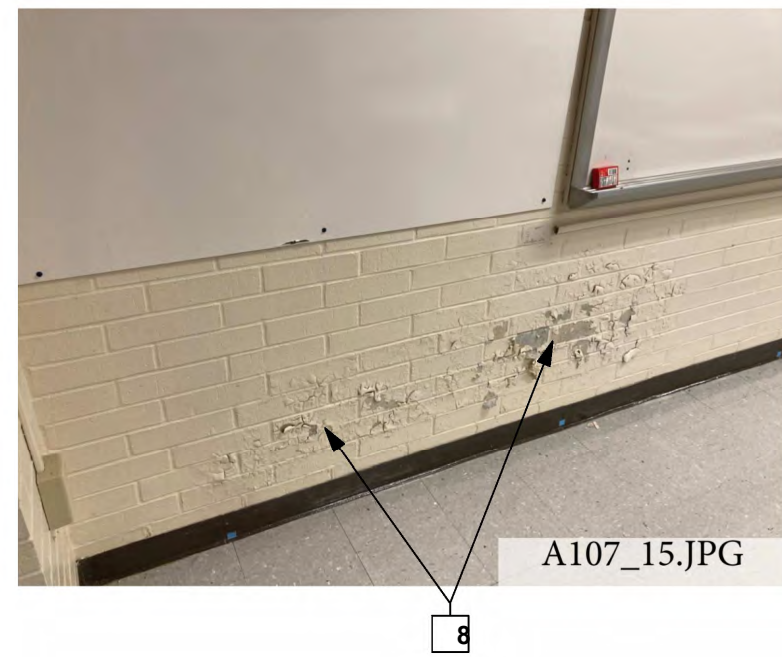
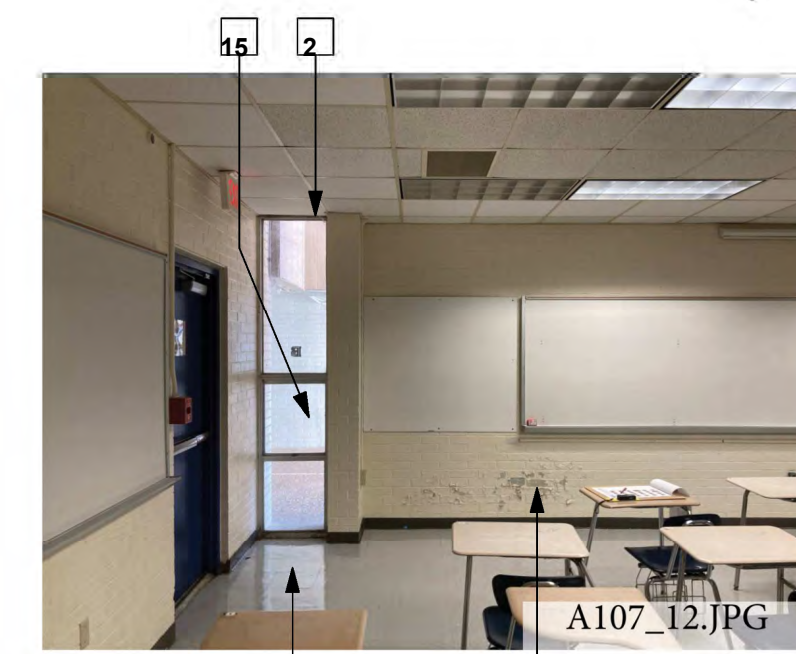
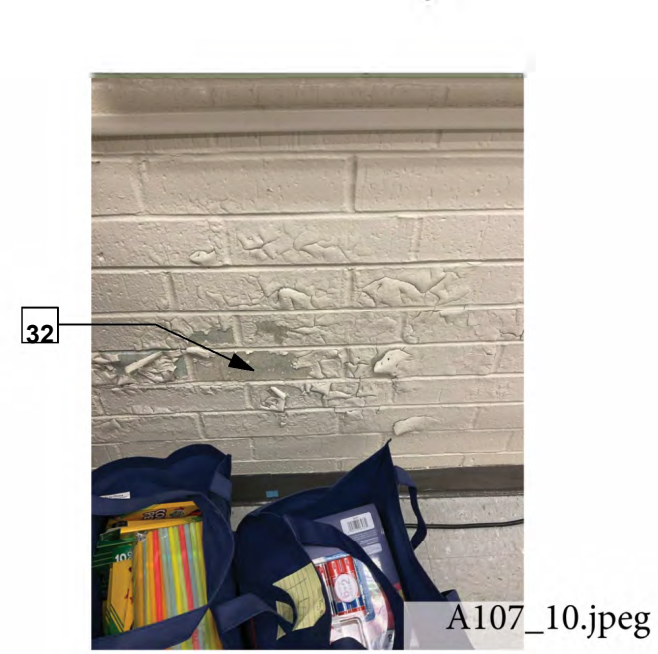
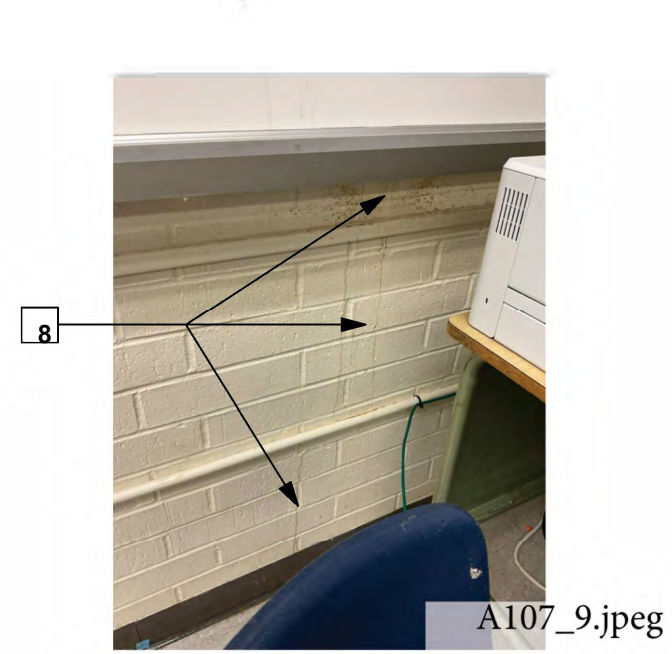
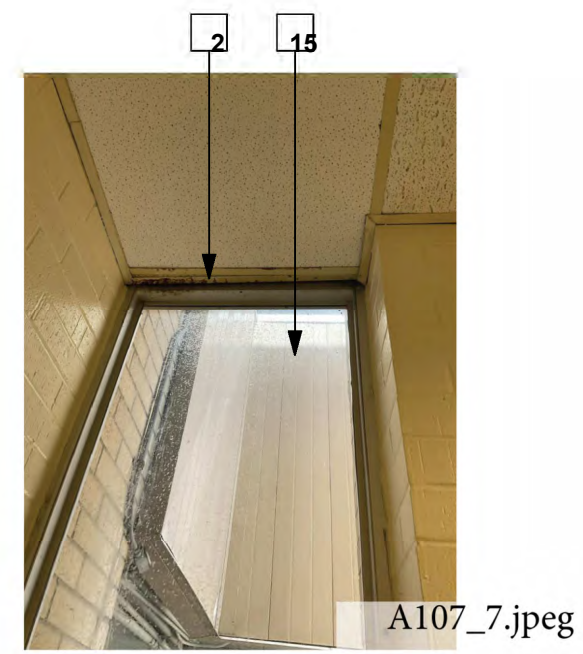
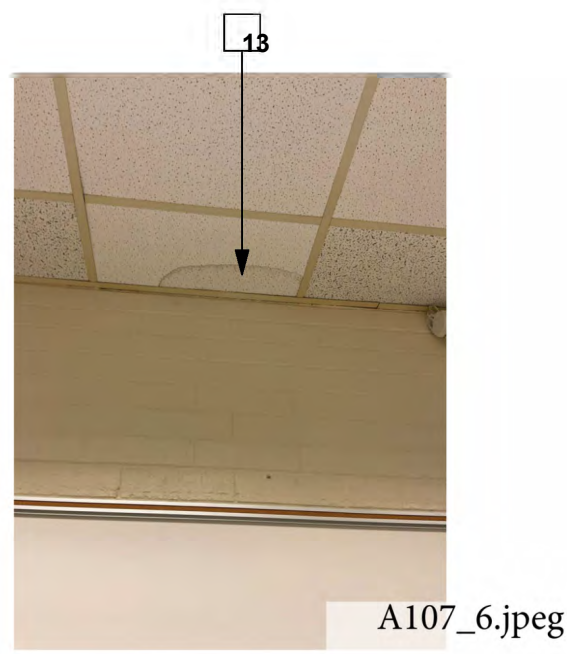
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20042-01-G
OWNER PROJECT NO.
HL-003-01.03.04.05.06.07
PROJECT MANAGER
TM

DATE ISSUED
06/28/2024

REVISED

NO.	DATE	DESCRIPTION

SHEET NUMBER
(A)A1.1
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RMG
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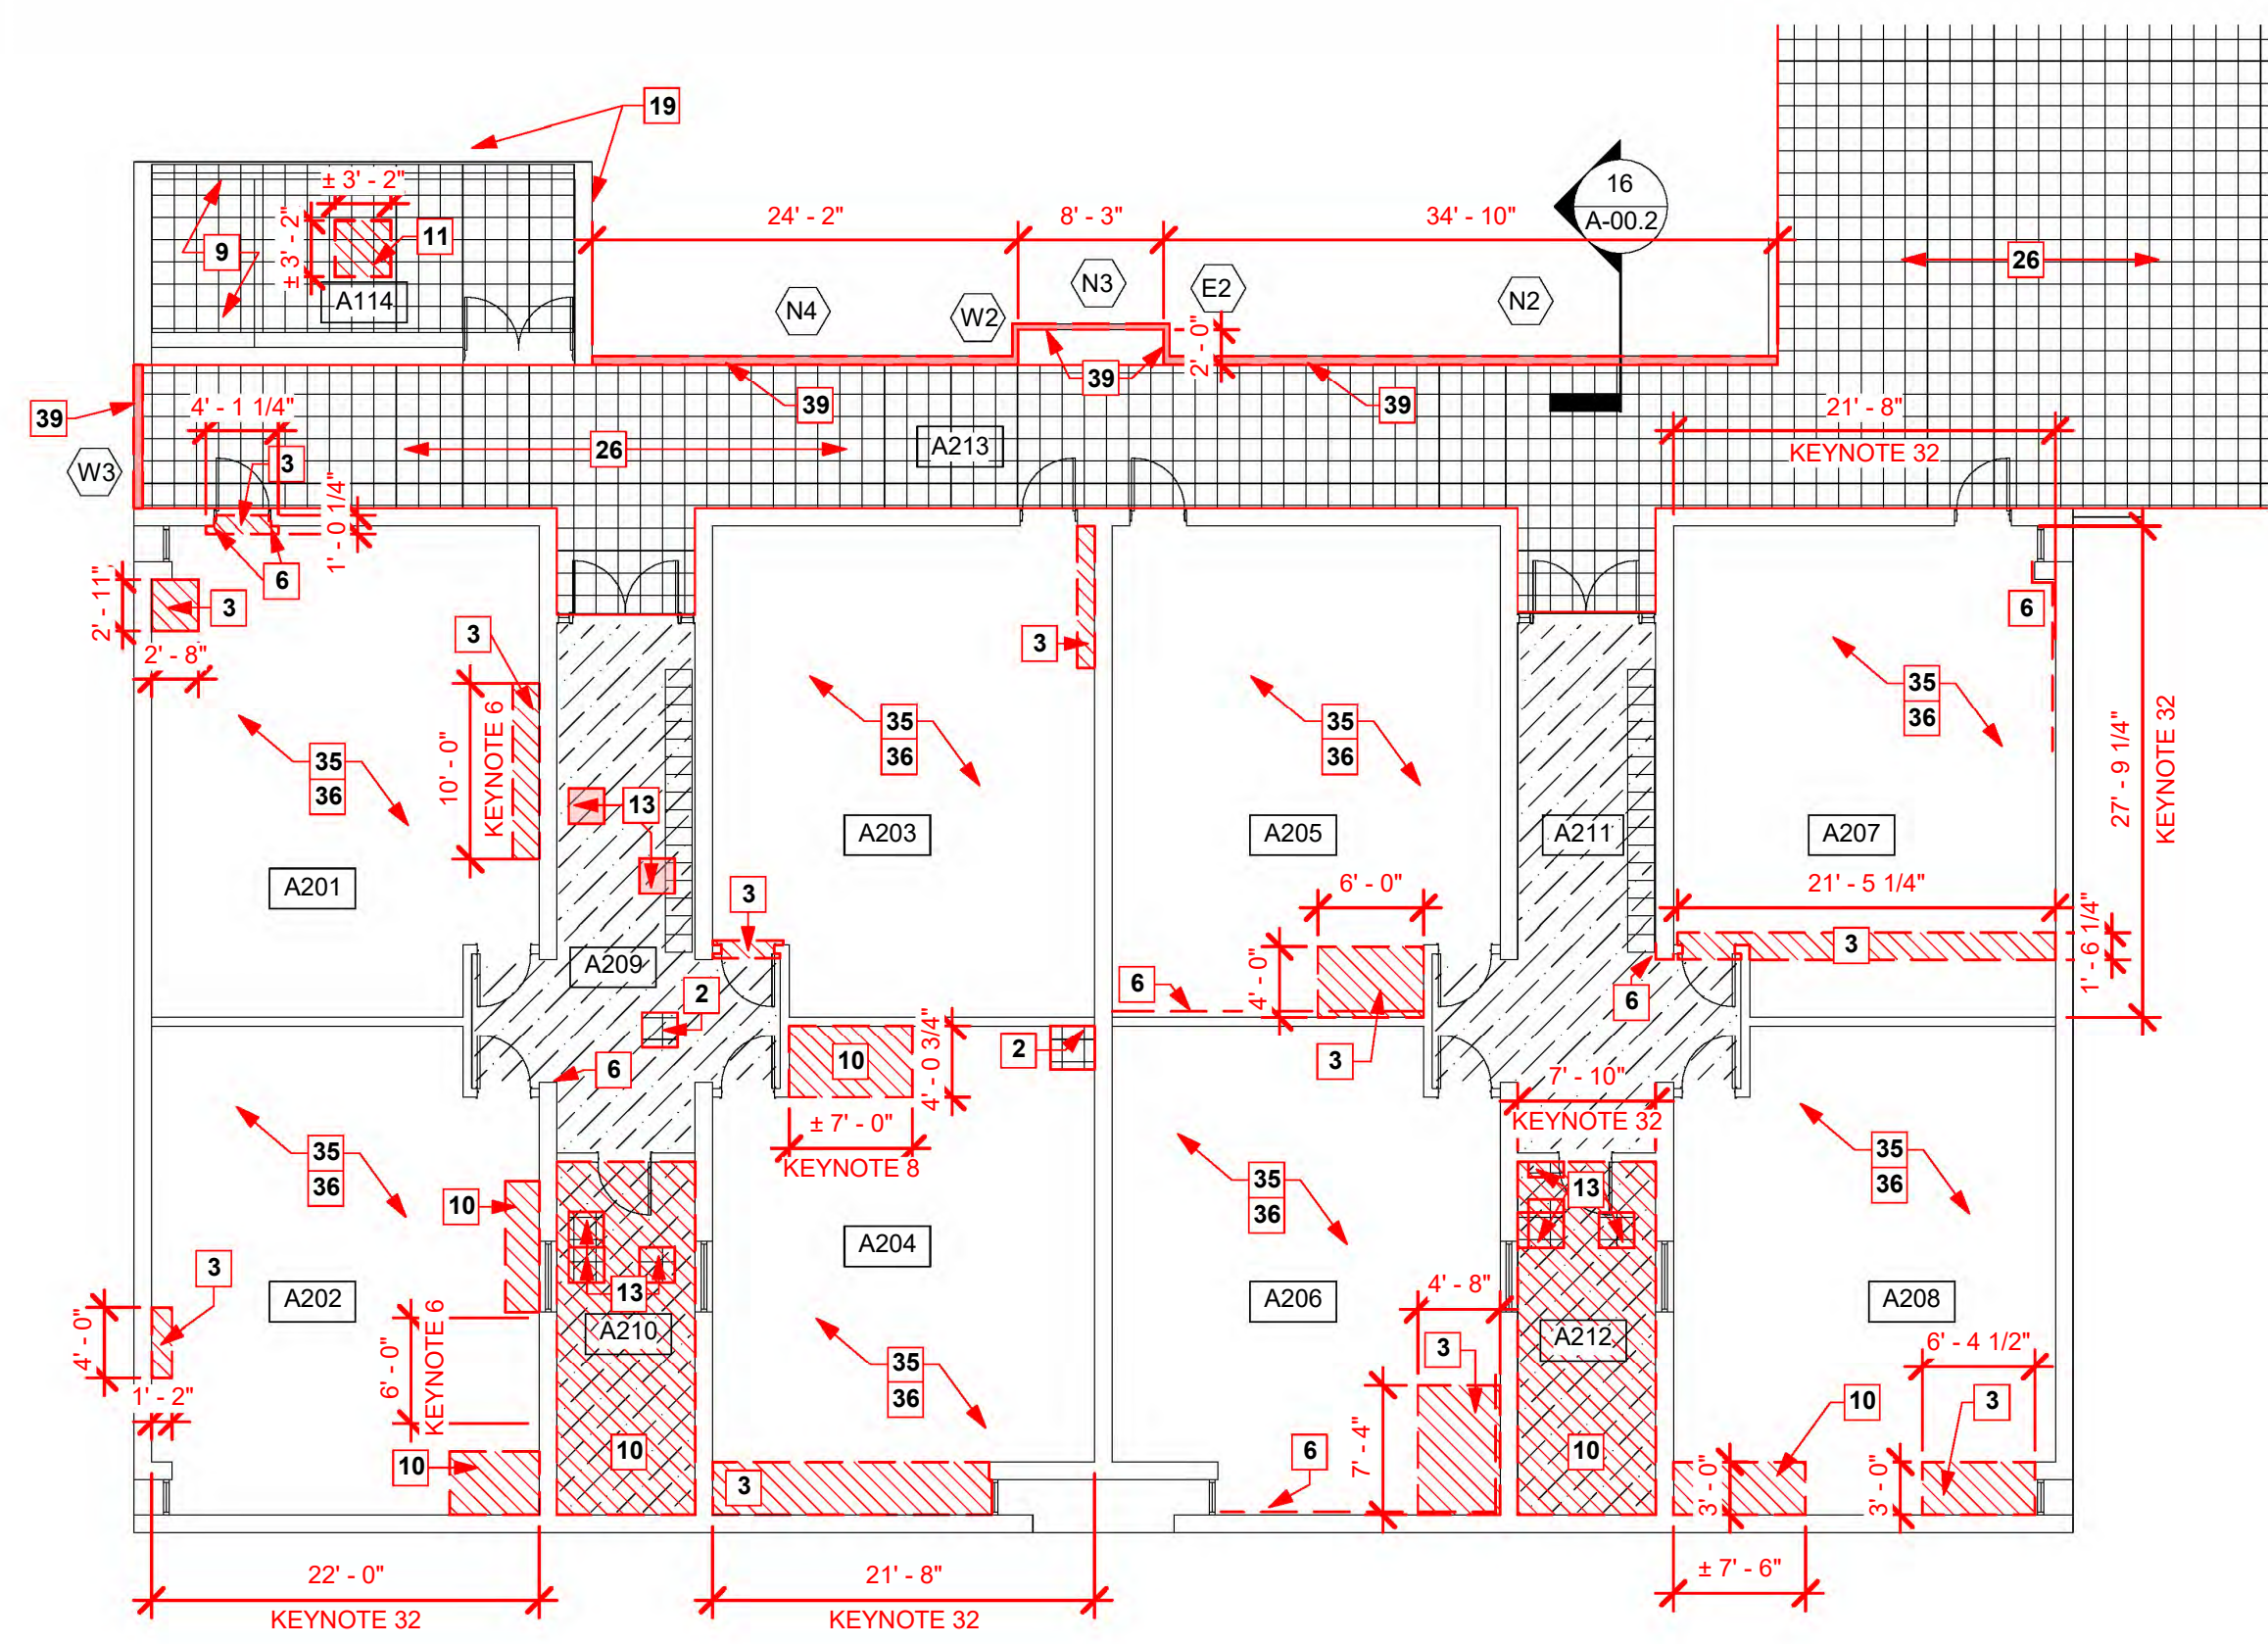
ARCHITECT
 RANDY MICHAEL GOODLOE
 No. 2019
 REGISTERED ARCHITECT
 LA LICENSE NO. 4086

HURRICANE LAURA REPAIRS TO
A.M. BARBE HIGH SCHOOL
 2200 W. McNEESE ST.
 FOR
CALCASIEU PARISH SCHOOL BOARD
 LAKE CHARLES, LA 70605
 HL-003-01,03,04,05,06,07


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SHEET NUMBER
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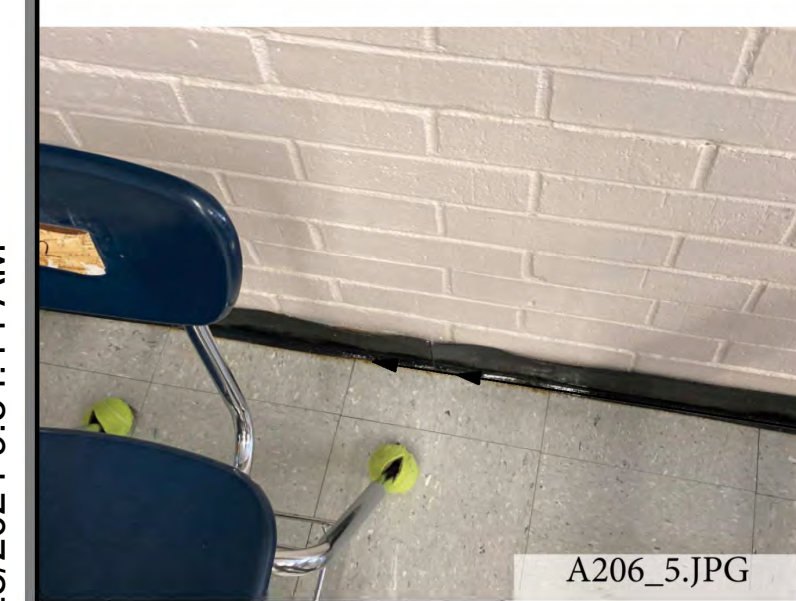
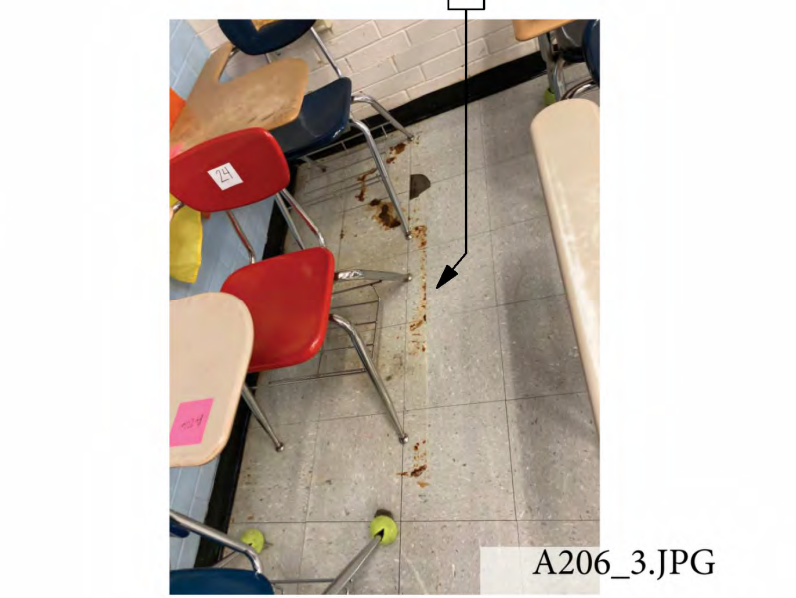
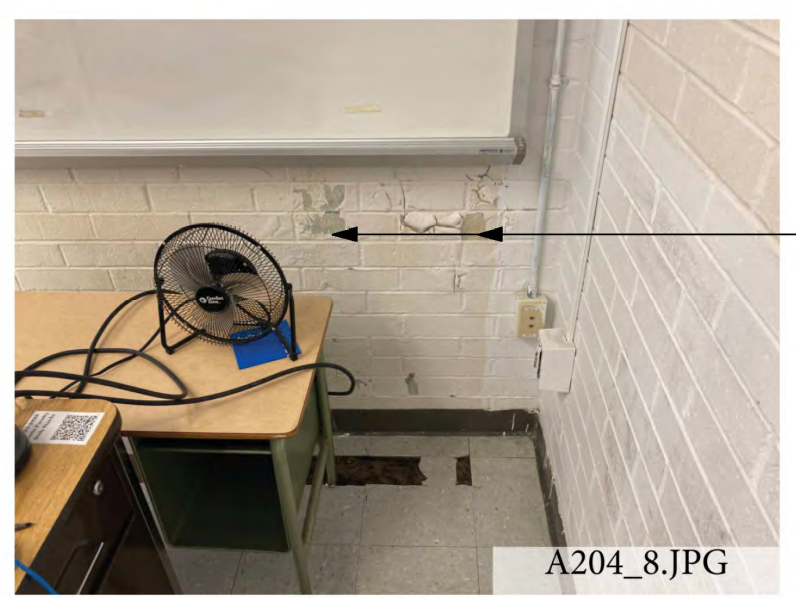
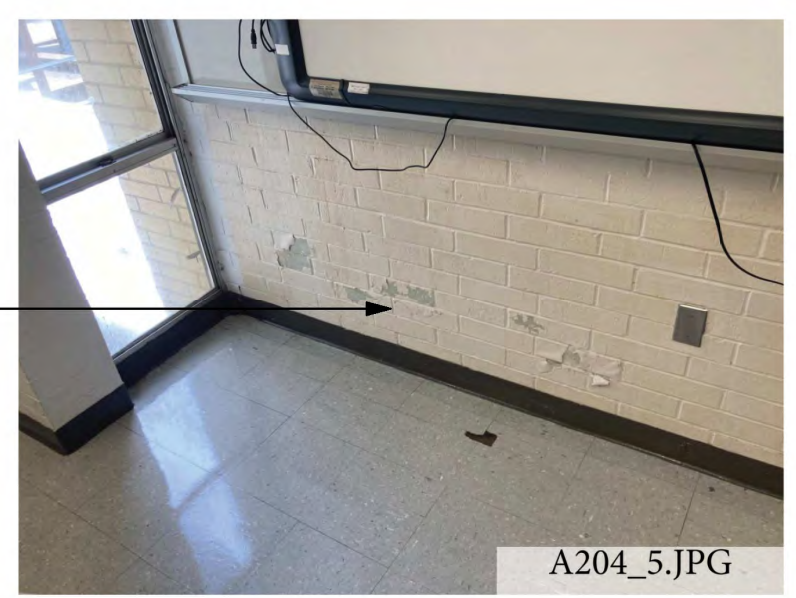
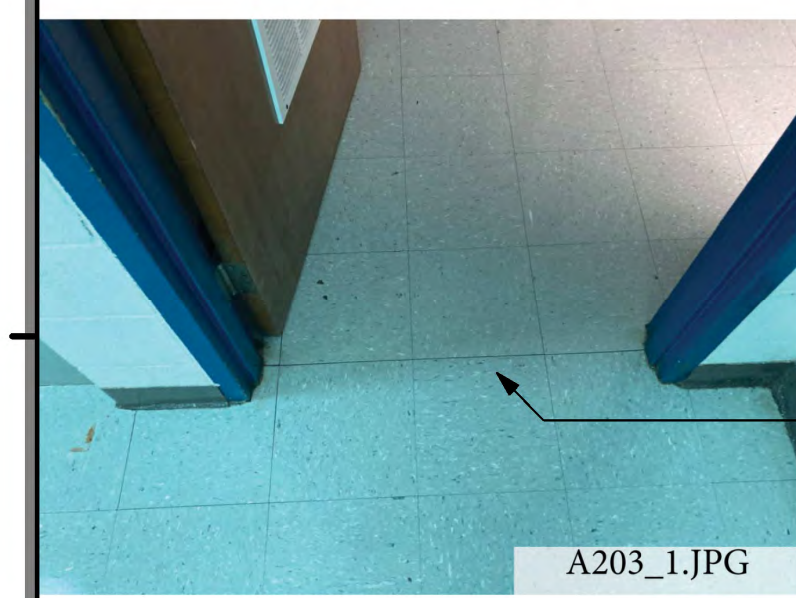


1 Zone 1 - Building A Second Floor
3/32" = 1'-0"



NOTE: IMAGES ARE FOR VISUAL REFERENCES TO HELP UNDERSTAND DAMAGES. THEY DO NOT REPRESENT THE ENTIRE SCOPE OF WORK AND SHOULD BE USED IN CONJUNCTION WITH THE DRAWINGS AND CURRENT CONDITIONS IN THE FIELD. CONTRACTOR SHALL CONFIRM CURRENT CONDITIONS IN THE FIELD PRIOR TO BIDDING - TYPICAL.



- KEYNOTES**
- SUSPENDED ACOUSTIC CEILING REPLACEMENT:** REMOVE AND REPLACE DAMAGED CEILING GRID AND CEILING TILE AS SPECIFIED.
 - CEILING GRID:** REMOVE AND REPLACE DAMAGED CEILING GRID. MATCH EXISTING. SEE UNIT PRICE NO. 3
 - VCT FLOORING REPAIRS:** REMOVE AND REPLACE VCT FLOORING AS SPECIFIED IN AREAS WHERE INDICATED. SEE UNIT PRICE NO. 3.
 - WINDOW REPAIRS:** REPLACE BROKEN WINDOW PANES, BLOCKS, AND GASKETS TO MATCH EXISTING. ALL SEALANTS SHALL BE REMOVED AND REPLACED AS SPECIFIED TO ENSURE WEATHER TIGHT SEAL. SEE ELEVATIONS.
 - STRUCTURAL CLAY BLOCK:** GLAZED STRUCTURAL CLAY BLOCK TO BE REMOVED AND REPLACED AS SPECIFIED TO MATCH EXISTING. CLEAN ALL CHALKING RESIDUE FROM EFFERVESCENCE.
 - VINYL BASE REPLACEMENT:** REPLACE DAMAGED OR MISSING BASE AS SPECIFIED TO MATCH EXISTING. SEE UNIT PRICE NO. 4
 - CARPET REPAIRS:** DAMAGED CARPET HAS BEEN REMOVED. CLEAN FLOOR AND INSTALL TAW CARPET TILE AS SPECIFIED.
 - PAINTING:** WALL SURFACE IS TO BE SANDED, PREPARED, AND REPAINT TO MATCH EXISTING CORNER TO CORNER. WATER STAINED WALL FROM ROOF LOSS.
 - PAINTED CEILING STRUCTURE:** CEILING INCLUDING METAL TRUSSES ARE TO BE CLEANED, PREPPED, AND REPAINTED END TO END TO MATCH EXISTING COLOR.
 - VCT FLOORING CLEANING:** CLEAN WATER STAINS FROM VCT FLOORING TO REMOVE ANY DISCOLORATION WHERE INDICATED. MOP AND WAX ALL VCT FLOORING AT THE END OF CONSTRUCTION.
 - SKYLIGHT REPAIRS:** REMOVE AND REPLACE SKYLIGHT TO MATCH EXISTING.
 - TERRAZZO FLOORING CLEANING:** CLEAN AND POLISH EXISTING TERRAZZO FLOORING. REFER TO ROOM SCHEDULE FOR CLARITY.
 - CEILING TILE REPLACEMENT:** REMOVE AND REPLACE DAMAGED OR MISSING ACOUSTIC CEILING TILE WITH NEW CEILING TILE AS SPECIFIED IN AREAS INDICATED. MATCH EXISTING TYPE AND SIZE. SEE UNIT PRICE NO. 1. INSTALL R-30 BATT INSULATION OVER TILE. SEE UNIT PRICE NO. 2
 - NOT USED.**
 - EXTERIOR WINDOWS AND DOORS:** CAULK AND RESEAL PERIMETER OF EXISTING WINDOWS AND DOORS.
 - CMU REPAIR:** RE-POINT DAMAGED CMU JOINTS AS SHOWN. PAINT WALL FROM END TO END IN COLOR TO MATCH EXISTING AS SPECIFIED. SEE PHOTOS.
 - BRICK REPAIR:** CAULK CRACKED AREAS AND REPAINT.
 - LOCKERS:** REPLACE DAMAGED UNITS AS SHOWN. MATCH EXISTING STYLE, SIZE AND COLORS.
 - BRICK WALLS:** CLEAN ALL WATER STAINS FROM ENTIRE BRICK WALL.
 - SHELVING REPLACEMENT:** REMOVE AND REPLACE DAMAGED SHELVING UNITS WITH GLASS DOORS. MATCH EXISTING MATERIALS, FINISHES AND CONSTRUCTION STYLE.
 - BASE CABINET:** REMOVE AND REPLACE DAMAGED BASE CABINET. MATCH EXISTING STYLE, SIZE, AND CONSTRUCTION. SALVAGE AND REINSTALL COUNTERTOP.
 - SECTIONAL DOOR:** REMOVE AND REPLACE OVERHEAD SECTIONAL DOOR AS SPECIFIED. CONTRACTOR TO PROVIDE ANY ADDITIONAL SUPPORT REQUIRED BY THE MANUFACTURER.
 - GYPSUM BOARD:** REMOVE AND REPLACE DAMAGED GYPSUM BOARD TO NEAREST FRAMING MEMBER. FINISH AND RE-PAIN WALL CORNER TO CORNER.
 - PREFINISHED GYPSUM BOARD WITH VINYL WALL COVER AND CORNER TRIM:** REMOVE AND REPLACE DAMAGED VINYL COVERED GYPSUM BOARD FROM FLOOR TO CEILING WHERE INDICATED ON FLOOR PLAN.
 - STOREFRONT WINDOW:** REMOVE AND REPLACE STOREFRONT WINDOW AS SPECIFIED.
 - STUCCO SOFFIT:** REMOVE & REPLACE STUCCO SOFFIT. COORDINATE WITH ABATEMENT SCOPE & ABATEMENT CONTRACTOR TO ENSURE WEATHER TIGHTNESS AND PHASING COORDINATION. SEE WALL SECTIONS & DETAILS.
 - GYPSUM CEILING REPAIRS:** REMOVE AND REPLACE DAMAGED GYPSUM CEILING BOARD TO NEAREST FRAMING MEMBER WHERE INDICATED, FINISH TO MATCH EXISTING AS SPECIFIED.
 - METAL ROOF PANEL REPAIRS:** REMOVE AND REPLACE DEFORMED OR MISSING METAL ROOF PANELS TO MATCH EXISTING.
 - CONCRETE FLOOR CLEANING:** CLEAN AND RESEAL FLOOR AS SPECIFIED.
 - BASE CABINET:** REMOVE AND REPLACE DAMAGED BASE CABINET. MATCH EXISTING STYLE, SIZE, AND CONSTRUCTION. SALVAGE AND REINSTALL COUNTERTOP. PROTECT ALL MECHANICAL CONNECTIONS.
 - TILE CLEANING:** CLEAN STAINS FROM WALL TILE TO REMOVE ANY DISCOLORATION WHERE INDICATED.
 - CLEAN/REPAINT MASONRY WALL:** MECHANICALLY REMOVE ALL LOOSE OR PEELING PAINT AND ALL CHALKING RESIDUE FROM EFFERVESCENCE FROM CORNER TO CORNER. PERFORM REQUIRED MOISTURE TESTING PRIOR TO REPAINTING WALL AS SPECIFIED.
 - PLASTER CEILING REPAIRS:** REMOVE AND REPLACE DAMAGED PLASTER CEILING WHERE INDICATED AS SPECIFIED, PAINT IN COLOR TO MATCH EXISTING.
 - MEP DAMAGES:** SEE MECHANICAL, PLUMBING AND ELECTRICAL PLANS.
 - FURNITURE SETTING AND RESETTING:** RELOCATE ALL EXISTING FURNITURE TO TEMPORARY ROOM IN MODULAR BUILDINGS WHILE EXISTING SPACE IS BEING REPAIRED. REINSTALL AND RESET FURNITURE ONCE REPAIRS ARE COMPLETE. SEE PHASING PLAN.
 - SUSPENDED CEILING INSULATION:** INSTALL R-19 BATT INSULATION AS SPECIFIED ABOVE PREVIOUSLY INSTALLED SUSPENDED CEILING TILE. SEE UNIT PRICE NO. 2.
 - BRICK WALL REPLACEMENT:** REMOVE AND REPLACE BRICK WALL AS INDICATED. DISPOSE OF OLD BRICK, MATCH NEW BRICK AND MORTAR TO EXISTING AS APPROVED BY ARCHITECT. SEE STRUCTURAL BUILDING TO REMAIN WEATHERPROOF AND CONDITIONED DURING REPAIRS.
 - DOOR REPAIR:** CLEAN, PREP AND RE-PAIN DOOR FRAME - SEE DOOR SCHEDULE.
 - CORRIDOR WALL REPAIR:** REMOVE DAMAGED STOREFRONT WINDOW AND EXISTING 3/4" PLYWOOD SHEATHING BELOW WINDOW. INSTALL NEW WINDOW PER SCHEDULE AND NEW 3/4" PLYWOOD SHEATHING. PAINT AS SPECIFIED, IN COLOR AS SELECTED. SEE DETAILS.
 - GLAZING REPAIR:** REMOVE AND REPLACE BROKEN GLASS. MATCH EXISTING TINT. PROVIDE SAFETY GLASS AS REQUIRED.
 - DOOR REPAIR:** REMOVE AND REPLACE EXISTING LEFT DOOR LEAF. PROVIDE AN INSULATED HOLLOW METAL DOOR WITH VISION PANEL TO MATCH RIGHT DOOR LEAF. REINSTALL EXISTING DOOR HARDWARE. PAINT AS DIRECTED.

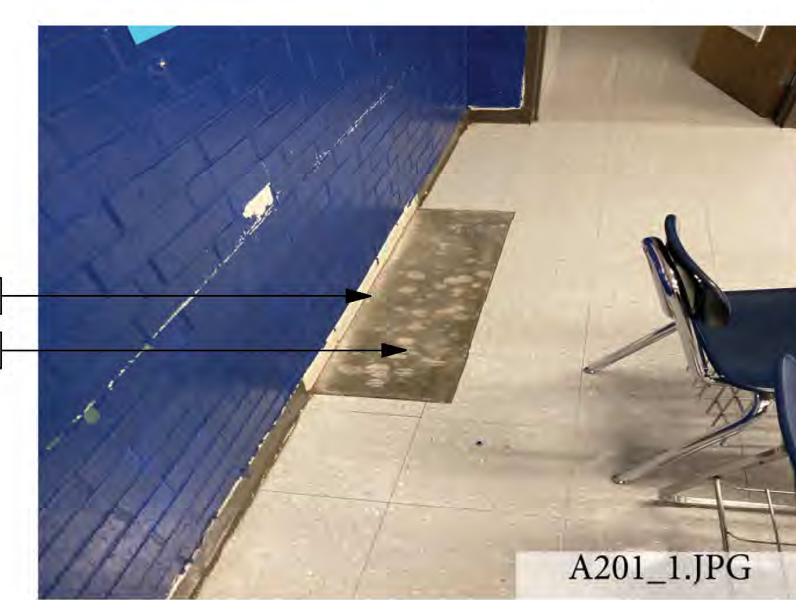

ROOMS - BUILDING A2

ROOM NUMBER	Area	Perimeter
A201	657 SF	105'-9"
A202	666 SF	106'-7"
A203	680 SF	106'-5"
A204	673 SF	108'-10"
A205	657 SF	104'-10"
A206	650 SF	107'-4"
A207	656 SF	105'-0"
A208	665 SF	105'-10"
A209	331 SF	102'-3"
A210	181 SF	61'-1"
A211	339 SF	104'-3"
A212	173 SF	59'-1"
A213	1399 SF	280'-8"
A214	416 SF	86'-6"

*THESE MEASUREMENTS ARE APPROXIMATE TO BE USED AS GUIDELINES ONLY. CONTRACTOR IS RESPONSIBLE FOR ALL FINAL MEASUREMENTS.

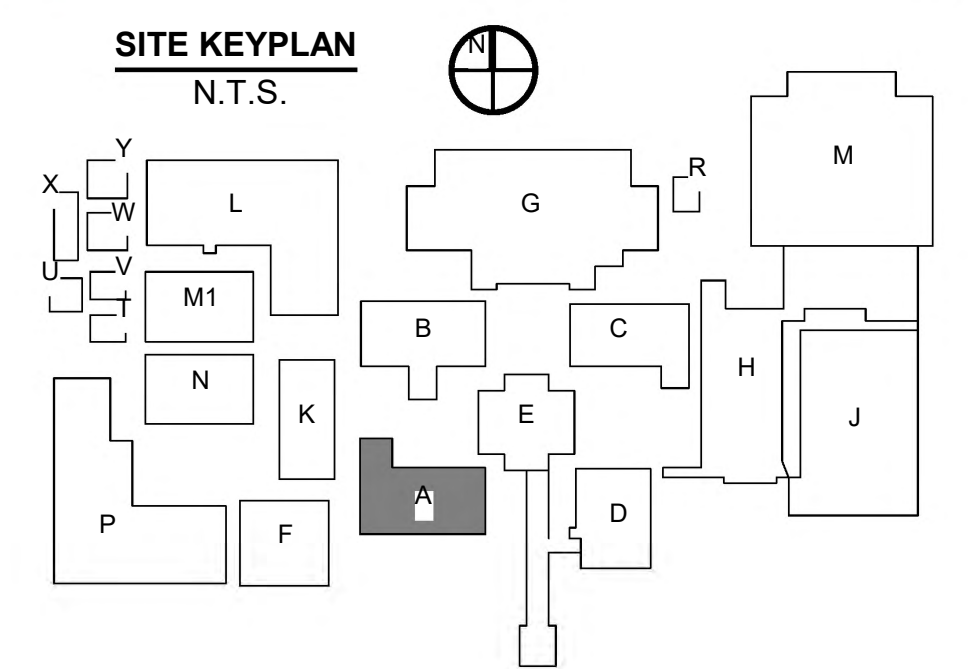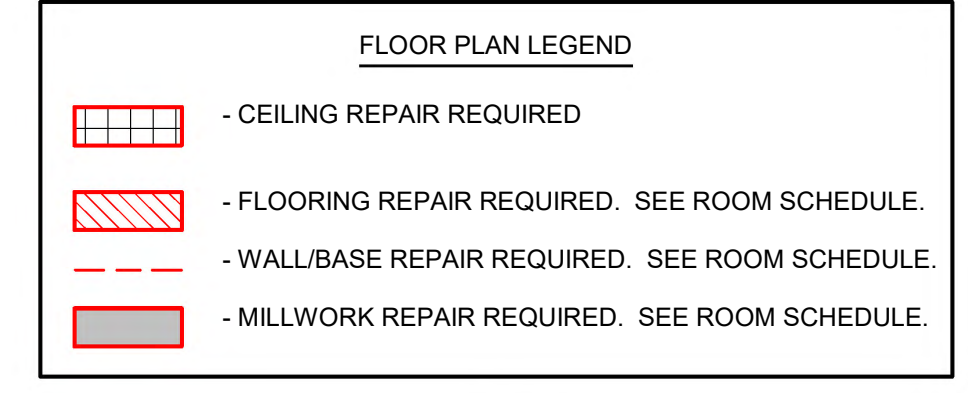

RMG ARCHITECT

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LA. LICENSE NO. 4086

HURRICANE LAURA REPAIRS TO
A.M. BARBE HIGH SCHOOL
2200 W. McNEESE ST.
FOR
CALCASIEU PARISH SCHOOL BOARD
LAKE CHARLES, LA 70605
HL-003-01.03.04.05.06.07

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PROJECT MANAGER
TM

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06/28/2024
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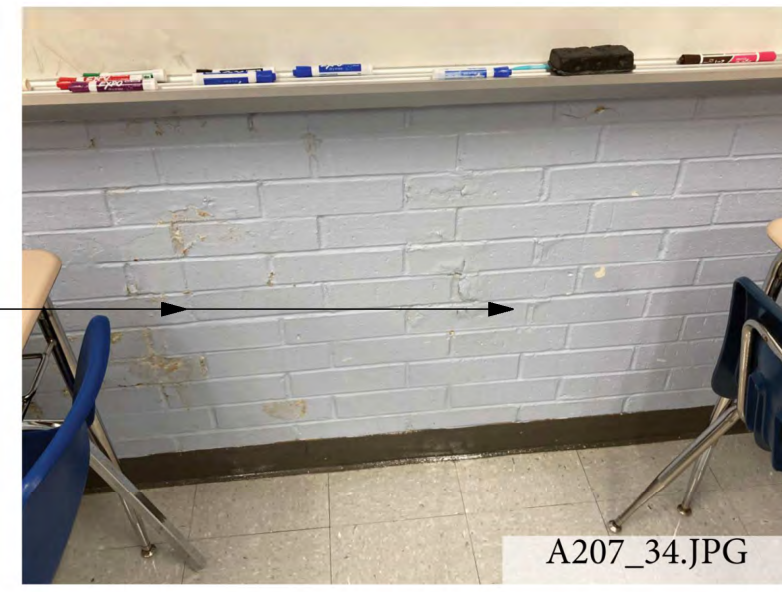
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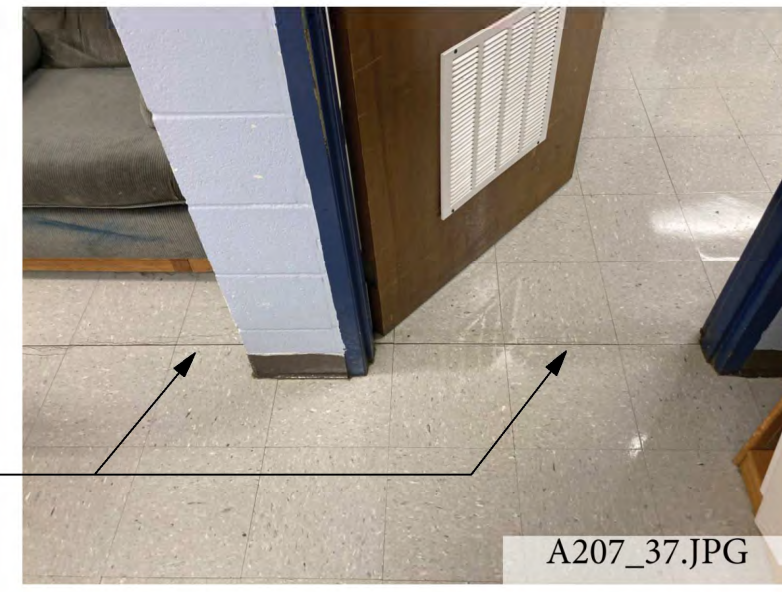
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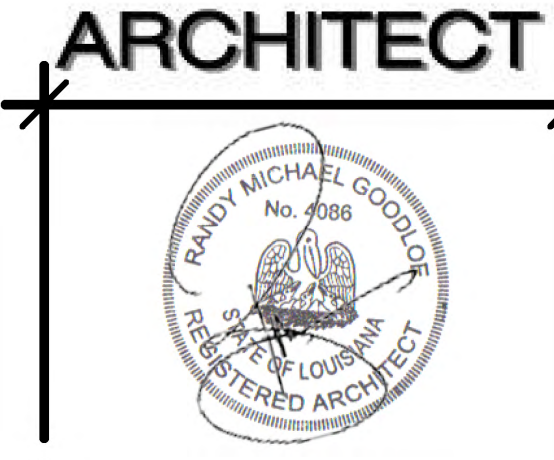
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PROJECT MANAGER TM
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SHEET NUMBER
(A)A2.2
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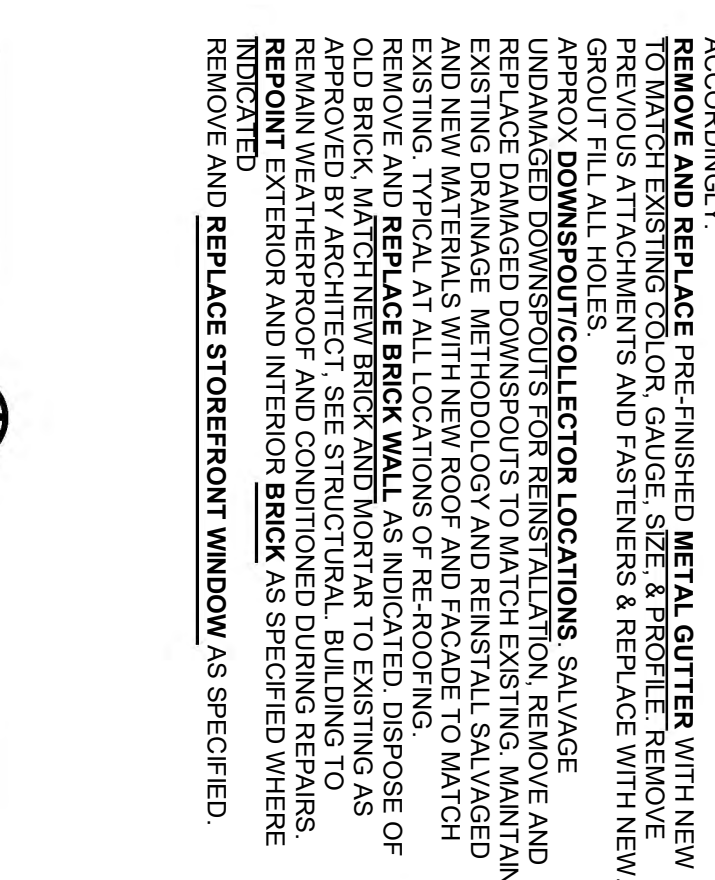
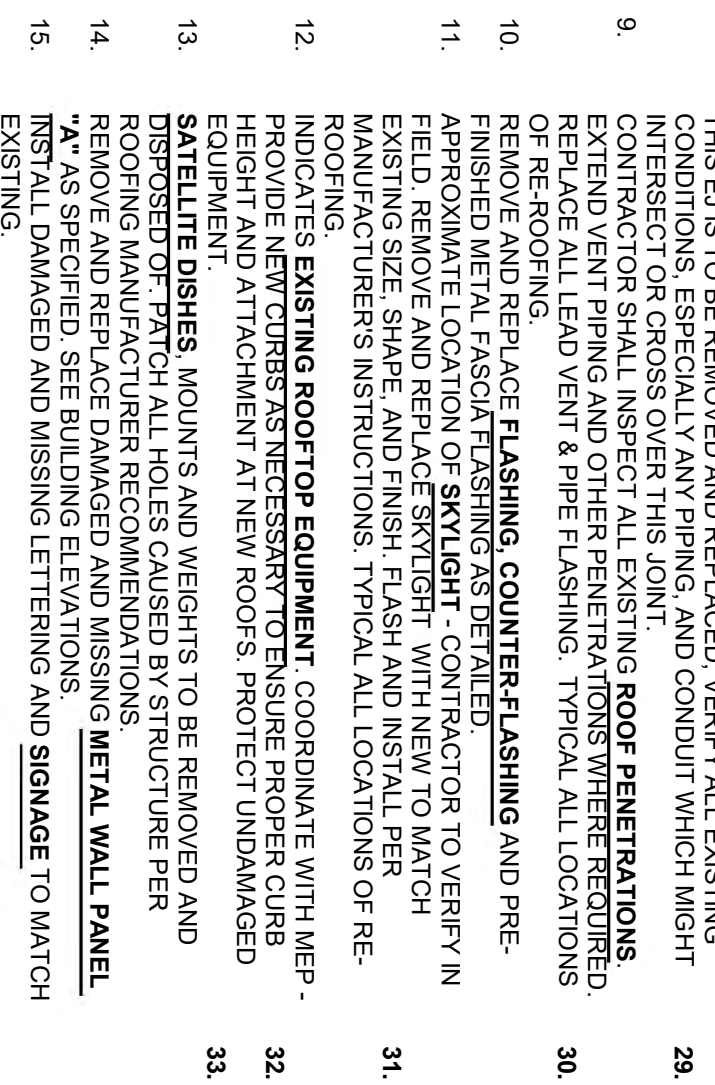
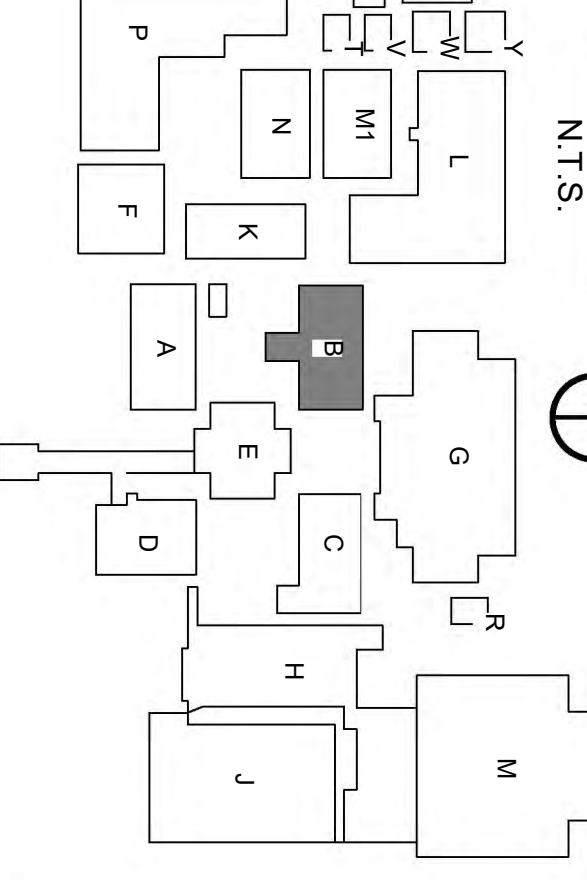
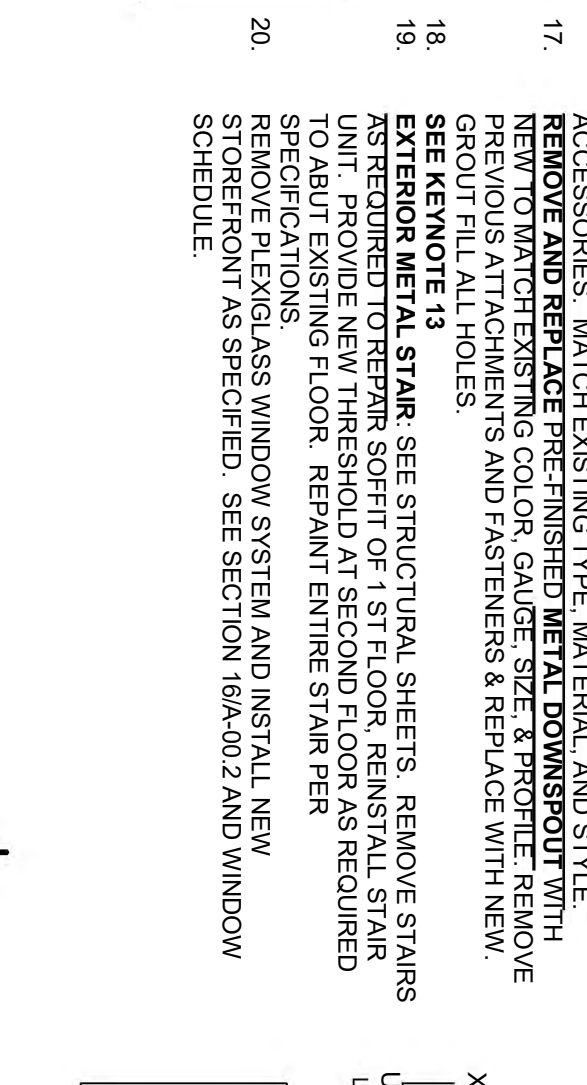
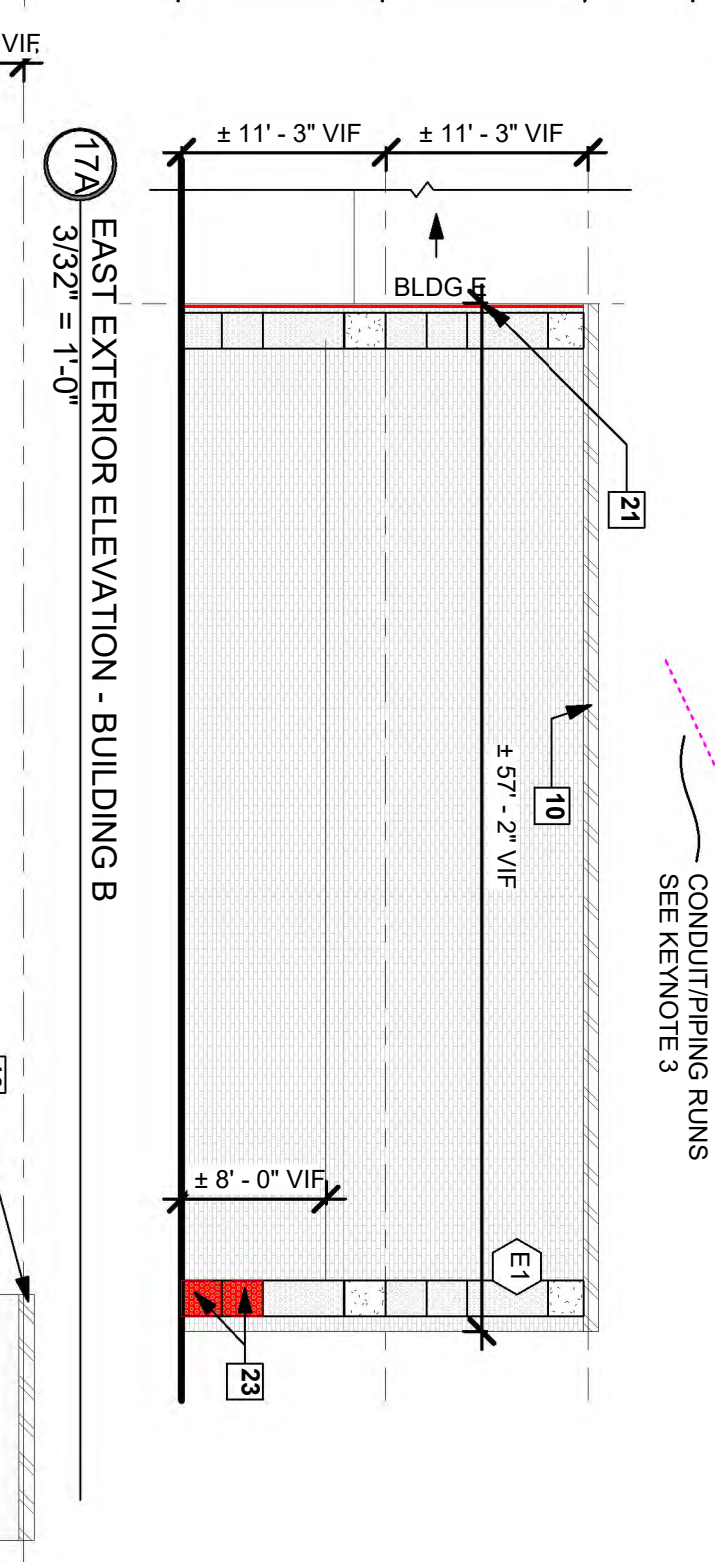
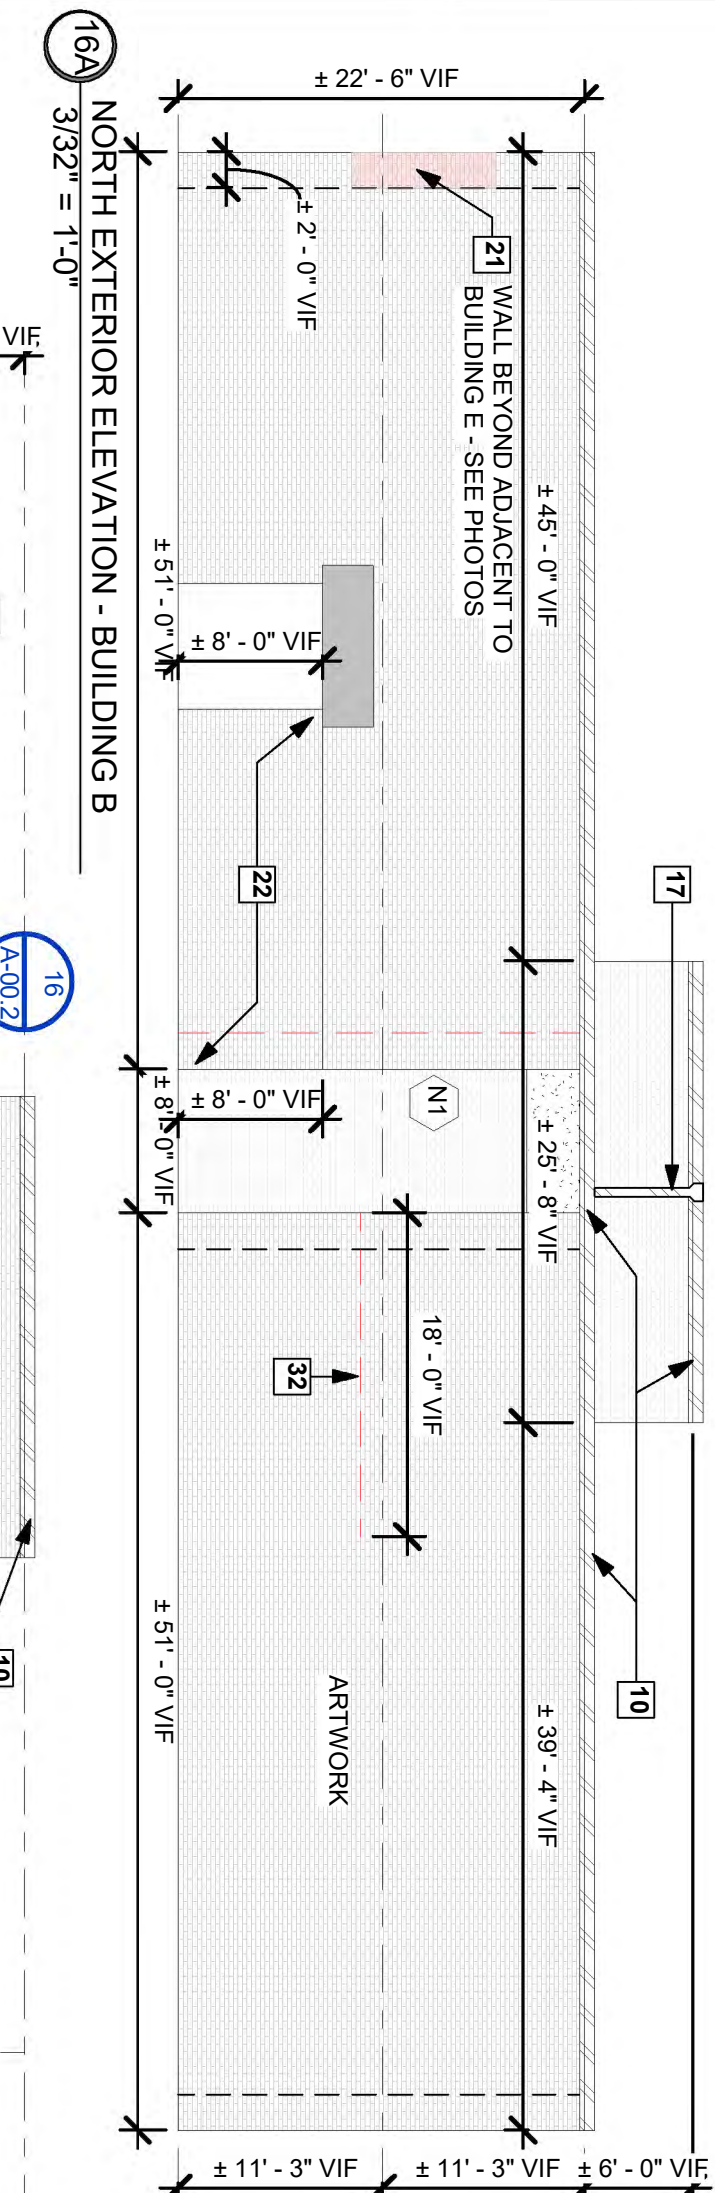
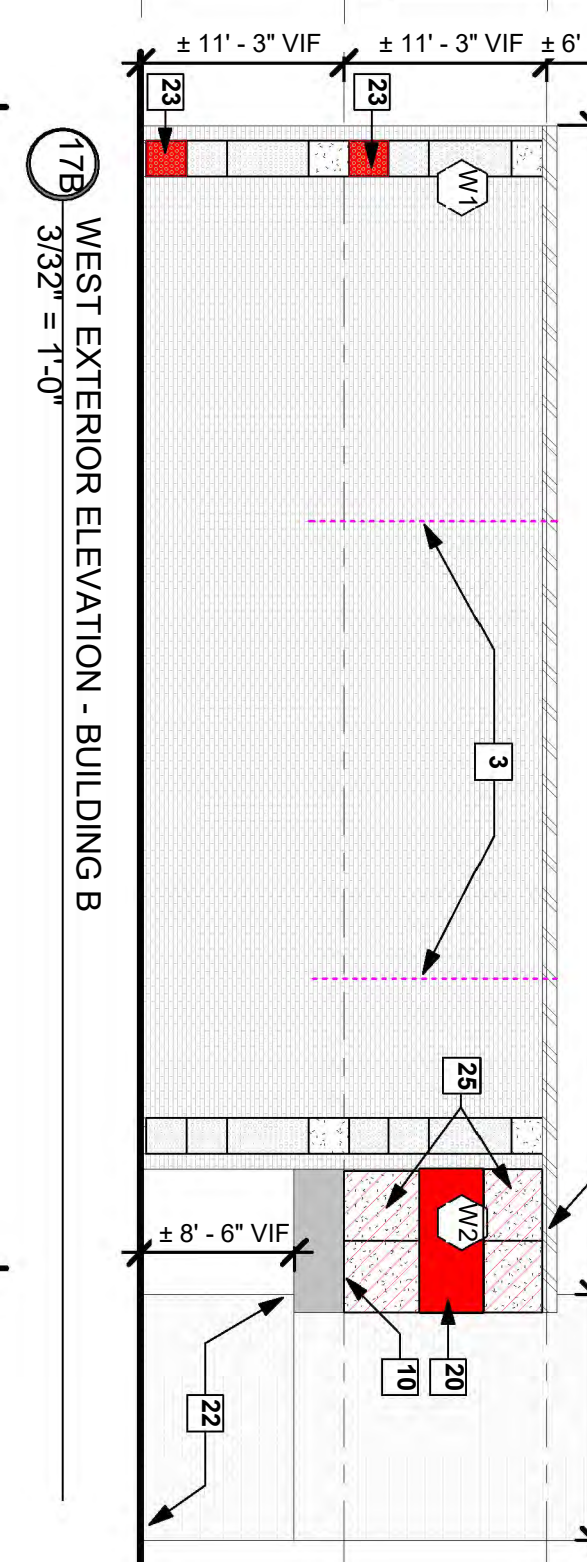
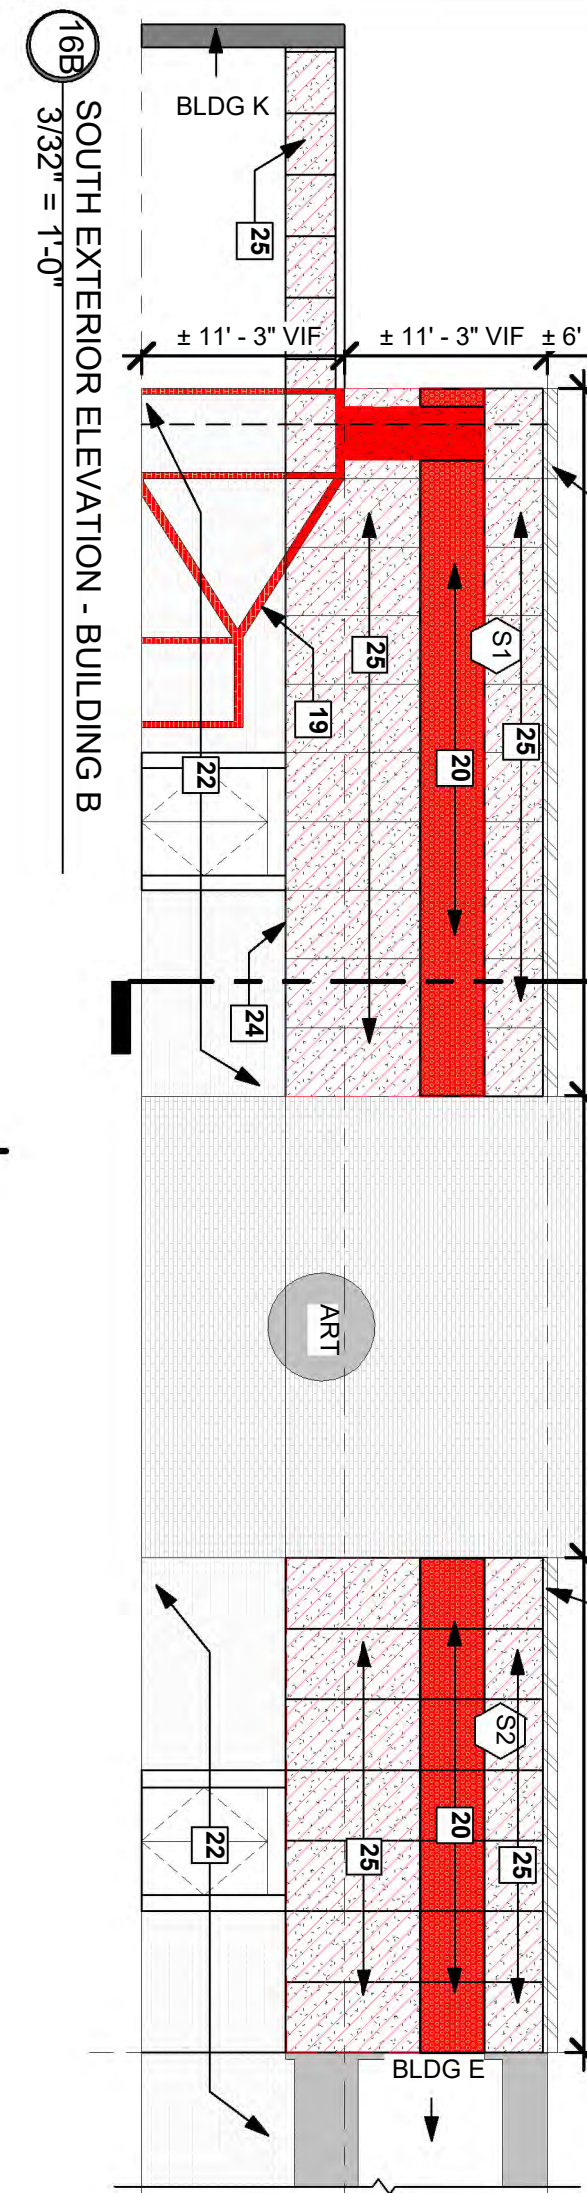
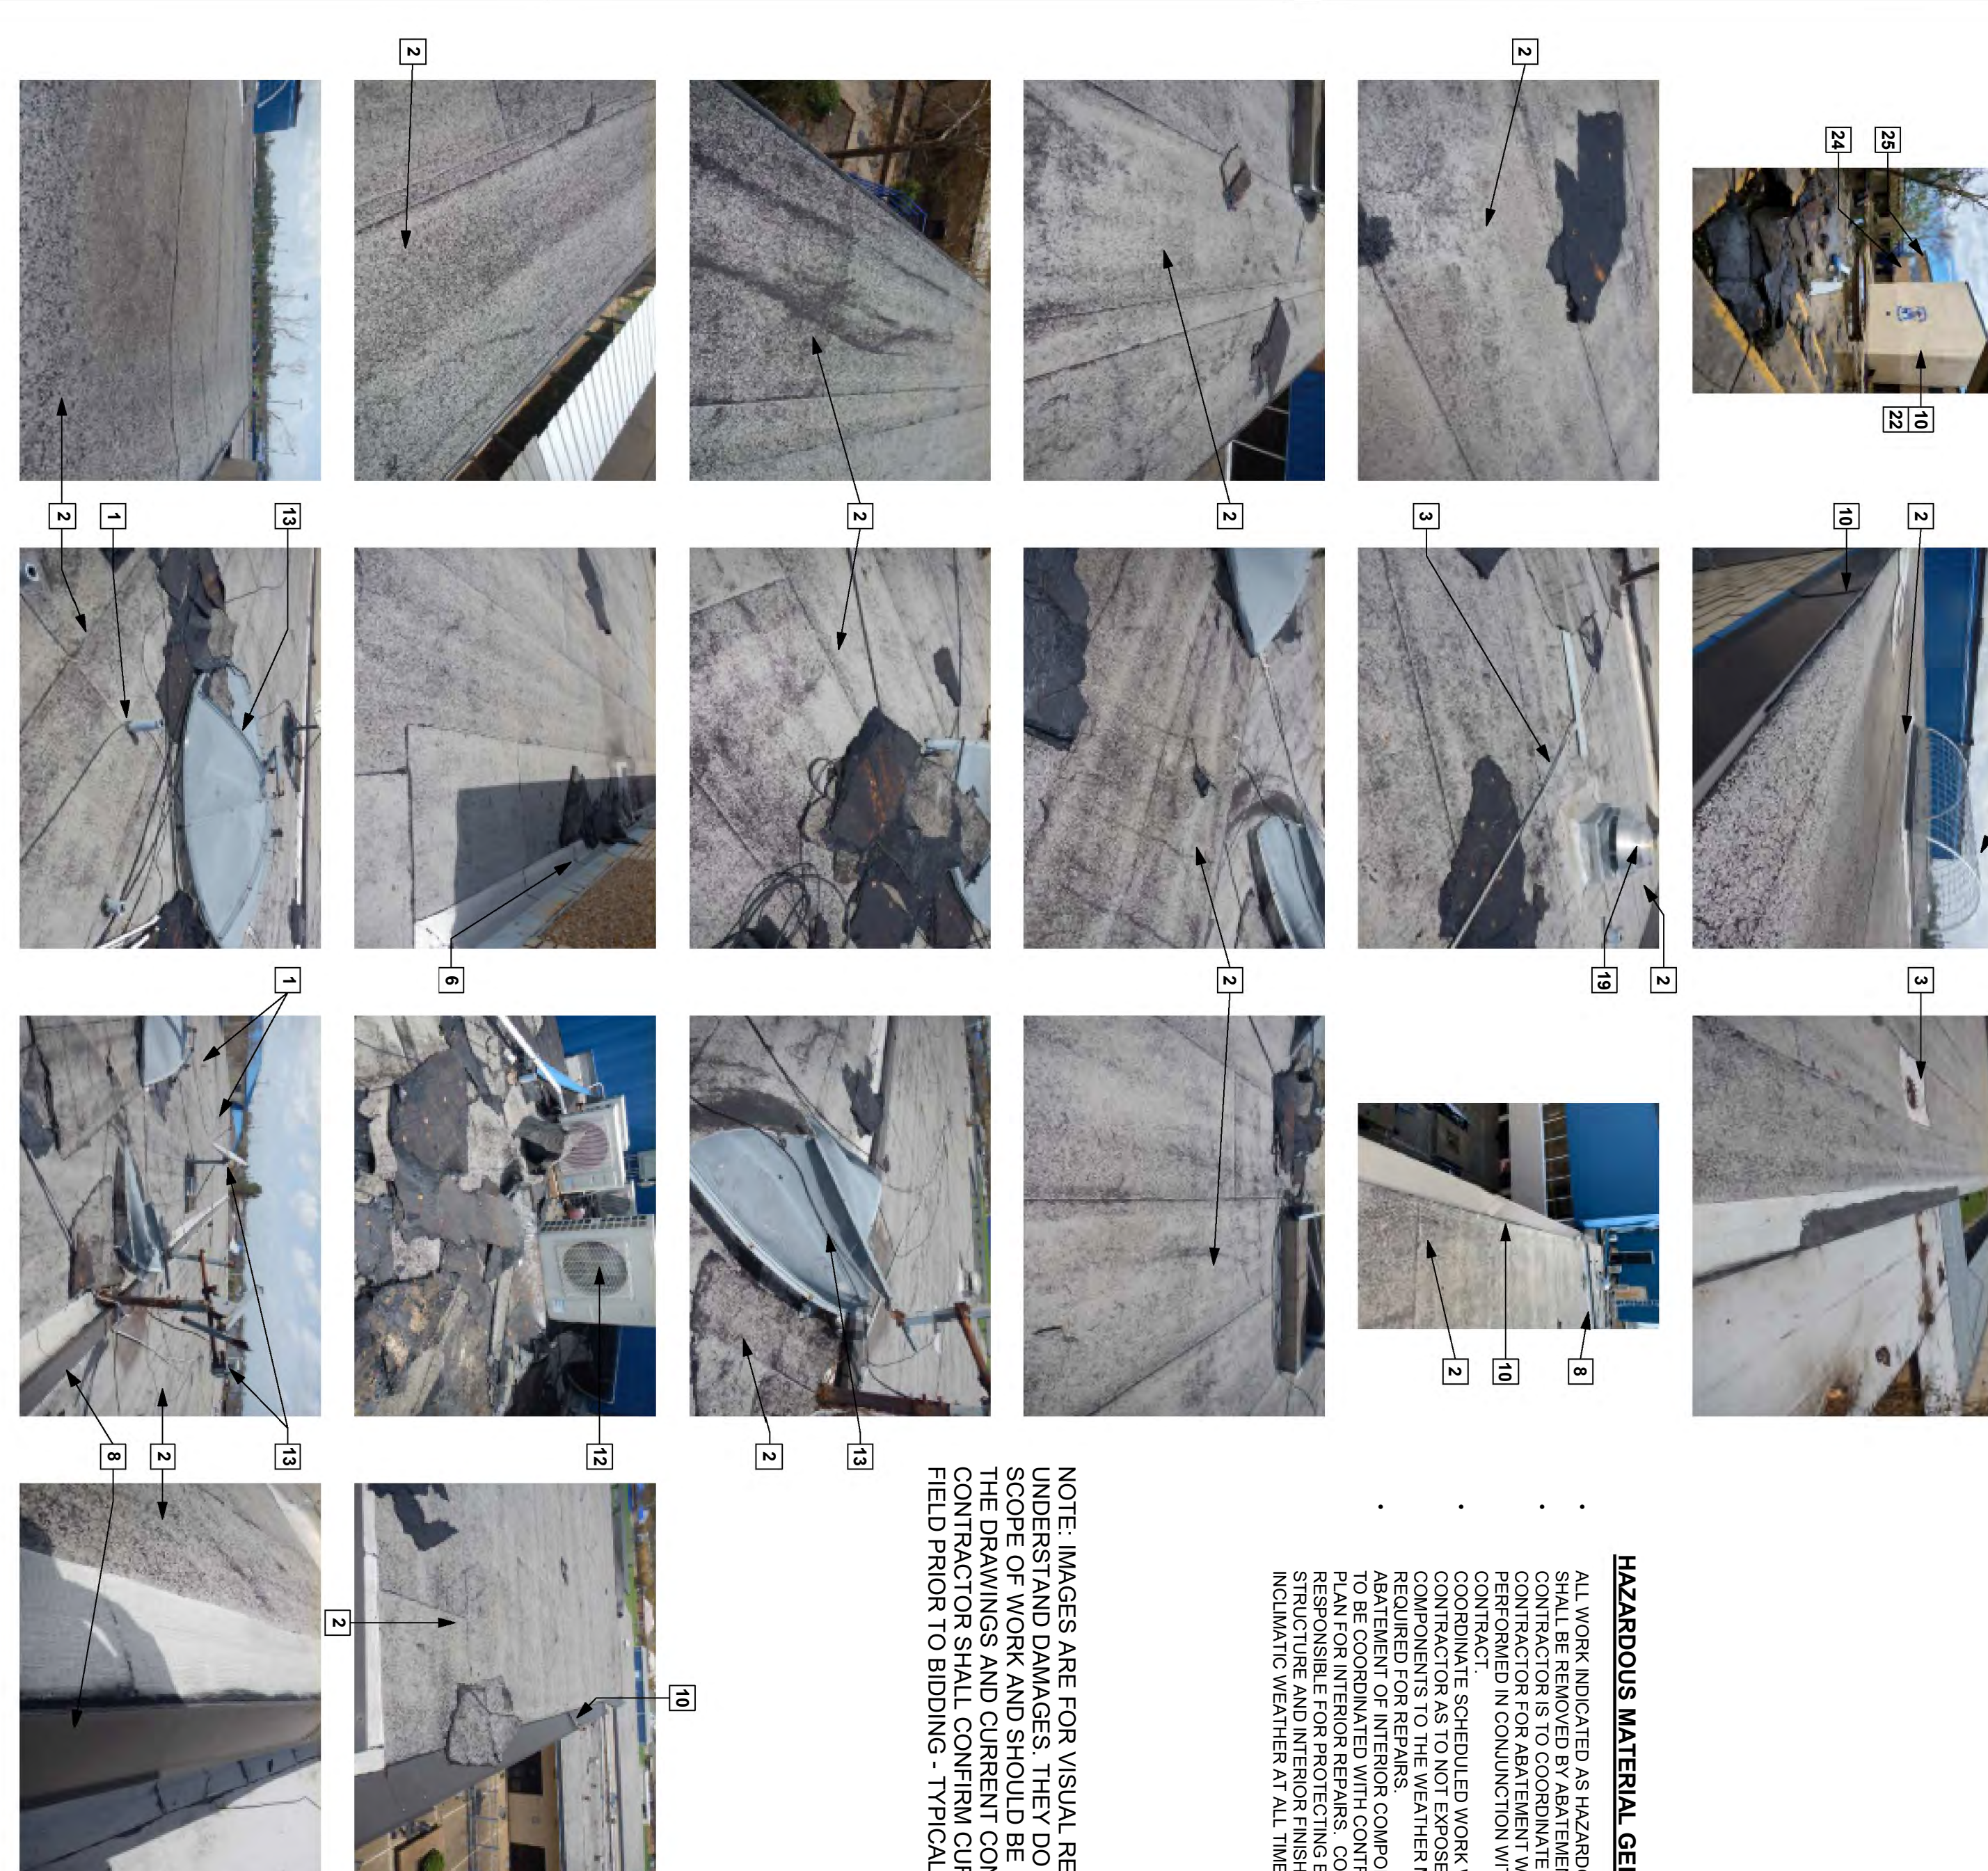


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OWNER PROJECT NO. HL-003-01.03.04.05.06.07
PROJECT MANAGER TM
DATE ISSUED 06/28/2024
REVISED



- 1. EXISTING PASSIVE AIR ROOF VENT TO BE REMOVED. TYPICAL AT RE...
- 2. SHADY REGION INDICATES EXISTING ROOFING ASSEMBLY TO BE REMOVED TO EXISTING ROOF DECKING SUBSTRATE BELOW...
- 3. EXISTING EXTERIOR RIGID CONDUIT/PIPING RUNS EXPOSED ON ROOFING ROOF WALKS. CONTRACTOR SHALL MAKE VISUAL INSPECTIONS ON SITE TO VERIFY THE EXTENT OF WORK WHICH BE...
- 4. APPROXIMATE LOCATION OF EXISTING ROOF DRAIN. CONTRACTOR TO REMOVE EXISTING ROOF DRAIN AND PATCH ROOFING ABOVE IT AND DRAIN TO ROOF TO DRAIN AT 1/4" PER 1'-0" MIN. TYPICAL AT...
- 5. EXISTING ROOFING MATERIALS AND FLASHING WHICH IS TO BE REMOVED FOR INSTALLATION OF ALL FLASHING AND TERMINATION BARS AS DETAIL.
- 6. APPROXIMATE LOCATION OF EXISTING ROOF EXPANSION JOINT. CONTRACTOR SHALL VISUALLY INSPECT THE EXISTING CONDITIONS AT THE SITE AND PROVIDE A NEW EXPANSION JOINT AS DETAIL. THE INSTALLER SHOULD ASSUME THAT ALL EXISTING WOOD BLOCKING SHALL BE REPLACED WITH NEW TREATED WOOD PRE-FINISHED EXPANSION JOINT COVER VINYL BELLOWS AND BASE FLASHING AS DETAIL. VERIFY EXACT ROUTING AND AREA WHERE THIS IS TO BE REMOVED AND REPLACED. VERIFY ALL EXISTING CONDITIONS ESPECIALLY ANY PIPING, AND CONDUIT WHICH MIGHT BE EXPOSED TO REMOVED WORK. CONTRACTOR SHALL VERIFY ALL EXISTING ROOFING MATERIALS AND FLASHING WHICH IS TO BE REMOVED AND REPLACE WITH NEW ROOFING MATERIALS AND FLASHING AS SPECIFIED BY THE MANUFACTURER'S RECOMMENDATIONS.
- 7. EXISTING ROOFING MATERIALS AND FLASHING WHICH IS TO BE REMOVED AND REPLACE WITH NEW ROOFING MATERIALS AND FLASHING AS SPECIFIED BY THE MANUFACTURER'S RECOMMENDATIONS.
- 8. REMOVE AND REPLACE PRE-FINISHED METAL DOWNSPOUT WITH NEW PRE-FINISHED METAL DOWNSPOUT TO MATCH EXISTING METAL DOWNSPOUTS TO MATCH EXISTING. REMOVE AND REPLACE DOWNSPOUTS TO MATCH EXISTING. MAINTAIN AND NEW MATERIALS WITH NEW ROOF AND FACADE TO MATCH EXISTING. TYPICAL AT ALL LOCATIONS OF RE-ROOFING.
- 9. REMOVE AND REPLACE BRICK WALL AS INDICATED. DISPOSE OF OLD BRICK MANTLE NEW BRICK AND MORTAR TO EXISTING AS REPAIR. PROVIDE NEW THRESHOLD AT SECOND FLOOR AS REQUIRED PER SPECIFICATIONS. REMOVE PLASTIC WINDOW SYSTEM AND INSTALL NEW STOREFRONT AS SPECIFIED. SEE SECTION 16A-00.2 AND WINDOW SCHEDULE.
- 10. REMOVE AND REPLACE PRE-FINISHED METAL DOWNSPOUT WITH NEW PRE-FINISHED METAL DOWNSPOUT TO MATCH EXISTING METAL DOWNSPOUTS TO MATCH EXISTING. REMOVE AND REPLACE DOWNSPOUTS TO MATCH EXISTING. MAINTAIN AND NEW MATERIALS WITH NEW ROOF AND FACADE TO MATCH EXISTING. TYPICAL AT ALL LOCATIONS OF RE-ROOFING.
- 11. REMOVE AND REPLACE BRICK WALL AS INDICATED. DISPOSE OF OLD BRICK MANTLE NEW BRICK AND MORTAR TO EXISTING AS REPAIR. PROVIDE NEW THRESHOLD AT SECOND FLOOR AS REQUIRED PER SPECIFICATIONS. REMOVE PLASTIC WINDOW SYSTEM AND INSTALL NEW STOREFRONT AS SPECIFIED. SEE SECTION 16A-00.2 AND WINDOW SCHEDULE.
- 12. REMOVE AND REPLACE PRE-FINISHED METAL DOWNSPOUT WITH NEW PRE-FINISHED METAL DOWNSPOUT TO MATCH EXISTING METAL DOWNSPOUTS TO MATCH EXISTING. REMOVE AND REPLACE DOWNSPOUTS TO MATCH EXISTING. MAINTAIN AND NEW MATERIALS WITH NEW ROOF AND FACADE TO MATCH EXISTING. TYPICAL AT ALL LOCATIONS OF RE-ROOFING.
- 13. REMOVE AND REPLACE BRICK WALL AS INDICATED. DISPOSE OF OLD BRICK MANTLE NEW BRICK AND MORTAR TO EXISTING AS REPAIR. PROVIDE NEW THRESHOLD AT SECOND FLOOR AS REQUIRED PER SPECIFICATIONS. REMOVE PLASTIC WINDOW SYSTEM AND INSTALL NEW STOREFRONT AS SPECIFIED. SEE SECTION 16A-00.2 AND WINDOW SCHEDULE.
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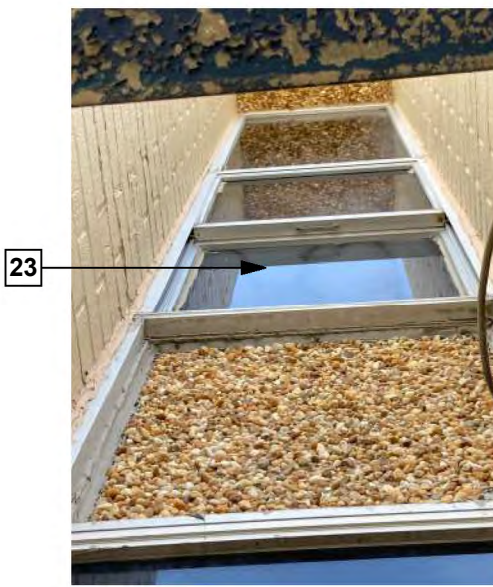
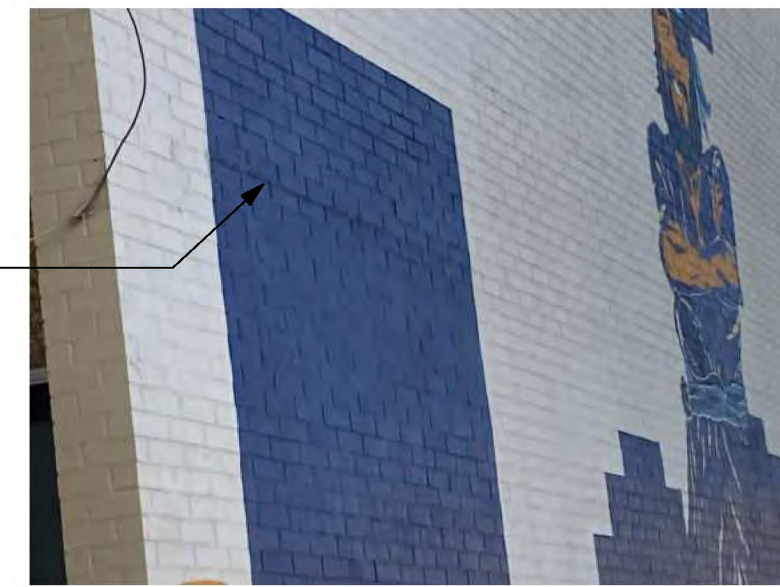
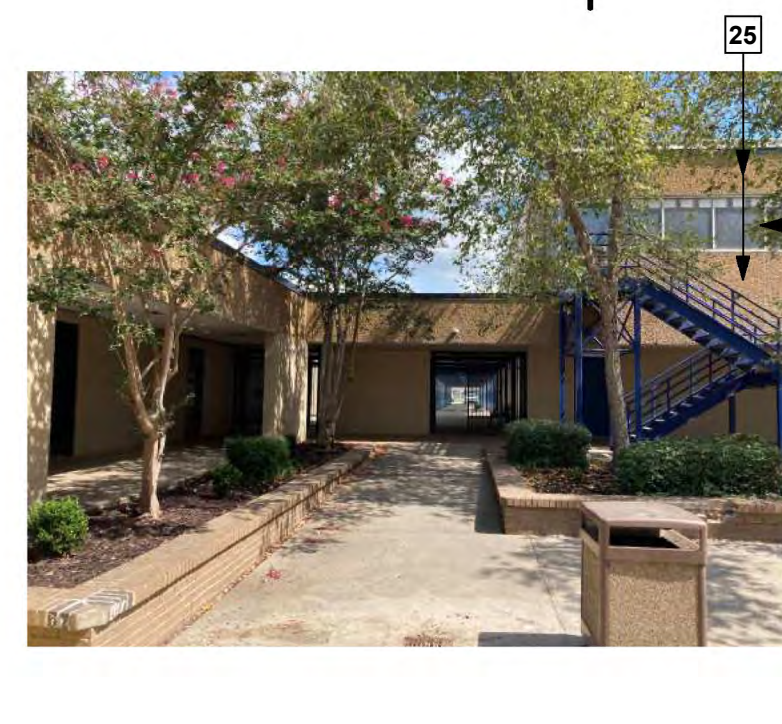
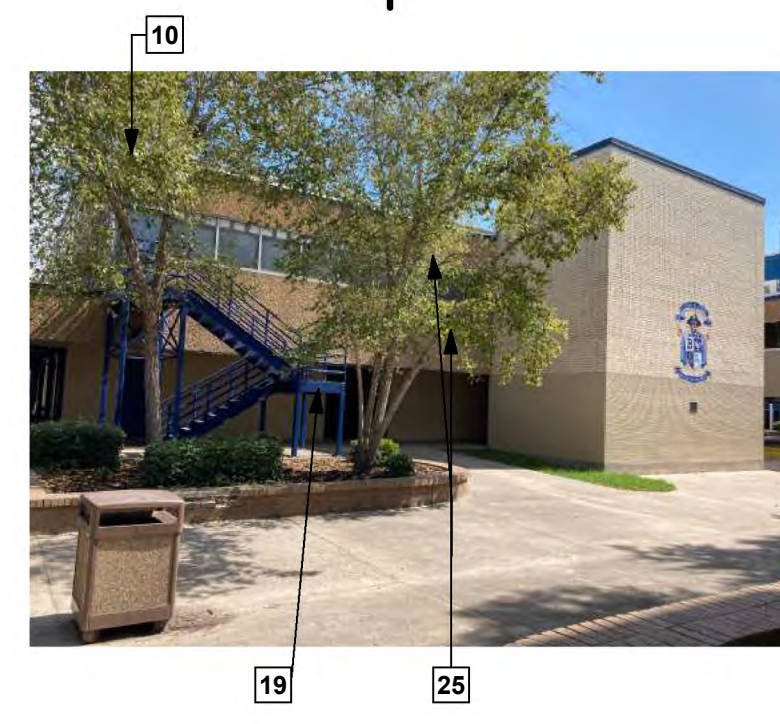
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HAZARDOUS MATERIAL GENERAL NOTES
ALL WORK INDICATED AS HAZARDOUS MATERIALS SHALL BE REMOVED BY ABATEMENT CONTRACTOR FOR DISPOSAL IN ACCORDANCE WITH THE CONTRACTOR'S RESPONSIBILITIES FOR ABATEMENT WORK. THE CONTRACTOR SHALL BE RESPONSIBLE FOR OBTAINING ALL NECESSARY PERMITS AND APPROVALS FROM THE APPROPRIATE AGENCIES. THE CONTRACTOR SHALL BE RESPONSIBLE FOR PROTECTING BUILDING STRUCTURE FROM ANY INCLEMENT WEATHER AT ALL TIMES.

NOTE: IMAGES ARE FOR VISUAL REFERENCES TO HELP UNDERSTAND DAMAGES. THEY DO NOT REPRESENT THE ENTIRE SCOPE OF WORK AND SHOULD BE USED IN CONJUNCTION WITH THE DRAWINGS AND CURRENT CONDITIONS IN THE FIELD. THE CONTRACTOR SHALL CONFIRM CURRENT CONDITIONS IN THE FIELD PRIOR TO BIDDING - TYPICAL.

ROOFING SYMBOL LEGEND







- EXISTING SKYLIGHT SEE KEYNOTE 18 / A-00.4
- ROOF DRAIN LOCATION SEE KEYNOTE 16 / A-00.4
- ROOF PIPING PENETRATION SEE KEYNOTE 9
- ROOF FAN VENT SEE KEYNOTE 12
- ROOF FAN VENT SEE KEYNOTE 12
- DOWNSPOUT SEE KEYNOTE 30
- MISC MEP SEE KEYNOTE 12
- TURBINE VENT SEE KEYNOTE 12
- EXPANSION JOINT SEE KEYNOTE 8 / A-00.4
- SCUPPER OPENING FOR DRAINAGE SEE KEYNOTE 28 / A-00.4
- ONE-WAY ROOF VENT TO BE REMOVED W/ ROOFING SEE KEYNOTE 3



NOTE: IMAGES ARE FOR VISUAL REFERENCES TO HELP UNDERSTAND DAMAGES. THEY DO NOT REPRESENT THE ENTIRE SCOPE OF WORK AND SHOULD BE USED IN CONJUNCTION WITH THE DRAWINGS AND CURRENT CONDITIONS IN THE FIELD. CONTRACTOR SHALL CONFIRM CURRENT CONDITIONS IN THE FIELD PRIOR TO BIDDING - TYPICAL.


DOOR SCHEDULE									
MARK	OPENING SIZE		DOOR TYPE	DOOR MATERIAL	DOOR FINISH	FRAME MATERIAL	FRAME FINISH	GLASS TYPE	COMMENTS
	WIDTH	HEIGHT							
218A	3'-0"	7'-0"	TYPE A	ALUMINUM	CLEAR ANODIZED	ALUMINUM	CLEAR ANODIZED	G3	REPLACE UNIT

WINDOW SCHEDULE				
MARK	SIZE	FRAME		COMMENTS
		TYPE	MATERIAL	
W1	SEE ELEVATION	STOREFRONT	EXISTING	REPLACE DAMAGED GLASS AS INDICATED
W2	SEE ELEVATION	STOREFRONT	ALUMINUM, CLEAR ANODIZED	REPLACE ENTIRE UNIT
N1	SEE ELEVATION	STOREFRONT	EXISTING	REPLACE DAMAGED GLASS AS INDICATED
E1	SEE ELEVATION	STOREFRONT	EXISTING	REPLACE DAMAGED GLASS AS INDICATED
S1	SEE ELEVATION	STOREFRONT	ALUMINUM, CLEAR ANODIZED	REPLACE ENTIRE UNIT
S2	SEE ELEVATION	STOREFRONT	ALUMINUM, CLEAR ANODIZED	REPLACE ENTIRE UNIT

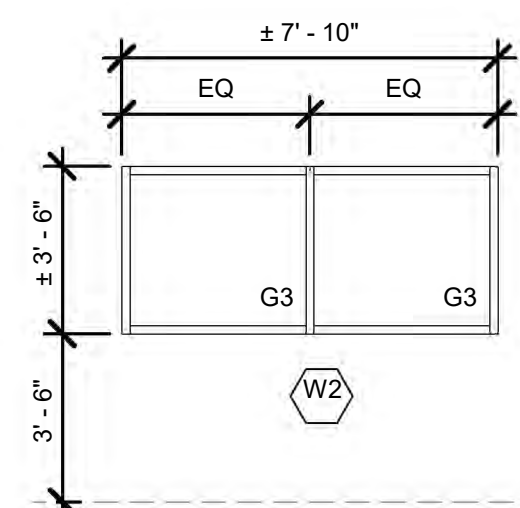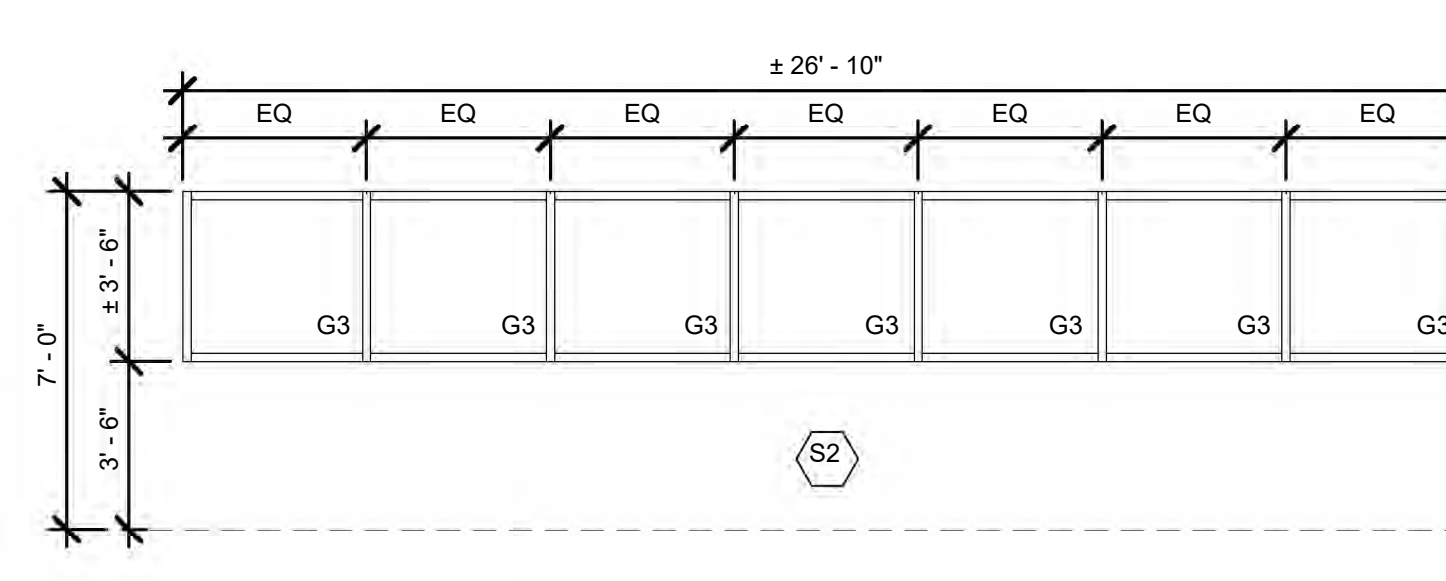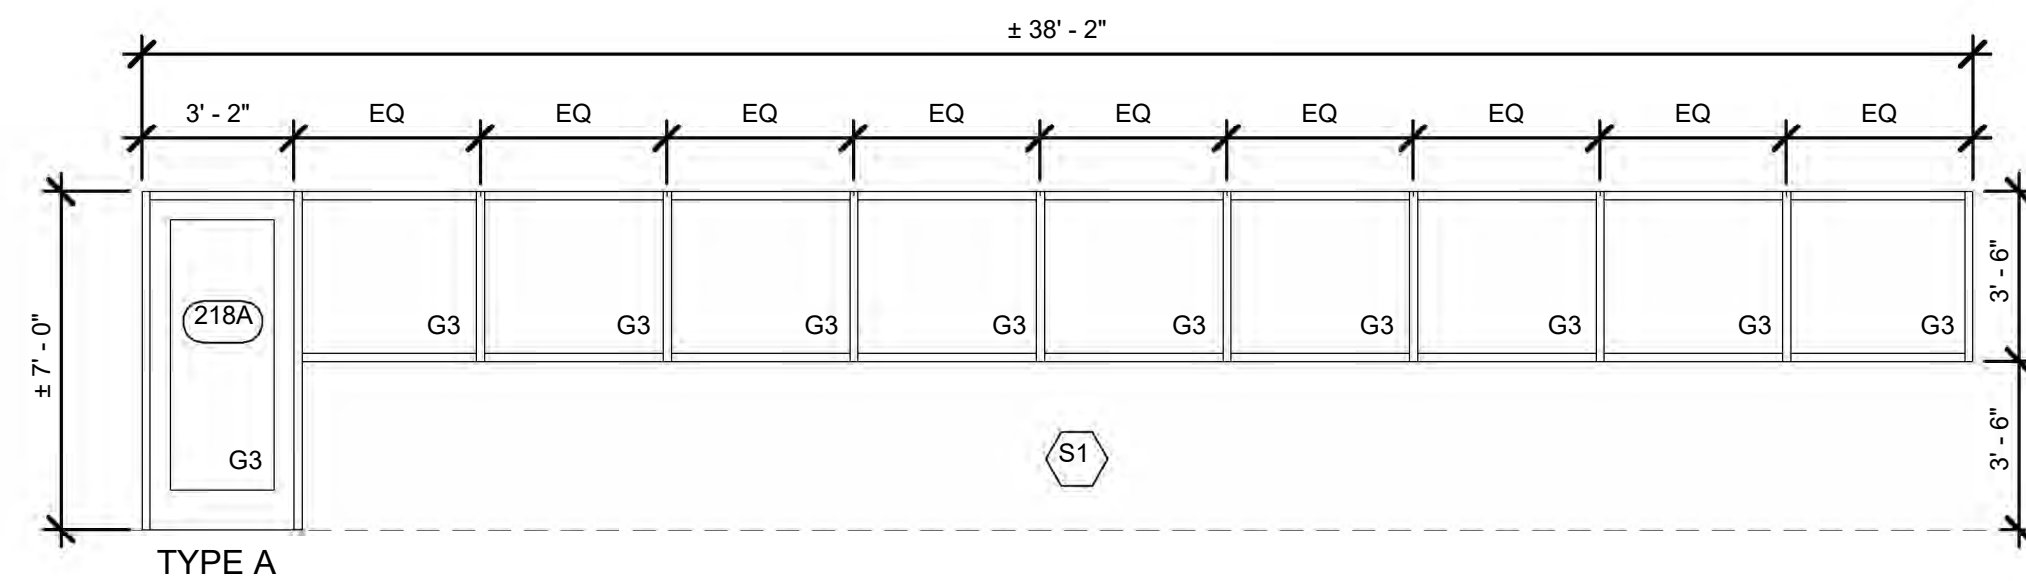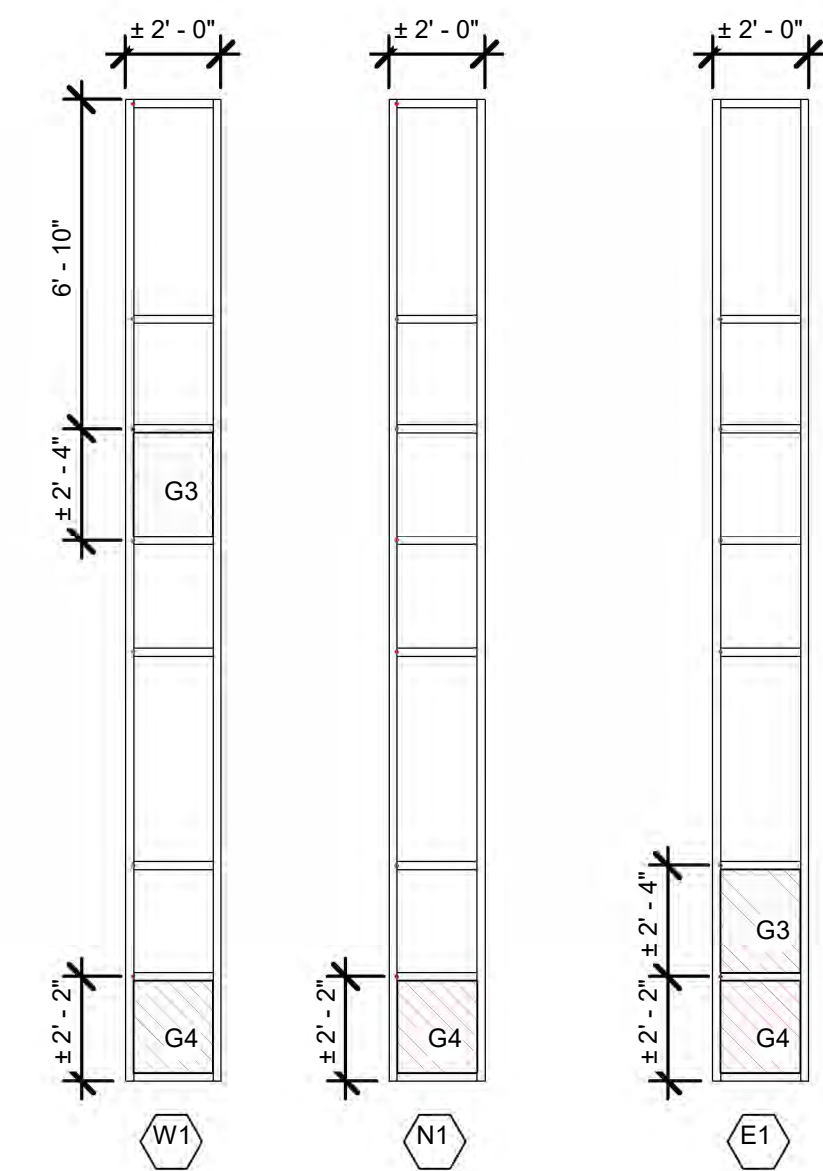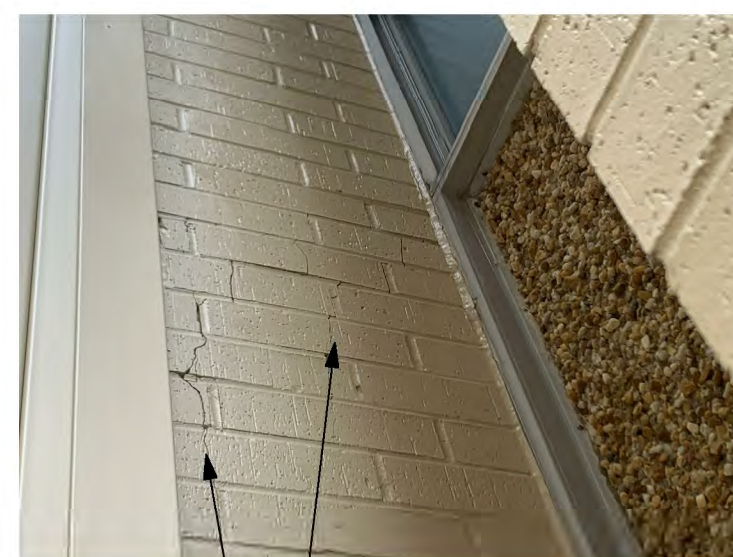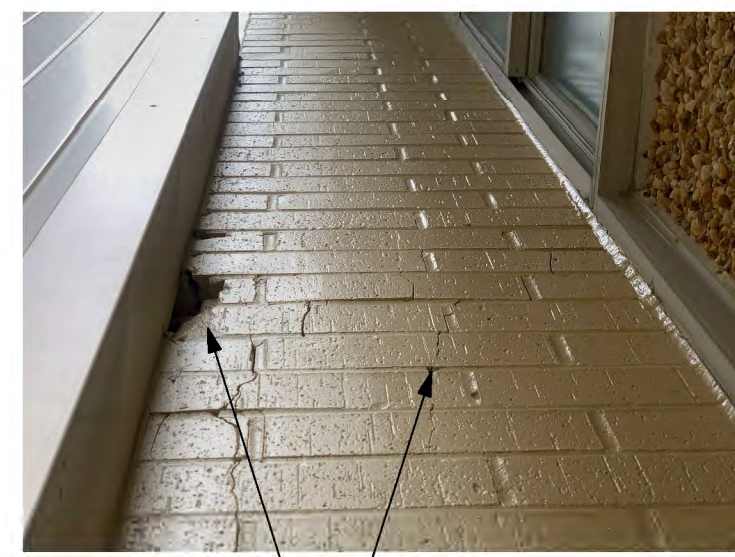

GLAZING SCHEDULE	
G1	CLEAR, INSULATED GLASS AS SPECIFIED.
G2	SPANDRAL GLASS AS SPECIFIED.
G3	TINTED, INSULATED GLASS AS SPECIFIED.
G4	ALUMINUM WINDOW PANEL AS SPECIFIED.

*GLAZING OF NEW STOREFRONT UNITS ARE TO BE LARGE MISSILE IMPACT AS SPECIFIED. REPLACEMENT GLAZING IS TO MATCH EXISTING.

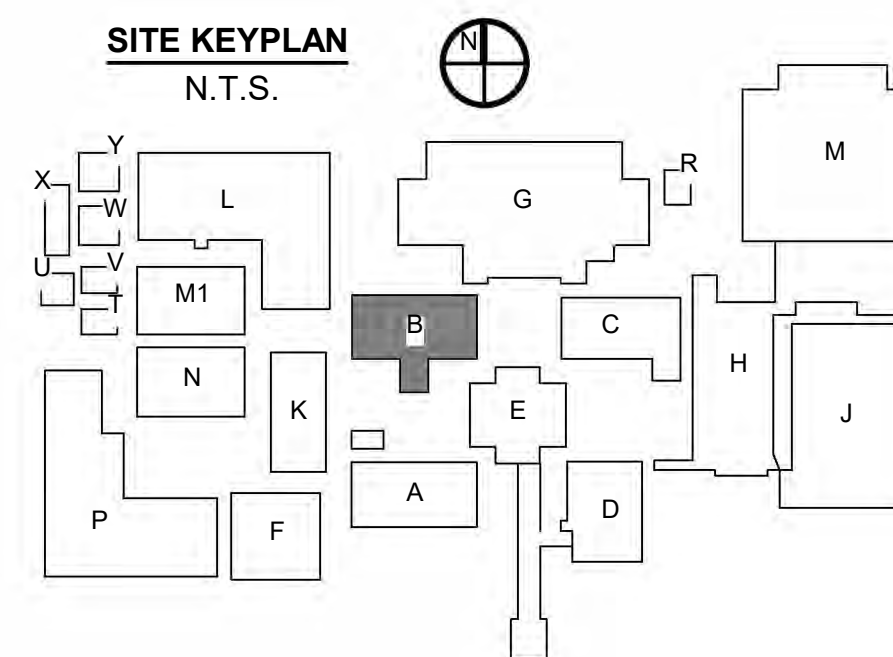

- KEYNOTES**
- EXISTING **PASSIVE AIR ROOF VENT TO BE REMOVED**. TYPICAL AT RE-ROOFED AREAS.
 - SHADED REGION INDICATES EXISTING ROOFING ASSEMBLY TO BE REMOVED TO EXISTING ROOF DECKING SUBSTRATE BELOW, AND NEW ROOFING INSTALLED. ALL DEBRIS IS TO BE REMOVED FROM THE SITE. SEE SPECIFICATIONS. ROOFTOP PENETRATIONS AND EQUIPMENT TO BE VERIFIED BY CONTRACTOR IN THE FIELD.
 - INDICATES **EXISTING RIGID CONDUIT/PIPING RUNS** EXPOSED ON EXISTING ROOF. CONTRACTOR SHALL MAKE VISUAL INSPECTIONS ON SITE TO VERIFY THE EXTENT OF WORK WHICH BE REQUIRED TO MOVE, REPAIR, AND RELOCATE THESE CONDUIT/PIPING RUNS DURING THE PROCESS OF RE-ROOFING AND TO ENSURE THAT THE NEW ROOF SLOPES ARE INTEGRATED AND ACCOUNTED FOR WHERE EXTENSIONS OF THESE CONDUITS AND WIRING IS REQUIRED. PROVIDE NEW "RUNNER CURBS" FOR SUPPORT OF ALL HARD PIPING WHICH IS TO REMAIN ON ROOF AFTER NEW INSTALLATION. SPACE CURBS AS REQUIRED SO CONDUIT AND PIPING DOES NOT SAG BETWEEN THESE LOCATIONS. INSTALL AS DETAILED.
 - SEE KEYNOTE 12.
 - APPROXIMATE LOCATION OF **EXISTING ROOF DRAIN**. CONTRACTOR SHALL VERIFY EXISTING DRAINS AND LOCATIONS. REPLACE CLAMPS AND COVERS TO MATCH EXISTING - PATCH ROOFING AROUND DRAINS. SLOPE ROOF TO DRAIN AT 1/4" PER 1'-0" MIN. TYPICAL AT LOCATIONS OF RE-ROOFING. CONTRACTOR SHALL VERIFY LOCATION OF EXISTING OVERFLOW DRAINS AND SHALL MAINTAIN ALL OVERFLOWS IN FINAL ROOFING ASSEMBLY.
 - SEE DETAILS FOR **FLASHING AND COUNTERFLASHING** WHICH IS TO TIE INTO THE EXISTING BUILDING ENVELOPE. VERIFY CLEARANCES AND LOCATIONS FOR INSTALLATION OF ALL FLASHING AND TERMINATION BARS AS DETAILED.
 - SEE KEYNOTE 3.
 - INDICATES APPROXIMATE AREA AND LOCATION OF **ROOF EXPANSION JOINT**. CONTRACTOR SHALL VISUALLY INSPECT THE EXISTING CONDITIONS AT THE SITE AND PROVIDE A NEW EXPANSION JOINT AS DETAILED. THE INSTALLER SHOULD ASSUME THAT ALL EXISTING WOOD BLOCKING SHALL BE REPLACED WITH NEW TREATED WOOD BLOCKING AS PER DETAILS. PROVIDE NEW CANT STRIP, FLASHING, PRE-FINISHED EXPANSION JOINT COVER, VINYL BELLOW, AND BASE FLASHING AS DETAILED. VERIFY EXACT ROUTING AND AREA WHERE THIS EJ IS TO BE REMOVED AND REPLACED. VERIFY ALL EXISTING CONDITIONS, ESPECIALLY ANY PIPING, AND CONDUIT WHICH MIGHT INTERSECT OR CROSS OVER THIS JOINT.
 - CONTRACTOR SHALL INSPECT ALL EXISTING **ROOF PENETRATIONS**. EXTEND VENT PIPING AND OTHER PENETRATIONS WHERE REQUIRED. REPLACE ALL LEAD VENT & PIPE FLASHING. TYPICAL ALL LOCATIONS OF RE-ROOFING.
 - REMOVE AND REPLACE **FLASHING, COUNTER-FLASHING** AND PRE-FINISHED METAL FASCIA FLASHING AS DETAILED.
 - APPROXIMATE LOCATION OF **SKYLIGHT** - CONTRACTOR TO VERIFY IN FIELD. REMOVE AND REPLACE SKYLIGHT WITH NEW, TO MATCH EXISTING SIZE, SHAPE, AND FINISH. VERIFY ALL EXISTING MANUFACTURER'S INSTRUCTIONS. TYPICAL ALL LOCATIONS OF RE-ROOFING.
 - INDICATES **EXISTING ROOFTOP EQUIPMENT**. COORDINATE WITH MEP. PROVIDE NEW CURBS AS NECESSARY TO ENSURE PROPER CURB HEIGHT AND ATTACHMENT AT NEW ROOFS. PROTECT UNDAMAGED EQUIPMENT.
 - SATELLITE DISHES**, MOUNTS AND WEIGHTS TO BE REMOVED AND DISPOSED OF. PATCH ALL HOLES CAUSED BY STRUCTURE PER ROOFING MANUFACTURER RECOMMENDATIONS.
 - REMOVE AND REPLACE DAMAGED AND MISSING **METAL WALL PANEL** "E" AS SPECIFIED. SEE BUILDING ELEVATIONS.
 - INSTALL DAMAGED AND MISSING LETTERING AND **SIGNAGE** TO MATCH EXISTING.
 - ROOF ACCESSORY REPLACEMENT**: REPLACE DAMAGED ROOF ACCESSORIES. MATCH EXISTING TYPE, MATERIAL, AND STYLE.
 - REMOVE AND REPLACE PRE-FINISHED METAL DOWNSPOUT WITH NEW TO MATCH EXISTING COLOR, GAUGE, SIZE, & PROFILE. REMOVE PREVIOUS ATTACHMENTS AND FASTENERS & REPLACE WITH NEW. GROUT FILL ALL HOLES.
 - SEE KEYNOTE 13.
 - EXTERIOR METAL STAIR**: SEE STRUCTURAL SHEETS. REMOVE STAIRS AS REQUIRED TO REPAIR SOFFIT OF 1ST FLOOR. REINSTALL STAIR UNIT. PROVIDE NEW THRESHOLD AS REQUIRED TO ABUT EXISTING FLOOR.
 - REMOVE PLYWOOD AND INSTALL NEW CLEAR **PLEXIGLASS PANEL** TO MATCH ADJACENT PANELS. REMOVE AND REPLACE ACCOMPANYING HORIZONTAL AND VERTICAL MULLIONS WHERE PLYWOOD IS INSTALLED.
 - REMOVE AND **REPLACE DAMAGED BRICK FACADE** AND MORTAR AS INDICATED. DISPOSE OF DAMAGED BRICK, MATCH NEW BRICK AND MORTAR TO EXISTING AS APPROVED BY ARCHITECT. PRESERVE SUBSTRATE. REMOVE OLD BRICK TIES AND WATER-PROOFING. INSTALL NEW WATERPROOFING AND BRICK TIES AT A MIN. OF 24" O.C. VERTICAL AND HORIZONTAL. WATERPROOFING TO BE TAPED WITH MANUFACTURER APPROVED TAPE AND LAPPED TO PREVENT MOISTURE PENETRATION INTO THE BUILDING ENVELOPE.
 - CLEAN, PRIME & **RE-PAINT WALLS AND ARTWORK** TO COVER SCUFFS AND DAMAGE FROM STORM DEBRIS. COLOR AND PAINT DESIGNS TO MATCH EXISTING AS APPROVED BY ARCHITECT.
 - REMOVE AND **REPLACE DAMAGED AND MISSING GLASS** TO MATCH EXISTING. PROVIDE CAULKING AND GASKETING FOR WATER-TIGHT SEAL. WHERE PLYWOOD HAS BEEN INSTALLED, REMOVE & DISPOSE OF PLYWOOD WHEN NEW GLASS IS INSTALLED.
 - EXISTING STUCCO SOFFIT TO BE REMOVED** BY ABATEMENT CONTRACTOR. INSTALL NEW 5/8" GLASS-MAT GYPSUM BOARD ON NEW METAL SUSPENSION SYSTEM AS SPECIFIED. INSTALL NEW CEMENT BOARD STUCCO SYSTEM FINISH AS SPECIFIED. COORDINATE WITH ABATEMENT SCOPE & ABATEMENT CONTRACTOR TO ENSURE WEATHER-TIGHTNESS AND PHASING COORDINATION.
 - COORDINATE REMOVAL OF (METAL PANELS WHERE APPLICABLE AND) **AGGREGATE PANELS (HAZARDOUS MATERIAL)** WITH ABATEMENT SCOPE AND ABATEMENT CONTRACTOR. COORDINATE AND INSTALL NEW FACADE PANELS AS SPECIFIED. SALVAGE AND REINSTALL MEP COMPONENTS AT SAME LOCATIONS - COORDINATE WITH MEP.
 - SEE KEYNOTE 3.
 - SHADED REGION INDICATES EXISTING ROOFING ASSEMBLY TO BE REMOVED INCLUDING ROOF DECKING SUBSTRATE TO STRUCTURE BELOW, AND NEW ROOFING AND DECKING INSTALLED. ALL DEBRIS IS TO BE REMOVED FROM THE SITE. SEE SPECIFICATIONS. ROOFTOP PENETRATIONS AND EQUIPMENT TO BE VERIFIED BY CONTRACTOR IN THE FIELD.
 - PROVIDE **SCUPPER** THROUGH ROOF EDGE. SLOPE ROOFING AT 1/4" PER 1'-0" MIN. TO ENSURE POSITIVE DRAINAGE. COORDINATE LOCATIONS AND SIZES WITH EXISTING WITH SCUPPERS TO BE PROVIDED AS DETAILED AND ROOF TAPER PROVIDED ACCORDINGLY.
 - REMOVE AND **REPLACE PRE-FINISHED METAL GUTTER** WITH NEW TO MATCH EXISTING COLOR, GAUGE, SIZE, & PROFILE. REMOVE PREVIOUS ATTACHMENTS AND FASTENERS & REPLACE WITH NEW. GROUT FILL ALL HOLES.
 - APPROX **DOWNSPOUT/COLLECTOR LOCATIONS**. SALVAGE UNDAMAGED DOWNSPOUTS FOR REINSTALLATION. REMOVE AND REPLACE DAMAGED DOWNSPOUTS TO MATCH EXISTING. MAINTAIN EXISTING DRAINAGE METHODOLOGY AND REINSTALL SALVAGED AND NEW MATERIALS WITH NEW ROOF AND FACADE TO MATCH EXISTING. TYPICAL ALL LOCATIONS OF RE-ROOFING.
 - REMOVE AND **REPLACE BRICK WALL** AS INDICATED. DISPOSE OF OLD BRICK, MATCH NEW BRICK AND MORTAR TO EXISTING AS APPROVED BY ARCHITECT. SEE STRUCTURAL BUILDING TO REMAIN WEATHERPROOF AND CONDITIONED DURING REPAIRS.
 - REPOINT** EXTERIOR AND INTERIOR BRICK AS SPECIFIED WHERE INDICATED. REPOINT IN COLOR TO MATCH EXISTING FROM END TO END.
 - REMOVE AND **REPLACE STOREFRONT WINDOW** AS SPECIFIED.

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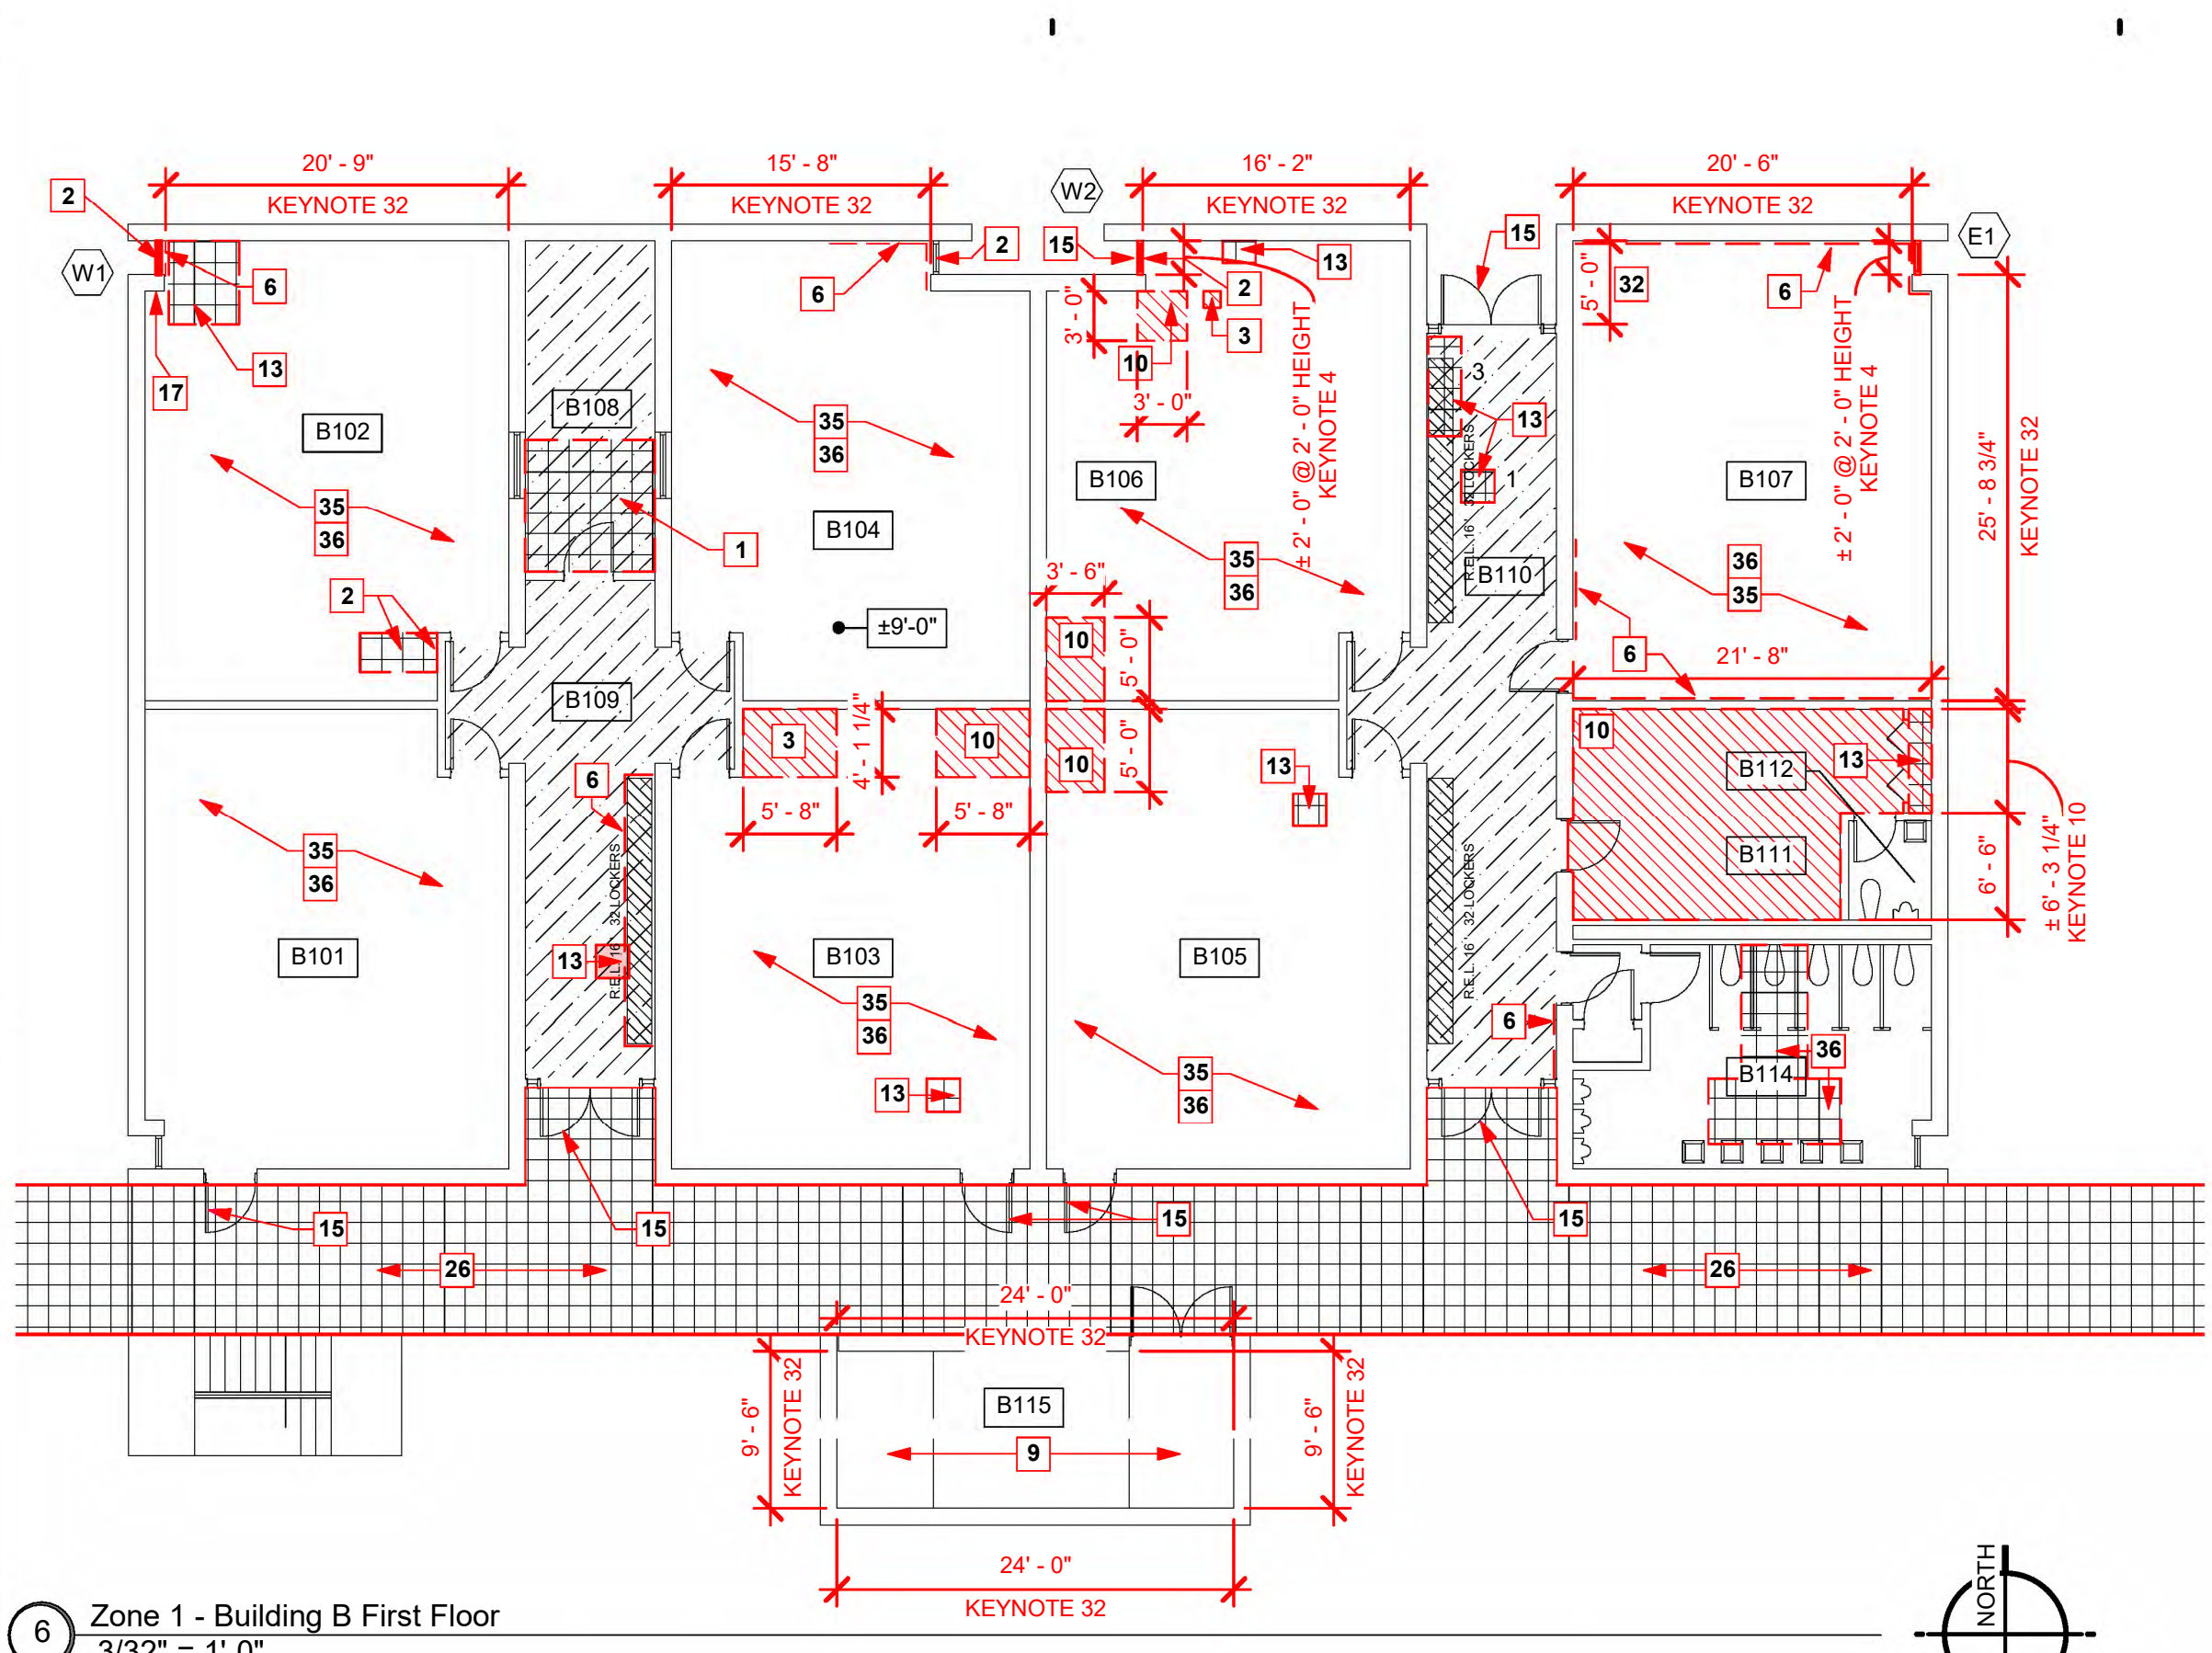
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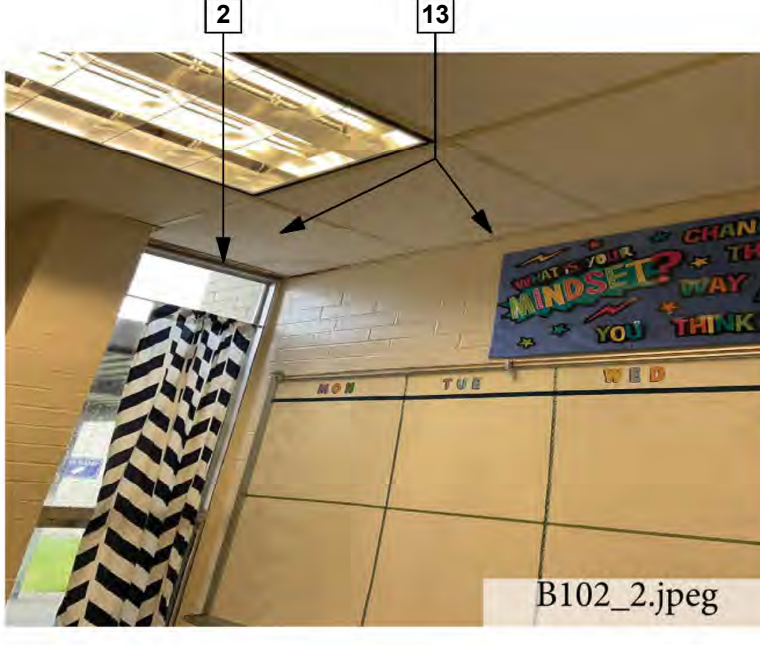
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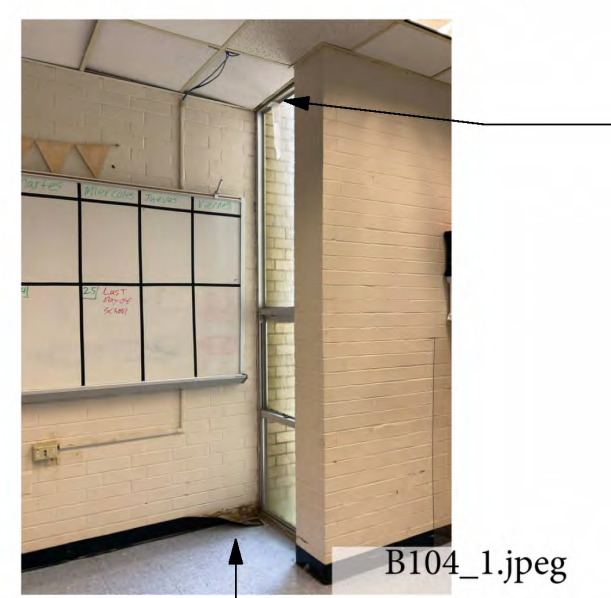
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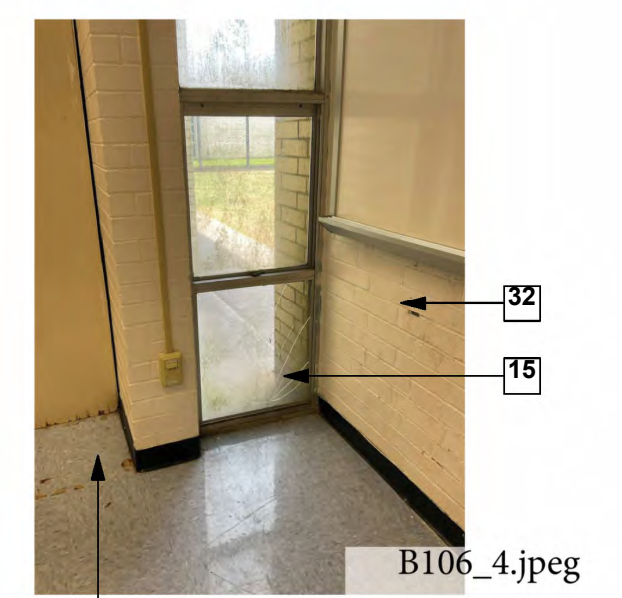
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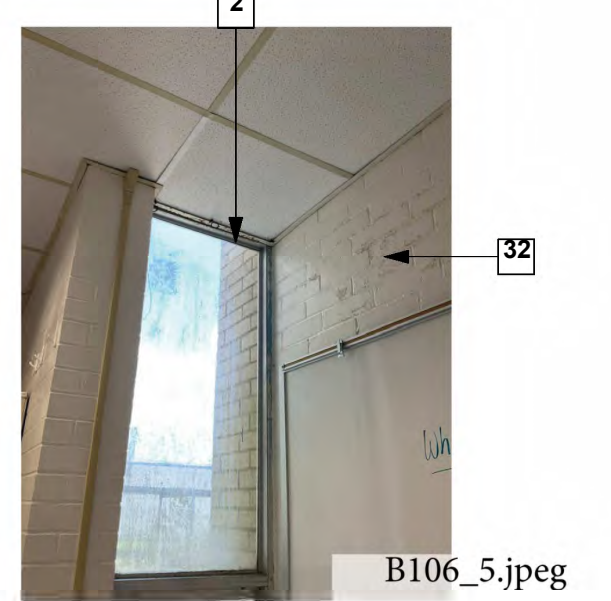
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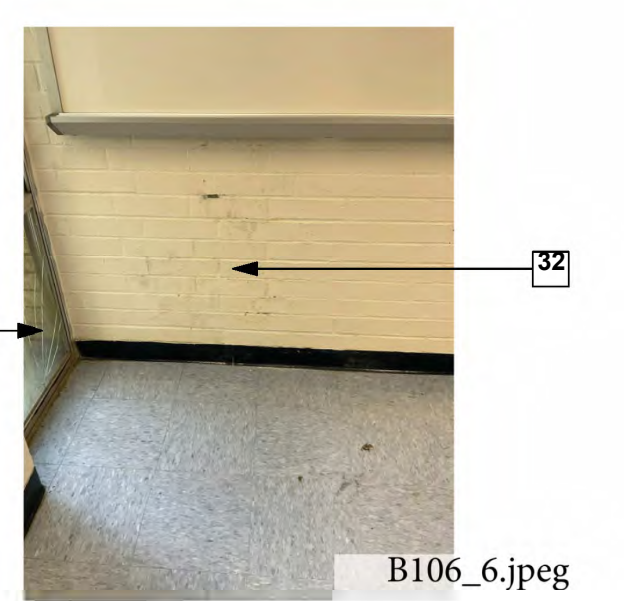
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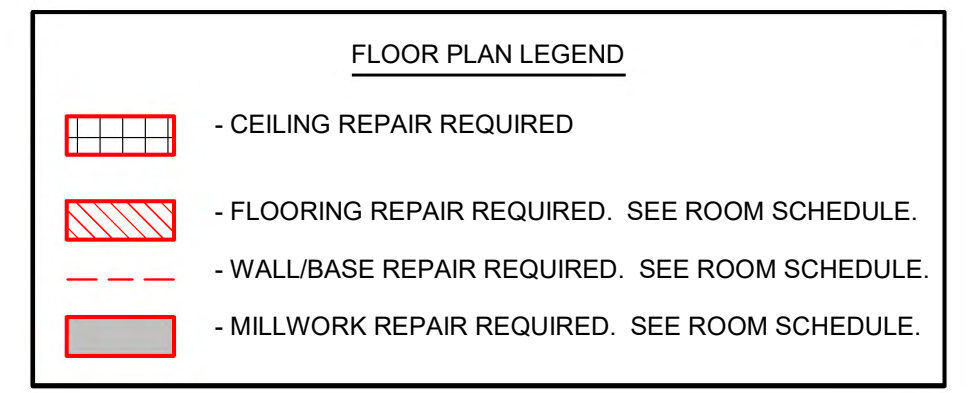


B106_7.jpeg



B106_10.JPG


- KEYNOTES**
- SUSPENDED ACOUSTIC CEILING REPLACEMENT:** REMOVE AND REPLACE DAMAGED CEILING GRID AND CEILING TILE AS SPECIFIED.
 - CEILING GRID:** REMOVE AND REPLACE DAMAGED CEILING GRID. MATCH EXISTING. SEE UNIT PRICE NO. 5
 - VCT FLOORING REPAIRS:** REMOVE AND REPLACE VCT FLOORING AS SPECIFIED IN AREAS WHERE INDICATED. SEE UNIT PRICE NO. 3.
 - WINDOW REPAIRS:** REPLACE BROKEN WINDOW PANES, BLOCKS, AND GASKETS TO MATCH EXISTING. ALL SEALANTS SHALL BE REMOVED AND REPLACED AS SPECIFIED TO ENSURE WEATHER TIGHT SEAL. SEE ELEVATIONS.
 - STRUCTURAL CLAY BLOCK:** GLAZED STRUCTURAL CLAY BLOCK TO BE REMOVED AND REPLACED AS SPECIFIED TO MATCH EXISTING. CLEAN ALL CHALKING RESIDUE FROM EFFERVESCENCE.
 - VINYL BASE REPLACEMENT:** REPLACE DAMAGED OR MISSING BASE AS SPECIFIED TO MATCH EXISTING. SEE UNIT PRICE NO. 4
 - CARPET REPAIRS:** DAMAGED CARPET HAS BEEN REMOVED. CLEAN FLOOR AND INSTALL NEW CARPET TILE AS SPECIFIED.
 - PAINTING:** WALL SURFACE IS TO BE SANDED, PREPARED, AND REPAINT TO MATCH EXISTING CORNER TO CORNER. WATER STAINED WALL FROM ROOF LOSS.
 - PAINTED CEILING STRUCTURE:** CEILING INCLUDING METAL TRUSSES ARE TO BE CLEANED, PREPPED, AND REPAINTED END TO END TO MATCH EXISTING COLOR.
 - VCT FLOORING CLEANING:** CLEAN WATER STAINS FROM VCT FLOORING TO REMOVE ANY DISCOLORATION WHERE INDICATED. MOP AND WAX ALL VCT FLOORING AT THE END OF CONSTRUCTION.
 - SKYLIGHT REPAIR:** REMOVE AND REPLACE SKYLIGHT TO MATCH EXISTING.
 - TERRAZZO FLOORING CLEANING:** CLEAN AND POLISH EXISTING TERRAZZO FLOORING. REFER TO ROOM SCHEDULE FOR CLARITY.
 - CEILING TILE REPLACEMENT:** REMOVE AND REPLACE DAMAGED OR MISSING ACOUSTIC CEILING TILE WITH NEW CEILING TILE AS SPECIFIED IN AREAS INDICATED. MATCH EXISTING TYPE AND SIZE. SEE UNIT PRICE NO. 1. INSTALL R-30 BATT INSULATION OVER TILE. SEE UNIT PRICE NO. 2
 - NOT USED.**
 - EXTERIOR WINDOWS AND DOORS:** CAULK AND RESEAL PERIMETER OF EXISTING WINDOWS AND DOORS.
 - CMU REPAIR:** RE-POINT DAMAGED CMU JOINTS AS SHOWN. PAINT WALL FROM END TO END IN COLOR TO MATCH EXISTING AS SPECIFIED. SEE PHOTOS.
 - BRICK REPAIR:** CAULK CRACKED AREAS AND REPAINT.
 - LOCKERS:** REPLACE DAMAGED UNITS AS SHOWN. MATCH EXISTING STYLE, SIZE AND COLORS.
 - BRICK WALLS:** CLEAN ALL WATER STAINS FROM ENTIRE BRICK WALL.
 - SHELVING REPLACEMENT:** REMOVE AND REPLACE DAMAGED SHELVING UNITS WITH GLASS DOORS. MATCH EXISTING MATERIALS, FINISHES AND CONSTRUCTION STYLE.
 - BASE CABINET:** REMOVE AND REPLACE DAMAGED BASE CABINET. MATCH EXISTING STYLE, SIZE, AND CONSTRUCTION. SALVAGE AND REINSTALL COUNTERTOP.
 - SECTIONAL DOOR:** REMOVE AND REPLACE OVERHEAD SECTIONAL DOOR AS SPECIFIED. CONTRACTOR TO PROVIDE ANY ADDITIONAL SUPPORT REQUIRED BY THE MANUFACTURER.
 - GYPSUM BOARD:** REMOVE AND REPLACE DAMAGED GYPSUM BOARD TO NEAREST FRAMING MEMBER. FINISH AND RE-PAIN WALL CORNER TO CORNER.
 - PREFINISHED GYPSUM BOARD WITH VINYL WALL COVER AND CORNER TRIM:** REMOVE AND REPLACE DAMAGED VINYL COVERED GYPSUM BOARD FROM FLOOR TO CEILING WHERE INDICATED ON FLOOR PLAN.
 - STOREFRONT WINDOW:** REMOVE AND REPLACE STOREFRONT WINDOW AS SPECIFIED.
 - STUCCO SOFFIT:** REMOVE & REPLACE STUCCO SOFFIT. COORDINATE WITH ABATEMENT SCOPE & ABATEMENT CONTRACTOR TO ENSURE WEATHER-TIGHTNESS AND PHASING COORDINATION. SEE WALL SECTIONS & DETAILS.
 - GYPSUM CEILING REPAIRS:** REMOVE AND REPLACE DAMAGED GYPSUM CEILING BOARD TO NEAREST FRAMING MEMBER WHERE INDICATED. FINISH TO MATCH EXISTING AS SPECIFIED.
 - METAL ROOF PANEL REPAIRS:** REMOVE AND REPLACE DEFORMED OR MISSING METAL ROOF PANELS TO MATCH EXISTING.
 - CONCRETE FLOOR CLEANING:** CLEAN AND RESEAL FLOOR AS SPECIFIED.
 - BASE CABINET:** REMOVE AND REPLACE DAMAGED BASE CABINET. MATCH EXISTING STYLE, SIZE, AND CONSTRUCTION. SALVAGE AND REINSTALL COUNTERTOP. PROTECT ALL MECHANICAL CONNECTIONS.
 - TILE CLEANING:** CLEAN STAINS FROM WALL TILE TO REMOVE ANY DISCOLORATION WHERE INDICATED.
 - CLEAN/REPAINT MASONRY WALL:** MECHANICALLY REMOVE ALL LOOSE OR PEELING PAINT AND ALL CHALKING RESIDUE FROM EFFERVESCENCE FROM CORNER TO CORNER. PERFORM REQUIRED MOISTURE TESTING PRIOR TO REPAIRING WALL AS SPECIFIED.
 - PLASTER CEILING REPAIRS:** REMOVE AND REPLACE DAMAGED PLASTER CEILING WHERE INDICATED AS SPECIFIED, PAINT IN COLOR TO MATCH EXISTING.
 - MFP DAMAGES:** SEE MECHANICAL, PLUMBING AND ELECTRICAL PLANS.
 - FURNITURE SETTING AND RESETTING:** RELOCATE ALL EXISTING FURNITURE TO TEMPORARY ROOM IN MODULAR BUILDINGS WHILE EXISTING SPACE IS BEING REPAIRED. REINSTALL AND RESET FURNITURE ONCE REPAIRS ARE COMPLETE. SEE PHASING PLAN.
 - SUSPENDED CEILING INSULATION:** INSTALL R-19 BATT INSULATION AS SPECIFIED ABOVE PREVIOUSLY INSTALLED SUSPENDED CEILING TILE. SEE UNIT PRICE NO. 2.
 - BRICK WALL REPLACEMENT:** REMOVE AND REPLACE BRICK WALL AS INDICATED. DISPOSE OF OLD BRICK, MATCH NEW BRICK AND MORTAR TO EXISTING AS APPROVED BY ARCHITECT. SEE STRUCTURAL. BUILDING TO REMAIN WEATHERPROOF AND CONDITIONED DURING REPAIRS.
 - DOOR REPAIR:** CLEAN, PREP AND RE-PAIN DOOR FRAME - SEE DOOR SCHEDULE.
 - CORRIDOR WALL REPAIR:** REMOVE DAMAGED STOREFRONT WINDOW AND EXISTING 3/4" PLYWOOD SHEATHING BELOW WINDOW. INSTALL NEW WINDOW PER SCHEDULE AND NEW 3/4" PLYWOOD SHEATHING. PAINT AS SPECIFIED, IN COLOR AS SELECTED. SEE DETAILS.
 - GLAZING REPAIR:** REMOVE AND REPLACE BROKEN GLASS. MATCH EXISTING TINT. PROVIDE SAFETY GLASS AS REQUIRED.
 - DOOR REPAIR:** REMOVE AND REPLACE EXISTING LEFT DOOR LEAF. PROVIDE AN INSULATED HOLLOW METAL DOOR WITH VISION PANEL TO MATCH RIGHT DOOR LEAF. REINSTALL EXISTING DOOR HARDWARE. PAINT AS DIRECTED.



ROOMS - BUILDING B1

ROOM NUMBER	Area	Perimeter
B101	647 SF	103'-10"
B102	660 SF	104'-11"
B103	640 SF	103'-8"
B104	634 SF	104'-7"
B105	648 SF	103'-10"
B106	639 SF	104'-11"
B107	681 SF	105'-7"
B108	179 SF	59'-6"
B109	342 SF	101'-6"
B110	473 SF	125'-3"
B111	217 SF	68'-1"
B112	37 SF	24'-7"
B115	404 SF	82'-3"

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HURRICANE LAURA REPAIRS TO
A.M. BARBE HIGH SCHOOL
2200 W. McNEESE ST.
FOR
CALCASIEU PARISH SCHOOL BOARD
LAKE CHARLES, LA 70605
HL-003-01,03,04,05,06,07

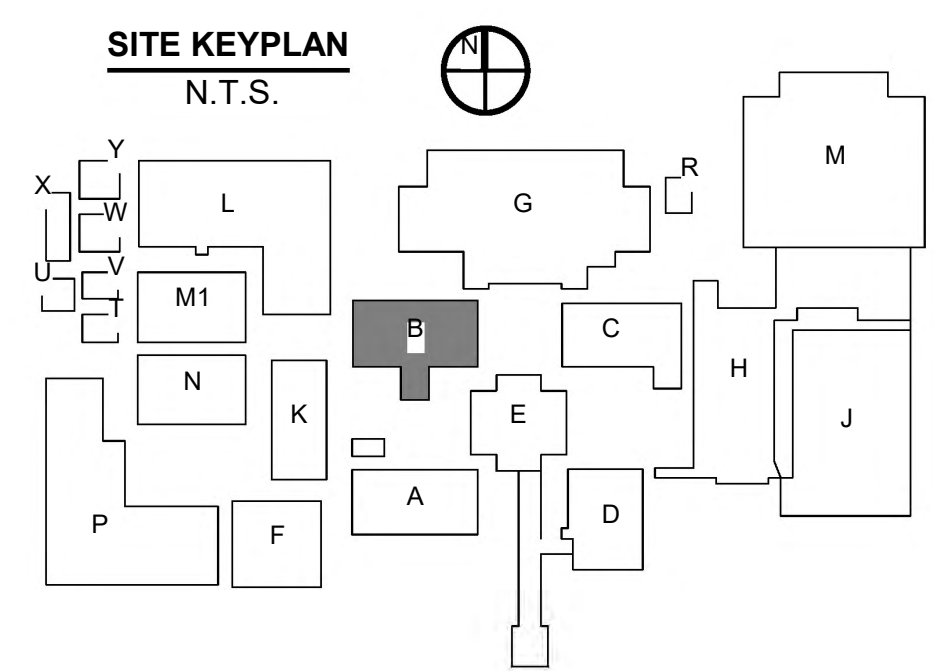
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RMG PROJECT NO.
20042-01-G
OWNER PROJECT NO.
HL-003-01,03,04,05,06,07
PROJECT MANAGER
TM

DATE ISSUED
06/28/2024

REVISED

NO.	DATE	DESCRIPTION

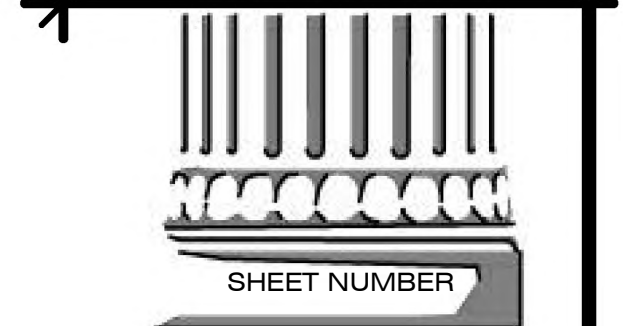

(B)A1.1
BLDG B 1ST FLOOR



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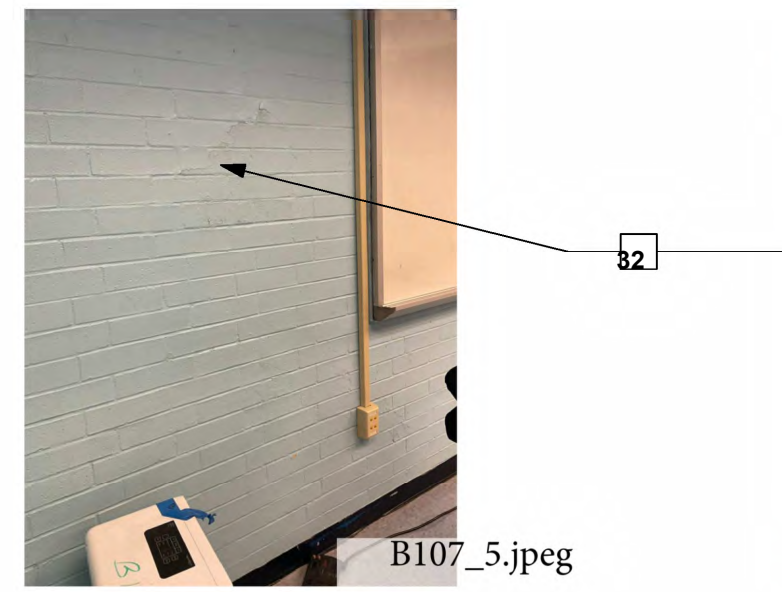
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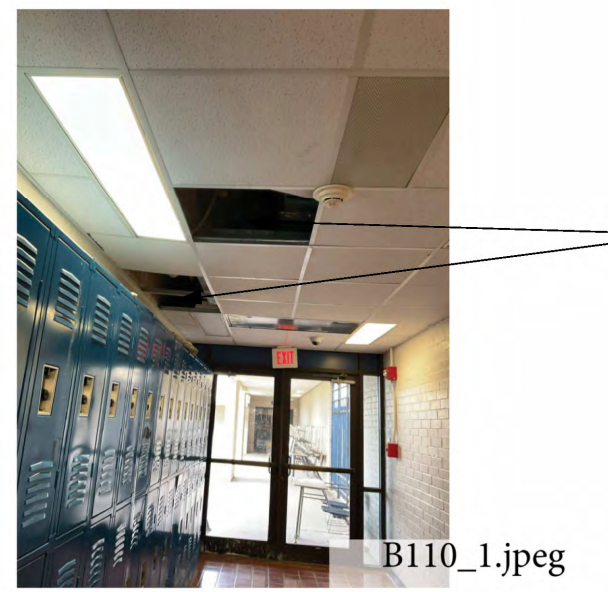
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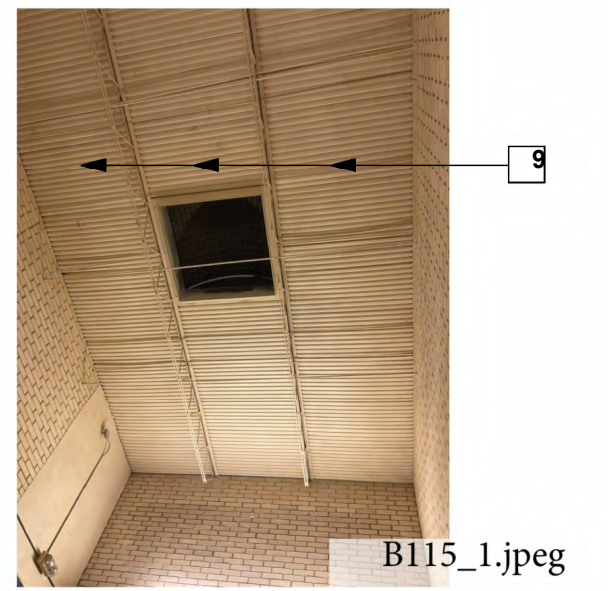
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B115_6.JPG

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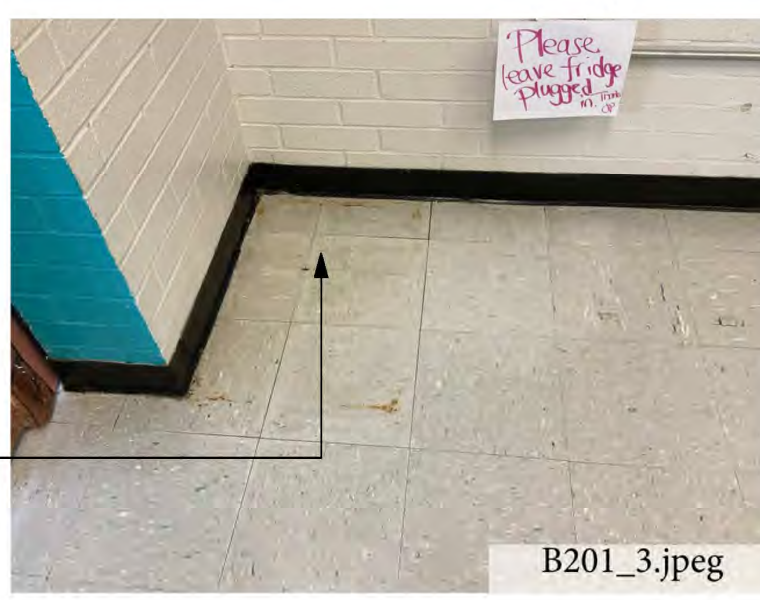
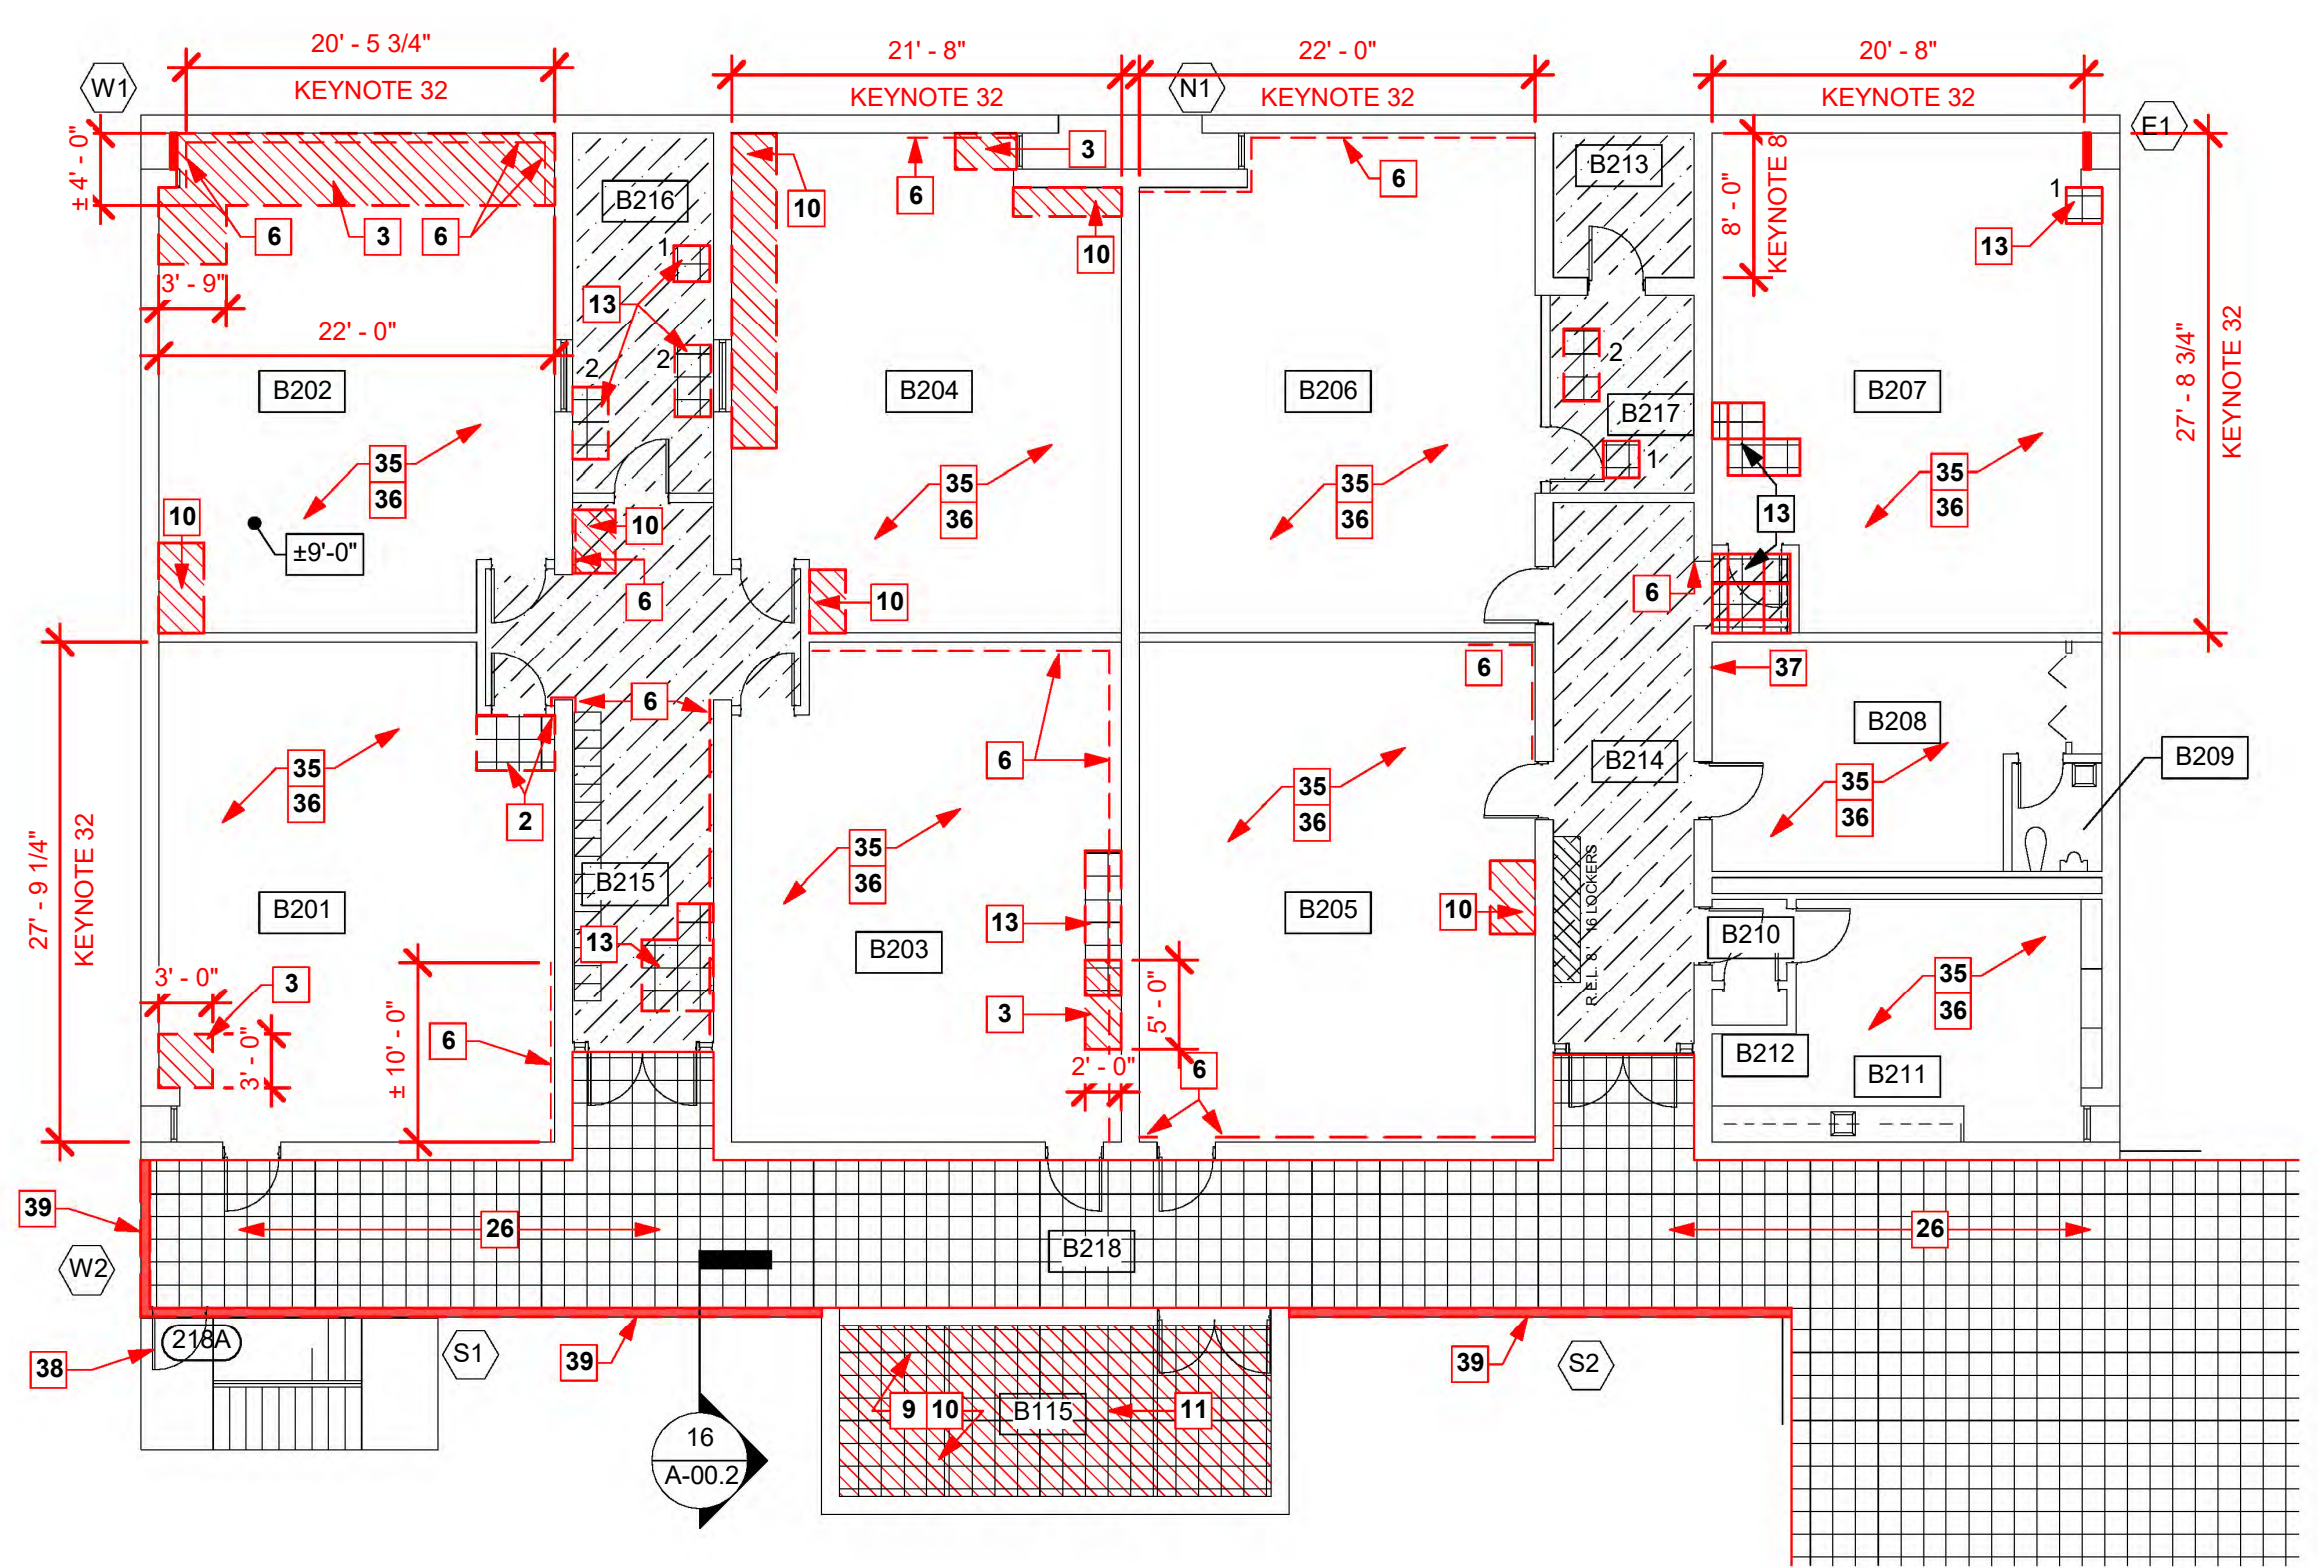


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OWNER PROJECT NO.	HL-003-01,03,04,05,06,07
PROJECT MANAGER	TM
DATE ISSUED	06/28/2024
REVISED	

SHEET NUMBER
(B)A1.2
 BLDG'B 1ST FLOOR



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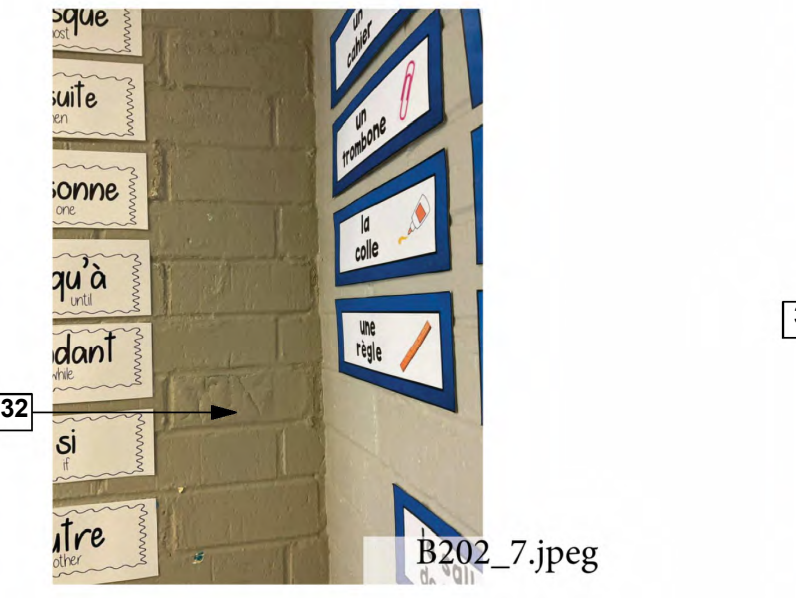
6 Zone 1 - Building B Second Floor
3/32" = 1'-0"




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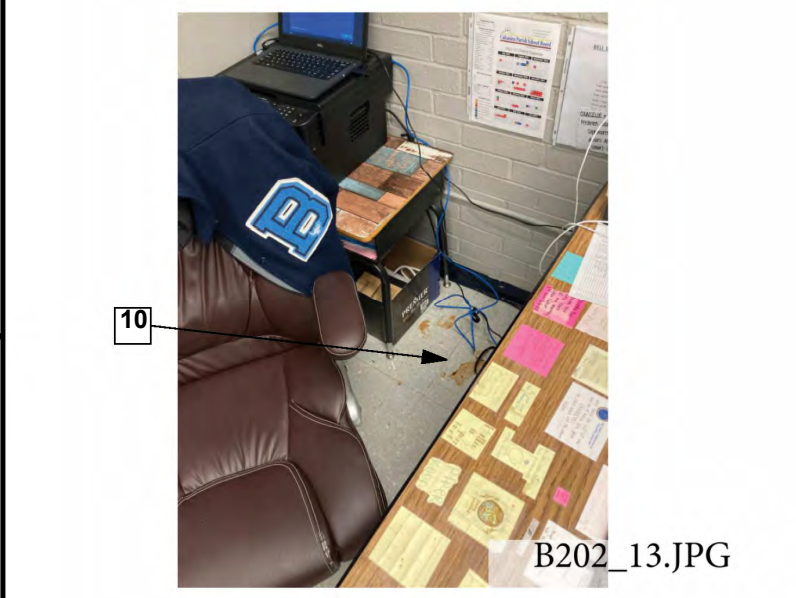
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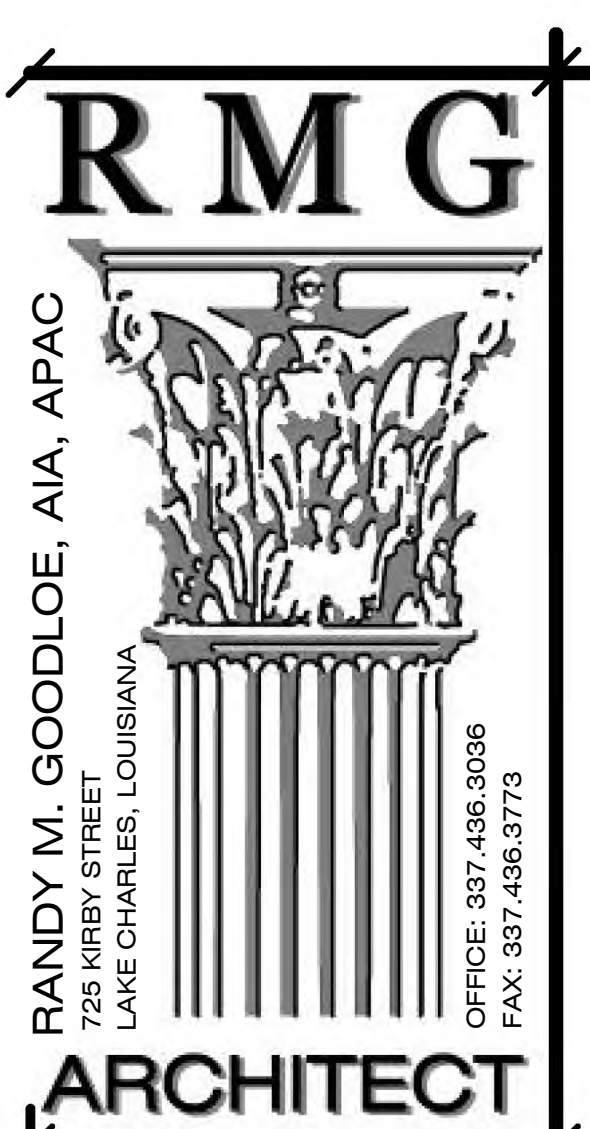


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- KEYNOTES**
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 - CEILING GRID:** REMOVE AND REPLACE DAMAGED CEILING GRID. MATCH EXISTING. SEE UNIT PRICE NO. 5
 - VCT FLOORING REPAIRS:** REMOVE AND REPLACE VCT FLOORING AS SPECIFIED IN AREAS WHERE INDICATED. SEE UNIT PRICE NO. 3
 - WINDOW REPAIRS:** REPLACE BROKEN WINDOW PANE, BLOCKS, AND GASKETS TO MATCH EXISTING. ALL SEALANTS SHALL BE REMOVED AND REPLACED AS SPECIFIED TO ENSURE WEATHER TIGHT SEAL. SEE ELEVATIONS.
 - STRUCTURAL CLAY BLOCK:** GLAZED STRUCTURAL CLAY BLOCK TO BE REMOVED AND REPLACED AS SPECIFIED TO MATCH EXISTING. CLEAN ALL CHALKING RESIDUE FROM EFFERVESCENCE
 - VINYL BASE REPLACEMENT:** REPLACE DAMAGED OR MISSING BASE AS SPECIFIED TO MATCH EXISTING. SEE UNIT PRICE NO. 4
 - CARPET REPAIRS:** DAMAGED CARPET HAS BEEN REMOVED. CLEAN FLOOR AND INSTALL NEW CARPET TILE AS SPECIFIED.
 - PAINTING:** WALL SURFACE IS TO BE SANDED, PREPARED, AND REPAINT TO MATCH EXISTING CORNER TO CORNER. WATER STAINED WALL FROM ROOF LOSS.
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 - SKYLIGHT REPAIRS:** REMOVE AND REPLACE SKYLIGHT TO MATCH EXISTING. FLOORING REFER TO ROOF CLARITY
 - TERRAZZO FLOORING CLEANING:** CLEAN AND POLISH EXISTING TERRAZZO FLOORING REFER TO ROOF CLARITY
 - CEILING TILE REPLACEMENT:** REMOVE AND REPLACE DAMAGED OR MISSING ACOUSTIC CEILING TILE WITH NEW CEILING TILE AS SPECIFIED IN AREAS INDICATED. MATCH EXISTING TYPE AND SIZE. SEE UNIT PRICE NO. 1. INSTALL R-30 BATT INSULATION OVER TILE. SEE UNIT PRICE NO. 2
 - NOT USED**
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 - GYPSUM CEILING REPAIRS:** REMOVE AND REPLACE DAMAGED GYPSUM CEILING BOARD TO NEAREST FRAMING MEMBER WHERE INDICATED, FINISH TO MATCH EXISTING AS SPECIFIED.
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 - CLEAN/REPAINT MASONRY WALL:** MECHANICALLY REMOVE ALL LOOSE OR PEELING PAINT AND ALL CHALKING RESIDUE FROM EFFERVESCENCE FROM CORNER TO CORNER. PERFORM REQUIRED MOISTURE TESTING PRIOR TO REPAINTING WALL AS SPECIFIED.
 - PLASTER CEILING REPAIRS:** REMOVE AND REPLACE DAMAGED PLASTER CEILING WHERE INDICATED AS SPECIFIED, PAINT IN COLOR TO MATCH EXISTING.
 - MEP DAMAGES:** SEE MECHANICAL, PLUMBING AND ELECTRICAL PLANS.
 - FURNITURE SETTING AND RESETTING:** RELOCATE ALL EXISTING FURNITURE TO TEMPORARY ROOM IN MODULAR BUILDINGS WHILE EXISTING SPACE IS BEING REPAIRED. REINSTALL AND RESET FURNITURE ONCE REPAIRS ARE COMPLETE. SEE PHASING PLAN.
 - SUSPENDED CEILING INSULATION:** INSTALL R-19 BATT INSULATION AS SPECIFIED ABOVE PREVIOUSLY INSTALLED SUSPENDED CEILING TILE. SEE UNIT PRICE NO. 2.
 - BRICK WALL REPLACEMENT:** REMOVE AND REPLACE BRICK WALL AS INDICATED. DISPOSE OF OLD BRICK. MATCH NEW BRICK AND MORTAR TO EXISTING AS APPROVED BY ARCHITECT. SEE STRUCTURAL. BUILDING TO REMAIN WEATHERPROOF AND CONDITIONED DURING REPAIRS.
 - DOOR REPAIR:** CLEAN, PREP AND RE-PAINT DOOR FRAME - SEE DOOR SCHEDULE.
 - CORRIDOR WALL REPAIR:** REMOVE DAMAGED STOREFRONT WINDOW AND EXISTING 3/4" PLYWOOD SHEATHING BELOW WINDOW. INSTALL NEW WINDOW PER SCHEDULE AND NEW 3/4" PLYWOOD SHEATHING. PAINT AS SPECIFIED, IN COLOR AS SELECTED. SEE DETAILS.
 - GLAZING REPAIR:** REMOVE AND REPLACE BROKEN GLASS. MATCH EXISTING TINT. PROVIDE SAFETY GLASS AS REQUIRED.
 - DOOR REPAIR:** REMOVE AND REPLACE EXISTING LEFT DOOR LEAF. PROVIDE AN INSULATED HOLLOW METAL DOOR WITH VISION PANEL TO MATCH RIGHT DOOR LEAF. REINSTALL EXISTING DOOR HARDWARE. PAINT AS DIRECTED.



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ARCHITECT

RANDY MICHAEL GOODLOE
No. 2858
STATE OF LOUISIANA
REGISTERED ARCHITECT

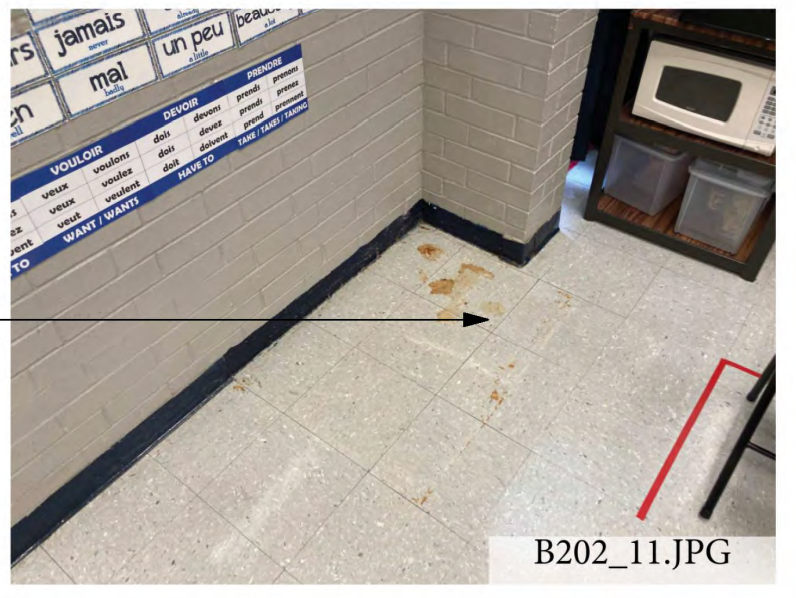LA. LICENSE NO. 4086

HURRICANE LAURA REPAIRS TO
A.M. BARBE HIGH SCHOOL
2200 W. McNEESE ST.
FOR
CALCASIEU PARISH SCHOOL BOARD
LAKE CHARLES, LA 70605
HL-003-01.03.04.05.06.07

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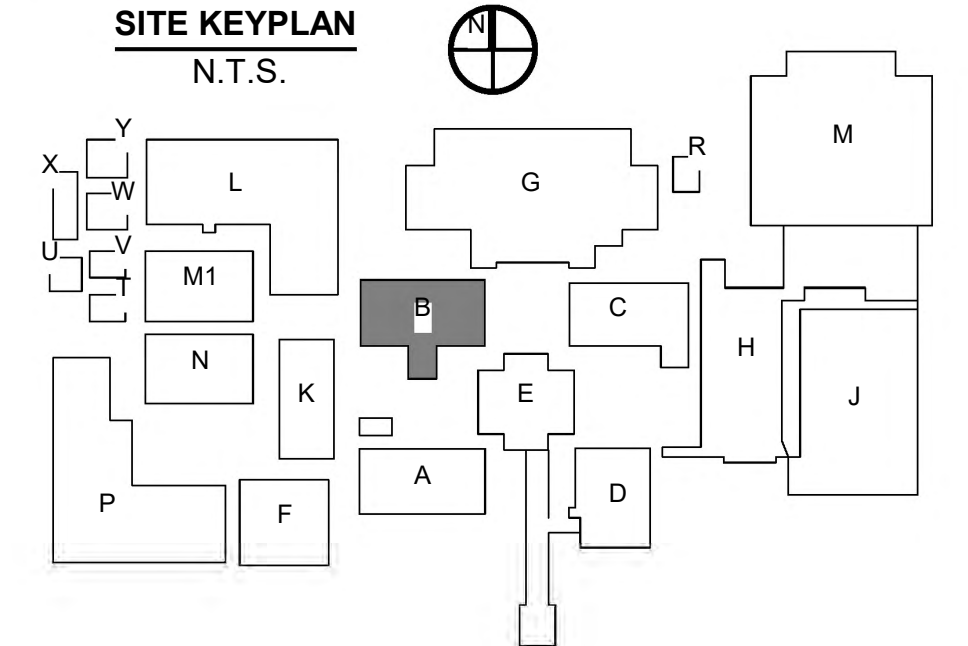
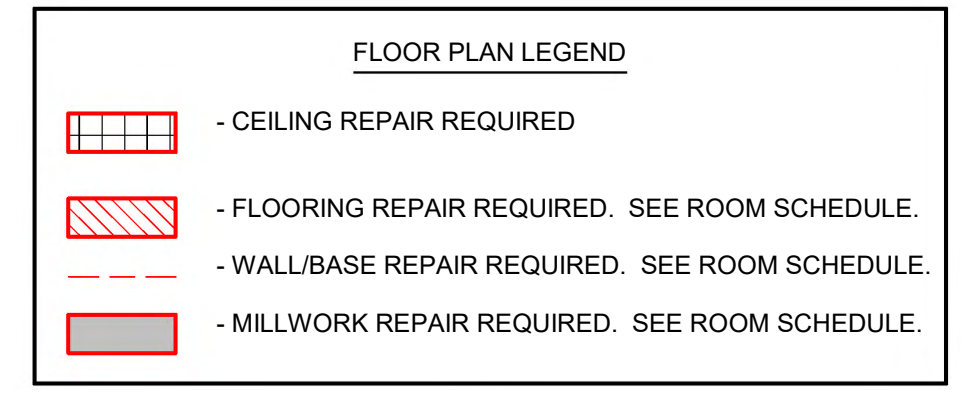
DATE ISSUED
06/28/2024

REVISED

SHEET NUMBER
(B)A2.1
BLDG B 2ND FLOOR

ROOMS - BUILDING B2

ROOM NUMBER	Area	Perimeter
B201	646 SF	103'-8"
B202	661 SF	105'-0"
B203	640 SF	103'-5"
B204	635 SF	104'-8"
B205	663 SF	103'-8"
B206	658 SF	104'-11"
B207	635 SF	104'-11"
B208	224 SF	69'-6"
B209	41 SF	32'-0"
B210	7 SF	10'-4"
B211	311 SF	75'-0"
B212	4 SF	8'-6"
B213	121 SF	45'-1"
B214	284 SF	89'-0"
B215	314 SF	94'-8"
B216	210 SF	67'-0"
B217	74 SF	34'-6"




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B206_2.jpeg



B206_3.jpeg



B207_2.jpeg

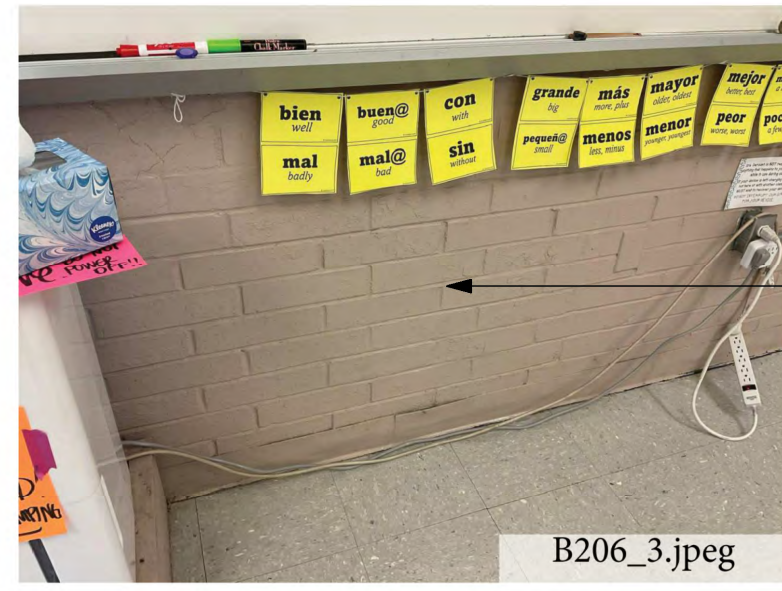

B207_6.jpeg



B207_7.jpeg



B207_9.JPG



B215_1.jpeg




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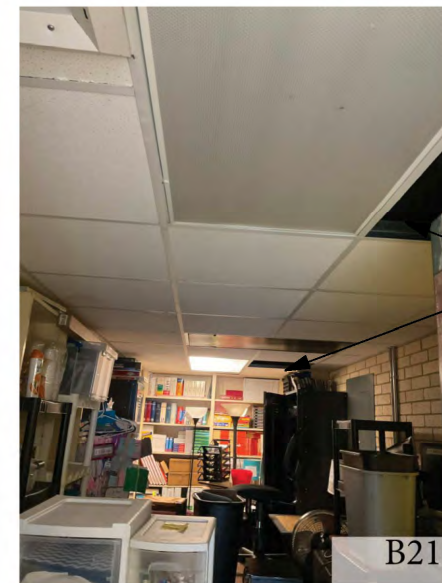
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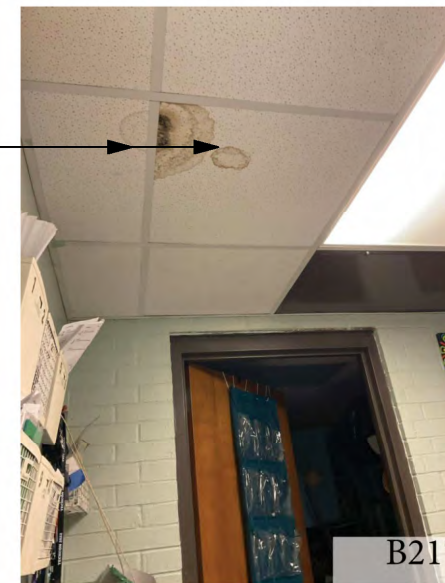
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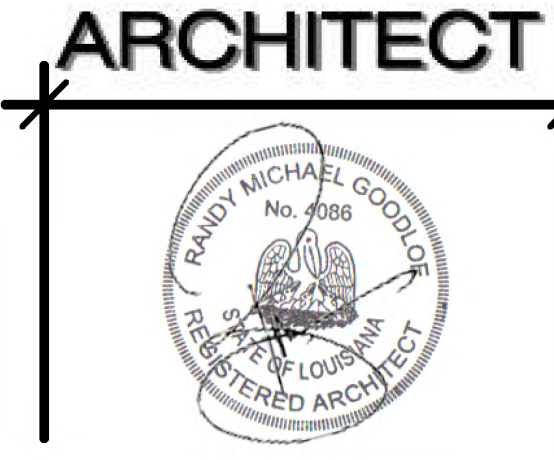
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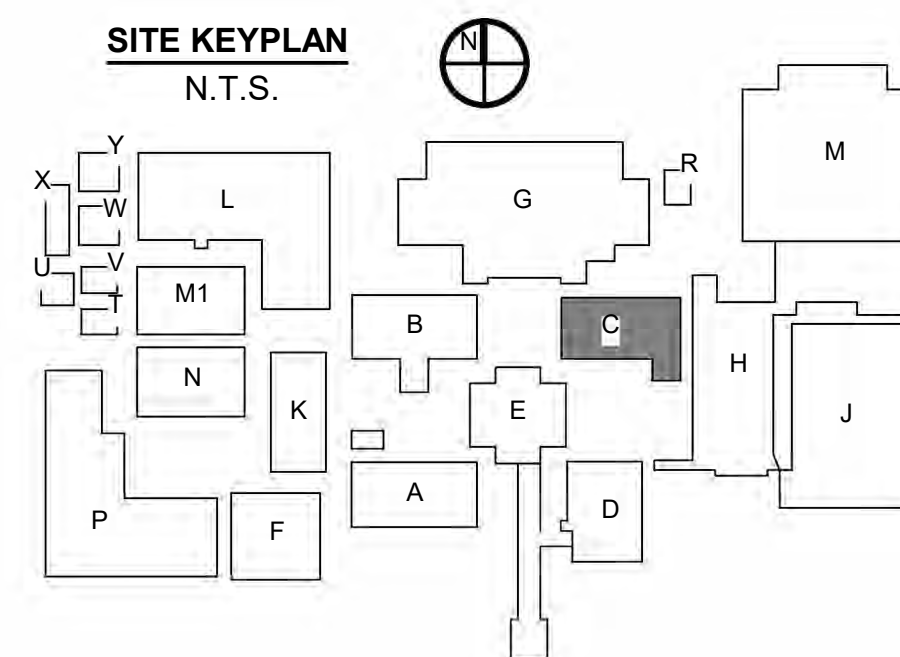
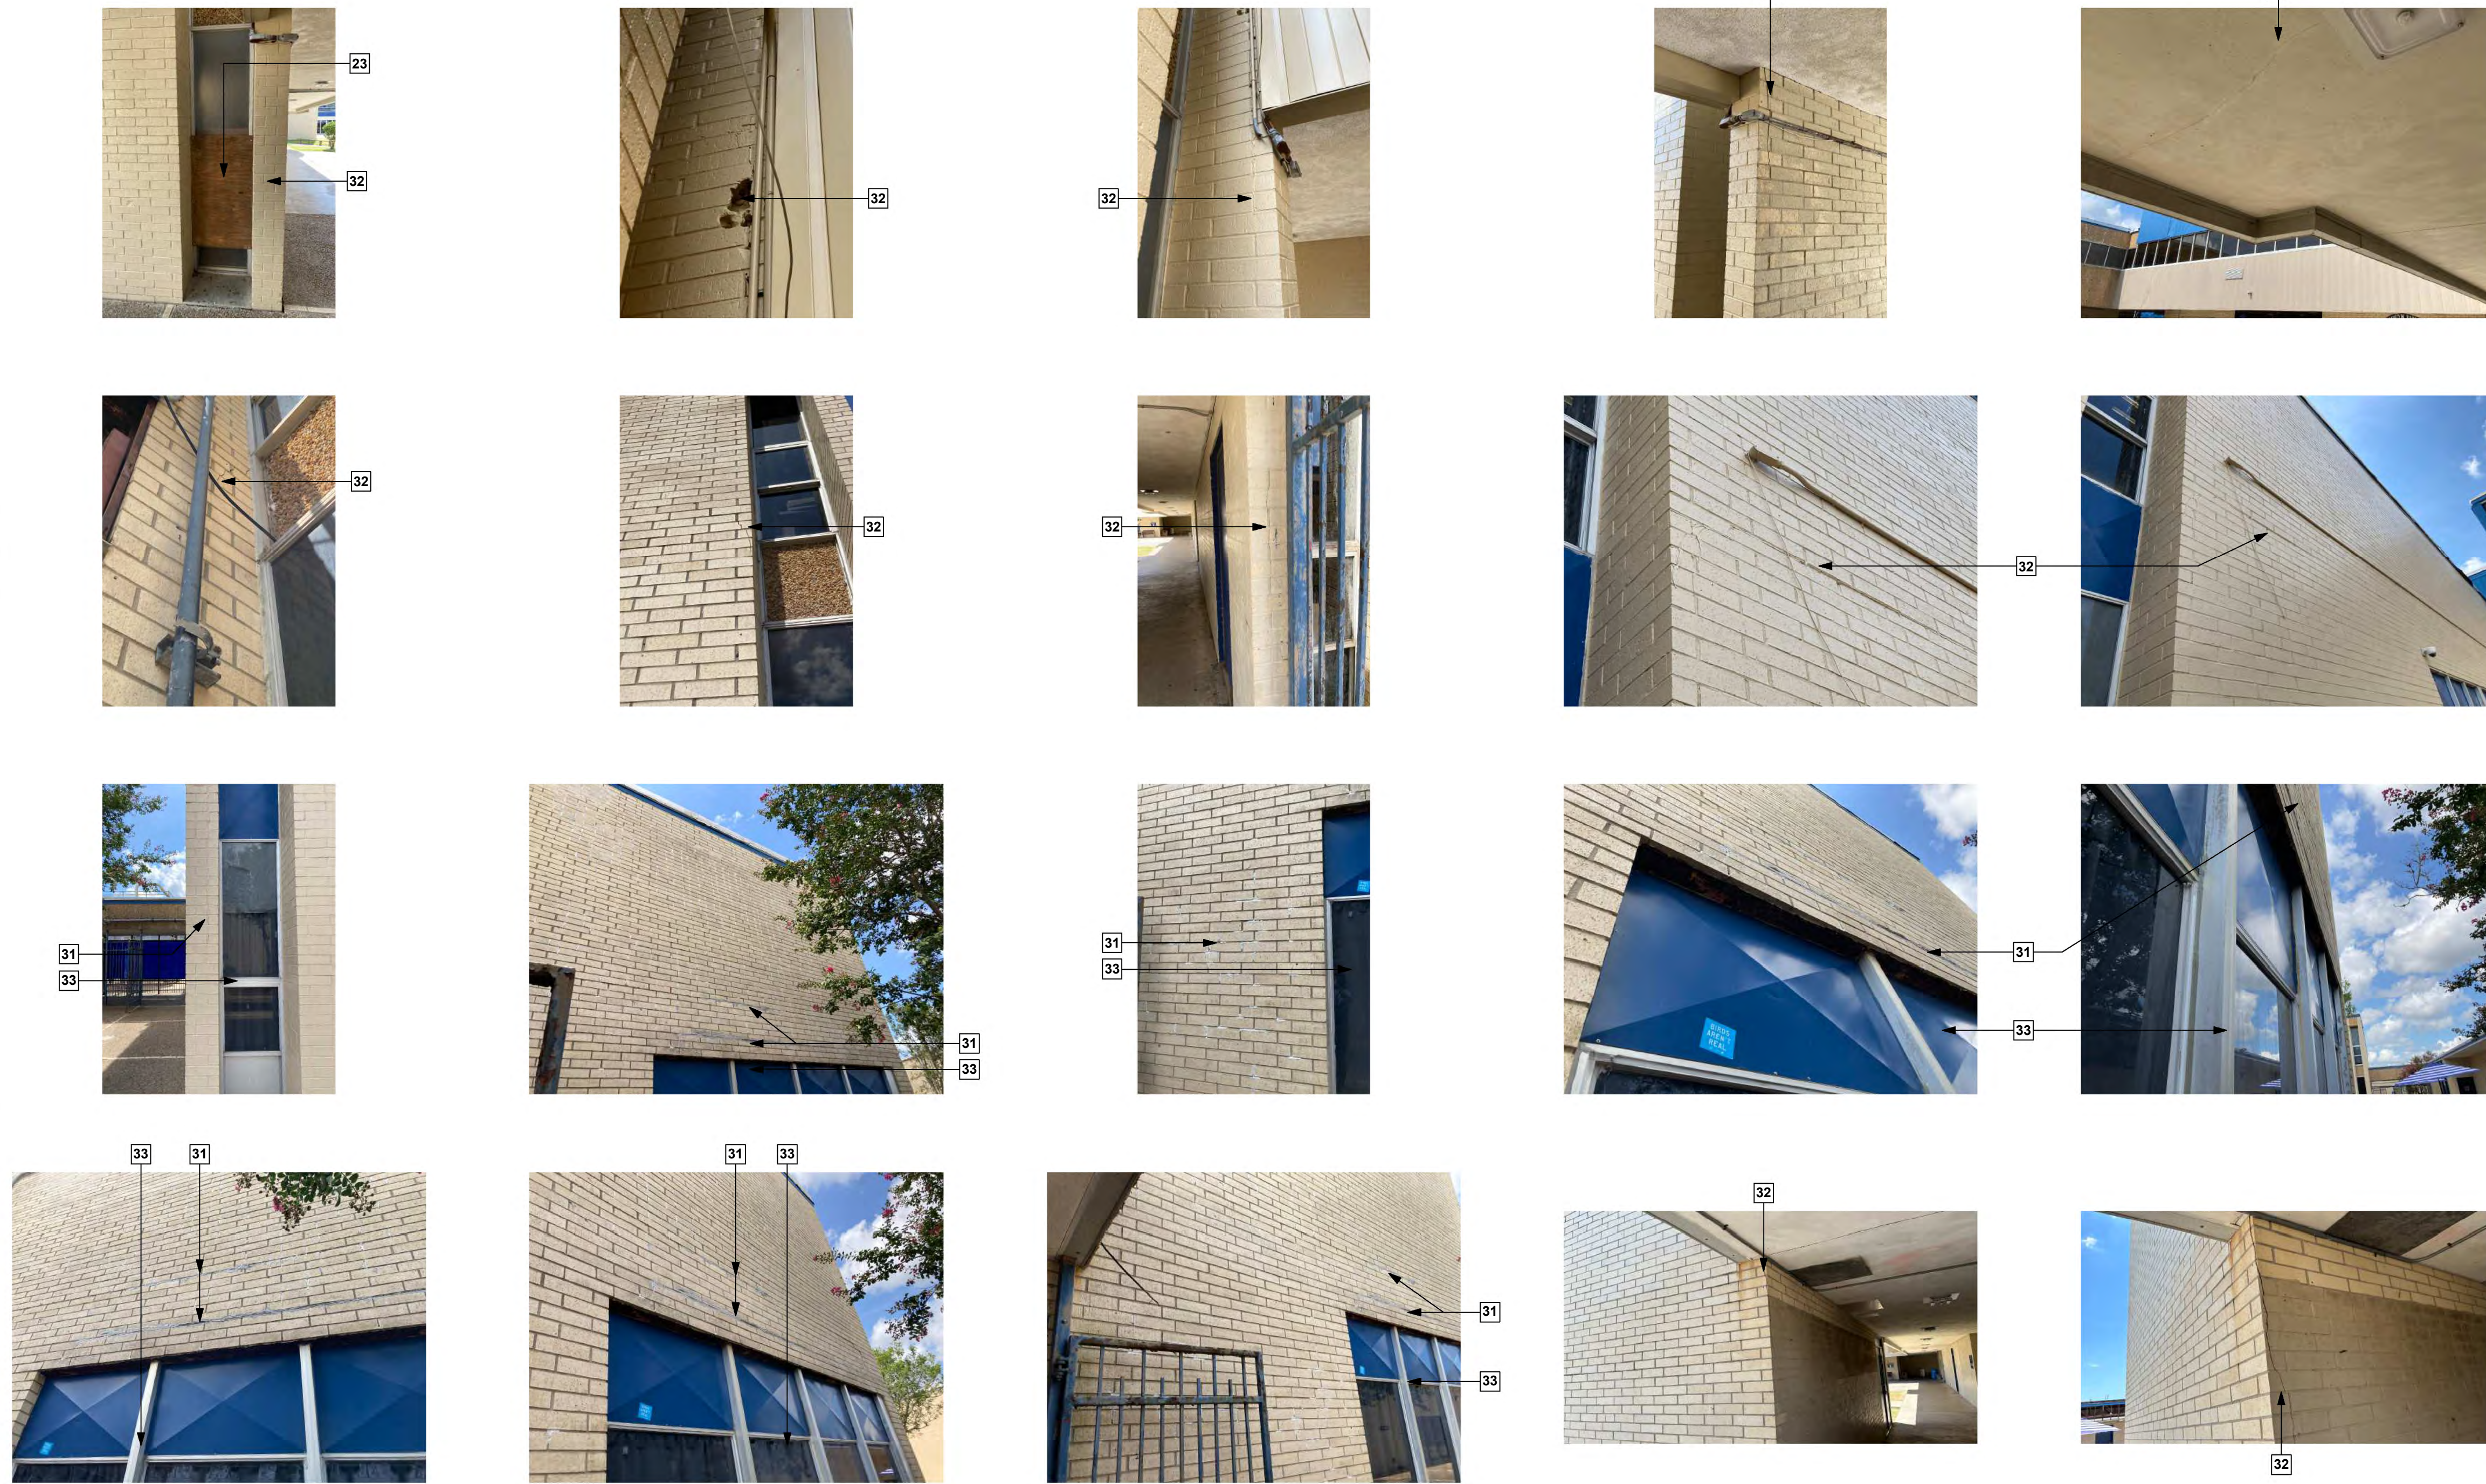


HURRICANE LAURA REPAIRS TO
A.M. BARBE HIGH SCHOOL
2200 W. McNEESE ST.
FOR
CALCASIEU PARISH SCHOOL BOARD
LAKE CHARLES, LA 70605
HL-003-01,03,04,05,06,07

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RMG PROJECT NO. 20042-01-G
OWNER PROJECT NO. HL-003-01,03,04,05,06,07
PROJECT MANAGER TM
DATE ISSUED 06/28/2024
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- KEYNOTES**
- EXISTING PASSIVE AIR ROOF VENT TO BE REMOVED. TYPICAL AT RE-ROOFED AREAS. SHADED REGION INDICATES EXISTING ROOFING ASSEMBLY TO BE REMOVED TO EXISTING ROOF DECKING SUBSTRATE BELOW, AND NEW ROOFING INSTALLED. ALL DEBRIS IS TO BE REMOVED FROM THE SITE. SEE SPECIFICATIONS. ROOFTOP PENETRATIONS AND EQUIPMENT TO BE VERIFIED BY CONTRACTOR IN THE FIELD.
 - INDICATES EXISTING RIGID CONDUIT/PIPING RUNS EXPOSED ON EXISTING ROOF. CONTRACTOR SHALL MAKE VISUAL INSPECTIONS ON SITE TO VERIFY THE EXTENT OF WORK WHICH BE REQUIRED TO MOVE, REPAIR, AND RELOCATE THESE CONDUIT/PIPING RUNS DURING THE PROCESS OF RE-ROOFING AND TO ENSURE THAT THE NEW ROOF SLOPES ARE INTEGRATED AND ACCOUNTED FOR WHERE EXTENSIONS OF THESE CONDUITS AND WIRING IS REQUIRED. PROVIDE NEW "RUNNER CURBS" FOR SUPPORT OF ALL HARD PIPING WHICH IS TO REMAIN ON ROOF AFTER NEW INSTALLATION. SPACE CURBS AS REQUIRED SO CONDUIT AND PIPING DOES NOT SAG BETWEEN THESE LOCATIONS. INSTALL AS DETAILED. **SEE KEYNOTE 12**
 - APPROXIMATE LOCATION OF EXISTING ROOF DRAIN. CONTRACTOR SHALL VERIFY EXISTING DRAINS AND LOCATIONS. REPLACE CLAMPS AND COVERS TO MATCH EXISTING - PATCH ROOFING AROUND DRAINS. SLOPE ROOF TO DRAIN AT 1/4" PER 1'-0" MIN. TYPICAL AT LOCATIONS OF RE-ROOFING. CONTRACTOR SHALL VERIFY LOCATION OF EXISTING OVERFLOW DRAINS AND SHALL MAINTAIN ALL OVERFLOWS IN FINAL ROOFING ASSEMBLY.
 - SEE DETAILS FOR FLASHING AND COUNTERFLASHING WHICH IS TO TIE INTO THE EXISTING BUILDING ENVELOPE. VERIFY CLEARANCES AND LOCATIONS FOR INSTALLATION OF ALL FLASHING AND TERMINATION BARS AS DETAILED. **SEE KEYNOTE 3**
 - INDICATES APPROXIMATE AREA AND LOCATION OF ROOF EXPANSION JOINT. CONTRACTOR SHALL VISUALLY INSPECT THE EXISTING CONDITIONS AT THE SITE AND PROVIDE A NEW EXPANSION JOINT AS DETAILED. THE INSTALLER SHOULD ASSURE THAT ALL EXISTING WOOD BLOCKING SHALL BE REPLACED WITH NEW TREATED WOOD BLOCKING AS PER DETAILS. PROVIDE NEW CANT STRIP, FLASHING, PRE-FINISHED EXPANSION JOINT COVER, VINYL BELLOWS, AND BASE FLASHING AS DETAILED. VERIFY EXACT ROUTING AND AREA WHERE THIS IS TO BE REMOVED AND REPLACED. VERIFY ALL EXISTING CONDITIONS, ESPECIALLY ANY PIPING, AND CONDUIT WHICH MIGHT INTERSECT OR CROSS OVER THIS JOINT.
 - CONTRACTOR SHALL INSPECT ALL EXISTING ROOF PENETRATIONS. EXTEND VENT PIPING AND OTHER PENETRATIONS WHERE REQUIRED. REPLACE ALL LEAD VENT & PIPE FLASHING. TYPICAL ALL LOCATIONS OF RE-ROOFING.
 - REMOVE AND REPLACE FLASHING, COUNTER-FLASHING AND PRE-FINISHED METAL FASCIA FLASHING AS DETAILED.
 - APPROXIMATE LOCATION OF SKYLIGHT - CONTRACTOR TO VERIFY IN FIELD. REMOVE AND REPLACE SKYLIGHT WITH NEW, TO MATCH EXISTING SIZE, SHAPE, AND FINISH. FLASH AND INSTALL PER MANUFACTURER'S INSTRUCTIONS. TYPICAL ALL LOCATIONS OF RE-ROOFING.
 - INDICATES EXISTING ROOFTOP EQUIPMENT. COORDINATE WITH MEP. PROVIDE NEW CURBS AS NECESSARY TO ENSURE PROPER CURB HEIGHT AND ATTACHMENT AT NEW ROOFS. PROTECT UNDAMAGED EQUIPMENT.
 - SATELLITE DISHES. MOUNTS AND WEIGHTS TO BE REMOVED AND DISPOSED OF. PATCH ALL HOLES CAUSED BY STRUCTURE PER ROOFING MANUFACTURER RECOMMENDATIONS.
 - REMOVE AND REPLACE DAMAGED AND MISSING METAL WALL PANEL "E" AS SPECIFIED. SEE BUILDING ELEVATIONS.
 - INSTALL DAMAGED AND MISSING LETTERING AND SIGNAGE TO MATCH EXISTING.
 - ROOF ACCESSORY REPLACEMENT: REPLACE DAMAGED ROOF ACCESSORIES. MATCH EXISTING TYPE, MATERIAL, AND STYLE.
 - REMOVE AND REPLACE PRE-FINISHED DOWNPOUT WITH NEW TO MATCH EXISTING COLOR, GAUGE, SIZE, & PROFILE. REMOVE PREVIOUS ATTACHMENTS AND FASTENERS & REPLACE WITH NEW. GROUT FILL ALL HOLES.
 - SEE KEYNOTE 13
 - EXTERIOR METAL STAIR: SEE STRUCTURAL SHEETS. REMOVE STAIRS AS REQUIRED TO REPAIR SCOFF OF 1 ST FLOOR. REINSTALL STAIR UNIT. PROVIDE NEW THRESHOLD AS REQUIRED TO ABUT EXISTING FLOOR.
 - REMOVE PLYWOOD AND INSTALL NEW CLEAR PLEXIGLASS PANEL TO MATCH ADJACENT PANELS. REMOVE AND REPLACE ACCOMPANYING HORIZONTAL AND VERTICAL MULLIONS WHERE PLYWOOD IS INSTALLED.
 - REMOVE AND REPLACE DAMAGED BRICK FACADE AND MORTAR AS INDICATED. DISPOSE OF DAMAGED BRICK, MATCH NEW BRICK AND MORTAR TO EXISTING AS APPROVED BY ARCHITECT. PRESERVE SUBSTRATE. REMOVE OLD BRICK TIES AND WATER PROOFING. INSTALL NEW WATERPROOFING AND BRICK TIES AT A MIN. OF 24" O.C. VERTICAL AND HORIZONTAL. WATERPROOFING TO BE TAPED WITH MANUFACTURER APPROVED TAPE AND LAPPED TO PREVENT MOISTURE PENETRATION INTO THE BUILDING ENVELOPE.
 - CLEAN, PREP & RE-PAINT WALLS & ARTWORK TO COVER SCUFFS AND DAMAGE FROM STORM DEBRIS. CONTRACTOR TO PROVIDE PAINT DESIGNS TO MATCH EXISTING AS APPROVED BY ARCHITECT.
 - REMOVE AND REPLACE DAMAGED AND MISSING GLASS TO MATCH EXISTING. PROVIDE CAULKING AND GASKETING FOR WATER-TIGHT SEAL. WHERE PLYWOOD HAS BEEN INSTALLED, REMOVE & DISPOSE OF PLYWOOD WHEN NEW GLASS IS INSTALLED.
 - EXISTING STUCCO SOFFIT TO BE REMOVED BY ABATEMENT CONTRACTOR. INSTALL NEW 5/8" GLASS-MAT GYPSUM BOARD ON NEW METAL SUSPENSION SYSTEM AS SPECIFIED. INSTALL NEW CEMENT BOARD STUCCO SYSTEM FINISH AS SPECIFIED. COORDINATE WITH ABATEMENT SCOPE & ABATEMENT CONTRACTOR TO ENSURE WEATHER-TIGHTNESS AND PHASING COORDINATION.
 - COORDINATE REMOVAL OF (METAL PANELS WHERE APPLICABLE AND) AGGREGATE PANELS (HAZARDOUS MATERIAL) WITH ABATEMENT SCOPE AND ABATEMENT CONTRACTOR. COORDINATE AND INSTALL NEW FACADE PANELS AS SPECIFIED. SALVAGE AND REINSTALL MEP COMPONENTS AT SAME LOCATIONS - COORDINATE WITH MEP. **SEE KEYNOTE 3**
 - SHADED REGION INDICATES EXISTING ROOFING ASSEMBLY TO BE REMOVED INCLUDING ROOF DECKING SUBSTRATE TO STRUCTURE BELOW, AND NEW ROOFING AND DECKING INSTALLED. ALL DEBRIS IS TO BE REMOVED FROM THE SITE. SEE SPECIFICATIONS. ROOFTOP PENETRATIONS AND EQUIPMENT TO BE VERIFIED BY CONTRACTOR IN THE FIELD.
 - PROVIDE SCUPPER THROUGH ROOF EDGE. SLOPE ROOFING AT 1/4" PER 1'-0" MIN. TO ENSURE POSITIVE DRAINAGE. COORDINATE LOCATIONS AND SIZES WITH EXISTING. NEW SCUPPERS TO BE PROVIDED AS DETAILED AND ROOF TAPER PROVIDED ACCORDINGLY.
 - REMOVE AND REPLACE PRE-FINISHED METAL GUTTER WITH NEW TO MATCH EXISTING COLOR, GAUGE, SIZE, & PROFILE. REMOVE PREVIOUS ATTACHMENTS AND FASTENERS & REPLACE WITH NEW. GROUT FILL ALL HOLES.
 - APPROX DOWNPOUT/COLLECTOR LOCATIONS. SALVAGE UNDAMAGED DOWNPOUTS FOR REINSTALLATION. REMOVE AND REPLACE DAMAGED DOWNPOUTS TO MATCH EXISTING. MAINTAIN EXISTING DRAINAGE METHODOLOGY AND REINSTALL SALVAGED AND NEW MATERIALS WITH NEW ROOF AND FACADE TO MATCH EXISTING. TYPICAL AT ALL LOCATIONS OF RE-ROOFING.
 - REMOVE AND REPLACE BRICK WALL AS INDICATED. DISPOSE OF OLD BRICK, MATCH NEW BRICK AND MORTAR TO EXISTING AS APPROVED BY ARCHITECT. SEE STRUCTURAL BUILDING TO REMAIN.
 - WEATHERPROOF AND CONDITIONED DURING REPAIRS.
 - REPORT EXTERIOR AND INTERIOR BRICK AS SPECIFIED WHERE INDICATED. REPAINT IN COLOR TO MATCH EXISTING FROM END TO END.
 - REMOVE AND REPLACE STOREFRONT WINDOW AS SPECIFIED.

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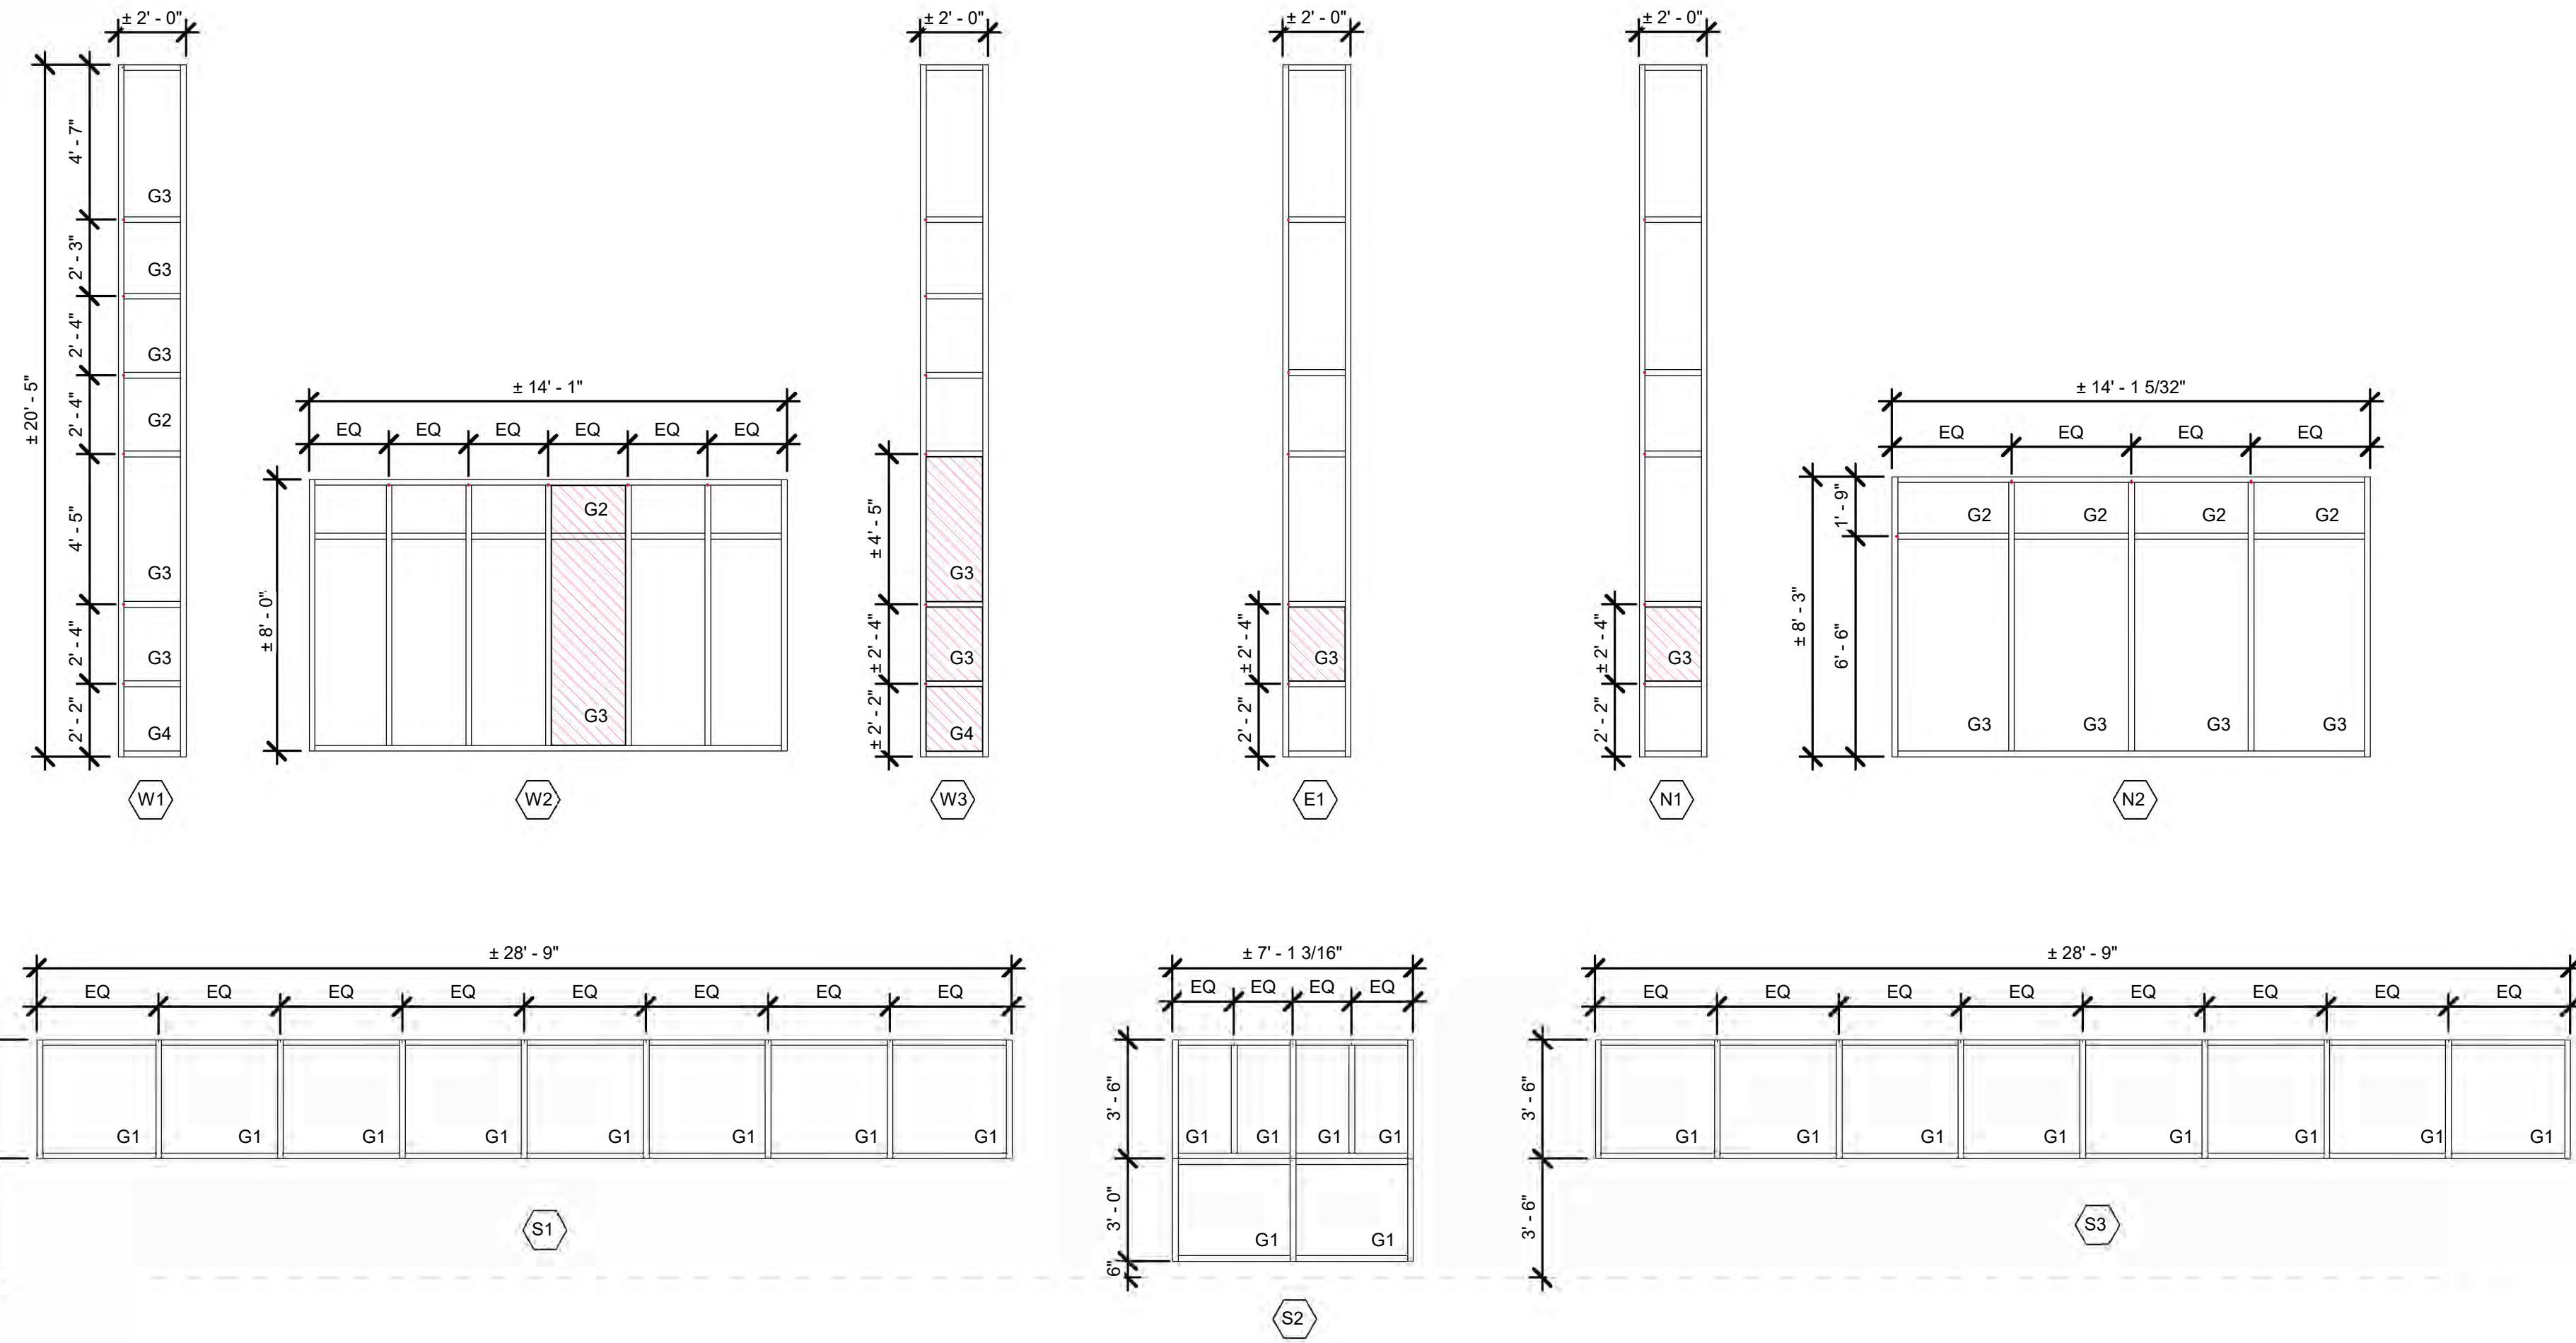
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SHEET NUMBER

(C)A0.2

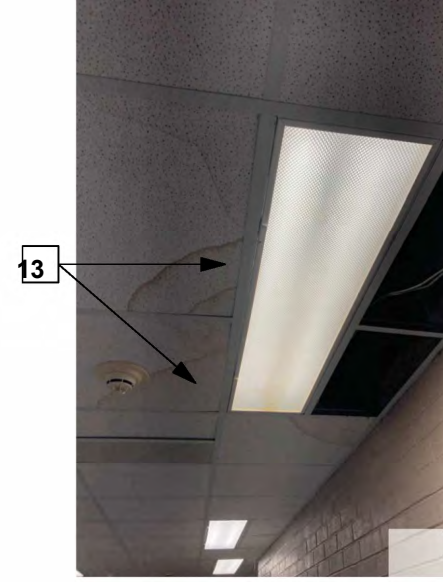BUILDING C

REFERENCE IMAGES



GLAZING SCHEDULE

G1 - CLEAR, INSULATED GLASS AS SPECIFIED.
 G2 - SPANDRAL GLASS AS SPECIFIED.
 G3 - TINTED, INSULATED GLASS AS SPECIFIED.
 G4 - ALUMINUM WINDOW PANEL AS SPECIFIED.

*GLAZING OF NEW STOREFRONT UNITS ARE TO BE LARGE MISSILE IMPACT AS SPECIFIED. REPLACEMENT GLAZING IS TO MATCH EXISTING.

*SIZES ARE APPROXIMATE. VERIFY IN FIELD.

MARK	SIZE	FRAME		COMMENTS
		TYPE	MATERIAL	
W1	SEE ELEVATION	STOREFRONT	ALUMINUM, CLEAR ANODIZED	REPLACE ENTIRE UNIT
W2	SEE ELEVATION	STOREFRONT	EXISTING	REPLACE DAMAGED GLASS AS INDICATED
W3	SEE ELEVATION	STOREFRONT	EXISTING	REPLACE DAMAGED GLASS AS INDICATED
E1	SEE ELEVATION	STOREFRONT	EXISTING	REPLACE DAMAGED GLASS AS INDICATED
N1	SEE ELEVATION	STOREFRONT	EXISTING	REPLACE DAMAGED GLASS AS INDICATED
N2	SEE ELEVATION	STOREFRONT	ALUMINUM, CLEAR ANODIZED	REPLACE ENTIRE UNIT
S1	SEE ELEVATION	STOREFRONT	ALUMINUM, CLEAR ANODIZED	REPLACE ENTIRE UNIT
S2	SEE ELEVATION	STOREFRONT	ALUMINUM, CLEAR ANODIZED	REPLACE ENTIRE UNIT
S3	SEE ELEVATION	STOREFRONT	ALUMINUM, CLEAR ANODIZED	REPLACE ENTIRE UNIT

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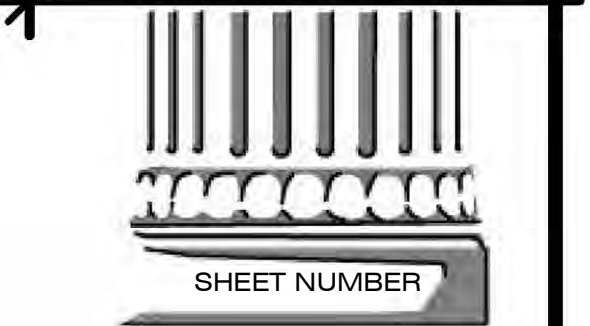
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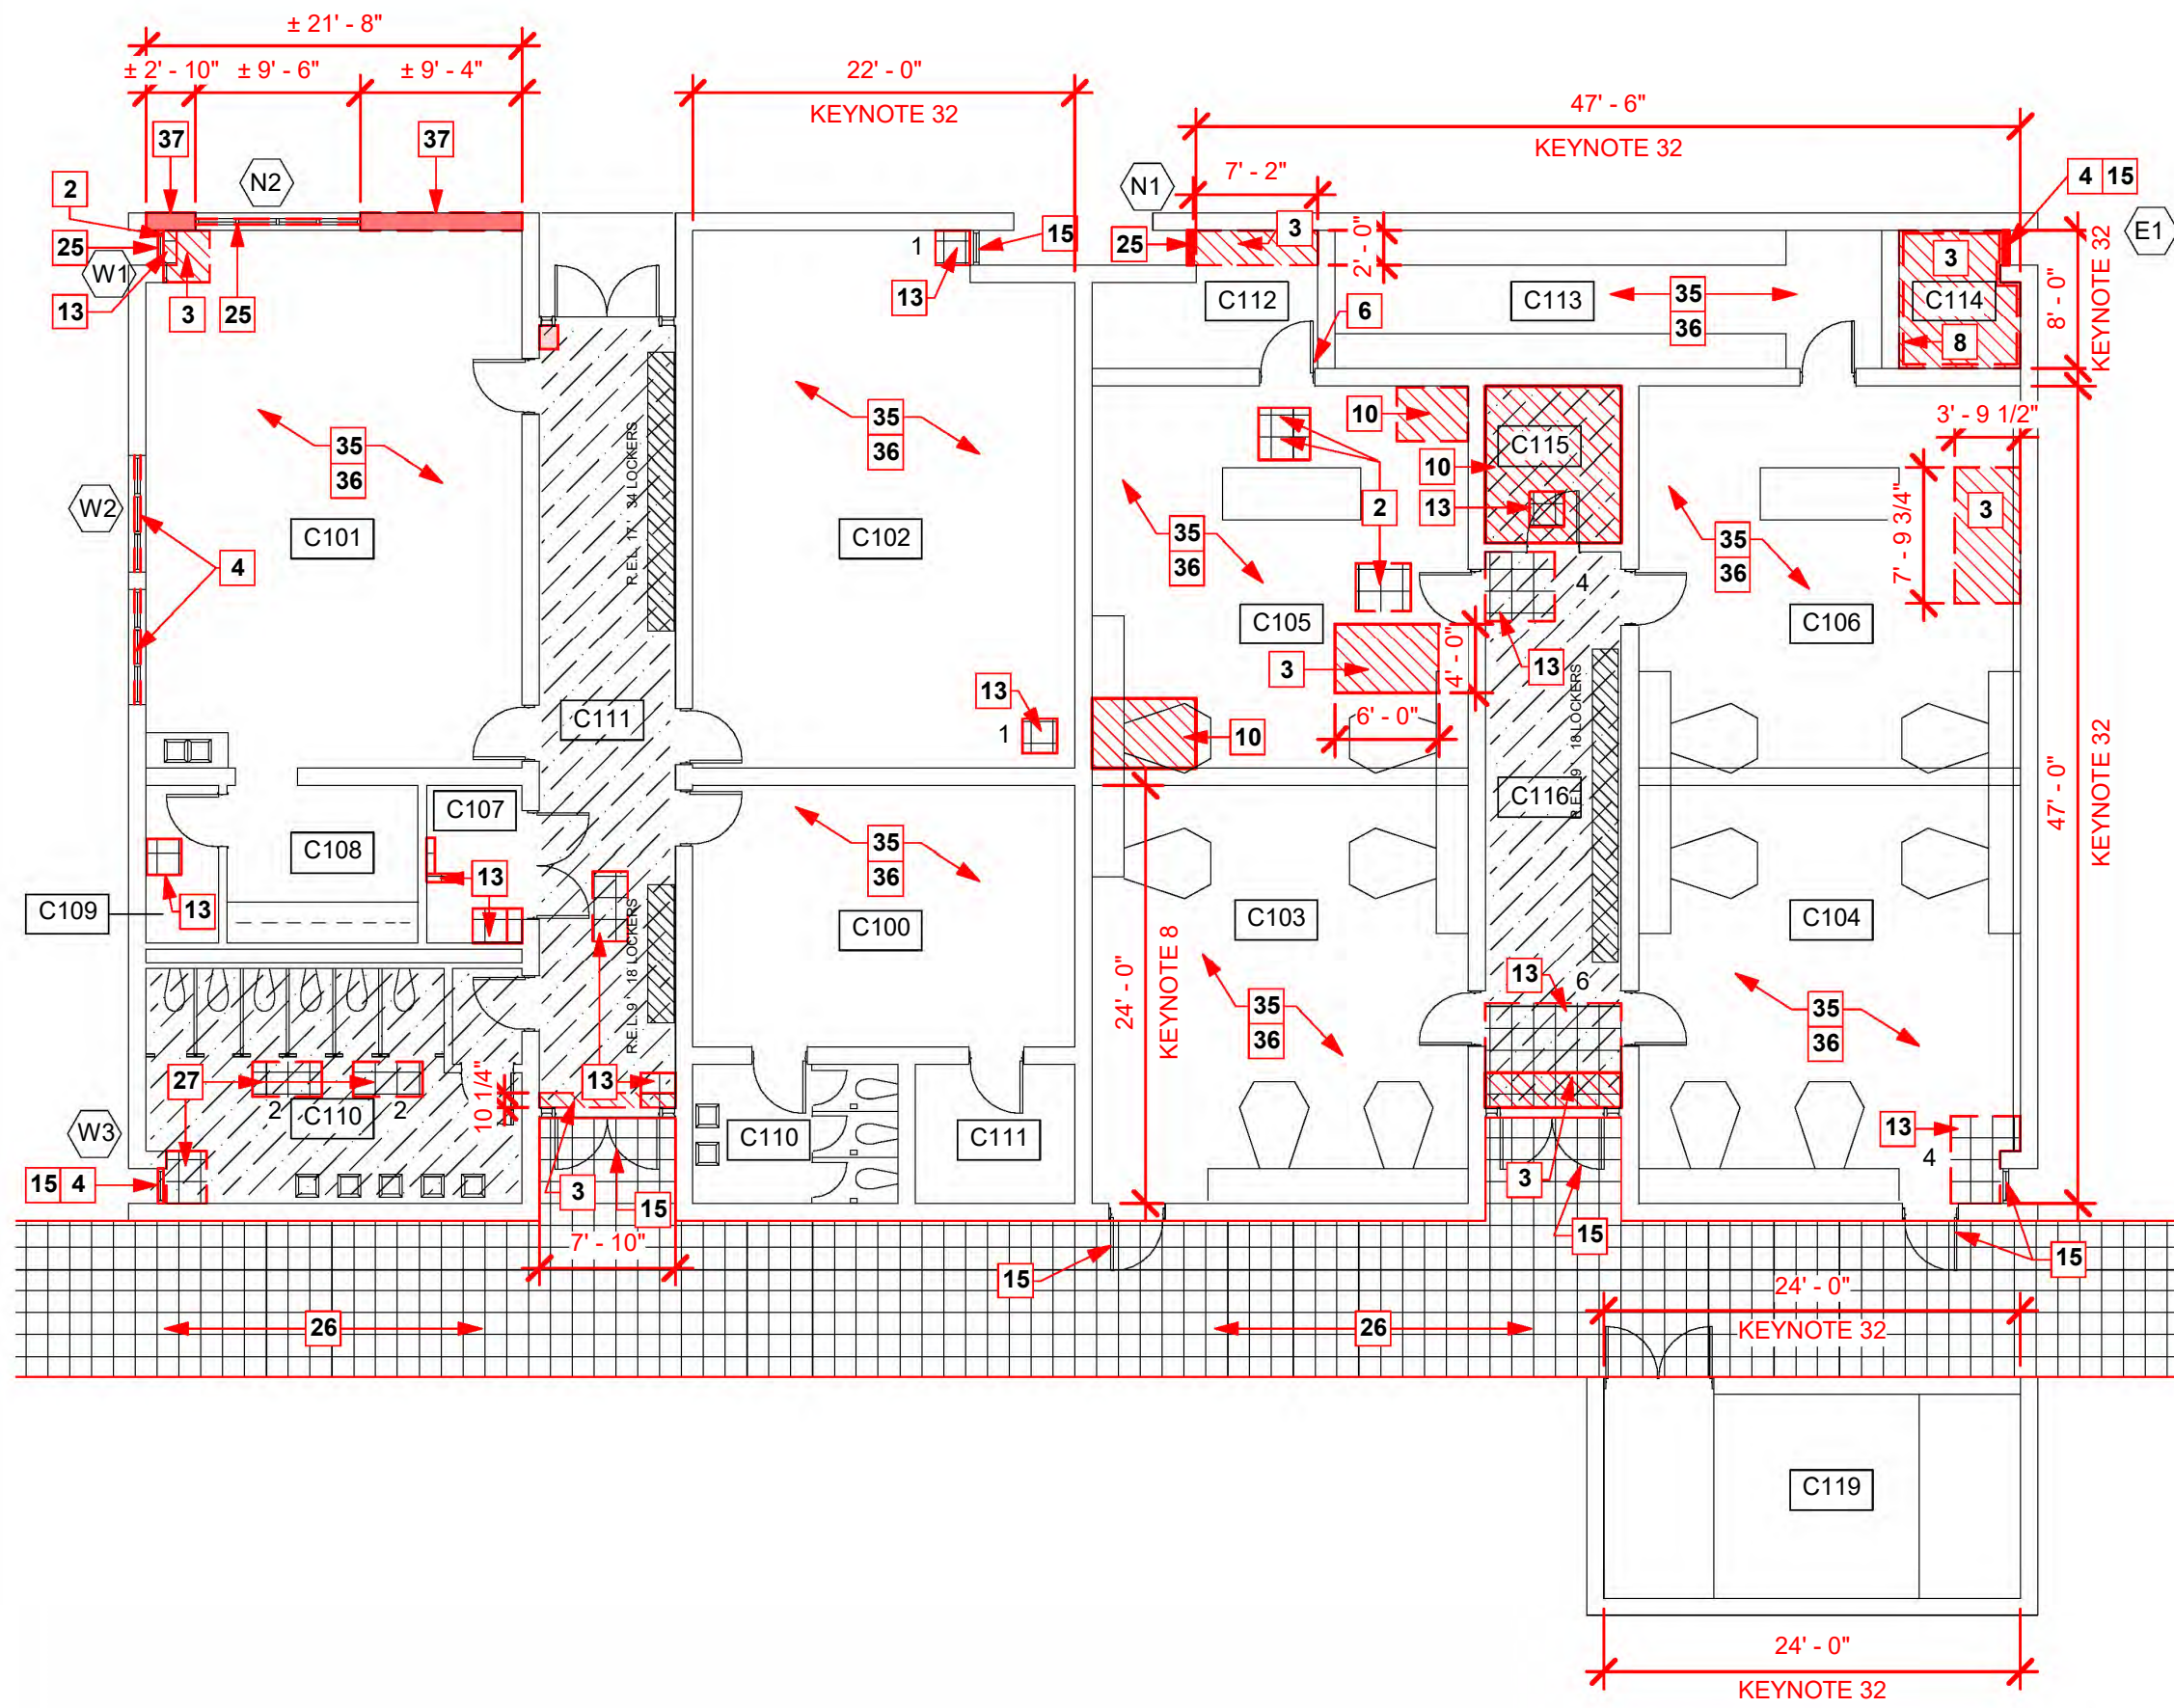
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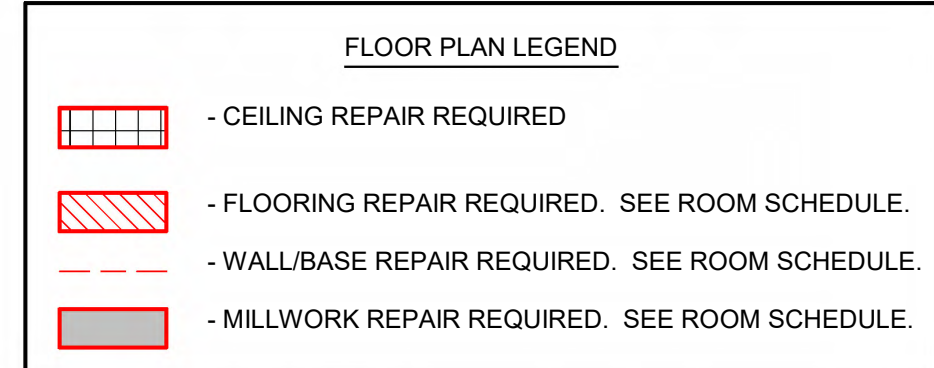
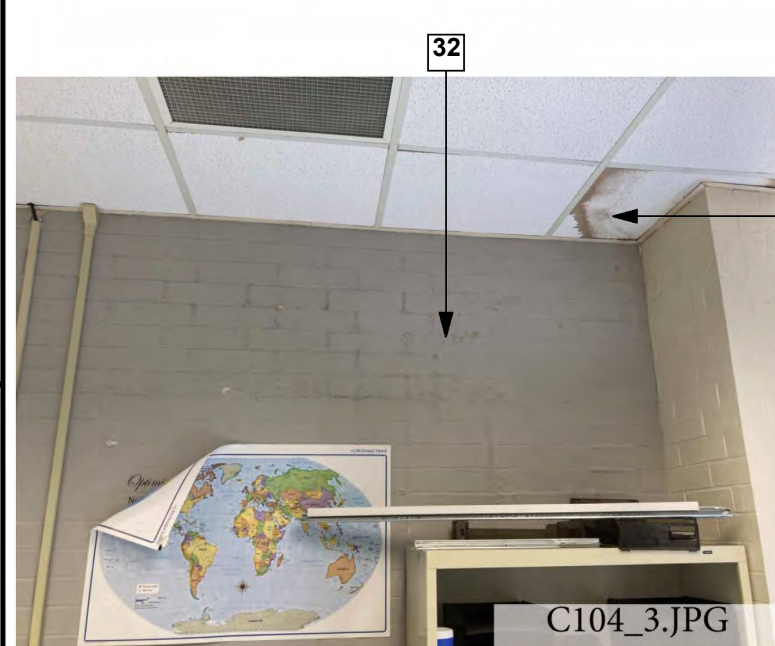
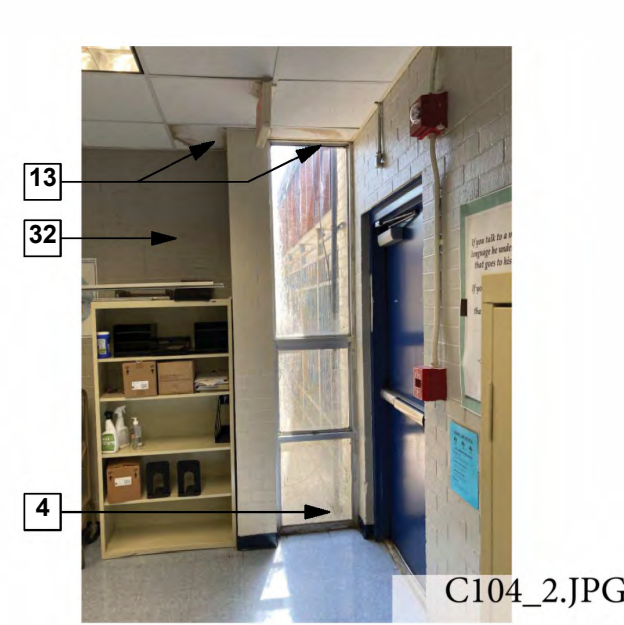
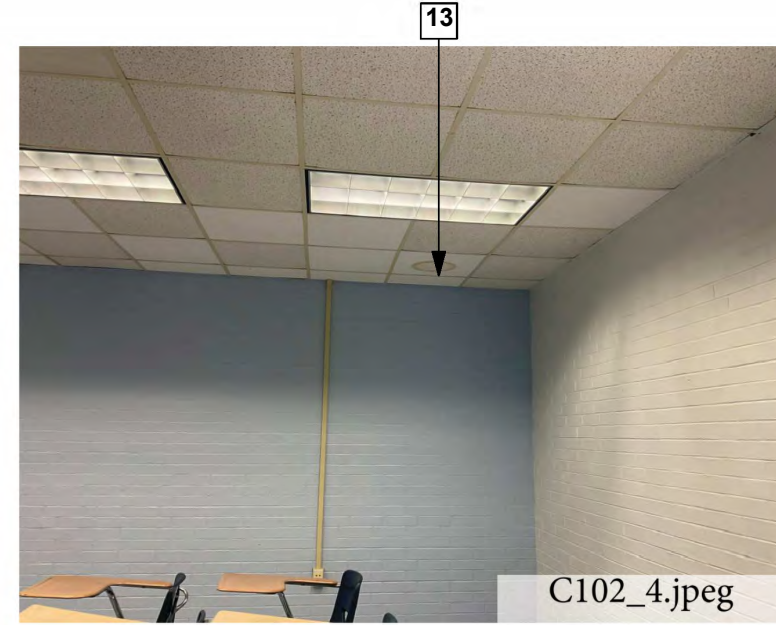
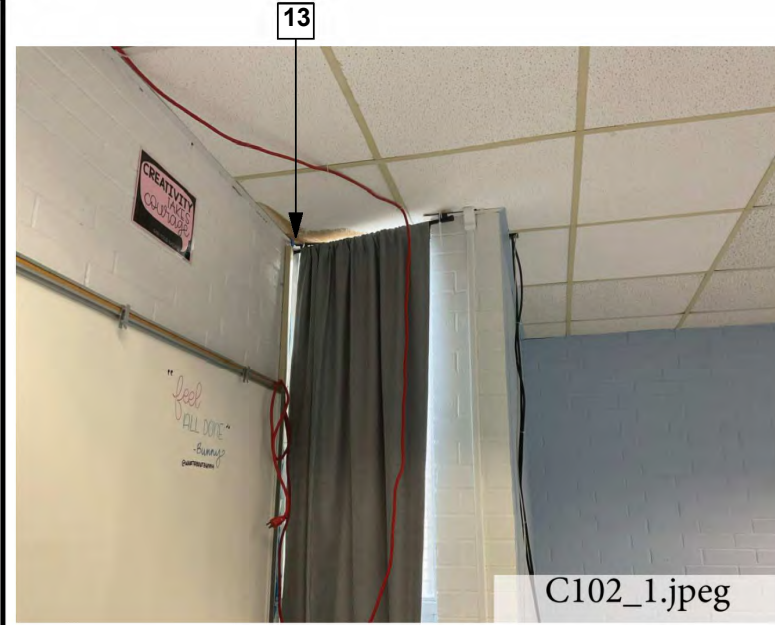
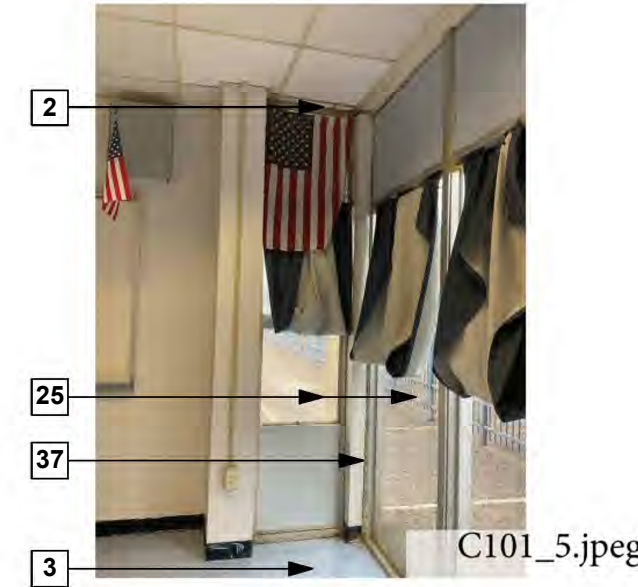
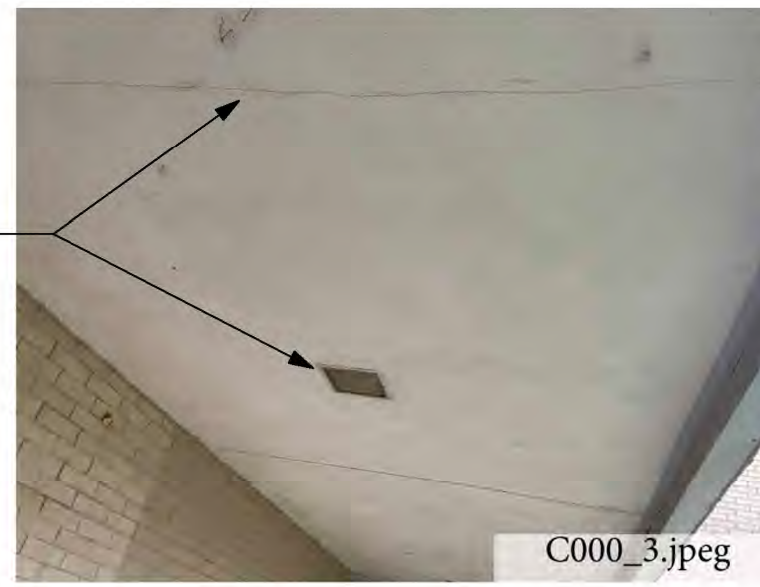
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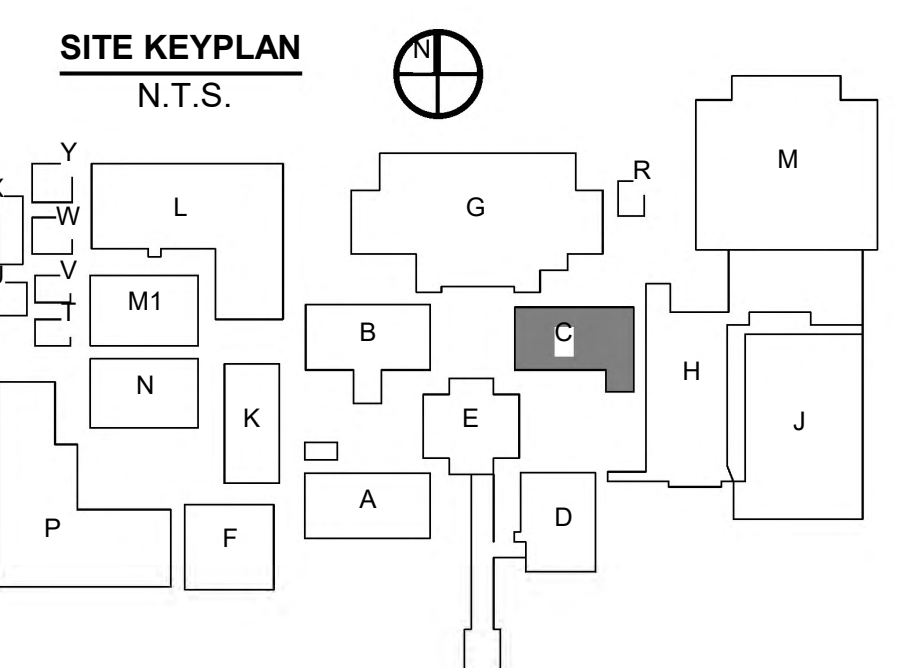
6 Zone 1 - Building C First Floor
3/32" = 1'-0"



ROOMS - BUILDING C1

ROOM NUMBER	Area	Perimeter
C101	692 SF	107'-3"
C102	689 SF	108'-3"
C103	499 SF	89'-5"
C104	513 SF	90'-7"
C105	305 SF	75'-9"
C108	352 SF	106'-3"
C113	73 SF	34'-4"
C114	257 SF	80'-3"
C115	524 SF	91'-8"
C116	251 SF	78'-10"
C117	58 SF	30'-7"
C118	40 SF	26'-10"
C120	93 SF	43'-5"

*THESE MEASUREMENTS ARE APPROXIMATE TO BE USED AS GUIDELINES ONLY. CONTRACTOR IS RESPONSIBLE FOR ALL FINAL MEASUREMENTS.



- KEYNOTES**
- SUSPENDED ACOUSTIC CEILING REPLACEMENT:** REMOVE AND REPLACE DAMAGED CEILING GRID AND CEILING TILE AS SPECIFIED.
 - CEILING GRID:** REMOVE AND REPLACE DAMAGED CEILING GRID. MATCH EXISTING. SEE UNIT PRICE NO. 5.
 - VCT FLOORING REPAIRS:** REMOVE AND REPLACE VCT FLOORING AS SPECIFIED IN AREAS WHERE INDICATED. SEE UNIT PRICE NO. 3.
 - WINDOW REPAIRS:** REPLACE BROKEN WINDOW PANE, BLOCKS, AND GASKETS TO MATCH EXISTING. ALL SEALANTS SHALL BE REMOVED AND REPLACED AS SPECIFIED TO ENSURE WEATHER TIGHT SEAL. SEE ELEVATIONS.
 - STRUCTURAL CLAY BLOCK:** GLAZED STRUCTURAL CLAY BLOCK TO BE REMOVED AND REPLACED AS SPECIFIED TO MATCH EXISTING. CLEAN ALL CHALKING RESIDUE FROM EFFERVESCENCE.
 - VINYL BASE REPLACEMENT:** REPLACE DAMAGED OR MISSING BASE AS SPECIFIED TO MATCH EXISTING. SEE UNIT PRICE NO. 4.
 - CARPET REPAIRS:** DAMAGED CARPET HAS BEEN REMOVED. CLEAN FLOOR AND INSTALL NEW CARPET TILE AS SPECIFIED.
 - PAINTING:** WALL SURFACE IS TO BE SANDED, PREPARED, AND REPAINT TO MATCH EXISTING CORNER TO CORNER. WATER STAINED WALL FROM ROOF LOSS.
 - PAINTED CEILING STRUCTURE:** CEILING INCLUDING METAL TRUSSES ARE TO BE CLEANED, PREPPED, AND REPAINTED END TO END TO MATCH EXISTING COLOR.
 - VCT FLOORING CLEANING:** CLEAN WATER STAINS FROM VCT FLOORING TO REMOVE ANY DISCOLORATION WHERE INDICATED. MOP AND WAX ALL VCT FLOORING AT THE END OF CONSTRUCTION.
 - SKYLIGHT REPAIRS:** REMOVE AND REPLACE SKYLIGHT TO MATCH EXISTING.
 - TERRAZZO FLOORING CLEANING:** CLEAN AND POLISH EXISTING TERRAZZO FLOORING TO ROOM SCHEDULE FOR CLARITY.
 - CEILING TILE REPLACEMENT:** REMOVE AND REPLACE DAMAGED OR MISSING ACOUSTIC CEILING TILE WITH NEW CEILING TILE AS SPECIFIED IN AREAS INDICATED. MATCH EXISTING TYPE AND SIZE. SEE UNIT PRICE NO. 1. INSTALL R-30 BATT INSULATION OVER TILE. SEE UNIT PRICE NO. 2.
 - NOT USED.**
 - EXTERIOR WINDOWS AND DOORS:** CAULK AND RESEAL PERIMETER OF EXISTING WINDOWS AND DOORS.
 - CMU REPAIR:** RE-POINT DAMAGED CMU JOINTS AS SHOWN. PAINT WALL FROM END TO END IN COLOR TO MATCH EXISTING AS SPECIFIED. SEE PHOTOS.
 - BRICK REPAIR:** CAULK CRACKED AREAS AND REPAINT.
 - LOCKERS:** REPLACE DAMAGED UNITS AS SHOWN. MATCH EXISTING STYLE, SIZE AND COLORS.
 - BRICK WALLS:** CLEAN ALL WATER STAINS FROM ENTIRE BRICK WALL.
 - SHELVING REPLACEMENT:** REMOVE AND REPLACE DAMAGED SHELVING UNITS WITH **GLASS DOORS**. MATCH EXISTING MATERIALS, FINISHES AND CONSTRUCTION STYLE.
 - BASE CABINET:** REMOVE AND REPLACE DAMAGED BASE CABINET. MATCH EXISTING STYLE, SIZE, AND CONSTRUCTION. SALVAGE AND REINSTALL COUNTERTOP.
 - SECTIONAL DOOR:** REMOVE AND REPLACE OVERHEAD SECTIONAL DOOR AS SPECIFIED. CONTRACTOR TO PROVIDE ANY ADDITIONAL SUPPORT REQUIRED BY THE MANUFACTURER.
 - GYPSUM BOARD:** REMOVE AND REPLACE DAMAGED GYPSUM BOARD TO NEAREST FRAMING MEMBER. FINISH AND RE-PAINT WALL CORNER TO CORNER.
 - PREFINISHED GYPSUM BOARD WITH VINYL WALL COVER AND CORNER TRIM:** REMOVE AND REPLACE DAMAGED VINYL COVERED GYPSUM BOARD FROM FLOOR TO CEILING WHERE INDICATED ON FLOOR PLAN.
 - STOREFRONT WINDOW:** REMOVE AND REPLACE STOREFRONT WINDOW AS SPECIFIED.
 - STUCCO SOFFIT:** REMOVE & REPLACE STUCCO SOFFIT. COORDINATE WITH ABATEMENT SCOPE & ABATEMENT CONTRACTOR TO ENSURE WEATHER-TIGHTNESS AND PHASING COORDINATION. SEE WALL SECTIONS & DETAILS.
 - GYPSUM CEILING REPAIRS:** REMOVE AND REPLACE DAMAGED GYPSUM CEILING BOARD TO NEAREST FRAMING MEMBER WHERE INDICATED. FINISH TO MATCH EXISTING AS SPECIFIED.
 - METAL ROOF PANEL REPAIRS:** REMOVE AND REPLACE DEFORMED OR MISSING METAL ROOF PANELS TO MATCH EXISTING.
 - CONCRETE FLOOR CLEANING:** CLEAN AND RESEAL FLOOR AS SPECIFIED.
 - BASE CABINET:** REMOVE AND REPLACE DAMAGED BASE CABINET. MATCH EXISTING STYLE, SIZE, AND CONSTRUCTION. SALVAGE AND REINSTALL COUNTERTOP. PROTECT ALL MECHANICAL CONNECTIONS.
 - TILE CLEANING:** CLEAN STAINS FROM WALL TILE TO REMOVE ANY DISCOLORATION WHERE INDICATED.
 - CLEAN/REPAINT MASONRY WALL:** MECHANICALLY REMOVE ALL LOOSE OR PEELING PAINT AND ALL CHALKING RESIDUE FROM EFFERVESCENCE FROM CORNER TO CORNER. PERFORM REQUIRED MOISTURE TESTING PRIOR TO REPAINTING WALL AS SPECIFIED.
 - PLASTER CEILING REPAIRS:** REMOVE AND REPLACE DAMAGED PLASTER CEILING WHERE INDICATED AS SPECIFIED. PAINT IN COLOR TO MATCH EXISTING.
 - MEP DAMAGES:** SEE MECHANICAL, PLUMBING AND ELECTRICAL PLANS.
 - FURNITURE SETTING AND RESETTING:** RELOCATE ALL EXISTING FURNITURE TO TEMPORARY ROOM IN MODULAR BUILDINGS WHILE EXISTING SPACE IS BEING REPAIRED. REINSTALL AND RESET FURNITURE ONCE REPAIRS ARE COMPLETE. SEE PHASING PLAN.
 - SUSPENDED CEILING INSULATION:** INSTALL R-19 BATT INSULATION AS SPECIFIED ABOVE PREVIOUSLY INSTALLED SUSPENDED CEILING TILE. SEE UNIT PRICE NO. 2.
 - BRICK WALL REPLACEMENT:** REMOVE AND REPLACE BRICK WALL AS INDICATED. DISPOSE OF OLD BRICK. MATCH NEW BRICK AND MORTAR TO EXISTING AS APPROVED BY ARCHITECT. SEE STRUCTURAL. BUILDING TO REMAIN WEATHERPROOF AND CONDITIONED DURING REPAIRS.
 - DOOR REPAIR:** CLEAN, PREP AND RE-PAINT DOOR FRAME - SEE DOOR SCHEDULE.
 - CORRIDOR WALL REPAIR:** REMOVE DAMAGED STOREFRONT WINDOW AND EXISTING 3/4" PLYWOOD SHEATHING BELOW WINDOW. INSTALL NEW WINDOW PER SCHEDULE AND NEW 3/4" PLYWOOD SHEATHING. PAINT AS SPECIFIED, IN COLOR AS SELECTED. SEE DETAILS.
 - GLAZING REPAIR:** REMOVE AND REPLACE BROKEN GLASS. MATCH EXISTING TINT. PROVIDE SAFETY GLASS AS REQUIRED.
 - DOOR REPAIR:** REMOVE AND REPLACE EXISTING LEFT DOOR LEAF. PROVIDE AN INSULATED HOLLOW METAL DOOR WITH VISION PANEL TO MATCH RIGHT DOOR LEAF. REINSTALL EXISTING DOOR HARDWARE. PAINT AS DIRECTED.

ARCHITECT

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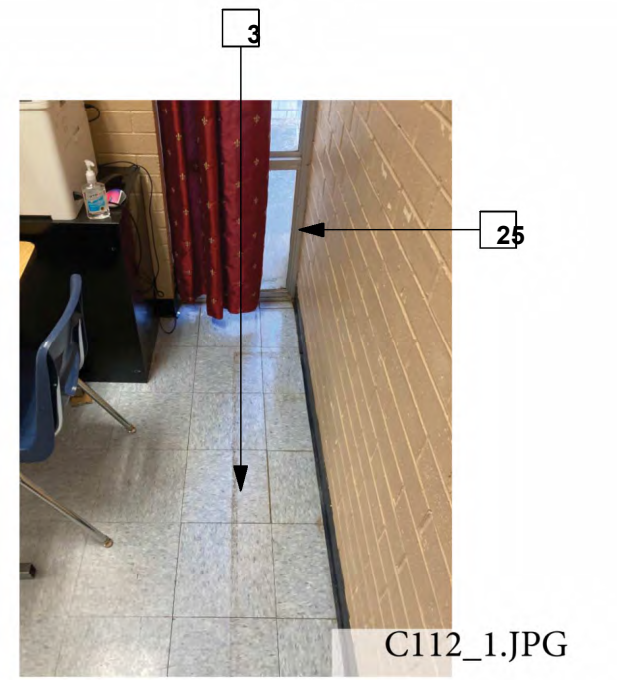
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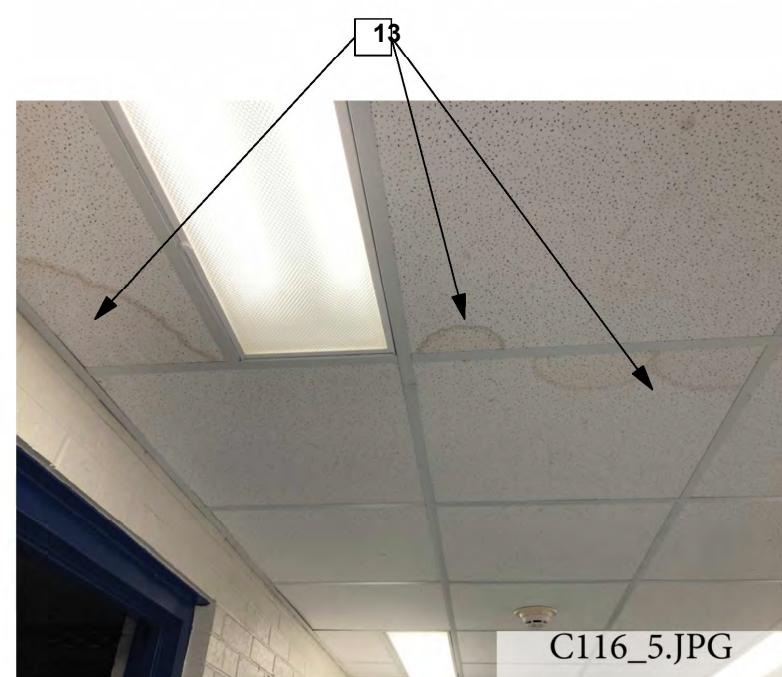
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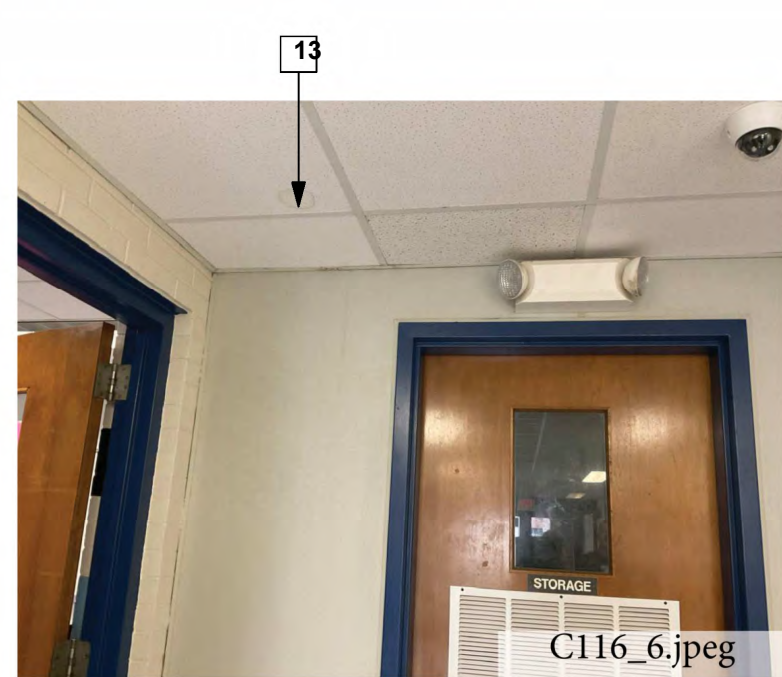
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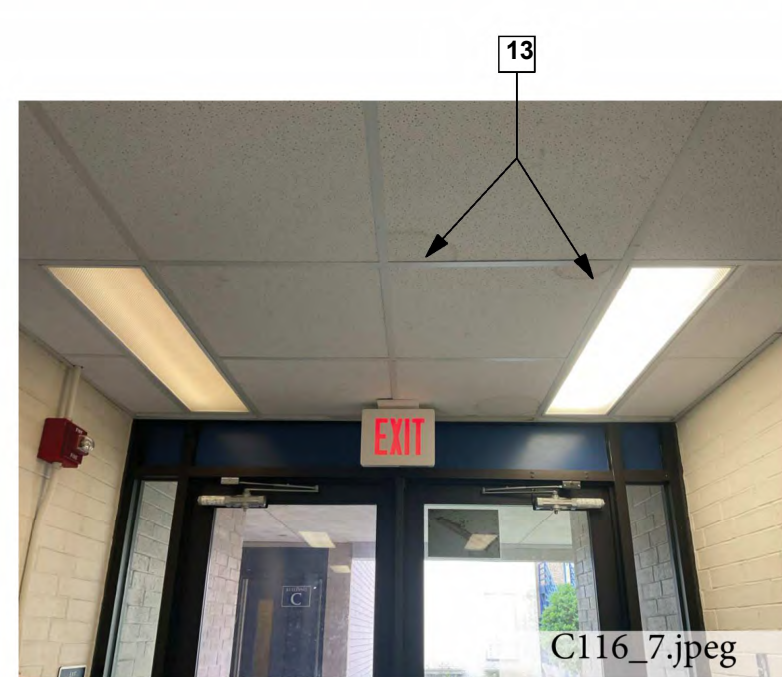
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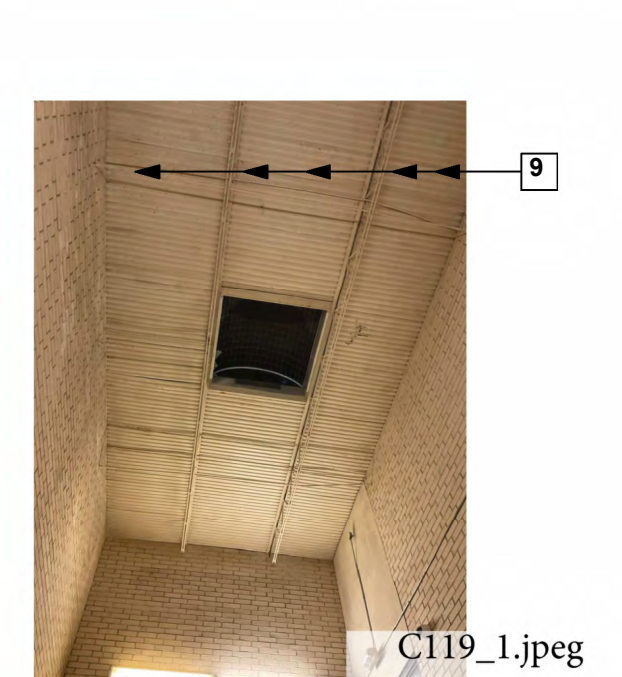
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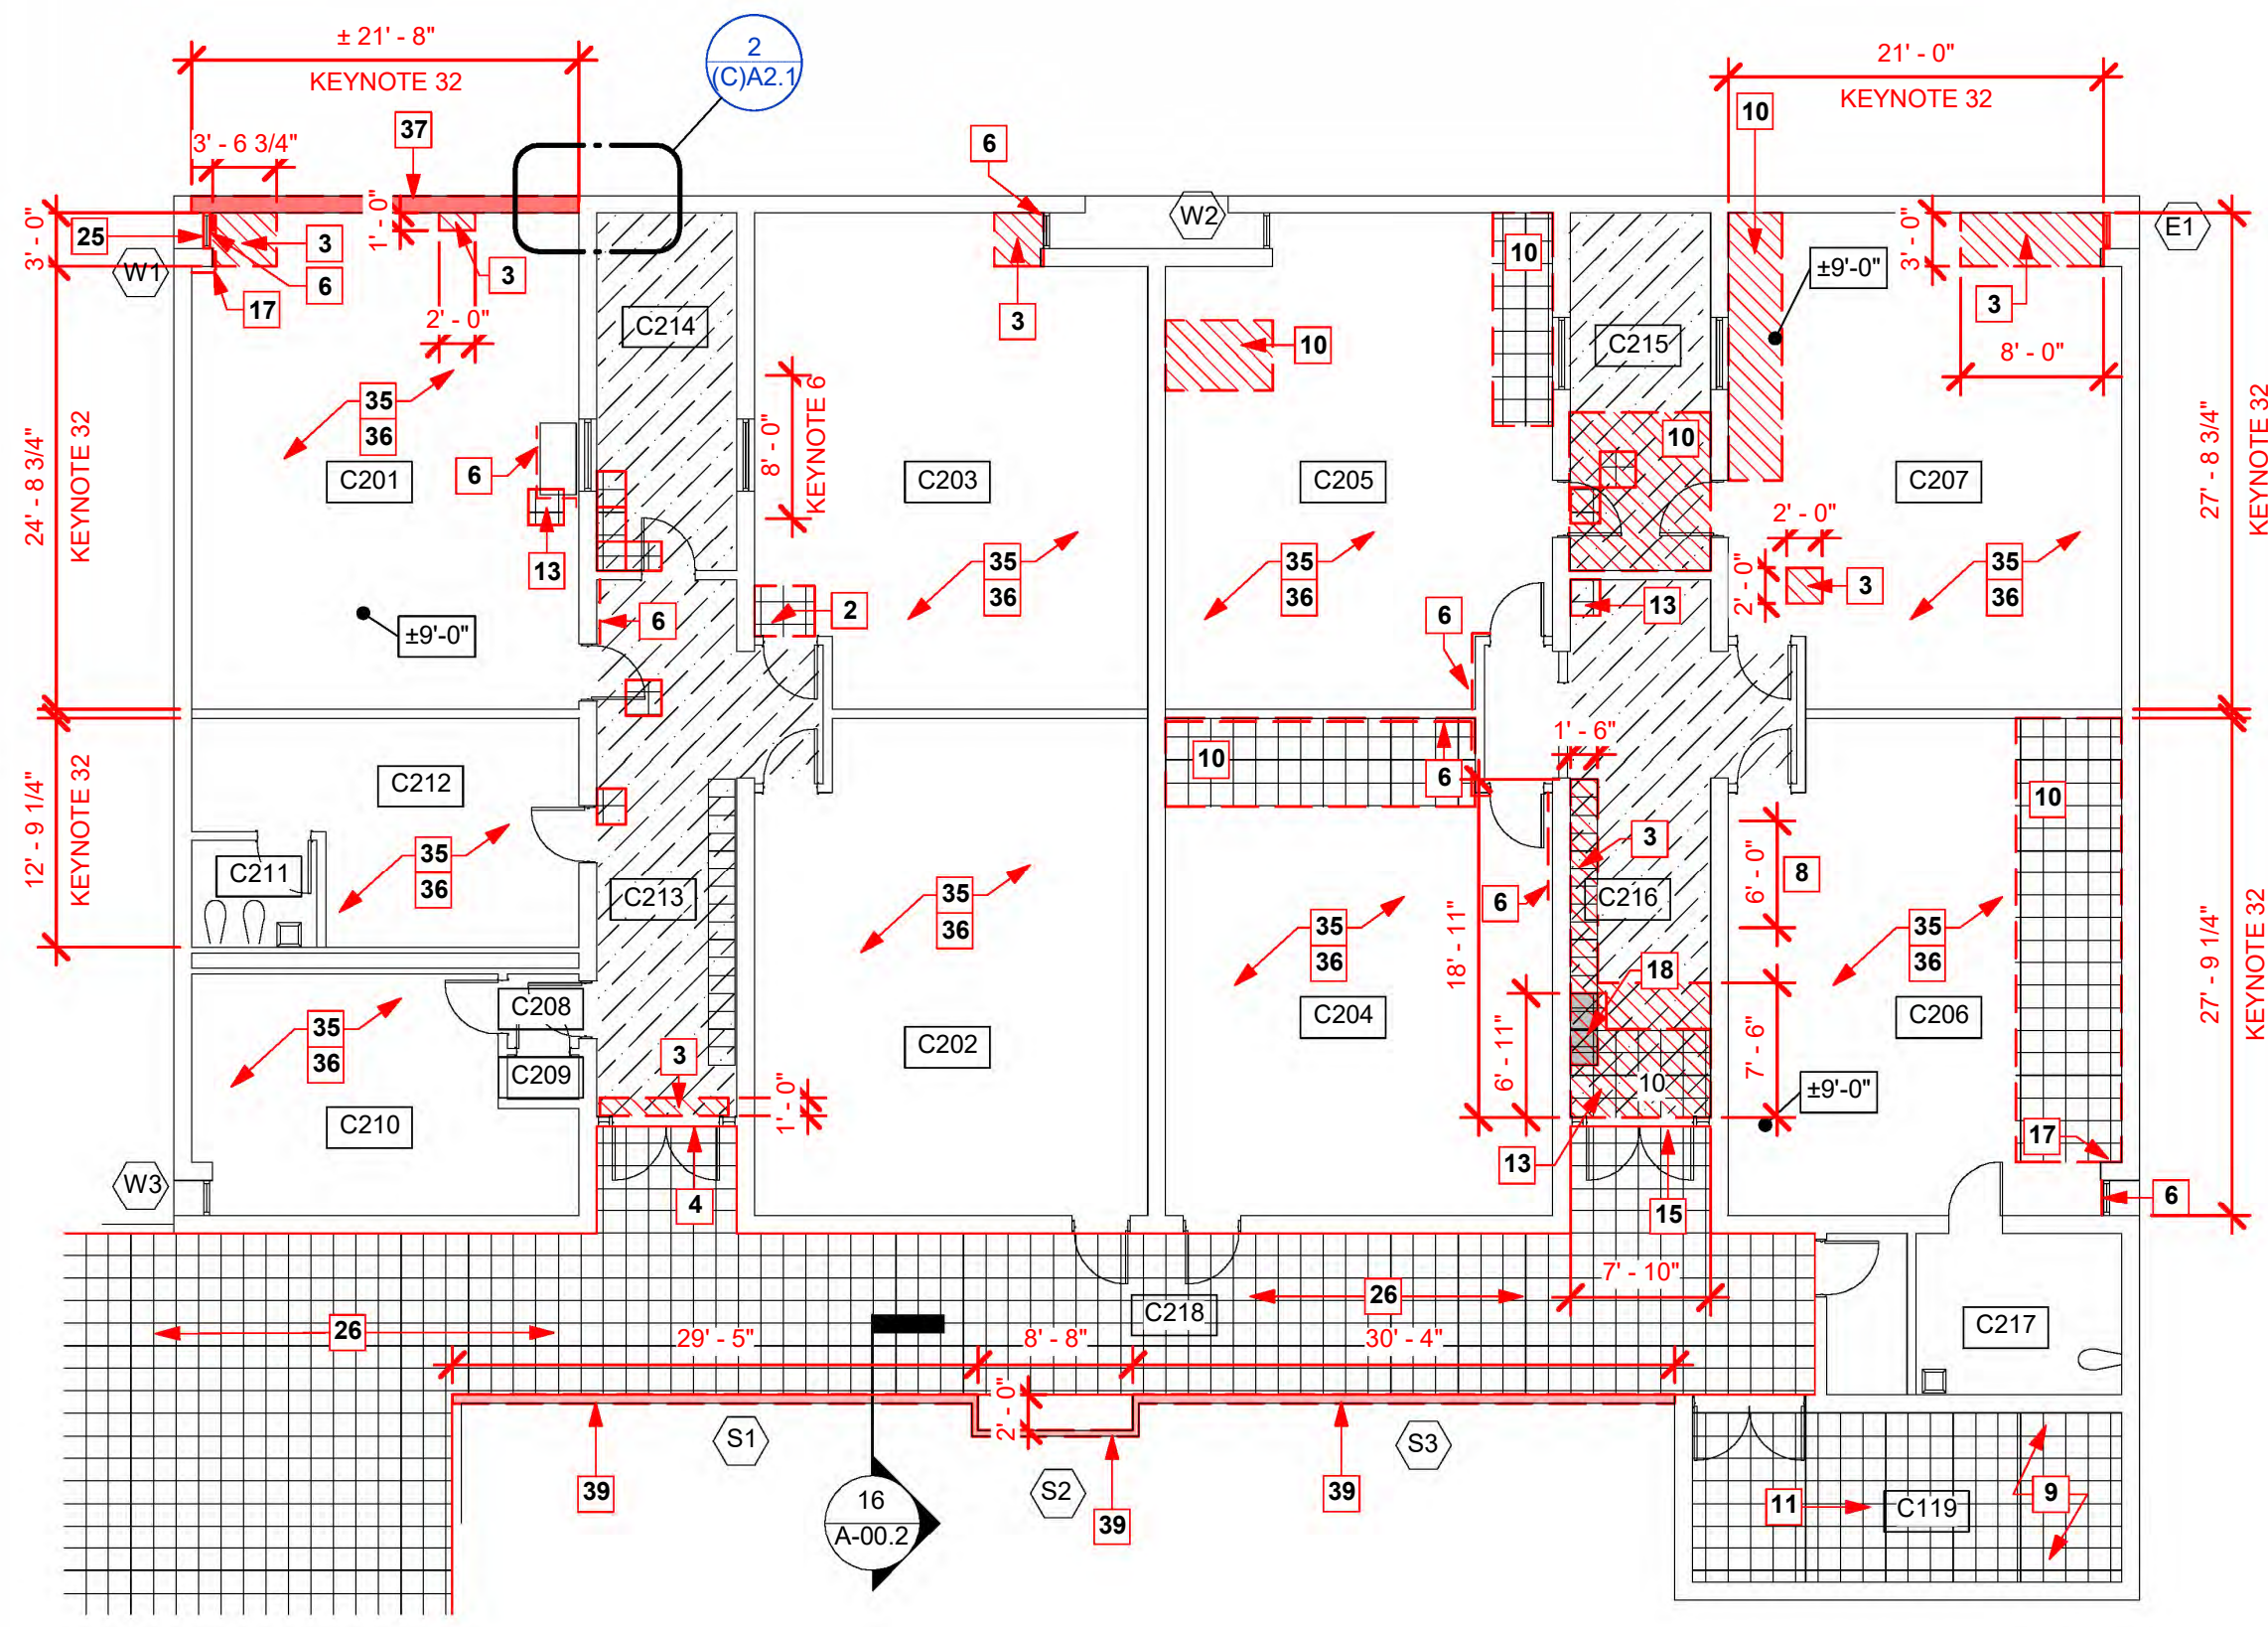
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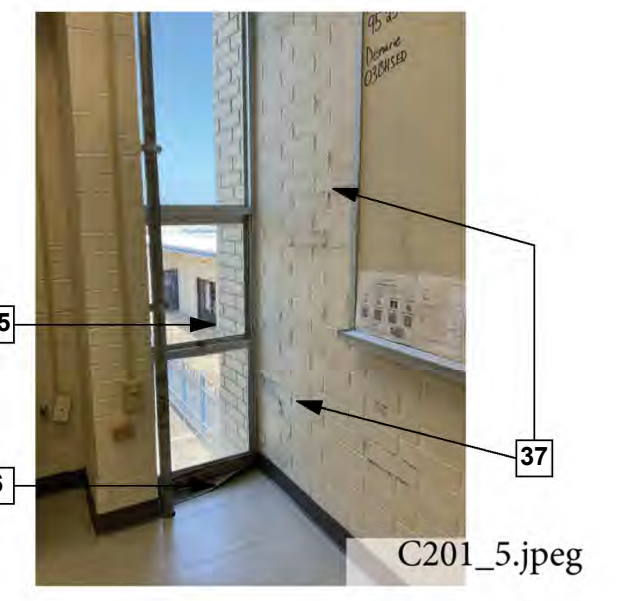
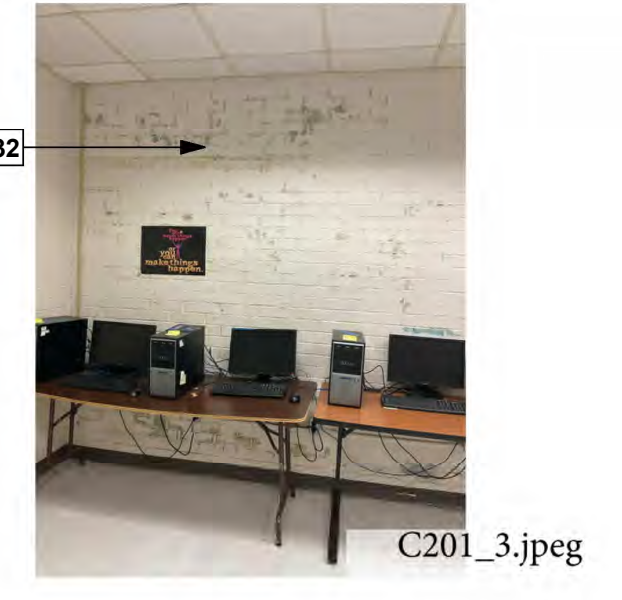
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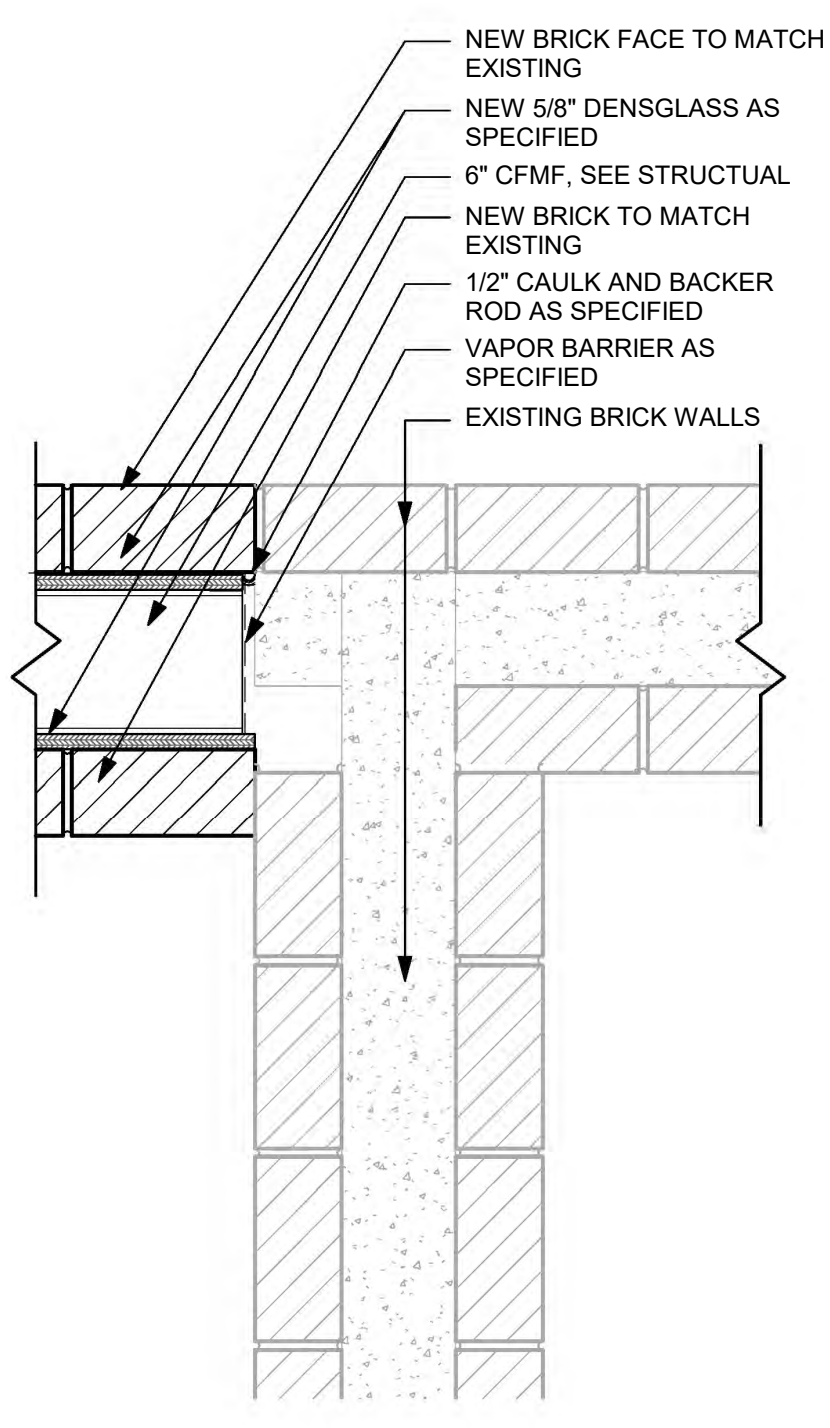
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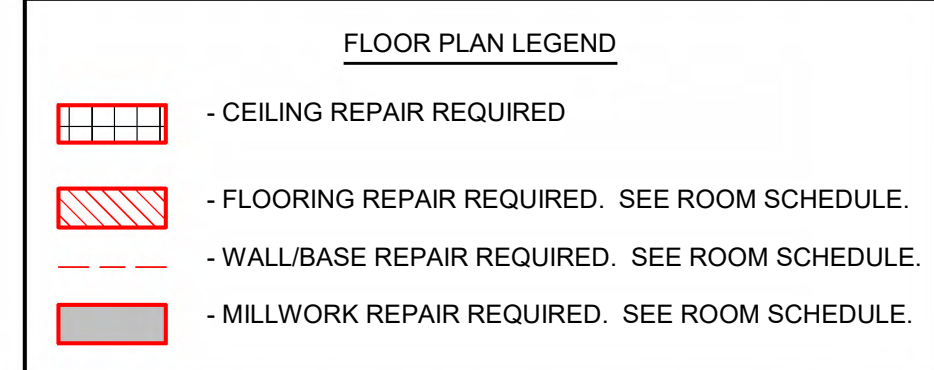
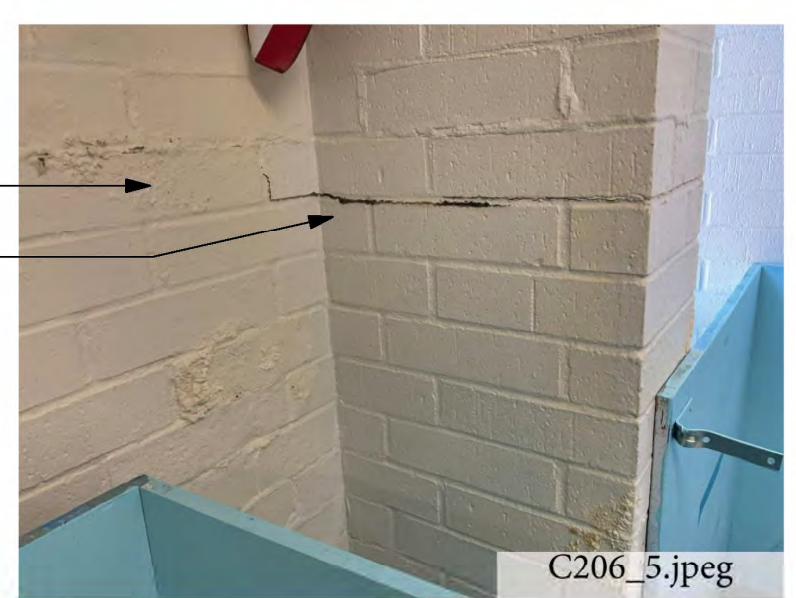
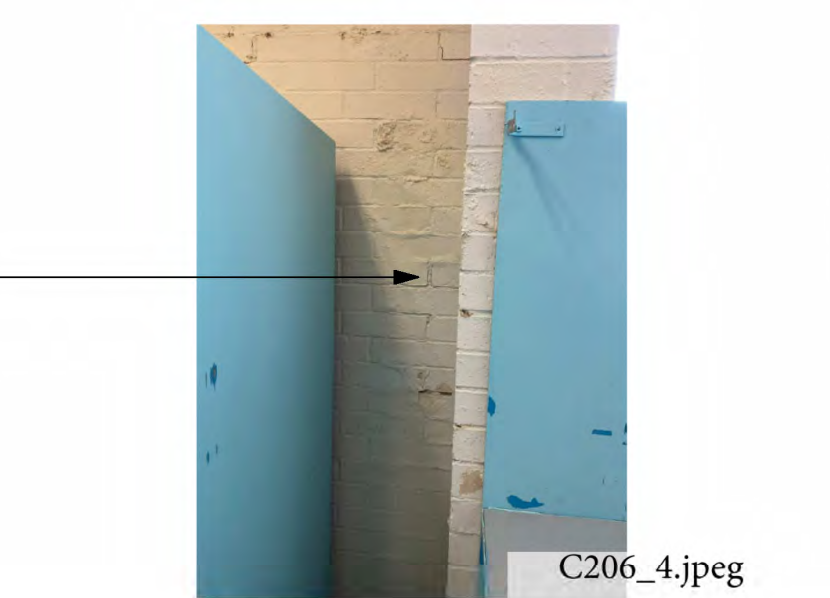
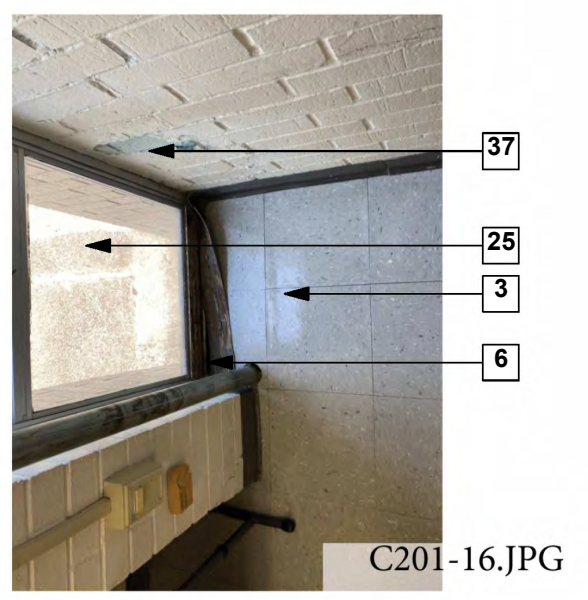
6 Zone 1 - Building C Second Floor
3/32" = 1'-0"



2 Zone 1 - Building C Second Floor - PLAN SECTION
1 1/2" = 1'-0"




- KEYNOTES**
- SUSPENDED ACOUSTIC CEILING REPLACEMENT:** REMOVE AND REPLACE DAMAGED CEILING GRID AND CEILING TILE AS SPECIFIED.
 - CEILING GRID:** REMOVE AND REPLACE DAMAGED CEILING GRID. MATCH EXISTING. SEE UNIT PRICE NO. 3
 - VCT FLOORING REPAIRS:** REMOVE AND REPLACE VCT FLOORING AS SPECIFIED IN AREAS WHERE INDICATED. SEE UNIT PRICE NO. 3
 - WINDOW REPAIRS:** REPLACE BROKEN WINDOW PANES, BLOCKS, AND GASKETS TO MATCH EXISTING. ALL SEALANTS SHALL BE REMOVED AND REPLACED AS SPECIFIED TO ENSURE WEATHER TIGHT SEAL. SEE ELEVATIONS.
 - STRUCTURAL CLAY BLOCK:** GLAZED STRUCTURAL CLAY BLOCK TO BE REMOVED AND REPLACED AS SPECIFIED TO MATCH EXISTING. CLEAN ALL CHALKING RESIDUE FROM EFFERVESCENCE.
 - VINYL BASE REPLACEMENT:** REPLACE DAMAGED OR MISSING BASE AS SPECIFIED TO MATCH EXISTING. SEE UNIT PRICE NO. 4
 - CARPET REPAIRS:** DAMAGED CARPET HAS BEEN REMOVED. CLEAN FLOOR AND INSTALL NEW CARPET TILE AS SPECIFIED.
 - PAINTING:** WALL SURFACE IS TO BE SANDED, PREPARED, AND REPAINT TO MATCH EXISTING CORNER TO CORNER. WATER STAINED WALL FROM ROOF LOSS.
 - PAINTED CEILING STRUCTURE:** CEILING INCLUDING METAL TRUSSES ARE TO BE CLEANED, PREPPED, AND REPAINTED END TO END TO MATCH EXISTING COLOR
 - VCT FLOORING CLEANING:** CLEAN WATER STAINS FROM VCT FLOORING TO REMOVE ANY DISCOLORATION WHERE INDICATED. MOP AND WAX ALL VCT FLOORING AT THE END OF CONSTRUCTION.
 - SKYLIGHT REPAIR:** REMOVE AND REPLACE SKYLIGHT TO MATCH EXISTING.
 - TERRAZZO FLOORING CLEANING:** CLEAN AND POLISH EXISTING TERRAZZO FLOORING. REFER TO ROOM SCHEDULE FOR CLARITY.
 - CEILING TILE REPLACEMENT:** REMOVE AND REPLACE DAMAGED OR MISSING ACOUSTIC CEILING TILE WITH NEW CEILING TILE AS SPECIFIED IN AREAS INDICATED. MATCH EXISTING TYPE AND SIZE. SEE UNIT PRICE NO. 1. INSTALL R-30 BATT INSULATION OVER TILE. SEE UNIT PRICE NO. 2
 - NOT USED.**
 - EXTERIOR WINDOWS AND DOORS:** CAULK AND RESEAL PERIMETER OF EXISTING WINDOWS AND DOORS.
 - CMU REPAIR:** RE-POINT DAMAGED CMU JOINTS AS SHOWN. PAINT WALL FROM END TO END IN COLOR TO MATCH EXISTING AS SPECIFIED. SEE PHOTOS.
 - BRICK REPAIR:** CAULK CRACKED AREAS AND REPAIR.
 - LOCKERS:** REPLACE DAMAGED UNITS AS SHOWN. MATCH EXISTING STYLE, SIZE AND COLORS.
 - BRICK WALLS:** CLEAN ALL WATER STAINS FROM ENTIRE BRICK WALL.
 - SHELVING REPLACEMENT:** REMOVE AND REPLACE DAMAGED SHELVING UNITS WITH GLASS DOORS. MATCH EXISTING MATERIALS, FINISHES AND CONSTRUCTION STYLE.
 - BASE CABINET:** REMOVE AND REPLACE DAMAGED BASE CABINET. MATCH EXISTING STYLE, SIZE, AND CONSTRUCTION. SALVAGE AND REINSTALL COUNTERTOP.
 - SECTIONAL DOOR:** REMOVE AND REPLACE OVERHEAD SECTIONAL DOOR AS SPECIFIED. CONTRACTOR TO PROVIDE ANY ADDITIONAL SUPPORT REQUIRED BY THE MANUFACTURER.
 - GYPSUM BOARD:** REMOVE AND REPLACE DAMAGED GYPSUM BOARD TO NEAREST FRAMING MEMBER. FINISH AND RE-PAINT WALL CORNER TO CORNER.
 - PREFINISHED GYPSUM BOARD WITH VINYL WALL COVER AND CORNER TRIM:** REMOVE AND REPLACE DAMAGED VINYL COVERED GYPSUM BOARD FROM FLOOR TO CEILING WHERE INDICATED ON FLOOR PLAN.
 - STOREFRONT WINDOW:** REMOVE AND REPLACE STOREFRONT WINDOW AS SPECIFIED.
 - STUCCO SOFFIT:** REMOVE & REPLACE STUCCO SOFFIT. COORDINATE WITH ABATEMENT SCOPE & ABATEMENT CONTRACTOR TO ENSURE WEATHER-TIGHTNESS AND PHASING COORDINATION. SEE WALL SECTIONS & DETAILS.
 - GYPSUM CEILING REPAIRS:** REMOVE AND REPLACE DAMAGED GYPSUM CEILING BOARD TO NEAREST FRAMING MEMBER WHERE INDICATED. FINISH TO MATCH EXISTING AS SPECIFIED.
 - METAL ROOF PANEL REPAIRS:** REMOVE AND REPLACE DEFORMED OR MISSING METAL ROOF PANELS TO MATCH EXISTING.
 - CONCRETE FLOOR CLEANING:** CLEAN AND RESEAL FLOOR AS SPECIFIED.
 - BASE CABINET:** REMOVE AND REPLACE DAMAGED BASE CABINET. MATCH EXISTING STYLE, SIZE, AND CONSTRUCTION. SALVAGE AND REINSTALL COUNTERTOP. PROTECT ALL MECHANICAL CONNECTIONS.
 - TILE CLEANING:** CLEAN STAINS FROM WALL TILE TO REMOVE ANY DISCOLORATION WHERE INDICATED.
 - CLEAN/REPAINT MASONRY WALL:** MECHANICALLY REMOVE ALL LOOSE OR PEELING PAINT AND ALL CHALKING RESIDUE FROM EFFERVESCENCE FROM CORNER TO CORNER. PERFORM REQUIRED MOISTURE TESTING PRIOR TO REPAINTING WALL AS SPECIFIED.
 - PLASTER CEILING REPAIRS:** REMOVE AND REPLACE DAMAGED PLASTER CEILING WHERE INDICATED AS SPECIFIED. PAINT IN COLOR TO MATCH EXISTING.
 - MFP DAMAGES:** SEE MECHANICAL, PLUMBING AND ELECTRICAL PLANS.
 - FURNITURE SETTING AND RESETING:** RELOCATE ALL EXISTING FURNITURE TO TEMPORARY ROOM IN MODULAR BUILDINGS WHILE EXISTING SPACE IS BEING REPAIRED. REINSTALL AND RESET FURNITURE ONCE REPAIRS ARE COMPLETE. SEE PHASING PLAN.
 - SUSPENDED CEILING INSULATION:** INSTALL R-19 BATT INSULATION AS SPECIFIED ABOVE PREVIOUSLY INSTALLED SUSPENDED CEILING TILE. SEE UNIT PRICE NO. 2
 - BRICK WALL REPLACEMENT:** REMOVE AND REPLACE BRICK WALL AS INDICATED. DISPOSE OF OLD BRICK, MATCH NEW BRICK AND MORTAR TO EXISTING AS APPROVED BY ARCHITECT. SEE STRUCTURAL. BUILDING TO REMAIN WEATHERPROOF AND CONDITIONED DURING REPAIRS.
 - DOOR REPAIR:** CLEAN, PREP AND RE-PAINT DOOR FRAME - SEE DOOR SCHEDULE
 - CORRIDOR WALL REPAIR:** REMOVE DAMAGED STOREFRONT WINDOW AND EXISTING 3/4" PLYWOOD SHEATHING BELOW WINDOW. INSTALL NEW WINDOW PER SCHEDULE AND NEW 3/4" PLYWOOD SHEATHING. PAINT AS SPECIFIED, IN COLOR AS SELECTED. SEE DETAILS.
 - GLAZING REPAIR:** REMOVE AND REPLACE BROKEN GLASS. MATCH EXISTING TINT. PROVIDE SAFETY GLASS AS REQUIRED.
 - DOOR REPAIR:** REMOVE AND REPLACE EXISTING LEFT DOOR LEAF. PROVIDE AN INSULATED HOLLOW METAL DOOR WITH VISION PANEL TO MATCH RIGHT DOOR LEAF. REINSTALL EXISTING DOOR HARDWARE. PAINT AS DIRECTED.



ROOMS -BUILDING C2

ROOM NUMBER	Area	Perimeter
C201	603 SF	98' - 9"
C202	602 SF	100' - 4"
C203	589 SF	99' - 0"
C204	601 SF	100' - 5"
C205	589 SF	99' - 1"
C206	598 SF	100' - 0"
C207	593 SF	99' - 7"
C212	197 SF	69' - 1"
C213	156 SF	55' - 0"
C215	324 SF	100' - 9"

*THESE MEASUREMENTS ARE APPROXIMATE TO BE USED AS GUIDELINES ONLY. CONTRACTOR IS RESPONSIBLE FOR ALL FINAL MEASUREMENTS.

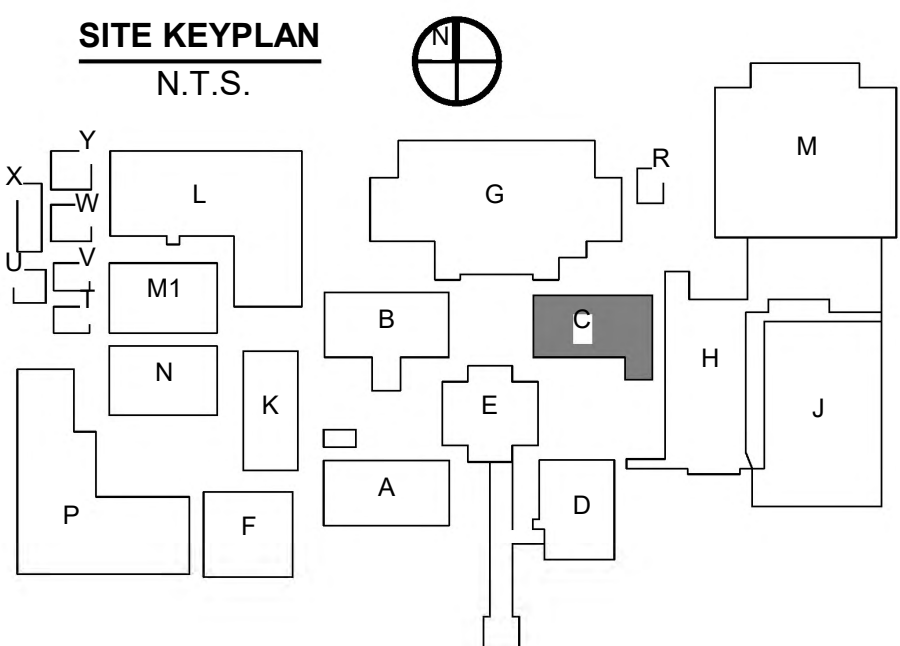

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HL-003-01.03.04.05.06.07

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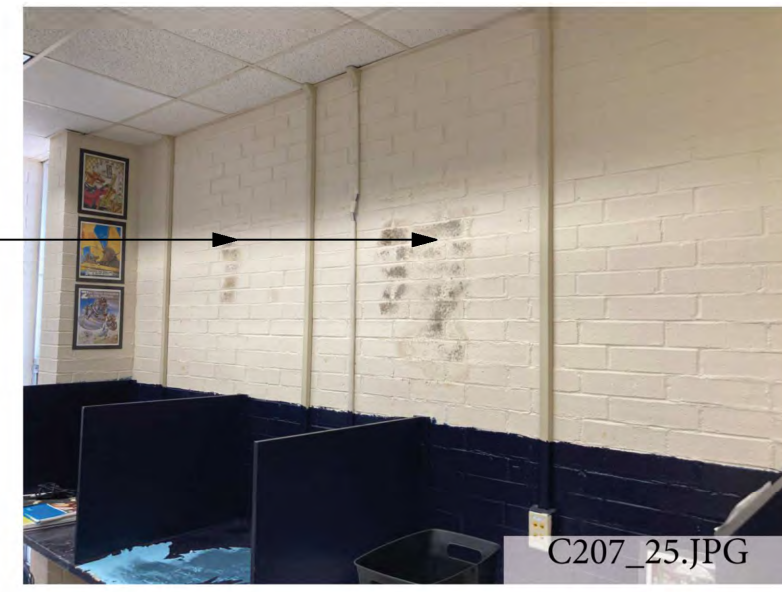
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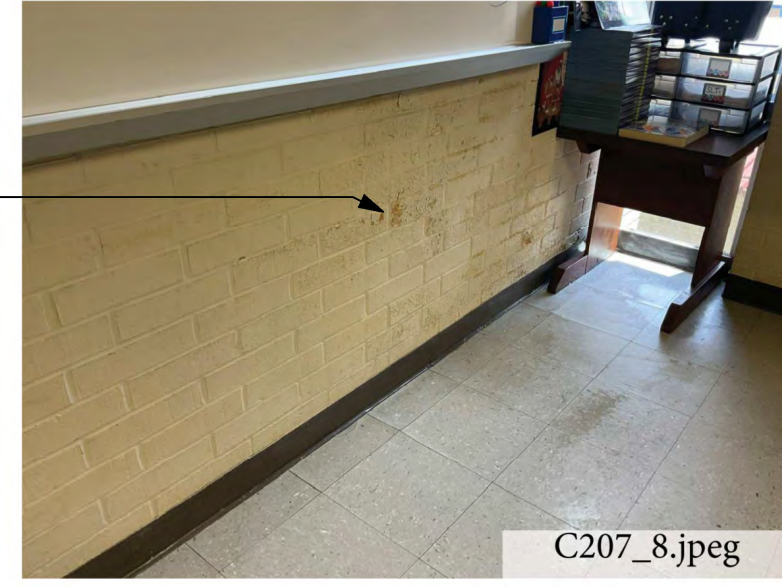
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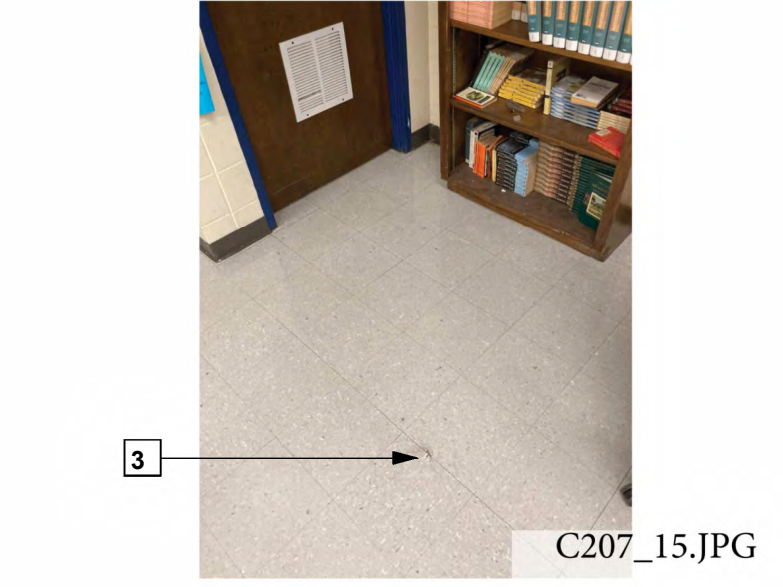
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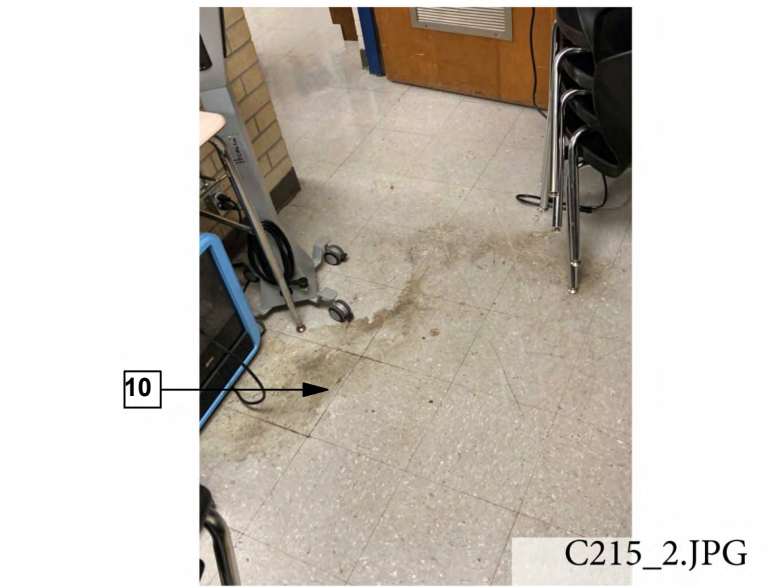
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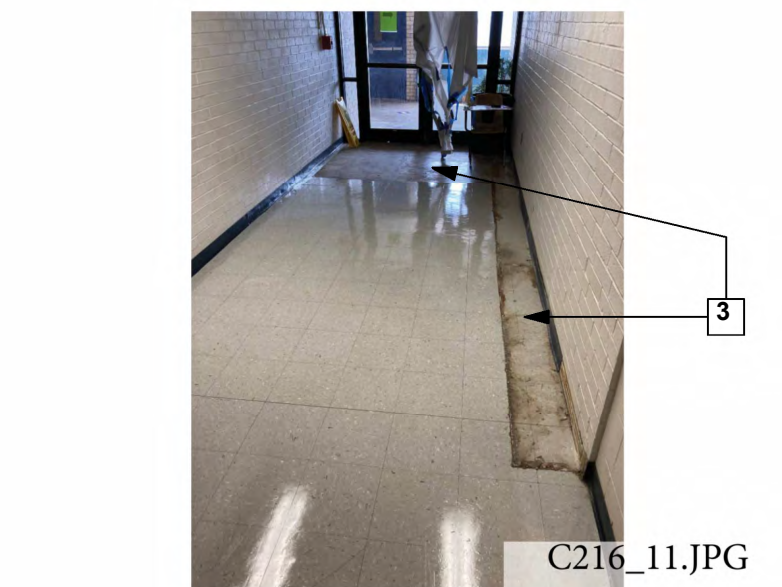
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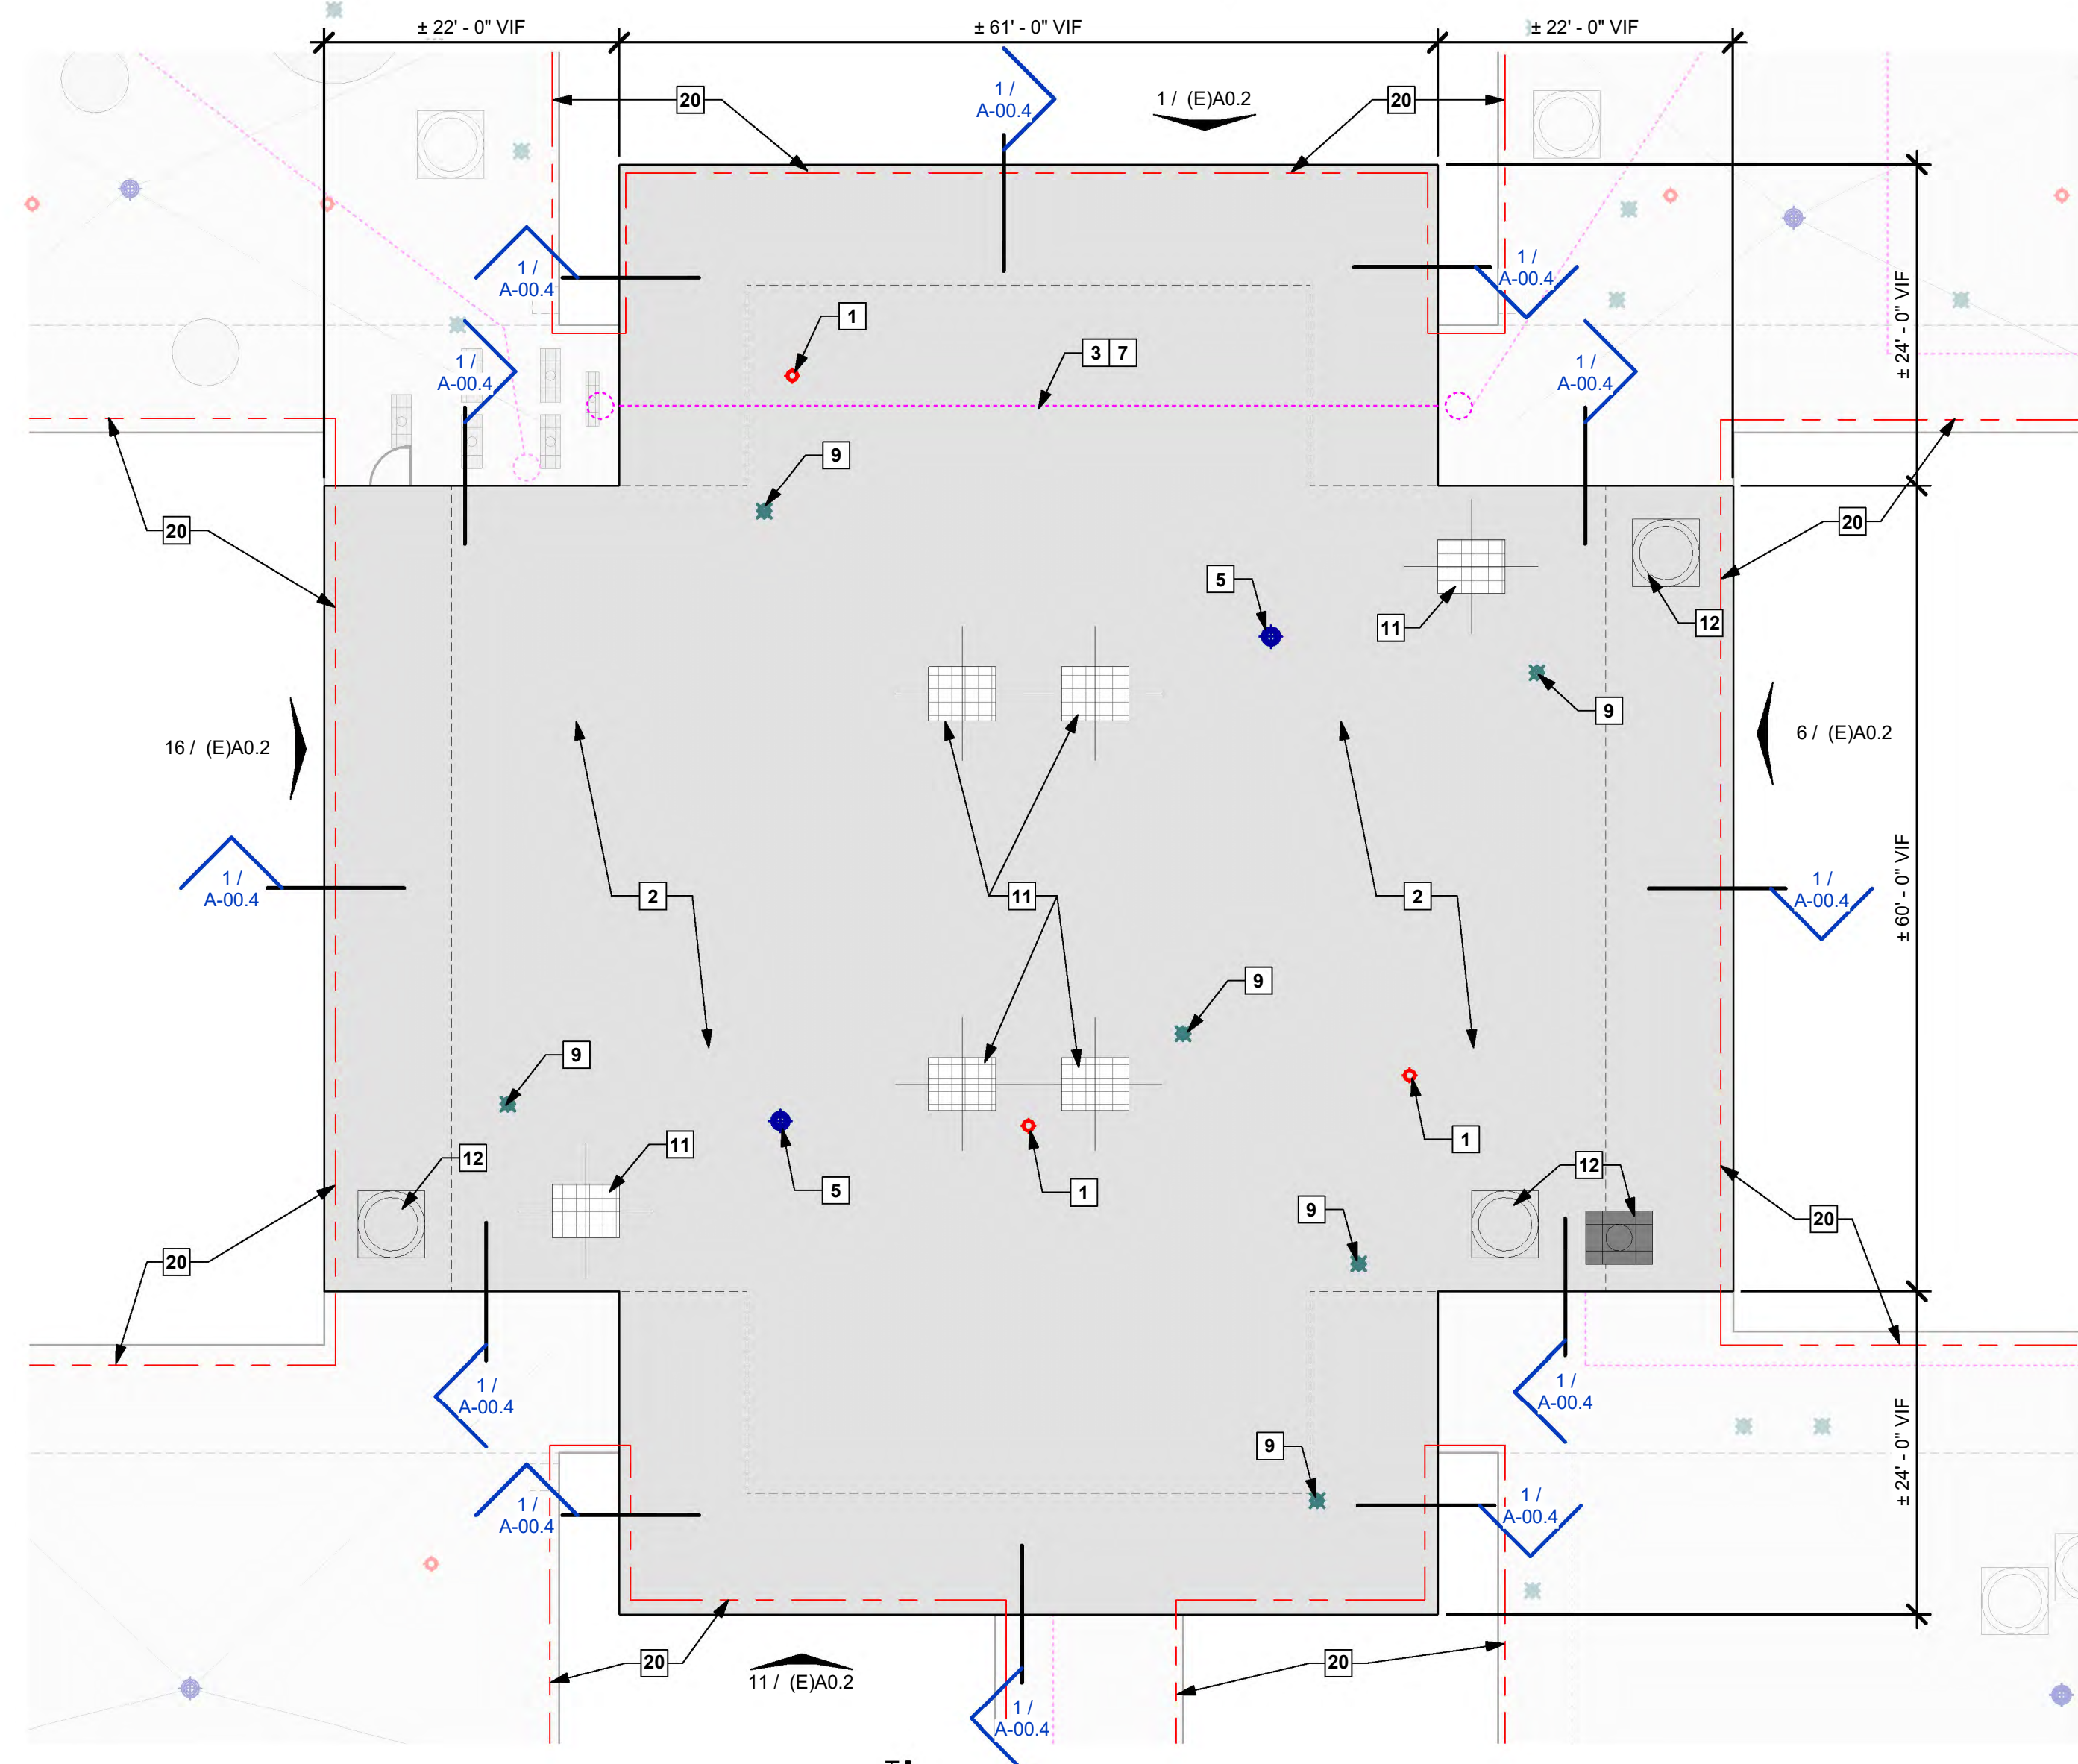
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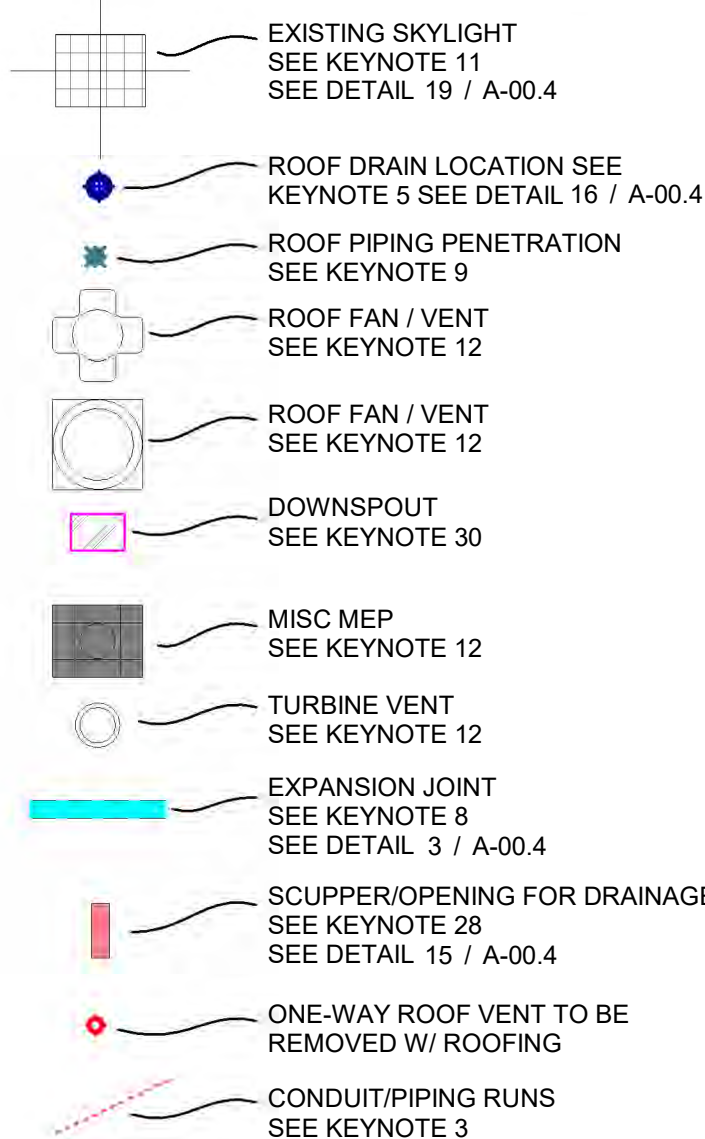


13 ROOF PLAN - BUILDING E
3/32" = 1'-0"



KEYNOTES

- PASSIVE AIR ROOF VENT REPLACEMENT:** EXISTING PASSIVE AIR ROOF VENT TO BE REMOVED.
- ROOF ASSEMBLY REPLACEMENT:** SHADED REGION INDICATES EXISTING ROOFING ASSEMBLY TO BE REMOVED TO EXISTING METAL ROOF DECKING SUBSTRATE BELOW, AND NEW ROOFING INSTALLED. ALL DEBRIS IS TO BE REMOVED FROM THE SITE. SEE SPECIFICATIONS FOR EXTENT OF DEMOLITION AND SITE CONSTRAINTS.
- RIGID CONDUIT REPAIR (VIF):** INDICATES EXISTING RIGID CONDUIT RUNS EXPOSED ON EXISTING ROOF. CONTRACTOR SHALL MAKE VISUAL INSPECTIONS ON SITE TO VERIFY THE EXTENT OF WORK WHICH BE REQUIRED TO MOVE AND RELOCATE THESE CONDUIT RUNS DURING THE PROCESS OF RE-ROOFING AND TO ENSURE THAT THE NEW ROOF SLOPES ARE INTEGRATED AND ACCOUNTED FOR WHERE EXTENSIONS OF THESE CONDUITS AND WIRING IS REQUIRED.
- ROOF CURB REPLACEMENT:** ALL EXISTING ROOF CURBS TO BE REMOVED AND REPLACED IN AREAS BEING RE-ROOFED.
- ROOF DRAIN REPAIR (VIF):** APPROXIMATE LOCATION OF EXISTING ROOF DRAIN. CONTRACTOR SHALL VISUALLY INSPECT ALL CONDITIONS REPLACE DAMAGED COMPONENTS AND ADJUST TO NEW ROOF SLOPE.
- FLASHING VIF:** SEE DETAILS FOR FLASHING AND COUNTERFLASHING WHICH IS TO TIE INTO THE EXISTING BUILDING ENVELOPE. VERIFY CLEARANCES AND LOCATIONS FOR INSTALLATION OF ALL FLASHING AND TERMINATION BARS AS DETAILED.
- RUNNER CURB INSTALLMENT:** PROVIDE NEW 'RUNNER CURBS' FOR SUPPORT OF ALL HARD PIPING WHICH IS TO REMAIN ON ROOF AFTER NEW INSTALLATION. SPACE CURBS AS REQUIRED SO CONDUIT AND PIPING DOES NOT SAG BETWEEN THESE LOCATIONS. INSTALL AS DETAILED.
- ROOF EXPANSION JOINT REPAIR (VIF):** INDICATES APPROXIMATE AREA AND LOCATION OF ROOF EXPANSION JOINT. CONTRACTOR SHALL VISUALLY INSPECT THE EXISTING CONDITIONS AT THE SITE AND PROVIDE A NEW EXPANSION JOINT AS DETAILED WITHIN THESE DOCUMENTS. THE INSTALLER SHOULD ASSUME THAT ALL EXISTING WOOD BLOCKING SHALL BE REPLACED WITH NEW TREATED WOOD BLOCKING AS PER DETAILS. PROVIDE NEW CANT STRIP, FLASHING, PRE-FINISHED EXPANSION JOINT COVER, VINYL BELLOWS, AND BASE FLASHING AS DETAILED. VERIFY EXACT ROUTING AND AREA WHERE THIS EJ IS TO BE REMOVED AND REPLACED. VERIFY ALL EXISTING CONDITIONS, ESPECIALLY ANY PIPING, AND CONDUIT WHICH MIGHT INTERSECT OR CROSS OVER THIS JOINT.
- PLUMBING VENT REPLACEMENT (VIF):** CONTRACTOR SHALL VISUALLY INSPECT ALL EXISTING ROOFING PLUMBING VENTS WHICH ARE TO REMAIN. CONFIRM HEIGHTS OF VENT PIPING AND EXTEND WHERE REQUIRED DUE TO INSTALLATION OF NEW TAPERED INSULATION. EXTEND ALL VENTS AS REQUIRED TO MAINTAIN VERTICAL CLEARANCES CALLED FOR ON EACH RELATED CONSTRUCTION DETAIL. REPLACE ALL LEAD VENT & PIPE FLASHING. TYPICAL ALL LOCATIONS.
- FLASHING REPLACEMENT:** REMOVE AND REPLACE FLASHING, COUNTERFLASHING AND PRE-FINISHED METAL FASCIA FLASHING AS DETAILED.
- SKYLIGHT REPLACEMENT:** INSTALL NEW ALUMINUM SKYLIGHT GUARD TO MATCH EXISTING.
- HVAC REPAIR (VIF):** INDICATES EXISTING HVAC EQUIPMENT AT EXISTING ROOF WHICH IS TO REMAIN. COORDINATE WORK INVOLVED WITH THIS EQUIPMENT AND NEW ROOFING ASSEMBLY SO AS TO NOT DISRUPT SERVICE TO THE EXISTING BUILDING. IF SERVICE IS REQUIRED TO BE TEMPORARILY SUSPENDED WHILE NEW WORK IS TAKING PLACE, THE CONTRACTOR SHALL COORDINATE ANY AND ALL OUTAGES WITH THE OWNER AND WILL BE REQUIRED TO ONLY PERFORM THIS WORK AT TIMES WHEN SUSPENSION OF THIS SERVICE MINIMALLY AFFECTS THE OWNERS USE OF THE BUILDING. IF THE SERVICE CANNOT BE SUSPENDED DURING OWNER'S OPERATING HOURS, WORK MAY HAVE TO BE PERFORMED AFTER HOURS, OR ON WEEKENDS.
- SATELLITE INSTALLATION:** SEE DETAILS FOR SATELLITE MOUNTING UNIT.
- "A" METAL PANEL REPLACEMENT:** METAL WALL PANEL "E" - REMOVE AND REPLACE DAMAGED/MISSING METAL WALL PANEL AS SPECIFIED. SEE BUILDING ELEVATIONS.
- SIGNAGE INSTALLATION:** INSTALL MISSING LETTERING TO MATCH EXISTING.
- ROOF ACCESSORY REPLACEMENT:** REPLACE DAMAGED ROOF ACCESSORIES. MATCH EXISTING TYPE, MATERIAL, AND STYLE.
- DOWNSPOUT AND GUTTER CLEANING:** DOWNSPOUT/COLLECTOR LOCATIONS. SEE ELEVATIONS. CONTRACTOR IS TO REMOVE ALL DEBRIS FROM GUTTERS AND DOWNSPOUTS.
- SATELLITE REMOVAL:** REMOVE ALL SATELLITE COMPONENTS. THESE ARE NO LONGER IN USE.
- COPING:** SEE ROOFING SHEETS FOR COPING, OVERHANG & ROOFING SCOPES - TYP.
- TEMPORARY CHAIN LINK FENCING -** PROVIDE 6' TEMPORARY CHAIN LINK FENCING TO PROTECT STUDENT TRAFFIC DURING CONSTRUCTION. PROVIDE ACCESS TO THE GREATEST EXTENT POSSIBLE. COORDINATE WITH PHASING AND SCHOOL PRINCIPAL.
- WIND TURBINE REPLACEMENT:** REMOVE AND REPLACE WIND TURBINE TO MATCH EXISTING.
- PAINTING EXTERIOR:** CLEAN, PREP & RE-PAINT WALLS AND ARTWORK TO COVER SCUFFS AND DAMAGE FROM STORM DEBRIS. COLOR TO MATCH EXISTING AS APPROVED BY ARCHITECT.
- GLASS REPLACEMENT:** REMOVE AND REPLACE DAMAGED GLASS (OR PLYWOOD WHERE APPLICABLE) TO MATCH EXISTING. PROVIDE CAULKING AND GASKETING.
- STUCCO SOFFIT REPLACEMENT:** SOFFIT REMOVED BY OTHERS (HAZARDOUS MATERIAL). COORDINATE AND INSTALL NEW STUCCO SOFFIT.
- COORDINATE REMOVAL OF AGGREGATE PANELS (HAZARDOUS MATERIAL)** WITH ABATEMENT SCOPE AND ABATEMENT CONTRACTOR. COORDINATE AND INSTALL NEW GFRC FACADE PANELS AS SPECIFIED. REMOVE AND REPLACE DAMAGED WALL FRAMING - SEE STRUCTURAL AND WALL SECTIONS. SALVAGE AND REINSTALL MEP COMPONENTS AT SAME LOCATIONS - COORDINATE WITH MEP.
- DOWNSPOUT AND GUTTER REPLACEMENT:** REMOVE REMAINING ATTACHMENTS AND COMPONENTS OF DOWNSPOUT, GUTTER AND CONDUCTOR HEADS AND INSTALL NEW TO MATCH EXISTING COLOR, DIMENSION, GAUGE, AND MATERIAL. GROUT HOLES AT OLD STRAPS PRIOR TO NEW INSTALLATION & ATTACH AT INTERVALS EQUAL TO EXISTING SPACING. SALVAGE AND PREP REMAINING COMPONENTS FOR NEW INSTALLATION. CONTRACTOR IS TO REMOVE ALL DEBRIS FROM GUTTERS AND DOWNSPOUTS.
- BRICK REPAIR:** REMOVE AND REPLACE BRICK FACADE AS INDICATED. DISPOSE OF OLD BRICK. MATCH NEW BRICK AND MORTAR TO EXISTING AS APPROVED BY ARCHITECT. PRESERVE SUBSTRATE. REMOVE OLD BRICK TIES AND WATER PROOFING. INSTALL NEW WATERPROOFING AND BRICK TIES AT A MIN. OF 24" O.C. VERTICAL AND HORIZONTAL.
- PLASTER SOFFIT REPLACEMENT:** REMOVE REMAINING VINYL SOFFIT AND REPLACE TO MATCH EXISTING - PRESERVE LIGHT & REINSTALL AS NECESSARY.

ROOFING SYMBOL LEGEND



SITE KEYPLAN
N.T.S.

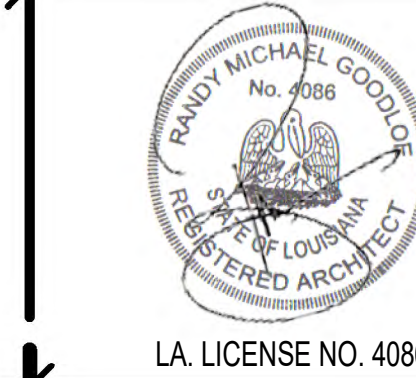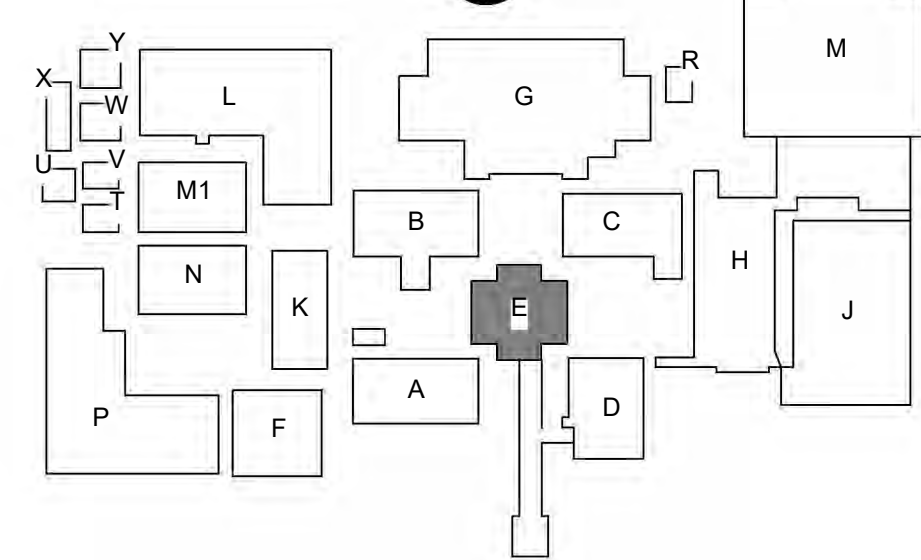


HURRICANE LAURA REPAIRS TO
A.M. BARBE HIGH SCHOOL
2200 W. McNEESE ST.
FOR
CALCASIEU PARISH SCHOOL BOARD
LAKE CHARLES, LA 70605
HL-003-01.03.04.05.06.07

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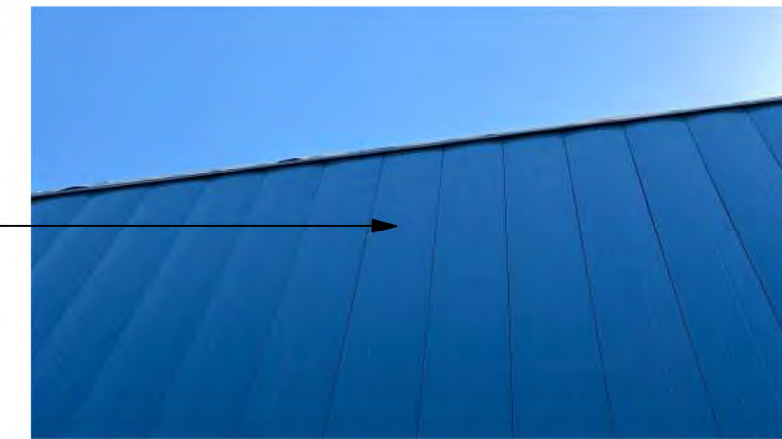
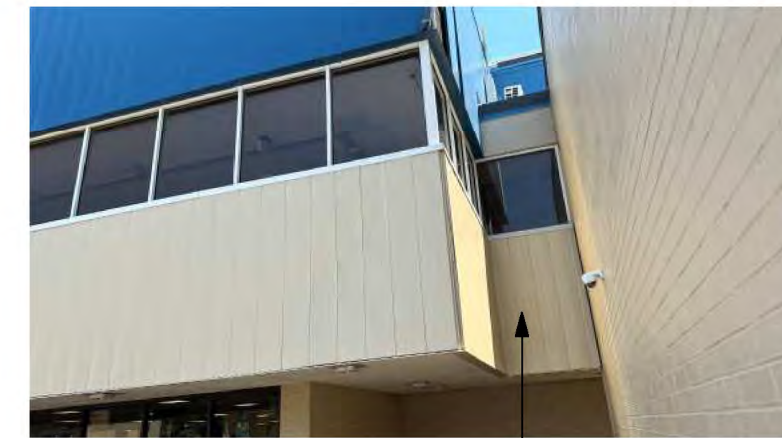
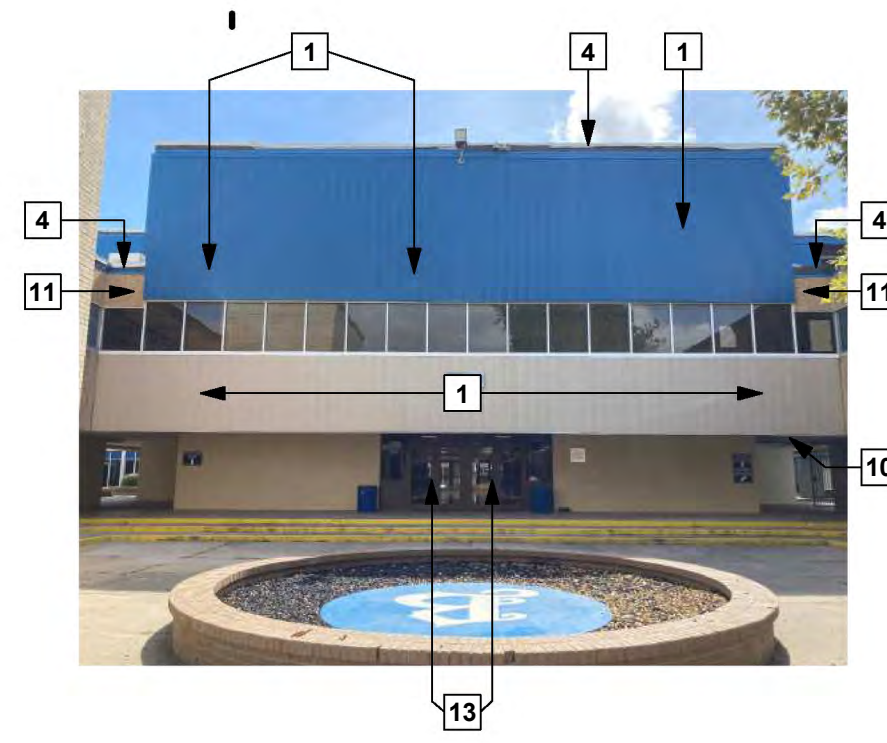
RMG PROJECT NO.
20042-01-G
OWNER PROJECT NO.
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DATE ISSUED
06/28/2024

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SHEET NUMBER
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KEYNOTES

- "A" METAL PANEL REPLACEMENT: METAL WALL PANEL "A" - REMOVE AND REPLACE DAMAGED/MISSING METAL WALL PANEL AS SPECIFIED. SEE BUILDING ELEVATIONS.
- DOWNSPOUT AND GUTTER REPLACEMENT: REMOVE REMAINING ATTACHMENTS AND COMPONENTS OF DOWNSPOUT, GUTTER AND CONDUCTOR HEADS AND INSTALL NEW TO MATCH EXISTING COLOR, DIMENSION, GAUGE, AND MATERIAL. GROUT HOLES AT OLD STRAPS PRIOR TO NEW INSTALLATION & ATTACH AT INTERVALS EQUAL TO EXISTING SPACING. SALVAGE AND PREP REMAINING COMPONENTS FOR NEW INSTALLATION. CONTRACTOR IS TO REMOVE ALL DEBRIS FROM GUTTERS AND DOWN SPOUTS.
- COPING: SEE ROOFING SHEETS FOR COPING, OVERHANG & ROOFING SCOPES - TYP.
- EXISTING LIGHT FIXTURE - CONTRACTOR IS TO WEATHER SEAL FIXTURE AT METAL WALL PANEL.
- NOT USED.
- BRICK REPAIR: REMOVE AND REPLACE BRICK FACADE AS INDICATED. DISPOSE OF OLD BRICK. MATCH NEW BRICK AND MORTAR TO EXISTING AS APPROVED BY ARCHITECT. PRESERVE SUBSTRATE. REMOVE OLD BRICK TIES AND WATER PROOFING. INSTALL NEW WATERPROOFING AND BRICK TIES AT A MIN. OF 24" O.C. VERTICAL AND HORIZONTAL.
- PAINTING EXTERIOR: CLEAN, PREP & RE-PAINT WALLS AND ARTWORK TO EXISTING AS APPROVED BY ARCHITECT.
- GLASS REPLACEMENT: REMOVE AND REPLACE DAMAGED GLASS (OR PLYWOOD WHERE APPLICABLE) TO MATCH EXISTING. PROVIDE CAULKING AND GASKETING.
- STUCCO SOFFIT REPLACEMENT: SOFFIT REMOVED BY OTHERS (HAZARDOUS MATERIAL), COORDINATE AND INSTALL NEW STUCCO SOFFIT.
- AGGREGATE PANEL REPLACEMENT: DELAMINATED & DAMAGED AGGREGATE PANELS REMOVED BY OTHERS (HAZARDOUS MATERIAL), COORDINATE AND INSTALL NEW FACADE PANEL AS SPECIFIED. REINSTALL MEP COMPONENTS AT SAME LOCATIONS.
- CONDUIT REPAIR: REPAIR CONDUIT AND MEP EQUIPMENT TO WORKING ORDER PER MEP DOCUMENTS.
- GLAZING REPLACEMENT: REMOVE DAMAGED GLAZING SYSTEM AND REPLACE WITH NEW TO MATCH EXISTING AS SPECIFIED. PROVIDE NEW CONTINUOUS 4X4 STEEL ANGLE WELDED TO STRUCTURE FOR SUPPORT.
- DOOR REPLACEMENT: REMOVE REMAINING DOOR DEBRIS AND COVERINGS AND REPLACE TO MATCH EXISTING, INCLUDING FRAMES, HARDWARE, AND GASKETING. SEE DOOR SCHEDULE.
- METAL PANEL REPLACEMENT: REMOVE REMAINING DAMAGED METAL PANEL ASSEMBLY AND REPLACE WITH NEW SYSTEM TO MATCH EXISTING. COORDINATE REMOVAL AND INSTALLATION TO PREVENT WEATHER INTRUSION.
- SOFFIT PANEL REPLACEMENT: REMOVE AND REPLACE SOFFIT PANELS TO MATCH EXISTING - APPROX. 3'X3' PANELS.
- GLASS AND GLAZING REPLACEMENT: REMOVE AND DISPOSE OF MESH, BROKEN & REMAINING GLASS AND GLAZING - REPLACE WITH SOLID PANELS AS SPECIFIED.
- DOWNSPOUT AND GUTTER CLEANING: DOWNSPOUT/COLLECTOR LOCATIONS. CONTRACTOR IS TO REMOVE ALL DEBRIS FROM GUTTERS AND DOWN SPOUTS.
- GUTTER REPAIR - RESEAL ALL JOINTS, PROVIDE ALL RIVETS

WINDOW SCHEDULE

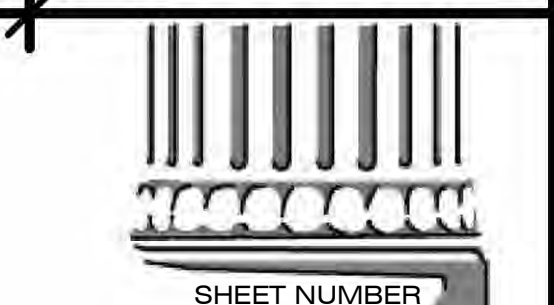MARK	SIZE	FRAME		COMMENTS
		TYPE	MATERIAL	
N1	SEE ELEVATION	STOREFRONT	ALUMINUM, ANODIZED, DARK BRONZE	REPLACE ENTIRE UNIT
N2	SEE ELEVATION	STOREFRONT	ALUMINUM, ANODIZED, DARK BRONZE	REPLACE ENTIRE UNIT
S1	SEE ELEVATION	STOREFRONT	ALUMINUM, ANODIZED, DARK BRONZE	REPLACE ENTIRE UNIT
S2	SEE ELEVATION	STOREFRONT	ALUMINUM, ANODIZED, DARK BRONZE	REPLACE ENTIRE UNIT

DOOR SCHEDULE

MARK	OPENING SIZE		HARDWARE	DOOR			FRAME		GLASS	COMMENTS
	WIDTH	HEIGHT		TYPE	MATERIAL	FINISH	MATERIAL	FINISH		
E101A	6'-0"	7'-0"	H-1	STOREFRONT	ALUMINUM	DARK BRONZE	ALUMINUM	DARK BRONZE	G3	REPLACE ENTIRE UNIT
E101B	6'-0"	7'-0"	H-1	STOREFRONT	ALUMINUM	DARK BRONZE	ALUMINUM	DARK BRONZE	G3	REPLACE ENTIRE UNIT
E101C	6'-0"	7'-0"	H-1	STOREFRONT	ALUMINUM	DARK BRONZE	ALUMINUM	DARK BRONZE	G3	REPLACE ENTIRE UNIT
E101D	6'-0"	7'-0"	H-1	STOREFRONT	ALUMINUM	DARK BRONZE	ALUMINUM	DARK BRONZE	G3	REPLACE ENTIRE UNIT





DOOR HARDWARE

H-1 - STORM RATED UNIT - MUST BE SUPPLIED BY DOOR MANUFACTURER FROM TESTED UNITS AVAILABLE. CONTINUOUS HINGES, WEATHER STRIPPING, THRESHOLD, SILENCERS, HEAD/FOOT BOLT, FIRE EXIT DEVICE WITH LEVER SET, CLOSERS.


GLAZING SCHEDULE

G1 - CLEAR, INSULATED GLASS AS SPECIFIED.
 G2 - SPANDRAL GLASS AS SPECIFIED.
 G3 - TINTED, INSULATED GLASS AS SPECIFIED.
 G4 - ALUMINUM WINDOW PANEL AS SPECIFIED.

*GLAZING OF NEW STOREFRONT UNITS ARE TO BE LARGE MISSILE IMPACT AS SPECIFIED. REPLACEMENT GLAZING IS TO MATCH EXISTING.

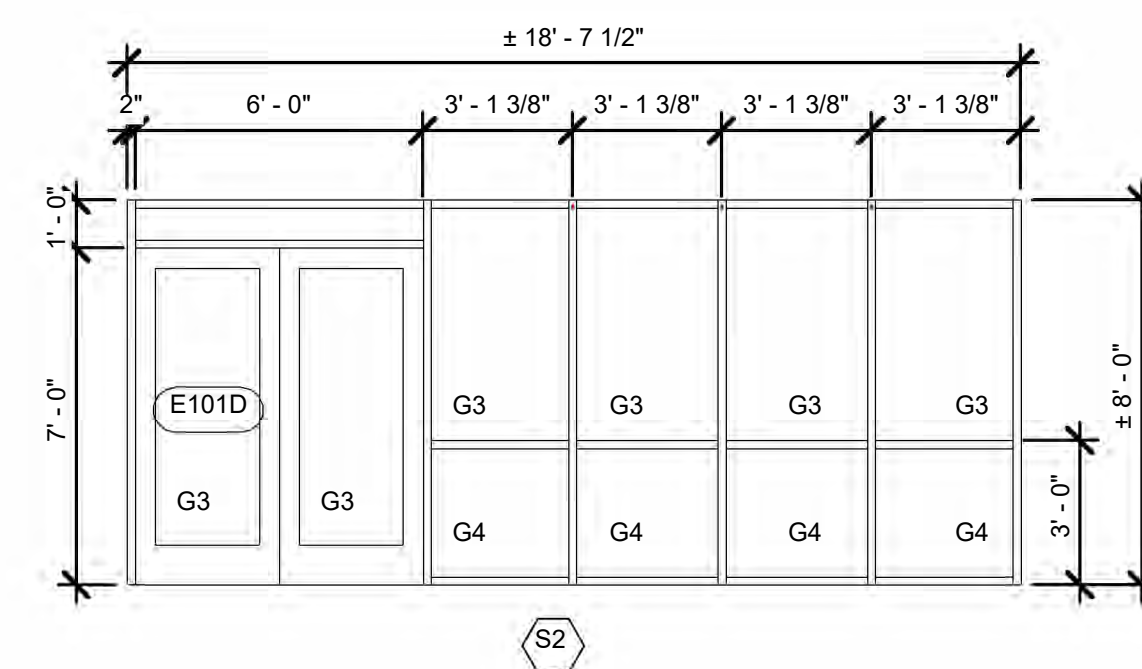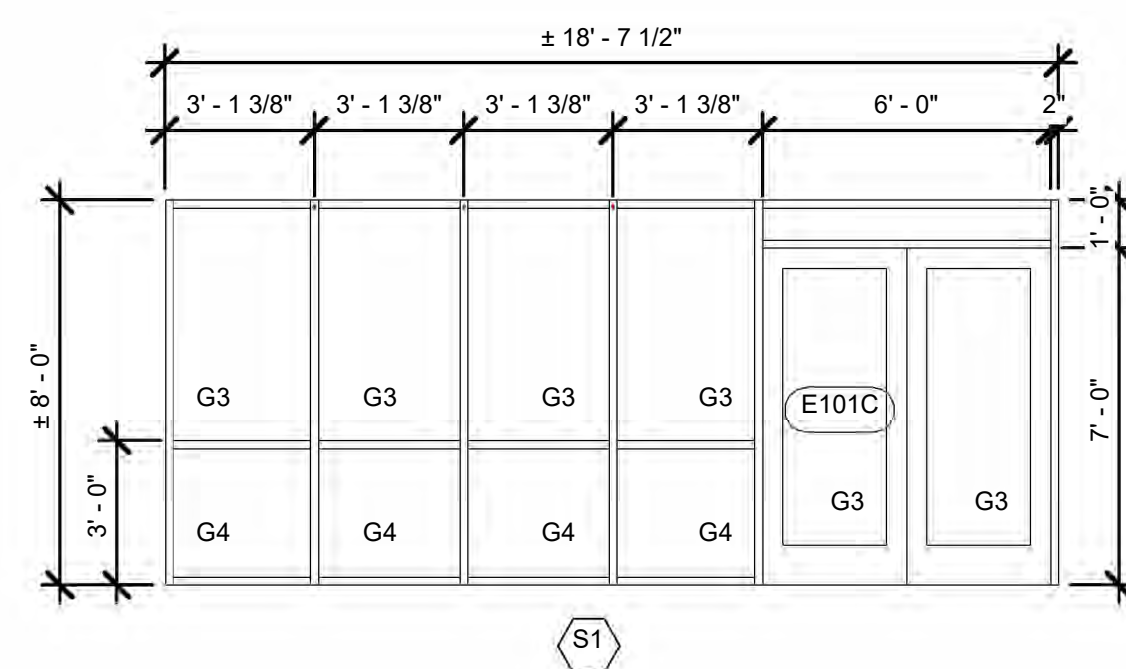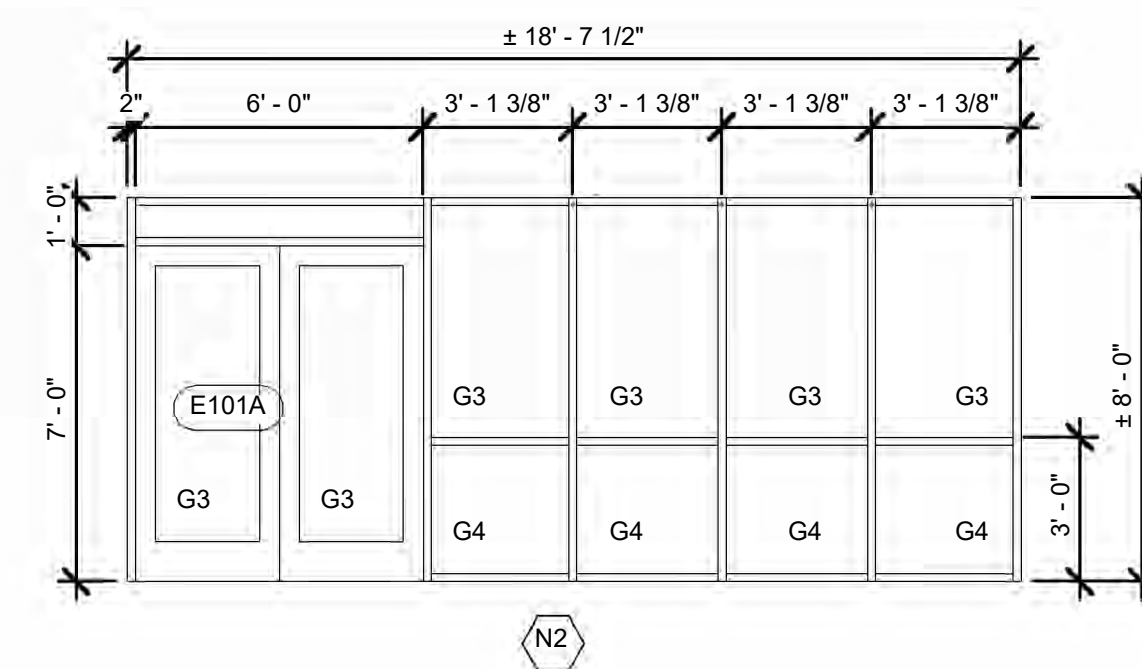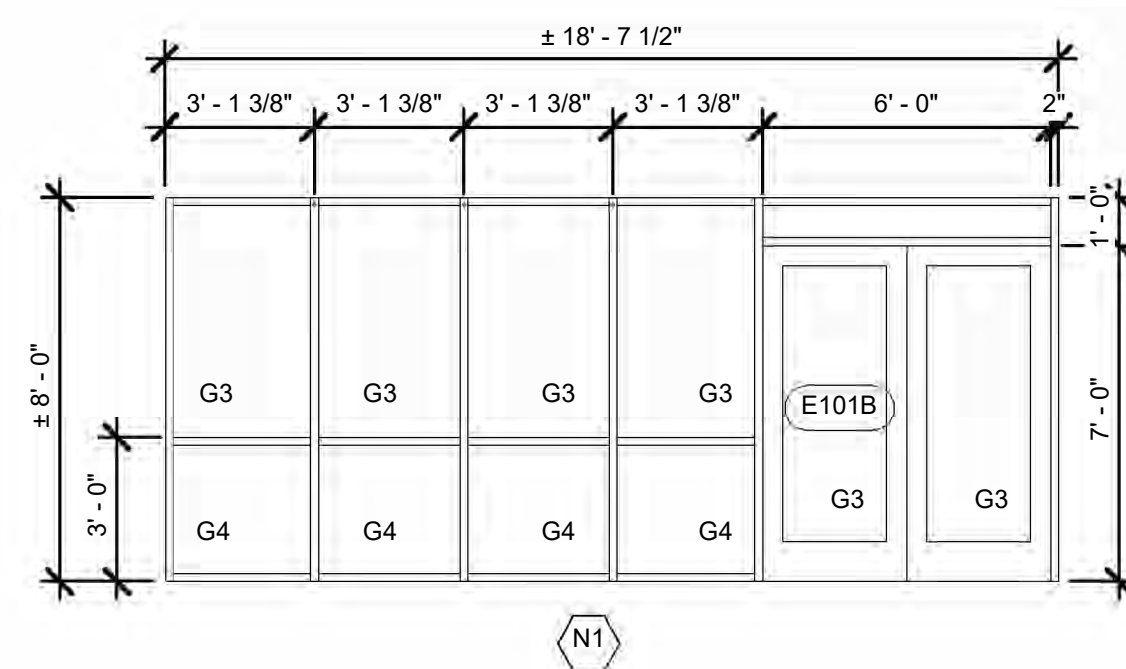

SITE KEYPLAN

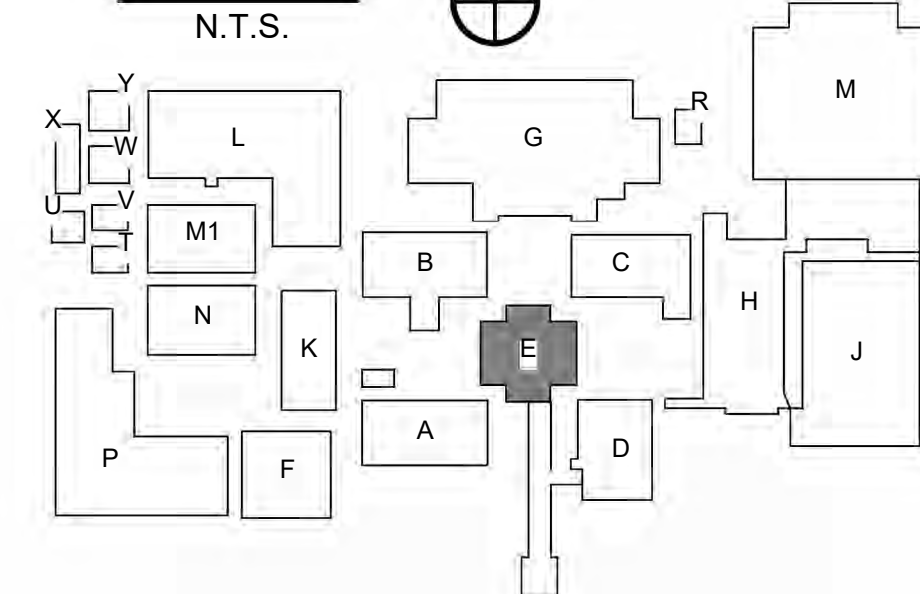

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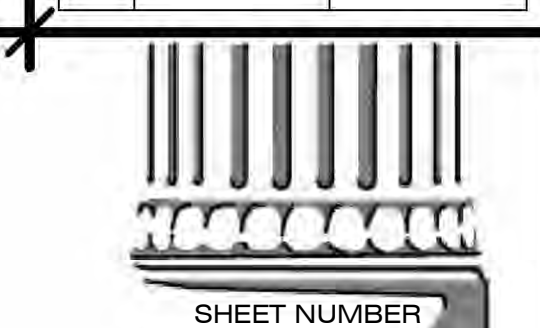
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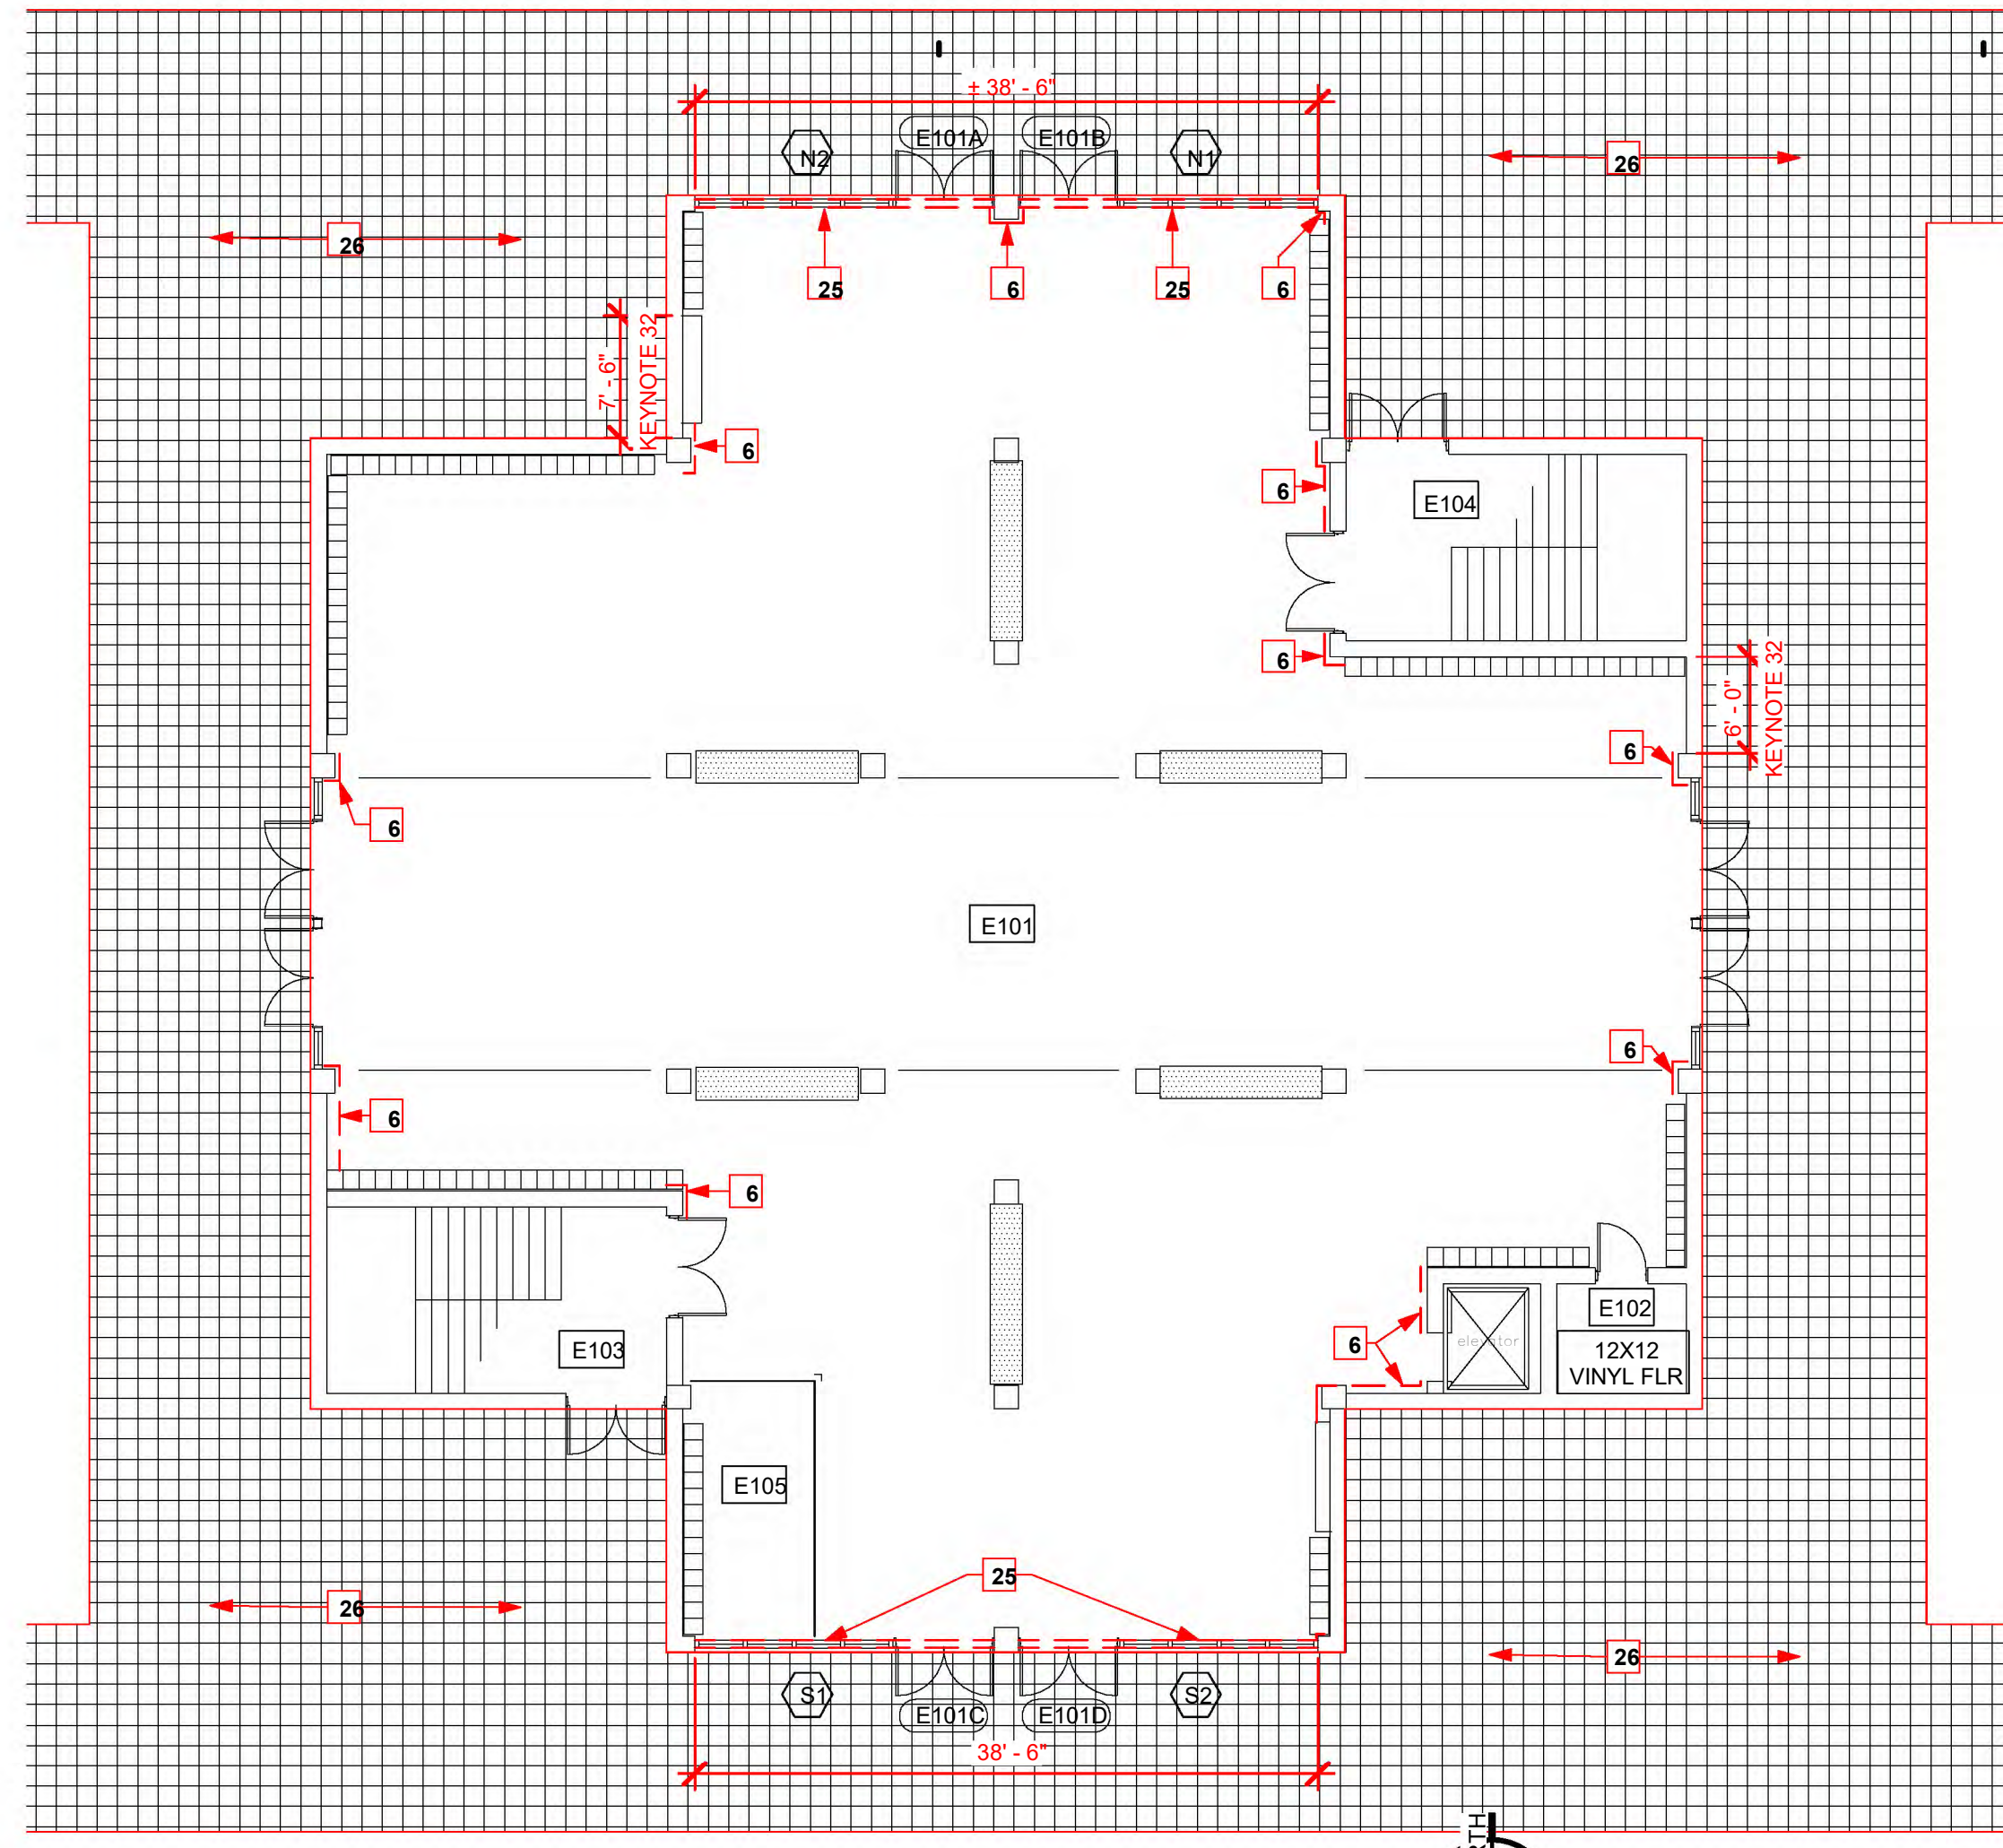
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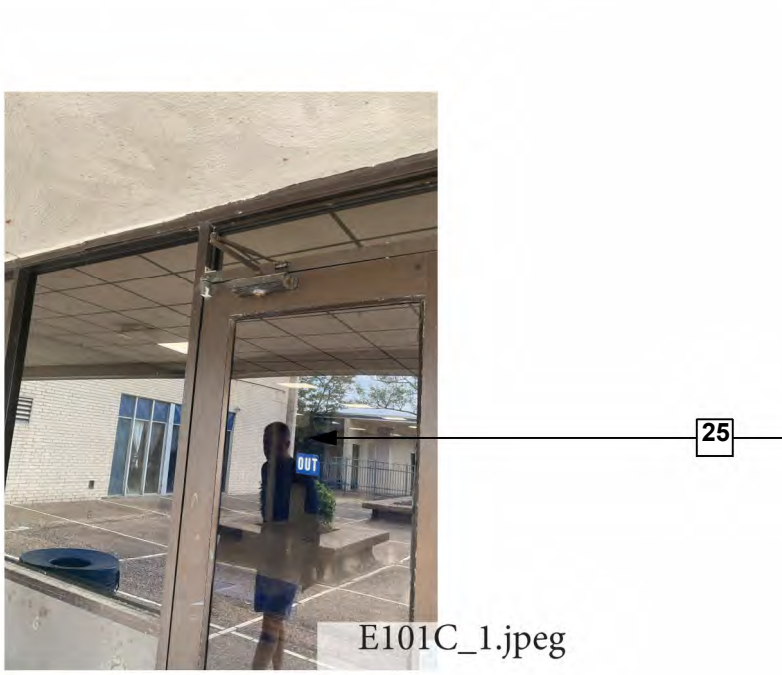
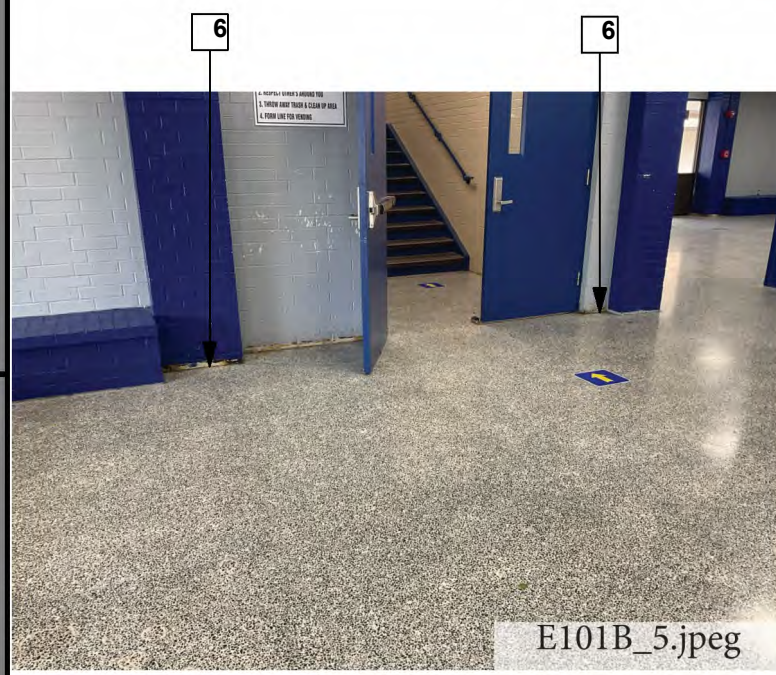
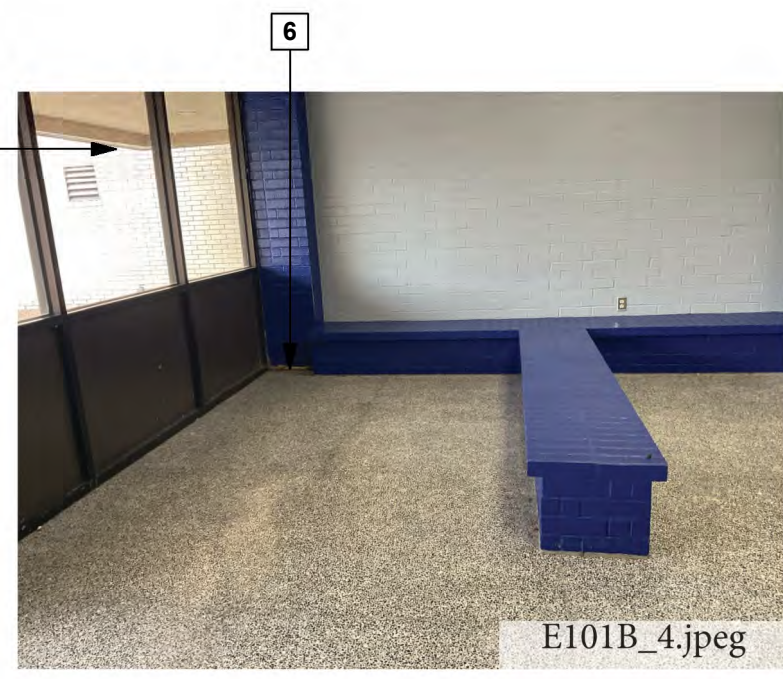
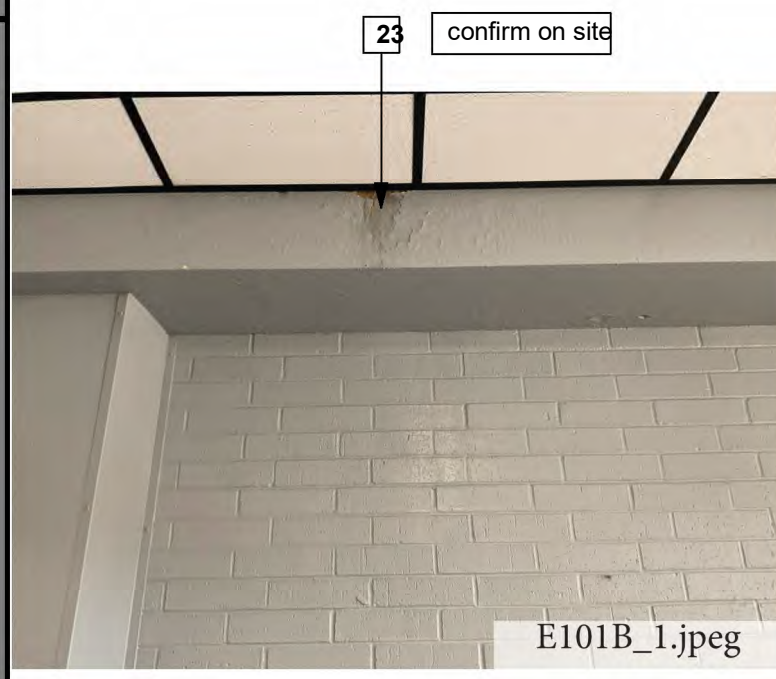
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 BUILDING E
 REFERENCE IMAGES




6 BUILDING E - 1ST FLOOR
3/32" = 1'-0"



ROOMS - BUILDING E1		
ROOM NUMBER	Area	Perimeter
E101	5578 SF	356' - 4"
E105	145 SF	49' - 4"

THESE MEASUREMENTS ARE APPROXIMATE TO BE USED AS GUIDELINES ONLY. CONTRACTOR IS RESPONSIBLE FOR ALL FINAL MEASUREMENTS.

FLOOR PLAN LEGEND	
	- CEILING REPAIR REQUIRED
	- FLOORING REPAIR REQUIRED. SEE ROOM SCHEDULE.
	- WALL/BASE REPAIR REQUIRED. SEE ROOM SCHEDULE.
	- MILLWORK REPAIR REQUIRED. SEE ROOM SCHEDULE.

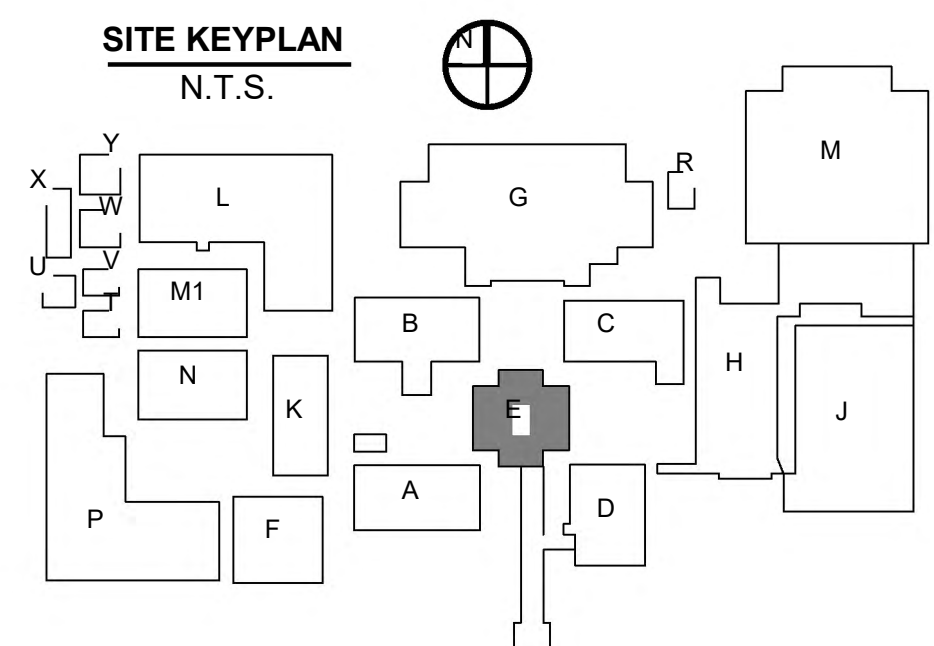

- KEYNOTES:**
- SUSPENDED ACOUSTIC CEILING REPLACEMENT:** REMOVE AND REPLACE DAMAGED CEILING GRID AND CEILING TILE AS SPECIFIED.
 - CEILING GRID:** REMOVE AND REPLACE DAMAGED CEILING GRID. MATCH EXISTING. SEE UNIT PRICE NO. 5.
 - VCT FLOORING REPAIRS:** REMOVE AND REPLACE VCT FLOORING AS SPECIFIED IN AREAS WHERE INDICATED. SEE UNIT PRICE NO. 3.
 - WINDOW REPAIRS:** REPLACE BROKEN WINDOW PANES, BLOCKS, AND GASKETS TO MATCH EXISTING. ALL SEALANTS SHALL BE REMOVED AND REPLACED AS SPECIFIED TO ENSURE WEATHER TIGHT SEAL. SEE ELEVATIONS.
 - STRUCTURAL CLAY BLOCK:** GLAZED STRUCTURAL CLAY BLOCK TO BE REMOVED AND REPLACED AS SPECIFIED TO MATCH EXISTING. CLEAN ALL CHALKING RESIDUE FROM EFFERVESCENCE.
 - VINYL BASE REPLACEMENT:** REPLACE DAMAGED OR MISSING BASE AS SPECIFIED TO MATCH EXISTING. SEE UNIT PRICE NO. 4.
 - CARPET REPAIRS:** DAMAGED CARPET HAS BEEN REMOVED. CLEAN FLOOR AND INSTALL NEW CARPET TILE AS SPECIFIED.
 - PAINTING:** WALL SURFACE IS TO BE SANDED, PREPARED, AND REPAINT TO MATCH EXISTING CORNER TO CORNER. WATER STAINED WALL FROM ROOF LOSS.
 - PAINTED CEILING STRUCTURE:** CEILING INCLUDING METAL TRUSSES ARE TO BE CLEANED, PREPPED, AND REPAINTED END TO END TO MATCH EXISTING COLOR.
 - VCT FLOORING CLEANING:** CLEAN WATER STAINS FROM VCT FLOORING TO REMOVE ANY DISCOLORATION WHERE INDICATED. MOP AND WAX ALL VCT FLOORING AT THE END OF CONSTRUCTION.
 - SKYLIGHT REPAIRS:** REMOVE AND REPLACE SKYLIGHT TO MATCH EXISTING.
 - TERRAZZO FLOORING CLEANING:** CLEAN AND POLISH EXISTING TERRAZZO FLOORING. REFER TO ROOM SCHEDULE FOR CLARITY.
 - CEILING TILE REPLACEMENT:** REMOVE AND REPLACE DAMAGED OR MISSING ACOUSTIC CEILING TILE WITH NEW CEILING TILE AS SPECIFIED IN AREAS INDICATED. MATCH EXISTING TYPE AND SIZE. SEE UNIT PRICE NO. 1. INSTALL R-30 BATT INSULATION OVER TILE. SEE UNIT PRICE NO. 2.
 - NOT USED.**
 - EXTERIOR WINDOWS AND DOORS:** CAULK AND RESEAL PERIMETER OF EXISTING WINDOWS AND DOORS.
 - CMU REPAIR:** RE-POINT DAMAGED CMU JOINTS AS SHOWN. PAINT WALL FROM END TO END IN COLOR TO MATCH EXISTING AS SPECIFIED. SEE PHOTOS.
 - BRICK REPAIR:** CAULK CRACKED AREAS AND REPAIR.
 - LOCKERS:** REPLACE DAMAGED UNITS AS SHOWN. MATCH EXISTING STYLE, SIZE AND COLORS.
 - BRICK WALLS:** CLEAN ALL WATER STAINS FROM ENTIRE BRICK WALL.
 - SHELVING REPLACEMENT:** REMOVE AND REPLACE DAMAGED SHELVING UNITS WITH GLASS DOORS. MATCH EXISTING MATERIALS, FINISHES AND CONSTRUCTION STYLE.
 - BASE CABINET:** REMOVE AND REPLACE DAMAGED BASE CABINET. MATCH EXISTING STYLE, SIZE, AND CONSTRUCTION. SALVAGE AND REINSTALL COUNTERTOP.
 - SECTIONAL DOOR:** REMOVE AND REPLACE OVERHEAD SECTIONAL DOOR AS SPECIFIED. CONTRACTOR TO PROVIDE ANY ADDITIONAL SUPPORT REQUIRED BY THE MANUFACTURER.
 - GYPNUM BOARD:** REMOVE AND REPLACE DAMAGED GYPNUM BOARD TO NEAREST FRAMING MEMBER. FINISH AND RE-PAINT WALL CORNER TO CORNER.
 - PREFINISHED GYPNUM BOARD WITH VINYL WALL COVER AND CORNER TRIM:** REMOVE AND REPLACE DAMAGED VINYL COVERED GYPNUM BOARD FROM FLOOR TO CEILING WHERE INDICATED ON FLOOR PLAN.
 - STOREFRONT WINDOW:** REMOVE AND REPLACE STOREFRONT WINDOW AS SPECIFIED.
 - STUCCO SOFFIT:** REMOVE & REPLACE STUCCO SOFFIT. COORDINATE WITH ABATEMENT SCOPE & ABATEMENT CONTRACTOR TO ENSURE WEATHER-TIGHTNESS AND PHASING COORDINATION. SEE WALL SECTIONS & DETAILS.
 - GYPNUM CEILING REPAIRS:** REMOVE AND REPLACE DAMAGED GYPNUM CEILING BOARD TO NEAREST FRAMING MEMBER WHERE INDICATED. FINISH TO MATCH EXISTING AS SPECIFIED.
 - METAL ROOF PANEL REPAIRS:** REMOVE AND REPLACE DEFORMED OR MISSING METAL ROOF PANELS TO MATCH EXISTING.
 - CONCRETE FLOOR CLEANING:** CLEAN AND RESEAL FLOOR AS SPECIFIED.
 - BASE CABINET:** REMOVE AND REPLACE DAMAGED BASE CABINET. MATCH EXISTING STYLE, SIZE, AND CONSTRUCTION. SALVAGE AND REINSTALL COUNTERTOP. PROTECT ALL MECHANICAL CONNECTIONS.
 - TILE CLEANING:** CLEAN STAINS FROM WALL TILE TO REMOVE ANY DISCOLORATION WHERE INDICATED.
 - CLEAN/REPAINT MASONRY WALL:** MECHANICALLY REMOVE ALL LOOSE OR PEELING PAINT AND ALL CHALKING RESIDUE FROM EFFERVESCENCE FROM CORNER TO CORNER. PERFORM REQUIRED MOISTURE TESTING PRIOR TO REPAINTING WALL AS SPECIFIED.
 - PLASTER CEILING REPAIRS:** REMOVE AND REPLACE DAMAGED PLASTER CEILING WHERE INDICATED AS SPECIFIED. PAINT IN COLOR TO MATCH EXISTING.
 - MEP DAMAGES:** SEE MECHANICAL, PLUMBING AND ELECTRICAL PLANS.
 - FURNITURE SETTING AND RESETTING:** RELOCATE ALL EXISTING FURNITURE TO TEMPORARY ROOM IN MODULAR BUILDINGS WHILE EXISTING SPACE IS BEING REPAIRED. REINSTALL AND RESET FURNITURE ONCE REPAIRS ARE COMPLETE. SEE PHASING PLAN.
 - SUSPENDED CEILING INSULATION:** INSTALL R-19 BATT INSULATION AS SPECIFIED ABOVE PREVIOUSLY INSTALLED SUSPENDED CEILING TILE. SEE UNIT PRICE NO. 2.
 - BRICK WALL REPLACEMENT:** REMOVE AND REPLACE BRICK WALL AS INDICATED. DISPOSE OF OLD BRICK, MATCH NEW BRICK AND MORTAR TO EXISTING AS APPROVED BY ARCHITECT. SEE STRUCTURAL. BUILDING TO REMAIN WEATHERPROOF AND CONDITIONED DURING REPAIRS.
 - DOOR REPAIR:** CLEAN, PREP AND RE-PAINT DOOR FRAME - SEE DOOR SCHEDULE.
 - CORRIDOR WALL REPAIR:** REMOVE DAMAGED STOREFRONT WINDOW AND EXISTING 3/4" PLYWOOD SHEATHING BELOW WINDOW. INSTALL NEW WINDOW PER SCHEDULE AND NEW 3/4" PLYWOOD SHEATHING. PAINT AS SPECIFIED, IN COLOR AS SELECTED. SEE DETAILS.
 - GLAZING REPAIR:** REMOVE AND REPLACE BROKEN GLASS. MATCH EXISTING TINT. PROVIDE SAFETY GLASS AS REQUIRED.
 - DOOR REPAIR:** REMOVE AND REPLACE EXISTING LEFT DOOR LEAF. PROVIDE AN INSULATED HOLLOW METAL DOOR WITH VISION PANEL TO MATCH RIGHT DOOR LEAF. REINSTALL EXISTING DOOR HARDWARE. PAINT AS DIRECTED.

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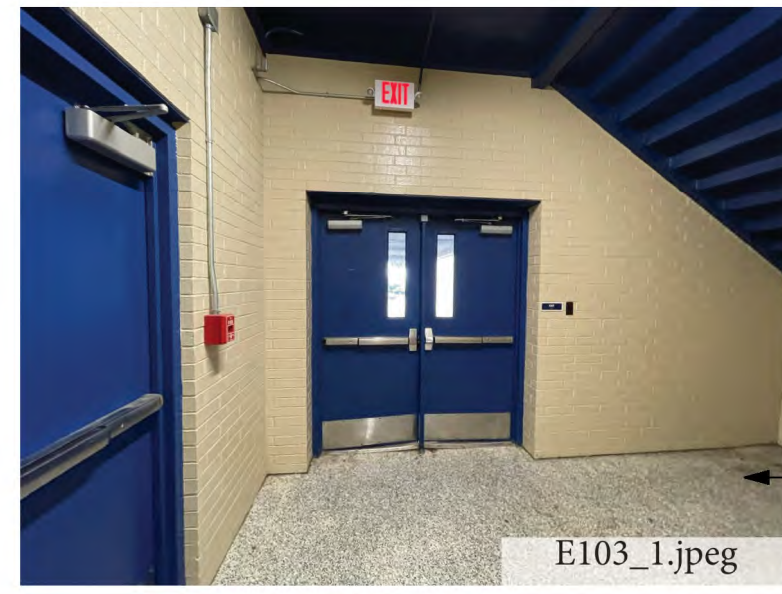
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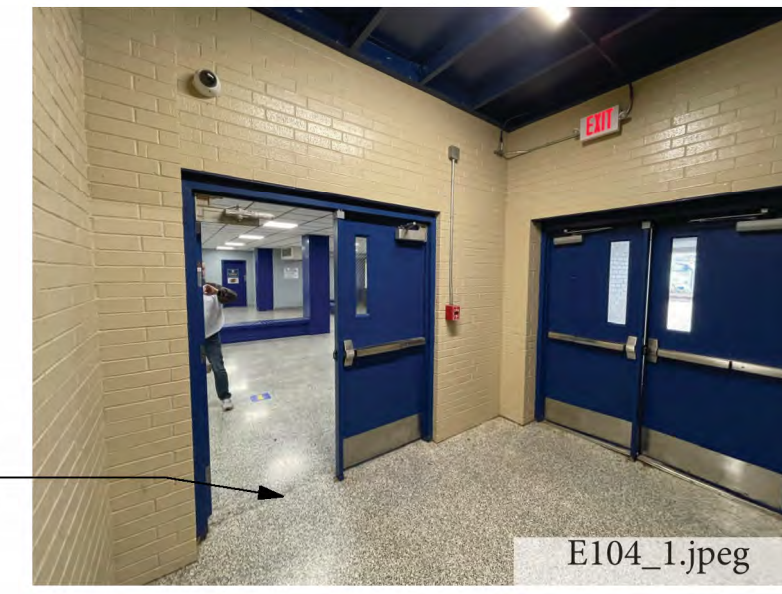
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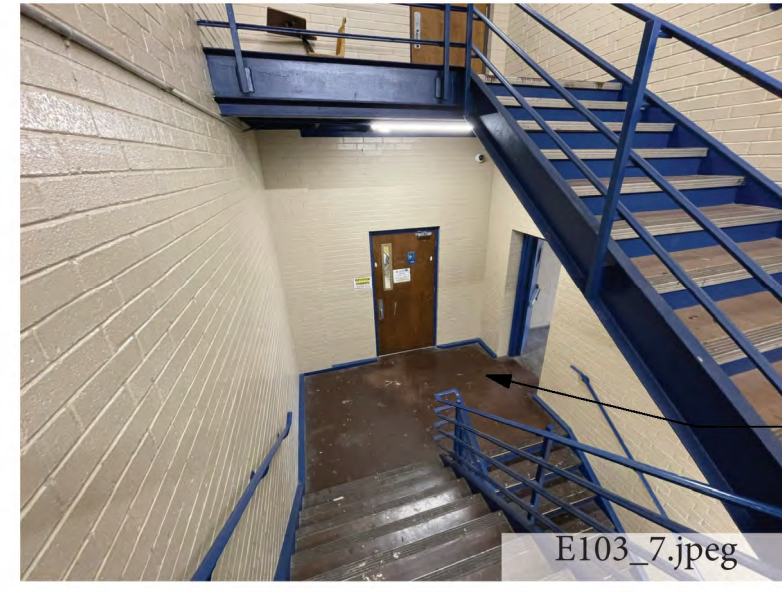
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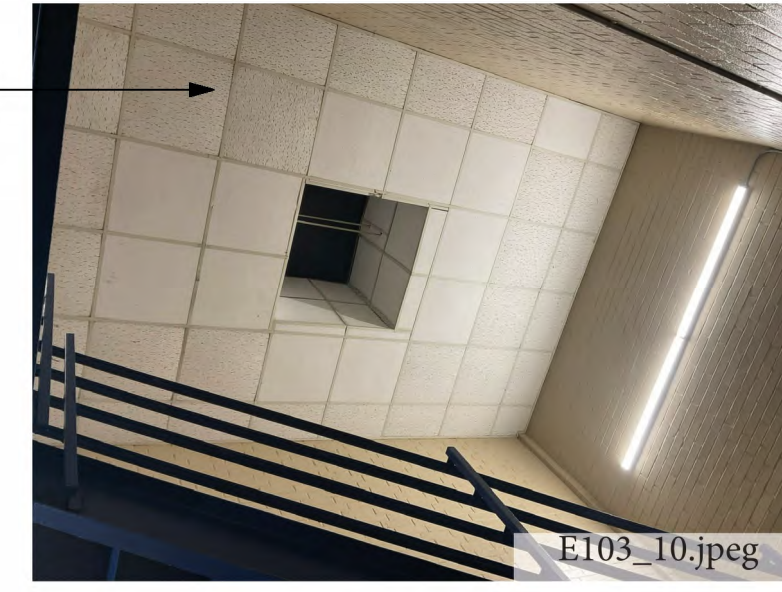
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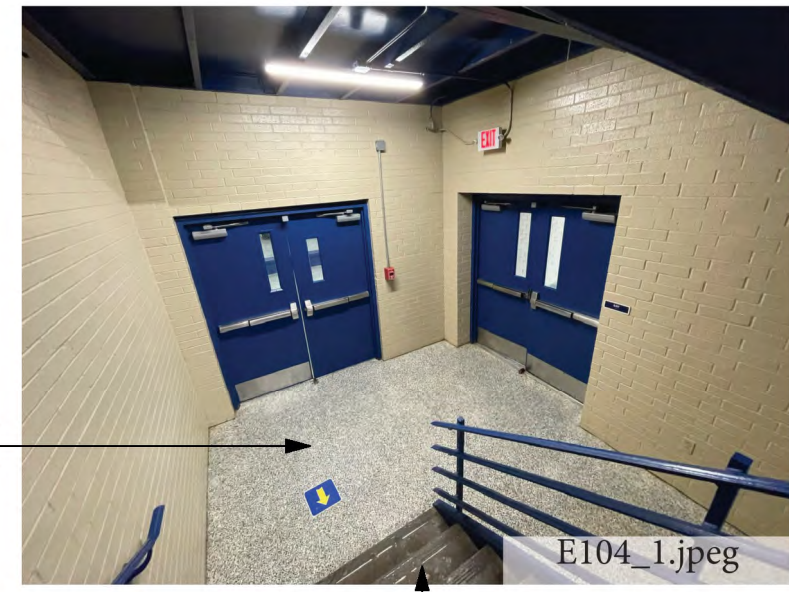
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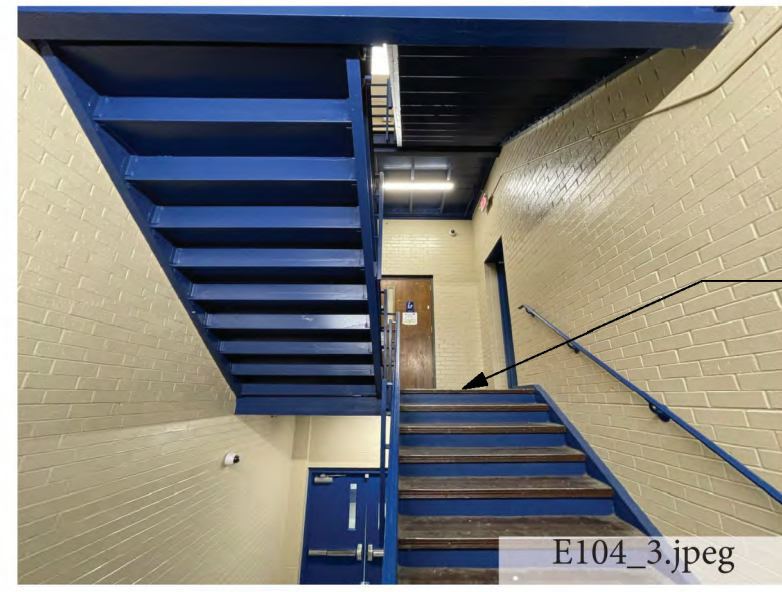
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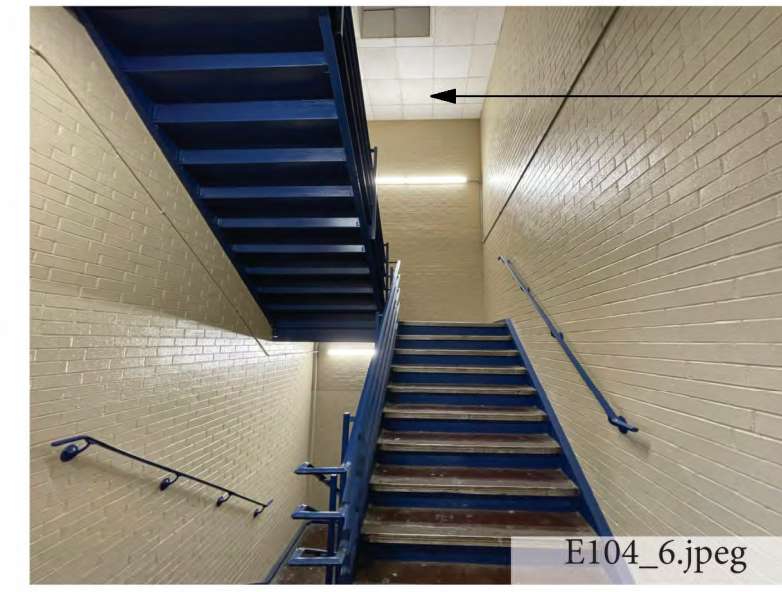
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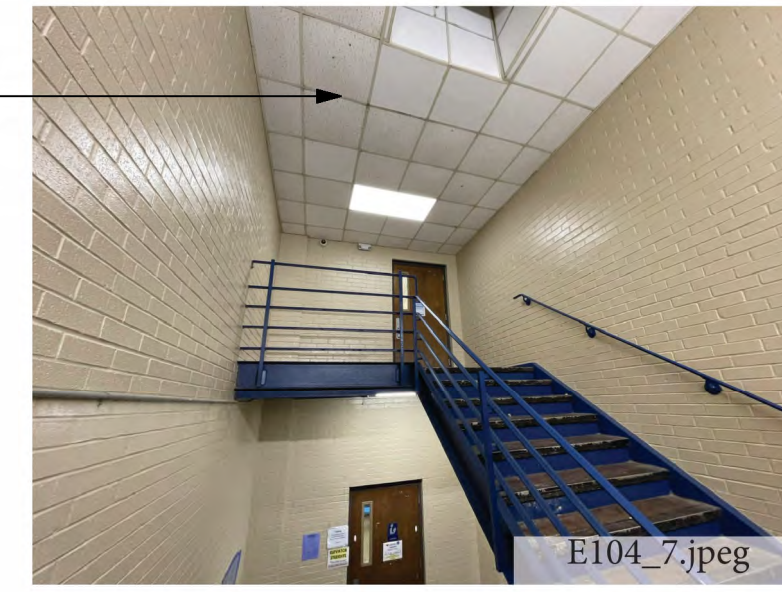
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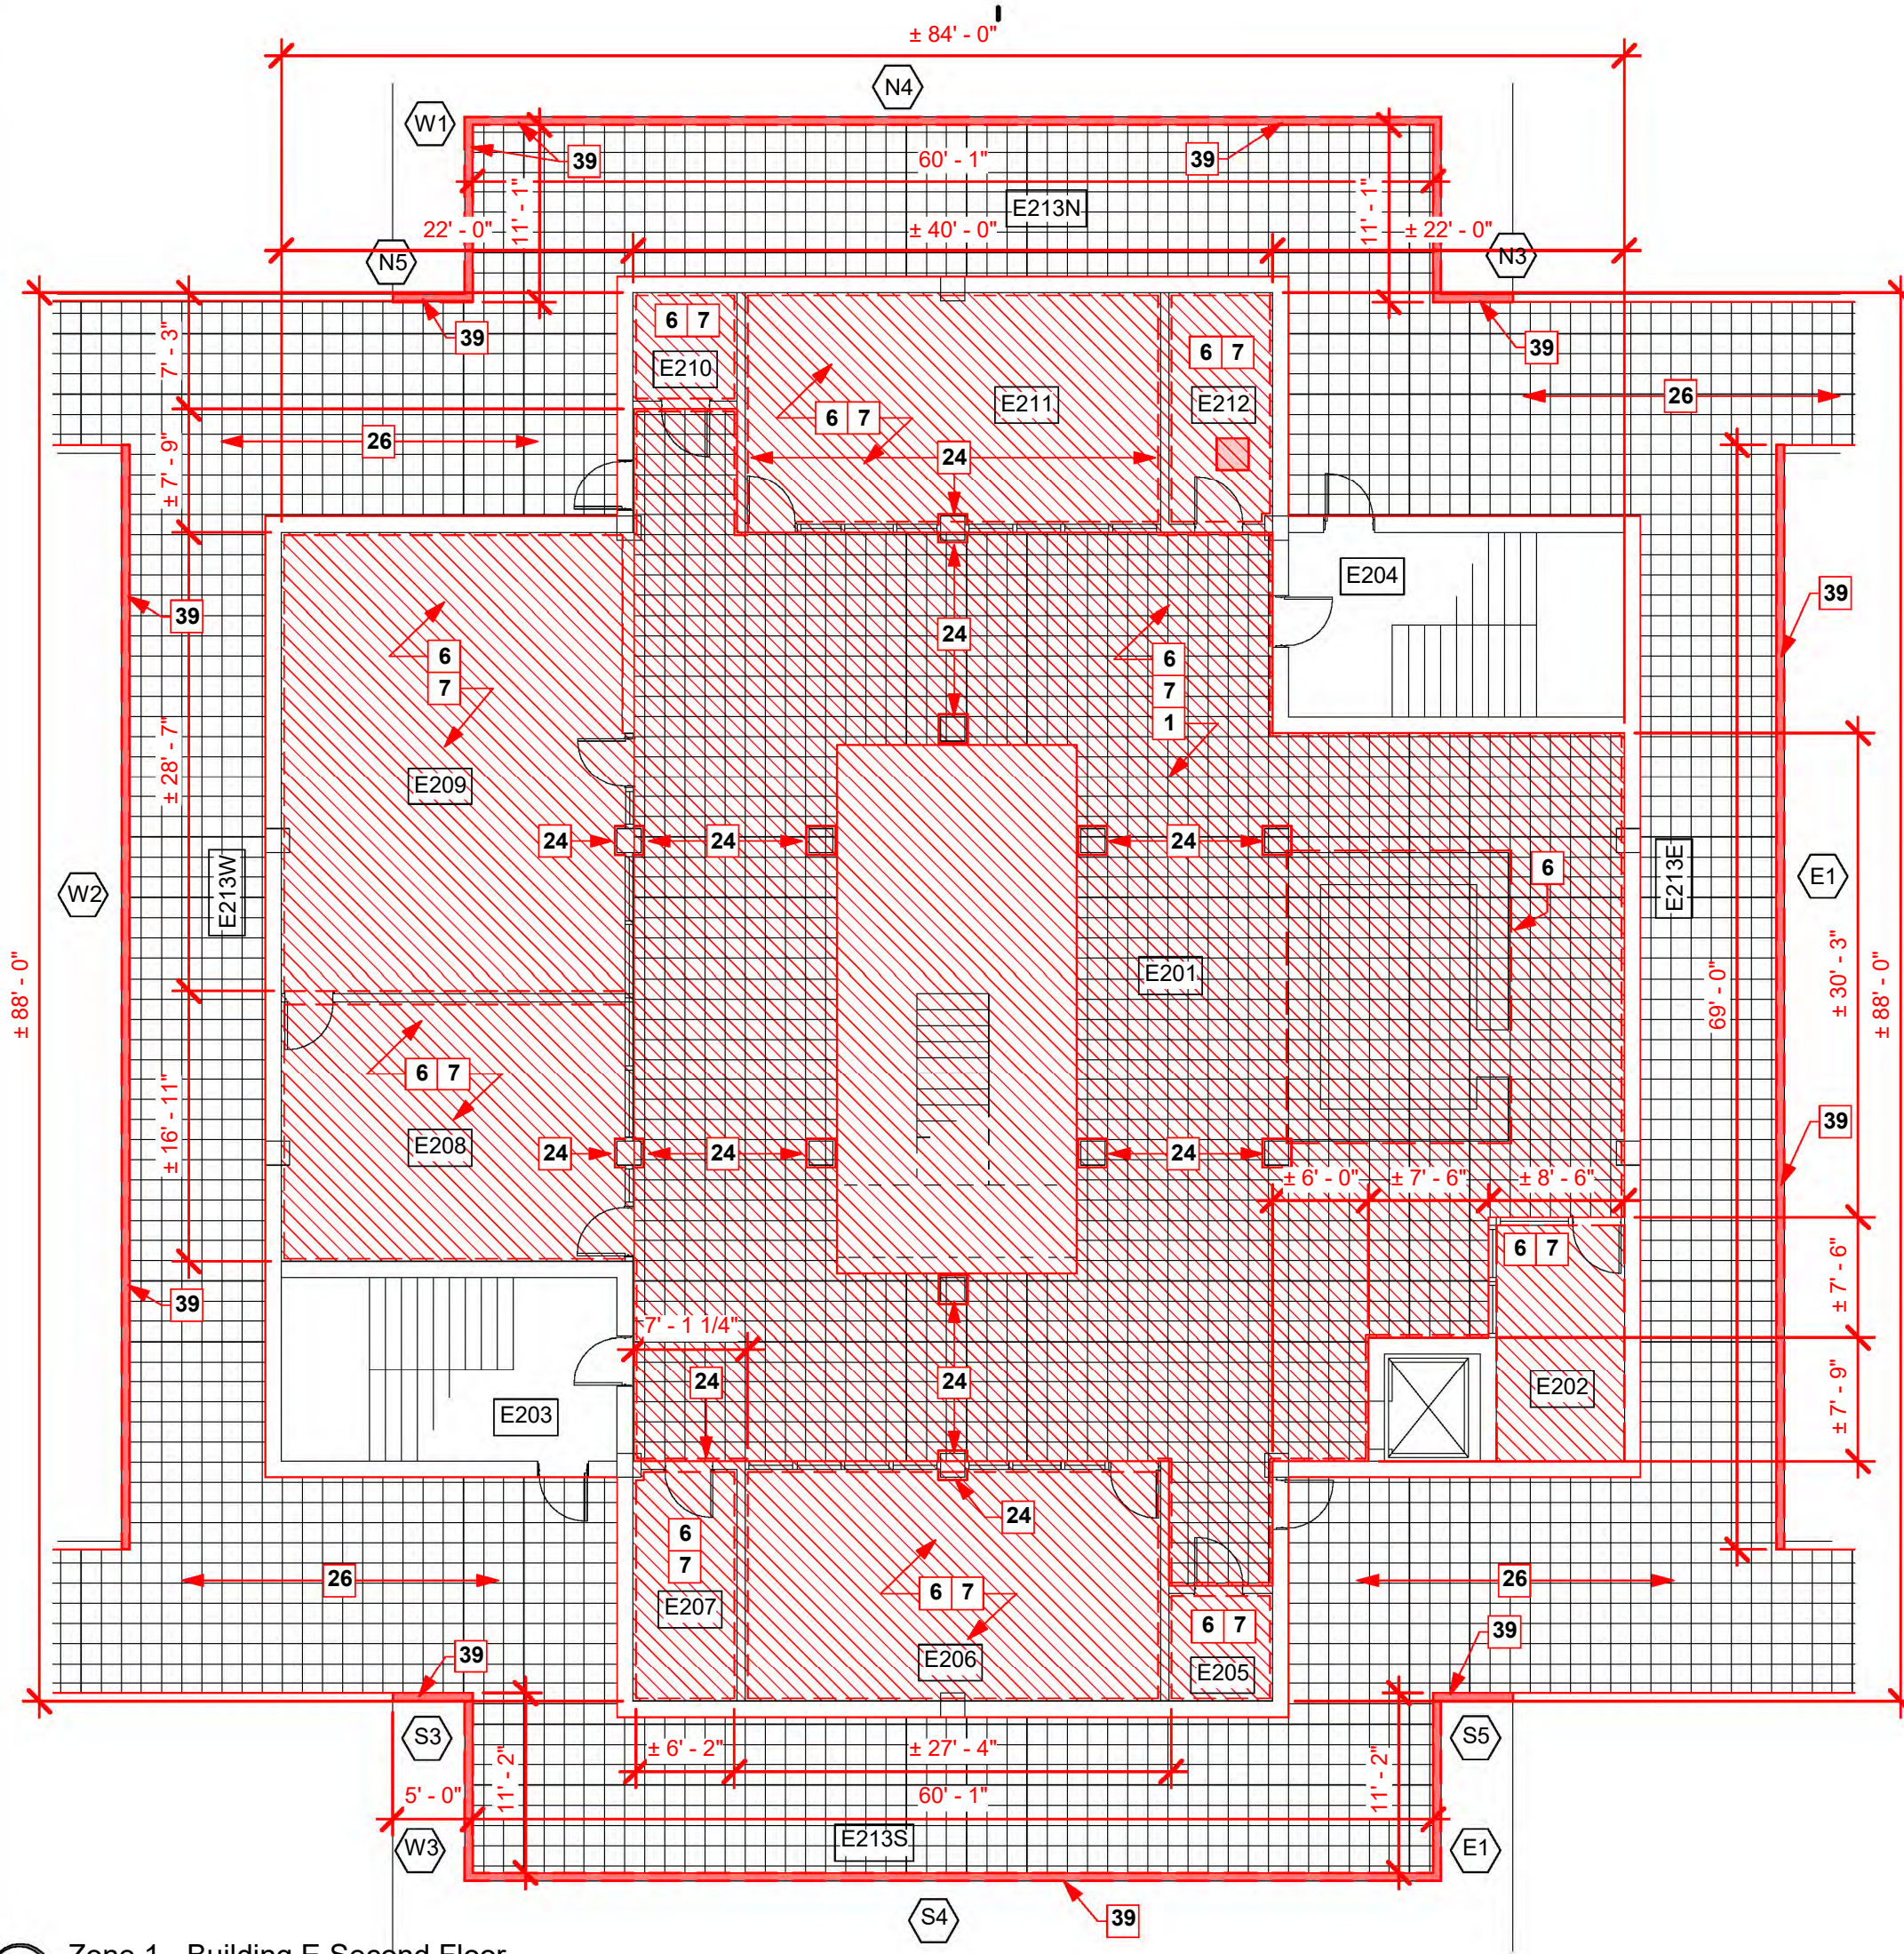
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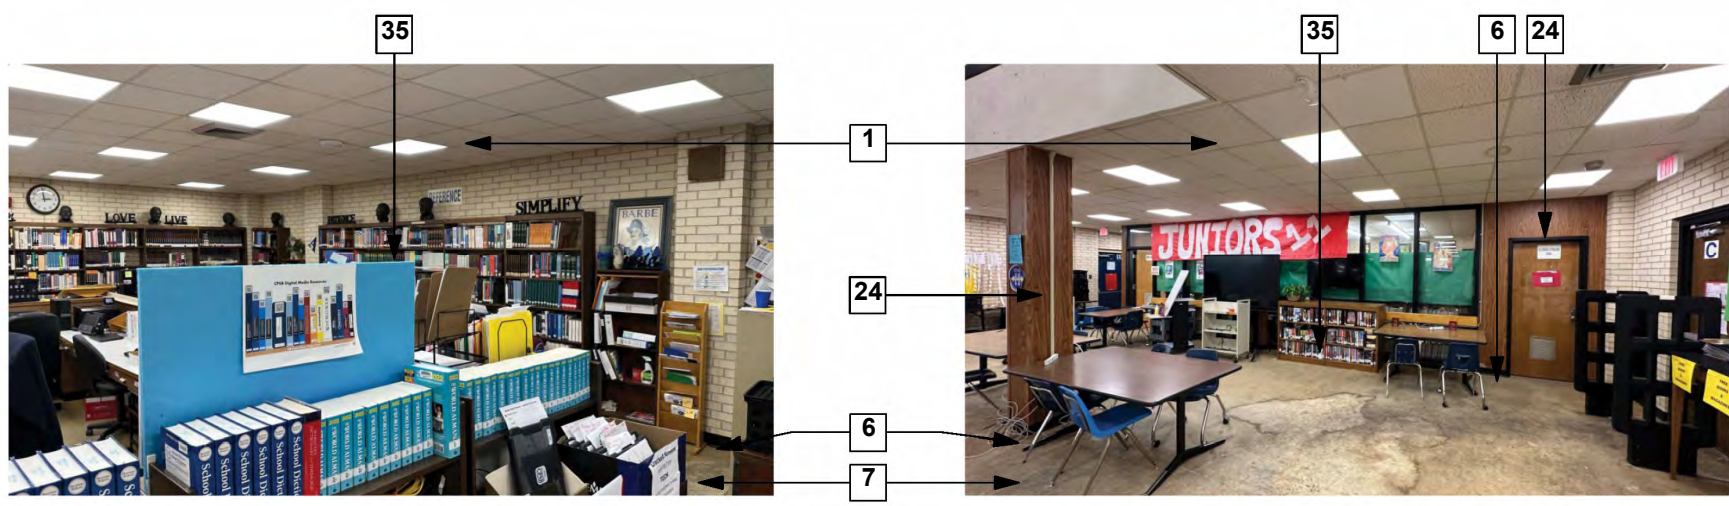
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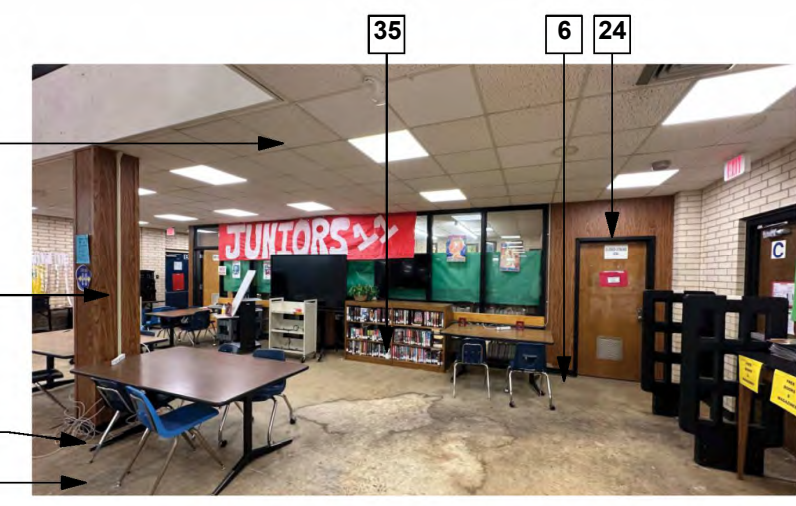
SHEET NUMBER
(E)A1.2
BLDG# 1ST FLOOR



6 Zone 1 - Building E Second Floor
3/32" = 1'-0"




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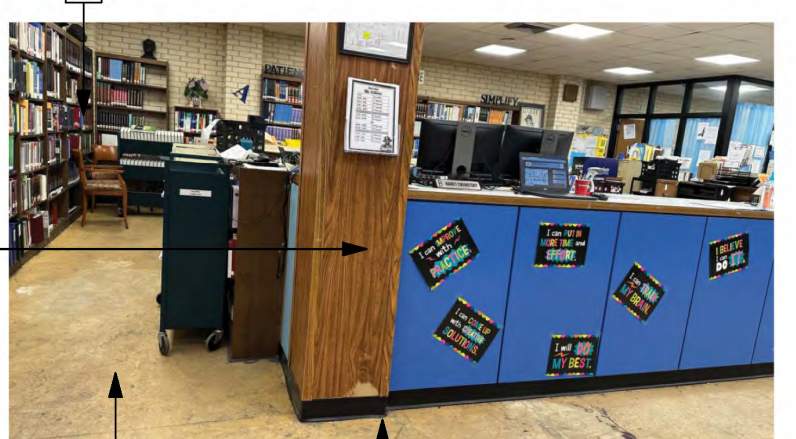
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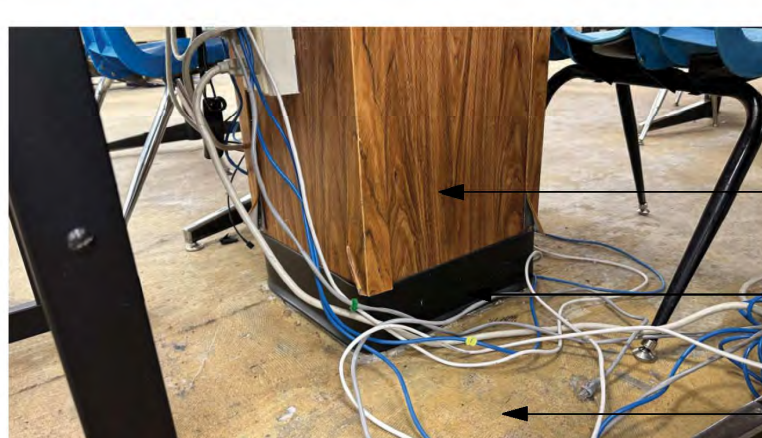
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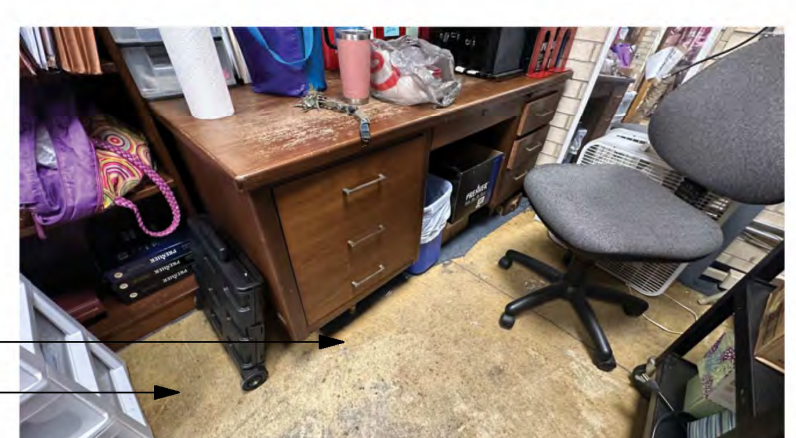
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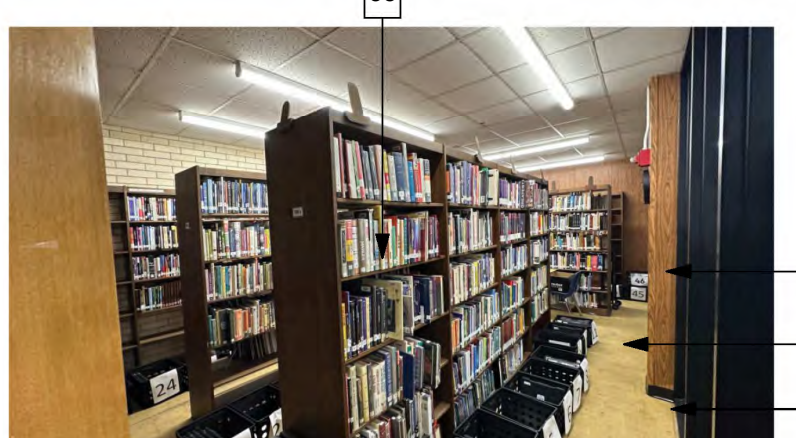
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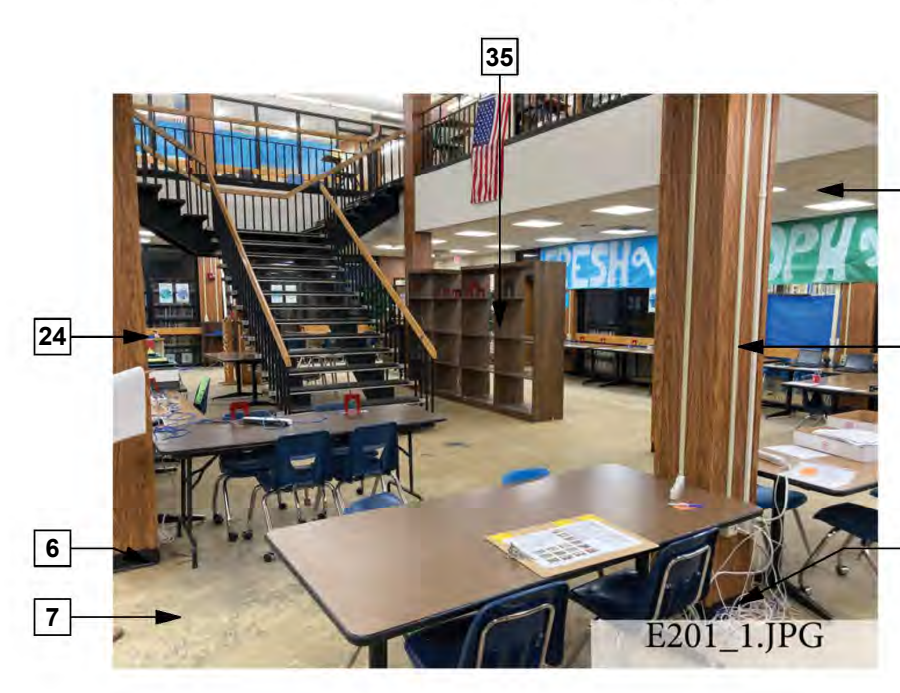
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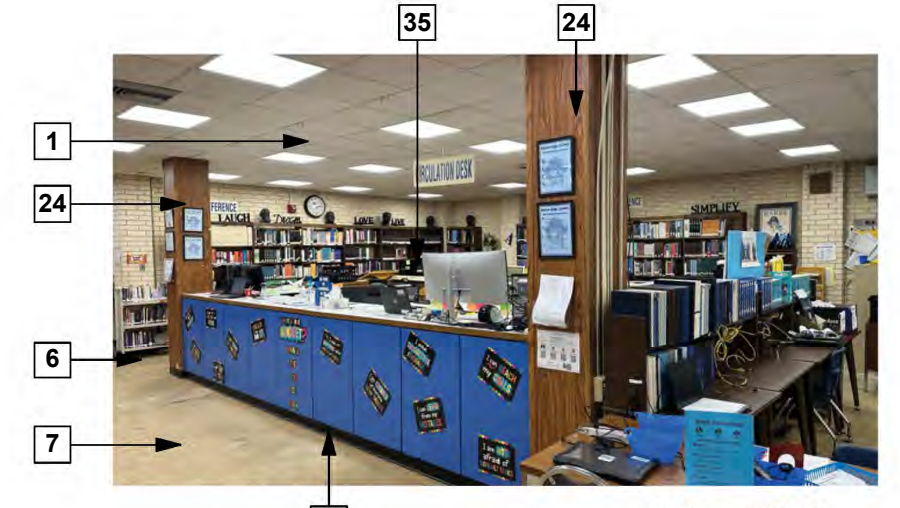
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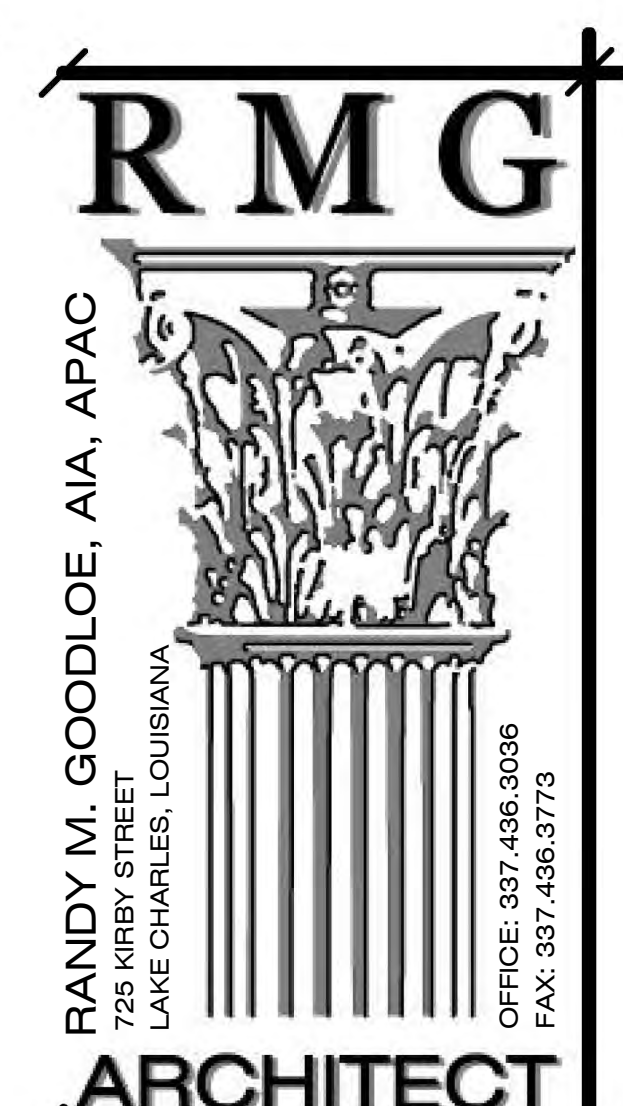
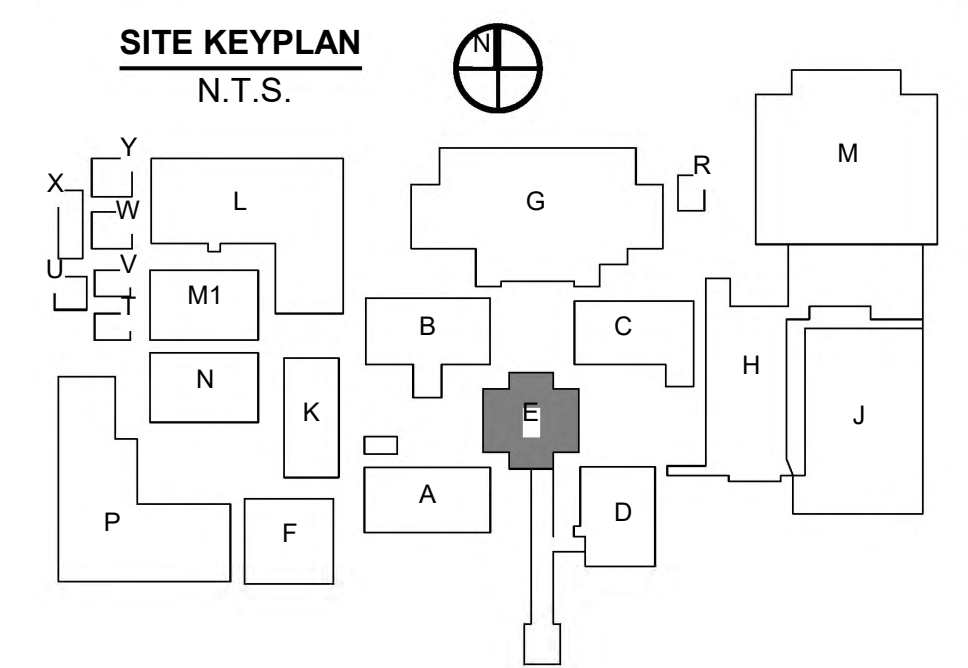
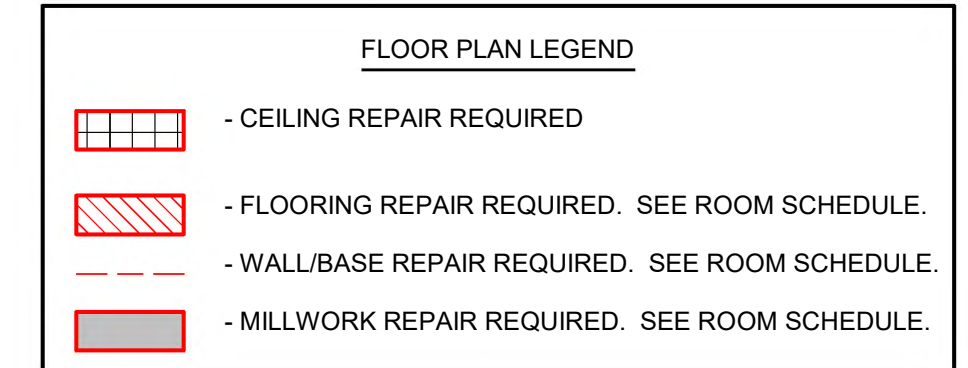
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- KEYNOTES**
- SUSPENDED ACOUSTIC CEILING REPLACEMENT:** REMOVE AND REPLACE DAMAGED CEILING GRID AND CEILING TILE AS SPECIFIED.
 - CEILING GRID:** REMOVE AND REPLACE DAMAGED CEILING GRID. MATCH EXISTING. SEE UNIT PRICE NO. 5.
 - VCT FLOORING REPAIRS:** REMOVE AND REPLACE VCT FLOORING AS SPECIFIED IN AREAS WHERE INDICATED. SEE UNIT PRICE NO. 3.
 - WINDOW REPAIRS:** REPLACE BROKEN WINDOW PANE, BLOCKS, AND GASKETS TO MATCH EXISTING. ALL SEALANTS SHALL BE REMOVED AND REPLACED AS SPECIFIED TO ENSURE WEATHER TIGHT SEAL. SEE ELEVATIONS.
 - STRUCTURAL CLAY BLOCK:** GLAZED STRUCTURAL CLAY BLOCK TO BE REMOVED AND REPLACED AS SPECIFIED TO MATCH EXISTING. CLEAN ALL CHALKING RESIDUE FROM EFFERVESCENCE.
 - VINYL BASE REPLACEMENT:** REPLACE DAMAGED OR MISSING BASE AS SPECIFIED TO MATCH EXISTING. SEE UNIT PRICE NO. 4.
 - CARPET REPAIRS:** DAMAGED CARPET HAS BEEN REMOVED. CLEAN FLOOR AND INSTALL NEW CARPET TILE AS SPECIFIED.
 - PAINTING:** WALL SURFACE IS TO BE SANDED, PREPARED, AND REPAINT TO MATCH EXISTING CORNER TO CORNER. WATER STAINED WALL FROM ROOF LOSS.
 - PAINTED CEILING STRUCTURE:** CEILING INCLUDING METAL TRUSSES ARE TO BE CLEANED, PREPPED, AND REPAINTED END TO END TO MATCH EXISTING COLOR.
 - VCT FLOORING CLEANING:** CLEAN WATER STAINS FROM VCT FLOORING TO REMOVE ANY DISCOLORATION WHERE INDICATED. MOP AND WAX ALL VCT FLOORING AT THE END OF CONSTRUCTION.
 - SKYLIGHT REPAIRS:** REMOVE AND REPLACE SKYLIGHT TO MATCH EXISTING.
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 - NOT USED.**
 - EXTERIOR WINDOWS AND DOORS:** CAULK AND RESEAL PERIMETER OF EXISTING WINDOWS AND DOORS.
 - CMU REPAIR:** RE-POINT DAMAGED CMU JOINTS AS SHOWN. PAINT WALL FROM END TO END IN COLOR TO MATCH EXISTING AS SPECIFIED. SEE PHOTOS.
 - BRICK REPAIR:** CAULK CRACKED AREAS AND REPAIR.
 - LOOKERS:** REPLACE DAMAGED UNITS AS SHOWN. MATCH EXISTING STYLE, SIZE AND COLORS.
 - BRICK WALLS:** CLEAN ALL WATER STAINS FROM ENTIRE BRICK WALL.
 - SHELVING REPLACEMENT:** REMOVE AND REPLACE DAMAGED SHELVING UNITS WITH GLASS DOORS. MATCH EXISTING MATERIALS, FINISHES AND CONSTRUCTION STYLE.
 - BASE CABINET:** REMOVE AND REPLACE DAMAGED BASE CABINET. MATCH EXISTING STYLE, SIZE, AND CONSTRUCTION. SALVAGE AND REINSTALL COUNTERTOP.
 - SECTIONAL DOOR:** REMOVE AND REPLACE OVERHEAD SECTIONAL DOOR AS SPECIFIED. CONTRACTOR TO PROVIDE ANY ADDITIONAL SUPPORT REQUIRED BY THE MANUFACTURER.
 - GYPSUM BOARD:** REMOVE AND REPLACE DAMAGED GYPSUM BOARD TO NEAREST FRAMING MEMBER. FINISH AND RE-PAINT WALL CORNER TO CORNER.
 - PREFINISHED GYPSUM BOARD WITH VINYL WALL COVER AND CORNER TRIM:** REMOVE AND REPLACE DAMAGED VINYL COVERED GYPSUM BOARD FROM FLOOR TO CEILING WHERE INDICATED ON FLOOR PLAN.
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 - STUCCO SOFFIT:** REMOVE AND REPLACE STUCCO SOFFIT. COORDINATE WITH ABATEMENT SCOPE & ABATEMENT CONTRACTOR TO ENSURE WEATHER TIGHTNESS AND PHASING COORDINATION. SEE WALL SECTIONS & DETAILS.
 - GYPSUM CEILING REPAIRS:** REMOVE AND REPLACE DAMAGED GYPSUM CEILING BOARD TO NEAREST FRAMING MEMBER WHERE INDICATED, FINISH TO MATCH EXISTING AS SPECIFIED.
 - METAL ROOF PANEL REPAIRS:** REMOVE AND REPLACE DEFORMED OR MISSING METAL ROOF PANELS TO MATCH EXISTING.
 - CONCRETE FLOOR CLEANING:** CLEAN AND RESEAL FLOOR AS SPECIFIED.
 - BASE CABINET:** REMOVE AND REPLACE DAMAGED BASE CABINET. MATCH EXISTING STYLE, SIZE, AND CONSTRUCTION. SALVAGE AND REINSTALL COUNTERTOP. PROTECT ALL MECHANICAL CONNECTIONS.
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 - CLEAN/REPAINT MASONRY WALL:** MECHANICALLY REMOVE ALL LOOSE OR PEELING PAINT AND ALL CHALKING RESIDUE FROM EFFERVESCENCE FROM CORNER TO CORNER. PERFORM REQUIRED MOISTURE TESTING PRIOR TO REPAINTING WALL AS SPECIFIED.
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 - FURNITURE SETTING AND RESETTING:** RELOCATE ALL EXISTING FURNITURE TO TEMPORARY ROOM IN MODULAR BUILDINGS WHILE EXISTING SPACE IS BEING REPAIRED. REINSTALL AND RESET FURNITURE ONCE REPAIRS ARE COMPLETE. SEE PHASING PLAN.
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 - DOOR REPAIR:** CLEAN, PREP AND RE-PAINT DOOR FRAME - SEE DOOR SCHEDULE.
 - CORRIDOR WALL REPAIR:** REMOVE DAMAGED STOREFRONT WINDOW AND EXISTING 3/4" PLYWOOD SHEATHING BELOW WINDOW. INSTALL NEW WINDOW PER SCHEDULE AND NEW 3/4" PLYWOOD SHEATHING. PAINT AS SPECIFIED, IN COLOR AS SELECTED. SEE DETAILS.
 - GLAZING REPAIR:** REMOVE AND REPLACE BROKEN GLASS. MATCH EXISTING TINT. PROVIDE SAFETY GLASS AS REQUIRED.
 - DOOR REPAIR:** REMOVE AND REPLACE EXISTING LEFT DOOR LEAF. PROVIDE AN INSULATED HOLLOW METAL DOOR WITH VISION PANEL TO MATCH RIGHT DOOR LEAF. REINSTALL EXISTING DOOR HARDWARE. PAINT AS DIRECTED.

ROOMS -BUILDING E2

ROOM NUMBER	Area	Perimeter
E201	3526 SF	296' - 7"
E205	61 SF	31' - 2"
E206	322 SF	74' - 4"
E207	106 SF	42' - 10"
E208	387 SF	79' - 7"
E209	659 SF	103' - 5"
E210	53 SF	29' - 2"
E211	341 SF	77' - 2"
E212	105 SF	42' - 9"

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HURRICANE LAURA REPAIRS TO
A.M. BARBE HIGH SCHOOL
2200 W. McNEESE ST.
FOR
CALCASIEU PARISH SCHOOL BOARD
LAKE CHARLES, LA 70605
HL-003-01.03.04.05.06.07

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RMG PROJECT NO.
20042-01-G
OWNER PROJECT NO.
HL-003-01.03.04.05.06.07
PROJECT MANAGER
TM

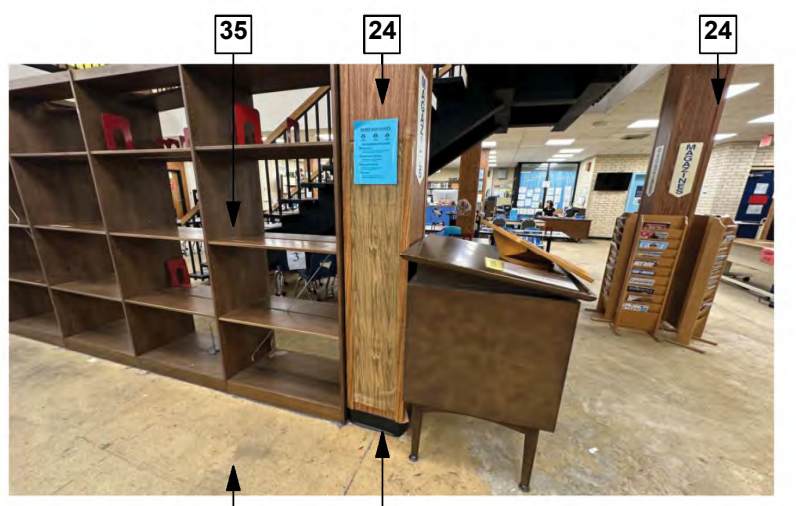DATE ISSUED
06/28/2024
REVISED

SHEET NUMBER
(E)A2.1
BLDG E 2ND FLOOR



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E211_1.JPG



E211_2.JPG



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ARCHITECT






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HL-003-01,03,04,05,06,07




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RMG PROJECT NO. 20042-01-G
OWNER PROJECT NO. HL-003-01,03,04,05,06,07
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SHEET NUMBER
(E)A2.2
BLDG 2ND FLOOR





1 Zone 1 - Building E Third Floor
3/32" = 1'-0"

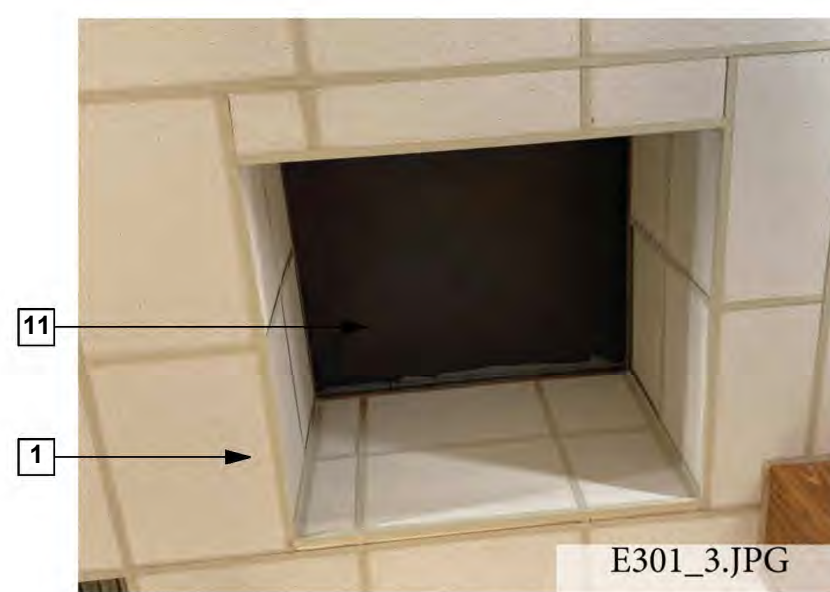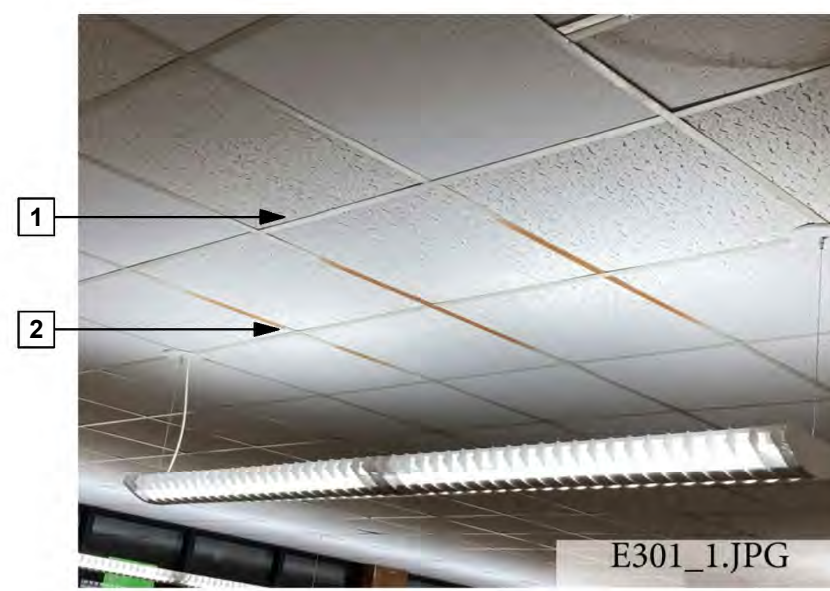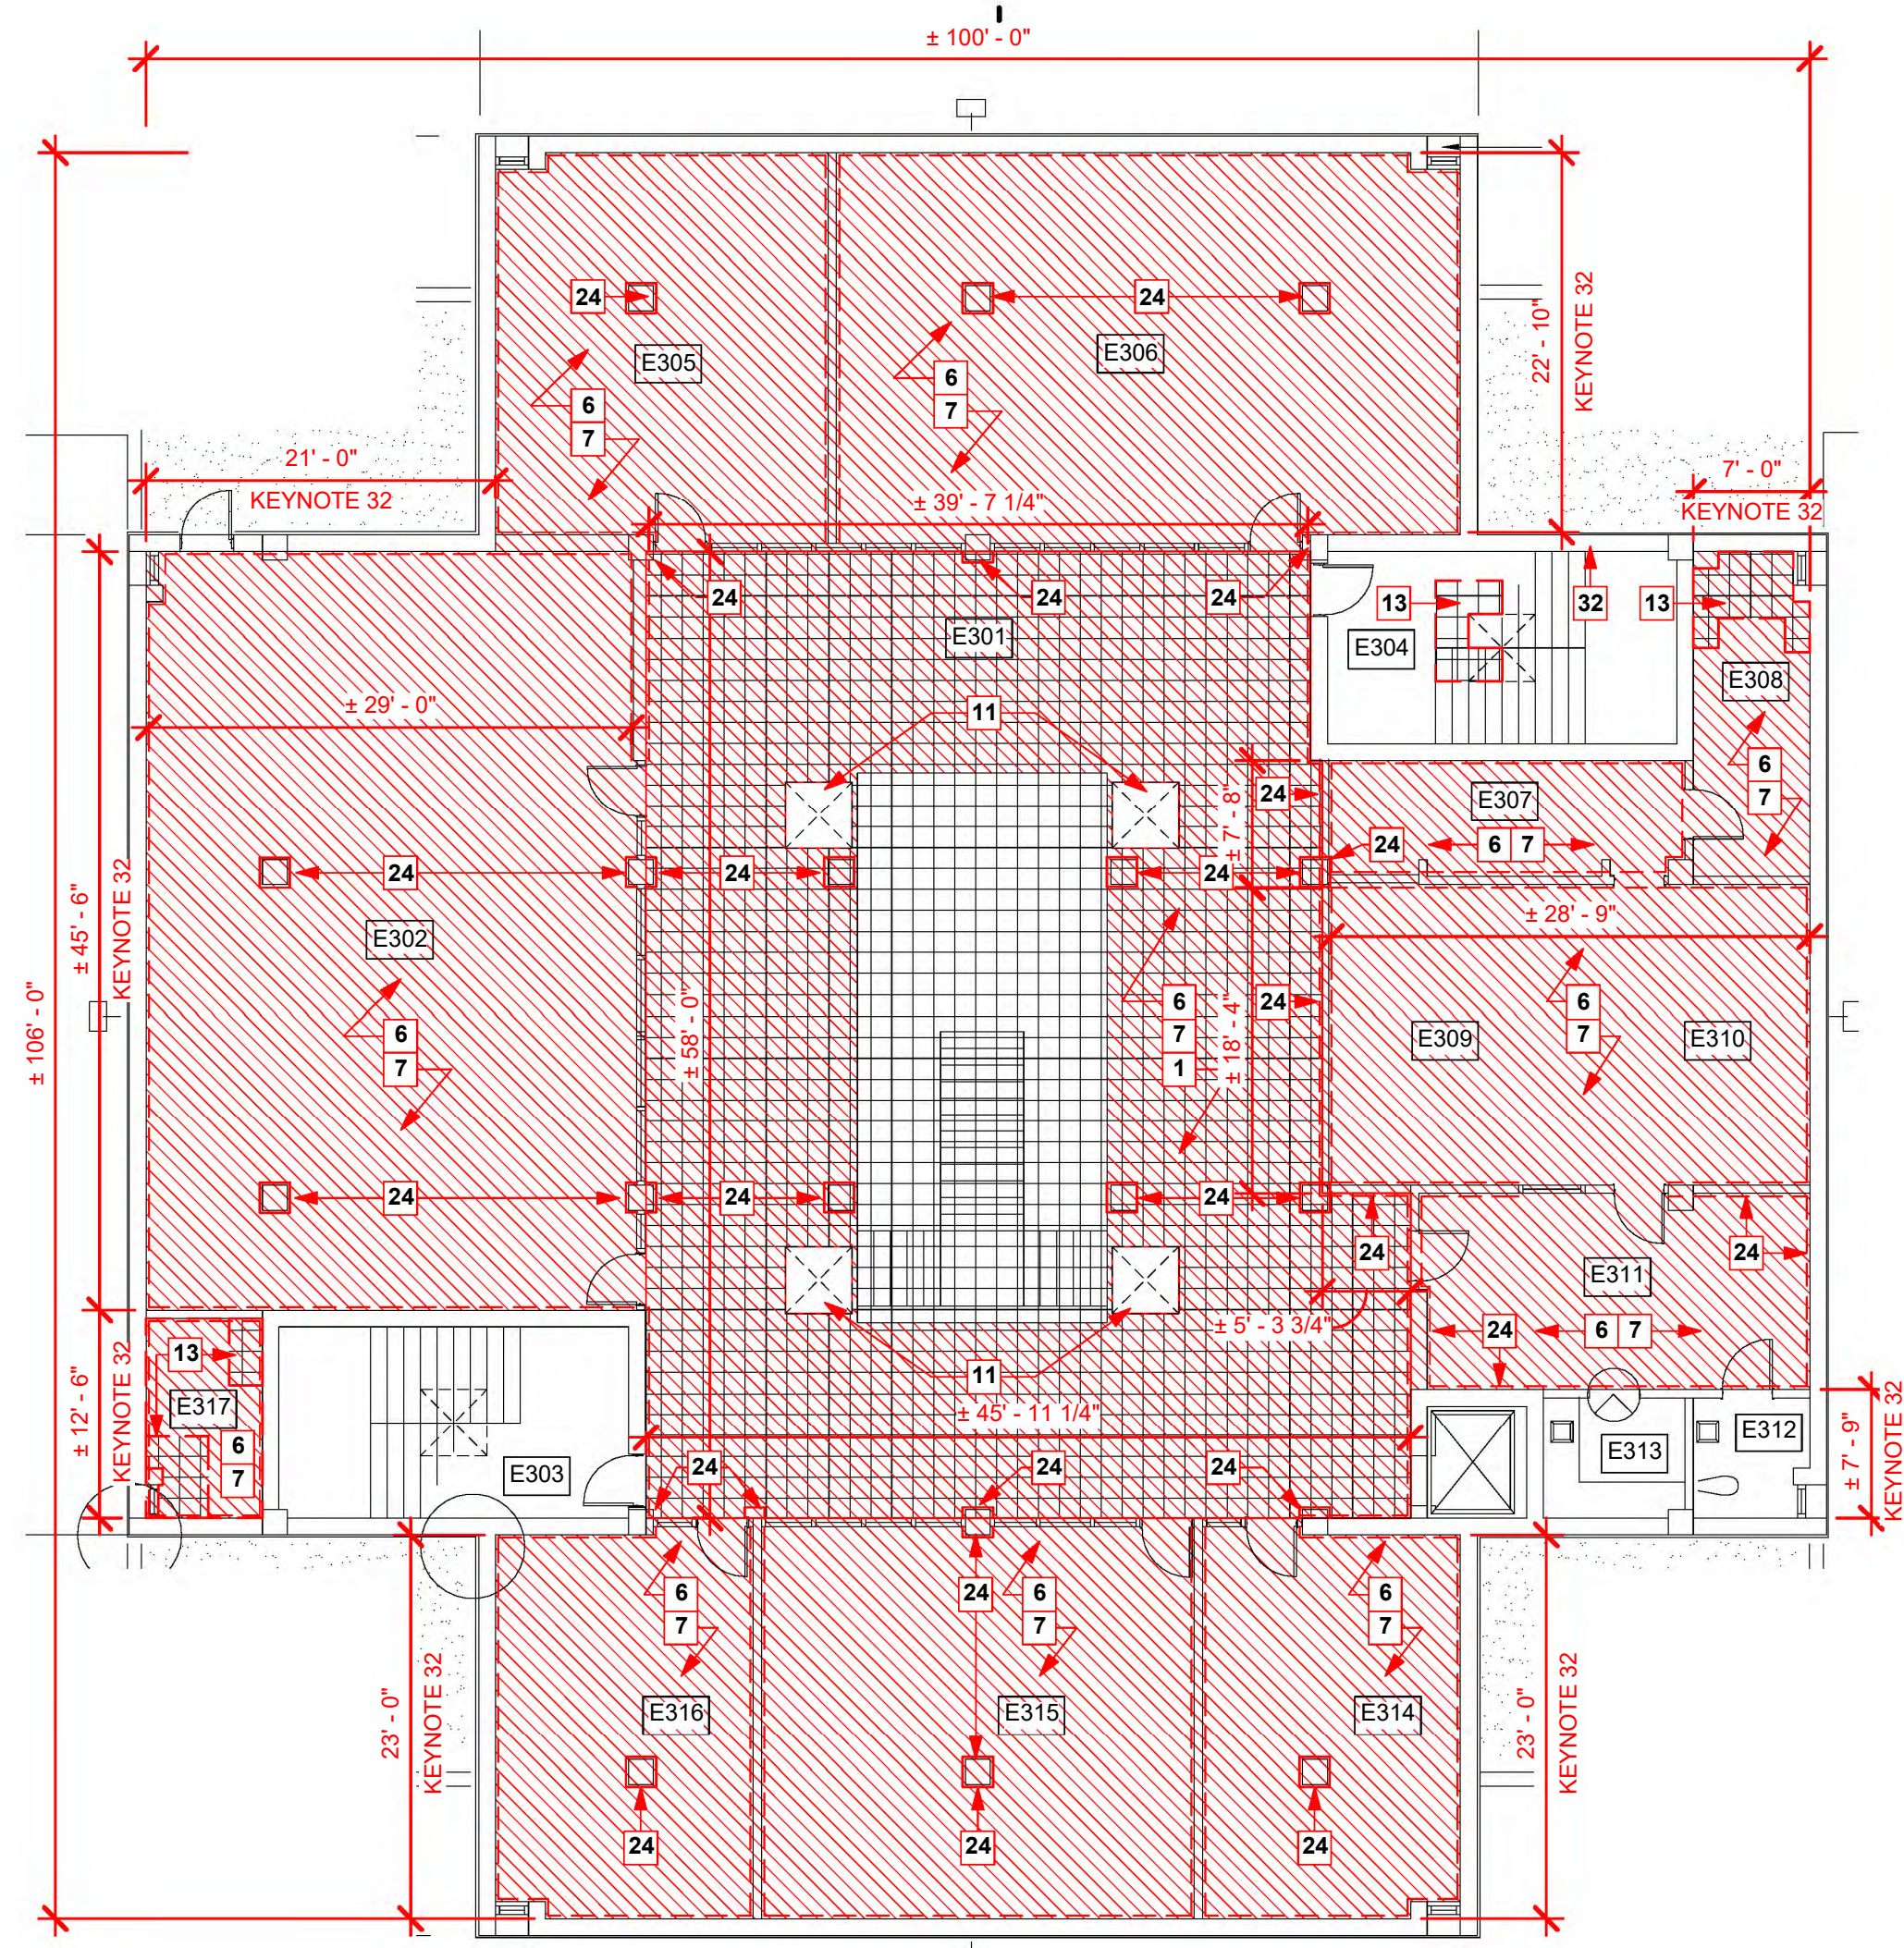

ROOMS - BUILDING E3		
ROOM NUMBER	Area	Perimeter
E301	2653 SF	239' - 7"
E302	1631 SF	163' - 7"
E303	265 SF	68' - 8"
E304	265 SF	68' - 8"
E305	578 SF	97' - 1"
E306	1140 SF	137' - 10"
E307	158 SF	60' - 4"
E308	130 SF	53' - 6"
E309	328 SF	72' - 6"
E310	248 SF	84' - 7"
E311	285 SF	68' - 6"
E314	378 SF	78' - 9"
E315	606 SF	98' - 9"
E316	424 SF	82' - 10"
E317	133 SF	46' - 6"
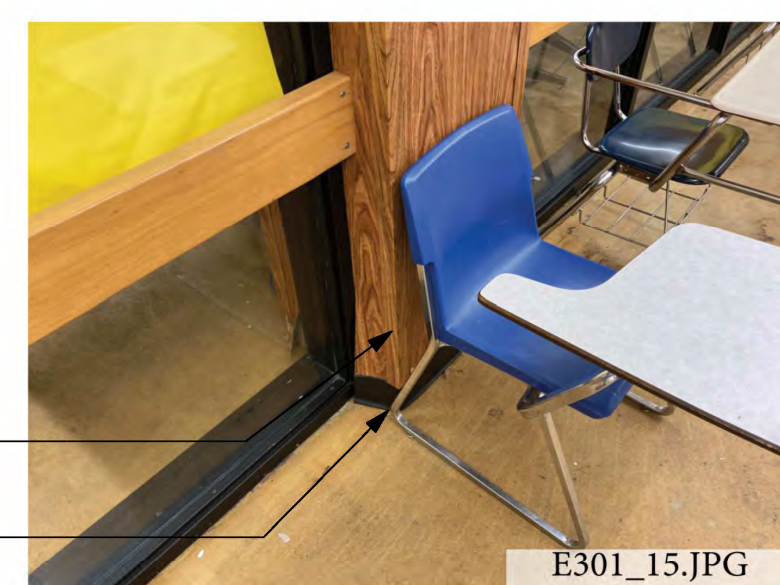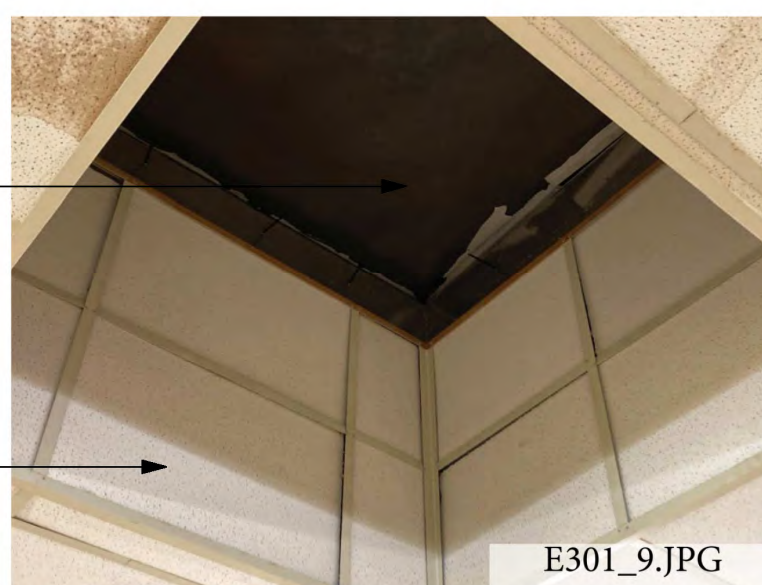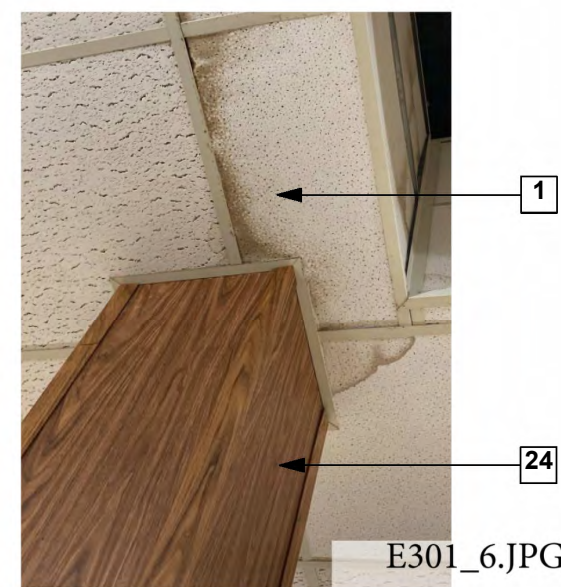
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RMG
 RANDY M. GOODLOE, AIA, APAC
 725 KIRBY STREET
 LAKE CHARLES, LOUISIANA
 OFFICE: 337.436.3036
 FAX: 337.463.9779

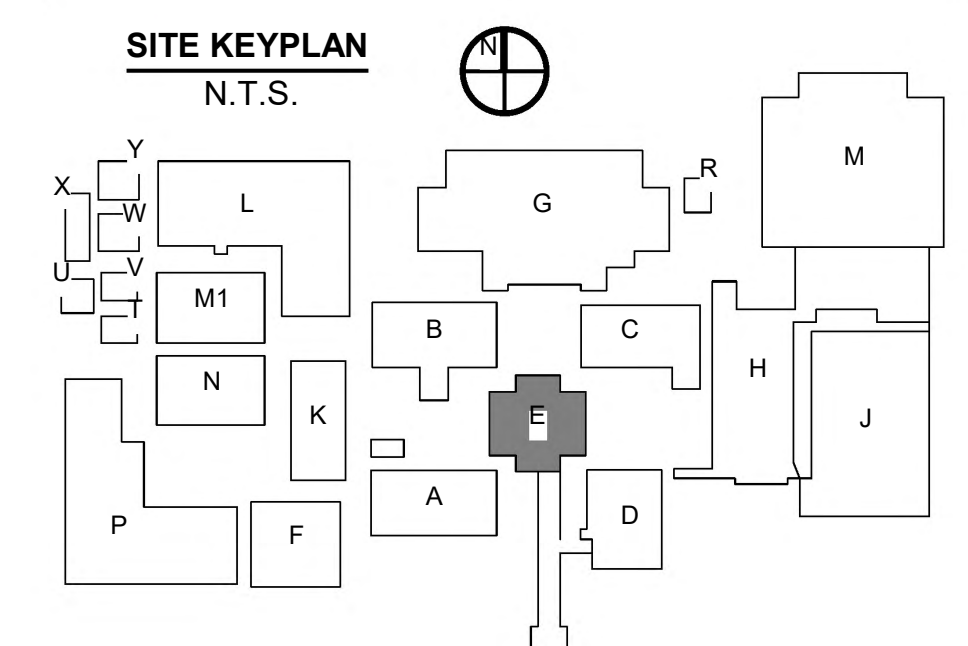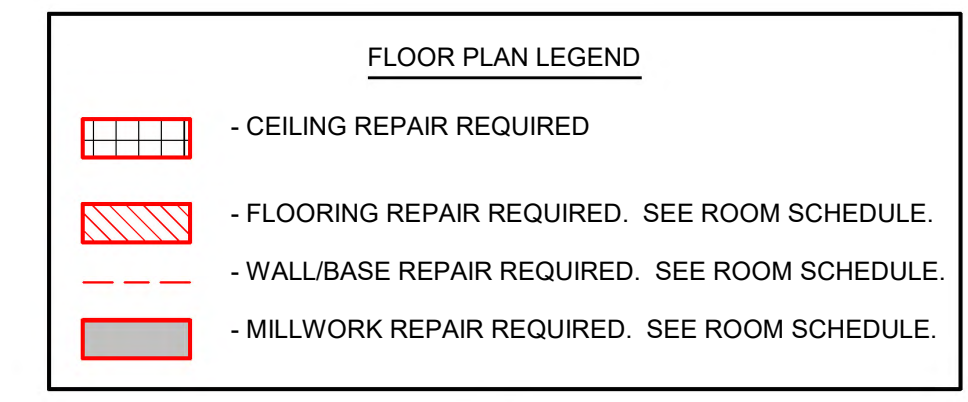ARCHITECT
 RANDY MICHAEL GOODLOE
 No. 2585
 STATE OF LOUISIANA
 REGISTERED ARCHITECT
 LA. LICENSE NO. 4086


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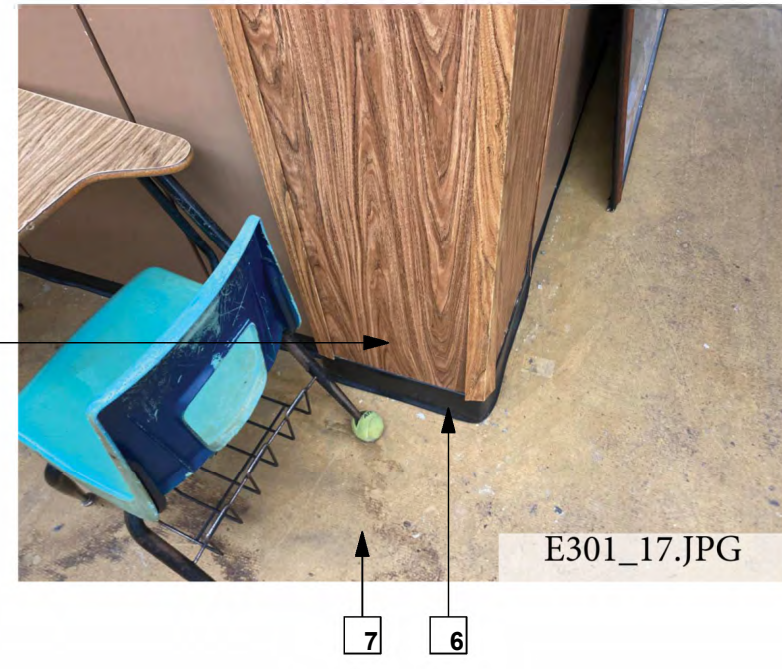
RMG PROJECT NO.
20042-01-G
 OWNER PROJECT NO.
HL-003-01.03.04.05.06.07
 PROJECT MANAGER
TM
 DATE ISSUED
06/28/2024

REVISIONS
 SHEET NUMBER
(E)A3.1
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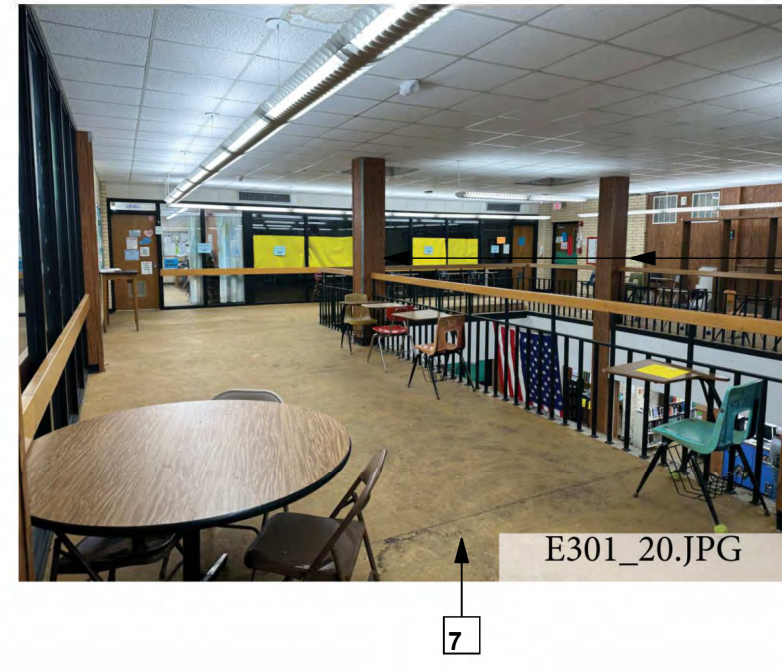
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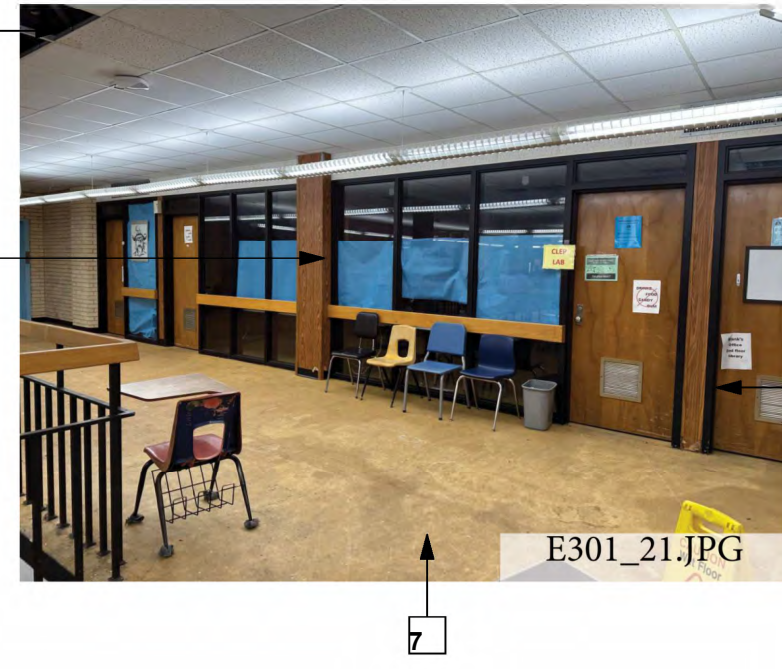
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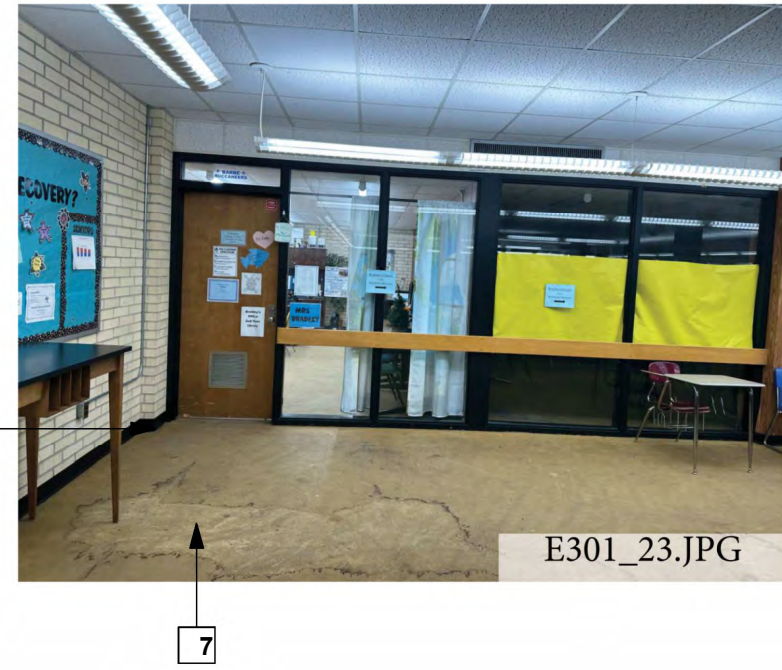
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E301_21.JPG




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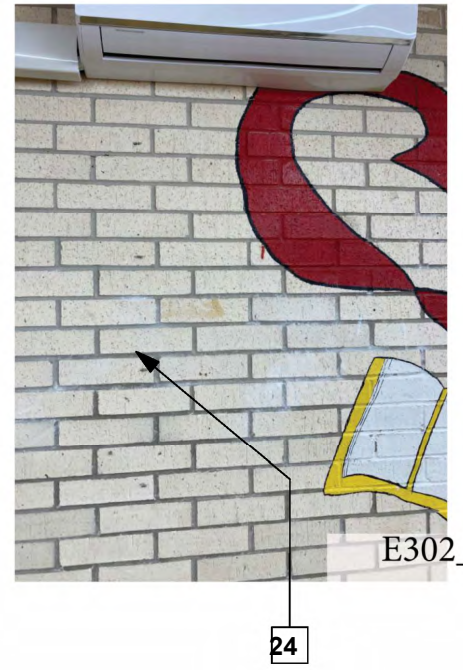
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E301_24.JPG

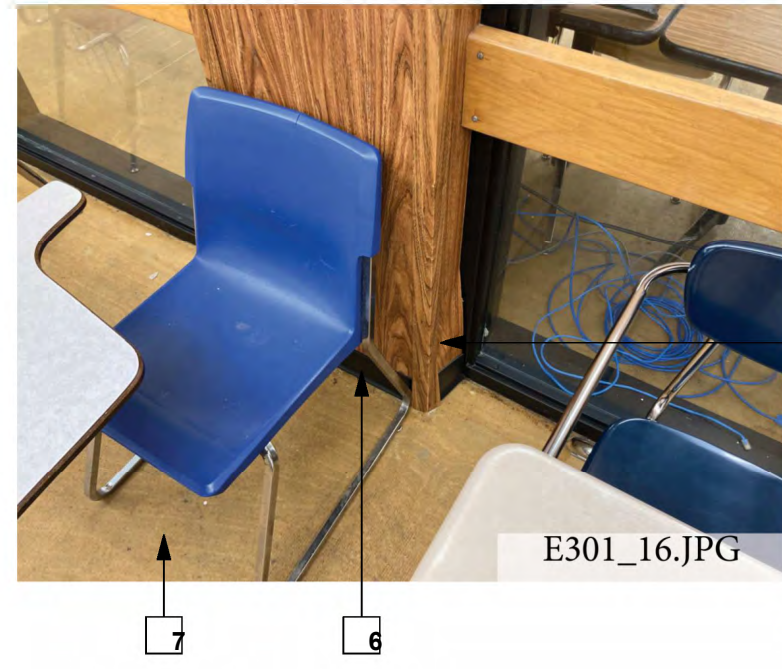

E301_25.JPG



E302_1.JPG

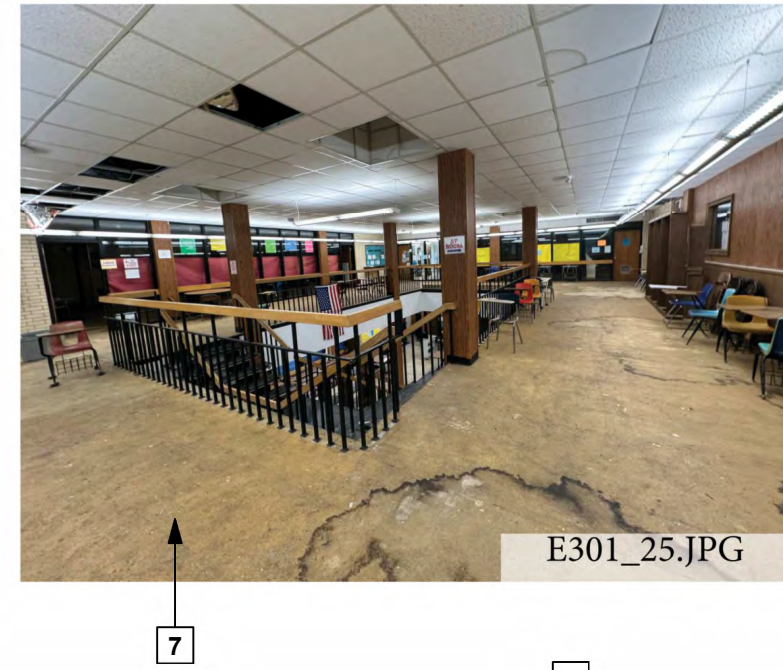

E302_2.JPG



E302_3.JPG



E302_4.JPG



E302_5.JPG




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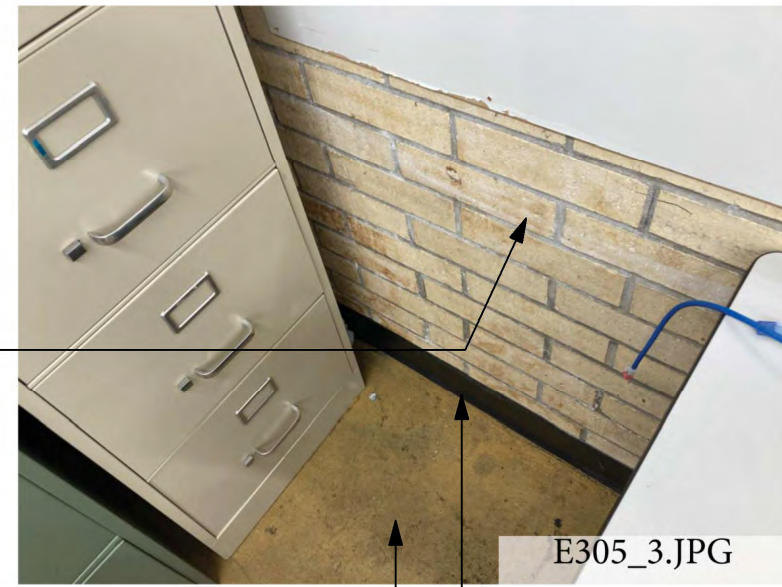
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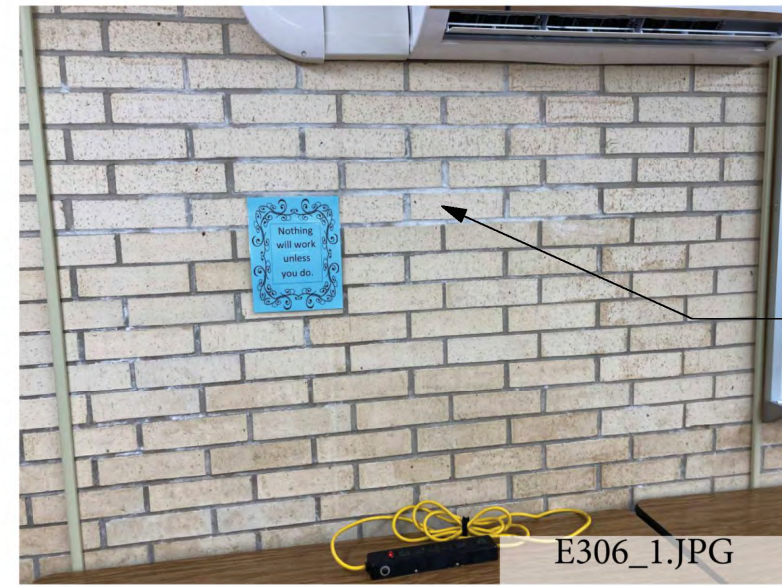
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E305_2.JPG



E305_3.JPG



E306_1.JPG

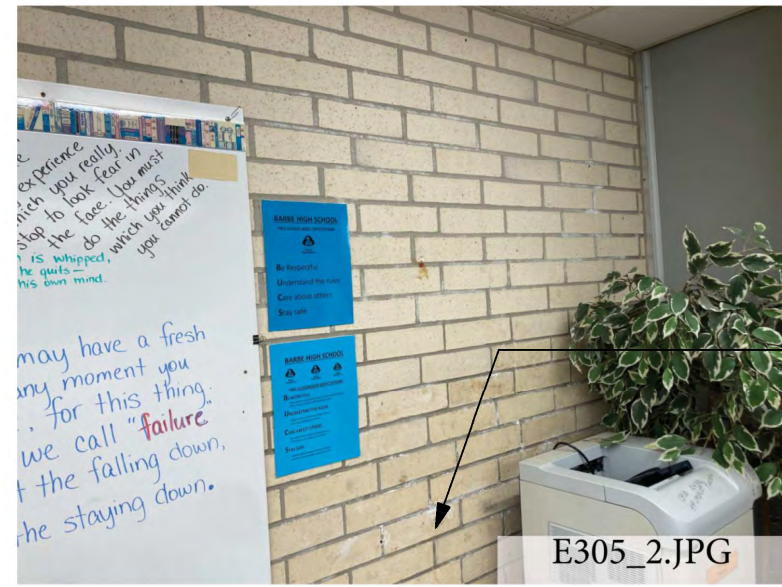


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E306_3.JPG



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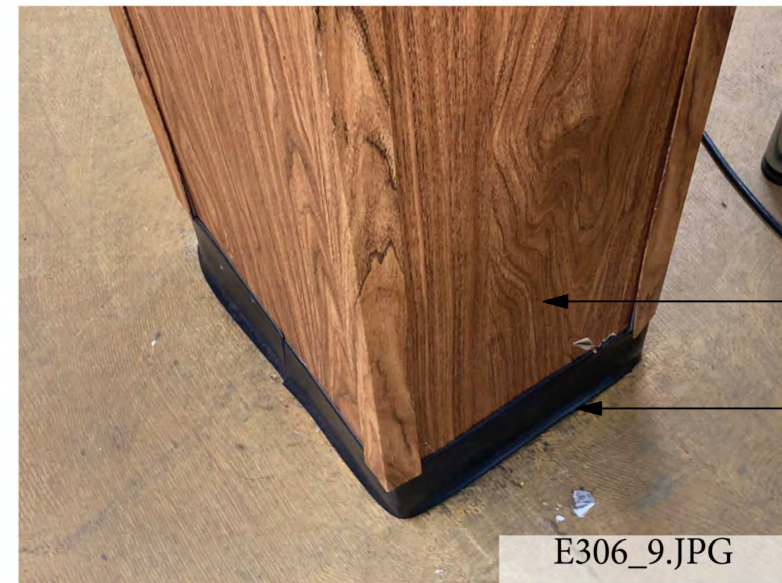
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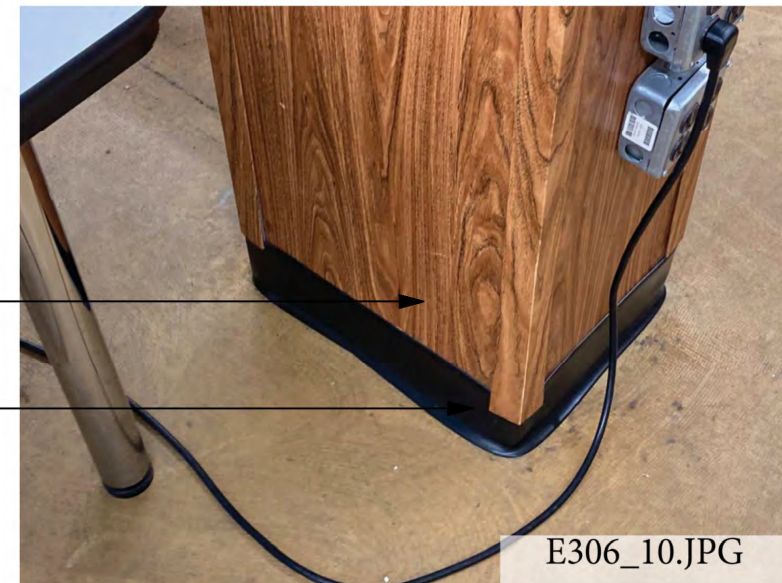
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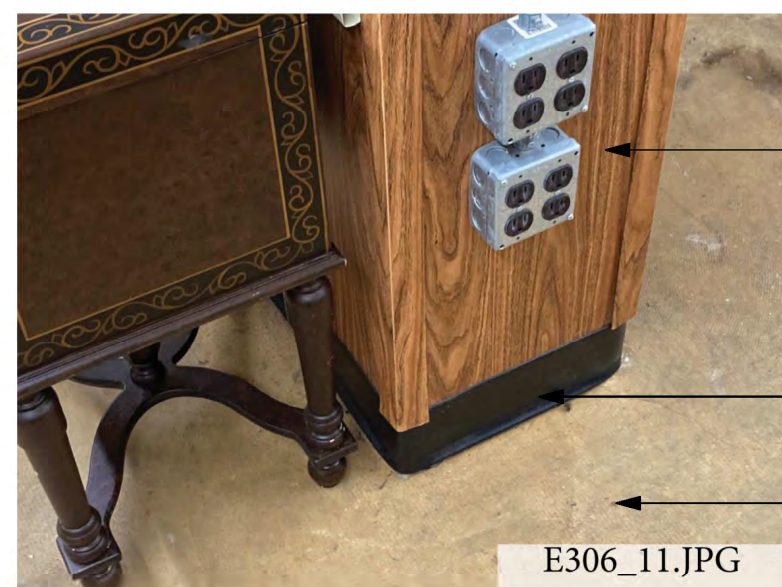
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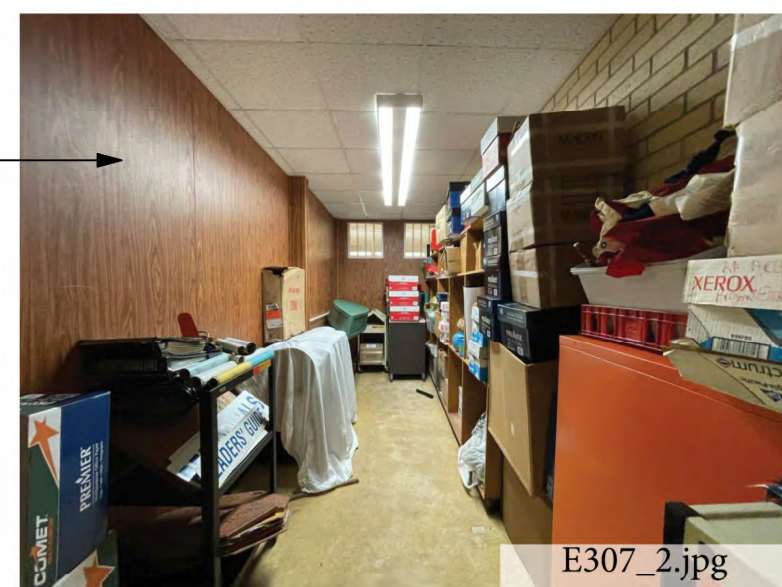
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E306_14.JPG



E307_1.JPG

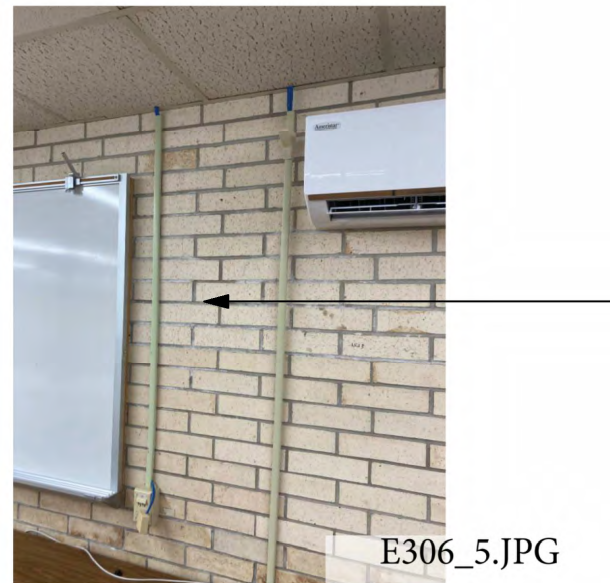

E307_2.JPG

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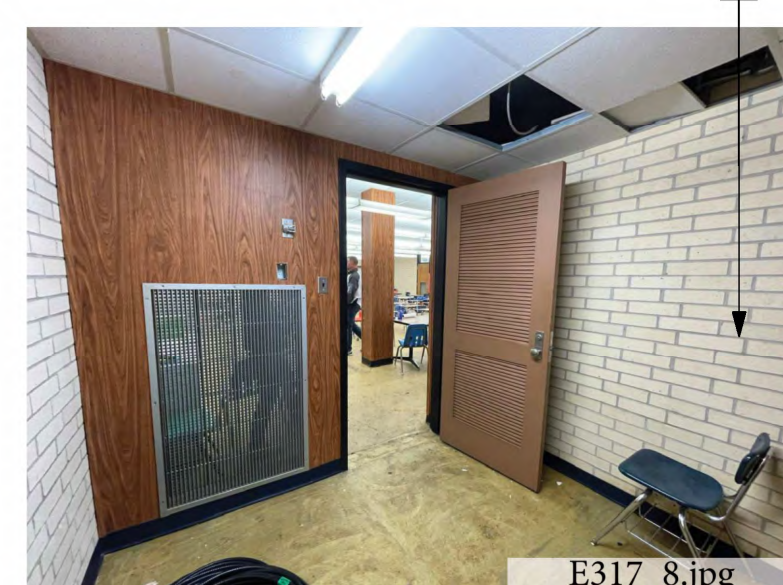
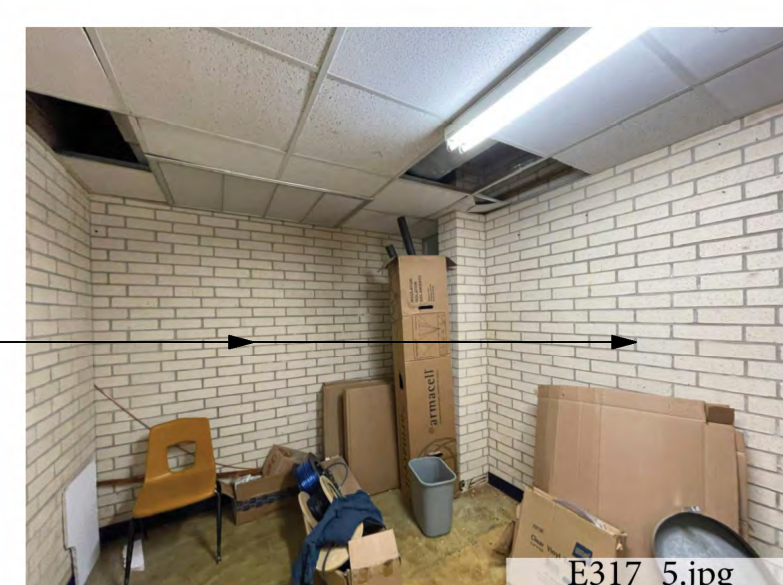
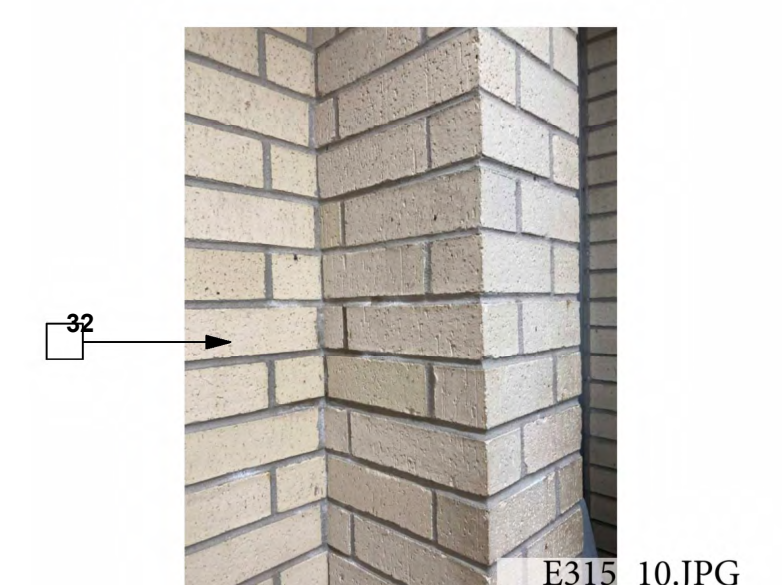
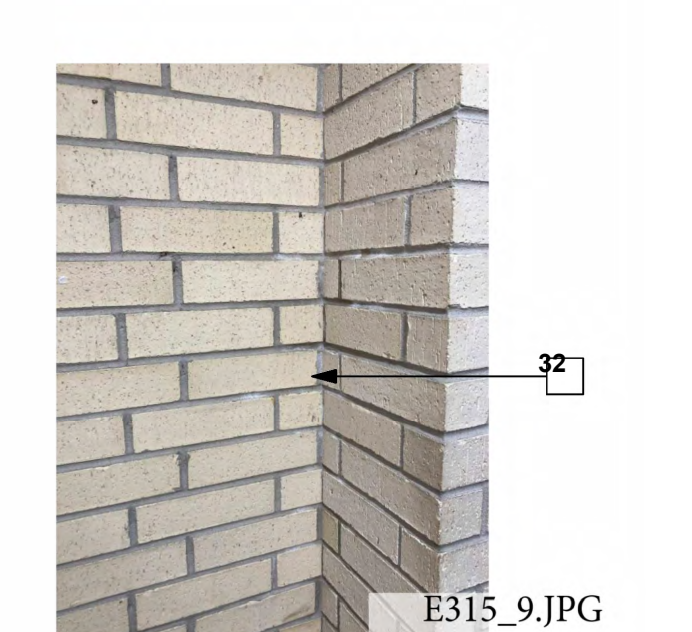
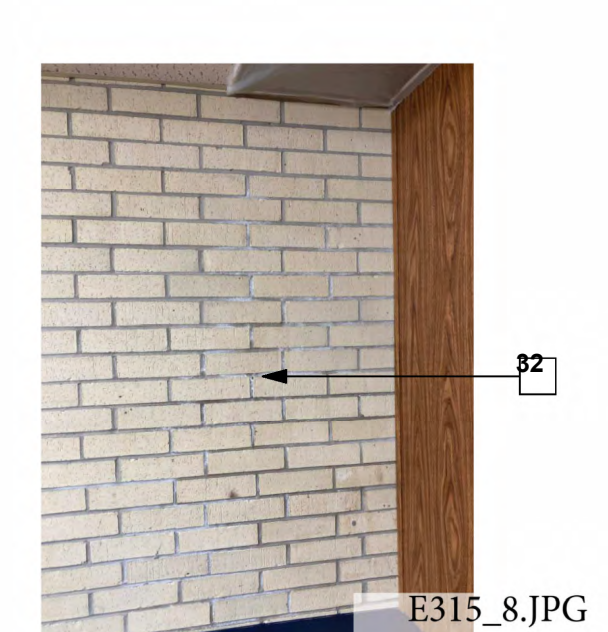
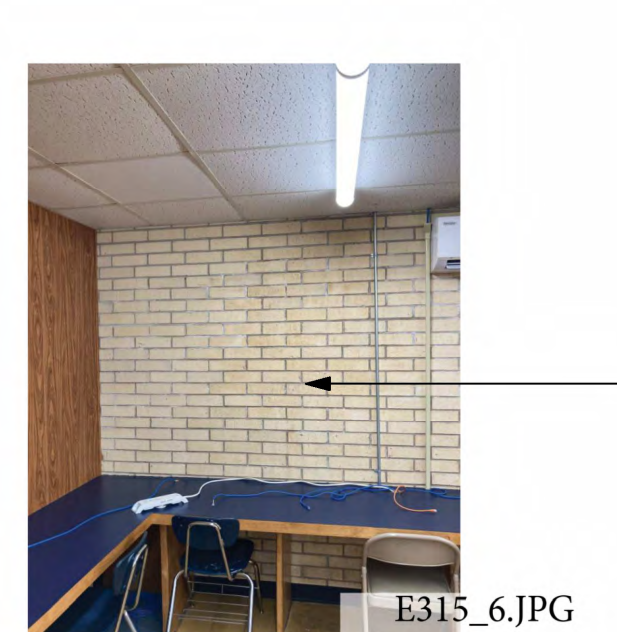
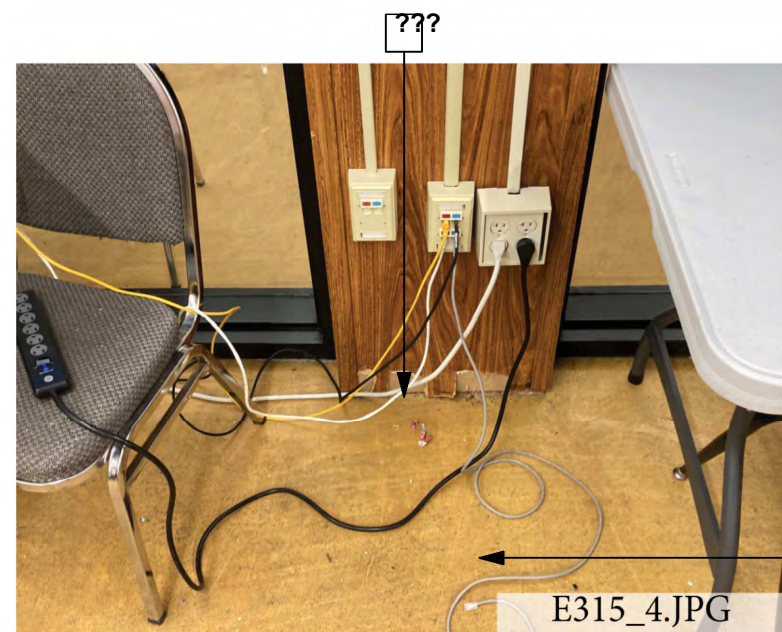
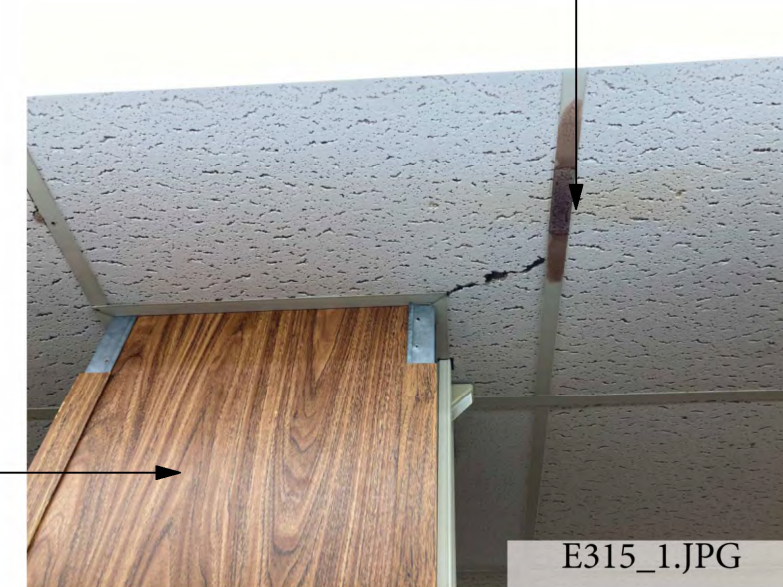
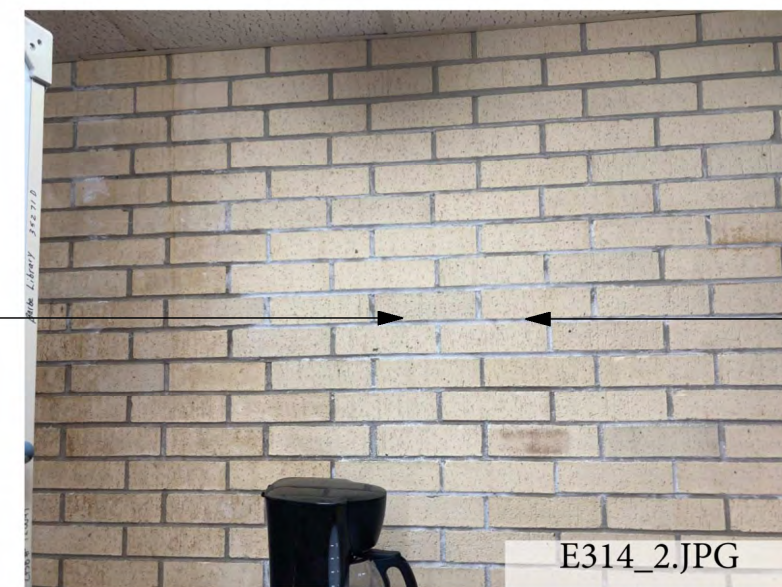
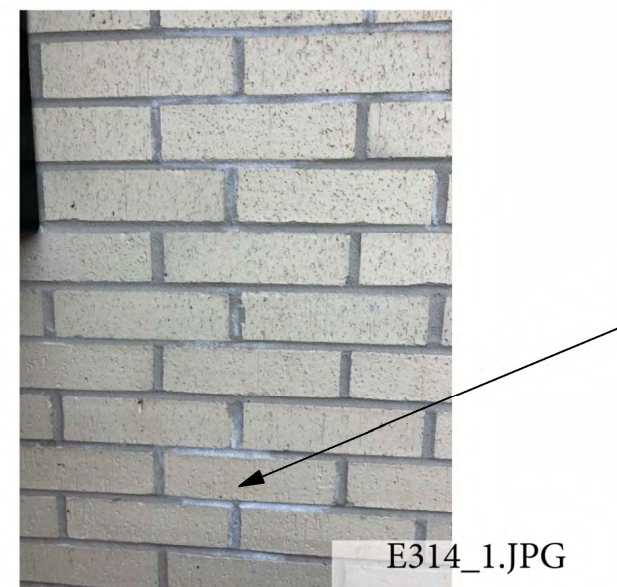
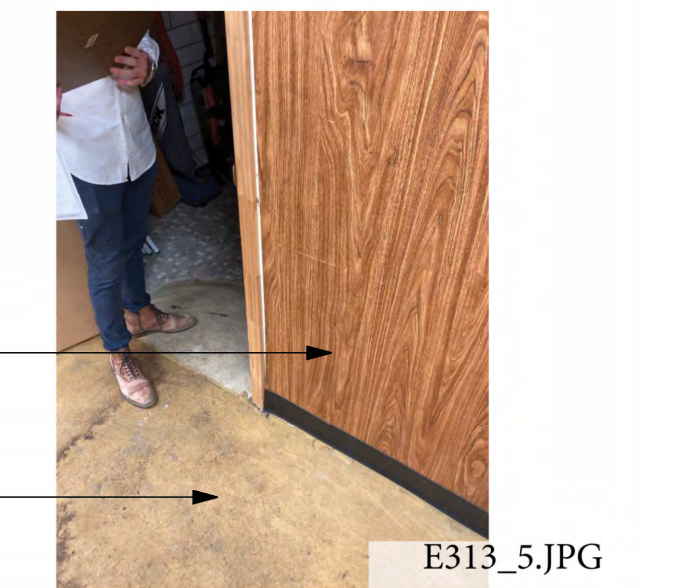
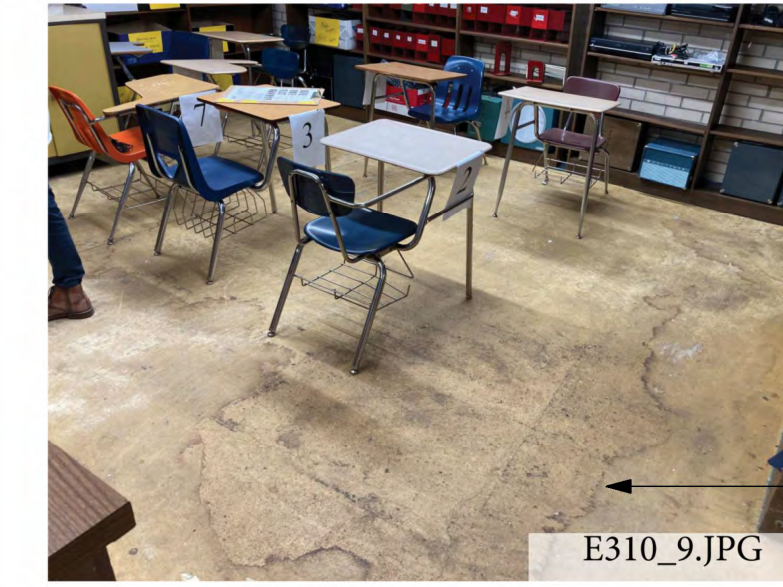
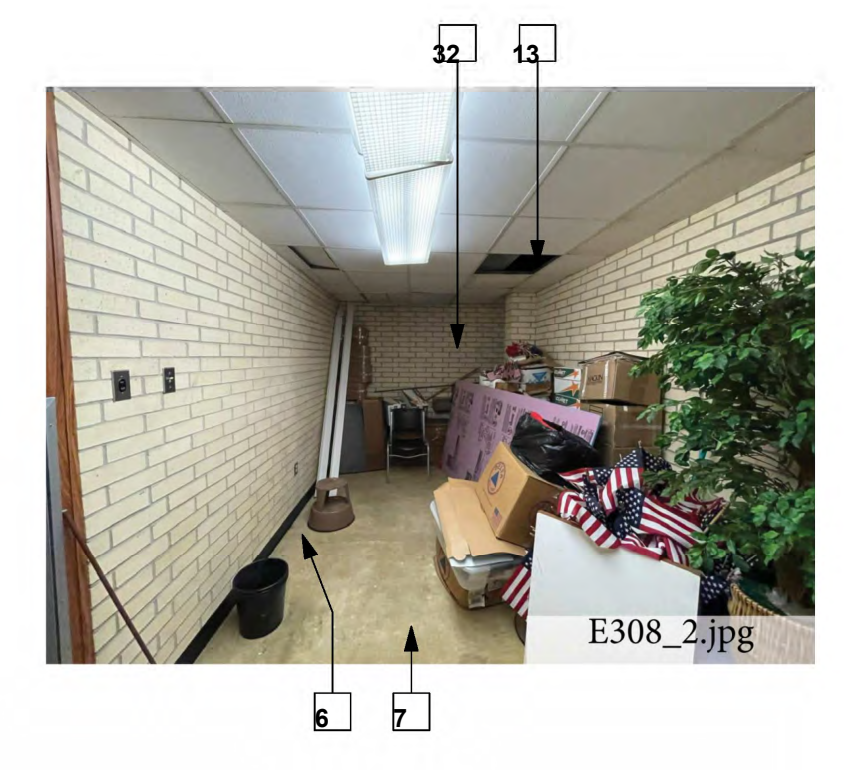
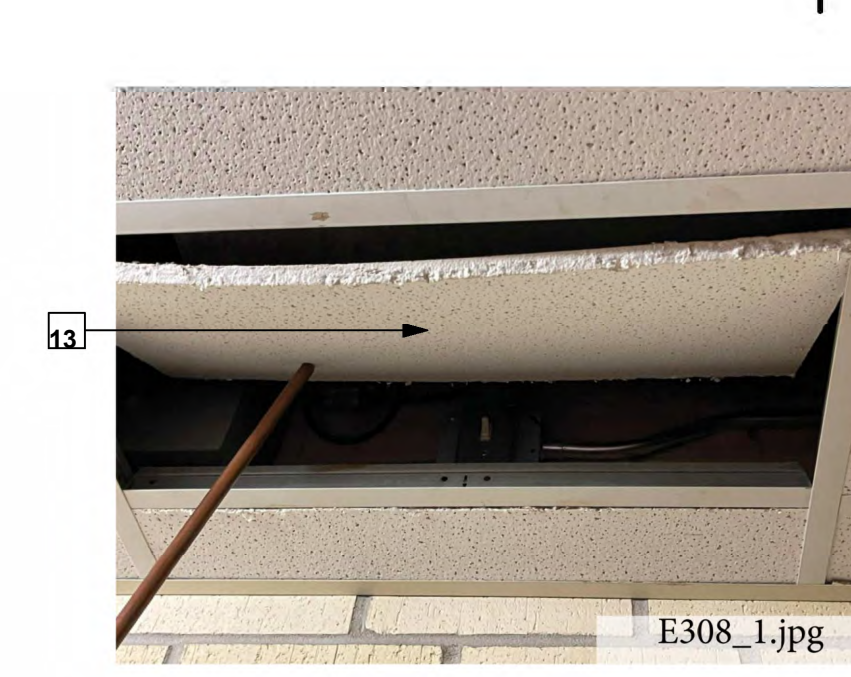
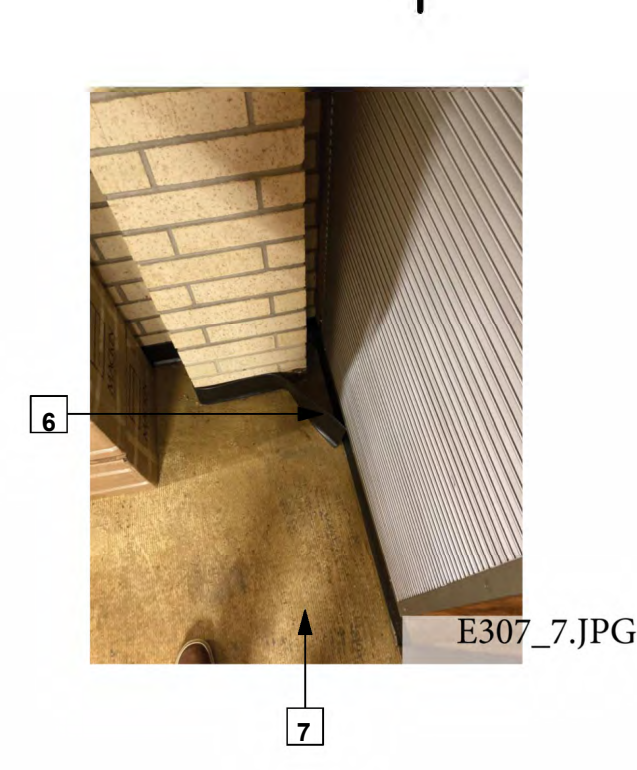
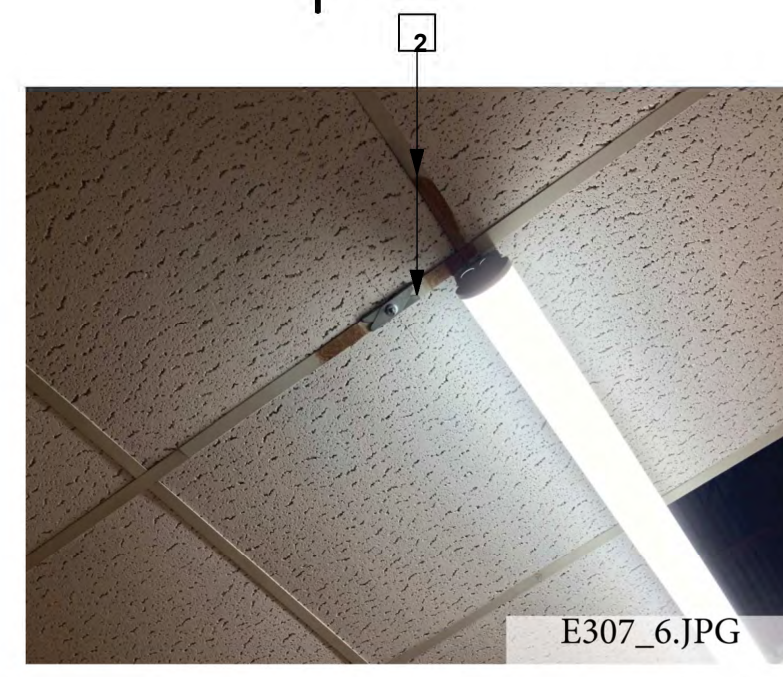
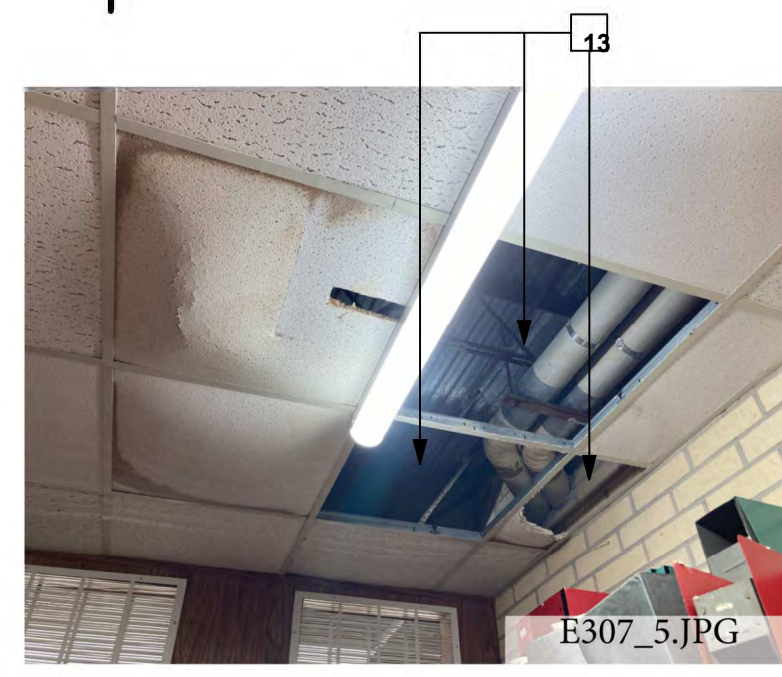
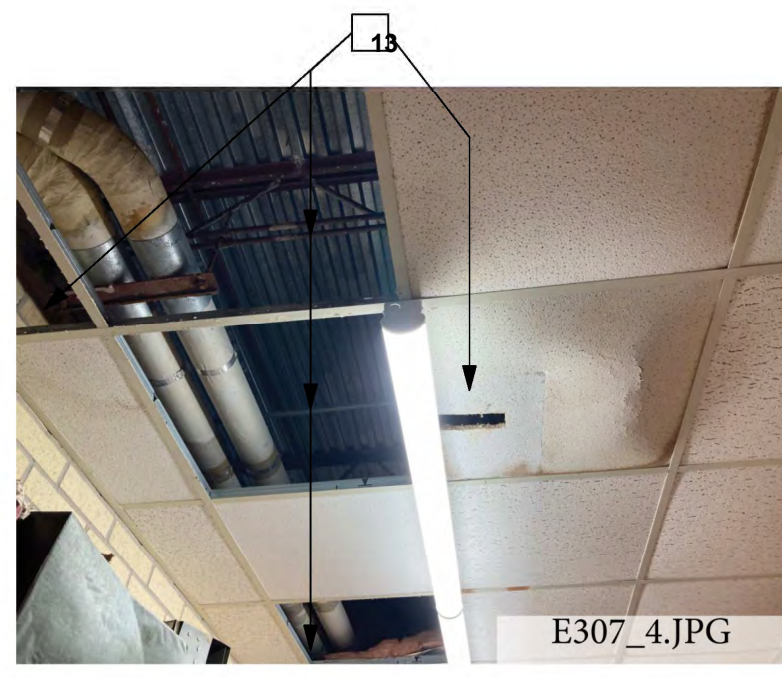
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 LAKE CHARLES, LA 70605
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