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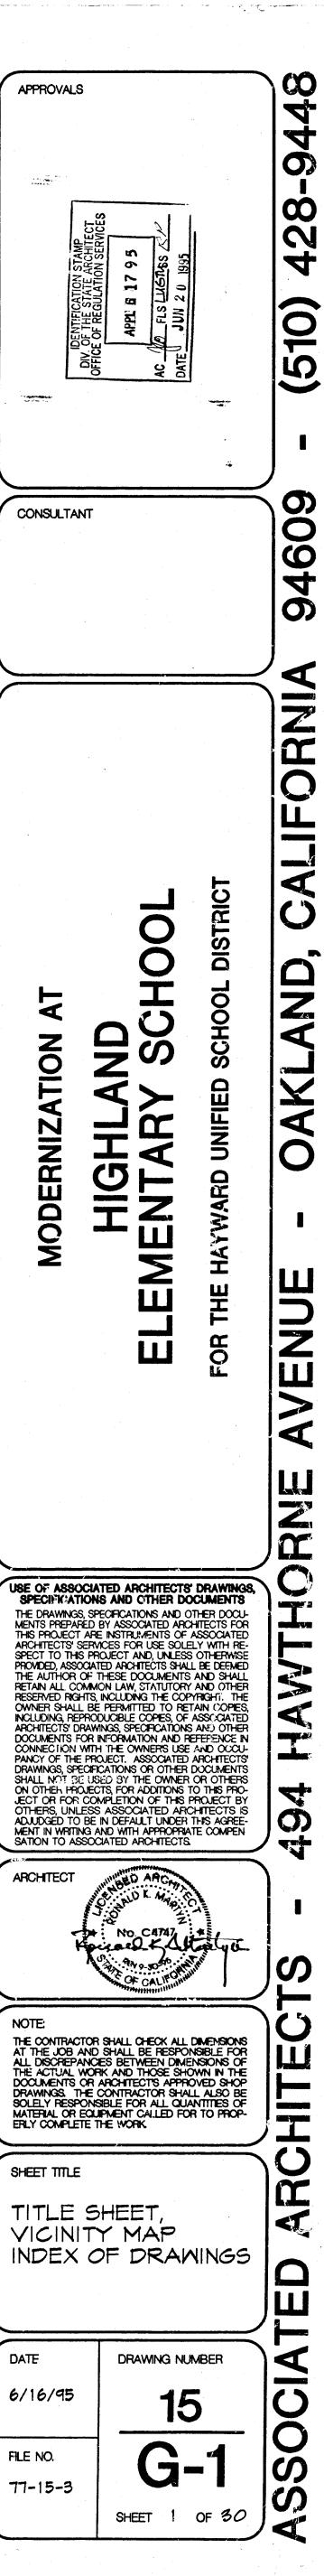
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DEFERRED APPROVAL ITEMS

MODERNIZATION AT

HIGHLAND ELEMENTARY SCHOOL

FOR THE HAYWARD UNIFIED SCHOOL DISTRICT



	·		•				
	A		F _.		M	·	S
A.C. ACOUS. AC.T. A.D.F. ADJ. A.F.F. AGGR. A.LAV. ALUM. APPROX. A.T.S. AW. \$ \$(5)	ASPHALT CONCRETE ACOUSTIC TILE ACCESSIBLE DRINKING FOUNTAIN ADJUSTABLE ABOVE FINISH FLOOR AGGREGATE ACCESSIBLE LAVATORY ALUMINUM APPROXIMATELY ACCESSIBLE TOILET STALL ACOUSTICAL WORK AND ANGLE(S) AT	F.A. D.N. C. C. S. F.	FIRE ALARM FLOOR DRAIN FOUNDATION FIRE EXTINGUISHER CABINET FINISHED FLOOR FIRE HOSE CABINET FLAT HEAD WOOD SCREW FINISHED FIXTURE FLOOR FLASHING FLUORESCENT FACE OF CONCRETE FACE OF FINISH FACE OF STUD FACE OF WALL FLOOR SINK FOOT, FEET FOOTING FUTURE	MAX. M.B. M.D.O. MECH. MEMB. MFGR. MIN. (20) MISC. MTL. MUL. M.W.	MAXIMUM MACHINE BOLT / MARKER BOARD MEDIUM DENSITY OVERLAY MECHANICAL MEMBRANE MANUFACTURER MINIMUM MINUTE MISCELLANEOUS MOUNTED METAL MULLION MECHANICAL WORK	S. A. D. S. C. D. T. D. S. A. D. S.	SOUTH SUPPLY AIR SEE ARCHITECTURAL DRAWINGS SOLID CORE SEE CIVIL DRAWINGS STORM DRAIN SECTION SEE ELECTRICAL DRAWINGS SQUARE FOOT SHOWER SHEET SIMILAR SINK SEE LANDSCAPE DRAWINGS SHEET METAL SEE MECHANICAL DRAWINGS SHEET METAL SEE MECHANICAL DRAWINGS SHEET METAL SCREW SANITARY NAPKIN DISPENSER SANITARY NAPKIN DISPENSER SANITARY NAPKIN RECEPTACLE SEE PLUMBING DRAWINGS SPECIFICATIONS SQUARE
	В				N	S.S.D. S.ST.	SEE STRUCTURAL DRAWINGS STAINLESS STEEL
BD. BLDG. BLK'G. BM. BOT. BTWN.	BOARD BUILDING BLOCKING BEAM BOTTOM BETWEEN		G	N. (N) N.A. N.I.C. NO. NOM. NTS.	NORTH NEW NOT APPLICABLE NOT IN CONTRACT NUMBER NOMINAL NOT TO SCALE	STD. STL. STOR. STRIP. STRUCT. SUSP. SYM.	STANDARD STEEL STORAGE STRIPPING STRUCTURAL SUSPENDED, SUSPENSION SYMMETRICAL, SYMMETRY
	C	GA. GALV. G.B. G.CO. GL. GND. G.S.M. GYP.BD.	GAUGE GALVANIZED GRAB BAR GRADE CLEANOUT GLASS, GLAZING GROUND GALVANIZED SHEET METAL GYPSUM BOARD		0		T
CAB. C.B. CEM. CER. CLG. CLKG. CLOS. CLR. COMB. COMB. COMP. CONC.	CABINET CATCH BASIN / CHALKBOARD CEMENT CERAMIC CEILING CAULKING CLOSET CLEAR COLUMN COMBINATION COMMUNICATION COMPOSITION CONCRETE	HARDBD. H.C. HDW. HDW'D	H HARDBOARD HOLLOW CORE HARDWARE HARDWOOD	O.C. OFF. OPN'G OPP. O.S.	ON CENTER OFFICE OPENING OPPOSITE OVERFLOW SCUPPER	T. T&B T&G T.B. TB. TEL. TEMP. TERR. TH. T.O.S. T.P.D. T.S. TW.	TREAD TOP AND BOTTOM TONGUE AND GROOVE TOWEL BAR TACK BOARD TELEPHONE TEMPERED TERRAZZO THICK TOP OF CONCRETE TOP OF STEEL TOILET PAPER DISPENSER TUBE (TUBULAR) STEEL TOP OF WALL
CONF. CONST. JT. CONT. CORR. CR. CSK. CTR. 4 □(S)	CONSTRUCTION JOINT CONTINUOUS CORRIDOR CENTER OF RADIUS COUNTERSINK CENTER CENTER CHANNEL(S)	H.MTL. HT. HORIZ. HR.	HOLLOW METAL HEIGHT HORIZONTAL HOUR	P.A. PART'N PERF. PL. LAM. PLAS. PLYWD. POL. PT. P.T.D. P.T.D.F.	PUBLIC ADDRESS PARTITION PERFORATED PLATE PLASTIC LAMINATE PLASTER PLYWOOD POLISHED PAIR POINT PAPER TOWEL DISPENSER PRESSURE TREATED DOUGLAS FIR	U.L. UNF. U.O.N.	U UNDERWRITERS LABORATORY UNFINISHED UNLESS OTHERWISE NOTED
	D	I.E. INFO. INSUL. INT.	INVERT ELEVATION INFORMATION INSULATION INTERIOR	P.T.R. P.V.C.	PAPER TOWEL RECEPTACLE POLY VINYL CHLORIDE		
DBL. DET. D.F. DIA. DN. DR.	DOUBLE DETAIL DRINKING FOUNTAIN DIAMETER DOWN DOOR				Q		V
D.S. D.S.P. DWG. DWL.	DOWNSPOUT DRY STAND PIPE DRAWING DOWEL		j	QT.	QUARRY TILE	V.C.T. VERT. V.I.F. VT.	VINYL COMPOSITION TILE VERTICAL VERIFY IN FIELD VINYL TILE
		JAN. JT.	JANITOR JOINT			v 1.	V 1) V 1 com 1 1 1 1 1 1 1 1 1 1 1 1 1 1 1 1 1 1 1

RADIUS

ROUND

R.C.P.

R.D.

RD.

REF.

REINF

REQ'D.

RHWS.

ROOF'G.

R.O.

RWD.

R.W.L.

EXISTING

EXPANSION JOINT

ELECTRICAL WORK

ELECTRIC WATER COOLER

ELEVATION

ELECTRICAL

EQUIPMENT

EXPANSION

EXPOSED

EXTERIOR

LAM. PLAS.

LAV.

LAMINATED PLASTIC

LAVATORY

LIGHT

(E)

EQUIP.

E.W.

E.W.C.

EXPO.

EXT.

RETURN AIR

ROOF DRAIN

REINFORCED

REQUIRED

ROOFING

REDWOOD

REFRIGERATOR

ROUGH OPENING

RESILIENT TILE

RAIN WATER LEADER

REIFORCED CONCRETE PIPE

ROUND HEAD WOOD SCREW

WEST

MINDOM

MITHOUT

WHERE OCCURS

WET STAND PIPE

WELDED WIRE MESH

WATERPROOF

WAINSCOT

MDM.

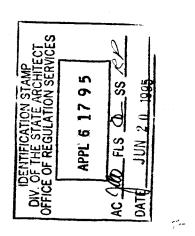
W/O

M.M.M.

WATER CLOSET (TOILET)


GENERAL NOTES

- THE CONTRACTOR SHALL VERIFY ALL EXISTING CONDITIONS AT THE SITE PRIOR TO CONSTRUCTION.
- 2. WORK ON THE SITE INCLUDES THE RETENTION OF EXISTING STRUCTURES AND UTILITIES TO REMAIN WHILE NEW CONSTRUCTION IS UNDERWAY. THE CONTRACTOR SHALL BE RESPONSIBLE FOR LOCATING AND MAINTAINING IN SERVICE ALL UTILITIES TO EXISTING STRUCTURES. SHOULD INTENTIONAL INTERRUPTION OF ANY UTILITY SERVICE BE REQUIRED BY NEW WORK, THE CONTRACTOR IS TO NOTIFY THE OWNER AND ARCHITECT ONE WEEK PRIOR TO INTERRUPTION OF SERVICE. THE CONTRACTOR SHALL VERIFY LOCATION OF ALL EXISTING UTILITY LINES IN CONSTRUCTION AREA AND REROUTE ANY WHICH MAY INTERFERE WITH THE WORK. REPAIR OF ANY BROKEN UTILITY LINES IS THE RESPONSIBILITY OF THE CONTRACTOR.
- 3. THE CONTRACTOR SHALL PROTECT ALL EXISTING SITE IMPROVEMENTS THAT ARE NOT PART OF THE WORK OR ARE TO BE INCORPORATED INTO THE WORK. PROTECTION SHALL ENCOMPASS, BUT NOT BE LIMITED TO, THE FOLLOWING EXISTING ITEMS: BUILDINGS, TREES, SIDEWALKS, PAVING, CURBS, FENCING AND PLANTED AREAS. ALL DAMAGE RESULTING FROM THE WORK SHALL BE REPAIRED OR REPLACED IN KIND AT NO COST TO THE OWNER.
- 4. THE INTENT OF THE CONTRACT DOCUMENTS IS TO MODERNIZE (REMODEL) THE EXISTING SCHOOL BUILDINGS. SHOULD ANY CONDITIONS DEVELOP NOT COVERED BY THE CONTRACT DOCUMENTS, A CHANGE ORDER DETAILING AND SPECIFYING THE REQUIRED WORK SHALL BE SUBMITTED TO AND APPROVED BY THE OFFICE OF REGULATION SERVICES BEFORE PROCEEDING WITH THE WORK.



CONSULTANT

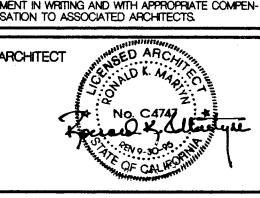USE OF ASSOCIATED ARCHITECTS' DRAWINGS SPECIFICATIONS AND OTHER DOCUMENTS THE DRAWINGS, SPECIFICATIONS AND OTHER DOCUMENTS PREPARED BY ASSOCIATED ARCHITECTS FOR THIS PROJECT ARE INSTRUMENTS OF ASSOCIATED ARCHITECTS' SERVICES FOR USE SOLELY WITH RESPECT TO THIS PROJECT AND, UNLESS OTHERWISE PROVIDED, ASSOCIATED ARCHITECTS SHALL BE DEEMED THE AUTHOR OF THESE DOCUMENTS AND SHALL RETAIN ALL COMMON LAW, STATUTORY AND OTHER RESERVED RIGHTS, INCLUDING THE COPYRIGHT. THE OWNER SHALL BE PERMITTED TO RETAIN COPIES, INCLUDING, REPRODUCIBLE COPIES, OF ASSOCIATED ARCHITECTS' DRAWINGS, SPECIFICATIONS AND OTHER DOCUMENTS FOR INFORMATION AND REFERENCE IN CONNECTION WITH THE OWNER'S USE AND OCCUPANCY OF THE PROJECT. ASSOCIATED ARCHITECTS' DRAWINGS, SPECIFICATIONS OR OTHER DOCUMENTS SHALL NOT BE USED BY THE OWNER OR OTHERS ON OTHER PROJECT SPOJECT OR FOR COMPLETION OF THIS PROJECT BY OTHERS, UNLESS ASSOCIATED ARCHITECTS IS ADJUDGED TO BE IN DEFAULT UNDER THIS AGREEMENT IN WRITING AND WITH APPROPRIATE COMPENSATION TO ASSOCIATED ARCHITECTS. THE DRAWINGS, SPECIFICATIONS AND OTHER DOCU-



THE CONTRACTOR SHALL CHECK ALL DIMENSIONS AT THE JOB AND SHALL BE RESPONSIBLE FOR ALL DISCREPANCES BETWEEN DIMENSIONS OF THE ACTUAL WORK AND THOSE SHOWN IN THE DOCUMENTS OR ARCHITECT'S APPROVED SHOP DRAWINGS. THE CONTRACTOR SHALL ALSO BE SOLELY RESPONSIBLE FOR ALL QUANTITIES OF MATERIAL OR EQUIPMENT CALLED FOR TO PROPERLY COMPLETE THE WORK.

SHEET TITLE

ABBREVIATIONS, GENERAL NOTES, LEGEND

AR

DRAWING NUMBER


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SHEET 2 OF 30

APPLICABLE CODES

- I. CALIFORNIA BUILDING CODE, PART 2, TITLE 24 (1991 UNIFORM BUILDING CODE AND CALIFORNIA AMENDMENTS).
- 2. CALIFORNIA ELECTRICAL CODE, PART 3, TITLE 24 (1990 NATIONAL ELECTRICAL CODE AND CALIFORNIA AMENDMENTS).
- 3. CALIFORNIA MECHANICAL CODE, PART 4, TITLE 24 (1991 UNIFORM MECHANICAL CODE AND CALÌFORNIA AMENDMENTS).
- 4. CALIFORNIA PLUMBING CODE, PART 5, TITLE 24 (1991 UNIFORM PLUMBING CODE AND CALIFORNIA AMENDMENTS).
- 5. CALIFORNIA FIRE CODE, PART 9, TITLE 24 (1991 UNIFORM FIRE CODE AND CALIFORNIA AMENDMENTS).
- 6. CALIFORNIA REFERENCED STANDARDS CODE, PART 12, TITLE 24 (1991 UNIFORM BUILDING CODE STANDARDS AND CALIFORNIA AMENDMENTS).

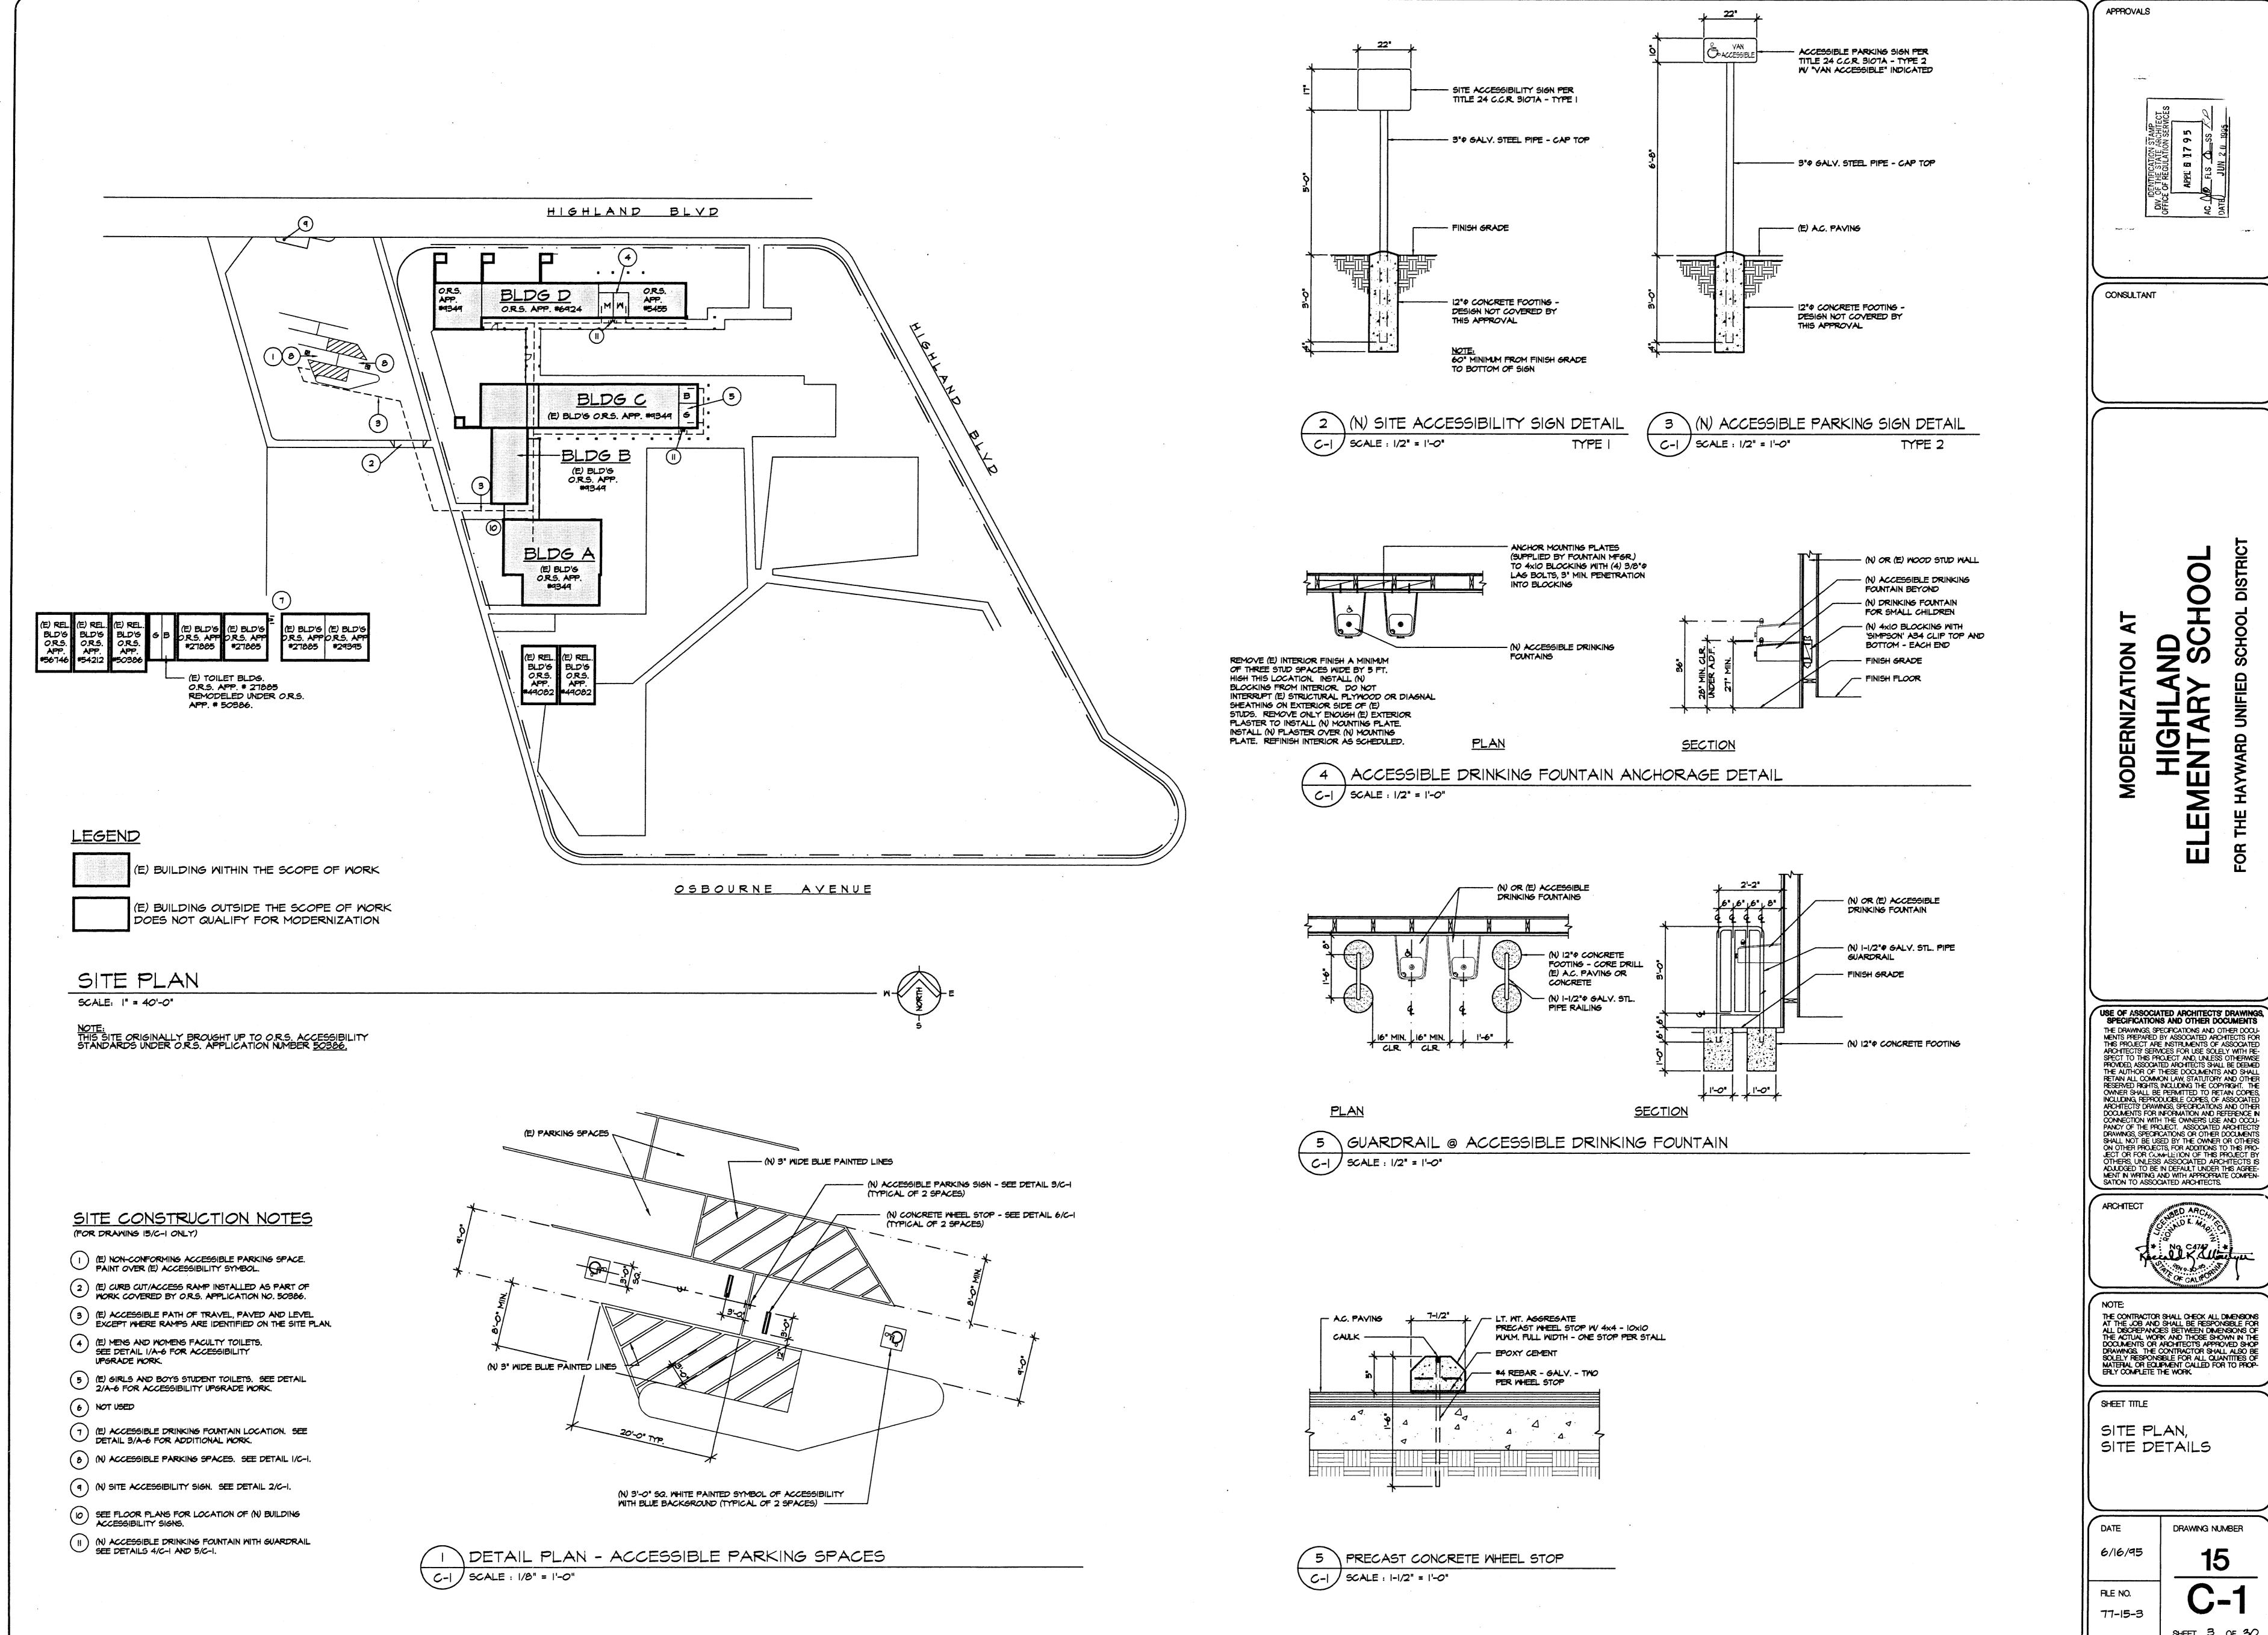7. PUBLIC SAFETY, TITLE 19, CALIFORNIA CODE OF REGULATIONS, STATE FIRE MARSHAL REGULATIONS.




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SITE PLAN, SITE DETAILS

DRAWING NUMBER

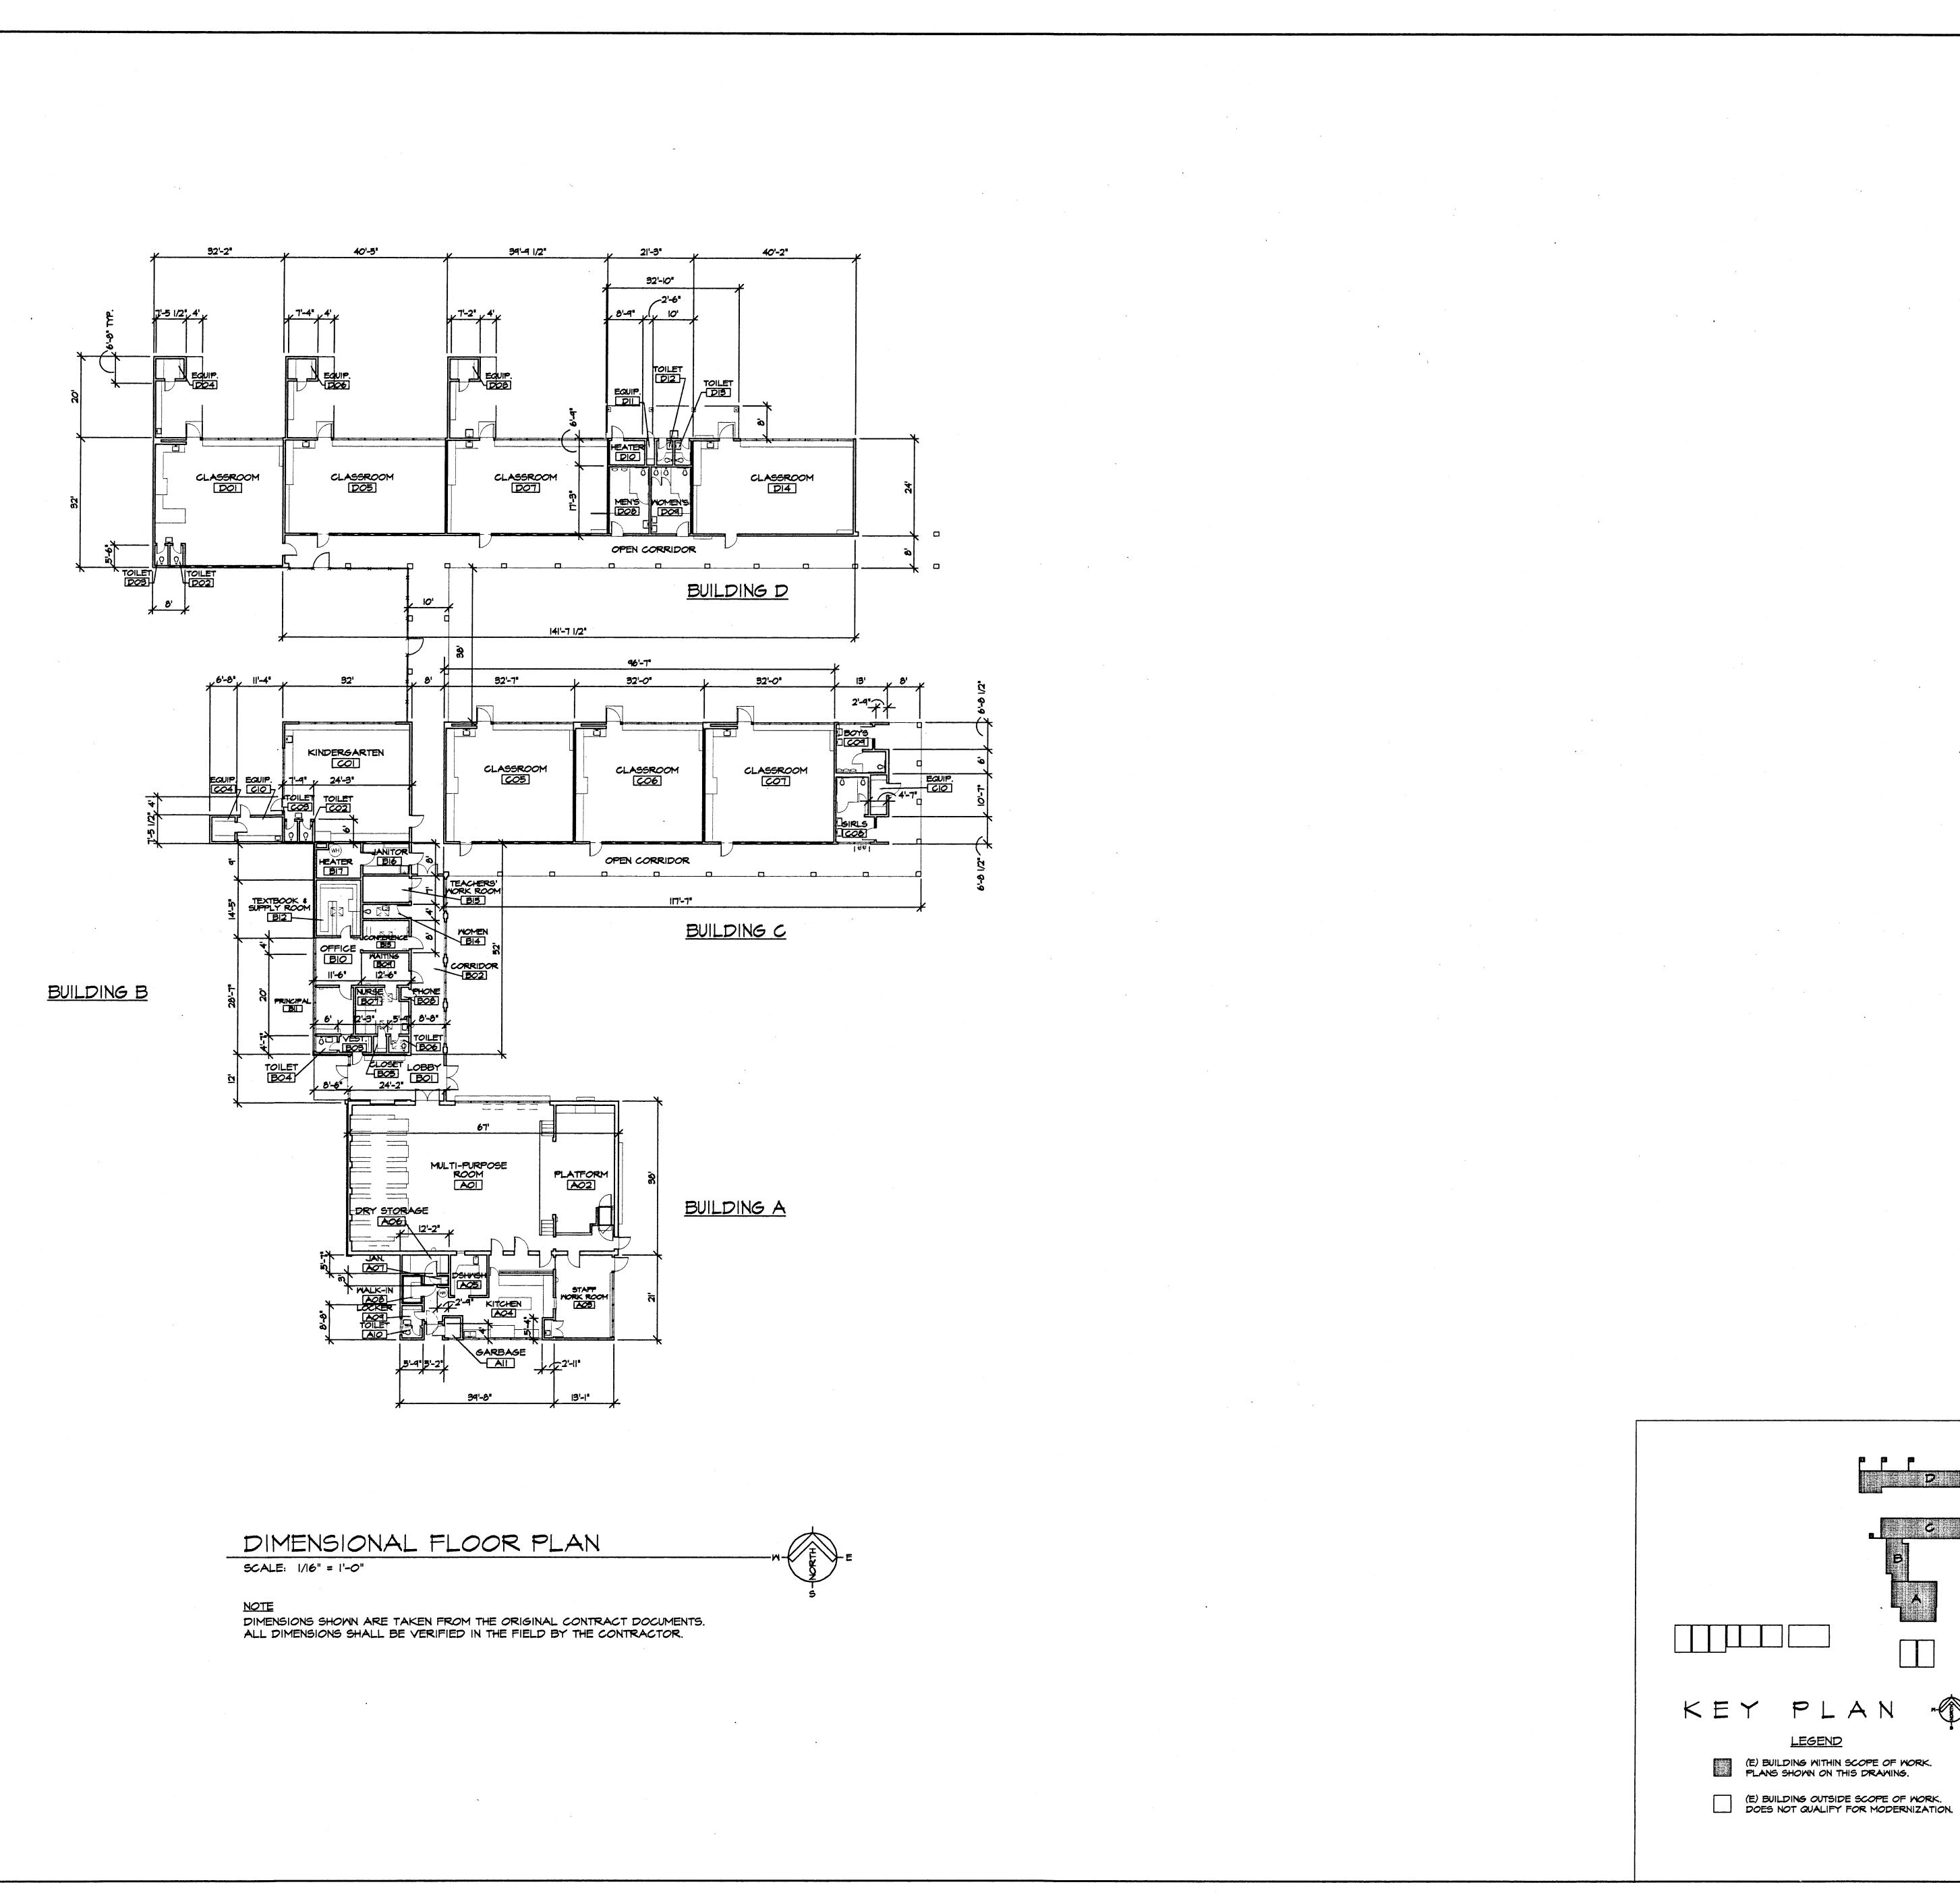SHEET 3 OF 30



CONSULTANT

MODERNIZ

USE OF ASSOCIATED ARCHITECTS' DRAWINGS, SPECIFICATIONS AND OTHER DOCUMENTS

THE DRAWINGS, SPECIFICATIONS AND OTHER DOCUMENTS PREPARED BY ASSOCIATED ARCHITECTS FOR THIS PROJECT ARE INSTRUMENTS OF ASSOCIATED ARCHITECTS' SERVICES FOR USE SOLELY WITH RESPECT TO THIS PROJECT AND, UNLESS OTHERWISE PROVIDED, ASSOCIATED ARCHITECTS SHALL BE DEEMED THE AUTHOR OF THESE DOCUMENTS AND SHALL RETAIN ALL COMMON LAW, STATUTORY AND OTHER RESERVED RIGHTS, INCLUDING THE COPYRIGHT. THE OWNER SHALL BE PERMITTED TO RETAIN COPIES, INCLUDING, REPRODUCIBLE COPIES, OF ASSOCIATED ARCHITECTS' DRAWINGS, SPECIFICATIONS AND OTHER DOCUMENTS FOR INFORMATION AND REFERENCE IN CONNECTION WITH THE OWNERS USE AND OCCUPANCY OF THE PROJECT. ASSOCIATED ARCHITECTS' DRAWINGS, SPECIFICATIONS OR OTHER DOCUMENTS SHALL NOT BE USED BY THE OWNER OR OTHERS ON OTHER PROJECTS, FOR ADDITIONS TO THIS PROJECT OR FOR COMPLICTION OF THIS PROJECT BY OTHERS, UNLESS ASSOCIATED ARCHITECTS IS ADJUDGED TO BE IN DEFAULT UNDER THIS AGREEMENT IN WRITING AND WITH APPROPRIATE COMPENSATION TO ASSOCIATED ARCHITECTS.

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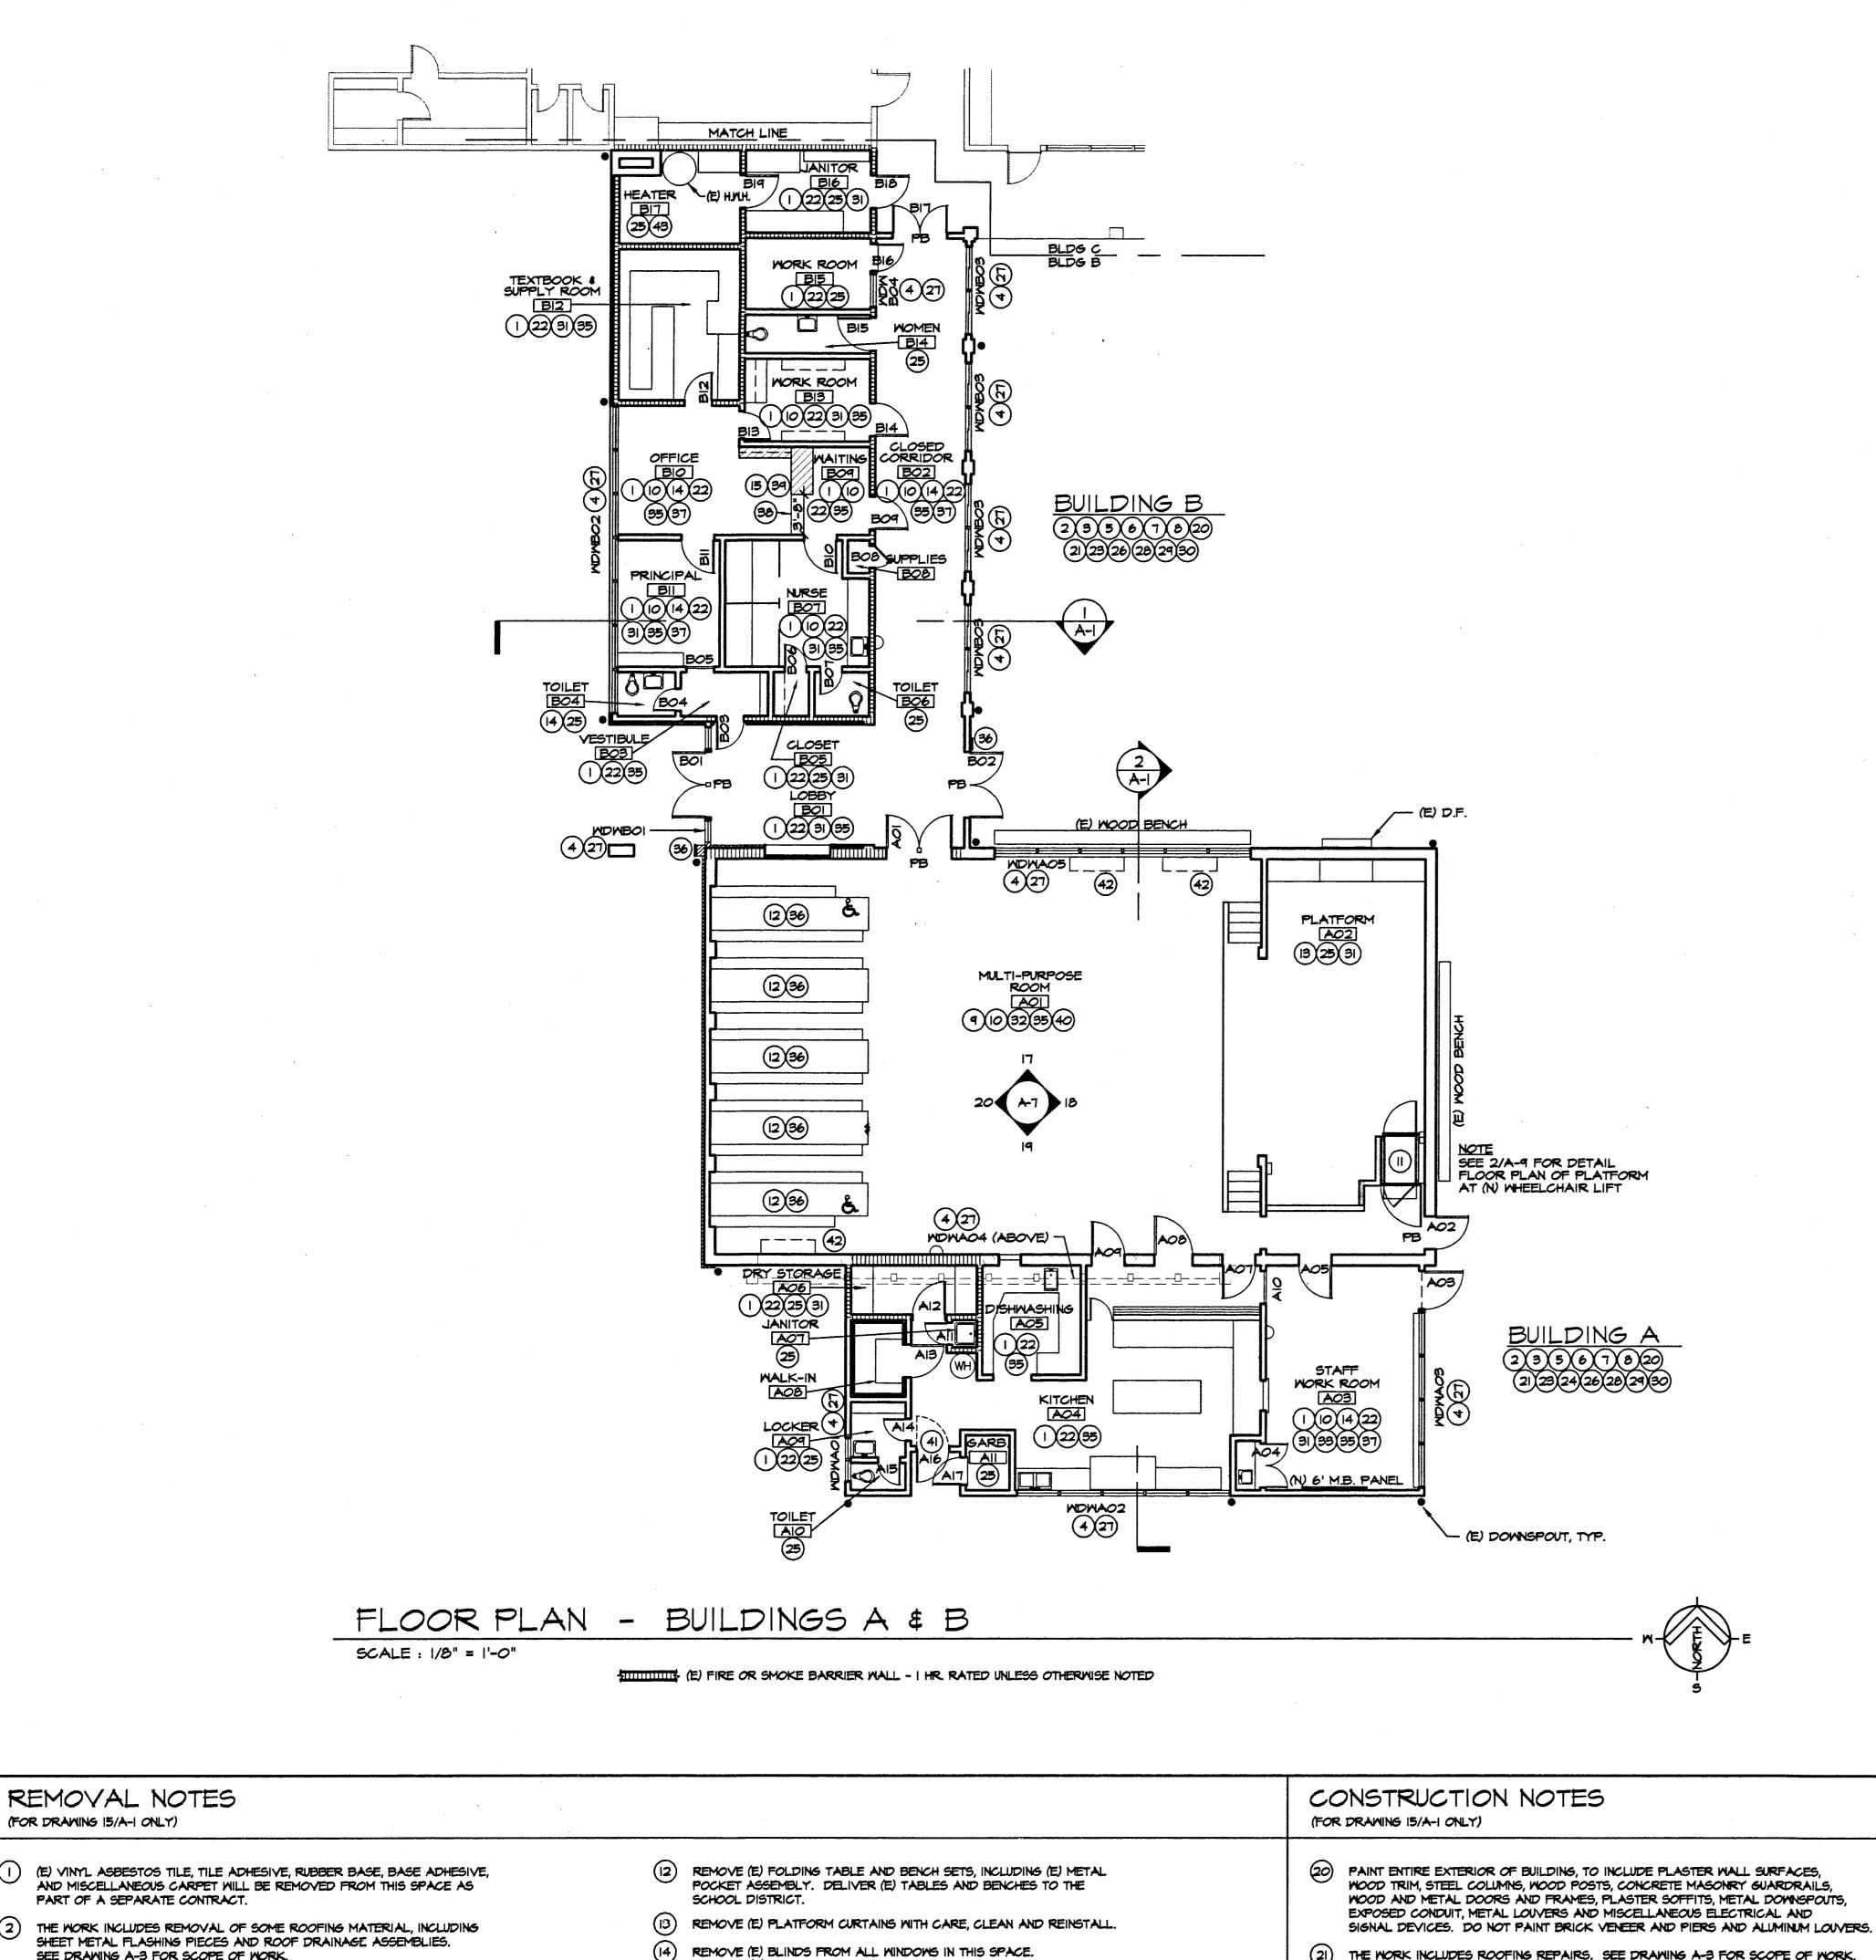
DRAWING NUMBER

SHEET TITLE

6/16/95

77-15-3

DIMENSIONAL FLOOR PLAN



DELIVER (E) BLINDS TO THE SCHOOL DISTRICT.

REMOVE (E) CASEMORK.

PRINCIPA TYP. SECTION @ BLDG B + 15'-0" FIN. CLG. EL. MULTI-PURPOSE ROOM KITCHEN

> USE OF ASSOCIATED ARCHITECTS' DRAWINGS SPECIFICATIONS AND OTHER DOCUMENTS SPECIFICATIONS AND OTHER DOCUMENTS
> THE DRAWINGS, SPECIFICATIONS AND OTHER DOCUMENTS PREPARED BY ASSOCIATED ARCHITECTS FOR THIS PROJECT ARE INSTRUMENTS OF ASSOCIATED ARCHITECTS SERVICES FOR USE SOLELY WITH RESPECT TO THIS PROJECT AND, UNILESS OTHERWISE PROVIDED, ASSOCIATED ARCHITECTS SHALL BE DEEMED THE AUTHOR OF THESE DOCUMENTS AND SHALL RETAIN ALL COMMON LAW, STATUTORY AND OTHER RESERVED RIGHTS, INCLUDING THE COPYRIGHT. THE OWNER SHALL BE PERMITTED TO RETAIN COPIES, INCLUDING, REPRODUCIBLE COPIES, OF ASSOCIATED ARCHITECTS' DRAWINGS, SPECIFICATIONS AND OTHER DOCUMENTS FOR INFORMATION AND REFERENCE IN CONNECTION WITH THE OWNER'S USE AND OCCUPANCY OF THE PROJECT. ASSOCIATED ARCHITECTS' DRAWINGS, SPECIFICATIONS OR OTHER DOCUMENTS SHALL NOT BE USED BY THE OWNER OR OTHERS ON OTHER PROJECT'S, ROW AUDITIONS TO THIS PROJECT OR FOR COMPLETION OF THIS PROJECT BY OTHERS, UNLESS ASSOCIATED ARCHITECTS IS ADJUDGED TO BE IN DEFAULT UNDER THIS AGREEMENT IN WRITING AND WITH APPROPRIATE COMPENSATION TO ASSOCIATED ARCHITECTS.

CONSULTANT

ODERNIZ

THE CONTRACTOR SHALL CHECK ALL DIMENSIONS AT THE JOB AND SHALL BE RESPONSIBLE FOR ALL DISCREPANCIES BETWEEN DIMENSIONS OF THE ACTUAL WORK AND THOSE SHOWN IN THE DOCUMENTS OR ARCHITECT'S APPROVED SHOP DRAWINGS. THE CONTRACTOR SHALL ALSO BE SOLELY RESPONSIBLE FOR ALL QUANTITIES OF MATERIAL OR EQUIPMENT CALLED FOR TO PROPERLY COMPLETE THE WORK.

SHEET TITLE FLOOR PLAN

BUILDINGS A & B

DRAWING NUMBER

77-15-3

(21) THE WORK INCLUDES ROOFING REPAIRS. SEE DRAWING A-3 FOR SCOPE OF WORK.

TO REMAIN. REFINISH PER ROOM FINISH SCHEDULE.

FINISH PER ROOM FINISH SCHEDULE, OR AS DETAILED.

(E) CEILING (SOFFIT) AND WALL FINISHES TO REMAIN, UNLESS NOTED OTHERWISE. RE-FINISH PER ROOM FINISH SCHEDULE.

THE WORK INCLUDES INSTALLATION OF (N) DOORS, DOOR FRAMES AND DOOR HARDWARE SEE THE DOOR SCHEDILLE ON DRAWING ALE FOR EXTENT OF

WORK AT EACH OPENING.

RE-GLAZE (E) METAL OR WOOD SASH IN THIS GROUP OF WINDOWS AS SCHEDULED.
SEE WINDOW REGLAZING SCHEDULE ON DRAWING A-9 AND SPECIFICATION.

(28) (N) MECHANICAL WORK REQUIRED THIS BUILDING. SEE THE MECHANICAL DRAWINGS.

(29) (N) PLUMBING WORK REQUIRED THIS BUILDING. SEE THE PLUMBING DRAWINGS.

(32) INSTALL (N) DRAPERIES AT ALL WINDOWS THIS SPACE.

(E) CONCRETE FLOOR SLAB ON GRADE. SEE FLOOR COVERING SPECIFICATIONS

FOR PREP AND REPAIR. RE-COVER PER ROOM FINISH SCHEDULE.

(E) EXTERIOR AND INTERIOR WOOD STUD PARTITIONS, INDICATED

(24) (N) EXTERIOR AND INTERIOR WOOD STUD PARTITIONS, INDICATED

HARDWARE. SEE THE DOOR SCHEDULE ON DRAWING A-5 FOR EXTENT OF

(30) (N) ELECTRICAL WORK REQUIRED THIS BUILDING. SEE THE ELECTRICAL DRAWINGS.

(31) (E) CASEMORK TO BE REFINISHED THIS SPACE. SEE THE ROOM FINISH SCHEDULE

33) INSTALL (N) MARKERBOARD PANELS OVER (E) CHALKBOARDS IN THIS SPACE. SEE THE FLOOR PLANS AND DRAWING A-7 FOR TYPICAL CLASSROOM INTERIOR ELEVATIONS. SEE ALSO DETAILS 5/A-4 \$ 6/A-4.

INSTALL (N) BUILDING ACCESSIBILITY SIGN - TYPE 3, SEE SPECIFICATIONS. INSTALL (N) ACOUSTIC TILE CEILING FINISH. SEE ROOM FINISH SCHEDULE.

INSTALL (N) FOLDING TABLE AND BENCH SETS, INCLUDING (N) METAL

POCKET ASSEMBLIES. SEE DETAIL 25/A-8. INSTALL (N) HORIZONTAL BLINDS.

TYP. SECTION @ BLDG A

LINE OF CARPET AND VINYL TILE TRANSITION.

(N) CASEMORK SHOWN HATCHED. SEE DETAIL PLAN 21/A-7.

(N) MAXIMUM OCCUPANCY SIGN - TYPE 6, SEE SPECIFICATION.

(4) INSTALL (N) ALUMINUM SCREEN DOOR THIS LOCATION

42) PATCH (E) PLYWOOD WAINSCOT AT WALL BEHIND UNIT VENTILATORS AS REQUIRED TO PROVIDE SMOOTH SURFACE TO RECEIVE (N) VINYL WALL COVERING. SEE

(N) CONCRETE FLOOR SLAB OVER (E) SLAB. SEE DETAIL 20/A-8.

LEGEND

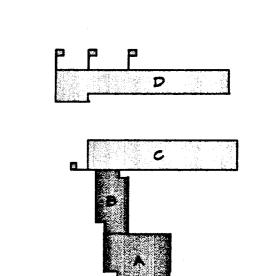
(E) BUILDING WITHIN SCOPE OF WORK. PLANS SHOWN ON THIS DRAWING.

(E) BUILDING OUTSIDE SCOPE OF WORK.

(E) BUILDING WITHIN SCOPE OF WORK.

PLANS SHOWN ON ANOTHER DRAWING.

DOES NOT QUALIFY FOR MODERNIZATION.



SHEET 5 OF 30

REMOVAL NOTES

PART OF A SEPARATE CONTRACT.

SEE DRAWING A-3 FOR SCOPE OF WORK.

FIXTURES TO THE SCHOOL DISTRICT.

REINSTALL OR REPLACE IN KIND.

(N) WHEELCHAIR LIFT.

3) THE WORK INCLUDES REMOVAL OF CERTAIN DOORS, DOOR FRAMES AND

(4) REMOVE (E) GLAZING FROM ALL METAL OR WOOD SASH IN THIS GROUP

5 THE WORK INCLUDES REMOVAL OF CERTAIN INTERIOR FINISHES, IN THIS BUILDING. SEE THE ROOM FINISH SCHEDULE ON DRAWING A-4 FOR

THE WORK INCLUDES REMOVAL OF CERTAIN PIECES OF (E) MECHANICAL EQUIPMENT IN THIS BUILDING. SEE THE MECHANICAL DRAWINGS. DELIVER EQUIPMENT TO THE SCHOOL DISTRICT.

THE WORK INCLUDES REMOVAL OF CERTAIN (E) PLUMBING FIXTURES IN THIS BUILDING. SEE THE PLUMBING DRAMINGS. DELIVER UNDAMAGED

(8) THE WORK INCLUDES REMOVAL OF CERTAIN PIECES OF (E) ELECTRICAL

REMOVE (E) DRAPERIES FROM ALL WINDOWS IN THIS SPACE. DELIVER DRAPERIES TO THE SCHOOL DISTRICT. (E) DRAPERY TRACKS TO REMAIN.

EQUIPMENT AND FIXTURES IN THIS BUILDING. SEE THE ELECTRICAL DRAWINGS. DELIVER EQUIPMENT AND FIXTURES TO THE SCHOOL

(10) REMOVE (E) WOOD TRIM WHERE REQUIRED TO ACCOMPLISH THE WORK.

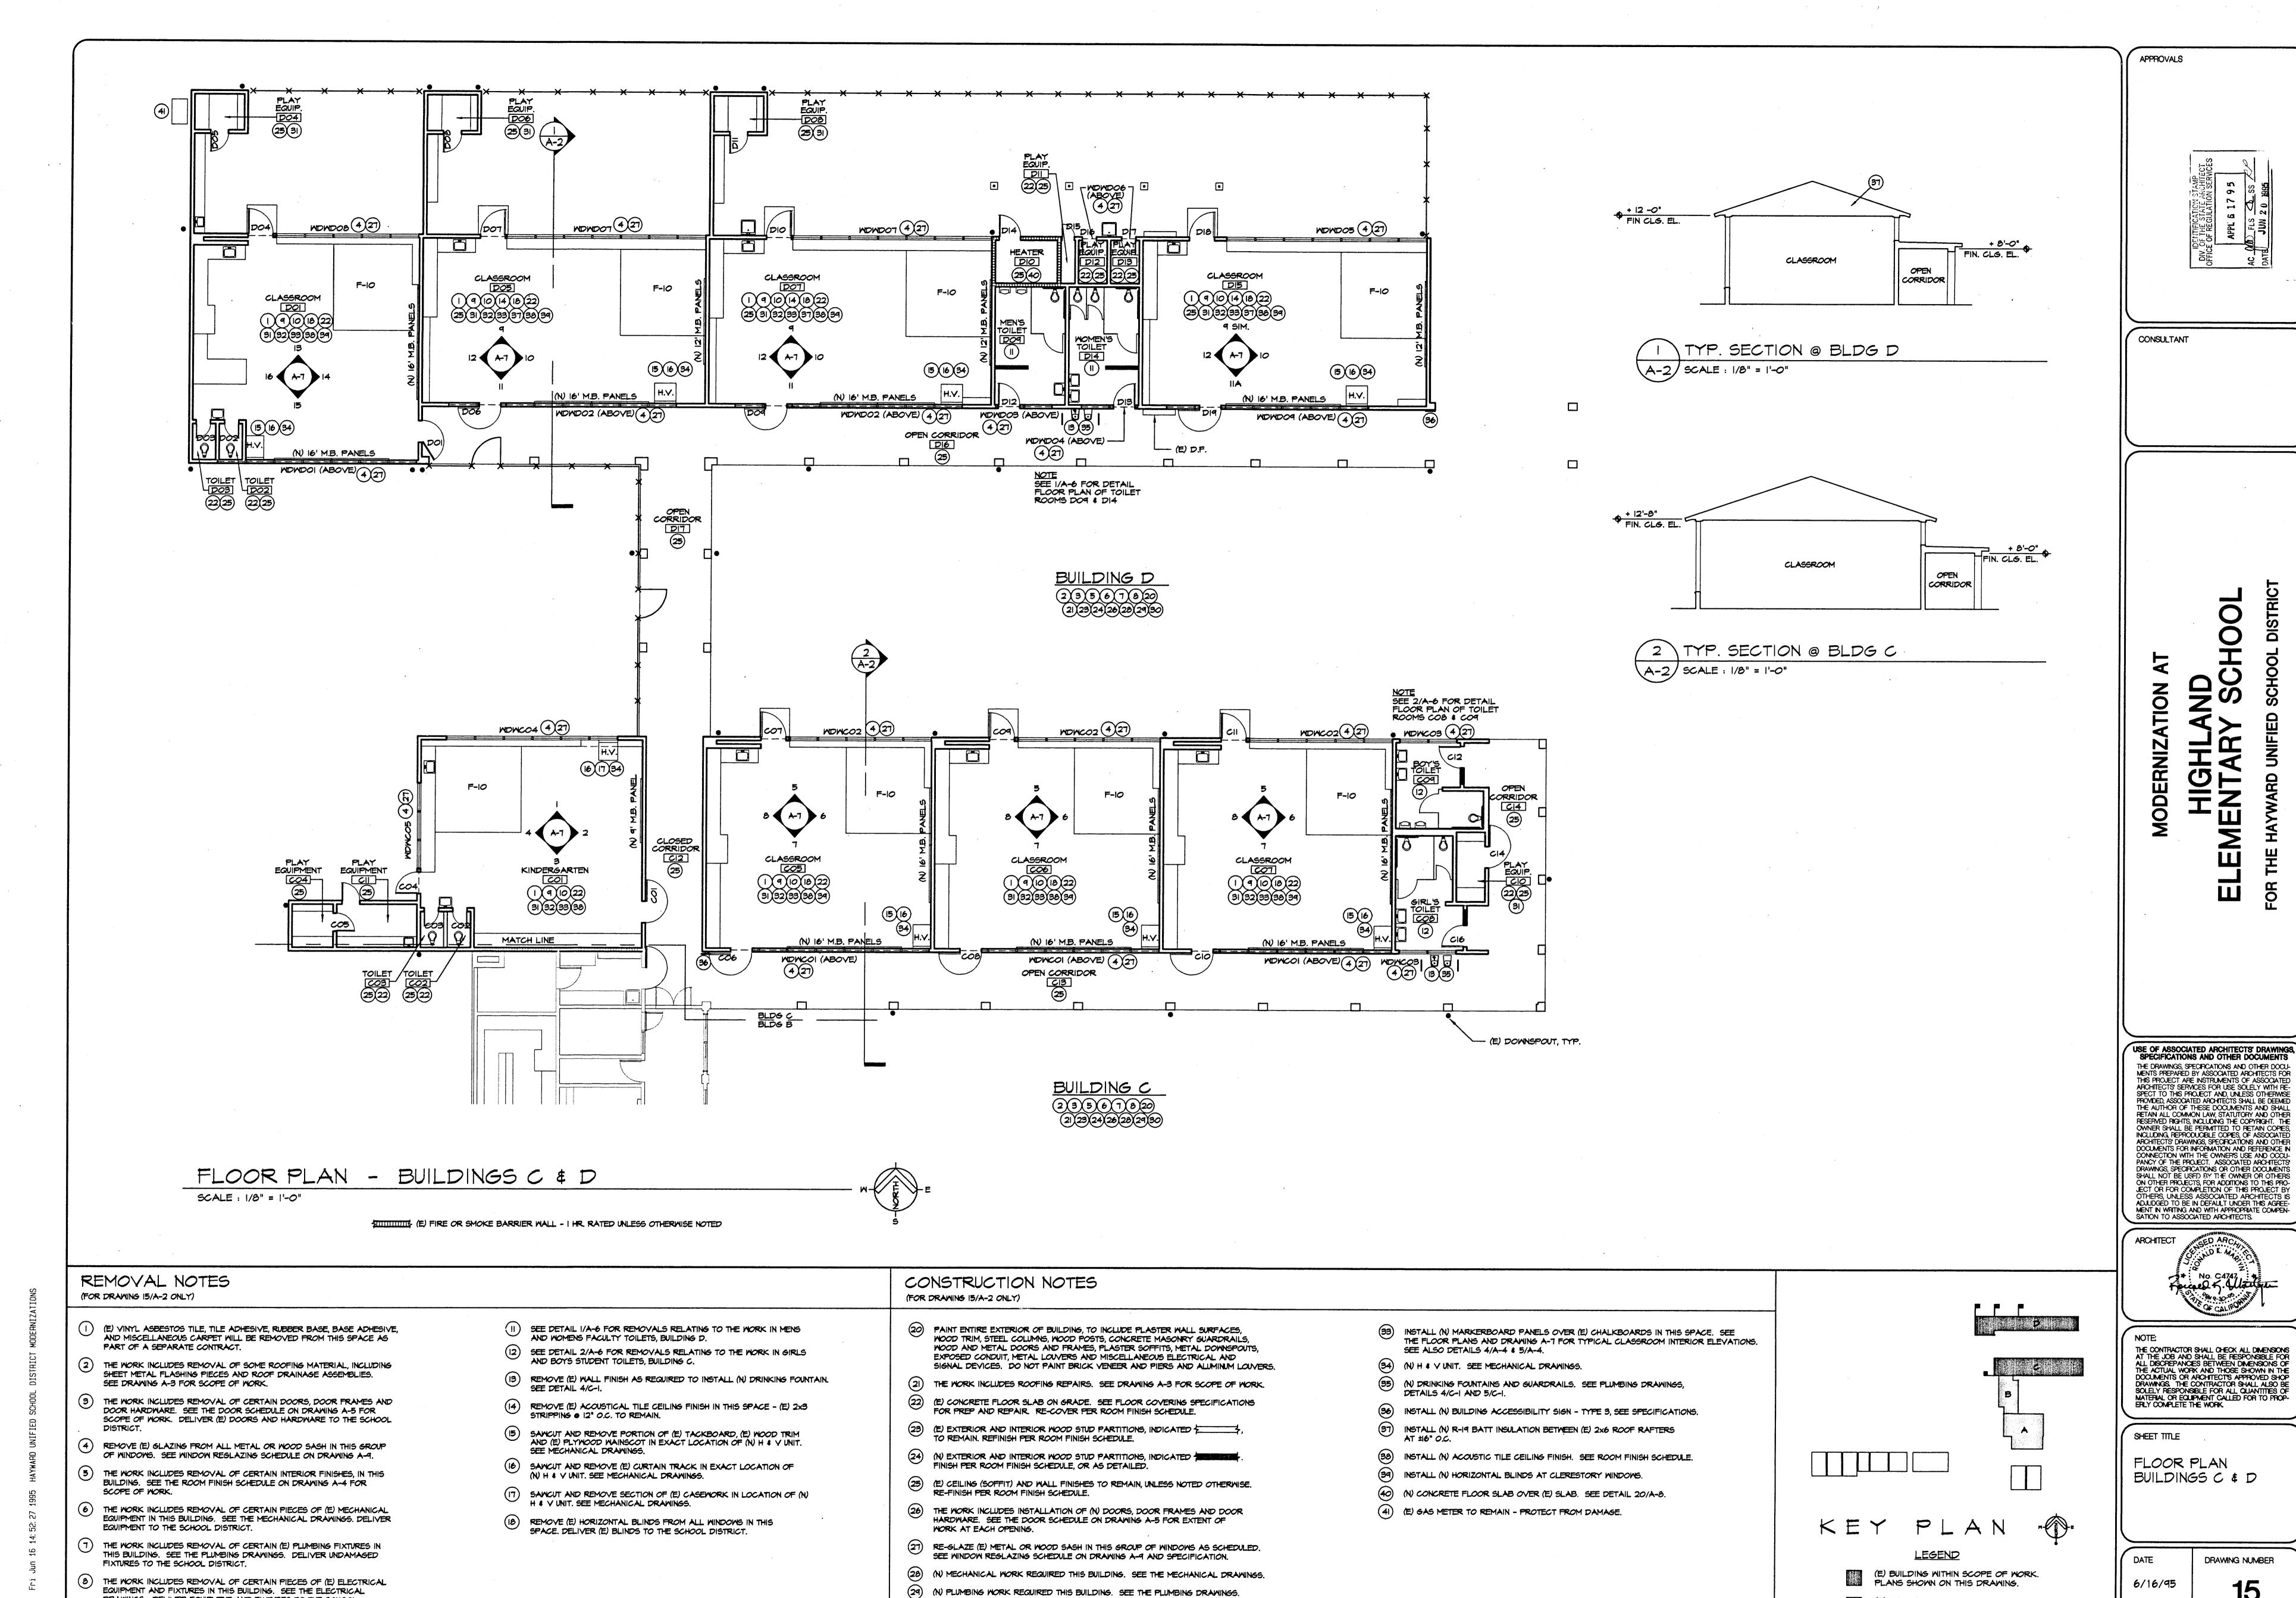
SEE DETAIL I/A-10 FOR REMOVALS RELATING TO INSTALLATION OF THE

OF WINDOWS. SEE WINDOW REGLAZING SCHEDULE ON DRAWING A-9.

DOOR HARDWARE. SEE THE DOOR SCHEDULE ON DRAWING A-5 FOR

SCOPE OF WORK. DELIVER (E) DOORS AND HARDWARE TO THE SCHOOL

(FOR DRAWING 15/A-I ONLY)



(30) (N) ELECTRICAL WORK REQUIRED THIS BUILDING. SEE THE ELECTRICAL DRAWINGS.

(31) (E) CASEMORK TO BE REFINISHED THIS SPACE. SEE THE ROOM FINISH SCHEDULE

(32) INSTALL (N) DRAPERIES AT ALL WINDOWS THIS SPACE.

DRAWINGS. DELIVER EQUIPMENT AND FIXTURES TO THE SCHOOL

(E) WOOD TRIM WHERE REQUIRED TO ACCOMPLISH THE WORK.

REINSTALL OR REPLACE IN KIND.

PREMOVE (E) DRAPERIES FROM ALL WINDOWS IN THIS SPACE. DELIVER DRAPERIES TO THE SCHOOL DISTRICT. (E) DRAPERY TRACKS TO REMAIN.

DRAWING NUMBER

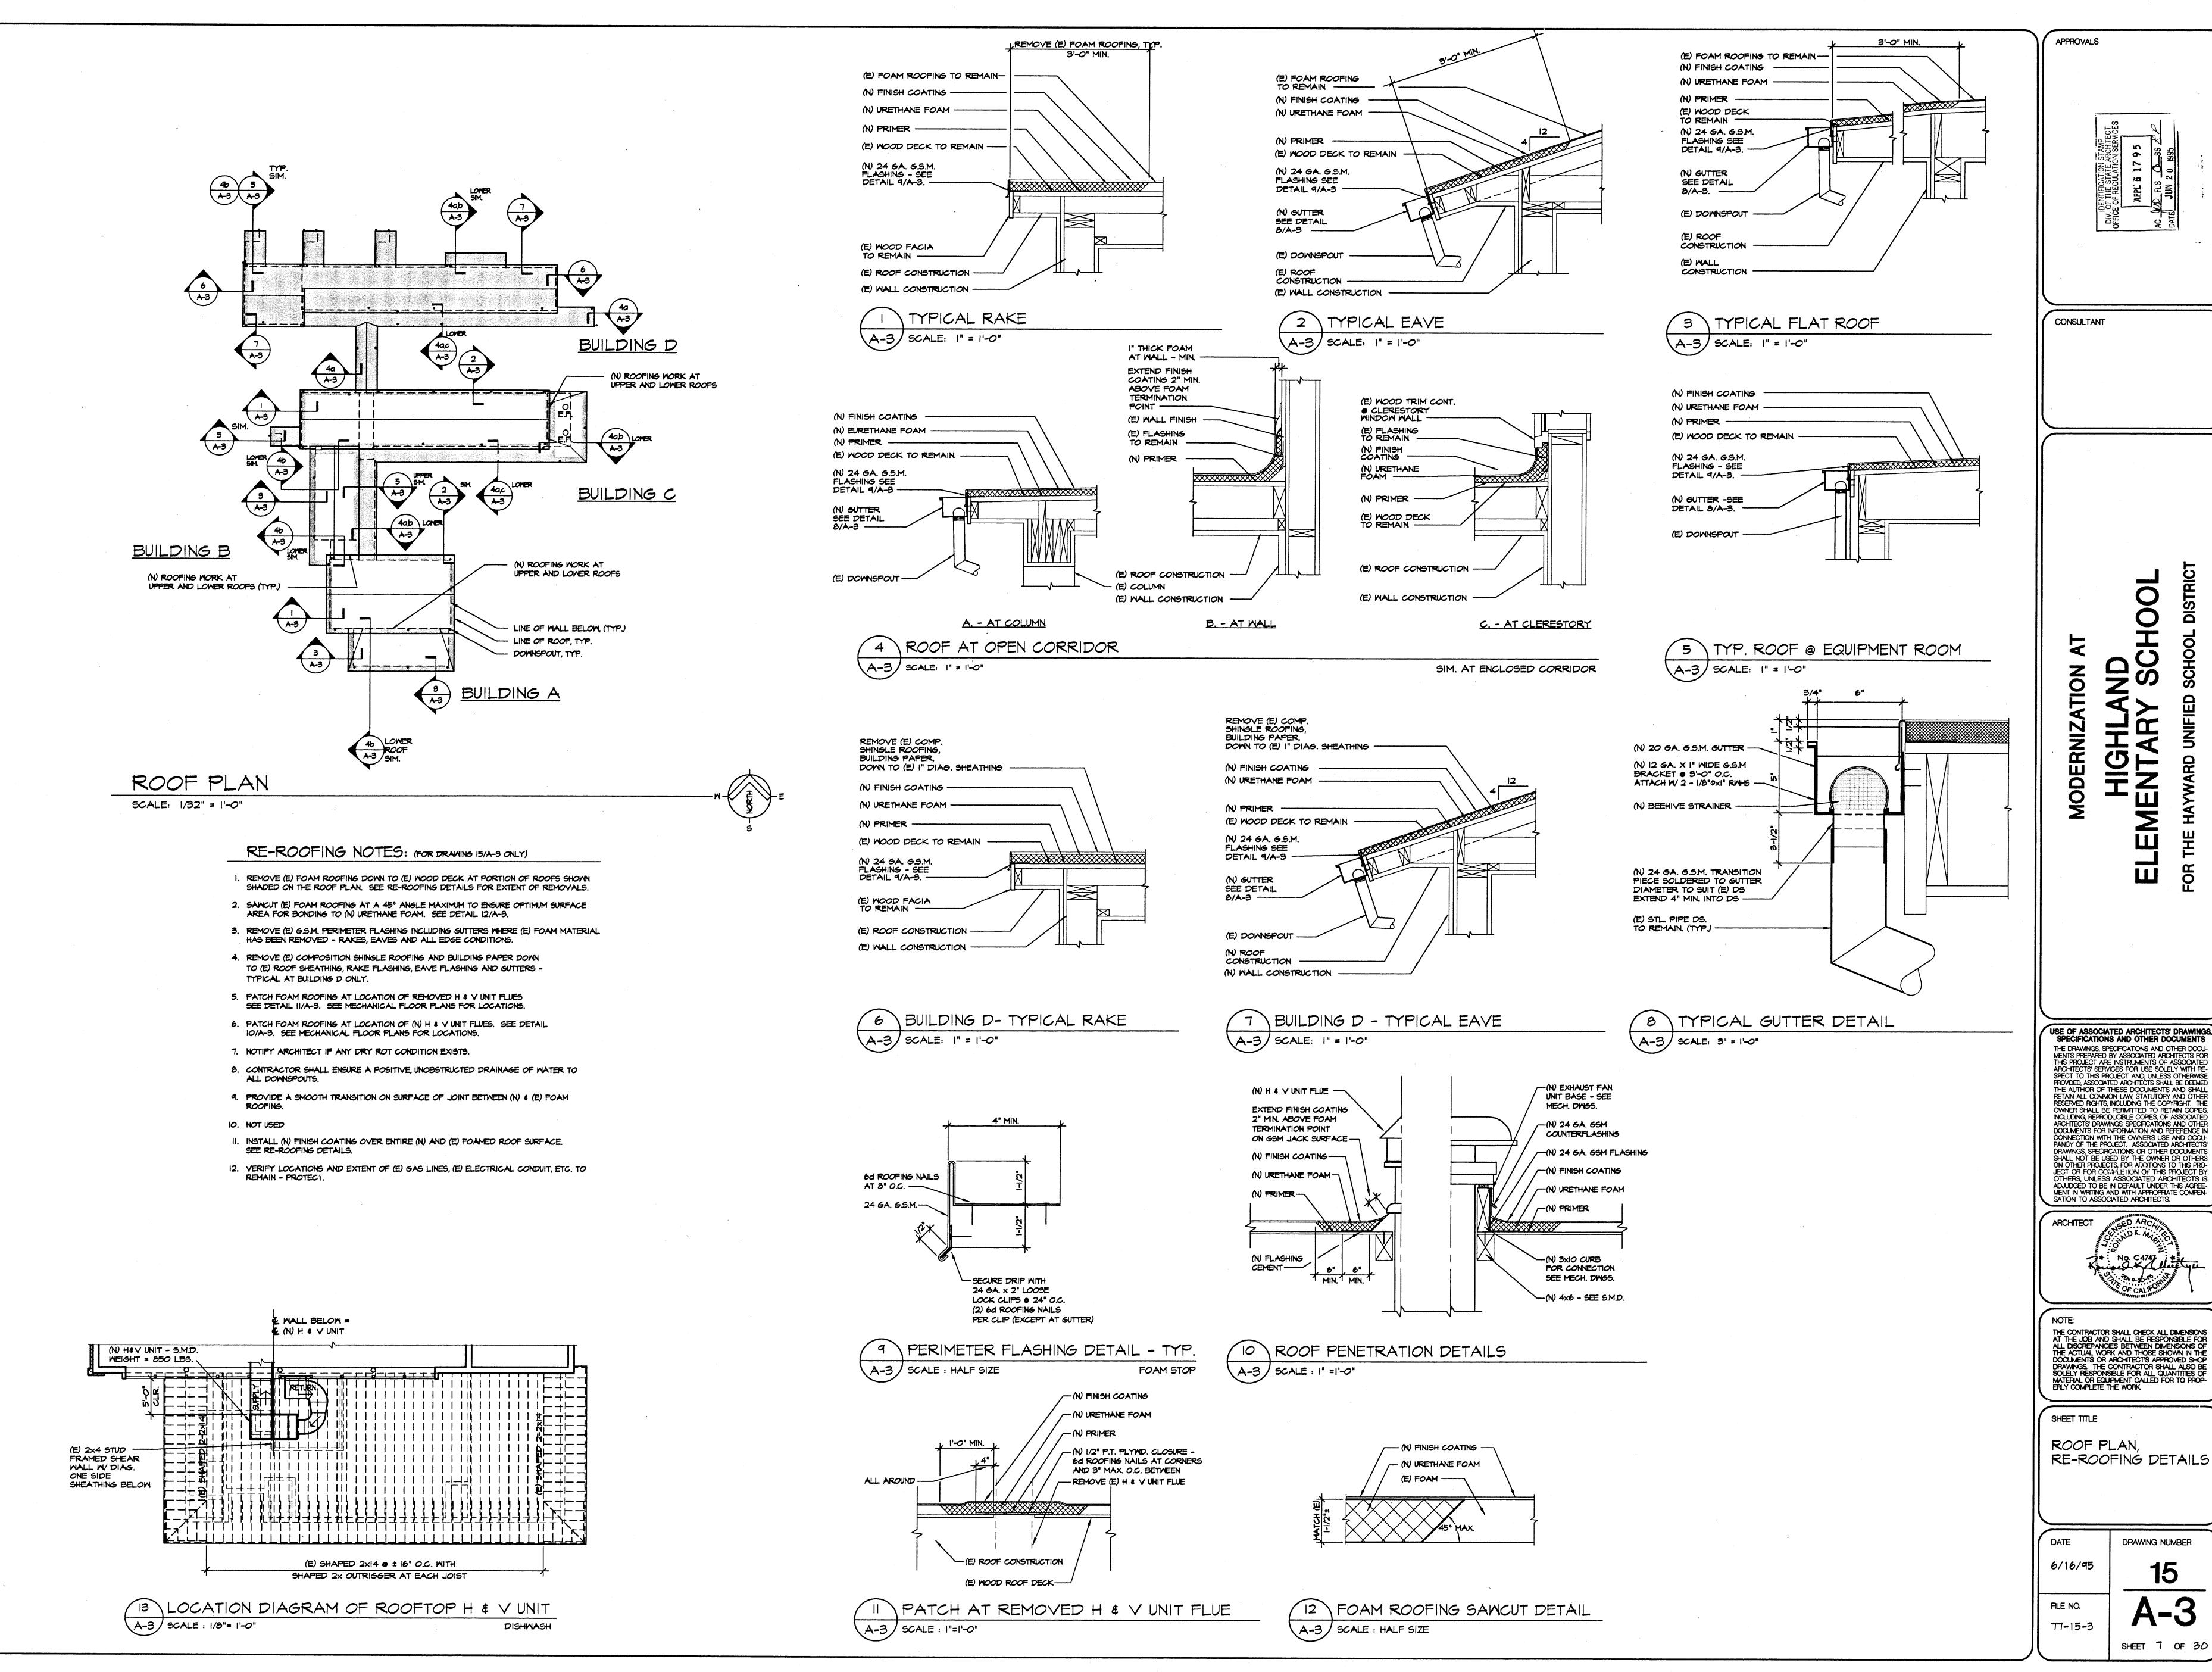
(E) BUILDING WITHIN SCOPE OF WORK.

PLANS SHOWN ON ANOTHER DRAWING.

(E) BUILDING OUTSIDE SCOPE OF WORK. DOES NOT QUALIFY FOR MODERNIZATION. FILE NO.

77-15-3

SHEET 6 OF 30




SHEET 7 OF 30

(510)


ORNI

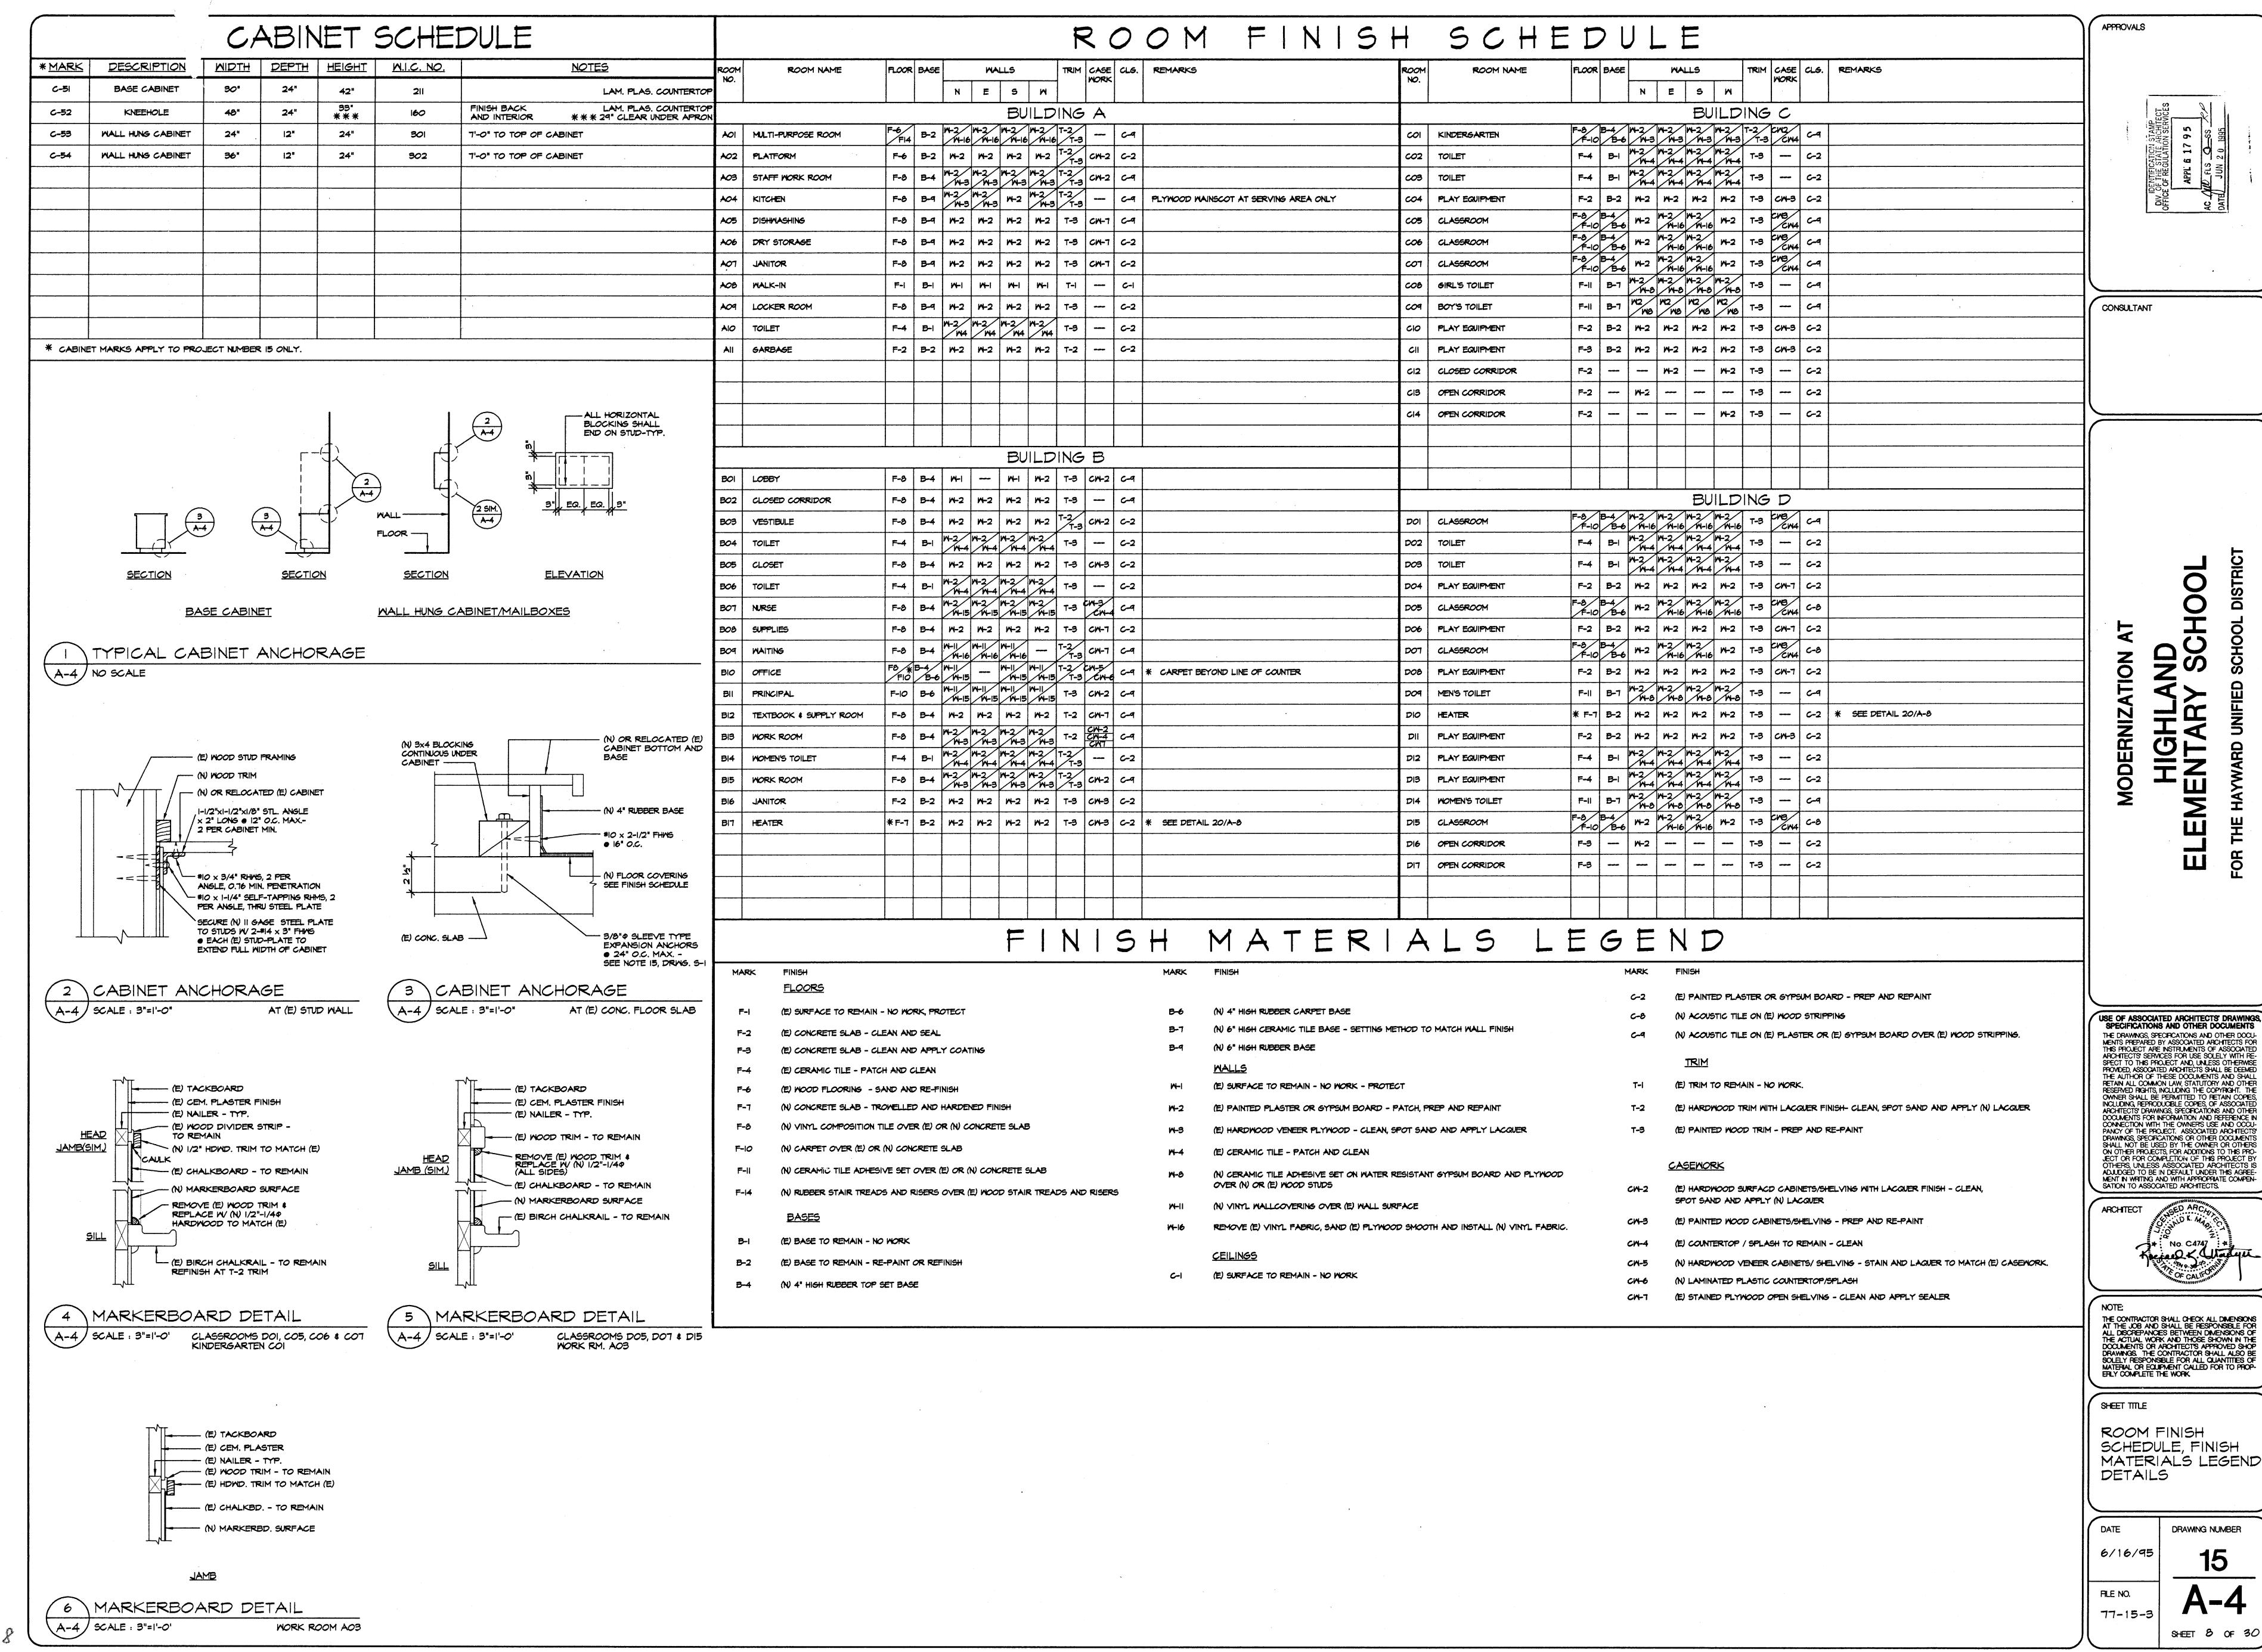DRAWING NUMBER




MATERIALS LEGEND

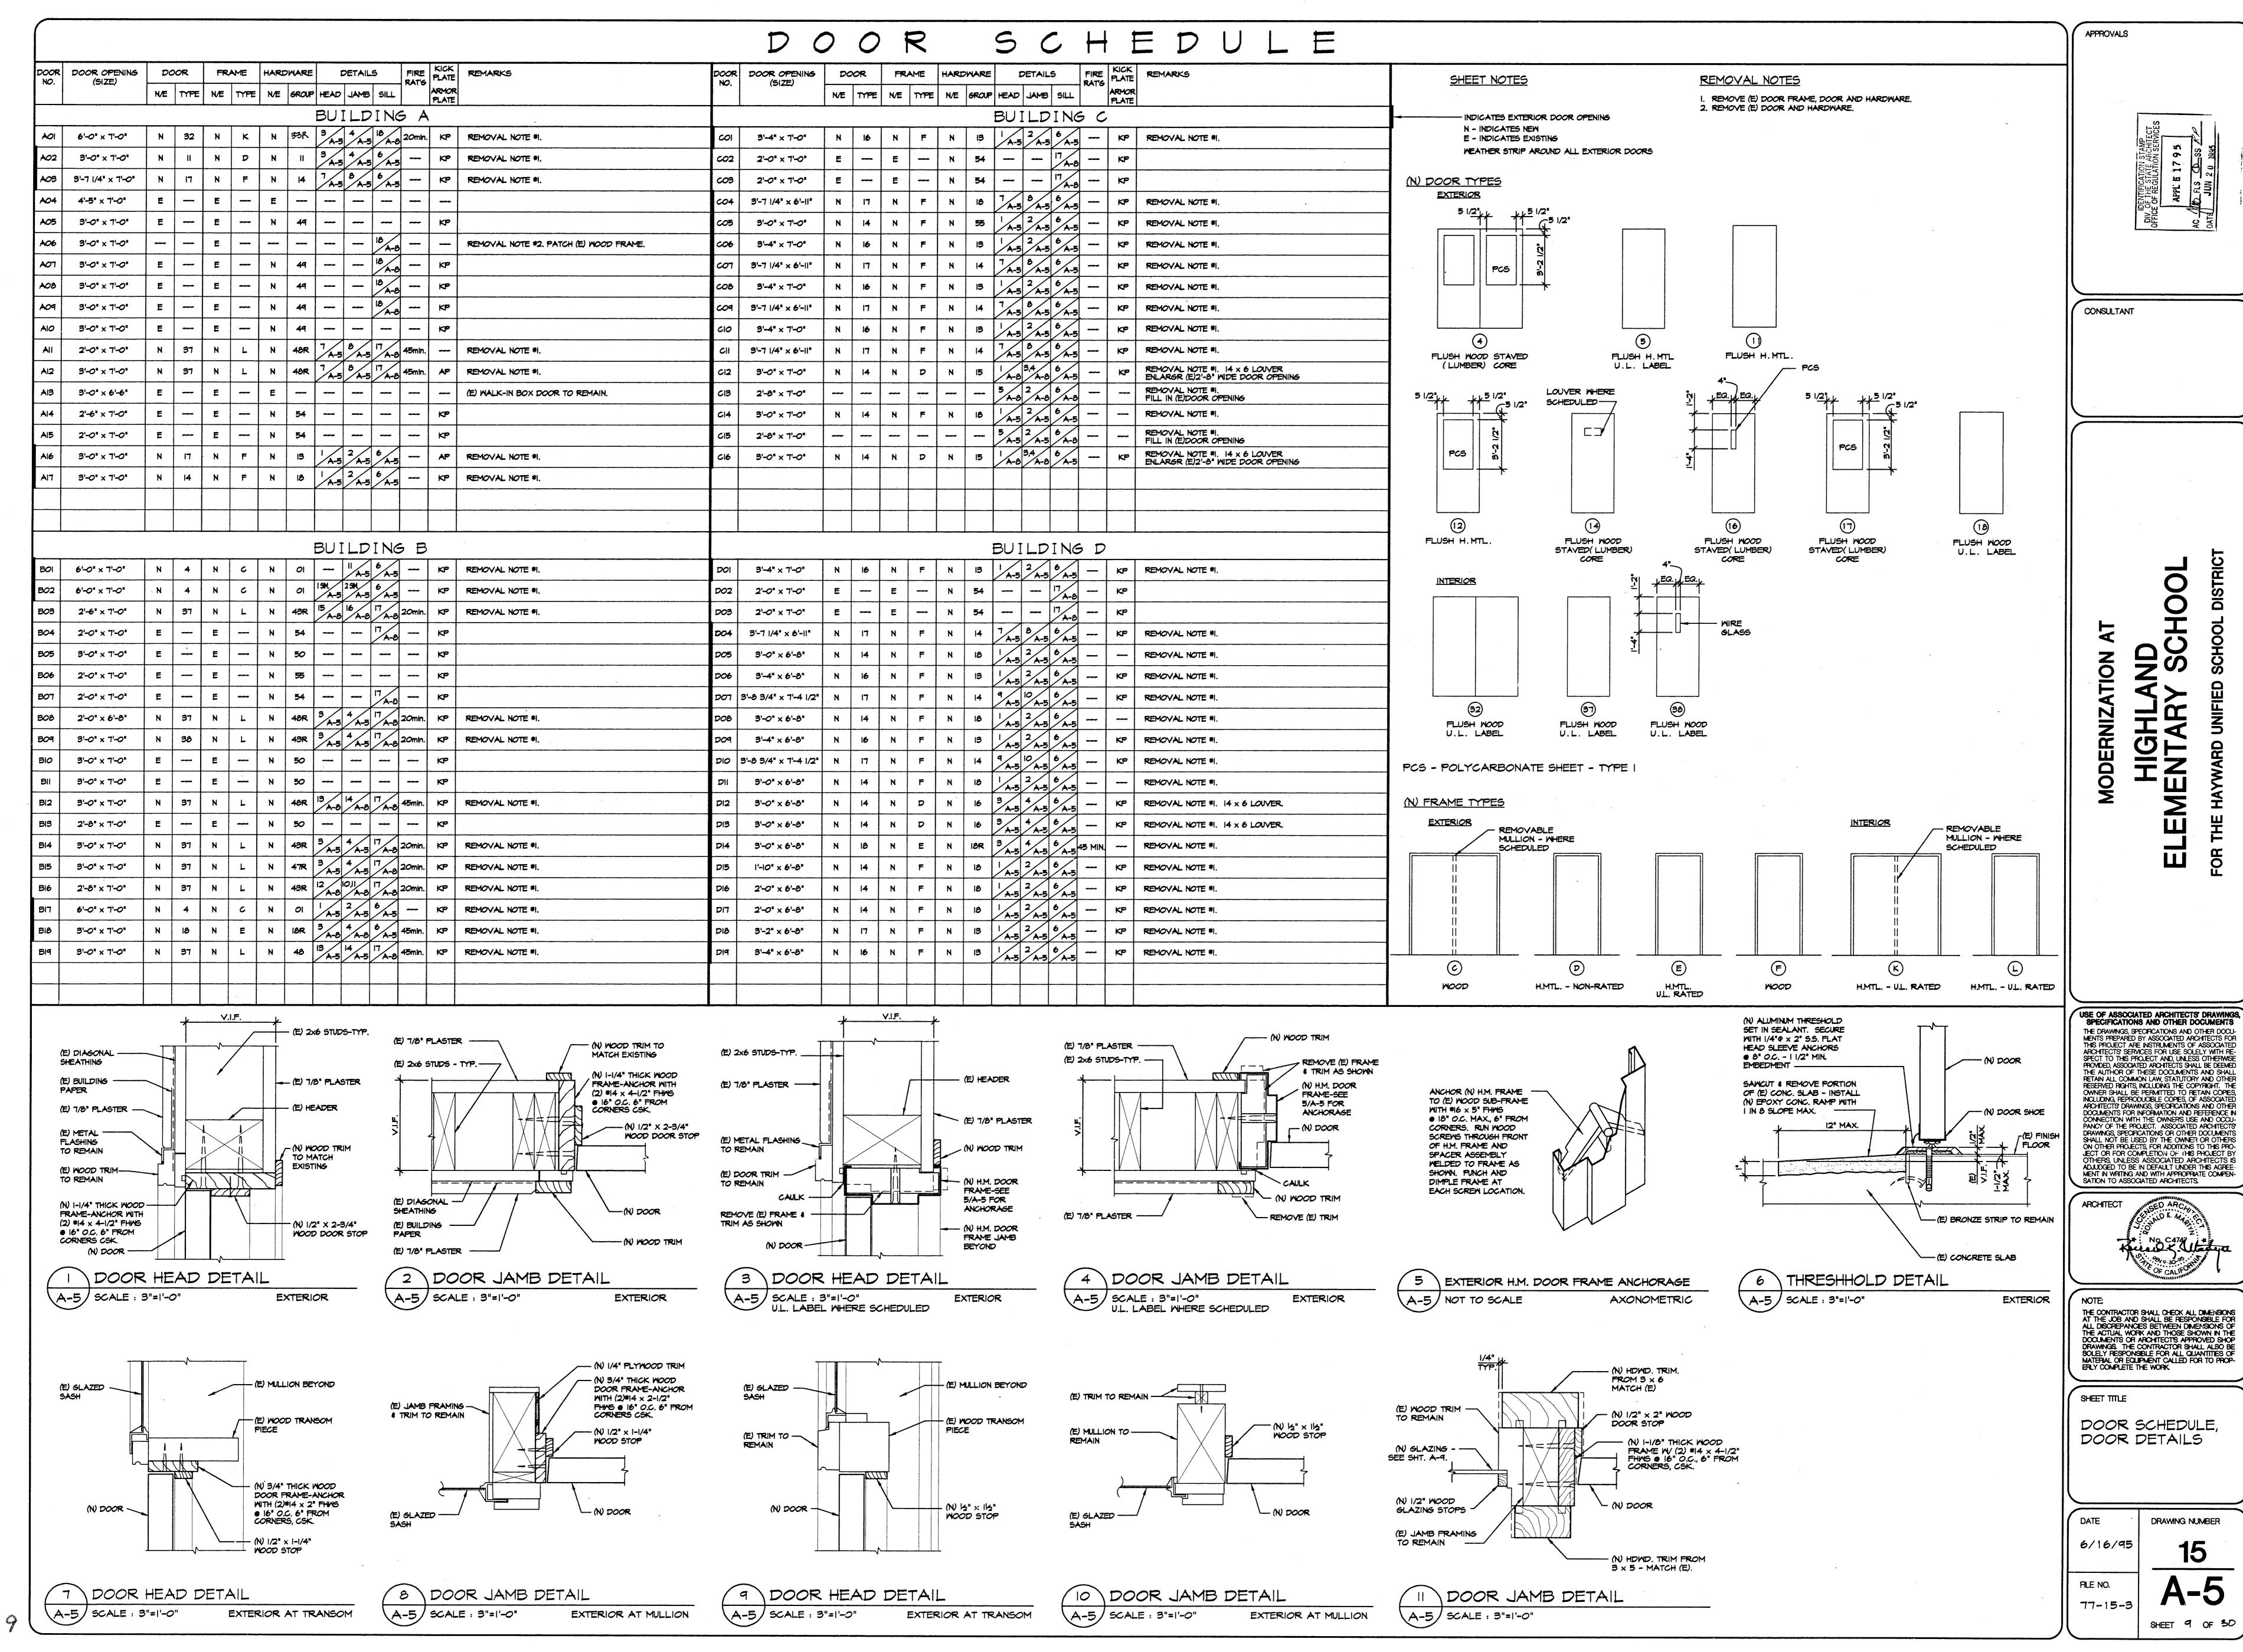
(510)



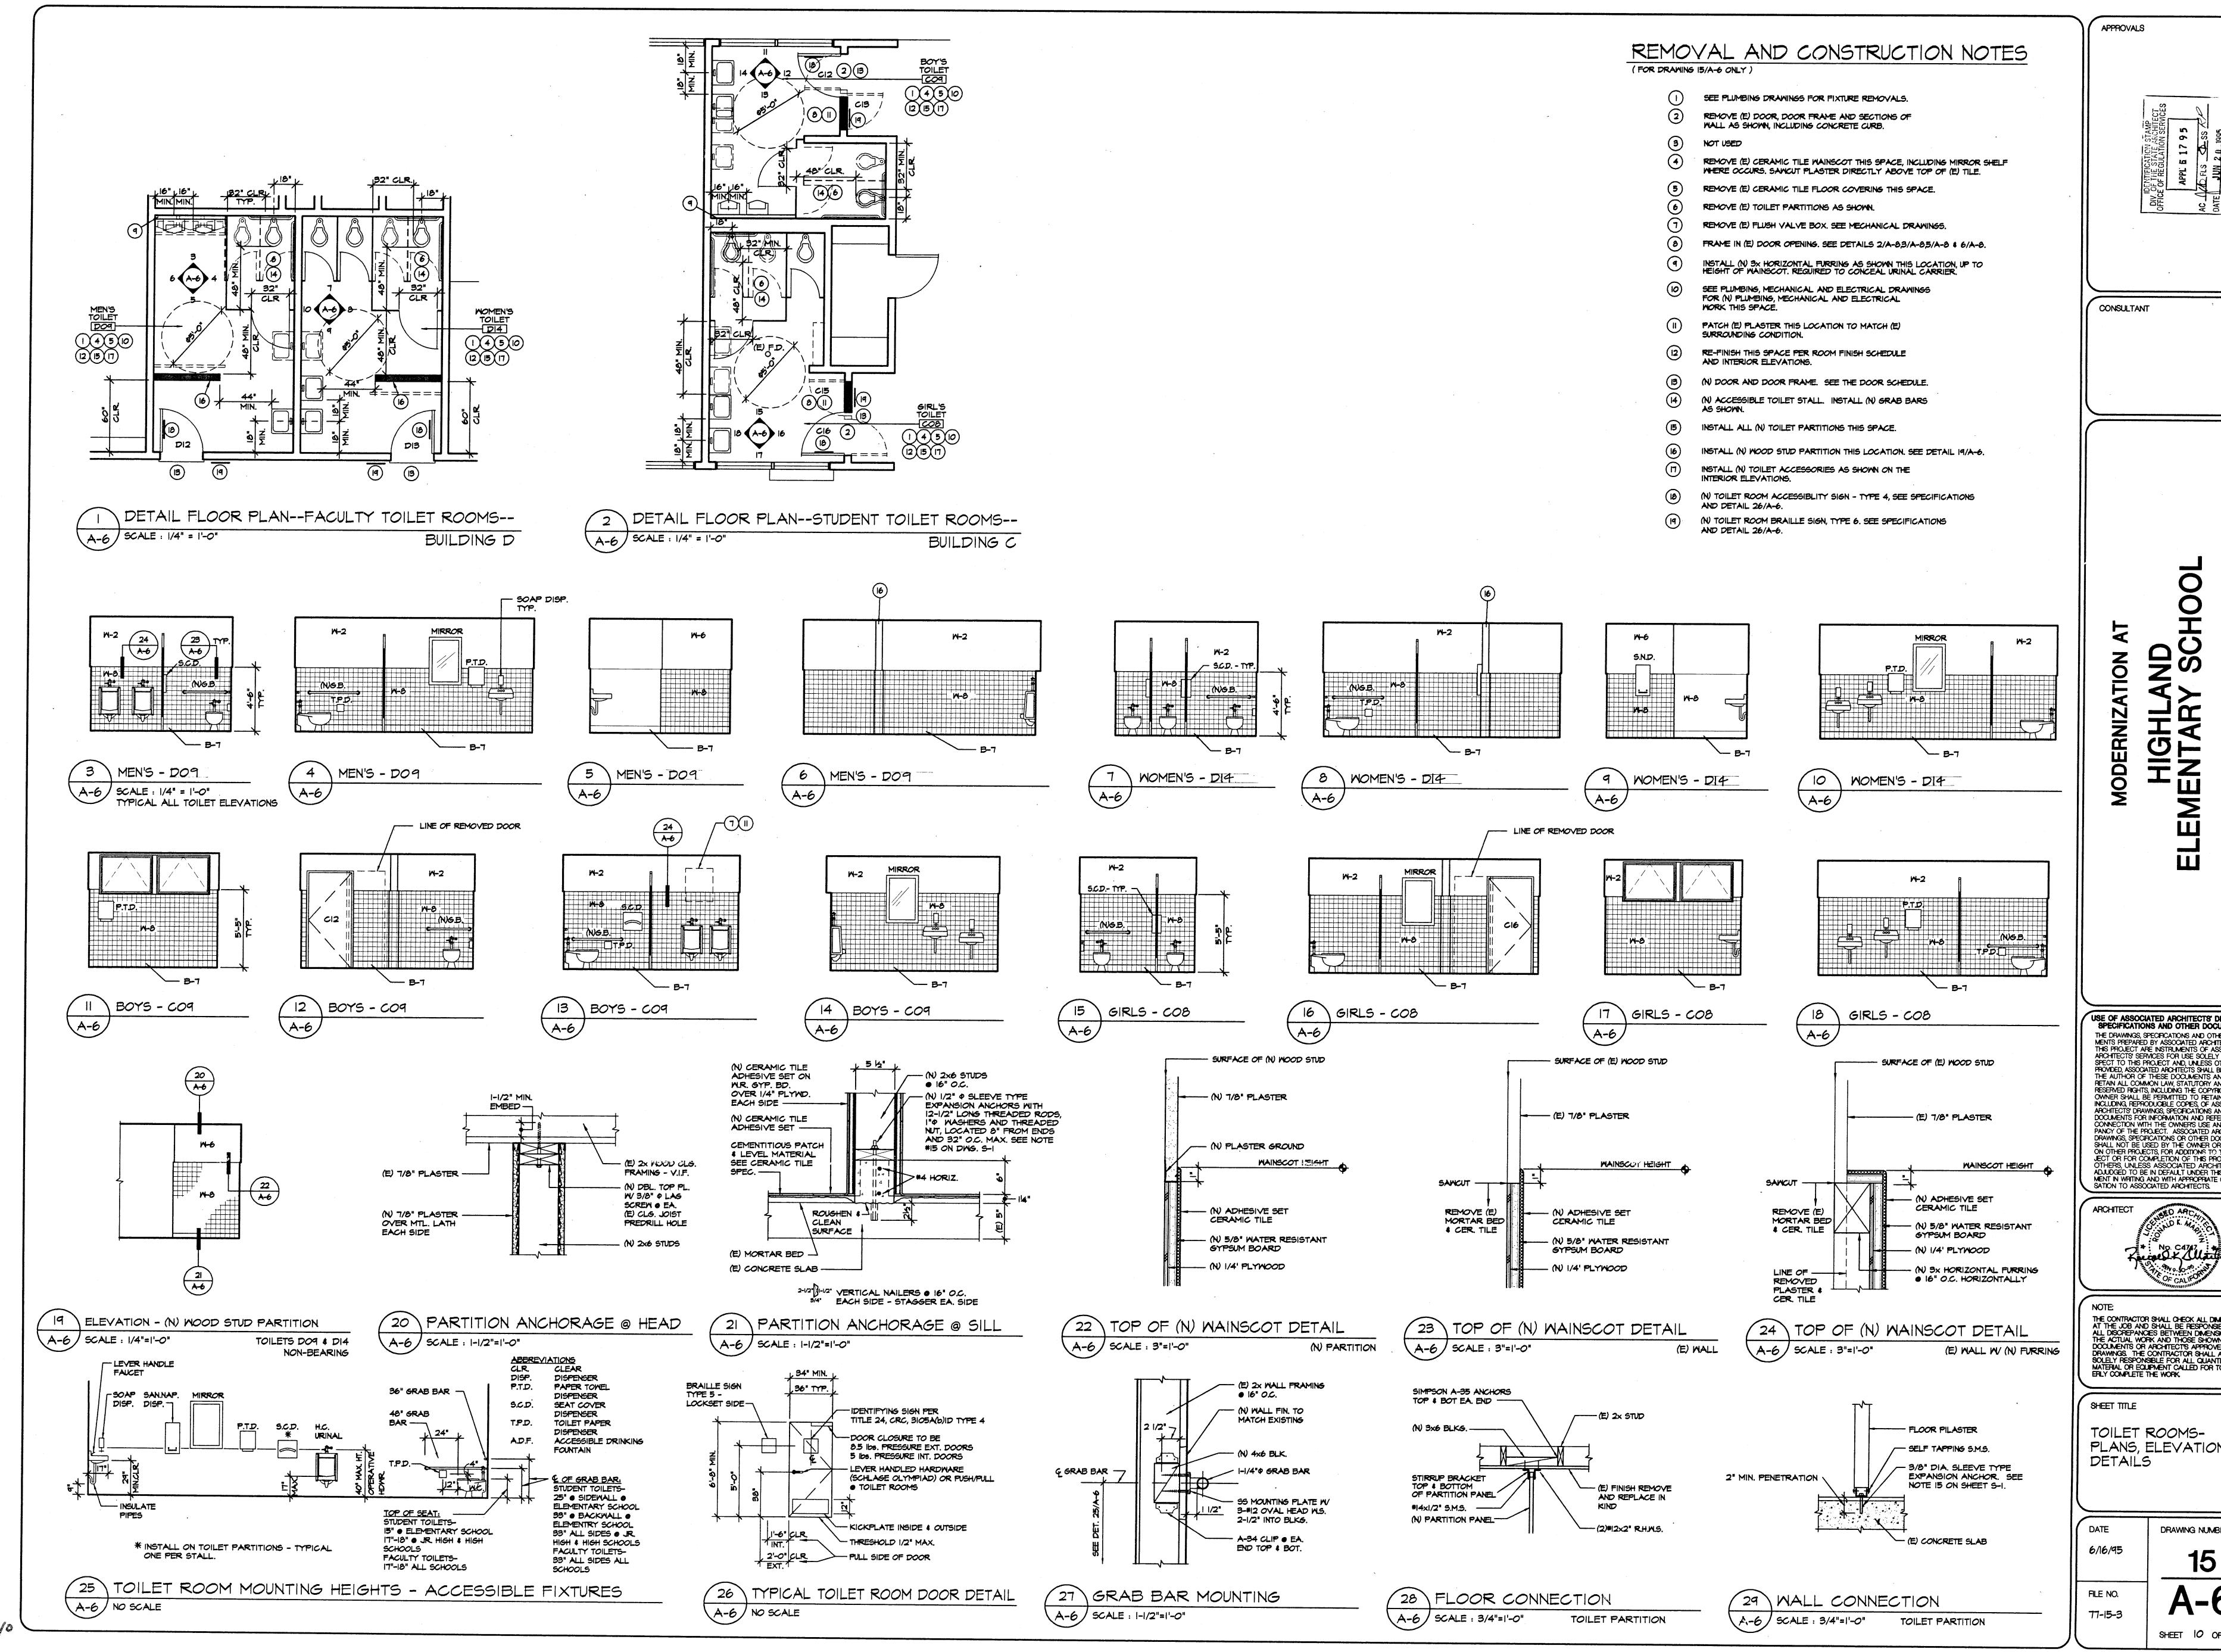00D\77-15-03\15a-5 Fri Jun 16 16:00:08 1995 HAYWARD UNIFIED SCHOOL DISTRICT MODERNIZATIONS




SPECIFICATIONS AND OTHER DOCUMENTS
THE DRAWINGS, SPECIFICATIONS AND OTHER DOCUMENTS PREPARED BY ASSOCIATED ARCHITECTS FOR THIS PROJECT ARE INSTRUMENTS OF ASSOCIATED ARCHITECTS' SERVICES FOR USE SOLELY WITH RESPECT TO THIS PROJECT AND, UNLESS OTHERWISE PROVIDED, ASSOCIATED ARCHITECTS SHALL BE DEEMED THE AUTHOR OF THESE DOCUMENTS AND SHALL RETAIN ALL COMMON LAW, STATUTORY AND OTHER RESERVED RIGHTS, INCLUDING THE COPYRIGHT. THE OWNER SHALL BE PERMITTED TO RETAIN COPIES, INCLUDING, REPRODUCIBLE COPIES, OF ASSOCIATED ARCHITECTS' DRAWINGS, SPECIFICATIONS AND OTHER DOCUMENTS FOR INFORMATION AND REFERENCE IN CONNECTION WITH THE OWNERS USE AND OCCUPANCY OF THE PROJECT. ASSOCIATED ARCHITECTS' DRAWINGS, SPECIFICATIONS OR OTHER DOCUMENTS SHALL NOT BE USED BY THE OWNER OR OTHERS ON OTHER PROJECTS, FOR ADDITIONS TO THIS PROJECT OR FOR COMPLETION OF THIS PROJECT OF SECONDAL TO DE IN DEFAULT UNDER THIS AGREEMENT IN WRITING AND WITH APPROPRIATE COMPENSATION TO ASSOCIATED ARCHITECTS.

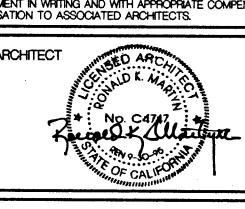


THE CONTRACTOR SHALL CHECK ALL DIMENSIONS AT THE JOB AND SHALL BE RESPONSIBLE FOR ALL DISCREPANCIES BETWEEN DIMENSIONS OF THE ACTUAL WORK AND THOSE SHOWN IN THE DOCUMENTS OR ARCHITECT'S APPROVED SHOP DRAWINGS. THE CONTRACTOR SHALL ALSO BE SOLELY RESPONSIBLE FOR ALL QUANTITIES OF MATERIAL OR EQUIPMENT CALLED FOR TO PROPERLY COMPLETE THE WORK.


PLANS, ELEVATIONS, DRAWING NUMBER

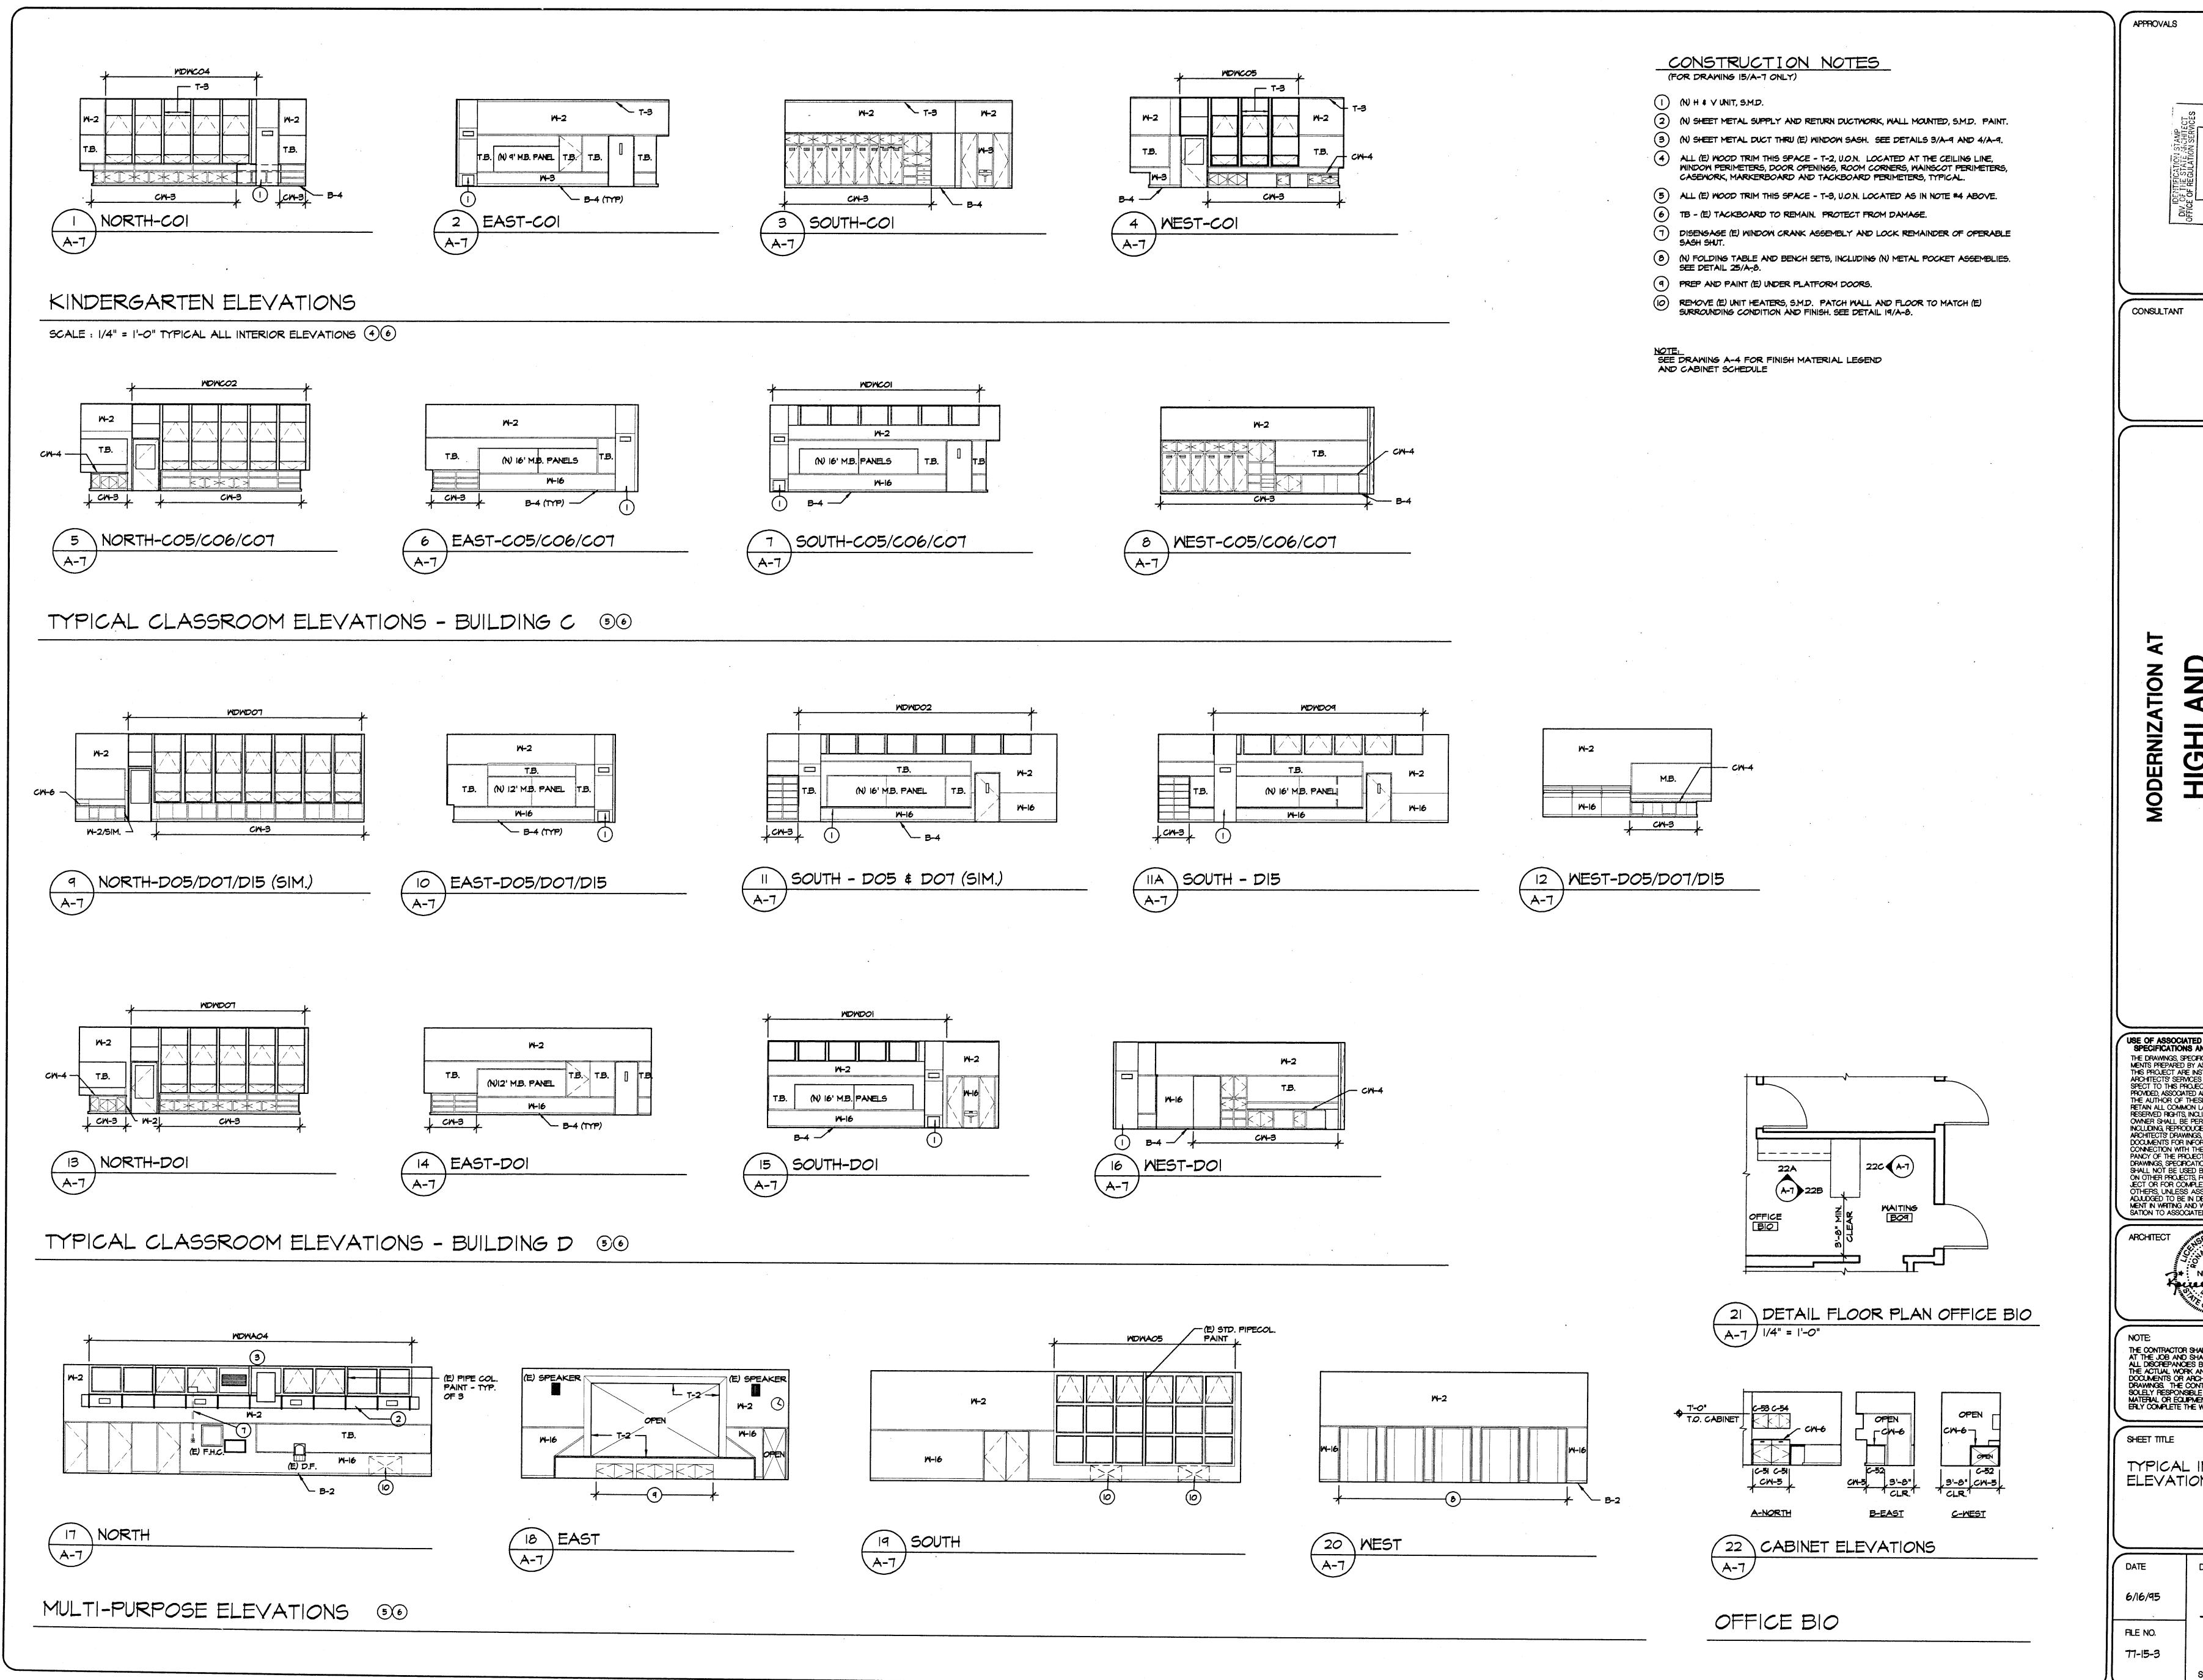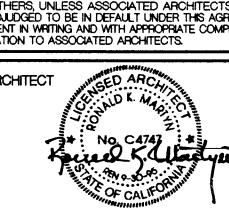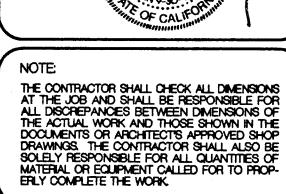SHEET 10 OF 30



USE OF ASSOCIATED ARCHITECTS' DRAWINGS SPECIFICATIONS AND OTHER DOCUMENTS SPECIFICATIONS AND OTHER DOCUMENTS
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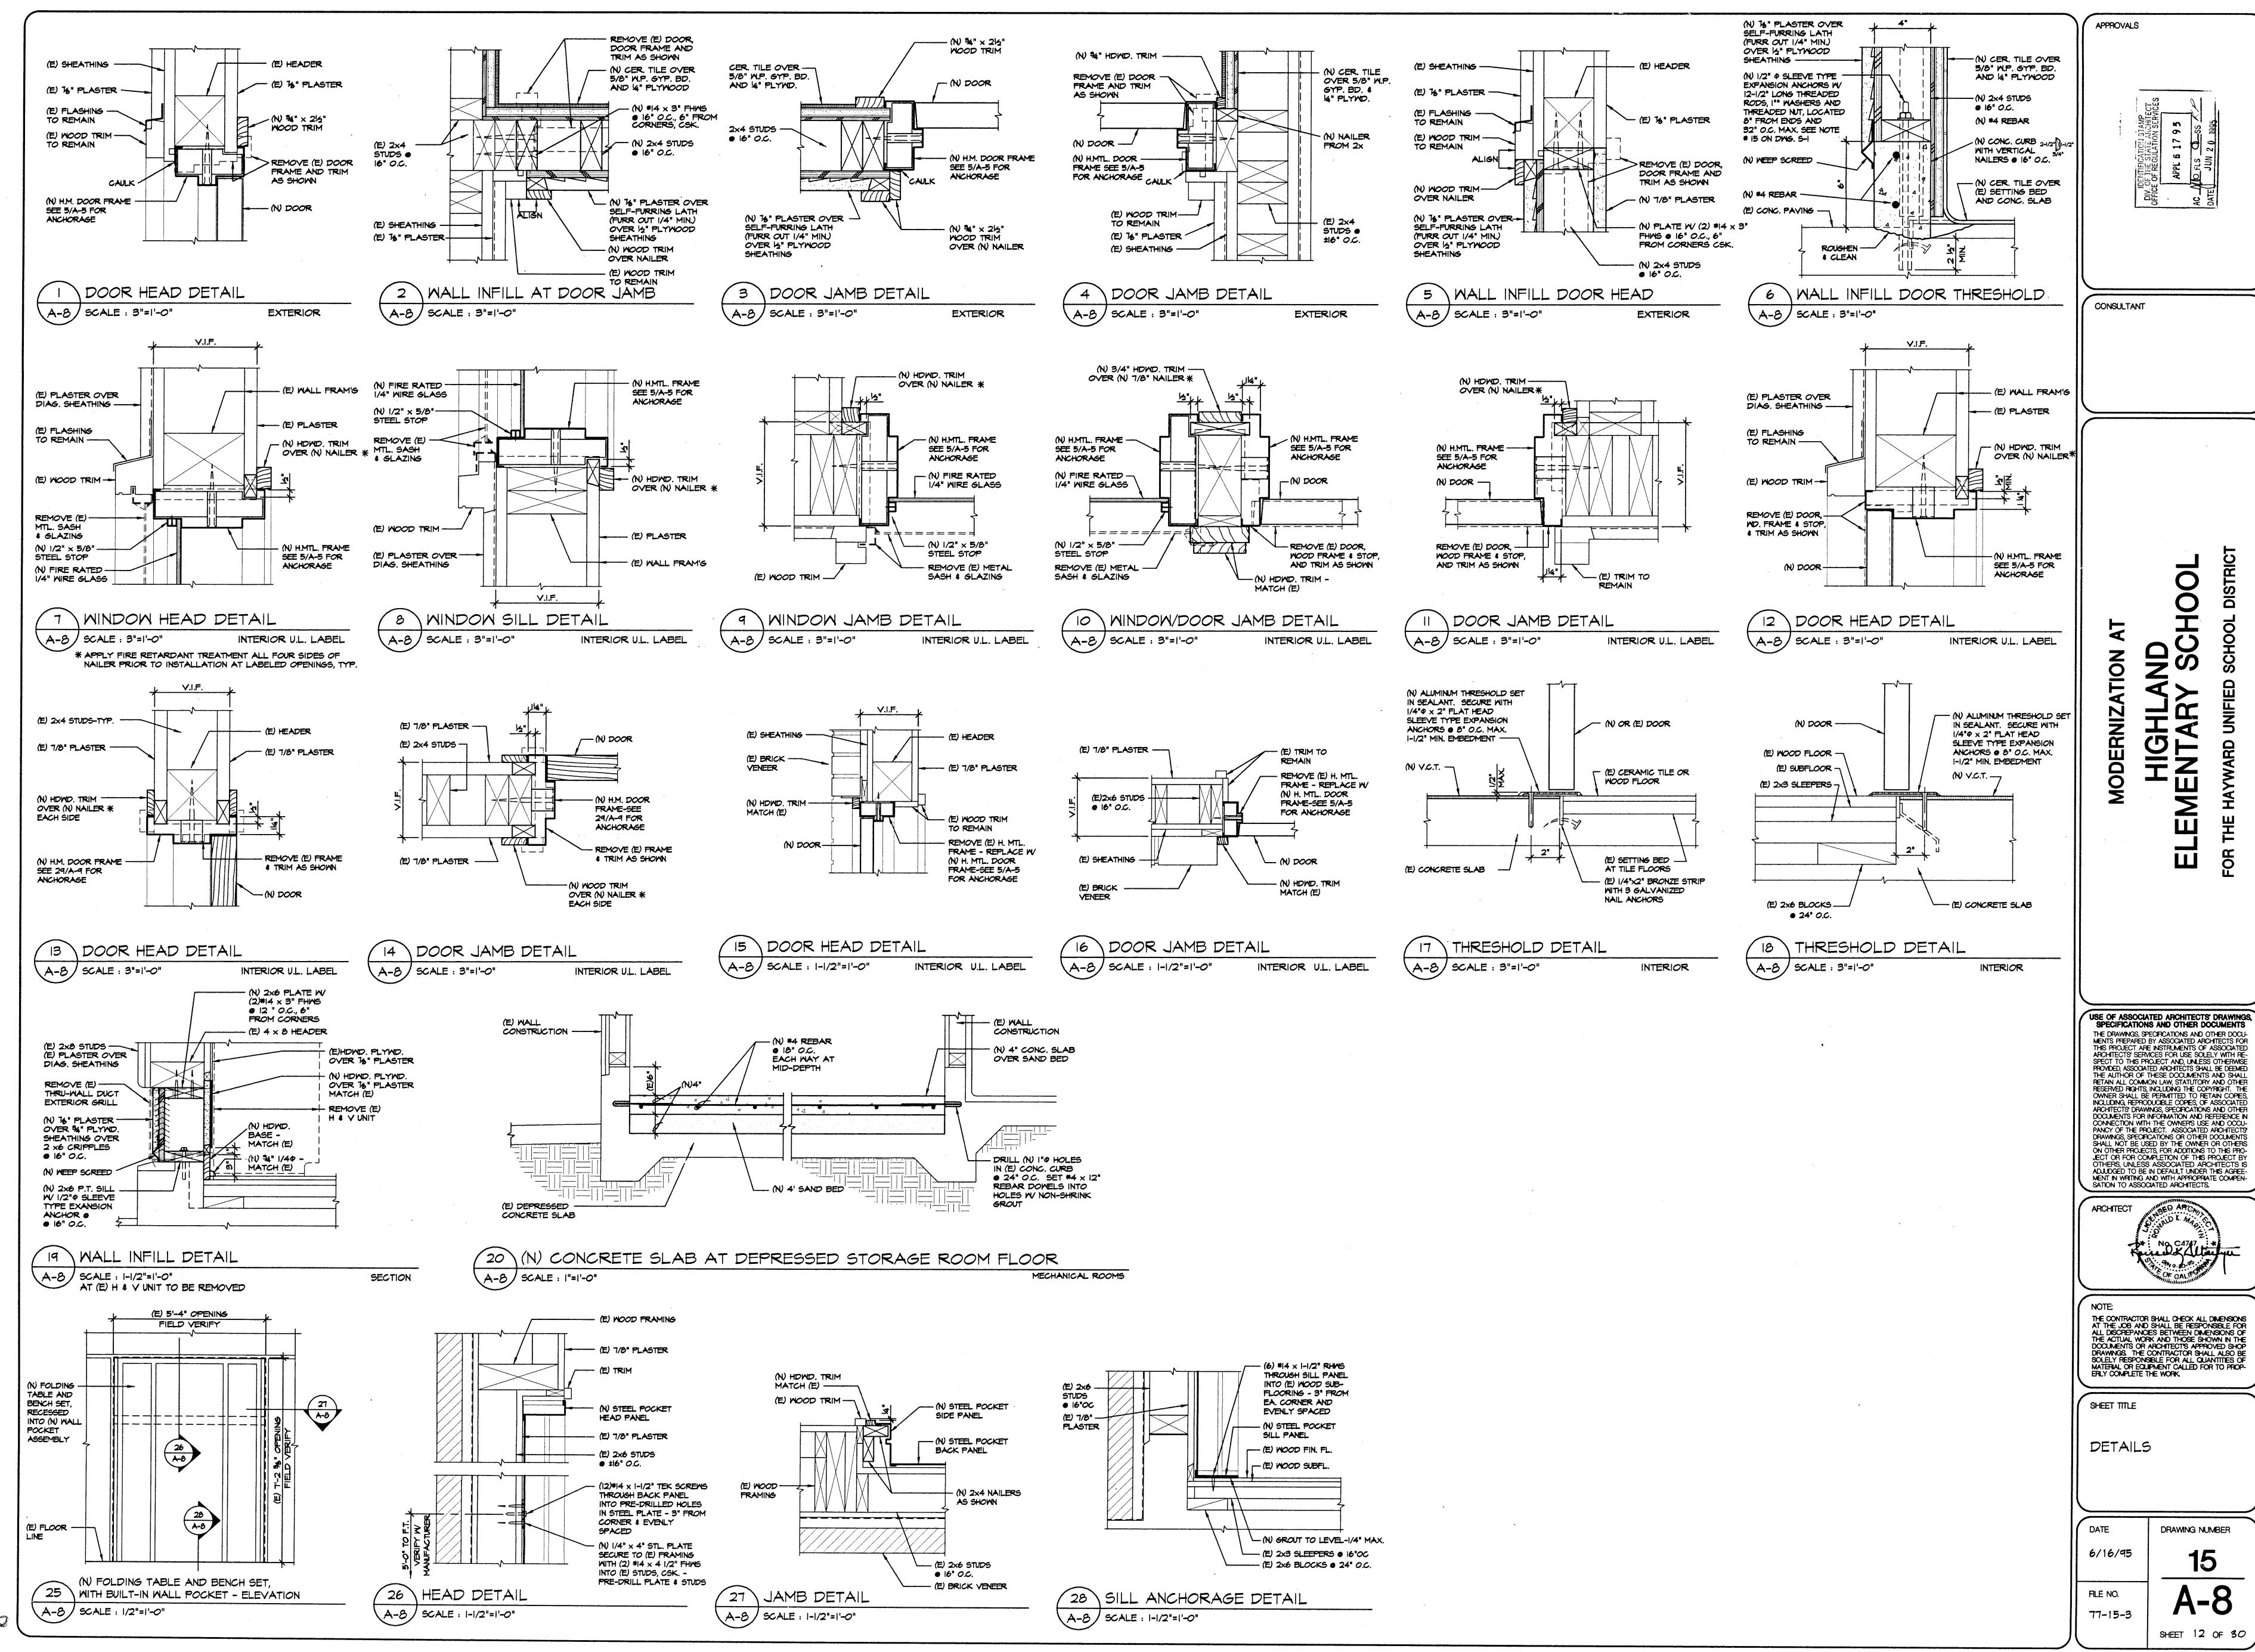




TYPICAL INTERIOR ELEVATIONS

DRAWING NUMBER


SHEET II OF 30




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N

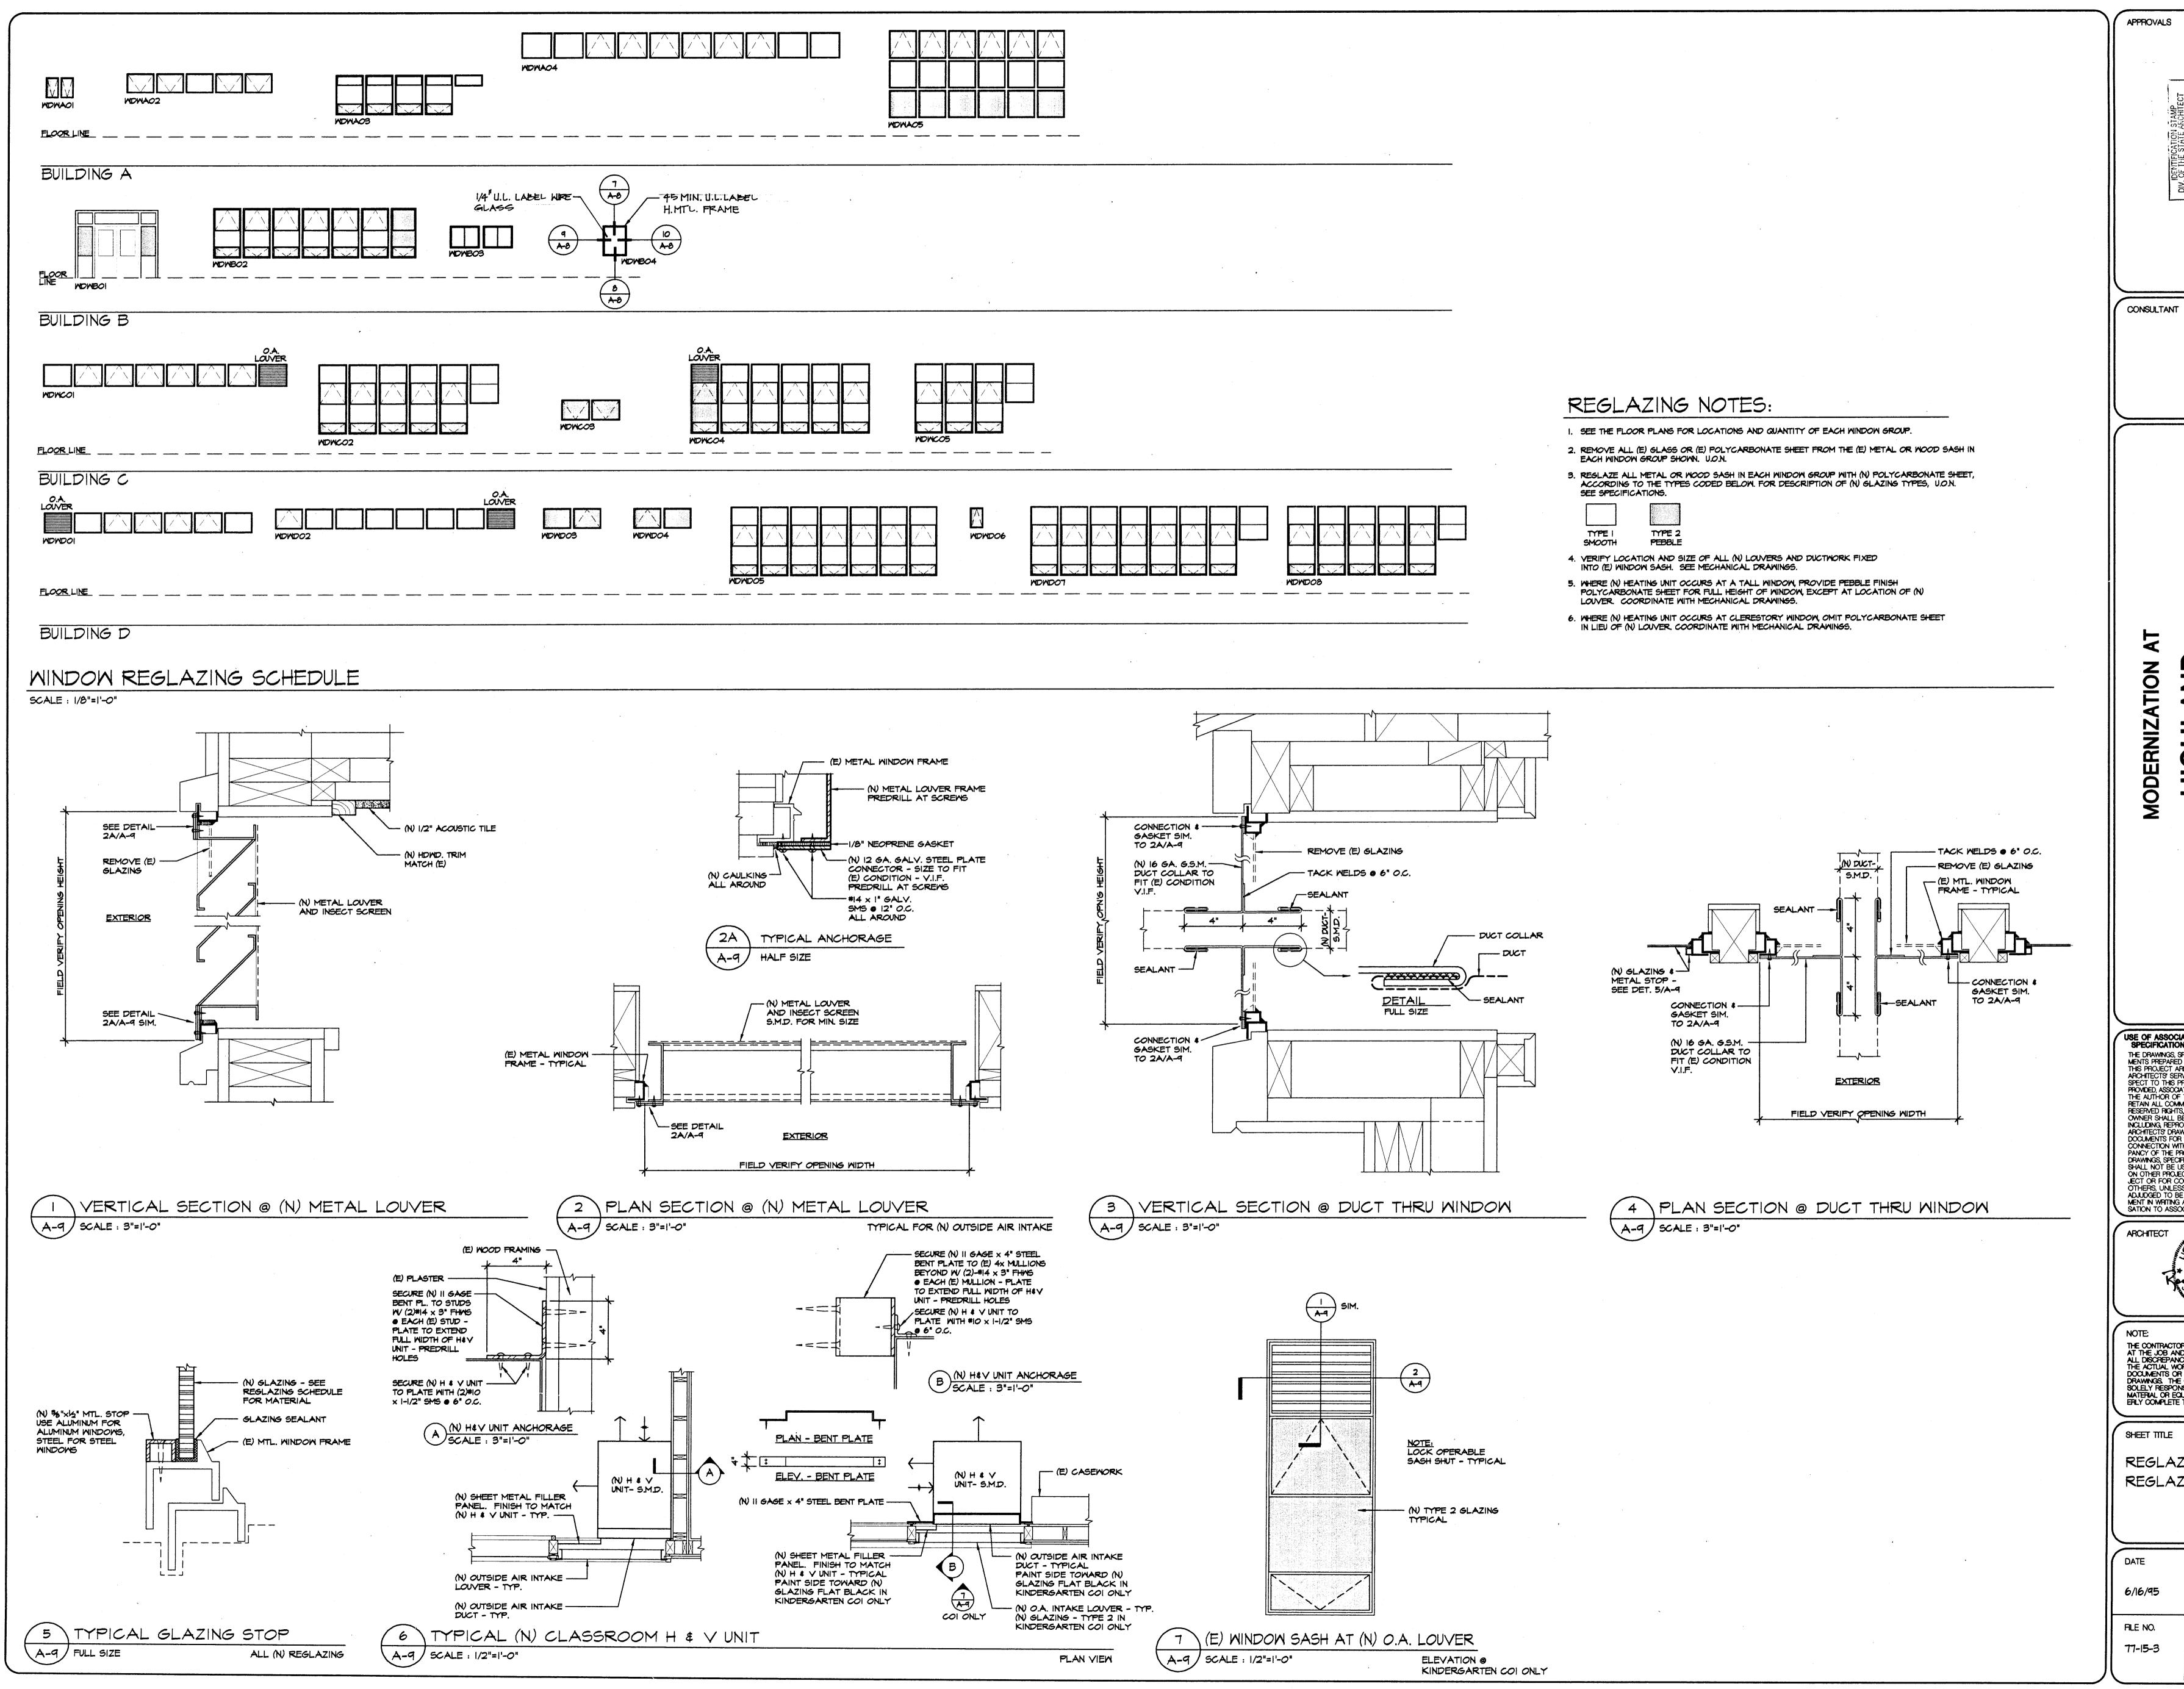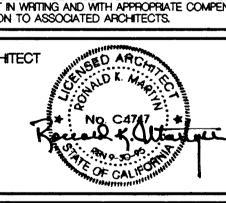(510)



USE OF ASSOCIATED ARCHITECTS' DRAWINGS, SPECIFICATIONS AND OTHER DOCUMENTS SPECIFICATIONS AND OTHER DOCUMENTS
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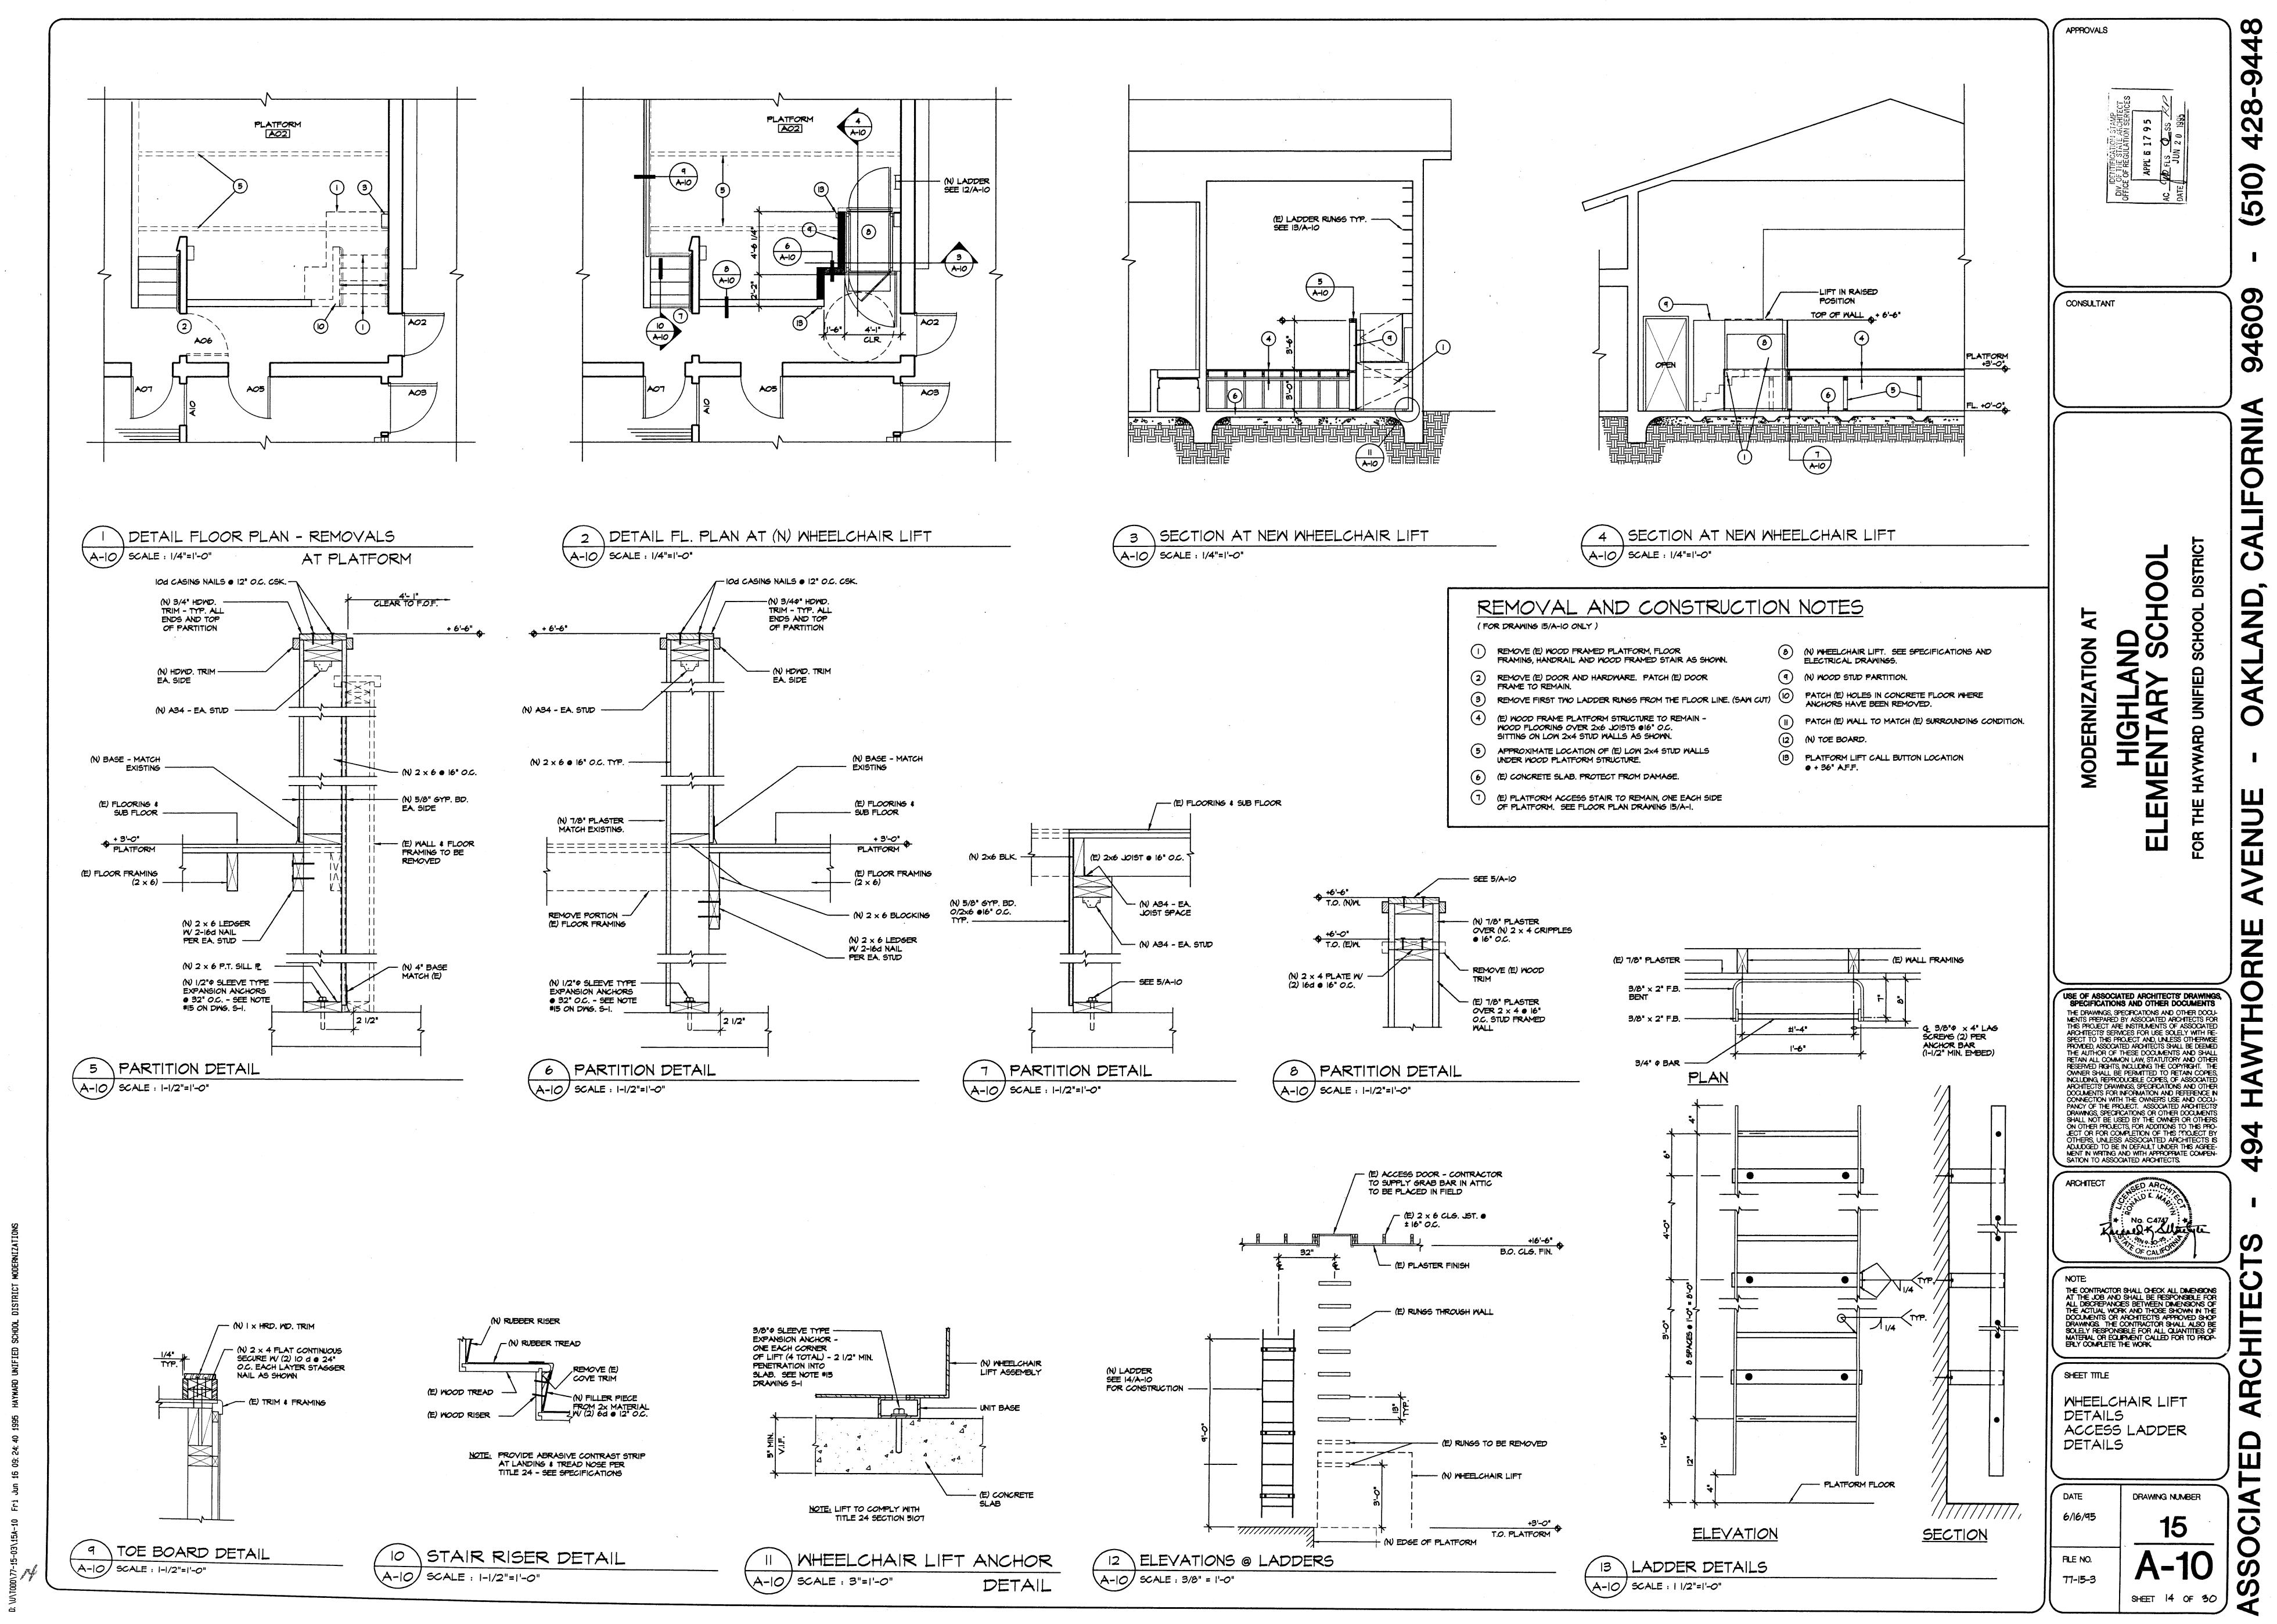
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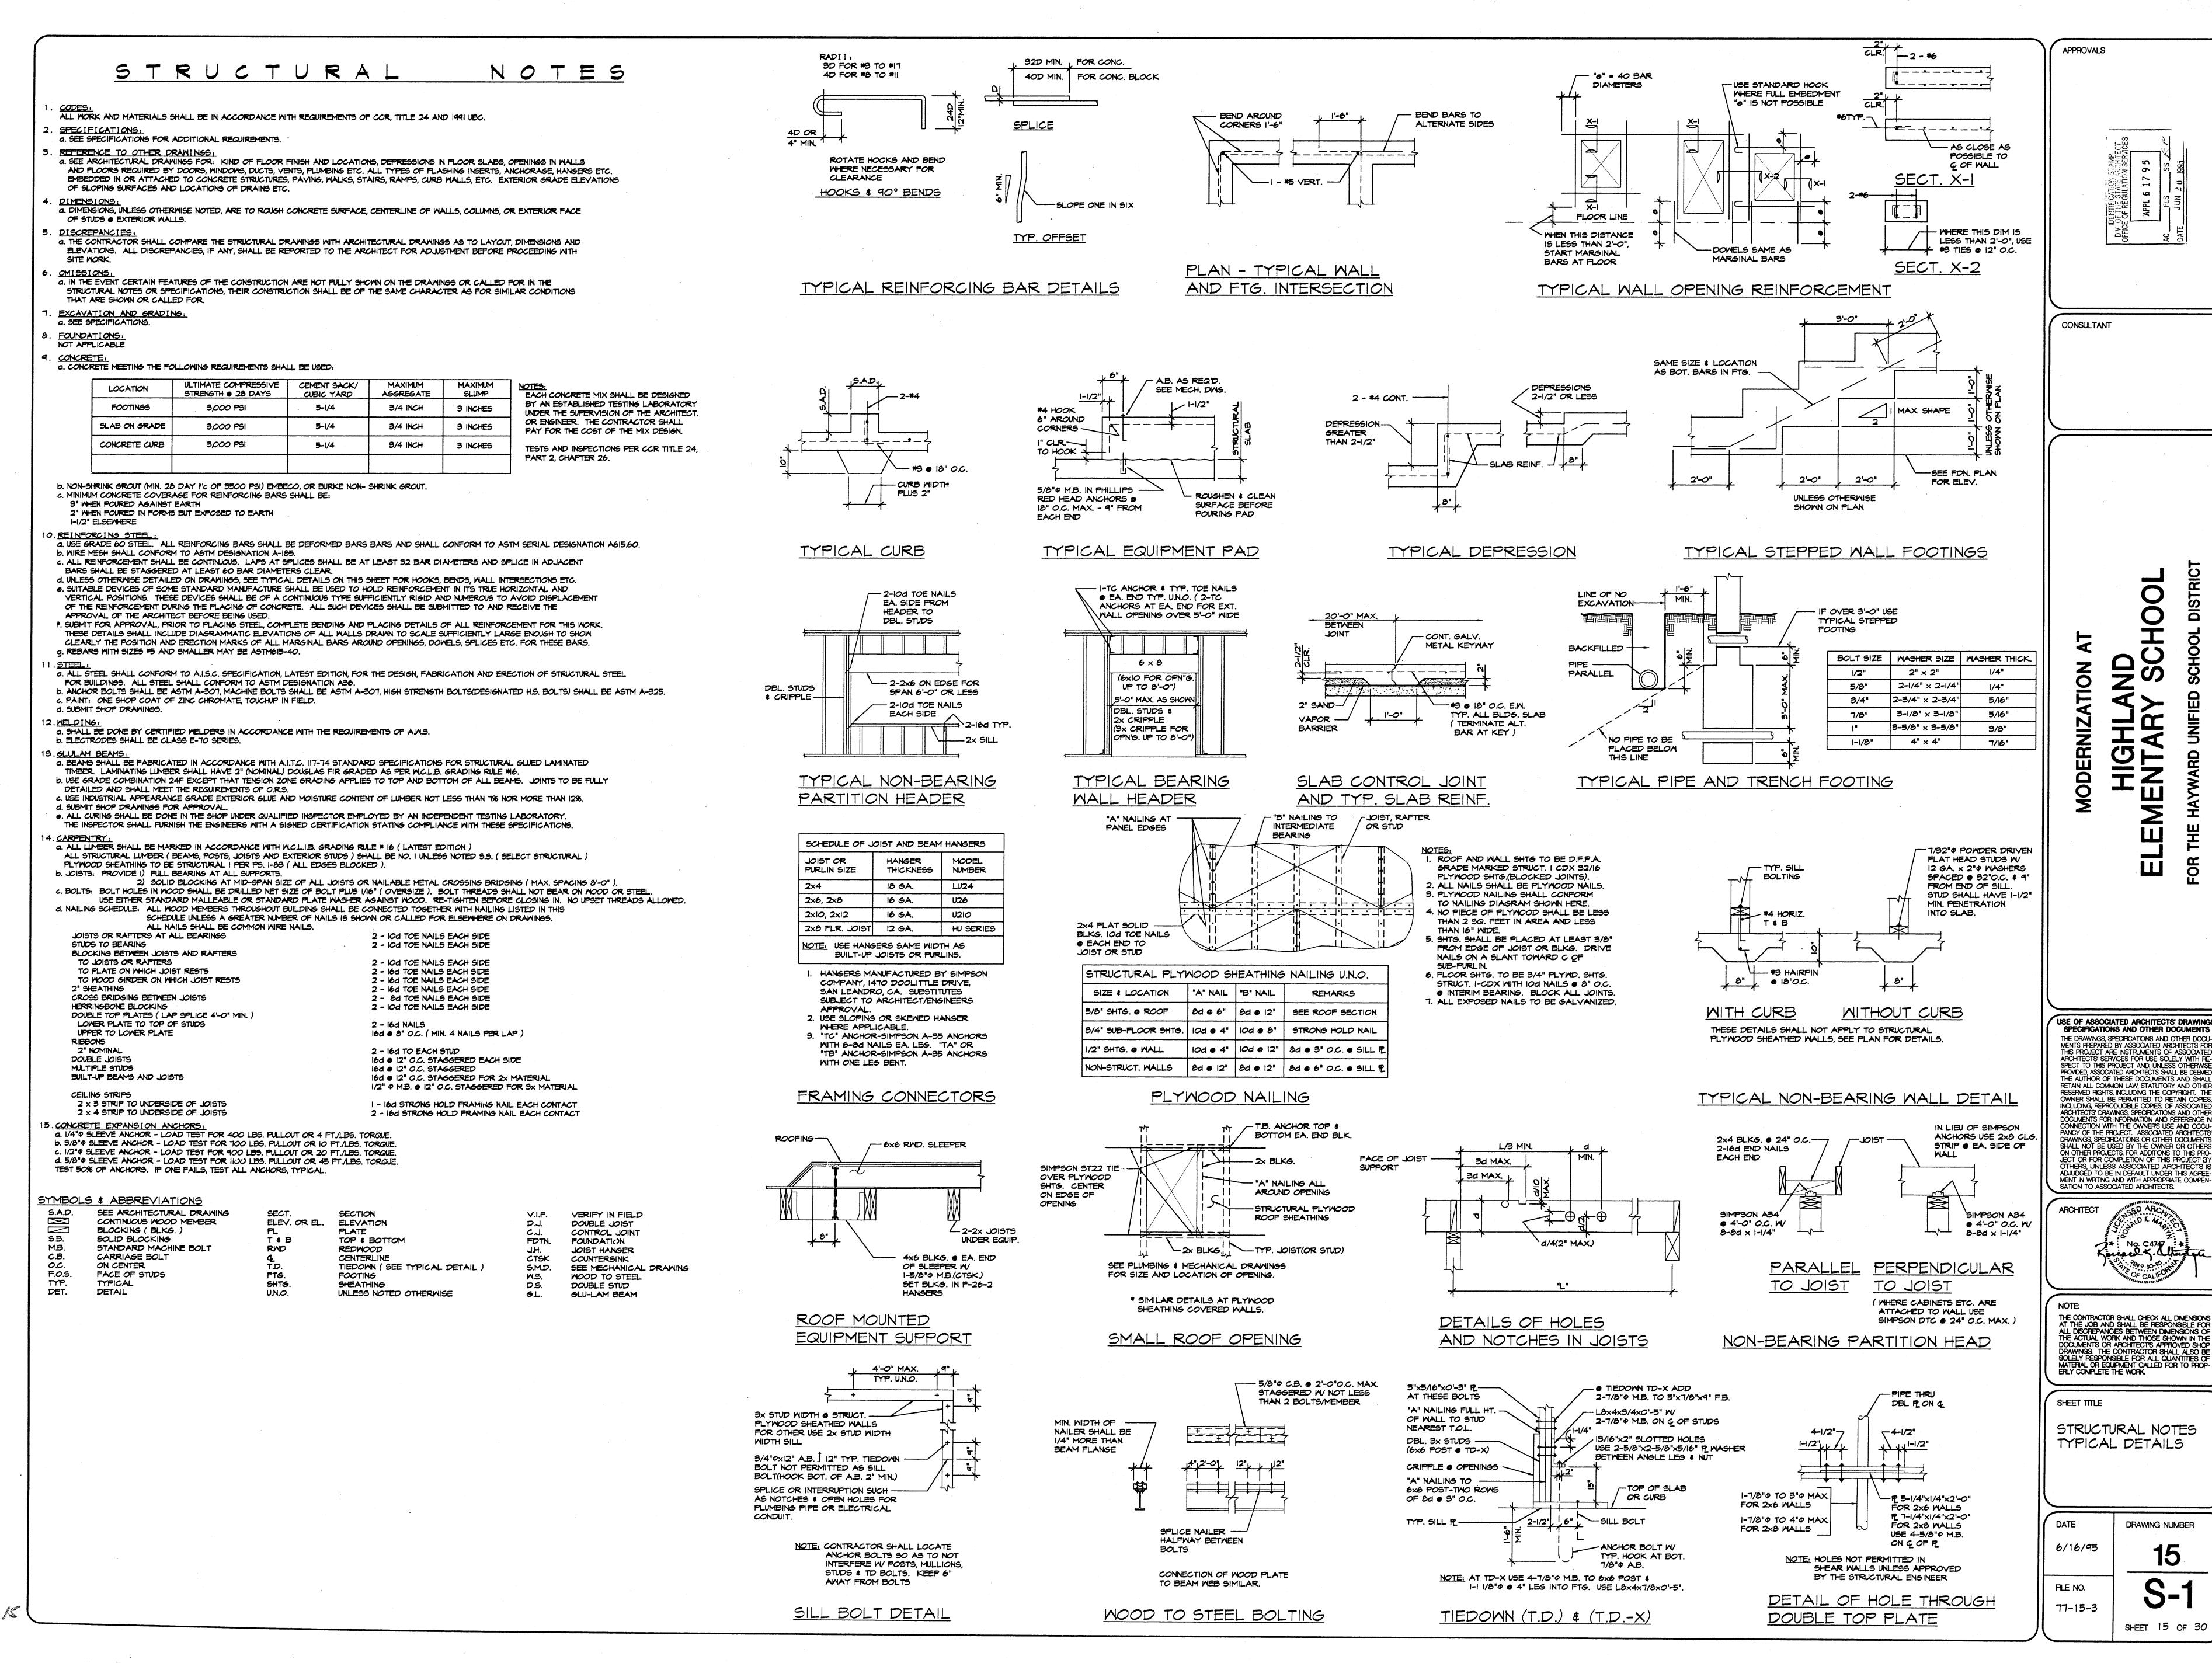
REGLAZING SCHEDULE REGLAZING DETAILS

ED

DRAWING NUMBER

SHEET 13 OF 30





S

NNIS\DRAWINGS\77-00-00\77-15-3\S1 Fri Jun 16 17:30:59 1995

I ECEND

		PLUM	BING		
SYMBOL	ABBREV	DESCRIPTION	SYMBOL	ABBREV	DESCRIPTION
s	5	SANITARY SEWER PIPING ABOVE FLOOR/GRADE		FD	FLOOR DRAIN
	5	SANITARY SEWER PIPING BELOW FLOOR/GRADE	C+	DN/DROP	PIPING DOWN/DROP
V	V	SANITARY VENT PIPING	<u> </u>	RAP	PIPING RISE/UP
—— 6——	6	NATURAL GAS PIPING	<u> </u>	wco	WALL CLEANOUT
	CM	DOMESTIC COLD WATER PIPING	 1	U	PIPE UNION
	HM	DOMESTIC HOT WATER PIPING		. "	FIFE UNION
	FCO	FLOOR CLEANOUT		B∨	BALL VALVE
	(N)	NEW WORK	•	VTR	VENT THRU ROOF
	(E)	EXISTING WORK TO REMAIN	>	HB	HOSE BIBB
				67	GATE VALVE
	(RIN)	(E) WORK REINSTALLED		ec	GAS COCK
/////////////////////////////////////	(R)	(E) WORK TO BE REMOVED	·	DWG GALY	DRAWING GALVANIZED
⊗ `	CP	CONNECTION POINT OF (N) TO (E) WORK		CLG	CEILING
	AP	ACCESS PANEL		MTD TYP	MOUNTED TYPICAL
	-	PIPING PLUG OR CAP		In.WG PNL	INCHES WATER GAUGE PANEL
	AD CD	ACCESS DOOR CONDENSATE DRAIN		I I	·
—	CKV	CHECK VALVE			
~~~~	(F) FPC	FUTURE FLEXIBLE PIPING CONNECTION			
		MECHA	NICAL		
SYMBOL	ABBREV	DESCRIPTION	SYMBOL	ABBREV	DESCRIPTION
(Tip)			A		•
		SECTION AT ROUND DUCT			
		SECTION AT	\$   \$	AVD	AUTOMATIC VOLUME DAMPER
	SD	RECTANGULAR SUPPLY DUCT	'		·
		SECTION AT	<del>  ]  </del>		
	ED/RAD	RECTANGULAR EXHAUST DUCT OR		MVD	MANUAL VOLUME DAMPER
		OUTDOOR AIR SECTION AT			
	RD	RECTANGULAR RETURN DUCT	В		
		TAPER	}   }	BDD	BACKDRAFT DAMPER
		TAKEOFF			•
·					90° RADIUS ELBOW
	Φ	ROUND DUCT			R/D = 1.5 MIN
<u></u>				·	
		CEILING EXHAUST AIR	1		90° ELBOW
<b>—</b>	CEG/CER	GRILLE OR REGISTER			W/ TURNING VANES
		WALL SUPPLY	,		
	MSR	AIR REGISTER	ļ		LINED DUCT
<b>-</b>	WEG/WER	WALL EXHAUST AIR GRILLE OR REGISTER			
- <b>&amp;-</b> -		AIR FLOW DIRECTION	-		SINGLE LINE DUCTWORK LINED
		AND LEGIS DIRECTION		1 A.T	SINGLE LINE DUCT WORK
×		SHEET NOTE INDICATOR		LAT MFR	LEAVING AIR TEMPERATURE MANUFACTURER
$\xrightarrow{\mathbf{x}}$		REGISTER TAG		MTG (N)	MOUNTING NEW WORK
×				NTS	NOT TO SCALE
	AFC BLO	ABOVE FINISHED CEILING BLANK OFF (GSM)		OA PD	OUTSIDE AIR PRESSURE DROP
	(E)	EXISTING TO REMAIN		(R) (R/RP)	(E) WORK TO BE REMOVED (E) WORK REMOVED & REPLACED BY (N)
	EA Eat	EXHAUST AIR ENTERING AIR TEMPERATURE		RA	RETURN AIR
	ef Eqpt	EXHAUST FAN EQUIPMENT		RPM RV	REVOLUTIONS/MINUTE ROOF VENT OF RELIEF VENT
	ESP	EXTERNAL STATIC PRESSURE		SA SHT	SUPPLY AIR SHEET
ļ	FLA GA	FULL LOAD AMPS U.S. GAUGE		SP	STATIC PRESSURE
				1	THERMOSTAT
	65M	GALVANIZED SHEET METAL		TAD	TRANSFER AIR DUCT
	69M	GALVANIZED SHEET METAL		TAD	TRANSFER AIR DUCT UNDERCUT DOOR

#### PLUMBING GENERAL NOTES:

- I. EACH FLOOR DRAIN SHALL BE CLEANED AND FLUSHED OUT. DRAINS SHALL BE FREE FLOWING. REPLACE STRAINER AS NOTED IN FIXTURE AND EQUIPMENT SCHEDULE, AND ON THE DRAWINGS.
- 2. EACH FLOOR DRAIN TRAP PRIMER SHALL BE REPLACED AS NOTED IN THE FIXTURE AND EQUIPMENT SCHEDULE, AND ON THE DRAWINGS.
- 3. ALL (E) WALL OR CEILING ACCESS PANELS AND DOORS WITHIN TOILET ROOMS SHALL BE REMOVED AND REPLACED WITH (N).
- 4. CAP AND PLUG ALL UNUSED SERVICES ABOVE CEILING, WITHIN WALL OR BELOW FLOOR. PATCH WALLS, CEILINGS, AND FLOORS TO MATCH FINISHED CONSTRUCTION.
- 5. SAWCUT (E) CONCRETE FLOORS AS REQUIRED TO MAKE CONNECTIONS TO (E) BELOW FLOOR SERVICES. (E) SERVICES ARE SHOWN IN THEIR APPROXIMATE LOCATIONS BASED UPON AVAILABLE RECORD INFORMATION. VERIFY LOCATIONS OF ALL EXISTING SERVICES PRIOR TO START OF WORK.
- 6. REUSE (E) VENT PIPING UNLESS OTHERWISE NOTED AND CAP UNUSED VENT CONNECTIONS.
- 7. RELOCATE (E) PIPING FOR SERVICES TO REMAIN IN USE WHERE IT INTERFERES WITH AREAS OF NEW CONSTRUCTION AND WHERE SHOWN ON THE DRAWINGS.
- 8. ALL (N) VENTS SHALL BE OFFSET AT TOP PLATES OF (E) AND (N) PARTITIONS. DO NOT CUT, BORE OR NOTCH TOP PLATES.

### **GENERAL NOTES**

- I. SEE ARCHITECTURAL DRAWINGS FOR EXACT PLACEMENT AND QUANTITY OF ALL FIXTURES.
- 2. BEFORE STARTING WORK, VERIFY LOCATIONS, ELEVATIONS AND SIZES OF ALL PIPING AND EQUIPMENT REQUIRING PLUMBING CONNECTIONS.
- 3. VERIFY EXACT LOCATION, SIZE AND CONSTRUCTION OF EXISTING LINES.
- 4. COORDINATE PLUMBING WORK WITH ALL OTHER WORK TO AVOID CONFLICT. RUN DUCTWORK, WIRING AND PIPING TO CLEAR ARCHITECTURAL OPENINGS, STRUCTURAL MEMBERS, OR OTHER OBSTRUCTIONS.
- 5. COMBINE ALL VERTICAL VENTS WHERE PRACTICAL.
- 6. INSTALL CLEANOUTS IN ACCORDANCE WITH THE UNIFORM PLUMBING CODE AND LOCAL REQUIREMENTS.
- 7. RUN ALL CHI AND HIM LINES ABOVE CEILING UNLESS NOTED OTHERWISE.
- 8. INSPECT (E) EXPOSED & ACCESSIBLE VALVES AT THESE LOCATIONS AND REPLACE OR
- REPAIR DAMAGED OR LEAKING VALVES. 9. ALL (R) PIPING, DUCT WORK, CONDUIT & WIRING SHALL BE DEMOLISHED TO POINTS OF CONCEALMENT WITHIN FLOOR. WALL OR CEILING CONSTRUCTION. PATCH OPENINGS
- VACATED BY (R) MATERIALS TO MATCH (E) OR (N) FINISHES AS SPECIFIED. 10. THE PROJECT INSPECTOR AND CONTRACTOR SHALL INSPECT (E) WOODS FRAMING UNCOVERED BY THE WORK. ALL DETERIORATED OR OTHERWISE UNACCEPTABLE MEMBERS SHALL BE REPORTED TO THE ARCHITECT AND REPLACED OR REPAIRED IN

ACCORDANCE WITH O.R.S. APPROVED DETAILS PROVIDED BY THE ARCHITECT.

- II. (E) AND (N) WOOD FRAMING, INCLUDING STUDS AND JOISTS, SHALL NOT BE NOTCHED OR BORED EXCEPT AS IDENTIFIED IN THESE PLANS AND SPECIFICATIONS. REFER TO DRAWING S-I, "DETAILS OF HOLES AND NOTCHES IN JOISTS".
- 12. ALL PIPES, DUCTS AND CONDUITS SHALL BE SUPPORTED AND BRACED FOR THE SMACNA "GUIDELINES FOR SEISMIC RESTRAINTS OF MECHANICAL SYSTEMS AND PLUMBING PIPING SYSTEMS".

IN ACCORDANCE WITH TITLE 24, SECTION 2336(b) AND TABLE No. 23-P, DETAILS SHALL BE PROVIDED FOR THE SEISMIC ANCHORAGE OF ALL MECHANICAL AND ELECTRICAL EQUIPMENT. ANCHORAGE DETAILS SHALL BE BASED UPON APPROPRIATE DESIGN CALCULATIONS.

FOR EQUIPMENT WEIGHING 400 POUNDS OR MORE ANCHORAGE DETAILS AND APPROPRIATE DESIGN CALCULATIONS SHALL BE SUBMITTED AS PART OF THE MECHANICAL AND ELECTRICAL DRAWING. "DEFERRED APPROVAL" ITEMS WILL NOT BE PERMITTED UNLESS SPECIFICALLY APPROVED BY THE PLAN CHECK SUPERVISOR.

EXCEPTION: ATTACHMENTS OF EQUIPMENT WEIGHING LESS THAN 400 POUNDS AND SUPPORTED DIRECTLY ON THE FLOOR OR ROOF STRUCTURE, FURNITURE, OR TEMPORARY OR MOVABLE EQUIPMENT AND EQUIPMENT WEIGHING LESS THAN 20 POUNDS THAT IS SUPPORTED BY VIBRATION ISOLATION DEVICES SUSPENDED FROM THE ROOF, WALL OR FLOOR, NEED NOT BE DETAILED ON THE PLANS PROVIDED THE FOLLOWING NOTES ARE INCLUDED ON THE MECHANICAL AND ELECTRICAL PLANS.

THIS TABLE HAS BEEN PREPARED FOR AN IMPORTANCE FACTOR OF I=1.0 AND FOR SEISMIC ZONE 4. MAKE APPROPRIATE ADJUSTMENT FOR ANY OTHER VALUES.

ALL MECHANICAL EQUIPMENT SHALL BE BRACED OR ANCHORED TO RESIST A HORIZONTAL FORCE ACTING IN ANY DIRECTION USING THE FOLLOWING

CRITERIA: FIXED EQUIPMENT ON GRADE 20% OF OPERATING WEIGHT FIXED EQUIPMENT ON STRUCTURE 30% OF OPERATING WEIGHT

EMERGENCY POWER EQUIPMENT ON GRADE 30% OF OPERATING WEIGHT EMERGENCY POWER EQUIPMENT ON STRUCTURE 40% OF OPERATING WEIGHT

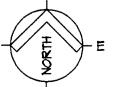
SIMULTANEOUS VERTICAL FORCE - USE 1/3X HORIZONTAL FORCE.

FOR FLEXIBLY MOUNTED EQUIPMENT SEE TITLE 24, SECTION 2336(b)P.


WHERE ANCHORAGE DETAILS ARE NOT SHOWN ON THE DRAWINGS. THE FIELD INSTALLATION SHALL BE SUBJECT TO THE APPROVAL OF THE STRUCTURAL ENGINEER AND THE FIELD REPRESENTATIVE OF THE OFFICE OF THE STATE ARCHITECT.

HIGHLAND BLVD (E) WATER METER ASSY -- (E) I-I/2"G BELOW GRADE (E) GAS METER ASSY 0.R.S. (E) BUILDING O.S.A. APP. #6924 # 9349 # 5455 (E) 3"CW BELOW GRADE (E) 3"G BELOW GRADE BLDG C (E) BLDG O.S.A. APP. #9349 (E) BLDG O.S.A. APP. (E) BLDG O.S.A. APP. (E) REL (E) REL (E) REL BLDG BLDG O.R.S. O.S.A. O.S.A. APP. APP. (E) BLDG (E) BLDG 0.5.A. APP. 0.5.A. APP. (E) BLDG (E) BLDG 0.S.A. APP. 0.S.A. APP. #27885 #27885 #2*188*5 #29395 (E) REL (E) REL BLDG BLDG O.S.A. O.S.A. APP. #56746 | #54212 | #50386 - (E) TOILET REL BLDG. |*49082||*49082| O.R.S. APP. # 27885 REMODELED UNDER O.R.S. APP. # 50386 LEGEND (E) BUILDING WITHIN THE SCOPE OF WORK OSBOURNE AVENUE (E) BUILDING OUTSIDE THE SCOPE OF WORK DOES NOT QUALIFY FOR MODERNIZATION

SITE PLAN




APPROVALS

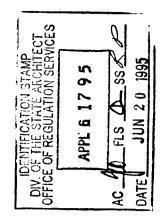

CONSULTANT



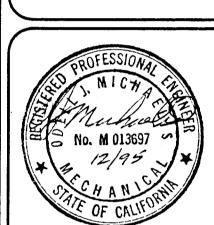

MODERNIZ

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THE CONTRACTOR SHALL CHECK ALL DIMENSIONS AT THE JOB AND SHALL BE RESPONSIBLE FOR ALL DISCREPANCIES BETWEEN DIMENSIONS OF THE ACTUAL WORK AND THOSE SHOWN IN THE DOCUMENTS OR ARCHITECT'S APPROVED SHOP DRAWINGS. THE CONTRACTOR SHALL ALSO BE SOLELY RESPONSIBLE FOR ALL QUANTITIES OF MATERIAL OR EQUIPMENT CALLED FOR TO PROPERLY COMPLETE THE WORK.

SHEET TITLE

MECHANICAL & PLUMBING SITE PLAN LEGEND & NOTES

DRAWING NUMBER

	FURNACE SCHEDULE											
		HEATIN	IG, MBH			SU	IPPLY F	AN				
MARK	MANUFACTURER & MODEL No.	INPUT	OUTPUT	CFM	ESP	SPEED (2)	ВНР	НР	ELECTRICAL	AIR FILTERS	WEIGHT	REMARKS
F-I	STERLING PV-20	150	120	3,000	0.5	-	1.2	1.5	208/34/60	4 - 20"x20"x2"	800	(3) ROOF TOP
F-2	COMFORT MAKER GUA 080 (1)	80	64	1000	0.5	LOW	.25	1/2	115/14/60	i - 16"x25"xi"	440	
F-3	COMFORT MAKER GUA 080 (1)	80	64	1000	0.5	LOW	.25	1/2	115/14/60	-  6"x25"x "	440	
F-4	COMFORT MAKER GUA 080 (1)	80	64	1000	05	LOW	.25	1/2	115/14/60	-  6"x25"x "	440	
F-5	COMFORT MAKER GUA 080 (1)	80	64	1000	05	LOM	.25	1/2	115/14/60	l - 16"x25"xi"	440	
F-6	COMFORT MAKER GUA 080 (1)	80	64	1000	0.5	LOM	.25	1/2	115/14/60	-  6"x25"x "	440	
F-7	COMFORT MAKER GUA 080 (1)	80	64	1000	0.5	LOM	.25	1/2	115/14/60	i - 16"x25"xi"	440	
F-8	COMFORT MAKER GUA 080 (1)	80	64	1000	0.5	LOW	.25	1/2	115/14/60	-  6"x25"xi"	440	
F-9	COMFORT MAKER GUA 080 (I)	80	64	1000	0.5	LOW	.25	1/2	115/14/60	-  6"x25"x "	440	
												-

- I. PROVIDE FLAME AIR FURNACE ENCLOSURE.
- 2. PROVIDE 3-SPEED SUPPLY FAN OPERATION.
- 3. PROVIDE STAINLESS STEEL HEAT EXCHANGER & BURNER.

	EXHAUST FAN SCHEDULE										
MADIZ	MANUFACTURER		F	AN		MOTOR		CONTROLS	OPERATING	DEMARKS	
MARK	MARK & MODEL No.   "COOK"		SP	RPM	SONES	HP	WATT	ELECTRICAL POWER	BY	<b>W</b> EIGHT LBS	REMARKS
EF-I	ACRU-B-100R28	300	0.25	-	2.2	1/6	125	115/14/60	EMS CONTRACTOR	45	2 3 4 5
EF-2	ACRU-B-100R28	30ó	0.25	-	2.2	1/6	125	115/14/60	EMS CONTRACTOR	45	2 3 4 5
EF-3	ACRU-B-100R28	300	0.25	-	2.2	1/6	125	115/14/60	EMS CONTRACTOR	45	2 3 4 5
EF-4	ACRU-B-100R28	300	0.25	-	2.2	1/6	125	115/14/60	EMS CONTRACTOR	45	2 3 4 5
EF-5 THR) O	GEMINI- 5-10	200	0.25	1050	1.6	-	81	115/14/60	ELECTRICAL CONTRACTOR	35	2 3 6

- NOTES:

  | FAN UNITS SHALL BE U.L. LISTED.
- 2 BACK DRAFT DAMPERS
- 3 BIRD SCREEN
- 4 DISCONNECT SWITCH
- $\langle$  5  $\rangle$  VCG CURB
- 6 CONN TO LIGHT SWITCH

REGISTER SCHEDULE							
MARK	MANUFACTURER & MODEL No. "METALAIRE"	TYPE	SERVICE	NECK SIZE (W".x H")	REMARKS		
l	MODEL 42-CD	WSG	SUPPLY	36 × 6	W MODEL OBDE		
2	MODEL 2000FD	WER	EXHAUST	40 x 18	FITTED W OBD		
3	MODEL HD-RH	WEG	RELIEF	24 × 24	MOUNTED 6 (E) RV		
4	MODEL CC5	CER	EXHAUST	10 × 10			
5	MODEL CC5	CER	RELIEF	16 × 16			

### NOTES:

- 1. ALL REGISTERS SHALL BE OF ALUMINUM CONSTRUCTION.
- 2. ALL REGISTERS HAVE OFF-WHITE PAINTED FINISH.

ROOF VENT SCHEDULE						
ITEM	MANUFACTURER & MODEL No. "COOK"	THROAT SIZE (INCHES)	DUTY	CURB TYPE	BACK DRAFT DAMPER	REMARKS
RV-I THRU RV-7	MODEL PR-12	Ι2"Φ	RELIEF	VCG	L-10	

MARK	FIXTURE / EQUIPMENT	MODEL NO.	SIZE / CAPACITY	TRIM / ACCESSORIES	REMARKS
MC-I	WATER CLOSET	"MADERA" AQUAMETER 2234.015	35 GPF MAX	I-1/2" TOP FLUSH VALVE "#95" SEAT LOCATE FLUSH VALVE HANDLE AT WIDE SIDE OF STALL AT LOCATIONS	"SIPHON JET" FLOOR OUTLET
WC-2	STAFF WATER CLOSET (HC)	"NEW CADET" AQUAMETER 3043.102	3.5 GPF MAX	I-I/2" TOP FLUSH VALVE "#95" SEAT LOCATE FLUSH VALVE HANDLE AT WIDE SIDE OF STALL SEE ARCH. FOR HC LOCATIONS AND HEIGHT REQUIREMENTS	"SIPHON JET" FLOOR OUTLET
L-I	LAVATORY (HC)	"LUCERNE" 0355.012	20-1/2" X 18-1/4" 1.25 GPM	802A-255 W 369 HANDLES FOR DUAL TEMP. 857-E12-669 FOR SINGLE TEMP. 7723.018 GRID DRAIN, INSULATE TRAP & SUPPLY LINES W "TRUEBRO" HANDI-LAY KIT	CONCEALED ARM SUPPORT
UR	URINAL (HC)	"ALLBROOK" 6541.i32	I.O GPF MAX 3/4" TOP SPUD	PROVIDE "SLONE" ROYAL FLUSH VALVE AT URINALS NOT SERVED BY AUTOMATIC FLUSHING SYSTEM.	"SIPHON JET" WALL OUTLET
DF-I	DRINKING FOUNTAIN (HC)	1075		POLISHED POLYMARBLE	WALL MOUNTED ADJACENT TO DF-2 FOR HEIGHT SEE ARC
DF-2	DRINKING FOUNTAIN	1075		POLISHED POLYMARBLE	WALL MOUNTED HEIGHT ABOVE DF-I FOR HEIGHT SEE ARC
FCO	FLOOR CLEANOUT	4043	4" MAX PIPE SIZE	TOP SET FLUSH TO FLOOR	
MCO	WALL CLEANOUT	"J.R. SMITH" 4472	4" MAX PIPE SIZE	LOCATED ON FIXTURE SIDE	W SHALLOW STAINLE STEEL COVER
SA	WATER HAMMER ARRESTOR	"J.R.SMITH" 5000 SERIES		FACTORY PRE-CHARGED	
HB-I	HOSE BIBB	No. 13LK	3/4"	CHROME PLATED, VACUUM BREAKER LOOSE KEY	
(E)FD	EXISTING FLOOR DRAIN			INSTALL (N) POLISHED BRONZE STRAINER	
FD	FLOOR DRAIN	"J.R.SMITH" 2010	2"	W TRAP PRIMER CONNECTION, 6" POLISHED BRONZE STRAINER	
πP	TRAP PRIMER	"PRECISION PLUMBING PRODUCTS" P-2	l/2"		SEE PLUMBING GENL NOTE 3

- 1. SEE THE PLUMBING SPECIFICATIONS FOR THE MANUFACTURERS OF THE MODELS LISTED.
- 2. SEE THE PLUMBING SPECIFICATIONS FOR FIXTURE STOP AND TRAP TYPES.
- 3. CONCEAL ALL TRAP PRIMERS AND PRIMER PIPING WITH TRAP PRIMERS ACCESSIBLE AS SHOWN ON THE DRAWINGS.

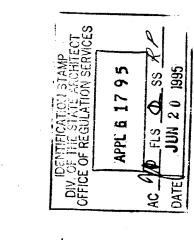
	FIXTURE UNIT AND CONNECTION CHART (6)							
ADDD	FIVE		FIXTURE UNITS		FIXTURE CONNECTIONS (1)			
ABBK	ABBR FIXTURE	COLD WATER	HOT WATER	DRAIN & VENT	WATER (2)	DRAINAGE	VENT	
Ж	WATER CLOSET (FV)	10	-	6	1 (5)	4	2	
UR	URINAL (FV)	5	-	2	3/4 (5)	2	1-1/2	
L	LAVATORY (SINGLE)	2	2		1/2	1-1/2	I-I/2	
			<del></del>	<u> </u>				
DF	DRINKING FOUNTAIN	2	<u> </u>		1/2	1-1/2	I-I/4	
HB	HOSE BIBB	5	-		3/4	<u>-</u>	-	

FIXTURE CONNECTIONS LISTED ARE NOMINAL PIPE SIZE - INCHES. SIZE TO "DROP EAR" ELBOW OR SIMILAR FITTING. NOT USED

5 INCREASE ONE PIPE SIZE IF TOTAL DEVELOPED LENGTH EXCEEDS 12".

6 THIS SCHEDULE SHALL BE USED TO SIZE BRANCH PIPING NOT SHOWN ON DRAWINGS.

NOT USED






**AVENUE** 

THE CONTRACTOR SHALL CHECK ALL DIMENSIONS AT THE JOB AND SHALL BE RESPONSIBLE FOR ALL DISCREPANCIES BETWEEN DIMENSIONS OF THE ACTUAL WORK AND THOSE SHOWN IN THE DOCUMENTS OR ARCHITECT'S APPROVED SHOP DRAWINGS. THE CONTRACTOR SHALL ALSO BE SOLELY RESPONSIBLE FOR ALL QUANTITIES OF MATERIAL OR EQUIPMENT CALLED FOR TO PROPERLY COMPLETE THE WORK.


SHEET TITLE

MECHANICAL & **PLUMBING** SCHEDULES

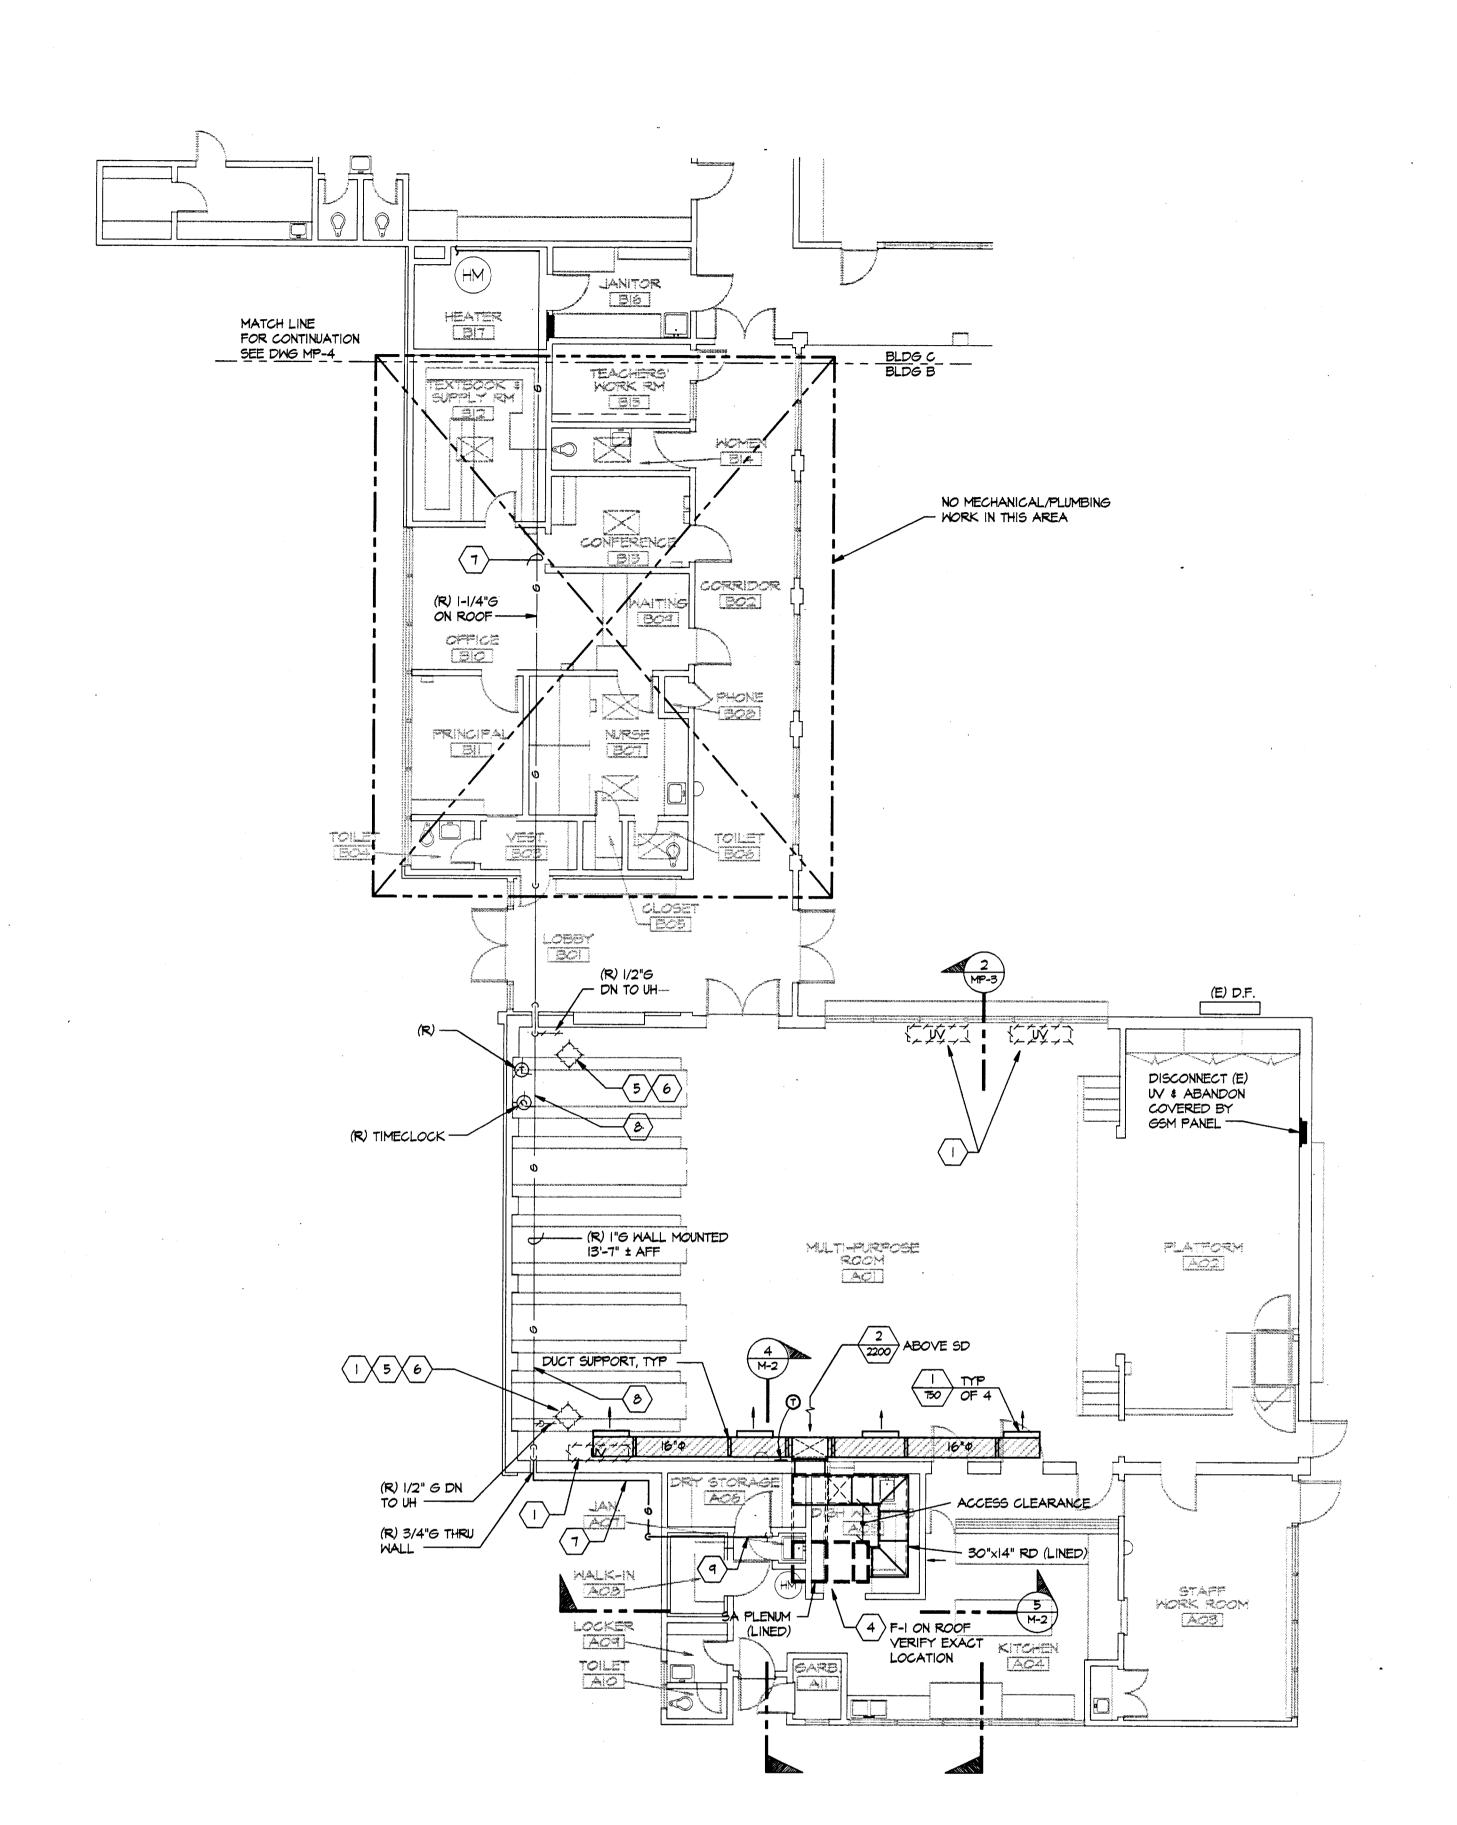DRAWING NUMBER



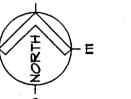
FLOOR PLAN - BUILDINGS A & B MP-3 SCALE: 1/8" = 1'-0"



### SHEET NOTES:


- (R) UNIT VENTILATOR, HEATING HOT WATER PIPING, ELEC WIRING BLO DUCT & PATCH.

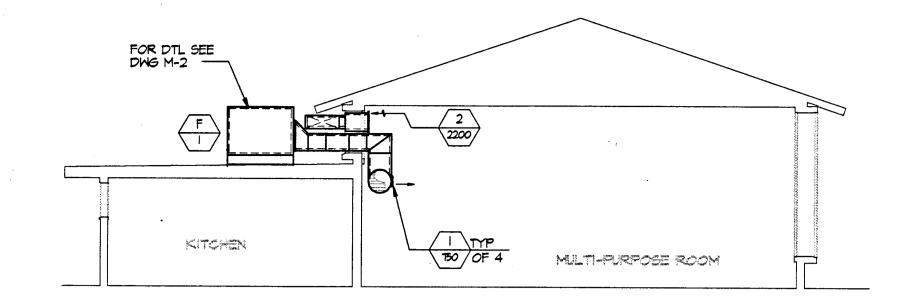- (N) FURNACE MOUNTED ON STAND ABOVE ROOF.
- (R) UH SUSPENDED FROM CEILING INCLUDING UNIT SUPPORTS, ELECTRICAL WIRING CONDUITS & THERMOSTAT CONTROL SYSTEMS.
- $\langle 6 \rangle$  (R) 4" FLUE ENTIRELY FROM (R) UH TO OUTLET ABOVE ROOF.
- PROVIDE (N) I 1/2"G WITH (N) PIPE CLAMPS ATTACHED TO (E) ROOF SLEEPER AND (N) ROOF SLEEPERS AS REQUIRED.
- PROVIDE (N) I 1/2"G WITH (N) WALL SUPPORTS SEE DWG P-1
- PROVIDE (N) I 1/2"G TO (N) F-1 WITH (N) PIPE CLAMPS ATTACHED TO (E) ROOF SLEEPERS AND (N) ROOF SLEEPERS AS REQUIRED.



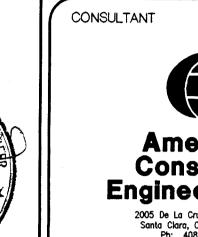**MECHANICAL & PLUMBING** NEW WORK SECTION @ BLDG A MP-3 SCALE: 1/8" = 1'-0"






SHEET TITLE


MECHANICAL & PLUMBING DEMOLITION & NEW WORK FLOOR PLAN BLDGS. A & B

DRAWINĠ NUMBER

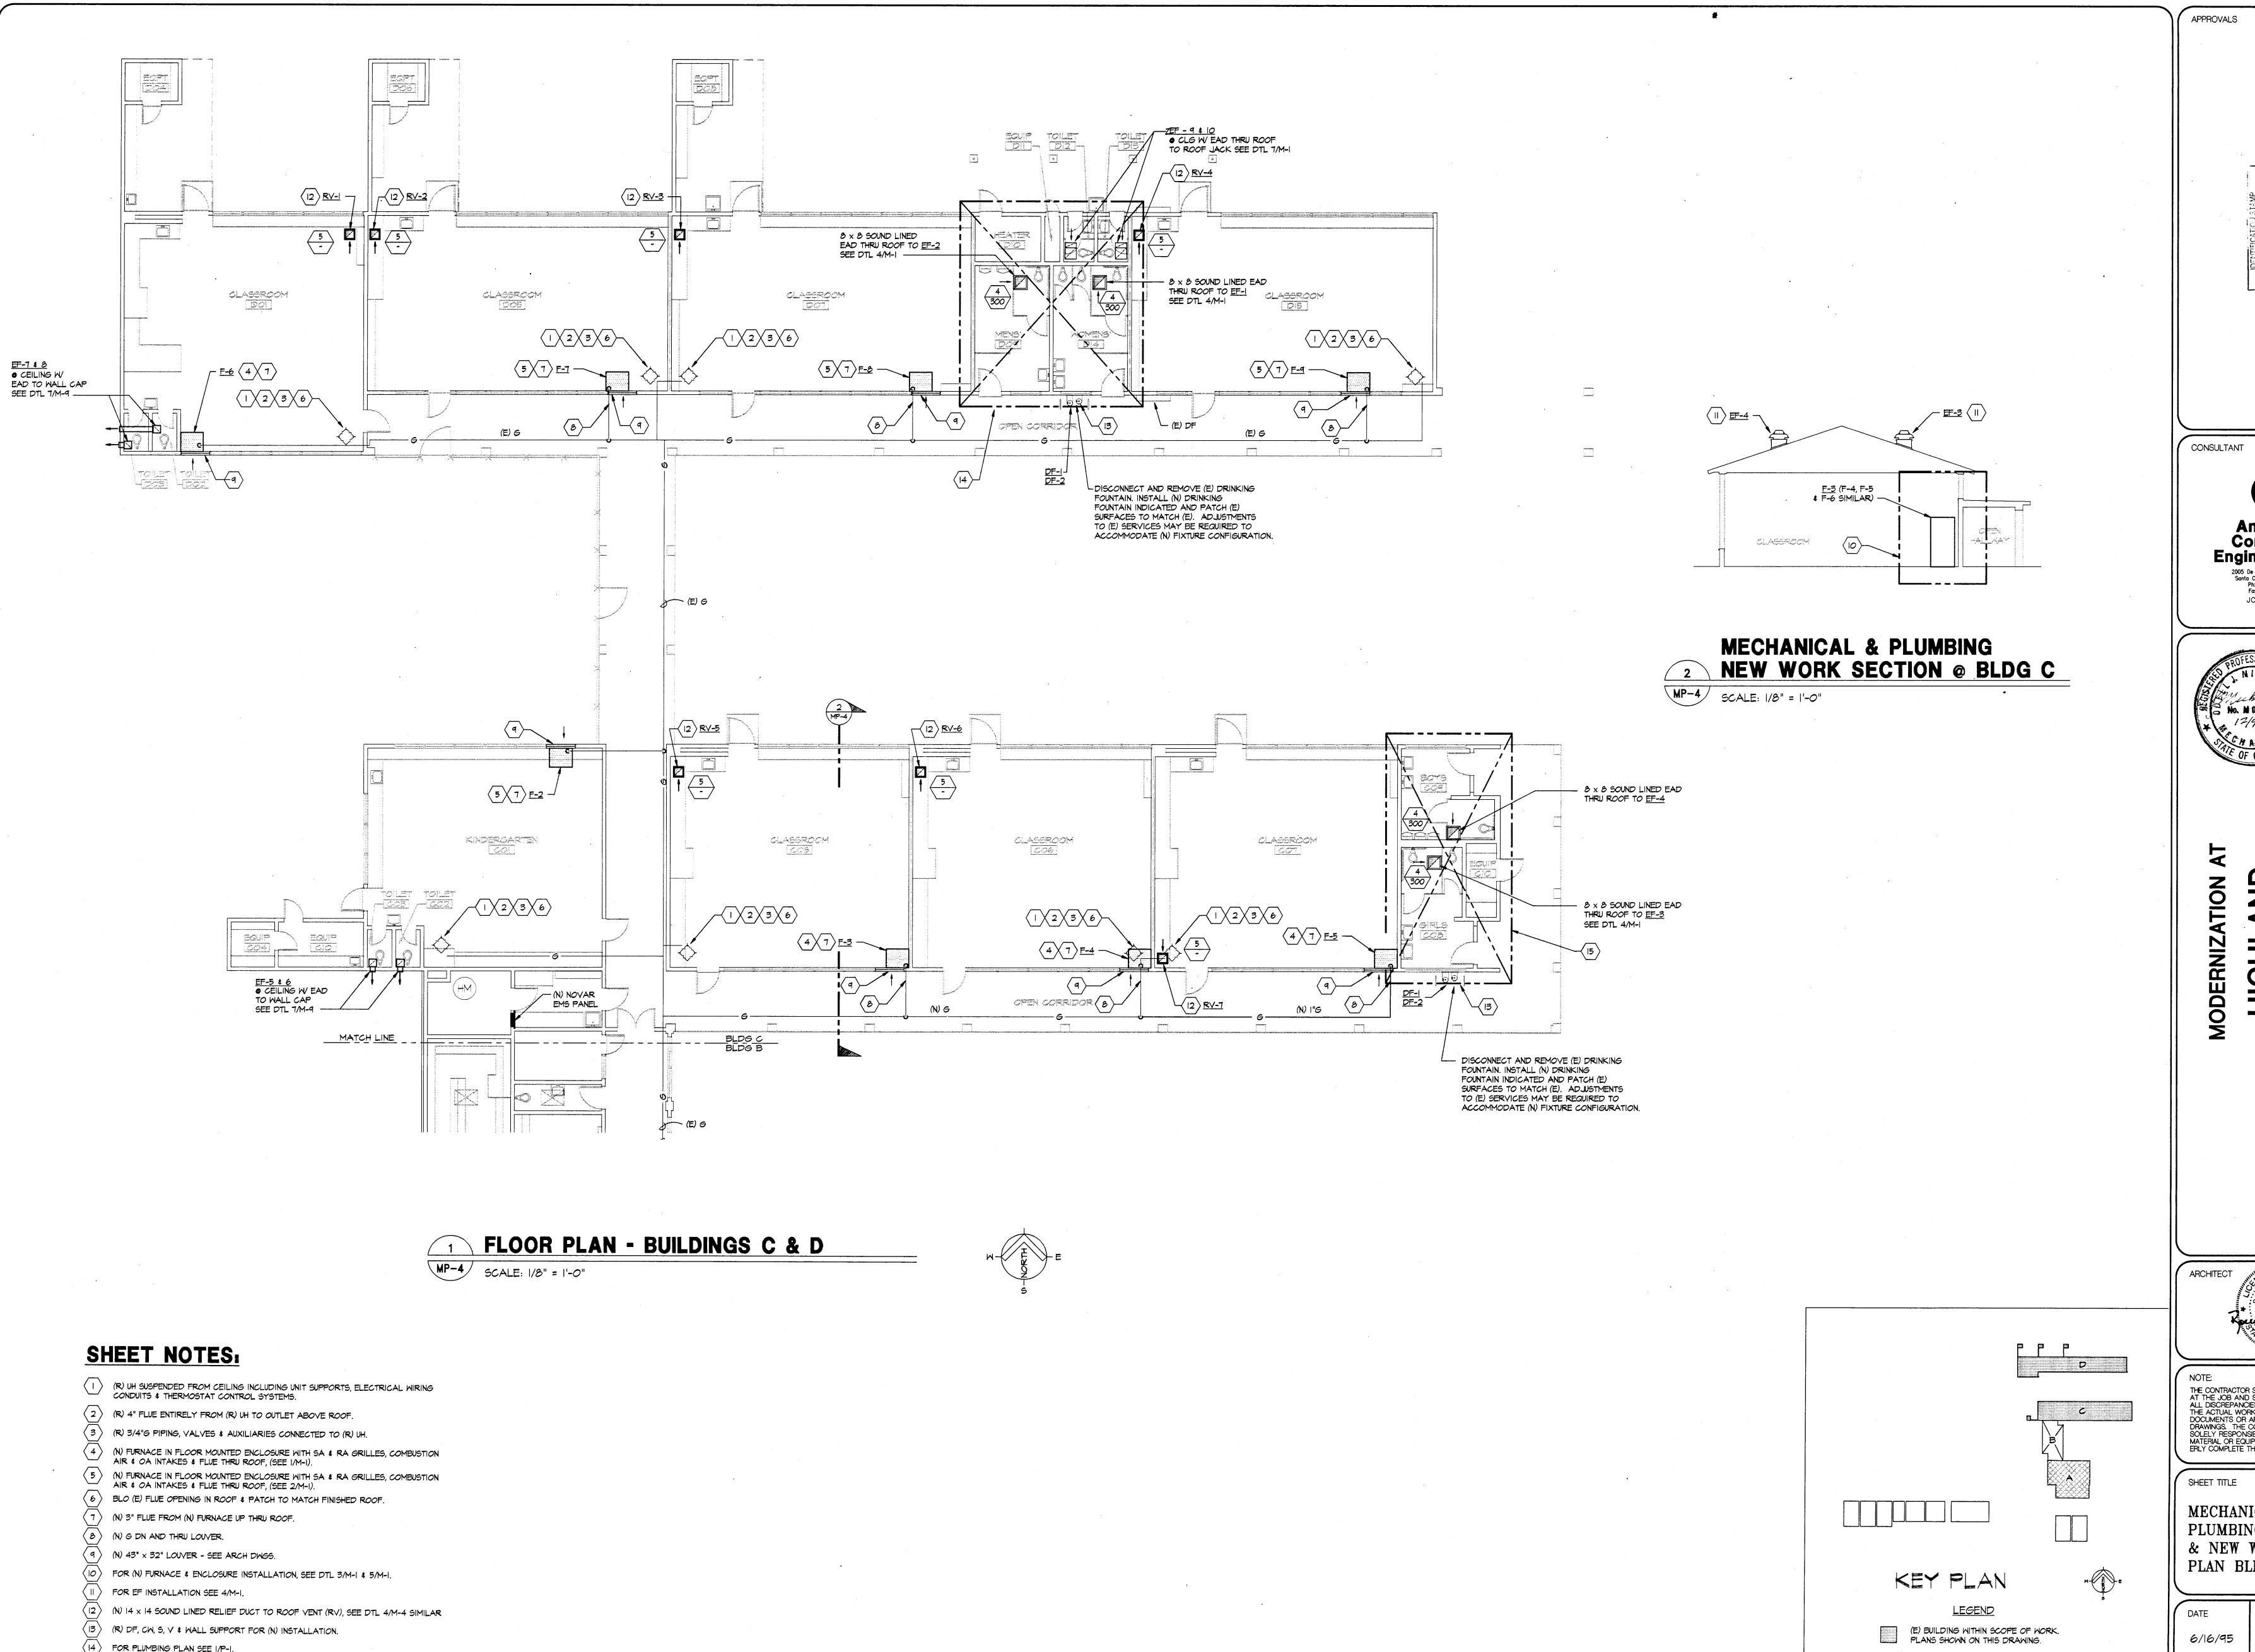KEY PLAN (E) BUILDING WITHIN SCOPE OF WORK.
PLANS SHOWN ON THIS DRAWING. (E) BUILDING WITHIN SCOPE OF WORK.
PLANS SHOWN ON ANOTHER DRAWING. (E) BUILDING OUTSIDE SCOPE OF WORK.
DOES NOT QUALIFY FOR MODERNIZATION. (E) BUILDING OUTSIDE SCOPE OF MECHANICAL/PLUMBING WORK.



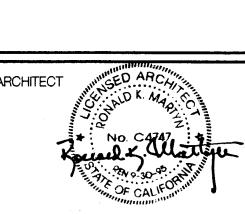American Consulting Engineers, Inc. 2005 De La Cruz Bivd, Suite 151 Santa Clara, CA 95050-3030 Ph: 408/986-8388 Fax: 408/986-9129 JOB # 94638



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MECHANICAL &

PLUMBING DEMOLITION & NEW WORK FLOOR PLAN BLDGS C & D

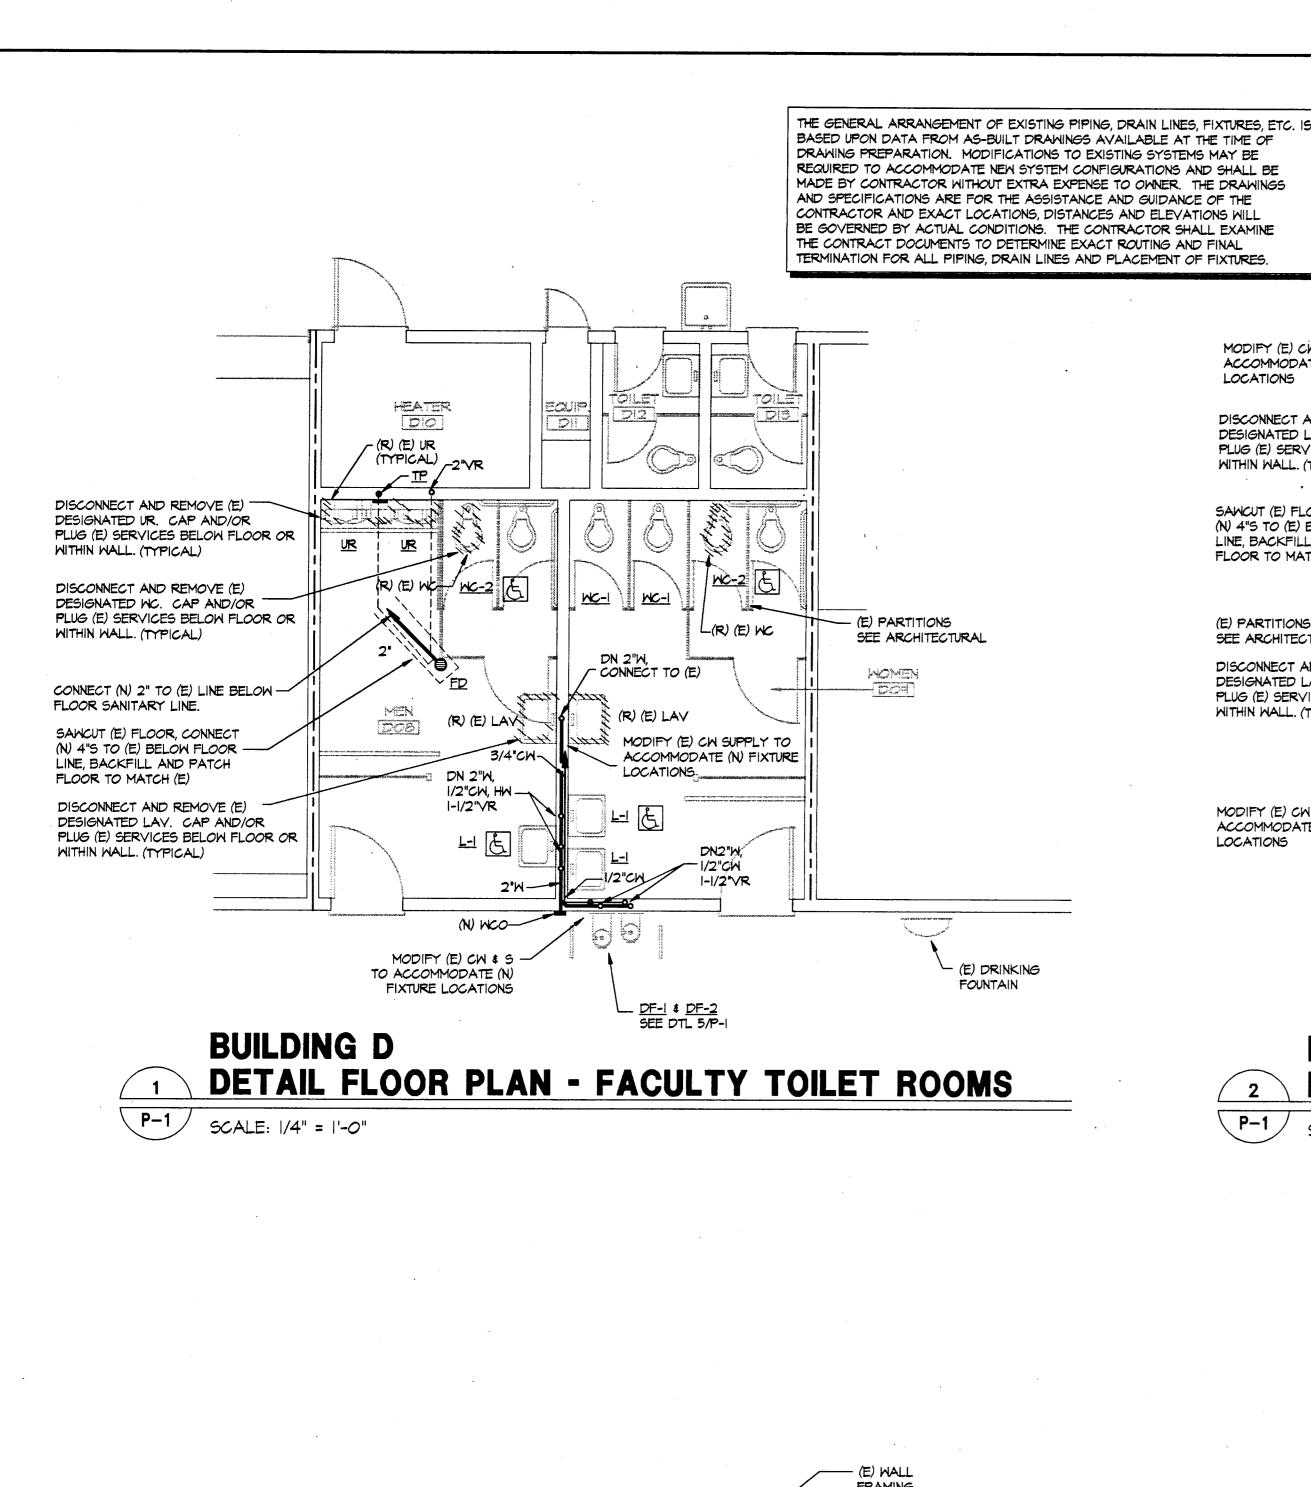
DRAWING NUMBER

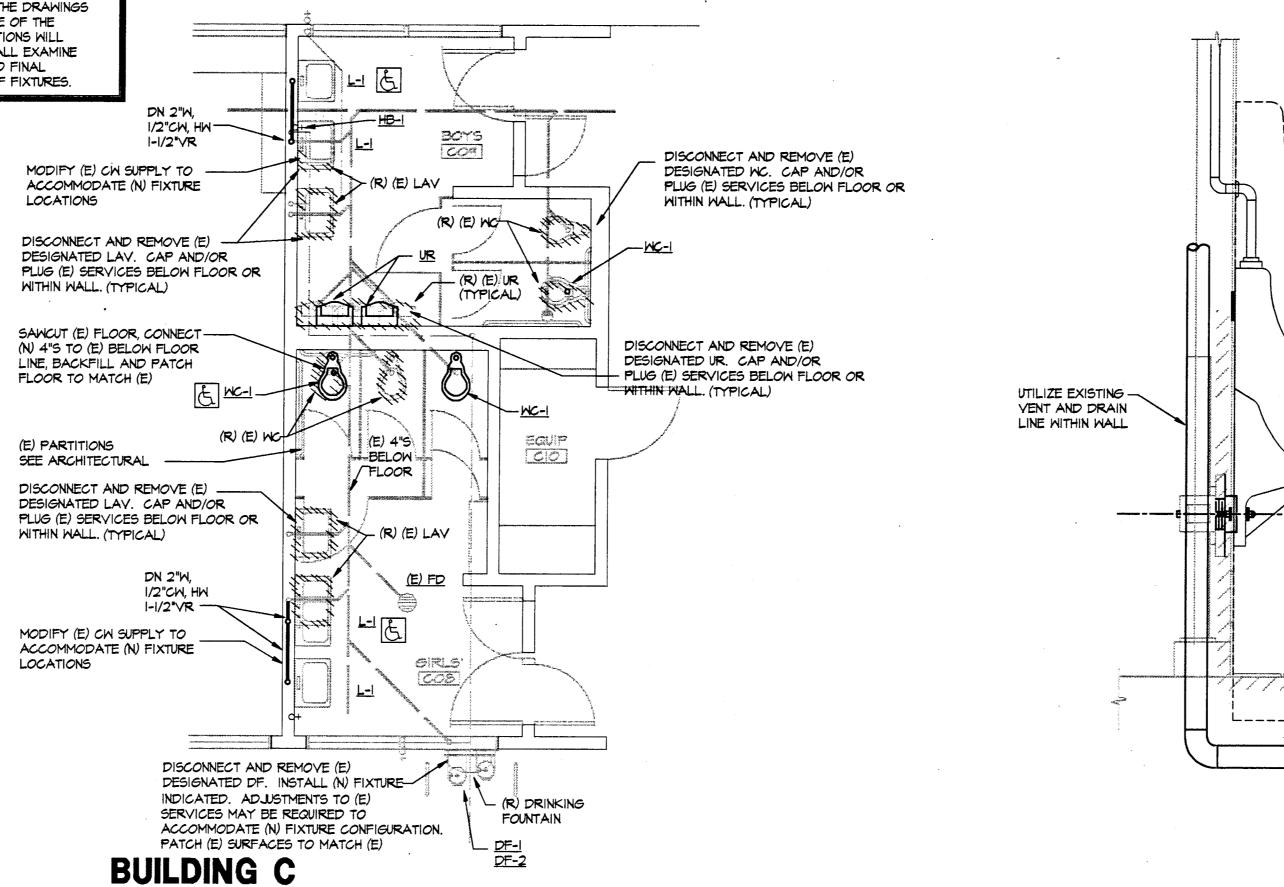
(E) BUILDING WITHIN SCOPE OF WORK.
PLANS SHOWN ON ANOTHER DRAWING.

(E) BUILDING OUTSIDE SCOPE OF WORK. DOES NOT QUALIFY FOR MODERNIZATION.

(E) BUILDING OUTSIDE SCOPE OF MECHANICAL/PLUMBING WORK.


(15) FOR PLUMBING PLAN SEE 2/P-1.





DETAIL FLOOR PLAN - STUDENT TOILET ROOMS

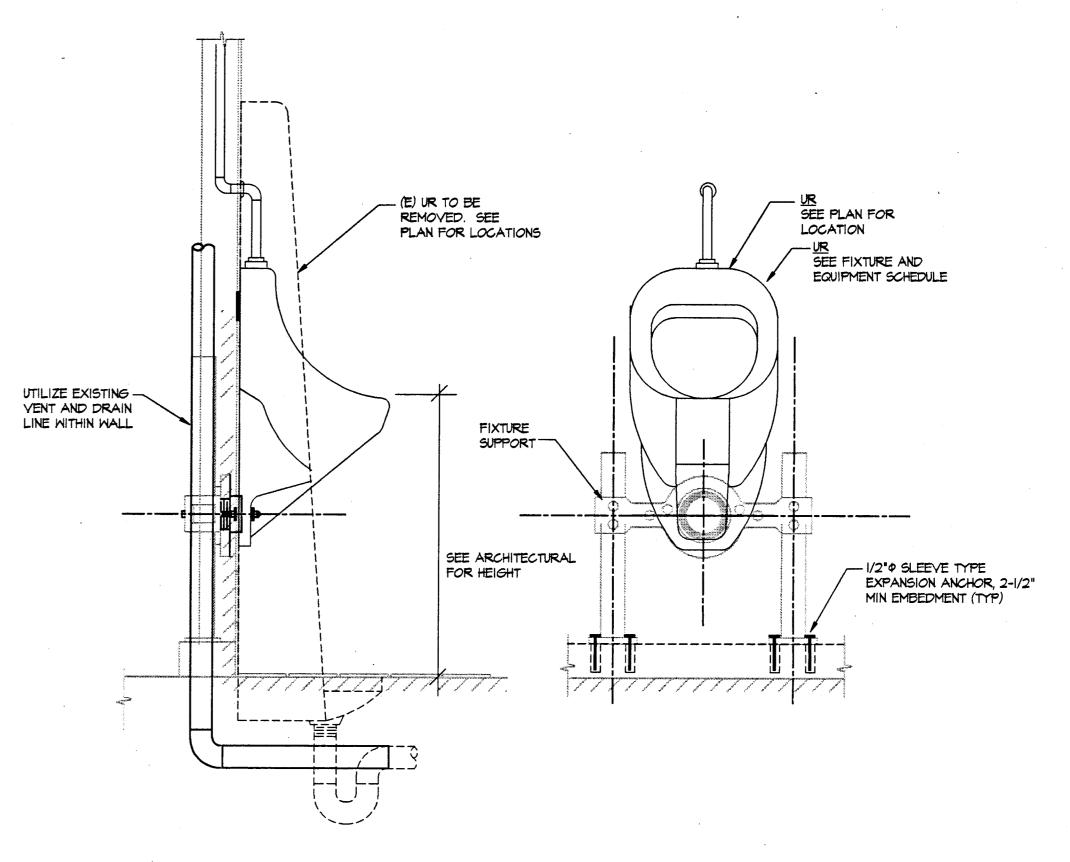SCALE: 1/4" = 1'-0"





NOT TO SCALE

CONTINUOUS PLATE

FOR BATTERY OF

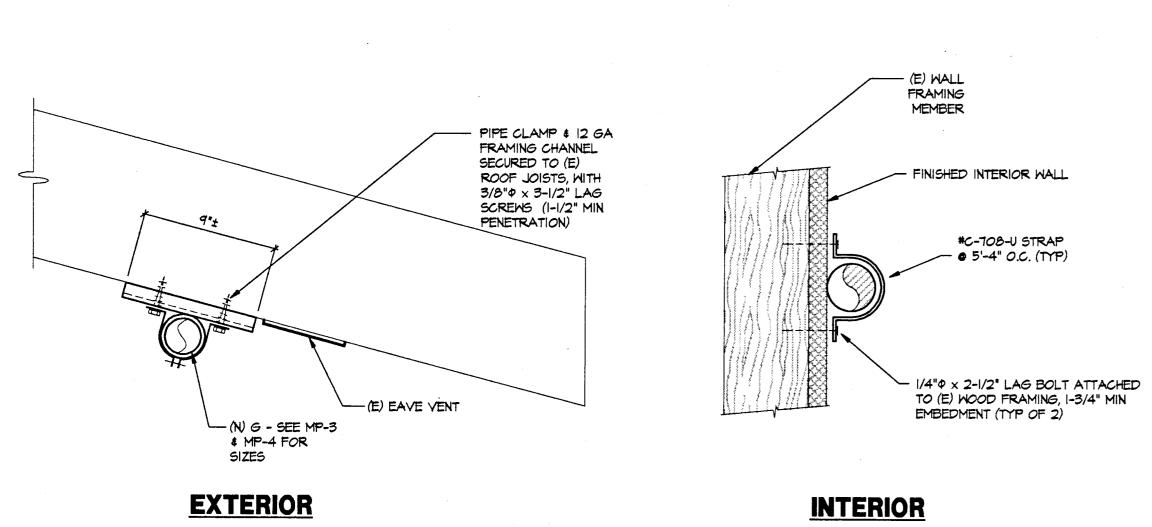
1/4" THK STEEL PLATE

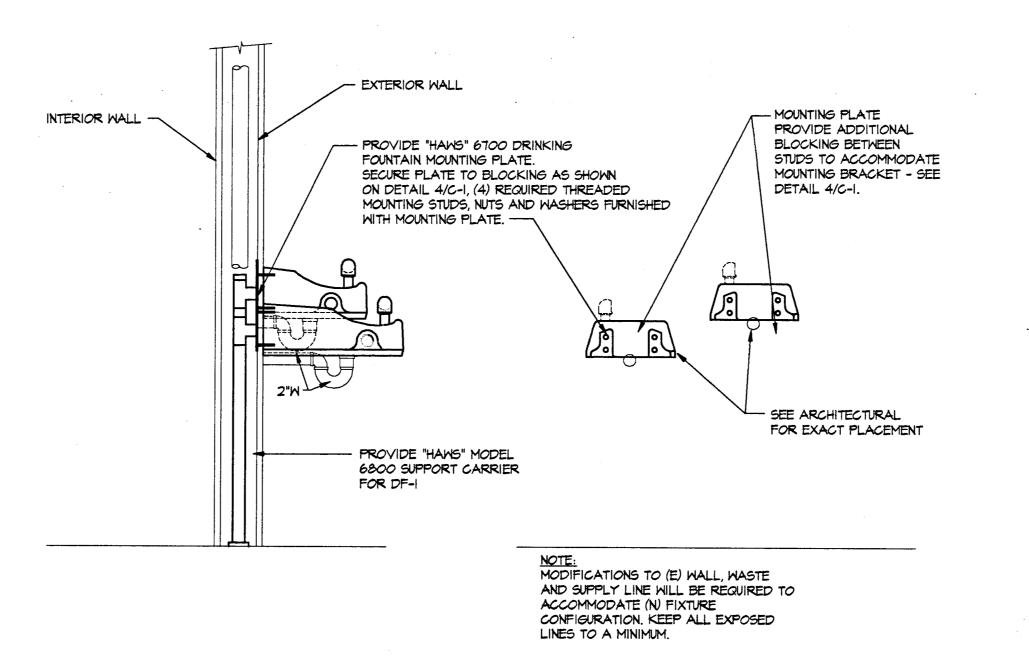
SECURE PLATE TO EACH WOOD STUD W/ (2)

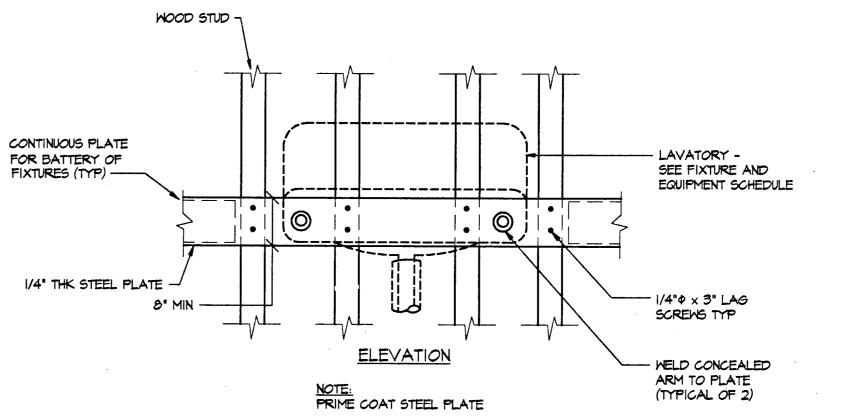
1/4" 0 x 3" LAG SCREWS

(TYPICAL) ---


FIXTURES -









# DRINKING FOUNTAIN MOUNTING DETAIL P-1 NOT TO SCALE

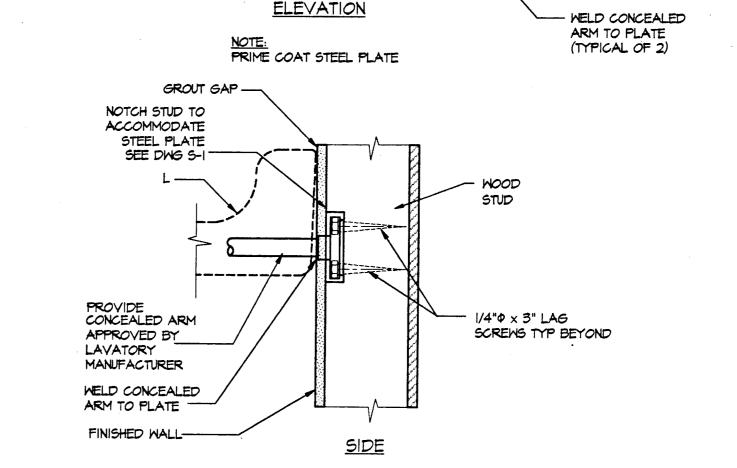

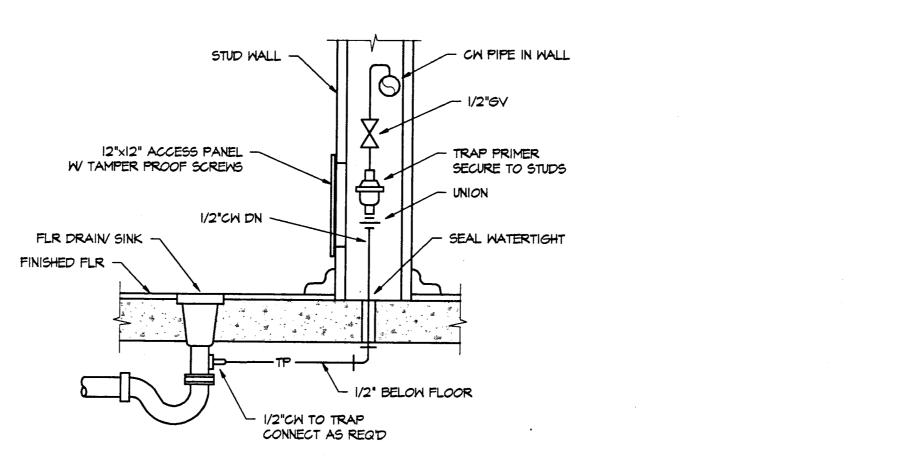




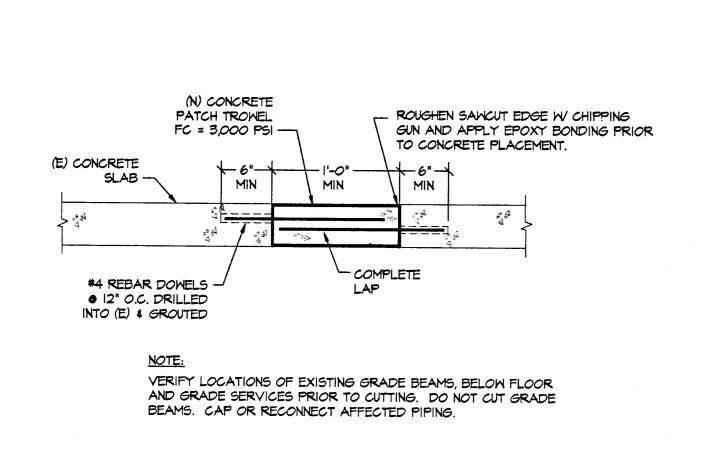

GAS PIPE SUPPORT DETAILS



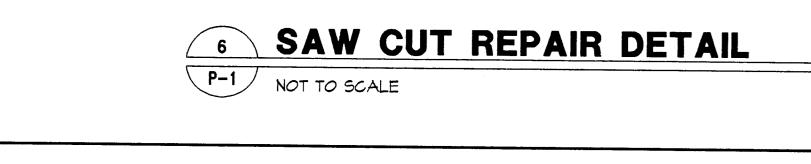

NOT TO SCALE



VENUE

CONSULTANT

TION

MODE

SHEET TITLE

77-15-3

PROVIDED CONCEALED ARM

American Consulting


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JOB # 94638

- (E) \$ (N) G PIPING SEE MECH/PLBG DWGS. FOR SIZES \$ ROUTING REDWOOD SLEEPER 4"  $\times$  4" LENGTH TO SUIT. THICKNESS OF SLEEPER SHALL ALLOW FOR CONTINUITY OF PIPE LEVEL.
- 3 CLEAN OFF AREA, INSTALL PIPE SUPPORT SLEEPER
  AS RECOMMENDED BY APPROVED FOAM ROOFING MANUFACTURER
- 4 SUPERSTRUT TO CLAMP
- SUPERSTRUT BP-1400 GALV. CHANNEL
- $\langle 6 \rangle$  1/4" $\phi$  Galv Nuts, Washers & Bolts
- $\langle 7 \rangle$  3/8" $\phi$  x 3" Long galv Lag Bolt thru into sleeper
- 8 (E) FOAM ROOF






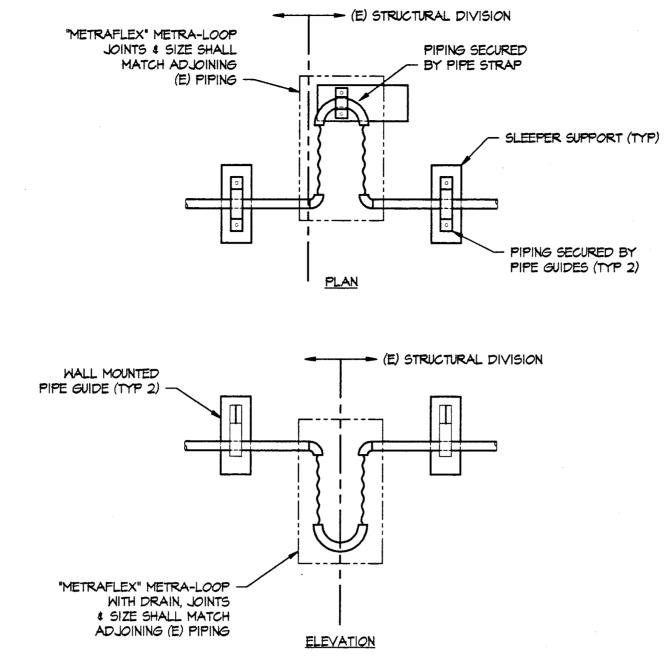NOTE: A FLEX CONNECTION AND SHUT-OFF VALVE SHALL BE PROVIDED BETWEEN STRUCTURES. VERIFY ALL LOCATIONS PRIOR TO START OF WORK

# FLEXIBLE GAS PIPING CONNECTION



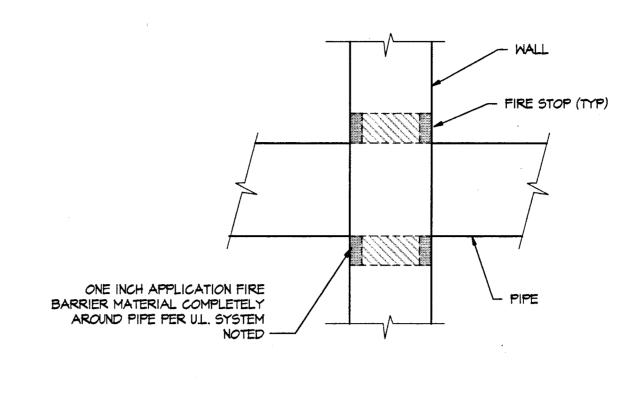

NOTE: INSTALL PER U.L. FIRE RESISTANCE DIRECTORY SYSTEM #147.

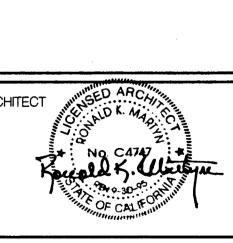


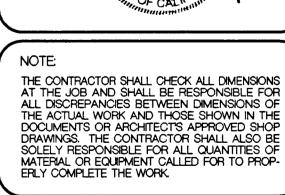


CONSULTANT





American Consulting Engineers, Inc.






PLUMBING DETAILS

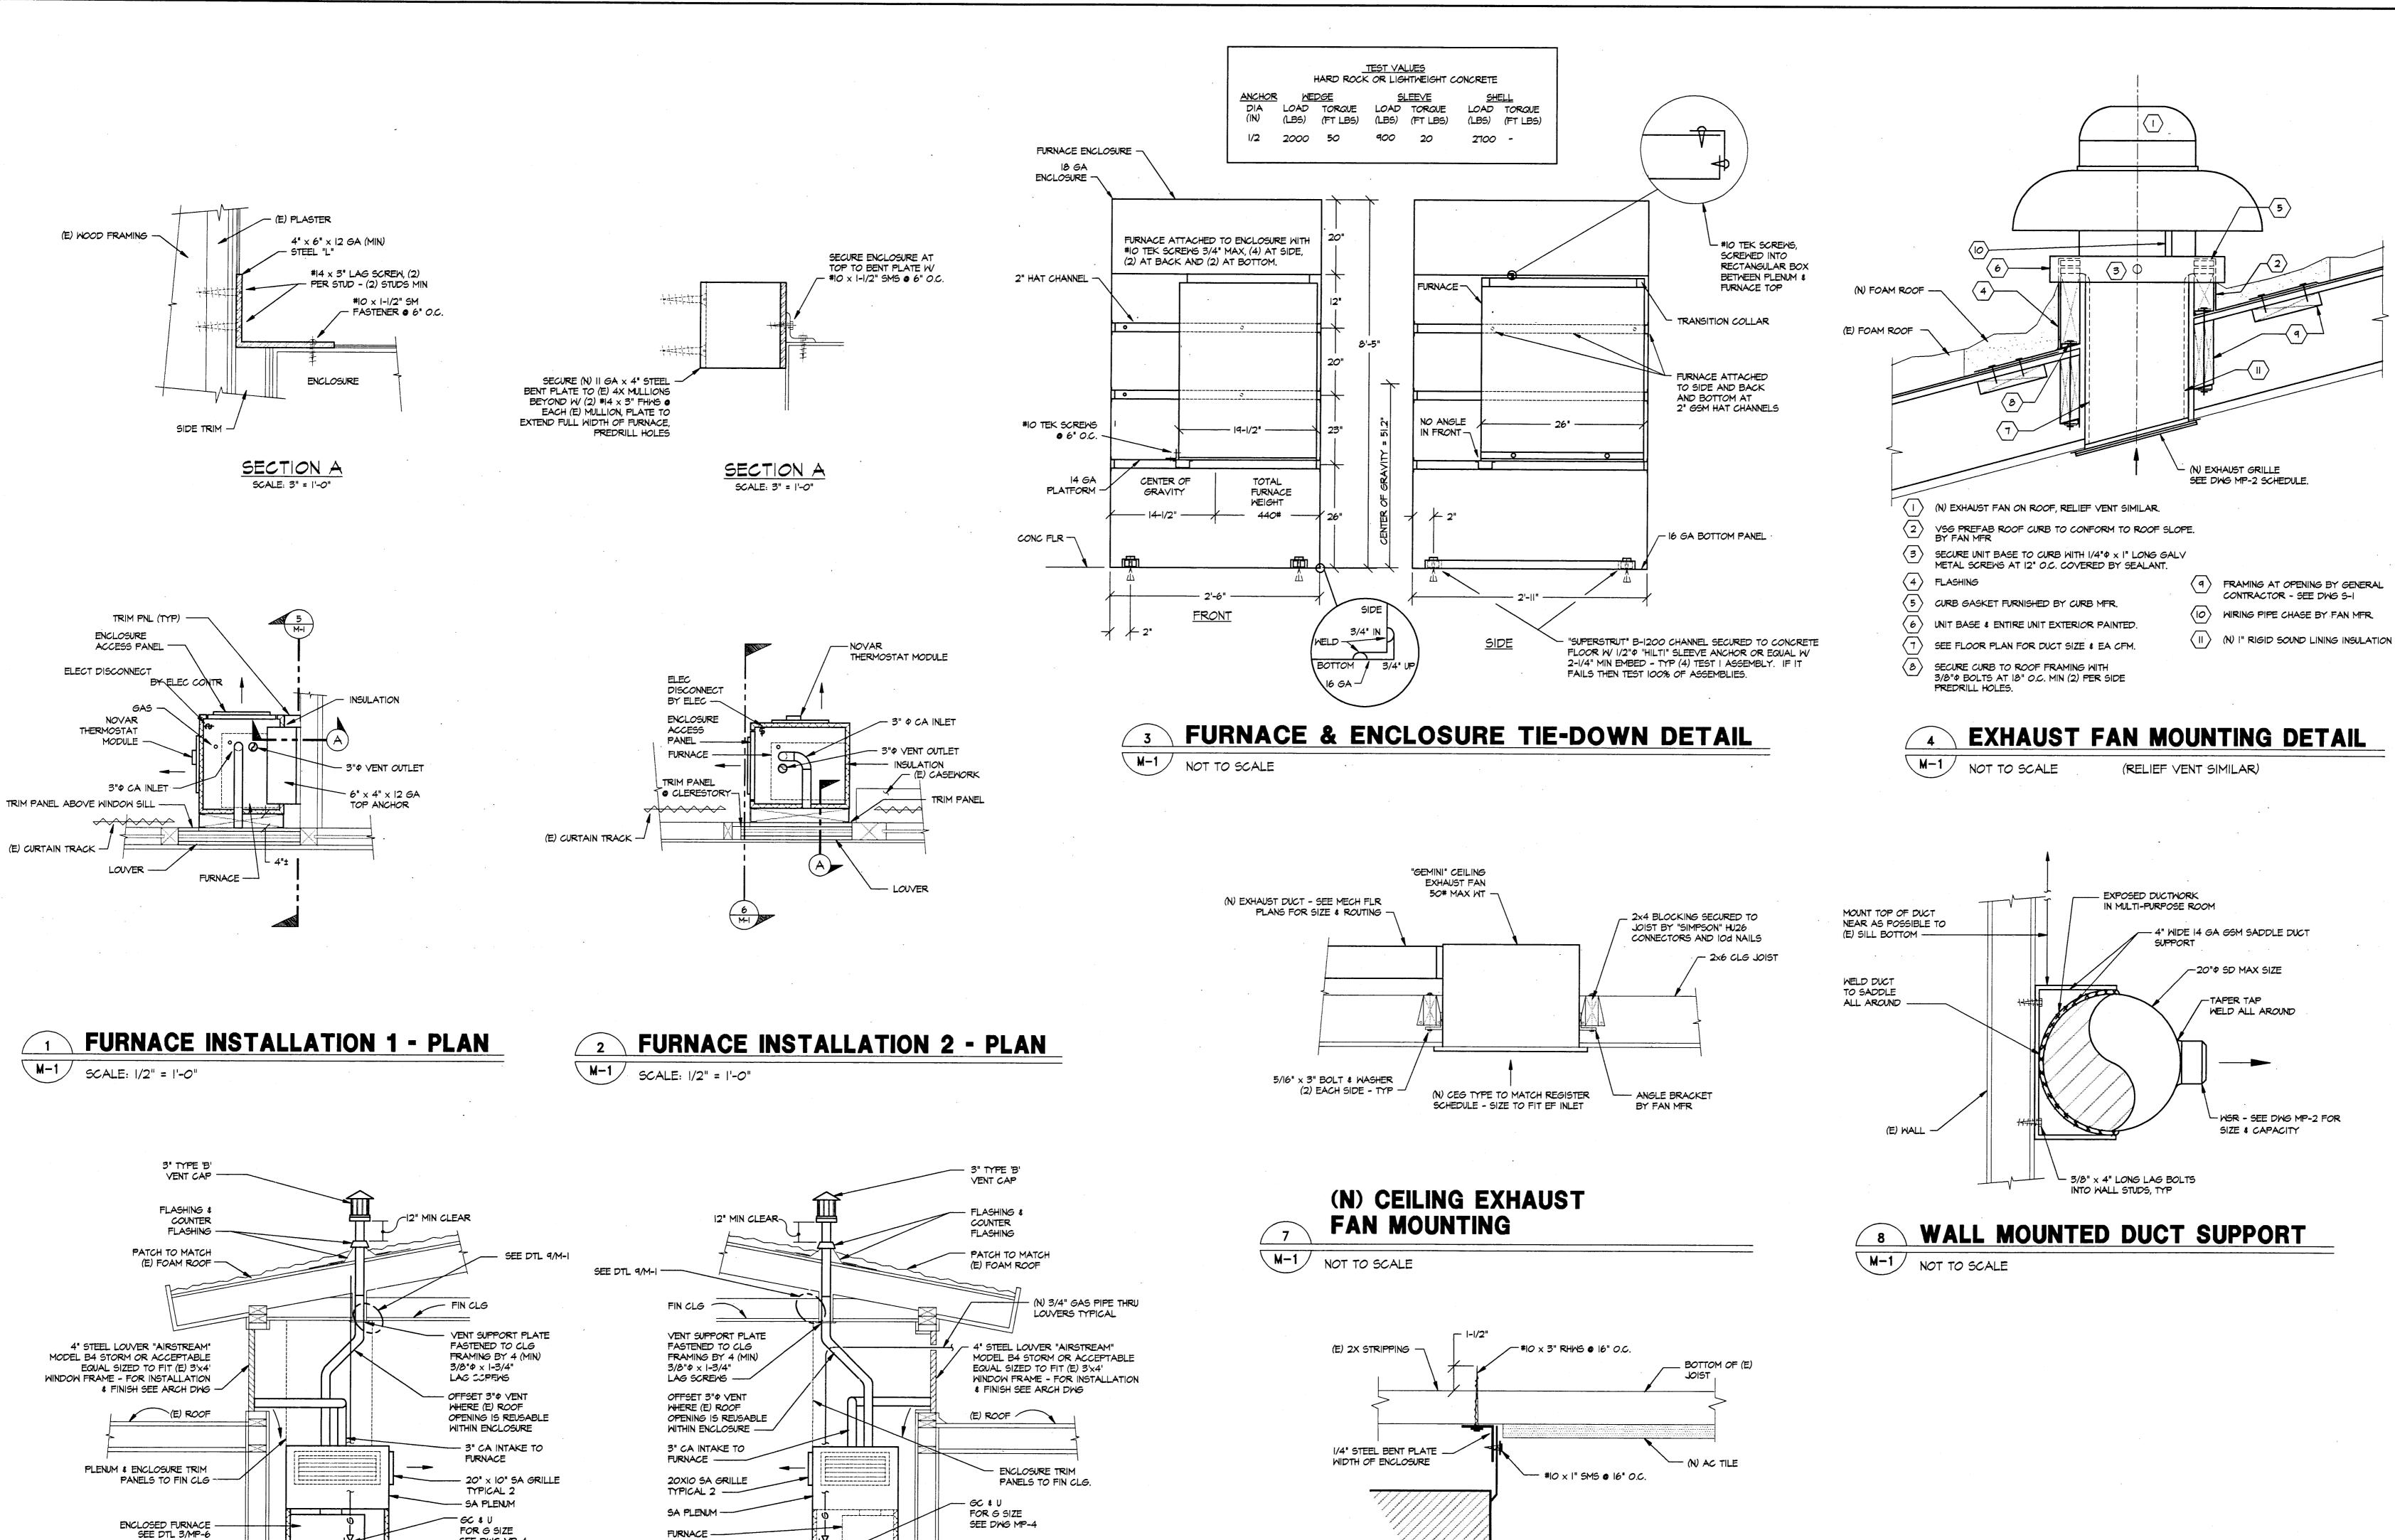

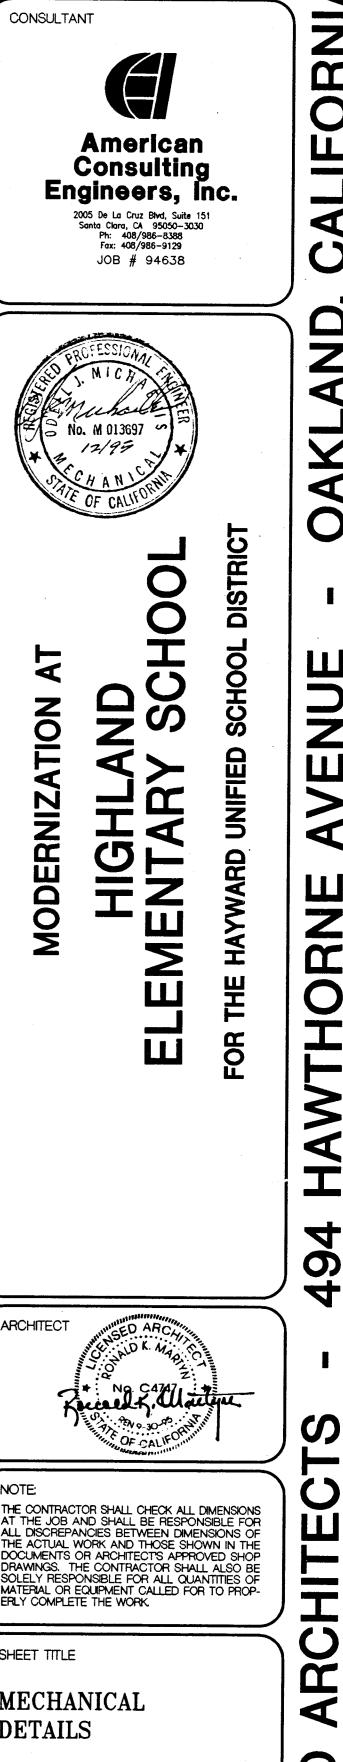

**APPROVALS** 

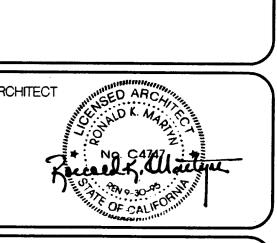

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SHEET TITLE

MECHANICAL **DETAILS** 

I" INSULATION

BY ELECT CONTR -

OA PLENUM -

(E) GRADE -

SECTION @ CLASSROOM FURNACE 1

12" x 18" AVD -

James James

M-1 SCALE: 1/2" = 1'-0"

(BY ENCL MFR)

NOVAR THERMOSTAT

ELEC DISCONNECT BY ELEC

20x14 RA GRILLE

CLASSROOM FLOOR -

MIXING PLENUM

REPLACEABLE

FOR & SIZE SEE DWG MP-4

THERMOSTAT MODULE

REPLACEABLE I" AIR FILTER

____ 20" × 14" RA GRILLE

CLASSROOM FLOOR

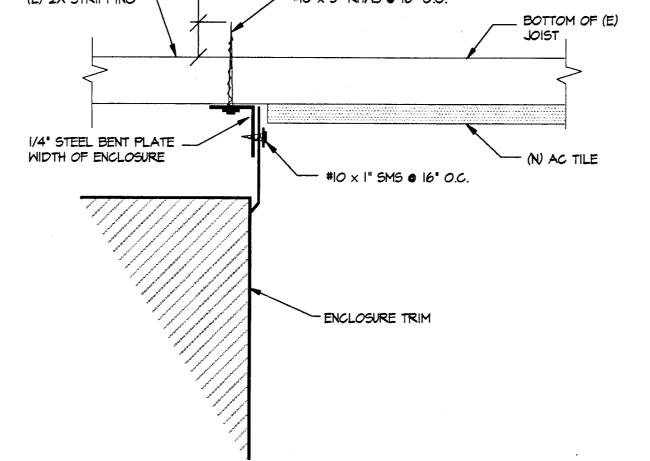
6 SECTION @ CLASSROOM FURNACE 2 M-1 SCALE: 1/2" = 1'-0"

- 1-1/2" INSULATION

(BY ENCL MFR)


OA PLENUM 450 CFM MINIMUM


----- I2xI8 AVD



**FURNACE TRIM** INSTALLATION AT CEILING DETAIL

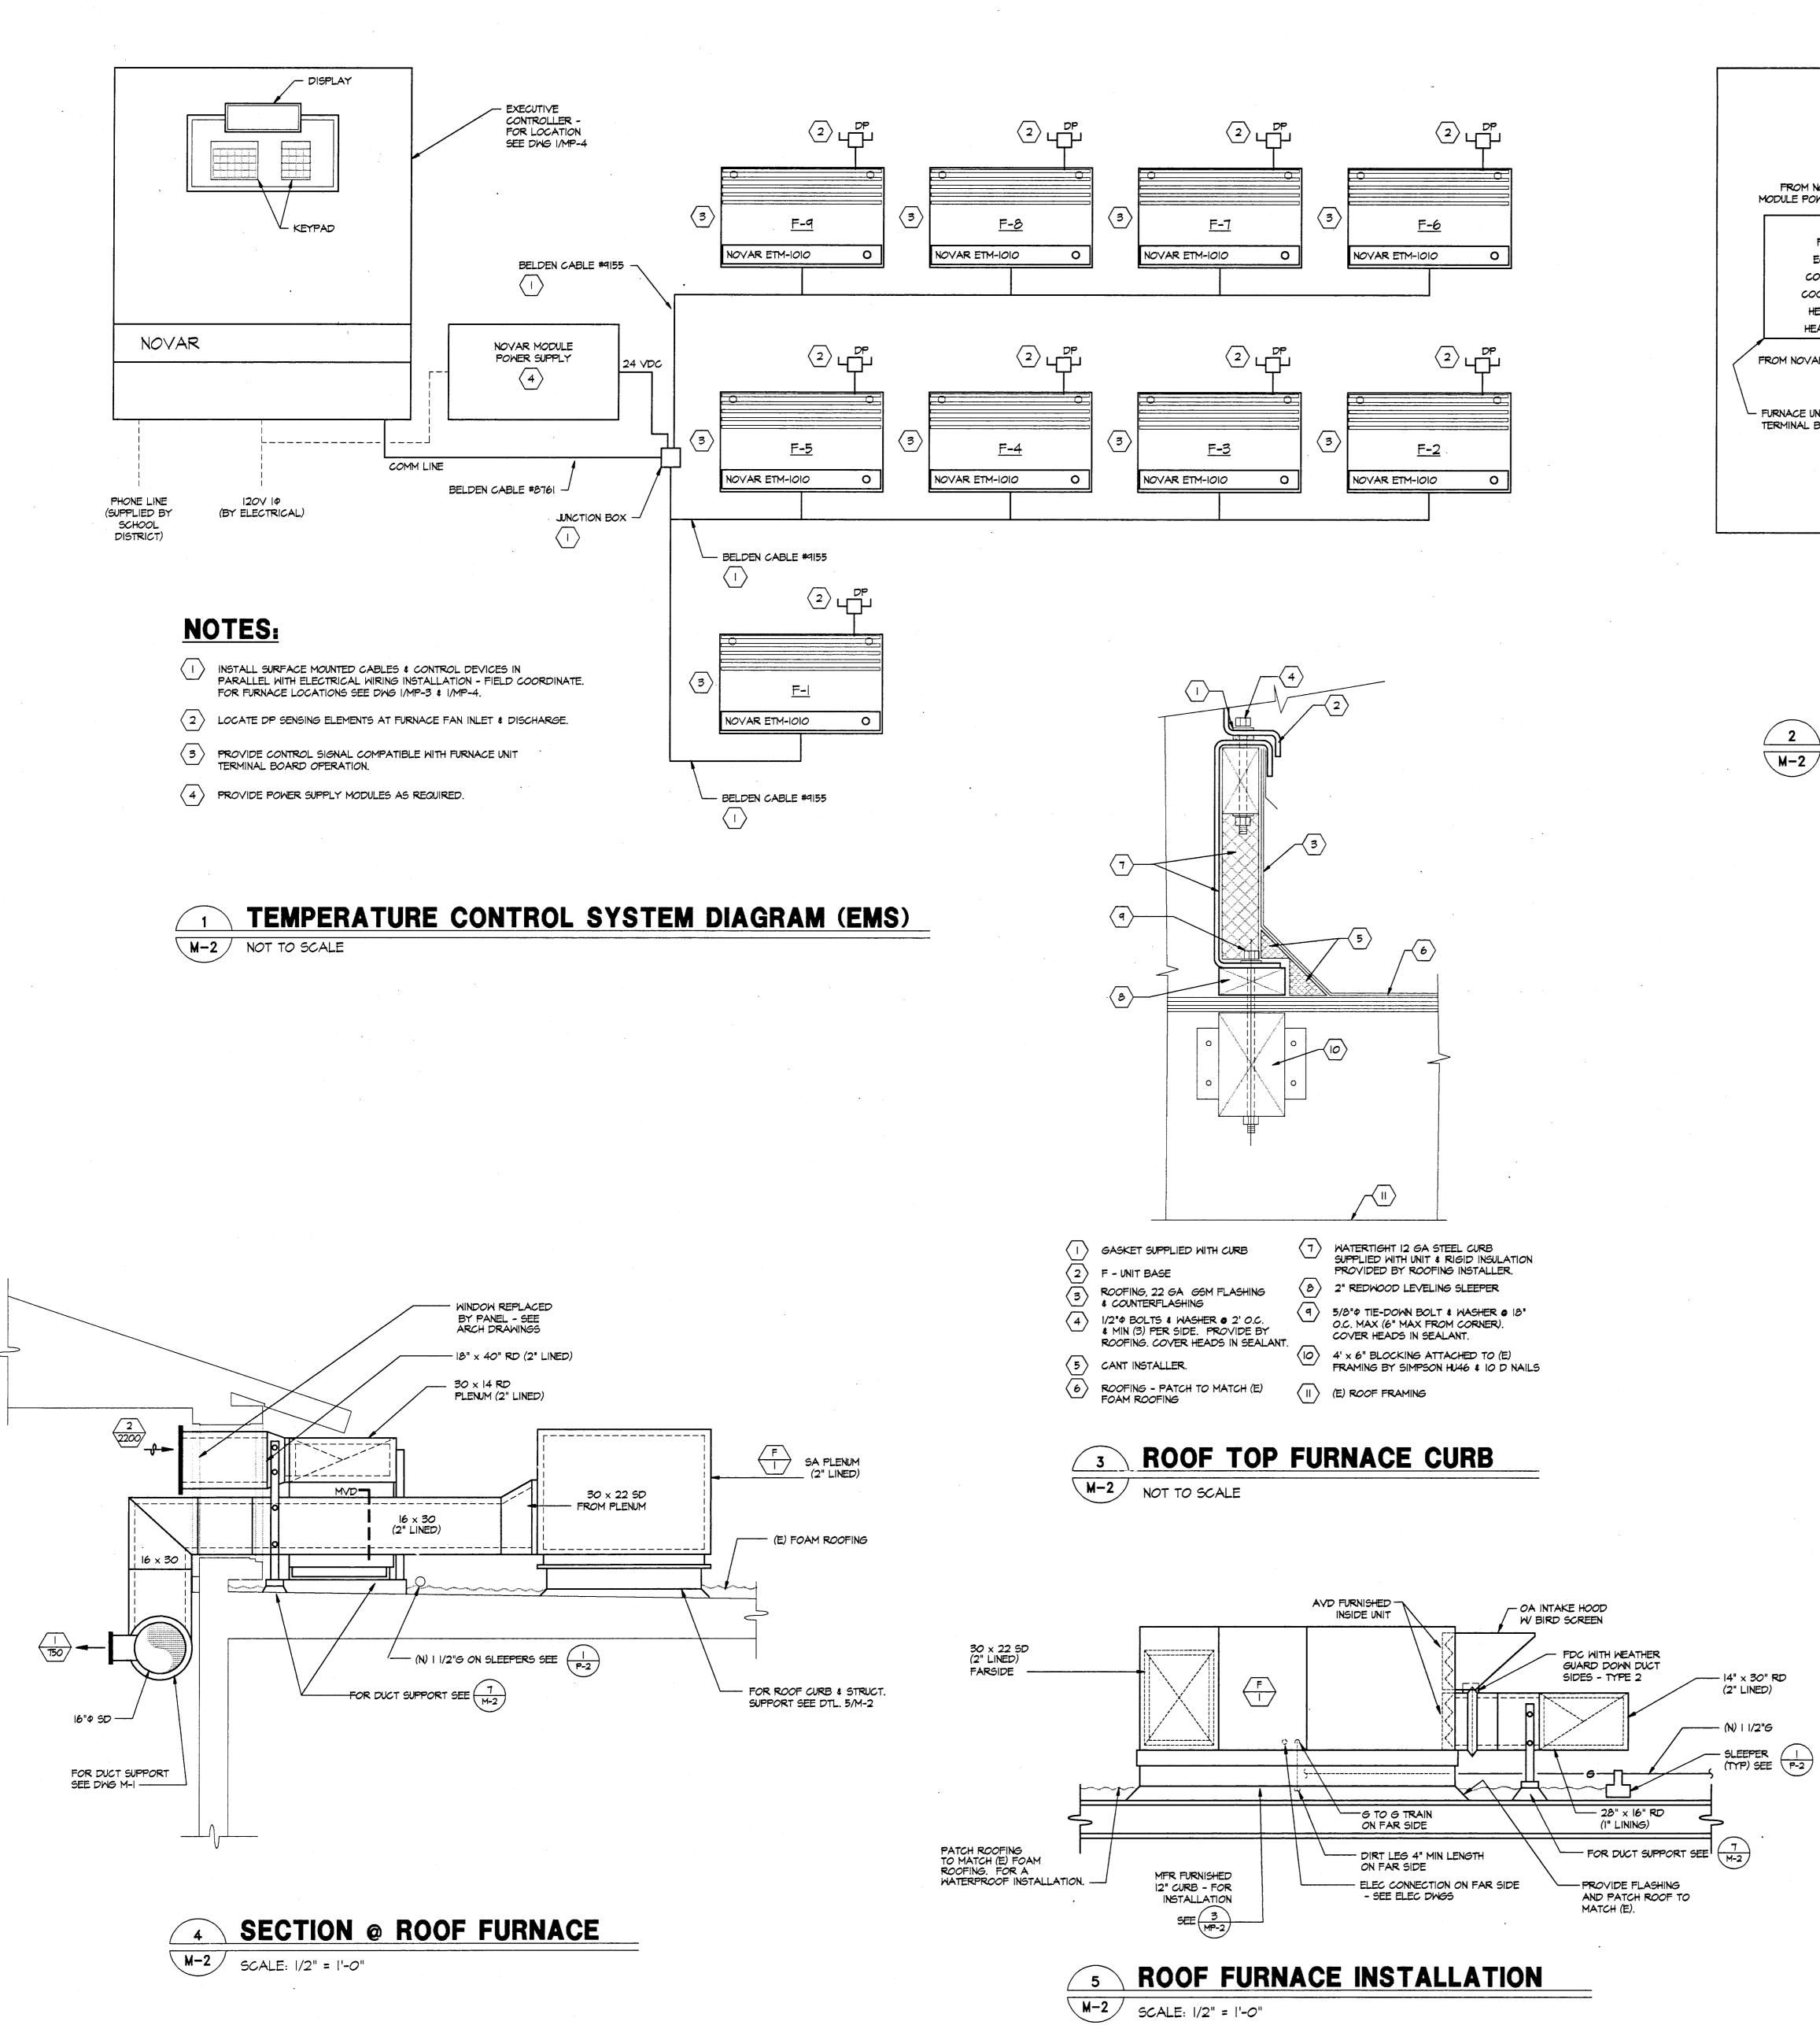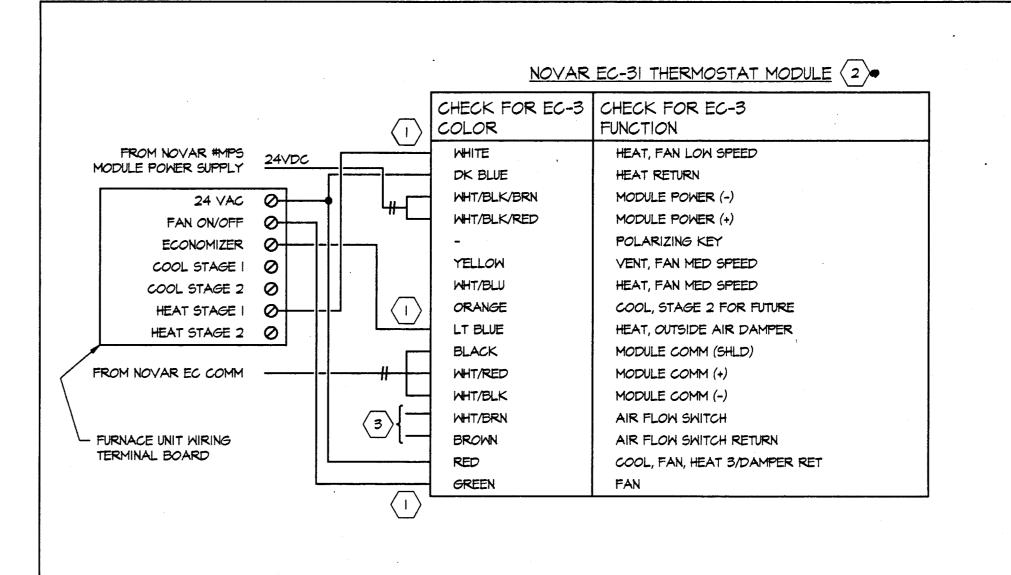NOT TO SCALE






### **NOTES:**

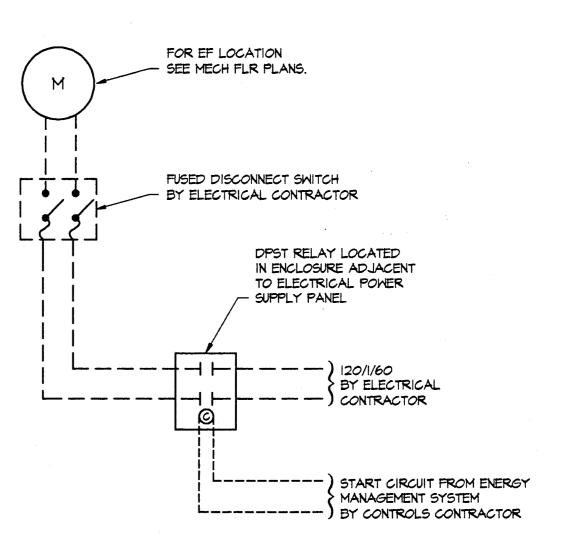
- PROVIDE CONTROL SIGNAL COMPATIBLE WITH FURNACE UNIT TERMINAL BOARD OPERATION.
- 2 MODULES ARE MOUNTED ON FURNACE ENCLOSURES, EXCEPT AT F-1; SEE DWG MP-3.
- 3 PROVIDE DP SENSOR & WIRING





### EXHAUST FAN CONTROL DIAGRAM

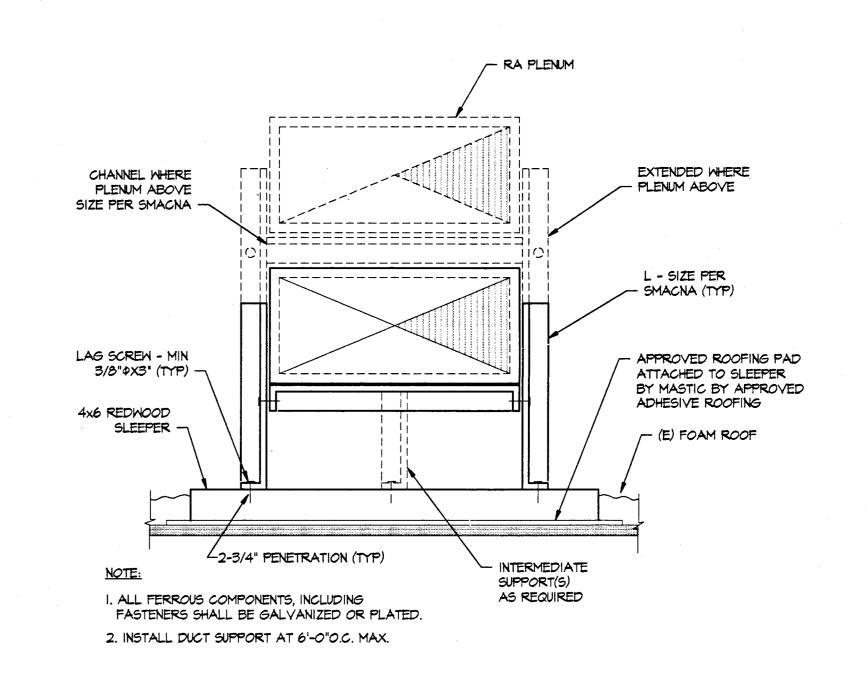M-2 NOT TO SCALE



### ROOF DUCT SUPPORT INSTALLATION

M-2 NOT TO SCALE

**APPROVALS** 

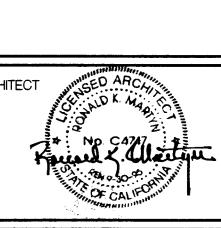
CONSULTANT

6 No. M 013697 "

12/95



MODE



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SHEET TITLE

**MECHANICAL** CONTROL DIAGRAMS & DETAILS

DRAWING NUMBER

77-15-3

TYPE	LAMPS	DESCRIPTION	IAPTICU
		DESCRIPTION	WEIGH
<b>A</b> .	F32T8/835 FLUORESCENT 32 WATTS T8 STYLE 85 CRI 3500K		
		DAY-BRITE 2-X43-DLII90 ELECTRONIC "TO" SERIES NATIONAL - BFPA 24-348RS(TO-KI9 ELECTRONIC) SERIES LIGHTOLIER - SPB2-FSKA-3-40 120 SO SERIES	
Al	F32T8/835 FLUORESCENT 32 WATTS T8 STYLE 85 CRI 3500K	2'x4', 3-LAMP, SURFACE MOUNTED FLUORESCENT FIXTURE. METAL SIDED SHALLOW BODY. FLUSH STEEL DOOR FRAME WITH STEEL LATCHES AND HINGES. BAKED WHITE ENAMEL, ELECTRONIC 3-LAMP BALLAST SUITABLE FOR OPERATION WITH TO STYLE LAMPS. LENS SHALL BE PRISMATIC VIRGIN ACRYLIC MINIMUM 3/16" DEEP, "K-19" OR APPROVED EQUAL. 120 VOLT.	42 LB
		DAY-BRITE 2-X43-DLII9O ELECTRONIC "T8" SERIES NATIONAL - BFPA 24-348RS(T8-KI9 ELECTRONIC) SERIES LIGHTOLIER - SPB2-FSKA-3-40 120 SO SERIES	
A2	F32T8/835 FLUORESCENT 32 WATTS T8 STYLE 85 CRI 3500K	2'x4', 2-LAMP, SURFACE MOUNTED FLUORESCENT FIXTURE. METAL SIDED SHALLOW BODY. FLUSH STEEL DOOR FRAME WITH STEEL LATCHES AND HINGES. BAKED WHITE ENAMEL. ELECTRONIC 2-LAMP BALLAST SUITABLE FOR OPERATION WITH TO STYLE LAMPS. LENS SHALL BE PRISMATIC VIRGIN ACRYLIC MINIMUM 3/16" DEEP, "K-19" OR APPROVED EQUAL.	42 LBS
		DAY-BRITE 2X42-DLII90-ELECTRONIC "TB" SERIES NATIONAL - BFPA 24-248RS(TB-KI9 ELECTRONIC) SERIES LIGHTOLIER - SPB2-FSKA-3-40 120 SO SERIES	
A3	F32T8/835 FLUORESCENT 32 WATTS T8 STYLE 85 CRI 3500K	2'x4', 2-LAMP, SURFACE MOUNTED FLUORESCENT FIXTURE. METAL SIDED SHALLOW BODY. FLUSH STEEL DOOR FRAME WITH STEEL LATCHES AND HINGES. BAKED WHITE ENAMEL. ELECTRONIC 2-LAMP BALLAST SUITABLE FOR OPERATION WITH TO STYLE LAMPS. LENS SHALL BE PRISMATIC VIRGIN ACRYLIC MINIMUM 3/16" DEEP, "K-I9" OR APPROVED EQUAL. BALLAST SHALL BE EMERGENCY TYPE FOR SINGLE LAMP AT 1100 LUMEN OUTPUT. 120 VOLT	42 LB5
		DAY-BRITE 2X42-DLI190-ELECTRONIC "T8" EB SERIES  NATIONAL - BFPA 24-248RS(T8-KI9 ELECTRONIC) EMER. SERIES  LIGHTOLIER - SPB2-FSKA-3-40 120 SO EMER. SERIES	
В	F32T8/835 FLUORESCENT 32 WATTS T8 STYLE 85 CRI 3500K	9-1/2"x51", 2-LAMP, SURFACE MOUNTED WRAP-AROUND FLUORESCENT FIXTURE. STEEL BODY, BAKED WHITE ENAMEL. ULTRA VIOLET STABILIZED IMPACT RESISTANT .187" THICK POLYCARBONATE LENS SEALED TO BODY WITH CLOSED CELL GASKET, PYRAMIDAL PRISM DESIGN ON LENS BOTTOM AND VERTICAL PERIMETER RIB. ELECTRONIC BALLAST SUITABLE FOR USE WITH TO STYLE LAMPS. LENS SECURED WITH TAMPER RESISTANT SCREWS. PROVIDE 3 SCREWDRIVERS TO OWNER. 120 VOLT	37 LBS
		THOMAS INDSL2424-4ESX SERIES OR DESIGN PLAN-SNB-82I-ELECTRONIC BALLAST "T8" LAMPS SERIES WILLIAMS - 9122-X SERIES ELECT BALLAST T8 SERIES	
C	F32T8/835 FLUORESCENT 32 WATT T8 STYLE 85 CRI 3500K	6"x 6"x 48" LONG 2-LAMP WALL MOUNTED DIRECT/INDIRECT FLUORESCENT. WHITE BLADE BAFFLE, MATTE WHITE FINISH. HOUSING SHALL BE DIE FORMED 20 GAUGE STEEL WITH 3/8" REGRESSION AT BOTTOM FOR RIGIDITY. INSTALL ABOVE TOILET MIRROR VERIFY EXACT LOCATION WITH ARCHITECTURAL DRAWING PRIOR TO TO ROUGH-IN. 120 VOLT  LITECONTROL - WID-66N-24RS-T8-BW-CWM SSB SERIES OR NATIONAL - S66-ID/D-W-232/OCT-CBW-120-48ELECTRONIC SERIES	36 LBS
D	100 WATT	WILLIAMS - R6647F2-RWALL TO SOB SERIES  12" SQUARE RECESSED METAL HALIDE LIGHTING FIXT. TRIM-FLAT	41 LBS
	METAL HALIDE HORZ. CLEAR	WITH TAMPER RESISTANT SCREWS AND HARDWARE. DROPPED PRISMATIC POLYCARBONATE LENS. INTERNAL HIGH POWER FACTOR BALLAST POTTED FOR LOW NOISE. LONG NARROW LIGHT DISTRIBUTION PATTERN. 120 VOLT  HYDREL HP3A-MHIOO/120/HNC/PFD/BL/TPH-SERIES OR MOLDCAST - MDL-5-09-16-12-TPH SERIES OR	
וס	HORZ.	KIRLIN - RS51252-26-38-45 SERIES  12" SQUARE SURFACE MOUNTED METAL HALIDE LIGHTING FIXT. WITH TAMPER RESISTANT SCREWS AND HARDWARE. DROPPED PRISMATIC POLYCARBONATE LENS. INTERNAL HIGH POWER FACTOR BALLAST POTTED FOR LOW NOISE. LONG NARROW LIGHT DISTRIBUTION PATTERN. 120 VOLT	4l LBS
		HYDREL HP3A-MHIOO/12O/HNC/SDE/BL/TPH-SERIES OR MOLDCAST - MDL-5-00-16-12-TPH SERIES OR COLE -	
E	L L	IO INCH SQUARE SURFACE MOUNTED FLUORESCENT FIXTURE. MAXIMUM 2-1/2" DEEP PRISMATIC POLYCARBONATE REFRACTOR. HIGH POWER FACTOR BALLAST. 120 VOLT  DESIGNPLAN - NBQ62ILP - SERIES LIGHTOLIER - 6783- W/2D LAMP SERIES	27 LBS
F	32 WATTS TO STYLE 05 CRI	LUMINAIRE - DWLIOIO-22CL SERIES  4'x4', 8-LAMP SURFACE MOUNTED FLUORESCENT FIXTURE. ONE PIECE METAL BODY, BAKED WHITE SEMI-GLOSS ENAMEL. FLAT BLACK FINISH INSIDE PERIMETER. FLUSH STEEL DOOR FRAME WITH STEEL LATCHES AND HINGES. PARABOLIC SPECULAR 4" DEEP ALUMINUM LOUVERS. TWO 4-LAMP ELECTRONIC BALLAST SUITABLE FOR OPERATION WITH T8 STYLE LAMPS. 120 VOLT DAY-BRITE LS844-0-64A44-120 "T8" (2) ELB ELECTRONIC SERIES WILLIAMS - SU4-44-8400C-88S SERIES	48 LBS
×		METALUX - 4PMX-840-588HI20 T8 ELECTRONIC SERIES	6 LBS
		SOLID STATE. BATTERIES SHALL BE COMPLETELY SEALED & MAINTENANCE FREE. 120V  EMERGI-LITE - LEDPXN-I-GBB SERIES DUAL-LITE - EXCALIBUR-CWGBB-LEDE SERIES GUTH - BP-GCLED-2-B-CBN SERIES	
Υ	INTENSITY TUNGSTEN	EMERGENCY LIGHT, DUAL VOLTAGE 120/277, AUTOMATIC CHARGING CIRCUITRY, INSTANTANEOUS TRANSFER, TEST SWITCH WITH LONG LIFE LED AC CHARGE MONITOR LIGHT. THE CHARGER SHALL JTILIZE AN INTEGRATED CIRCUIT WHICH SAMPLES THE BATTERY IN RELATION TO ITS TEMPERATURE, STATE OF CHARGE AND INPUT VOLTAGE FLUCTUATIONS. THE CHARGER CIRCUITRY SHALL BE CURRENT LIMITING, TEMPERATURE COMPENSATED, AND REVERSE POLARITY PROTECTED. HIGH IMPACT THERMOPLASTIC HOUSING WITH ACRYLIC LAMP SHIELD. LAMPS SHALL BE MOUNTED IN POLISHED REFLECTORS. UNIT SHALL PROVIDE ILLUMINATION FOR A MINIMUM OF 90 MINUTES. UNIT SHALL BE LISTED EMERGENCY	6 LBS

LIGHT FIXTURE LENS SHALL BE PER UBC CODE SECTION 5209, 1988

### GENERAL NOTES:

- 1. ALL CONDUIT UNLESS OTHERWISE INDICATED ON DRAWINGS SHALL AS A MINIMUM HAVE (2) # 12'S WITH (1) # 12 GROUND.
- 2. COORDINATE ALL CONDUIT RUNS, ELECTRICAL EQUIPMENT & PANELS W/ ALL OTHER WORK TO AVOID CONFLICTS.
- 3. ELECTRICAL CONTRACTOR SHALL BE RESPONSIBLE FOR ALL ELECTRICAL WORK IDENTIFIED & REQUIRED BY THE MECHANICAL DOCUMENTS. WORK SHALL INCLUDE BUT NOT BE LIMITED BY THE FOLLOWING: DISCONNECT SWITCHES, FUSES, STARTERS, CONTROL POWER, CONDUIT & JUNCTION BOXES FOR THE THERMOSTATS & FOR AIR HANDLER UNITS.
- 4. SEE ARCHITECTURAL DOCUMENTS FOR EXACT PLACEMENT OF LIGHTING FIXTURES. 5. ELECTRICAL CONTRACTOR SHALL PROVIDE & INSTALL A COMPLETE TELEPHONE SYSTEM WHICH SHALL INCLUDE TRENCHING & BACKFILL, MOUNTING BOARDS, A
- 6. ALL FLUORESCENT LIGHT FIXTURES WITH 3 OR 4 LAMPS, UNLESS OTHERWISE NOTED, SHALL BE CIRCUITED FOR DUAL LEVEL SWITCHING. INSIDE LAMPS SHALL

COMPLETE CONDUIT SYSTEM, PLASTER RINGS, ETC.

BE SWITCHED SEPARATELY FROM OUTSIDE LAMPS.

- 7. ELECTRICAL CONTRACTOR SHALL REFER TO THE ARCHITECTURAL DOCUMENTS TO CONFIRM CEILING TYPES. ELECTRICAL CONTRACTOR SHALL PROVIDE ALL REQ'D FIXTURE MOUNTING HARDWARE. PROVIDE & INSTALL U.L. LISTED FIRE STOP ENCLOSURES FOR ALL RECESSED FLUORESCENT FIXTURES IN FIRE RATED CLGS.
- 8. LIGHTING FIXTURES WITH EMERGENCY BATTERY BACKUP SHALL HAVE LAMPS SWITCHED & BATTERY UNIT ON "NON-SWITCHED" CIRCUIT.
- 9. ALL CONDUIT FOR EXTERIOR LIGHTING UNITS SHALL BE RUN INSIDE THE BUILDING W FLASHING, CAULKING & SEALS FOR CONDUIT AT THE WALL.
- 10. STUB UP INTO CEILING SPACE FROM EACH NEW PANEL, FOUR (4) 3/4" CONDUITS FOR FUTURE REQUIREMENTS.
- II. THE ELECTRICAL CONTRACTORS SHALL BE REQUIRED TO VISIT THE SITE PRIOR TO THE SUBMISSION OF BID. THE CONTRACTORS SHALL HAVE FAMILIARIZED THEMSELVES W ALL DISCERNIBLE CONDITIONS & NO EXTRA PAYMENT WILL BE ALLOWED FOR WORK REQUIRED BECAUSE OF THESE CONDITIONS, WHETHER SPECIFICALLY MENTIONED OR NOT.
- 12. ALL ELECTRICAL HOLES & PENETRATIONS AFFECTED BY ELECTRICAL CONTRACTOR SCOPE OF WORK DURING CONSTRUCTION SHALL BE PATCHED & PAINTED TO MATCH EXISTING OR NEW CONDITION.
- 13. ALL SIGNAL SYSTEM CONNECTIONS ARE NOT SHOWN ON FLOOR PLANS, SEE RISER DIAGRAM.
- 14. ALL FEEDER SIZES NOT SHOWN ON THE FLOOR PLANS, SEE SINGLE LINE DIAGRAM DRAWING.
- 15. CONTRACTOR SHALL DO ALL CUTTING & PATCHING OF EXISTING CORRIDOR CEILING TO SUIT THE FLUSH MOUNTED TYPE LIGHT FIXTURE. PATCHING & PAINTING SHALL BE OF THE SAME WORKMANSHIP, MATERIALS AND FINISH AND SHALL MATCH ACCURATELY WITH THE EXISTING CEILING.
- 16. ALL ELECTRICAL PANELS, JUNCTION BOXES, RECEPTACLES AND OTHER ELECTRICAL DEVICES SHALL BE TAGGED WITH THEIR RESPECTIVE PANEL OR EQUIPMENT AND CIRCUIT NUMBER IDENTIFICATIONS. PANEL OR EQUIPMENT IDENTIFICATION SHALL BE BLACK/WHITE PHENOLIC NAMEPLATE WITH 1/4" HIGH ENGRAVED LETTERS. RECEPTACLES, JUNCTION BOXES SHALL BE BRADY OR "DYMO" LABELS WITH 1/4"

### **GENERAL DEMOLITION NOTES:**

- I. THE ELECTRICAL CONTRACTOR SHALL REVIEW ANY EXISTING DRAWINGS AVAILABLE AND ALLOW FOR ALL DEMOLITION THAT IS NECESSARY TO COMPLETE INSTALLATION OF NEW ELECTRICAL WORK.
- 2. REMOVE ALL ELECTRICAL EQUIPMENT AND WIRING UNLESS OTHERWISE NOTED. REMOVED ELECTRICAL ITEMS SHALL BE STORED AT A PREDETERMINED LOCATION AS DIRECTED BY THE SCHOOL DISTRICT.
- 3. "SCHOOL SECURITY SYSTEM" TO REMAIN "AS-IS" CONTRACTOR IS RESPONSIBLE TO INFORM SCHOOL DISTRICT OR ARCHITECT OF ANY WORK REQUIRED TO FACILITATE THIS CONTRACT'S WORK. WRITTEN APPROVAL FROM SCHOOL DISTRICT MUST BE OBTAINED PRIOR TO ANY WORK ON SECURITY SYSTEM.
- 4. PROVIDE PLATE COVERS TO ALL ABANDONED FLUSH OUTLETS OR BOXES. PAINT ALL PLATE COVERS TO MATCH EXISTING WALLS OR CEILING.
- 5. EXISTING RECEPTACLES, EXHAUST FAN SWITCHES, JUNCTION BOXES AND OTHER MECHANICAL EQUIPMENT ELECTRICALLY CONNECTED AT THE KITCHEN AREA SHALL

### DEFERRED APPROVAL REQUESTED PLAN SUBMITTAL DRS/ORS NO. # FILE #

### FIRE ALARM GENERAL NOTES:

- WIRE/CONDUCTORS USED IN WET LOCATIONS SHALL BE OF AN APPROVED TYPE IN ACCORDANCE WITH [ 3-310-8(b), T24 CEC. ]. (i.e.: THHW OR THWN).
- 2. OUTSIDE CONDUITS SHALL BE EQUIPPED WITH WATER TIGHT COUPLINGS AND CONNECTORS.
- 3. AUDIBLE ALARM PRODUCED BY "FACP" SHALL BE CAPABLE OF PRODUCING THE CALIFORNIA UNIFORM FIRE SIGNAL.
- 4. THE FOLLOWING SHALL BE SUPERVISED BY THE "FACP": a. FIRE SPRINKLER WATER FLOW ALARMS WITHIN 90 SECONDS OF SYSTEM ACTIVATION, b. ALL FIRE PROTECTION WATER CONTROL VALVES FOR TAMPER TROUBLE, C. ALL FIXED EXTINGUISHING SYSTEMS.
- 5. FOR CLASS A/B WIRING INITIATING DEVICES, THEY SHALL BE ZONED BY FLOOR AND BY WING, AS ACCEPTABLE TO THE LOCAL FIRE AUTHORITY. VERIFY ACCEPTANCE FROM
- LOCAL FIRE AUTHORITY.
- 6. FIRE ALARM ANNUNCIATOR LOCATION SHALL BE APPROVED BY LOCAL FIRE AUTHORITY. VERIFY ACCEPTANCE FROM LOCAL FIRE AUTHORITY WITH STAMPED SITE PLAN.
- 7. ALL DEVICES SHALL BE "CSFM" LISTED.
- 8. EXTERIOR DEVICES SHALL BE LISTED FOR EXTERIOR USE BY "CSFM".
- 9. ALL MANUAL PULL STATIONS SHALL BE MOUNTED AT 48" CENTERLINE ABOVE
- 10. MANUAL PULL STATIONS SHALL BE SPACED WITH NO MORE THAN 200 FEET OF TRAVEL DISTANCE BETWEEN THEM AND IN THE DIRECTION OF EGRESS.
- II. SMOKE DETECTORS ARE REQUIRED THROUGH-OUT THE COMMON ATMOSPHERE WHEN USED AS AN INTERVENING ROOM.
- 12. STROBES ARE REQUIRED IN THE FOLLOWING AREAS:
- a. ALL RESTROOMS, b. MUSIC PRACTICE ROOMS,
- c. BAND ROOMS,
- d. SYMNASIUM, e. OCCUPATIONAL SHOPS,

SMOKE IN RETURN AIR DUCTS.

- F. MULTI-PURPOSE ROOMS, g. OCCUPIED ROOMS WHERE AMBIENT NOISE IMPAIRS HEARING THE FIRE ALARM SIGNAL. (i.e. KITCHENS).
- h. CORRIDORS, i. LOBBY'S.
- k. MEETING ROOMS. 13. ALL "HVAC" FANS IN EXCESS OF 2000 CFM SHALL "SHUT-OFF" UPON DETECTION OF
- 14. PROVIDE DETAILS OF THROUGH-PENETRATION FIRE-STOP SYSTEMS FOR ALL PIPE/CABLE/ CONDUIT PASSING THROUGH FIRE RATED WALLS/FLOORS REQUIRING PROTECTED OPENINGS.
- 15. SYSTEM APPROVAL TEST SHALL BE WITNESSED BY A DEPUTY STATE FIRE MARSHAL.

#### FIRE SYSTEM NOTES:

- THE FIRE PROTECTION SIGNALING SYSTEM SHALL CONFORM TO THE CALIFORNIA BUILDING CODE, SECTION 809, THE CALIFORNIA ELECTRICAL CODE, ARTICLE 760 & CHAPTER 60 CALIFORNIA BUILDING CODE.
- ELECTRICAL CONTRACTOR SHALL SUBMIT SHOP DRAWINGS TO DSA/ORS FOR REVIEW AND APPROVAL. A COMPLETE SET OF SHOP DRAWINGS SHALL INCLUDE BUT NOT BE LIMITED BY THE FOLLOWING:
- A. FLOOR PLAN OF THE POINT TO POINT WIRING CONNECTIONS.
- B. A DIAGRAM OF THE POWER CIRCUITRY. . BATTERY CALCULATIONS FOR MINIMUM 24 HOURS + 5 MIN ALARM MODE.
- D. CUT SHEETS OF ALL THE APPROVED DEVICES AND CSFM LISTING NUMBERS INDICATED ON ALL SHEETS.
- F. TYPE OF WIRE BEING USED AND STATEMENT THAT ALL WIRE IS RUN
- IN CONDUIT OR PROTECTED FROM DAMAGE ABOVE "T-BAR" CEILING. G. VOLTAGE DROP CALCULATIONS.
- H. SYMBOL LEGEND FOR FIRE ALARM COMPONENTS. J. SEQUENCE OF EVENTS WHEN FIRE ALARM SYSTEM IS ACTIVATED.
- THE FIRE PROTECTION SIGNALING SYSTEM SHALL NOT BE INSTALLED UNTIL THE SHOP DRAWINGS, INCLUDING THE STATE FIRE MARSHAL LISTING NUMBERS FOR EACH COMPONENT OF THE SYSTEM, HAVE BEEN SUBMITTED AND APPROVED BY THE "DIVISION OF STATE ARCHITECT/ OFFICE OF REGULATION SERVICES" FIRE/LIFE SAFETY. CONTRACTOR

SHALL PROVIDE COPIES OF APPROVED PLANS AND THE PROJECT

- INSPECTOR OF RECORD PRIOR TO BEGINNING WORK. 4. CONTRACTOR SHALL TEST THE ENTIRE FIRE PROTECTION SIGNALING SYSTEM WITH THE LOCAL FIRE AUTHORITY AND THE PROJECT INSPECTOR OF RECORD AS RECORD AS WITNESS. CONTRACTOR SHALL REPEAT TESTING AS NECESSARY UNTIL SATISFACTORY RESULTS ARE ACHIEVED.
- 5. THE LOCATION OF THE AUTOMATIC FIRE ALARM SYSTEM DETECTORS, MANUAL STATIONS, AUDIBLE DEVICES AND RELATED EQUIPMENT AS SHOWN ON THE PLANS ARE ONLY FOR REFERENCE AND DO NOT CONSTITUTE SHOP DRAWINGS.
- 6. THE FIRE ALARM SYSTEM IS A "DEFERRED APPROVAL" ITEM AND IS AN EXTENSION OF THE EXISTING SYSTEM AS SHOWN ON THE DRAWINGS.

THE FIRE PROTECTION SIGNALING SYSTEM SHALL NOT BE INSTALLED UNTIL SHOP DRAWINGS, INCLUDING STATE FIRE MARSHAL LISTING SHEETS FOR EACH COMPONENT OF THE SYSTEM HAVE BEEN SUBMITTED AND APPROVED BY THE DIVISION OF THE STATE ARCHITECT/ OFFICE OF REGULATION SERVICES.

### **ABBREVIATIONS**

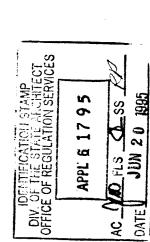
A, AMP	AMPERE	MH	MANHOLE
AFF	ABOVE FINISHED FLOOR	MTD	MOUNTED
BKR	BREAKER	MTG	MOUNTING
C	CONDUIT	(N)	NEW
C/B	CIRCUIT BREAKER	NIC	NOT IN CONTRACT
CKT	CIRCUIT	NIEC	NOT IN ELECTRICAL
CL	CENTER LINE	MILO	CONTRACT
CLG	CEILING	No.	NUMBER
co	CONDUIT ONLY	NTS	NOT TO SCALE
CTR	CENTER	0.0.	ON CENTER
DET	DETAIL	PF	POWER FACTOR
DIM	DIMENSION		OR & PHASE
EQPT	EQUIPMENT	PB	PULL BOX
EXIST, (E)	EXISTING	PNL	PANEL
FA	FIRE ALARM	HGT	HEIGHT
FIN	FINISH	(R)	EXISTING TO BE
FL	FLOOR		REMOVED
(F)	FUTURE	RSC	RIGID STEEL CONDUIT
GND	GROUND .	S.A.D.	SEE ARCHITECTURAL DWGS
10	INTERCOM	SHT	SHEET
JB	JUNCTION BOX	SM	SMITCH
ΚV	KILOVOLT	SWBD	SWITCHBOARD
KVA	KILOVOLT AMPERES	TRANSF	TRANSFORMER
KW	KILOWATT	TYP	TYPICAL
LTG	LIGHTING	U.O.N.	UNLESS OTHERWISE NOTED
MCM	THOUSAND CIRCULAR MILS	<b>V</b>	VOLT
MH	MANHOLE	M	WATT
		WP	WEATHERPROOF
		XFMR	TRANSFORMER

### CVMRAI LICT

SYMBO	L LIST.
	LUMINAIRE - SEE SCHEDULE
<del></del>	LUMINAIRE - SEE SCHEDULE
$\circ$	LUMINAIRE - SEE SCHEDULE
Ю	LUMINAIRE - WALL MOUNTED SEE SCHEDULE  EXIT LIGHT - SEE SCHEDULE - INCLUDING FLOOR LEVEL EXIT
•	SIGN PER TITLE 24 GEC. 3314 (e). EMERGENCY EXIT LIGHT INSTALL AS DIRECTED
\$	SINGLE POLE SWITCH, +48" AFF U.O.N.
<b>\$</b> a	SINGLE POLE SWITCH, +48" AFF U.O.N., a = CIRCUIT CONTROLLED
\$₃ <i>व</i>	THREE WAY SMITCH +48" AFF U.O.N.
<b>季</b> 回	MOTOR RATED SWITCH HUBBELL 3031-IA AT "MOTOR"  LIGHTING DIMMER AT +48" AFF U.O.N.
Фс	DUPLEX RECEPTACLE, CEILING MOUNTED
Φ	CONVENIENCE RECEPTACLE WALL MOUNTED - DUPLEX AT +18" AFF U.O.N.
<b>(</b>	SPECIAL OUTLET
ø	GFIC CONVENIENCE RECEPTACLE - DUPLEX AT +18" AFF U.O.N.
<b>⊕</b>	RECEPTACLE DOUBLE DUPLEX AT +18" AFF U.O.N.
•	"SURGE PROTECTOR" DUPLEX RECEPTAGLE @ 18"AFF U.O.N.
—— Ņ ——	WIRE RACEWAY, INSTALL AS NOTED OR AT +36" AFF  WIRE RACEWAY RISER OR DROP DOWN
<b>-</b> • <b>¥</b>	WALL TELEPHONE/HANDSET OUTLET - PROVIDE 3/4" CONDUIT
▼	TO ABOVE CEILING U.O.N. INSTALL AT +18" AFF U.O.N.  DATA WALL OUTLET - PROVIDE 3/4" CONDUIT TO
_	ABOVE CEILING U.O.N. INSTALL AT +18" AFF U.O.N.
<b>X</b>	COMBINATION OF VOICE/DATA/TV OR VCR. SEE DETAIL DWG.
<b>9</b>	INTERIOR SPEAKERS CEILING OR WALL MOUNTED
<b>(S)</b>	EXTERIOR SPEAKER, VANDAL-PROOF AT 8'-0" AFF U.O.N.
© (2)	CLOCK 8,-0" AFF U.O.N. VERIFY BEFORE INSTALLATION
	TV OUTLET - 4-11/16" x 2-1/8" DEEP BOX WITH I GANG RING AND 5/8" HOLE IN COVER.
<b>(</b> T)	THERMOSTAT - ROUTE 1/2" CONDUIT TO UNIT SERVED. VERIFY WITH MECHANICAL DRAWINGS. MOUNT AT +48" AFF U.O.N.
	PANELBOARD - SURFACE OR FLUSH MOUNTED  MAIN SWITCHBOARD
(M)	"PG&E" METER W CURRENT TRANSFORMER
4 0	JUNCTION BOX - CEILING OR WALL MOUNTED, SIZE TO CODE,
<u>(</u> )	TAPE AND TAG WIRES. PROVIDE FLEX AND/OR RECEPTAGLE AS REQUIRED TO CONNECT EQUIPMENT
<del></del>	CONDUIT - CONCEALED IN WALLS OR CEILING
 	CONDUIT - EXPOSED  CONDUIT - IN OR BELOW FLOOR: 3/4" MIN
*10	CONDUIT - HOME RUN TO PANEL, TERMINAL CABINET, ETC. RUNS MARKED WITH CROSSHATCHES INDICATE NUMBER OF #12 AWG WIRES. CROSSHATCH WITH SUBSCRIPT "G" INDICATES GREEN GROUND WIRE. SIZE CONDUIT ACCORDING TO SPECIFICATIONS AND APPLICABLE CODE. CROSSHATCHES WITH "#10" INDICATES WIRE SIZE OTHER THAN #12'S
$\sim$	FLEX CONDUIT WITH CONNECTION
— E —	CONDUIT EMERGENCY SYSTEM CAPPED CONDUIT
<del>}</del>	CONDUIT CONTINUATION
모	FUSED DISCONNECT SWITCH - SEE SINGLE DIAGRAM FOR SIZE.
	TRANSFORMER - SEE SINGLE LINE FOR SIZE
₽ -	MANUAL PULL STATION FIRE PROTECTION SYSTEM AT +48" AFF TO TO CENTER LINE OF DEVICE
¥	FIRE PROTECTION STROBE LIGHT; INSTALL AT +80" AFF OR 6" BELOW CEILING WHICHEVER IS LOWER.
¥	FIRE PROTECTION HORN/STROBE DEVICE; INSTALL AT +90" AFF OR 6" BELOW CEILING WHICHEVER IS LOWER.
(M)	FIRE PROTECTION "MINI" HORN DEVICE; INSTALL AT +90" AFF OR 6" BELOW CEILING WHICHEVER IS LOWER.
(MP)	FIRE PROTECTION EXTERIOR HORN; INSTALL AT +90" ON WALL UNLESS OTHERWISE NOTED.
Ž.	BELL/BUZZER SIGNALING DEVICE FIRE PROTECTION SYSTEM; INSTALL AT + 90" OR 6" BELOW CEILING WHICHEVER IS LOWER.
F	SMOKE DETECTOR FIRE PROTECTION SYSTEM. INSTALL ON 4" SQ 2-1/8" DEEP JUNCTION BOX
FC	HEAT/RATE OF RISE DETECTOR FIRE PROTECTION SYSTEM. INSTALL ON 4" SQ 2-1/8" DEEP JUNCTION BOX. "C" INDICATES DEVICE INSTALLED ABOVE CEILING
<b>⊗</b>	SECURITY DOOR CONTACTS
E-1	DETAIL OR SECTION DESIGNATION
4F35)	LUMINAIRE REFERENCE SYMBOL
MD)	MOTION DETECTOR OR CEILING SENSOR LIGHT CONTROL
(1)	SHEET REFERENCE SYMBOL - SEE ASSOCIATED NOTE ON SAME SHEET
\'/	and the second s

GROUND ROD


APPROVALS



CONSULTANT






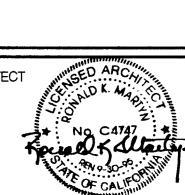


THE CONTRACTOR SHALL CHECK ALL DIMENSIONS AT THE JOB AND SHALL BE RESPONSIBLE FOR ALL DISCREPANCIES BETWEEN DIMENSIONS OF THE ACTUAL WORK AND THOSE SHOWN IN THE DOCUMENTS OR ARCHITECT'S APPROVED SHOP DRAWINGS. THE CONTRACTOR SHALL ALSO BE SOLELY RESPONSIBLE FOR ALL QUANTITIES OF MATERIAL OR EQUIPMENT CALLED FOR TO PROPERLY COMPLETE THE WORK.

ELECTRICAL SYMBOLS FIXTURE, SCHEDULE

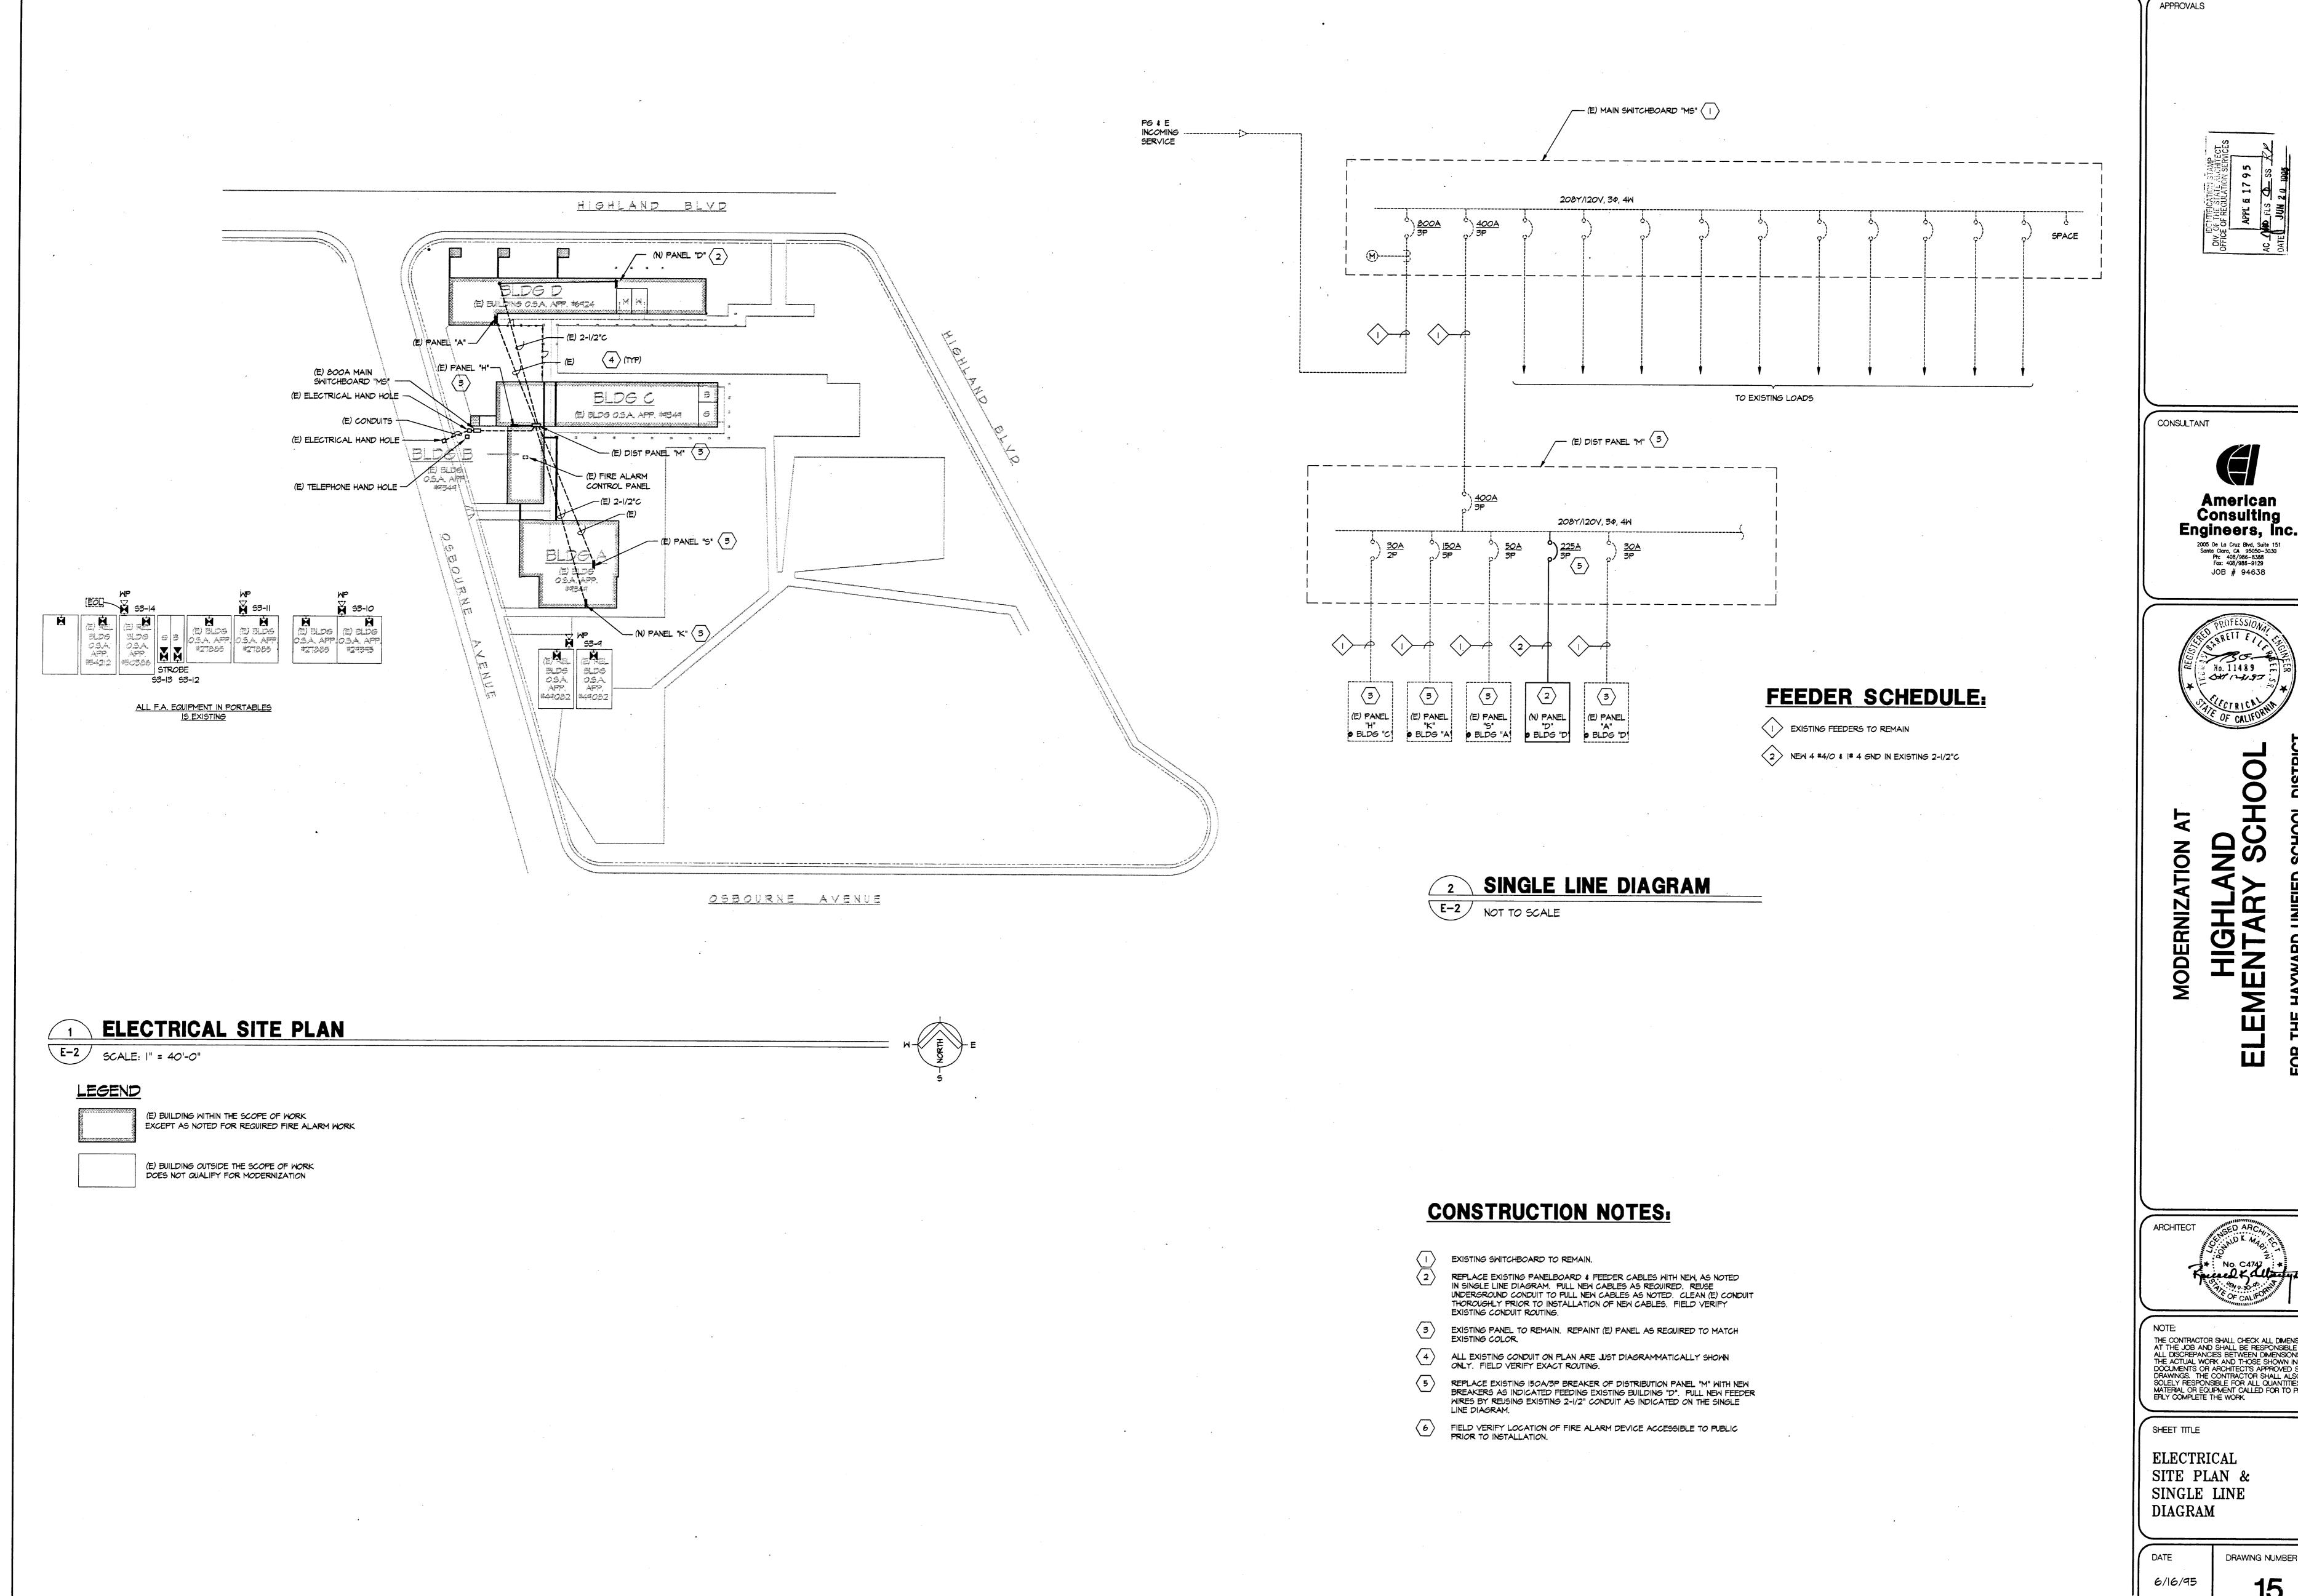& GENERAL NOTES



American Consulting

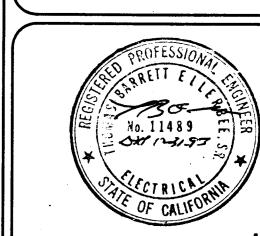

THE CONTRACTOR SHALL CHECK ALL DIMENSIONS AT THE JOB AND SHALL BE RESPONSIBLE FOR ALL DISCREPANCIES BETWEEN DIMENSIONS OF THE ACTUAL WORK AND THOSE SHOWN IN THE DOCUMENTS OR ARCHITECT'S APPROVED SHOP DRAWINGS. THE CONTRACTOR SHALL ALSO BE SOLELY RESPONSIBLE FOR ALL QUANTITIES OF MATERIAL OR EQUIPMENT CALLED FOR TO PROPERLY COMPLETE THE WORK.

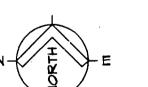
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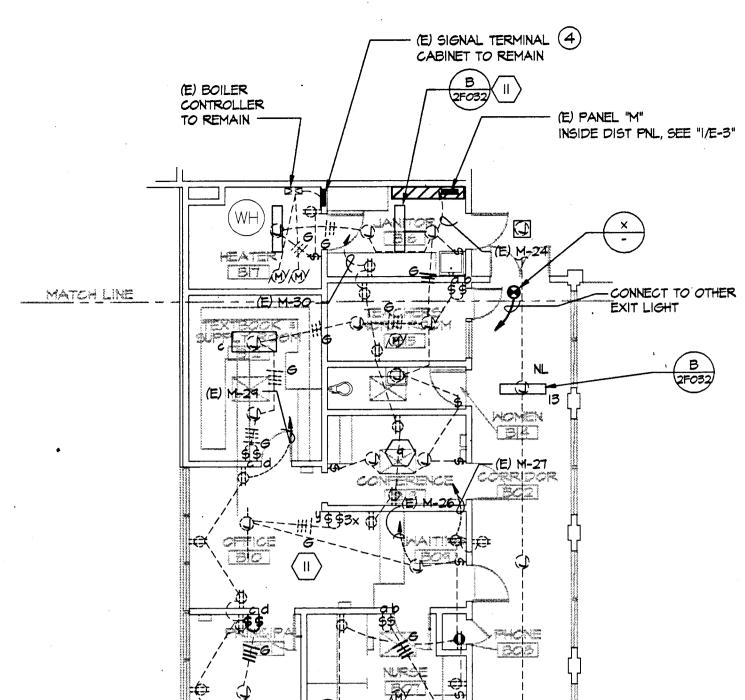
77-15-3

ELECTRICAL

1 FLOOR PLAN - BUILDINGS A & B

E-3 SCALE: 1/8" = 1'-0"





PARTIAL FLOOR PLAN


### **DEMOLITION NOTES:**

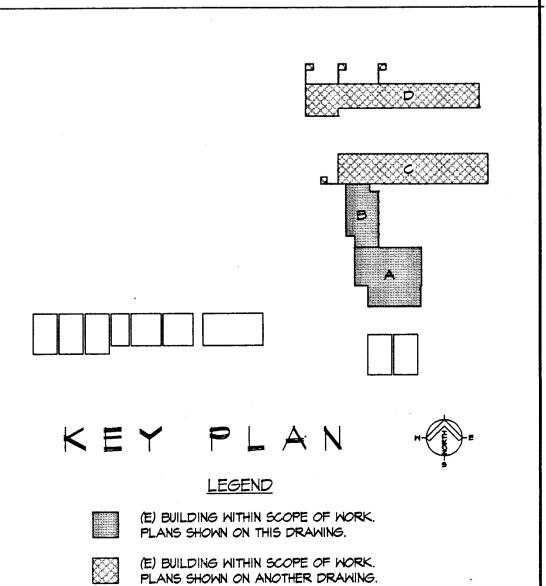- REMOVE ALL EXISTING RECEPTACLES AND WIRING BACK TO SOURCE. CONCEALED CONDUIT OR UNDERGROUND CONDUIT TO REMAIN FOR REUSE. MAINTAIN & CLEAN THOROUGHLY ALL CONCEALED OR UNDERGROUND CONDUIT IN PLACE PRIOR TO INSTALLATION OF NEW WIRES AND CABLES. EXPOSED CONDUIT INSIDE OFFICES SHALL BE REMOVED & BE ROUTED TO NEW RACEWAY AS INDICATED IN PLAN OR NOTES.
- REMOVE EXISTING FLUORESCENT LIGHT FIXTURES AND WIRING BACK TO SOURCE. ALL REMOVED EXISTING LIGHT FIXTURES SHALL BE TURNED OVER TO SCHOOL DISTRICT.

  CONCEALED OR UNDERGROUND CONDUIT TO BE ABANDONED IN PLACE. EXPOSED CONDUIT SHALL BE REMOVED AS INDICATED.
- REMOVE EXISTING WALL CLOCKS, INTERCOM, FIRE ALARM DEVICE, SPEAKER & OTHER SIGNAL DEVICES OF ADMINISTRATION OR BUILDING B. MAINTAIN EXISTING CONCEALED OR UNDERGROUND CONDUITS FOR REUSE. EXPOSED CONDUITS IN THE OFFICES AND OTHER WORKROOM AREAS SHALL NOT BE ALLOWED EXCEPT IN OTHER AREAS SUCH AS STORE, JANITORIAL & UTILITY ROOMS. EXISTING EXPOSED CONDUIT OUTSIDE THE BUILDINGS ESPECIALLY AT THE CORRIDOR AREAS SHALL REMAIN FOR REUSE.
- REMOVE EXISTING PUBLIC ADDRESS TERMINALS, WIRING ENTIRELY & OTHER ACCESSORIES AND LEAVE THE CABINET IN PLACE FOR REUSE. REPAINT THE CABINET AS REQUIRED AND TO BE ACCEPTABLE TO THE SCHOOL DISTRICT. CONCEALED CONDUITS TO REMAIN IN PLACE
- FREMOVE EXISTING FIRE ALARM CONTROL PANEL & ITS WIRING ENTIRELY. REMOVE ALL (E) ELECTRICAL MOLDING CONNECTIONS FROM THE CONTROL PANEL TO A DEVICE.
- 6 REMOVE EXISTING DOWNLIGHT FIXTURES & WIRING. EXISTING CONCEALED CONDUITS ABOVE CEILING AND JUNCTION BOXES SHALL REMAIN FOR REUSE.
- REMOVE EXISTING EXIT LIGHTS & WIRING. CONCEALED CONDUITS TO REMAIN FOR REUSE.
- DISCONNECT & REMOVE EXISTING UNIT VENTILATOR CONDUIT & WIRING BACK TO SOURCE PANEL. CONCEALED CONDUIT ABOVE CEILING SHALL BE ABANDONED IN PLACE. PATCH & PAINT OPENINGS LEFT BY REMOVED CONDUITS TO MATCH EXISTING WALLS OR CEILING.
- REMOVE EXISTING LIGHT SWITCH & WIRING BACK TO (E) PANEL "S". ABANDON & PROVIDE PLATE COVER AS REQUIRED.
- REMOVE ELECTRICAL CONNECTION SUCH AS MOUNTING HARDWARE, JUNCTION BOX, MANUAL STARTER OR SWITCH, CONDUIT AND WIRING BACK TO SOURCE AS REQUIRED. PATCH & PAINT ELECTRICAL HOLES TO MATCH EXISTING WALLS.
- REMOVE EXISTING (48) RECESSED TYPE DOWN LIGHTING & WIRING. PATCH & PAINT ALL LIGHT HOLES EXCEPT JUNCTION BOX WHERE TO PULL NEW WIRES FOR NEW LIGHT FIXTURES SHOWN. REWIRE AS NECESSARY TO SUIT THE LIGHTING INSTALLATION.

### **CONSTRUCTION NOTES:**

- INSTALL NEW RECEPTACLES NEMA 5-15R AND WIRING TO REPLACE ALL THE EXISTING RECEPTACLES.
  REUSE EXISTING CONCEALED CONDUITS UP TO SOURCE PANEL. THIS IS TYPICAL TO ALL RECEPTACLES IN THE OFFICES. PATCH & PAINT ALL ELECTRICAL HOLES TO MATCH EXISTING WALLS.
- INSTALL NEW LIGHT FIXTURES, SWITCHES & WIRING. REUSE EXISTING CONCEALED CONDUITS UP TO SOURCE PANEL LIGHTING. PATCH & PAINT ALL ELECTRICAL HOLES TO MATCH EXISTING WALL OR CEILING. DAMAGED CEILING TILES DURING INSTALLATION OF WIRING & FIXTURES SHALL BE REPLACE WITH NEW CEILING TILES AS REQUIRED.
- INSTALL NEW HANDSET TO REPLACE EXISTING. PULL NEW WIRE AS REQUIRED. REUSE EXISTING CONDUIT TO INSTALL NEW WIRES.
- 4 INSTALL NEW SURFACE MOUNTED SPEAKER TO REPLACE EXISTING.
- 5 INSTALL NEW WALL MOUNTED CLOCK AND WIRING TO REPLACE EXISTING. REUSE EXISTING CONDUIT TO INSTALL NEW WIRES.
- 6 INSTALL NEW FIRE ALARM EQUIPMENT AND WIRING. CONTRACTOR TO ROUTE CONCEALED WHERE POSSIBLE. WHERE NOT POSSIBLE ROUTE HUBBELL PREMISETRAK. CONNECT PULLSTATION AND HEAT DETECTORS TO NEAREST "CSFM LISTED" SPEAKER IN ROOM OR AS SHOWN. SEE RISER DIAGRAM ROUTE HORN-STROBES DIRECTLY TO (E) FIRE ALARM PANEL AS REQUIRED.
- NEW HEAT DETECTORS & WIRING TYPICAL TO ALL OFFICES. CONTRACTOR TO CONNECT TO NEW CSFM LISTED SPEAKER IN ROOM.
- 8 NOT USED.
- REPLACED EXISTING LIGHT FIXTURES WITH NEW FIXTURE AS INDICATED. REUSE EXISTING CONCEALED CONDUIT TO PULL NEW WIRES AS REQUIRED.
- (IO) EXISTING RECEPTACLES & CIRCUITS TO REMAIN.
- INSTALL NEW LIGHT FIXTURES, SWITCH & WIRING AS REQUIRED. EXTEND NEW WIRING WITH HUBBELL "WALLTRAK-I" TO SUIT THE NEW LIGHTING INSTALLATION.
- EXISTING ELECTRIC FANS & RECEPTACLES SHALL REMAIN.
- INSTALL NEW EXIT LIGHT AND WIRE BACK TO SOURCE PANEL. REUSE EXISTING CONCEALED CONDUIT TO PULL NEW WIRES.
- INSTALL FUSIBLE HEAVY DUTY DISCONNECT SWITCH, 30A, 240V, 3P NEMA 3R ENCLOSURE FOR MULTI-PURPOSE HEATING FURNACE LOCATED AT ROOF OF LOBBY AREA. MAKE ALL NECESSARY CONNECTIONS TO HEATING FURNACE AS REQUIRED. VERIFY TO MECH DWG THE EXACT LOCATION.
- NOT USED.
- INSTALL NEW DESK TELEPHONE TO REPLACE EXISTING. INSTALL NEW WIRES AS REQUIRED. REUSE EXISTING CONDUIT TO PULL NEW WIRES.
- REMOVE (E) FIXTURE & INSTALL JUNCTION BOX PLATE COVER. PAINT JUNCTION BOX PLATE COVER TO MATCH WITH EXISTING CEILING.
- PROVIDE 120VAC, 10 POWER CONNECTIONS TO WHEELCHAIR LIFT FROM EXISTING STAGE PANEL "S". VERIFY OR COORDINATE WITH ARCHITECTURAL DWGS. PRIOR TO INSTALLATION OF CONDUIT. MAKE ALL NECESSARY CONNECTIONS TO WHEELCHAIR LIFT AS REQUIRED.



(E) BUILDING OUTSIDE SCOPE OF WORK.
DOES NOT QUALIFY FOR MODERNIZATION.

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OFFICE OF REGULATION SERVICES

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APPROVALS



JOB # 94638



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NOTE:
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LECTRICAL

ELECTRICAL FLOOR PLAN BLDGS A & B

DATE DRAWING NUMBER

6/16/95

FILE NO.

77-15-3

SHEET 26 OF 3

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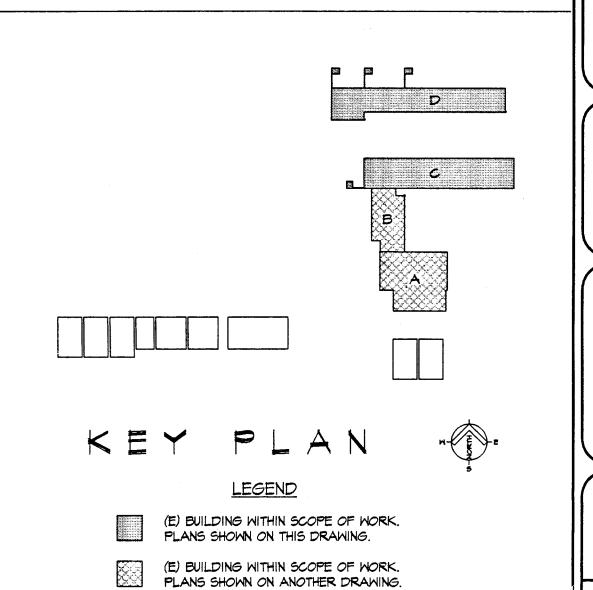
### **DEMOLITION NOTES:**

- REMOVE ALL EXISTING RECEPTACLES AND WIRING BACK TO SOURCE. CONCEALED CONDUIT OR UNDERGROUND CONDUIT TO REMAIN FOR REUSE. CLEAN THOROUGHLY ALL CONCEALED OR UNDERGROUND CONDUIT PRIOR TO INSTALLATION OF NEW WIRES AND CABLES. EXPOSED CONDUIT INSIDE CLASSROOMS AND OFFICES SHALL BE REMOVED & BE ROUTED TO NEW RACEWAY AS INDICATED IN PLAN OR NOTES. OUTDOOR EXPOSED CONDUIT SHALL BE MAINTAINED IN PLACE FOR REUSE.
- REMOVE EXISTING (12) LIGHT FIXTURES AND WIRING BACK TO SOURCE. ALL REMOVED EXISTING LIGHT FIXTURES SHALL BE TURNED OVER TO OWNER OR SCHOOL DISTRICT. CONCEALED OR UNDERGROUND CONDUIT TO REMAIN AND SHALL BE THOROUGHLY MAINTAINED AND CLEANED PRIOR TO INSTALLATION OF NEW WIRES AND CABLES. EXPOSED CONDUIT INSIDE CLASSROOMS SHALL BE REMOVED & BE ROUTED TO NEW RACEWAY AS INDICATED IN PLAN OR NOTES. OUTDOOR EXPOSED CONDUIT SHALL BE
- REMOVE ALL EXISTING SIGNAL OR COMMUNICATION DEVICE AND WIRING BACK TO SOURCE SUCH AS FIRE ALARM SYSTEM, INTERCOM/PUBLIC ADDRESS/TEL HANDSET, TV SYSTEM, CLOCK SYSTEM & SPEAKER SYSTEM UNLESS OTHERWISE NOTED. CONCEALED CONDUIT OR UNDERGROUND CONDUIT TO REMAIN FOR REUSE. MAINTAIN & CLEAN CONDUIT THOROUGHLY PRIOR TO INSTALLATION OF NEW WIRES & CABLES. EXPOSED CONDUIT INSIDE CLASSROOMS AND OFFICES SHALL BE REMOVED & BE ROUTED
  - TO NEW RACEWAY AS INDICATED IN PLAN OR NOTES. OUTDOOR EXPOSED CONDUIT SHALL BE MAINTAINED IN PLACE FOR REUSE.
- REMOVE EXISTING "UV" UNIT VENTILATION SWITCH OR STARTER, JUNCTION BOXES, MTG. HARDWARE, EXPOSED CONDUIT & WIRING BACK TO SOURCE AS REQUIRED. PATCH & PAINT ALL ELECTRICAL HOLES TO MATCH EXISTING WALLS OR CEILING.
- REMOVE EXISTING LIGHT FIXTURES, LIGHT SWITCHES AND ITS WIRING BACK TO SOURCE PANEL

#### **CONSTRUCTION NOTES:**

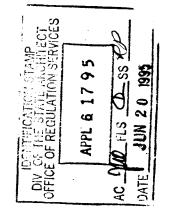
- INSTALL NEW RECEPTACLES NEMA 5-20R AND WIRING TO REPLACE ALL THE EXISTING RECEPTACLES. REUSE EXISTING CONCEALED CONDUITS UP TO SOURCE PANEL. THIS IS TYPICAL TO ALL RECEPTACLES IN THE CLASSROOMS. PATCH & PAINT ALL ELECTRICAL HOLES TO MATCH EXISTING WALLS.
- 2 INSTALL NEW LIGHT FIXTURES, SWITCHES & WIRING. REUSE EXISTING CONCEALED CONDUITS UP TO SOURCE PANEL. EXTEND WIRING WITH HUBBELL "WALLTRAK-I" AS REQUIRED TO SUIT THE NEW LIGHTING INSTALLATION AS INDICATED ON PLAN. EXPOSED CONDUIT OR FLEXIBLE CONDUIT INSTALLATION NOT ACCEPTABLE. SEE NOTE 10. PATCH & PAINT ALL ELECTRICAL HOLES TO MATCH EXISTING WALL OR CEILING. DAMAGED CEILING TILES DURING INSTALLATION OF WIRING & FIXTURES SHALL BE REPLACED WITH NEW CEILING TILES AS REQUIRED.
- REPLACE EXISTING SPEAKER WITH NEW "CSFM LISTED" SPEAKER. REUSE EXISTING WIRING AS REQUIRED.
- NEW TY JACK AND DUPLEX RECEPTACLE ON THE HUBBELL "WALLTRAK 22". PROVIDE NECESSARY FITTINGS TO SUIT THE INSTALLATION OF TV JACK & RECEPTACLE. THE BOX SHALL BE HUBBELL "WTI2TGBD" (TWO GANG BOX W/ DIVIDER) WITH FACE PLATES "KP2I48".
- 5 INSTALL NEW WALL MOUNTED CLOCK AND WIRING TO REPLACE EXISTING. REUSE EXISTING CONDUIT TO INSTALL NEW WIRES. SEE RISER DIAGRAM SHEET "E-5".
- (6) INSTALL NEW FIRE ALARM DEVICE AND WIRING INSIDE THE CLASSROOM. DRILL WALL TO INSTALL CONDUIT OUTSIDE THE ROOM AS SHOWN ON PLAN. USE CONDUIT "LB'S" AND "T'S" FITTING TO INSTALL FIRE ALARM DEVICES WHERE VISIBLE TO PUBLIC. ROUTE CONDUITS ALONG WALL UP TO EXISTING FIRE ALARM CONTROL PANEL.
- 7) INSTALL NEW HUBBELL :BASETRAK/POLYTRAK" MULTI-CHANNEL RACEWAY WITH DATA 06' O.C. & RECEPTACLES @ 6' O.C. AS SHOWN. SEE DETAIL-I FOR BASETRAK INSTALLATION. ALL RECEPTACLES AND BOXES SHALL BE IN-LINE DEVICE "BT3IND" W/ DUPLEX NEMA 5-20R RECEPTACLES
- (8) INSTALL NEW HUBBELL "BASETRAK/POLYTRAK" MULTI CHANNEL RACEWAY WITH RECEPTACLES 7' O.C. AS SHOWN. SEE TYPICAL "BASETRAK" INSTALLATION DETAIL- 2/E-6.
- (9) INSTALL HUBBELL "PREMISETRAK-2"TO CONNECT FROM (E) LIGHTING JUNCTION BOX TO ANOTHER
- (10) LIGHTING LAYOUT OF THIS CLASSROOM IS THE SAME AS CLASSROOM "DI4". INSTALL NEW LIGHT SWITCHES AS REQUIRED.
- (II) LIGHTING LAYOUT OF THIS CLASSROOM IS THE SAME AS CLASSROOM "COT". INSTALL NEW LIGHT SWITCHES AS REQUIRED.
- 12 NEW HEAT DETECTORS & WIRING CONNECT TO NEW CSFM LISTED CLASSROOM SPEAKER IN ROOM. TYPICAL TO ALL CLASSROOMS.
- REMOVE EXISTING RECEPTACLE & USE (E) JUNCTION BOX TO SERVE AS AS RACEWAY FOR THE NEW HUBBELL "BASETRAK" WHICH IS TO BE INSTALLED SAME HEIGHT AS THE EXISTING RECEPTACLES. PROVIDE & INSTALL JUNCTION BOX PLATE COVER WITH 3/4" KNOCK-OUT PRIOR TO INSTALLATION OF "BASETRAK" RACEWAY. SEE TYPICAL BASETRAK INSTALLATION DETAIL- 1/E-6.
- INSTALL HEATING FURNACE MANUAL STARTER SWITCH INSIDE THE FURNACE ENCLOSURE @ \$48"
  ABOVE FINISHED FLOOR. MAKE ALL NECESSARY CONNECTIONS TO FURNISH AS REQUIRED. SEE DETAIL 6/E-6 FOR FURNACE SWITCH LOCATION AND CONNECTION. TYPICAL TO ALL HEATING UNITS.
- INSTALL NEW TELEPHONE/HANDSET AT SAME LOCATION AS BEFORE. REUSE (E) CONDUIT TO ROUTE NEW WIRES TO NEW INTERCOM/PA CONTROL CABINET LOCATED AT ADMINISTRATION BUILDING.
- $\langle 16 \rangle$  Install New Time clock located in Room "DIO" as shown. See DWG E-6 FOR TIME CLOCK WIRING DIAGRAM.
- PHOTO ELECTRIC CELL, PARAGON #CW-201-00 OR TORK #2101. INSTALL ON THE ROOF OF BUILDING LOCATION TO SUIT THE PHOTO CELL INSTALLATION.
- NEW HEAT DETECTORS & WIRING. TYPICAL FOR ALL CLASSROOMS. CONNECT TO NEW "CSFM LISTED" SPEAKER IN ROOM.
- CONNECT (N) EXHAUST FAN TO LIGHT CIRCUITS AND CONTROLLED AT THE LIGHT SWITCH AS SHOWN.

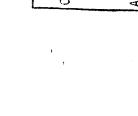
  MAKE ALL NECESSARY CONNECTIONS TO THE EXHAUST FAN AS REQUIRED.
- 21 INSTALL LIGHTING MOTION DETECTORS AS SHOWN ON PLAN. MOTION DETECTOR SHALL BE UNENCO MODEL #C-500-2000 PROVIDED WITH POWER PACK MODEL #211-1 (120VAC). INSTALL NEW EXTENSION JUNCTION BOX WITH COVER (1/2" K.O.) MOUNTED ON THE EXISTING JUNCTION BOX TO INSTALL THE POWER PACK SWITCH. CONTRACTOR TO MODIFY EXISTING INSTALLATION TO SUIT ALL THE LIGHTING REQUIREMENTS. PROVIDE ALL MOUNTING HARDWARE AS REQUIRED. THIS IS TYPICAL TO ALL CLASSROOMS.
- (22) CONNECT (N) EXHAUST FAN WITH POWER, EMS CONTRACTOR TO CONTROL START/STOP OPERATION.



(E) BUILDING OUTSIDE SCOPE OF WORK. DOES NOT QUALIFY FOR MODERNIZATION.

APPROVALS





CONSULTANT

American Consulting Engineers, inc. 2005 De La Cruz Blvd, Suite 151 Santa Clara, CA 95050-3030 Ph: 408/986-8388 Fax: 408/986-9129 JOB # 94638



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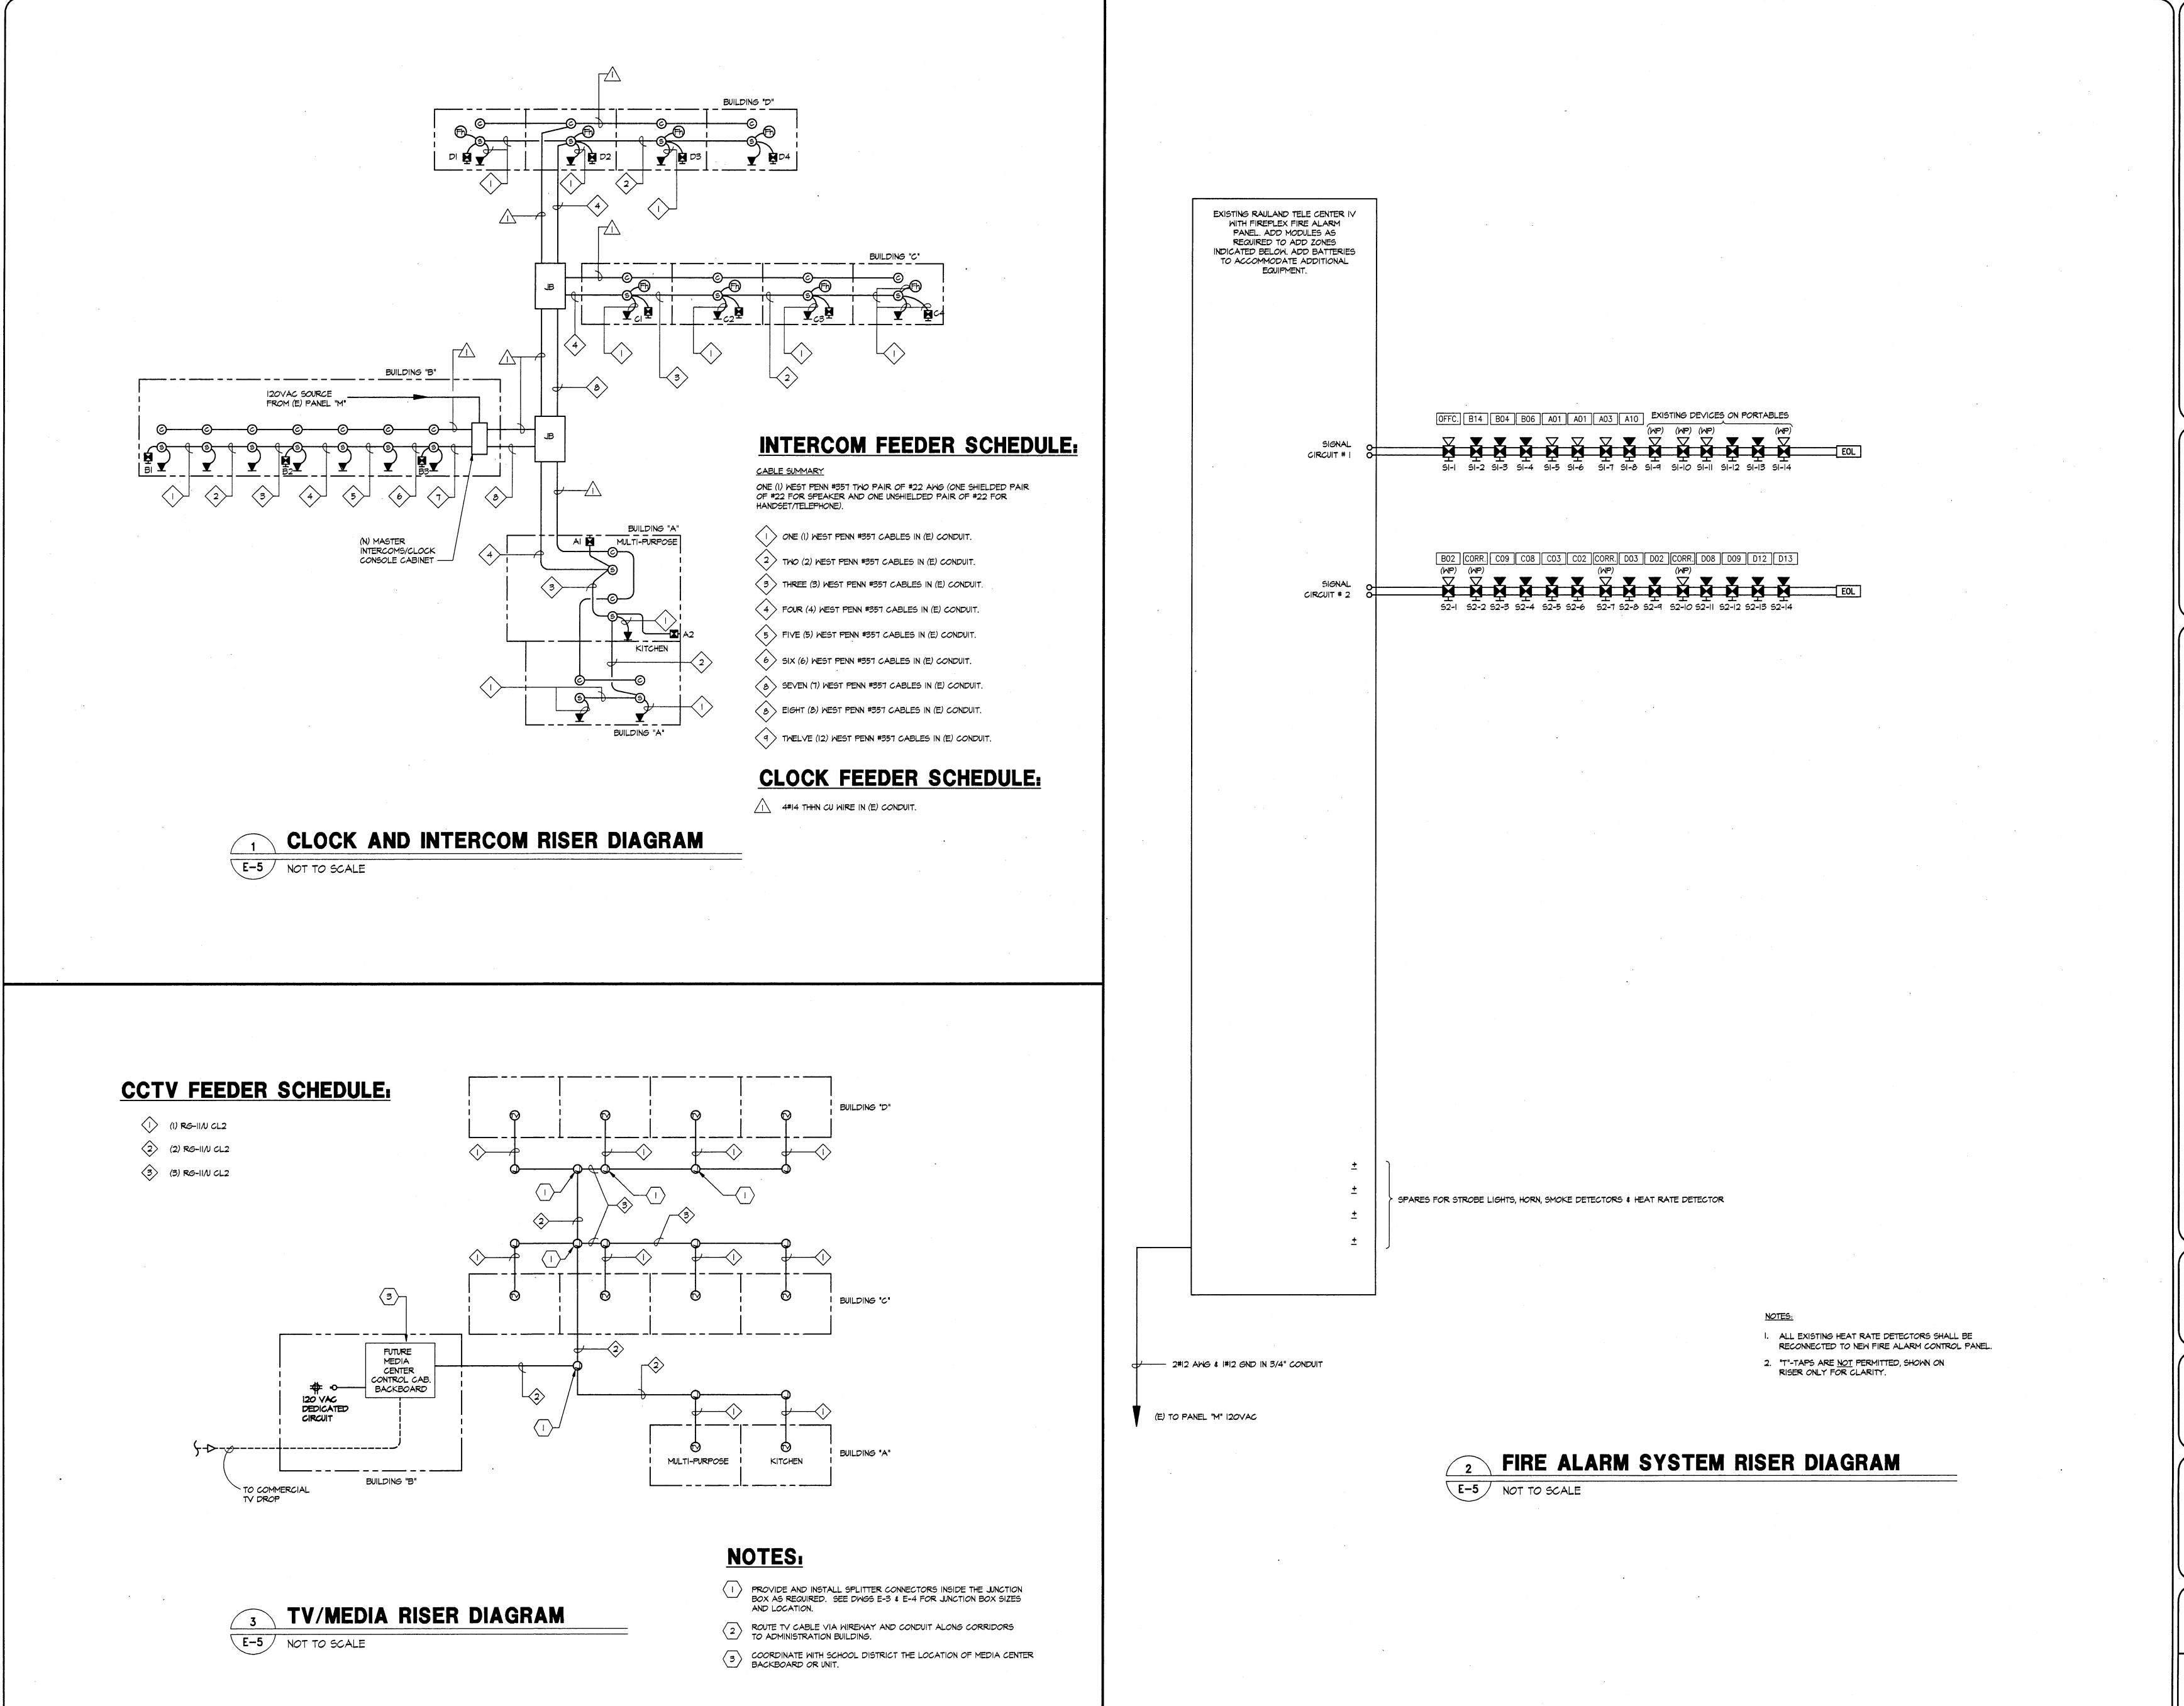
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ELECTRICAL FLOOR PLAN BLDGS C & D

DATE DRAWING NUMBER

77-15-3


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**APPROVALS** 

CONSULTANT


Engineers, Inc. 2005 De La Cruz Blvd, Suite 151 Santa Clera, CA 95050 Ph: 408/986-8388 Fax: 408/986-9129 JOB # 94638




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CLOCK/INTERCOM AND TV/MEDIA RISER DIAGRAM

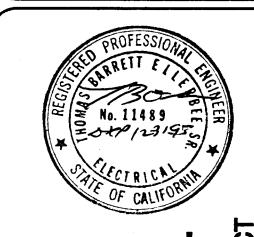77-15-3

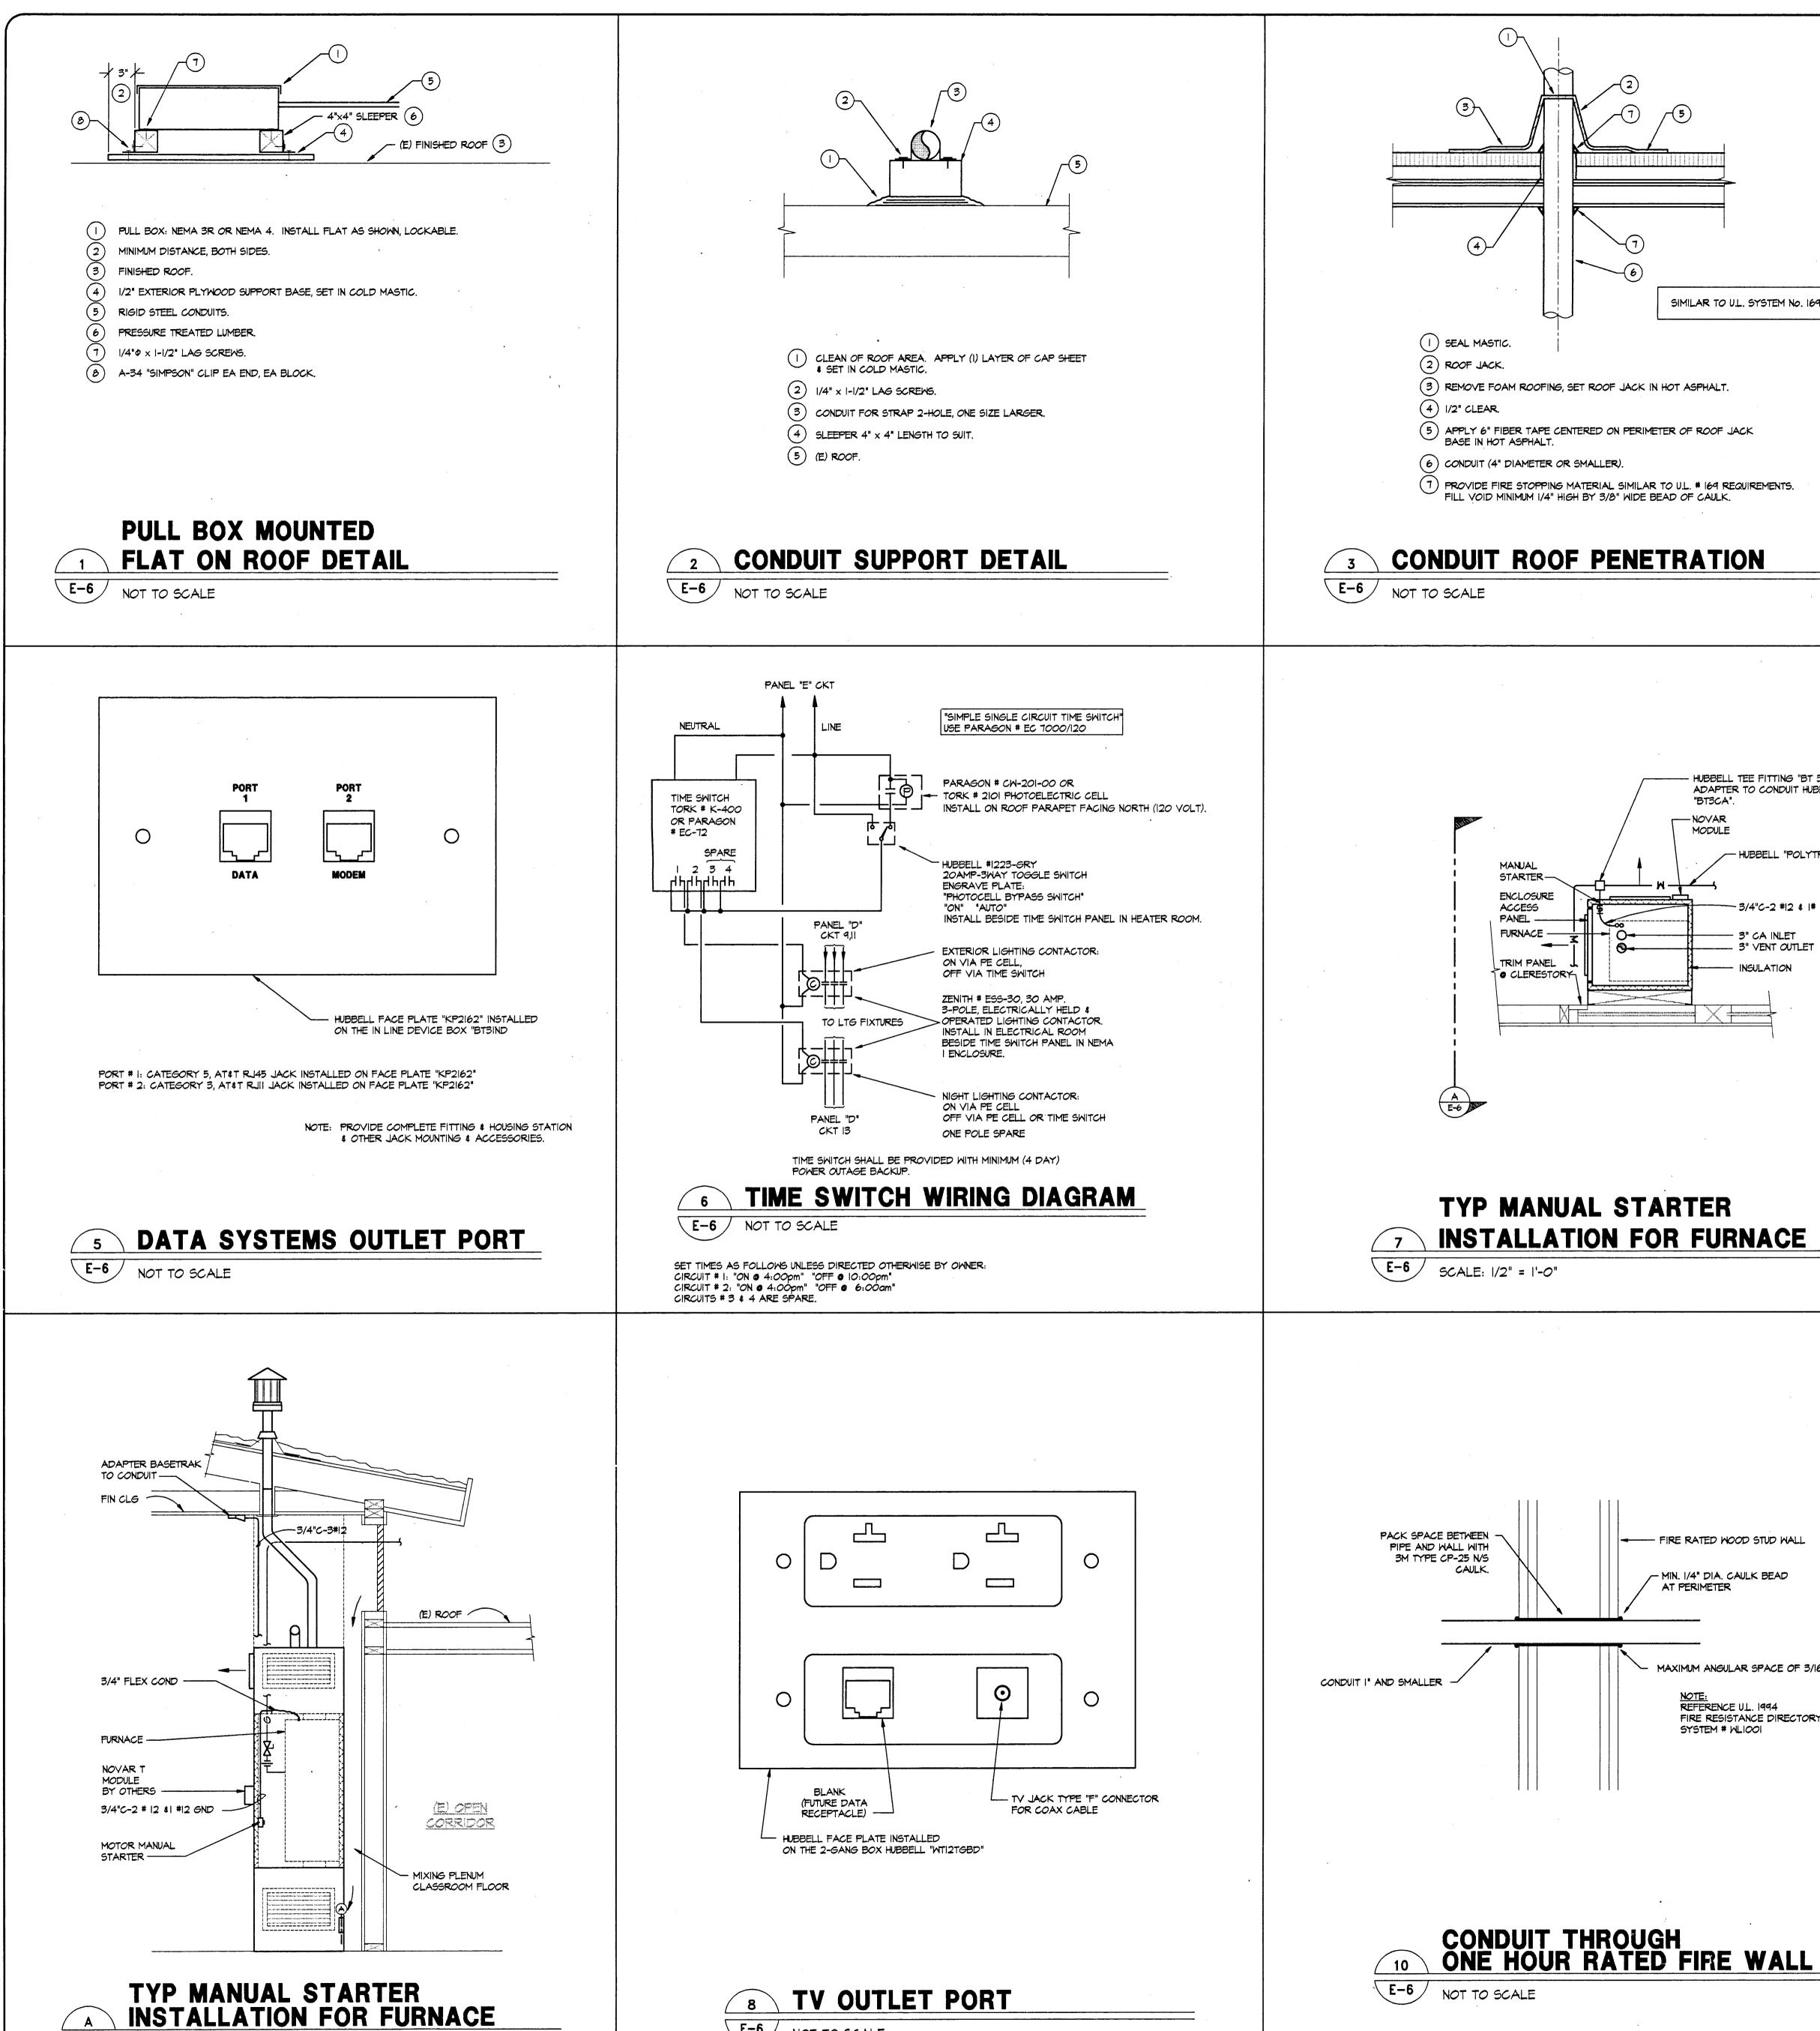

E-6 NOT TO SCALE

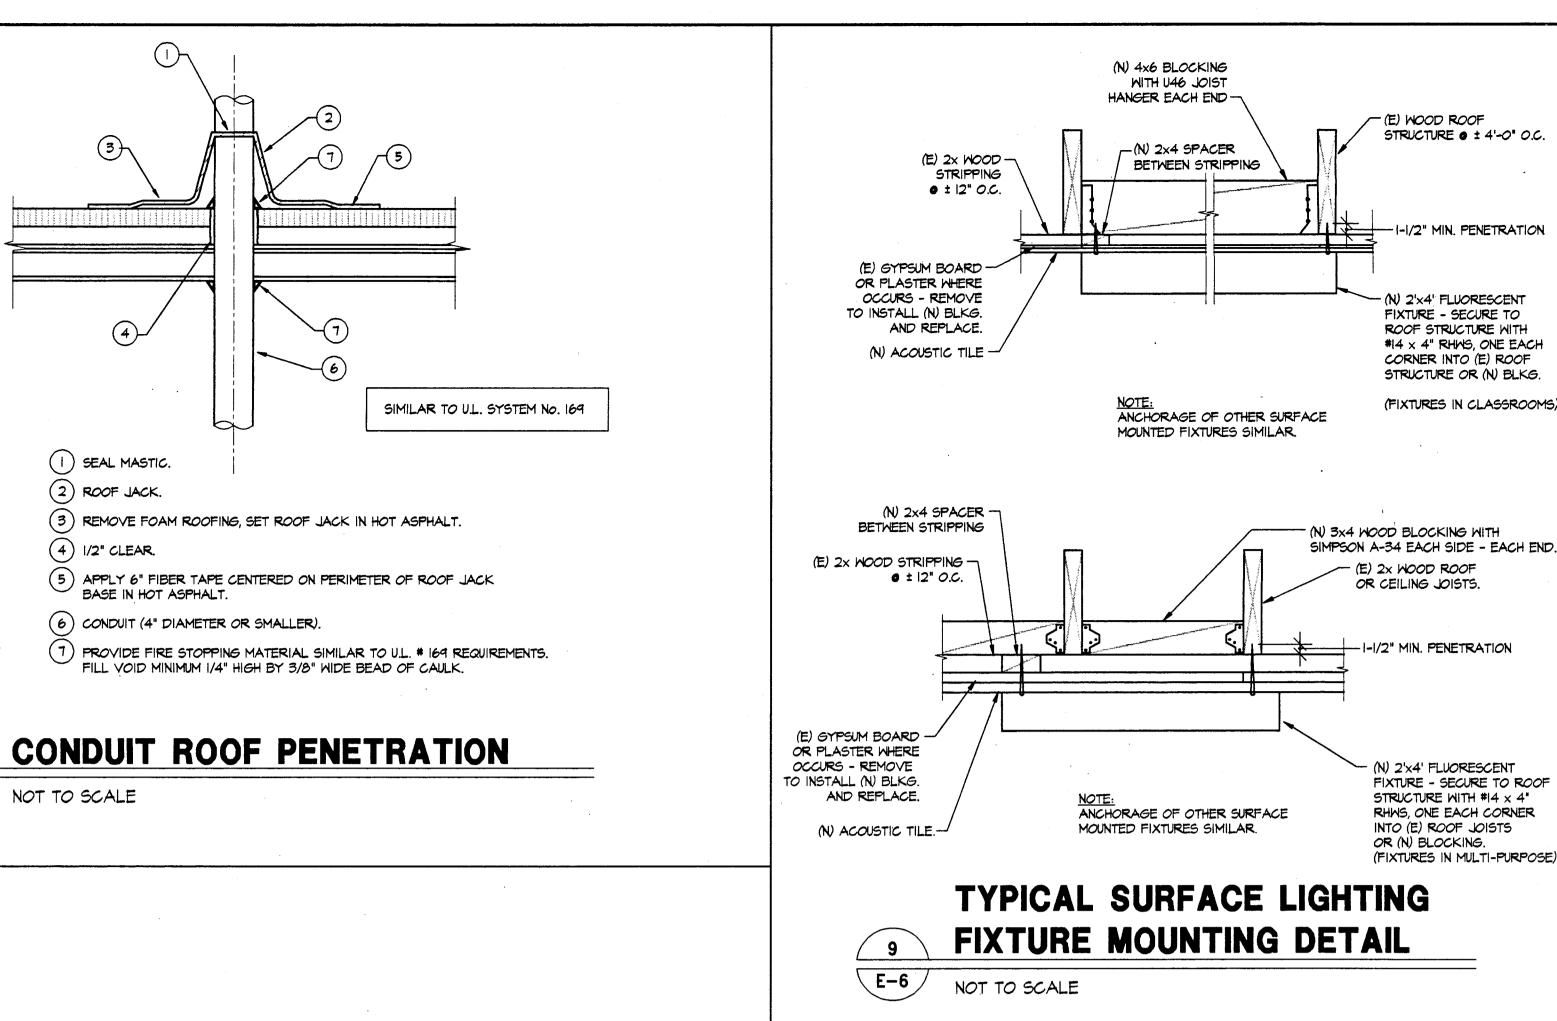

HUBBELL TEE FITTING "BT STC" \$

ADAPTER TO CONDUIT HUBBELL

- HUBBELL "POLYTRAK"

3" CA INLET

INSULATION

- 3" VENT OUTLET

-3/4"C-2 #12 \$ I# 12 GND

"BT3CA"

MODULE

FIRE RATED WOOD STUD WALL

AT PERIMETER

- MIN. 1/4" DIA. CAULK BEAD

MAXIMUM ANGULAR SPACE OF 3/16"

FIRE RESISTANCE DIRECTORY VOL. II

REFERENCE UL. 1994

SYSTEM # WLIOOI

----NOVAR



BUILDING LIGHTING SHUT-OFF: THE BUILDING LIGHTING SHUT-OFF SYSTEM CONSISTS OF AN AUTOMATIC TIME SWITCH, WITH A ZONE FOR EACH FLOOR; OR THE BUILDING IS SEPARATELY METERED AND LESS THAN 5,000 SQUARE FEET, EXEMPT FROM THE SHUT-OFF REQUIREMENTS.

OVER RIDE FOR BUILDING LIGHTING SHUT-OFF: THE AUTOMATIC BUILDING SHUT-OFF SYSTEM IS PROVIDED WITH A MANUAL, ACCESSIBLE OVER RIDE SWITCH IN SIGHT OF THE LIGHTS. THE AREA OF OVER RIDE IS NOT TO EXCEED 5,000 SF.

AUTOMATIC CONTROL DEVICES CERTIFIED: ALL AUTOMATIC CONTROL DEVICES SPECIFIED ARE CERTIFIED, ALL ALTERNATE EQUIPMENT SHALL BE CERTIFIED AND INSTALLED AS DIRECTED BY THE MANUFACTURER.

FLUORESCENT BALLASTS AND LUMINAIRES CERTIFIED: ALL FLUORESCENT FIXTURE SPECIFIED FOR THE PROJECT ARE CERTIFIED AND LISTED IN THE

DIRECTORY. ALL INSTALLED FIXTURES SHALL BE CERTIFIED. TANDEM WIRING FOR TWO-LAMP BALLASTS: ALL ONE AND THREE LAMP FLUORESCENT FIXTURES ARE TANDEM WIRED WITH TWO (2) LAMP BALLASTS WHERE REQUIRED BY STANDARDS # 132; OR ALL THREE LAMP FLUORESCENT FIXTURES

ARE SPECIFIED WITH ELECTRONIC HIGH-FREQUENCY BALLASTS AND ARE EXEMPT FROM TWO-LAMP TANDEM WIRING REQUIREMENTS. INDIVIDUAL ROOM/AREA CONTROLS:

EACH ROOM AND AREA IN THIS BUILDING IS EQUIPPED WITH A SEPARATE SWITCH OR OCCUPANCY SENSOR DEVICE FOR EACH AREA WITH FLOOR-TO-CEILING WALLS.

UNIFORM REDUCTION FOR INDIVIDUAL ROOMS: ALL ROOMS AND AREAS GREATER THAN 100 SQUARE FEET AND MORE THAN 1.2 WATTS PER SQUARE FOOT OF LIGHTING LOAD SHALL BE CONTROLLED WITH BI-LEVEL SWITCHING FOR UNIFORM

REDUCTION OF LIGHTING WITHIN THE ROOM. DAYLIT AREA CONTROL: ALL ROOMS WITH WINDOWS AND SKYLIGHTS, THAT ARE GREATER THAN 250 SQUARE FEET, AND THAT ALLOW FOR THE EFFECTIVE USE OF DAYLIGHT IN THE AREA SHALL HAVE 50% OF THE LAMPS IN EACH DAYLIT AREA CONTROLLED BY A SEPARATE SWITCH; OR THE EFFECTIVE USE OF DAYLIGHT THROUGH OUT THE SPACE CANNOT BE ACCOMPLISHED BECAUSE THE WINDOWS ARE CONTINUOUSLY SHADED BY A BUILDING ON THE ADJACENT LOT. DIAGRAM OF SHADING DURING DIFFERENT TIMES

CONTROL OF EXTERIOR LIGHTS: EXTERIOR MOUNTED FIXTURES AND SERVED FROM THE ELECTRICAL PANEL INSIDE THE BUILDING ARE CONTROLLED WITH A DIRECTIONAL PHOTO CELL CONTROL ON THE ROOF AND A CORRESPONDING RELAY IN THE ELECTRICAL PANEL.

IN ACCORDANCE WITH TITLE 24, SECTION 2336(b) AND TABLE No. 23-P, DETAILS SHALL BE PROVIDED FOR THE SEISMIC ANCHORAGE OF ALL MECHANICAL AND ELECTRICAL EQUIPMENT. ANCHORAGE DETAILS SHALL BE BASED UPON APPROPRIATE DESIGN CALCULATIONS.

FOR EQUIPMENT WEIGHING 400 POUNDS OR MORE ANCHORAGE DETAILS AND APPROPRIATE DESIGN CALCULATIONS SHALL BE SUBMITTED AS PART OF THE MECHANICAL AND ELECTRICAL DRAWING. "DEFERRED APPROVAL" ITEMS WILL NOT BE PERMITTED UNLESS SPECIFICALLY APPROVED BY THE PLAN CHECK SUPERVISOR.

EXCEPTION: ATTACHMENTS OF EQUIPMENT WEIGHING LESS THAN 400 POUNDS AND SUPPORTED DIRECTLY ON THE FLOOR OR ROOF STRUCTURE, FURNITURE, OR TEMPORARY OR MOVABLE EQUIPMENT AND EQUIPMENT WEIGHING LESS THAN 20 POUNDS THAT IS SUPPORTED BY VIBRATION ISOLATION DEVICES SUSPENDED FROM THE ROOF, WALL OR FLOOR, NEED NOT BE DETAILED ON THE PLANS PROVIDED THE FOLLOWING NOTES ARE INCLUDED ON THE MECHANICAL AND ELECTRICAL PLANS.

ALL MECHANICAL EQUIPMENT SHALL BE BRACED OR ANCHORED TO RESIST A HORIZONTAL FORCE ACTING IN ANY DIRECTION USING THE FOLLOWING

FIXED EQUIPMENT ON GRADE 20% OF OPERATING WEIGHT EMERGENCY POWER EQUIPMENT ON GRADE 30% OF OPERATING WEIGHT EMERGENCY POWER EQUIPMENT ON STRUCTURE 40% OF OPERATING WEIGHT

OF YEAR IS INCLUDED ON PLANS.

SIMULTANEOUS VERTICAL FORCE - USE 1/3X HORIZONTAL FORCE. FOR FLEXIBLY MOUNTED EQUIPMENT SEE TITLE 24, SECTION 2336(b)2.

WHERE ANCHORAGE DETAILS ARE NOT SHOWN ON THE DRAWINGS, THE FIELD INSTALLATION SHALL BE SUBJECT TO THE APPROVAL OF THE STRUCTURAL ENGINEER AND THE FIELD REPRESENTATIVE OF THE OFFICE OF THE STATE ARCHITECT.

THIS TABLE HAS BEEN PREPARED FOR AN IMPORTANCE FACTOR OF I=1.0 AND FOR SEISMIC ZONE 4. MAKE APPROPRIATE ADJUSTMENT FOR ANY OTHER VALUES.



No. 11489

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APPROVALS

**ARCHITECT** 

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ELECTRICAL DETAILS

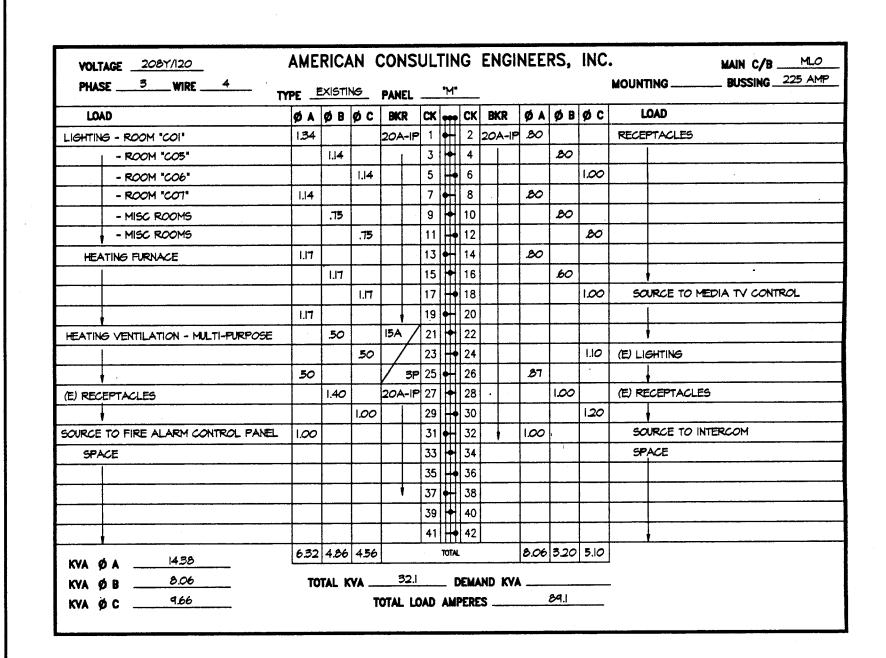
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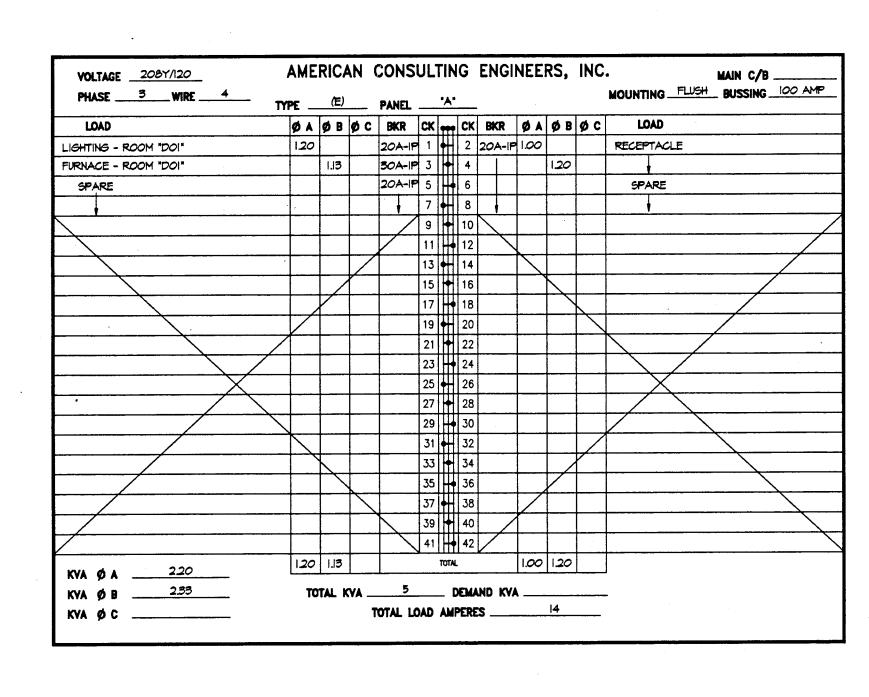
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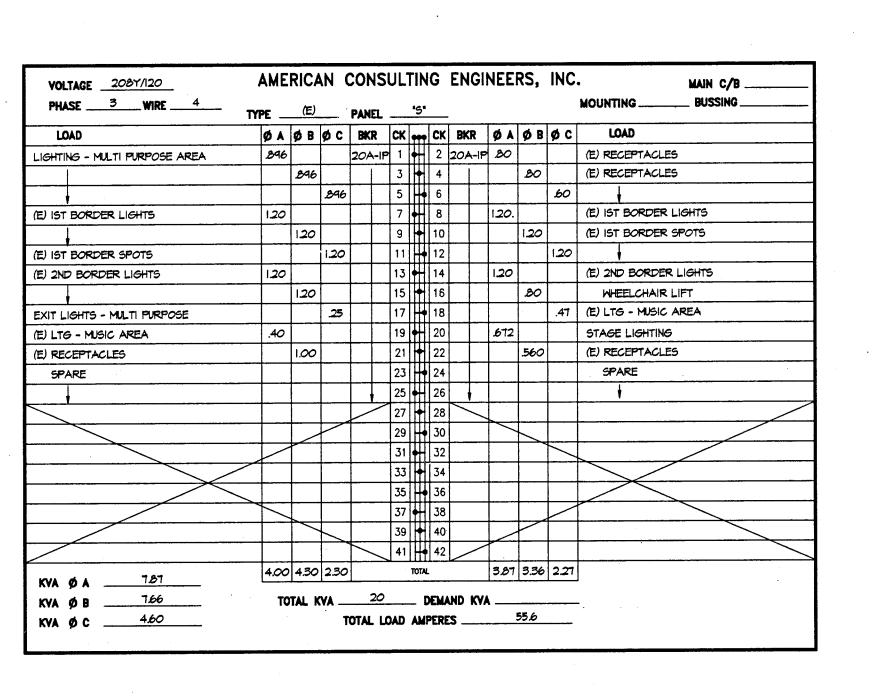
SHEET 29 OF 30


E-6 | SCALE: 1/2" = 1'-0"





PHASE 3 WIRE 4	TYPE	SI		PANEI	_	<b>"</b> L	) <b>"</b>						MOUNTING FLUSH BUSSING 225 /		
LOAD	ØA	ØΒ	øс	BKR	CI	( 99	e C	K E	KR	ØA	ØΒ	øс	LOAD		
LIGHTING - ROOM "DI4"	1.14			20A-	IP 1	•	- 2	2 20	A-IF	80			RECEPTACLES		
- ROOM "DOT"		1.14					4				1.00				
- ROOM "DO5"			1.14				• 6					1.00			
- MISC ROOMS	.375				7	•	-   8	В		80					
CORRIDOR LIGHTING		1.20			9		1	0			20				
CORRIDOR LIGHTING			1.20				1					20			
NIGHT LIGHTING	.75				13	3	1	4					120 VAC TO TIME SWITCH/PE.		
FURNACE - ROOM - "DI4"		.67			15	5	1	6					SPARE		
- ROOM - "DOT"			.67		17	7	1	8	T						
- ROOM - "DOS"	.67				19	3	2	20							
WATER HEATER		120		30A	2	1	2	22							
WATER HEATER			1.20	/ 2	<b>p</b> 2.	3	2	4	1						
SPARE					2	5	2	26							
					2	7	2	28							
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ELECTRICAL PANEL SCHEDULES

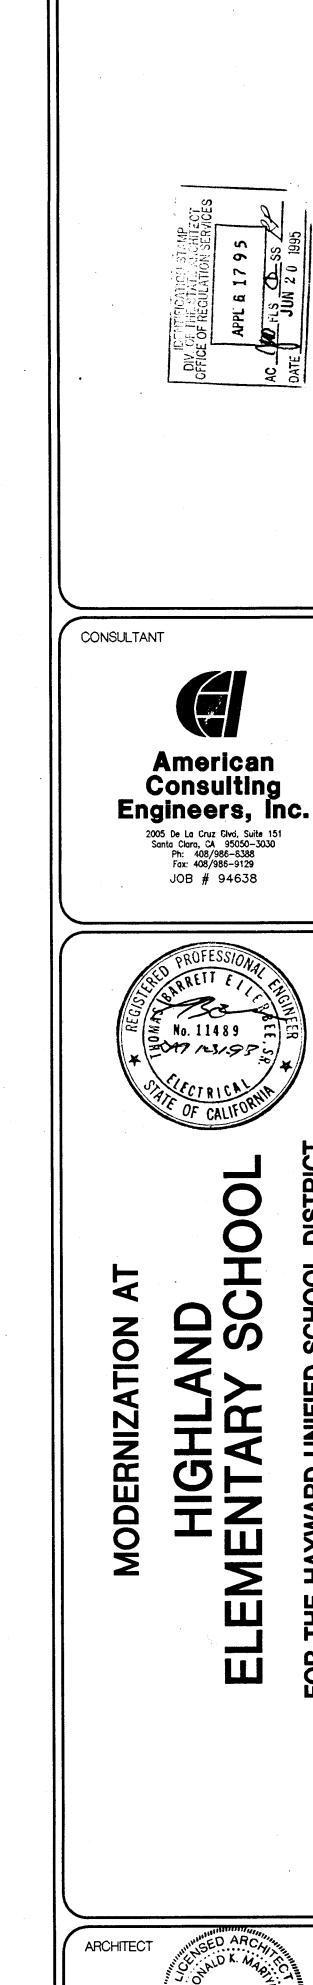APPROVALS