


**GENERAL PLAN NOTES:**

- THESE DRAWINGS ARE INTENDED TO OUTLINE THE GENERAL SCOPE OF THE WORK. CONTRACTORS SHALL ALSO BE RESPONSIBLE FOR ADHERING TO ALL APPLICABLE CODES & GENERALLY ACCEPTED TRADE PRACTICES.
- ALL DIMENSIONS ARE FROM FACE OF STUD TO FACE OF STUD, MASONRY UNLESS NOTED OTHERWISE.
- PROVIDE NECESSARY BLOCKING/ANCHORING, AS REQUIRED FOR ANY & ALL ITEMS THAT MUST BE SECURED TO THE WALL, INCLUDING WALL MOUNTED CABINETS & EQUIPMENT, AUDIO/VISUAL, & SECURITY COMPONENTS. VERIFY LOCATIONS WITH OWNER.
- PROVIDE BLOCKING AT ALL WOOD BASE, CABINETS & SHELF BRACKETS & WALL MOUNTED RESTROOM EQUIPMENT.
- ALL DOORS TO BE LOCATED 6" FROM THE ADJACENT PERPENDICULAR STUD WALL FRAMING. PROVIDE 12" CLEAR ON PUSH SIDE OF DOOR (IF BOTH LATCH & CLOSER) & 18" CLEAR ON PULL SIDE OF ALL DOORS PER ADA.
- REFER TO DOOR SCHEDULE FOR SIZE, TYPE & FINISH OF ALL NEW DOORS & FRAMES.
- ALL WALLS THAT TERMINATE AT 6" ABOVE CEILINGS SHALL BE BRACED TO THE STRUCTURE ABOVE WITH 25 GA. 3 5/8" METAL STUD BRACES AT 48" O.C. MAXIMUM.
- PROVIDE CONTROL JOINTS ON CONTINUOUS GYPSUM BOARD SURFACES IN EXCESS OF 20'-0" AT A MAXIMUM INCREMENT OF 20'-0" ON CENTER, U.N.O.
- REFER TO PLUMBING PLANS FOR ALL SPECIFICATIONS & FIXTURE QUANTITIES. THE ARCHITECTURAL FLOOR PLAN SHOWS ONLY DESIGN INTENT.
- PLUMBING FIXTURES TO BE PROVIDED & INSTALLED BY G.C. UNLESS INDICATED OTHERWISE. COORDINATE ELECTRICAL & PLUMBING CONNECTIONS WITH OWNER/TENANT.
- REFER TO THE FINISH PLAN & SCHEDULE SHEETS FOR ALL INTERIOR FLOOR & WALL FINISHES, COLORS & MATERIALS. COORDINATE WITH THE SPECIFICATIONS & ARCHITECTURAL FLOOR PLANS AS REQUIRED.
- PROVIDE SIGNAGE AS REQUIRED BY CODE. REFER TO SPECIFICATIONS SECTION 10 1400-SIGNAGE.
- ALL FURNITURE & EQUIPMENT BY OTHERS, U.N.O. G.C. TO COORDINATE ALL BUILT-INS WITH OWNER PRIOR TO CONSTRUCTION.
- VERIFY ELECTRICAL OUTLET & DATA BOX LOCATIONS W/ OWNER AFTER ELECTRICAL BOX INSTALLATION & PRIOR TO CONDUIT INSTALLATION. COORDINATE WITH MILLWORK, FURNITURE & EQUIPMENT LOCATIONS. RUN EXPOSED CONDUIT IN CLEAN & ORDERLY MANNER.
- COORDINATE THE LOCATION & INSTALLATION OF ALL MECHANICAL & ELECTRICAL DEVICES, REGISTERS, FIXTURES, ETC. PRIOR TO INSTALLATION OF FINISH MATERIALS.



107 1/2 N. PENNSYLVANIA AVE.  
SUITE 2F  
INDEPENDENCE, KANSAS 67301  
620-331-6171  
www.EchelonAD.com

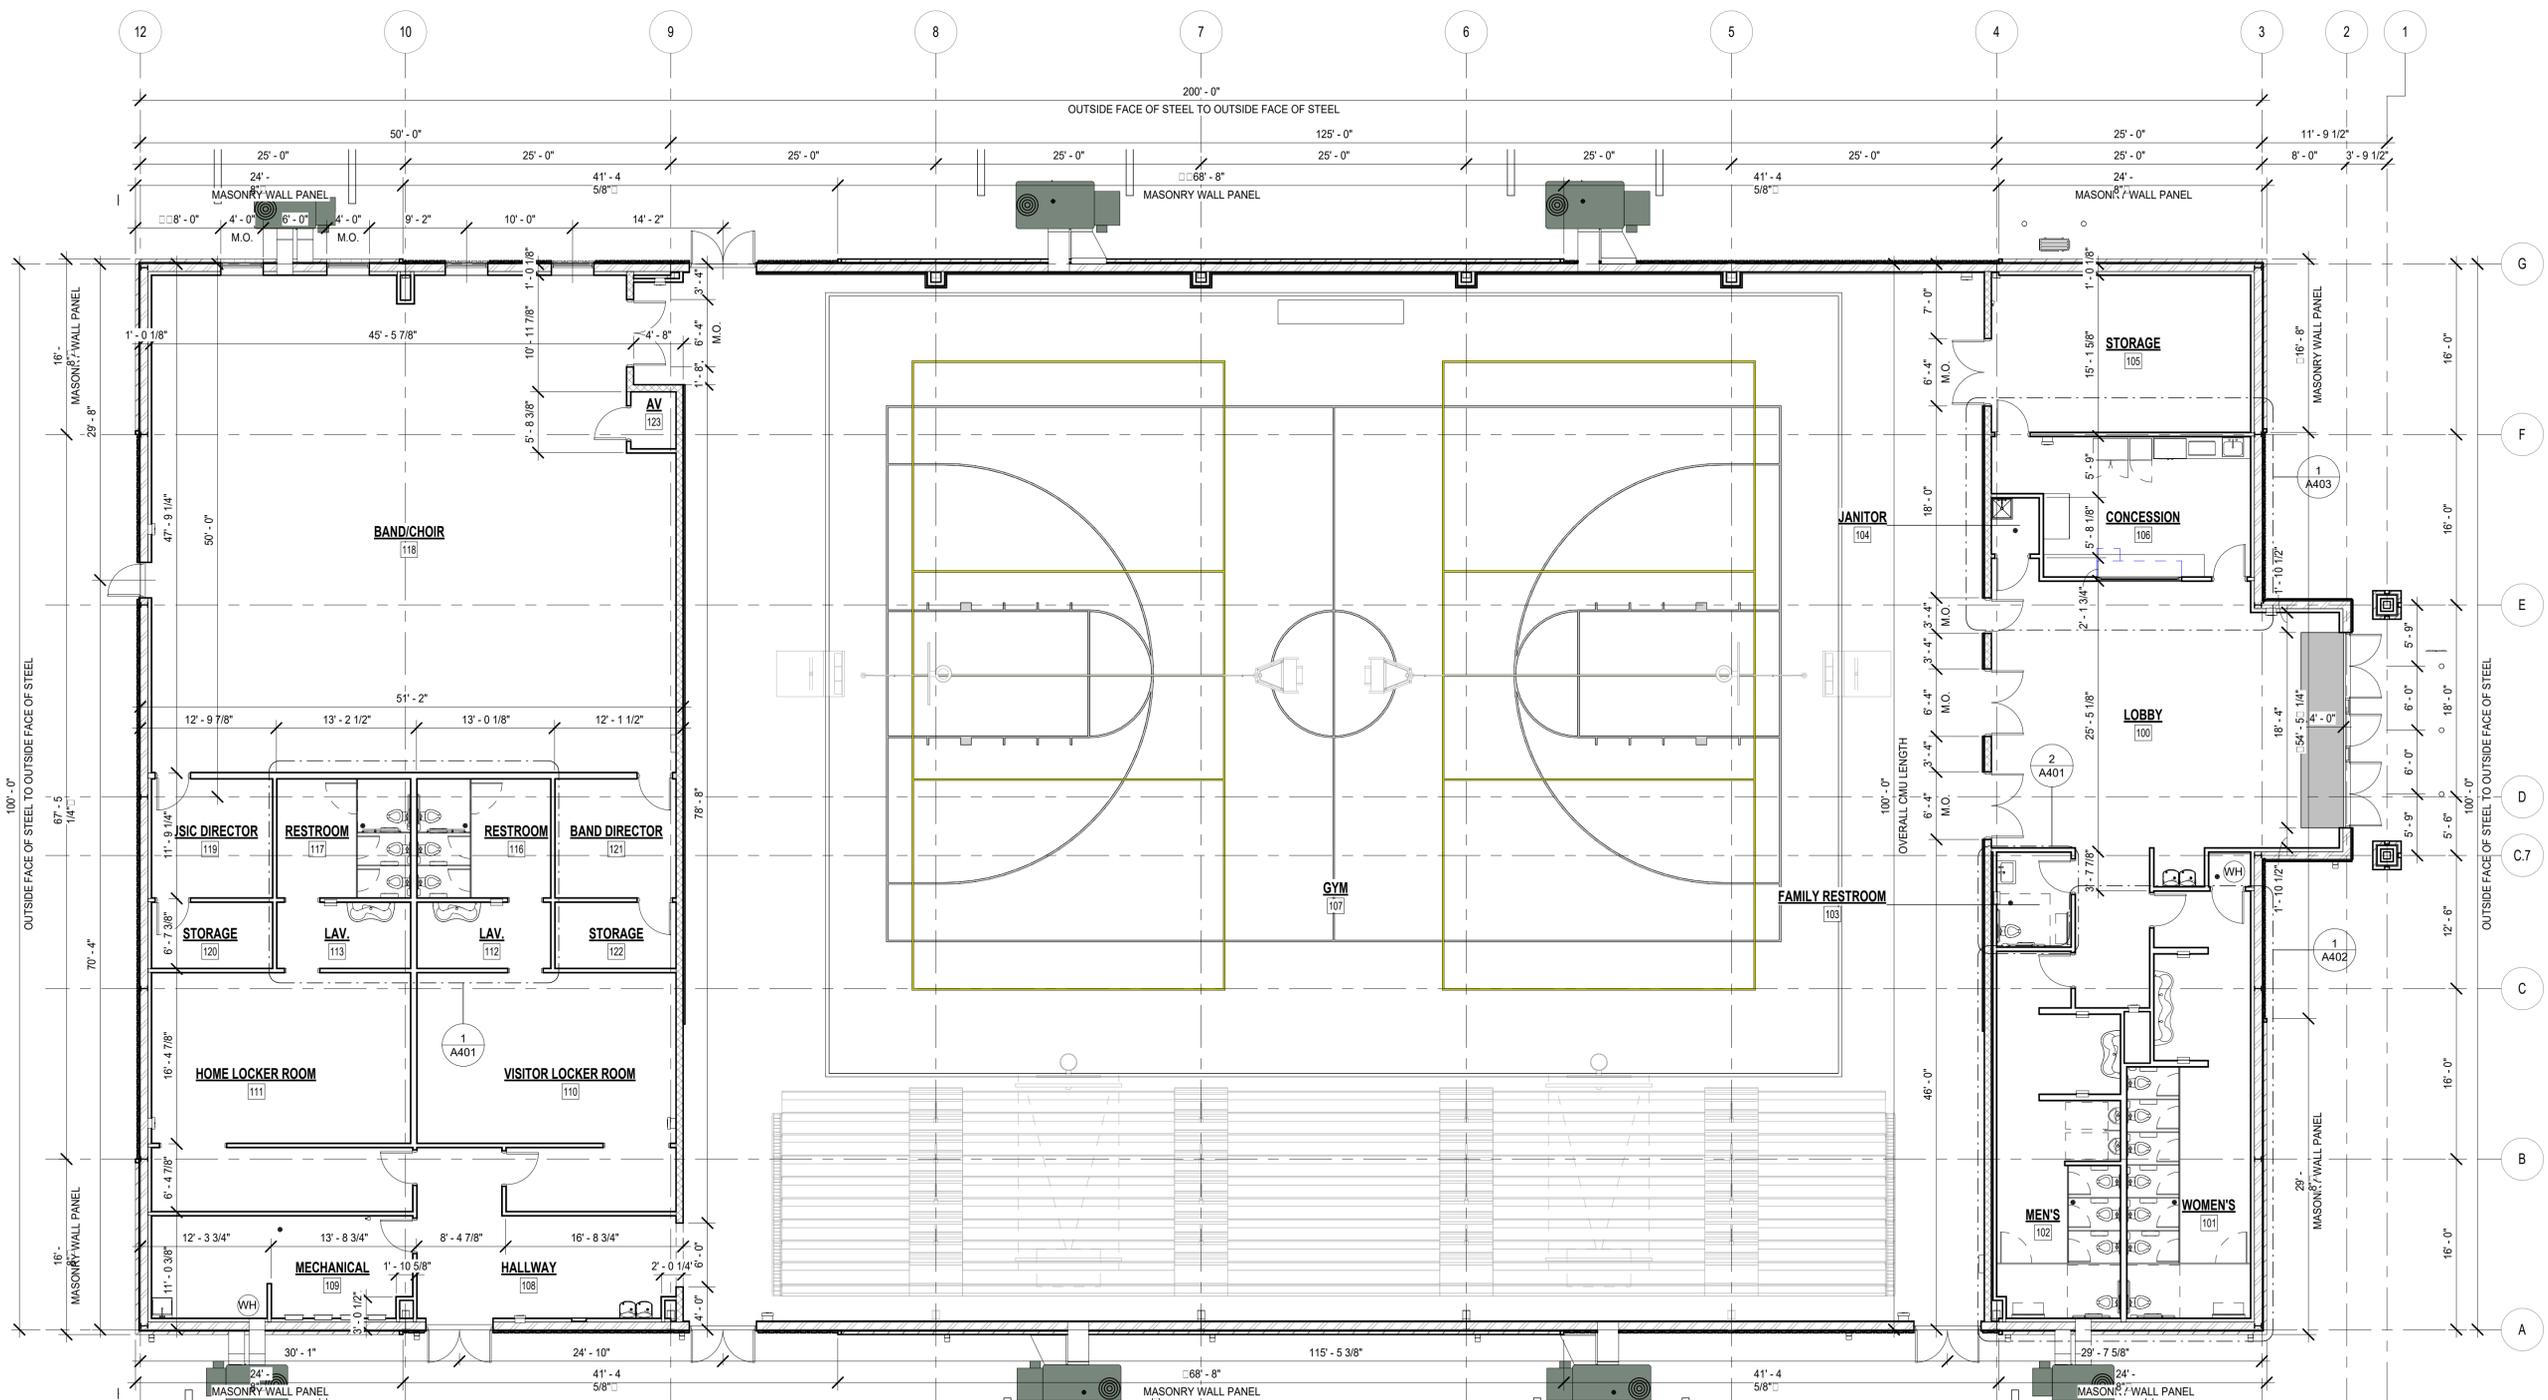

**1 DIMENSION PLAN**  
1/8" = 1'-0"

NEW CONSTRUCTION  
**A NEW GYM FOR USD506**  
601 HIGH SCHOOL AVE., ALTAMONT, KS 67330


DRAWING	
<b>DIMENSION PLAN</b>	
MANAGER	DRAWN BY
SAC	KG
REVISIONS	
PROJECT NUMBER	
23-09	
DATE	
8/14/2023	
SHEET NUMBER	
<b>A101</b>	

**REFLECTED CEILING LEGEND**

	2X2 CEILING TILE <i>RE: MEP DWG'S</i>		EXIT DEVICE <i>RE: MEP DWG'S</i>
	GYPSUM BOARD SOFFIT <i>RE: MEP DWG'S</i>		EMERGENCY LIGHT <i>RE: MEP DWG'S</i>
	2X2 LIGHT TROFFER <i>RE: MEP DWG'S</i>		SMOKE DETECTOR <i>RE: MEP DWG'S</i>
	RECESSED CAN LIGHT <i>RE: MEP DWG'S</i>		FIRE ALARM STROBE <i>RE: MEP DWG'S</i>
	HIGH BAY LIGHT <i>RE: MEP DWG'S</i>		FIRE ALARM HORN/STROBE <i>RE: MEP DWG'S</i>
	WALL MOUNT STRIP LIGHT <i>RE: MEP DWG'S</i>		WALL MOUNTED CAMERA <i>RE: MEP DWG'S</i>
	MECHANICAL RETURN AIR DIFFUSER <i>RE: MEP DWG'S</i>		HORN SYSTEM <i>RE: MEP DWG'S</i>
	MECHANICAL SUPPLY AIR DIFFUSER <i>RE: MEP DWG'S</i>		SPEAKER SYSTEM <i>RE: MEP DWG'S</i>
	MECHANICAL EXHAUST FAN <i>RE: MEP DWG'S</i>		WIRELESS INTERNET TRANSMITTER <i>RE: MEP DWG'S</i>
	DUCT WORK <i>RE: MEP DWG'S</i>		CLG ELEVATION HEIGHT INDICATOR

**GENERAL CEILING NOTES:**

1. THESE DRAWINGS ARE INTENDED TO OUTLINE THE GENERAL SCOPE OF THE WORK. CONTRACTOR SHALL ALSO BE RESPONSIBLE FOR ADHERING TO ALL APPLICABLE CODES & GENERALLY ACCEPTED TRADE PRACTICES.
2. THE CONTRACTOR SHALL NOTIFY THE ARCHITECT OF ANY DISCREPANCIES BETWEEN THE REFLECTED CEILING PLANS & THE ELECTRICAL DRAWINGS.
3. REFER TO MECHANICAL & ELECTRICAL DRAWINGS FOR FIRE ALARM & EMERGENCY LIGHTING COMPONENTS.
4. COORDINATE ALL MECHANICAL SYSTEM BULK HEADSIZES WITH MECHANICAL DRAWINGS PRIOR TO INSTALLATION OF SPRINKLER SYSTEM.
5. THE REFLECTED CEILING PLANS INDICATE ONLY ARCHITECTURAL FEATURES/FINISH/ELEVATIONS ETC. OF THE CEILING DESIGN. REFER TO ELECTRICAL & HVAC PLANS FOR FIXTURE QUANTITIES, MANUFACTURER'S MODEL NUMBERS & EQUIPMENT SPECIFICATIONS. NOTIFY THE ARCHITECT IF THE REFLECTED CEILING PLANS DIFFER FROM THE HVAC & ELECTRICAL PLANS.
6. SPRINKLER HEADS & RECESSED CAN LIGHTS ARE TO BE LOCATED IN THE CENTER OF THE AFFECTED CEILING PANEL WHERE THE CEILING PANEL CENTER REVEALS THE SPRINKLER HEAD OR LIGHT FIXTURES. LABEL LOCATED IN THE CENTER OF THE 2' x 2' PORTION OF THAT CEILING PANEL.
7. PROVIDE ACCESS PANELS (FIRE-RATED IN RATED ASSEMBLIES) FOR ACCESS OF ALL SERVICEABLE MEP EQUIPMENT ABOVE HARD LID CEILINGS (COORDINATE SIZE & TYPE WITH MEP DRAWINGS & EQUIPMENT REQUIREMENTS).
8. NEATLY FINISH ALL GYP. BRO. WALL TO DISSIMILAR MATERIAL TRANSITIONS WHERE TO REMAIN EXPOSED TO VIEW. USE TEAR-AWAY TYPE BEAD TRIM & SEALANT AS REQUIRED.
9. PAINT STRUCTURAL ELEMENTS AT CEILING. REFERENCE FINISH PLAN.

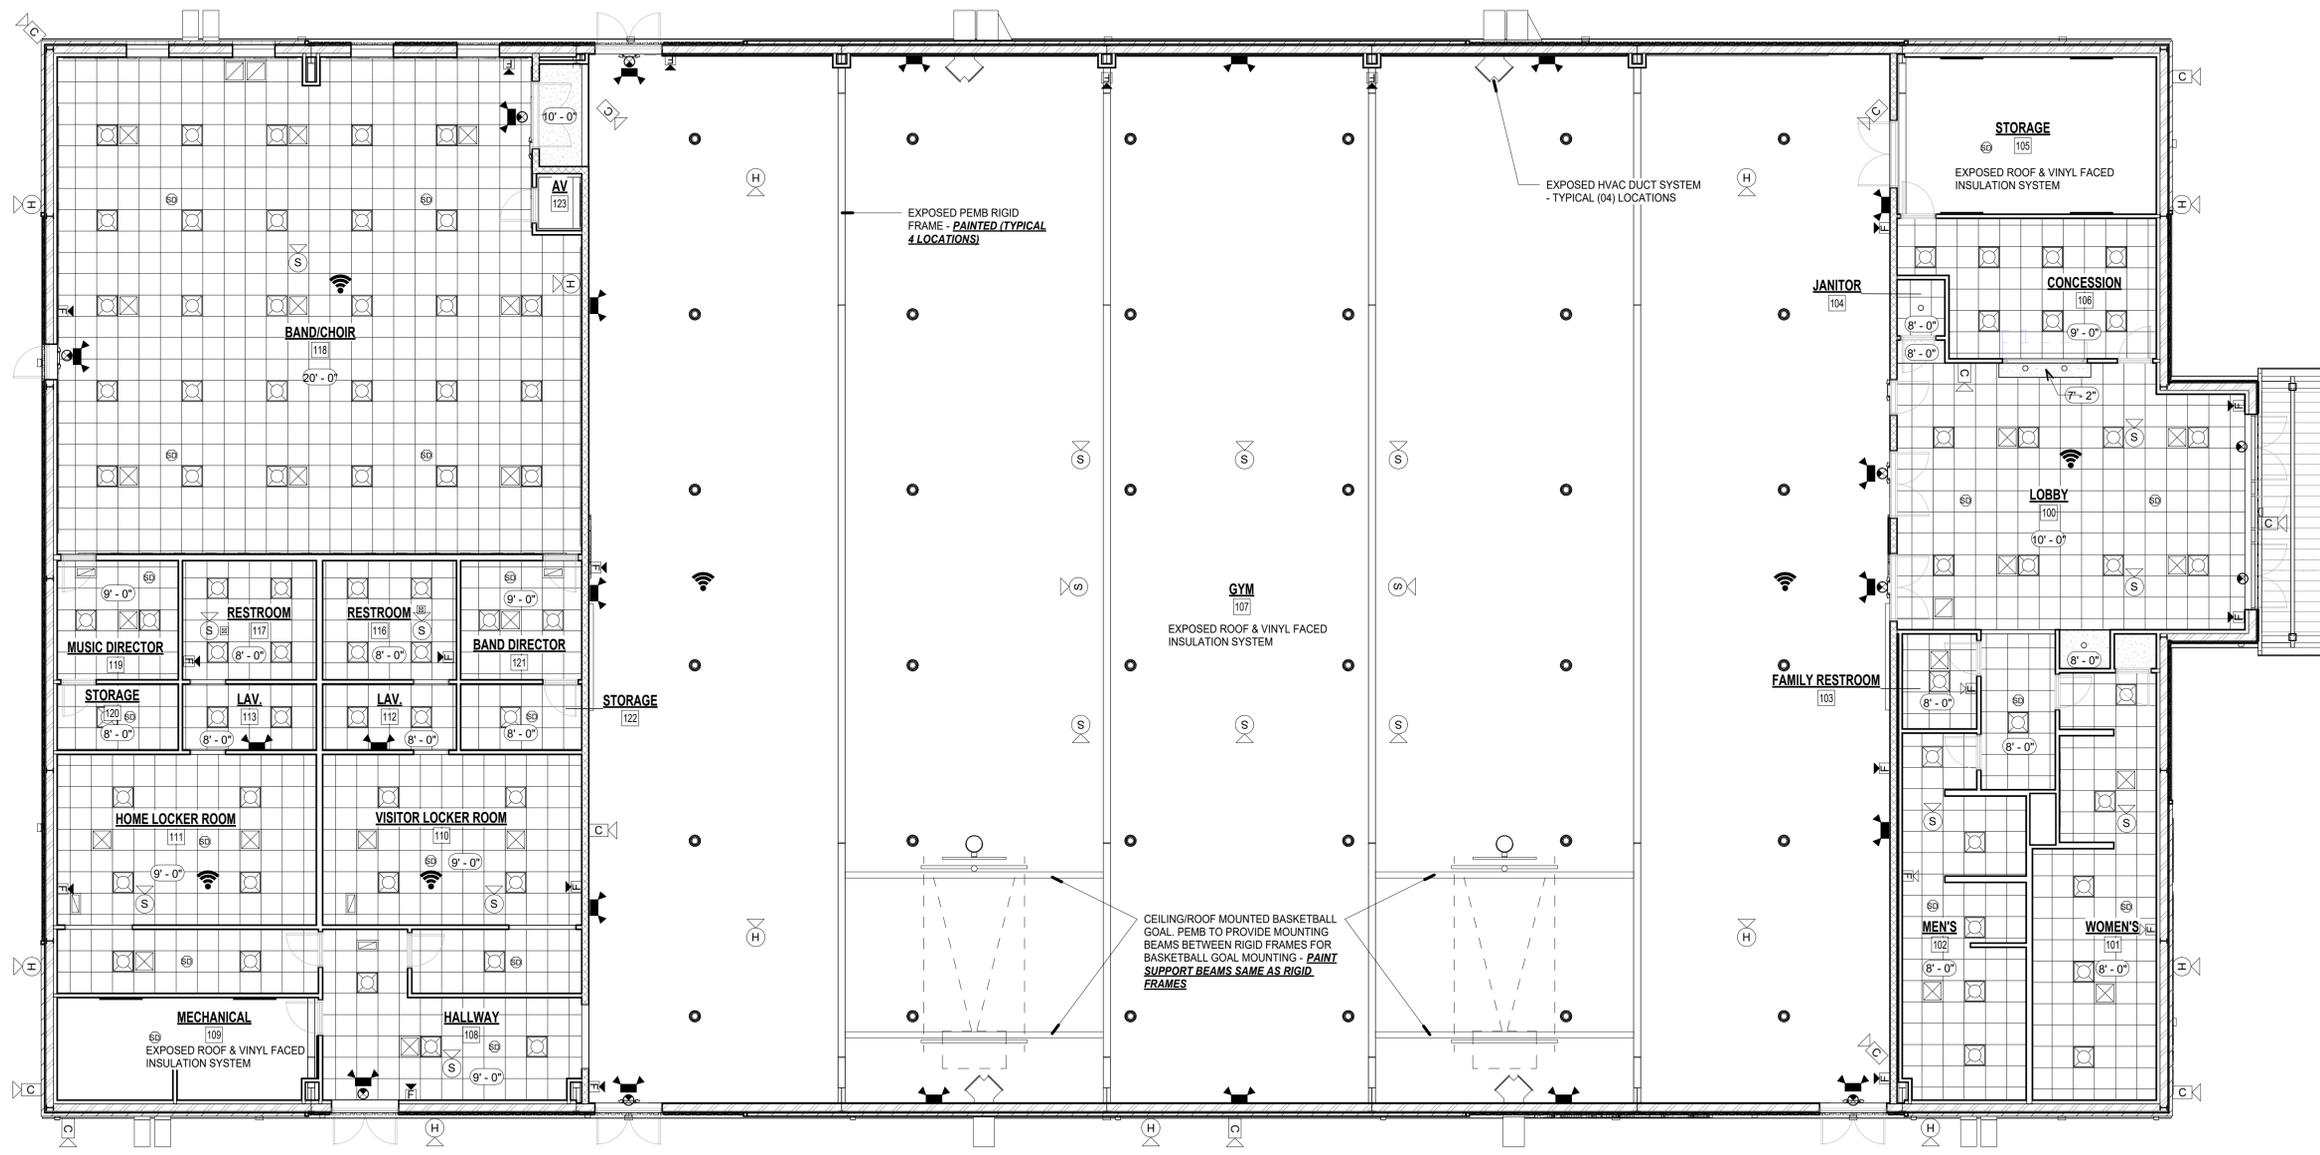

**1 FIRST FLOOR REFLECTED CEILING PLAN**  
1/8" = 1'-0"



**ECHELON**  
ARCH + DESIGN

107 1/2 N. PENNSYLVANIA AVE.  
SUITE 2F  
INDEPENDENCE, KANSAS 67301

620-331-6171  
www.EchelonAD.com

CERTIFIED BY

NEW CONSTRUCTION

**A NEW GYM FOR USD506**


601 HIGH SCHOOL AVE., ALTAMONT, KS 67330

DRAWING

**REFLECTED CEILING PLAN**

MANAGER	DRAWN BY
SAC	KG
REVISIONS	
PROJECT NUMBER	
23-09	
DATE	
8/14/2023	
SHEET NUMBER	

**A103**

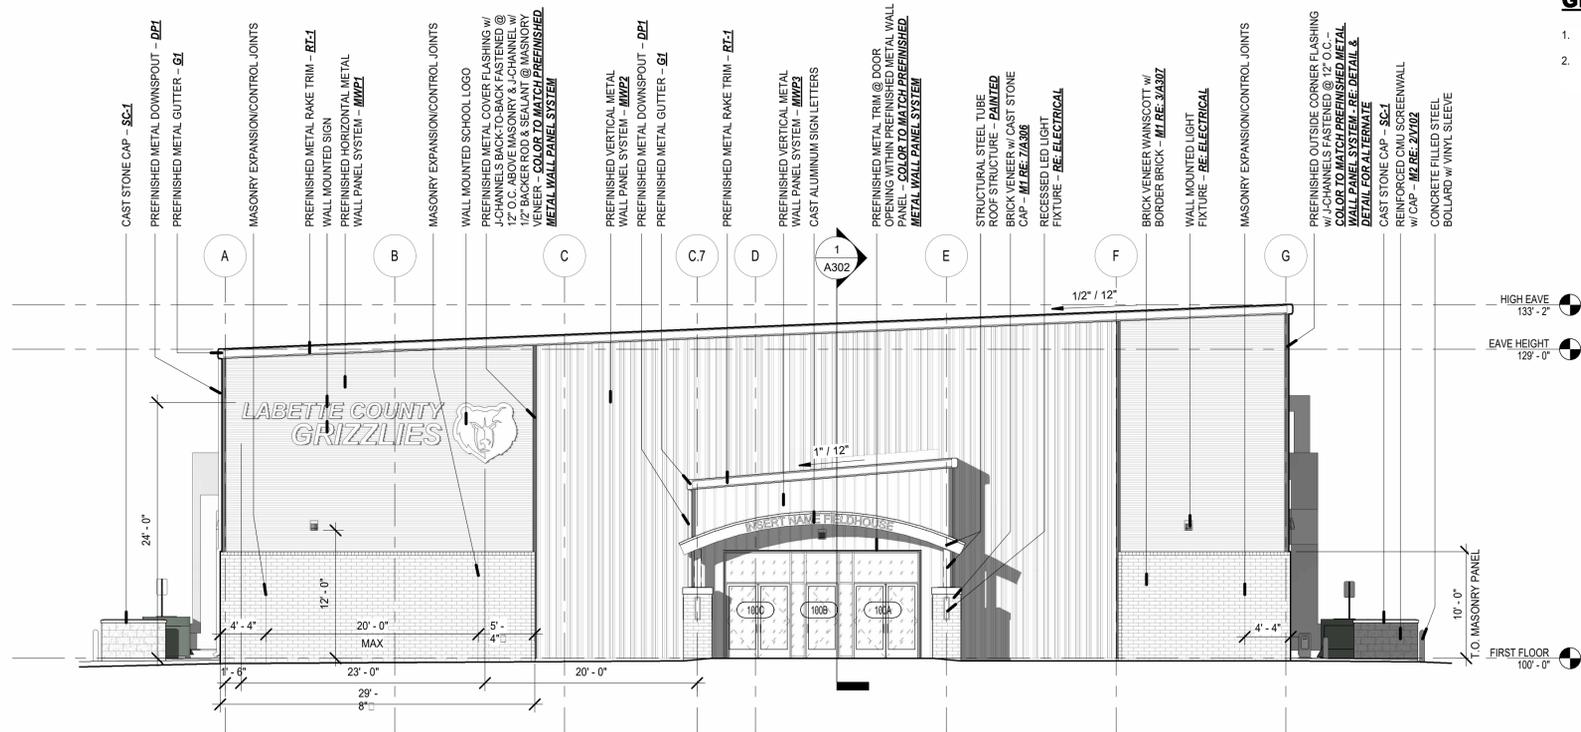

**1 EAST EXTERIOR ELEVATION**

1/8" = 1'-0"

**GENERAL PLAN NOTES:**

1. REFER TO SHEET A503 FOR WINDOW TYPES/SIZES & LOCATIONS.
2. EXTERIOR DOORS OTHER THAN MAIN ENTRY SHOWN AS ALUMINUM STOREFRONT - RE: A502 FOR H.M. FRAME & INSULATED METAL DOORS ALT. BID NOTE

**EXTERIOR ELEVATIONS FINISH SCHEDULE:**

**PREFINISHED METAL WALL PANELS**

- MWP1 - PAC-CLAD PRECISION SERIES BOX RIB BOX RIB 1, COLOR SANDSTONE
- MWP2 - PAC-CLAD PRECISION SERIES BOX RIB BOX RIB 4, COLOR SANDSTONE
- MWP3 - PAC-CLAD REVEAL WALL PANELS, COLOR GRAPHITE

G1 - GUTTERS PAC-CLAD CARDINAL RED

DP1 - DOWNSPOUT, PAC-CLAD CARDINAL RED


RT-1 - RAKE TRIM, PAC-CLAD CARDINAL RED

**MASONRY**

- M1 - BRICK MASONRY: KANSAS BRICK & TILE, UTILITY BRICK, #530 DARK BURGANDY
- M2 - CMU; CAPITOL CONCRETE, GROUND FACED CMU SHADOW

SF-1 - ALUMINUM STOREFRONT, EQUAL TO KAWNEER, CHAMPAGNE OR PLATINUM ICE

SC-1 - CAST STONE CAP - COLOR, LIMESTONE

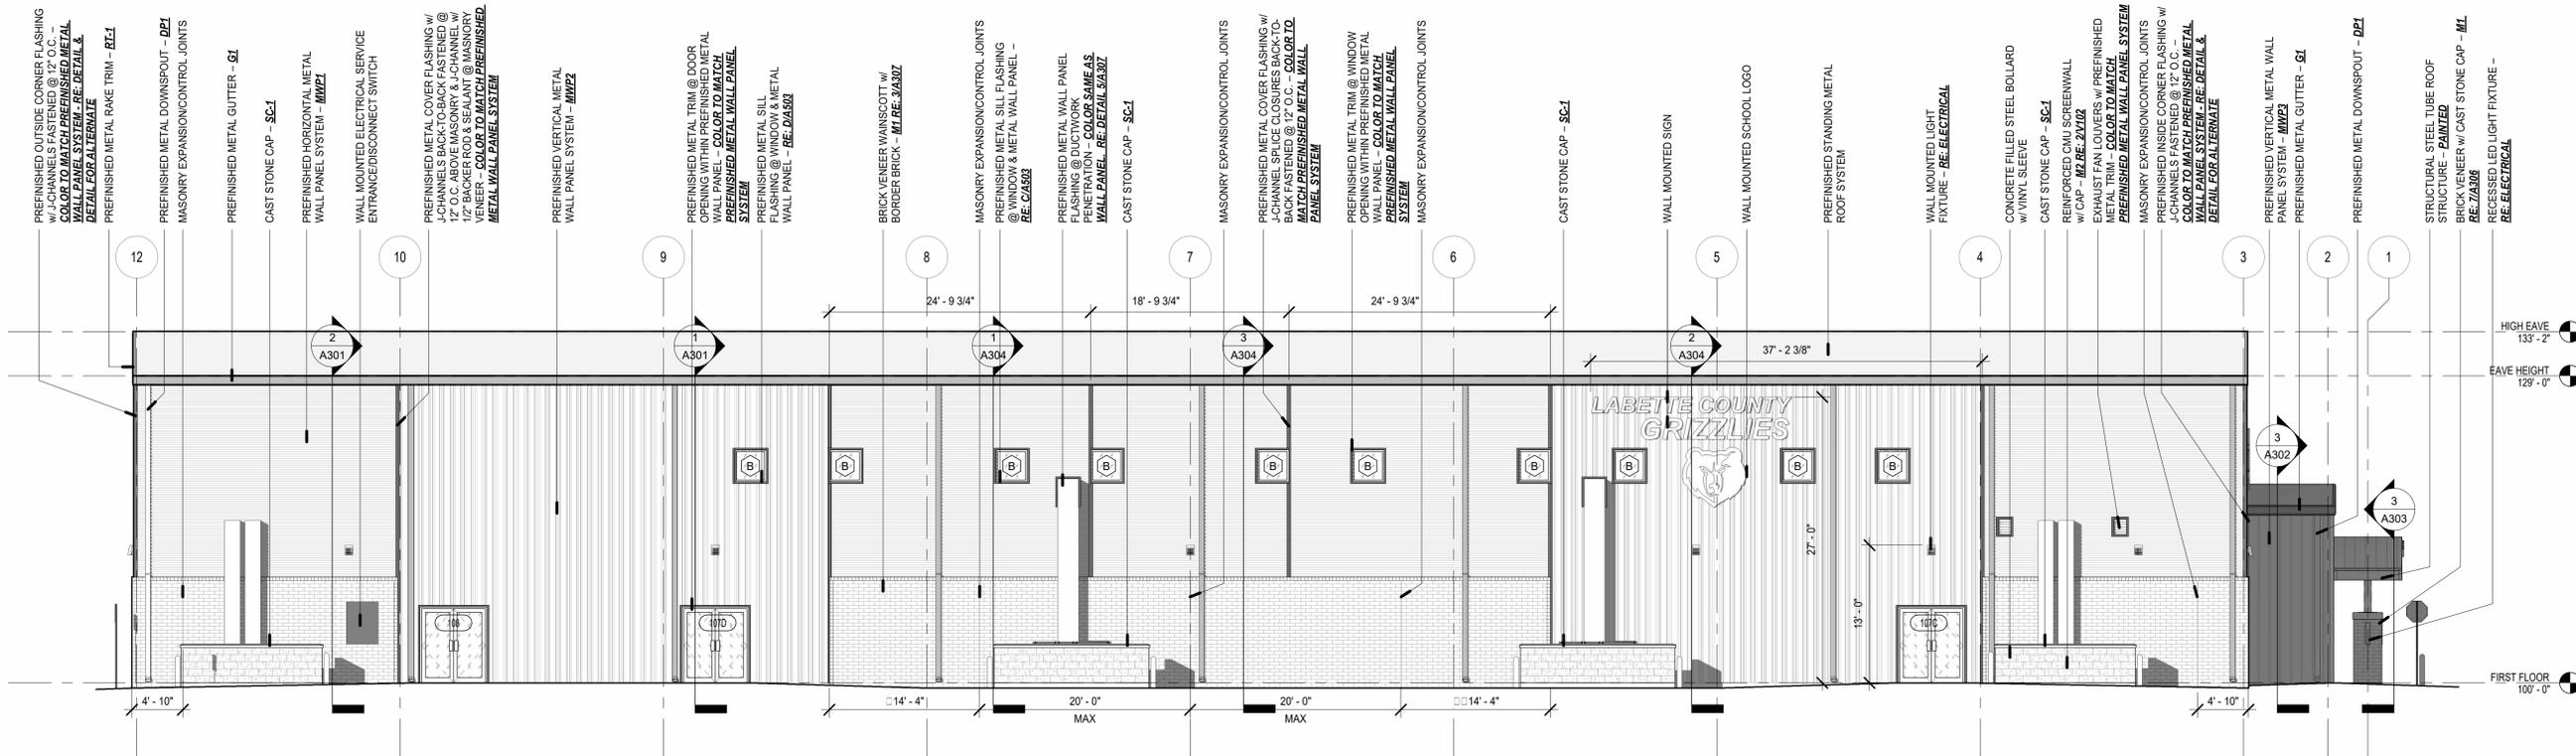

**2 SOUTH EXTERIOR ELEVATION**

1/8" = 1'-0"



107 1/2 N. PENNSYLVANIA AVE.  
SUITE 2F  
INDEPENDENCE, KANSAS 67301

620-331-6171  
www.EchelonAD.com

CERTIFIED BY



NEW CONSTRUCTION  
**A NEW GYM FOR USD506**  
601 HIGH SCHOOL AVE., ALTAMONT, KS 67330


DRAWING

**EXTERIOR ELEVATIONS**

MANAGER: SAC  
DRAWN BY: KG  
REVISIONS:

PROJECT NUMBER: 23-09  
DATE: 8/14/2023  
SHEET NUMBER:


**A201**

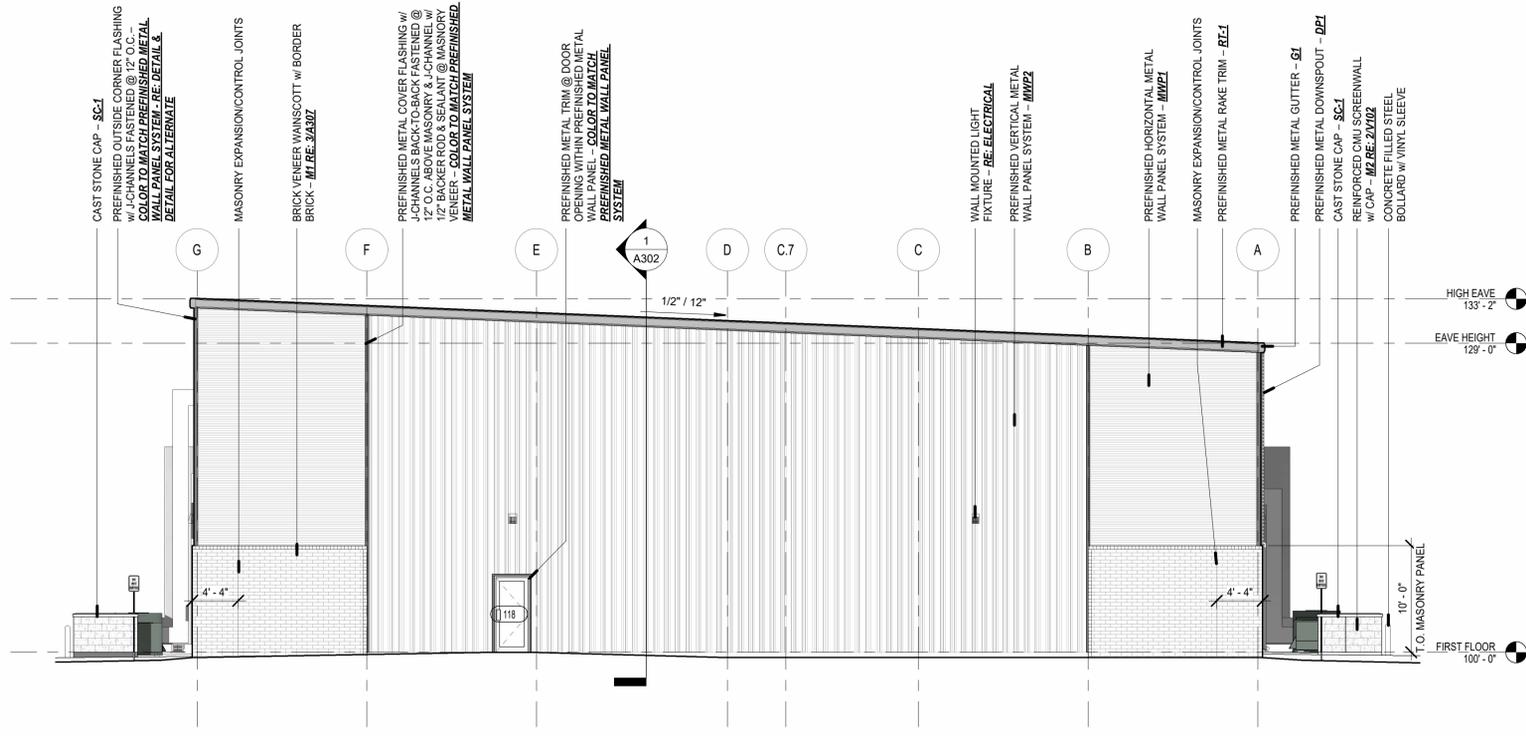

**1 WEST EXTERIOR ELEVATION**  
1/8" = 1'-0"

- GENERAL PLAN NOTES:**
- REFER TO SHEET A503 FOR WINDOW TYPES/SIZES & LOCATIONS.
  - EXTERIOR DOORS OTHER THAN MAIN ENTRY SHOWN SHOWN AS ALUMINUM STOREFRONT - RE: A502 FOR H.M. FRAME & INSULATED METAL DOORS ALT. BID NOTE

- EXTERIOR ELEVATIONS FINISH SCHEDULE:**
- PREFINISHED METAL WALL PANELS**  
**MWP1** - PAC-CLAD PRECISION SERIES BOX RIB BOX RIB 1, COLOR SANDSTONE  
**MWP2** - PAC-CLAD PRECISION SERIES BOX RIB BOX RIB 4, COLOR SANDSTONE  
**MWP3** - PAC-CLAD REVEAL WALL PANELS, COLOR GRAPHITE
- G1** - GUTTERS PAC-CLAD CARDINAL RED  
**DP1** - DOWNSPOUT, PAC-CLAD CARDINAL RED  
**RT-1** - RAKE TRIM, PAC-CLAD CARDINAL RED
- MASONRY**  
**M1** - BRICK MASONRY: KANSAS BRICK & TILE, UTILITY BRICK, #530 DARK BURGANDY  
**M2** - CMU; CAPITOL CONCRETE, GROUND FACED CMU SHADOW
- SF-1** - ALUMINUM STOREFRONT, EQUAL TO KAWNEER, CHAMPAGNE OR PLATINUM ICE  
**SC-1** - CAST STONE CAP - COLOR, LIMESTONE

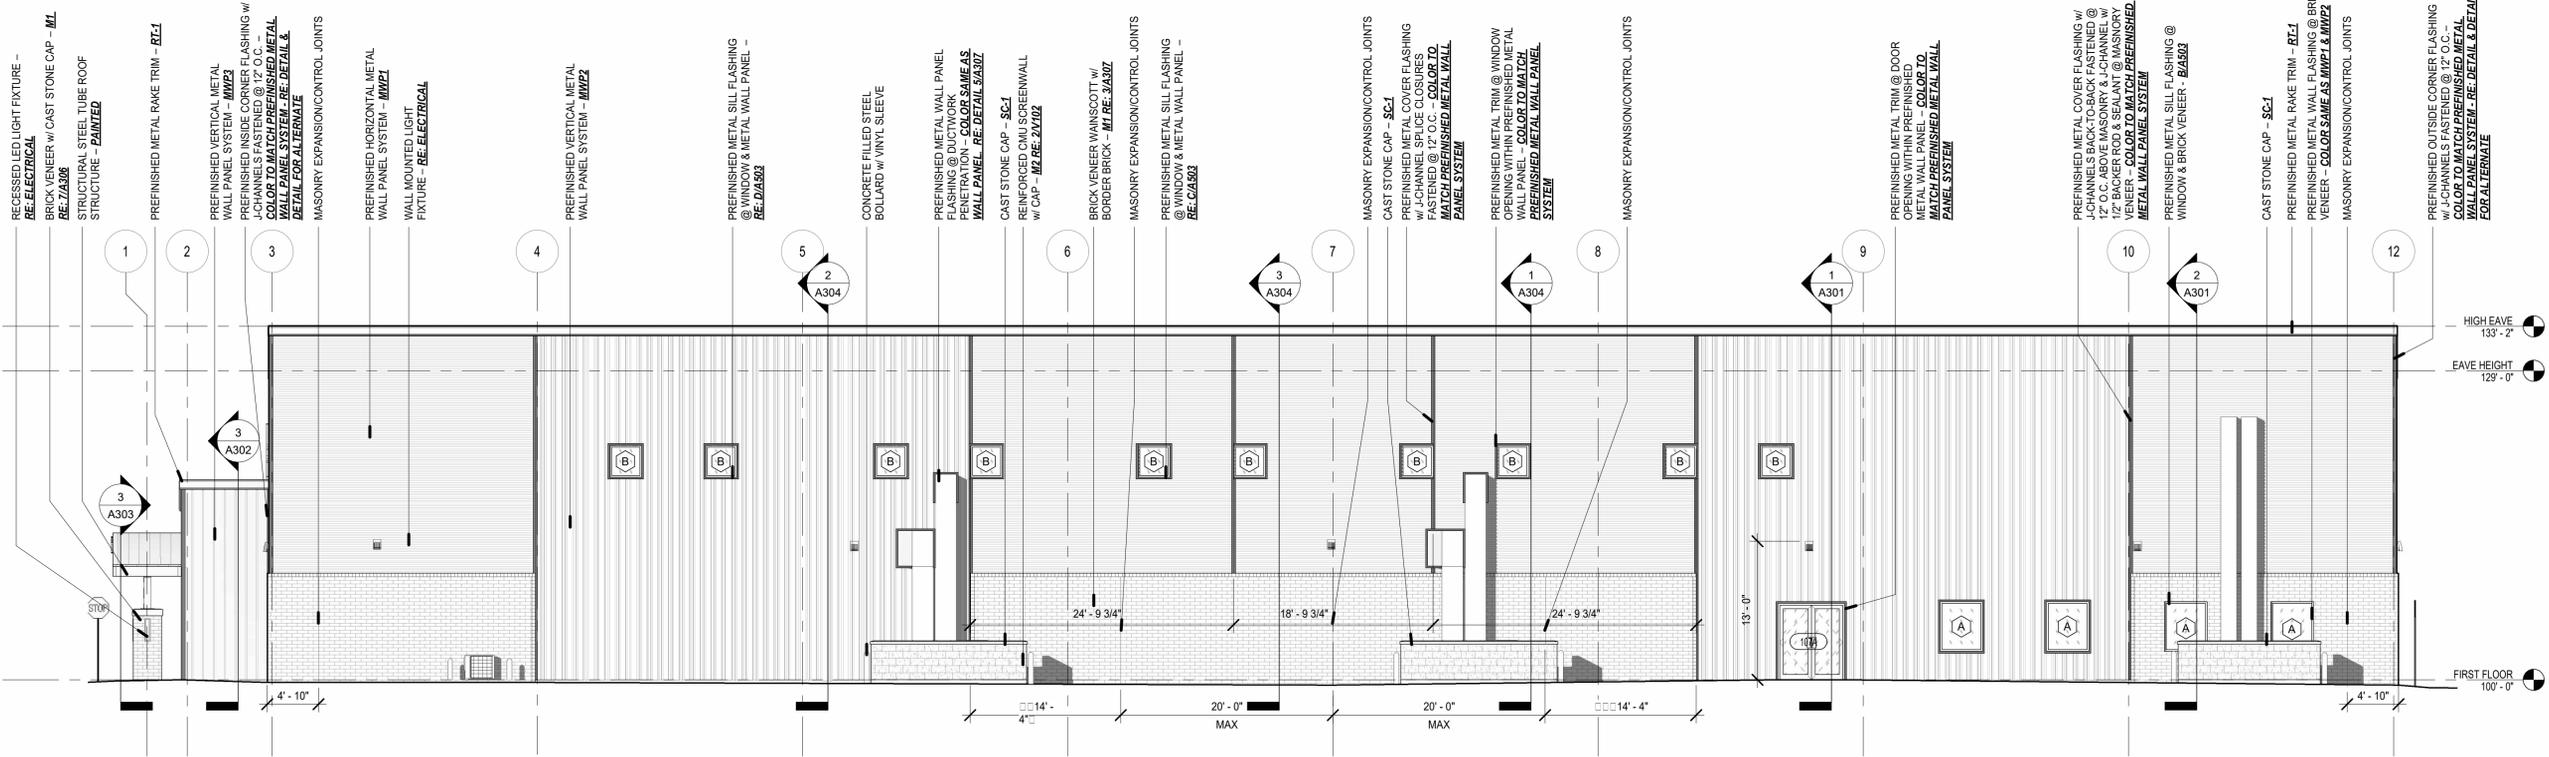

**2 NORTH EXTERIOR ELEVATION**  
1/8" = 1'-0"



NEW CONSTRUCTION

**A NEW GYM FOR USD506**

601 HIGH SCHOOL AVE., ALTAMONT, KS 67330


DRAWING

**EXTERIOR ELEVATIONS**


MANAGER: SAC  
 DRAWN BY: KG  
 REVISIONS:

PROJECT NUMBER: 23-09  
 DATE: 8/14/2023  
 SHEET NUMBER:

**A202**

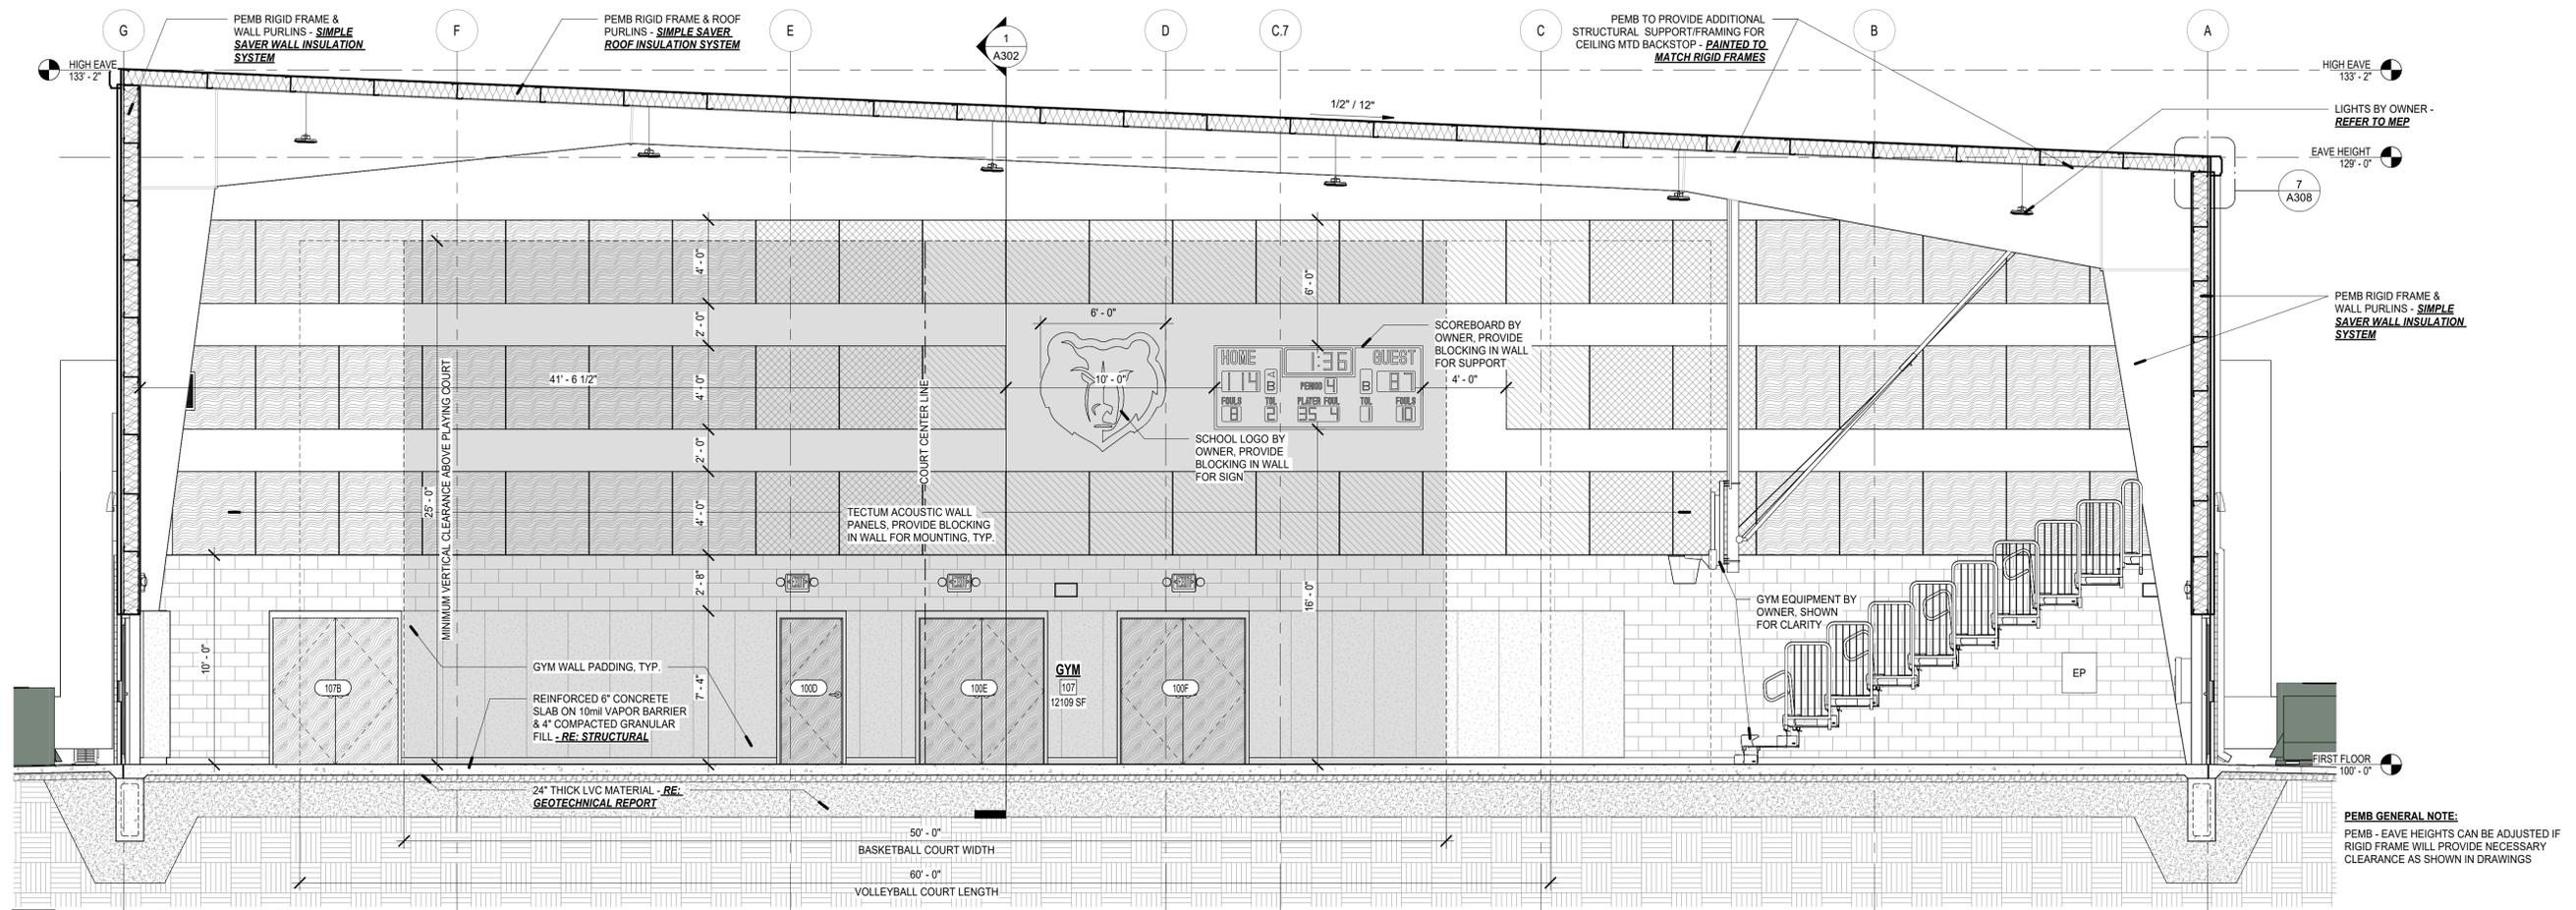

**1 N/S SECTION @ GYM**  
1/4" = 1'-0"

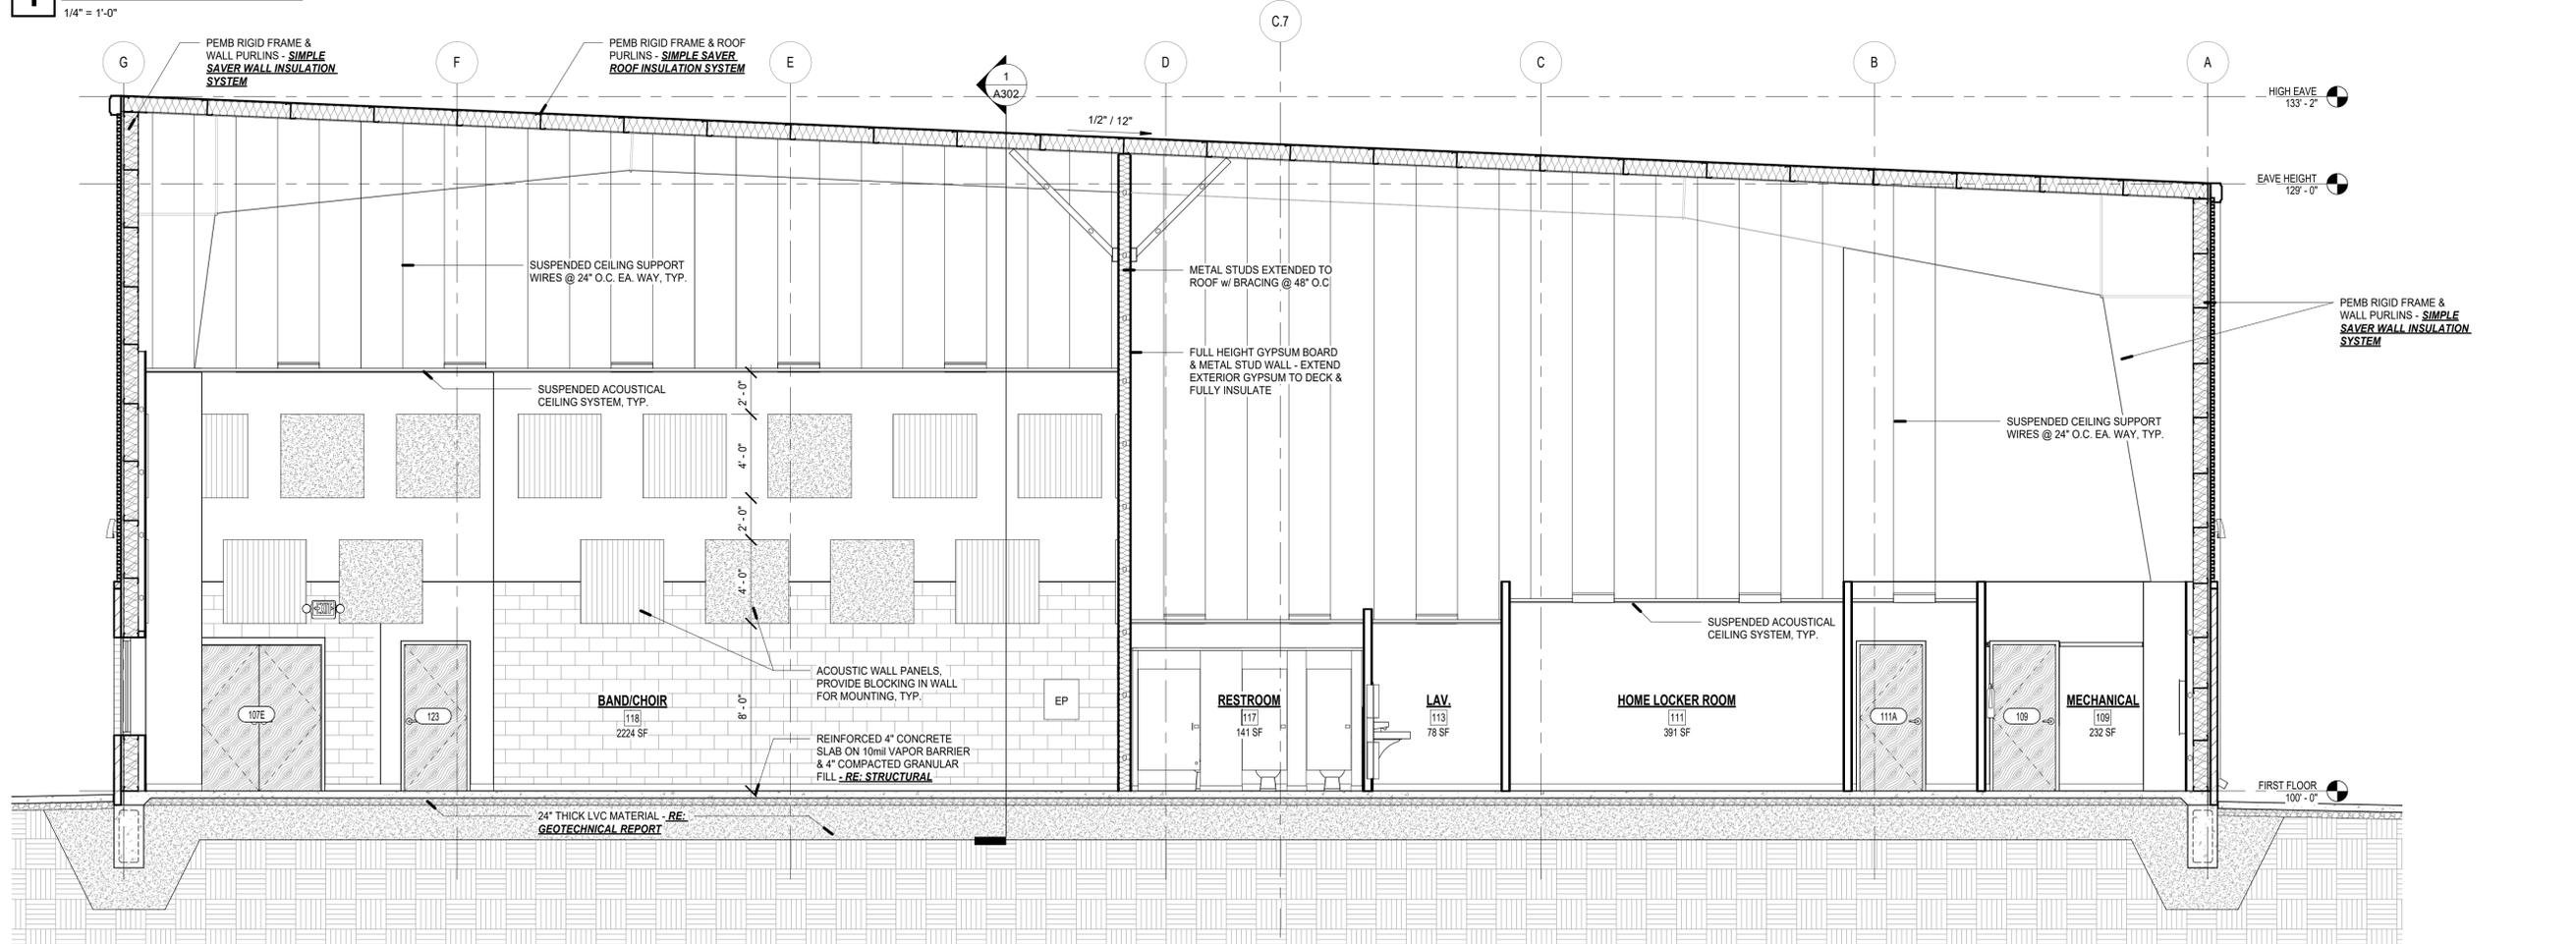

**2 N/S SECTION @ LOCKER ROOM**  
1/4" = 1'-0"



**BUILDING SECTIONS**

MANAGER	DRAWN BY
SAC	KG
REVISIONS	

PROJECT NUMBER	23-09
DATE	8/14/2023
SHEET NUMBER	



CERTIFIED BY



NEW CONSTRUCTION

**A NEW GYM FOR USD506**  
601 HIGH SCHOOL AVE., ALTAMONT, KS 67330


DRAWING

**BUILDING SECTIONS**


MANAGER	DRAWN BY
SAC	KG
REVISIONS	

PROJECT NUMBER	23-09
DATE	8/14/2023
SHEET NUMBER	


**A302**

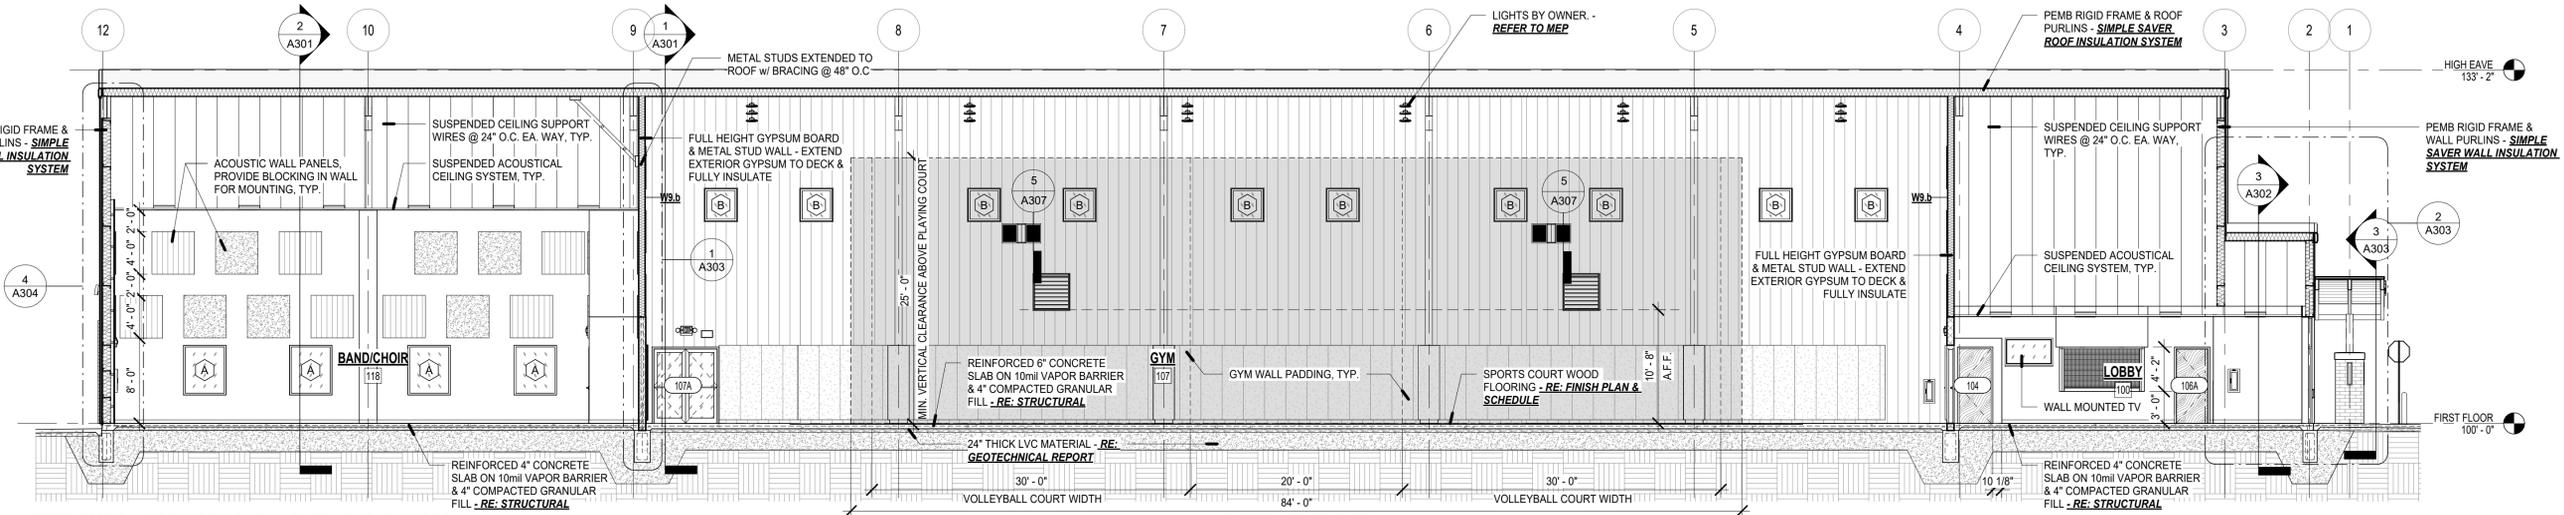

**1 W/E SECTION @ GYM & LOBBY**  
1/8" = 1'-0"

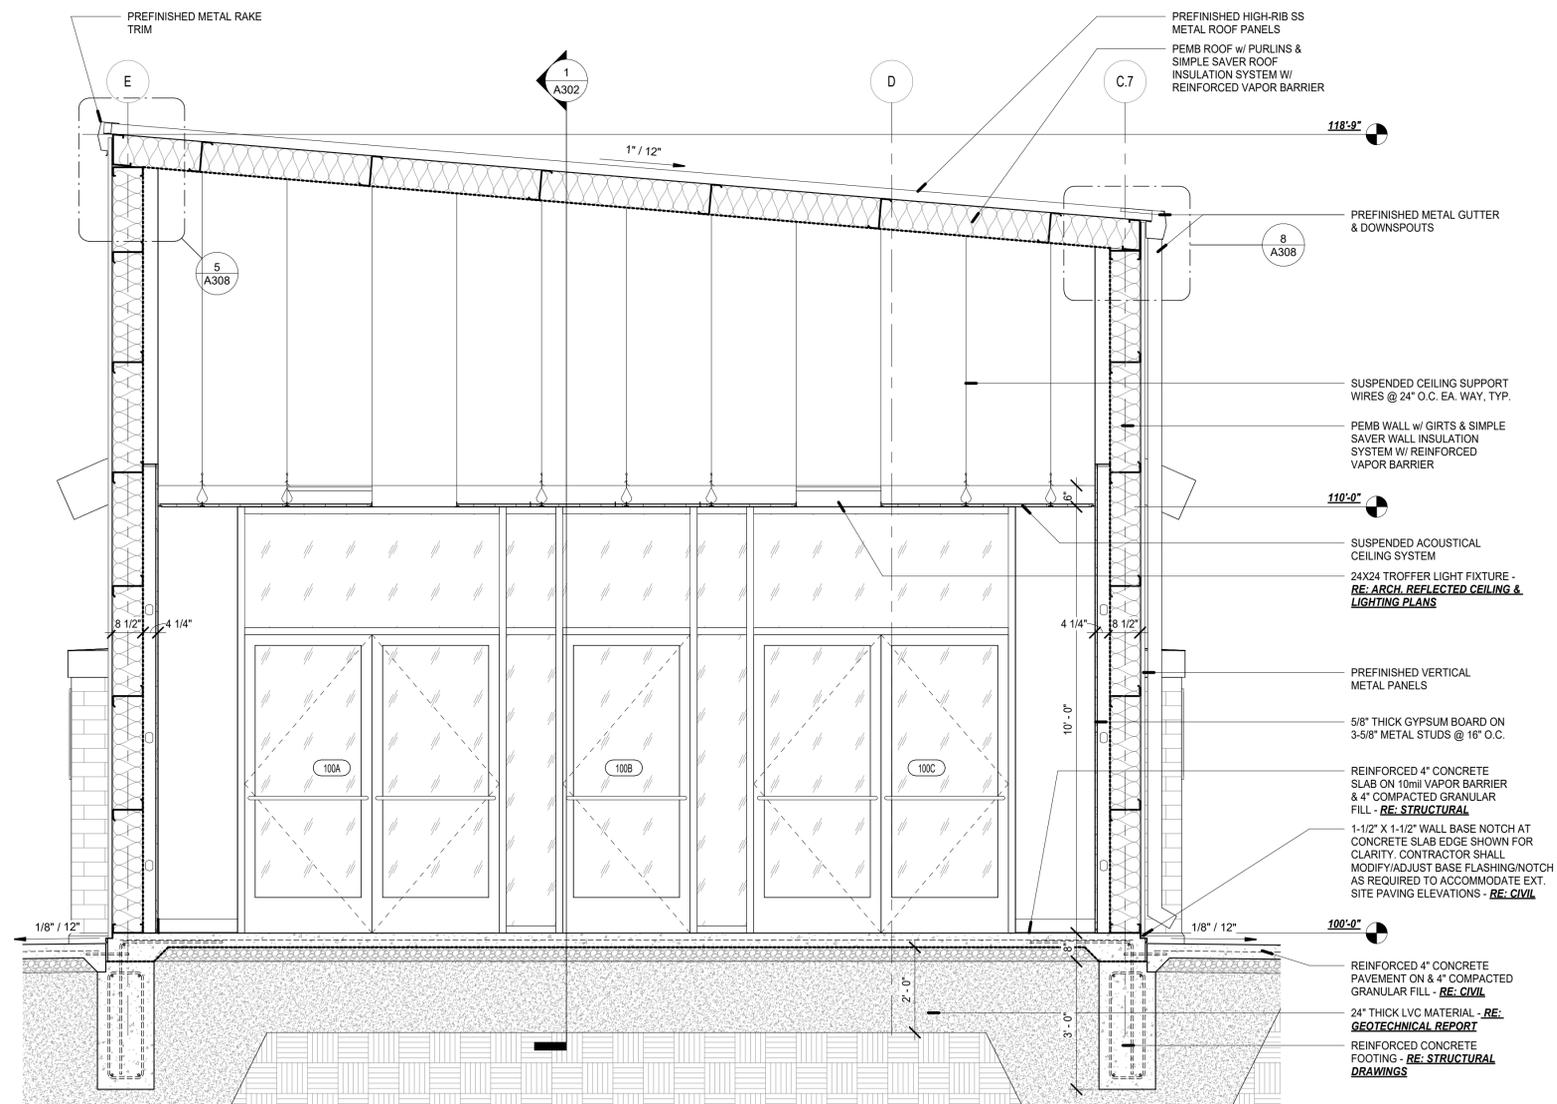


**3 N/S SECTION @ ENTRY**  
1/2" = 1'-0"

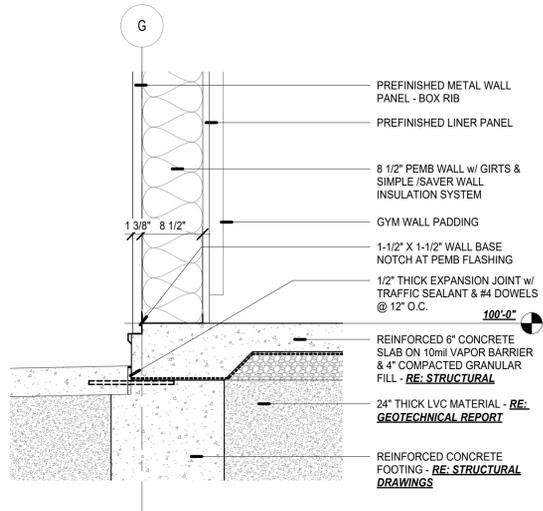


**1 BASE OF EXTERIOR WALL DETAIL @ GYM - METAL**

1" = 1'-0"

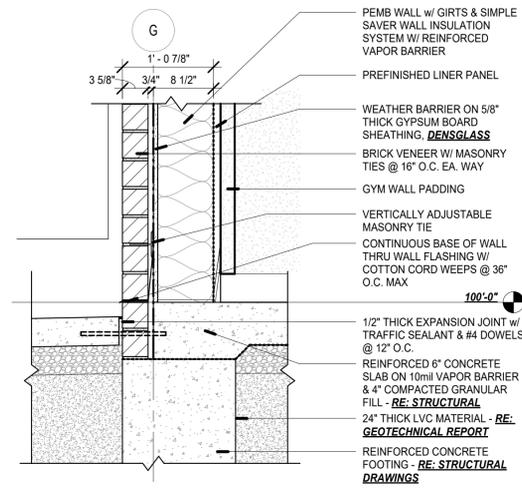


**2 BASE OF WALL DETAIL @ GYM - BRICK**

1" = 1'-0"

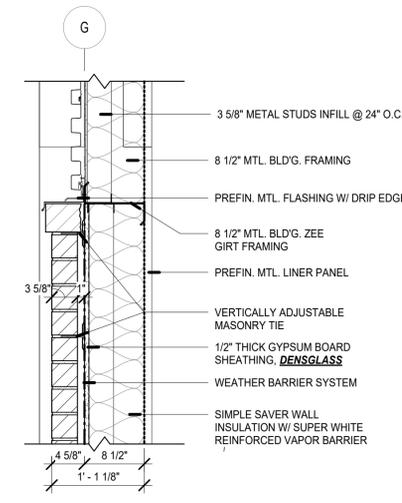


**3 BRICK/METAL DETAIL @ GYM**

1" = 1'-0"

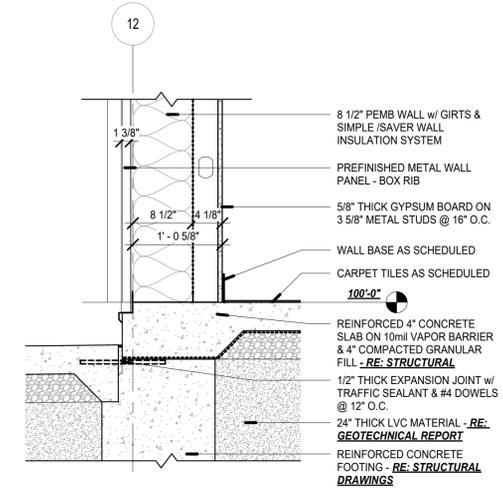

**4 BASE OF WALL @ BAND ROOM**

1" = 1'-0"

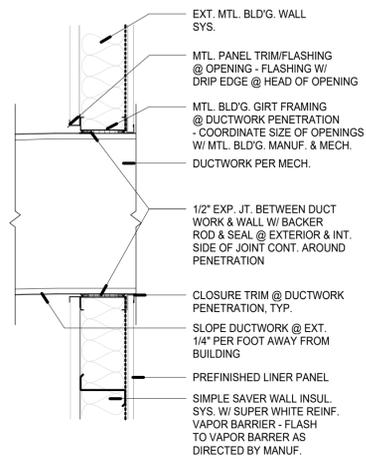

**5 DUCTWORK FLASHING DETAIL**

3/4" = 1'-0"



NEW CONSTRUCTION  
**A NEW GYM FOR USD506**  
601 HIGH SCHOOL AVE., ALTAMONT, KS 67330

DRAWING  
**WALL DETAILS**


MANAGER: SAC | DRAWN BY: KG  
REVISIONS:

PROJECT NUMBER: 23-09  
DATE: 8/14/2023  
SHEET NUMBER:

**A307**


**ELEVATION GENERAL NOTES:**

1. REFER TO SHEET A503 FOR WINDOW TYPE, SIZE, AND LOCATION

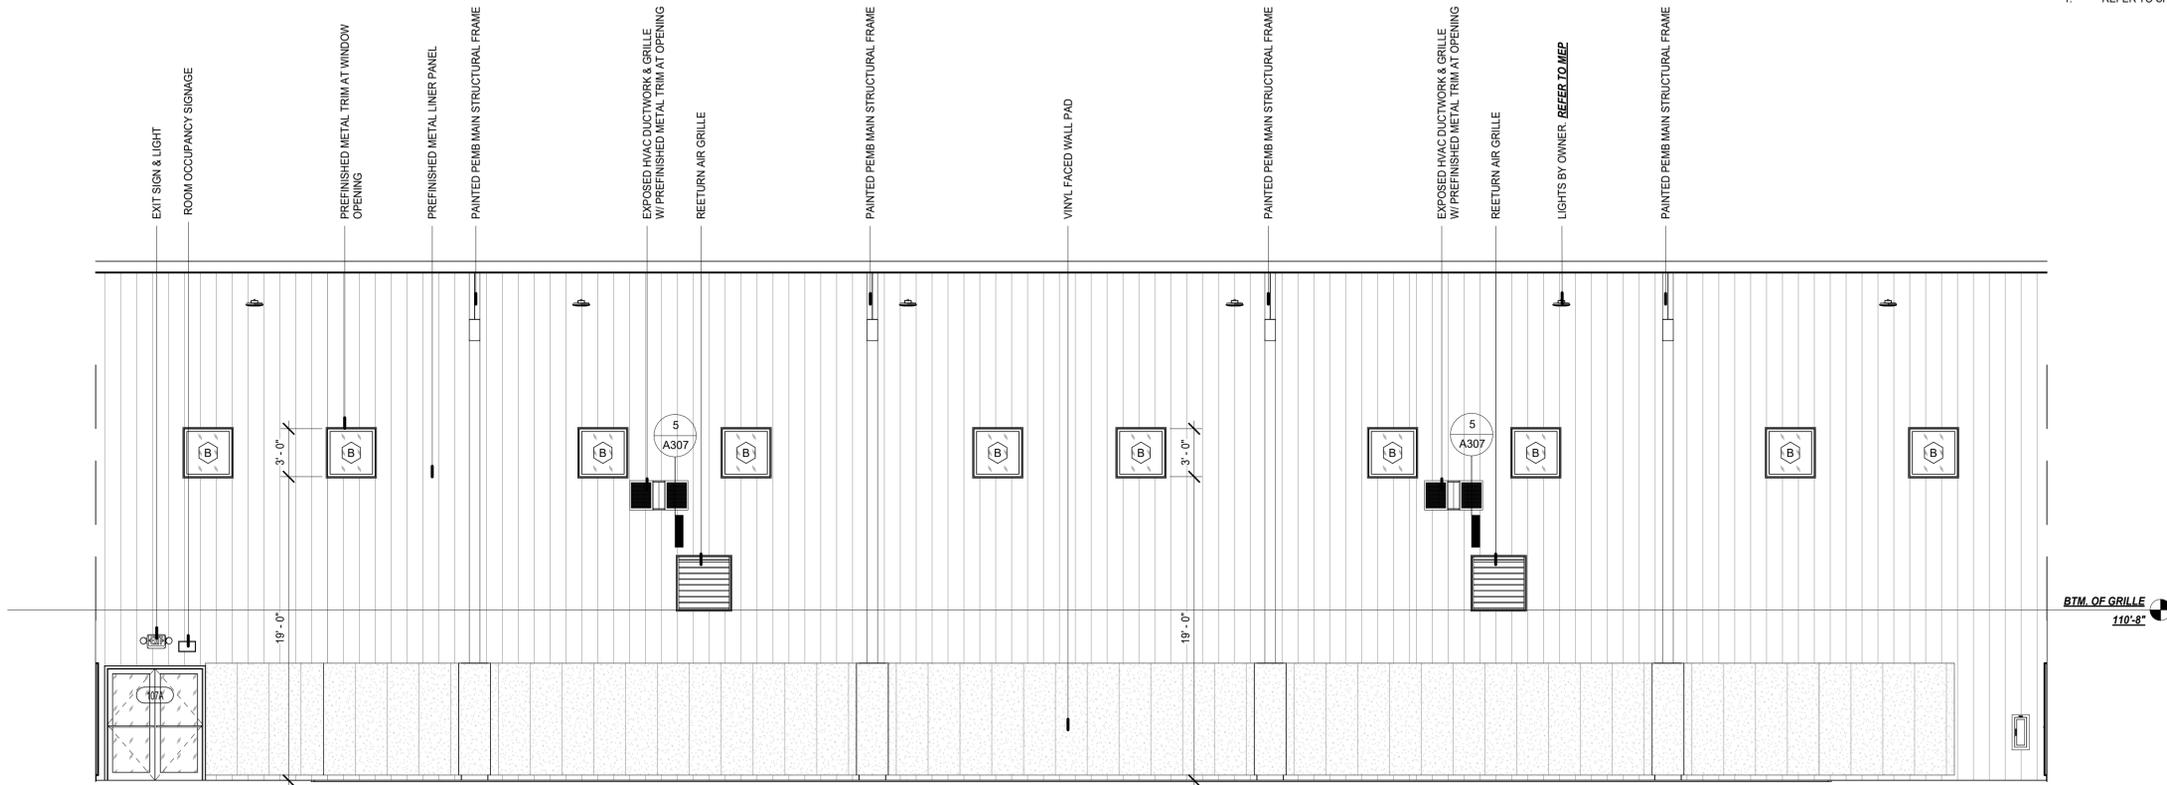

**1 GYM NORTH ELEVATION**

3/16" = 1'-0"

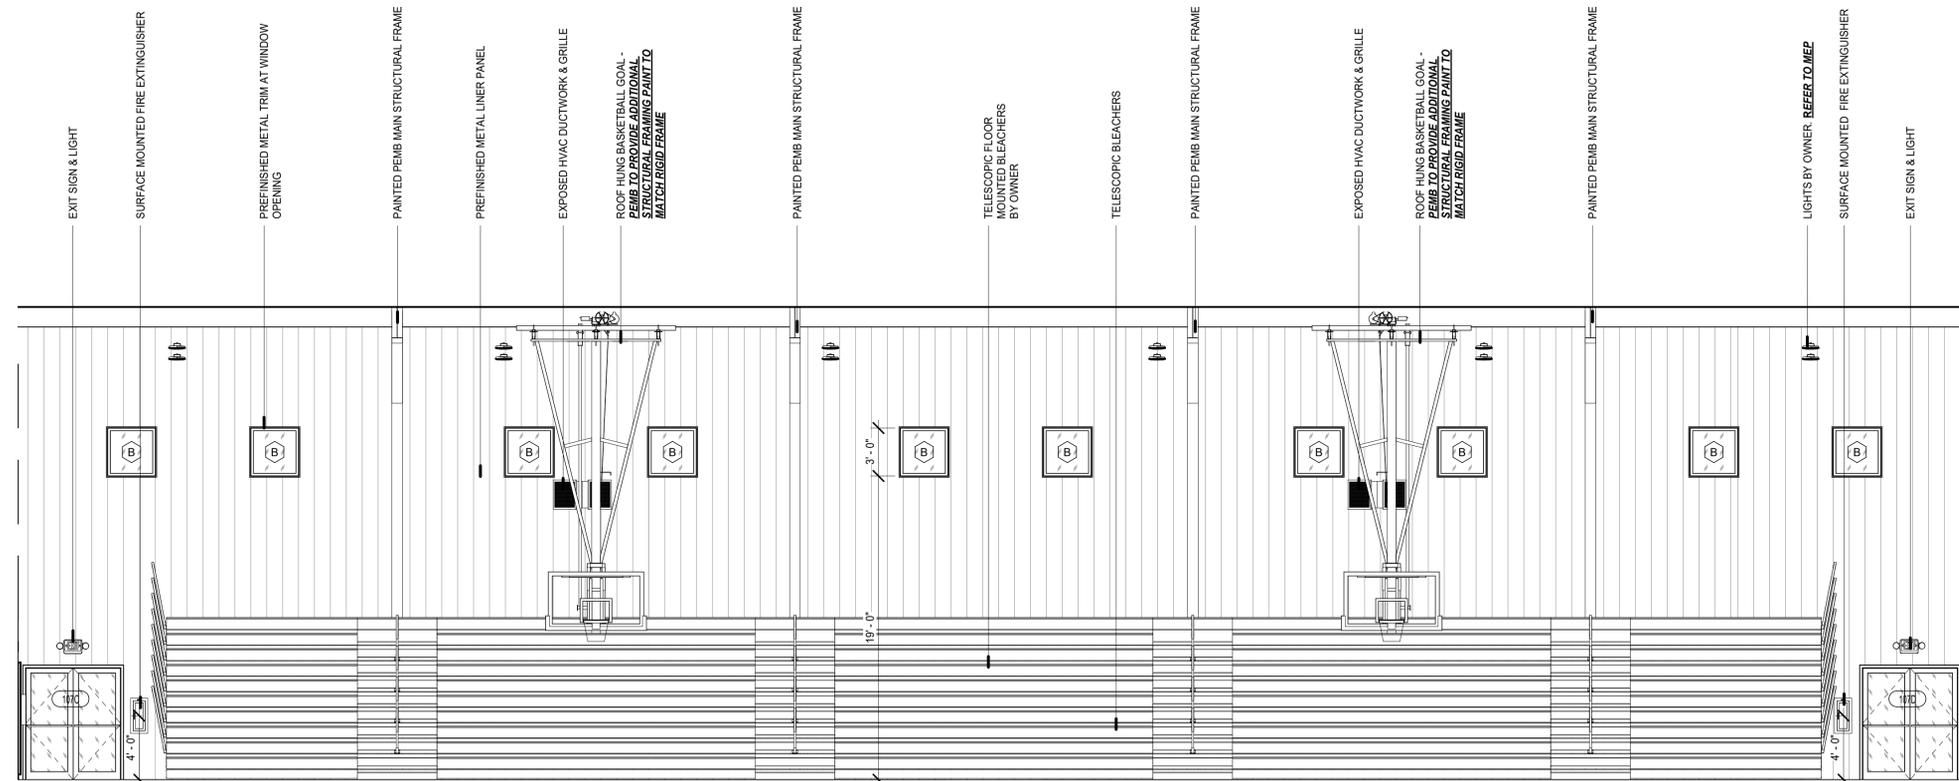

**2 GYM SOUTH ELEVATION**

3/16" = 1'-0"



107 1/2 N. PENNSYLVANIA AVE.  
SUITE 2F  
INDEPENDENCE, KANSAS 67301

620-331-6171  
www.EchelonAD.com

CERTIFIED BY



NEW CONSTRUCTION  
**A NEW GYM FOR USD506**  
601 HIGH SCHOOL AVE., ALTAMONT, KS 67330

DRAWING

**GYM ELEVATIONS**

MANAGER	DRAWN BY
SAC	KG
REVISIONS	

PROJECT NUMBER  
23-09


DATE  
8/14/2023

SHEET NUMBER


**A405**






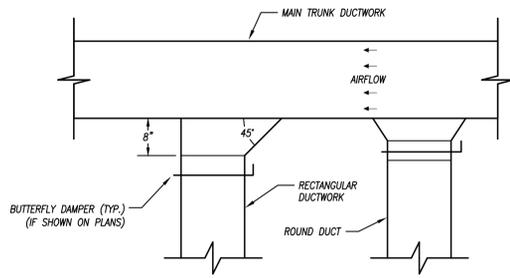


**DUCTWORK TAKEOFF**  
NOT TO SCALE

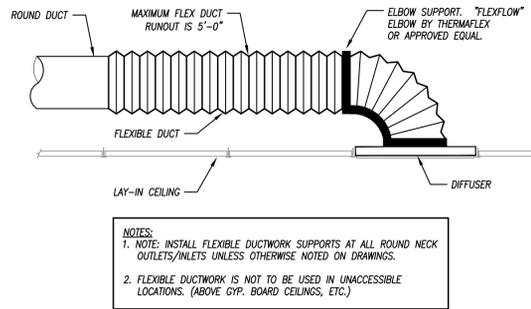

**FLEXIBLE DUCT CONNECTION TO DIFFUSER**  
NOT TO SCALE

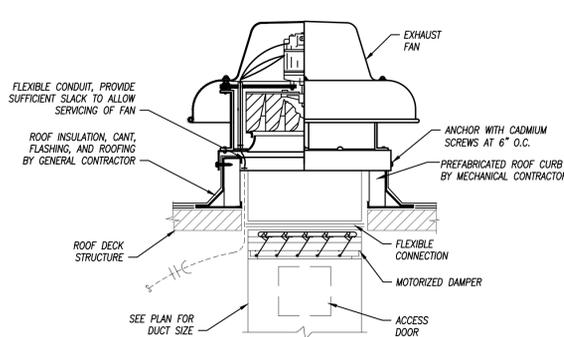

**EXHAUST FAN DETAIL**  
NOT TO SCALE

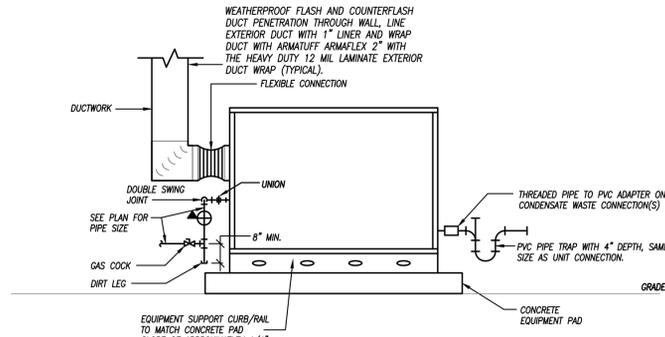

**GROUND MOUNTED RTU DETAIL**  
NOT TO SCALE

**DUCTWORK INSULATION SCHEDULE**

PURPOSE	DUTY	DUCT	LOCATION	STYLE	MATERIAL	INSULATION APPLICATION	THICKNESS	NOTES
SUPPLY	LOW PRESSURE/VELOCITY		CONCEALED	RECTANGULAR	FIBERGLASS	LINED	1/2"	----
			CONCEALED	ROUND	MINERAL FIBER	WRAPPED	1-1/2"	----
			EXPOSED	RECTANGULAR	FIBERGLASS	LINED	1/2"	----
			EXPOSED	ROUND	FIBERGLASS	LINED	1/2"	----
			UNCONDITIONED ATTICS	ALL	MINERAL FIBER	WRAPPED	1-1/2"	1
			EXTERIOR	ALL	FLEXIBLE ELASTOMERIC	WRAPPED	2"	----
RETURN	LOW PRESSURE/VELOCITY		CONCEALED	RECTANGULAR	FIBERGLASS	LINED	1-1/2"	----
			CONCEALED	ROUND	MINERAL FIBER	WRAPPED	1-1/2"	----
			EXPOSED	RECTANGULAR	FIBERGLASS	LINED	1/2"	----
			EXPOSED	ROUND	FIBERGLASS	LINED	1/2"	----
			RETURN/TRANSFER BOOTS	RECTANGULAR	FIBERGLASS	LINED	1/2"	----
			UNCONDITIONED ATTICS	ALL	MINERAL FIBER	WRAPPED	1-1/2"	1
EXHAUST	LOW PRESSURE/VELOCITY		CONCEALED	RECTANGULAR	FIBERGLASS	LINED	1/2"	----
			CONCEALED	ROUND	FIBERGLASS	LINED	1/2"	2
			EXPOSED	RECTANGULAR	FIBERGLASS	LINED	1/2"	----
			EXPOSED	ROUND	FIBERGLASS	LINED	1/2"	2

**NOTES:**  
 1. IN ADDITION TO OTHER SCHEDULED INSULATION.  
 2. PROVIDE LINER ONLY WITHIN 10" OF FAN FOR ACOUSTICS.  
**GENERAL REMARKS (APPLICABLE TO ALL TYPES):**  
 1) ALL DUCTWORK, INSULATION AND MATERIALS IN PLENUMS MUST MEET ASTM E84 FLAME/SMOKE RATING OF 25/50.  
 2) ALL INSULATION THICKNESSES SHALL MEET ASHRAE 90.1 - 2010 REQUIREMENTS AT A MINIMUM.  
 3) REFER TO SPECIFICATIONS FOR MORE DETAILED INFORMATION FOR INSULATION PRODUCTS AND SYSTEMS.

**OWNER WILL PURCHASE THIS EQUIPMENT, CONTRACTOR TO RECEIVE AND INSTALL EQUIPMENT**

**ROOF TOP UNIT SCHEDULE - THREE PHASE ELECTRIC WITH GAS HEAT**

PLAN MARK	MANUFACTURER	MODEL NUMBER	SIZE	REFRIGERANT	MINIMUM EFFICIENCY	AIRFLOW	COMPRESSORS	COOLING CAPACITY	CFM	EXTERNAL STATIC	OA CFM	HEATING CAPACITY	ELECTRICAL	WEIGHT	FILTER	NOTES
RTU-1	LUXAIRE	ZJ-090 N1882B	7.5 TON	R-410A	13 IEER	HORIZONTAL	(2) SCROLLS	88,000 BTUH	2,500	0.7"	300	120 MBH	208 V, 3 PH, 60 AMP	1100 LBS	MERV 13	1,2,3,4
RTU-2	LUXAIRE	ZJ-120 N1882B	10 TON	R-410A	12.8 IEER	HORIZONTAL	(2) SCROLLS	124,000 BTUH	3,400	0.7"	350	180 MBH	208 V, 3 PH, 60 AMP	1200 LBS	MERV 13	1,2,3,4
RTU-3	LUXAIRE	ZJ-120 N1882B	10 TON	R-410A	12.8 IEER	HORIZONTAL	(2) SCROLLS	124,000 BTUH	3,400	0.7"	350	180 MBH	208 V, 3 PH, 60 AMP	1200 LBS	MERV 13	1,2,3,4
RTU-4	LUXAIRE	ZJ-120 N1882B	10 TON	R-410A	12.8 IEER	HORIZONTAL	(2) SCROLLS	124,000 BTUH	3,400	0.7"	350	180 MBH	208 V, 3 PH, 60 AMP	1200 LBS	MERV 13	1,2,3,4
RTU-5	LUXAIRE	ZJ-120 N1882B	10 TON	R-410A	12.8 IEER	HORIZONTAL	(2) SCROLLS	124,000 BTUH	3,400	0.7"	350	180 MBH	208 V, 3 PH, 60 AMP	1200 LBS	MERV 13	1,2,3,4
RTU-6	LUXAIRE	ZJ-061 N0882B	5 TON	R-410A	14.5 SEER	HORIZONTAL	(2) SCROLLS	59,000 BTUH	2,000	0.7"	200	80 MBH	208 V, 3 PH, 45 AMP	800 LBS	MERV 13	1,2,3,4
RTU-7	LUXAIRE	ZJ-061 N0882B	5 TON	R-410A	14.5 SEER	HORIZONTAL	(2) SCROLLS	59,000 BTUH	2,000	0.7"	200	80 MBH	208 V, 3 PH, 45 AMP	800 LBS	MERV 13	1,2,3,4

**NOTES LEGEND**  
 1. PROVIDE CONCRETE PAD, DISCONNECT SWITCH, HAIL GUARDS, HOT GAS HUMIDITY CONTROL, AND ECONOMIZER.  
 2. PROVIDE WALL MOUNTED 7-DAY PROGRAMMABLE THERMOSTAT.  
 3. PROVIDE INTERNAL VIBRATION ISOLATION FOR THE RTU FAN AND COMPRESSORS.  
 4. PROVIDE EQUIPMENT SUPPORT CURB/RAIL TO MATCH CONCRETE PAD SLOPE OF APPROXIMATELY 1/4" PER FOOT SLOPE.

**OWNER WILL PURCHASE THIS EQUIPMENT, CONTRACTOR TO RECEIVE AND INSTALL EQUIPMENT**

**MINI-SPLIT DUCTLESS HEAT PUMP SCHEDULE**

PLAN MARK	MANUFACTURER	MODEL NUMBER	NOMINAL SIZE	COOLING MBH	HEATING MBH (47° AMBIENT)	HEATING MBH (5° AMBIENT)	ELECTRICAL	MOCF AMPS	MIN CIRCUIT AMPS	DISCONNECT	NOTES
MSPH-1	DAIKIN	NTXMPH20A122B	1.5 TON	19.0	22.0	22.0	208/240V, 1#	40	29.5	YES	1,2

**NOTES LEGEND**  
 1. PROVIDE WITH CONDENSATE PUMP.  
 2. VERIFY EXACT REFRIGERANT LINE SIZES WITH MANUFACTURER.

**OWNER WILL PURCHASE THIS EQUIPMENT, CONTRACTOR TO RECEIVE AND INSTALL EQUIPMENT**

**MINI-SPLIT DUCTLESS EVAPORATOR SCHEDULE**

PLAN MARK	MANUFACTURER	MODEL NUMBER	NOMINAL SIZE	MAX CFM CLIGHTG	ENTERING AIR DRYWET	COOLING MBH	HEATING MBH	ELECTRICAL	NOTES
MSEV-1A	MITSUBISHI	NTXWPH09B112A	0.75 TON	360/430	80/67	9.0	9.6	208/240V, 1#	1,2
MSEV-1B	MITSUBISHI	NTXCKS09A112A	0.75 TON	230/230	80/67	9.0	11.0	208/240V, 1#	1,2

**NOTES LEGEND**  
 1. PROVIDE WIRED REMOTE THERMOSTAT, AND CONDENSATE PUMP.  
 2. VERIFY EXACT REFRIGERANT LINE SIZES WITH MANUFACTURER.

**EXHAUST FAN SCHEDULE**


PLAN MARK	MANUFACTURER	MODEL NUMBER	MOUNTING	SERVICE	CFM	STATIC PRESSURE	ELECTRICAL	DRIVE	DISCONNECT	DAMPER	NOTES
EF-1	GREENHECK	SP-B90	CEILING	EXHAUST	75	1/4"	50 WATTS, 120V, 1 PHASE	DIRECT	YES	BACKDRAFT	1
EF-2	GREENHECK	SP-A510	CEILING	EXHAUST	450	1/4"	224 WATTS, 120V, 1 PHASE	DIRECT	YES	BACKDRAFT	3
EF-3	GREENHECK	SP-A700	CEILING	EXHAUST	525	1/4"	350 WATTS, 120V, 1 PHASE	DIRECT	YES	BACKDRAFT	3
EF-4	GREENHECK	SP-A700	CEILING	EXHAUST	500	1/4"	350 WATTS, 120V, 1 PHASE	DIRECT	YES	BACKDRAFT	3
EF-5	GREENHECK	SP-A700	CEILING	EXHAUST	500	1/4"	350 WATTS, 120V, 1 PHASE	DIRECT	YES	BACKDRAFT	3
EF-6	GREENHECK	SP-A250	CEILING	EXHAUST	225	1/4"	83 WATTS, 120V, 1 PHASE	DIRECT	YES	BACKDRAFT	3
EF-7	GREENHECK	SP-A250	CEILING	EXHAUST	225	1/4"	83 WATTS, 120V, 1 PHASE	DIRECT	YES	BACKDRAFT	4

**NOTES:**  
 1. PROVIDE WITH WALL DISCHARGE MODEL WC-6 WITH BUILT IN BIRDSCREEN AND BACK DRAFT DAMPER.  
 2. PROVIDE WITH WALL DISCHARGE HOODED WALL CAP MODEL WC-8 WITH BUILT IN BIRDSCREEN AND BACK DRAFT DAMPER.  
 3. PROVIDE WITH WALL DISCHARGE HOODED WALL CAP MODEL WC-18X8 WITH BUILT IN BIRDSCREEN AND BACK DRAFT DAMPER.  
 4. SHARE WALL CAP WITH EF-6

**GRILLE, REGISTER & DIFFUSER SCHEDULE**

PLAN MARK	MANUFACTURER	MODEL NUMBER	SERVICE	MOUNT TYPE	VOLUME DAMPER	MATERIAL	MATERIAL COLOR	NOTES
A	PRICE	SMD-3P	SUPPLY	GRID	NO	STEEL	WHITE	2
B	PRICE	520-D	SUPPLY	FLANGE	YES	STEEL	WHITE	
C	NOT USED							
D	PRICE	535-D	RETURN/EXHAUST	GRID	NO	STEEL	WHITE	1
E	TITUS	33RL-HEAVY DUTY	RETURN	FLANGE	NO	STEEL	WHITE	

**NOTES LEGEND**  
 1. PROVIDE WITHOUT SCREW HOLES WHERE USED IN A GRID CEILING.  
 2. PAN TO FIT A 2'X2' GRID.

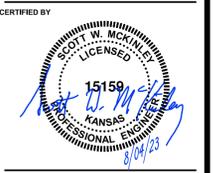

**HVAC  
DETAILS &  
SCHEDULES**

MANAGER	DRAWN BY
SWM	NSG
REVISIONS	

PROJECT NUMBER	23-09
DATE	08/04/2023
SHEET NUMBER	