


ARCHITECTURE

45 Hawthorne Street, Suite 5, Medford, Oregon 97504 | 541-500-8588

MEDFORD SCHOOL DISTRICT 2838 W MAIN STREET MEDFORD, OR 97501

OAK GROVE ES OUTDOOR EATING SPACE

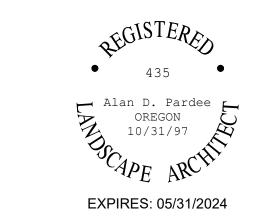


PROJECT NO: M-0347-23 DRAWN: CHECKED: ADP DATE: 03-15-24

SITE KEY PLAN

1"=20'

L0.1

SITE KEY PLAN

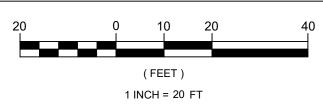



ARCHITECTURE

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OAK GROVE ES OUTDOOR EATING SPACE

GENERAL NOTES

VERIFY LOCATIONS OF ALL BELOW GRADE UTILITIES PRIOR TO BEGINNING WORK. SURVEY DOES NOT INDICATE ALL UTILITY LINES CROSSING THE SITE. CONTRACTOR IS RESPONSIBLE FOR COORDINATING ALL UTILITY LOCATES.

ENGINEERED WOOD FIBER TO BE REMOVED

ASPHALT TO BE REMOVED.

CONCRETE TO BE REMOVED.

- B. STAKE LAYOUT FOR REVIEW BY MEDFORD SCHOOL DISTRICT, PROJECT MANAGER, AND LANDSCAPE ARCHITECT PRIOR TO INSTALLATION.
- C. COORDINATE ALL WORK THIS SHEET WITH SITE PLANS.
- D. CONTRACTOR SHALL DISPOSE OF ALL CONSTRUCTION AND DEMOLITION DEBRIS IN ACCORDANCE WITH LOCAL AND STATE REGULATIONS.

KEY NOTES - DEMOLITION PLAN

- 1) EXISTING ASPHALT TO BE REMOVED.
- 2 EXISTING CONCRETE TO BE REMOVED.
- 3 CLEAR AND GRUB OUT EXISTING LAWN AND ENGINEERED WOOD FIBER IN
- 4 EXISTING IRRIGATION: EXISTING IRRIGATION IMPROVEMENTS WITHIN THE CONSTRUCTION AREA SHALL BE REMOVED AND SPRINKLERS AND VALVES PROVIDED TO MSD. IRRIGATION LINES OUTSIDE OF THE CONSTRUCTION AREA SHALL BE CUT, CAPPED AND MARKED ON THE PROJECT SITE PLAN AND PROVIDED TO MSD AFTER PROJECT COMPLETION. CONTRACTOR IS RESPONSIBLE FOR INSTALLING NEW IRRIGATION AS NEEDED TO PROVIDE FULL SPRINKLER COVERAGE OF THE AFFECTED LANDSCAPE AREA TO REMAIN. ADDITIONALLY, CONTRACTOR IS RESPONSIBLE FOR MAINTAINING THE LANDSCAPE AFFECTED BY PROJECT CONSTRUCTION INCLUDING PROVIDING SUPPLEMENTAL IRRIGATION FOR DURATION OF CONSTRUCTION UNTIL FINAL ACCEPTANCE BY MSD.
- (5) EXISTING LAWN AREA TO REMAIN UNDISTURBED.
- (6) EXISTING CONCRETE TO REMAIN.
- (7) EXISTING ASPHALT TO REMAIN.
- 8 EXISTING PLAY AREA TO REMAIN.
- 9 EXISTING TRANSFORMER AND ASSOCIATED BOLLARDS: PROTECT IN
- (10) EXISTING MANHOLE AND STORM DRAIN. LINE EXTENDS TO THE NORTHEAST. FIELD LOCATE AND CONFIRM.
- (12) EXISTING SHED TO REMAIN.
- PLAYGROUND ELEMENTS IN THIS AREA TO BE REINSTALLED PER MFR'S INSTRUCTIONS IN THEIR CURRENT LOCATIONS AS DIRECTED BY MSD.

1"=10'

(14) EXISTING UTILITY LINES TO REMAIN.




EXPIRES: 05/31/2024

REVISION ID:	DATE:


PROJECT NO:	M-0347-23
DRAWN:	MMW
CHECKED:	ADP
DATE:	03-15-24


DEMOLITION PLAN

L1.0/

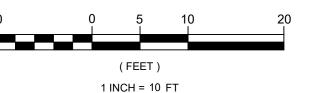

DEMOLITION PLAN

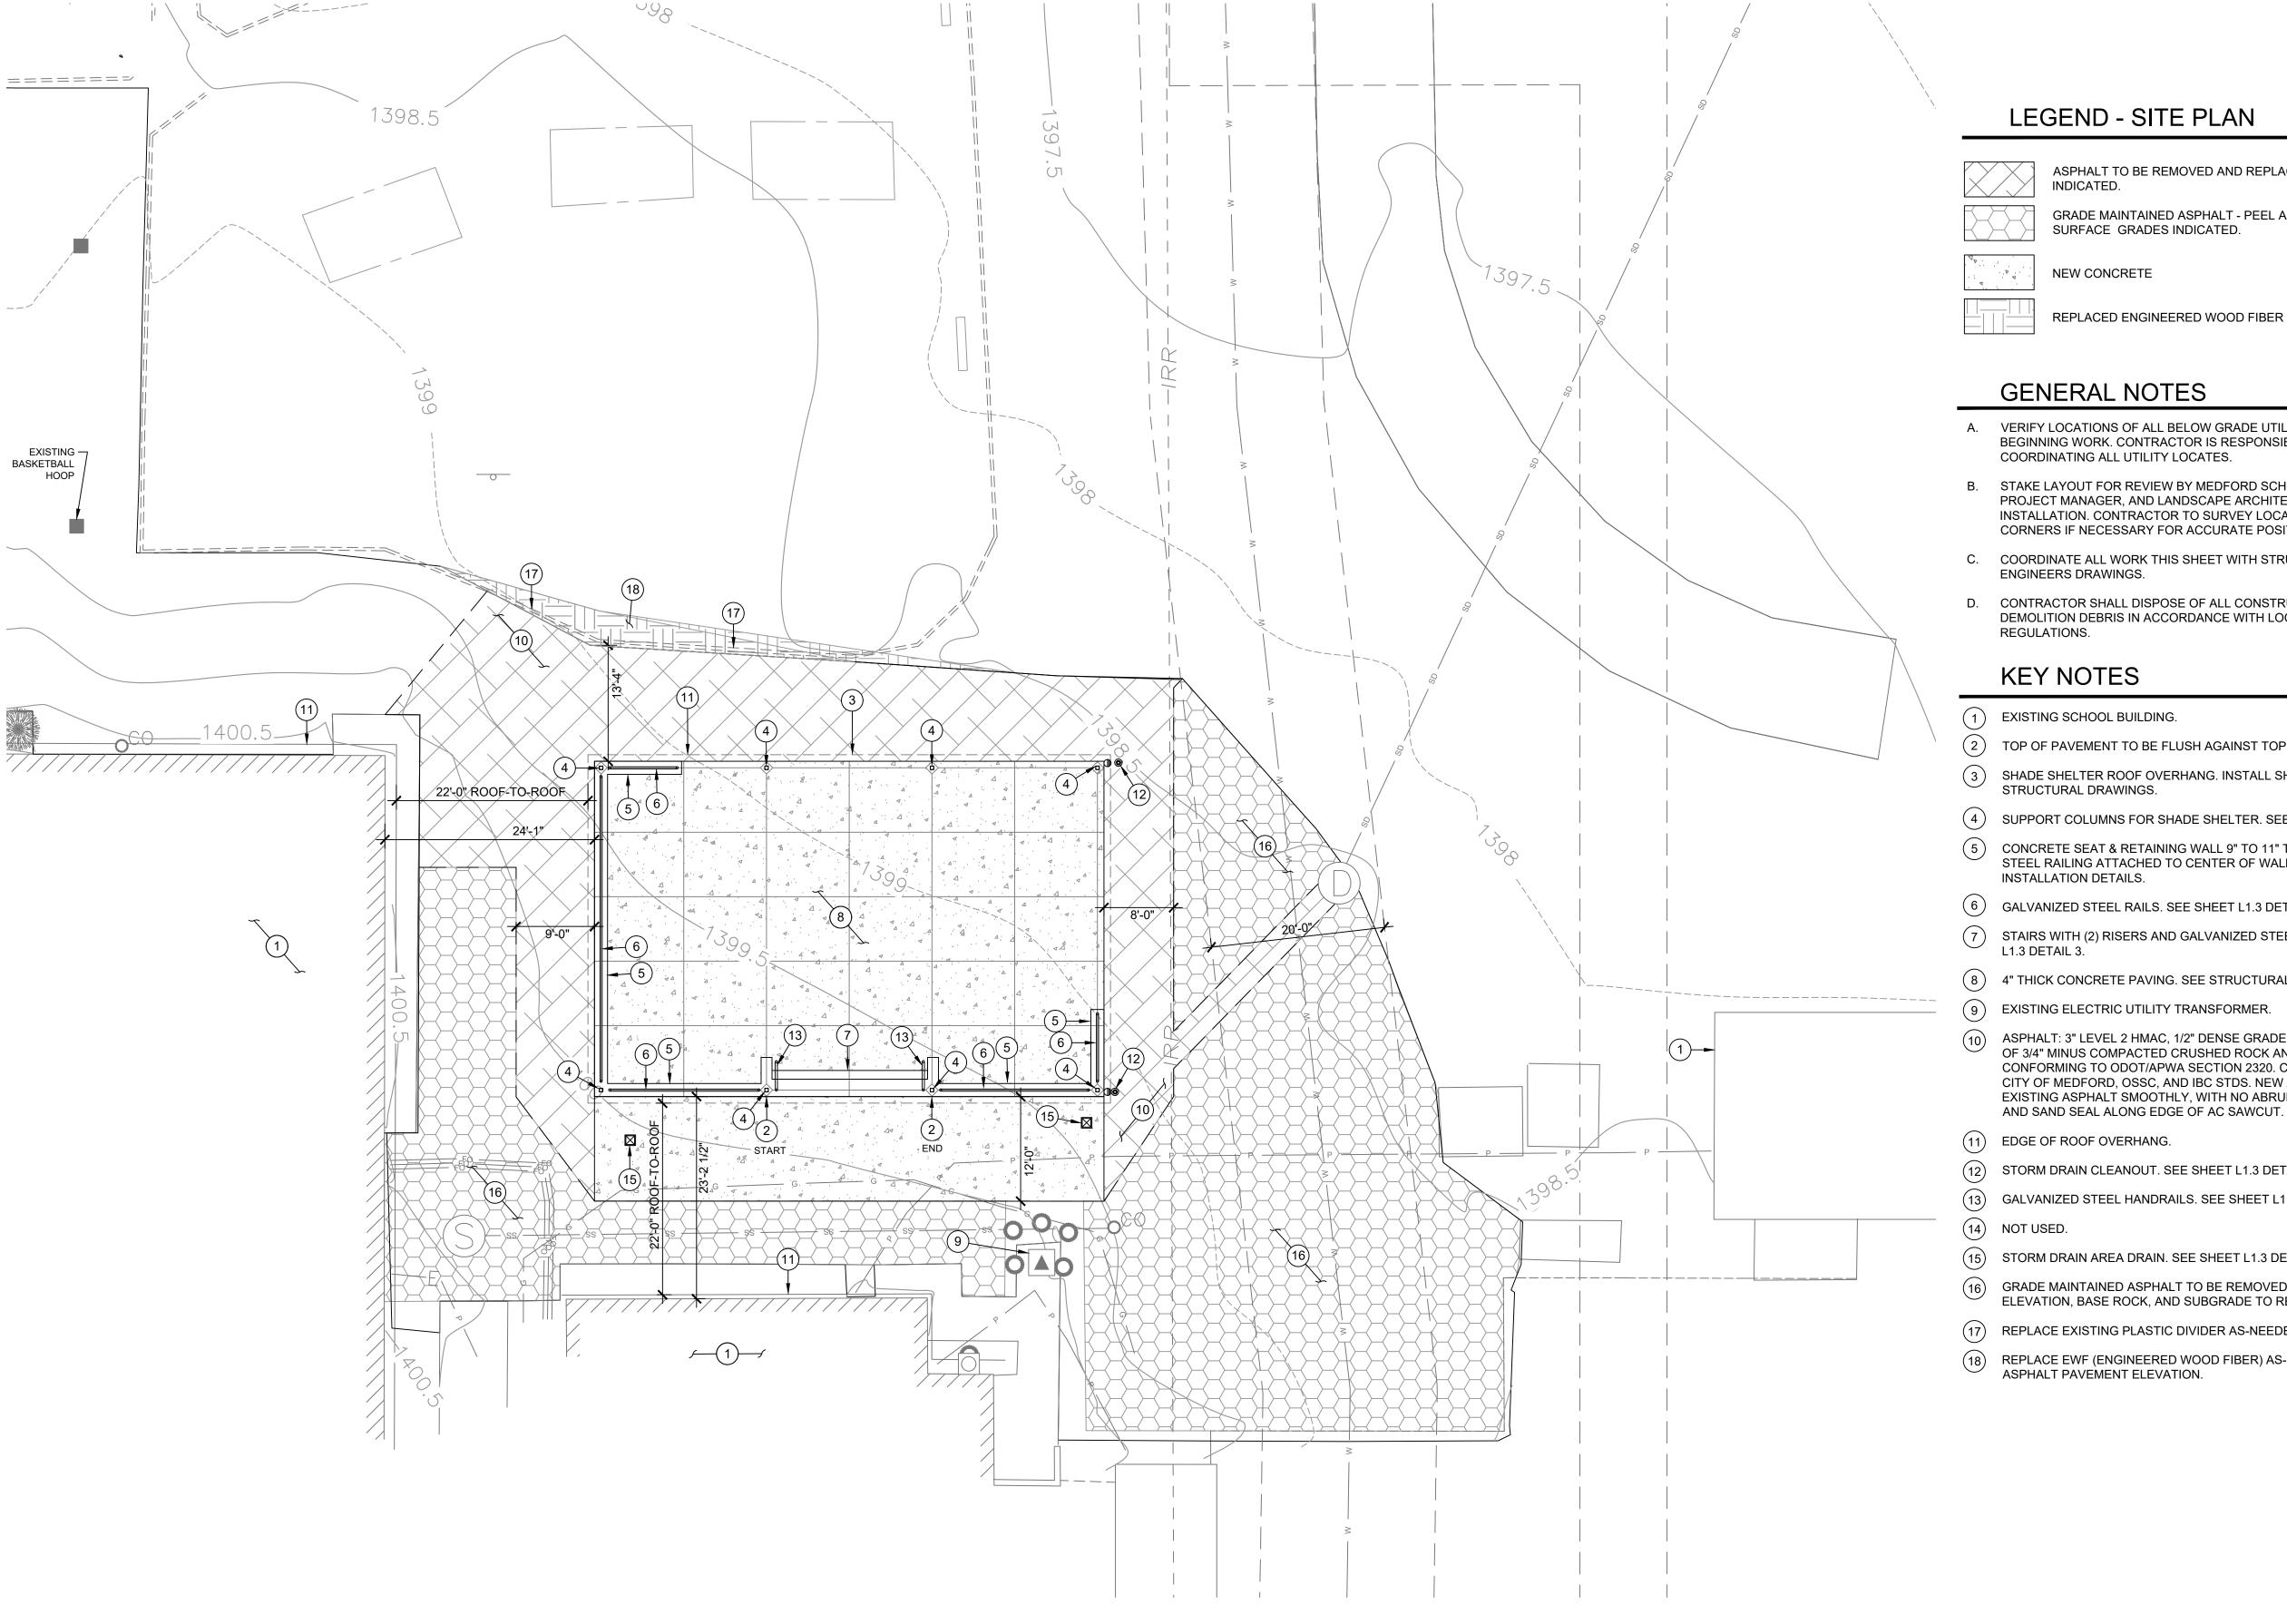


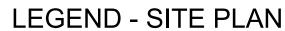

ASPHALT TO BE REMOVED AND REPLACED AT NEW GRADES

GRADE MAINTAINED ASPHALT - PEEL AND REPLACE AT EXISTING SURFACE GRADES INDICATED.


- A. VERIFY LOCATIONS OF ALL BELOW GRADE UTILITIES PRIOR TO BEGINNING WORK. CONTRACTOR IS RESPONSIBLE FOR
- STAKE LAYOUT FOR REVIEW BY MEDFORD SCHOOL DISTRICT, PROJECT MANAGER, AND LANDSCAPE ARCHITECT PRIOR TO INSTALLATION. CONTRACTOR TO SURVEY LOCATE SHELTER CORNERS IF NECESSARY FOR ACCURATE POSITIONING.
- C. COORDINATE ALL WORK THIS SHEET WITH STRUCTURAL ENGINEERS DRAWINGS.
- D. CONTRACTOR SHALL DISPOSE OF ALL CONSTRUCTION AND DEMOLITION DEBRIS IN ACCORDANCE WITH LOCAL AND STATE
- 2 TOP OF PAVEMENT TO BE FLUSH AGAINST TOP OF ADJACENT SEAT WALL.
- SHADE SHELTER ROOF OVERHANG. INSTALL SHADE SHELTER PER
- SUPPORT COLUMNS FOR SHADE SHELTER. SEE STRUCTURAL DRAWINGS.
- CONCRETE SEAT & RETAINING WALL 9" TO 11" TALL x 18" WIDE WITH STEEL RAILING ATTACHED TO CENTER OF WALL. SEE SHEET L1.3 FOR
- 6 GALVANIZED STEEL RAILS. SEE SHEET L1.3 DETAILS 1 AND 2.
- STAIRS WITH (2) RISERS AND GALVANIZED STEEL RAILINGS. SEE SHEET
- 8 4" THICK CONCRETE PAVING. SEE STRUCTURAL DRAWINGS.
- (9) EXISTING ELECTRIC UTILITY TRANSFORMER.
- ASPHALT: 3" LEVEL 2 HMAC, 1/2" DENSE GRADED, MAX RAP 20%, OVER 12" OF 3/4" MINUS COMPACTED CRUSHED ROCK AND WOVEN FABRIC CONFORMING TO ODOT/APWA SECTION 2320. COMPLY w/ APPLICABLE CITY OF MEDFORD, OSSC, AND IBC STDS. NEW ASPHALT SHALL MEET EXISTING ASPHALT SMOOTHLY, WITH NO ABRUPT GRADE CHANGE. TACK AND SAND SEAL ALONG EDGE OF AC SAWCUT.
- (12) STORM DRAIN CLEANOUT. SEE SHEET L1.3 DETAIL 4.
- (13) GALVANIZED STEEL HANDRAILS. SEE SHEET L1.3 DETAIL 3.
- (15) STORM DRAIN AREA DRAIN. SEE SHEET L1.3 DETAIL 5.
- GRADE MAINTAINED ASPHALT TO BE REMOVED AND REPLACED. SURFACE ELEVATION, BASE ROCK, AND SUBGRADE TO REMAIN UNCHANGED.
- (17) REPLACE EXISTING PLASTIC DIVIDER AS-NEEDED.
- (18) REPLACE EWF (ENGINEERED WOOD FIBER) AS-NEEDED TO MEET NEW ASPHALT PAVEMENT ELEVATION.

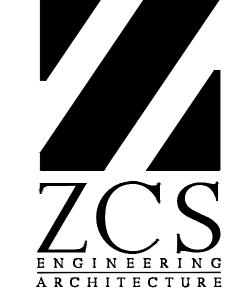

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OAK GROVE ES OUTDOOR EATING SPACE





EXPIRES: 05/31/2024

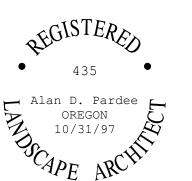PROJECT NO: M-0347-23 DRAWN: CHECKED: 03-15-24

1"=10'

SITE PLAN

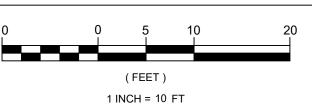

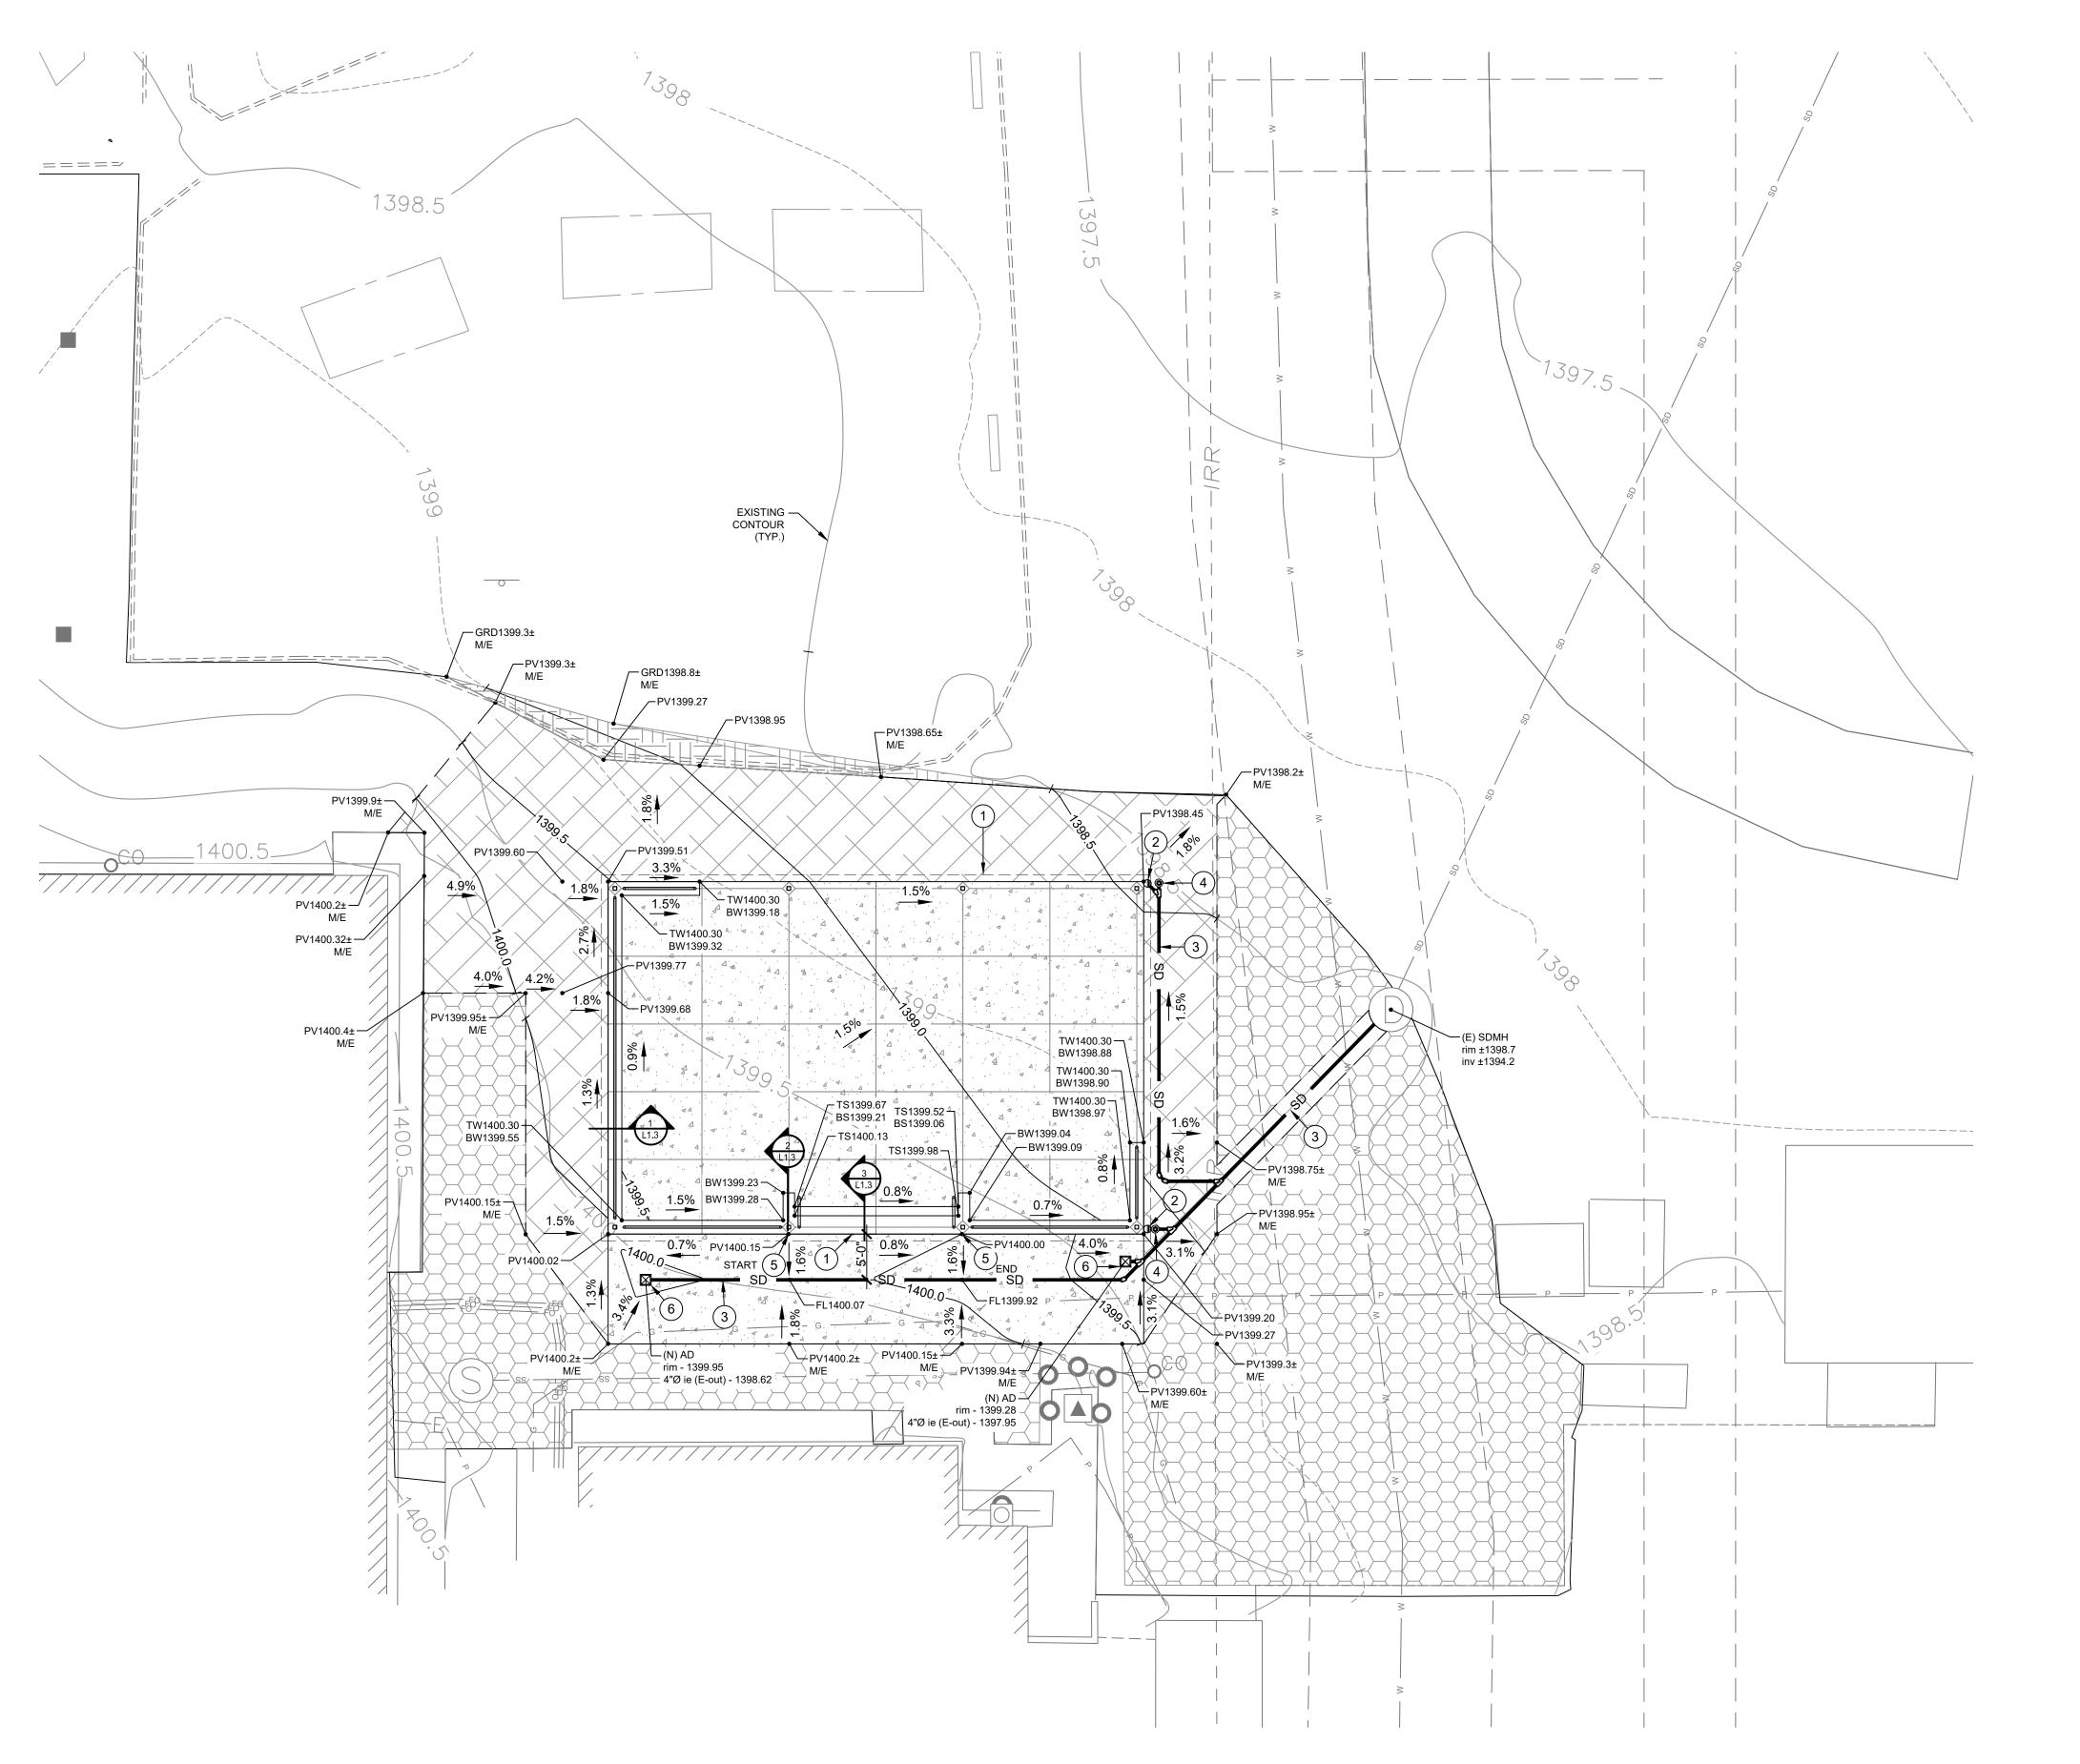

LEGEND - GRADING AND DRAINAGE PLAN

TS1399.63 — PROPOSED ELEVATION

—1400.0— PROPOSED CONTOUR

PROPOSED SLOPE

SD — PROPOSED STORM DRAIN LINE

KEY NOTES

- RAIN GUTTERS CONTINUOUS ALONG LOW EDGE OF ROOF.
- 2 3" CAST IRON DOWNSPOUTS: PROVIDE AND INSTALL DOWNSPOUTS CONNECTING DIRECTLY TO IN-GROUND DRAINLINE. ATTACH TO COLUMNS.
- 4" SCHEDULE 40 PVC DRAINLINE: INSTALL AT 12" DEPTH, SLOPE TO DRAIN AND CONNECT TO EXISTING STORM MANHOLE AT LOCATION INDICATED. USE KOR-N-SEAL BOOT AT MANHOLE CONNECTION.
- (4) STORM DRAIN CLEANOUT. SEE SHEET L1.3 DETAIL 4.
- (5) TOP OF PAVEMENT TO BE FLUSH AGAINST TOP OF ADJACENT SEAT WALL.
- (6) STORM DRAIN AREA DRAIN. SEE SHEET L1.3 DETAIL 5.

ABBREVIATIONS

BOTTOM OF STAIR BS **BOTTOM OF WALL** BW **FLOWLINE** FL GRADE GRD PAVEMENT TOP OF STAIR TOP OF WALL MATCH EXISTING M/E


SUMMARY - IMPERVIOUS SURFACES

NEW ASPHALT (REGRADED): 2,036 SF

NEW CONCRETE (REGRADED): 2,954 SF

TOTAL: 4,990 SF

4,990 SF < 5,000 SF; NO STORMWATER TREATMENT REQUIRED.

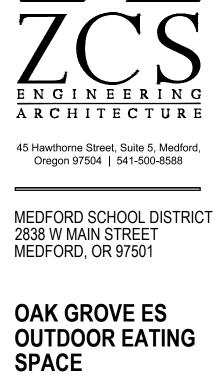


EXPIRES: 05/31/2024


REVISION ID:	DATE:
PROJECT NO:	M-0347-23


03-15-24

GRADING AND DRAINAGE PLAN L1.2

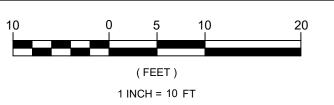


1"=10'

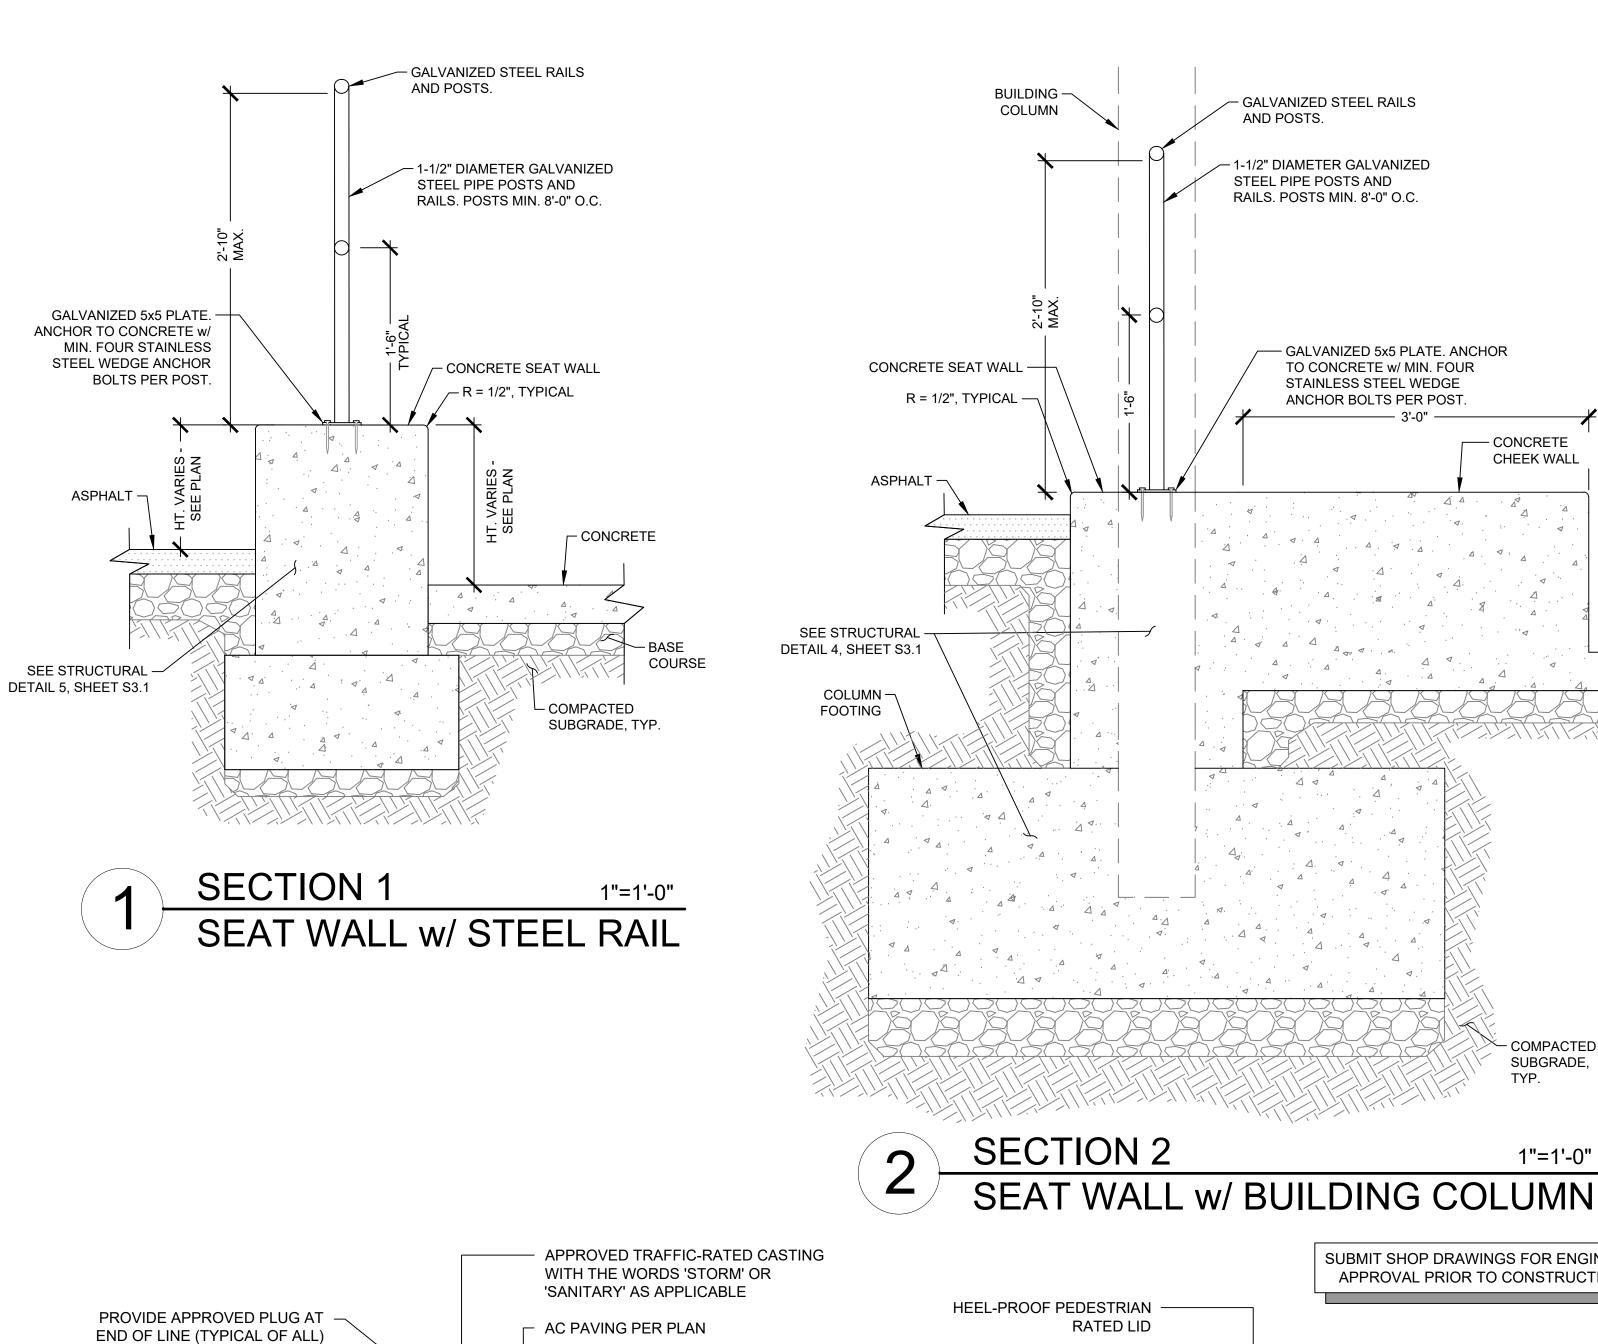


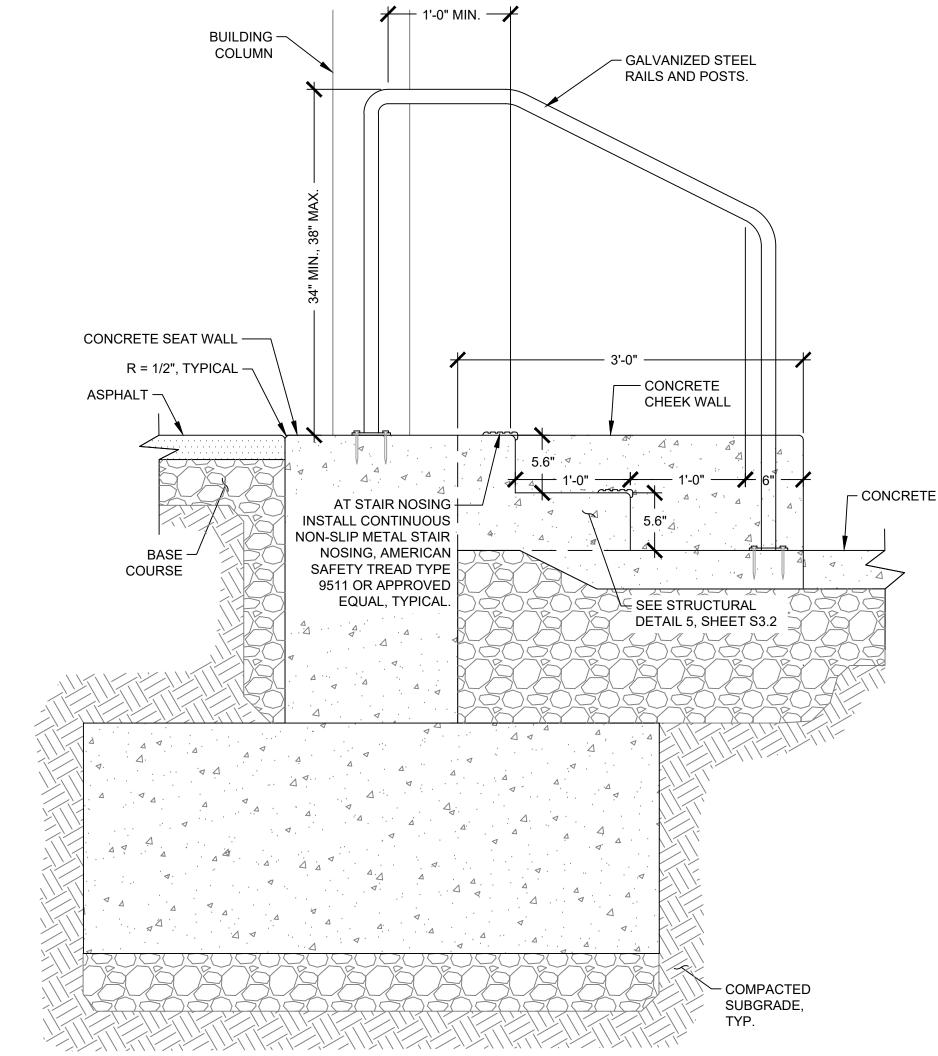

SECTION 3 1"=1'-0" STAIRS w/ HANDRAIL

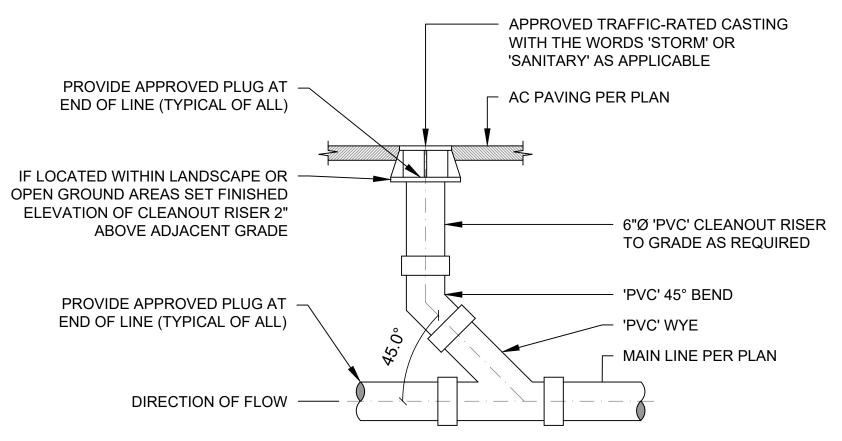

TYPICAL PRIVATE NTS
CLEANOUT TO GRADE

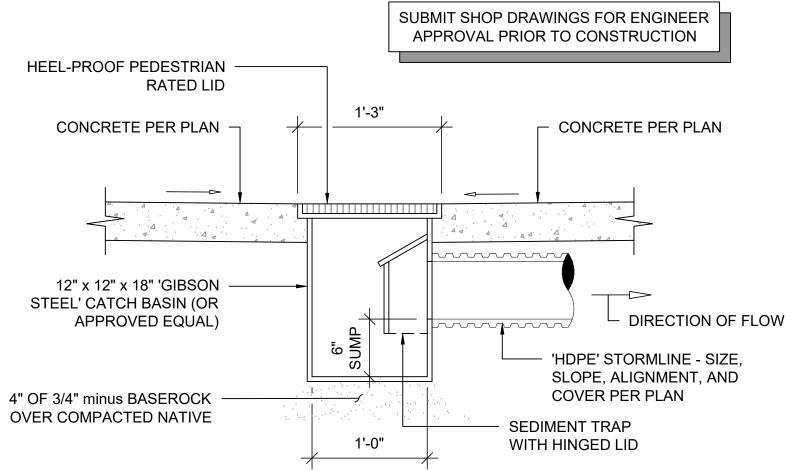

- CONCRETE

CHEEK WALL

SUBGRADE,

COURSE

STEEL AREA DRAIN 1"=1'-0"

AEGISTERED 435 Alan D. Pardee OREGON 10/31/97 E 10/31/9, OF ARCHIVE EXPIRES: 05/31/2024

ARCHITECTURE

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MEDFORD SCHOOL DISTRICT

2838 W MAIN STREET MEDFORD, OR 97501

OAK GROVE ES

SPACE


OUTDOOR EATING

REVISION ID: DATE:

PROJECT NO: M-0347-23

DRAWN: CHECKED: DATE: 03-15-24

LANDSCAPE DETAILS L1.3

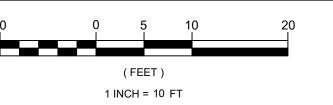

1"=10'