


ENGINEERING ARCHITECTURE

45 Hawthorne Street, Suite 5, Medford, Oregon 97504 | 541-500-8588

MEDFORD SCHOOL DISTRICT 2323 SISKIYOU BLVD, MEDFORD, OR 97504

HOOVER ES OUTDOOR EATING SPACE

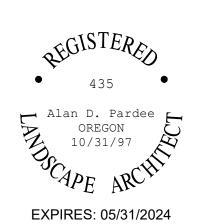

REVISION ID:	DATE:
	•
PROJECT NO:	M-0366-23
DRAWN:	MMW


CHECKED: 3-15-2024


SITE KEY PLAN

1"=400'

L0.1

SITE KEY PLAN

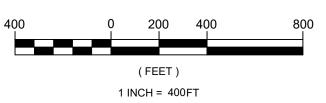

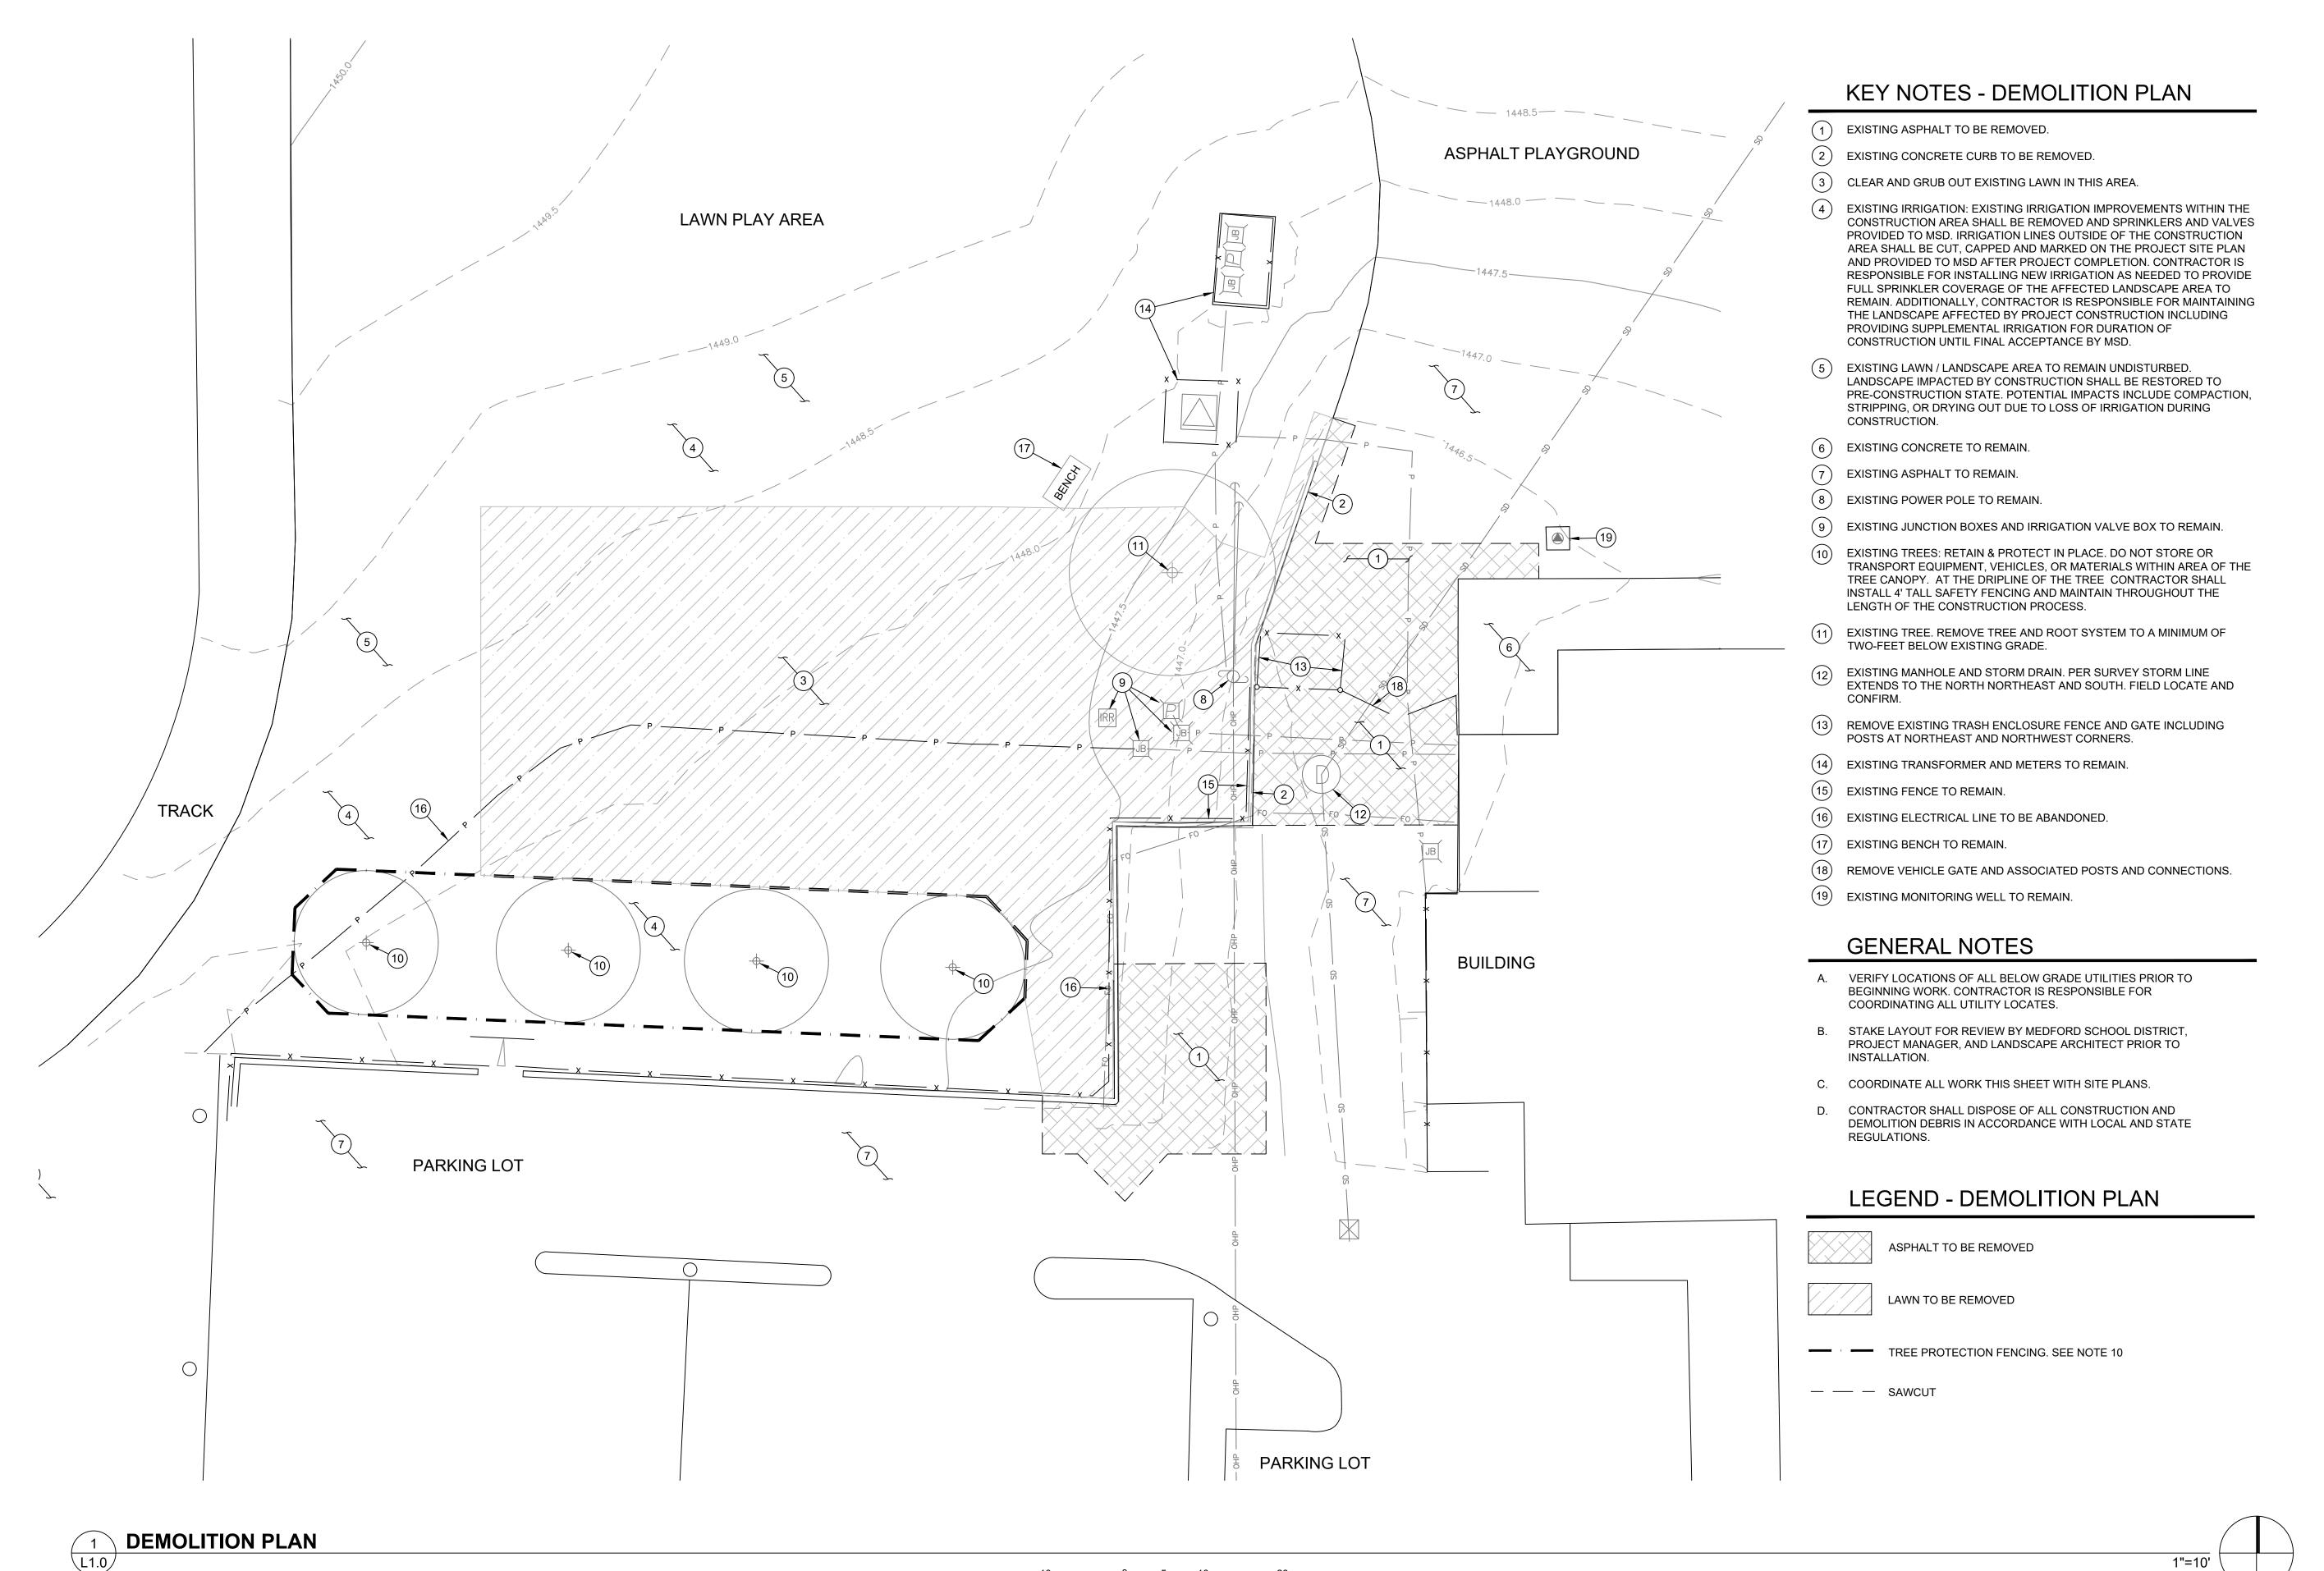

1 INCH = 10 FT

ARCHITECTURE

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MEDFORD SCHOOL DISTRICT 2323 SISKIYOU BLVD, MEDFORD, OR 97504

HOOVER ES OUTDOOR EATING SPACE


435 Alan D. Pardee ECAPE ARCHI

EXPIRES: 05/31/2024

↑ REVISION ID:

PROJECT NO: M-0366-23 DRAWN: CHECKED: 3-15-2024

DEMOLITION PLAN

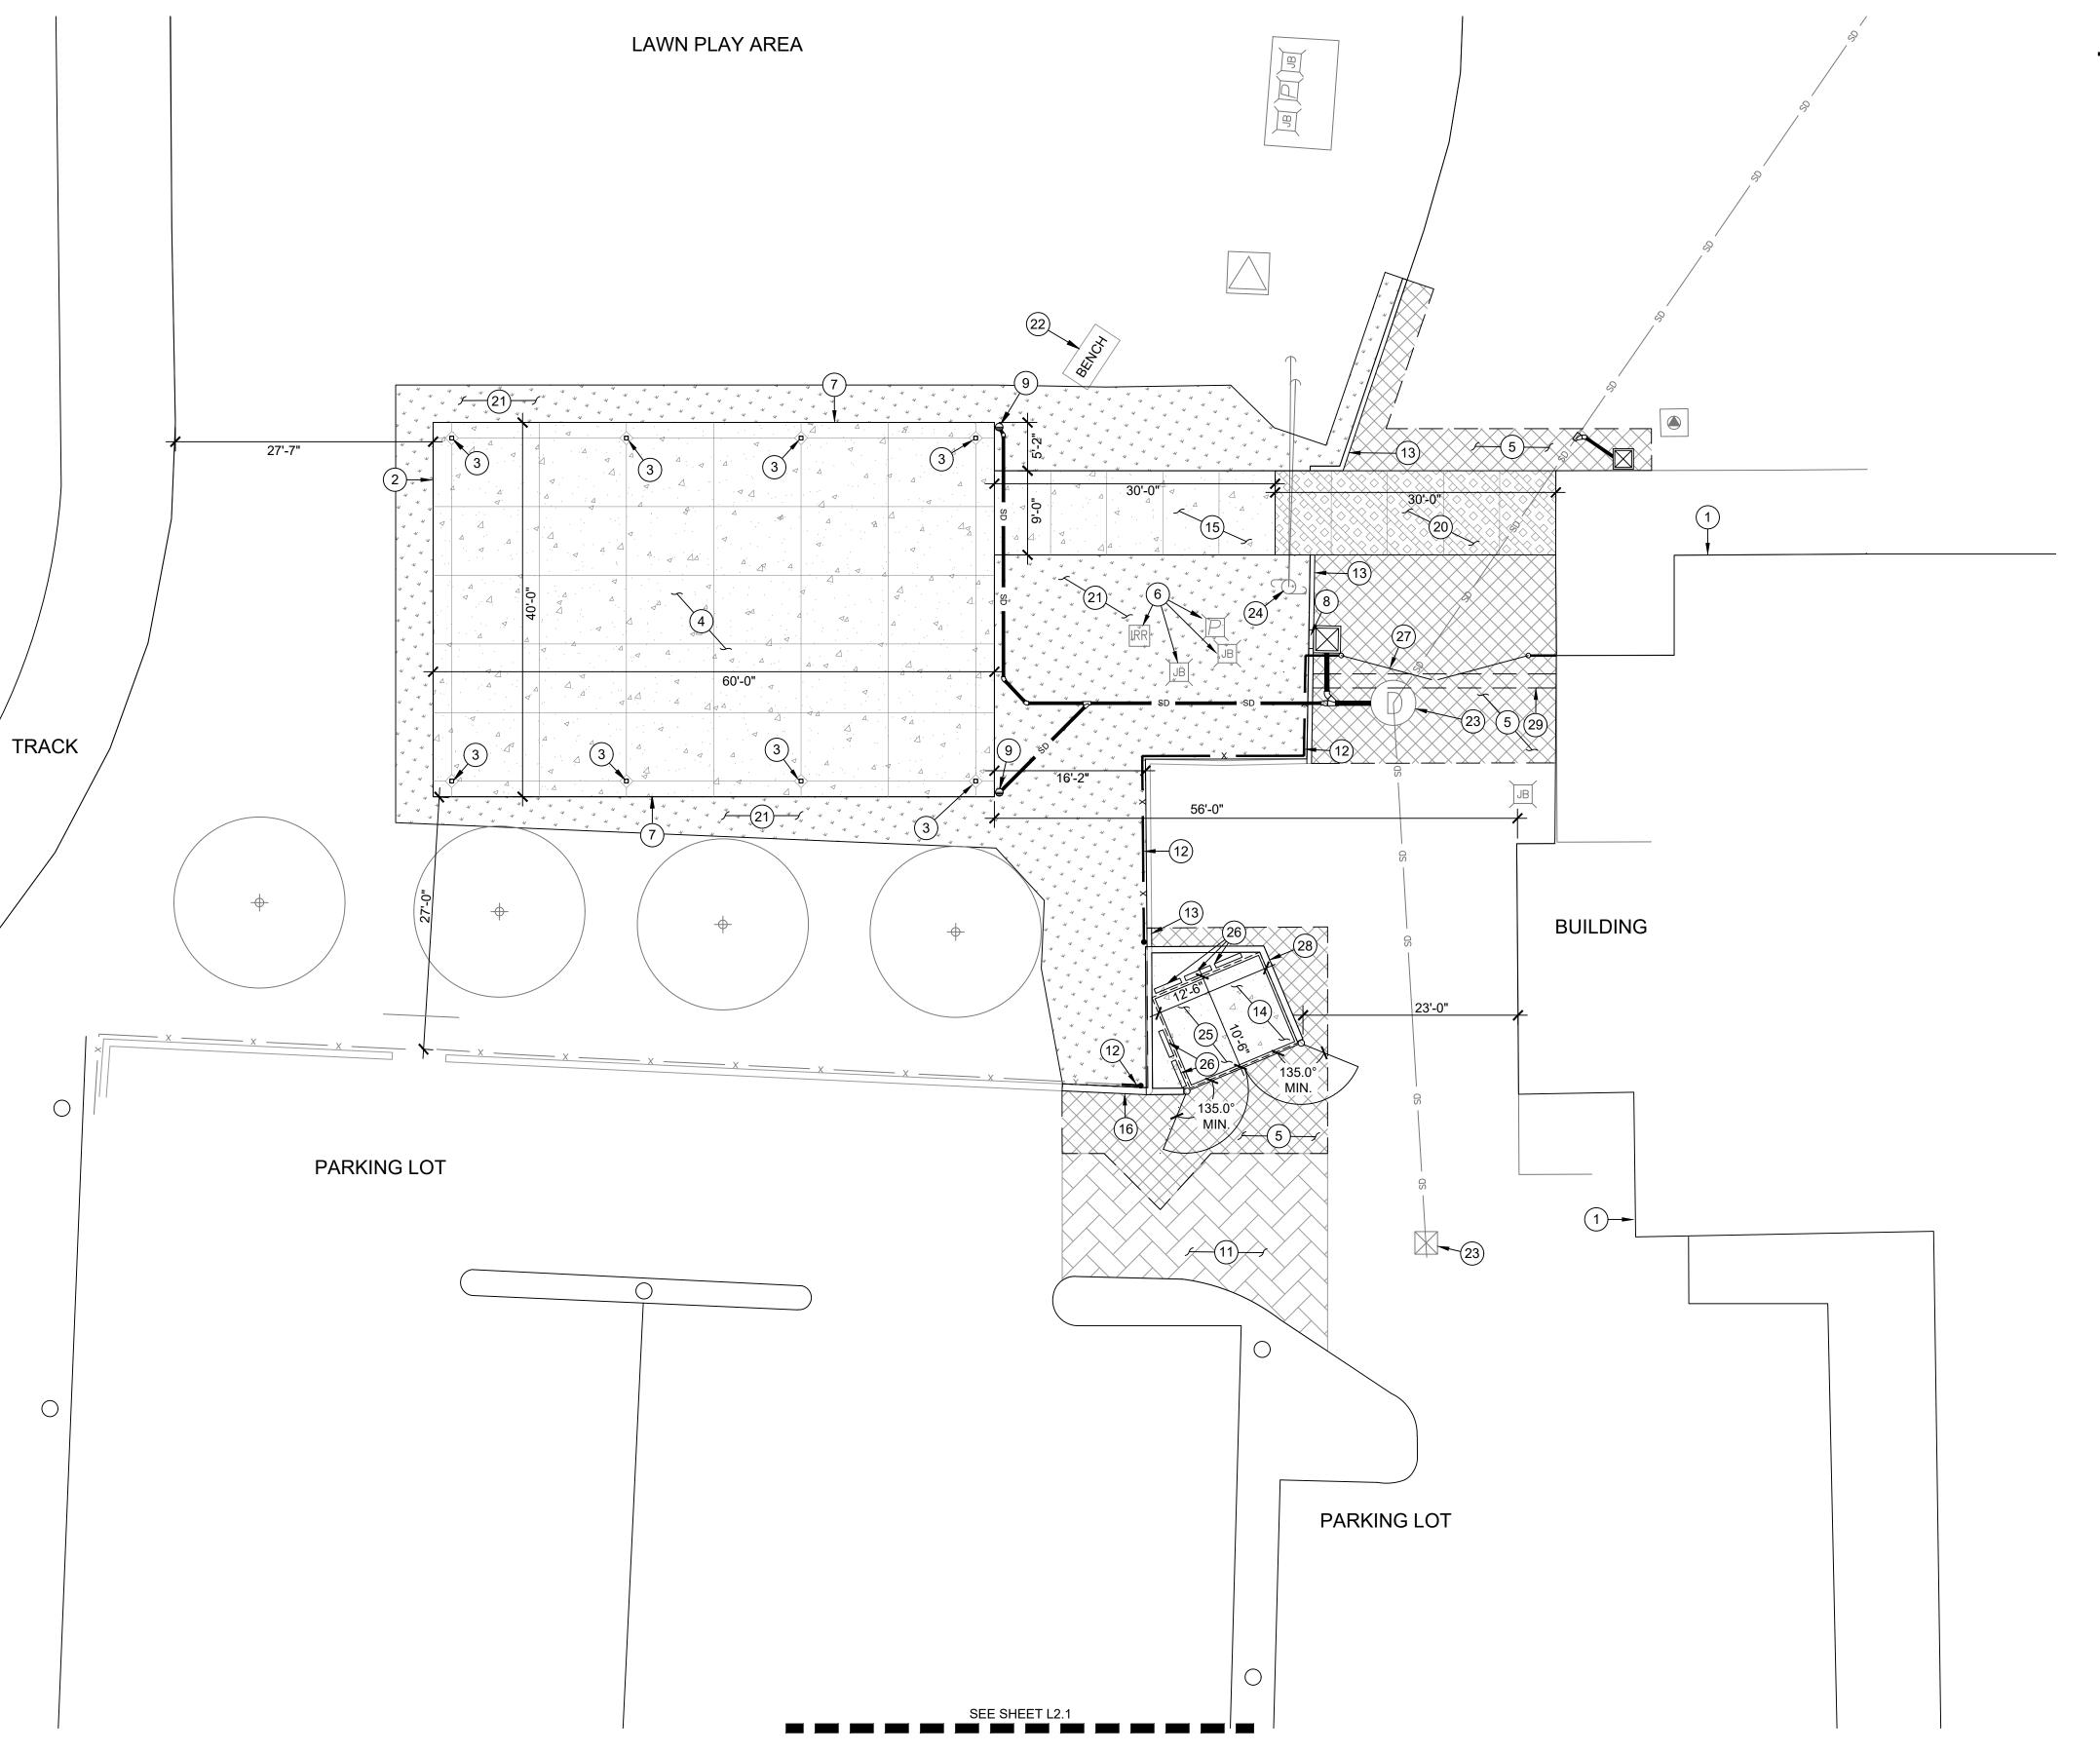

SITE PLAN

LEGEND

(

CONCRETE.



REINFORCED CONCRETE.



ASPHALT.



LANDSCAPE REPAIR.

ASPHALT REPAIR.

GENERAL NOTES

- A. VERIFY LOCATIONS OF ALL BELOW GRADE UTILITIES PRIOR TO BEGINNING WORK. CONTRACTOR IS RESPONSIBLE FOR COORDINATING ALL UTILITY LOCATES.
- B. STAKE LAYOUT FOR REVIEW BY MEDFORD SCHOOL DISTRICT, PROJECT MANAGER, AND LANDSCAPE ARCHITECT PRIOR TO INSTALLATION. CONTRACTOR TO SURVEY LOCATE SHELTER CORNERS IF NECESSARY FOR ACCURATE POSITIONING.
- C. COORDINATE ALL WORK THIS SHEET WITH STRUCTURAL ENGINEERS DRAWINGS.
- D. CONTRACTOR SHALL DISPOSE OF ALL CONSTRUCTION AND DEMOLITION DEBRIS IN ACCORDANCE WITH LOCAL AND STATE REGULATIONS.

KEY NOTES - SITE PLAN


- 1 EXISTING SCHOOL BUILDING.
- (2) SHADE SHELTER. INSTALL SHADE SHELTER PER STRUCTURAL DRAWINGS.
- 3 SUPPORT COLUMNS FOR SHADE SHELTER. SEE STRUCTURAL DRAWINGS.
- 4" THICK CONCRETE PAVING WITHIN SHADE SHELTER. SEE STRUCTURAL DRAWINGS FOR ADDITIONAL INFORMATION.
- ASPHALT: 3" LEVEL 2 HMAC, 1/2" DENSE GRADED, MAX RAP 20%, OVER 12" OF 3/4" MINUS COMPACTED CRUSHED ROCK AND WOVEN FABRIC CONFORMING TO ODOT/APWA SECTION 2320. COMPLY w/ APPLICABLE CITY OF MEDFORD, OSSC, AND IBC STDS. NEW ASPHALT SHALL MEET EXISTING ASPHALT SMOOTHLY, WITH NO ABRUPT GRADE CHANGE.
- 6 EXISTING ELECTRIC JUNCTION BOXES AND IRRIGATION VALVE BOX. RETAIN AND PROTECT IN PLACE.
- (7) RAIN GUTTER: INSTALL RAIN GUTTER ON THIS SIDE.
- 8) INSTALL CURB CUT. SEE DETAIL 3/L4.0.
- 9 3" CAST IRON DOWNSPOUTS: PROVIDE AND INSTALL DOWNSPOUTS CONNECTING DIRECTLY TO IN GROUND DRAIN LINE. SEE DETAIL 1/L4.0.
- (10) NOT USED.
- MAINTAINED ASPHALT TO BE REPAIRED AS-NEEDED. SURFACE ELEVATION, BASE ROCK AND SUBGRADE TO REMAIN UNCHANGED
- 12 INSTALL NEW CHAIN LINK FENCE.
- (13) INSTALL NEW 6" CONCRETE CURB TO MATCH EXISTING. SEE DETAIL 5/L4.0.
- 14) TRASH ENCLOSURE.
- CONCRETE. 4" THICK CONCRETE PAVING OVER 6" OF 3/4" MINUS COMPACTED CRUSHED. CONCRETE SHALL COMPLY W/ APPLICABLE CITY OF MEDFORD, OSSC, & IBC STANDARDS.
- 16 INSTALL NEW 9" WIDE CURB TO MATCH EXISTING.
- NOT USED.
- 18 NOT USED.
- (19) NOT USED.
- (20) 6" THICK REINFORCED CONCRETE PAVING. SEE DETAIL 6/L4.0.
- (21) LANDSCAPING TO BE REPLACED IN KIND.
- 22) EXISTING BENCH REMAIN.
- EXISTING STORM STRUCTURE TO REMAIN. RIM TO BE FLUSH WITH NEW ASPHALT, IF APPLICABLE.
- (24) EXISTING POWER POLE TO REMAIN.
- (25) NEW TRASH ENCLOSURE. SEE STRUCTURAL DRAWINGS.
- (26) CONCRETE WHEEL BUMPER.
- (27) NEW 20' WIDE STEEL CHAIN-LINK GATE COMPRISED OF TWO 10' LEAF GATES.
- PAINT NEW TRASH ENCLOSURE EXTERIOR WALLS TO MATCH EXTERIOR OF ADJACENT SCHOOL BUILDING.
- CONTRACTOR TO INSTALL 6" SLEEVE AT A DEPTH OF 24" AND INSTALL IRRIGATION CONTROL WIRE.

ENGINEERING ARCHITECTURE

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MEDFORD SCHOOL DISTRICT 2323 SISKIYOU BLVD, MEDFORD, OR 97504

HOOVER ES OUTDOOR EATING SPACE

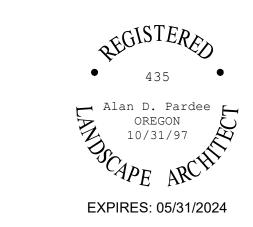

↑ REVISION ID: DATE:

ROJECT NO:	M-0366-23
RAWN:	MMW


1"=10'

CHECKED:

SITE PLAN


3-15-2024

1 INCH = 10 FT

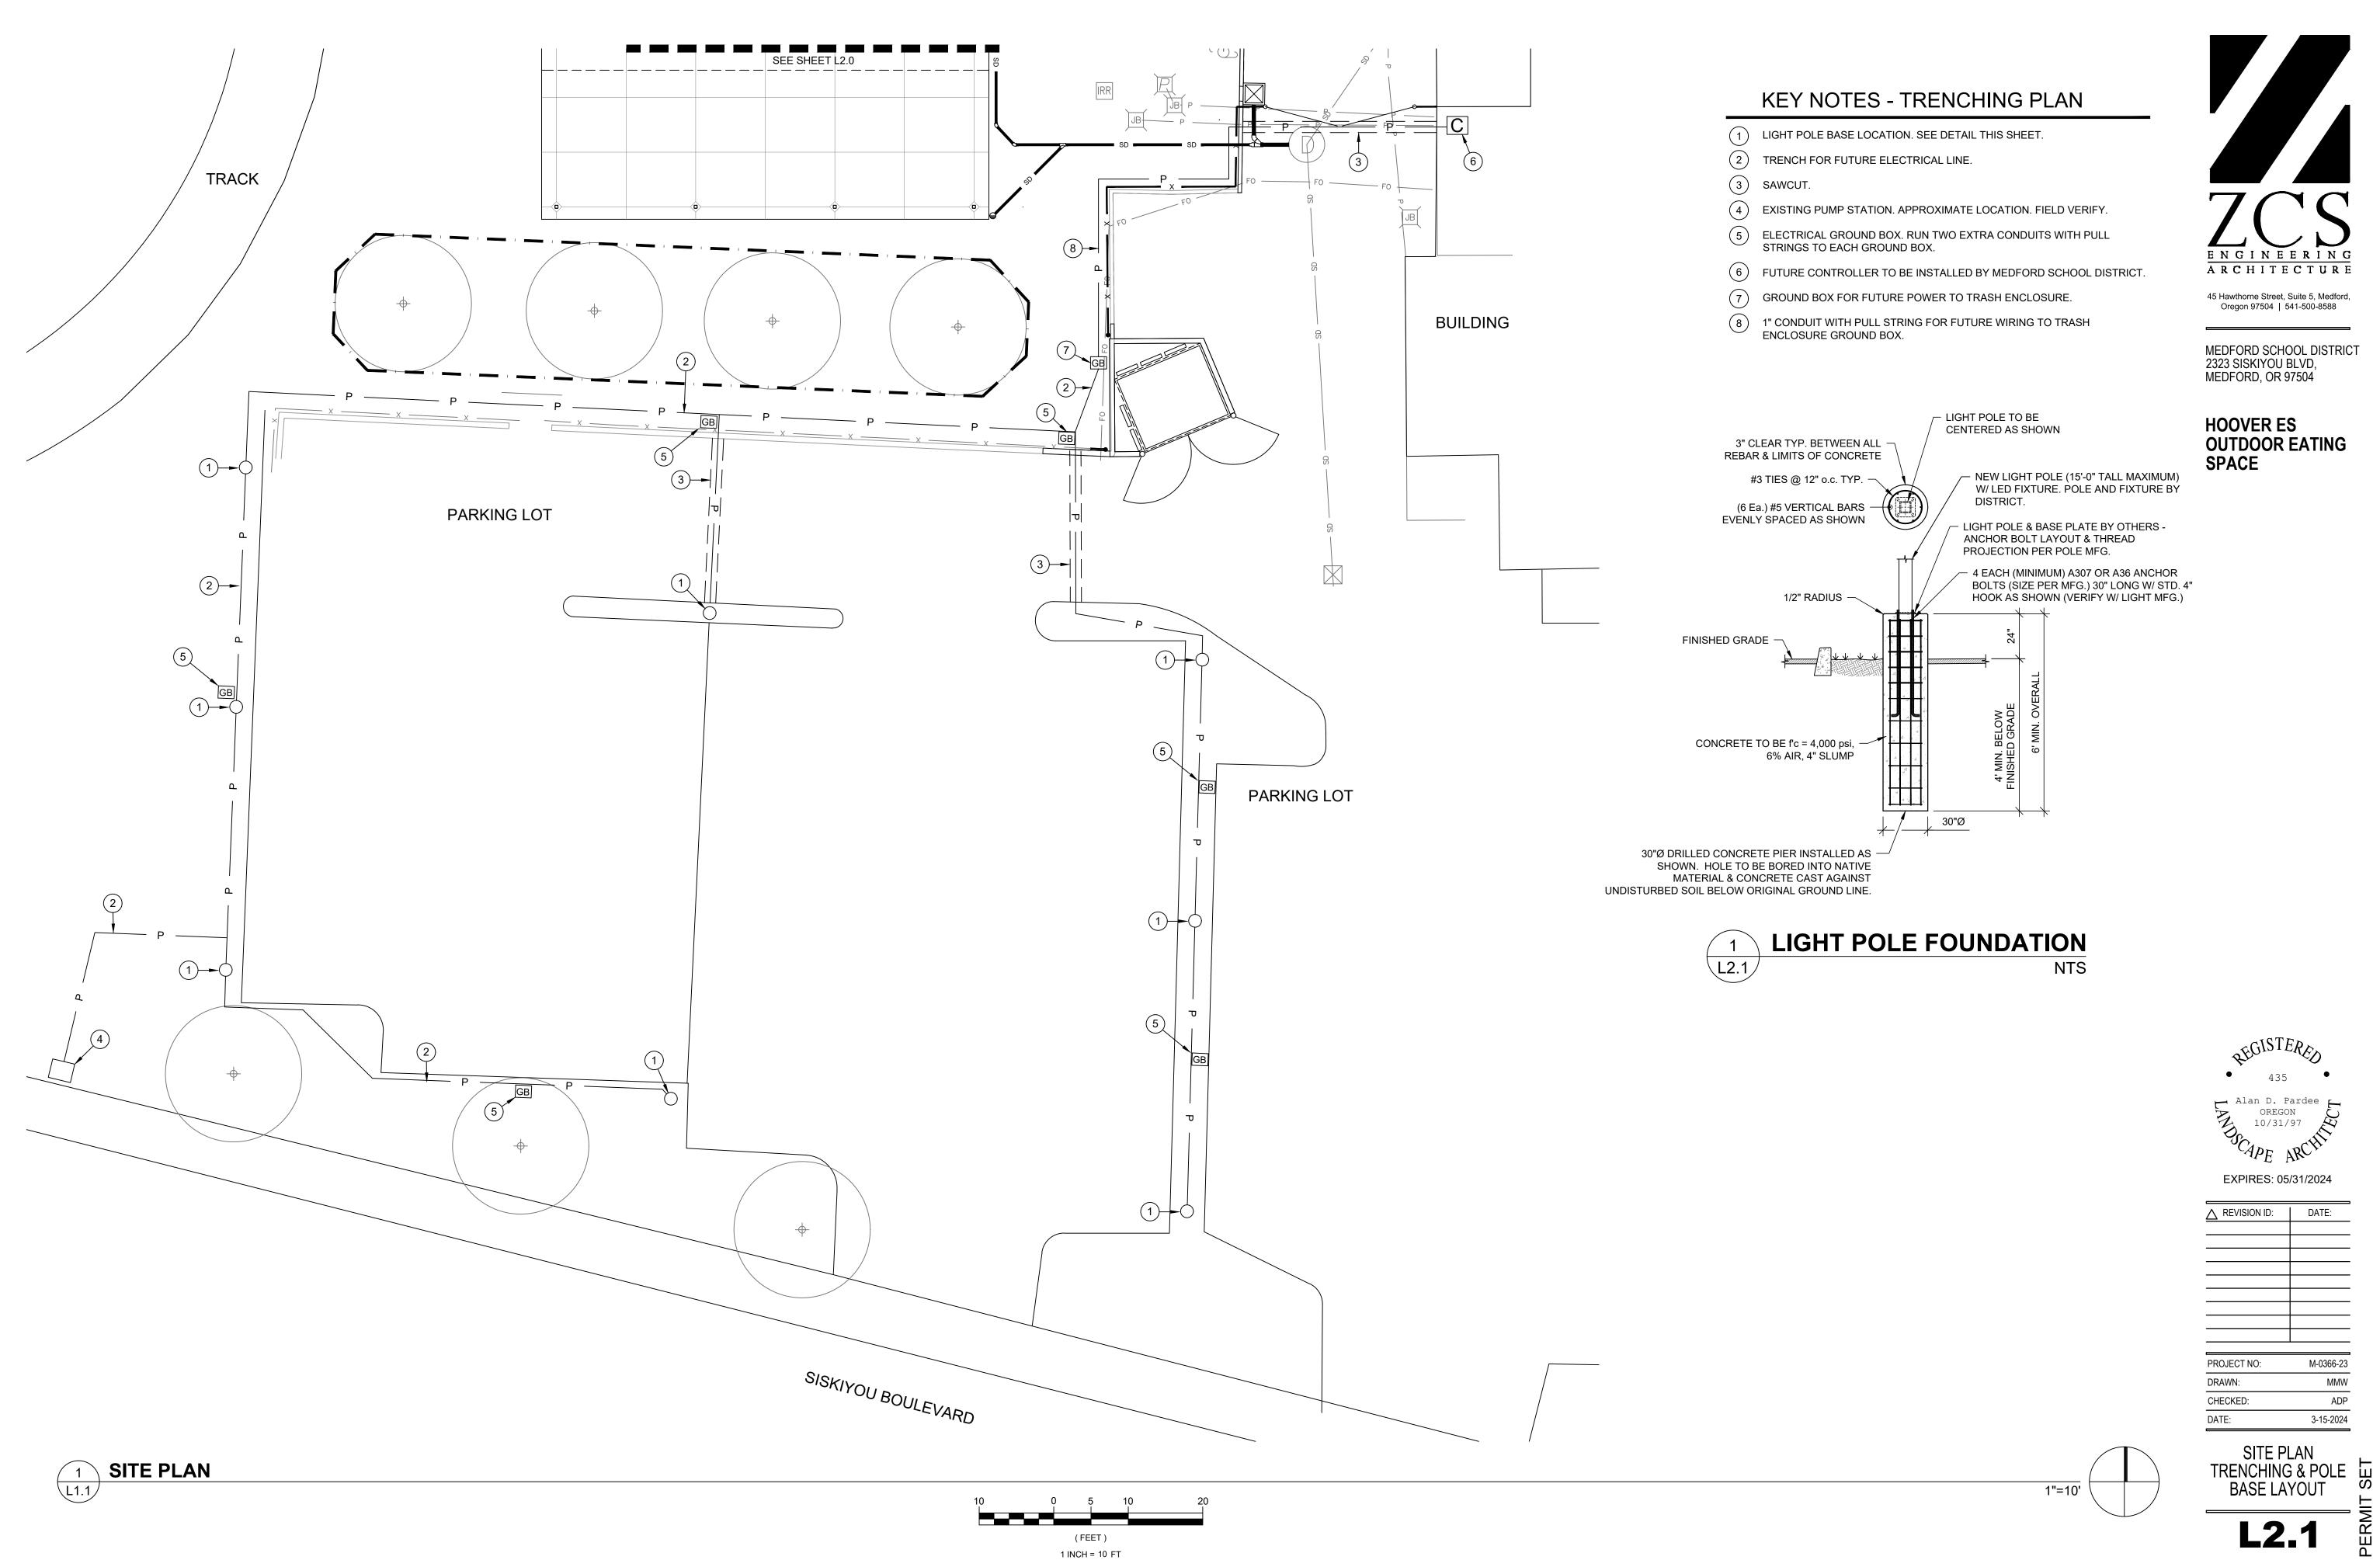

M-0366-23 3-15-2024

L2.1

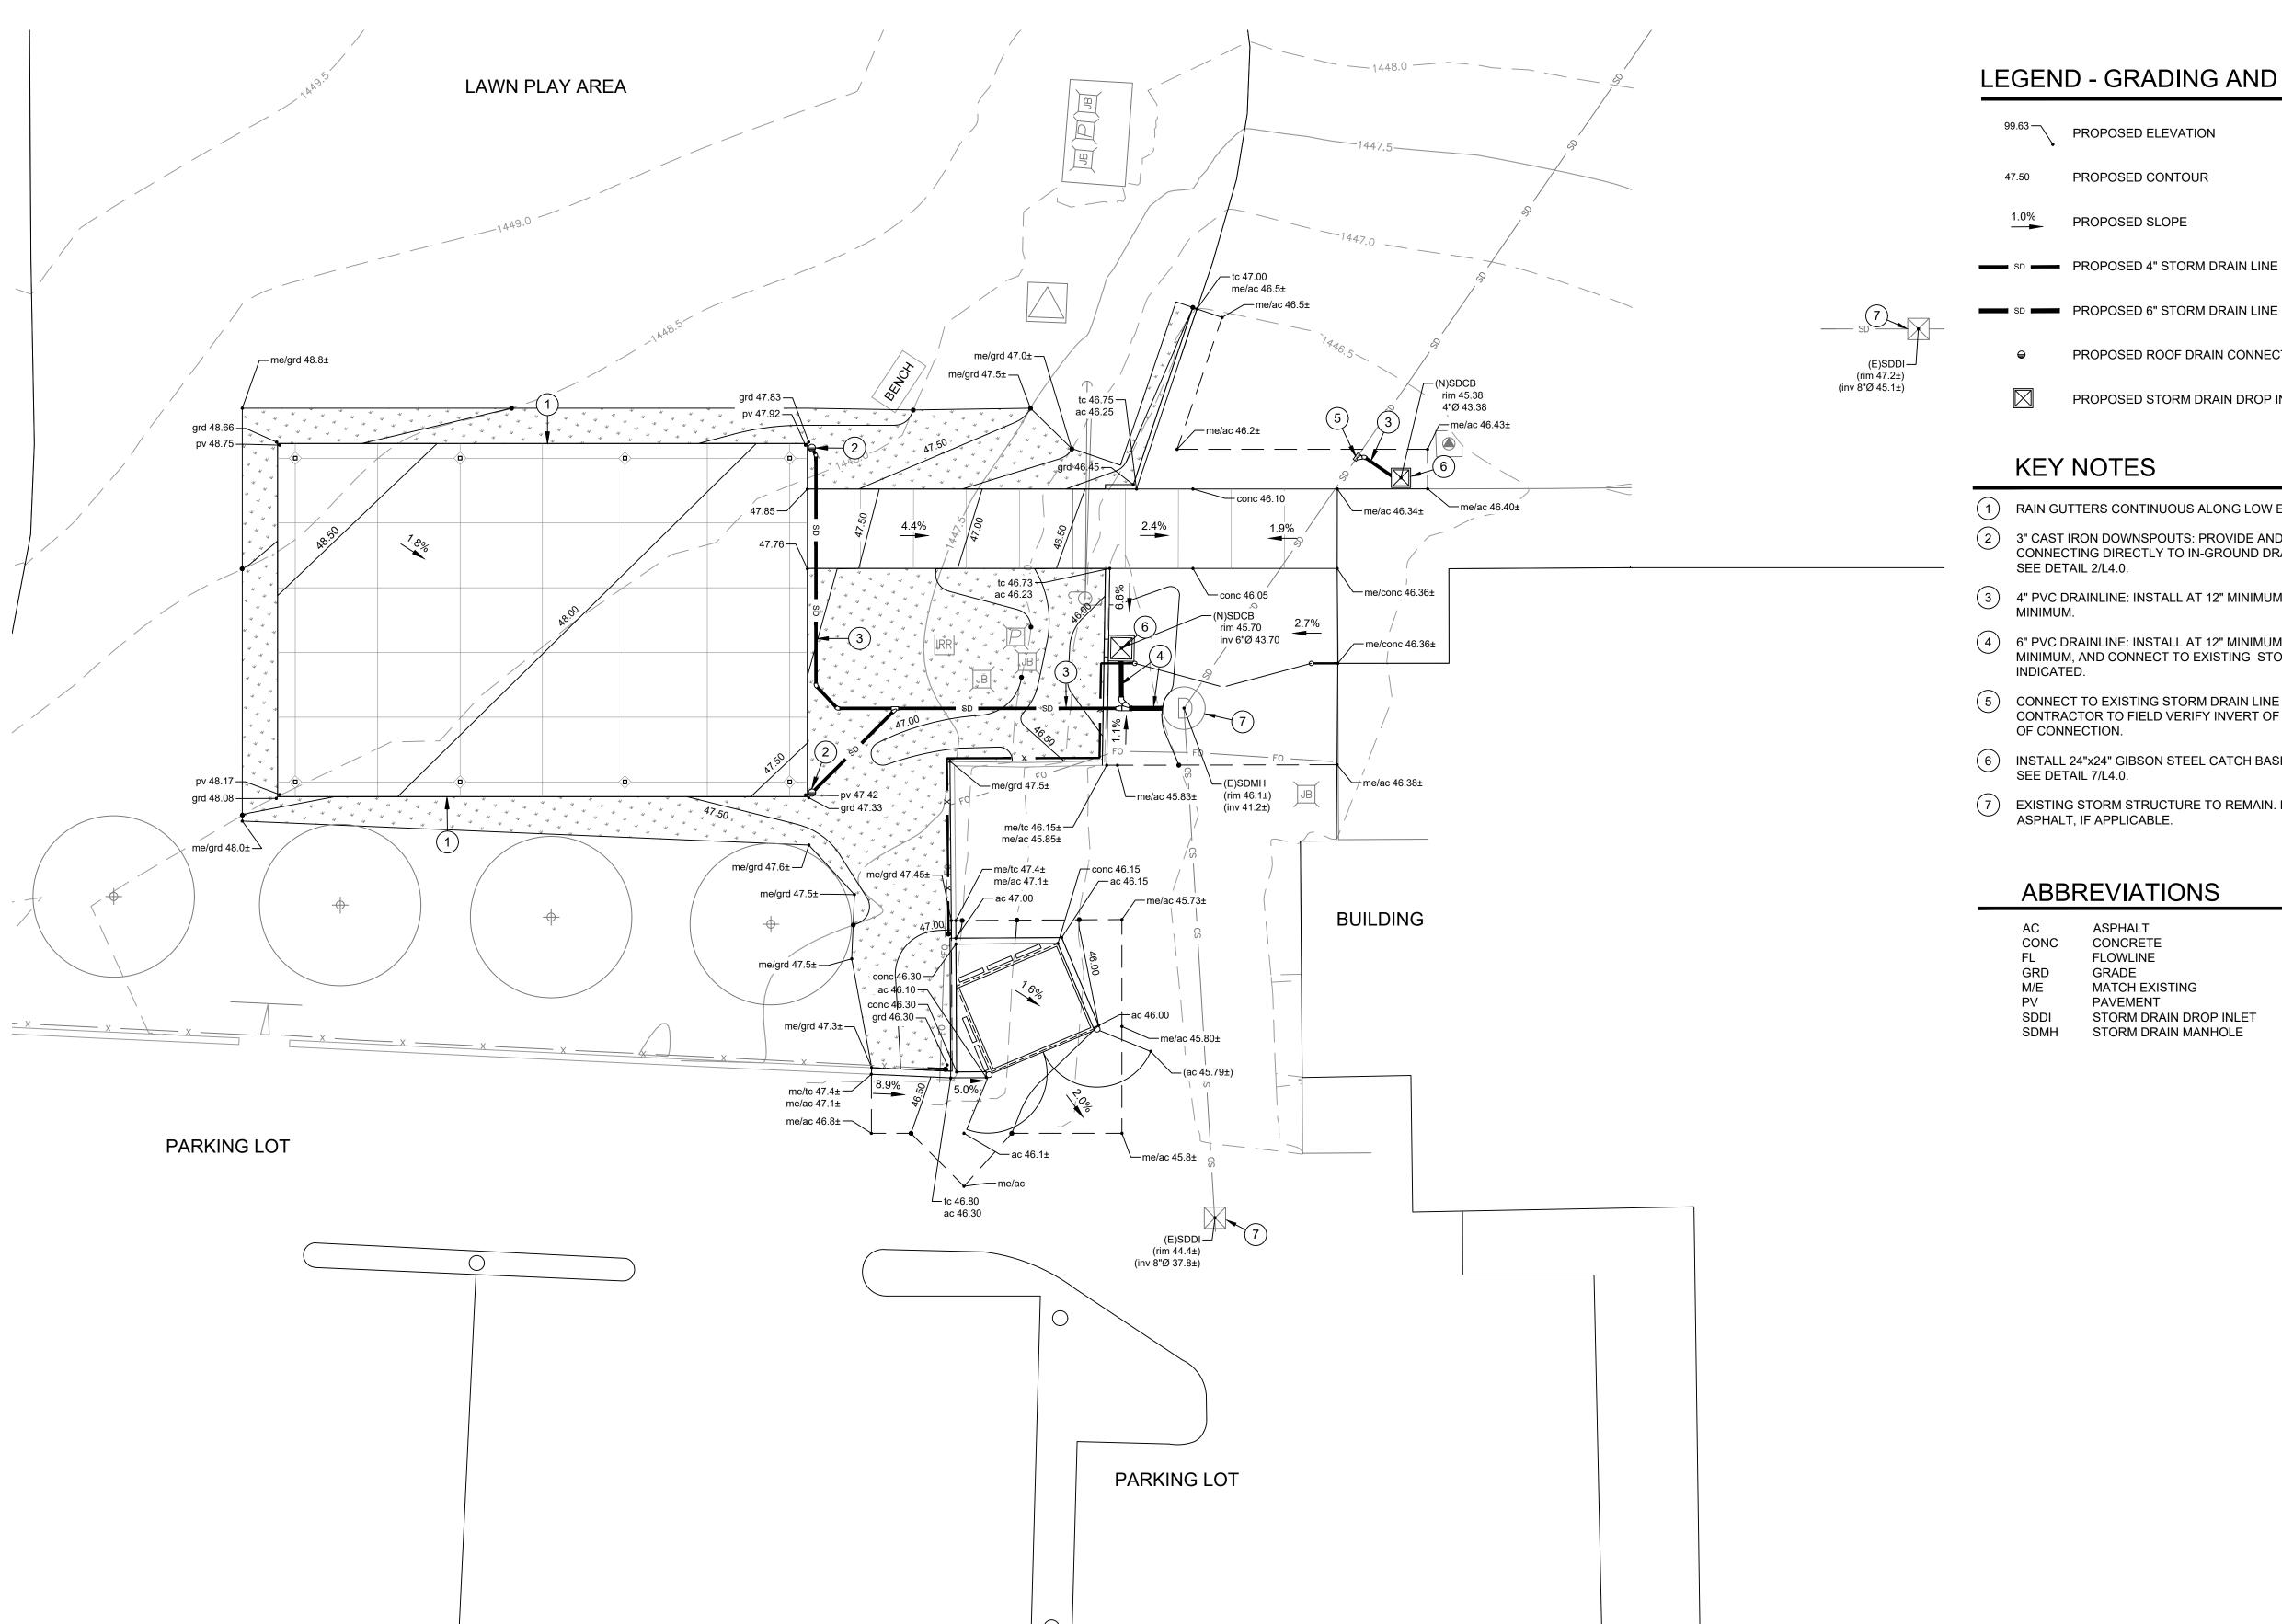

1 INCH = 10 FT

LEGEND - GRADING AND DRAINAGE PLAN

PROPOSED ELEVATION

PROPOSED CONTOUR

PROPOSED SLOPE

PROPOSED ROOF DRAIN CONNECTION PER DETAIL 2/L4.0.

PROPOSED STORM DRAIN DROP INLET PER DETAIL 7/L4.0.

- (1) RAIN GUTTERS CONTINUOUS ALONG LOW EDGE OF ROOF.
- 2 3" CAST IRON DOWNSPOUTS: PROVIDE AND INSTALL DOWNSPOUTS CONNECTING DIRECTLY TO IN-GROUND DRAINLINE. ATTACH TO COLUMNS.
- 3 4" PVC DRAINLINE: INSTALL AT 12" MINIMUM DEPTH, SLOPE AT 1.0% MINIMUM.
- 6" PVC DRAINLINE: INSTALL AT 12" MINIMUM DEPTH, SLOPE AT 1.0% MINIMUM, AND CONNECT TO EXISTING STORM MANHOLE AT LOCATION
- CONNECT TO EXISTING STORM DRAIN LINE AT LOCATION INDICATED. CONTRACTOR TO FIELD VERIFY INVERT OF EXISTING DRAIN LINE AT POINT
- 6 INSTALL 24"x24" GIBSON STEEL CATCH BASIN WITH TRAFFIC-RATED GRATE. SEE DETAIL 7/L4.0.
- (7) EXISTING STORM STRUCTURE TO REMAIN. RIM TO BE FLUSH WITH NEW ASPHALT, IF APPLICABLE.

ABBREVIATIONS

ASPHALT CONCRETE **FLOWLINE** GRADE MATCH EXISTING PAVEMENT


STORM DRAIN DROP INLET SDMH STORM DRAIN MANHOLE

ARCHITECTURE

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MEDFORD SCHOOL DISTRICT 2323 SISKIYOU BLVD, MEDFORD, OR 97504


HOOVER ES OUTDOOR EATING SPACE

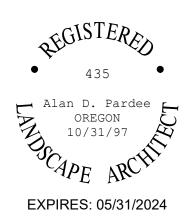


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3-15-2024


GRADING AND DRAINAGE PLAN



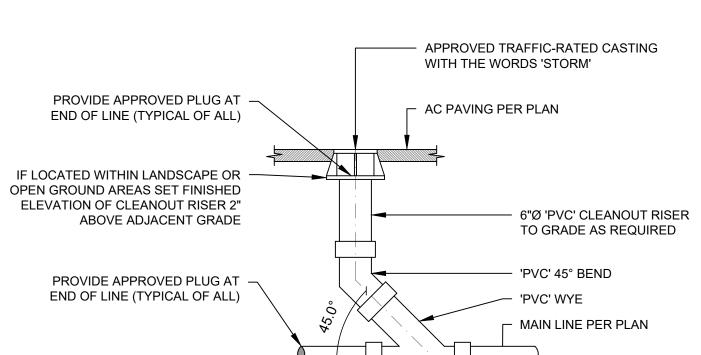

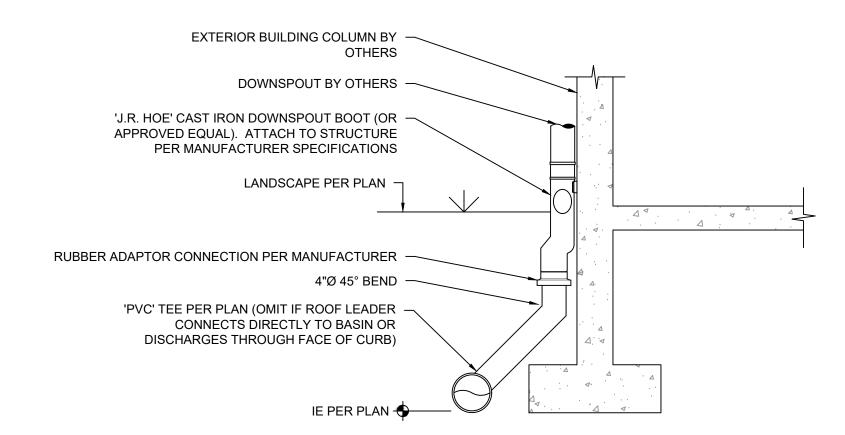
TYPICAL DOWNSPOUT CONNECTION

SUBMIT SHOP DRAWINGS FOR ENGINEER APPROVAL PRIOR TO CONSTRUCTION

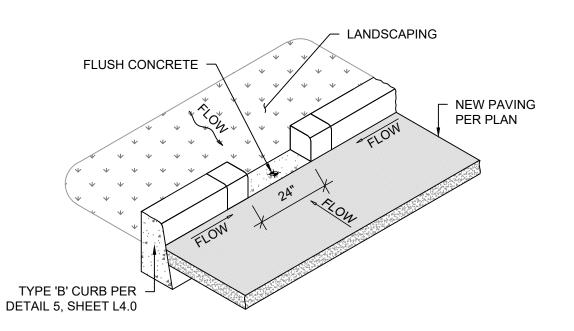





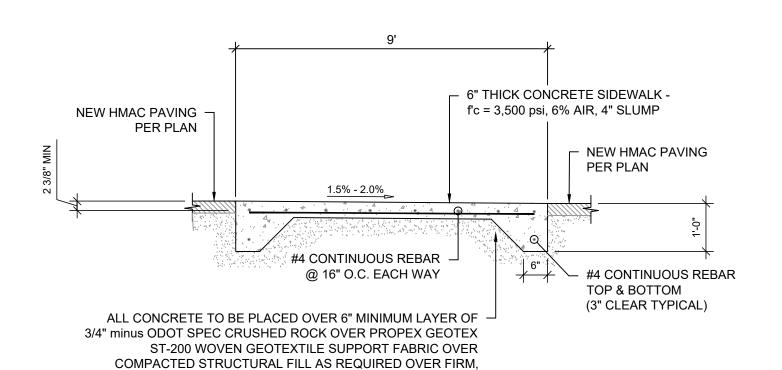


PREPARATION NOTES FOR ADDITIONAL INFORMATION PROVIDE CONTROL JOINTS @ 'X' o.c.

AND 3/8" ISOLATION JOINTS @ 3x 'X' o.c.

(COORDINATE WITH PLAN)


UNDISTURBED, NON-ORGANIC NATIVE MATERIAL - SEE SITE

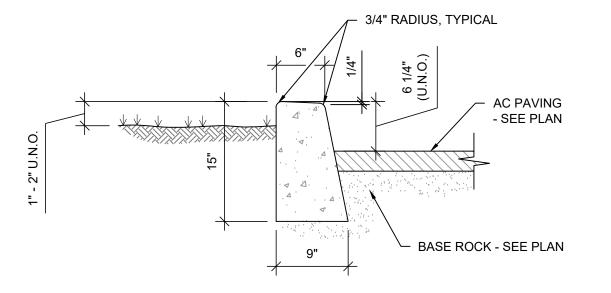


PROVIDE CONTRACTION JOINTS AT 15' MAXIMUM SPACING AND AT ENDS OF EACH INLET AND RAMP. PROVIDE 3/8" ISOLATION JOINT (HOLD JOINT FILLER DOWN 1/2", TYPICAL) AT 100' MAXIMUM SPACING,

L4.0/


REINFORCED SIDEWALK SECTION WITH ASPHALT

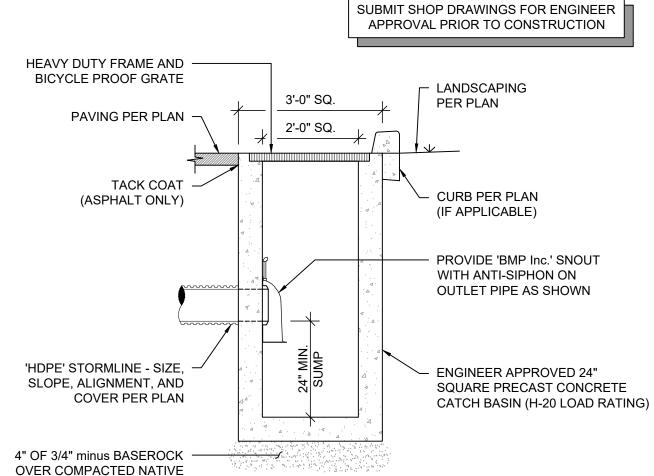



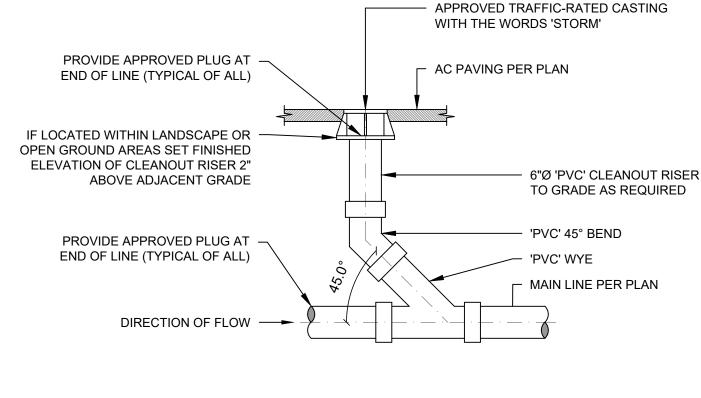




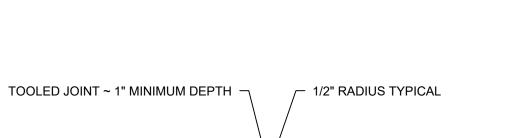

REINFORCING CONTINUOUS

THROUGH JOINT (IF APPLICABLE)

TOOLED CONTROL JOINT

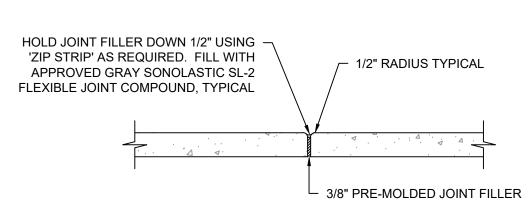

ISOLATION JOINT



L4.0

3/4" = 1'

NOTES:

\L4.0

TYPE 'B' STANDARD CURB

AND AT POINTS OF TANGENCY, AND AT EACH DRIVEWAYS END.

3. COORDINATE JOINT SPACING TO MATCH CONCRETE SIDEWALK SCORING SPACING.

1" = 1'

NTS

PROJECT NO:	M-0366-23
DRAWN:	MMV
CHECKED:	ADF

OREGON 10/31/97

EXPIRES: 05/31/2024

REVISION ID:

ARCHITECTURE

45 Hawthorne Street, Suite 5, Medford,

Oregon 97504 | 541-500-8588

MEDFORD SCHOOL DISTRICT

OUTDOOR EATING SPACE

2323 SISKIYOU BLVD,

MEDFORD, OR 97504

HOOVER ES

3-15-2024

LANDSCAPE **DETAILS**

L4.0

LANDSCAPE DETAILS

SCALE: AS SHOWN