

**1000 Midjay Dr,
Liberty, MO 64068**

Architectural rendering of South Valley Middle School. The building is a large, modern structure with a dark brown facade and a blue entrance section. The school's name and logo are visible on the upper left side of the building. A paved walkway leads to the entrance, and a grassy area is in the foreground. Several people are shown walking on the path.

DESIGN TEAM

GENERAL		A412		VERTICAL CIRCULATION & ENLARGED PLANS		E201A		POWER PLAN - LEVEL 1 & MEZZANINE - AREA A	
G000	COVER SHEET	A501	DOOR SCHEDULE, DOOR TYPES & FRAME TYPES	A502	DOOR & WINDOW DETAILS	E301	ELECTRICAL ONE-LINE DIAGRAM	E302	ELECTRICAL SCHEDULES AND DETAILS
G010	CODE INFORMATION	A601A	FINISH FLOOR PLAN - LEVEL 1 - AREA A	A621	INTERIOR ELEVATIONS	E303	ELECTRICAL SCHEDULES AND DETAILS	E304	ELECTRICAL SCHEDULES AND DETAILS
G101	CODE SITE PLAN/OVERALL CODE PLAN	A622	INTERIOR ELEVATIONS	A623	INTERIOR ELEVATIONS	TECHNOLOGY			
G102	ENLARGED CODE PLAN - STORM SHELTER PLAN	A661	INTERIOR DETAILS	A662	INTERIOR DETAILS	AV001	GENERAL NOTES AND LEGENDS	AV101A	AV FLOOR PLAN - LEVEL 1 - AREA A
DEMOLITION - CIVIL		A681	MATERIAL FINISH LEGEND & FINISH SCHLEDULE	A701A	SIGNAGE & ENVIRONMENTAL GRAPHICS FLOOR PLAN - AREA A - LEVEL 1	AV121A	AV REFLECTED CEILING PLAN - LEVEL 1 - AREA A	AV301	AV BUILDING SECTIONS
DC101	DEMOLITION PLAN	A711	SIGNAGE & ENVIRONMENTAL GRAPHICS SCHEDULES	A720	SIGNAGE & ENVIRONMENTAL GRAPHICS EXTERIOR ELEVATIONS & DETAILS	AV501	AV EQUIPMENT MOUNTING DETAILS	AV502	AV RACK AND CONNECTION PANEL DETAILS
DEMOLITION - ARCHITECTURE		STRUCTURAL		FIRE PROTECTION		AV601	AV ONE-LINE DIAGRAM	FIRE PROTECTION	
DA101	DEMOLITION FLOOR PLAN - OVERALL - LEVEL 1	S001	GENERAL NOTES	FP101	OVERALL FIRE PROTECTION PLAN - LEVEL 1	THEATRICAL			
DEMOLITION - ELECTRICAL		S002	SCHEDULES	TH002					
DE101A	DEMOLITION LIGHTING PLAN - LEVEL 1 - AREA A	S003	CMU DETAILS	TH003					
ARCHITECTURAL SITE		S100	FOUNDATION PLAN	TH100					
AS101	ARCHITECTURAL SITE PLAN	S101	LOW ROOF FRAMING PLAN	TH101					
AS201	SITE DETAILS	S102	HIGH ROOF FRAMING PLAN	TH102					
CIVIL		S200	FOUNDATION SECTIONS	TH110					
C100	CIVIL INFORMATION SHEET	S201	FOUNDATION SECTIONS	TH111					
C101	OVERALL SITE PLAN	S202	FOUNDATION SECTIONS	TH112					
C102	EXISTING CONDITIONS PLAN	S203	FOUNDATION SECTIONS	TH130					
C103	UTILITY PLAN	S300	TYPICAL FRAMING DETAILS						
C104	PAVING PLAN	S301	ROOF FRAMING SECTIONS						
C105	GRADING PLAN	S302	FRAMING SECTIONS						
C106	EROSION CONTROL PLAN	S303	FRAMING SECTIONS						
C200	DETAILS	S500	STORM SHELTER DETAILS						
LANDSCAPE		MECHANICAL/ELECTRICAL							
L100	LANDSCAPE PLAN	ME101	MECHANICAL AND ELECTRICAL SYMBOLS AND ABBREVIATIONS						
ARCHITECTURE		ME212	OVERALL MECHANICAL AND ELECTRICAL ROOF PLAN						
A001	GENERAL ARCHITECTURAL INFORMATION	ME212A	MECHANICAL AND ELECTRICAL ROOF PLAN - AREA A						
A002	SLAB, PRECAST, & CMU JOINTS	ME301	MECHANICAL AND ELECTRICAL SCHEDULES						
A101	FLOOR PLAN - LEVEL 1 - OVERALL	ME302	MECHANICAL AND ELECTRICAL SCHEDULES						
A101A	FLOOR PLAN - LEVEL 1 - AREA A	ME401	MECHANICAL AND ELECTRICAL DETAILS						
A121A	REFLECTED CEILING PLAN - LEVEL 1 - AREA A	ME402	MECHANICAL AND ELECTRICAL DETAILS						
A121B	REFLECTED CEILING PLAN - LEVEL 1 - AREA B	ME403	MECHANICAL AND ELECTRICAL DETAILS						
A121C	REFLECTED CEILING PLAN - LEVEL 1 - AREA C	MECHANICAL							
A121D	REFLECTED CEILING PLAN - LEVEL 1 - AREA D	M101A	HVAC PLAN - LEVEL 1 & MEZZANINE - AREA A						
A121E	REFLECTED CEILING PLAN - LEVEL 1 - AREA E	M301	HVAC CONTROL DIAGRAMS						
A141	ROOF PLAN	PLUMBING							
A142	ROOF DETAILS	P100A	UNDERSLAB PLUMBING PLAN - LEVEL 1 - AREA A						
A201	EXTERIOR ELEVATIONS - OVERALL	P101	OVERALL PLUMBING PLAN - LEVEL 1						
A301	BUILDING SECTIONS	P101A	PLUMBING PLAN - LEVEL 1 & MEZZANINE - AREA A						
A331	WALL SECTIONS - MULTIPURPOSE	P301	PLUMBING RISER DIAGRAMS						
A332	WALL SECTIONS - CONNECTION	ELECTRICAL							
A333	WALL SECTIONS - CONNECTION & ENTRY	E101	OVERALL LIGHTING PLAN - LEVEL 1						
A334	WALL SECTIONS - CONNECTION	E101A	LIGHTING PLAN - LEVEL 1 & MEZZANINE - AREA A						
A335	WALL SECTION - SUPPORT	E201	OVERALL POWER PLAN - LEVEL 1						
A361	EXTERIOR DETAILS								
A362	EXTERIOR DETAILS								
A363	EXTERIOR DETAILS								
A371	EXTERIOR DETAILS								
A372	EXTERIOR DETAILS								
A411	VERTICAL CIRCULATION & ENLARGED PLANS								

ARCHITECT:

Hollis + Miller Architects
1828 Walnut Street Ste 922
Kansas City, MO 64108
CONTACT: Kyle LaBarre
PHONE: 816.442.7700
FAX: 816.599.2545

CONSTRUCTION MANAGER:

Newkirk Novak Construction Partners
11200 W 79th Street
Lenexa, KS 66214
CONTACT: Brandon Stanley
PHONE: 913.312.9535

CIVIL ENGINEER:

MKEC Engineering, Inc
11827 W. 112th Street, Suite 200
Overland Park, KS 66210
CONTACT: Brian Hill/Braden Taylor
PHONE: 913.317.9390
FAX: 913.317.9385

STRUCTURAL ENGINEER:

Bob D. Campbell & Co.
4338 Belleview Ave.
Kansas City, MO 64111
CONTACT: Wayne Davis
PHONE: 816.531.4144

MECH/ELECT ENGINEER:

Smith & Boucher Engineers
25618 West 103rd St.
Olathe, KS 66061
CONTACT: Ryan Diediker
PHONE: 913.345.2127
FAX: 913.345.0617

GEOTECHNICAL ENGINEER:

Kruger Technologies, Inc.
8721 Melrose Drive
Lenexa, KS 66214
CONTACT: Dylan Kruger
PHONE: 913.498.1114
FAX: 913.498.1116

THEATRICAL CONSULTANT:

Peerbolte Creative
109 E. Pine St.
Warrensburg, MO 64093-0754
CONTACT: Shannon Johnson
PHONE: 660.429.1383

AV/ACOUSTICS CONSULTANT

Avant Acoustics
14827 West 95th St.
Lenexa, KS 66215
CONTACT: John Hodgson
PHONE: 913.888.9111

ALTERNATES

ALTERNATE 1:

BASE BID: NO WORK
ALTERNATE : ALTERNATE INCLUDES ALL LABOR, MATERIALS, EQUIPMENT AND APPURTENANANCES NECESSARY TO REPLACE ALL EXISTING CEILING TILE (GRIDS TO REMAIN). REFER TO SHEETS DA101 AND REFLECTED CEILING PLANS.

VICINITY MAP

Avant Acoustics
14827 West 95th St.
Lenexa, KS 66215
CONTACT: John Hodgson
PHONE: 913.888.9111

1000 Midjay Dr, Liberty, MO 64068

**CONFORMED
CONSTRUCTION
DOCUMENTS**



JOB NO: 23019
DRAWN BY: ES
CHECKED BY: JE
DATE: 08.31.2023

G000

COVER SHEET

	1	2	3	4	5	6	7	8	9	10	11	12	13	14	15	16	17	
R																		
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BLDG 4 - ADDITION TO EXISTING STRUCTURE

BUILDING INFORMATION

OCCUPANCY CLASSIFICATION:	Educational, Group E (305.1)
CONSTRUCTION TYPE:	II-B (602.2, Non-combustible, non-protected)
BUILDING HEIGHT: Allowable Height (Table 504.3): Building Height: Allowable Stories (Table 504.4): Building Stories:	75' above grade plane 20' 3 stories above grade plane 1
BUILDING AREA: Sprinkler Qualifier (Table 506.2): Allowable Area Building Area	S1: Building one story max. above grade plane with automatic sprinkler system 59,595 sq ft Existing: 37,144 + New: 1,250 = Total: 38,394 sq ft
OCCUPANCY SEPARATION:	No separation requirement (Table 508.4)
INCIDENTAL USE SEPARATION:	No separation requirement (509.3)
FIRE RESISTANCE RATINGS:	(Per Table 601, 602)
Primary Structural Frame: Exterior Bearing Walls: Interior Bearing Walls: Exterior Nonbearing Walls: Interior Nonbearing Walls: Floor Construction / Secondary Members: Roof Construction / Secondary Members:	0-Hour fire-resistance rating 0-Hour fire-resistance rating 0-Hour fire-resistance rating 0-Hour fire-resistance rating 0-Hour fire-resistance rating 0-Hour fire-resistance rating 0-Hour fire-resistance rating
Fire Walls	No fire walls
Fire Barriers	Existing: 2-Hour shafts, exit enclosures and passageway walls (Section 707) 90 Minute door with 90 Minute glazing, 100 or 1,296 sq in max (Table 716.1(2)) No Windows Permitted except those meeting ASTM E119 or UL 263 (Table 716.1(3))
Fire Partitions	No fire partitions
Smoke Barriers / Partitions	Existing: 1-Hour rated wall assembly (709) 20 Minute door with 20 Minute Glazing (Table 716.1(2)) 45 Minute Glazing at door sidelights and transoms (Table 716.1(2)) 45 Minute Fire Windows (Table 716.1(3))
Shafts	No shaft enclosures

BLDG 4 - ADDITION TO EXISTING STRUCTURE

EGRESS COMPONENTS

NUMBER OF EXITS:	2 per space greater than 49 occupants (Table 1006.2.1) 3 per space with load 501 to 1,000; 4 per space over 1,000
DEAD-END CORRIDORS:	50' Max. with automatic sprinkler system in groups B, E, F, I-1, M, R-1, R-2, R-4, S, U (1020.4, Exception 2)
COMMON PATH OF TRAVEL:	75' (Table 1006.2.1)
TRAVEL DISTANCE TO EXIT:	250' Maximum for A, E, F-1, I-1, M, R, S-1 with sprinkler (Table 1017.2)
CORRIDOR CONSTRUCTION: CORRIDOR WIDTH:	0-hour fire rating in A, B, E, F, I-2, I-4, M, S, U occupancies with sprinkler (1020.1) 44" minimum corridor width (Table 1020.2) 72" minimum for Group E corridor with required capacity of 100 or more (Table 1020.2)
MEANS OF EGRESS CAPACITY:	0.2" for stairways (1005.3.1) / 0.15" for doors / other (1005.3.2) (sprinklered bldg)

BLDG 4 - ADDITION TO EXISTING STRUCTURE

FIRE SAFETY FEATURES

SPRINKLER:	Automatic sprinkler system provided throughout Sprinkler installed per NFPA 13 (903.3.1.1)
FIRE ALARM SIGNALING: EMERGENCY LIGHTING / POWER: SMOKE CONTROL SYSTEM:	Existing System Existing System Existing System

BLDG 4 - ADDITION TO EXISTING STRUCTURE

PLUMBING FIXTURES

Water Closets (Male): Water Closets (Female): Lavatories (Male): Lavatories (Female): Drinking Fountains: Service Sink:	E: 1 per 50 - Existing to Remain E: 1 per 50 - Existing to Remain E: 1 per 50 - Existing to Remain E: 1 per 50 - Existing to Remain E: 1 per 50 - Existing to Remain Existing to Remain
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BLDG 4 - ADDITION TO EXISTING STRUCTURE

BUILDING AREA CALCULATIONS

506.2	Allowable Area Determination: Equation 5-2	
	$A_a = [A_t + (NS \times F)] \times S_a$ where: Aa = Allowable area (square feet, typ.) At = Tabular allowable area factor (per sprinkler qualifier) in accordance with Table 506.2 NS = Tabular allowable area factor per Table 506.2 (regardless of whether building is sprinklered) F = Area factor increase due to frontage(percentage) per Section 506.3 Sa = Actual number of stories above grade plane: not to exceed 3 (4 if building is fully sprinklered).	At = 58000 NS = 14500 F = 0.11 Sa = 1
	Aa = 59595 sq ft	
506.3	Frontage Increase: Per Equation 5-5: If = $[FP - 0.25] W/30$ where: F = Area increase due to frontage F = Building perimeter that fronts a public way or open space having 20 feet open minimum width P = Perimeter of entire building (feet) W = Width of public way of open space (feet) – min. 20' to be allowed, use 30' max. If = 0.11	F = 476 P = 1329 W = 30

BLDG 3 - EXISTING - NO WORK

BUILDING INFORMATION

OCCUPANCY CLASSIFICATION:	Educational, Group E (305.1)
CONSTRUCTION TYPE:	II-B (602.2, Non-combustible, non-protected)
BUILDING HEIGHT: Allowable Height (Table 504.3): Building Height: Allowable Stories (Table 504.4): Building Stories:	75' above grade plane 20' 3 stories above grade plane 1
BUILDING AREA: Sprinkler Qualifier (Table 506.2): Allowable Area Building Area	S1: Building one story max. above grade plane with automatic sprinkler system 58000 57036
OCCUPANCY SEPARATION:	No separation requirement (Table 508.4)
INCIDENTAL USE SEPARATION:	No separation requirement (509.3)
FIRE RESISTANCE RATINGS:	(Per Table 601, 602)
Primary Structural Frame: Exterior Bearing Walls: Interior Bearing Walls: Exterior Nonbearing Walls: Interior Nonbearing Walls: Floor Construction / Secondary Members: Roof Construction / Secondary Members:	0-Hour fire-resistance rating 0-Hour fire-resistance rating 0-Hour fire-resistance rating 0-Hour fire-resistance rating 0-Hour fire-resistance rating 0-Hour fire-resistance rating 0-Hour fire-resistance rating
Fire Walls	No fire walls
Fire Barriers	Existing: 2-Hour shafts, exit enclosures and passageway walls (Section 707) 90 Minute door with 90 Minute glazing, 100 or 1,296 sq in max (Table 716.1(2)) No Windows Permitted except those meeting ASTM E119 or UL 263 (Table 716.1(3))
Fire Partitions	No fire partitions
Smoke Barriers / Partitions	Existing: 1-Hour rated wall assembly (709) 20 Minute door with 20 Minute Glazing (Table 716.1(2)) 45 Minute Glazing at door sidelights and transoms (Table 716.1(2)) 45 Minute Fire Windows (Table 716.1(3))
Shafts	No shaft enclosures

BLDG 3 - EXISTING - NO WORK

EGRESS COMPONENTS

NUMBER OF EXITS:	2 per space greater than 49 occupants (Table 1006.2.1) 3 per space with load 501 to 1,000; 4 per space over 1,000
DEAD-END CORRIDORS:	50' Max. with automatic sprinkler system in groups B, E, F, I-1, M, R-1, R-2, R-4, S, U (1020.4, Exception 2)
COMMON PATH OF TRAVEL:	75' (Table 1006.2.1)
TRAVEL DISTANCE TO EXIT:	250' Maximum for A, E, F-1, I-1, M, R, S-1 with sprinkler (Table 1017.2)
CORRIDOR CONSTRUCTION: CORRIDOR WIDTH:	0-hour fire rating in A, B, E, F, I-2, I-4, M, S, U occupancies with sprinkler (1020.1) 44" minimum corridor width (Table 1020.2) 72" minimum for Group E corridor with required capacity of 100 or more (Table 1020.2)
MEANS OF EGRESS CAPACITY:	0.2" for stairways (1005.3.1) / 0.15" for doors / other (1005.3.2) (sprinklered bldg)

BLDG 3 - EXISTING - NO WORK

FIRE SAFETY FEATURES

SPRINKLER:	Automatic sprinkler system provided throughout Sprinkler installed per NFPA 13 (903.3.1.1)
FIRE ALARM SIGNALING: EMERGENCY LIGHTING / POWER: SMOKE CONTROL SYSTEM:	Existing System Existing System Existing System

BLDG 3 - EXISTING - NO WORK

PLUMBING FIXTURES

Water Closets (Male): Water Closets (Female): Lavatories (Male): Lavatories (Female): Drinking Fountains: Service Sink:	E: 1 per 50 - Existing to Remain E: 1 per 50 - Existing to Remain E: 1 per 50 - Existing to Remain E: 1 per 50 - Existing to Remain E: 1 per 50 - Existing to Remain Existing to Remain
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BLDG 2 - ADDITION TO EXISTING STRUCTURE

BUILDING INFORMATION

OCCUPANCY CLASSIFICATION:	Assembly, Group A-4 (303.5)
CONSTRUCTION TYPE:	II-B (602.2, Non-combustible, non-protected)
BUILDING HEIGHT: Allowable Height (Table 504.3): Building Height: Allowable Stories (Table 504.4): Building Stories:	75' above grade plane 32' 3 stories above grade plane 1
BUILDING AREA: Sprinkler Qualifier (Table 506.2): Allowable Area Building Area	S1: Building one story max. above grade plane with automatic sprinkler system 40755 sq ft Existing: 24,900 + New: 960 = Total: 25,860 sq ft
OCCUPANCY SEPARATION:	No separation requirement (Table 508.4)
INCIDENTAL USE SEPARATION:	No separation requirement (509.3)
FIRE RESISTANCE RATINGS:	(Per Table 601, 602)
Primary Structural Frame: Exterior Bearing Walls: Interior Bearing Walls: Exterior Nonbearing Walls: Interior Nonbearing Walls: Floor Construction / Secondary Members: Roof Construction / Secondary Members:	1-Hour fire-resistance rating 1-Hour fire-resistance rating 1-Hour fire-resistance rating 1-Hour fire-resistance rating 1-Hour fire-resistance rating 1-Hour fire-resistance rating 1-Hour fire-resistance rating
Fire Walls	2-Hour (Table 706.4) 90 Minute door with 90 Minute glazing (Table 716.1(2)) No Windows Permitted except those meeting ASTM E119 or UL 263 (Table 716.1(3))
Fire Barriers	Existing: 2-Hour shafts, exit enclosures and passageway walls (Section 707) 90 Minute door with 90 Minute glazing, 100 or 1,296 sq in max (Table 716.1(2)) No Windows Permitted except those meeting ASTM E119 or UL 263 (Table 716.1(3))
Fire Partitions	No fire partitions
Smoke Barriers / Partitions	Existing: 1-Hour rated wall assembly (709) 20 Minute door with 20 Minute Glazing (Table 716.1(2)) 45 Minute Glazing at door sidelights and transoms (Table 716.1(2)) 45 Minute Fire Windows (Table 716.1(3))
Shafts	No shaft enclosures

BLDG 2 - ADDITION TO EXISTING STRUCTURE

EGRESS COMPONENTS

NUMBER OF EXITS:	2 per space greater than 49 occupants (Table 1006.2.1) 3 per space with load 501 to 1,000; 4 per space over 1,000
DEAD-END CORRIDORS:	50' Max. with automatic sprinkler system in groups B, E, F, I-1, M, R-1, R-2, R-4, S, U (1020.4, Exception 2)
COMMON PATH OF TRAVEL:	75' (Table 1006.2.1)
TRAVEL DISTANCE TO EXIT:	250' Maximum for A, E, F-1, I-1, M, R, S-1 with sprinkler (Table 1017.2)
CORRIDOR CONSTRUCTION: CORRIDOR WIDTH:	0-hour fire rating in A, B, E, F, I-2, I-4, M, S, U occupancies with sprinkler (1020.1) 44" minimum corridor width (Table 1020.2)
MEANS OF EGRESS CAPACITY:	0.2" for stairways (1005.3.1) / 0.15" for doors / other (1005.3.2) (sprinklered bldg)

BLDG 2 - ADDITION TO EXISTING STRUCTURE

FIRE SAFETY FEATURES

SPRINKLER:	Automatic sprinkler system provided throughout Sprinkler installed per NFPA 13 (903.3.1.1)
FIRE ALARM SIGNALING: EMERGENCY LIGHTING / POWER: SMOKE CONTROL SYSTEM:	Existing System Existing System Existing System

BLDG 2 - ADDITION TO EXISTING STRUCTURE

PLUMBING FIXTURES

Water Closets (Male): Water Closets (Female): Lavatories (Male): Lavatories (Female): Drinking Fountains: Service Sink:	A-4: 1 per 125 A-4: 1 per 65 A-4: 1 per 200 A-4: 1 per 200 A-4: 1 per 500 1 Service Sink
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BLDG 2 - ADDITION TO EXISTING STRUCTURE

BUILDING AREA CALCULATIONS

506.2	Allowable Area Determination: Equation 5-2	
	$A_a = [A_t + (NS \times F)] \times S_a$ where: Aa = Allowable area (square feet, typ.) At = Tabular allowable area factor (per sprinkler qualifier) in accordance with Table 506.2 NS = Tabular allowable area factor per Table 506.2 (regardless of whether building is sprinklered) F = Area factor increase due to frontage(percentage) per Section 506.3 Sa = Actual number of stories above grade plane: not to exceed 3 (4 if building is fully sprinklered).	At = 38000 NS = 9500 F = 0.29 Sa = 1
	Aa = 40755 sq ft	
506.3	Frontage Increase: Per Equation 5-5: If = $[FP - 0.25] W/30$ where: F = Area increase due to frontage F = Building perimeter that fronts a public way or open space having 20 feet open minimum width P = Perimeter of entire building (feet) W = Width of public way of open space (feet) – min. 20' to be allowed, use 30' max. If = 0.29	F = 399 P = 740 W = 30

PROJECT INFORMATION

PROJECT NUMBER:	23018
PROJECT NAME:	South Valley Middle School Addition
OWNER:	Liberty School District 1000 Midjay Dr Liberty, MO 64068
AUTHORITY HAVING JURISDICTION:	City of Liberty, MO Planning & Development 101 E. Kansas Street Liberty, MO 64068
RESPONDING FIRE SERVICE:	City of Liberty Fire Department
ANTICIPATED OCCUPANCY:	April/May, 2025
ADOPTED CODES AND ORDINANCES:	2018 International Building Code 2018 International Existing Building Code 2017 National Electric Code (NFPA 70) 2018 International Mechanical Code 2018 International Plumbing Code 2012 International Energy Conservation Code 2009 ICC A117.1 Accessible and Usable Buildings and Facilities 2016 ASME A17.1 Safety Code for Elevators and Escalators 2014 ICC 500 Standard on Design and Construction of Storm Shelters Amendments

BLDG 1 - ADDITION

BUILDING INFORMATION

OCCUPANCY CLASSIFICATION:	Assembly, Group A-4 (303.5)
CONSTRUCTION TYPE:	II-B (602.2, Non-combustible, non-protected) Addition to existing structure
BUILDING HEIGHT: Allowable Height (Table 504.3): Building Height: Allowable Stories (Table 504.4): Building Stories:	75' above grade plane 34' 3 stories above grade plane 1
BUILDING AREA: Sprinkler Qualifier (Table 506.2): Allowable Area Building Area	S1: Building one story max. above grade plane with automatic sprinkler system 38000 10000
OCCUPANCY SEPARATION:	No separation requirement (Table 508.4)
INCIDENTAL USE SEPARATION:	No separation requirement (509.3)
FIRE RESISTANCE RATINGS:	(Per Table 601, 602)
Primary Structural Frame: Exterior Bearing Walls: Interior Bearing Walls: Exterior Nonbearing Walls: Interior Nonbearing Walls: Floor Construction / Secondary Members: Roof Construction / Secondary Members:	0-Hour fire-resistance rating 0-Hour fire-resistance rating 0-Hour fire-resistance rating 0-Hour fire-resistance rating 0-Hour fire-resistance rating 0-Hour fire-resistance rating 0-Hour fire-resistance rating
Fire Walls	2-Hour (Table 706.4) 90 Minute door with 90 Minute glazing (Table 716.1(2)) No Windows Permitted except those meeting ASTM E119 or UL 263 (Table 716.1(3))
Fire Barriers	No fire barriers
Fire Partitions	No fire partitions
Smoke Barriers / Partitions	No smoke barriers / partitions
Shafts	No shaft enclosures

BLDG 1 - ADDITION

EGRESS COMPONENTS

NUMBER OF EXITS:	2 per space greater than 49 occupants (Table 1006.2.1) 3 per space with load 501 to 1,000; 4 per space over 1,000
DEAD-END CORRIDORS:	50' Max. with automatic sprinkler system in groups B, E, F, I-1, M, R-1, R-2, R-4, S, U (1020.4, Exception 2)
COMMON PATH OF TRAVEL:	75' (Table 1006.2.1)
TRAVEL DISTANCE TO EXIT:	250' Maximum for A, E, F-1, I-1, M, R, S-1 with sprinkler (Table 1017.2)
CORRIDOR CONSTRUCTION: CORRIDOR WIDTH:	0-hour fire rating in A, B, E, F, I-2, I-4, M, S, U occupancies with sprinkler (1020.1) 44" minimum corridor width (Table 1020.2)
MEANS OF EGRESS CAPACITY:	0.2" for stairways (1005.3.1) / 0.15" for doors / other (1005.3.2) (sprinklered bldg)

BLDG 1 - ADDITION

FIRE SAFETY FEATURES

SPRINKLER:	Automatic sprinkler system provided throughout Sprinkler installed per NFPA 13 (903.3.1.1)
FIRE ALARM SIGNALING: EMERGENCY LIGHTING / POWER: SMOKE CONTROL SYSTEM:	Connect to Existing System Connect to Existing System Connect to Existing System

BLDG 1 - ADDITION

PLUMBING FIXTURES

Water Closets (Male): Water Closets (Female): Lavatories (Male): Lavatories (Female): Drinking Fountains: Service Sink:	A-4: 1 per 125 A-4: 1 per 65 A-4: 1 per 200 A-4: 1 per 200 A-4: 1 per 500 1 Service Sink
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BLDG 1 - ADDITION

BUILDING AREA CALCULATIONS

506.2	Allowable Area Determination: Equation 5-2	
	$A_a = [A_t + (NS \times F)] \times S_a$ where: Aa = Allowable area (square feet, typ.) At = Tabular allowable area factor (per sprinkler qualifier) in accordance with Table 506.2 NS = Tabular allowable area factor per Table 506.2 (regardless of whether building is sprinklered) F = Area factor increase due to frontage(percentage) per Section 506.3 Sa = Actual number of stories above grade plane: not to exceed 3 (4 if building is fully sprinklered).	At = 38000 NS = 9500 F = 0.75 Sa = 1
	Aa = 45125 sq ft	
506.3	Frontage Increase: Per Equation 5-5: If = $[FP - 0.25] W/30$ where: F = Area increase due to frontage F = Building perimeter that fronts a public way or open space having 20 feet open minimum width P = Perimeter of entire building (feet) W = Width of public way of open space (feet) – min. 20' to be allowed, use 30' max. If = 0.75	F = 2027 P = 3027 W = 30

South Valley Middle School Storm Shelter Addition
Liberty Public Schools
1000 Midjay Dr, Liberty, MO 64068

REVISIONS:

#	Description	Date
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Kevin E. Nelson
A-2019015618

This Professional Address and Seal shall be the sole responsibility of the signatory and shall remain the property of the signatory. All drawings, specifications and documents created by the signatory shall be the property of the signatory and shall remain the property of the signatory.

JOB NO: 23019
DRAWN BY: KL
CHECKED BY: JB
DATE: 08.31.2023

G010

CODE INFORMATION

Please consider the environment before printing this.

we design the future[®]
1828 Walnut Street Suite 922
Kansas City, MO 64108
1.816.442.7700
115 Wilcox Street Suite 210
Castle Rock, CO 80104
1.720.949.1689
HOLLISANDMILLER.COM
Holla + Miller Architects
Missouri State Certificate of Authority
Architecture # 0000561
Bob D Campbell
Structural Engineer
State Certificate of Authority #000442
4338 Bellevue Ave
Kansas City, MO 64111
816.531.4144 phone
Smith & Boucher, Inc.
Mechanical, Electrical, & Plumbing
State Certificate of Authority #EGC000178
25615 W 103rd Street
Olathe, KS 66061
913.345.2127 phone
MKEC Engineering, Inc.
Civil Engineer
State Certificate of Authority
Engineering #2001009364
Landscaping #2006027139
Surveying #2006027138
11827 W 112th Street, Suite 200
Overland Park, KS 66210
913.317.9390 phone
Peerbolte Creative
Theoretical Consultant
109 E Pine St.
Warrensburg, MO 64093-0752
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Code BLDG 1 Occupant Load Table

Rm No	Room Name	Function of Space	Area (SF)	Occupant Load Factor	Space Occupant Load
A103	Multipurpose	Assembly With Fixed Seats	5805 SF	0 SF	491
A107	Mechanical	Accessory Storage Areas, Mechanical Equipment Room	111 SF	300 SF	1
A108	Platform	Stages and Platforms	1740 SF	15 SF	117
Level 1					609
					609

Code BLDG 2 Occupant Load Table

Rm No	Room Name	Function of Space	Area (SF)	Occupant Load Factor	Space Occupant Load
A111	AV / Elec	Accessory Storage Areas, Mechanical Equipment Room	151 SF	300 SF	1
A112	Storage	Accessory Storage Areas, Mechanical Equipment Room	393 SF	300 SF	2
Level 1					3
A200	Mezzanine Storage	Accessory Storage Areas, Mechanical Equipment Room	820 SF	300 SF	3
Level 2					3
	Total Building Occupant Load				6

CODE LEGEND

1:20

1:20

1:20

1:20

1:20

1 HOUR FIRE PARTITION W/ 20 MIN DOORS

1:45

1:45

1:45

1:45

1:45

1 HOUR FIRE BARRIER W/ 45 MIN. DOORS

2:FB

2:FB

2:FB

2:FB

2:FB

2 HOUR FIRE BARRIER W/ 90 MIN DOORS

2:FW

2:FW

2:FW

2:FW

2:FW

2 HOUR FIRE WALL W/ 90 MIN DOORS

1S:20

1S:20

1S:20

1S:20

1S:20

EXISTING CONDITION

HIGH WIND AREA

NEW ADDITION

EXISTING BUILDING - NO WORK

EXISTING BUILDING - ALTERATION LEVEL 1
ALTERATIONS DO NOT INVOLVE SPACE RECONFIGURATION

FRONTAGE AREA

FD

FIRE HYDRANT

FDC

FIRE DEPARTMENT CONNECTION

FACP

FIRE ALARM CONTROL PANEL

FDA

FIRE DEPARTMENT ACCESS (KNOX BOX)

FE

FIRE EXTINGUISHER:
ON BRACKET: MOUNT HANDLE 48" MAX AFF
IN CABINET: BOTTOM OF CABINET 32" AFF

123 / 345

EXIT COMPONENT

123

CAPACITY

123

ACTUAL OCCUPANT LOAD

456

OCCUPANT COUNT @ ROOM EXIT

456

OCCUPANT SUM

131' - 6"

TRAVEL DISTANCE

BLDG 4 - ADDITION TO EXISTING STRUCTURE

NEW ENTRY CONNECTION TO THE EXISTING BUILDING SHALL BE INCLUDED IN THE EXISTING ALLOWABLE AREA IN BLDG 4 - EXISTING

BLDG 4 - EXISTING

PREVIOUS BUILDING CODE DATA PER 1994 UBC

BLDG 1 - ADDITION

OCCUPANT GROUP: A-4
TYPE OF CONSTRUCTION: IIB

BLDG 2 - ADDITION TO EXISTING STRUCTURE

CONNECTION FROM THE EXISTING BUILDING TO NEW STORM SHELTER IS TO BE INCLUDED IN THE EXISTING ALLOWABLE AREA IN BLDG 2 - EXISTING

BLDG 2 - EXISTING

PREVIOUS BUILDING CODE DATA PER 1994 UBC

OCCUPANT LOAD IN EXISTING GYM TO REMAIN AS IS AND NOT TO CHANGE

South Valley Middle School Storm Shelter Addition

Liberty Public Schools

1000 Midjay Dr, Liberty, MO 64068

REVISIONS:

#	Description	Date
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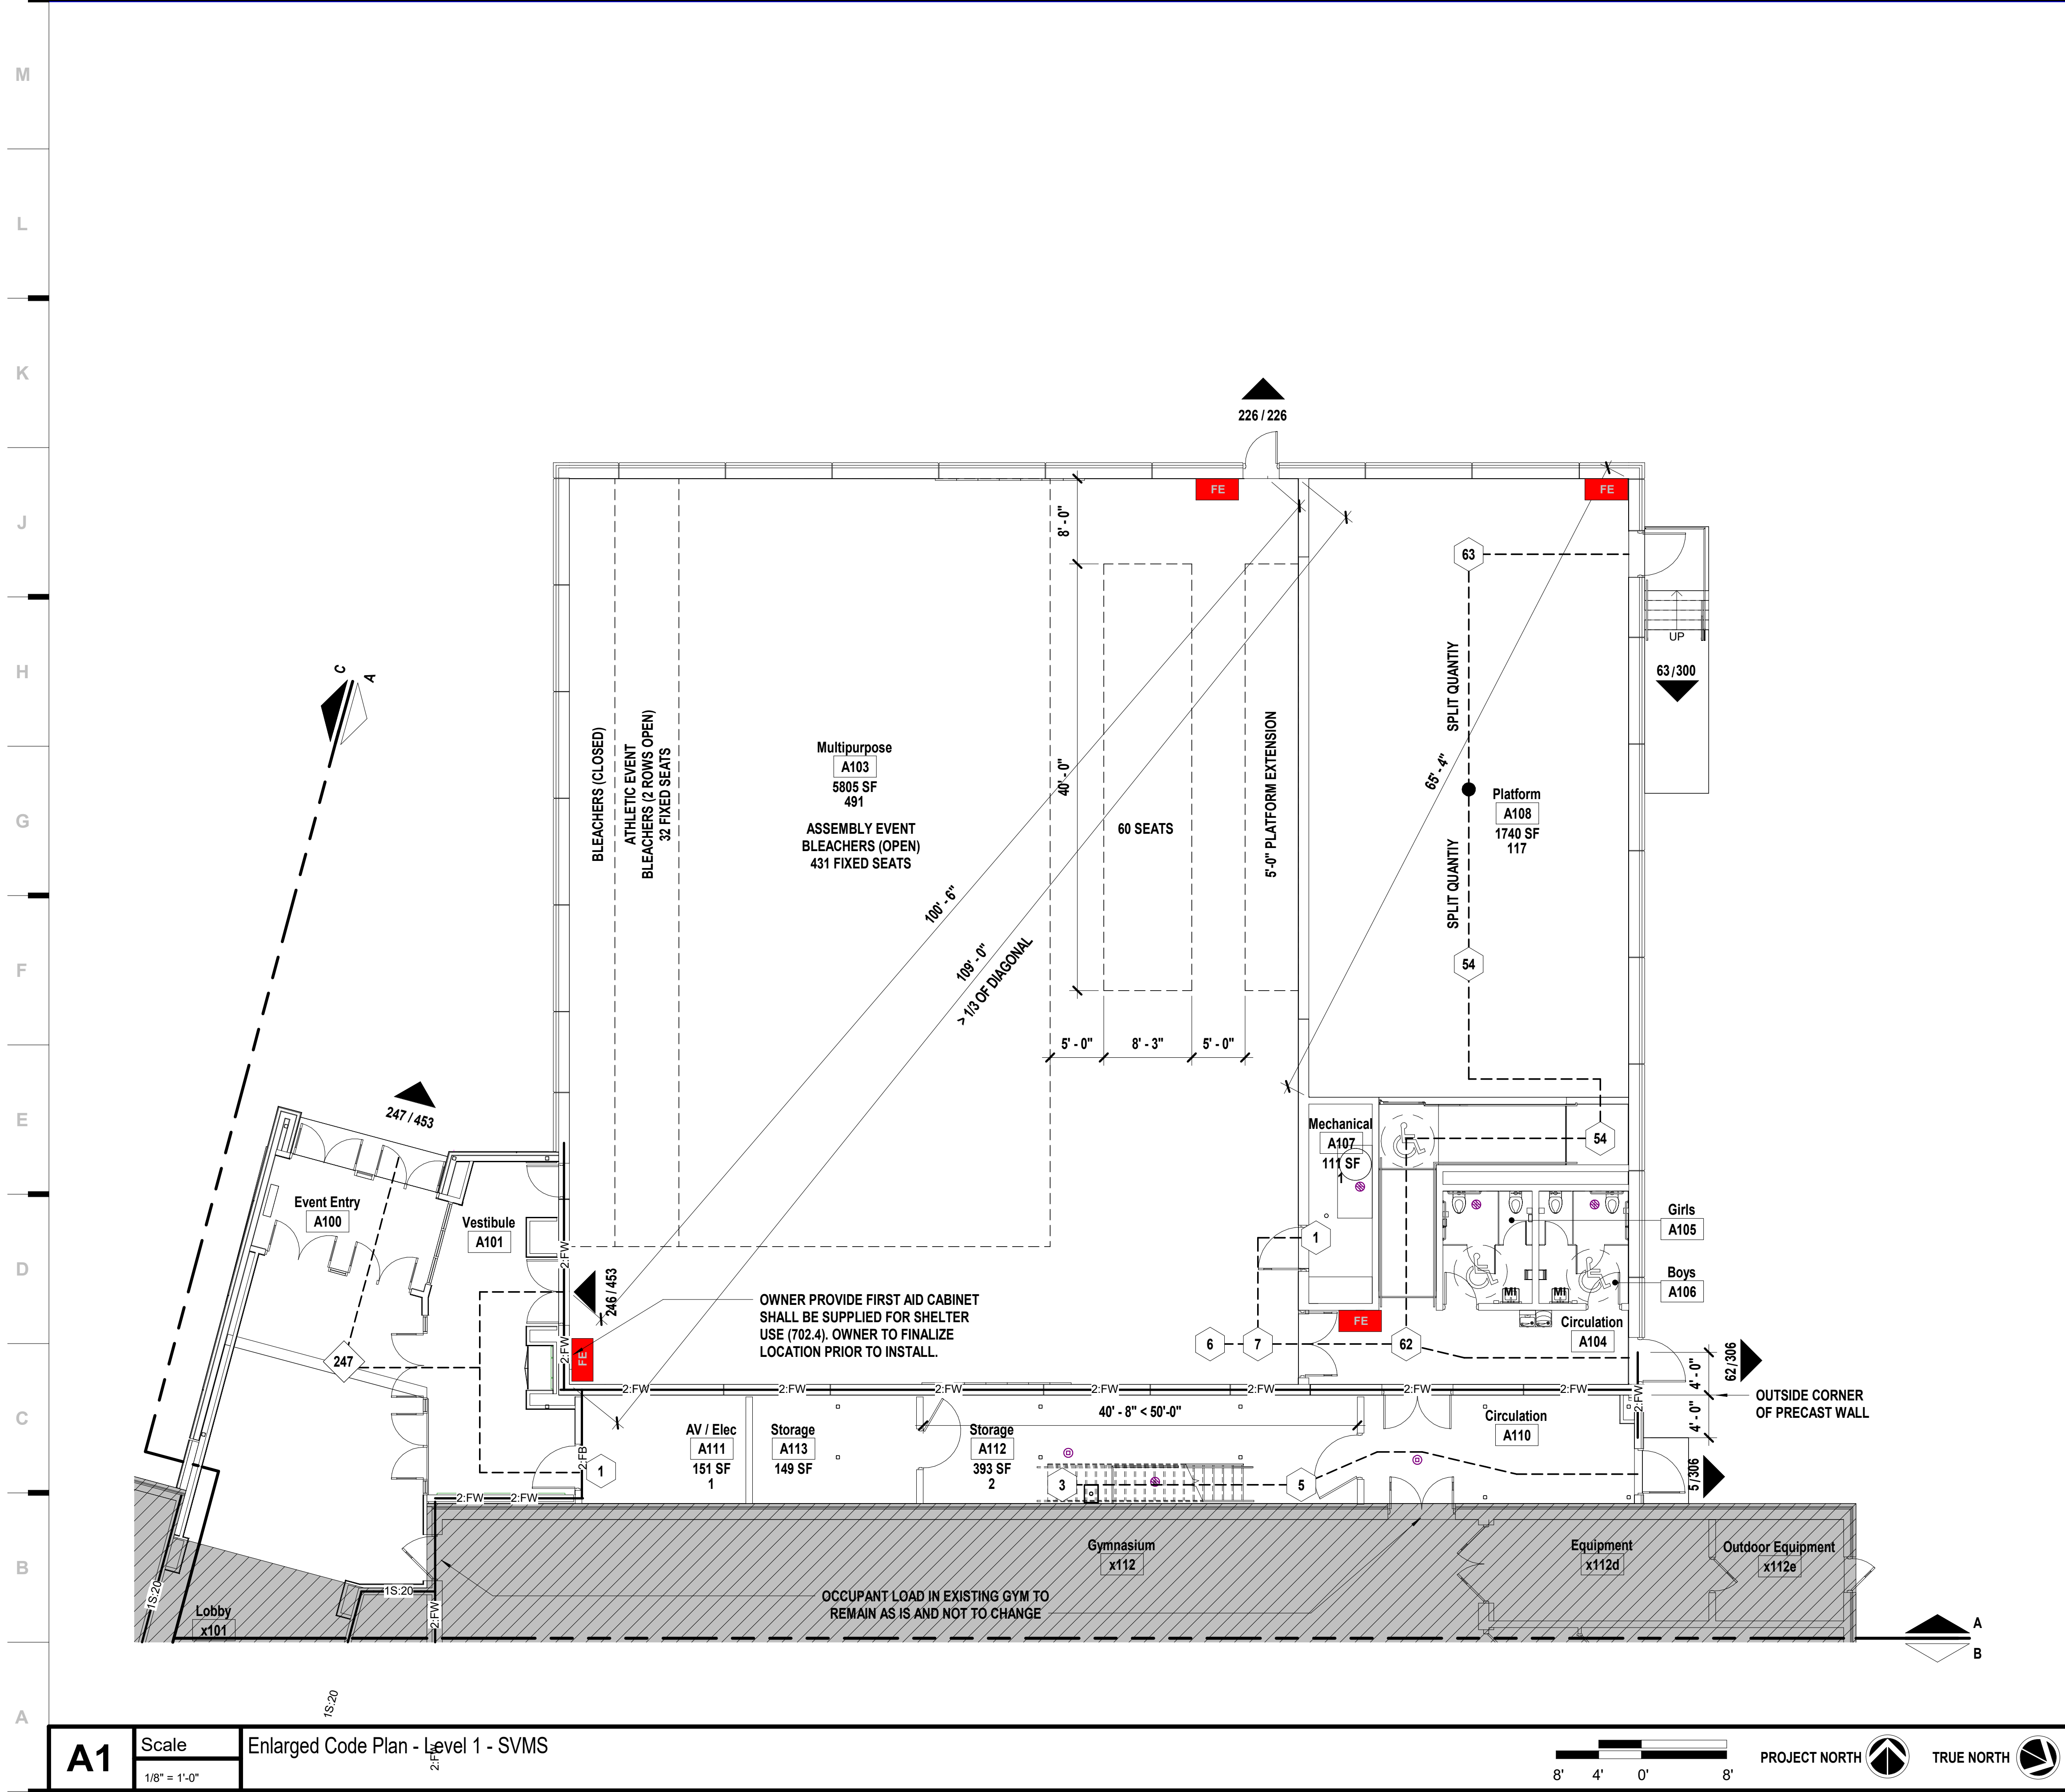
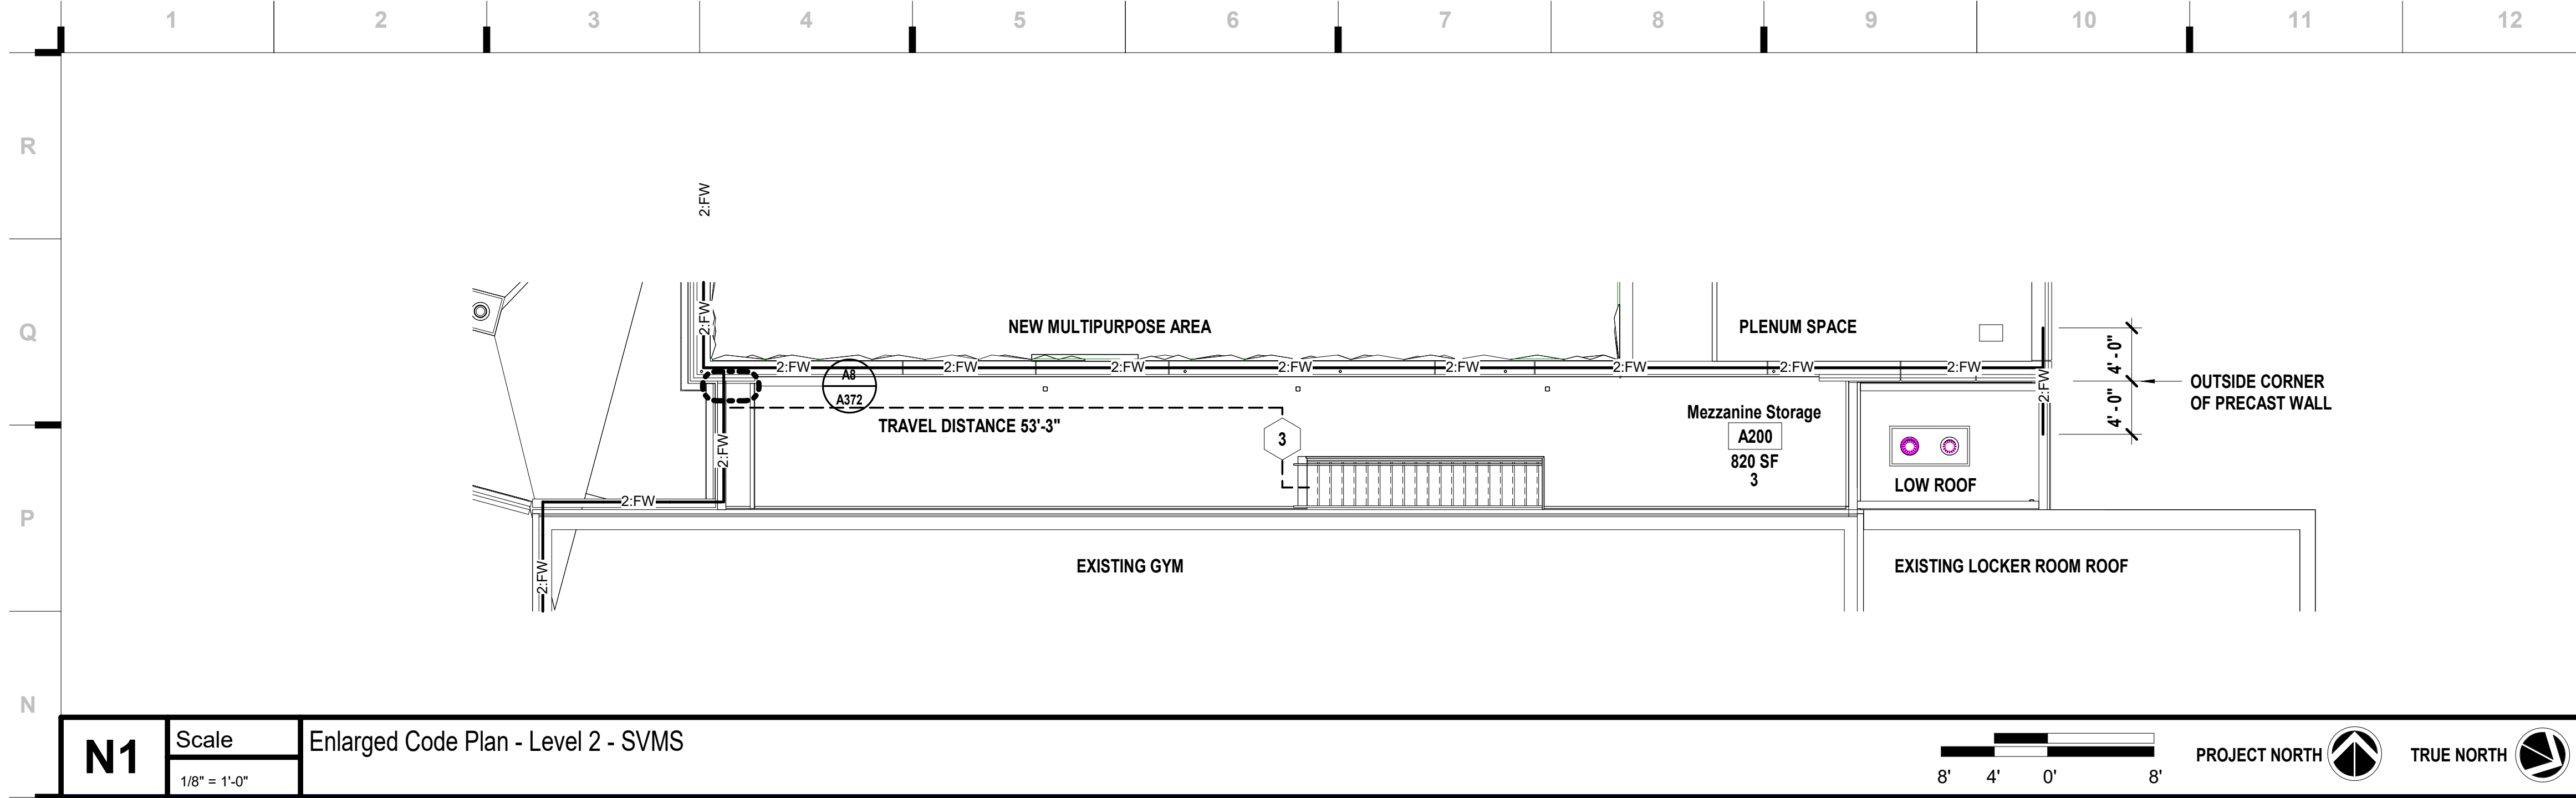
OCTOBER 11, 2023

Kevin E. Nelson
A-2019015618

This Professional Address and Affix to this stamp applies to the project and shall remain in effect for the project. All drawings, specifications and documents prepared by the architect shall be submitted to the architect for review and approval. The architect shall not be responsible for any errors or omissions in the drawings, specifications or documents prepared by the architect or for any errors or omissions in the construction of the project.

JOB NO: 23019
DRAWN BY: KL
CHECKED BY: JB
DATE: 08.31.2023

G101



STORM SHELTER OCCUPANT LOAD		
USABLE SPACES WITHIN SHELTER:		
GROSS AREA OF USABLE SPACES:	9403 SF	
USABLE FLOOR AREA OF SHELTER:	8830 SF	
USABLE SPACE IS BASED UPON ACTUAL NET AREA PER 501.1.2.2		
STANDING OR SEATED OCCUPANTS:	1766	
WHEELCHAIR SPACES	9	
TOTAL OCCUPANCY OF SHELTER:	1775	

VENTILATION AREA		
TOTAL OCCUPANCY OF SHELTER:	1775	
VENTING AREA PER OCCUPANT:	6 SQ IN (TABLE 702.1.1)	
MINIMUM VENTING AREA REQUIRED:	10650 SQ IN	


REQUIRED SANITATION FACILITIES		
TOILET FACILITIES:	REQUIRED: 4	PROVIDED: 4
HANDWASHING FACILITIES:	REQUIRED: 2	PROVIDED: 2

GYMNASIUM OCCUPANT LOAD		
ASSEMBLY		
ASSEMBLY EVENT		
BLEACHERS	FIXED' at 18"/occ	431
TEMPORARY SEATING	420 sf at 7 sf/occ	60
TEMPORARY STAGE	0 sf at 15 sf/occ	0
TOTAL ASSEMBLY OCCUPANTS:		491
ATHLETIC EVENT		
BLEACHERS	FIXED' at 18"/occ	60
GYM FLOOR	3205 sf at 50 sf/occ	65
TOTAL ATHLETIC OCCUPANTS:		125

CODE LEGEND		
1:20	1:20	1:20
1 HOUR FIRE PARTITION W/ 20 MIN DOORS	1:45	1:45
1 HOUR FIRE BARRIER W/ 45 MIN. DOORS	2:FB	2:FB
2 HOUR FIRE BARRIER W/ 90 MIN DOORS	2:FW	2:FW
2 HOUR FIRE WALL W/ 90 MIN DOORS	1S:20	1S:20
EXISTING CONDITION		
HIGH WIND AREA		
NEW ADDITION		
EXISTING BUILDING - NO WORK		
EXISTING BUILDING - ALTERATION LEVEL 1		
ALTERATIONS DO NOT INVOLVE SPACE RECONFIGURATION		
FRONTAGE AREA		
FH	FIRE HYDRANT	
FDC	FIRE DEPARTMENT CONNECTION	
FACP	FIRE ALARM CONTROL PANEL	
FDA	FIRE DEPARTMENT ACCESS (KNOX BOX)	
FE	FIRE EXTINGUISHER:	
	ON BRACKET: MOUNT HANDLE 48" MAX AFF	
	IN CABINET: BOTTOM OF CABINET 32" AFF	
	EXIT COMPONENT	
123 / 345	CAPACITY	
123	ACTUAL OCCUPANT LOAD	
456	OCCUPANT COUNT @ ROOM EXIT	
131' - 6"	OCCUPANT SUM	
	TRAVEL DISTANCE	

Code BLDG 1 Occupant Load Table						
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Hollis + Miller Architects
Missouri State Certificate of Authority
Architecture #000051

Bob D Campbell
Structural Engineer
State Certificate of Authority #000442
4338 Bellevue Ave
Kansas City, MO 64111
816.531.4144 phone

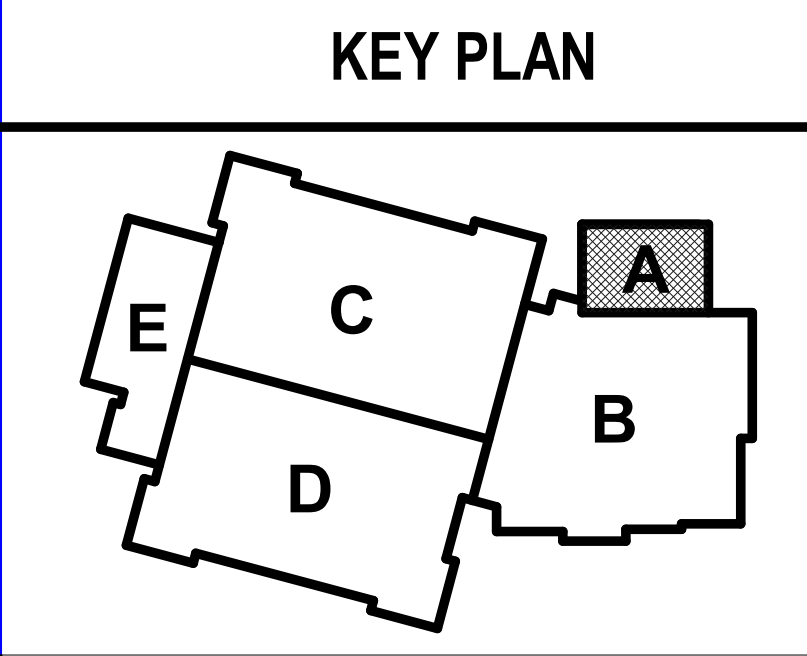Smith & Boucher, Inc.
Mechanical, Electrical, & Plumbing
State Certificate of Authority #EGC000178
25615 W 103rd Street
Olathe, KS 66061
913.345.2127 phone

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State Certificate of Authority
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11827 W 112th Street, Suite 200
Overland Park, KS 66210
913.317.9390 phone

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Theatrical Consultant
109 E Pine St.
Warrensburg, MO 64093-0752
660.429.1383 phone

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14827 West 95th St
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913.888.9111 phone

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Liberty Public Schools
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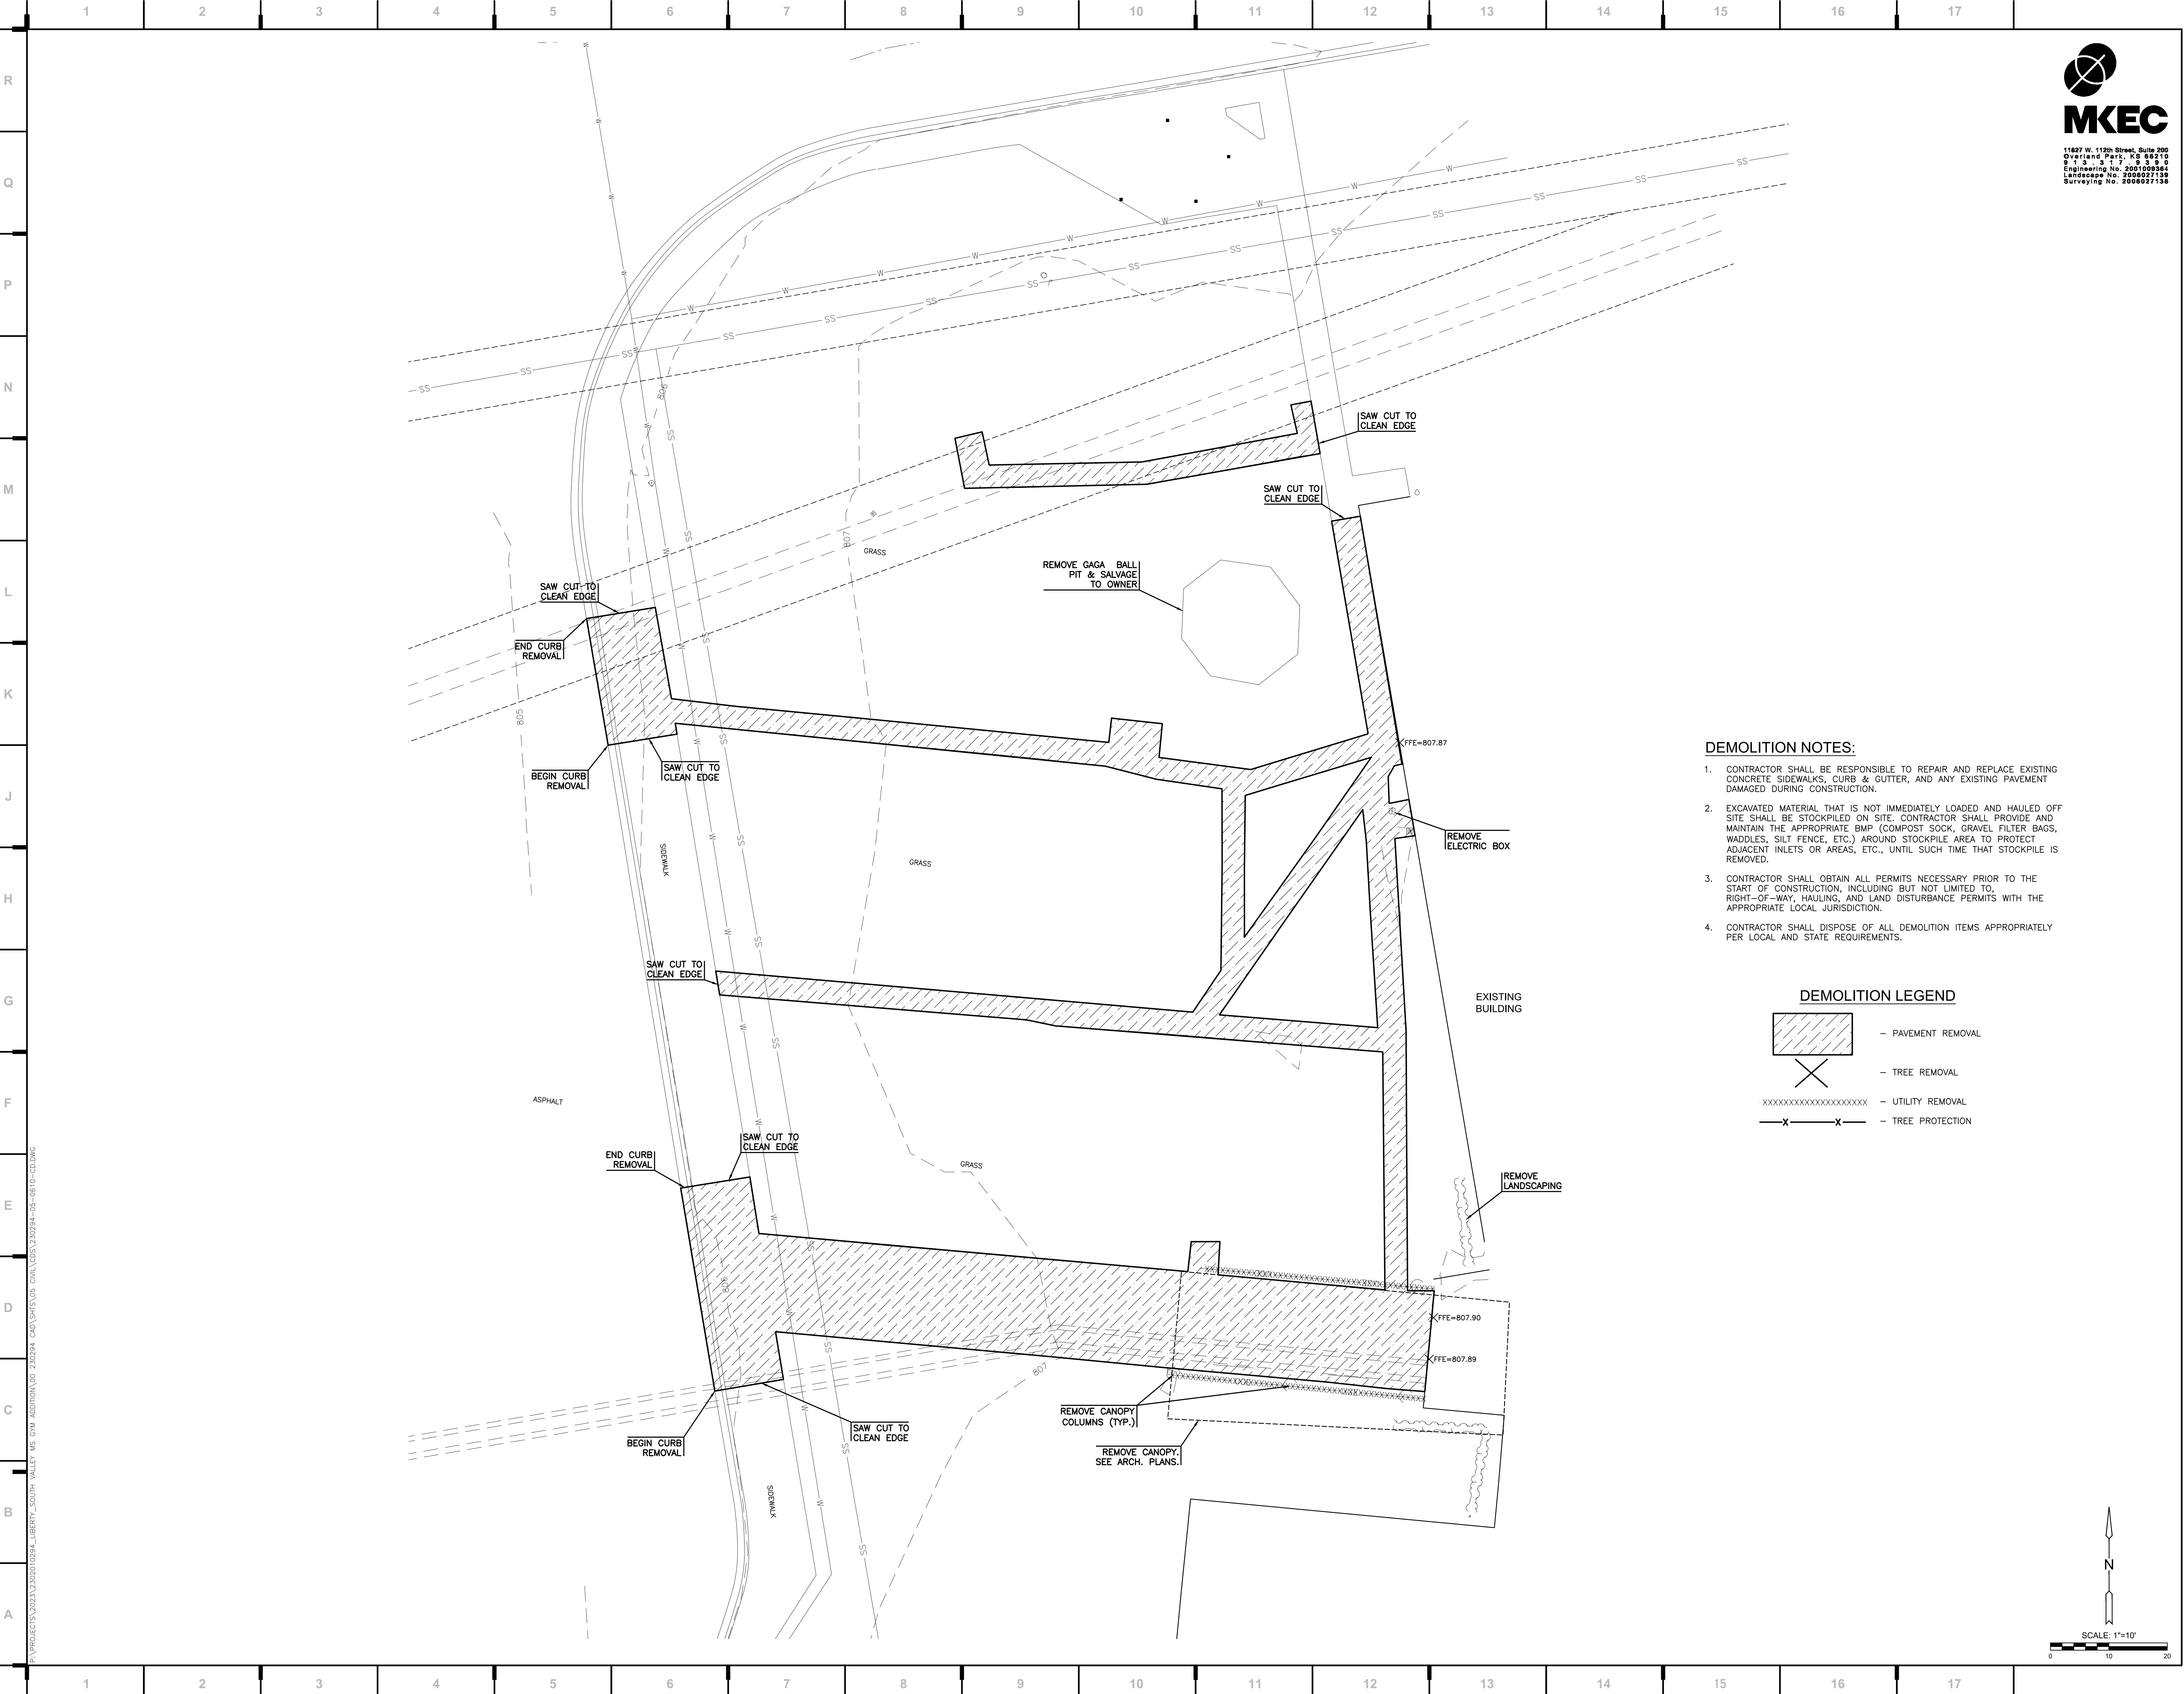
#	Description	Date
1	Addendum 01	09.14.2023
2	Addendum 02	10.09.2023

Kevin E. Nelson
A-2019015618
A-2019015618

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JOB NO: 23019
DRAWN BY: KL
CHECKED BY: JB
DATE: 08.31.2023

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11827 W. 112th Street, Suite 200
Overland Park, KS 66210
Engineering No. 2001009364
Landscape No. 2008027139
Surveying No. 2008027139

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1828 Walnut Street Suite 922
Kansas City, MO 64108
T 816.442.7700

115 Wilcox Street Suite 210
Castle Rock, CO 80104
T 720.949.1689

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Hollis + Miller Architects
Missouri State Certificate of Authority
Architecture # 000181
Structure # 200601333

MKEC Engineering, Inc.
Civil Engineering / Landscape Architecture
State Certificate of Authority #: 2001009364
Engineering: 2001009364
Landscape: 2008027139
Surveying: 2008027139
11827 W. 112th St. Ste 200
Overland Park, KS 66210
913.317.5395 phone


Smith & Boucher Engineers
Mech/Elect/Plumb Engineer
State Certificate of Authority #ECC-0001787
25501 W. Valley Parkway, Ste 200
Olathe, KS 66061
913.345.2127 phone

Bob D Campbell
Structural Engineer
State Certificate of Authority #000442
4338 Bellevue Ave
Kansas City, MO 64111
816.531.4144 phone

DEMOLITION NOTES:

1. CONTRACTOR SHALL BE RESPONSIBLE TO REPAIR AND REPLACE EXISTING CONCRETE SIDEWALKS, CURB & GUTTER, AND ANY EXISTING PAVEMENT DAMAGED DURING CONSTRUCTION.
2. EXCAVATED MATERIAL THAT IS NOT IMMEDIATELY LOADED AND HAULED OFF SITE SHALL BE STOCKPILED ON SITE. CONTRACTOR SHALL PROVIDE AND MAINTAIN THE APPROPRIATE BMP (COMPOST SOCK, GRAVEL FILTER BAGS, WADDLES, SILT FENCE, ETC.) AROUND STOCKPILE AREA TO PROTECT ADJACENT INLETS OR AREAS, ETC., UNTIL SUCH TIME THAT STOCKPILE IS REMOVED.
3. CONTRACTOR SHALL OBTAIN ALL PERMITS NECESSARY PRIOR TO THE START OF CONSTRUCTION, INCLUDING BUT NOT LIMITED TO, RIGHT-OF-WAY, HAULING, AND LAND DISTURBANCE PERMITS WITH THE APPROPRIATE LOCAL JURISDICTION.
4. CONTRACTOR SHALL DISPOSE OF ALL DEMOLITION ITEMS APPROPRIATELY PER LOCAL AND STATE REQUIREMENTS.

DEMOLITION LEGEND

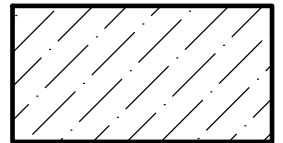

- PAVEMENT REMOVAL
- TREE REMOVAL
- UTILITY REMOVAL
- TREE PROTECTION


South Valley Middle School Storm Shelter Addition

Liberty Public Schools

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REVISIONS:

#	Description	Date

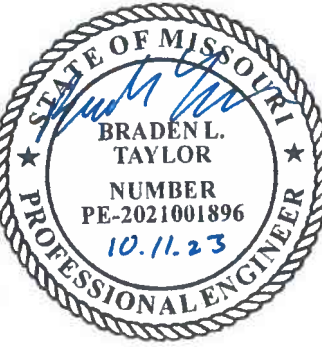

BRADEN L. TAYLOR, P.E.
LISC. #2021001896


JOB NO: 23019
DRAWN BY: SEK
CHECKED BY: BLT
DATE: 10.11.2023

DC101

DEMOLITION PLAN

1

RE: MEP DRAWINGS FOR EXTENT



REMOVE EXISTING MARKERBOARDS INCLUDING BRACKETS, SALVAGE TO OWNER

RELOCATE ANY/ALL WALL DEVICES. RE: MEP DRAWINGS FOR EXTENT


N1

Scale

Existing Vestibule - Right - For Reference Only

Not to Scale

2



REMOVE EXISTING MECH. UNIT. RE: MEP DRAWINGS OF EXTENT.

RELOCATE ANY/ALL WALL DEVICES. RE: MEP DRAWINGS FOR EXTENT


N5

Scale

Existing Vestibule - Left - For Reference Only

Not to Scale

3



REMOVE EXISTING CANOPY. RE: ARCHITECTURE AND STRUCTURAL DRAWINGS OF EXTENT.

RE: CIVIL DRAWINGS FOR EXTENT OF SITE DEMO.


N9

Scale

Existing Exterior Canopy To Be Demo'd - For Reference Only

Not to Scale

4



REMOVE EXISTING CANOPY. RE: ARCHITECTURE AND STRUCTURAL DRAWINGS OF EXTENT.

RE: MEP DRAWINGS FOR EXTENT.

RE: CIVIL DRAWINGS FOR EXTENT OF SITE DEMO.

N13

Scale

Existing Exterior Gym Wall - For Reference Only

Not to Scale

A1

Scale

Overall Demolition Floor Plan - Level 1

1" = 20'-0"

20'

10'

0'

20'

PROJECT NORTH

TRUE NORTH

DEMOLITION NOTES

FLOORS & BASE

1 REMOVE EXISTING PORCELAIN TILE AND BASE INCLUDING ADHESIVE. SALVAGE FOR OWNER TO REPLACE MISMATCH TILES IN BUILDING. PREPARE SLAB FOR NEW FLOORING.

2 REMOVE EXISTING CONCRETE SLAB AS REQUIRED FOR NEW CONSTRUCTION. SAW CUT CONCRETE PRIOR TO REMOVAL. DO NOT SAW CUT INTO EXISTING FOUNDATIONS OR OTHER STRUCTURAL MEMBERS.

3 REMOVE EXISTING CONCRETE SLAB AS REQUIRED FOR UNDER SLAB MECHANICAL, ELECTRICAL AND PLUMBING WORK. SAW CUT CONCRETE PRIOR TO REMOVAL. DO NOT SAW CUT INTO EXISTING FOUNDATIONS OR OTHER STRUCTURAL MEMBERS. COORDINATE WITH MEP SHEETS FOR NEW WORK AND CAPPING OF ABANDONED SERVICES

WALLS

1 REMOVE ALL/PORTION OF EXISTING CMU/BRICK WALL. COORDINATE EXTENTS OF REMOVAL WITH NEW CONSTRUCTION AND REMOVAL/REROUTING OF CONDUIT, WIRING, SWITCHES AND DUCTWORK. SALVAGE BRICK FOR REUSE AS MAY BE REQUIRED.

2 REMOVE ALL/PORTION OF EXISTING CMU WALL. COORDINATE EXTENTS OF REMOVAL WITH NEW CONSTRUCTION AND REMOVAL/REROUTING OF CONDUIT, WIRING, SWITCHES AND DUCTWORK WITH MEP DRAWINGS.

3 REMOVE EXISTING ALUMINUM OR HOLLOW METAL FRAMED GLAZING SYSTEM.

4 PREP EXISTING DOOR AND FRAME FOR NEW PAINT AND NEW HARDWARE.

5 REMOVE ALL/PORTION OF EXISTING FACE BRICK, INSULATION, AND BRICK TIES. COORDINATE EXTENTS OF REMOVAL WITH NEW CONSTRUCTION AND REMOVAL/REROUTING OF CONDUIT, WIRING, SWITCHES AND DUCTWORK. SALVAGE BRICK FOR REUSE AS MAY BE REQUIRED.

CEILINGS

1 REMOVE EXISTING LAY-IN ACOUSTICAL TILE AND SUSPENSION SYSTEM. EXISTING HANGER WIRE MAY BE REUSED FOR NEW SUSPENSION SYSTEM.

2 REMOVE EXISTING SOFFITS AND ALL EXISTING FRAMING.

3 REMOVE EXISTING GYPSUM BOARD CEILINGS AND SUSPENSION SYSTEM. EXISTING HANGER WIRE MAY BE REUSED FOR NEW SUSPENSION SYSTEM

DEMOLITION LEGEND

ALTERNATE 1: EXISTING LAY-IN ACOUSTICAL TILE & SUSPENSION SYSTEM TO BE REMOVED. EXISTING HANGER WIRE MAY BE REUSED FOR NEW SUSPENSION SYSTEM.

GENERAL DEMOLITION NOTES

1. DEMOLITION INCLUDES THE REMOVAL OF EXISTING CONSTRUCTION WHICH CONFLICTS WITH WORK TO BE BUILT/INSTALLED IN NEW CONSTRUCTION. TRANSITIONS BETWEEN DEMOLITION AND EXISTING TO REMAIN TO BE CAREFULLY COORDINATED

2. DASHED LINES INDICATE EXISTING CONSTRUCTION TO BE DEMOLISHED/REMOVED

3. HALF-TONE SHADING INDICATES EXISTING CONSTRUCTION TO REMAIN

4. EVERY DETAIL OF THE DEMOLITION WORK MAY NOT BE COVERED ON THESE DRAWINGS, BUT THE DEMOLITION CONTRACTOR SHALL COORDINATE WITH THE GC/OM TO ENSURE ALL REQUIRED ITEMS ARE REMOVED IN ORDER FOR NEW WORK TO BE COMPLETED

5. IN AREAS SCHEDULED FOR DEMOLITION, ALL ACCESSORIES ATTACHED TO THE CEILINGS, FLOOR AND WALLS ARE TO BE REMOVED, INCLUDING BRACKETS, SCREWS, SIGNAGE, SURFACE MOUNTED ELECTRICAL AND TECHNOLOGY; REMOVE ALL WINDOW COVERINGS; MINI-BLINDS, ROLLER SHADES AND ALL BRACKETS

6. THE OWNER WILL IDENTIFY ALL ITEMS TO BE SALVAGED PRIOR DEMOLITION STARTING. CONTRACTOR SHALL SALVAGE AND TURN OVER TO THE OWNER ALL EQUIPMENT IDENTIFIED. ALL REMAINING ITEMS SHALL BE REMOVED BY THE DEMOLITION CONTRACTOR

7. DO NOT DISTURB SOIL UNDER EXISTING FOOTINGS AND/OR FLOOR SLABS NOTED TO REMAIN

8. COORDINATE THE REMOVAL OF ALL/PORTIONS OF LOAD BEARING ELEMENTS WITH THE STRUCTURAL ENGINEER PRIOR TO REMOVAL. PROVIDE TEMPORARY SHORING AS REQUIRED

9. REFER TO MEP DEMOLITION SHEETS FOR EXISTING MECHANICAL, ELECTRICAL AND PLUMBING TO BE REMOVED

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Kansas City, MO 64108
816.442.7700

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Castle Rock, CO 80104
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Hollis + Miller Architects
Missouri State Certificate of Authority
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Bob D Campbell
Structural Engineer
State Certificate of Authority #000442
4338 Bellevue Ave
Kansas City, MO 64111
816.631.4144 phone

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State Certificate of Authority #EGC000178
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AV/Acoustics Consultant
14827 West 95th St.
Lenexa, KS 66215
913.888.9111 phone

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REVISIONS:

#	Description	Date
1	Addendum 01	09.14.2023

STATE OF MISSOURI

KEVIN E. NELSON

A-2019015619

ARCHITECT

OCTOBER 11, 2023


Kevin E. Nelson
A-2019015618

The Professional Address and Affiliation of the signed architect is to be retained and clearly shown on this sheet. All drawings, specifications and other documents are submitted to the state and are the property of the architect, and the architect expressly reserves any and all liability for such plans, drawings, or documents not existing when signed.

JOB NO: 23019
DRAWN BY: KL
CHECKED BY: JB
DATE: 08.31.2023

DA101

DEMOLITION FLOOR PLAN - OVERALL - LEVEL 1

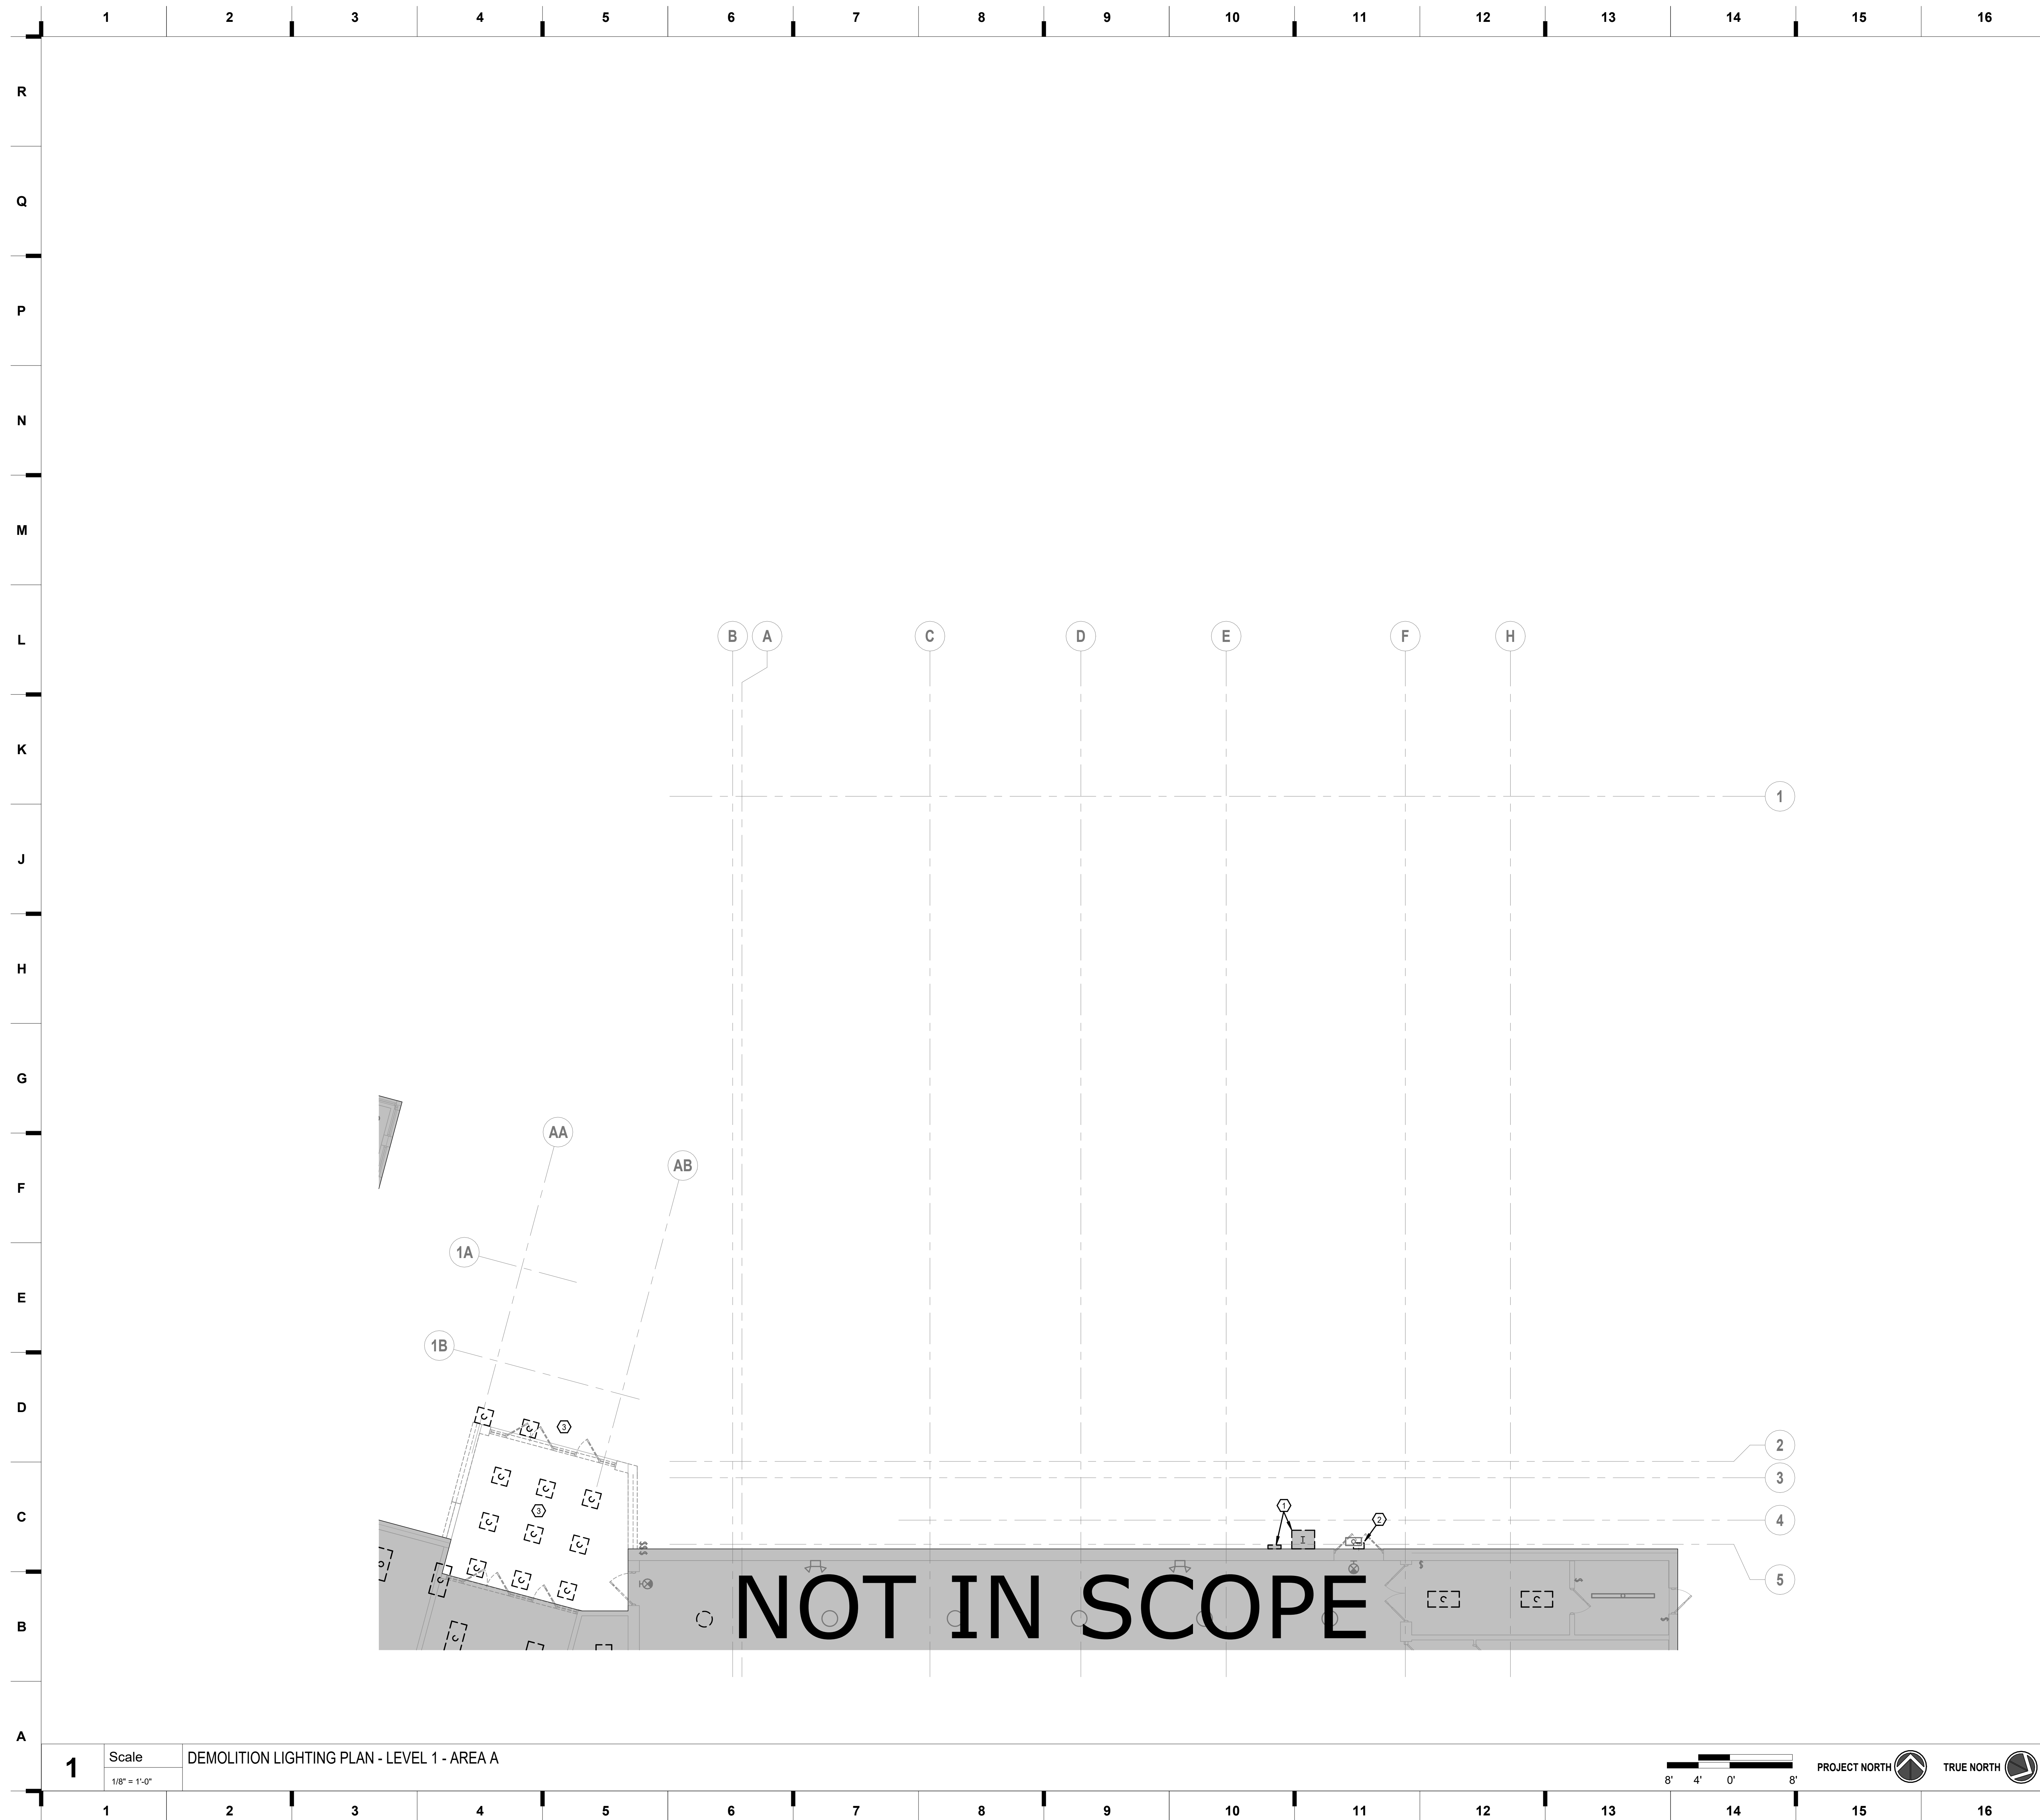

SHEET KEYNOTE LEGEND

GENERAL NOTES

1. THE EXISTING CONDITIONS INDICATED ON THE DRAWINGS ARE TAKEN FROM THE BEST INFORMATION AVAILABLE AND FROM A VISUAL INSPECTION. THE CHANGES TO BE CONSTRUED AS "AS-BUILT" CONDITIONS. THE INFORMATION IS USED TO HELP ESTABLISH THE EXTENT OF THE NEW WORK. THE CONTRACTOR SHALL VERIFY THE CONDITIONS AT THE PROJECT SITE AND PERFORM THE WORK AS REQUIRED TO MEET THE EXISTING CONDITIONS AND THE EXTENT OF THE WORK INDICATED.
2. DASHED LINES INDICATED MECHANICAL OR ELECTRICAL EQUIPMENT TO BE REMOVED. THE CHANGES TO BE REMOVED SOLID LINES REPRESENT EXISTING EQUIPMENT OR MATERIAL TO REMAIN, EXCEPT WHERE OTHERWISE INDICATED.
3. DISCONNECT AND REMOVE ALL CIRCUITRY, DISCONNECTS, CONTROLLERS AND CONDUIT THAT BECOMES UNNECESSARY AS THE NEW EQUIPMENT IS INSTALLED. REMOVE ALL EXISTING EQUIPMENT INDICATED TO BE REMOVED. LABEL ALL CIRCUIT BREAKERS IN EXISTING PANELBOARDS NO LONGER IN USE AS SHOWN ON THE DRAWINGS. UNLESS OTHERWISE INDICATED, THE FLOOR LINE OR WALL LINE TO FACILITATE RESTORATION OF FINISH.
4. VERIFY AND RESTORE CONTINUITY OF ALL EXISTING CIRCUITRY INDICATED TO REMAIN IN USE. WHERE REMOVAL OF EXISTING WIRING INTERRUPTS ELECTRICAL CONTINUITY, THE CONTRACTOR SHALL REPAIR OR REPLACE THE EXISTING OR ALL REQUIRED CIRCUITRY, CONDUIT, JUNCTION BOXES, ETC. TO INSURE CONTINUED ELECTRICAL CONTINUITY.
5. RELOCATE AND RECONNECT ANY MECHANICAL EQUIPMENT AND ANY ELECTRIC FIXTURES, DEVICES OR EQUIPMENT THAT MUST REMAIN IN PLACE. THE CONTRACTOR SHALL VERIFY THE REVISIONS INDICATED ON THE DRAWINGS OR INDICATED IN THE SPECIFICATIONS OR TO MEET NEC CODE REQUIRED CLEARANCES.
6. ELECTRIC RACK BOX COVERING AND INSTALL BLANK JUNCTION BOX COVERING ON ALL EXISTING JUNCTION BOXES WITHIN THE CONSTRUCTION AREA.

PLAN NOTES:



- ① DEMO EXTERIOR MOUNTED TRANSFORMER AND PANEL, DEMO BACK CONDUIT AND CAP AS NEEDED TO POUR NEW SLAB OVER THE TOP.
- ② DEMO EXTERIOR MOUNTED LIGHT FIXTURE, REPAIR LIGHT CIRCUIT AS NEEDED TO MAINTAIN EXISTING TO REMAIN EXTERIOR LIGHTS ON CIRCUIT.
- ③ DEMO ALL LIGHTS, POWER AND LOW VOLTAGE DEVICES ASSOCIATED WITH DEMO'D VESTIBULE AND EXTERIOR AWNING. REPAIR ALL CIRCUITS WITH EXISTING TO REMAIN UP TO MAINTAIN ALL EXISTING DEVICES. SALVAGE AND TURN OVER TO OWNER ALL CARD READER, CAMERA AND LOW VOLTAGE DEVICES.

South Valley Middle School Storm Shelter Addition

Liberty School District
1000 Midjavy Dr, Liberty, MO 64068

**Conformed
Construction
Documents**

#	Description	Date
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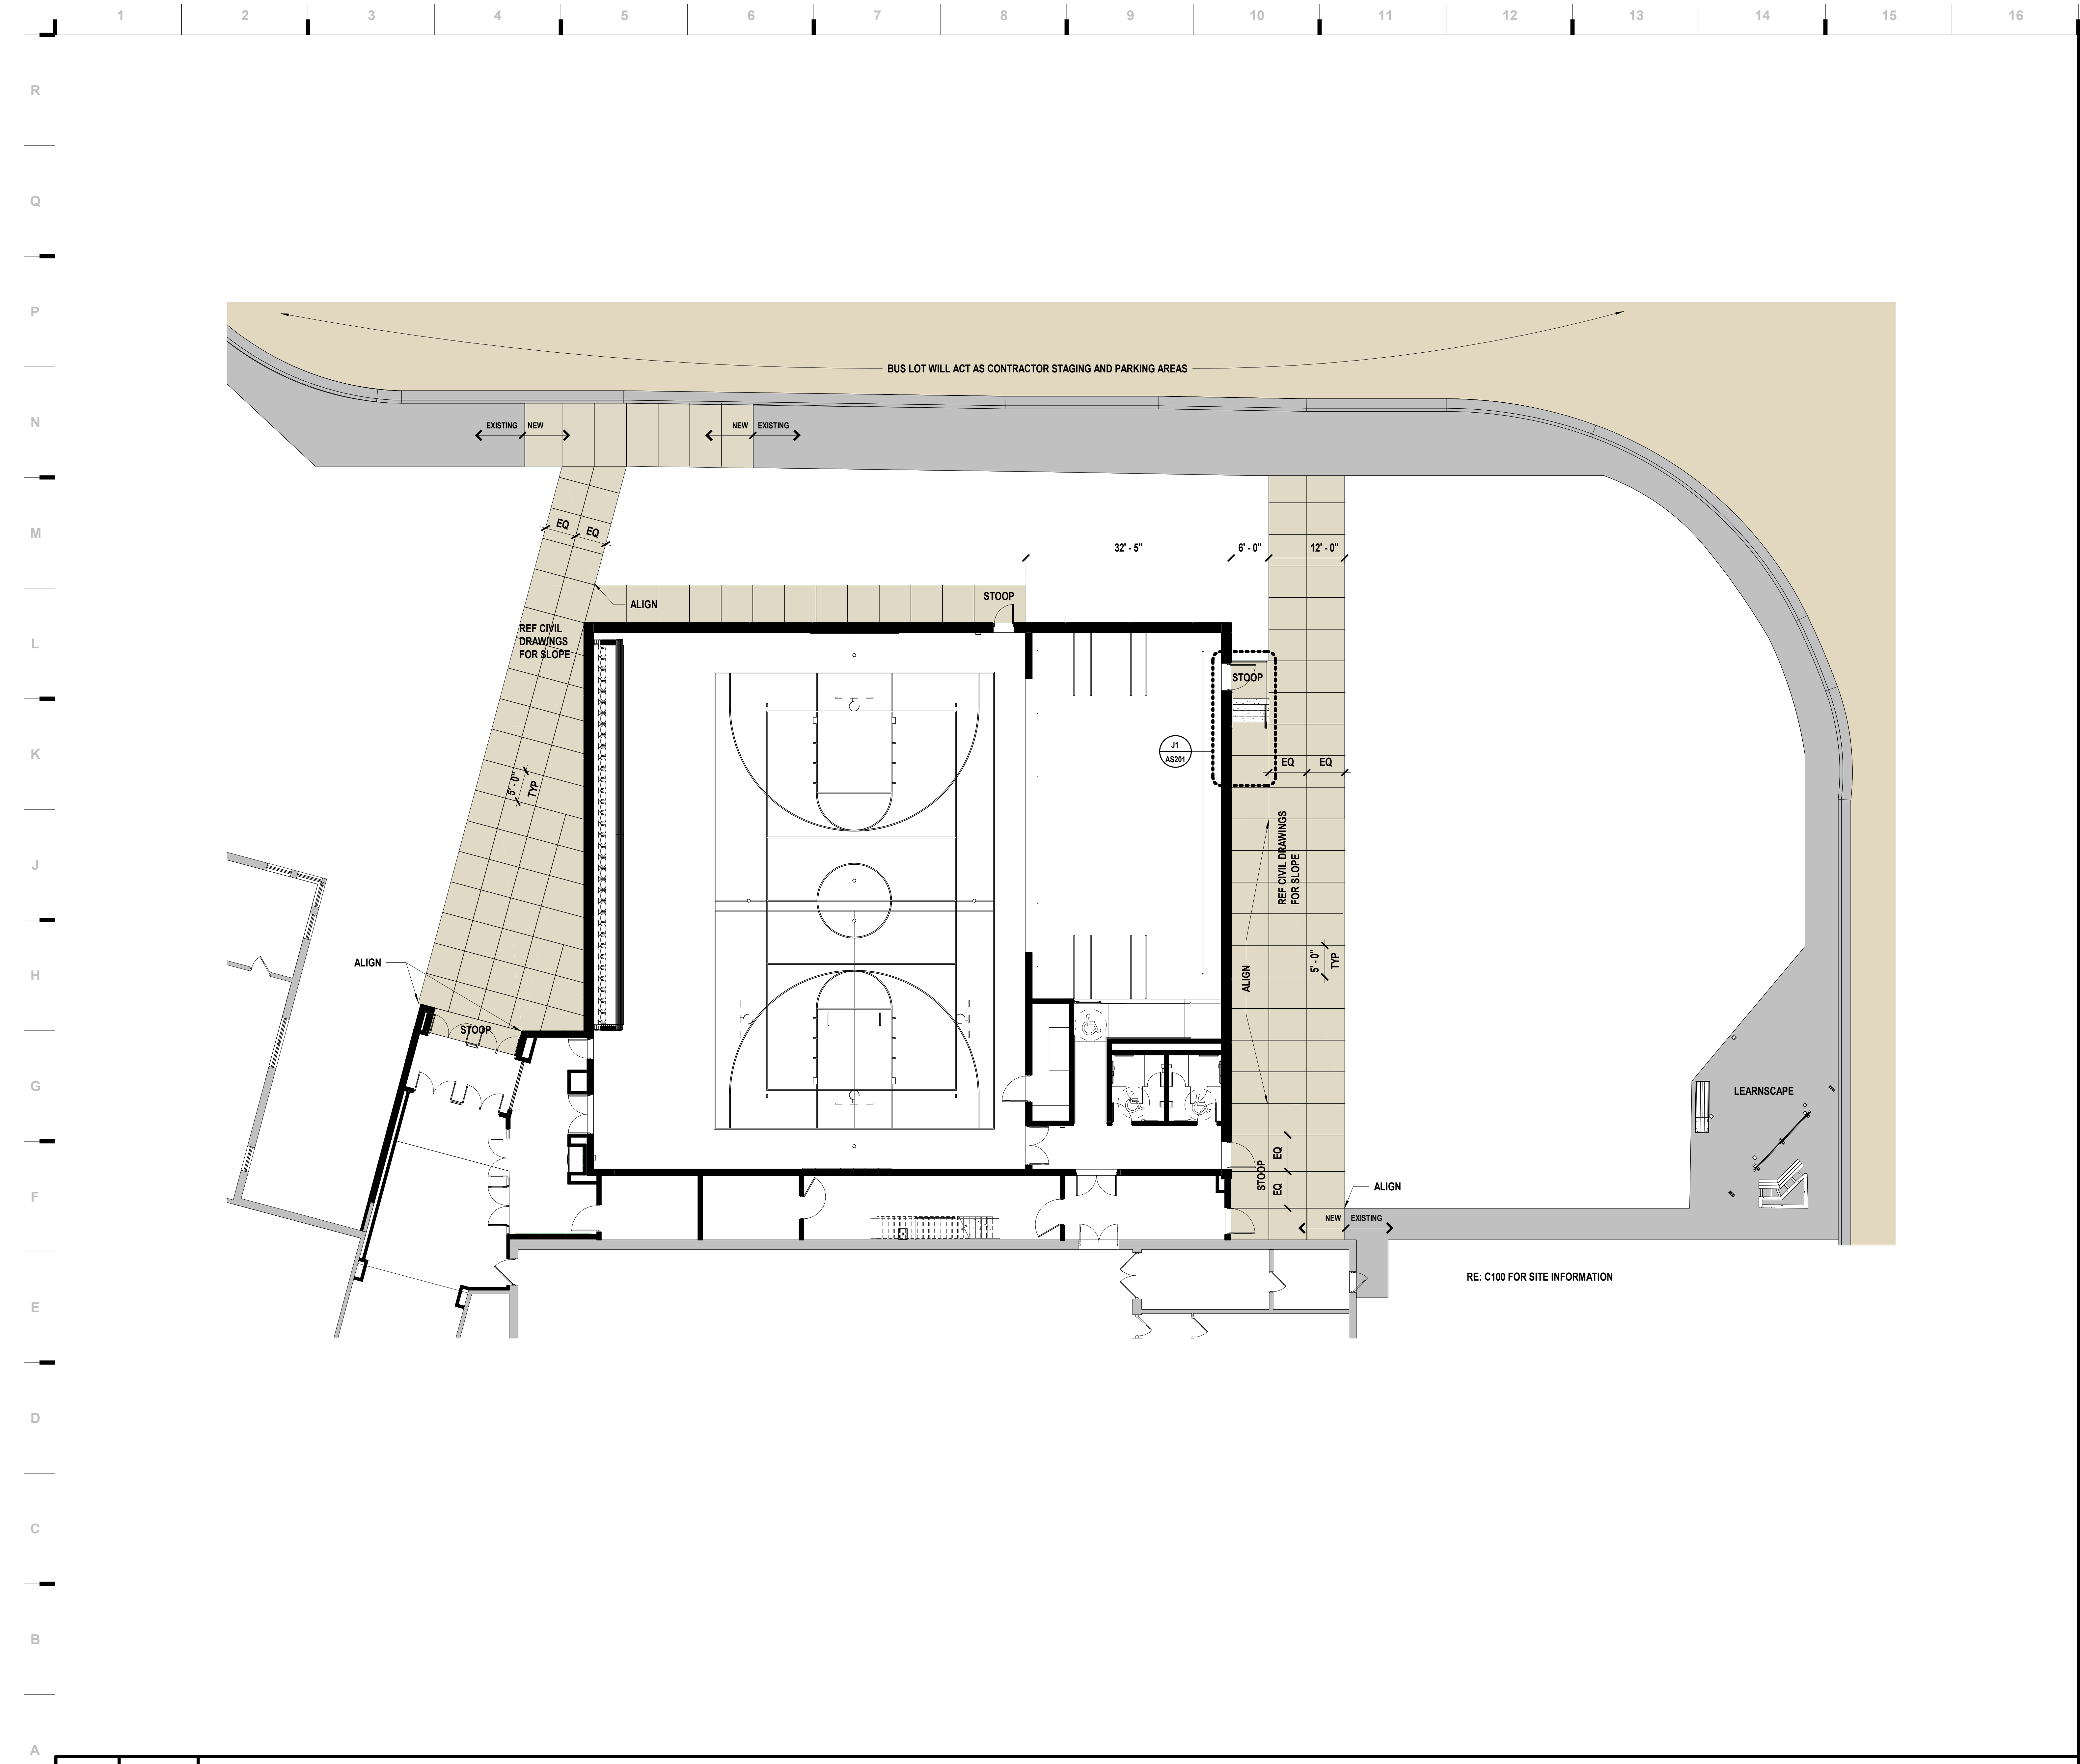

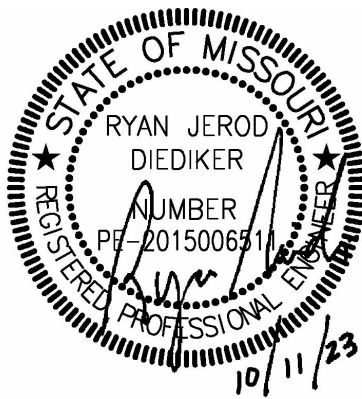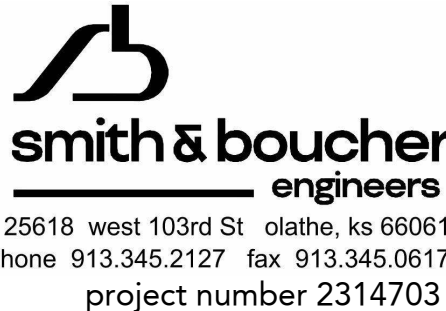
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CHECKED BY: RJI
DATE: 10.11.2023

DE101A

DEMOLITION LIGHTING PLAN - LEVEL 1 - AREA A

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SHEET KEYNOTE LEGEND

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Missouri State Certificate of Authority
Architecture # 000061

Bob D Campbell
Structural Engineer
State Certificate of Authority #000442
4338 Bellevue Ave
Kansas City, MO 64111
816.531.4144 phone
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State Certificate of Authority #EGC000178
25615 W 103rd Street
Olathe, KS 66061
913.345.2127 phone
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Civil Engineer
State Certificate of Authority
Engineering #2001009364
Landscaping #2006027139
Surveying #2006027138
11827 W 112th Street, Suite 200
Overland Park, KS 66210
913.317.9390 phone
Peerbolte Creative
Theatrical Consultant
109 E Pine St.
Warrensburg, MO 64093-0752
660.429.1383 phone
Avant Acoustics
AV/Acoustics Consultant
14827 West 95th St
Lenexa, KS 66215
913.888.9111 phone

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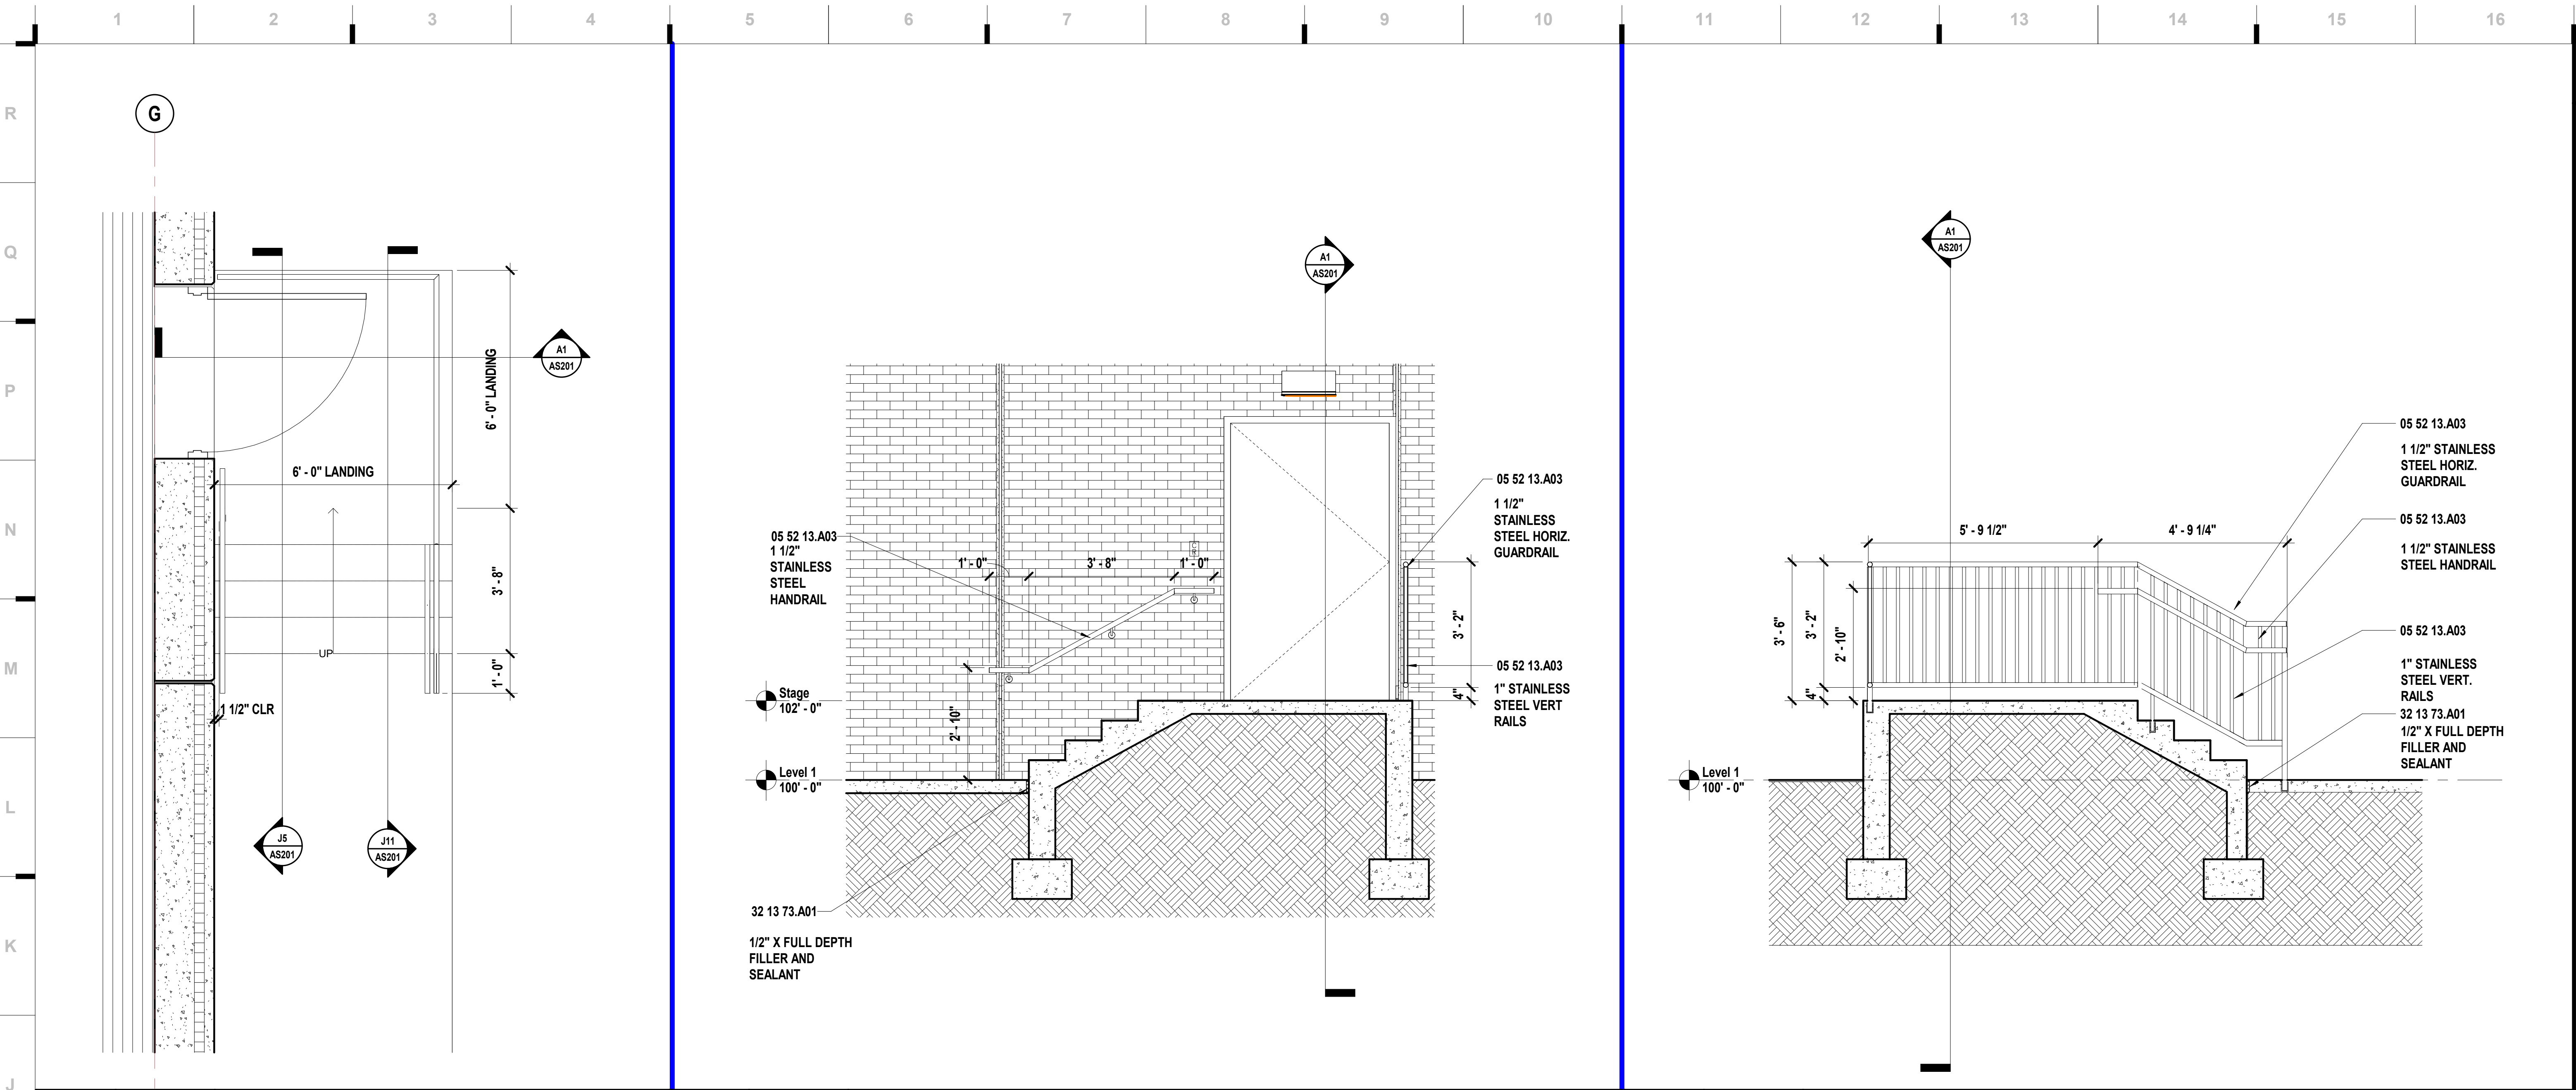
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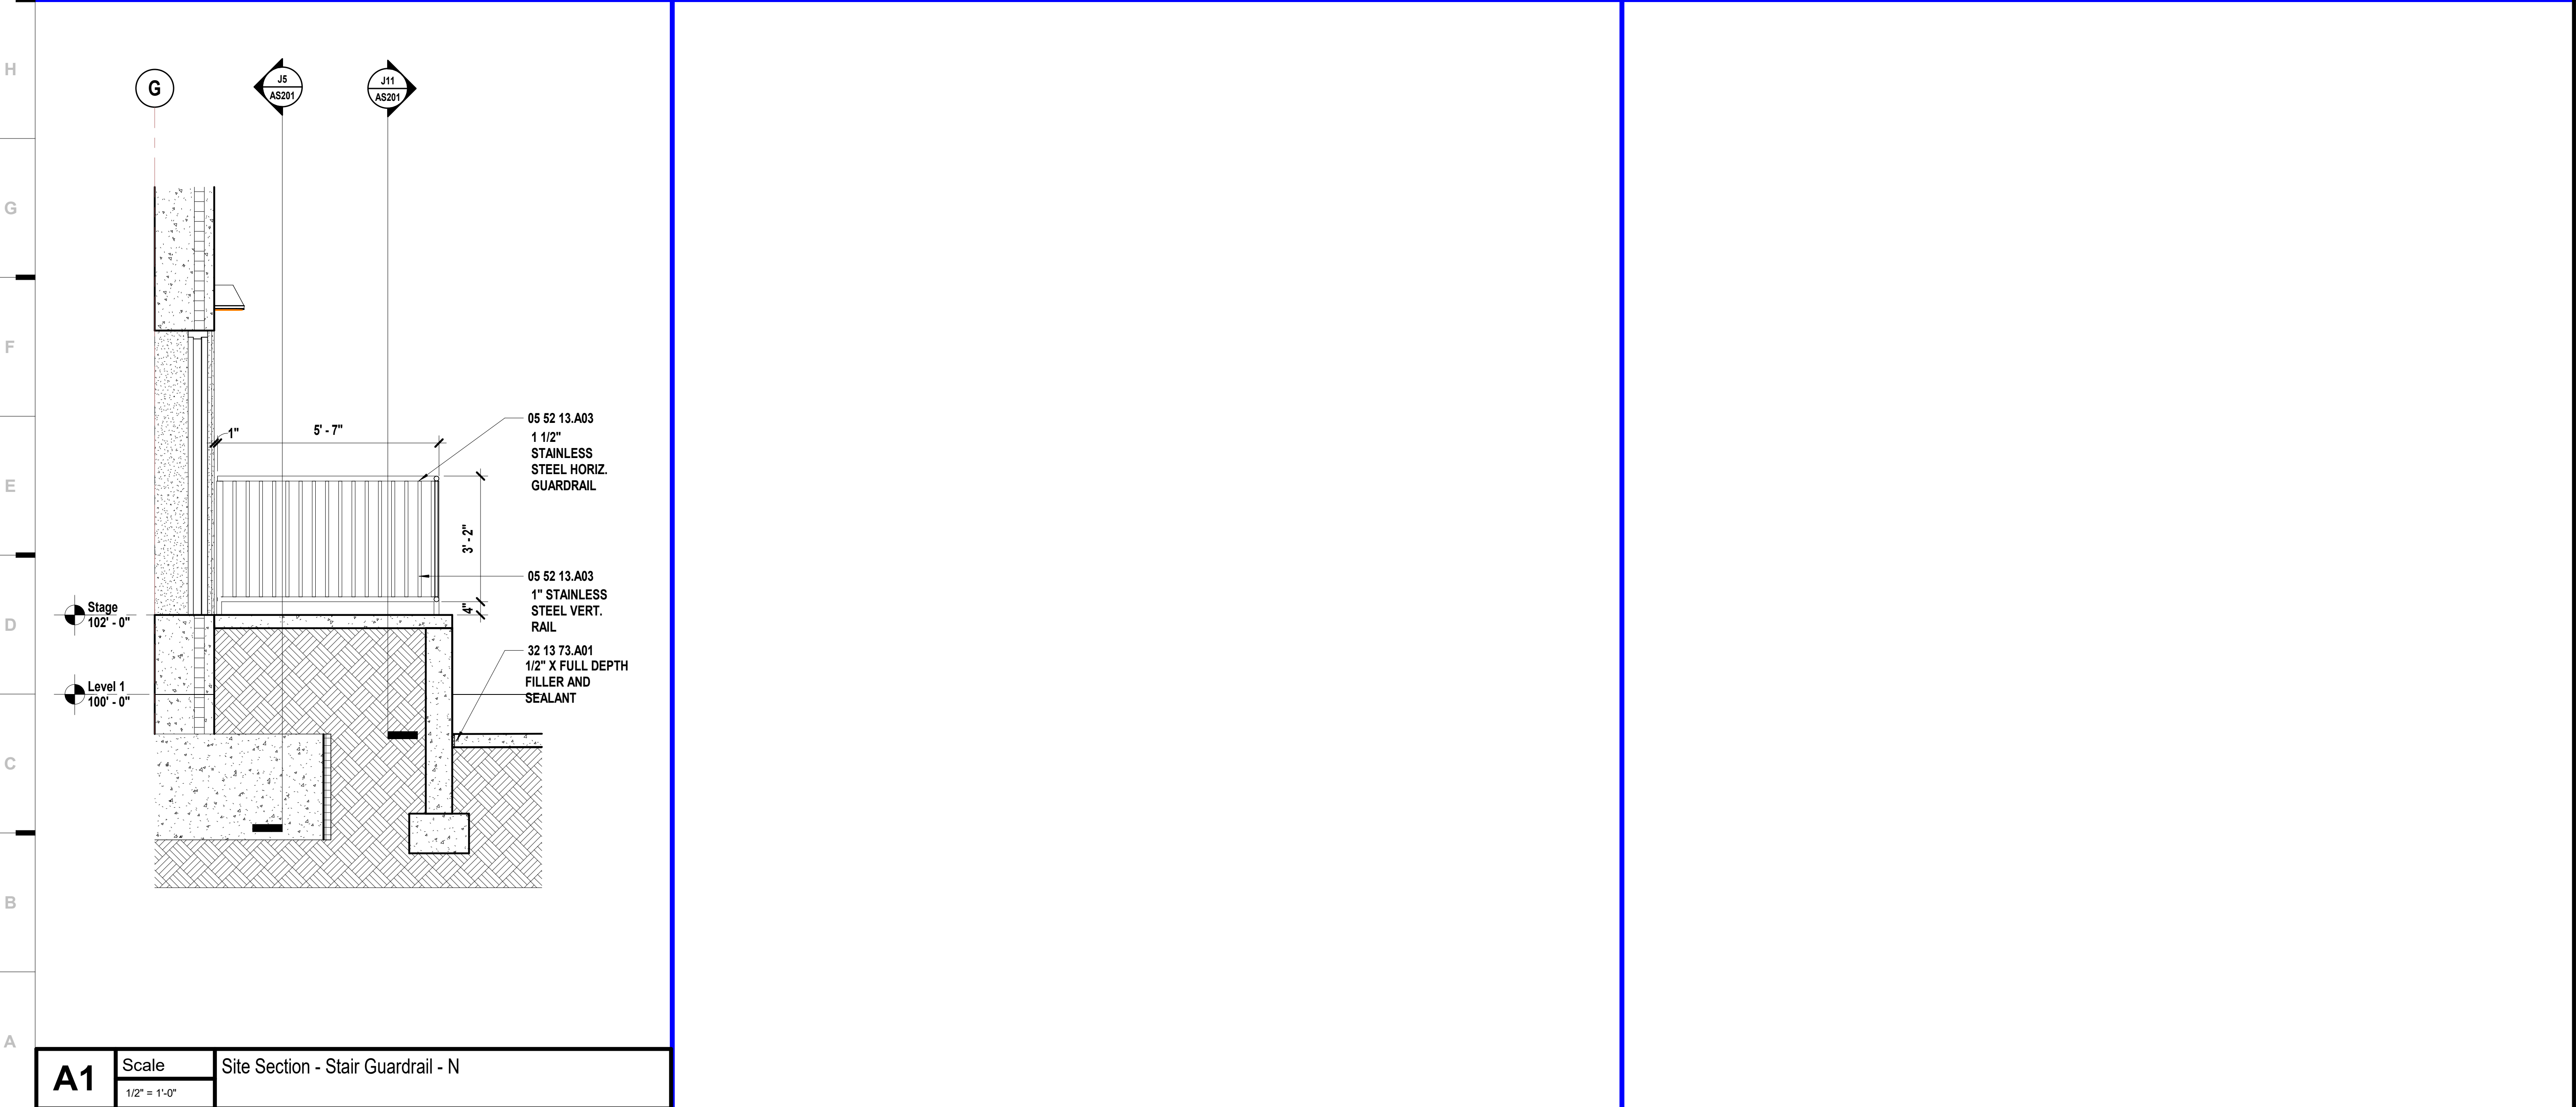
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AS101

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J1	Scale	Enlarged Plan - Area A - Stage A108 Stair	J5	Scale	Site Section - Stair Handrail	J11	Scale	Site Section - Stair Railing - E
	1/2" = 1'-0"			1/2" = 1'-0"			1/2" = 1'-0"	



A1	Scale	Site Section - Stair Guardrail - N
	1/2" = 1'-0"	

SHEET KEYNOTE LEGEND

05 52 13.A03

32 13 73.A01

STAINLESS STEEL PIPE AND TUBE RAILINGS

EXPANSION/ISOLATION JOINT W/SEALANT

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State Certificate of Authority
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STATE OF MISSOURI

KEVIN E. NELSON

A-2019015618

ARCHITECT

OCTOBER 11, 2023

Kevin E. Nelson
A-2019015618

This Professional Address and Affiliation is the only address used to the extent and liability of the work. All drawings, documents and other documents are submitted to the work and are not intended to be a contract. The architect and his/her firm shall not be responsible for any and all errors or omissions in any drawings, documents or other documents.

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AS201

SITE DETAILS

architects™

hollis + miller

CONFORMED CONSTRUCTION DOCUMENTS



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Architecture # 0000161
Structure # 2006031533

Bob D Campbell
Structural Engineer
State Certificate of Authority #000442
4338 Belleview Ave
Kansas City, MO 64111
816.531.4144 phone

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**Conformed
Construction
Documents**

[illegible]

C100

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Surveying No. 2008027138

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Engineering: 2001009364
Landscape: 2008027138
Surveying: 2008027138
11827 W. 112th St. Ste 200
Overland Park, KS 66210
913.317.5395 phone

Smith & Boucher Engineers
Mech/Elect/Plumb Engineer
State Certificate of Authority #ECC-0001787
25501 W. Valley Parkway, Ste 200
Olathe, KS 66061
913.345.2127 phone

Bob D Campbell
Structural Engineer
State Certificate of Authority #000442
4338 Bellevue Ave
Kansas City, MO 64111
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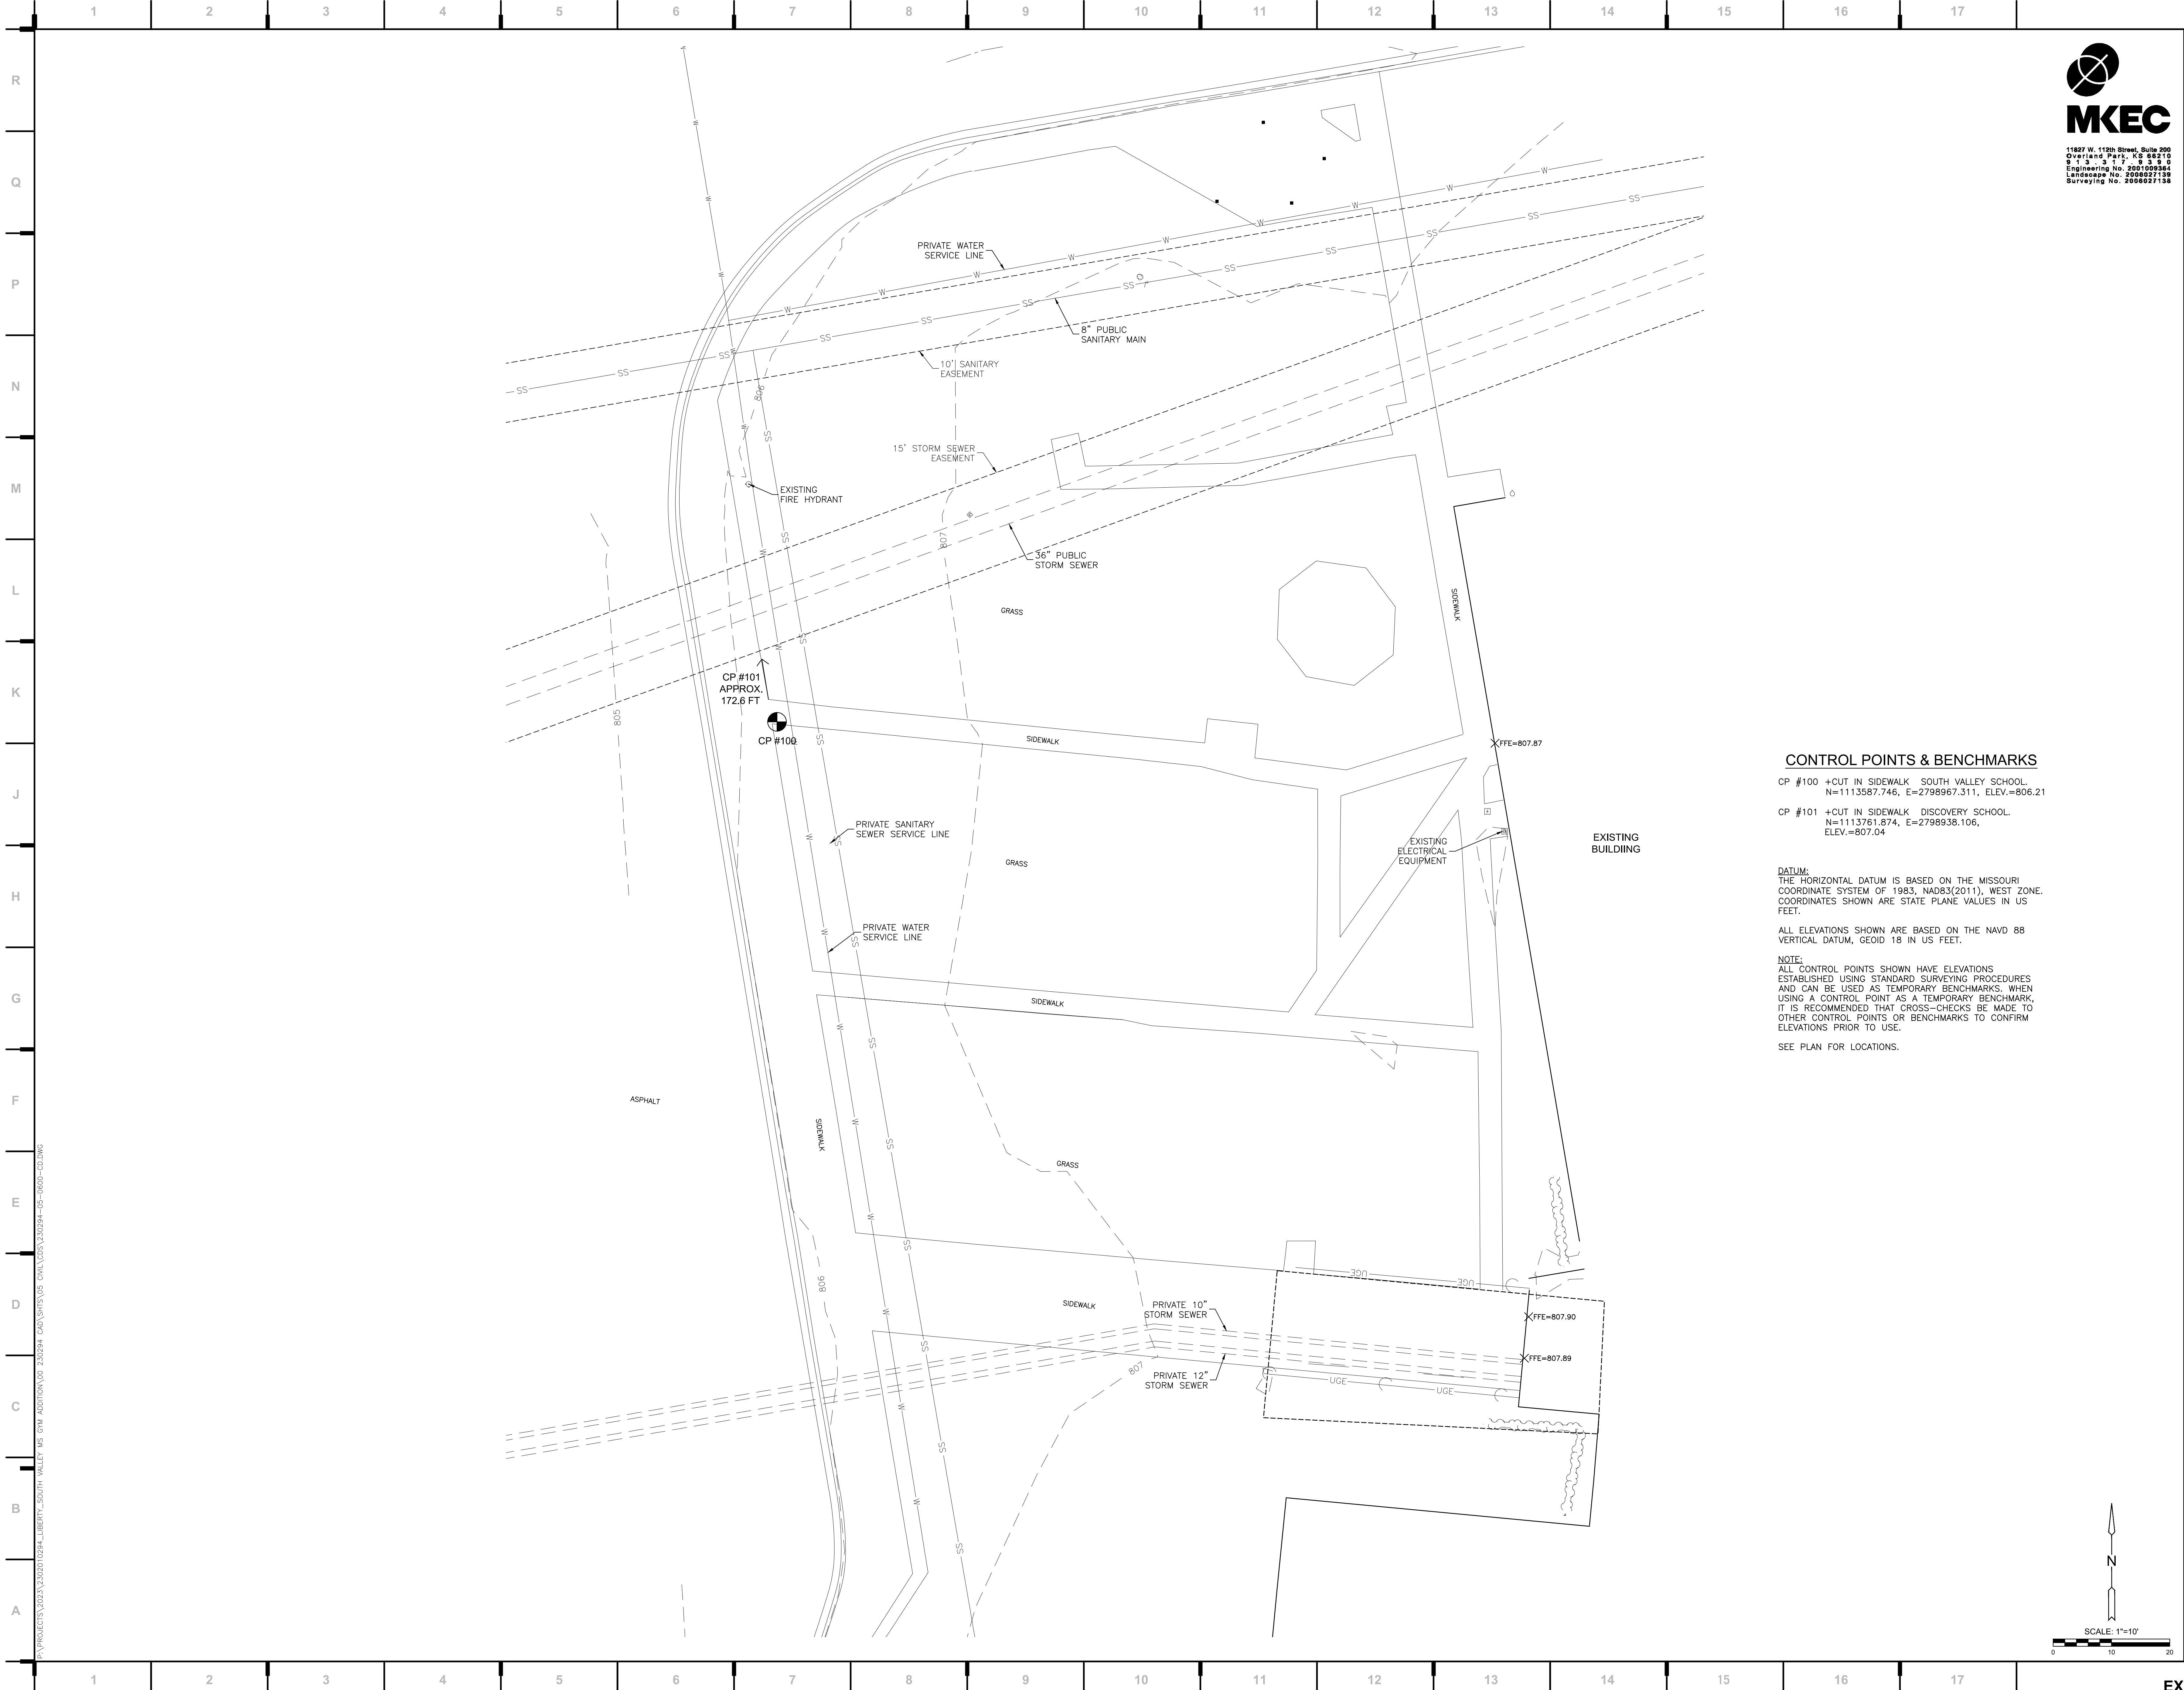


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OVERALL SITE PLAN



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Structure # 2006031333

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State Certificate of Authority #:
Engineering: 2001009364
Landscaping: 2008027138
Surveying: 2008027138
11827 W. 112th St. Ste 200
Overland Park, KS 66210
913.317.5595 phone

Smith & Boucher Engineers
Mech/Elect/Plumb Engineer
State Certificate of Authority #EGC-0001787
25501 W. Valley Parkway, Ste 200
Olathe, KS 66061
913.345.2127 phone

Bob D Campbell
Structural Engineer
State Certificate of Authority #000442
4338 Bellevue Ave
Kansas City, MO 64111
816.531.4144 phone

CONTROL POINTS & BENCHMARKS

CP #100 +CUT IN SIDEWALK SOUTH VALLEY SCHOOL.
N=1113587.746, E=2798967.311, ELEV.=806.21

CP #101 +CUT IN SIDEWALK DISCOVERY SCHOOL.
N=1113761.874, E=2798938.106,
ELEV.=807.04

DATUM:
THE HORIZONTAL DATUM IS BASED ON THE MISSOURI
COORDINATE SYSTEM OF 1983, NAD83(2011), WEST ZONE.
COORDINATES SHOWN ARE STATE PLANE VALUES IN US
FEET.

ALL ELEVATIONS SHOWN ARE BASED ON THE NAVD 88
VERTICAL DATUM, GEOID 18 IN US FEET.

NOTE:
ALL CONTROL POINTS SHOWN HAVE ELEVATIONS
ESTABLISHED USING STANDARD SURVEYING PROCEDURES
AND CAN BE USED AS TEMPORARY BENCHMARKS. WHEN
USING A CONTROL POINT AS A TEMPORARY BENCHMARK,
IT IS RECOMMENDED THAT CROSS-CHECKS BE MADE TO
OTHER CONTROL POINTS OR BENCHMARKS TO CONFIRM
ELEVATIONS PRIOR TO USE.

SEE PLAN FOR LOCATIONS.

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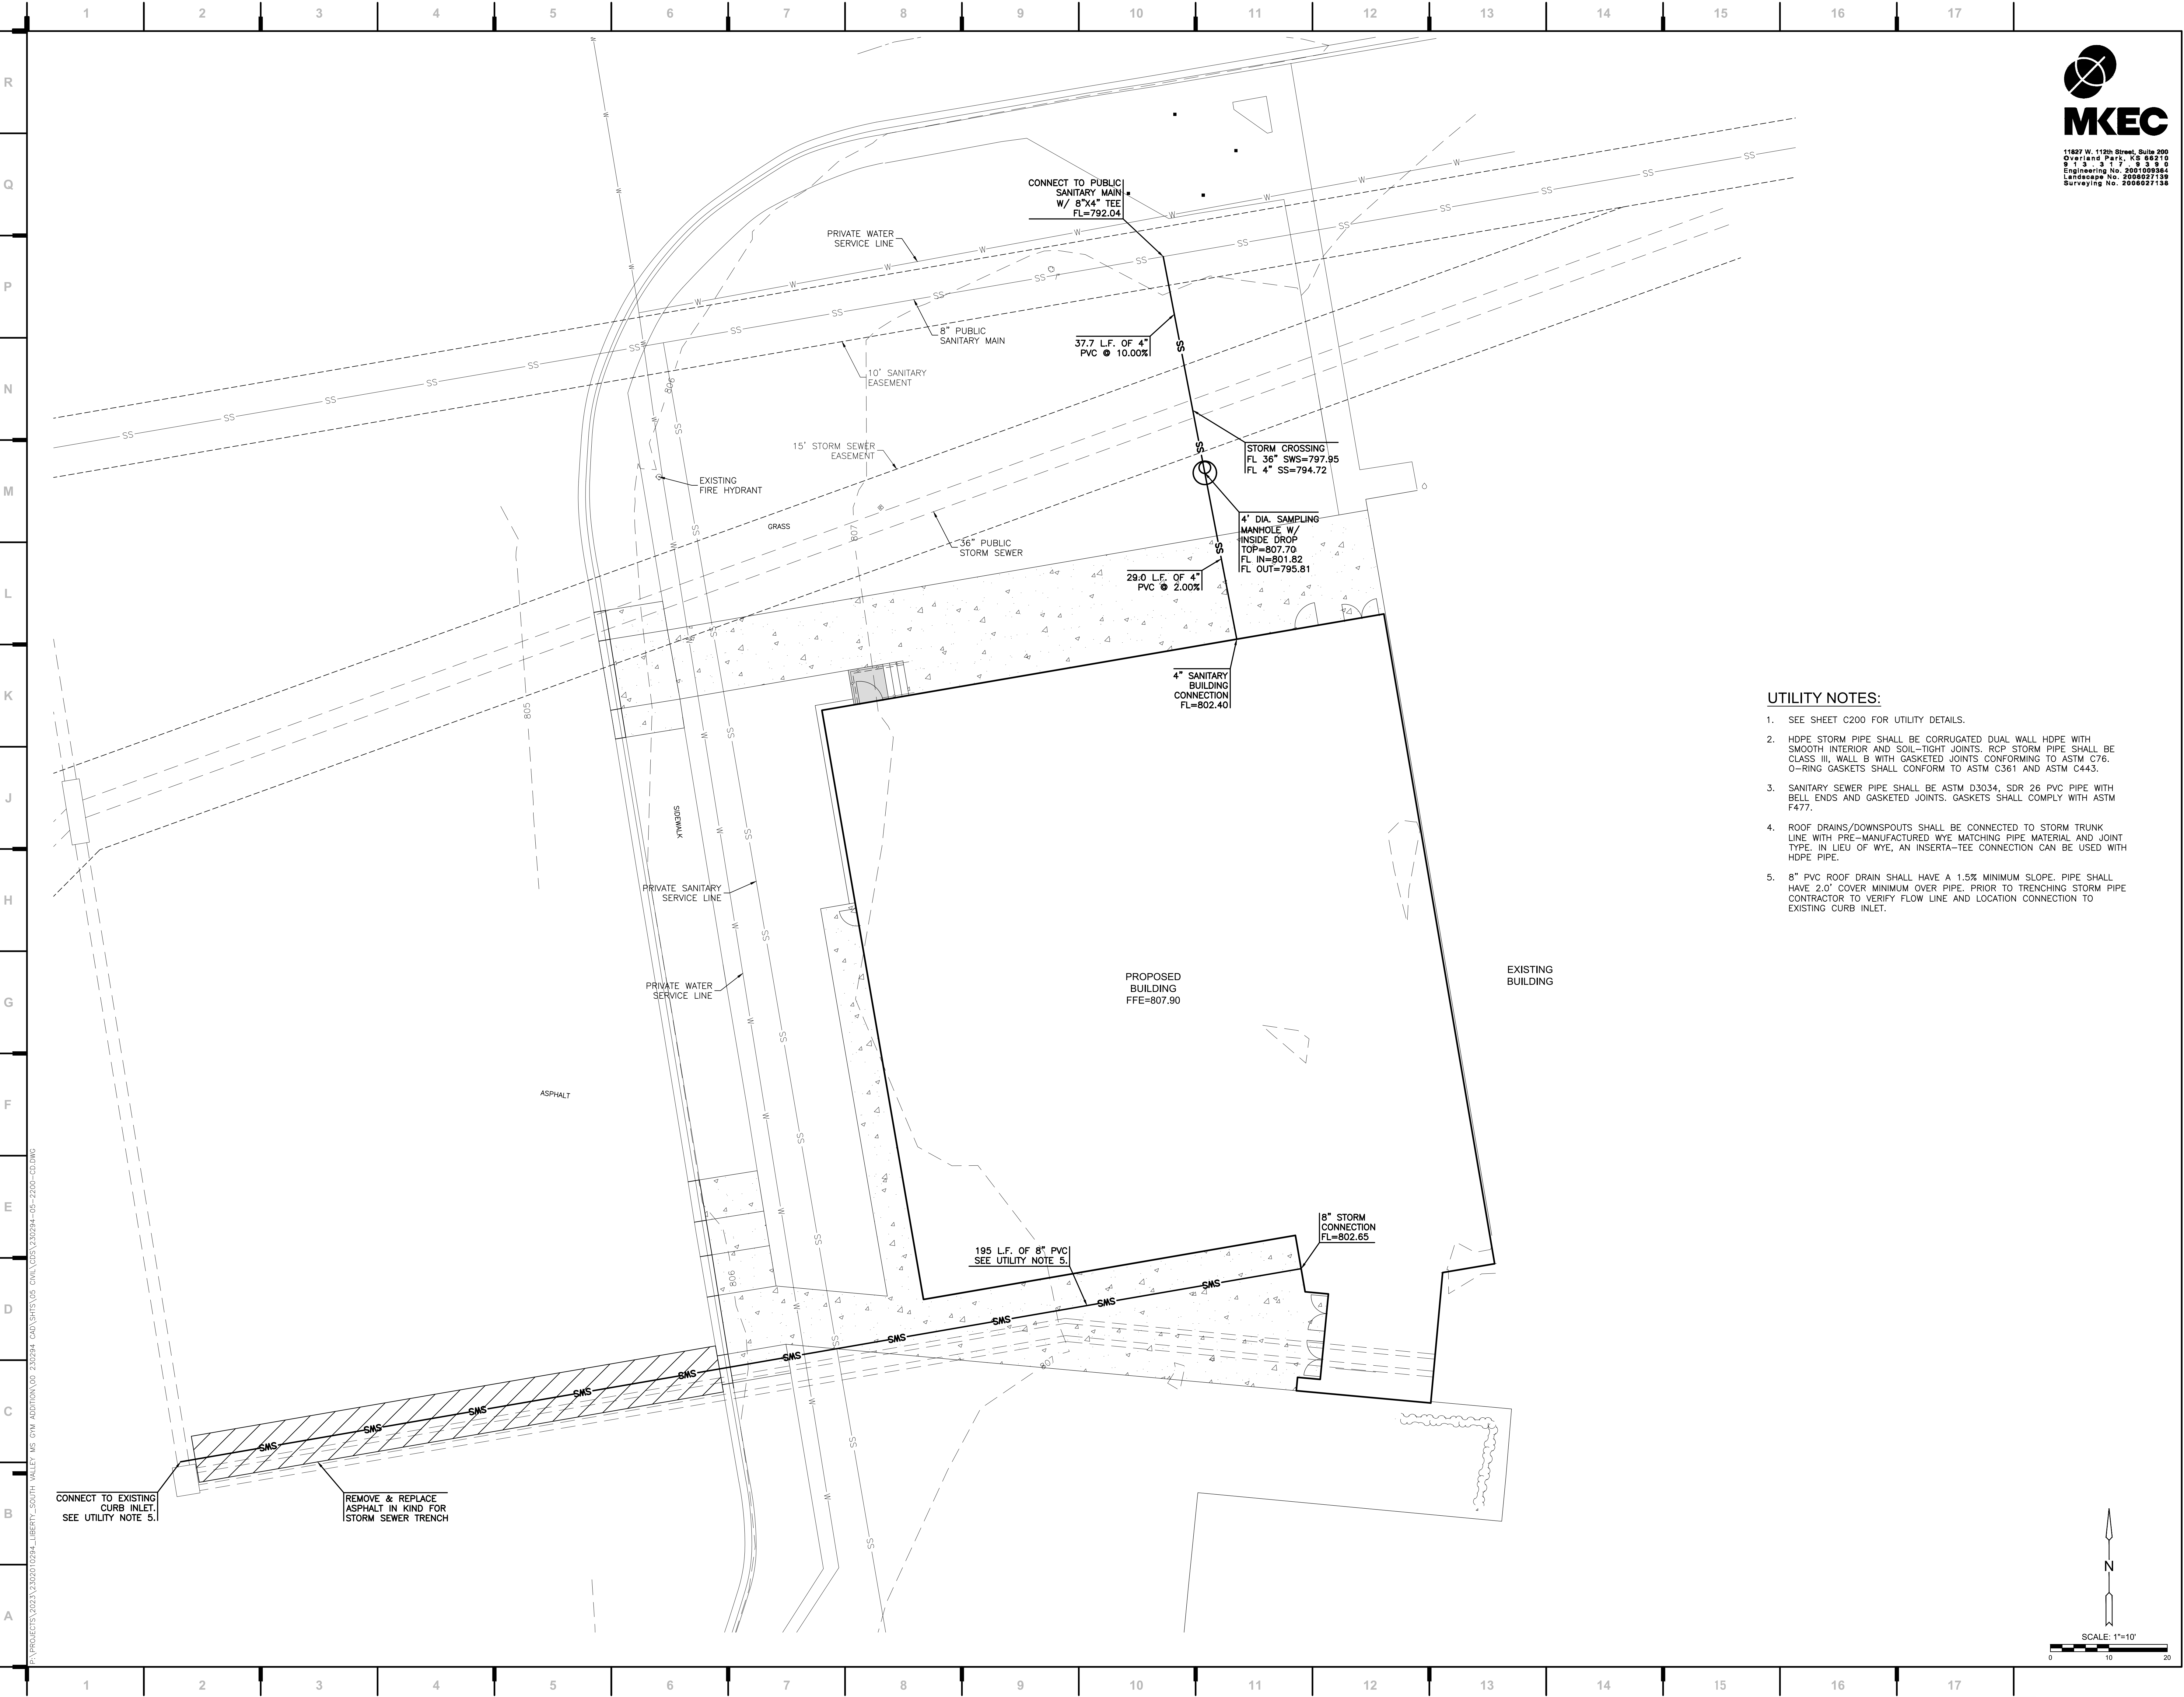
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Missouri State Certificate of Authority
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State Certificate of Authority #: Engineering: 2001009364
Landscape: 2008027139
Surveying: 2008027139
11827 W. 112th St. Ste 200
Overland Park, KS 66210
913.317.5395 phone

Smith & Boucher Engineers
Mech/Elect/Plumb Engineer
State Certificate of Authority #ECC-0001787
25501 W. Valley Parkway, Ste 200
Olathe, KS 66061
913.345.2127 phone

Bob D Campbell
Structural Engineer
State Certificate of Authority #000442
4338 Bellevue Ave
Kansas City, MO 64111
816.531.4144 phone

UTILITY NOTES:

1. SEE SHEET C200 FOR UTILITY DETAILS.
2. HDPE STORM PIPE SHALL BE CORRUGATED DUAL WALL HDPE WITH SMOOTH INTERIOR AND SOIL-TIGHT JOINTS. RCP STORM PIPE SHALL BE CLASS III, WALL B WITH GASKETED JOINTS CONFORMING TO ASTM C76. O-RING GASKETS SHALL CONFORM TO ASTM C361 AND ASTM C443.
3. SANITARY SEWER PIPE SHALL BE ASTM D3034, SDR 26 PVC PIPE WITH BELL ENDS AND GASKETED JOINTS. GASKETS SHALL COMPLY WITH ASTM F477.
4. ROOF DRAINS/DOWNSPOUTS SHALL BE CONNECTED TO STORM TRUNK LINE WITH PRE-MANUFACTURED WYE MATCHING PIPE MATERIAL AND JOINT TYPE. IN LIEU OF WYE, AN INSERT-TEE CONNECTION CAN BE USED WITH HDPE PIPE.
5. 8" PVC ROOF DRAIN SHALL HAVE A 1.5% MINIMUM SLOPE. PIPE SHALL HAVE 2.0' COVER MINIMUM OVER PIPE. PRIOR TO TRENCHING STORM PIPE CONTRACTOR TO VERIFY FLOW LINE AND LOCATION CONNECTION TO EXISTING CURB INLET.

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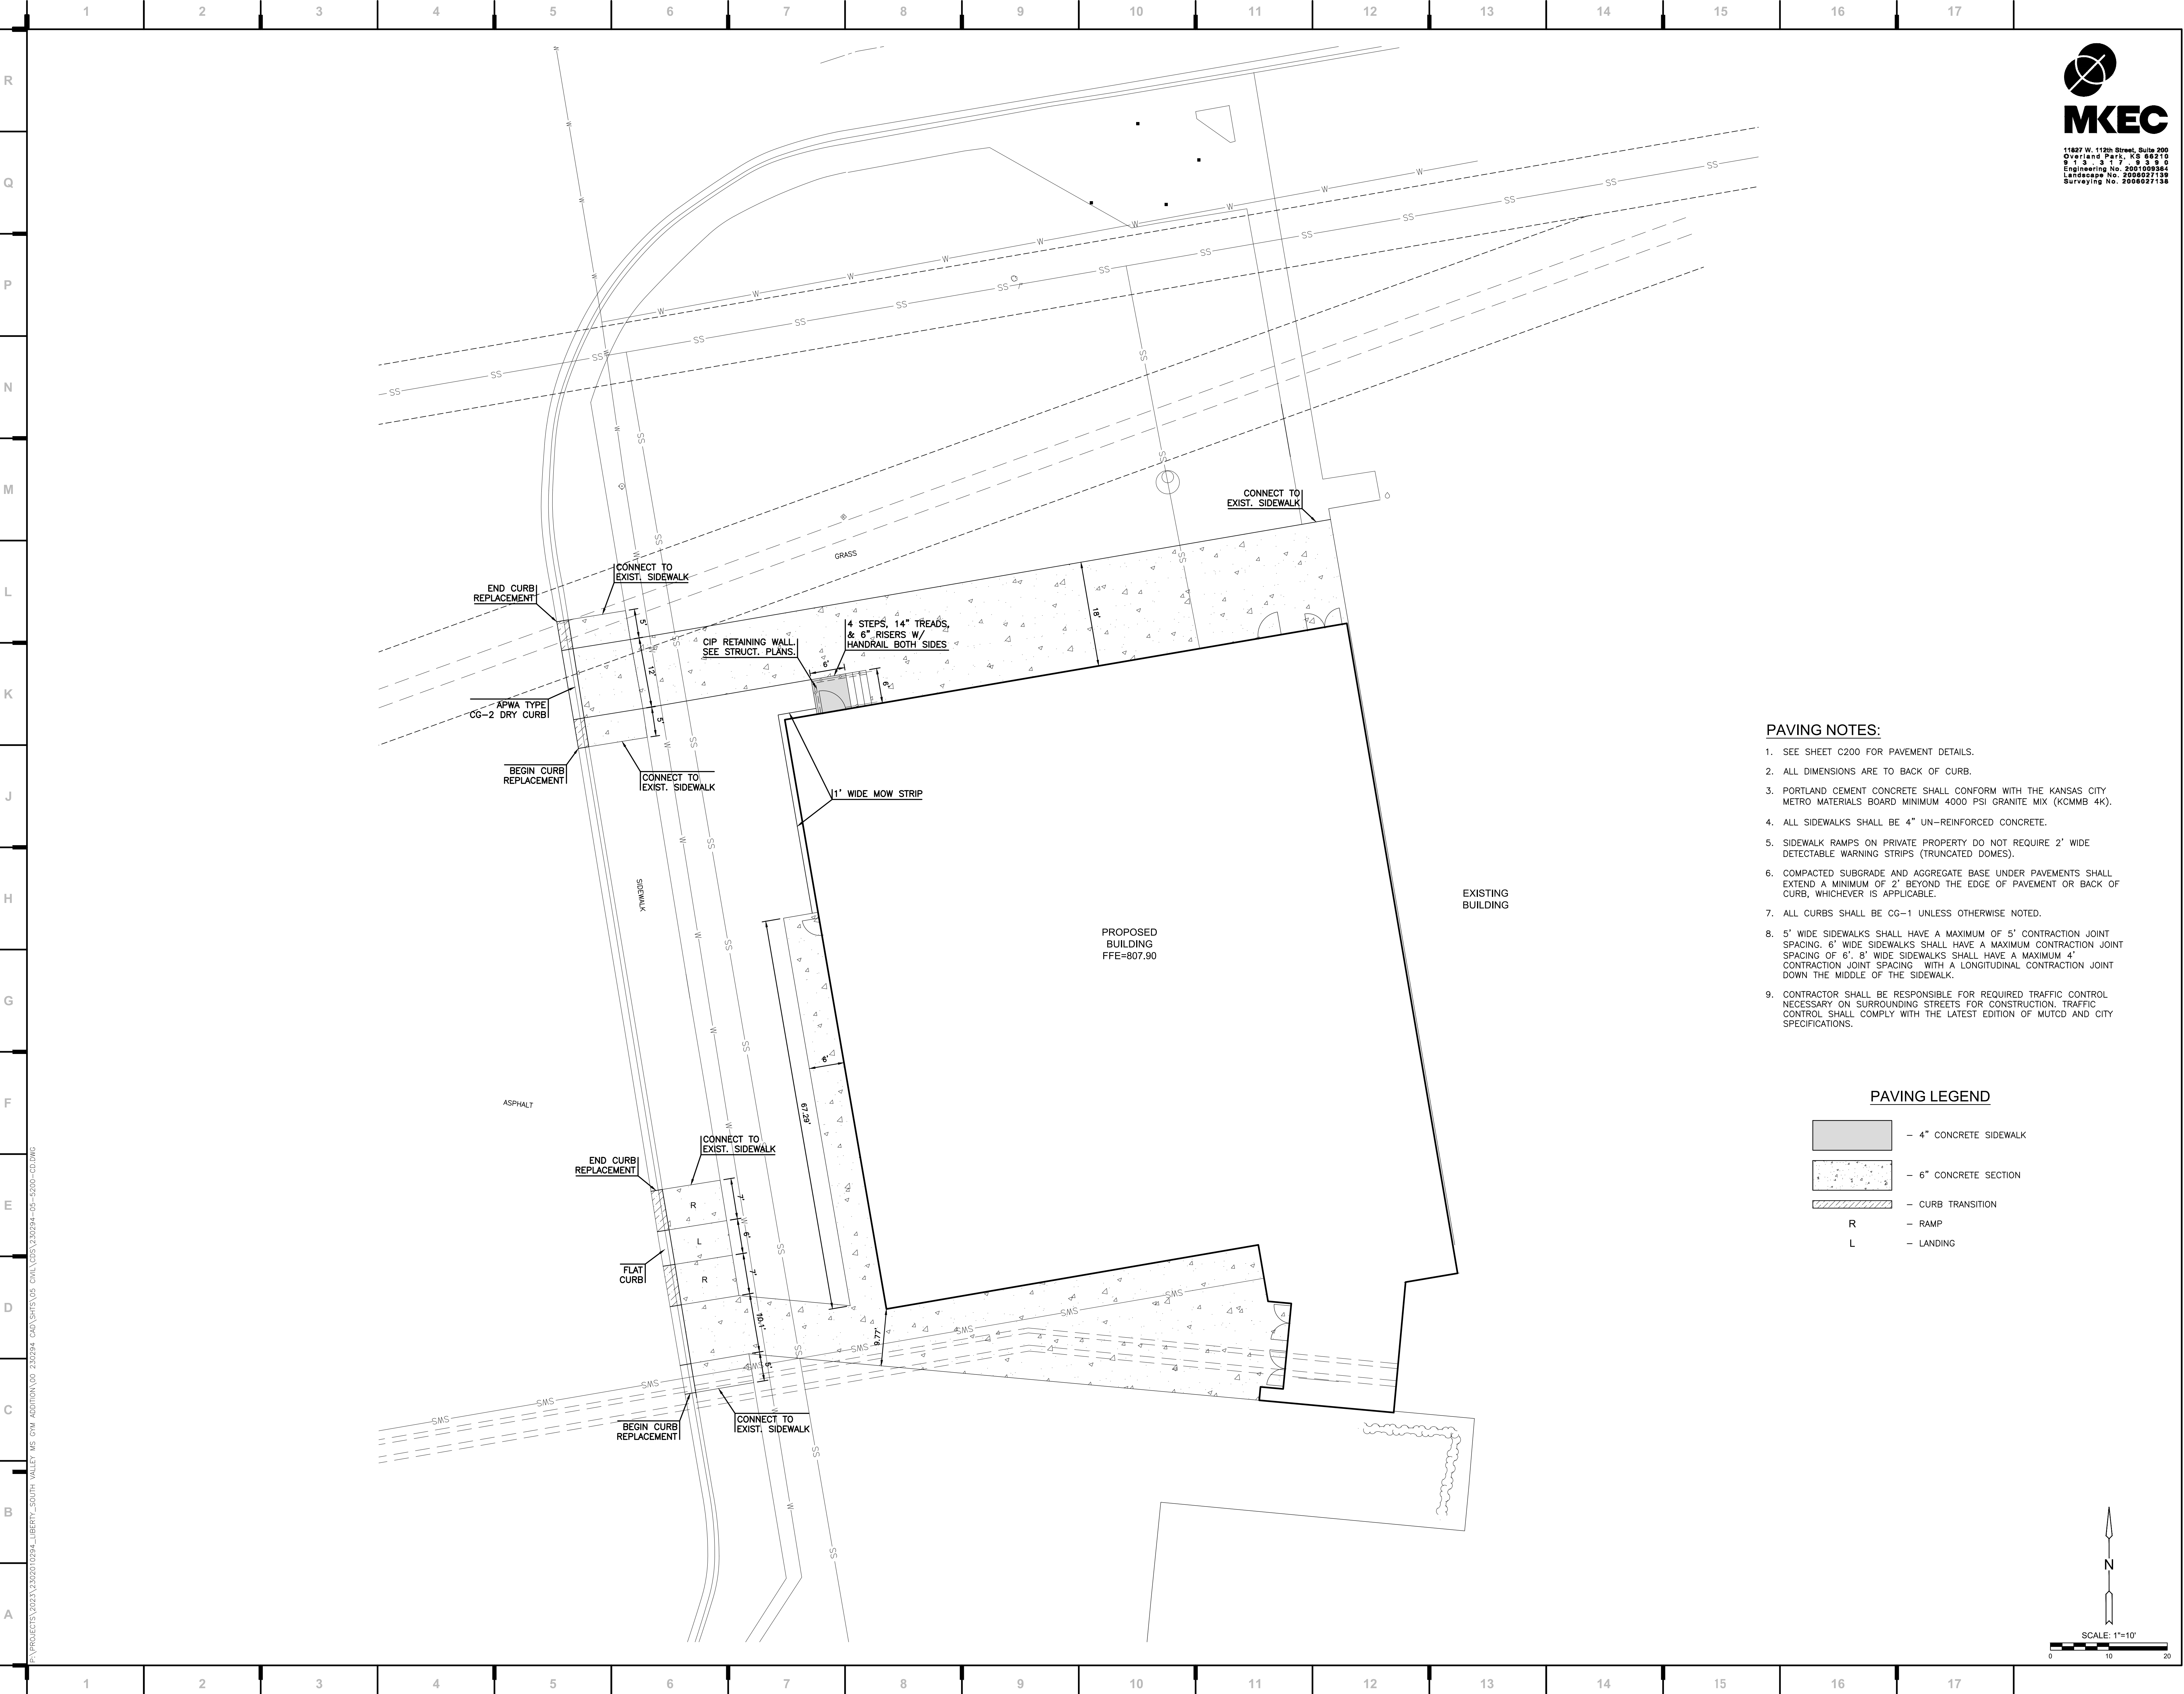
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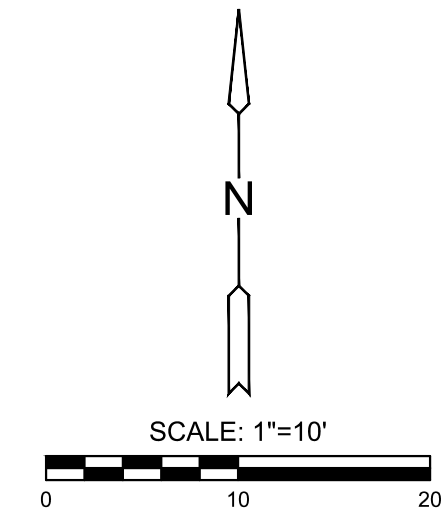
C103



- PAVING NOTES:**
1. SEE SHEET C200 FOR PAVEMENT DETAILS.
 2. ALL DIMENSIONS ARE TO BACK OF CURB.
 3. PORTLAND CEMENT CONCRETE SHALL CONFORM WITH THE KANSAS CITY METRO MATERIALS BOARD MINIMUM 4000 PSI GRANITE MIX (KCMMB 4K).
 4. ALL SIDEWALKS SHALL BE 4" UN-REINFORCED CONCRETE.
 5. SIDEWALK RAMPS ON PRIVATE PROPERTY DO NOT REQUIRE 2' WIDE DETECTABLE WARNING STRIPS (TRUNCATED DOMES).
 6. COMPACTED SUBGRADE AND AGGREGATE BASE UNDER PAVEMENTS SHALL EXTEND A MINIMUM OF 2' BEYOND THE EDGE OF PAVEMENT OR BACK OF CURB, WHICHEVER IS APPLICABLE.
 7. ALL CURBS SHALL BE CG-1 UNLESS OTHERWISE NOTED.
 8. 5' WIDE SIDEWALKS SHALL HAVE A MAXIMUM OF 5' CONTRACTION JOINT SPACING. 6' WIDE SIDEWALKS SHALL HAVE A MAXIMUM CONTRACTION JOINT SPACING OF 6'. 8' WIDE SIDEWALKS SHALL HAVE A MAXIMUM 4' CONTRACTION JOINT SPACING WITH A LONGITUDINAL CONTRACTION JOINT DOWN THE MIDDLE OF THE SIDEWALK.
 9. CONTRACTOR SHALL BE RESPONSIBLE FOR REQUIRED TRAFFIC CONTROL NECESSARY ON SURROUNDING STREETS FOR CONSTRUCTION. TRAFFIC CONTROL SHALL COMPLY WITH THE LATEST EDITION OF MUTCD AND CITY SPECIFICATIONS.

PAVING LEGEND

[Pattern]	- 4" CONCRETE SIDEWALK
[Pattern]	- 6" CONCRETE SECTION
[Pattern]	- CURB TRANSITION
R	- RAMP
L	- LANDING



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Landscape No. 2008027139
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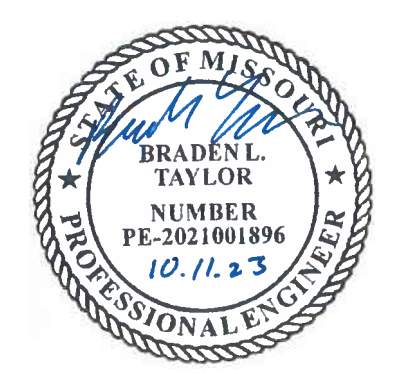
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913.345.2127 phone
Bob D Campbell
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State Certificate of Authority #000442
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Kansas City, MO 64111
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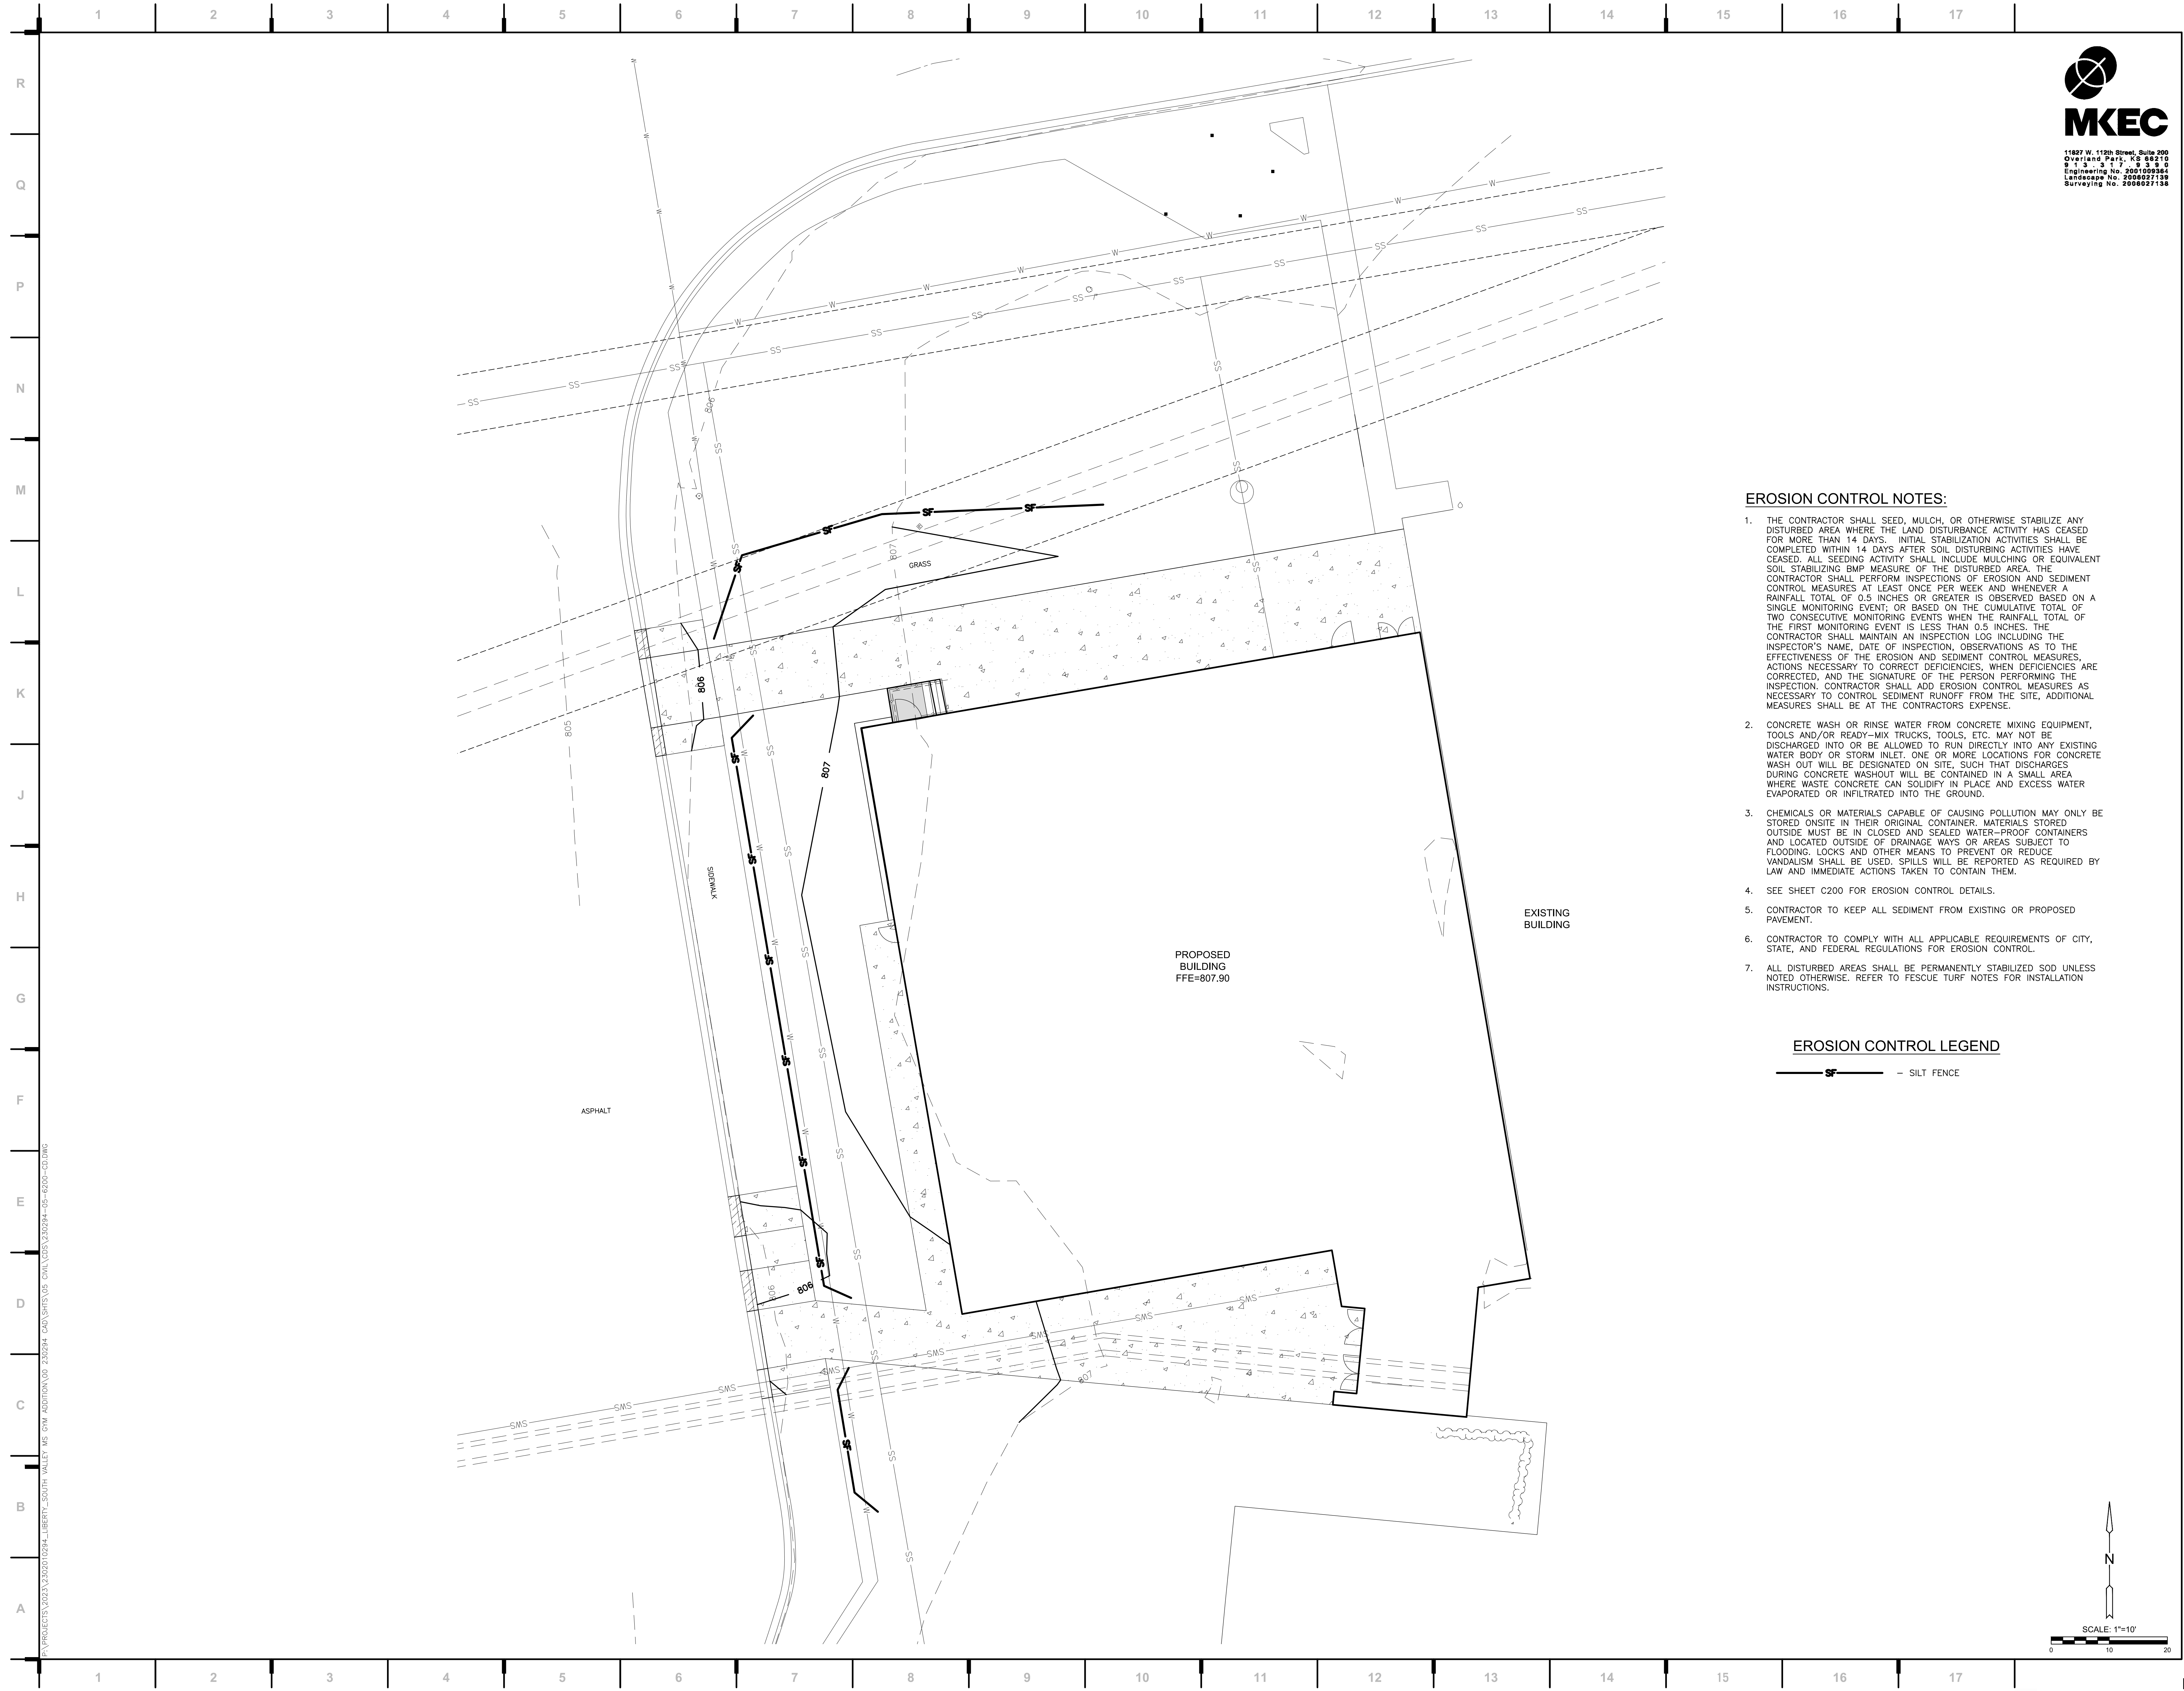
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State Certificate of Authority #: 2001009364
Engineering: 2001009364
Landscape: 2008027139
Surveying: 2008027139
11827 W. 112th St. Ste 200
Overland Park, KS 66210
913.317.5595 phone

Smith & Boucher Engineers
Mech/Elect/Plumb Engineer
State Certificate of Authority #WEC-0001787
25501 W. Valley Parkway, Ste 200
Olathe, KS 66061
913.345.2127 phone

Bob D Campbell
Structural Engineer
State Certificate of Authority #000442
4338 Bellevue Ave
Kansas City, MO 64111
816.531.4144 phone

EROSION CONTROL NOTES:

1. THE CONTRACTOR SHALL SEED, MULCH, OR OTHERWISE STABILIZE ANY DISTURBED AREA WHERE THE LAND DISTURBANCE ACTIVITY HAS CEASED FOR MORE THAN 14 DAYS. INITIAL STABILIZATION ACTIVITIES SHALL BE COMPLETED WITHIN 14 DAYS AFTER SOIL DISTURBING ACTIVITIES HAVE CEASED. ALL SEEDING ACTIVITY SHALL INCLUDE MULCHING OR EQUIVALENT SOIL STABILIZING BMP MEASURE OF THE DISTURBED AREA. THE CONTRACTOR SHALL PERFORM INSPECTIONS OF EROSION AND SEDIMENT CONTROL MEASURES AT LEAST ONCE PER WEEK AND WHENEVER A RAINFALL TOTAL OF 0.5 INCHES OR GREATER IS OBSERVED BASED ON A SINGLE MONITORING EVENT; OR BASED ON THE CUMULATIVE TOTAL OF TWO CONSECUTIVE MONITORING EVENTS WHEN THE RAINFALL TOTAL OF THE FIRST MONITORING EVENT IS LESS THAN 0.5 INCHES. THE CONTRACTOR SHALL MAINTAIN AN INSPECTION LOG INCLUDING THE INSPECTOR'S NAME, DATE OF INSPECTION, OBSERVATIONS AS TO THE EFFECTIVENESS OF THE EROSION AND SEDIMENT CONTROL MEASURES, ACTIONS NECESSARY TO CORRECT DEFICIENCIES, WHEN DEFICIENCIES ARE CORRECTED, AND THE SIGNATURE OF THE PERSON PERFORMING THE INSPECTION. CONTRACTOR SHALL ADD EROSION CONTROL MEASURES AS NECESSARY TO CONTROL SEDIMENT RUNOFF FROM THE SITE. ADDITIONAL MEASURES SHALL BE AT THE CONTRACTORS EXPENSE.
2. CONCRETE WASH OR RINSE WATER FROM CONCRETE MIXING EQUIPMENT, TOOLS AND/OR READY-MIX TRUCKS, TOOLS, ETC. MAY NOT BE DISCHARGED INTO OR BE ALLOWED TO RUN DIRECTLY INTO ANY EXISTING WATER BODY OR STORM INLET. ONE OR MORE LOCATIONS FOR CONCRETE WASH OUT WILL BE DESIGNATED ON SITE, SUCH THAT DISCHARGES DURING CONCRETE WASHOUT WILL BE CONTAINED IN A SMALL AREA WHERE WASTE CONCRETE CAN SOLIDIFY IN PLACE AND EXCESS WATER EVAPORATED OR INFILTRATED INTO THE GROUND.
3. CHEMICALS OR MATERIALS CAPABLE OF CAUSING POLLUTION MAY ONLY BE STORED ONSITE IN THEIR ORIGINAL CONTAINER. MATERIALS STORED OUTSIDE MUST BE IN CLOSED AND SEALED WATER-PROOF CONTAINERS AND LOCATED OUTSIDE OF DRAINAGE WAYS OR AREAS SUBJECT TO FLOODING. LOCKS AND OTHER MEANS TO PREVENT OR REDUCE VANDALISM SHALL BE USED. SPILLS WILL BE REPORTED AS REQUIRED BY LAW AND IMMEDIATE ACTIONS TAKEN TO CONTAIN THEM.
4. SEE SHEET C200 FOR EROSION CONTROL DETAILS.
5. CONTRACTOR TO KEEP ALL SEDIMENT FROM EXISTING OR PROPOSED PAVEMENT.
6. CONTRACTOR TO COMPLY WITH ALL APPLICABLE REQUIREMENTS OF CITY, STATE, AND FEDERAL REGULATIONS FOR EROSION CONTROL.
7. ALL DISTURBED AREAS SHALL BE PERMANENTLY STABILIZED SOD UNLESS NOTED OTHERWISE. REFER TO FESCUE TURF NOTES FOR INSTALLATION INSTRUCTIONS.

EROSION CONTROL LEGEND

 - SILT FENCE

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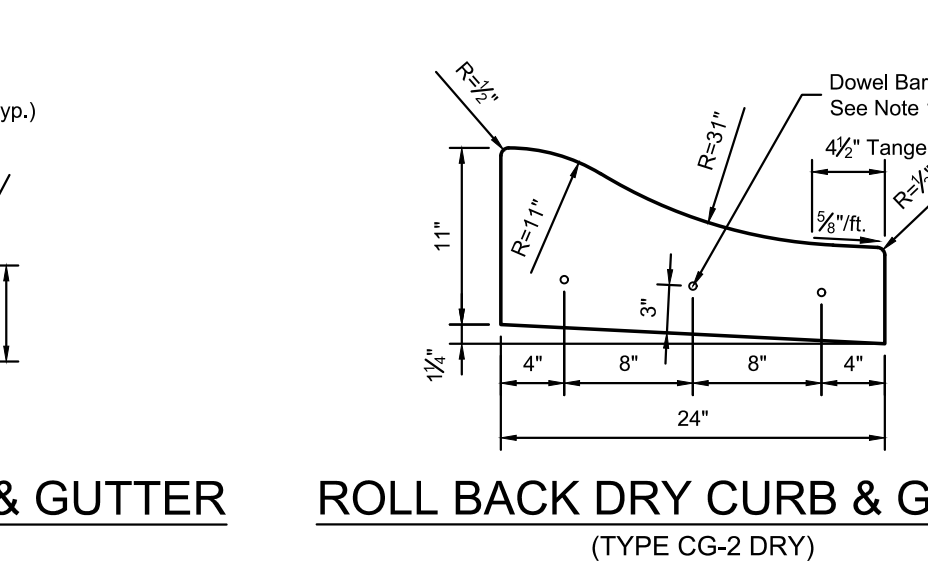
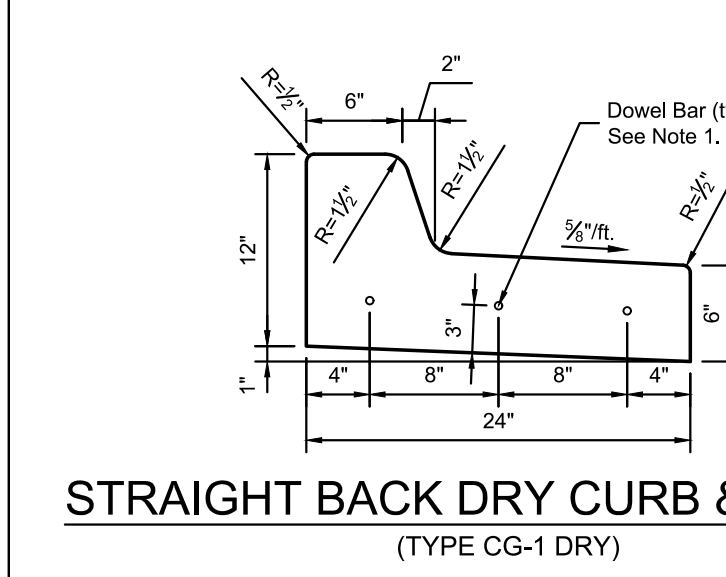
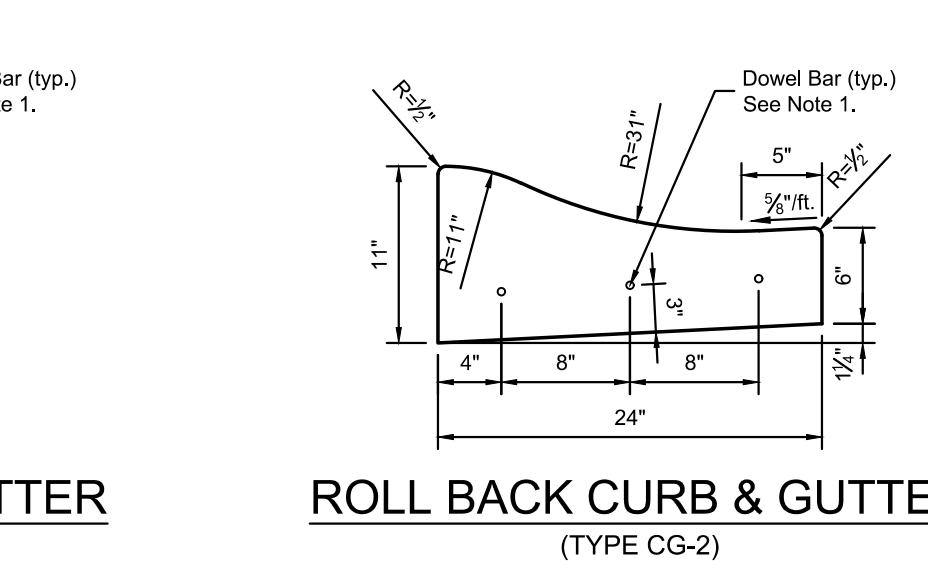
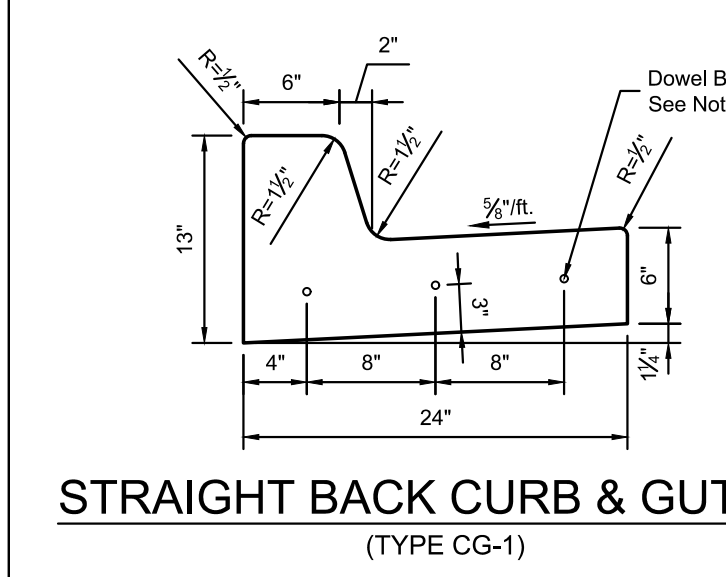
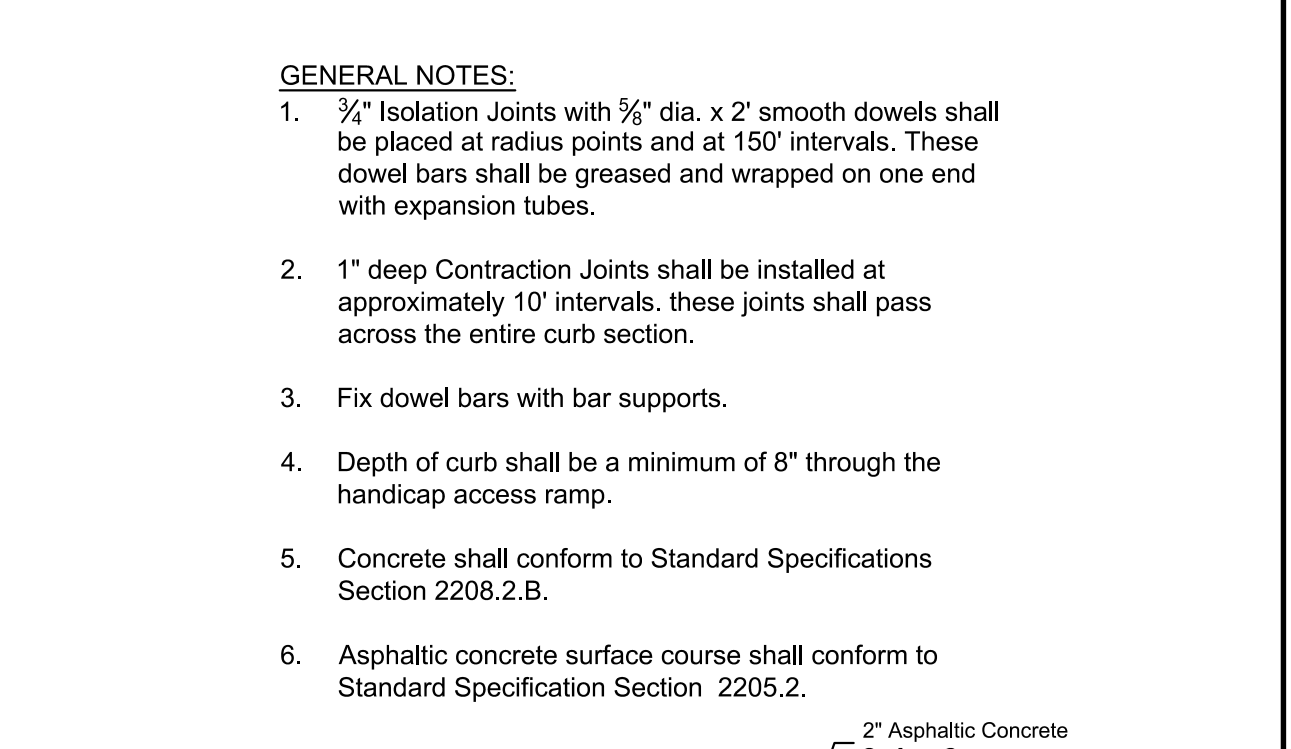
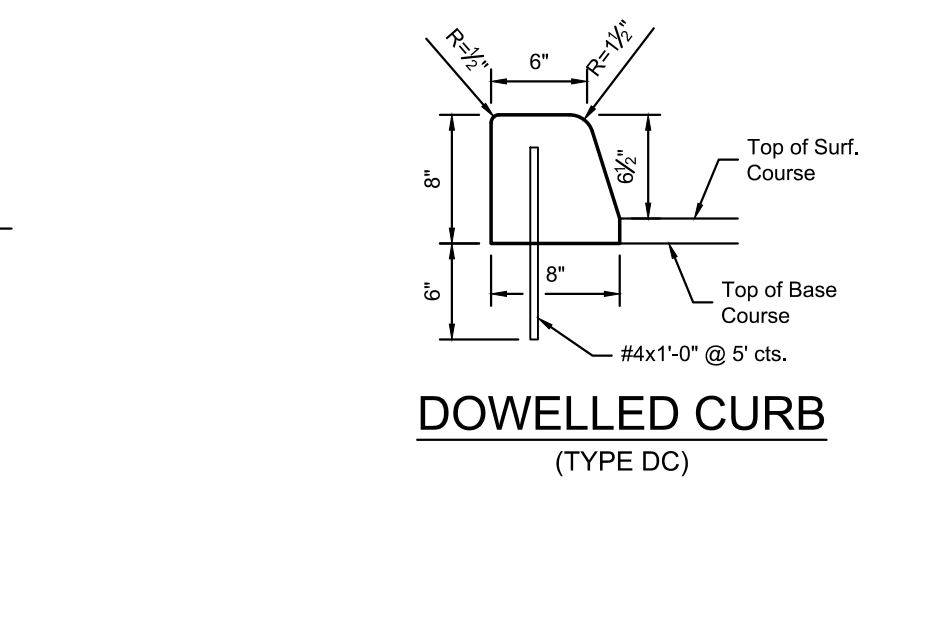
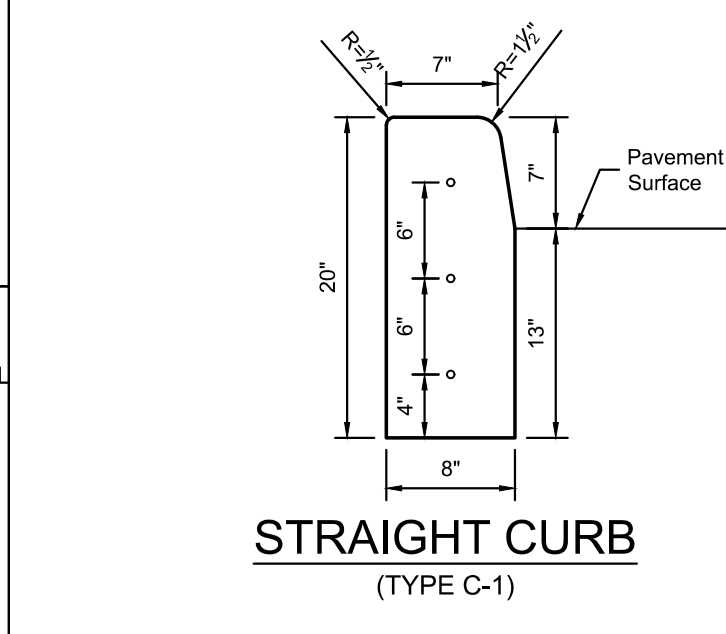
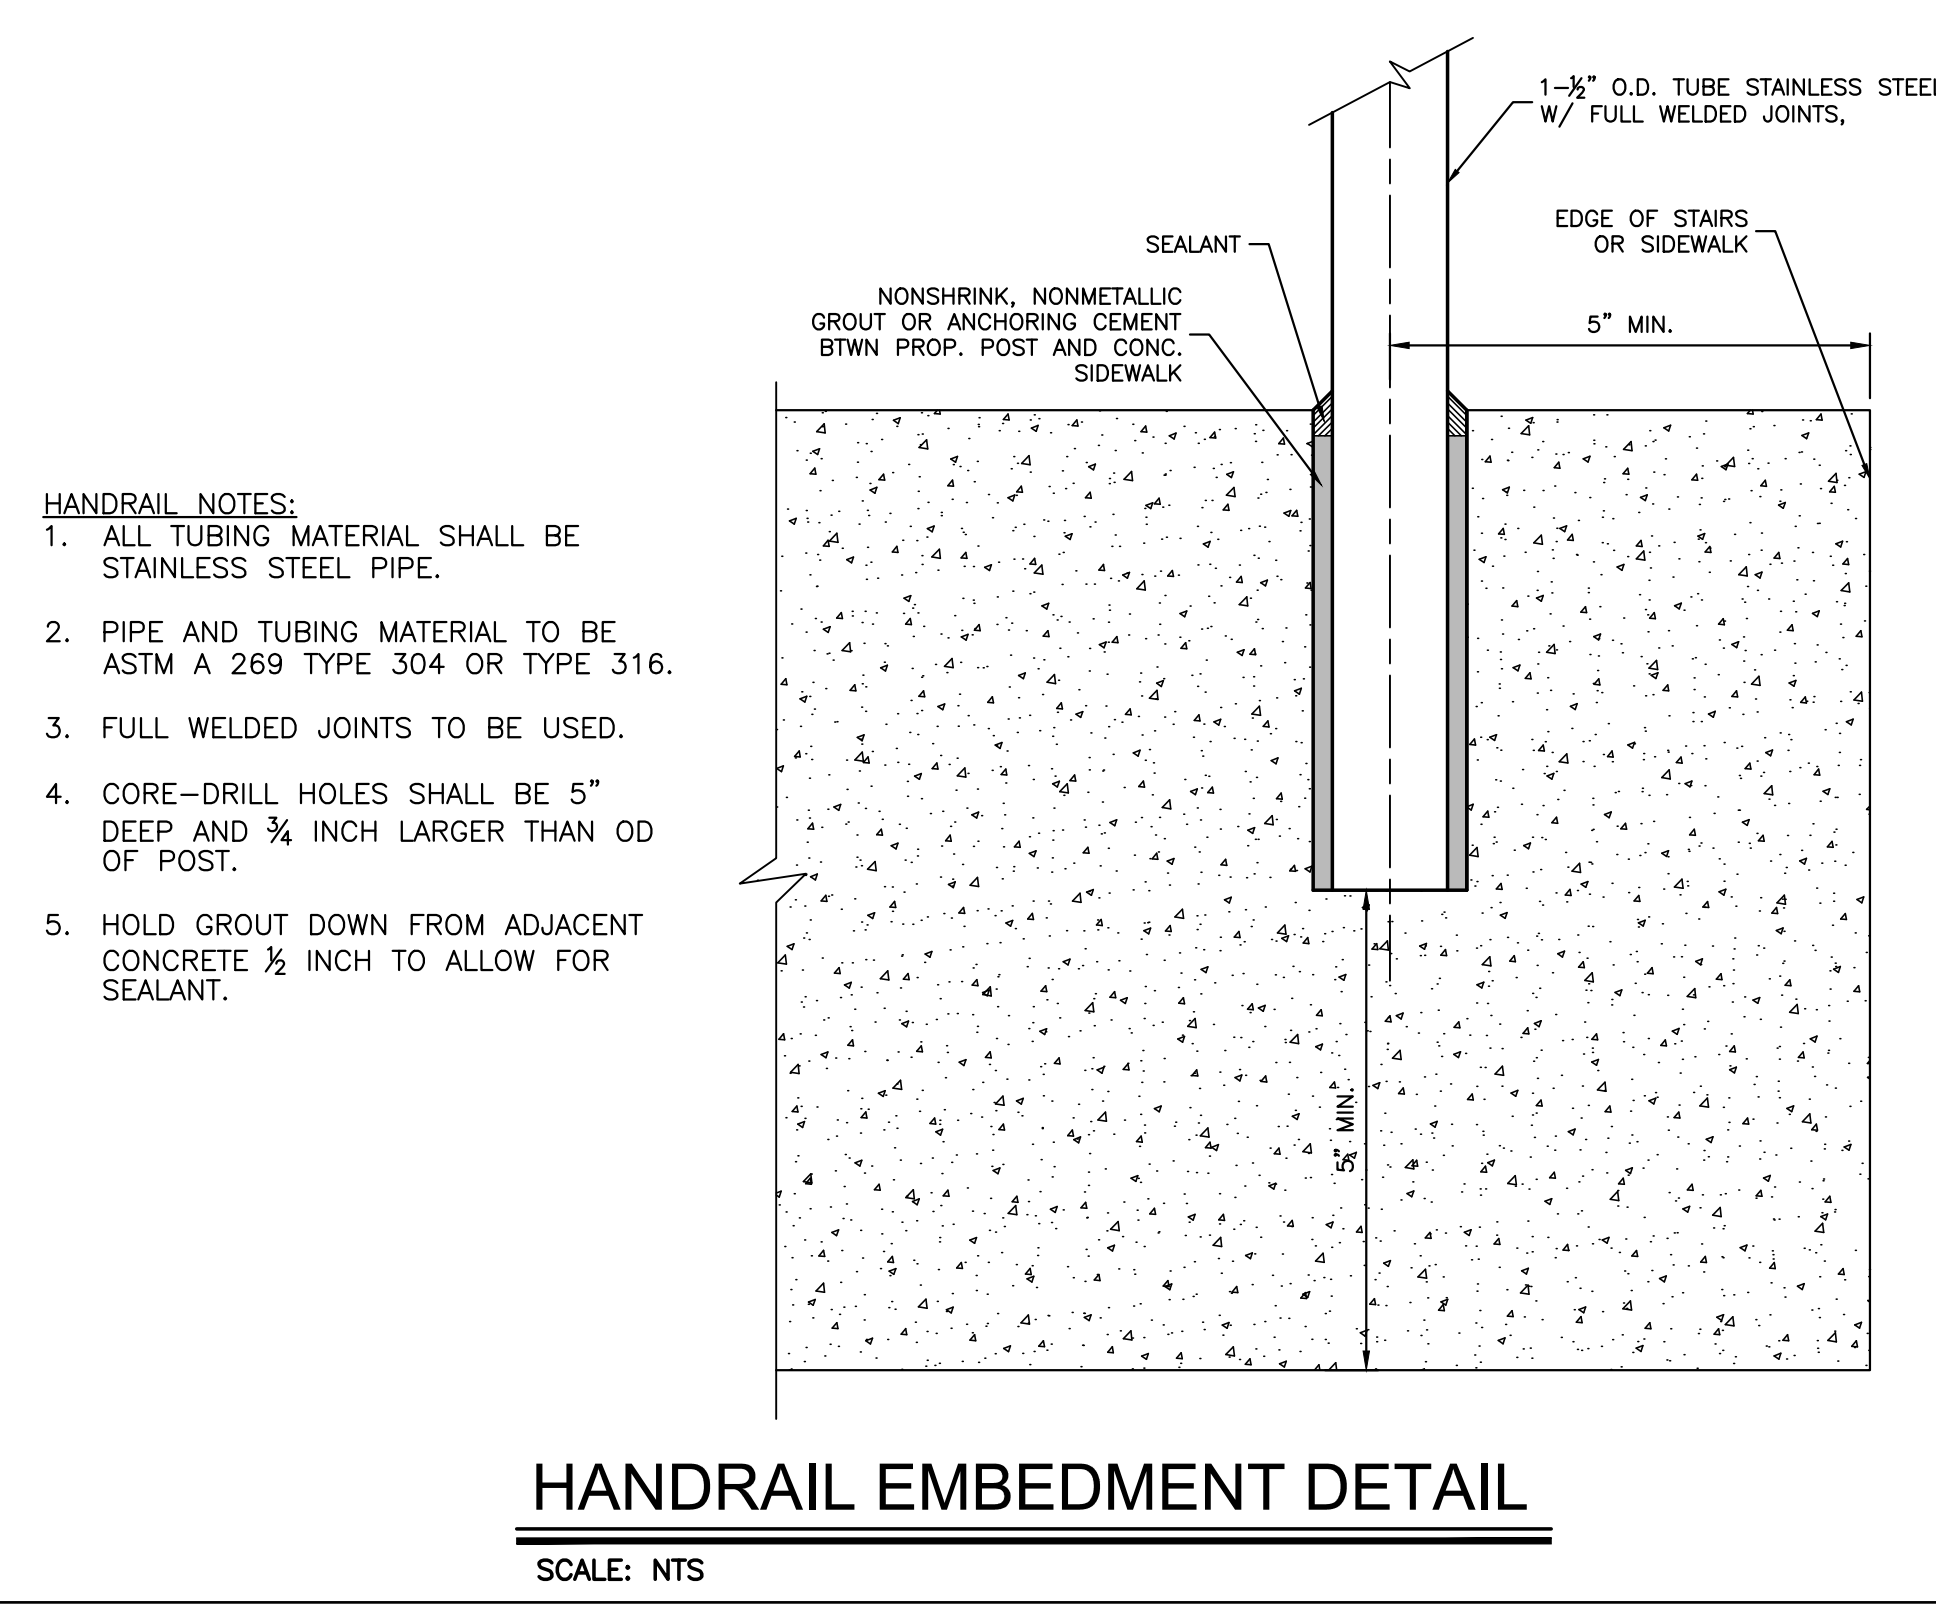
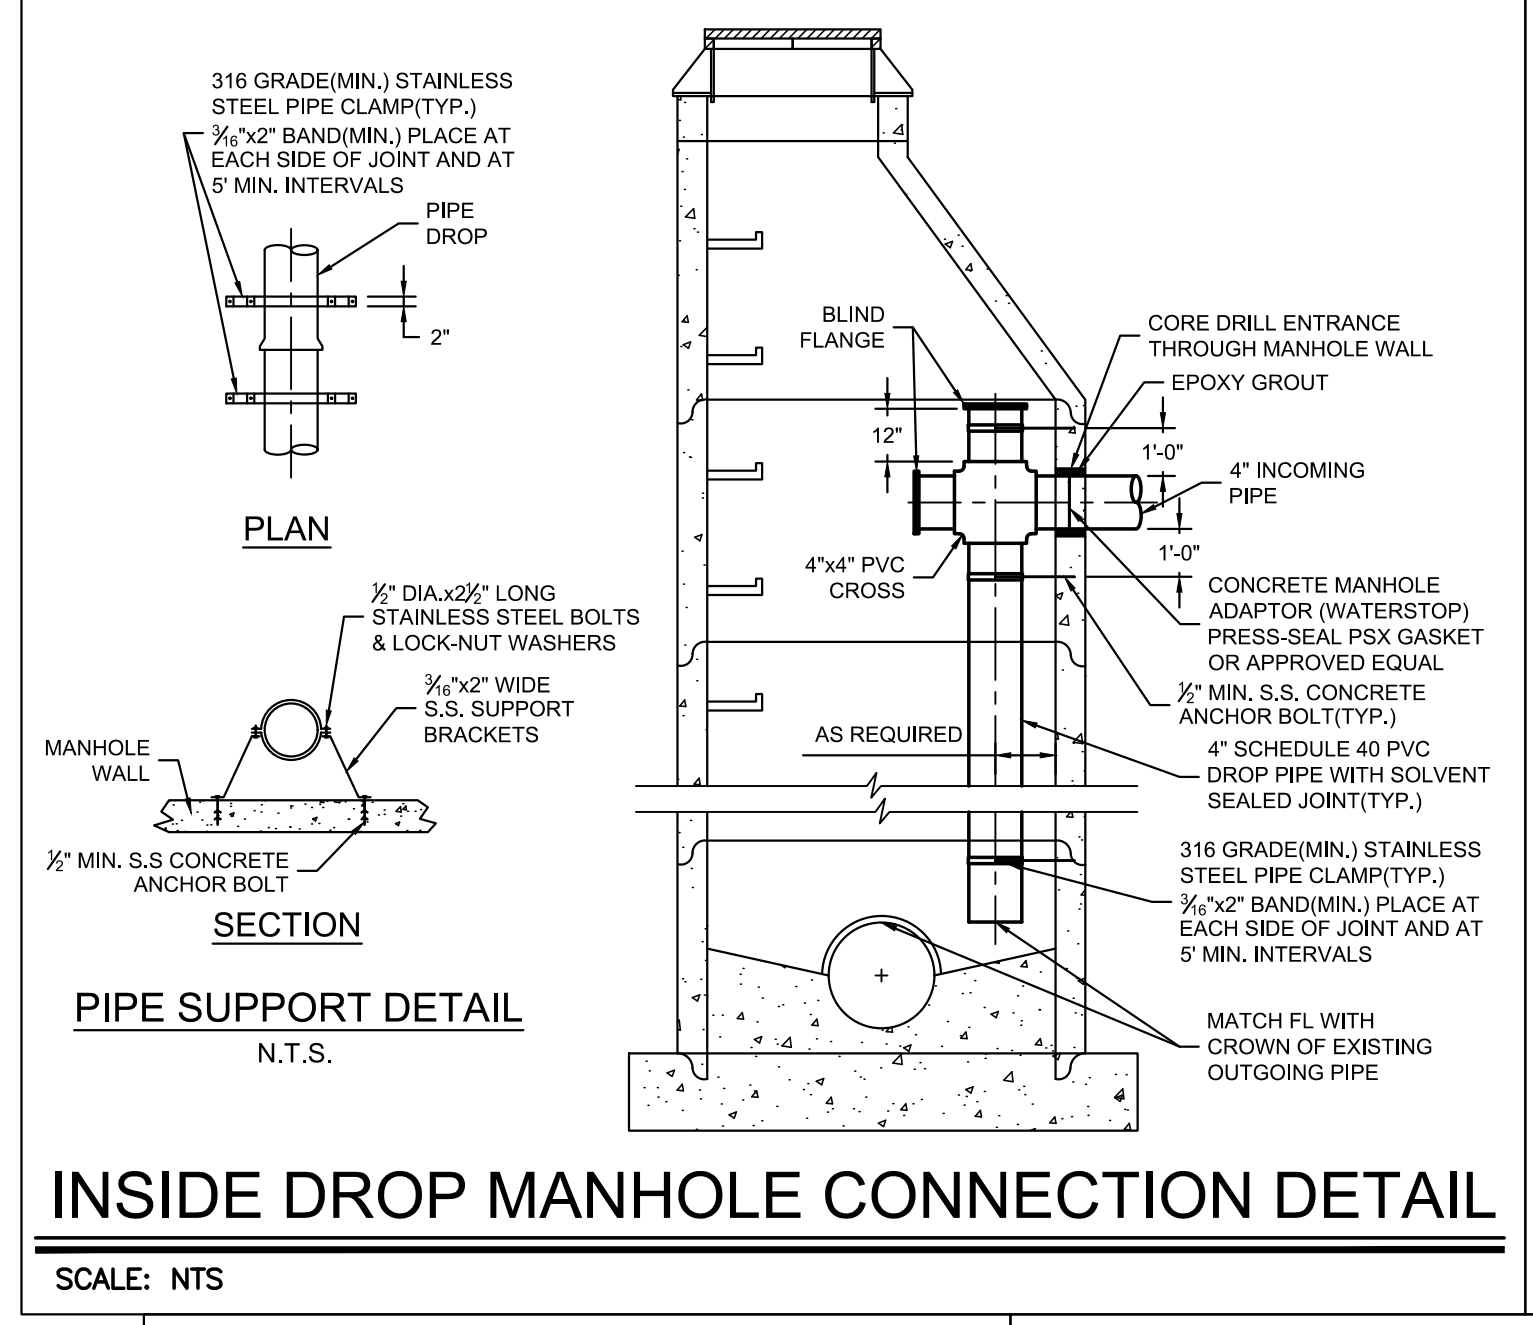
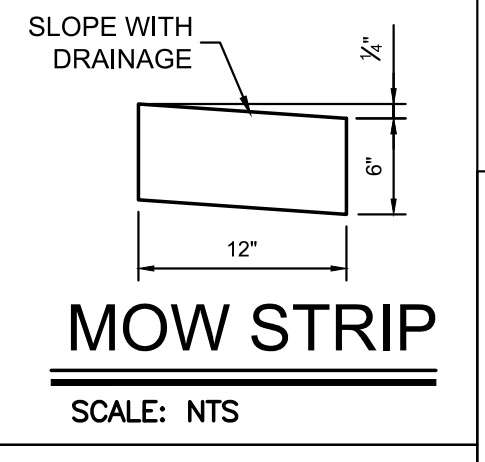
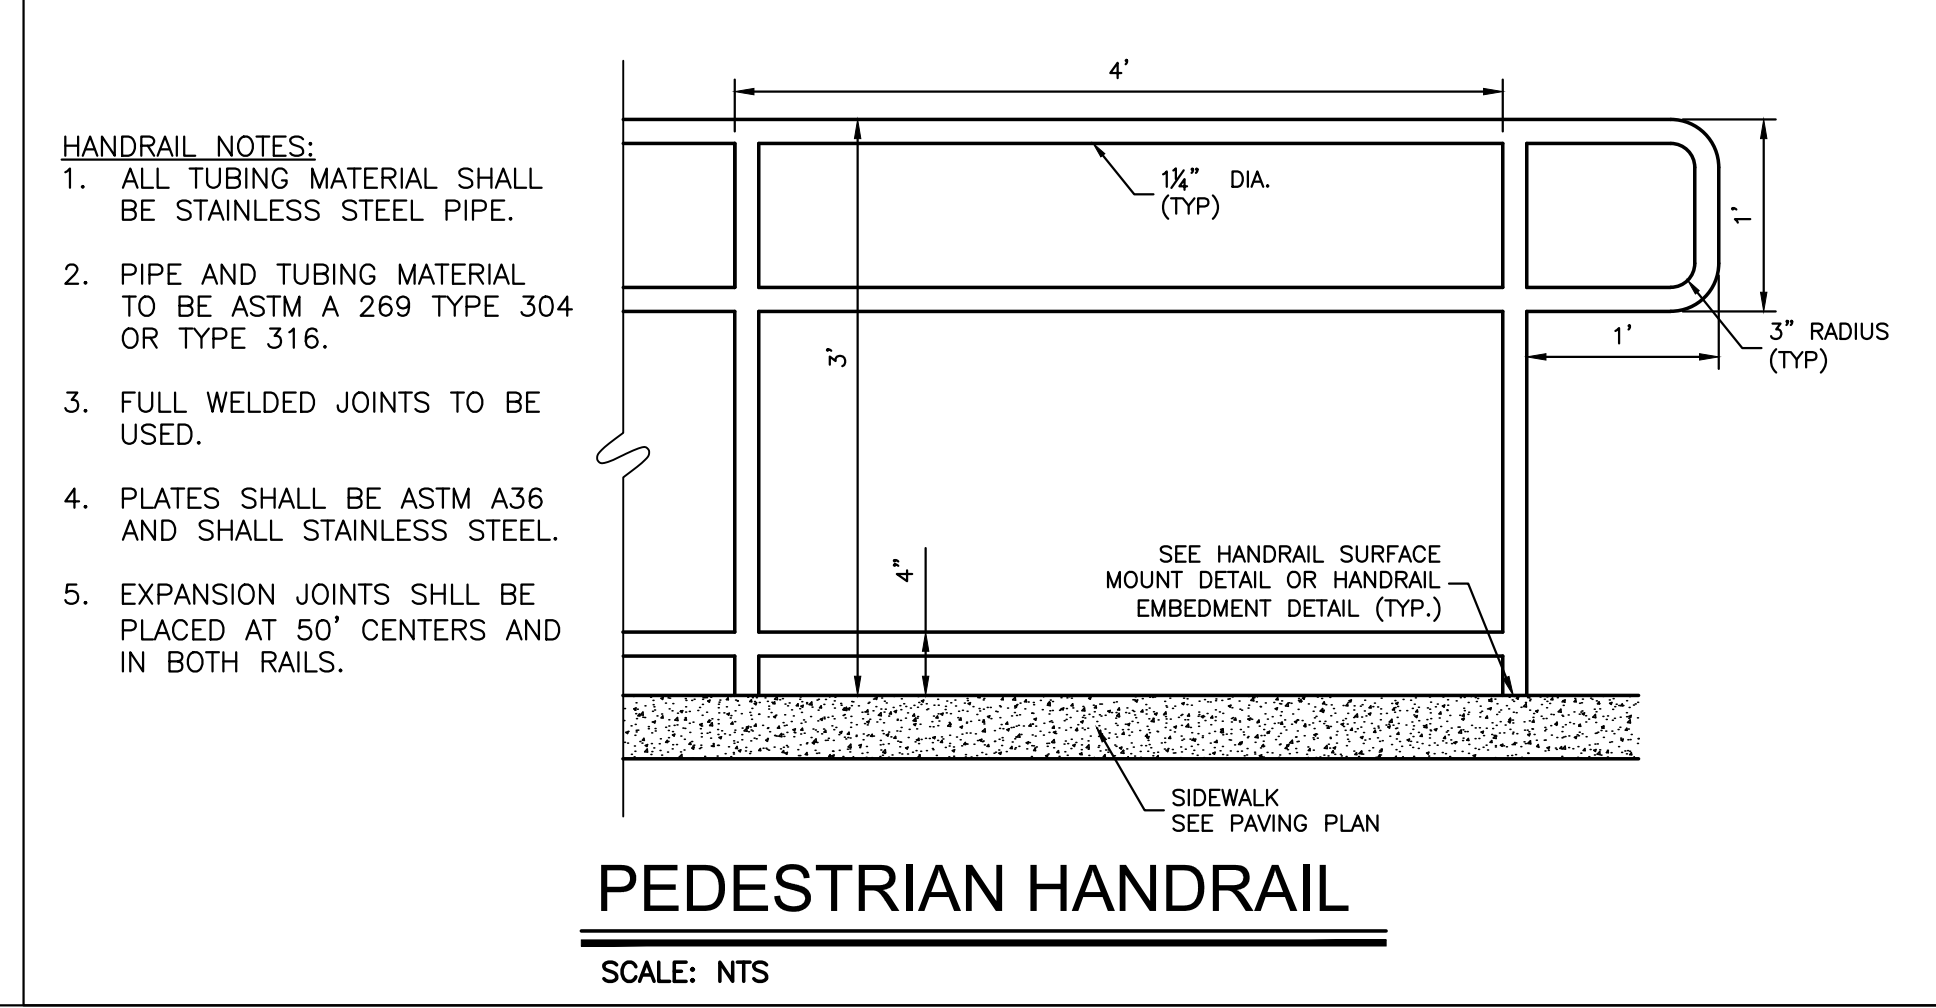
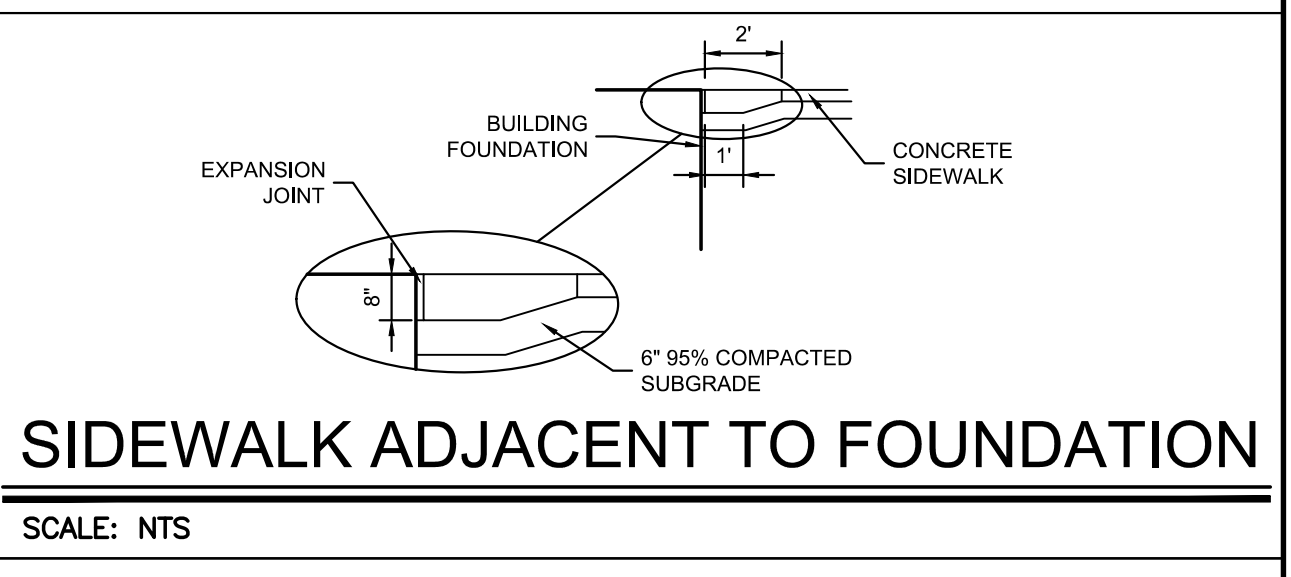
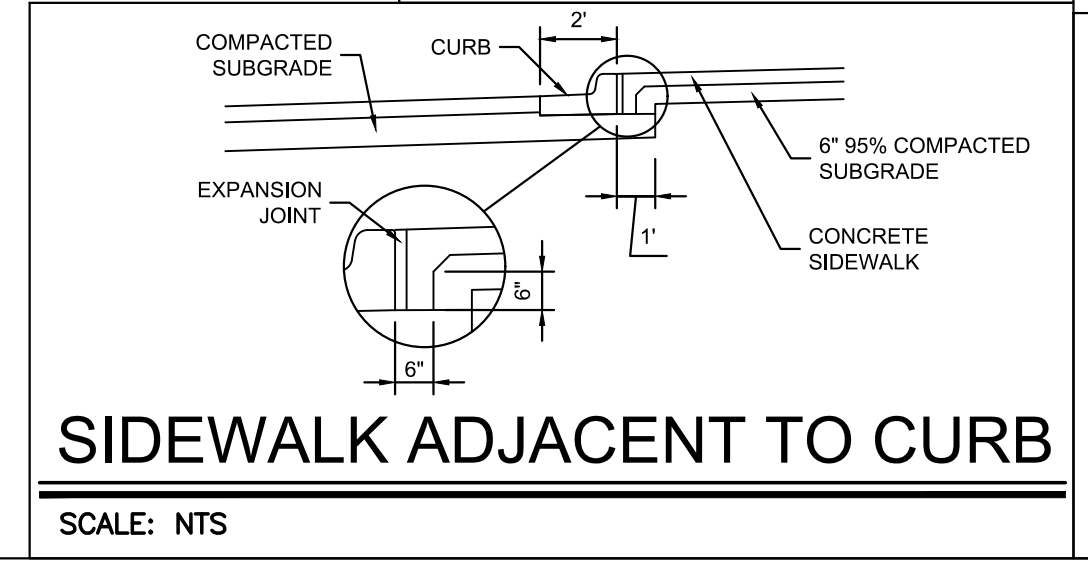
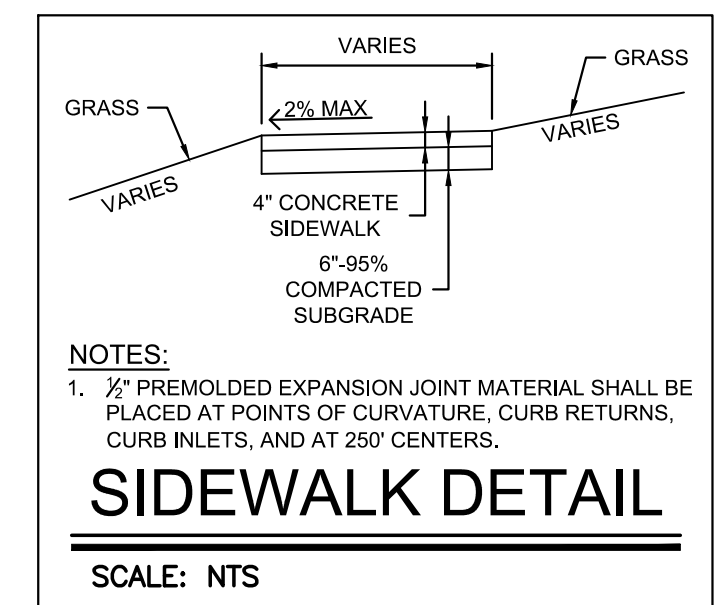
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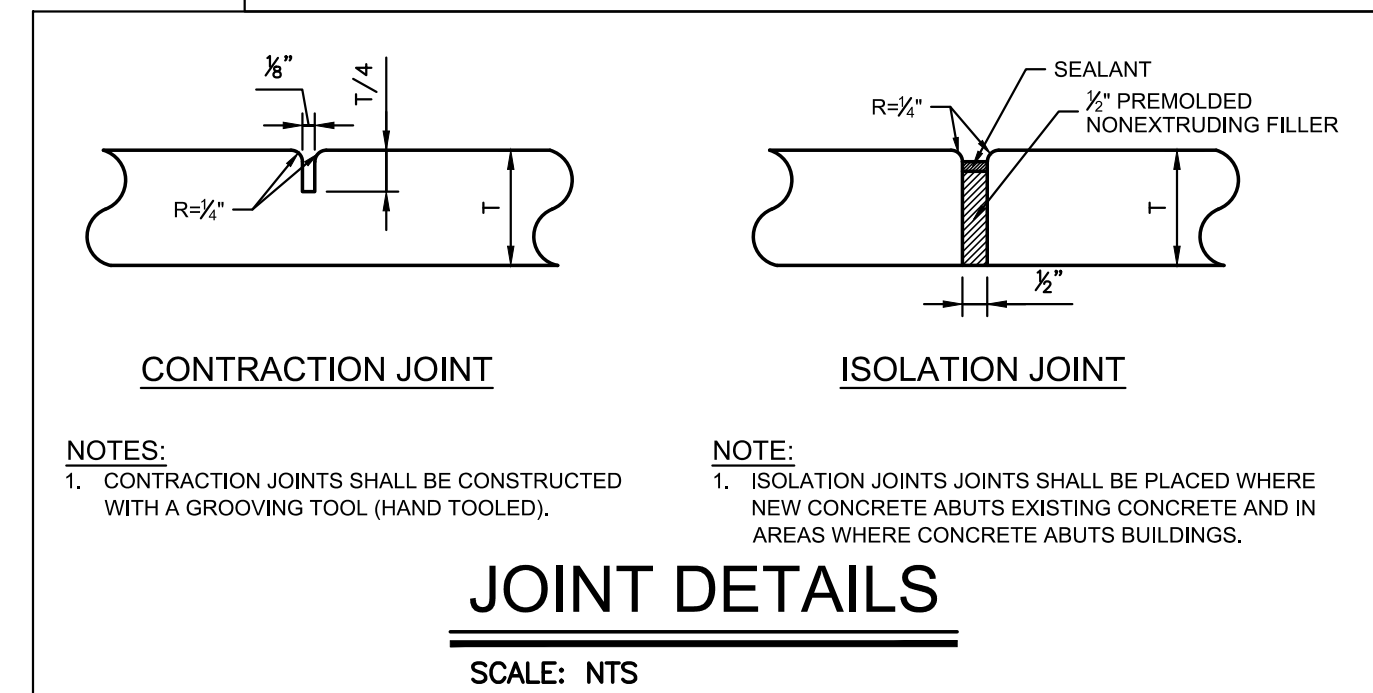
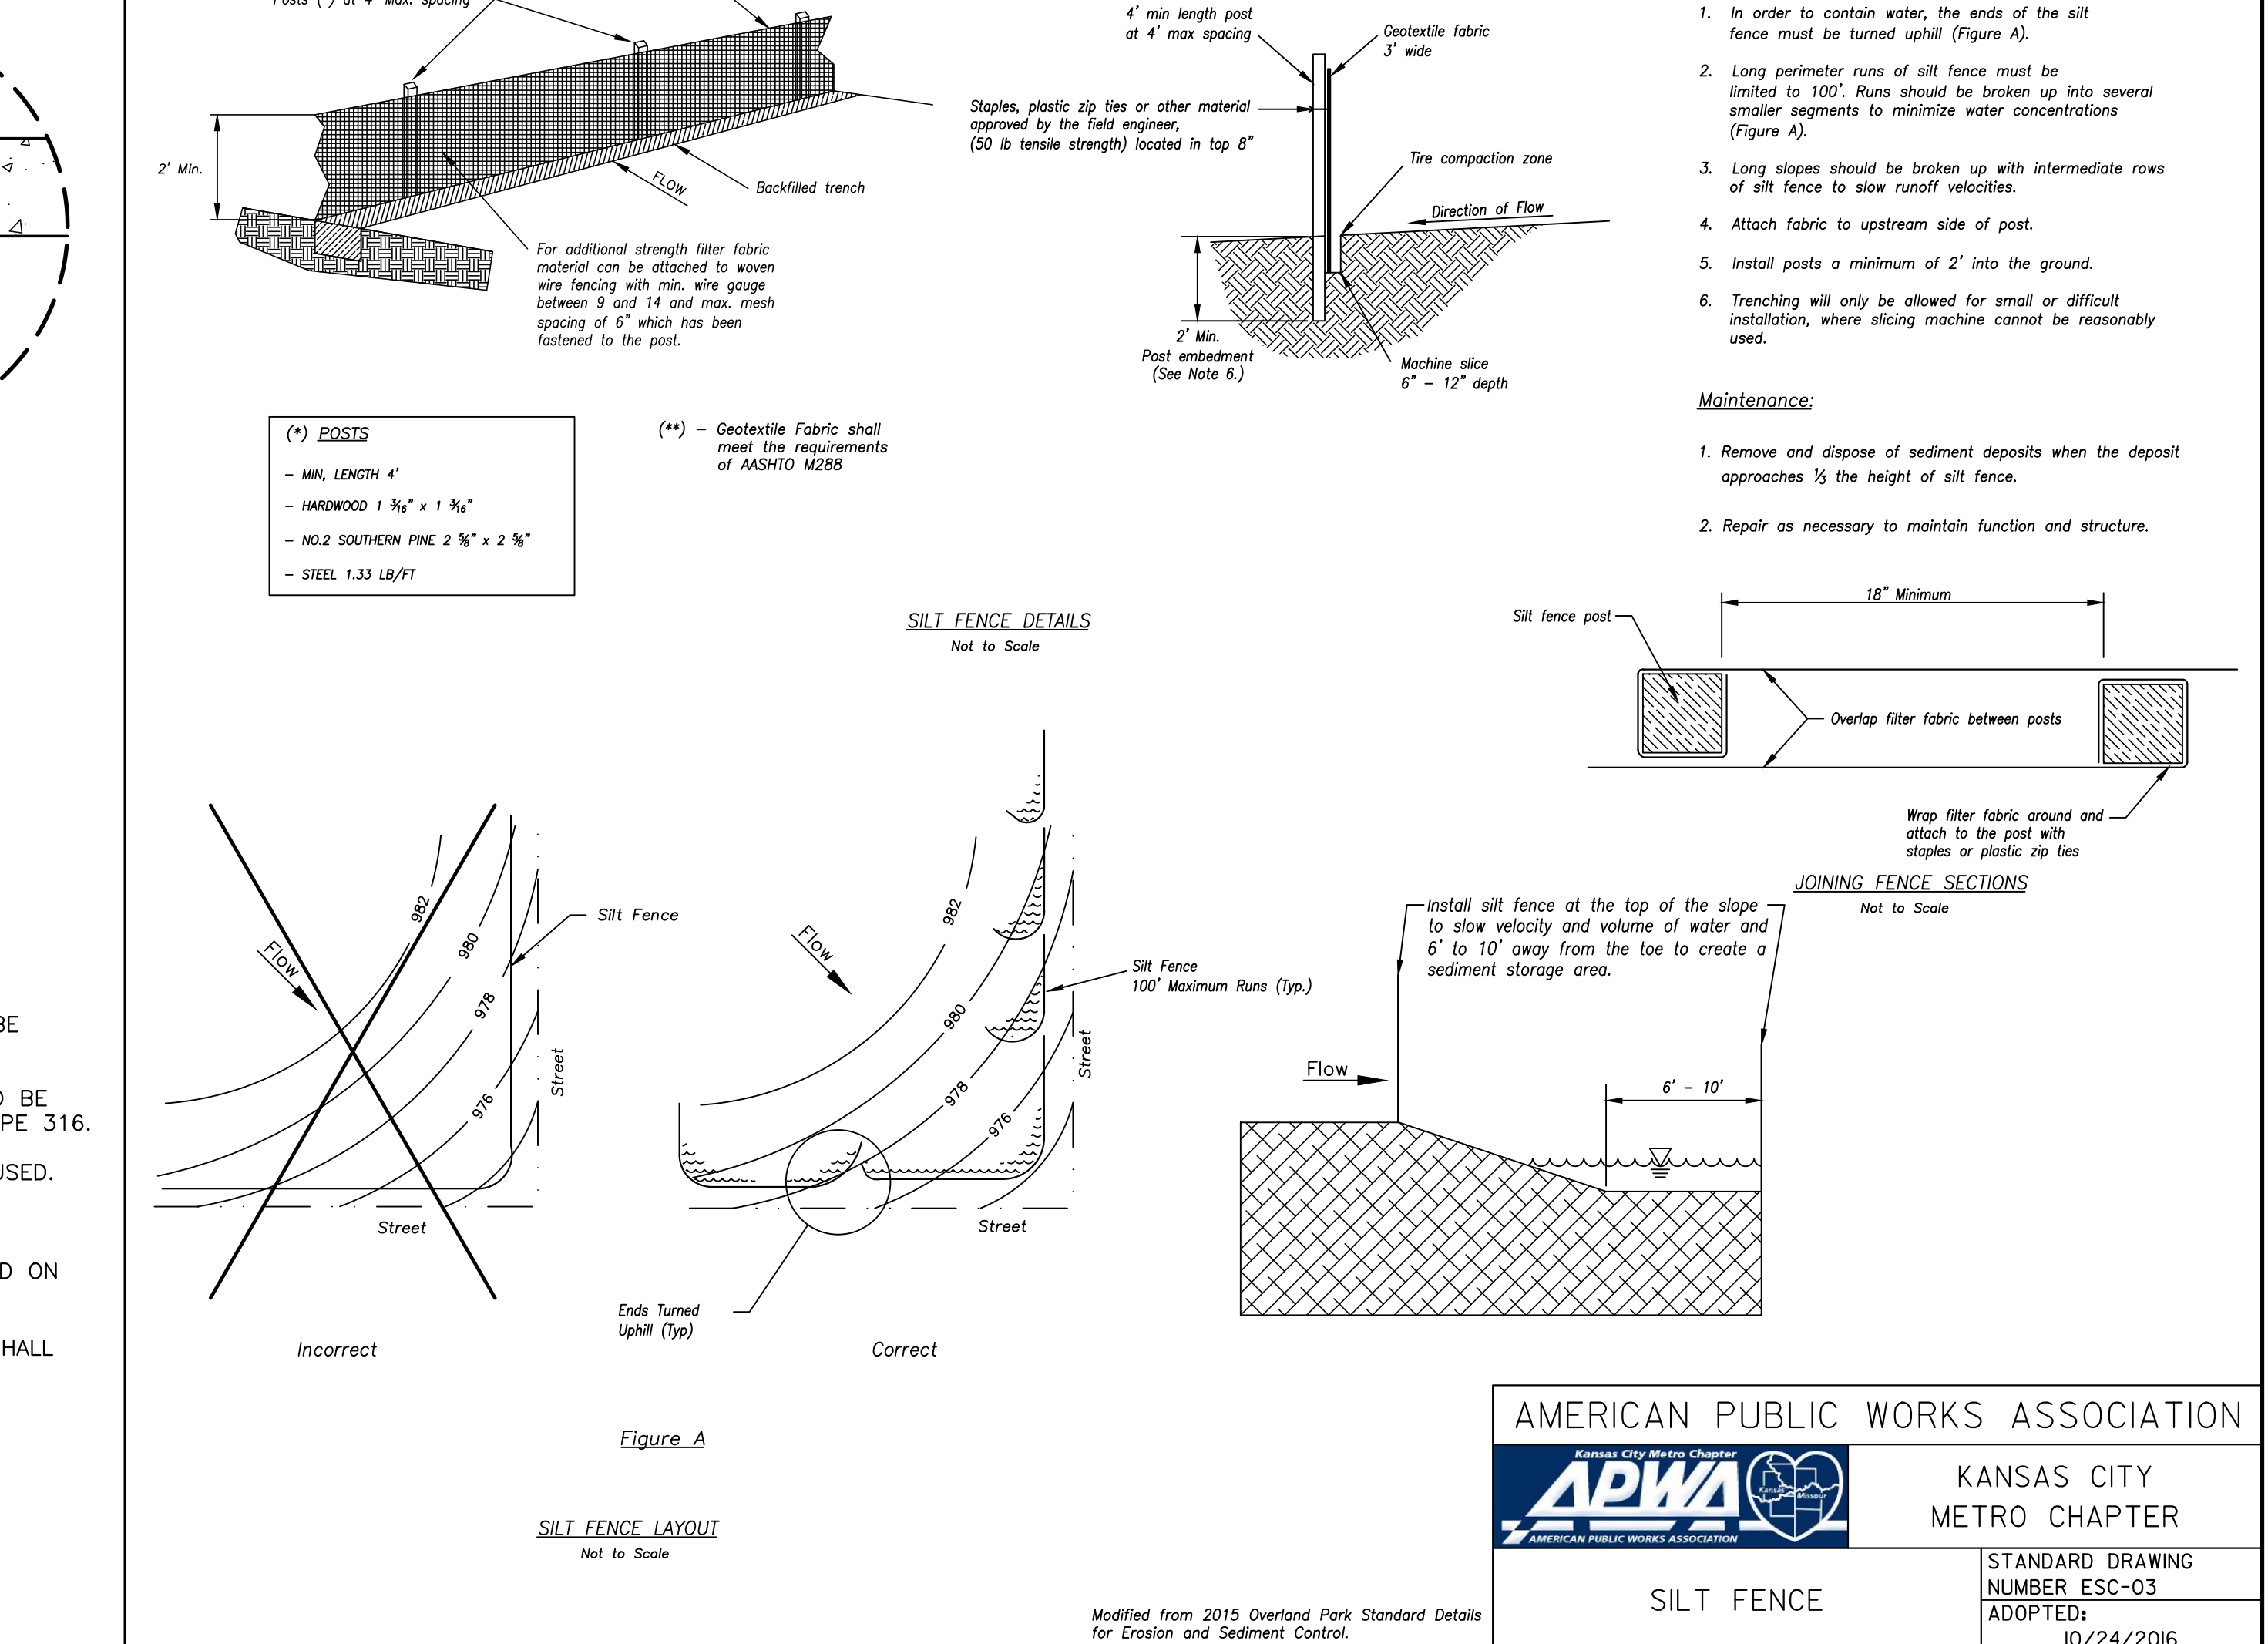
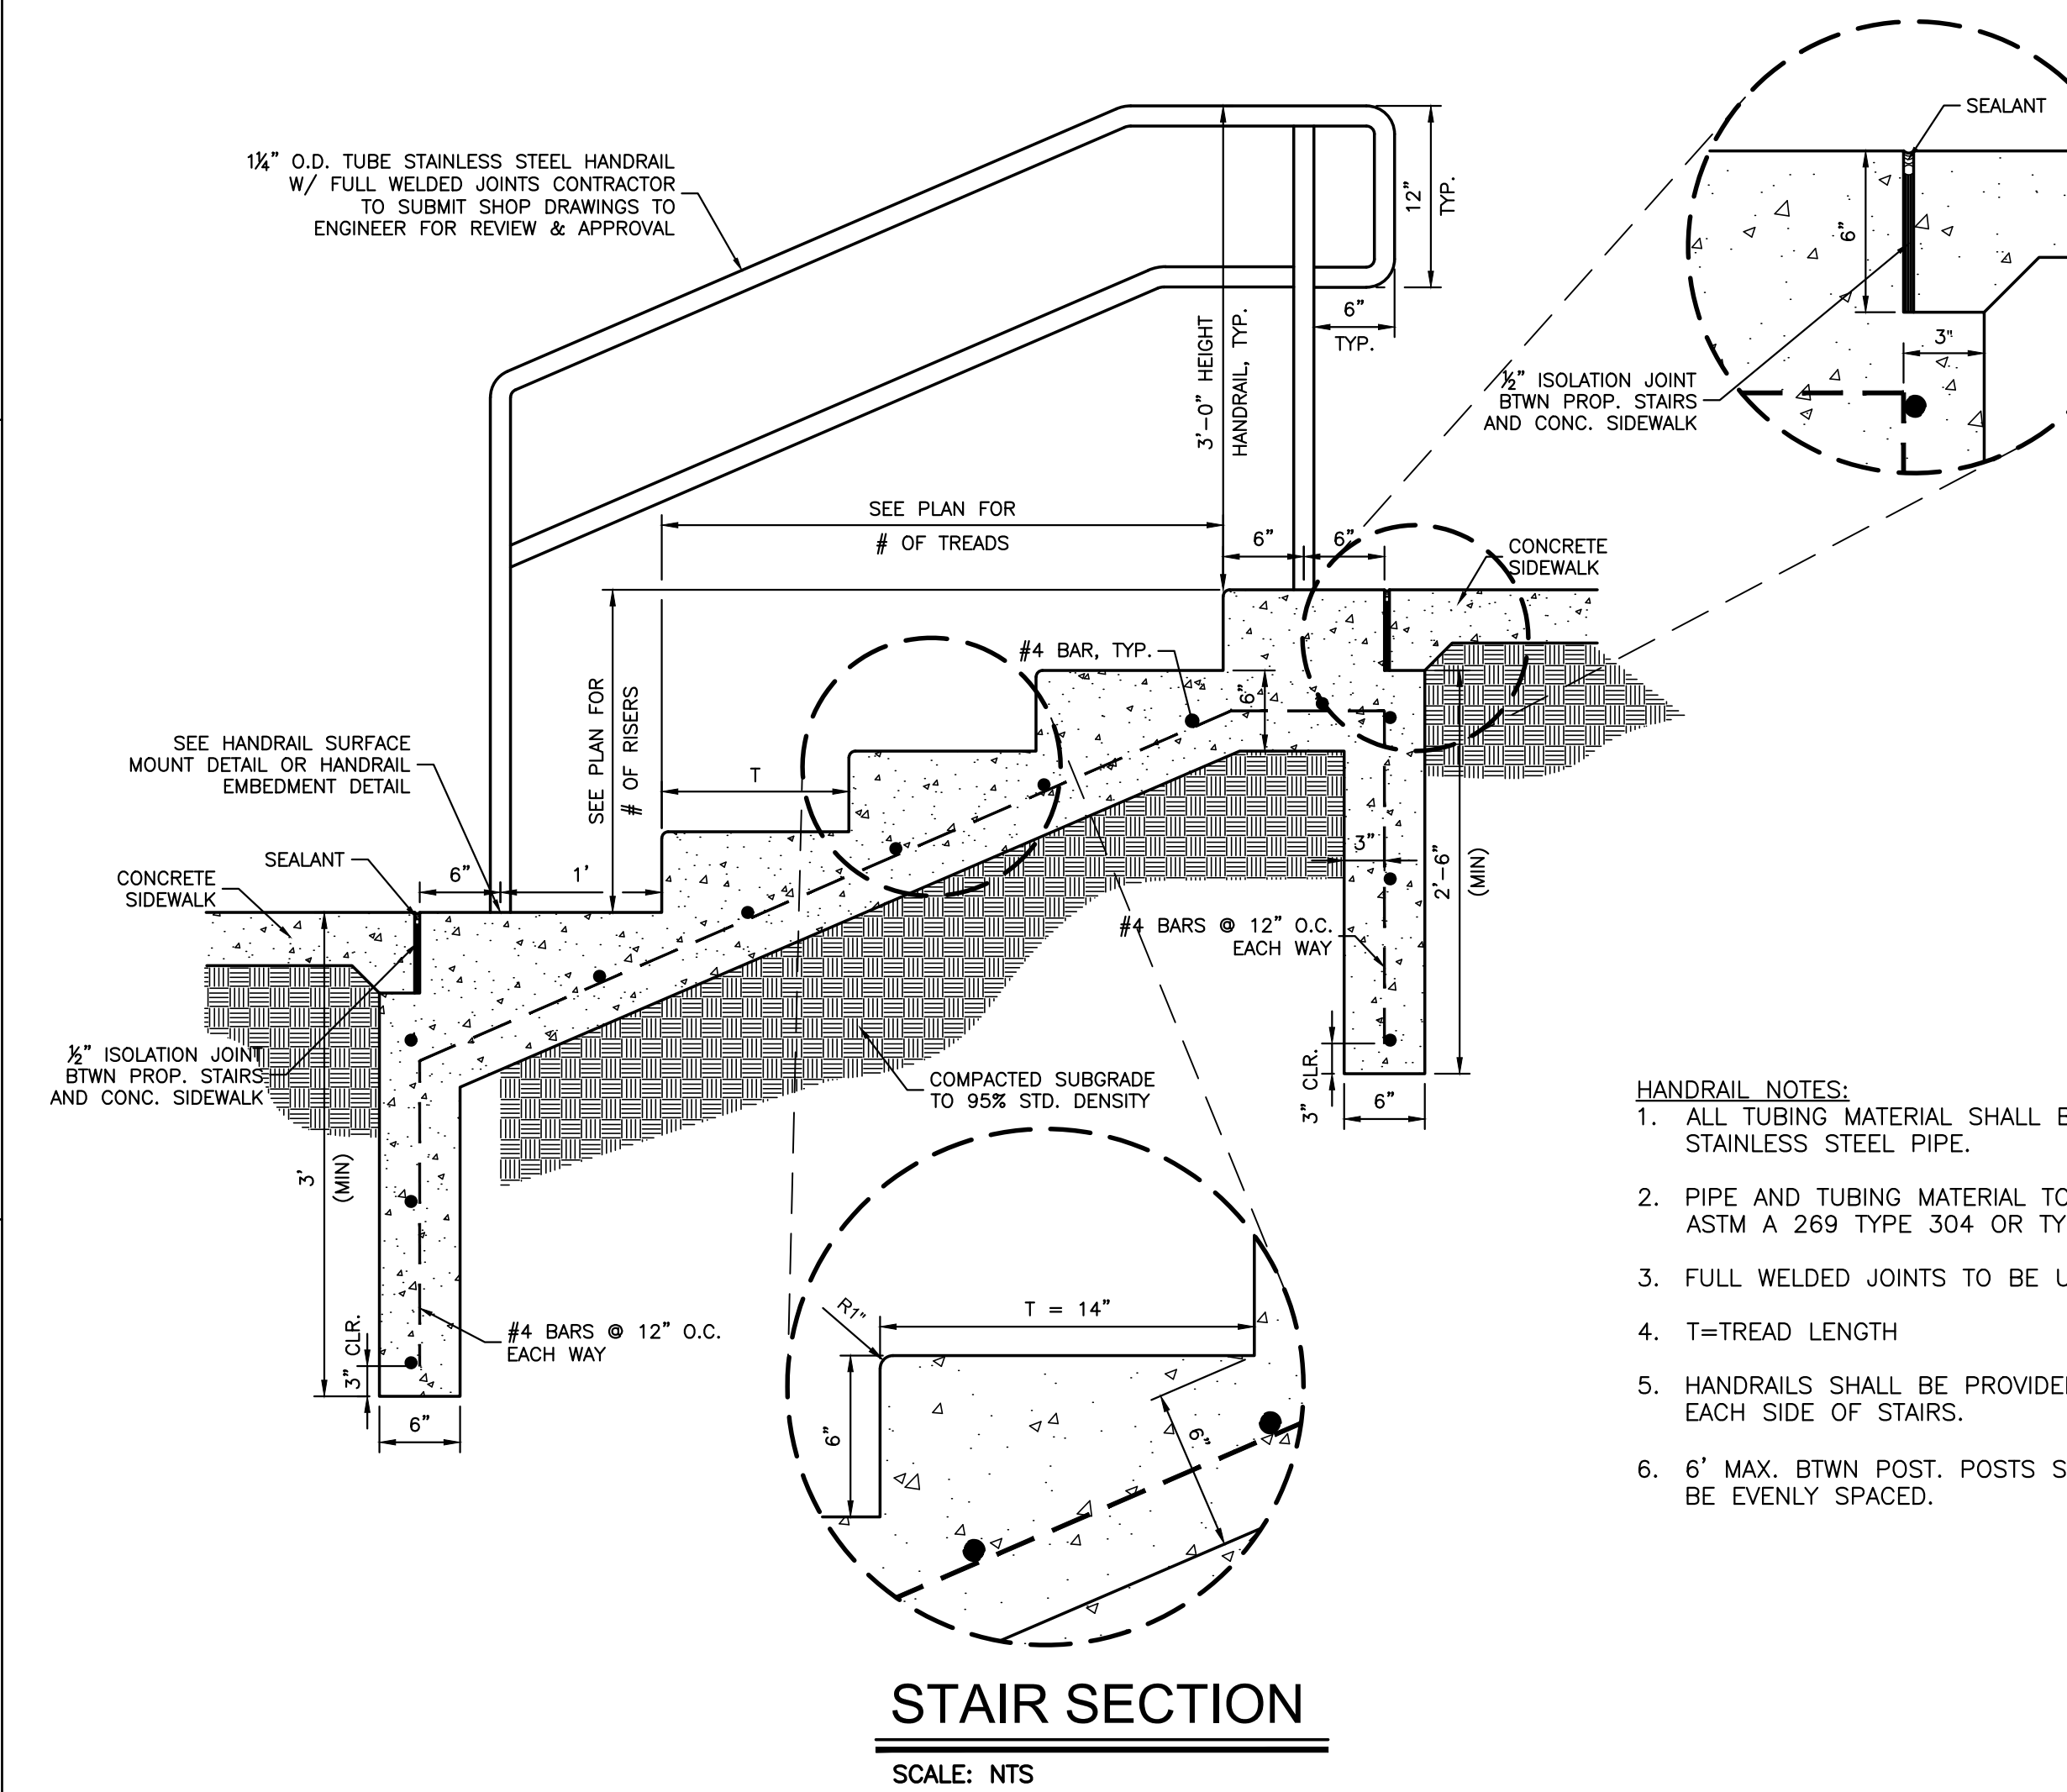
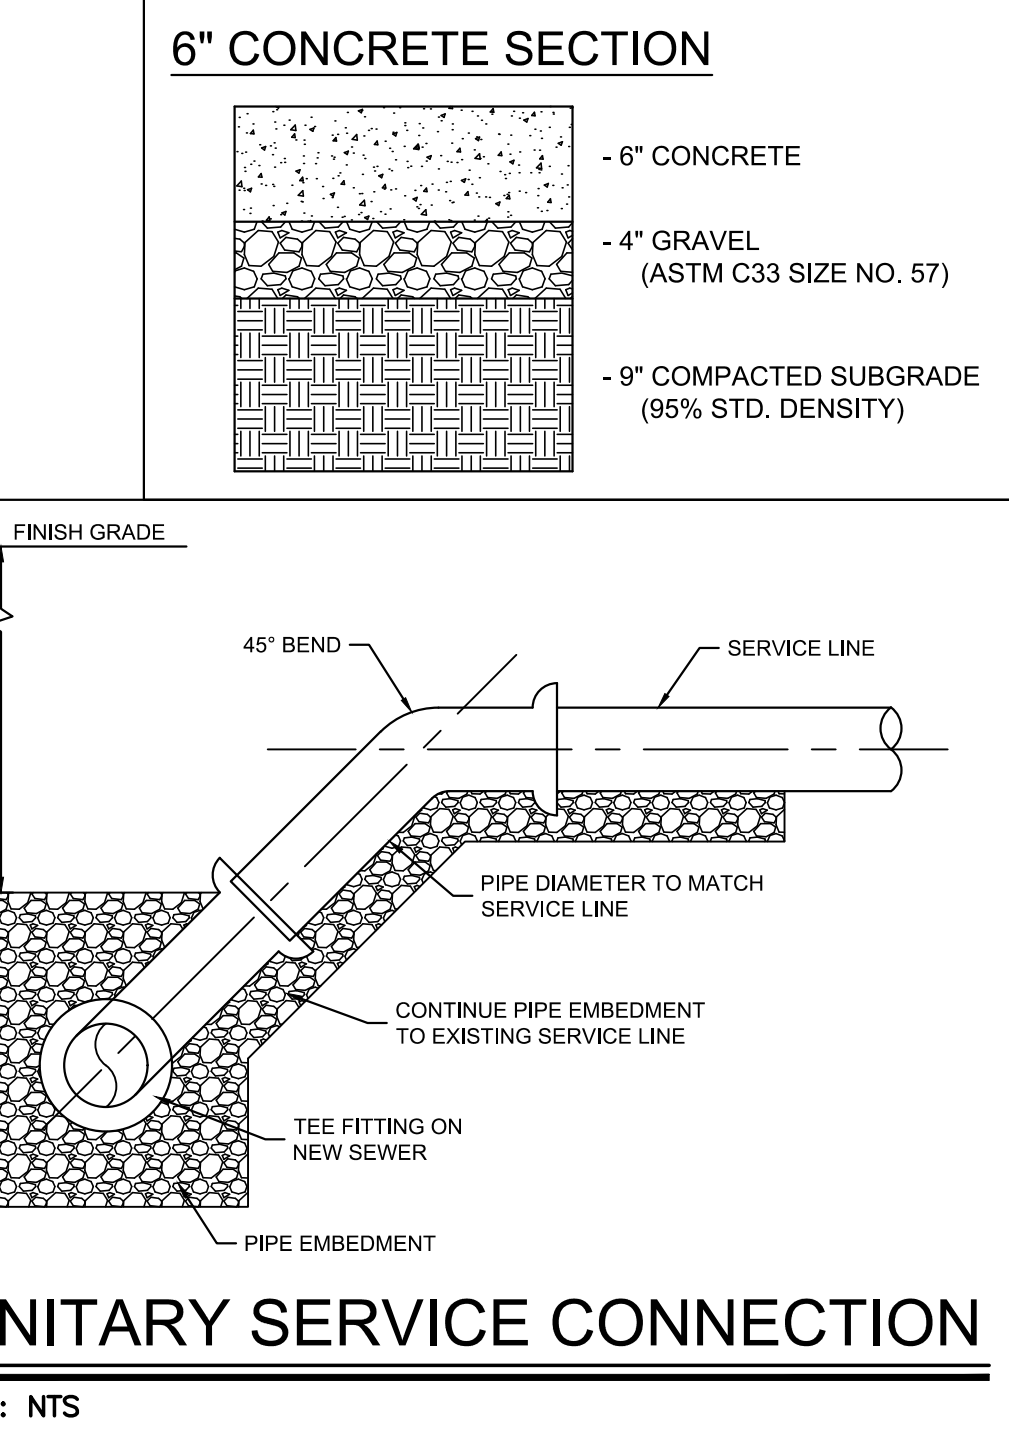


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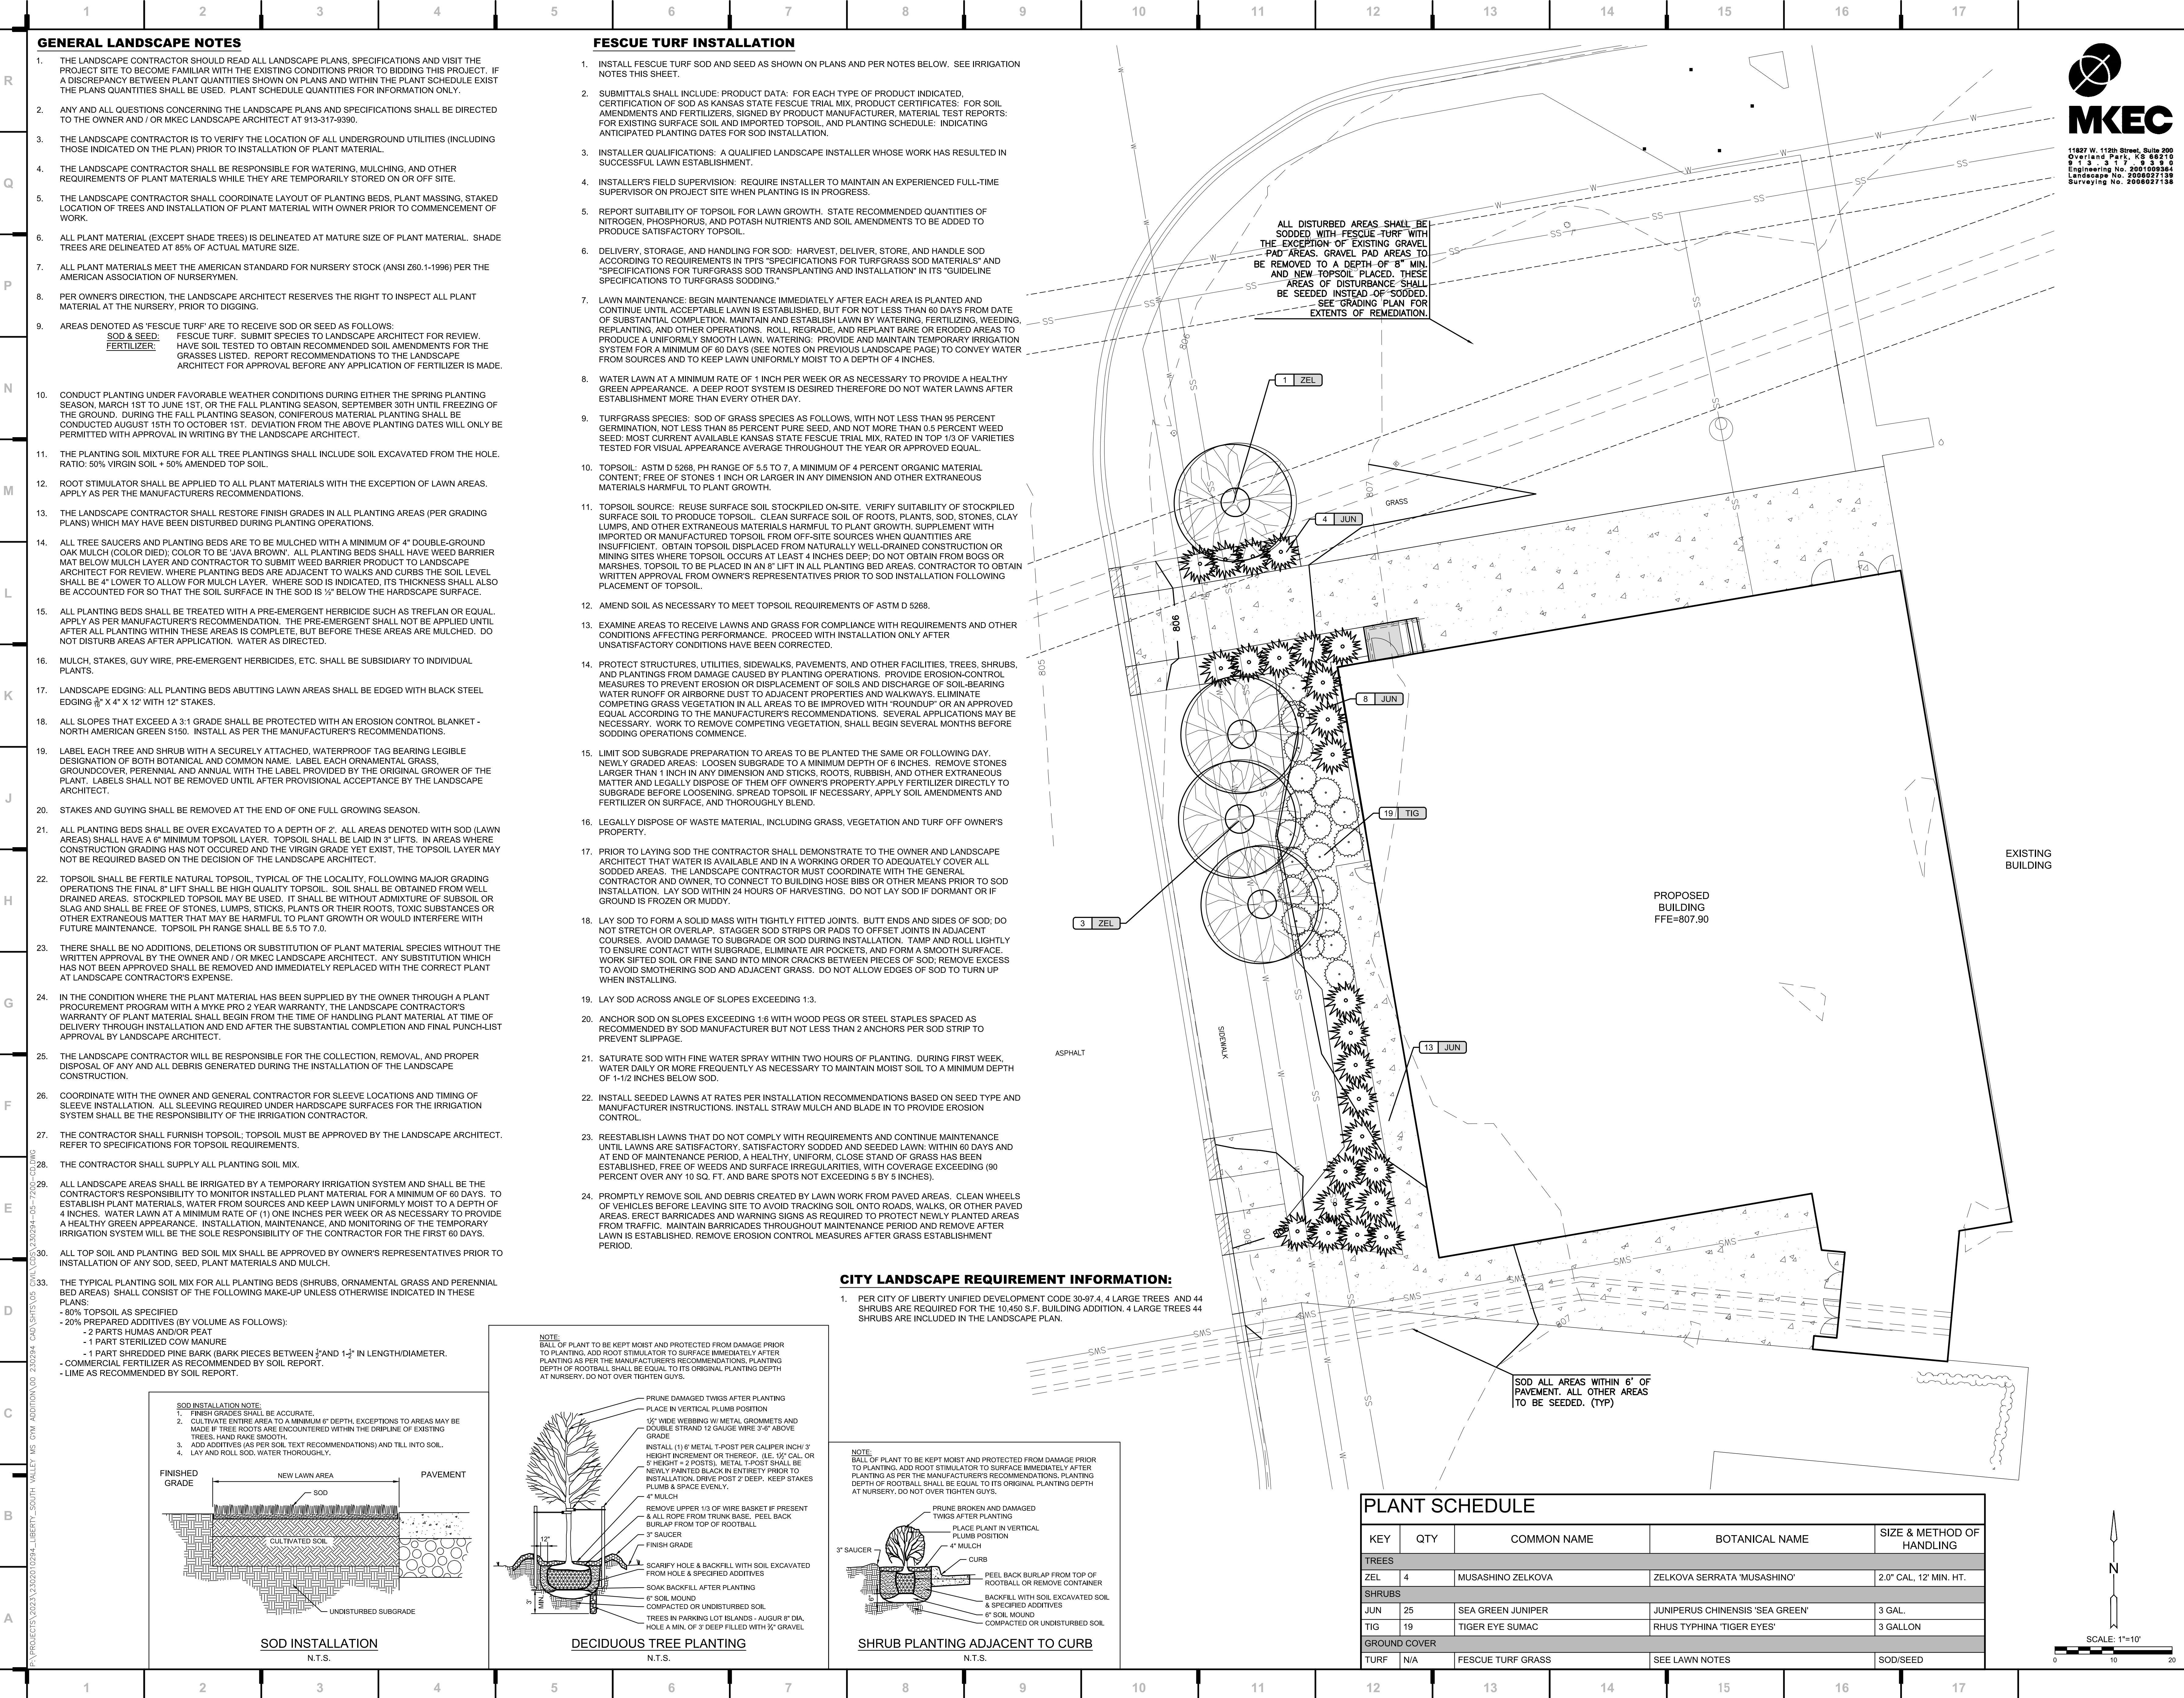
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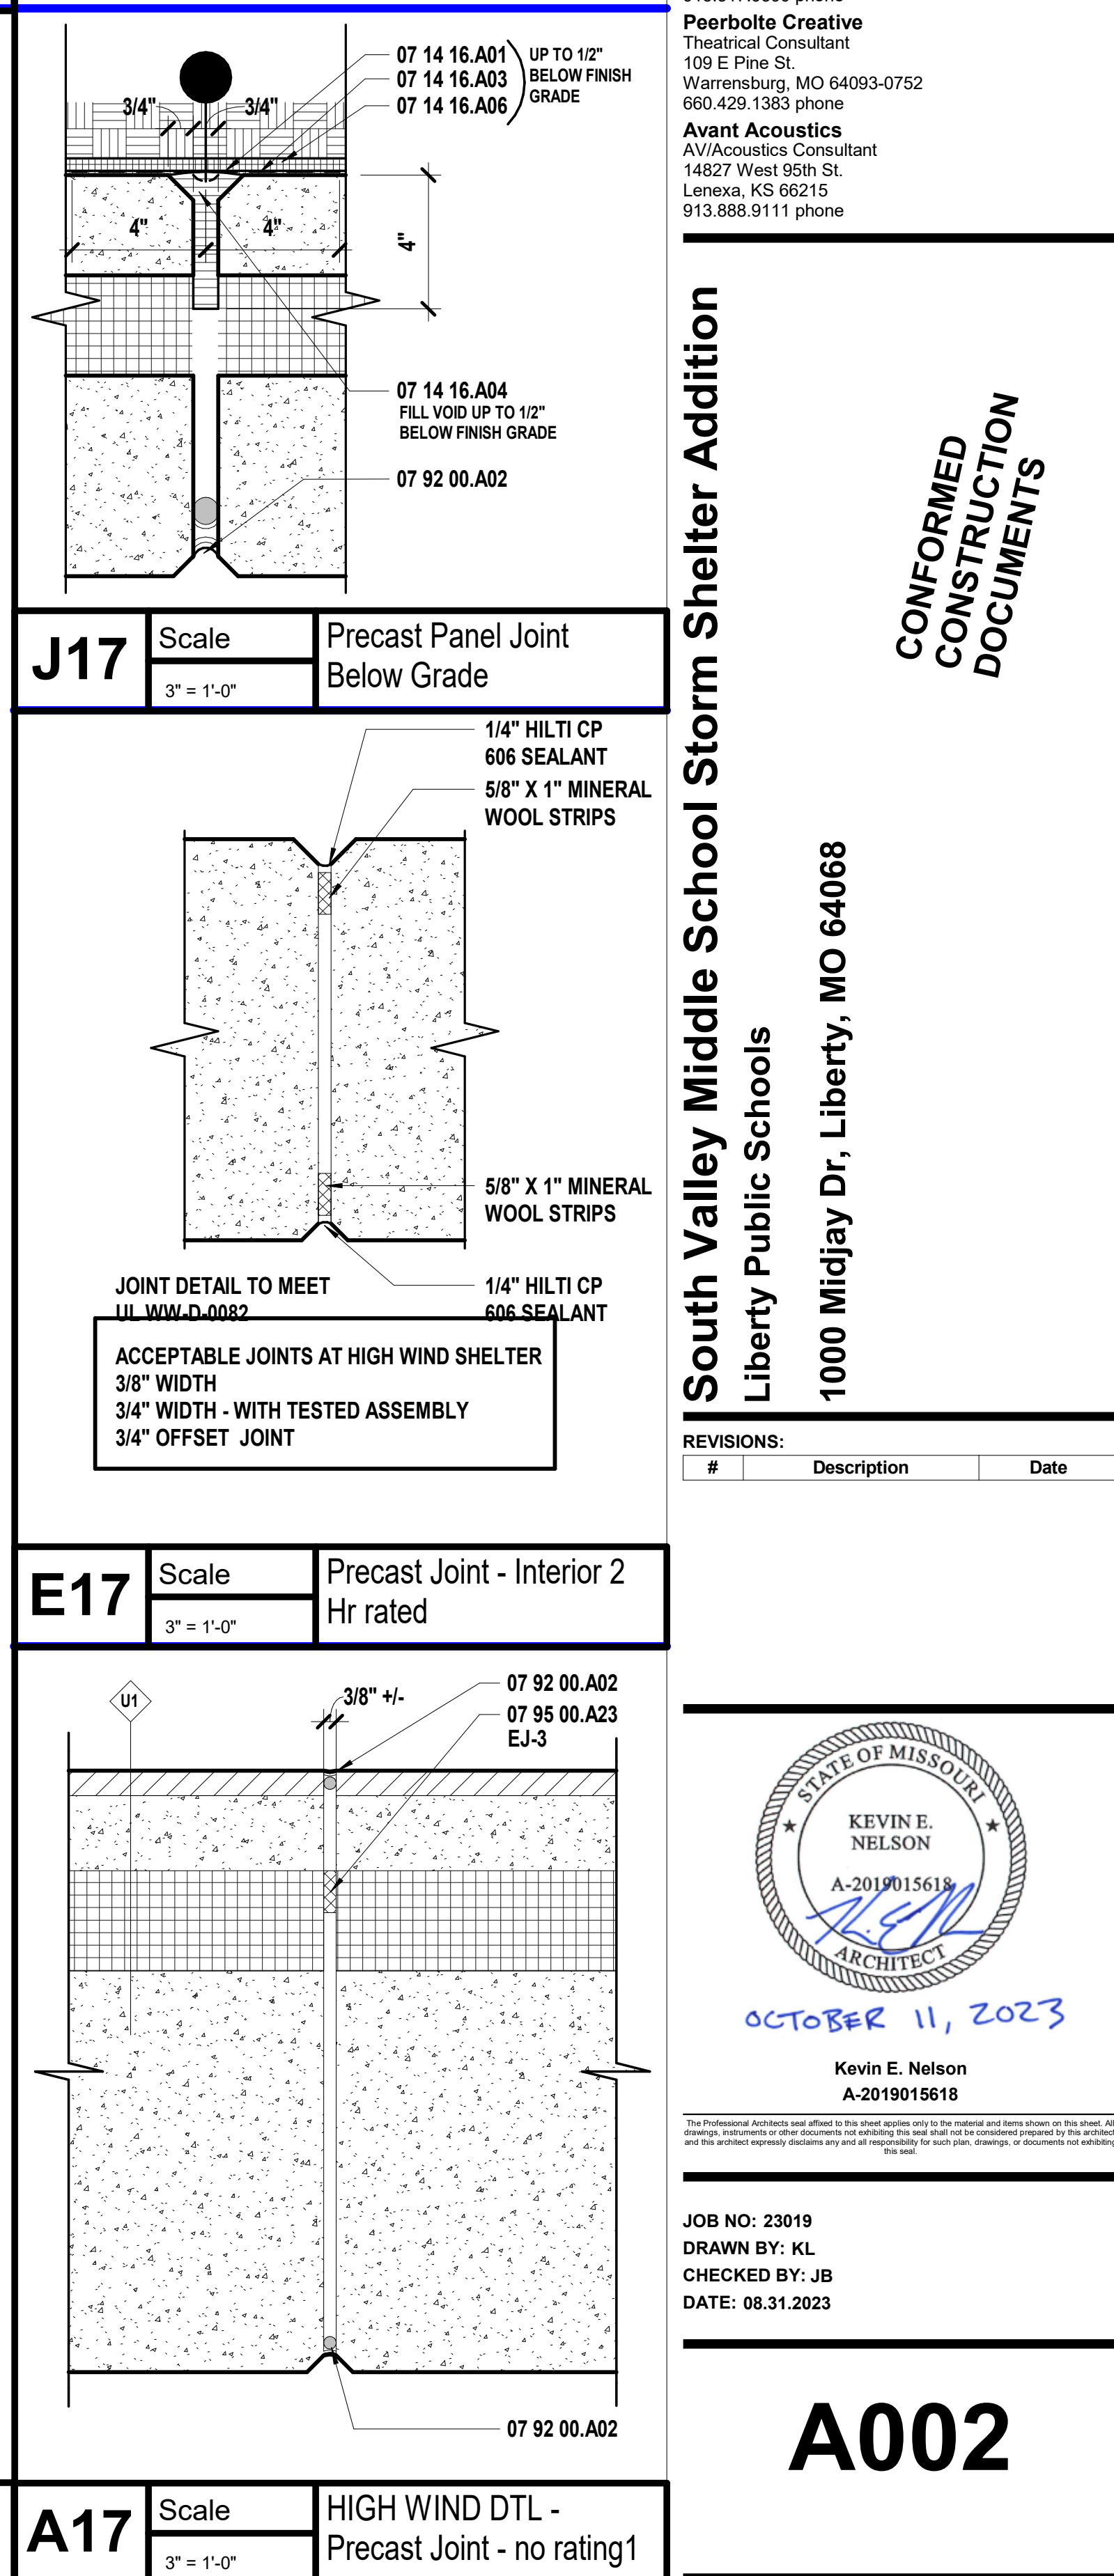
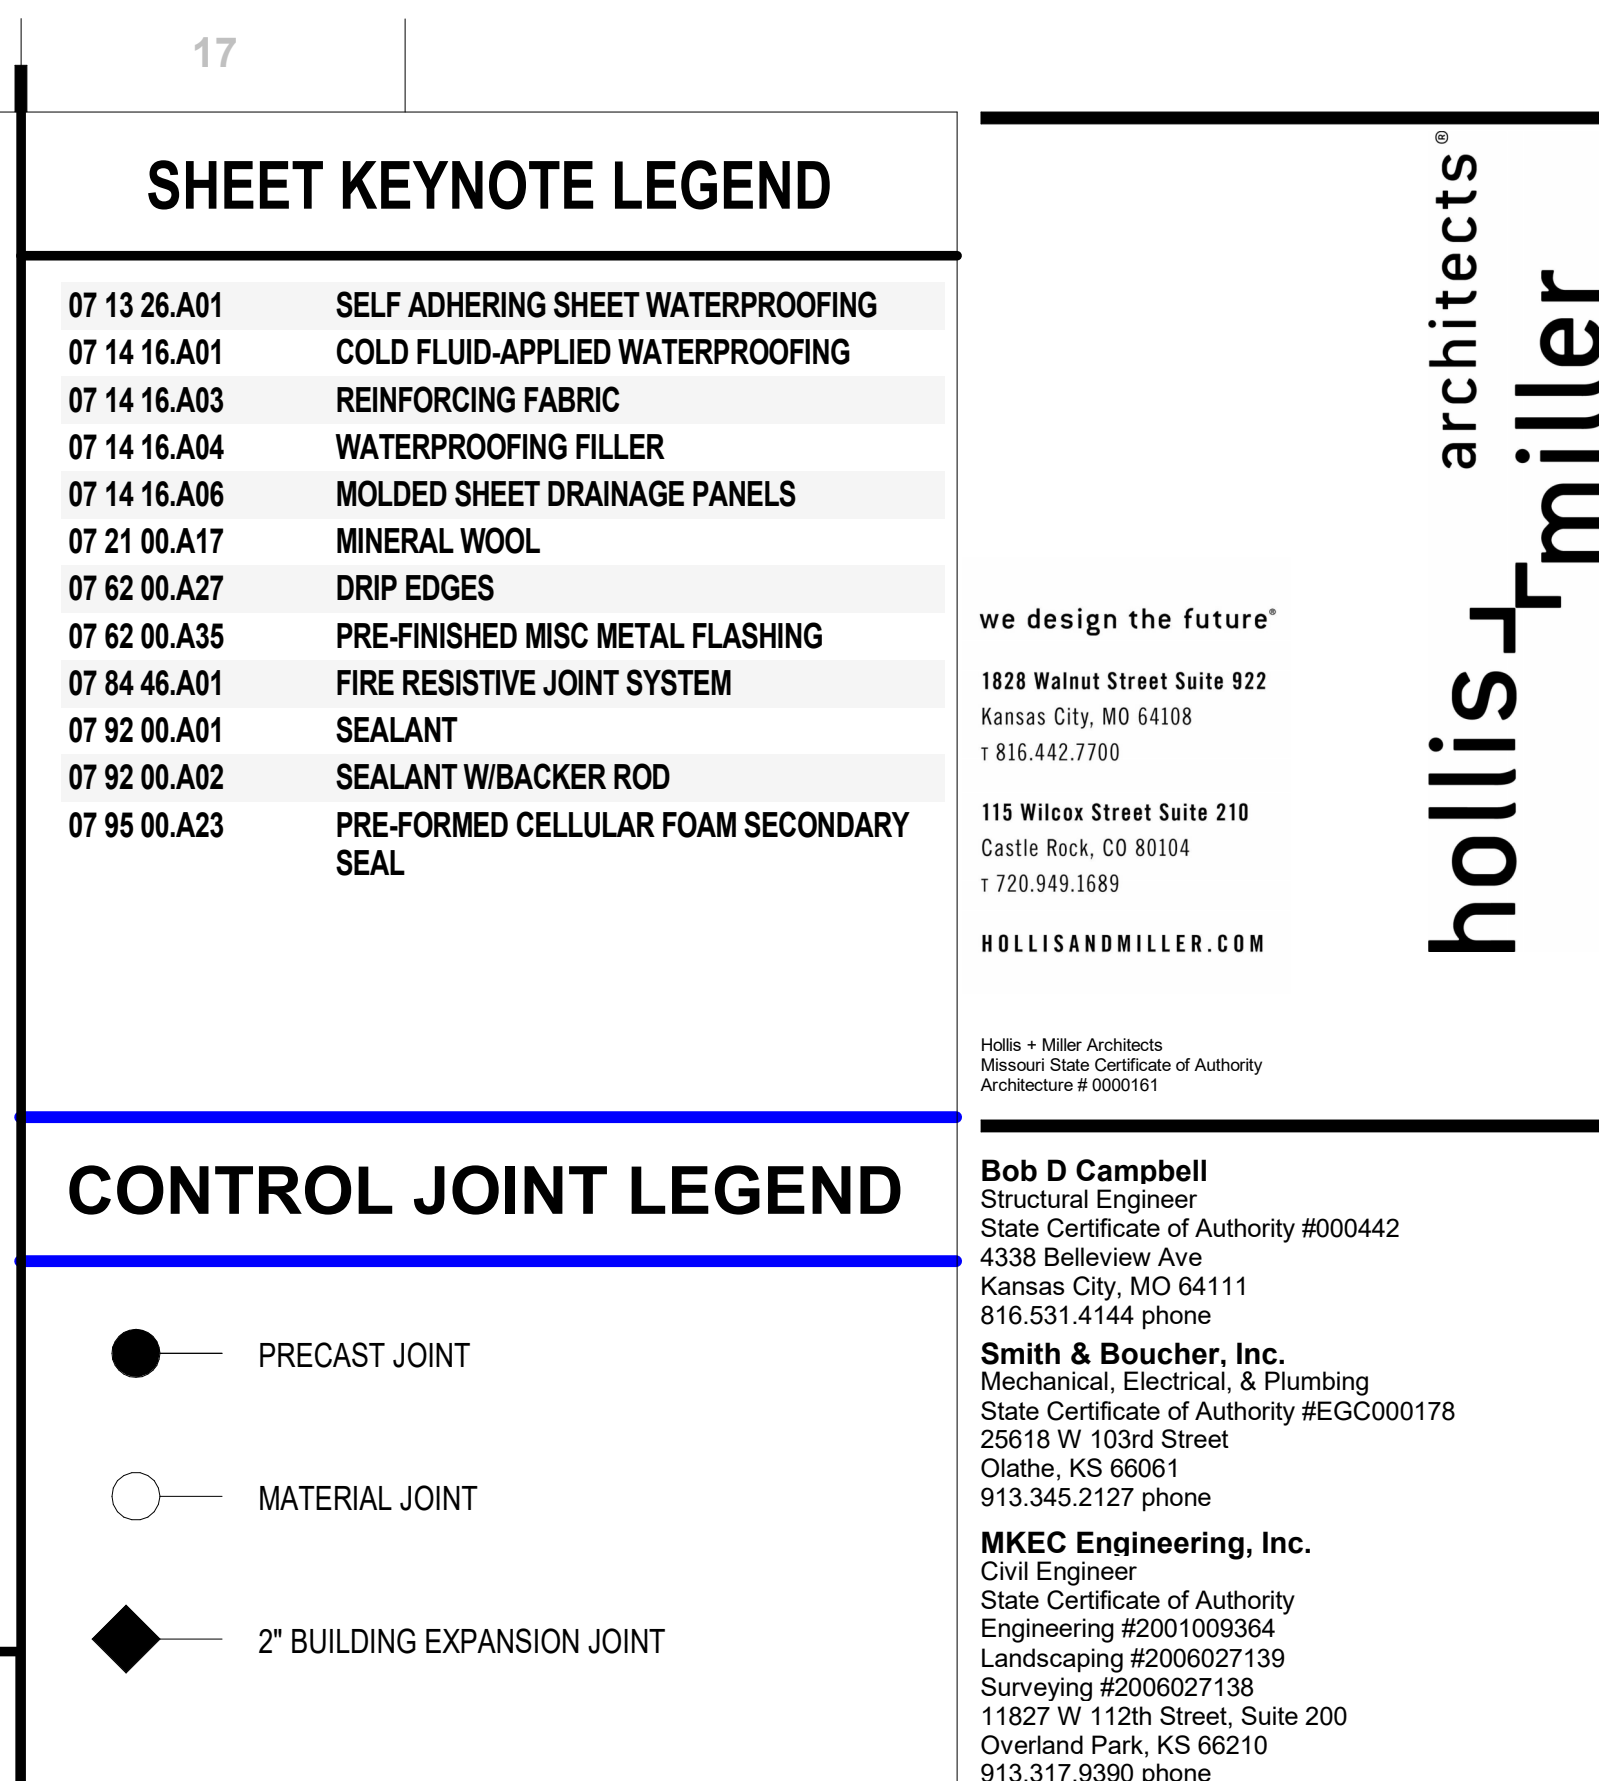
BRADEN L. TAYLOR, P.E.
LISC. #2021001896


JOB NO: 23019
DRAWN BY: SEK
CHECKED BY: BLT
DATE: 10.11.2023

STANDARD DRAWING
NUMBER ESC-03
ADOPTED:
10/24/2016

C200





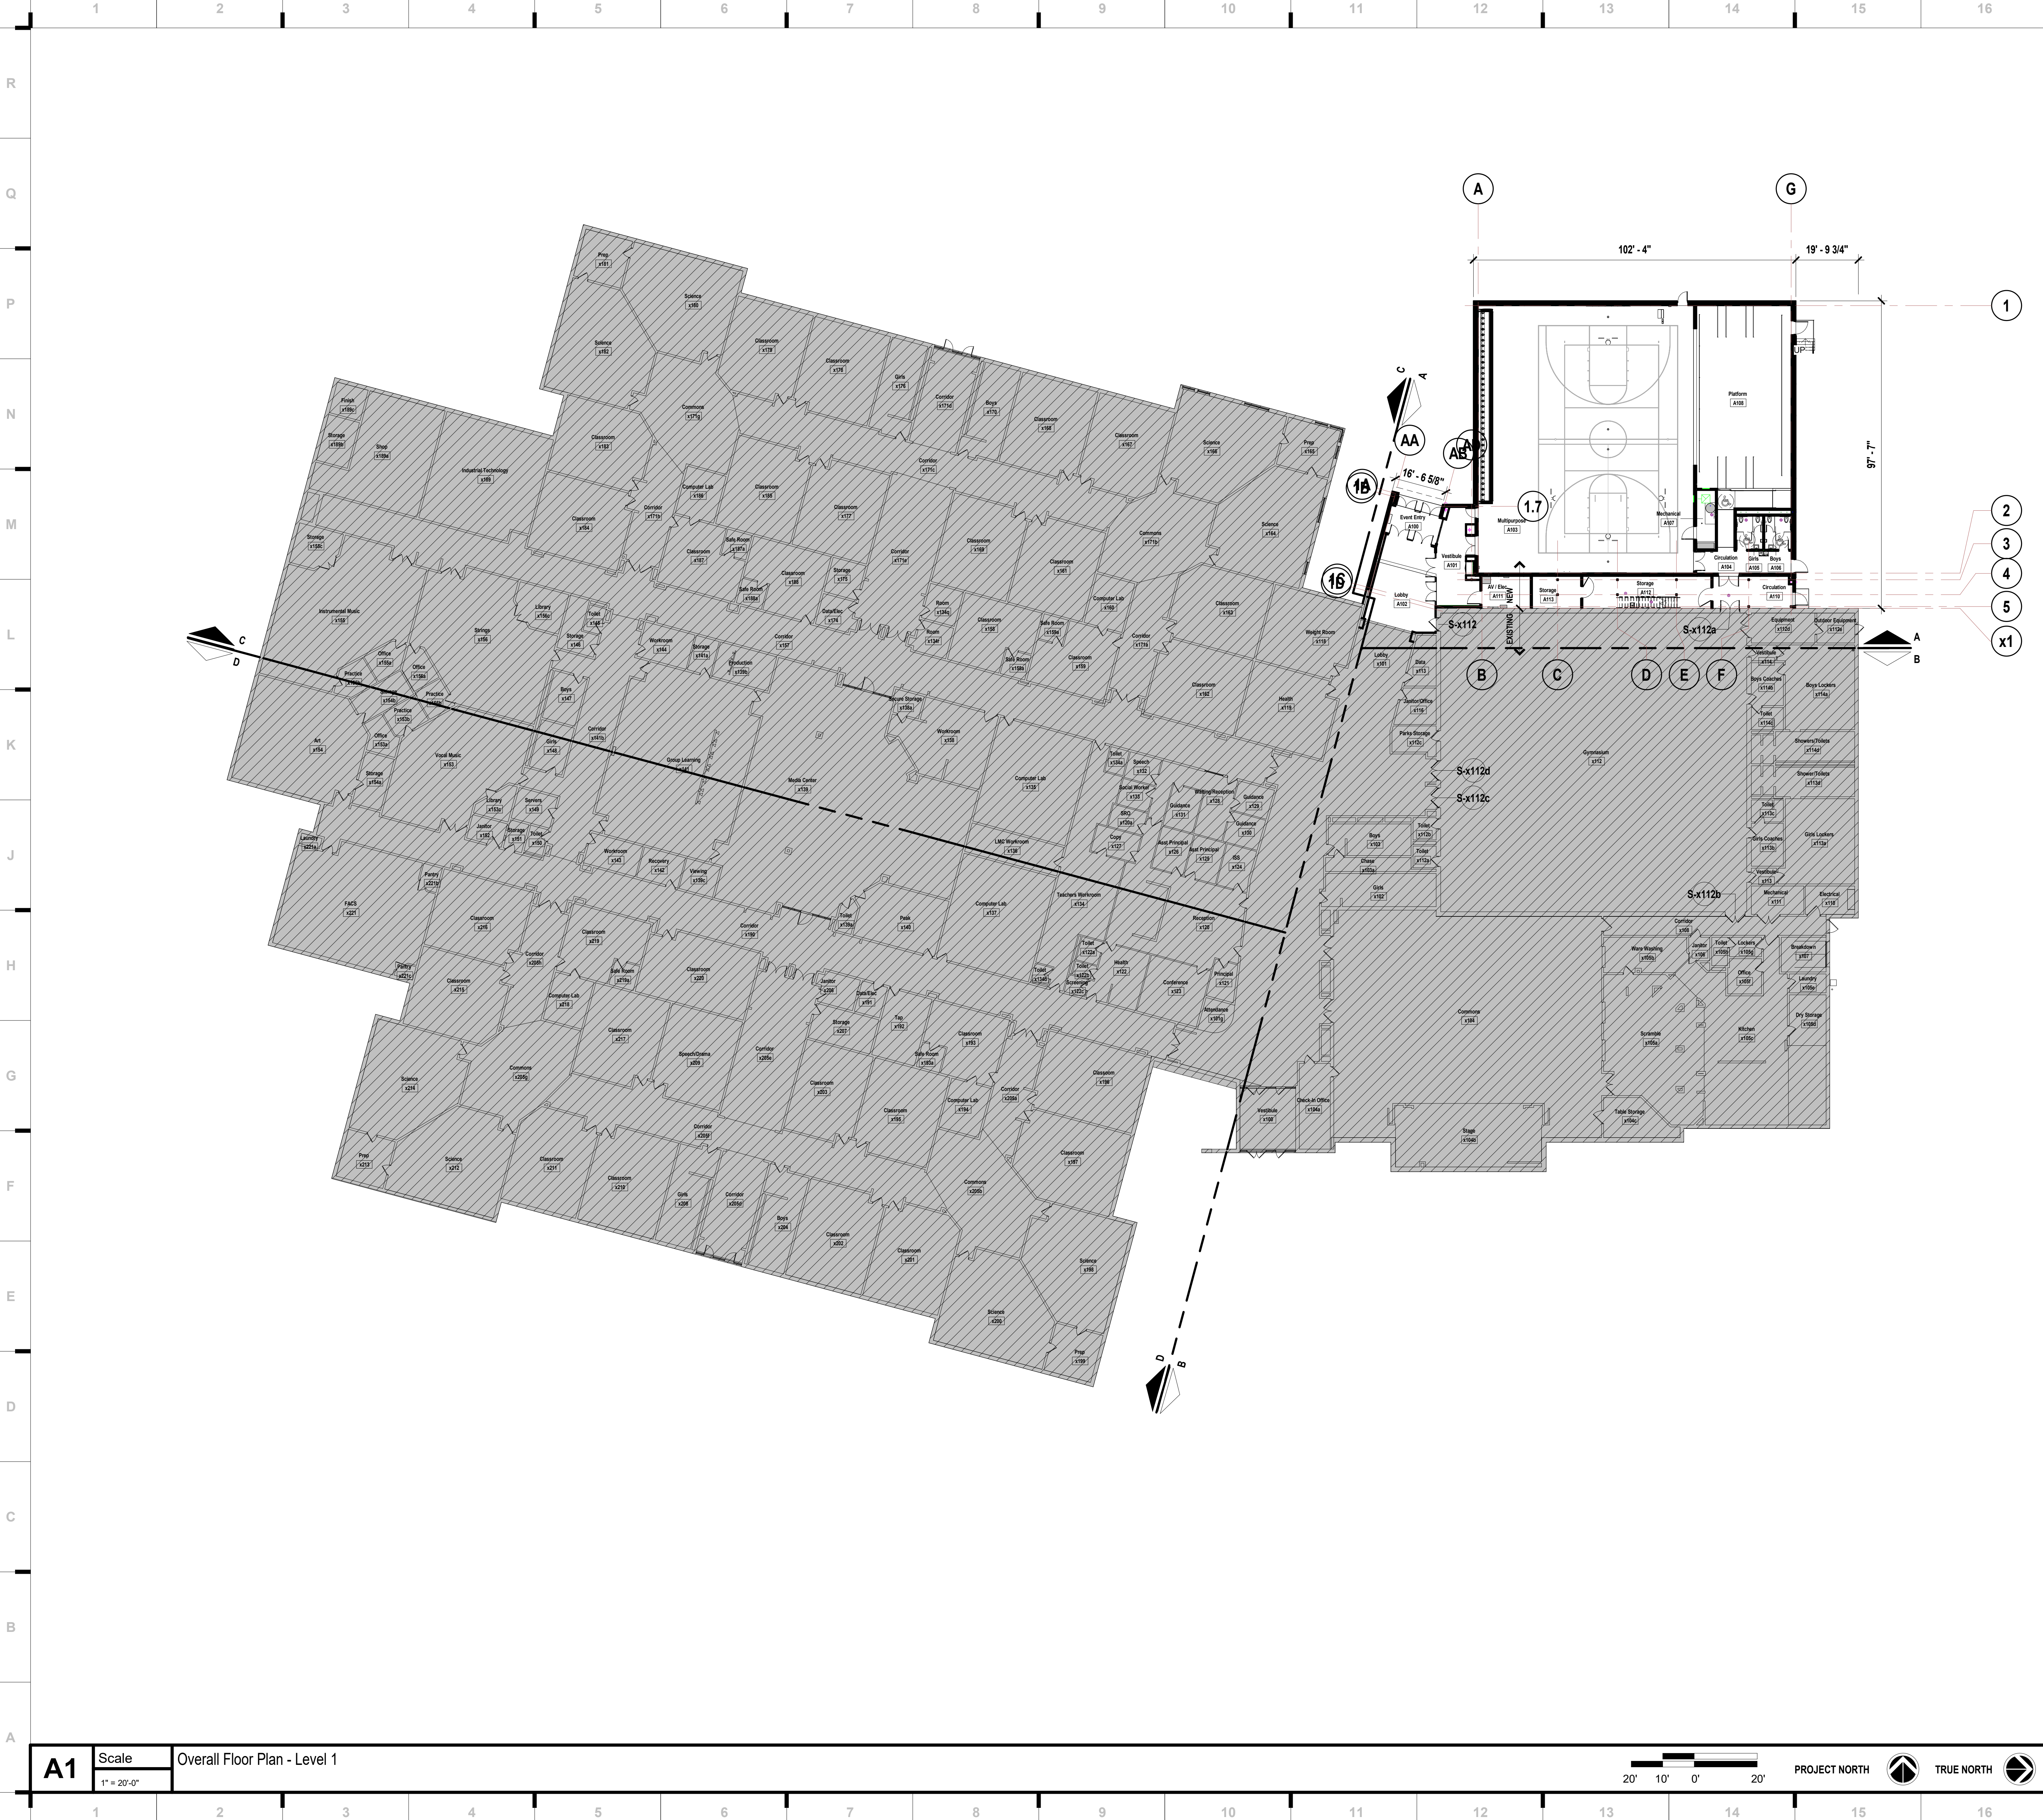


SHEET KEYNOTE LEGEND

- 1
- 2
- 3
- 4
- 5
- X1

SHEET NOTES

- REFER TO SHEET G000 FOR SHEET INDEX
- DO NOT SCALE THIS DRAWING
- INTERIOR DIMENSIONS ARE TO THE FOLLOWING, UNLESS NOTED OTHERWISE:
 - A. TO FACE OF STUD
 - B. TO FACE OF MASONRY UNIT
 - C. TO FACE OF DOOR AND WINDOW ROUGH OPENINGS
- EXTERIOR DIMENSIONS ARE TO THE FOLLOWING, UNLESS NOTED OTHERWISE:
 - A. TO FACE OF STUD
 - B. TO FACE OF MASONRY UNIT
 - C. TO FACE OF PRECAST
- COORDINATE LOCATIONS WHERE BACKING IS REQUIRED FOR WALL HUNG CASEWORK, MARKERBOARDS, WALL HUNG ACCESSORIES AND TECHNOLOGY
- COORDINATE FINISHES TO REMAIN WITH DEMOLITION SHEET

KEY PLAN

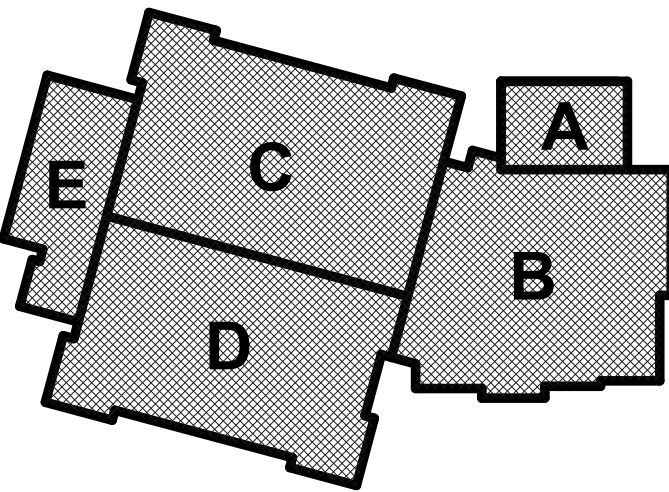

South Valley Middle School Storm Shelter Addition
Liberty Public Schools
1000 Midjay Dr, Liberty, MO 64068


REVISIONS:		
#	Description	Date
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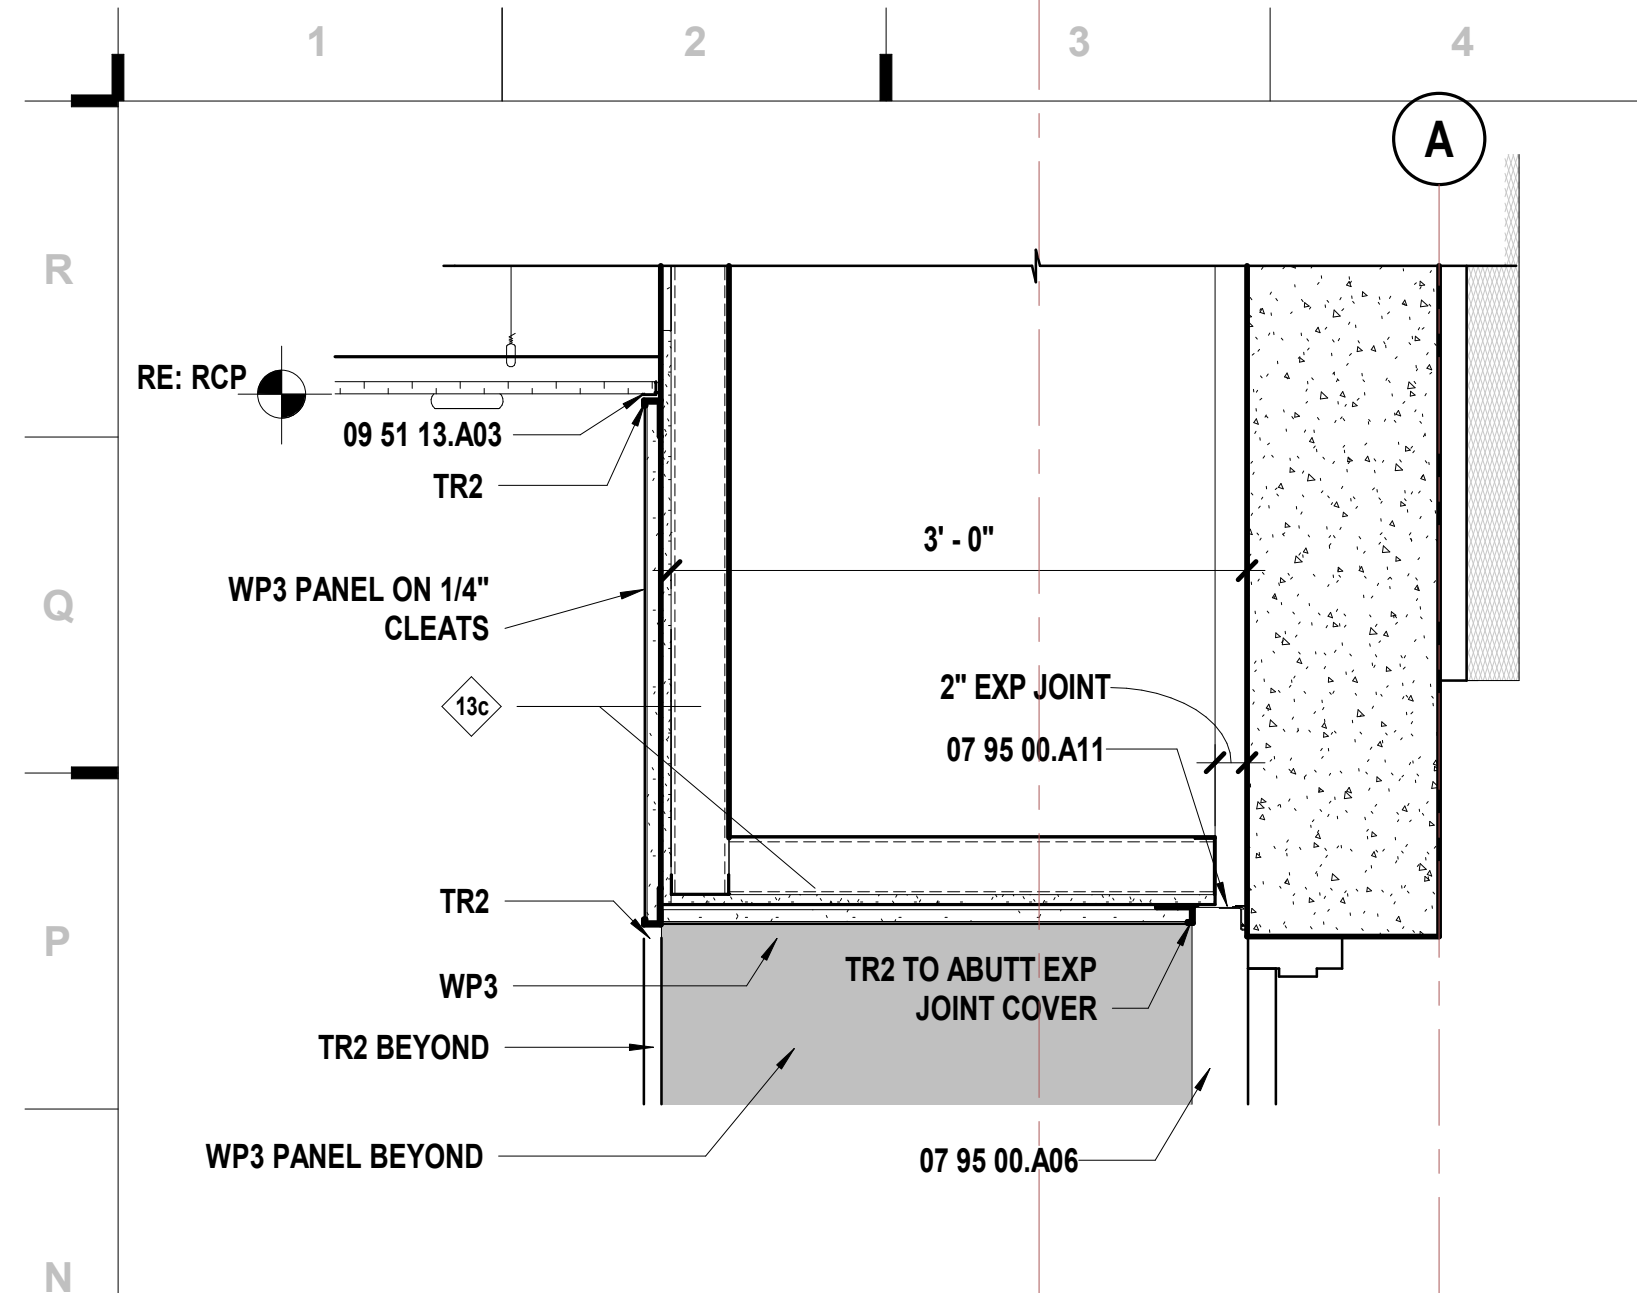


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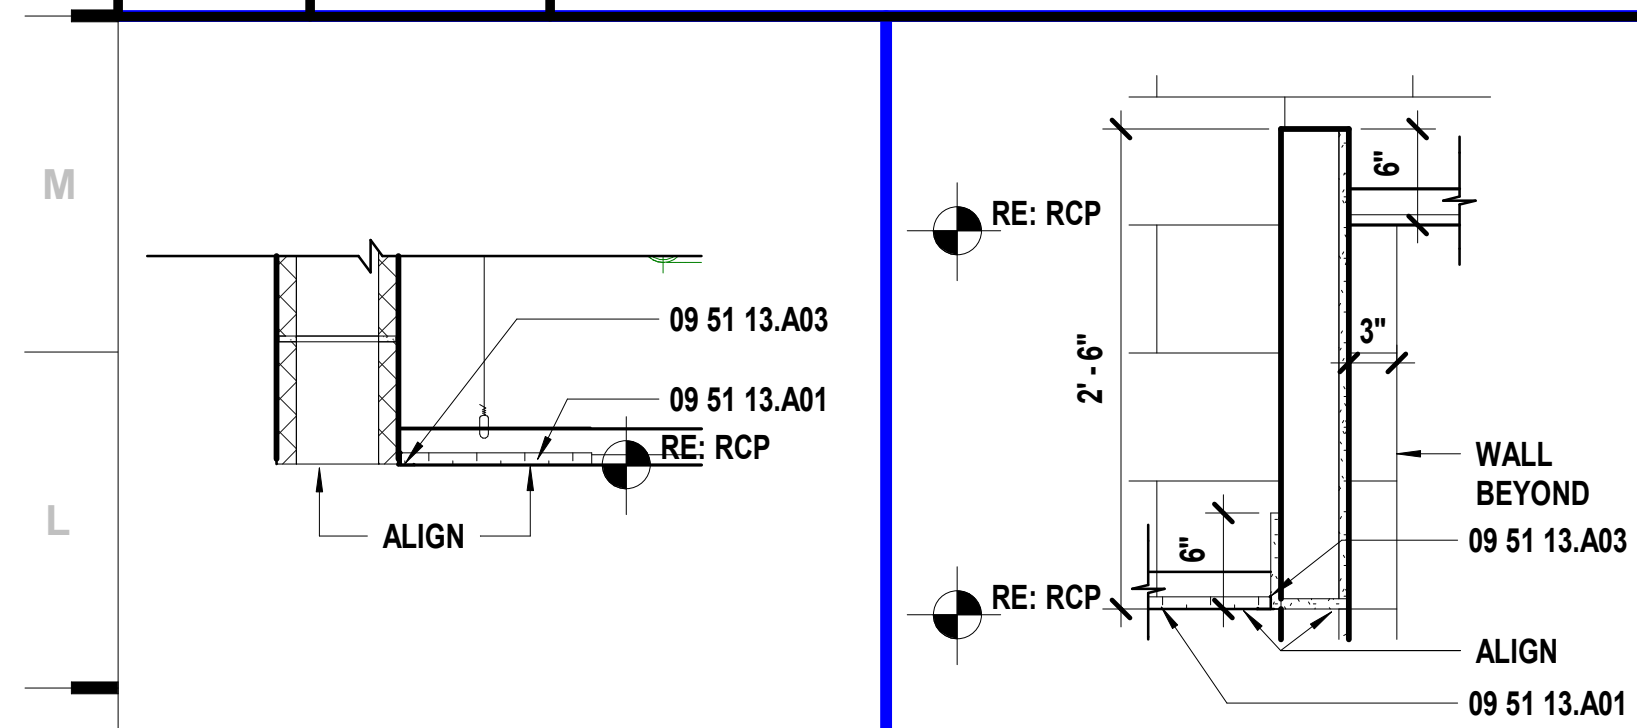
JOB NO: 23019
DRAWN BY: LB
CHECKED BY: JB
DATE: 08.31.2023

A101




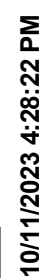


N1	Scale	Ceiling Detail - Multipurpose A103 - Entry
	1" = 1'-0"	




				Ceiling Detail -	
K1	Scale 1" = 1'-0"	Ceiling Detail - Circulation Ramp	K3	Scale 1" = 1'-0"	Circulation Ramp2

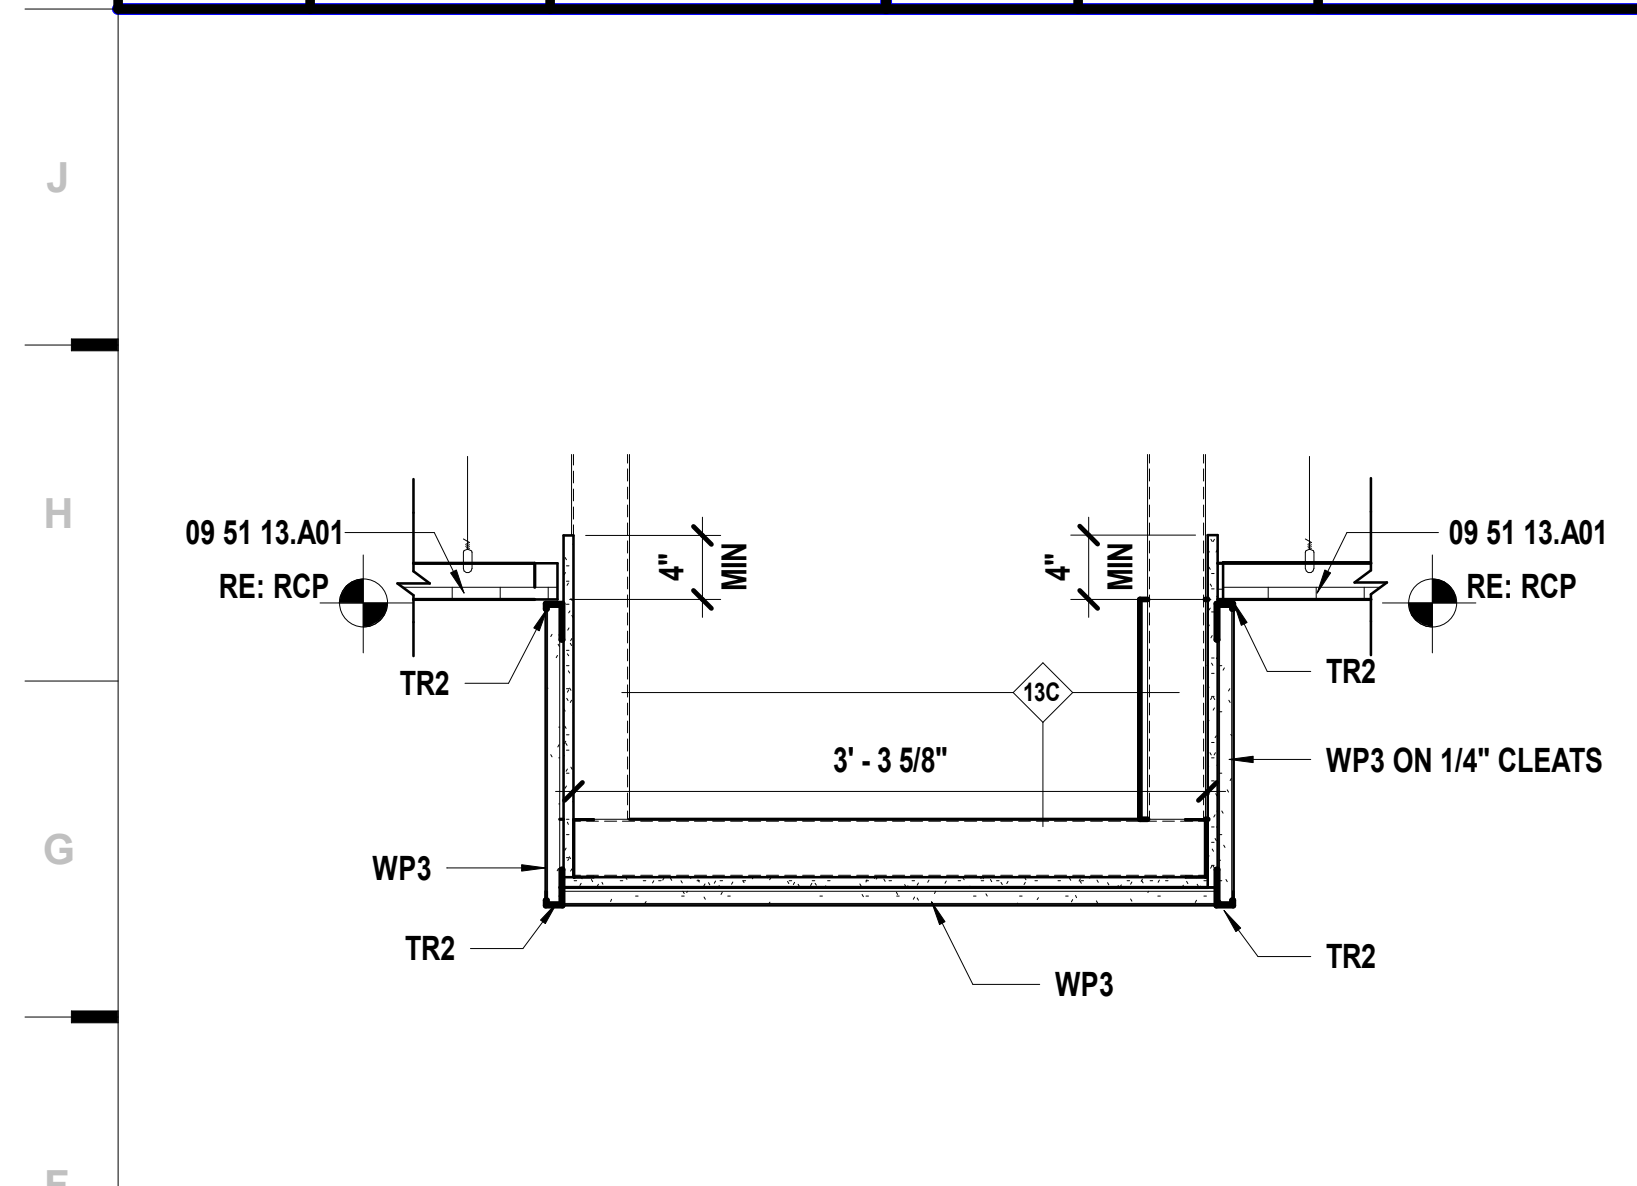


F1	Scale	Ceiling Detail - Lobby A102
	1" = 1'-0"	

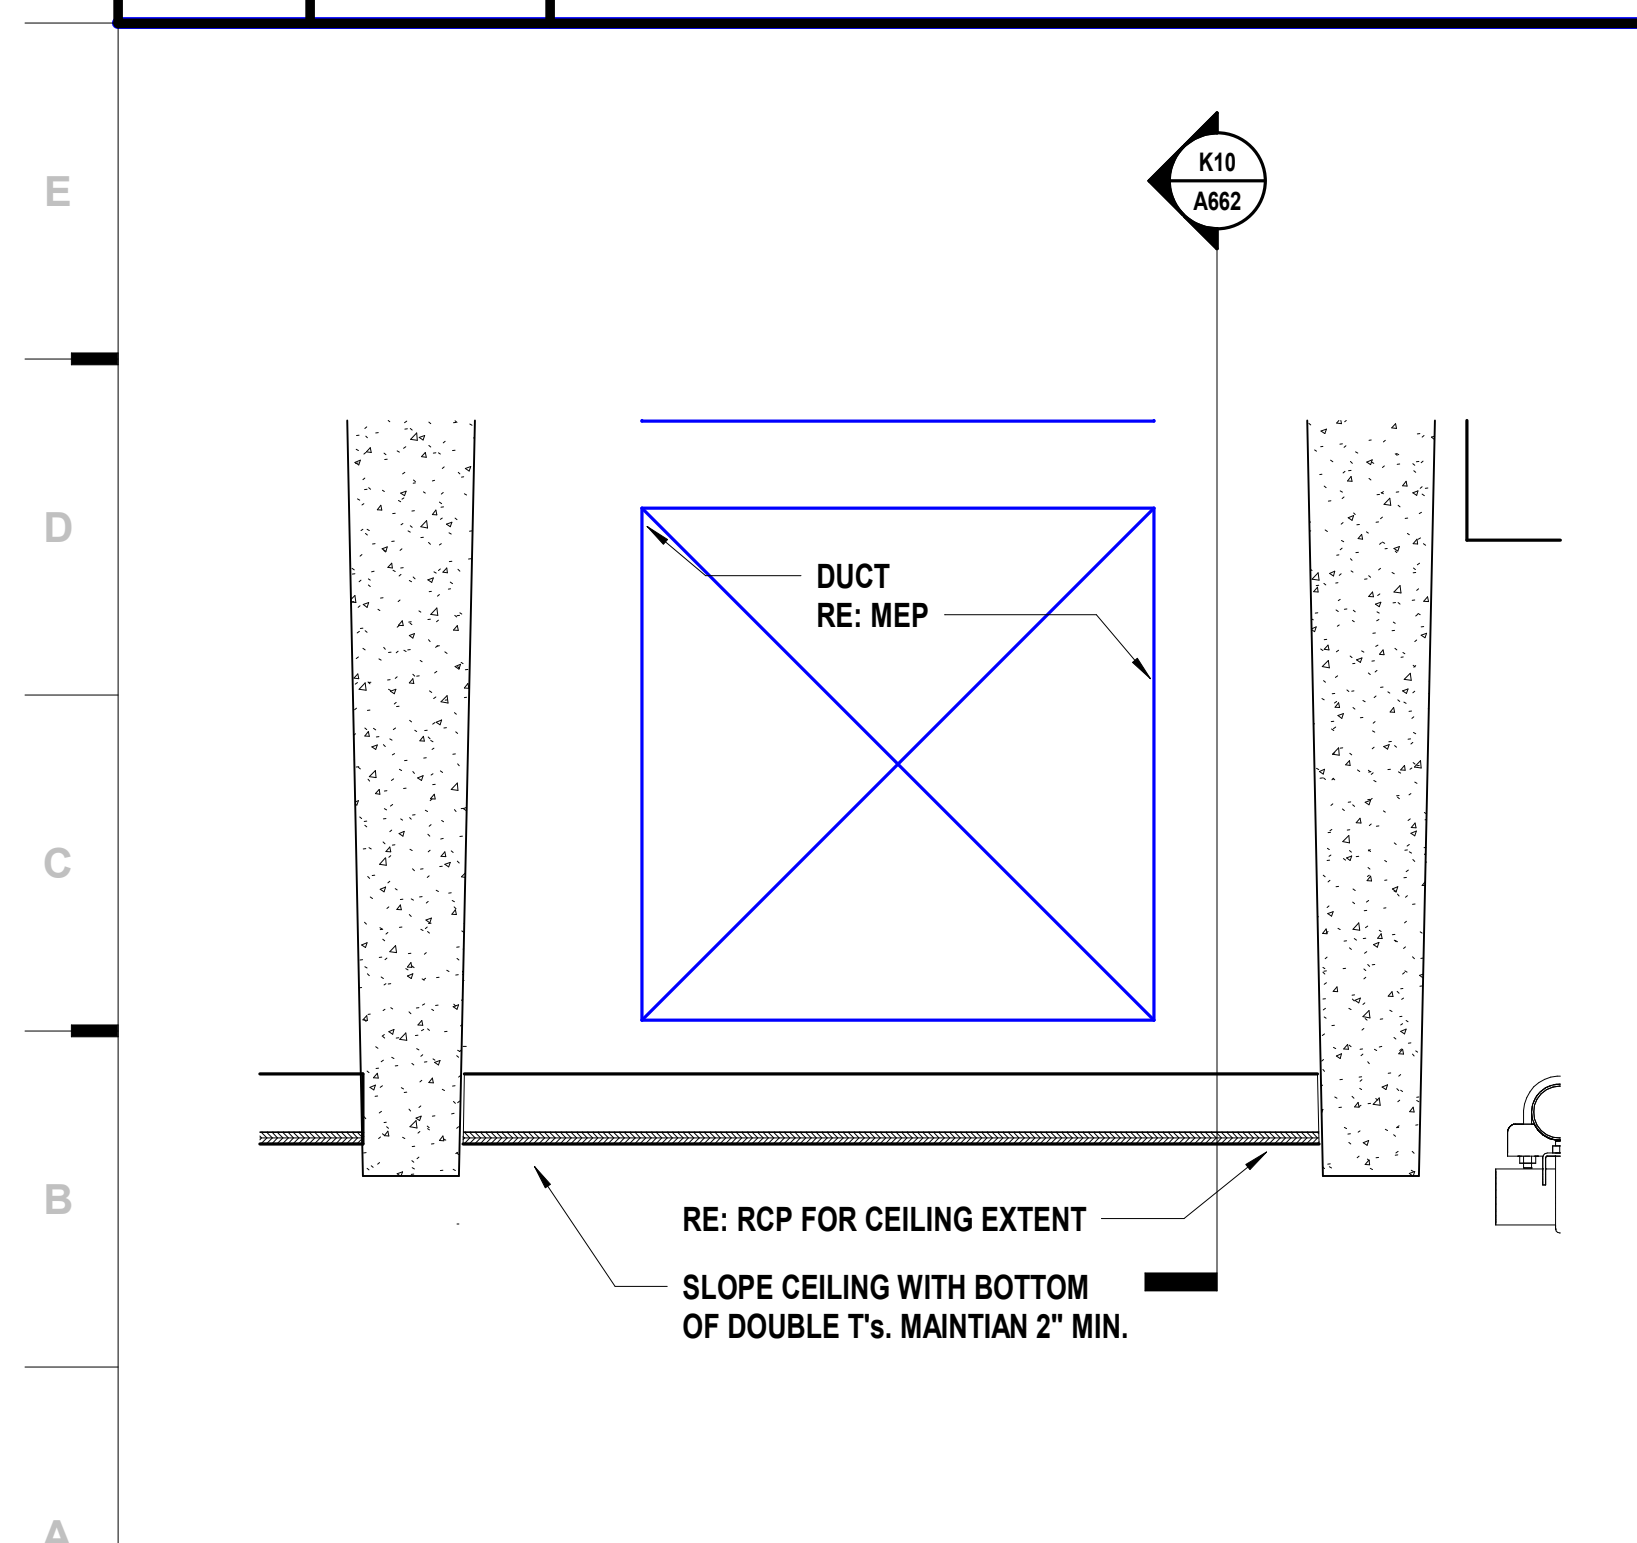

A1	Scale	Ceiling Detail - Circulation Ramp1
	1" = 1'-0"	

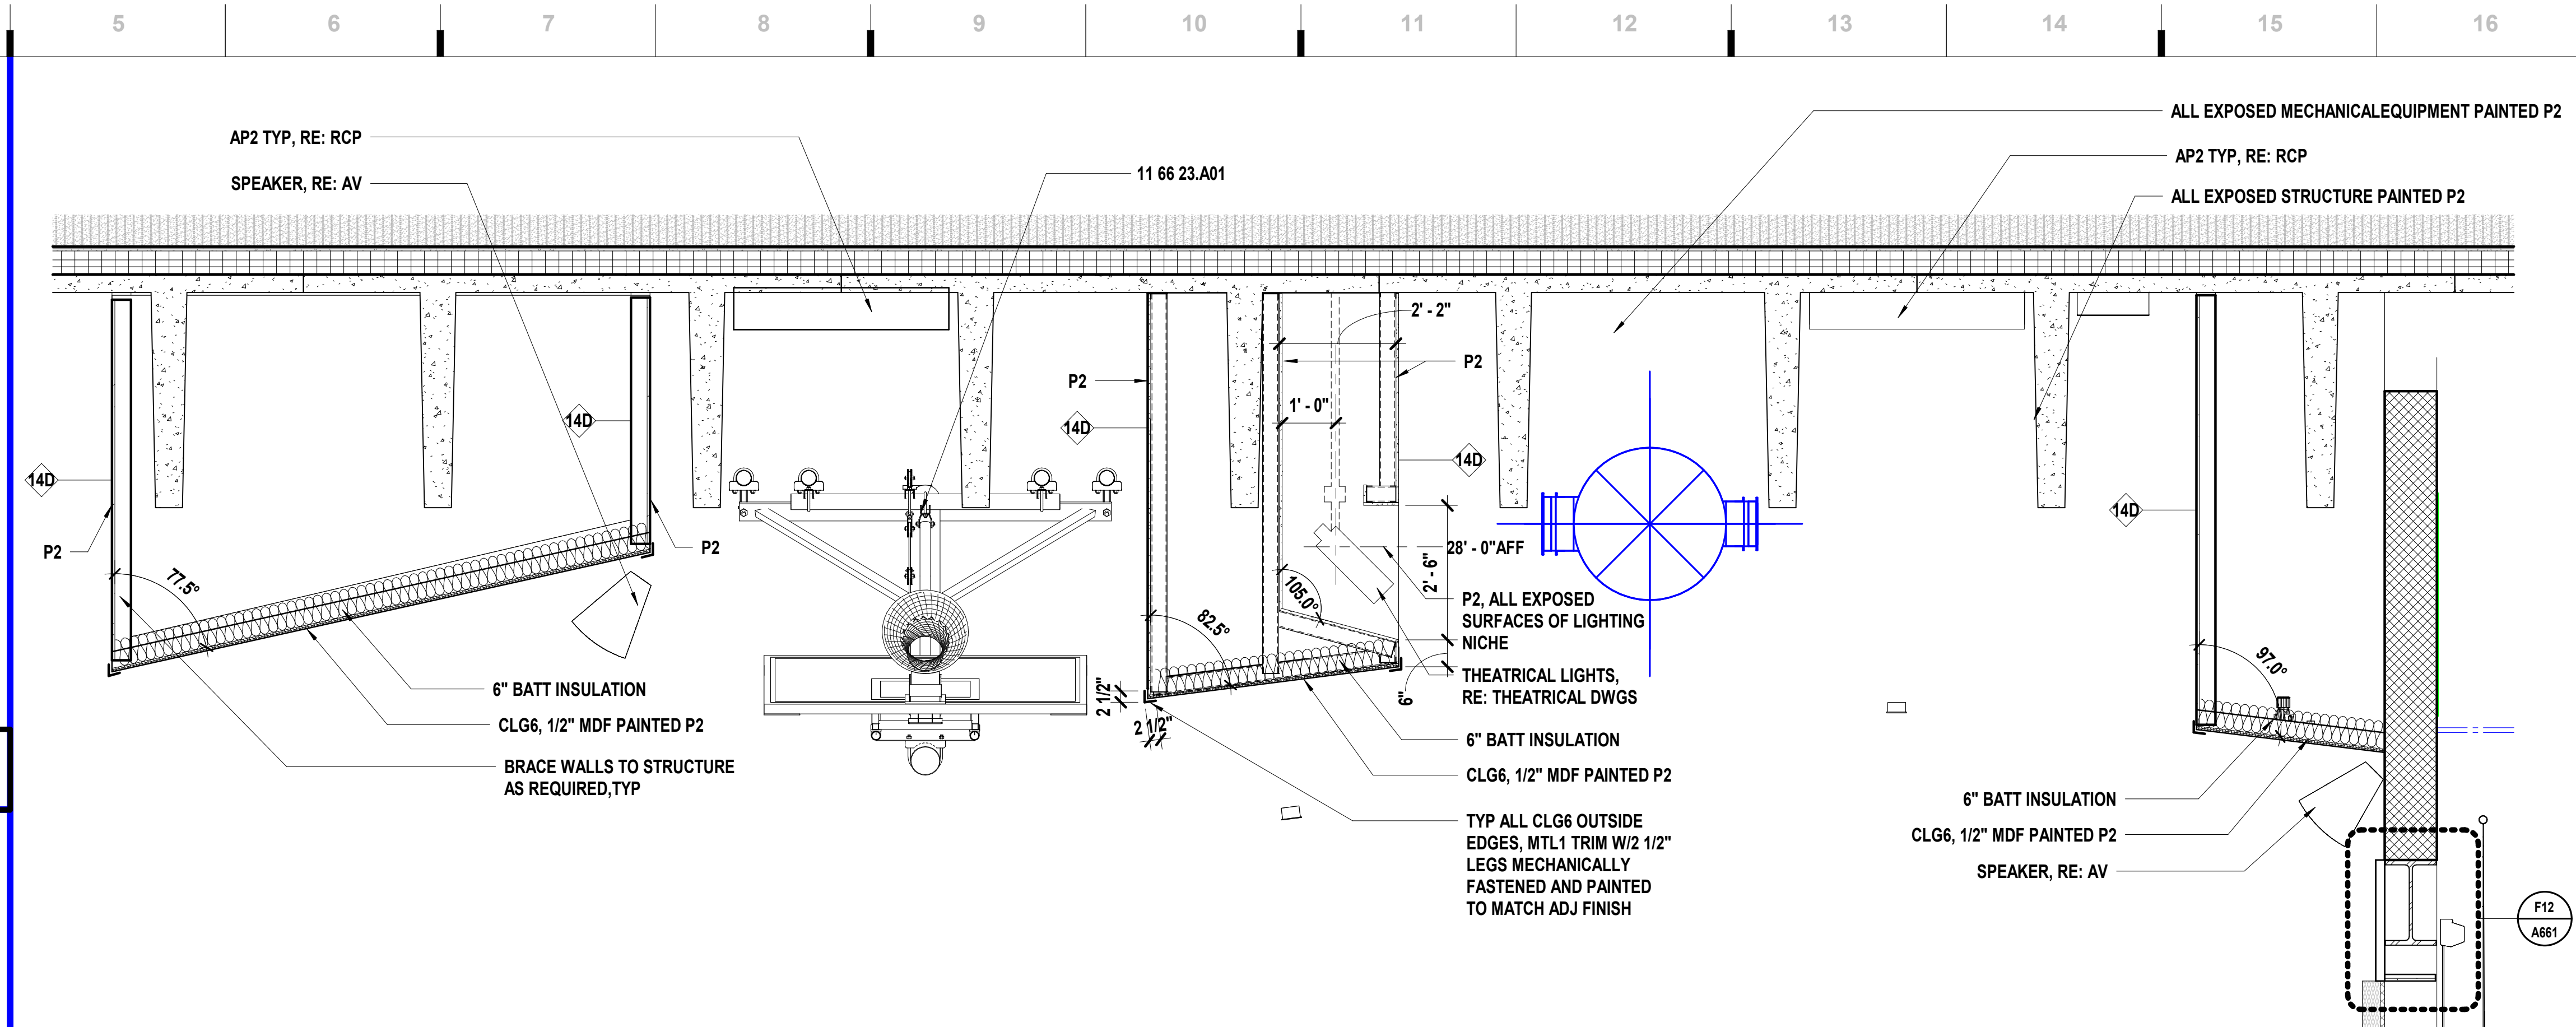

L5	Scale	Ceiling Detail - CLG6 Clouds
	1/2" = 1'-0"	

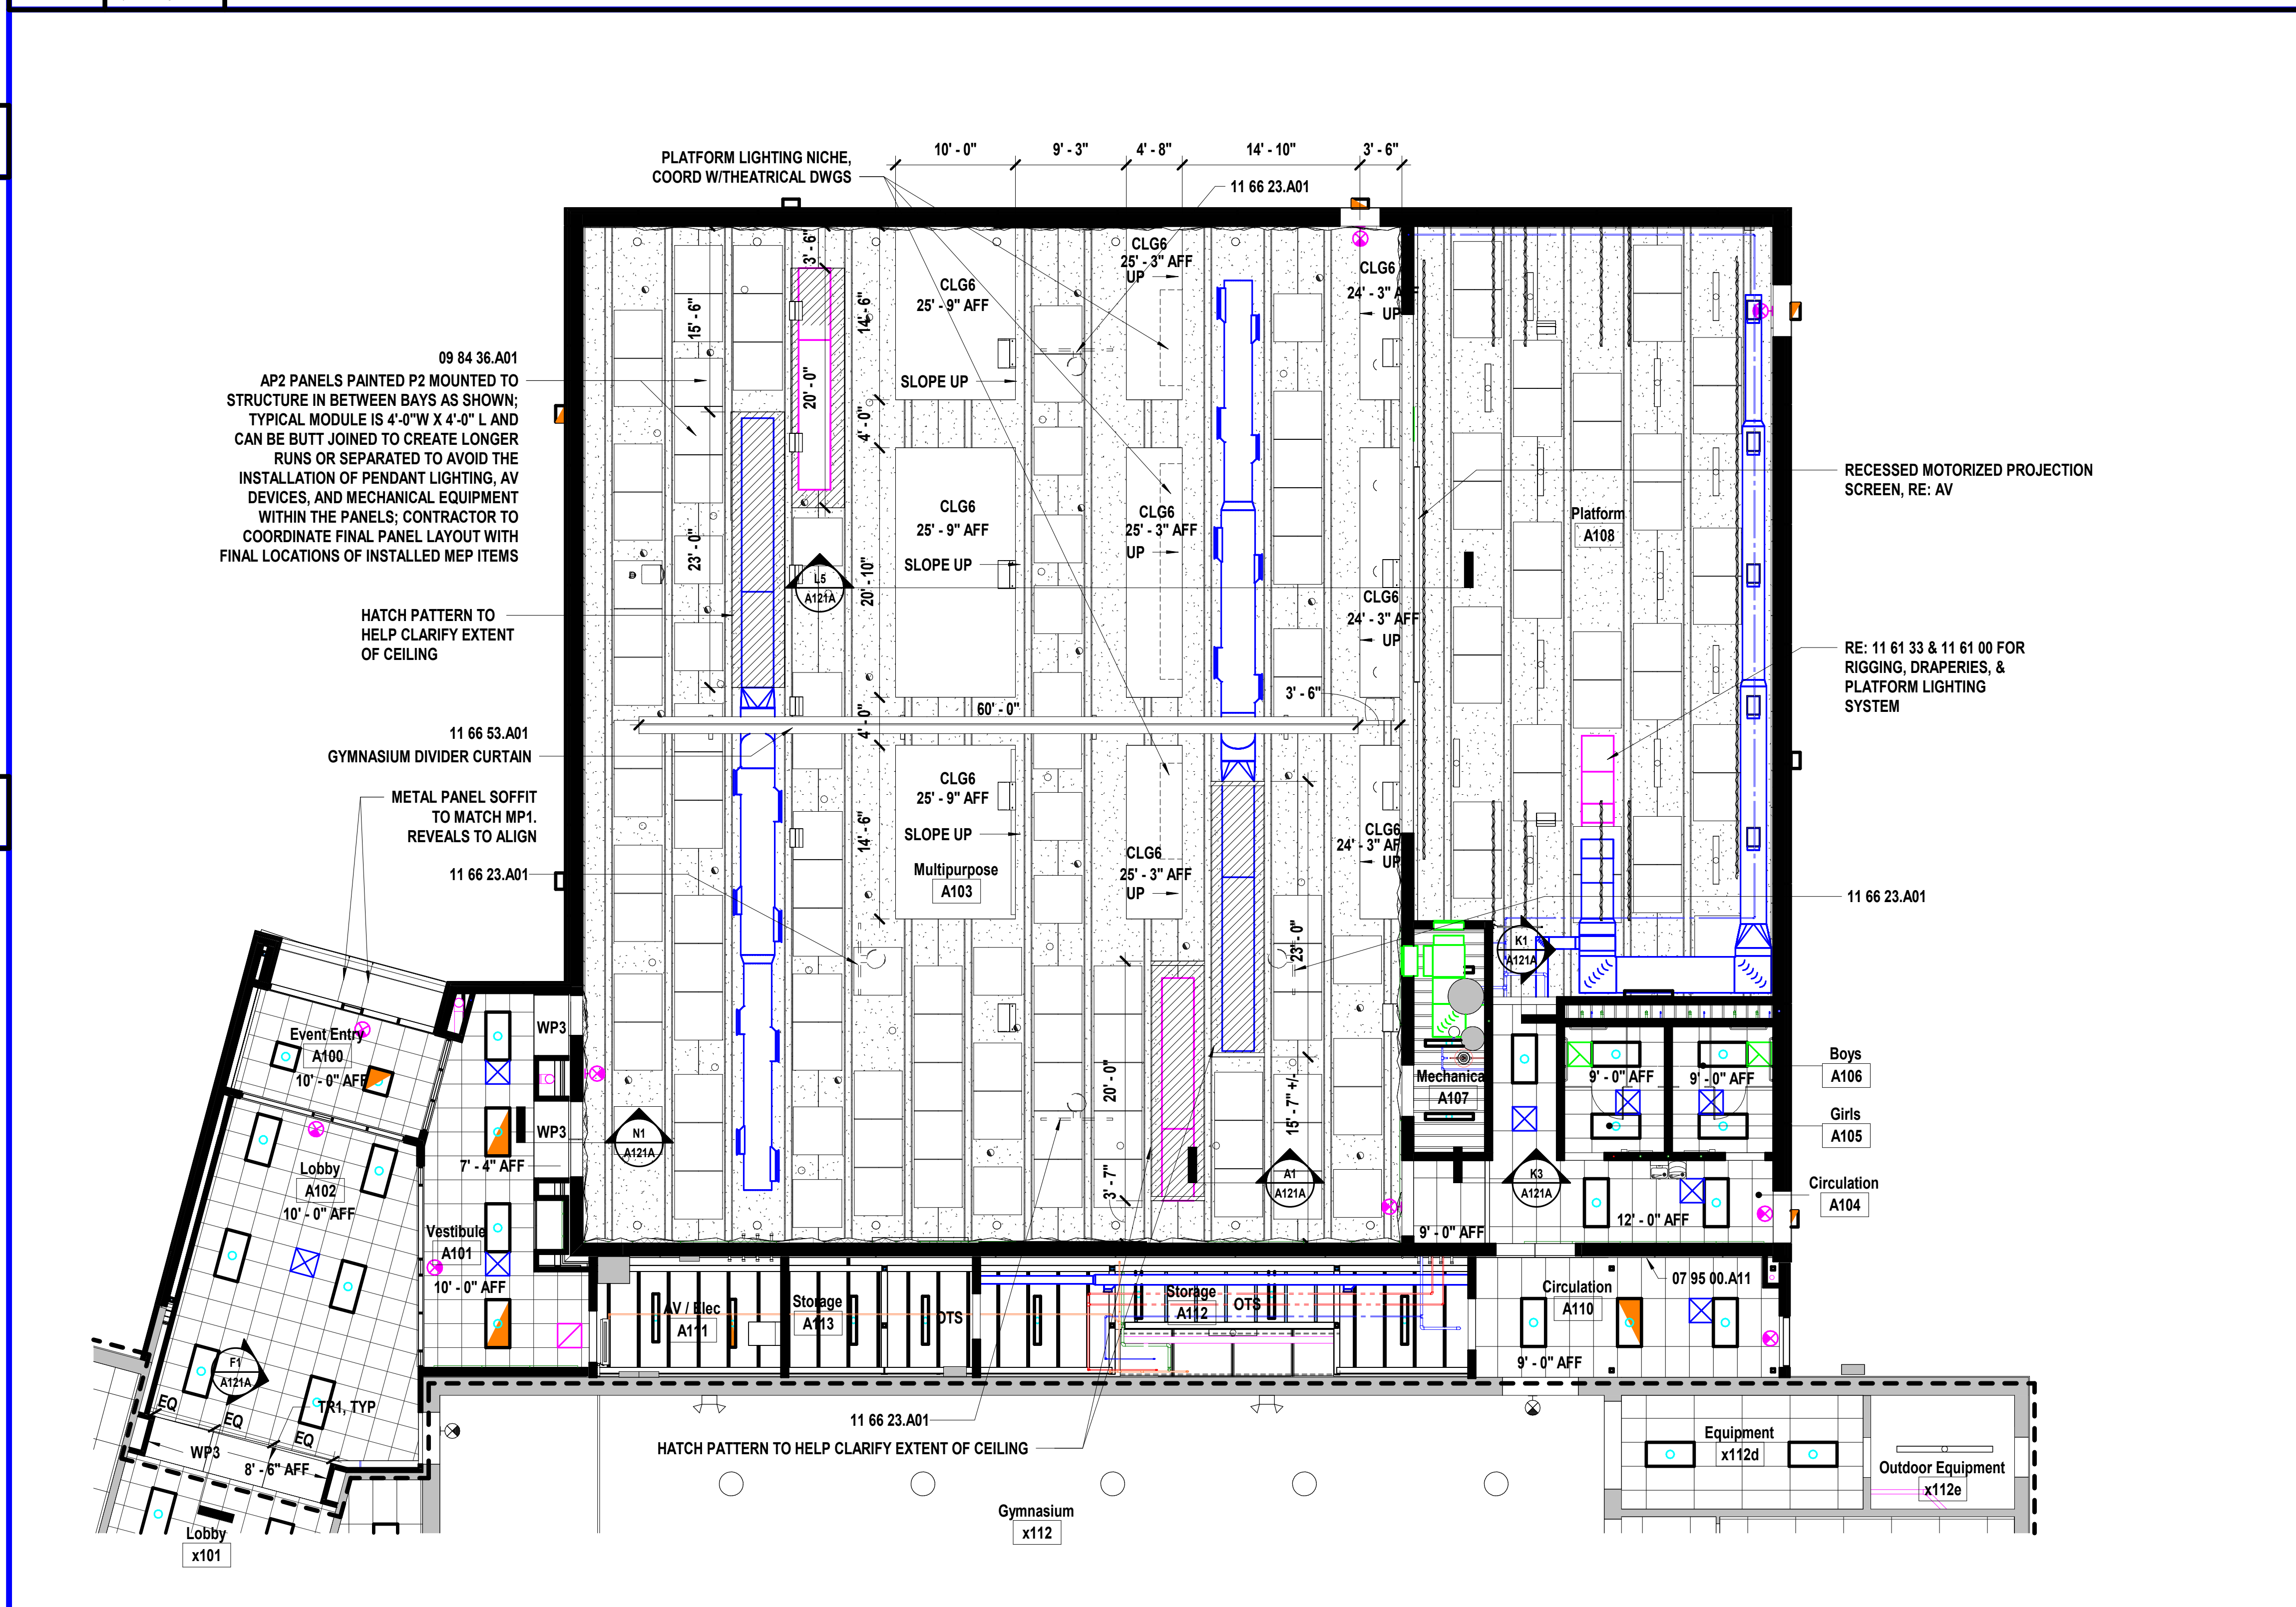

A5	Scale	Reflected Ceiling Plan - Level 1 - Area A
	1/8" = 1'-0"	

SHEET KEYNOTE LEGEND

07 95 00.A06	WALL-TO-WALL JOINT SYSTEM
07 95 00.A11	CEILING-TO-WALL JOINT SYSTEM
09 51 13.A01	ACOUSTICAL CEILING PANELS
09 51 13.A03	EDGE MOLDINGS AND TRIM
09 84 36.A01	SOUND-ABSORBING CEILING PANELS
11 66 23.A01	OVERHEAD BACKBOARD SUPPORTS
11 66 53.A01	GYMNASIUM DIVIDER CURTAIN ASSEMBLY

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Structural Engineer
State Certificate of Authority #000442
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SHEET MATERIAL FINISH LEGEND

ID	MATERIAL	COLOR/FINISH
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SHEET NOTES




ALTERNATE NO.1
ALL EXISTING ROOMS TO RECEIVE NEW ACOUSTICAL CEILING
TILE (ACT) TO REPLACE EXISTING. EXISTING GRIDS TO REMAIN.

1. CLASSROOMS, STORAGE ROOMS, OFFICES, LOCKER ROOMS, SUPPORT SPACES TO RECEIVE **CLG1** (24x48) OR **CLG2** (24x24) TO MATCH EXISTING GRID SIZE

2. LOBBIES, RECEPTION, PUBLIC CIRCULATION, CLASSROOM CORRIDORS, VESTIBULES, MEDIA CENTER, & COMMONS TO RECIEVE **CLG3**

3. KITCHEN, CAFETERIA, RESTROOMS, SHOWERS & OTHER WET SPACES TO RECEIVE **CLG4** (24x48) OR **CLG5** (24x24) TO MATCH EXISTING GRID SIZE

KEY PLAN

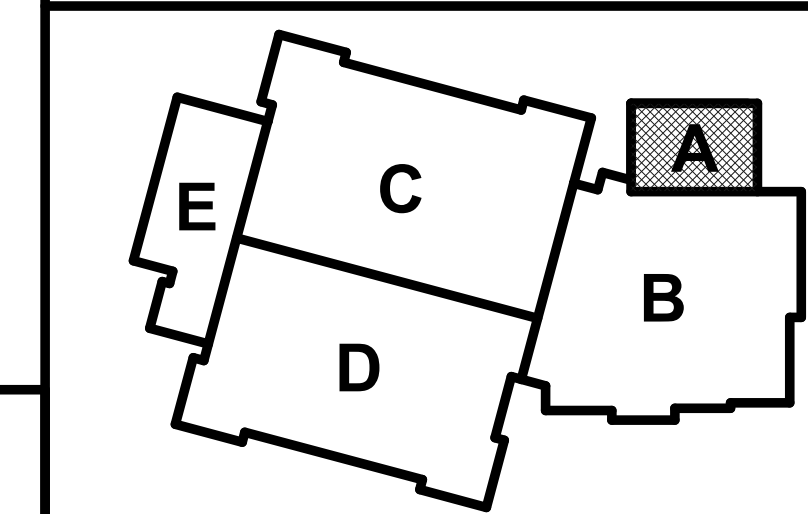

South Valley Middle School Storm Shelter Addition

Liberty Public Schools
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CONFORMED
CONSTRUCTION
DOCUMENTS

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
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A-2012247812

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DRAWN BY: ES
CHECKED BY: JB
DATE: 08.31.2023


A121A

REFLECTED CEILING PLAN - LEVEL 1 - AREA A

 Please consider the environment before printing this.

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A1 Scale Reflected Ceiling Plan - Level 1 - Area B
1/8" = 1'-0"

1 2 3 4 5 6 7 8 9 10 11 12 13 14 15 16

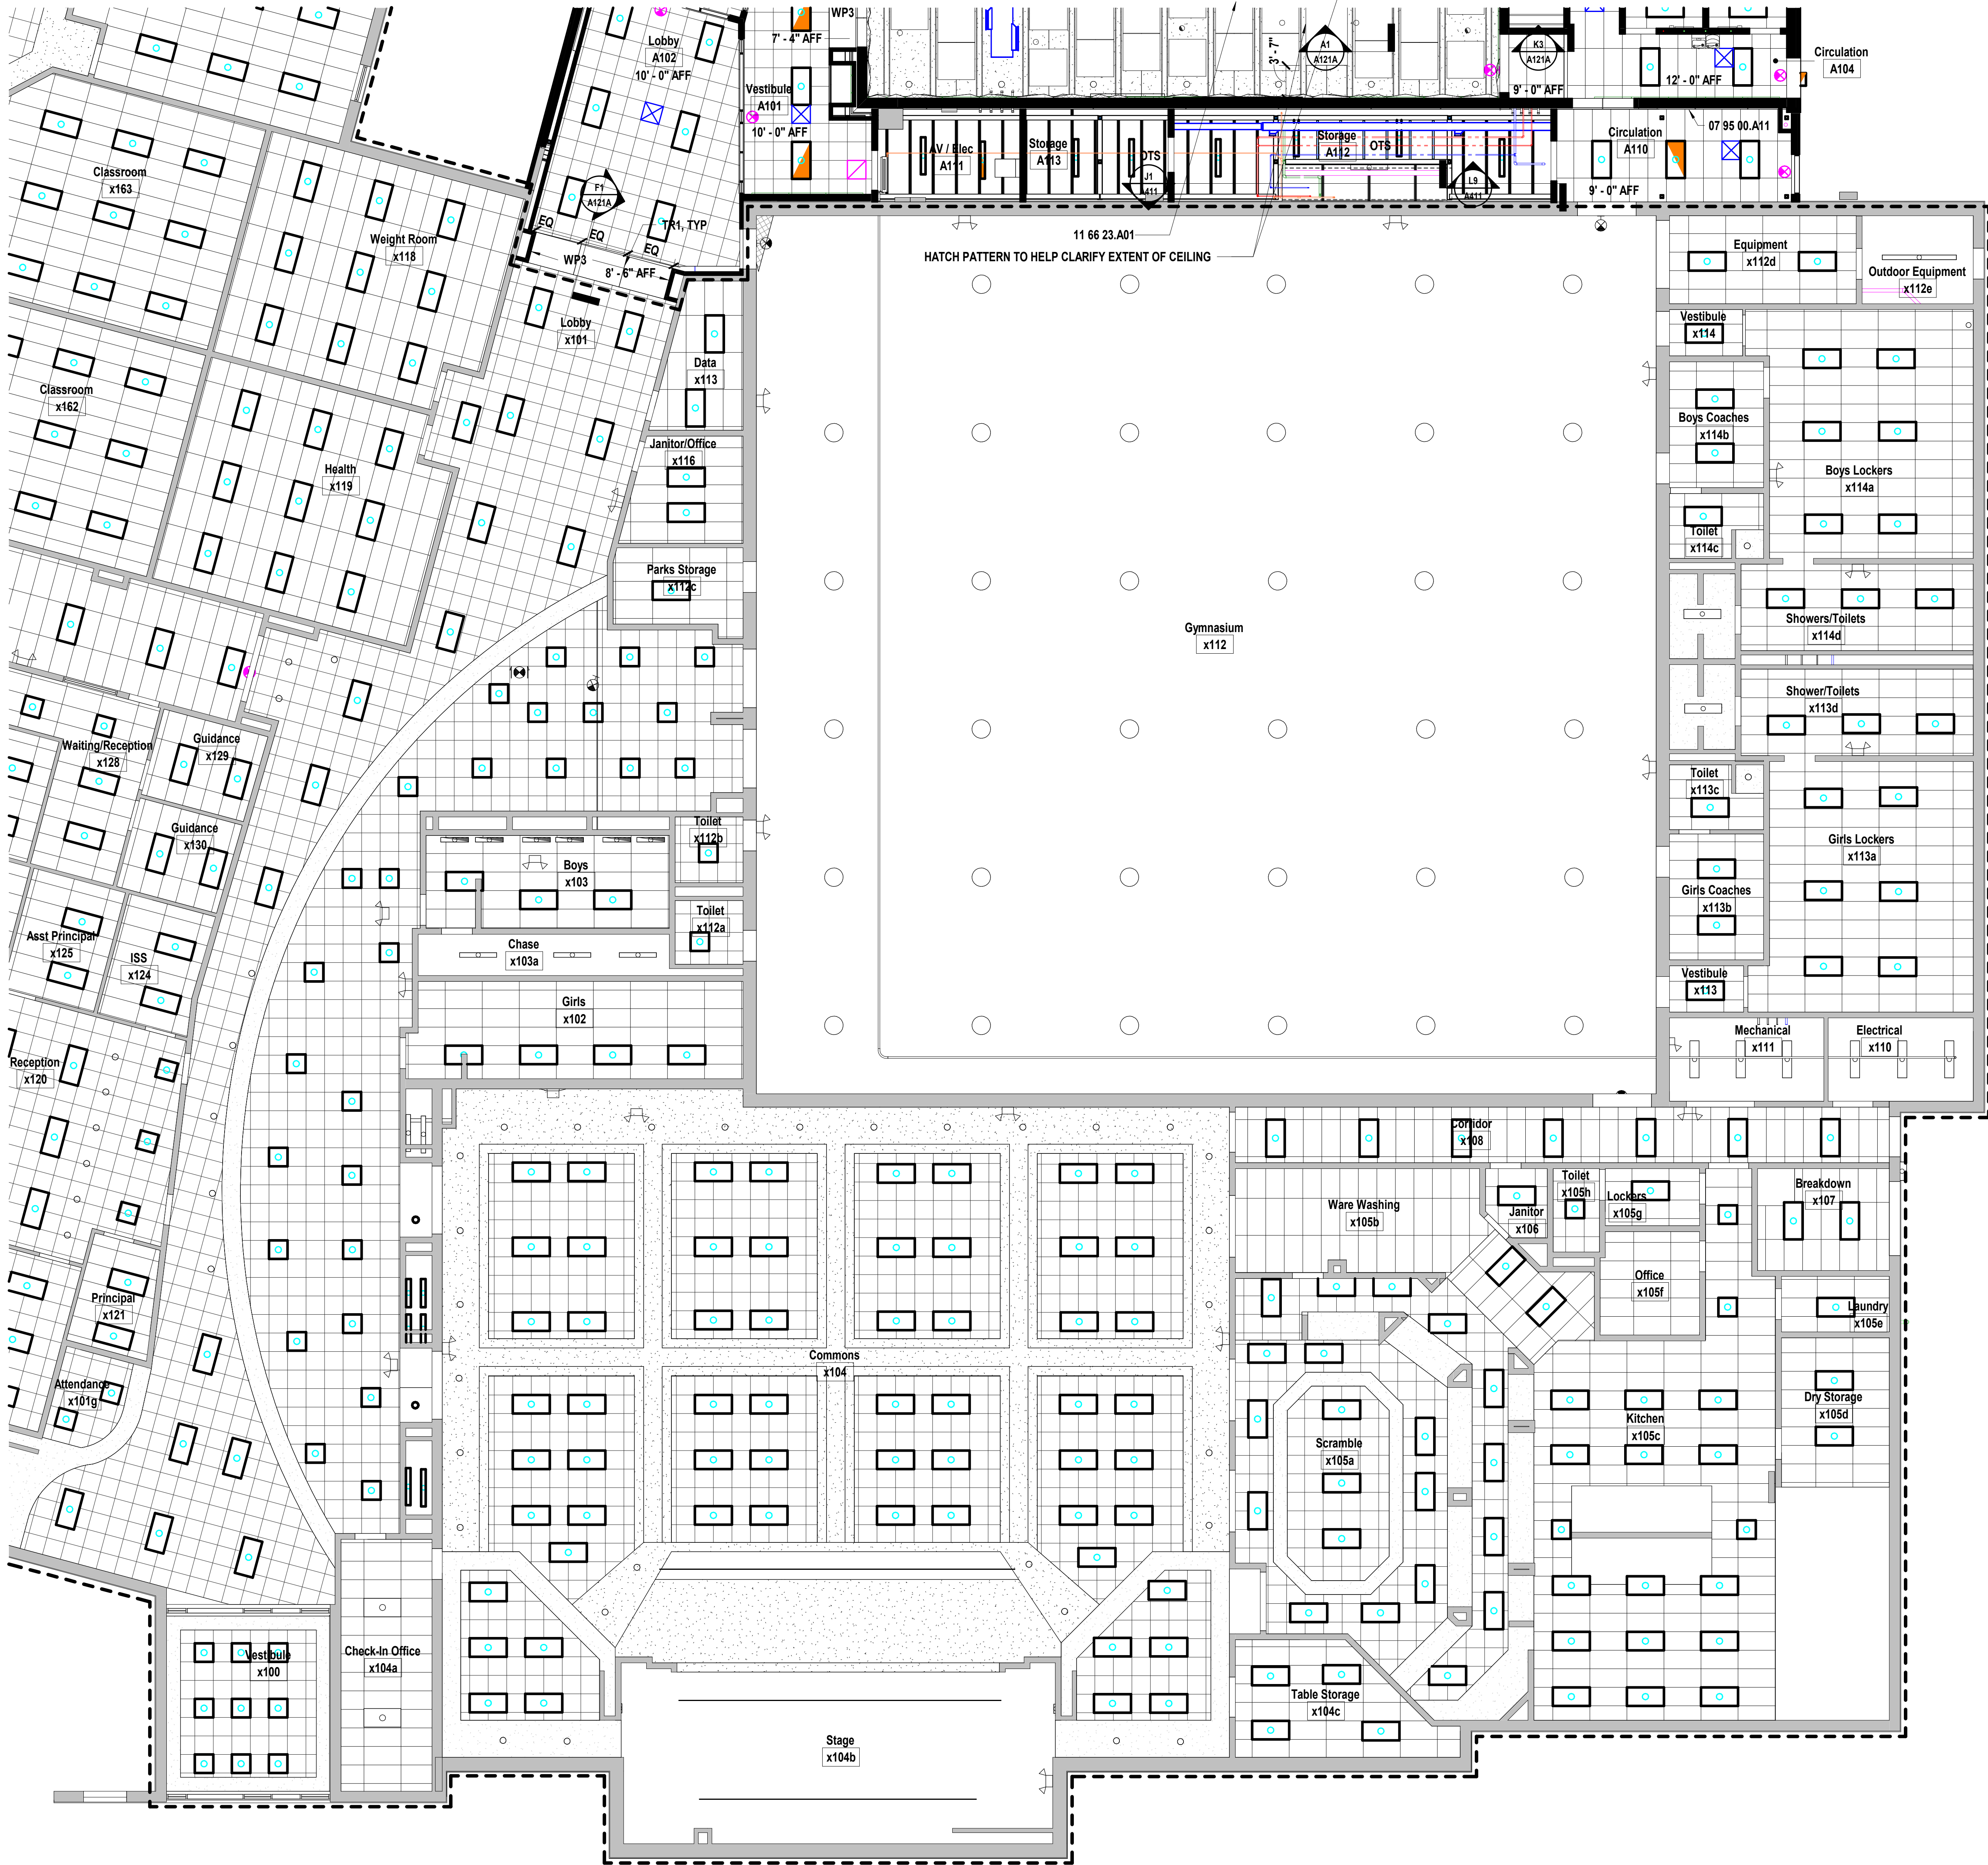SHEET KEYNOTE LEGEND

07 95 00.A11
11 66 23.A01
CEILING-TO-WALL JOINT SYSTEM
OVERHEAD BACKBOARD SUPPORTS

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State Certificate of Authority #000442
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913.317.9390 phone

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SHEET MATERIAL FINISH LEGEND

ID	MATERIAL	COLOR/FINISH
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SHEET NOTES

ALTERNATE NO.1 SCOPE WITHIN BOUNDARY LINE


ALTERNATE NO.1
ALL EXISTING ROOMS TO RECEIVE NEW ACOUSTICAL CEILING
TILE (ACT) TO REPLACE EXISTING. EXISTING GRIDS TO REMAIN.

1. CLASSROOMS, STORAGE ROOMS, OFFICES, LOCKER ROOMS,
SUPPORT SPACES TO RECEIVE CLG1 (24x48) OR CLG2 (24x24) TO
MATCH EXISTING GRID SIZE

2. LOBBIES, RECEPTION, PUBLIC CIRCULATION, CLASSROOM
CORRIDORS, VESTIBULES, MEDIA CENTER, & COMMONS TO
RECEIVE CLG3

3. KITCHEN, CAFETERIA, RESTROOMS, SHOWERS & OTHER WET
SPACES TO RECEIVE CLG4 (24x48) OR CLG5 (24x24) TO MATCH
EXISTING GRID SIZE

KEY PLAN

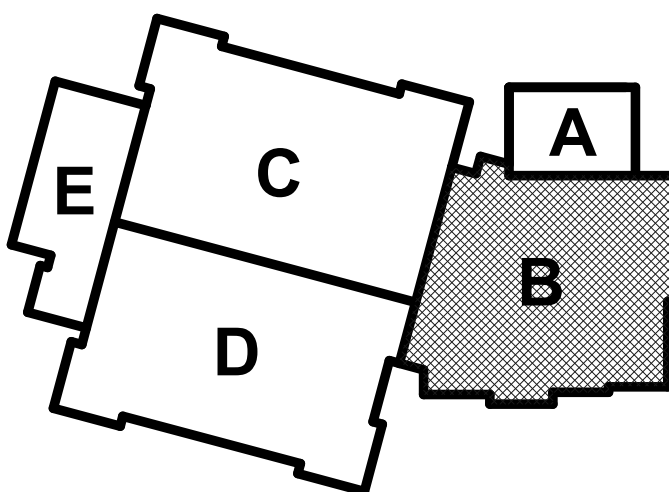

South Valley Middle School Storm Shelter Addition
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REVISIONS:		
#	Description	Date
1	Amendment 01	10.06.2023




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DATE: 08.31.2023

A121B


REFLECTED CEILING PLAN - LEVEL 1 - AREA B

Please consider the environment before printing this.

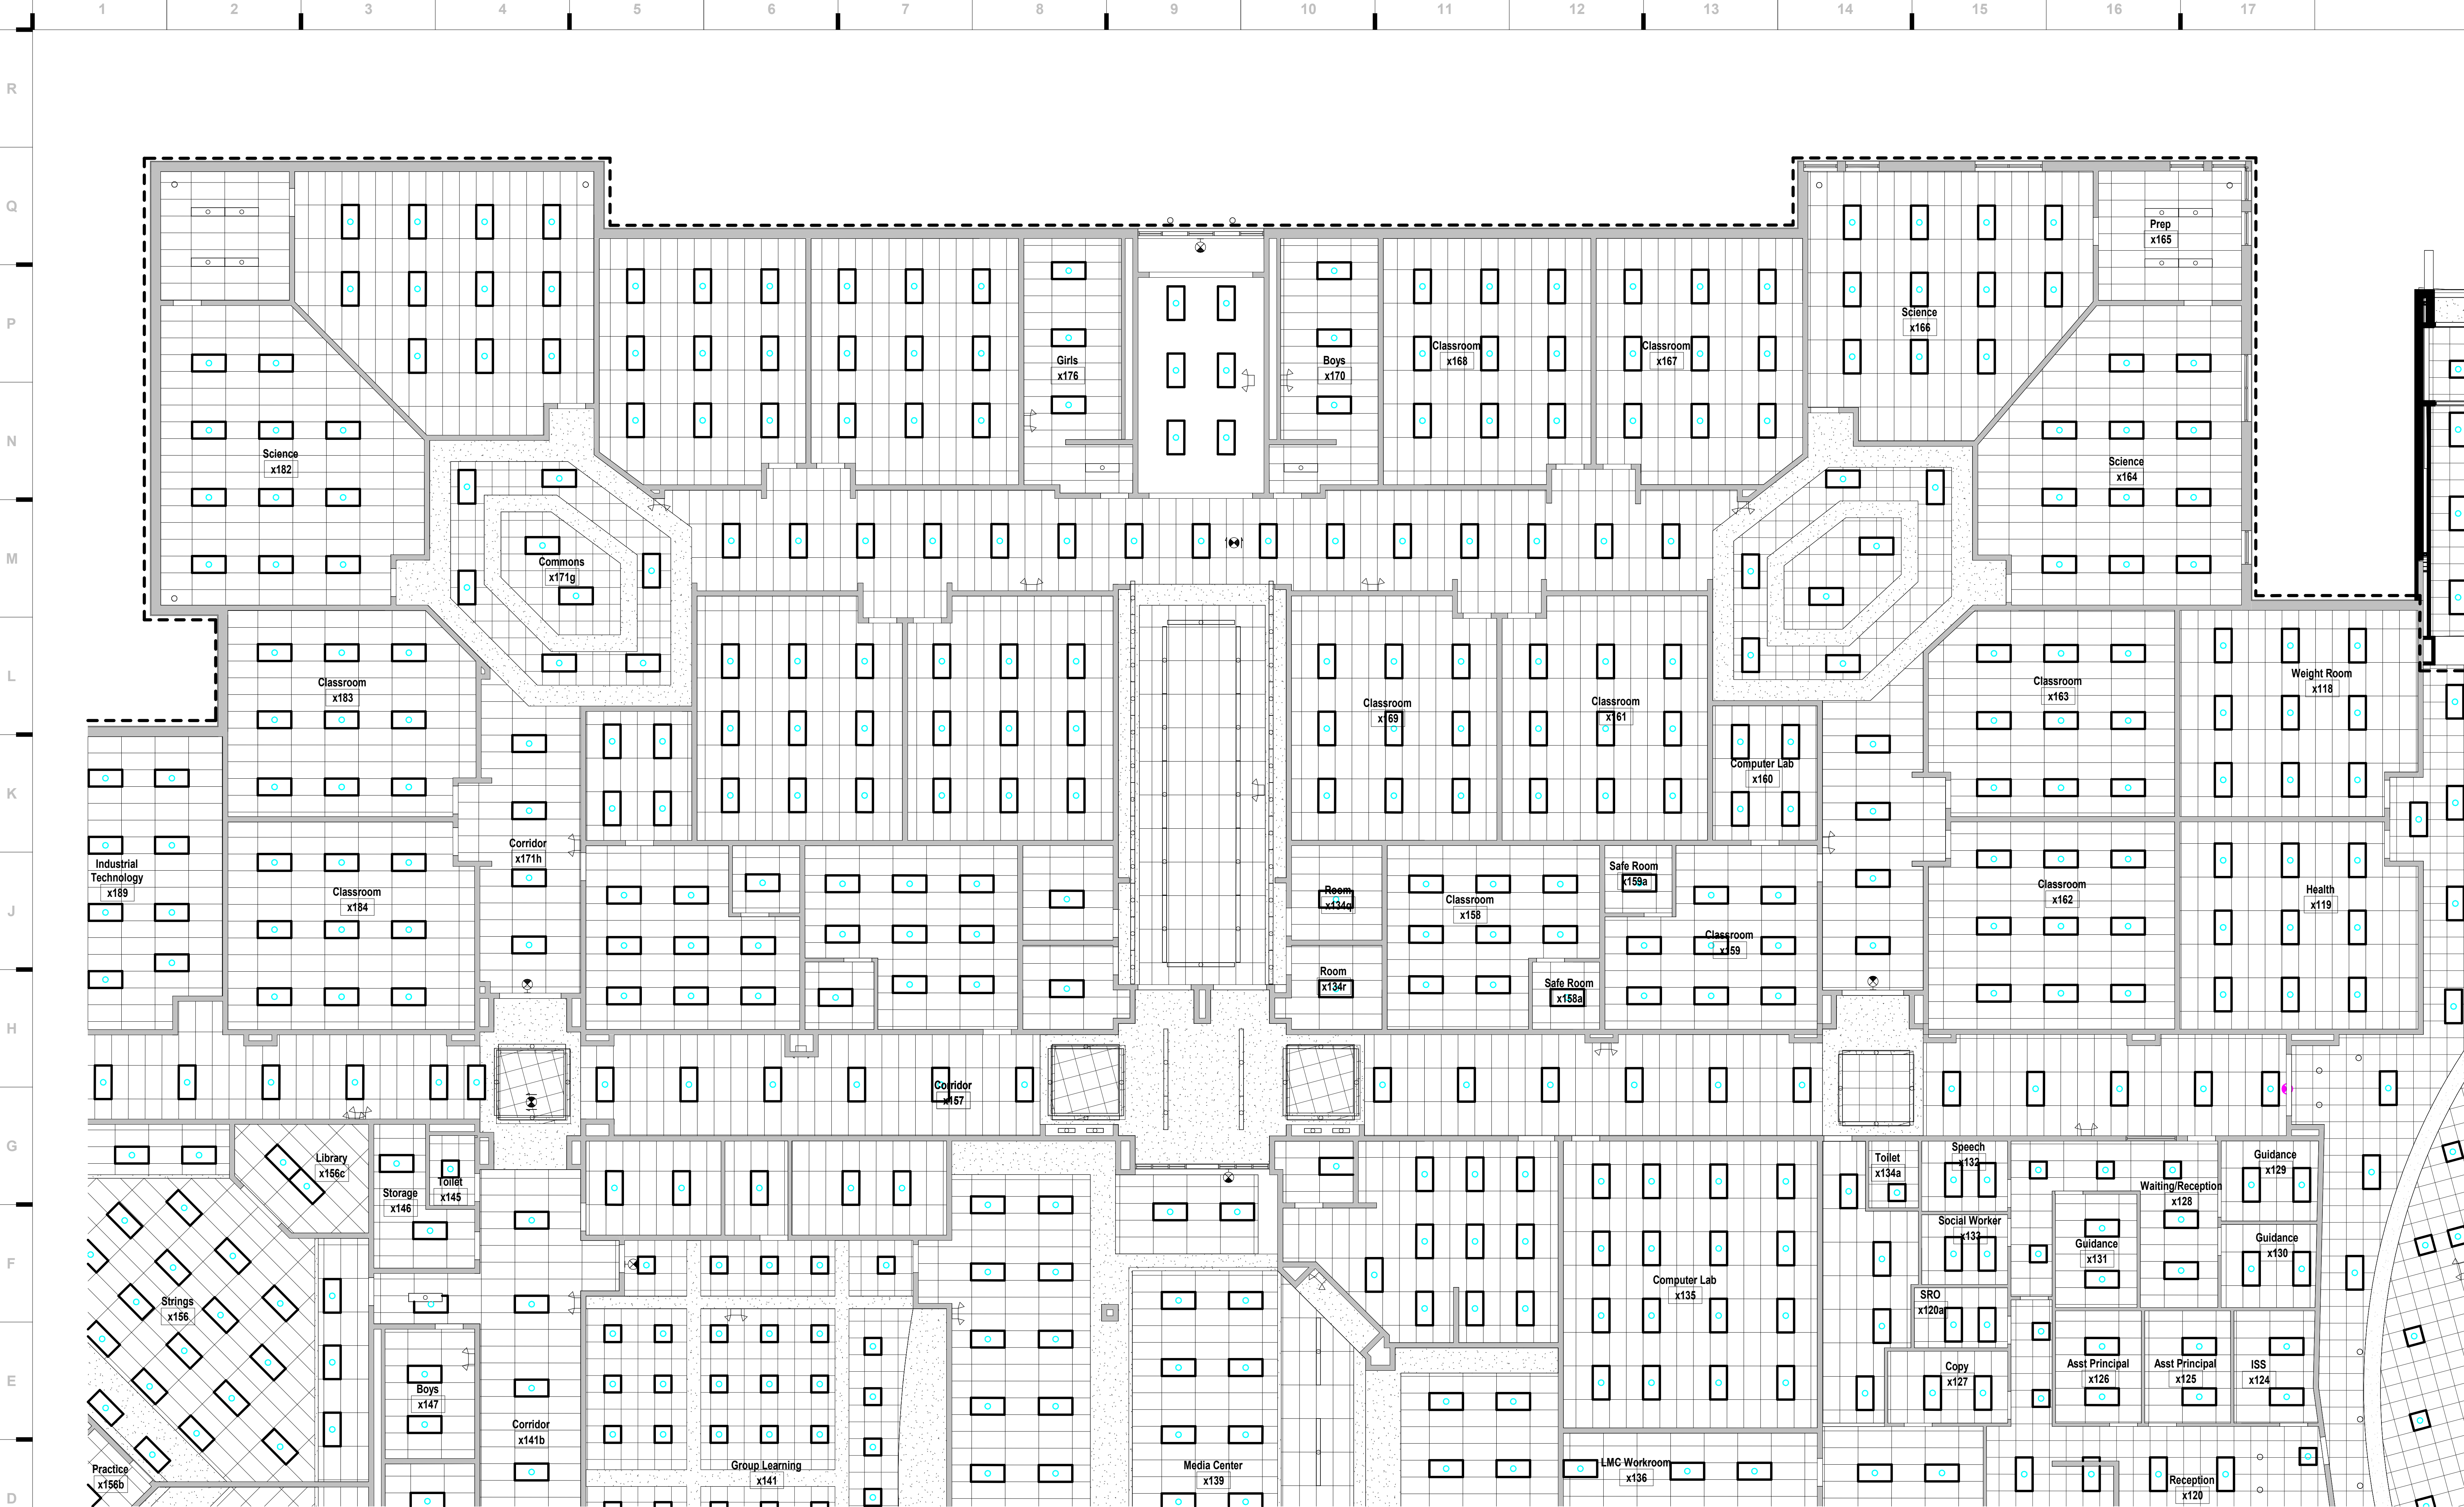

C1 Scale Reflected Ceiling Plan - Level 1 - Area C
1/8" = 1'-0"

SHEET NOTES

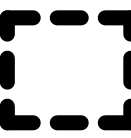
 ALTERNATE NO.1 SCOPE WITHIN BOUNDARY LINE
ALTERNATE NO.1
ALL EXISTING ROOMS TO RECEIVE NEW ACOUSTICAL CEILING TILE (ACT) TO REPLACE EXISTING. EXISTING GRIDS TO REMAIN.

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3. KITCHEN, CAFETERIA, RESTROOMS, SHOWERS & OTHER WET SPACES TO RECEIVE CLG4 (24x48) OR CLG5 (24x24) TO MATCH EXISTING GRID SIZE

SHEET MATERIAL FINISH LEGEND

ID	MATERIAL	COLOR/FINISH
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KEY PLAN

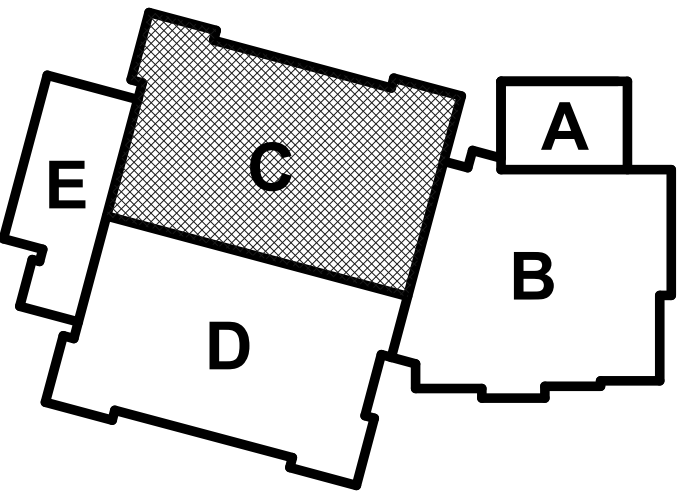

South Valley Middle School Storm Shelter Addition
Liberty Public Schools
1000 Midjay Dr, Liberty, MO 64068

REVISIONS:

#	Description	Date
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Structural Engineer
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CONFIRMED
CONSTRUCTION
DOCUMENTS

1 2 3 4 5 6 7 8 9 10 11 12 13 14 15 16 17

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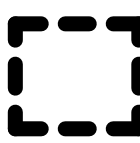
B

A



C1 Scale Reflected Ceiling Plan - Level 1 - Area D
1/8" = 1'-0"

SHEET NOTES


 ALTERNATE NO.1 SCOPE WITHIN BOUNDARY LINE
ALTERNATE NO.1
ALL EXISTING ROOMS TO RECEIVE NEW ACOUSTICAL CEILING TILE (ACT) TO REPLACE EXISTING. EXISTING GRIDS TO REMAIN.

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3. KITCHEN, CAFETERIA, RESTROOMS, SHOWERS & OTHER WET SPACES TO RECEIVE CLG4 (24x48) OR CLG5 (24x24) TO MATCH EXISTING GRID SIZE

SHEET MATERIAL FINISH LEGEND

ID	MATERIAL	COLOR/FINISH
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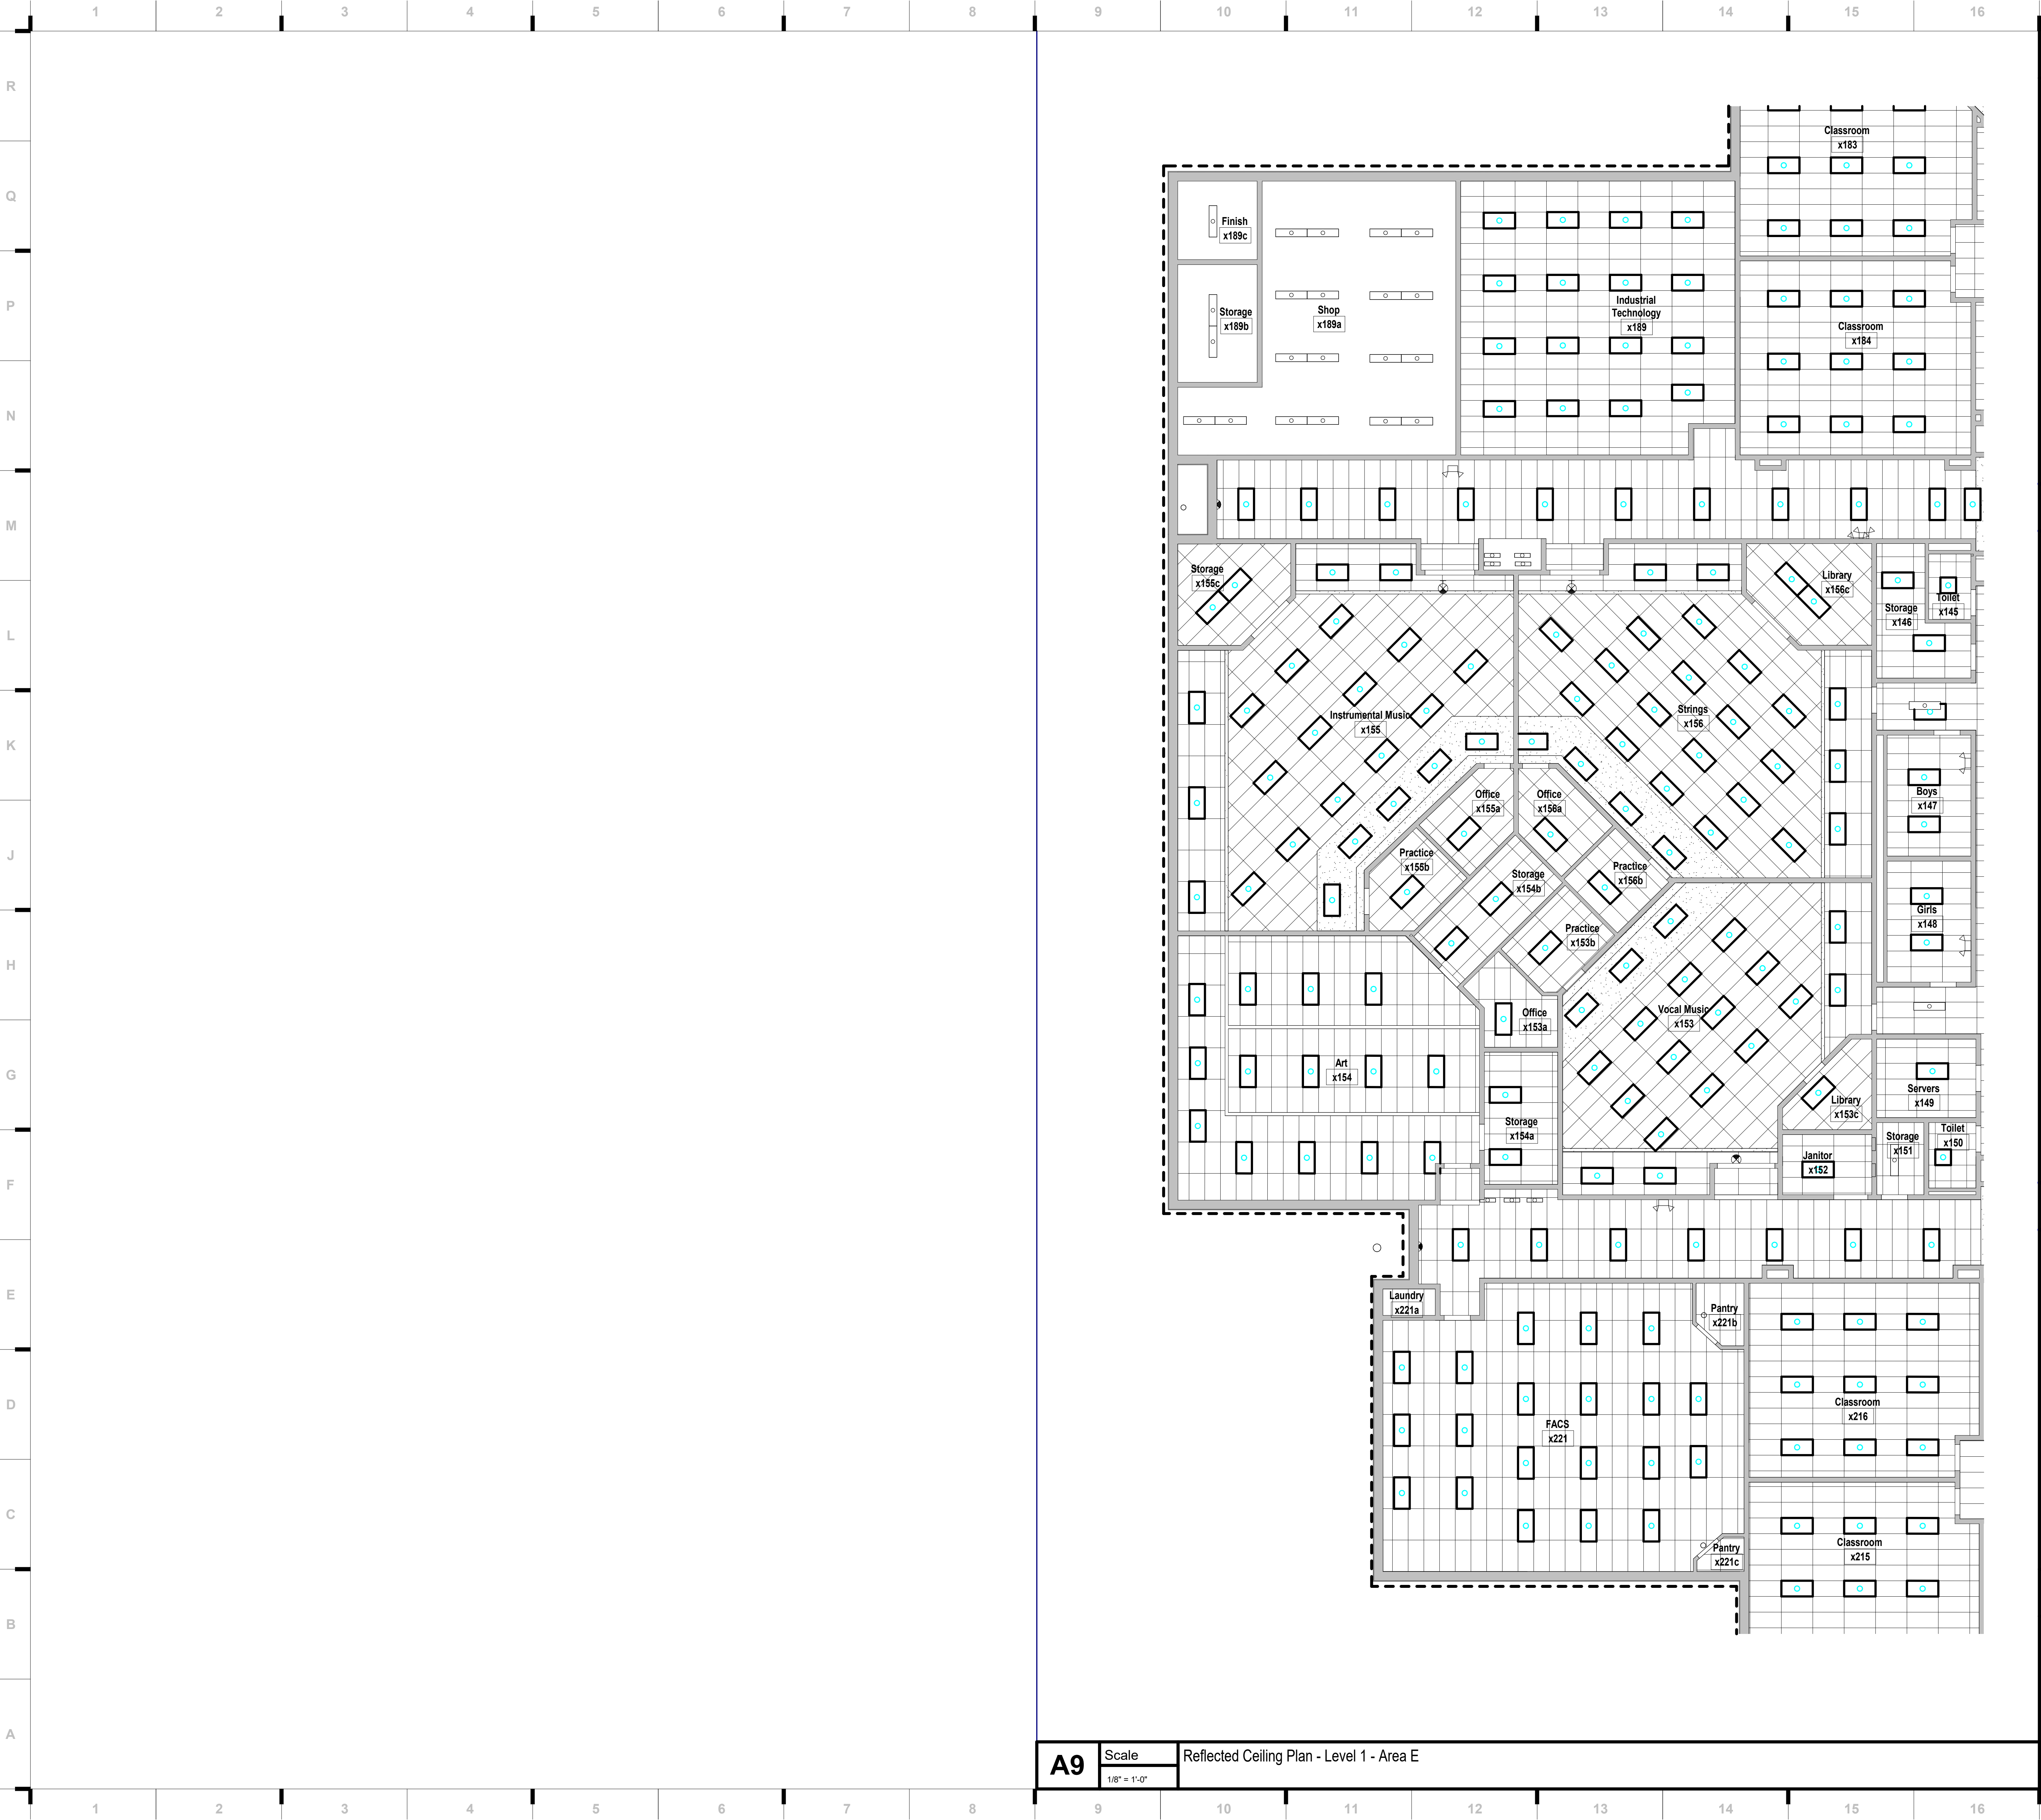
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A121D

REFLECTED CEILING PLAN - LEVEL 1 - AREA D
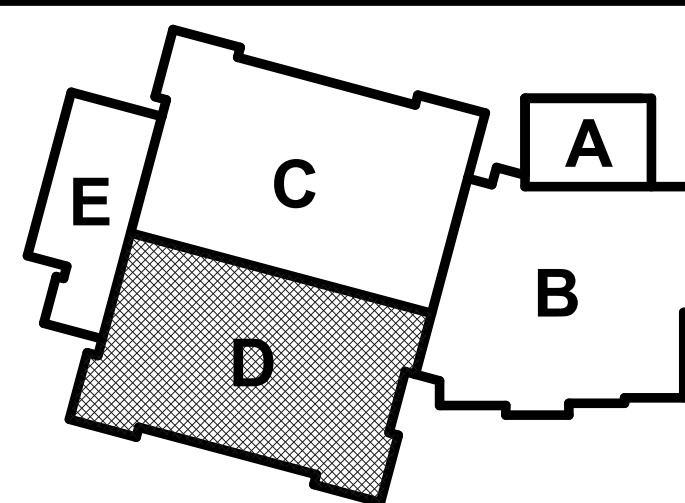
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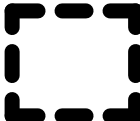
A9 Scale Reflected Ceiling Plan - Level 1 - Area E

SHEET KEYNOTE LEGEND

SHEET MATERIAL FINISH LEGEND


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SHEET NOTES

 ALTERNATE NO.1 SCOPE WITHIN BOUNDARY LINE

- ALTERNATE NO.1
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3. KITCHEN, CAFETERIA, RESTROOMS, SHOWERS & OTHER WET SPACES TO RECEIVE CLG4 (24x48) OR CLG5 (24x24) TO MATCH EXISTING GRID SIZE

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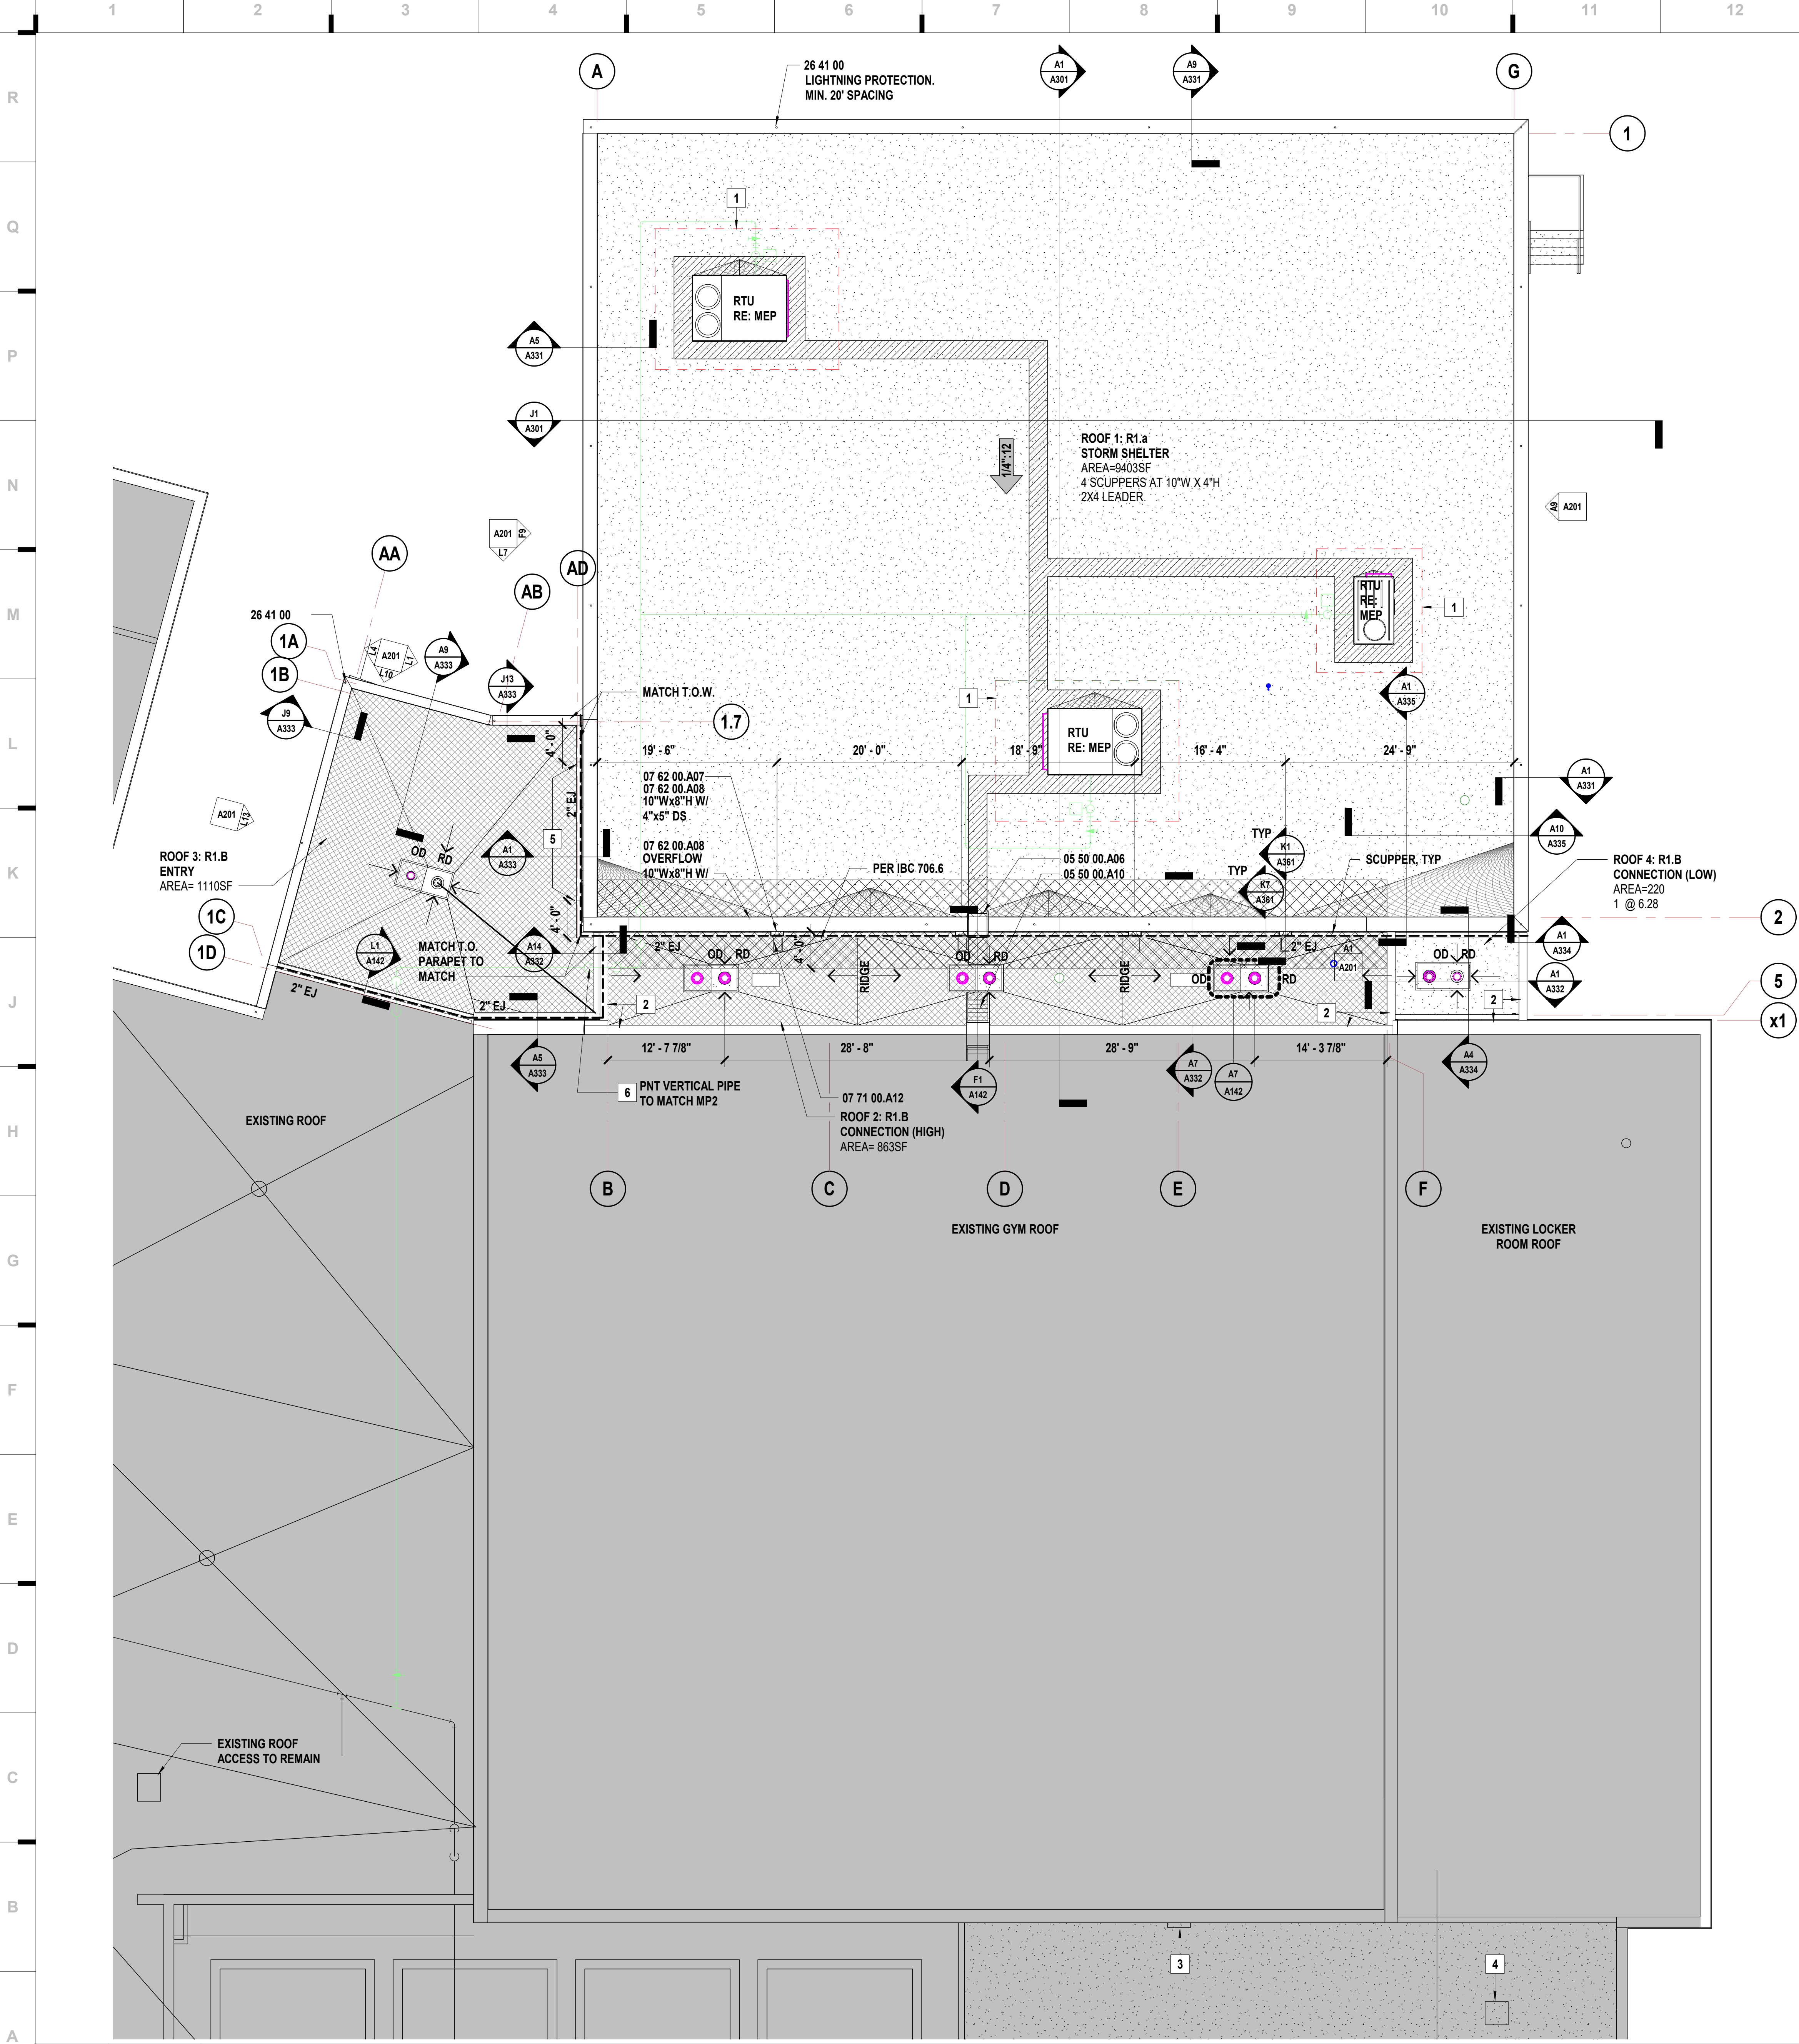

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A-2019015618

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A121E

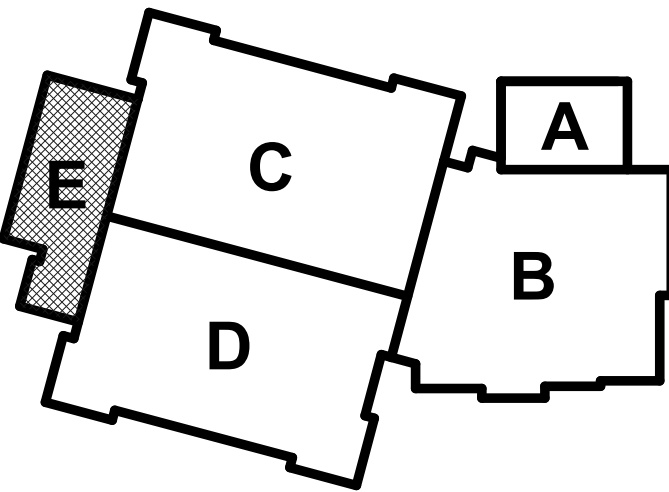REFLECTED CEILING PLAN - LEVEL 1 - AREA E



ROOF TYPE LEGEND

R1.a

MOD BIT W/ 5.2" INSULATION

07 52 16.A01

W/ VENTED BASE SHEET

07 52 16.A25

07 52 16.A20

PRE-CAST T

RE: STRUCTURAL

R1.b

MOD BIT TAPERED INSULATION

07 52 16.A01

07 52 16.A25

07 52 16.A20

METAL DECK

RE: STRUCTURAL

SHEET KEYNOTE LEGEND

05 50 00.A06

METAL LADDER

05 50 00.A10

SHIP'S LADDER WITH PLATFORM RETURN

07 52 16.A01

MODIFIED BITUMINOUS ROOFING SYSTEM

07 52 16.A20

ROOF INSULATION

07 52 16.A25

COVERBOARD

07 62 00.A07

DOWNSPOUTS

07 62 00.A08

SCUPPERS

07 71 00.A12

SPLASH PANS

26 41 00

ROOF PLAN LEGEND

SLOPED STRUCTURE
RE: STRUCTURAL FOR ROOF BEARING
HEIGHTS/SLOPE

SLOPE PROVIDED BY TAPERED
INSULATION OVER FLAT STRUCTURE @
SLOPE INDICATED

TAPERED INSULATION CRICKET

ROOF MEMBRANE 07 52 16.A01

WALKWAY PADS 07 52 16.A16

EXISTING ROOF AREA

BUILDING EXPANSION JOINTS PATH.
REFER TO SPECIFIC DETAILS FOR MORE
INFORMATION.

SHEET NOTES

1.

REFER TO PLUMBING DRAWINGS FOR ROOF DRAIN DETAILS

2.

REFER TO MECHANICAL DRAWINGS FOR ROOF MOUNTED
EQUIPMENT AND CURBS

3.

REFER TO PLUMBING DRAWINGS FOR EXPOSED GAS PIPING
AND SUPPORTS

KEYNOTES

1

UNIT MOUNTED SCREEN, MFR TO PROVIDE FULL COLOR
RANGE IN SUBMITAL. FINAL COLOR TO BE SELECTED BY
ARCHITECT
RE: MEP FOR MORE INFORMATION

2

NEW T.O.W. TO ALIGN WITH EXISTING T.O.W. COPING TO
MATCH. SM2

3

EXISTING ROOF LADDER TO EXISTING GYM ROOF TO
REMAIN

4

EXISTING ROOF ACCESS TO REMAIN

5

SLOPE TOP OF PAREPET, FIELD CUT REGLET PER PRECAST
MFR

6

GAS LINE, RE: MEP

KEY PLAN

E

C

D

B

A

JOB NO: 23019

DRAWN BY: KL

CHECKED BY: JB

DATE: 08.31.2023

A141

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DOCUMENTS

STATE OF MISSOURI

KEVIN E. NELSON

A-2019015618

OCTOBER 11, 2023

Kevin E. Nelson

A-2019015618

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JOB NO: 23019


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CHECKED BY: JB


DATE: 08.31.2023

A141


ROOF PLAN

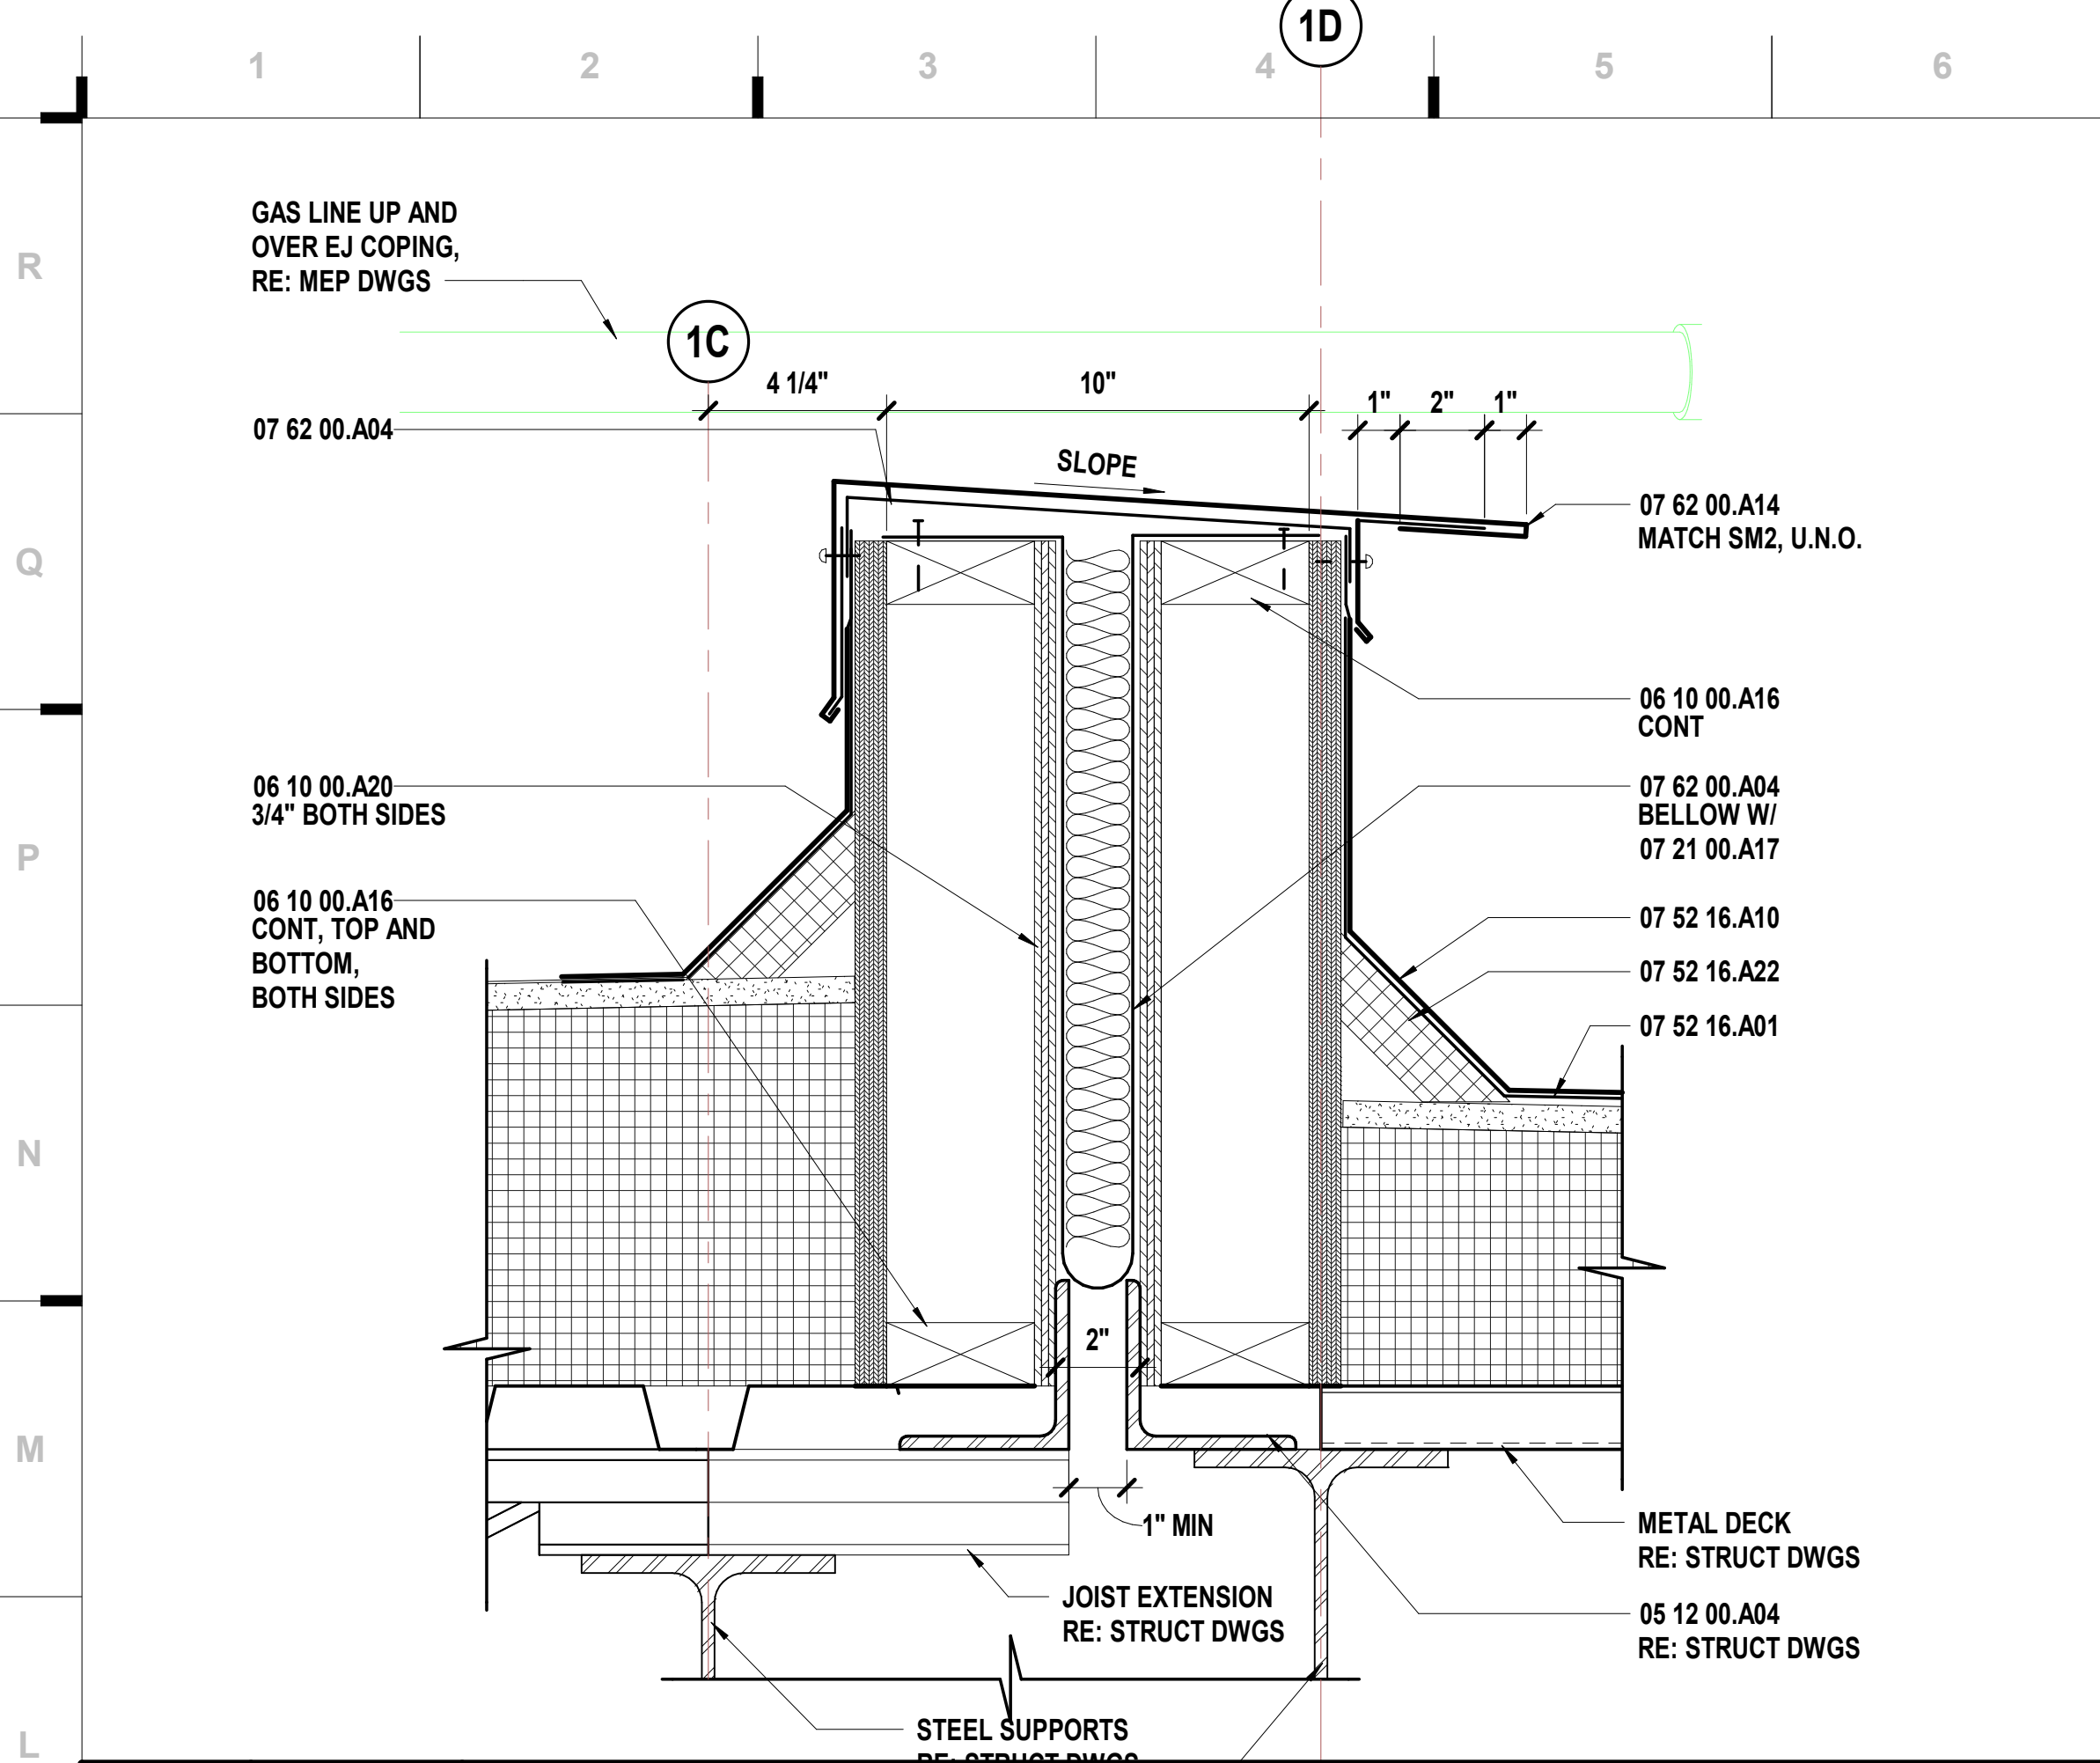


L1 Scale 3" = 1'-0" Roof Detail - Expansion Joint Detail @ BUR/Mod Bit Roof

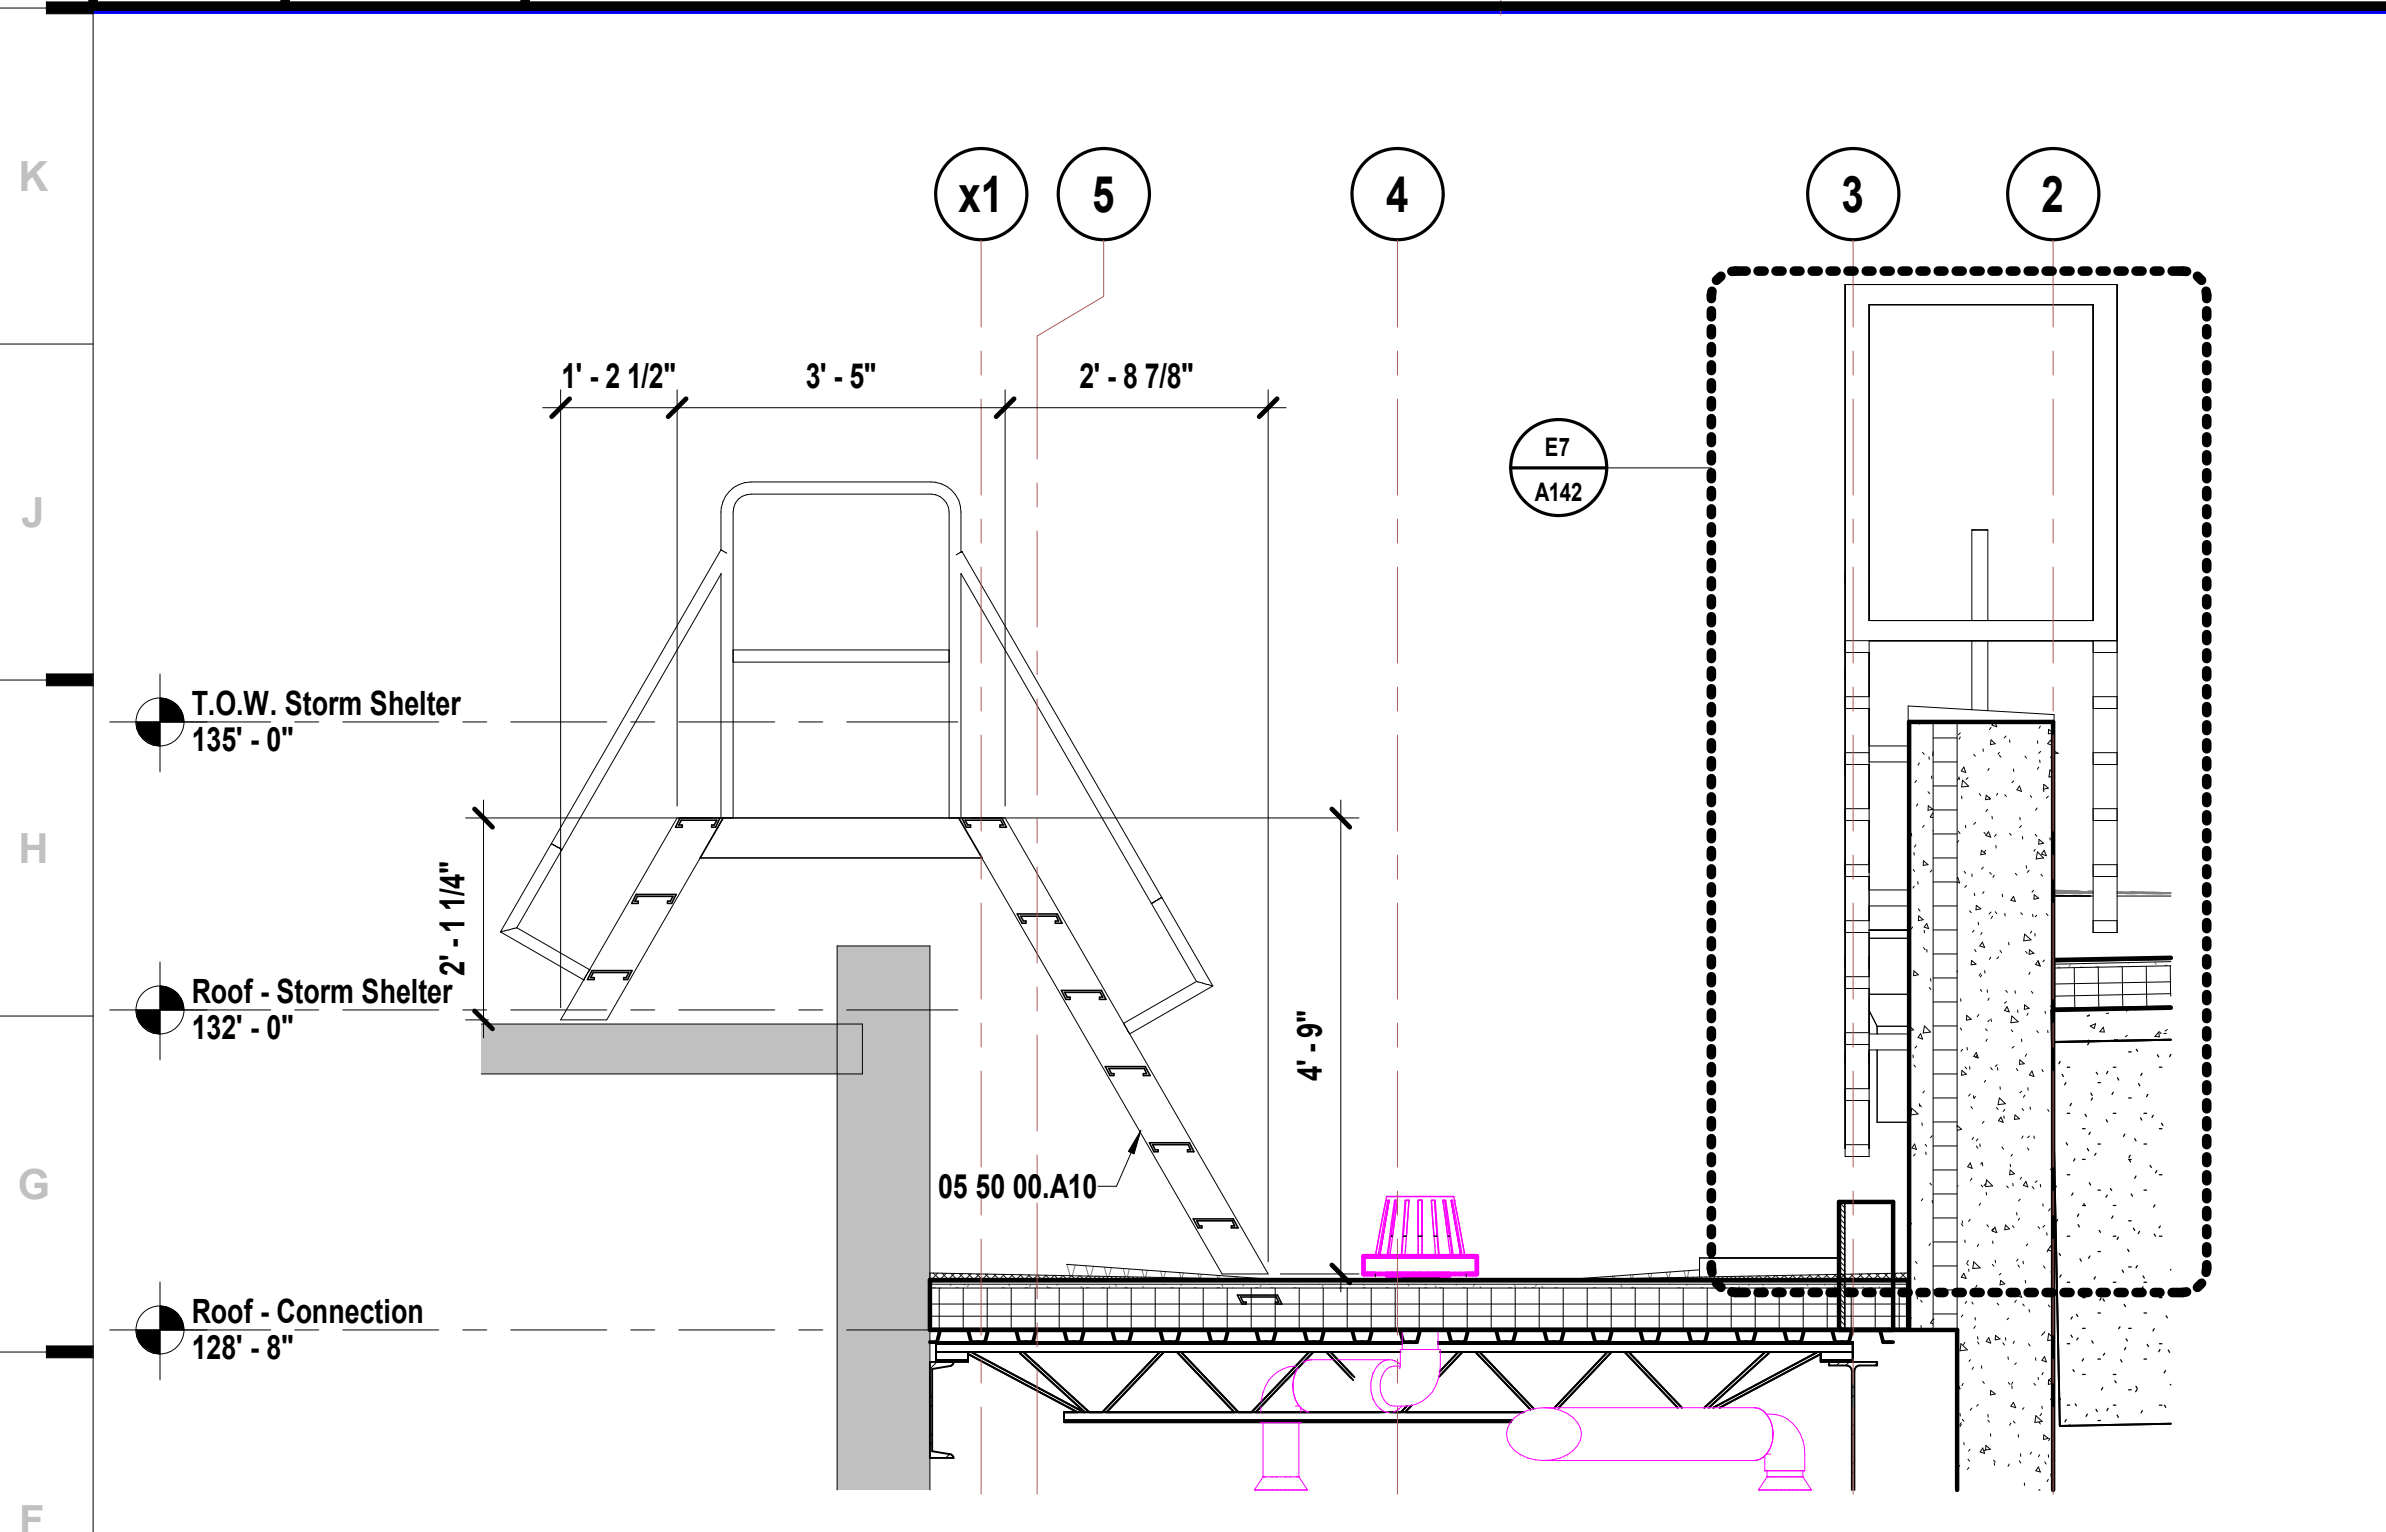


F1 Scale 1/2" = 1'-0" Wall Section - Area A - Connection/Existing - S

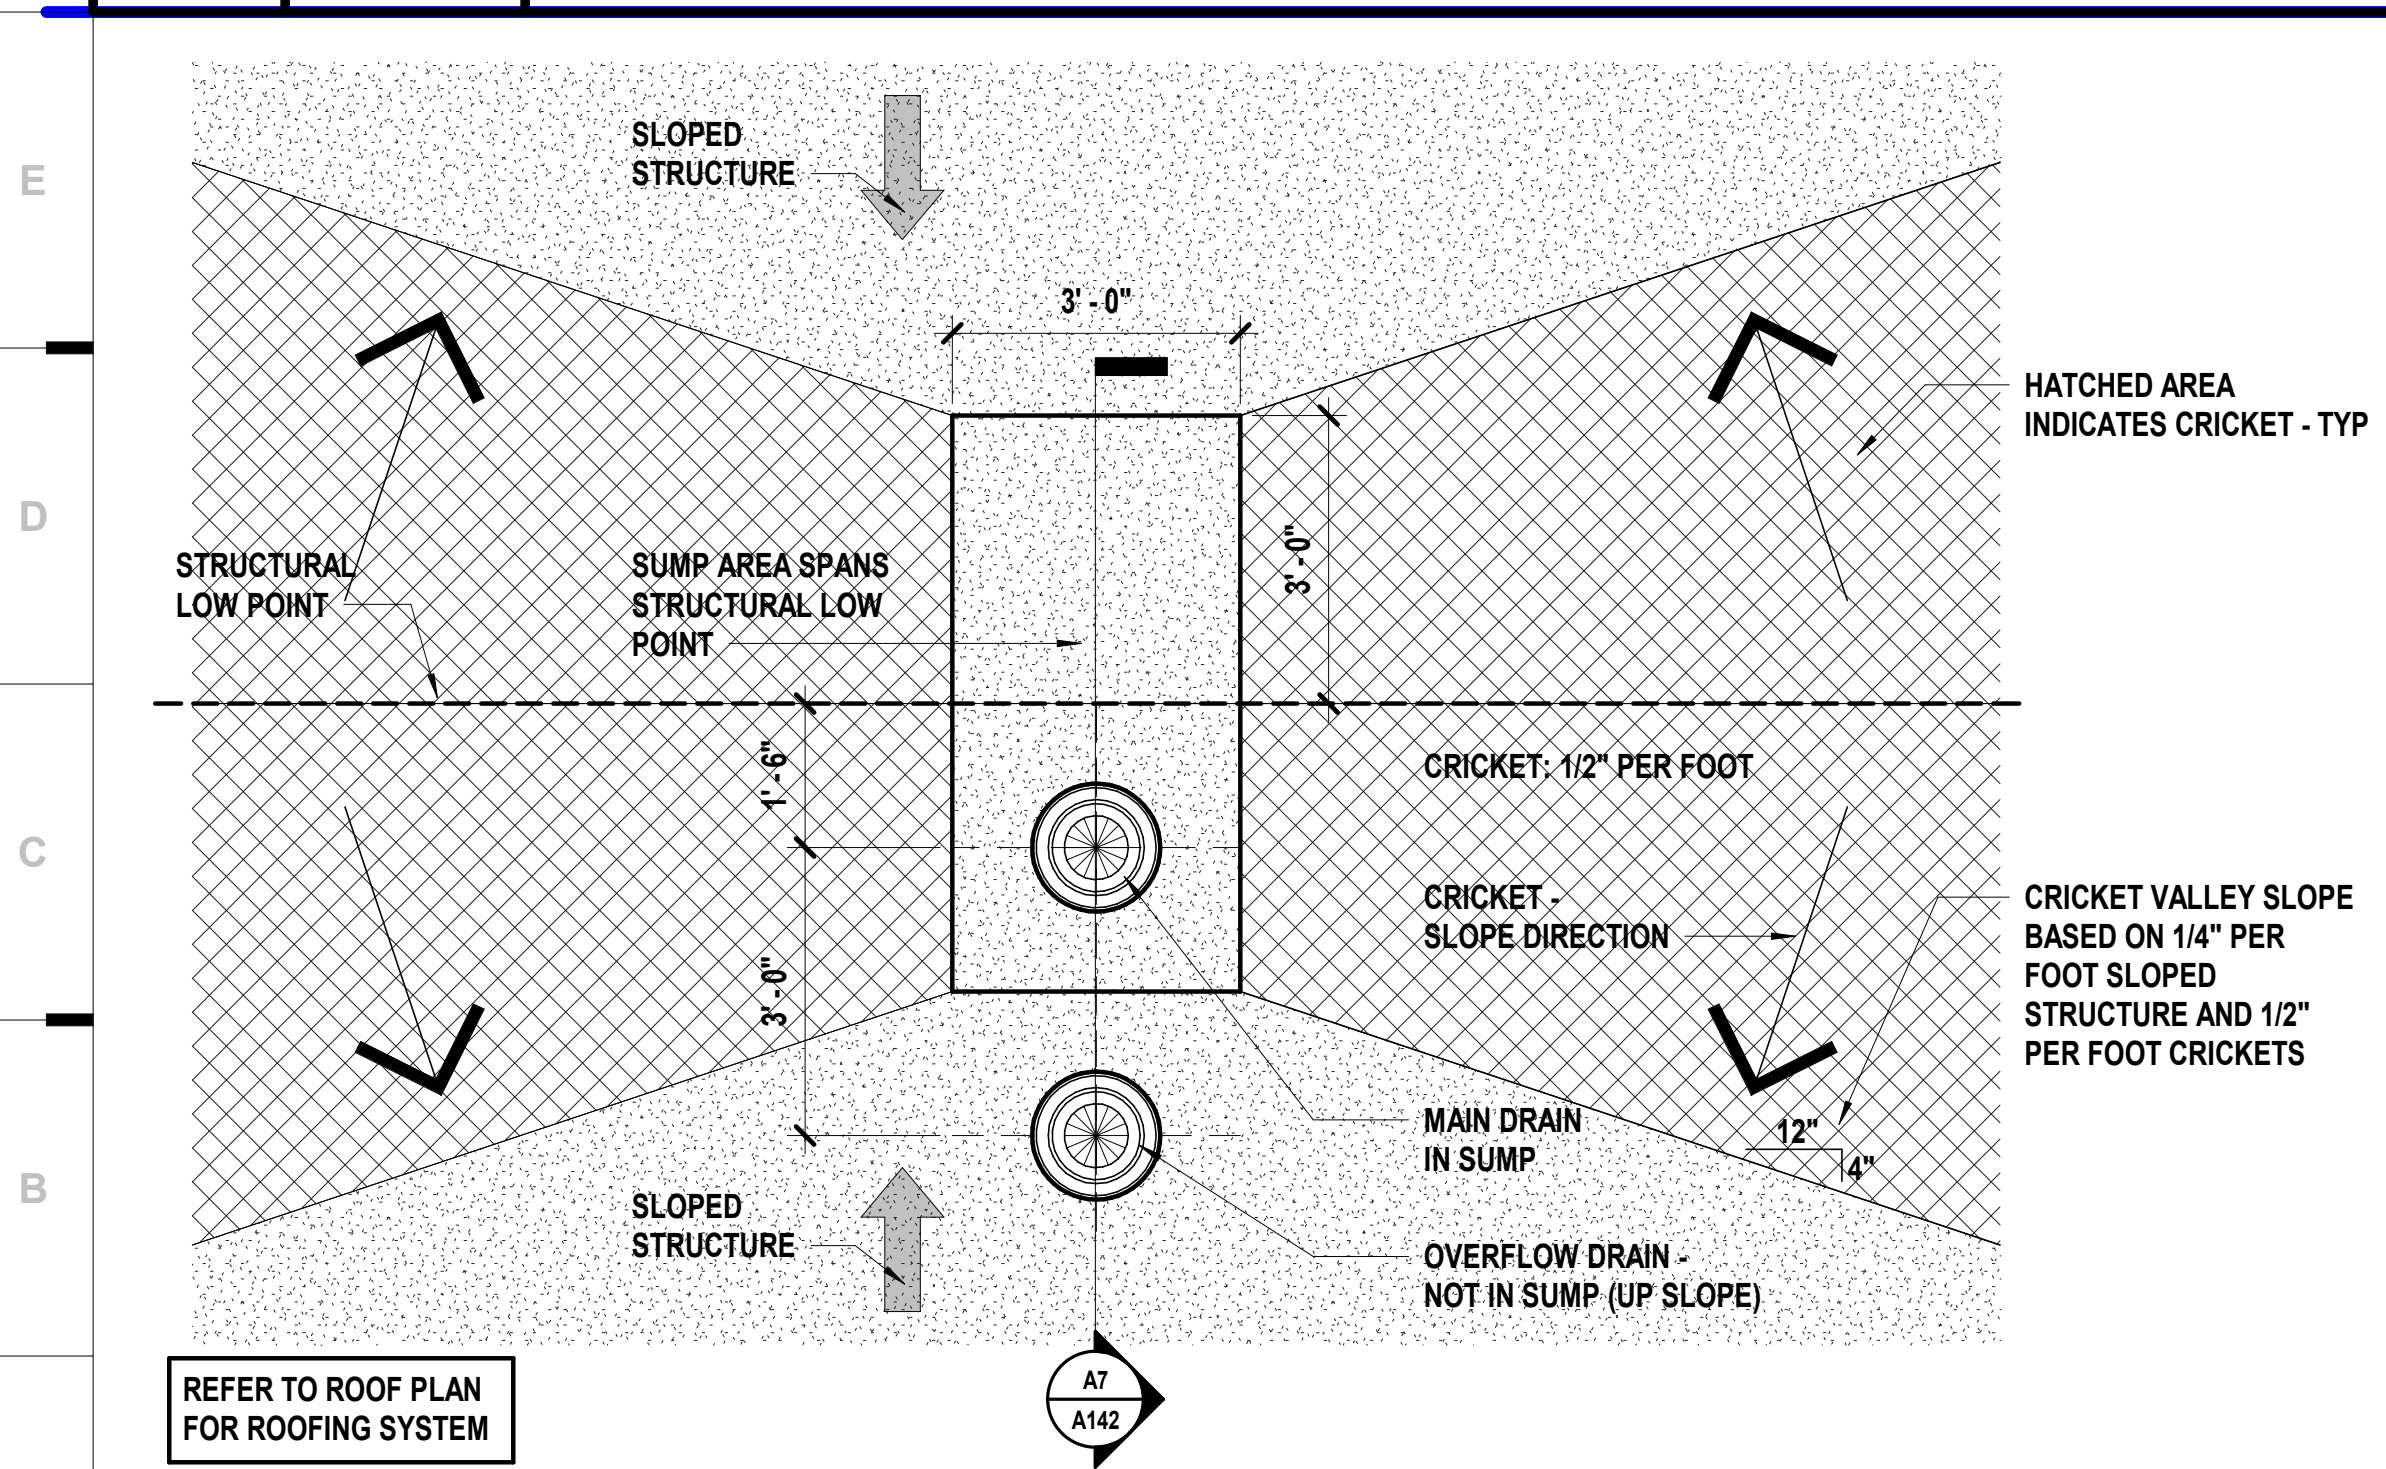


A1 Scale 1/2" = 1'-0" Roof Detail - Roof Drain Layout @ a Valley

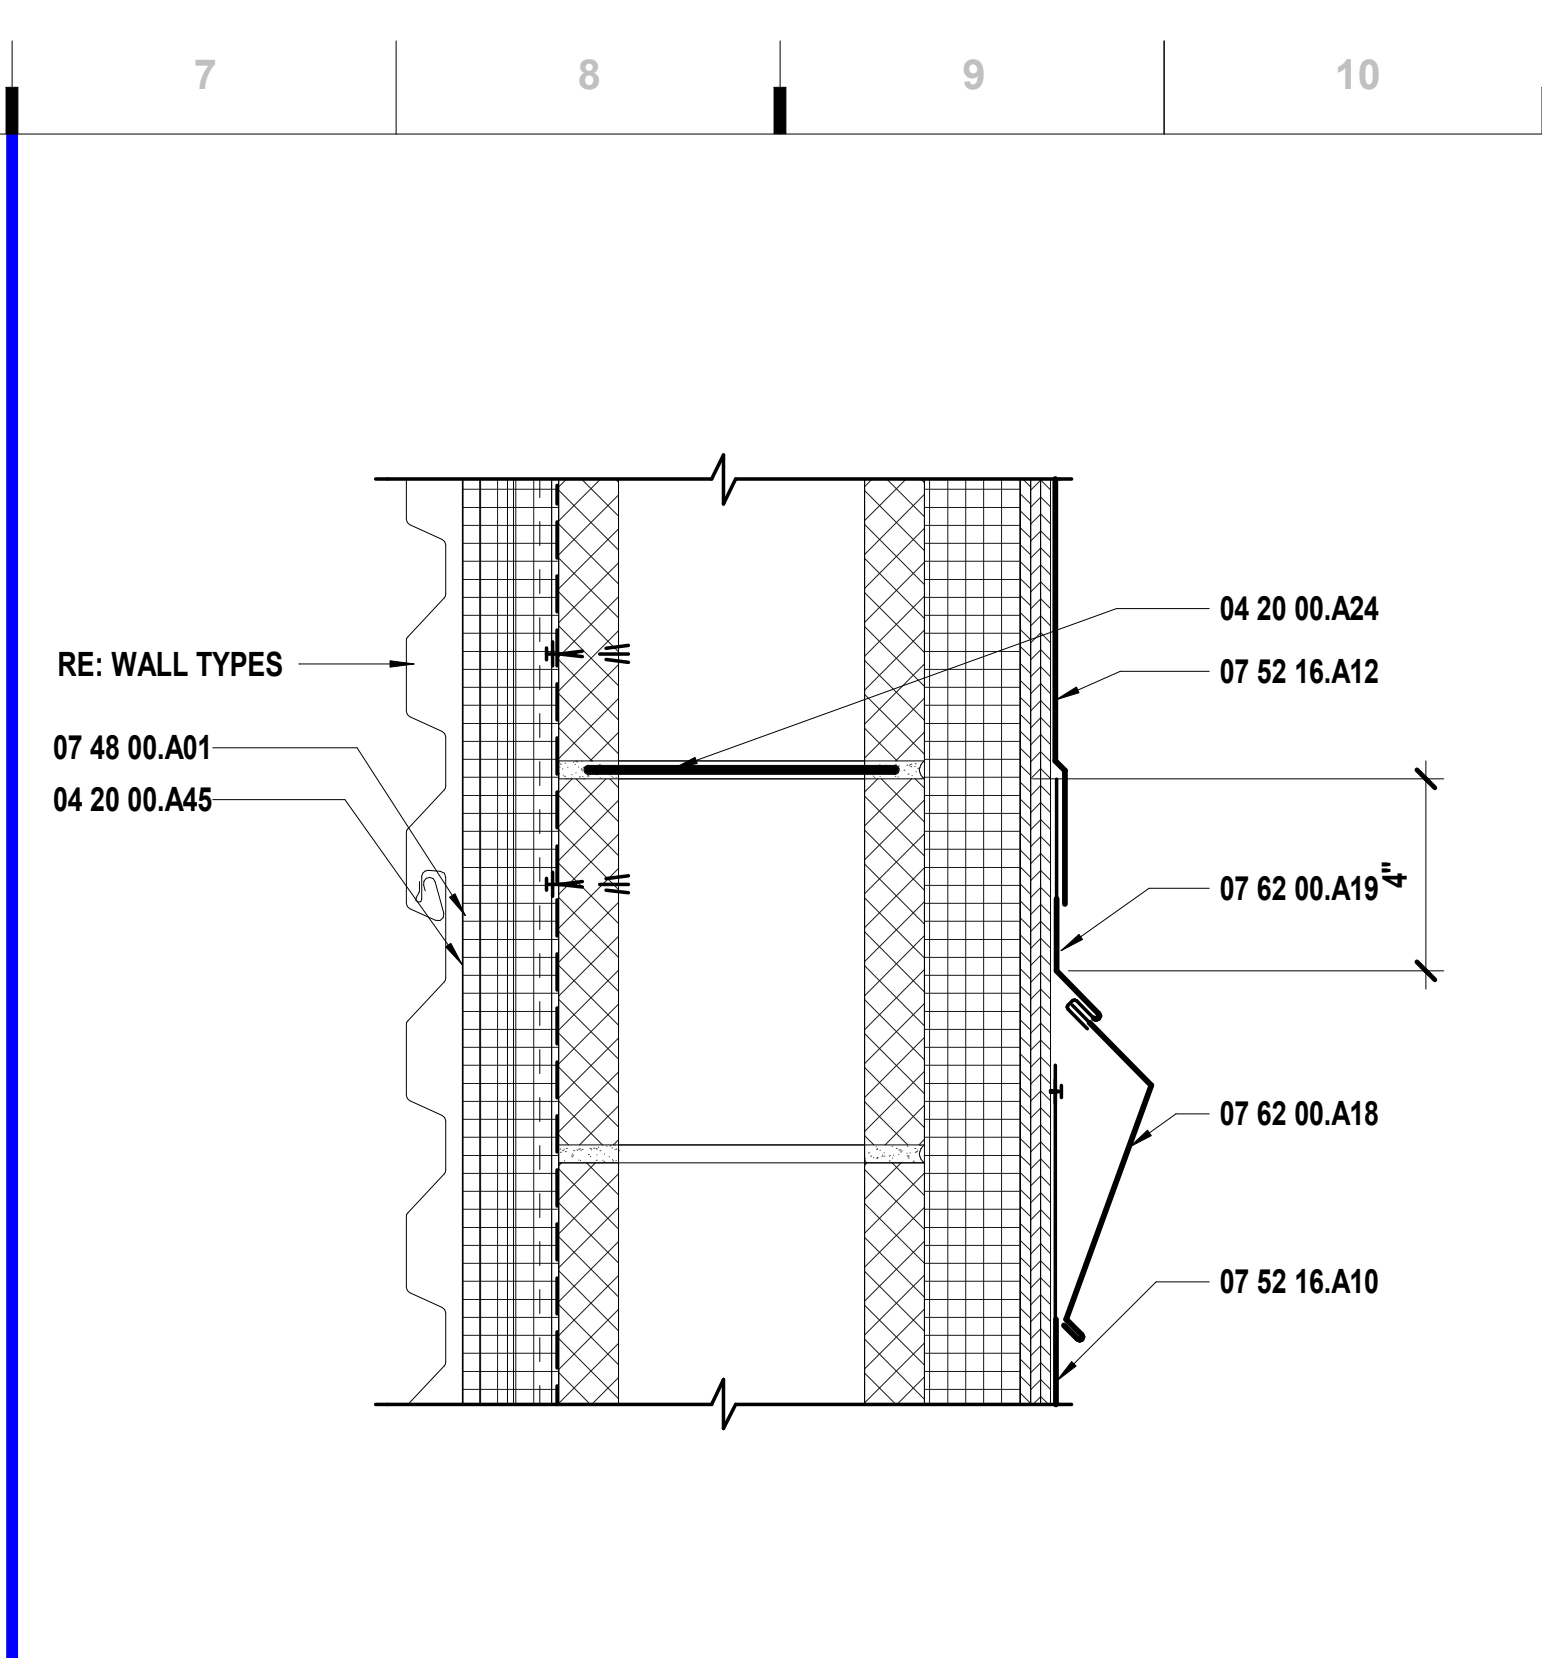


M7 Scale 3" = 1'-0" Exterior Detail - Wall Flashing @ Parapets Greater Than 24" High

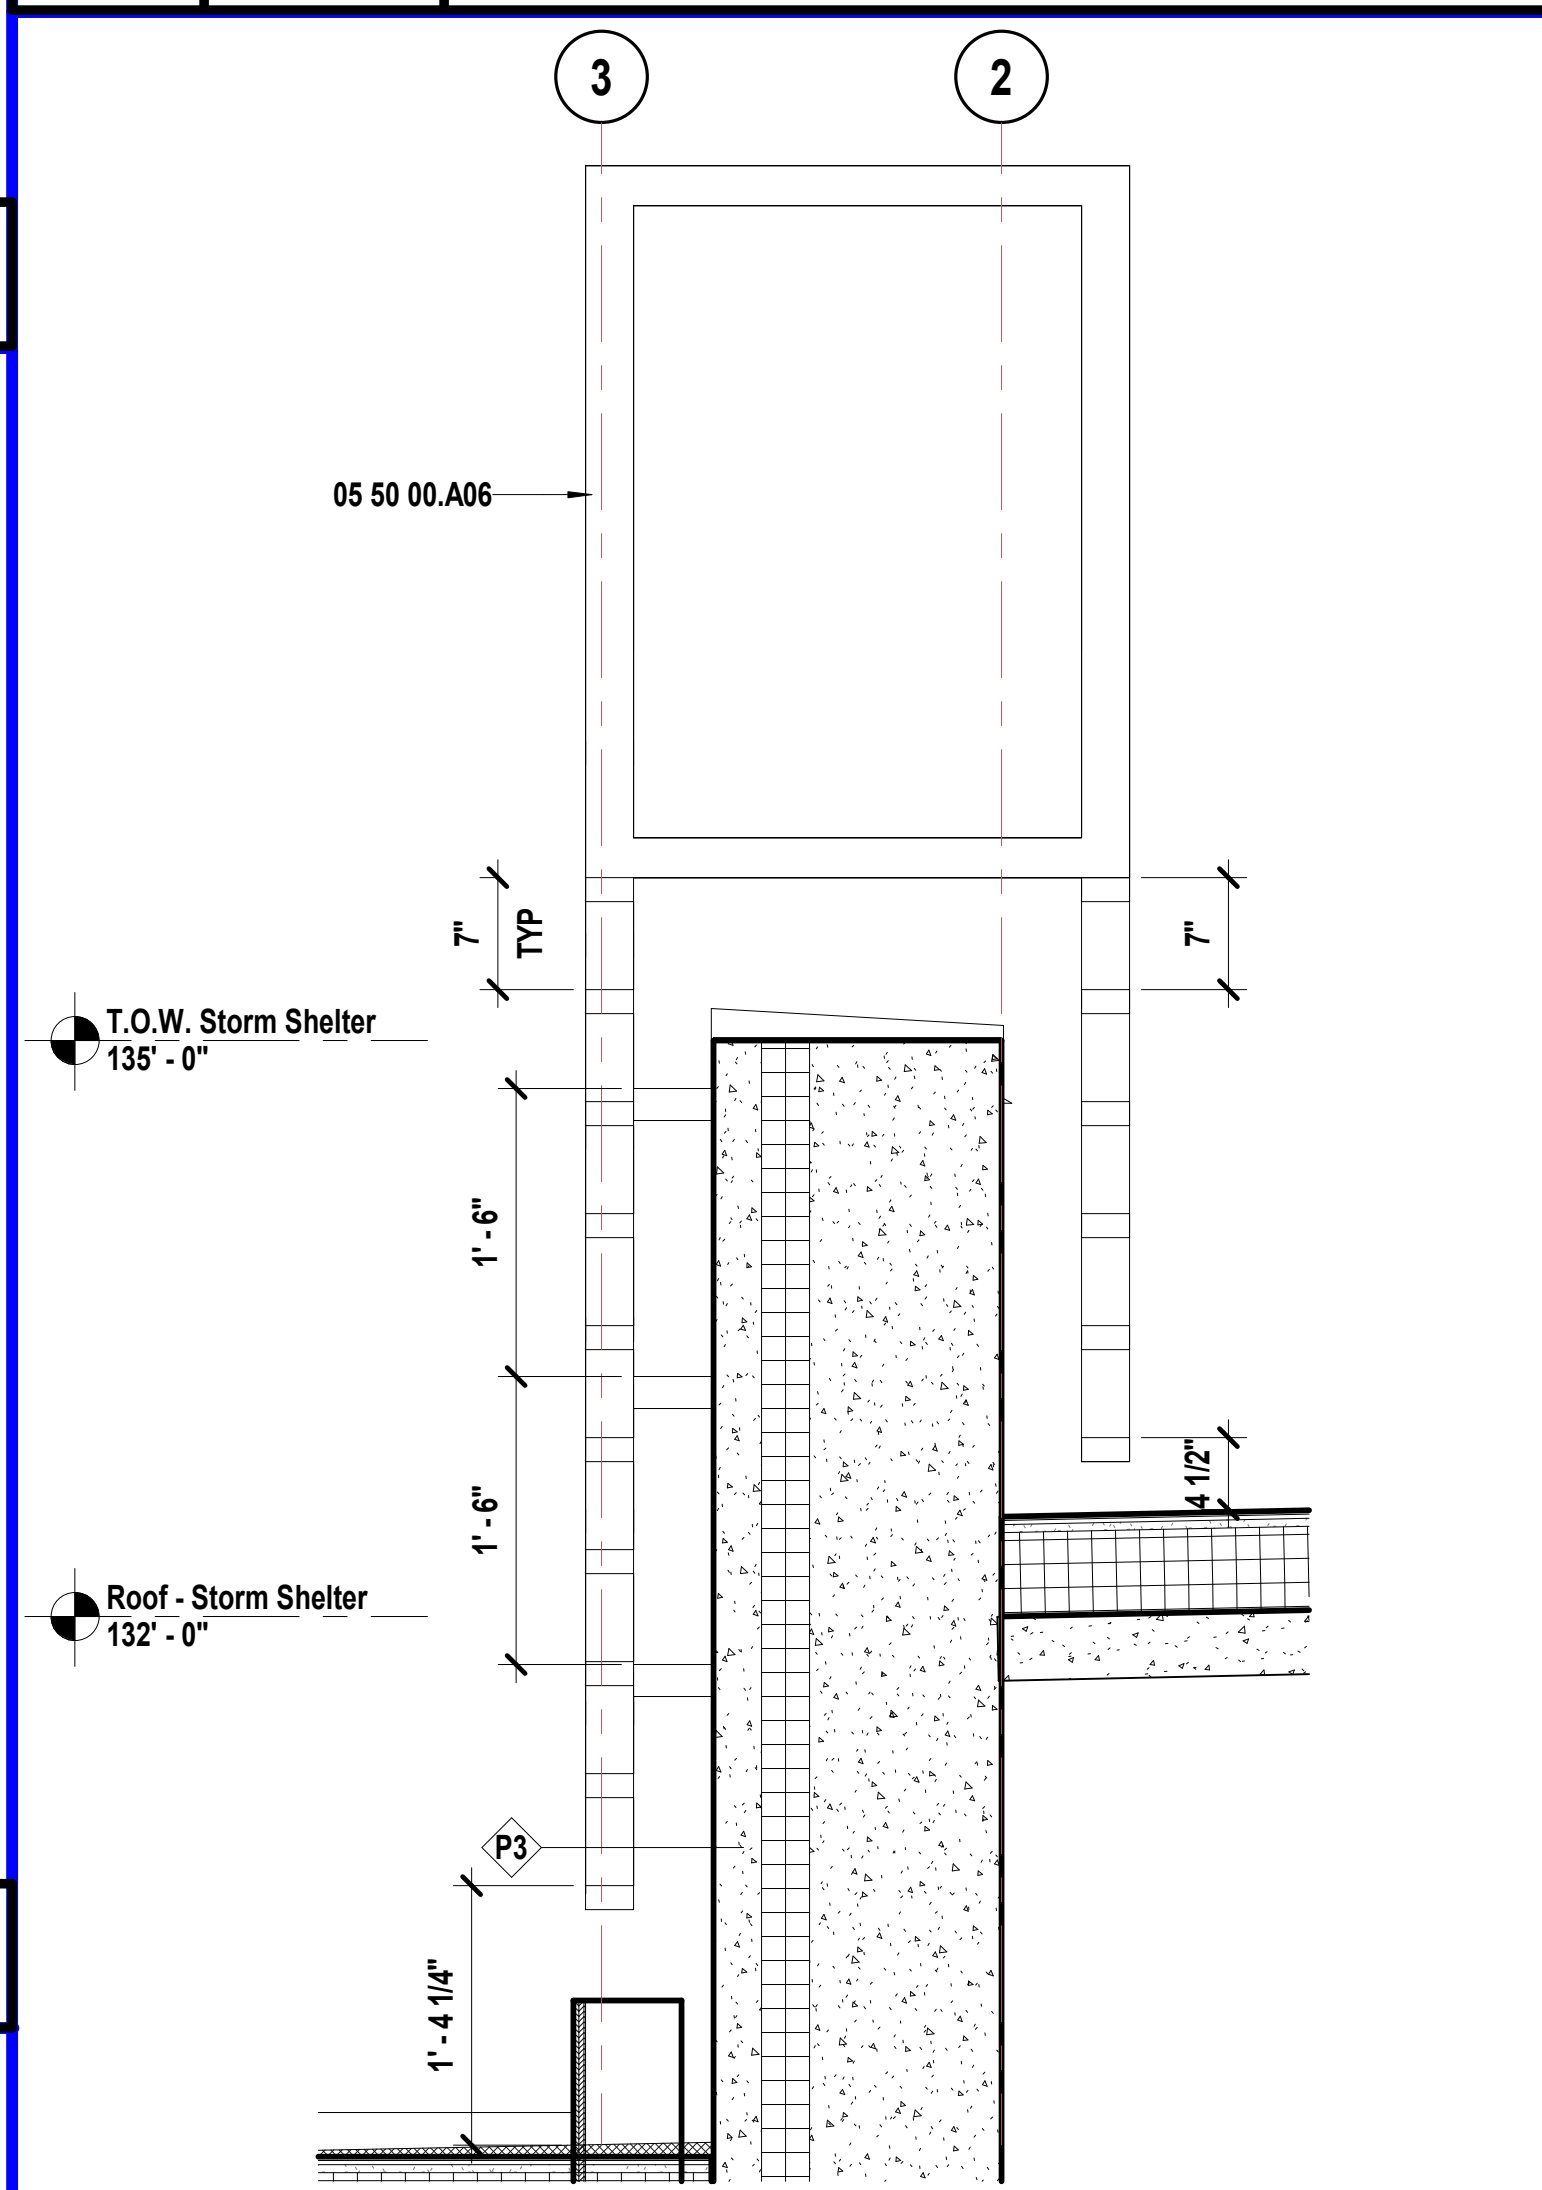


E7 Scale 1" = 1'-0" Roof Detail - Ladder to Precast Roof

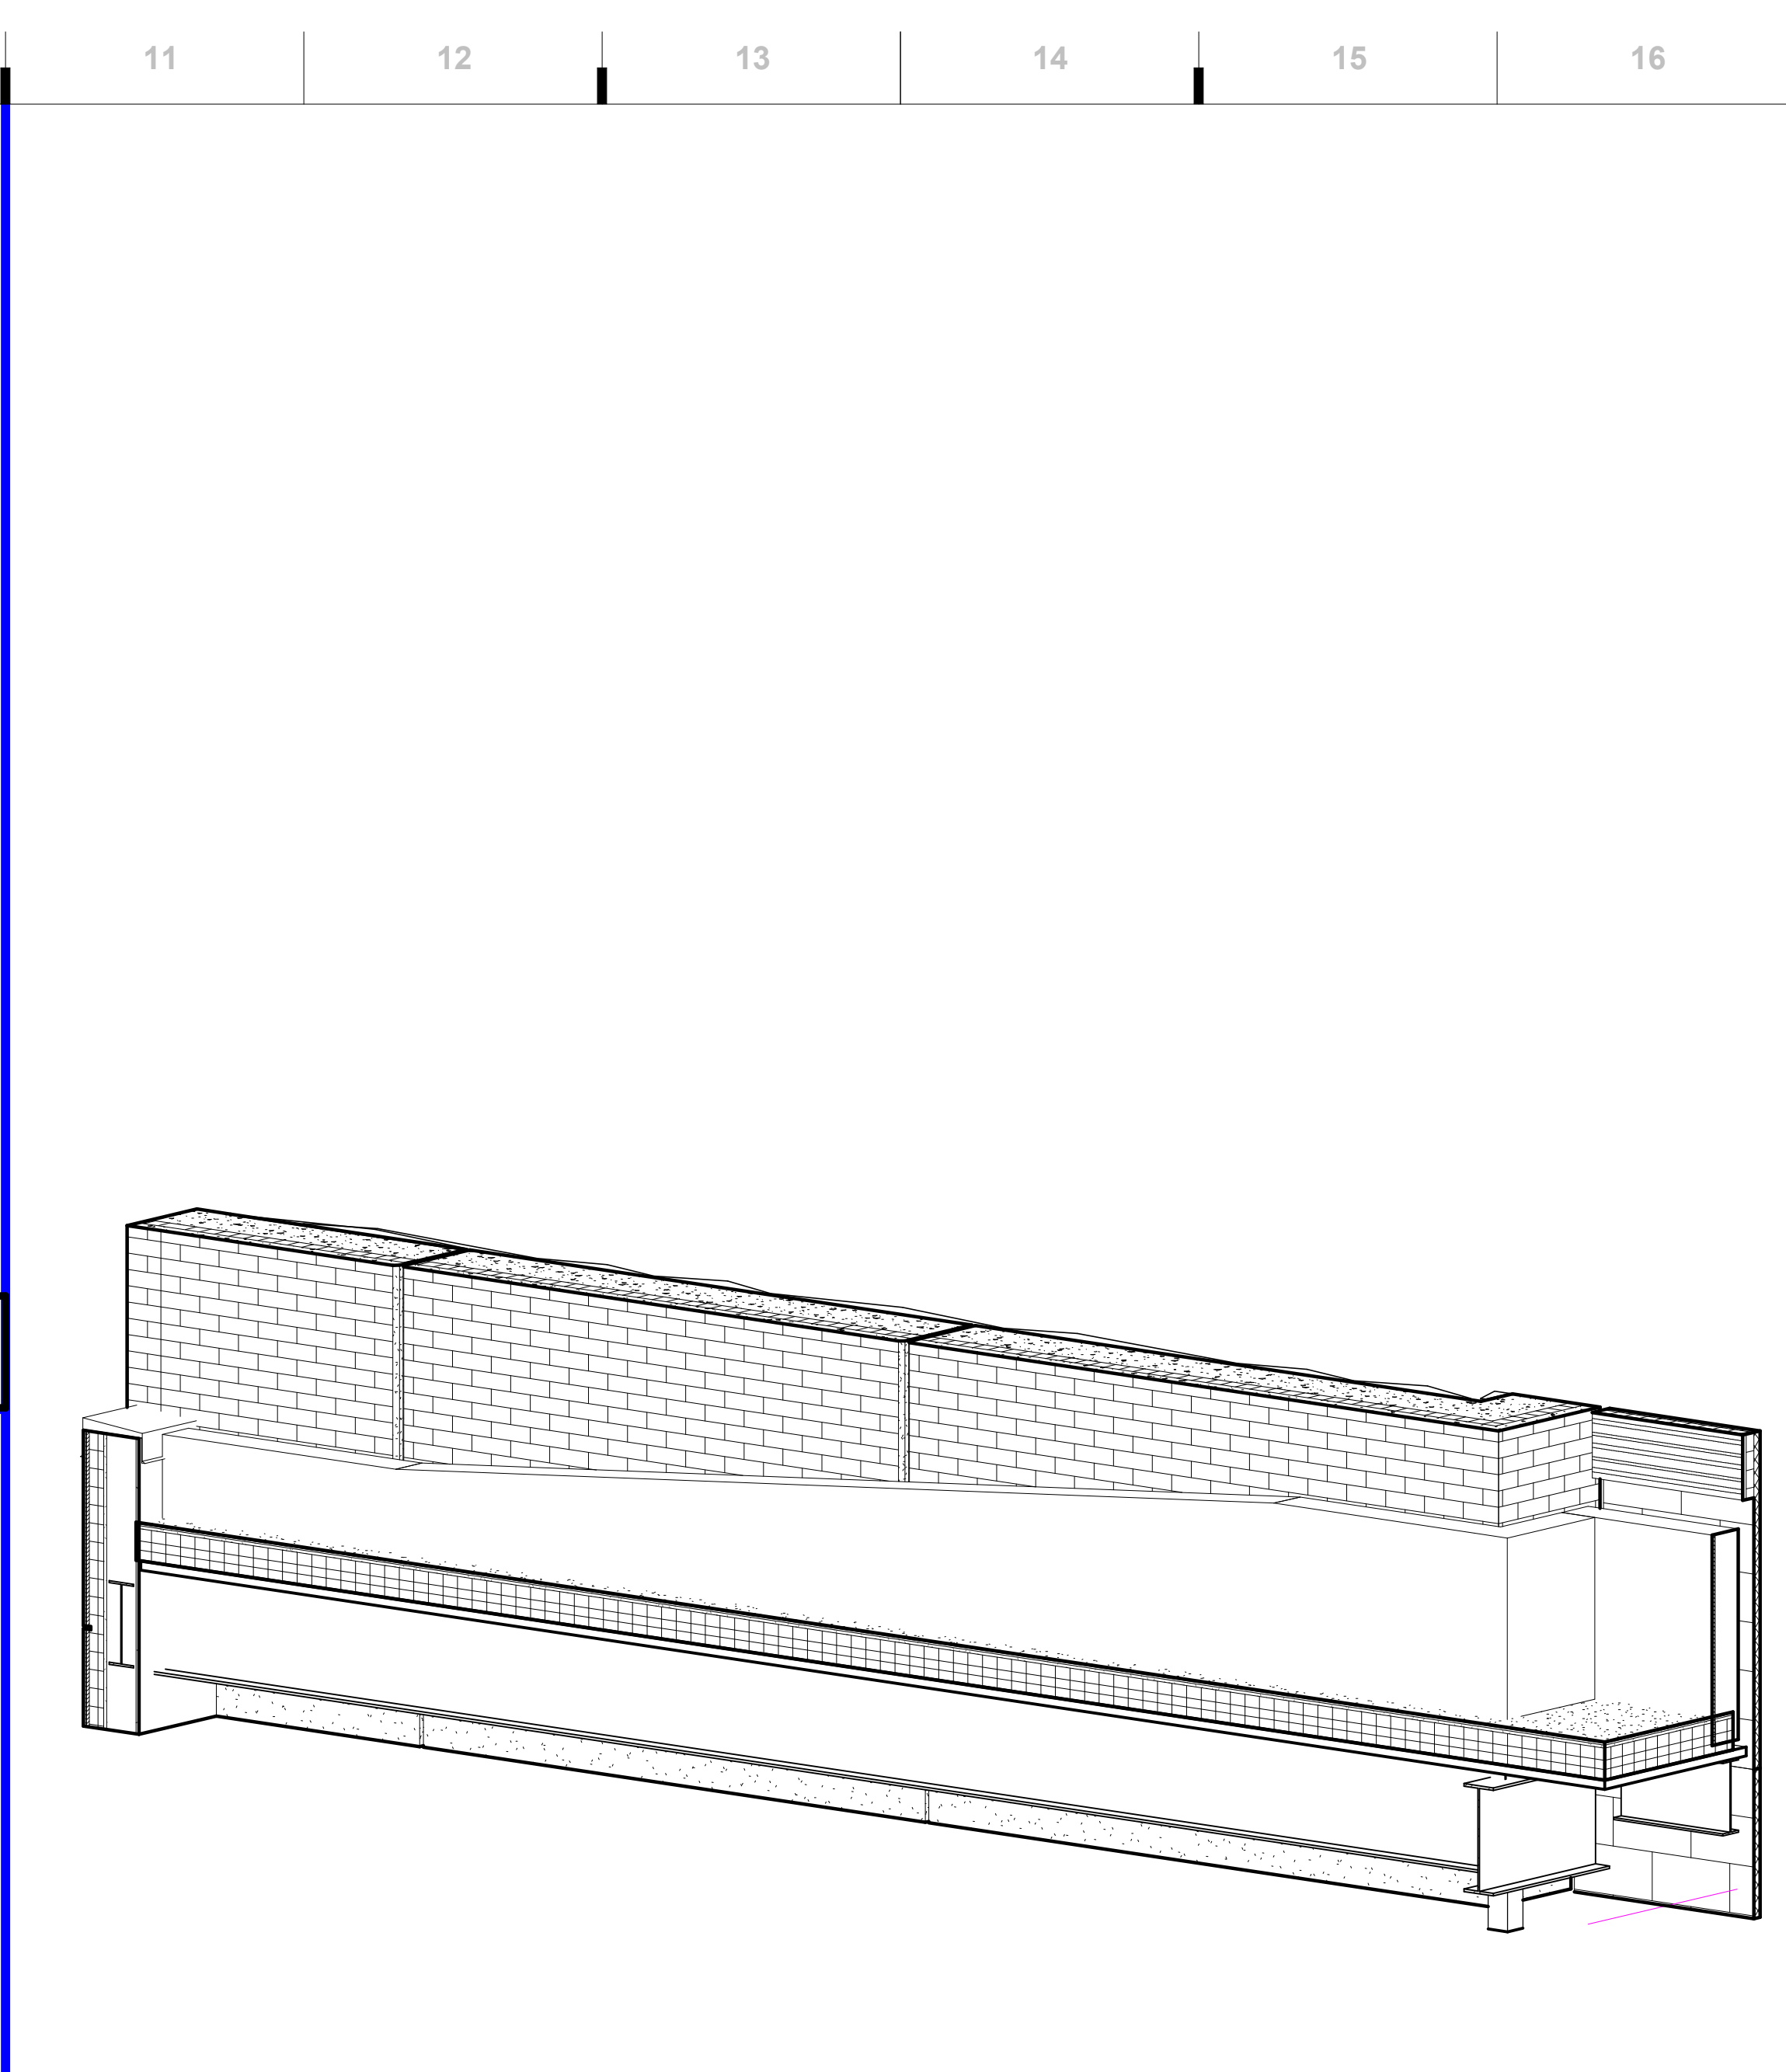

J11 Scale Roof Detail - NW Corner EJ

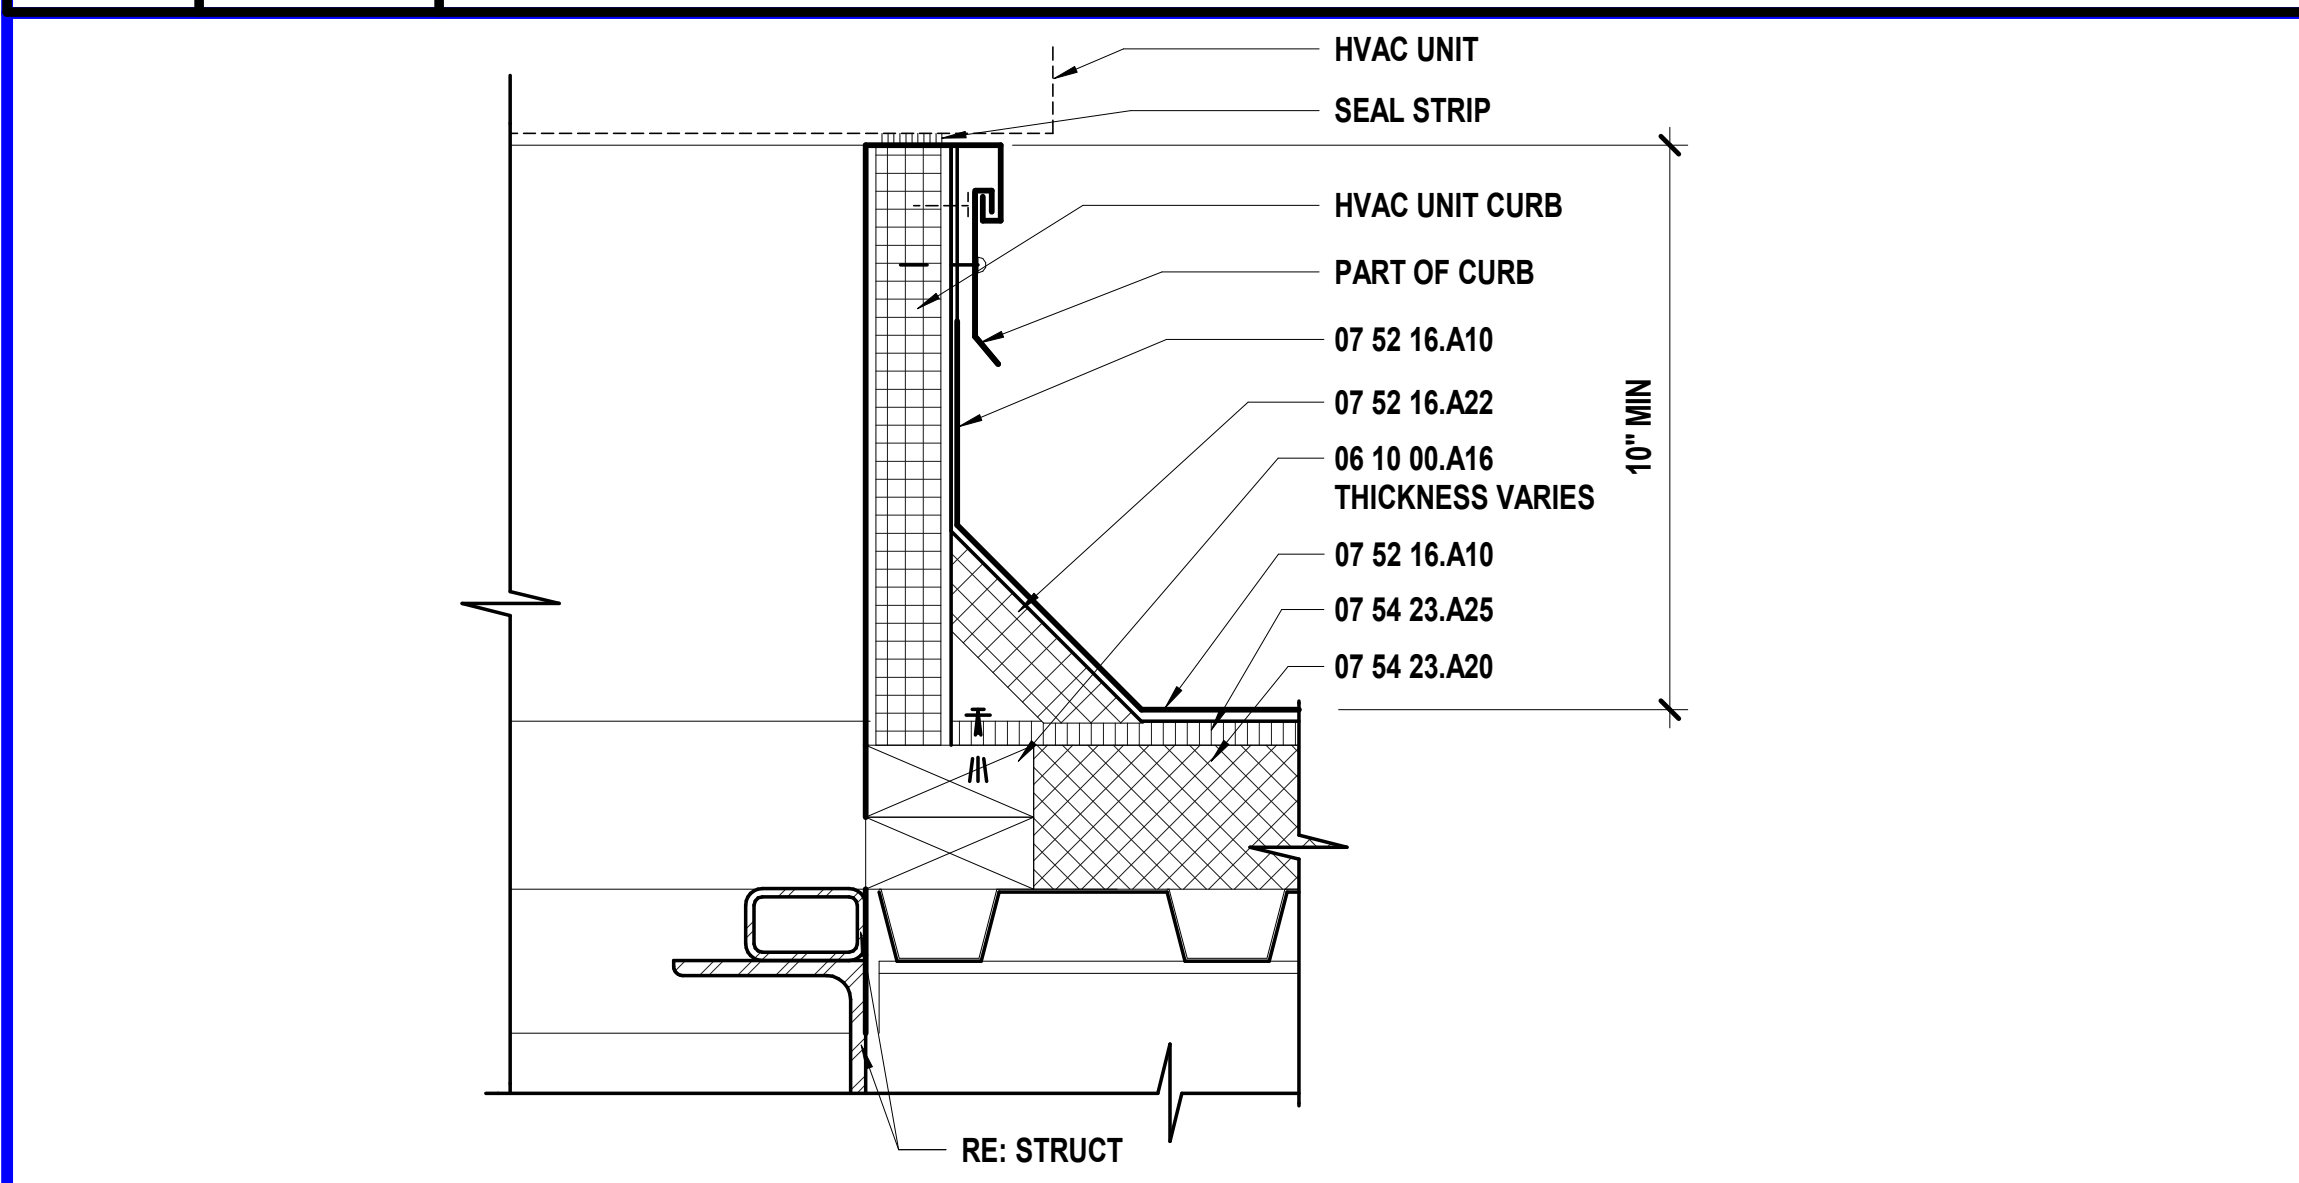

E11 Scale 3" = 1'-0" Roof Detail - Premanufactured Curb @ Mod-Bit Roof

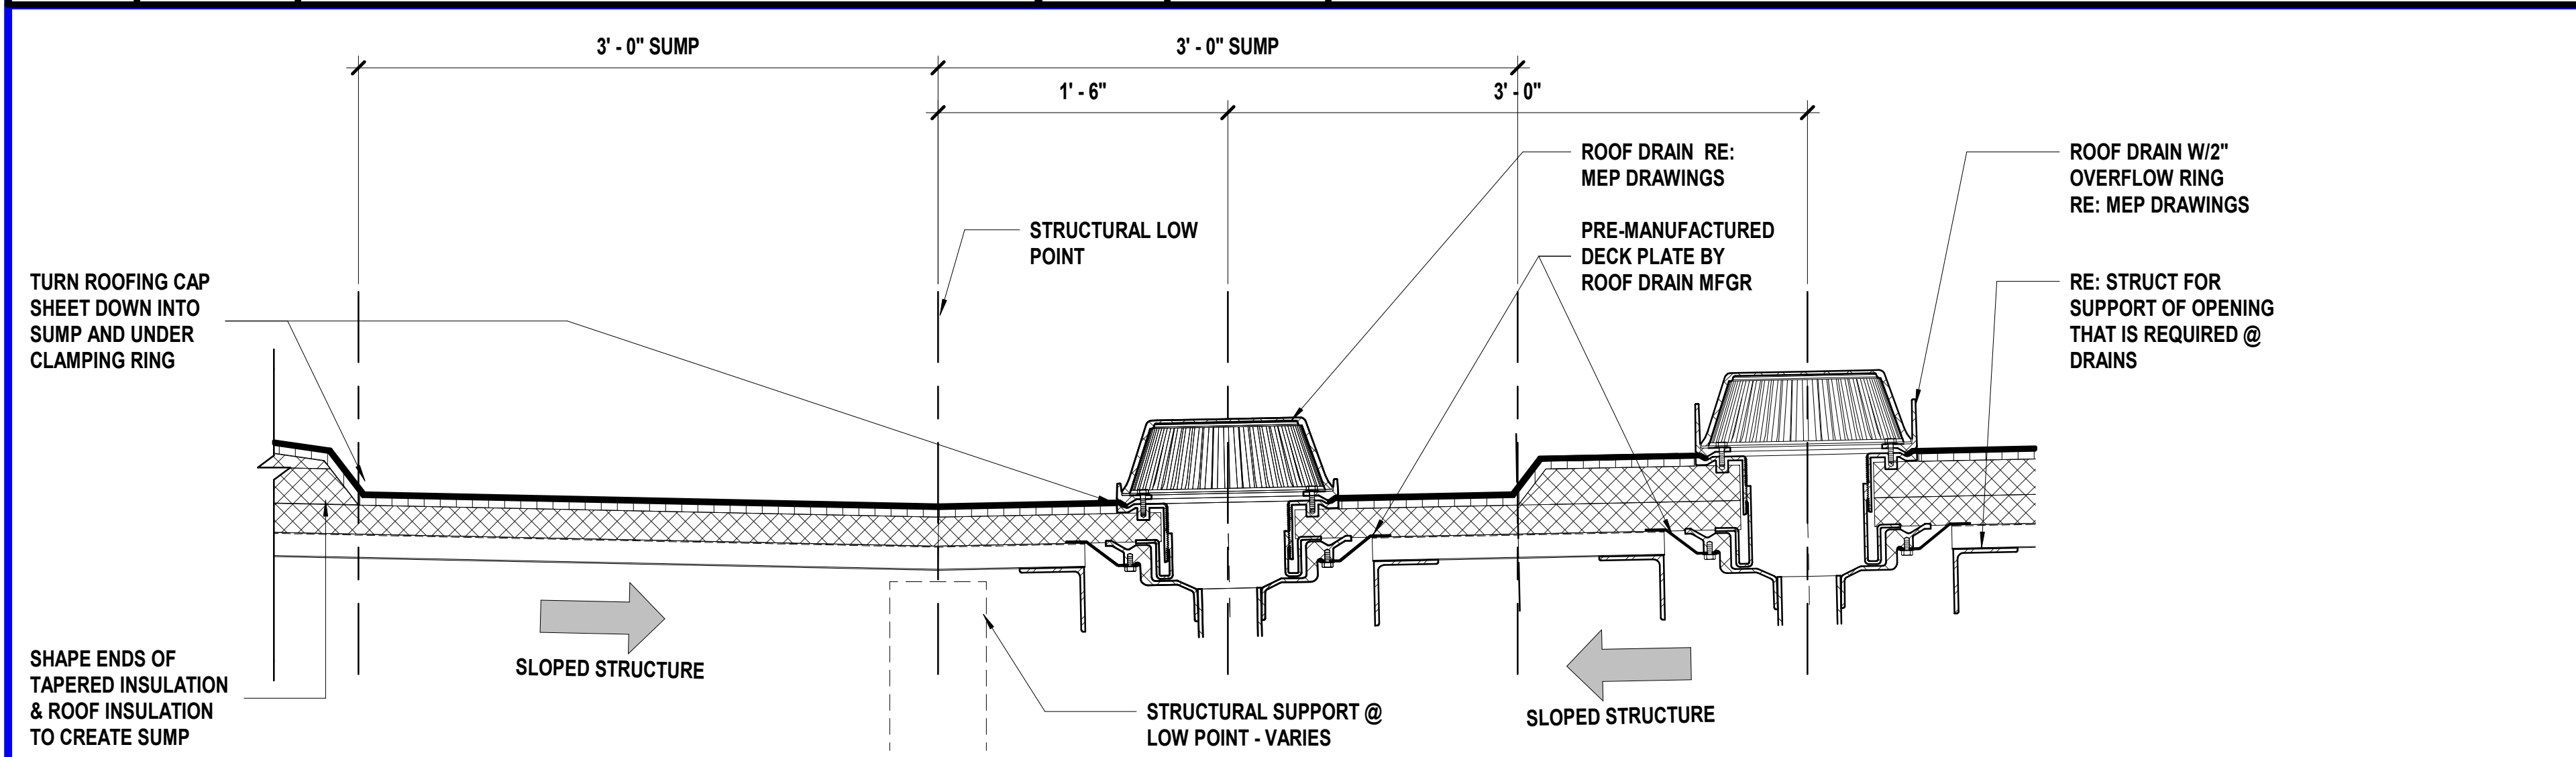

A7 Scale 1 1/2" = 1'-0" Roof Detail - Roof Drain & Overflow

SHEET KEYNOTE LEGEND

04 20 00.A24	MASONRY JOINT REINFORCEMENT
04 20 00.A45	CAVITY WALL INSULATION
05 12 00.A04	ANGLE
05 50 00.A06	METAL LADDER
05 50 00.A10	SHIP'S LADDER WITH PLATFORM RETURN
06 10 00.A16	FIRE-RETARDANT TREATED WOOD BLOCKING & NAILERS
06 10 00.A20	FIRE-RETARDANT TREATED PLYWOOD BLOCKING AND BACKING PANELS
07 21 00.A17	MINERAL WOOL
07 48 00.A01	RAINSCREEN FURRING SYSTEM
07 52 16.A01	MODIFIED BITUMINOUS ROOFING SYSTEM
07 52 16.A10	BASE FLASHING
07 52 16.A12	VERTICAL WALL FLASHING (EPDM)
07 52 16.A22	INSULATION CANT STRIPS
07 54 23.A20	ROOF INSULATION
07 54 23.A25	COVERBOARD
07 62 00.A04	FLEXIBLE MEMBRANE CLOSURE
07 62 00.A14	ROOF TO ROOF EXPANSION JOINT COVER
07 62 00.A18	COUNTER FLASHING
07 62 00.A19	COUNTER FLASHING RECEIVER

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Hollis + Miller Architects
Missouri State Certificate of Authority
Architecture #000061

Bob D Campbell
Structural Engineer
State Certificate of Authority #000442
4338 Bellevue Ave
Kansas City, MO 64111
816.531.4144 phone

Smith & Boucher, Inc.
Mechanical, Electrical, & Plumbing
State Certificate of Authority #EGC000178
25615 W 103rd Street
Olathe, KS 66061
913.345.2127 phone

MKEC Engineering, Inc.
Civil Engineer
State Certificate of Authority
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Landscaping #2006027139
Surveying #2006027138
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913.317.9390 phone

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660.429.1383 phone

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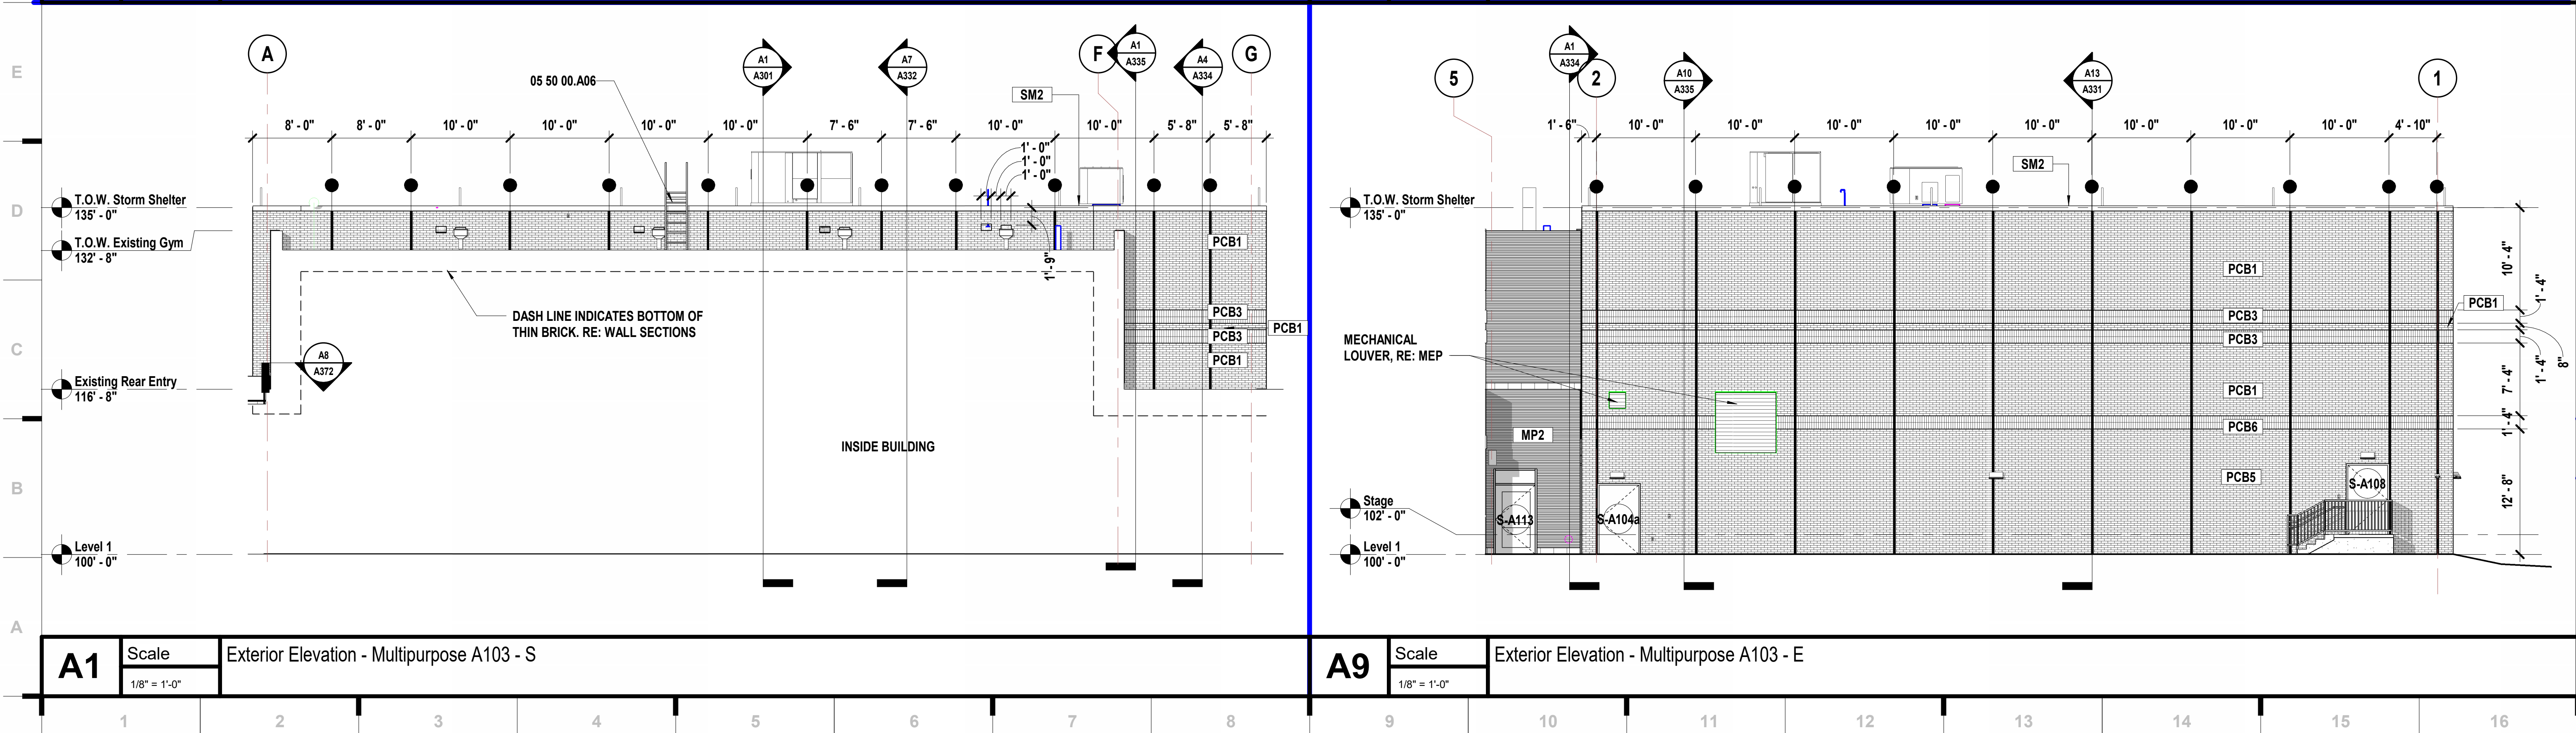
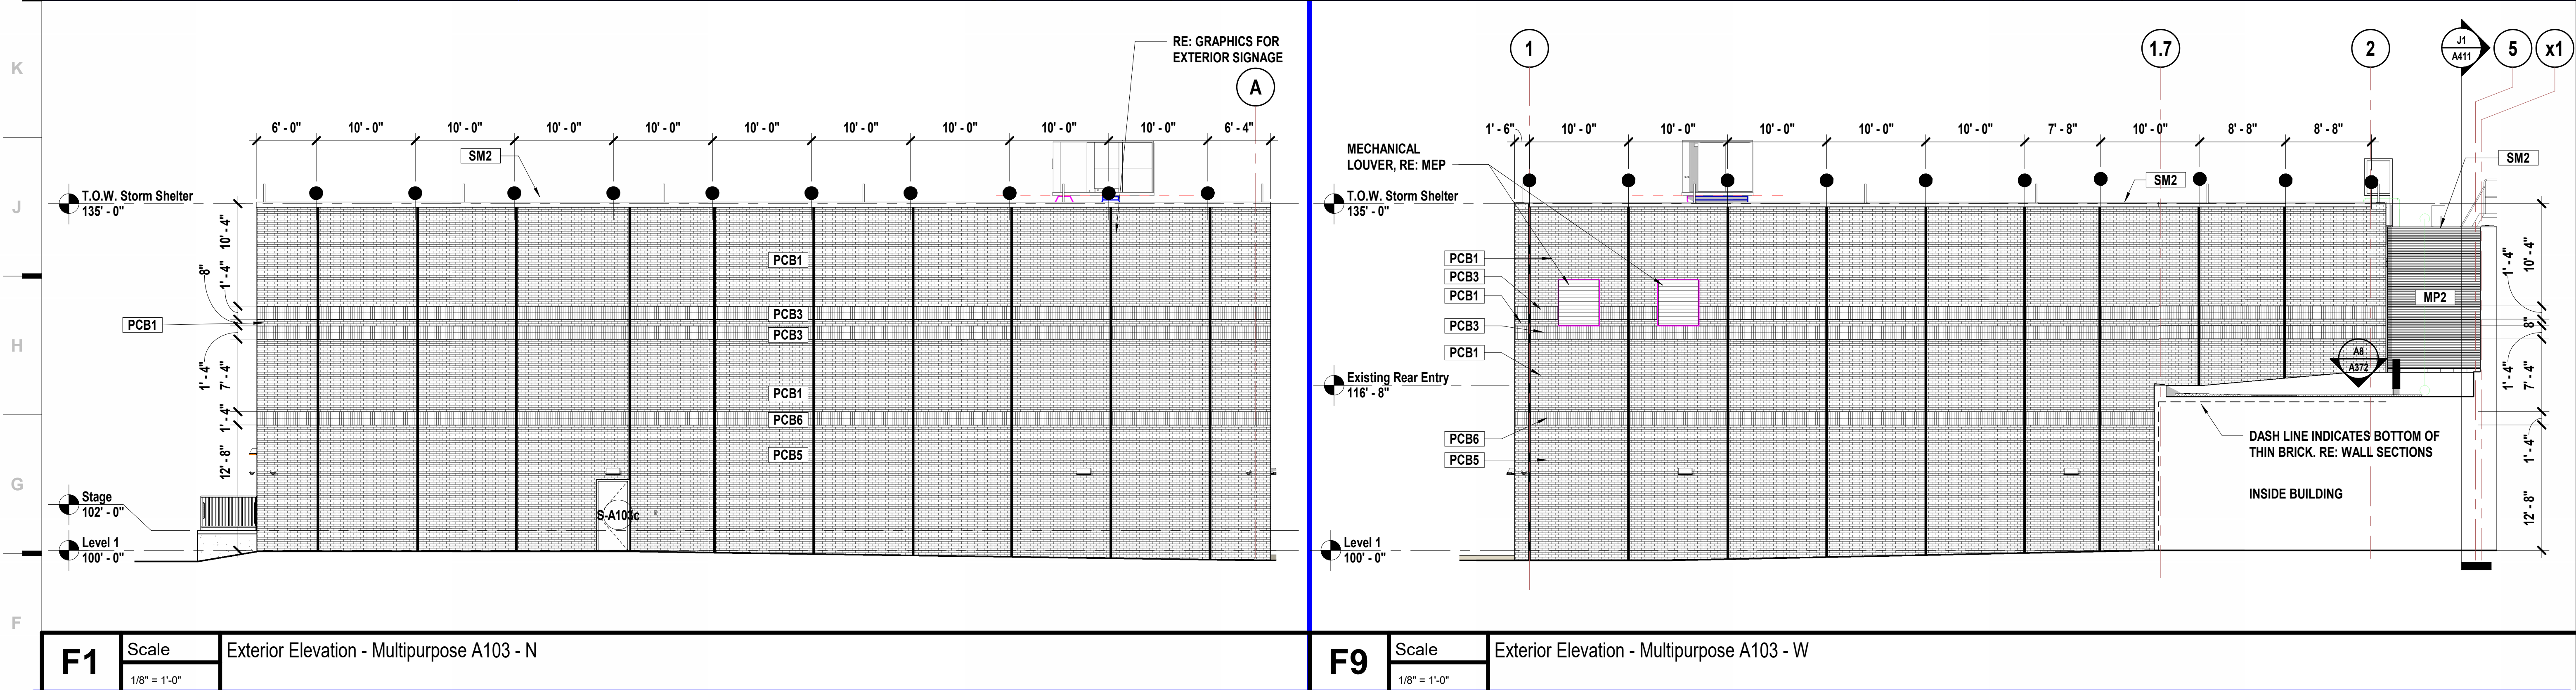
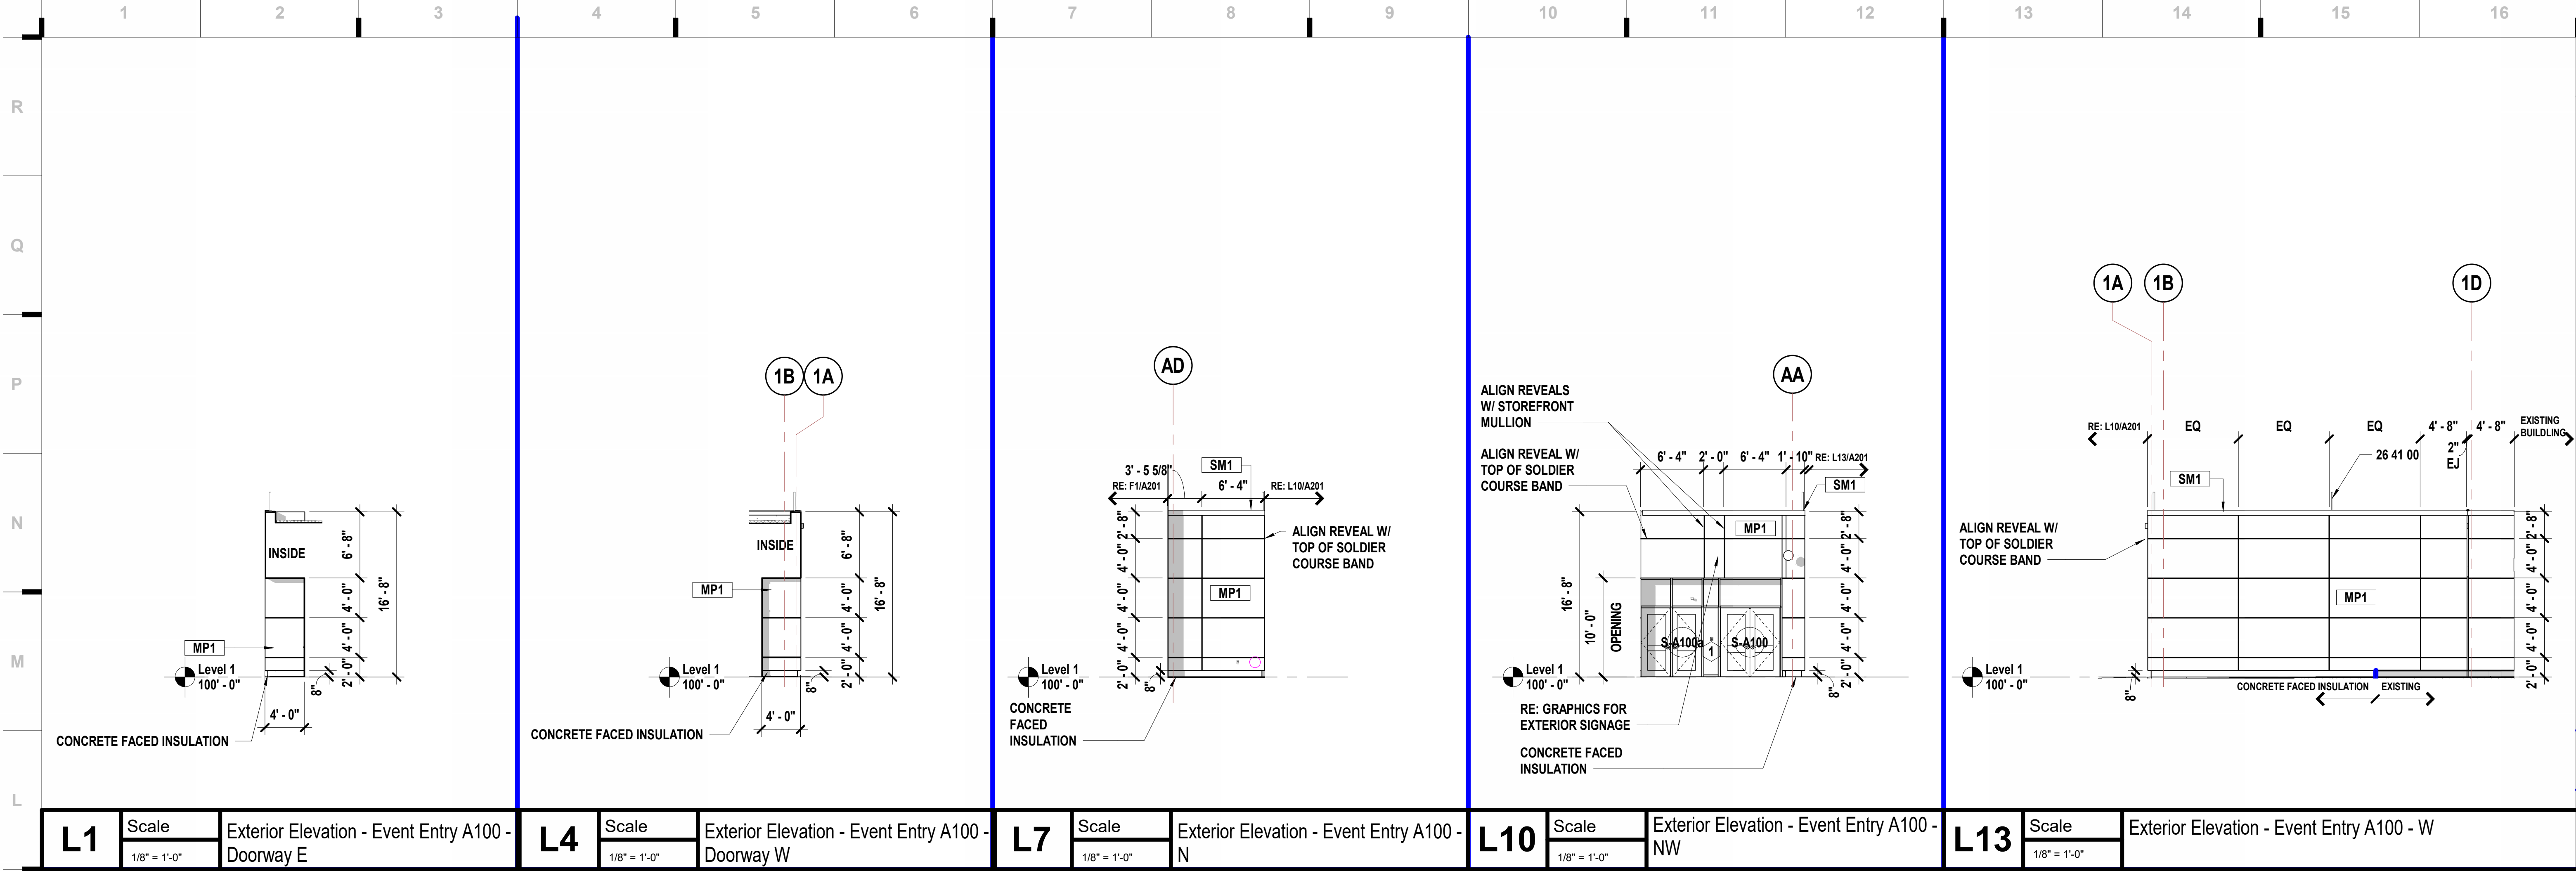
KEVIN E. NELSON
A-2019015618
ARCHITECT
OCTOBER 11, 2023
Kevin E. Nelson
A-2019015618

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CHECKED BY: JB
DATE: 08.31.2023

A142

ROOF DETAILS



SHEET KEYNOTE LEGEND

03 41 00.A03	BRICK-FACED PRECAST STRUCTURAL CONCRETE
05 50 00.A06	METAL LADDER
07 42 13.A03	CONCEALED FASTENER METAL WALL PANELS
07 42 43.A01	METAL-FACED COMPOSITE MATERIAL WALL PANELS
07 62 00.A13	COPING
26 41 00	

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Hollis + Miller Architects
Missouri State Certificate of Authority
Architect # 000001

Bob D Campbell
Structural Engineer
State Certificate of Authority #000442
4338 Bellevue Ave
Kansas City, MO 64111
816.531.4144 phone

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11827 W 112th Street, Suite 200
Overland Park, KS 66210
913.317.9390 phone

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Theatrical Consultant
109 E Pine St.
Warrensburg, MO 64093-0752
660.429.1383 phone

Avant Acoustics
AV/Acoustics Consultant
14827 West 95th St.
Lenexa, KS 66215
913.888.9111 phone

EXTERIOR MATERIAL LEGEND

PCB1 = PRECAST W/ THIN BRICK - BLEND 1
03 41 00.A03 BRICK-FACED PRECAST STRUCTURAL CONCRETE
BOD: METROBRICK
COLOR: 45% 350 MAINSTREET - FLASHED
25% 310 MAINSTREET - RED
30% 458 BROWNSTONE - FLASHED
SIZE/ PATTERN: MODULAR SIZE, RUNNING BOND

PCB5 = PRECAST W/ THIN BRICK
03 41 00.A03 BRICK-FACED PRECAST STRUCTURAL CONCRETE
BOD: ENDICOTT
COLOR: EXECUTIVE IRON SPOT VELOUR
SIZE/ PATTERN: MODULAR SIZE, RUNNING BOND

PCB3 = PRECAST W/ THIN BRICK - BLEND 1
03 41 00.A03 BRICK-FACED PRECAST STRUCTURAL CONCRETE
BOD: METROBRICK
COLOR: 45% 350 MAINSTREET - FLASHED
25% 310 MAINSTREET - RED
30% 458 BROWNSTONE - FLASHED
SIZE/ PATTERN: MODULAR SIZE, SOLDIER COURSE

PCB6 = PRECAST W/ THIN BRICK
03 41 00.A03 BRICK-FACED PRECAST STRUCTURAL CONCRETE
BOD: SUMMERVILLE
COLOR: 96 - WILLIAMSTOWN
SIZE/ PATTERN: MODULAR SIZE, SOLDIER COURSE

MP1 = METAL PANEL TYPE 1
07 42 43.A01 METAL-FACED COMPOSITE MATERIAL WALL PANELS
BOD: CITADEL - ENVELOPE 2000 REVEAL (RV)
COLOR: SERIES G: PREMIUM KYNAR 500 - REGAL
BLUE
SIZE/ PATTERN: FLAT ACM W/EXTRUSIONS

MP2 = METAL PANEL TYPE 2
07 42 13.A03 CONCEALED FASTENER METAL WALL PANELS
BOD: CENTRIA CS-660
COLOR: SAGE BROWN
SIZE/ PATTERN: HORIZONTAL

SM1 = SHEET METAL TYPE 1
07 62 00.A13 COPING
BOD: N/A
COLOR: MATCH MP1 = METAL PANEL TYPE 1
SIZE/ PATTERN: PER DETAILS

SM2 = SHEET METAL TYPE 2
07 62 00.A13 COPING
BOD: N/A
COLOR: DARK BRONZE (MATCH EXISTING COPING)
SIZE/ PATTERN: PER DETAILS

SHEET NOTES

- REFER TO SHEET G000 FOR SHEET INDEX
- DO NOT SCALE THIS DRAWING
- WALL MOUNTED LIGHT FIXTURES, LAMBS TONGUES AND OTHER MEP ITEMS ARE SHOWN FOR PLACEMENT ONLY

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1	Addendum 01	09.14.2023

Kevin E. Nelson
A-2019015618
OCTOBER 11, 2023

STATE OF MISSOURI
KEVIN E. NELSON
A-2019015618
ARCHITECT

Job NO: 23019
Drawn BY: LB
Checked BY: JB
Date: 08.31.2023


A201

EXTERIOR ELEVATIONS - OVERALL

Please consider the environment before printing this.



J1 Scale Section - Multipurpose A103 - E/W
1/4" = 1'-0"

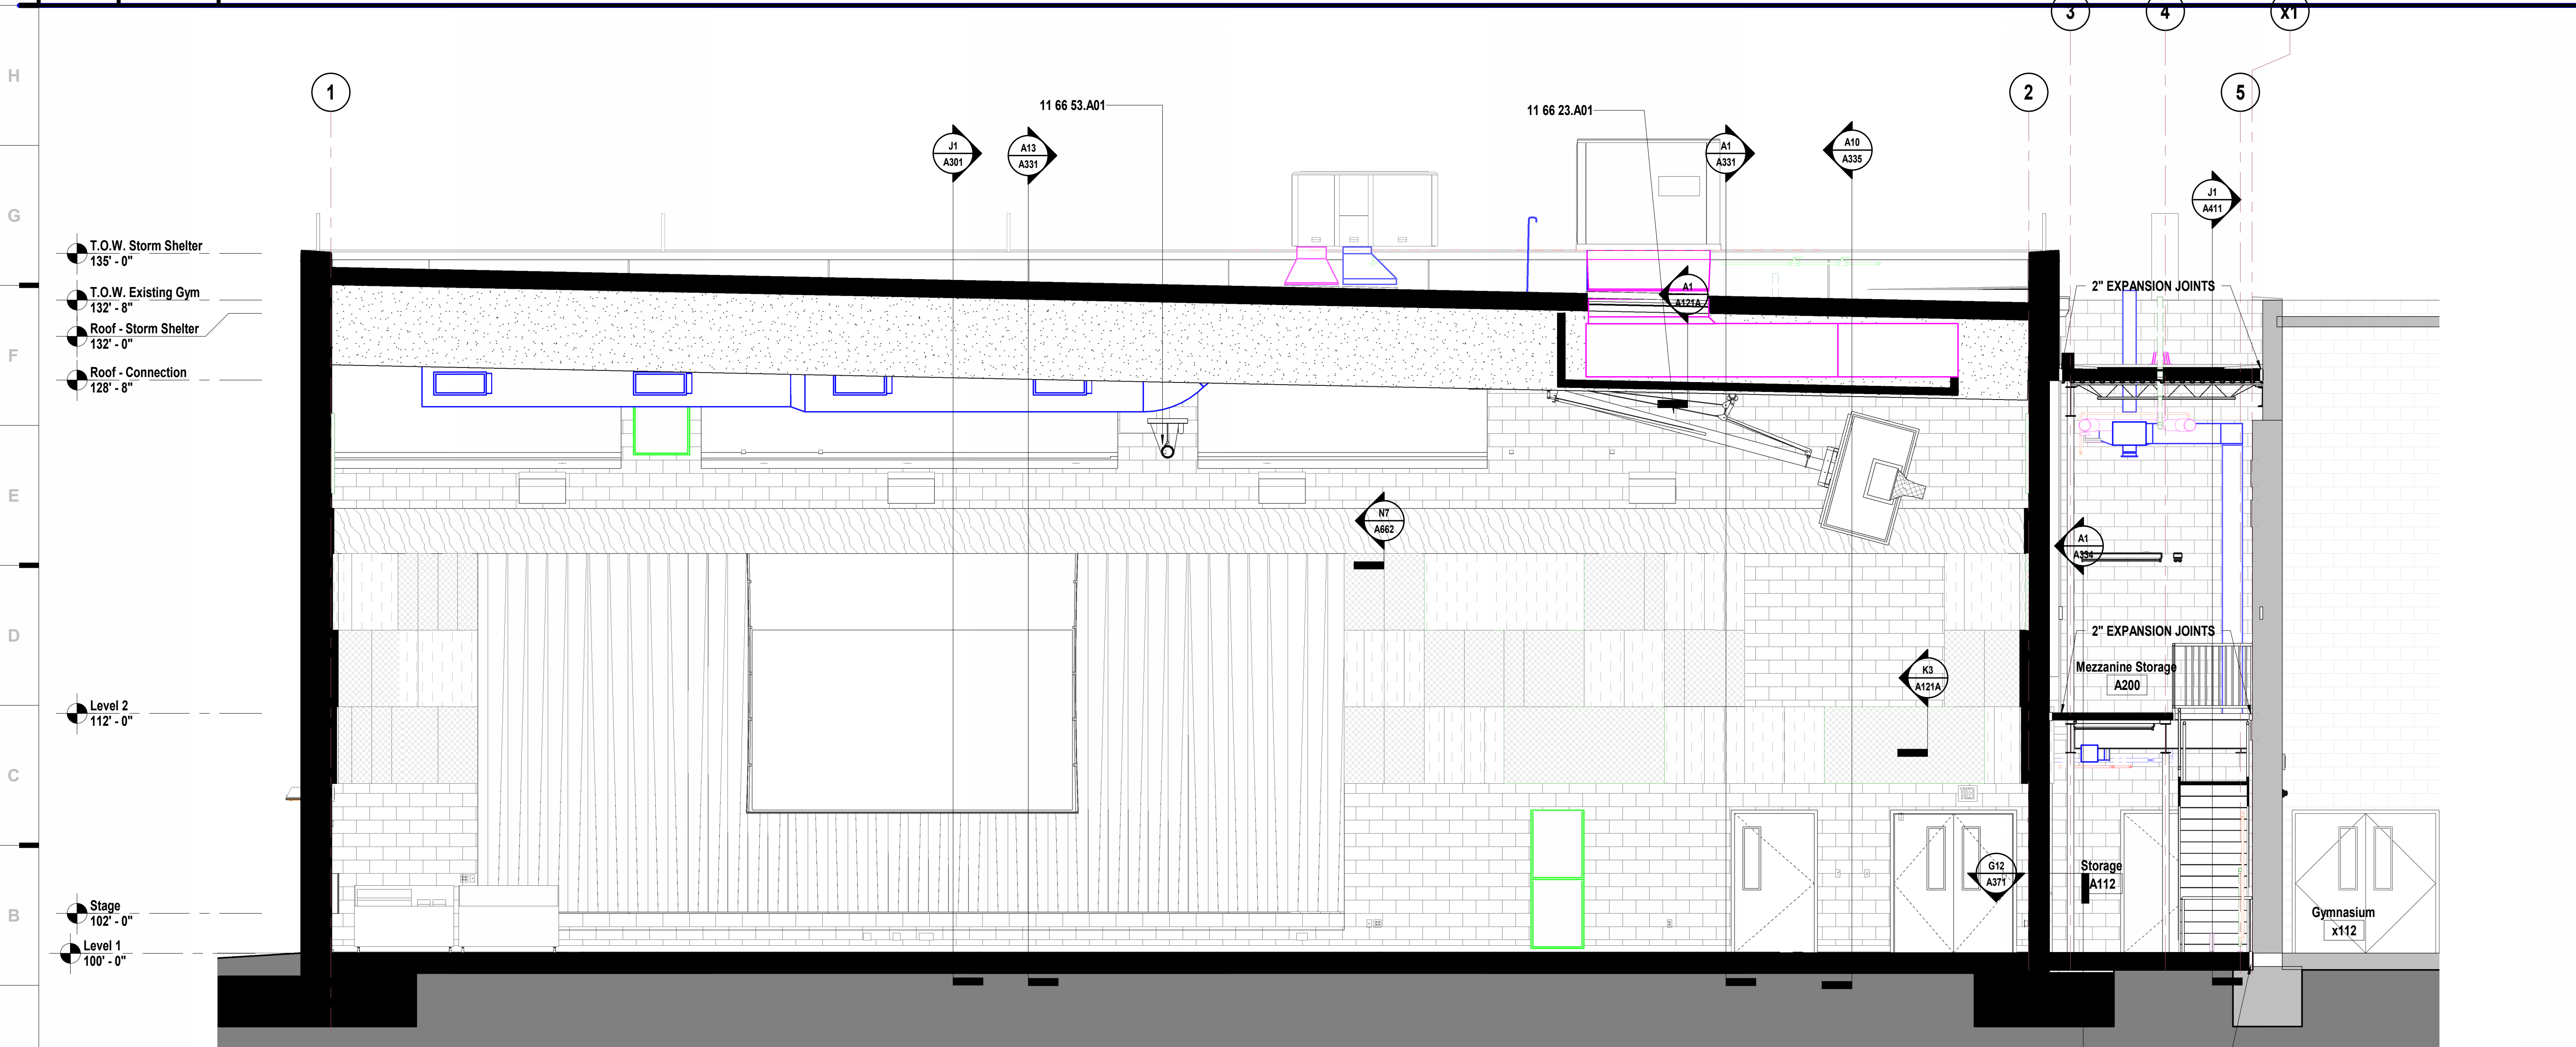

A1 Scale Section - Multipurpose A103 - N/S
1/4" = 1'-0"

SHEET KEYNOTE LEGEND

11 66 23.A01 OVERHEAD BACKBOARD SUPPORTS
11 66 53.A01 GYMNASIUM DIVIDER CURTAIN ASSEMBLY

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Structural Engineer
State Certificate of Authority #000442
4338 Bellevue Ave
Kansas City, MO 64111
816.531.4144 phone
Smith & Boucher, Inc.
Mechanical, Electrical, & Plumbing
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913.317.9390 phone

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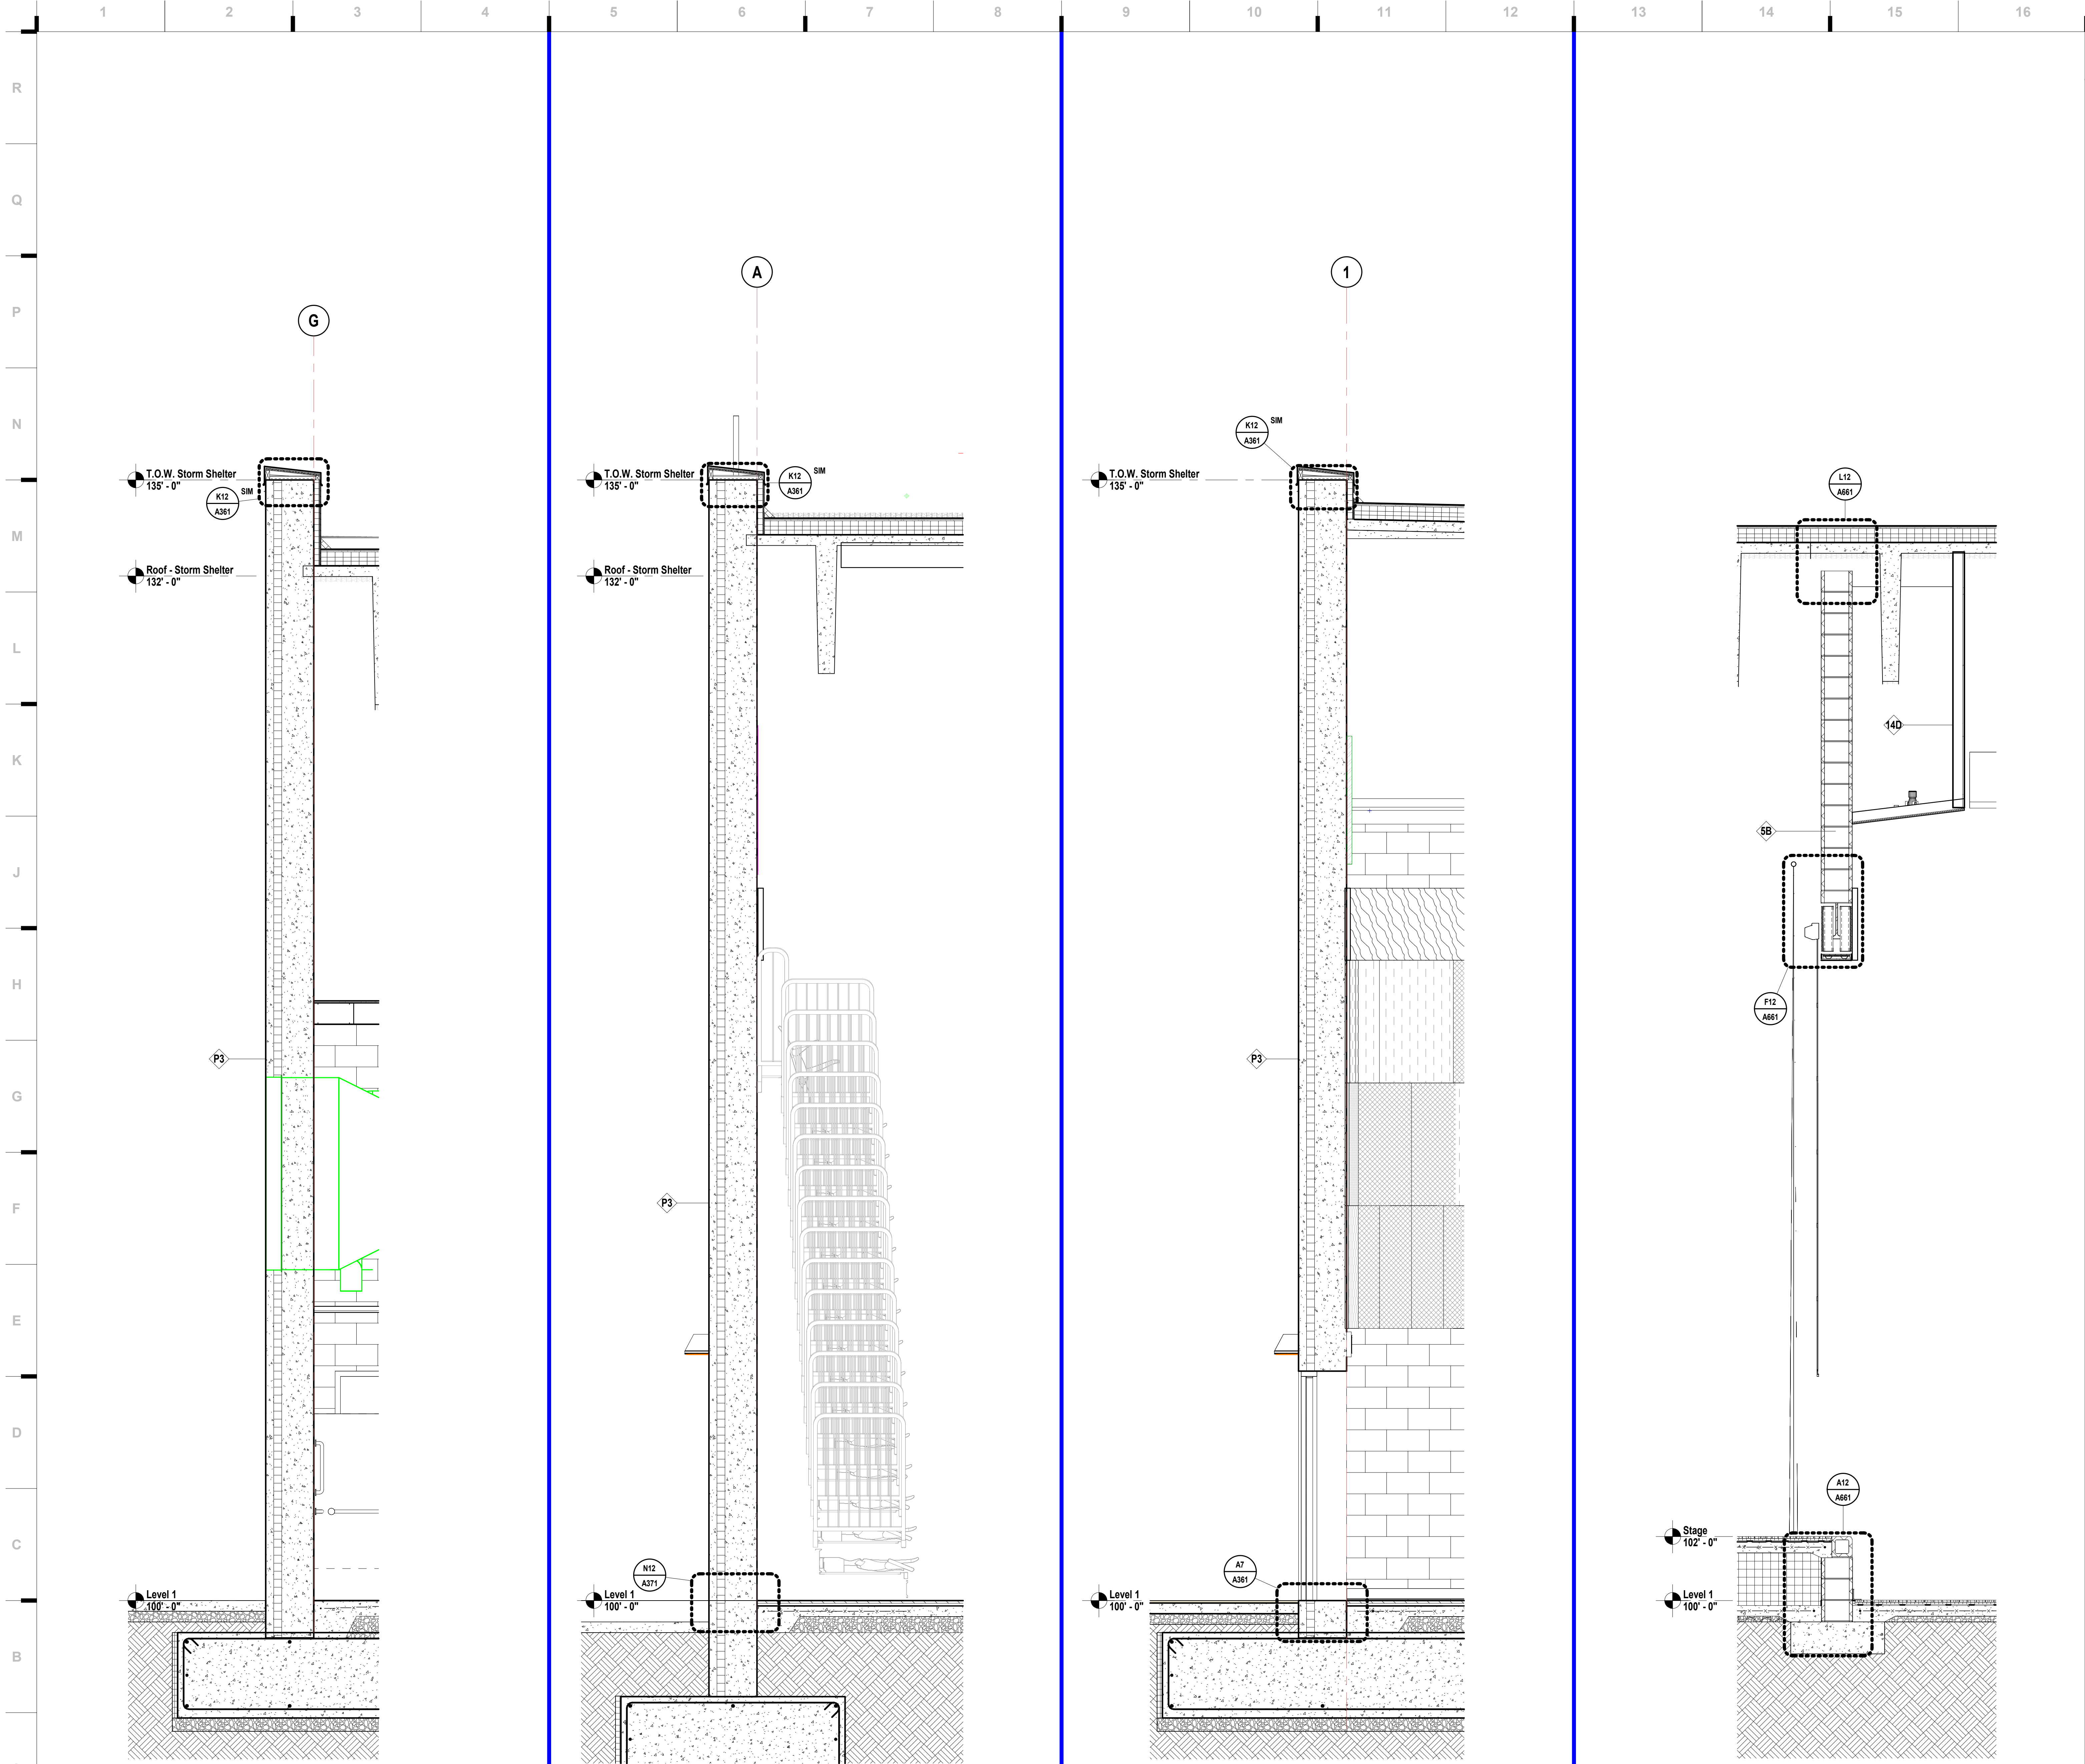
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A301

BUILDING SECTIONS

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A1	Scale	Wall Section - Area A - Multipurpose - E
	1/2" = 1'-0"	
A5	Scale	Wall Section - Area A - Multipurpose - W
	1/2" = 1'-0"	
A9	Scale	Wall Section - Area A - Multipurpose - N
	1/2" = 1'-0"	
A13	Scale	Wall Section - Area A - Multipurpose/Stage - E
	1/2" = 1'-0"	

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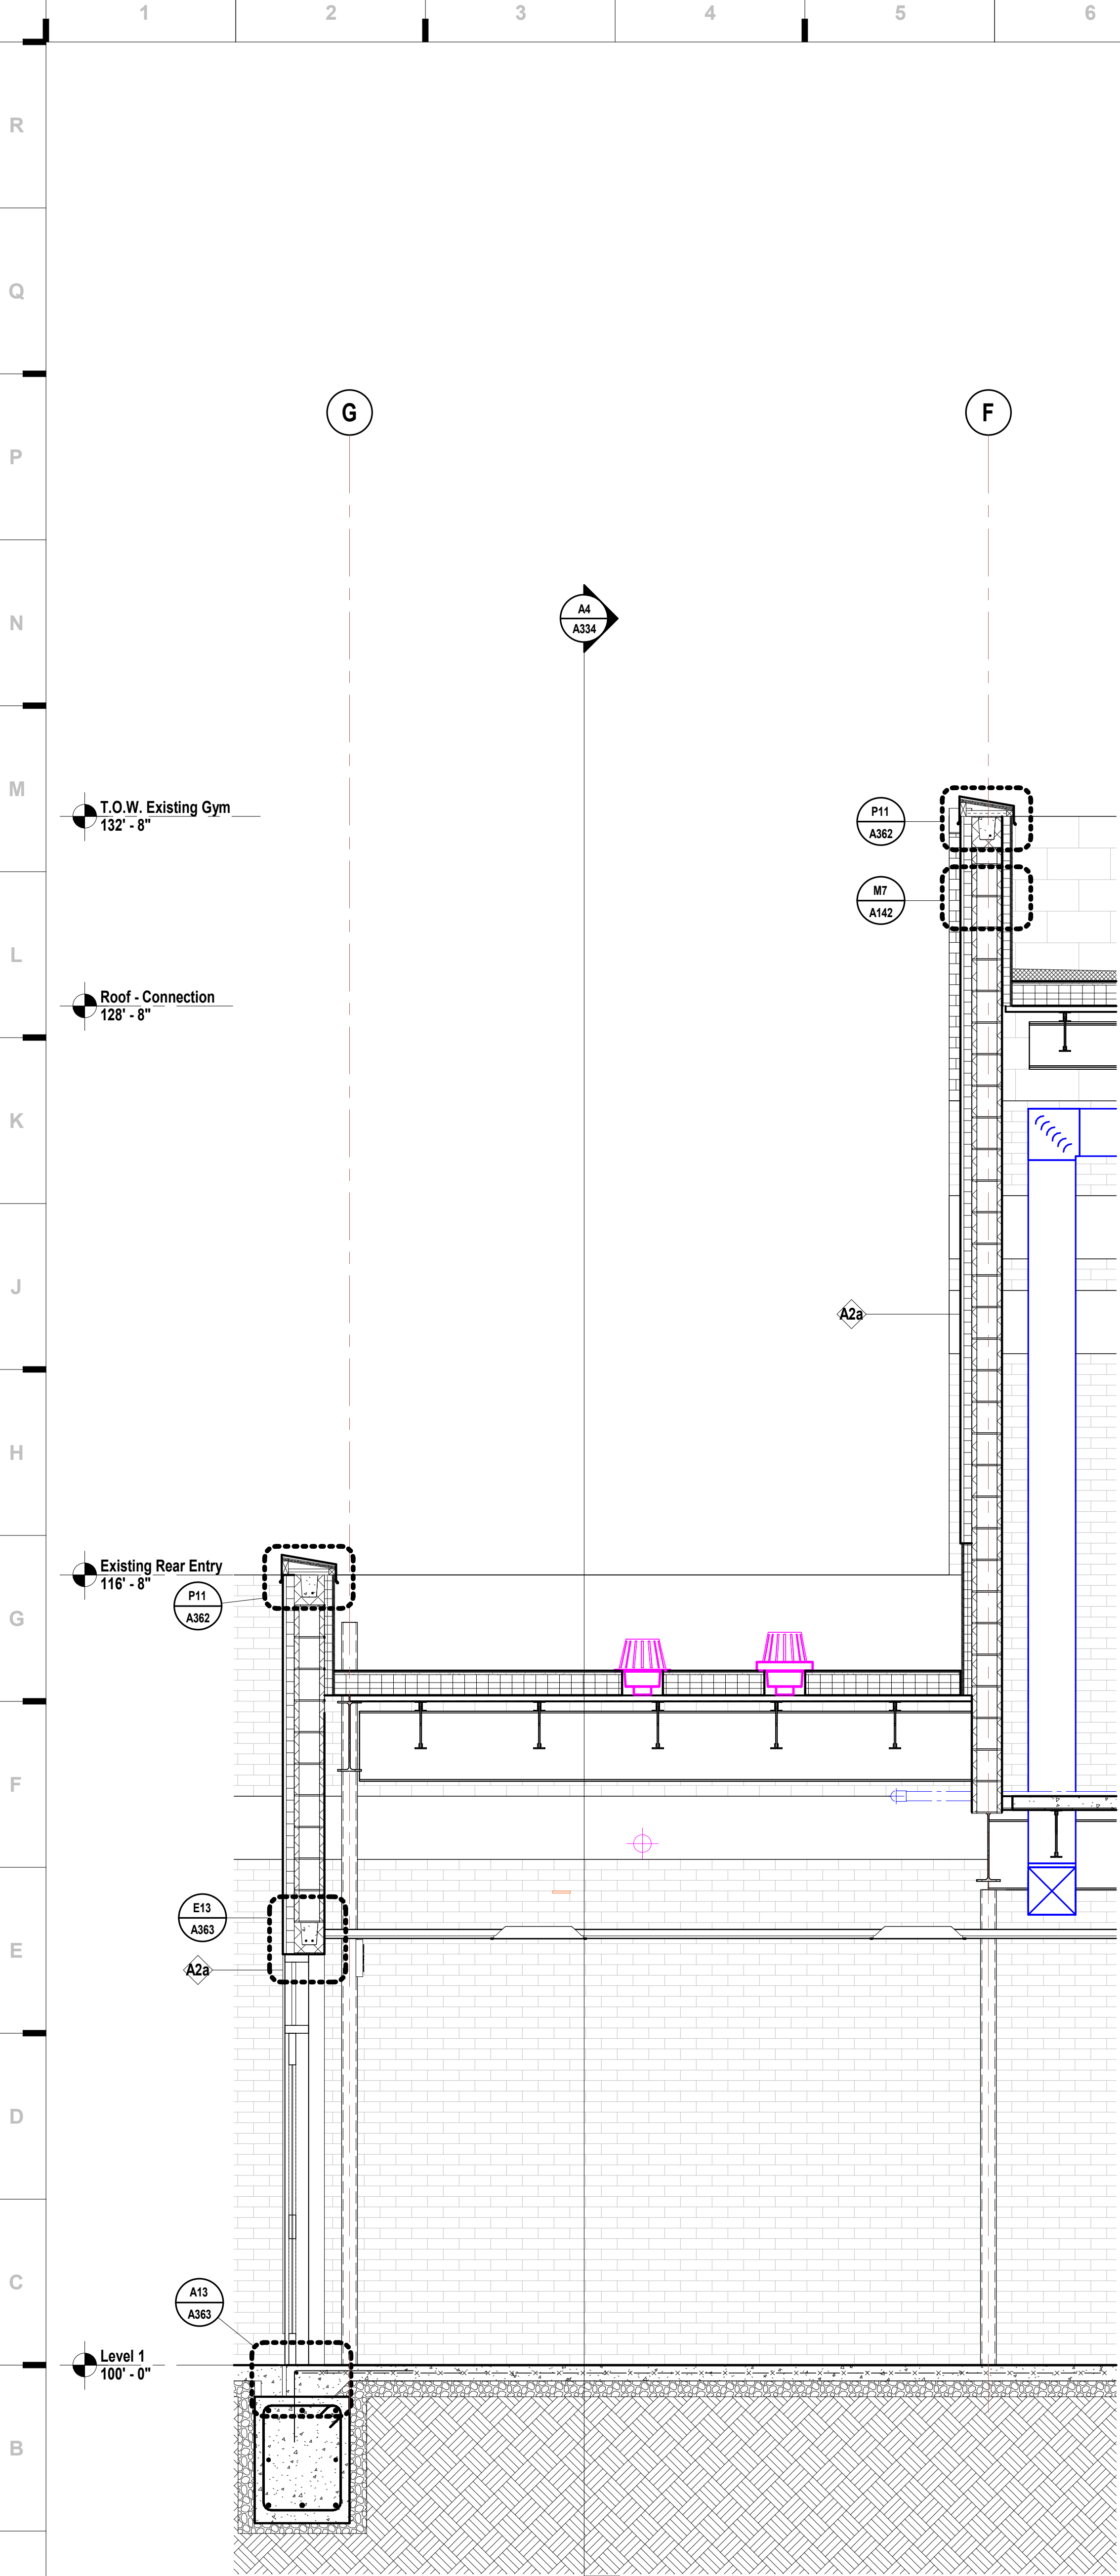
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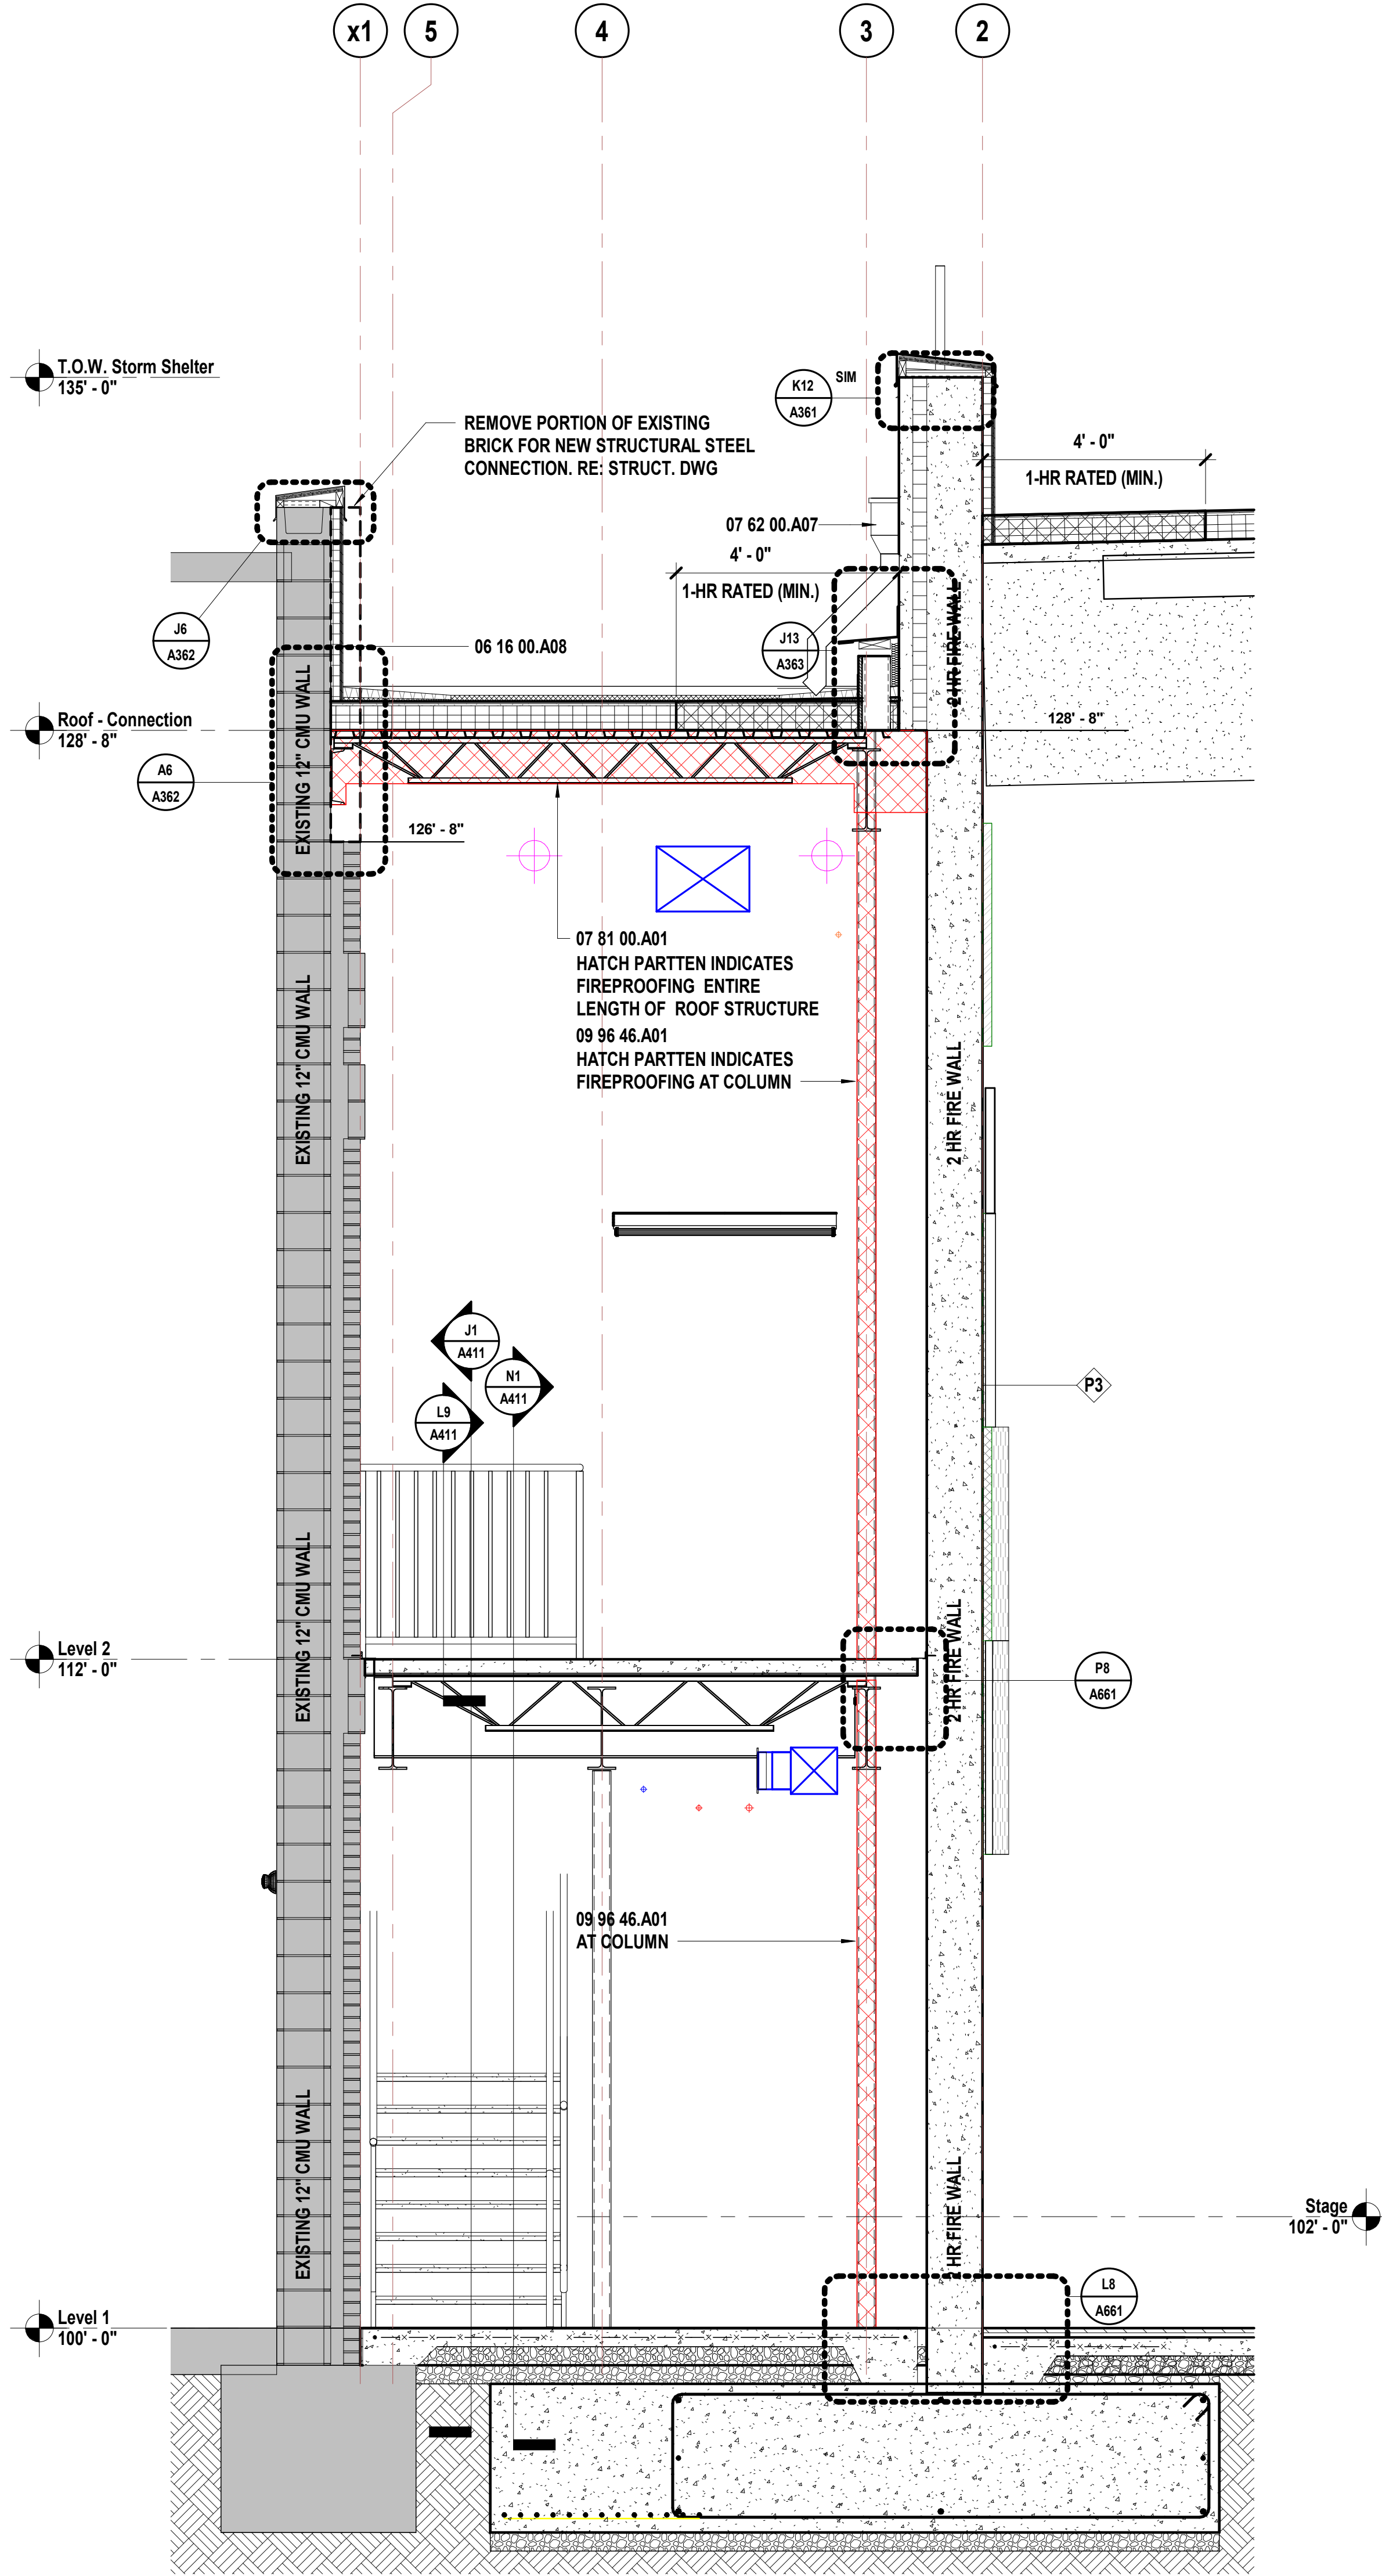
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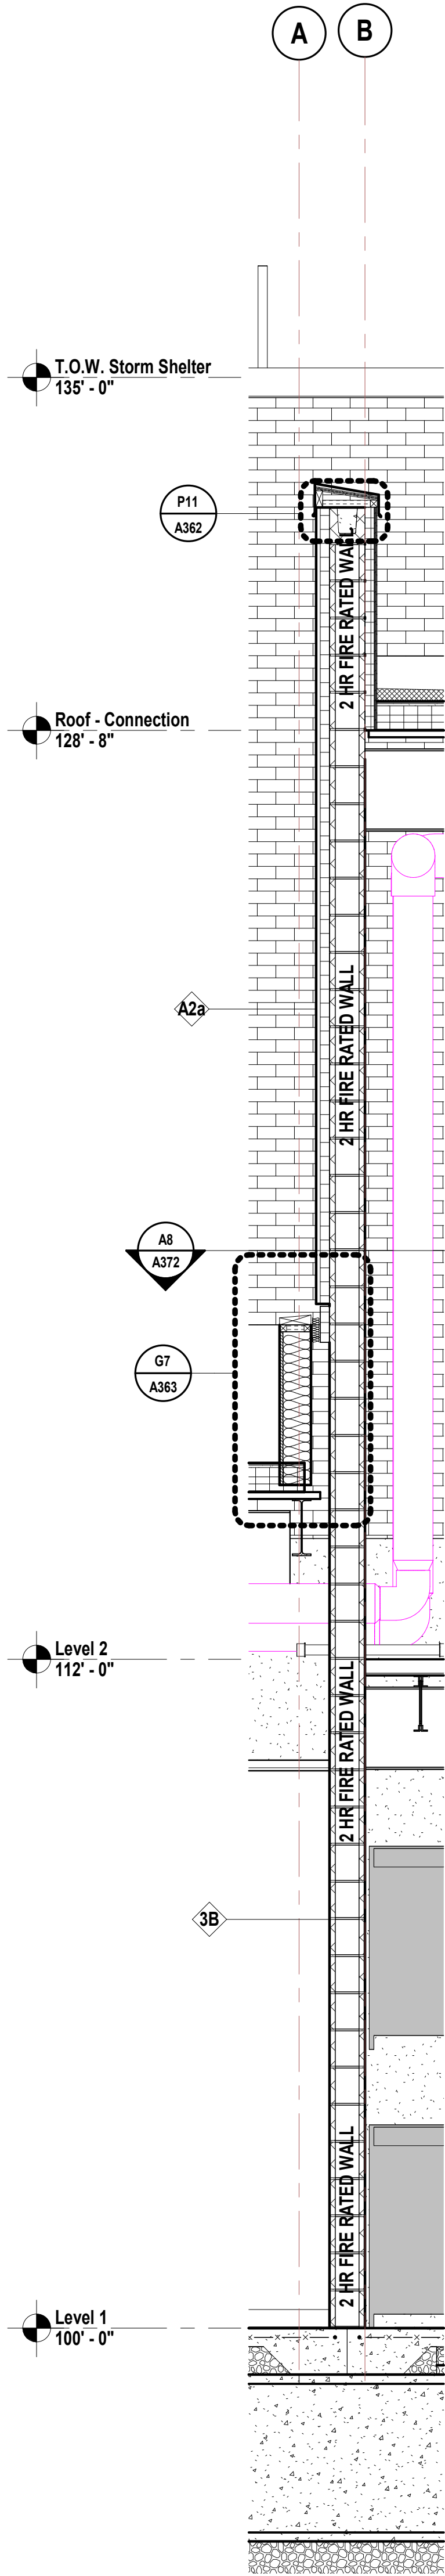
A331



A1 Scale 1/2" = 1'-0" Wall Section - Area A - Connection - E



A7 Scale 1/2" = 1'-0" Wall Section - Area A - Connection/Existing - S Wall



A14 Scale 1/2" = 1'-0" Wall Section - Area A - Connection/Vestibule - Plan West Wall

SHEET KEYNOTE LEGEND

06 16 00.A08	COMPOSITE INSULATED ROOF SHEATHING
07 62 00.A07	DOWNSPOUTS
07 81 00.A01	FIREPROOFING
09 96 46.A01	INTUMESCENT PAINT

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1	Addendum 05	10.06.2023
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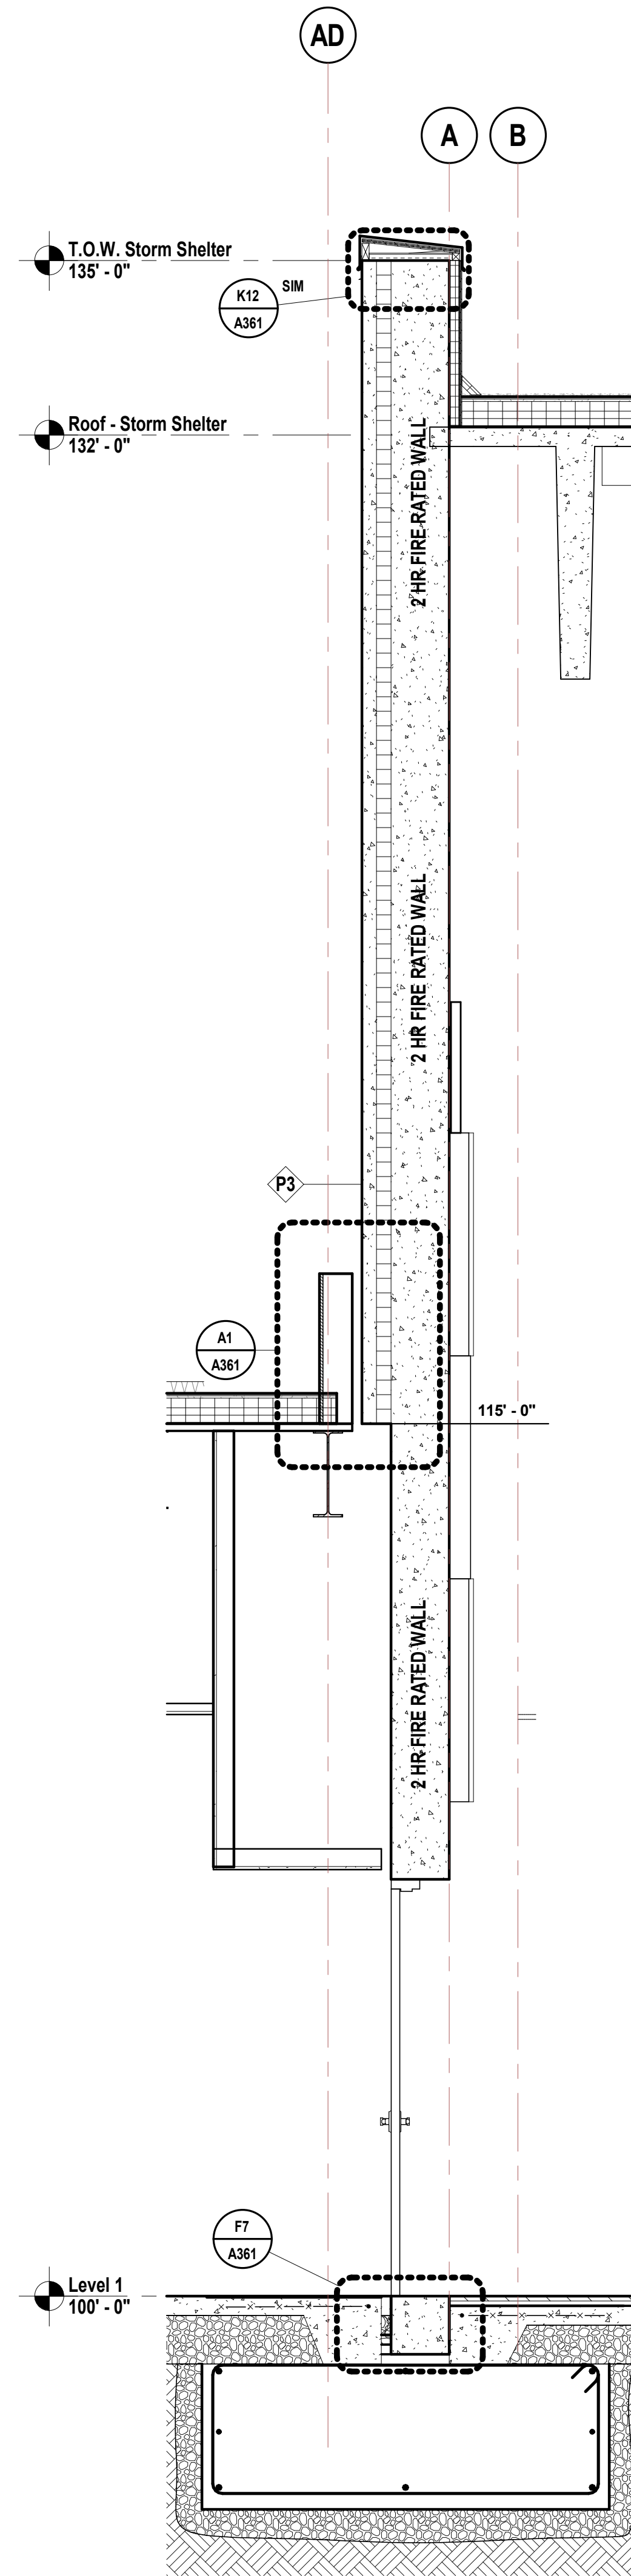
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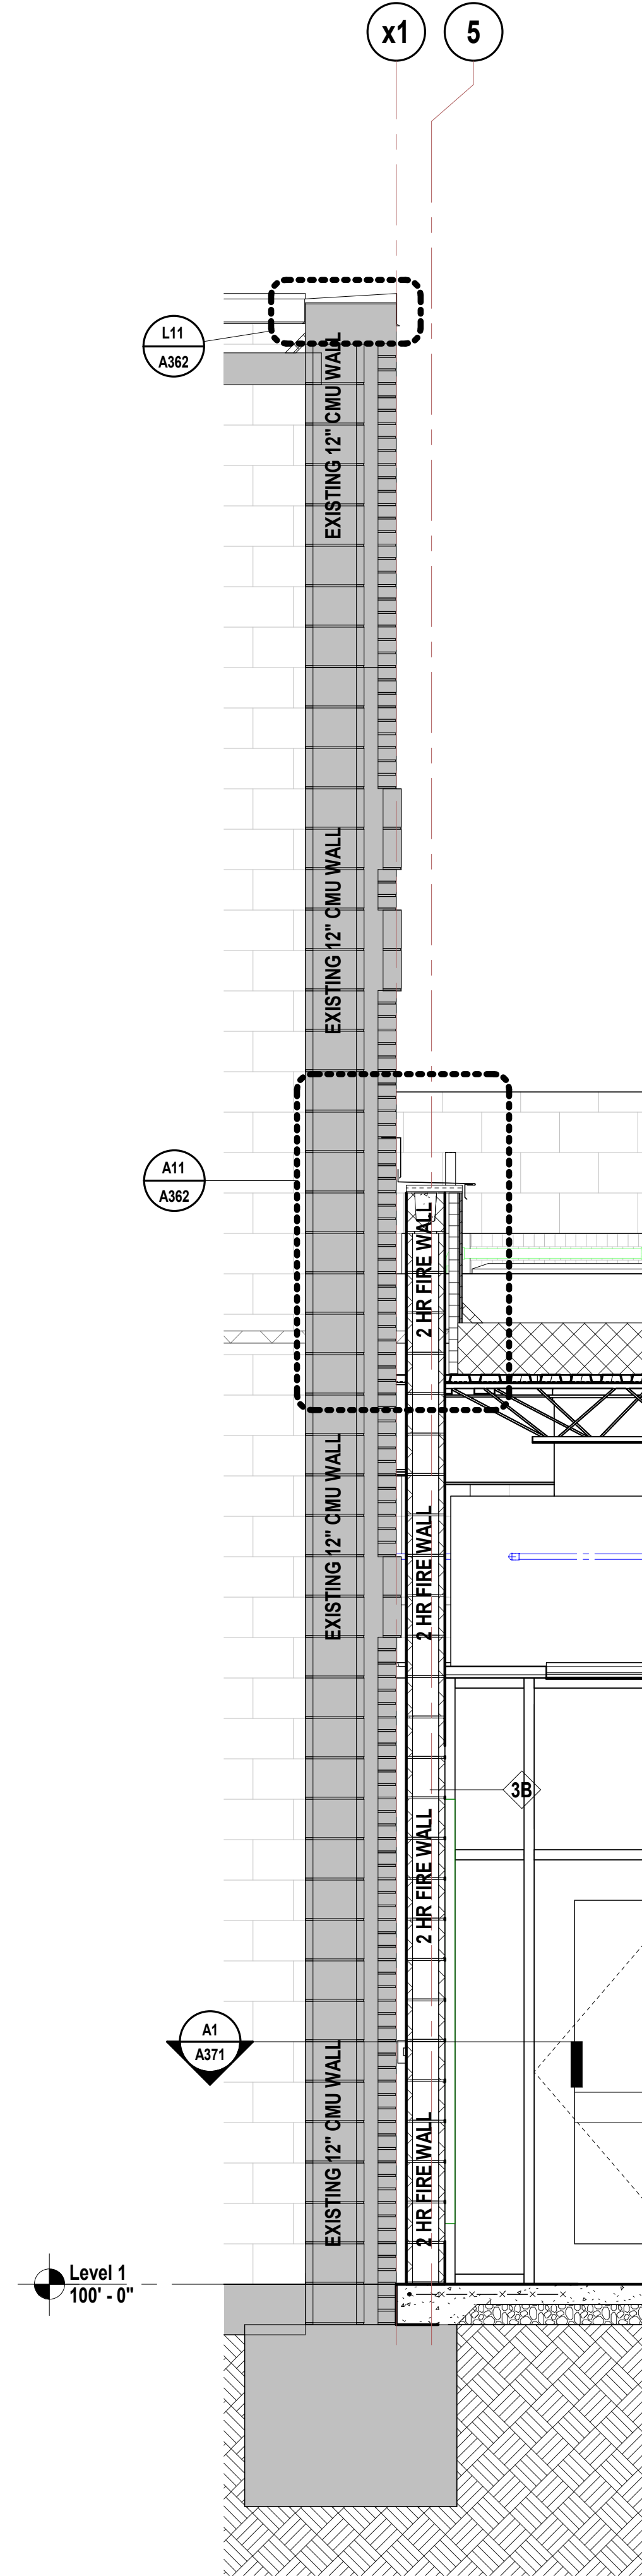
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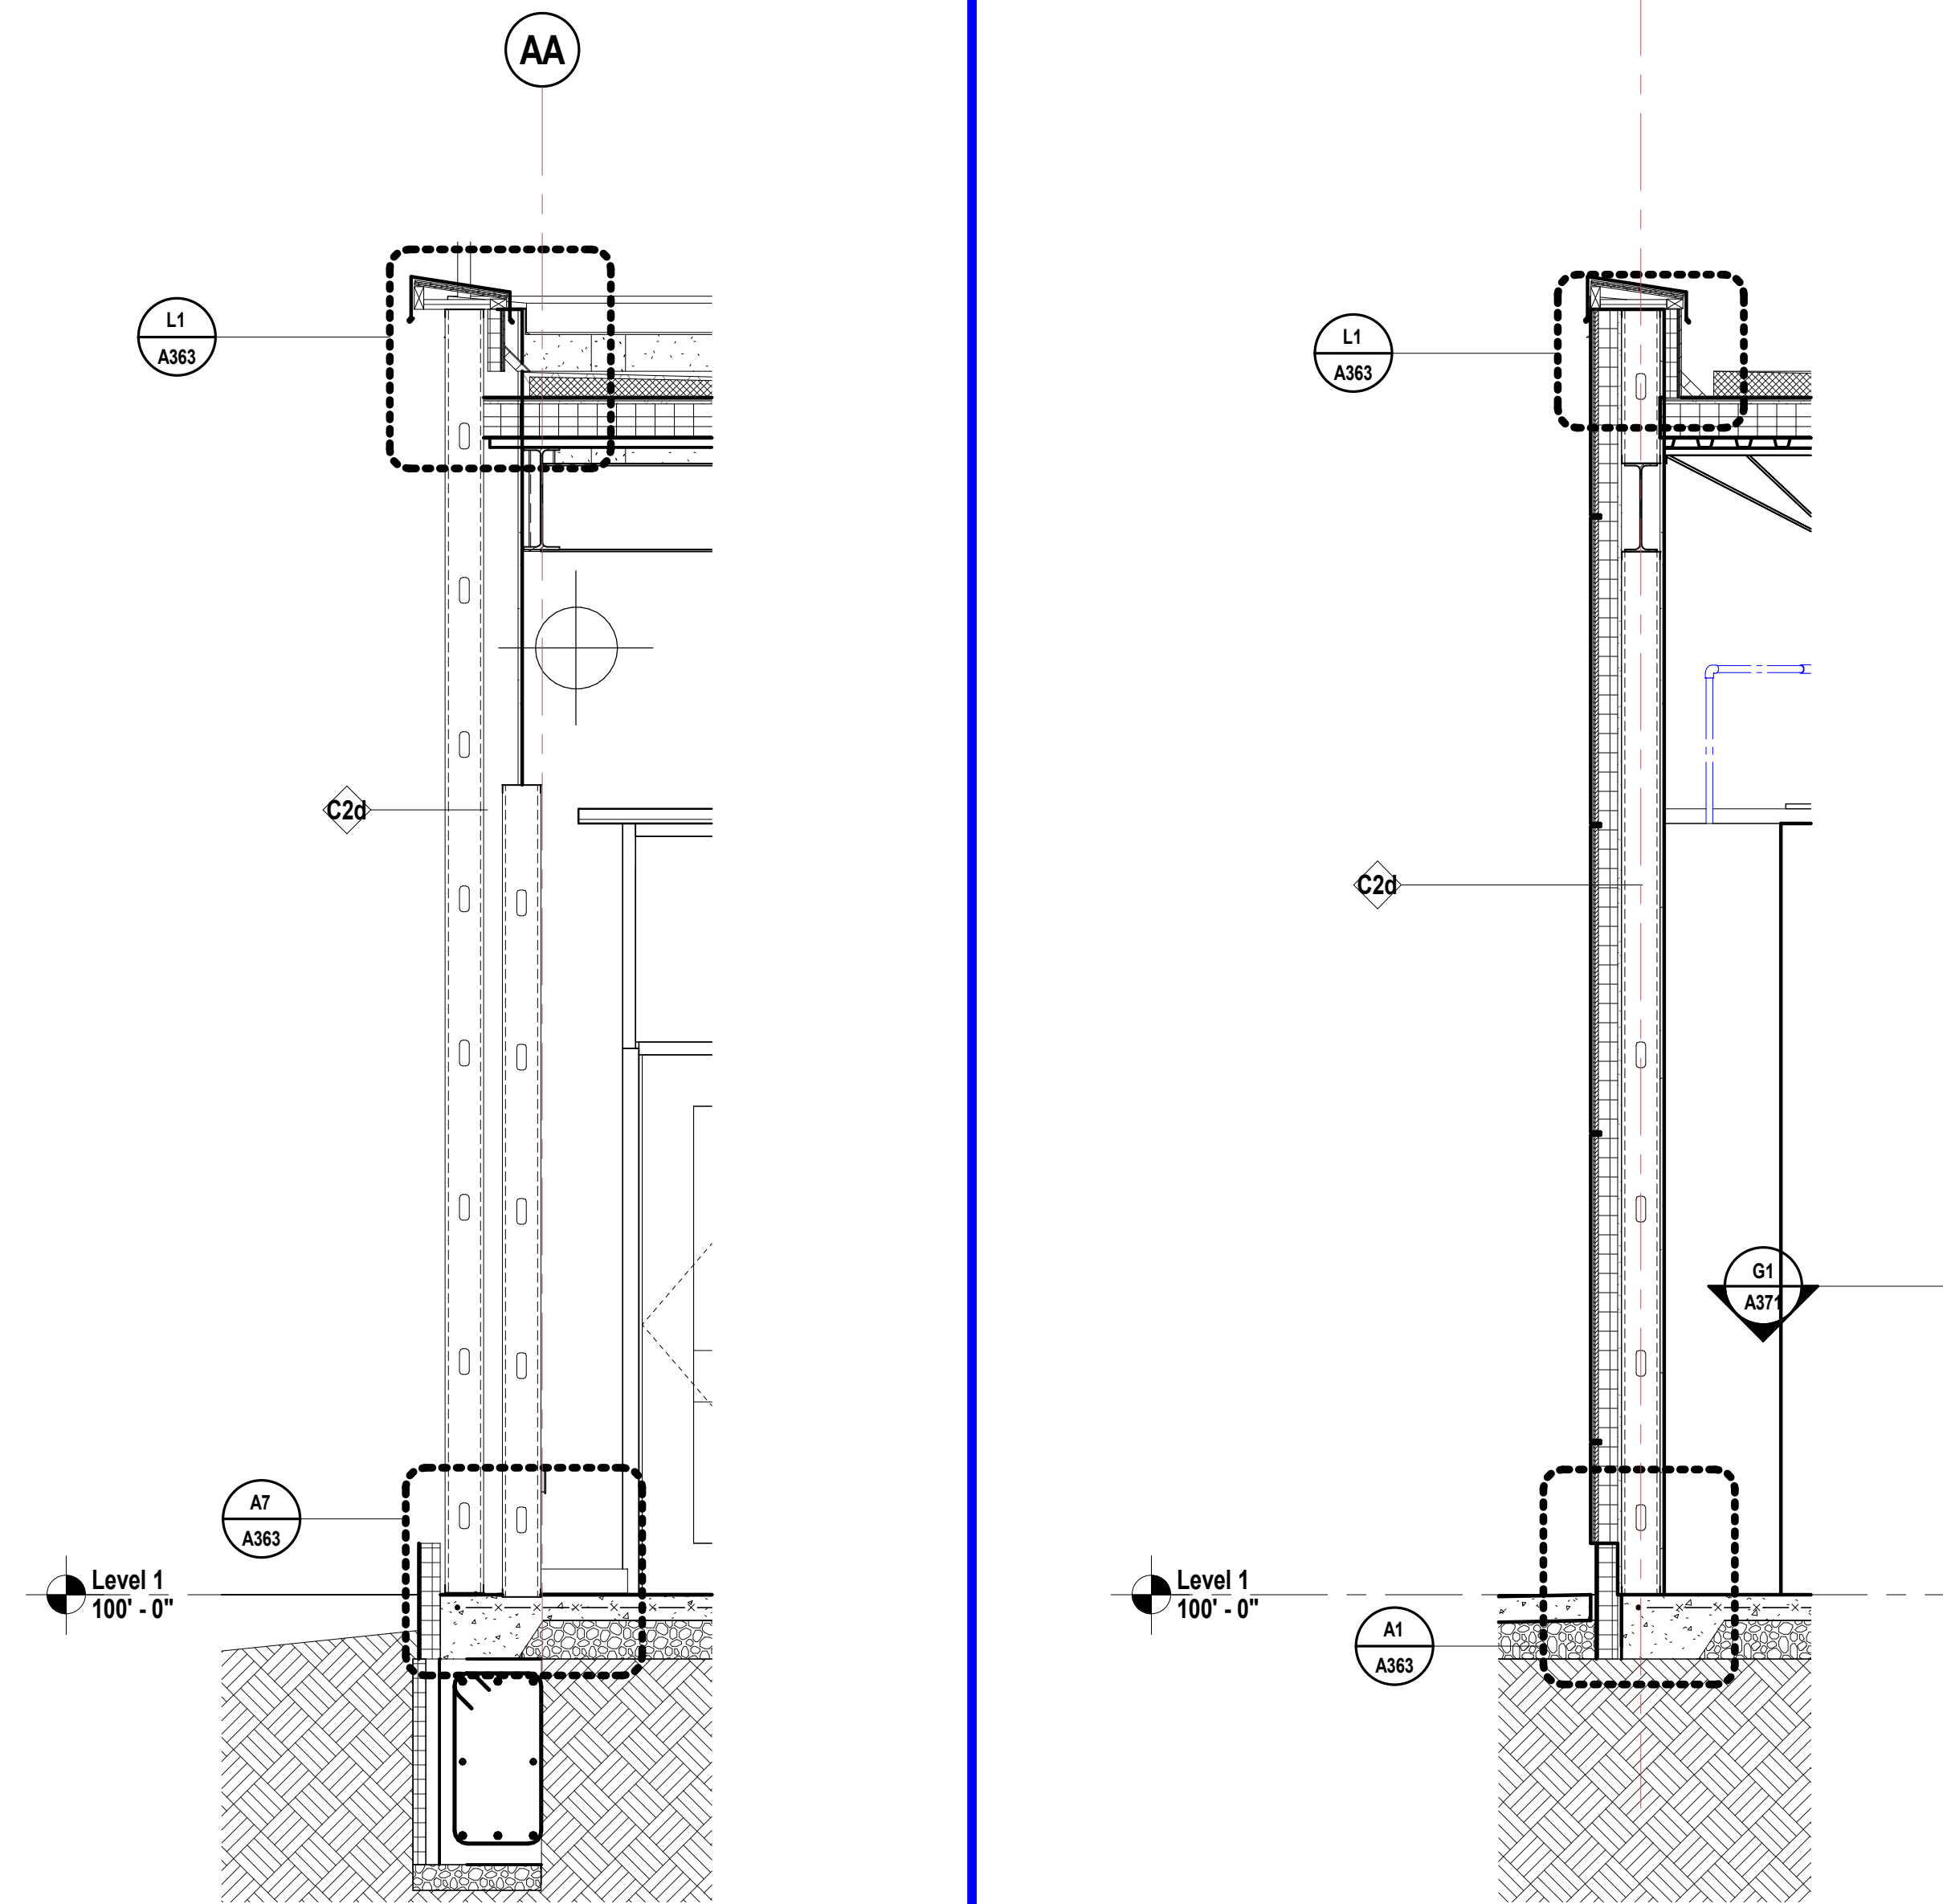
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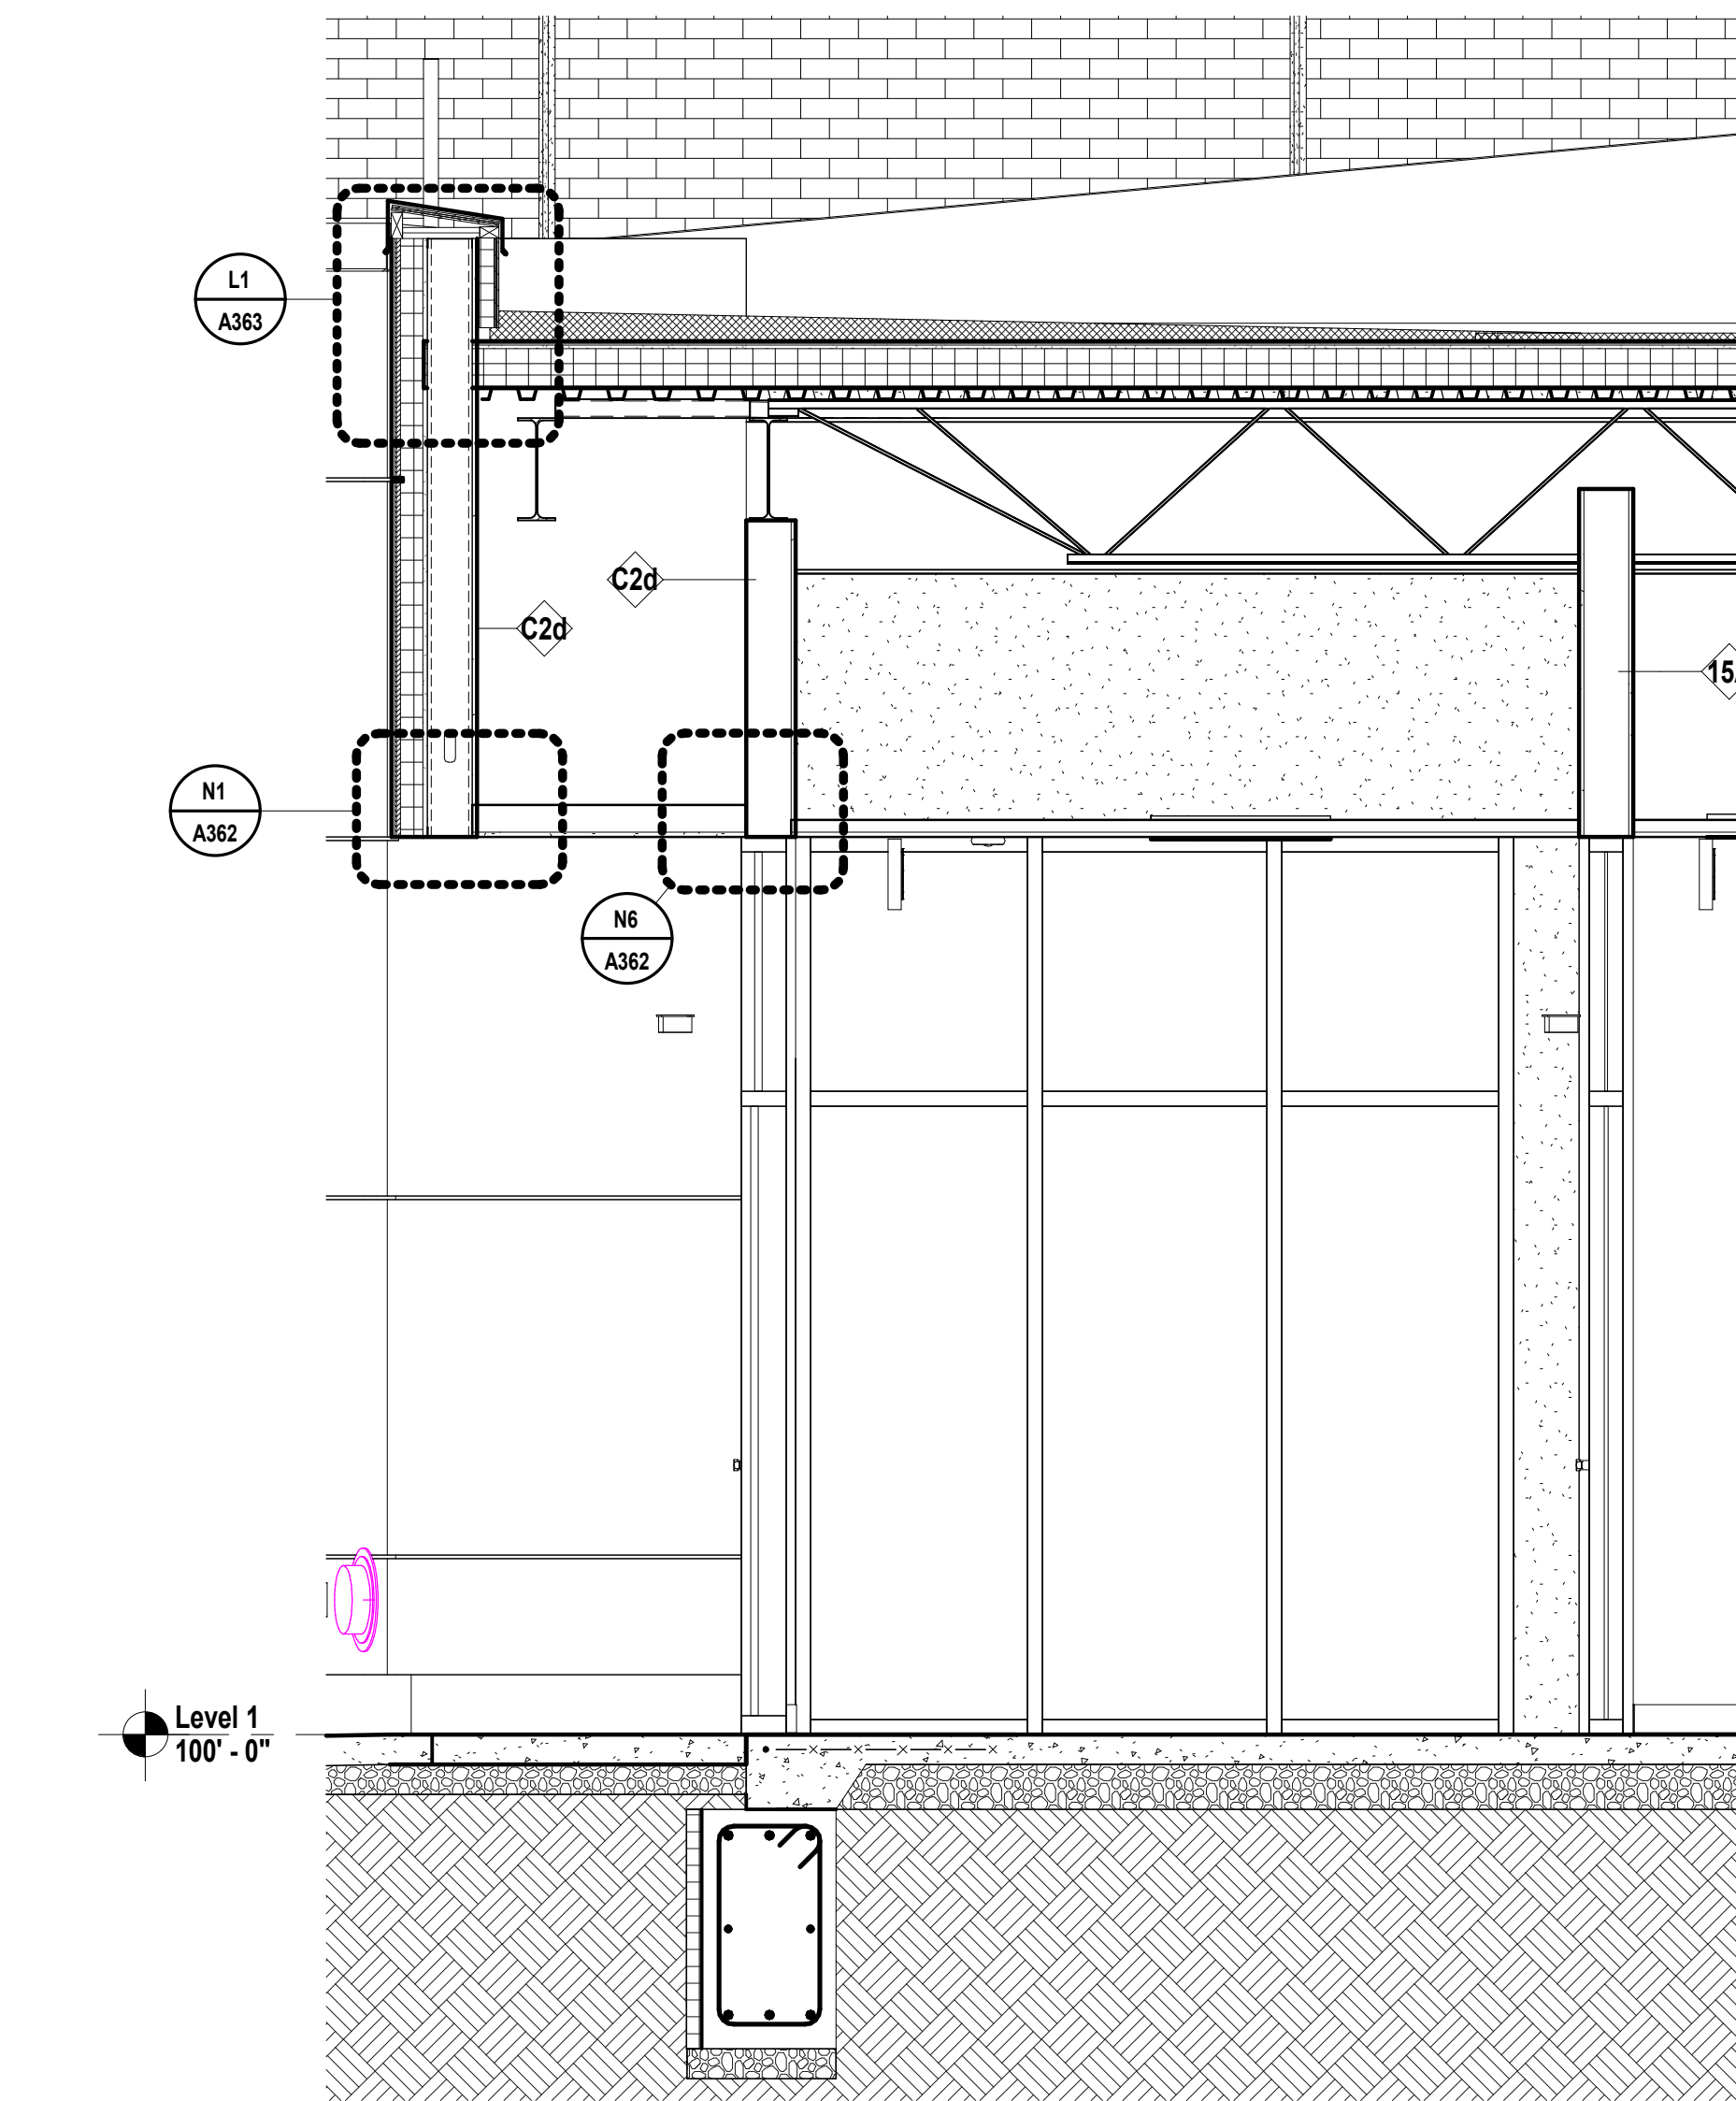
A1	Scale	Wall Section - Area A - Multipurpose/Vestibule - W
	1/2" = 1'-0"	



A5	Scale	Wall Section - Area A - Vestibule/Existing - S
	1/2" = 1'-0"	



J9	Scale	Wall Section - Area A - Entry - W
	1/2" = 1'-0"	



A9	Scale	Wall Section - Area A - Entry - N/S
	1/2" = 1'-0"	

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Missouri State Certificate of Authority
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Structural Engineer
State Certificate of Authority #000442
4338 Belleview Ave
Kansas City, MO 64111
816.531.4144 phone

Smith & Boucher, Inc.
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State Certificate of Authority #EGC000178
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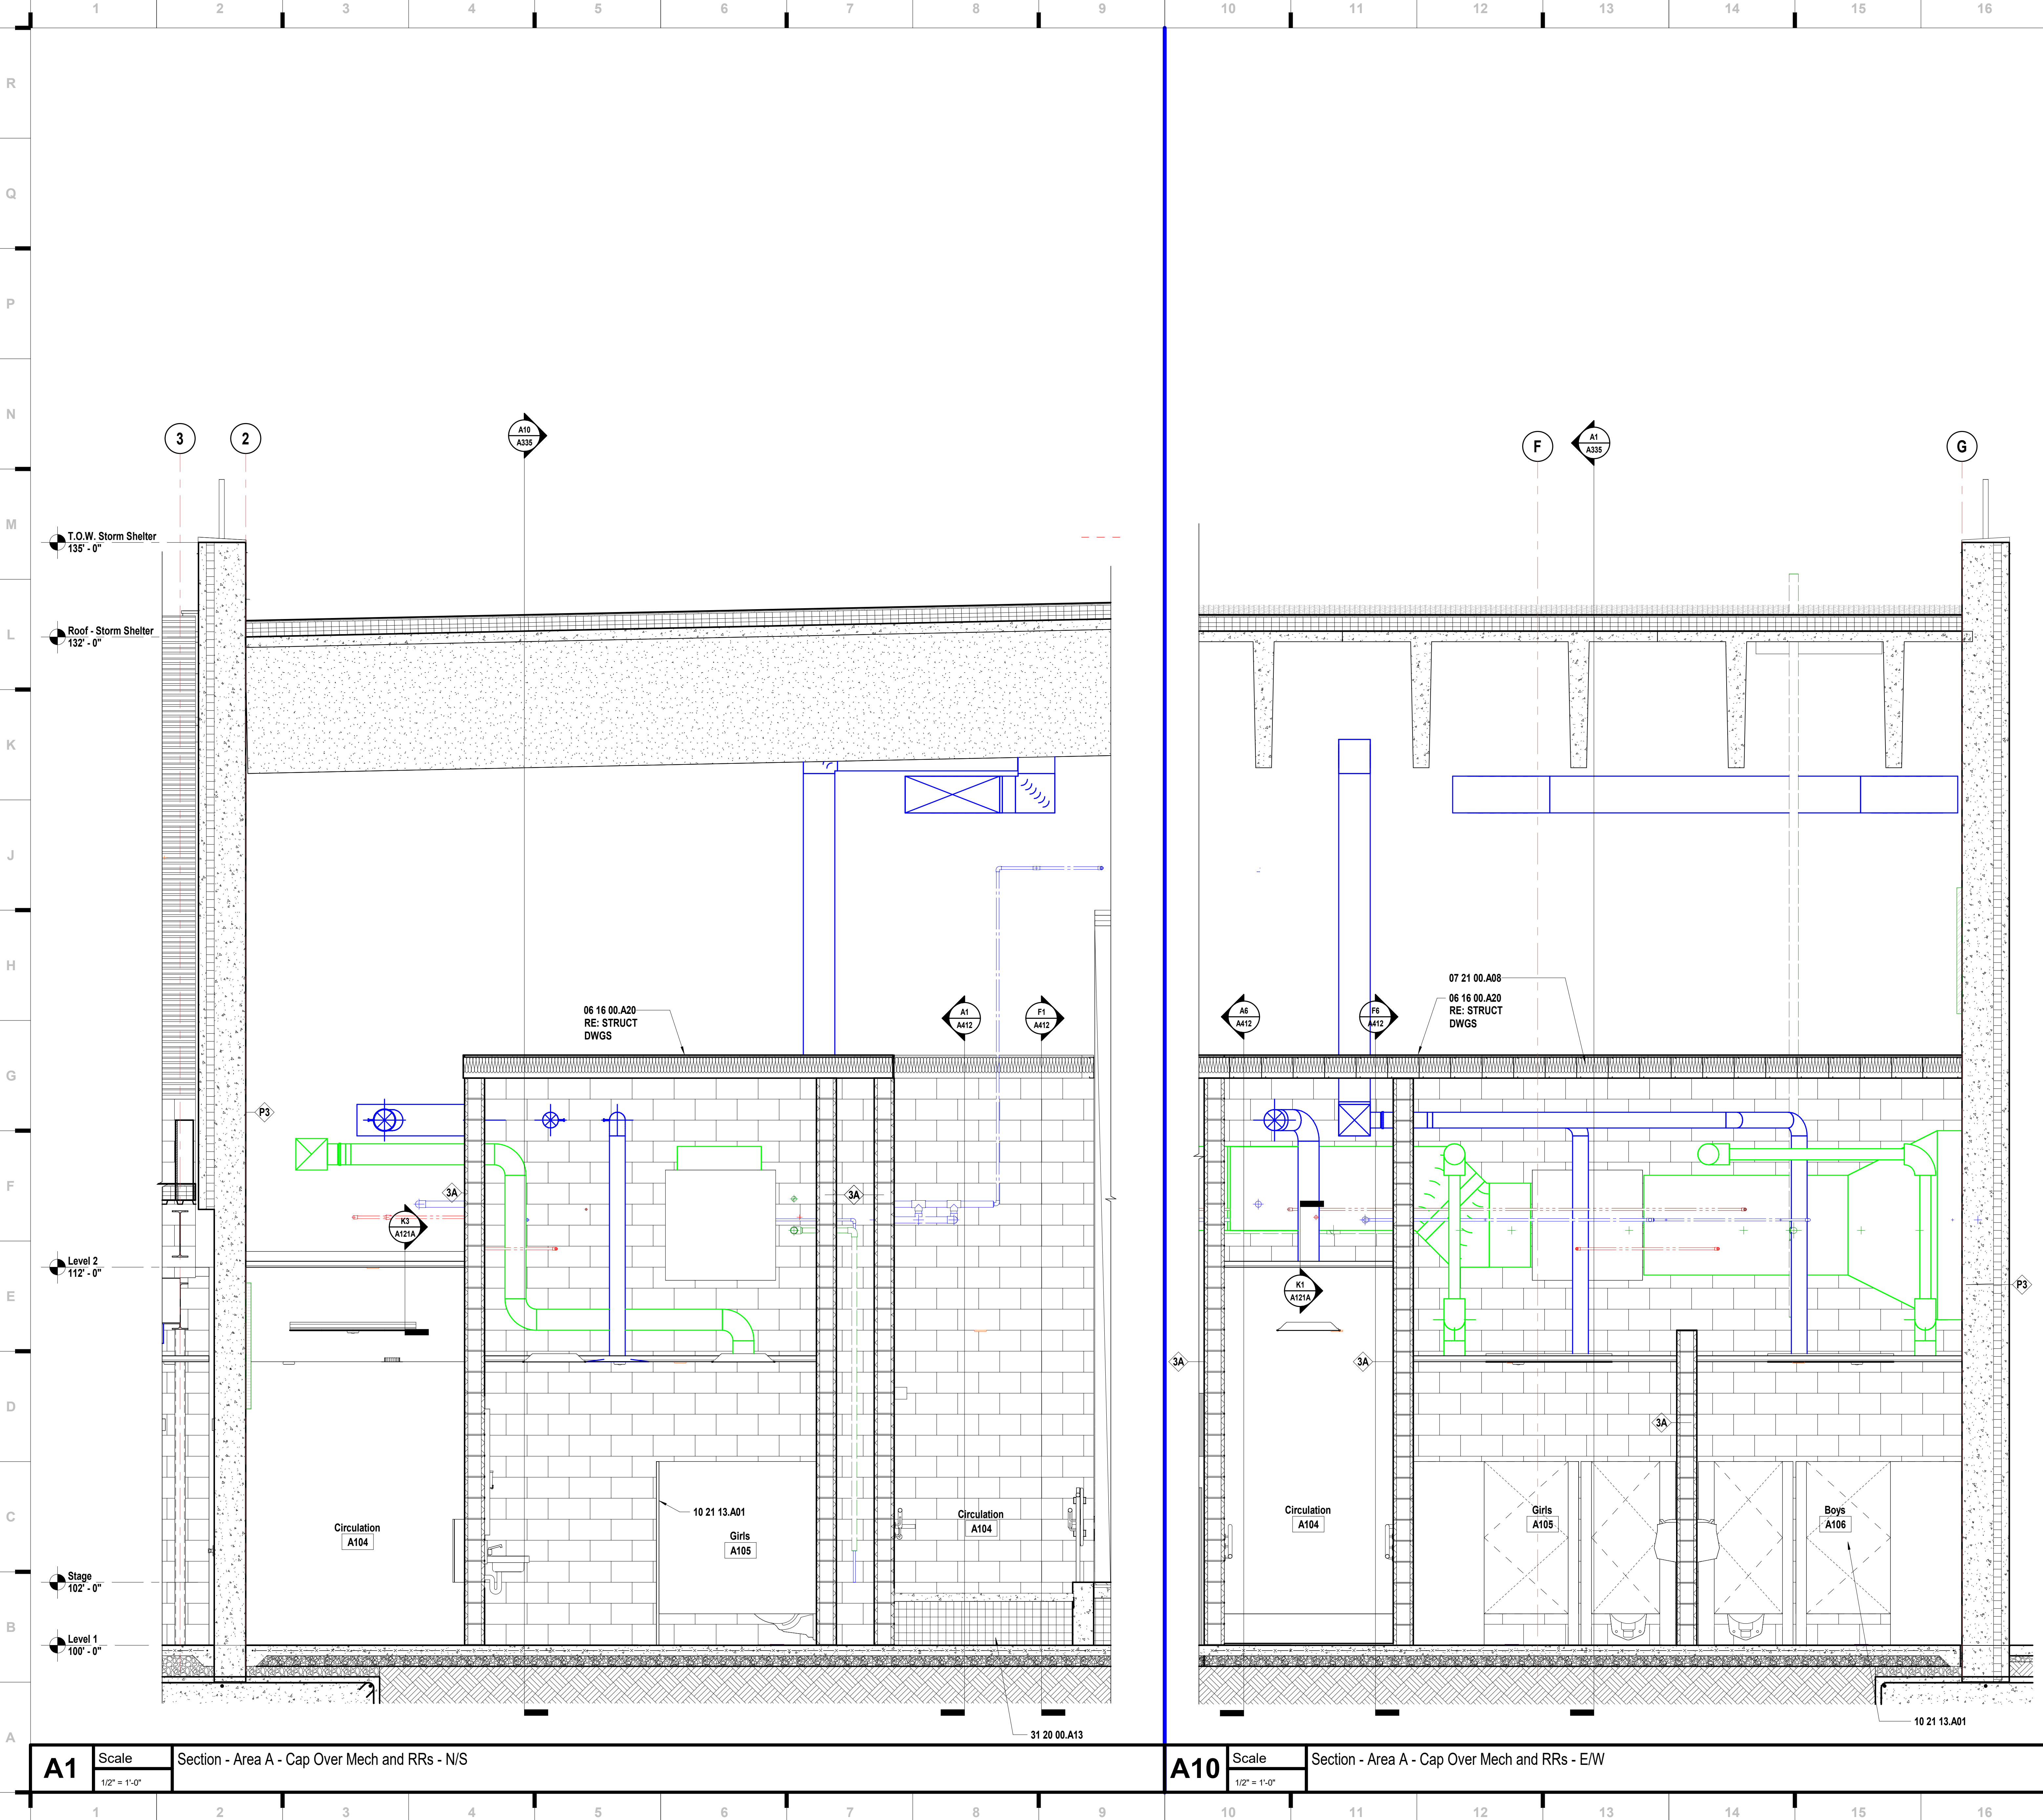
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A333

WALL SECTIONS - CONNECTION



06 16 00.A20

STRUCTURAL CONCRETE PANEL

07 21 00.A08

UNFACED GLASS FIBER BLANKET INSULATION

10 21 13.A01

TOILET COMPARTMENTS

31 20 00.A13

GEOFOAM

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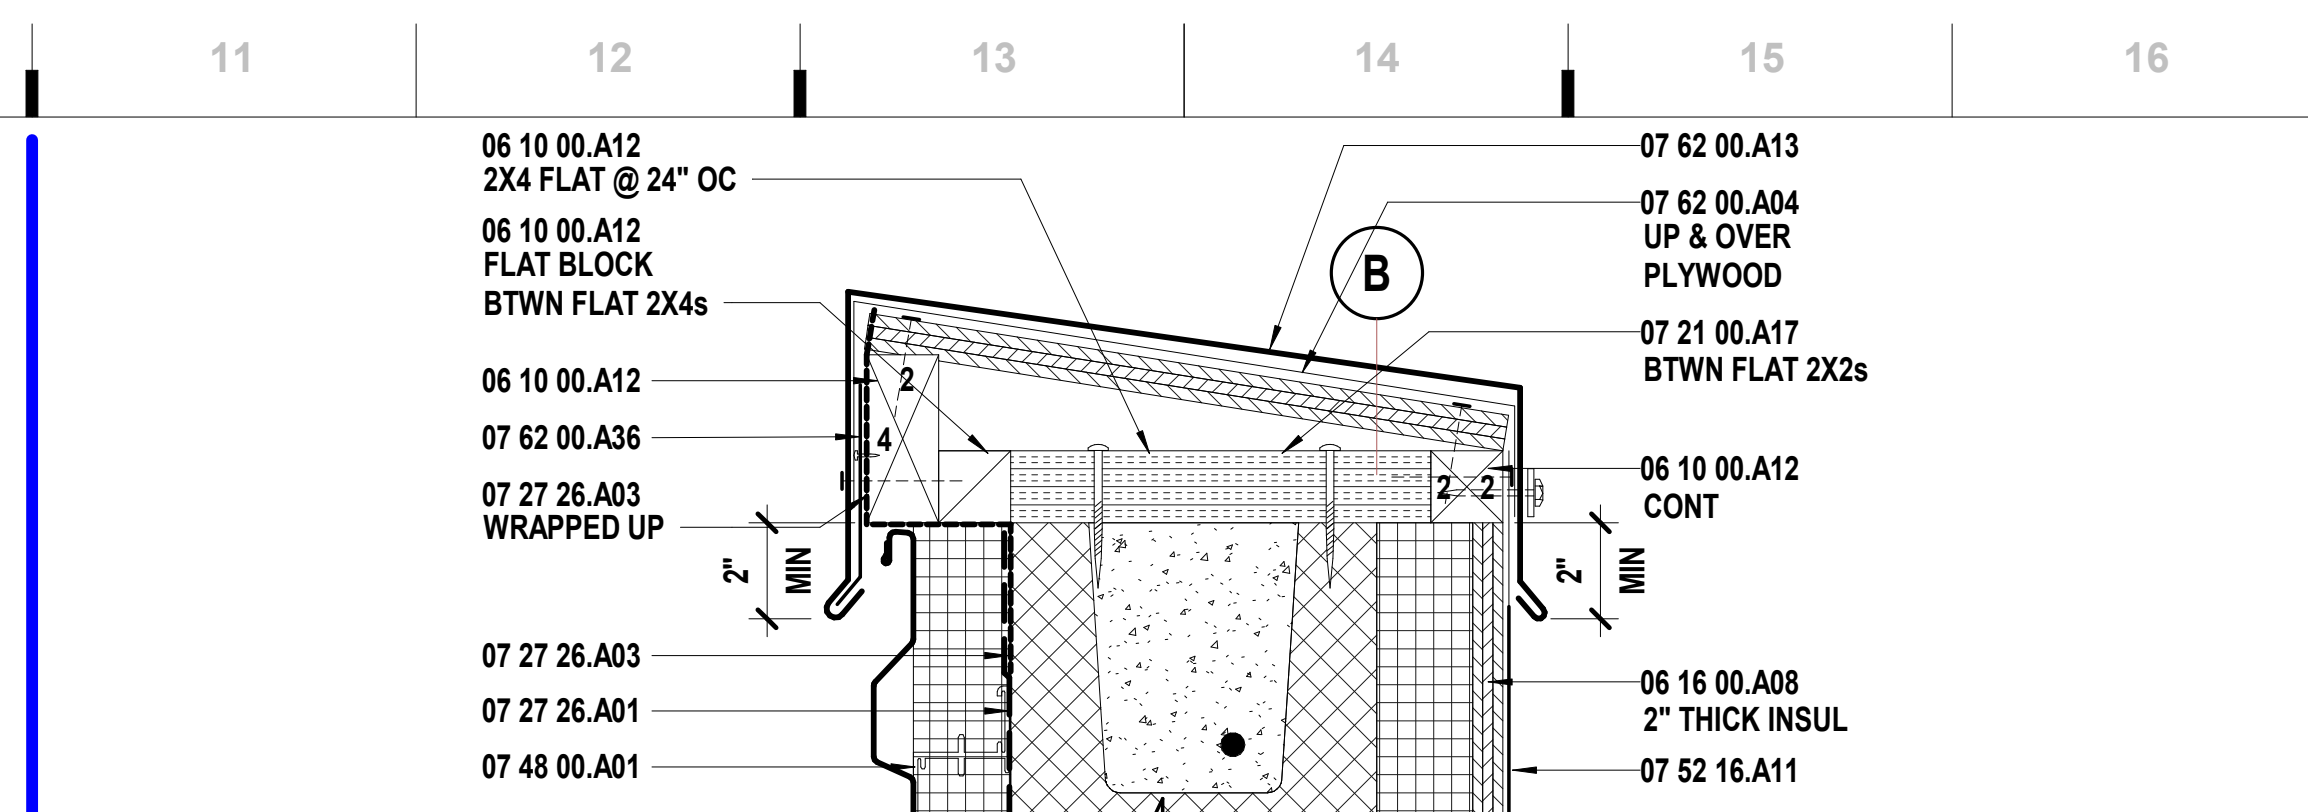
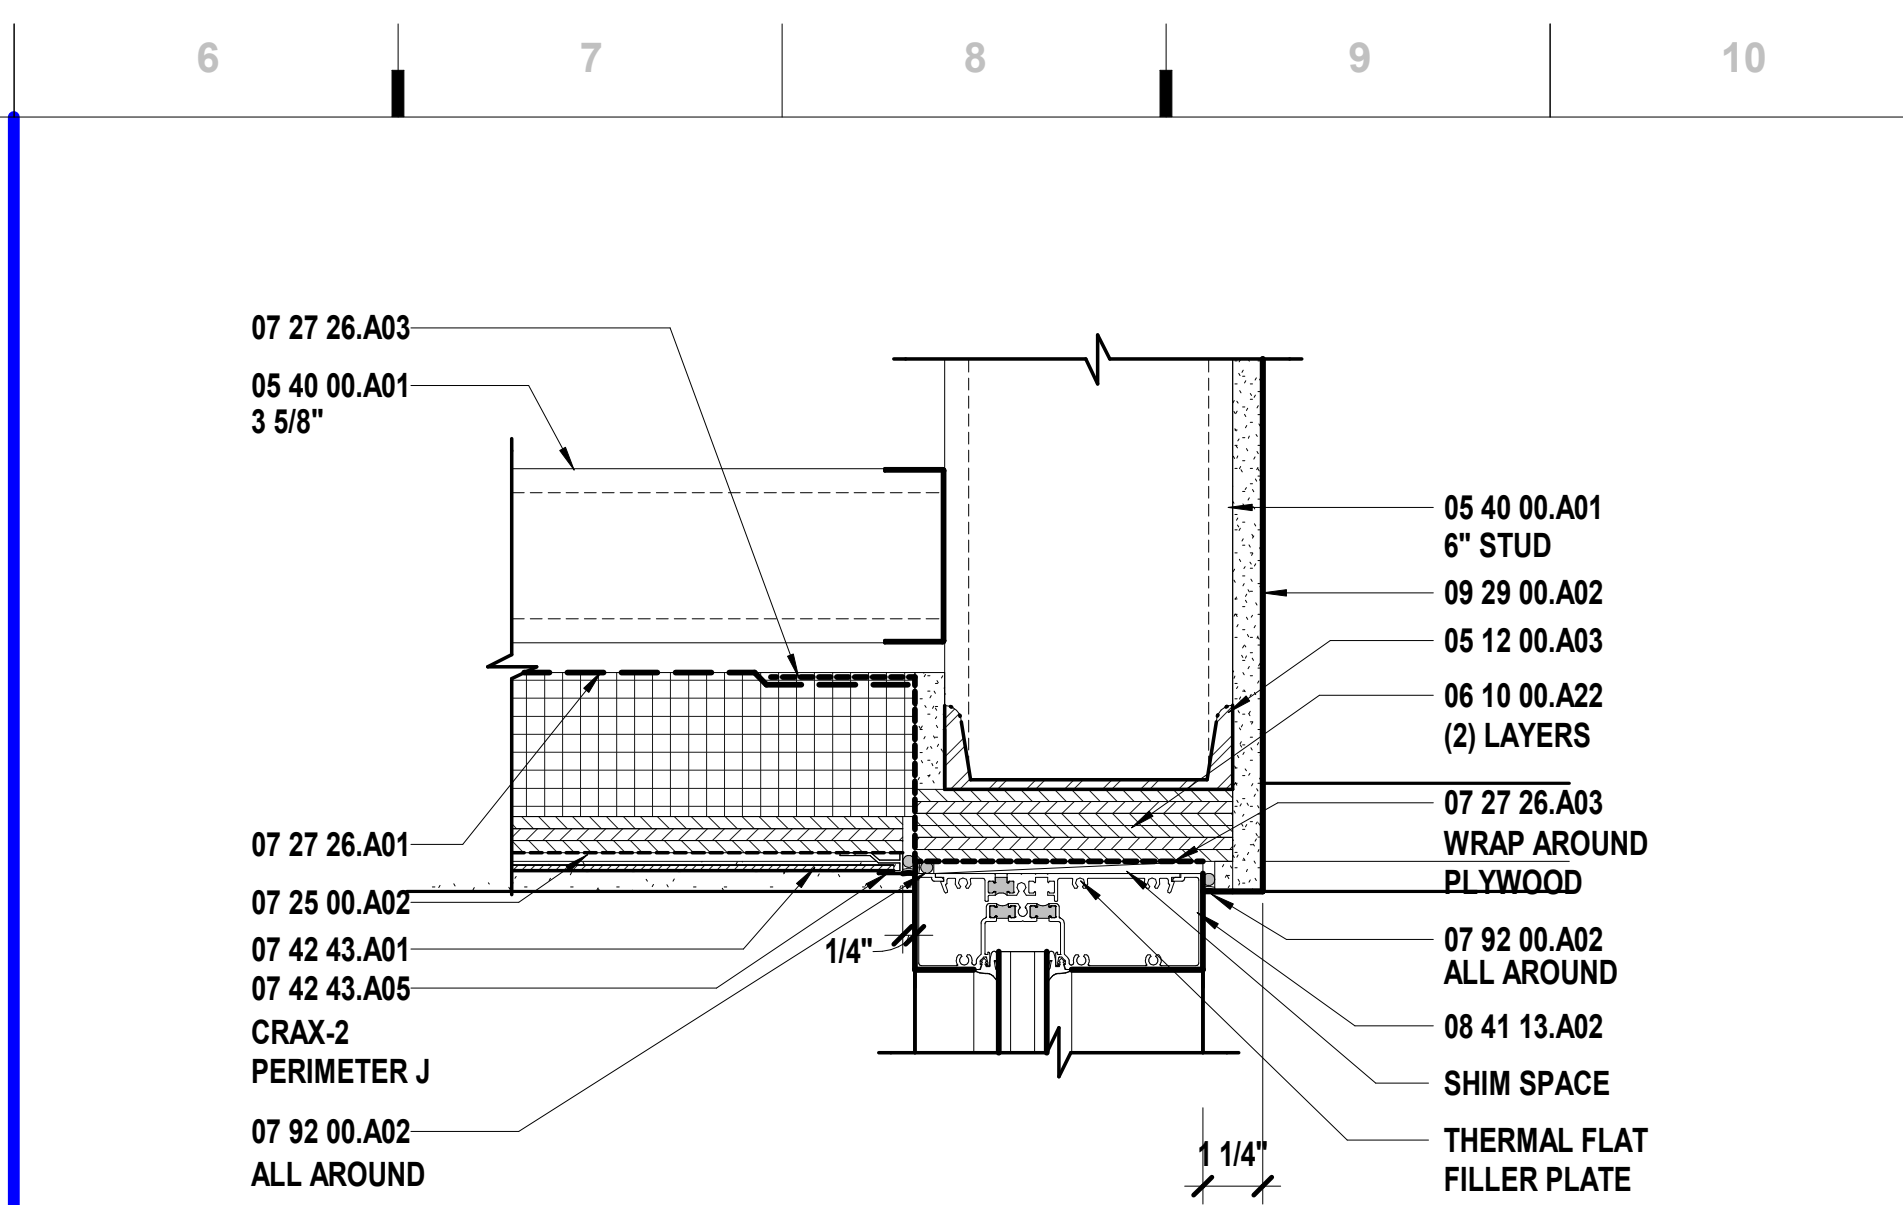
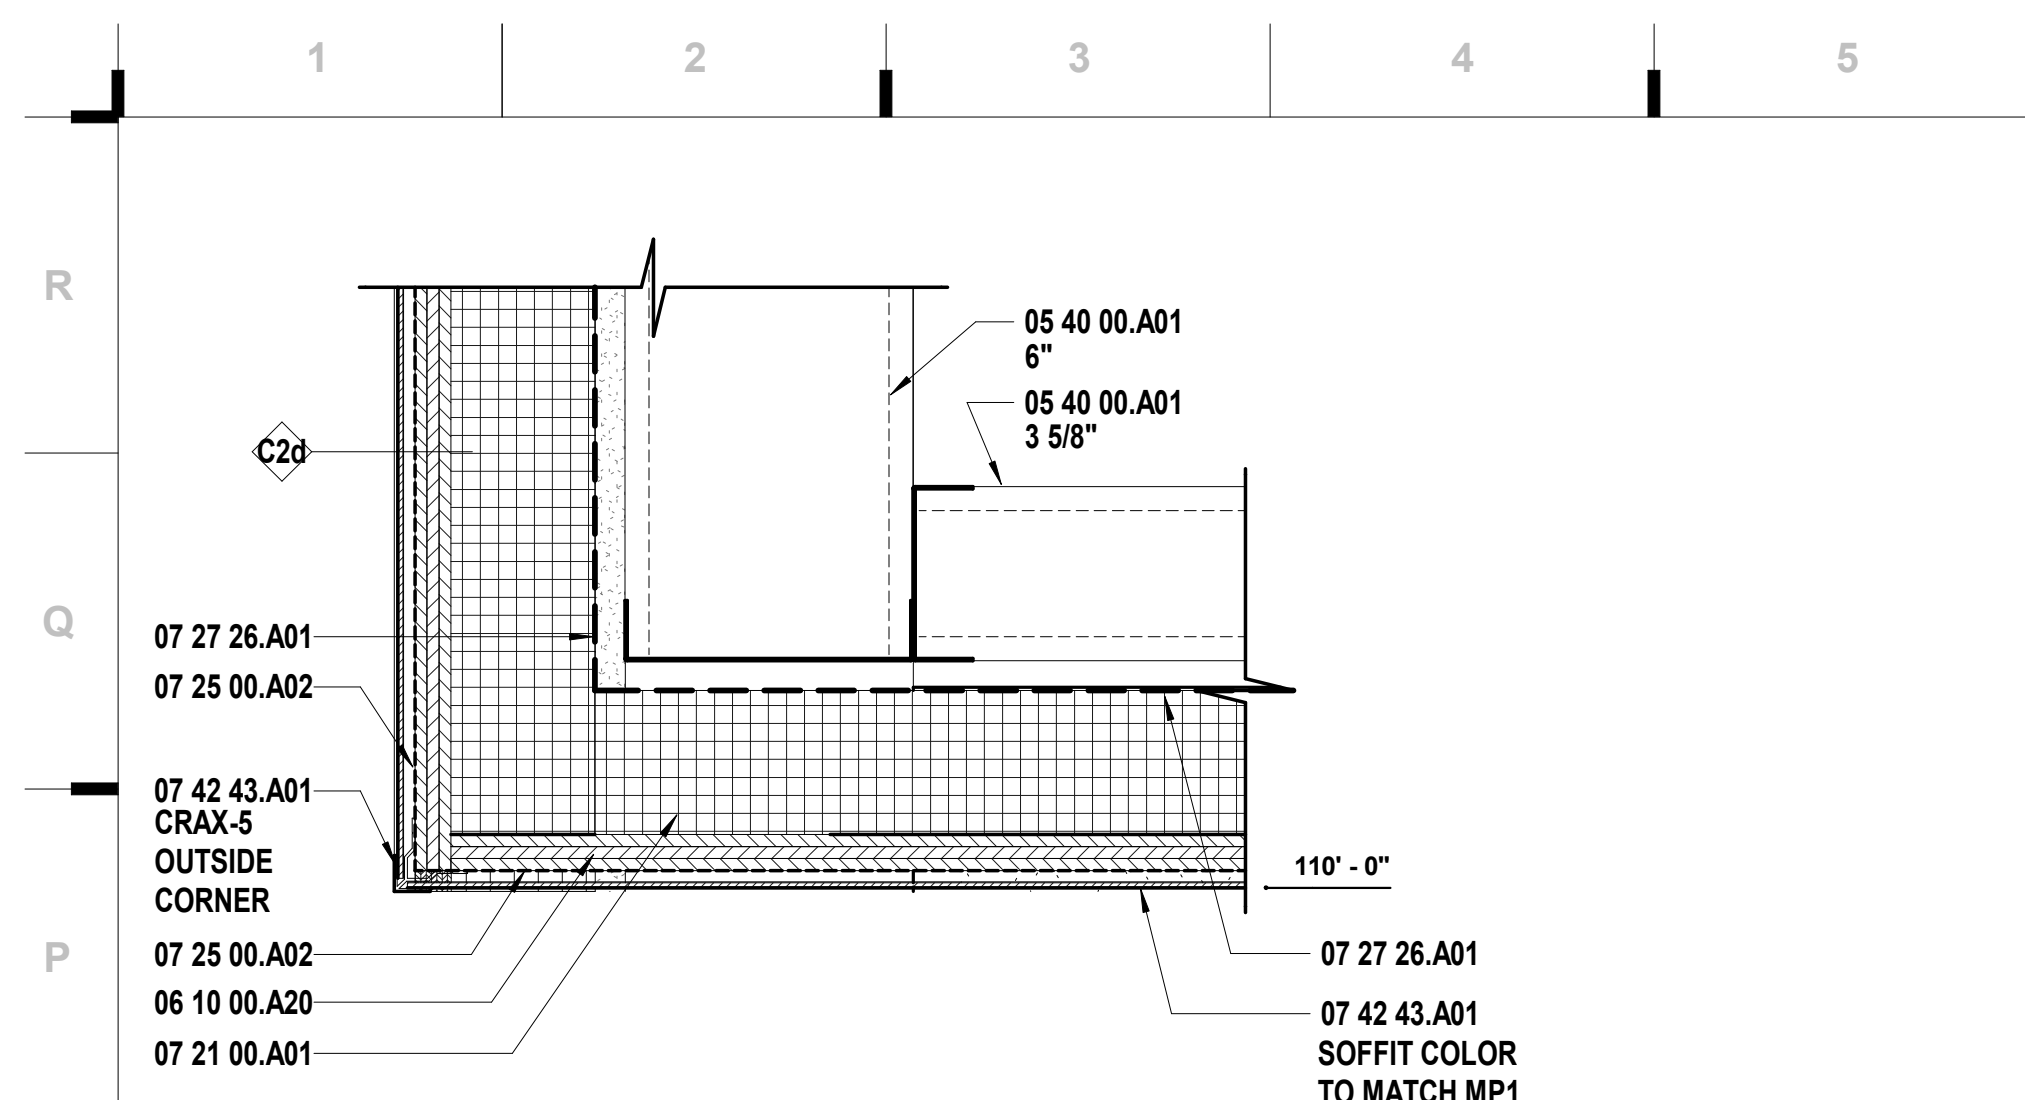
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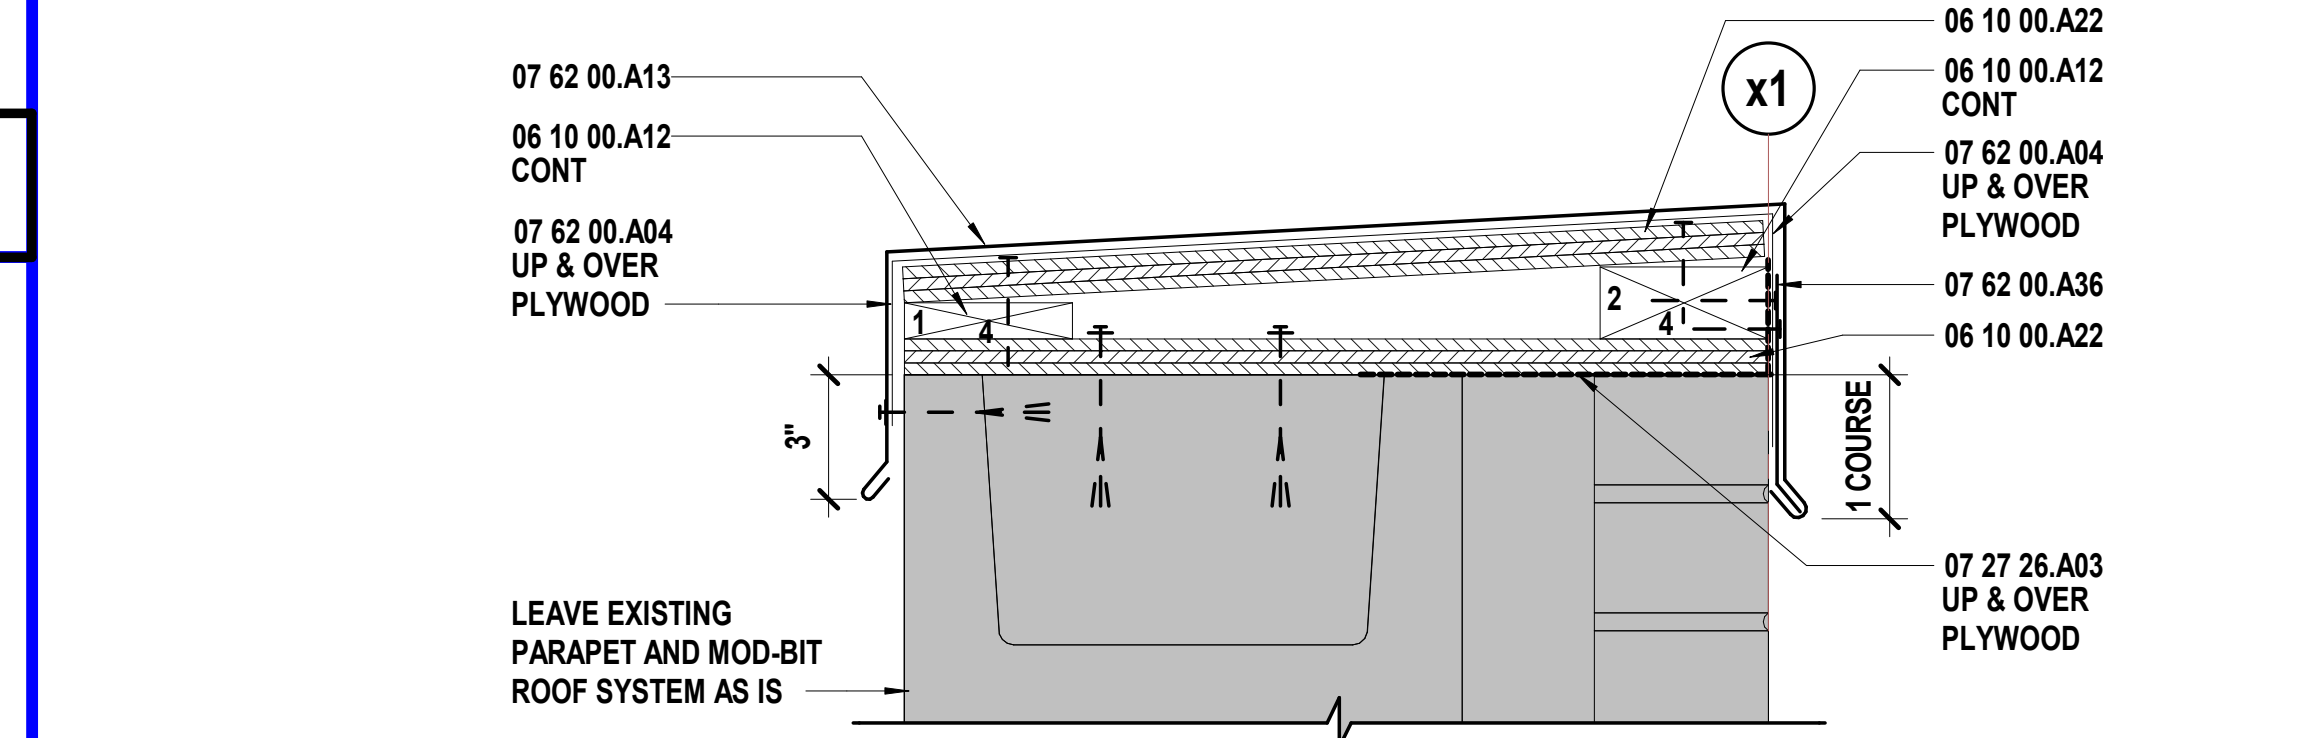
10/11/2023 4:39:48 PM

WALL SECTION - SUPPORT


Please consider the environment before printing this.



P11	Scale	Parapet Detail - Area A - Storage A200 - W
	3" = 1'-0"	




L11	Scale	Section Detail - Area A - Coping at Existing Exterior Wall
	3" = 1'-0"	

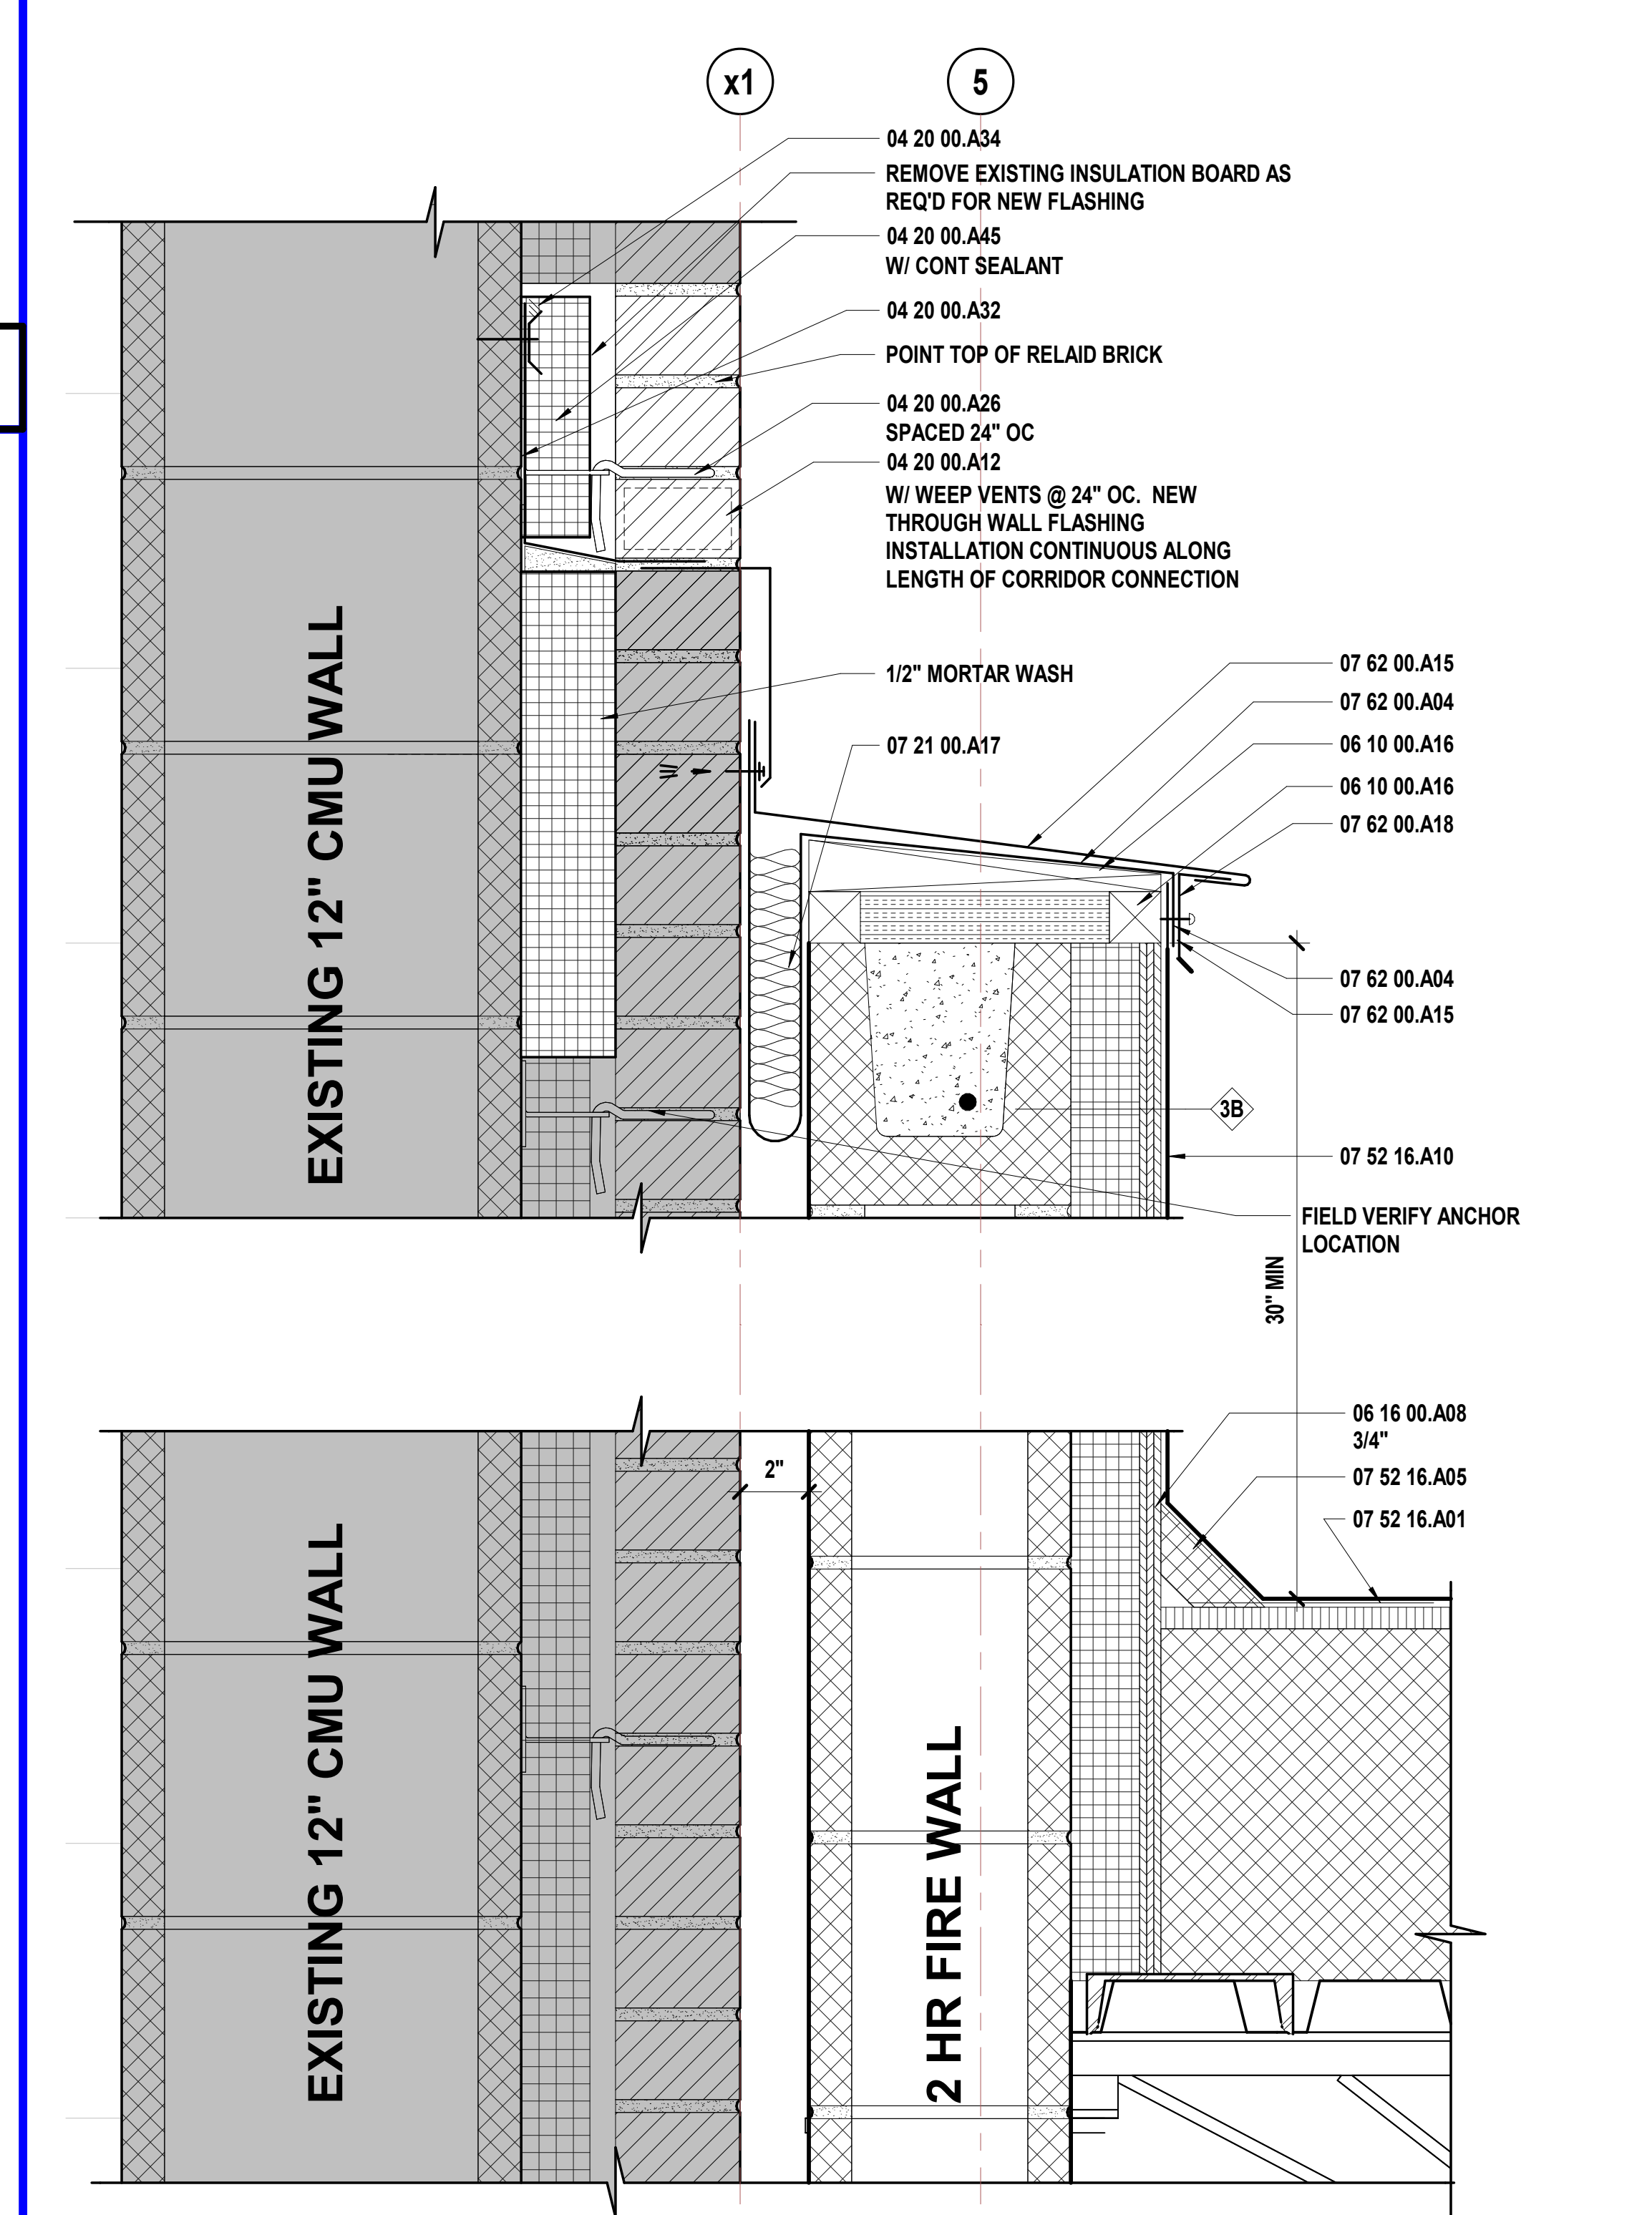


A11	Scale	Roof Connection Detail @ Existing Masonry Wall
	3" = 1'-0"	

N1	Scale	Section Detail - Entry @ Level 2
	3" = 1'-0"	

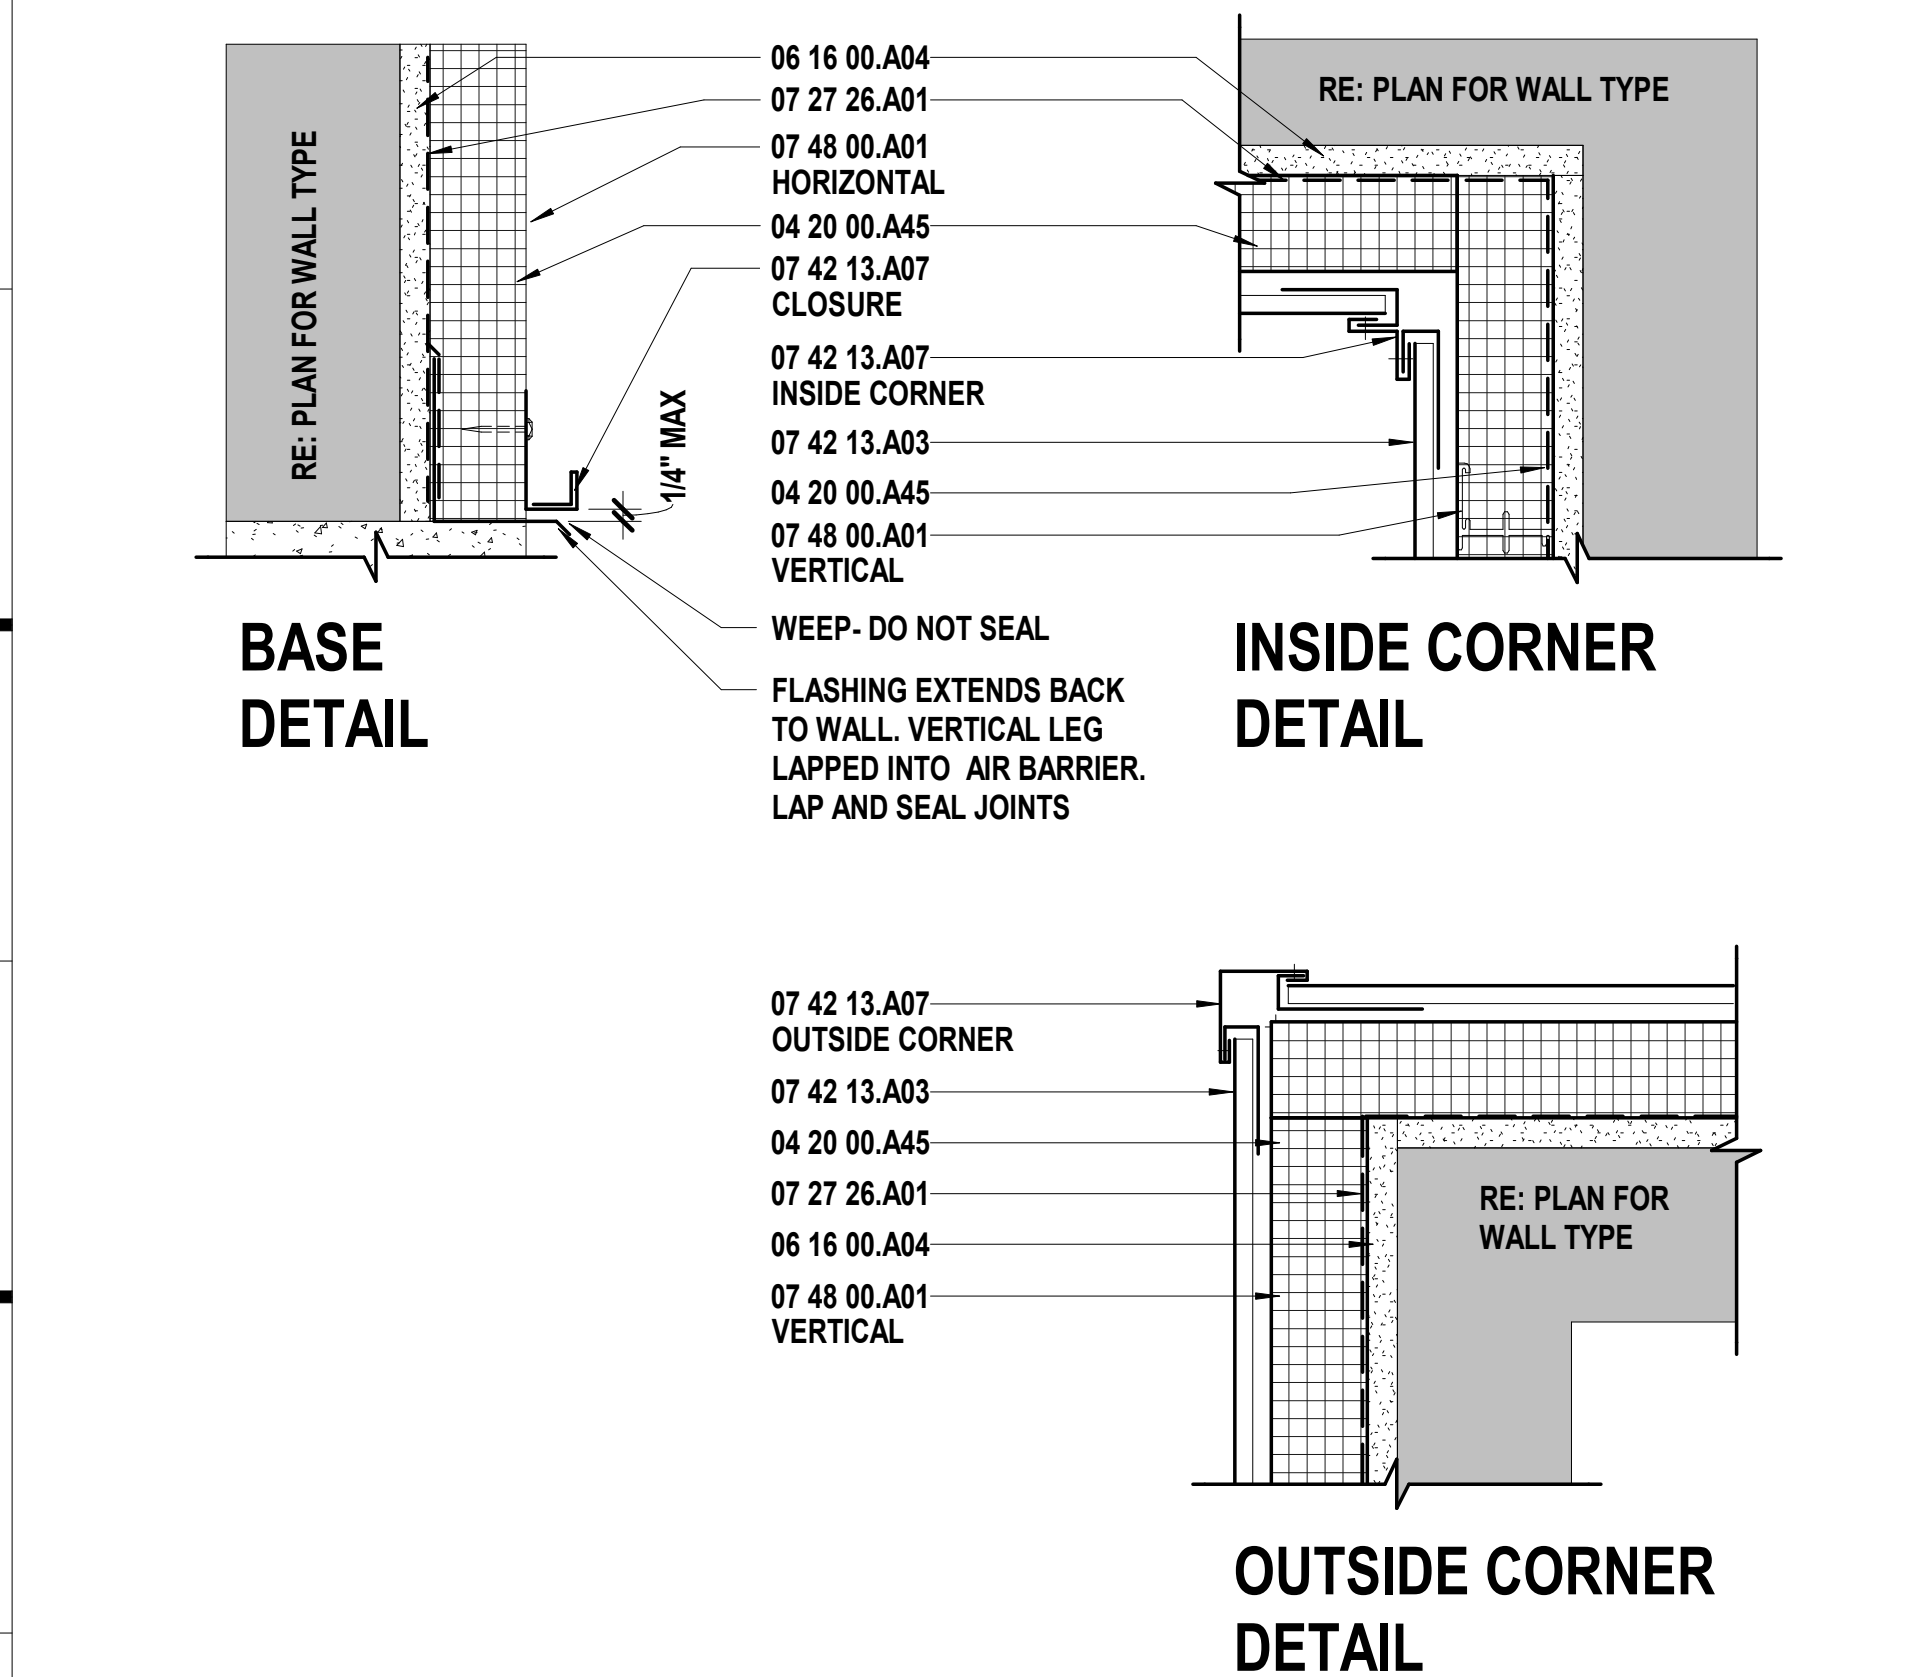


G1	Scale	Metal Panel - Centria - MP2
	3" = 1'-0"	

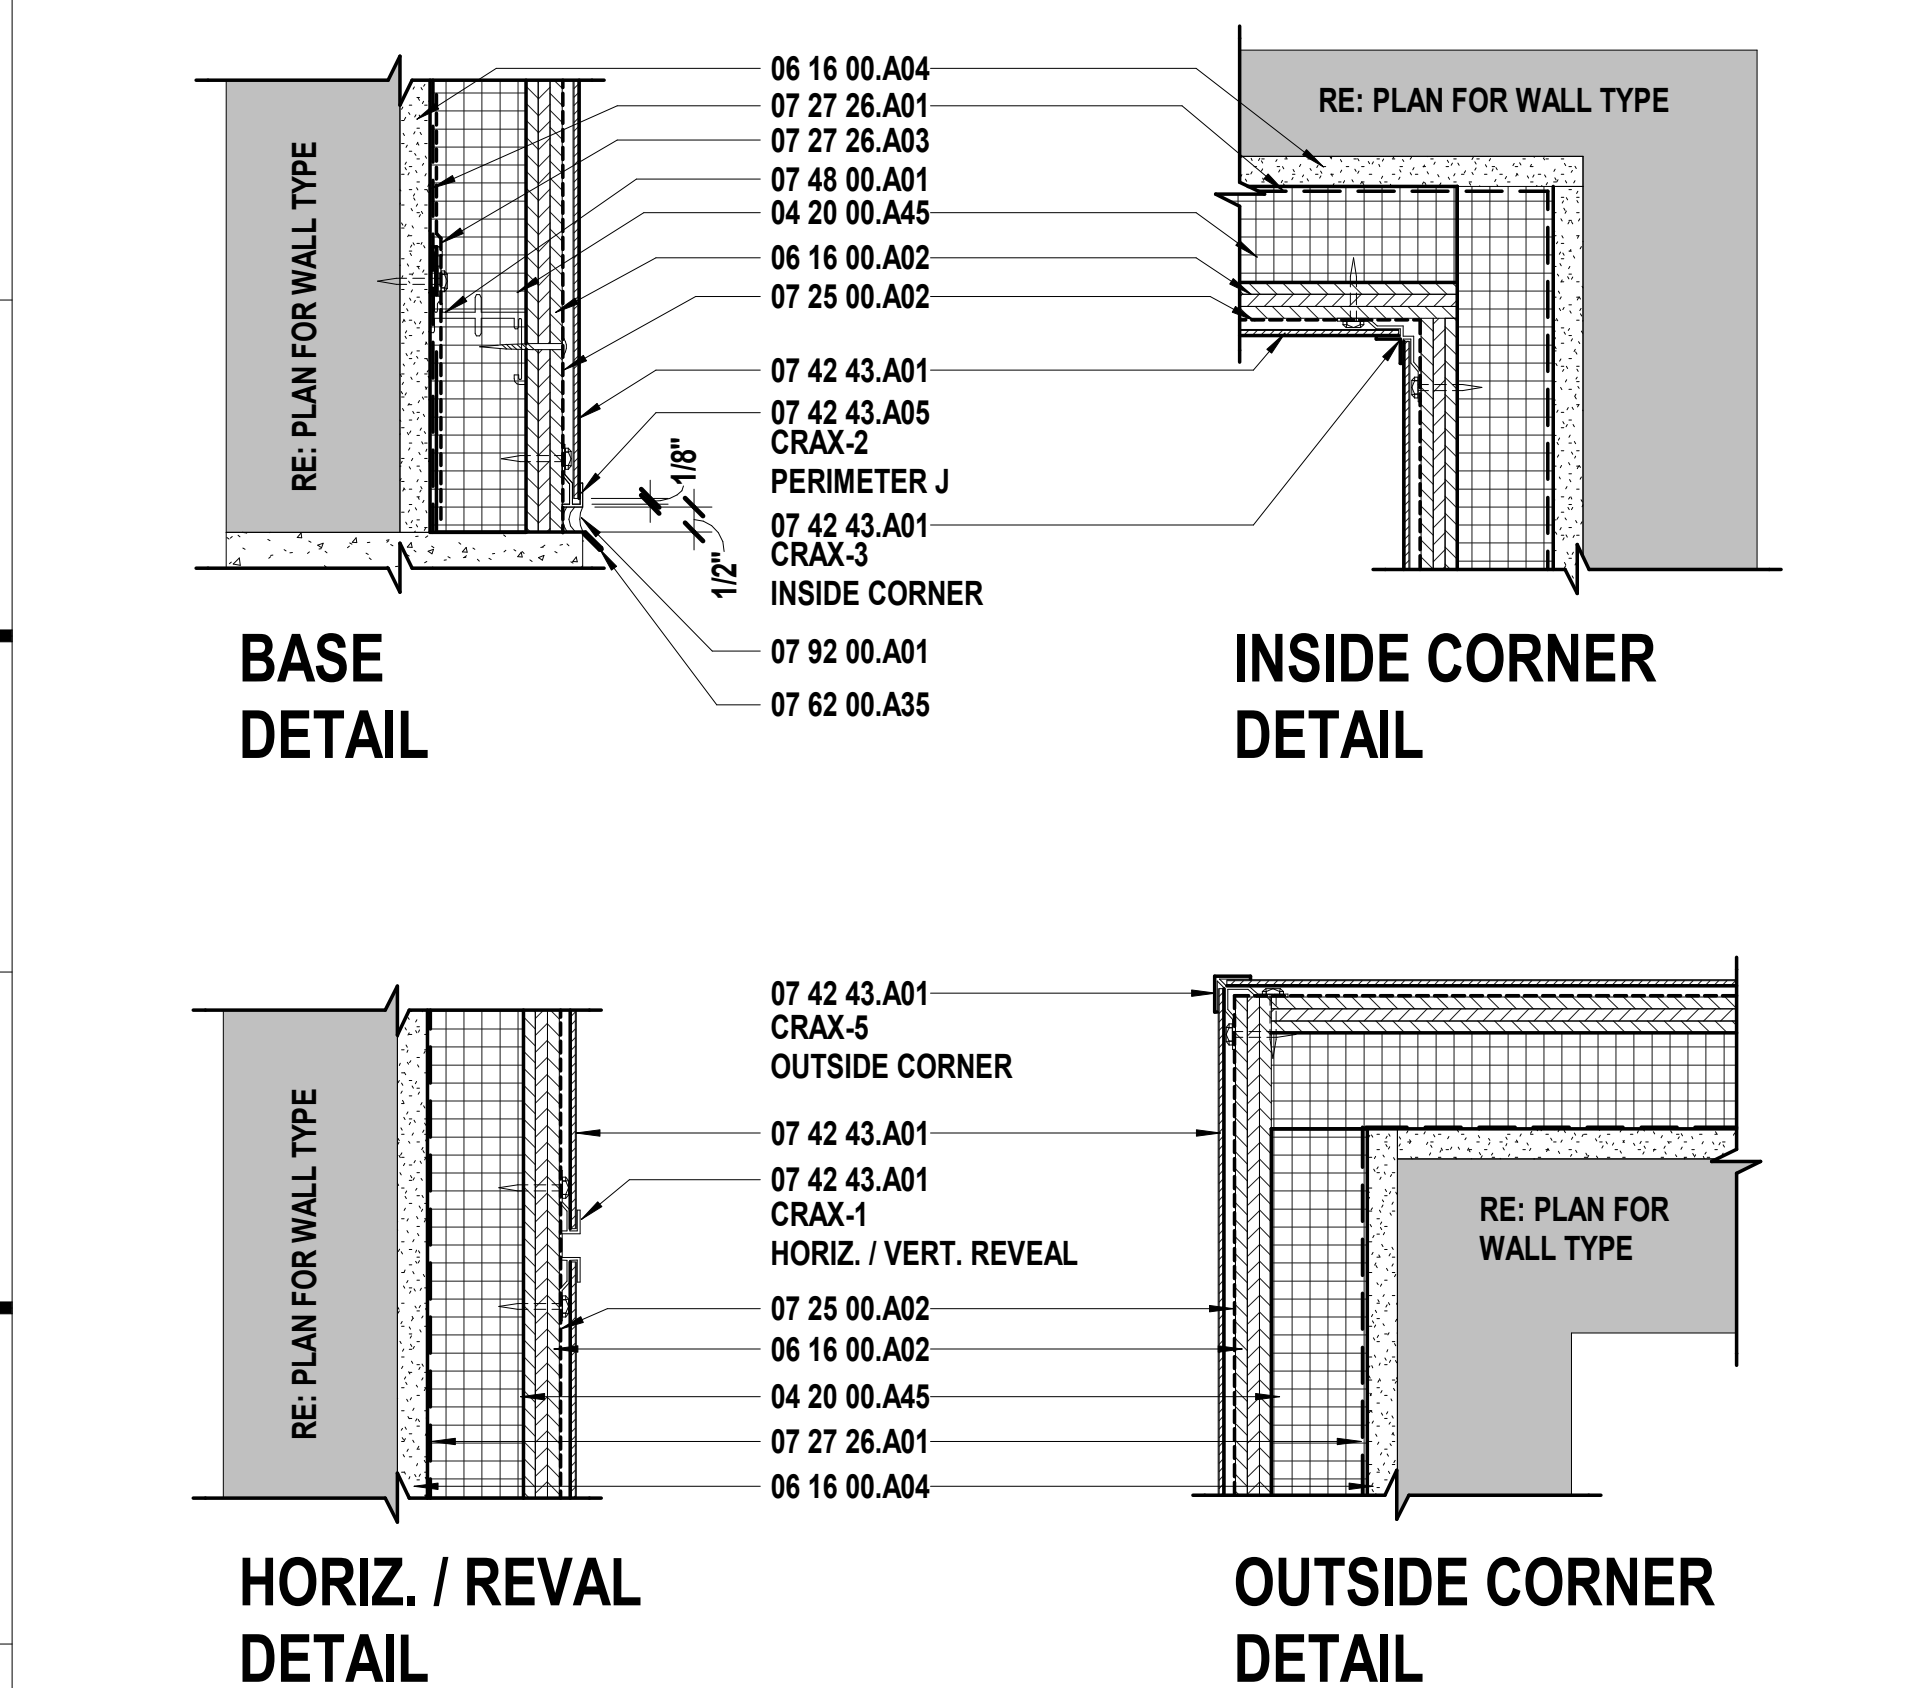


A1	Scale	Metal Panel - Citadel - MP1
	3" = 1'-0"	

N6	Scale	Detail - Storefront
	3" = 1'-0"	

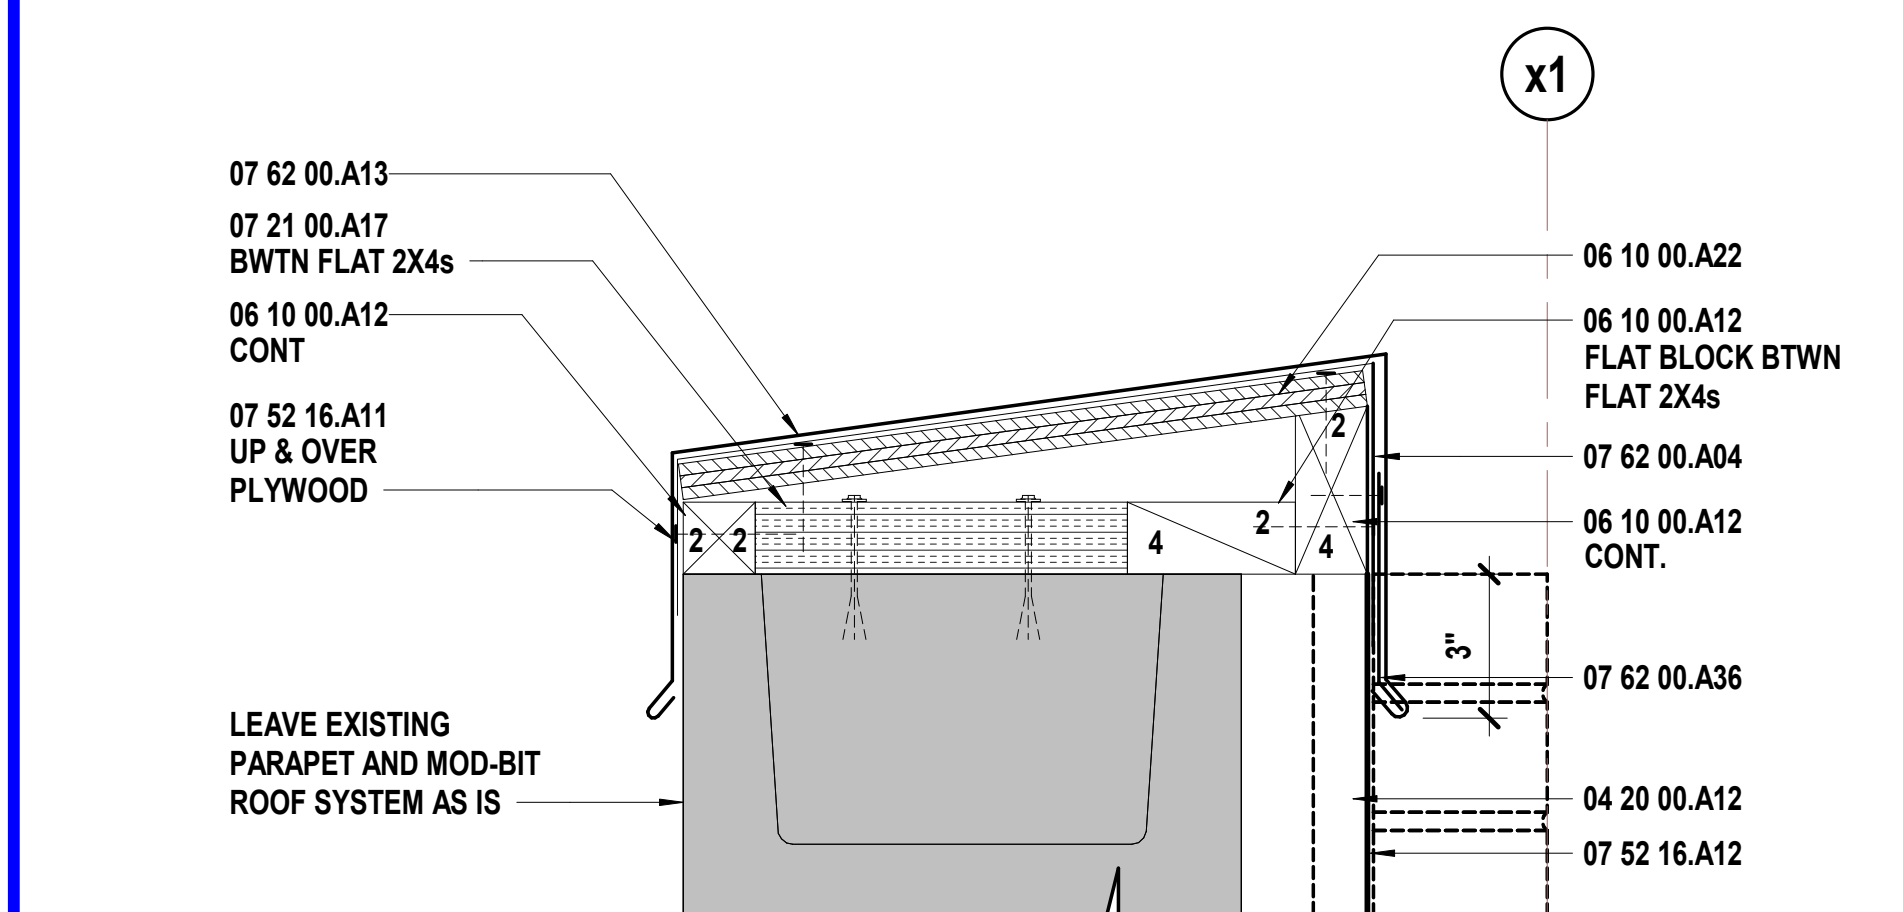

J6	Scale	Section Detail - Area A - Parapet Connection to Existing Gym
	3" = 1'-0"	

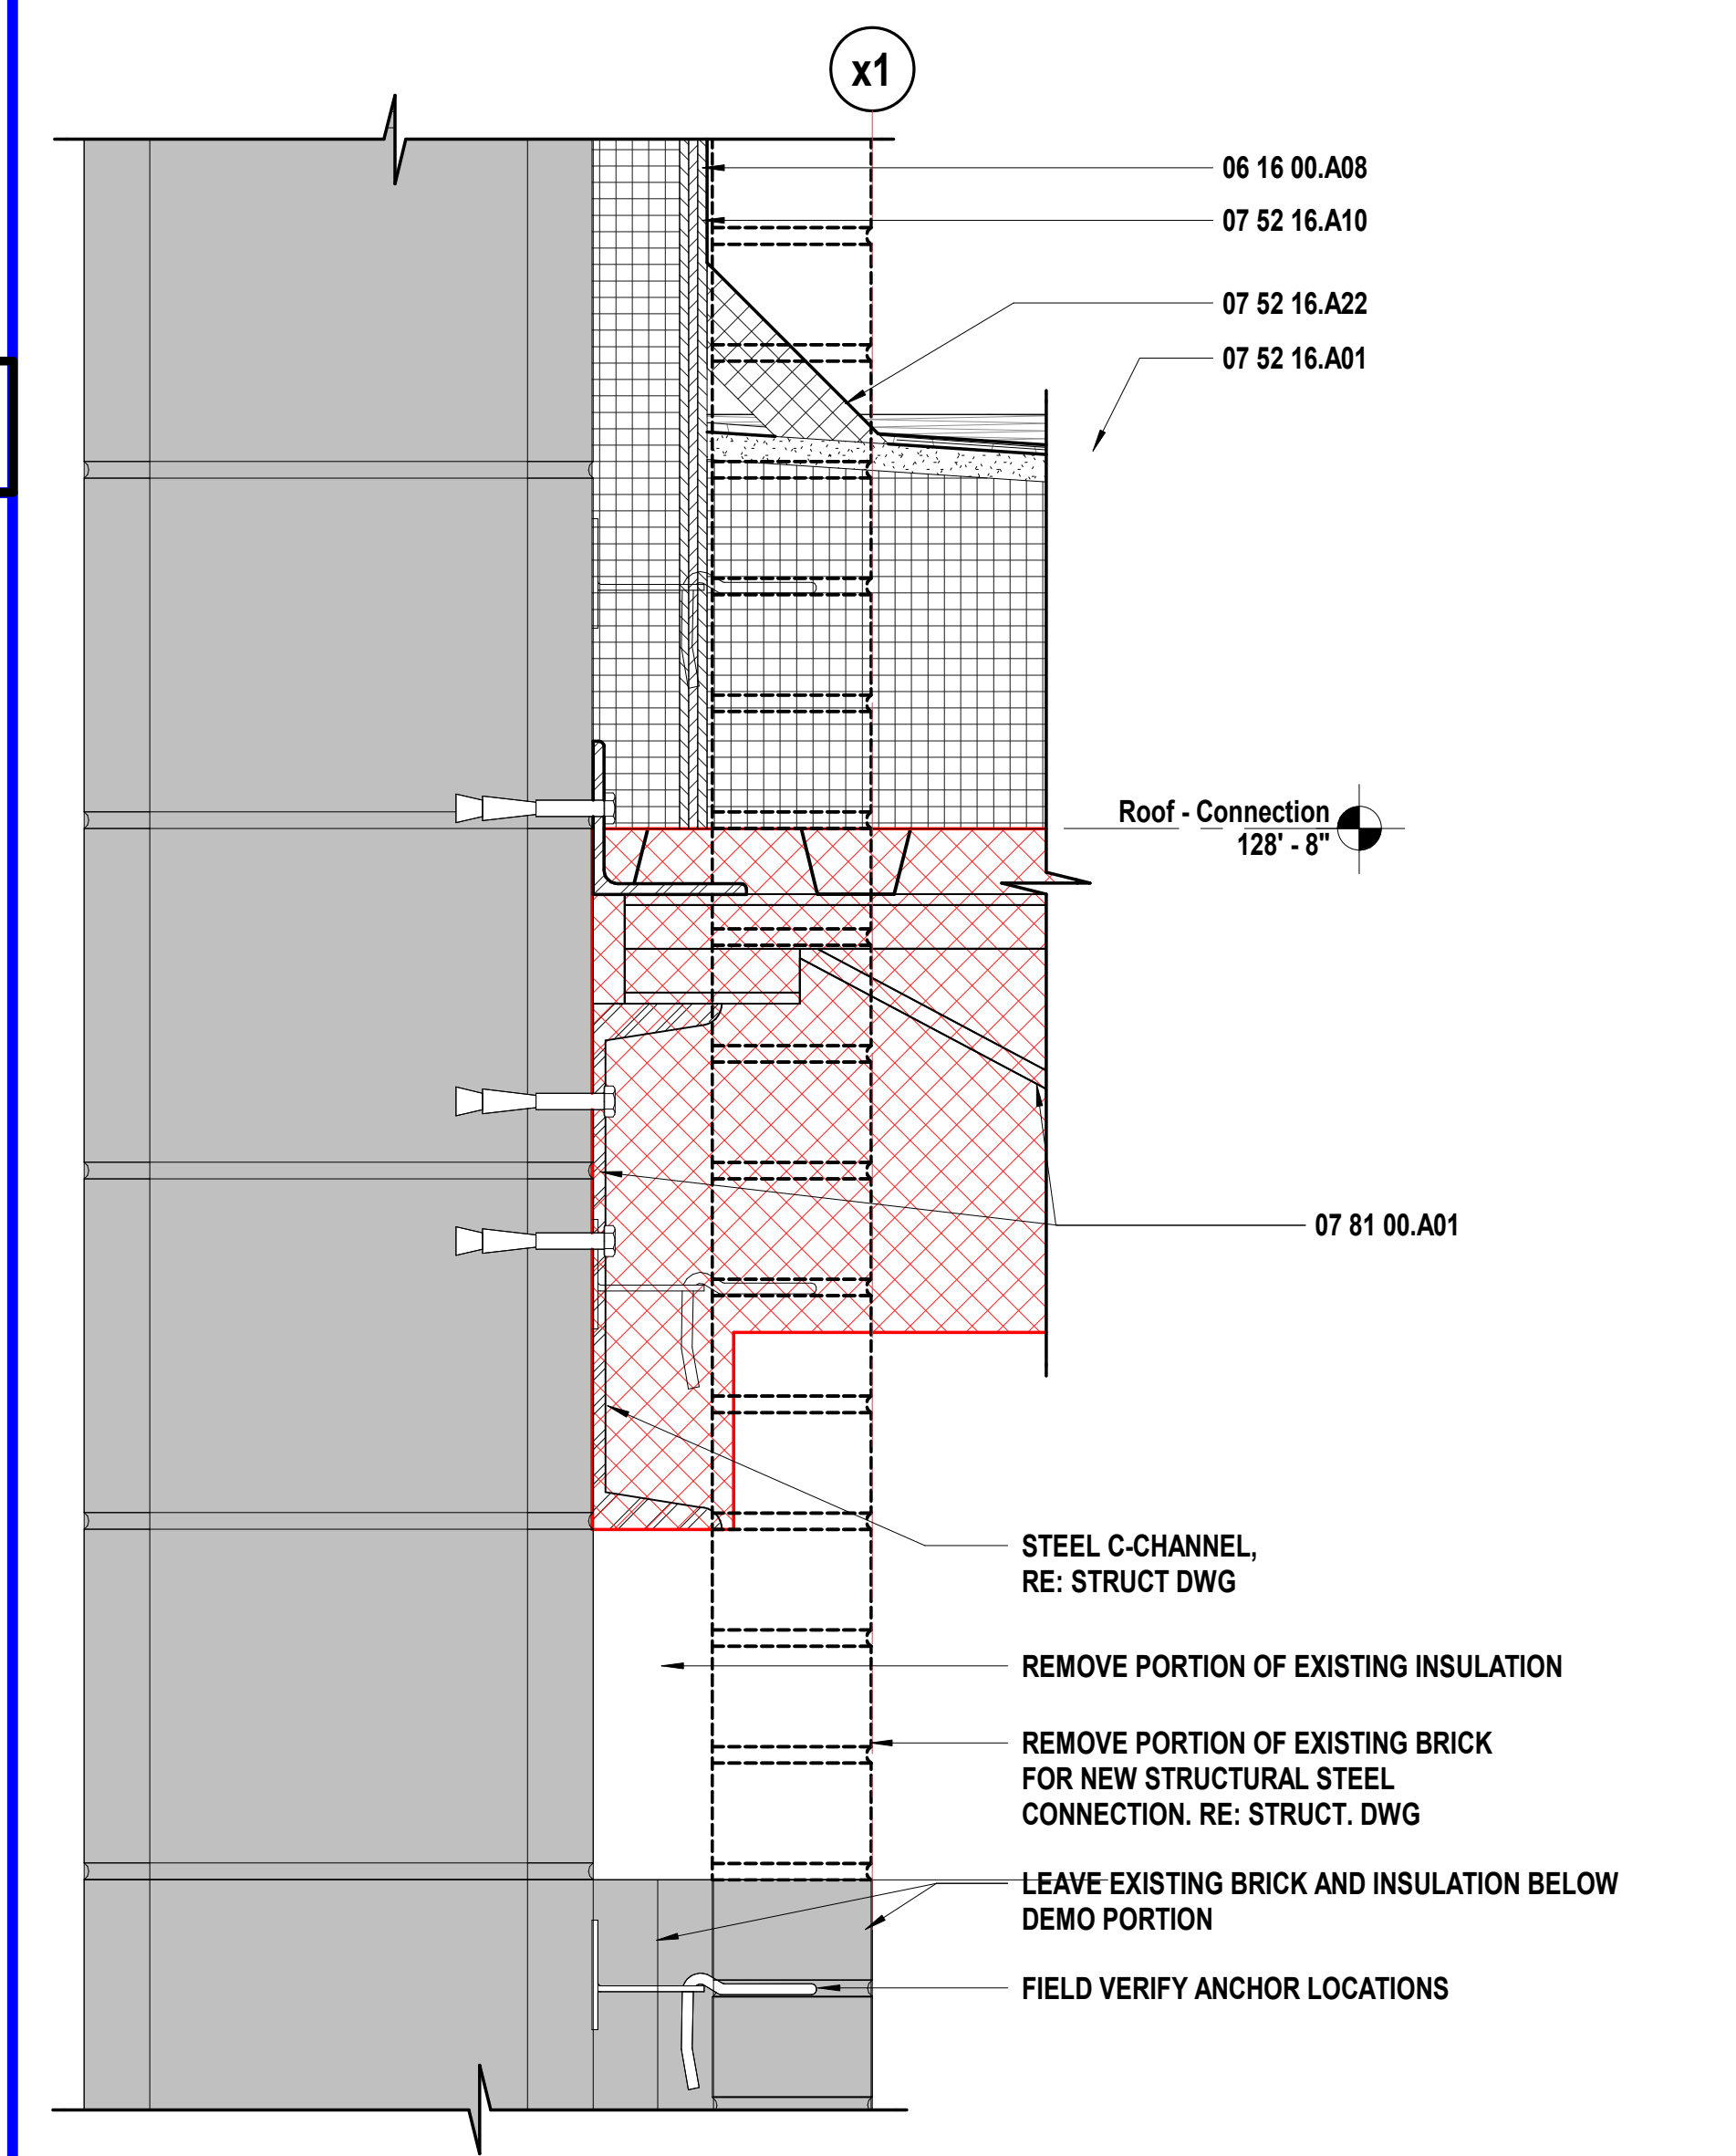

A6	Scale	Section Detail - Area A - Storage - Connection to Existing @ Roof
	3" = 1'-0"	

SHEET KEYNOTE LEGEND

04 20 00.0.012	FACE BRICK
04 20 00.0.A26	ADJUSTABLE MASONRY VENEER ANCHORS
04 20 00.0.A32	EMBEDDED FLEXIBLE FLASHING
04 20 00.0.A34	FLASHING TERMINATION BARS
04 20 00.0.A45	CAVITY WALL INSULATION
05 12 00.0.A03	CHANNEL
05 40 00.0.A01	COLD-FORMED METAL FRAMING
06 10 00.0.A12	PRESERVATIVE TREATED WOOD BLOCKING/NAILERS
06 10 00.0.A16	FIRE-RETARDANT TREATED WOOD BLOCKING & NAILERS
06 10 00.0.A20	FIRE-RETARDANT TREATED PLYWOOD BLOCKING AND BACKING PANELS
06 10 00.0.A22	PRESERVATIVE TREATED PLYWOOD BLOCKING
06 16 00.0.A02	FIRE-RETARDANT TREATED PLYWOOD
06 16 00.0.A04	GLASS-MAT GYPSUM WALL SHEATHING
06 16 00.0.A08	COMPOSITE INSULATED ROOF SHEATHING
07 21 00.0.A01	EXTRUDED POLYSTYRENE BOARD INSULATION
07 21 00.0.A17	MINERAL WOOL
07 25 00.0.A02	SELF-ADHERING WEATHER BARRIERS
07 27 26.0.A01	VAPOR RETARDING FLUID-APPLIED AIR BARRIER
07 27 26.0.A03	TRANSITION MEMBRANE
07 42 13.0.A03	CONCEALED FASTENER METAL WALL PANELS
07 42 13.0.A07	FLASHING AND TRIM
07 42 43.0.A01	METAL-FACED COMPOSITE MATERIAL WALL PANELS
07 42 43.0.A05	TRIM
07 48 00.0.A01	RAINSCREEN FURRING SYSTEM
07 52 16.0.A01	MODIFIED BITUMINOUS ROOFING SYSTEM
07 52 16.0.A05	VENTED BASE SHEET
07 52 16.0.A10	BASE FLASHING
07 52 16.0.A11	VERTICAL WALL FLASHING (MODIFIED BITUMINOUS)
07 52 16.0.A12	INSULATION WALL FLASHING (EPDM)
07 52 16.0.A22	VENTILATION CANT STRIPS
07 62 00.0.A04	FLEXIBLE MEMBRANE CLOSURE
07 62 00.0.A13	COPING
07 62 00.0.A15	ROOF TO WALL EXPANSION JOINT COVER
07 62 00.0.A18	COUNTER FLASHING
07 62 00.0.A35	PRE-FINISHED MISC METAL FLASHING
07 62 00.0.A36	CLEAT
07 81 00.0.A01	FIREPROOFING
07 92 00.0.A01	SEALANT
07 92 00.0.A02	SEALANT W/BACKER ROD
08 41 13.0.A02	THERMAL BROKEN STOREFRONT FRAMING (6")
09 29 00.0.A01	GYPSUM BOARD - TYPE X

South Valley Middle School Storm Shelter Addition

Liberty Public Schools
1000 Midjray Dr, Liberty, MO 64068

REVISIONS:		
#	Description	Date



OCTOBER 11, 2023

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A-2019015618


JOB NO: 23019
DRAWN BY: KL
CHECKED BY: JB
DATE: 08.31.2023

A362


EXTERIOR DETAILS

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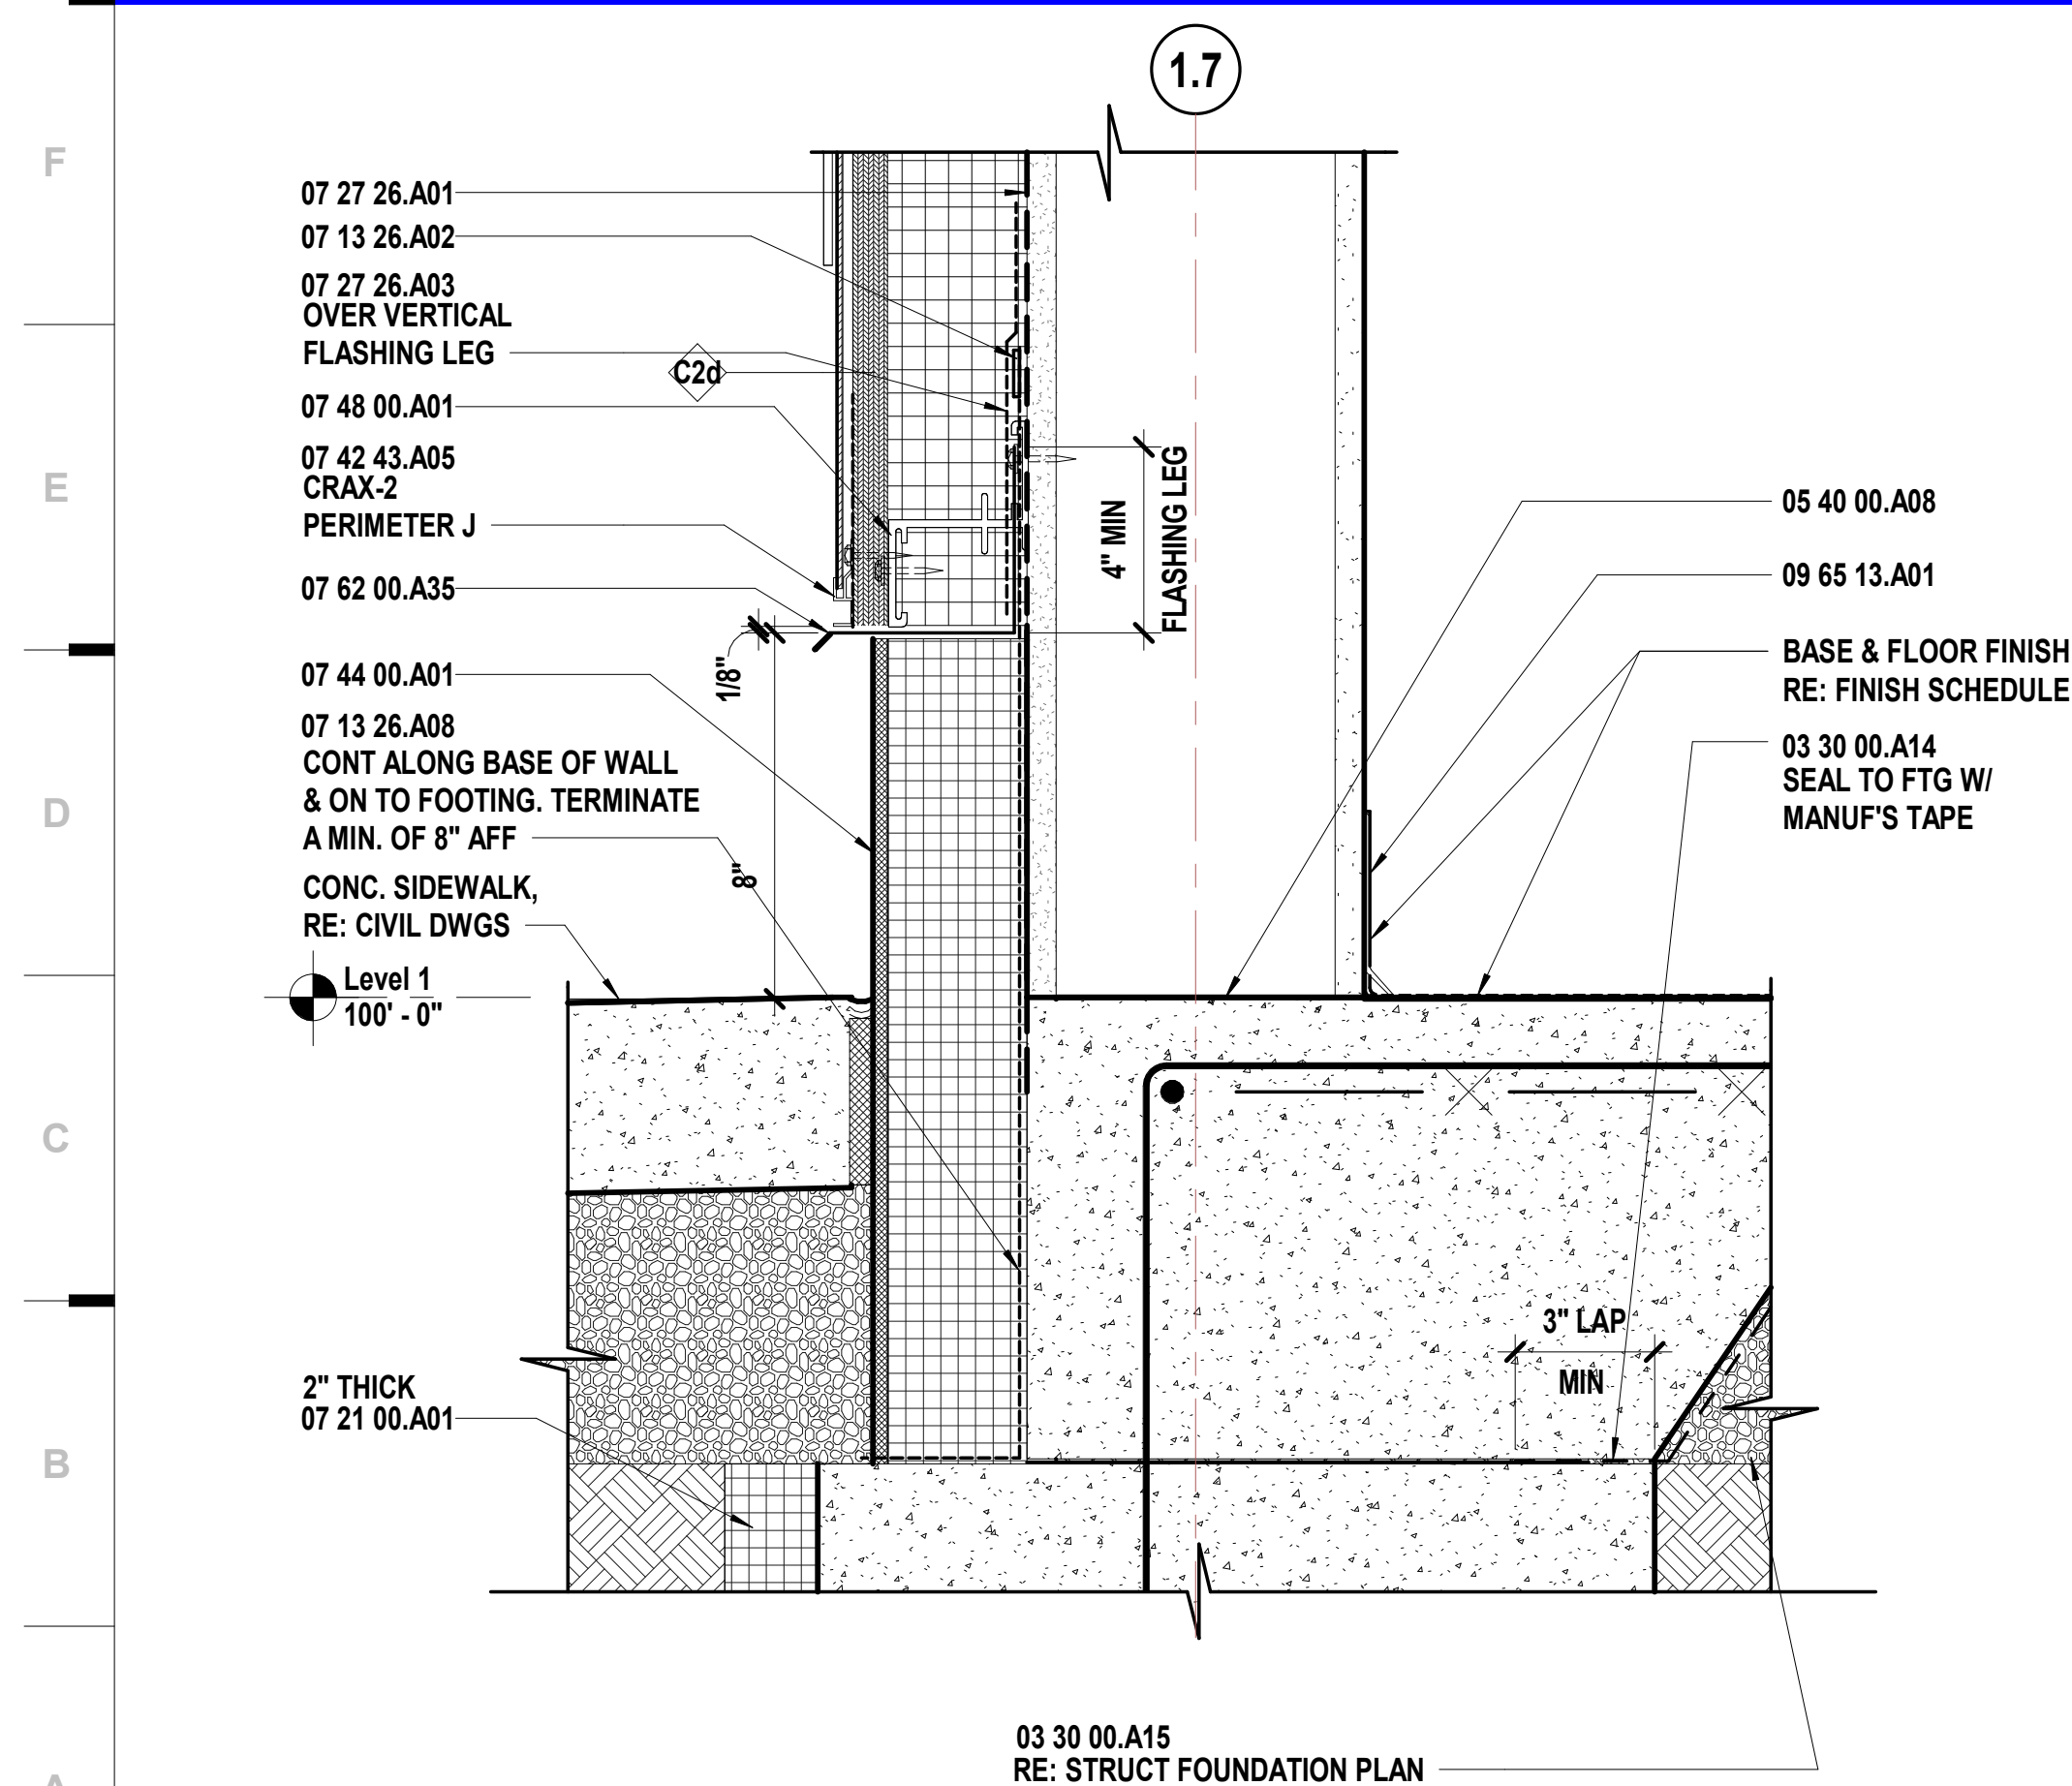
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CONSTRUCTION
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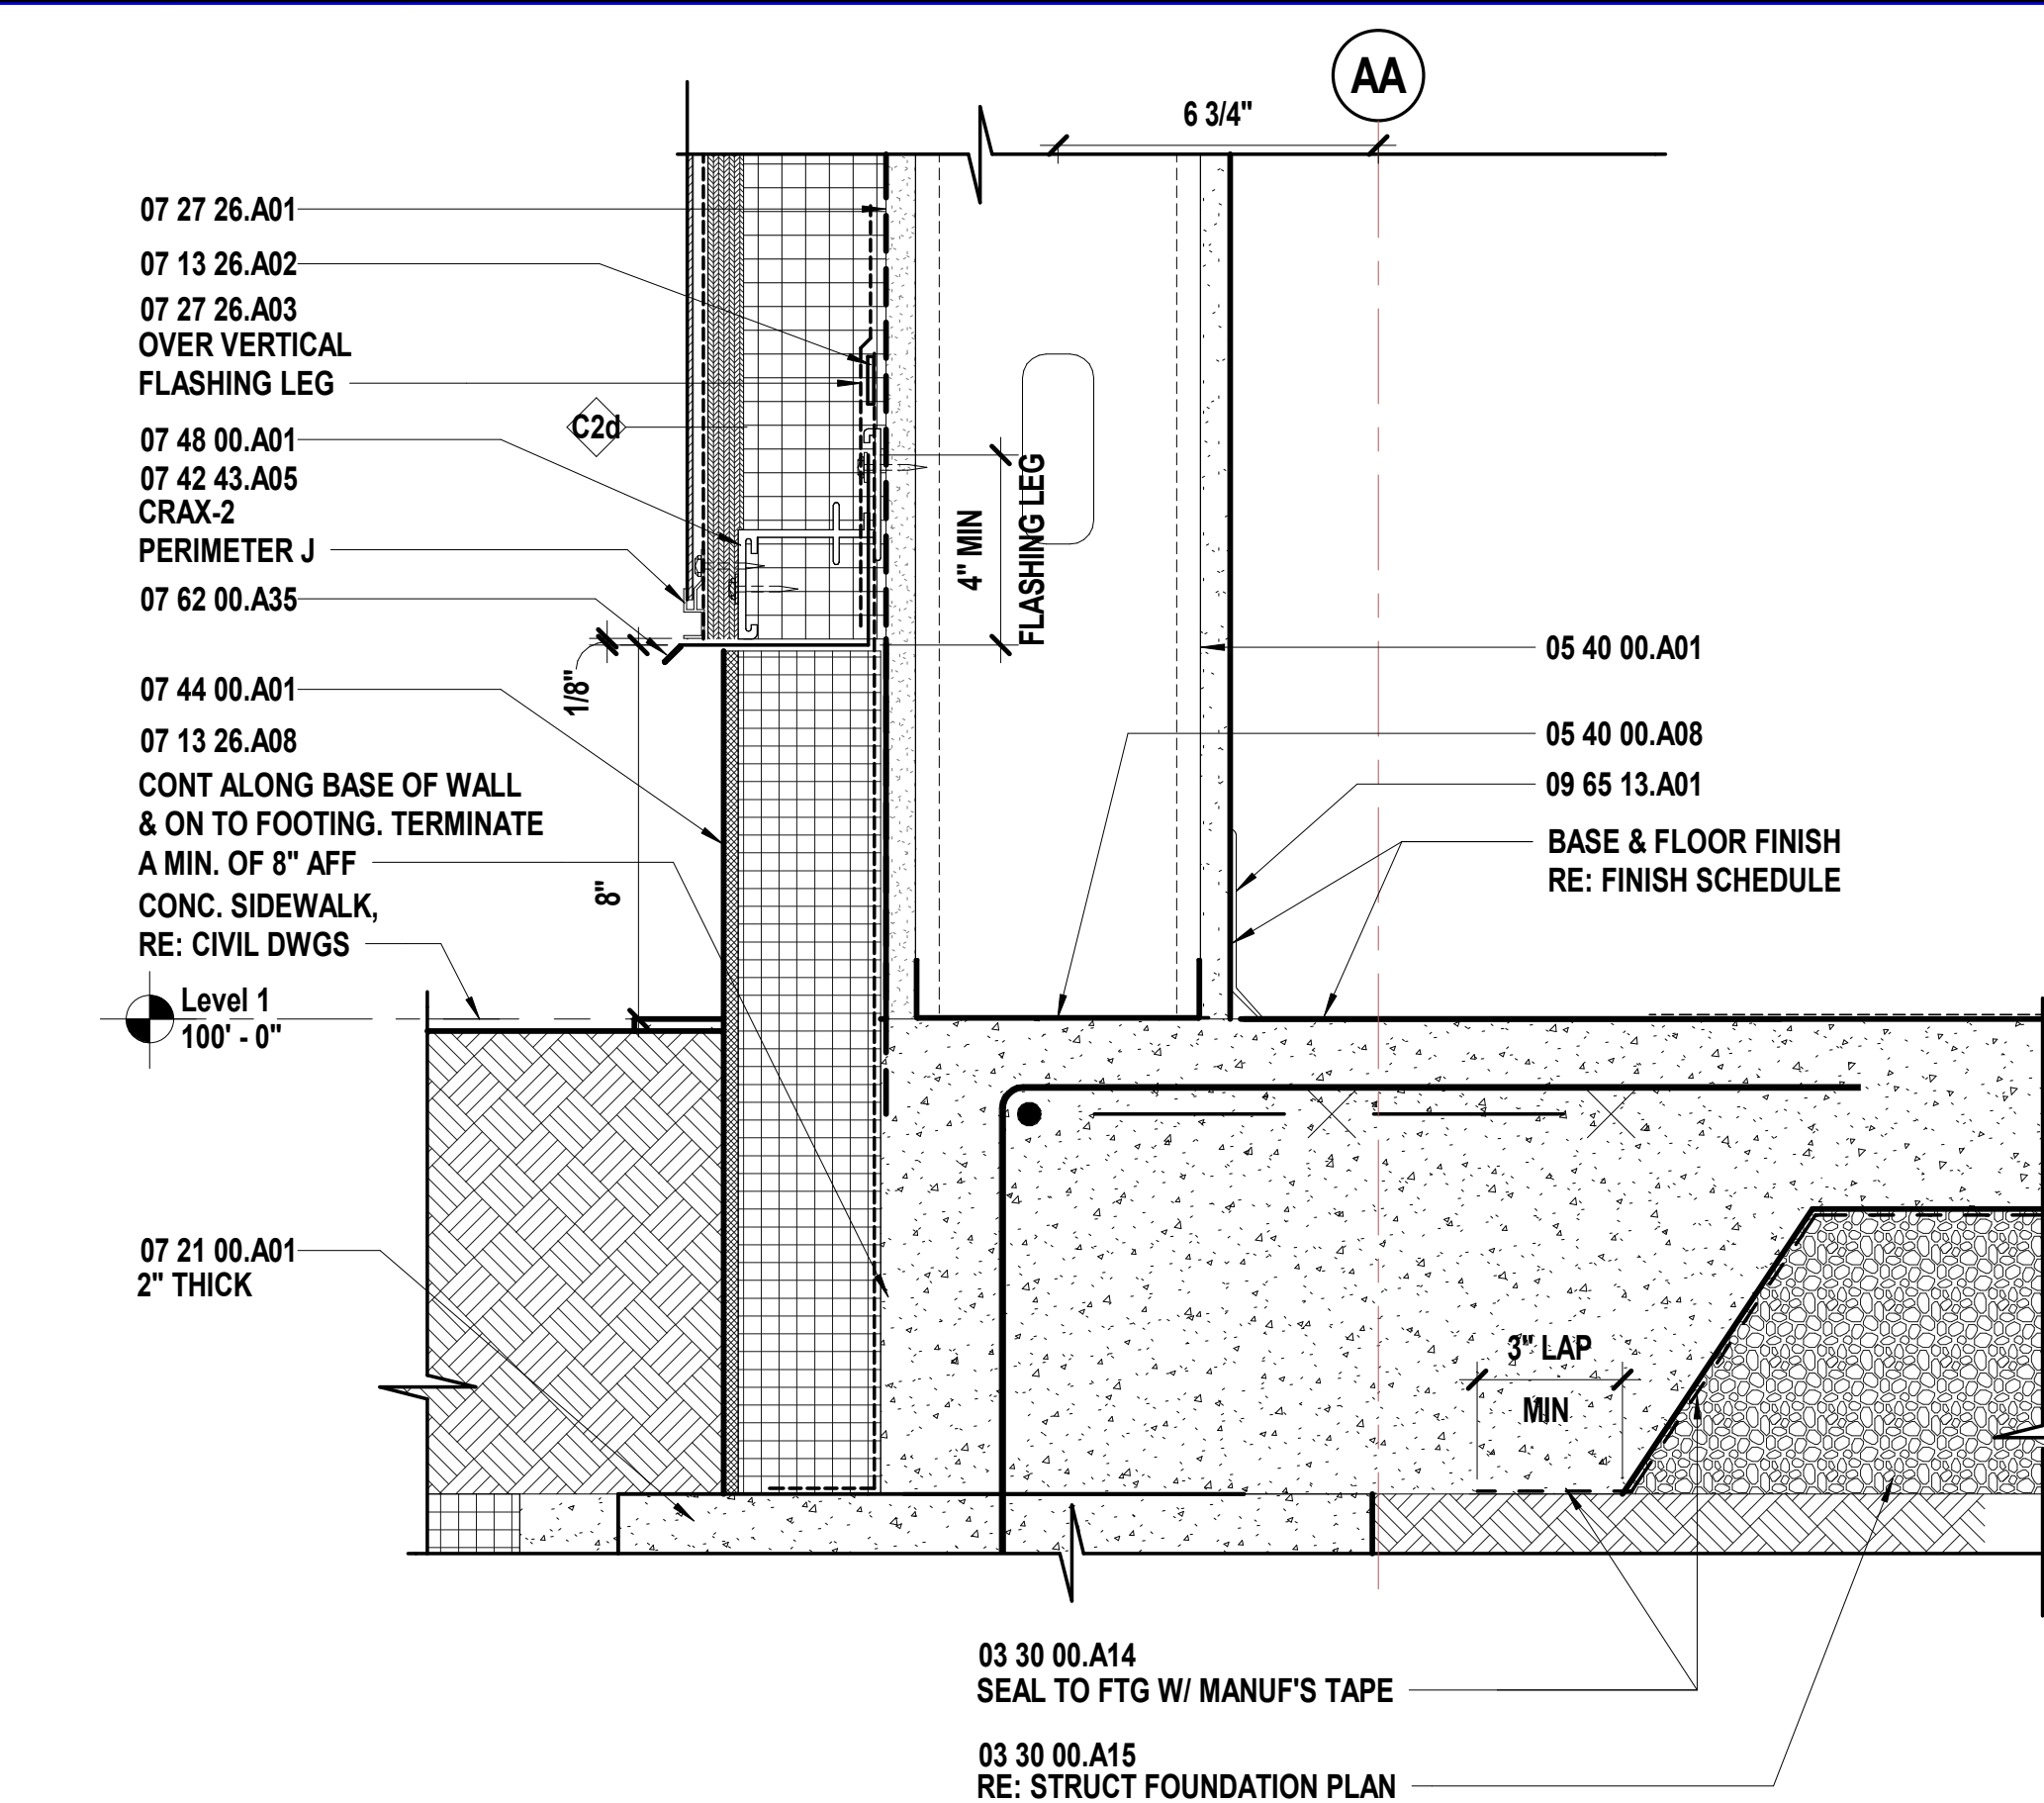
L1	Scale	Section Detail - Parapet at Entry
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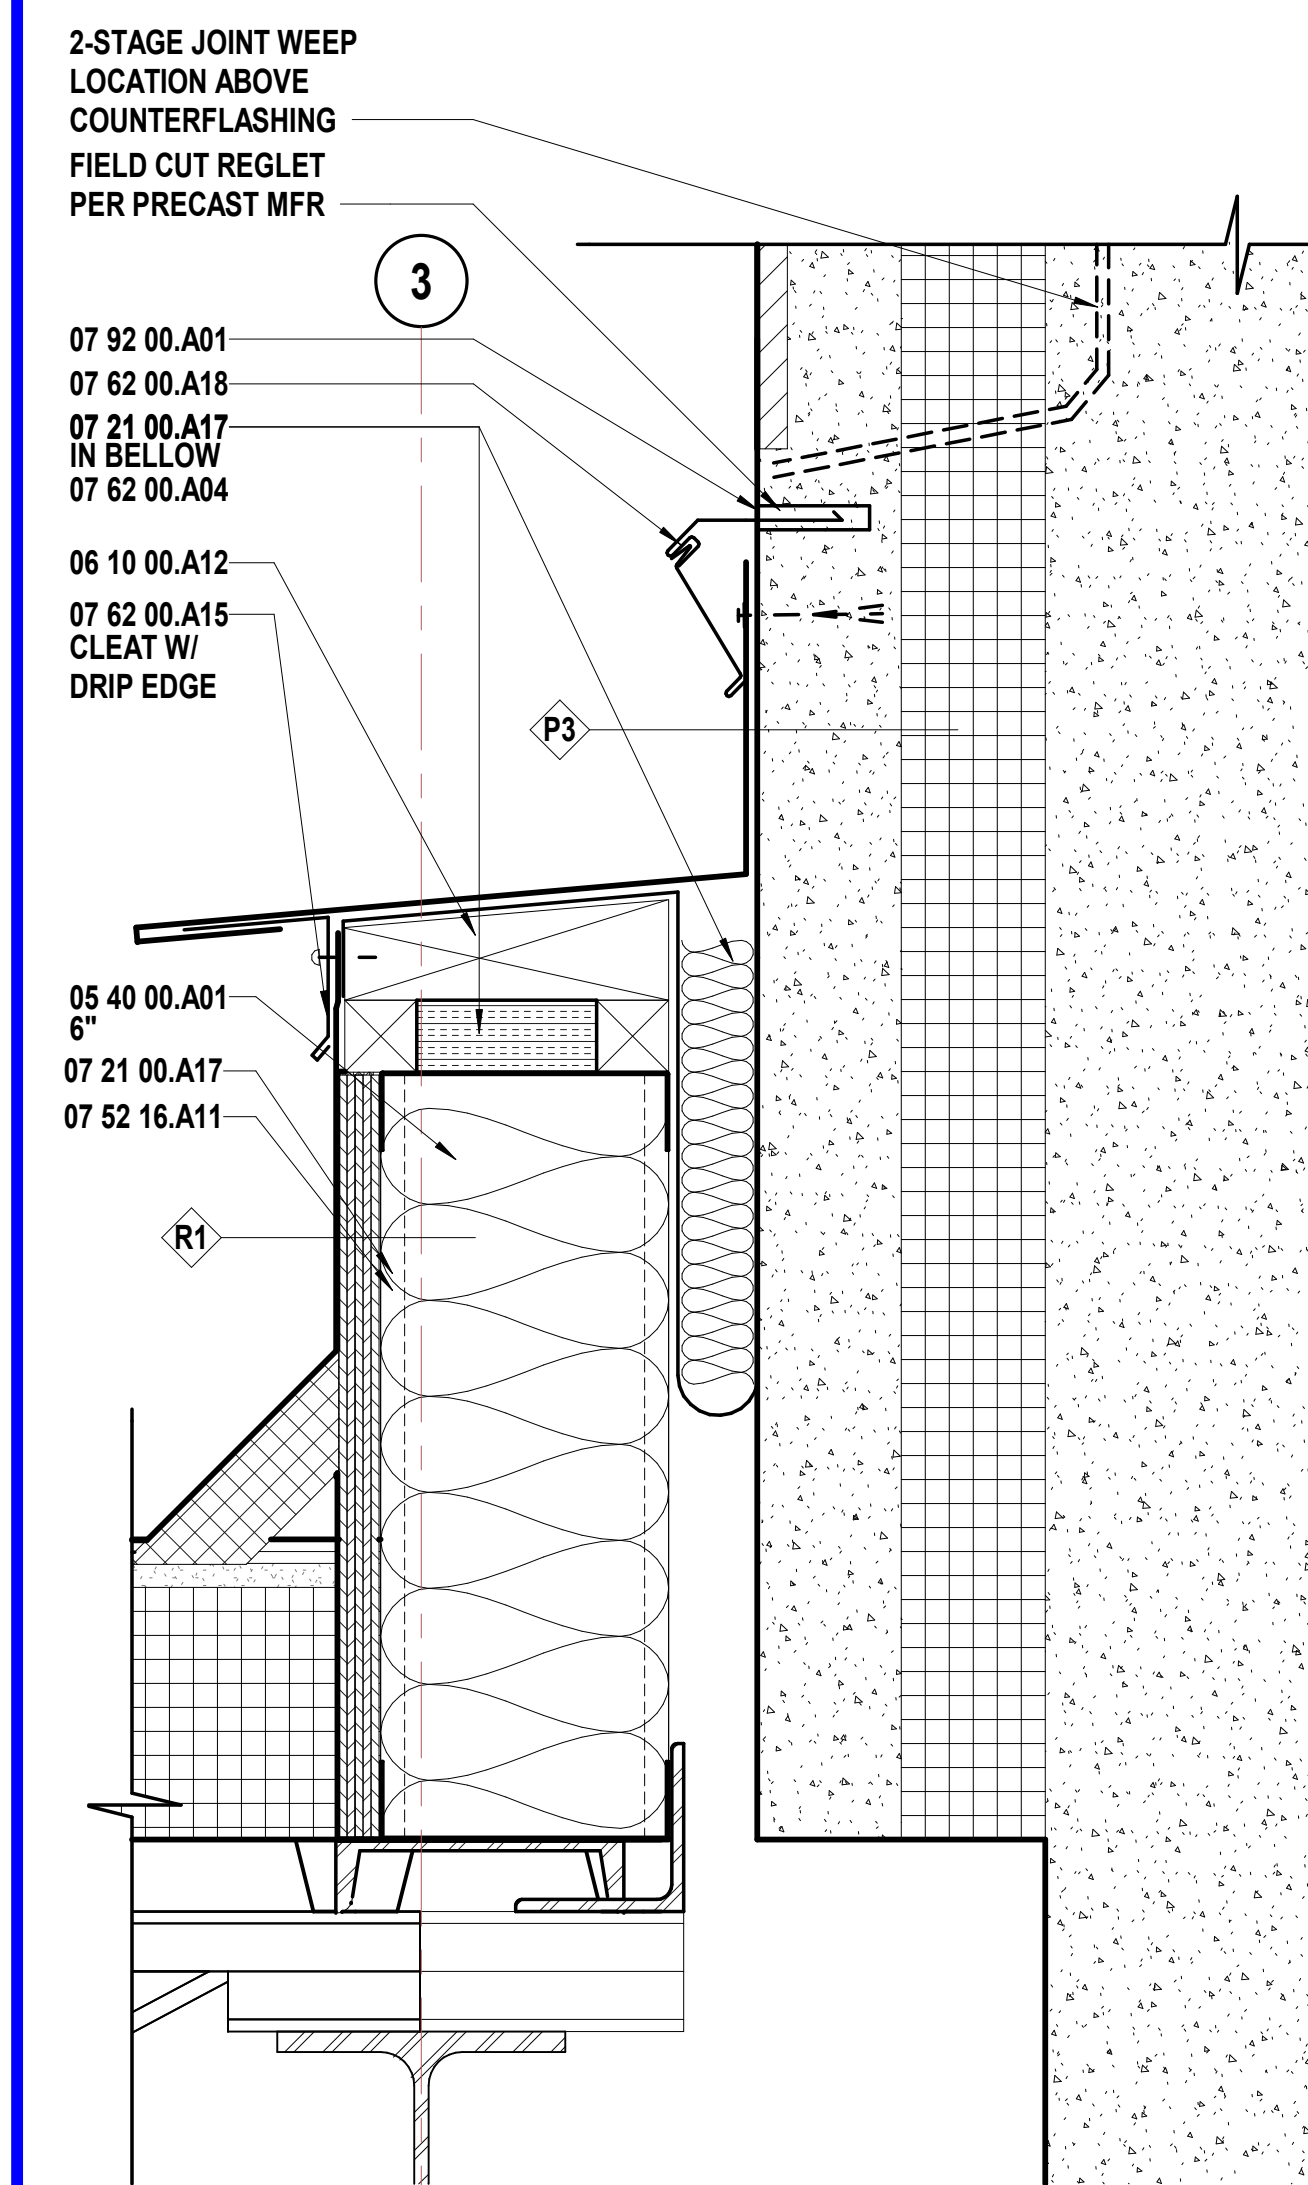
G7	Scale	Section Detail - Area A - Roof Connection
	3" = 1'-0"	

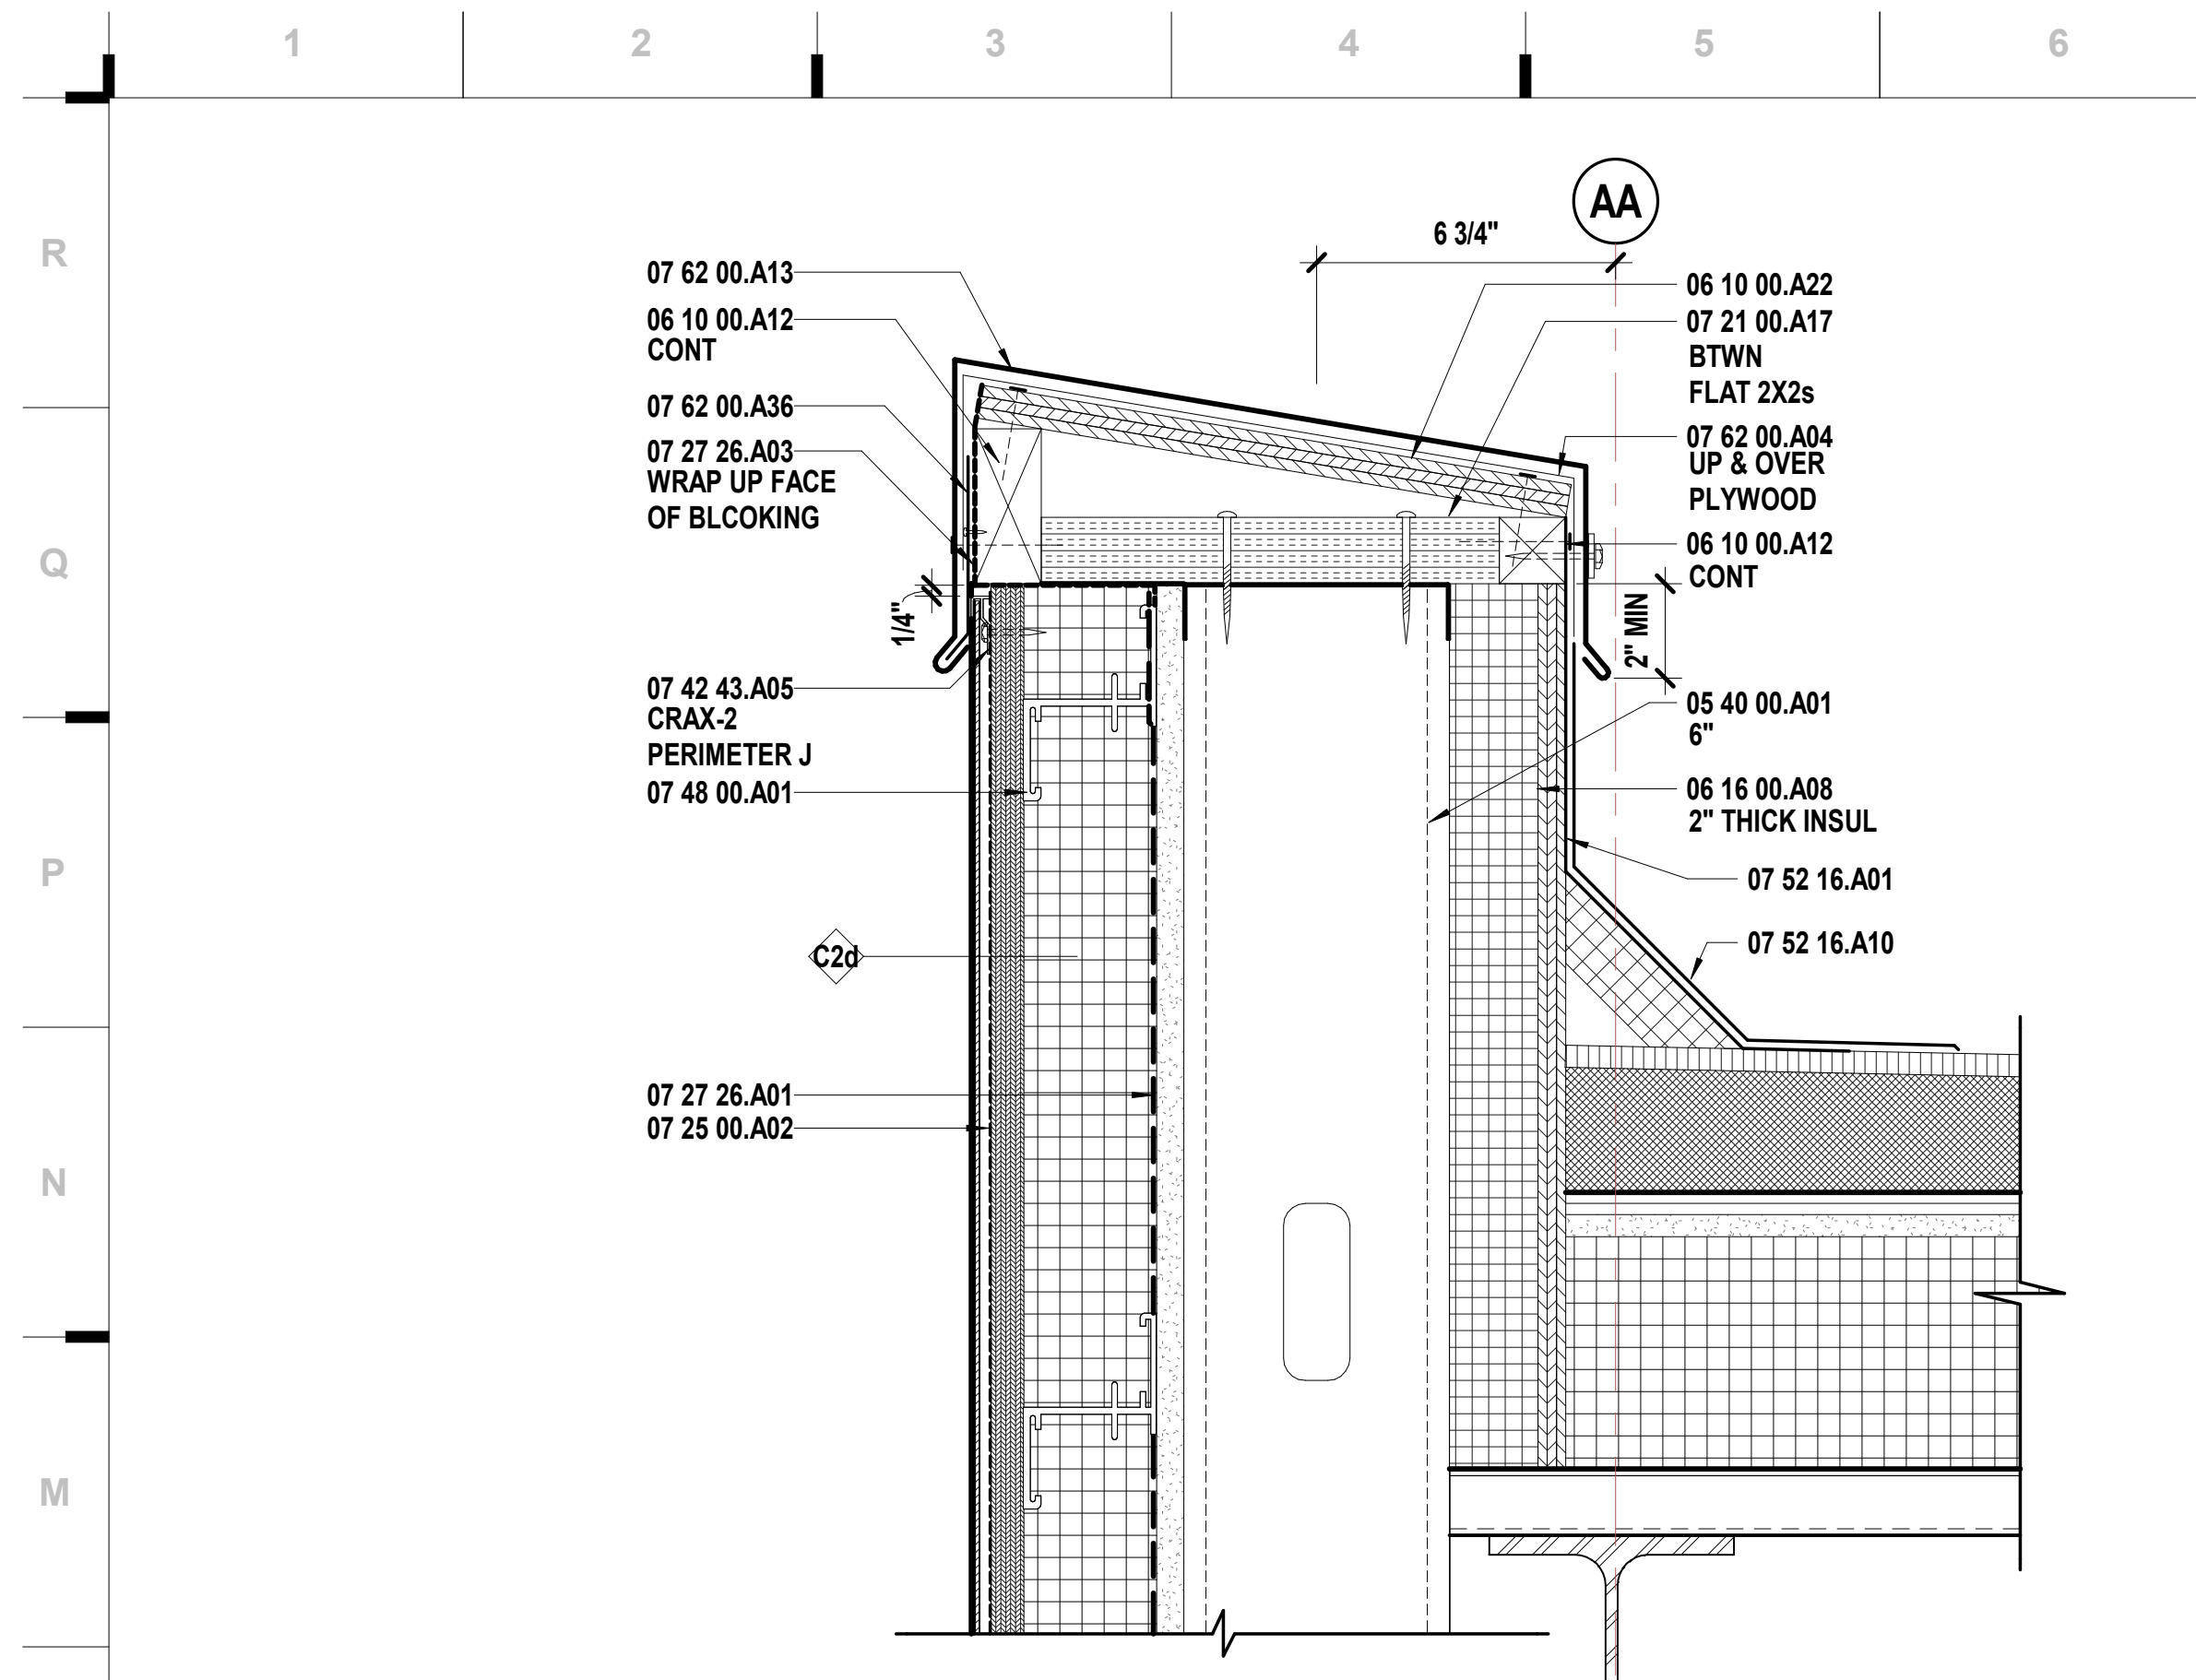


A1	Scale	Section Detail - Entry @ Footing
	3" = 1'-0"	

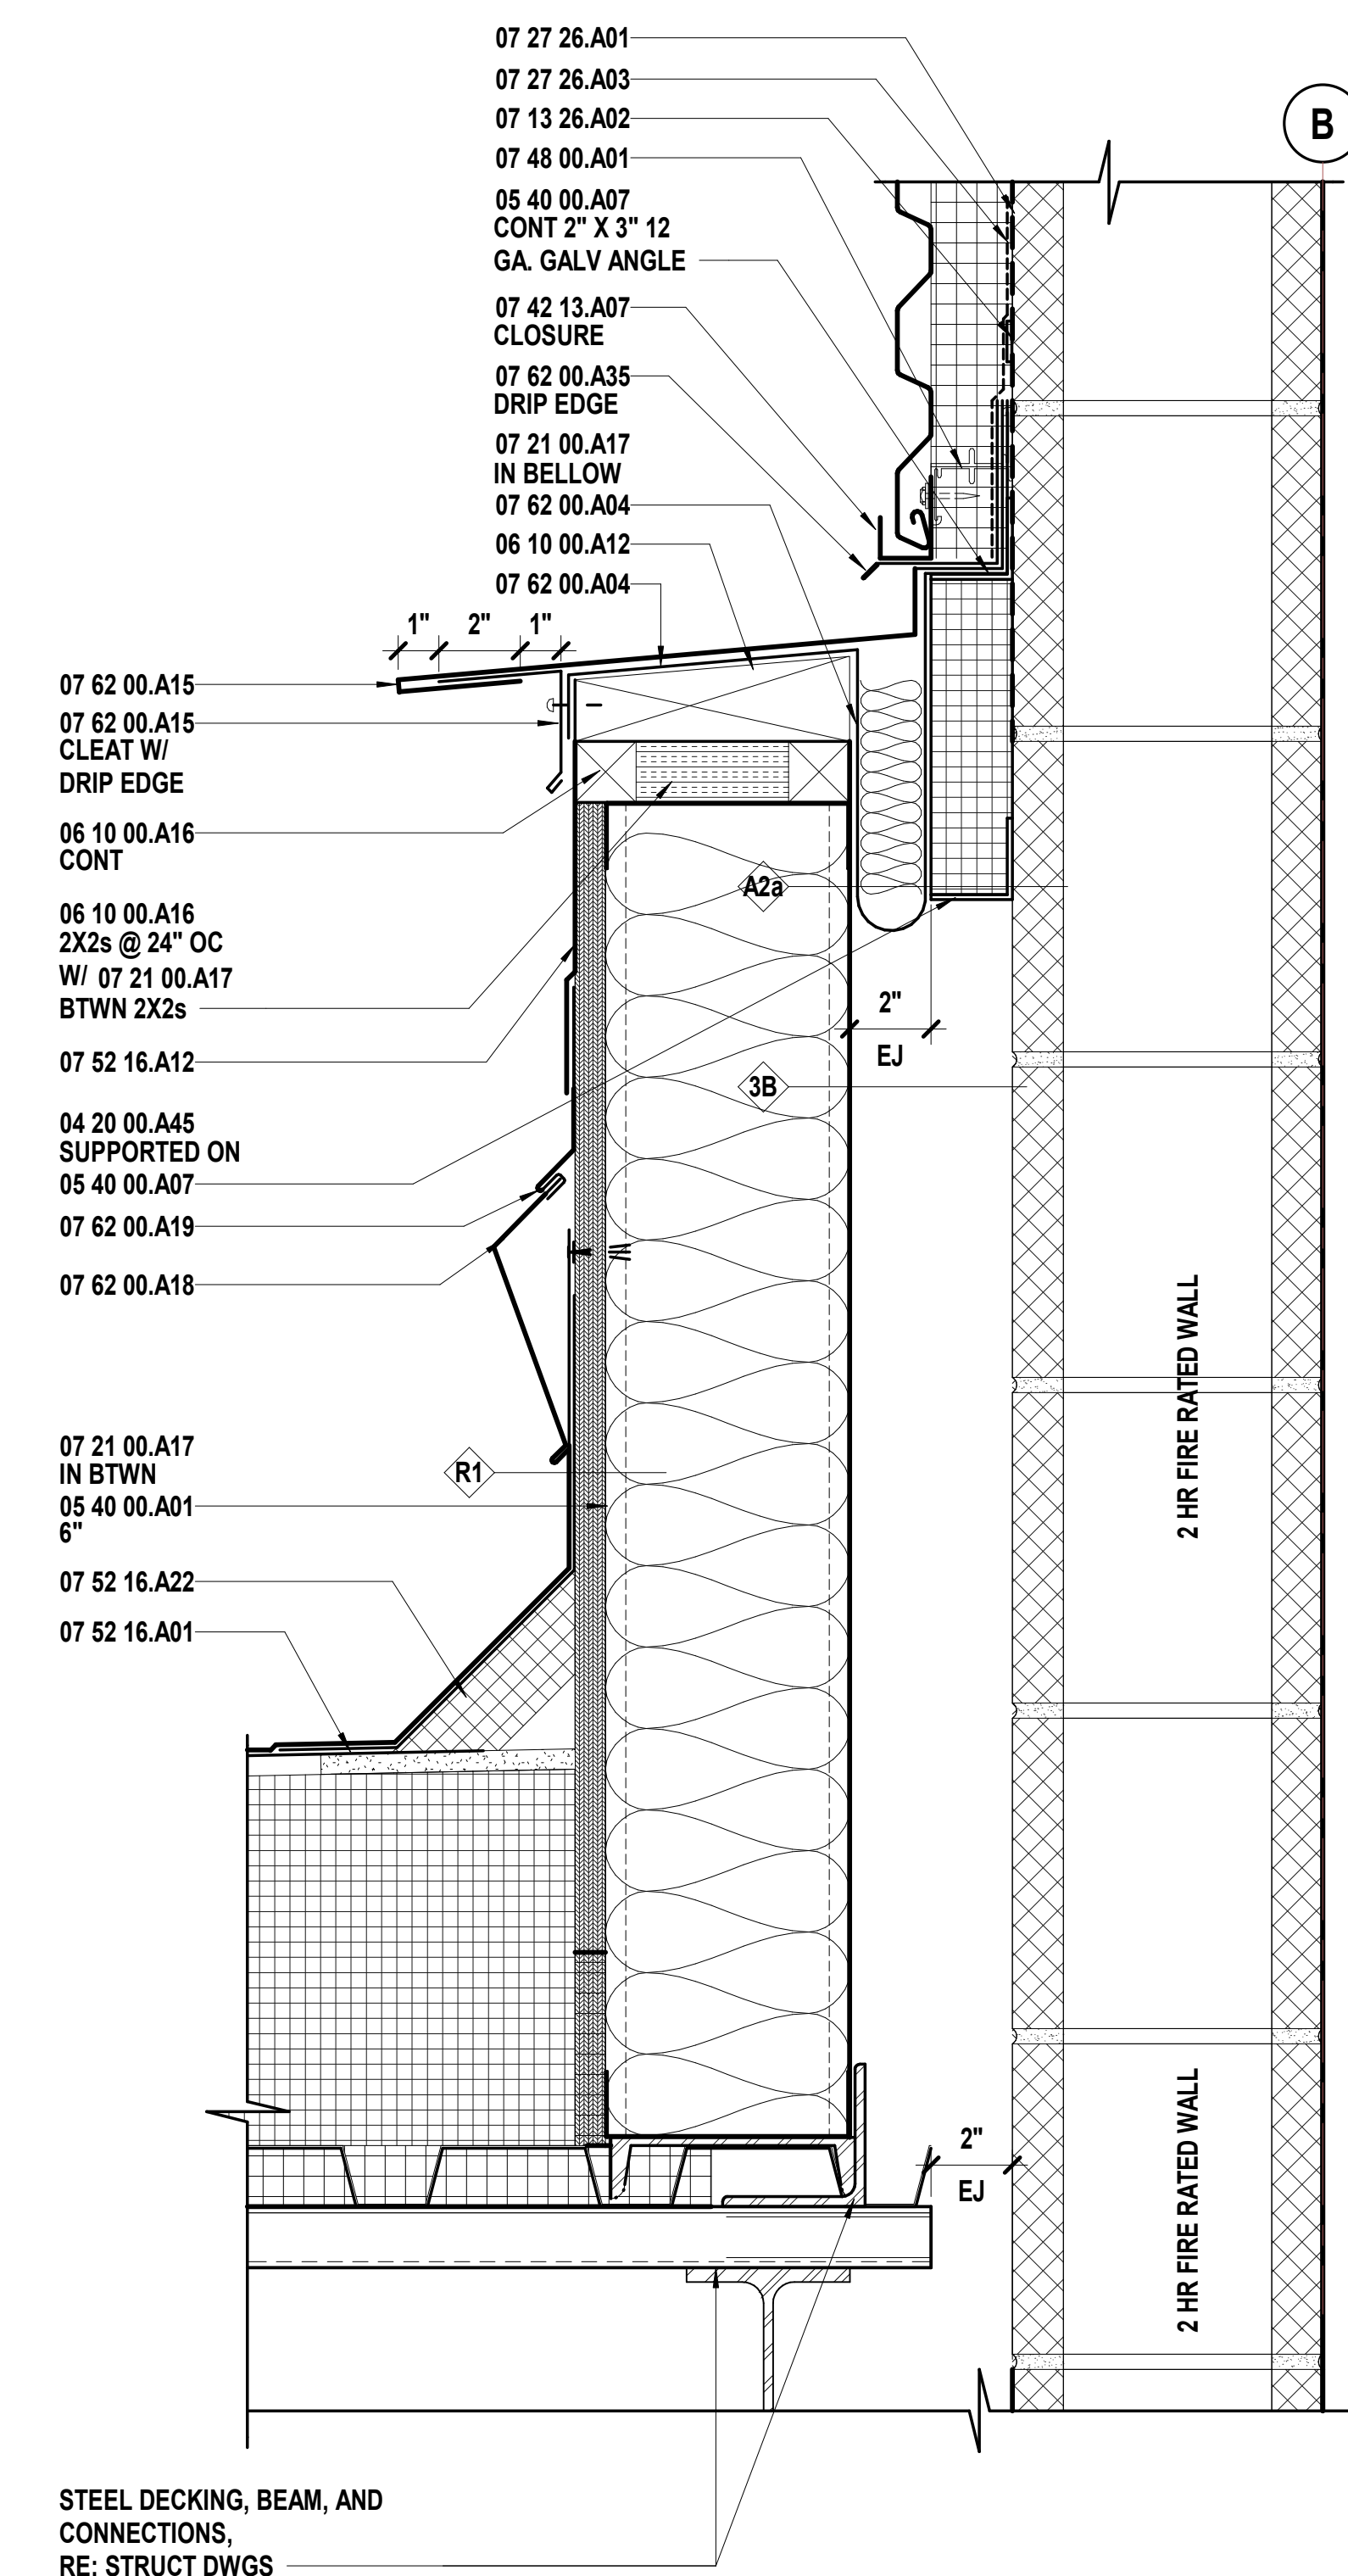


A7	Scale	Section Detail - Entry @ Slab
	3" = 1'-0"	



J13	Scale	Section Detail - Area A - Storage Connection to Multipurpose
	3" = 1'-0"	

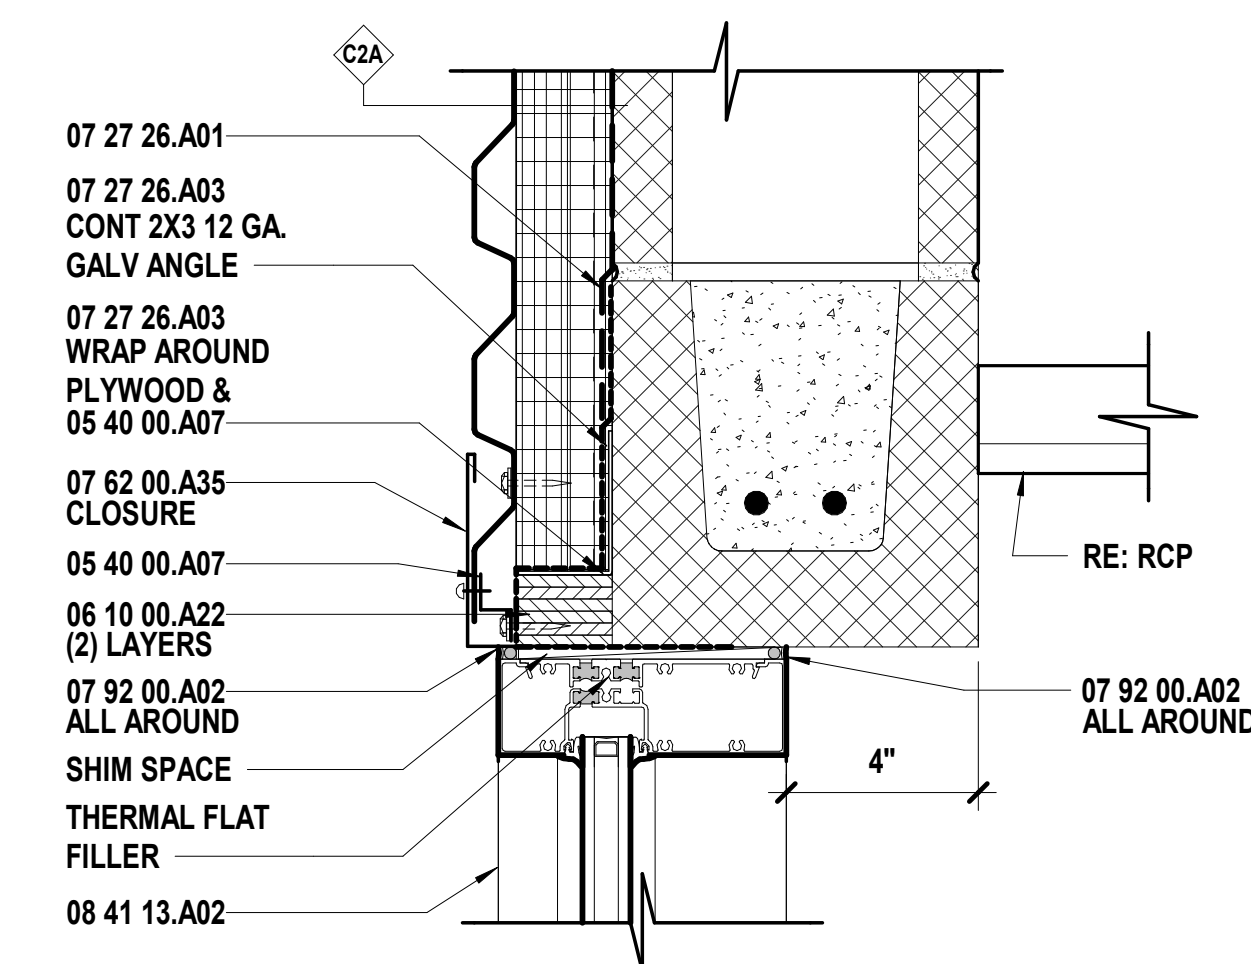

E13	Scale	Section Detail - Area A - Circulation A110 - Door Header - E
	3" = 1'-0"	

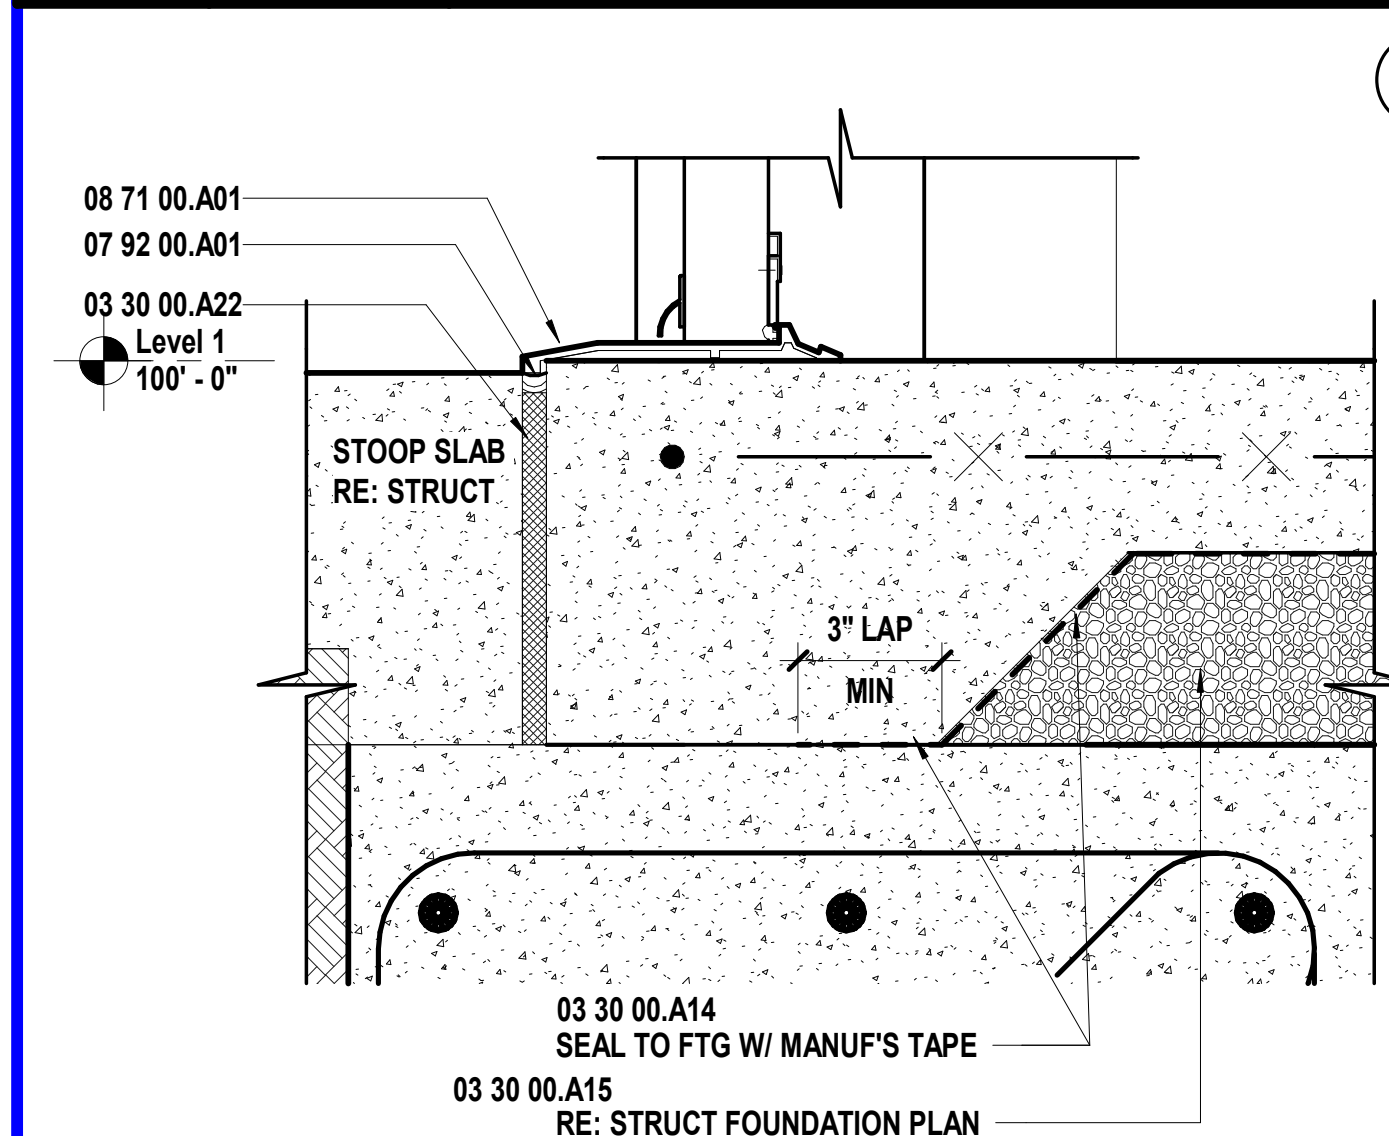

A13	Scale	Section Detail - Area A - Circulation A110 - E
	3" = 1'-0"	

SHEET KEYNOTE LEGEND

03 30 00.A14	VAPOR RETARDERS
03 30 00.A15	GRANULAR DRAINAGE FILL
03 30 00.A22	EXPANSION/ISOLATION JOINT
04 20 00.A45	CAVITY WALL INSULATION
05 40 00.A01	COLD-FORMED METAL FRAMING
05 40 00.A07	MISCELLANEOUS FRAMING/FURRING
05 40 00.A08	ISOLATION STRIP MEMBRANE
06 10 00.A12	PRESERVATIVE TREATED WOOD BLOCKING/NAILERS
06 10 00.A16	FIRE-RETARDANT TREATED WOOD BLOCKING & NAILERS
06 10 00.A22	PRESERVATIVE TREATED PLYWOOD BLOCKING
06 16 00.A08	COMPOSITE INSULATED ROOF SHEATING
07 13 26.A02	TERMINATION BAR
07 13 26.A08	MOISTURE BARRIER
07 21 00.A01	EXTRUDED POLYSTYRENE BOARD INSULATION
07 21 00.A17	MINERAL WOOL
07 25 00.A02	SELF-ADHERING WEATHER BARRIERS
07 27 26.A01	VAPOR RETARDING FLUID-APPLIED AIR BARRIER
07 27 26.A03	TRANSITION MEMBRANE
07 42 13.A07	FLASHING AND TRIM
07 42 43.A05	TRIM
07 44 00.A01	CONCRETE-FACED RIGID INSULATION
07 48 00.A01	RAINSCREEN FURRING SYSTEM
07 52 16.A01	MODIFIED BITUMINOUS ROOFING SYSTEM
07 52 16.A10	BASE FLASHING
07 52 16.A11	VERTICAL WALL FLASHING (MODIFIED BITUMINOUS)
07 52 16.A12	VERTICAL WALL FLASHING (EPDM)
07 52 16.A22	INSULATION CANT STRIPS
07 62 00.A04	FLEXIBLE MEMBRANE CLOSURE
07 62 00.A13	COPING
07 62 00.A15	ROOF TO WALL EXPANSION JOINT COVER
07 62 00.A18	COUNTER FLASHING
07 62 00.A19	COUNTER FLASHING RECEIVER
07 62 00.A35	PRE-FINISHED MISC METAL FLASHING
07 62 00.A36	CLEAT
07 92 00.A01	SEALANT
07 92 00.A02	SEALANT W/BACKER ROD
08 41 13.A02	THERMAL BROKEN STOREFRONT FRAMING (6")
08 71 00.A01	THRESHOLDS
09 65 00.A01	RESILIENT BASE

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Missouri State Certificate of Authority
Architecture # 0000161

Bob D Campbell
Structural Engineer
State Certificate of Authority #000442
4338 Belleview Ave
Kansas City, MO 64111
816.531.4144 phone

Smith & Boucher, Inc.
Mechanical, Electrical, & Plumbing
State Certificate of Authority #EGC000178
25618 W 103rd Street
Olathe, KS 66061
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Civil Engineer
State Certificate of Authority
Engineering #2001009364
Landscaping #2006027139
Surveying #2006027138
11827 W 112th Street, Suite 2
Overland Park, KS 66210
913.317.9390 phone

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109 E Pine St.
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Lenexa, KS 66215
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South Valley Middle School Storm Shelter Addition
Liberty Public Schools
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CONSTRUCTION
DOCUMENTS

#	Description	Date
1	Addendum 01	09.14.2023
2	Addendum 04	09.29.2023




OCTOBER 11, 2023

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A-2019015618

JOB NO: 23019
DRAWN BY: KL
CHECKED BY: JB
DATE: 08.31.2023

A363

EXTERIOR DETAILS

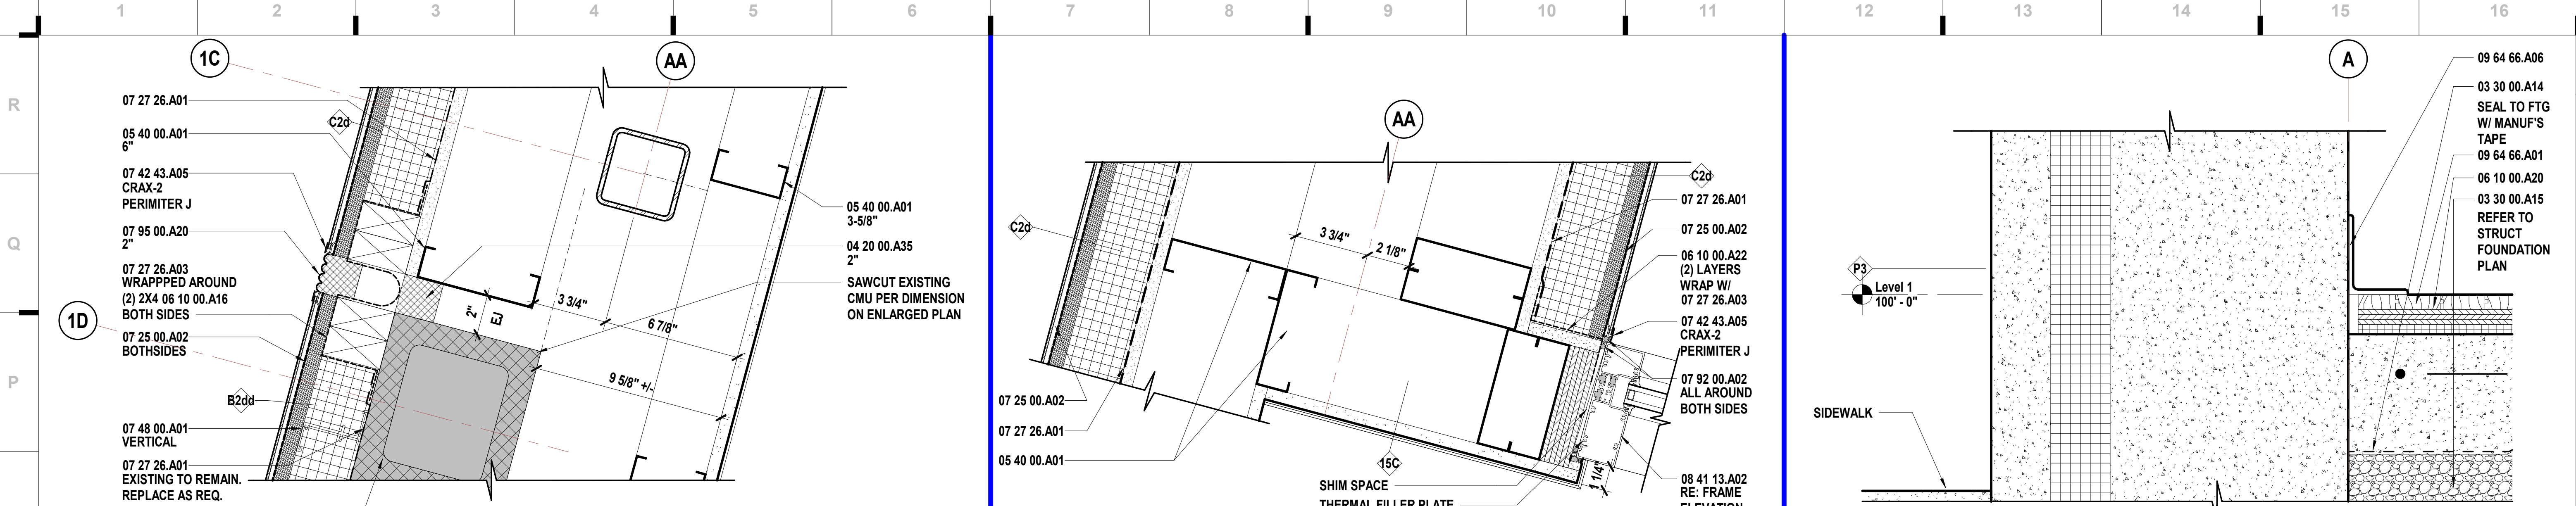

N1

Scale
3" = 1'-0"

Plan Detail - Area A - Lobby A102 - Connection to Existing

N7


Scale
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Plan Detail - Area A - Entry

N12

Scale
3" = 1'-0"


Section Detail - Area A - Multipurpose A103 - Plan West

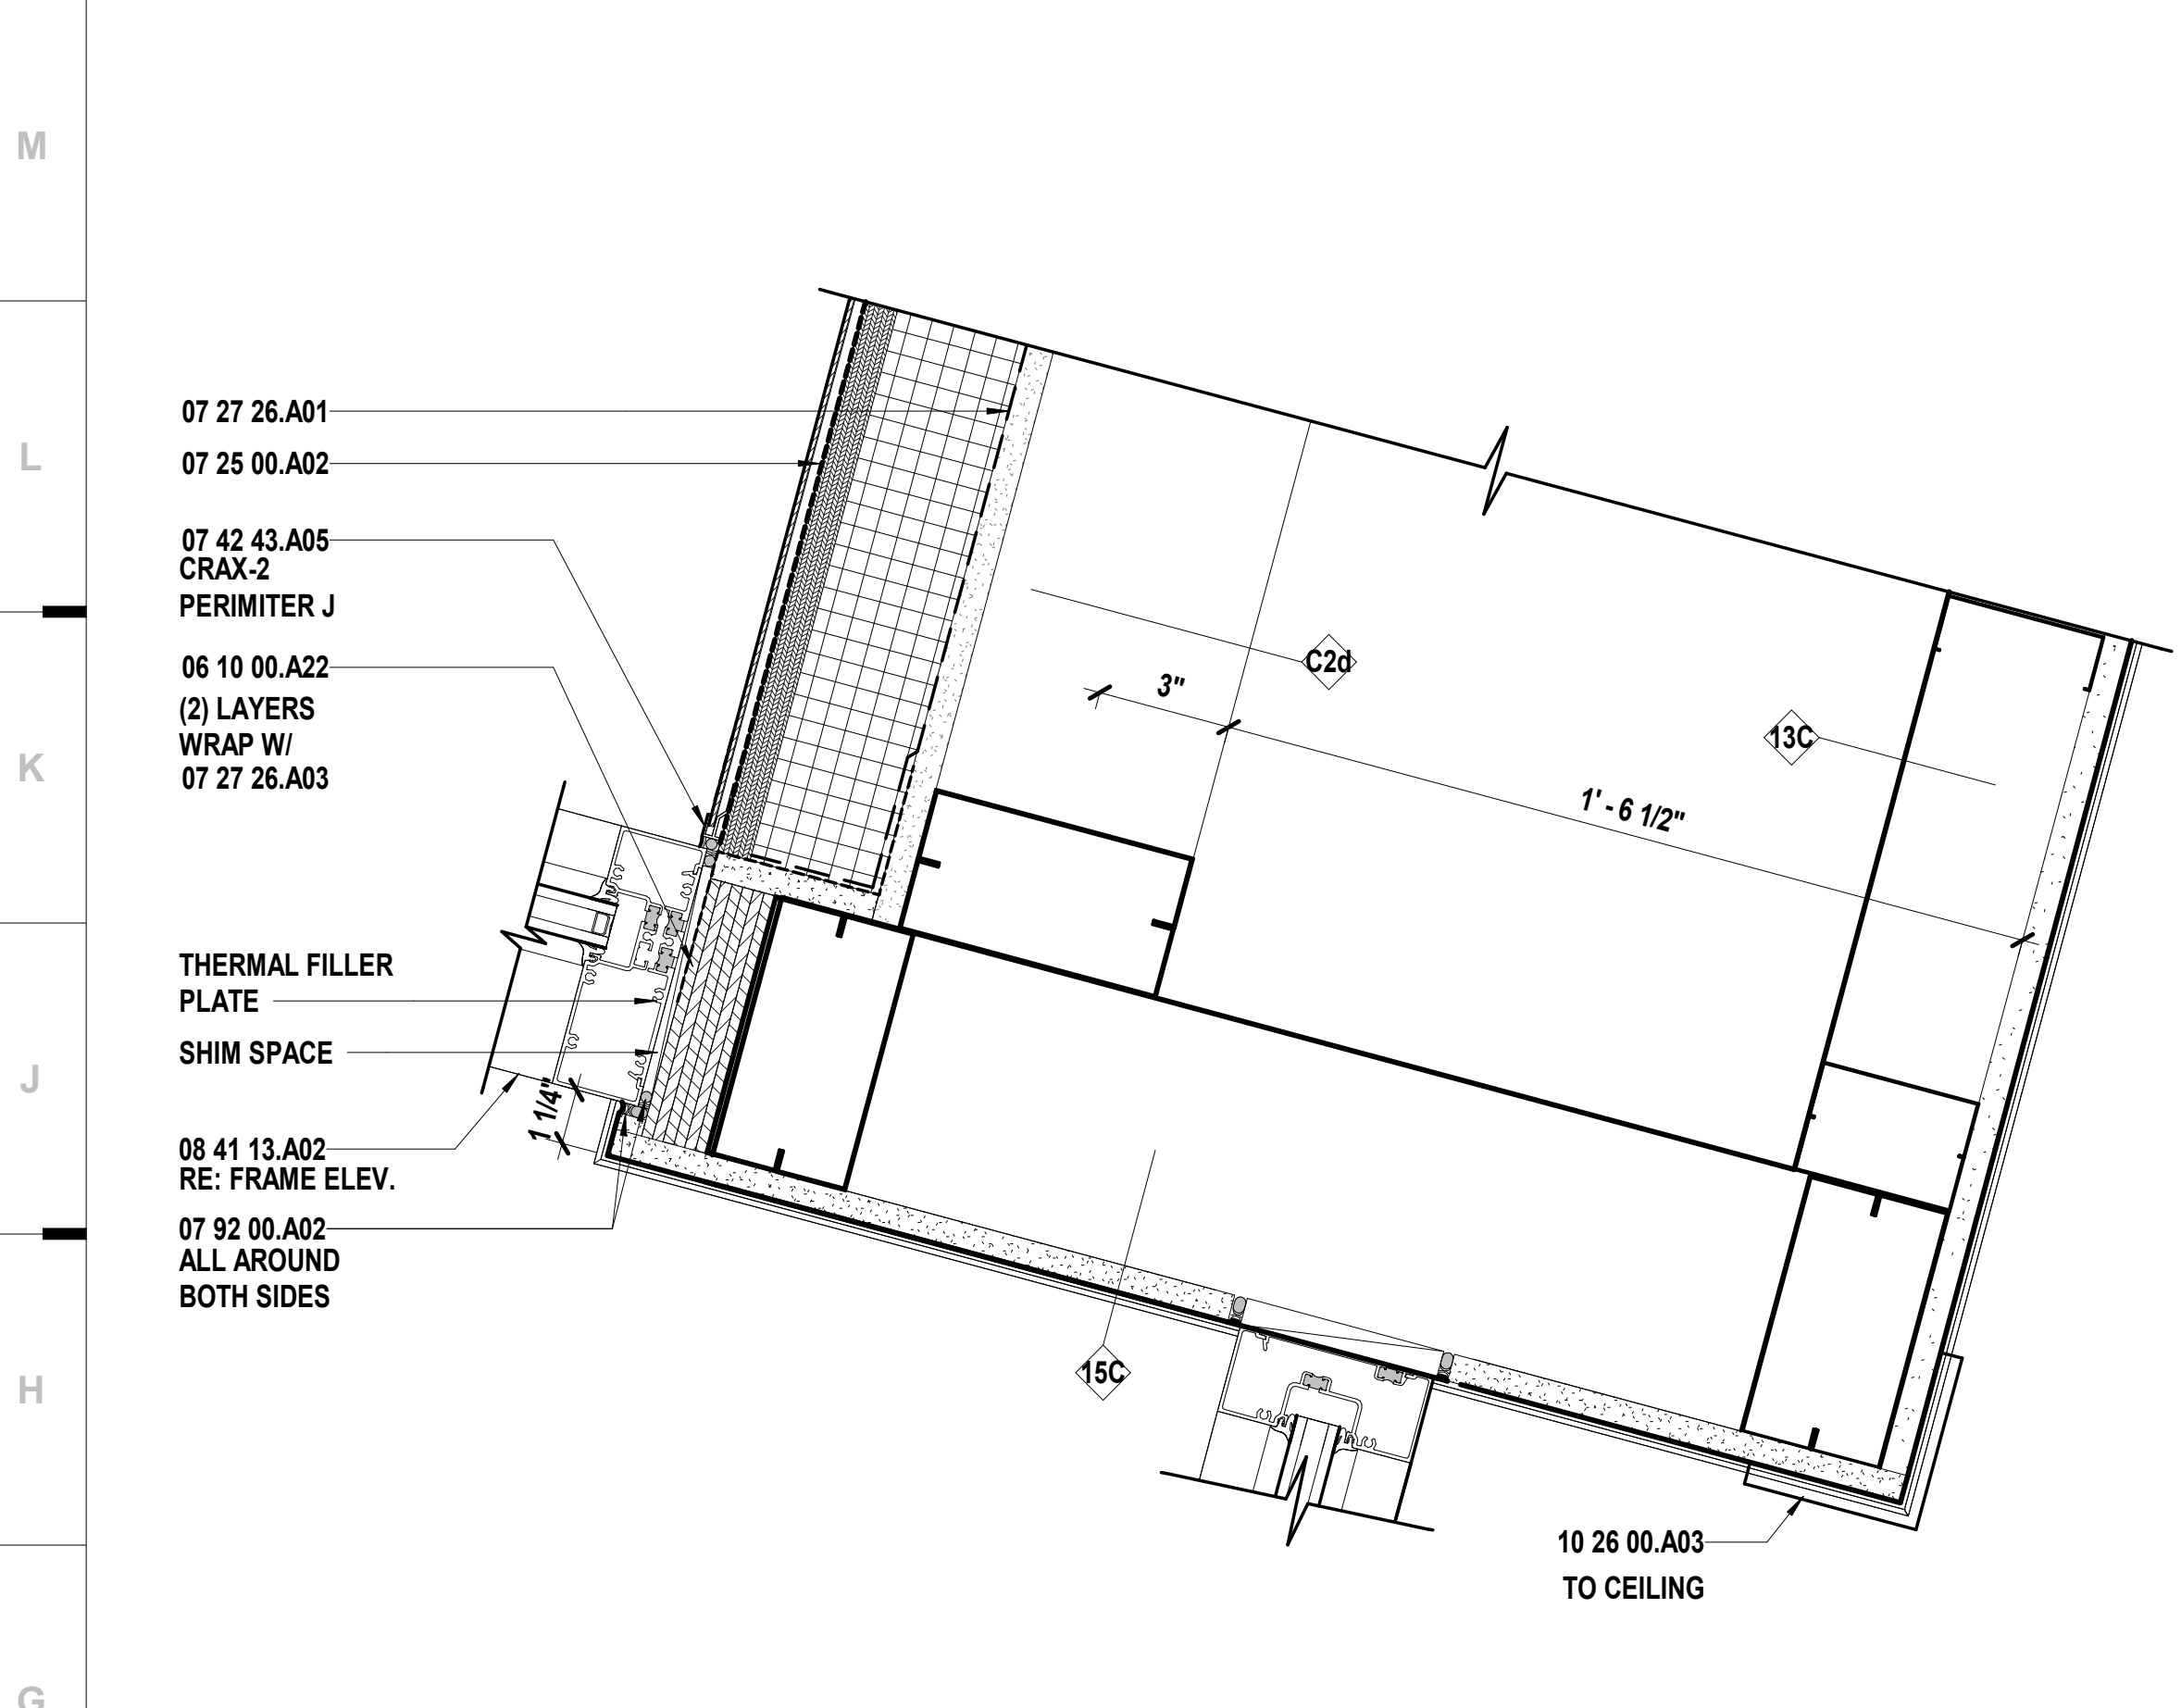

G1

Scale
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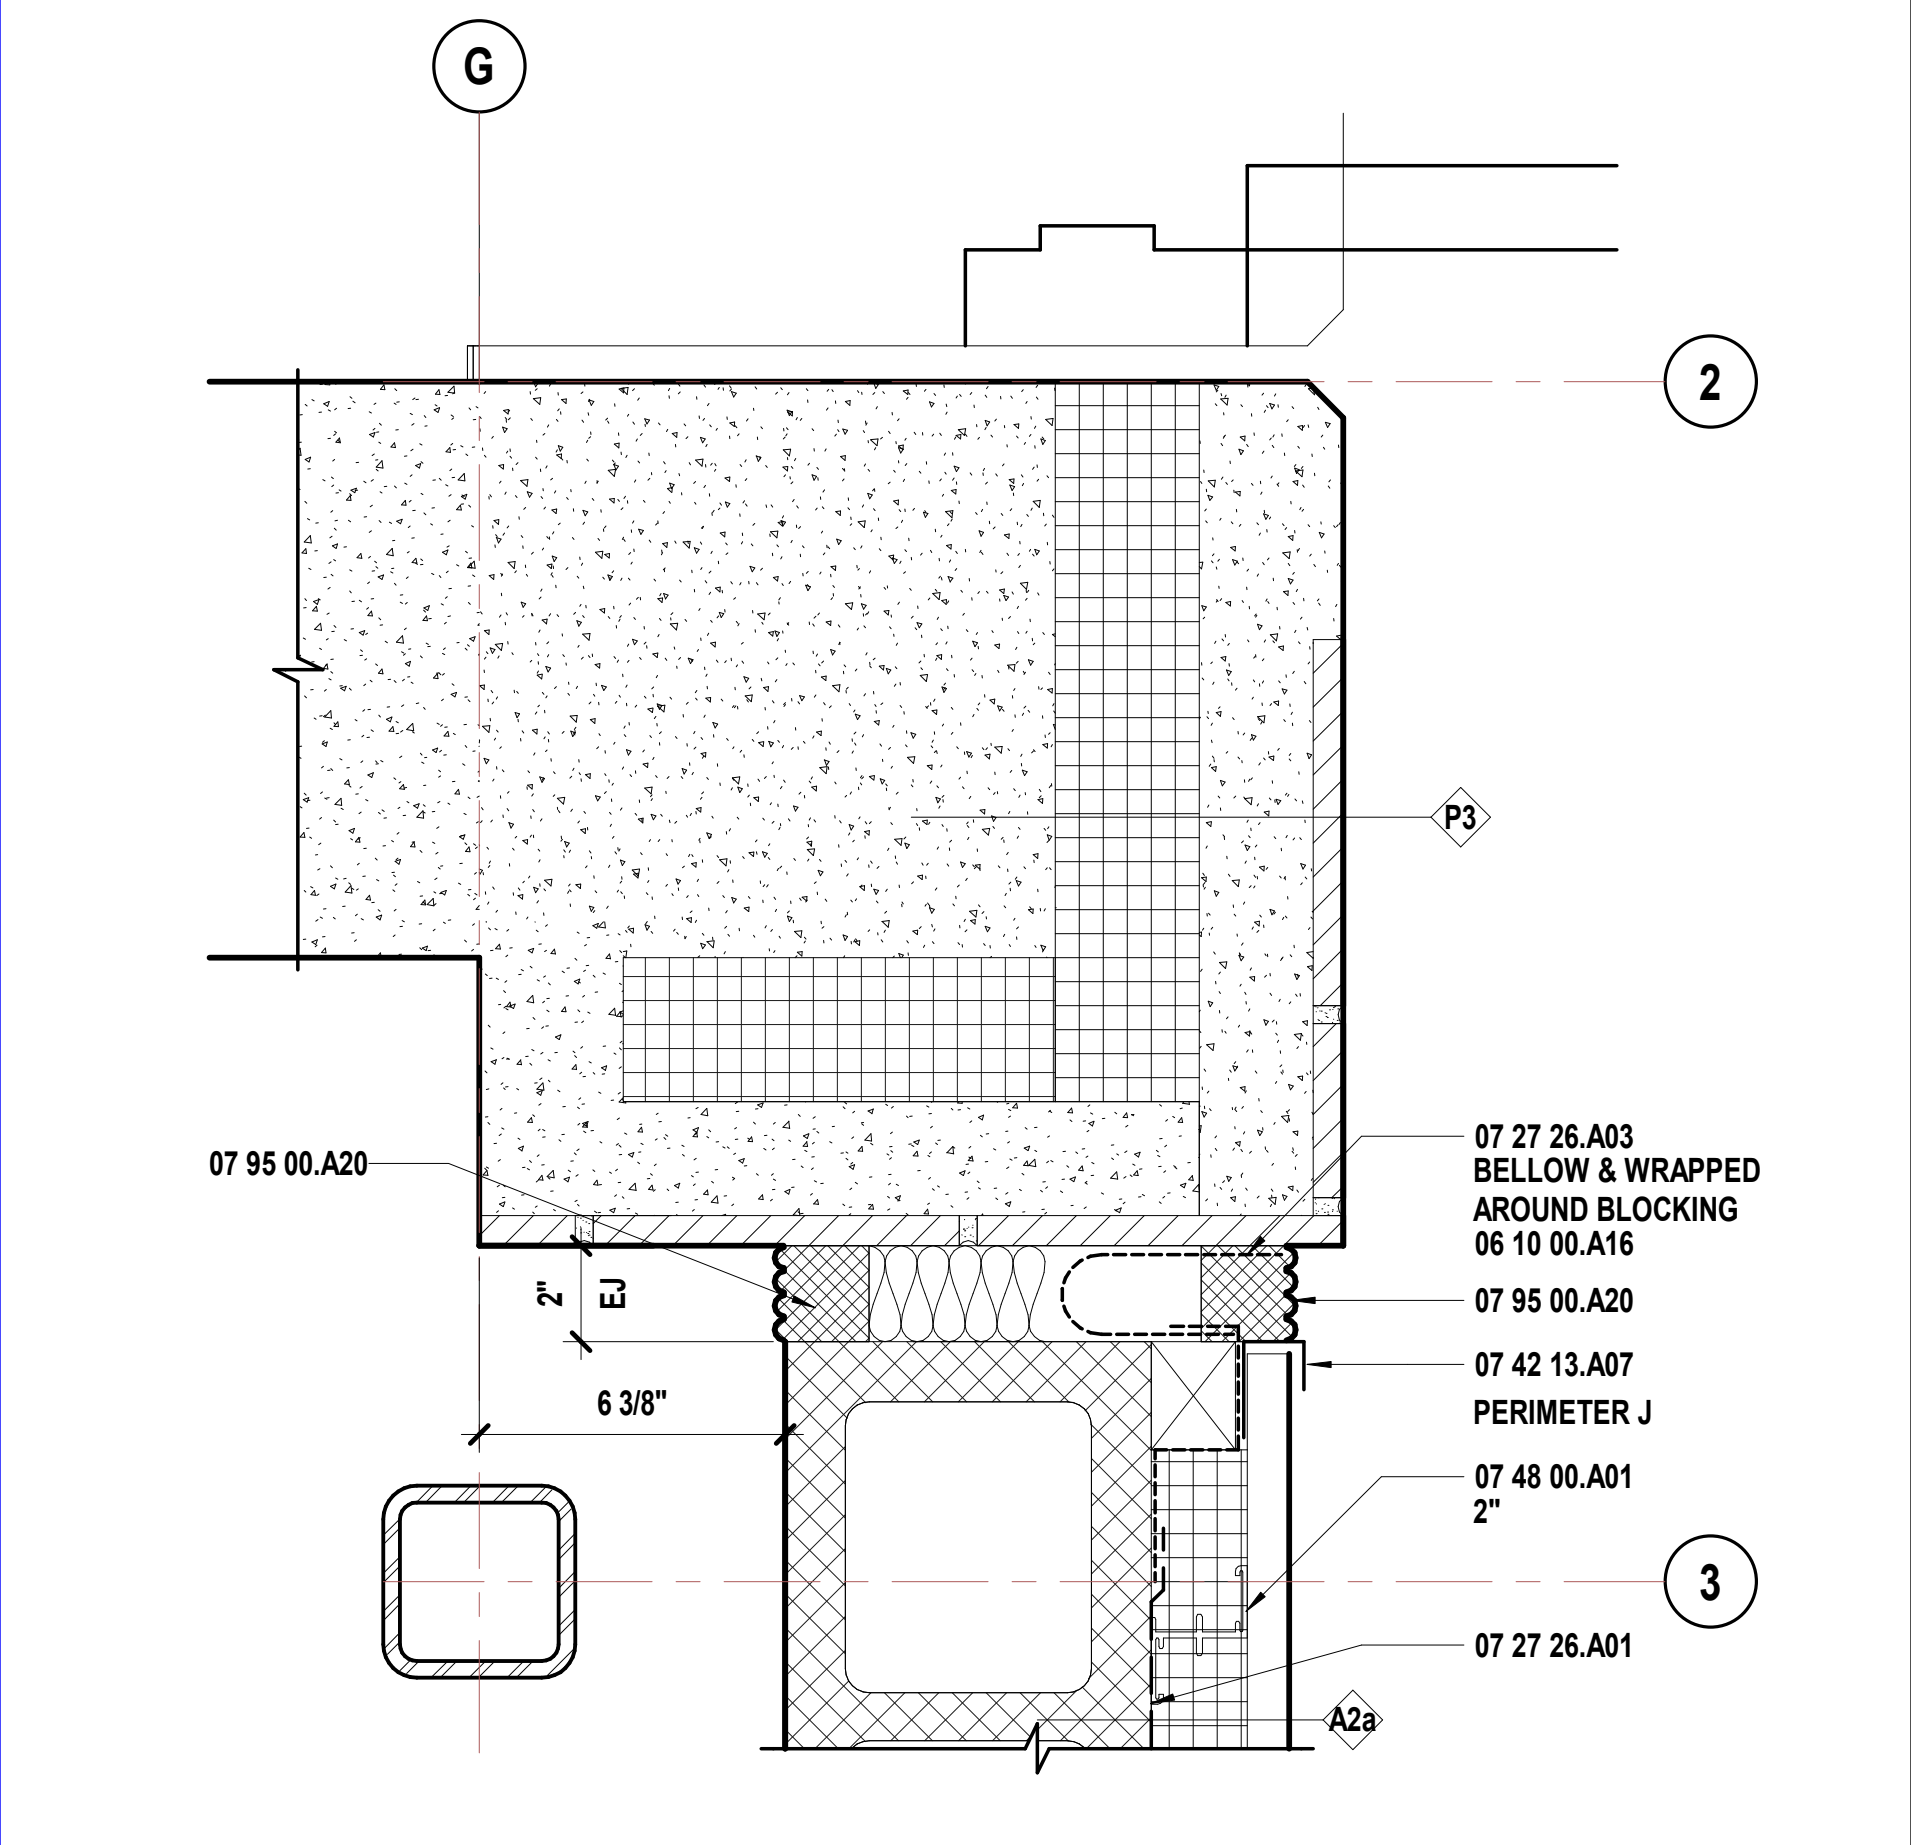
Plan Detail - Area A - Vestibule A101 - Plan East

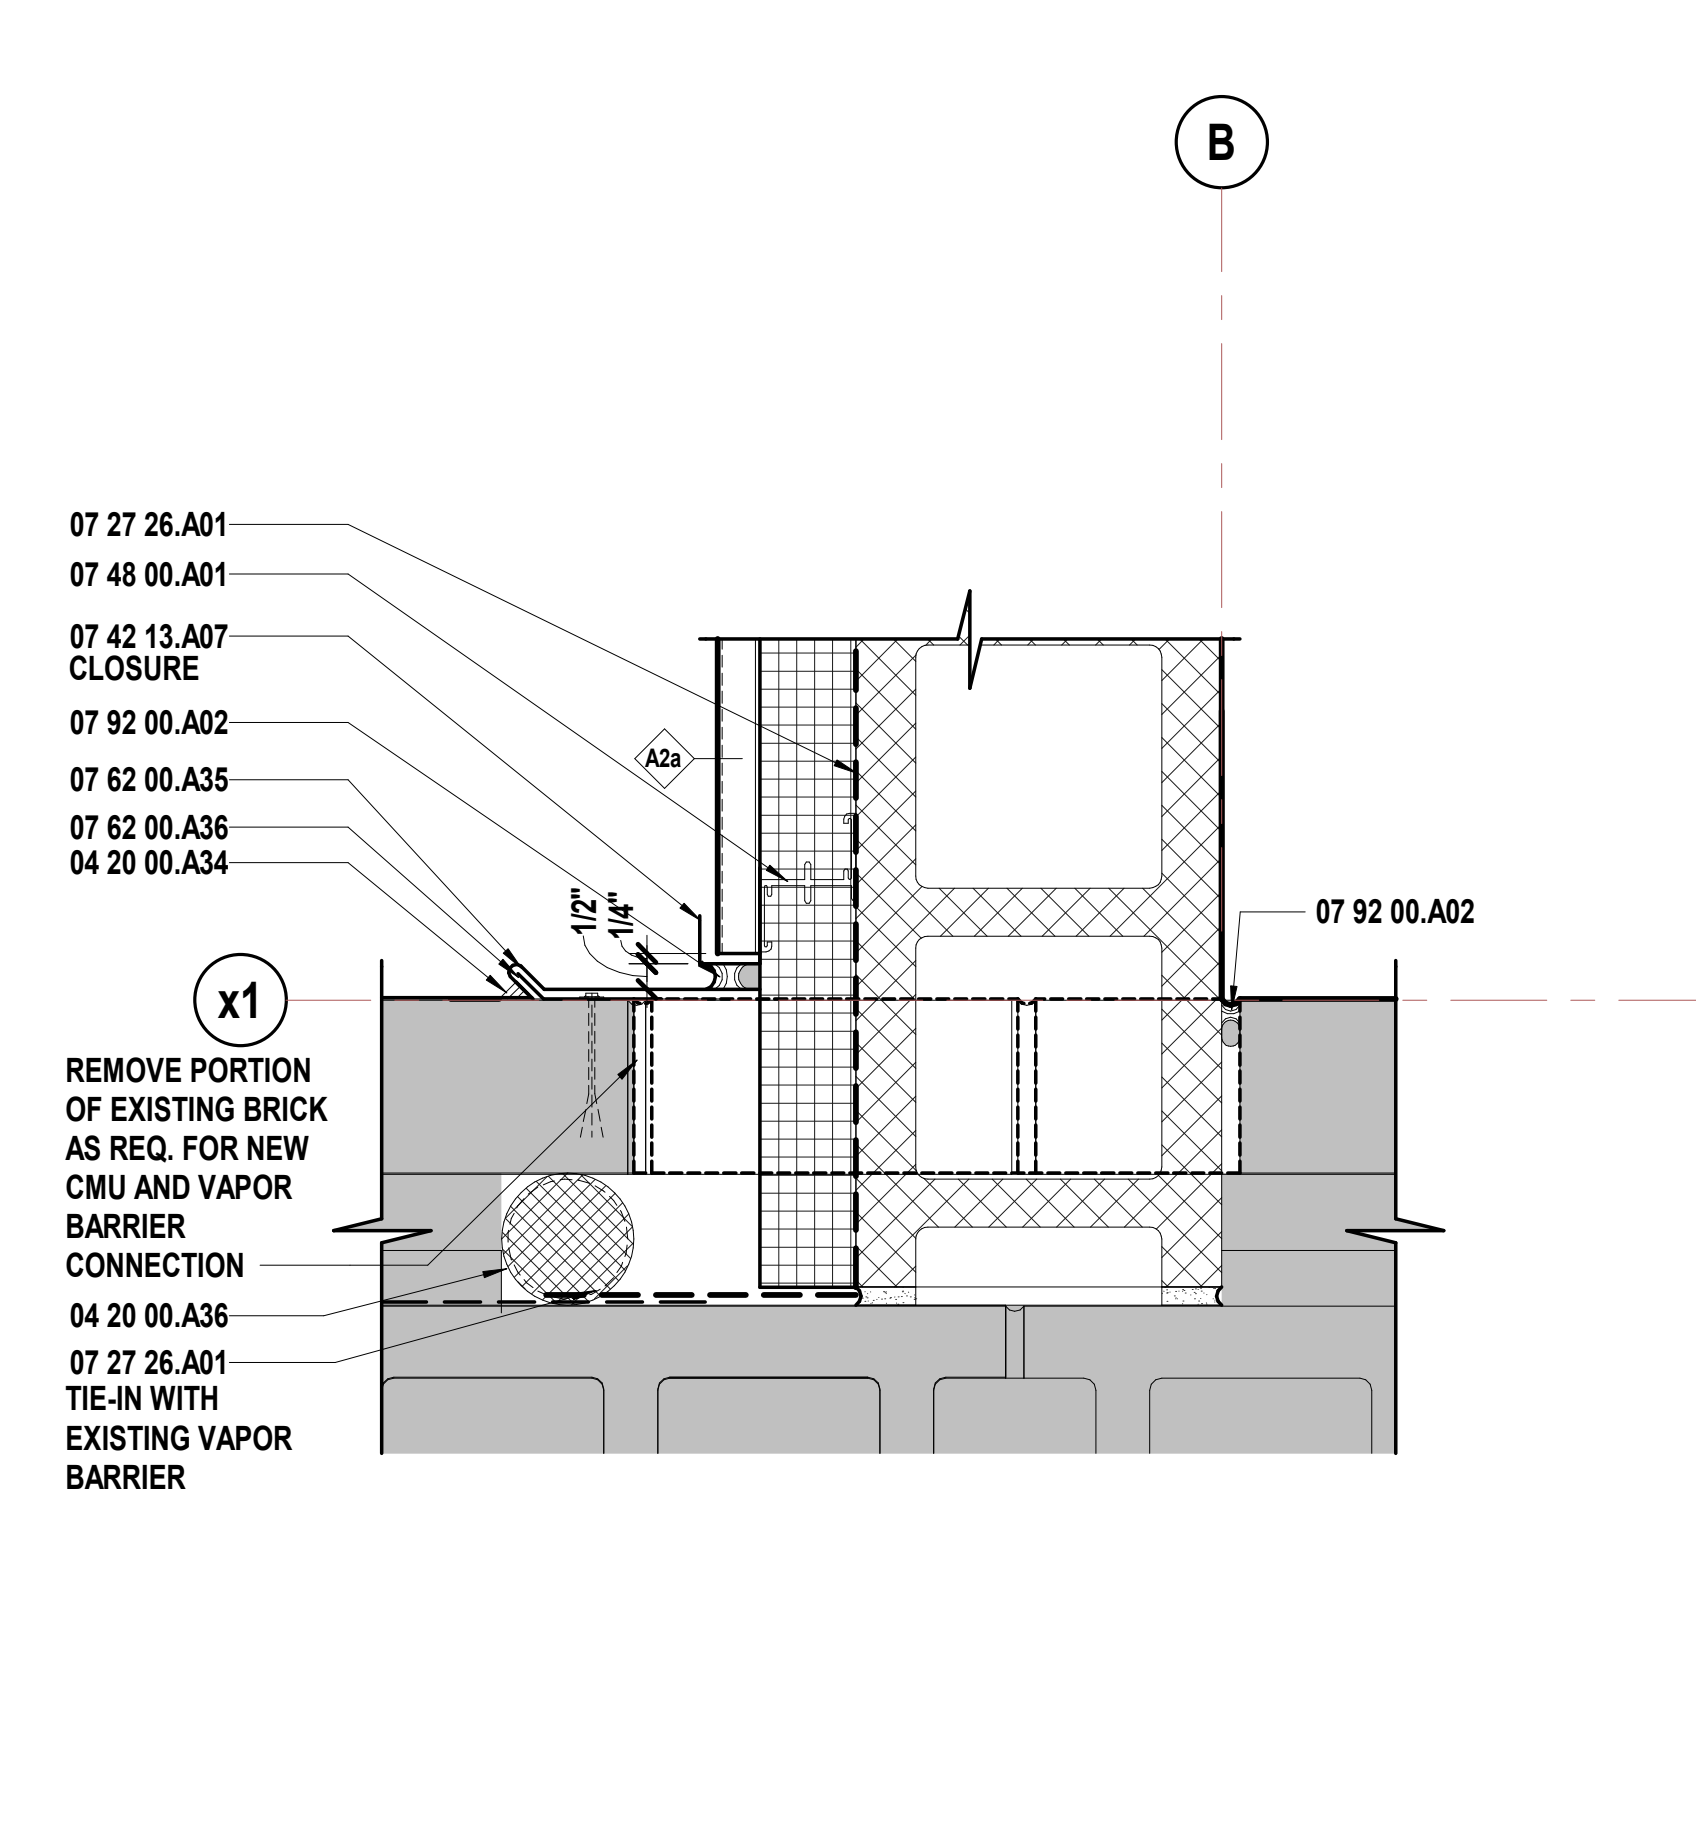

G7

Scale
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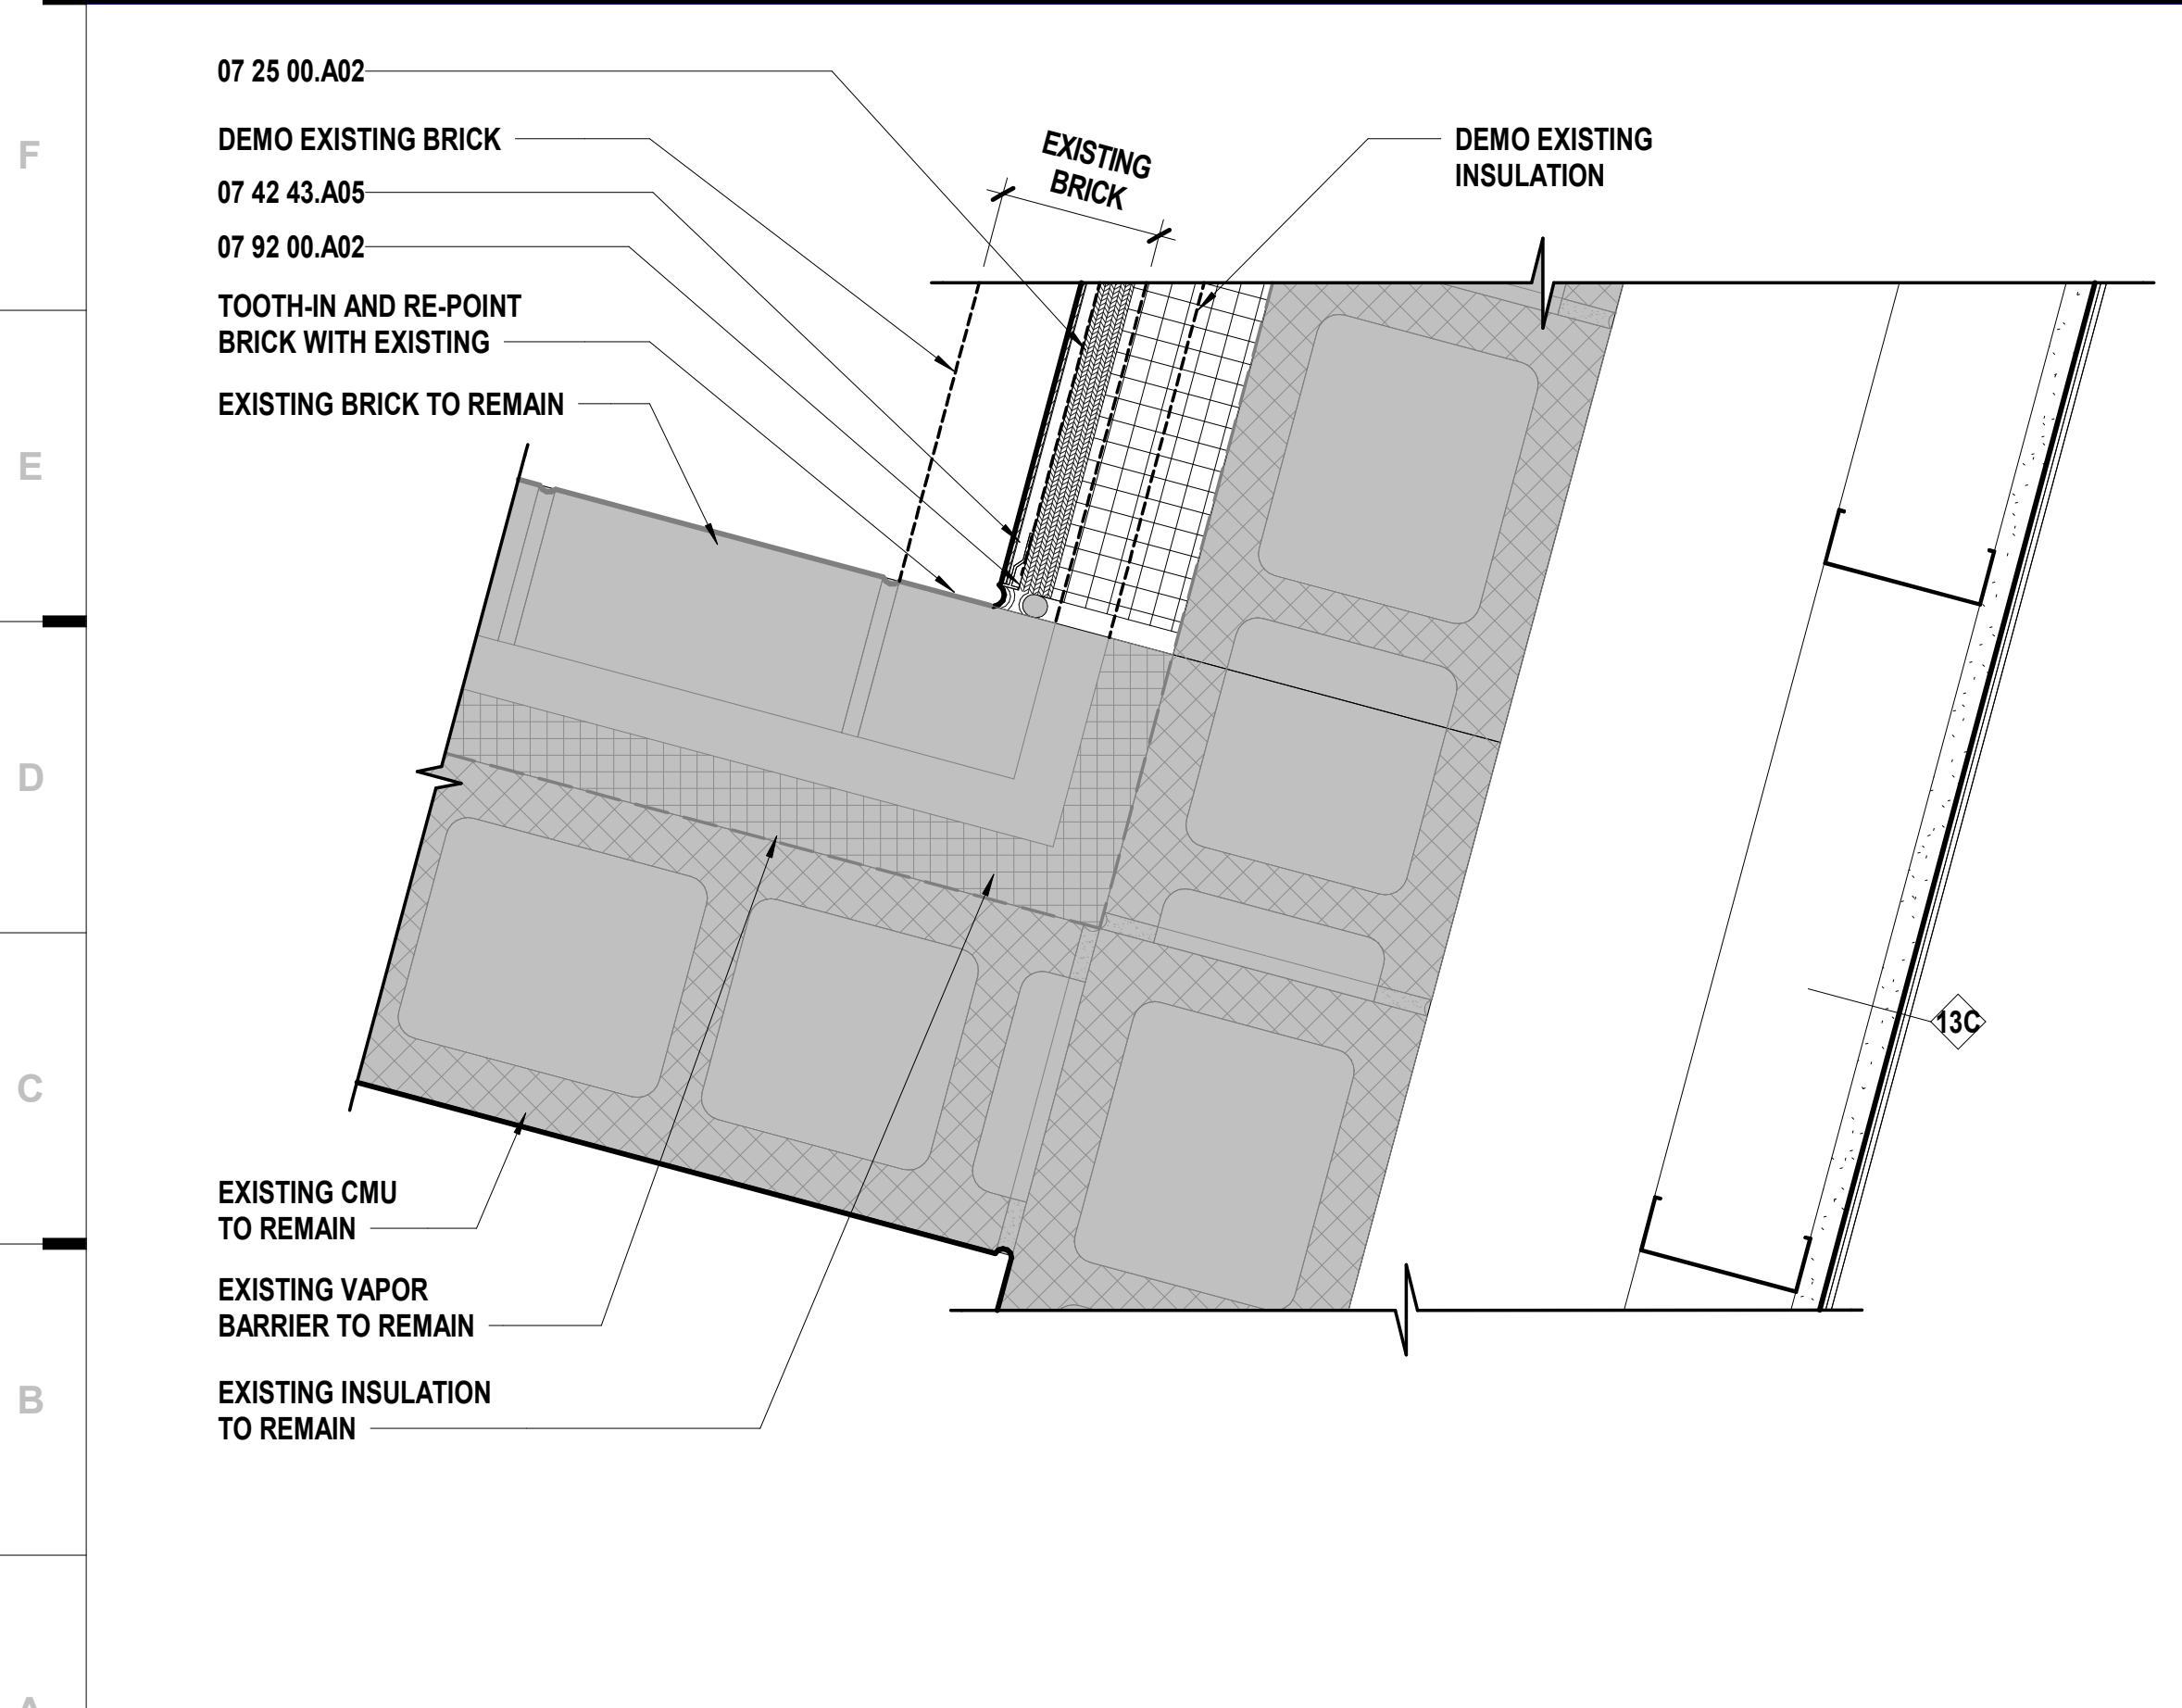
Plan Detail - Area A - Storage A200 - Connection to Existing



G12

Scale
3" = 1'-0"


Plan Detail - Area A - Circulation A110 - Plan East



A1

Scale
3" = 1'-0"


Plan Detail - Area A - Metal Panels over Existing Wall

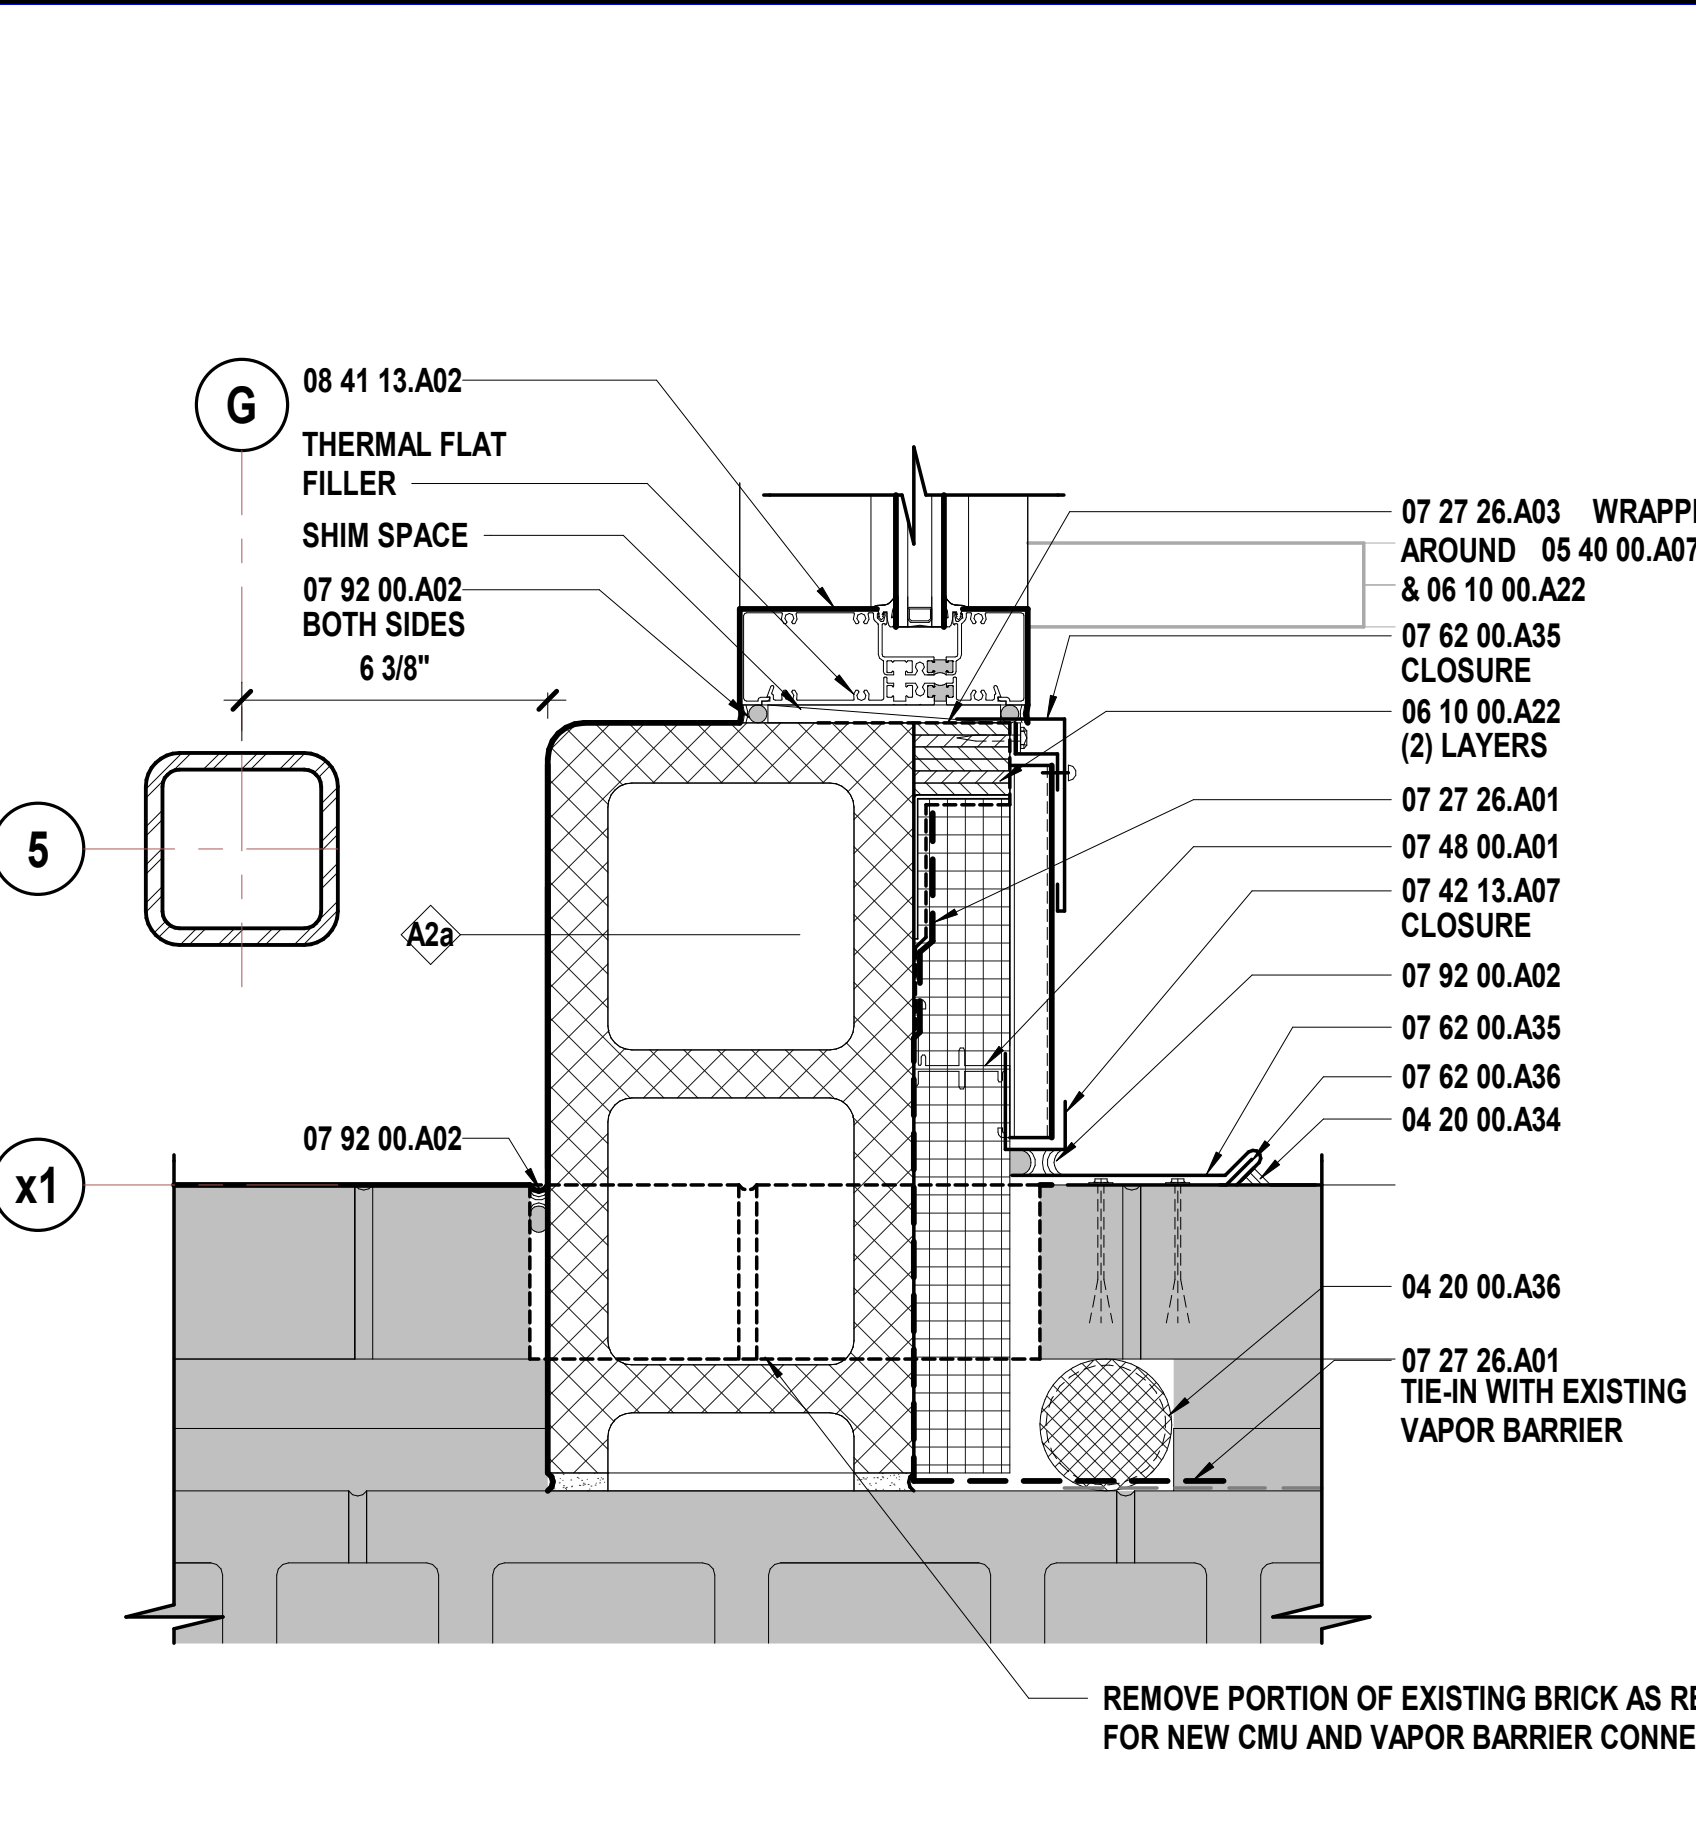

A7

Scale
3" = 1'-0"

Plan Detail - Area A - Circulation A110 - Connection to Existing

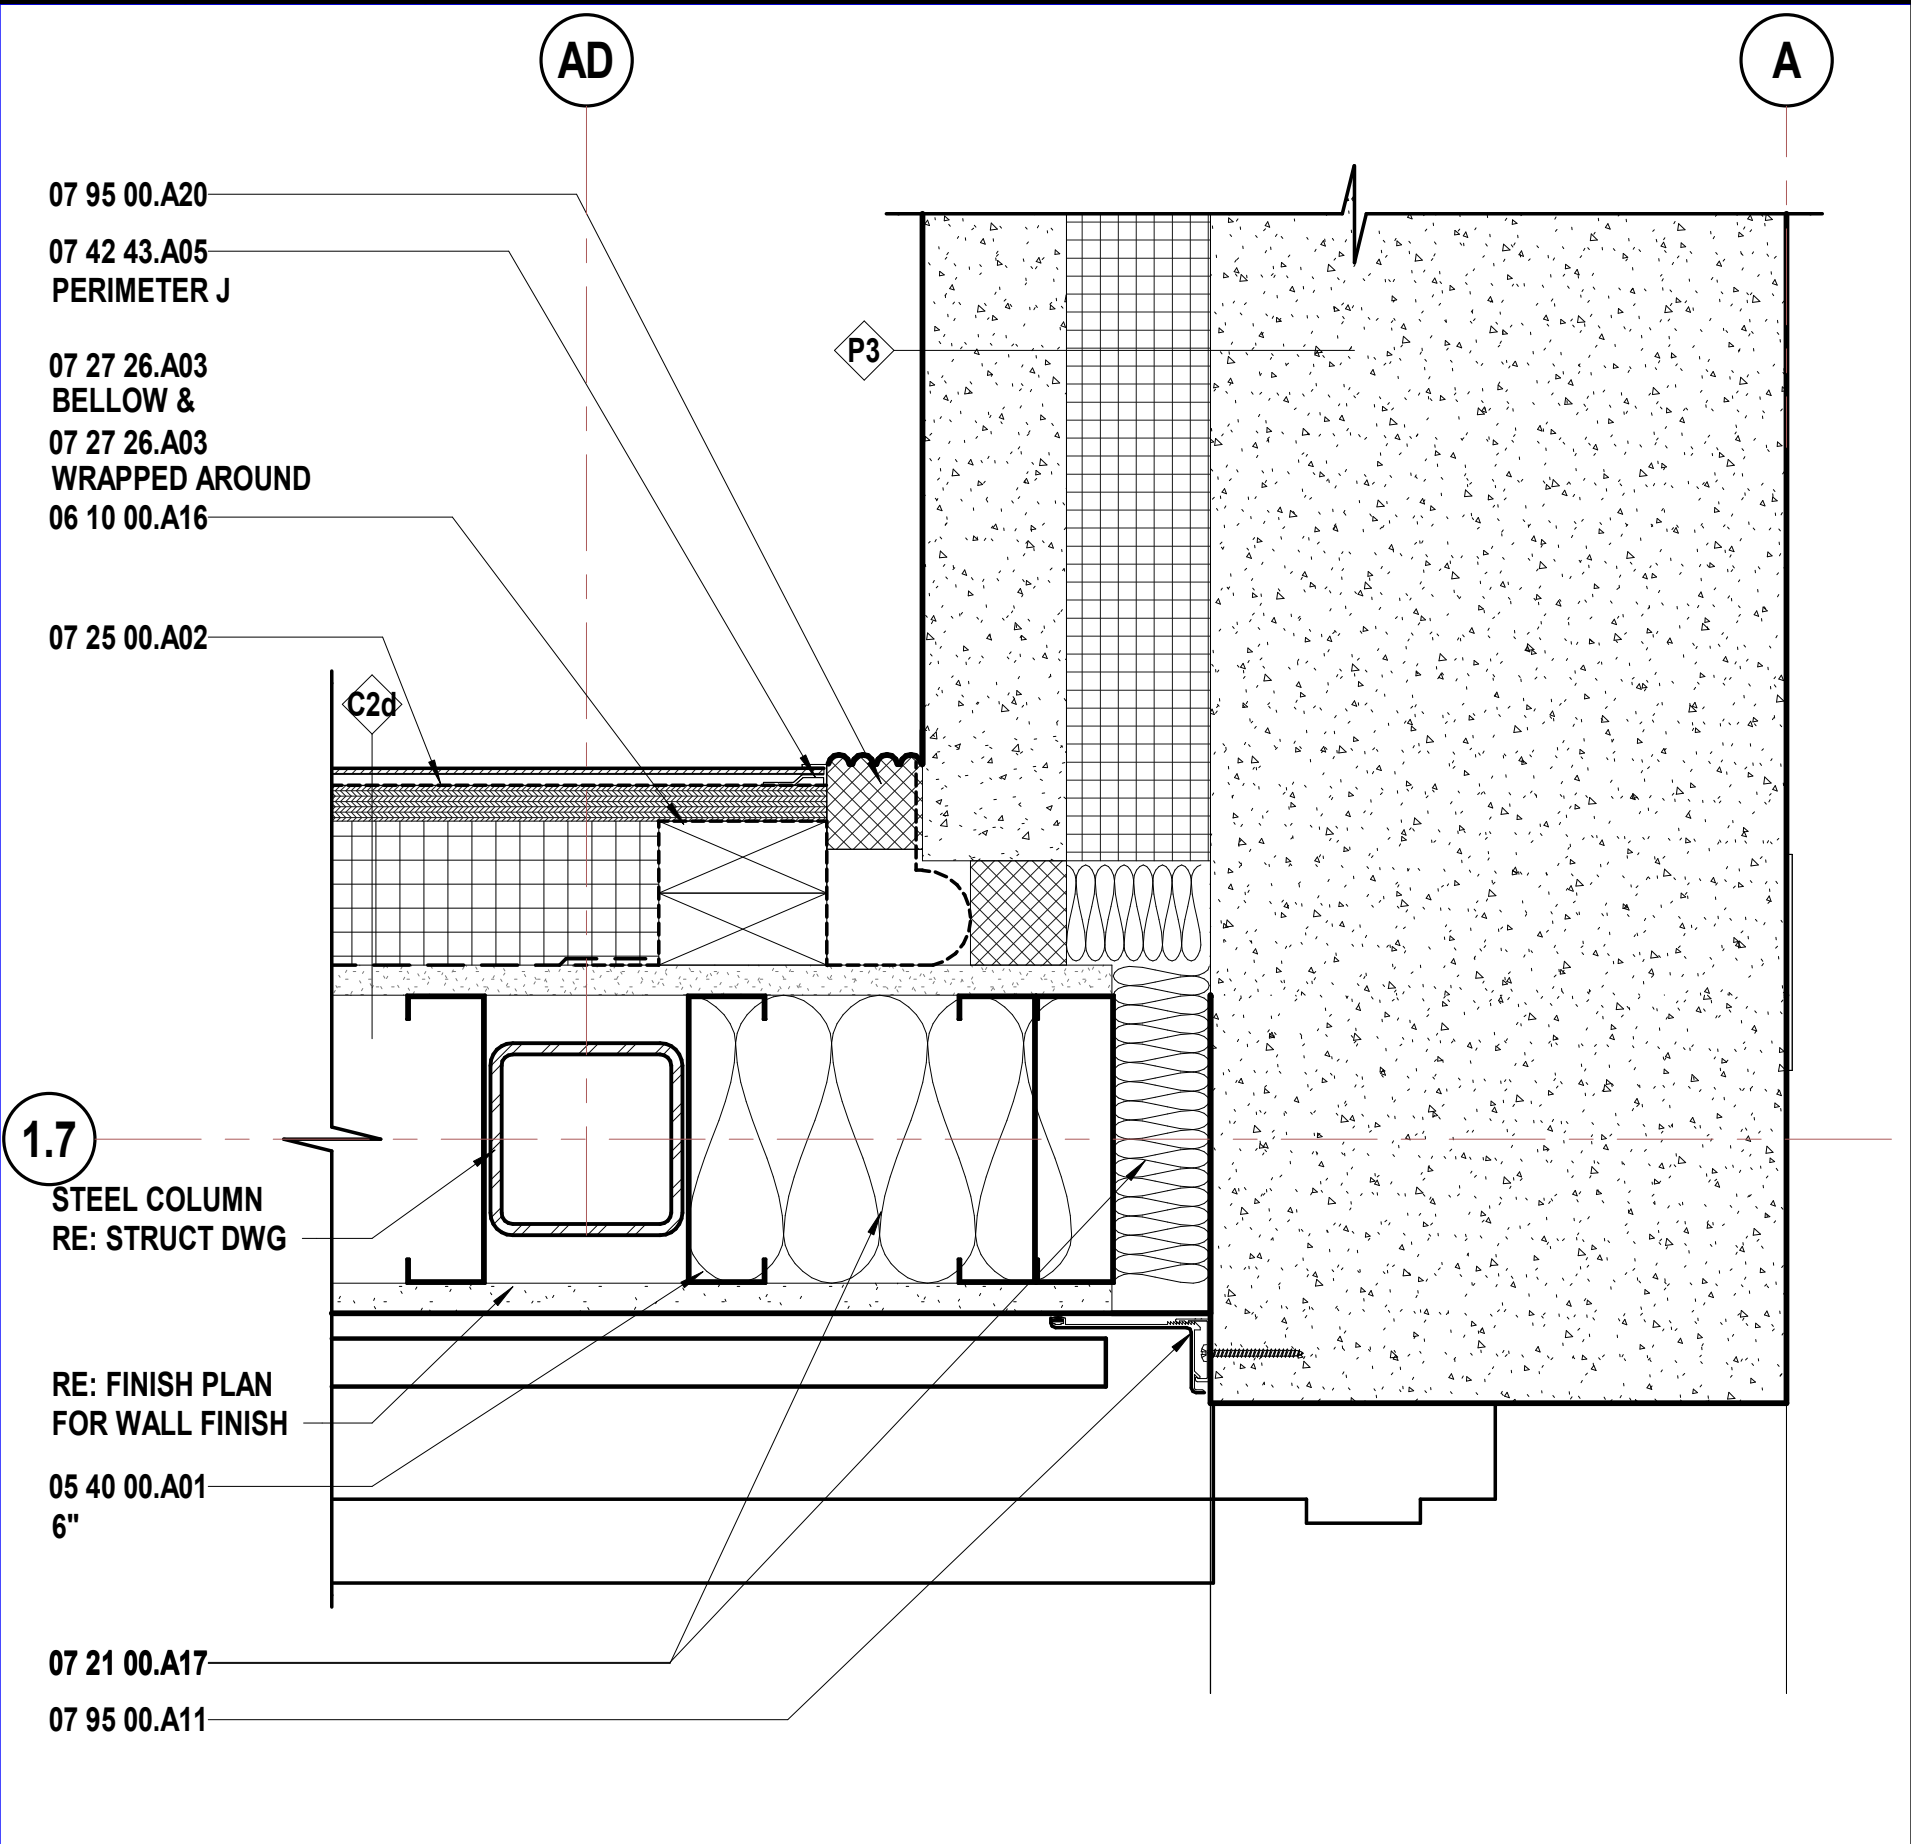

A12

Scale
3" = 1'-0"

Plan Detail - Vestibule A101 to Multipurpose A103 Plan North

SHEET KEYNOTE LEGEND

03 30 00.A14	VAPOR RETARDERS
03 30 00.A15	GRANULAR DRAINAGE FILL
04 20 00.A34	FLASHING TERMINATION BARS
04 20 00.A35	COMPRESSIBLE FILLERS
04 20 00.A36	TUBULAR COMPRESSIBLE FILLERS
05 40 00.A01	COLD-FORMED METAL FRAMING
05 40 00.A07	MISCELLANEOUS FRAMING/FURRING
06 10 00.A16	FIRE-RETARDANT TREATED WOOD BLOCKING & NAILERS
06 10 00.A20	FIRE-RETARDANT TREATED PLYWOOD BLOCKING AND BACKING PANELS
06 10 00.A22	PRESERVATIVE TREATED PLYWOOD BLOCKING
07 21 00.A17	MINERAL WOOL
07 25 00.A02	SELF-ADHERING WEATHER BARRIERS
07 27 26.A01	VAPOR RETARDING FLUID-APPLIED AIR BARRIER
07 27 26.A03	TRANSITION MEMBRANE
07 42 13.A07	FLASHING AND TRIM
07 42 43.A05	TRIM
07 48 00.A01	RAINSCREEN FURRING SYSTEM
07 62 00.A35	PRE-FINISHED MISC METAL FLASHING
07 62 00.A36	CLEAT
07 92 00.A02	SEALANT W/BACKER ROD
07 95 00.A11	CEILING-TO-WALL JOINT SYSTEM
07 95 00.A20	EXTERIOR PRE-FORMED CELLULAR FOAM
08 41 13.A02	THERMAL BROKEN STOREFRONT FRAMING (6")
09 64 66.A01	WOOD ATHLETIC FLOOR
09 64 66.A06	RESILIENT WALL BASE (VENTED)
10 26 00.A03	CORNER GUARDS

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Structural Engineer
State Certificate of Authority #000442
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913.317.9390 phone

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South Valley Middle School Storm Shelter Addition

Liberty Public Schools

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CONFORMED
CONSTRUCTION
DOCUMENTS

REVISIONS:		
#	Description	Date

1	Addendum 01	09.14.2023
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OCTOBER 11, 2023

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JOB NO: 23019
DRAWN BY: KL
CHECKED BY: JB
DATE: 08.31.2023

A371

EXTERIOR DETAILS


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JOB NO: 23019
DRAWN BY: KL
CHECKED BY: JE
DATE: 08.31.2023


EXTERIOR DETAILS

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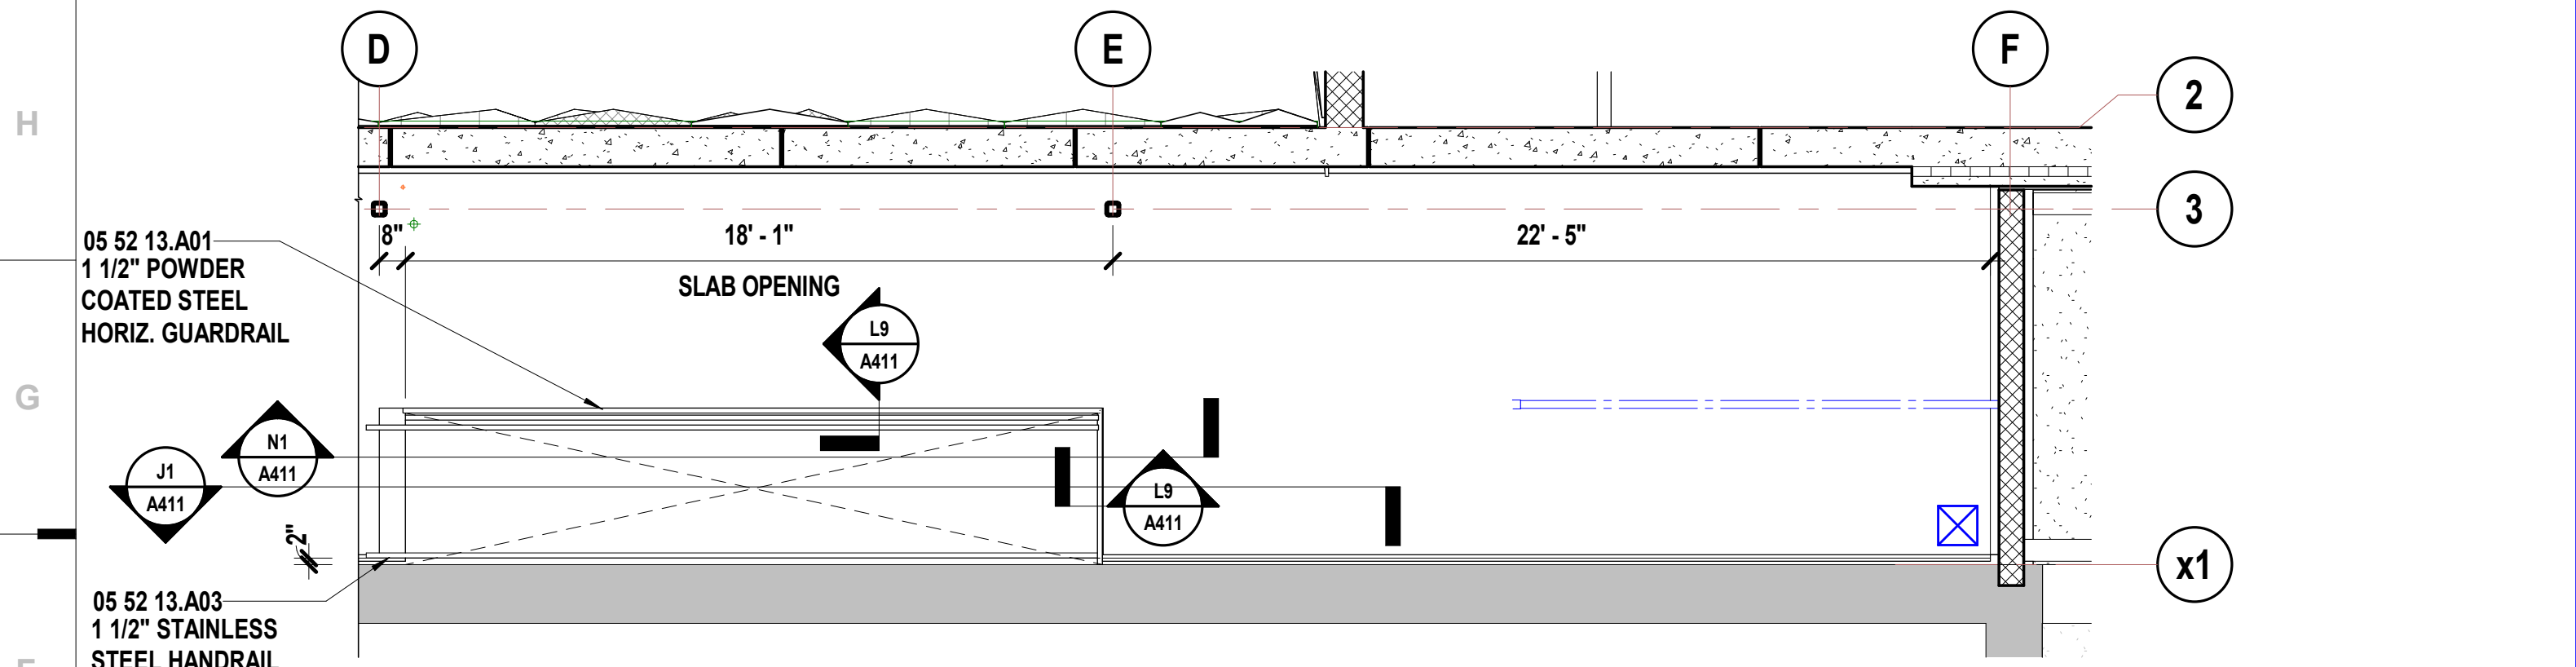





N1 Scale 1/4" = 1'-0" Stair Section - Area A - Storage A112 to Mezzanine Storage A200 - N

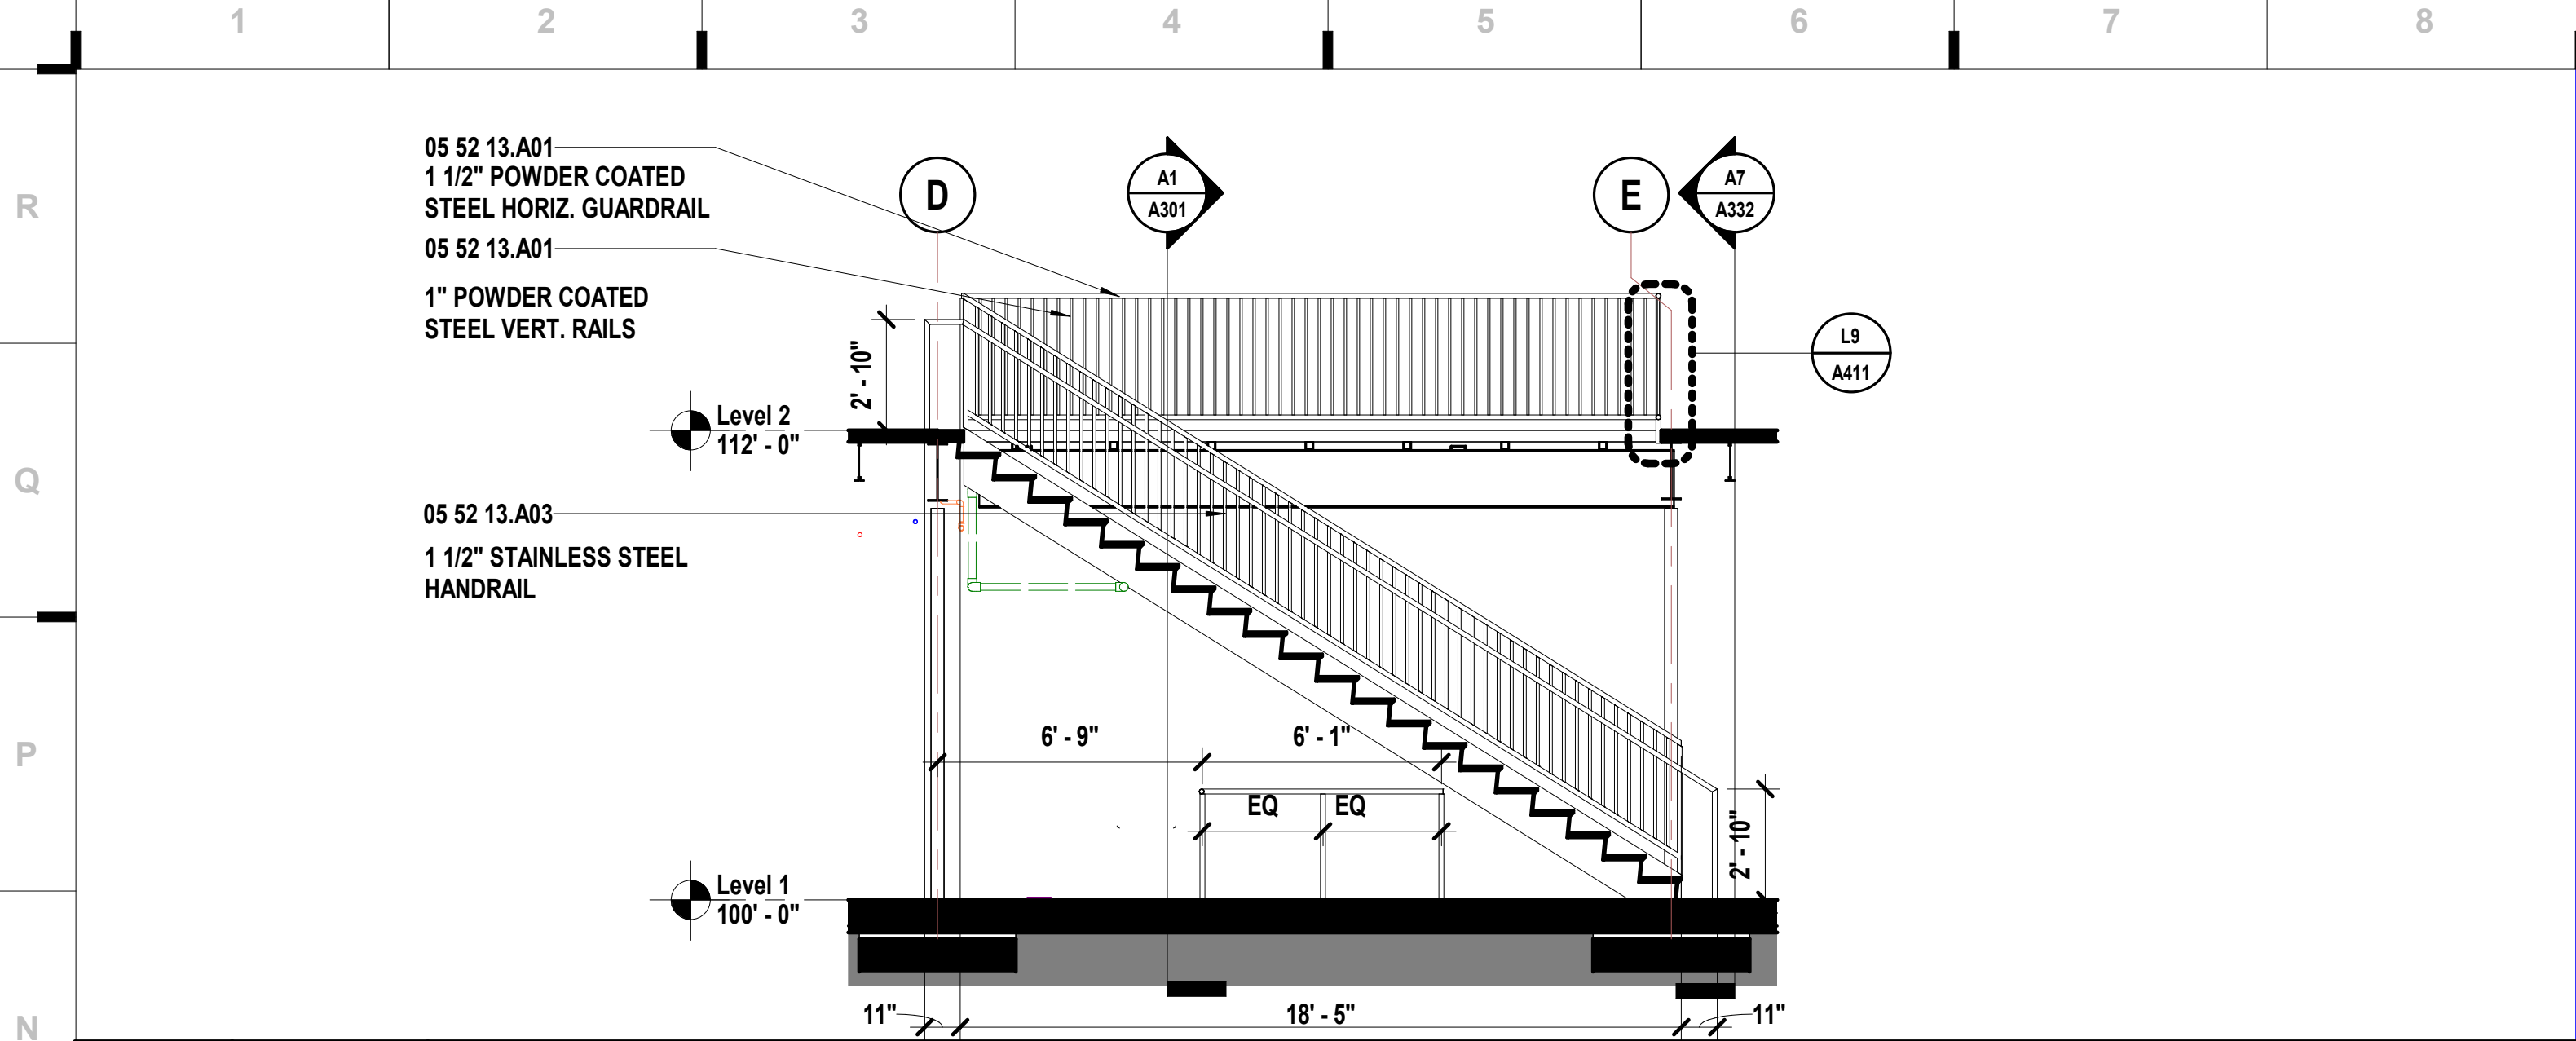

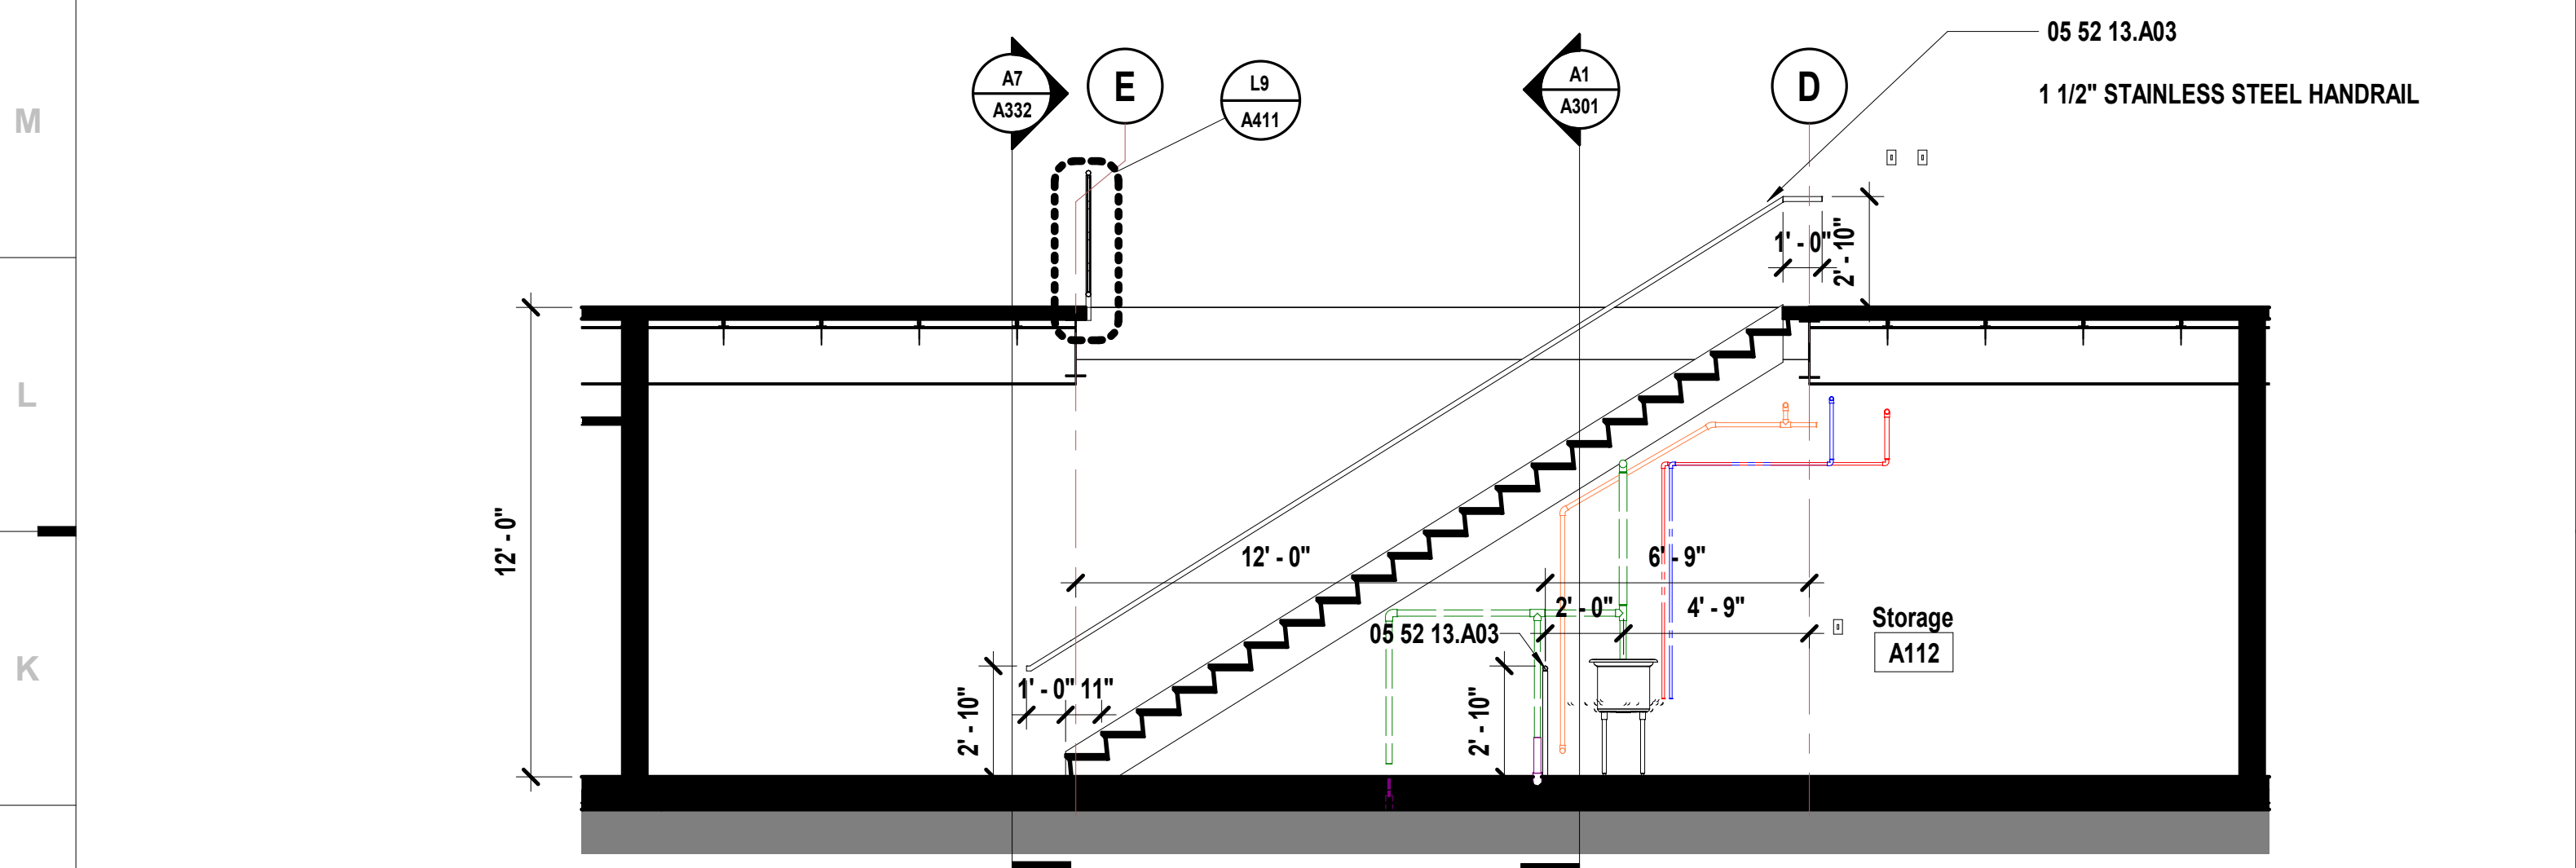
J1 Scale 1/4" = 1'-0" Stair Section - Area A - Storage A112 to Mezzanine Storage A200 - S




F1 Scale 1/4" = 1'-0" Floor Plan - Mezzanine Level - Opening

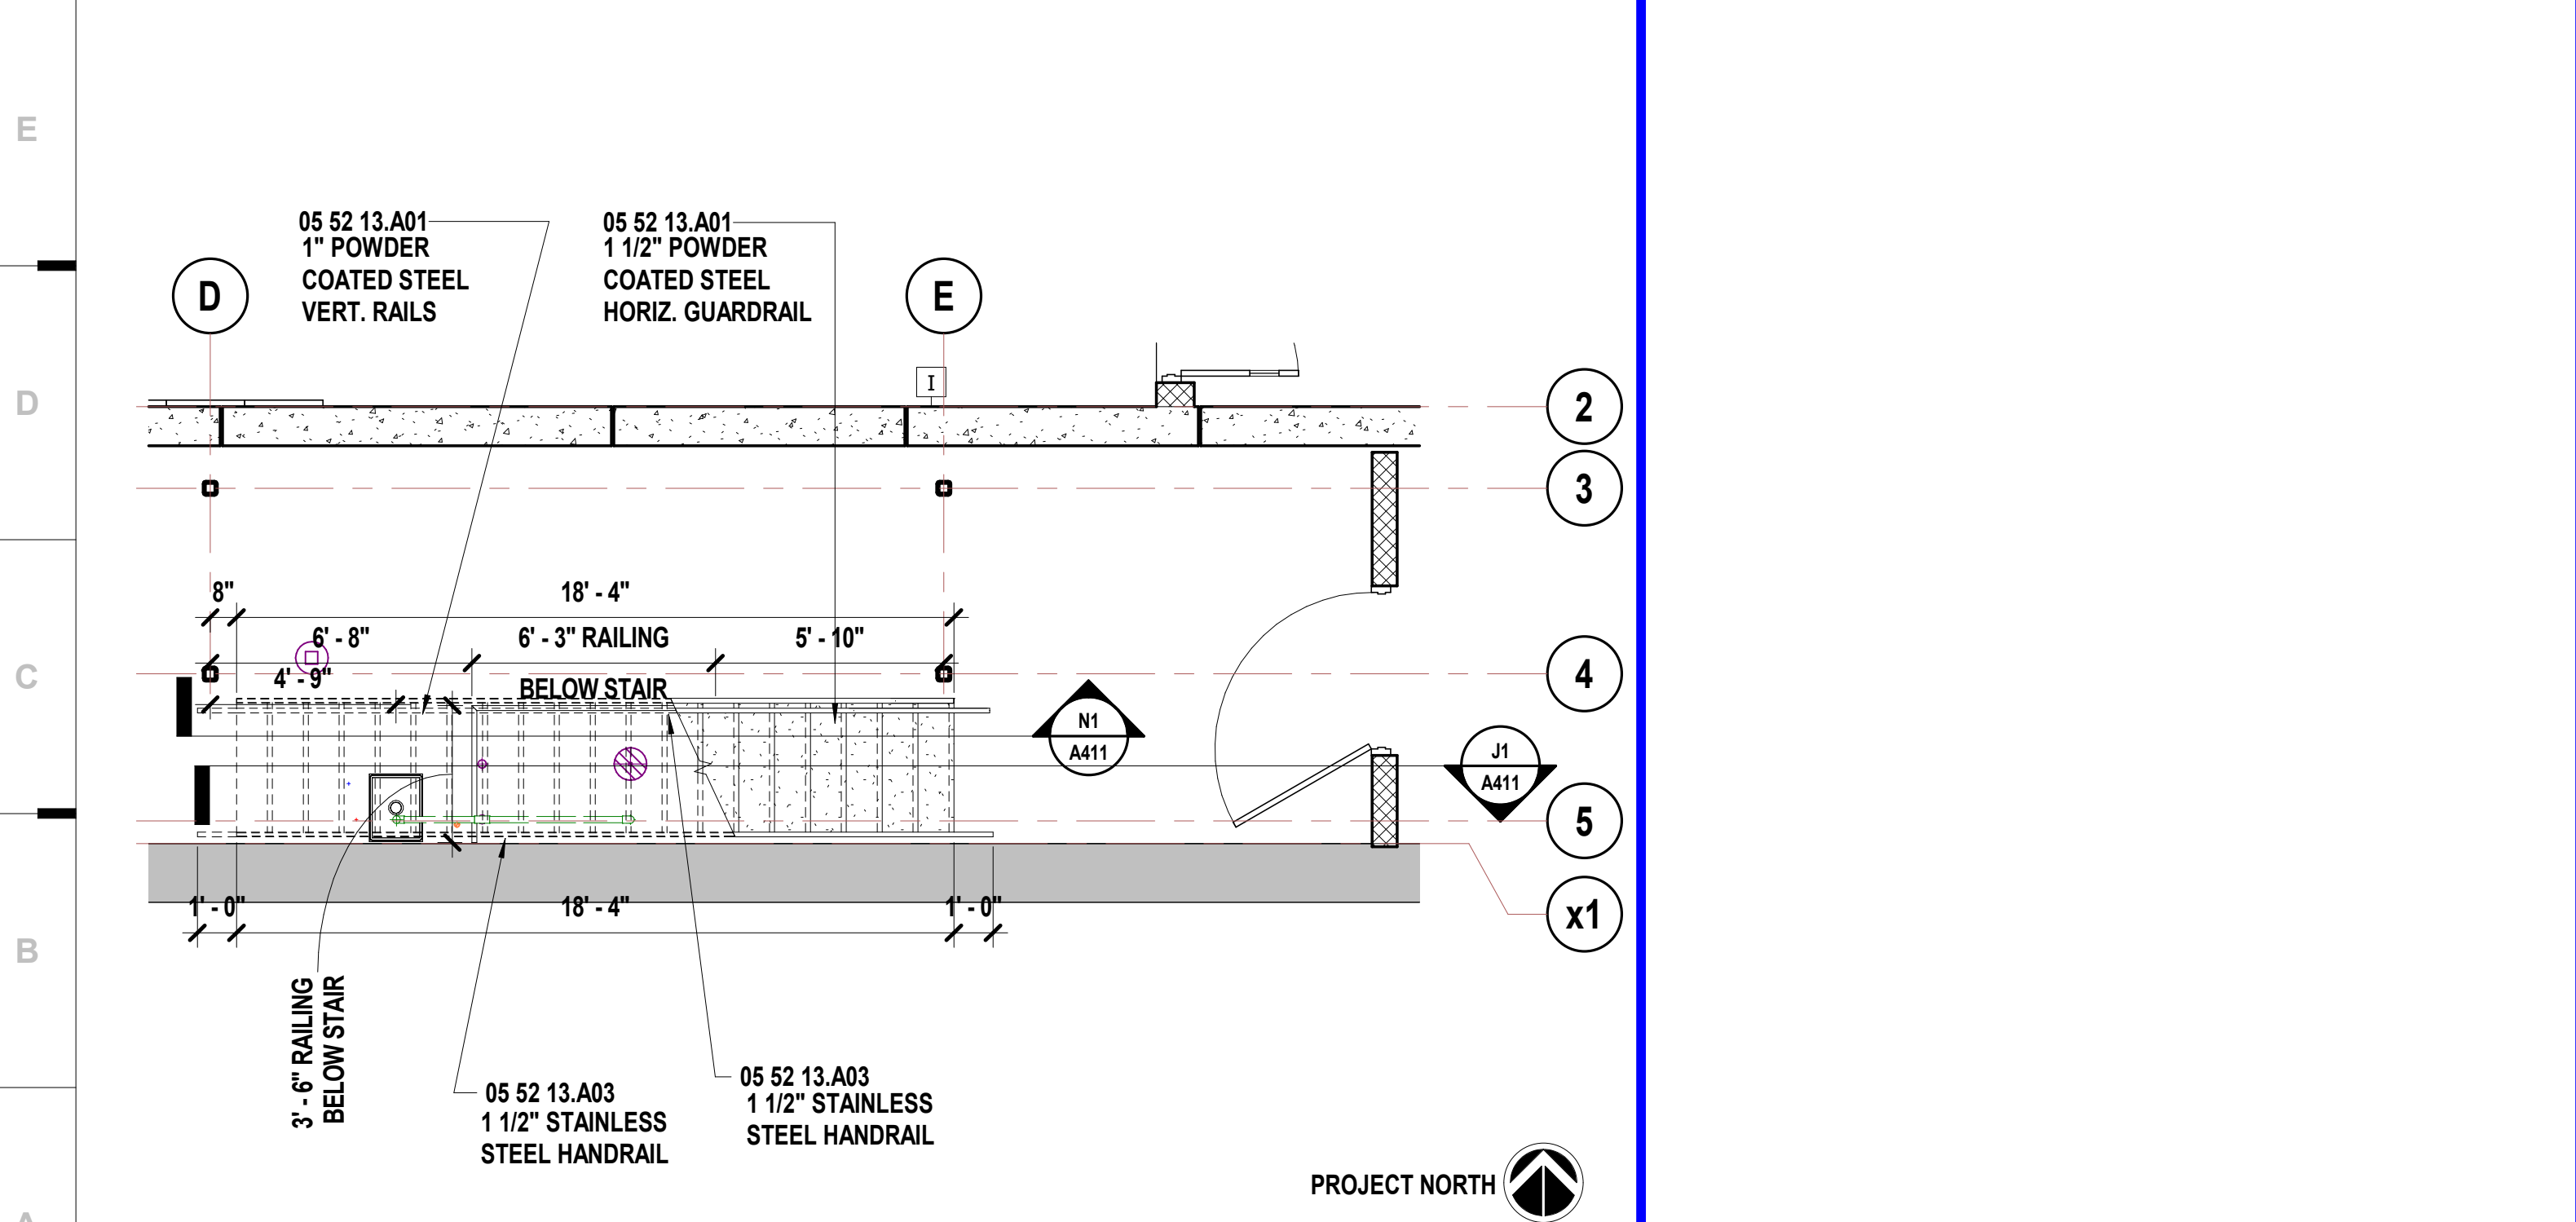

A1 Scale 1/4" = 1'-0" Stair Plan - Area A - Storage A112

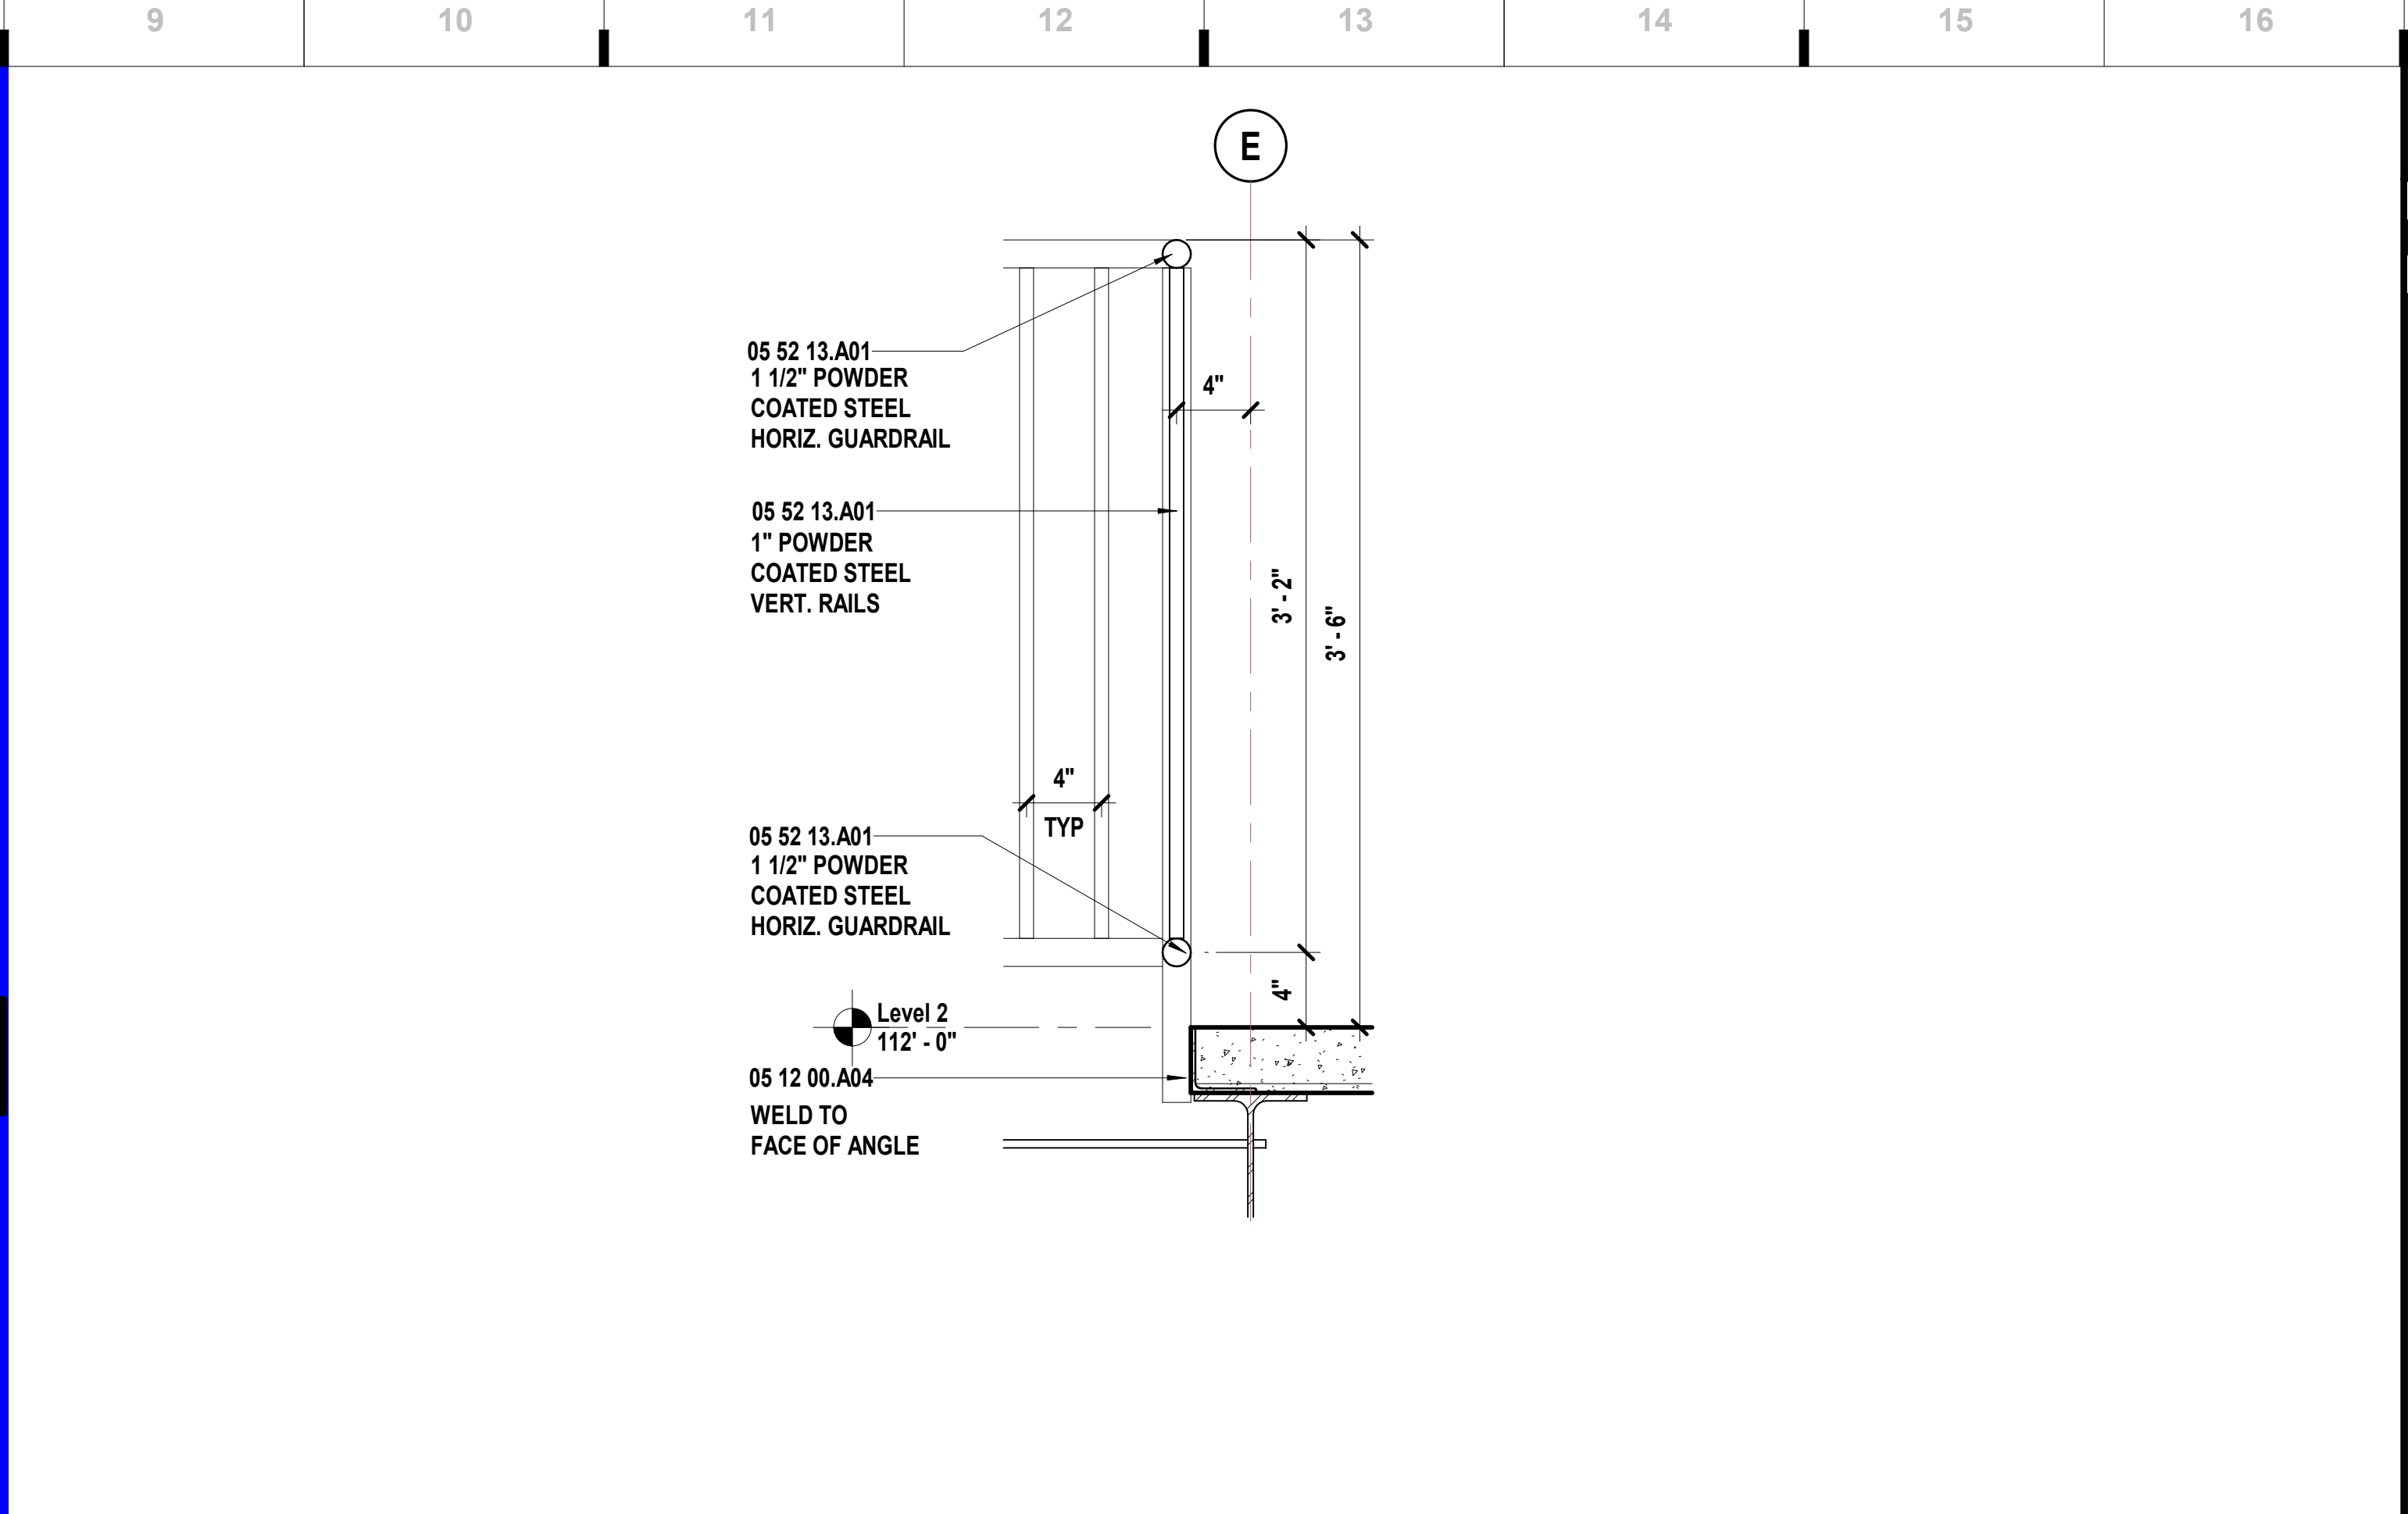

L9 Scale 1 1/2" = 1'-0" Section - Area A - Storage A200 - Guardrail

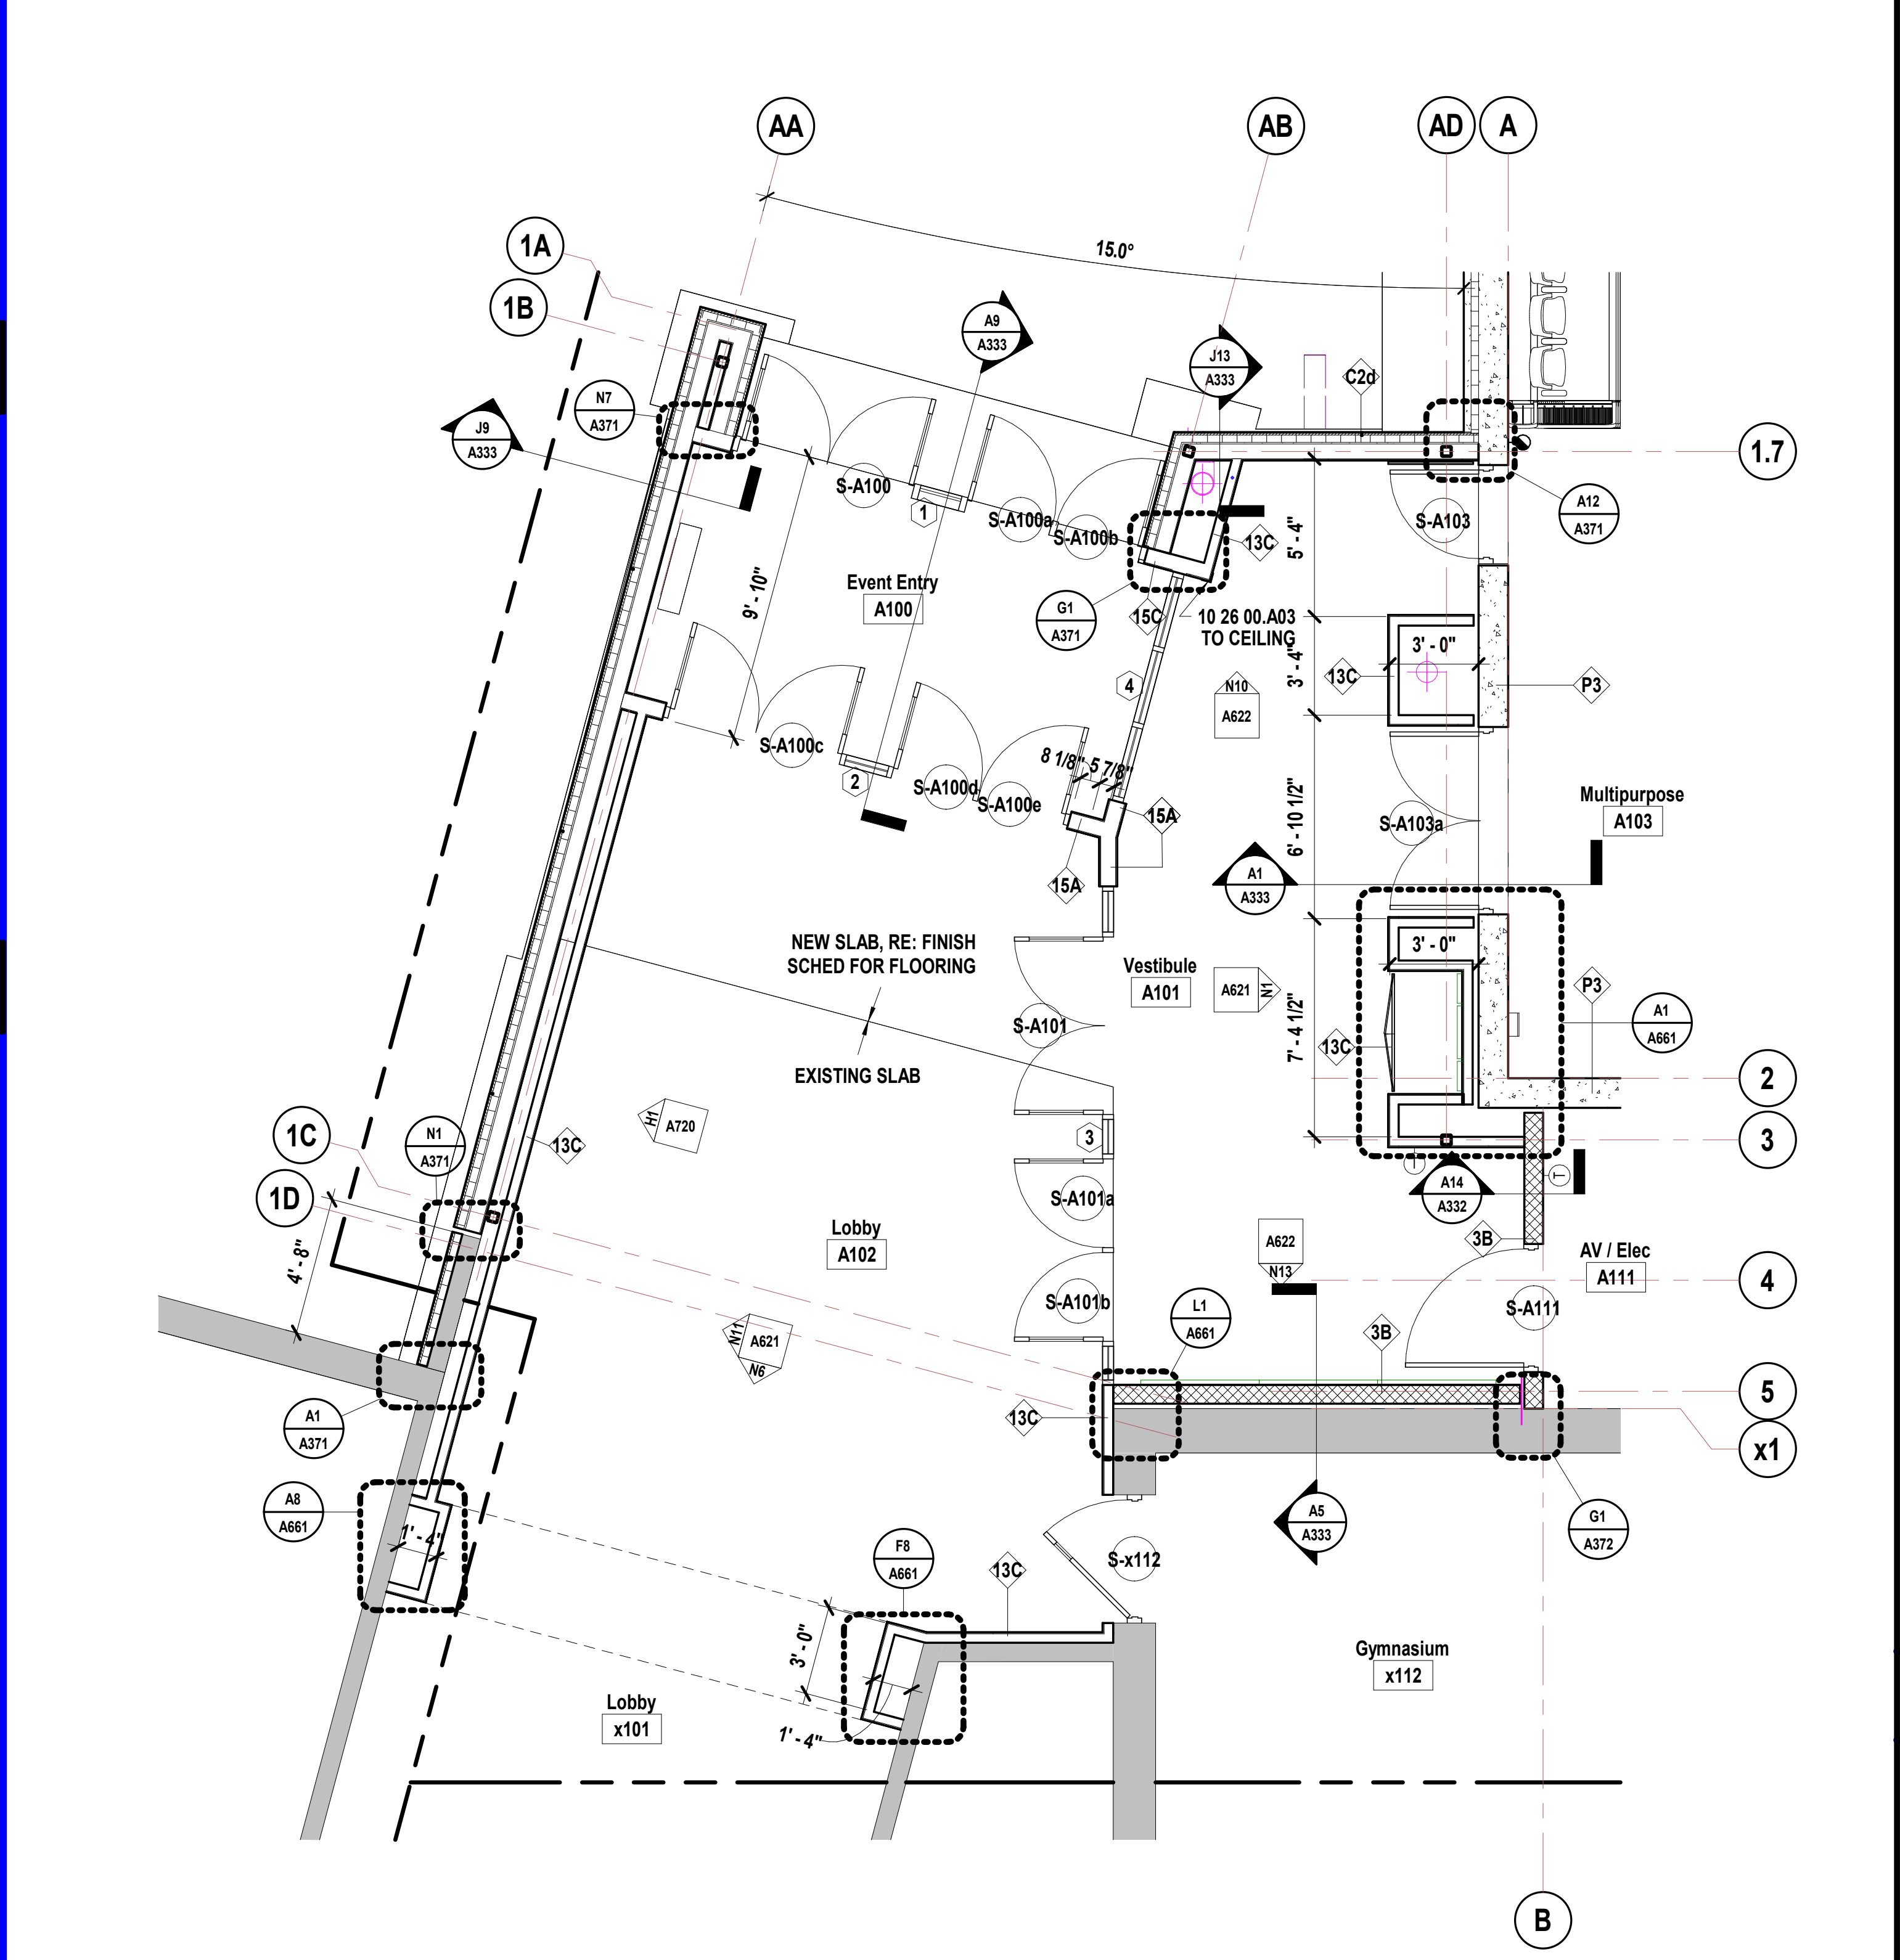

A9 Scale 1/4" = 1'-0" Floor Plan - Level 1 - Area A - Event Entry A100 & Vestibule A101

SHEET KEYNOTE LEGEND

05 12 00.A04	ANGLE
05 52 13.A01	STEEL PIPE AND TUBE RAILINGS
05 52 13.A03	STAINLESS STEEL PIPE AND TUBE RAILINGS
10 26 00.A03	CORNER GUARDS

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Missouri State Certificate of Authority
Architecture #000061

Bob D Campbell
Structural Engineer
State Certificate of Authority #000442

4338 Bellevue Ave
Kansas City, MO 64111
816.531.4144 phone

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913.345.2127 phone

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11827 W 112th Street, Suite 200
Overland Park, KS 66210
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AV/Acoustics Consultant
14827 West 95th St.
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#	Description	Date
1	Addendum 01	09.14.2023



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JOB NO: 23019

DRAWN BY: LB




CHECKED BY: JL

DATE: 08.31.2023

A411

VERTICAL CIRCULATION & ENLARGED PLANS

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TOILET, BATH AND LAUNDRY ACCESSORY LEGEND			
TAG	ACCESSORY	KEYNOTE	RESPONSIBILITY
TTD	TOILET TISSUE DISPENSER	10 28 00.A01	OFCl
PTD	PAPER TOWEL DISPENSER	10 28 00.A02	OFCl
SD	SOAP DISPENSER	10 28 00.A05	OFCl
GB	GRAB BARS	10 28 00.A06	CFCI
VGB	VERTICAL GRAB BAR	10 28 00.A06	CFCI
SNR	SANITARY NAPKIN RECEPTOR	10 28 00.A08	CFCI
MI	MIRROR - SINGLE	10 28 00.A10	CFCI
CH	COAT HOOK	10 28 00.A15	CFCI

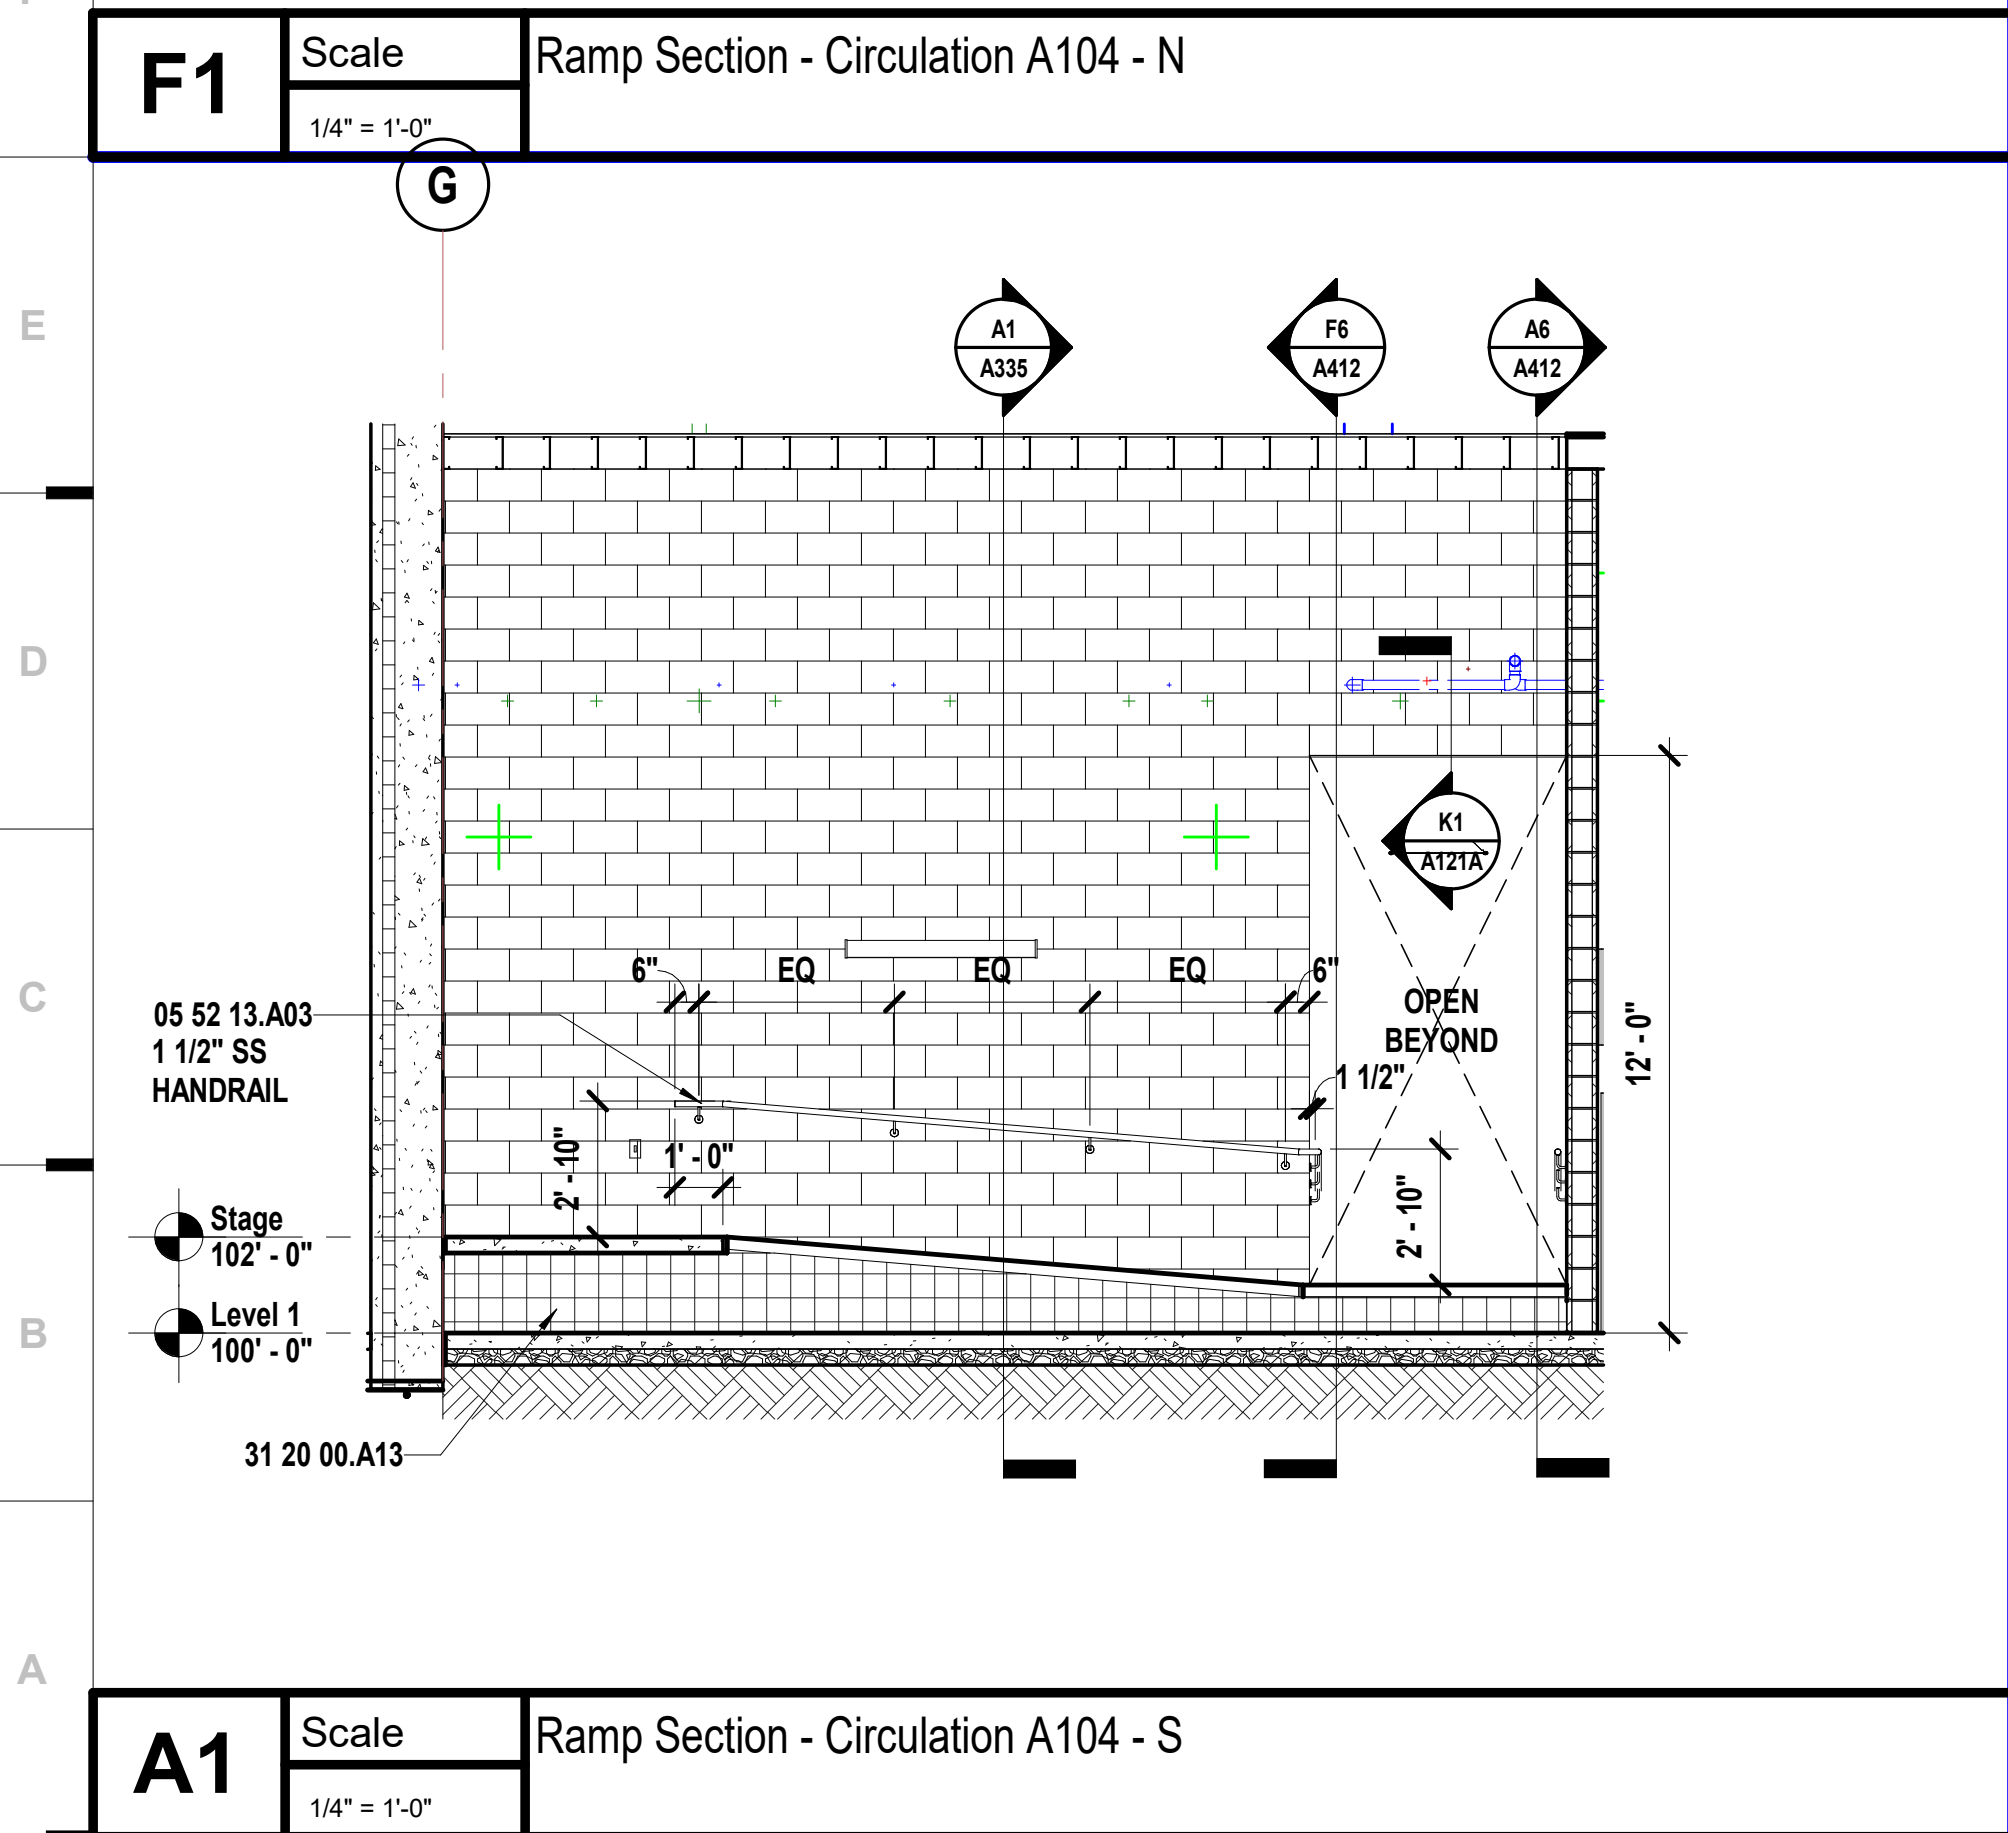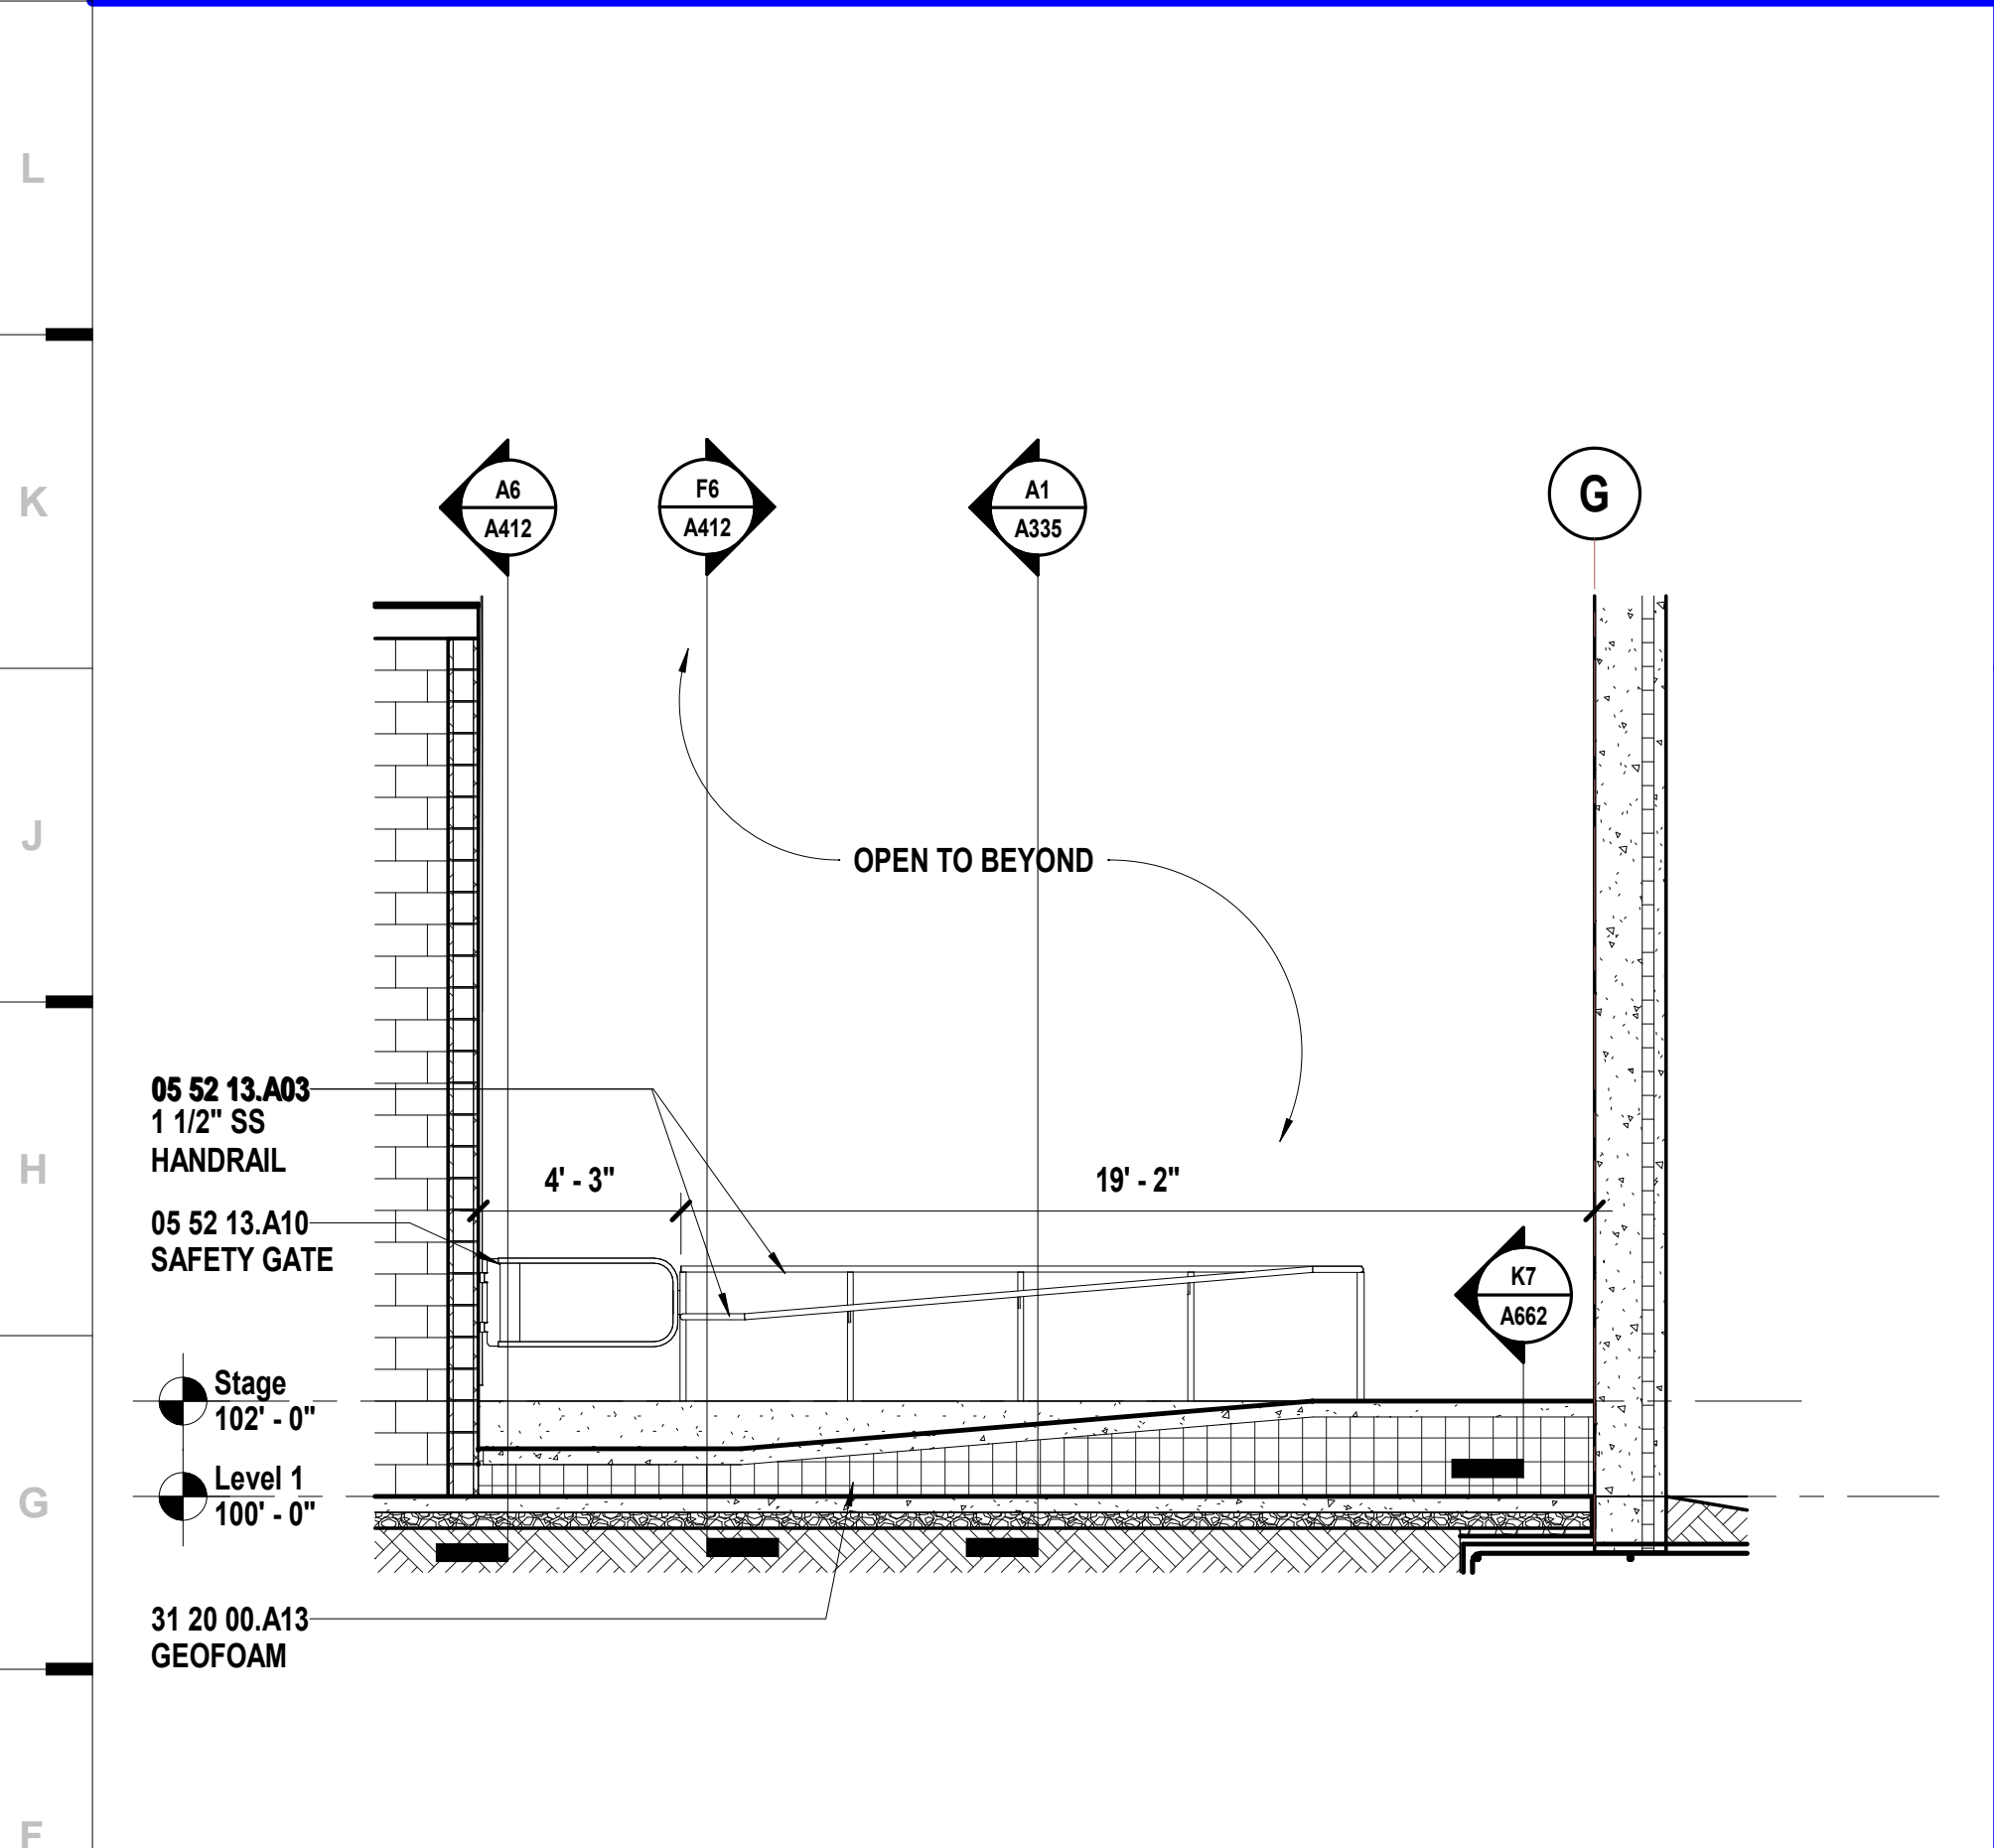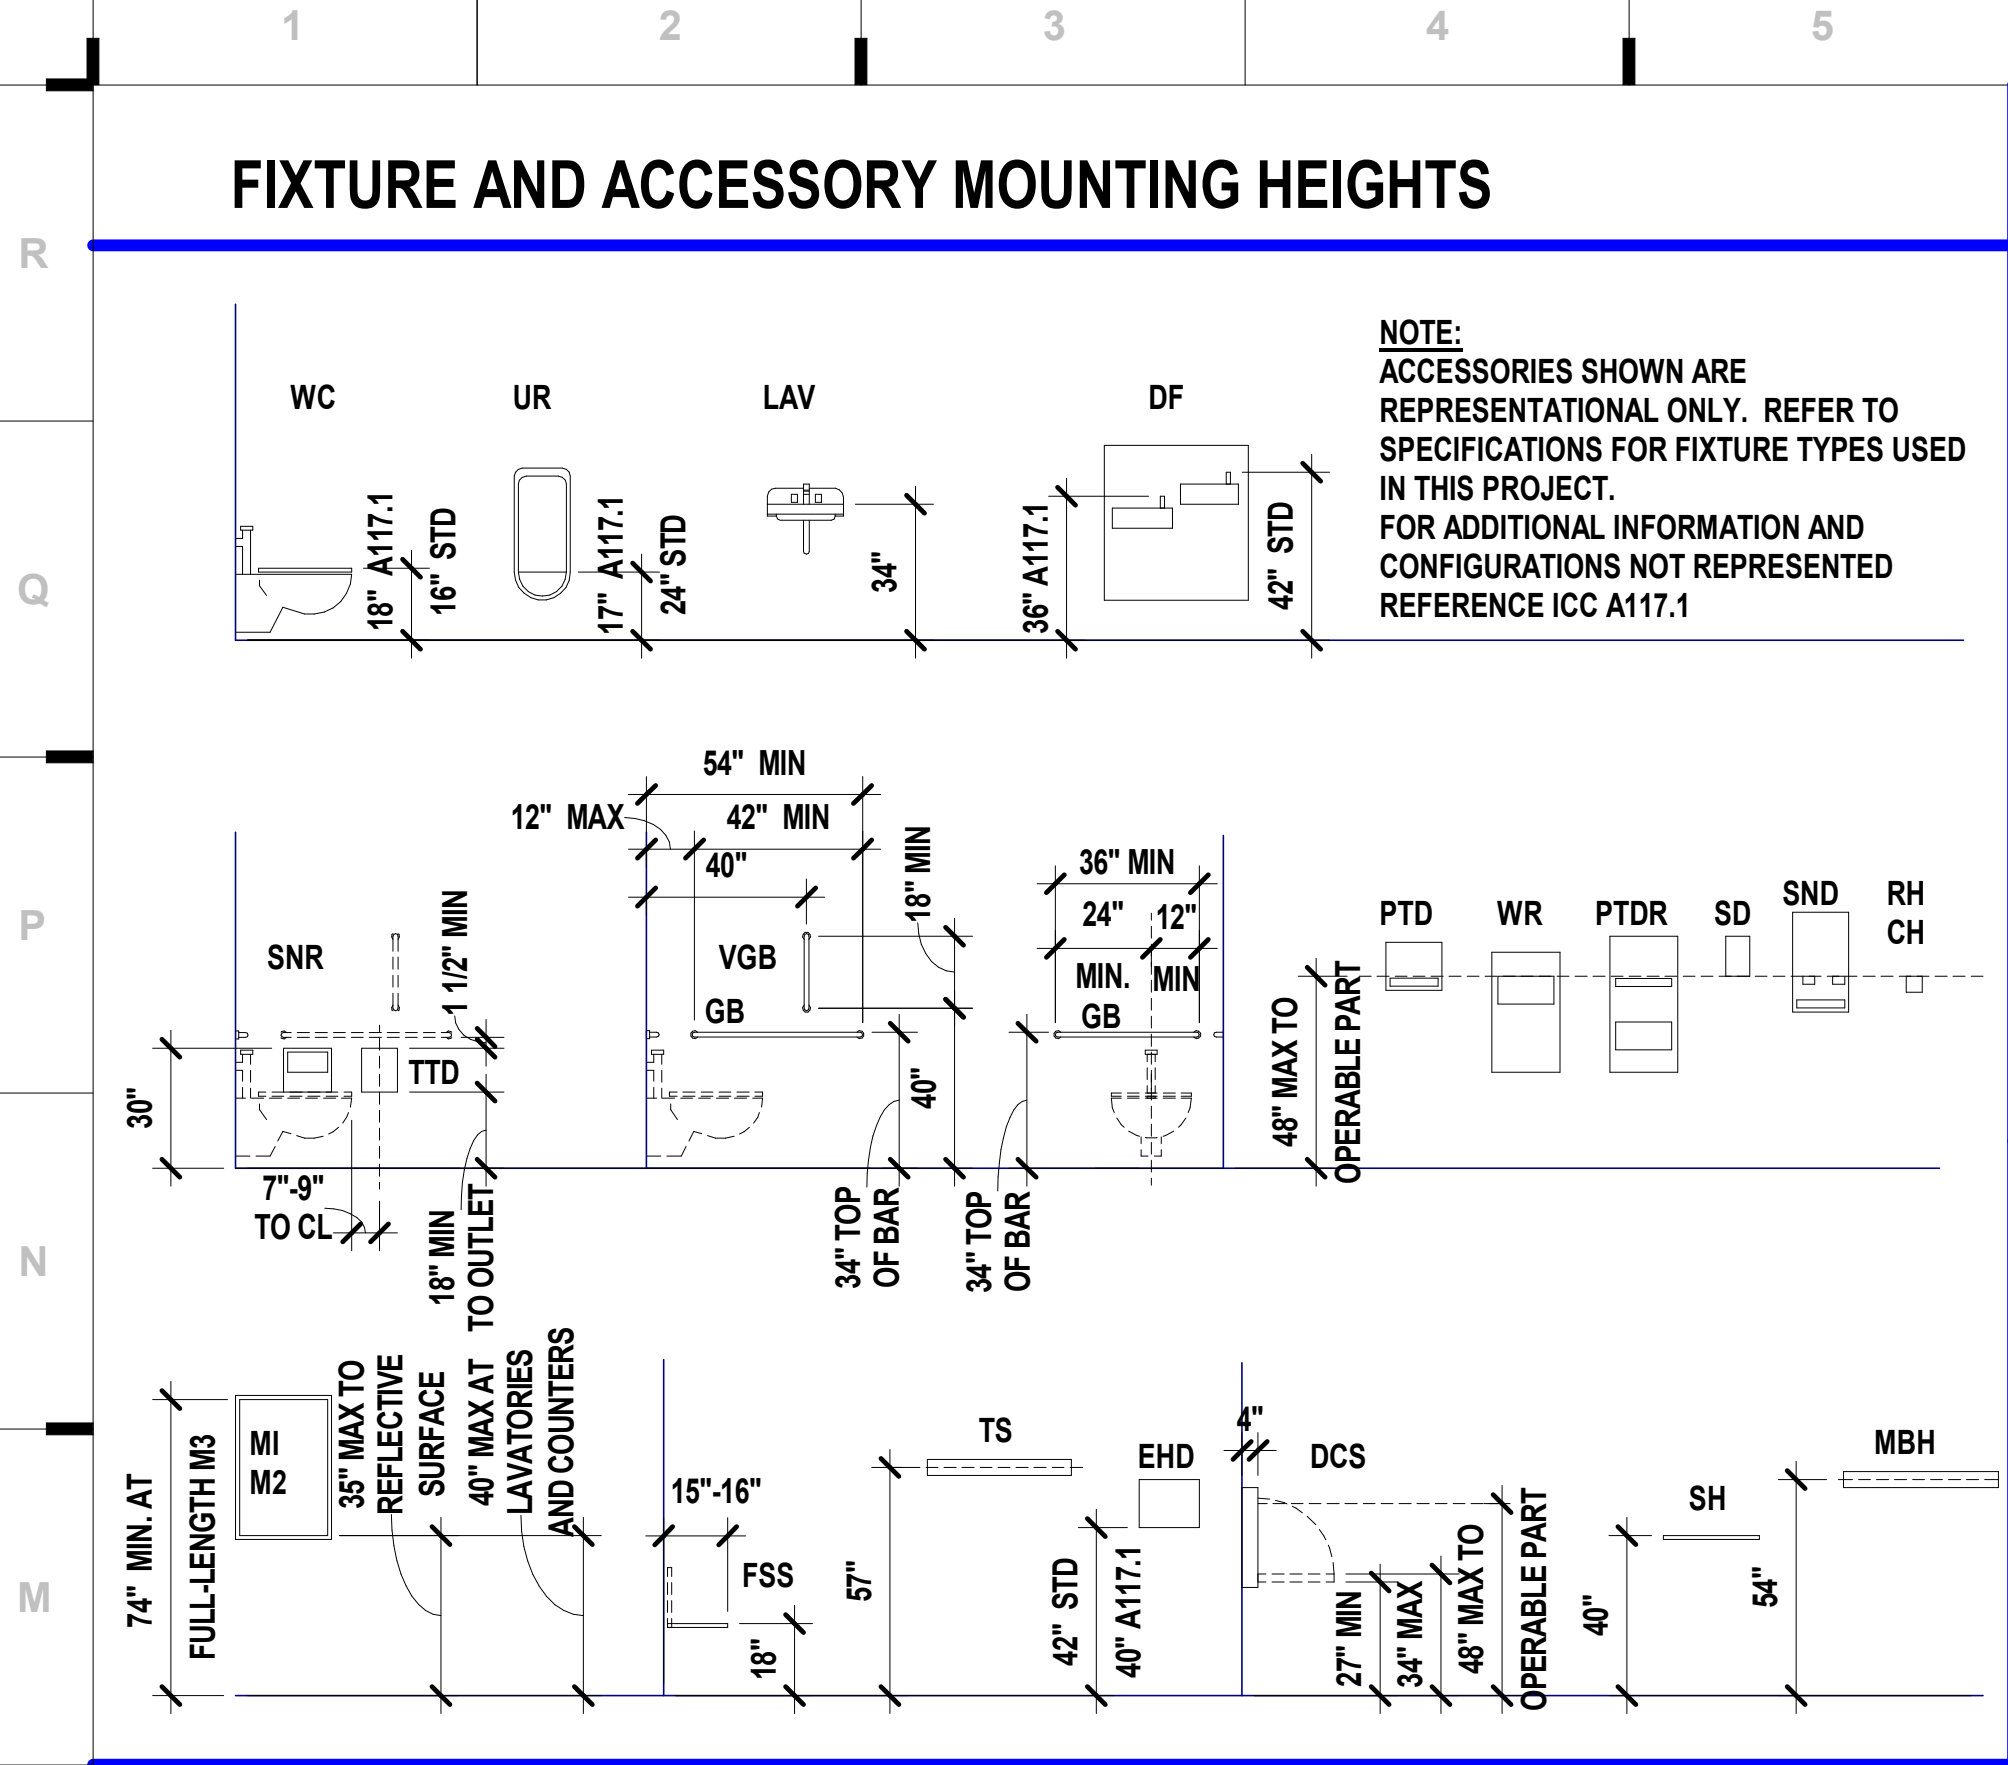NOTES:




TAGS ABOVE WITH A "C" PREFIX (IE CGB) DENOTE CHILD MOUNTING HEIGHTS

CF = CONTRACTOR FURNISH

CI = CONTRACTOR INSTALL

OF = OWNER FURNISH

OI = OWNER INSTALL

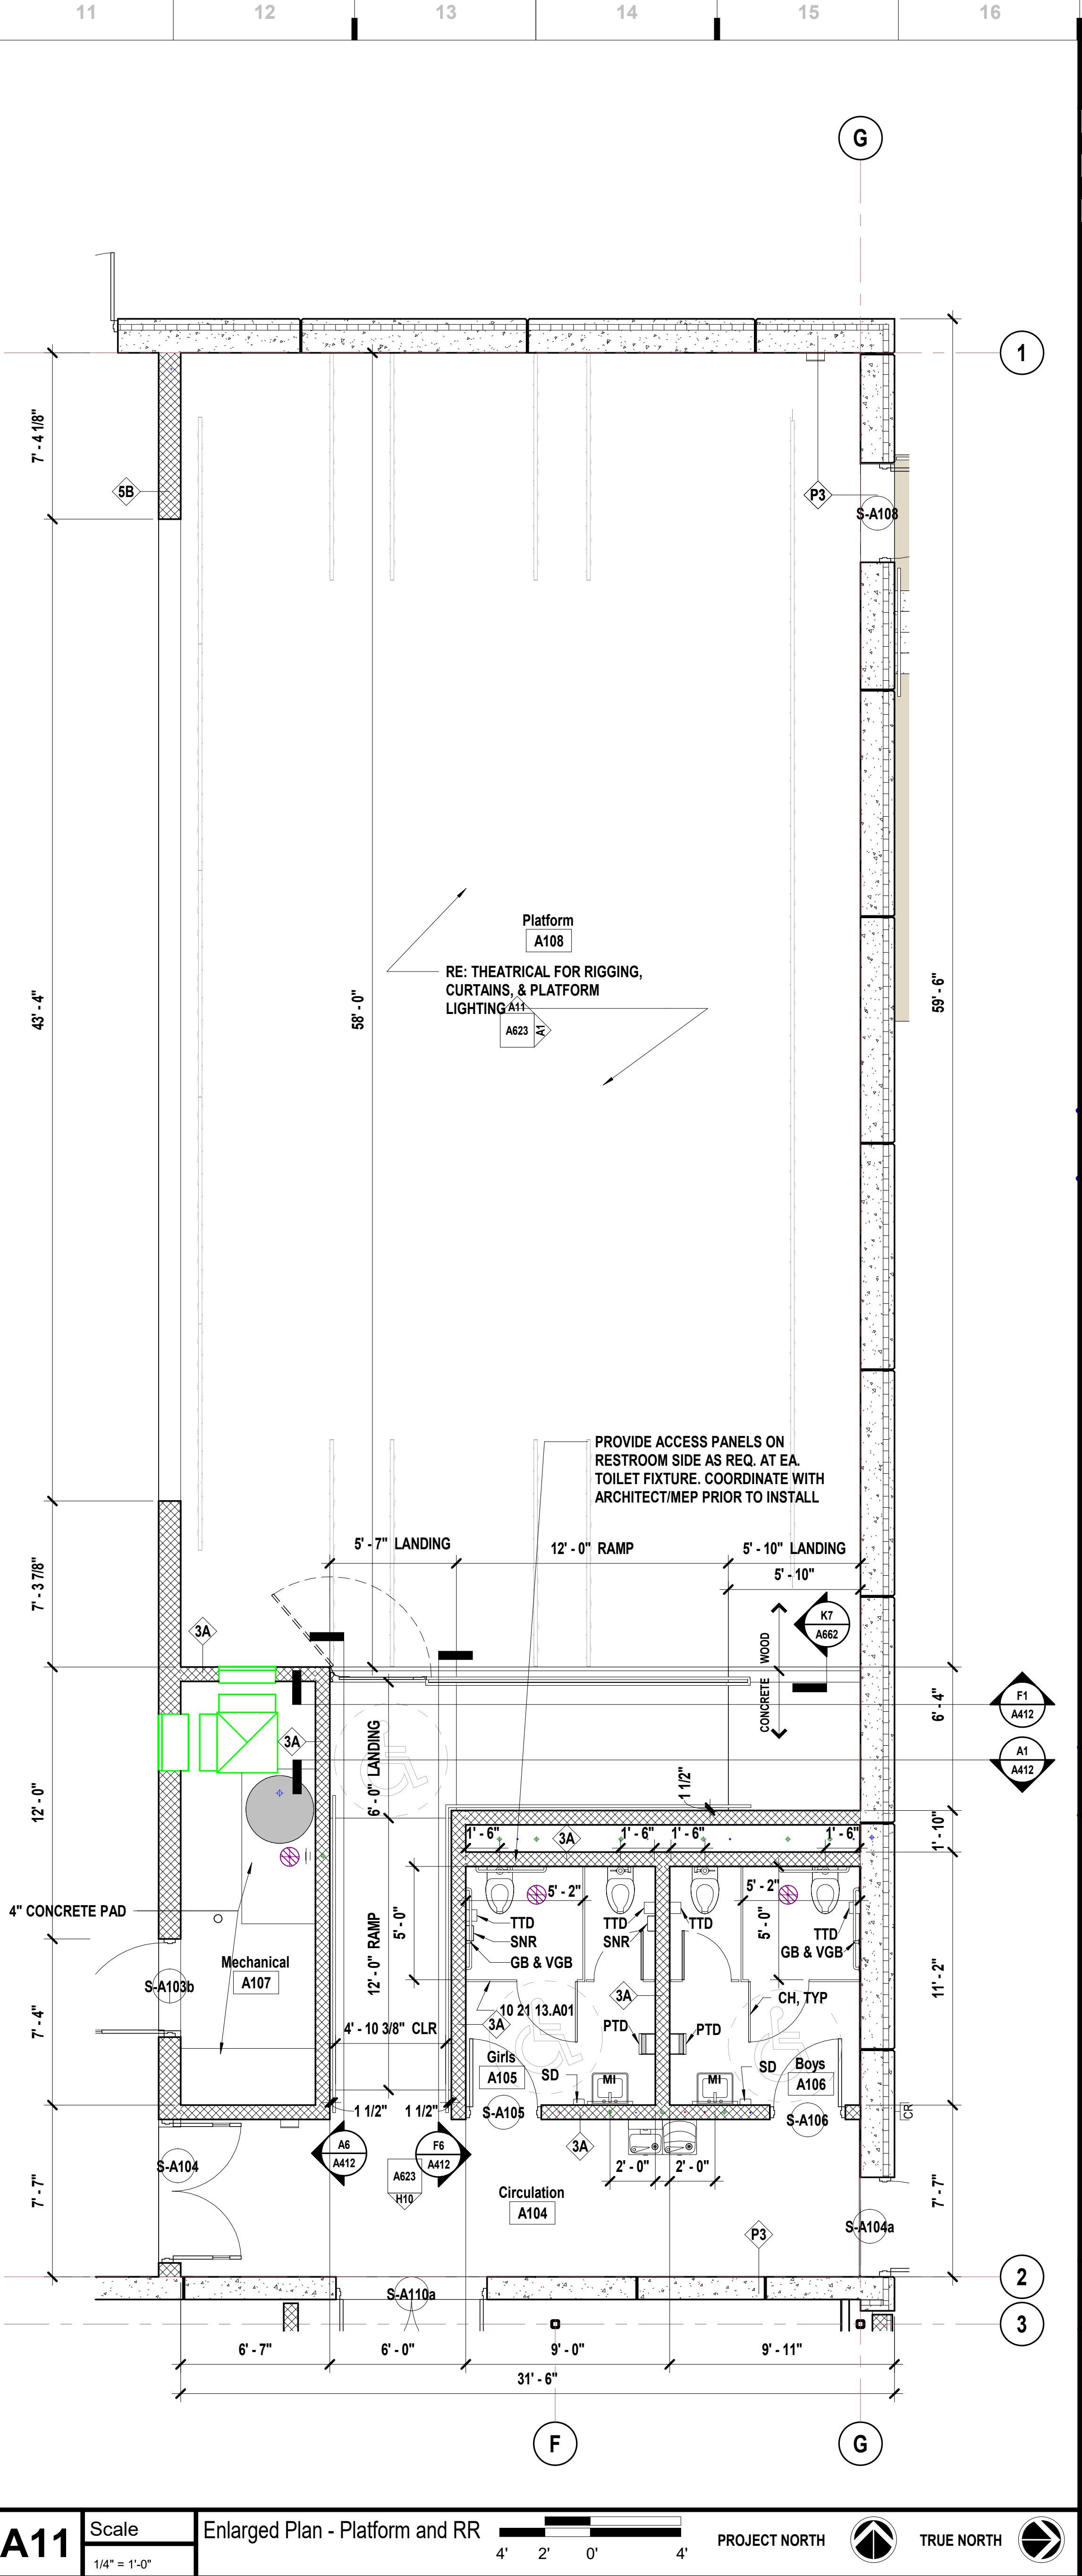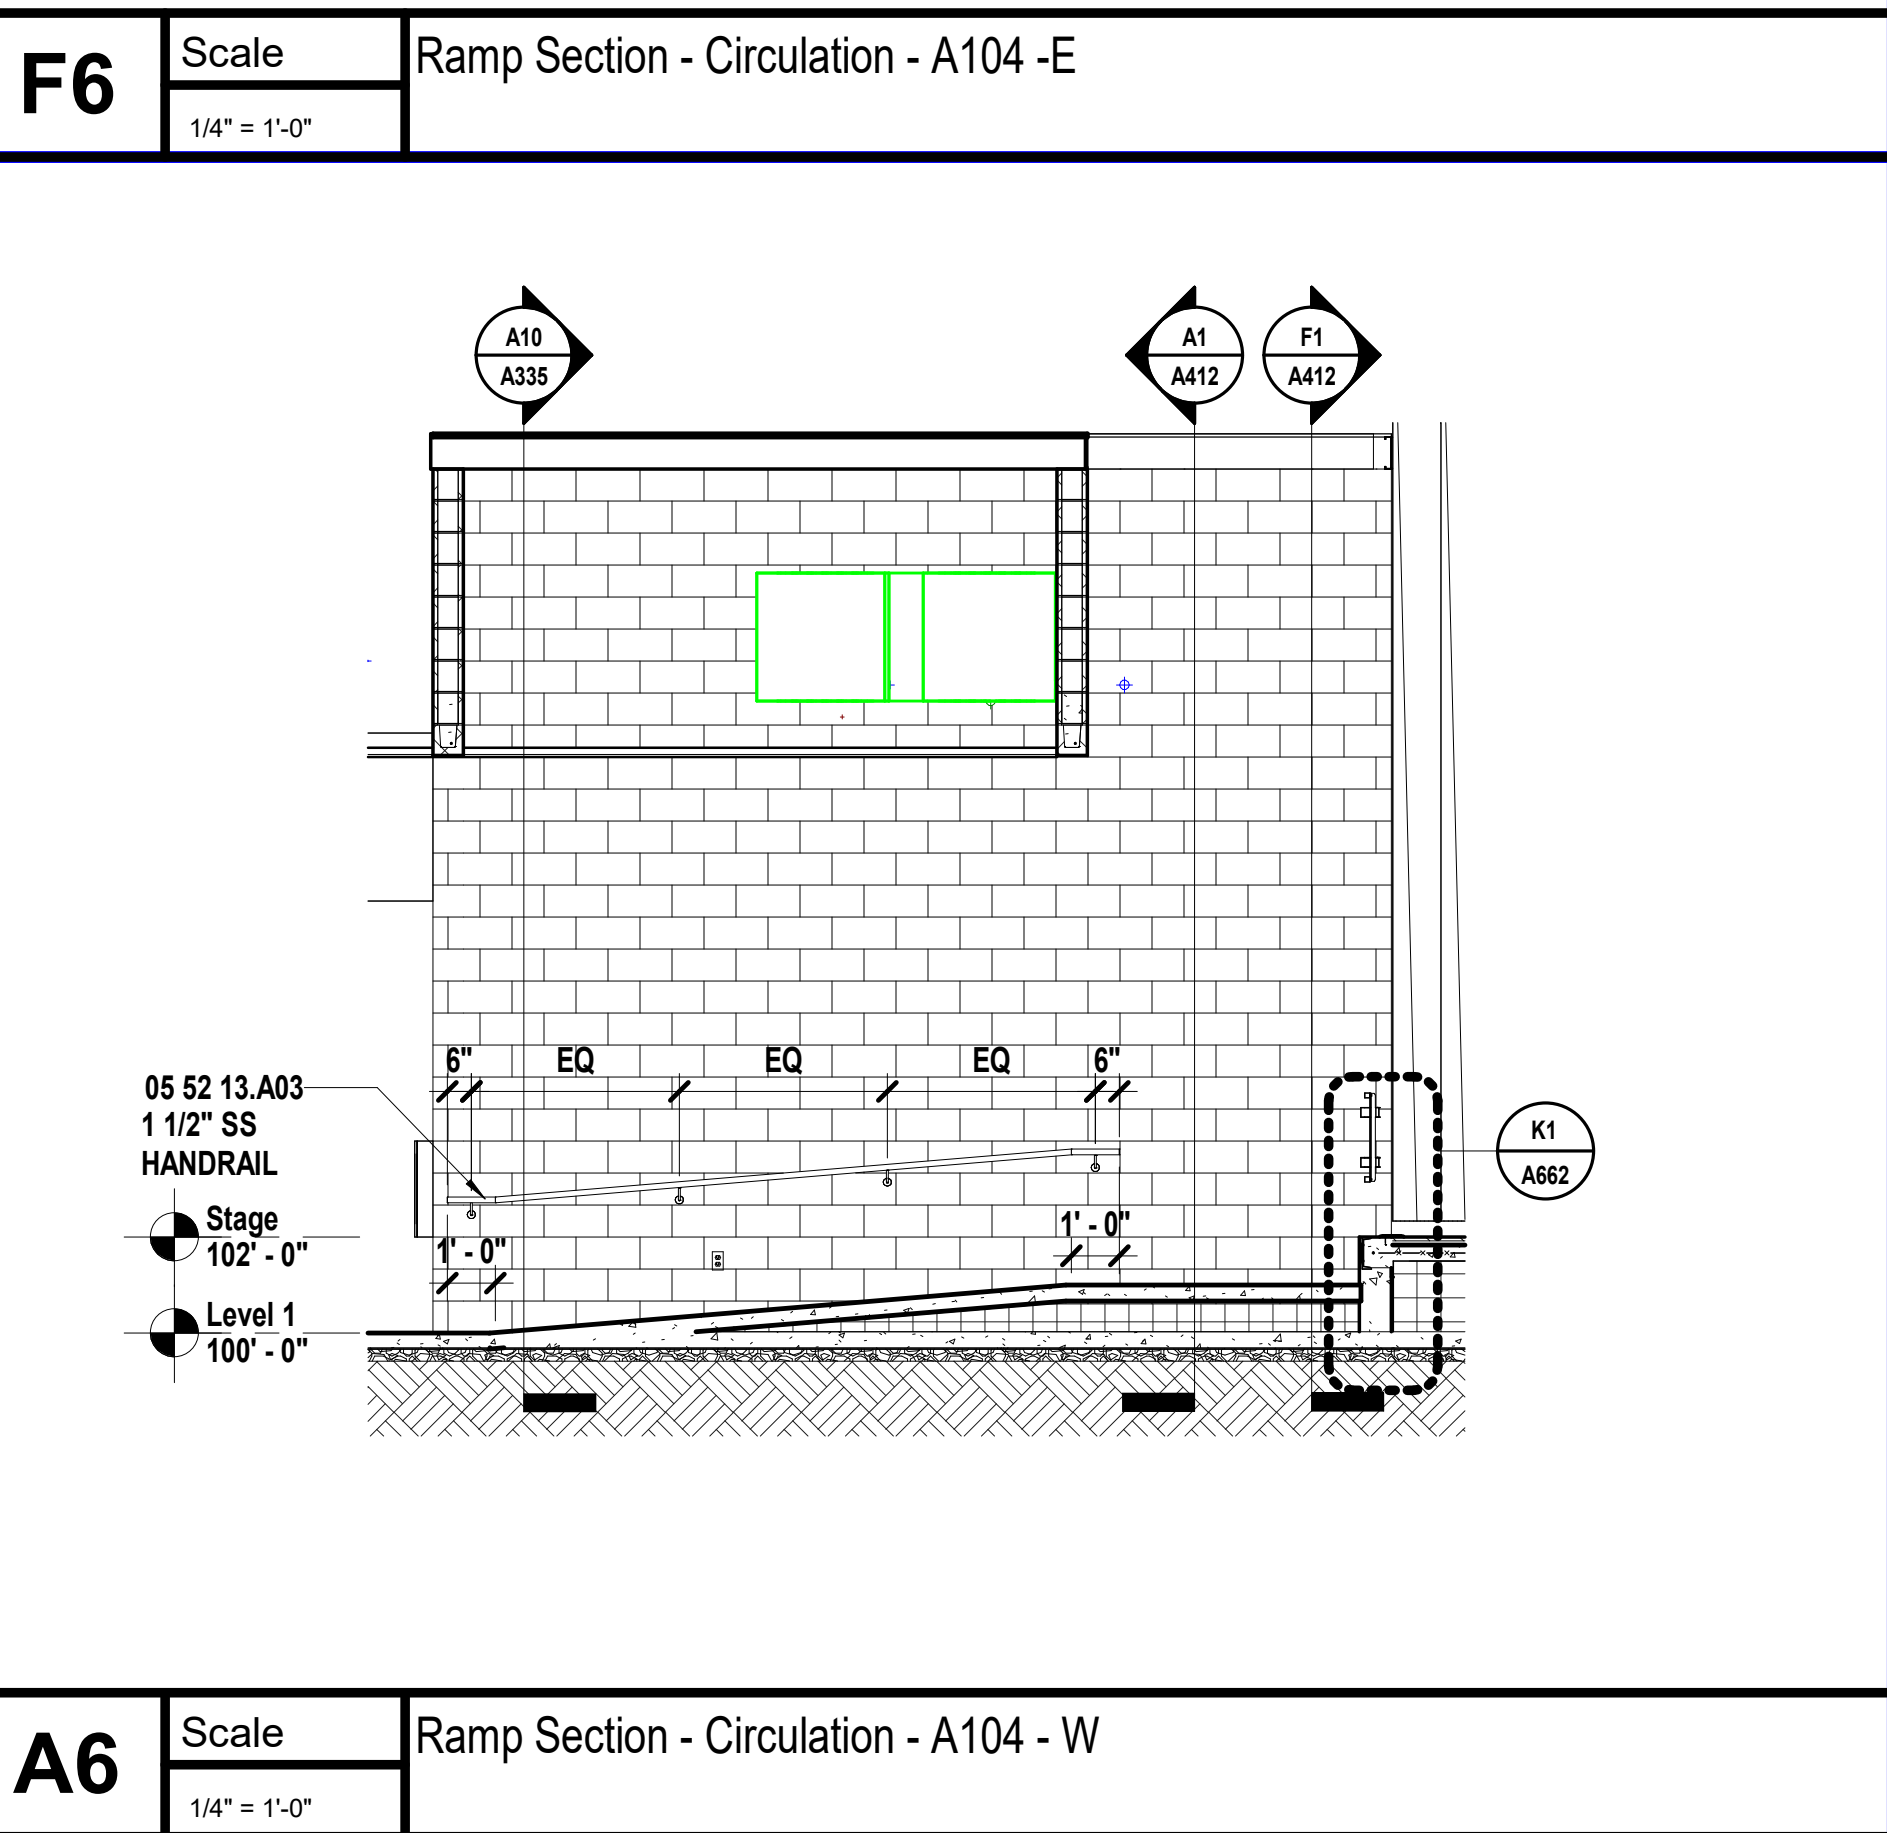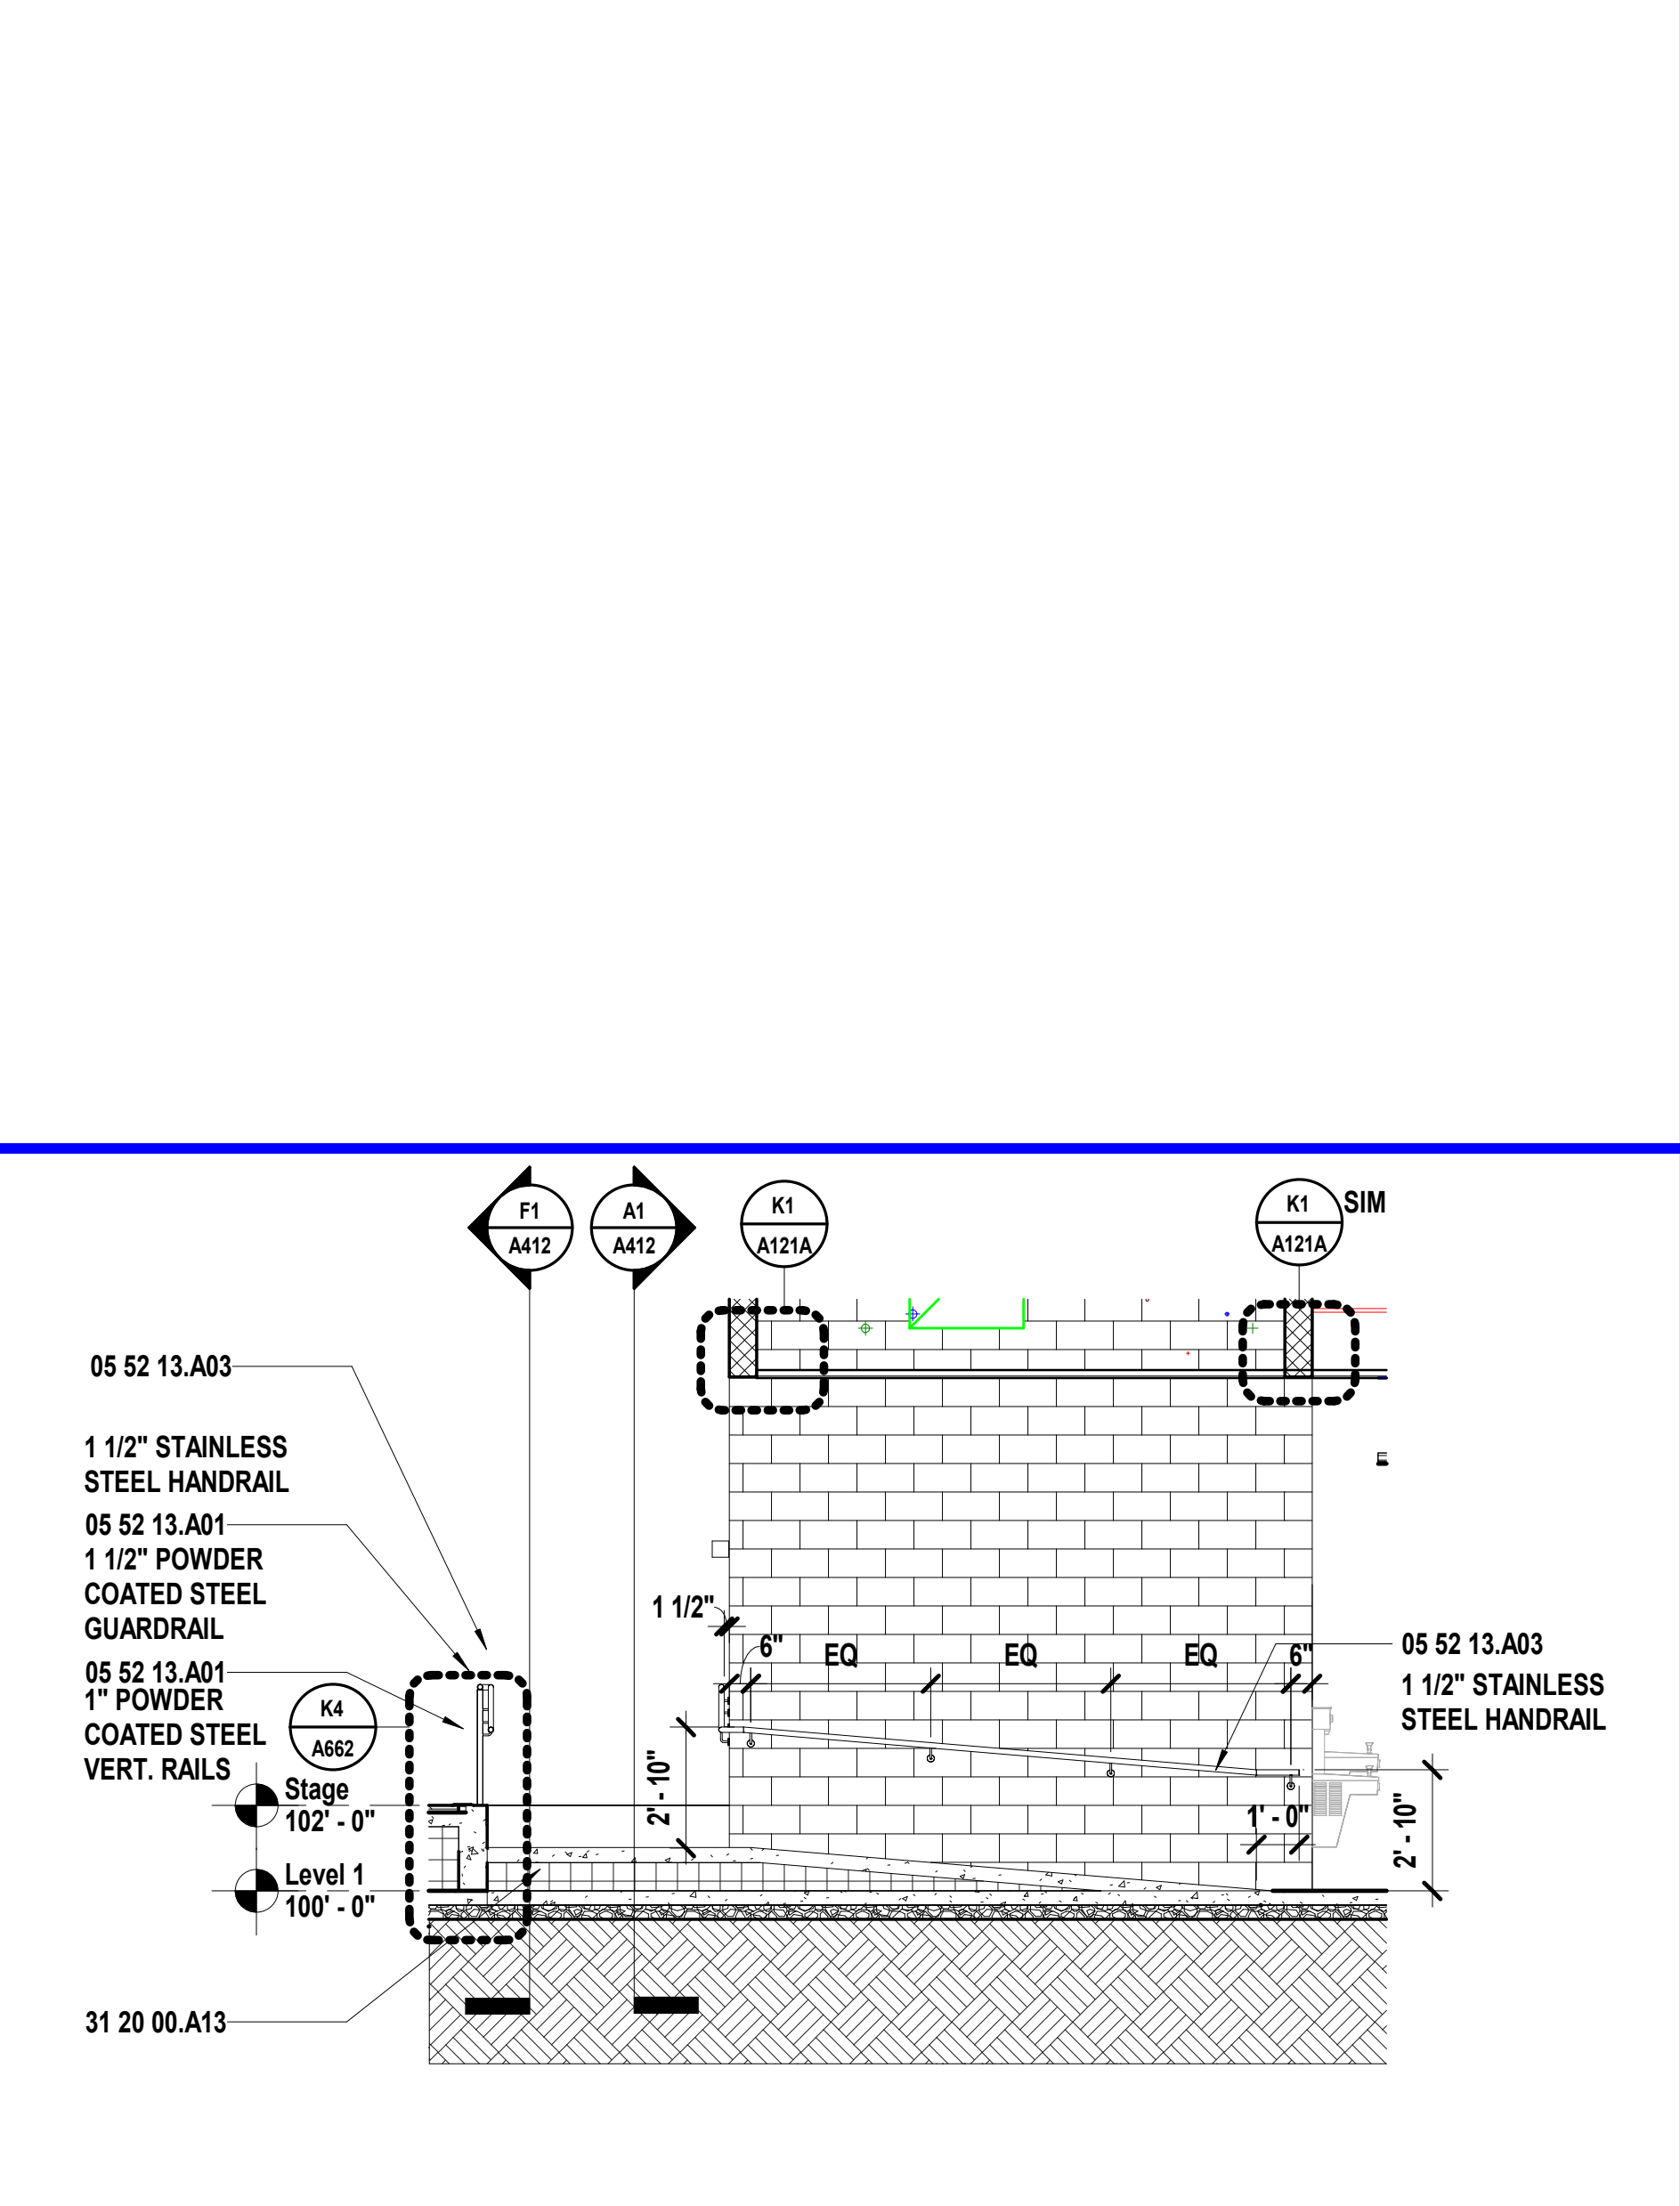

SHEET KEYNOTE LEGEND	
05 52 13.A01	STEEL PIPE AND TUBE RAILINGS
05 52 13.A03	STAINLESS STEEL PIPE AND TUBE RAILINGS
05 52 13.A10	GATE
10 21 13.A01	TOILET COMPARTMENTS
31 20 00.A13	GEOFOAM

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Bob D Campbell
Structural Engineer
State Certificate of Authority #000442
4338 Bellevue Ave
Kansas City, MO 64111
816.531.4144 phone

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913.317.9390 phone


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Theatrical Consultant
109 E Pine St.
Warrensburg, MO 64093-0752
660.429.1383 phone

Avant Acoustics
AV/Acoustics Consultant
14827 West 95th St.
Lenexa, KS 66215
913.888.9111 phone

RE: THEATRICAL FOR RIGGING,
CURTAINS, & PLATFORM
LIGHTING A11

- SHEET NOTES**
- REFER TO SHEET G000 FOR SHEET INDEX
 - DO NOT SCALE THIS DRAWING
 - INTERIOR DIMENSIONS ARE TO THE FOLLOWING, UNLESS NOTED OTHERWISE:
 - A. TO FACE OF STUD
 - B. TO FACE OF MASONRY UNIT
 - C. TO FACE OF DOOR AND WINDOW ROUGH OPENINGS
 - REFER TO INTERIOR ELEVATIONS, THIS SHEET, FOR PLACEMENT OF ALL WALL MOUNTED/RECESSED ITEMS
 - COORDINATE LOCATIONS WHERE BACKING REQUIRED FOR TOILET ACCESSORIES

- SHEET NOTES**
- DO NOT SCALE THIS DRAWING

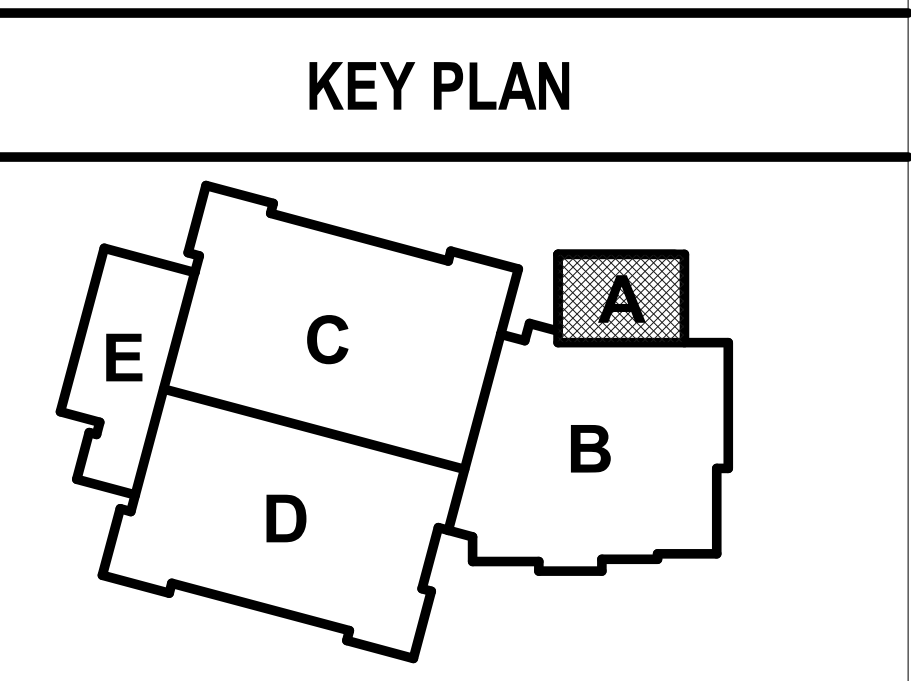

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1828 Walnut Street Suite 922
Kansas City, MO 64108
816.442.7700

115 Wilcox Street Suite 210
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720.949.1589

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Hollis + Miller Architects
Missouri State Certificate of Authority
Architecture #000051

Bob D Campbell
Structural Engineer
State Certificate of Authority #000442
4338 Bellevue Ave
Kansas City, MO 64111
816.531.4144 phone

Smith & Boucher, Inc.
Mechanical, Electrical, & Plumbing
State Certificate of Authority #EGC000178
25615 W 103rd Street
Olathe, KS 66061
913.345.2127 phone

MKEC Engineering, Inc.
Civil Engineer
State Certificate of Authority
Engineering #200100364
Landscaping #2006027139
Surveying #2006027138
11827 W 112th Street, Suite 200
Overland Park, KS 66210
913.317.9390 phone

Peerbolte Creative
Theatrical Consultant
109 E Pine St.
Warrensburg, MO 64093-0752
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14827 West 95th St.
Lenexa, KS 66215
913.888.9111 phone

South Valley Middle School Storm Shelter Addition
Liberty Public Schools
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CONFORMED CONSTRUCTION DOCUMENTS

REVISIONS:

#	Description	Date
1	Issued for Construction	09.14.2023

Kevin E. Nelson
A-2019015618
ARCHITECT

OCTOBER 11, 2023


Kevin E. Nelson
A-2019015618

JOB NO: 23019
DRAWN BY: LB
CHECKED BY: JL
DATE: 08.31.2023


A412

DOOR SCHEDULE


DOOR			Frame			All DETAILS on A501 UNO						Remarks
Number	Size	Type	Glass	Type	Material	Head	Strike	Hinge	Thresh	Fire Rating		
S-A100	PR 3'-0" x 7'-0" x 1 3/4"	E9	31	1	ALUM	RE: FRAME ELEV	RE: FRAME ELEV	RE: FRAME ELEV	--	--	REMOVABLE CENTER MULLION	
S-A100a	3'-0" x 7'-0" x 1 3/4"	E9	31	1	ALUM	RE: FRAME ELEV	RE: FRAME ELEV	RE: FRAME ELEV	--	--	FIXED CENTER MULLION	
S-A100b	3'-0" x 7'-0" x 1 3/4"	E9	--	1	ALUM	RE: FRAME ELEV	RE: FRAME ELEV	F11/A501	--	--	FIXED CENTER MULLION, CR, CALL BOX, ADA CONTROL	
S-A100c	PR 3'-0" x 7'-0" x 1 3/4"	E9	21	2	ALUM	RE: FRAME ELEV	RE: FRAME ELEV	RE: FRAME ELEV	--	--	REMOVABLE CENTER MULLION	
S-A100d	3'-0" x 7'-0" x 1 3/4"	E9	21	2	ALUM	RE: FRAME ELEV	RE: FRAME ELEV	RE: FRAME ELEV	--	--	FIXED CENTER MULLION	
S-A100e	3'-0" x 7'-0" x 1 3/4"	E9	--	2	ALUM	RE: FRAME ELEV	RE: FRAME ELEV	RE: FRAME ELEV	--	--	FIXED CENTER MULLION, CR	
S-A101	PR 3'-0" x 7'-0" x 1 3/4"	E9	21	3	ALUM	RE: FRAME ELEV	RE: FRAME ELEV	RE: FRAME ELEV	--	--	REMOVABLE CENTER MULLION	
S-A101a	3'-0" x 7'-0" x 1 3/4"	E9	--	3	ALUM	RE: FRAME ELEV	RE: FRAME ELEV	RE: FRAME ELEV	--	--	FIXED CENTER MULLION	
S-A101b	3'-0" x 7'-0" x 1 3/4"	E9	--	3	ALUM	RE: FRAME ELEV	RE: FRAME ELEV	RE: FRAME ELEV	--	--	FIXED CENTER MULLION	
S-A103	3'-0" x 7'-0" x 1 3/4"	F1	--	A	HM	A14/A501	A14/A501	A14/A501	--	90MIN		
S-A103a	PR 3'-0" x 7'-0" x 1 3/4"	F1	--	A	HM	A14/A501	--	A14/A501	--	90MIN		
S-A103b	4'-0" x 7'-0" x 1 3/4"	A3	--	A	HM	A7/A501	A3/A501	A3/A501	--	--		
S-A103c	3'-0" x 7'-0" x 1 3/4"	F1	--	A	HM	F14/A501	F11/A501	F11/A501	--	--		
S-A104	PR 3'-0" x 7'-0" x 1 3/4"	B3	--	A	HM	A7/A501	--	A1/A501 & A3/A501	--	--		
S-A104a	4'-0" x 7'-0" x 1 3/4"	F1	--	A	HM	F14/A501	F11/A501	F11/A501	--	--		
S-A105	3'-0" x 7'-0" x 1 3/4"	A3	--	A	HM	A7/A501	A3/A501	A5/A501	--	--		
S-A106	3'-0" x 7'-0" x 1 3/4"	A3	--	A	HM	A7/A501	A3/A501	A3/A501	--	--		
S-A108	4'-0" x 7'-0" x 1 3/4"	F1	--	A	HM	F14/A501	F11/A501	F11/A501	--	--		
S-A110a	PR 3'-2" x 7'-0" x 1 3/4"	F1	--	A	HM	A14/A501	--	A14/A501	--	90MIN		
S-A111	4'-0" x 7'-0" x 1 3/4"	A3	--	A	HM	A7/A501	A3/A501	A3/A501	--	90MIN		
S-A112	4'-0" x 7'-0" x 1 3/4"	A3	--	A	HM	A7/A501	A3/A501	A3/A501	--	--		
S-A112a	3'-6" x 7'-0" x 1 3/4"	A3	--	A	HM	A7/A501	A3/A501	A3/A501	--	--		
S-A113	4'-0" x 7'-0" x 1 3/4"	E9	21	5	ALUM	RE: FRAME ELEV	RE: FRAME ELEV	RE: FRAME ELEV	--	--		
S-x112	4'-0" x 7'-0" x 1 3/4"	--	--	--	--	--	--	--	--	--	EXISTING DOOR & FRAME TO REMAIN, PNT	
S-x112a	PR 3'-0" x 7'-0" x 1 3/4"	--	--	--	--	--	--	--	--	--	EXISTING DOOR & FRAME TO REMAIN, PNT	
S-x112b	PR 3'-0" x 7'-0" x 1 3/4"	--	--	--	--	--	--	--	--	--	EXISTING DOOR & FRAME TO REMAIN, REMOVE MAGLOCKS	
S-x112c	PR 3'-0" x 7'-0" x 1 3/4"	--	--	--	--	--	--	--	--	--	EXISTING DOOR & FRAME TO REMAIN, REMOVE MAGLOCKS	
S-x112d	PR 3'-0" x 7'-0" x 1 3/4"	--	--	--	--	--	--	--	--	--	EXISTING DOOR & FRAME TO REMAIN, REMOVE MAGLOCKS	

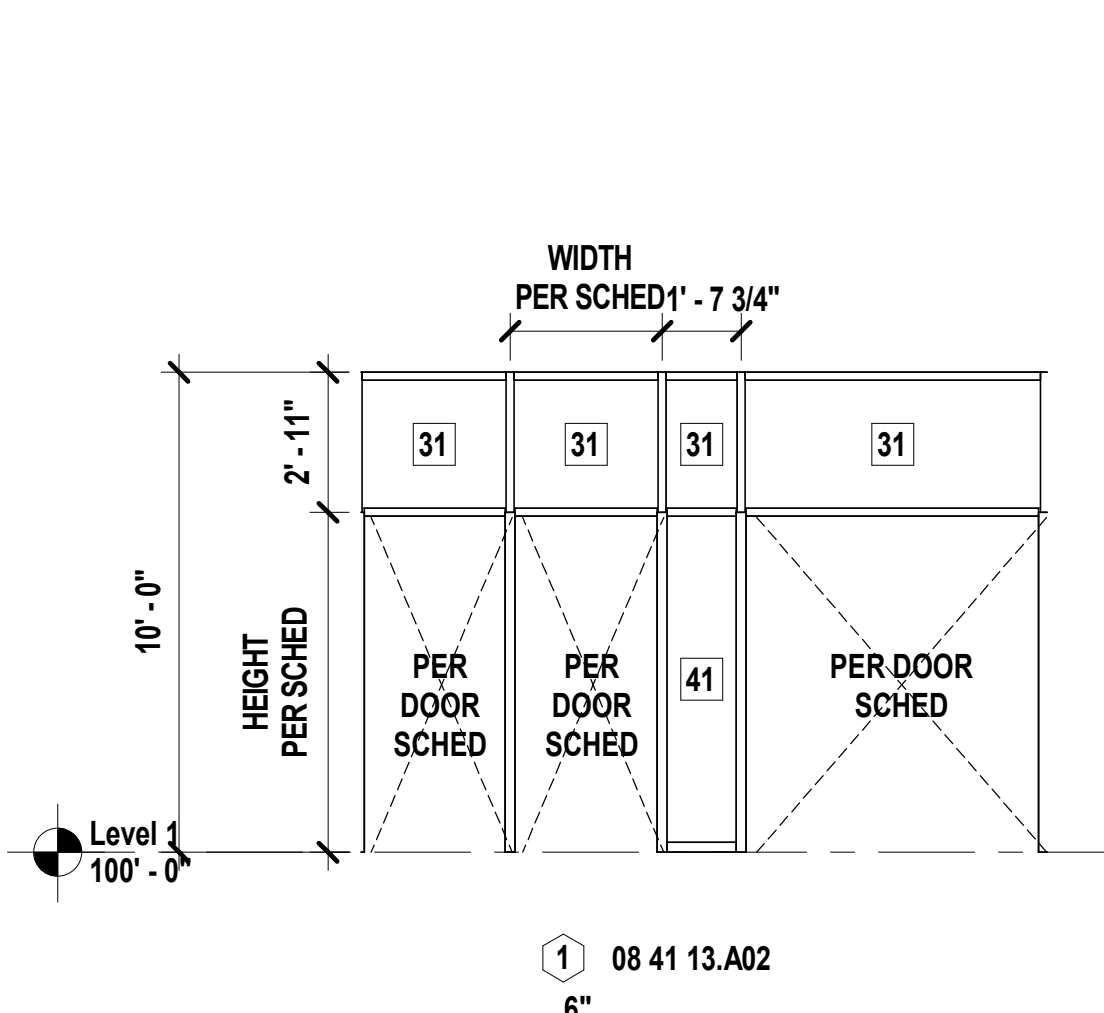


N10 Scale 1/4" = 1'-0" Exterior Window Frame

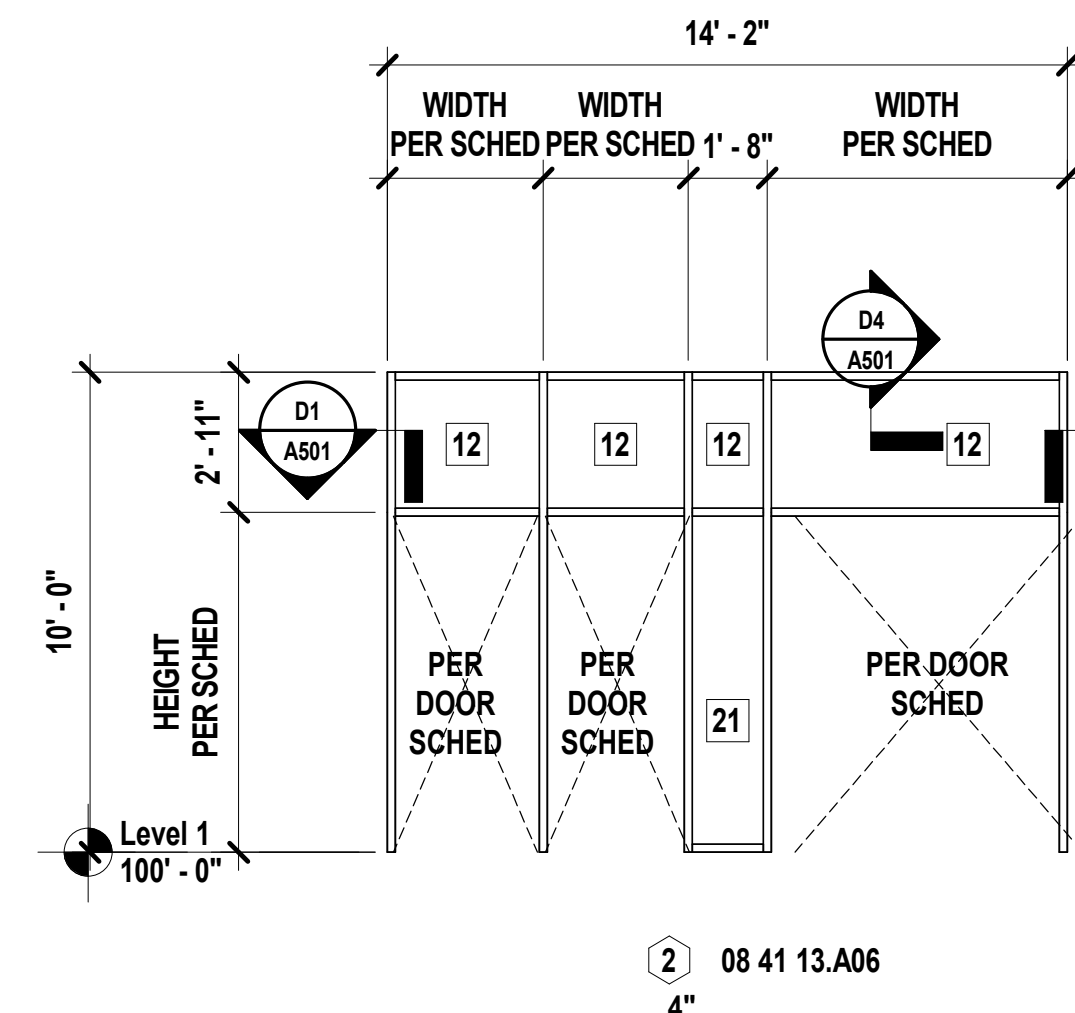

N13 Scale 1/4" = 1'-0" Interior Window Frame

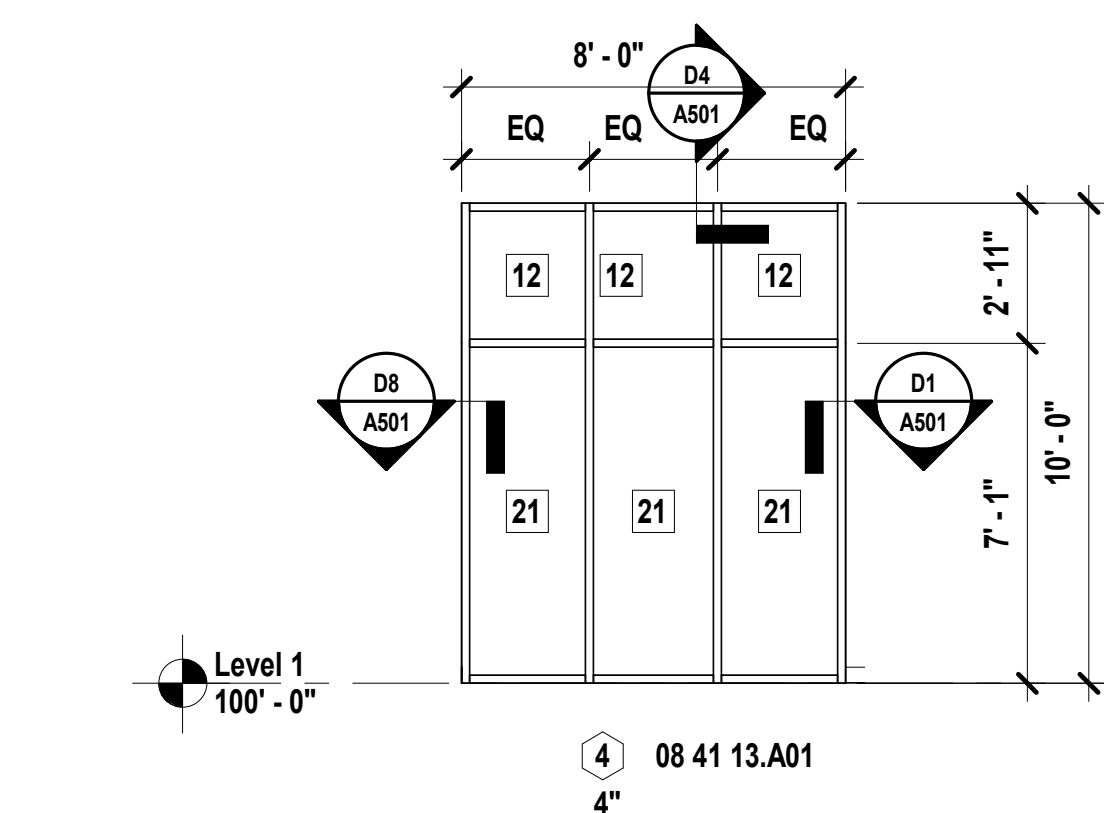

K12 Scale 1/4" = 1'-0" Interior Window Frame by Gym

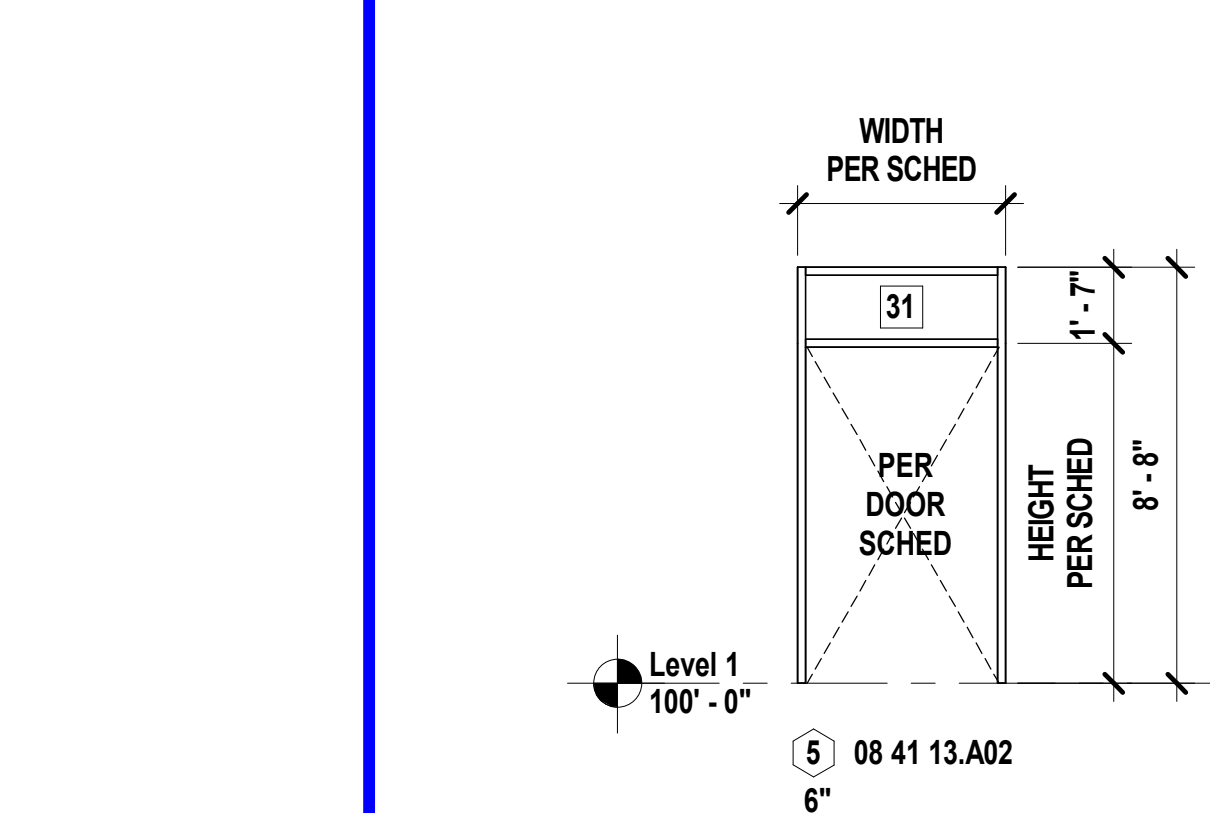

K15 Scale 1/4" = 1'-0" Exterior Window Frame 2

SHEET KEYNOTE LEGEND

06 10 00.A19	PLYWOOD BLOCKING AND BACKING PANELS
07 62 00.A27	DRIP EDGES
07 84 46.A01	FIRE RESISTIVE JOINT SYSTEM
07 92 00.A01	SEALANT
07 92 00.A02	SEALANT W/BACKER ROD
08 11 13.A21	HOLLOW METAL DOOR - HIGH WIND DOOR ASSEMBLY
08 11 13.A31	HOLLOW METAL FRAME
08 41 13.A01	THERMAL BROKEN STOREFRONT FRAMING (4.5")
08 41 13.A02	THERMAL BROKEN STOREFRONT FRAMING (6")
08 41 13.A06	NON-THERMAL BROKEN STOREFRONT FRAMING (4.5")
09 21 16.A01	NON-STRUCTURAL FRAMING
09 29 00.A11	GYPSUM BOARD TRIM

Bob D Campbell
Structural Engineer
State Certificate of Authority #000442
4338 Bellevue Ave
Kansas City, MO 64111
816.531.4144 phone

Smith & Boucher, Inc.
Mechanical, Electrical, & Plumbing
State Certificate of Authority #EGC000178
29615 W 103rd Street
Olathe, KS 66061
913.345.2127 phone


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Civil Engineer
State Certificate of Authority #2001009364
Landscaping #2006027139
Surveying #2006027138
11827 W 112th Street, Suite 200
Overland Park, KS 66210
913.317.9390 phone

Peerbolte Creative
Theatrical Consultant
109 E Pine St.
Warrensburg, MO 64093-0752
660.429.1383 phone

Avant Acoustics
AV/Acoustics Consultant
14827 West 95th St
Lenexa, KS 66215
913.888.9111 phone

South Valley Middle School Storm Shelter Addition
Liberty Public Schools
1000 Midjay Dr, Liberty, MO 64068

REVISIONS:		
#	Description	Date
1	Addendum 01	09.14.2023

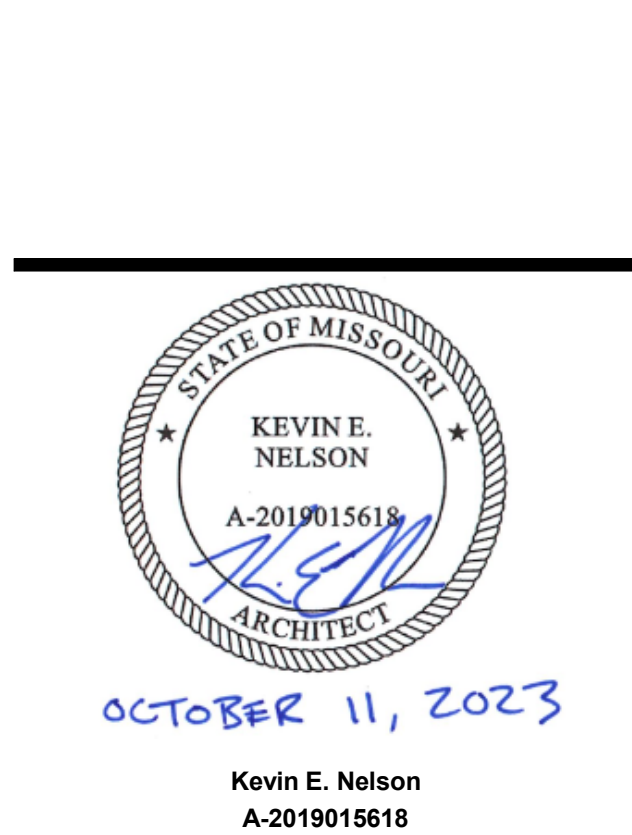

JOB NO: 23019
DRAWN BY: KL
CHECKED BY: JB
DATE: 08.31.2023

A501

A1	Scale	HIGH WIND DTL - Exterior Wall Louver - Interior Elevation				
	3/4" = 1'-0"					
		1	2	3	4	5

A11	Scale	Threshold Detail - Threshold HM Door Sill @ Wood Floor					
	3" = 1'-0"						
		11	12	13	14	15	16


03 30 00.A14	VAPOR RETARDERS
03 30 00.A15	GRANULAR DRAINAGE FILL
07 21 00.A01	EXTRUDED POLYSTYRENE BOARD INSULATION
08 11 13.A01	HOLLOW METAL DOOR - HEAVY DUTY
08 71 00.A01	THRESHOLDS
09 64 66.A01	WOOD ATHLETIC FLOOR
09 64 66.A06	RESILIENT WALL BASE (VENTED)

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
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Mechanical, Electrical, & Plumbing
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Olathe, KS 66061
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R
—
Q

K
—
J

A

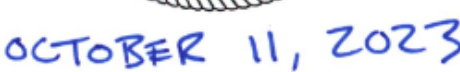

03 30 00.A14	VAPOR RETARDERS
09 65 13.A06	RESILIENT MOLDING ACCESSORY
11 66 23.A05	VOLLEYBALL FLOOR SLEEVES

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Civil Engineer
State Certificate of Authority
Engineering #2001009364
Landscaping #2006027139
Surveying #2006027138
11827 W 112th Street, Suite 2
Overland Park, KS 66210
913.317.9390 phone


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DOCUMENTS

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1. REFER TO SHEET G000 FOR SHEET INDEX
2. FINISH FLOOR PATTERNS TO BE CENTERED IN EACH ROOM UNO
3. CORNER GUARD LOCATIONS ARE INDICATED BY SYMBOL AND ARE TO BE FULL HEIGHT FROM TOP OF BASE
4. COORDINATE FLOORING INSTALLATION WITH CASEWORK TO ENSURE FLOORING EXTENDS UNDER CABINET TOE SPACES AND OPEN KNEE/APPLIANCE SPACES
5. ALL CLOSETS AND ALCOVES WITHOUT SEPARATE ROOM NUMBERS TO HAVE SAME FLOORING AND PATTERNS AS THE LARGER, IDENTIFIED ROOM
6. NOT ALL FLOORING MATERIALS SHOWN ON FINISH PLANS. REFER TO FINISH SCHEDULE FOR MATERIALS IN LOCATIONS NOT SHOWN
7. PATTERNS SHOWN THIS SHEET SHOULD REFLECT PATTERN OF MATERIAL MODULE

#	Description	Date
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Kevin E. Nelso
A-2019015618


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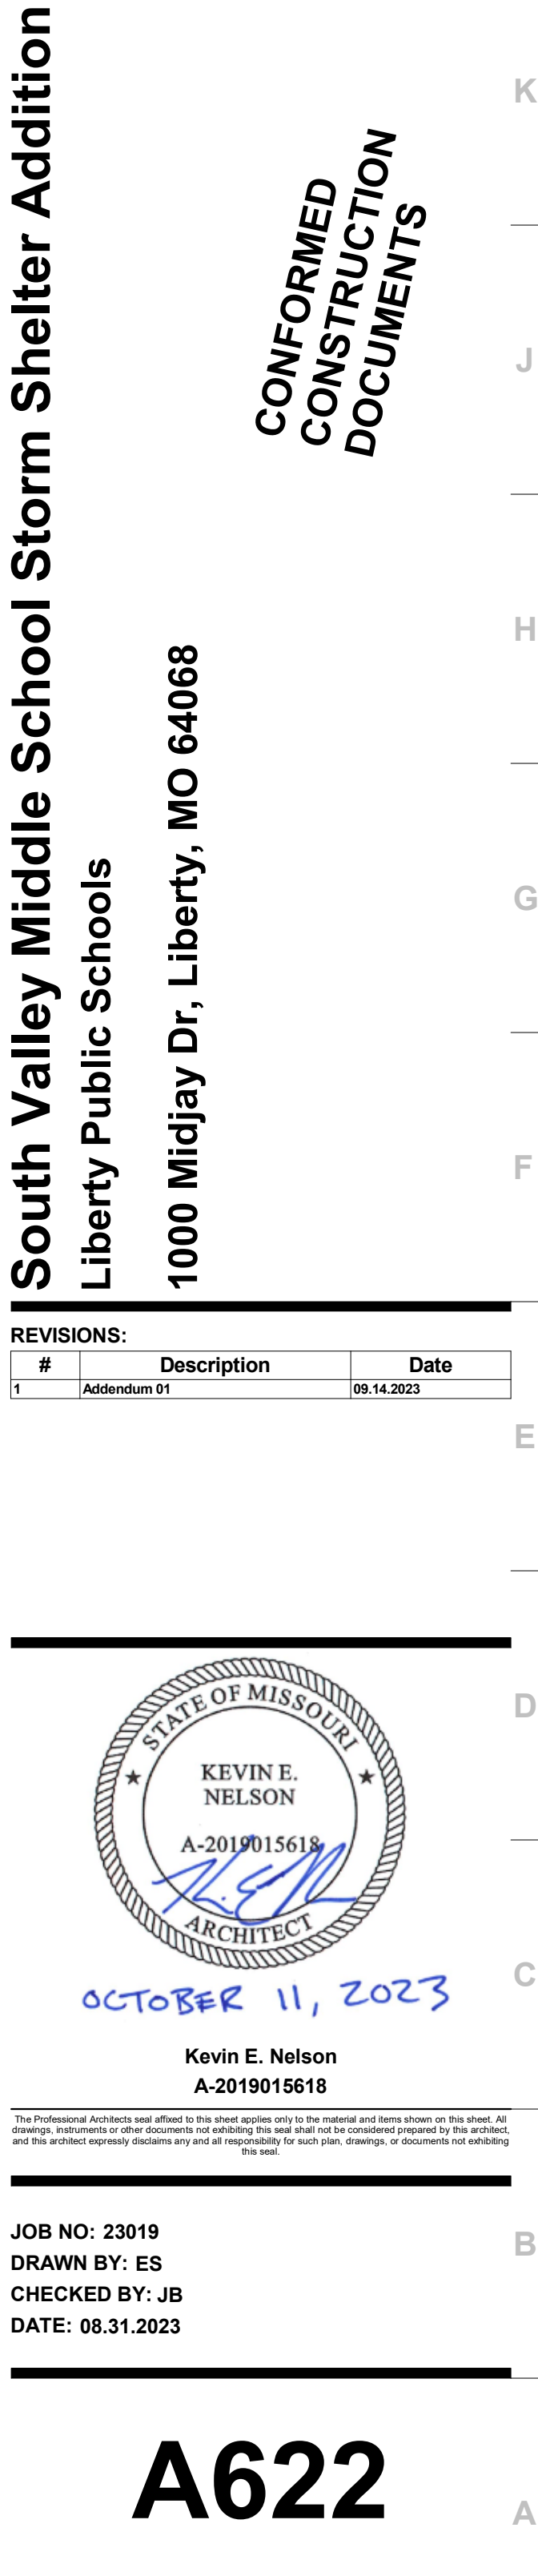
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A601A


FINISH FLOOR PLAN - LEVEL 1 - AREA A
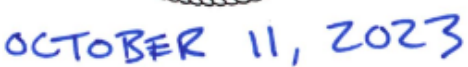
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Structural Engineer
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4338 Bellevue Ave
Kansas City, MO 64111
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ARCHITECT




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DATE: 08.31.2023




10/11/2023 4:32:19 PM

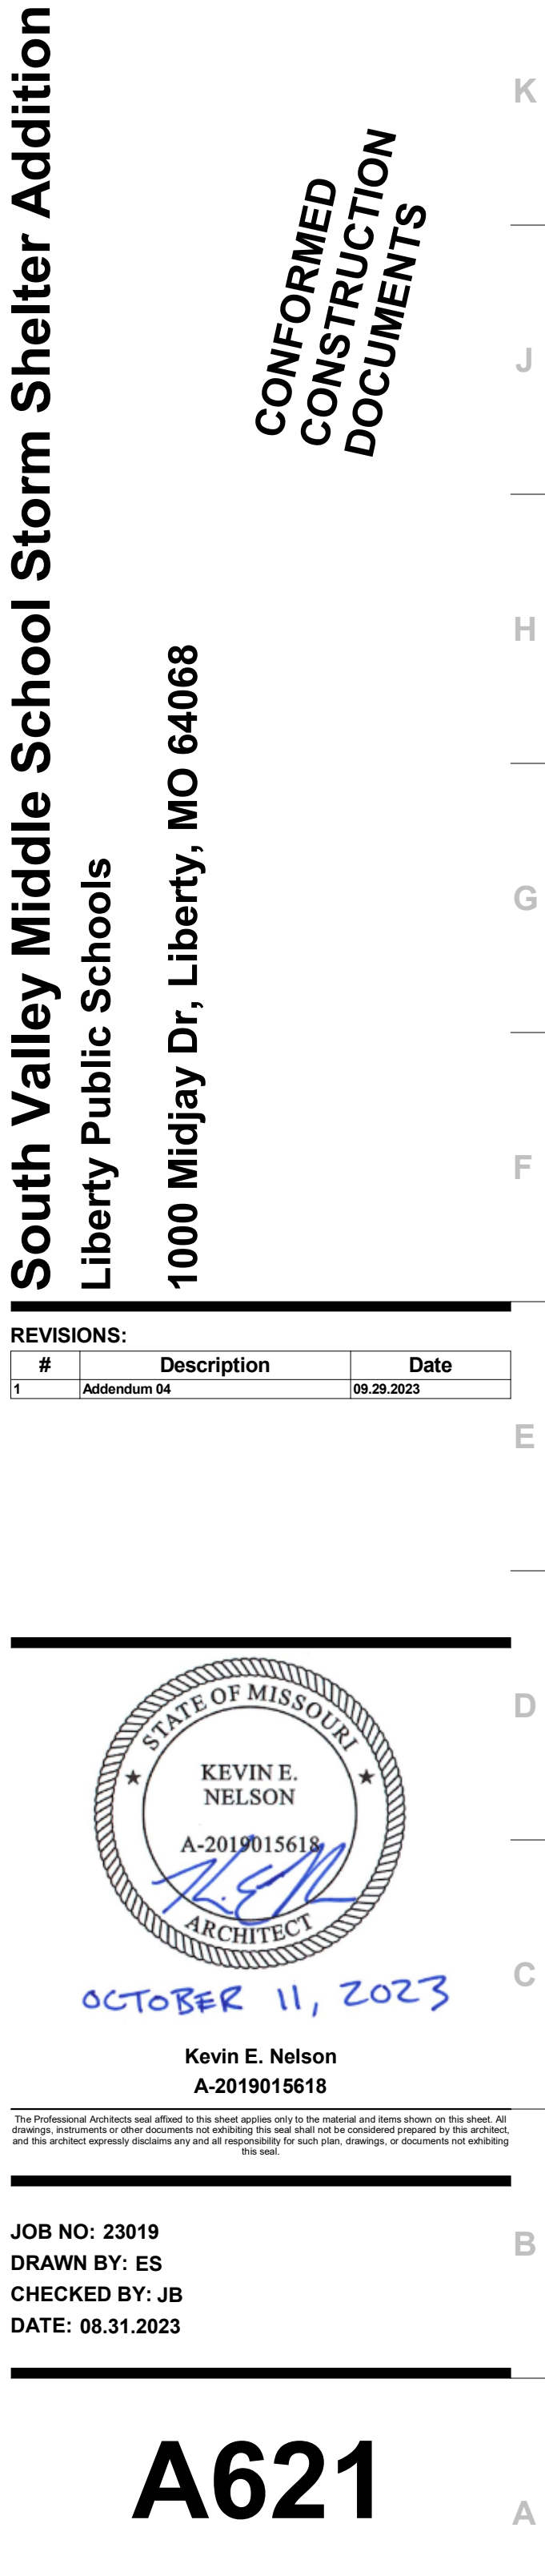

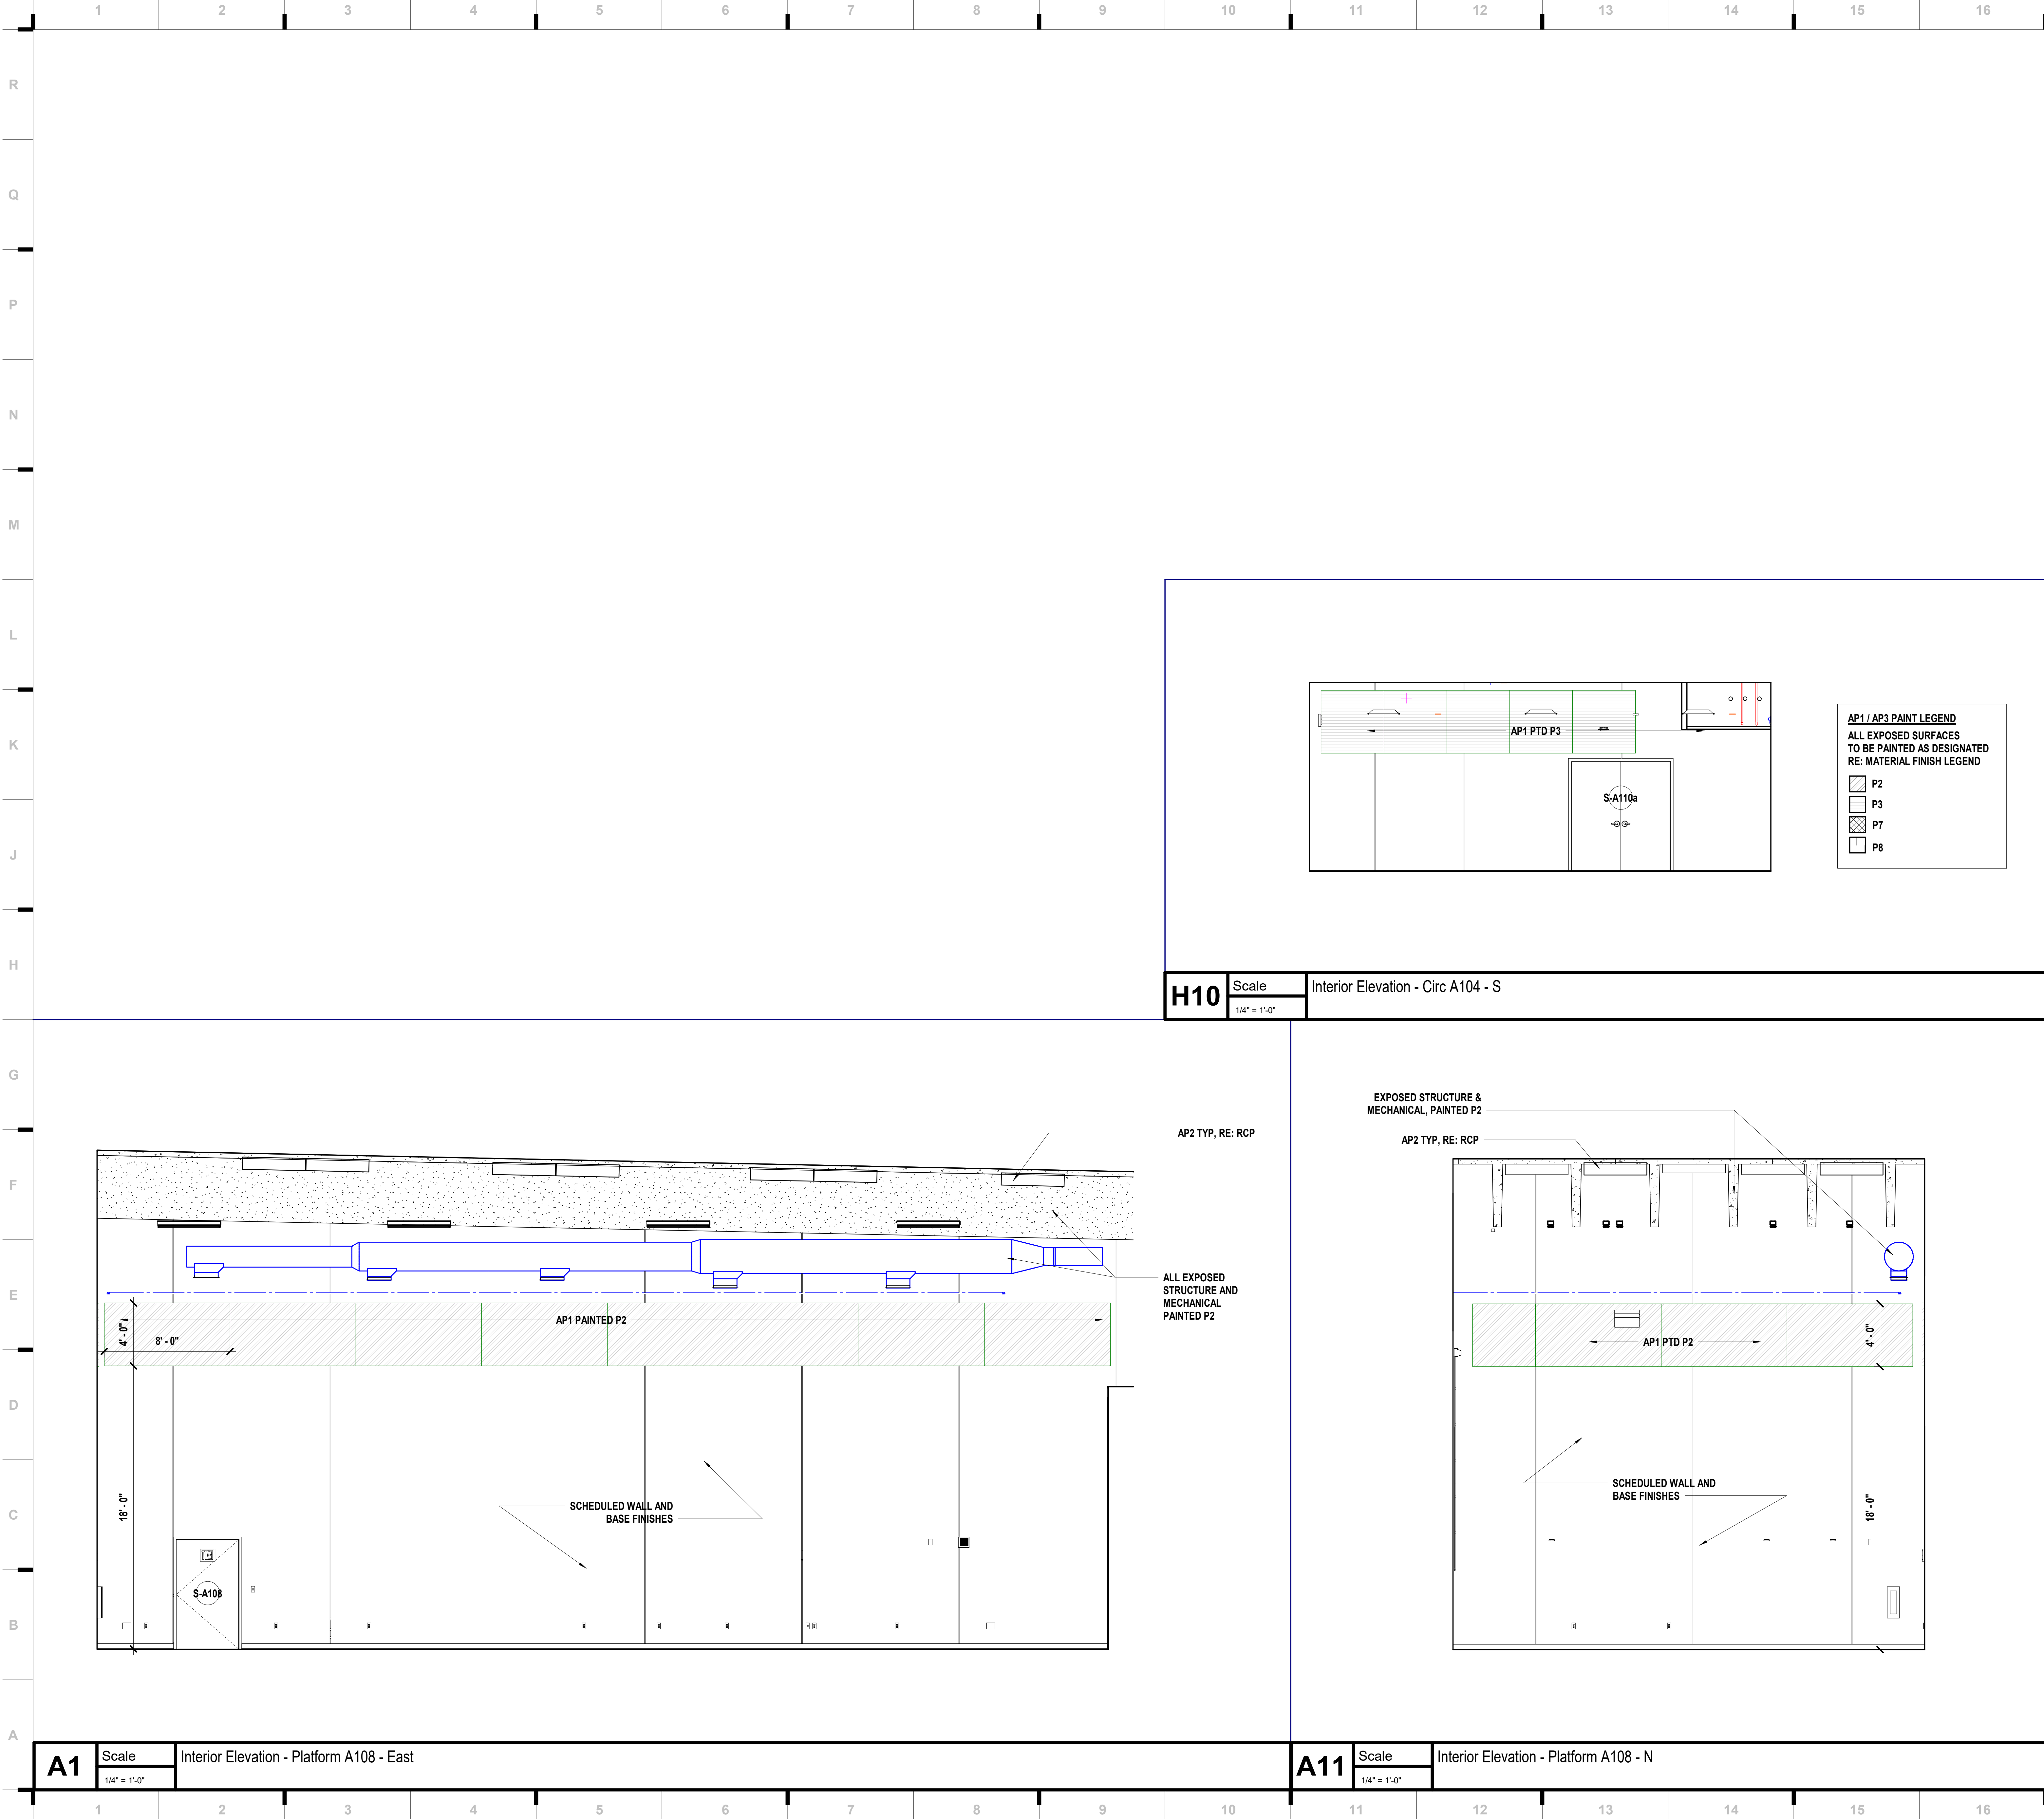L1 Scale 3" = 1'-0" Plan Detail - Area A - Lobby A102 / Vestibule A101



L8 Scale 1 1/2" = 1'-0" Section Detail - Area A - Storage to Multipurpose @ Base of Wall

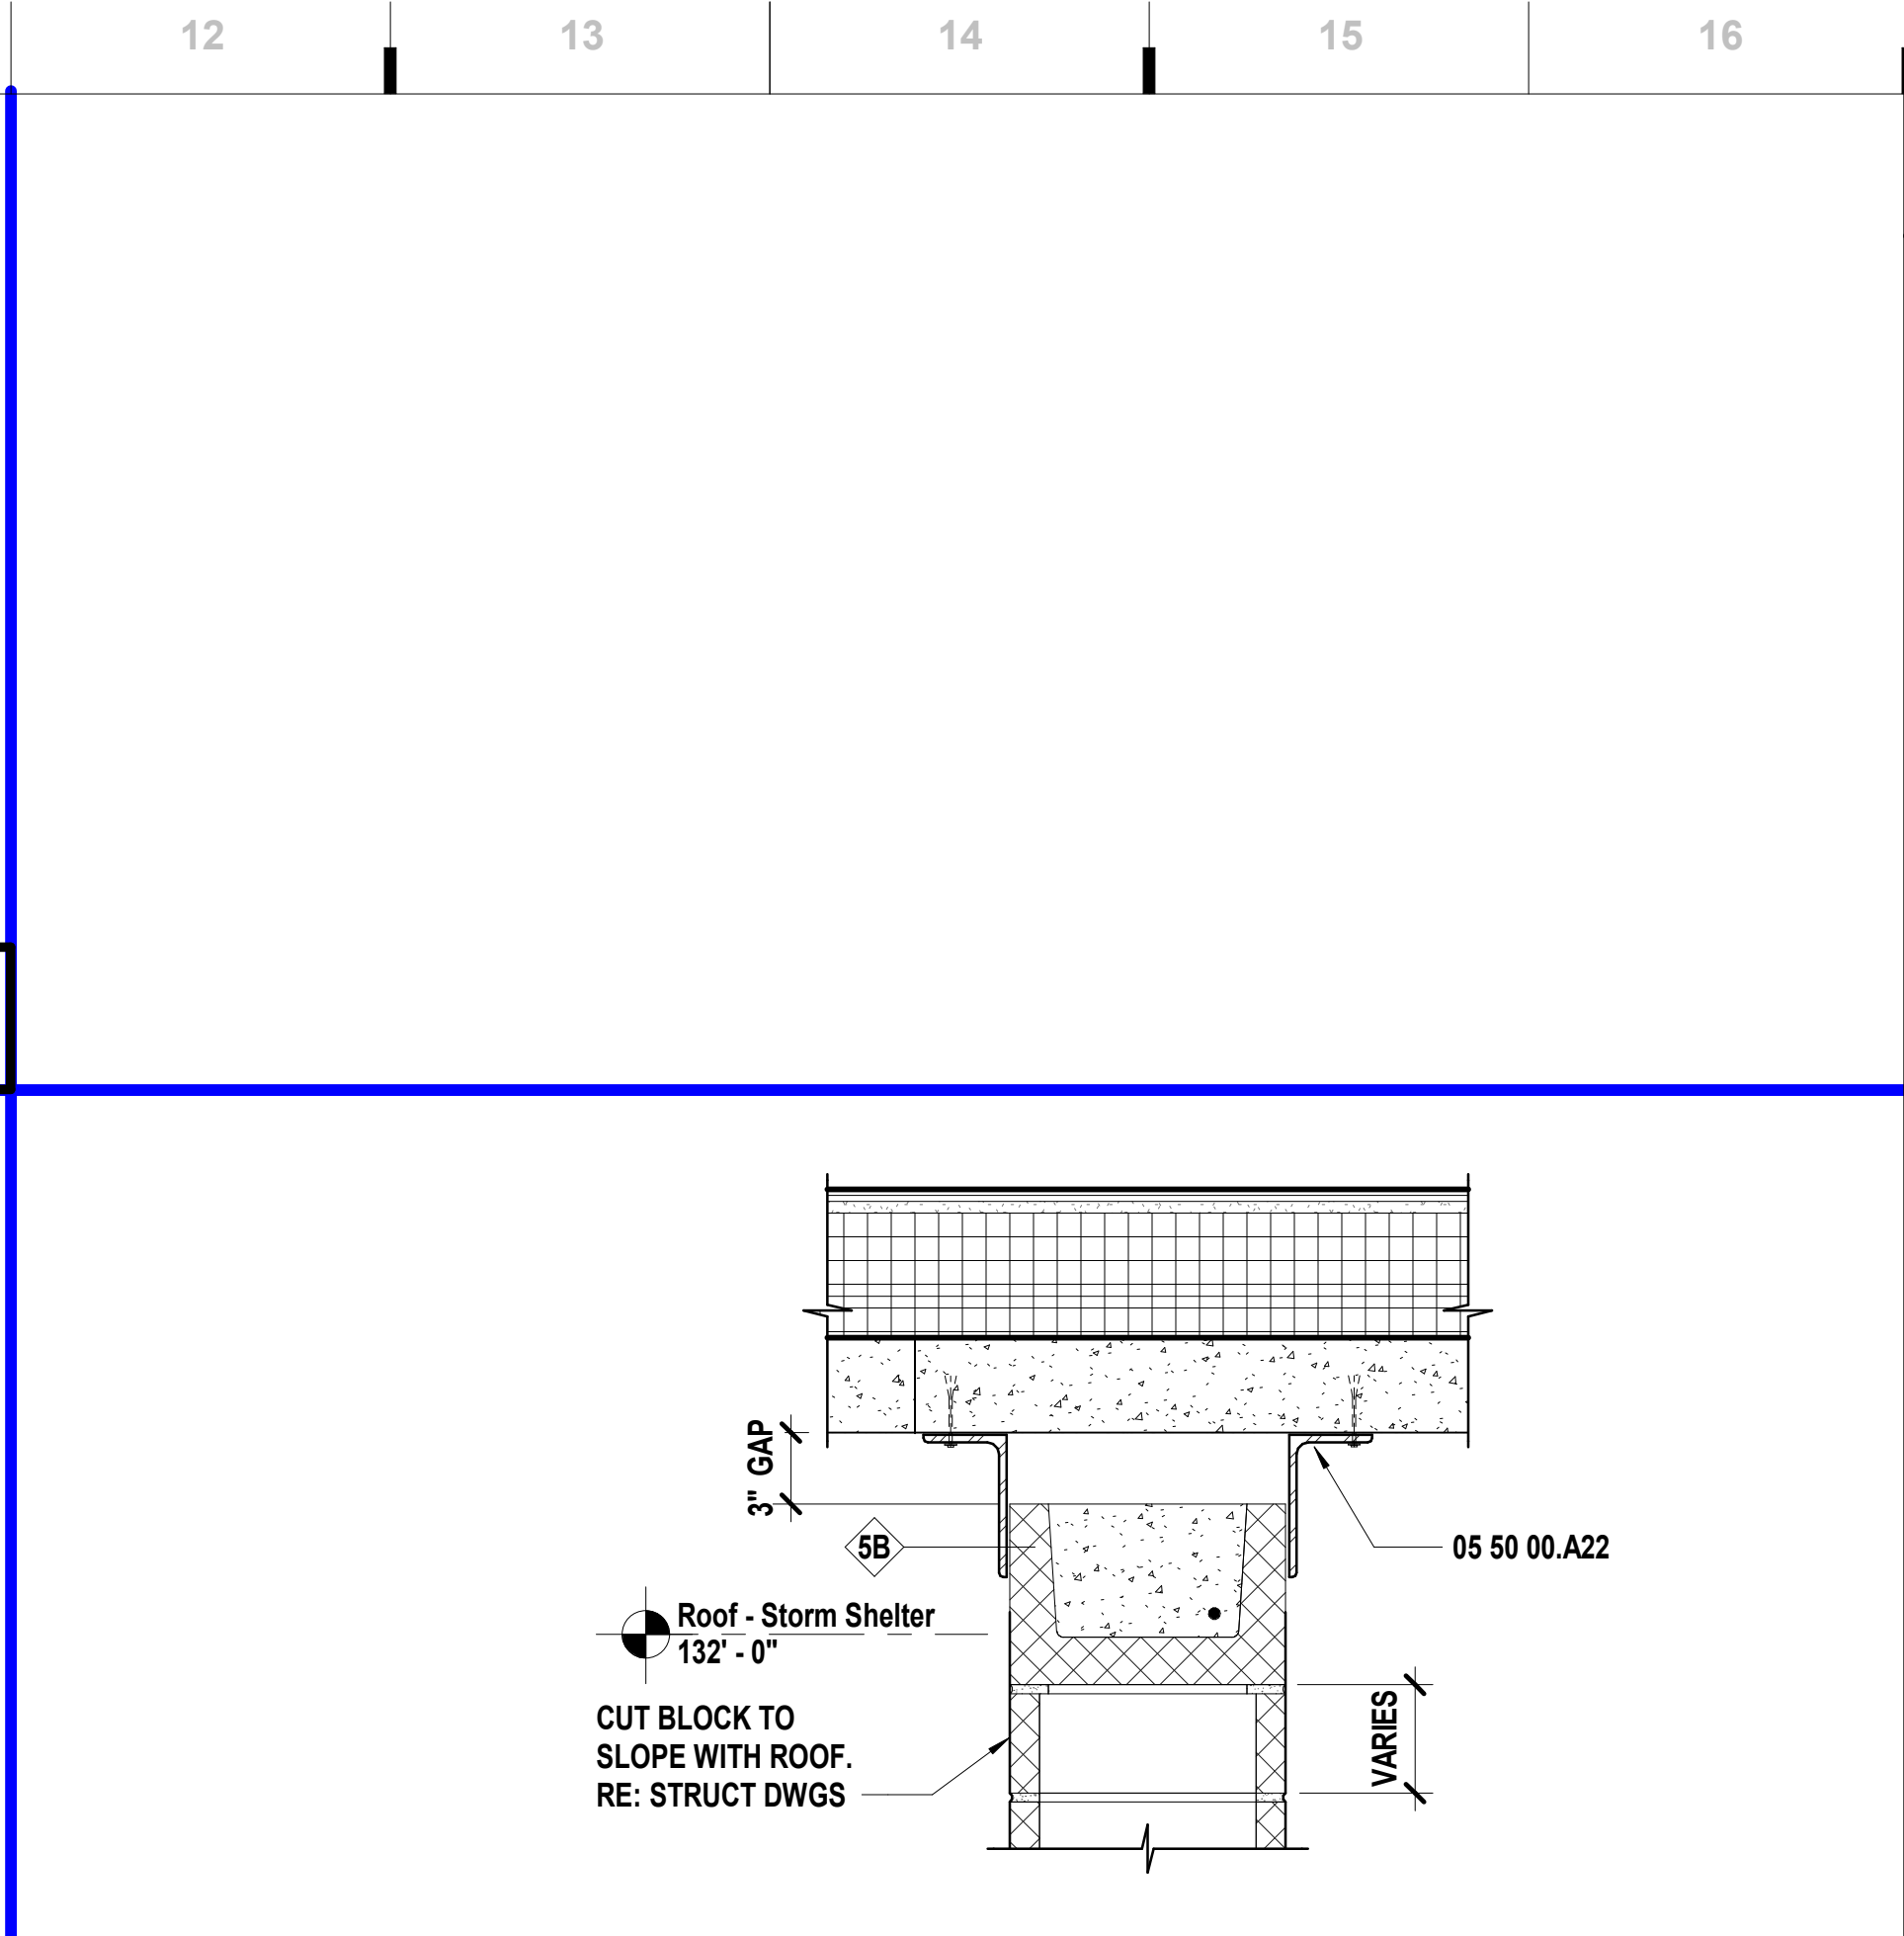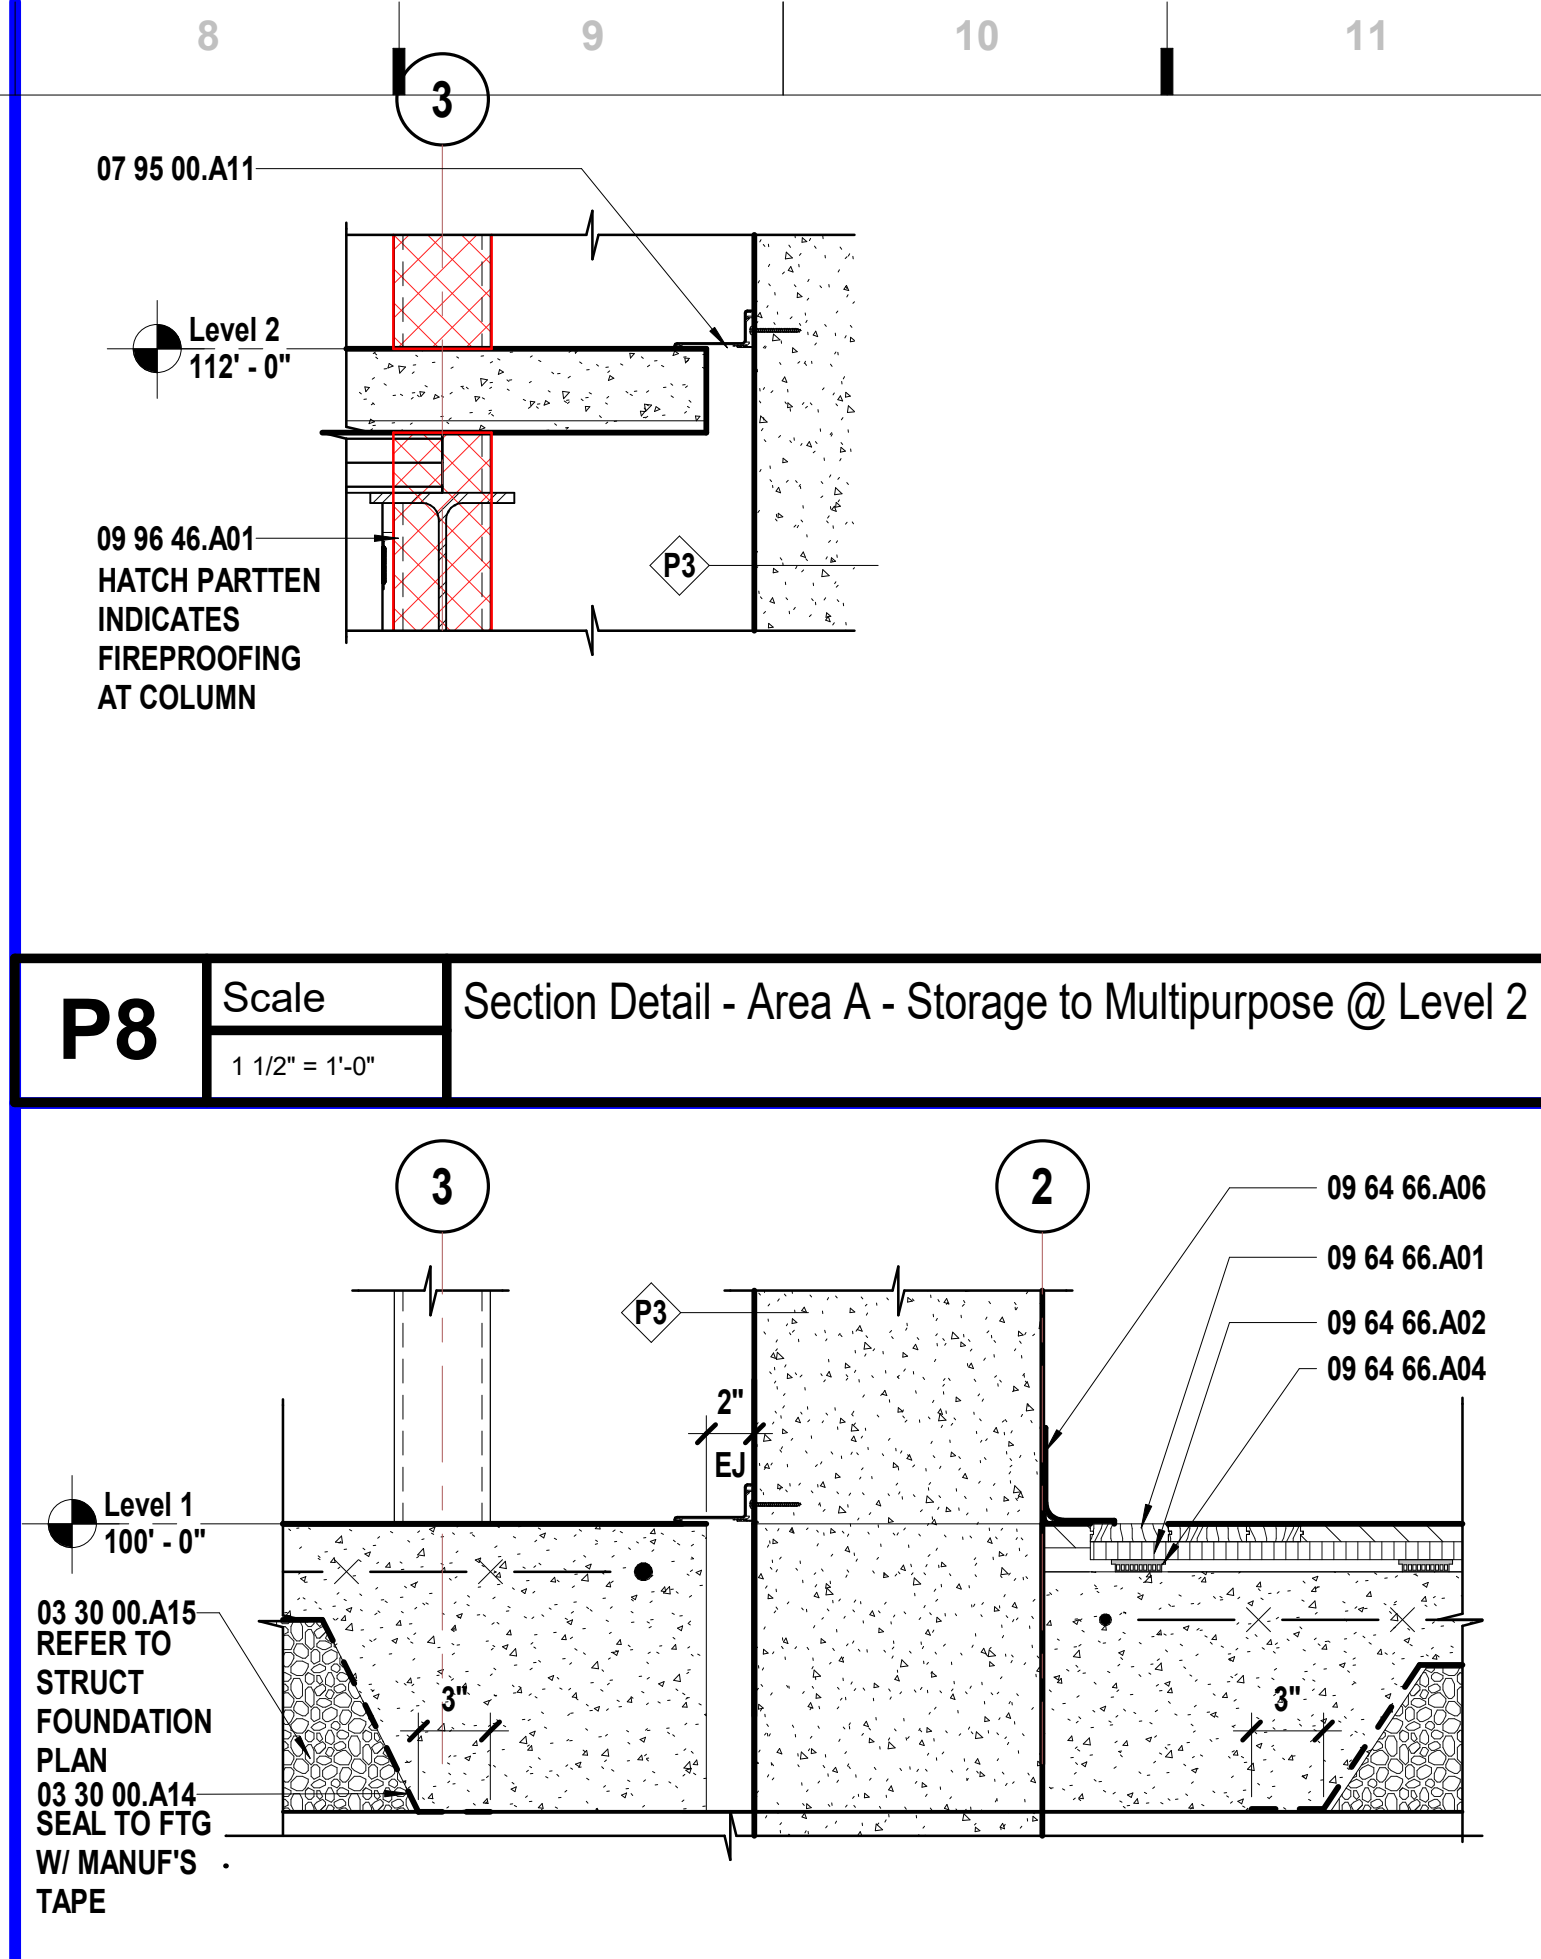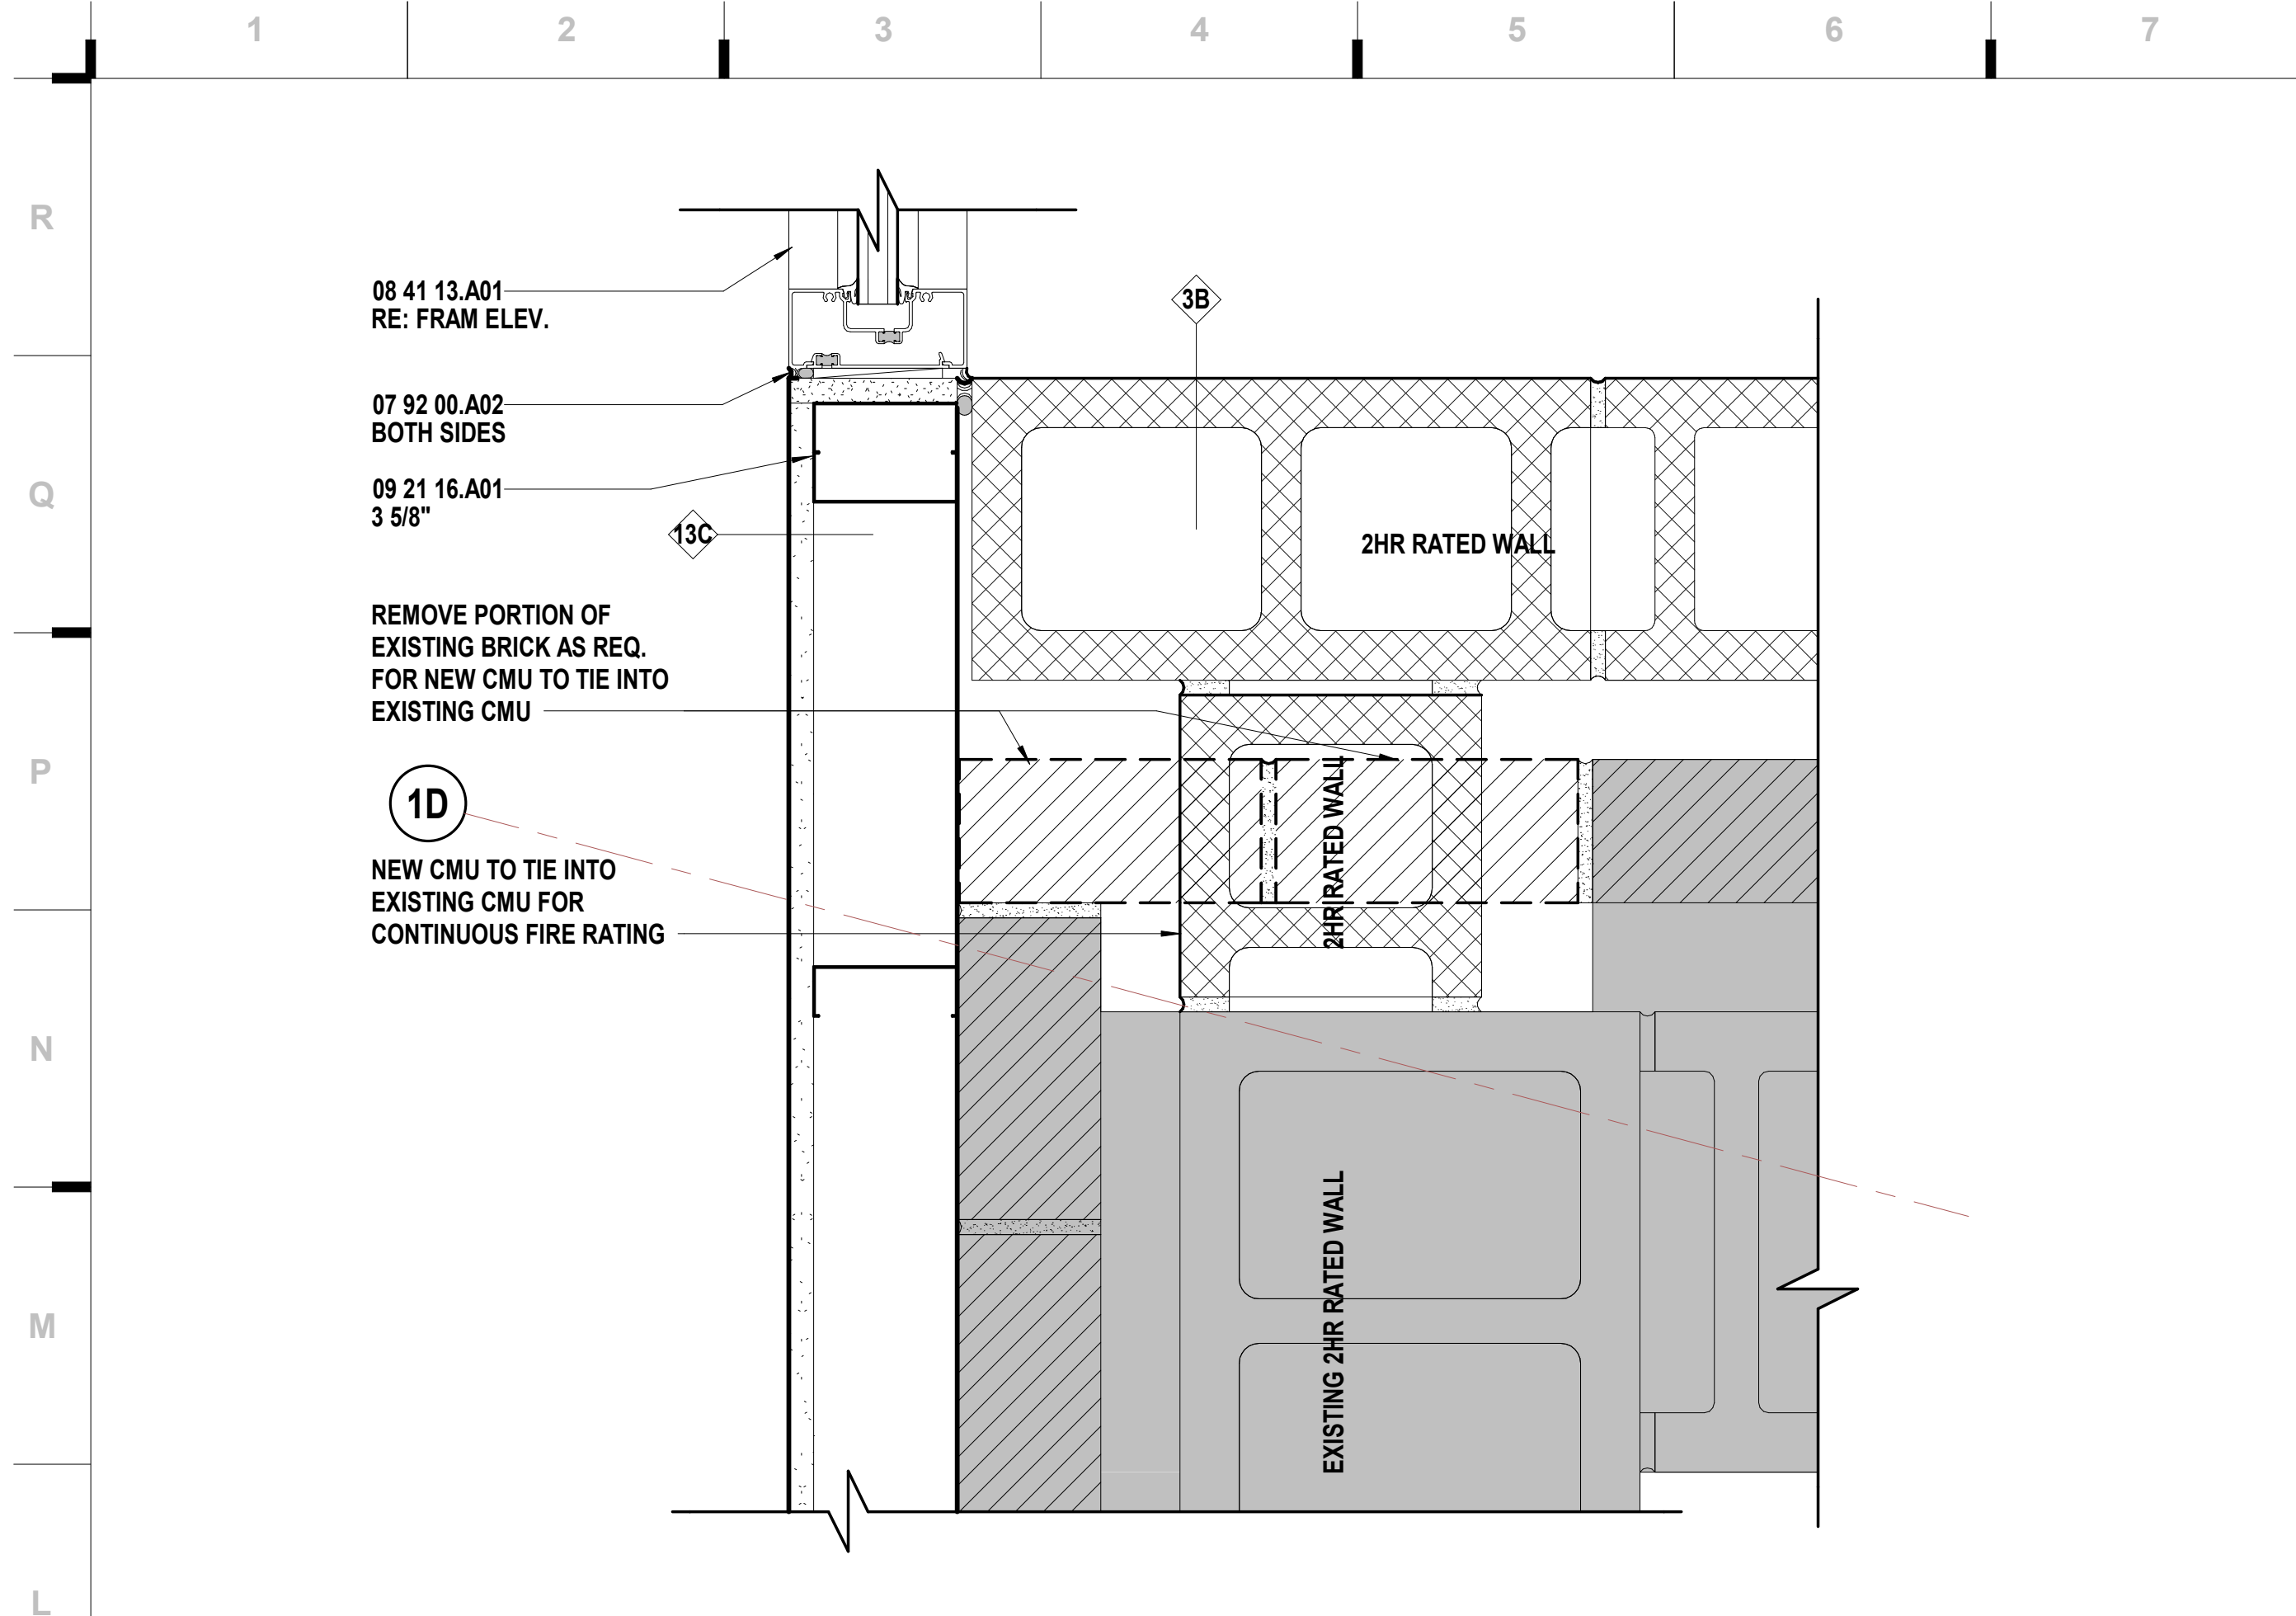L12 Scale 1 1/2" = 1'-0" Section Detail - Area A - Platform A108 / Multipurpose A103 Top of Wall

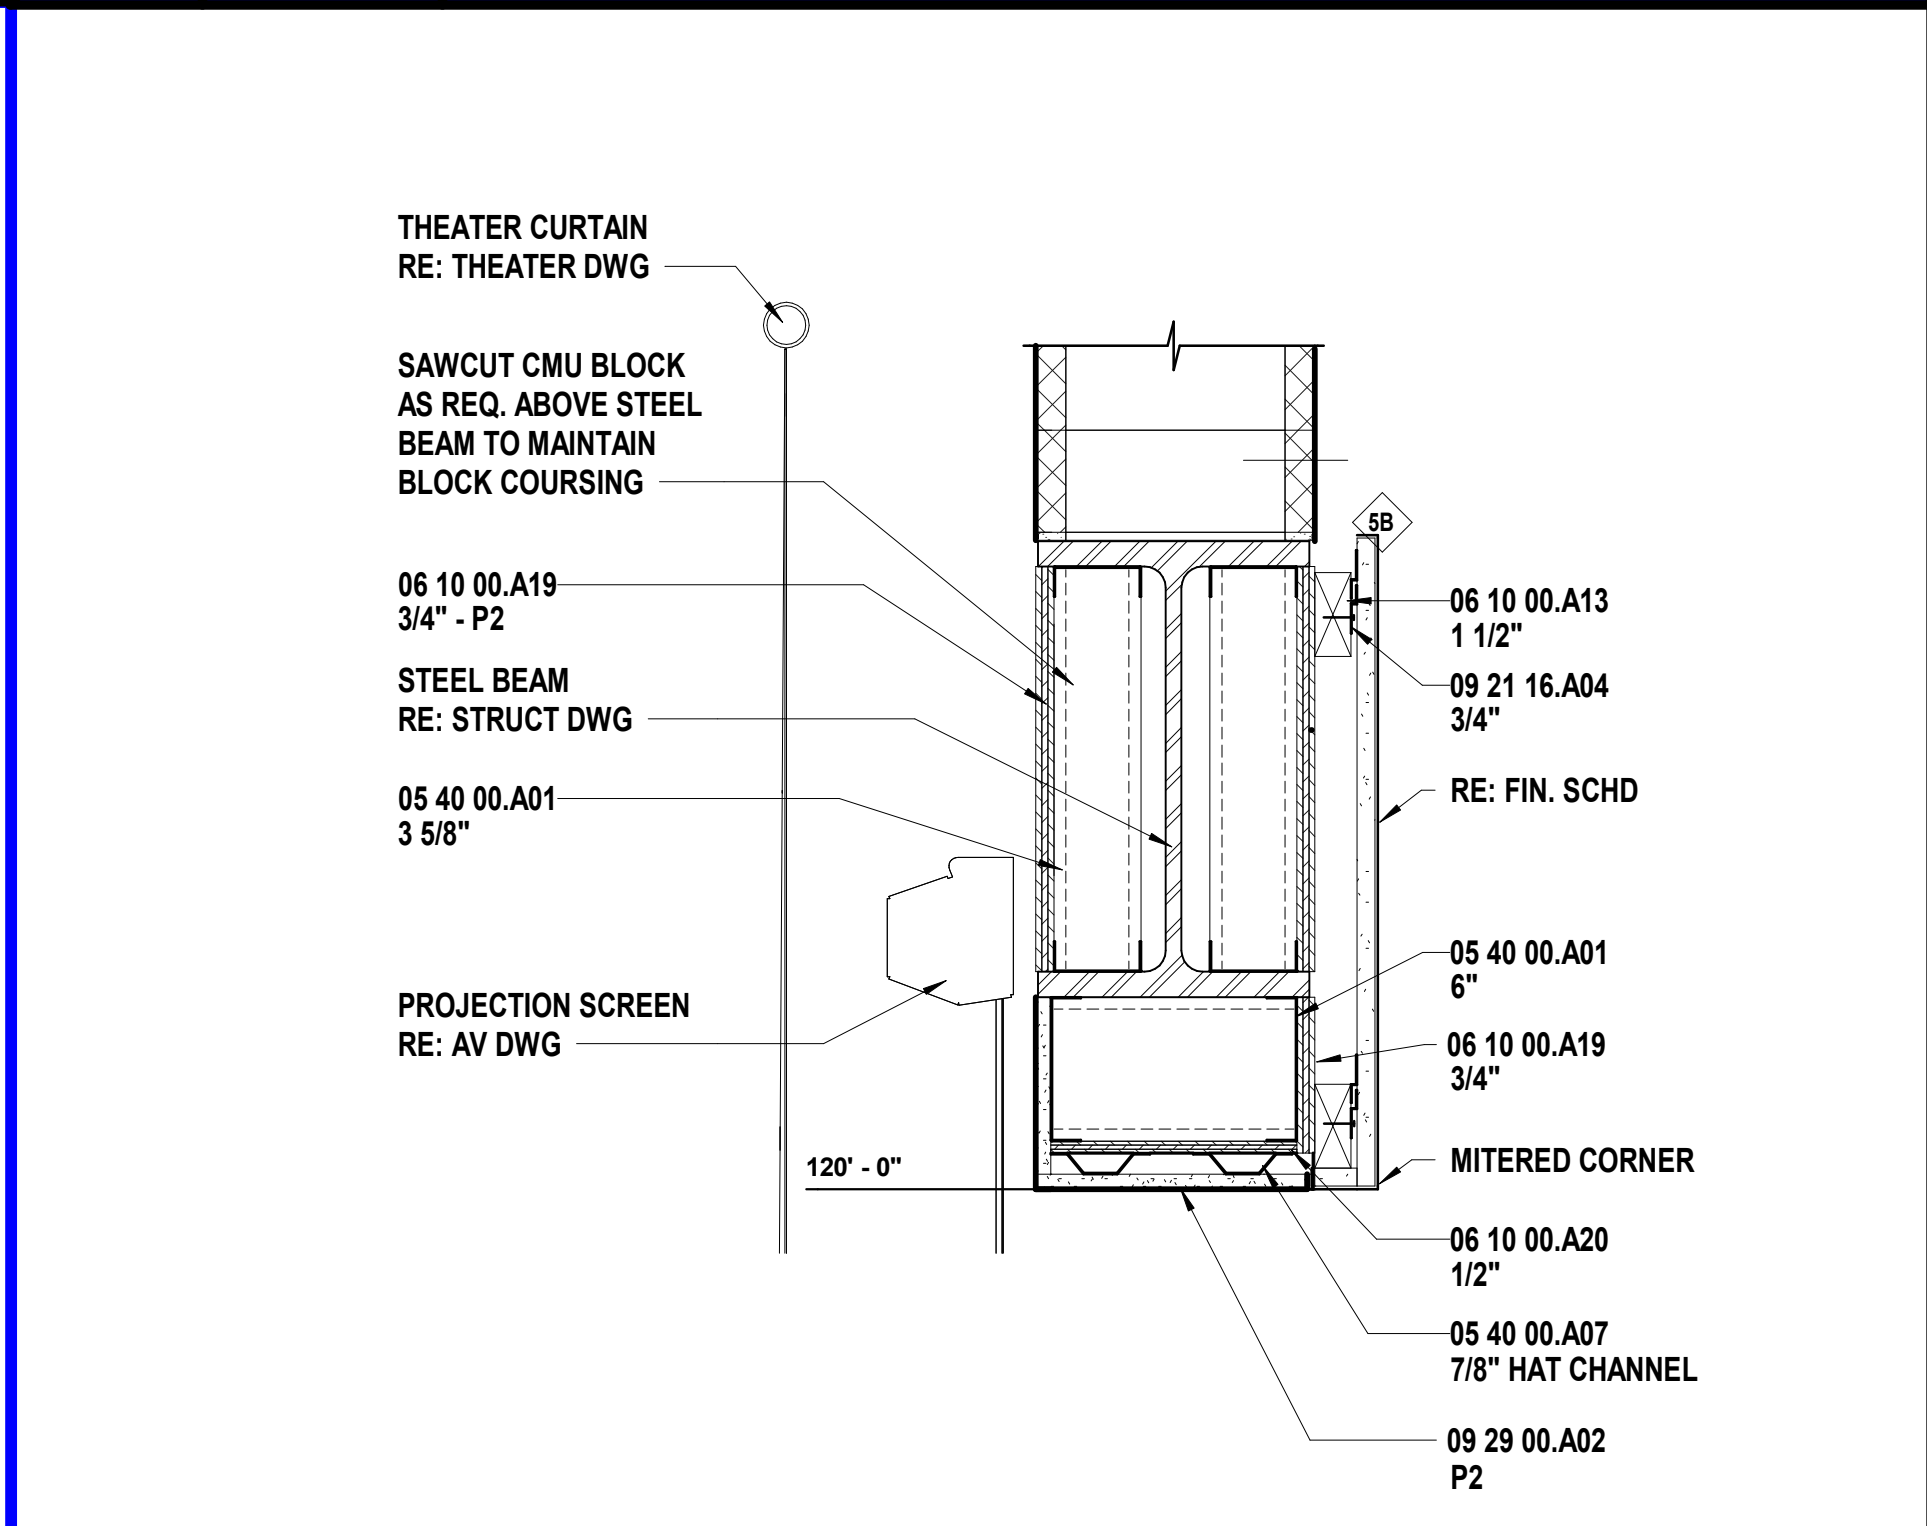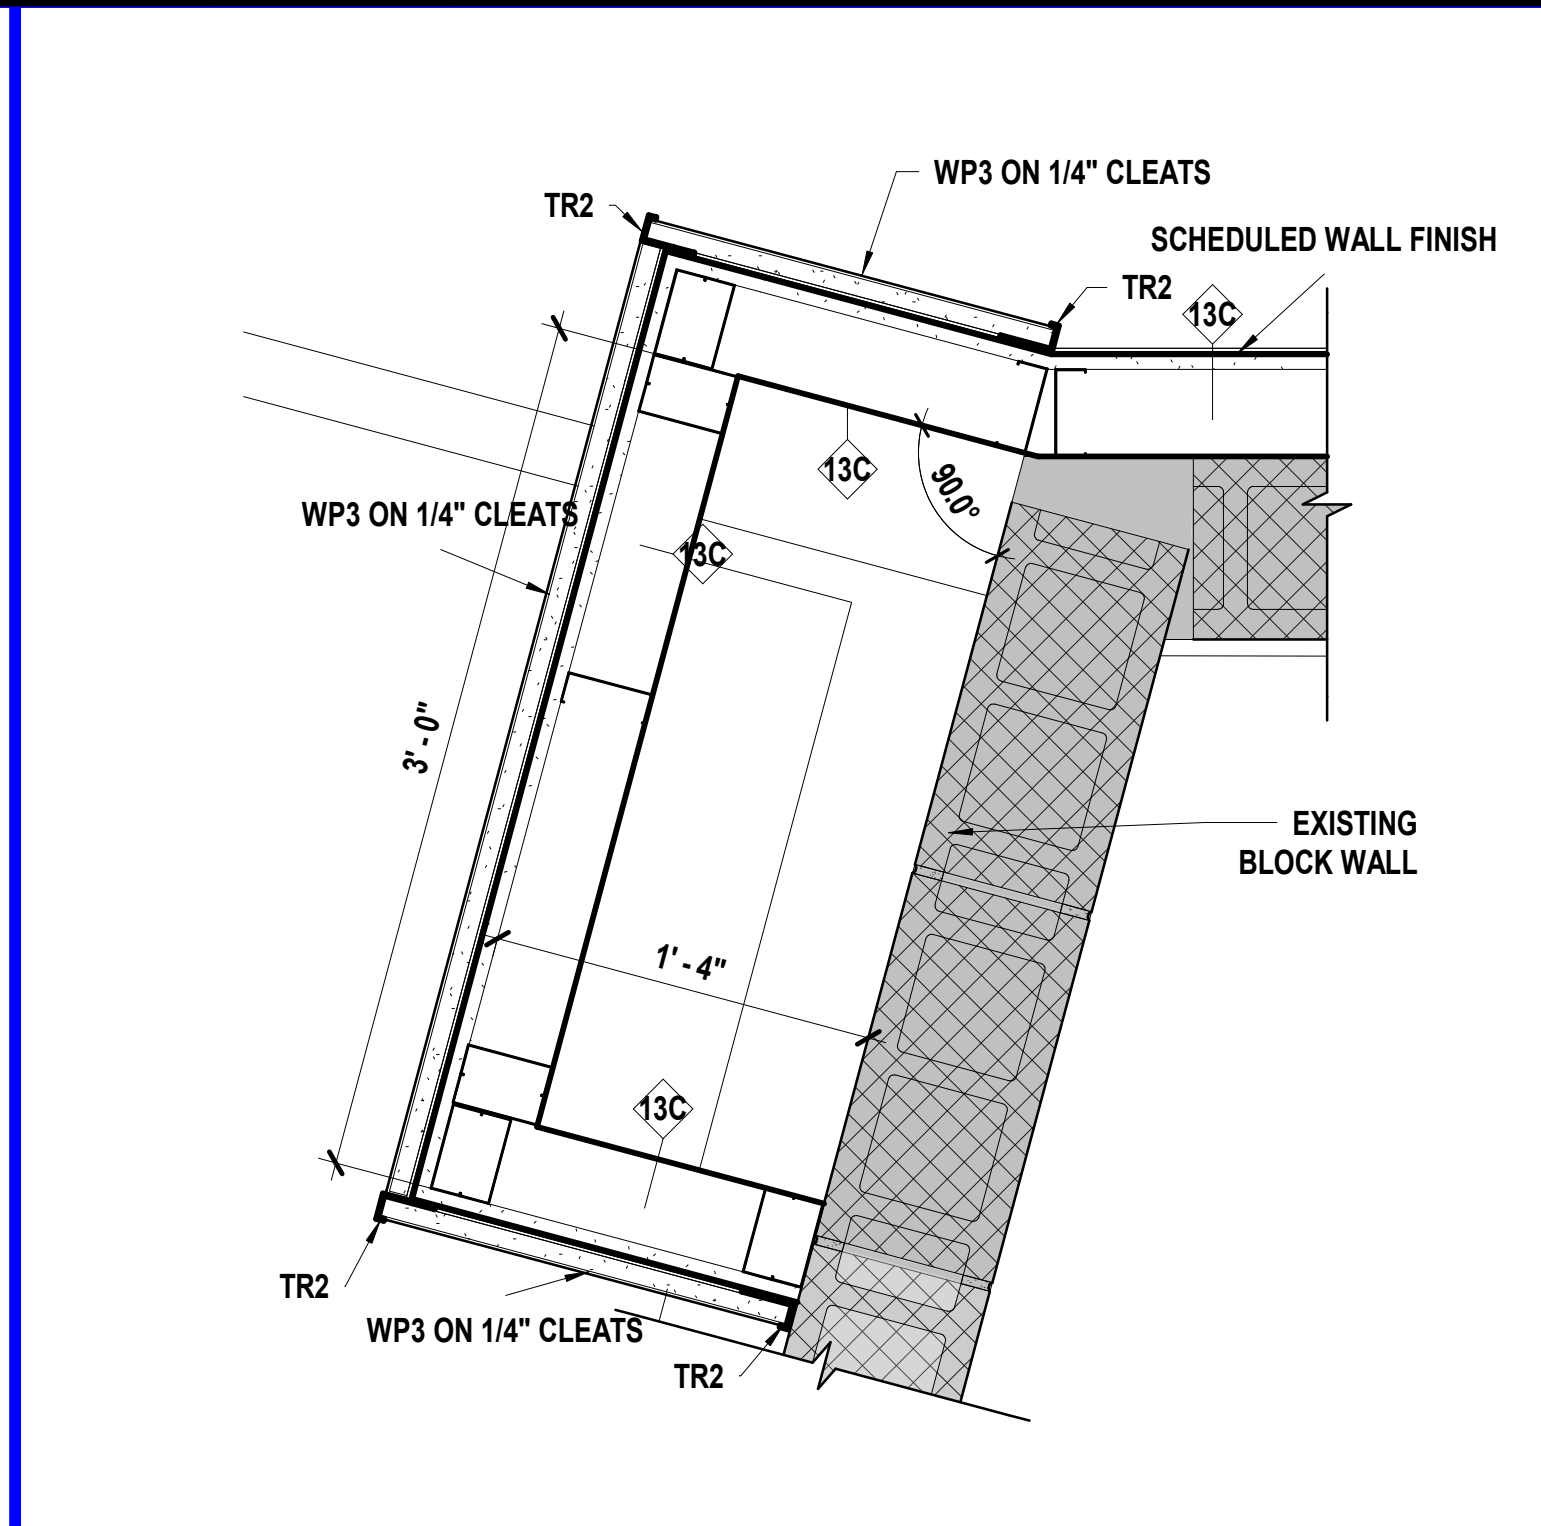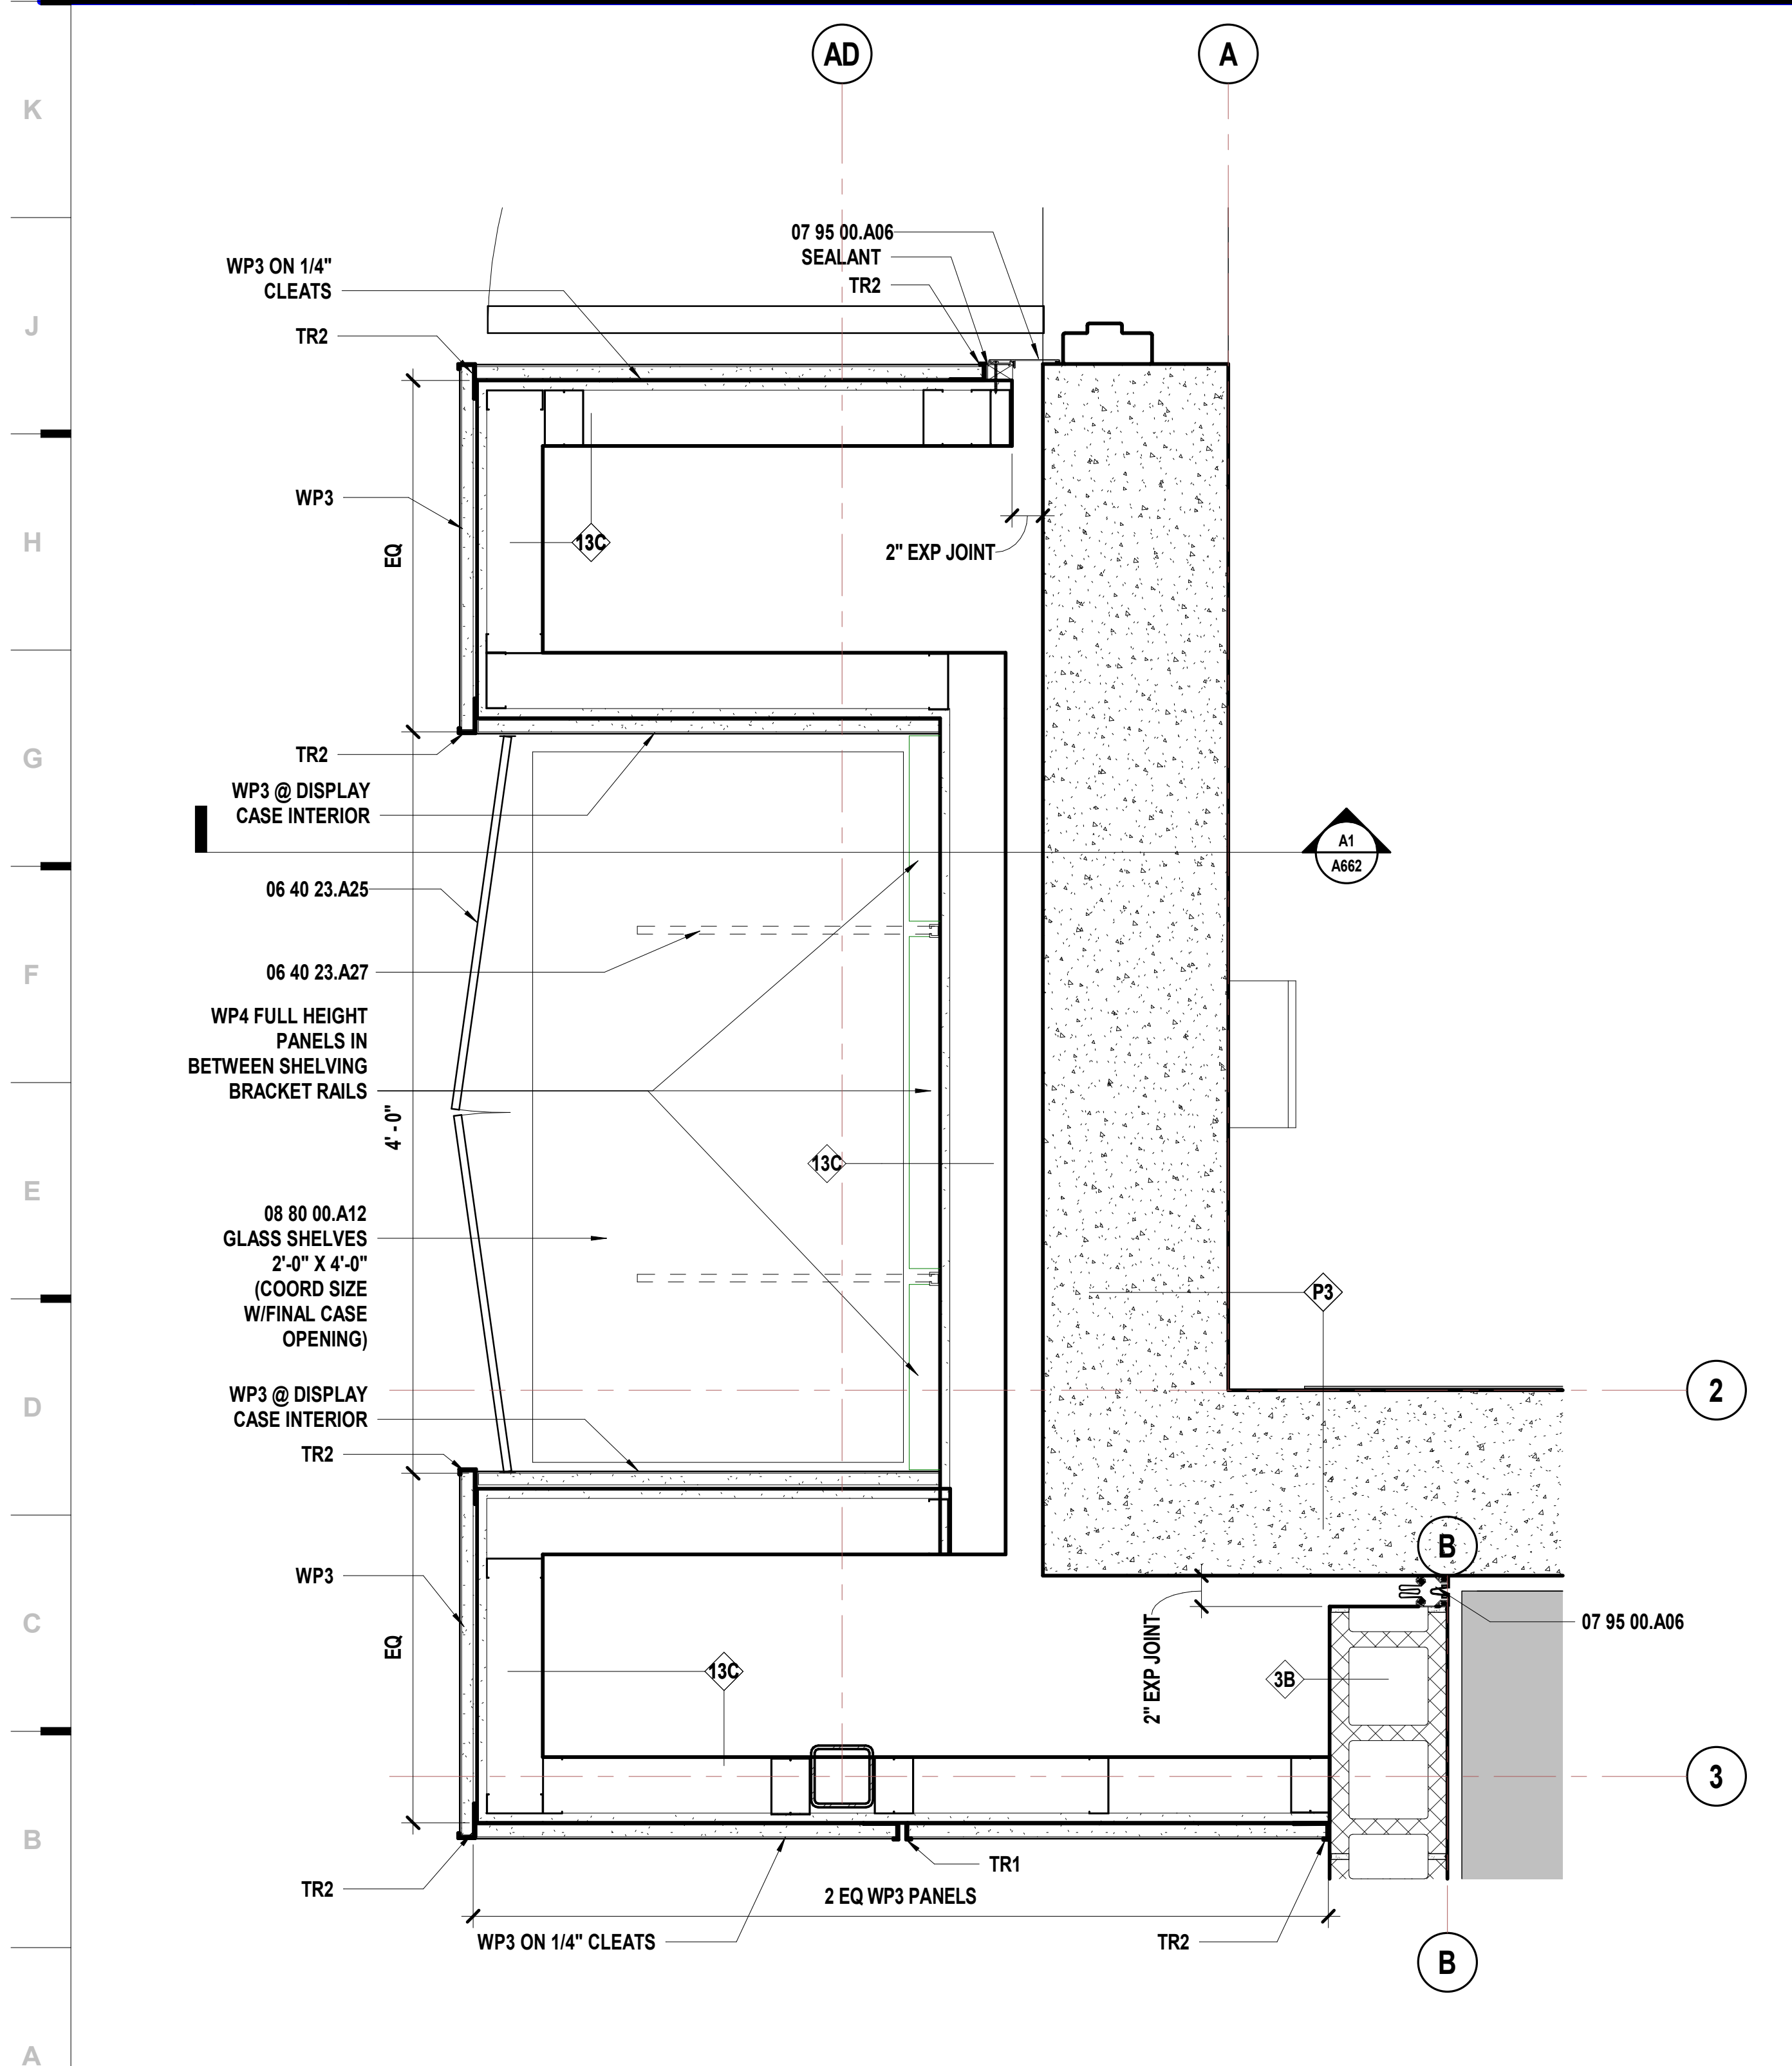

F8 Scale 1 1/2" = 1'-0" Plan Detail - Area A - Lobby A102 - Plan East

F12 Scale 1 1/2" = 1'-0" Section Detail - Area A - Platform A108 - Proscenium Head

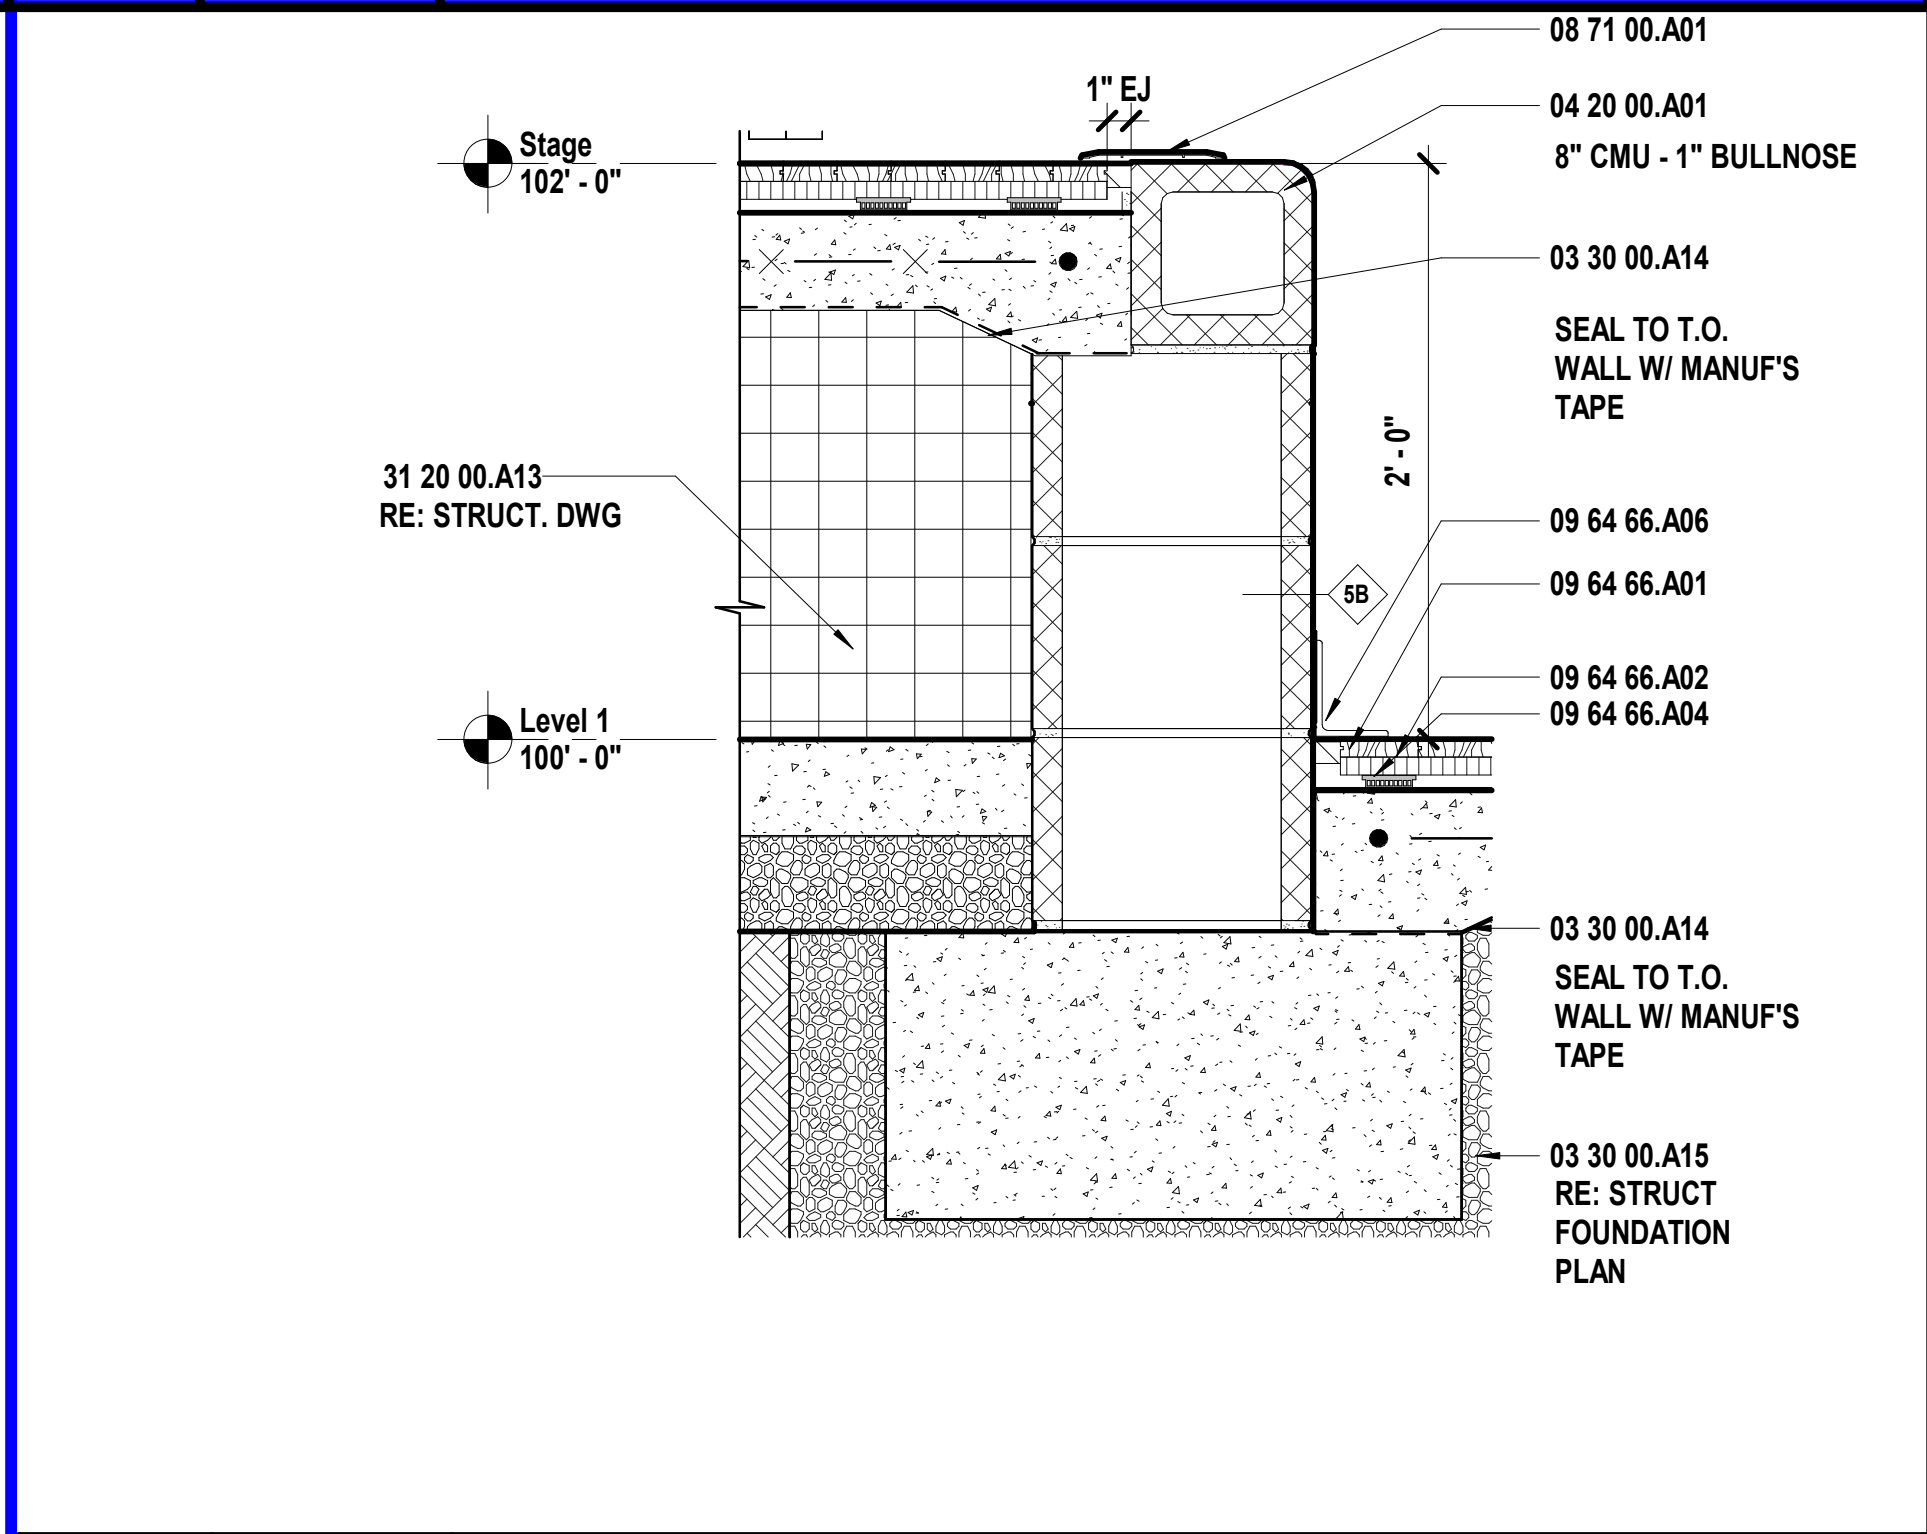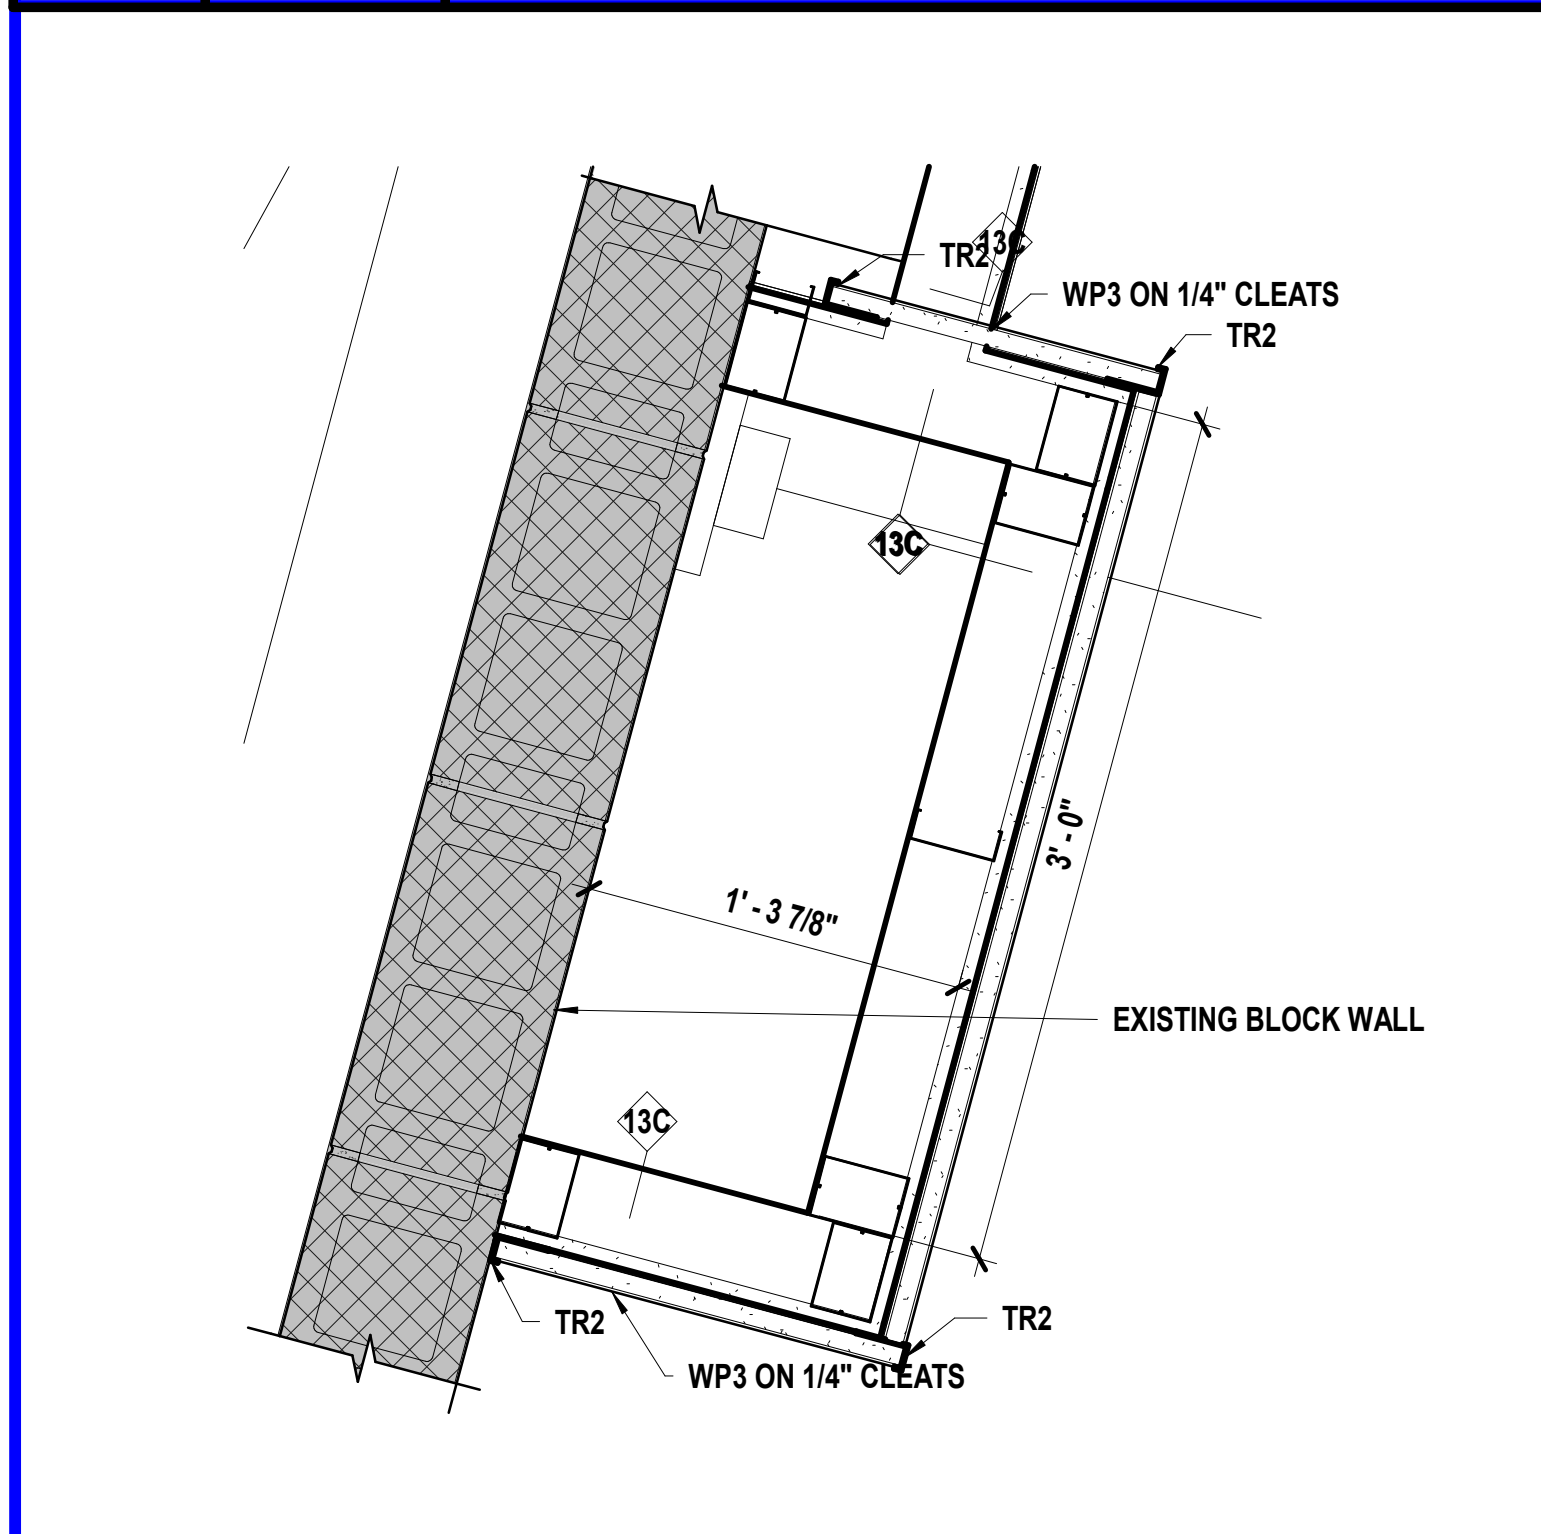

A8 Scale 1 1/2" = 1'-0" Plan Detail - Area A - Lobby A102 - Plan West

A12 Scale 1 1/2" = 1'-0" Section Detail - Area A - Platform A108 - Proscenium Base

A1 Scale 1 1/2" = 1'-0" Plan Detail - Area A - Vestibule A101 - Corner

SHEET KEYNOTE LEGEND

03 30 00.A14	VAPOR RETARDERS
03 30 00.A15	GRANULAR DRAINAGE FILL
04 20 00.A01	CONCRETE MASONRY UNITS
05 40 00.A01	COLD-FORMED METAL FRAMING
05 40 00.A07	MISCELLANEOUS FRAMING/FURRING
05 50 00.A22	LOOSE STEEL LINTEL
06 10 00.A13	WOOD BLOCKING/NAILERS
06 10 00.A19	PLYWOOD BLOCKING AND BACKING PANELS
06 10 00.A20	FIRE-RETARDANT TREATED PLYWOOD BLOCKING AND BACKING PANELS
06 40 23.A25	SWINGING DISPLAY CASE DOOR SYSTEM
06 40 23.A27	DISPLAY CASE SHELVING SYSTEM
07 92 00.A02	SEALANT W/BACKER ROD
07 95 00.A06	WALL-TO-WALL JOINT SYSTEM
07 95 00.A11	CEILING-TO-WALL JOINT SYSTEM
08 41 13.A01	THERMAL BROKEN STOREFRONT FRAMING (4.5")
08 71 00.A01	THRESHOLDS
08 80 00.A12	3/8\" CLEAR FULLY-TEMPERED MONOLITHIC FLOAT GLASS
09 21 16.A01	NON-STRUCTURAL FRAMING
09 21 16.A04	Z-SHAPED FURRING
09 29 00.A02	GYPSUM BOARD - TYPE X
09 64 66.A01	WOOD ATHLETIC FLOOR
09 64 66.A02	UNDERLAYMENT
09 64 66.A04	RESILIENT PADS
09 64 66.A06	RESILIENT WALL BASE (VENTED)
09 96 46.A01	INTUMESCENT PAINT
31 20 00.A13	GEOFOAM

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CONFORMED CONSTRUCTION DOCUMENTS

REVISIONS:		
#	Description	Date
1	Addendum 01	09.14.2023
2	Addendum 04	09.29.2023

STATE OF MISSOURI

KEVIN E. NELSON

A-2019015618

OCTOBER 11, 2023

Kevin E. Nelson
A-2019015618

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A661

INTERIOR DETAILS



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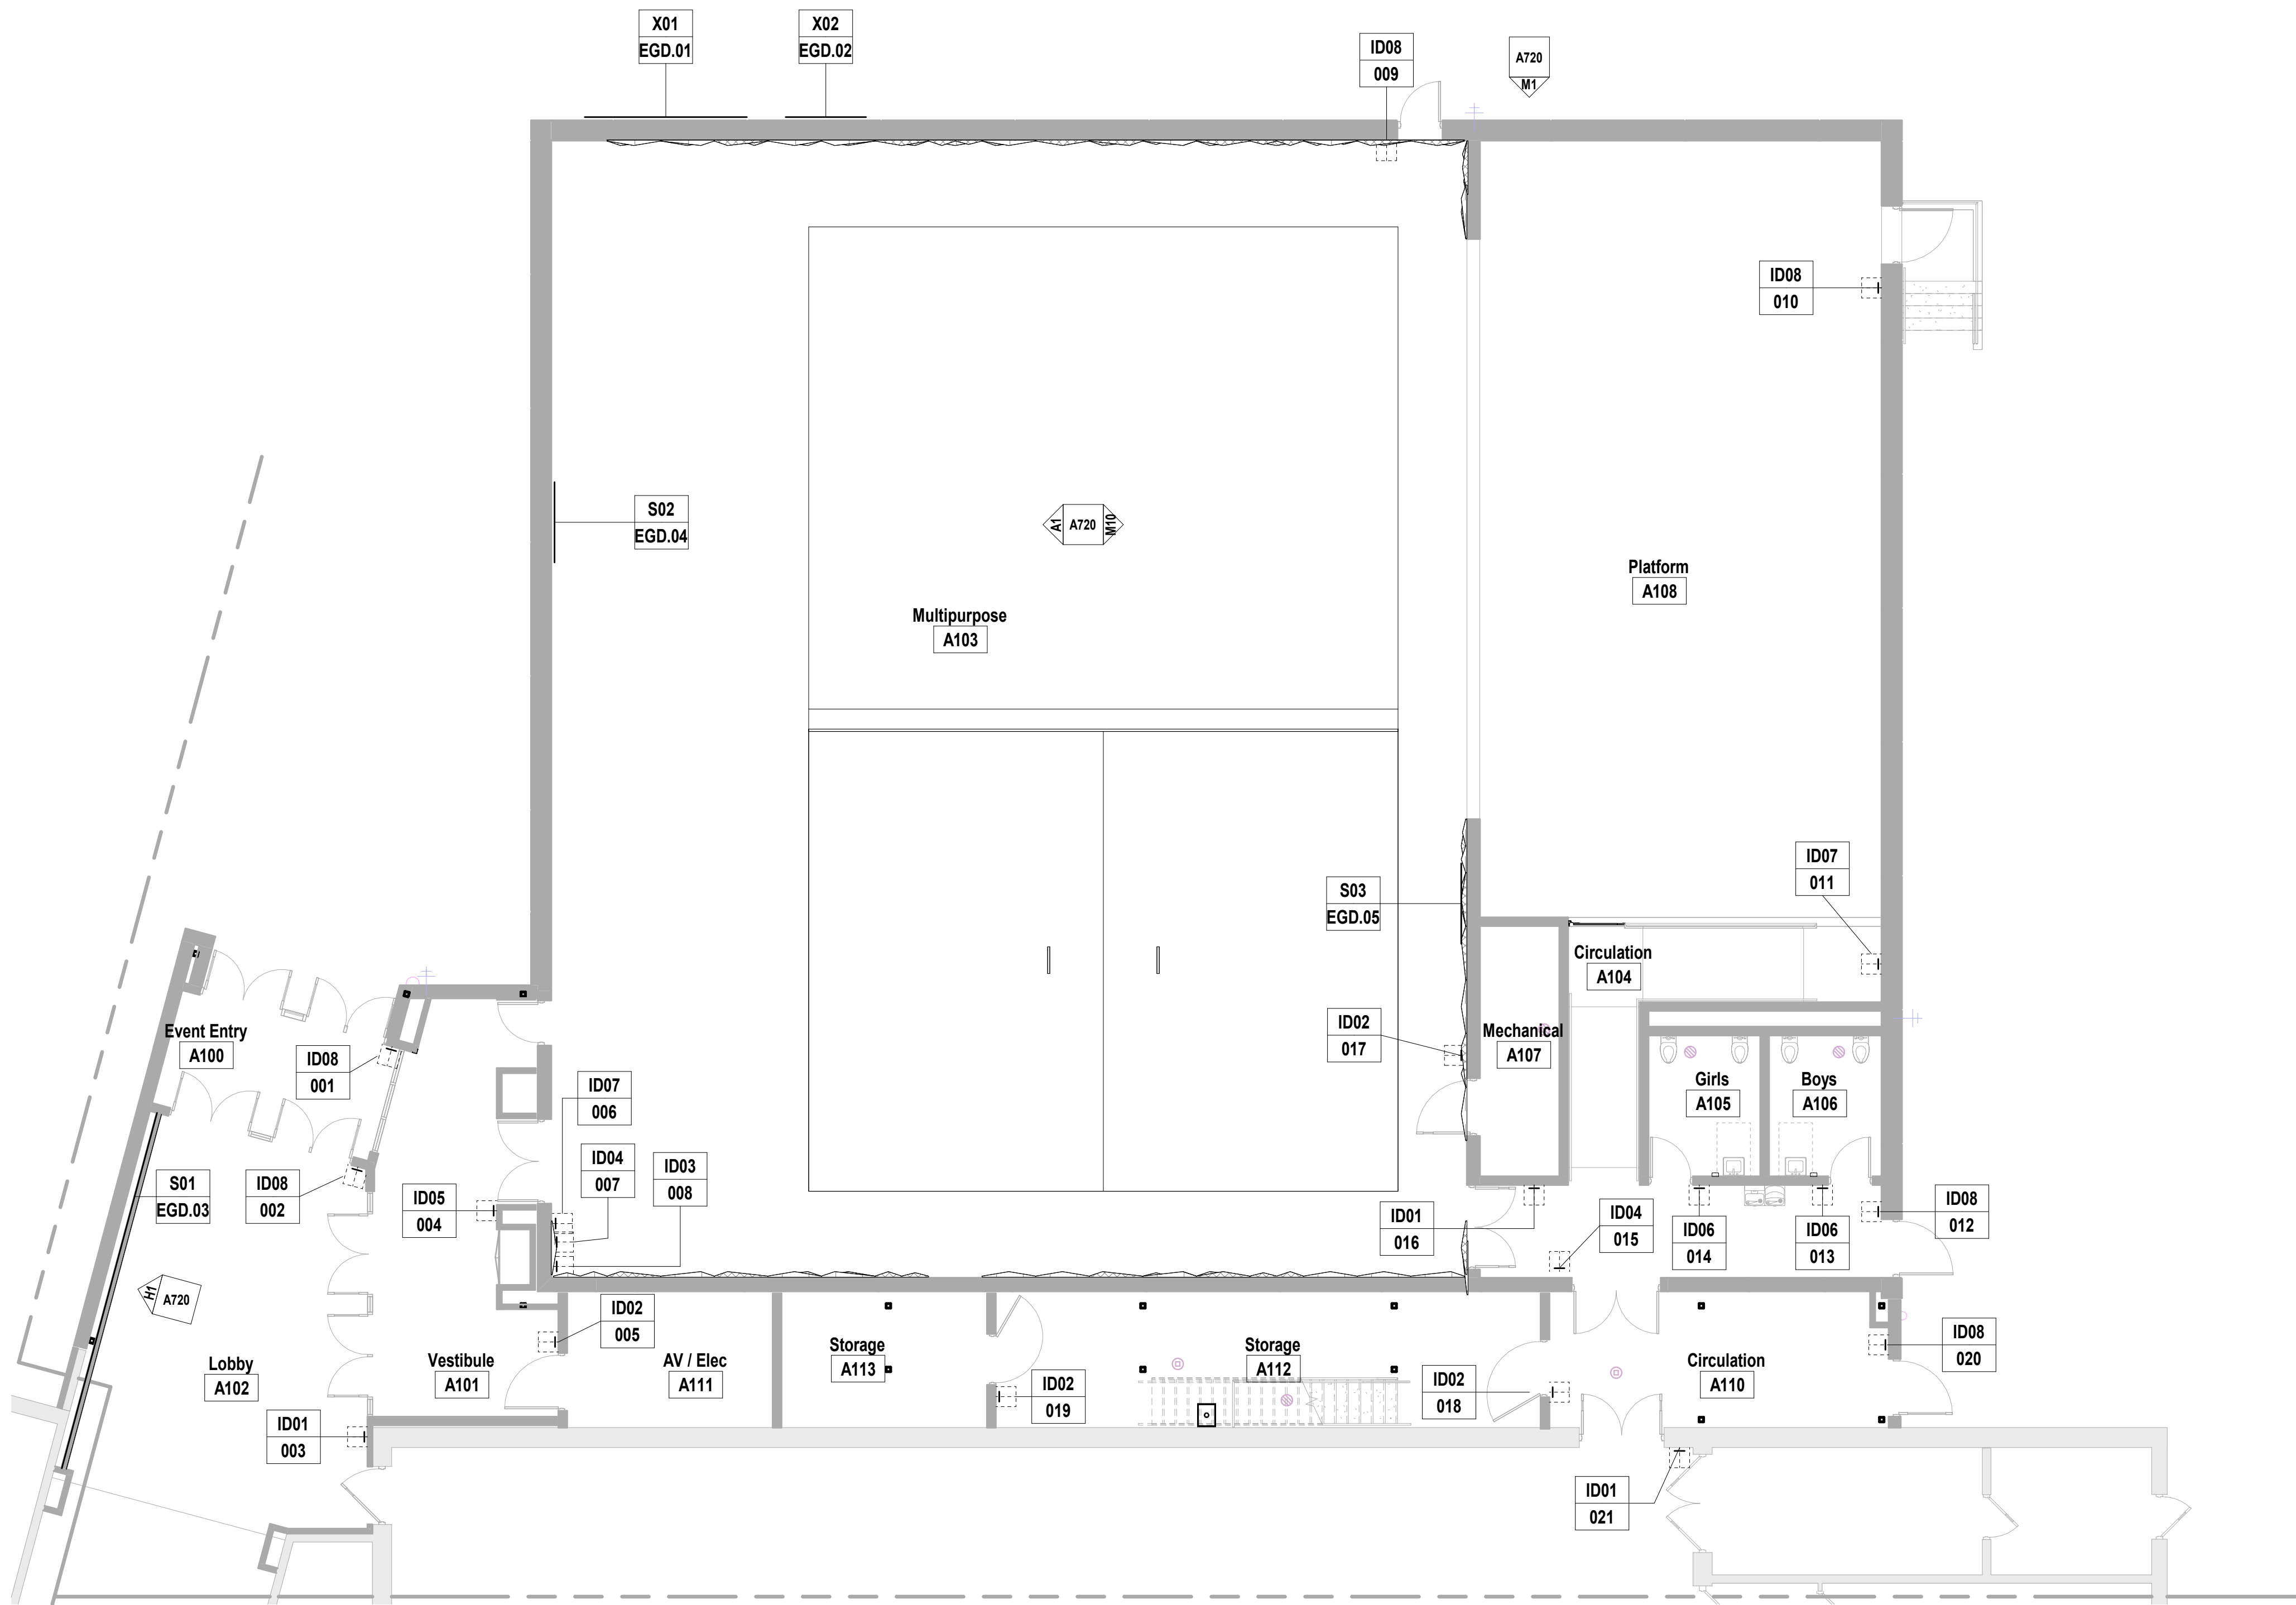
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4338 Belleview Ave
Kansas City, MO 64111
816.531.4144 phone

Smith & Boucher, Inc.
Mechanical, Electrical, & Plumbing
State Certificate of Authority #EGC000178
25618 W 103rd Street
Olathe, KS 66061
913.345.2127 phone

MKEC Engineering, Inc.
Civil Engineer
State Certificate of Authority
Engineering #2001009364
Landscaping #2006027139
Surveying #2006027138
11827 W 112th Street, Suite 1
Overland Park, KS 66210
913.317.9390 phone

Peerbolte Creative
Theatrical Consultant
109 E Pine St.
Warrensburg, MO 640
660.429.1383 phone

Avant Acoustics
AV/Acoustics Consultant
14827 West 95th St.
Lenexa, KS 66215
913.888.9111 phone




A1 Scale Level 1
1/8" = 1'-0"

EGD GENERAL NOTES

- THESE GENERAL NOTES ARE SUPPLEMENTAL TO THE PROJECT MANUAL.
- CONTRACTOR TO REVIEW THE DRAWINGS (INCLUDING BUT NOT LIMITED TO ARCHITECTURAL, MECHANICAL, STRUCTURAL, SITE, AND ELECTRICAL DRAWINGS) AND FIELD VERIFY SITE CONDITIONS TO CONFIRM SIZES AND LOCATIONS OF SIGNAGE AND ANY SIGNAGE-RELATED ELEMENTS.
 - ANY DISCREPANCIES AND/OR CONFLICTS SHALL BE REPORTED TO THE ARCHITECT IN WRITING BEFORE PROCEEDING WITH FABRICATION OR ORDERING OF MATERIALS.
 - REFER TO FINAL ART FOR ADDITIONAL INSTRUCTIONS AND INFORMATION ON NON-PRINTING LAYERS.
 - PRE-INSTALL COORDINATION MEETING IS MANDATORY.
 - CONTRACTOR SHALL SUBMIT FULLY-DETAILED WORKING (SHOP) DRAWINGS OF ALL SIGNS AND GRAPHICS CONTAINED IN THIS PACKAGE TO THE ARCHITECT. DRAWINGS SHALL BE REVIEWED AND HAVE SIGNED APPROVAL PRIOR TO FABRICATION OR ORDERING OF MATERIALS. REFER TO PROJECT MANUAL.
 - ALL SIGNS ARE TO BE FABRICATED FROM MATERIALS SPECIFIED UNLESS OTHERWISE APPROVED IN WRITING BY CLIENT AND ARCHITECT.
 - CONTRACTOR IS RESPONSIBLE FOR DETERMINING PROPER MOUNTING, FASTENING AND ANCHORING METHODS FOR ALL SIGNS UNLESS NOTED OTHERWISE. DETERMINATION TO ACCOUNT FOR SURFACE MATERIAL SIGN IS BEING MOUNTED TO. SEE ALSO SECTION 10 14 00 OF THE SPECIFICATIONS.
 - DRAWINGS CONTAINED IN THIS PACKAGE ARE FOR AESTHETIC AND FUNCTIONAL DESIGN, ONLY. NO INSTRUCTIONS FOR STRUCTURAL APPROPRIATENESS HAVE BEEN MADE. IT IS THE RESPONSIBILITY OF THE FABRICATOR TO ENSURE THAT ALL ELEMENTS ARE FABRICATED FOR A STABLE AND DURABLE INSTALLATION WHILE ADHERING TO THE AESTHETIC DETAILS INDICATED.
 - ALL FASTENERS ARE TO BE CONCEALED UNLESS NOTED OTHERWISE. ANY VISIBLE FASTENERS TO BE COUNTER-SUNK AND PAINTED TO MATCH ADJACENT MATERIAL, UNLESS NOTED OTHERWISE.
 - ALL TEXT SHOWN IS FOR REFERENCE ONLY. UNLESS NOTED OTHERWISE, SIGNAGE CONTRACTOR TO CONFIRM MESSAGE SCHEDULE WITH ARCHITECT FOR EXACT TEXT ON EACH SIGN.
 - LAY OUT EACH SIGN MESSAGE FOR APPROVAL PER SPECIFICATION SECTION 10 14 23.
 - ALL GRAPHICS SHOWN ARE PLACEHOLDER IMAGES.
 - CONTRACTOR TO COORDINATE BLOCKING NEEDS WITH ARCHITECT AND CONSTRUCTION MANAGER.
 - PROVIDE ACCESSIBLE PANELS TO ALL TRANSFORMERS. FINAL LOCATION OF TRANSFORMERS TO BE APPROVED BY ARCHITECT.
 - FOR SIGNS WITH ILLUMINATION, ALLOW FOR 10 (TEN) FEET OF CABLE PER SIGN FOR CONNECTION TO ELECTRICAL JUNCTION BOX.
 - PROVIDE APPROPRIATE CHEMICAL BOND BREAK BETWEEN ALL DISSIMILAR METALS (INCLUDING BETWEEN SIGN PARTS OR BETWEEN SIGNS AND MOUNTING SUBSTRATE).
 - CONTRACTOR TO VERIFY ALL EXISTING FINISHES AND NOTIFY ARCHITECT OF ANY DISCREPANCIES BEFORE PERFORMING ANY WORK.

KEY PLAN

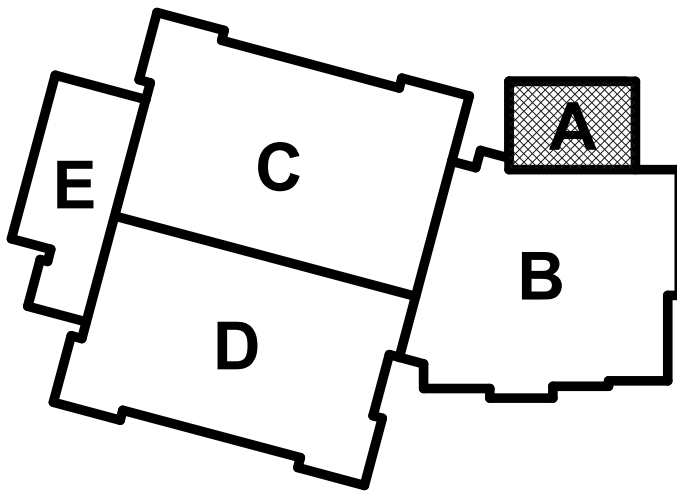

we design the future®
1828 Walnut Street Suite 922
Kansas City, MO 64108
1 816.442.7700
115 Wilcox Street Suite 210
Castle Rock, CO 80104
1 720.949.1689
HOLLISANDMILLER.COM

Hollis + Miller Architects
Missouri State Certificate of Authority
Architecture # 000051

Bob D Campbell
Structural Engineer
State Certificate of Authority #000442
4338 Bellevue Ave
Kansas City, MO 64111
816.531.4144 phone

Smith & Boucher, Inc.
Mechanical, Electrical, & Plumbing
State Certificate of Authority #EGC000178
25615 W 103rd Street
Olathe, KS 66061
913.345.2127 phone

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Civil Engineer
State Certificate of Authority
Engineering #2001009364
Landscaping #2006027139
Surveying #2006027138
11827 W 112th Street, Suite 200
Overland Park, KS 66210
913.317.9390 phone

Peerbolte Creative
Theatrical Consultant
109 E Pine St.
Warrensburg, MO 64093-0752
660.429.1383 phone

Avant Acoustics
AV/Acoustics Consultant
14827 West 95th St
Lenexa, KS 66215
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South Valley Middle School Storm Shelter Addition
Liberty Public Schools
1000 Midjay Dr, Liberty, MO 64068

REVISIONS:

#	Description	Date
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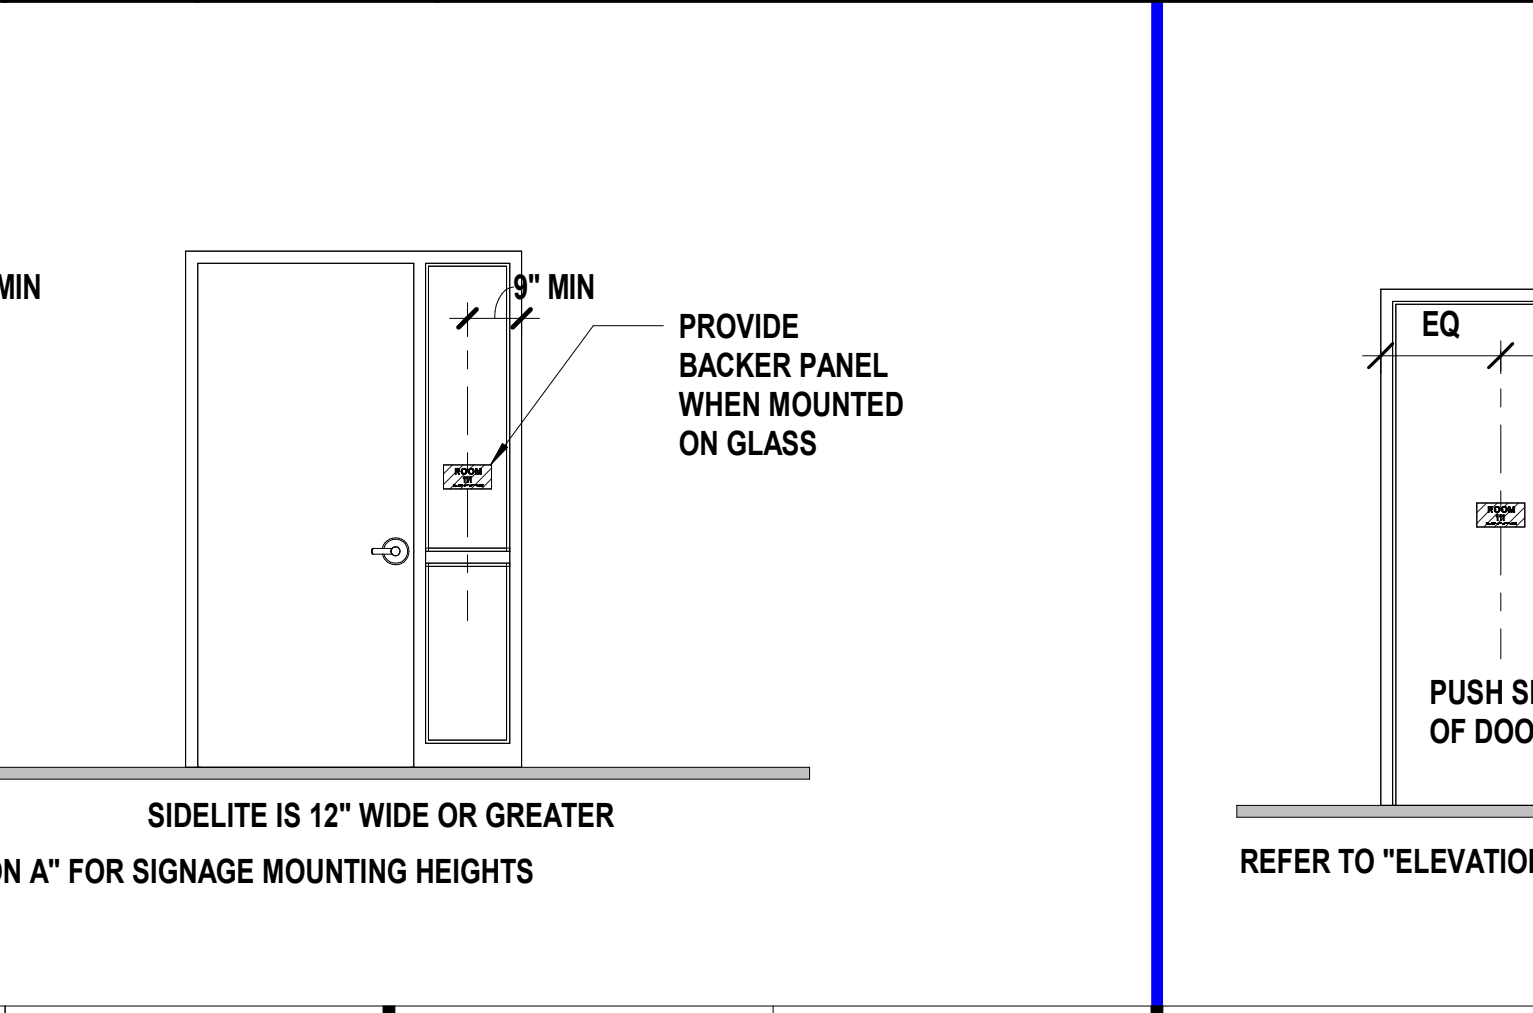
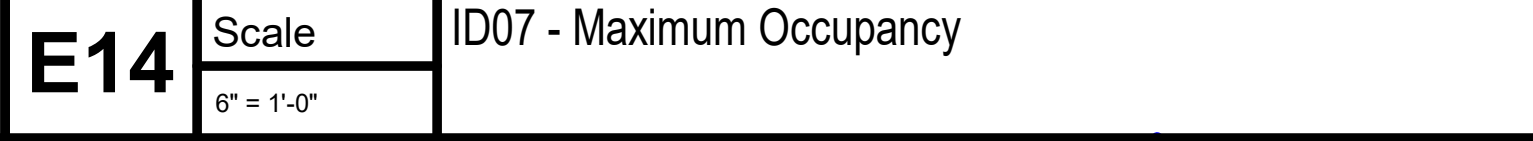
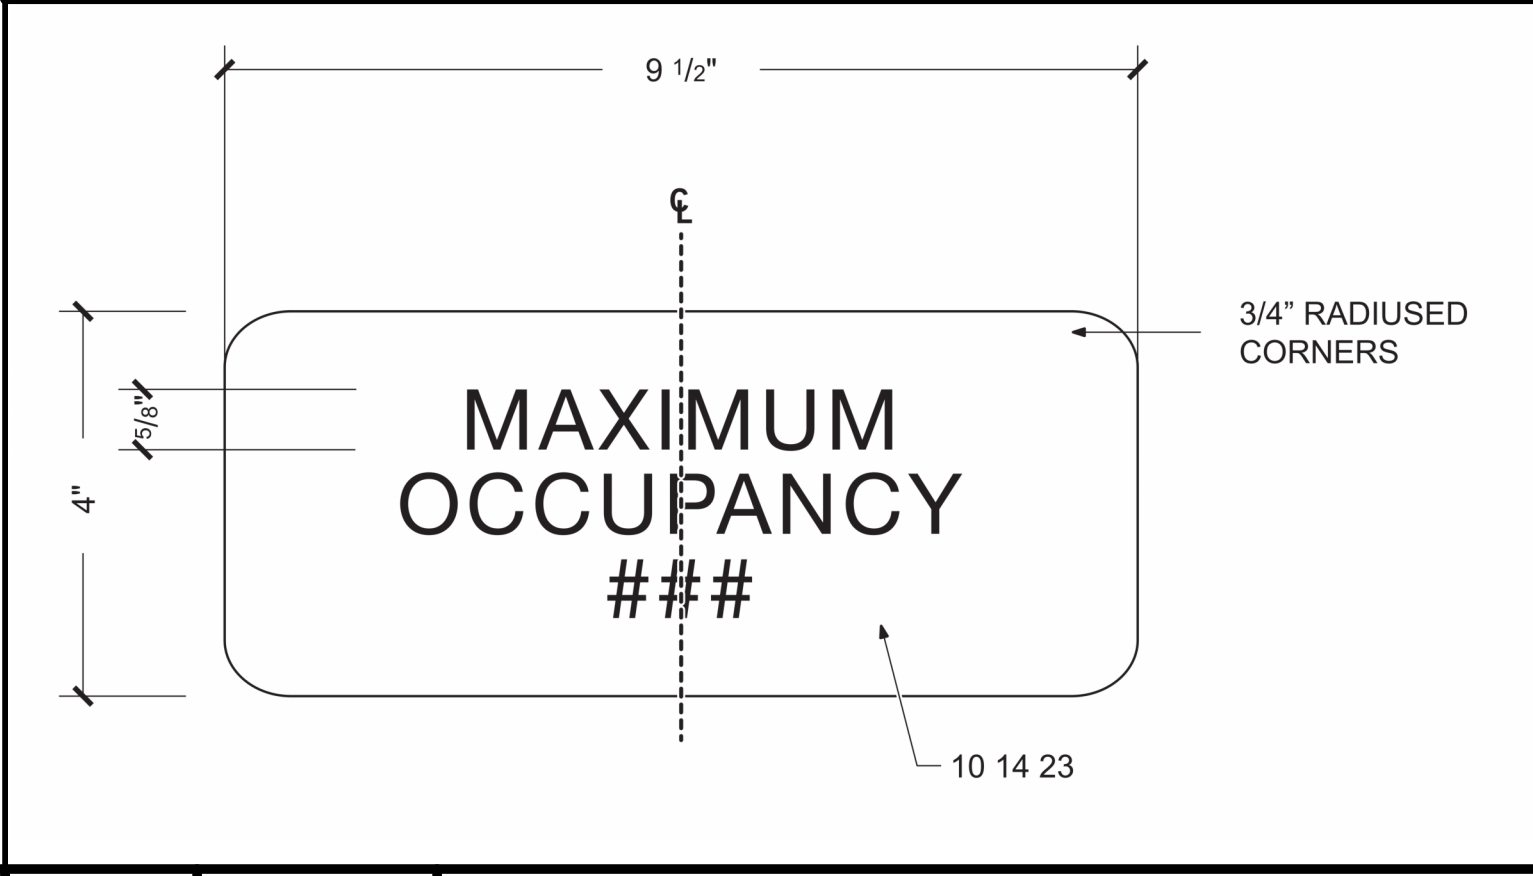
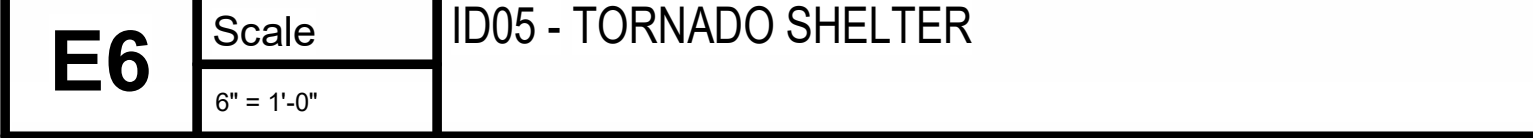
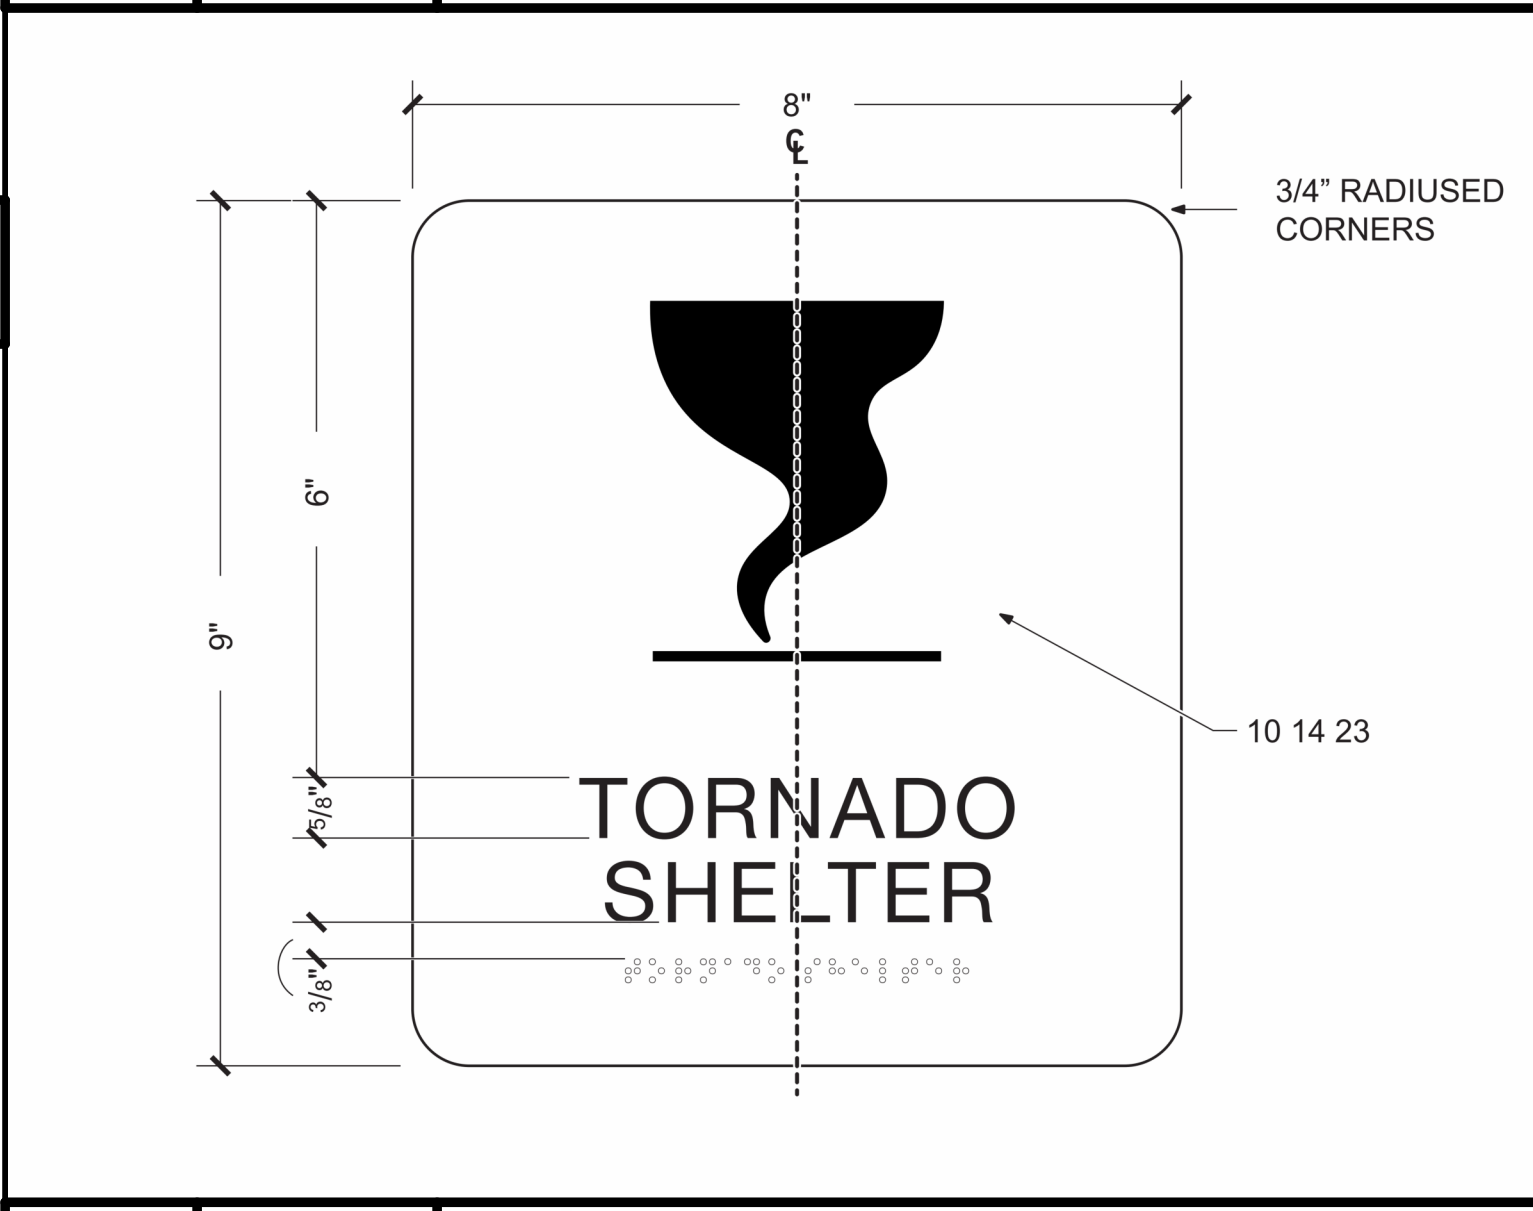
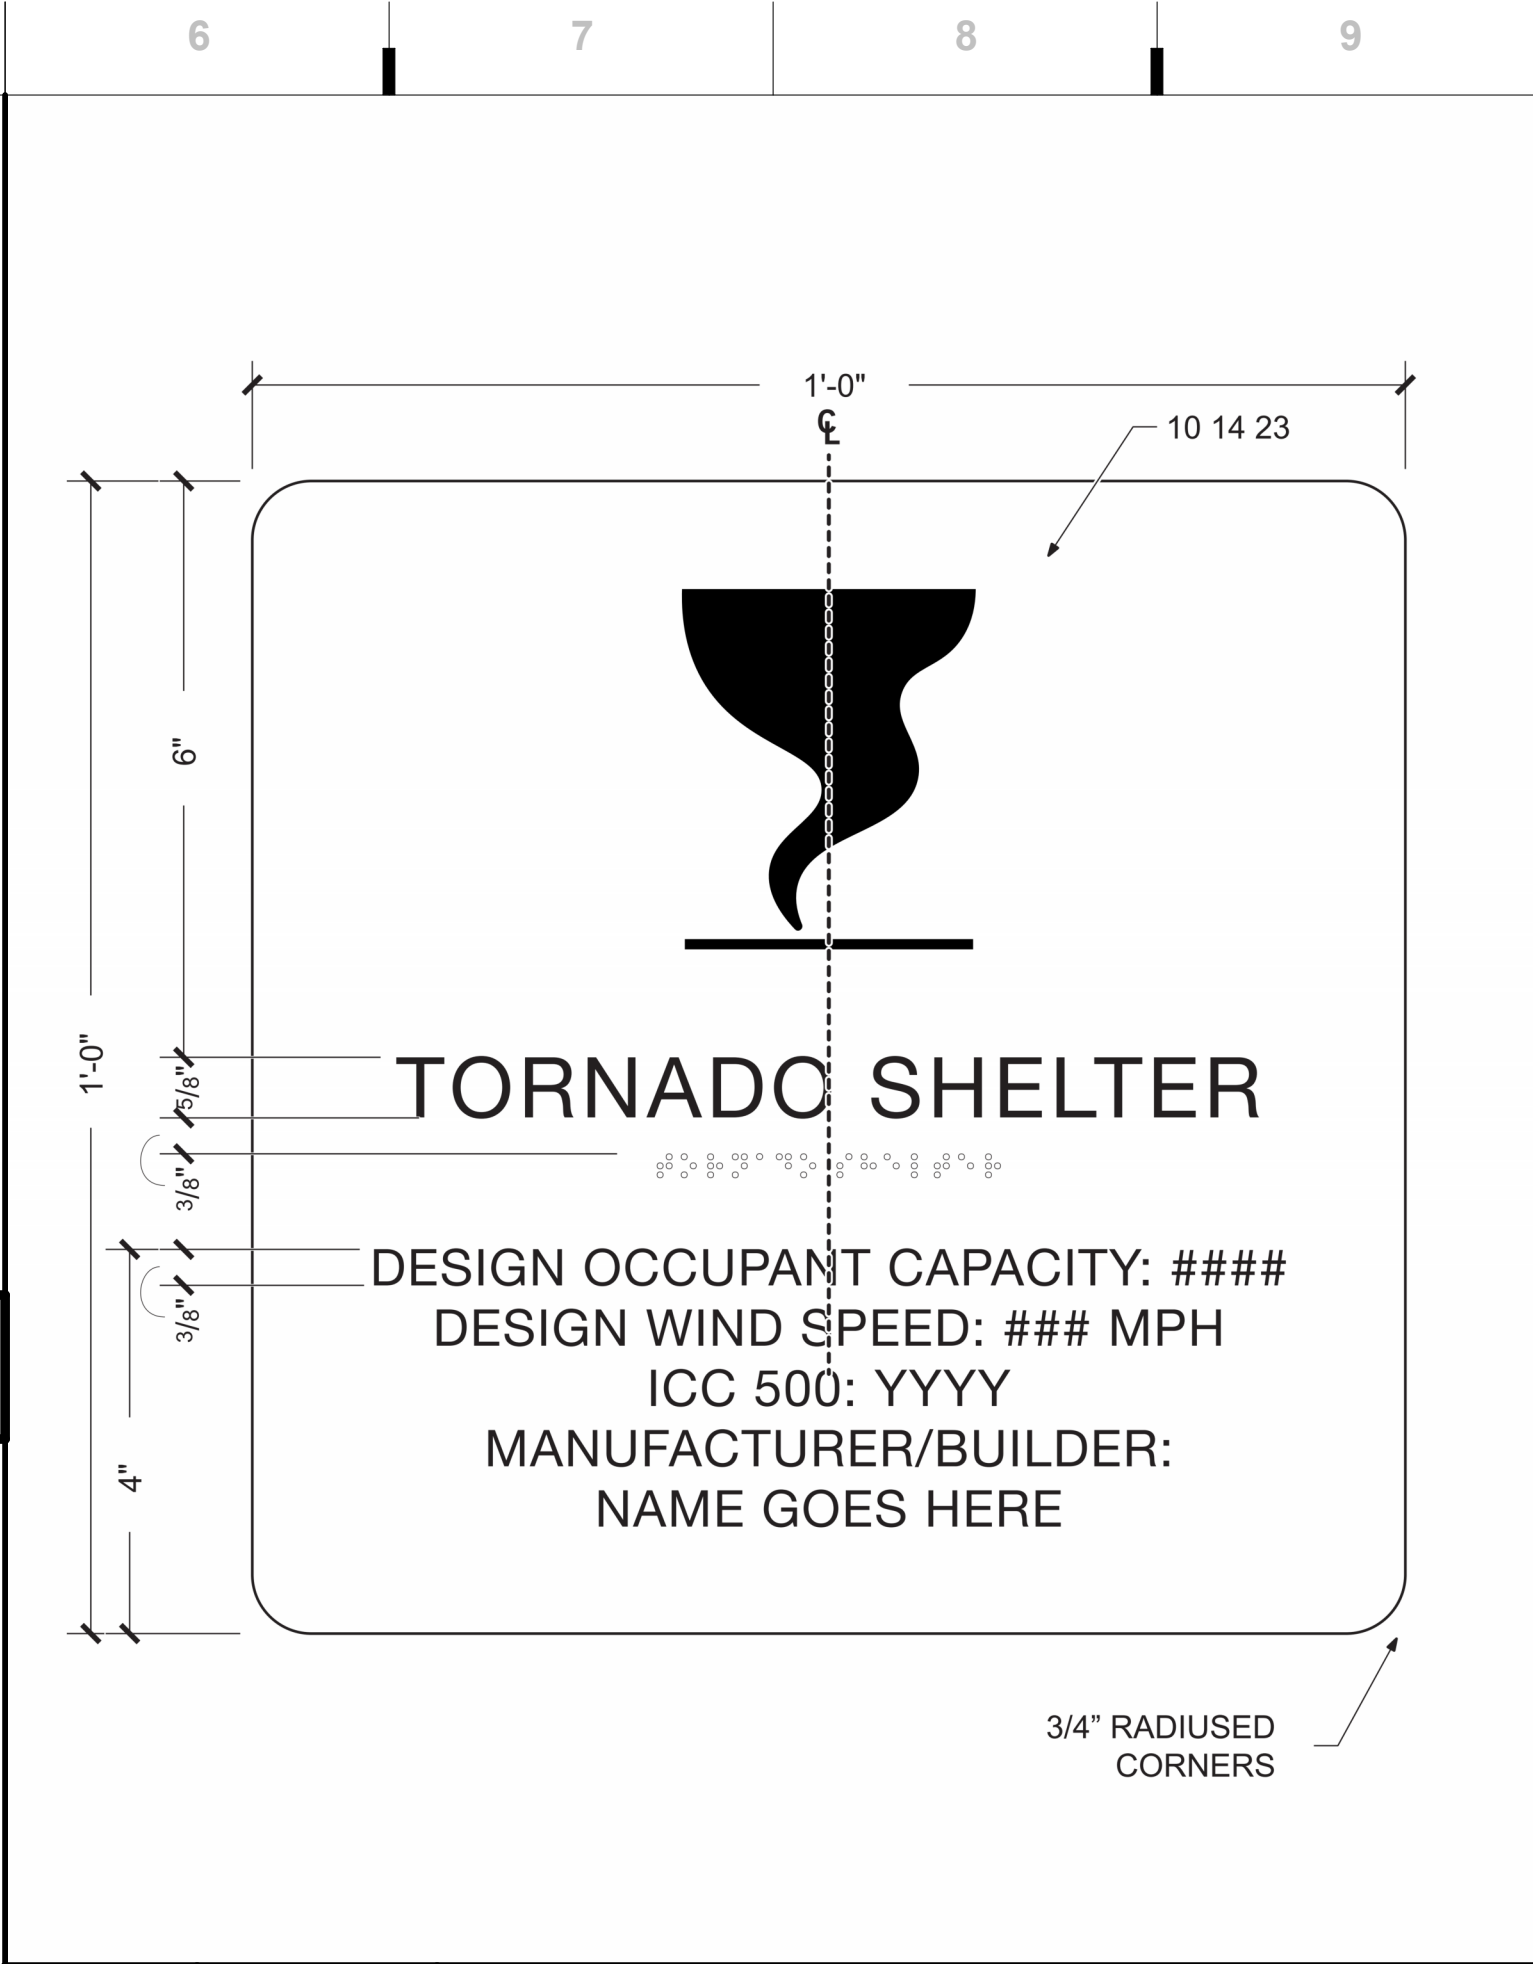
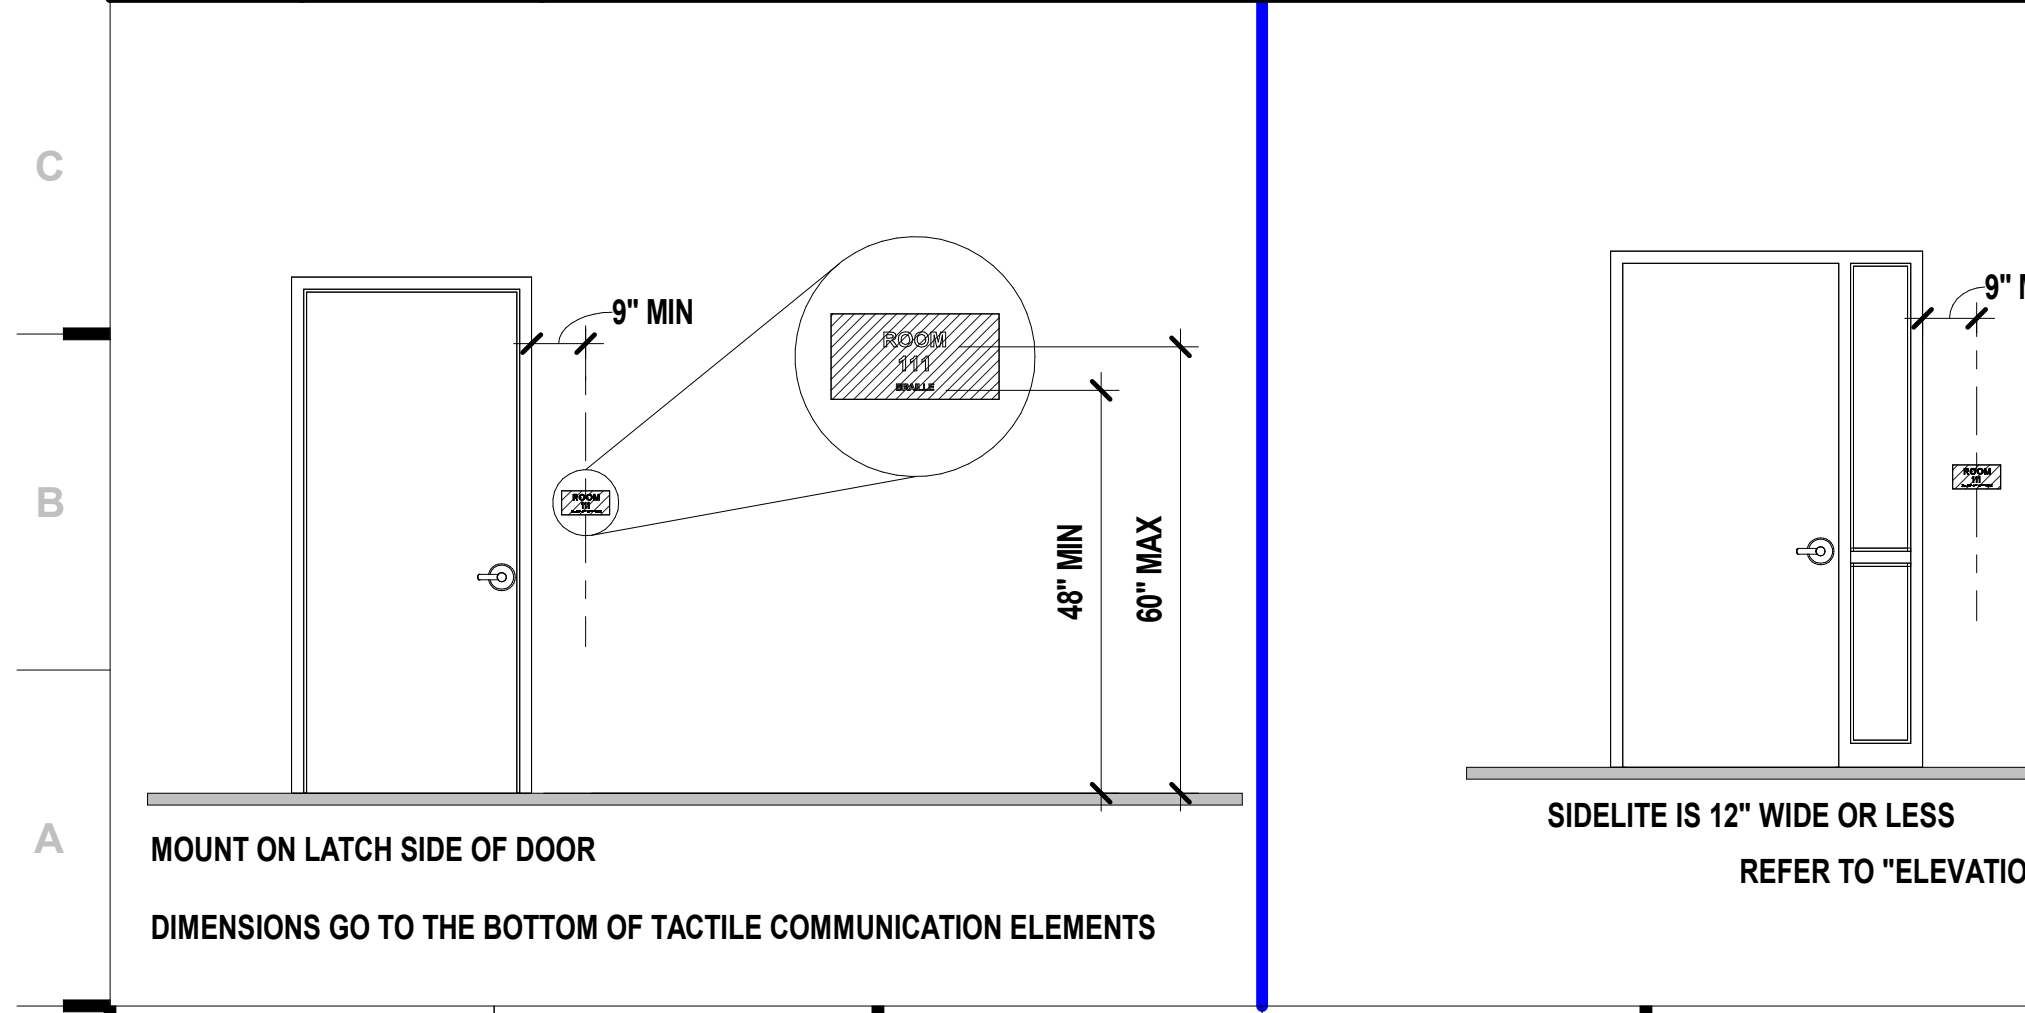
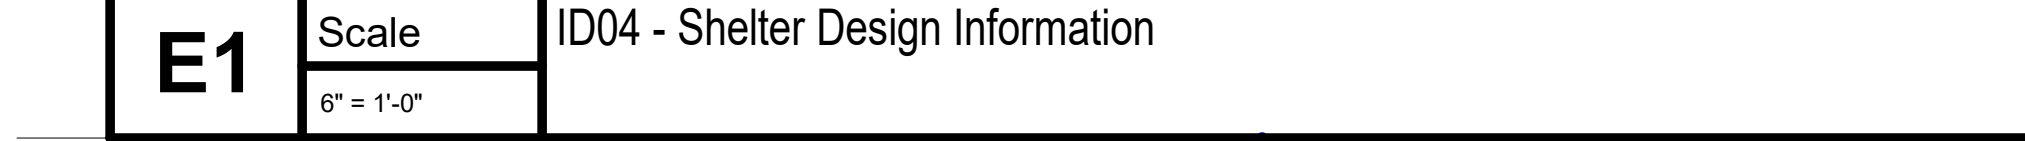
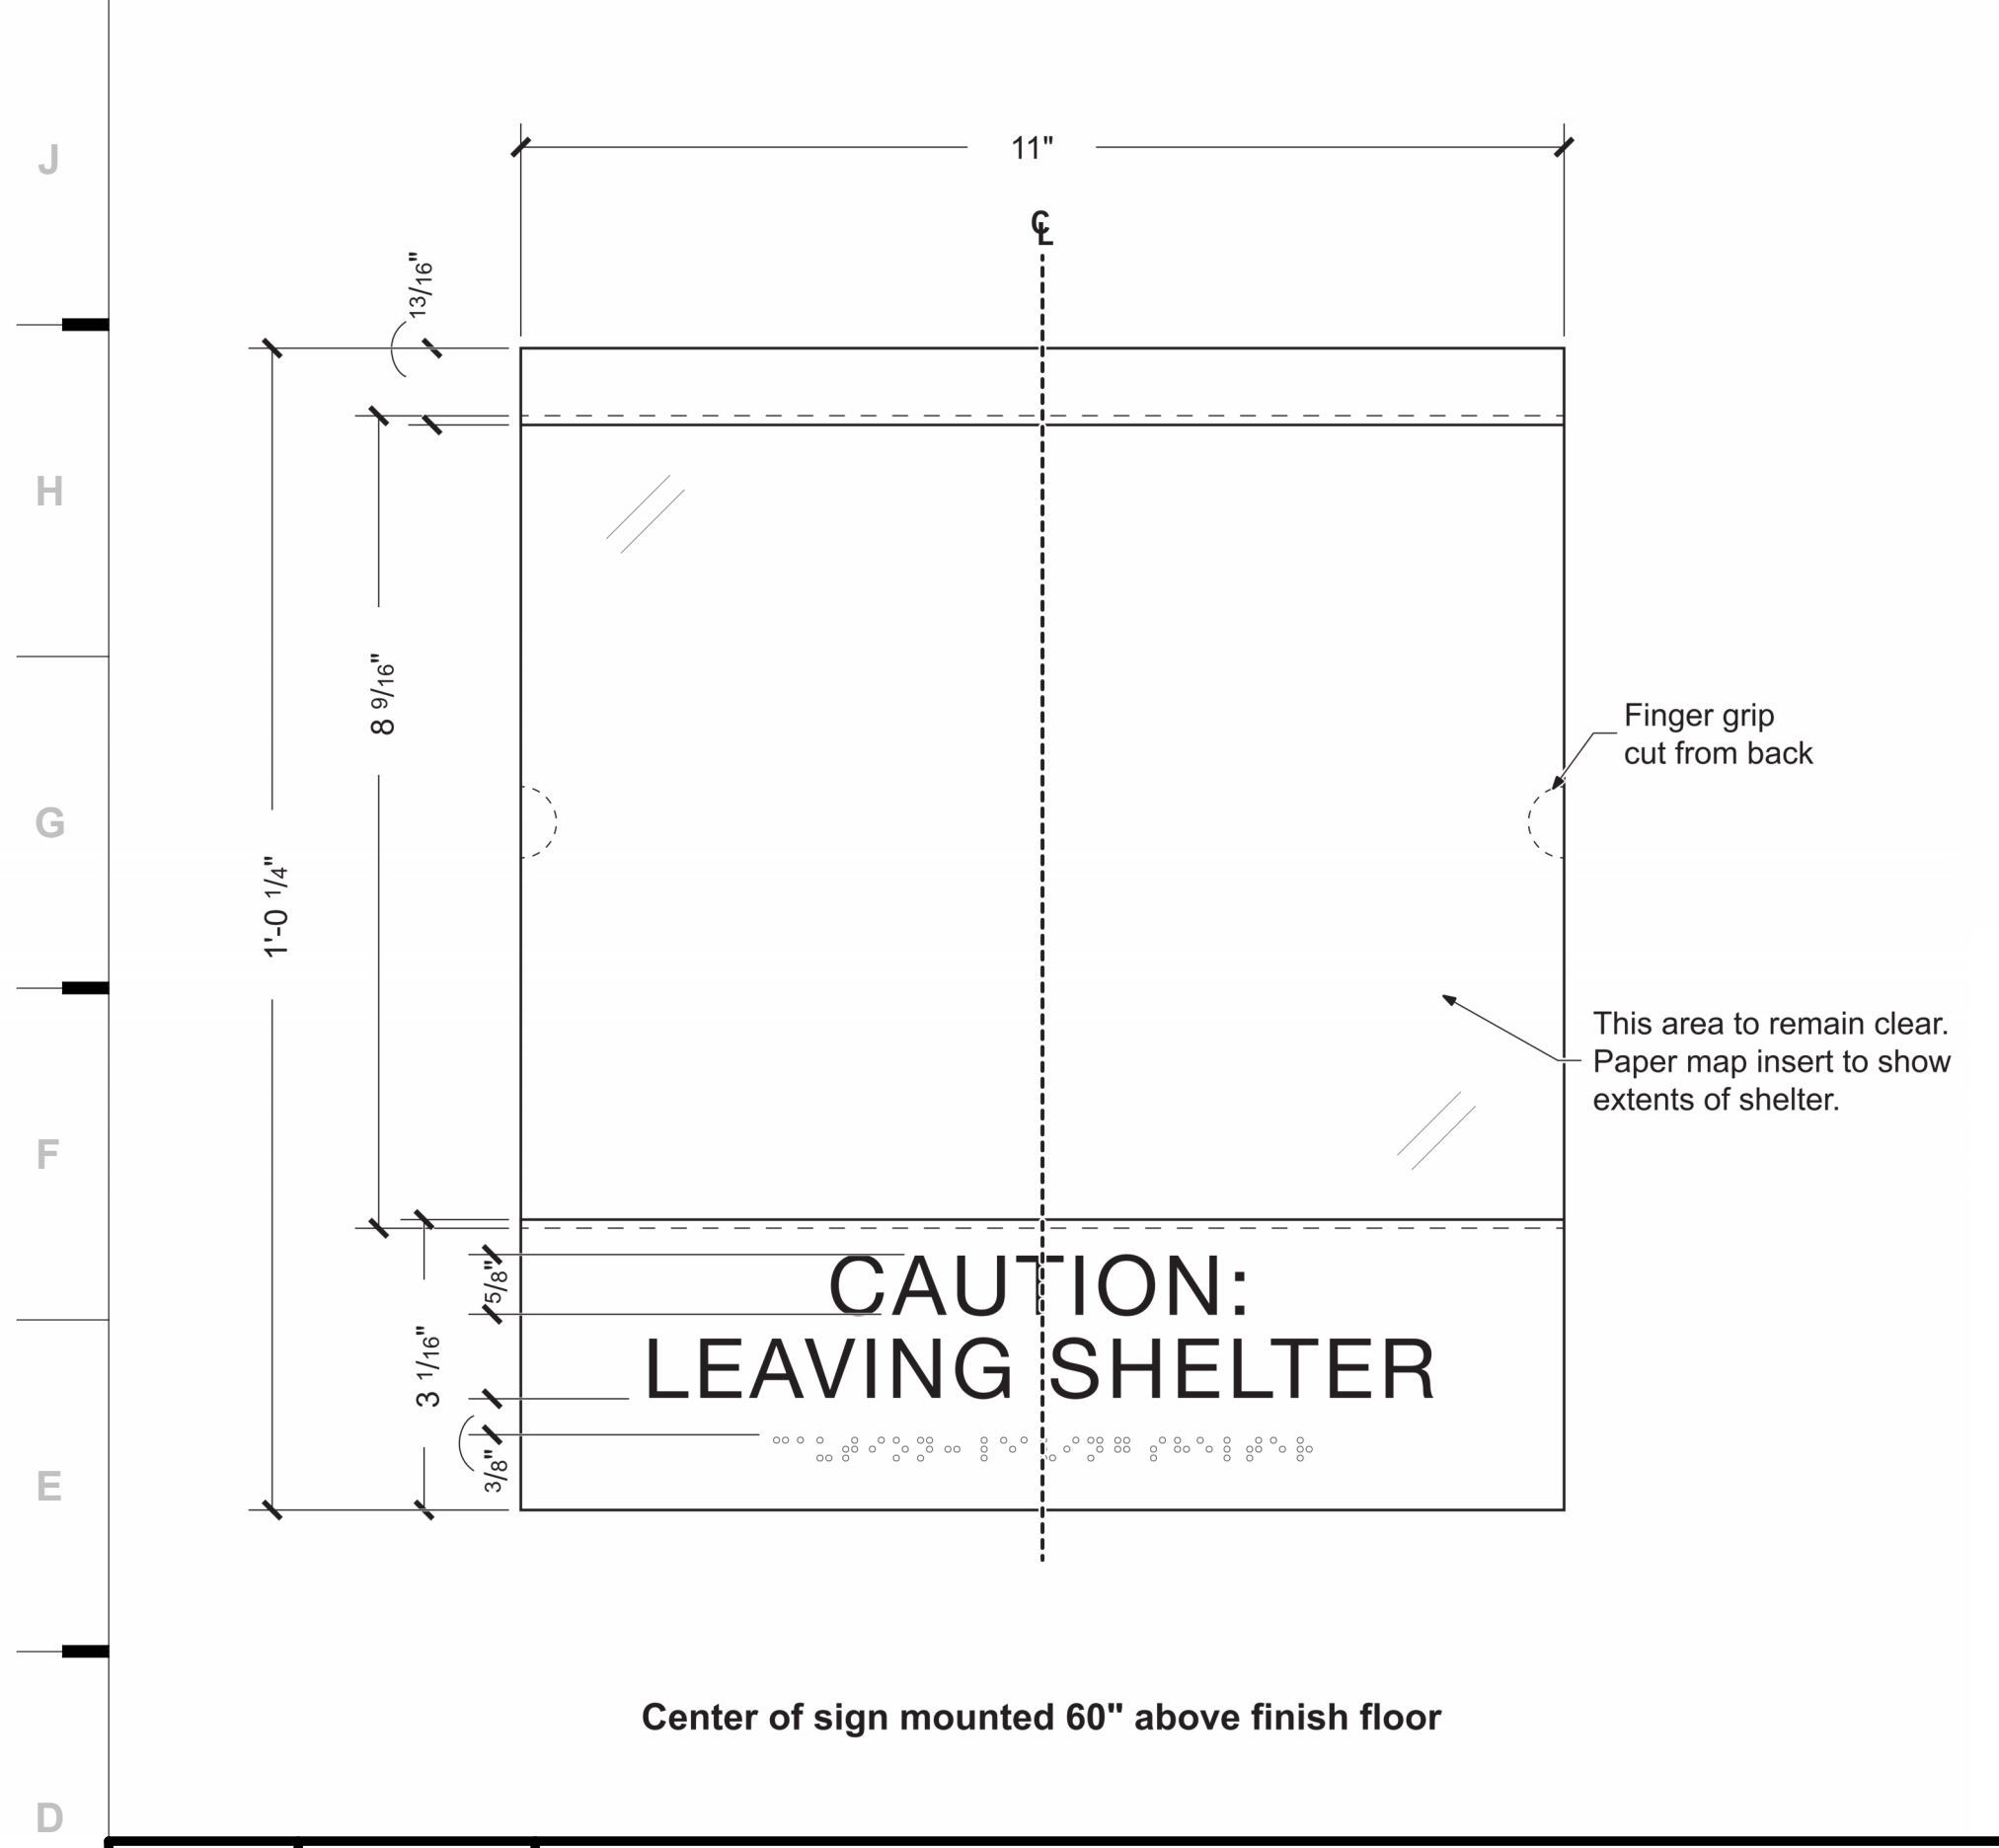
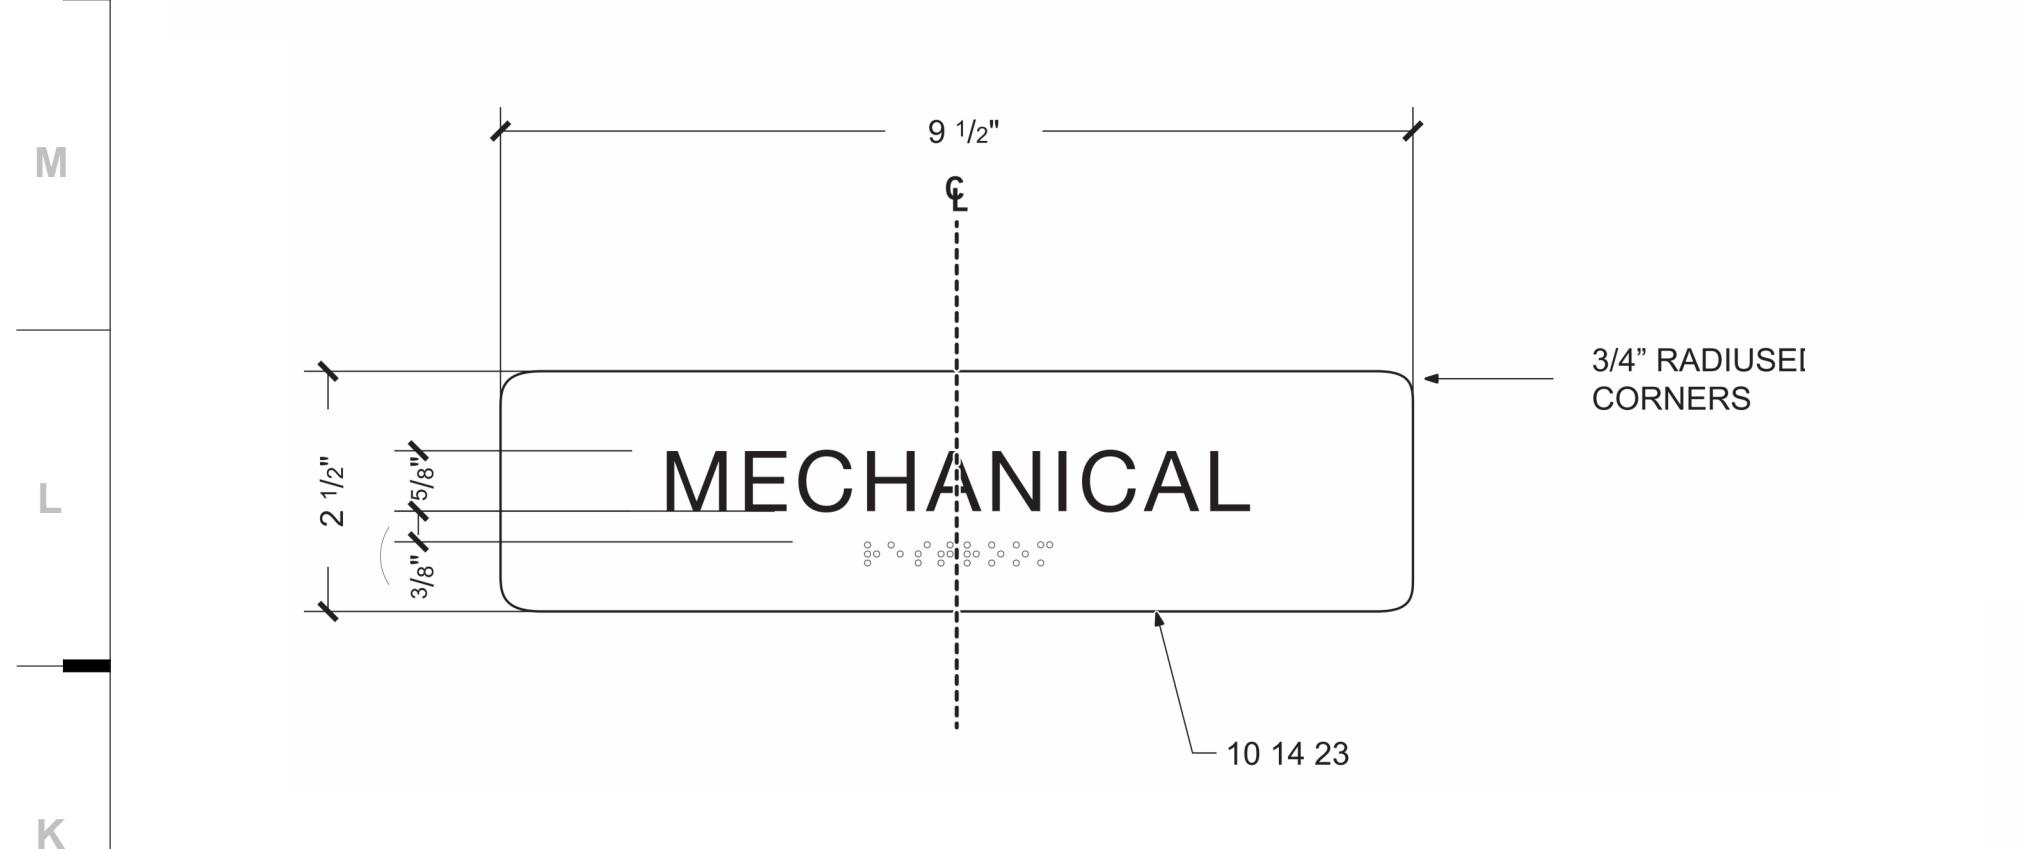
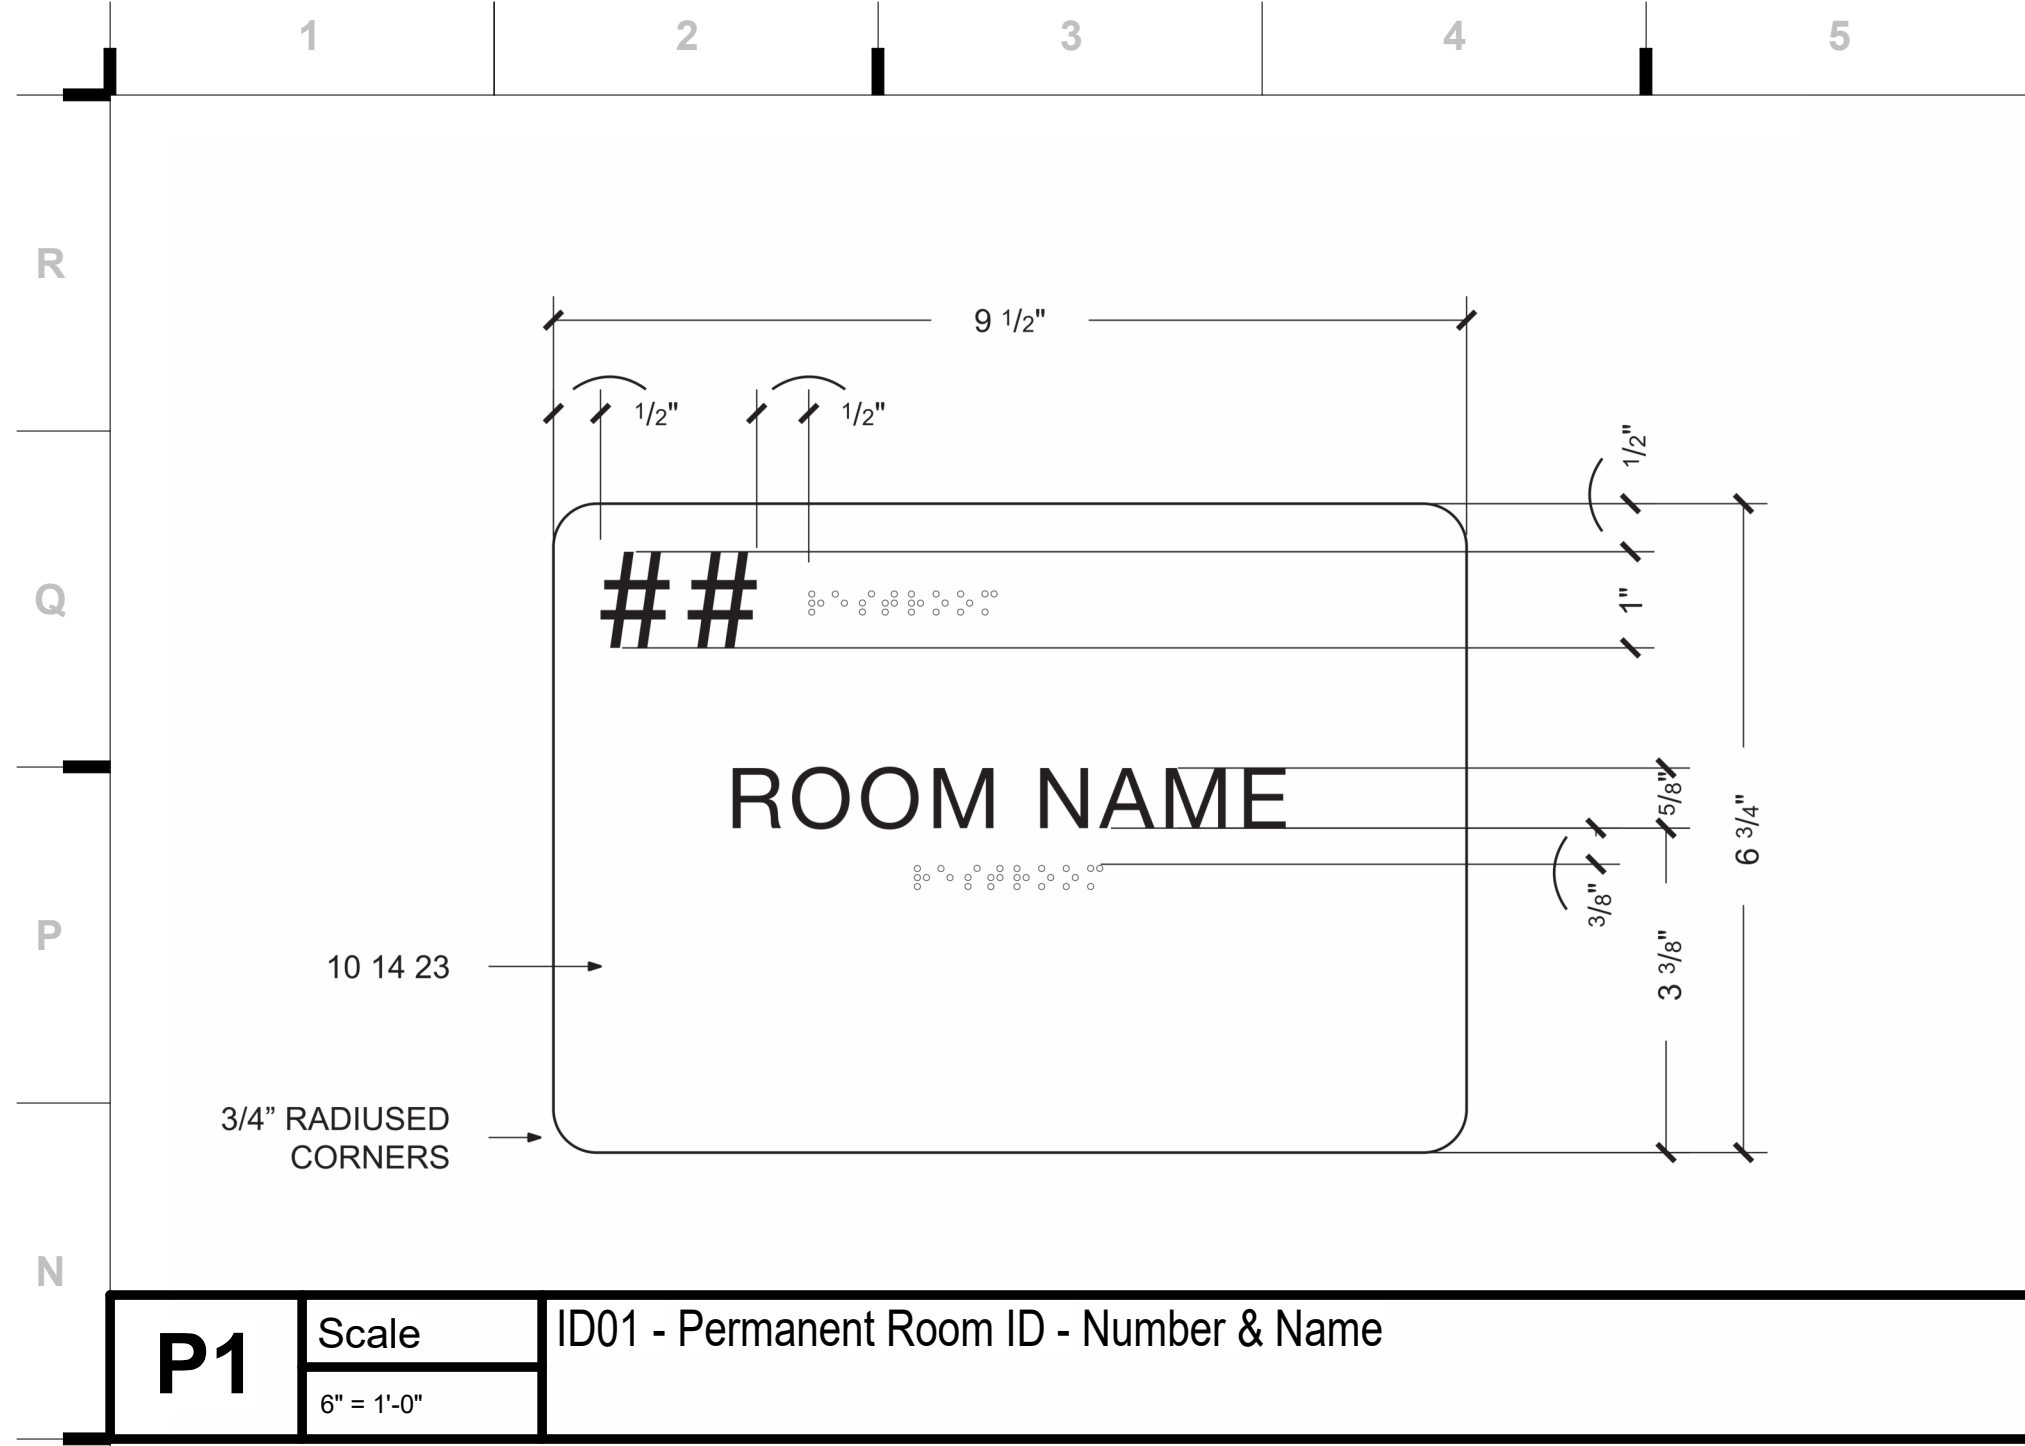
Kevin E. Nelson
A-2019015618

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JOB NO: 23019
DRAWN BY: MM
CHECKED BY: JCC
DATE: 08.31.2023




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ADA & Code Signage Schedule							
Sign #	Sign Type	# On Sign	Message On Sign	# on Drawing	Name on Drawing	Mounting Surface/ Method	Comments
001	ID08						
002	ID08						
003	ID01						
004	ID05						
005	ID02						
006	ID07						
007	ID04						
008	ID03						
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014	ID06						
015	ID04						
016	ID01						
017	ID02						
018	ID02						
019	ID02						
020	ID08						
021	ID01						

Environmental Graphics Schedule				
Sign #	Sign Type	Keynote	Description	Comments
EGD.03	S01			
EGD.04	S02			
EGD.05	S03			
EGD.01	X01			
EGD.02	X02			



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• NOTE

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ARTWORK TO BE SUPPLIED BY ARCHITECT

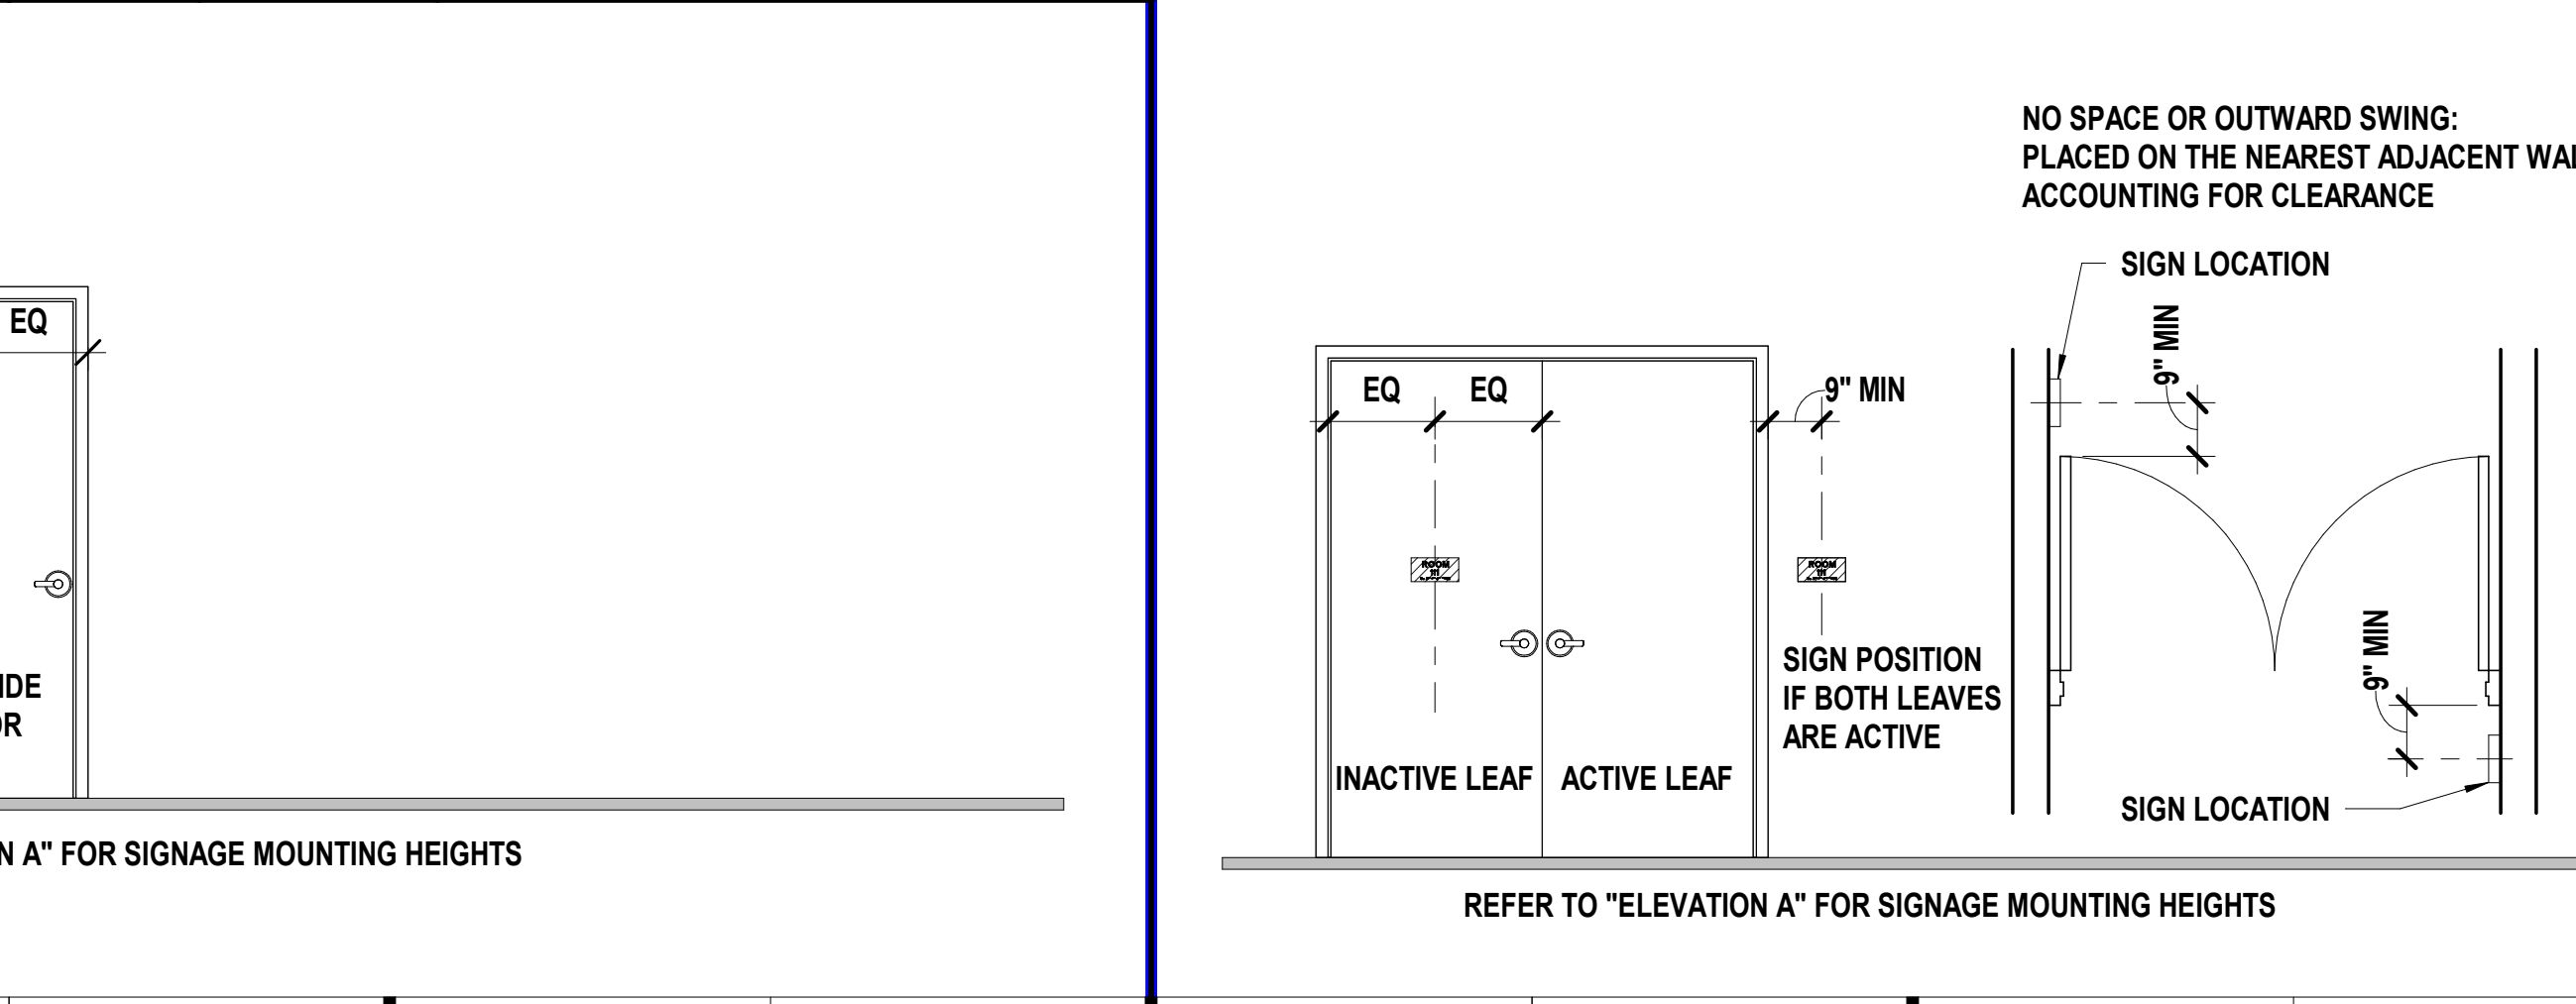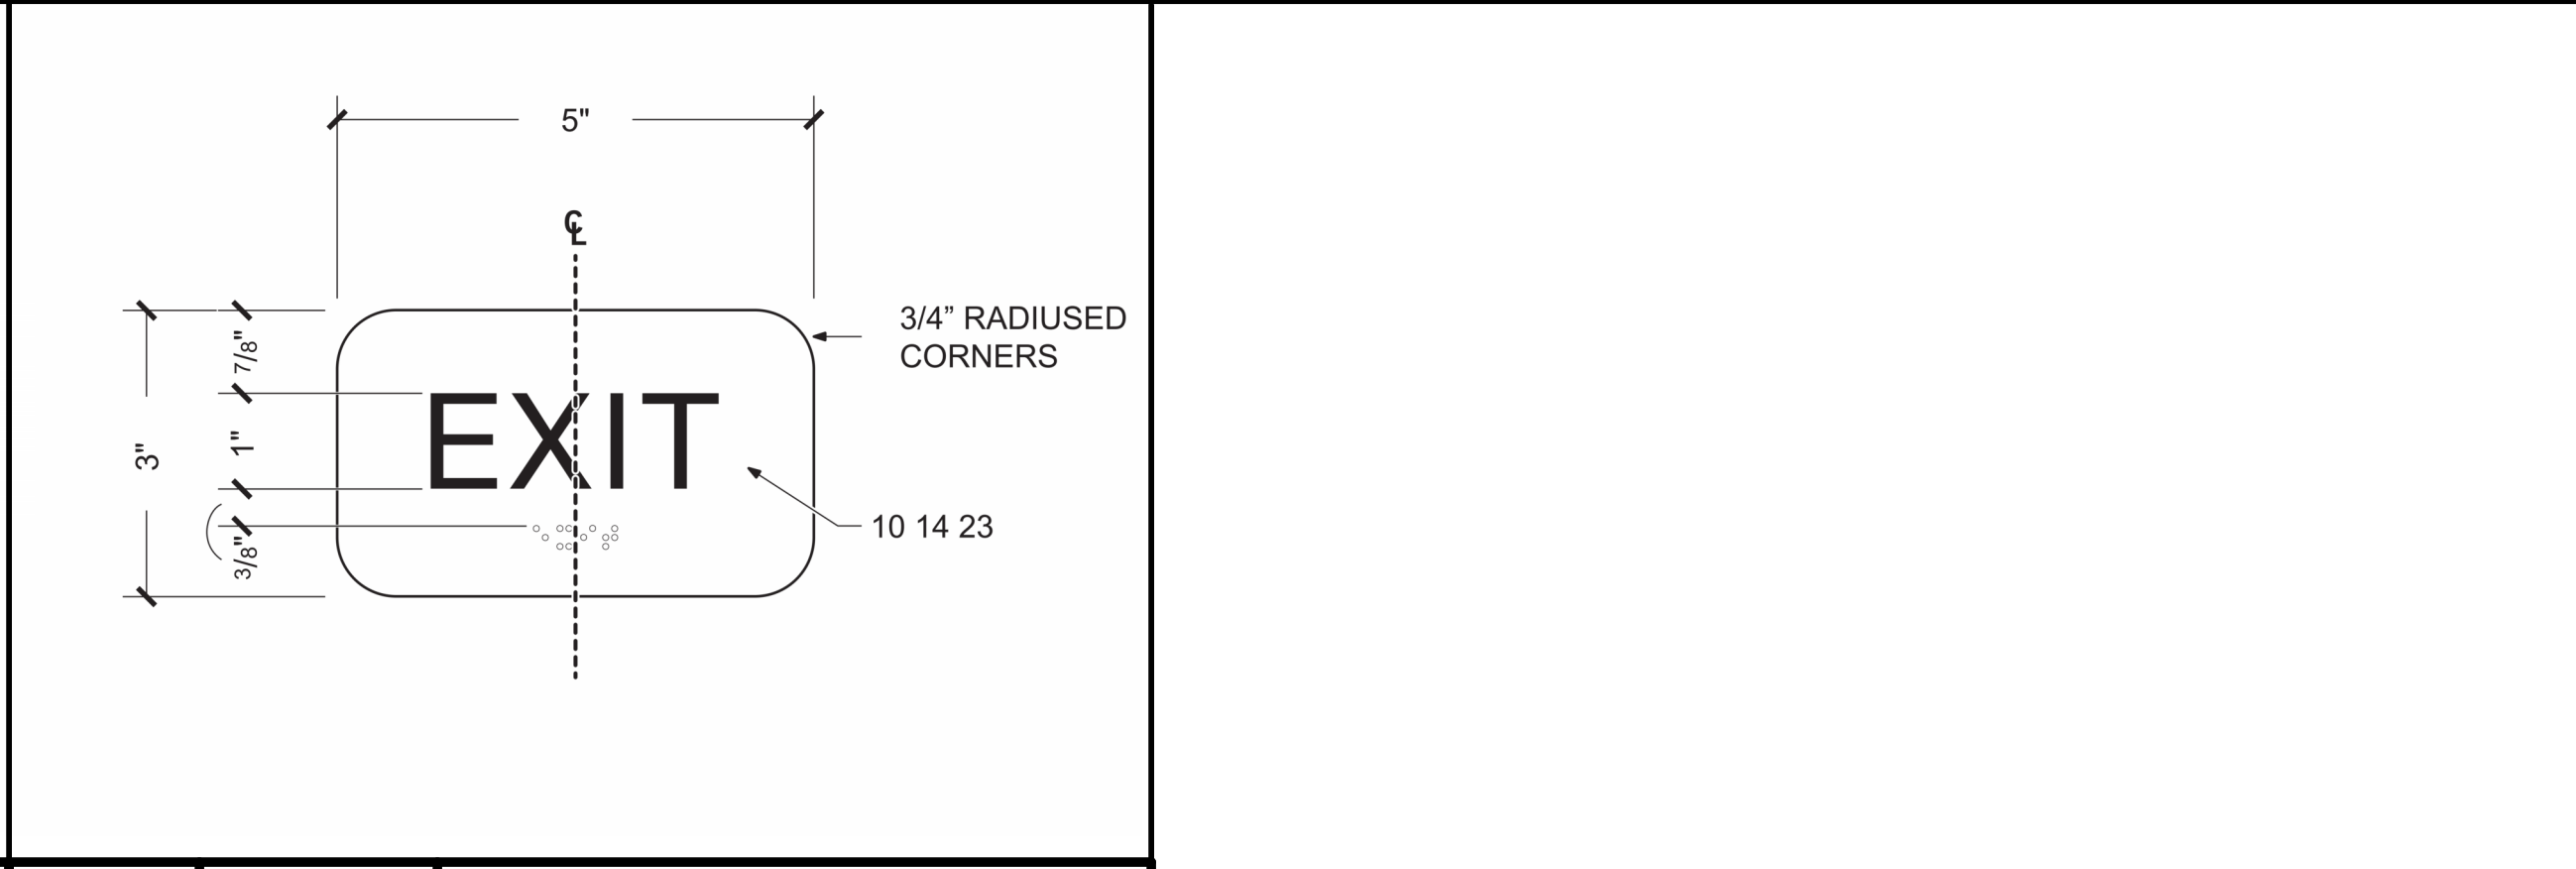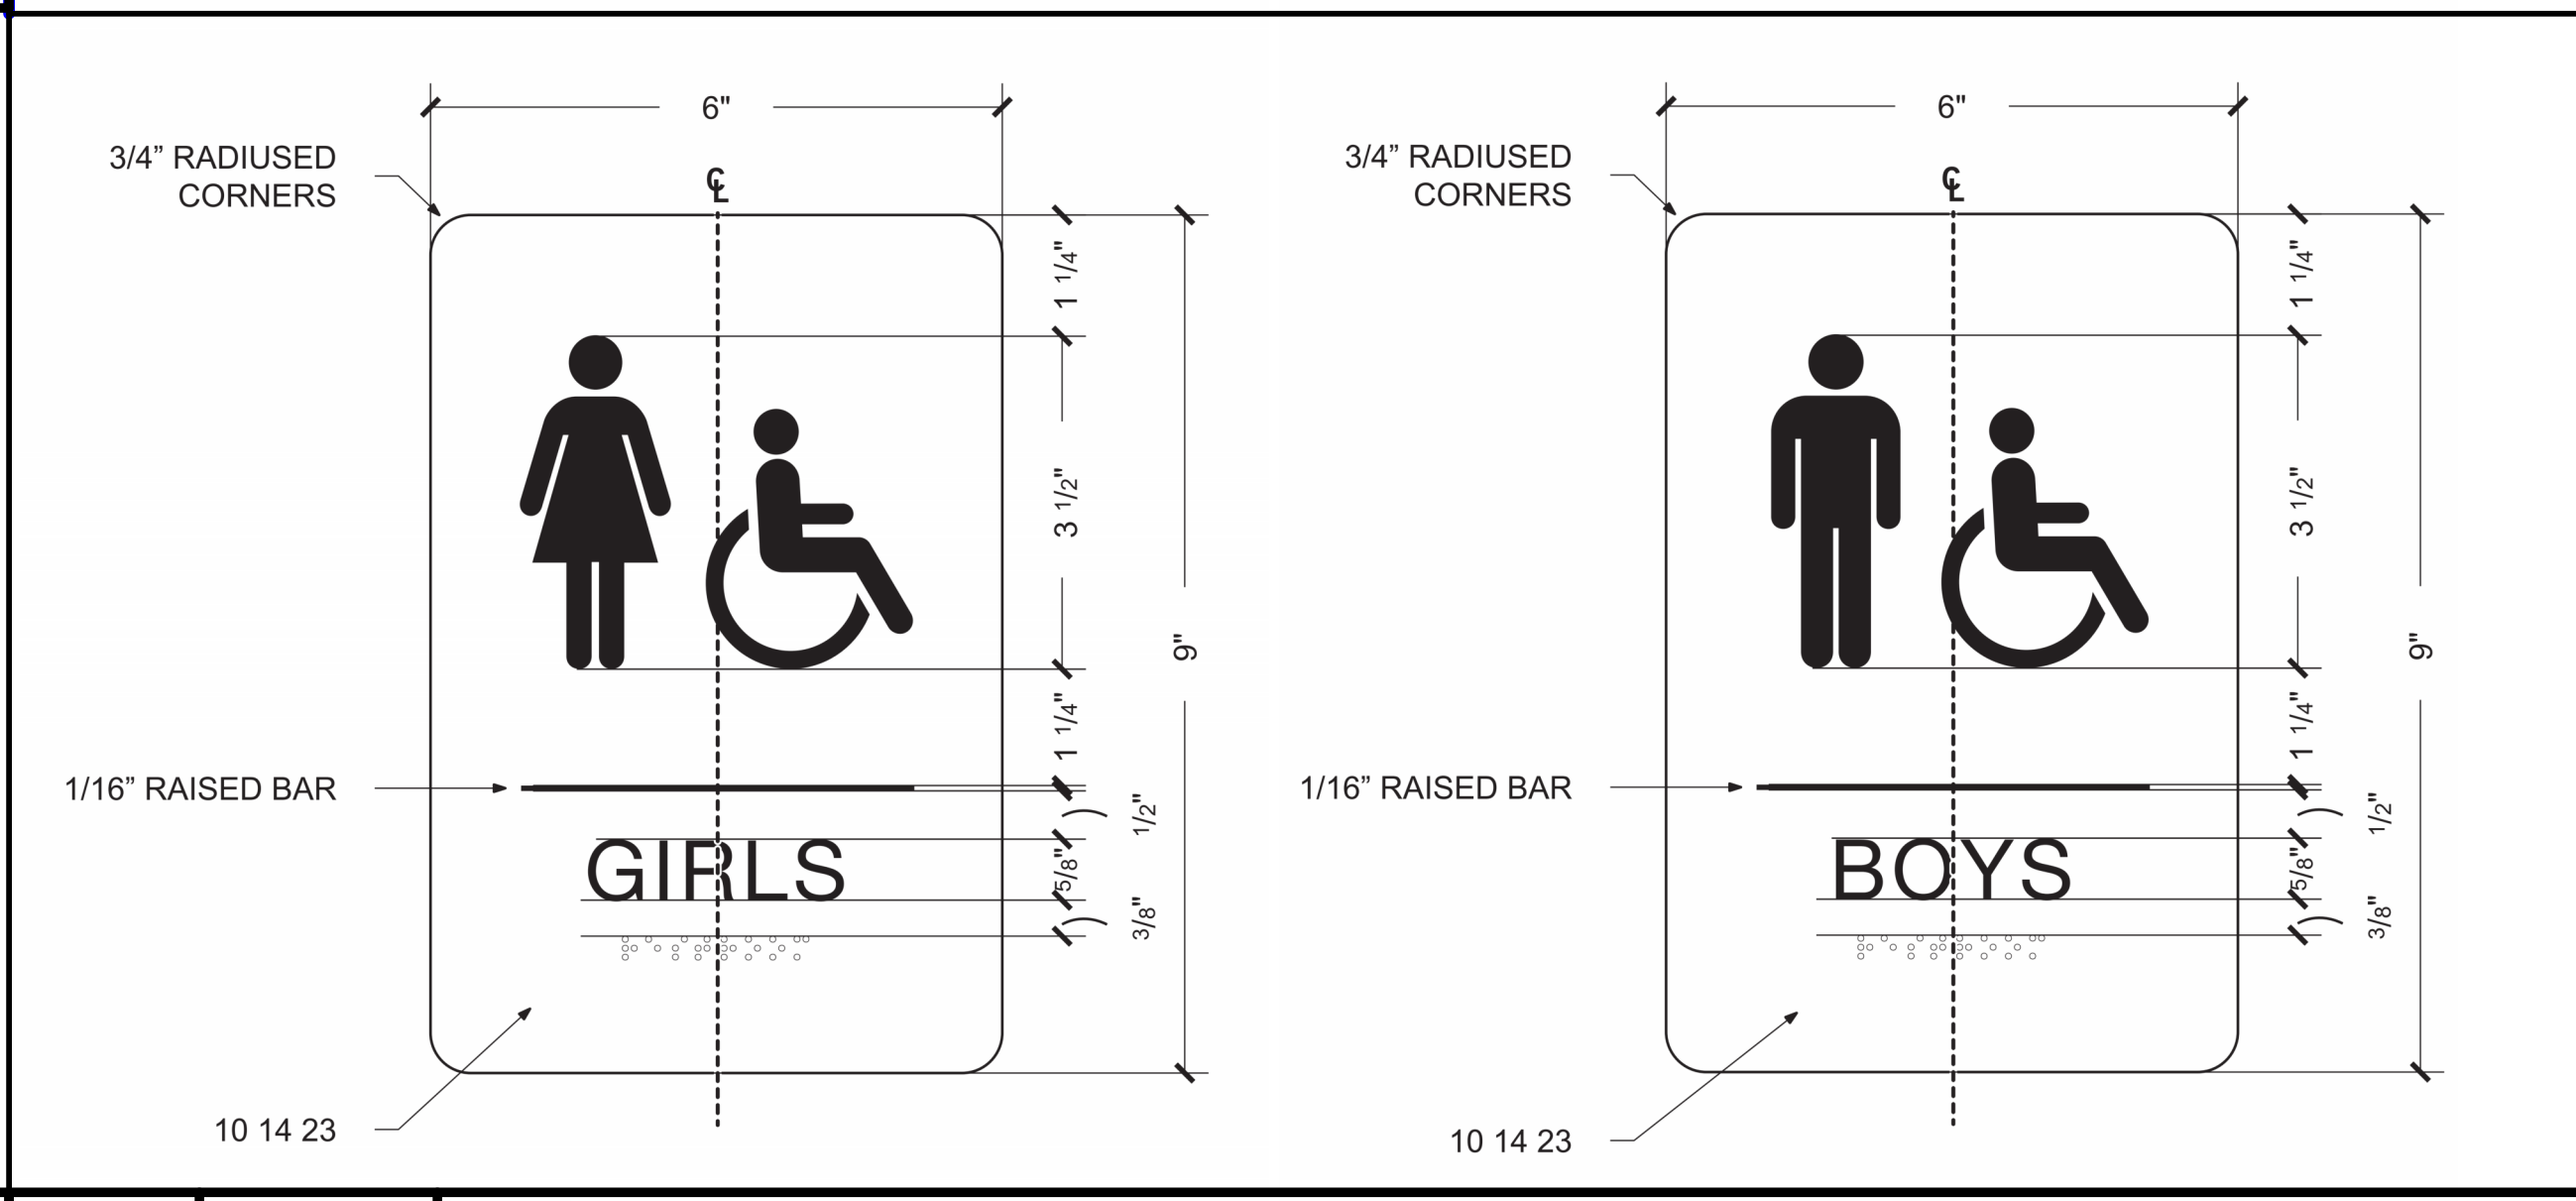ALL DIMENSIONS AND MOUNTING CONDITIONS MUST BE VERIFIED IN THE FIELD PRIOR TO FINAL ARTWORK RELEASE

ALL ATTACHMENTS TO BE CONCEALED UNO. PROVIDE BLOCKING AS REQUIRED FOR SECURE ANCHORAGE. SEE ARCHITECTURAL WALL FOR CONSTRUCTION

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Kansas City, MO 64108
1 816.442.7700

115 Wilcox Street Suite 210
Castle Rock, CO 80104
1 720.949.1689

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Hollis + Miller Architects
Missouri State Certificate of Authority
Architecture #000001
Structure #000001333

Bob D Campbell
Structural Engineer
State Certificate of Authority #000442
4338 Bellevue Ave
Kansas City, MO 64111
816.531.4144 phone

Smith & Boucher, Inc.
Mechanical, Electrical, & Plumbing
State Certificate of Authority #EGC000178
22615 W 103rd Street
Olathe, KS 66061
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MKEC Engineering, Inc.
Civil Engineer
State Certificate of Authority
Engineering #2001009364
Landscaping #2008027139
Surveying #2006027138
11827 W 112th Street, Suite 200
Overland Park, KS 66210
913.317.9390 phone

Peerbolte Creative
Theatrical Consultant
109 E Pine St.
Warrensburg, MO 64093-0752
660.429.1383 phone

Avant Acoustics
AV/Acoustics Consultant
14827 West 95th St
Lenexa, KS 66215
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PROJECT PICTOGRAMS

WOMEN

MEN

TORNADO

South Valley Middle School Storm Shelter Addition

Liberty Public Schools

1000 Midjay Dr, Liberty, MO 64068

REVISIONS:

#	Description	Date

CHECK

SET

JOB NO: 23019

DRAWN BY: MM

CHECKED BY: JCC

DATE: 08.31.2023

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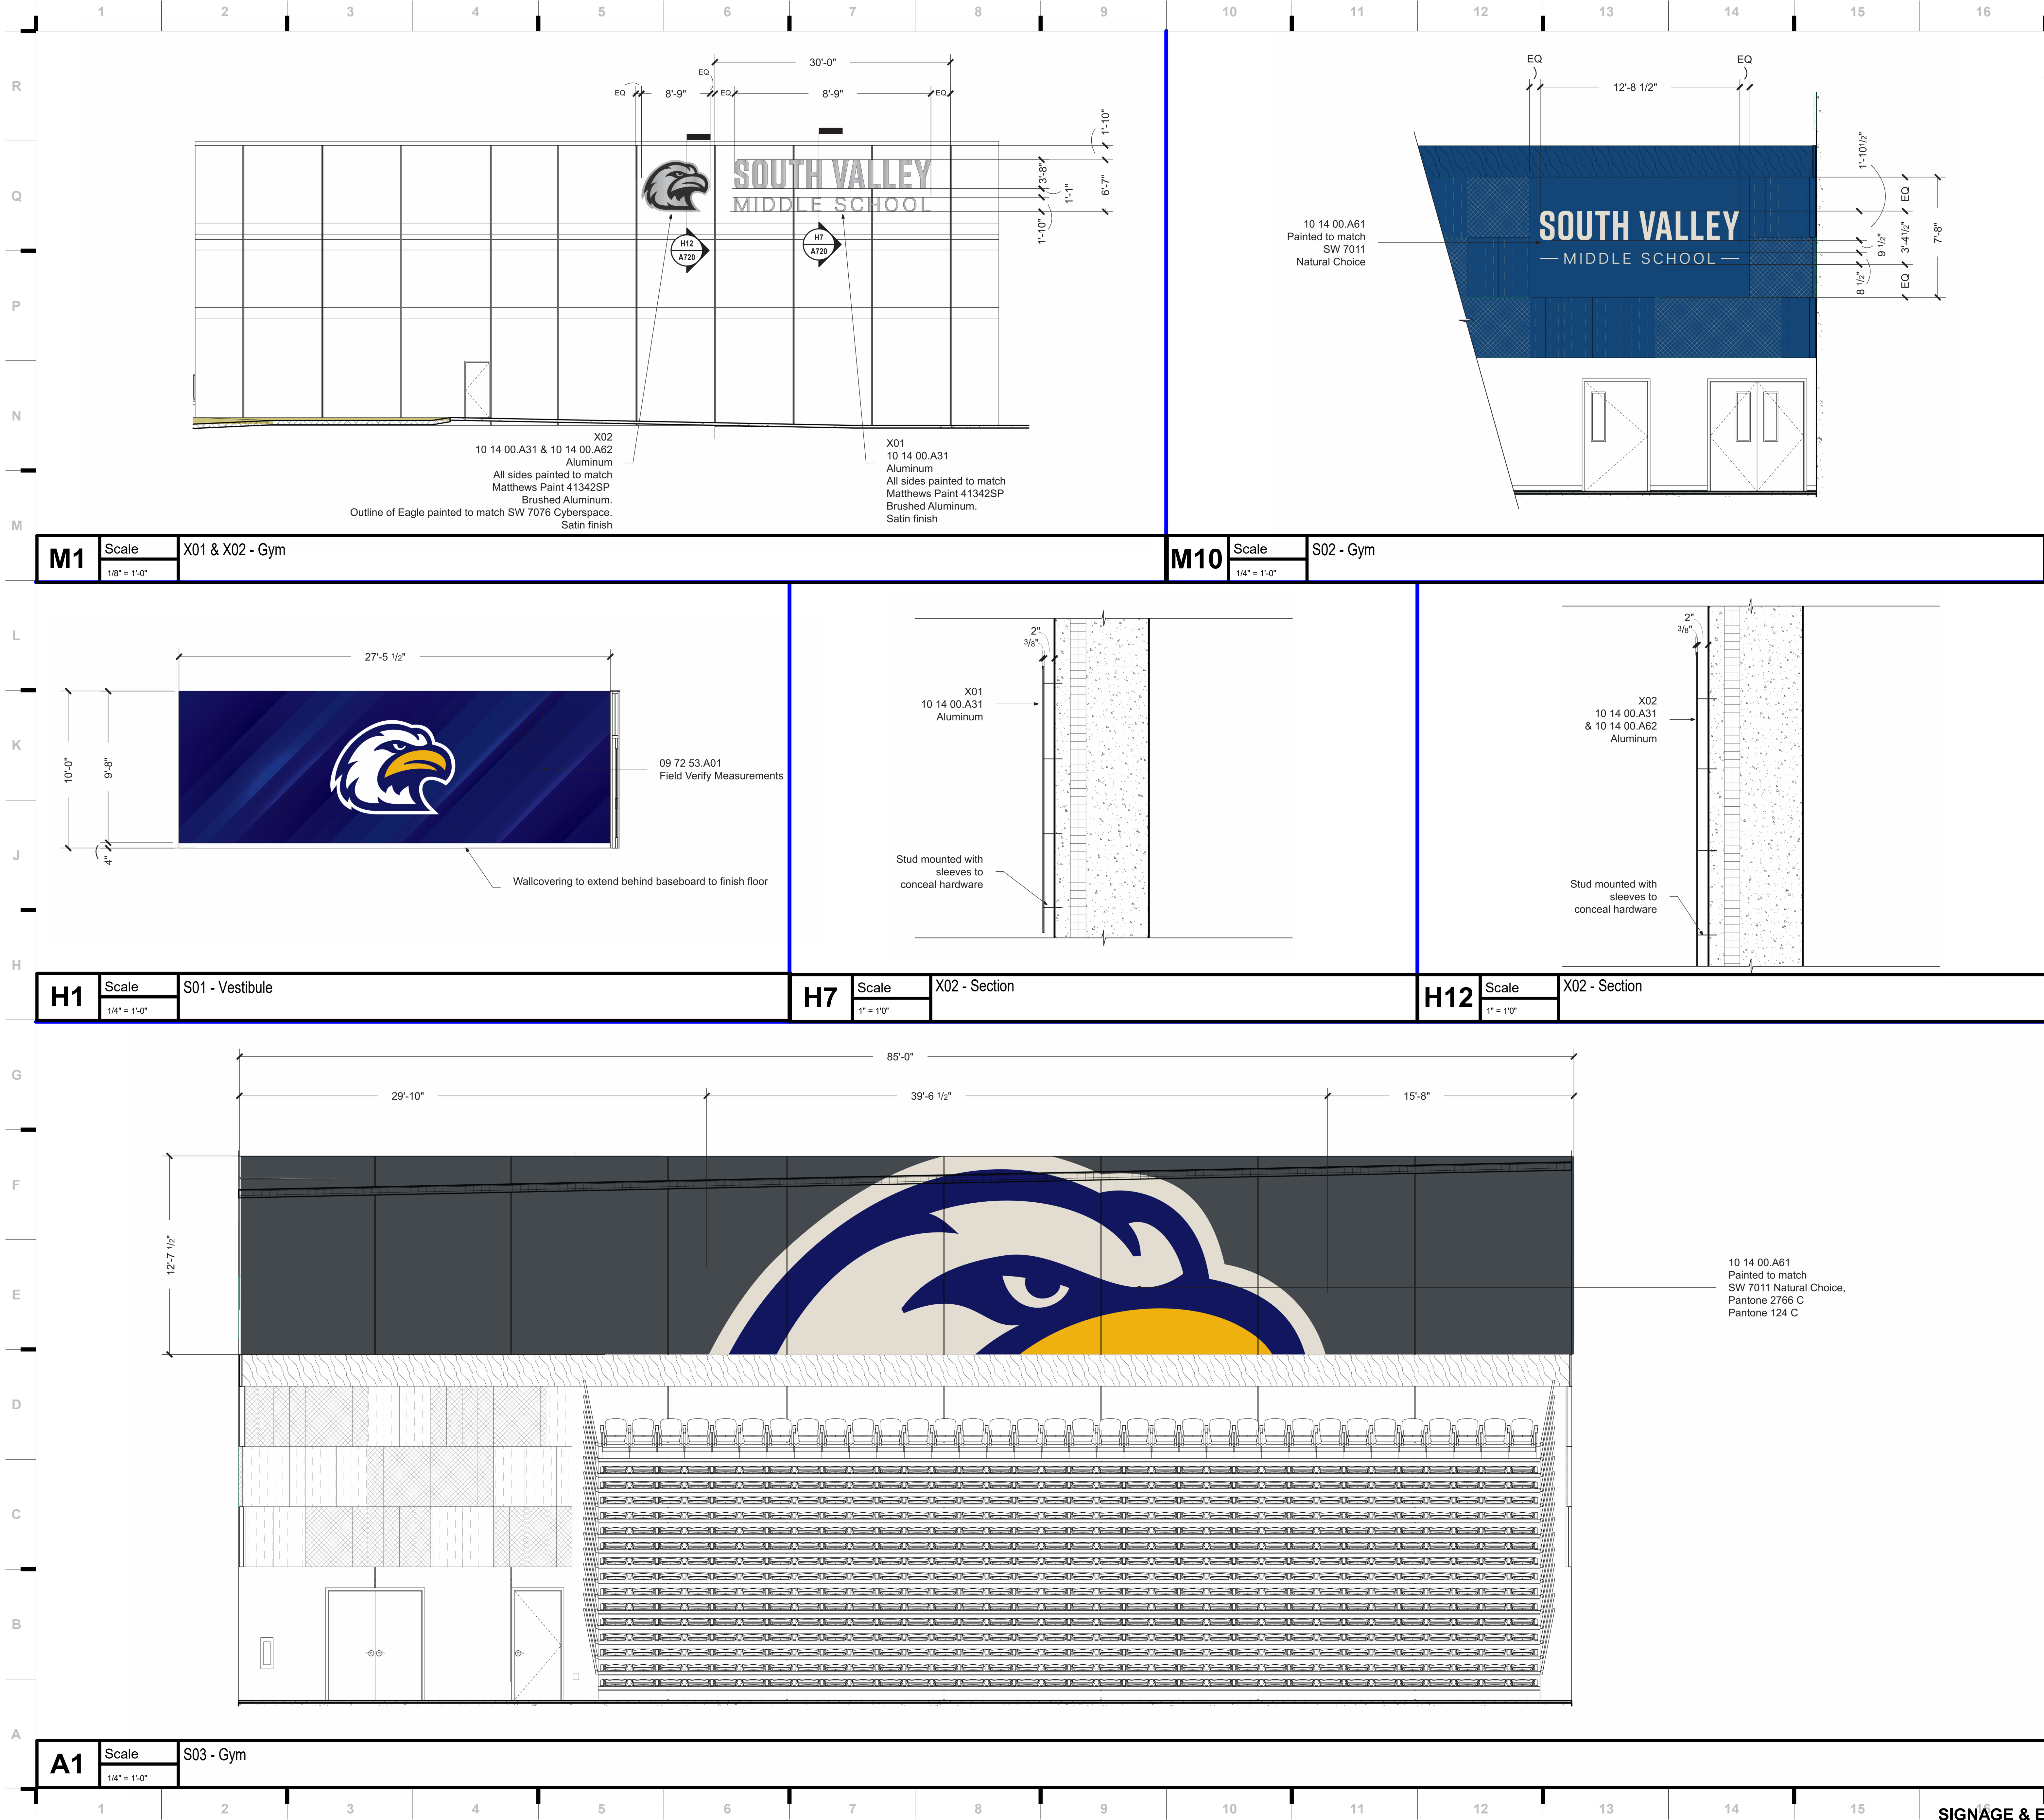
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SHEET KEYNOTE LEGEND

09 72 53.A01 - WALLCOVERING
10 14 00.A31 - CUSTOM FLAT CUT
10 14 00.A61 - HIGH EPOXY PAINT
10 14 00.A62 - EXTERIOR PAINT

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4338 Bellevue Ave
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REVISIONS:

#	Description	Date
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Kevin E. Nelson
A-2019015618
ARCHITECT

OCTOBER 11, 2023

Kevin E. Nelson
A-2019015618

This Professional Address and Email is the only address used by the architect and shall be used for all correspondence. The architect shall not be responsible for any correspondence sent to any other address. The architect shall not be responsible for any correspondence sent to any other address. The architect shall not be responsible for any correspondence sent to any other address.

JOB NO: 23019
DRAWN BY: MM
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GENERAL NOTES - STRUCTURAL

1. General Information

- The contractor shall verify dimensions and conditions before construction and notify the engineer of any discrepancies, inconsistencies, or difficulties affecting the work before proceeding.
- The contractor shall coordinate all disciplines, verifying size and location of all openings, whether shown on structural drawings or not, as called for on architectural, mechanical, or electrical drawings. In the case of work in an existing building the contractor shall scan existing structure to locate all rebar in the area of the new corepening using ground penetrating radar and notify the engineer of record for review prior to coring/cutting. Conflicts, inconsistencies, or other difficulties affecting structural work shall be called to the architect or engineer's attention for direction before proceeding.
- All design and construction work for this project shall conform to the requirements of the following governing design codes:
 - International Building Code (IBC 2018) as amended by the city of Liberty, MO.
 - Minimum Design Loads for Buildings and Other Structures (ASCE7-6)
 - Specification for Structural Steel Buildings (AISC 360-16)
 - Member Design Basis is Allowable Stress Design (ASD)
 - Connection Design Basis is Allowable Stress Design (ASD)
 - Structural Welding Code (AWS D1.3-98)
 - Building Code Requirements for Structural Concrete (ACI 318-14)
 - Building Code Requirements for Masonry Structures (ACI 530-11/TMS 402-11)
 - North American Specification for the Design of Cold-Formed Steel Structural Members (AIS S100/573-1)
- These drawings are for this specific project and no other use is authorized.

2. Structural Load Design Criteria

- Floor Live = 100psf (An allowance of 15psf has been made for partitions as a uniformly distributed live load where the live load stated above is 80psf or less Floor Dead = 5psf
 - Roof Live = 30psf; Roof Collateral Dead = 20psf
 - Snow: Pg = 20psf, Pf = 14psf, Is = 1.0, Ce = 1.0, Cst = 1.0, Drift per ASCE/SEI 7
 - Lateral Loads:
 - Wind: V = 115 mph, Exposure B
Occupancy [Risk] Category II, Iw=1.0 GCp=-0.18
Design wind pressures to be used for the design of exterior component and cladding materials on the designated zones of wall and roof surfaces shall be per section 30.7 and Table 30.7-2 of ASCE/SEI 7. Tabulated pressures shall be multiplied by effective area reduction factors, exposure adjustment factors, and topographic factors where applicable
 - Seismic: Ss = 0.034, S1 = 0.069
Occupancy [Risk] Category II, Iw=1.0
Site Classification C, Sds = 0.082, Sd1 = 0.069
Seismic Design Category B
Basic Seismic Force-resisting System:
Ordinary Reinforced Masonry Shear Walls
Equivalent Lateral Force Procedure
R = 2, Omega = 2%, Cd=1.14
- This project is designed to resist the most critical effects resulting from the load combinations of section 1605.3 of the International Building Code.

3. Concrete

- All concrete for foundations (walls, grade beams, footings and piers) shall develop minimum ultimate compressive design strength of 3500 psi in 28 days, but not less than 500 pounds of cement shall be used per cubic yard of concrete regardless of strengths obtained, not over 6 gallons of water per 100 pounds of cement and not over 4 inches of slump.
- All concrete for interior/floorwork (without floor covering) shall develop minimum ultimate compressive design strength of 4000 psi in 28 days, but not less than 525 pounds of cement shall be used per cubic yard of concrete regardless of strengths obtained, not over 5.75 gallons of water per 100 pounds of cement and not over 4 inches of slump. Concrete mix shop drawing shall contain testing data proving concrete design mix shrinkage is less than 0.034% at 28 days when tested according to ASTM C157 (air drying method only).
- All concrete for interior/floorwork (with floor covering) shall develop minimum ultimate compressive design strength of 4000 psi in 28 days, but not less than 540 pounds of cement shall be used per cubic yard of concrete regardless of strengths obtained, not over 5.40 gallons of water per 100 pounds of cement and not over 4 inches of slump. Concrete mix shop drawing shall contain testing data proving concrete design mix shrinkage is less than 0.034% at 28 days when tested according to ASTM C157 (air drying method only).
- All concrete for exterior/floorwork shall have a minimum design compressive strength of 4500 psi in 28 days, with not less than 560 pounds of cement per cubic yard of concrete, not over 5 gallons of water per 100 pounds of cement, with 6% +/- air entrainment, and a maximum of 4 inches of slump.
- All concrete for columns shall develop a minimum ultimate compressive design strength of 4000 psi in 28 days, but not less than 560 pounds of cement shall be used per cubic yard of concrete regardless of strengths obtained, not over 5 gallons of water per 100 pounds of cement and not over 4 inches of slump.
- The preceding minimum mix requirements may have water-reducing admixtures conforming to ASTM C494 added to the mix at manufacturer's dosage rates for improved workability.
- The preceding minimum mix requirements may be up to 15% maximum of the cement content replaced with an approved ASTM C618 Class C fly ash, provided the total minimum cementitious content is not reduced.
- The use of fly ash is NOT permitted.
- Combined aggregate (coarse plus fine) for all concrete shall be well graded from coarsest to finest with no more than 10 percent and not less than 8 percent retained on an individual sieve, except that less than 8 percent may be retained on coarsest sieve and on No. 50 and finer sieves. Submit this gradation report with the concrete mix design shop drawings.
- All interior concrete slabs on grade shall be placed over 15 mil, Class A Vapor Barrier per ASTM E1745 with at least that 01 perme, tested after mandatory conditioning. All joints shall be lapped and sealed per manufacturer's recommendations. All penetrations, as well as damaged vapor barrier material shall also be sealed per manufacturer's recommendation prior to concrete placement. Install barrier per manufacturer recommended details at all discontinuous edges (at interior columns, exterior edge of slab, etc.) to ensure terms of warranty are followed as prescribed by the project soils report.
- All concrete is reinforced concrete unless specifically called out as unreinforced. Reinforce all concrete not otherwise shown with same steel as in similar sections or areas. Any details not shown shall be detailed per ACI 315 and meet requirements of ACI 318, current editions.
- Control joints in dirt formed slab to be as shown on plans. Where not shown, limit controlled areas to not more than 144 square feet, or 12 feet on any side. Slab panel side ratio shall not exceed 1 1/2 to 1.
- Contractor shall verify that all concrete inserts, reinforcing and embedded items are correctly located and rigidly secured prior to concrete placement.
- Construction joints in beams, slabs, and grade beams shall occur at midspan (middle third) unless noted otherwise. Provide 2 x 4 horizontal keys at construction joints for shear transfer.
- No aluminum items shall be embedded in any concrete.

4. Reinforcing Steel

- All reinforcing steel shall conform to the requirements of ASTM A615 or A706 grade 60 steel. Welded plain wire fabric shall be supplied in sheets and conform to the requirements of ASTM A185.
- Clear coverage of concrete over reinforcing steel shall be as follows:
 - Concrete placed against earth: 3"
 - Formed concrete against earth: 2"
 - Slabs: 1 1/2"
 - Beams or Columns: 2"
 - Other: 2"All coverage shall be nominal bar diameter minimum.
- All dowels shall be the same size and spacing as adjoining main bars (splice lap 48 bar diameters or 24" minimum unless noted otherwise).
- At corners of all walls, beams, and grade beams supply corner bars (minimum 2'-0" in each direction or 48 bar diameters) in outside face of wall, matching size and spacing of horizontal bars. Where there are no vertical bars in outside face of wall, supply 3 - #4 vertical support bars for corner bars.
- Bars marked control shall be lapped and sealed per manufacturer's recommendations (2'-0" minimum) at splices and embedments, unless shown otherwise. Splice top bars near midspan and splice bottom bars over supports, unless noted otherwise.
- At all holes in concrete walls and slabs add 2 - #5 bars (opening dimension plus 96 diameters long) at each of four sides and add 2 - #5 x 5'-0" diagonally at each of four corners of hole. Openings in 8" thick walls are reinforced similar, but with 1 - #5 instead of 2 - #5, respectively.
- Unless otherwise covered on architectural plans or specifications, vertical control joints in concrete wall shall be spaced at a maximum of 20'-0" on center and coordinated with the architect. Every other horizontal wall reinforcing bar shall be discontinuous at control joints except heavy top and bottom bars unless noted otherwise. Provide base seal waterproof style number 772 (by Greenstreak Inc. or approved equal) on dirt face side of wall at all walls below grade.
- Accessories shall be as specified in latest edition of the ACI Detailing Handbook and the concrete Reinforcing Steel Institute Design Handbook. Maximum accessory spacing shall be 4'-0" on center, and all accessories on exposed surfaces are to have plastic coated feet.
- All slabs and stairs not shown otherwise shall be 6" thick with #4 bars at 12" on center each way. All exterior porches and stoops not otherwise detailed may be constructed in any standard manner, solid or hollow, but must be reinforced with #4 bars at 12" on center each way minimum. Porches shall be dowelled to adjacent walls or grade beams with #4 bars at 12" on center, hooked or embedded 48 diameters into both members. Slope porches 1/8" per foot for drainage unless noted otherwise.

5. Structural Steel

- All structural steel beams and columns shall be ASTM A992, grade 50 steel and all miscellaneous steel shapes shall be ASTM A36 grade steel (except at moment connections where plates shall be ASTM A572, grade 50). Hollow Structural Sections (HSS) shall be ASTM A500, grade C. Fabrication and erection shall be in accordance with AISC 303-05 Code of Standard Practice for Steel Buildings and Bridges in the 13th Edition of the AISC Steel Construction Manual.
- All welding shall conform to the recommendations of the AWS.
- All structural steel and connections, 1/2" of 1/8" fillet weld each side (minimum).
- All bolts shall be otherwise specified shall be 3/4" diameter high strength (ASTM A325-N). All bolts shall be fully pretensioned. All beam connections shall be designed per the AISC Manual of Steel Construction "Frame Beam Connections" for the indicated reactions or at least 0.4 x beam total shear capacity, Vn/Omega, shown in the maximum total uniform load table, whichever is greater, and, shall account for the state the project is located and shop drawings and connection calculations shall bear higher seal.
- All anchor bolts shall be 3/4" diameter, ASTM F1554, Grade 36 unless noted otherwise. Washers of minimum size and thickness for the given anchor diameter in Table 14-2.2 of the AISC Steel Construction Manual shall be provided at every column anchor bolt. Washers shall have a standard size hole for the anchor bolt. At braced frames washers shall be welded all around to the column base plate with 3/16" fillet weld.
- Design, fabrication and erection of all open-web bar joists shall comply with the recommendations of The Steel Joist Institute (SJI). Joists shall be designed to support loads given in the standard load tables of SJI Specs and Tables plus an additional point load of 200 lbs. on the top or bottom chord on structural steel without additional web reinforcing.
- All K-series joists shall bear 2'-1/2" minimum on anchor steel beams and be welded to the beams with 1 1/2" of 1/8" fillet weld each side (minimum).
- All K-series joists bearing on masonry walls shall have 6" x 3/8" x 6" bearing plates set in bond beams. Bearing plates shall be located not more than 1/2" from the face of the wall on the bearing side. Joists shall bear 4" minimum on bearing plates and be welded to beams or bearing plates with 2'-1/2" of 1/8" fillet weld each side (minimum).
- Steel joists shall be designed for 20psf net uplift resulting from wind loading as measured 12ft. from a building corner, 15psf net uplift as measured 8ft. from the leading edge, and 10psf net uplift as measured 12ft. from the leading edge.
- All openings in steel joist roof to have 3x3x1/4 angle frame set between joists. Support mechanical equipment with 4x4x5/16 angles laid between joists from 4x4x5/16 angles (length equals mechanical equipment plus 4 inches at each end and next panel point) laid parallel to and welded to top and/or bottom chord of joists to distribute load to joint panel points.
- All steel joists shall have a midspan camber approximately equal to that recommended by The Steel Joist Institute Specifications.
- Design and installation of steel decking shall comply with the recommendations of the Steel Deck Institute (SDI). All decking shall be galvanized unless noted otherwise.

6. Post Installed Anchors

- Post-installed anchors shall be used only where specified on the drawings unless approved in writing by the engineer of record. See drawings for anchor diameter, spacing and embedment. Performance values of the anchors shall be obtained for specified products using appropriate design procedures and/or standards as required by the governing building code. Anchors installed in concrete shall have an ICC-ES Evaluation Service Report. Special inspection is required for all post installed anchors. The contractor shall coordinate an on-site meeting with the post installed anchor manufacturer field representative to educate the construction team on the anchor installation guidelines and requirements.
- Mechanical anchors used in cracked and uncracked concrete shall have been tested and qualified for use in accordance with ACI 308.2 and ICC-ES AC108. All anchors shall be installed per the anchor manufacturer's written instructions.
- Adhesive anchors used in cracked and uncracked concrete shall have been tested and qualified for use in accordance with ICC-ES AC308. All anchors shall be installed per the anchor manufacturer's written instructions.
- Mechanical anchors used in solid grouted masonry shall have been tested and qualified for use in accordance with ICC-ES E-1001. All anchors shall be installed per the anchor manufacturer's written instructions.
- Adhesive anchors used in solid grouted masonry shall have been tested and qualified for use in accordance with ICC-ES AC08. All anchors shall be installed per the anchor manufacturer's written instructions.
- Fanchors used in hollow concrete masonry shall have been tested and qualified in accordance with ICC-ES AC108 or ICC-ES AC08 as appropriate. All anchors shall be installed per the anchor manufacturer's written instructions with appropriate screen tubes used for adhesives.

7. Foundations

- The soil investigation was prepared by Kruger Technologies, Inc., the report number is 223117G and the telephone number is 913-488-1114.
- Spread footings, grade beams, and retaining walls are designed to bear on engineered fill or undisturbed soil capable of safely sustaining 2,000 psf.
- Retaining walls are designed for an active lateral load of 40 pc equivalent fluid pressure. Contractor shall provide for dewatering at excavations from either surface water or seepage.
- All foundation excavations shall be inspected by a qualified soil engineer, approved by the architect and/or structural engineer, prior to placement of soil or concrete. This inspection shall be at the owner's expense.
- Fanchors in the structural portion retaining the backfill shall have attained its design strength prior to being backfilled.
- Moisture content in soils beneath building locations should not be allowed to change after footing excavations and after grading for slabs on grade are completed. If subgrade materials become desiccated or softened by water or other conditions, recompacted materials to the density and water content specified for engineered fill. Do not place concrete on frozen ground.

8. Concrete Masonry Units

- Concrete block used in exterior walls or load bearing walls shall meet the requirements of ASTM C90 and have a minimum net compressive strength of 2650 psi and laid up using type N mortar such that f'm equals 2000 psi. Mortar shall be volume proportion based cement lime mortar. Proportioning shall be completed by block measure. Any block in contact with earth shall be normal weight units, laid using type "S" mortar and grouted solid.
- The contractor shall provide adequate temporary bracing for all masonry walls during construction.
- All concrete block shall have 9 gage (or larger) horizontal joint reinforcing (ladder or truss) per architectural drawings and specifications (16" maximum vertical spacing).
- Cavity wall construction shall be reinforced as designed for specific concrete block used. The horizontal joint reinforcing shall be of the ladder or truss style per specification and continuous between brick and block, as prescribed by the architectural drawings.
- Concrete block shall be reinforced as follows in 6", 8", 10", and 12" walls:
 - Vertical reinforcing shall be a minimum of 1 - #4 bar in 6" and 8" walls and 2 - #4 bars in 10" and 12" walls at 4'-0" on center, at each corner, at each door and window jamb, each side of control joints and in the end void of each length of wall. Lap splices for masonry vertical reinforcing shall be 48 bar diameters, 24" minimum.
 - Horizontal reinforcing:
 - Horizontal joint reinforcing as noted above.
 - Continuous horizontal bars shall be indicated per section or detail in bond beam or optional running bond beam where noted. Where bond beams are continuous at corners of walls, supply corner bars matching size of horizontal bars (minimum 2'-0" or 40 bar diameters in each direction).
 - GROUT, where noted above, shall have a minimum design ultimate compressive strength of 2500 psi at 28 day test and 3/8" maximum aggregate size.
 - Non-load bearing concrete block walls shall be isolated from adjacent structural elements with vertical 3/8" control joints and at the top of the wall with 1" air space or compressible material and support per architectural detail.
 - Unless otherwise covered on architectural plans or specifications, vertical control joints in masonry of construction shall be 3/8" wide, full height of wall. Joints shall be spaced at a maximum of 24'-0" on center and coordinated with the architect. All horizontal joint reinforcing shall be discontinuous at control joints in masonry. All bond beam horizontal reinforcing shall be continuous through control joints.
 - Lintels over all openings up to 6'-0" wide in new and existing masonry walls not otherwise covered shall be one 6x3 1/2x2x16 angle for each 4" width of masonry. All exterior lintels to be galvanized.
 - Walls shall be anchored top and bottom by dowels matching wall vertical reinforcing(unless noted otherwise) from floor slab bottom and bracing angles at the top, per details on the drawings.

9. Light Gage Metal Structural Framing

- All load bearing, light gage structural studs, track, and bridging shall be of the type, size, gage, and spacing as shown on the plans, minimum.
- All materials shall be 33,000 psi minimum yield, except studs of 16 gage or heavier shall have a minimum yield of 50,000 psi.
- All products and materials shall be in accordance with latest editions of the AISI "Specifications for the Design of Cold-Formed Structural Members."
- All framing components shall be cut squarely or at an angle to fit squarely against supporting steel and connections. Spacing of axially loaded members is not permitted. Members shall be held firmly in place until properly fastened. Attachments of similar components shall be by welding, screw fastening, or bolting. Wire tying of components is not permitted.
- Tracks shall be securely anchored to floor and overhead members. Special anchorage requirements required for wind bracing shall be as shown on the plans.
- Prior to fabrication and erection of the structure, the contractor shall submit shop drawings, complete with detail of erection, fabrications, attachments, anchorages, lintels, etc., for review by the architect/engineer.
- Shipment, handling, and erection of trusses shall be by experience, qualified persons and shall be performed in a manner so as not to endanger life or property. Apparent truss damage shall be reported to the truss manufacturer for evaluation prior to erection. Cutting or alteration of trusses is not permitted without written authorization from the truss manufacturer. Contractor shall coordinate truss layout for openings and penetrations required by other trades including plumbing, HVAC, electrical, roof access hatches, chases, etc.

10. Precast Concrete Members

- The contractor/supplier is responsible for the design of all the precast members and connection between them and other structural members. Submit design calculations, sealed by an engineer licensed in the state of the project location, for review by the architect/engineer of record.
- All precast members are to be designed in accordance with ACI 318-14, 2018 IBC and other applicable codes, standards (see specs) and design criteria shown on design drawings.
- Precast concrete members shall conform to the 2018 IBC for the required fire ratings (refer to architects documents).
- All wall panels should be designed for building wind loads, seismic loads, gravity loads, and transmit these loads to the foundation through properly designed connections.
- Provide blockouts and openings for mechanical/electrical equipment. Refer to mechanical/electrical drawings.
- Shop drawings shall be complete and shall include a layout plan, fabrication details, estimated camber, connection and anchorage details and member identification marks. Identification marks shall appear on manufactured units to facilitate correct field placement.
- Precast supplier shall design and all components to meet the requirements of the ICC500-2014 code.

11. Deferred Submittal and Shop Drawing

- Bob D. Campbell and Company, Inc. will review the General Contractor's (GC) shop drawings and related submittals (as indicated below) with respect to the ability of the detailed work, when complete, to be a properly functioning integral element of the overall structural system designed by Bob D. Campbell and Company, Inc.
- Deferred submittals shall be submitted to the architect of record for review who shall forward to the building official for review and approval. Design calculations for deferred submittals shall be submitted with the submittals as the shop drawings for review. Design calculations shall be prepared and sealed by a Professional Engineer licensed in the state of the project. The deferred submittal items shall not be installed until the deferred submittal items have been reviewed and approved by the building official.
- Prior to submittal of a shop drawing or any related material to Bob D. Campbell and Company, Inc., the GC shall:
 - Review and ensure for conformance with the means, methods, techniques, sequences and operations of construction and safety precautions and programs incidental thereto, all of which are the sole responsibility of the GC.
 - Review and ensure for conformance with the means, methods, techniques, sequences and operations of construction and safety precautions and programs incidental thereto, all of which are the sole responsibility of the GC.
 - Stamp each submission as approved.
- Bob D. Campbell and Company, Inc. shall assume that no submission comprises a shop drawing or related material (if any) required are indicated below.
- Bob D. Campbell and Company, Inc. shall review shop drawings and related materials with the architect and structural engineer, prior to the above requirements. Bob D. Campbell and Company, Inc. shall return without comment unrequired material or submissions without GC approval stamp.
- Shop drawings and related material (if any) required are indicated below. Should Bob D. Campbell and Company, Inc. require more than ten (10) working days to perform the review, Bob D. Campbell and Company, Inc. shall not notify the GC.
- Concrete mix designs and material (if any) required are indicated below and compounds applied to the concrete after placement.
- Reinforcing steel shop drawings including erection drawings and bending details. Bar list will not be reviewed for correct quantities, admixtures and compounds applied to the concrete after placement.
- GROUT mix designs (for CMU).
- Construction and control joint plans and/or elevations.
- Structural steel shop drawings including erection drawings and piece details. Include joint, decking and connector submittals. Include miscellaneous framing specified on the structural drawings, but do not submit framing specified on non-structural drawings for Bob D. Campbell and Company, Inc. review.
- Deferred Submittal: Structural steel.
- Deferred Submittal: Railings and guardrails
- Deferred Submittal: Metal stair framing
- Deferred Submittal: Exterior cold-formed metal framing shop drawings and design calculations
- Deferred Submittal: Exterior curtain wall
- Deferred Submittal: Structural steel connection design calculations submitted concurrently with structural steel shop drawings.
- Miscellaneous anchors shown on the structural drawings.
- Deferred Submittal: Precast concrete shop drawings including erection drawings and connection details.
- Deferred Submittal: Precast concrete design calculations.

12. Statement of Structural Special Inspections

- The structural design for this project is based on completion of special inspections during construction in accordance with section 1704 of the International Building Code. The owner shall employ one or more qualified special inspectors to provide the required special inspections.
- The special inspector shall furnish inspection reports to the building official, owner, architect and structural engineer, and any other designated person.
- All discrepancies shall be brought to the immediate attention of the contractor for correction, then, if uncorrected, to the proper design authority, building official and structural engineer.
- The special inspector shall submit a final signed report stating that the work requiring special inspection was, to the best of the inspector's knowledge, in conformance with the approved plans and specifications and the applicable workmanship provisions of the building code.
- The following inspections and tests are required with the frequency (continuous or periodic) as defined within the referenced section or standard listed below. The General Contractor shall provide notification to the inspector when items requiring inspection are ready to be inspected and provide access for those inspections.
 - Shop Fabrication - structural steel and steel bar joist per Section 1704.2.5 unless AISC certified shop
 - Shop Fabrication - precast concrete per Section 1704.2.5 unless PC certified shop
 - Steel Construction per Section 1705.2 and the quality assurance requirements of AISC 341 Chapter J (as referenced by AISC 360)
 - Cold-Formed Steel Deck per Section 1705.2.2 and the quality assurance requirements of SDI QA/QC.
 - Cold-formed steel trusses spanning 80 feet or greater per Section 1705.2.2.2
 - Concrete Construction per Section 1705.3 and Table 1705.3
 - Reinforcing Steel Welding
 - Reinforcing Steel Placement
 - Design Mix Verification
 - Concrete Sampling and Testing
 - Concrete Placement
 - Concrete Curing
 - Erection of Precast
 - Formwork Shape, Location and Dimensions
 - Masonry Construction per Section 1705.4 and the quality assurance requirements of TMS 602 Level 2.
 - Verification of Soils per Table 1705.6

13. Copyright and Disclaimer

- All drawings in the structural set (S-series drawings) are the copyrighted work of Bob D. Campbell and company, Inc. These drawings may not be photographed, traced, or copies in any manner without the written permission of Bob D. Campbell and Company, Inc. Exception: Original drawings may be printed for distribution to the owner, architect, and general contractor for coordination, bidding, and construction. Subcontractors may not reproduce these drawings for any purpose or in any manner.
- I, Wayne E. Davis, P.E., registered engineer and a representative of Bob D. Campbell and Company, Inc., do hereby accept professional responsibility as required by the professional registration laws of this state for the structural design drawings consisting of S-series drawings. I hereby disclaim responsibility for all other drawings in the construction document package, they being the responsibility of other design professionals whose seals and signed statements may appear elsewhere in the construction document package.

STRUCTURAL ABBREVIATIONS

@ AND
Ø ROUND, DIAMETER
ADTL ADDITIONAL
AFF ABOVE FINISHED FLOOR
ALT ALTERNATE
ARCH ARCHITECTURAL
BLDG BUILDING
BT BOTTOM OF
BM BEAM
BOT BOTTOM
BRG BEARING
CMB CAMBER
CD-# CONCRETE DECK TYPE
CJ COMPLETE JOINT PENETRATION
CL CENTERLINE
CMU CONCRETE MASONRY UNIT
COL COLUMN
CONN CONNECTION
CONC CONCRETE
CONN CONNECTION
COORD COORDINATE
COV, C/R COVER
DBL DOUBLE
DET DETAIL
DIA DIAMETER
DIM DIMENSION
DL DEAD LOAD
DWG DRAWING
EA EACH
EF EACH FACE
EJ EXPANSION JOINT
EL, ELEV ELEVATION
EMBED EMBEDMENT, EMBEDDED
ENGR ENGINEER
EOU EDGE OF DECK
EOR ENGINEER OF RECORD
EOS EDGE OF SLAB
EQAL EQUAL
EQUIP EQUIPMENT
EXT EXTERIOR
EXTG, EXIST EXISTING
FDN FOUNDATION
FIN FINISH
FLR FLOOR
FS FAR SIDE
FTG FOOTING
FV FIELD VERIFY

AT AND
ROUND, DIAMETER
ADTL ADDITIONAL
AFF ABOVE FINISHED FLOOR
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BASE PLATE SHAPE (NOT TO SCALE)

EXTERIOR METAL STUD SCHEDULE		
FLOOR	TYP. STUD SIZE & SPACING	
1st	6", 16ga @ 16"o.c. (1 5/8" FLANGE)	

NOTE:

1. STUDS NOTED ABOVE ARE MINIMUM SIZE REQUIRED.
2. STUDS SUPPLIER SHALL DESIGN WALL FRAMING COMPONENTS AND ALL CONNECTIONS. SUBMIT SEALED SHOP DRAWINGS AND CALCULATIONS FOR REVIEW.

Structural Foundation Schedule					
NOTE: 1) EXTERIOR FOOTINGS OR FOOTING AT GRADE BEAM SHALL MATCH GRADE BEAM DEPTH AND BE PLACED WITH GRADE BEAM. PROVIDE SPECIFIED REBAR TOP AND BOTTOM WITH # 4 STANDEES TO SUPPORT MATS. 2) PROVIDE REINFORCING PER SCHEDULE EACH WAY IN TOP OF FTG. AT GRADE BEAM, PROVIDE MOMENT FRAME AND BRACED BAY COLUMNS. 3) CENTER FOOTINGS ON COLUMNS AND/OR WALL CENTER LINES PER PLAN UNLESS NOTED OTHERWISE (U.N.O.).					
Type Mark	Length	Width	Footing Thickness	Bottom Bars	Quantity (E.W. Bott)
4.0	4'-0"	4'-0"	1'-0"	Rebar: # 4	8
4.0A	4'-0"	4'-0"	2'-8"	Rebar: # 4	8
4.0B	4'-0"	4'-0"	3'-0"	Rebar: # 4	8


ASCE 7-16 BASIC LOAD CASE 1.0W COMPONENT AND CLADDING WIND PRESSURE DIAGRAM NOTES:

1. REFER TO GENERAL NOTES FOR WIND LOAD DESIGN CRITERIA.
2. POSITIVE LOADS ACT IN A PERPENDICULAR DIRECTION TOWARDS THE SURFACE. NEGATIVE LOADS ACT IN A PERPENDICULAR DIRECTION AWAY FROM THE SURFACE.
3. WIND LOADS CALCULATED ARE BASED ON THE PROVISIONS OF ASCE 7. VALUES SHOWN ARE DETERMINED ASSUMING AN ENCLOSED BUILDING WITH AN INTERNAL PRESSURE COEFFICIENT $i = +0.18$. WIND SPEED $V = 140$ KNOTS. EXPOSED BASIC LOAD CATEGORY 1.
4. LINEAR INTERPOLATION IS PERMITTED FOR TRIBUTARY AREAS BETWEEN VALUES GIVEN IN TABLE 6.4.5 OF ASCE 7. PERMITTED FOR EXPOSURE CATEGORIES C OR D $0.4Kz$, BUT NOT LESS THAN 4 PERCENT OF THE LEAST HORIZONTAL DIMENSION OR 3 FT.
5. FIGURES SHOWN ARE ILLUSTRATIVE ONLY AND ARE NOT INTENDED TO DEPICT THE ACTUAL STRUCTURE.
6. ALL DESIGNERS USING THIS WIND LOAD DIAGRAM MUST INDEPENDENTLY VERIFY THE PRESSURE COEFFICIENTS ON THE APPLICATION OF THE FOLLOWING CONDITIONS:
 - a. ROOF PRESSURES ARE FOR FLAT ROOF ONLY. WIND LOADS FOR THE DESIGN OF SLOPED ROOFS (WITH ANGLES GREATER THAN 10 DEGREES) SHALL BE OBTAINED USING THE PROVISIONS OF ASCE 7-16.
 - b. PARAPETS SHALL BE DESIGNED FOR COMBINED AND CLADDING LOADS PER ASCE 7-16.
7. 9.12.4.4. PARAPET 3'-0" OR HIGHER: TREAT THE TOP SURFACE OF THE PARAPET OF THE ROOF ZONE 3 MAY BE TREATED AS ZONE 2 ROOF PRESSURE AND EXPOSURE C.


COLUMN BASE PLATE AND ANCHOR-ROD CRITERIA				
ANCHOR-ROD DIAMETER	MAX. BASE PLATE HOLE DIAMETER	MIN. PLATE WASHER SIZE	MIN. PLATE WASHER THICKNESS	EMBEDDED ANCHOR PLATE SIZE
3/4"	1 5/16"	2"	1/4"	1/2"x2 1/2"x2 1/2"
7/8"	1 9/16"	2 1/2"	5/16"	1/2"x2 1/2"x2 1/2"
1"	1 7/8"	3"	3/8"	5/8"x3"x3"
1 1/4"	2 1/8"	3 1/2"	1/2"	5/8"x3 1/2"x3 1/2"
1 1/2"	2 3/8"	4"	1/2"	5/8"x3 1/2"x3 1/2"
1 3/4"	2 7/8"	4 1/2"	5/8"	3/4"x3 1/2"x3 1/2"
2"	3 1/4"	5"	3/4"	3/4"x3 1/2"x3 1/2"
2 1/2"	3 3/4"	5 1/2"	7/8"	3/4"x3 1/2"x3 1/2"

NOTES:

1. HOLE SIZES PROVIDED ARE BASED ON ANCHOR ROD SIZE AND CORRELATE WITH ACI 117 (ACI, 2010).
2. CIRCULAR OR SQUARE WASHERS MEETING THE WASHER SIZE ARE ACCEPTABLE.
3. HOLE IN PLATE WASHER SHALL BE 1/16" LARGER THAN ANCHOR DIAMETER.

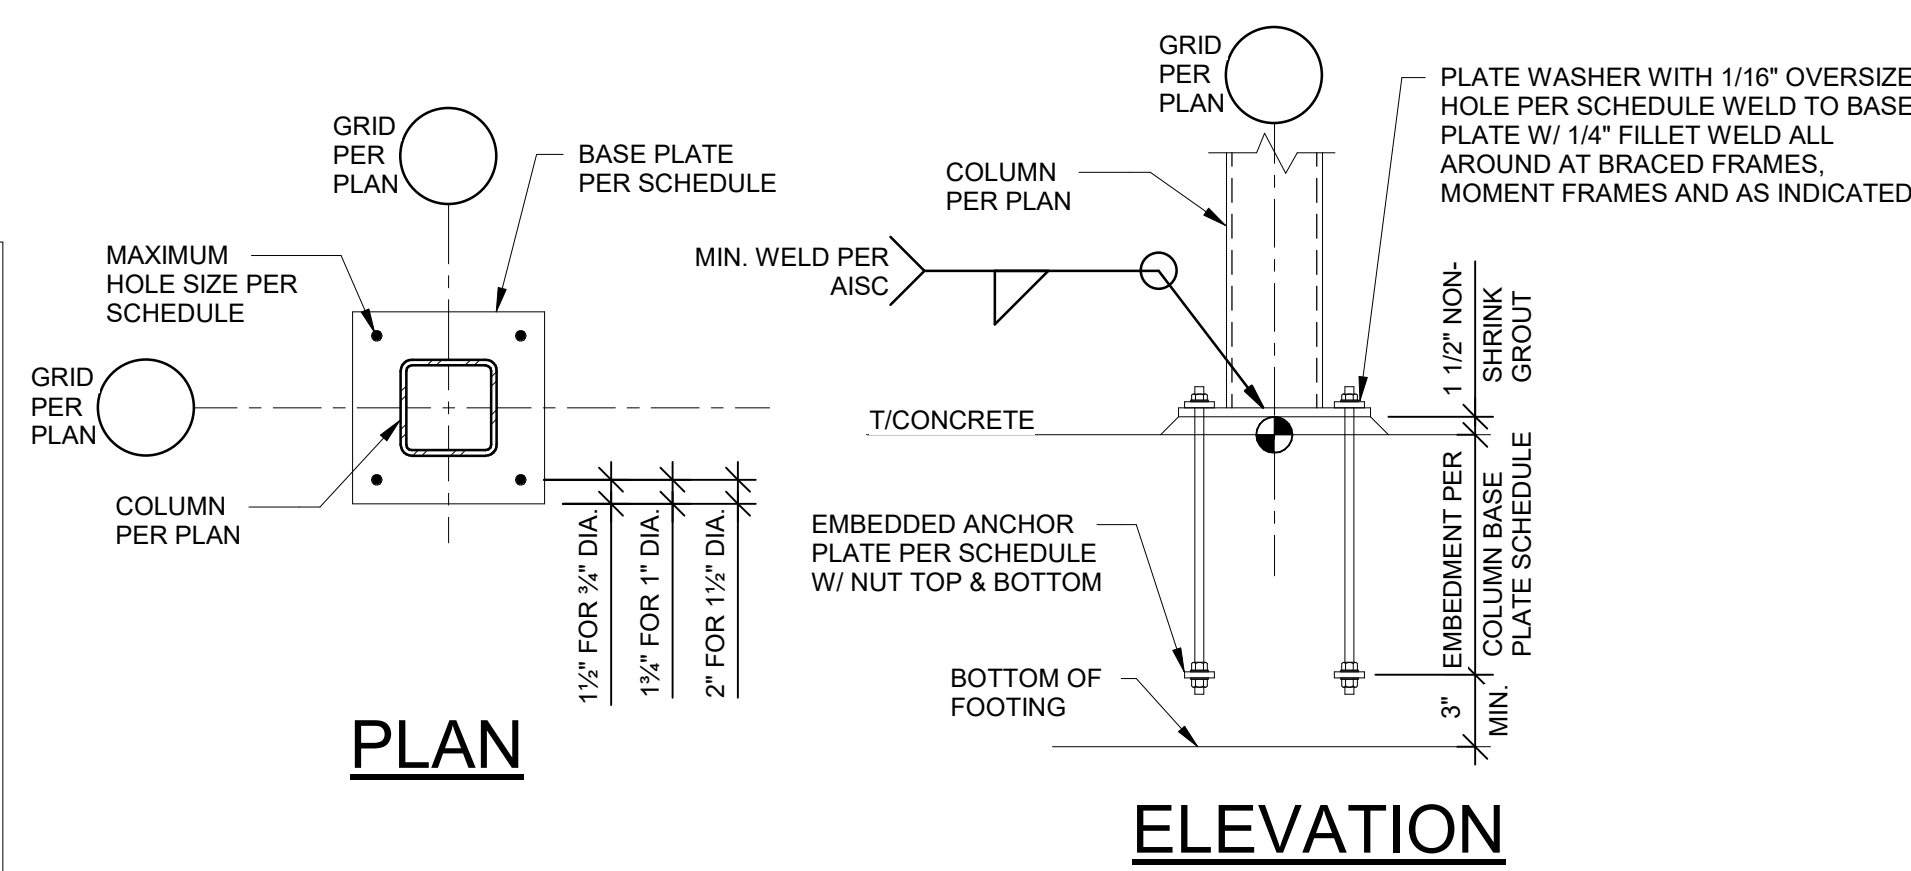

1 TYPICAL BASE PLATE DETAIL

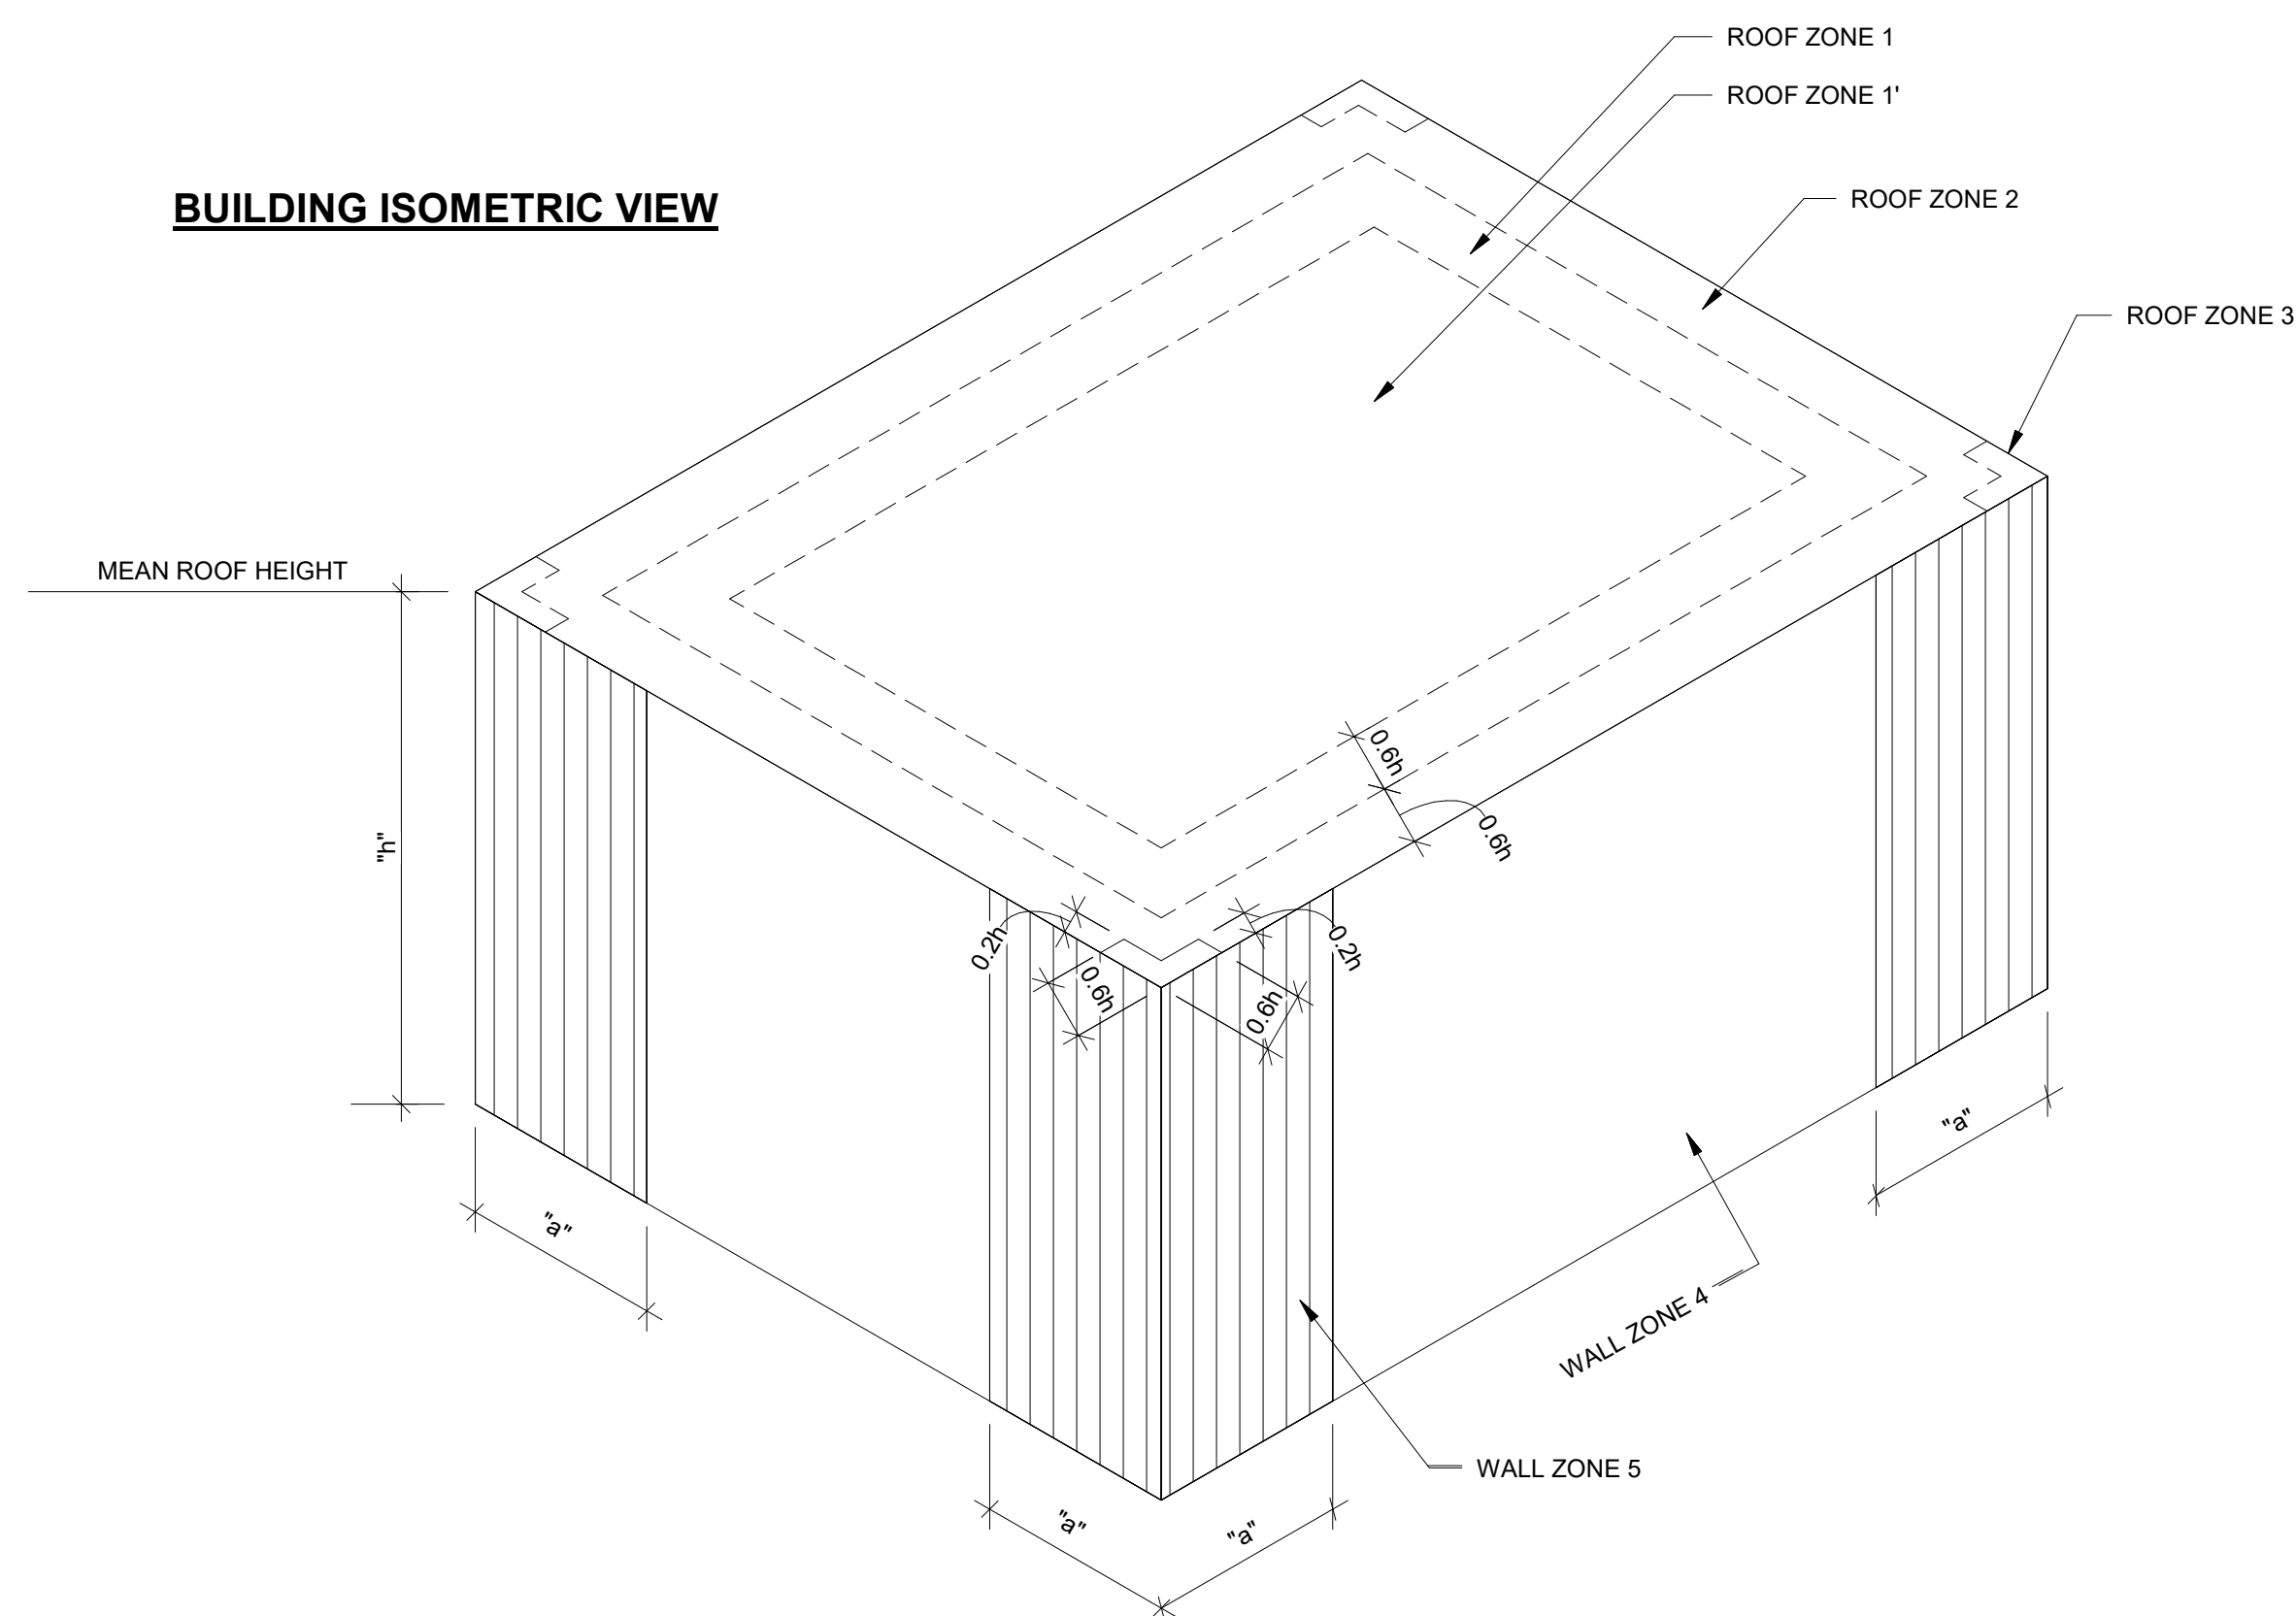

FLAT ROOF (SLOPE LESS THAN 3 DEGREES) BUILDING COMPONENT AND CLADDING DESIGN WIND PRESSURES (+) AND SUCTION (-) (PSF)														
EFFECTIVE AREA (SQ. FT.)	10		20		50		100		200		500		1000	
ZONE 1	-35.7	9.4	-33.8	8.4	-30.0	7.9	-28.1	7.5	-26.3	7.5	-22.5	7.5	-22.5	7.5
ZONE 1'	-20.6	9.4	-20.6	8.4	-20.6	7.9	-20.6	7.5	-17.8	7.5	-14.1	7.5	-11.5	7.5
ZONE 2	-46.9	9.4	-44.1	8.4	-40.3	7.9	-37.5	7.5	-33.8	7.5	-30.0	7.5	-30.0	7.5
ZONE 3	-63.8	9.4	-58.2	8.4	-50.7	7.9	-44.1	7.5	-37.5	7.5	-30.0	7.5	-30.9	7.5
ZONE 4	-24.4	22.5	-23.5	22.5	-22.5	21.6	-20.6	18.8	-19.7	18.8	-18.8	18.8	-18.8	15.6
ZONE 5	-30.0	22.5	-28.1	22.5	-25.3	21.6	-23.5	18.8	-21.6	18.8	-18.8	18.8	-18.8	15.6

3 BUILDING COMPONENTS & CLADDING WIND LOADS DIAGRAM

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Kansas City, MO 64108
T 816.442.7700

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Castle Rock, CO 80104
T 720.949.1689

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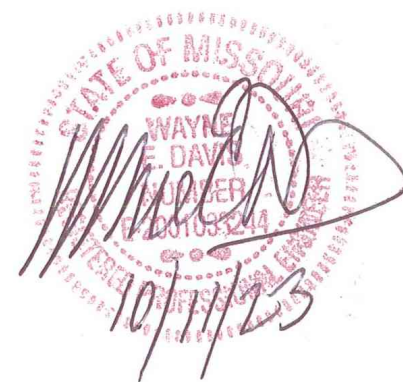
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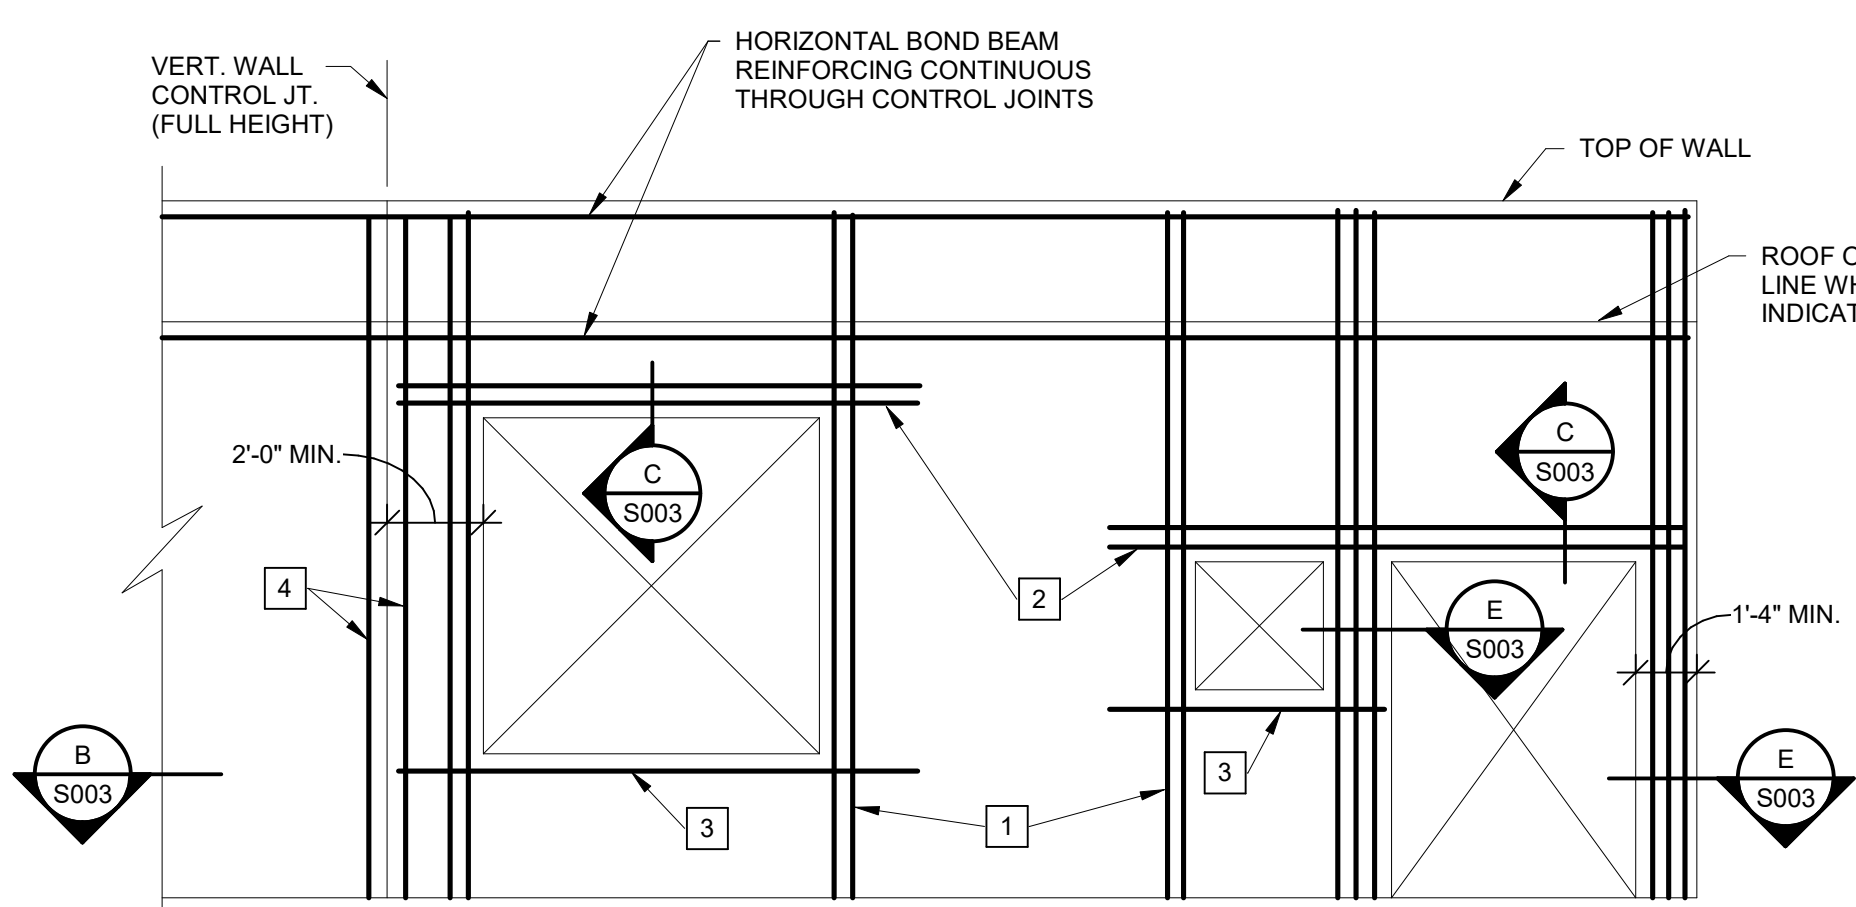
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The Professional Architects seal affixed to this sheet applies only to the material and items shown on this sheet. All drawings, instruments or other documents not exhibiting this seal shall not be considered prepared by this architect.

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DATE: 10.11.2023

S002



TYPICAL CMU WALL REINFORCING AT OPENINGS

LEGEND:

- FULL HEIGHT VERTICAL BARS AS JAMB REINFORCING IN FIRST 2 CELLS ADJACENT TO OPENING. REINFORCE EACH CELL WITH SIZE & QUANTITY OF BAR TO MATCH WALL REINFORCING (1 BAR TYPICAL IN 8" WALLS AND 2 BARS TYPICAL IN 12" WALLS).
- LINTEL REINFORCING PER SECTION C. EXTEND 2'-0" PAST EDGE OF OPENING ON EACH SIDE (TYPICAL).
- 2-#5 CONTINUOUS HORIZONTAL BARS AS SILL REINFORCING IN 8" COURSE BELOW OPENING (U.N.O.), EXTEND 2'-0" PAST EDGE OF OPENING ON EACH SIDE (TYPICAL).
- FULL HEIGHT VERTICAL BARS PER MASONRY VERTICAL REINFORCING SCHEDULE LOCATED IN END CELL AT EACH SIDE OF VERTICAL WALL CONTROL JOINTS.


GENERAL CRITERIA: (SECTION A CONTINUED):

- VERTICAL REINFORCING BARS SHALL BE DOWELED TO FOUNDATION WITH A DOWEL OF MATCHING SIZE AND SPACING.
- CONTRACTOR SHALL COORDINATE AND VERIFY OPENINGS IN MASONRY WALLS. OPENINGS SHALL BE DETAILED ON REINFORCING STEEL SHOP DRAWING ELEVATIONS.
- VERTICAL CONTROL JOINTS IN MASONRY WALLS SHALL BE 3/8" WIDE, FULL HEIGHT OF WALL. JOINTS SHALL BE SPACED AT A MAXIMUM OF 24'-0" ON CENTER AND NOT LESS THAN 2'-0" FROM THE EDGE OF ANY OPENING. ALL HORIZONTAL JOINT REINFORCING SHALL BE DISCONTINUOUS AT CONTROL JOINTS. ALL BOND BEAM HORIZONTAL REINFORCING SHALL BE CONTINUOUS THROUGH CONTROL JOINTS. CONTRACTOR SHALL COORDINATE AND VERIFY ALL CONTROL JOINT LOCATIONS.

MASONRY VERTICAL REINFORCING SCHEDULE FOR LOAD BEARING MASONRY (CMU) WALLS			
WALL THICKNESS	LOCATION	VERTICAL REINF. (IN GROUTED CELLS)	SPACING
8"	ALL 8" WALLS (U.N.O.)	1-#5	32"oc
12"	ALL 12" WALLS (U.N.O.)	2-#5	16"oc
NOTES: 1. IN ADDITION TO SPACING SHOWN IN SCHEDULE, VERTICAL REINFORCING SHALL BE PROVIDED IN GROUTED CELLS AT THE FOLLOWING LOCATIONS A.) IN THE FIRST 2 CELLS ADJACENT TO EACH OPENING B.) IN THE END CELLS ON EACH SIDE OF VERTICAL CONTROL JOINTS C.) IN THE END CELLS OF EACH LENGTH OF WALL D.) AT EACH CORNER OF WALLS 2. ALL MASONRY VOIDS AND BOND BEAMS TO BE GROUTED SHALL BE FREE OF DEBRIS AND MORTAR DROPPINGS PRIOR TO GROUTING. ANY MASONRY w/ DROPPINGS OR DEBRIS OBSERVED IN VOIDS SHALL BE REJECTED.			

A CMU WALL ELEVATION

1 1/2" = 1'-0"

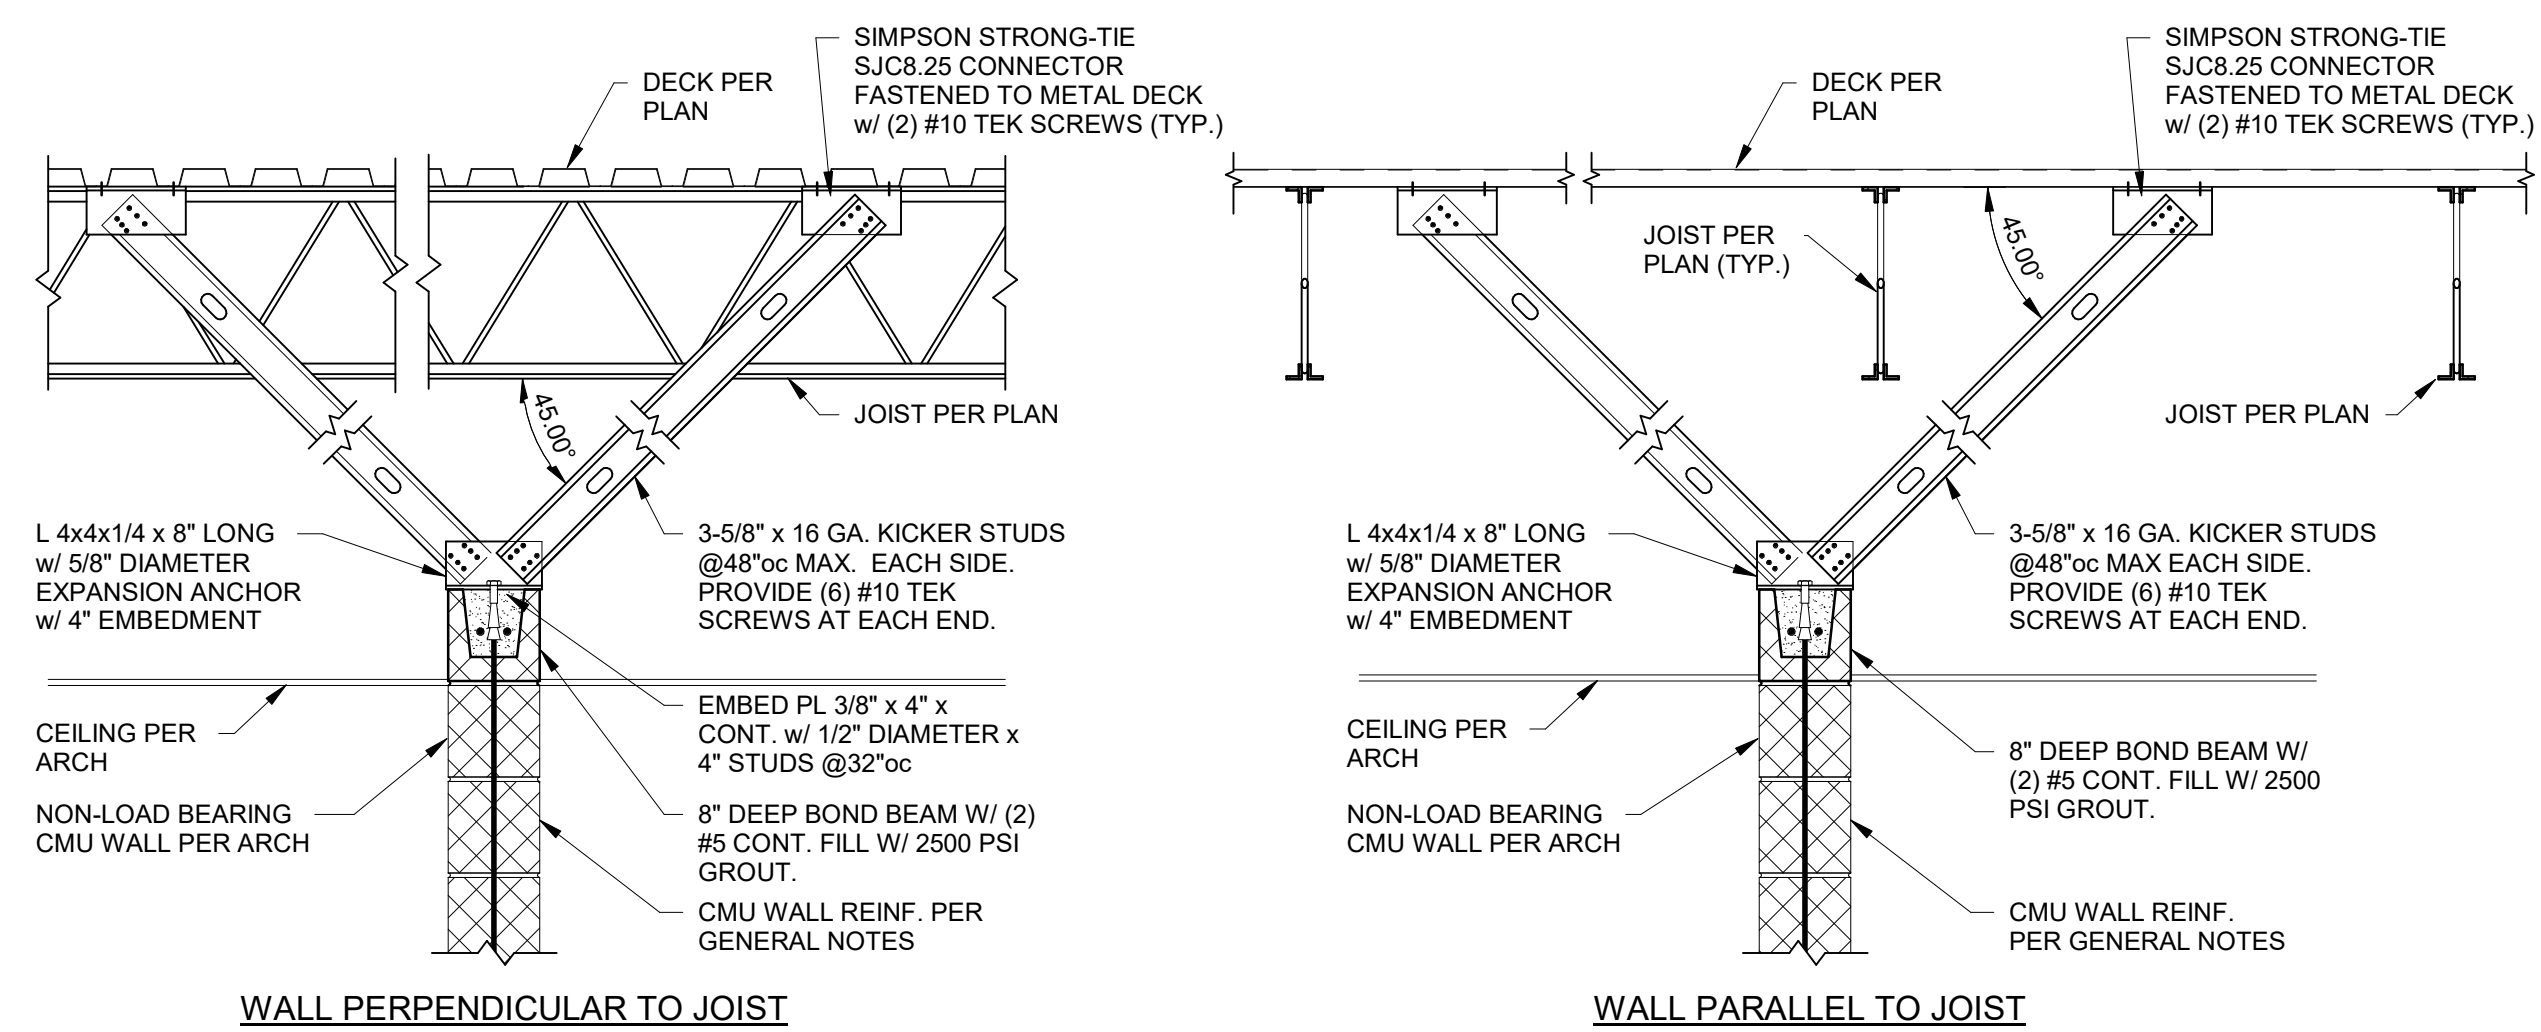


WALL PERPENDICULAR TO JOIST

WALL PARALLEL TO JOIST

TYPICAL BRACING DETAILS FOR NON-LOAD-BEARING CMU WALLS THAT DO NOT EXTEND TO DECK
(REFER TO ARCHITECTURAL DRAWINGS FOR LOCATION)


3 SECTION

3/4" = 1'-0"

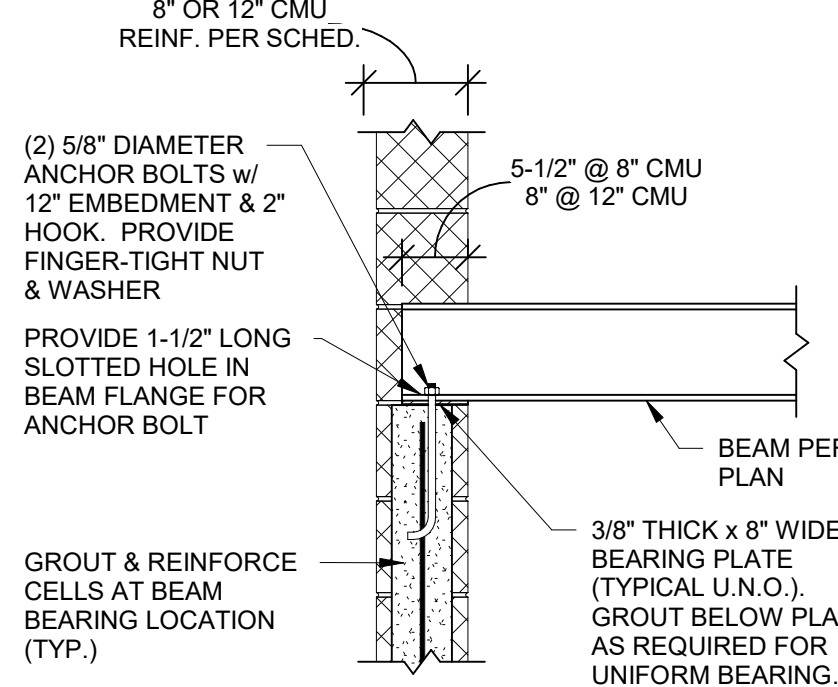

7 SECTION


3/4" = 1'-0"

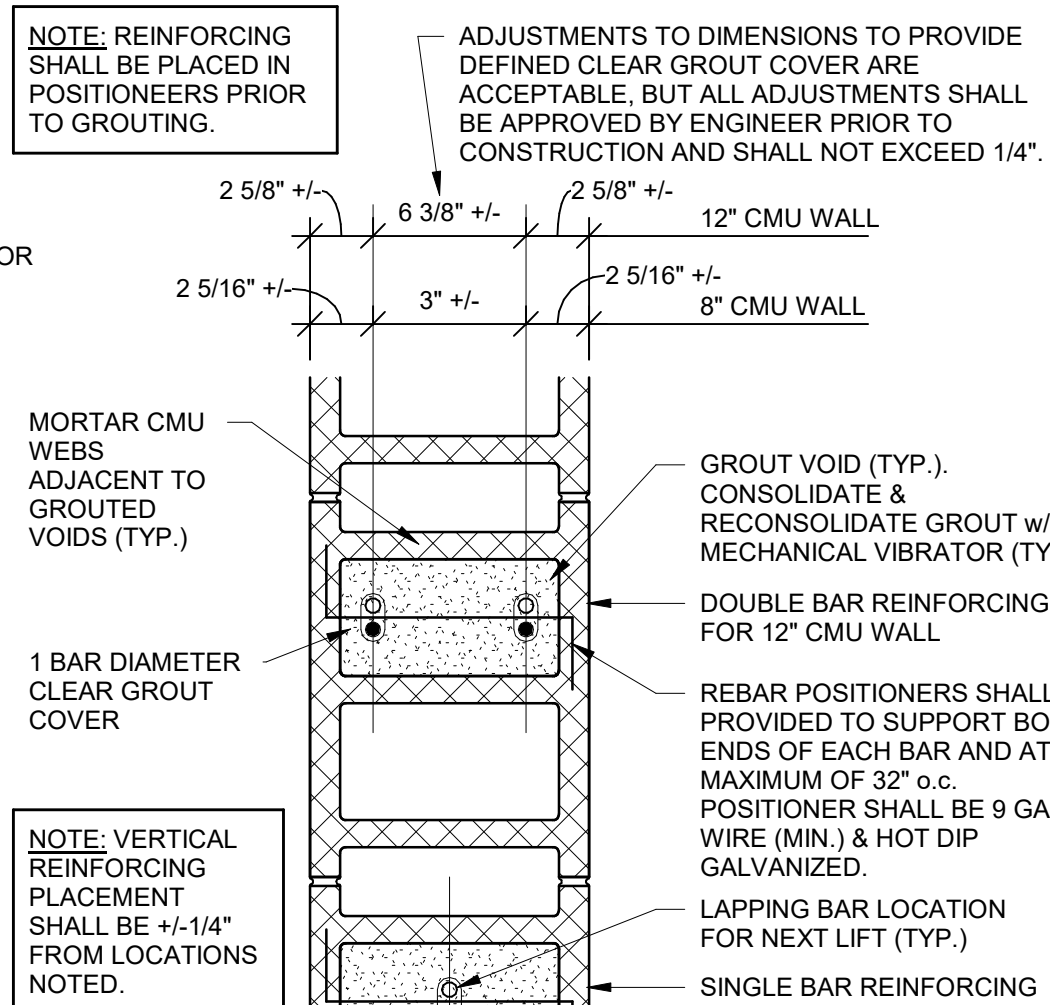

TYPICAL REBAR POSITIONING DETAIL

B SECTION

1 1/2" = 1'-0"

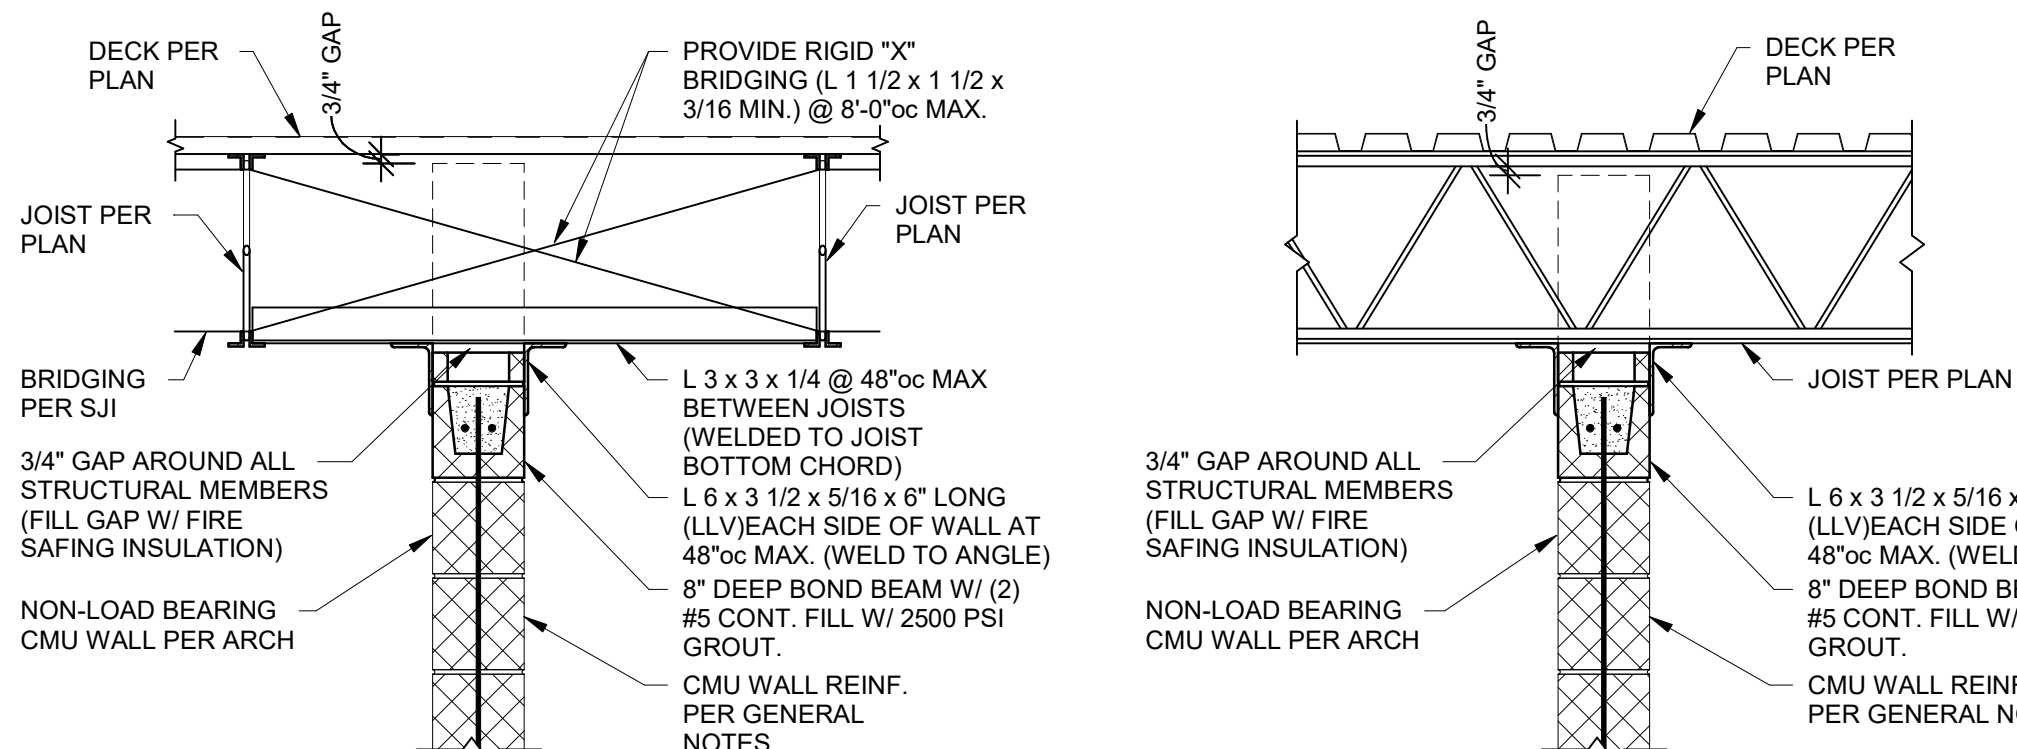


WALL PARALLEL TO JOIST

WALL PERPENDICULAR TO JOIST

TYPICAL BRACING DETAILS FOR NON-LOAD-BEARING CMU WALLS THAT EXTEND TO DECK
(REFER TO ARCHITECTURAL DRAWINGS FOR LOCATION)

1 SECTION

3/4" = 1'-0"

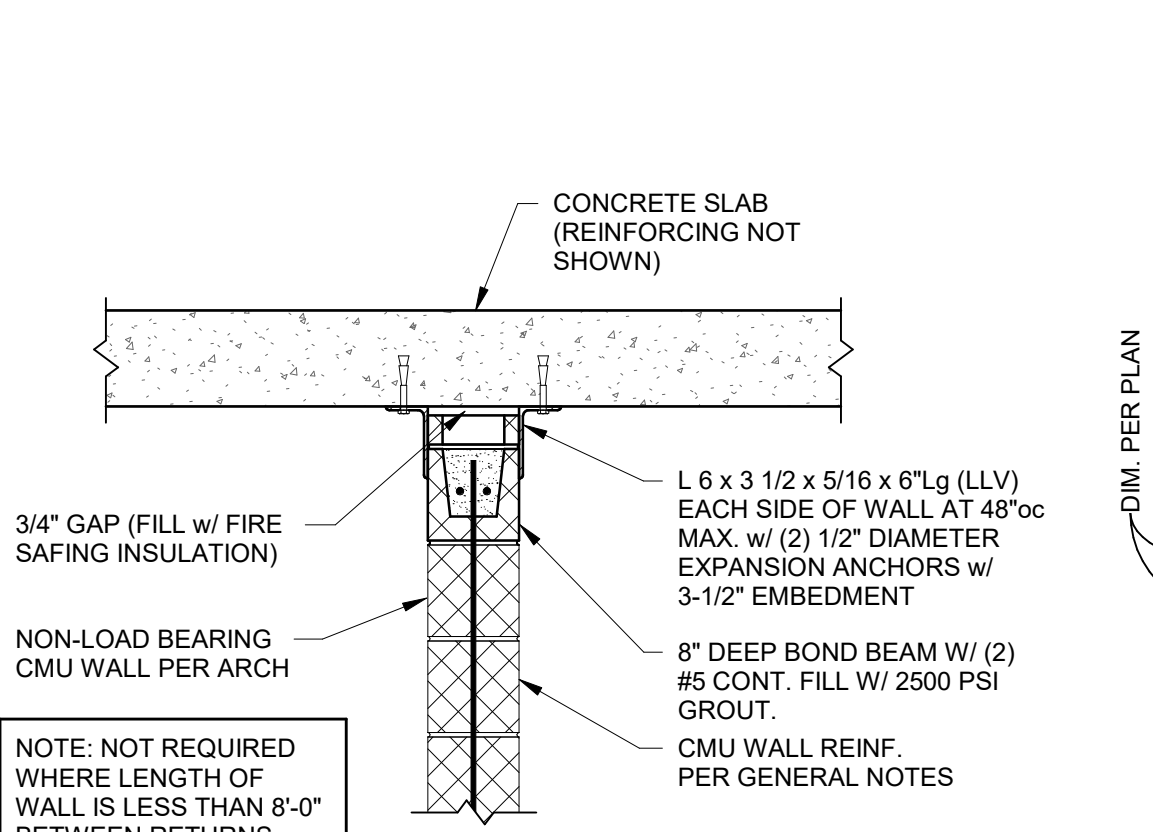

TYPICAL TOP OF CMU WALL BRACING
BELOW CONCRETE SLAB


4 SECTION

3/4" = 1'-0"



5 SECTION

3/4" = 1'-0"

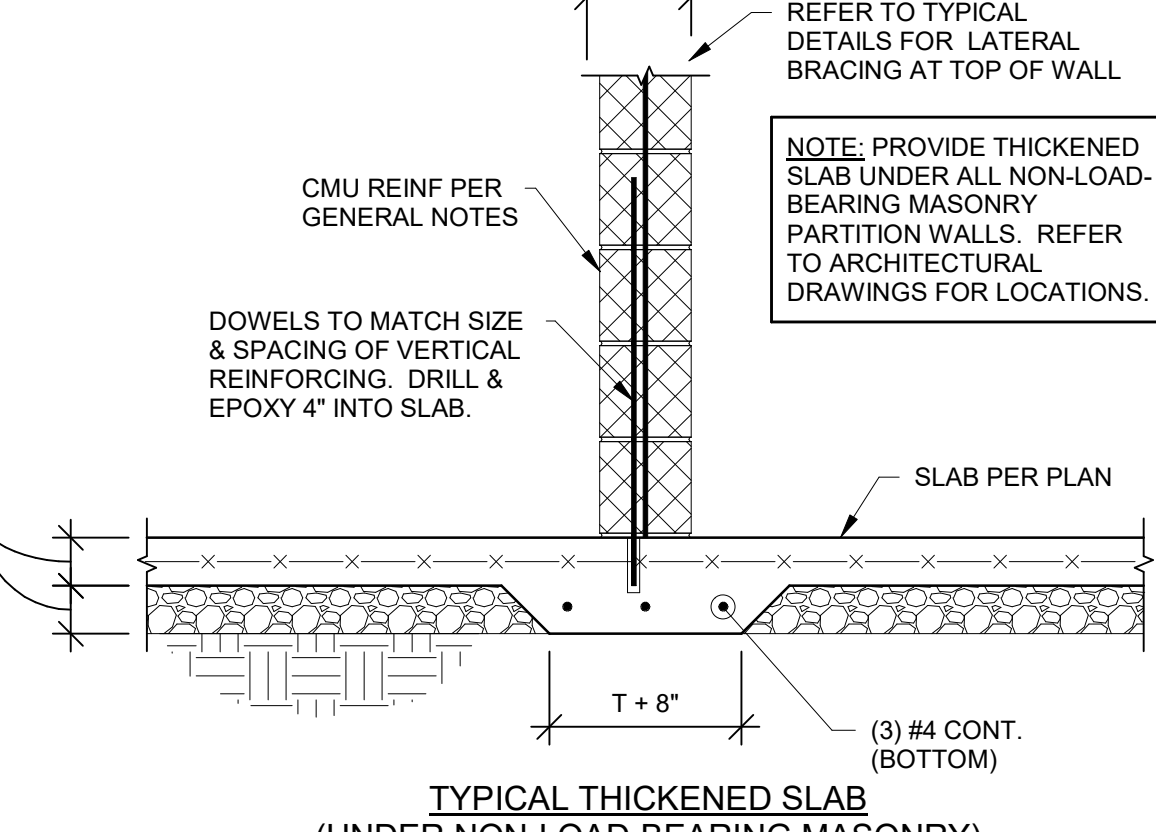

TYPICAL THICKENED SLAB
(UNDER NON-LOAD-BEARING MASONRY)

4 SECTION

3/4" = 1'-0"



4 SECTION

3/4" = 1'-0"



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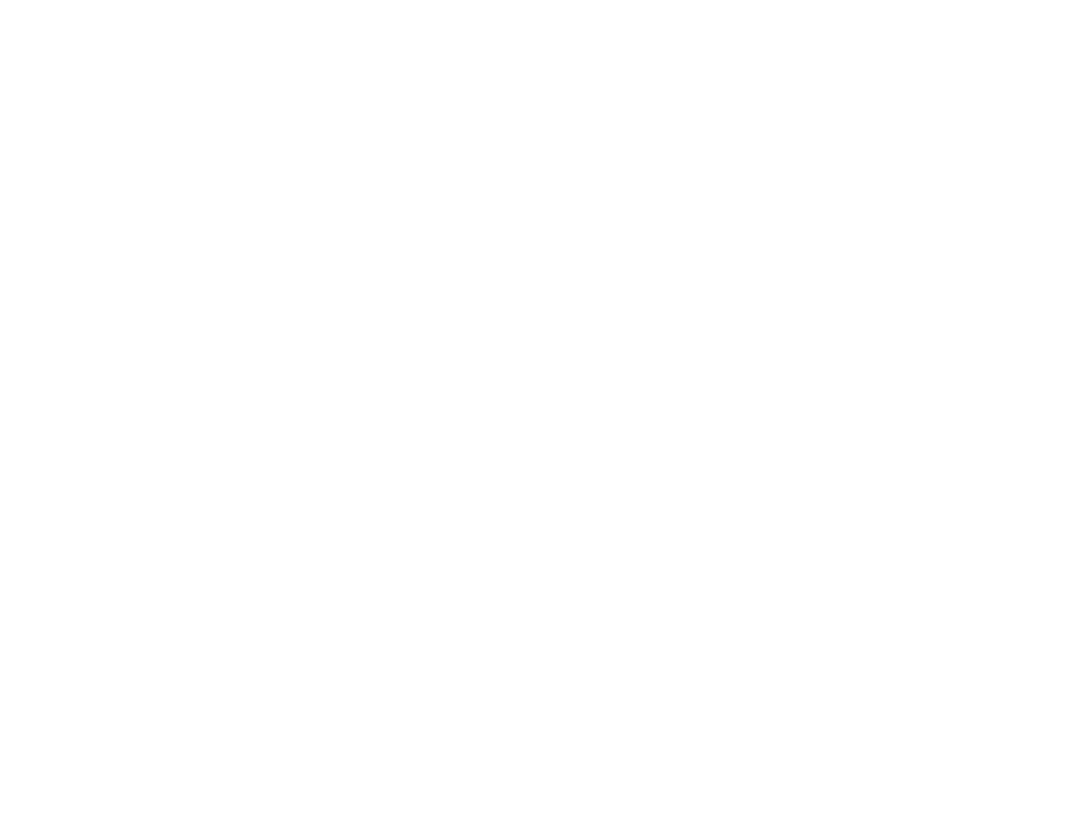
4 SECTION

3/4" = 1'-0"



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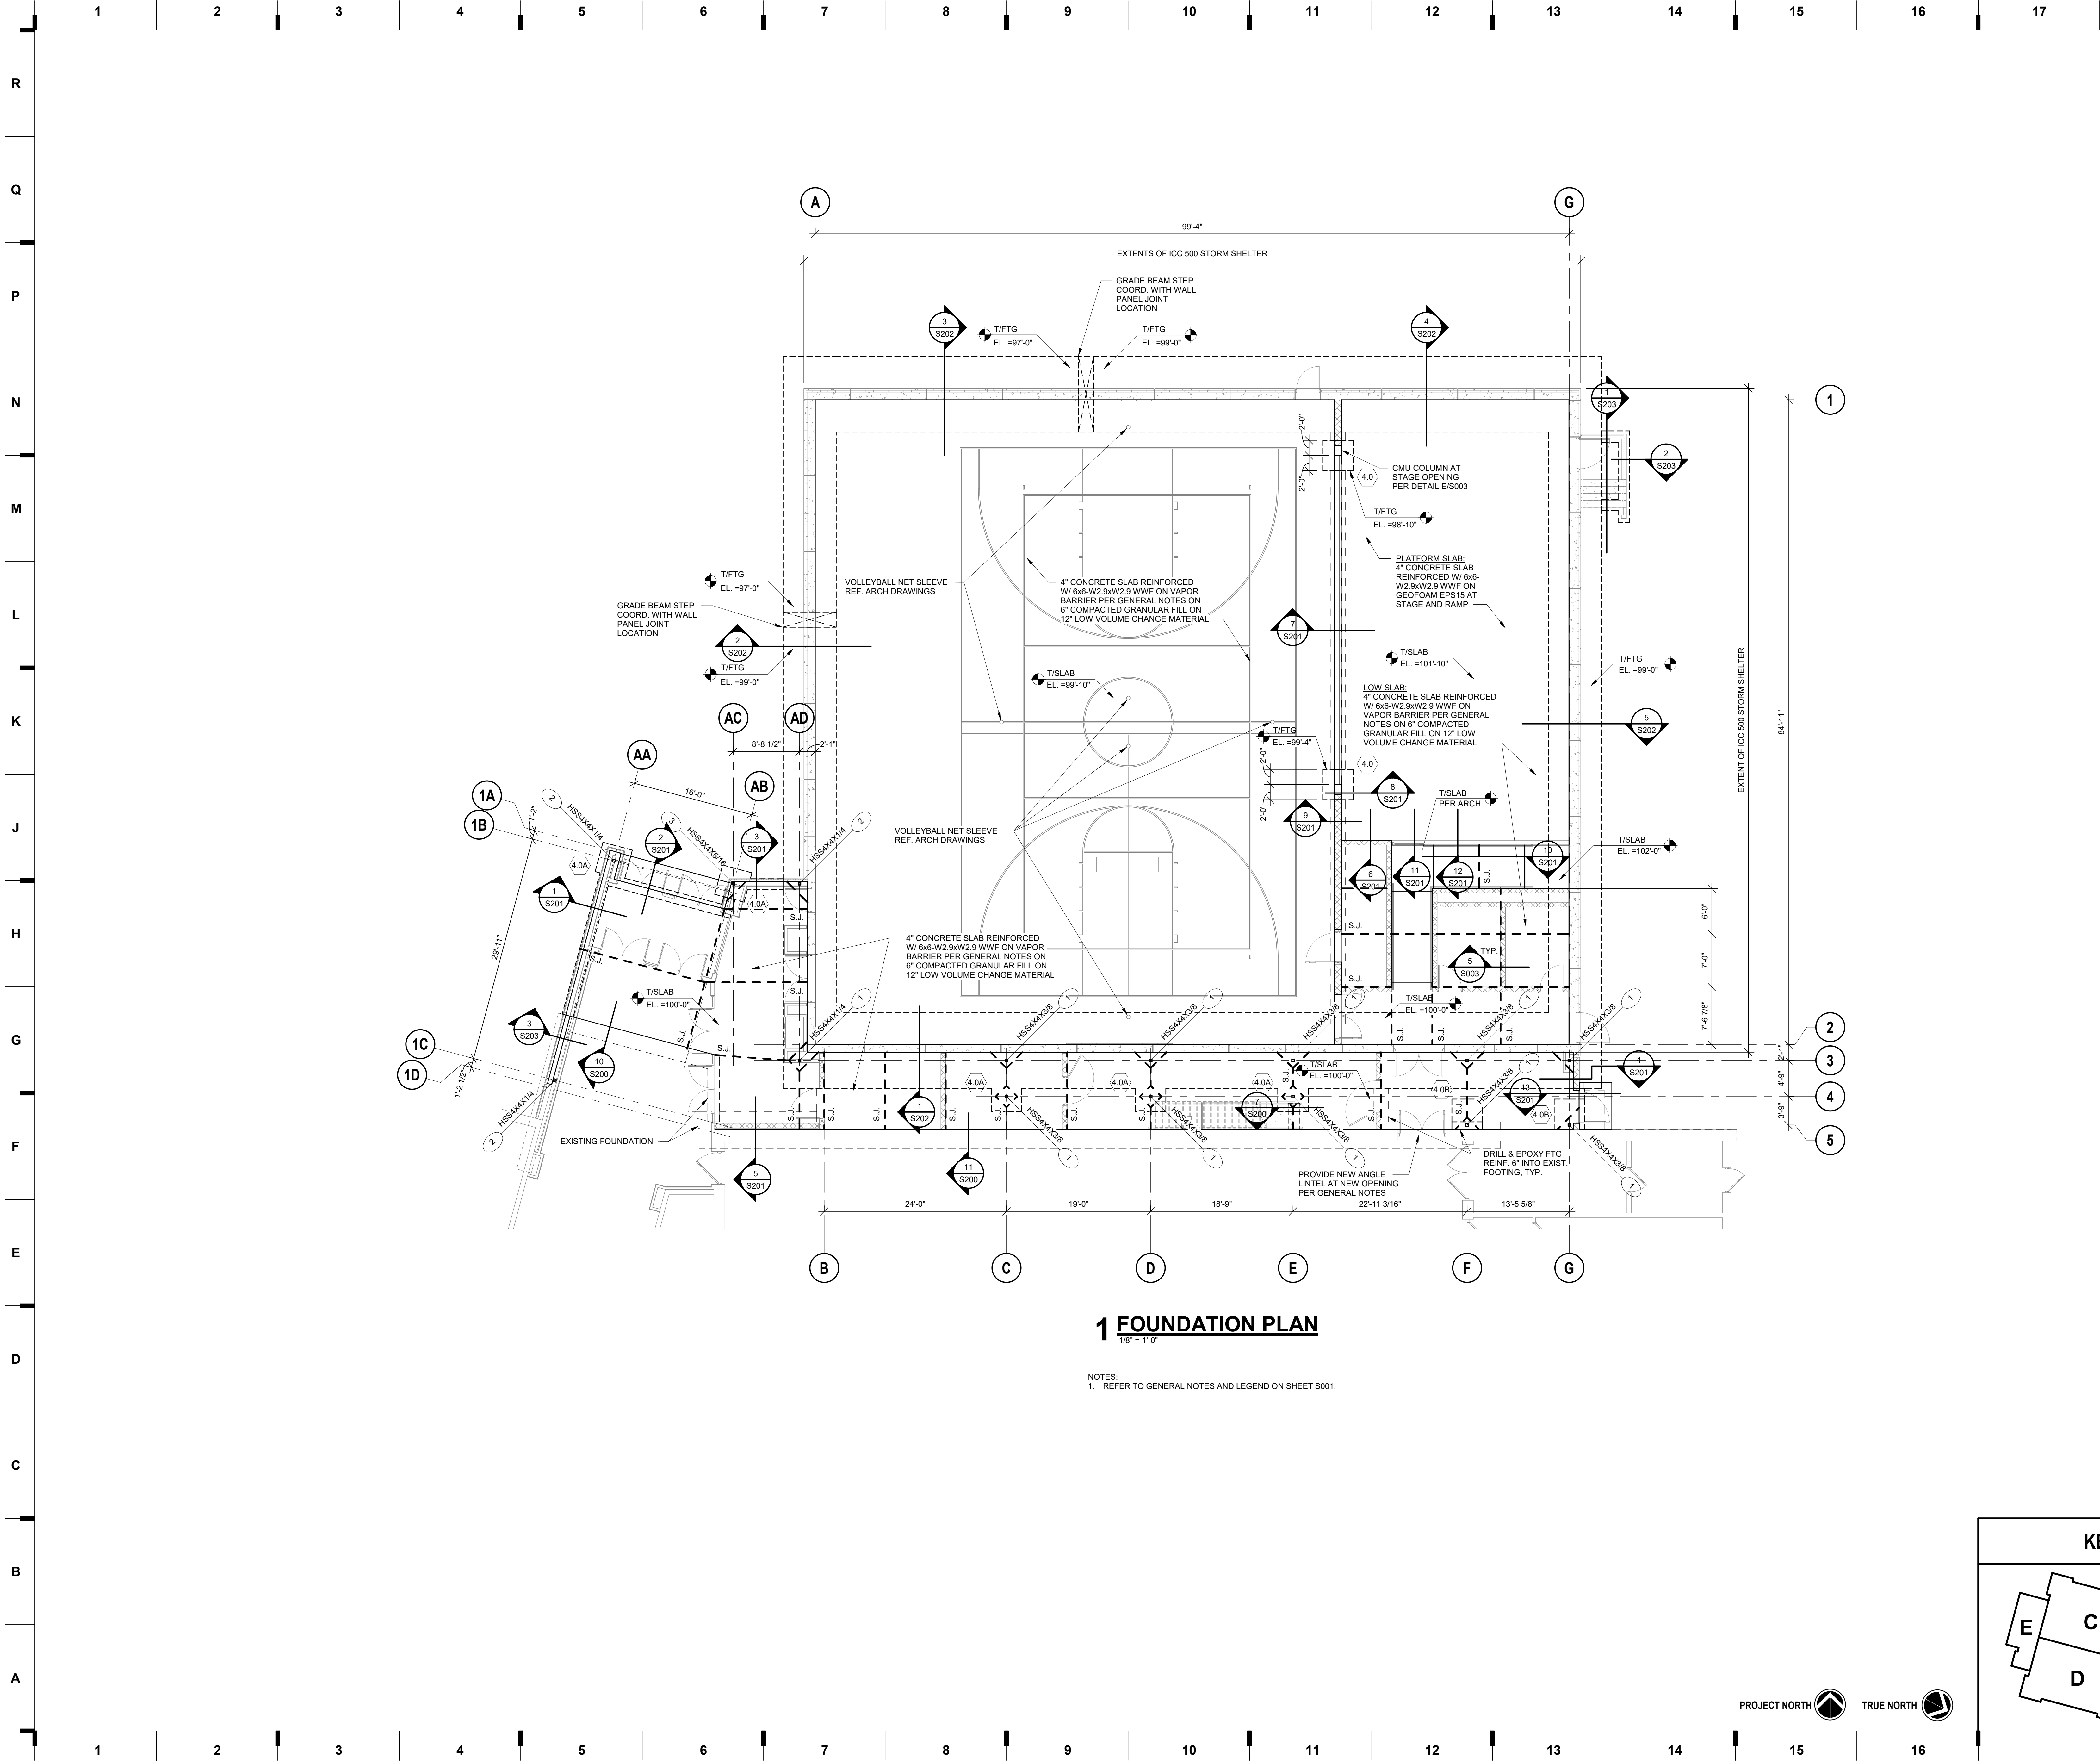
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4 SECTION

3/4" = 1'-0"






1 FOUNDATION PLAN
1/8" = 1'-0"

NOTES:
1. REFER TO GENERAL NOTES AND LEGEND ON SHEET S001.

KEY PLAN

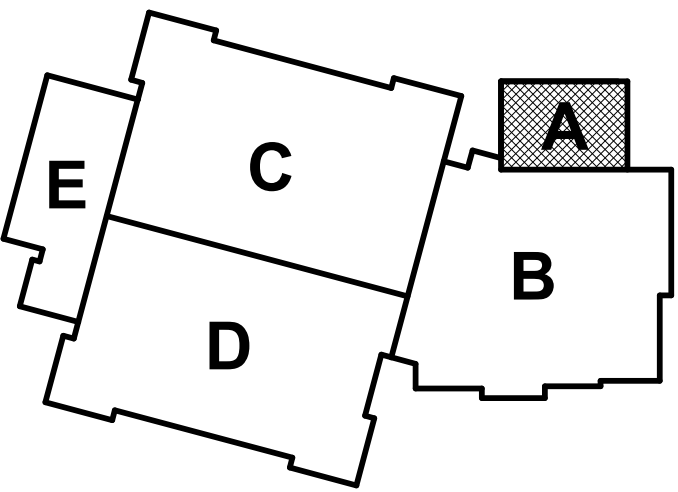

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Missouri State Certificate of Authority
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Bob D Campbell
Structural Engineer
State Certificate of Authority #000442
4338 Bellevue Ave
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816.531.4144 phone

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Overland Park, KS 66210
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#	Description	Date
1	Addendum 01	08/14/2023
2	Addendum 04	09/29/2023



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S100

FOUNDATION PLAN



PROJECT NORTH  TRUE NORTH 



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#	Description	Date
1	Addendum 01	09/14/2023

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Structural Engineer
State Certificate of Authority #000442
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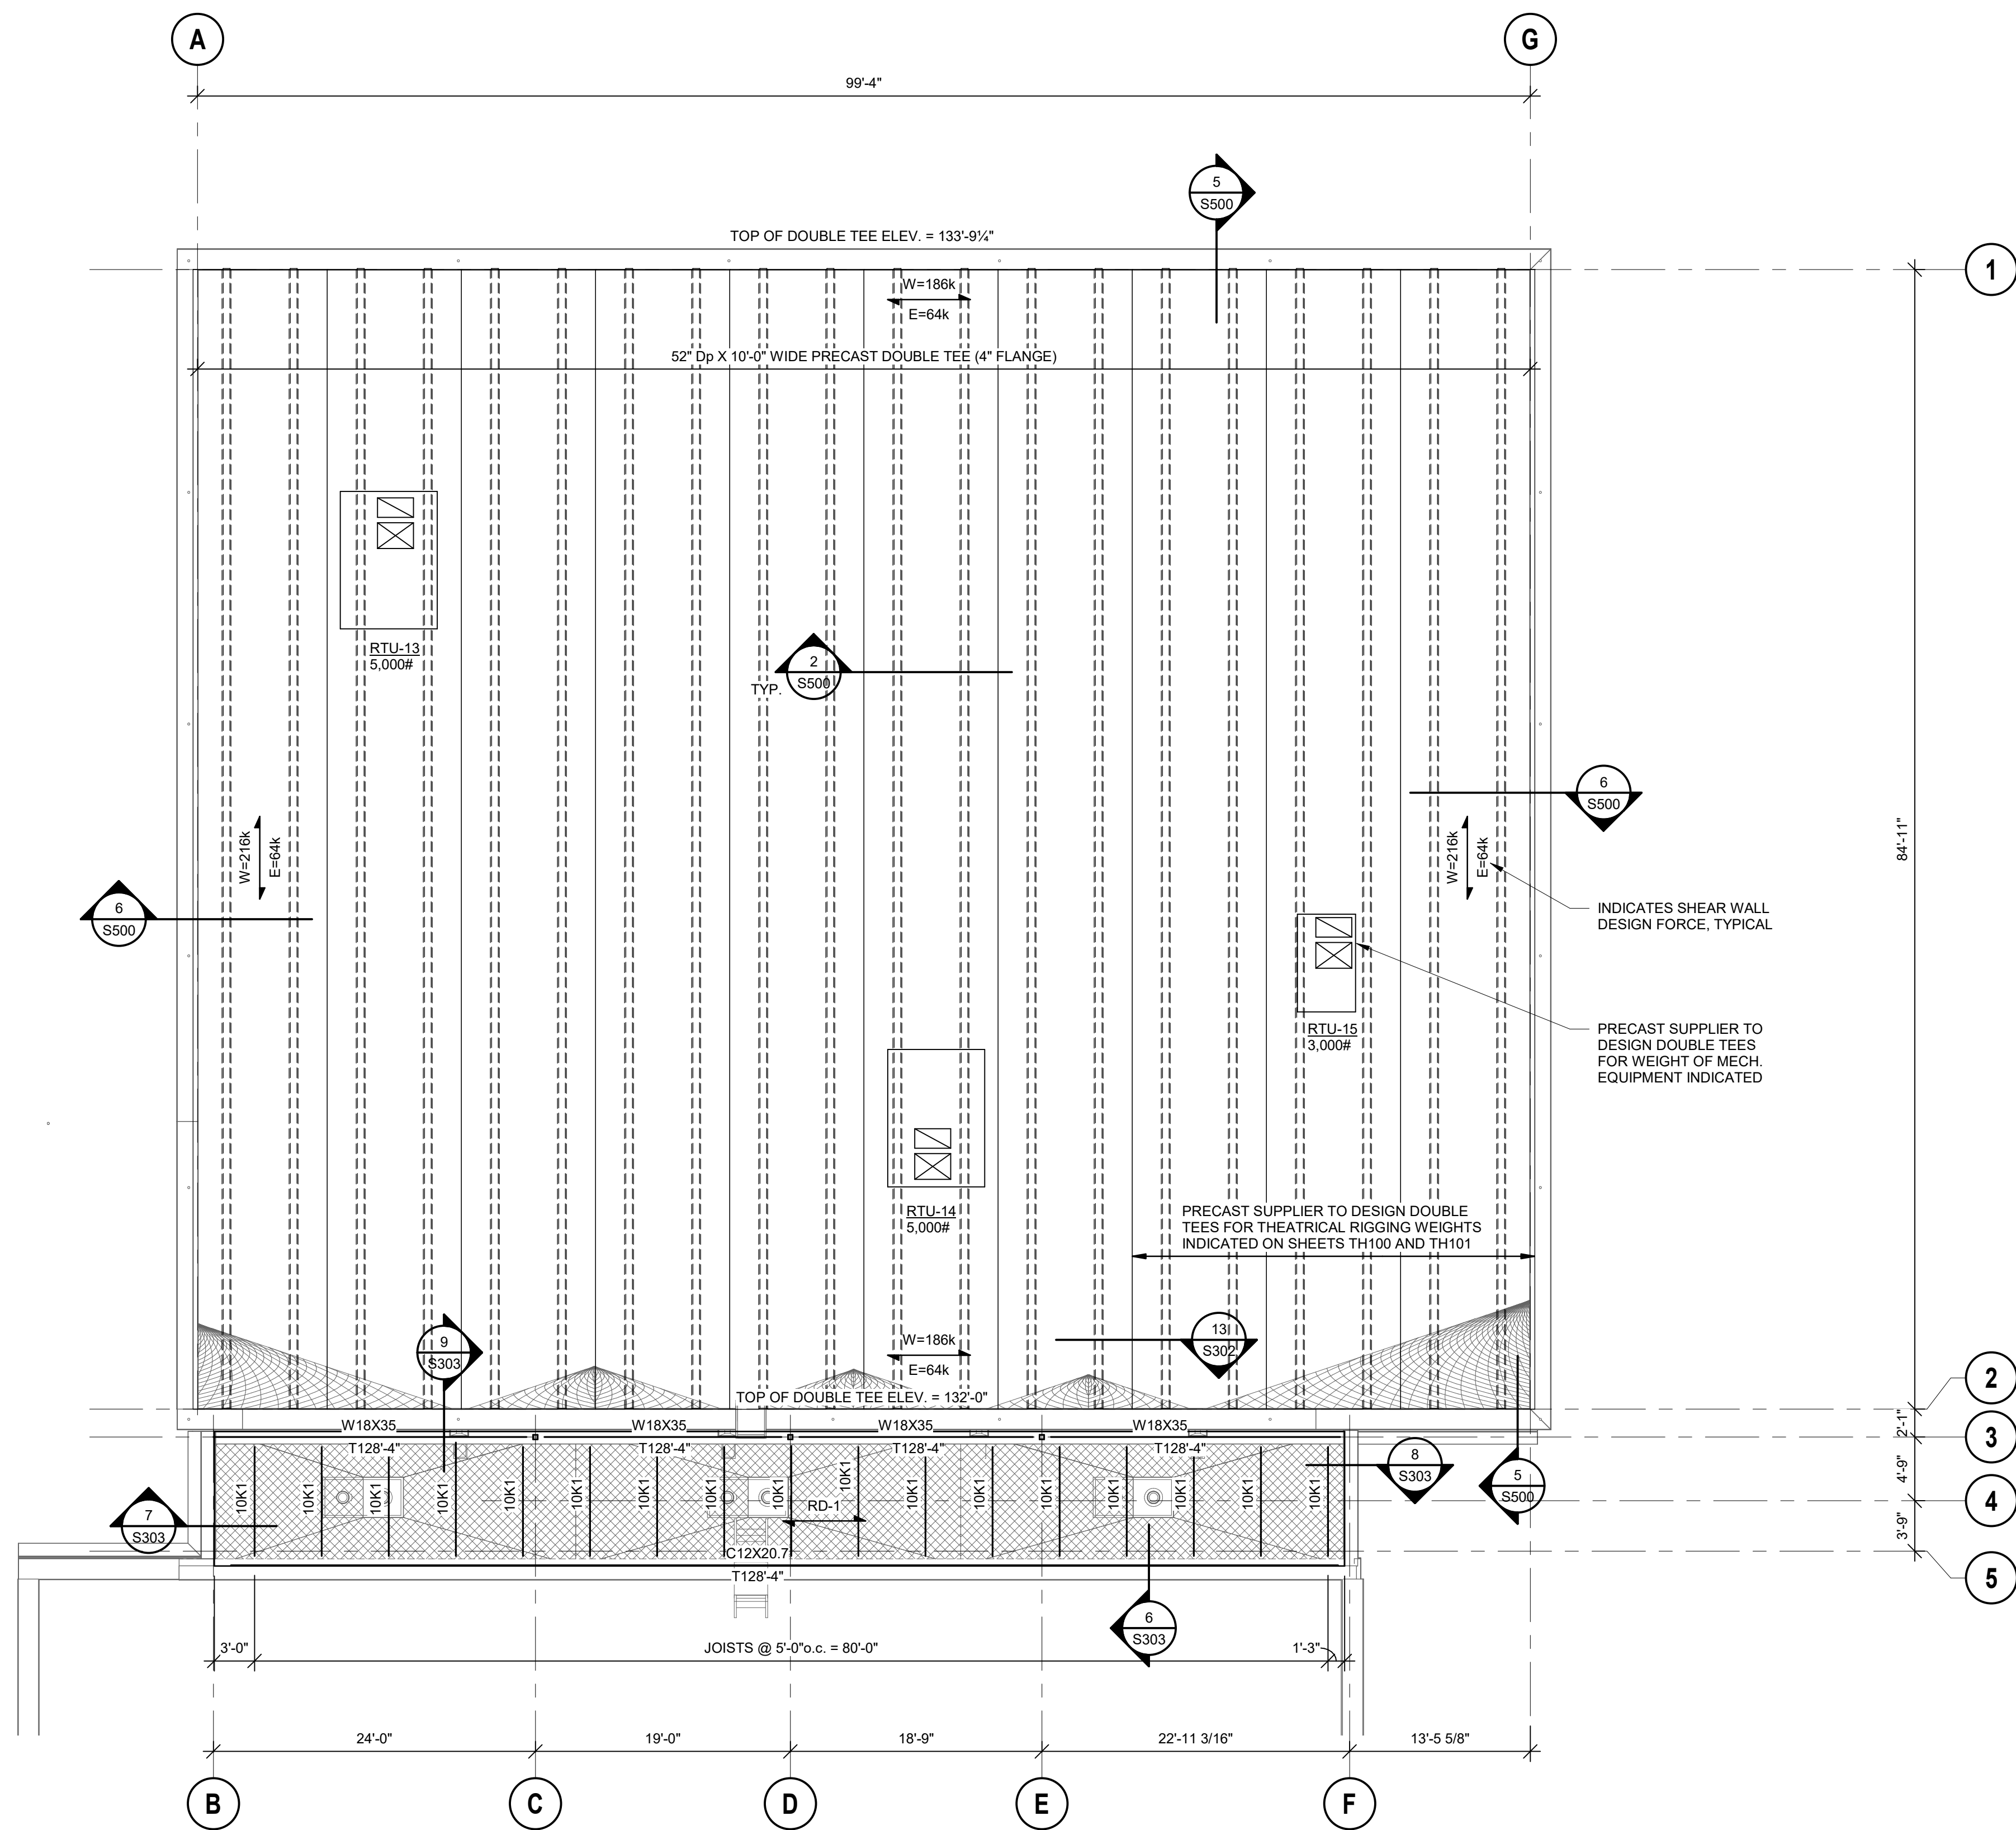
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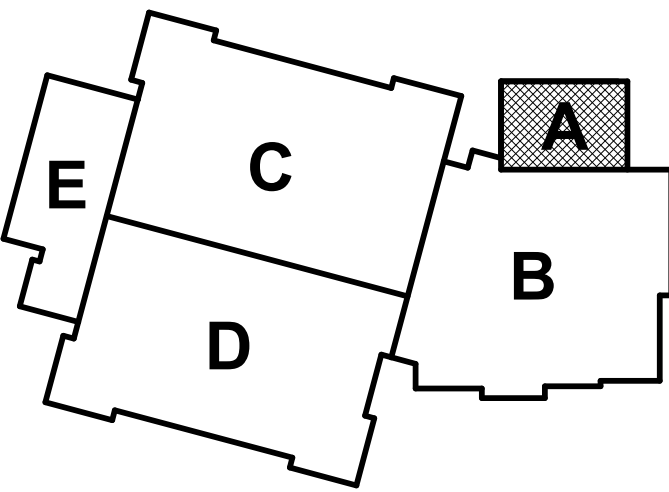
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1 ROOF FRAMING PLAN
1/8" = 1'-0"


KEY PLAN



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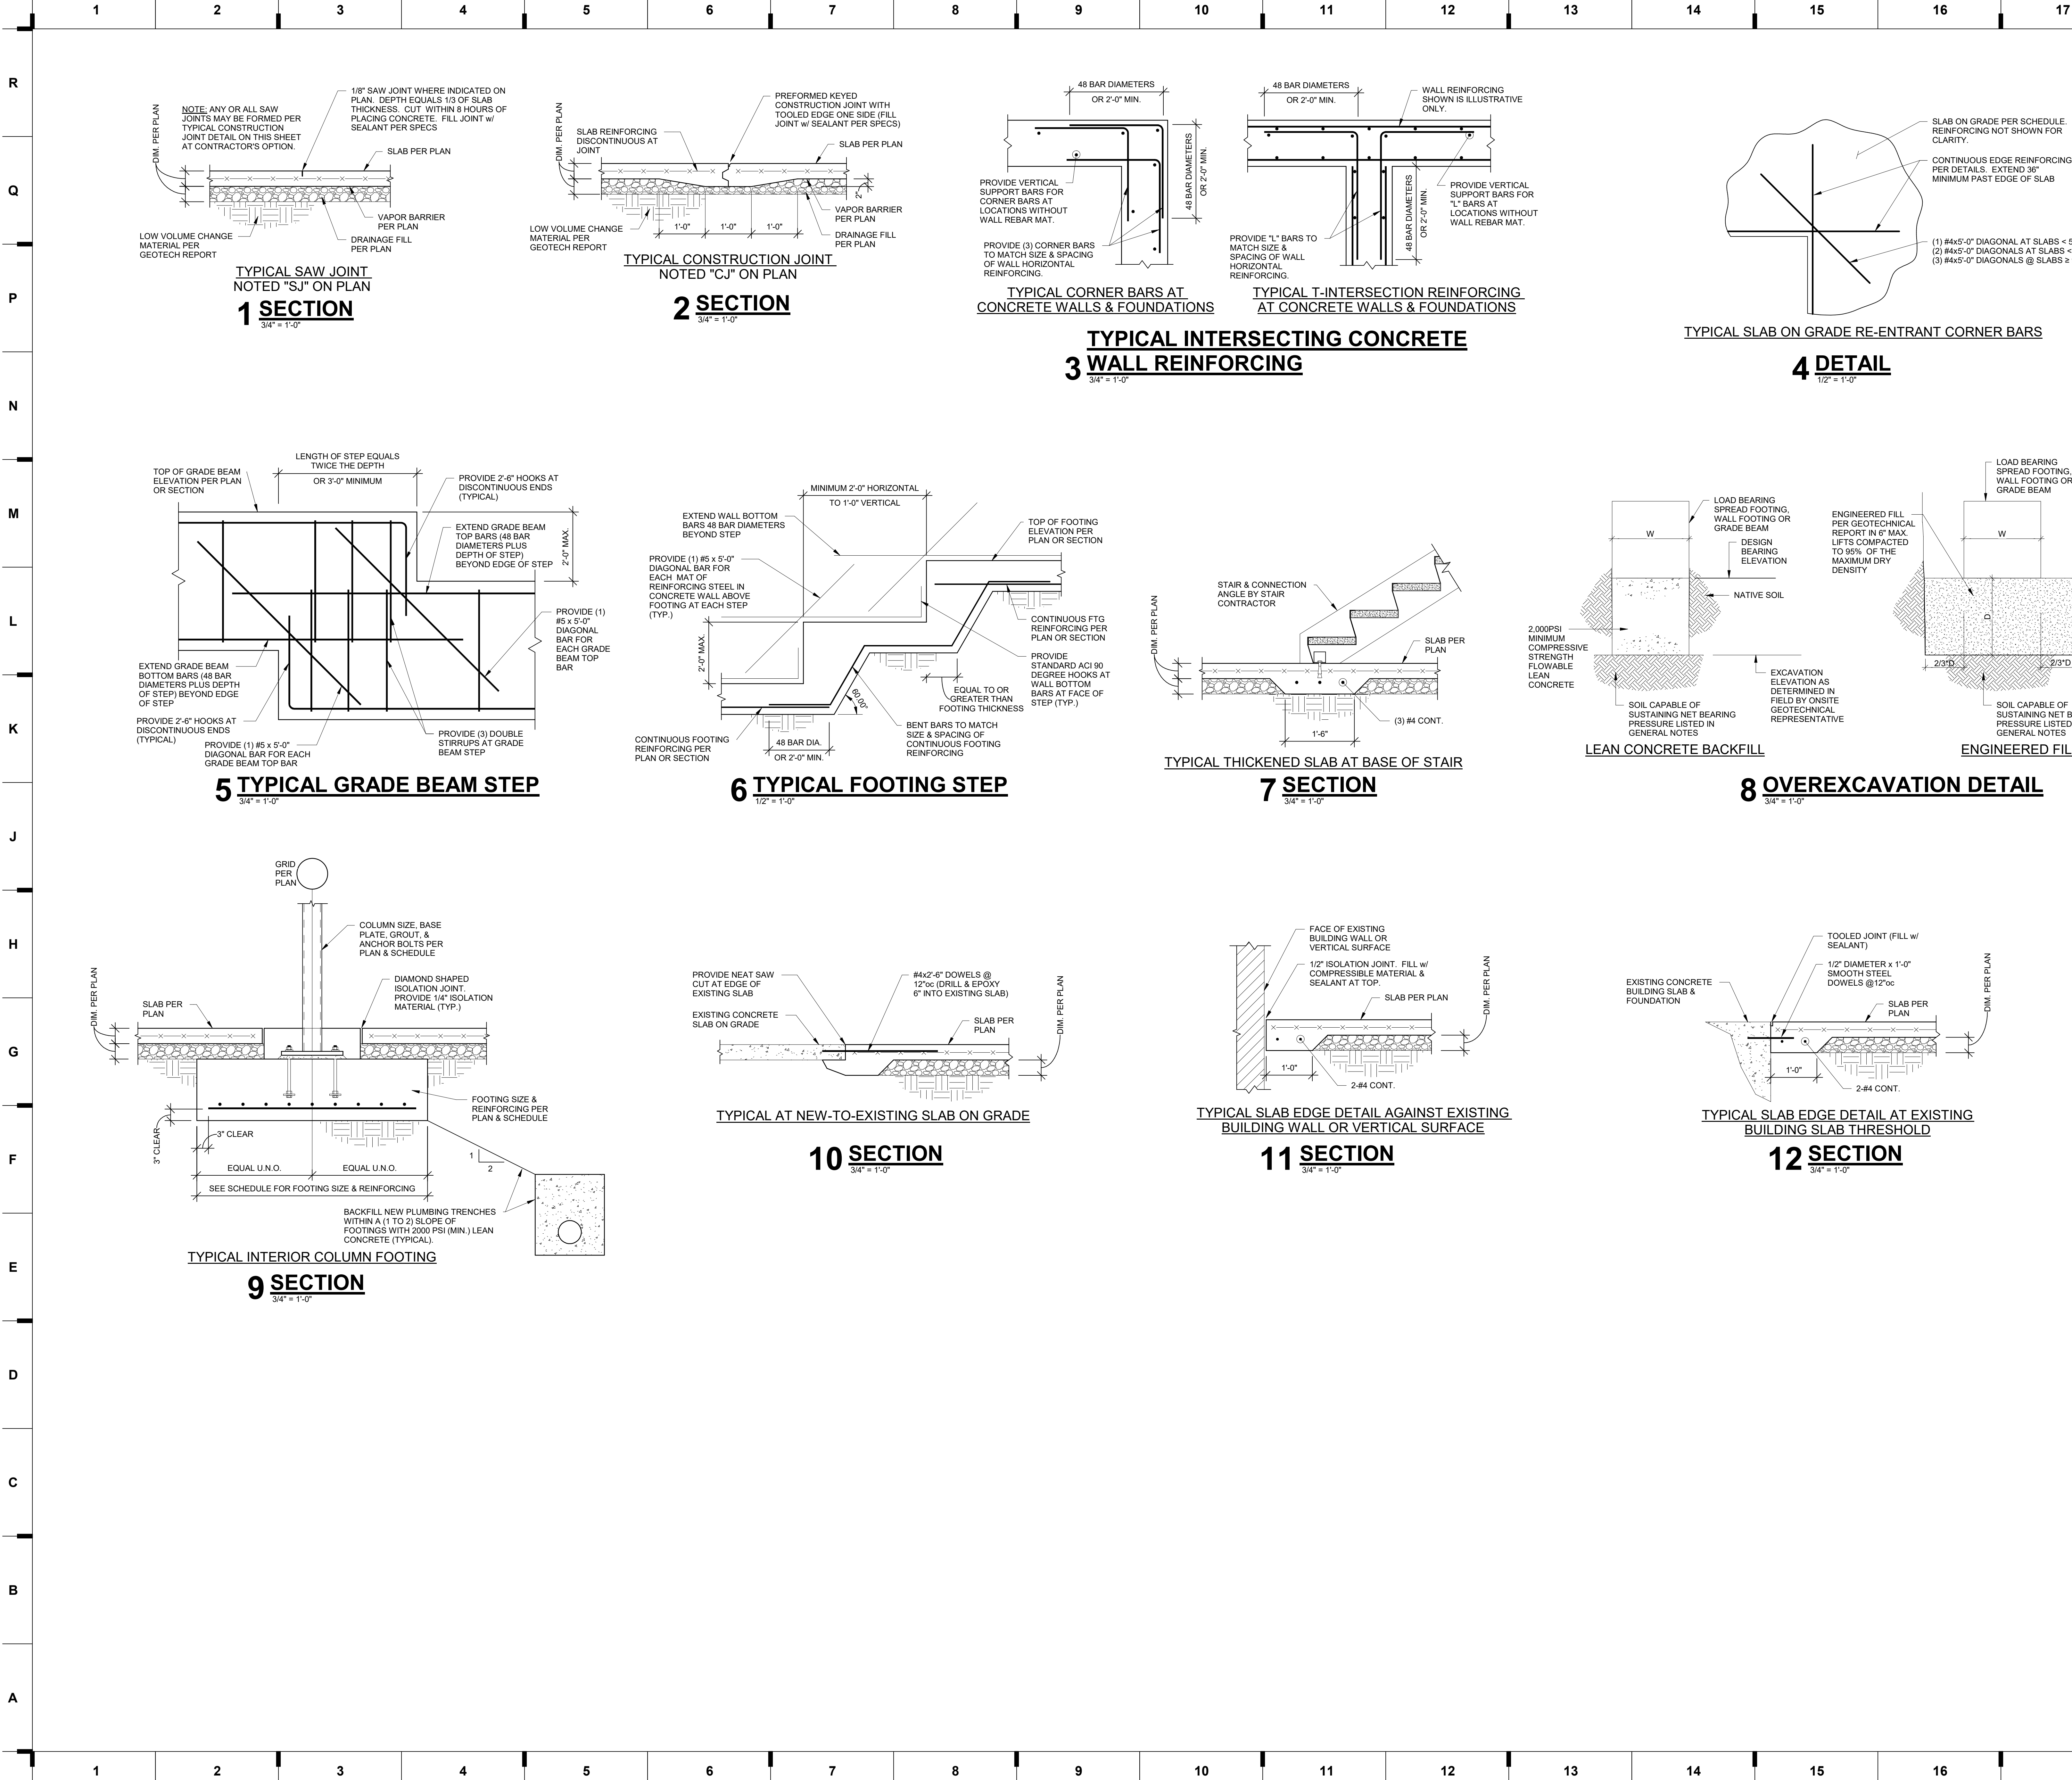
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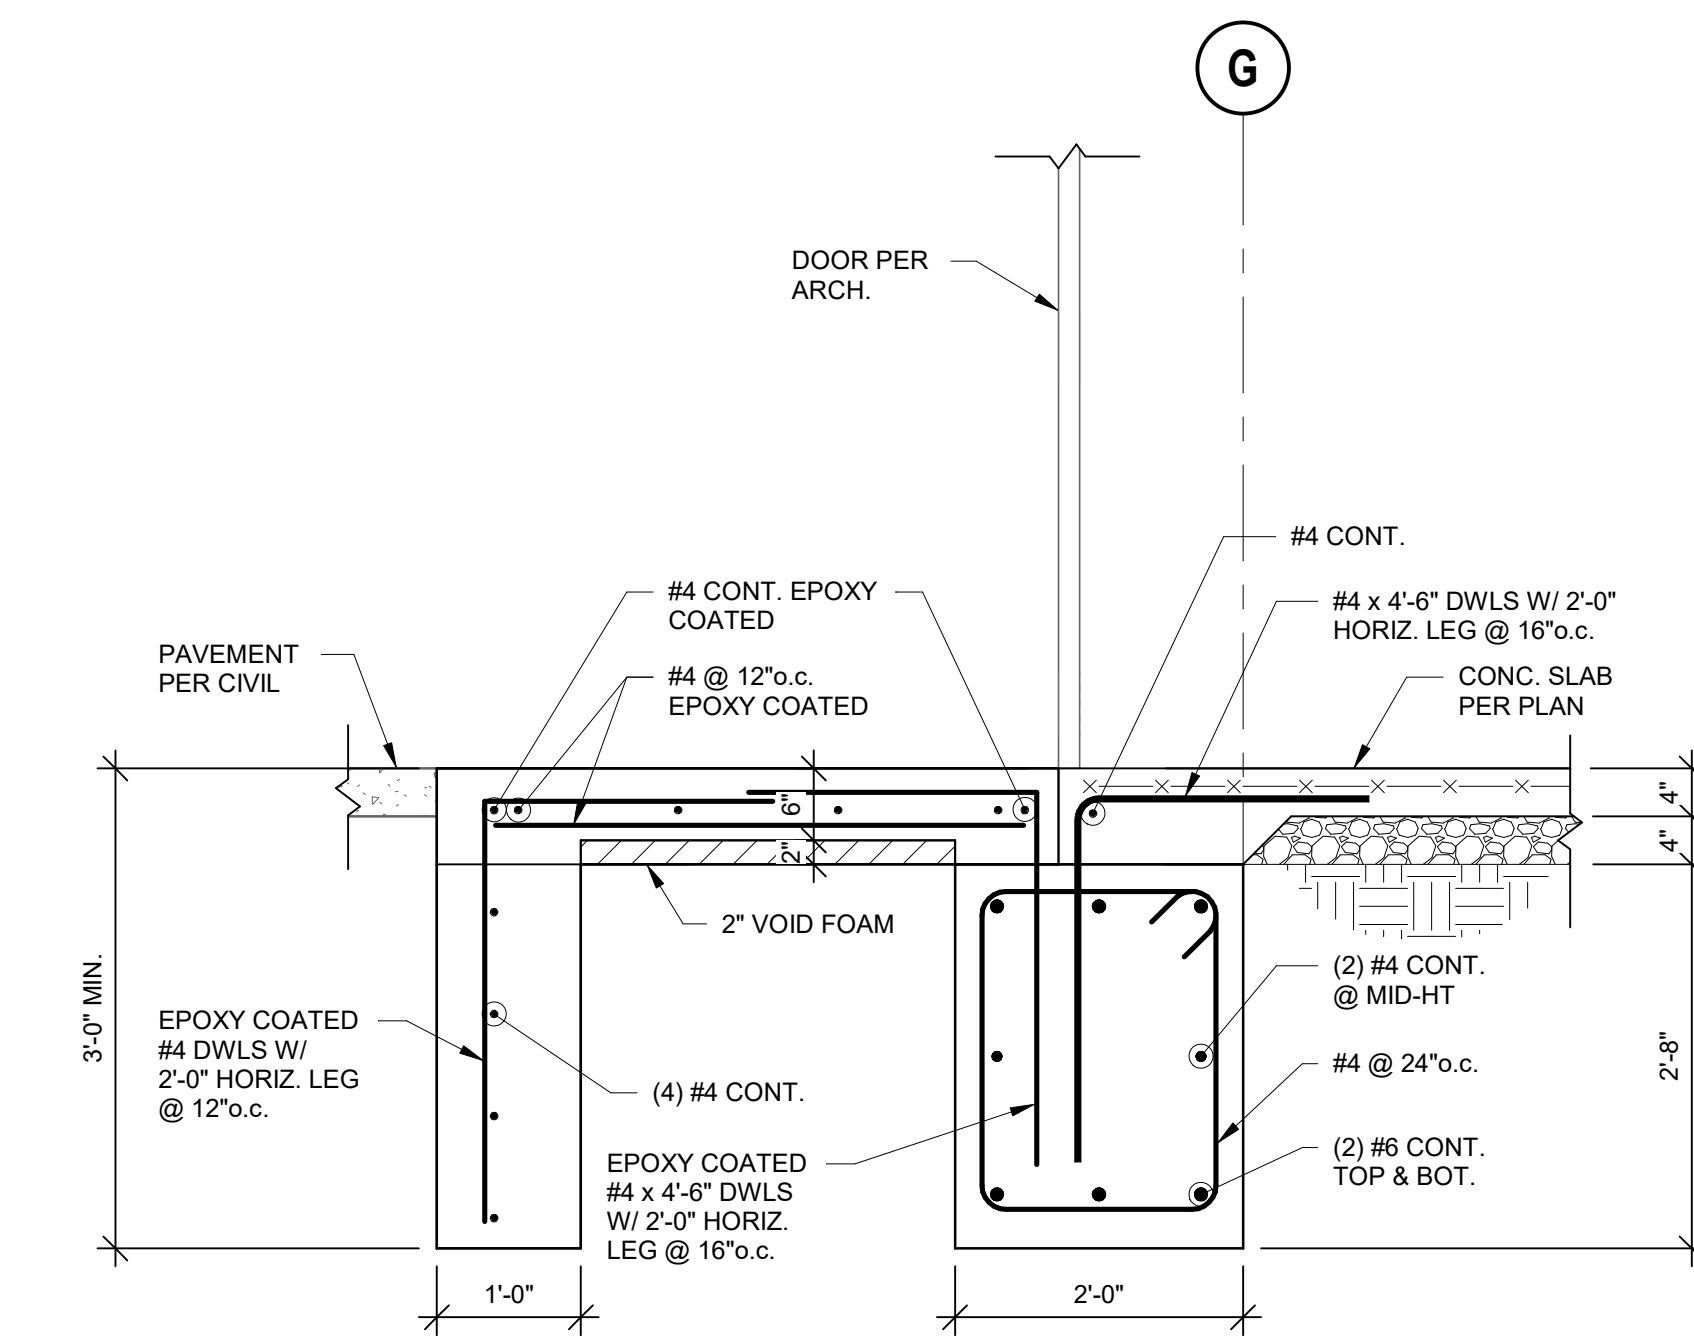
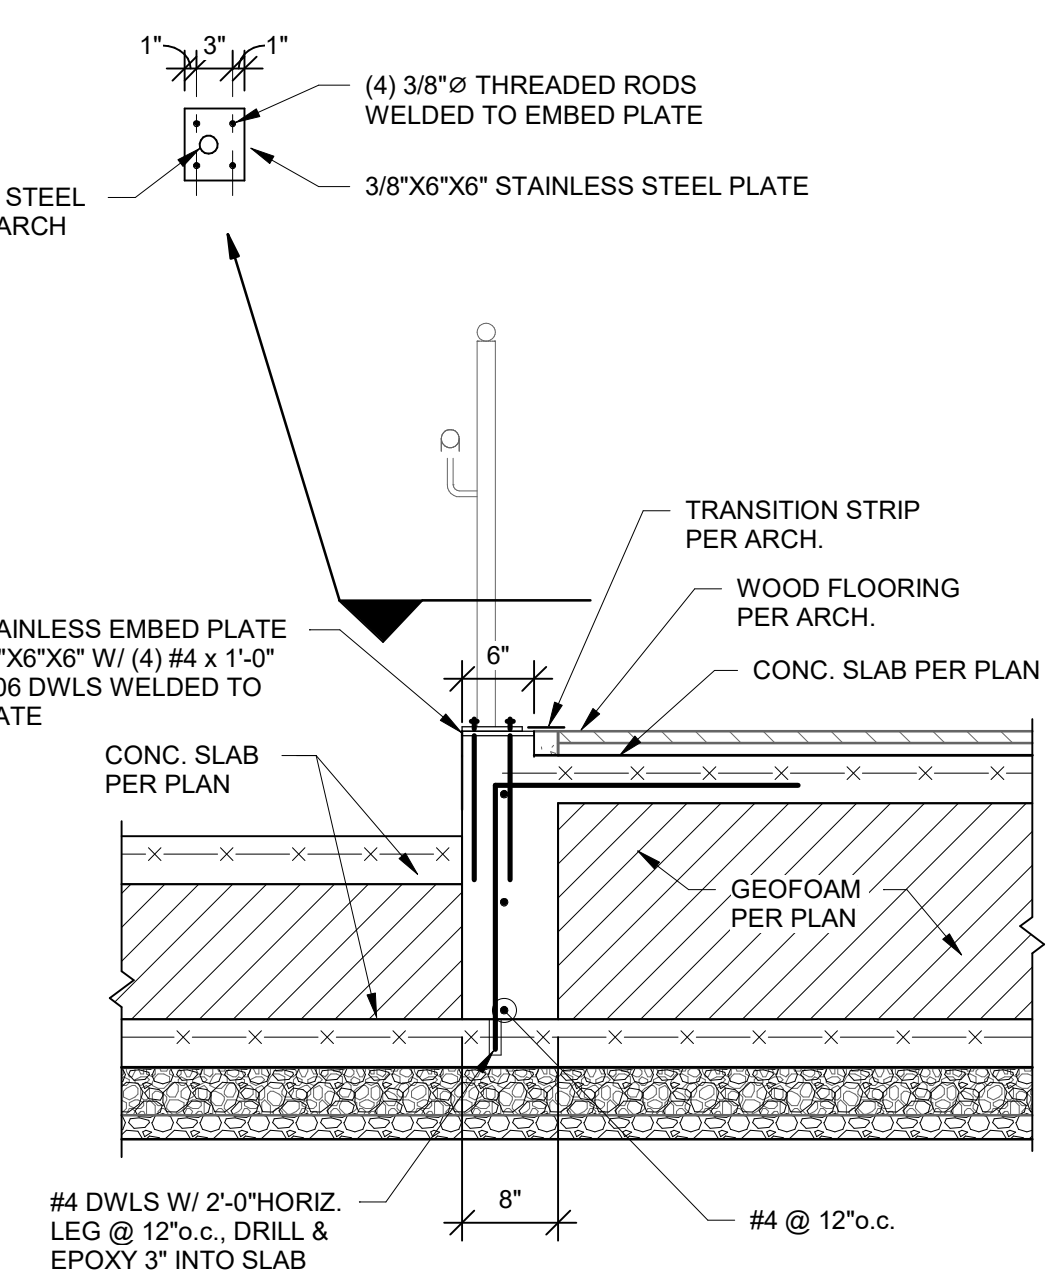
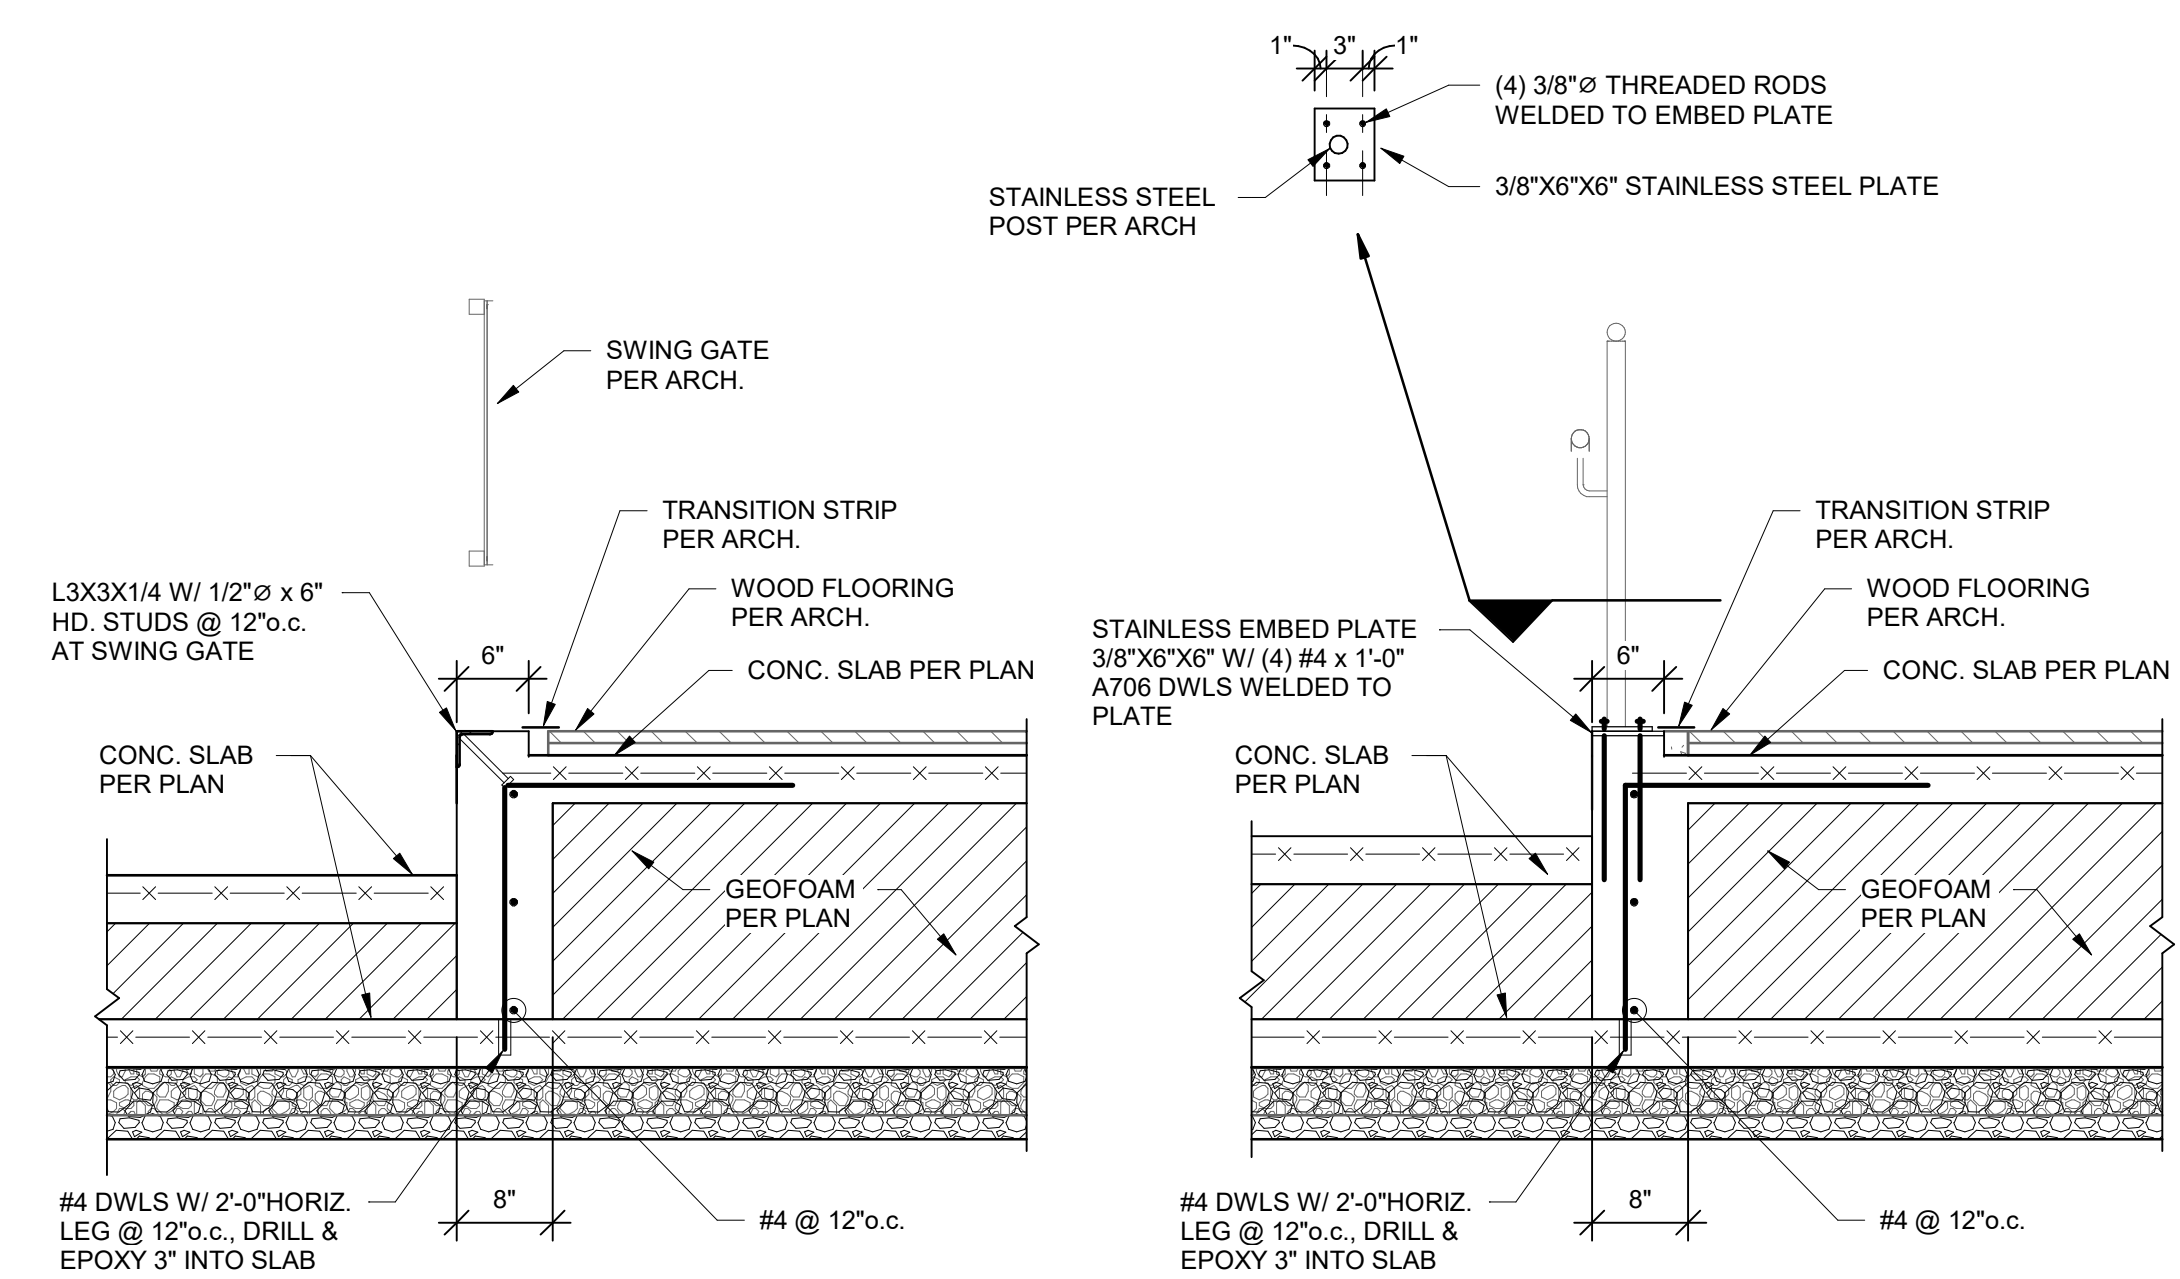
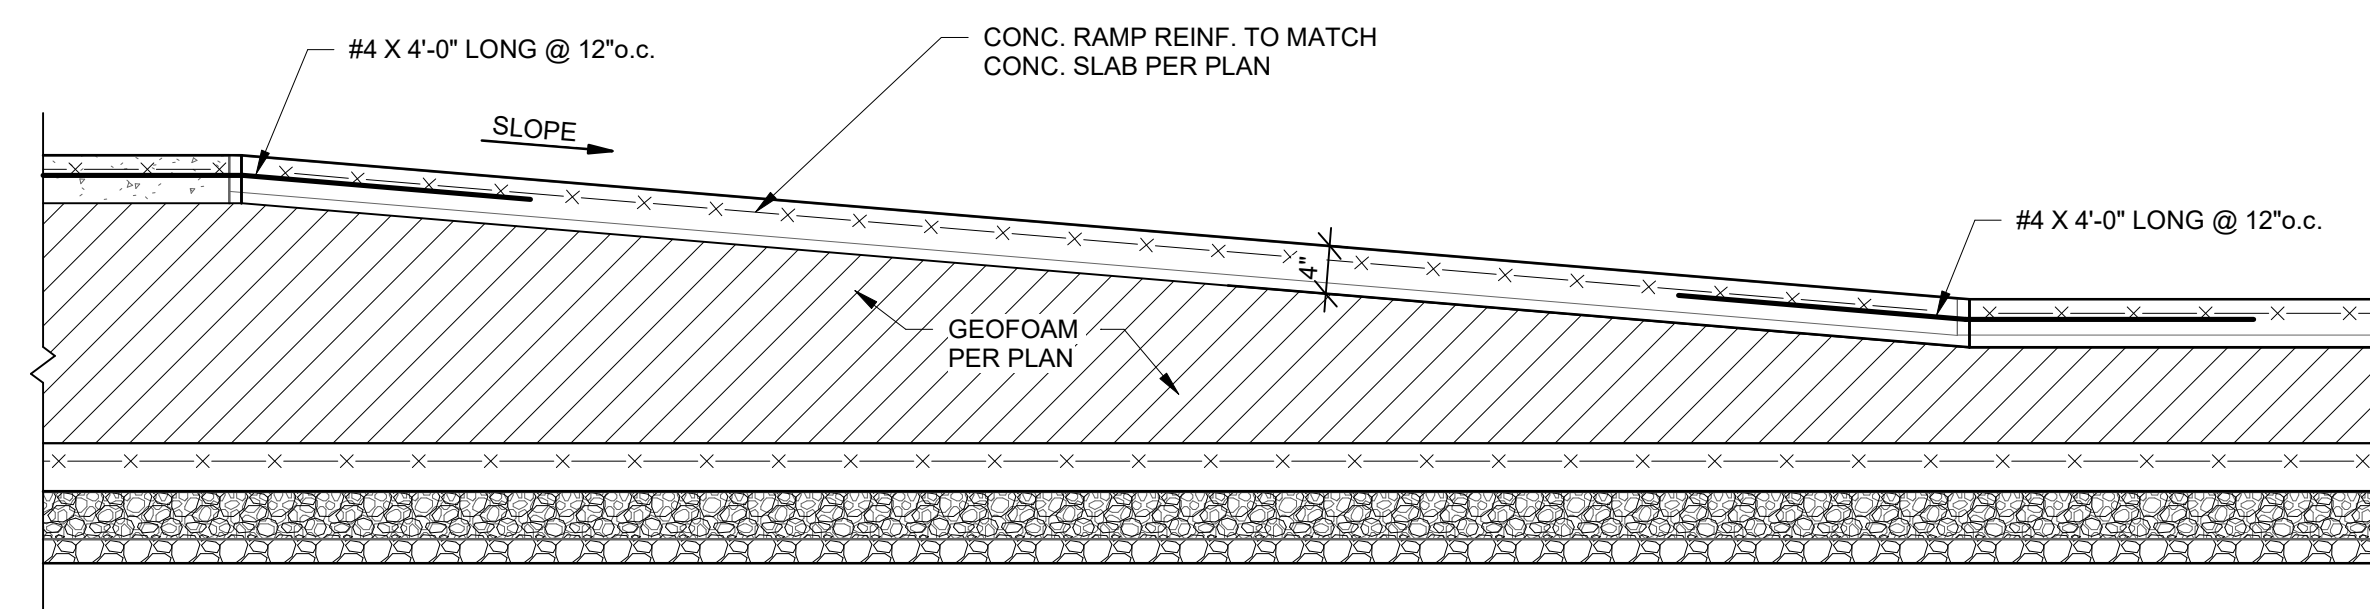
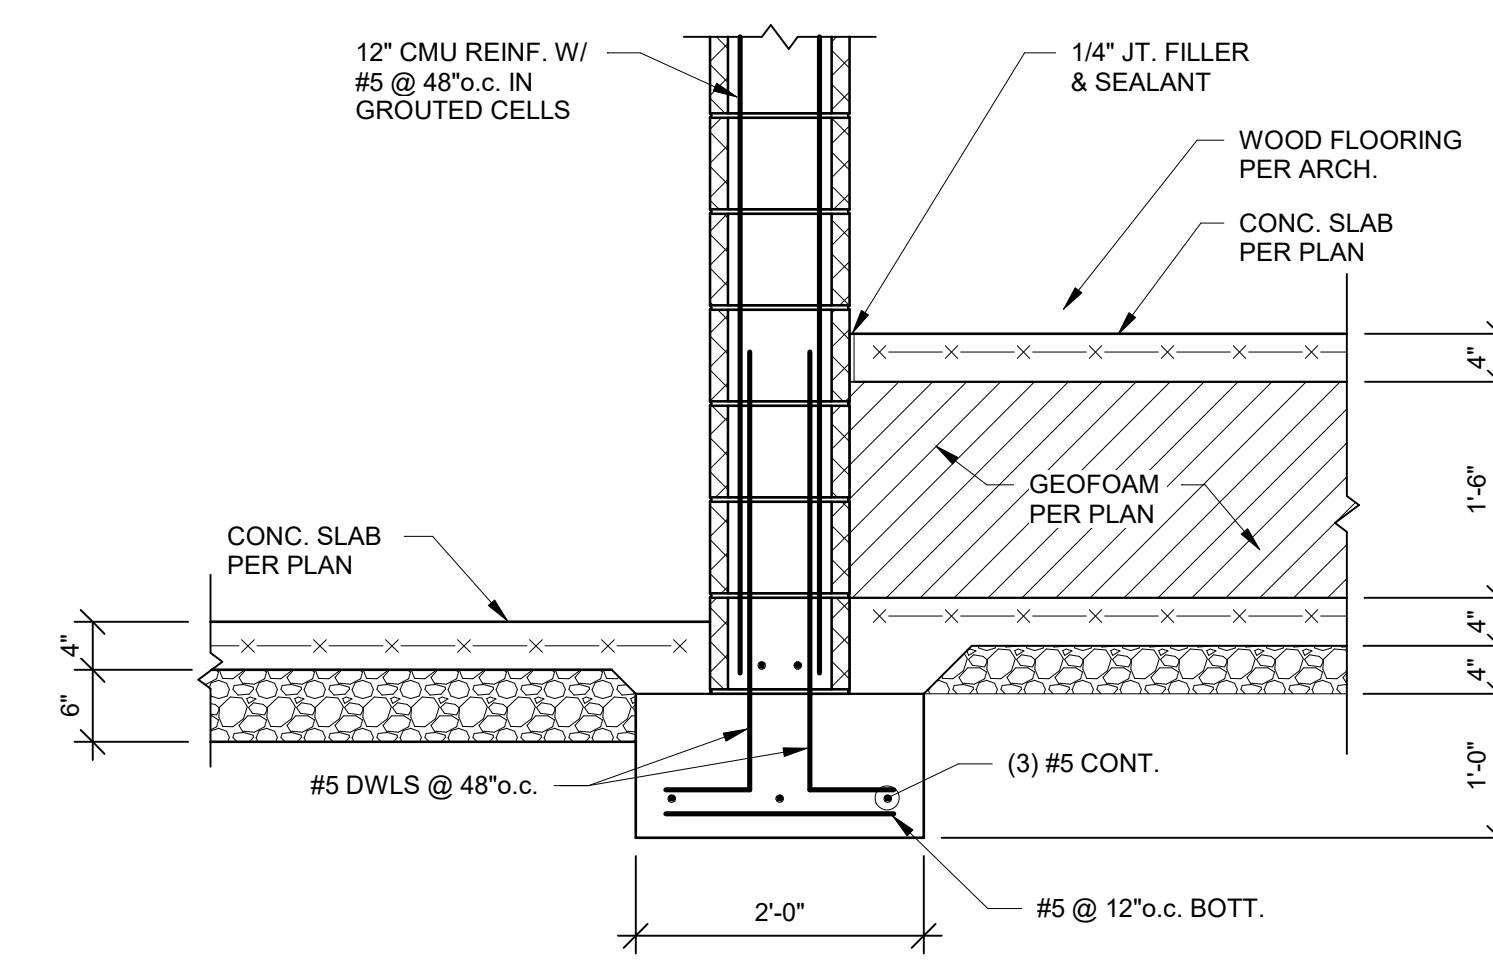
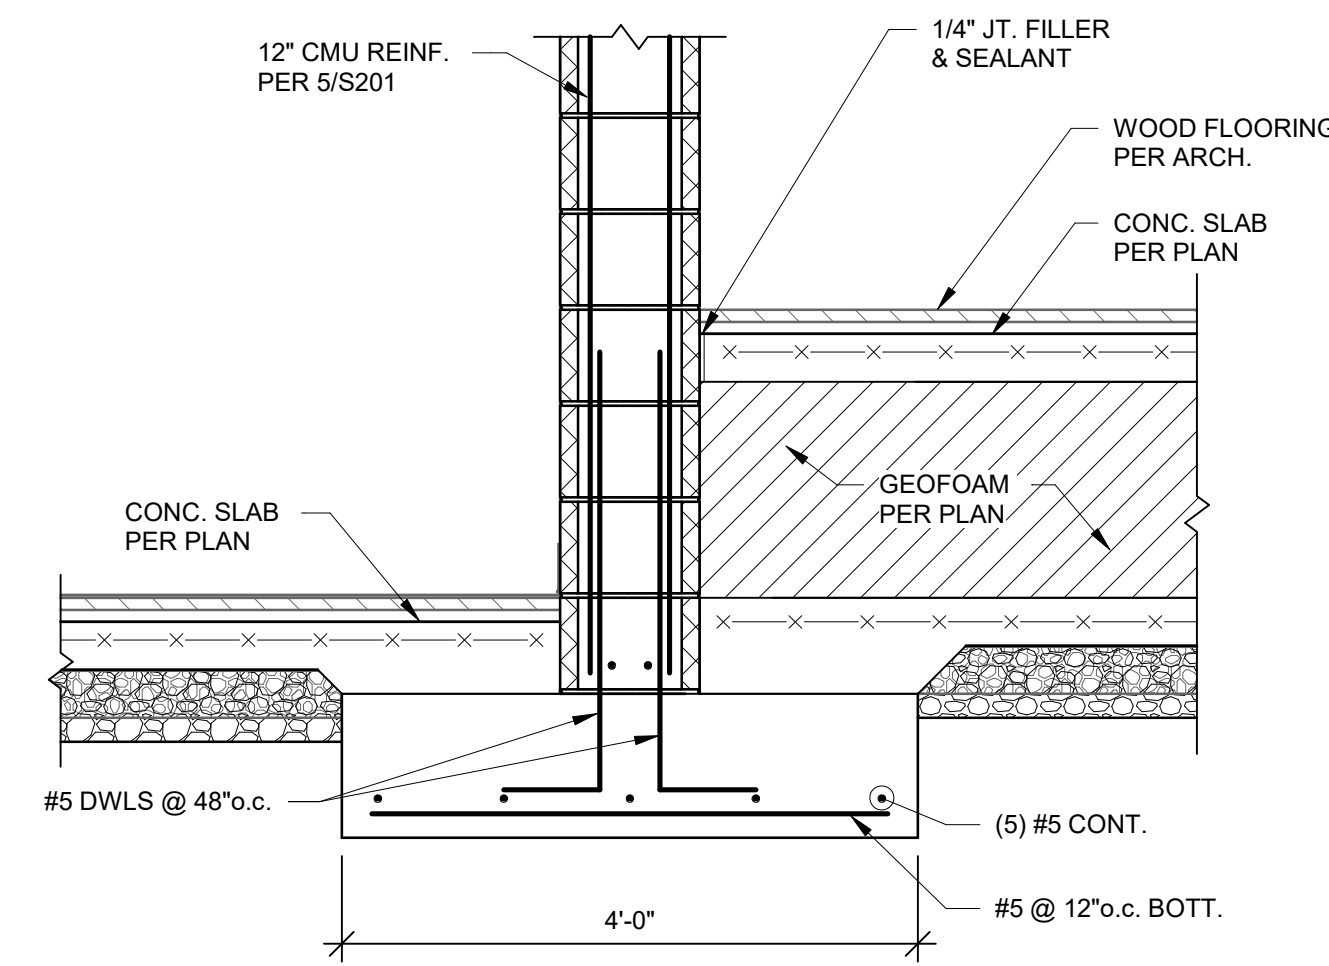
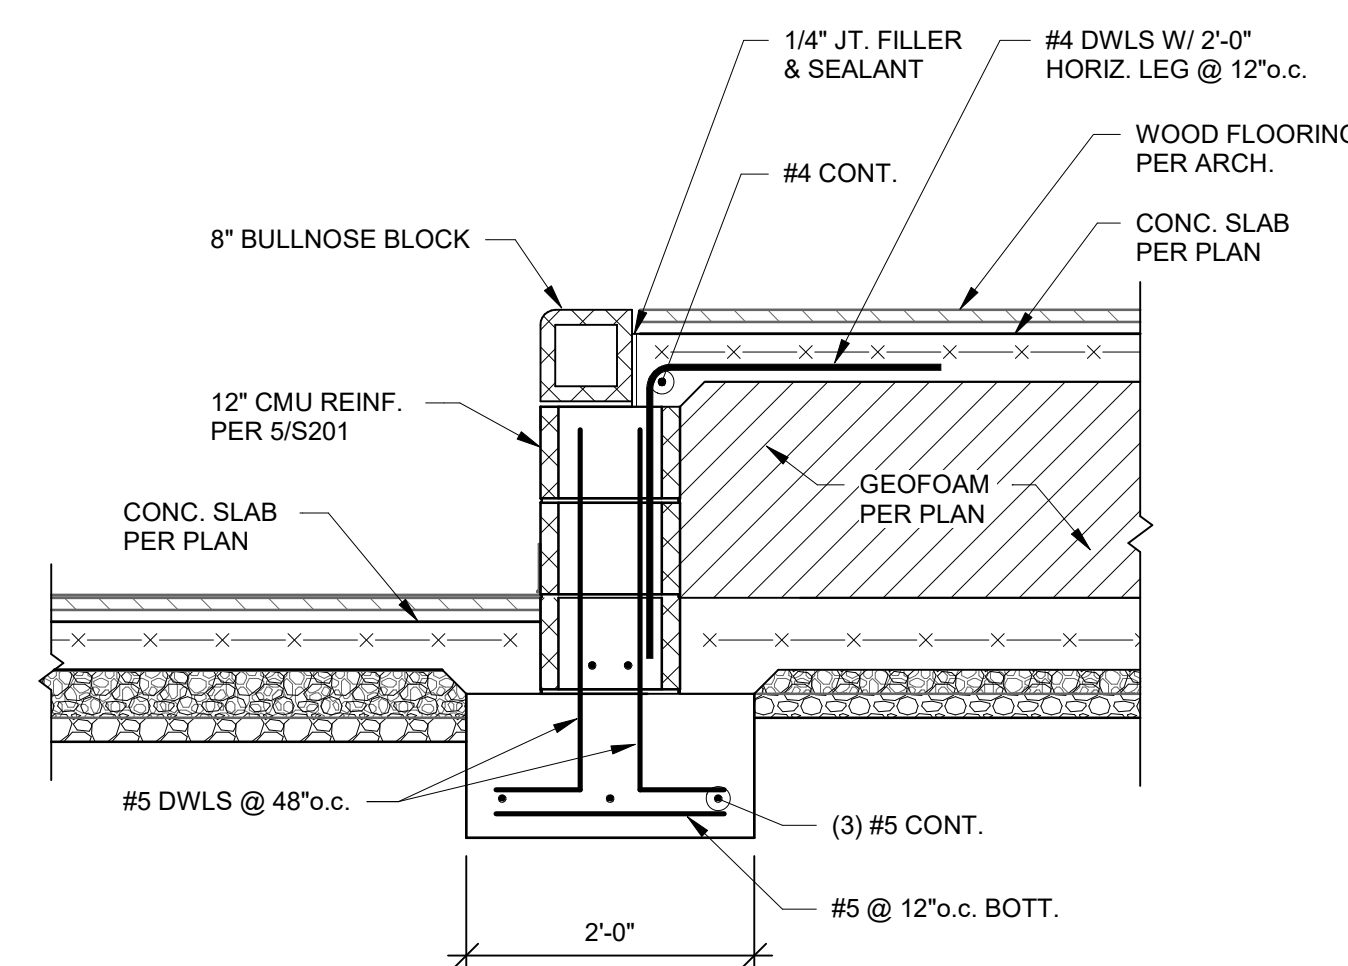
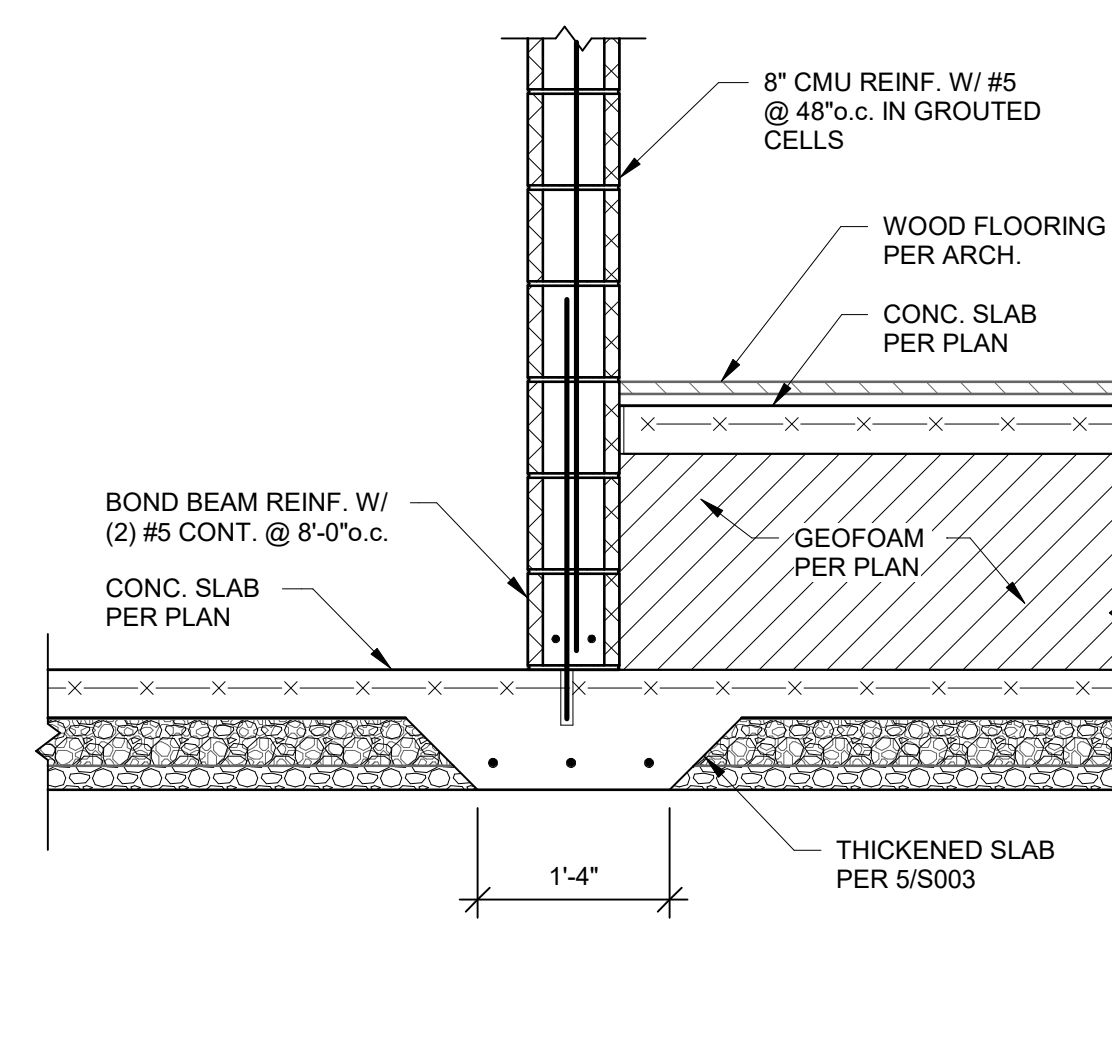
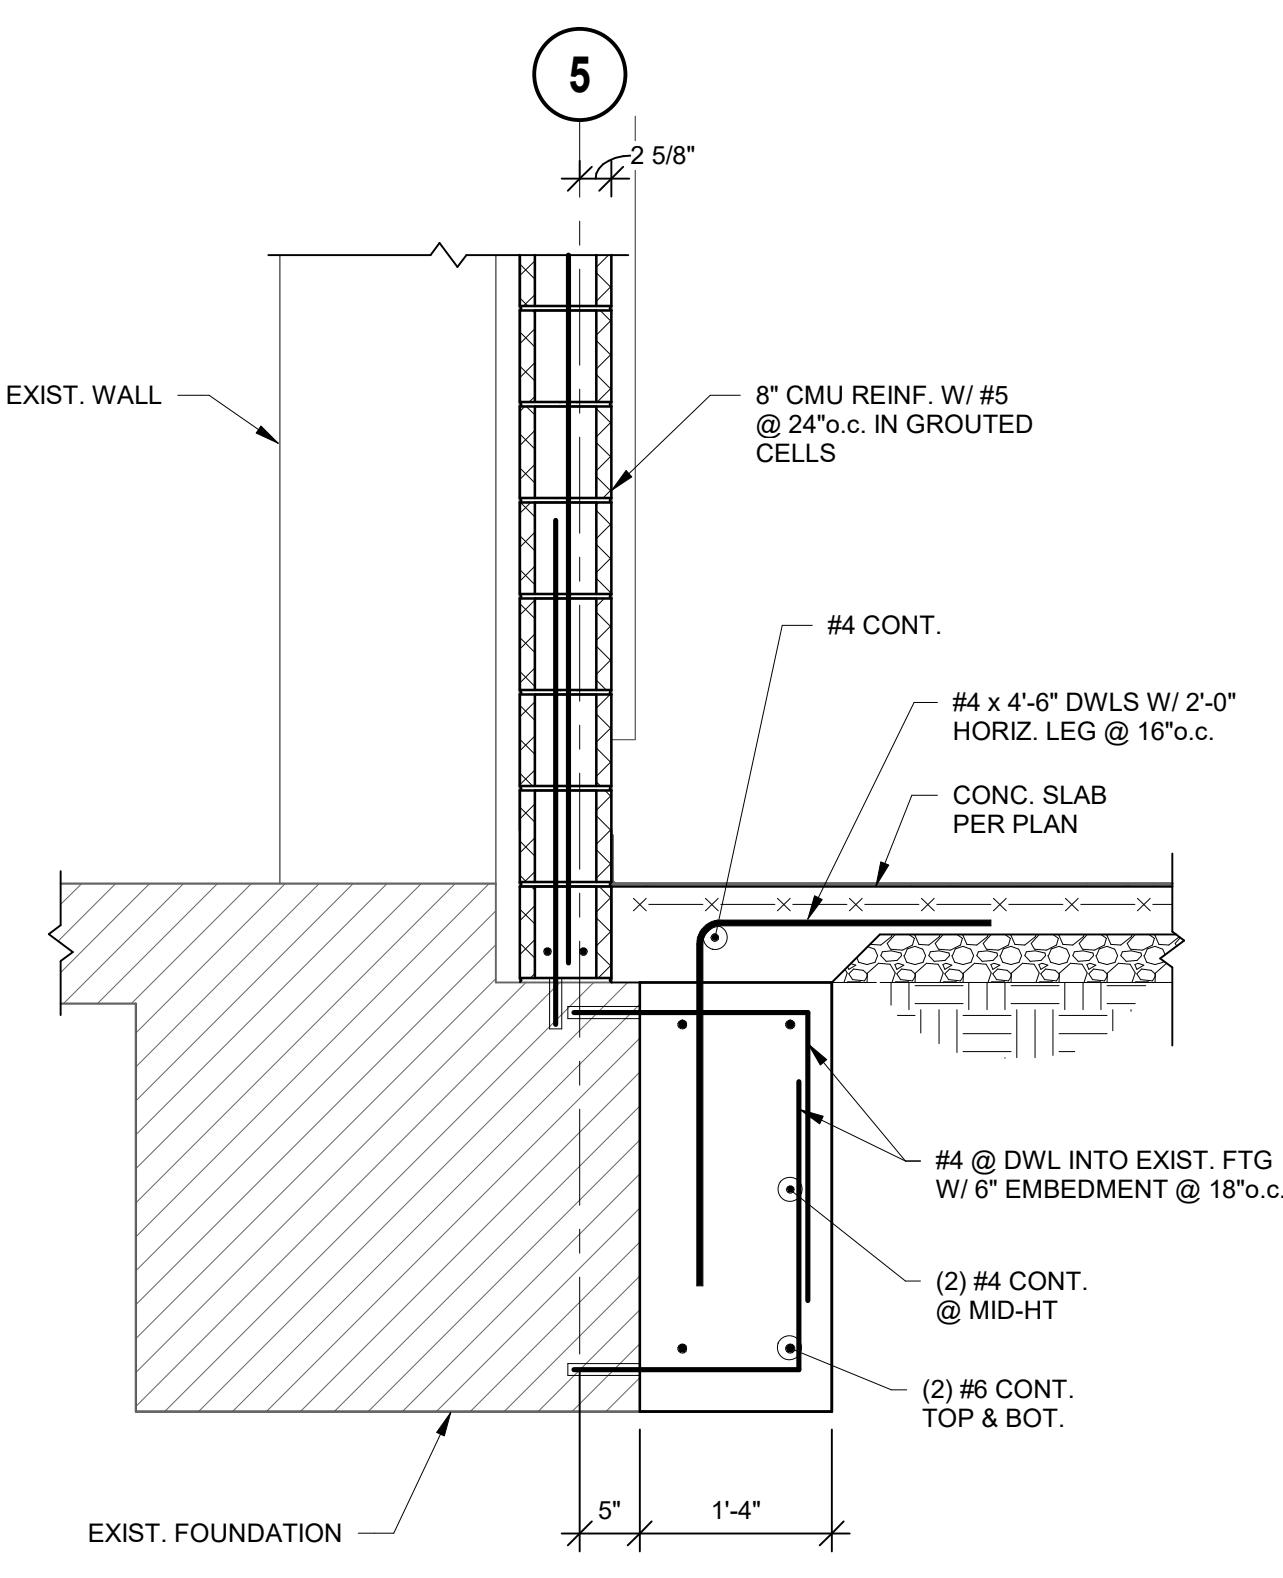
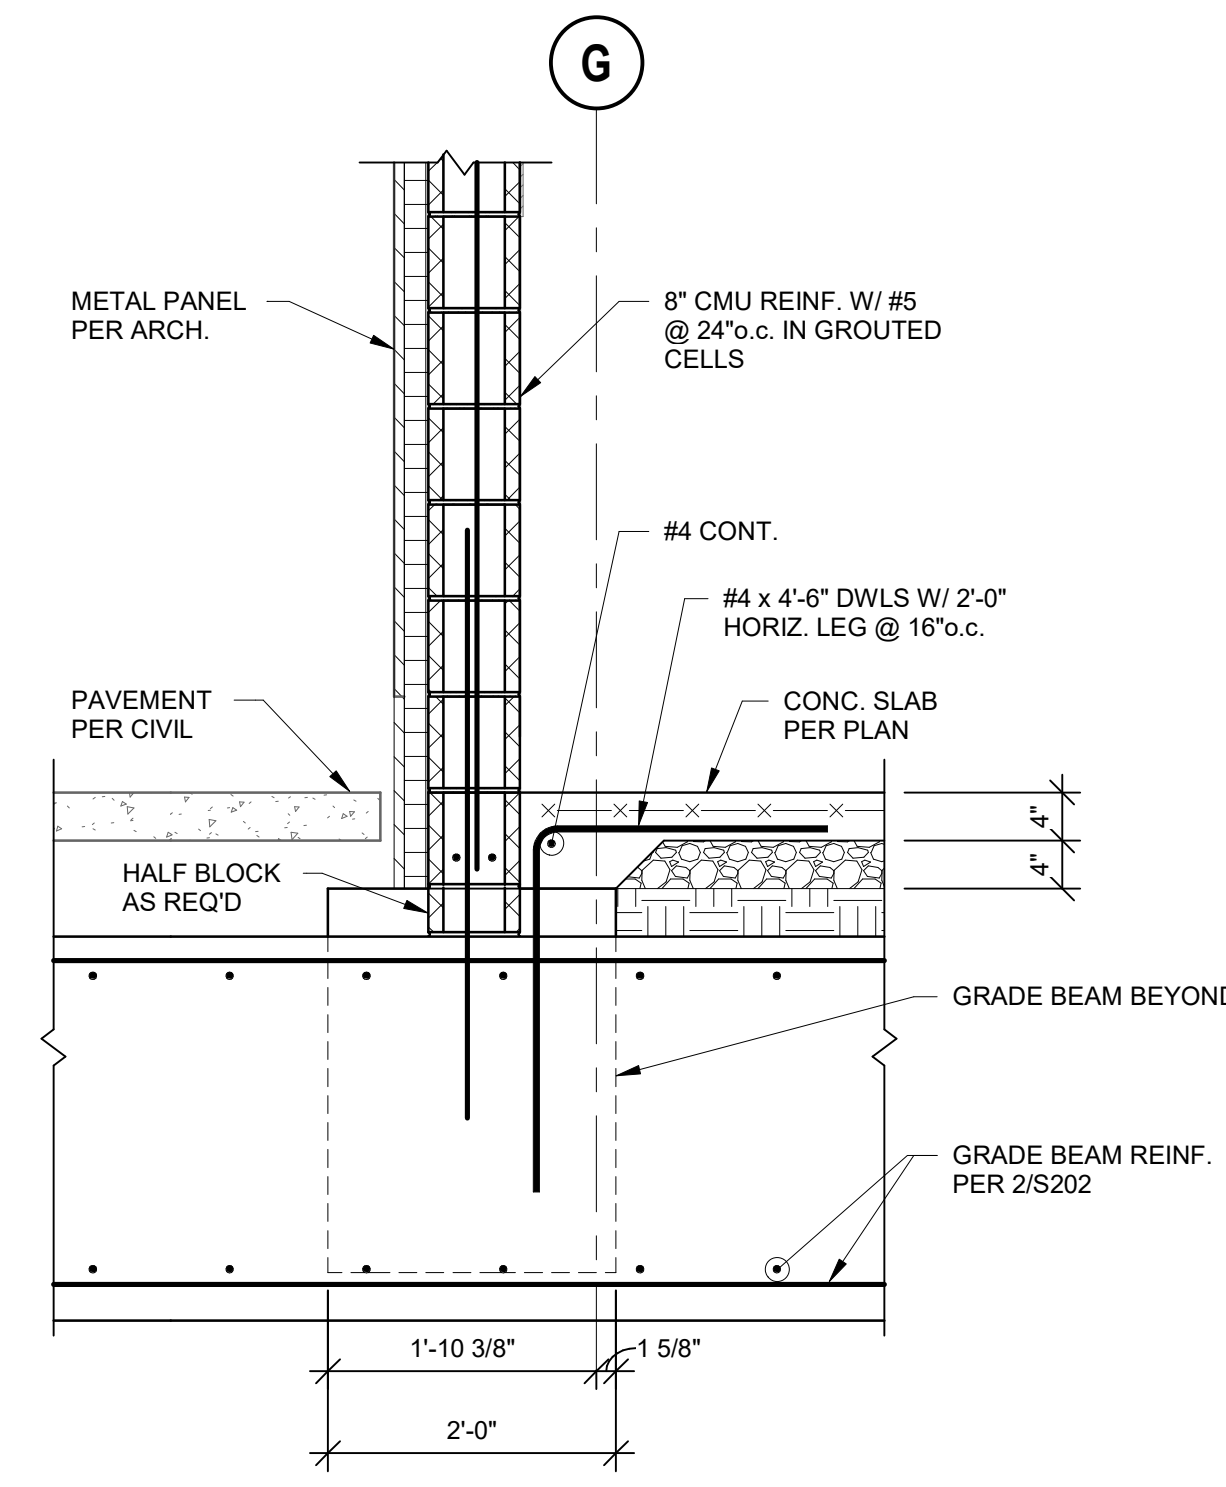
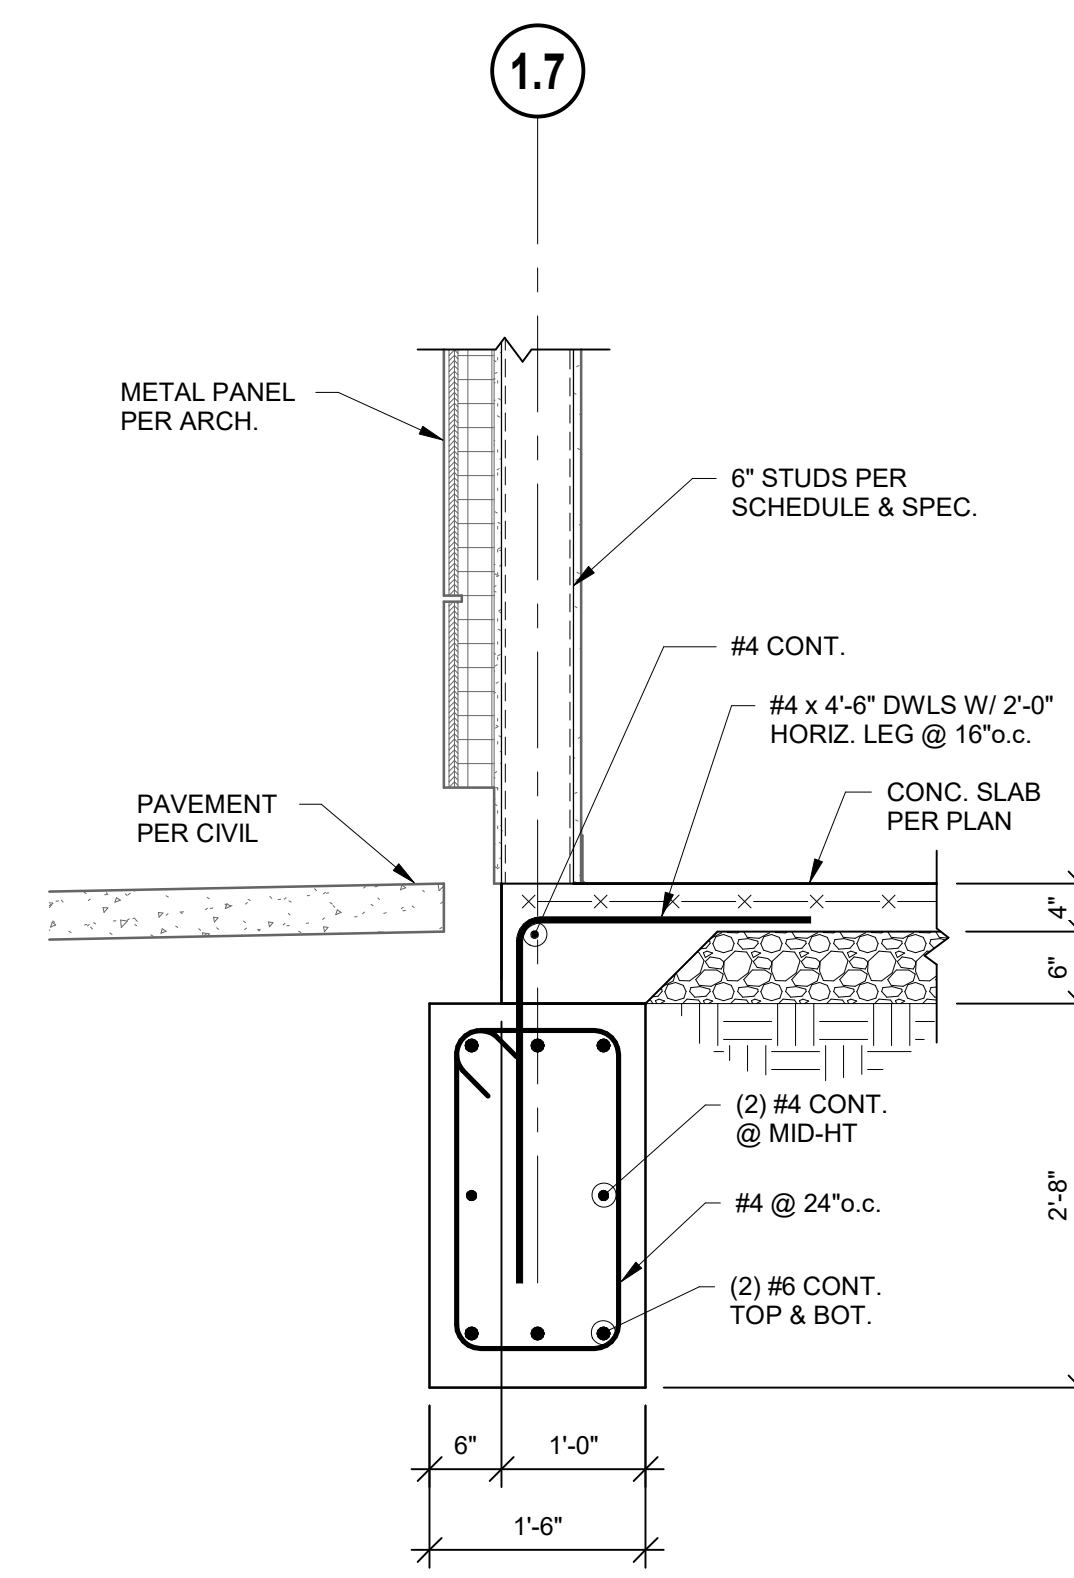
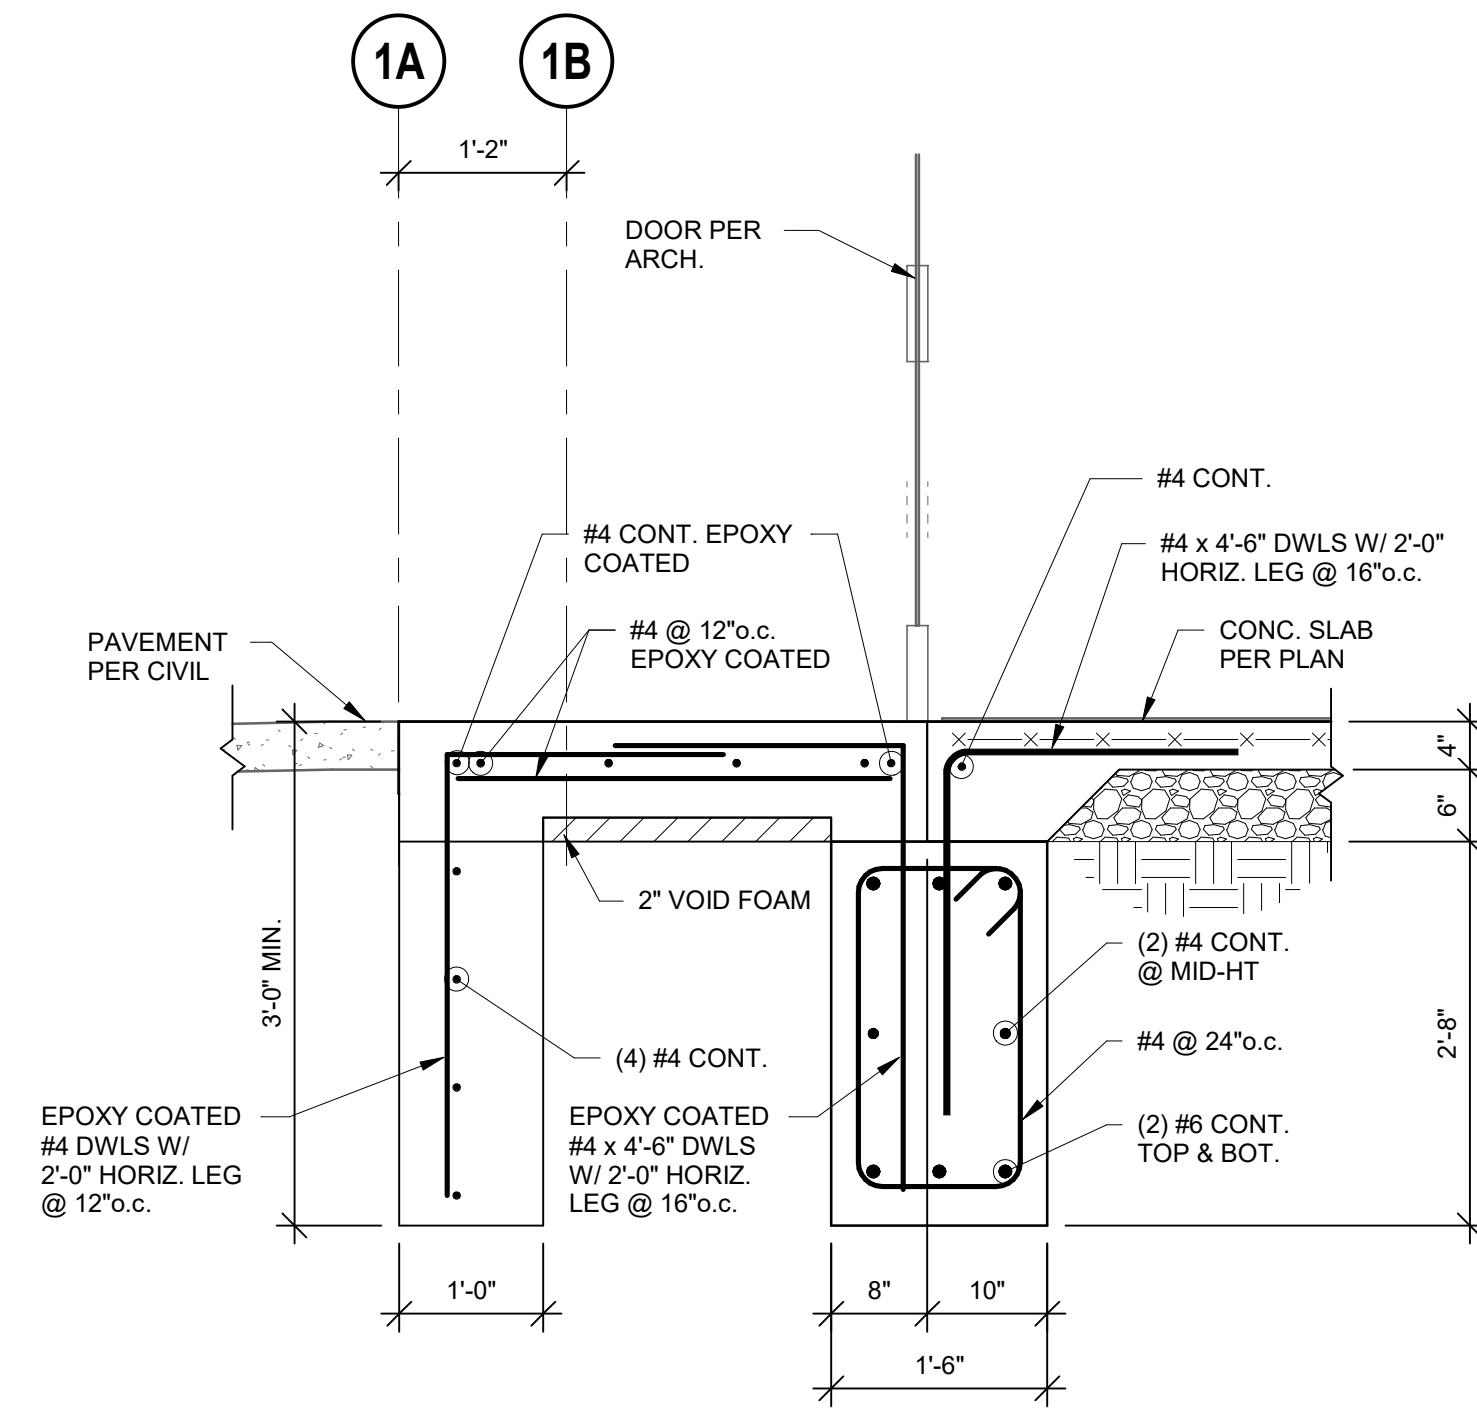
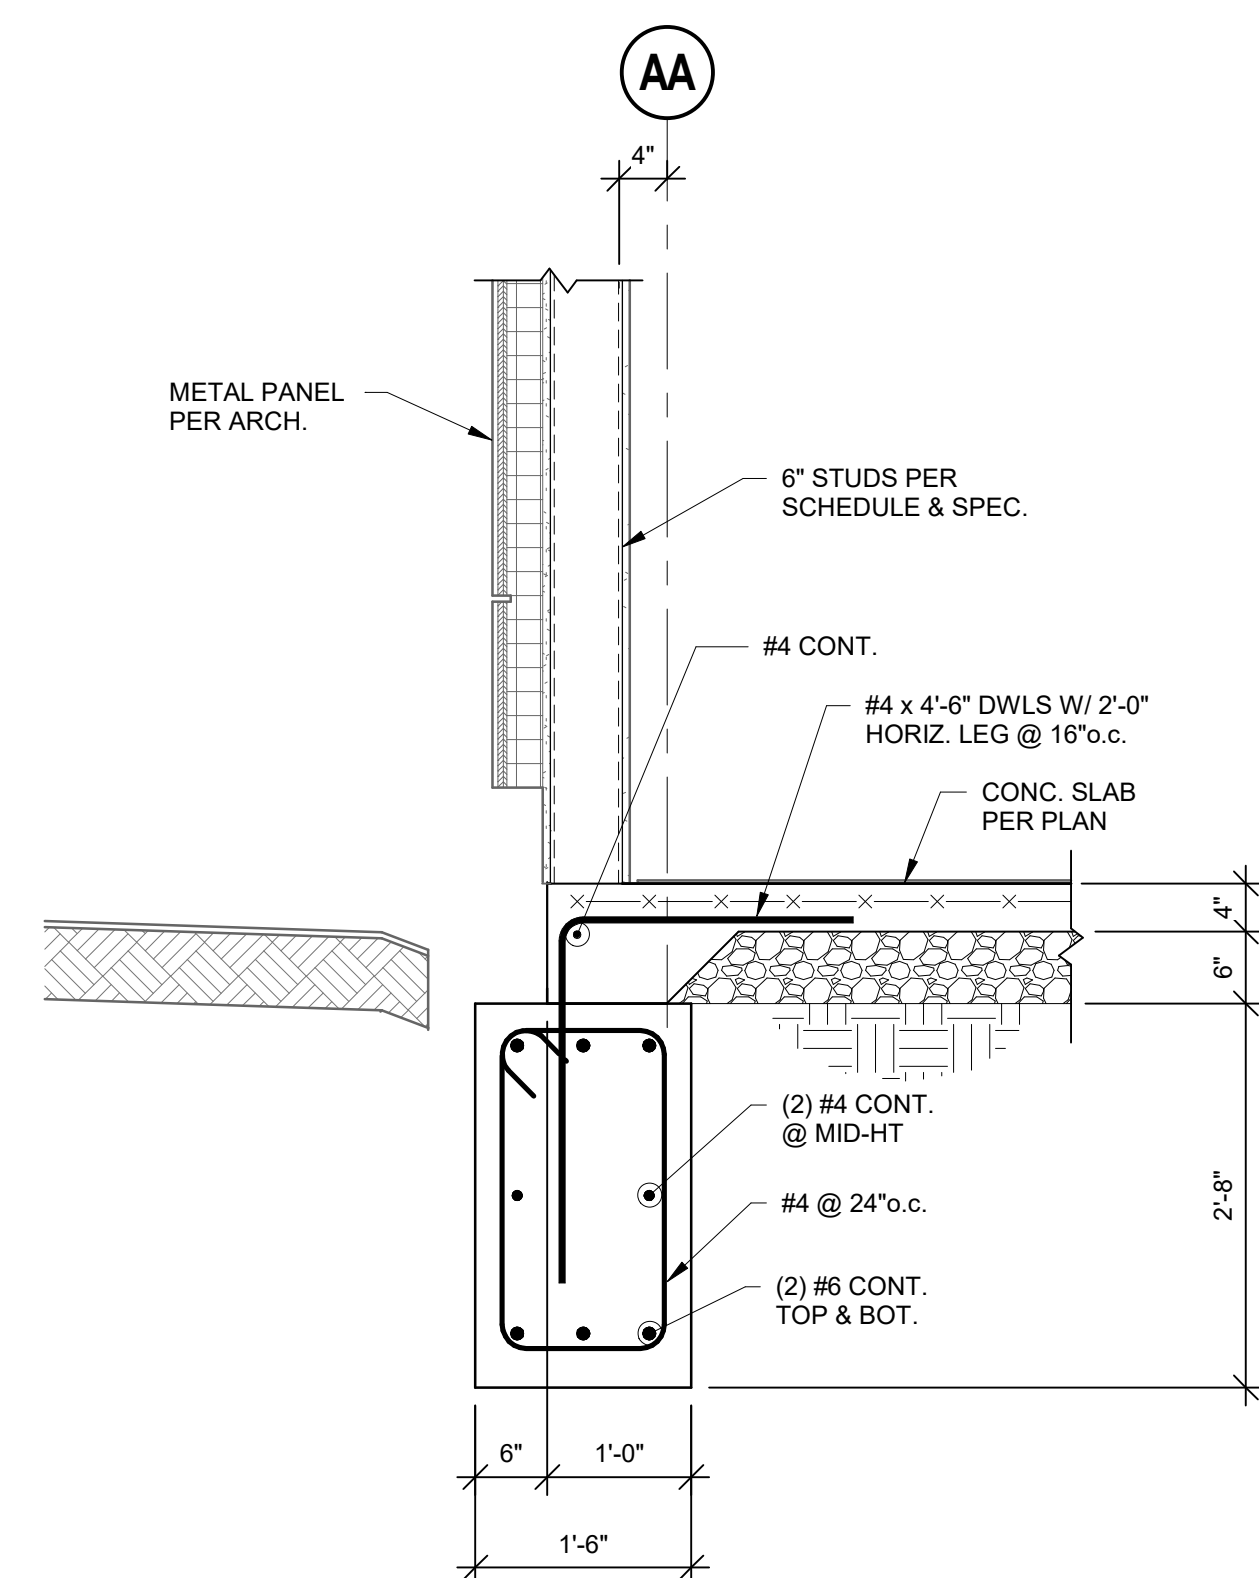
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Surveying #2006027138
11827 W 112th Street, Suite 200
Overland Park, KS 66210
913.317.9390 phone
Peerbolte Creative
Theatrical Consultant
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Warrensburg, MO 64093-0754
660.429.1363 phone

South Valley Middle School Storm Shelter Addition
Liberty School District
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Bob D Campbell
Structural Engineer
State Certificate of Authority #000442
4338 Belleview Ave
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816.531.4144 phone

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State Certificate of Authority #EGC000178
25618 W 103rd Street
Olathe, KS 66061
913.345.2127 phone
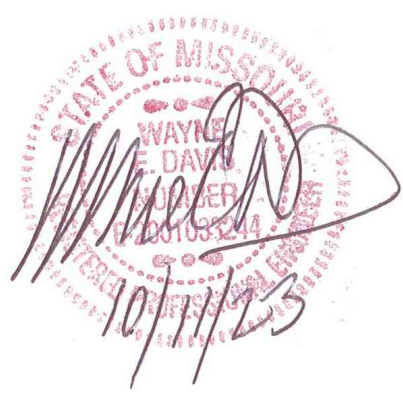
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Civil Engineer
State Certificate of Authority
Engineering #2001009364
Landscaping #2006027139
Surveying #2006027138
11827 W 112th Street, Suite 200
Overland Park, KS 66210
913.317.9390 phone

Peerbolte Creative
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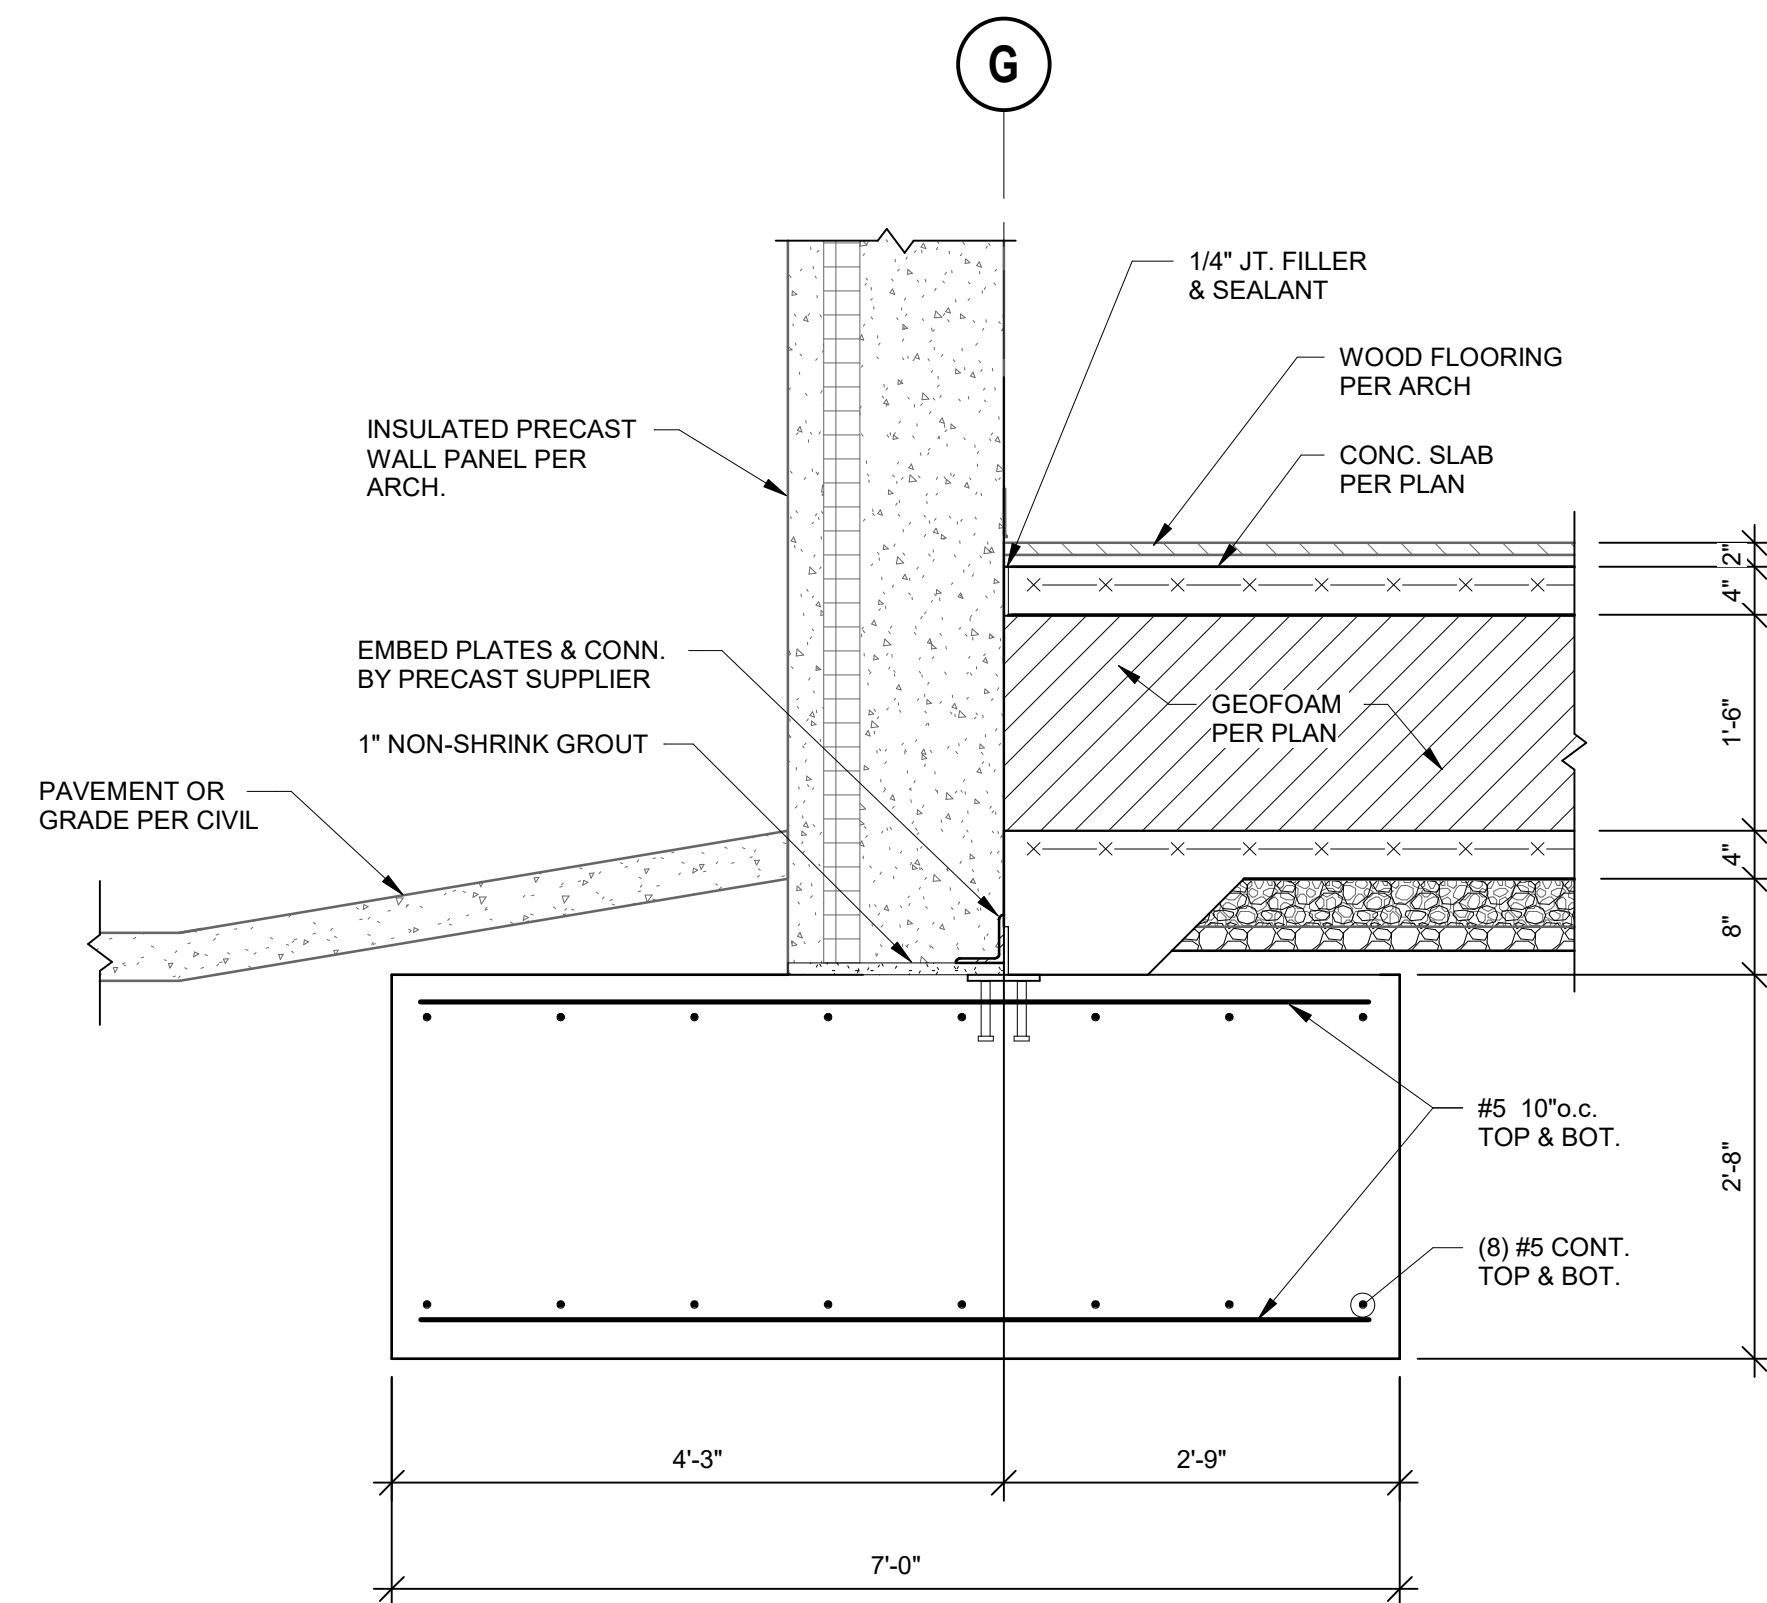
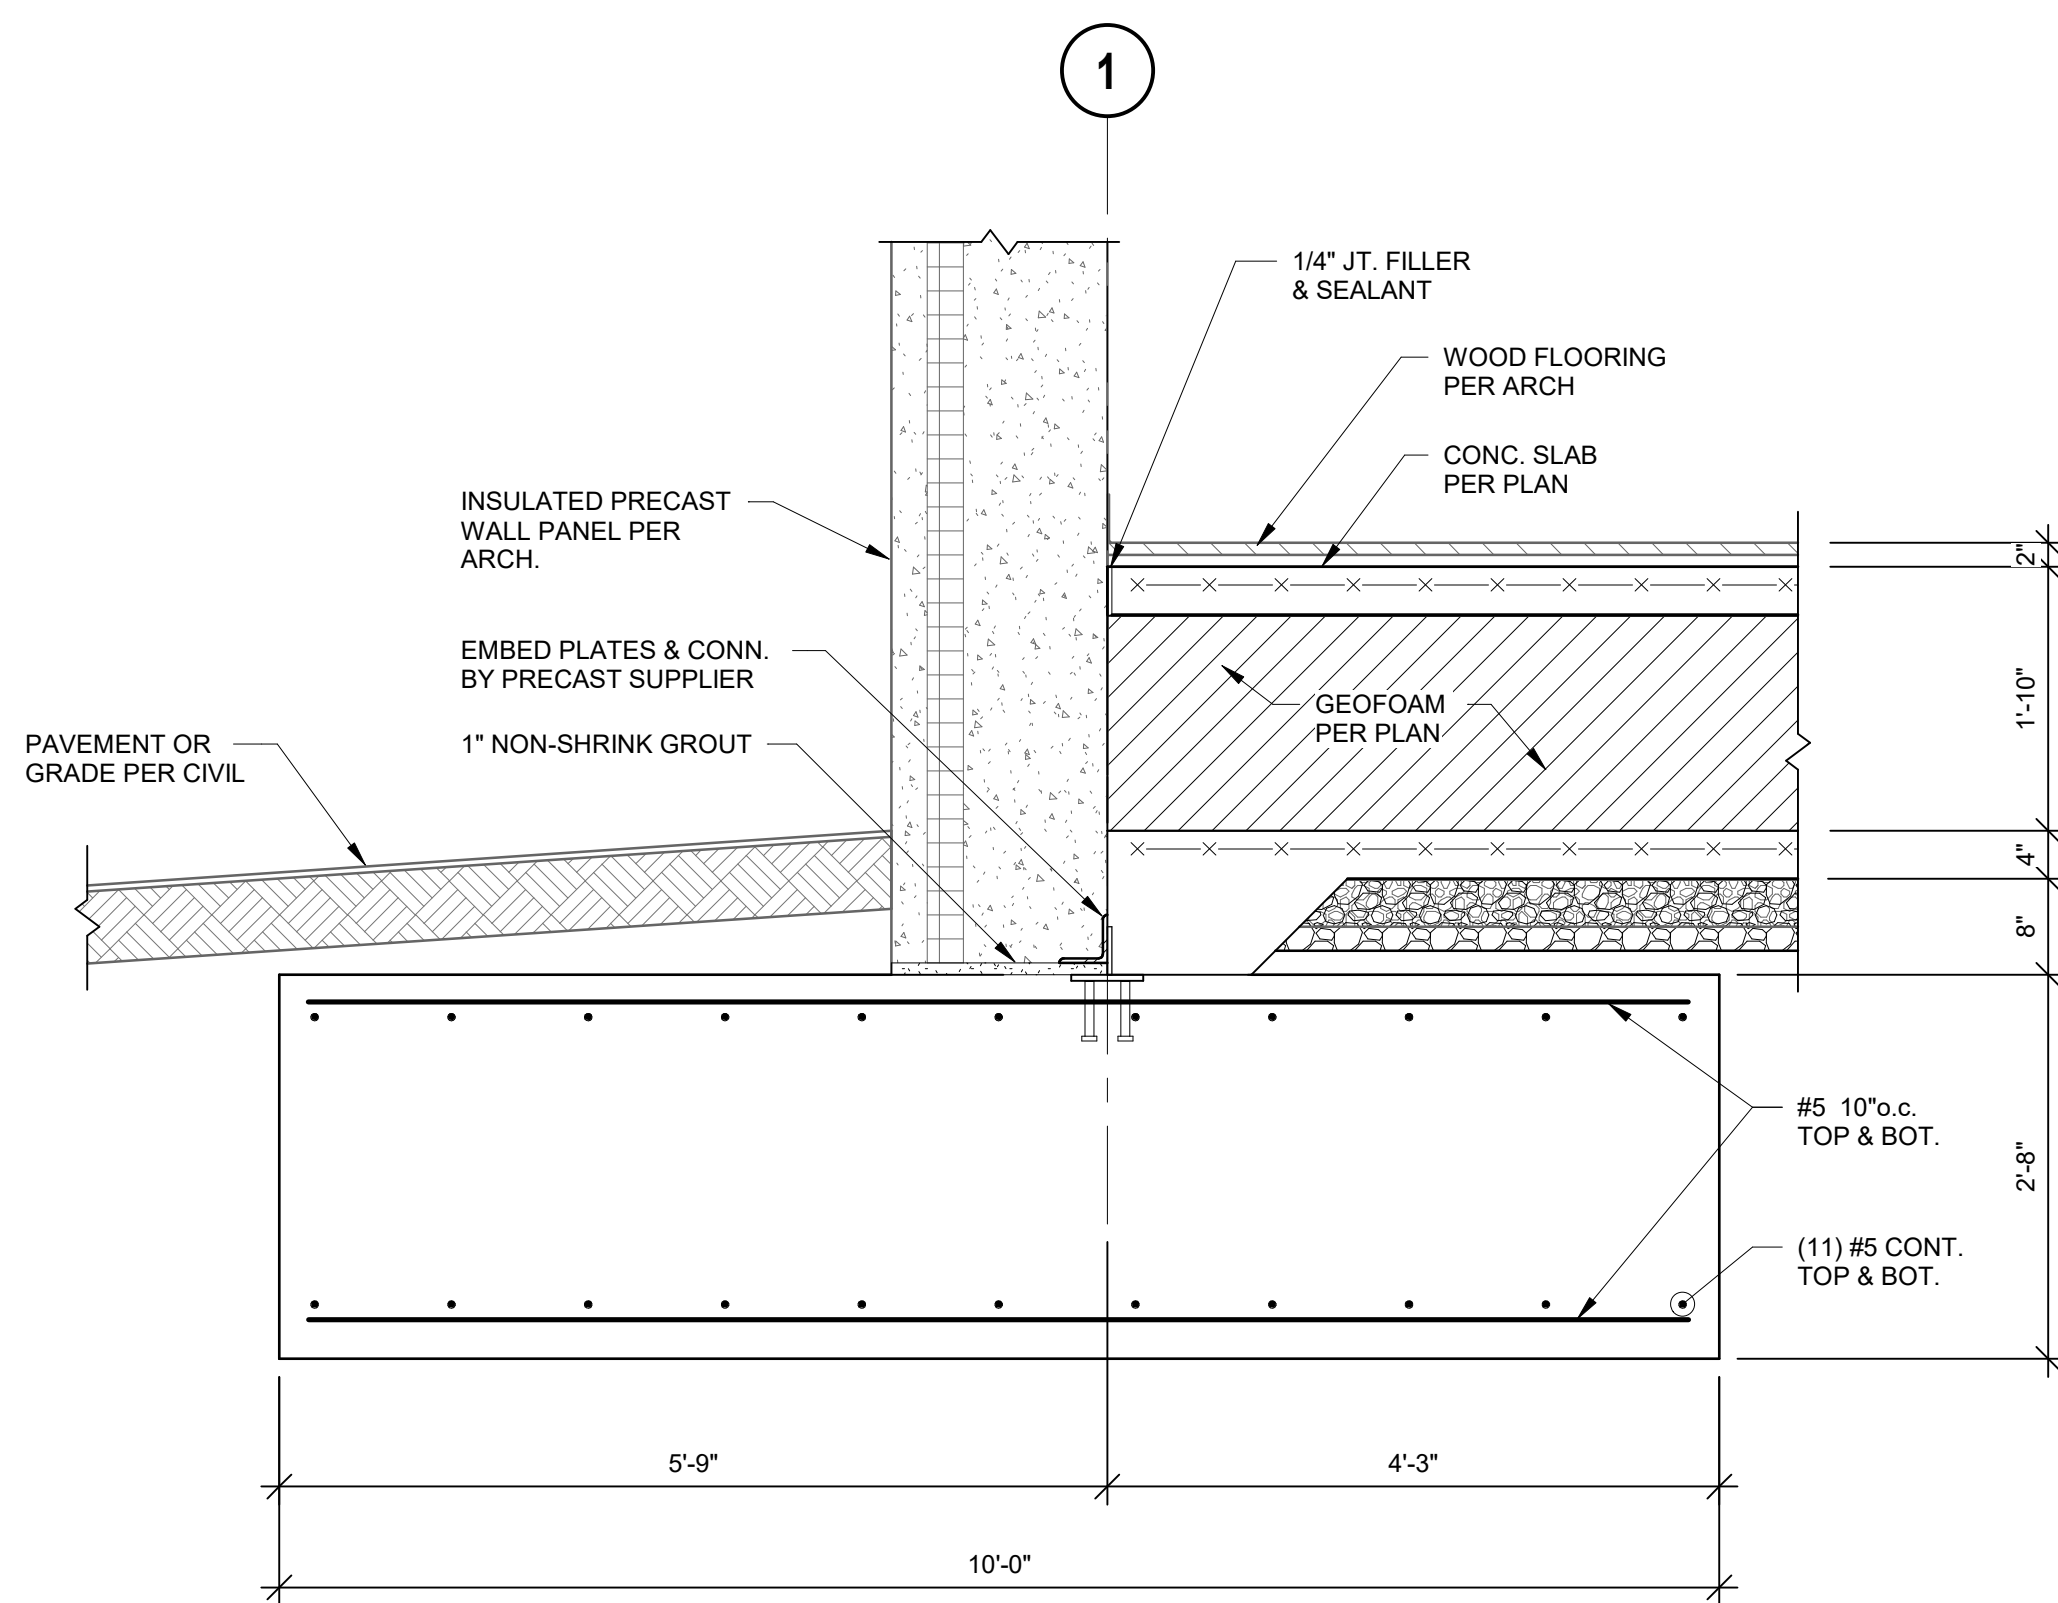
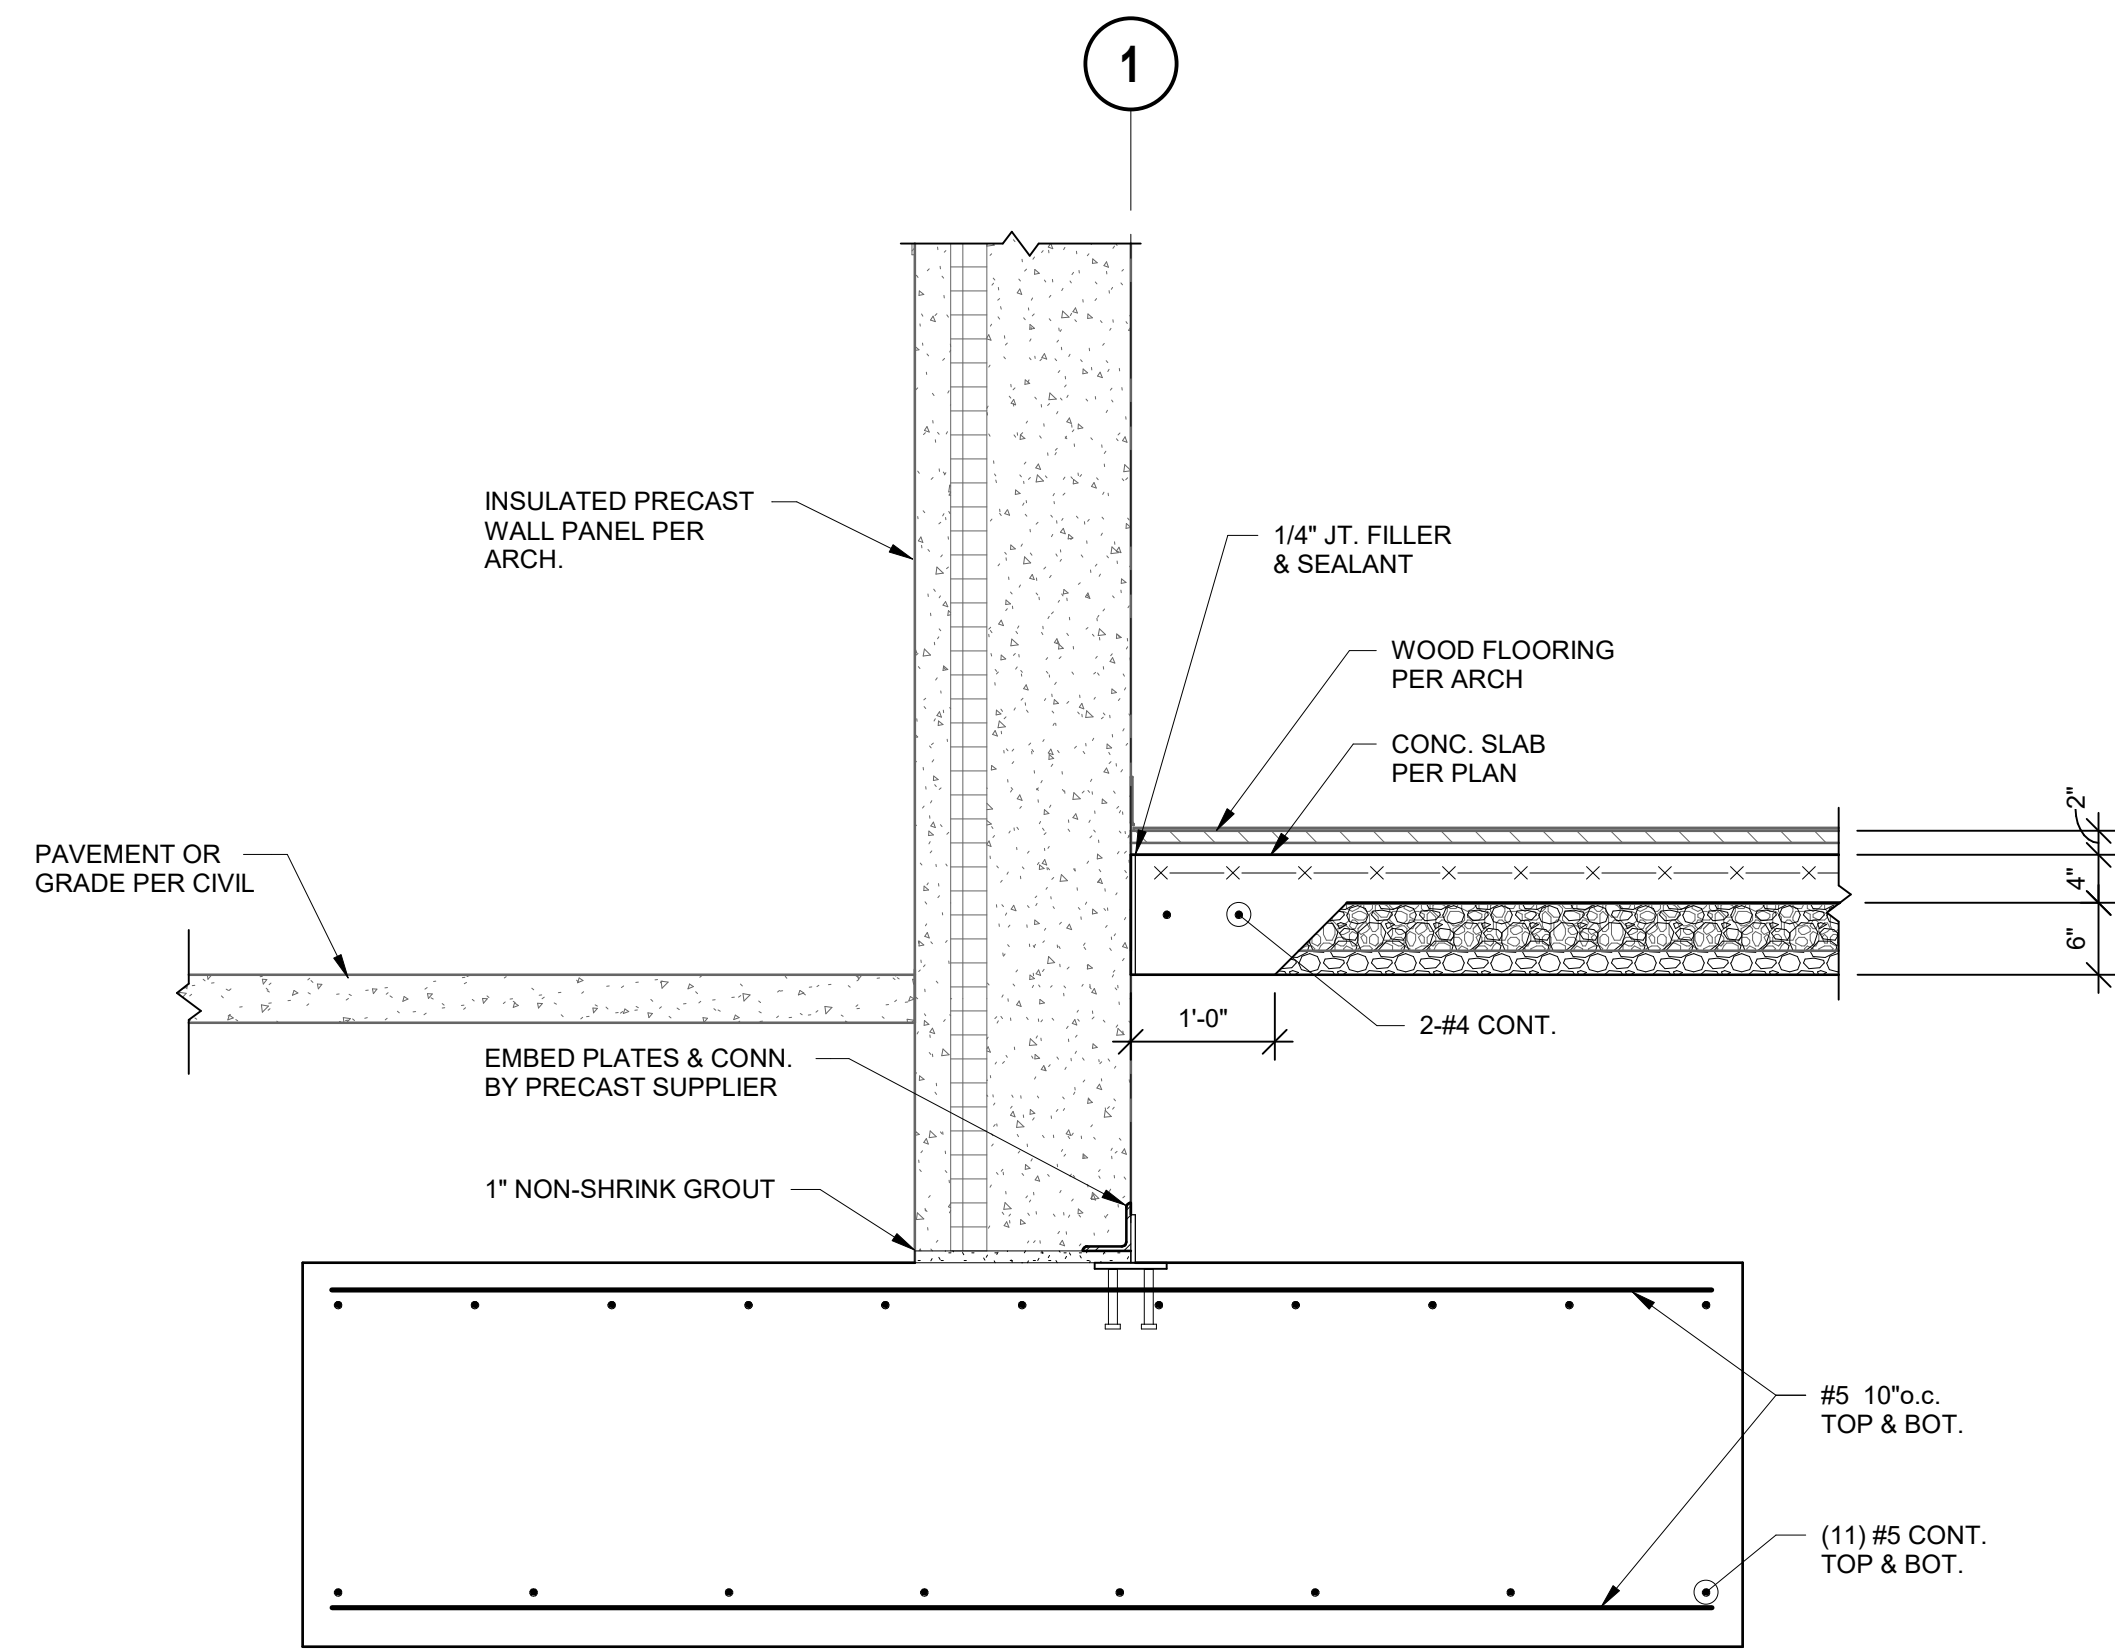
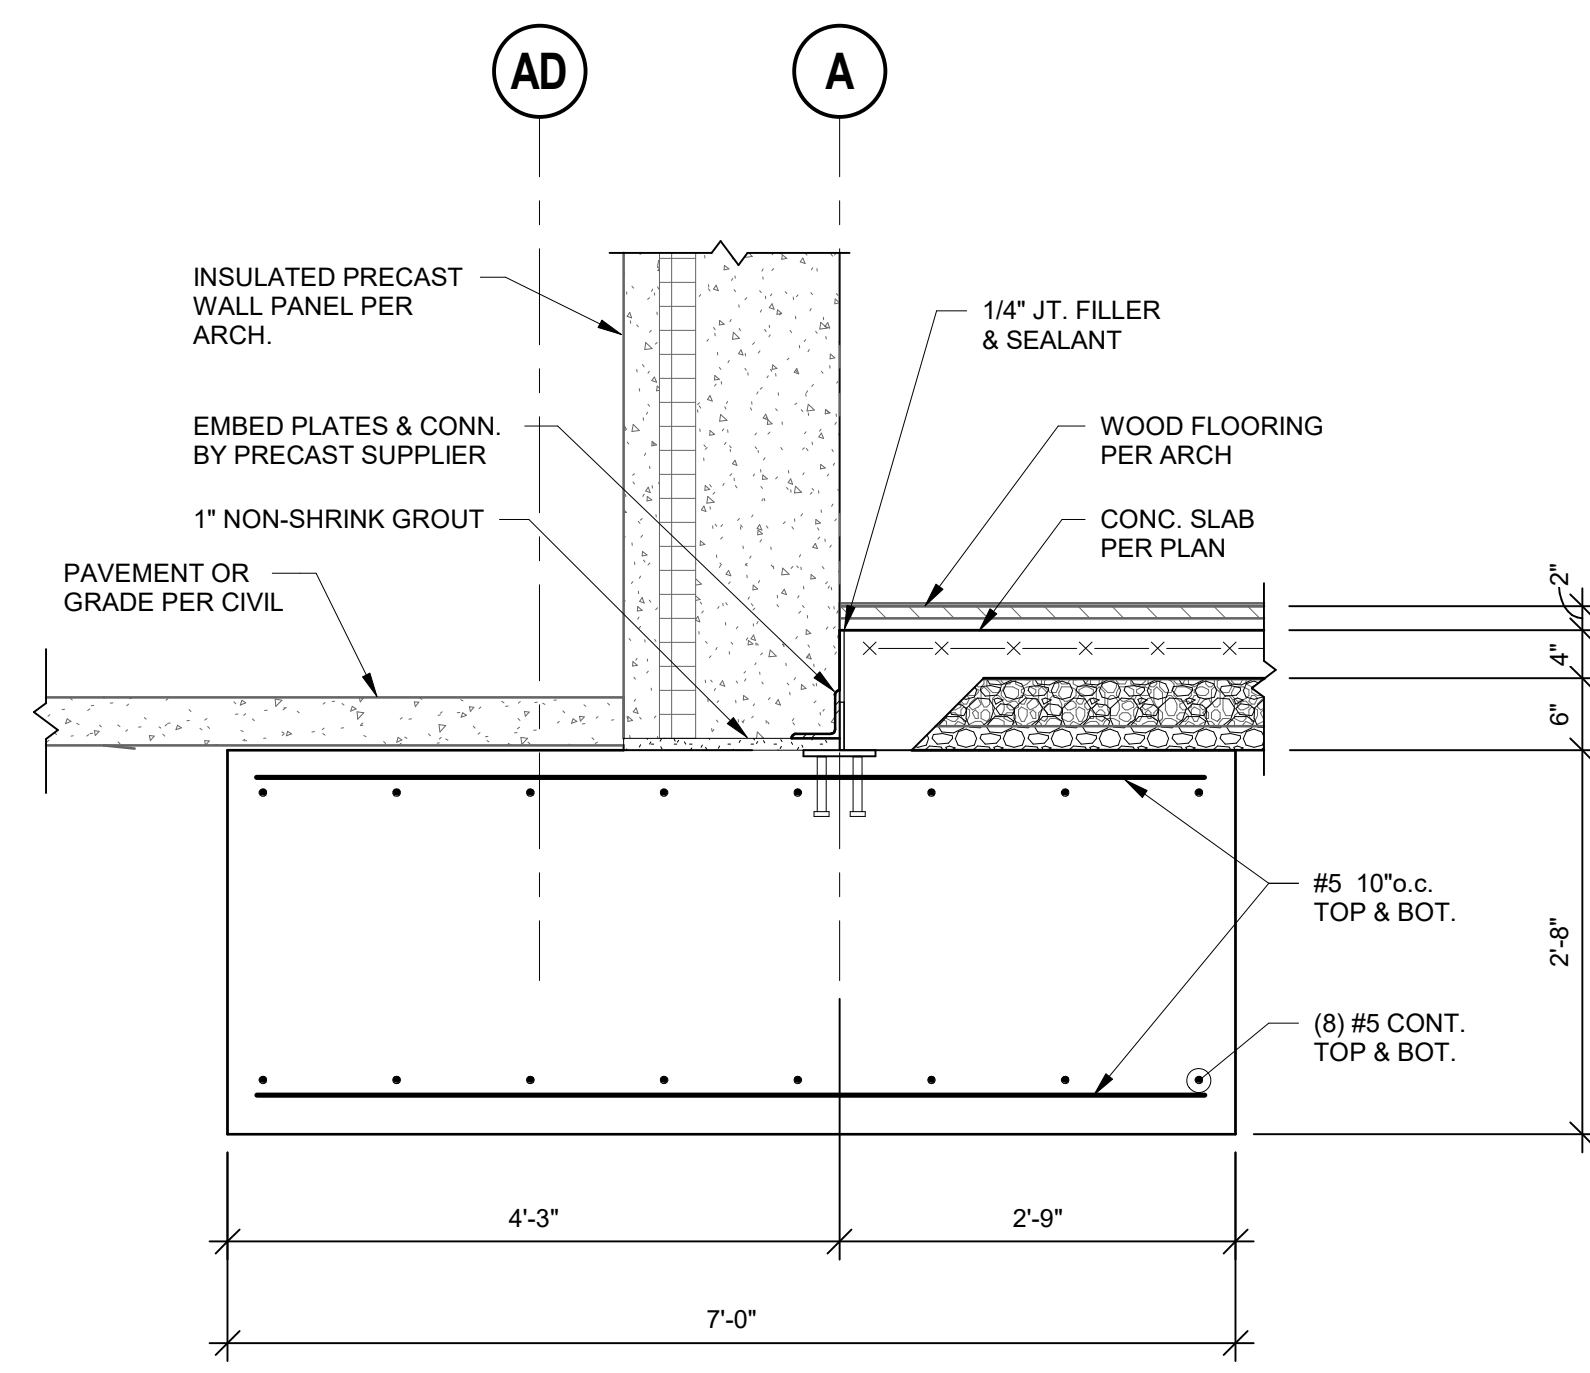
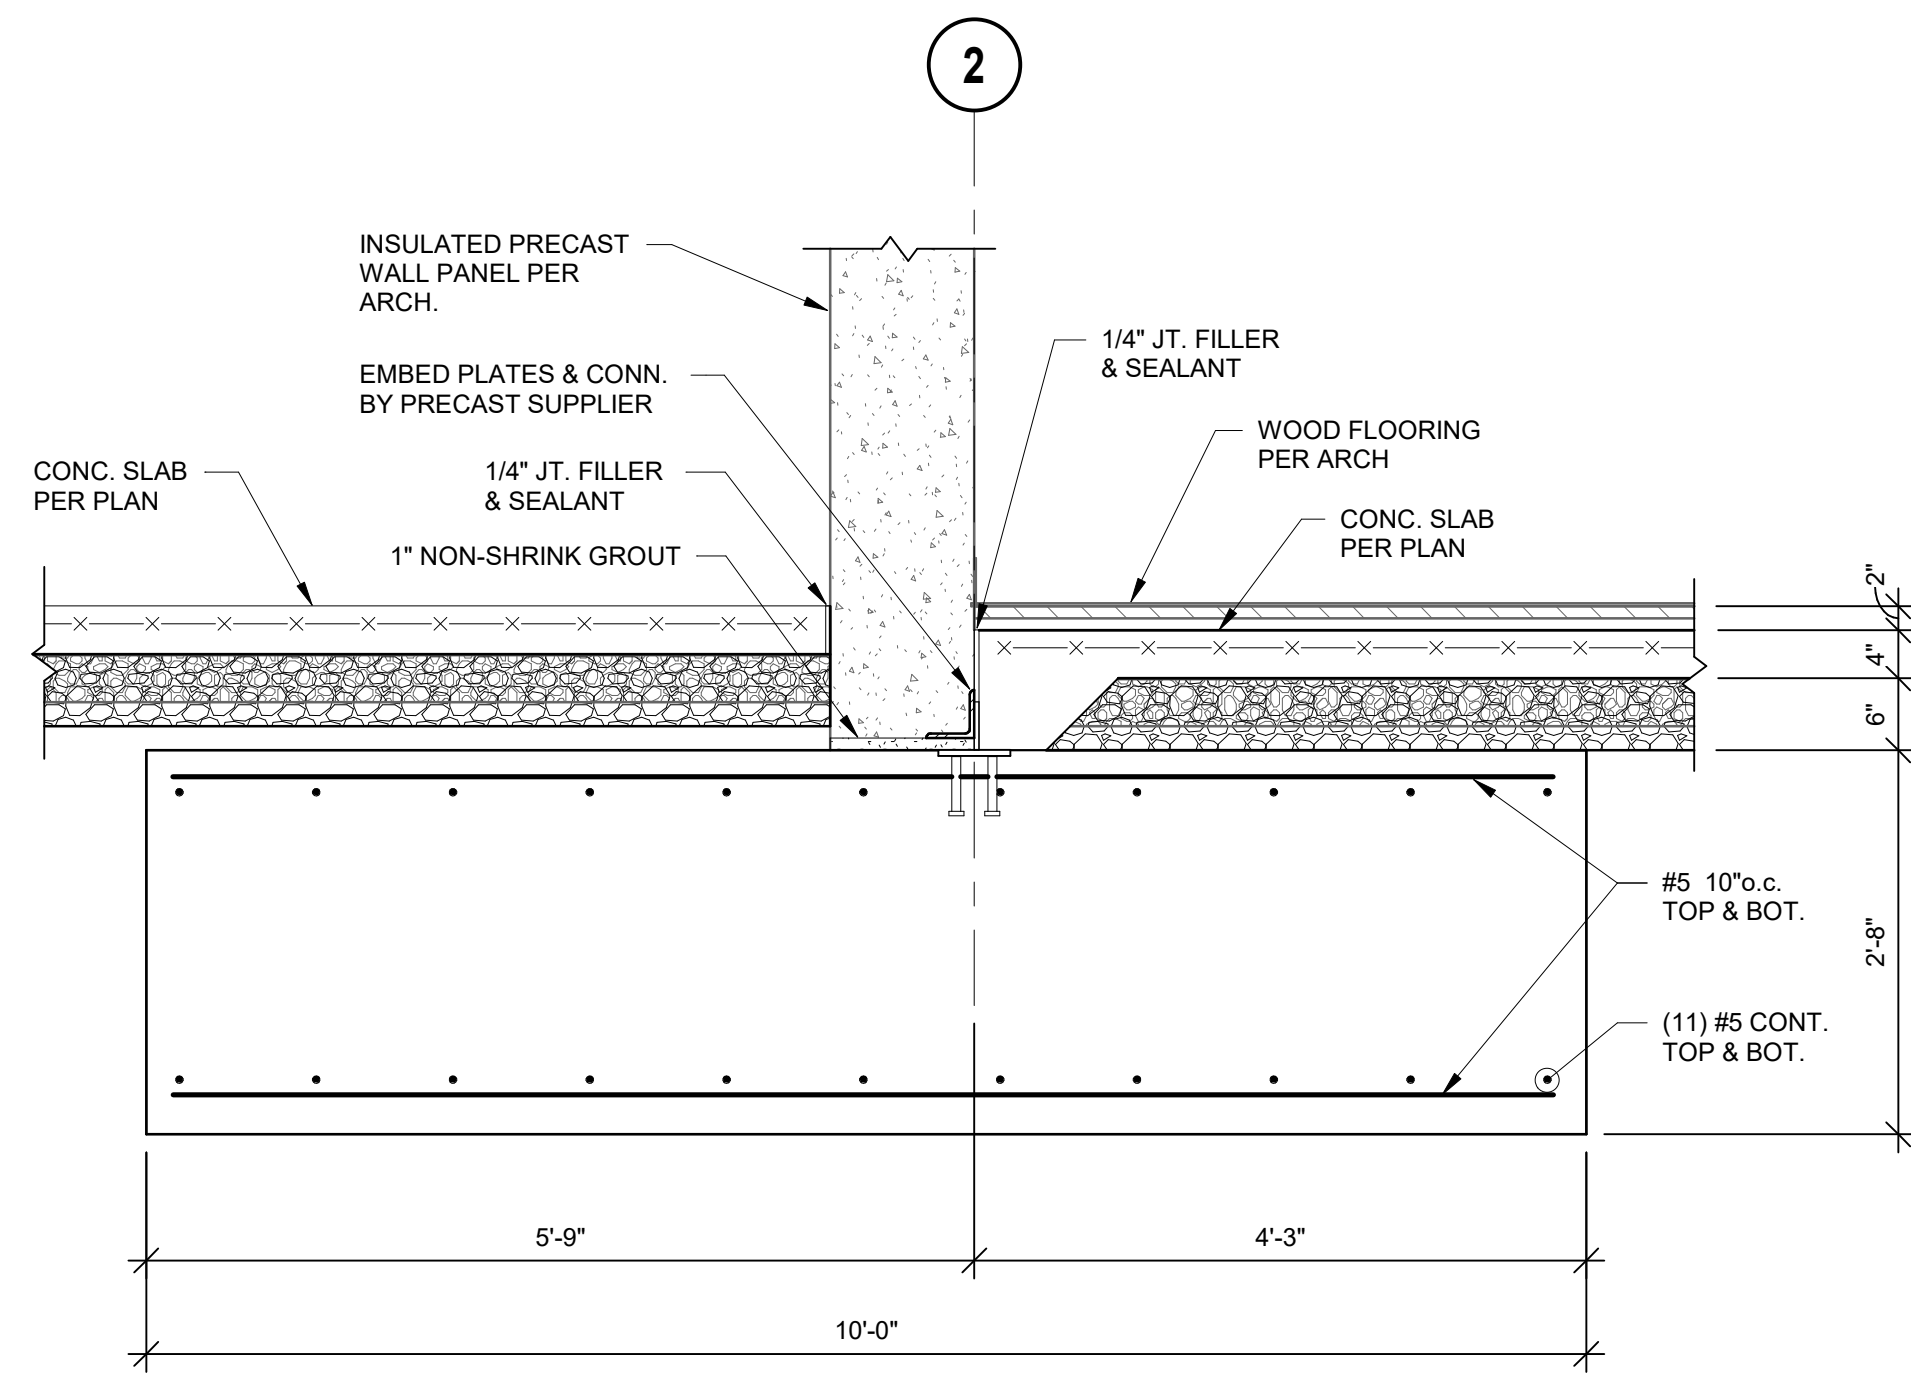
**Conformed
Construction
Documents**

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Bob D Campbell
Structural Engineer
State Certificate of Authority #000442
4338 Bellevue Ave
Kansas City, MO 64111
816.531.4144 phone

Smith & Boucher, Inc.
Mechanical, Electrical, & Plumbing
State Certificate of Authority #EGC000178
25616 W 103rd Street
Olathe, KS 66061
913.345.2127 phone

MKEC Engineering, Inc.
Civil Engineer
State Certificate of Authority
Engineering #0001000364
Landscaping #2006027139
Surveying #2006027138
11827 W 112th Street, Suite 200
Overland Park, KS 66210
913.317.9390 phone

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Theatrical Consultant
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South Valley Middle School Storm Shelter Addition

Liberty School District

1000 Midjay Dr, Liberty, MO 64068

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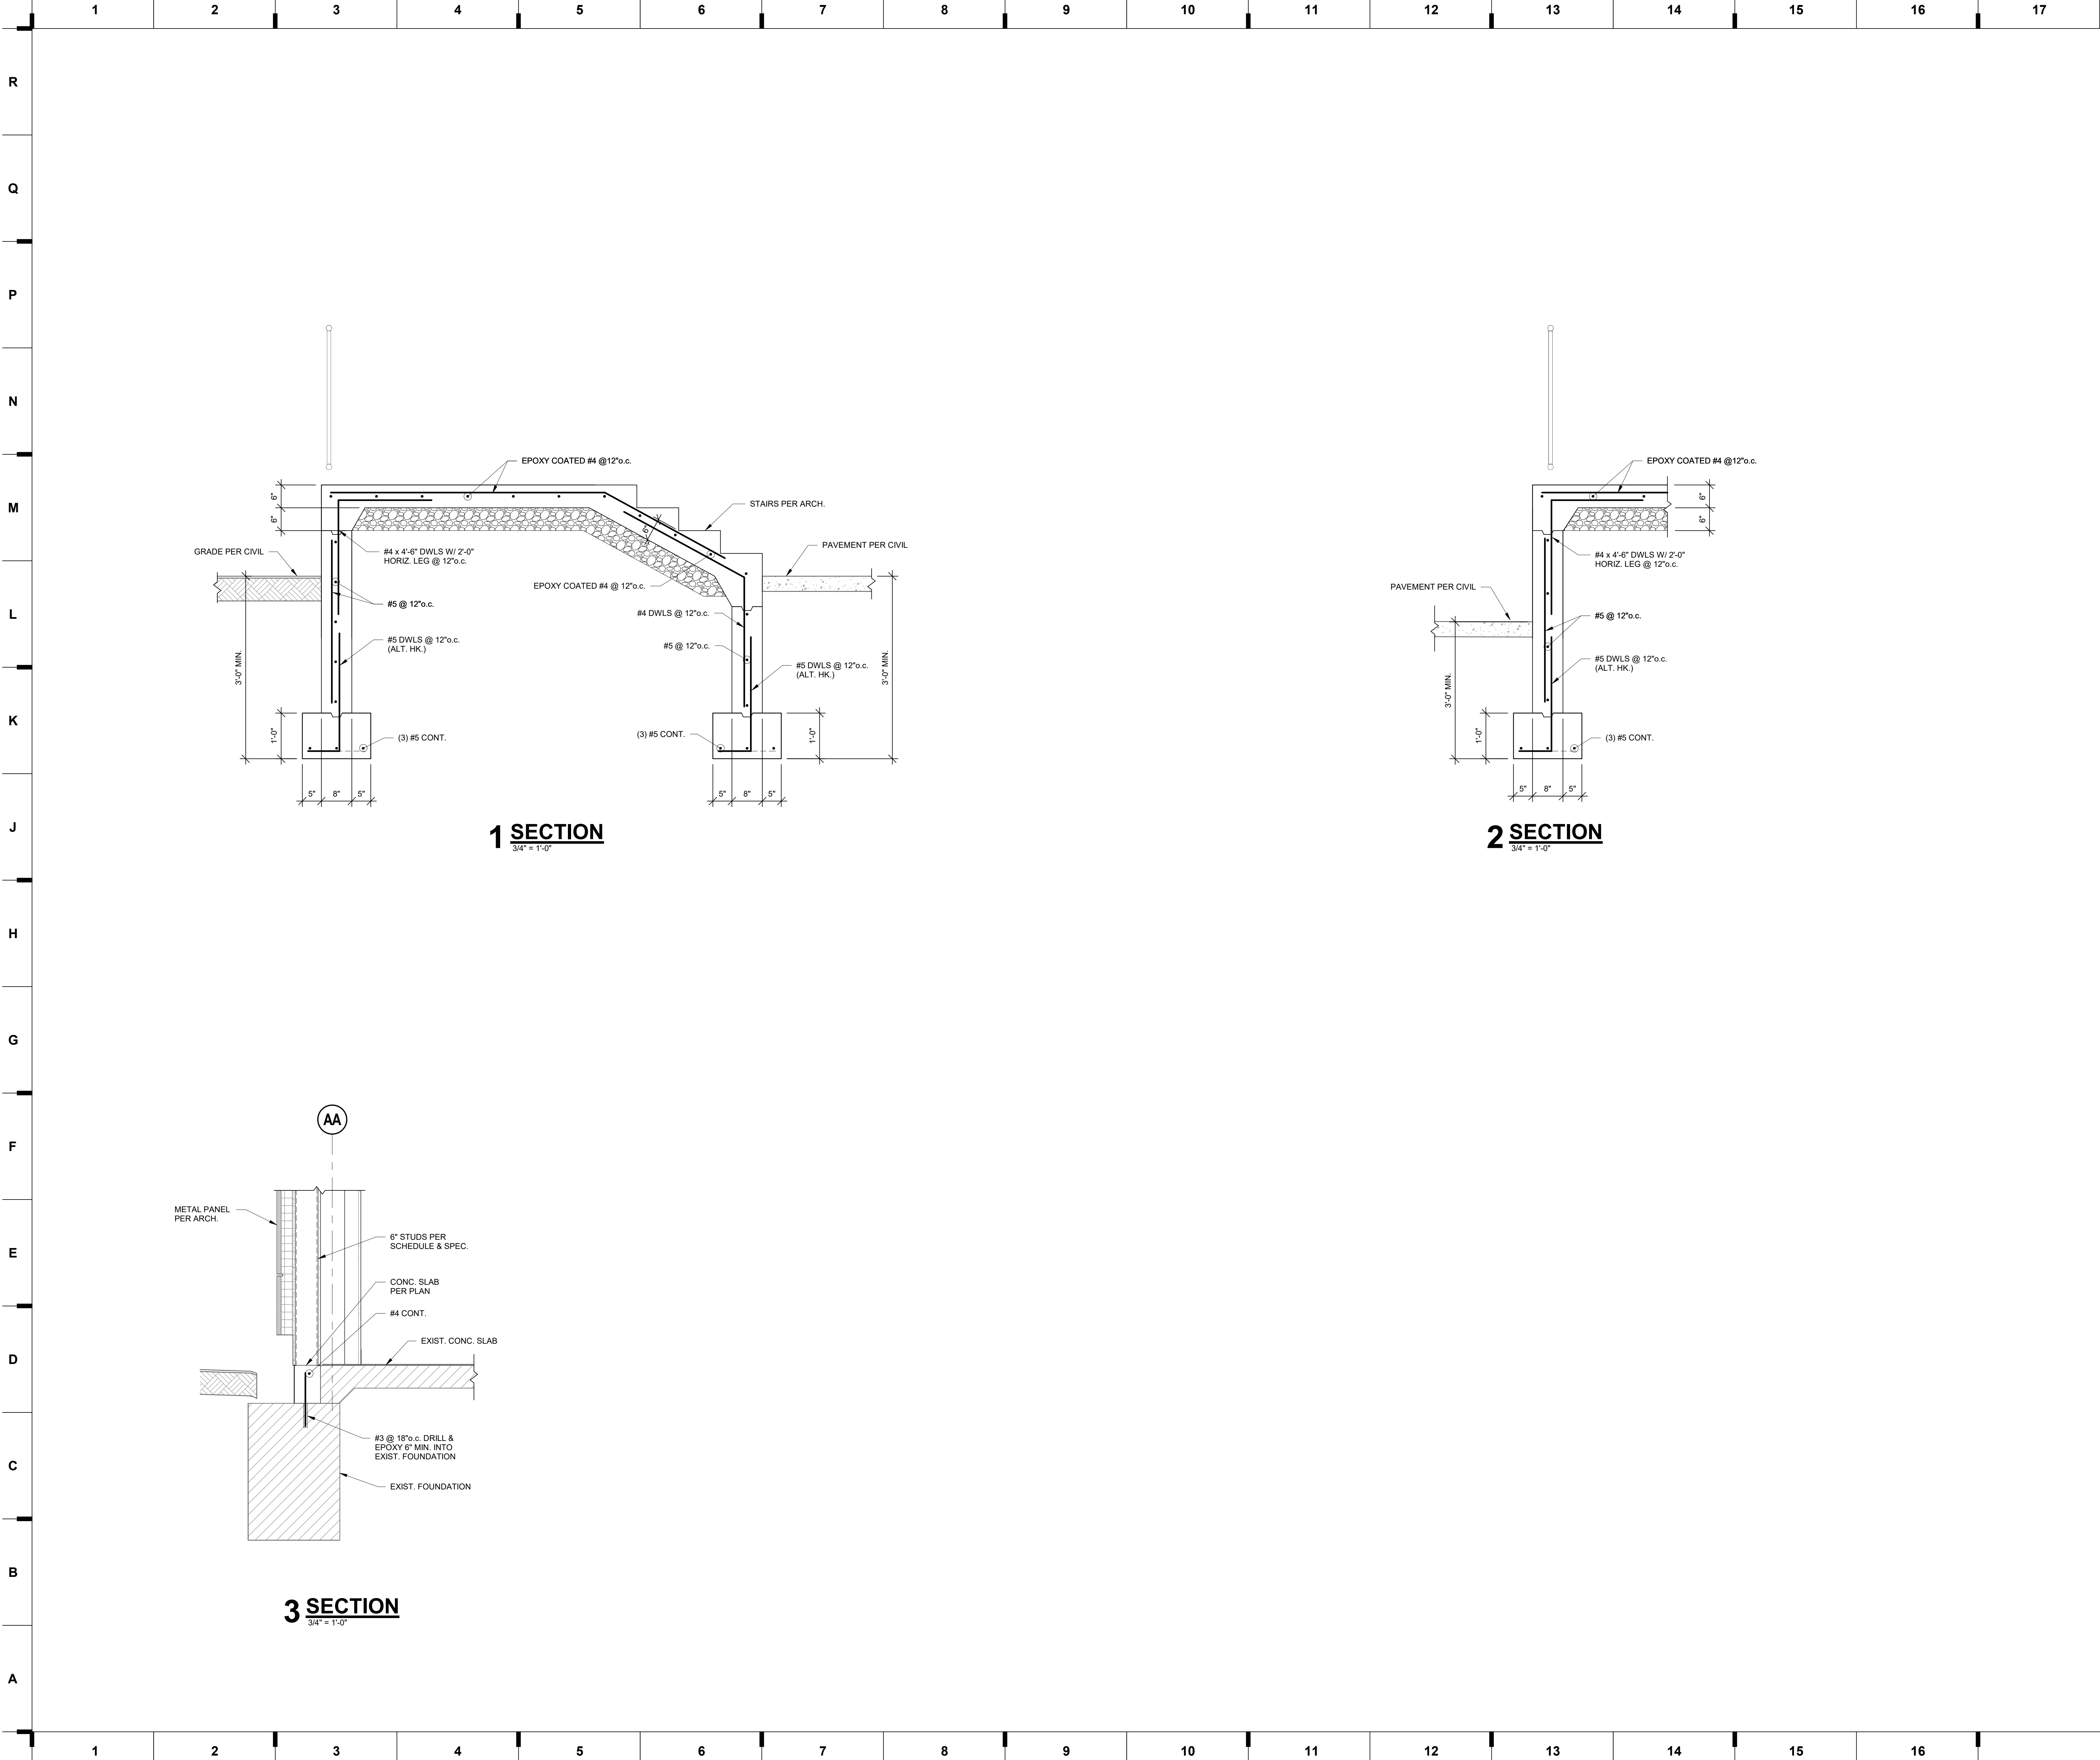
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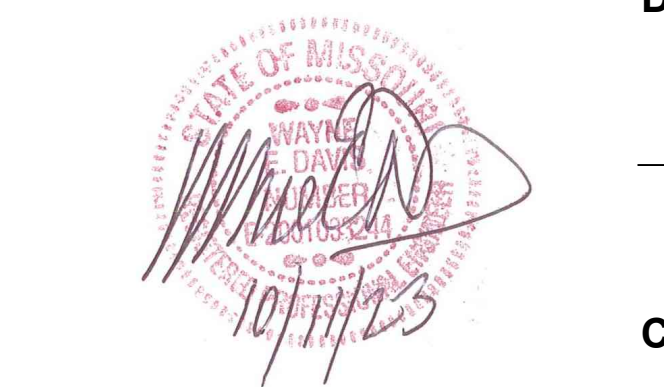
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Landscaping #2006027139
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Overland Park, KS 66210
913.317.9390 phone

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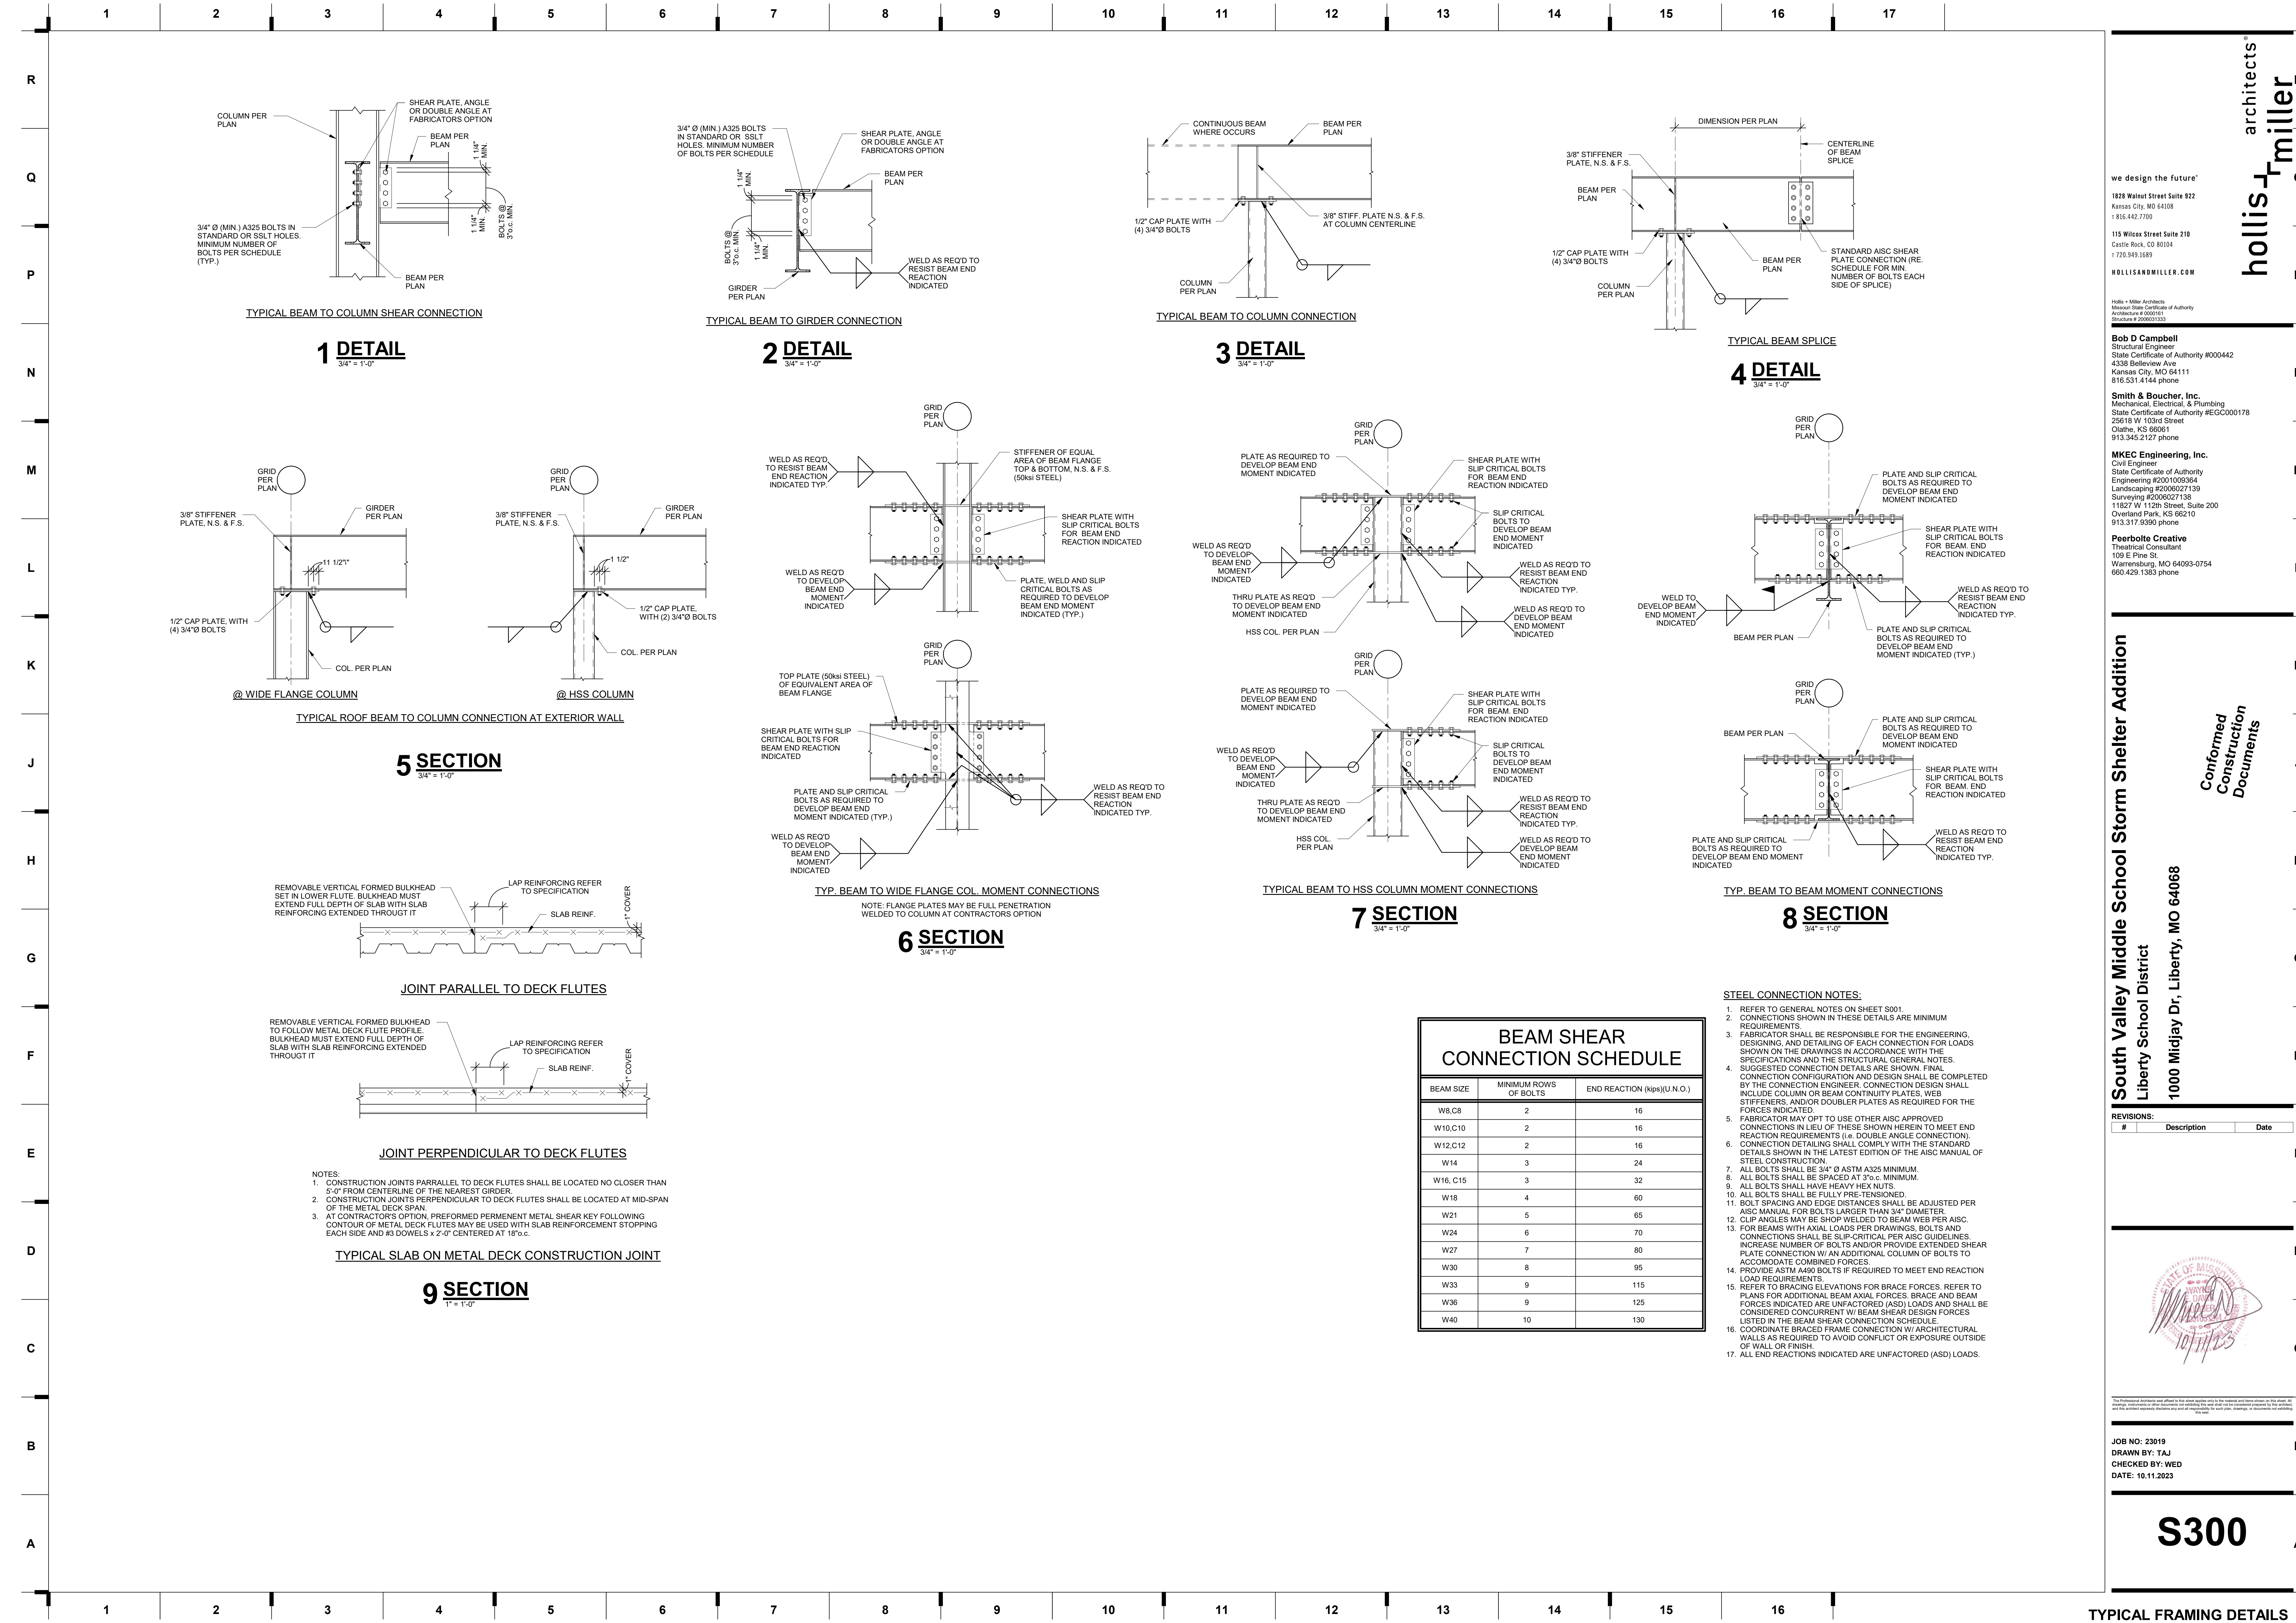
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Bob D Campbell
Structural Engineer
State Certificate of Authority #000442
4338 Bellevue Ave
Kansas City, MO 64111
816.531.4144 phone

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Mechanical, Electrical, & Plumbing
State Certificate of Authority #EGC000178
25618 W 103rd Street
Olathe, KS 66061
913.345.2127 phone

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Civil Engineer
State Certificate of Authority
Engineering #2001006284
Landscaping #2006027139
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11827 W 112th Street, Suite 200
Overland Park, KS 66210
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Theatrical Consultant
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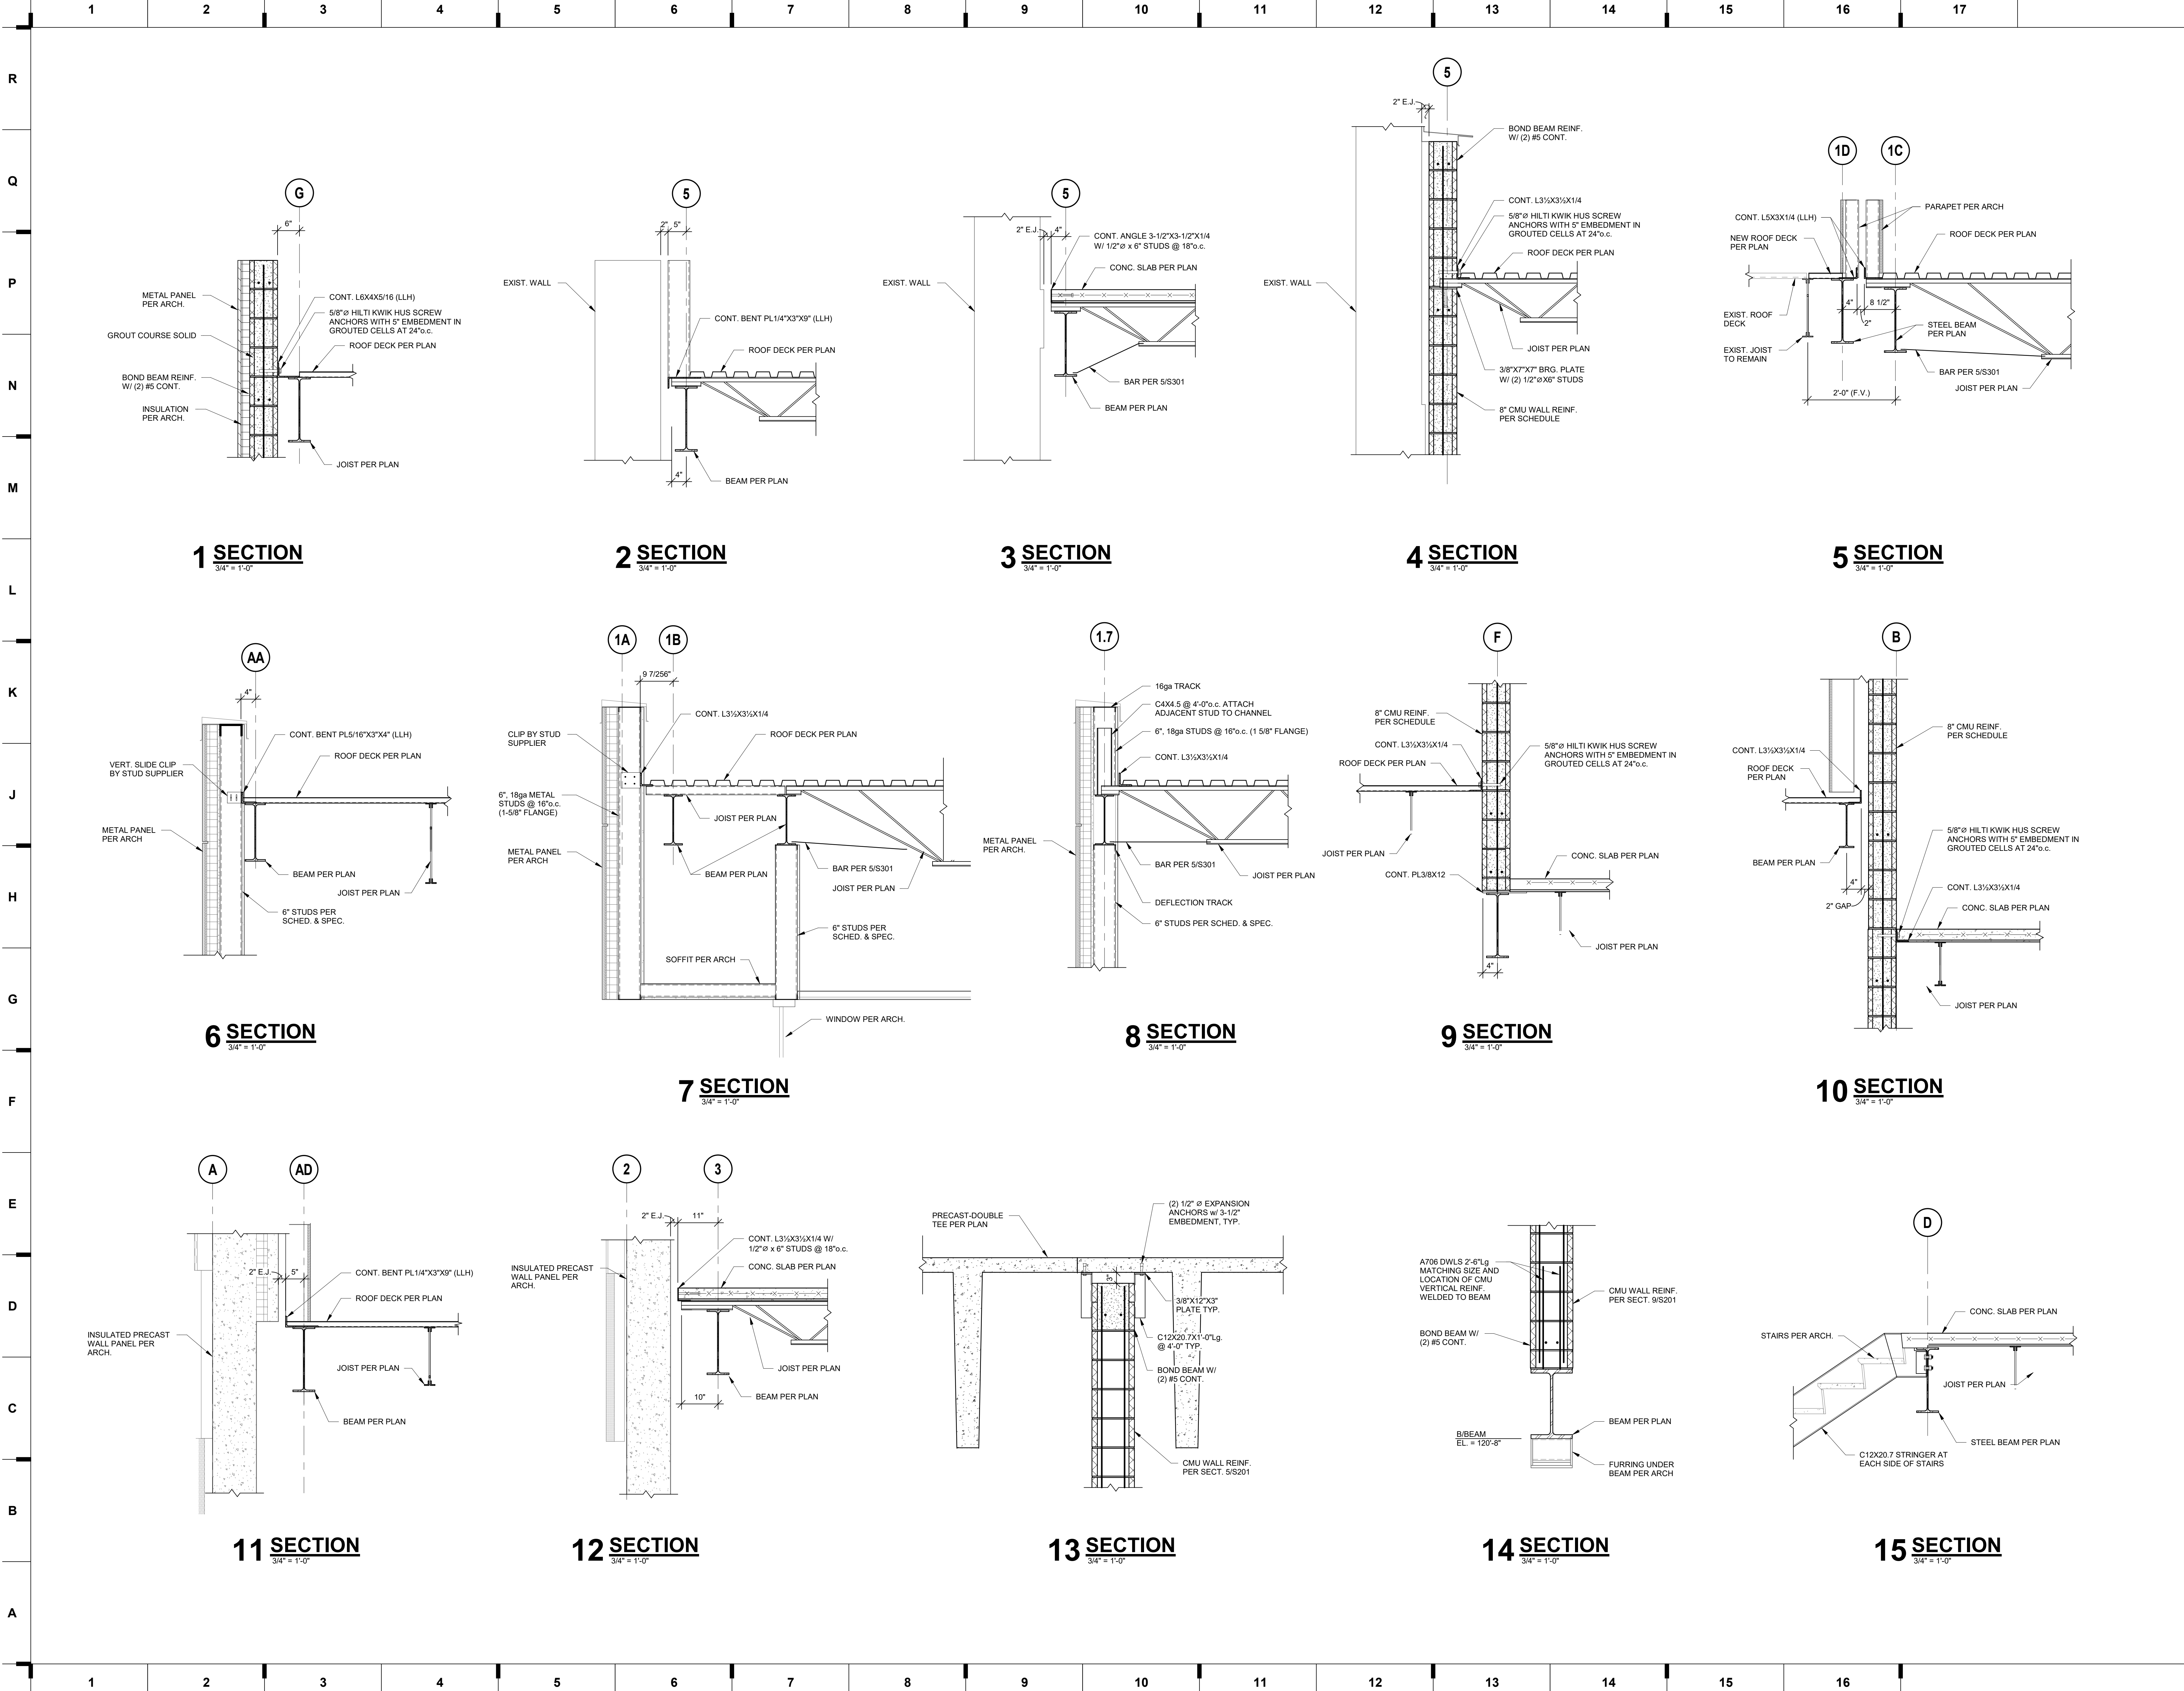
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Architecture #0000101
Structure #200001333

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Structural Engineer
State Certificate of Authority #000442
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Kansas City, MO 64111
816.531.4144 phone

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Mechanical, Electrical, & Plumbing
State Certificate of Authority #EGC000178
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Olathe, KS 66061
913.345.2127 phone

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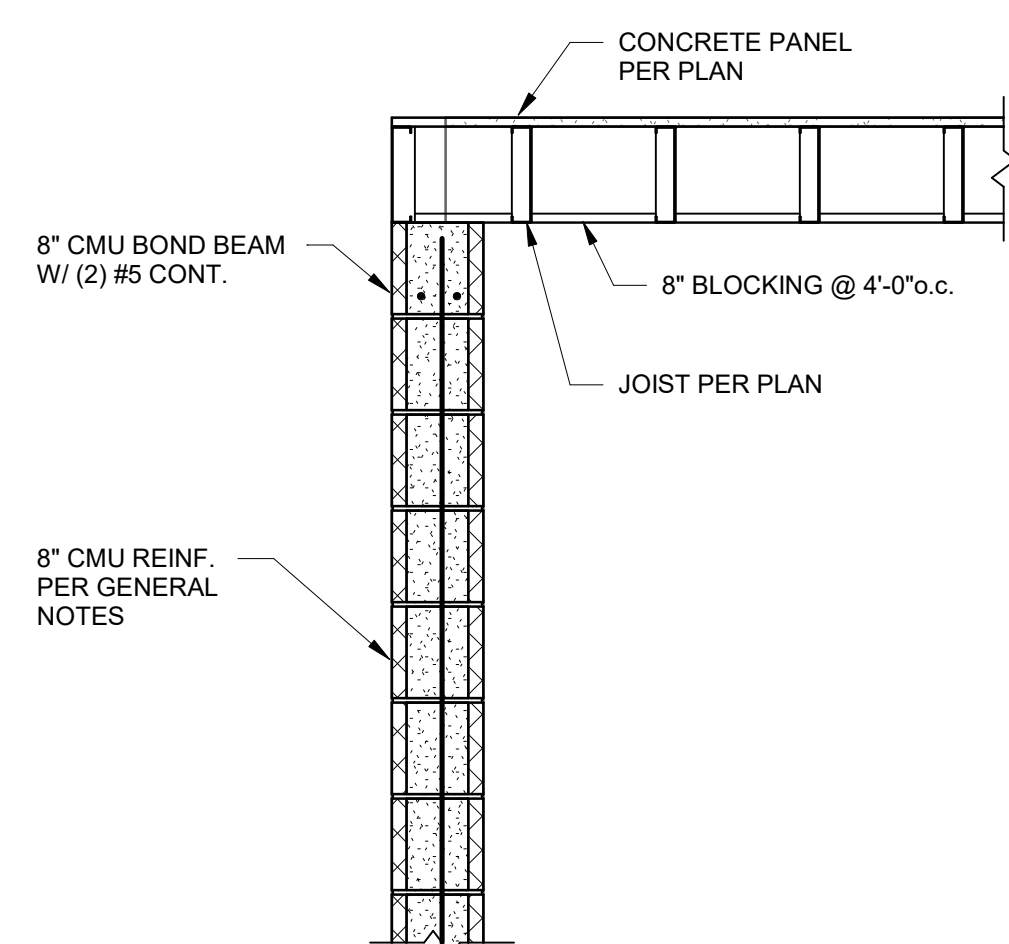
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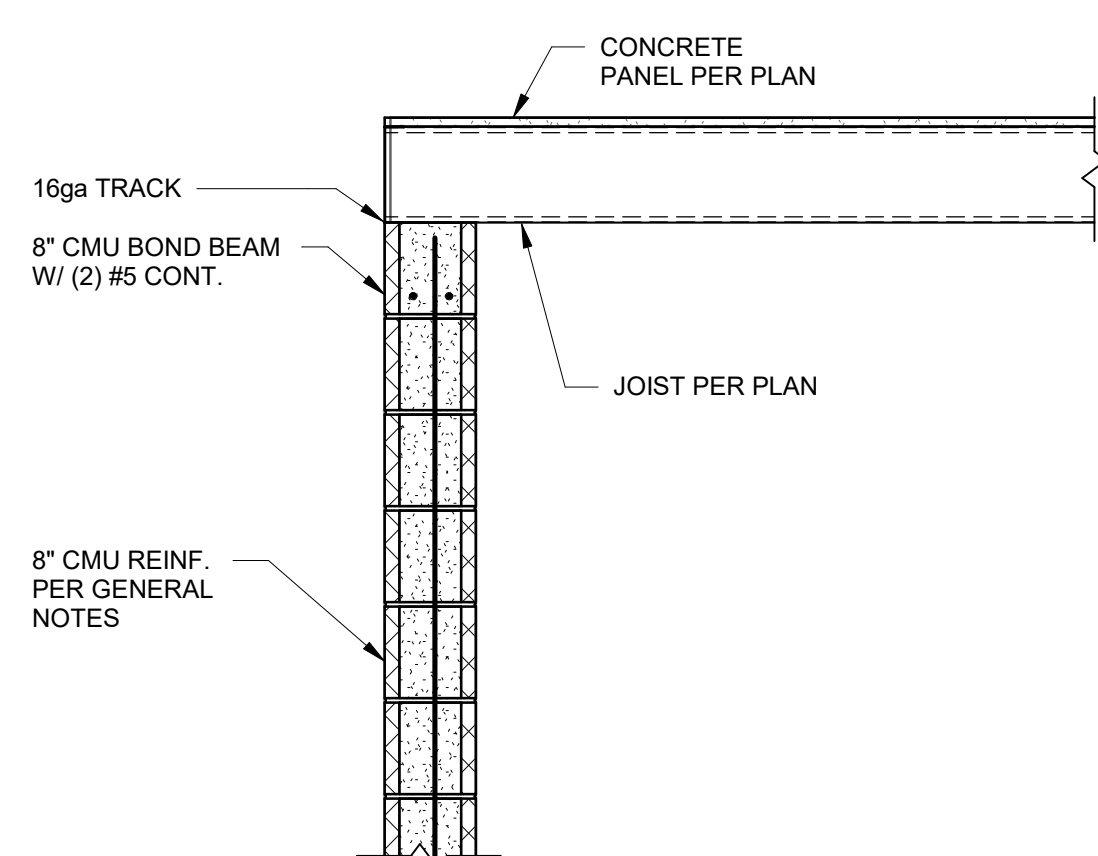


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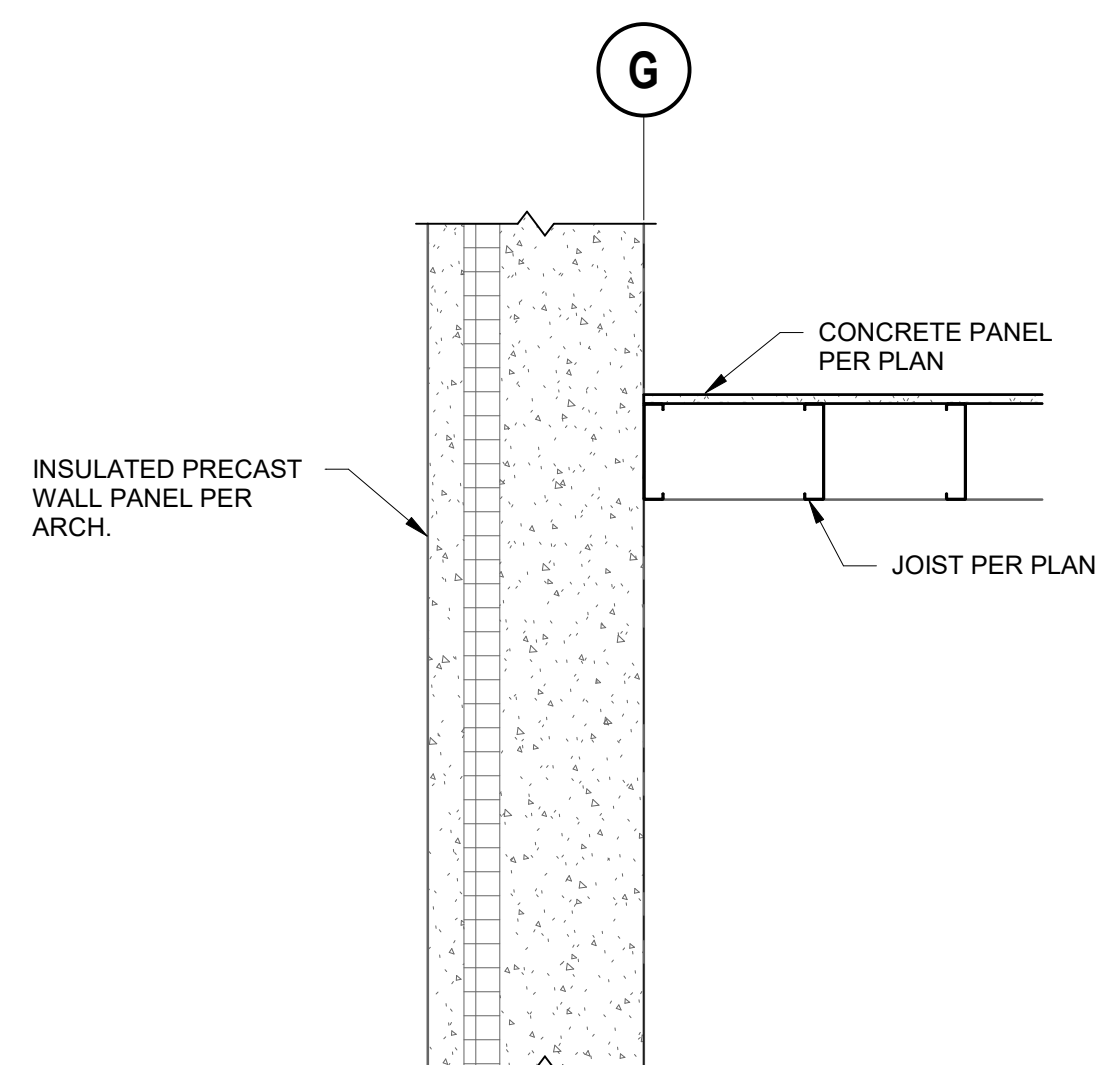
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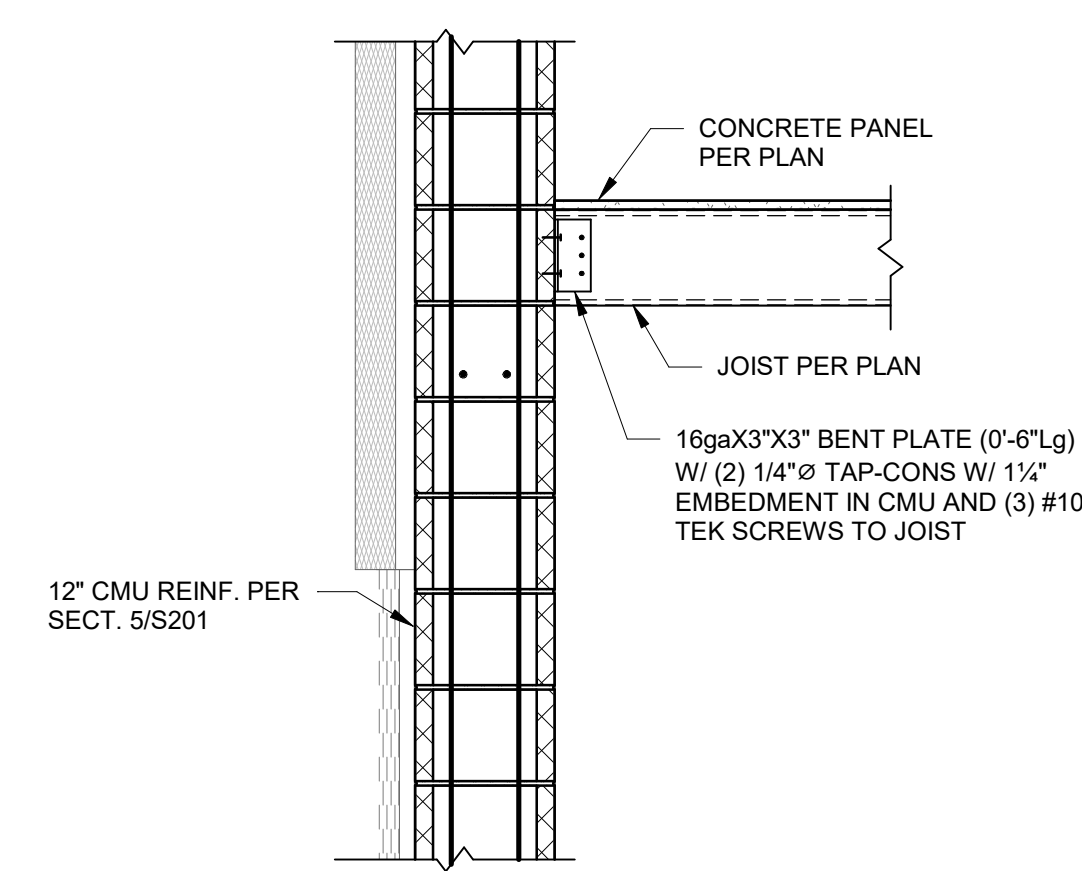
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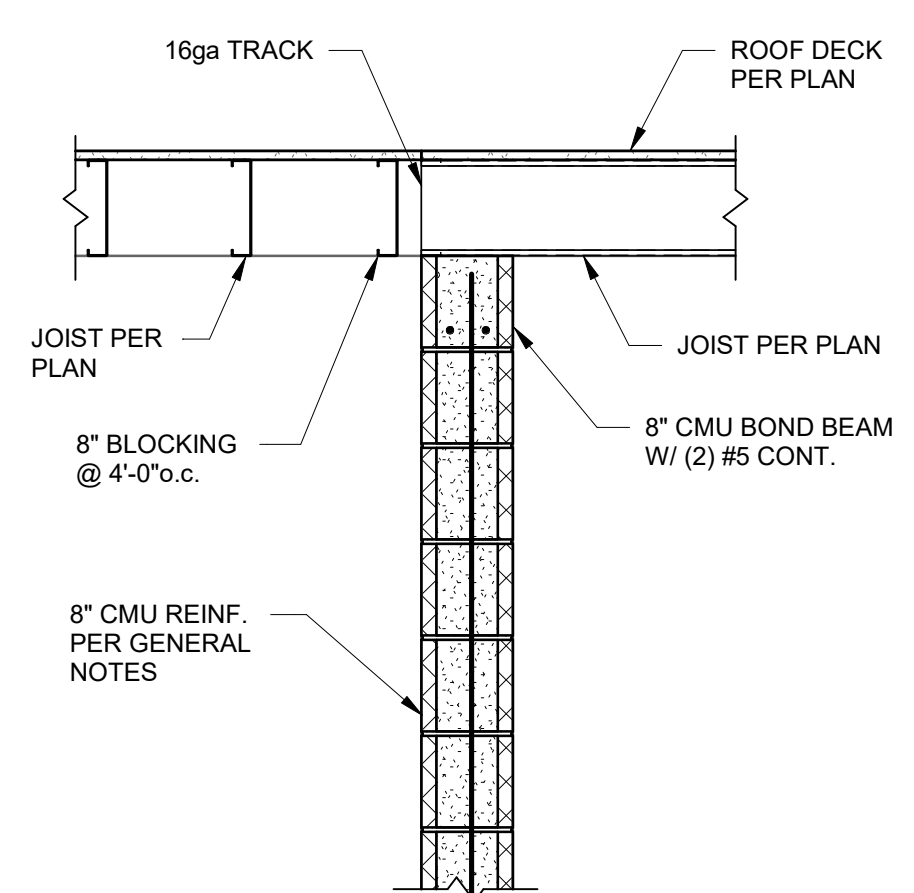
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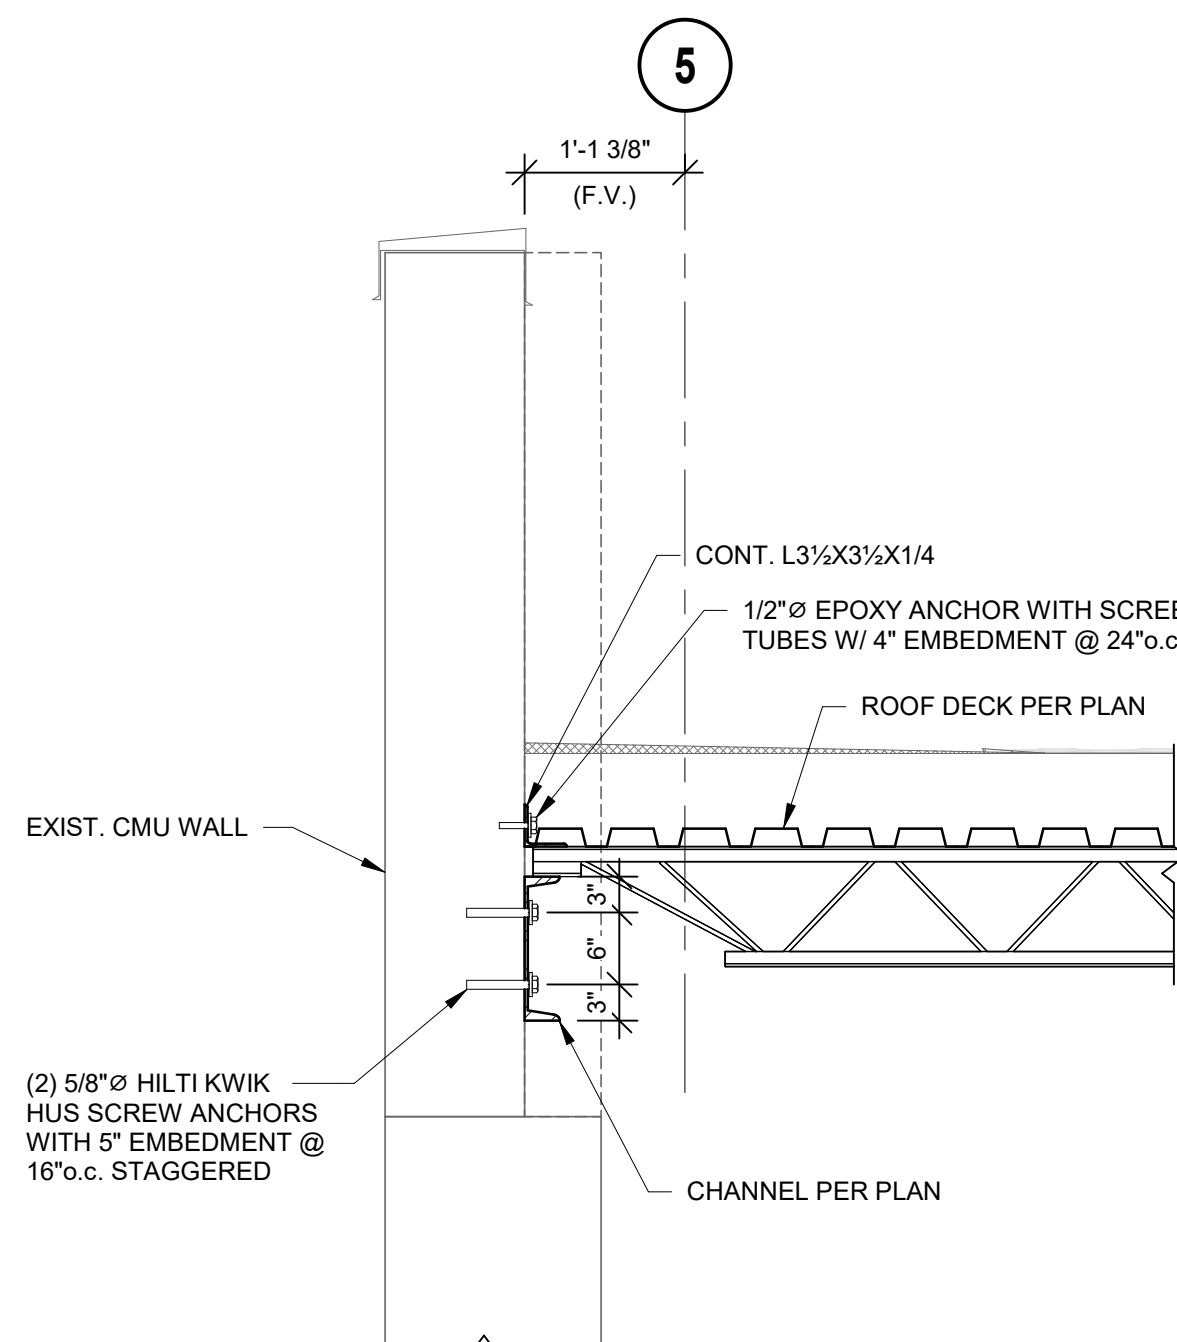
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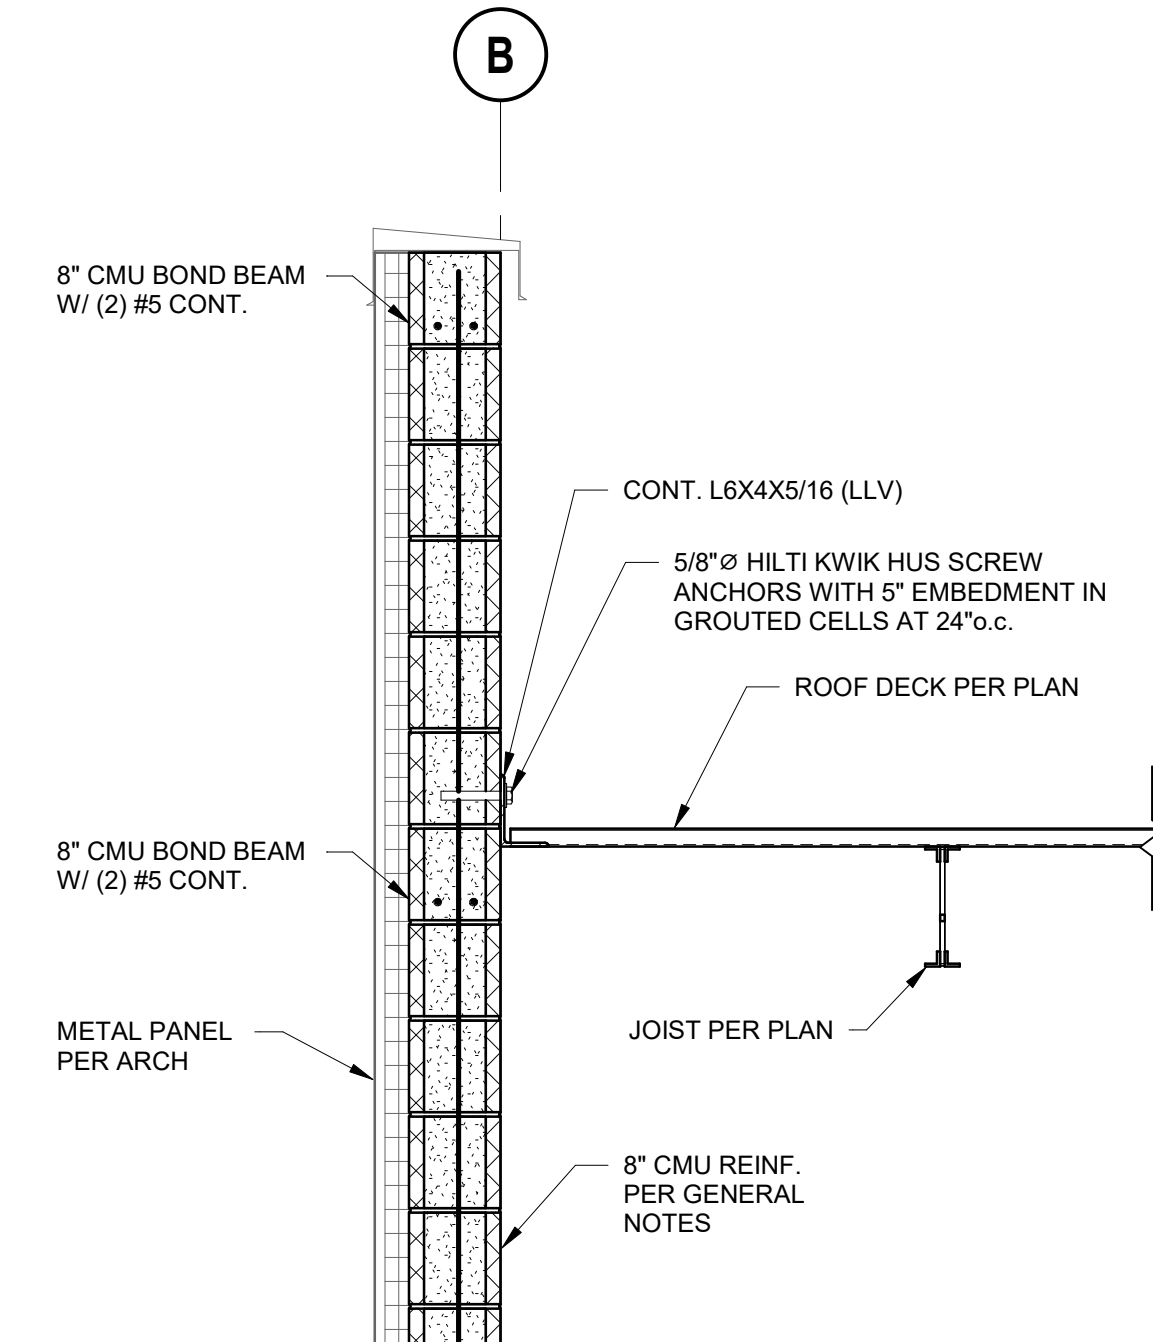
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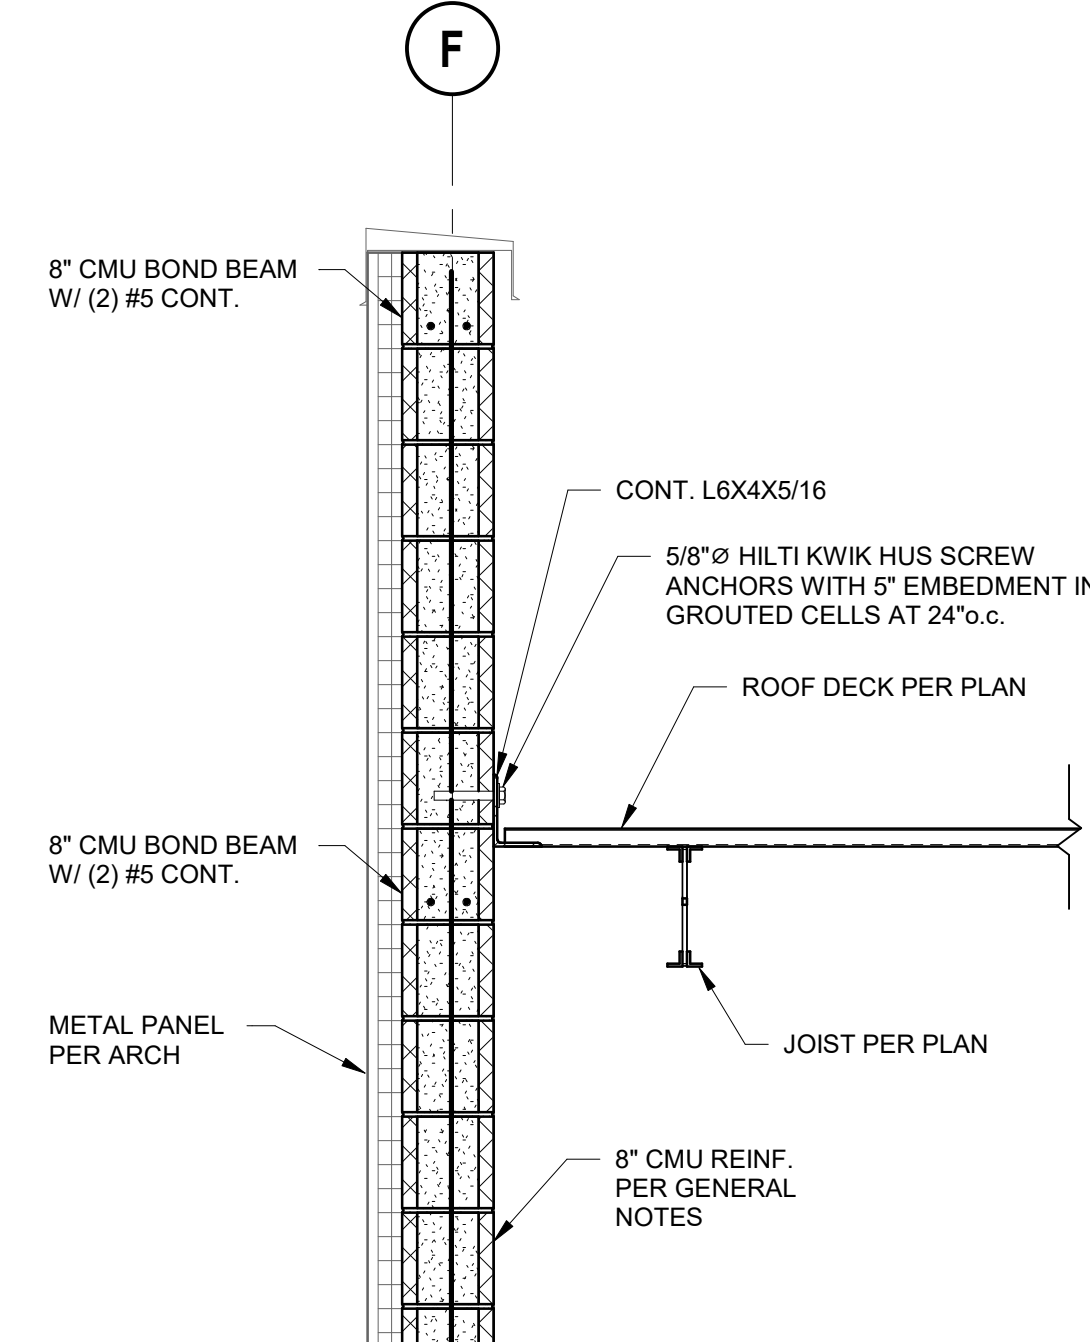
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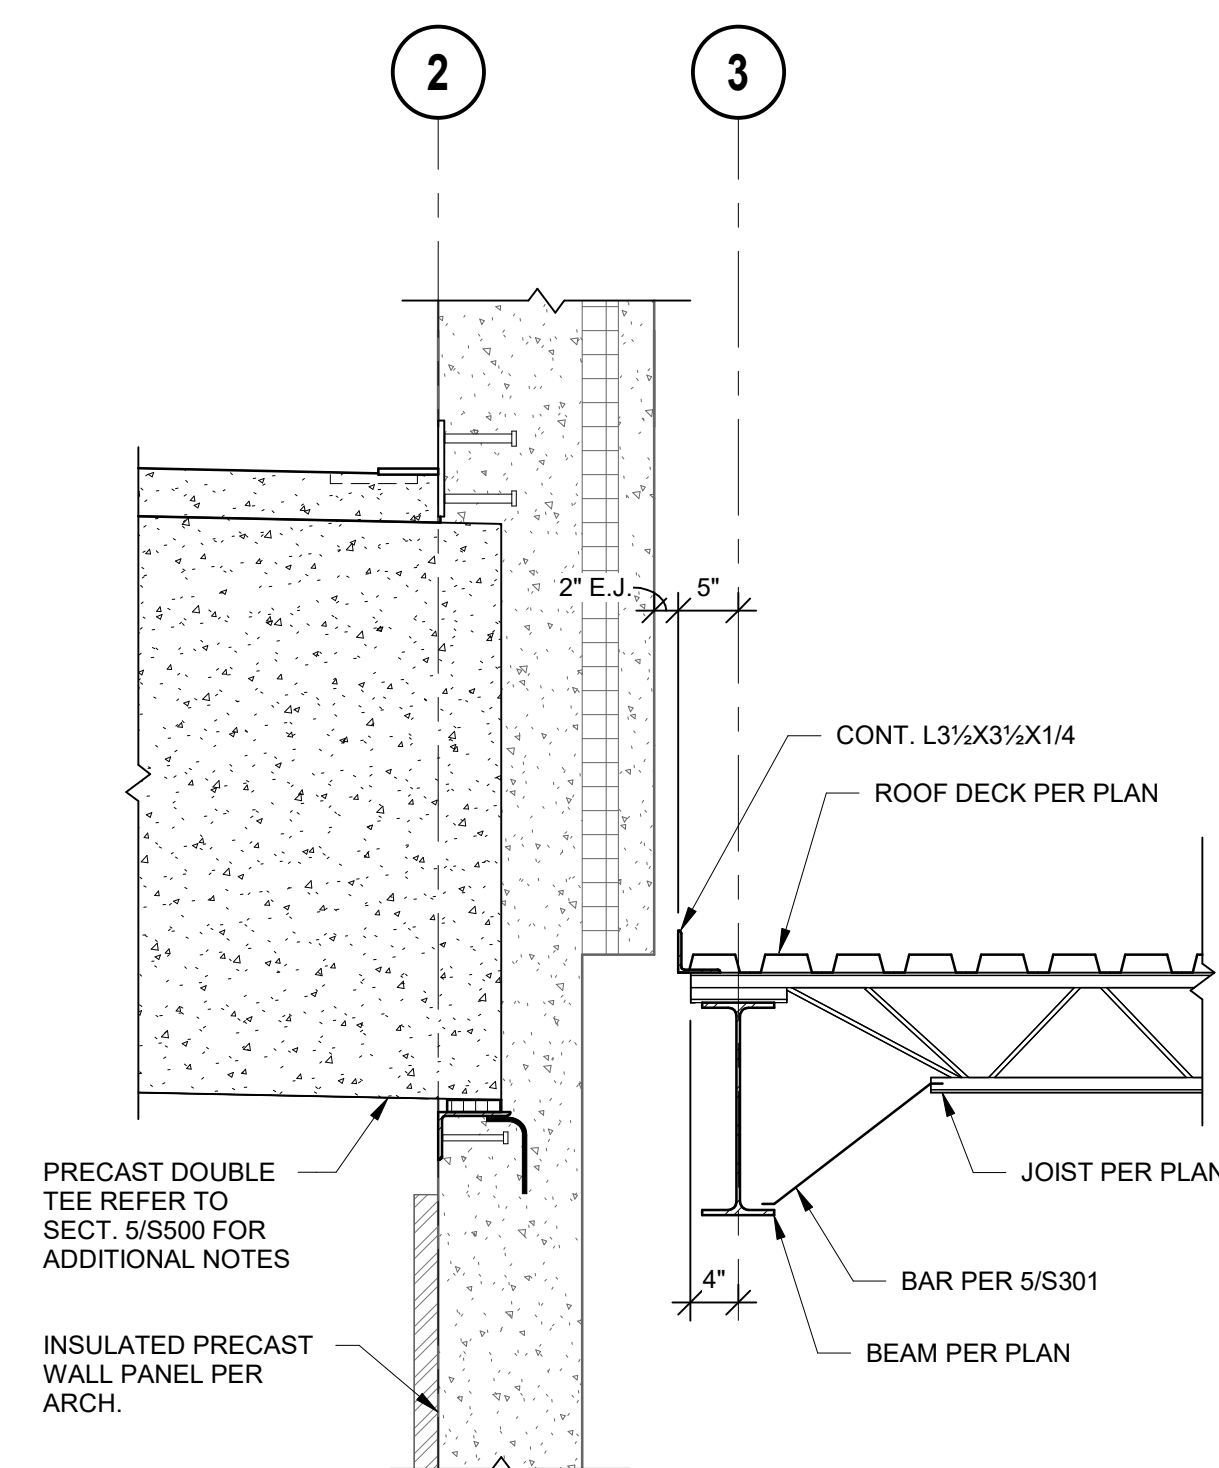
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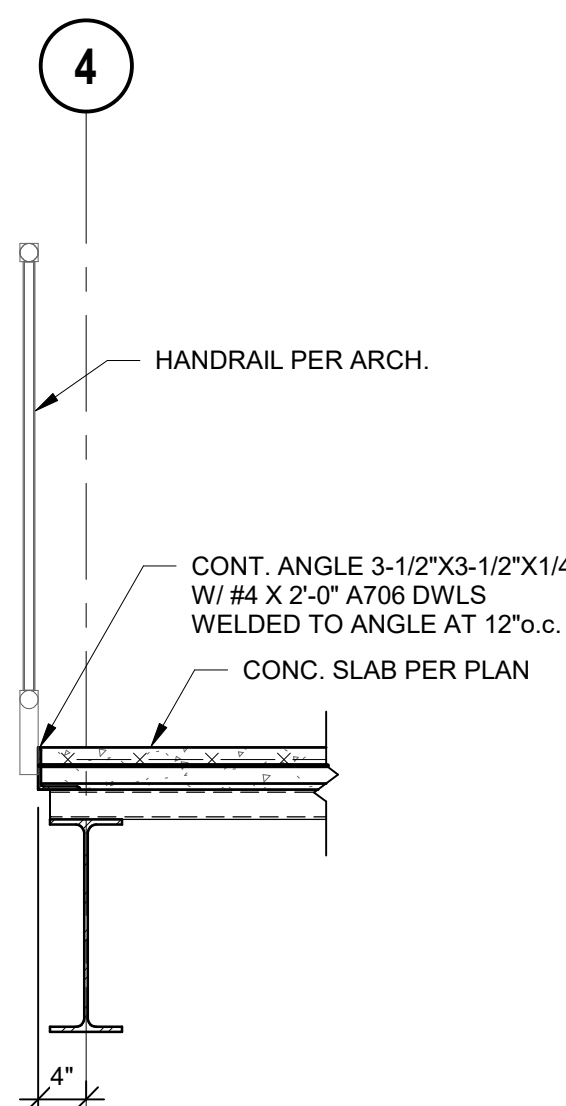
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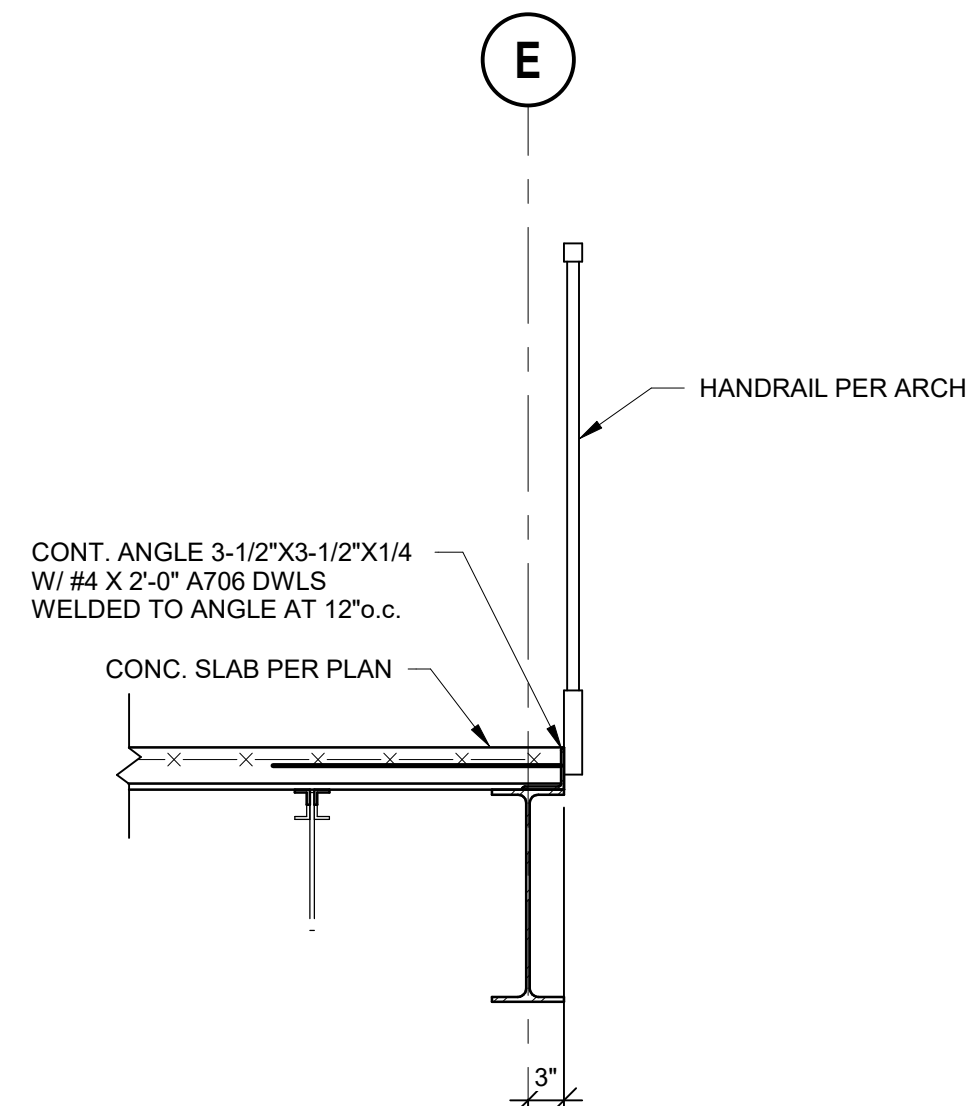
8 SECTION



9 SECTION



10 SECTION



11 SECTION

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GENERAL NOTES - STRUCTURAL
- ICC 500-2014 STORM SHELTER

1. Design Information
- A. Type of Shelter: Community Tornado
- B. Design and construction for all components of the storm shelter areas of this project shall conform to the provision of the ICC/NSA Standard for the Design and Construction of Storm Shelters, ICC 500-2014 as referenced by the 2018 IBC, and the governing design codes listed in the main structural general notes.
- a. Floor Live = 100 psf
- b. Roof Live = 100 psf
- c. Snow: Refer to main structural general notes
- d. Wind:
- Design Wind Speed, V = 250 mph
 - 1. Missile Impact Speed Requirement:
 - A. Vertical Surfaces: 100 mph
 - B. Horizontal Surfaces: 67 mph
 - Risk Category: III
 - Importance Factor, Iw = 1.0
 - Exposure Category: C
 - Internal Pressure Coefficient, GCp1 = +/- 0.55
 - Topographic Factor, Kzt = 1.0
 - Directionality Factor, Kd = 1.0
 - Design wind pressures to be used for the design of exterior component and cladding material on the designated zones of wall and roof surfaces shall be per ASCE 7-16. Tabulated pressures shall be multiplied by effective area reduction factors, exposure adjustment factors, and topographic factors where applicable.
- e. Seismic:
- S₁ = X, XXXg; S₂ = X, XXXg
 - Occupancy (Risk) Category III
 - Importance Factor, I_e = 1.25
 - Site Classification C
 - S_{0.2} = 0.08g; S₁ = X, XXXg
 - Seismic Design Category B
 - Basic Seismic Force-resisting System: Ordinary Precast Concrete Shear Walls
 - Equivalent Lateral Force Procedure
 - R = X; Omega = X; C_s = X
- f. Rainfall Intensity, i = 3.6in/hr
- Design rainfall intensity is based on the 100-year hourly rainfall rate indicated in IBC-2018 Figure 1611.1.
- g. Soil bearing: Refer to main structural general notes
- C. This project is designed to resist the most critical effects resulting from the load combinations of ASCE 7-16
- D. The shelter has not been constructed within an area susceptible of flooding.
- E. Duct, pipe and conduit openings in walls and roofs shall be protected with Cyclone Shrouds by RPH Advanced Building Solutions or equal or FEMA rated louvers.
- Re. Mechanical Specification.
- F. Shielding by adjacent building has not been considered.
- G. Structure has been designed to withstand missile impact.
- H. Lay down, rollover and collapse hazards have been considered.
- I. Roof/walls assemblies have been designed to withstand missile impact loads and wind pressure criteria.
- J. Storm shelter has been designed to transfer all forces from loading outlined in Chapter 3 of ICC 500-2014 to the foundations.
- K. Storm shelter has been designed to resist all design wind pressures in accordance with section 304 of ICC 500-2014.
- L. Concrete slab on grade has not been used to resist lateral loads.


2. Statement of Structural Special Inspections

- A. The structural design for this project is based on completion of special inspections during construction in accordance with section 1704 of the International Building Code and section 106 of ICC-500 2014. The owner shall employ one or more qualified special inspectors to provide the required special inspections.
- B. The special inspector shall furnish inspection reports to the building official, owner, architect and structural engineer, and any other designated person.
- C. All discrepancies shall be brought to the immediate attention of the contractor for correction, then, if uncorrected, to the proper design authority, building official and structural engineer.
- D. The special inspector shall submit a final signed report stating that the work requiring special inspection was, to the best of the inspector's knowledge, in conformance with the approved plans and specifications and the applicable workmanship provisions of the building code.
- E. The following inspections and tests are required with the frequency (continuous or periodic) as defined within the referenced section or standard listed below. The General Contractor shall provide notification to the inspector when items requiring inspection are ready to be inspected and provide access for those inspections.
- Shop Fabrication - precast concrete per Section 1704.2.5 and ICC-500 section 106.2.1 unless PCI certified shop
 - Concrete Construction per Section 1705.3 and Table 1705.3
 - Reinforcing Steel Placement [Periodic]
 - Reinforcing Steel Welding [Periodic]
 - Cast in Place Anchors [Periodic]
 - Post Installed Anchors
 - Adhesive Anchors [Continuous]
 - Mechanical Anchors [Periodic]
 - Design Mix Verification [Periodic]
 - Concrete Sampling and Testing [Periodic]
 - Concrete Placement [Periodic]
 - Concrete Curing [Continuous]
 - Prestressed Concrete Stressing and Grouting [Periodic]
 - Erection of Precast [Periodic]
 - Verification of In-situ Concrete Strength Prior to Stressing Post-Tensioned Concrete [Periodic]
 - Formwork Shape, Location and Dimensions [Periodic]
 - Verification of Soils per Table 1705.6
 - Verify use of proper material, densities, and lift thicknesses during placement and compaction of compacted fill [Continuous]
 - All other required soil inspections [Periodic]
 - Inspections and Tests of Cast-In-Place Deep Foundation per Table 1705.8 [Continuous]
 - Verification of wind-resisting components:
 - Verify roof covering, roof deck, and roof framing connections are in accordance with the construction documents [Periodic]
 - Verify exterior wall coverings and wall connections to roof and floor diaphragms and framing are in accordance with the construction documents [Periodic]
- F. Structural Observations:
- A. Owner shall employ a registered design professional to conduct visual observations of the construction of the structural system for general conformance to the approved construction documents at significant construction stages and at completion of the construction of the structural system. Structural observation does not relieve any other inspection requirements.


3. ICC 500 Contractor Responsibility

- A. Per ICC 500-2014, section 107.3, each contractor responsible for the construction fabrication, or installation of any component listed in ICC 500 section 107.3.1 shall submit a written statement of responsibility to the authority having jurisdiction, the responsible design professional, and the owner prior to the commencement of work on the system or component. The contractor's statement of responsibility shall contain:
- Acknowledgement of awareness of the special requirements contained in the quality assurance plan
 - Acknowledgement that control will be exercised to obtain compliance with the construction documents.
 - Procedures for exercising control within the contractor's organization, the method and frequency, and the distribution of reports.
 - Identification and qualifications of the person exercising such control and their position in the organization.


EXCEPTION: A written statement of responsibility shall not be required for the fabrication of storm shelter components that have been inspected and labeled by an approved agency as meeting the requirements of the applicable code and the ICC 500-2014 standards.

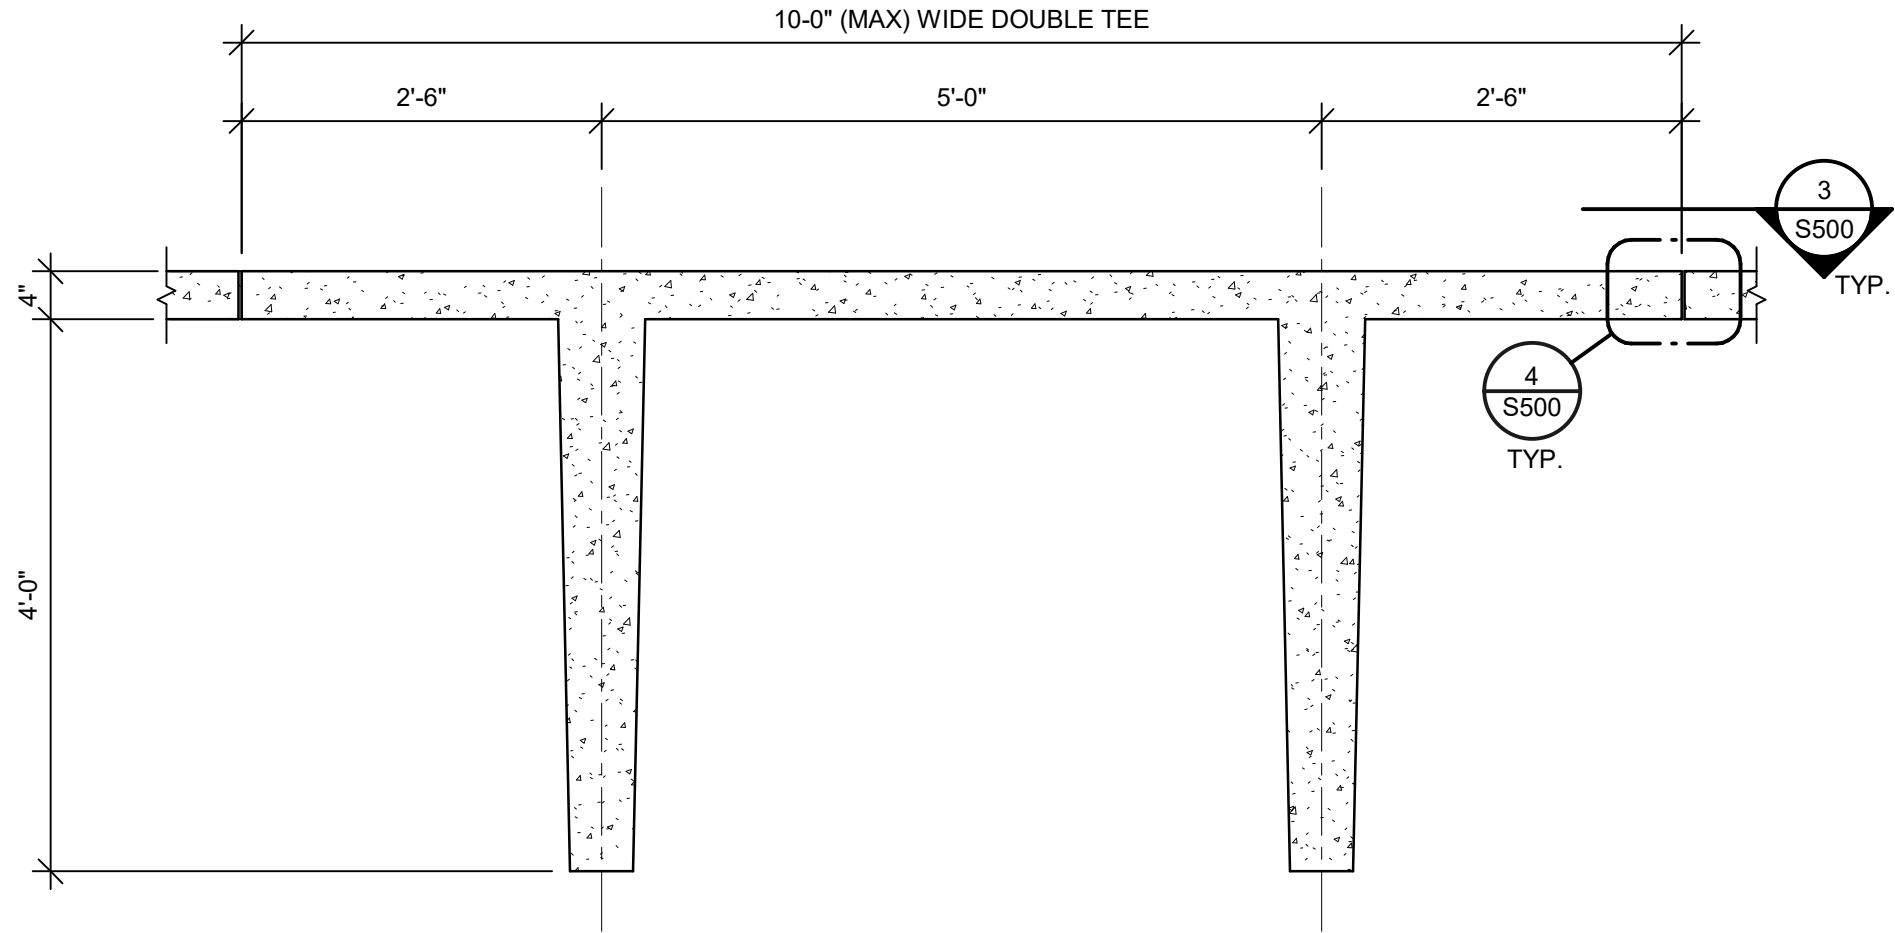

2 SECTION
3/4" = 1'-0"

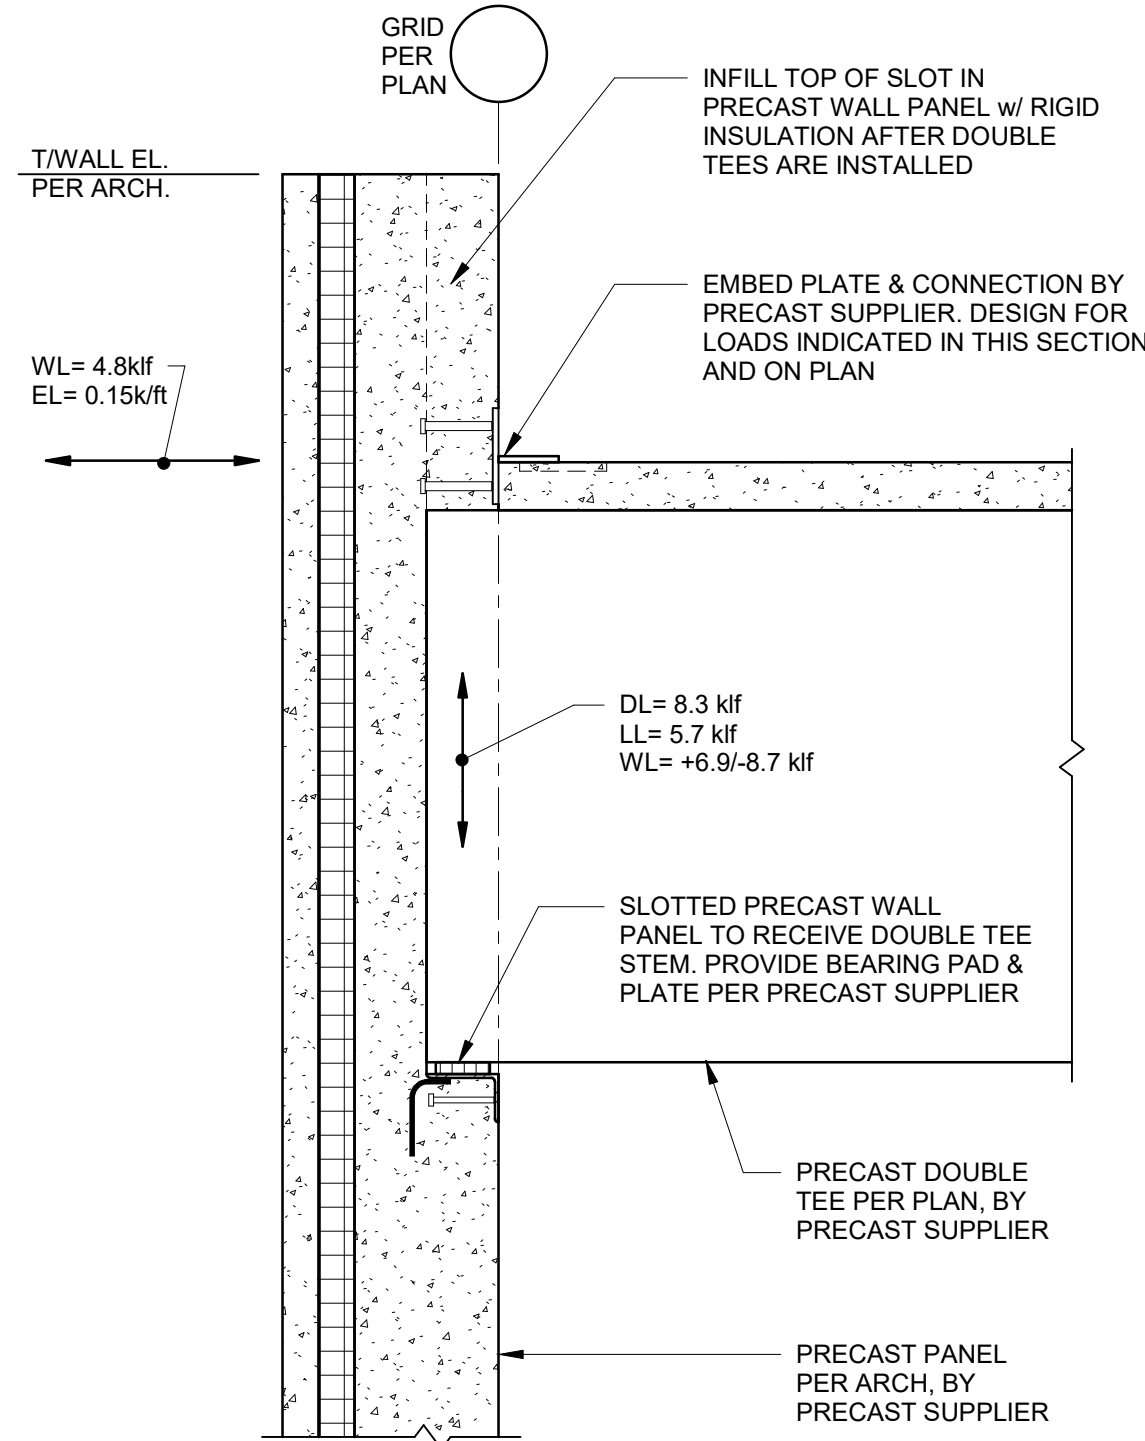


5 SECTION
3/4" = 1'-0"

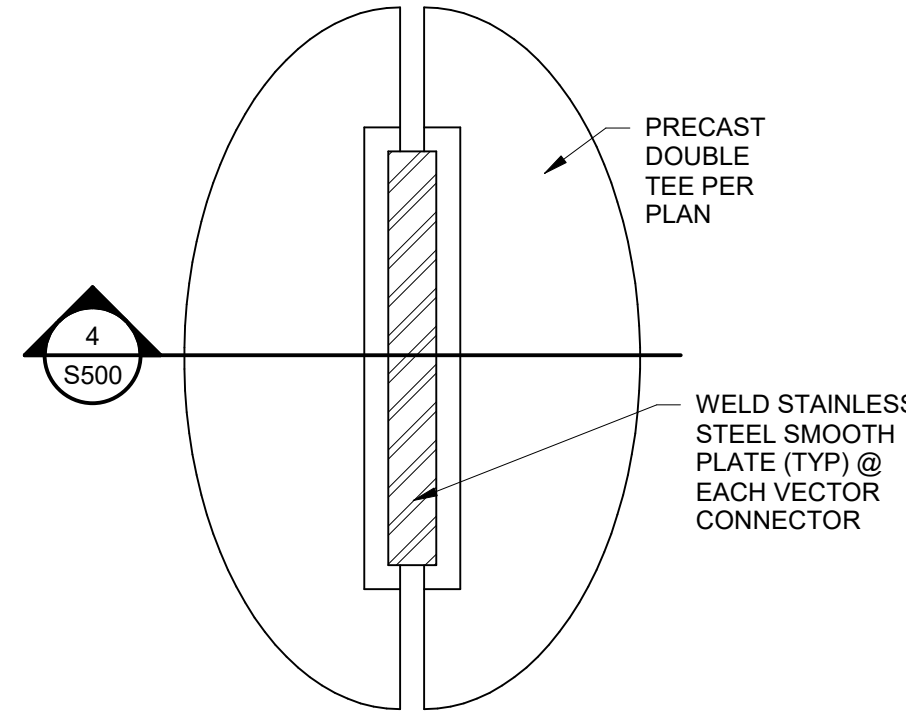


TYPICAL DOUBLE TEE FLANGE
CONNECTION DETAIL

3 DETAIL
1/12" = 1'-0"

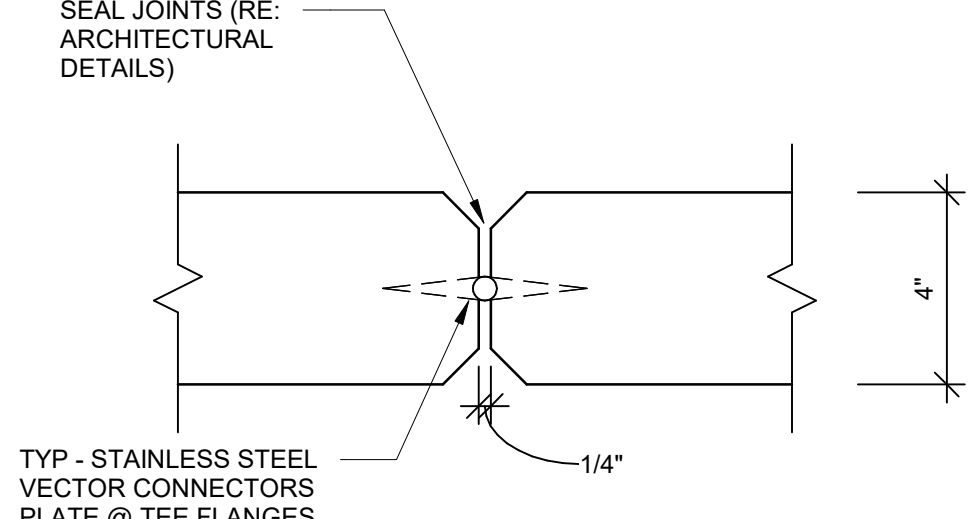


4 SECTION
3/8" = 1'-0"

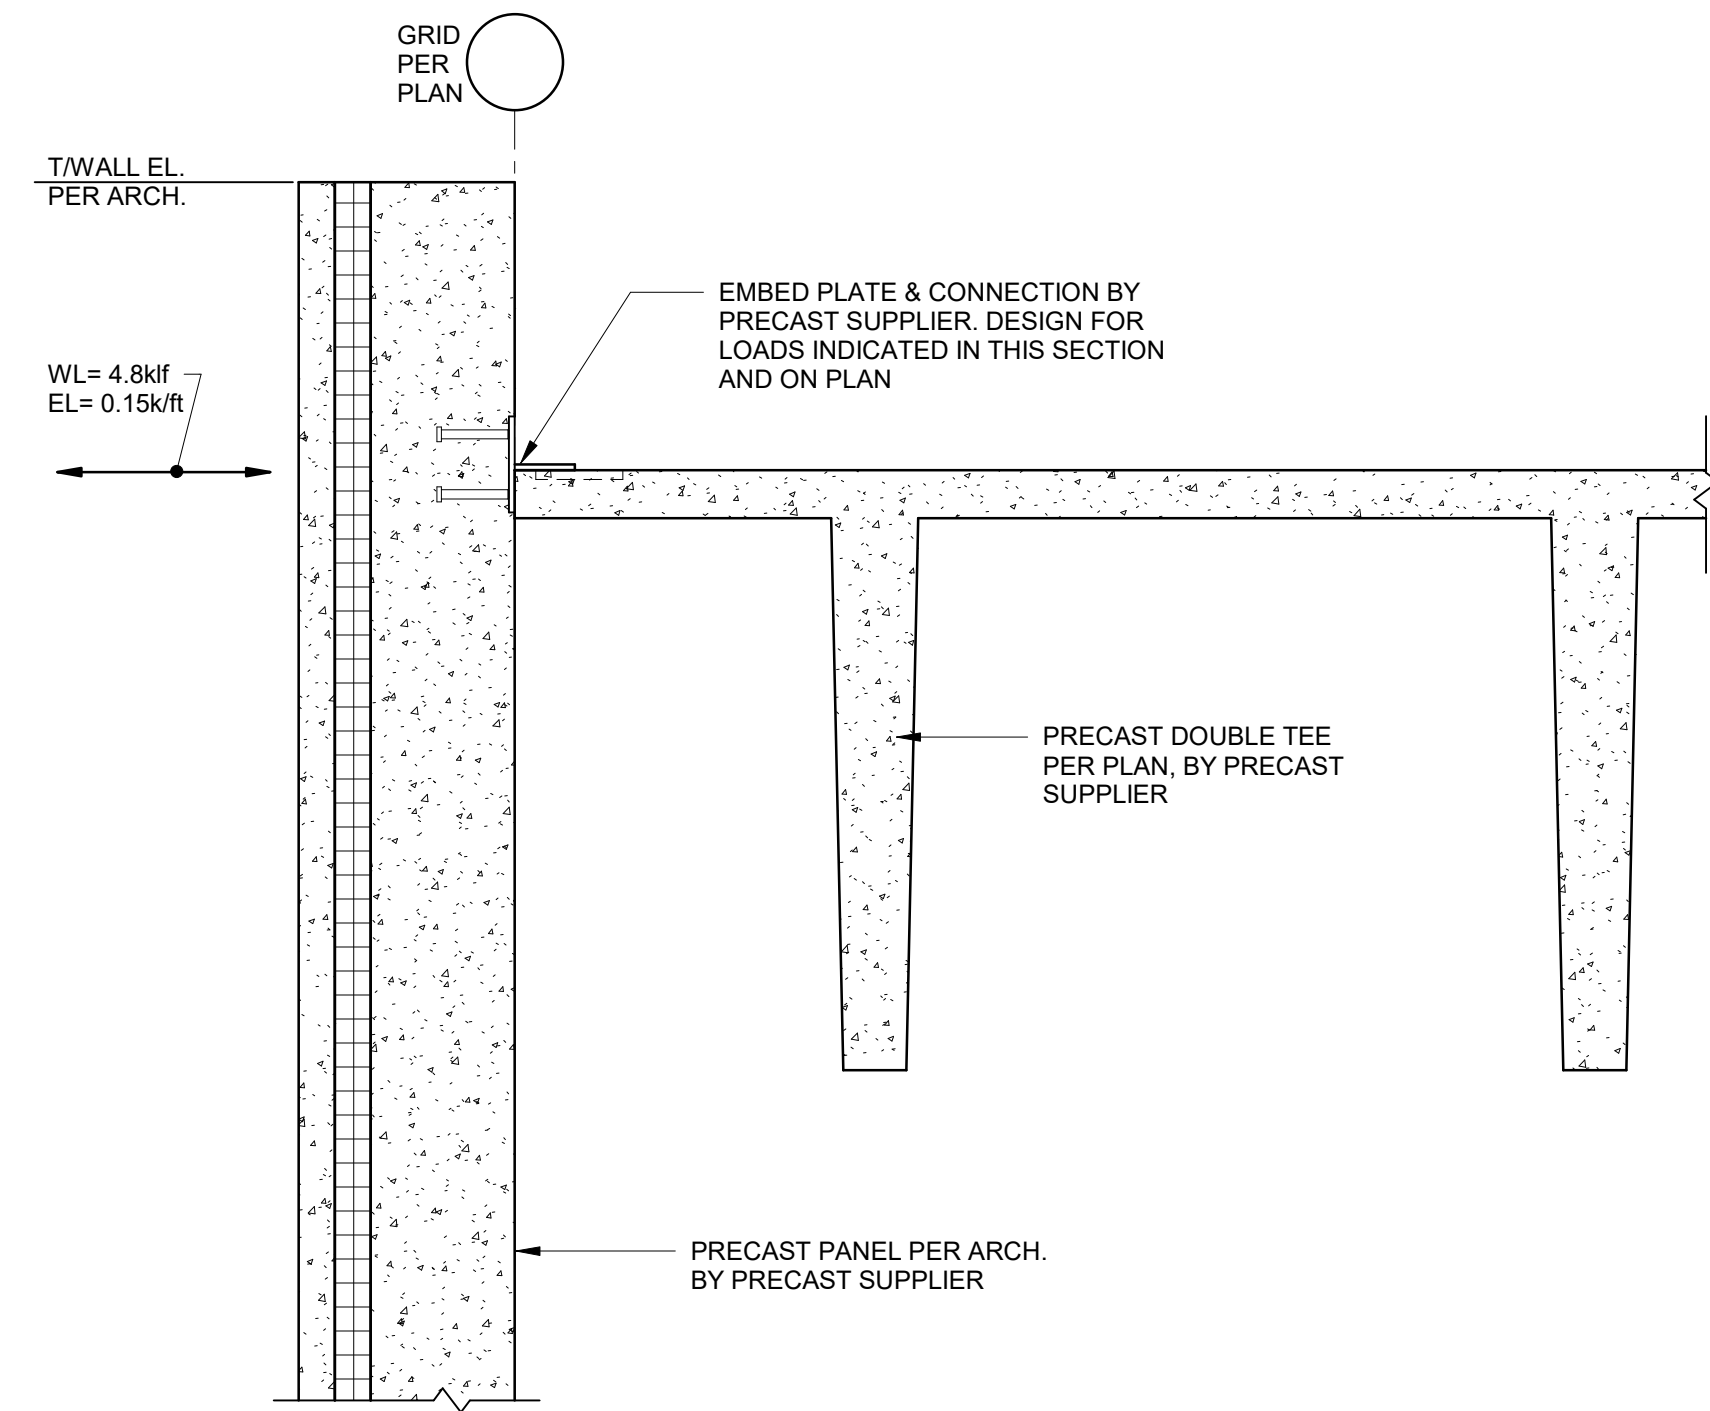

6 SECTION
3/4" = 1'-0"

IMPACT RESISTANCE OF CONCRETE WALL ASSEMBLIES

Test results from a number of investigations (Twisdale and Dunn, 1981) suggest that 6-inch-thick reinforced concrete walls are needed to stop a 15-pound wood 2x4 test missile impacting at 100 mph without threshold spalling. TTU research indicates that a 6-inch reinforced concrete wall (Figure B8-16, illustrations [a] and [b]) can resist this test missile). Reinforced concrete walls constructed with insulating concrete forms (ICFs) with a uniform concrete section at least 4 inches thick (Figure B8-21, illustration [b]) can also provide sufficient protection.

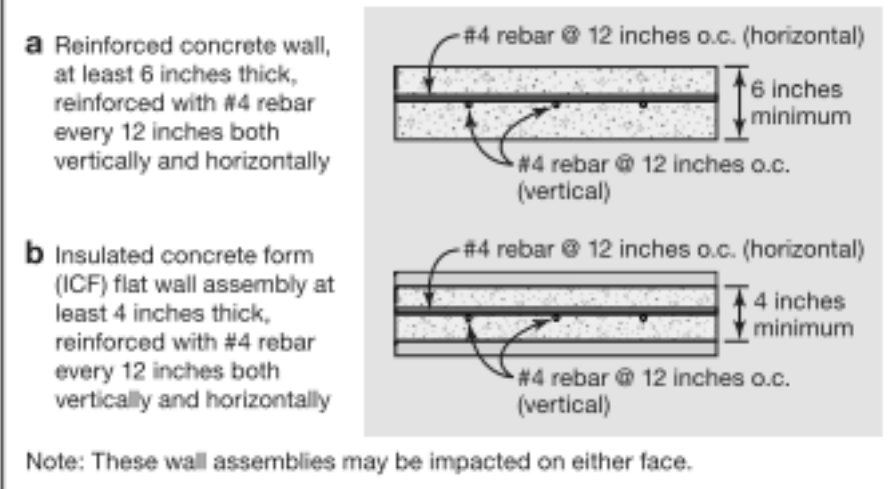

IMPACT RESISTANCE OF CONCRETE ROOF ASSEMBLIES

The TTU research also shows that a 4-inch-thick reinforced concrete roof slab on removable forms or on steel decking is able to resist a 15-pound wood 2x4 test missile impacting at 67 mph (the free-falling missile impact speed given in Tables B3-3 through B3-5). For more detail on wall and roof assemblies that have passed the tornado missile impact test, see "Wall Sections that Passed Previous Missile Impact Tests" on the safe room website at <https://www.fcma.gov/emergency-managers/risk-management/safe-rooms/resources>.

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Missouri State Certificate of Authority
Architecture # 0000101
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Bob D Campbell
Structural Engineer
State Certificate of Authority #000442
4338 Bellevue Ave
Kansas City, MO 64111
816.531.4144 phone
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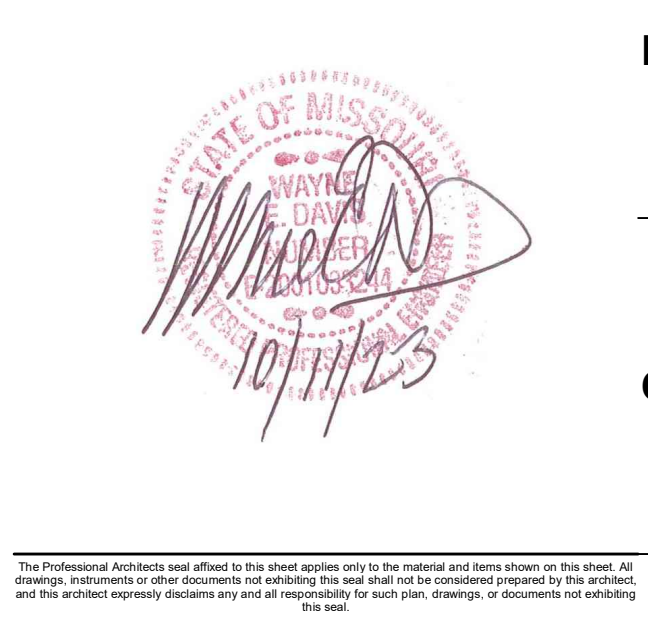
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913.317.9390 phone

Peebolte Creative
Theatrical Consultant
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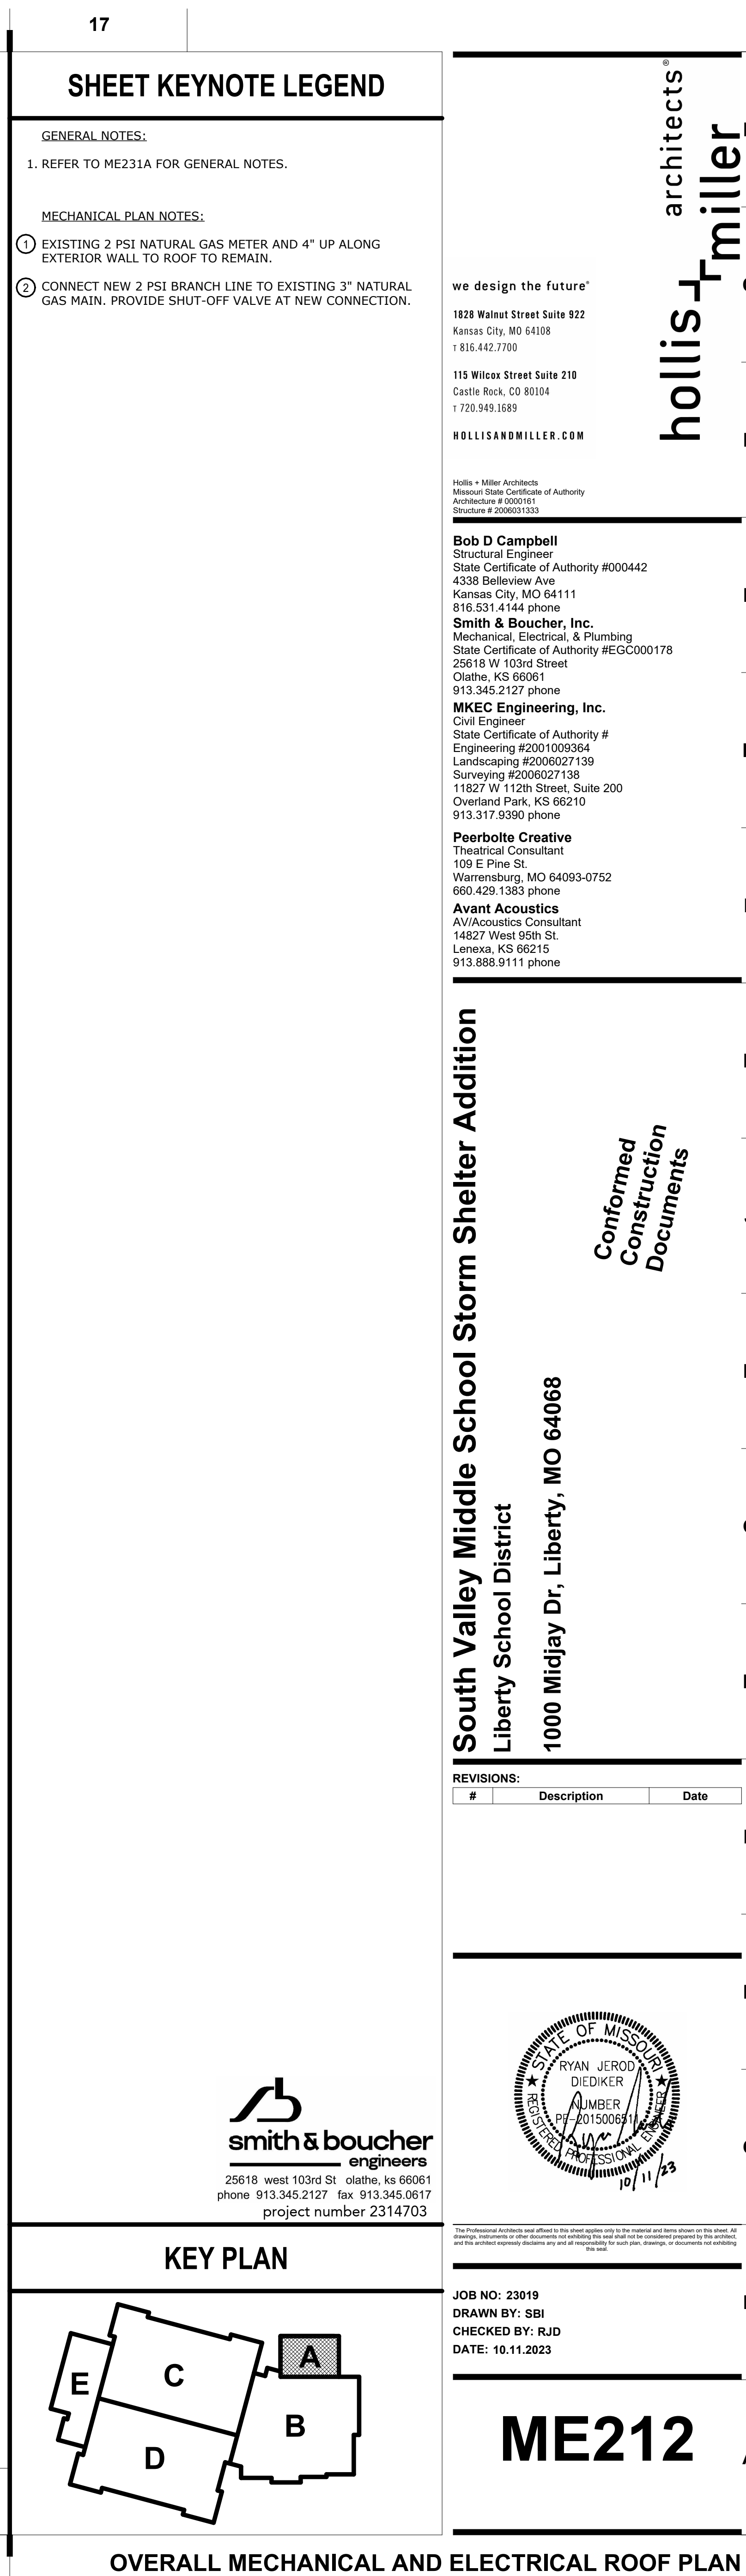
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PROJECT NAME: 2314703 - 2314703 South Valley Middle School Storm Shelter Addition & LED Lighting
AUTOCAD FILE LOCATION: \\S:\Projects\2314703\Drawings\ME301.dwg
LAST CORRECTION BY: DATE: 11/11/23
PLOTTED BY: DATE: 11/11/23
Bobbly Charles

DOMESTIC WATER HEATER - ELEC	
DESIGNATION	EW-H-5
UNIT DATA	
MANUFACTURER	A.O. SMITH
MODEL	DEL-20S
CAPACITY (GALLONS)	20
RECOVERY @ 100°F RISE (GPH)	19
OUTLET TEMP. (°F)	140
ELEMENTS (NO.)	1
TOTAL INPUT (KW)	4.5
VOLTS/PHASE	
ELEC/CONTROL	
PANEL & CIRCUIT	HP6-3
WIRE & CONDUIT	(2)#10,#10G, 1/2"C
OVERCURRENT DEVICE	25A-1P CB
DISCONNECT	30A-1P NF
REFERENCE DRAWING/DETAIL	P101A
REMARKS	--

PLUMBING DRAWDOWN TANK SCHEDULE	
DESIGNATION	ST-1
UNIT DATA	
LOCATION	STORAGE
SERVICE	DOMESTIC WATER
MANUFACTURER	WESSELS
MODEL NO.	FX 300V
PRECHARGE PRESSURE (PSIG)	40
MAX. PRESSURE (PSIG)	60
TANK TOTAL VOLUME (GAL)	80
USEABLE VOLUME (GAL)	65
HEIGHT (IN.)	55
DIAMETER (IN.)	25
WEIGHT (LB)	200
REFERENCE DRAWING/DETAIL	P101A
REMARKS	--

PIPE INSULATION SCHEDULE - PLUMBING			
SERVICE	PIPE SIZE	INSULATION	NOTES
DOMESTIC COLD WATER	1/2" - 1-1/4"	1/2" FIBERGLASS, ASJ	1,2,3,4
	1-1/2" AND LARGER	1" FIBERGLASS, ASJ	
DOMESTIC HOT WATER	1/2" - 1-1/4"	1" FIBERGLASS, ASJ	1,2,3
RE-CIRCULATING HOT WATER	1-1/2" AND LARGER	1-1/2" FIBERGLASS, ASJ	
EXPOSED FIXTURE WASTETRAPS AND DOMESTIC HOT WATER AT HANDICAPPED ACCESSIBLE SINKS AND LAVATORIES	ALL	TRUBRO LAV AGUARD MOLDED PROTECTIVE PIPE COVER OVER 1/2" FIBERGLASS INSULATION	

- NOTES:
- FOR ALL PIPING 2-1/2" AND LARGER, PROVIDE CALCIUM SILICATE INSERTS AT ALL HANGERS AND SUPPORT LOCATIONS.
 - ALL INSULATION SHALL HAVE A MAXIMUM OF 25 FLAME SPREAD/50 SMOKE DEVELOPMENT RATING.
 - ELBOW AND FITTING INSULATION SHALL BE OF SAME THICKNESS AS ADJACENT STRAIGHT PIPE INSULATION.
 - FITTING INSULATION TO HAVE ASJ OR SUPPLEMENTAL VAPOR BARRIER SEALED TO ADJACENT PIPE INSULATION.

HVAC PIPE INSULATION SCHEDULE			
SERVICE	PIPE SIZE	INSULATION	NOTES
CONDENSATE DRAIN	1/2" - 2"	1/2" FIBERGLASS, ASJ	1,2,3,4
	2-1/2" AND LARGER	1" FIBERGLASS, ASJ	
REFRIGERANT SUCTION			
REFRIGERANT HOT GAS	ALL	1/2" FLEXIBLE CLOSED CELL ELASTOMERIC, UV PAINT OUTDOORS	2,3

- NOTES:
- FOR ALL PIPING 2-1/2" AND LARGER, PROVIDE CALCIUM SILICATE OR CELLULAR GLASS INSERTS AT ALL HANGERS AND SUPPORT LOCATIONS.
 - ALL INSULATION SHALL HAVE A MAXIMUM OF 25 FLAME SPREAD/50 SMOKE DEVELOPMENT RATING.
 - ELBOW AND FITTING INSULATION SHALL BE OF SAME THICKNESS AS ADJACENT STRAIGHT PIPE INSULATION.
 - FITTING INSULATION TO HAVE ASJ OR SUPPLEMENTAL VAPOR BARRIER SEALED TO ADJACENT PIPE INSULATION.

DUCTWORK SCHEDULE					
SERVICE	DUCT SHAPE	SMACNA REQUIREMENTS			OTHER REQUIREMENTS
		CLASSIFICATION	SEAL CLASS	LEAKAGE CLASS	
SUPPLY AIR DUCTS (LOW PRESSURE)	RECTANGULAR	2" WG POSITIVE	B	12	1", 3LB DENSITY LINER
	(EXPOSED AND CONCEALED)				PAINTABLE WHERE EXPOSED
	ROUND	2" WG POSITIVE	B	3	INSULATED - SEE SCHEDULE
	(CONCEALED)				
	ROUND	4" WG POSITIVE	B	3	PAINTABLE WHERE EXPOSED
	(EXPOSED)	SPIRAL SEAM			
RETURN AIR DUCTS	RECTANGULAR	2" WG NEGATIVE	B	12	1", 3LB DENSITY LINER
	(EXPOSED AND CONCEALED)				PAINTABLE WHERE EXPOSED
TRANSFER AIR DUCTS	RECTANGULAR	2" WG NEGATIVE	B	12	1/2", 3LB DENSITY LINER
					PAINTABLE WHERE EXPOSED
GENERAL EXHAUST DUCTS TO THE INLET OF THE FAN	RECTANGULAR	2" WG NEGATIVE	B	12	
	(EXPOSED AND CONCEALED)				PAINTABLE WHERE EXPOSED
	ROUND	4" WG NEGATIVE	A	3	
	(EXPOSED)	SPIRAL SEAM			PAINTABLE WHERE EXPOSED

- NOTES:
- SEE DUCTWORK INSULATION SCHEDULE FOR REQUIREMENTS ON DUCT INSULATION

DUCTWORK INSULATION SCHEDULE	
SERVICE	INSULATION
CONCEALED DUCTWORK AS FOLLOWS:	
ALL ROUND SUPPLY AIR AND UNLINED BRANCH TAKE-OFFS FOR ROUND DUCTS AND IN-LINE TRANSITIONS.	1-1/2", 1.5 LB. RIGID FIBERGLASS BLANKET, VAPOR BARRIER FACED, WITH HEAVY DUTY FOIL-SCRM-KRAFT FACING.
EXHAUST AIR BETWEEN ISOLATION DAMPER AND PENETRATION OF BUILDING EXTERIOR.	

- NOTES:
- SEE DUCTWORK SCHEDULE FOR ITEMS THAT ARE TO BE LINED.
 - EXPOSED, LOW PRESSURE, ROUND AND FLAT OVAL SUPPLY AIR DUCTWORK IS NOT INSULATED.

DRAIN SCHEDULE		
MARK	MANUFACTURER/ MODEL	DESCRIPTION
FD-1	ZURN Z41SS	CAST IRON DRAIN WITH ADJUSTABLE TOP AND 8" NICKEL BRASS STRAINER WITH VANDAL RESISTANT SCREWS.
RD-1	ZURN ZZC100NH	CAST IRON ROOF DRAIN WITH CAST IRON DOME STRAINER, ADJUSTABLE ROOF FLANGE AND VANDAL RESISTANT SCREWS.
ORD-1	ZURN ZZC100NHW2	CAST IRON ROOF DRAIN WITH CAST IRON DOME STRAINER, ADJUSTABLE ROOF FLANGE AND VANDAL RESISTANT SCREWS.
DSN-1	ZURN ZZARB19NH	CAST BRONZE DOWNSPOUT NOZZLE WITH NO-HUB OUTLET AND FLANGE TO SECURE NOZZLE TO WALL.

- NOTES:
- PROVIDE FLOOR DRAIN WITH SURE SEAL TRAP SEALER OR EQUAL.

PUMP SCHEDULE	
DESIGNATION	HWCP-5
UNIT DATA	
MANUFACTURER	BELL & GOSSETT
LOCATION	MECH
MODEL NO.	NBF-36
SERVICE	DOM. HOT WATER
PUMP TYPE	IN-LINE
GPM	5
PUMP HEAD (FT.)	25
MOTOR HORSEPOWER	1/6
MOTOR RPM	1725
VOLTAGE/PHASE	120/1
ELEC/CONTROL DATA	
PANEL & CIRCUIT	LP6-43
WIRE & CONDUIT	(2)#12,#12G, 1/2"C
OVERCURRENT DEVICE	15A-1P CB
DISCONNECT	NOTE 1
STARTER	--
COMBINATION STARTER	--
CONTROL	AQUASTAT
REFERENCE DRAWING/DETAIL	P101A
REMARKS	NOTE 1

- NOTES:
- PROVIDE MOTOR RATED TOGGLE SWITCH AT PUMP.

PLUMBING FIXTURE SCHEDULE						
MARK	MFG./ MODEL	DESCRIPTION	MANUFACTURER/MODEL	FITTINGS DESCRIPTION	NOTE	PIPING CONNECTIONS
						CW HW SAN VENT
EW-C-1	ELKAY LZSTLBWSLK	ADA COMPLIANT TWO STATION WALL MOUNT WATER COOLER WITH BOTTLE FILLING STATION AND BARRIER FREE ACCESS. STAINLESS STEEL BASIN. FLEX-GUARD SAFETY BUBBLER. HERMETICALLY-SEALED COMPRESSOR.	--	--	1	1/2" -- 1-1/2" 1-1/2"
L-1	SLOAN SS-3103	ADA COMPLIANT WALL HUNG LAVATORY. WHITE VITREOUS CHINA, WITH SPLASHBACK AND FRONT OVERFLOW. SINGLE HOLE CENTERSET FAUCET.	CHICAGO FAUCETS 116.599 AB.1	ADA COMPLIANT BATTERY OPERATED DUAL BEAM INFRARED SENSOR, CHROME PLATED DIE CAST METAL HAND WASHING FAUCET. METAL GRID DRAIN ASSEMBLY. 0.5GPM FLOW RATE.	1,2,3,4,5	1/2" 1/2" 2" 2"
RH-1	HOEPTNER 2131RE	FREEZE-PROOF ROOF HYDRANT WITH RECESSED DRAIN RESERVOIR. NO DRAIN REQUIRED. NO WINTERIZATION REQUIRED.	--	--	--	3/4" -- -- --
S-1	MUSTEE 15F	UTILITY SINK: FLOOR-MOUNTED, SINGLE COMPARTMENT, THERMOPLASTIC OR POLYPROPYLENE TUB. (2) FAUCET HOLES ON 4" CENTERS. STEEL LEGS.	CHICAGO FAUCETS 895	DECK MOUNTED GOOSENECK FAUCET WITH VANDAL PROOF WRISTBLADE HANDLES. 4" FIXED CENTERS, 5" RIGID/SWING GOOSENECK SPOUT. 2.2GPM FLOW RATE.	3,4,5	1/2" 1/2" 2" 2"
WC-1	SLOAN ST-2459	ADA COMPLIANT WATER CLOSET. WHITE VITREOUS CHINA, ELONGATED BOWL, WALL MOUNTED, FLUSH VALVE BOWL WITH TOP SPUD AND FLAT BOLT COVERS. 1.6 GALLON SIPHON JET FLUSHING ACTION.	SLOAN REGAL 111 SFSM-1.6	ADA COMPLIANT, EXPOSED WATER CLOSET BATTERY OPERATED ELECTRONIC FLUSH VALVE, CHROME PLATED METAL, WITH, 1" I.P.S. SCREWDRIVER BAK-CHEK ANGLE STOP WITH PROTECTIVE CAP, ADJUSTABLE TAILPIECE, VACUUM BREAKER FLUSH CONNECTION AND SPUD COUPLING FOR 1 1/2" TOP SPUD, 1.6 GALLON FLUSH.	--	1" -- 4" 2"
	WADE	PROVIDE CARRIER AS REQUIRED TO SUIT APPLICATION FOR MOUNTING IN CHASE. MOUNT TOP OF WATER CLOSET AT 18" AFF.	--	POINT OF USE THERMOSTATIC MIXING VALVE. CHROME FINISH. 1/2" FITTINGS. WALL MOUNTING PLATE.		
	CHURCH 9500C	SEAT: SOLID PLASTIC, OPEN FRONT, WHITE, ELONGATED BOWL, INTEGRAL BUMPERS, EXTERNAL CHECK HINGES WITH STAINLESS STEEL POSTS.	WATTS MIN/MIXING 2297321	BELOW SINK PLASTER TRAP WITH POLYCARBONATE PERFORATED BASKET. BASKET SHALL BE INSTALLED FOR MAINTENANCE ACCESS. BASKET SHALL BE CLEAR TO ALLOW VISIBILITY INTO THE UNIT.		
WC-2	SLOAN ST-2459	WATER CLOSET. WHITE VITREOUS CHINA, ELONGATED BOWL, WALL MOUNTED, FLUSH VALVE BOWL WITH TOP SPUD AND FLAT BOLT COVERS. 1.6 GALLON SIPHON JET FLUSHING ACTION.	SLOAN REGAL 111 SFSM-1.6	EXPOSED WATER CLOSET BATTERY OPERATED ELECTRONIC FLUSH VALVE, CHROME PLATED METAL, WITH, 1" I.P.S. SCREWDRIVER BAK-CHEK ANGLE STOP WITH PROTECTIVE CAP, ADJUSTABLE TAILPIECE, VACUUM BREAKER FLUSH CONNECTION AND SPUD COUPLING FOR 1 1/2" TOP SPUD, 1.6 GALLON FLUSH.	--	1" -- 4" 2"
	WADE	PROVIDE CARRIER AS REQUIRED TO SUIT APPLICATION FOR MOUNTING IN CHASE.	--	PROVIDE WALL AND SPUD FLANGES.		
	CHURCH 9500C	SEAT: SOLID PLASTIC, OPEN FRONT, WHITE, ELONGATED BOWL, INTEGRAL BUMPERS, EXTERNAL CHECK HINGES WITH STAINLESS STEEL POSTS.	WATTS MIN/MIXING 2297321	BELOW SINK PLASTER TRAP WITH POLYCARBONATE PERFORATED BASKET. BASKET SHALL BE INSTALLED FOR MAINTENANCE ACCESS. BASKET SHALL BE CLEAR TO ALLOW VISIBILITY INTO THE UNIT.		
WH-1	J.R. SMITH 5509QT	NON-FREEZE HYDRANT WITH INTEGRAL VACUUM BREAKER.	--	--	--	1/2" -- -- --

- NOTES:
- PROVIDE CHROME PLATED BRASS TAILPIECE AND GRID DRAIN.
 - PROVIDE CHROME PLATED BRASS P-TRAP.
 - PROVIDE LOOSE KEY STOPS AND FLEXIBLE RISERS.
 - INSULATE EXPOSED TAILPIECE, P-TRAP, AND WATER RISERS.
 - PROVIDE WITH ALL MOUNTING HARDWARE AS REQUIRED. FIXTURE STUDS AND NUTS SHALL BE STAINLESS STEEL.

LOUVER SCHEDULE													
PLAN MARK	SERVICE	TYPE	MANUFACTURER	MODEL NUMBER	MATERIAL	AIRFLOW (CFM)	MAX VELOCITY (FPM)	MAX PRESSURE DROP (W.G.)	MINIMUM FREE AREA (SF)	FREE AREA PERCENTAGE	LOUVER HEIGHT (FT)	LOUVER WIDTH (FT)	REMARKS
L-1	SHELTER	OA	RUSKIN	XP-500-WD	ALUMINUM	4450	1000	0.1	5.1	25%	4	4.5	1, 2, 3, 4, 5
L-2	SHELTER	OA	RUSKIN	XP-500-WD	ALUMINUM	4450	1000	0.1	5.1	25%	4	4.5	1, 2, 3, 4, 5
L-3	SHELTER	EA	RUSKIN	XP-500-WD	ALUMINUM	8900	1000	0.1	10.2	25%	6	6	1, 2, 3, 4, 5
L-4	SHELTER	EA	RUSKIN	XP-500-WD	ALUMINUM	300	1000	0.1	0.4	25%	1.5	1.5	1, 2, 3, 4, 5
L-5	RTU-13	SA	RUSKIN	XP500	ALUMINUM	8000	1100	0.3	7.3	50%	6	2.67	3, 6
L-6	RTU-13	RA	RUSKIN	XP500	ALUMINUM	8000	1100	0.3	7.3	50%	6	2.67	3, 6
L-7	RTU-14	SA	RUSKIN	XP500	ALUMINUM	8000	1100	0.3	7.3	50%	6	2.67	3, 6
L-8	RTU-14	RA	RUSKIN	XP500	ALUMINUM	8000	1100	0.3	7.3	50%	6	2.67	3, 6
L-9	RTU-15	SA	RUSKIN	XP500	ALUMINUM	3500	1100	0.3	3.2	50%	2.67	2.67	3, 6
L-10	RTU-15	RA	RUSKIN	XP500	ALUMINUM	3500	1100	0.3	3.2	50%	2.67	2.67	3, 6

- NOTES:
- 1100 FPM BEGINNING POINT OF WATER PENETRATION.
 - PROVIDE WITH BIRD AND INSECT SCREEN.
 - PROVIDE MOTORIZED DAMPER AND ACTUATOR WITH TRANSFORMER.
 - ICC500 RATINGS AND WIND-DRIVEN RAIN RATINGS WITH OUT OF WALL MOUNTING. COORDINATE EXACT MOUNTING DETAIL TO BE FLUSH WITH EXTERIOR SURFACE.
 - FINISH COLOR SHALL BE SELECTED BY ARCHITECT.
 - ICC500 RATING WITH OUT OF WALL MOUNTING. COORDINATE EXACT MOUNTING DETAIL TO BE FLUSH WITH EXTERIOR SURFACE.

AIR CONDITIONING UNIT SCHEDULE					
INDOOR UNIT					
DESIGNATION		AC-1		AC-2	
UNIT DATA	MANUFACTURER	MITSUBISHI		MITSUBISHI	
	TYPE	WALL		DUCTED	
	MODEL	PKA-A18LA		PEAD-A36AA8	
	CFM	455		1080	
	OSA CFM	-		30	
	TOTAL COOLING CAP (MBH) @ 95 DEG SEER/EEER AT AHRI	18		36	
	TOTAL HEATING CAP (MBH) @ 47 DEG	19.8 / 10.7		19.1 / 10.0	
ELEC DATA	TOTAL HEATING CAP (MBH) @ 17 DEG	-		36.0	
	TOTAL HEATING CAP (MBH) @ 17 DEG	-		22.0	
	HSPF AT AHRI	-		10.8	
	MCA	1		1	
	VOLTAGE/PHASE	208/1		208/1	
	PANEL AND CIRCUIT	NOTE 1		NOTE 1	
	WIRE AND CONDUIT	(2)#10,#10G, 1/2"C		(2)#8,#10,3/4"C	
REFERENCE DRAWING/DETAIL	OVERCURRENT DEVICE	NOTE 1		NOTE 1	
	DISCONNECT	30A-2P NF		30A-2P NF	
		M101A		M101A	
REMARKS		NOTE 3, 4		NOTE 3, 4	
OUTDOOR UNIT					
DESIGNATION		CU-1		CU-2	
UNIT DATA	MANUFACTURER	MITSUBISHI		MITSUBISHI	
	MODEL NO.	PUTY-A18NKA7		PUTZ-A36NKA7	
	AMBIENT AIR TEMP (DEG F.)	95		95	
	MCA	11		25	
	MOCF	28		31	
	VOLTAGE/PHASE	208/1		208/1	
	PANEL AND CIRCUIT	LP6-44.46		LP6-48.50	
ELEC DATA	WIRE AND CONDUIT	(2)#10,#10G, 1/2"C		(2)#8,#10,3/4"C	
	OVERCURRENT DEVICE	25A-2P CB		30A-2P CB	
	DISCONNECT	30A-2P NEMA 3R		60A-2P NEMA 3R	
REFERENCE DRAWING/DETAIL		ME231A		ME231A	
REMARKS		NOTE 2		-	

- NOTES:
- INDOOR UNIT CIRCULATED THROUGH OUTDOOR UNIT.
 - PROVIDE WIND BAFFLE FOR LOW AMBIENT OPERATION.
 - PROVIDE PROGRAMMABLE, WALL-MOUNTED CONTROLLER.
 - PROVIDE CONDENSATE PUMP.

FAN SCHEDULE		
DESIGNATION	EF-16	EF-17
FAN TYPE	INLINE	INLINE
SERVICE	STORM SHELTER	RESTROOMS
MANUFACTURER	GREENHECK	GREENHECK
MODEL	SO-27-M2	SO-98-VG
UNIT DATA	CFM	8900
	STATIC PRESSURE	1.0
	FAN RPM	860
	BRAKE HORSEPOWER	2.8
	MOTOR HORSEPOWER	3
	VOLTAGE/PHASE	480/3
ELEC/CONTROL	DRIVE	DIRECT
	PANEL & CIRCUIT	INV-1,3,5
	WIRE & CONDUIT	(3)#12,#12G, 1/2"C
	OVERCURRENT DEVICE	20A-3P CB
	DISCONNECT	30A-3P NF
	COMBINATION STARTER	VFD
REFERENCE DRAWING/DETAIL		M101A
REMARKS		NOTE 1, 2

- NOTES:
- PROVIDE BIRD SCREEN AND BACKDRAFT DAMPER.
 - PROVIDE VARIABLE FREQUENCY DRIVE (VFD).

GRILLE, REGISTER & DIFFUSER SCHEDULE							
PLAN MARK	MANUFACTURER MODEL NUMBER	SERVICE	MOUNT TYPE	VOLUME DAMPER	MATERIAL	COLOR	REMARKS
SD-1	TITUS TMS	SUPPLY	LAY-IN	NO	STEEL	WHITE	NOTE 1
SD-2	TITUS 300RL	SUPPLY	DUCT	YES	STEEL	NOTE 2	NOTE 1, 3
SD-3	TITUS US-DL	SUPPLY	SPIRAL DUCT	YES	STEEL	NOTE 2	NOTE 1
RG-1	TITUS 350RL	RETURN	LAY-IN	NO	STEEL	WHITE	NOTE 1, 4
RG-2	TITUS 350RL	RETURN	DUCT/WALL	NO	STEEL	NOTE 2	NOTE 1, 4
EG-1	TITUS 350RL	EXHAUST	LAY-IN	YES	STEEL	WHITE	NOTE 1, 4
EG-2	TITUS 350RL	EXHAUST	DUCT/WALL	YES	STEEL	NOTE 2	NOTE 1, 4

- NOTES:
- REFER TO THE PLANS FOR FACE SIZE AND DUCT CONNECTION SIZE.
 - FINISH COLOR SHALL BE SELECTED BY ARCHITECT.
 - PROVIDE ADJUSTIBLE DOUBLE DEFLECTION BLADES WITH FRONT BLADES PARALLEL TO LONG DIMENSION AND NO SCREW HOLES.
 - PROVIDE SINGLE DEFLECTION BLADES PARALLEL TO THE LONG DIMENSION AND NO SCREW HOLES.

UNIT HEATER SCHEDULE - ELEC	
DESIGNATION	ECUR-1
HEATER TYPE	HORIZONTAL
LOCATION	VESTIBULE
MOUNTING	SEMI-RECESSED
MANUFACTURER	RAYWALL
MODEL	T33D05
UNIT DATA	CFM
	FAN DRIVE
	HEATER KW
	AMPS
ELEC/CTRL DATA	VOLTAGE/PHASE
	PANEL & CIRCUIT
	WIRE & CONDUIT
	OVERCURRENT DEVICE
ELEC/CTRL DATA	DISCONNECT
	CONTROL
REFERENCE DRAWING/DETAIL	
REMARKS	

- NOTES:
- FURNISH WITH INTEGRAL THERMOSTAT.

smith & boucher
engineers
25618 west 103rd St. olathe, ks 66061
phone 913.345.2127 fax 913.345.0617
project number 2314703

we design the future™
1828 Walnut Street Suite 922
Kansas City, MO 64108
1.816.442.7700

115 Wilcox Street Suite 210
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Architecture # 0000181
Structure # 000003333

Bob D Campbell

[illegible]

PROJECT NAME: 254103 - South Valley Middle School Storm Shelter Addition
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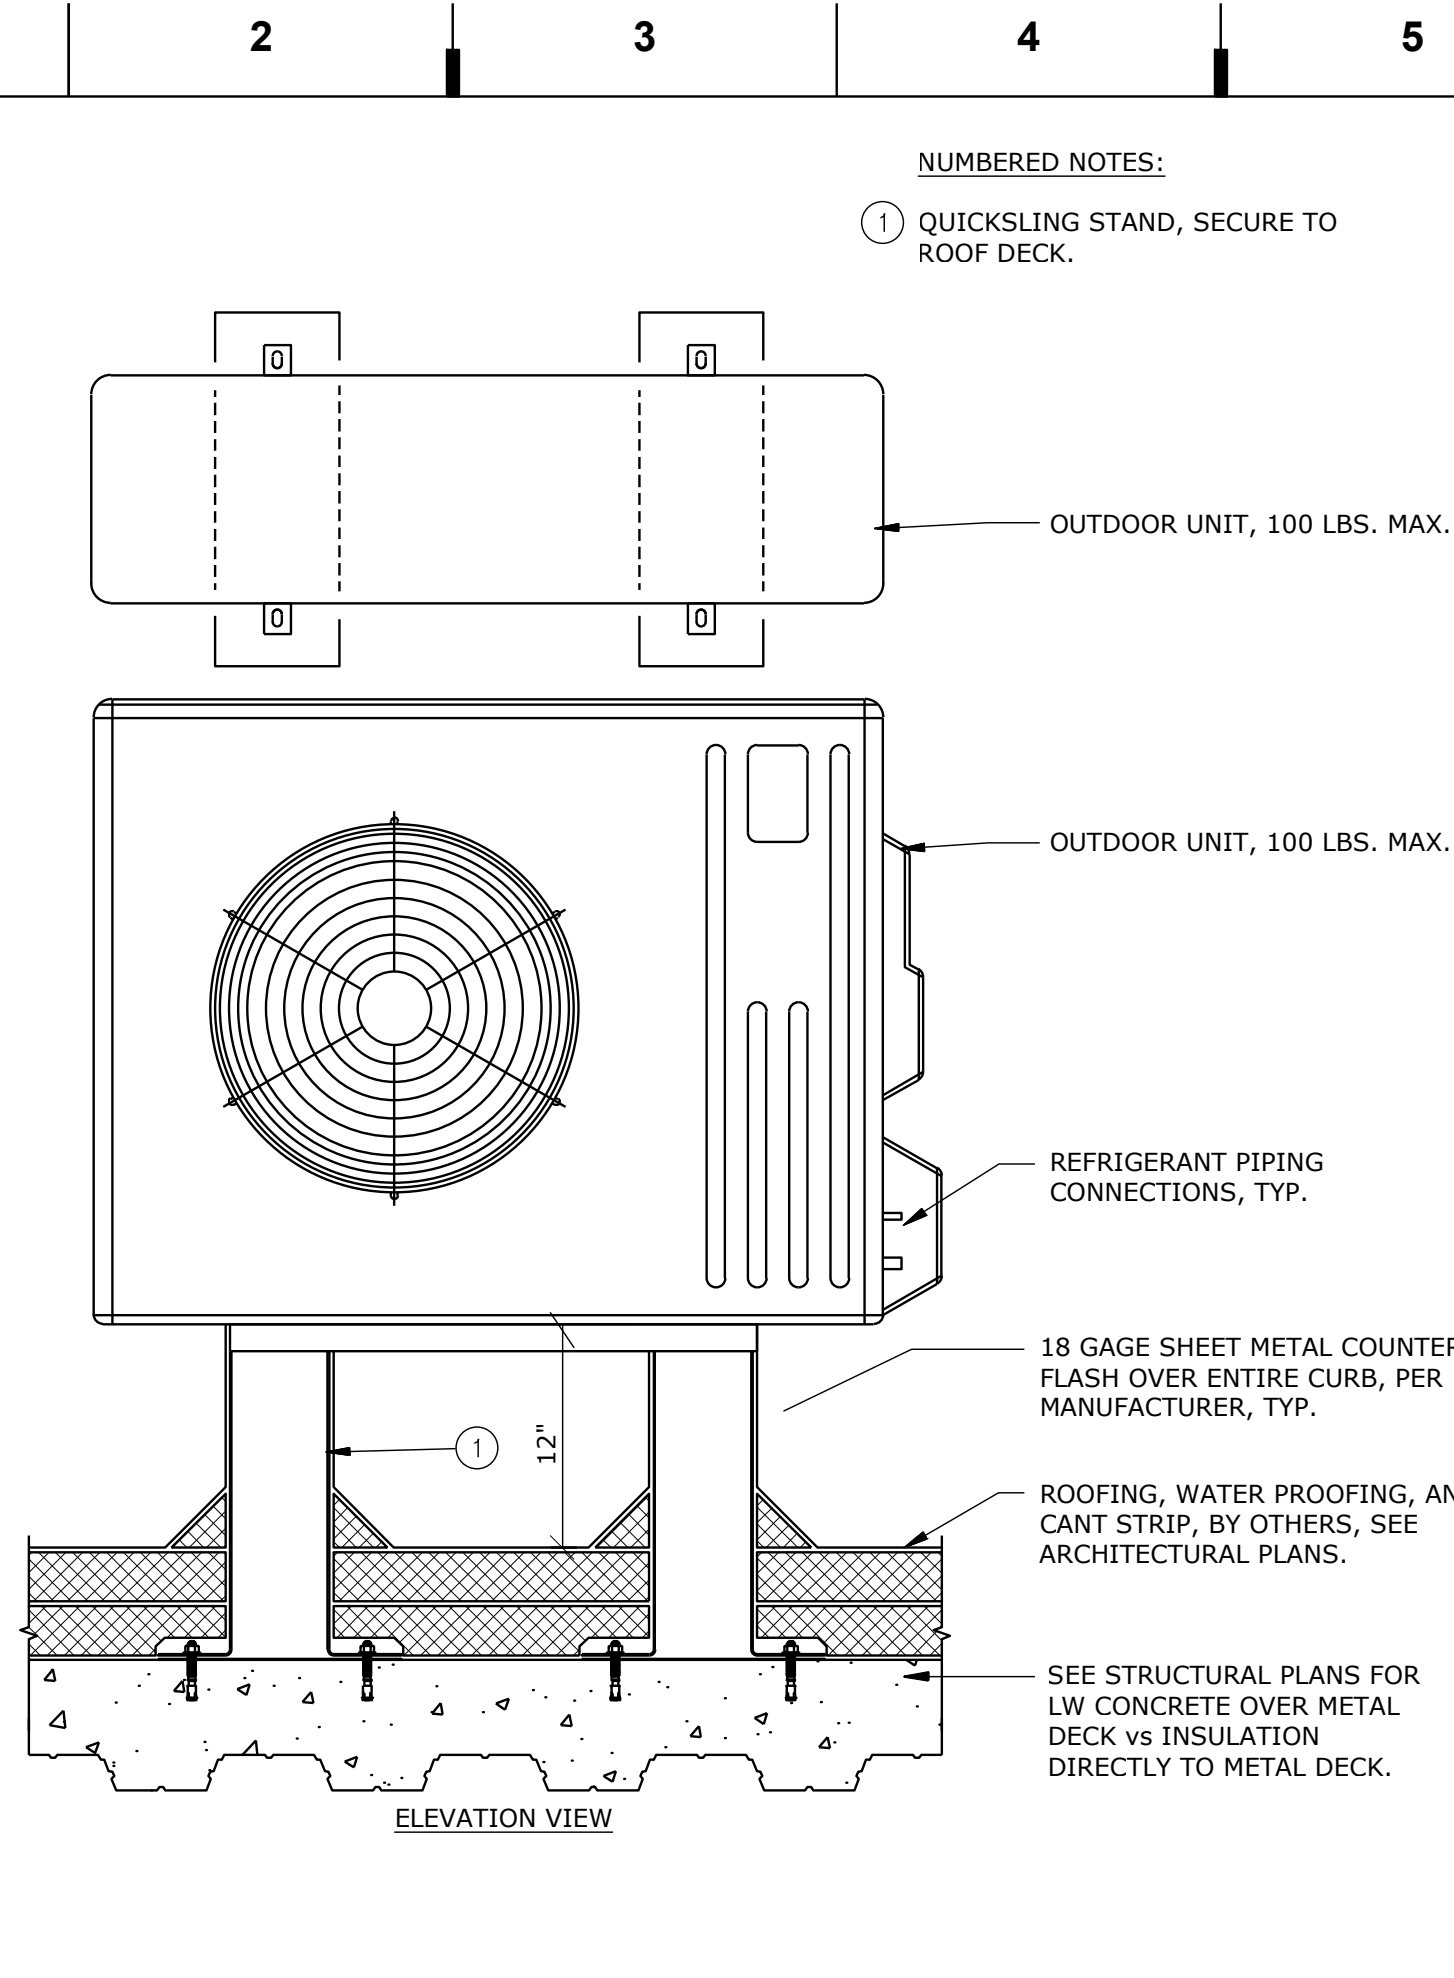
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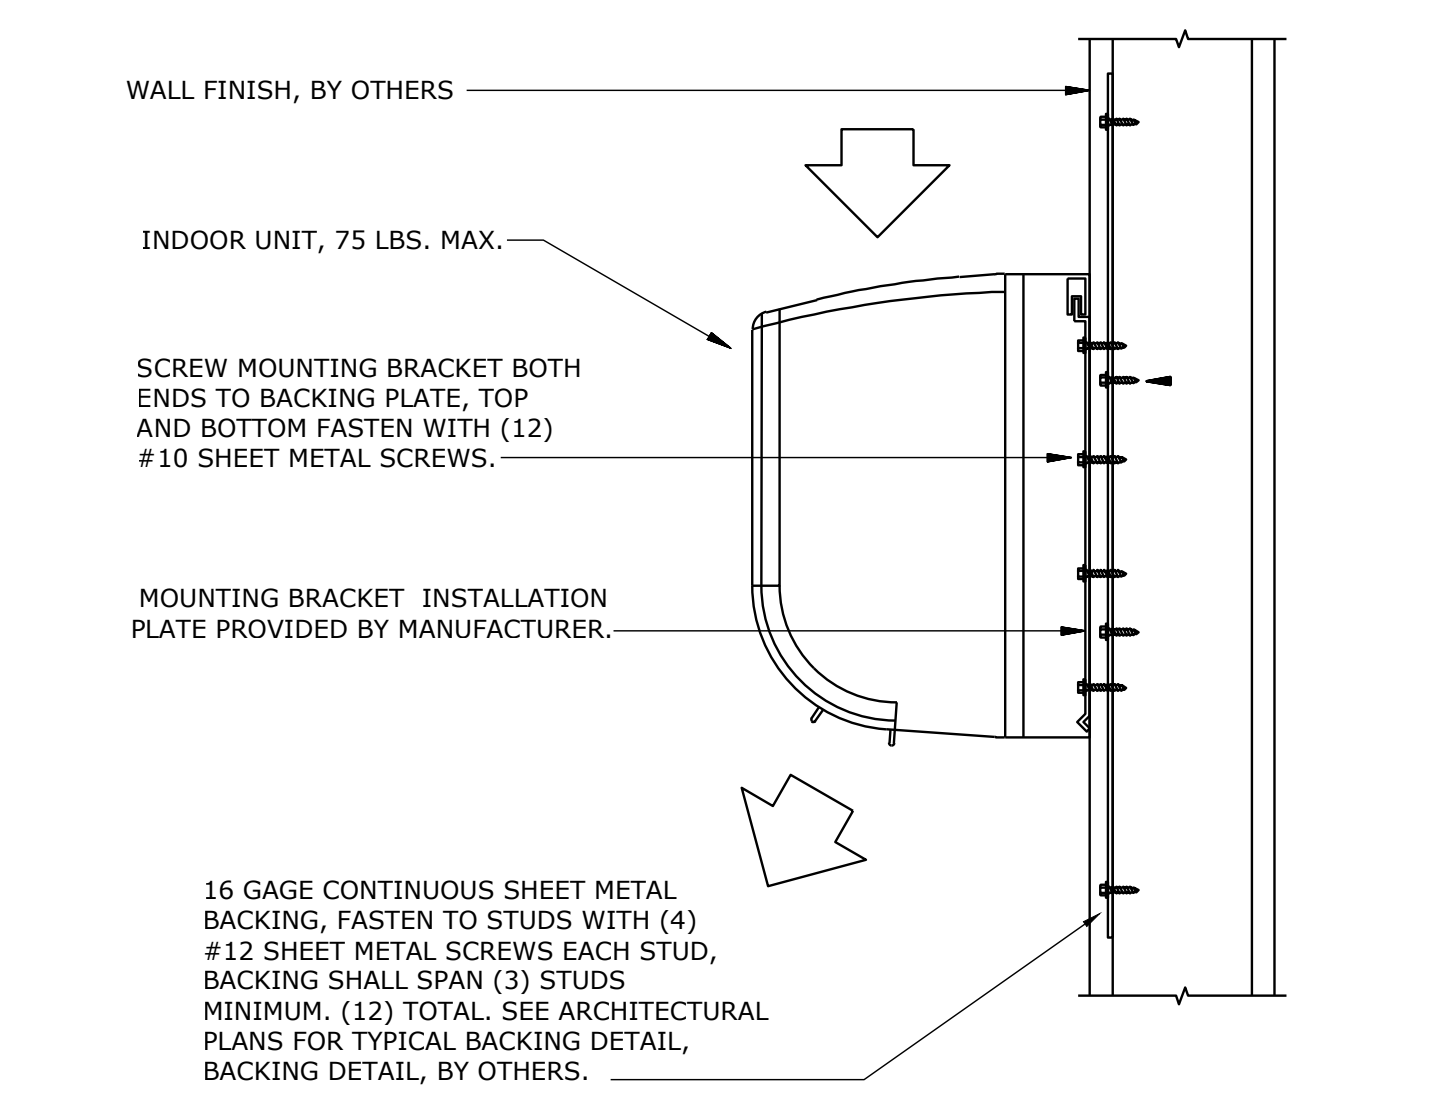
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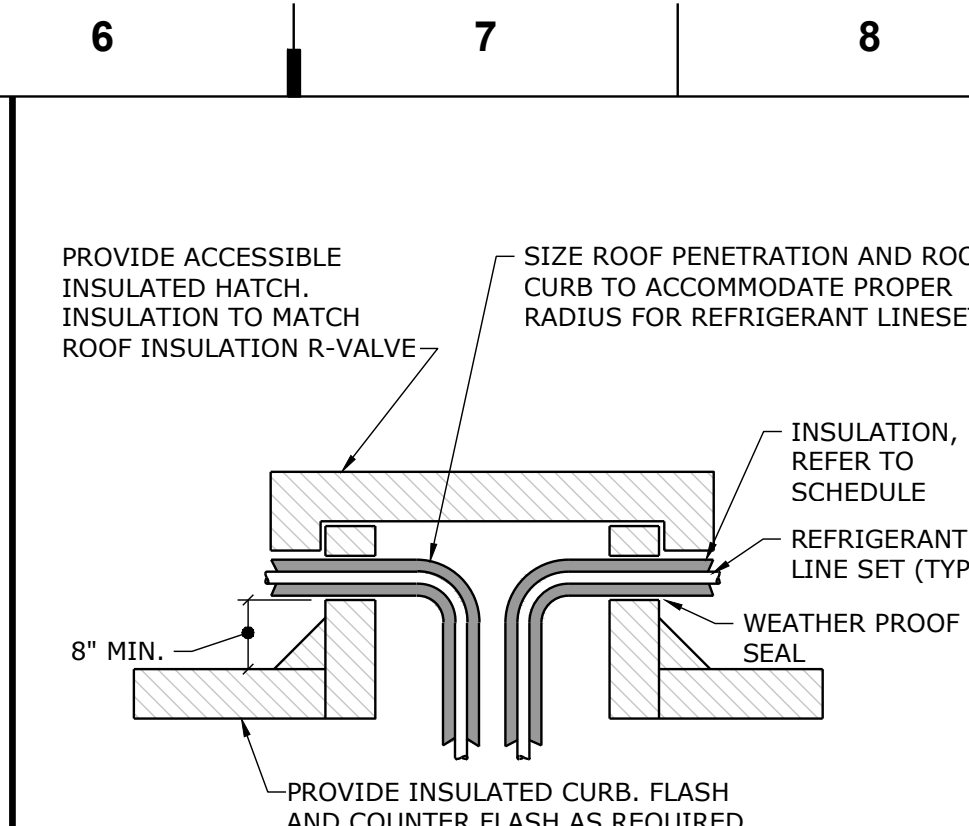
NUMBERED NOTES:
① QUICKSLING STAND, SECURE TO ROOF DECK.




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NOT TO SCALE




INDOOR SPLIT SYSTEM MOUNTING DETAIL
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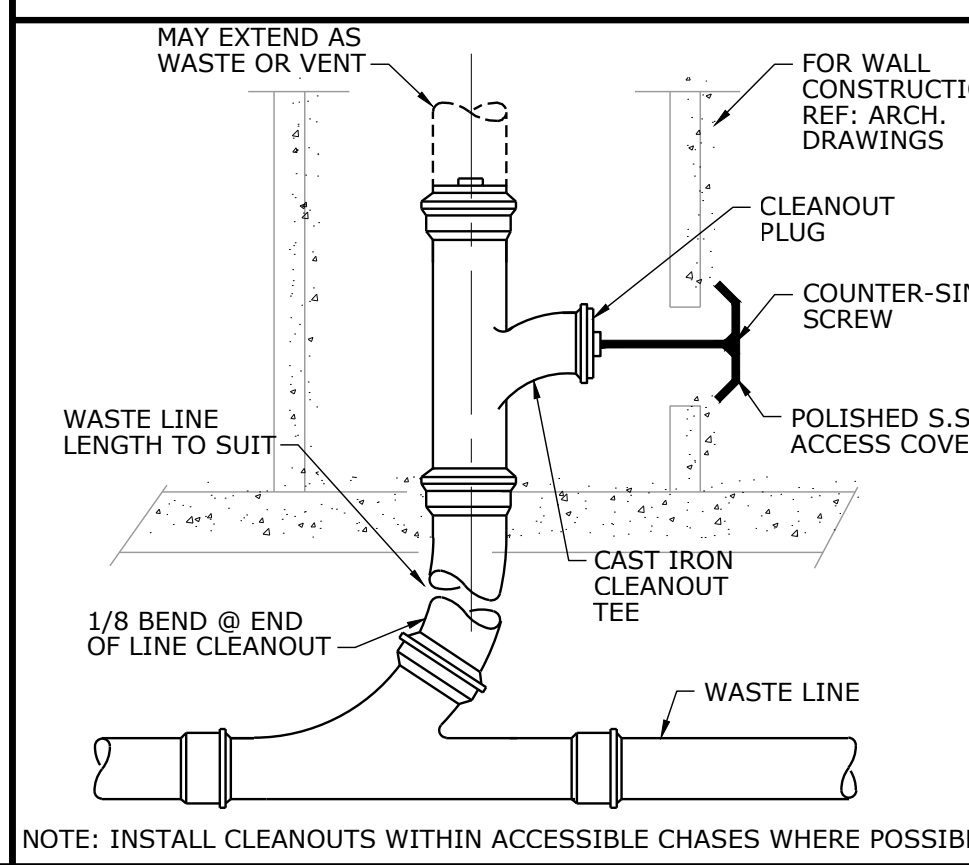
REFRIGERANT PIPING ROOF PENETRATION DETAIL
NOT TO SCALE




ROOF HYDRANT DETAIL
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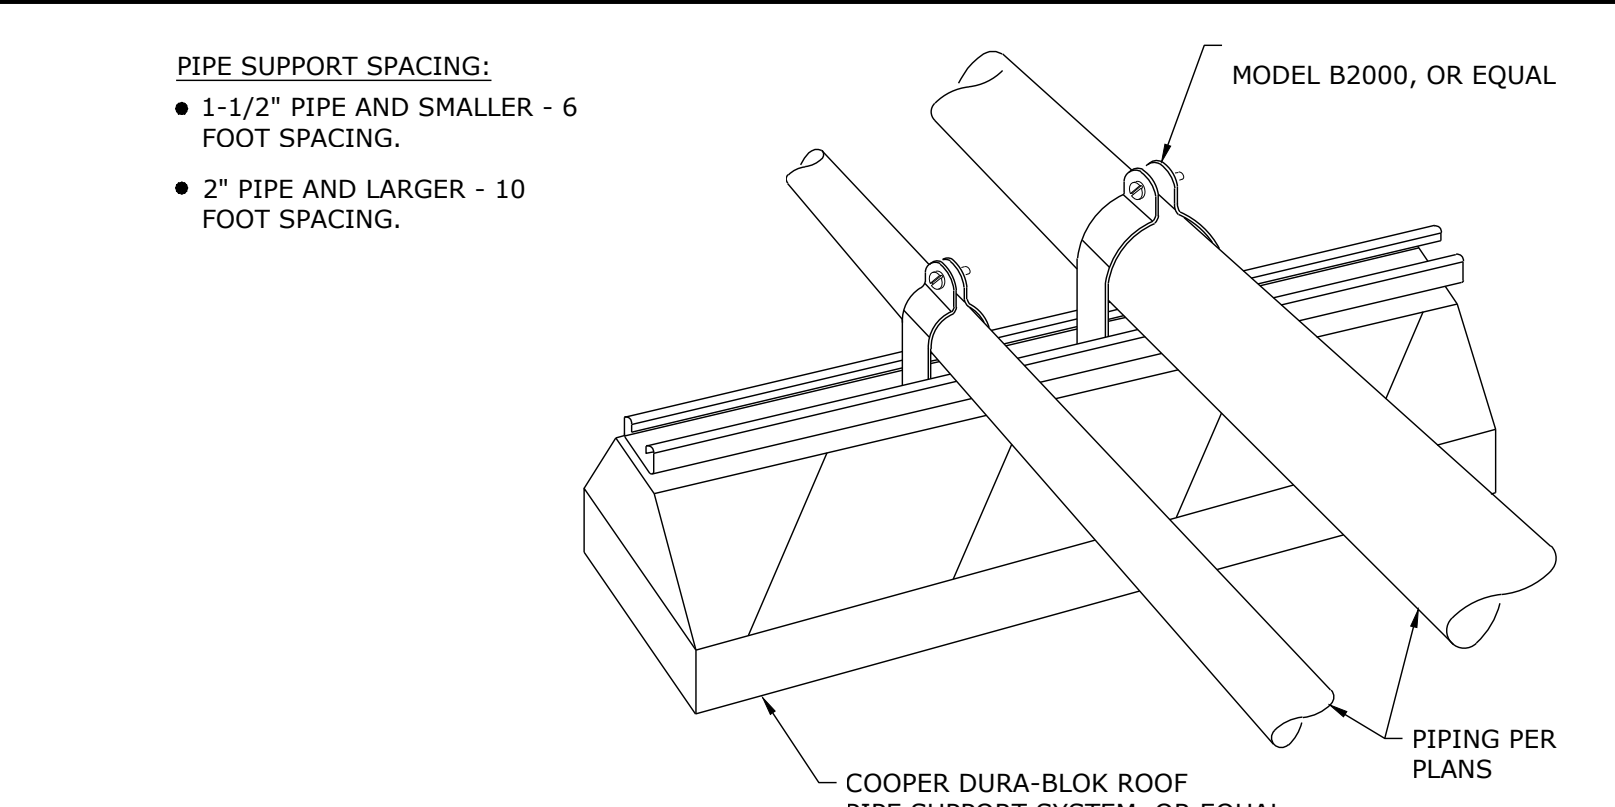
DOWNSPOUT NOZZLE DETAIL
NOT TO SCALE
AKA - LAMB'S TONGUE

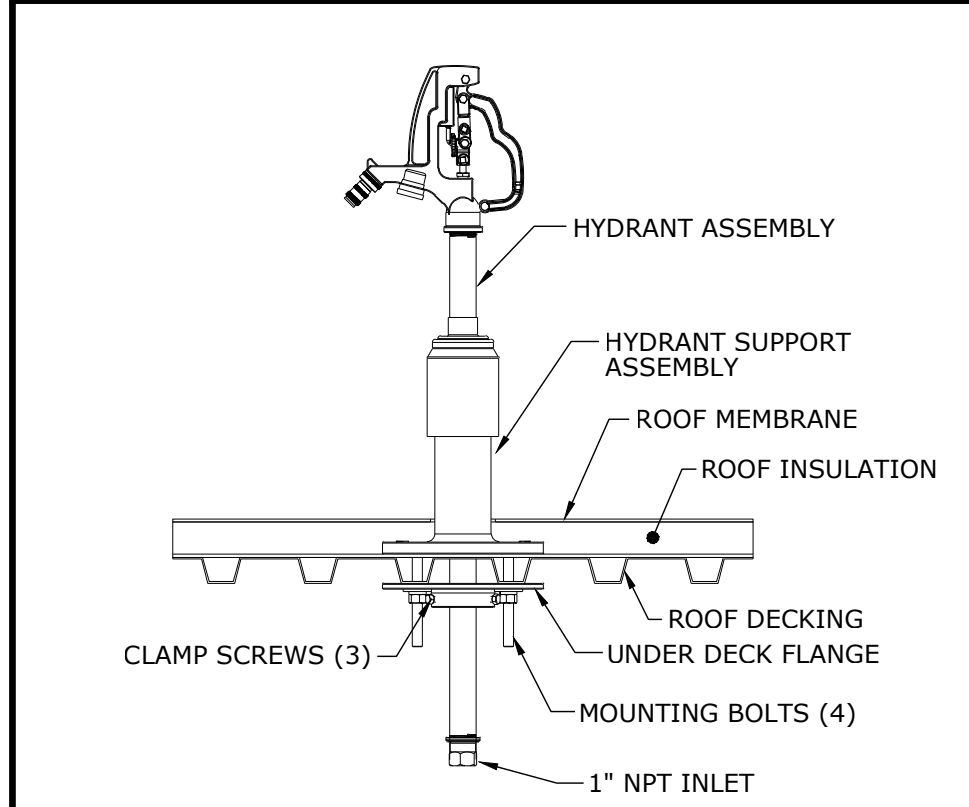


WALL CLEANOUT
NOT TO SCALE

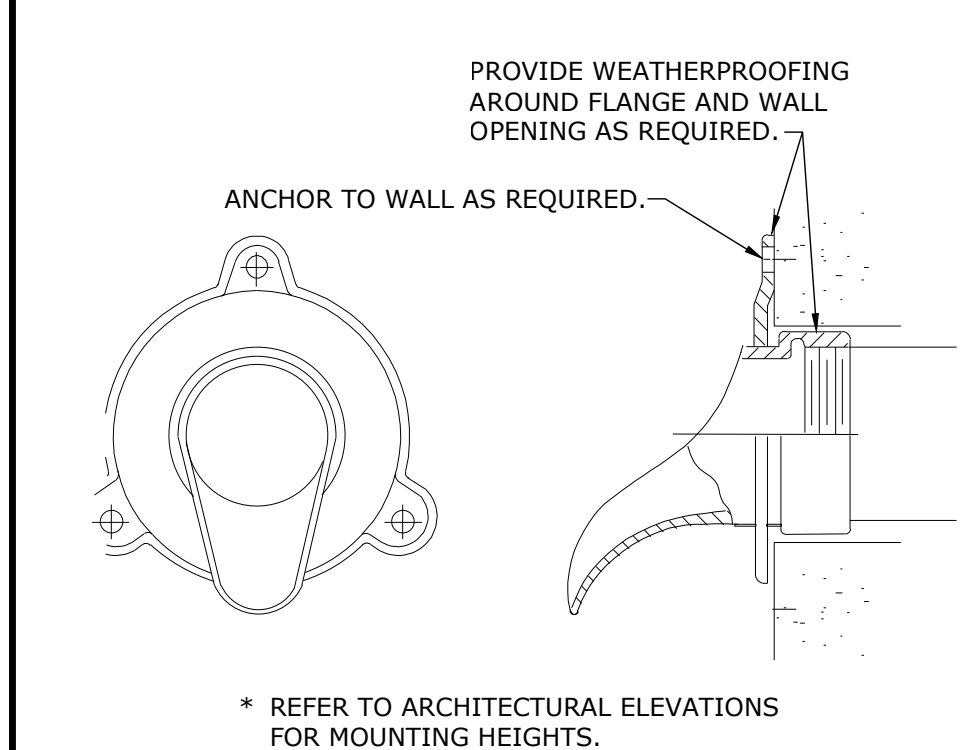


ROOF DRAIN WITH OVERFLOW
NOT TO SCALE

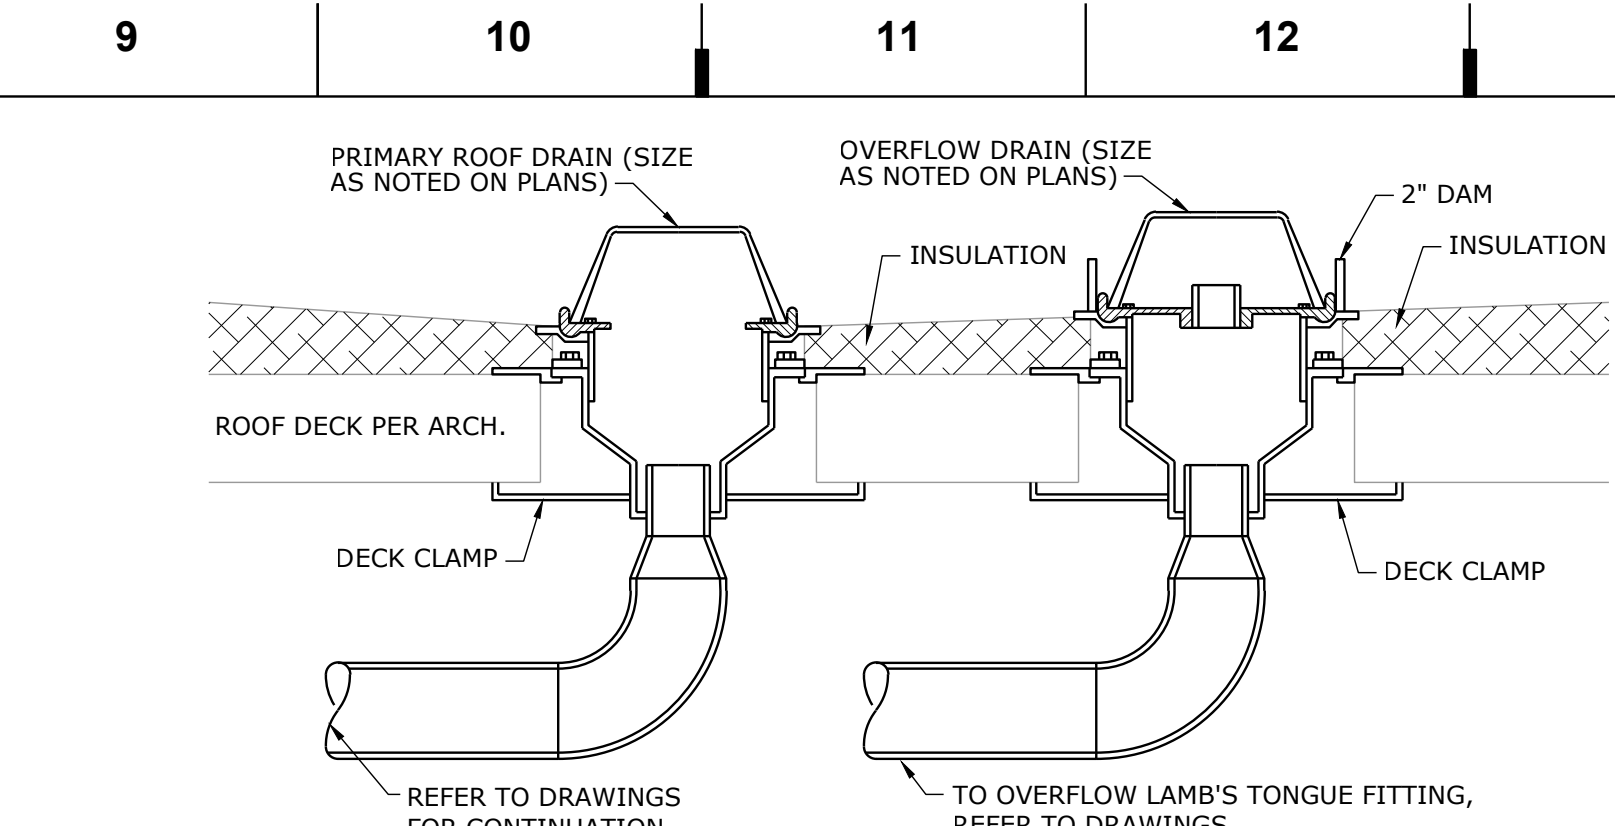


ROOF PIPING SUPPORT DETAIL
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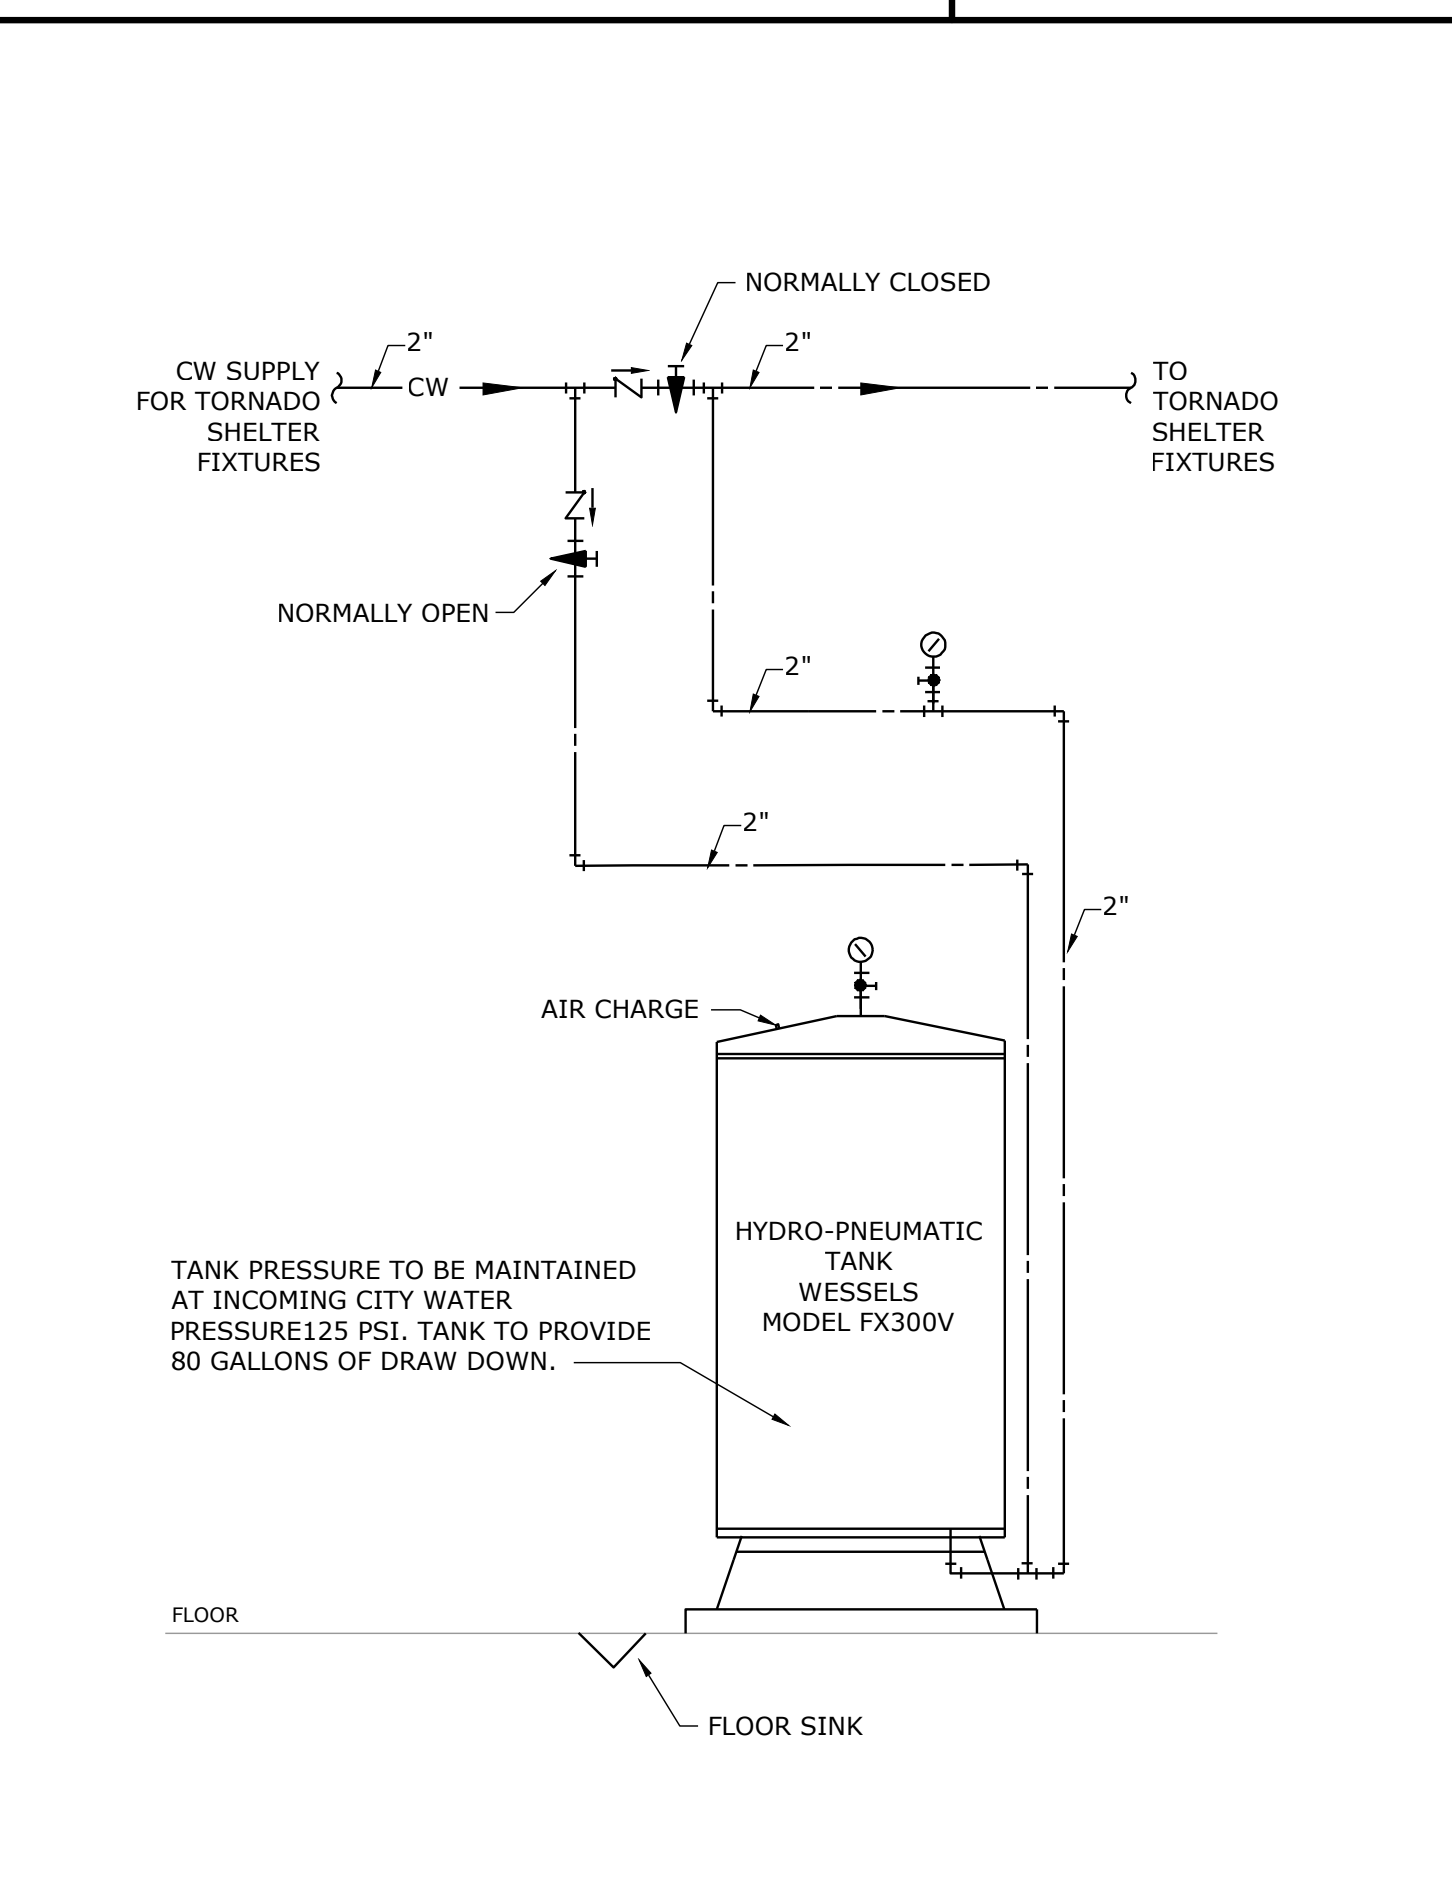
INDIRECT CONNECTION TO SANITARY DETAIL
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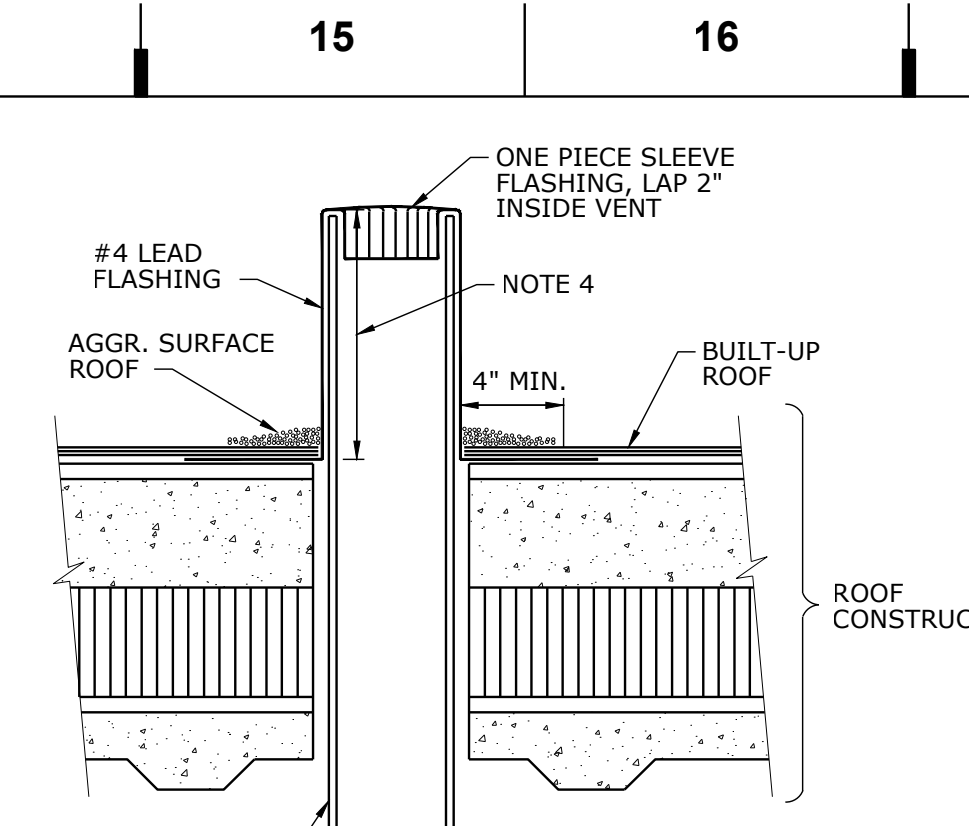
GRADE CLEANOUT DETAIL
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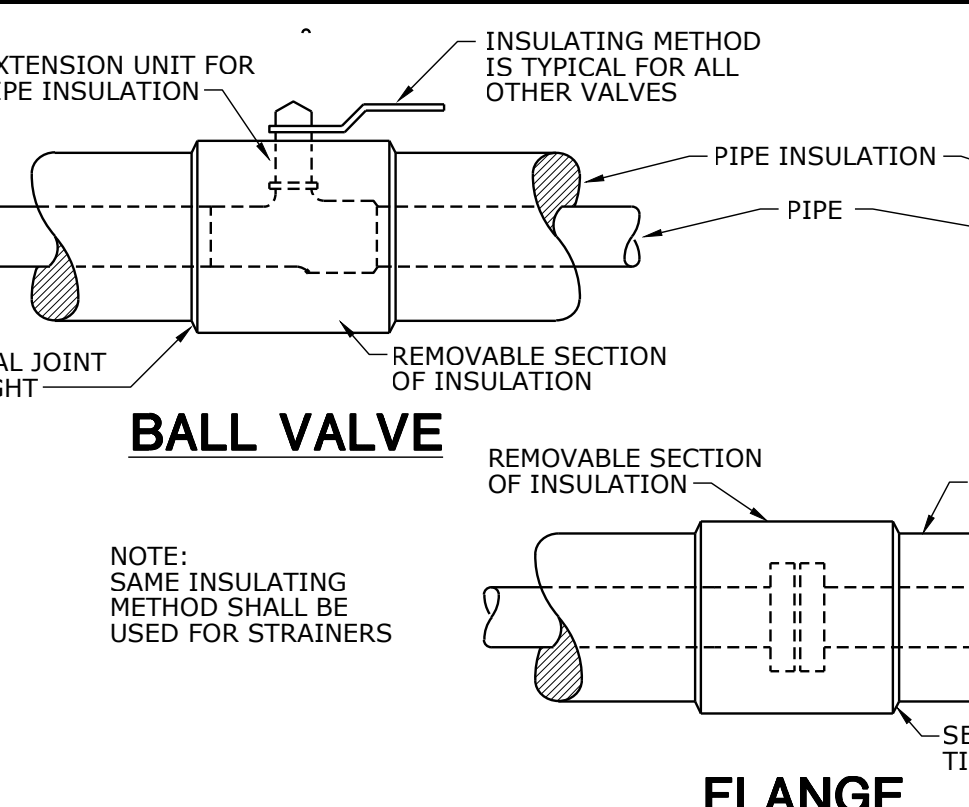
IN-LINE PUMP DETAIL
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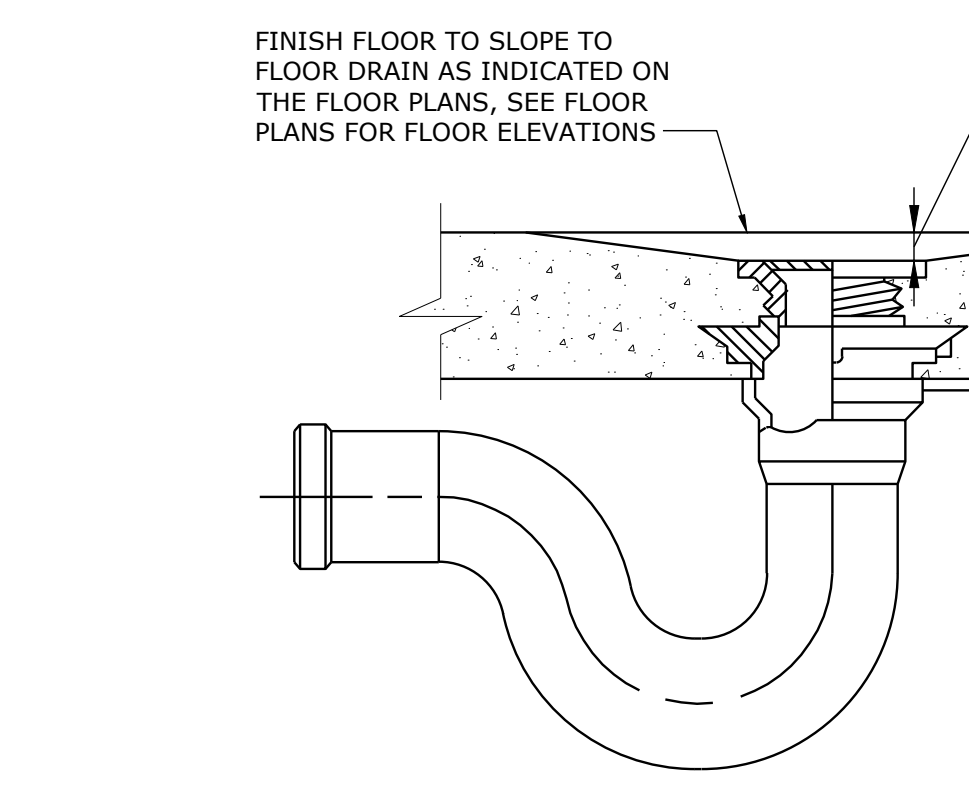
TORNADO SHELTER WATER SUPPLY SYSTEM DETAIL
NOT TO SCALE

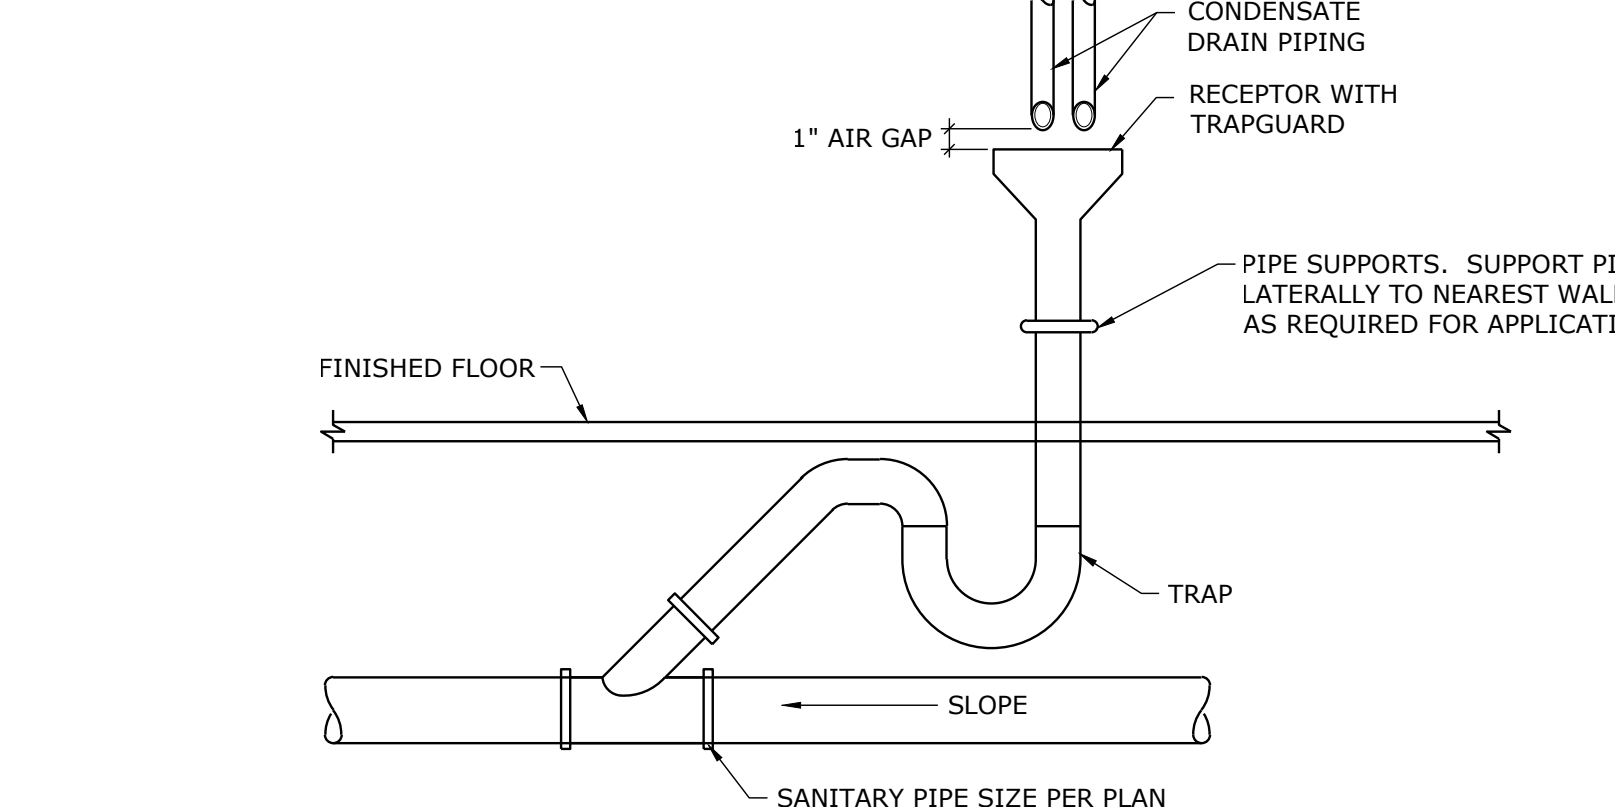


SECTION THRU PLUMBING VENT
NOT TO SCALE

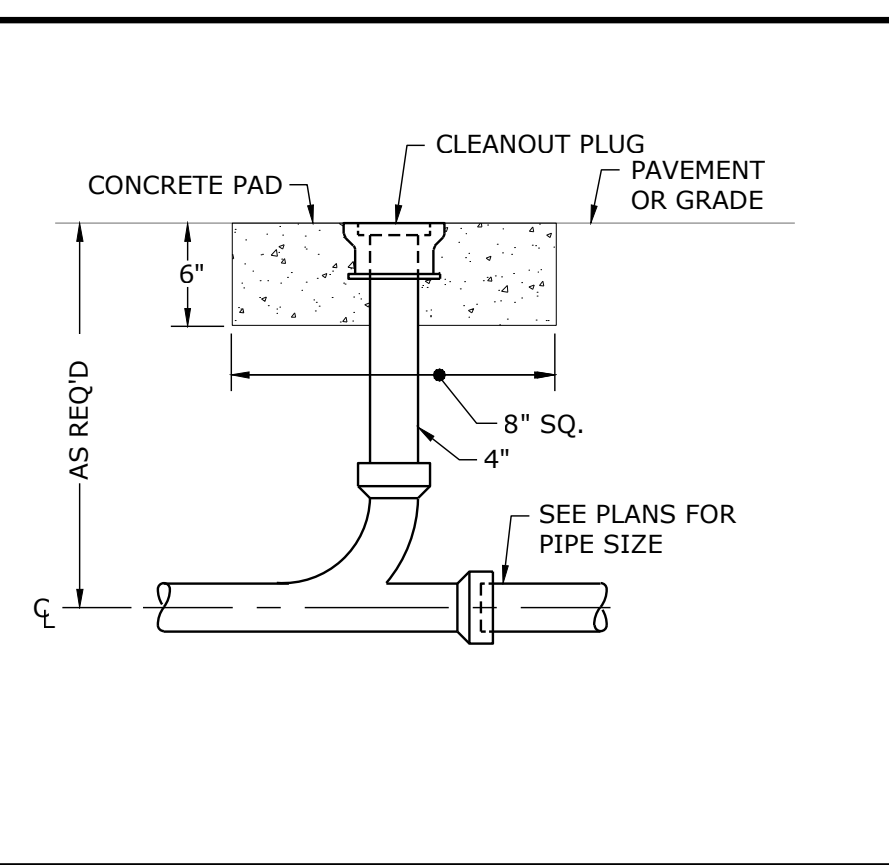


PIPE INSULATION DETAILS
NOT TO SCALE

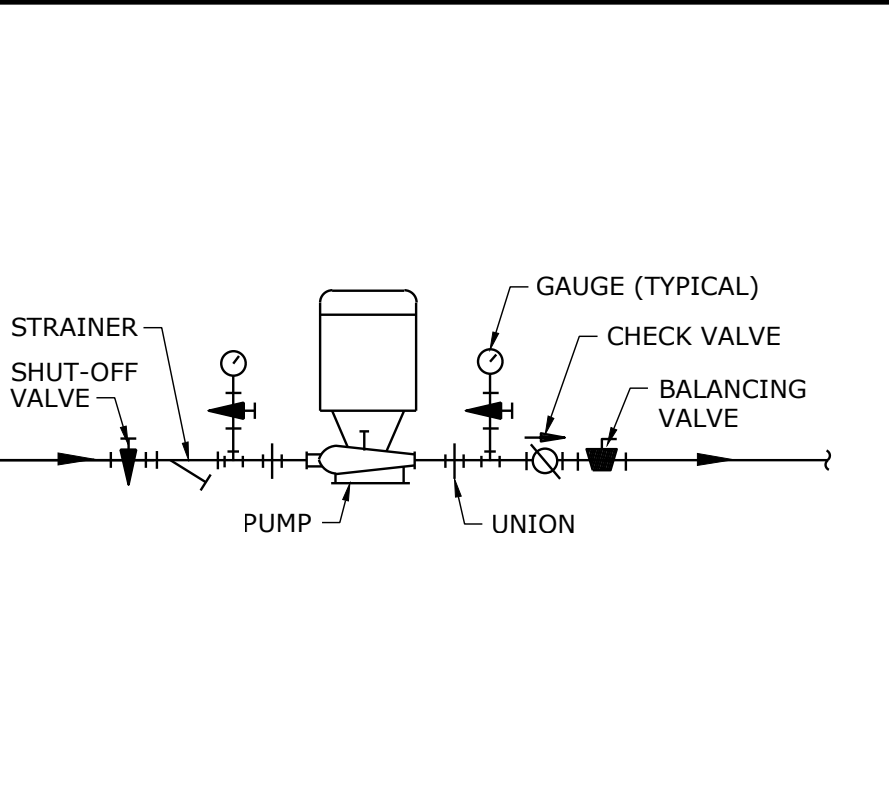

FLOOR DRAIN WITH SWEEP
NOT TO SCALE

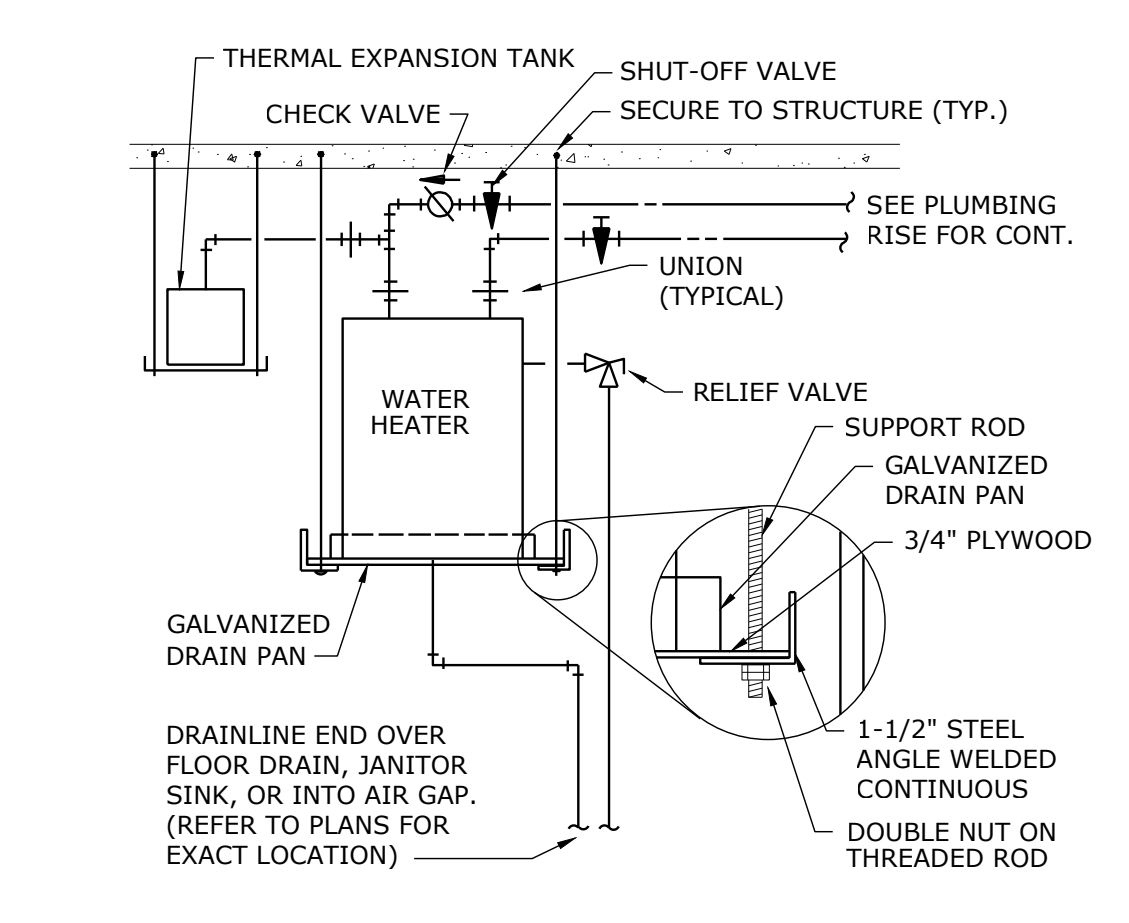

SUSPENDED WATER HEATER DETAIL
NOT TO SCALE

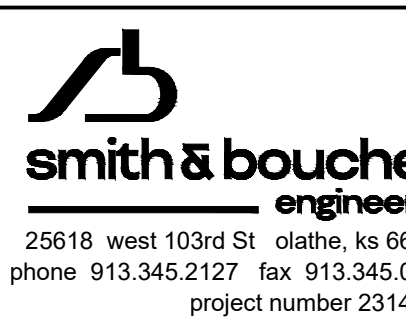

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Structural Engineer
State Certificate of Authority #000442
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816.531.4144 phone

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913.317.9390 phone


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South Valley Middle School Storm Shelter Addition
Liberty School District
1000 Midjay Dr, Liberty, MO 64068

REVISIONS:

#	Description	Date
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JOB NO: 23019
DRAWN BY: SBI
CHECKED BY: RJD
DATE: 10.11.2023


ME402

hollis + miller architects
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miller

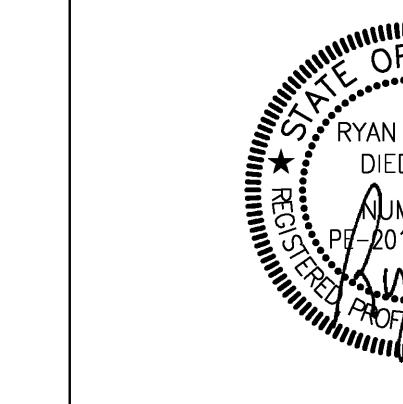
Conformed Construction Documents

A


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AUTOCAD FILE LOCATION: \\NAME: 2314703 - ME403.dwg
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PLOTTED BY: DATE: 10/11/23

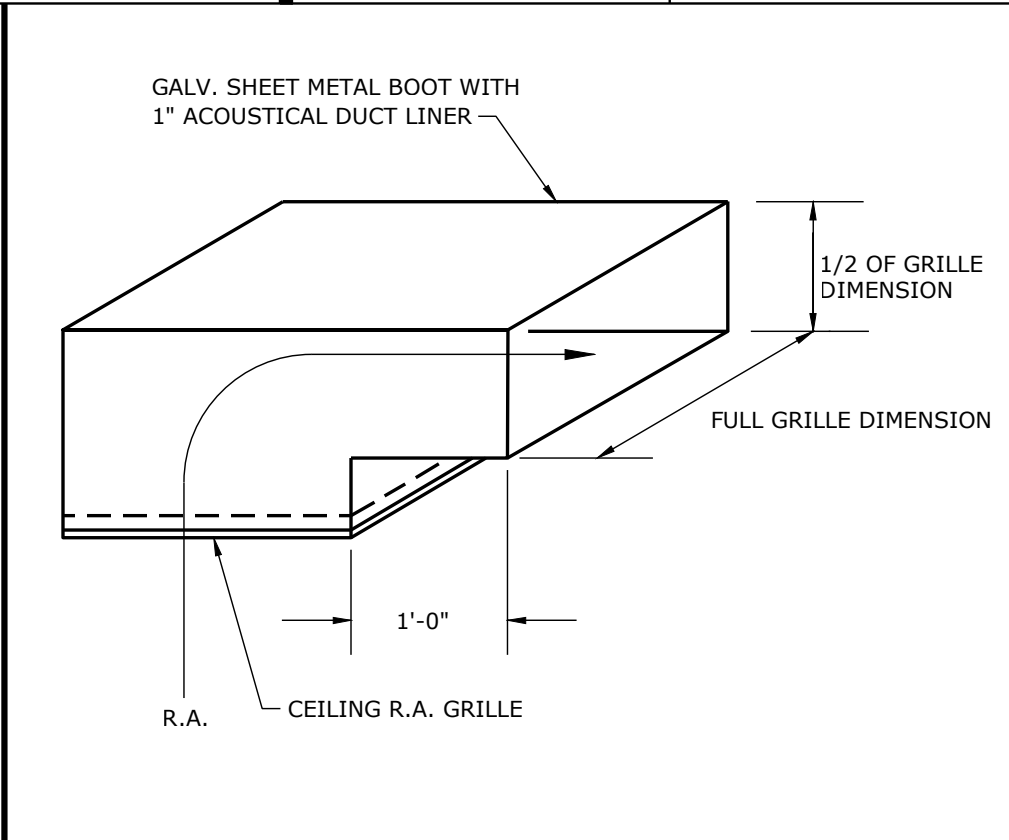


RETURN AIR BOOT DETAIL
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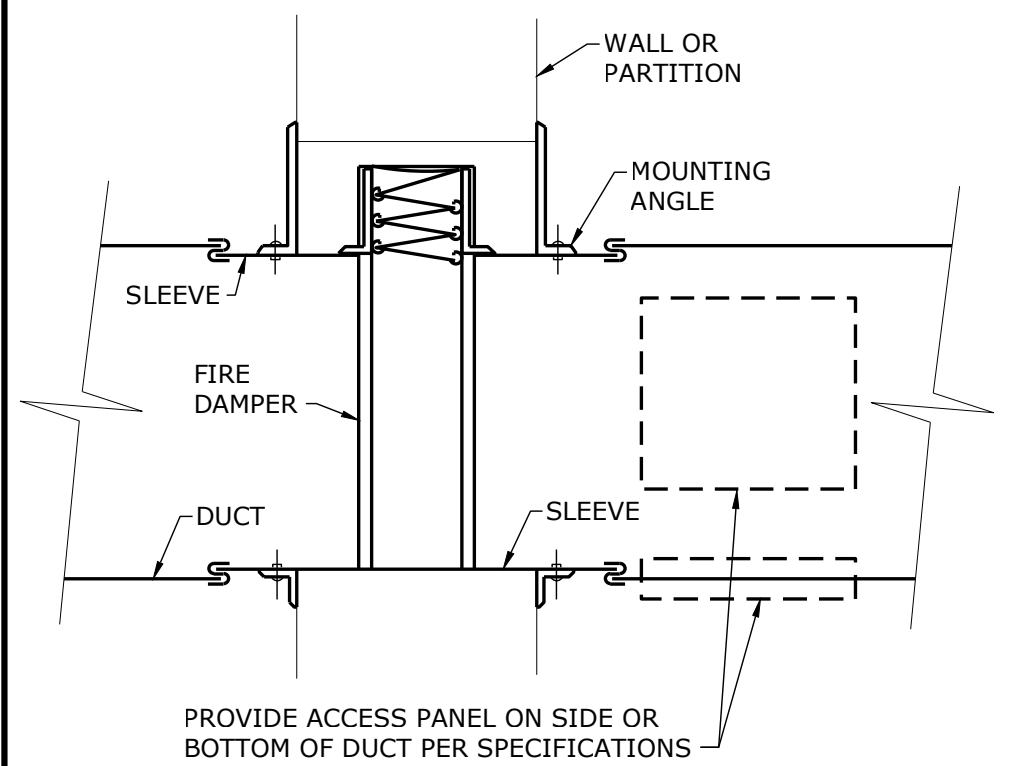
AIR TRANSFER BOOT DETAIL
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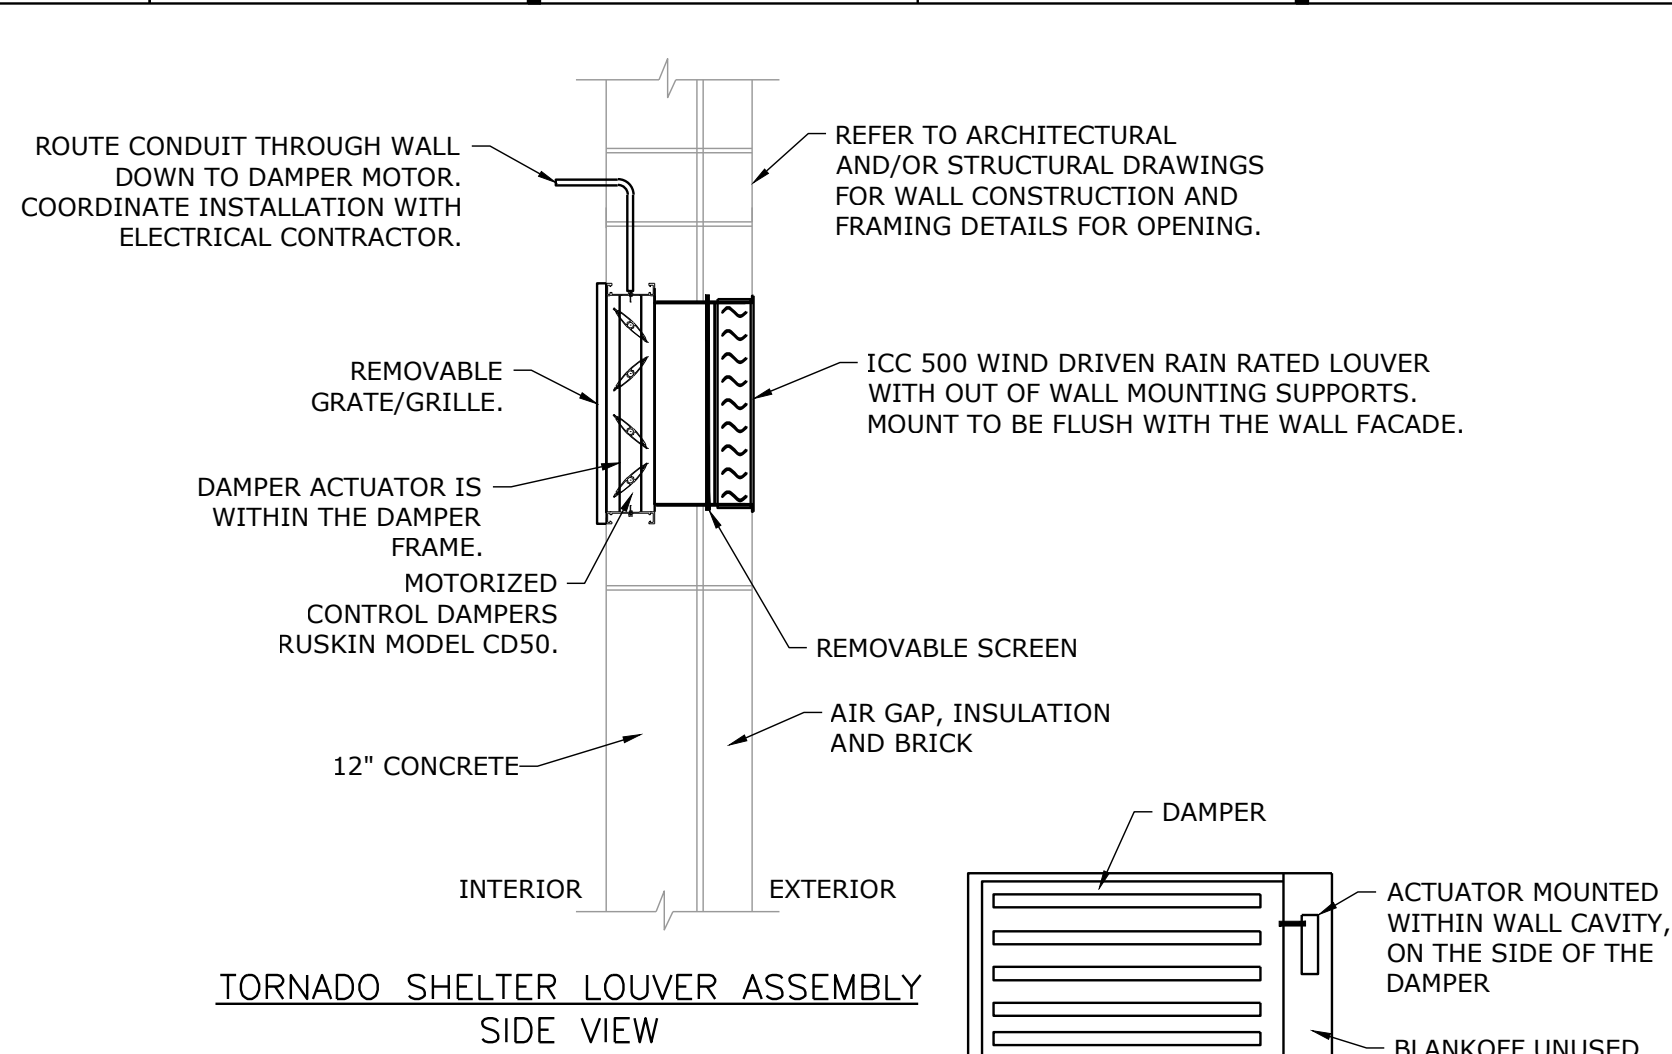
TYPICAL BRANCH DUCT TAKEOFF
NOT TO SCALE

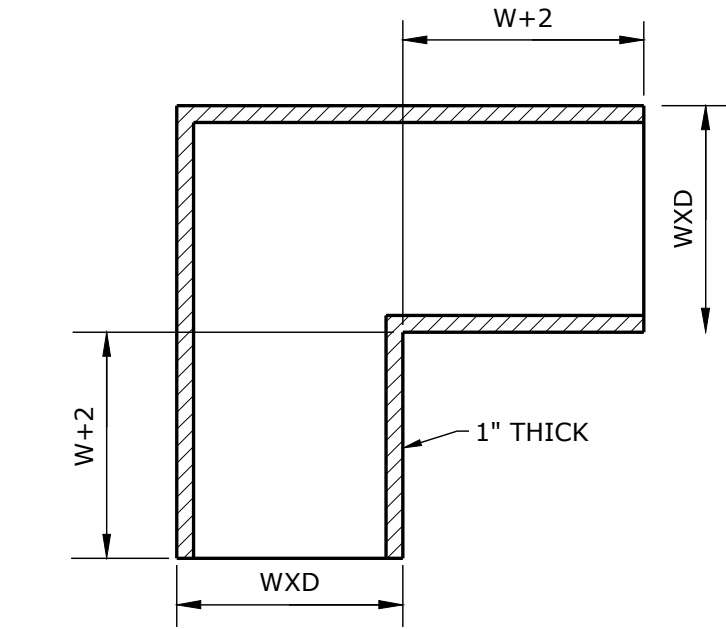

RTU-COND. DRAIN P-TRAP
NOT TO SCALE

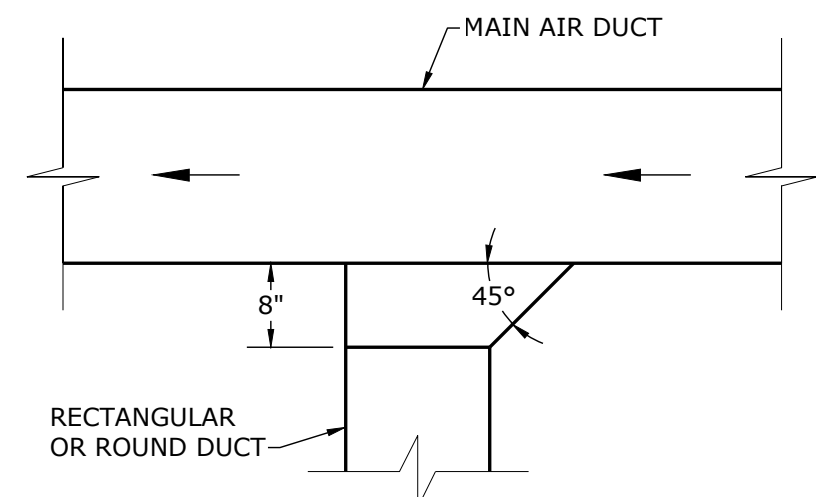


FIRE DAMPER DETAIL
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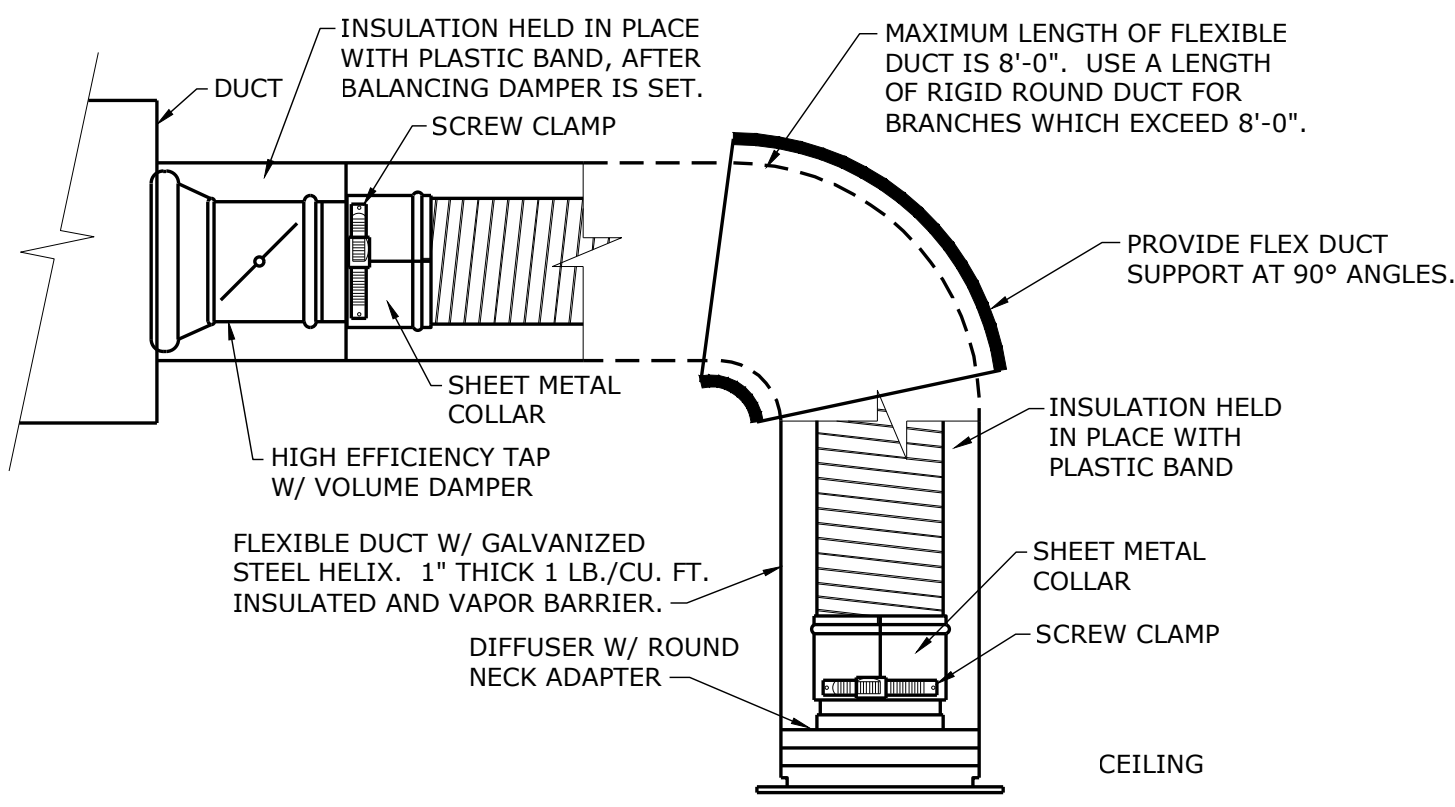


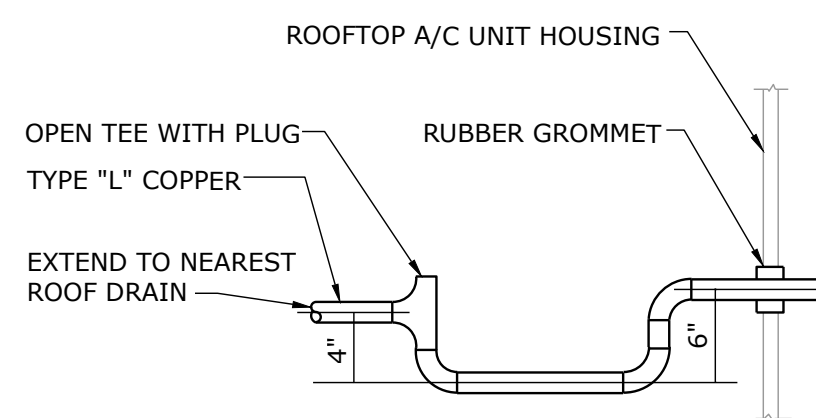- NOTES:**
1. REFER TO MANUFACTURER'S INSTALLATION DETAILS FOR INFORMATION ON LOUVER SPECIFICATIONS.
 2. SEAL ALL JOINTS AND SEAMS OF PLENUM AND DUCT TO PROVIDE WATER TIGHT CONSTRUCTION.
 3. PROVIDE WEEP HOLES TO ALLOW FOR PROPER DRAINAGE.
 4. DAMPER OPERATION: IN THE EVEN OF A TORNADO, UPON A MANUAL INPUT VIA LOCAL SWITCH, THE DAMPER SHALL BE OPENED TO PROVIDE VENTILATION AIR TO THE SPACE ONLY AFTER THE TORNADO HAS PASSED.
 5. PROVIDE STAND ALONE CONTROL SYSTEM WITHIN ICC 500 STORM SHELTER WITH 2 HOUR BATTERY BACK UP FOR ICC 500 CONTROL DAMPER AND ASSOCIATED EQUIPMENT.
 6. INSTALL MOTORIZED DAMPER ACTUATOR MOTOR IN THE AIR STREAM.


TORNADO SHELTER VENTILATION DETAIL
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EXPOSED ROUND DUCT WITH ANGLED DIFFUSERS
NOT TO SCALE

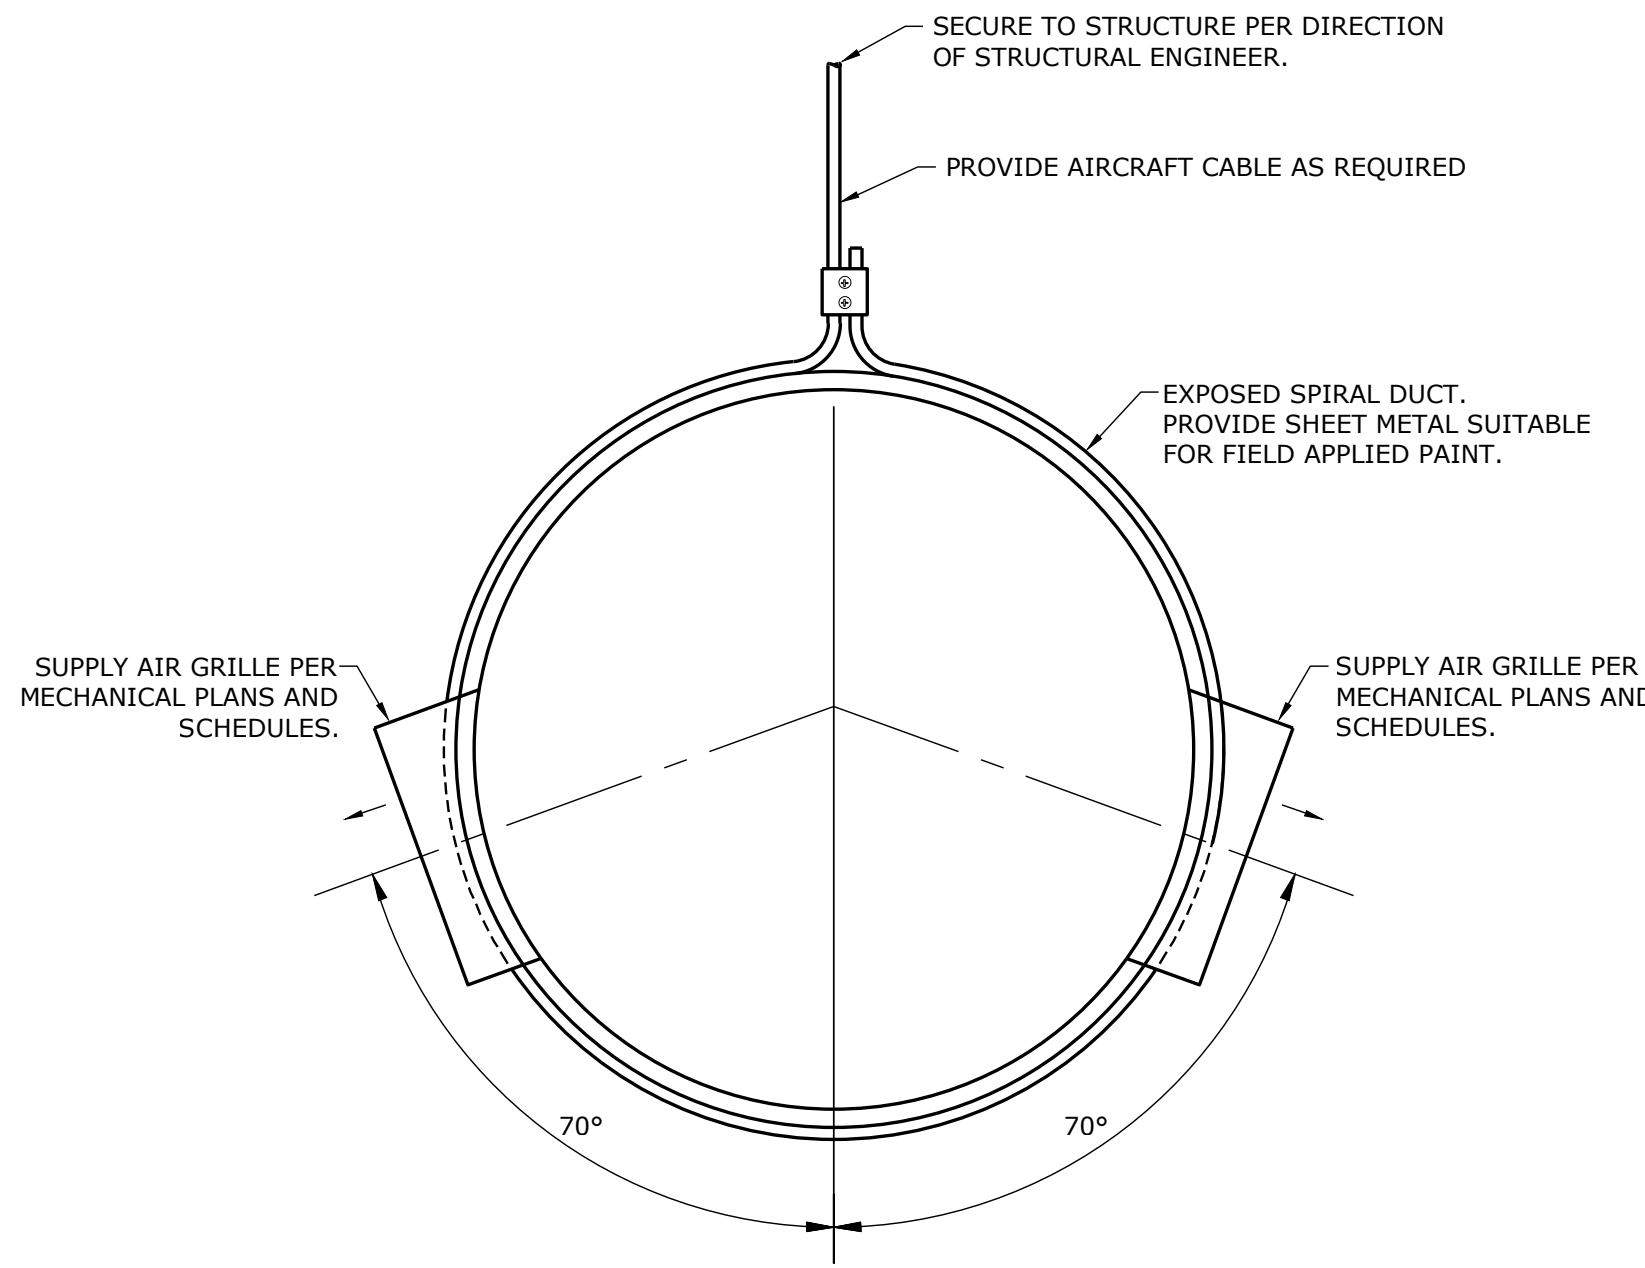


FLEXIBLE BRANCH DUCT DETAIL
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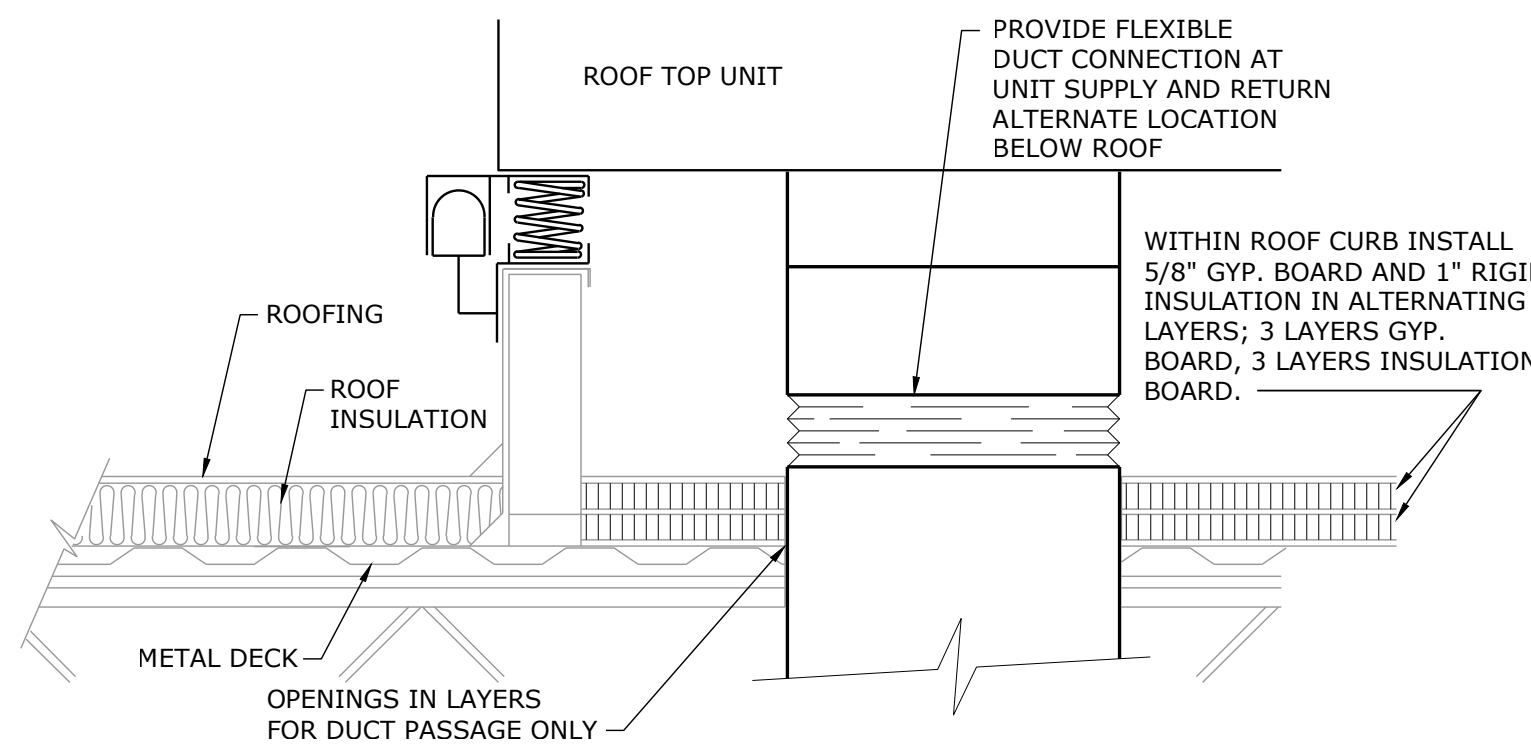
TORNADO SHELTER LOUVER ASSEMBLY

- NOTES:**
1. REFER TO MANUFACTURER'S INSTALLATION DETAILS FOR INFORMATION ON LOUVER SPECIFICATIONS.
 2. SEAL ALL JOINTS AND SEAMS OF PLENUM AND DUCT TO PROVIDE WATER TIGHT CONSTRUCTION.
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 5. PROVIDE STAND ALONE CONTROL SYSTEM WITHIN ICC 500 STORM SHELTER WITH 2 HOUR BATTERY BACK UP FOR ICC 500 CONTROL DAMPER AND ASSOCIATED EQUIPMENT.


TORNADO SHELTER VENTILATION DETAIL
NOT TO SCALE

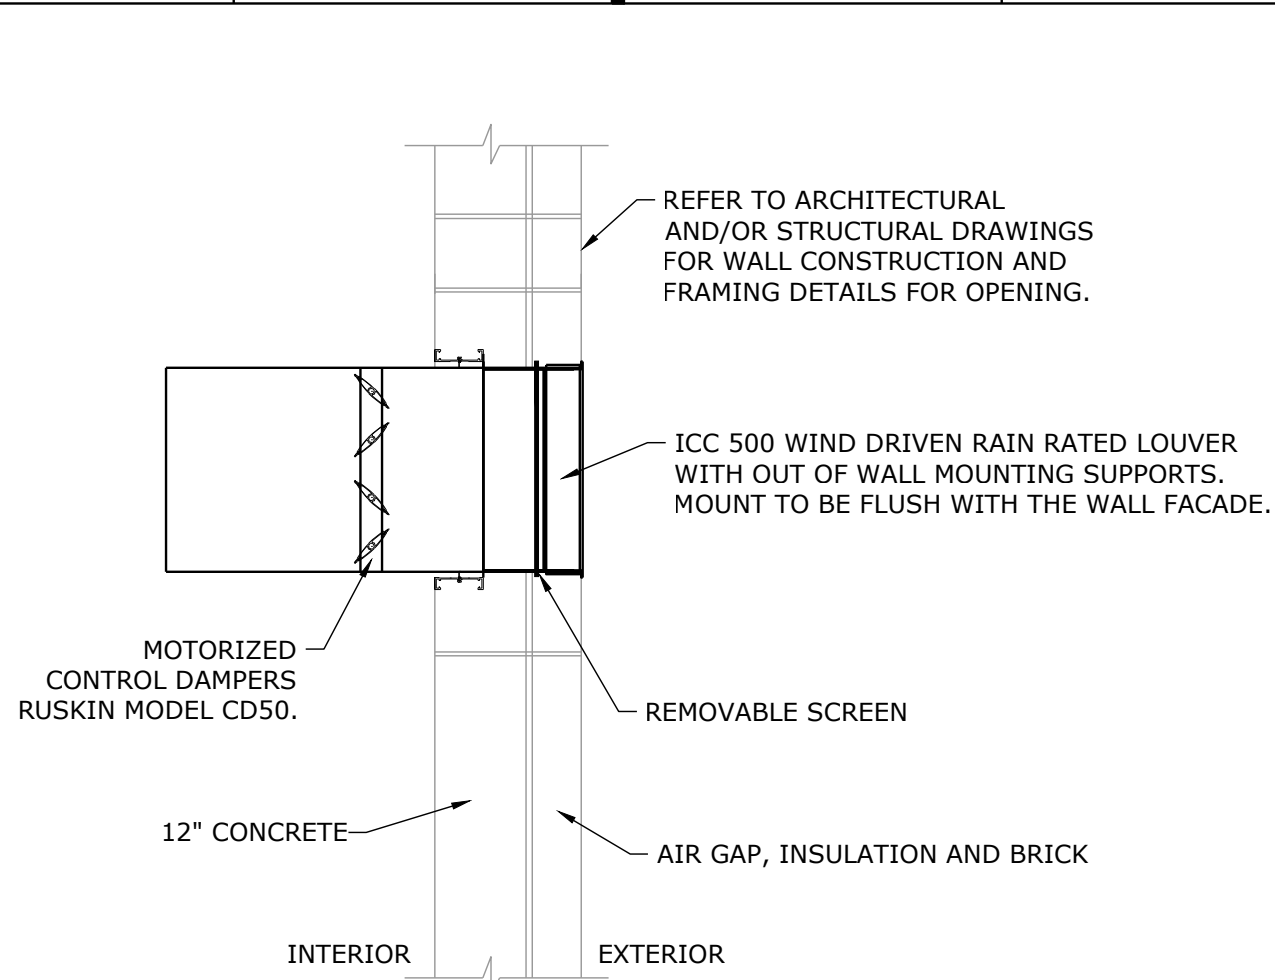

ROOFTOP UNIT DETAIL
NOT TO SCALE

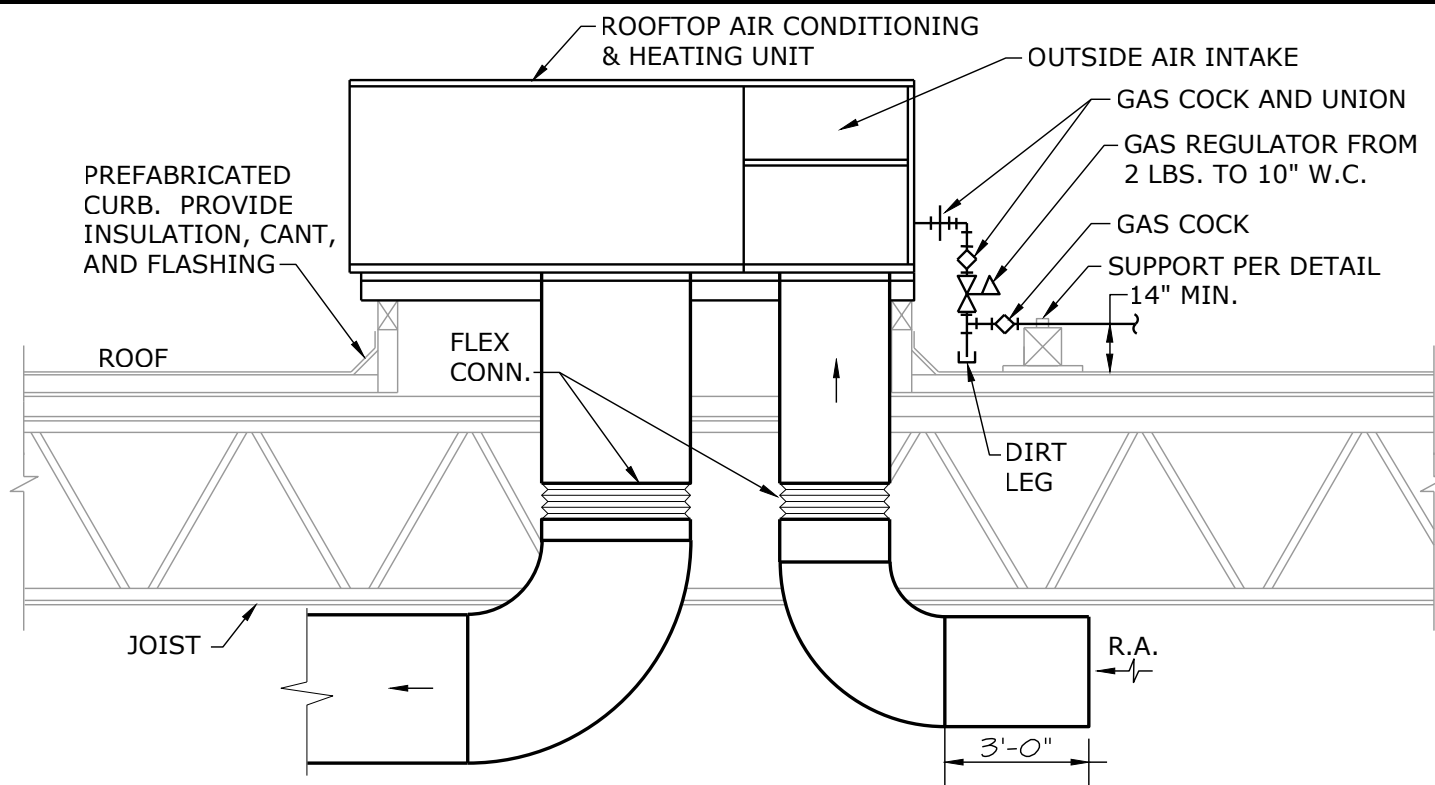

SECTION THRU ROOF CURB
NOT TO SCALE

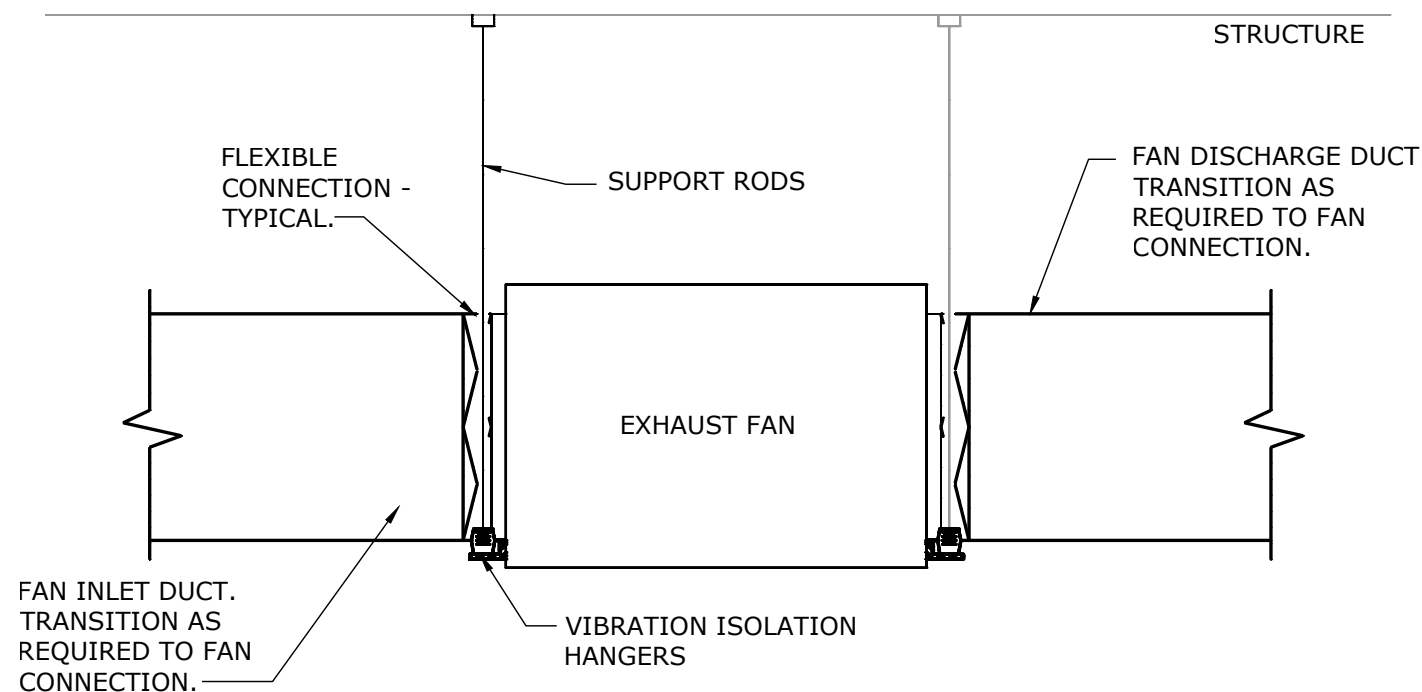

IN-LINE EXHAUST FAN DETAIL
NOT TO SCALE

smith & boucher
engineers
25618 west 103rd St. Olathe, KS 66061
phone 913.345.2127 fax 913.345.0617
project number 2314703

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t 816.442.7700
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Missouri State Certificate of Authority
Architecture # 0000181
Structure # 259003133

Bob D Campbell
Structural Engineer
State Certificate of Authority #000442
4338 Bellview Ave.
Kansas City, MO 64111
816.551.4144 phone

Smith & Boucher Inc.
Mechanical, Electrical & Plumbing
State Certificate of Authority #EGC000178
25618 W 103rd Street
Olathe, KS 66061
913.345.2127 phone

MKEC Engineering, Inc.
Civil Engineer
State Certificate of Authority #
Engineering: 2001009364
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11827 W 112th Street, Suite 200
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913.317.9390 phone

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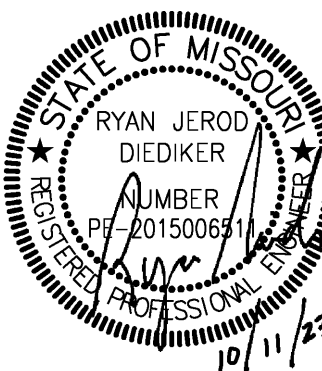
South Valley Middle School Storm Shelter Addition

Liberty School District

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REVISIONS:



#	Description	Date
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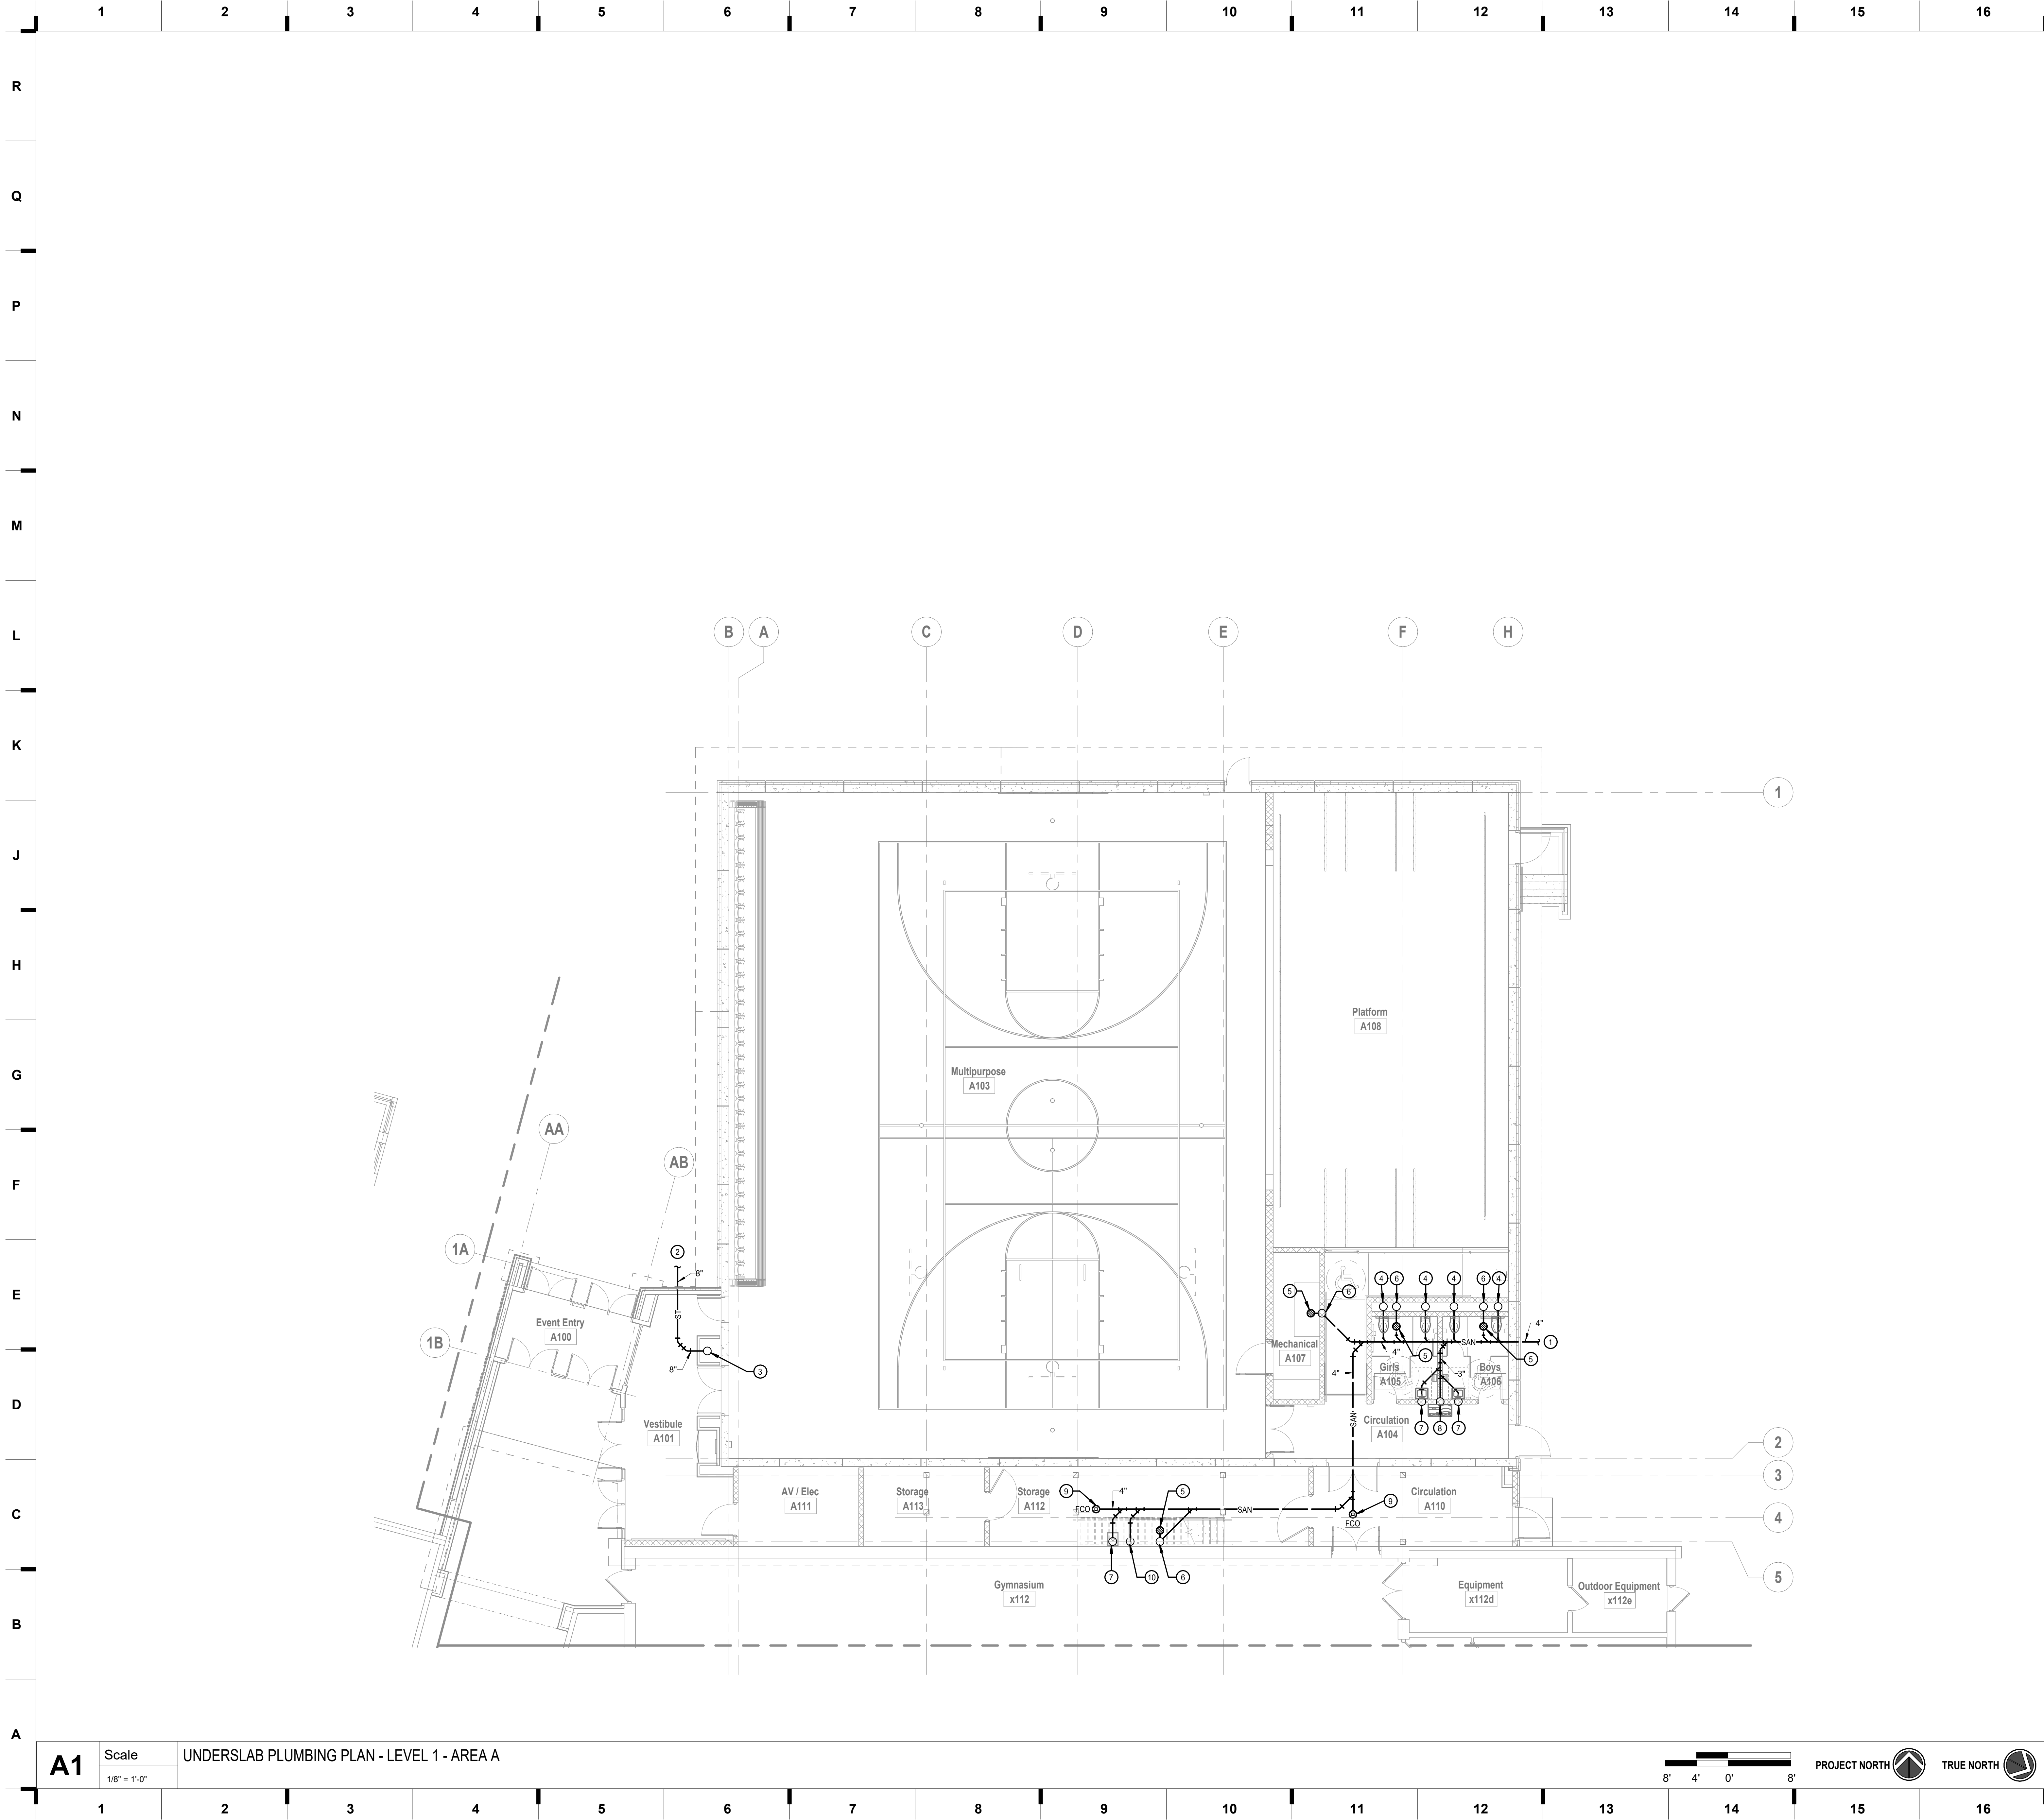
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JOB NO: 23019
DRAWN BY: SBI
CHECKED BY: RJD
DATE: 10.11.2023

ME403



South Valley Middle School Storm Shelter Addition
Liberty School District

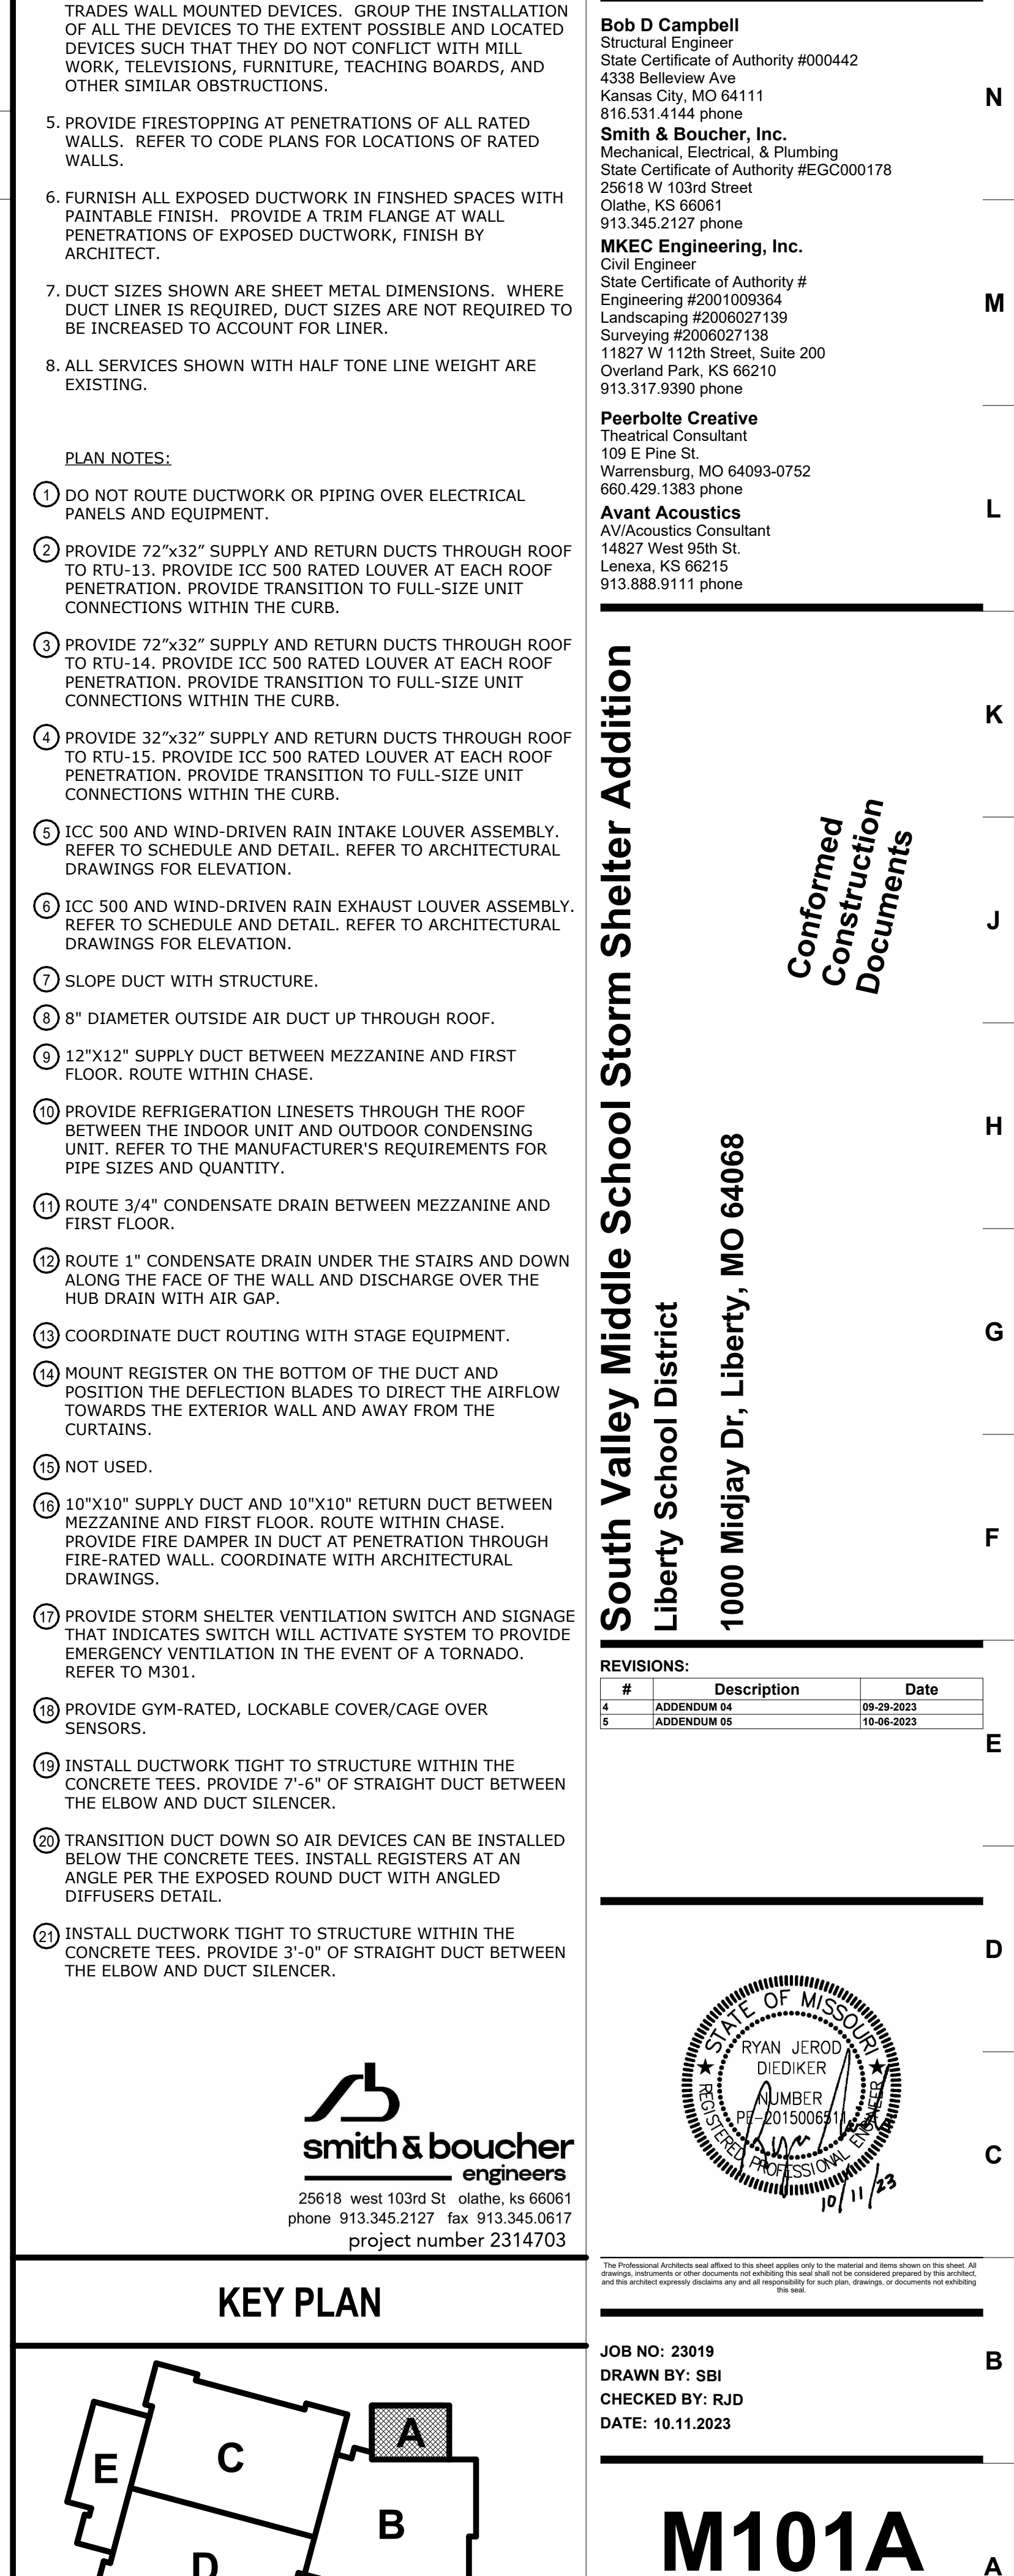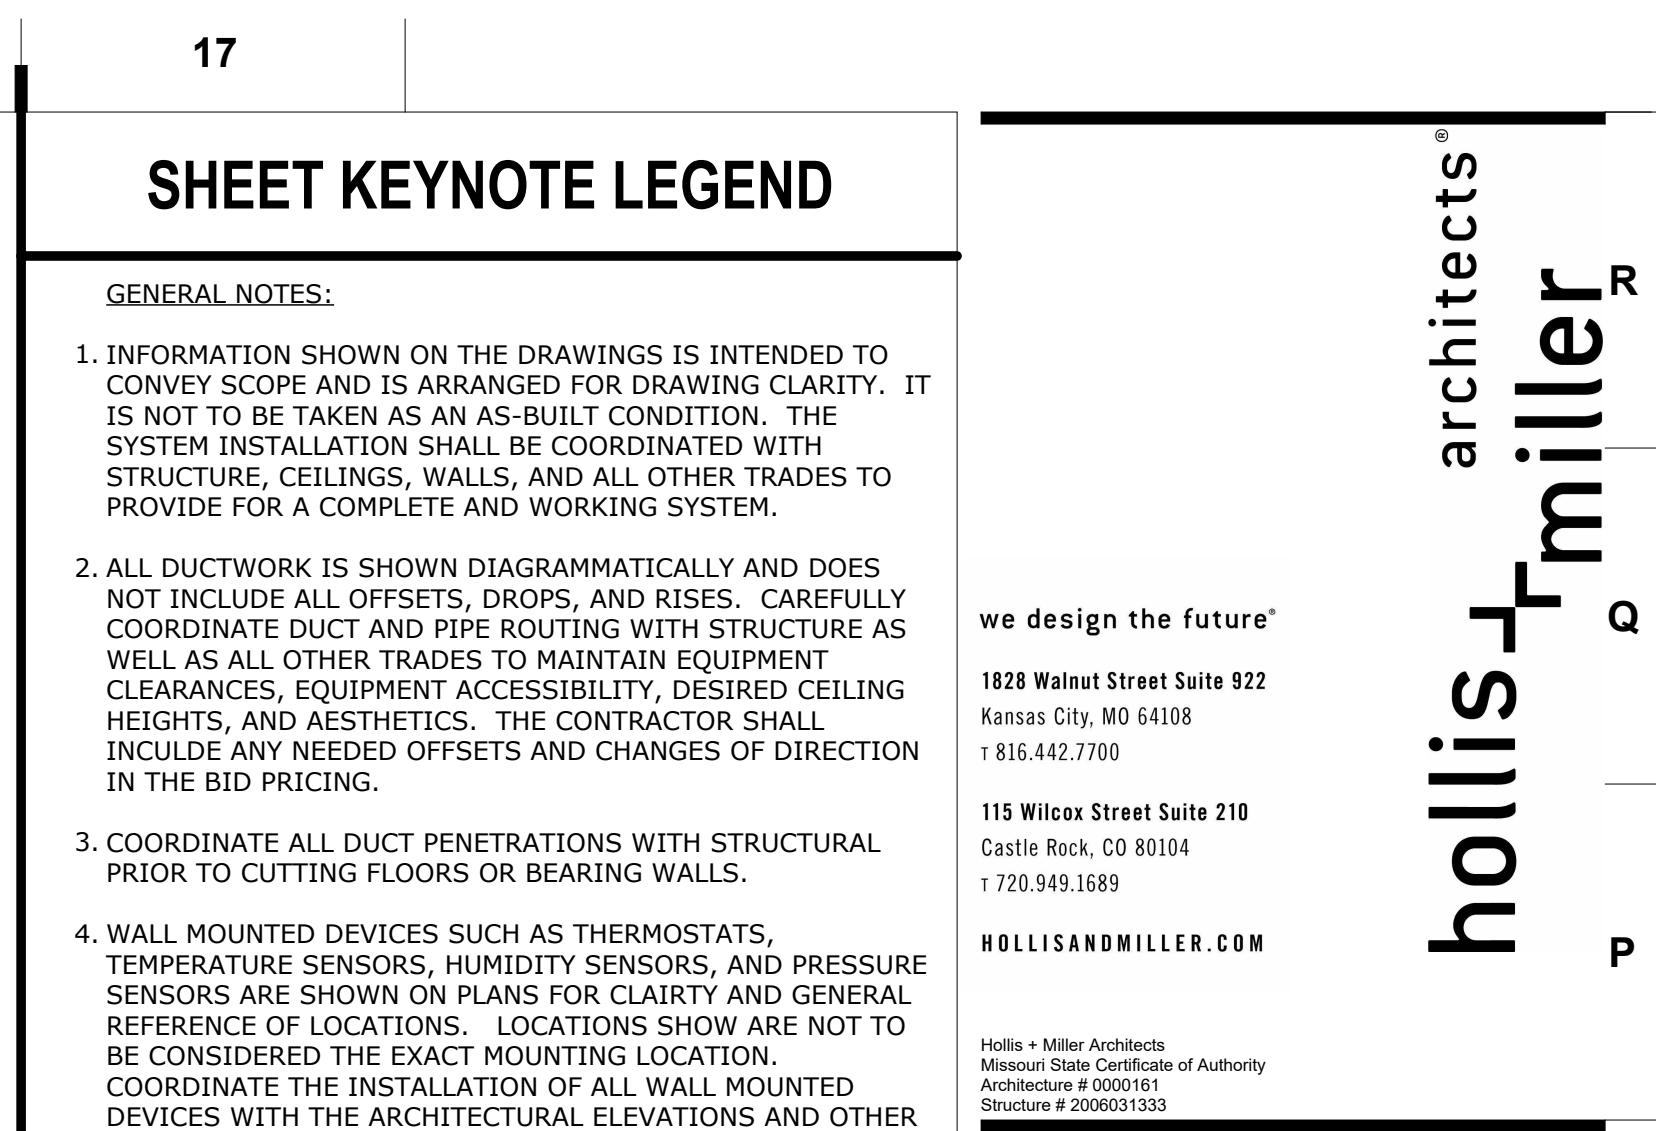

SHEET KEYNOTE LEGEND

GENERAL NOTES:
1. REFER TO P101 FOR GENERAL NOTES.

PLAN NOTES:

- ① 4" SANITARY SEWER EXIT LOCATION. ROUTE BELOW STRUCTURAL FOOTING. APPROXIMATE FLOWLINE 66" BELOW FINISHED FLOOR. COORDINATE EXACT LOCATION AND DEPTH WITH SITE UTILITIES CONTRACTOR PRIOR TO INSTALLATION. REFER TO CIVIL DRAWINGS FOR CONTINUATION.
- ② 8" STORM SEWER EXIT LOCATION. ROUTE BELOW STRUCTURAL FOOTING. APPROXIMATE FLOWLINE 63" BELOW FINISHED FLOOR. COORDINATE EXACT LOCATION AND DEPTH WITH SITE UTILITIES CONTRACTOR PRIOR TO INSTALLATION. REFER TO CIVIL DRAWINGS FOR CONTINUATION.
- ③ 8" STORM UP IN CHASE.
- ④ 4" SANITARY UP TO WATER CLOSET.
- ⑤ 2" SANITARY UP TO FLOOR DRAIN.
- ⑥ 2" SANITARY UP TO 1-1/2" VENT.
- ⑦ 2" SANITARY UP TO LAVATORY/SINK.
- ⑧ 2" SANITARY UP TO DRINKING FOUNTAIN.
- ⑨ 4" SANITARY UP TO FLOOR CLEANOUT.
- ⑩ 2" SANITARY UP TO HUB DRAIN.

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Architecture #20001051
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Structural Engineer
State Certificate of Authority #000442
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816.531.4144 phone

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Mechanical, Electrical, & Plumbing
State Certificate of Authority #EGC000178
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Olathe, KS 66061
913.345.2127 phone

MKEC Engineering, Inc.
Civil Engineer
State Certificate of Authority #
Engineering #2001000364
Landscaping #2006027139
Surveying #2006027138
11827 W 112th Street, Suite 200
Overland Park, KS 66210
913.317.9390 phone

Peerbolte Creative
Theatrical Consultant
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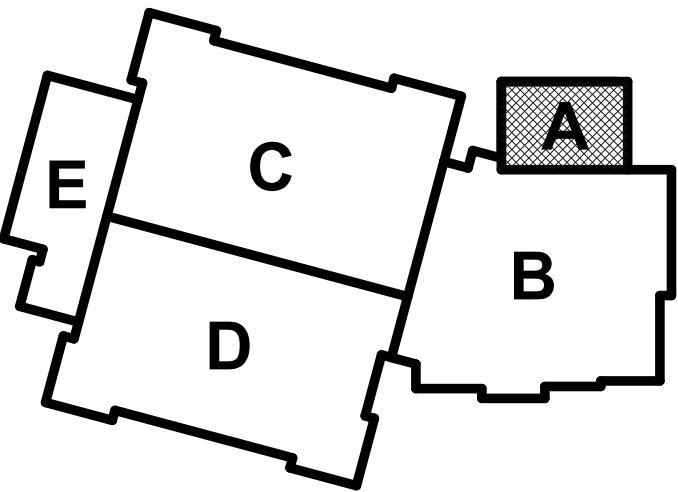
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KEY PLAN



JOB NO: 23019
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CHECKED BY: RJJ
DATE: 10.11.2023

P100A

UNDERSLAB PLUMBING PLAN - LEVEL 1 - AREA A

17

SHEET KEYNOTE LEGEND

GENERAL NOTES:

1. REFER TO P101 FOR GENERAL NOTES.

PLAN NOTES:

- ① 4" STORM AND 4" STORM OVERFLOW UP TO ROOF DRAIN.
- ② 8" STORM AND 8" STORM OVERFLOW BETWEEN MEZZANINE AND FIRST FLOOR. ROUTE WITHIN CHASE.
- ③ 8" STORM DOWN WITHIN CHASE AND THROUGH FLOOR.
- ④ 3/4" COLD WATER UP TO ROOF HYDRANT.
- ⑤ ROUTE HOT WATER PIPING DOWN IN WALL AND WITHIN 6" OF HOT WATER CONNECTION.
- ⑥ 8" STORM OVERFLOW DOWN TO DOWNSPOUT NOZZLE MOUNTED AT 24" ABOVE FINISHED GRADE.
- ⑦ 4" STORM OVERFLOW DOWN TO DOWNSPOUT NOZZLE MOUNTED AT 24" ABOVE FINISHED GRADE.
- ⑧ DO NOT ROUTE PIPING OVER ELECTRICAL AND AV PANELBOARDS AND EQUIPMENT.
- ⑨ ROUTE PIPING IN STAGE TIGHT TO THE BOTTOM OF STRUCTURE.
- ⑩ PIPING SHOWN OFFSET FOR CLARITY. ROUTE PIPING ABOVE THE CEILING FOR ALL PIPING LOCATED OUTSIDE OF THE MECHANICAL ROOM. REFER TO THE PLUMBING RISER DIAGRAMS AND DETAILS FOR ADDITIONAL INFORMATION.
- ⑪ SUSPEND THE WATER HEATER AND EXPANSION TANK ABOVE THE STORAGE TANK, WHICH IS SHOWN OFFSET FOR CLARITY. REFER TO THE PLUMBING RISER DIAGRAMS AND DETAILS FOR ADDITIONAL INFORMATION.
- ⑫ 2" VENT BETWEEN MEZZANINE AND FIRST FLOOR.
- ⑬ ROUTE PIPING DOWN AT LOWER CEILING AND UNDER THE STRUCTURAL BEAM BELOW THE MEZZANINE.
- ⑭ ROUTE PIPING BELOW THE STAIRS.
- ⑮ PROVIDE HUB DRAIN UNDER THE SINK FOR CONDENSATE FROM INDOOR SPLIT SYSTEMS.
- ⑯ ROUTE 8" STORM OVERFLOW AND 3/4" COLD WATER DOWN WITHIN THE WALL/CHASE. PIPING SHOWN OFFSET FOR CLARITY.

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Structural Engineer
State Certificate of Authority #000442
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816.531.4144 phone

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Mechanical, Electrical, & Plumbing
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913.345.2127 phone

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Landscaping #2003027139
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11827 W 112th Street, Suite 200
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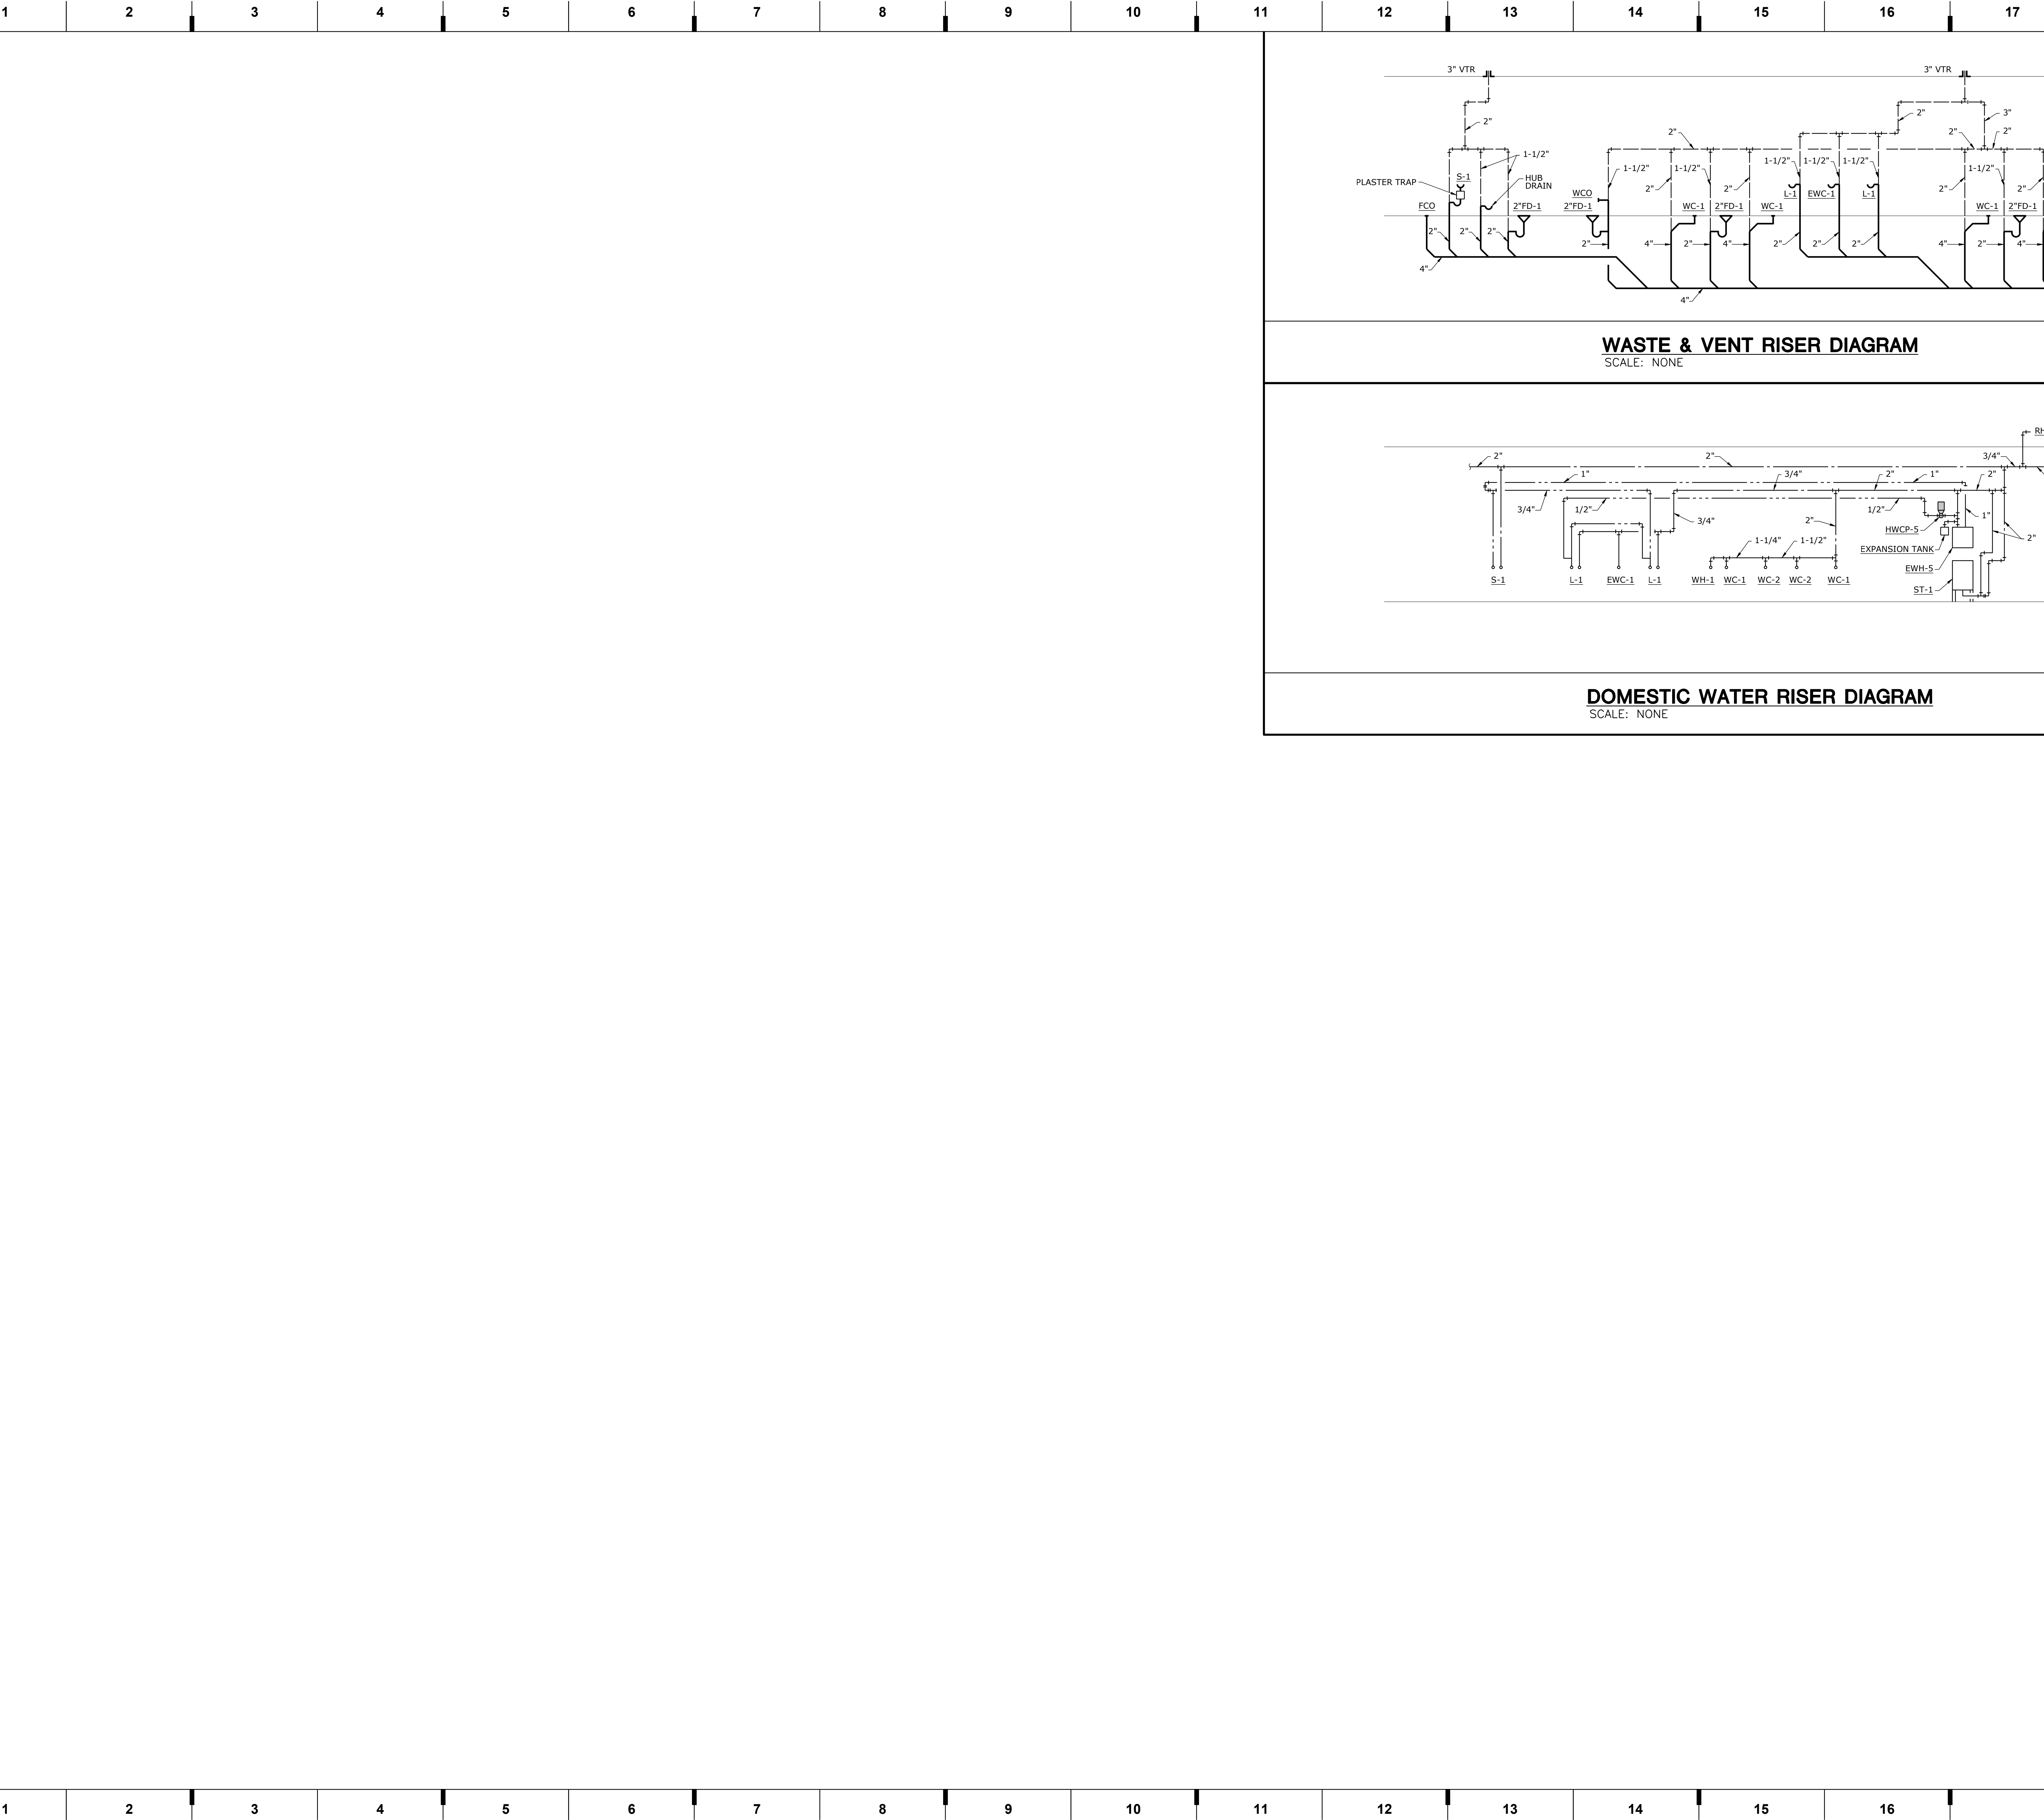
KEY PLAN

JOB NO: 23019
DRAWN BY: SBI
CHECKED BY: RJD
DATE: 10.11.2023

P101A

PLUMBING PLAN - LEVEL 1 & MEZZANINE - AREA A

PROJECT NAME: 2314703 - 1000 Midjay Dr, Liberty, MO 64068
LOCATION: 1000 Midjay Dr, Liberty, MO 64068
FILE: 2314703 - 1000 Midjay Dr, Liberty, MO 64068
DRAWING: 2314703 - 1000 Midjay Dr, Liberty, MO 64068
LAST CORRECTION BY: SBI
DATE: 10.11.2023
TIME: 9:26:11 AM
PLOT BY: RJD
DATE: 10.11.2023
TIME: 9:26:11 AM



WASTE & VENT RISER DIAGRAM
SCALE: NONE

DOMESTIC WATER RISER DIAGRAM
SCALE: NONE

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Architecture # 0002181
Structure # 2009031331

Bob D Campbell
Structural Engineer
State Certificate of Authority #000442
4338 Bellview Ave.
Kansas City, MO 64111
816.531.4144 phone

Smith & Boucher Inc.
Mechanical, Electrical & Plumbing
State Certificate of Authority #EGC000178
28618 W 103rd Street
Olathe, KS 66061
913.345.2127 phone

MKEC Engineering, Inc.
Civil Engineer
State Certificate of Authority #
Engineering: 2001009364
Landscaping: 2006027139
Surveying: 2006027138
11827 W 112th Street, Suite 200
Overland Park, KS 66210
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800.429.1583 phone


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Liberty School District

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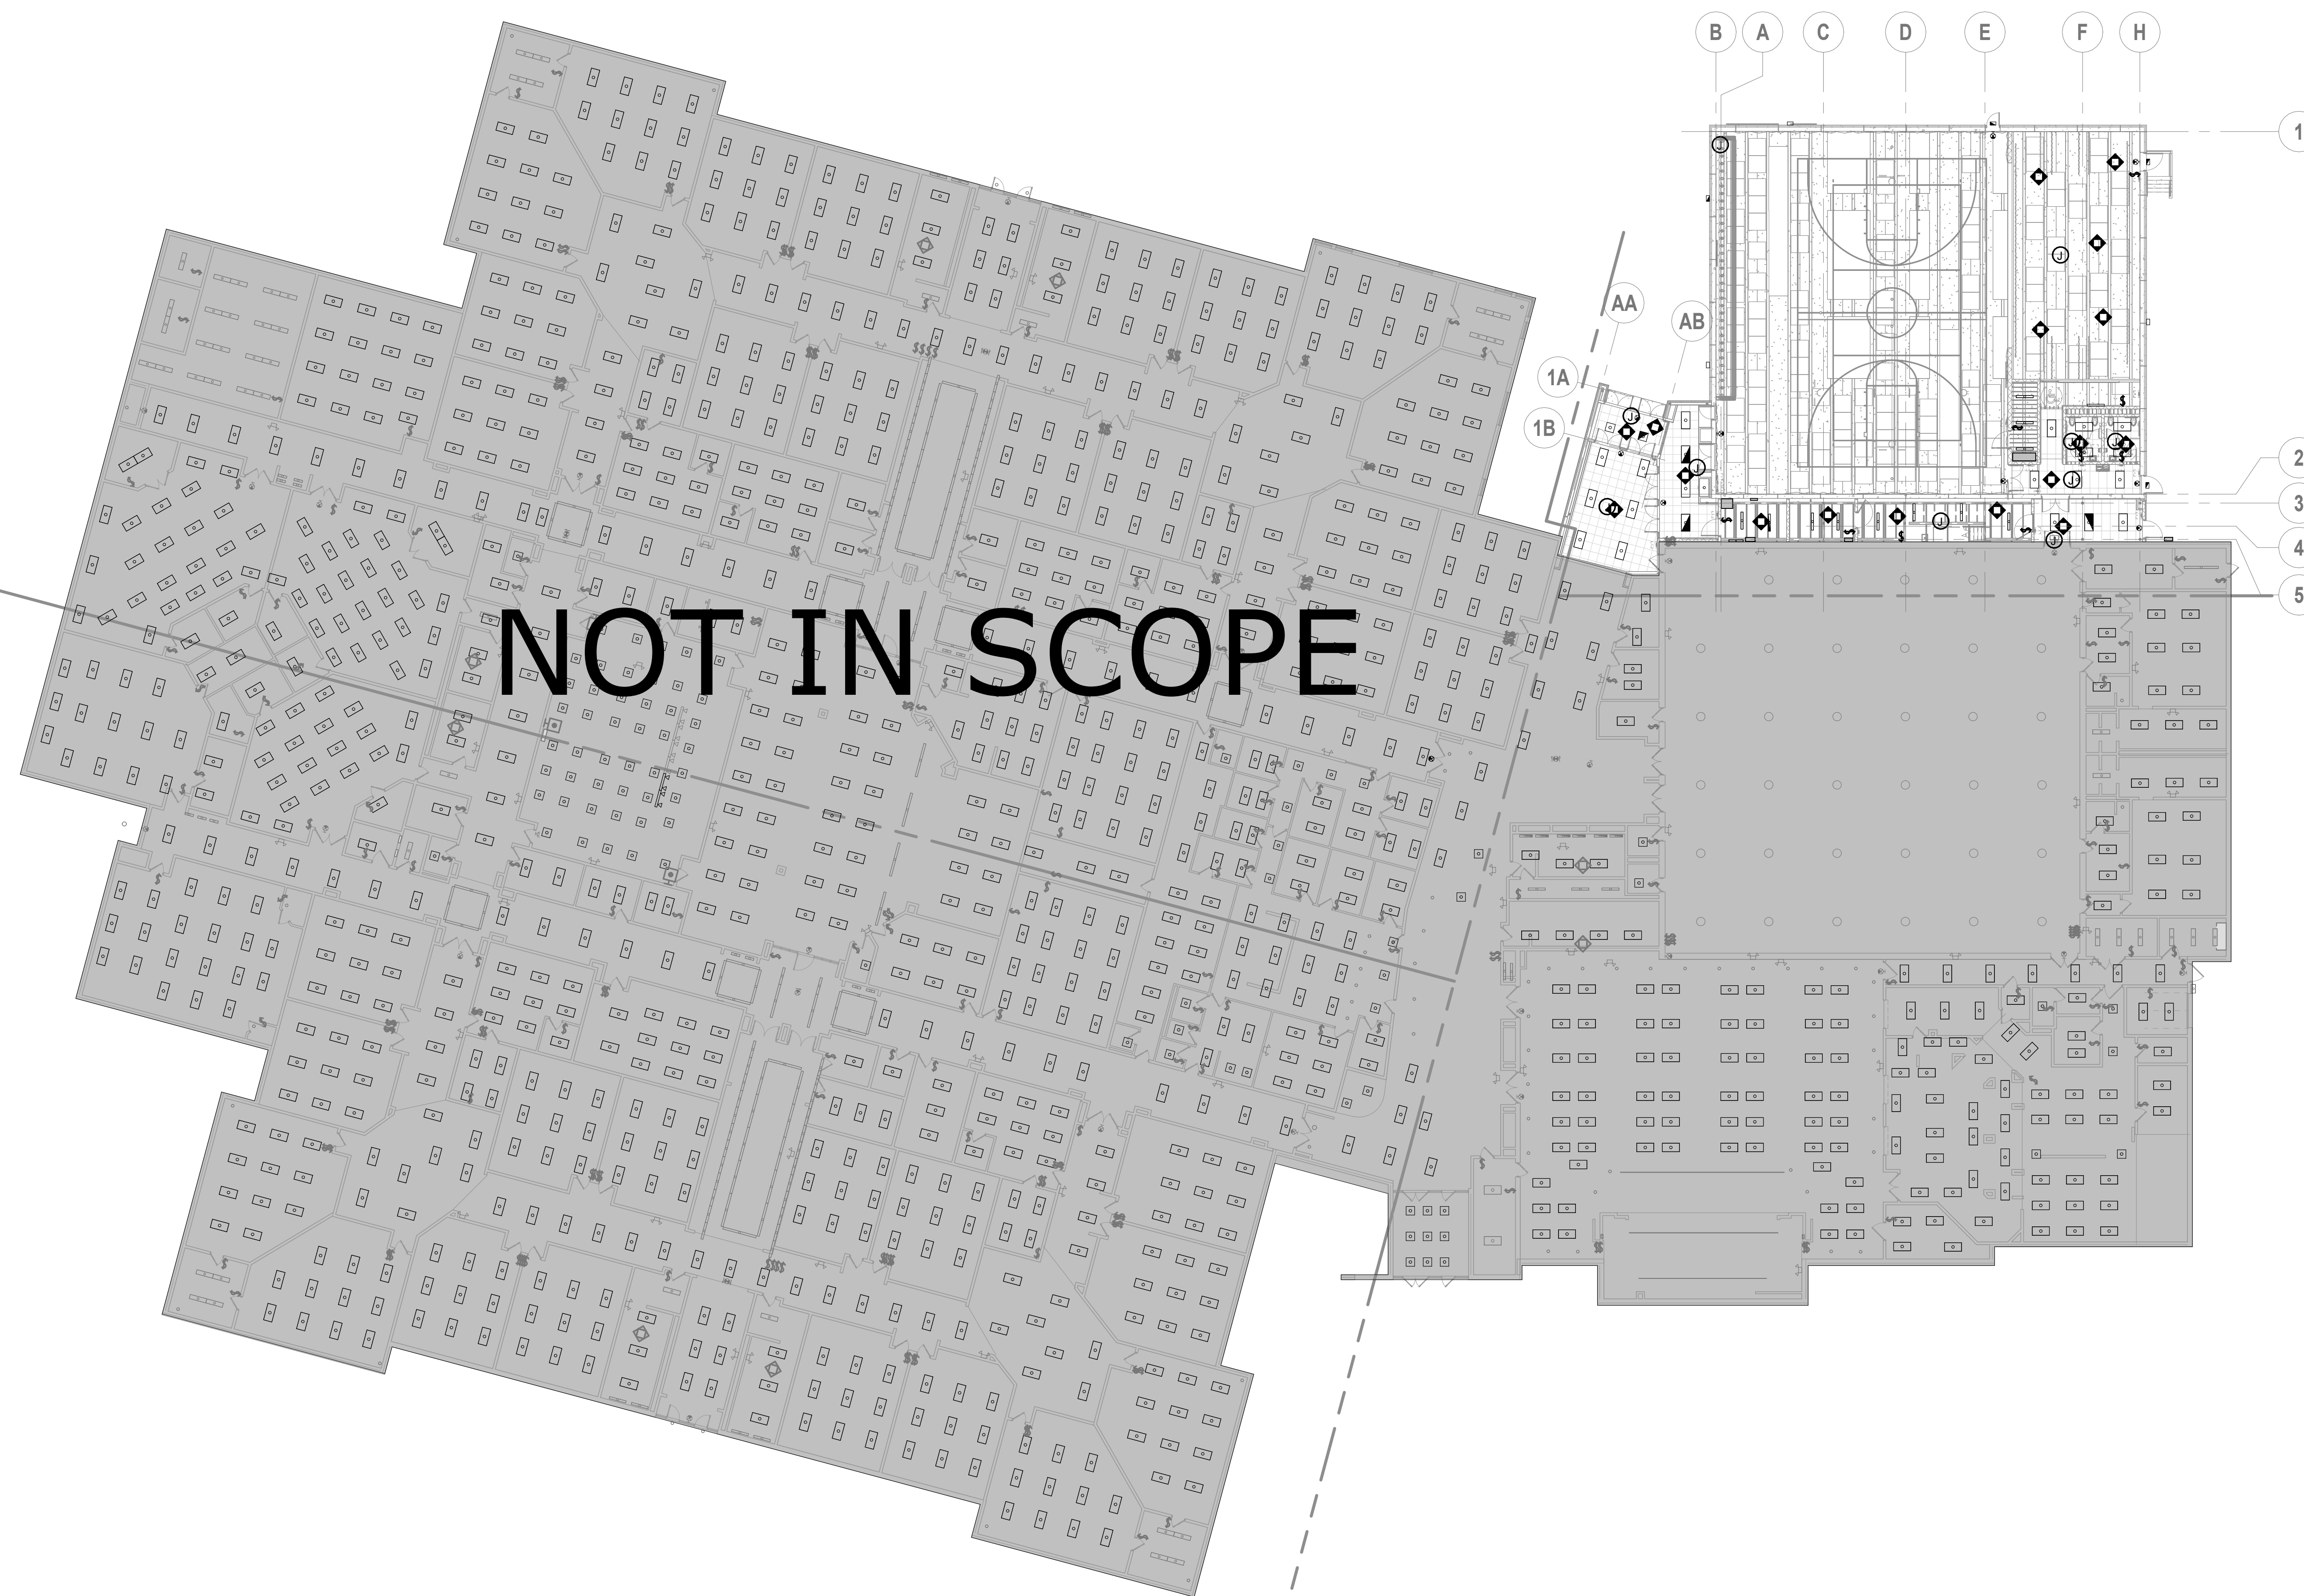
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P301




A1

Scale
1" = 20' 0"

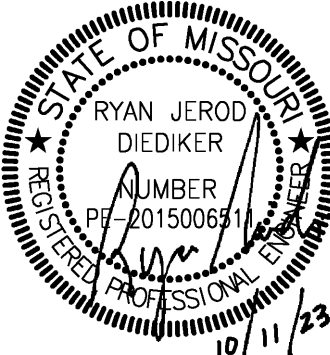OVERALL LIGHTING - LEVEL 1

1	2	3	4	5	6	7	8	9	10	11	12	13	14	15	16
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PROJECT NORTH

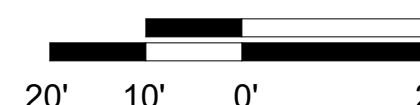


TRUE NORTH 

KEY PLAN



smith & boucher
engineers
25618 west 103rd St olathe, ks 66061
phone 913.345.2127 fax 913.345.0611
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

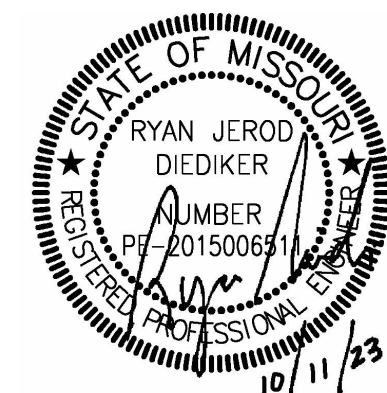
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E101

OVERALL LIGHTING PLAN - LEVEL 1

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Holla + Miller Architects
Missouri State Certificate of Authority
Architecture # 0000161
Structure # 2005031333

Bob D Campbell
Structural Engineer
State Certificate of Authority #000442
4338 Bellevue Ave
Kansas City, MO 64111

Smith & Boucher, Inc.
Mechanical, Electrical, & Plumbing
State Certificate of Authority #EGC000178
25618 W 103rd Street
Olathe, KS 66061
913.766.0000

MKEC Engineering, Inc.
Civil Engineer
State Certificate of Authority #
Engineering #2001009364
Landscaping #2006027139
Surveying #2006027138
11827 W 112th Street, Suite 200
Overland Park, KS 66210
613.217.0390 phone

Peerbolte Creative
Theatrical Consultant
109 E Pine St.
Warrensburg, MO 64093-0752
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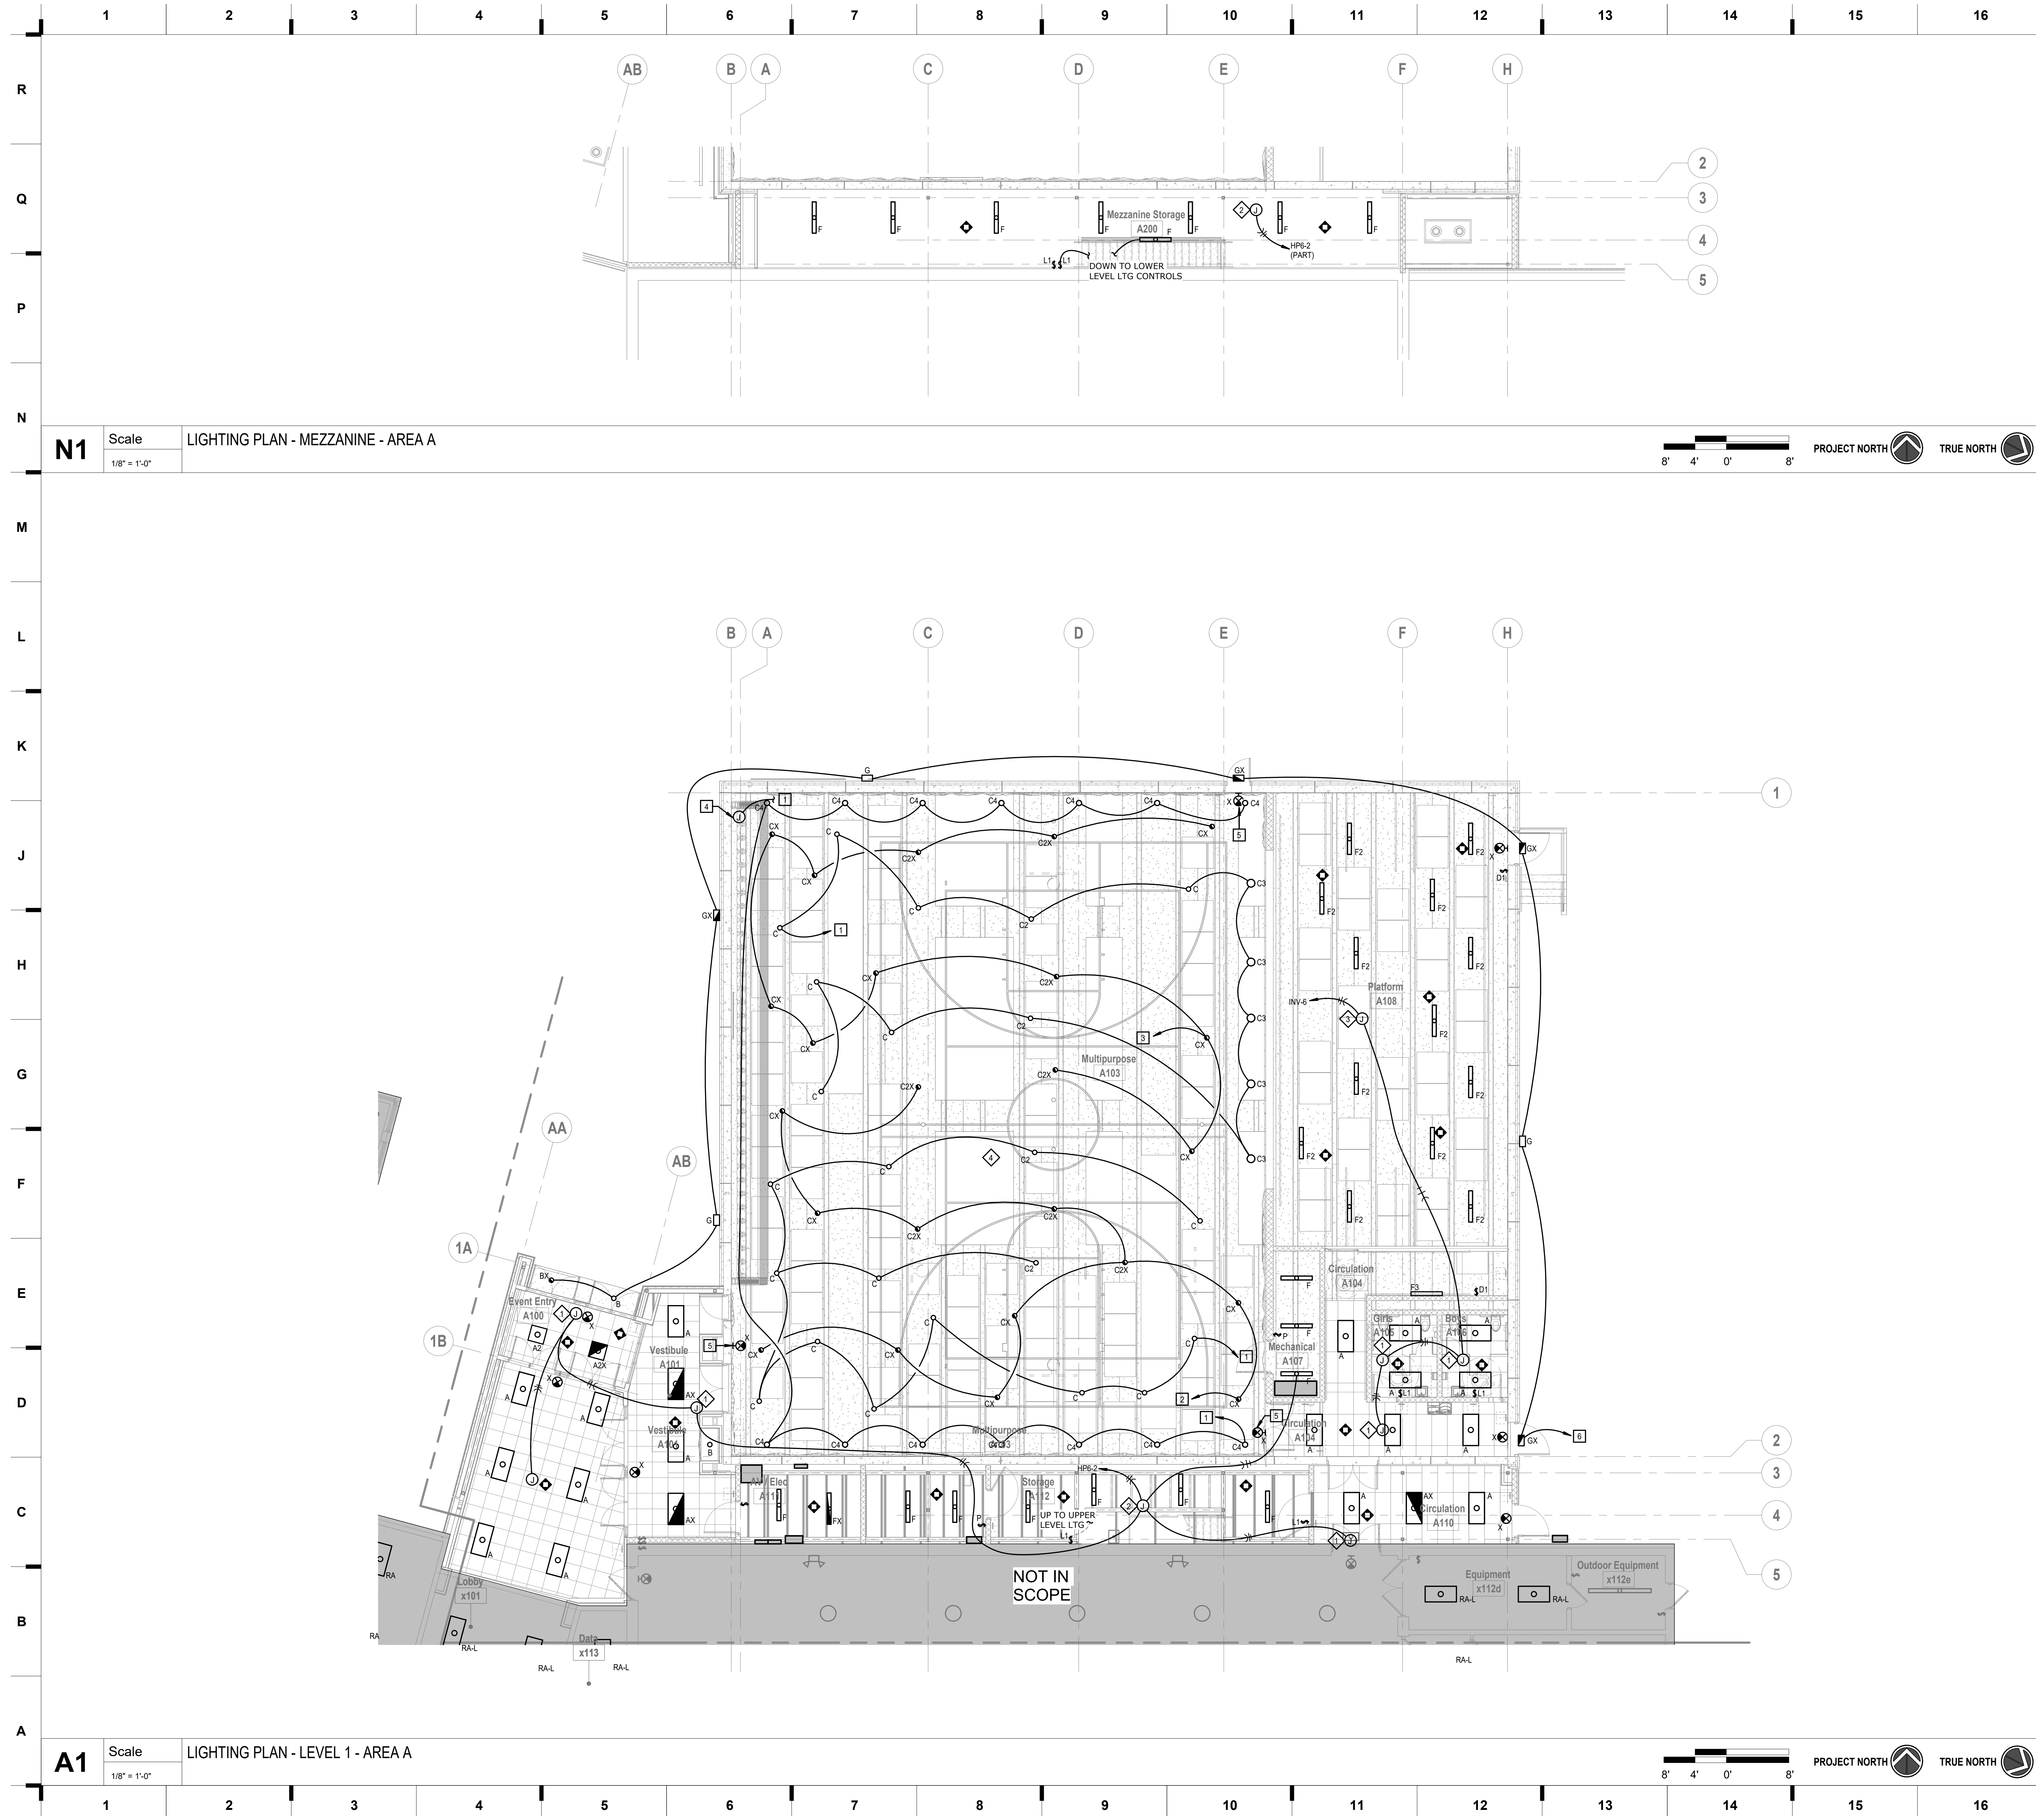
E

D

C

B

A



SHEET KEYNOTE LEGEND

- GENERAL NOTES:**
- REFER TO E100 FOR GENERAL NOTES.
- PLAN NOTES:**
- CIRCUIT THRU RELAY IN THEATRICAL LIGHTING CONTROL PANEL. REFER TO THEATRICAL PLANS.
 - CIRCUIT THROUGH EMERGENCY TRANSFER DEVICE AHEAD OF CIRCUIT FROM THEATRICAL RELAY PANEL. PROVIDE 277-120 1.5KVA TRANSFORMER MOUNTED ON WALL IN MECH A107 TO TRANSFORM 277V CIRCUIT FROM INVERTER TO 120V FEED FOR EMERGENCY TRANSFER DEVICE, CIRCUIT TO INV-2 CIRCUIT.
 - CIRCUIT THROUGH EMERGENCY TRANSFER DEVICE AHEAD OF CIRCUIT FROM THEATRICAL RELAY PANEL. PROVIDE 277-120 1.5KVA TRANSFORMER MOUNTED ON WALL IN MECH A107 TO TRANSFORM 277V CIRCUIT FROM INVERTER TO 120V FEED FOR EMERGENCY TRANSFER DEVICE, CIRCUIT TO INV-4 CIRCUIT.
 - POWER FOR INTERNAL BLEACHER AISLE LIGHTING, COORDINATE WITH BLEACHER SHOP DRAWINGS. PROVIDE 20A-1P TOGGLE SWITCH FOR LOCAL DISCONNECT, MOUNT NEAR DISCONNECTS OF BLEACHER MOTOR POWER.
 - PROVIDE WIRE GUARD OVER EXIT SIGN.
 - CIRCUIT EXTERIOR LIGHTING BACK TO MAIN ELECTRICAL ROOM AND PROVIDE NEW CONTACTOR CONNECTED TO EXISTING CONTACTOR TIME CLOCK VIA BMS. CIRCUIT WITH (2) #10, #10G, 1/2" C

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1828 Walnut Street Suite 922
Kansas City, MO 64108
1.816.442.7700

115 Wilcox Street Suite 210
Castle Rock, CO 80104
1.720.949.1589

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Hollis + Miller Architects
Missouri State Certificate of Authority
Architecture # 0000101
Structure # 200601133

Bob D Campbell
Structural Engineer
State Certificate of Authority #000442
4338 Bellevue Ave
Kansas City, MO 64111
816.531.4144 phone

Smith & Boucher, Inc.
Mechanical, Electrical, & Plumbing
State Certificate of Authority #EGC000178
25618 W 103rd Street
Olathe, KS 66061
913.345.2127 phone

MKEC Engineering, Inc.
Civil Engineer
State Certificate of Authority #
Engineering #2001005364
Landscaping #2006027139
Surveying #2006027138
11827 W 112th Street, Suite 200
Overland Park, KS 66210
913.317.9390 phone

Peerbolte Creative
Theatrical Consultant
109 E Pine St.
Warrensburg, MO 64093-0752
660.429.1383 phone

Avant Acoustics
AV/Acoustics Consultant
14827 West 95th St.
Lenexa, KS 66215
913.888.9111 phone

South Valley Middle School Storm Shelter Addition
Liberty School District
1000 Midjay Dr, Liberty, MO 64068


Conformed Construction Documents

REVISIONS:

#	Description	Date
1	ADDENDUM 05	10-04-2023

smith & boucher
engineers
25618 west 103rd St. olathe, ks 66061
phone 913.345.2127 fax 913.345.0617
project number 2314703

KEY PLAN

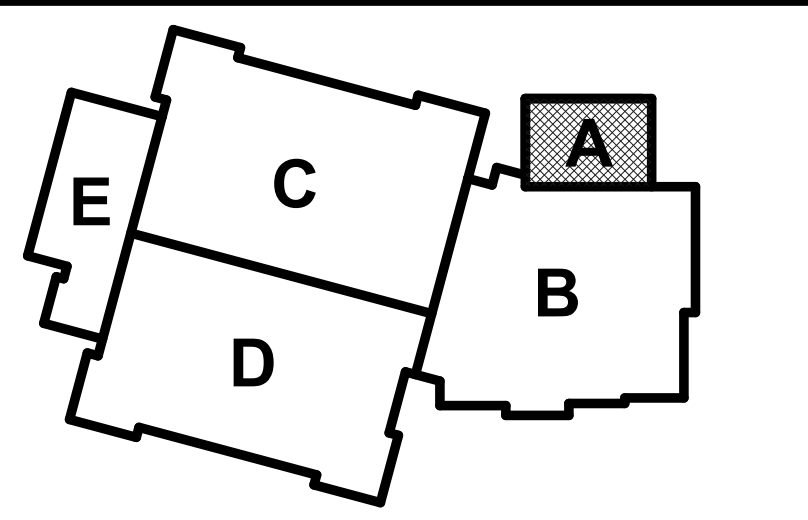

JOB NO: 23019
DRAWN BY: SBI
CHECKED BY: RJJ
DATE: 10.11.2023

E101A

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SHEET KEYNOTE LEGEND

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1828 Walnut Street Suite 922
Kansas City, MO 64108
t 816.442.7700
115 Wilcox Street Suite 210
Castle Rock, CO 80104
t 720.949.1689
HOLLISANDMILLER.COM

Holla + Miller Architects
Missouri State Certificate of Authority
Architecture #0200101
Structure # 2006031333

Bob D Campbell
Structural Engineer
State Certificate of Authority #000442
4338 Bellevue Ave
Kansas City, MO 64111
816.531.4144 phone

Smith & Boucher, Inc.
Mechanical, Electrical, & Plumbing
State Certificate of Authority #EGC000178
25618 W 103rd Street
Olathe, KS 66061
913.345.2127 phone

MKEC Engineering, Inc.
Civil Engineer
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Engineering #2001006364
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11827 W 112th Street, Suite 200
Overland Park, KS 66210
913.317.9390 phone

Peerbolte Creative
Theatrical Consultant
109 E Pine St.
Warrensburg, MO 64093-0752
660.429.1383 phone

Avant Acoustics
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14827 West 95th St.
Lenexa, KS 66215
913.888.9111 phone

South Valley Middle School Storm Shelter Addition

Liberty School District


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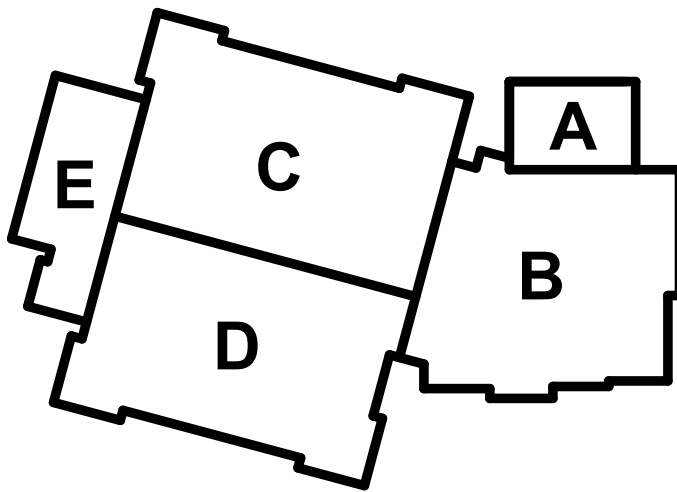
REVISIONS:

#	Description	Date
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smith & boucher
engineers
25618 west 103rd St. olathe, ks 66061
phone 913.345.2127 fax 913.345.0617
project number 2314703



KEY PLAN

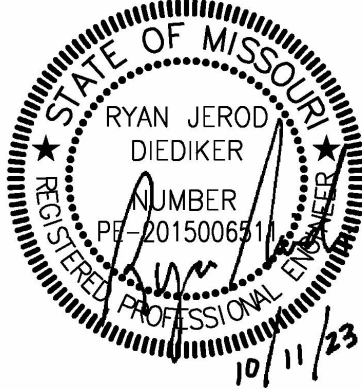


JOB NO: 23019
DRAWN BY: SBI
CHECKED BY: RJD
DATE: 10.11.2023

E201

OVERALL POWER PLAN - LEVEL 1


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SHEET KEYNOTE LEGEND

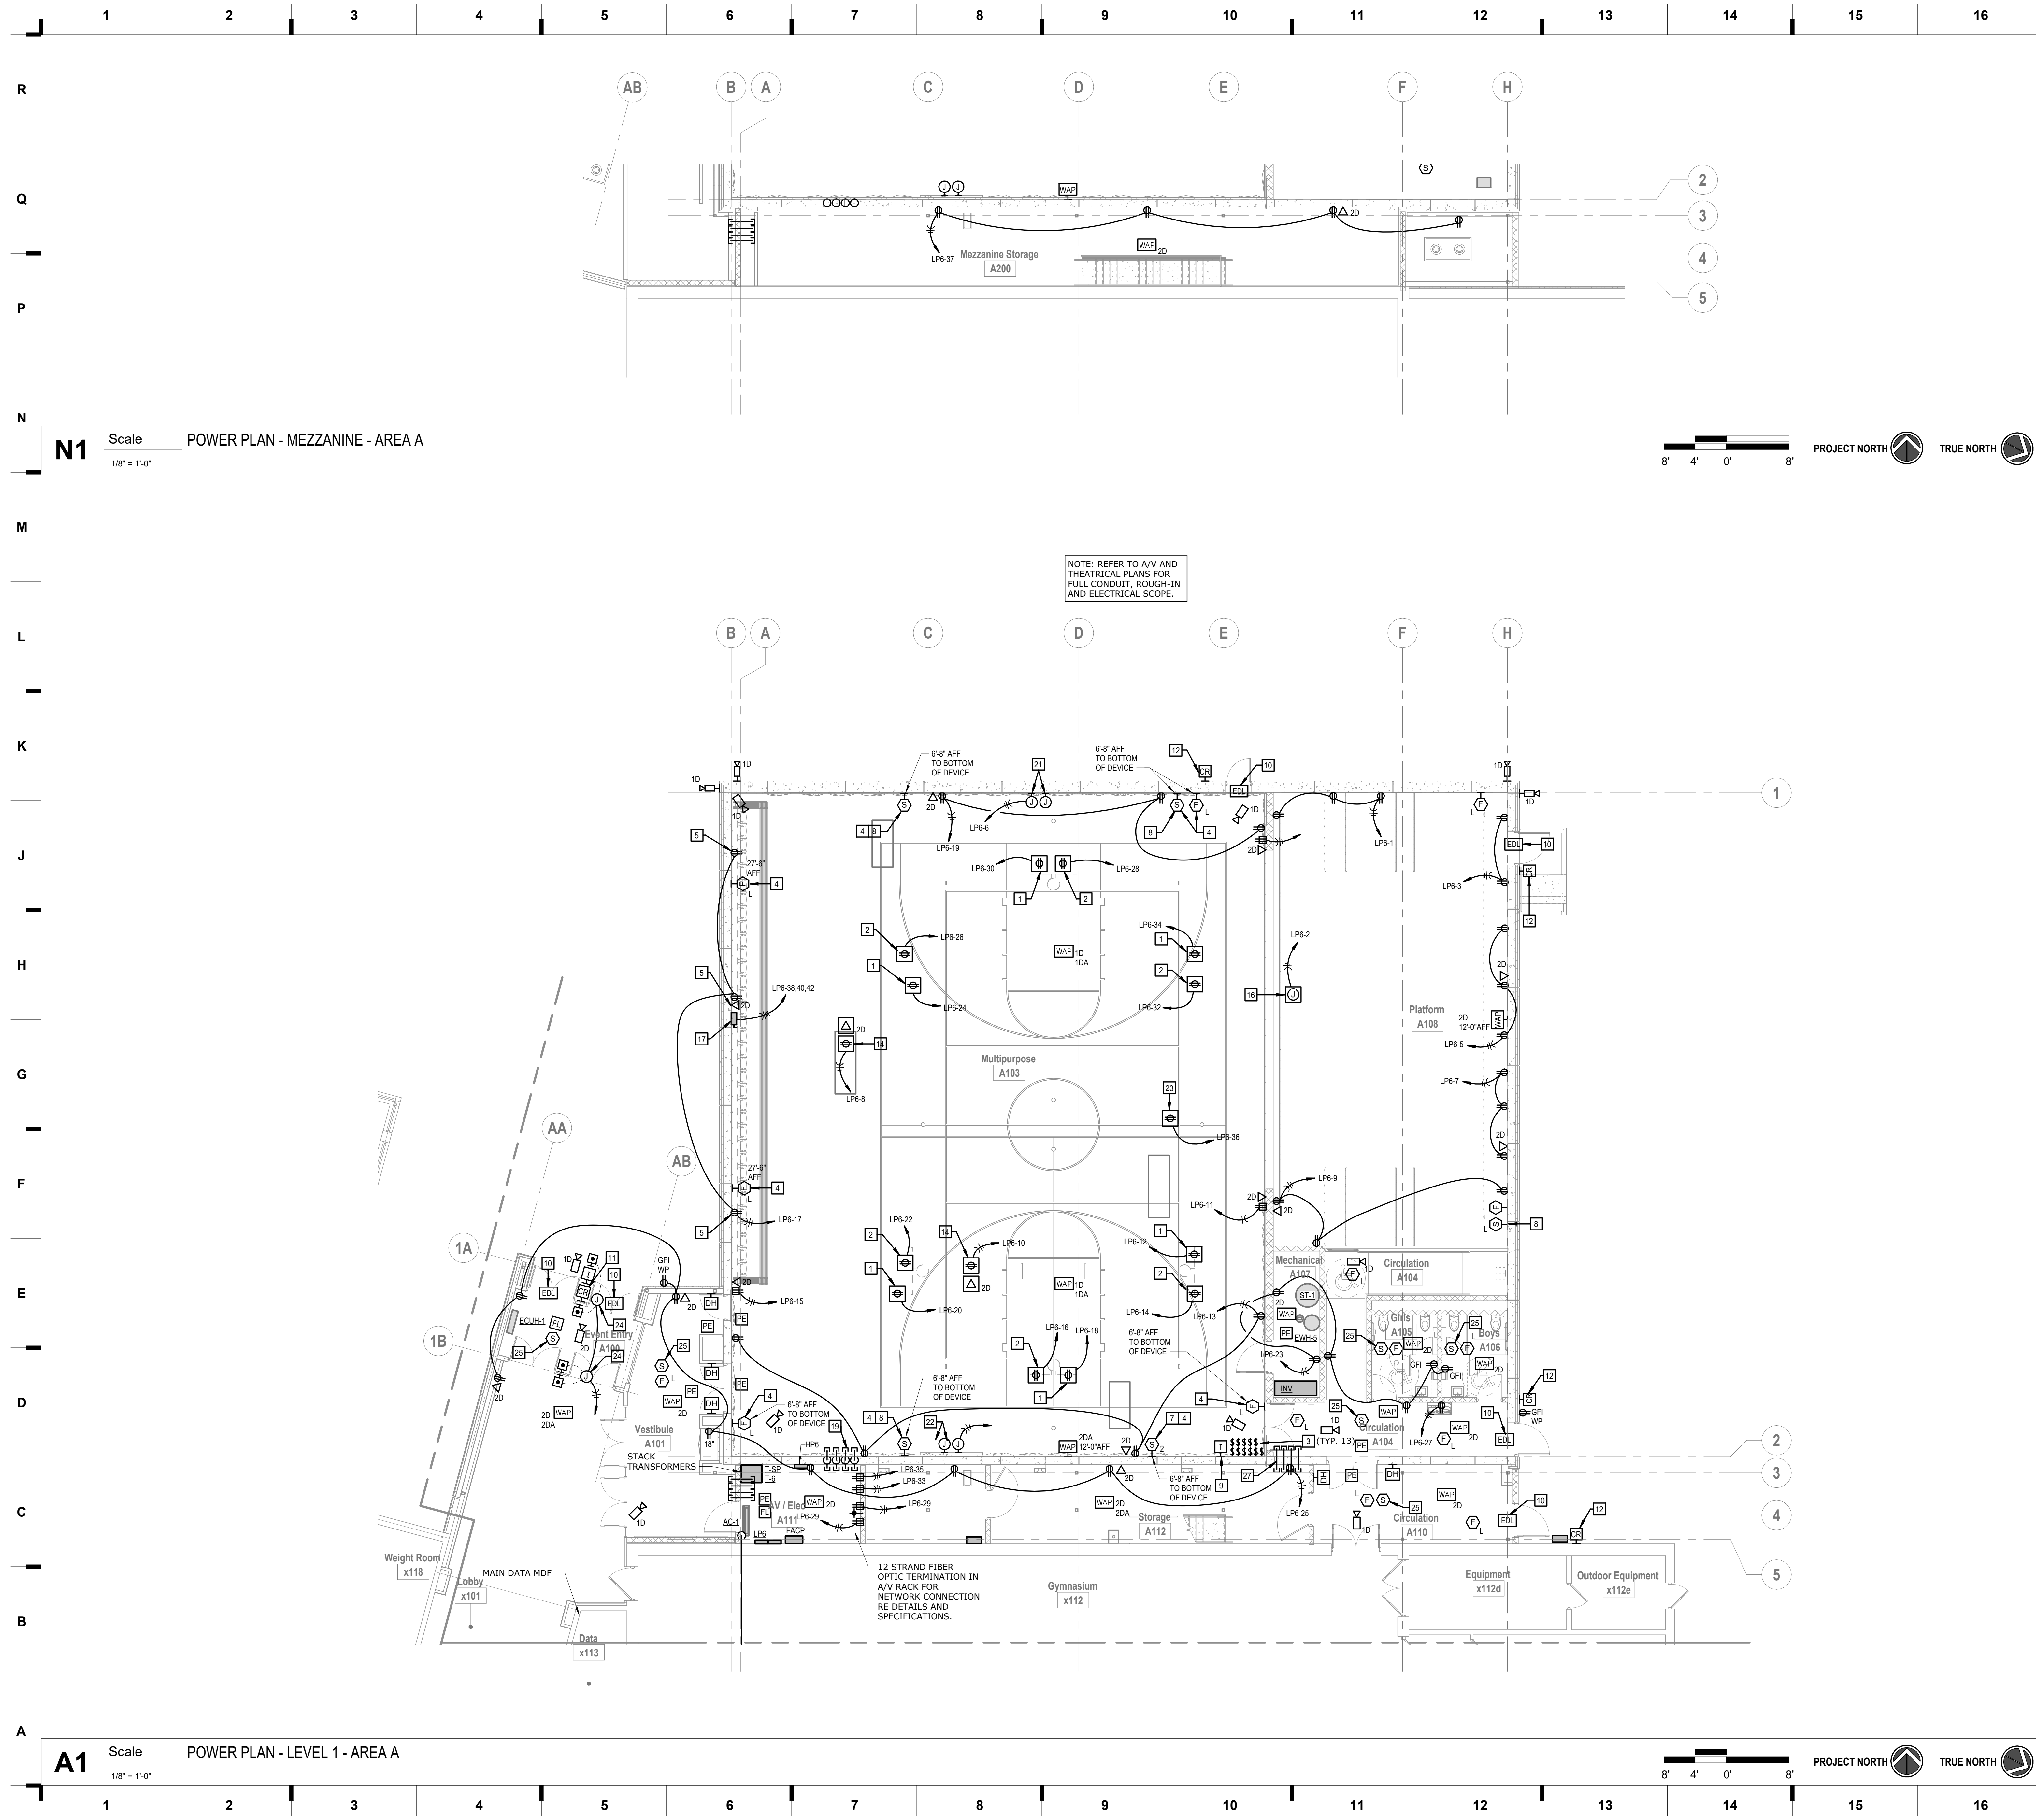- GENERAL NOTES:**
- REFER TO E200 FOR GENERAL NOTES.
- PLAN NOTES:**
- RECEPTACLE AND POWER FOR RETRACTABLE GOAL WINCH. CIRCUIT THROUGH GYM EQUIPMENT CONTACTOR PANEL. COORDINATE EXACT KEYED LIMIT SWITCH ON WALL. EQUIPMENT SHOP DRAWINGS PRIOR TO INSTALLATION.
 - RECEPTACLE AND POWER FOR RETRACTABLE ELECTRIC GOAL HEIGHT ADJUSTER. CIRCUIT THROUGH GYM EQUIPMENT CONTACTOR PANEL. COORDINATE KEYED LIMIT SWITCH ON WALL. GYM EQUIPMENT SHOP DRAWINGS PRIOR TO INSTALLATION.
 - KEYED LIMIT SWITCH FOR GYM EQUIPMENT MOTORS. COORDINATE WITH BASKETBALL SHOP DRAWINGS PRIOR TO INSTALLATION.
 - PROVIDE WIREGUARD OVER DEVICE.
 - DEVICE MOUNTED ABOVE TOP ROW OF BLEACHERS. COORDINATE WITH ARCHITECTURAL ELEVATIONS PRIOR TO ROUGH-IN.
 - 8" RECESSED TWO-WAY CEILING SPEAKER FOR INTERCOM/PUBLIC ADDRESS SYSTEM. ROUTE CABLING BACK TO MAIN HEAD END AND COORDINATE WITH EXISTING SYSTEM.
 - WALL MOUNTED 5W TWO-WAY LOUD SPEAKER FOR INTERCOM/PUBLIC ADDRESS SYSTEM. ROUTE CABLING BACK TO MAIN HEAD END AND COORDINATE WITH EXISTING SYSTEM.
 - WALL MOUNTED 5W ONE-WAY SPEAKER FOR INTERCOM/PUBLIC ADDRESS SYSTEM. ROUTE CABLING BACK TO MAIN HEAD END AND COORDINATE WITH EXISTING SYSTEM.
 - PROVIDE INTERCOM PUSHBUTTON AND ALL CABLING BACK TO HEAD END UNIT AND SPEAKER FOR COMPLETE WORKING SYSTEM. COORDINATE EXACT LOCATION WITH OWNER PRIOR TO ROUGH-IN.
 - ELECTRIC DOOR LOCK LOCATION, PROVIDE CONTROL CABLING PER SPECIFICATIONS, ROUTE BACK TO DOOR CONTROL HEAD END PANEL. COORDINATE EXACT REQUIREMENTS WITH OWNER AND ARCHITECT.
 - CARD READER MOUNTED IN MULLION AT 48" AFF, COORDINATE PATHWAY WITH DOOR HARDWARE PROVIDER.
 - CARD READER MOUNTED AT 48" AFF, COORDINATE PATHWAY WITH DOOR HARDWARE PROVIDER.
 - NOT USED.
 - DECK MOUNTED CEILING RECEPTACLE FOR PENDANT MOUNTED PROJECTOR IN GYM CEILING. COORDINATE EXACT LOCATION WITH AV DRAWINGS.
 - POWER FOR PROJECTION SCREEN. COORDINATE LOCATION AND ALL REQUIREMENTS WITH PROVIDED PROJECTOR SCREEN. COORDINATE WITH AV DRAWINGS.
 - RETRACTABLE BLEACHER POWER. PROVIDE 30A-3P NF BLEACHER SAFETY SWITCH. CIRCUIT WITH (4) #10, #10G, 1/2" C. COORDINATE EXACT ELECTRICAL REQUIREMENTS WITH BLEACHER SHOP DRAWINGS PRIOR TO ROUGH-IN.
 - (4) 2" CONDUIT SLEEVES THRU THE WALL ABOVE THE CEILING FOR LOW VOLTAGE CABLING.
 - (4) 2" CONDUIT SLEEVES STUBBED IN CORRIDOR PLENUM SPACE AND ROUTED IN THE WALL STUBBED UP TIGHT TO GYM ROOF DECK FOR LOW VOLTAGE CABLING.
 - (1) 2" CONDUIT SLEEVE THRU THE WALL ABOVE THE CEILING FOR LOW VOLTAGE CABLING.
 - PROVIDE POWER AND LOW VOLTAGE ROUGH-IN FOR FUTURE SCORE BOARD. PROVIDE WITH (2) BACK BOXES AND (3) 1-1/2" CONDUITS STUBBED TIGHT TO DECK. COORDINATE PLACEMENT OF BOXES WITH ARCHITECT/OWNER PRIOR TO ROUGH-IN.
 - PROVIDE POWER AND LOW VOLTAGE FOR SCORE BOARD. PROVIDE WITH (2) BACK BOXES AND (3) 1-1/2" CONDUITS STUBBED TIGHT TO DECK. CONTINUE ONE CONDUIT BACK TO AV LOCATION FOR CONTROL OF SCOREBOARD. COORDINATE WITH AV PLANS. COORDINATE ROUGH-IN HEIGHT WITH ARCHITECTURAL ELEVATIONS AND SCOREBOARD SHOP DRAWINGS.
 - RECEPTACLE AND POWER FOR RETRACTABLE DIVIDER CURTAIN. CIRCUIT THROUGH GYM EQUIPMENT CONTACTOR PANEL. COORDINATE EXACT ELECTRICAL REQUIREMENTS WITH GYM EQUIPMENT SHOP DRAWINGS PRIOR TO INSTALLATION.
 - POWER AND MULLION MOUNTED PUSH BUTTON CONTROL FOR MOTORIZED ACCESSIBLE DOOR, COORDINATE EXACT REQUIREMENTS AND LOCATION WITH DOOR HARDWARE PROVIDER. PROVIDE 6-PAIR CABLE PER DISTRICT STANDARDS BACK TO ACCESS CONTROL CABINET FOR INTEGRATION WITH ACCESS CONTROLS.
 - 8" RECESSED ONE-WAY CEILING SPEAKER FOR INTERCOM/PUBLIC ADDRESS SYSTEM. ROUTE CABLING BACK TO MAIN HEAD END AND COORDINATE WITH EXISTING SYSTEM.
 - GROUND BUS BAR CONNECTED TO SERVICE MAIN GROUND. REFER TO DETAILS.
 - (4) 4" CONDUIT SLEEVES THRU THE WALL INTO PLENUM SPACE OF CIRCULATION FOR LOW VOLTAGE CABLING.

KEY PLAN



POWER PLAN - LEVEL 1 & MEZZANINE - AREA A
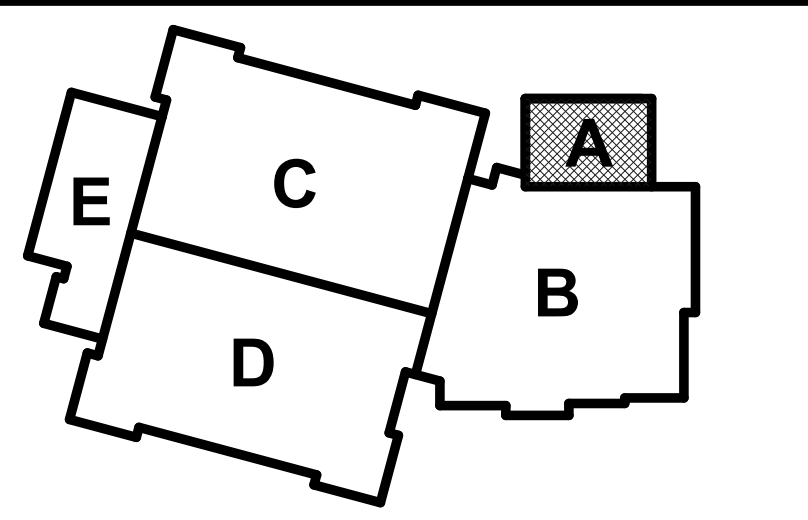
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1828 Walnut Street Suite 922
Kansas City, MO 64108
1.816.442.7700

115 Wilcox Street Suite 210
Castle Rock, CO 80104
1.720.949.1589

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Hollis + Miller Architects
Missouri State Certificate of Authority
Architecture #2000101
Structure #200011333

Bob D Campbell
Structural Engineer
State Certificate of Authority #000442
4338 Bellevue Ave
Kansas City, MO 64111
816.531.4144 phone

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Mechanical, Electrical, & Plumbing
State Certificate of Authority #EGC000178
25618 W 103rd Street
Olathe, KS 66061
913.345.2127 phone

MKEC Engineering, Inc.
Civil Engineer
State Certificate of Authority #
Engineering #200100364
Landscaping #2006027139
Surveying #2006027138
11827 W 112th Street, Suite 200
Overland Park, KS 66210
913.317.9390 phone

Peerbolte Creative
Theatrical Consultant
109 E Pine St.
Warrensburg, MO 64093-0752
660.429.1383 phone

Avant Acoustics
AV/Acoustics Consultant
14827 West 95th St.
Lenexa, KS 66215
913.888.9111 phone

South Valley Middle School Storm Shelter Addition
Liberty School District
1000 Midjay Dr, Liberty, MO 64068

REVISIONS:

#	Description	Date
1	ADDENDUM #1	09-14-2023

smith & boucher engineers


25618 west 103rd St. olathe, ks 66061
phone 913.345.2127 fax 913.345.0617
project number 2314703

STATE OF MISSOURI
RYAN JEROD DIEDER
JANUARY 20150081
10/11/23

JOB NO: 23019
DRAWN BY: SBI
CHECKED BY: RJJ
DATE: 10.11.2023

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Warrensburg, MO 64093
660.429.1383 phone
Avant Acoustics
AV/Acoustics Consultant
14827 West 95th St.
Lenexa, KS 66215
913.888.9111 phone

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INVERTER

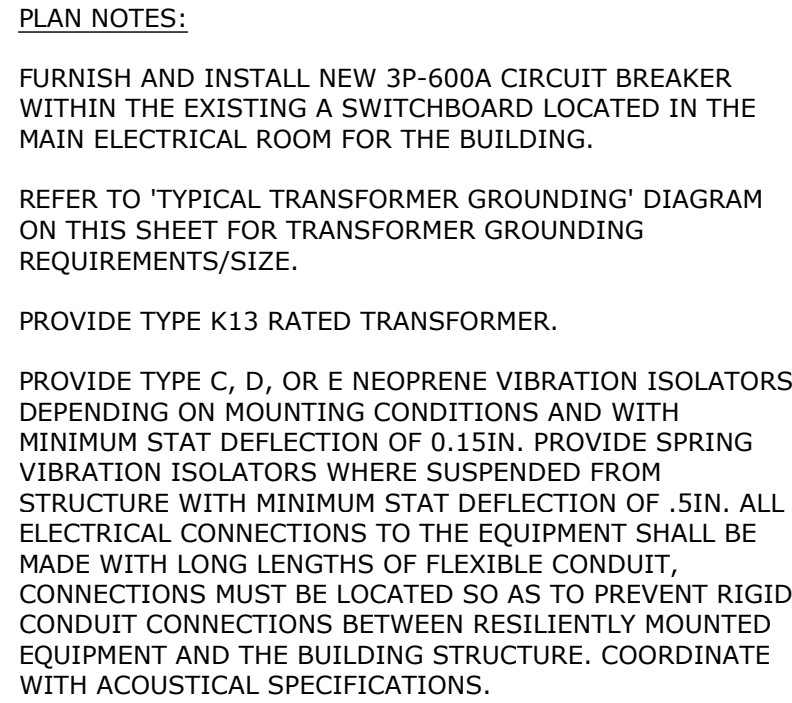INV-1

AIC:

42,000 A

RATED KVA:

12.5

VOLTAGE:

480Y/277 V

PHASES WIRES:

3 PH / 4 W

MOUNTING:

2" HOUSE KEEPING PAD

ENCLOSURE TYPE:


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CIRCUIT DESCRIPTION	POLES	AMPS	LOAD	CKT NO	NO	LOAD	AMPS	POLES	CIRCUIT DESCRIPTION
EF-16	3	20	1,332	1	2	1,231	20	1	SHELTER EM LTG #1
			1,332	3	4	984	20	1	SHELTER EM LTG #2
			1,332	5	6	984	20	1	SHELTER EM LTG #3
SPARE	1	20		7	8	100	20	1	SHELTER DAMPERS
SPARE	1	20		9	10		20	1	SPARE
	1			11	12			1	
SUBTOTAL	-	-	3,995	-	-	3,299	-	-	SUBTOTAL


NOTE: SIZE FOR 120MIN RUN TIME PER IECC SHELTER REQUIREMENTS.

UL 924 RATED. EQUIVALENT TO EVENLITE OR APPROVED EQUAL

MOTORS	(CONNECTED)= 4,095	(DEMAND)= 5,094	VA	(FACTORS)= 1.25	MAX	1.00	ALL OTHERS
RECEPTACLES	(CONNECTED)=	(DEMAND)=	VA	(FACTORS)= 1.25			1.00 0-10KVA 0.50 >10 KVA
LIGHTING	(CONNECTED)= 3,199	(DEMAND)= 3,999	VA	(FACTORS)= 1.25			
HEATING	(CONNECTED)=	(DEMAND)=	VA	(FACTORS)= 1.25			
COOLING	(CONNECTED)=	(DEMAND)=	VA	(FACTORS)= 1.00			
KITCHEN	(CONNECTED)=	(DEMAND)=	VA	(FACTORS)= 0.65			
OTHER	(CONNECTED)=	(DEMAND)=	VA	(FACTORS)= 1.00			
TOTAL	(CONNECTED)= 7,294	(DEMAND)= 9,093	VA	11.9	AMPS		TOTAL MAXIMUM DEMAND

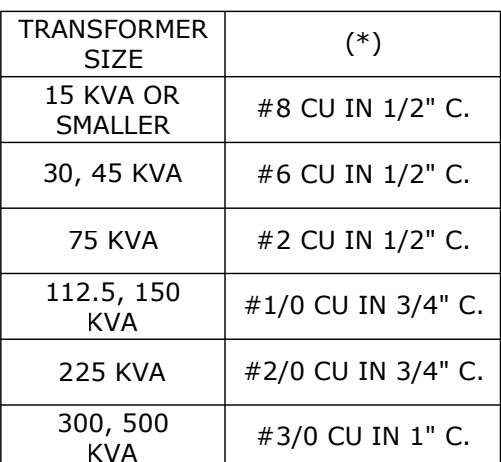

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A

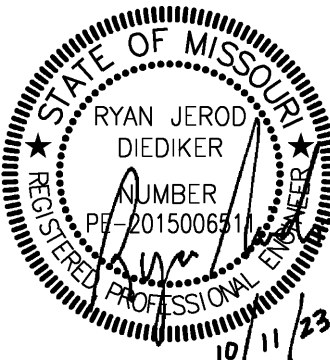PROJECT NAME: 2314703 - 03-01-2023, South Valley Middle School Storm Shelter Addition
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LAST CORRECTION BY: B. J. Bouché
PRINTED BY: B. J. Bouché
DATE: 10/11/2023
TIME: 9:55:18 AM

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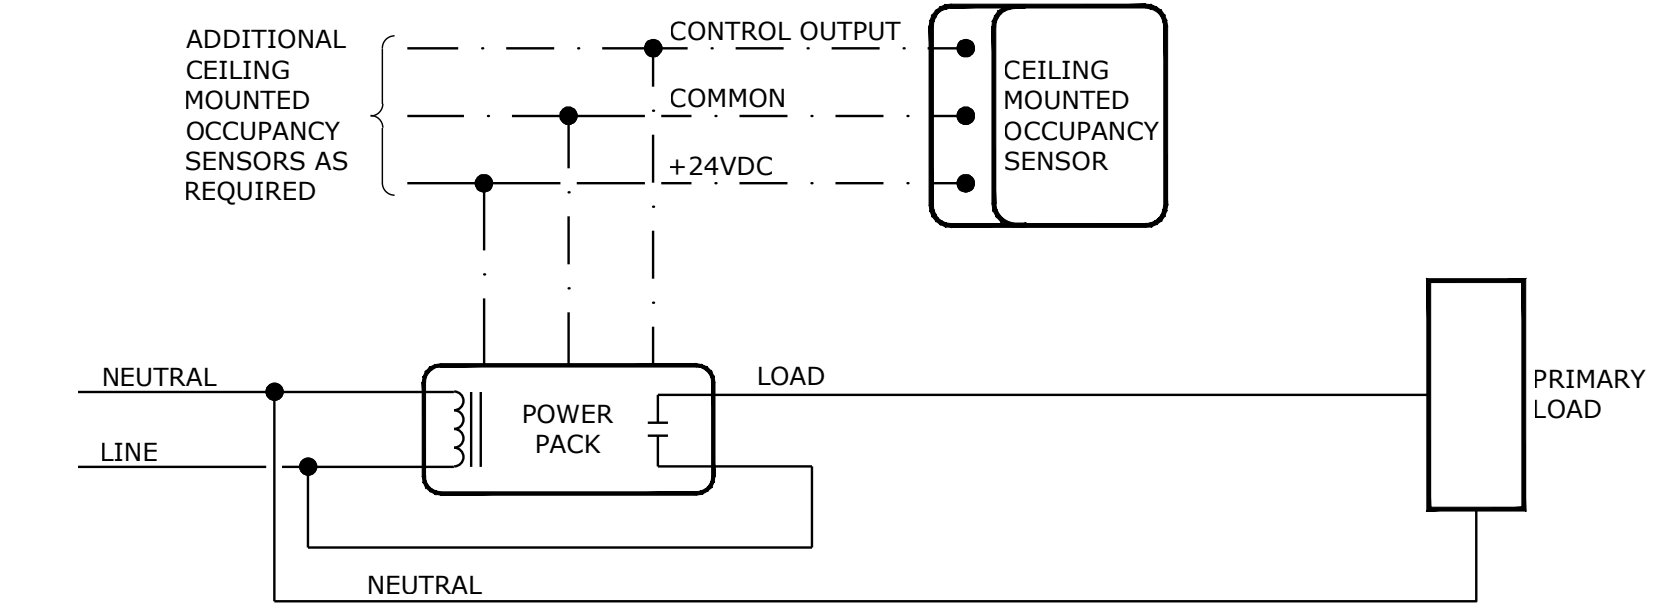
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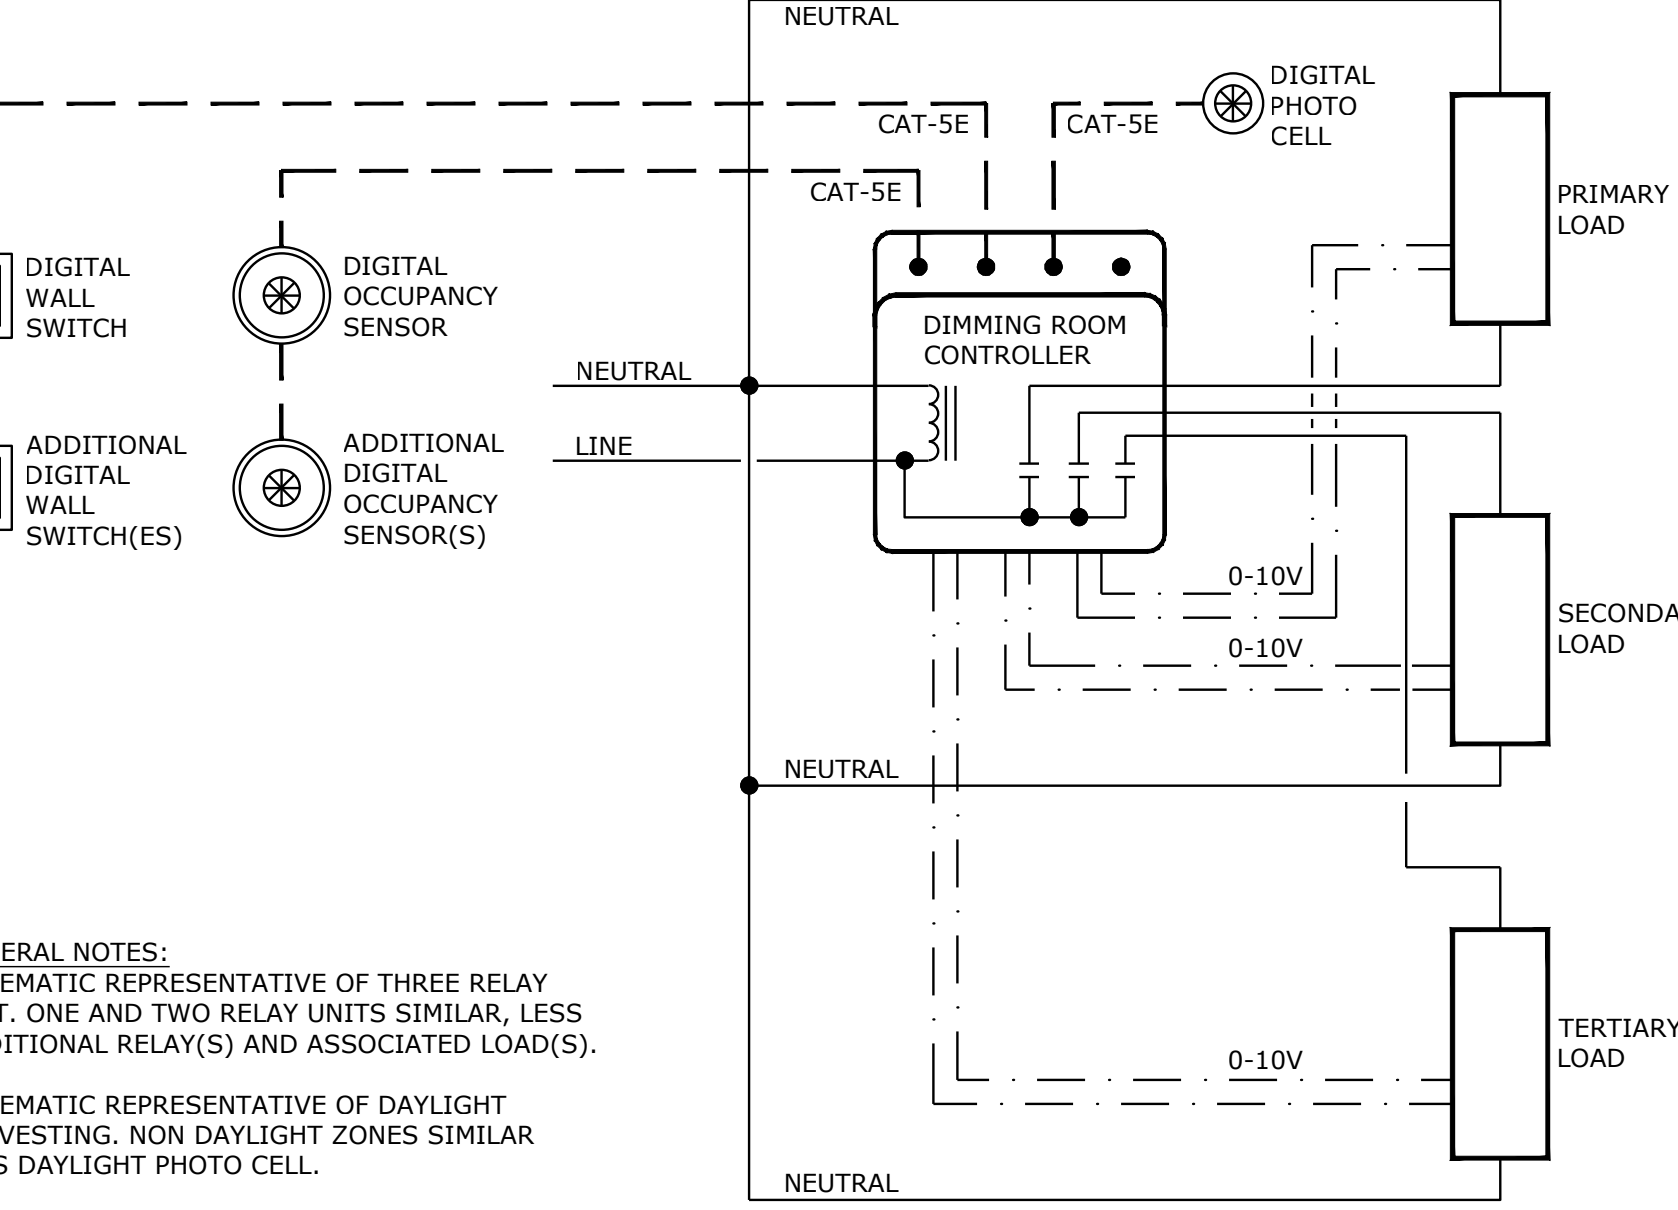
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LOW VOLTAGE OCCUPANCY SENSOR WIRING DIAGRAM WITH AUTOMATIC ON OPERATION

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DIGITAL ROOM CONTROLLER WIRING DIAGRAM

NOT TO SCALE

LIGHTING CONTROL REQUIREMENTS & DESCRIPTIONS - PER SPACE TYPE	
TYPE	LIGHTING CONTROL REQUIREMENTS FOR SPACE
1	<p>CONTROL METHOD: OCCUPANCY ON - OCCUPANCY OFF:</p> <p>POWER PACKS/CONTROLLERS:</p> <ul style="list-style-type: none">-LOCAL DEVICES IN ACCESSIBLE LOCATIONS AS REQUIRED TO ACHIEVE CONTROL METHOD INDICATED. <p>OCCUPANCY SENSOR(S):</p> <ul style="list-style-type: none">-TYPE AND MINIMUM QUANTITY NOTED ON PLANS. MODELS/SETTINGS AS NEEDED TO PROVIDE SMALL MOTION COVERAGE IN ENTIRE ROOM.-SET TIME DELAYS FOR SHUT-OFF AT 30 MINUTES.
2	<p>CONTROL METHOD: MANUAL ON - OCCUPANCY OFF - MANUAL ON/OFF CONTROLS:</p> <p>POWER PACKS/CONTROLLERS:</p> <ul style="list-style-type: none">-LOCAL DEVICES IN ACCESSIBLE LOCATIONS AS REQUIRED TO ACHIEVE CONTROL METHOD INDICATED. <p>OCCUPANCY SENSOR(S):</p> <ul style="list-style-type: none">-TYPE, LOCATION(S), AND MINIMUM QUANTITY NOTED ON PLANS. MODELS/SETTINGS AS NEEDED TO PROVIDE SMALL MOTION COVERAGE IN ENTIRE ROOM.-SET TIME DELAYS FOR SHUT-OFF AT 30 MINUTES. <p>ON/OFF ZONE SWITCHES:</p> <ul style="list-style-type: none">-LOCATION(S) AND QUANTITIES SHOWN ON FLOOR PLANS.-ZONE QUANTITIES FOR EACH SWITCH LOCATION DENOTED ON FLOOR PLANS.-ZONE DESIGNATIONS ARE DENOTED FOR EACH SWITCH WHEN DIFFERENT ZONES ARE CONTROLLED FROM DIFFERENT SWITCHES WITHIN THE SAME ROOM.-ZONES ARE DENOTED ON EACH ASSOCIATED LIGHT FIXTURE WHEN MULTIPLE ZONES ARE PRESENT WITHIN ROOM, USING LOWER CASE LETTERS AS FOLLOWS: "a", "b", ETC.-ON AND OFF CONTROL FOR EACH ZONE, WITH EITHER SEPARATE BUTTONS OR SINGLE BUTTON ROCKER STYLE. NOT TOGGLE STYLE.
3	<p>CONTROL METHOD: MANUAL ON - OCCUPANCY OFF - MANUAL DIMMING CONTROLS:</p> <p>POWER PACKS/CONTROLLERS:</p> <ul style="list-style-type: none">-LOCAL DEVICES IN ACCESSIBLE LOCATIONS AS REQUIRED TO ACHIEVE CONTROL METHOD INDICATED. <p>OCCUPANCY SENSOR(S):</p> <ul style="list-style-type: none">-TYPE, LOCATION, AND MINIMUM QUANTITY NOTED ON PLANS. MODELS/SETTINGS AS NEEDED TO PROVIDE SMALL MOTION COVERAGE IN ENTIRE ROOM.-SET TIME DELAYS FOR SHUT-OFF AT 30 MINUTES. <p>DIMMABLE ZONE SWITCHES:</p> <ul style="list-style-type: none">-LOCATION(S) AND QUANTITIES SHOWN ON FLOOR PLANS.-ZONE QUANTITIES FOR EACH SWITCH LOCATION DENOTED ON FLOOR PLANS.-ZONE DESIGNATIONS ARE DENOTED FOR EACH DIMMER LOCATION WHEN DIFFERENT ZONES ARE CONTROLLED FROM DIFFERENT DIMMERS WITHIN THE SAME ROOM.-ZONES ARE DENOTED ON EACH ASSOCIATED LIGHT FIXTURE WHEN MULTIPLE ZONES ARE PRESENT WITHIN ROOM, USING LOWER CASE LETTERS AS FOLLOWS: "a", "b", ETC.-ON AND OFF CONTROL FOR EACH ZONE, WITH EITHER SEPARATE BUTTONS OR SINGLE BUTTON ROCKER STYLE. NOT TOGGLE STYLE.-RAISE AND LOWER CONTROL FOR EACH ZONE, WITH EITHER SEPARATE BUTTONS OR SINGLE BUTTON ROCKER STYLE. NOT SLIDER STYLE. <p>AUTOMATIC DAYLIGHT HARVESTING PHOTOCELL(S), WHEN SHOWN ON PLANS:</p> <ul style="list-style-type: none">-AUTOMATICALLY RAISE/LOWER LIGHTING OUTPUT OF EACH LIGHTING ZONE, EITHER FULLY ARE PARTIALLY, WITHIN EACH DAYLIGHT ZONE(S) NOTED ON FLOOR PLANS.-DEDICATED CLOSED LOOP PHOTOCELL FOR EACH ROOM WITH DAYLIGHT ZONE(S).
4	<p>CONTROL METHOD: CONTROL VIA DMX FROM THEATRICAL PANEL: REFER TO THEATRICAL PLANS</p>

GENERAL NOTES:

NOTE 1: WHERE NOTED ABOVE, SCHEDULED BUILDING HOURS OF OPERATION ARE AS FOLLOWS: 6:30 AM TO 6:30 PM.

NOTE 2: CONTRACTOR MUST INCLUDE SHOP DRAWINGS WITH LIGHTING CONTROLS SUBMITTAL SHOWING WIRING SCHEMATICS/DIAGRAMS OVERLAYED ON FLOOR PLANS FOR EACH ROOM.

NOTE 3: ALL WALL MOUNTED LIGHTING CONTROLS MUST HAVE MATCHING FINISHES TO THOSE LISTED IN SPECIFICATION SECTION 262726 - WIRING DEVICES.

NOTE 4: PROVIDE A DIGITAL LIGHTING CONTROL SYSTEM FROM A MANUFACTURER LISTED IN SPECIFICATION SECTION 260923 - LIGHTING CONTROL DEVICES. WIRELESS SYSTEMS ARE NOT PERMITTED.

NOTE 5: CONTRACTOR TO MODIFY OCCUPANCY SENSOR LOCATIONS, AND/OR INCREASE QUANTITIES, AS REQUIRED BASED ON COVERAGE CAPABILITIES OF SUBMITTED PRODUCTS.

NOTE 6: CONTRACTOR MUST COORDINATE WITH LIGHT FIXTURE SCHEDULE, AND MOST IMPORTANTLY THE LIGHT FIXTURE SUBMITTAL, TO VERIFY DIMMING TYPE NEEDED FOR EACH RELAY/CONTROLLER.

NOTE 7: PROGRAM DAYLIGHT HARVESTING SETPOINTS AT NIGHT WITH ALL LIGHT FIXTURES AT FULL LIGHT OUTPUT. PHOTOCELL TO DIM LIGHTING BASED ON THIS SETPOINT IN A CLOSED LOOP SYSTEM.

NOTE 8: CONTRACTOR TO MODIFY PHOTOCELL LOCATIONS AS REQUIRED BASED ON SUBMITTED PRODUCTS.

OCCUPANCY CONTROL DEVICE SCHEDULE					
SYMBOL	DESCRIPTION	DETECTION TYPE	SETTINGS (TYPICAL)	MANUFACTURER/MODEL	NOTES
\$P	WALL MOUNTED SWITCH/OCCUPANCY SENSOR LINE VOLTAGE - SINGLE RELAY	PASSIVE INFRARED	ON: MANUAL OFF: 30 MINUTE DELAY	WATTSTOPPER CS-50	1,2
\$PD	WALL MOUNTED SWITCH/OCCUPANCY SENSOR LINE VOLTAGE - SINGLE RELAY - WITH DIMMING	DUAL TECHNOLOGY	ON: MANUAL OFF: 30 MINUTE DELAY TIME SCROLL: UP WARNING FLASH/SOUND: ON/ON	WATTSTOPPER DW-311	1,2
\$TS	WALL MOUNTED DIGITAL TIMER SWITCH LINE VOLTAGE - SINGLE RELAY	NONE	ON: MANUAL OFF: 2 HOUR DELAY TIME SCROLL: UP	WATTSTOPPER TS-400	1,2
\$L#	WALL MOUNTED LIGHTING SYSTEM ON/OFF SWITCH # INDICATES QUANTITY OF ZONES CONTROLLED AT EACH LOCATION	-	-	PER SUBMITTAL	1,2
\$D#	WALL MOUNTED LIGHTING SYSTEM DIMMER SWITCH # INDICATES QUANTITY OF ZONES CONTROLLED AT EACH LOCATION	-	-	PER SUBMITTAL	1,2
◇	CEILING MOUNTED LIGHTING SYSTEM OCCUPANCY SENSOR	PASSIVE INFRARED	-	PER SUBMITTAL	1,3,4
◇DT	CEILING MOUNTED LIGHTING SYSTEM OCCUPANCY SENSOR	DUAL TECHNOLOGY	-	PER SUBMITTAL	1,3,4

NOTE 1: THE MANUFACTURERS AND MODELS LISTED ARE THE BASIS OF DESIGN, ALL PRODUCT SUBSTITUTIONS SUBMITTED MUST BE APPROVED AS EQUAL. REFER TO DRAWINGS FOR QUANTITIES.

NOTE 2: ALL WALL MOUNTED LIGHTING CONTROLS MUST HAVE MATCHING FINISHES TO THOSE LISTED IN SPECIFICATION SECTION 262726 - WIRING DEVICES.

NOTE 3: OCCUPANCY SENSOR LOCATIONS SHOWN ON FLOOR PLANS ARE GENERIC, CONTRACTOR TO MODIFY LOCATIONS AS REQUIRED BASED COVERAGE CAPABILITIES OF SUBMITTED PRODUCTS.

NOTE 4: MODIFY LOCATIONS OF CEILING MOUNTED OCCUPANCY SENSORS AS REQUIRED SO THAT NO OCCUPANCY SENSOR IS WITHIN 4'-0" OF AN HVAC SUPPLY DIFFUSER.

LIGHT FIXTURE SCHEDULE						
TYPE	DESCRIPTION	MOUNTING	LAMP	VOLTS	MANUFACTURER	V-A
A	2x4' RECESSED BACK LIT FLAT PANEL. INTEGRAL 0-10V DIMMING DRIVER. ADJUSTABLE LUMEN OUTPUT ON FIXTURE	RECESSED GRID	LED 4900 LUMENS (DELIVERED) 3500K 80 CRI	UNV	WILLIAMS SERIES BP GE CURRENT LPL LITHONIA CPX SIGNIFY FLUX PANEL OR PRE-BID APPROVED EQUAL	50
B	4' OPEN APERTURE LED DOWNLIGHT WITH SEMI-SPECULAR LOW IRIDESCENT REFLECTOR. INTEGRAL DRIVER, PAINTED WHITE TRIM FLANGE. PROVIDE WITH 0-10V DIMMING DRIVER UL LISTED FOR WET LOCATIONS, HIGH AMBIENT TEMP.	RECESSED	LED 1,000 LUMENS (DELIVERED) 3500K 80 CRI	UNV	PATHWAY LIGHTING SERIES 4LB79V V LITHONIA LDN4 LIGHTOLIER SERIES LYTEPROFILE INTENSE SD4DR HE WILLIAMS 4DR	15
C	8" ROUND X 17" TALL, HARD STEM MOUNTED CYLINDER. 60 DEG DISTRIBUTION. FADE TO BLACK DMX DIMMING DRIVER. BLACK FINISH. FACE OF FIXTURE TO BE FLUSH WITH BOTTOM OF STRUCTURE.	PENDANT	LED 7,300 LUMENS (DELIVERED) 3500K 90 CRI	UNV	TIMES SQUARE CELESTE METEOR ATRIA 6	82
C2	SAME AS TYPE 'C' EXCEPT WITH 33 DEG DISTRIBUTION.	PENDANT	LED 7,700 LUMENS (DELIVERED) 3500K 90 CRI	UNV	TIMES SQUARE CELESTE METEOR ATRIA 6	82
C3	SAME AS TYPE 'C' EXCEPT RECESSED AND FLANGED CAN LIGHT. PROVIDE WITH SLOPED CEILING ADAPTER. BLACK FLANGE FINISH. CONFIRM WITH ARCHITECT.	PENDANT	LED 8,000 LUMENS (DELIVERED) 3500K 90 CRI	UNV	METEOER REV 6 GOTHAM EVO 6	82
C4	SAME AS TYPE 'C' EXCEPT WITH 40 DEG DISTRIBUTION AND WITH RGB COLOR CHANGING OUTPUT	PENDANT	LED	UNV	METOER ATRIA 4 TIMES SQUARE CELESTRE COLOR MIX	35
F	4'-0" LED STRIP LIGHT WITH WIRE GUARD. SQUARE LENS. INTEGRAL DRIVER. WHITE FINISH. 0-10V DIMMING DRIVER.	CHAIN HANG TO 8'-0" AFF UNLESS NOTED	90 CRI LED 3,000 LUMENS (DELIVERED) 3500K	UNV	OR PRE-BID APPROVED EQUAL WILLIAMS T5 SERIES LITHONIA Z SERIES DAY-BRITE FLUX STREAM STRIP COLUMBIA CSL	33
F2	SAME AS TYPE 'F' EXCEPT WITH LUMEN PACKAGE AS NOTED. NO WIRE GUARD. AIR CRAFT CABLE MOUNT. BLACK FINISH.	PEDANT	LED 8,000 LUMENS (DELIVERED) 3500K	UNV	OR PRE-BID APPROVED EQUAL WILLIAMS T5 SERIES LITHONIA Z SERIES DAY-BRITE FLUX STREAM STRIP COLUMBIA CSL	57
F3	SAME AS TYPE 'F' EXCEPT WALL MOUNTED. NO WIRE GUARD. BLACK FINISH.	WALL AT 8'-0"	LED 3,000 LUMENS (DELIVERED) 3500K	UNV	OR PRE-BID APPROVED EQUAL WILLIAMS T5 SERIES LITHONIA Z SERIES DAY-BRITE FLUX STREAM STRIP COLUMBIA CSL	33
G	LED EXTERIOR WEDGE TYPE WALL PACK. TYPE 3 DISTRIBUTION. COORDINATE FINISH AND MOUNTING HEIGHT WITH ARCHITECT.	WALL	LED 3,200 LUMEN (DELIVERED) 4000K 70 CRI	277	LITHONIA WEDGE2 GARCOO GWS	32
X	EDGE LIT EXIT SIGN RED LETTERING. ALUMINUM TRIM. PROVIDE ARROWS AS NOTED ON DRAWINGS, AND SINGLE OR DOUBLE SIDED AS NEEDED AND SHOWN ON DRAWINGS. PROVIDE TOP, BACK, OR SIDE MOUNT HARDWARE AS REQUIRED BY ARCHITECTURAL CONDITIONS. BATTERY CAPABLE OF 90 MINUTES OF EMERGENCY OPERATION.	SURFACE	LED	UNV	OR PRE-BID APPROVED EQUAL DUAL LITE LES SERIES LITHONIA EDGE LIT EXIT EVENLITE TEX EMERGLITE TOTAL EDGE OR PRE-BID APPROVED EQUAL	5

NOTE: PROVIDE FIXTURES DESIGNATED WITH AN X ON PLAN WITH 1200 LUMEN (OR MAX FIXTURE OUTPUT) MINIMUM 90MINUTE EMERGENCY BATTERY BACKUP UNLESS WHERE PROVIDED WITH INVERTER, REFER TO PLANS.

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1828 Walnut Street Suite 922
Kansas City, MO 64108
1.816.442.7700

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Castle Rock, CO 80104
1.720.949.1689

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Holla + Miller Architects
Missouri State Certificate of Authority
Architecture # 0002181
Structure # 2009031331

Bob D Campbell
Structural Engineer
State Certificate of Authority #000442
4338 Bellview Ave.
Kansas City, MO 64111
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Mechanical, Electrical & Plumbing
State Certificate of Authority #EGC000178
29615 W 103rd Street
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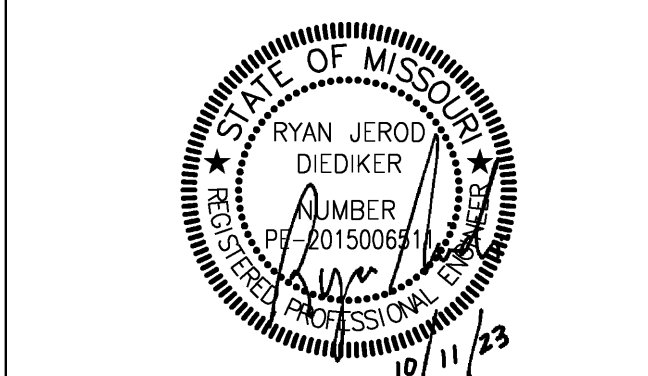
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14827 West 95th St.
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South Valley Middle School Storm Shelter Addition
Liberty School District
1000 Midjay Dr, Liberty, MO 64068

Conformed Construction Documents

REVISIONS:		
#	Description	Date
5	ADDENDUM 05	10-06-2023



JOB NO: 23019
DRAWN BY: SBI
CHECKED BY: RJD
DATE: 10.11.2023

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engineers


25618 west 103rd st. olathe, ks 66061
phone 913.345.2127 fax 913.345.0617
project number 2314703

E302

PROJECT NAME: 2314703 - 03-20-23 South Valley Middle School Storm Shelter Addition
AUTOCAD FILE LOCATION: \\NAME: X:\2314703\Drawings\06-2314703-E303.dwg
LAST CORRECTION BY: DATE: TIME: Bosty, Charles
PLOTED BY: DATE: TIME: Wednesday, October 11, 2023 9:25:30 AM

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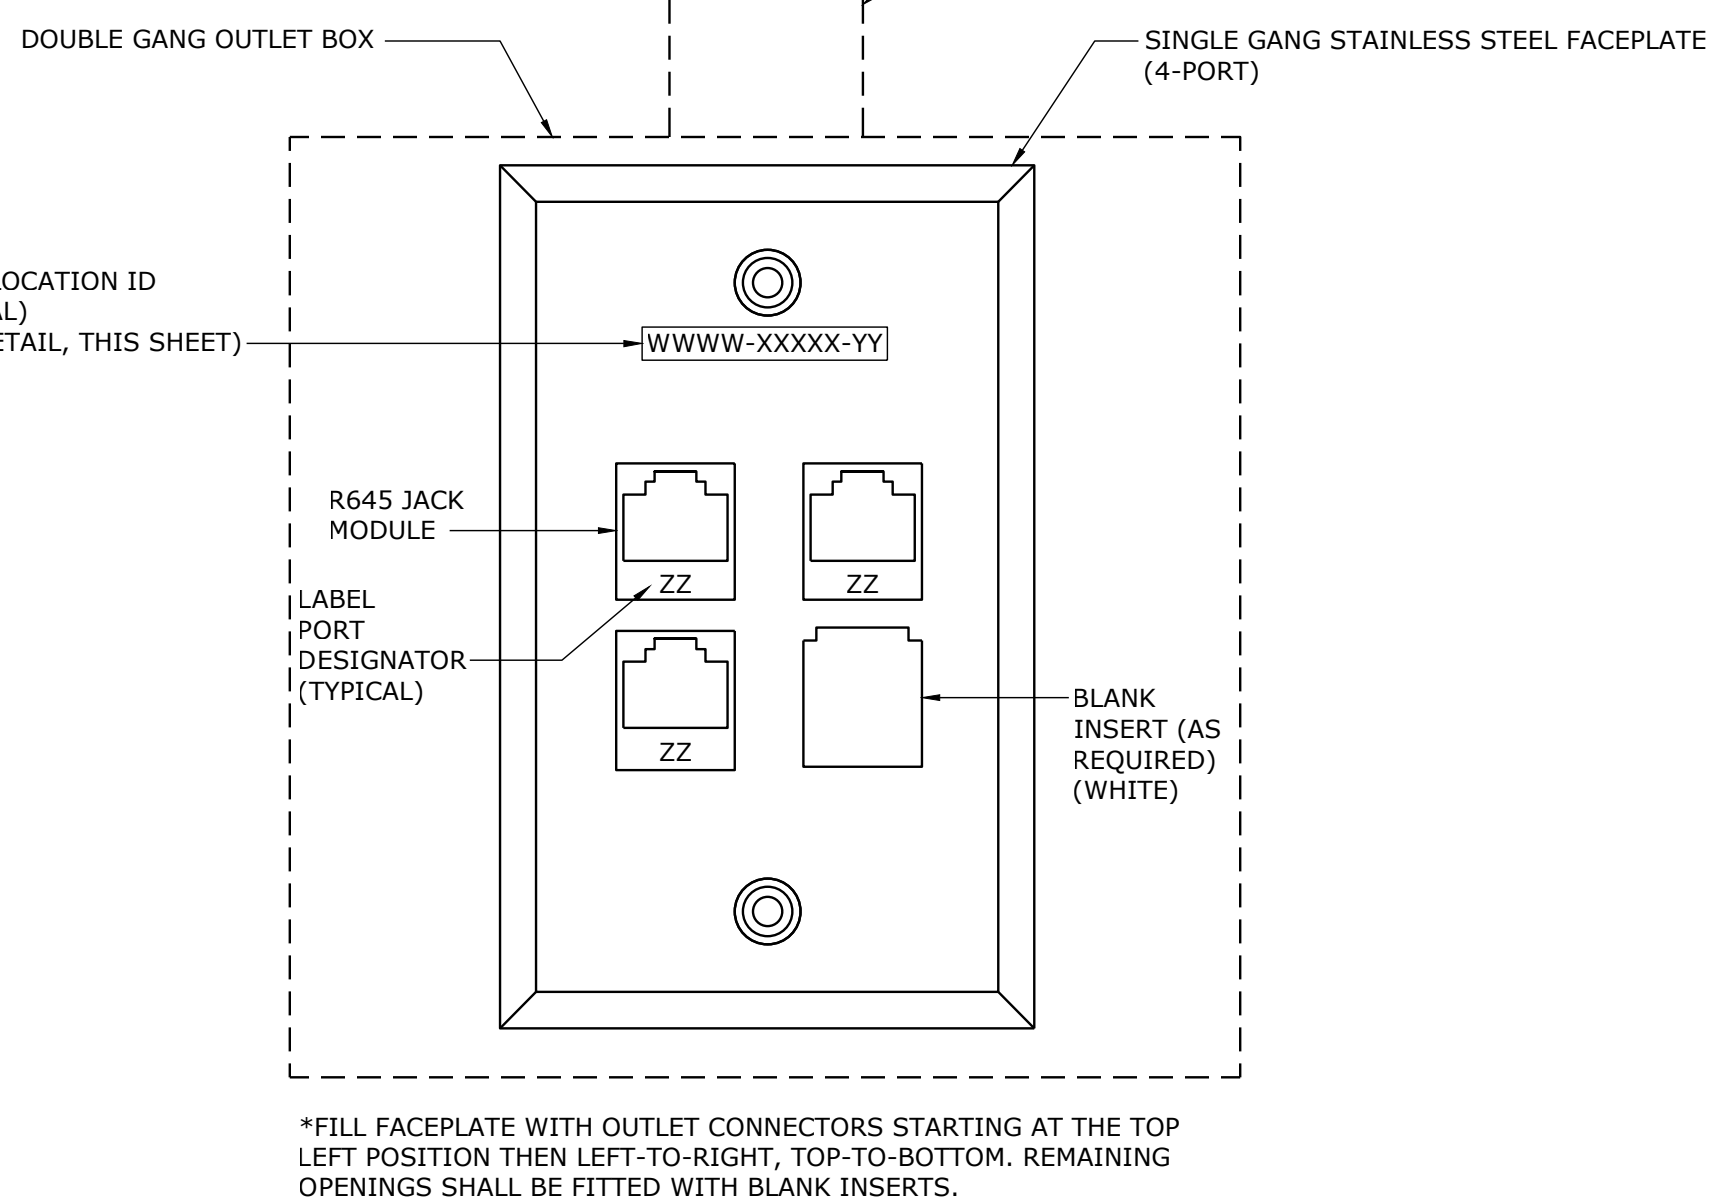
System No. W-L-3256
F Ratings - 1 and 2 Hr (See Item 1)
T Ratings - 1, 1-1/4 and 1-3/4 Hr (See Item 2)
L Rating At Ambient - Less Than 1 or 1.4 CFM
(See Item 3)
L Rating At 400 F - Less Than 1 or 1.4 CFM
(See Item 3)

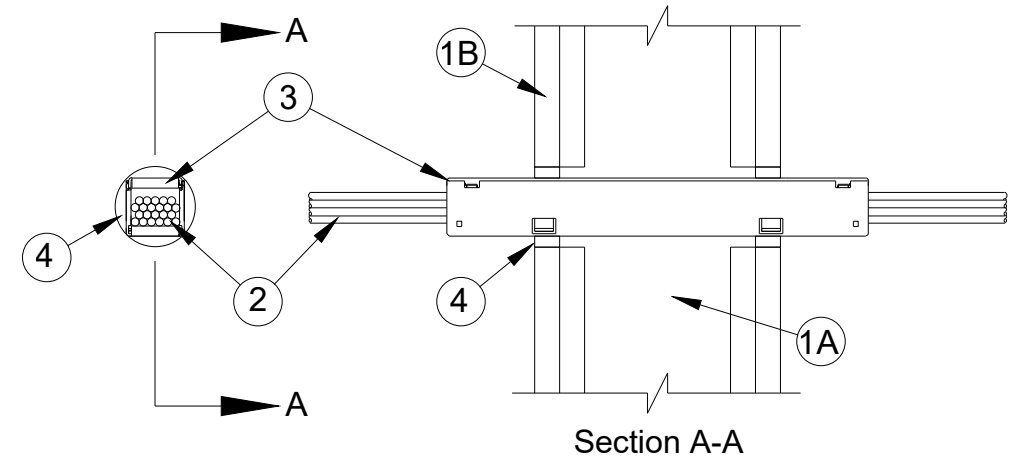

1. Wall Assembly - The 1 or 2 hr fire-rated gypsum board/stud wall assembly shall be constructed of the materials and in the manner described within the individual U300, U400 or V400 Series Wall or Partition Designs in the UL Fire Resistance Directory and shall incorporate the following construction features:
A. Studs - Wall framing shall consist of either wood studs or steel channel studs. Wood studs to consist of nominal 2 by 4 in. (51 by 102 mm) lumber spaced max 16 in. (406 mm) OC. Steel studs to be min 3 1/2 in. (89 mm) wide and spaced max 24 in. (605 mm) OC.
B. Gypsum Board* - Thickness, type, number of layers and fasteners as specified in the individual Wall and Partition Design. Opening in gypsum board to accommodate firestop device to be max 3 in. (76 mm) wide by max 2 1/2 in. (64 mm) high, or nom 2 in. (51 mm) diameter. The hourly F Rating of the firestop system is dependent upon the hourly rating of the wall in which it is installed.
C. Firestop Device* - Firestop device consists of a 1.4 by 1.4 by 10 1/2 in. (36 by 36 by 267 mm) long galv steel tube with an intumescent material lining. Firestop device to be installed in accordance with the accompanying installation instructions. Prior to installation - within wall, lid removed from device to capture grouped cables. After wall such that lid is on top and ends project an equal distance from the - approximate - exterior of the wall assembly. The space between the device - and the periphery of the opening shall be min 0 in. (0 mm, point contact) to max 1/2 in. (13 mm).
SPECIFIED TECHNOLOGIES INC. - EZ PATH Series 22 Fire - Rated Pathway
*Bearing the UL Classification Mark
2. Cables - Within the loading area for each firestop device module, the cables may represent a 0 to 100 percent visual fill. Cable fill to be distributed at a uniform height across the width of the firestop device module. Cables to be rigidly supported on both sides of the wall assembly. Any combination of the following types of cables may be used:
A. Max four per No. 22 AWG (or smaller) copper conductor data cable with polyvinyl chloride (PVC) or plenum rated jacketing and insulation.
B. Max RGL2 coaxial cable with fluorinated ethylene insulation and jacketing.
C. Fiber optic cable with polyvinyl chloride (PVC) or polyethylene (PE) jacket and insulation having a max diam of 1/4 in. (6 mm). The T Rating is 1 hr and 1-3/4 hr in 1 hr and 2 hr rated walls, respectively, when no cables are installed in firestop device. The T Rating is 1 hr and 1-3/4 hr in 1 hr and 2 hr rated walls, respectively, when cables are installed in firestop device.
The L Rating for the empty firestop device is less than 1.4 cfm at ambient and at 400F. When Item 3A is used, the L Rating with 100 percent visual fill of cable is less than 1 cfm at ambient and at 400F.
3. Firestop Device* - Firestop device consists of a 1.4 by 1.4 by 10 1/2 in. (36 by 36 by 267 mm) long galv steel tube with an intumescent material lining. Firestop device to be installed in accordance with the accompanying installation instructions. Prior to installation - within wall, lid removed from device to capture grouped cables. After wall such that lid is on top and ends project an equal distance from the - approximate - exterior of the wall assembly. The space between the device - and the periphery of the opening shall be min 0 in. (0 mm, point contact) to max 1/2 in. (13 mm).
SPECIFIED TECHNOLOGIES INC. - EZ PATH Series 22 Fire - Rated Pathway
*Bearing the UL Classification Mark
4. Fill, Void or Cavity Material* - Sealant - Min 5/8 in. (16 mm) thickness of sealant to be applied in annular space between firestop device and periphery of opening on each side of wall assembly. Nom 3/8 in. (10 mm) diam bead of fill material applied at the point contact location between the firestop device and gypsum board wall on both sides of the wall assembly.
SPECIFIED TECHNOLOGIES INC. - SpecSeal 100, 101, 102, 105, 120 or 129 Sealant, SpecSeal LC1 Sealant, SpecSeal LC150 Sealant, Reveal 300 Sealant or SpecSeal Series 50-300 Sealant
*Bearing the UL Classification Mark


TELECOMMUNICATIONS CABLING AT FIRE WALL PENETRATIONS

NOT TO SCALE




WALL MOUNTED PHONE/DATA OUTLET

NO SCALE

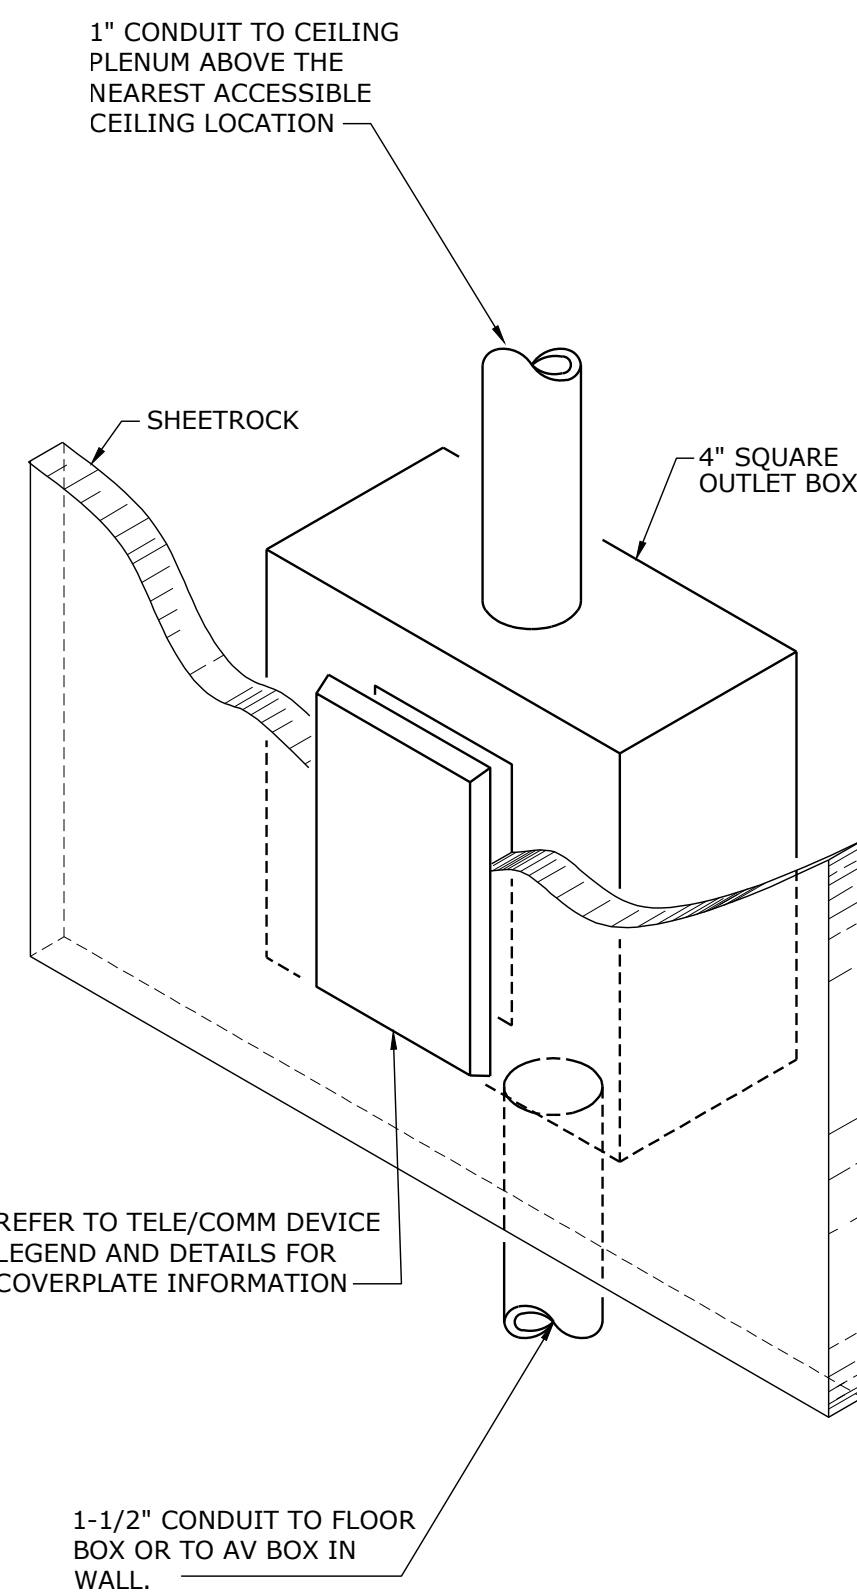

TV OUTLET DETAIL


NOT TO SCALE

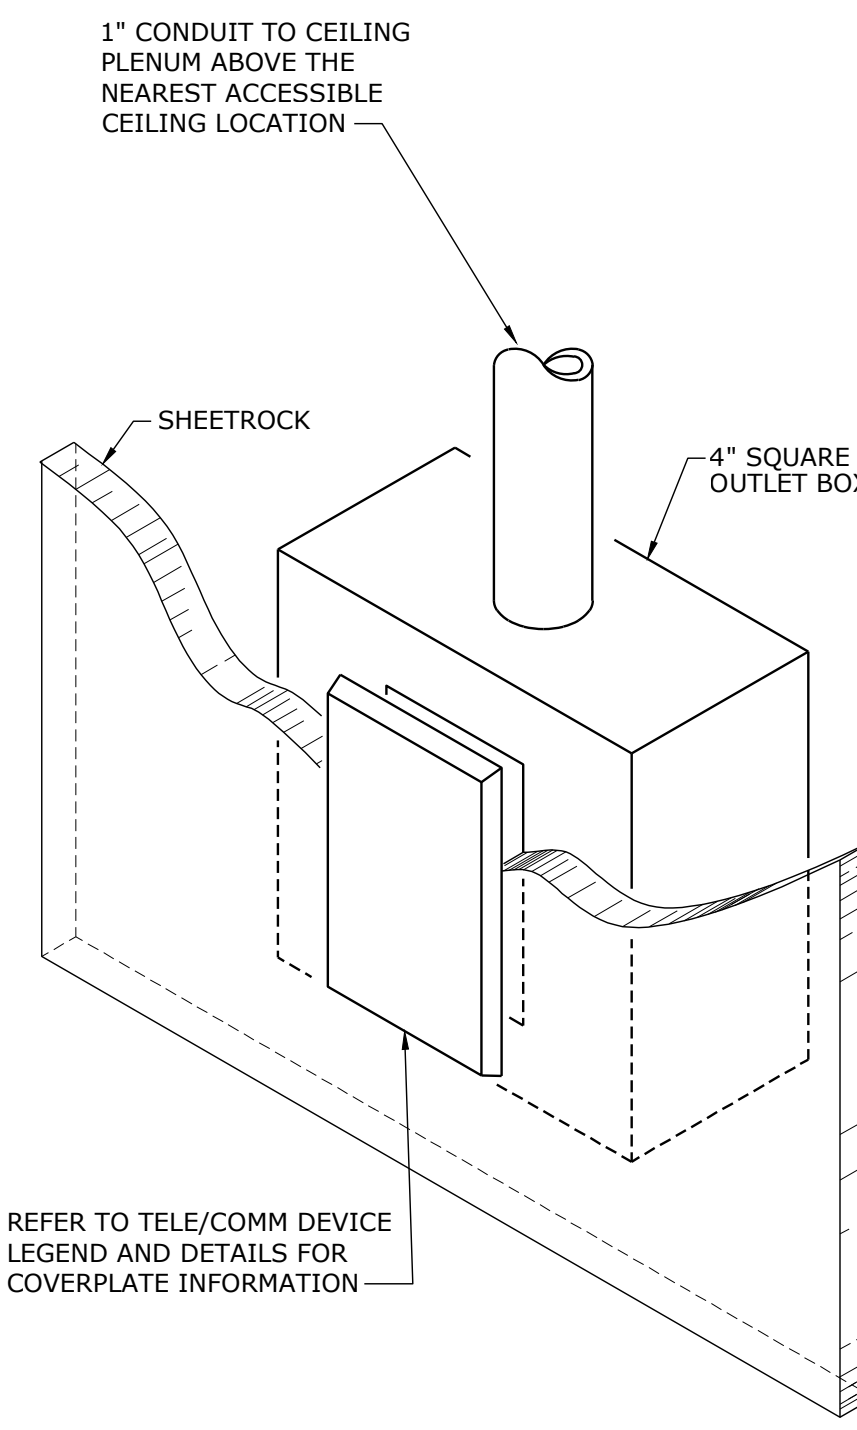

TELE/DATA OUTLET ROUGH-IN DETAIL


NOT TO SCALE

GROUND BUS ASSEMBLY:
1/4" X 2" X 20" COPPER GROUND BAR WITH (12) 5/16" PAIRS AND (3) 7/16" PAIRS ON 1-1/8" CENTERS.
1-3/8" STAND-OFF INSULATORS WITH 3/8: 16 HARDWARE.
GALVANIZED MOUNTING BRACKETS, 14 GAUGE.
GROUND BUS ASSEMBLY AS MANUFACTURED BY EMI OR EQUAL.

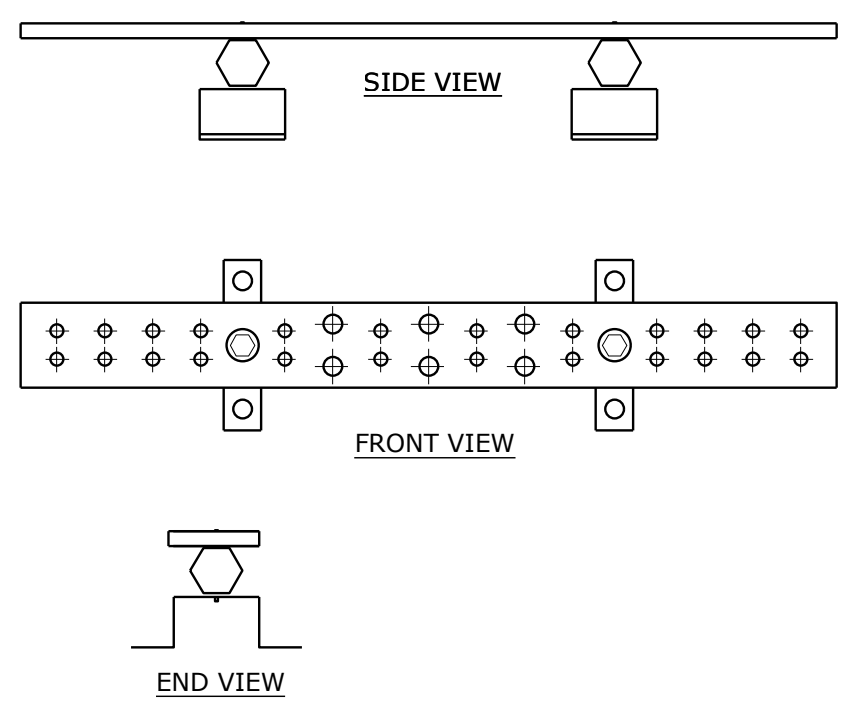

GROUND BUS - REMOTE CLOSETS

NOT TO SCALE

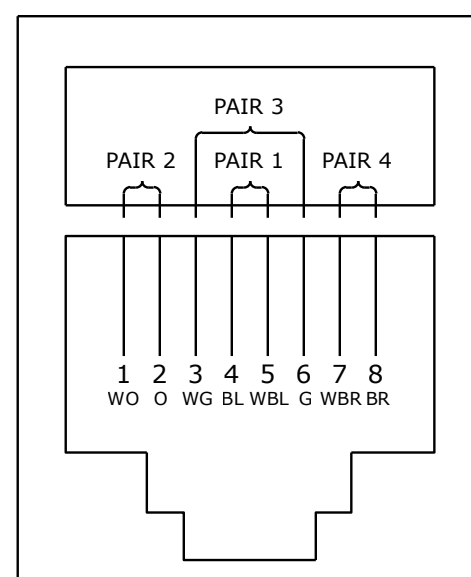


EIGHT POSITION JACK PIN/PAIR ASSIGNMENTS ANSI/TIA/EIA T568B

NOT TO SCALE


SYMBOL	DESCRIPTION (NOTE 1)
▽ #D #DA	WALL MOUNTED DATA OUTLET (#D) DATA CAT6 JACKS AS NOTED ON PLANS (#DA) DATA CAT6A JACKS AS NOTED ON PLANS
WAF #D #DA	WIRELESS ACCESS POINT DATA OUTLET (#D) DATA CAT6 JACKS AS NOTED ON PLANS (#DA) DATA CAT6A JACKS AS NOTED ON PLANS
TV #D #DA	DATA OUTLET FOR TV (#D) DATA CAT6 JACKS AS NOTED ON PLANS (#DA) DATA CAT6A JACKS AS NOTED ON PLANS
■ #D #DA	DATA OUTLET FOR IN FLOOR BOX/POKE THRU (#D) DATA CAT6 JACKS AS NOTED ON PLANS (#DA) DATA CAT6A JACKS AS NOTED ON PLANS
□ #D #DA	SECURITY CAMERA DATA OUTLET (#D) DATA CAT6 JACKS AS NOTED ON PLANS (#DA) DATA CAT6A JACKS AS NOTED ON PLANS

NOTES:
1. ALL CABLING ROUTED DIRECTLY TO TELECOMMUNICATIONS ROOM UNLESS SPECIFICALLY NOTED OTHERWISE. REFER TO FLOOR PLANS FOR ADDITIONAL INFORMATION.
2. REFER TO SPECIFICATIONS FOR FURTHER CABLING AND TERMINATION DETAILS.

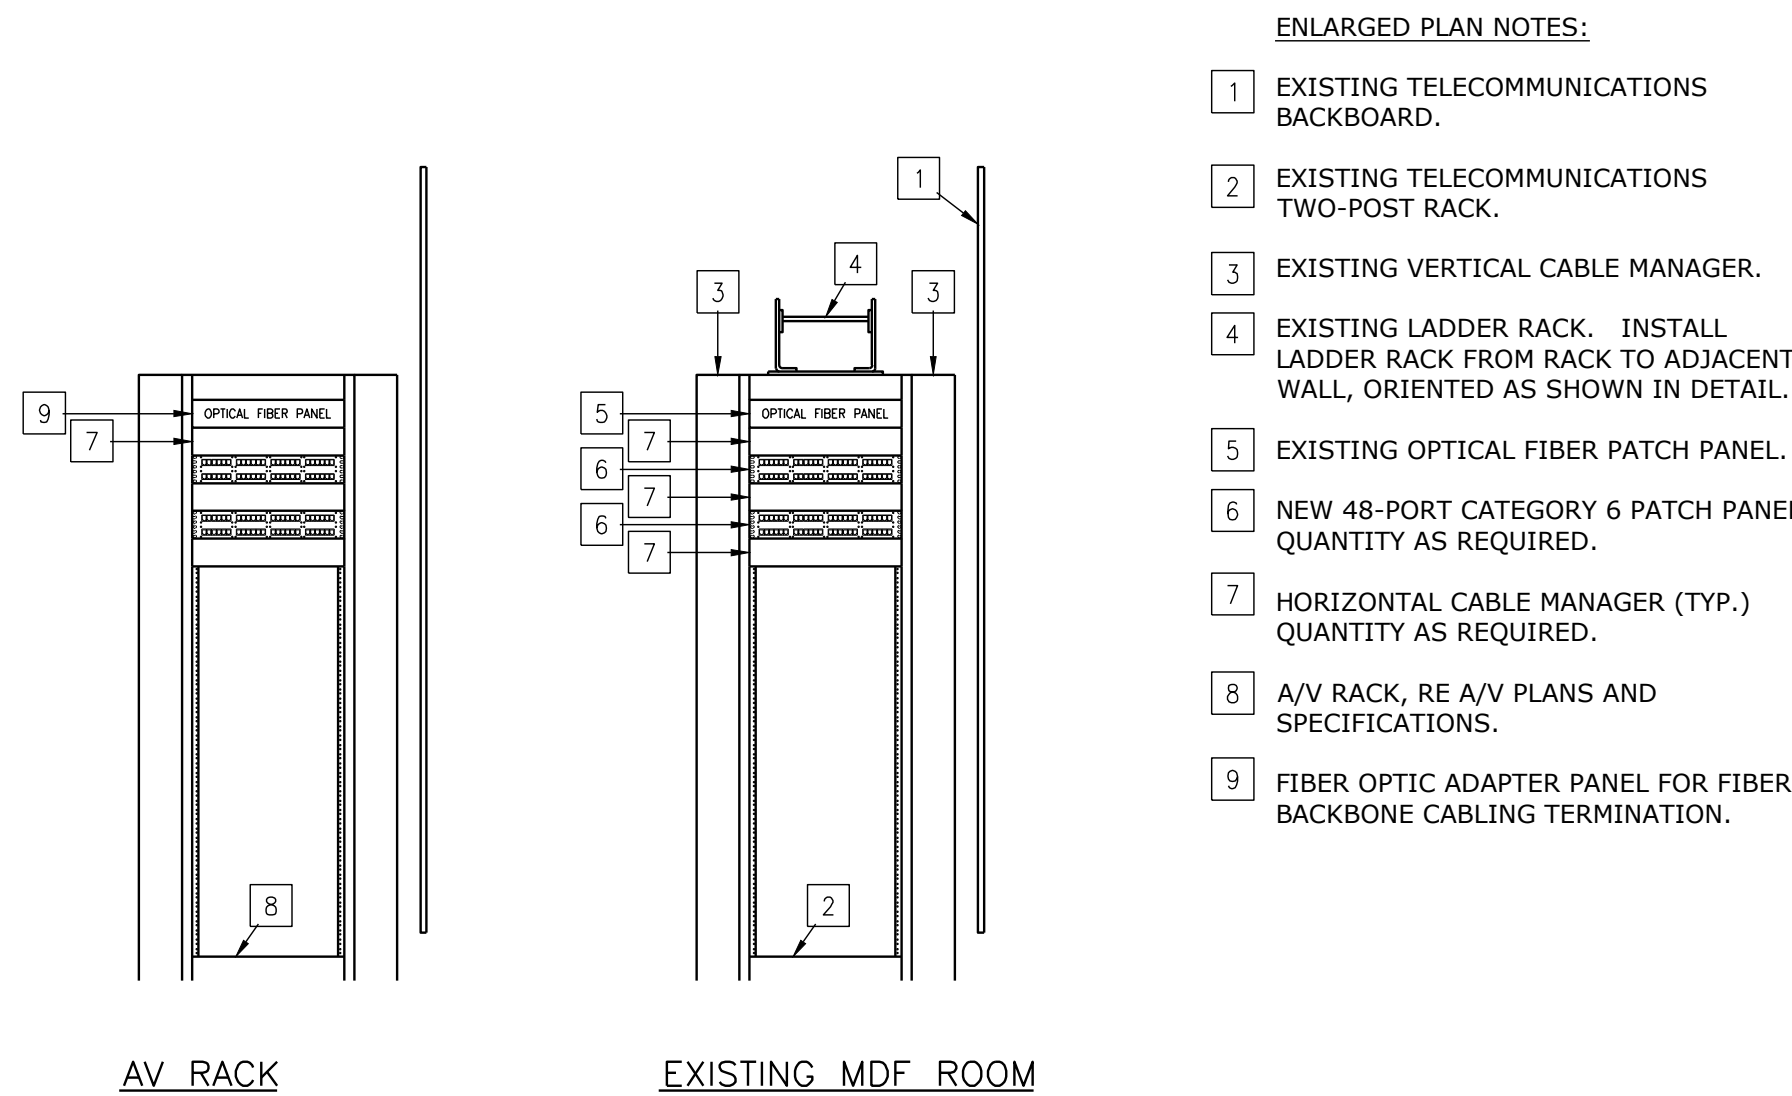



CABLING RACK ELEVATION

NO SCALE

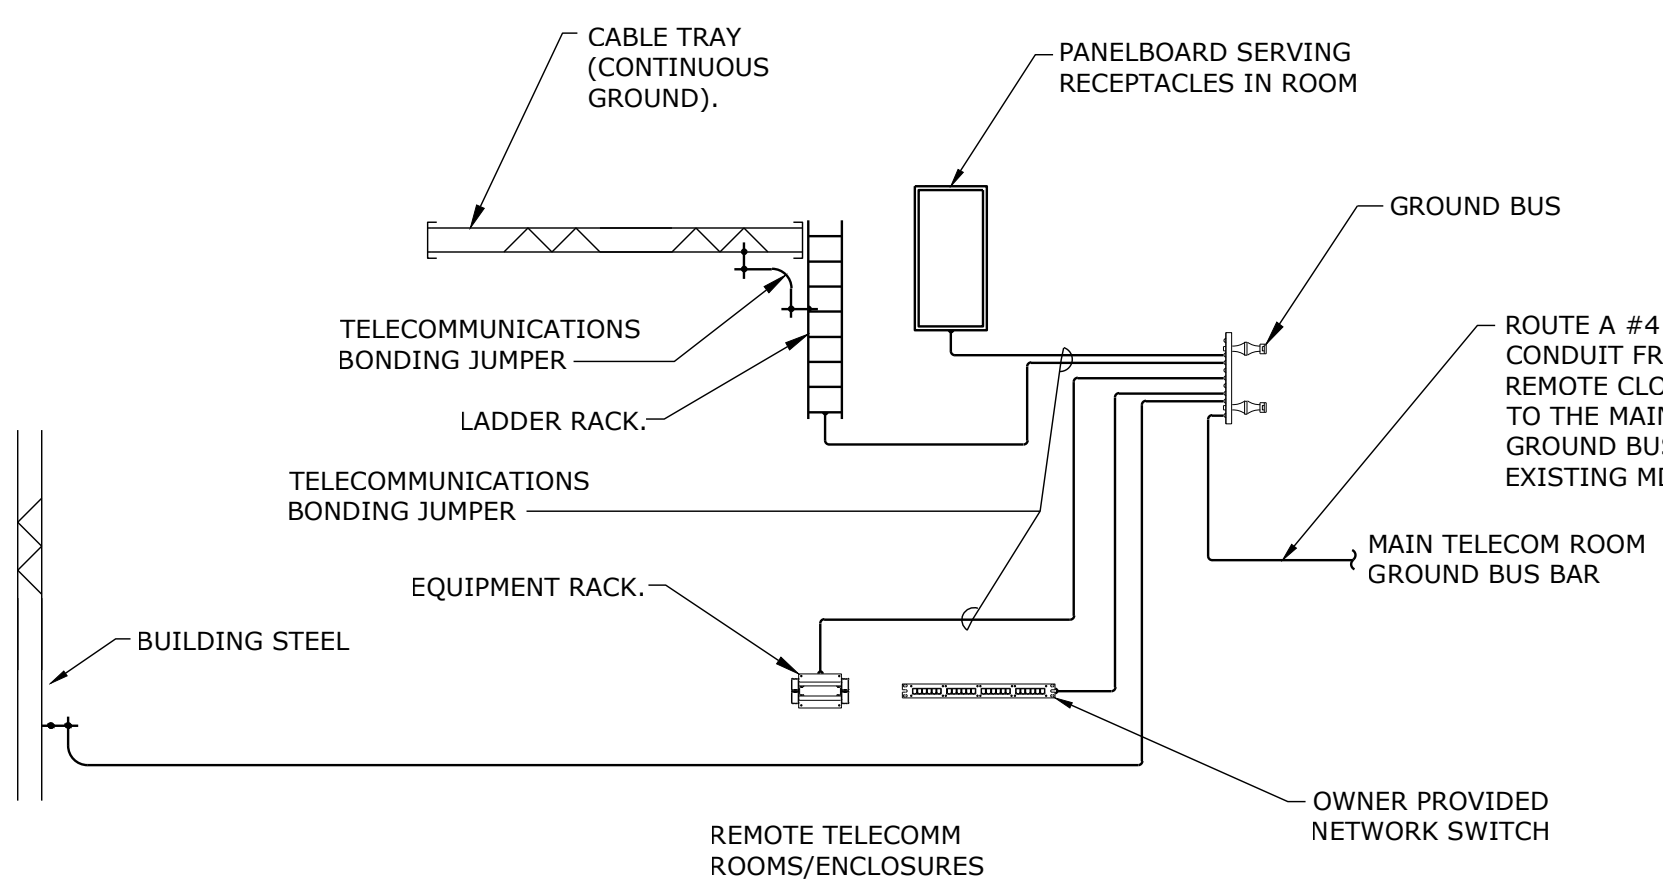

COMMUNICATIONS GROUNDING RISER DIAGRAM

NO SCALE

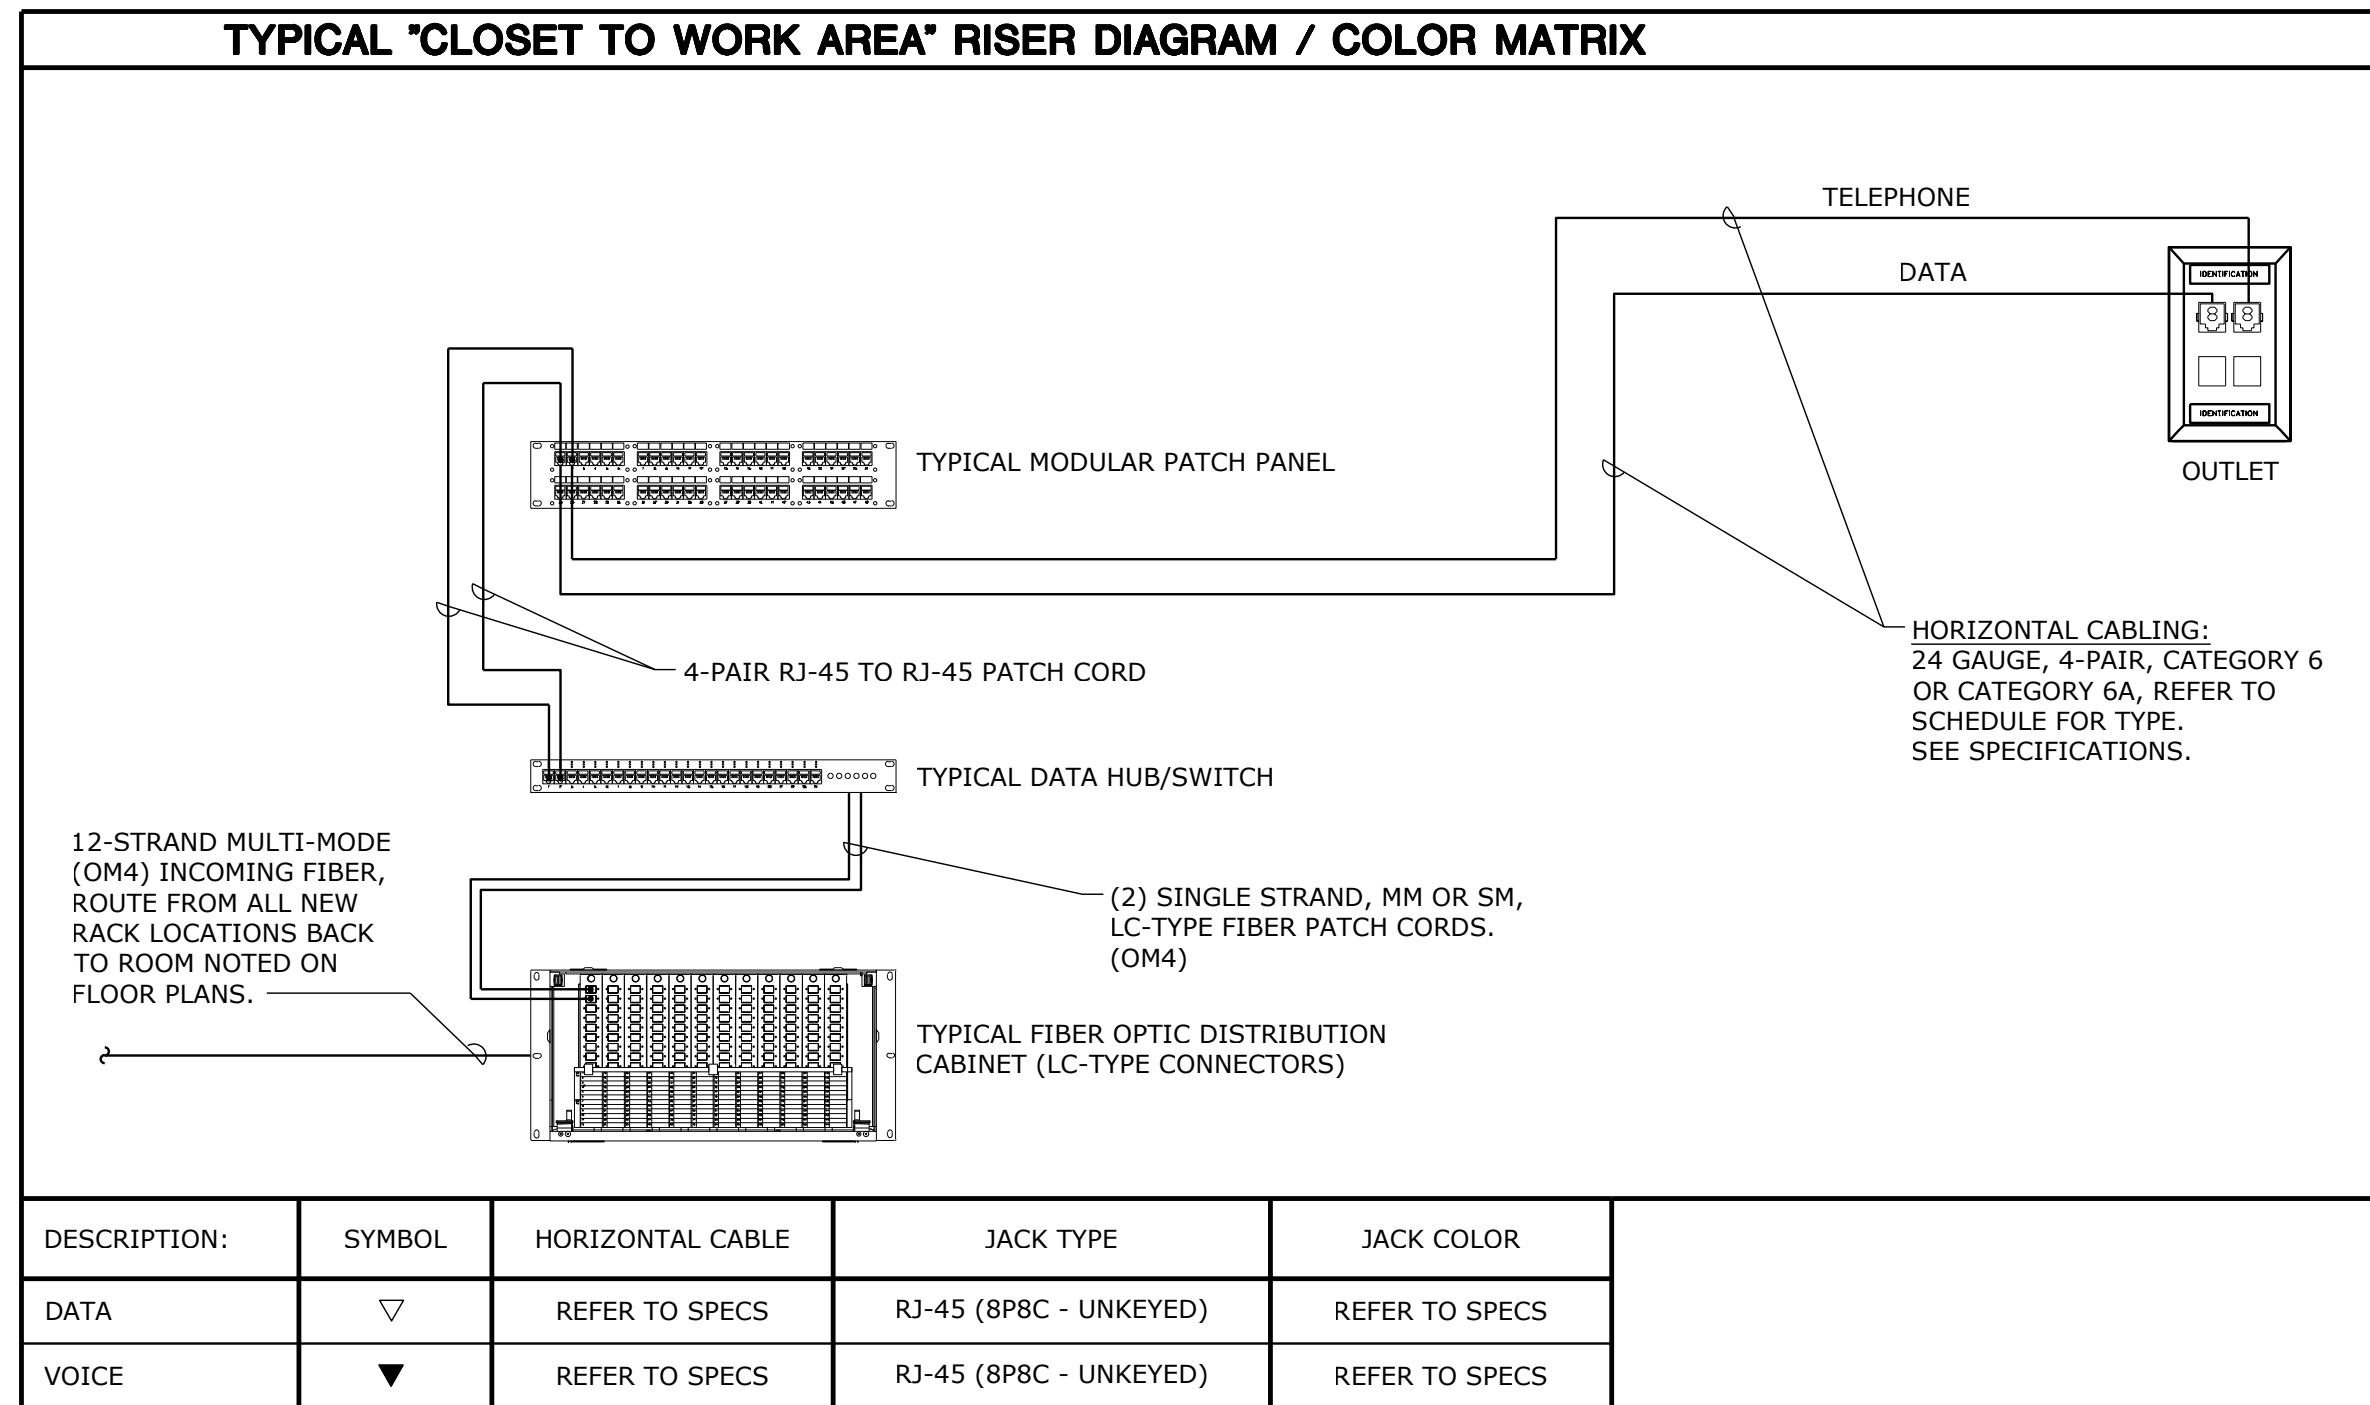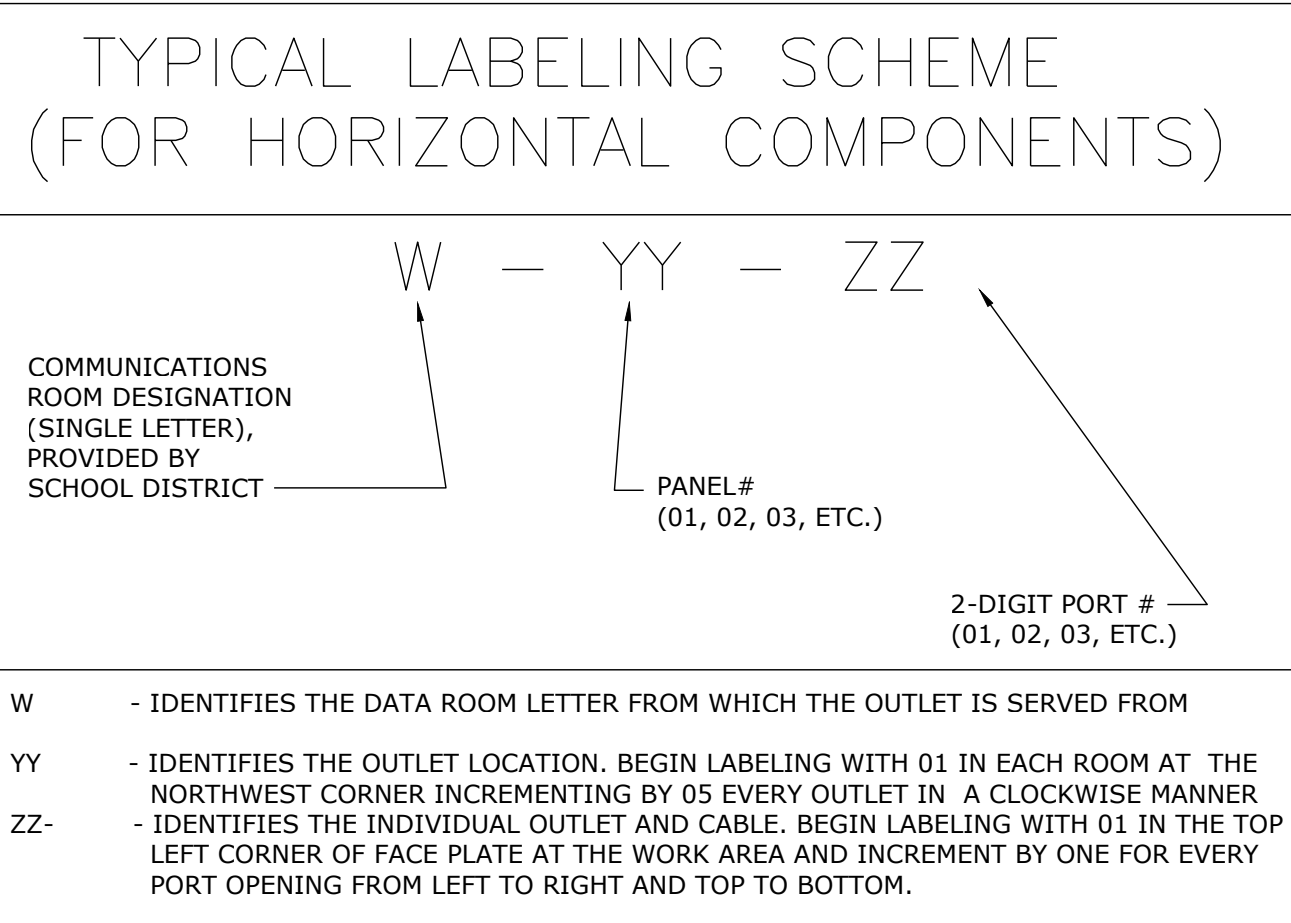

- TELECOMMUNICATIONS INSTALLATION NOTES:
1. THE COMPLETE INSTALLATION SHALL BE IN ACCORDANCE WITH THE A.D.A.A.G. (AMERICANS WITH DISABILITIES ACT ACCESSIBILITY GUIDELINES)
 2. CONCEAL ALL CONDUIT IN WALLS, PARTITIONS, ABOVE CEILING, AND IN FLOOR SLAB, ETC. UNLESS OTHERWISE INDICATED ON THE PLANS OR IN THE SPECIFICATIONS. CONDUIT IN MECHANICAL ROOMS, AND STORAGE ROOMS WITHOUT CEILINGS MAY BE EXPOSED ON BUILDING STRUCTURE.
 3. BOXES LOCATED ON OPPOSITE SIDES OF NON-RATED WALLS SHALL BE OFFSET A MINIMUM OF 6" HORIZONTALLY. BOXES ON OPPOSITE SIDES OF FIRE RATED WALLS SHALL BE OFFSET A MINIMUM OF 24" HORIZONTALLY. "THRU-THE-WALL" BOXES SHALL NOT BE ALLOWED WITHOUT PRIOR WRITTEN APPROVAL OF THE ARCHITECT/ENGINEER.
 4. FLUSH MOUNT ALL TELECOMMUNICATION OUTLETS TO MATCH RECEPTACLE HEIGHTS. EXCEPT WHERE OTHERWISE NOTED, OUTLETS MAY BE SURFACE MOUNTED WHEN CONDUIT IS SPECIFIED EXPOSED.
 5. CONTRACTOR SHALL VERIFY ALL FURNITURE, MODULAR FURNITURE AND EQUIPMENT LOCATIONS WITH ARCHITECTURAL PLANS, ELEVATIONS AND REVIEWED SHOP DRAWINGS. PRIOR TO MAKING THE ACTUAL TELECOMMUNICATIONS INSTALLATION THIS CONTRACTOR SHALL ADJUST OUTLETS OR CONNECTION LOCATIONS TO ACCOMMODATE FURNITURE AND/OR EQUIPMENT.
 6. TELECOMMUNICATIONS EQUIPMENT SHALL BE MOUNTED TO ALLOW ACCESS TO ELECTRICAL AND MECHANICAL EQUIPMENT. ALL MOUNTING OF TELECOMMUNICATION DEVICES ON EQUIPMENT SUPPLIED BY ANOTHER CONTRACTOR SHALL BE APPROVED IN ADVANCE BY THE OTHER CONTRACTOR.
 7. CONTRACTOR SHALL BE RESPONSIBLE FOR ALL OPENINGS REQUIRED IN WALLS. ALL OPENINGS SHALL BE REPAIRED TO MATCH EXISTING BY A QUALIFIED CONTRACTOR AT THE EXPENSE OF THIS CONTRACTOR. ALL CONDUITS THROUGH WALLS SHALL BE GROUTED OR SEALED INTO OPENINGS.
 8. ALL MATERIALS USED TO SEAL PENETRATIONS OF FIRE RATED WALLS AND FLOORS SHALL BE TESTED AND CERTIFIED AS A SYSTEM PER ASTM E814 STANDARDS FOR FIRE TESTS OF THROUGH-PENETRATIONS FIRESTOPS.

smith & boucher
engineers
25618 west 103rd St. olathe, ks 66061
phone 913.345.2127 fax 913.345.0617
project number 2314703

we design the future®
1828 Walnut Street Suite 922
Kansas City, MO 64108
1.816.442.7700
115 Wilcox Street Suite 210
Castle Rock, CO 80104
1.720.949.1689
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Holla + Miller Architects
Missouri State Certificate of Authority
Architecture # 0002181
Structural # 2009031331

Bob D Campbell
Structural Engineer
State Certificate of Authority #000442
4338 Bellview Ave.
Kansas City, MO 64111
913.531.4144 phone

Smith & Boucher Inc.
Mechanical, Electrical & Plumbing
State Certificate of Authority #EGC000178
25618 W 103rd Street
Olathe, KS 66061
913.345.2127 phone


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Civil Engineer
State Certificate of Authority #
Engineering: 2001009364
Landscaping: 2006027139
Surveying: 2006027138
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Overland Park, KS 66210
913.317.9390 phone

Peerbolt Creative
Theatrical Consultant
109 E Pine St
Warrensburg, MO 64093-0752
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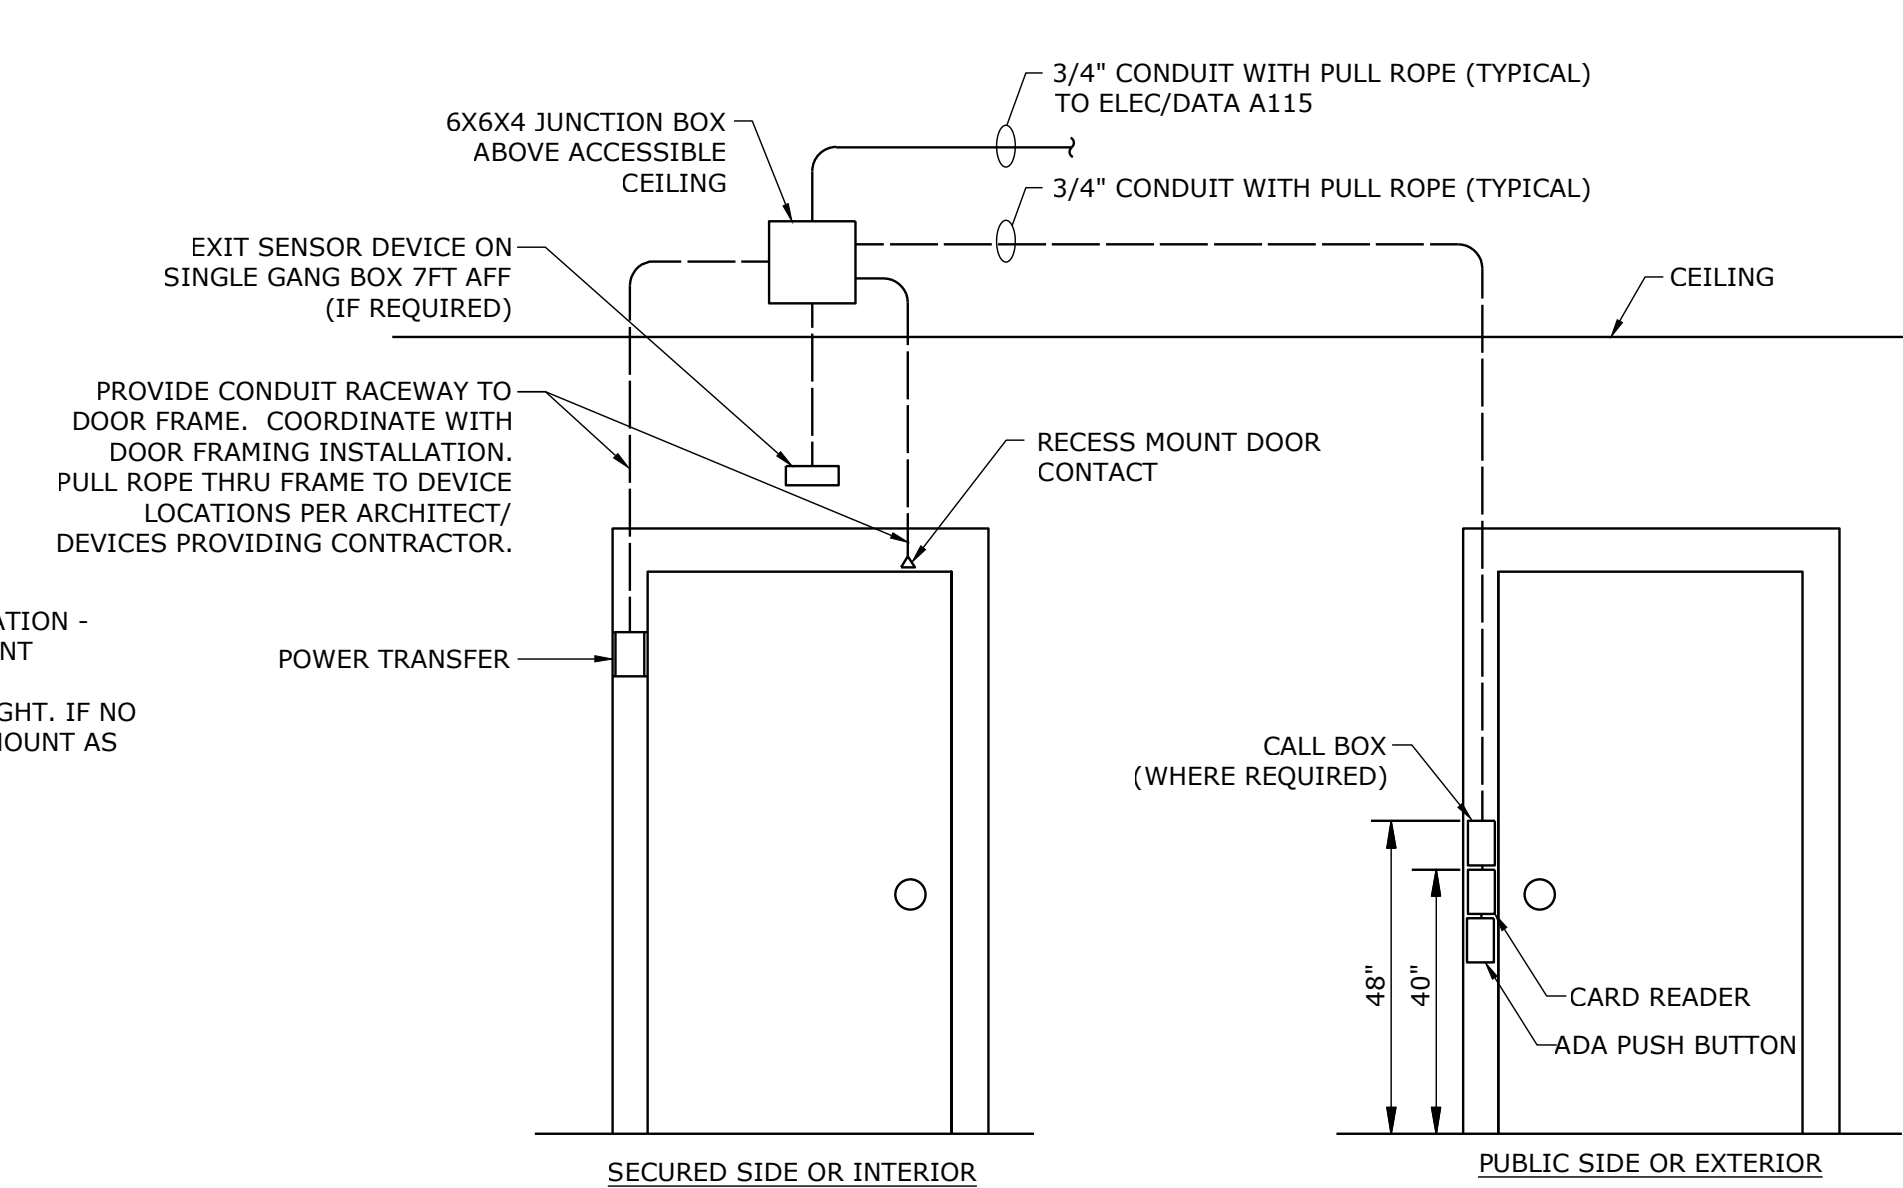
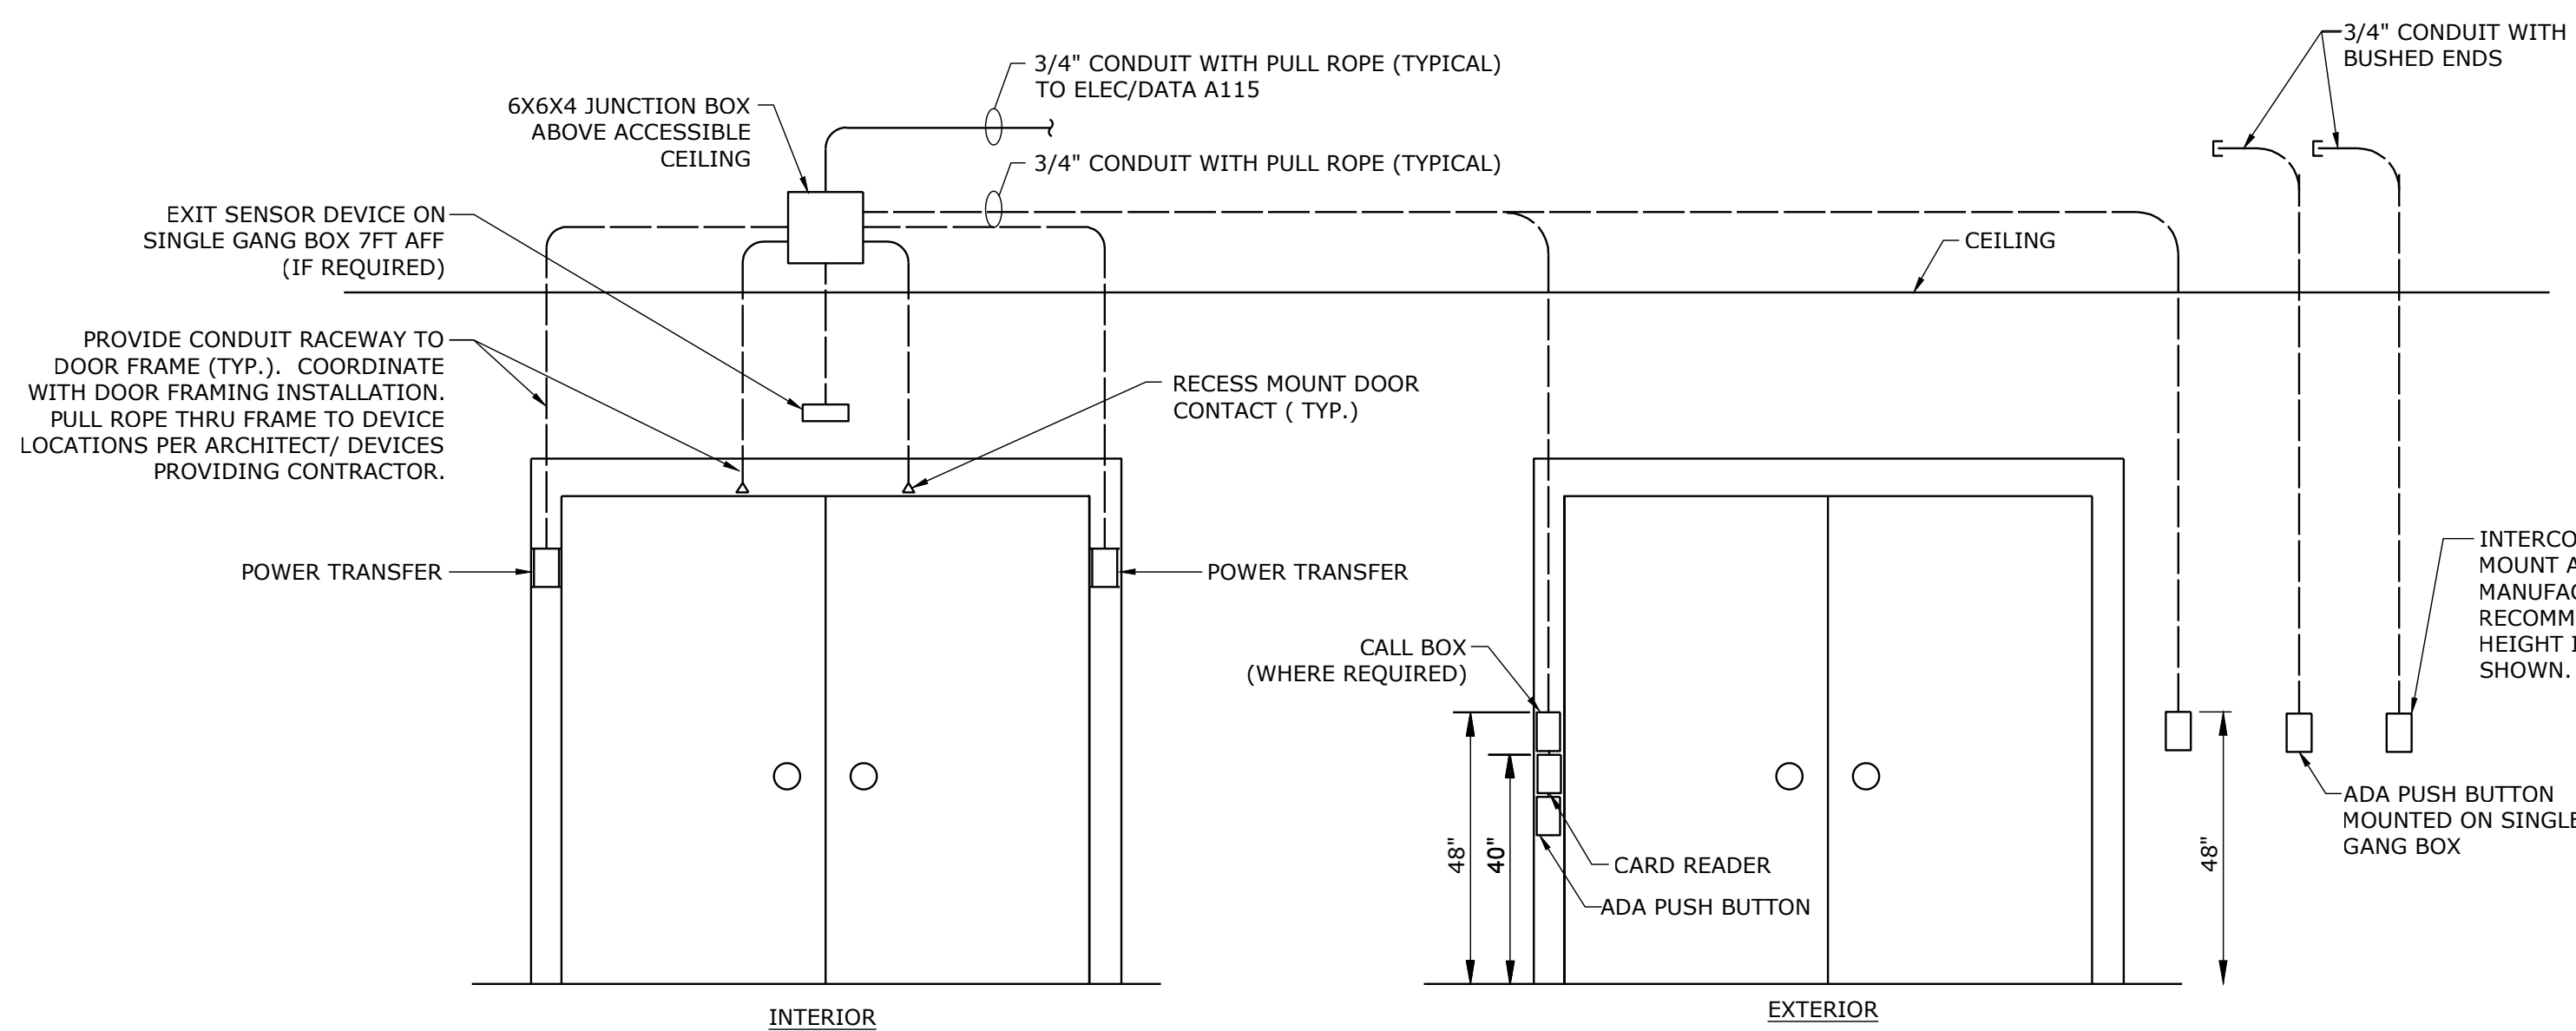
South Valley Middle School Storm Shelter Addition
Liberty School District
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REVISIONS:		
#	Description	Date




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DRAWN BY: SBI
CHECKED BY: RJD
DATE: 10.11.2023

E303

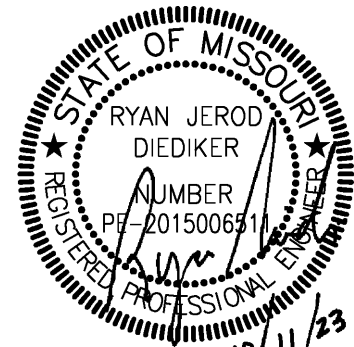


SECURITY DOOR ROUGH-IN - DOUBLE DOOR DETAIL
NOT TO SCALE (SYMBOL CR)

SECURITY DOOR ROUGH-IN - SINGLE DOOR DETAIL
NOT TO SCALE (SYMBOL CR)

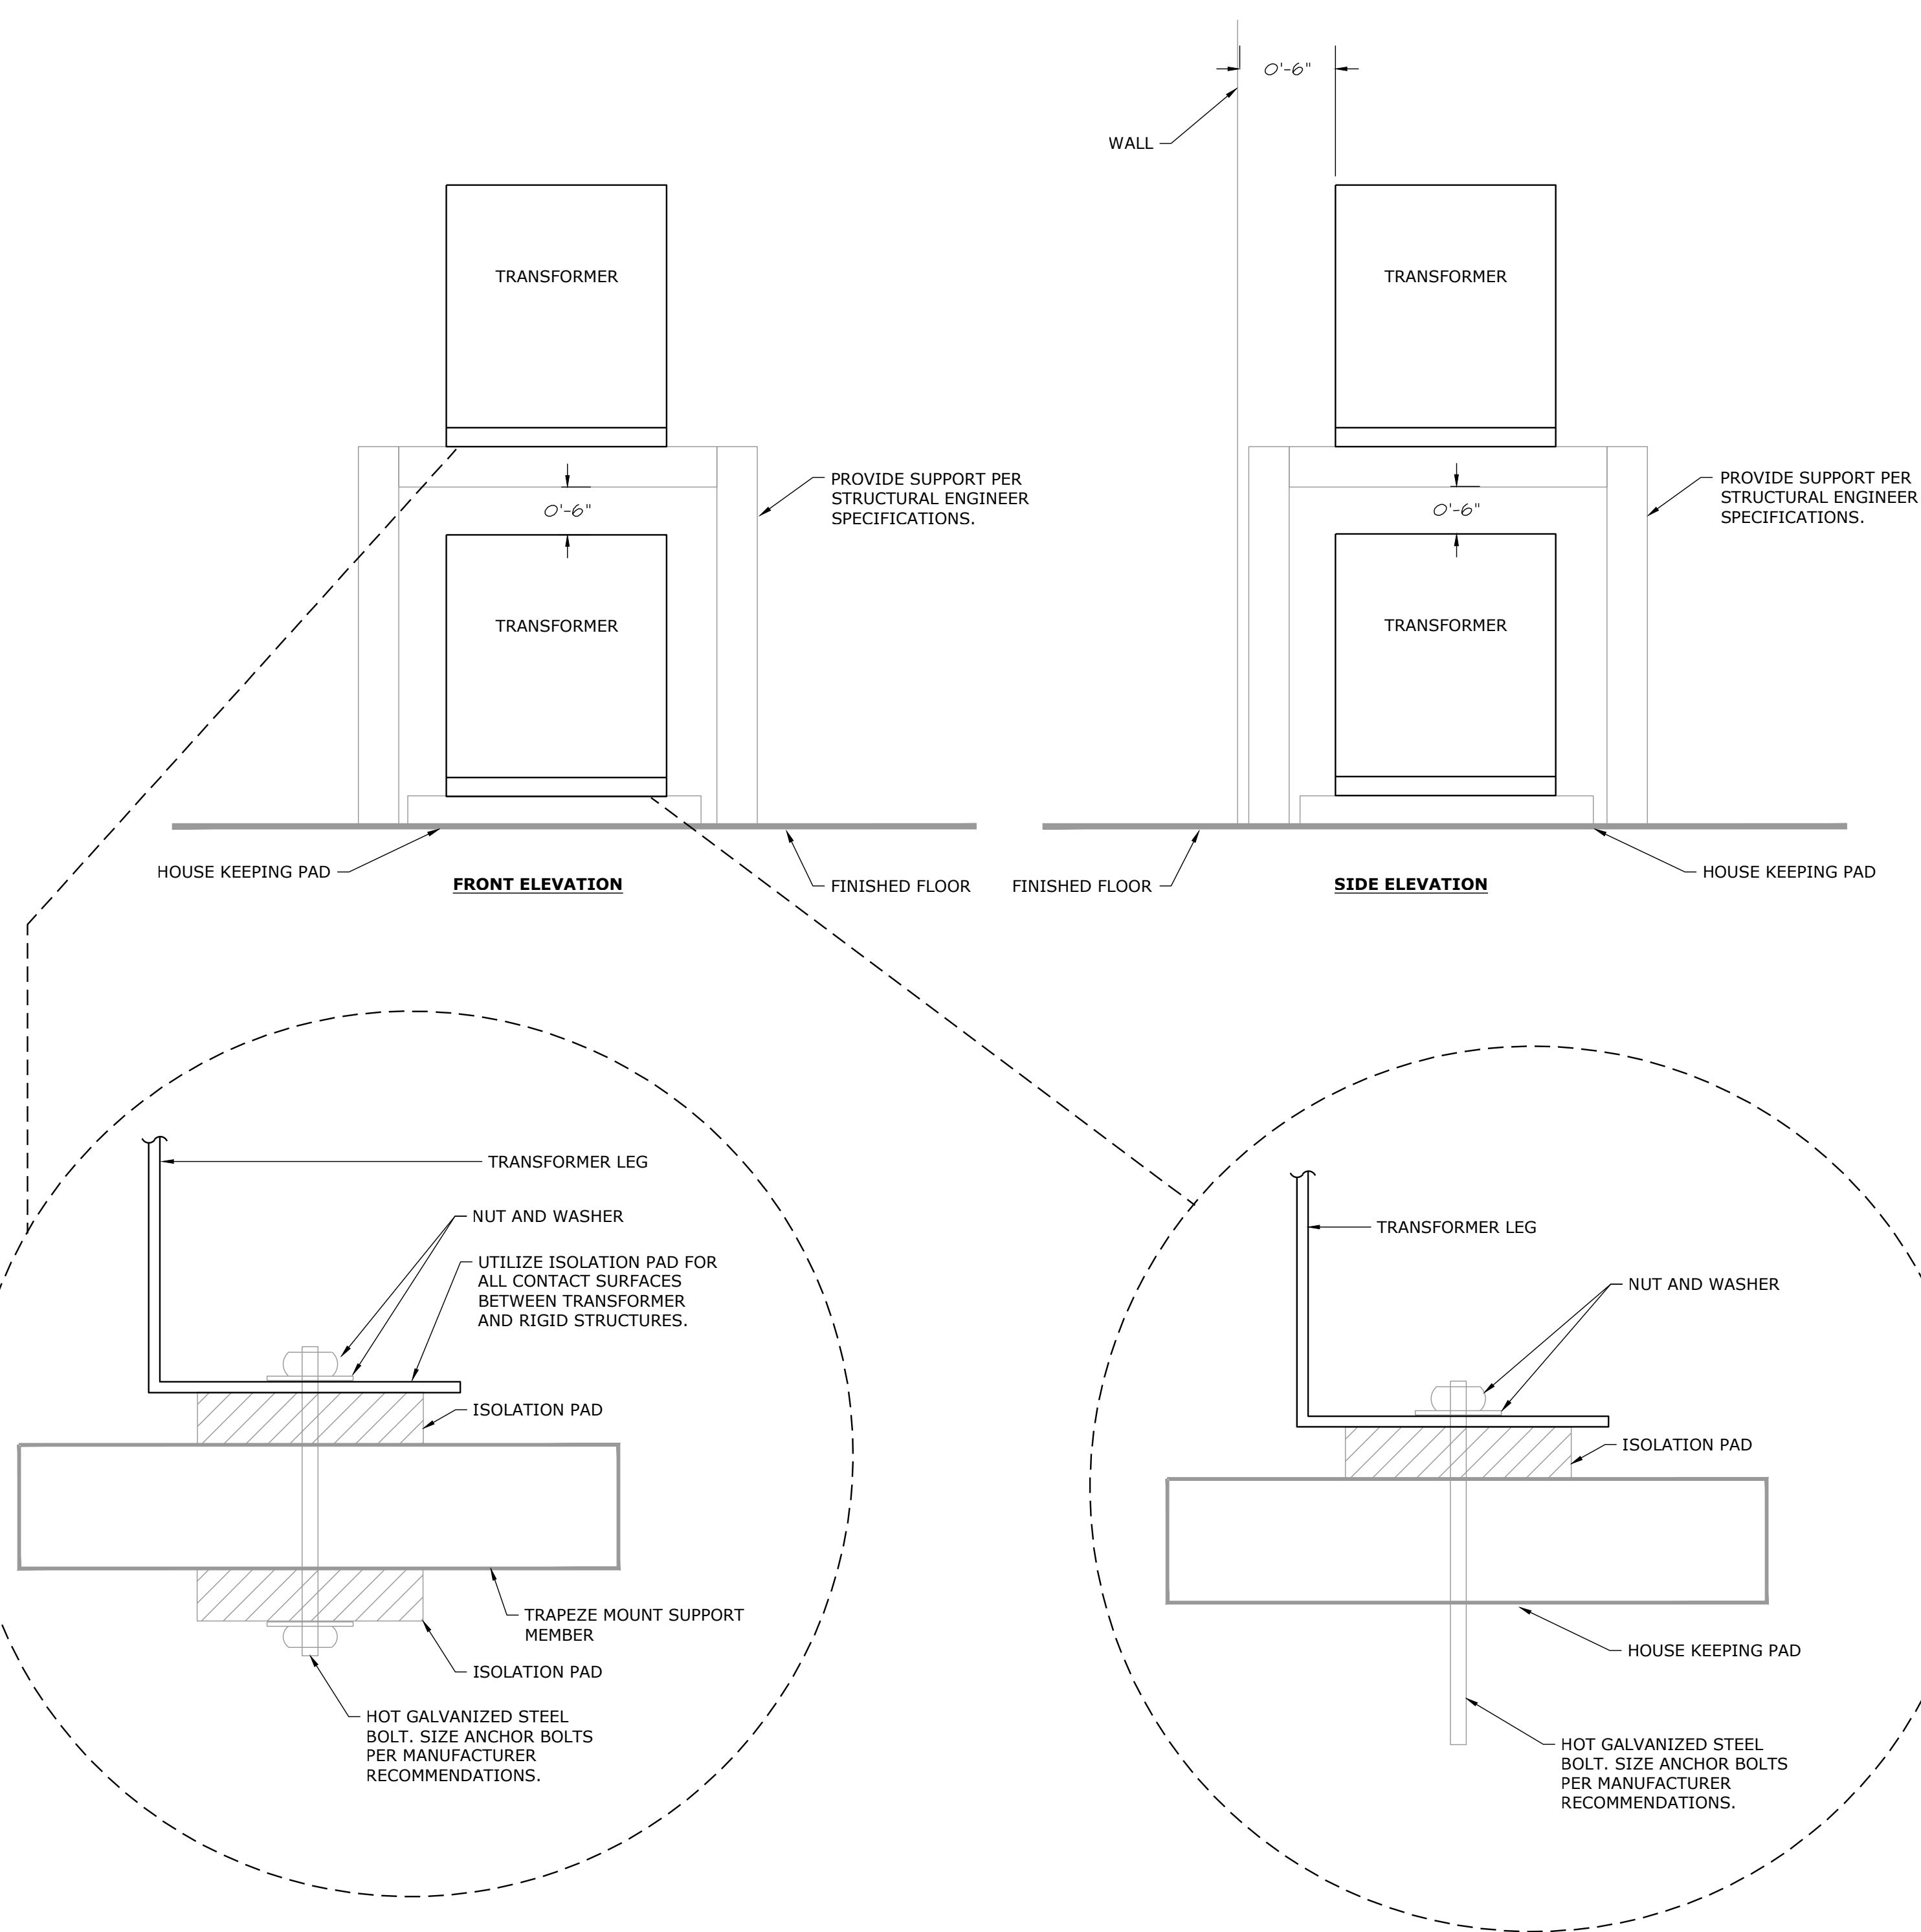

STACKED TRANSFORMER MOUNTING DETAIL

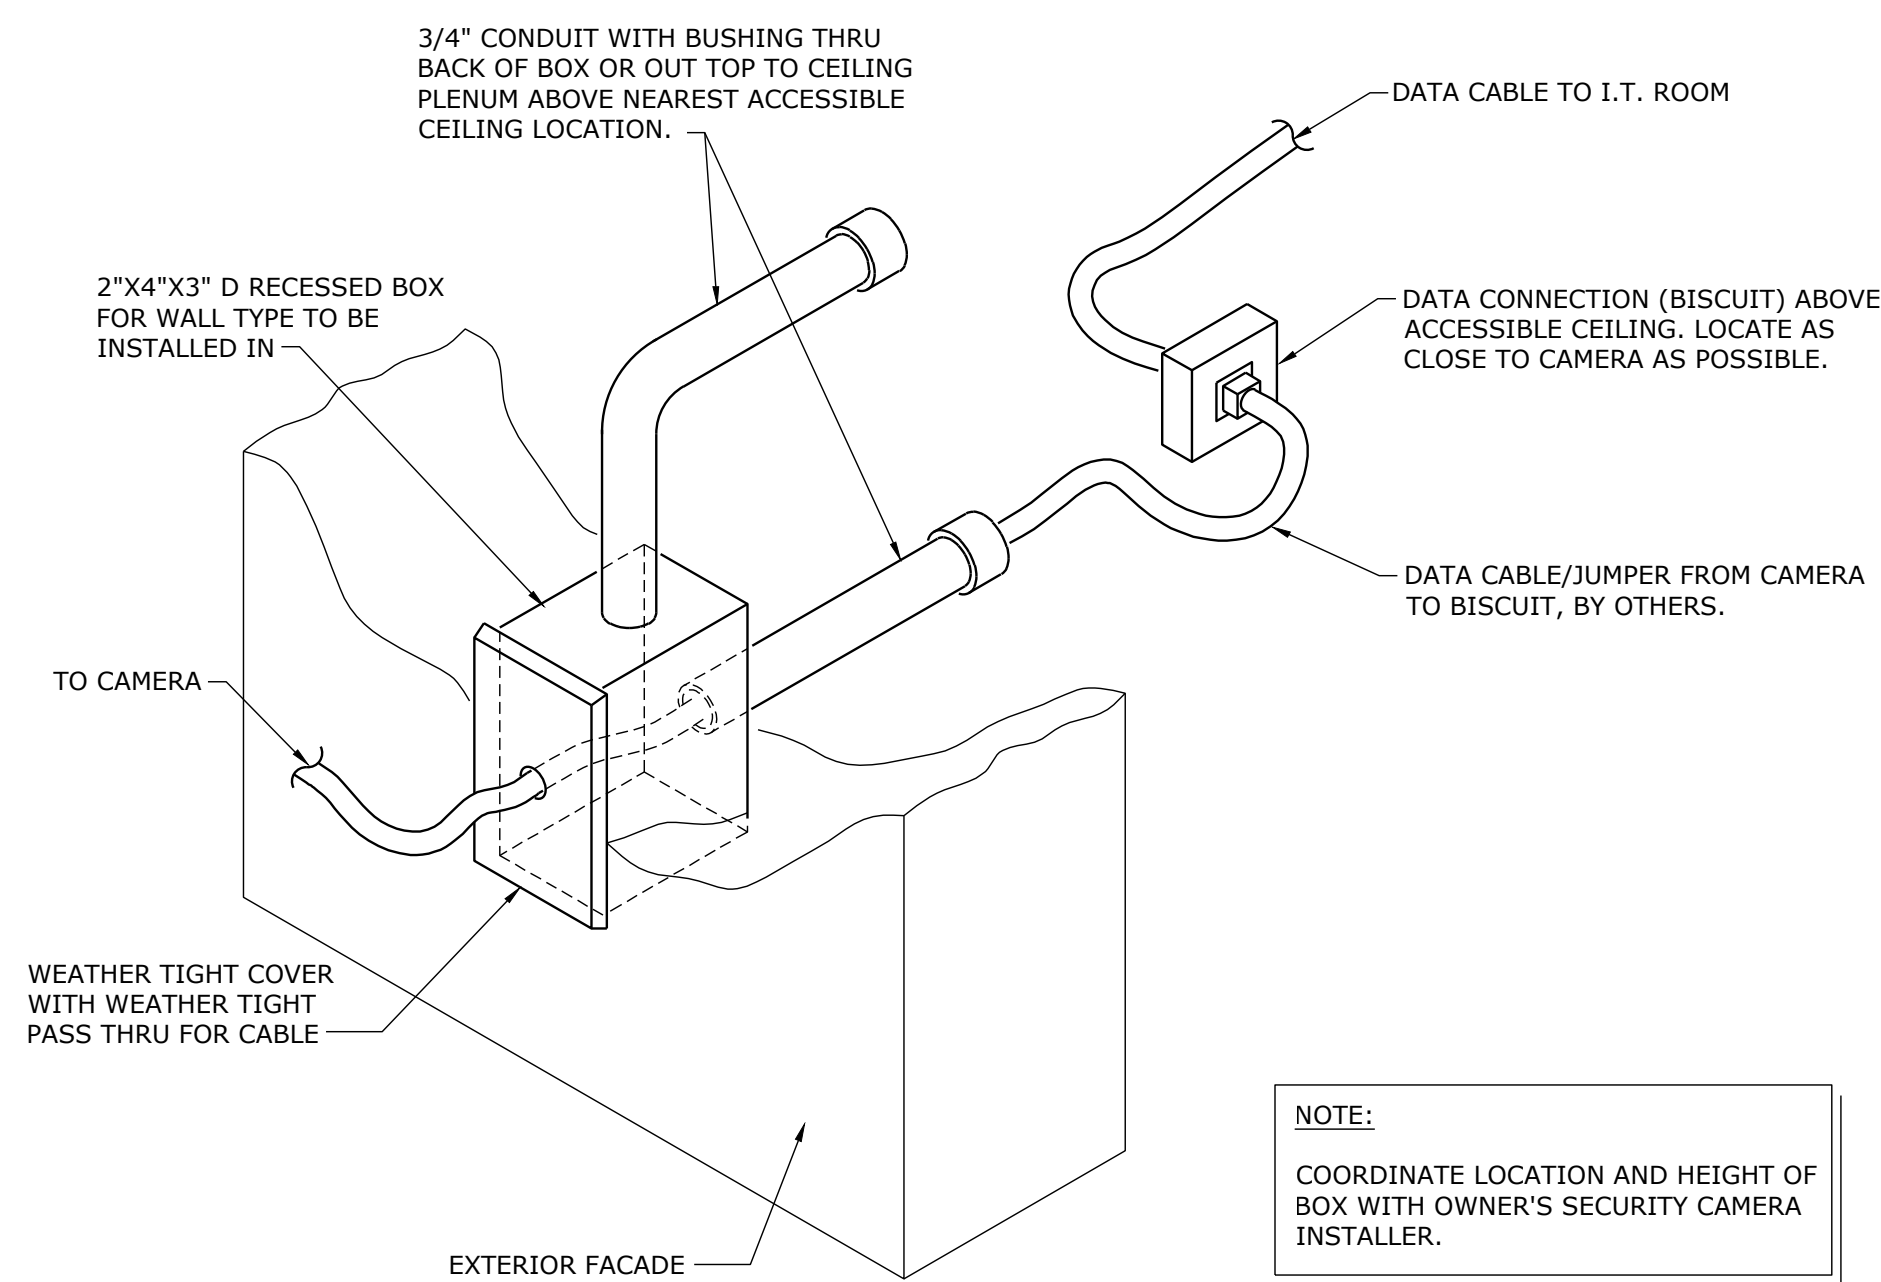

SECURITY POE CAMERA OUTLET DETAIL

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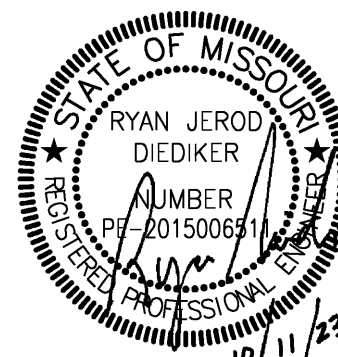
South Valley Middle School Storm Shelter Addition

Liberty School District


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**Conformed
Construction
Documents**

REVISIONS:		
#	Description	Date



JOB NO: 23019
DRAWN BY: SBI
CHECKED BY: RJD
DATE: 10.11.2023

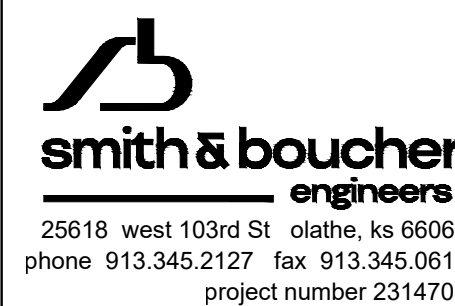

E304

10/11/2023 11:53:21 AM

ONE-LINE DIAGRAM SYMBOL LEGEND				CONDUIT, BOXES, AND ENCLOSURES GENERAL NOTES								AV EQUIPMENT GENERAL NOTES				ABBREVIATIONS																										
R		DISTRIBUTION AMPLIFIER.		<div>1. THE CONDUIT SYSTEM AND ALL BOXES AND ENCLOSURES INDICATED ON THESE DRAWINGS SHALL BE FURNISHED AND INSTALLED UNDER THE DIVISION 26 SPECIFICATIONS.</div> <div>2. ALL CIRCUITS SHALL BE INSTALLED WITHIN CONDUIT, UNLESS NOTED OTHERWISE. CONTRACTOR SHALL INSTALL CONDUIT AS SHOWN, WITH JUNCTION BOXES, FITTINGS, ETC. AS REQUIRED BETWEEN TERMINATION LOCATIONS.</div> <div>3. VERIFY LOCATIONS AND TYPES OF ALL EXISTING CONDUIT AND BOXES (IF ANY) PRIOR TO STARTING WORK.</div> <div>4. COORDINATE ALL WORK WITH ARCHITECTURAL, ELECTRICAL, AND TECHNOLOGY PLANS.</div> <div>5. CONDUIT SHALL BE MINIMUM 0.75-INCH DIAMETER. MEASURED PULL STRING SHALL BE FURNISHED, INSTALLED, AND SECURED IN ALL CONDUIT RACEWAYS.</div> <div>6. CONDUIT FOR MICROPHONE LEVEL CIRCUITS (M) SHALL BE CONSTRUCTED OF FERROUS METAL (EMT OR RIGID).</div> <div>7. CONDUIT SHALL NOT EXCEED 100 LINEAR FEET OR THE EQUIVALENT OF THREE 90 DEGREE BENDS BETWEEN JUNCTION BOXES.</div> <div>8. CONTRACTOR INSTALLING CONDUIT SYSTEM SHALL FURNISH AND INSTALL BLANK COVERS ON ALL BOXES INSTALLED BUT NOT USED FOR SYSTEM CONNECTIONS.</div> <div>9. CONDUIT ROUTING AND LOCATION OF CONNECTION BOXES SHALL BE PER ELECTRICAL SPECIFICATIONS.</div> <div>10. SYSTEM AC POWER CIRCUITS SHALL BE TWO WIRE (EACH WITH ITS OWN NEUTRAL CONDUCTOR) AND SHALL BE ROUTED TO EQUIPMENT RACKS AS REQUIRED.</div> <div>11. ALL CONDUIT INFRASTRUCTURE SHOWN ON THESE DRAWINGS IS TO BE PART OF THE BASE BID.</div> <div>12. ALL DIMENSIONAL NOTES ARE EXPRESSED BY H (HEIGHT), W (WIDTH), AND D (DEPTH), IN INCHES.</div> <div>13. MOUNT WALL BOXES AT 18" AFF TO MATCH ELECTRICAL WALL MOUNTED BOXES, UNLESS OTHERWISE NOTED.</div> <div>14. BOXES INDICATED TO BE WALL MOUNTED AT 48" AFF SHALL BE MOUNTED TO MATCH OTHER ELECTRICAL SWITCHES AND CONTROL PLATES.</div> <div>15. PRIMARY FUNCTION IS NOTED FOR EACH BOX. BOXES MAY HAVE MULTIPLE SUB-FUNCTIONS.</div> <div>16. ALL MOUNTING HEIGHTS ARE TO THE CENTER OF THE BOX.</div>								<div>1. ALL AV EQUIPMENT SHOWN ON THE DRAWINGS IS TO BE PART OF THE BASE BID, UNLESS SPECIFICALLY NOTED AS PART OF AN ALTERNATE.</div> <div>2. THIS FACILITY IS A NEW ADDITION TO AN EXISTING STRUCTURE. COORDINATE MOUNTING CONDITIONS WITH OTHER TRADES.</div> <div>3. COORDINATE ALL WORK WITH ARCHITECTURAL, ELECTRICAL, AND TECHNOLOGY PLANS.</div> <div>4. ALL DIMENSIONAL NOTES ARE EXPRESSED BY H (HEIGHT), W (WIDTH), AND D (DEPTH), IN INCHES.</div> <div>5. MOUNTING HEIGHTS SHOWN ARE TO THE BOTTOM EDGE OF THE EQUIPMENT.</div>				<div>AC AC POWER.</div> <div>ACP ACOUSTICAL CEILING PANEL.</div> <div>ACT ACOUSTICAL CEILING TILE.</div> <div>AFC ABOVE FINISHED CEILING. INDICATES DIMENSION ABOVE CEILING PANEL.</div> <div>AFF ABOVE FINISHED FLOOR. INDICATES DIMENSION ABOVE FLOOR SURFACE.</div> <div>AFILS AUDIO FREQUENCY INDUCTION LOOP SYSTEM.</div> <div>AP ACCESS POINT.</div> <div>AV AUDIO-VISUAL.</div> <div>B BLANK COVER FOR FUTURE USE.</div> <div>BP BLANK PANEL.</div> <div>C CONDUIT, DIAMETER EXPRESSED IN INCHES.</div> <div>DAN DIGITAL AUDIO NETWORK.</div> <div>FACP FIRE ALARM CONTROL PANEL.</div> <div>FO FIBER OPTIC.</div> <div>FP FLAT PANEL.</div> <div>HAS HEARING ASSISTANCE SYSTEM.</div> <div>GWB GYPSUM WALL BOARD.</div> <div>MCP METAL CEILING PANEL.</div> <div>MM MULTI-MODE (FIBER).</div> <div>NS AMBIENT NOISE SENSOR.</div> <div>PA PUBLIC ADDRESS SYSTEM/PAGING.</div> <div>PACS PAGING ANNOUNCEMENT CONTROL SYSTEM.</div> <div>PB PULLBOX.</div> <div>RF RADIO FREQUENCY.</div> <div>SM SINGLE-MODE (FIBER).</div> <div>STP SHIELDED TWISTED PAIR.</div> <div>TBD TO BE DETERMINED. CONTRACTOR TO FIELD VERIFY.</div> <div>TC TERMINATION CABINET.</div> <div>TELCO TELEPHONE UTILITY COMPANY.</div> <div>TP TOUCHPANEL.</div> <div>TV TELEVISION.</div> <div>UTP UNSHIELDED TWISTED PAIR.</div> <div>VP VENT PANEL.</div> <div>VPD VISUAL PAGING DISPLAY.</div> <div>XFMR TRANSFORMER.</div>																										
Q		STEREO-TO-MONO AUDIO COMBINER.																																								
		LOUDSPEAKER VOLUME CONTROL (P=PRIORITY OVERRIDE RELAY)																																								
		LOUDSPEAKER EACH WITH LOUDSPEAKER LINE MATCHING TRANSFORMER IF SHOWN. WITH CONNECTIONS AS NOTED. REFER TO PLANS FOR QUANTITIES. LOUDSPEAKER TYPE (X) INDICATED WITHIN SYMBOL. WHERE MULTIPLE POWER TAP VALUES ARE SHOWN FOR LINE MATCHING TRANSFORMERS IN A GIVEN LOUDSPEAKER CIRCUIT, REFER TO PLANS FOR SPECIFIC LOCATIONS.																																								
P		POWER AMPLIFIER, TYPE AND DETAILS AS INDICATED ON THE DRAWINGS.																																								
		AUDIO LINE MATCHING OR BRIDGING TRANSFORMER WITH RATED IMPEDANCE AS NOTED.																																								
		SCREW TERMINAL ON BARRIER STRIP. INSTALLED IN TERMINATION CABINETS UNLESS NOTED OTHERWISE.																																								
N		LOW VOLTAGE LIGHT EMITTING DIODE, COLOR AS INDICATED BY LETTER: G = GREEN Y = YELLOW R = RED																																								
		LOOSE CABLE, LENGTH AS INDICATED.																																								
M		FEMALE XLR RECEPTACLE OR CABLE CONNECTOR; 3 PINS UNLESS SUBSCRIPT INDICATES OTHERWISE.																																								
		MALE XLR RECEPTACLE OR CABLE CONNECTOR; 3 PINS UNLESS SUBSCRIPT INDICATES OTHERWISE.																																								
		PHONE JACK, SIZE AS INDICATED ON THE DRAWINGS.																																								
L		PHONE PLUG, SIZE AS INDICATED ON THE DRAWINGS.																																								
		RCA PHONO JACK.																																								
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K		BNC JACK.																																								
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J		FEMALE HD-15 CONNECTOR.																																								
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G		FEMALE RJ45 CONNECTOR.																																								
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		RJ45 PATCH PANEL CONNECTION.																																								
D		AC POWER CORD.																																								
		ANTENNA.																																								
		CONTINUATION OF EQUIPMENT OR LOUDSPEAKER CIRCUITS. REFER TO DRAWINGS FOR QUANTITIES.																																								
C		CONNECTION DESIGNATOR.																																								
		CIRCUIT CONTINUED ON DIFFERENT SHEET OR AT OTHER DIAGRAM LOCATION.																																								
		SHEET NUMBER WHERE CIRCUIT IS CONTINUED.																																								
B	"LABELS"		SLANTED TEXT IN QUOTES INDICATES EQUIPMENT LABELS.																																							
ONE-LINE DIAGRAM WIRE LEGEND																																										
		WIRES FOR AUDIO, VIDEO, OR RADIO FREQUENCY SIGNALS OVER COPPER CABLING. CABLE OR SIGNAL TYPE AS INDICATED.																																								
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South Valley Middle School Storm Shelter Addition
Liberty School District

1000 Midjay Dr, Liberty, MO 64068

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JOB NO: 23019
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Kansas City, MO 64108
t 816.442.7700
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Castle Rock, CO 80104
t 720.949.1689
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Holls + Miller Architects
Missouri State Certificate of Authority
Architecture # 0000161
Structure # 2006037333

Bob D Campbell
Structural Engineer
State Certificate of Authority #000442
4338 Bellevue Ave
Kansas City, MO 64111
816.531.4144 phone


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Mechanical, Electrical, & Plumbing
State Certificate of Authority #EGC000178
25618 W 103rd Street
Olathe, KS 66061
913.345.2127 phone

MKEC Engineering, Inc.
Civil Engineer
State Certificate of Authority
Engineering #2001009364
Landscaping #2006027139
Surveying #2006027138
11827 W 112th Street, Suite 200
Overland Park, KS 66210
913.317.9390 phone

Peerbolte Creative
Theatrical Consultant
109 E Pine St.
Warrensburg, MO 64093-0752
660.429.1383 phone

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14827 West 50th St.
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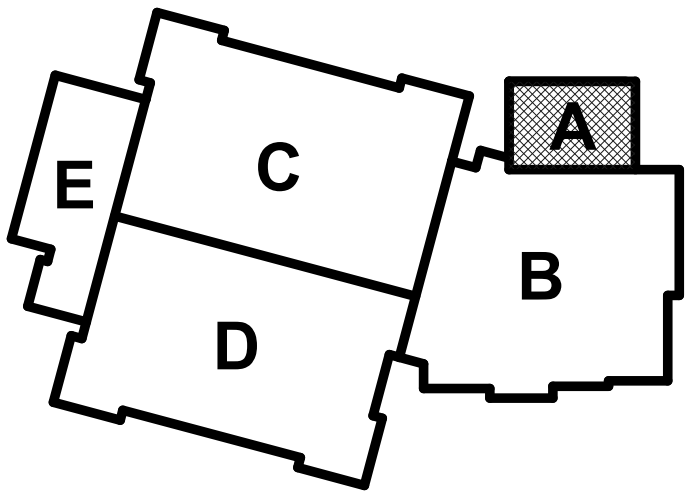
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SHEET KEYNOTE LEGEND

- 1 FLOORSTANDING SWINGOUT EQUIPMENT RACK.
- 2 COORDINATE EXACT LOUDSPEAKER POSITION WITH DIVIDER CURTAIN.
- 3 SHOTGUN RECORDING MIC INSTALLED IN LIGHTING POCKET, FACING THE STAGE. COORDINATE EXACT LOCATION WITH ARCHITECTURAL AND LIGHTING CONDITIONS. RE: DETAIL A7/AV501.
- 4 ANTENNAS INSTALLED IN NON-METALLIC CEILING BOX, NOMINAL 13"X15" SIZE. COORDINATE EXACT SIZE WITH EXACT ANTENNA PROVIDED. STAHLIN CLASSIC SERIES, INTEGRA ENCLOSURES, OR EQUIVALENT.
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KEY PLAN

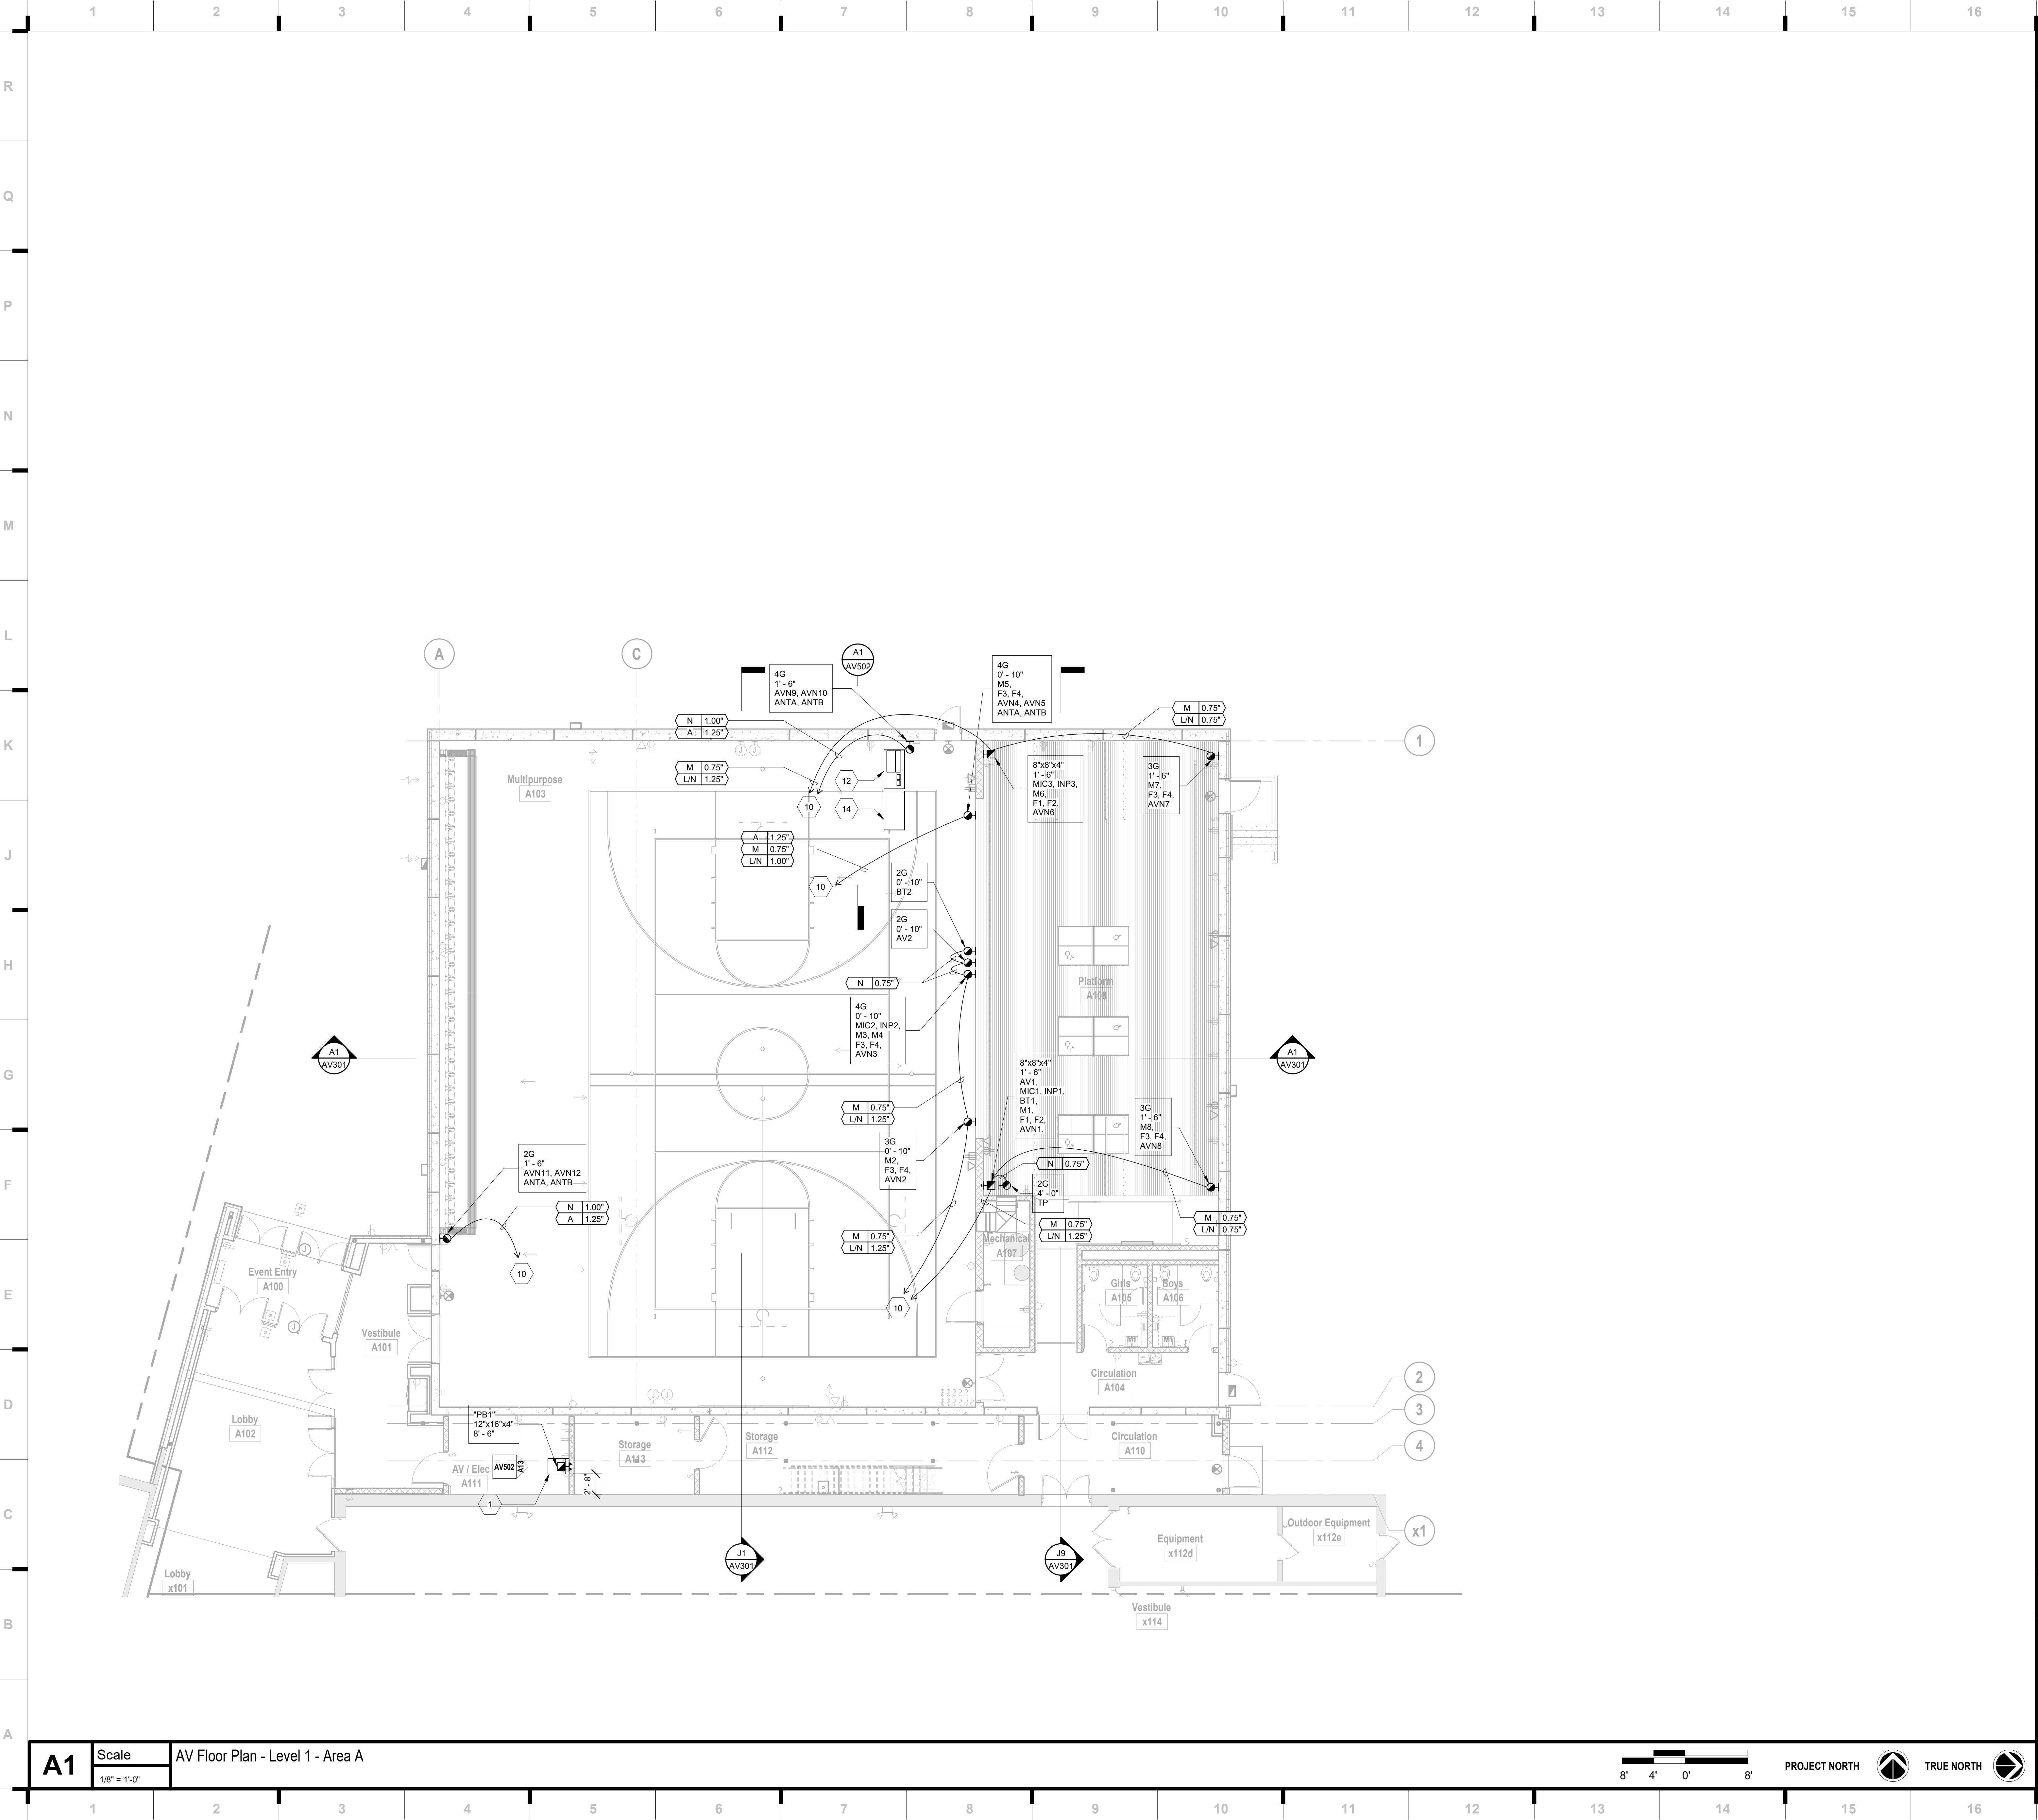

South Valley Middle School Storm Shelter Addition

Liberty School District
1000 Midjay Dr, Liberty, MO 64068

REVISIONS:

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JOB NO: 23019
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Missouri State Certificate of Authority
Architecture # 0000101
Structure # 200001033

Bob D Campbell
Structural Engineer
State Certificate of Authority #000442
4338 Bellevue Ave
Kansas City, MO 64111
816.531.4144 phone

Smith & Boucher, Inc.
Mechanical, Electrical, & Plumbing
State Certificate of Authority #EGC000178
25618 W 103rd Street
Olathe, KS 66061
913.345.2127 phone

MKEC Engineering, Inc.
Civil Engineer
State Certificate of Authority
Engineering #2001009364
Landscaping #2006027139
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11827 W 112th Street, Suite 200
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Theatrical Consultant
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Missouri State Certificate of Authority
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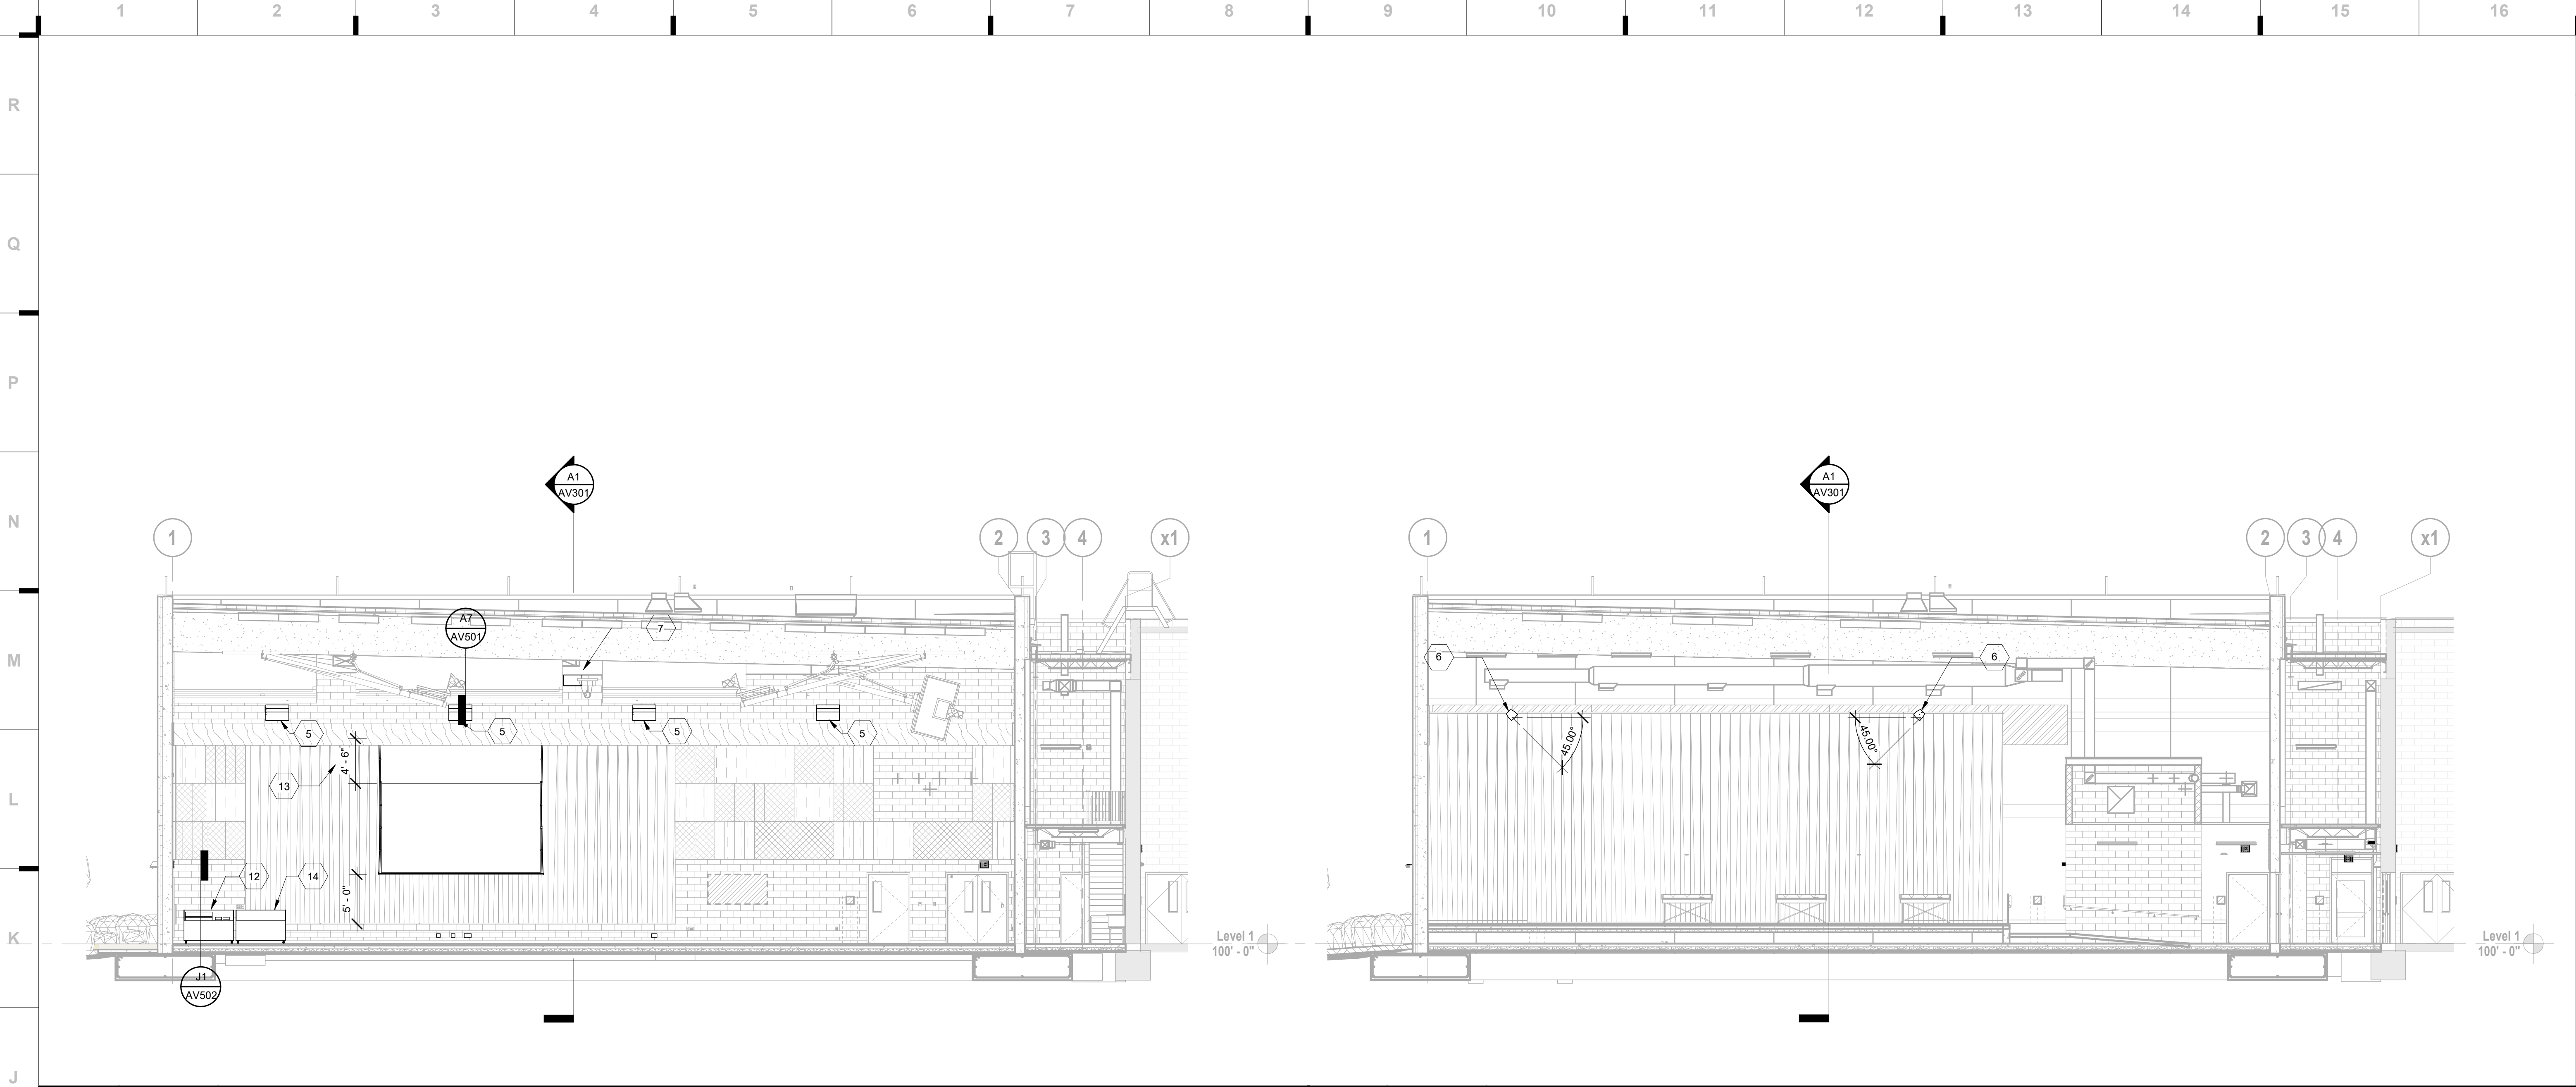
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J1


Scale1/8" = 1'-0"

AV Building Section - N-S

J9

Scale1/8" = 1'-0"

AV Building Section - N-S On Stage

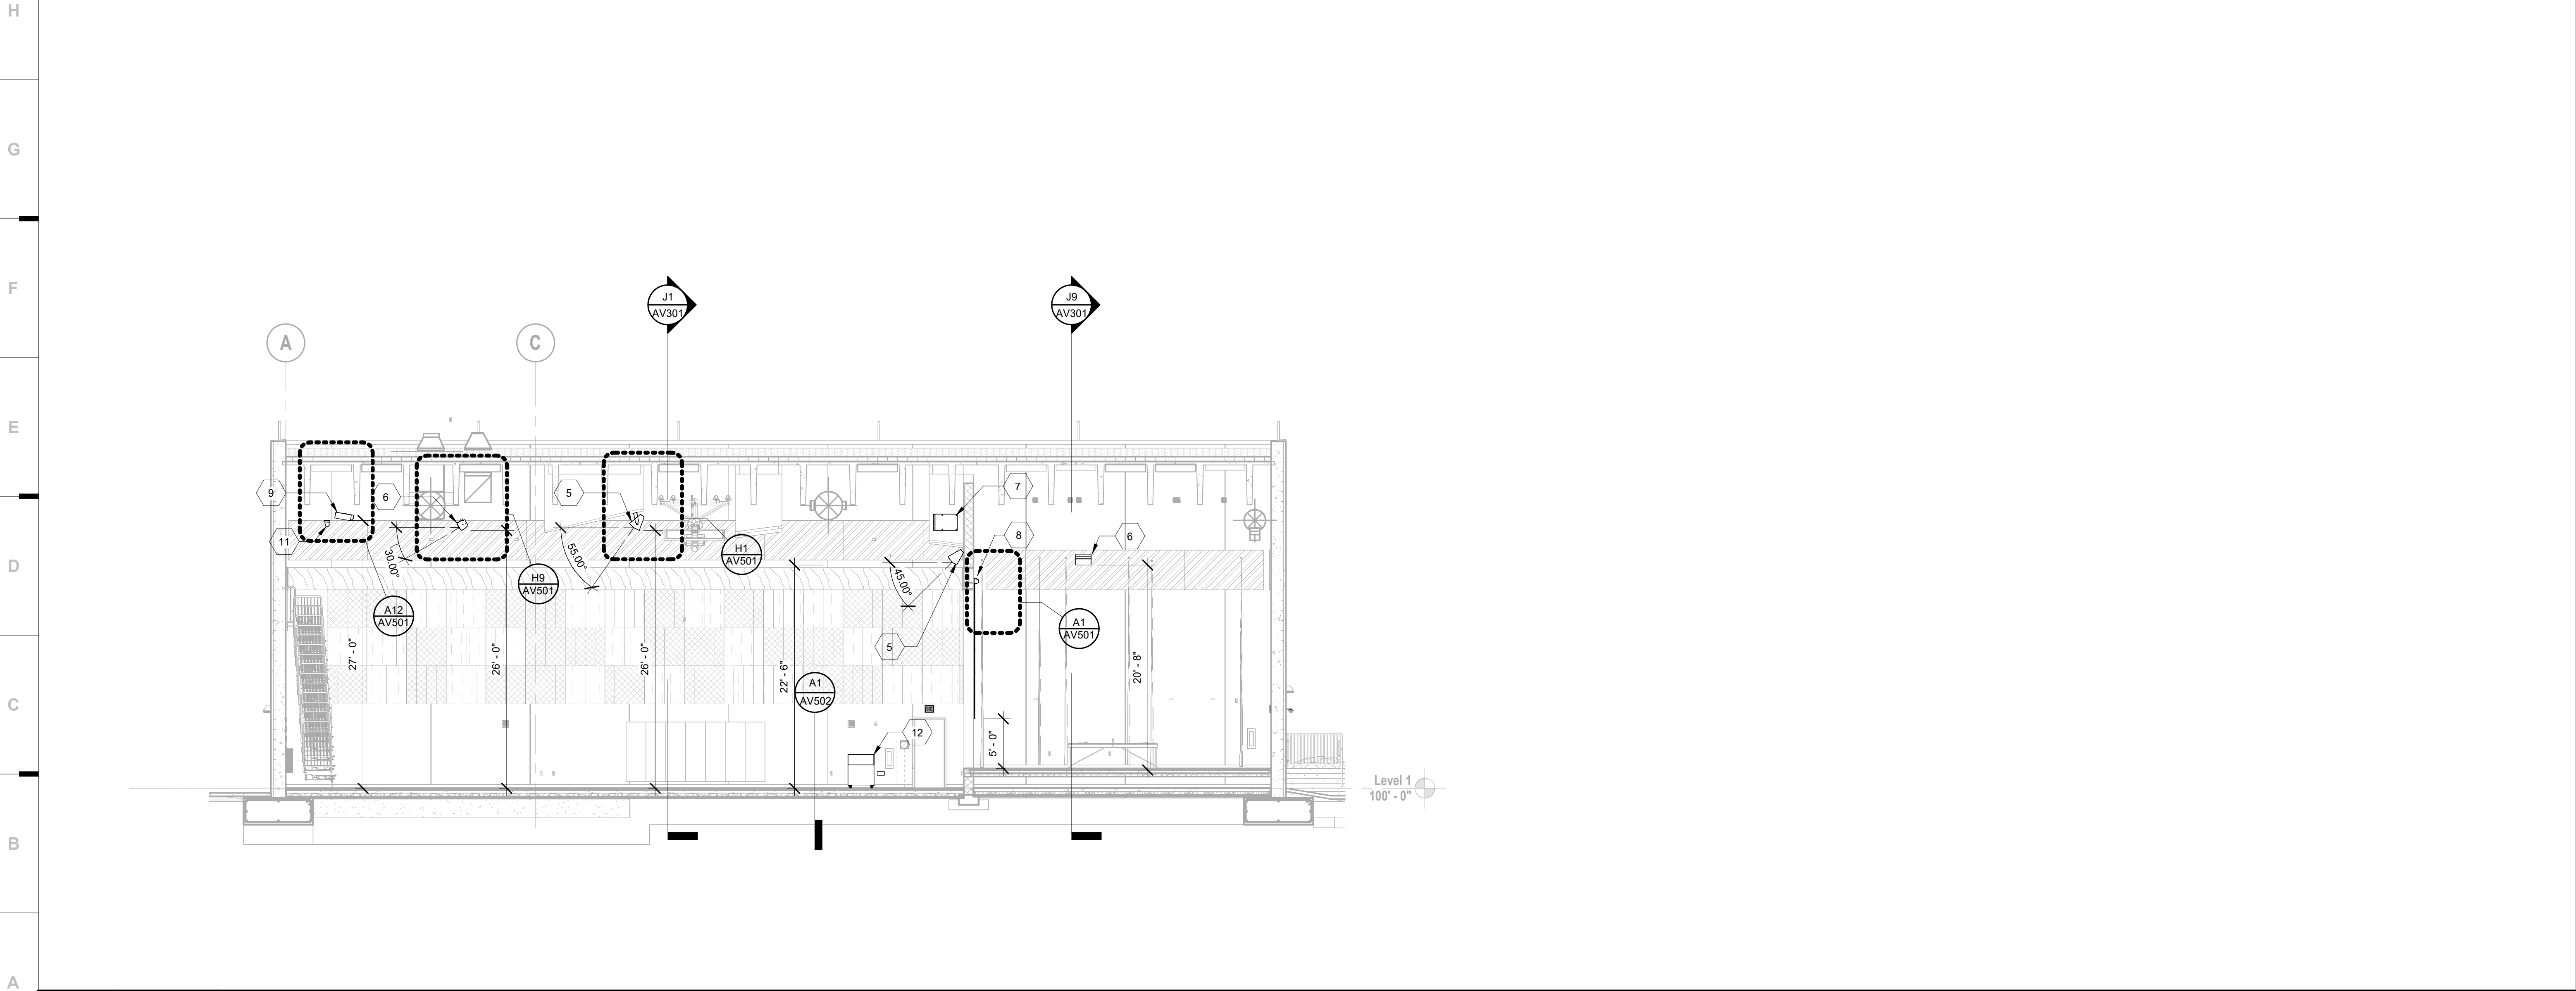

A1

Scale1/8" = 1'-0"

AV Building Section - E-W

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AV BUILDING SECTIONS

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EXPOSED 2-GANG CEILING BOX INSTALLED AT ROOF DECK IN AREAS WITHOUT GYPSUM BOARD CEILINGS. NEATLY ROUTE EXPOSED CONDUIT TO AND FROM ADJACENT LOUDSPEAKERS. PAINT TO MATCH CEILING. NEATLY ROUTE EXPOSED LOUDSPEAKER CABLING ALONG STRUCTURE TO LOUDSPEAKER BELOW.

FOR LOUDSPEAKERS INSTALLED IN AREAS WITHOUT A GYPSUM BOARD CEILING, INSTALL UNISTRUT SUBFRAMING TO ROOF STRUCTURE ABOVE. COORDINATE EXACT LOCATION WITH PRECAST CONCRETE TEE REINFORCEMENT. SUSPEND LOUDSPEAKER WITH WIRE ROPE AND OTHER MOUNTING HARDWARE AS REQUIRED. PAINT ALL MOUNTING HARDWARE TO MATCH CEILING.

MANUFACTURER'S U-BRACKET ATTACHED TO STRUCTURE. PROVIDE BLOCKING BEHIND GYPSUM BOARD CEILING.

2-GANG CEILING BOX INSTALLED ABOVE LOUDSPEAKER

CONDUIT TO AND FROM ADJACENT SPEAKERS CONCEALED IN CEILING.

TYPE 1 TWO-WAY LOUDSPEAKER

COVERAGE PATTERN OF LOUDSPEAKER. REFER TO BUILDING SECTION FOR DOWNTILT AIMING ANGLE.

80/40°

EXPOSED 2-GANG CEILING BOX INSTALLED AT ROOF DECK. NEATLY ROUTE EXPOSED CONDUIT TO AND FROM ADJACENT LOUDSPEAKERS. PAINT TO MATCH CEILING. NEATLY ROUTE EXPOSED LOUDSPEAKER CABLING ALONG STRUCTURE TO LOUDSPEAKER BELOW.

INSTALL UNISTRUT SUBFRAMING TO ROOF STRUCTURE ABOVE. COORDINATE EXACT LOCATION WITH PRECAST CONCRETE TEE REINFORCEMENT. SUSPEND LOUDSPEAKER WITH WIRE ROPE AND OTHER MOUNTING HARDWARE AS REQUIRED. PAINT ALL MOUNTING HARDWARE TO MATCH CEILING.

MANUFACTURER'S U-BRACKET.

ROTATE HORN TO PROVIDE COVERAGE PATTERN. REFER TO BUILDING SECTION FOR DOWNTILT AIMING ANGLE.




60/40°

GENERAL EQUIPMENT MOUNTING NOTES

- STRUCTURAL DETAILS, STRUCTURAL MEMBER TYPES, SIZES, AND ATTACHMENT METHODS ARE SHOWN FOR CONCEPT ONLY. ATTENTION IS CALLED TO THE SPECIFICATIONS FOR ADDITIONAL REQUIREMENTS REGARDING APPROVAL OF THE EXACT DETAILS TO BE USED.
- INSTALL LOUDSPEAKERS SO THERE ARE NO OBSTRUCTIONS TO EACH LOUDSPEAKER'S RATED COVERAGE PATTERN.
- LOUDSPEAKERS ARE DRAWN TO APPROXIMATE DIMENSIONS. VERIFY EXACT DIMENSIONS REQUIRED FOR LOUDSPEAKERS FURNISHED.
- PROVIDE ACCESS TO LOUDSPEAKERS DURING INSTALLATION, TESTING, AND EQUALIZATION ACTIVITIES. REORIENT LOUDSPEAKERS, IF SO REQUESTED BY ACOUSTICAL CONSULTANT, DURING SYSTEM TESTING AND EQUALIZATION ACTIVITIES.
- PAINT ALL LOUDSPEAKERS (UNLESS AN ENCLOSURE COLOR IS SPECIFIED OTHERWISE) AND MOUNTING HARDWARE TWO COATS OF SATIN ENAMEL, COLOR AS SELECTED BY THE ARCHITECT. USE PRIMER PER MANUFACTURER RECOMMENDATIONS. DO NOT PAINT CONES OF LOW FREQUENCY LOUDSPEAKERS OR DIAPHRAGMS OF HIGH FREQUENCY DRIVERS.

H1 Scale 1" = 1'-0" Type 1 Loudspeaker Mounting Detail

H9 Scale 1" = 1'-0" Type 2 Loudspeaker Mounting Detail

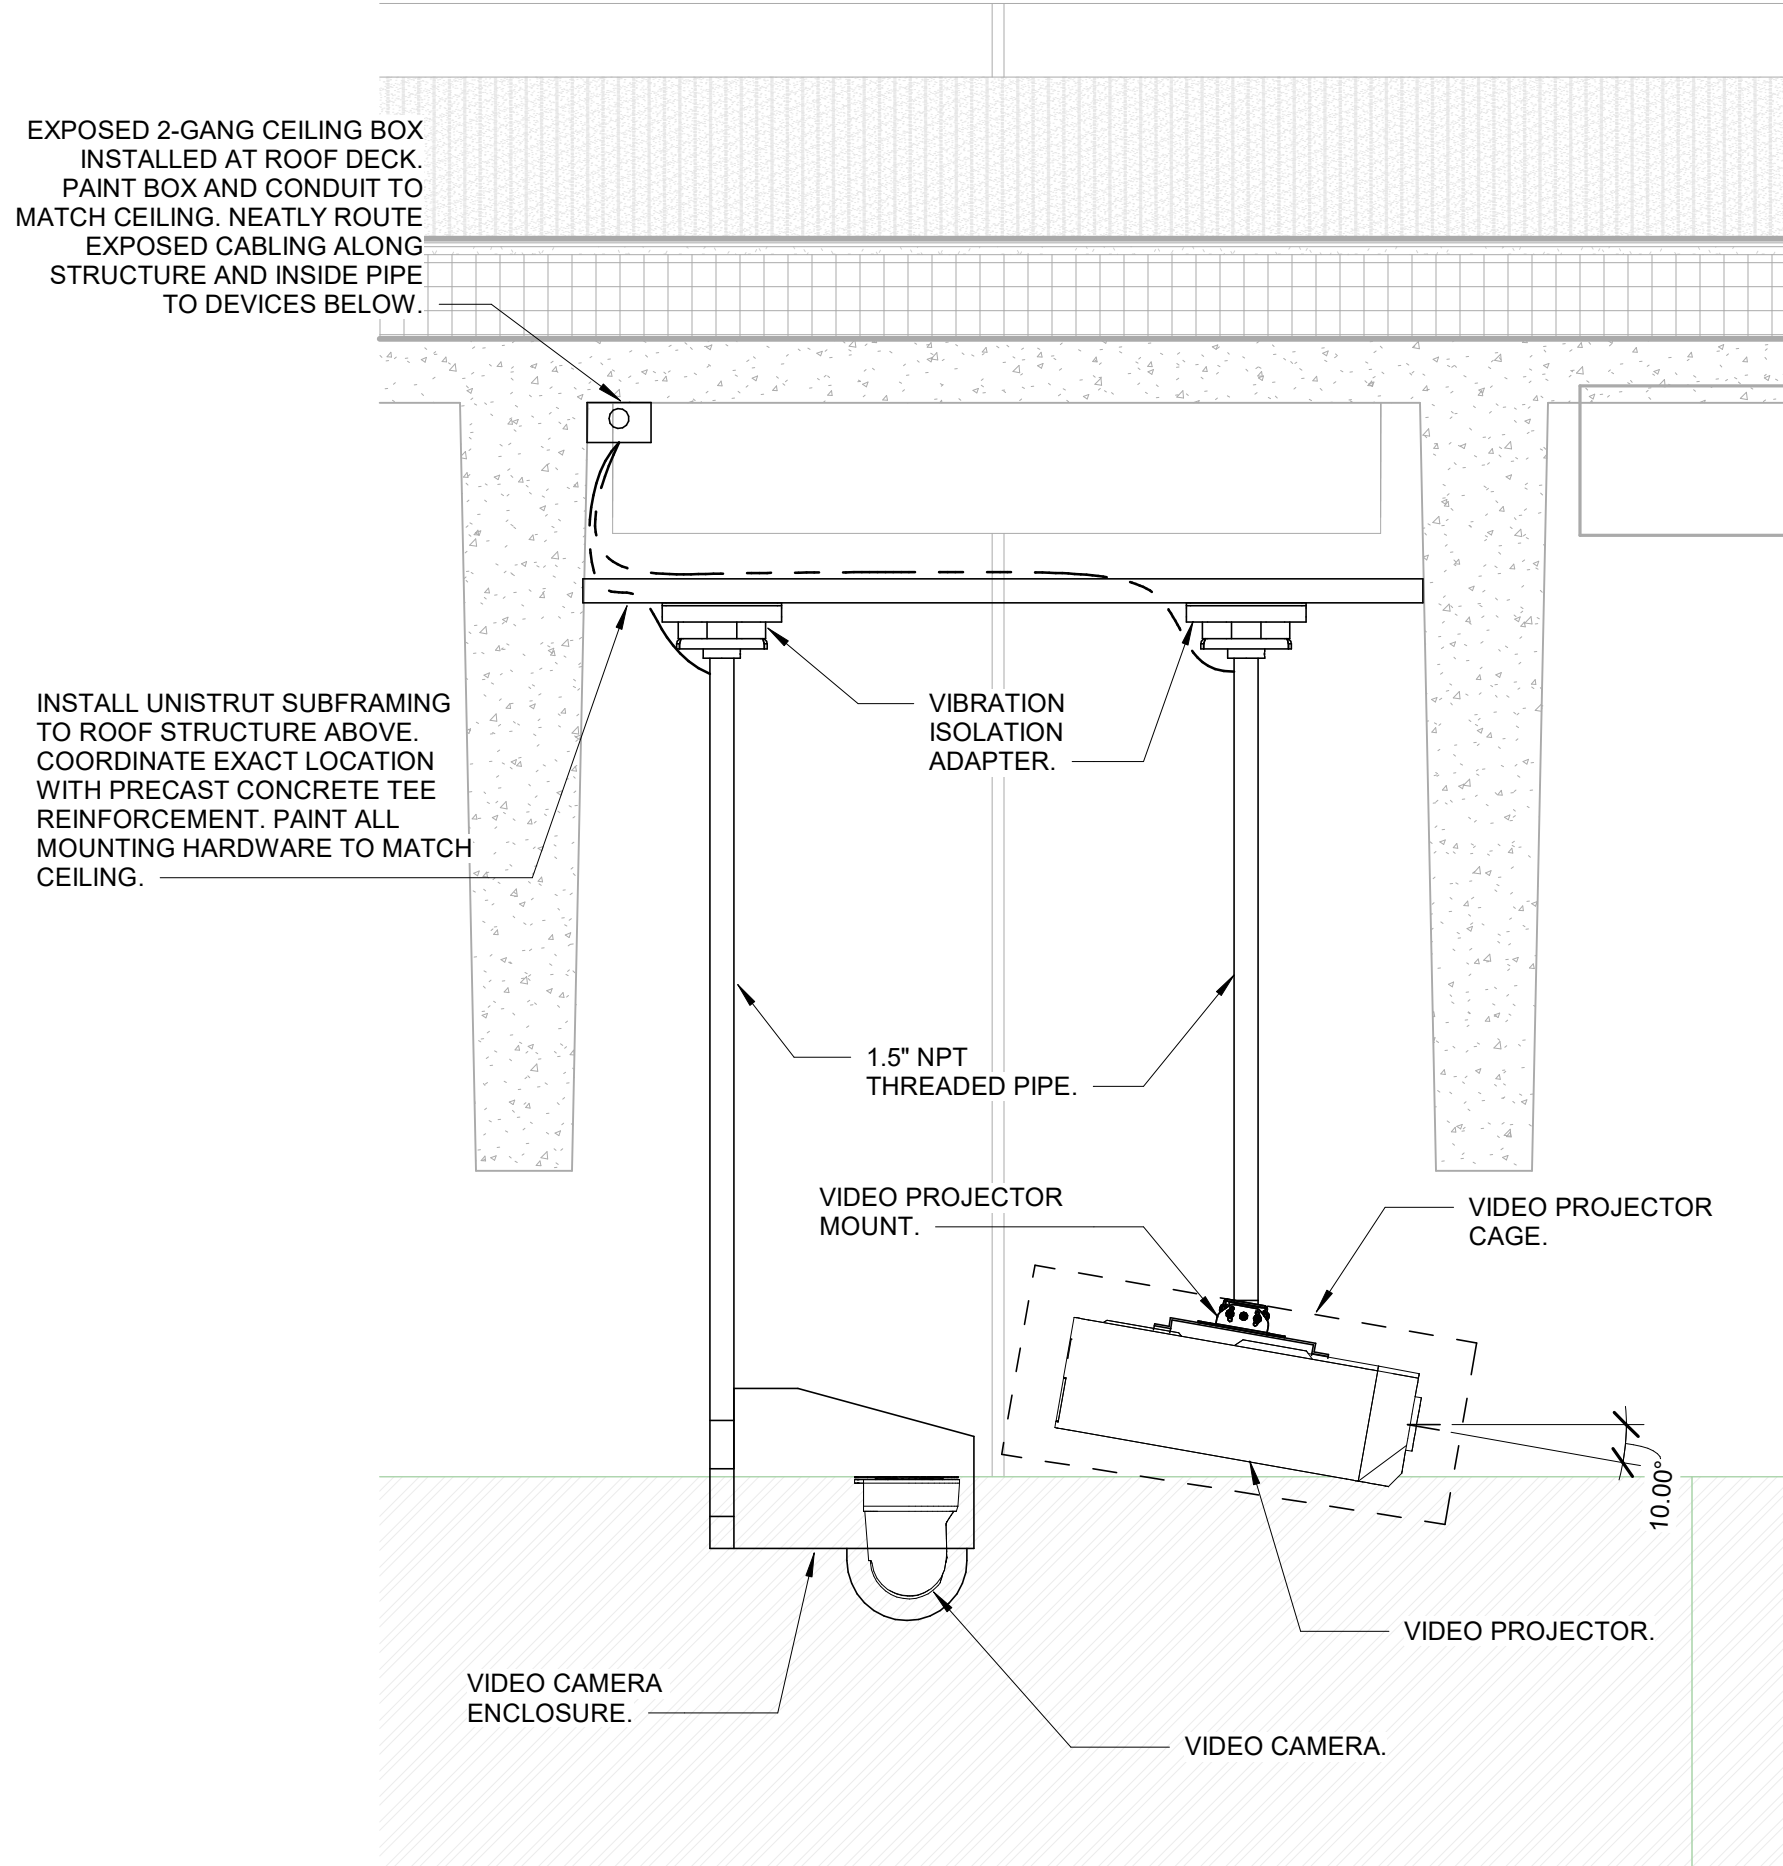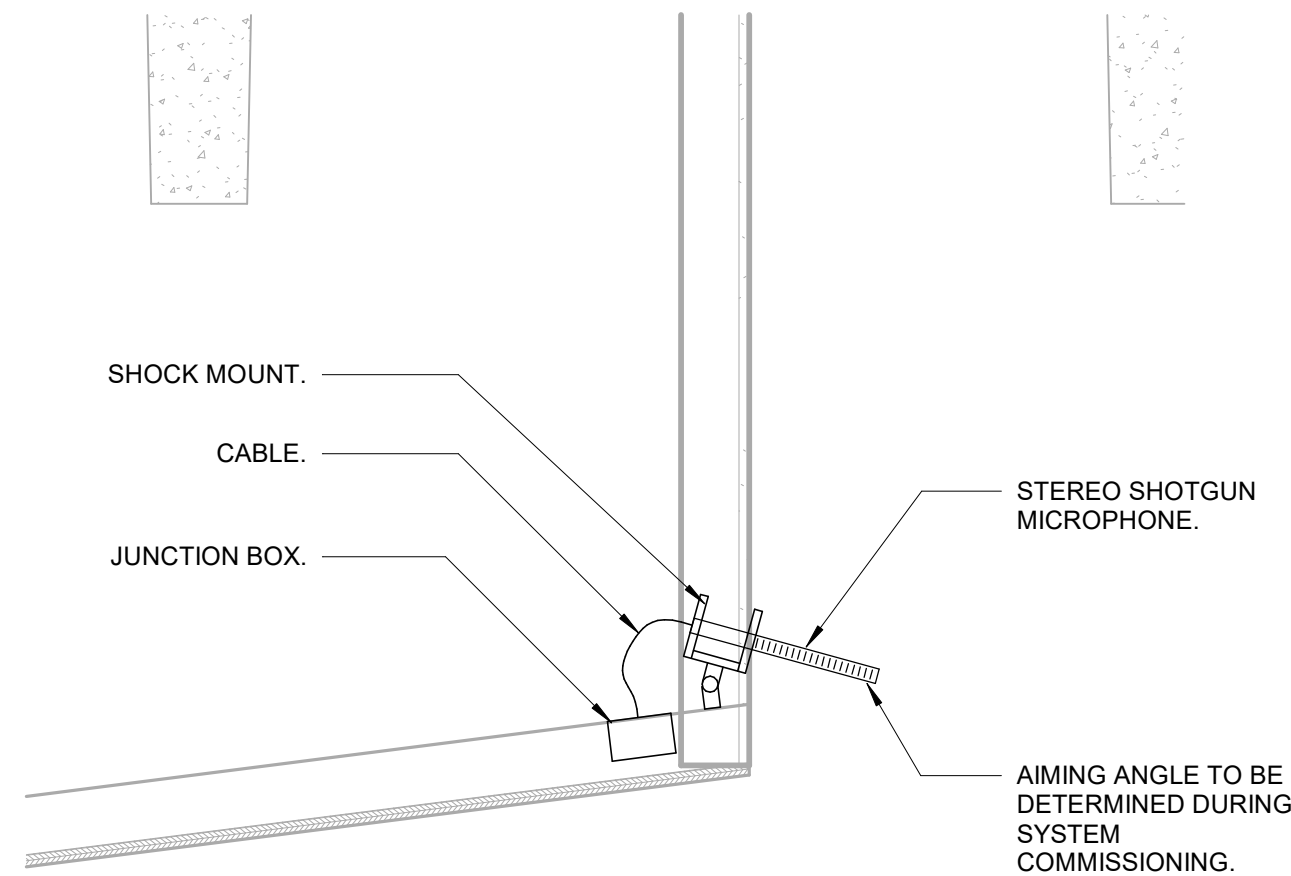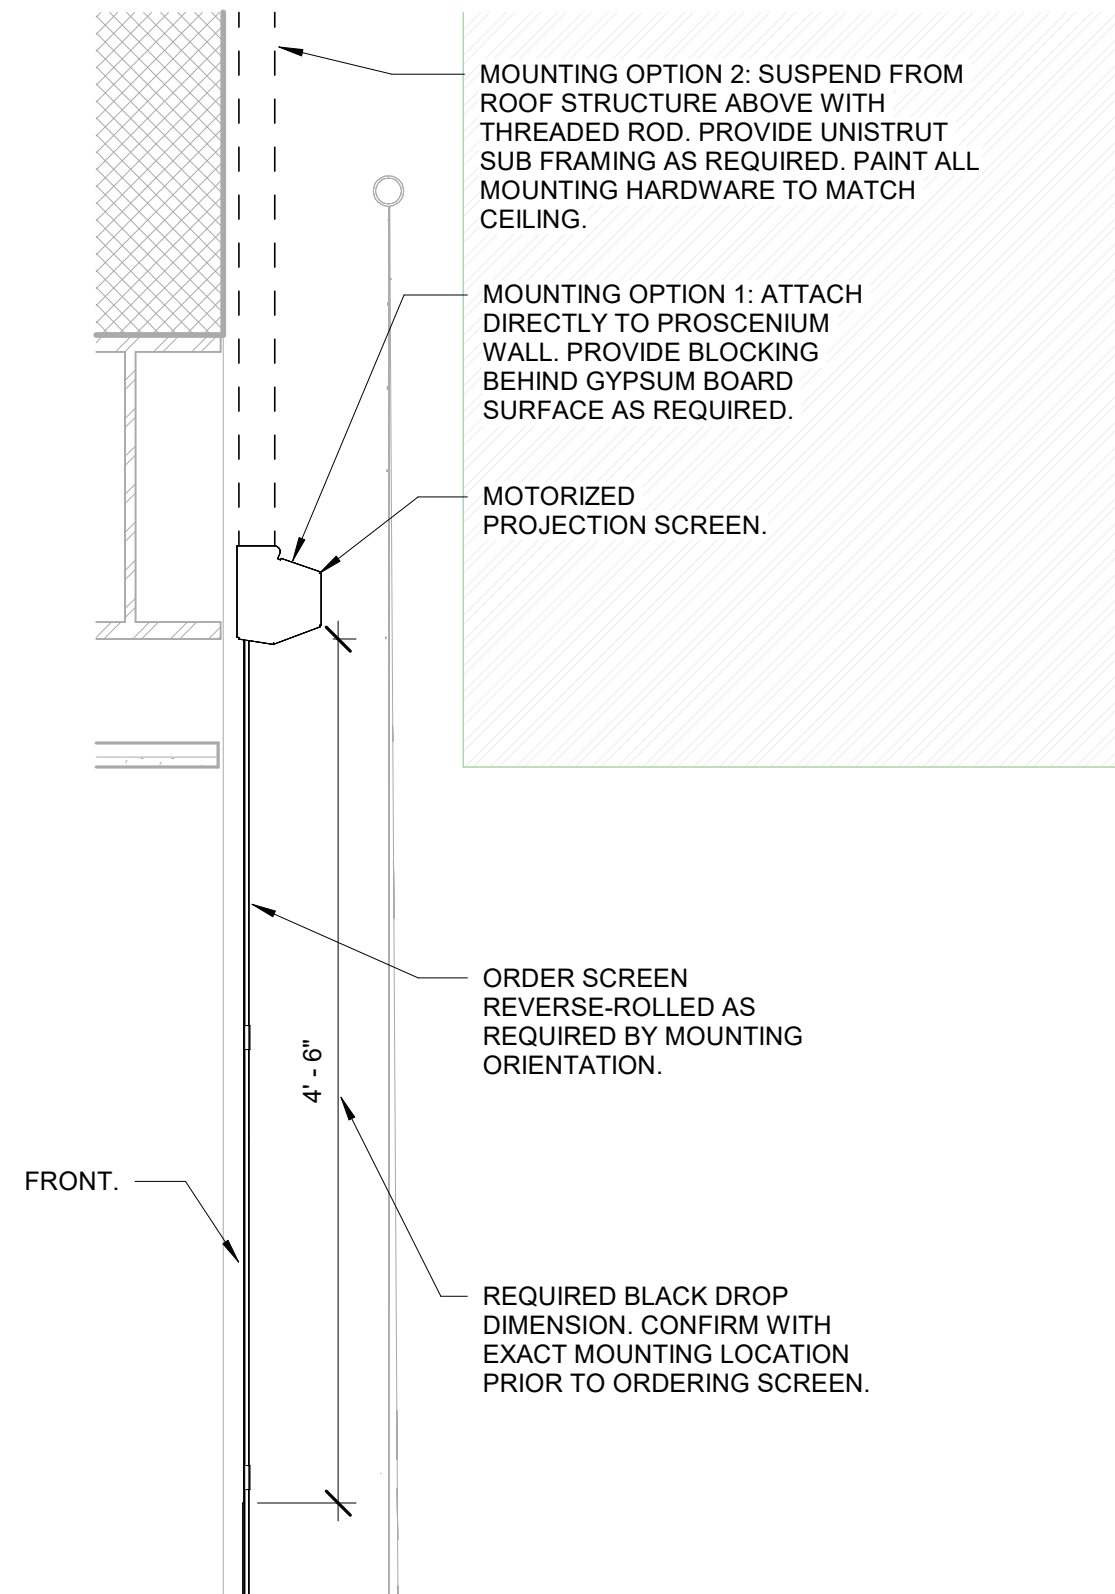

A1 Scale 1" = 1'-0" Projection Screen Mounting Detail

A7 Scale 1" = 1'-0" Recording Mic Mounting Detail

A12 Scale 1" = 1'-0" Projector and Camera Mounting Details

South Valley Middle School Storm Shelter Addition

Liberty School District

1000 Midjay Dr, Liberty, MO 64068

REVISIONS:		
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Structural Engineer
State Certificate of Authority #000442
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916.531.4144 phone


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Overland Park, KS 66210
913.317.9390 phone


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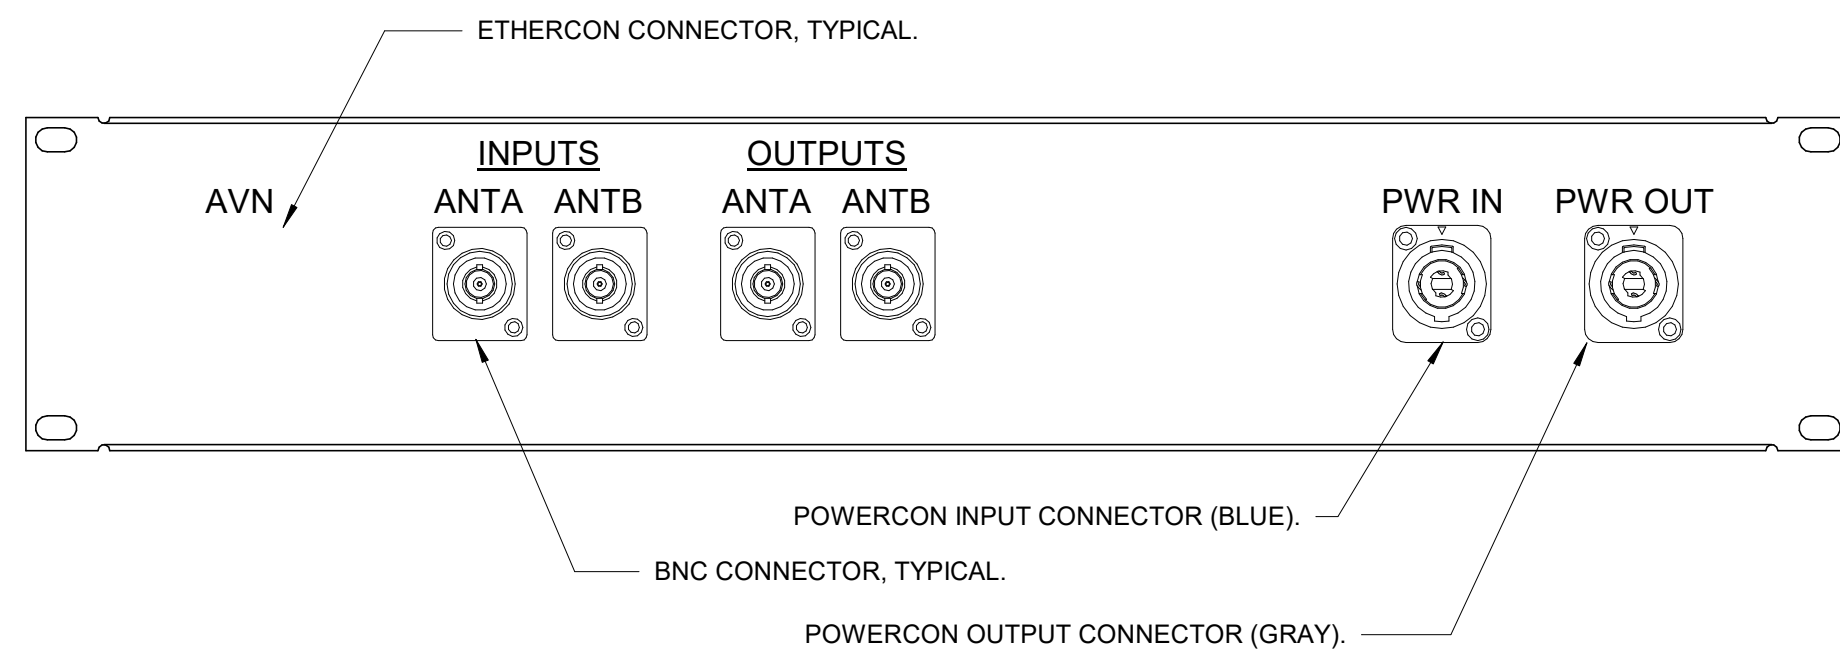
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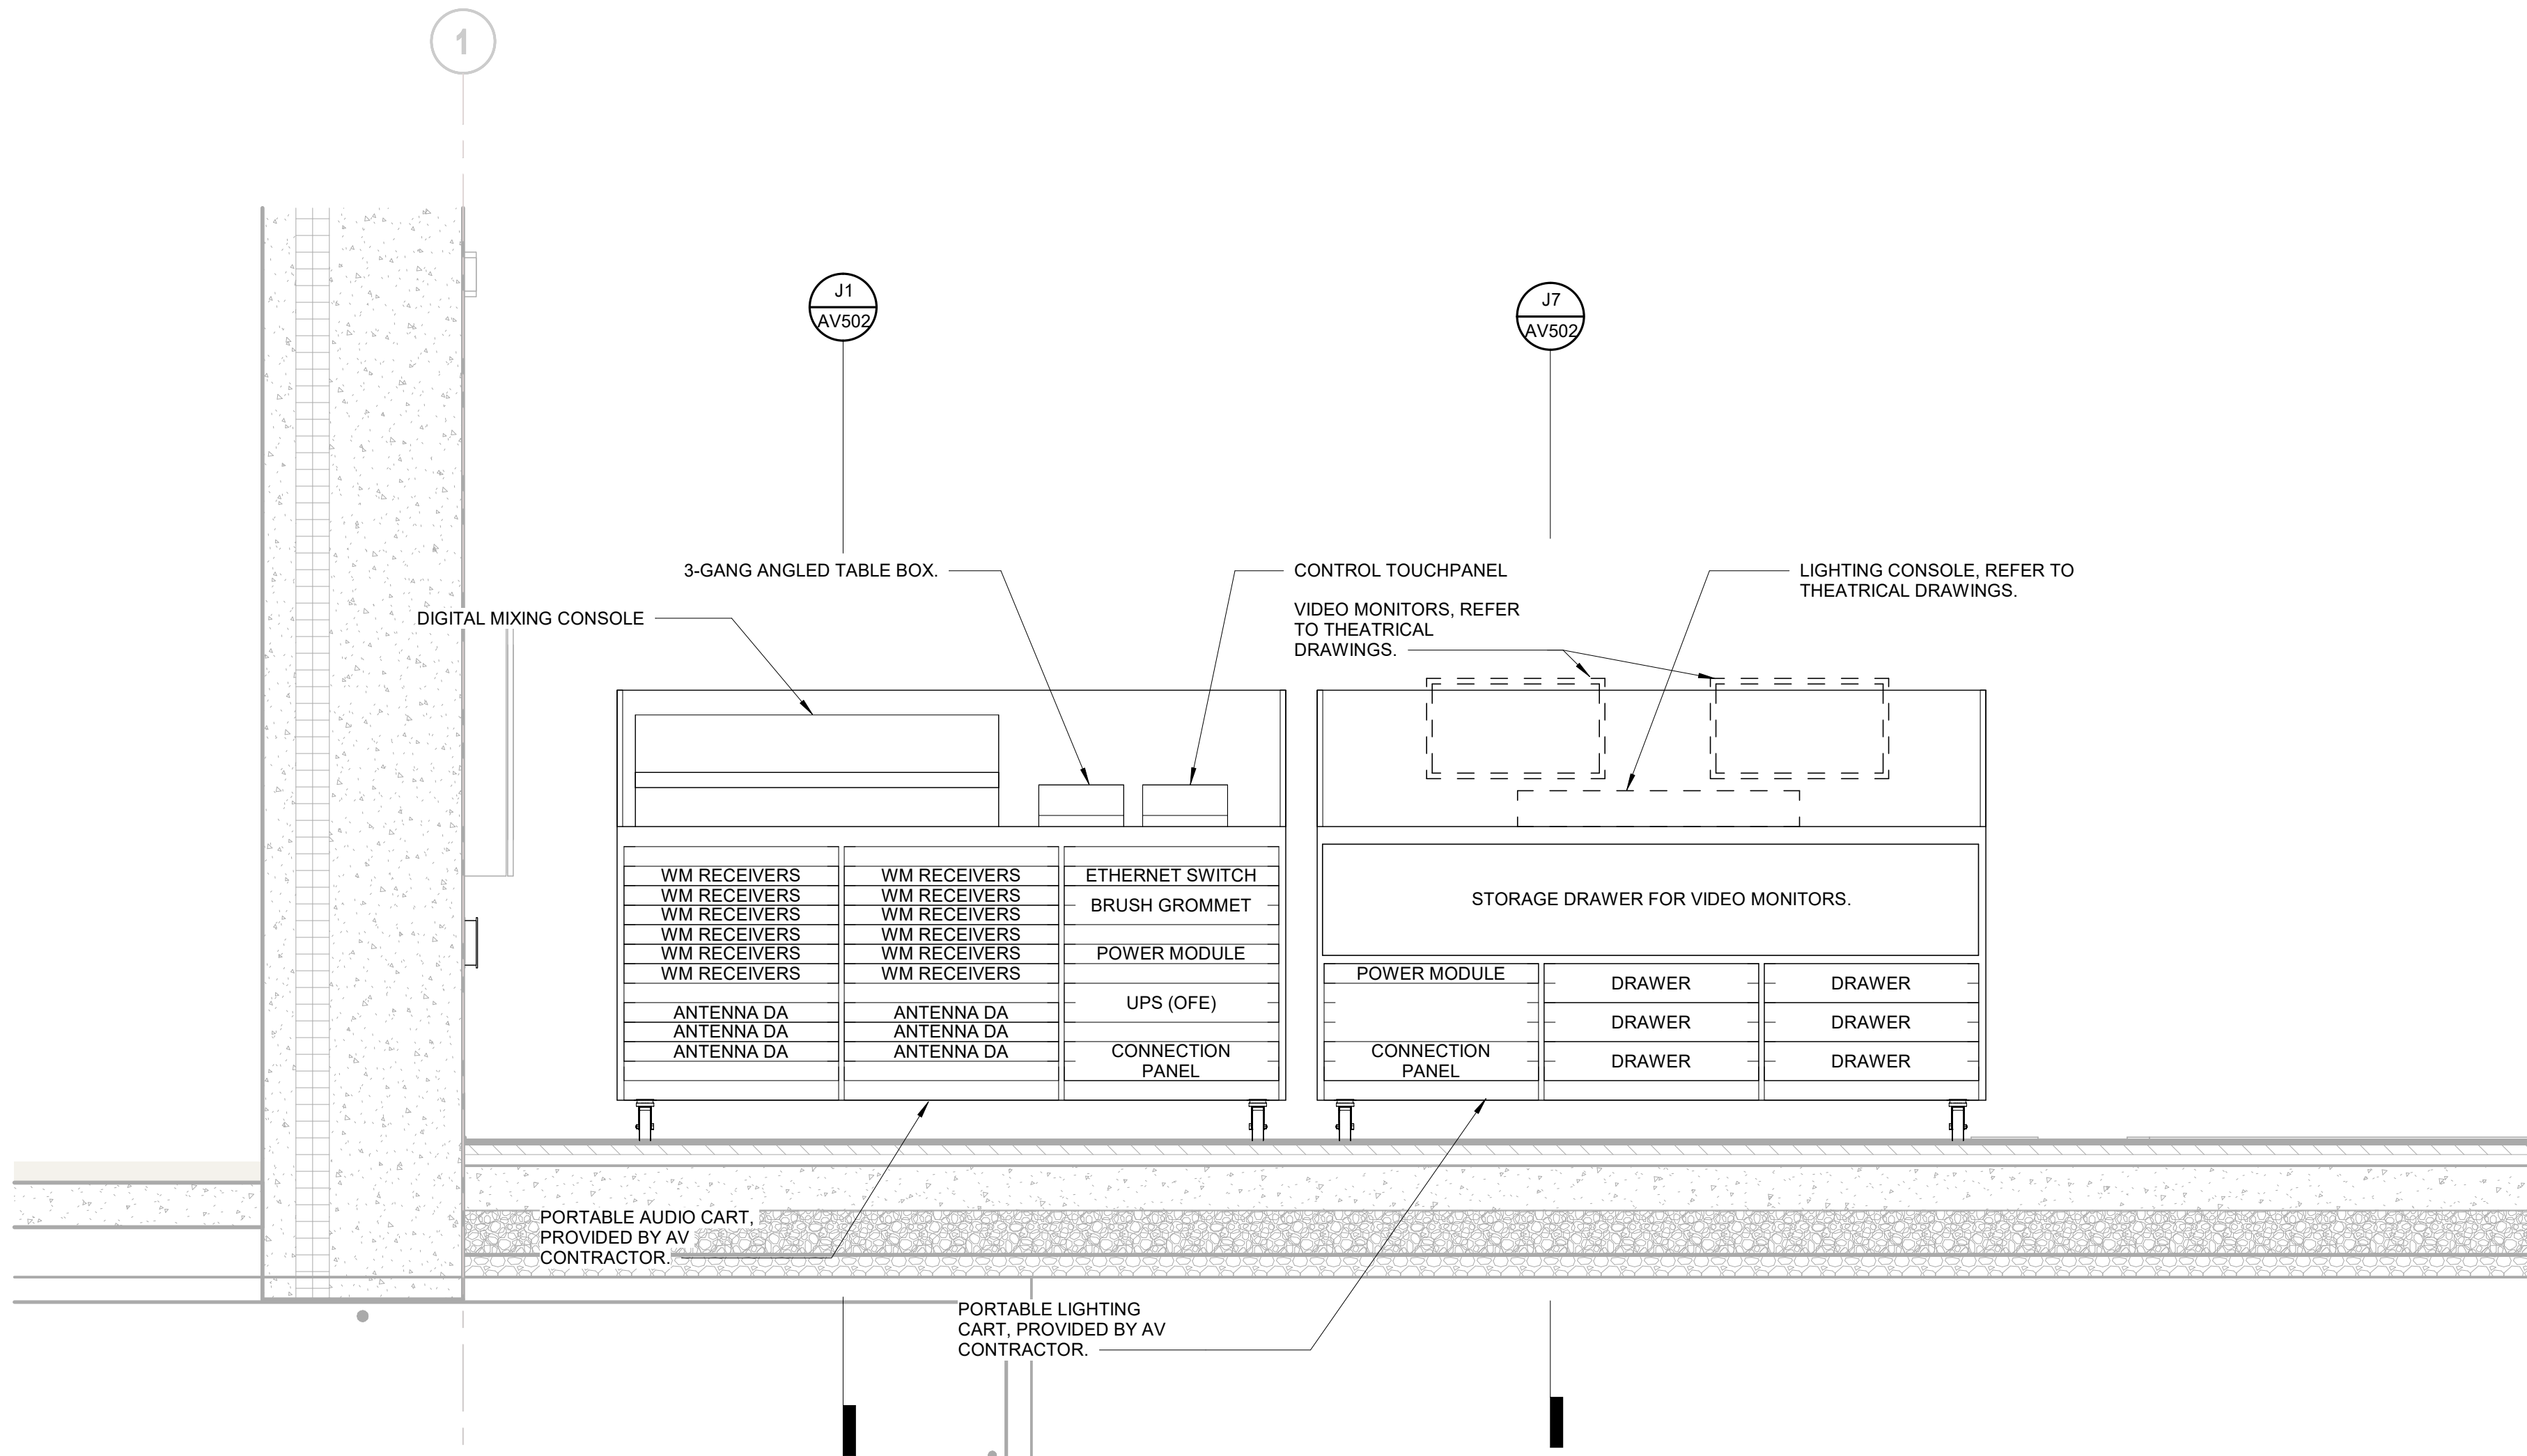
- GENERAL CONNECTION PANEL NOTES
- ALL CONNECTION PANELS SHALL HAVE COUNTERSUNK SCREW HOLES AND PHILLIPS COUNTERSUNK OR OVAL-HEAD SCREWS FINISHED TO MATCH PANEL. ALL LETTERING SHALL BE ENGRAVED AND FILLED DIRECTLY ON THE PANEL REGARDLESS OF PANEL COLOR. ALL PANEL MOUNTED CONNECTORS SHOULD MATCH THE FINISH COLOR OF THE PANEL WHEREVER POSSIBLE.
 - ALL STANDARD SIZED RACK PANELS USED TO MOUNT CONTROLS OR CONNECTORS SHALL HAVE FORMED EDGES, WITH ALL LETTERING ENGRAVED AND FILLED DIRECTLY ON THE PANEL.
 - VERIFY ALL DIMENSIONS AND SPACING FOR PANEL-MOUNTED COMPONENTS AND ENGRAVING. UNLESS NOTED OTHERWISE, ENGRAVED TEXT SHALL BE 3/16-INCH HIGH. SPACING BETWEEN PANEL-MOUNTED COMPONENTS SHALL BE SUFFICIENT TO ENABLE FRONT CABLE CONNECTIONS TO BE MADE EASILY.
 - CONNECTION PANEL LAYOUTS SHALL BE ACCORDING TO FUNCTION WITH ALL CONNECTIONS OF ONE TYPE LOCATED TOGETHER. LABELS SHALL BE LOCATED ABOVE THE CORRESPONDING CONNECTOR OR COMPONENT.
 - CONNECTION PANEL LAYOUTS SHOWN ARE FOR CONCEPT ONLY. REFER TO PLANS FOR ALL CONNECTION PANELS AND CONNECTIONS. SUBMIT A SHOP DRAWING FOR EACH CONNECTION PANEL WITH ALL CONNECTIONS, DEVICES, LABELS, COLORS AND SIZES CLEARLY INDICATED.
 - UNLESS NOTED OTHERWISE, STANDARD GANG CONNECTION PANELS SHALL BE SIERRA STAINLESS STEEL WALL PLATES, OR COLOR AS SELECTED BY ARCHITECT.
A. 12-INCHES OR SMALLER: 1/8-INCH THICK
B. LARGER THAN 12-INCHES: 3/16-INCH THICK
C. FIELD-VERIFY MOUNTING CONDITIONS FOR EACH BOX. FLUSH MOUNTED PLATES SHALL HAVE A MINIMUM 1/2-INCH FLANGE ON ALL SIDES.
 - UNLESS NOTED OTHERWISE, NEMA SIZE CONNECTION PANELS SHALL BE CLEAR ANODIZED BRUSHED ALUMINUM, OR COLOR AS SELECTED BY ARCHITECT.




M13 Scale 6" = 1'-0" Stage Connection Plate Detail

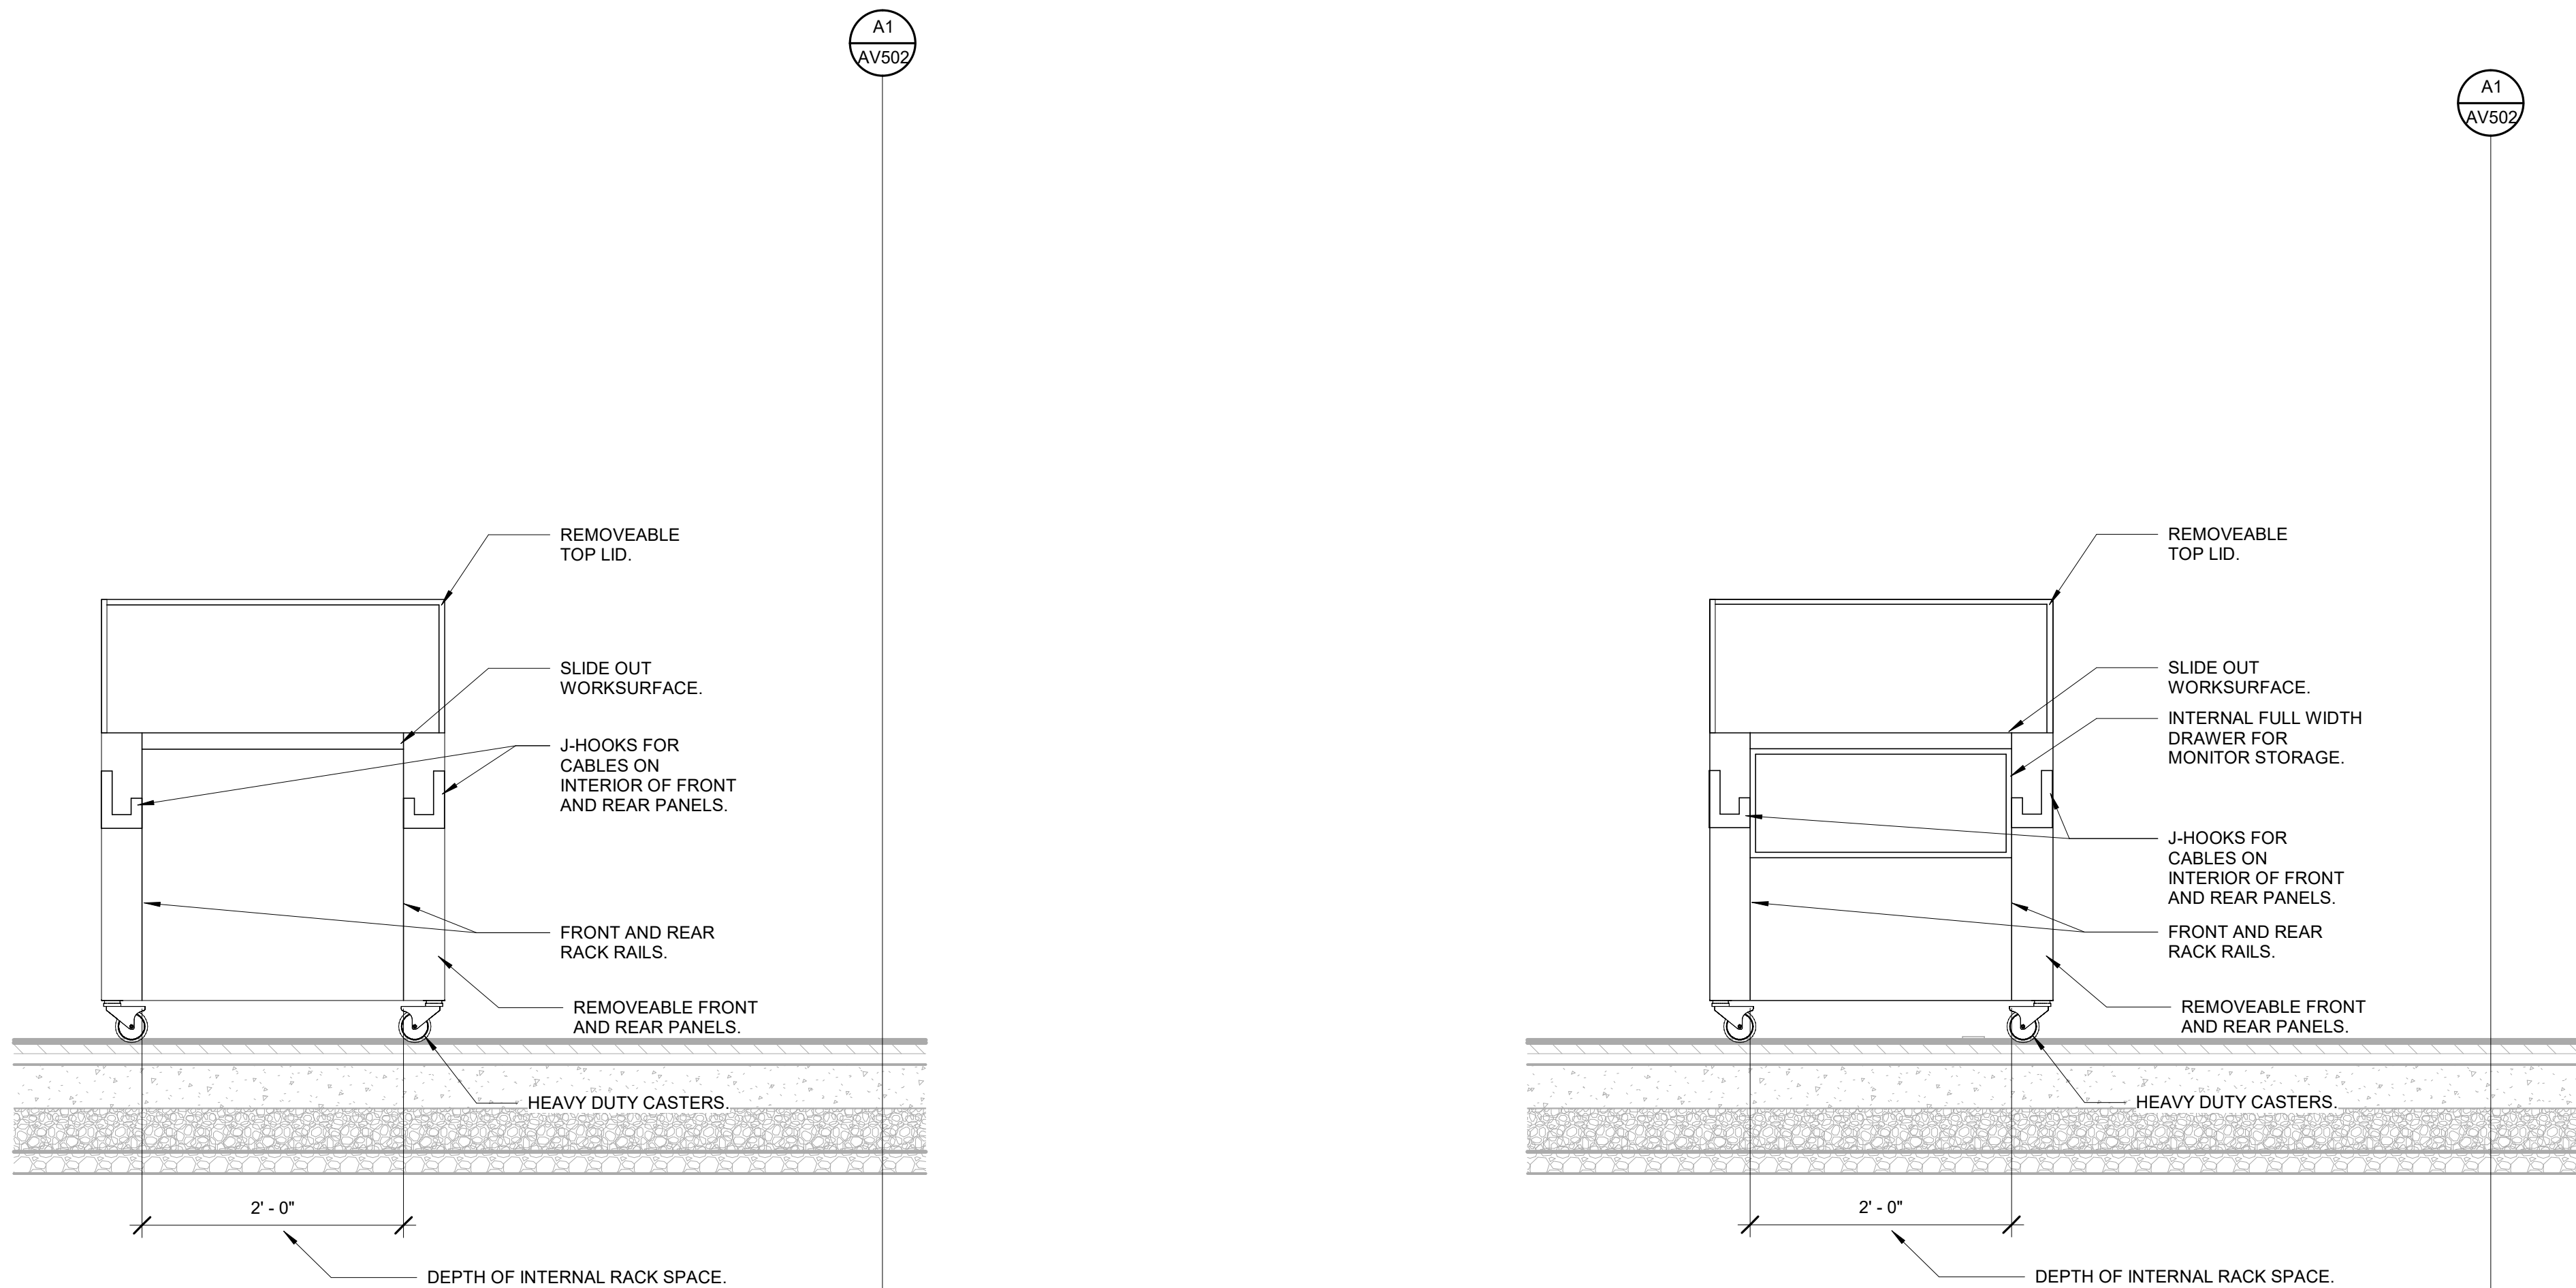

J13 Scale 6" = 1'-0" Audio Cart Connection Panel Detail

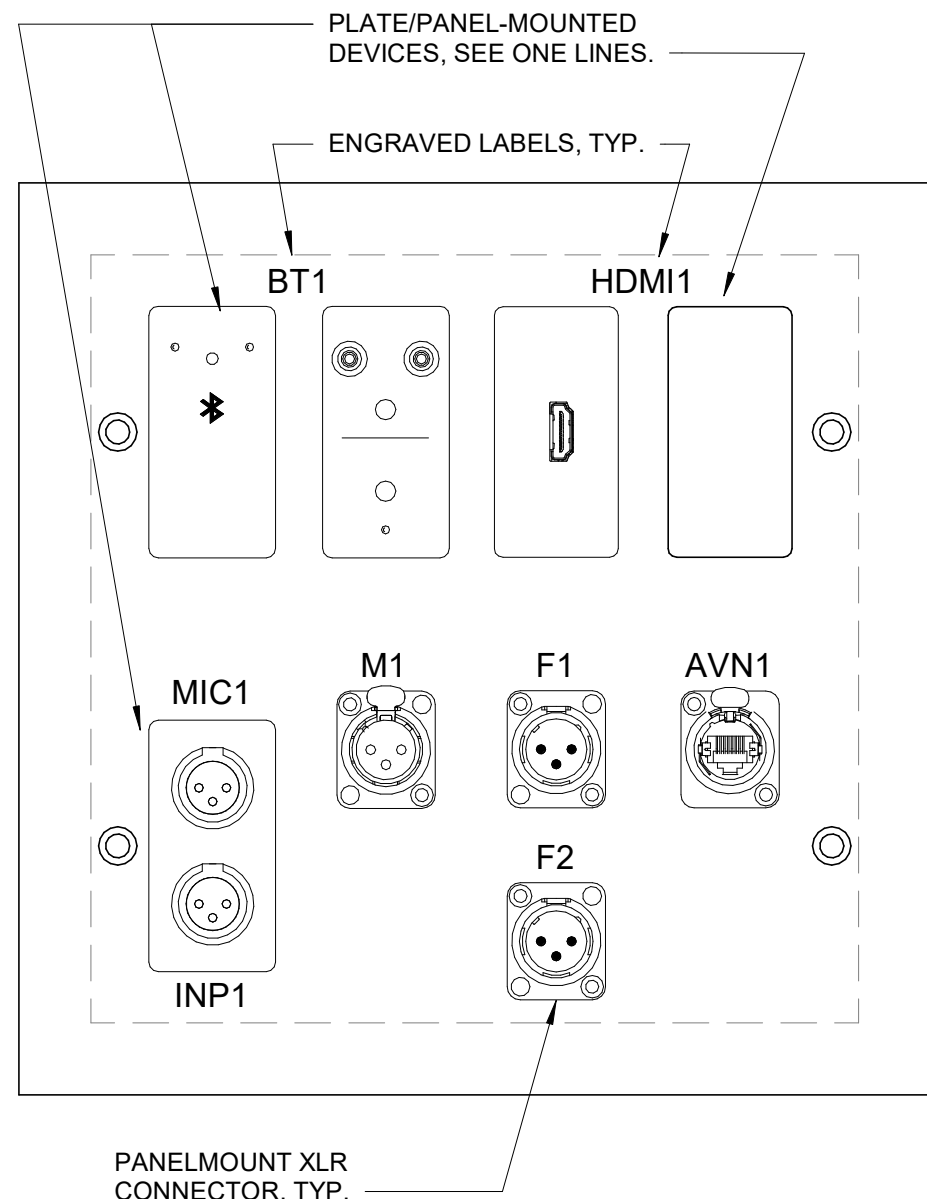

A1 Scale 1" = 1'-0" Portable Carts Front Elevation

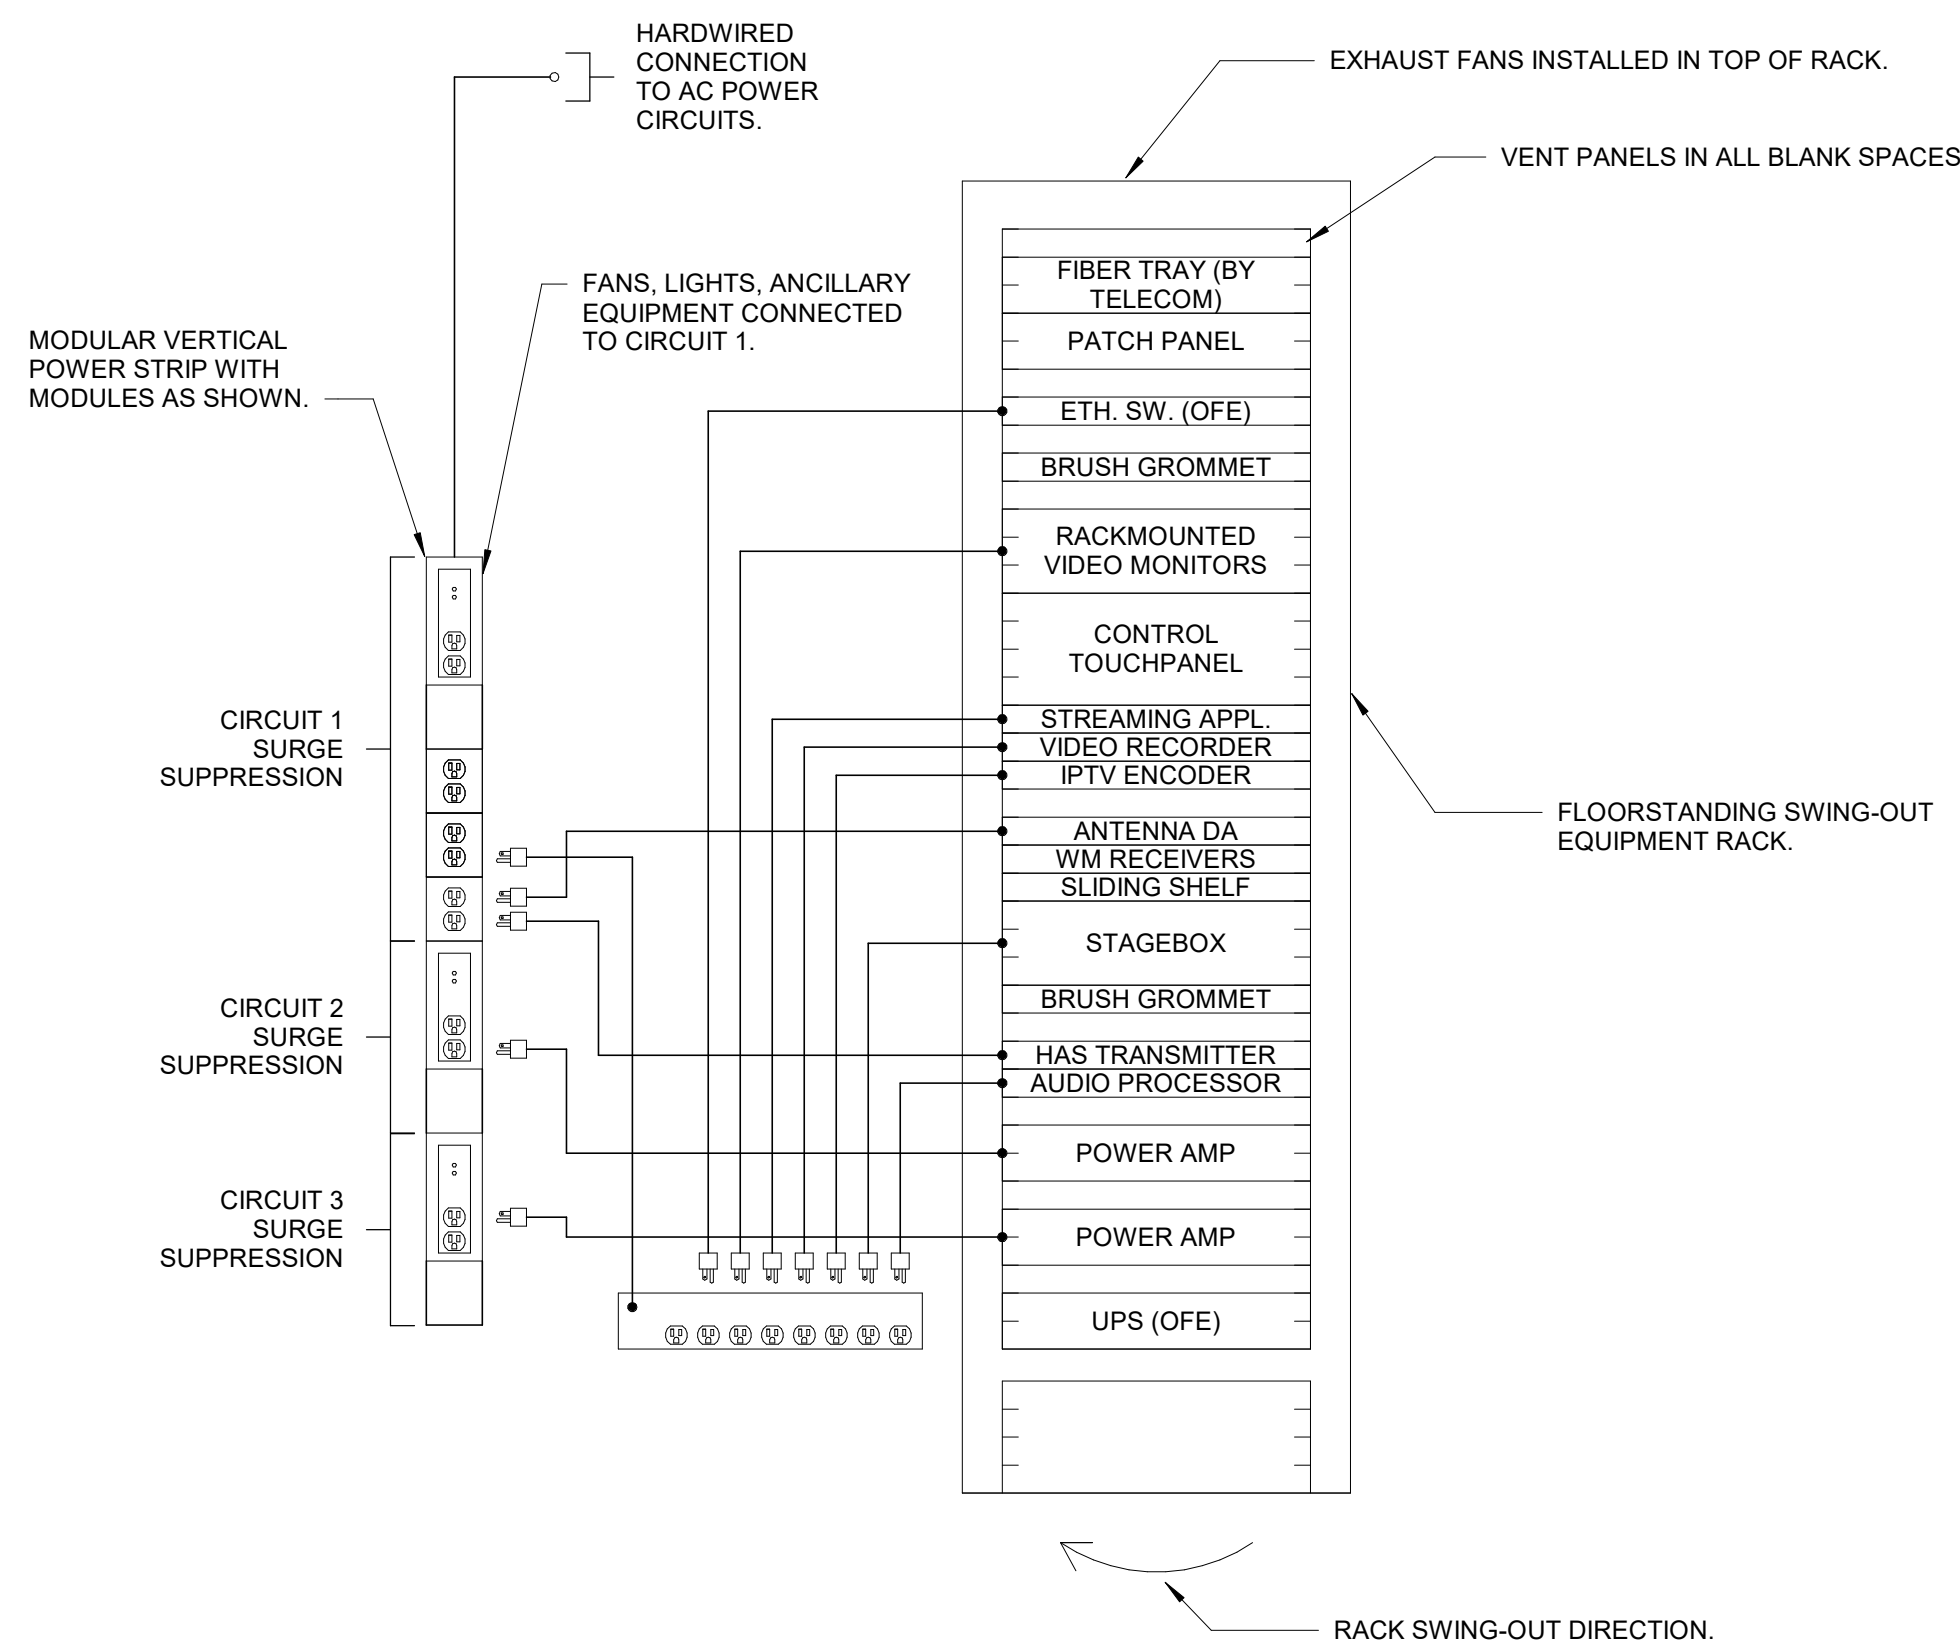

A13 Scale 1" = 1'-0" Equipment Rack Elevation

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Architecture # 0000161
Structure # 200601333

Bob D Campbell
Structural Engineer
State Certificate of Authority #000442
4338 Bellevue Ave
Kansas City, MO 64111
816.531.4144 phone

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Mechanical, Electrical, & Plumbing
State Certificate of Authority #EGC000178
25618 W 103rd Street
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913.345.2127 phone

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Surveying #2006027139
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Theatrical Consultant
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Warrensburg, MO 64093-0752
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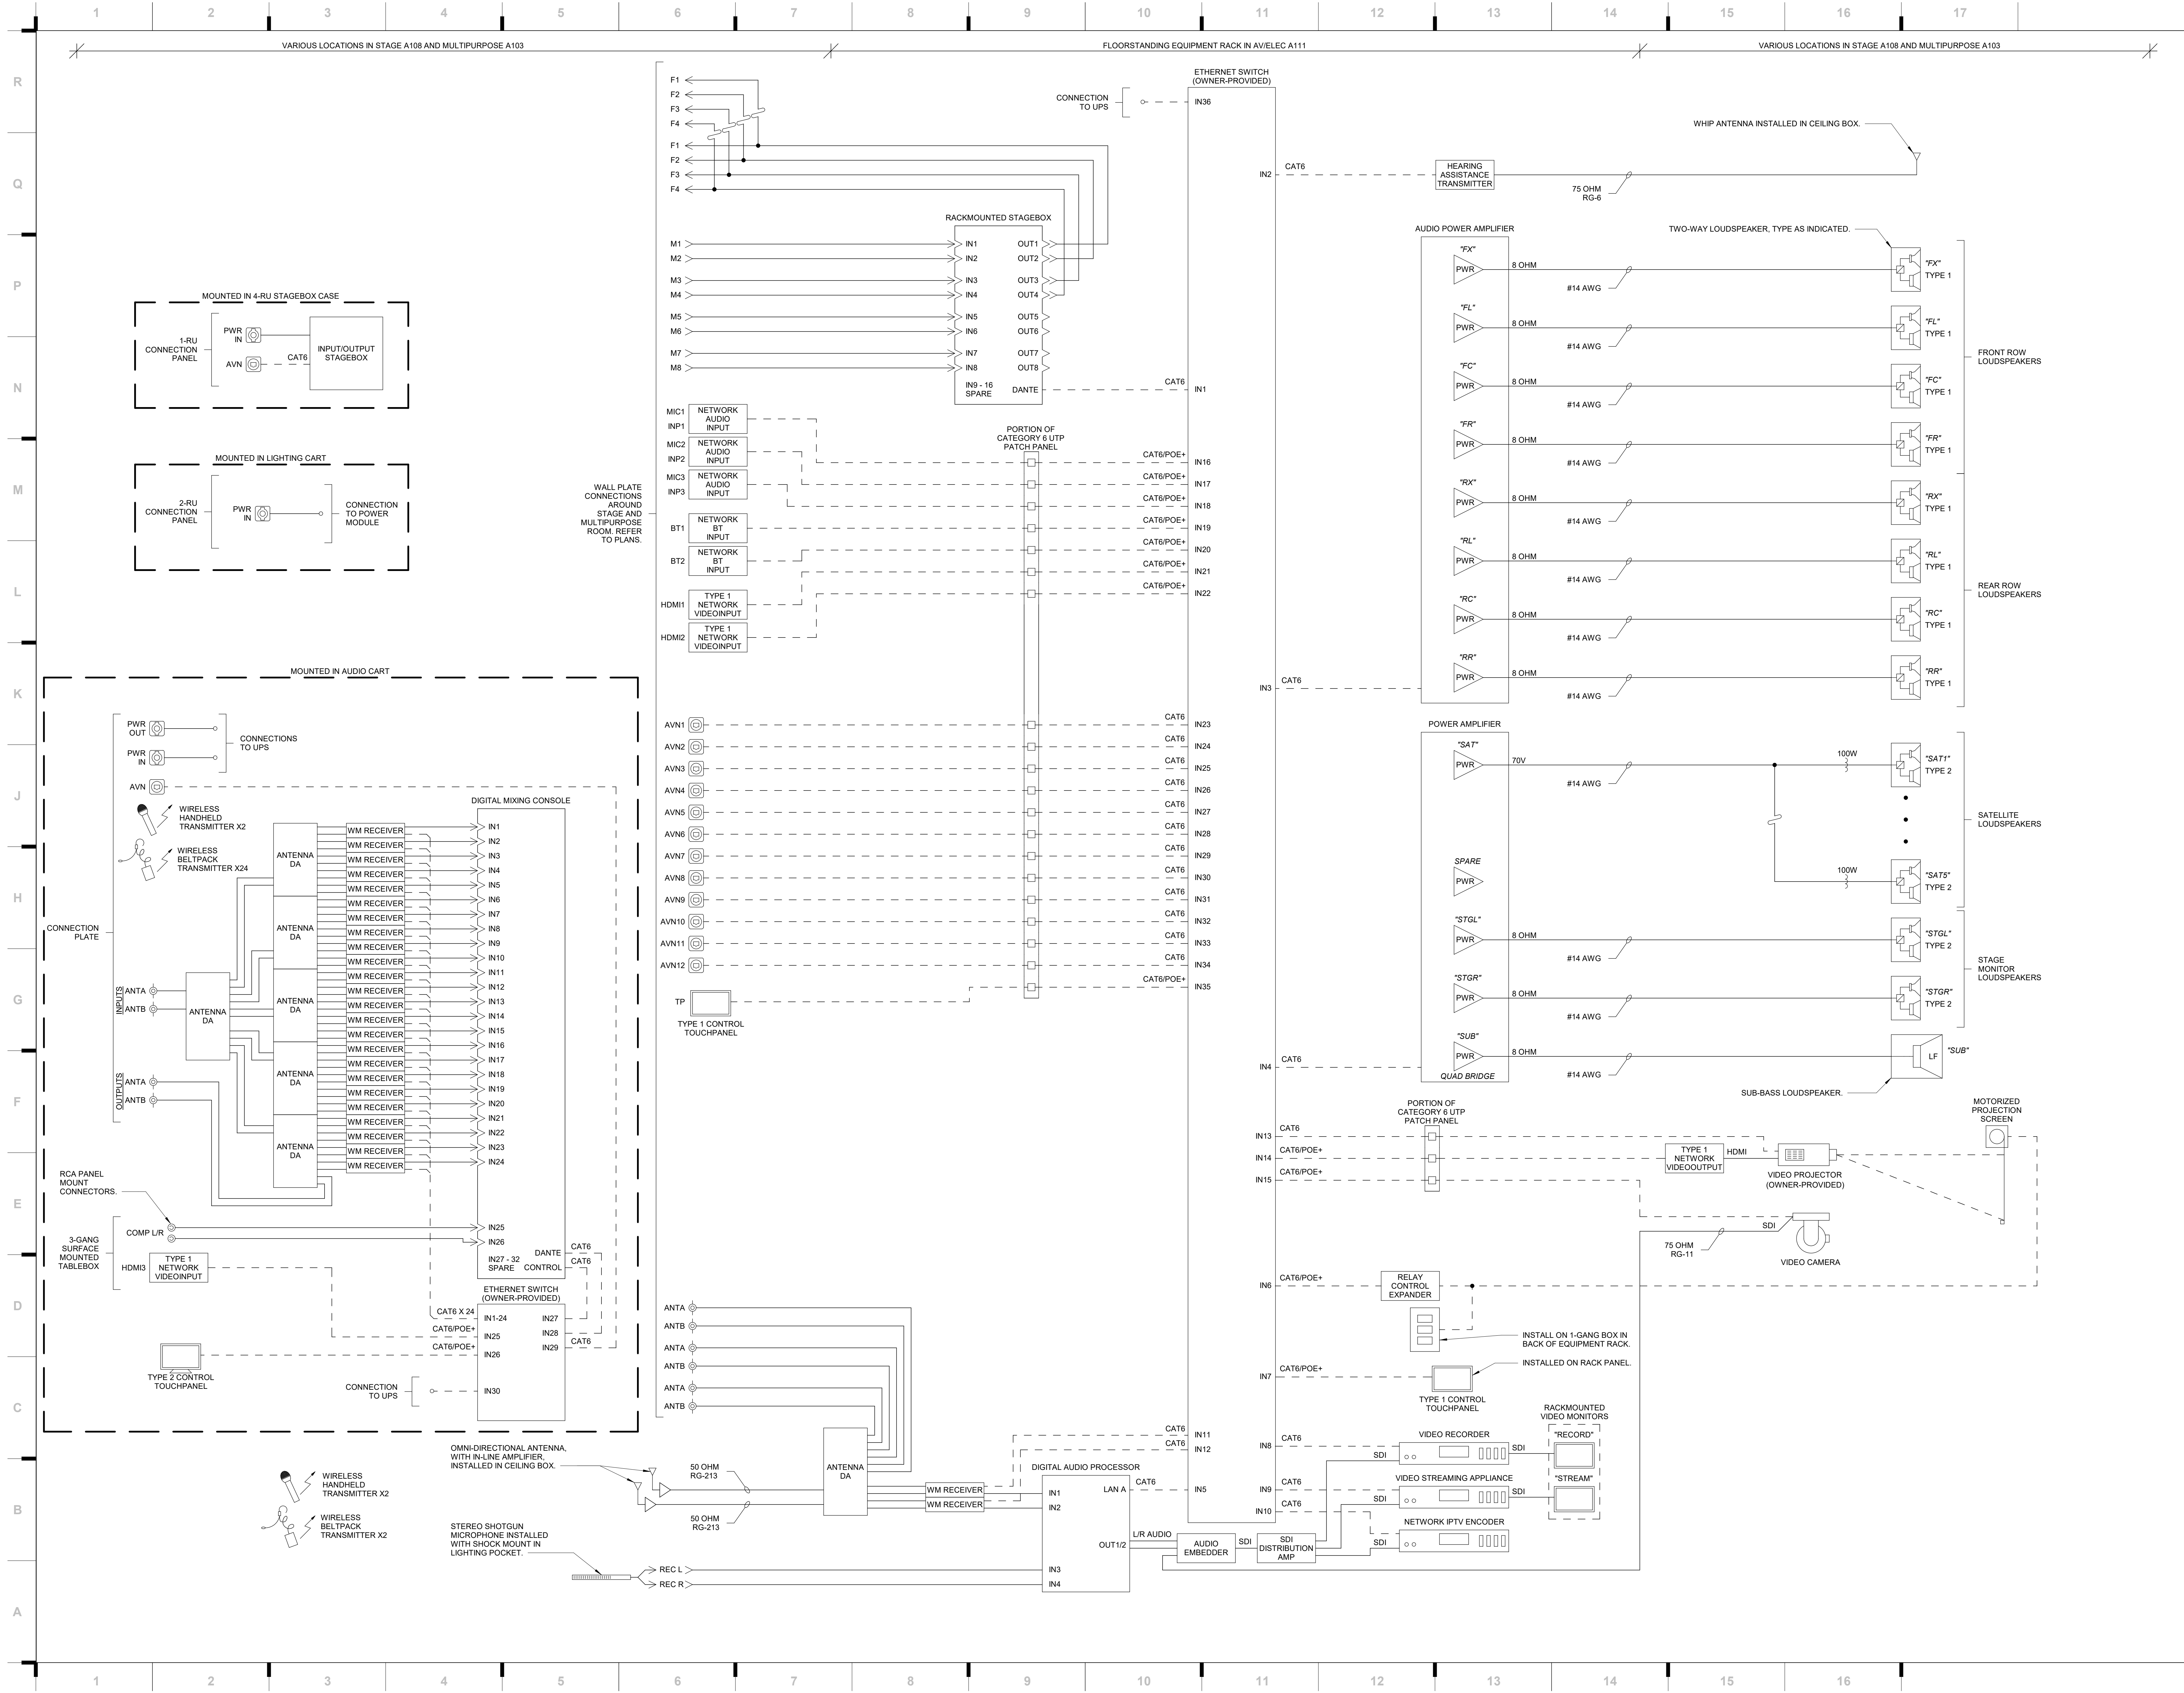
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Architecture # 0000101
Structure # 200601333

Bob D Campbell
Structural Engineer
State Certificate of Authority #000442
4338 Bellevue Ave
Kansas City, MO 64111
816.531.4144 phone

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Mechanical, Electrical, & Plumbing
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Overland Park, KS 66210
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109 E Pine St.
Warrensburg, MO 64093-0752
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South Valley Middle School Storm Shelter Addition

Liberty School District

1000 Midjay Dr, Liberty, MO 64068

REVISIONS:

#	Description	Date
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JOB NO: 23019
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AV601

AV ONE-LINE DIAGRAM

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SHEET KEYNOTE LEGEND

GENERAL NOTES:


1. PROVIDE NFPA 13 COMPLIANT SPRINKLER SYSTEM FOR THE ADDITION.
2. CAREFULLY COORDINATE ALL SPRINKLER HEAD TYPES, COLOR, AND EXPOSED PIPING LOCATIONS WITH ARCHITECT FOR DESIRED AESTHETICS OF THE SPACES PRIOR TO INSTALLATION.
 - a. REFER TO ARCHITECTURAL RCP LAYOUT FOR CEILING TYPES AND SPACES OPEN TO STRUCTURE.
 - b. GYP. CEILINGS REQUIRE CONCEALED HEADS WITH COVER- WHITE COLOR FOR WHITE CEILINGS- PROVIDE CUSTOM COLOR BY ARCHITECT.
 - c. WOOD AND OTHER SPECIALTY CEILINGS SHALL USE CONCEALED HEADS WITH CUSTOM FINISH BY ARCHITECT.
 - d. ACT CEILINGS PROVIDE SEMI-RECESSED PENDANT HEADS.
3. REFER TO SPECIFICATIONS FOR ADDITIONAL INFORMATION.
4. CAREFULLY COORDINATE PIPE ROUTING WITH STRUCTURE AS WELL AS ALL OTHER TRADES TO MAINTAIN EQUIPMENT CLEARANCES AND DESIRED CEILING HEIGHTS.
5. COORDINATE ALL PIPING PENETRATIONS WITH STRUCTURAL PRIOR TO CORE DRILLING.
6. PROVIDE FIRESTOPPING AT PENETRATIONS OF ALL RATED WALLS. REFER TO CODE PLANS FOR LOCATIONS OF RATED WALLS.
7. PROVIDE ICC 500 PROTECTION SHROUD FOR ALL PENETRATIONS OF THE ICC 500 SHELTER WALLS.

PLAN NOTES:

- 1 PROVIDE SPRINKLER SYSTEM FOR BUILDING ADDITION PER NFPA 13 REQUIREMENTS. PROVIDE ALL NECESSARY ACCESSORIES AND REQUIREMENTS FOR NEW ZONE. CONNECT TO THE EXISTING FIRE PROTECTION SYSTEM.
- 2 MODIFY THE EXISTING SPRINKLER SYSTEM AS REQUIRED TO ACCOMMODATE ROOM AND CEILING CHANGES.
- 3 EXISTING CEILINGS ARE BEING REPLACED. UNINSTALL THE EXISTING CEILING-MOUNTED SPRINKLER HEADS AND REINSTALL IN NEW CEILINGS. MODIFY THE EXISTING SPRINKLER SYSTEM AS REQUIRED TO ACCOMMODATE ROOM AND CEILING CHANGES.
- 4 COORDINATE ALL PIPE ROUTING AND SPRINKLER LOCATIONS WITH ARCHITECT AND THEATRICAL COMPONENTS.

smith & boucher
engineers
25618 west 103rd St. olathe, ks 66061
phone 913.345.2127 fax 913.345.0617
project number 2314703

KEY PLAN

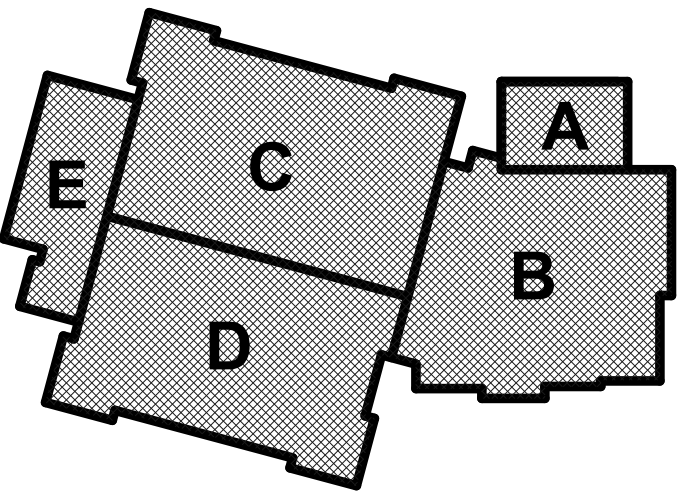


South Valley Middle School Storm Shelter Addition

Liberty School District

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FP101

OVERALL FIRE PROTECTION PLAN - LEVEL 1

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Bob D Campbell
Structural Engineer
State Certificate of Authority #000442
4338 Bellevue Ave
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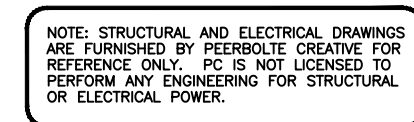
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RIGGING PLAN
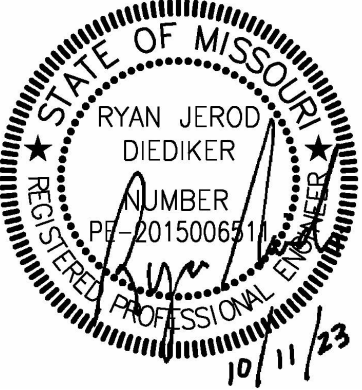
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Structural Engineer
State Certificate of Authority #000442
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Mechanical, Electrical, & Plumbing
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25618 W 103rd Street
Olathe, KS 66061
913.345.2127 phone

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Civil Engineer
State Certificate of Authority
Engineering #2001009364
Landscaping #2006027139
Surveying #2006027138
11827 W 112th Street, Suite 2
Overland Park, KS 66210
913.317.9390 phone

Peerbolte Creative
Theatrical Consultant
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Warrensburg, MO 64093-0755

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1	Addendum 01	09/14/2023
2	Addendum 04	09/28/2023

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RIGGING PLAN

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IDEN #	DIST. FROM DATUM	LINE SET DESCRIPTION	CURTAIN WIDTH	CURTAIN HEIGHT	CURTAIN FULLNESS	CURTAIN FABRIC	CURTAIN COLOR	LOW TRIM AFF*	TRACK # OR BATTEN LENGTH	DIST FROM CENTER LINE	TRACK OPERATION	STACKING	NOTES	HANGING	ESTIMATED LOAD
1	12"	MAIN VALANCE	47'4"	2'10"	75%	22 OZ ENCORE	TBD	17'1"^^	47'4" PIPE BATTEN	-	TIED TO BATTEN	-	DEAD HUNG	DEAD HUNG	300#
2	1'8"	GRAND DRAPE	26'0"(2)	21'0"	75%	22 OZ ENCORE	TBD	3/4"	(1)30'4" (1) 30'0" #280 TRACK	-	ENDLESS LINE PLATFORM RIGHT	BI-PARTING	4 CHAINS 8'AFF TWO 36" BAGS	DEAD HUNG	1,200#
3	2'8"	1ST LEG	10'0"	22'0"	50%	15 oz	BLACK	3/4"	(2)12'4" #280 TRACK	-	ENDLESS LINE OFF PLATFORM	ONE-WAY	4 CHAINS 8'AFF TWO 24" BAGS	DEAD HUNG	300#
4	3'5"	1ST BORDER	47'4"	6'0"	50%	15 OZ	BLACK	17'1"	47'4" PIPE BATTEN	-	TIED TO BATTEN	-	DEAD HUNG	DEAD HUNG	300#
5	5'4"	1ST ELECTRIC	-	-	-	-	-	21'1"	47'4" PIPE BATTEN	-	-	-	-	DEAD HUNG	1000#
6	6'0"	2ND LEG	10'(2)	23'(2)	50%	15 OZ	BLACK	3/4"	(2)12'4" #280 TRACK	-	ENDLESS LINE OFF PLATFORM	ONE-WAY	4 CHAINS 8'AFF TWO 24" BAGS	DEAD HUNG	300#
7	6'10"	SCENERY TRACK	-	-	-	-	-	21'0"	58'2" 280 TRACK	-	WALK ALONG	-	4 SCENERY CARRIERS	DEAD HUNG	1000#
8	8'8"	2ND BORDER	47'4"	6'0"	50%	15 OZ	BLACK	18'0"	47'4" PIPE BATTEN	-	TIED TO BATTEN	-	-	DEAD HUNG	300#
9	9'4"	3RD LEG	10'(2)	23'(2)	50%	15 OZ	TBD	3/4"	(1)12'4" (1) 12'6" #280 TRACK	-	ENDLESS LINE OFF PLATFORM	ONE-WAY	4 CHAINS 8'AFF TWO 24" BAGS	DEAD HUNG	300#
10	10'8"	2ND ELECTRIC	-	-	-	-	-	21'0"^^	47'4" PIPE BATTEN	-	-	-	DEAD HUNG	DEAD HUNG	1,500#
11	12'0"	MID TRAVELLER	26'0"(2)	22'0"	50%	15 OZ	BLACK	3/4"	(1)30'2" (1) 30'0" #280 TRACK	-	ENDLESS LINE OFF PLATFORM	BI-PARTING	4 CHAINS 8'AFF TWO 36" BAGS	DEAD HUNG	1,000#
12	13'4"	3RD BORDER	47'4"	5'0"	50%	15-OZ	BLACK	18'0"	47'4" PIPE BATTEN	-	TIED TO BATTEN	-	-	DEAD HUNG	300#
13	14'8"	SCENERY TRACK	-	-	-	-	-	21'0"^^	58'2" 280 TRACK	-	WALK ALONG	-	4 SCENERY CARRIERS	DEAD HUNG	1000#
14	15'8"	4TH LEG	10'(2)	23'(2)	50%	15-OZ	TBD	3/4"	(1)12'4" (1) 12'6" #280 TRACK	-	ENDLESS LINE OFF PLATFORM	ONE-WAY	4 CHAINS 8'AFF TWO 24" BAGS	DEAD HUNG	300#
15	17'4"	4TH BORDER	47'4"	6'0"	50%	15 OZ	BLACK	17'0"	47'4" PIPE BATTEN	-	TIED TO BATTEN	-	-	DEAD HUNG	300#
16	18'0"	SCENERY TRACK	-	-	-	-	-	23'0"^^	58'2" 280 TRACK	-	WALK ALONG	-	4 SCENERY CARRIERS	DEAD HUNG	1000#
17	19'4"	5TH LEG	10'(2)	23'(2)	50%	15-OZ	TBD	3/4"	(1)12'4" (1) 12'6" #280 TRACK	-	ENDLESS LINE OFF PLATFORM	ONE WAY	4 CHAINS 8'AFF TWO 24" BAGS	DEAD HUNG	300#
18	21'4"	SCENERY TRACK	-	-	-	-	-	23'0"^^	58'2" 280 TRACK	-	WALK ALONG	-	4 SCENERY CARRIERS	DEAD HUNG	1000#
19	22'8"	3RD ELECTRIC	-	-	-	-	-	23'0"^^	47'4" PIPE BATTEN	-	-	-	-	DEAD HUNG	1,500#
20	24'0"	UPPLATFORM TRAVLER	26'0"(2)	22'0"	50%	15 OZ	BLACK	3/4"	(1)30'2" (1) 30'0" #280 TRACK	-	ENDLESS LINE PLATFORM RIGHT	BI-PARTING	4 CHAINS 8'AFF TWO 36" BAGS	DEAD HUNG	1,000#
21	25'6"	SCENERY TRACK	-	-"	-	-	-	23'0"^^	58'2" TRACK	-	-	WALK ALONG	4 SCENERY CARRIERS	DEAD HUNG	1000#
22	27'0"	CYC	51'0"	22'0"	0%	-	GREY	3/4"	58'2" TRACK	-	ENDLESS LINE PLATFORM LEFT	ONE-WAY	2 CHAINS 8'AFF ONE 36" BAG	DEAD HUNG	500#

SCOREBOARD CURTAIN															
1	TBD	SCOREBOARD	4'6"	5'0"	0%	BANJO	TBD	15'1"	(1)13'8" 113 SPECIFINE	-	ENDLESS LINE HOUSE LEFT	BI-PARTING OP 10'0"AFF	MOUNT 3" ABOVE SCOREBOARD	WALL MOUNT	200#

*ABOVE STAGE FLOOR, TO CENTERLINE OF ELECTRIC LOWER BATTEN, OR BOTTOM OF CURTAIN.
ALL DIMENSIONS ARE APPROXIMATE. ACTUAL SIZES AND ELEVATIONS SHALL BE DETERMINED BY EXISTING CONDITIONS AND FIELD MEASUREMENTS.

A1

Scale

NO SCALE

RIGGING SCHEDULE

8'4'0'8'

PROJECT NORTH

TRUE NORTH

1	2	3	4	5	6	7	8	9	10	11	12	13	14	15	16
---	---	---	---	---	---	---	---	---	----	----	----	----	----	----	----

PEERROUTE CREATIVE LLC

109 E PINE STREET
PO BOX 754
WARRENSBURG MO, 64093
PHONE (660)429-1383
FAX (660)429-3666
www.peerbolte.com

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1828 Walnut Street Suite 922
Kansas City, MO 64108
t 816.442.7700

115 Wilcox Street Suite 210
Castle Rock, CO 80104
T 720.949.1689

HOLLISANDMILLER.COM

Hollis + Miller Architects
Missouri State Certificate of Authority
Architecture # 0000181

Bob D Campbell
Structural Engineer
State Certificate of Authority #000442
4338 Belleview Ave
Kansas City, MO 64111
816.531.4144 phone

Smith & Boucher, Inc.
Mechanical, Electrical, & Plumbing
State Certificate of Authority #EGC000178
25618 W 103rd Street
Olathe, KS 66061
913.345.2127 phone

MKEC Engineering, Inc.

Civil Engineer
State Certificate of Authority
Engineering #2001009364
Landscaping #2006027139
Surveying #2006027138
11827 W 112th Street, Suite 2
Overland Park, KS 66210
913.317.9390 phone

Peerbolte Creative
Theatrical Consultant
109 E Pine St.
Warrensburg, MO 64093-0750

660.429.1383 phone
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Lenexa, KS 66215
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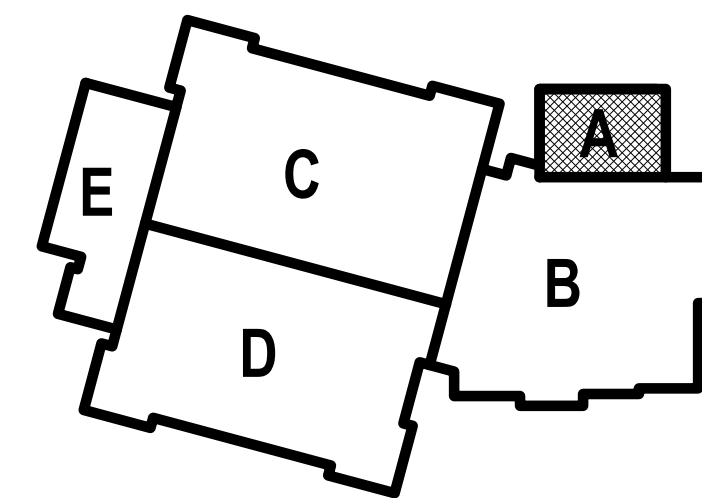
South Valley Middle School Shelter Addition

Liberty Public Schools

1000 Midjay Dr, Liberty, MO 64068

#	Description	Date
1	Addendum 01	09/14/2023
2	Addendum 04	09/28/2023

KEY PLAN





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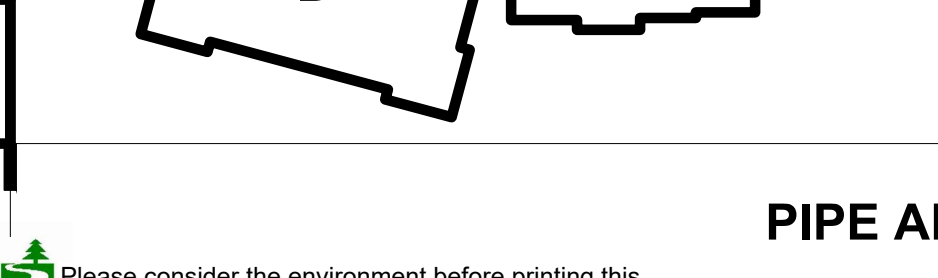
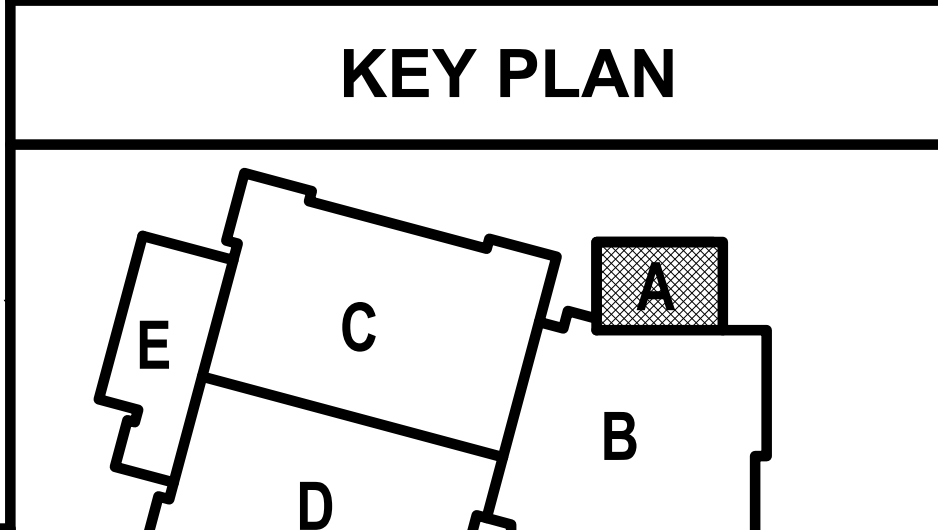
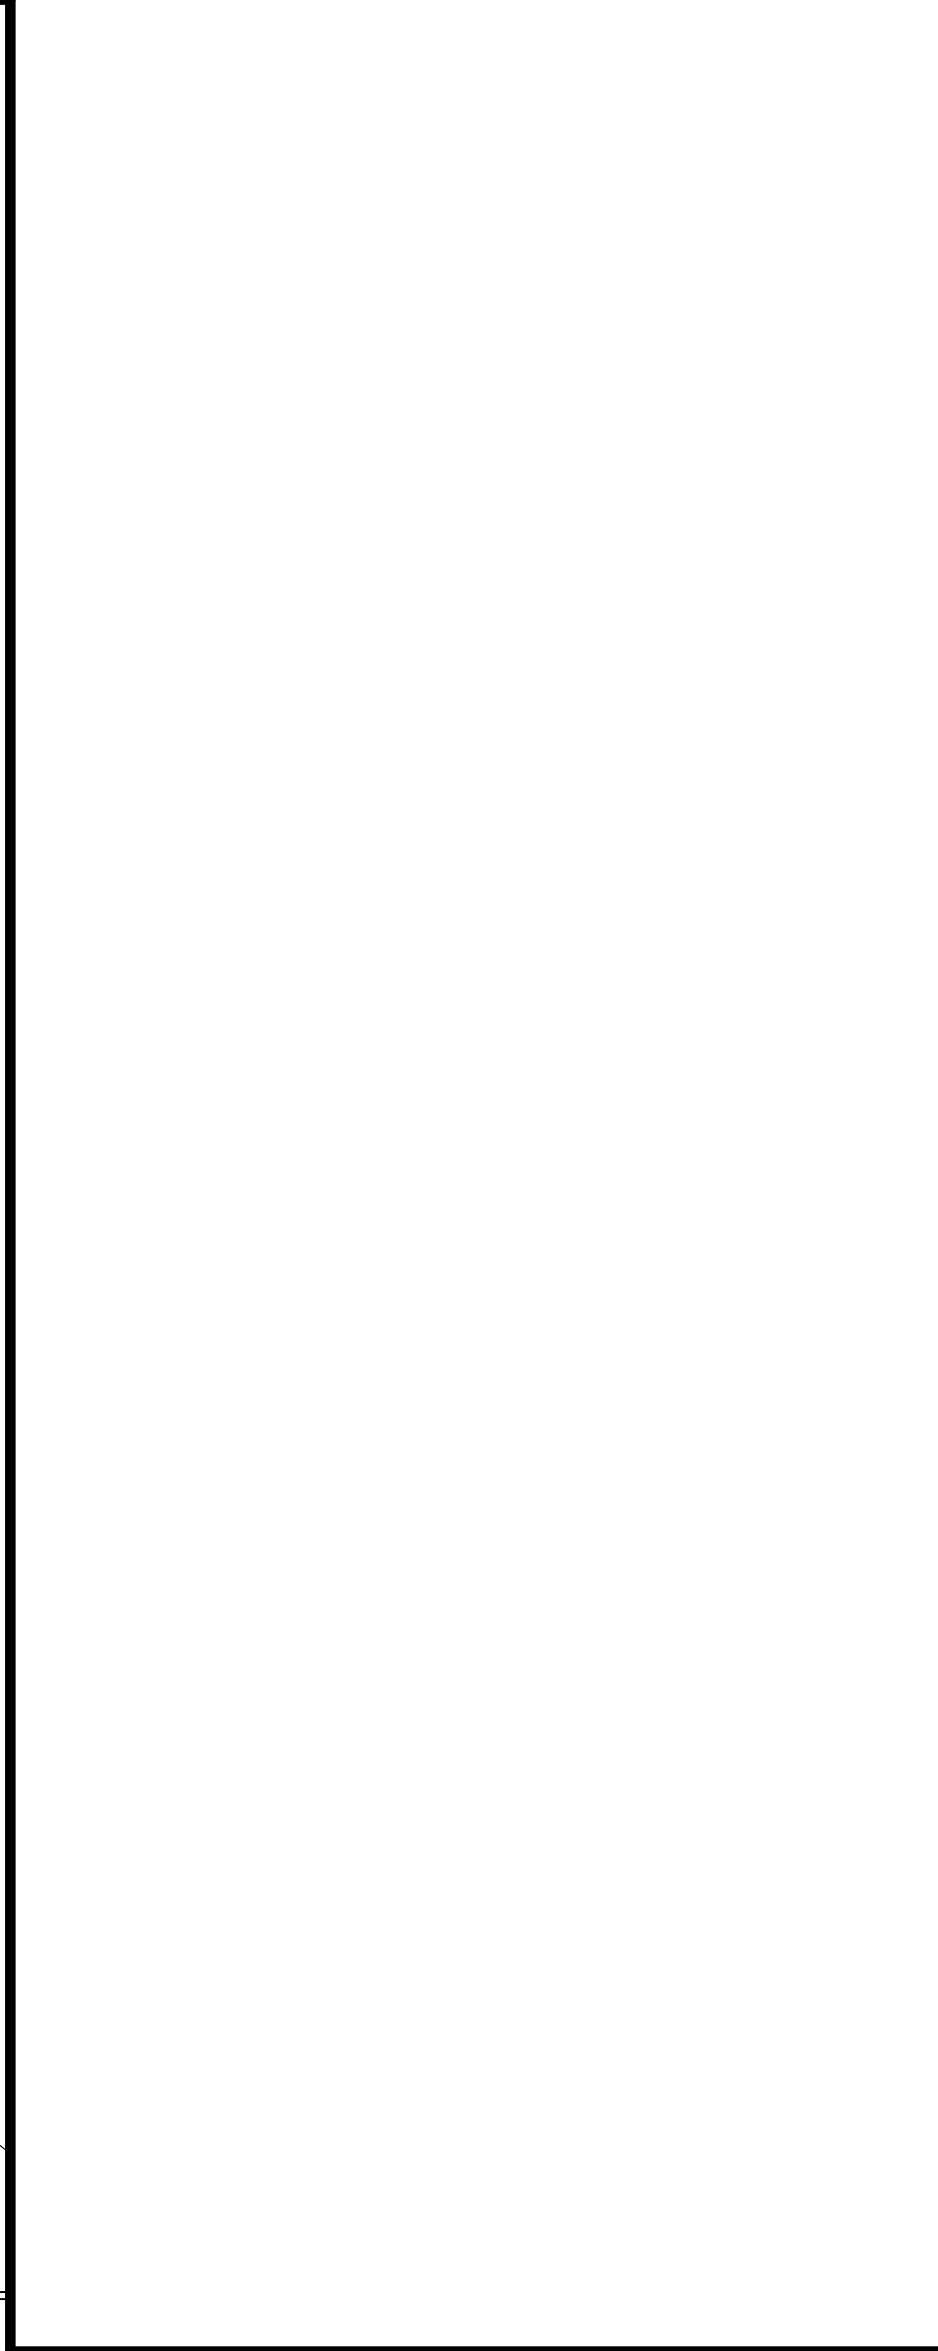
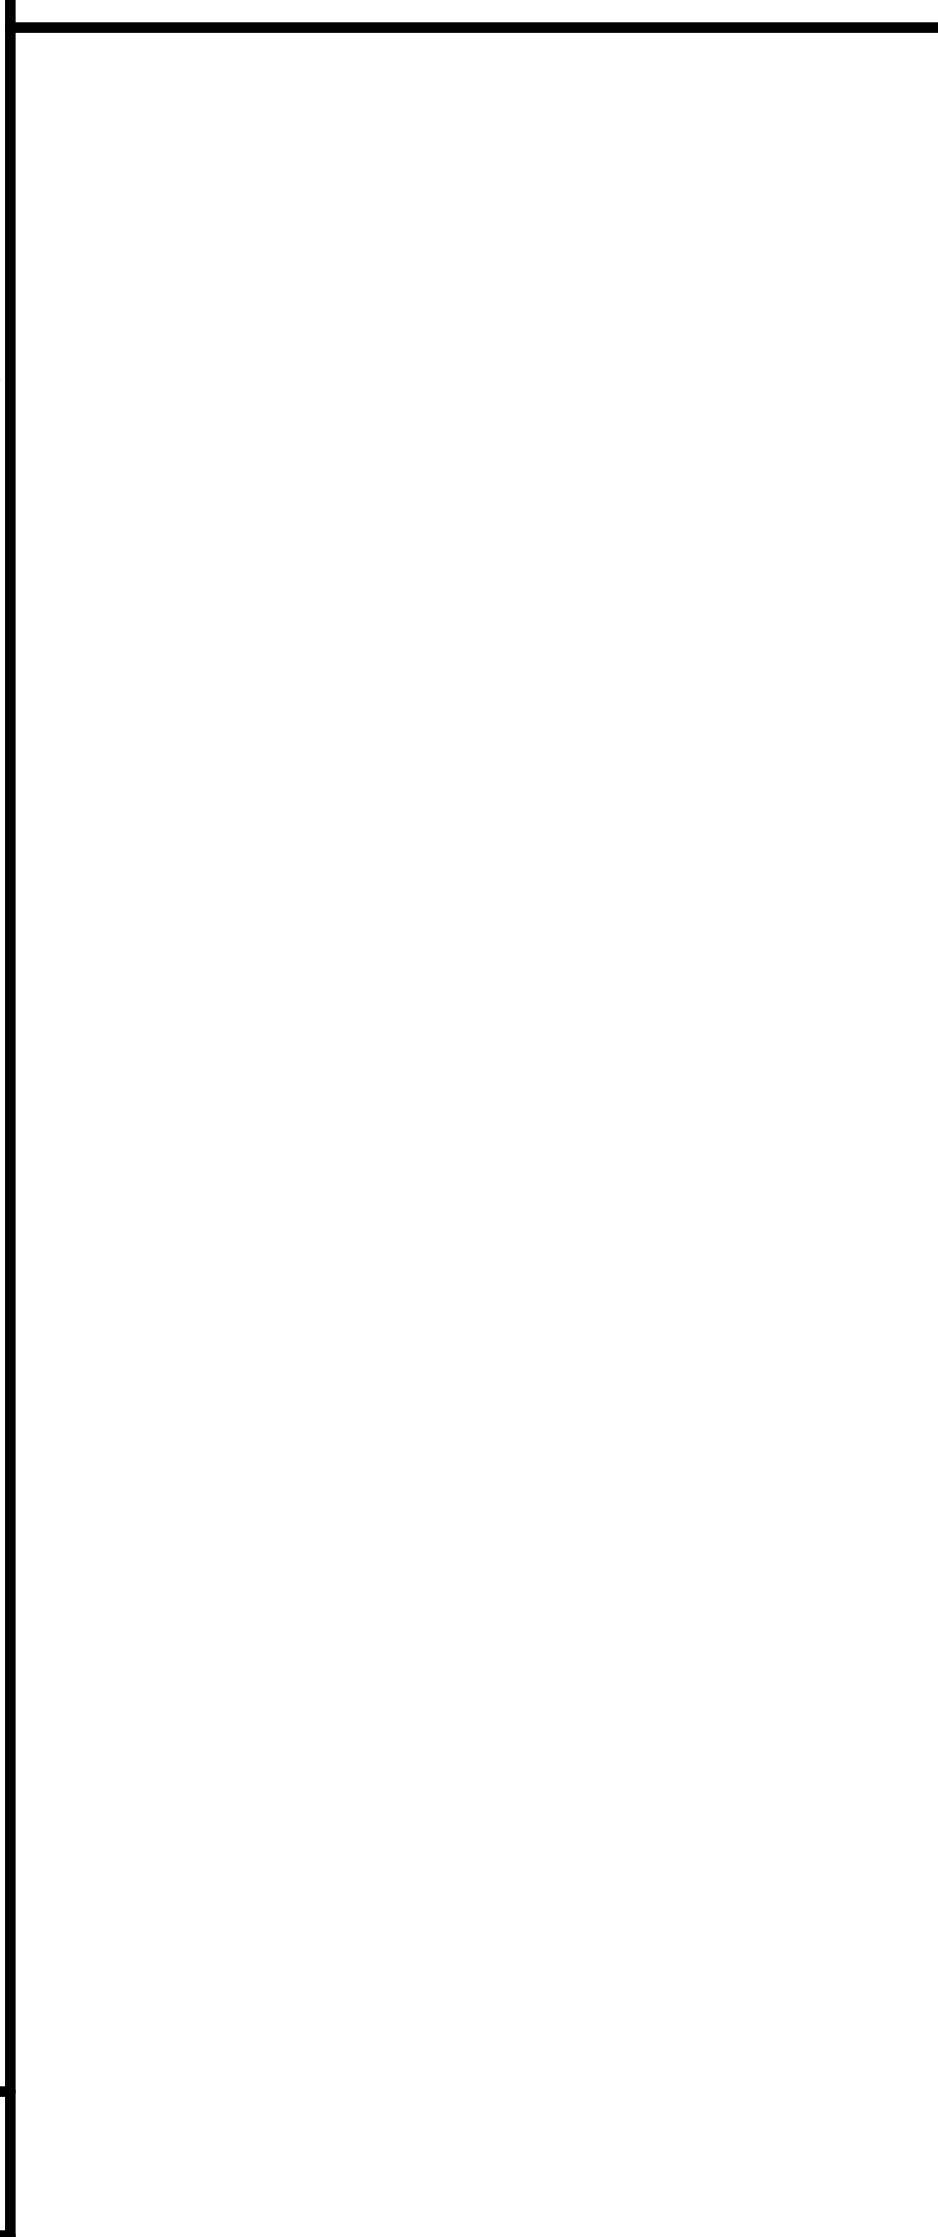
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TH101



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1 816.442.7700

115 Wilcox Street Suite 210
Castle Rock, CO 80104
1 720.949.1685
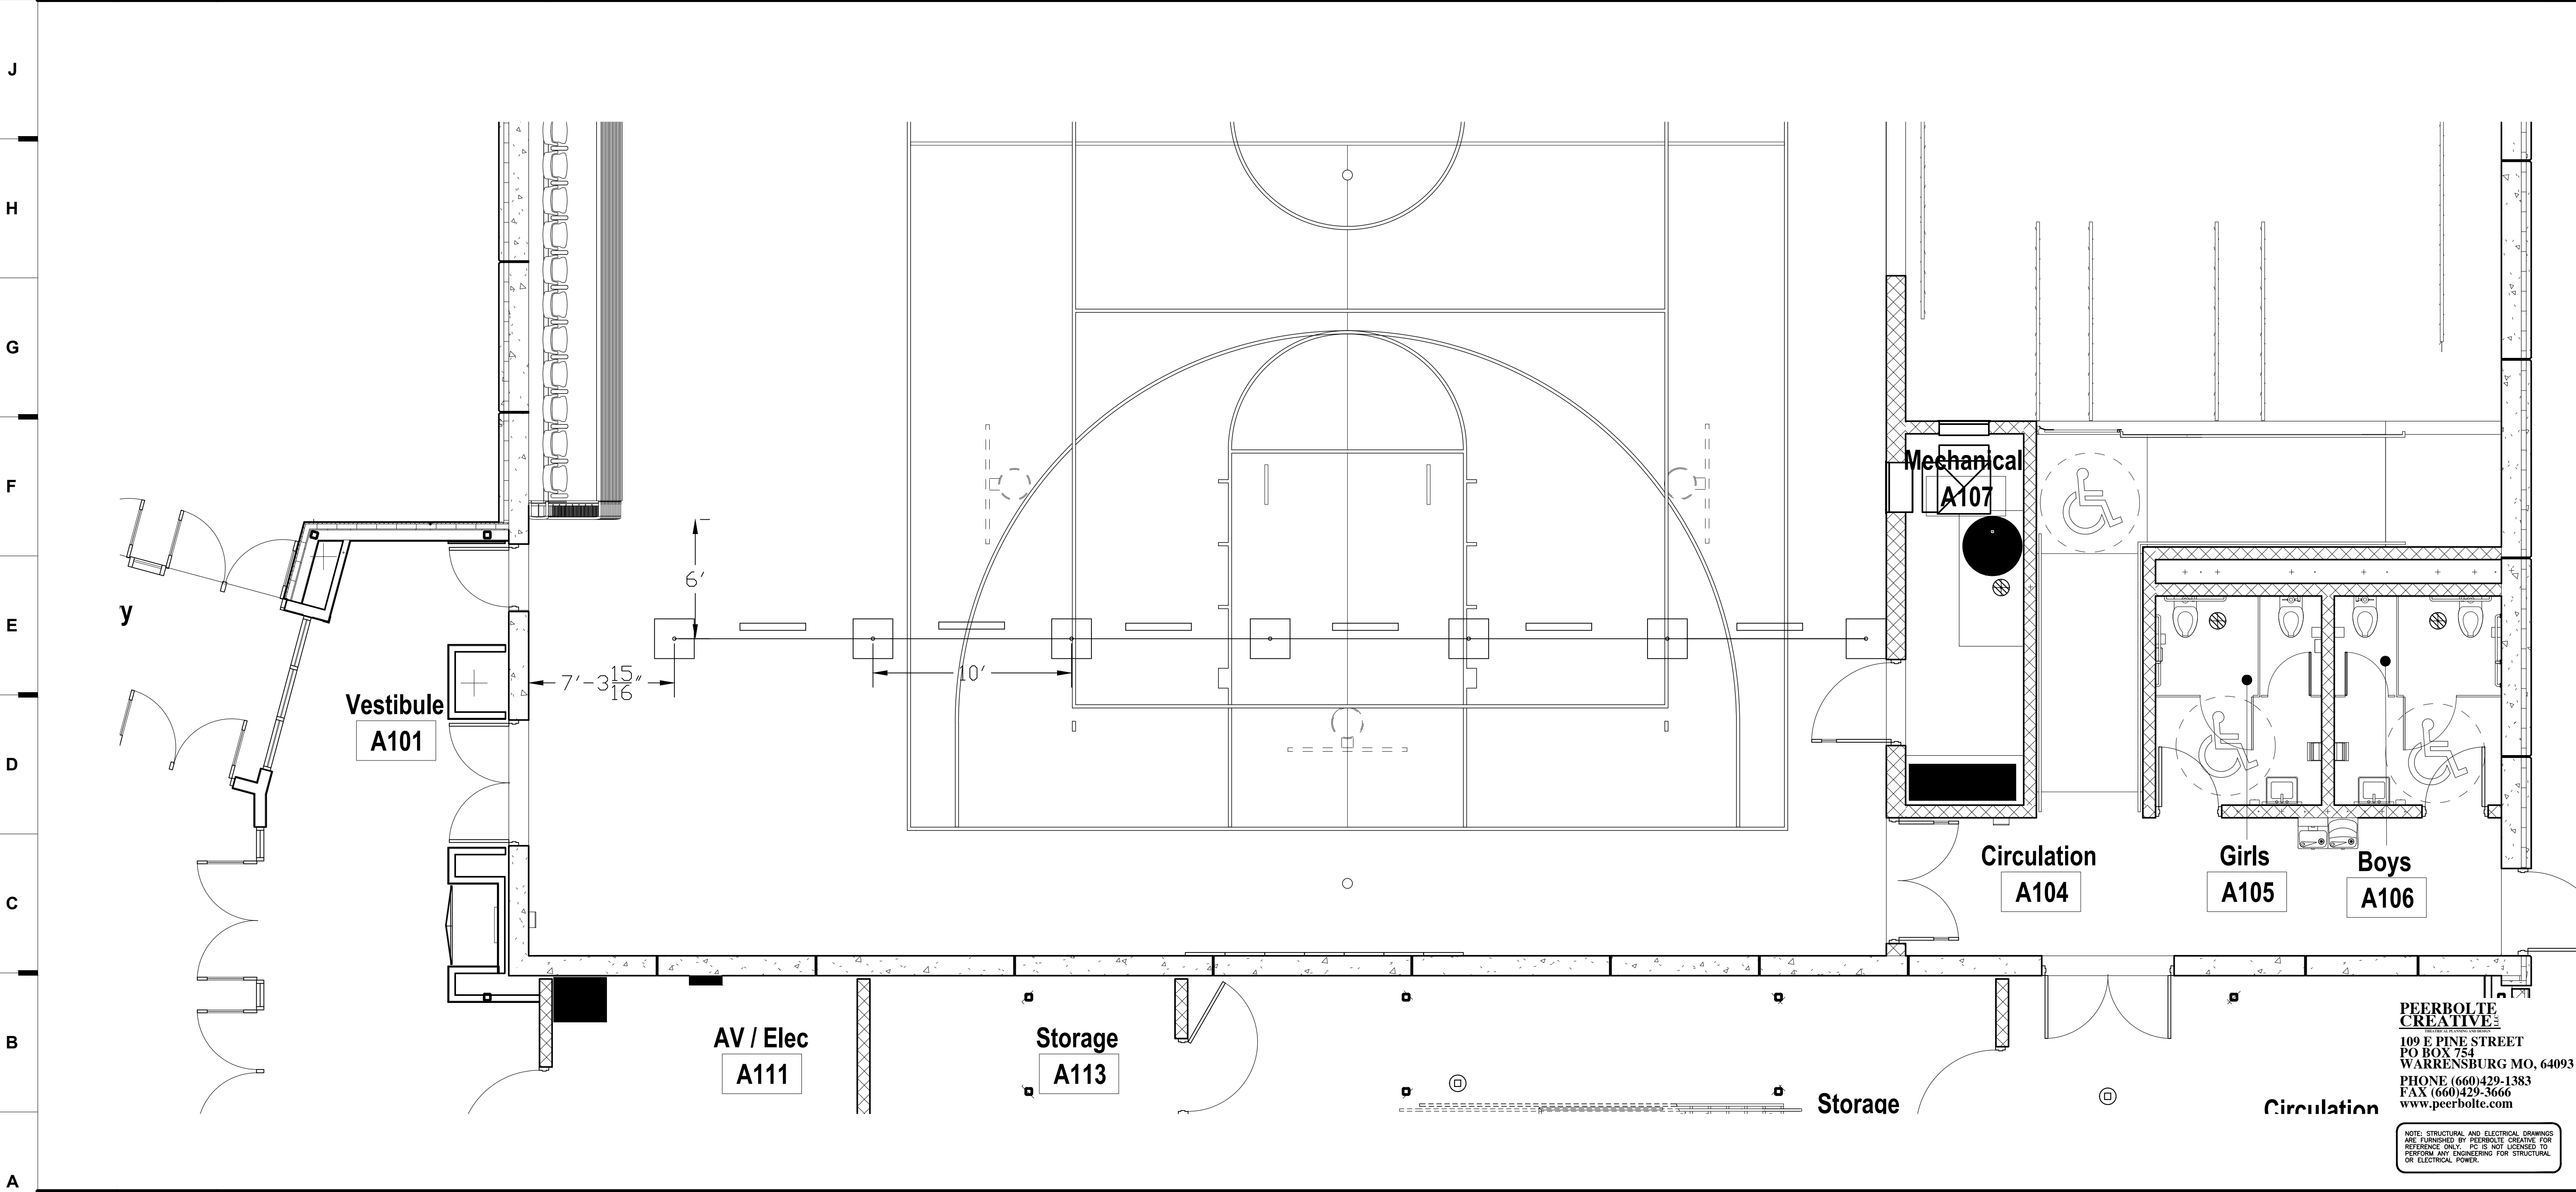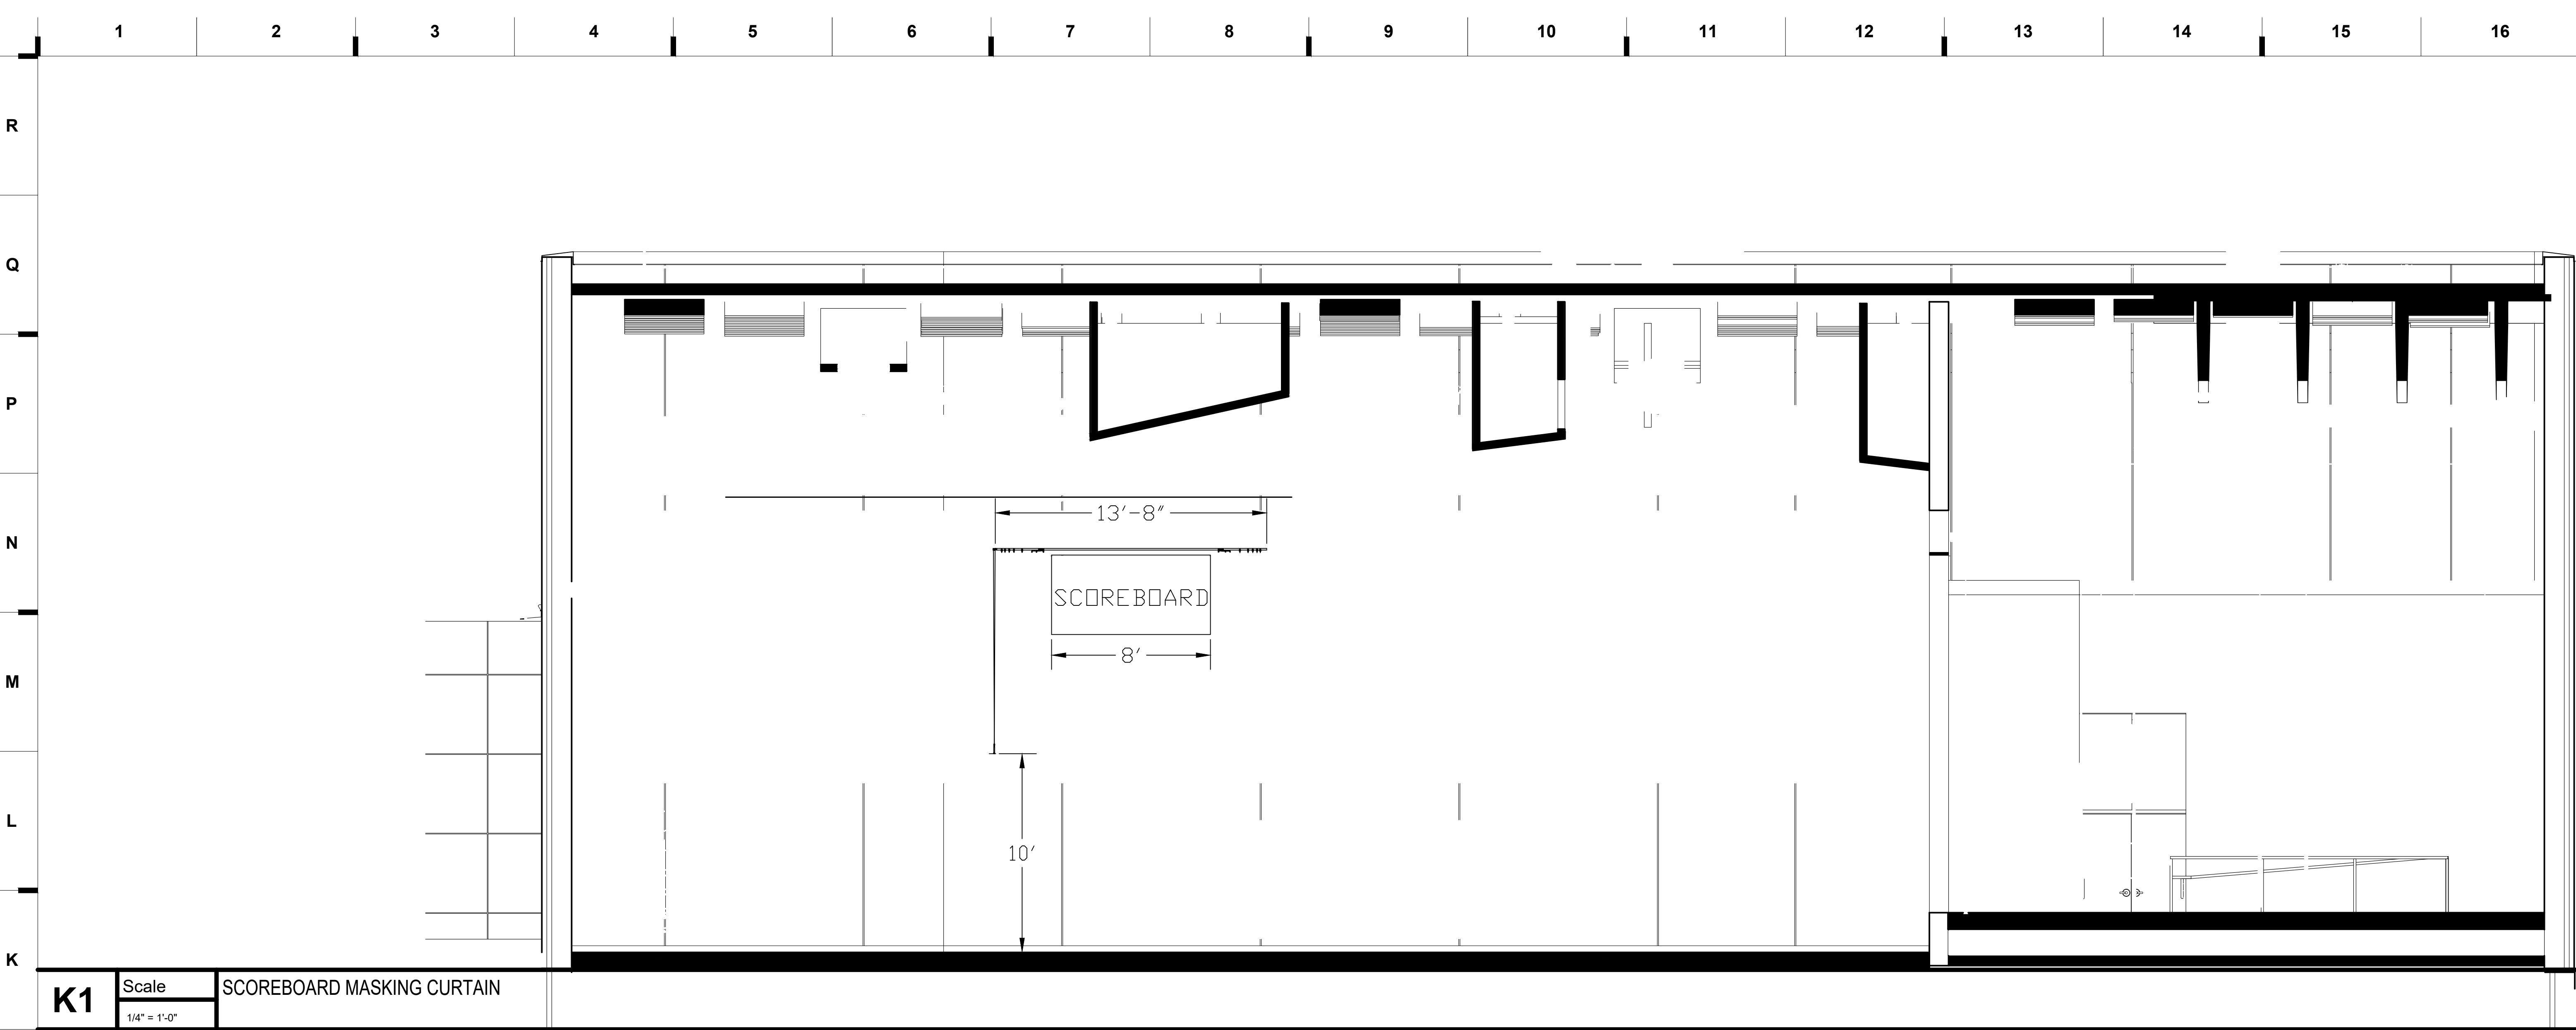
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Hollis + Miller Architects
Missouri State Certificate of Authority
Architecture # 000181

Bob D Campbell
Structural Engineer
State Certificate of Authority #000442
4338 Bellevue Ave
Kansas City, MO 64111
816.531.4144 phone

Smith & Boucher, Inc.
Mechanical, Electrical, & Plumbing
State Certificate of Authority #EGC000178
25619 W 103rd Street
Olathe, KS 66061
913.345.2127 phone

MKEC Engineering, Inc.
Civil Engineer
State Certificate of Authority
Engineering #2001002954
Landscaping #2006027138
Surveying #2006027138
11827 W 112th Street, Suite 200
Overland Park, KS 66210
913.317.8390 phone

Peerbolte Creative
Theatrical Consultant
109 E Pine St.
Warrensburg, MO 64093-0752
866-429-1383 phone

Avant Acoustics
AV/Acoustics Consultant
14827 West 95th St.
Lenexa, KS 66215
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South Valley Middle School Storm Shelter Addition
Liberty Public Schools
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Conformed
Construction
Documents

#	Description	Date
1	Addendum 01	09/14/2023
2	Addendum 04	09/28/2023

JOB NO: 23019
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DATE: 10.11.2023

TH102

PIPE AND DRAPE LAYOUT

Please consider the environment before printing this.

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P

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EQUIPMENT AND INSTALLATION SCHEDULE

ITEM	CONTRACTOR					
	ELECTRICAL	THEATRICAL LIGHTING	THEATRICAL RIGGING	THEATRICAL PIT COVER		OTHER
ARCHITECTURAL LIGHTING CONTROL SYSTEM		P,I,H				
THEATRICAL LIGHTING CONTROL NETWORKS		P,I,H				
THEATRICAL LIGHTING FIXTURES		P,I				
THEATRICAL RIGGING			P,I			
THEATRICAL DISTRIBUTION, PIPE AND WALL MOUNT OUTLET BOXES	H	P,I				
FLUSH/RECESSED THEATRICAL OUTLET BOXES OR POCKETS	I,H	P				
LOW VOLTAGE CABLE FOR THEATRICAL CONTROL NETWORKS	I	P,H				
RELAY PANEL	I,H	P,H				
DATA GRID IRON JUNCTION BOXES FOR ELECTRICS	I,H	P				
ALL CONDUIT	P,I					
ALL BACK BOXES	P,I					
LOAD CIRCUITS PULLED AND TERMINATED	P,I,H					
LOAD CIRCUIT BOXES AND COVER PLATES	P,I,H					
MOTORIZED RIGGING	H		P,I			

P=PROVIDE I=INSTALL H=HOOK UP R=REMOVE L=REINSTALL S=STORE

L1

Scale

EQUIPMENT AND INSTALLATION SCHEDULE

NO SCALE

L10

Scale

DEVICE ELEVATION

NO SCALE

POWER WIRING TO THEATRICAL CIRCUITS
POWER AND DMX CONTROL WIRING
TO HOUSE LIGHT CIRCUITS
BY ELECTRICAL CONTRACTOR

U# = (1) BELDEN 8471
UV# = (1) BELDEN 8471, (2) #16 AWG
N# = (1) BELDEN 1583A
LV# = (2) #16 AWG
D# = (1) BELDEN 9729
X# = (1) BELDEN 9729
*=STATION IS MOUNTED IN RACEWAY
IS AN IDENTIFIER (NOT QUANTITY)

1 FOH LEFT 2 CIRCUITS (1-2)
4 OUTLETS - 2 OUTLETS PER CIRCUIT

2 FOH CENTER 3 CIRCUITS (3-5)
12 OUTLETS - 4 OUTLETS PER CIRCUIT

3 FOH RIGHT 2 CIRCUITS (6-7)
4 OUTLETS - 2 OUTLETS PER CIRCUIT

4 1ST ELEC 6 CIRCUITS 5 RELAY 1 WL (8-12) (25)
34 OUTLETS - 3 OUTLETS PER RELAY CIRCUIT, 4 PER WL CIRCUIT

5 2ND ELEC 6 CIRCUITS 5 RELAY 1WL (13-17) (26)
34 OUTLETS - 3 OUTLETS PER RELAY CIRCUIT, 4 PER WL CIRCUIT

6 3RD ELEC 6 CIRCUITS 5 RELAY 1WL (18-22) (27)
25 OUTLETS - 3 OUTLETS PER RELAY CIRCUIT, 4 PRE WL CIRCUIT

7 PLATFORM 2 CIRCUITS (23-24)
2 OUTLETS - 1 OUTLETS PER CIRCUIT

8 GYM WALL 2 CIRCUITS (28-29)

9 HOUSE LIGHT 7 CIRCUITS (29-35)

10 3-PHASE SENSE CIRCUIT (ES36-ES38)

110V FLAT PANEL MONITOR
110V FLAT PANEL MONITOR
CONTROL CONSOLE
UPS

EMERGENCY LIGHTING TRANSFER SWITCH
DMX EMERGENCY BYPASS CONTROLLER
EMERGENCY BYPASS DETECTION KIT

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A1

Scale

THEATRICAL LIGHTING RISER DIAGRAM

NO SCALE

1

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16

8' 4' 0' 8'

PROJECT NORTH

TRUE NORTH

TH110

THEATRICAL RISER DIAGRAM

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REVISIONS:

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2	Addendum 04	09/28/2023

KEY PLAN

E

C

D

A

B

JOB NO: 23018

DRAWN BY: SCJ

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A

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