



OF CONSTRUCTION)

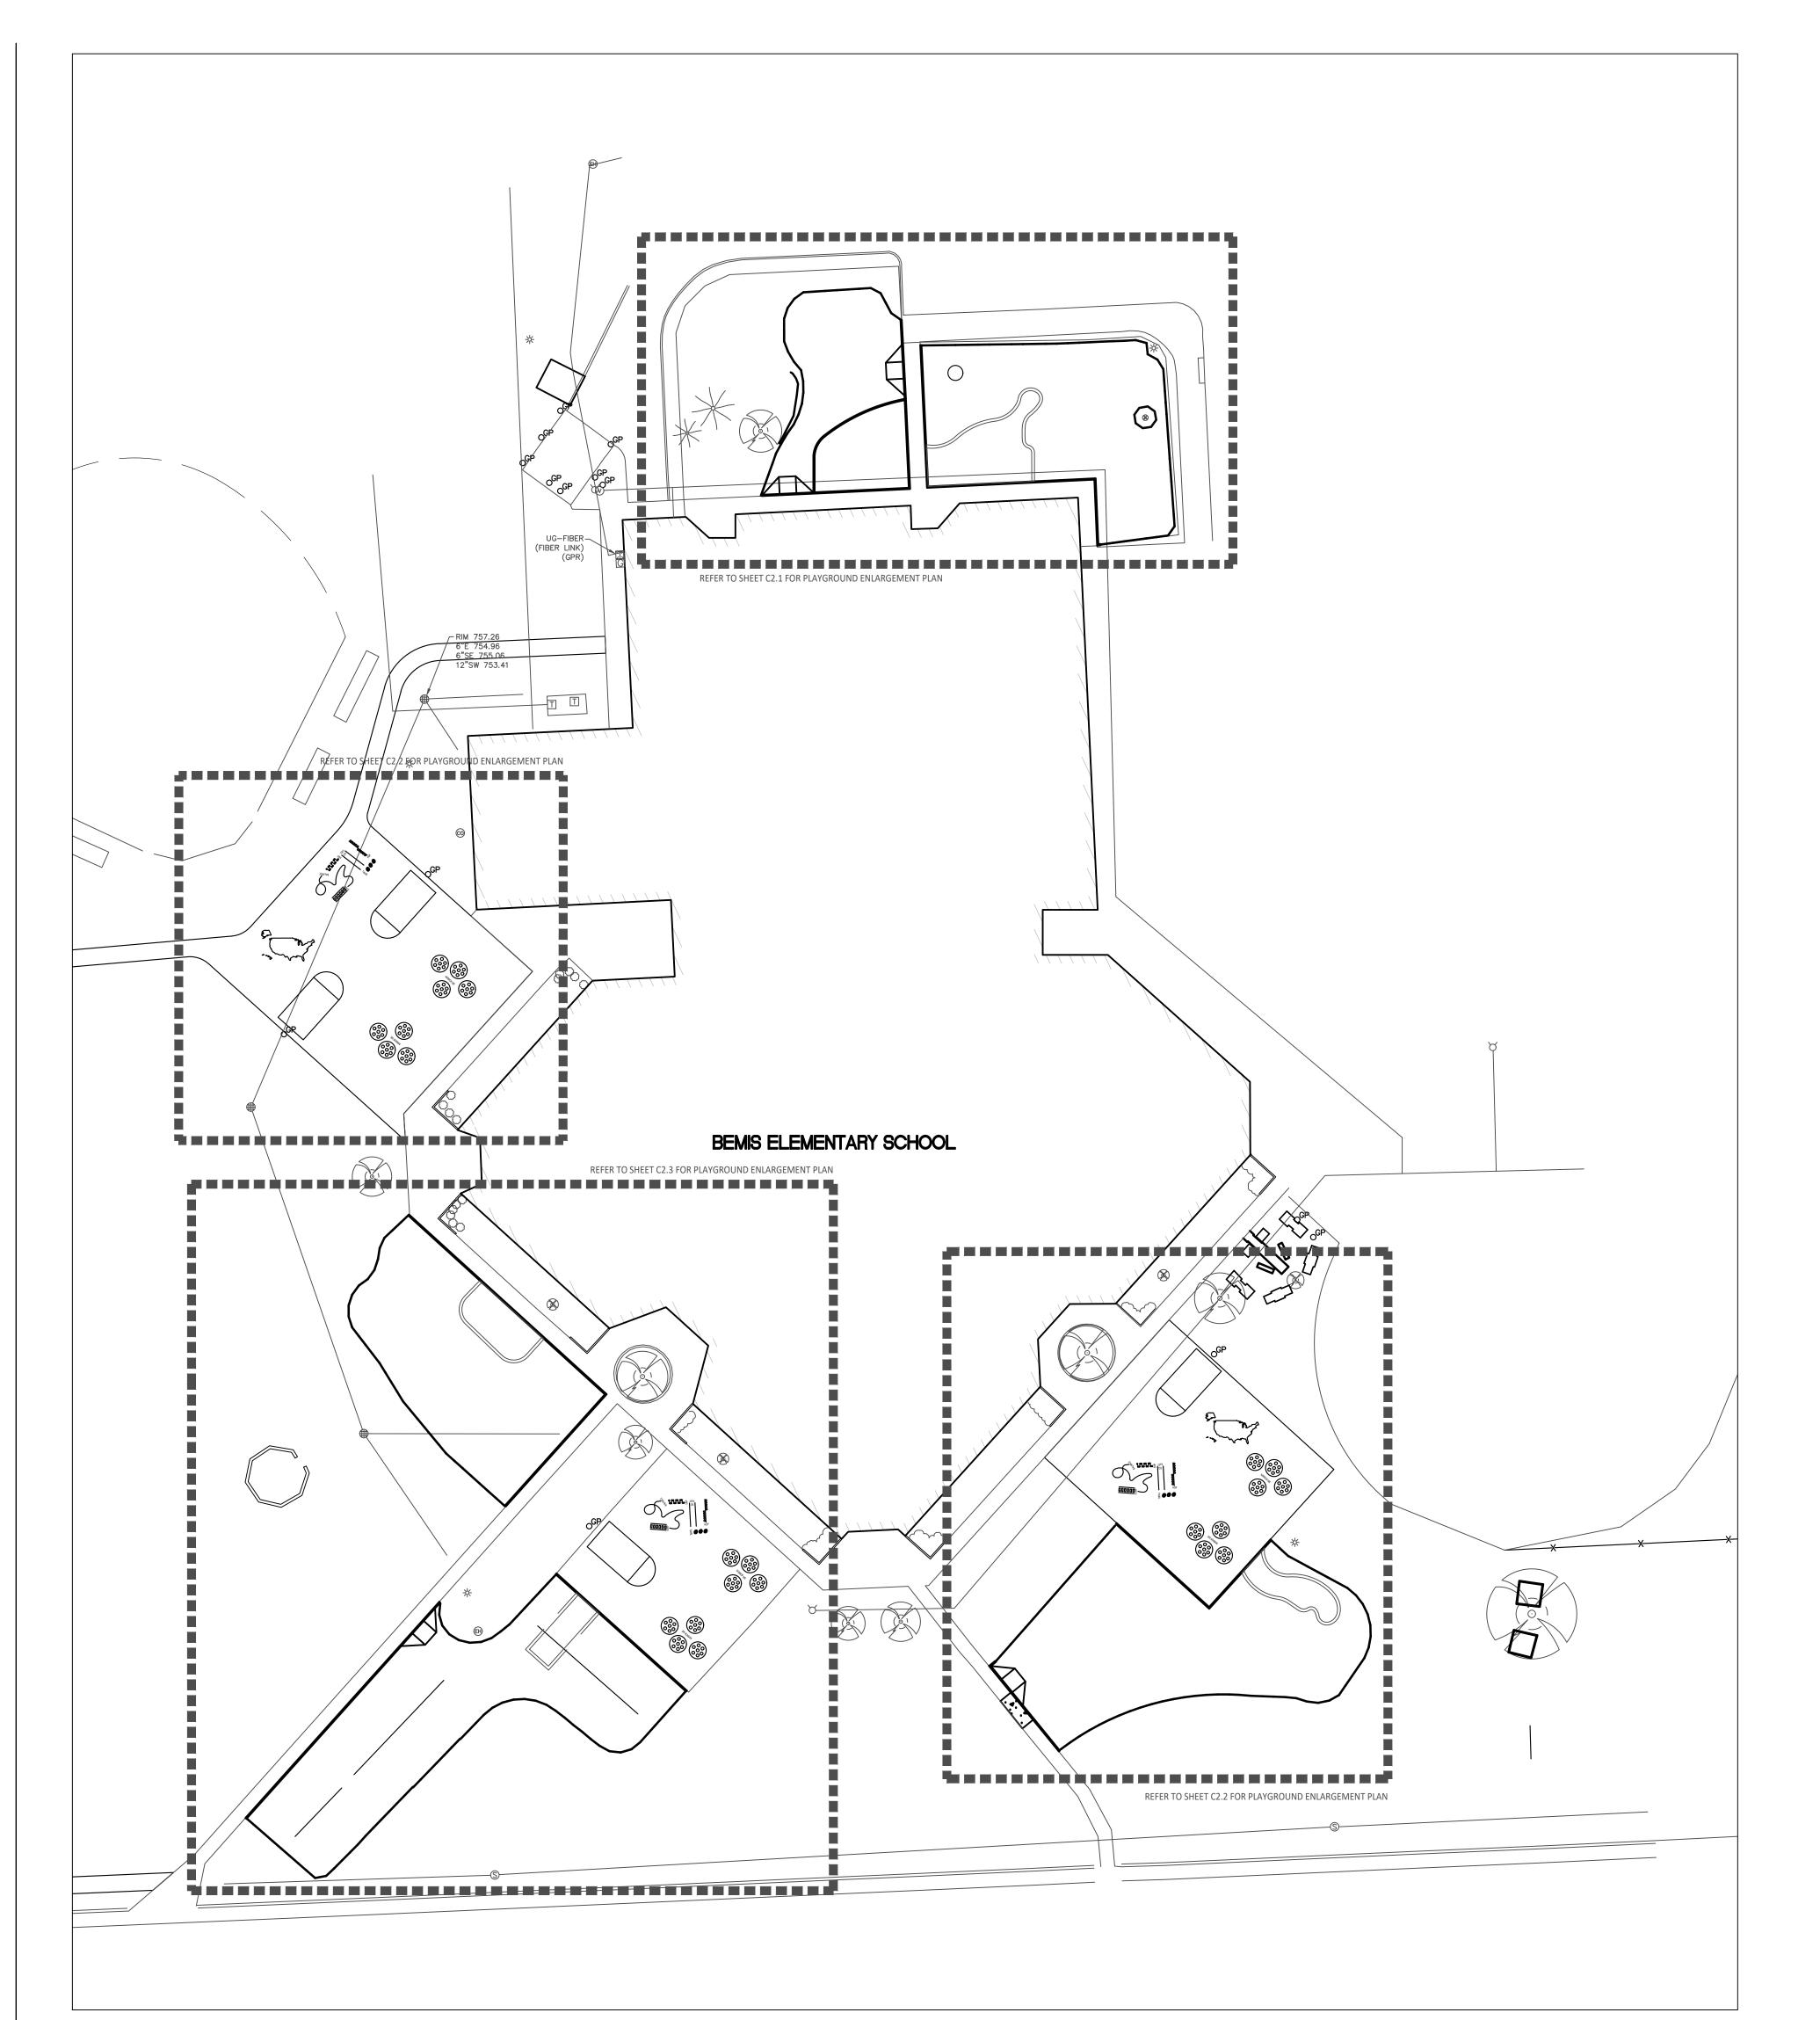

Overall Playground Layout Plan

Scale: 1" = 30'-0"

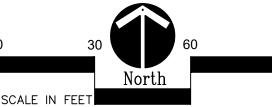

BARRIER-FREE NOTES

BARRIER-FREE PARKING AND ACCESSIBLE ROUTE(S) MUST COMPLY WITH THE AMERICANS WITH DISABILITIES ACT AND MICHIGAN BARRIER-FREE CODE REQUIREMENTS, INCLUDING BUT NOT LIMITED TO THE FOLLOWING: - 1:50 (2%) MAXIMUM CROSS-SLOPE ON ACCESSIBLE ROUTE.

- NO CHANGES IN LEVEL GREATER THAN 1/2" ALONG ACCESSIBLE ROUTE. - 1:20 (5%) MAXIMUM LONGITUDINAL SLOPE ON ACCESSIBLE ROUTE (EXCEPT WHERE RAMPS ARE PROVIDED). - 1:50 (2%) MAXIMUM SLOPE (IN ANY DIRECTION) IN B.F. PARKING AND ACCESS AISLES.

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CONCRETE CURBING OR PAVING INSTALLATION.


NOTE: VERIFY LOCATION OF NEW PLAYGROUND **EQUIPMENT PRIOR TO INSTALLATION OF ANY** CONCRETE CURB. CONCRETE CURB TO BE INSTALLED OUTSIDE OF FALL SAFETY ZONE OF EACH PIECE OF EQUIPMENT PER ASTM 1487-05 AND MANUFACTURER'S WRITTEN RECOMMENDATIONS.


LAYOUT NOTES:

SURVEY OF EXISTING CONDITIONS PROVIDED BY PEA GROUP, 1849 POND RUN, AUBURN HILLS, MICHIGAN 48326, (248)689-9090.


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- SITE LAYOUT POINTS SHOULD BE ESTABLISHED AND PROTECTED FOR FUTURE SITE

PROPOSED FEATURES LEGEND:

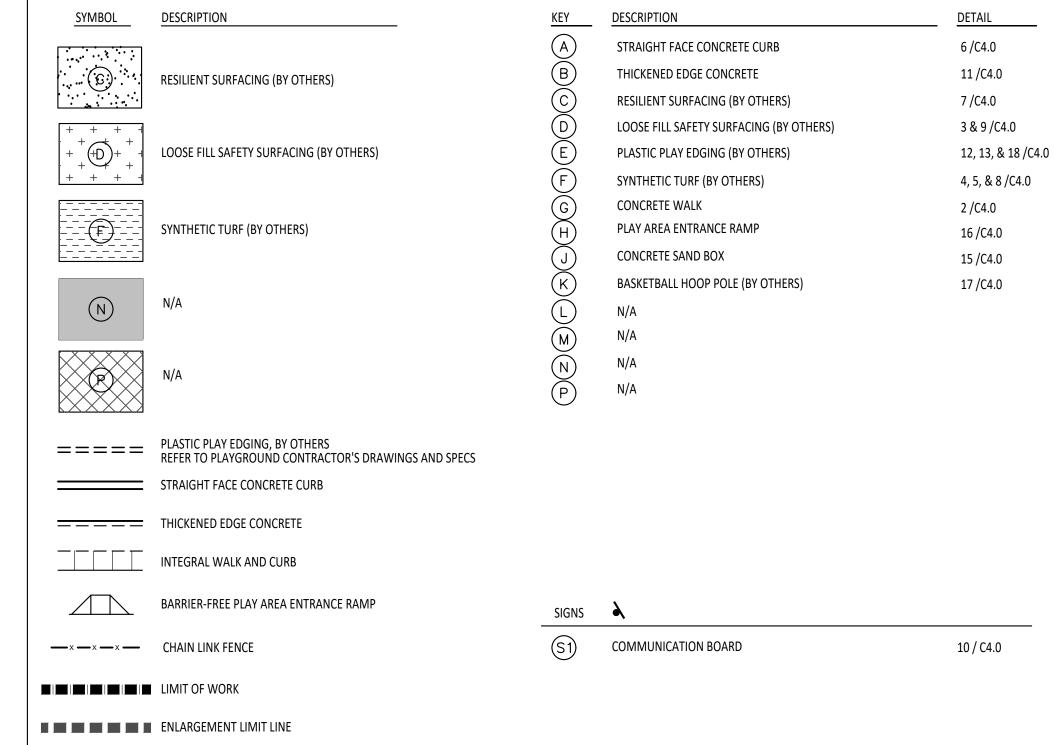

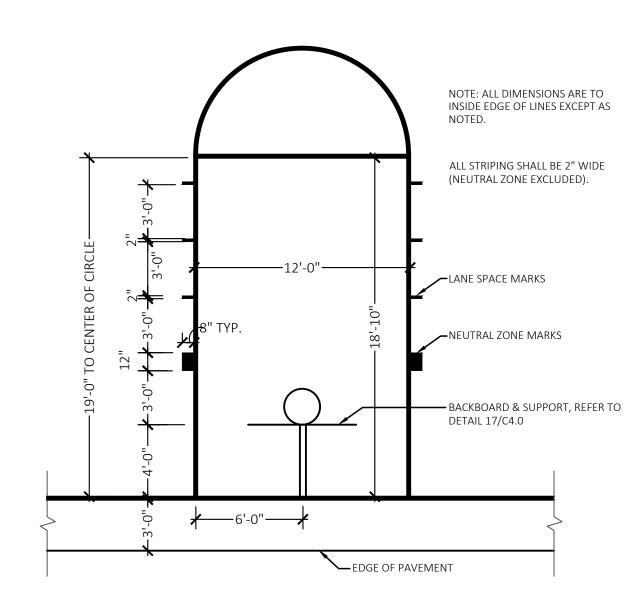

Basketball Lane Layout

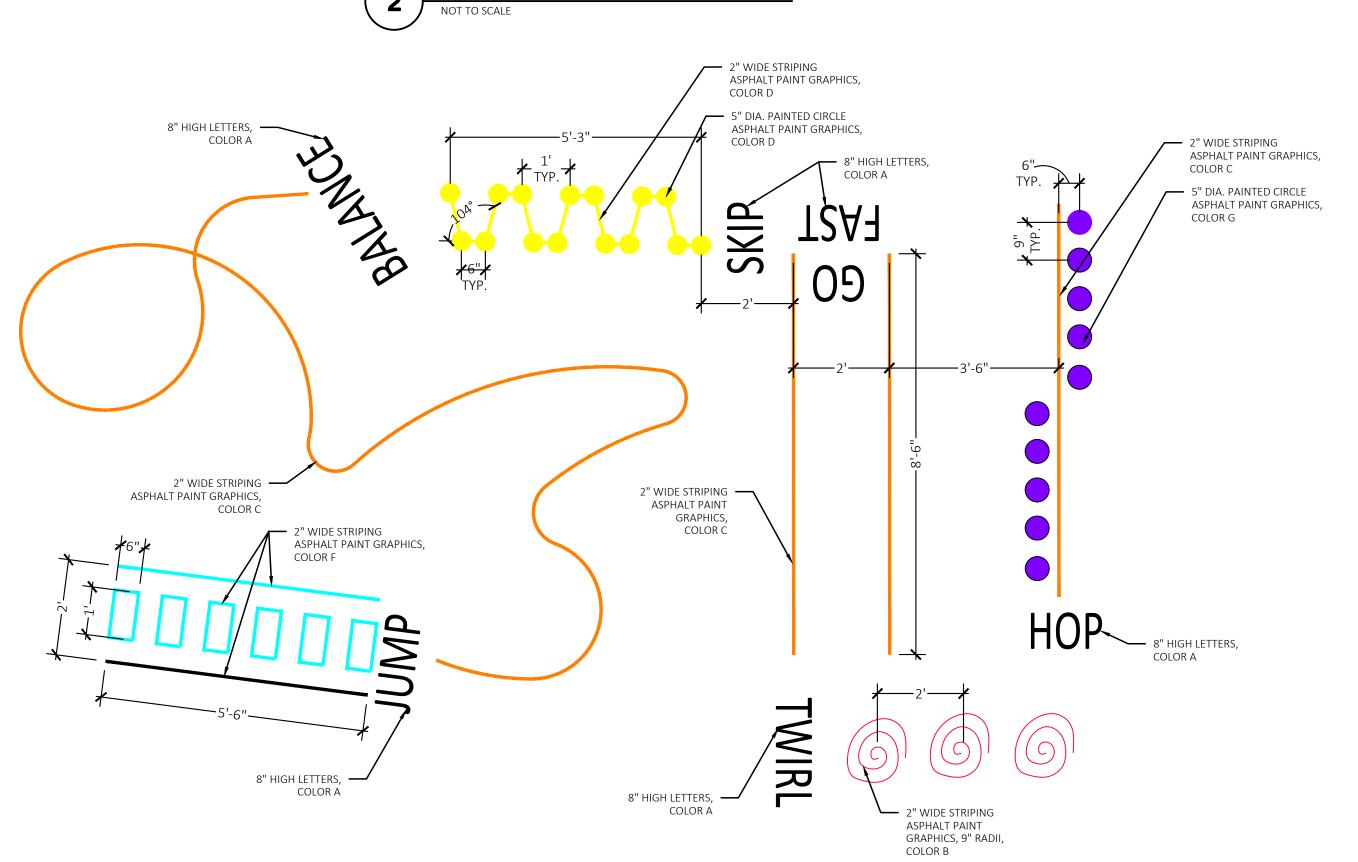





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REGISTRATION SEAL




Kalamazoo Michigan 49007 Phone (269) 381-3357 Fax (269) 381-2944

PROJECT TITLE **Bemis** Elementary School Playground Renovation Bid Package No.01A

Troy School District Troy, Michigan

DRAWING TITLE Overall Playground Layout Plan

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11-09-23	CONSTRUCTION DOCUMENTS
DATE:	ISSUED FOR:
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CHECKED	
APPROVED	
PROJECT NO. 22087B	

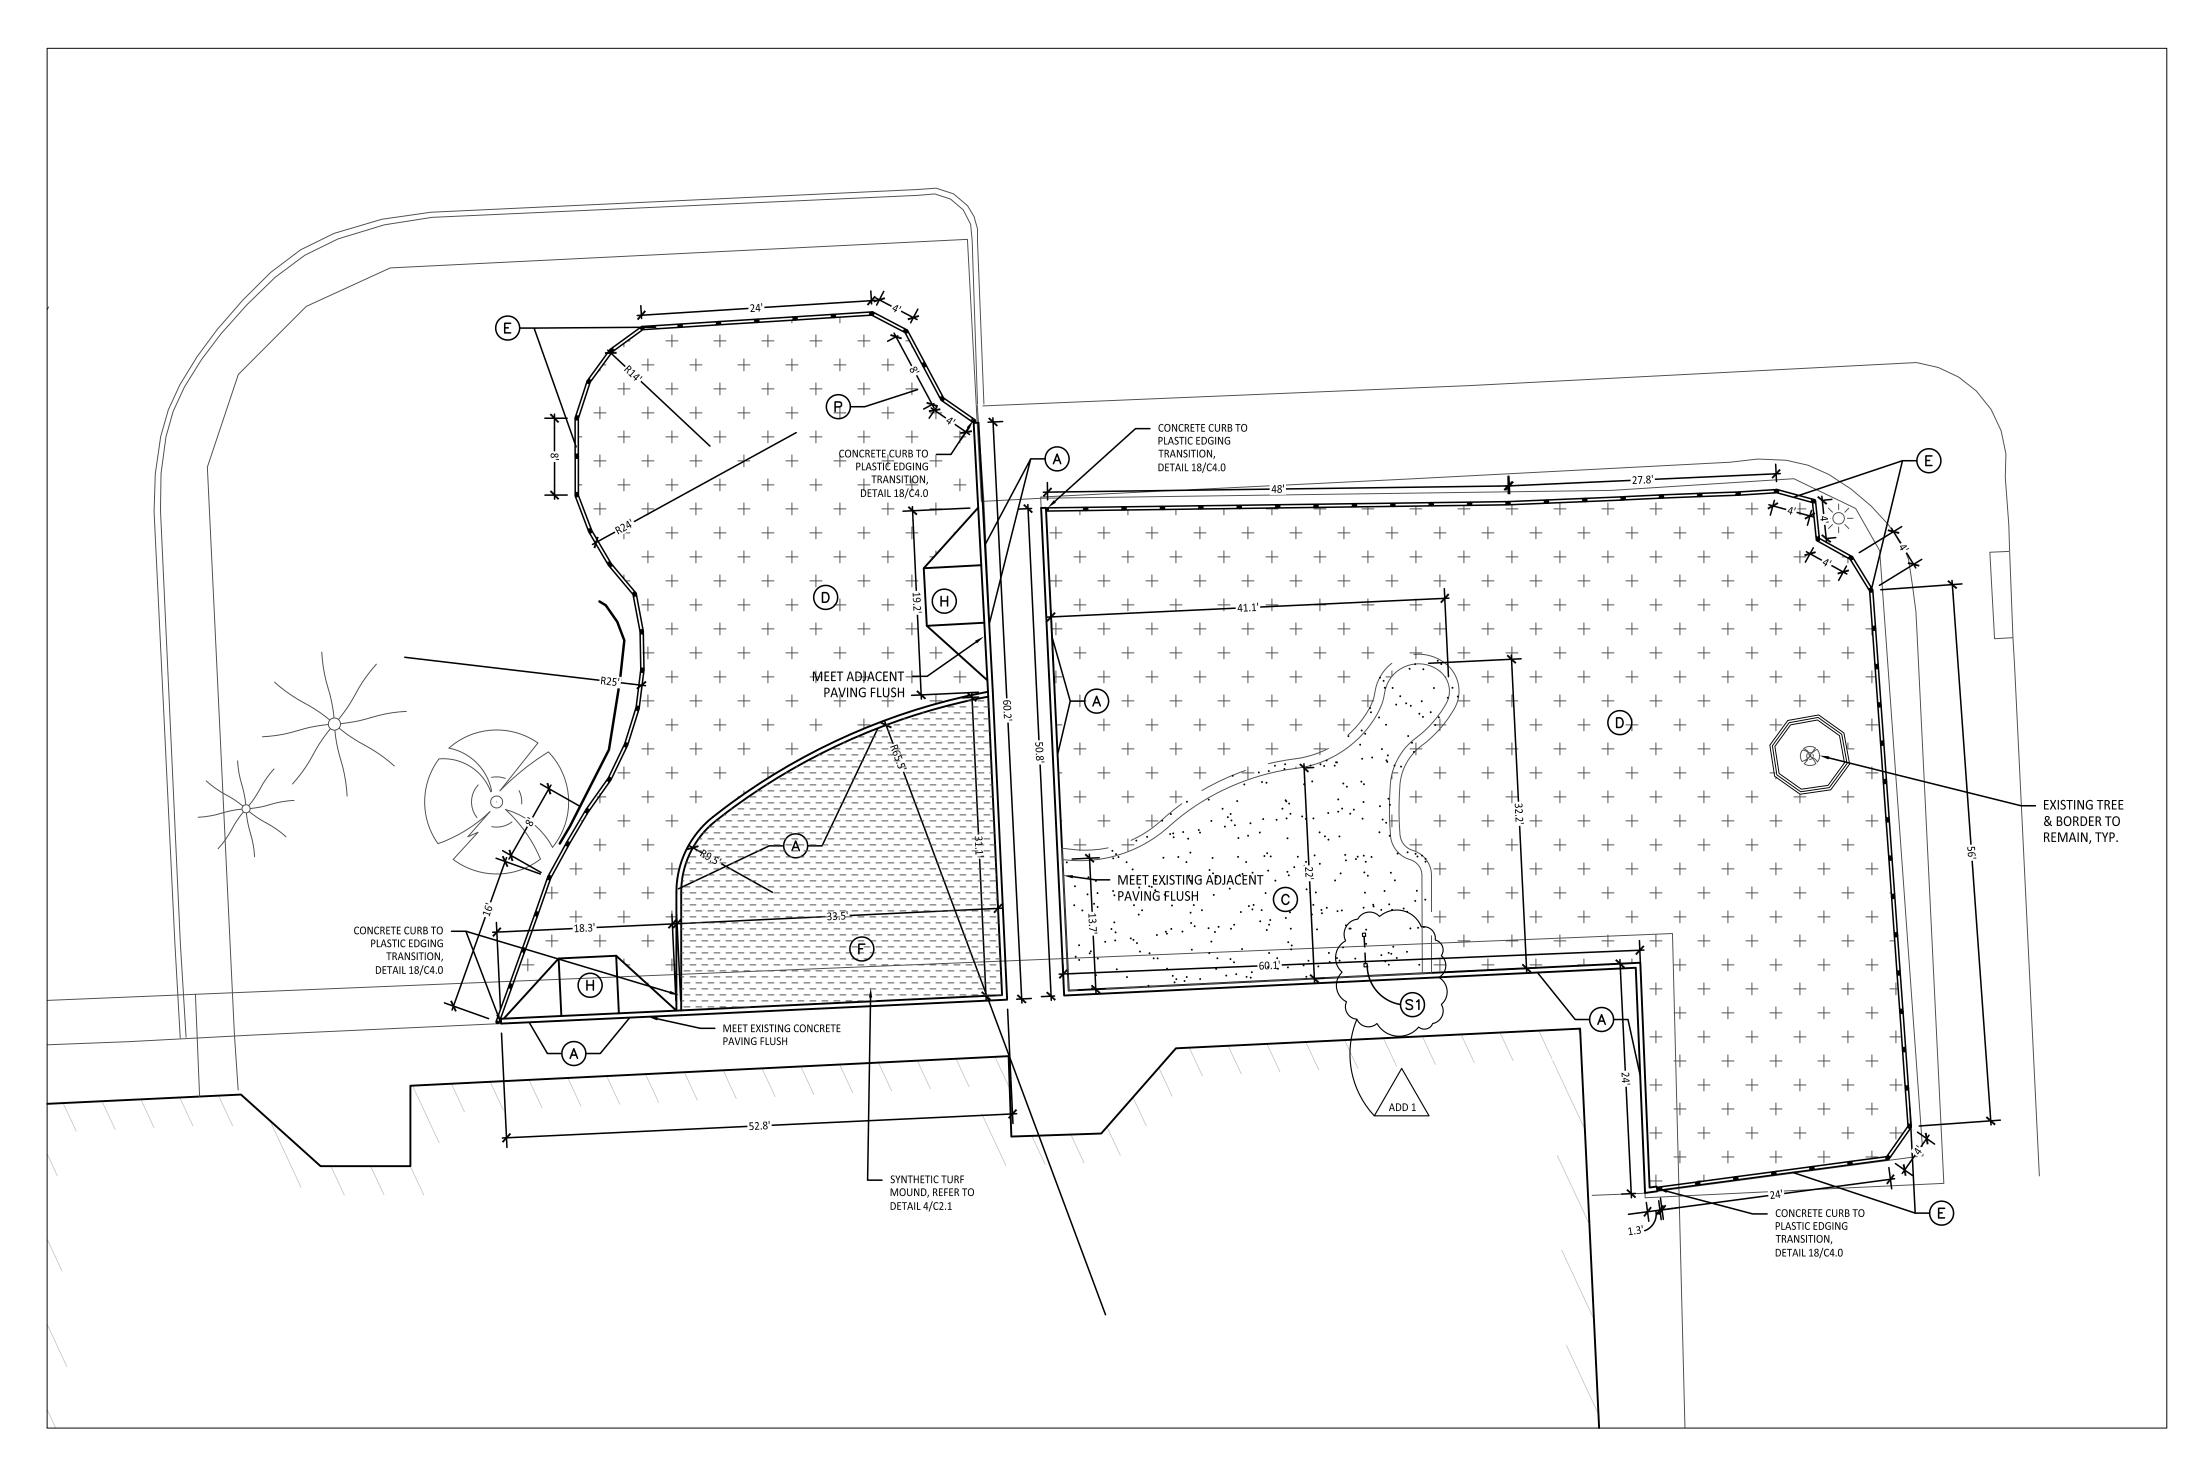

Playground Layout Enlargement Plan - Kindergarten

Scale: 1" = 10'-0"

5" DIA. PAINTED CIRCLE ——

COLOR D

ASPHALT PAINT GRAPHICS,

COLOR E

5" DIA. PAINTED CIRCLE 🗕


ASPHALT PAINT GRAPHICS,

5" DIA. PAINTED CIRCLE —

ASPHALT PAINT GRAPHICS,

Mirror Me Detail
Not to Scale

MIRROR ME

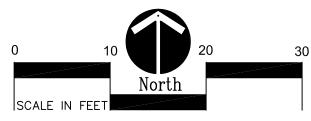

2" WIDE STRIPING x 6' DIAMETER, ASPHALT PAINT GRAPHICS, COLOR A ASPHALT PAINT GRAPHICS, — 5" DIA. PAINTED CIRCLE ASPHALT PAINT GRAPHICS, — 5" DIA. PAINTED CIRCLE ASPHALT PAINT GRAPHICS, ASPHALT PAINT GRAPHICS,

COLOR B

COLOR H

— 5" DIA. PAINTED CIRCLE

COLOR G



USA Map Detail

Not to Scale

REFER TO DETAIL -5/C4.0 FOR TURF TRANSITION TO CONCRETE 3" THICK CONCRETE CAP IN ALL SLOPED AREAS, 30° MAXIMUM SLOPE, INSTALLED BY SITE CONTRACTOR, COORDINATE WITH PLAYGROUND CONTRACTOR, TYP. CURB, TYP. STRAIGHT FACE — CONCRETE CURB, REFER TO DETAIL 6/C4.0 — AGGREGATE SUB BASE, TO BE INSTALLED BY PLAYGROUND CONTRACTOR,

SYNTHETIC TURF WITH INFILL, TO BE INSTALLED BY PLAYGROUND

Synthetic Turf Mound Detail

BARRIER-FREE NOTES

BARRIER-FREE PARKING AND ACCESSIBLE ROUTE(S) MUST COMPLY WITH THE AMERICANS WITH DISABILITIES ACT AND MICHIGAN BARRIER-FREE CODE REQUIREMENTS, INCLUDING BUT NOT LIMITED TO THE FOLLOWING: - 1:50 (2%) MAXIMUM CROSS-SLOPE ON ACCESSIBLE ROUTE. - NO CHANGES IN LEVEL GREATER THAN 1/2" ALONG ACCESSIBLE ROUTE.

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PROPOSED FEATURES LEGEND:

RESILIENT SURFACING (BY OTHERS)

SYNTHETIC TURF (BY OTHERS)

LOOSE FILL SAFETY SURFACING (BY OTHERS)

===== PLASTIC PLAY EDGING, BY OTHERS
REFER TO PLAYGROUND CONTRACTOR'S DRAWINGS AND SPECS

BARRIER-FREE PLAY AREA ENTRANCE RAMP

STRAIGHT FACE CONCRETE CURB

THICKENED EDGE CONCRETE

INTEGRAL WALK AND CURB

—×—×— CHAIN LINK FENCE

■ ■ ■ ■ ■ ■ ■ ENLARGEMENT LIMIT LINE

LAYOUT NOTES:

STRAIGHT FACE CONCRETE CURB

RESILIENT SURFACING (BY OTHERS)

PLASTIC PLAY EDGING (BY OTHERS)

BASKETBALL HOOP POLE (BY OTHERS)

SYNTHETIC TURF (BY OTHERS)

PLAY AREA ENTRANCE RAMP

CONCRETE SAND BOX

COMMUNICATION BOARD

CONCRETE WALK

SIGNS 🔪

LOOSE FILL SAFETY SURFACING (BY OTHERS)

THICKENED EDGE CONCRETE

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6 /C4.0

11 /C4.0

7 /C4.0

3 & 9 /C4.0

4, 5, & 8 /C4.0

2 /C4.0

16 /C4.0

15 /C4.0

17 /C4.0

12, 13, & 18 /C4.0

SITE LAYOUT POINTS SHOULD BE ESTABLISHED AND PROTECTED FOR FUTURE SITE



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REGISTRATION SEAL

CONSULTANT



141 E. Michigan Avenue, Suite 500 Kalamazoo Michigan 49007 Phone (269) 381-3357 Fax (269) 381-2944

PROJECT TITLE

Bemis Elementary School Playground Renovation Bid Package No.01A


Troy School District Troy, Michigan

DRAWING TITLE Playground Layout Enlargement Plans


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11-29-23	ADDENDUM #1	_
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CHECKED		
APPROVED		
PROJECT		

DRAWING NO.

C2.1

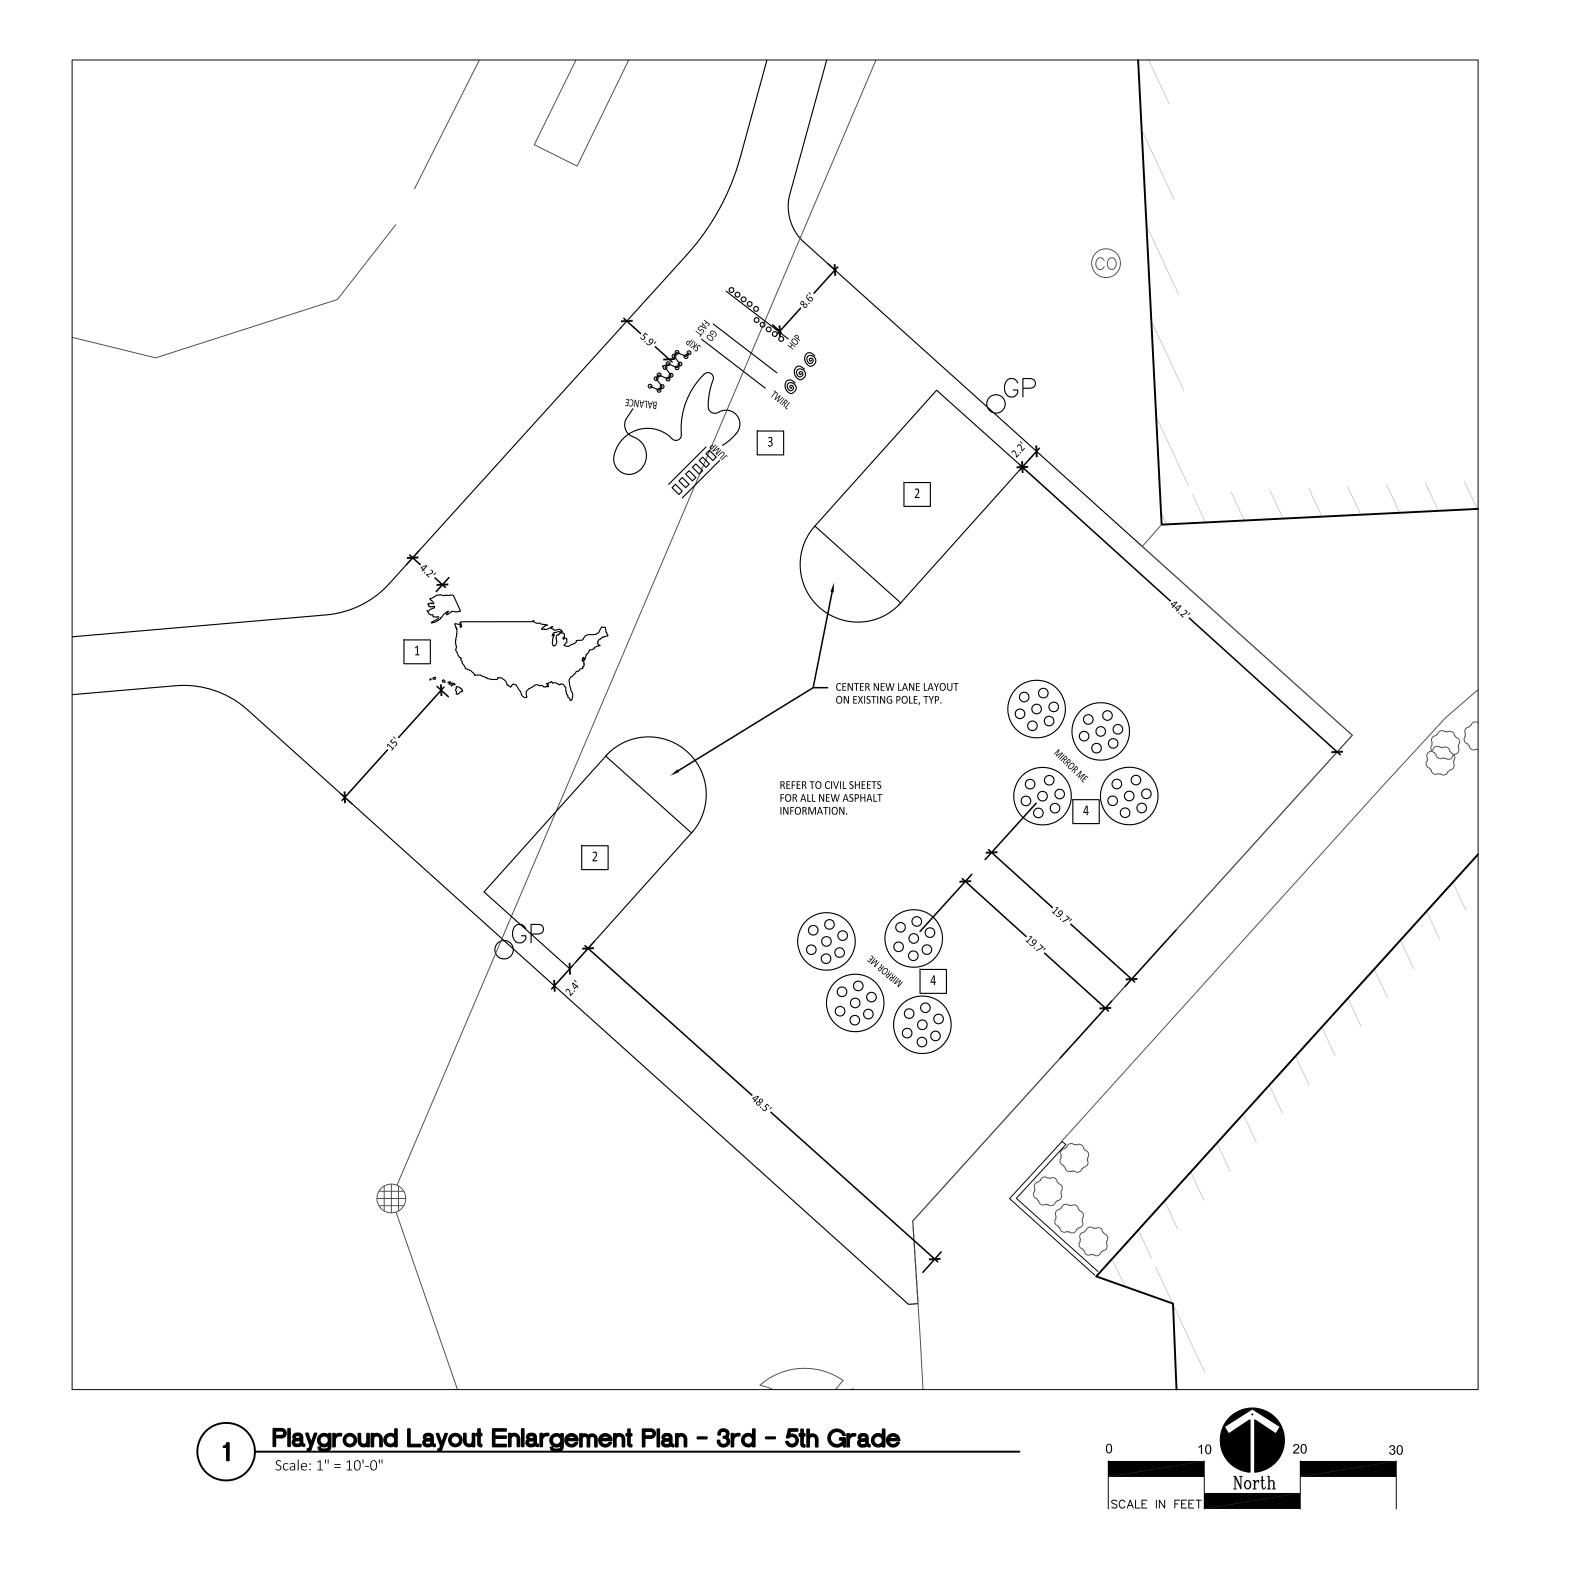



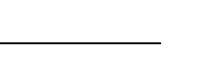

Playground Layout Enlargement Plan - 1st - 2nd Grade

Scale: 1" = 10'-0"

0 10 20 North

1ST - 2ND GRADE PAINTED GAMES SCHEDULE:

. ,		
SYMBOL	DESCRIPTION	<u>DETAIL</u>
1	MAP OF UNITED STATES	SEE SPECS., 3 / C2.1
2	BASKETBALL LANE LAYOUT	2 / C2.0
3	SILLY TRACK	3 / C2.0
4	MIRROR ME	2 / C2.1
5	N/A	

3RD - 5TH GRADE PAINTED GAMES SCHEDULE:

,		
SYMBOL	DESCRIPTION	DETAIL
1	MAP OF UNITED STATES	SEE SPECS., 3 / C2.1.
2	BASKETBALL LANE LAYOUT	2 / C2.0
3	SILLY TRACK	3 / C2.0
4	MIRROR ME	2 / C2.1
5	N/A	

PROPOSED FEATURES LEGEND:

SYMBOL	DESCRIPTION	KEY	DESCRIPTION	DETAIL
		A	STRAIGHT FACE CONCRETE CURB	6 /C4.0
(c)	RESILIENT SURFACING (BY OTHERS)	B	THICKENED EDGE CONCRETE	11 /C4.0
	,	Ċ	RESILIENT SURFACING (BY OTHERS)	7 /C4.0
+ + + +		D	LOOSE FILL SAFETY SURFACING (BY OTHERS)	3 & 9 /C4.0
+ + + + + +	LOOSE FILL SAFETY SURFACING (BY OTHERS)	Ē	PLASTIC PLAY EDGING (BY OTHERS)	12, 13, & 18 /C4.0
+ + + +		F	SYNTHETIC TURF (BY OTHERS)	4, 5, & 8 /C4.0
[G	CONCRETE WALK	2 /C4.0
	SYNTHETIC TURF (BY OTHERS)	(H)	PLAY AREA ENTRANCE RAMP	16 /C4.0
		J	CONCRETE SAND BOX	15 /C4.0
		K	BASKETBALL HOOP POLE (BY OTHERS)	17 /C4.0
	N/A	L	N/A	
		\overline{M}	N/A	
	N/A	(N)	N/A	
	N/A	(P)	N/A	
		O		
=====	PLASTIC PLAY EDGING, BY OTHERS REFER TO PLAYGROUND CONTRACTOR'S DRAWINGS AND SPECS			
	STRAIGHT FACE CONCRETE CURB			
	STRAIGHT FACE CONCRETE CORD			
	THICKENED EDGE CONCRETE			
	INTEGRAL WALK AND CURB			
	THE COME WILLIAMS COME			
	BARRIER-FREE PLAY AREA ENTRANCE RAMP	SIGNS	~	
	CHAINTING			10 / 64 0
xxx	CHAIN LINK FENCE	(S1)	COMMUNICATION BOARD	10 / C4.0
	LIMIT OF WORK			
	ENLARGEMENT LIMIT LINE			
	ENLANGEIVIENT LIIVIT LIIVE			

LAYOUT NOTES:

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- MANAGER IMMEDIATELY.
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EM INFO TMP-ARCHITECTURE.COM

REGISTRATION SEAL

CONSULTANT



141 E. Michigan Avenue, Suite 500 Kalamazoo Michigan 49007 Phone (269) 381-3357 Fax (269) 381-2944

PROJECT TITLE

Bemis Elementary School Playground Renovation Bid Package No.01A


Troy School District Troy, Michigan

Playground Layout Enlargement Plans

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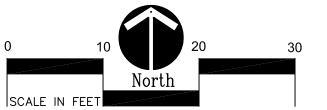
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Playground Layout Enlargement Plan - Swing Area

Scale: 1" = 10'-0"

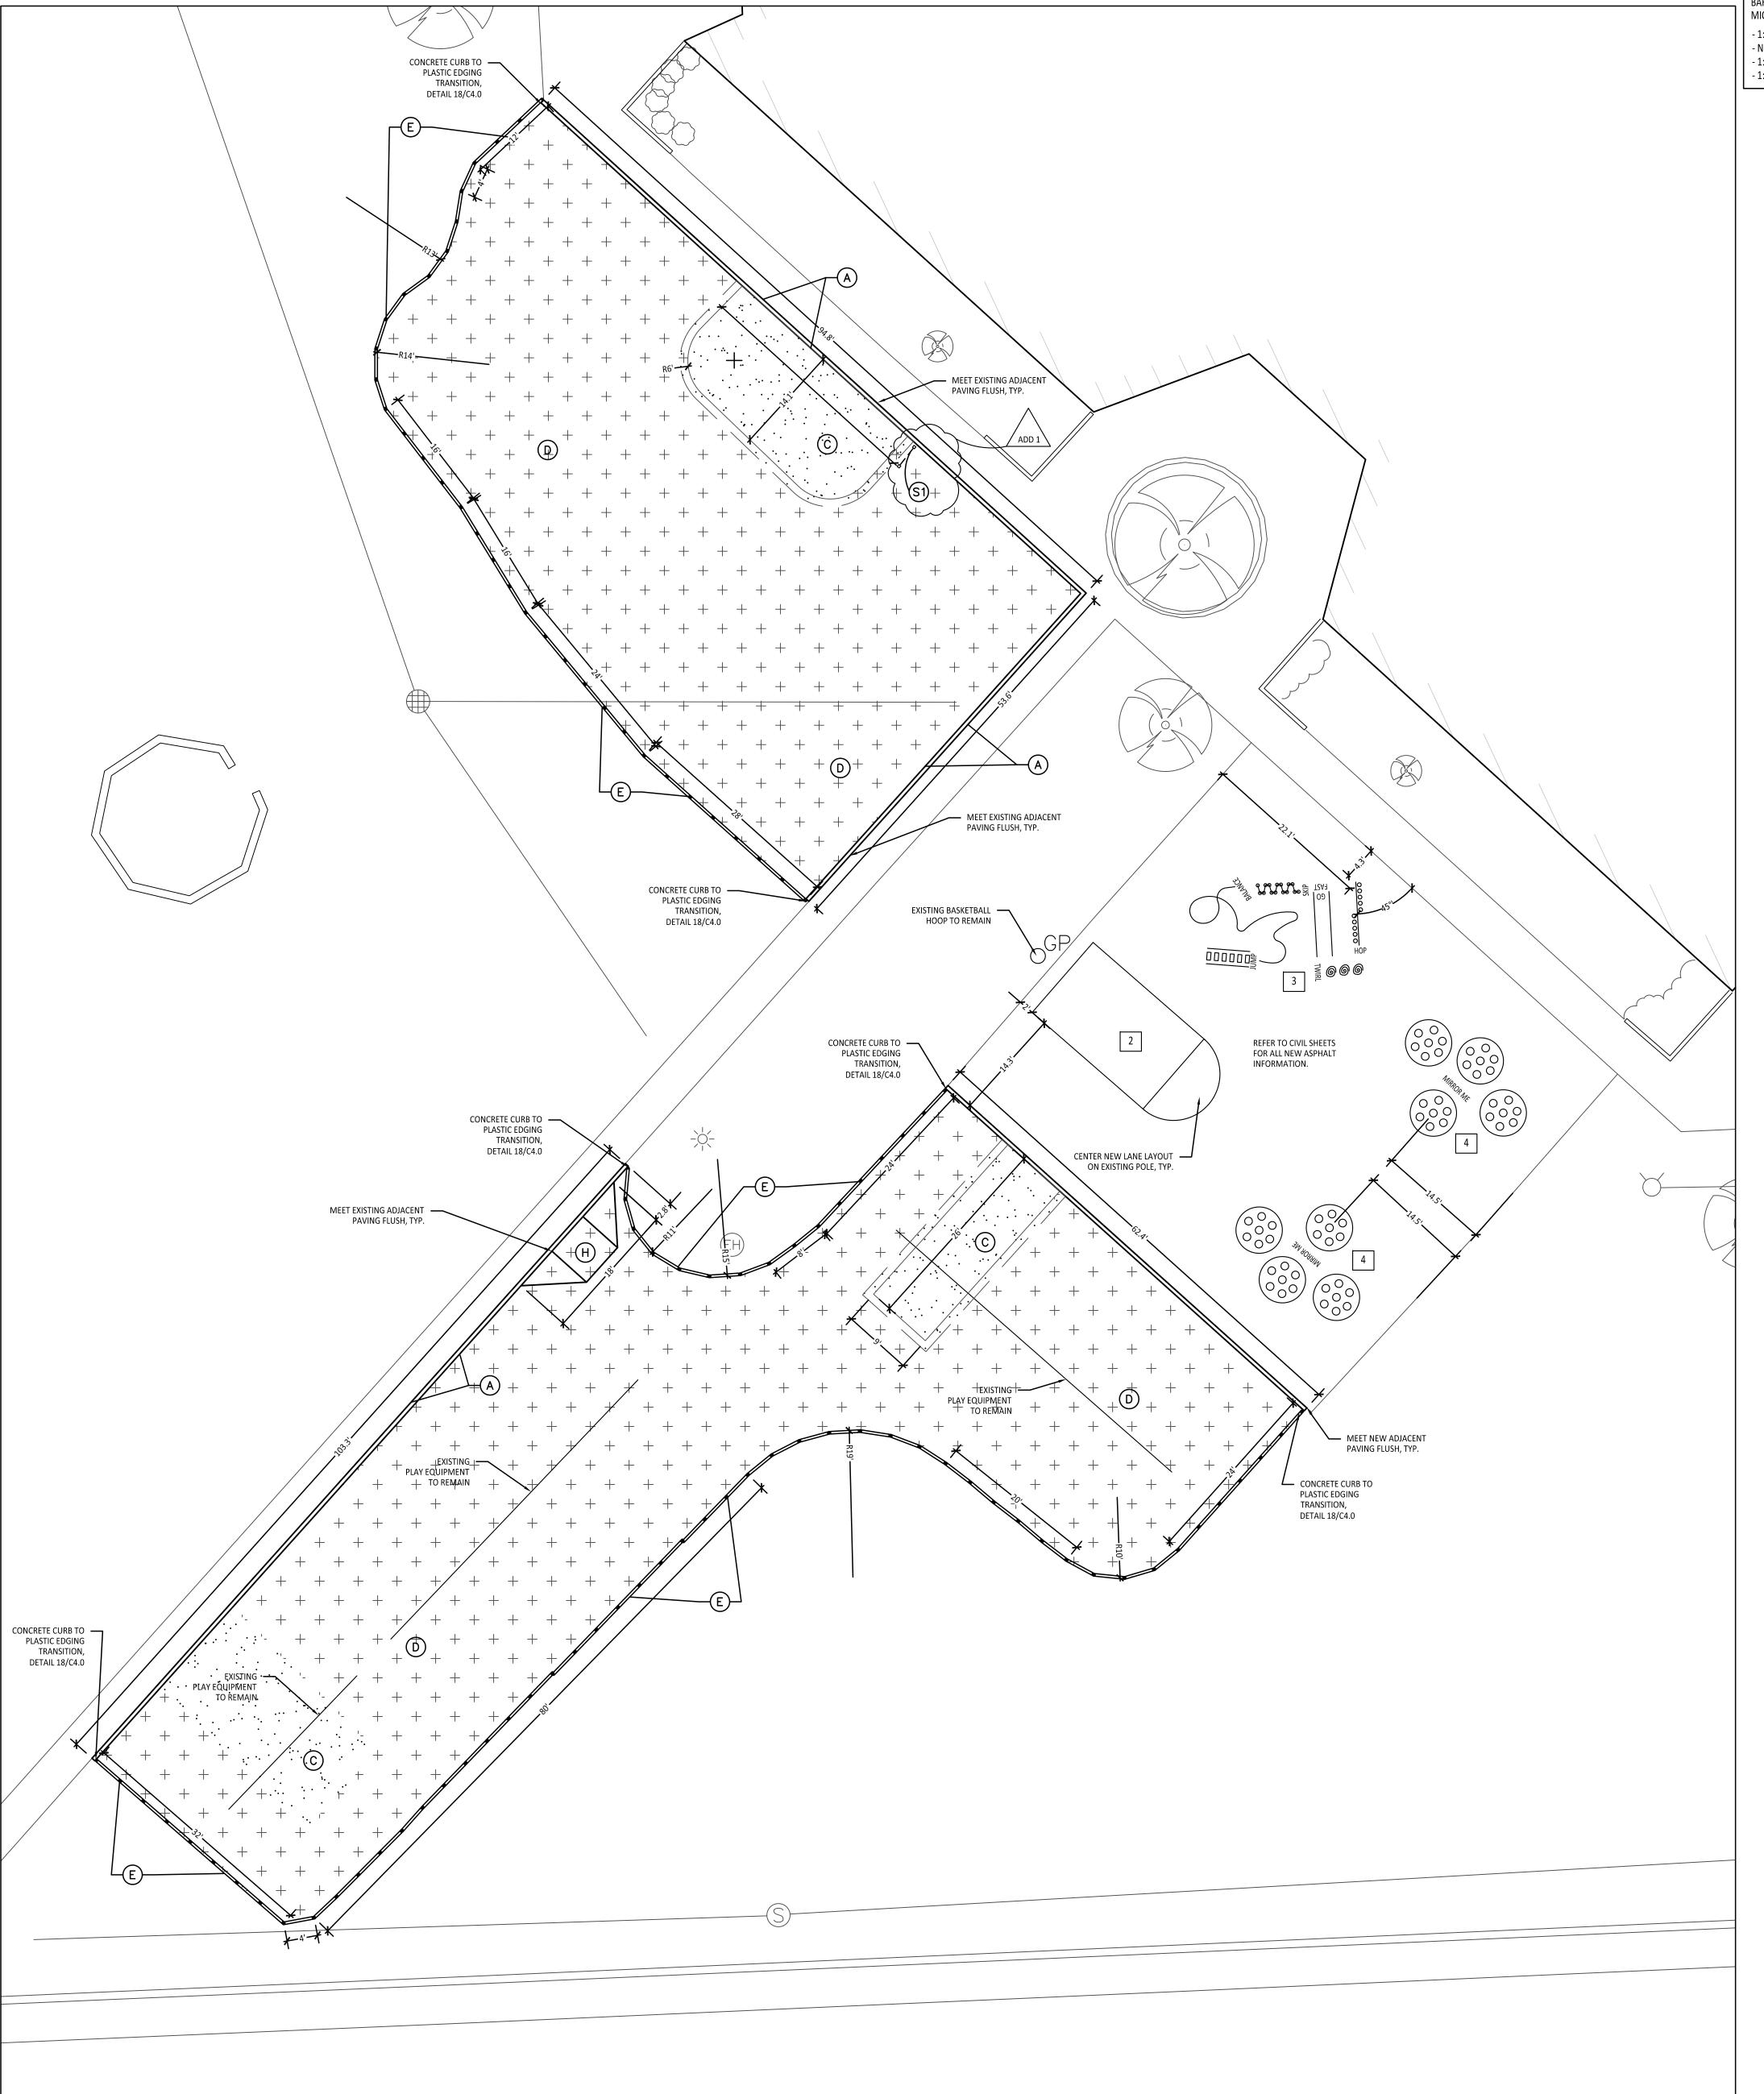

BARRIER-FREE NOTES

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LAYOUT NOTES:


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REGISTRATION SEAL

PROPOSED FEATURES LEGEND:



SWING AREA PAINTED GAMES SCHEDULE:

SYMBOL	DESCRIPTION	DETAIL
1	N/A	
2	BASKETBALL LANE LAYOUT	2 / C2.0
3	SILLY TRACK	3 / C2.0
4	MIRROR ME	2 / C2.1
5	N/A	

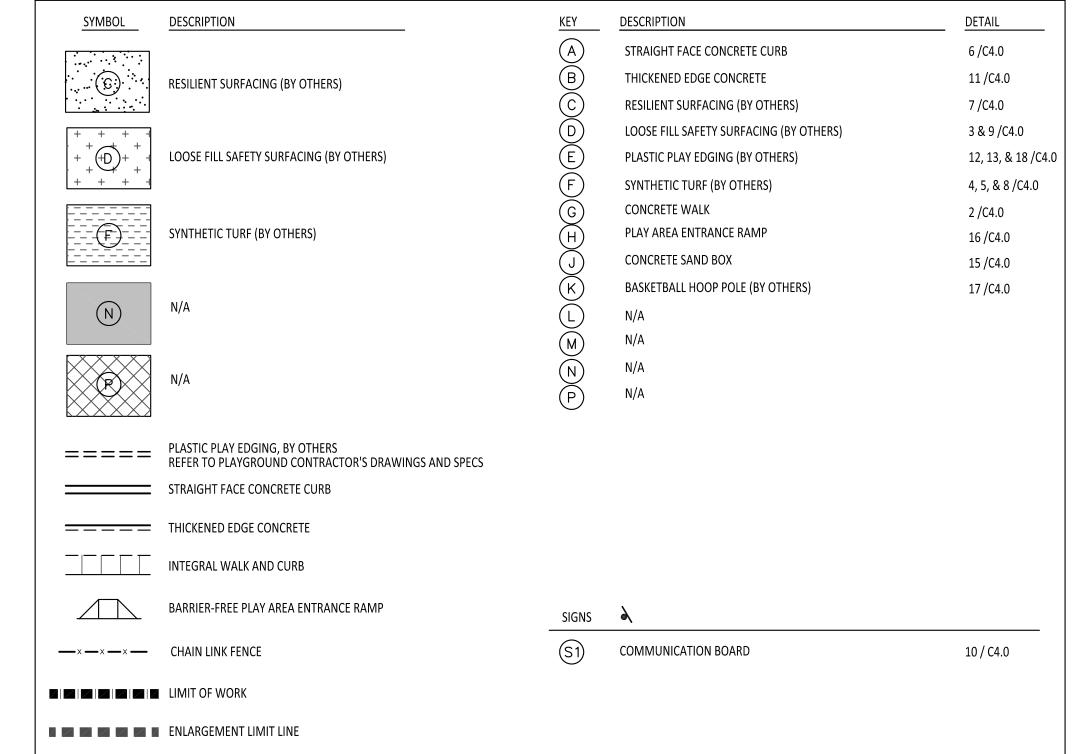CONSULTANT



141 E. Michigan Avenue, Suite 500 Kalamazoo Michigan 49007 Phone (269) 381-3357 Fax (269) 381-2944

PROJECT TITLE

Bemis Elementary School Playground Renovation Bid Package No.01A

Troy School District Troy, Michigan


DRAWING TITLE
Playground Layout
Enlargement Plans

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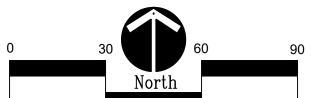
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Overall Playground Grading Plan






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 THE PROPOSED CRAPES NOTIFY THE OWNER PERSONNEL INTENDED TO DRAIN FREELY WITH NO PONDING. IF THIS CANNOT BE ACHIEVED USING
- THE PROPOSED GRADES, NOTIFY THE OWNER'S REPRESENTATIVE IMMEDIATELY FOR RESOLUTION.

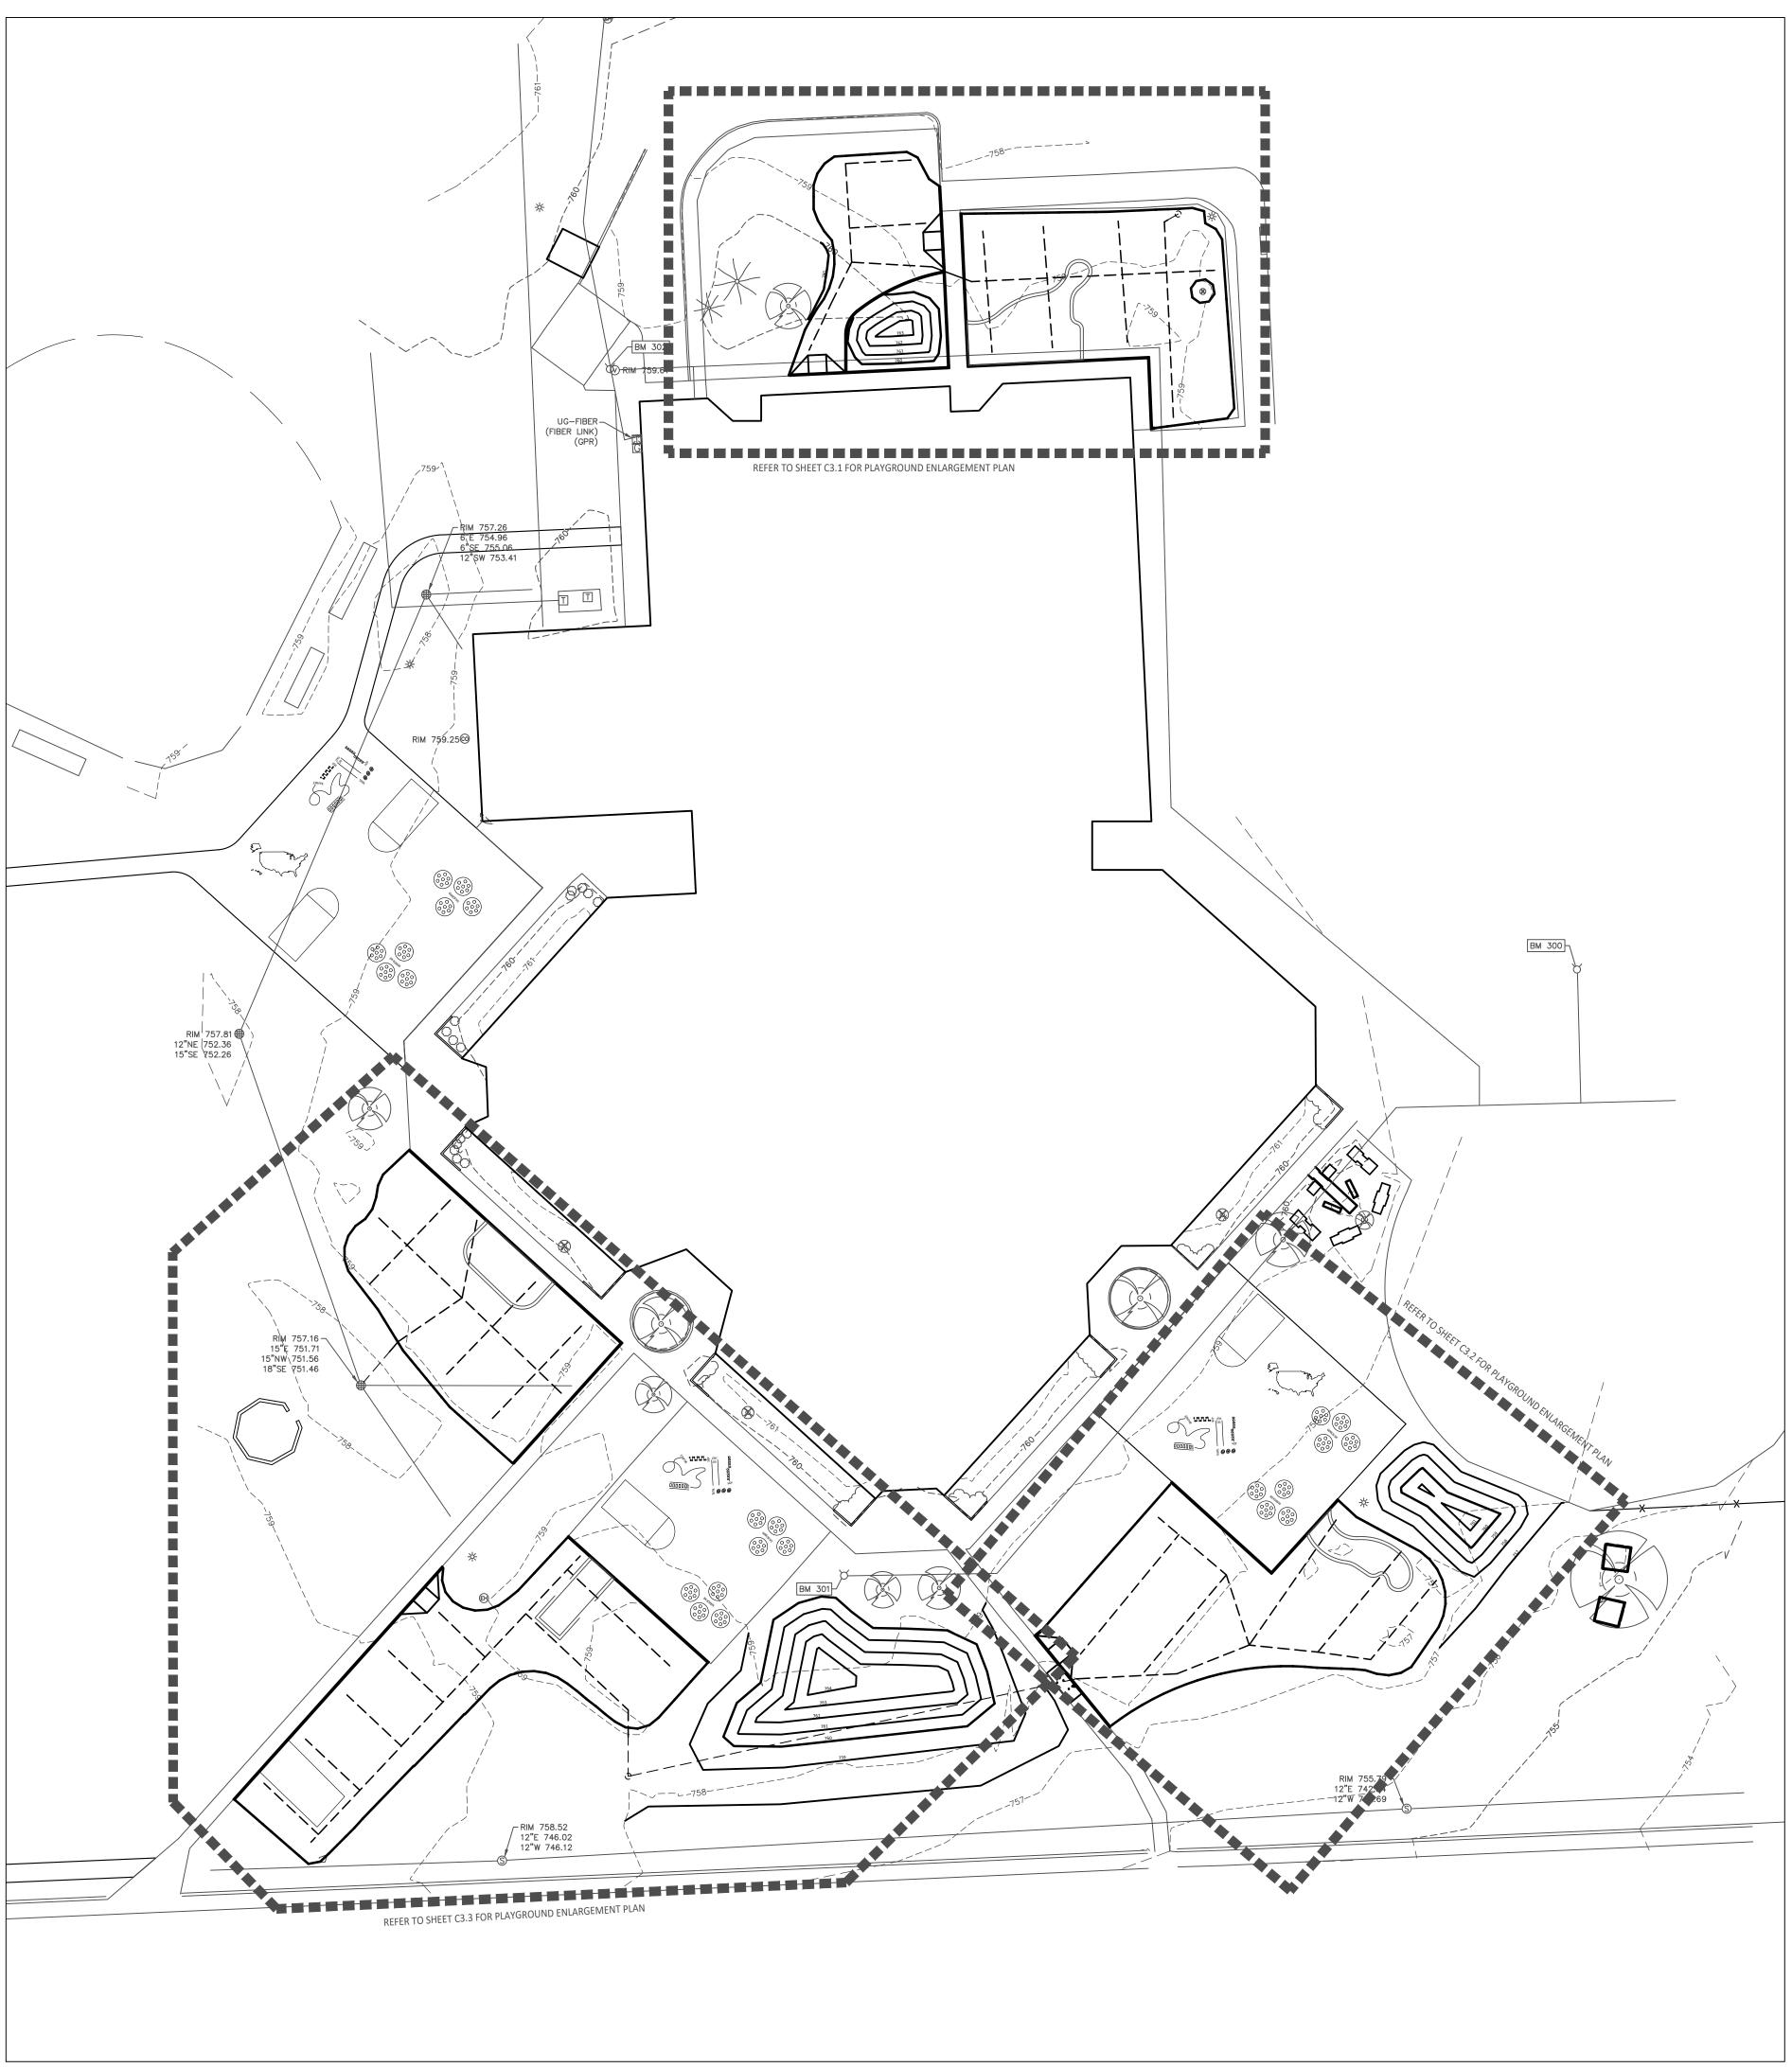 4. ALL NEW PAVEMENT ELEVATIONS AT EXTERIOR DOORS SHALL MATCH EXISTING FINISH FLOOR ELEVATIONS, TYPICAL.
- 5. ADJUST TOP OF EXISTING MANHOLES, CATCH BASINS, VAULT COVERS, ETC. TO NEW FINISH GRADE AS REQUIRED.
- 6. SEE SITE CIVIL PLANS FOR ALL ADDITIONAL SITE UTILITY DEMOLITION AND CONSTRUCTION.
- 7. ALL TOPSOIL AND EXCESS FILL MATERIAL SHALL BE STOCKPILED ON SITE SEPARATELY FOR LATER RE-USE. LOCATE STOCKPILES IN AREAS AS DIRECTED BY CONSTRUCTION MANAGER AND PROTECT FROM EFFECTS OF EROSION.

PROPOSED FEATURES LEGEND:



IMPORTANT NOTE

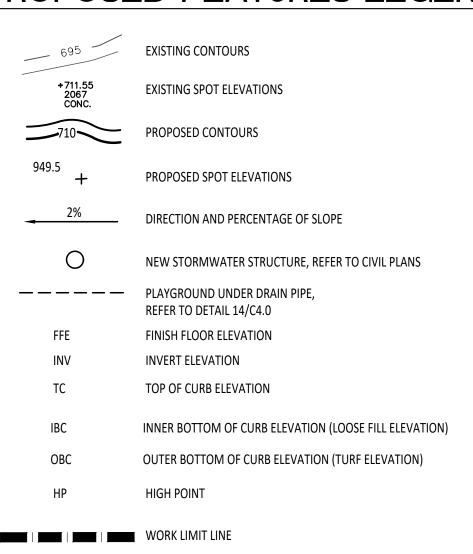GENERAL EARTHWORK NOTE:

CUTS AND FILLS AT THIS SITE MAY OR MAY NOT BALANCE. IT IS THE
CONTRACTOR'S RESPONSIBILITY TO VERIFY THE REQUIRED
EARTHWORK VOLUMES BASED ON THE GRADING PLAN SHOWN. IF FILL
IS REQUIRED, THE CONTRACTOR SHALL INCLUDE THE REQUIRED
VOLUME OF IMPORTED CLASS II SAND IN THE BASE BID PROPOSAL. IF
EXCESS SOILS NEED TO BE SPOILED, THE CONTRACTOR SHALL
INCLUDE HAULING AND SPOILING SOILS OFF SITE IN THE BASE BID
PROPOSAL. NO CONTRACT COST ADJUSTMENTS WILL BE CONSIDERED
FOR EARTHWORK REQUIRED TO BALANCE THE SITE.

IMPORTANT NOTE

- 1:50 (2%) MAXIMUM SLOPE (IN ANY DIRECTION) IN B.F. PARKING AND ACCESS AISLES.

BARRIER-FREE NOTES

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REGISTRATION SEAL

CONSULTANT



350 East Michigan Avenue Suite #415 Kalamazoo Michigan 49007 Phone (269) 381-3357 Fax (269) 381-2944

PROJECT TITLE

Bemis Elementary School Playground Renovation Bid Package No.01A

Troy School District Troy, Michigan

Orawing TITLE
Overall Playground
Grading Plan

DATE:	ISSUED FOR:
11-09-23	CONSTRUCTION DOCUMENTS
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PROJECT NO.


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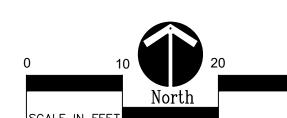
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1 Grading Enlargement Plan - Kindergarten

1" = 10'-0"




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- ALL NEW PAVEMENTS AND TURF AREAS ARE INTENDED TO DRAIN FREELY WITH NO PONDING. IF THIS CANNOT BE ACHIEVED US
- THE PROPOSED GRADES, NOTIFY THE OWNER'S REPRESENTATIVE IMMEDIATELY FOR RESOLUTION.
- A ALL NEW DAVEMENT ELEVATIONS AT EXTERIOR DOORS SHALL MATCH EXISTING FINISH FLOOR ELEVATIONS. TVDICAL
- 5. ADJUST TOP OF EXISTING MANHOLES, CATCH BASINS, VAULT COVERS, ETC. TO NEW FINISH GRADE AS REQU

AS DIRECTED BY CONSTRUCTION MANAGER AND PROTECT FROM EFFECTS OF EROSION.

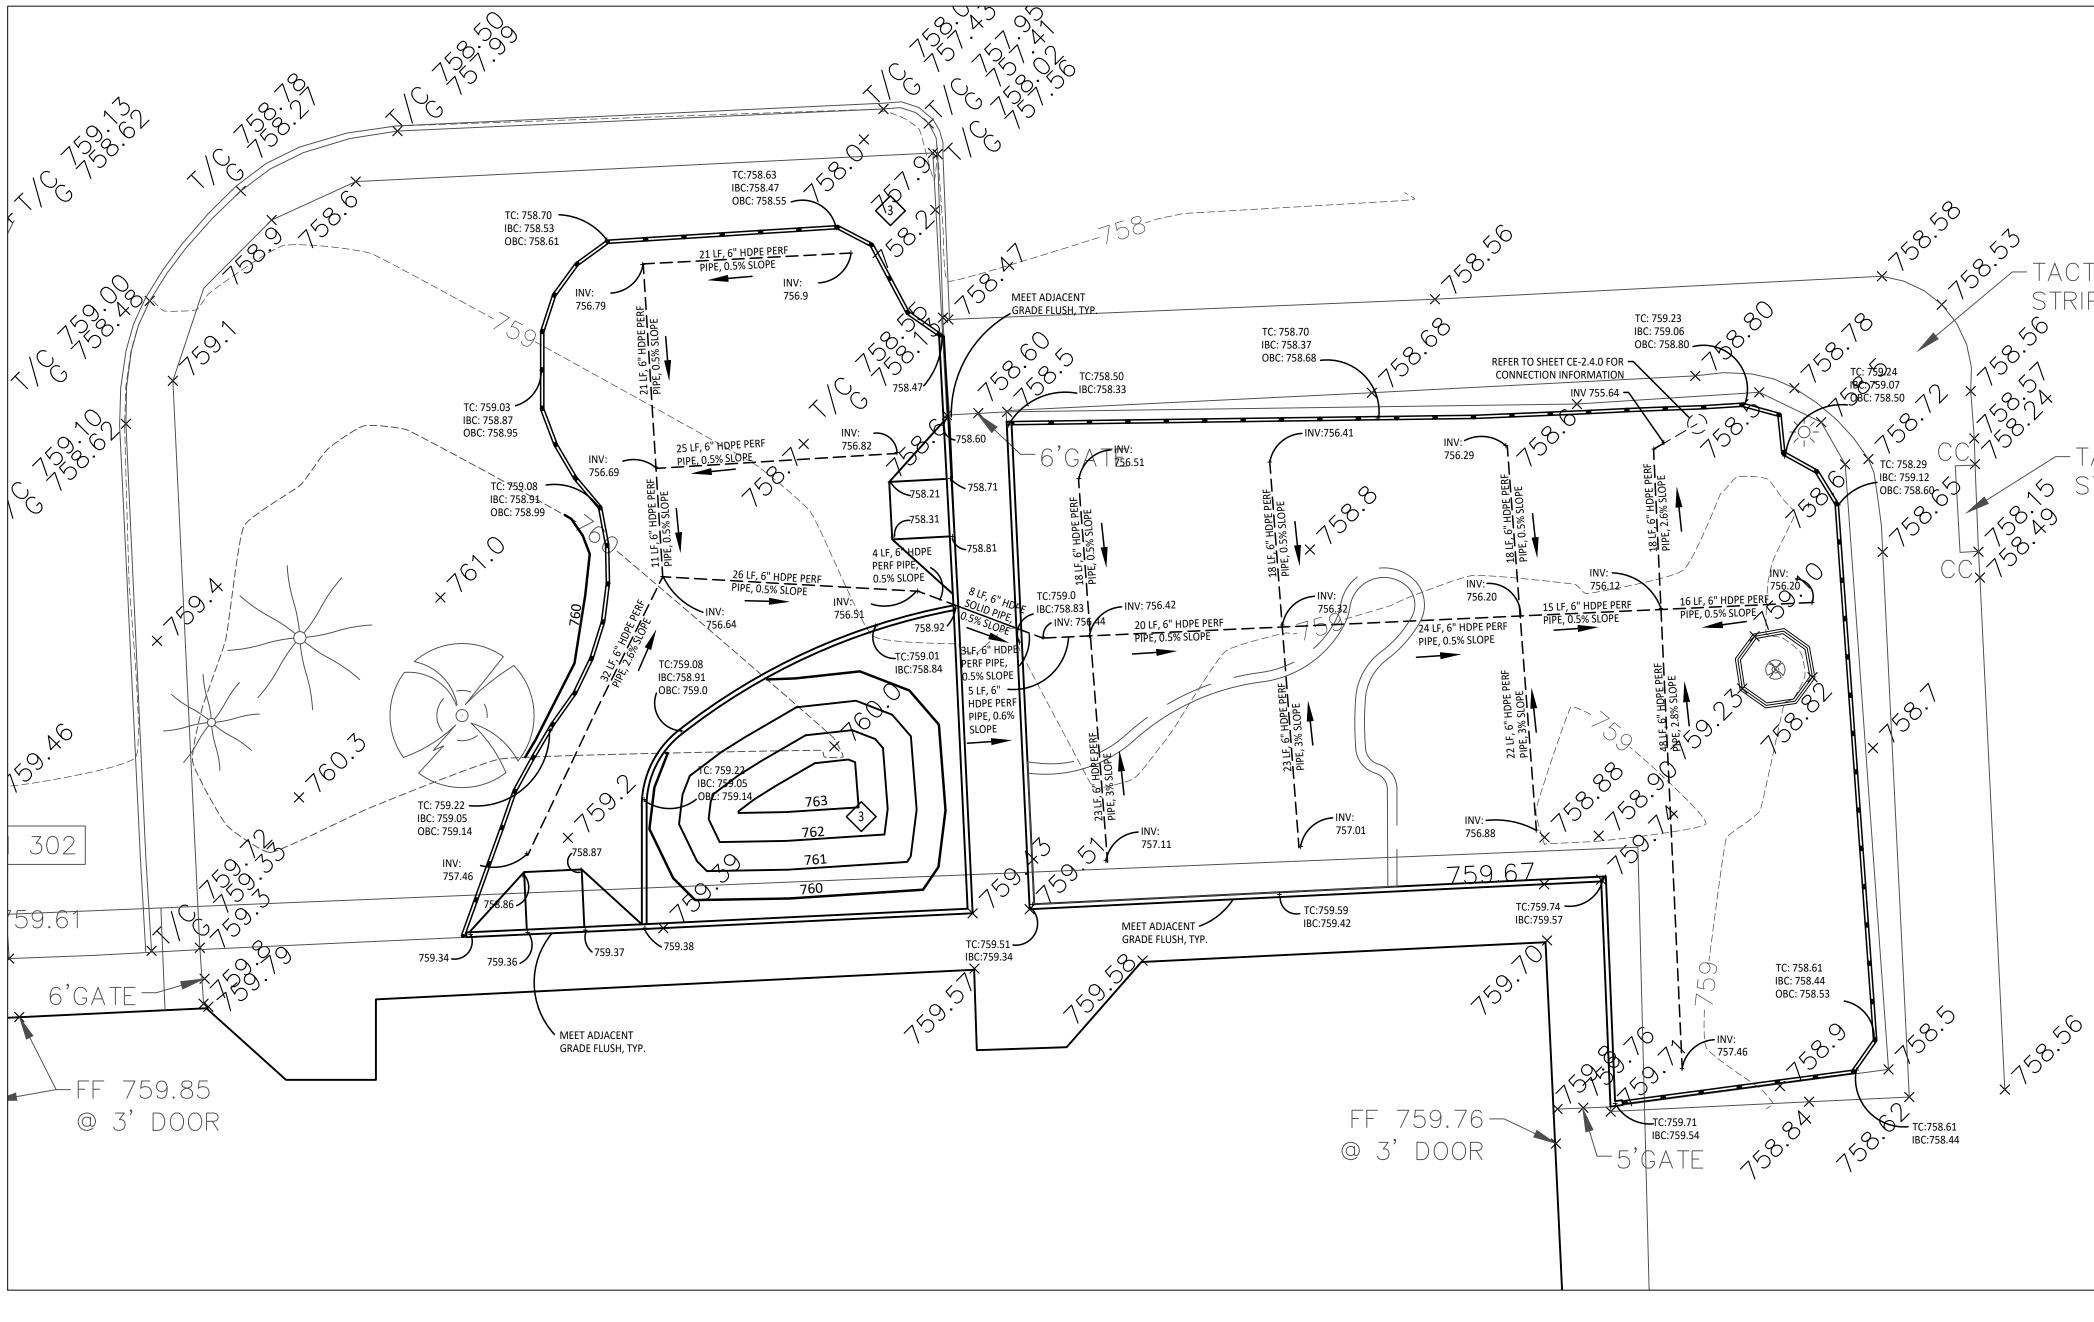- SEE SITE CIVIL PLANS FOR ALL ADDITIONAL SITE OTILITY DEMOLITION AND CONSTRUCTION.
 ALL TOPSOIL AND EXCESS FILL MATERIAL SHALL BE STOCKPILED ON SITE SEPARATELY FOR LATER RE-USE. LOCATE STOCKPILES IN AREAS

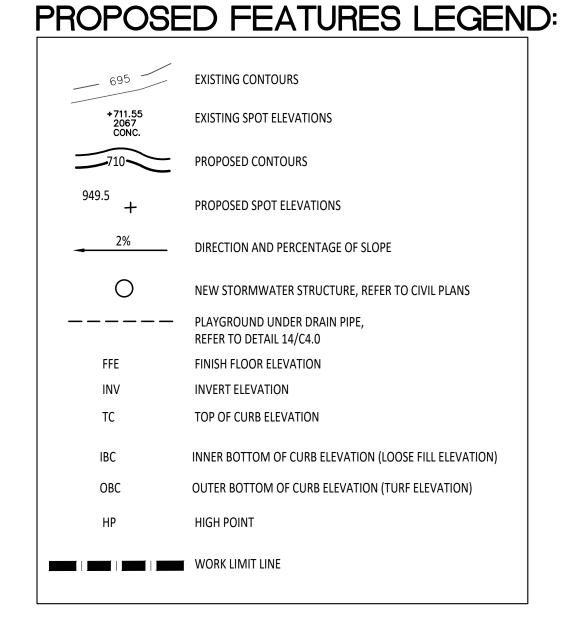

IMPORTANT NOTE

GENERAL EARTHWORK NOTE:

CUTS AND FILLS AT THIS SITE MAY OR MAY NOT BALANCE. IT IS THE CONTRACTOR'S RESPONSIBILITY TO VERIFY THE REQUIRED EARTHWORK VOLUMES BASED ON THE GRADING PLAN SHOWN. IF FILL IS REQUIRED, THE CONTRACTOR SHALL INCLUDE THE REQUIRED VOLUME OF IMPORTED CLASS II SAND IN THE BASE BID PROPOSAL. IF EXCESS SOILS NEED TO BE SPOILED, THE CONTRACTOR SHALL INCLUDE HAULING AND SPOILING SOILS OFF SITE IN THE BASE BID PROPOSAL. NO CONTRACT COST ADJUSTMENTS WILL BE CONSIDERED FOR EARTHWORK REQUIRED TO BALANCE THE SITE.

IMPORTANT NOTE

BARRIER-FREE NOTES

- BARRIER-FREE PARKING AND ACCESSIBLE ROUTE(S) MUST COMPLY WITH THE AMERICANS WITH DISABILITIES ACT AND MICHIGAN BARRIER-FREE CODE REQUIREMENTS, INCLUDING BUT NOT LIMITED TO THE FOLLOWING:
- 1:50 (2%) MAXIMUM CROSS-SLOPE ON ACCESSIBLE ROUTE.
- 1:50 (2%) MAXIMUM CROSS-SLOPE ON ACCESSIBLE ROUTE.
 NO CHANGES IN LEVEL GREATER THAN 1/2" ALONG ACCESSIBLE ROUTE.
- 1:20 (5%) MAXIMUM LONGITUDINAL SLOPE ON ACCESSIBLE ROUTE (EXCEPT WHERE RAMPS ARE PROVIDED).
 1:50 (2%) MAXIMUM SLOPE (IN ANY DIRECTION) IN B.F. PARKING AND ACCESS AISLES.

EROSION CONTROL REQUIREMENTS:

PERMANENT/TEMPORARY SEEDING

ALL CONSTRUCTION SHALL COMPLY WITH THE SOIL EROSION AND SEDIMENTATION CONTROL ACT (P.A. 347 OF 1972, AS AMENDED) AS ADMINISTERED BY CITY OF TROY AND OAKLAND COUNTY. THE FOLLOWING EROSION CONTROL DEVICES ARE REFERENCED IN THE STANDARD EROSION CONTROL HANDBOOK PUBLISHED BY THE MICHIGAN DEPARTMENT OF TRANSPORTATION. (MDOT DRAWING R-96-C, 8-9-2001)

ALL TEMPORARY EROSION CONTROL DEVICES SHALL BE REMOVED AT THE END OF

EXCAVATION, TO THE EXTENT POSSIBLE.

KEY DESCRIPTION TEMPORARY / PERMANENT

CONSTRUCTION. TEMPORARY EROSION CONTROL DEVICES SHOULD BE IN PLACE PRIOR TO



Playground Grading
Enlargement Plans
- Kindergarten

TMP ARCHITECTURE INC

1191 WEST SQUARE LAKE ROAD

BLOOMFIELD HILLS • MICHIGAN • 48302 PH • 248.338.4561 FX • 248.338.0223

EM · INFO @ TMP-ARCHITECTURE.COM

ARCHITECTS

Kalamazoo Michigan 49007

Phone (269) 381-3357

Fax (269) 381-2944

350 East Michigan Avenue Suite #415

Elementary School Playground Renovation Bid Package No.01A

REGISTRATION SEAL

CONSULTANT

PROJECT TITLE

Bemis


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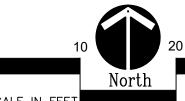
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Grading Enlargement Plan - 1st - 2nd Grade


1" = 10'-0"



GRADING NOTES:

- SURVEY OF EXISTING CONDITIONS PROVIDED BY PEA GROUP, 1849 POND RUN, AUBURN HILLS, MICHIGAN, 48326, (248)689-9090. VERIFY LOCATIONS OF ALL BELOW GRADE UTILITIES PRIOR TO BEGINNING WORK. 72 HOURS BEFORE YOU DIG CALL "MISS DIG" AT

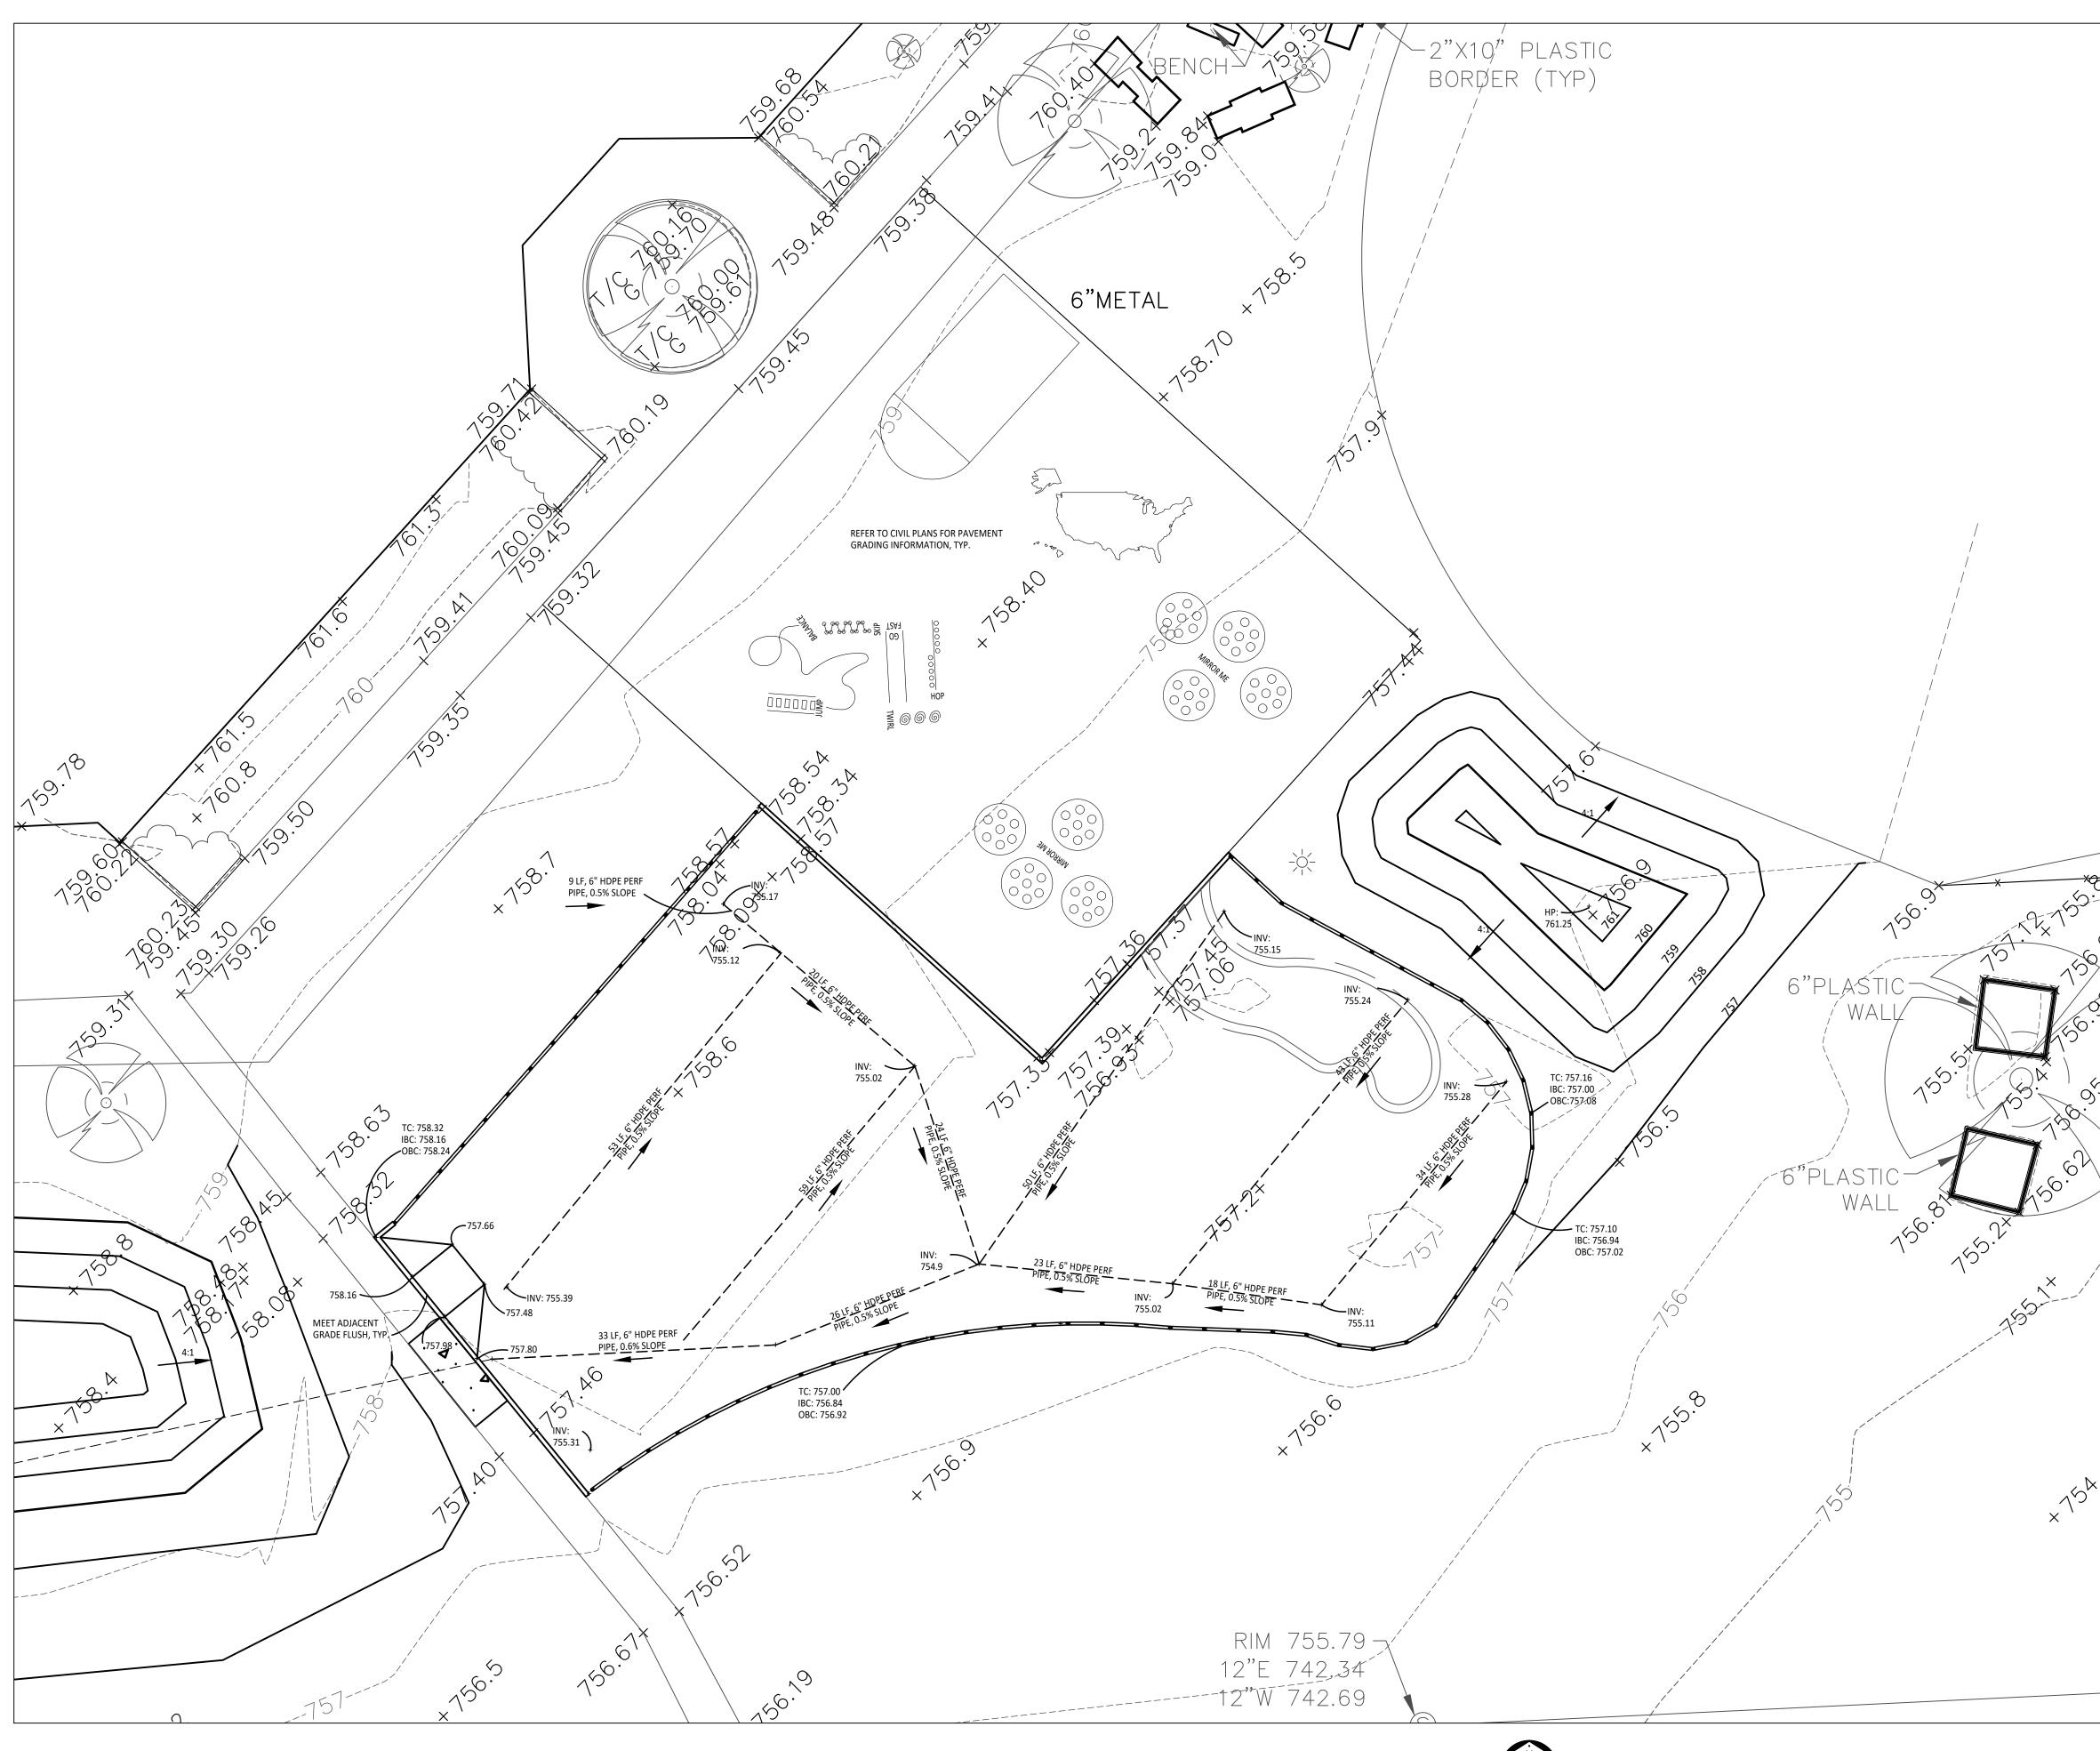- ALL NEW PAVEMENT ELEVATIONS AT EXTERIOR DOORS SHALL MATCH EXISTING FINISH FLOOR ELEVATIONS, TYPICAL
- ADJUST TOP OF EXISTING MANHOLES, CATCH BASINS, VAULT COVERS, ETC. TO NEW FINISH GRADE AS REQUIRED.
- SEE SITE CIVIL PLANS FOR ALL ADDITIONAL SITE UTILITY DEMOLITION AND CONSTRUCTION.
- ALL TOPSOIL AND EXCESS FILL MATERIAL SHALL BE STOCKPILED ON SITE SEPARATELY FOR LATER RE-USE. LOCATE STOCKPILES IN AREAS AS DIRECTED BY CONSTRUCTION MANAGER AND PROTECT FROM EFFECTS OF EROSION.

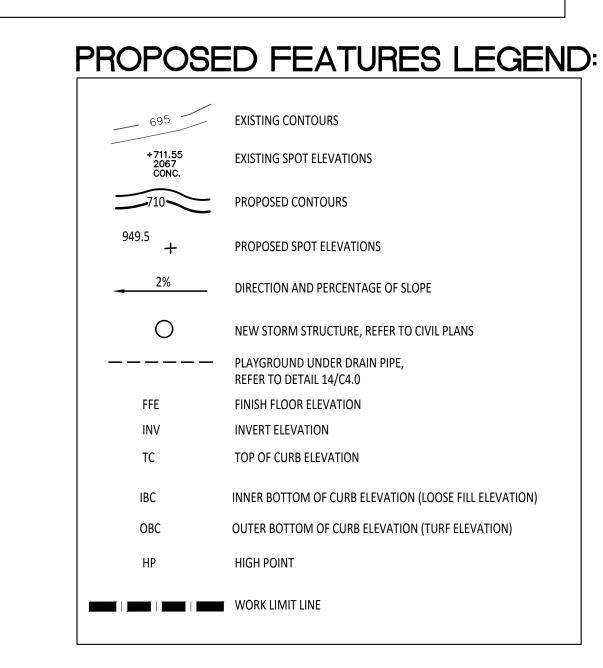

IMPORTANT NOTE

GENERAL EARTHWORK NOTE:

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IMPORTANT NOTE

- 1:50 (2%) MAXIMUM SLOPE (IN ANY DIRECTION) IN B.F. PARKING AND ACCESS AISLES.

BARRIER-FREE NOTES

BARRIER-FREE PARKING AND ACCESSIBLE ROUTE(S) MUST COMPLY WITH THE AMERICANS WITH DISABILITIES ACT AND

- 1:50 (2%) MAXIMUM CROSS-SLOPE ON ACCESSIBLE ROUTE.

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EROSION CONTROL REQUIREMENTS:

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KEY DESCRIPTION TEMPORARY / PERMANENT PERMANENT/TEMPORARY SEEDING



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REGISTRATION SEAL

CONSULTANT



350 East Michigan Avenue Suite #415 Kalamazoo Michigan 49007 Phone (269) 381-3357 Fax (269) 381-2944

PROJECT TITLE

Bemis Elementary School Playground Renovation Bid Package No.01A

Troy School District Troy, Michigan

DRAWING TITLE Playground Grading
Enlargement Plans
- 1st - 2nd Grade


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PROJECT NO.

DRAWING NO.

C3.2



GRADING NOTES:

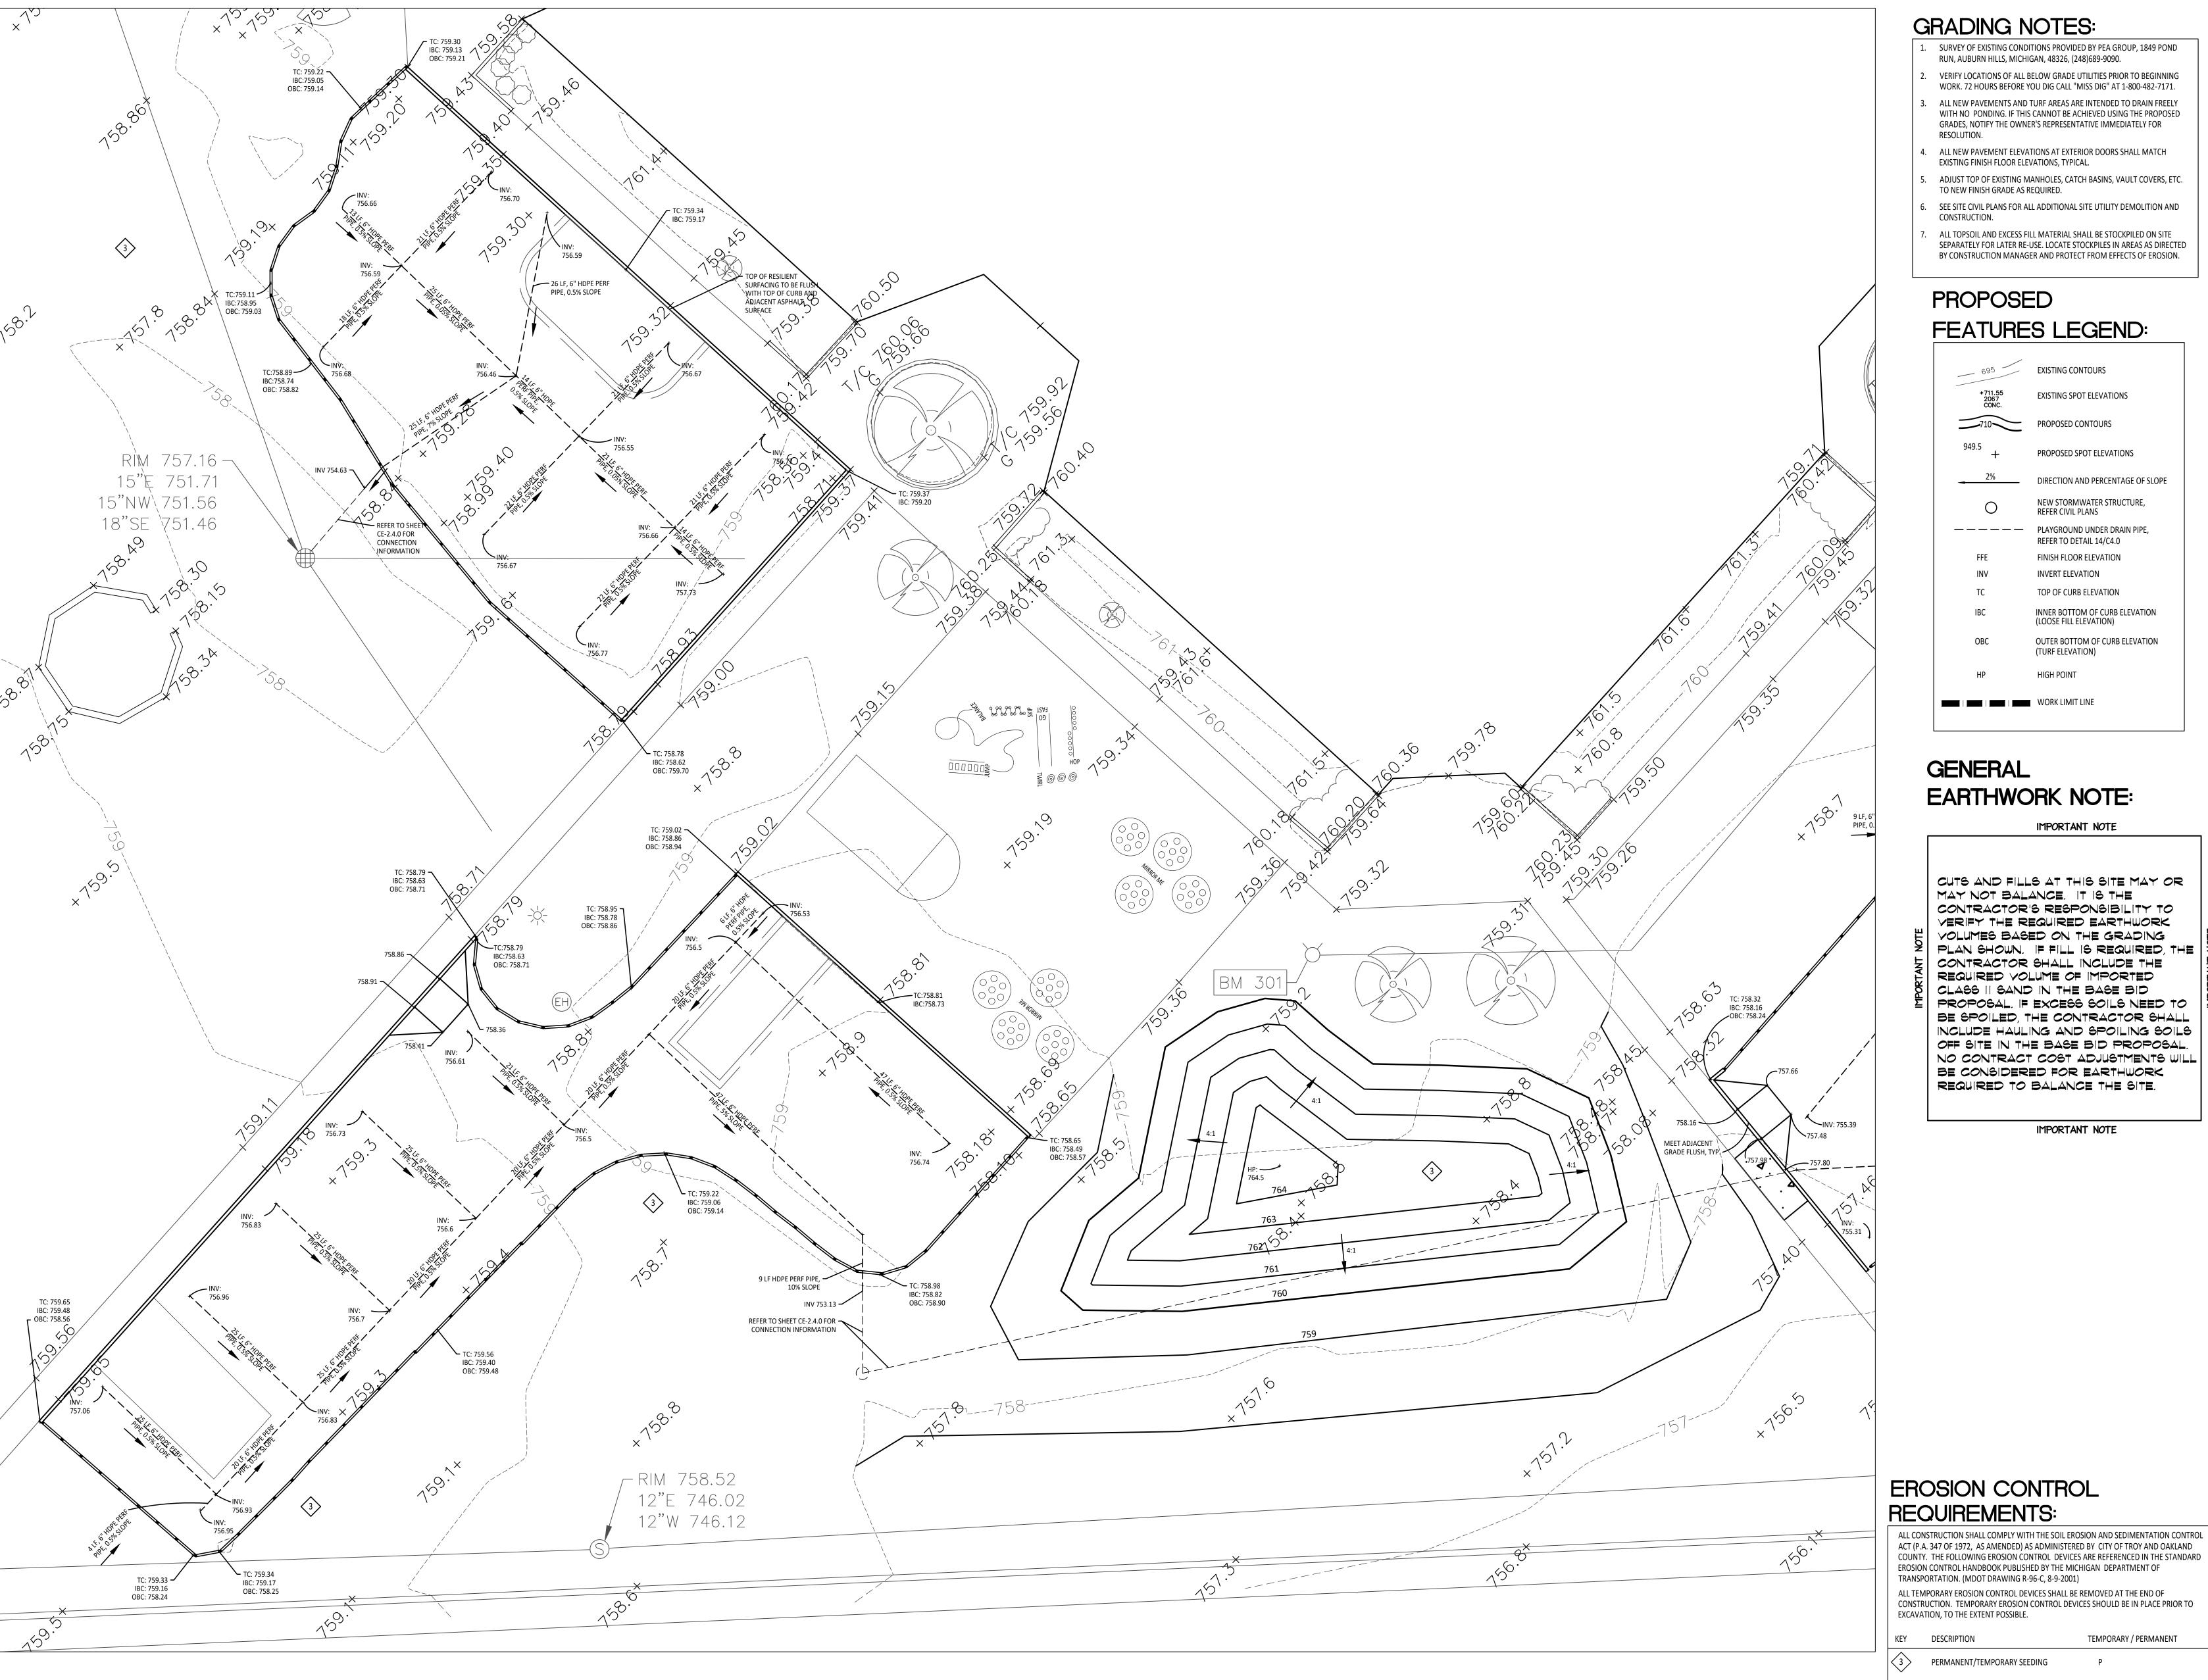
SURVEY OF EXISTING CONDITIONS PROVIDED BY PEA GROUP, 1849 POND RUN, AUBURN HILLS, MICHIGAN, 48326, (248)689-9090.

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PROPOSED

FEATURES LEGEND:



GENERAL EARTHWORK NOTE:
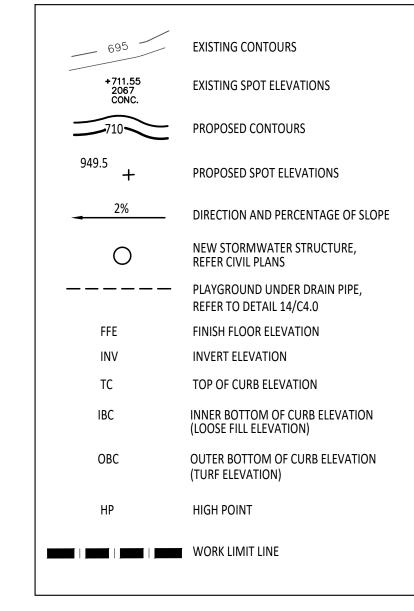
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IMPORTANT NOTE

ARCHITECTURE

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REGISTRATION SEAL

CONSULTANT



350 East Michigan Avenue Suite #415 Kalamazoo Michigan 49007 Phone (269) 381-3357 Fax (269) 381-2944

PROJECT TITLE

Bemis Elementary School Playground Renovation Bid Package No.01A

Troy School District Troy, Michigan

DRAWING TITLE Playground Grading Enlargement Plans - 3rd - 5th Grade

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11-09-23	CONSTRUCTION DOCUMENTS
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APPROVED ...

PROJECT NO.

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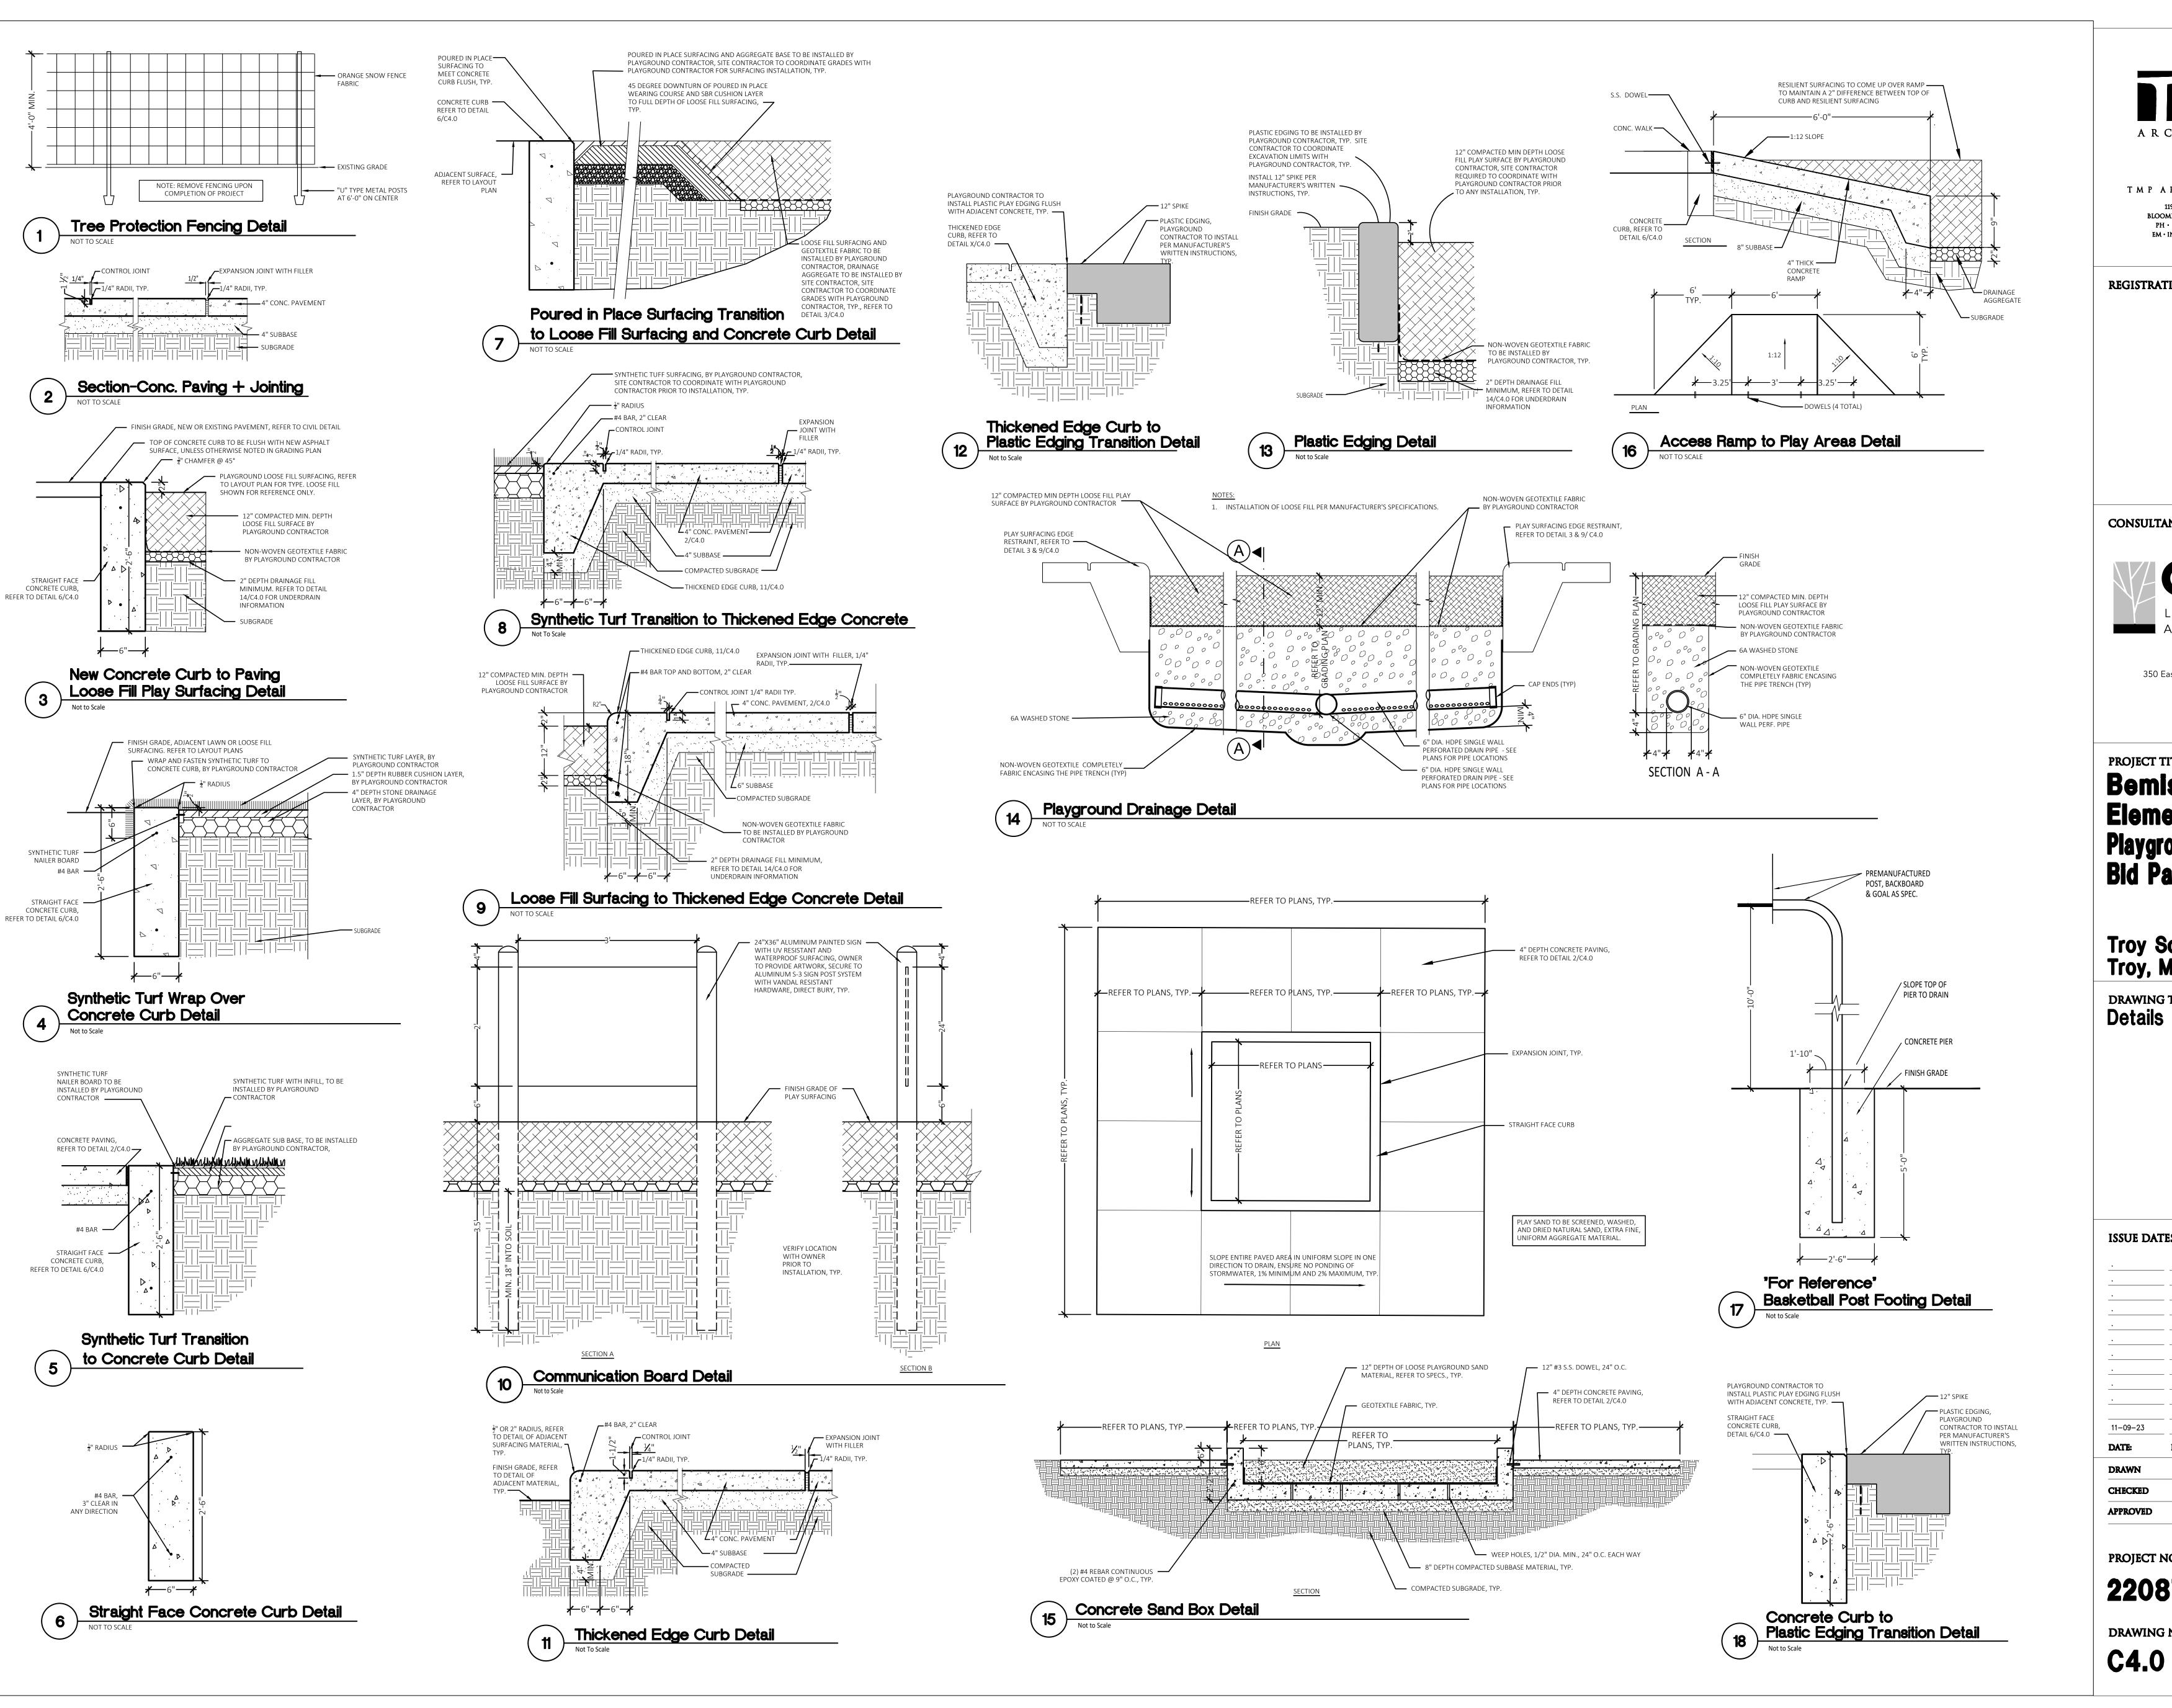
BARRIER-FREE NOTES

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- 1:20 (5%) MAXIMUM LONGITUDINAL SLOPE ON ACCESSIBLE ROUTE (EXCEPT WHERE RAMPS ARE PROVIDED).

- 1:50 (2%) MAXIMUM SLOPE (IN ANY DIRECTION) IN B.F. PARKING AND ACCESS AISLES.

1 Grading Enlargement Plan - 3rd - 5th Grade





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REGISTRATION SEAL

CONSULTANT



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PROJECT TITLE **Bemis** Elementary School Playground Renovation Bid Package No.01A

Troy School District Troy, Michigan

DRAWING TITLE **Details**

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REGISTRATION SEAL

GROUP t: 844.813.2949

Elementary School 3571 NORTHFIELD PARKWAY


Playground Renovation Bid Package No.01A


Troy School District Troy, Michigan


DRAWING TITLE
Topographic Survey

CONSTRUCTION DOCUMENTS

ISSUED FOR:

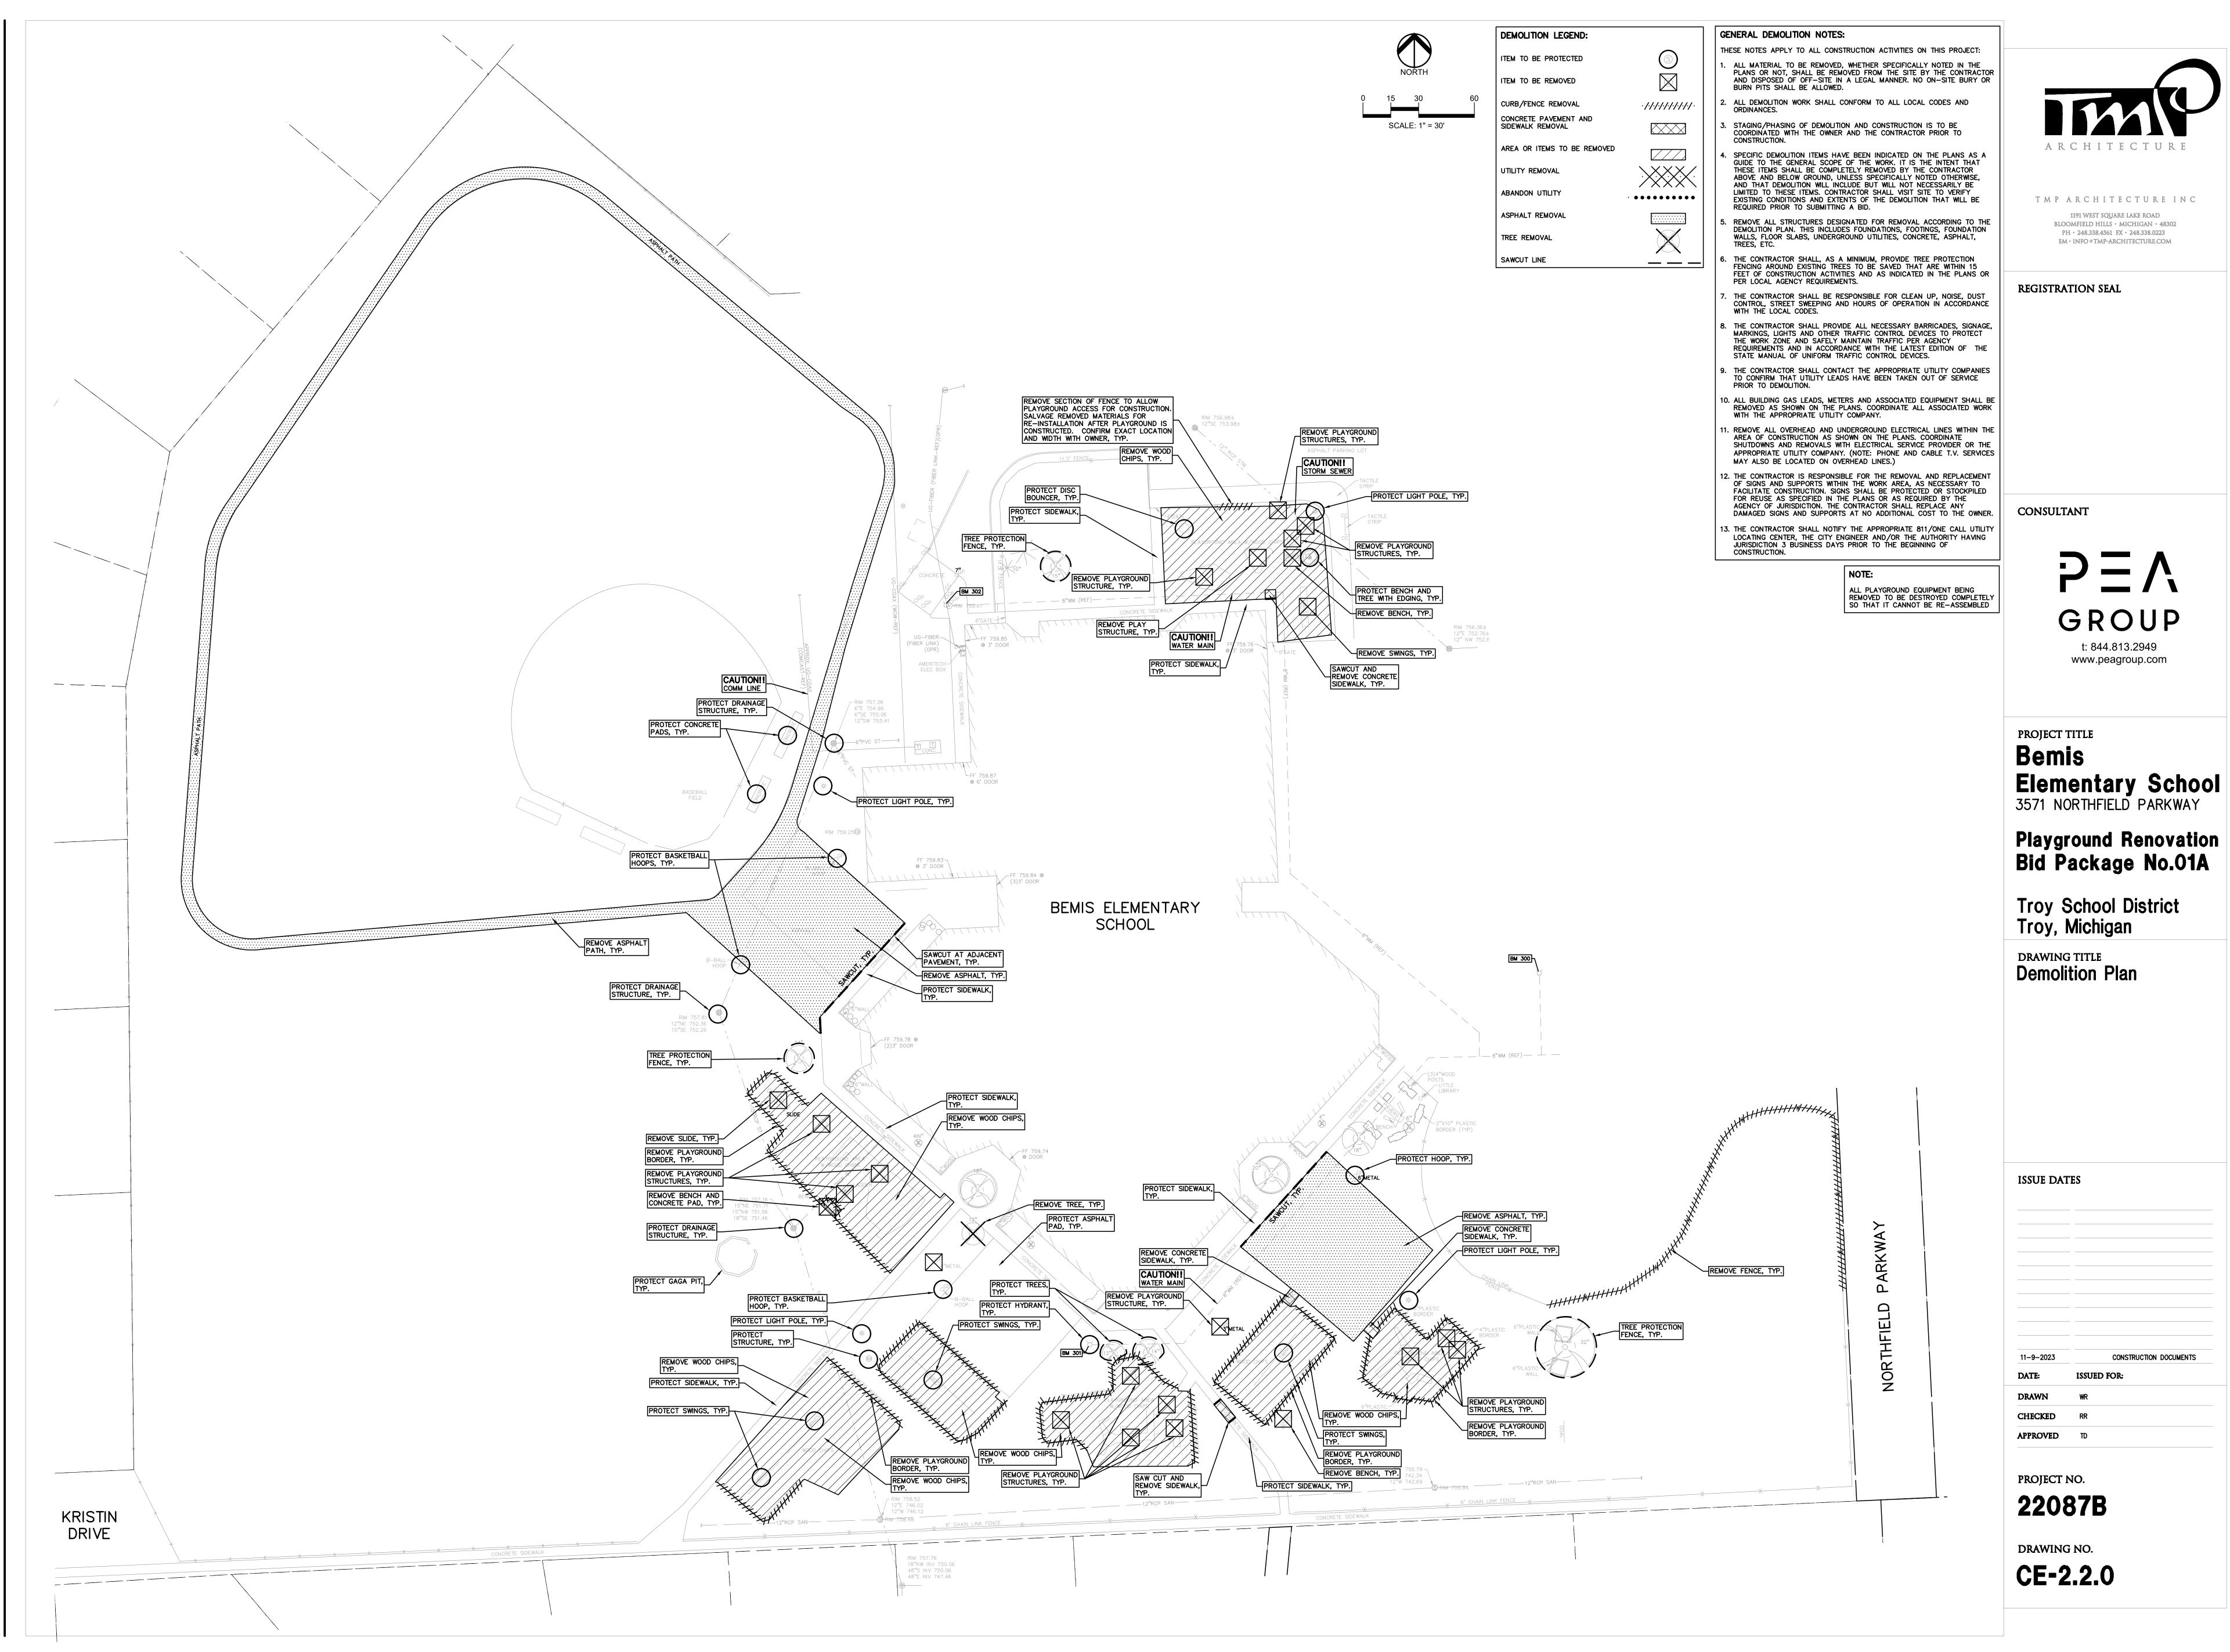

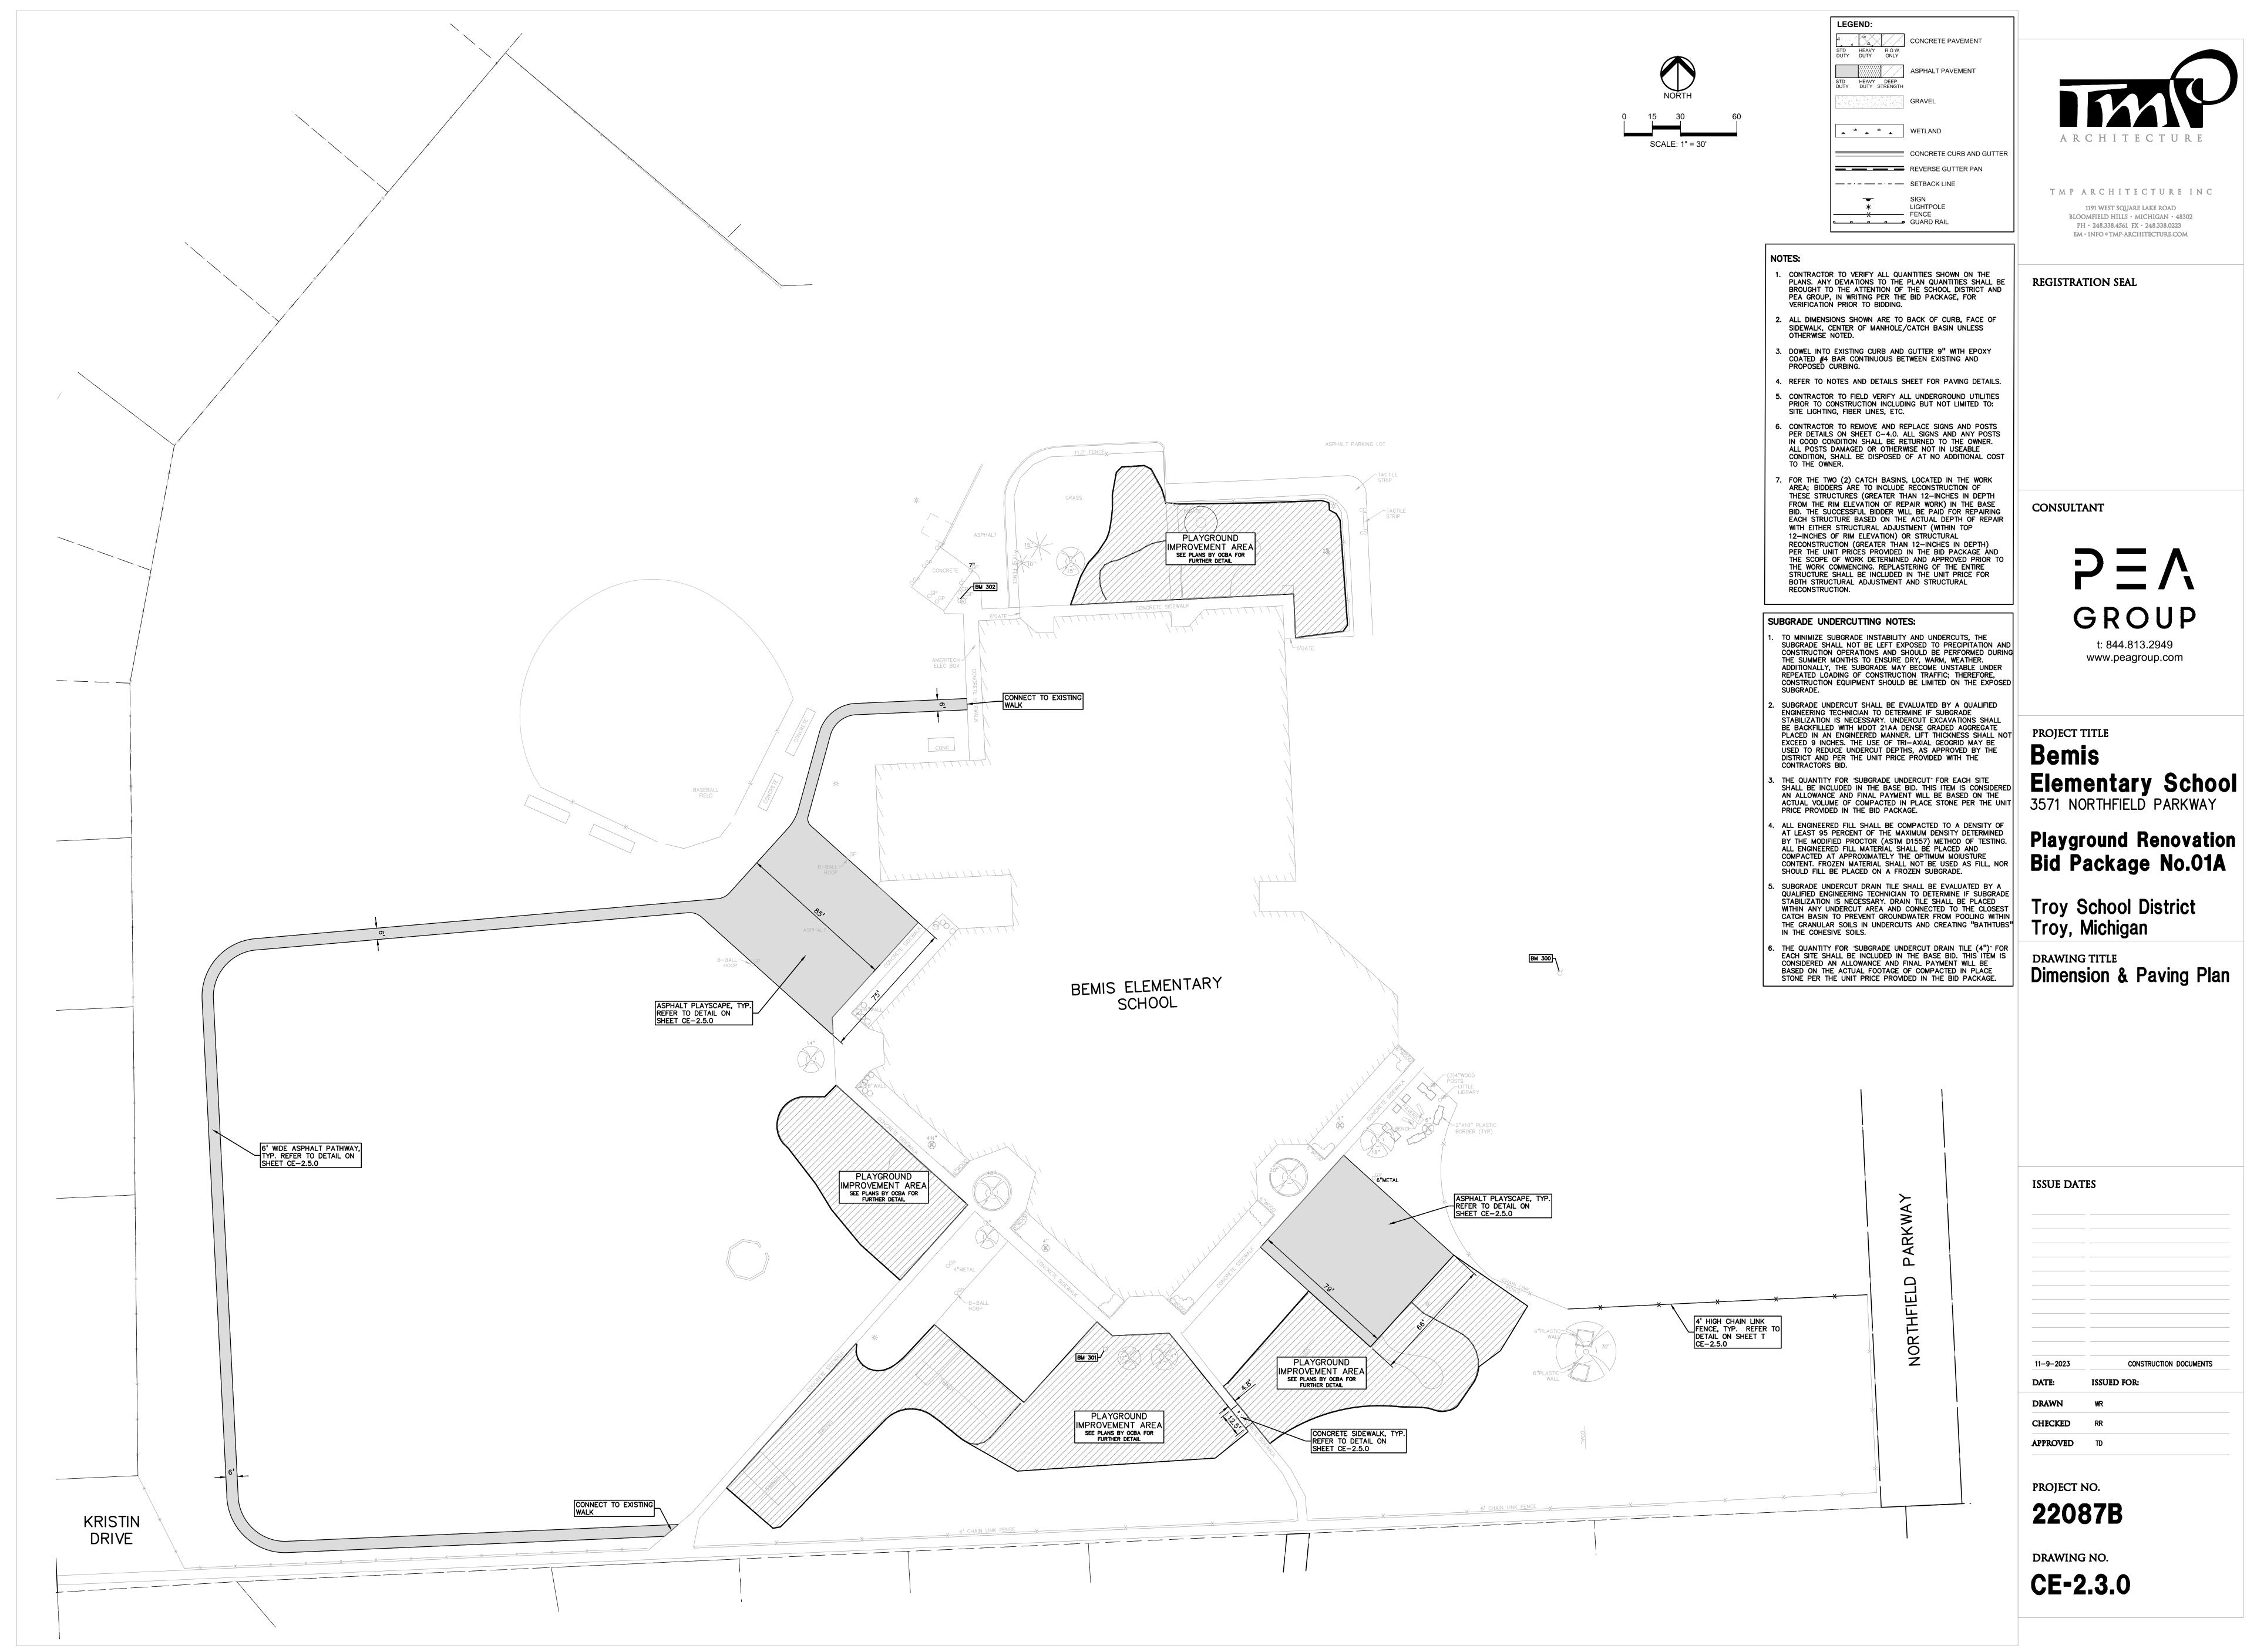

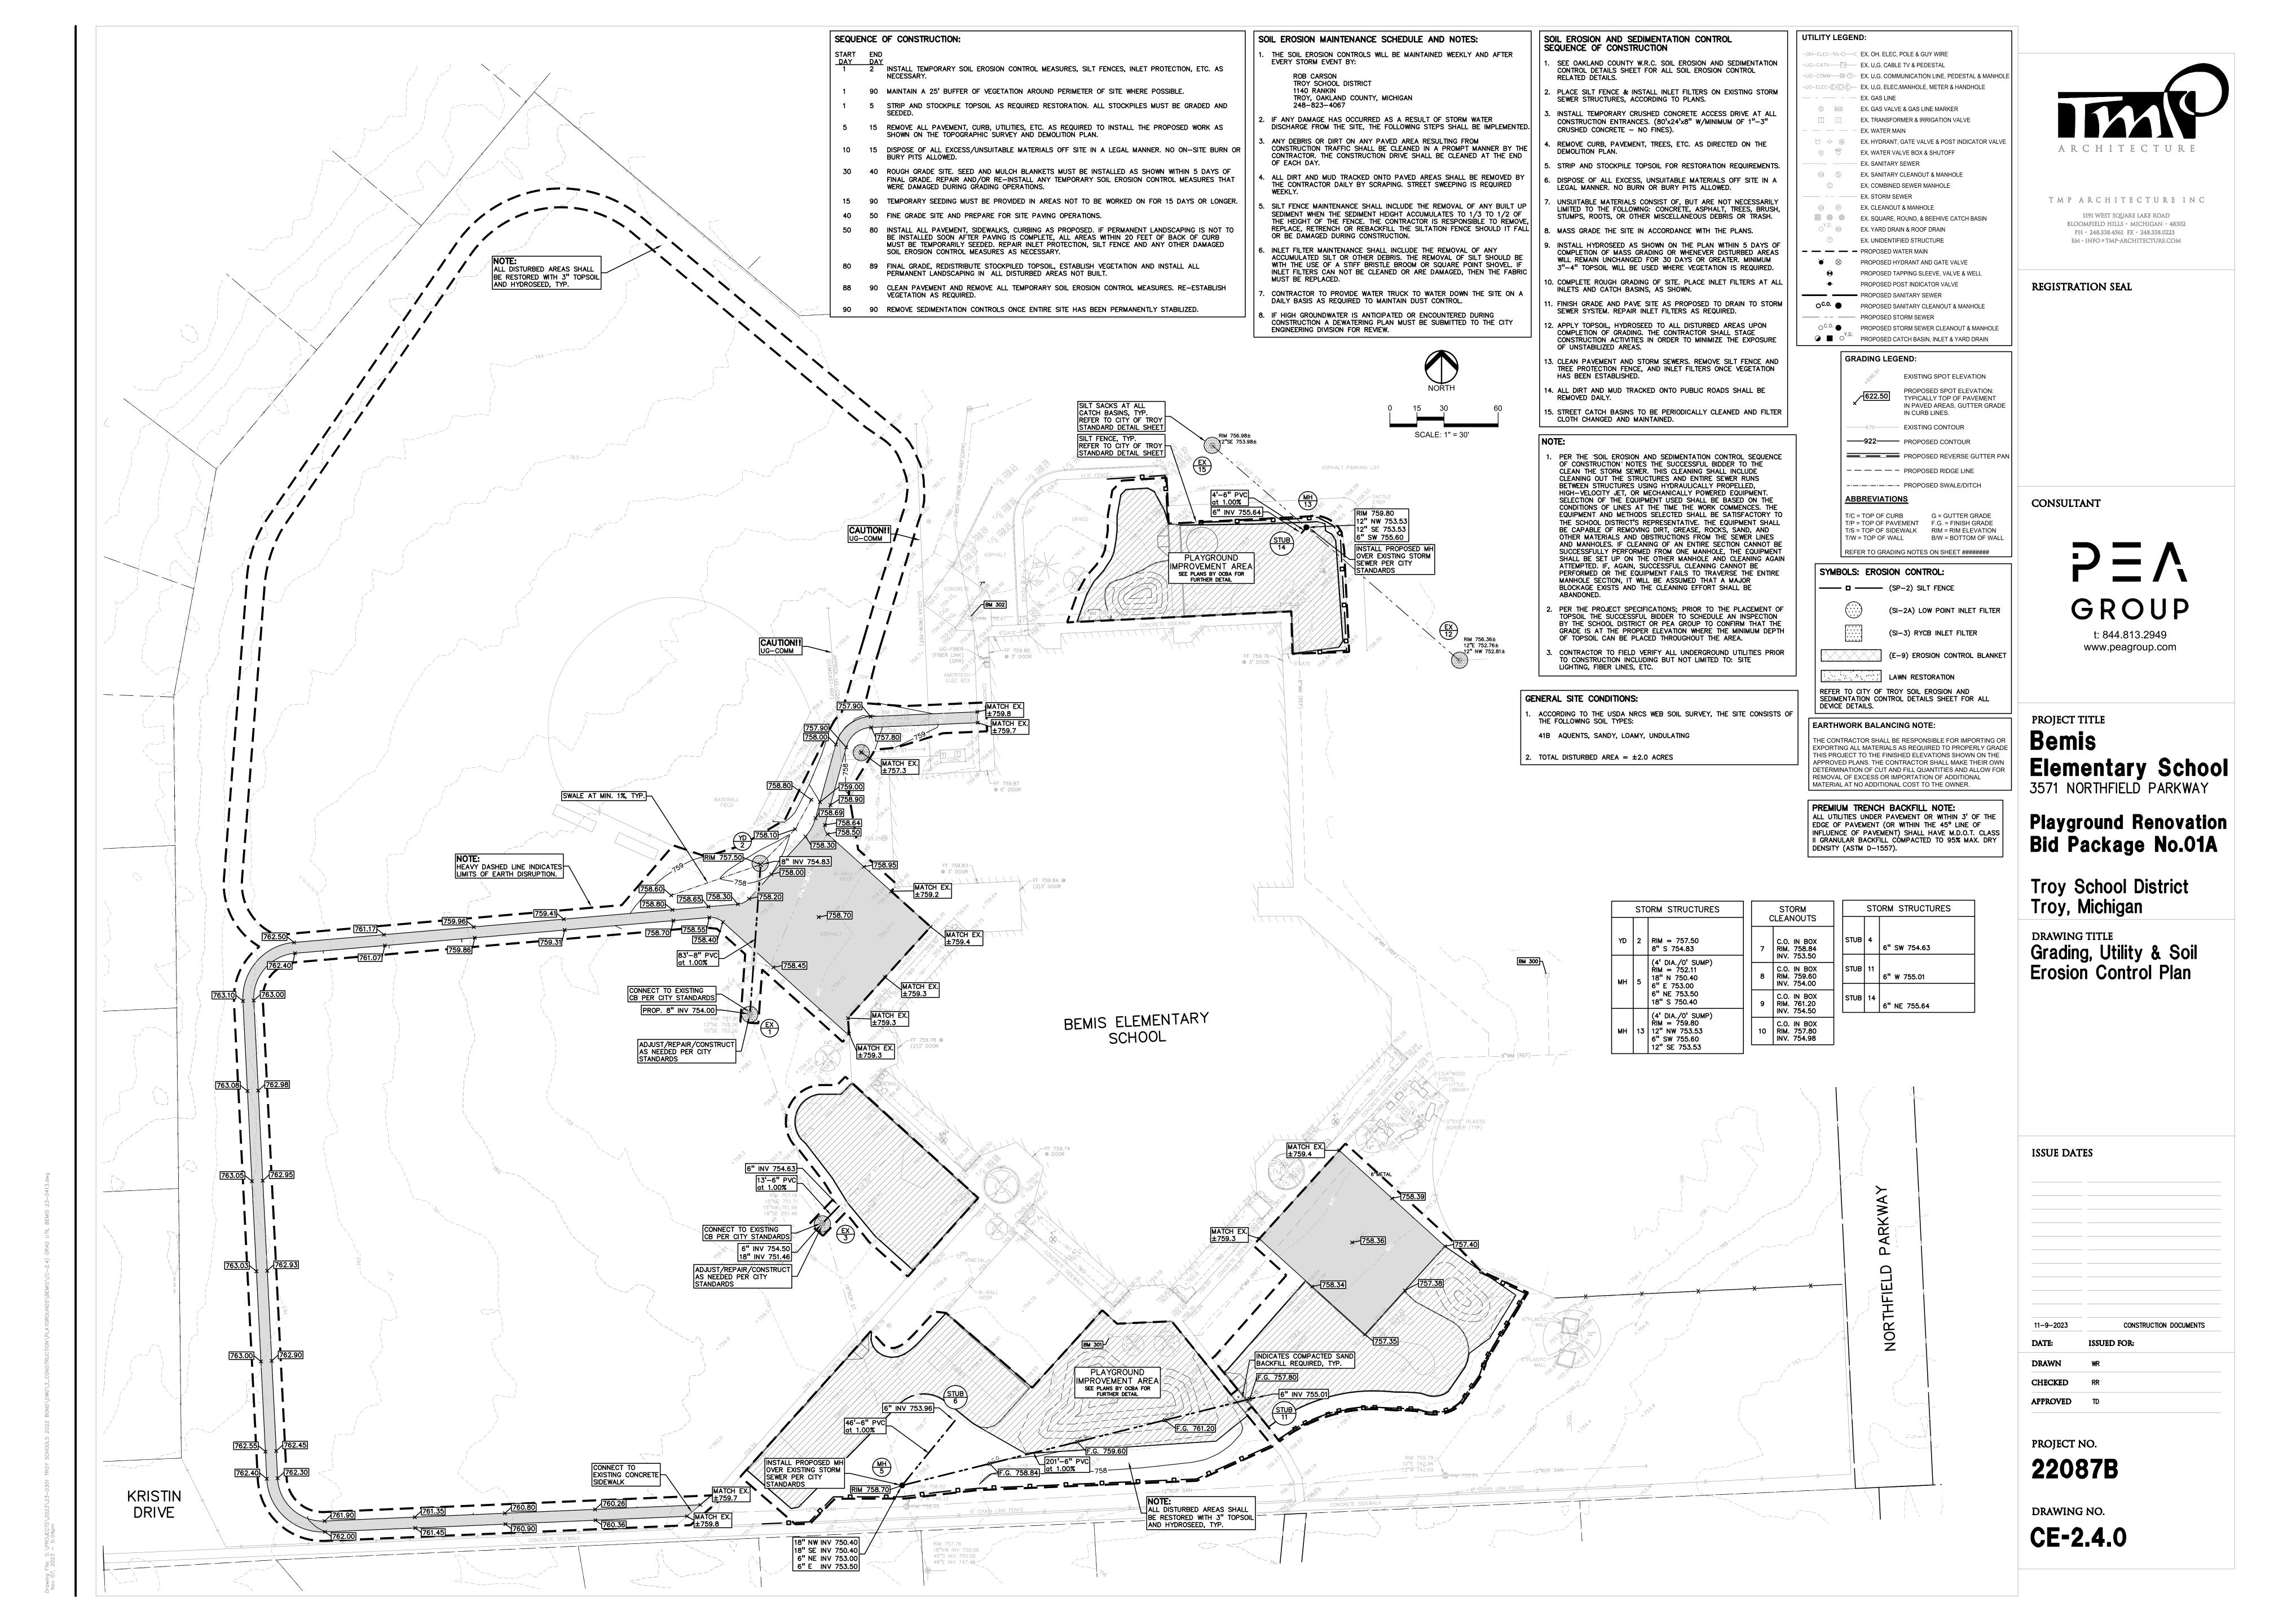

- ACCORDANCE WITH CURRENT OSHA, MDOT AND MUNICIPALITY STANDARDS THE CONTRACTOR SHALL NOTIFY THE CITY OF TROY ENGINEER AND/OR THE
- AUTHORITY HAVING JURISDICTION 3 BUSINESS DAYS PRIOR TO THE BEGINNING OF CONSTRUCTION. 3. THE CONTRACTOR MUST CONTACT THE ENGINEER SHOULD THEY ENCOUNTER
- ANY DESIGN ISSUES DURING CONSTRUCTION. IF THE CONTRACTOR MAKES DESIGN MODIFICATIONS WITHOUT THE WRITTEN DIRECTION OF THE DESIGN ENGINEER, THE CONTRACTOR DOES SO AT HIS OWN RISK. ALL NECESSARY PERMITS, TESTING, BONDS AND INSURANCES ETC., SHALL
- BE PAID FOR BY THE CONTRACTOR. THE OWNER SHALL PAY FOR ALL CITY
- . THE CONTRACTOR SHALL NOTIFY THE APPROPRIATE 811/ONE CALL UTILITY LOCATING CENTER, THE CITY ENGINEER AND/OR THE AUTHORITY HAVING JURISDICTION 3 BUSINESS DAYS PRIOR TO THE BEGINNING OF CONSTRUCTION. IF NO NOTIFICATION IS GIVEN AND DAMAGE RESULTS, SAID DAMAGE WILL BE REPAIRED AT SOLE EXPENSE OF THE CONTRACTOR. IF EXISTING UTILITY LINES ARE ENCOUNTERED THAT CONFLICT IN LOCATION WITH NEW CONSTRUCTION, THE CONTRACTOR SHALL NOTIFY THE DESIGN ENGINEER SO THAT THE CONFLICT MAY BE RESOLVED.
- CONTRACTOR TO VERIFY THAT THE PLANS AND SPECIFICATIONS ARE THE VERY LATEST PLANS AND SPECIFICATIONS AND FURTHERMORE, VERIFY THAT THESE PLANS AND SPECIFICATIONS HAVE BEEN APPROVED. ALL ITEMS CONSTRUCTED BY THE CONTRACTOR PRIOR TO RECEIVING FINAL APPROVAL HAVING TO BE ADJUSTED OR RE-DONE, SHALL BE AT THE CONTRACTORS EXPENSE. SHOULD THE CONTRACTOR ENCOUNTER A CONFLICT BETWEEN THESE PLANS AND/OR SPECIFICATIONS, THEY SHALL SEEK CLARIFICATION IN WRITING FROM THE ENGINEER BEFORE COMMENCEMENT OF CONSTRUCTION. FAILURE TO DO SO SHALL BE AT SOLE EXPENSE TO THE CONTRACTOR.
- ANY WORK WITHIN THE STREET OR HIGHWAY RIGHTS-OF-WAY SHALL BE PERFORMED IN ACCORDANCE WITH THE REQUIREMENTS OF THE AGENCIES HAVING JURISDICTION AND SHALL NOT BEGIN UNTIL ALL NECESSARY PERMITS HAVE BEEN ISSUED FOR THE WORK.
- ALL PROPERTIES OR FACILITIES IN THE SURROUNDING AREAS, PUBLIC OR PRIVATE, DESTROYED OR OTHERWISE DISTURBED DUE TO CONSTRUCTION, SHALL BE REPLACED AND/OR RESTORED TO THE ORIGINAL CONDITION BY
- . THE CONTRACTOR SHALL PROVIDE ALL NECESSARY BARRICADING, SIGNAGE, LIGHTS AND TRAFFIC CONTROL DEVICES TO PROTECT THE WORK AND SAFELY MAINTAIN TRAFFIC IN ACCORDANCE WITH LOCAL REQUIREMENTS AND THE MANUAL OF UNIFORM TRAFFIC CONTROL DEVICES (LATEST EDITION). THE DESIGN ENGINEER, OWNER, CITY OF TROY AND STATE SHALL NOT BE HELD LIABLE FOR ANY CLAIMS RESULTING FROM ACCIDENTS OR DAMAGES CAUSED BY THE CONTRACTOR'S FAILURE TO COMPLY WITH TRAFFIC AND PUBLIC SAFETY REGULATIONS DURING THE CONSTRUCTION PERIOD.
- 10. IT SHALL BE THE RESPONSIBILITY OF THE CONTRACTOR TO ADJUST THE TOP OF ALL EXISTING AND PROPOSED STRUCTURES (MANHOLES, CATCH BASINS, INLETS, GATE WELLS ETC.) WITHIN GRADED AND /OR PAVED AREAS TO FINAL GRADE SHOWN ON THE PLANS. ALL SUCH ADJUSTMENTS SHALL BE INCIDENTAL TO THE JOB AND WILL NOT BE PAID FOR SEPARATELY.

- IN AREAS WHERE NEW PAVEMENTS ARE BEING CONSTRUCTED, THE TOPSOIL AND SOIL CONTAINING ORGANIC MATTER SHALL BE REMOVED PRIOR TO PAVEMENT CONSTRUCTION.
- REFER TO ARCHITECTURAL PLANS FOR DETAILS OF FROST SLAB AT EXTERIOR BUILDING DOORS.
- CONSTRUCTION TRAFFIC SHOULD BE MINIMIZED ON THE NEW PAVEMENT. CONSTRUCTION TRAFFIC IS ANTICIPATED ON THE PAVEMENT STRUCTURE. THE INITIAL LIFT THICKNESS COULD BE INCREASED AND PLACEMENT OF THE FINAL LIFT COULD BE DELAYED UNTIL THE MAJORITY OF THE CONSTRUCTION ACTIVITIES HAVE BEEN COMPLETED. THIS ACTION WILL ALLOW REPAIR OF LOCALIZED FAILURE, IF ANY DOES OCCUR, AS WELL AS REDUCE LOAD DAMAGE ON THE PAVEMENT SYSTEM.
- 4. ALL EXPANSION JOINTS AND CONCRETE PAVEMENT JOINTS TO BE SEALED. 5. CONCRETE PAVEMENT JOINTING - UNLESS SHOWN OTHERWISE IN THE PLANS OR REQUIRED BY THE AUTHORITY HAVING JURISDICTION:
- 5.1. WHERE PROPOSED CONCRETE ABUTS A STRUCTURE, PROVIDE A MINIMUM 1/2" EXPANSION JOINT. THE JOINT FILLER BOARD MUST BE AT LEAST THE FULL DEPTH OF THE CONCRETE AND HELD DOWN A 1/2" TO ALLOW FOR SEALING. 5.2. WHERE PROPOSED CONCRETE ABUTS EXISTING CONCRETE OR IN
- BETWEEN POURS OF PROPOSED CONCRETE (CONSTRUCTION JOINT). PROVIDE 5/8" DOWELS EVERY 30" CENTER TO CENTER HALF WAY ALONG THE THICKNESS OF THE PROPOSED PAVEMENT. ALTERNATE DOWELS SIZES AND SPACING MUST BE APPROVED THE ENGINEER PRIOR TO
- COMMENCING WORK AND VIA THE SUBMITTAL PROCESS. WHERE PROPOSED CONCRETE ABUTS EXISTING OR PROPOSED SIDEWALK OR CURBING, PROVIDE A MINIMUM 1/2" EXPANSION JOINT. 5.4. CONTROL LONGITUDINAL AND/OR TRANSVERSE JOINTS SHALL BE PLACED TO PROVIDE PANELS WITHIN THE PAVEMENT AS SQUARE AS POSSIBLE WITH THE FOLLOWING MAXIMUM SPACING PARAMETERS:

5.4.1. 6-INCH THICK CONCRETE PAVEMENT: 12' X 12'

- 5.4.2. 8-INCH THICK CONCRETE PAVEMENT: 15' X 15' 5.5. IRREGULAR-SHAPED PANELS MAY REQUIRE THE USE OF REINFORCING MESH OR FIBER MESH AS DETERMINED BY THE ENGINEER. THE USE OF MESH MUST BE APPROVED THE ENGINEER PRIOR TO COMMENCING WORK
- AND VIA THE SUBMITTAL PROCESS.
 5.6. IF A JOINT PLAN IS NOT PROVIDED IN THE PLANS, THE CONTRACTOR SHALL SUBMIT ONE TO THE ENGINEER FOR REVIEW PRIOR TO COMMENCING WORK AND VIA THE SUBMITTAL PROCESS.
- 5. CONCRETE CURBING JOINTING UNLESS SHOWN OTHERWISE IN THE PLANS OR REQUIRED BY THE AUTHORITY HAVING JURISDICTION 6.1. JOINTS WHEN ADJACENT TO ASPHALT PAVEMENT 6.1.1. PLACE CONTRACTION JOINTS AT 10' INTERVALS
- 6.1.2. PLACE 1/2" EXPANSION JOINT AT CATCH BASINS, EXISTING AND PROPOSED SIDEWALK OR EXISTING CURBING. 6.1.3. PLACE 1" EXPANSION JOINT: 6.1.3.1. AT SPRING POINTS OF INTERSECTIONS OR ONE OF THE END OF RADIUS LOCATIONS IN A CURVE
- 6.1.3.2. AT 400' MAXIMUM INTERVALS ON STRAIGHT RUNS 6.1.3.3. AT THE END OF RADIUS AT OPPOSITE ENDS IN A CURBED LANDSCAPE ISLAND
- 6.2. JOINTS WHEN TIED TO CONCRETE PAVEMENT 6.2.1. PLACE CONTRACTION JOINTS OPPOSITE ALL TRANSVERSE CONTRACTION JOINTS IN PAVEMENT
- 6.2.2. PLACE 1/2" EXPANSION JOINT AT CATCH BASINS, EXISTING AND PROPOSÉD SIDEWALK OR EXISTING CURBING. 6.2.3. PLACE 1"EXPANSION JOINT OPPOSITE ALL TRANSVERSE EXPANSION

6.2.4. CURB AND GUTTER AND CONCRETE SHALL BE TIED TOGETHER

SIMILAR TO A LONGITUDINAL LANE TIE JOINT (MDOT B1 JOINT) 6.3. IN BETWEEN POURS OF PROPOSED CONCRETE CURBING (CONSTRUCTION

JOINTS IN PAVEMENT

- 6.3.1. CARRY THE REBAR CONTINUOUSLY BETWEEN POURS 6.3.2. IF THE REBAR IS NOT LONG ENOUGH TO CARRY CONTINUOUSLY, THEN TIE TWO PIECES OF REBAR PER THE LATEST MDOT
- **SPECIFICATIONS** CONCRETE SIDEWALK JOINTING - UNLESS SHOWN OTHERWISE IN THE PLANS OR REQUIRED BY THE AUTHORITY HAVING JURISDICTION 7.1. PLACE TRANSVERSE CONTRACTION JOINTS EQUAL TO THE WIDTH OF THE
- WALK WHEN WIDTH IS LESS THAN 8' 7.2. PLACE TRANSVERSE AND LONGITUDINAL CONTRACTION JOINTS EQUAL TO 1/2 THE WIDTH OF THE WALK WHEN WIDTH IS EQUAL TO OR GREATER
- 7.3. PLACE 1" EXPANSION JOINT WHERE ABUTTING SIDEWALK RAMP AND/OR RADIUS IN INTERSECTION 7.4. PLACE TRANSVERSE 1/2" EXPANSION JOINT AT MAXIMUM OF 100'
- 7.5. PLACE 1/2" EXPANSION JOINT WHEN ABUTTING A FIXED STRUCTURE,
- OTHER PAVEMENT (CONCRETE PAVEMENT AND DRIVE APPROACHES), UTILITY STRUCTURES, LIGHT POLE BASES AND COLUMNS. 7.6. WHEN ALONG A CURVE, JOINTS MUST BE PERPENDICULAR TO THE CURVE WITH A MINIMUM LENGTH OF 1 FOOT BEFORE INTERSECTING ANOTHER JOINT(S) IN ANY DIRECTION. NO JOINTS ARE ALLOWED TO BE

CUT AT AN ANGLÉ OTHER THAN 90° AT THE CURBLINE

GENERAL GRADING AND EARTHWORK NOTES:

- THESE NOTES APPLY TO ALL CONSTRUCTION ACTIVITIES ON THIS PROJECT CONTRACTOR SHALL FIELD VERIFY ALL EXISTING TREES AND BRUSH AND REMOVE ALL THAT ARE NECESSARY TO GRADE SITE.
- ALL GRADES ARE TO TOP OF PAVEMENT UNLESS OTHERWISE NOTED. THE STAGING OF CONSTRUCTION ACTIVITIES SHALL OCCUR ONLY WITHIN THE
- SITE BOUNDARIES. ANY CONSTRUCTION ACTIVITIES OUTSIDE OF THE WORK AREA BOUNDARIES SHALL BE AT THE SOLE RESPONSIBILITY AND RISK OF
- ALL SOIL EROSION AND SEDIMENTATION CONTROL MEASURES IS SHALL MEET THE REQUIREMENTS OF THE AUTHORIZED PUBLIC AGENCY OF JURISDICTION.
- ALL EARTHWORK AND GRADING OPERATIONS SHALL BE PERFORMED IN ACCORDANCE WITH THE PLANS AND SPECIFIACTIONS. REFER TO SOIL EROSION CONTROL PLAN FOR ADDITIONAL SOIL EROSION AND SEDIMENTATION CONTROL MEASURES AND NOTES.
- ALL LANDSCAPING IS TO BE COMPLETED BY STALLANTIS. THE CONTRACTOR SHALL NOTE EXISTING UNDERGROUND UTILITIES WITHIN
- AND ADJACENT TO THE SITE. BACKFILL FOR EXISTING UTILITY TRENCHES SHALL BE EXAMINED CRITICALLY. ANY TRENCHES FOUND TO HAVE SOF UNSTABLE OR UNSUITABLE BACKFILL MATERIAL, IN THE OPINION OF T THIRD PARTY TESTING COMPANY, THAT ARE TO BE WITHIN THE ZONE OF INFLUENCE OF PROPOSED BUILDINGS OR PAVEMENT SHALL BE COMPLETELY EXCAVATED AND BACKFILLED WITH SUITABLE MATERIAL.
- ON-SITE FILL CAN BE USED IF THE SPECIFIED COMPACTION REQUIREMENTS CAN BE ACHIEVED. IF ON-SITE SOIL IS USED, IT SHOULD BE CLEAN AND FREE OF FROZEN SOIL, ORGANICS, OR OTHER DELETERIOUS MATERIALS.
- D. THE FINAL SUBGRADE/EXISTING AGGREGATE BASE SHOULD BE THOROUGHLY PROOFROLLED USING A FULLY LOADED TANDEM AXLE TRUCK OR FRONT END LOADER UNDER THE OBSERVATION OF A GEOTECHNICAL/PAVEMENT ENGINEER. LOOSE OR YIELDING AREAS THAT CANNOT BE MECHANICALLY STABILIZED SHOULD BE REINFORCED USING GEOGRIDS OR REMOVED AND REPLACED WITH ENGINEERED FILL OR AS DICTATED BY FIELD CONDITIONS.
- . THE REMOVAL OF EXISTING SOIL TO GET TO FINAL SUBGRADE ELEVATION SHALL NOT BE CONSIDERED SUBGRADE UNDERCUTTING. IT IS PART OF THE EARTHWORKS TO BALANCE THE SITE AND ESTABLISH THE ELEVATIONS FOR THE PLACEMENT OF THE PROPOSED PAVEMENT ELEVATIONS. THIS SHALL NOT BE PAID FOR SEPARATELY, BUT INCLUDED IN THE EARTHWORKS FOR
- SUBGRADE UNDERCUTTING, INCLUDING BACKFILLING SHALL BE PERFORMED TO REPLACE MATERIALS SUSCEPTIBLE TO FROST HEAVING AND UNSTABLE SOIL CONDITIONS. ANY EXCAVATIONS THAT MAY BE REQUIRED BELOW THE TOPSOIL IN FILL AREAS OR BELOW SUBGRADE IN CUT AREAS WILL BE CLASSIFIED AS SUBGRADE UNDERCUTTING.
- SUBGRADE UNDERCUTTING SHALL BE PERFORMED WHERE NECESSARY AND HE EXCAVATED MATERIAL SHALL BECOME THE PROPERTY OF THE CONTRACTOR. ANY SUBGRADE UNDERCUTTING SHALL BE BACKFILLED AS RECOMMENDED IN THE GEOTECHNICAL ENGINEERING REPORT FOR THE
- 4. ANY SUB-GRADE WATERING REQUIRED TO ACHIEVE REQUIRED DENSITY SHALL BE CONSIDERED INCIDENTAL TO THE JOB.

CONSTRUCTION MATERIAL SUBMITTALS

- UNLESS REQUIRED OTHERWISE IN THE PROJECT SPECIFICATIONS, THE CONTRACTOR SHALL ONLY SUBMIT THE FOLLOWING CONSTRUCTION MATERIAL SUBMITTALS, AS APPLICABLE TO THE PLANS, FOR REVIEW BY THE ENGINEER. UNLESS APPROVED IN ADVANCE AND IN WRITING BY THE ENGINEER, ANY MATERIAL SUBMITTALS PROVIDED TO THE ENGINEER FOR REVIEW IN ADDITION TO THIS LIST SHALL BE RETURNED TO THE CONTRACTOR WITHOUT A REVIEW BEING
- SOIL EROSION AND SEDIMENTATION CONTROL MEASURES
- UTILITY TRENCH BACKFILL MATERIAL WITH ALL MATERIAL DATA INCLUDED IN THE SUBMITTAL BEING DATED WITHIN 60 DAYS OF THE SUBMITTAL UNLESS APPROVED OTHERWISE BY THE ENGINEER STORM SEWER STRUCTURES
- STORM SEWER STRUCTURE FRAME AND COVERS INCLUDING CLEAN OUTS 5. PAVEMENT AGGREGATE BASE MATERIAL WITH ALL MATERIAL DATA INCLUDED IN THE SUBMITTAL BEING DATED WITHIN 60 DAYS OF THE SUBMITTAL
- UNLESS APPROVED OTHERWISE BY THE ENGINEER PAVEMENT UNDERDRAIN MATERIAL AND BACKFILL WITH ALL BACKFILL MATERIAL DATA INCLUDED IN THE SUBMITTAL BEING DATED WITHIN 60 DAYS
- OF THE SUBMITTAL UNLESS APPROVED OTHERWISE BY THE ENGINEER PAVEMENT MIX DESIGNS SUBMITTED FOR REVIEW BY THE ENGINEER MUST FOLLOW THE CURRENT MOOT REVIEW CHECKLISTS AS SUMMARIZED BELOW AND ALL MATERIAL DATA INCLUDED IN THE SUBMITTAL BEING DATED WITHIN
- 60 DAYS OF THE SUBMITTAL UNLESS APPROVED OTHERWISE BY THE •8.1. CONCRETE MIX DESIGN REVIEW CHECKLIST (FORM 2000) •8.2. SUPERPAVE MIX DESIGN CHECKLIST (FORM 1862)
- •8.3. MARSHALL MIX DESIGN CHECKLIST (FORM 1849) SITE FENCING AND GATES
- ANY ITEMS SHOWN IN THE PLANS OR DETAIL SHEETS THAT SPECIFICALLY STATE FOR THE CONTRACTOR TO SUBMIT A SHOP DRAWING TO THE ENGINEER FOR REVIEW. THESE ITEMS INCLUDE, BUT ARE NOT LIMITED TO:
- ANY SPECIALITY ITEMS SHOWN IN THE PLANS OR DETAIL SHEETS THAT SPECIFICALLY DO NOT STATE FOR THE CONTRACTOR SHALL SUBMIT A SHOP DRAWING TO THE ENGINEER FOR REVIEW BUT THE CONTRACTOR REQUESTS TO BE REVIEWED. THE CONTRACTOR'S REQUEST FOR REVIEW MUST BE IN WRITING AND APPROVED BY THE ENGINEER PRIOR TO SUBMITTING THE INFORMATION.

GENERAL UTILITY NOTES:

- ALL WORKMANSHIP AND MATERIALS SHALL BE IN ACCORDANCE WITH THE STANDARDS AND SPECIFICATIONS OF THE CITY OF TROY. ALL TRENCHES UNDER OR WITHIN THREE (3) FEET OR THE FORTY-FIVE (45) DEGREE ZONE OF INFLUENCE LINE OF EXISTING AND/OR PROPOSED PAVEMENT, BUILDING PAD OR DRIVE APPROACH SHALL BE BACKFILLED WITH SAND COMPACTED TO AT LEAST NINETY-FIVE (95) PERCENT OF MAXIMUM UNIT WEIGHT (ASTM D-1557). ALL OTHER TRENCHES TO BE COMPACTED TO 90% OR BETTER.
- WHERE EXISTING MANHOLES OR SEWER PIPE ARE TO BE TAPPED, DRILL HOLES 4" CENTER TO CENTER, AROUND PERIPHERY OF OPENING TO CREATE A PLANE OF WEAKNESS JOINT BEFORE BREAKING SECTION OUT.
- THE LOCATIONS AND DIMENSIONS SHOWN ON THE PLANS FOR EXISTING UTILITIES ARE IN ACCORDANCE WITH AVAILABLE INFORMATION WITHOUT UNCOVERING AND MEASURING. THE DESIGN ENGINEER DOES NOT GUARANTEE THE ACCURACY OF THIS INFORMATION OR THAT ALL EXISTING UNDERGROUND FACILITIES ARE SHOWN. CONTRACTOR SHALL FIELD VERIFY
- THE CONTRACTOR SHALL COORDINATE TO ENSURE ALL REQUIRED PIPES, CONDUITS, CABLES AND SLEEVES ARE PROPERLY PLACED FOR THE INSTALLATION OF GAS, ELECTRIC, PHONE, CABLE, IRRIGATION, ETC. IN SUCH A MANNER THAT WILL FACILITATE THEIR PROPER INSTALLATION PRIOR TO THE PLACEMENT OF THE PROPOSED PAVEMENT AND LANDSCAPING.
- PIPE LENGTHS INDICATED ARE FROM CENTER OF STRUCTURE AND TO END OF SECTION UNLESS NOTED OTHERWISE.
- CONTRACTOR SHALL INSPECT ALL EXISTING PUBLIC STORM SEWER, SANITARY SEWER AND WATER MAIN STRUCTURES WITHIN THE LIMITS OF CONSTRUCTION AND WITH THE GOVERNING AGENCY INSPECTOR PRIOR TO ESTABLISHING FINAL GRADE. NOTIFY THE ENGINEER. OWNER/DEVELOPER. AND GOVERNING AGENCY IF STRUCTURE IS DEEMED TO BE STRUCTURALLY UNSOUND AND/OR IN NEED OF REPAIR.

STORM SEWER NOTES:

- ALL STORM SEWER LEADS SHALL BE CONSTRUCTED AT 1.00% MINIMUM
- ALL STORM SEWER 10" OR LESS AND/OR LEADS SHALL BE SDR 26. JOINTS FOR P.V.C. PIPE SHALL BE ELASTOMERIC (RUBBER GASKET) AS

GENERAL BARRIER FREE NOTES:

SPECIFIED IN A.S.T.M. DESIGNATION D-3212.

THE FOLLOWING NOTES PROVIDE AN OUTLINE OF SOME OF THE REQUIREMENTS CONTAINED WITHIN THE "STANDARDS FOR ACCESSIBLE DESIGN - AMERICANS WITH DISABILITIES ACT 2010", AND "ACCESSIBLE AND USEABLE BUILDINGS AND FACILITIES", ICC/ANSI A117.1-2009. THE CONTRACTOR IS RESPONSIBLE FOR ALL OF THE REQUIREMENTS PRESENTED WITHIN THESE DOCUMENTS, WHICH ARE AVAILABLE IN FULL UPON REQUEST.


- AN ACCESSIBLE ROUTE CONSISTS OF WALK SURFACES, CURB RAMPS AND RAMPS. AT LEAST ONE ACCESSIBLE ROUTE SHALL BE PROVIDED WITHIN THE SITE FROM ACCESSIBLE PARKING SPACES, ACCESSIBLE PASSENGER LOADING ZONES, PUBLIC STREETS AND SIDEWALKS, AND PUBLIC TRANSPORTATION STOPS TO THE BUILDING OR FACILITY ENTRANCE THEY SERVE. HE RUNNING SLOPE OF ALL WALKING SURFACES SHALL NOT EXCEED 5% (1:20) AND THE CROSS-SLOPE SHALL NOT EXCEED 2% (1:48). WALKING SURFACES MUST BE LEVEL WITH PERMITTED VERTICAL CHANGES IN LEVEL NOT TO EXCEED 1/4", OR BEVELED CHANGES IN LEVEL NOT TO EXCEED 1/2". REFER TO DETAIL DET-8 THIS SHEET. ANY CHANGE IN LEVEL
- GREATER THAN 1/2" MUST BE RAMPED. TURNING SPACES ALONG ACCESSIBLE ROUTES MUST BE AT LEAST 5 FEET WIDE IN ALL DIRECTIONS AND NOT EXCEED 2% SLOPE (1:48) IN ANY ACCESSIBLE ROUTES WILL BE DESIGNED TO BE A MINIMUM OF 5 FEET WIDE. THE MINIMUM CLEAR WIDTH IS 3 FEET RAMPS ALONG ACCESSIBLE ROUTES WILL HAVE A RUNNING SLOPE GREATER
- THAN 5% (1:20) AND LESS THAN 8.3% (1:12). THE CROSS-SLOPE OF RAMP RUNS SHALL NOT EXCEED 2% (1:48) 8. THE MINIMUM CLEAR WIDTH OF ANY RAMP IS 36 INCHES. THE MAXIMUM RISE FOR ANY RAMP (NOT INCLUDING CURB RAMPS) SHALL NOT EXCEED 30 INCHES, LANDINGS ARE REQUIRED AT THE TOP AND BOTTOM OF EACH RAMP. LANDINGS SHALL HAVE A CROSS-SLOPE NOT EXCEEDING 2% (1:48), SHALL BE 5 FEET LONG AND AT LEAST AS WIDE AS THE RAMP CLEAR WIDTH. IF THERE IS A CHANGE OF DIRECTION AT A LANDING, THEN THE LANDING MUST BE AT LEAST 5 FEET WIDE AND 5 FEET
- 10. CURB RAMPS ALONG ACCESSIBLE ROUTES SHALL NOT RISE MORE THAN 6 INCHES, NOR BE STEEPER THAN 8.3% (1:12). APPROACHING SLOPES TO THE RAMP CANNOT EXCEED 5%, WHICH INCLUDES SIDEWALKS, PAVEMENT, **GUTTERS ETC.** IF CURB RAMP SIDES ARE FLARED, THE FLARES SHALL NOT BE STEEPER THAN 10% (1:10). 12. LANDINGS ARE REQUIRED AT THE TOP OF ALL CURB RAMPS. THE CLEAR
- LENGTH OF THE LANDING SHALL BE A MINIMUM OF 36" AND WILL BE AS WIDE AS THE CURB RAMP. 3. CURB RAMPS SHALL BE LOCATED OR PROTECTED TO PREVENT THEIR OBSTRUCTION BY PARKED VEHICLES.

 4. HANDRAILS ARE NOT REQUIRED ON CURB RAMPS. 15. WHERE DETECTABLE WARNING IS REQUIRED AT CURB RAMPS, THE
- DETECTABLE WARNING SHALL BE 24" MINIMUM IN DEPTH AND SHALL EXTEND THE FULL WIDTH OF THE RAMP. THE DETECTABLE WARNING SHALL BE LOCATED SO THE EDGE NEAREST THE CURB IS 6 INCHES MINIMUM AND 8 INCHES MAXIMUM FROM THE CURB LINE. 16. ACCESSIBLE PARKING SPACES ON SITE SHALL BE PROVIDED AS REQUIRED IN
- SECTION 502 OF THE A.D.A. IF THE SITE HAS MORE THAN ONE PARKING FACILITY, EACH FACILITY IS REQUIRED TO MEET THESE REQUIREMENTS SEPARATELY. THE REQUIRED NUMBER OF SPACES SHALL BE BASED ON THE TOTAL NUMBER OF PARKING SPACES IN EACH PARKING FACILITY ON SITE. . FOR EVERY SIX OR FRACTION OF SIX ACCESSIBLE PARKING SPACES, ONE VAN ACCESSIBLE SPACE SHALL BE PROVIDED.
- B. ACCESSIBLE PARKING SPACES SHALL BE LOCATED ON THE SHORTEST ACCESSIBLE ROUTE FROM PARKING TO A BUILDING ENTRANCE. IF THERE IS MORE THAN ONE ACCESSIBLE ENTRANCE, PARKING SHALL BE DISPERSED ALONG THE SHORTEST ACCESSIBLE ROUTE TO THE ACCESSIBLE ENTRANCES. . BARRIER FREE CAR PARKING SPACES SHALL BE A MINIMUM OF 8 FEET WIDE WITH AN ACCESS AISLE 5 FEET WIDE MINIMUM. VAN ACCESSIBLE PARKING SPACES SHALL BE AT LEAST 11 FEET WIDE WITH A 5' WIDE ACCESS AISLE. VAN ACCESSIBLE SPACES ARE ALSO ACCEPTABLE WITH AN 8 FOOT WIDTH AND 8 FOOT WIDE ACCESS AISLE. THE ACCESS AISLE IN ALL CASES MUST EXTEND THE FULL LENGTH OF THE PARKING SPACE.


 20. SURFACE SLOPES WITHIN THE PARKING SPACES AND AISLES SHALL NOT
- EXCEED 2% (1:48) 21. ACCESSIBLE AREAS INCLUDING PARKING SPACES, AISLES AND PATHWAYS, REQUIRE A MINIMUM VERTICAL CLEARANCE OF 98 INCHES. 22. ACCESSIBLE PARKING SPACES ARE REQUIRED TO BE IDENTIFIED BY SIGNS. THE SIGNS SHALL INCLUDE THE INTERNATIONAL SYMBOL OF ACCESSIBILITY


VAN PARKING SPACES ARE REQUIRED TO BE DESIGNATED AS "VAN


ACCESSIBLE". REFER TO DETAILS ON THIS SHEET.

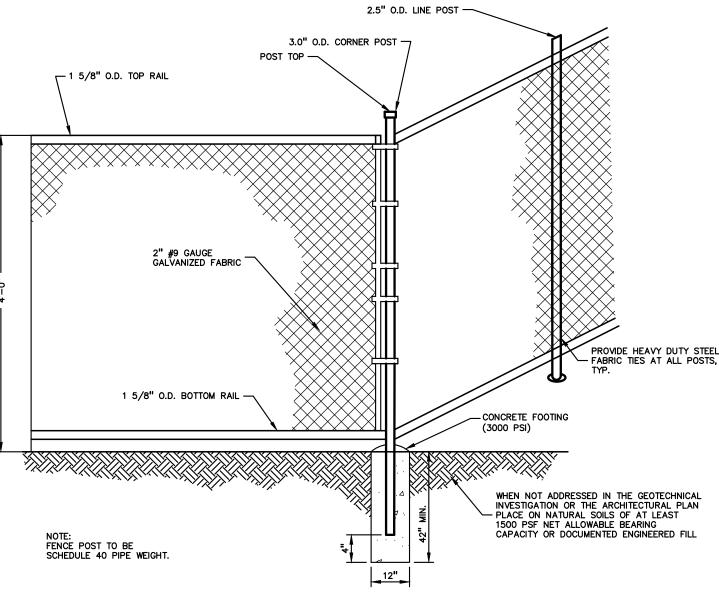


CHAIN LINK FENCE DETAIL

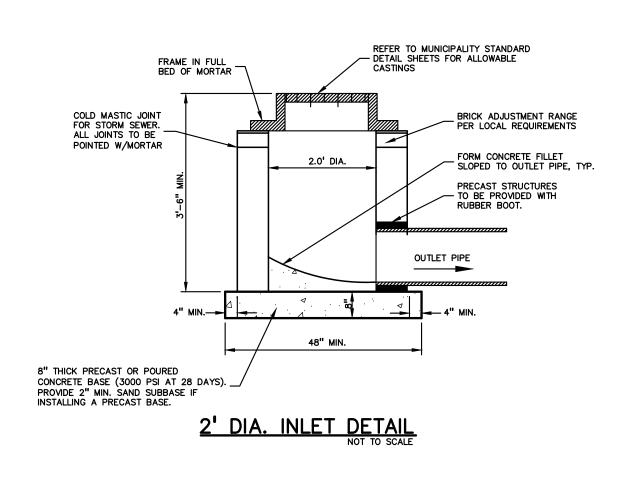


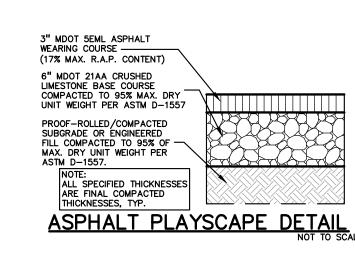

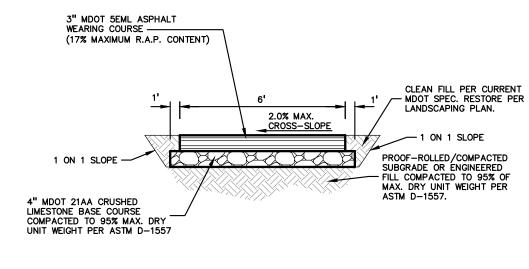

ASPHALT PATHWAY DETAIL

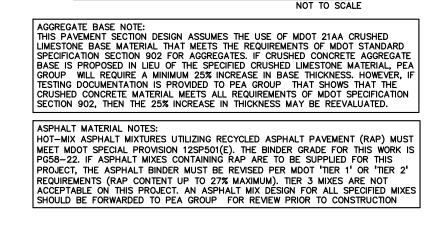

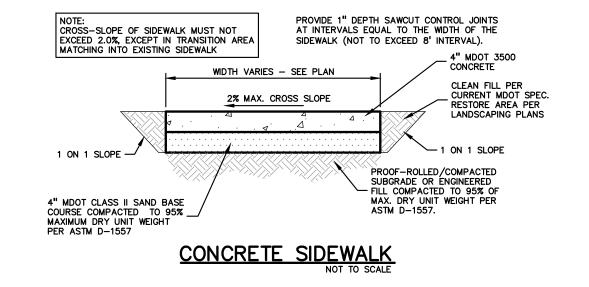



1191 WEST SQUARE LAKE ROAD BLOOMFIELD HILLS • MICHIGAN • 48302 PH • 248.338.4561 FX • 248.338.0223 EM · INFO @ TMP-ARCHITECTURE.COM

TMP ARCHITECTURE INC

REGISTRATION SEAL

CONSULTANT

t: 844.813.2949 www.peagroup.com

PROJECT TITLE

Bemis Elementary School 3571 NORTHFIELD PARKWAY

Playground Renovation Bid Package No.01A

Troy School District Troy, Michigan

DRAWING TITLE **Notes & Details**

ISSUE DATES

CONSTRUCTION DOCUMENTS DATE: ISSUED FOR:

CHECKED **APPROVED** TD

PROJECT NO. **22087B**

DRAWN

DRAWING NO.

CE-2.5.0

Project Information

Type of soil being disrupted:

Derived from: Soil Survey Soil Borings Other

Present the chronological sequence and expected time of year for each major phase of earth disruption.

DATE

-adjacent property

-lake -----

Site Clearing

Soil Erosion Control

Mass Balancing

Underground Utilities

Paving

ground cover is not acceptable.

Length of Buffer Zone Drop of Buffer Zone

Restoration / Stabilization

Indicate the measures proposed to prevent sediment from leaving the site:

The graph listed below is used to determine the adequacy of an existing vegetative buffer zone

EXAMPLE

← DISTRUBED → UNDISTURBED AREA

% of Slope of Buffer Zone 4' / 80' x 100%

for use as a sediment filter. This graph is only applicable if the vegetation is a dense well-grown

stand of ground cover, at least 4" in height. An area covered with bushes and trees without a good

Hydrologic Characteristics of Site

a. Type of "Offsite" drainage outlet(s) available for this site:


County Drain Name of Drain: Lake/Pond Name of Lake/Pond: River/Stream Name of River/Stream: Enclosed Drain Name of Enclosed Drain: Detention Basin (with outlet) Wetland Retention Basin (no oulet) Overland Flow


- Distance to nearest lake, stream, pond, open drain, or wetland:
- Does the project include any work or disruption with a flood plain
- Does the project include work within the cross-section of a lake/stream (Yes or No)?
- Is a MDEQ Permit required (Yes or No)? If Yes, what is the MDEQ Permit Number (if known):
- If MDEQ Permit is required and application has not been submitted, what is the expected date of submittal?

Builders and developers working in Troy are responsible for complying with the regulations for temporary Storm Drain inserts, also known as "siltsacks". The inserts are used on many construction projects to catch sediment not captured upstream by other construction-related erosion control devices and can be an important temporary environmental safeguard.

- Builders must clean and/or replace the inserts when half of the trap is filled with sediment.
- Builders must inspect and maintain the inserts whenever 1/2 inch of rain falls within a 24-hour period. The inserts are to be removed by the builders within 30 days of site stabilization or after the temporary erosion measures are no longer needed.
- If inserts are removed during times of flooding, the builder is responsible for re-installing them per

Silt sock inserts are required for all developments with curb inlets or pavement inlets. Rear yard catch basins may utilize a non-woven Geotextile fabric.

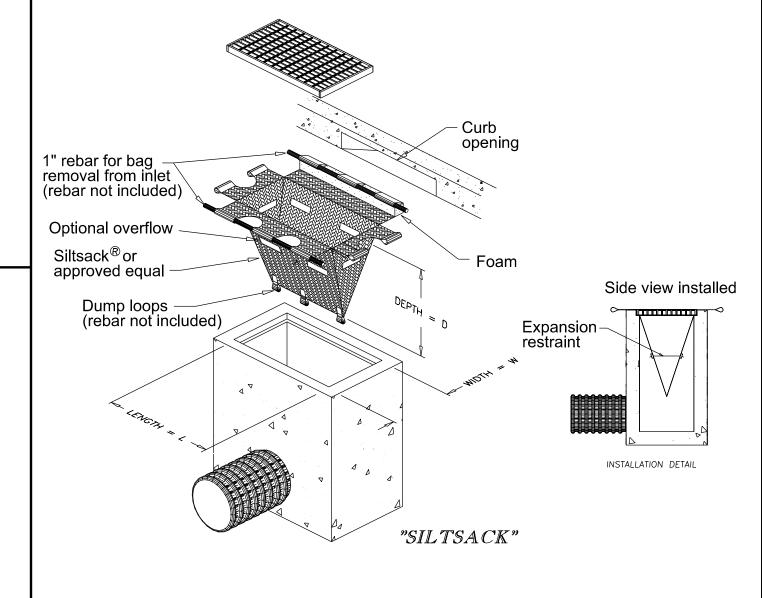

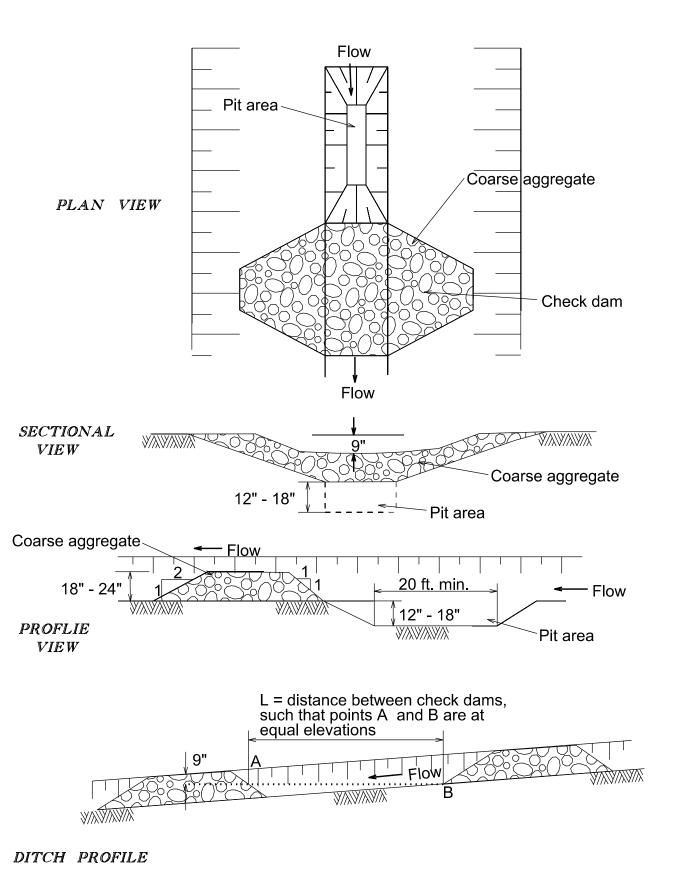

SOIL EROSION & SEDIMENTATION CONTROL NOTES


- 1. The following items are intended to be a guide to the contractor in evaluating Soil Erosion control requirements for the project. Specific Soil Erosion control devices and locations may be detailed on the plans. The contractor should also note that Soil Erosion and Sedimentation controls are included in the project unless specified otherwise on the plans or in the specifications.
- 2. All erosion and Sediment control work shall conform to the permit requirements and the standards and specifications of the City of Troy.
- Daily inspections shall be made by the contractor for effectiveness of Soil Erosion and Sedimentation control measures and any necessary repairs shall be performed without delay.
- 4. Erosion and any sedimentation from work on this site shall be contained on the site and not allowed to collect on any off-site areas or in waterways.
- 5. Waterways include natural or man-made open ditches, streams, storm
- 6. Contractor shall apply temporary soil erosion and sedimentation control measures when required or as directed. Contractor shall remove temporary measures as soon as permanent stabilization of slopes, ditches, and other earth changes has been accomplished.
- 7. Staging the work will be done by the contractor as indicated on the Soil Erosion plans and as required to ensure progressive stabilization of disturbed
- 8. The contractor will establish soil erosion control measures in the early stages of construction. Sediment control measures will be applied as a perimeter defense against any transporting of silt off the site.
- 9. Engineer and owner certification must be included on the plans.

10. Separate sheets showing soil erosion and sedimentation control plans must


- 11. The following guidelines are to be implemented:
- a. Check Dams:


drains, lakes and ponds.


- Stone size must be increased with increased slope and velocity.
- Side slope of the dam should be 2:1 or flatter. Straw bales are not to be used for check dams.
- Add stones as needed to maintain design height and cross section. Any accumulation of sediment shall be removed and stockpiled in a
- stabilized area to prevent the material from eroding back into the drainage
- Vegetative Buffer Zones:
- Vegetation must be maintained in a vigorous condition.
- Reshape and reseed areas where concentrated flow occurs or vegetation
- To be used for sheet flows only.
- Not to be used as a roadway.
- Silt Fence:
- Must be installed along the contour line. is not to be used in areas of concentrated flow
- Must be trenched in at least 6 inches and backfilled. Multiple rows are to be used up a slope.
- Accumulated sediment must be periodically removed. Where necessary, a support fence shall be used to support the geotextile
- To be removed after site is permanently stabilized.
- d. Inlet Sediment Trap:
- The sediment deposition area and nonwoven geotextile filter fabric should be cleaned of all accumulated sediment after each storm.
- After all contributing areas are stabilized, the filter fabric will be removed, sediment deposition area filled, and a sod inlet filter placed over the disrupted lawn area.
- The filter material used to backfill parking lot drainage holes will be peastone. The side excavation for the placement of this material will not be deeper than the invert of the drainage holes.
- Inlet Filters After Paving or Grading:
- Inlet filters will remain in place until all denuded areas contributing to them are stabilized with vegetation.
- Periodic inspection and maintenance will be provided to insure that filters are functioning properly.
- Sod Inlet Filter:
- Sod inlet filters will only be used to handle light concentrations of sediment. Recommended for use after final grading is complete and during the
- establishment of a vegetative cover. Catch basin inlet covers may be wrapped in a non-woven geotextile filter
- fabric for additional filtration
- Periodic inspection and maintenance must be provided to insure efficient

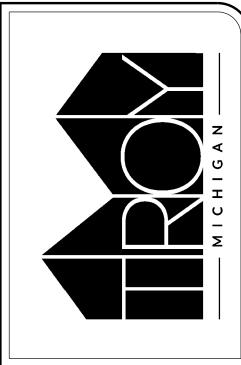


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	L EROSION CONTROL DETAILS INEERING DEPARTMENT	19	S				
t	ONTROL	DATE: JUNE 2019	REMARKS				
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INLET SEDIMENT TRAP LAWN OR PARKING LOT

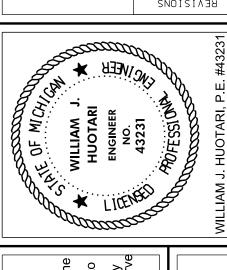Sod inlet filter are pads of sod placed around a storm drain inlet or catch basin.

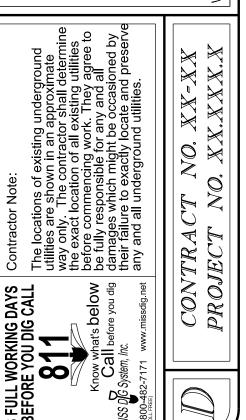
Sod inlet filters are installed to slow the flow of water into an inlet or catch basin and to filter

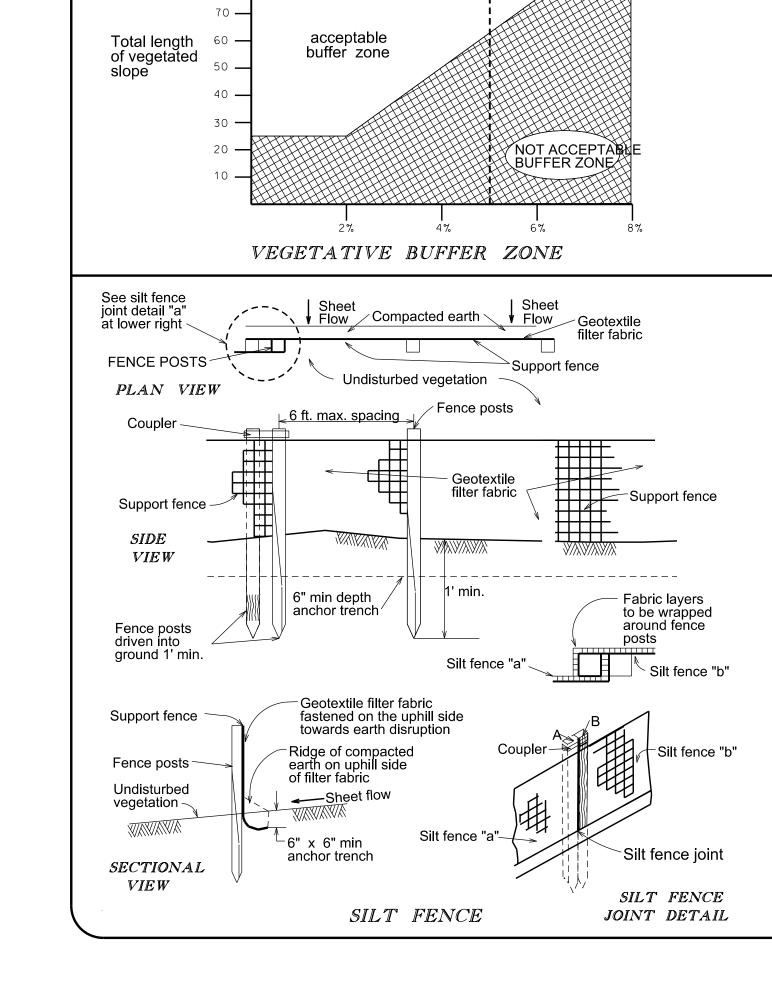out appreciable amounts of sediment in the process. Where applicable

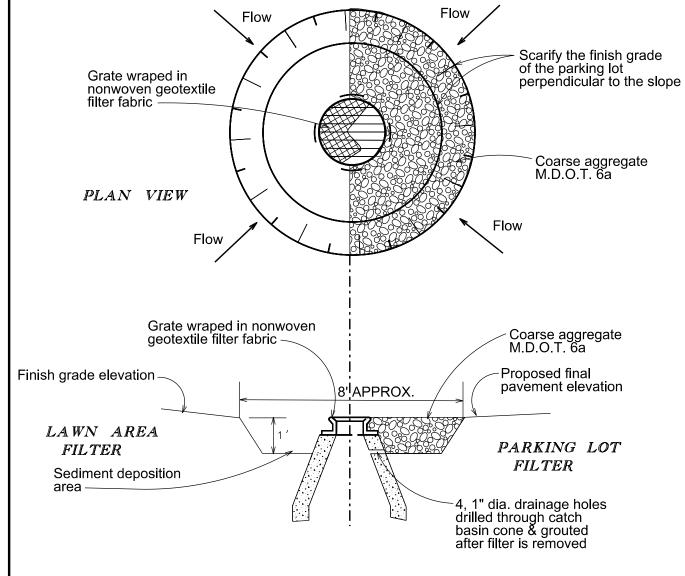Definition


Purpose

Sod inlet filters should only be used to handle light concentrations of sediment. They are best used after final grading is completed and during the establishment of a vegetative cover.

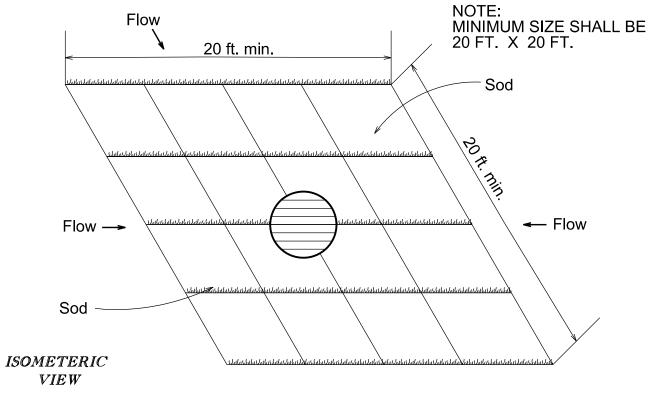

SEDIMENT TRAP WITH CHECK DAM

SOD INLET FILTER

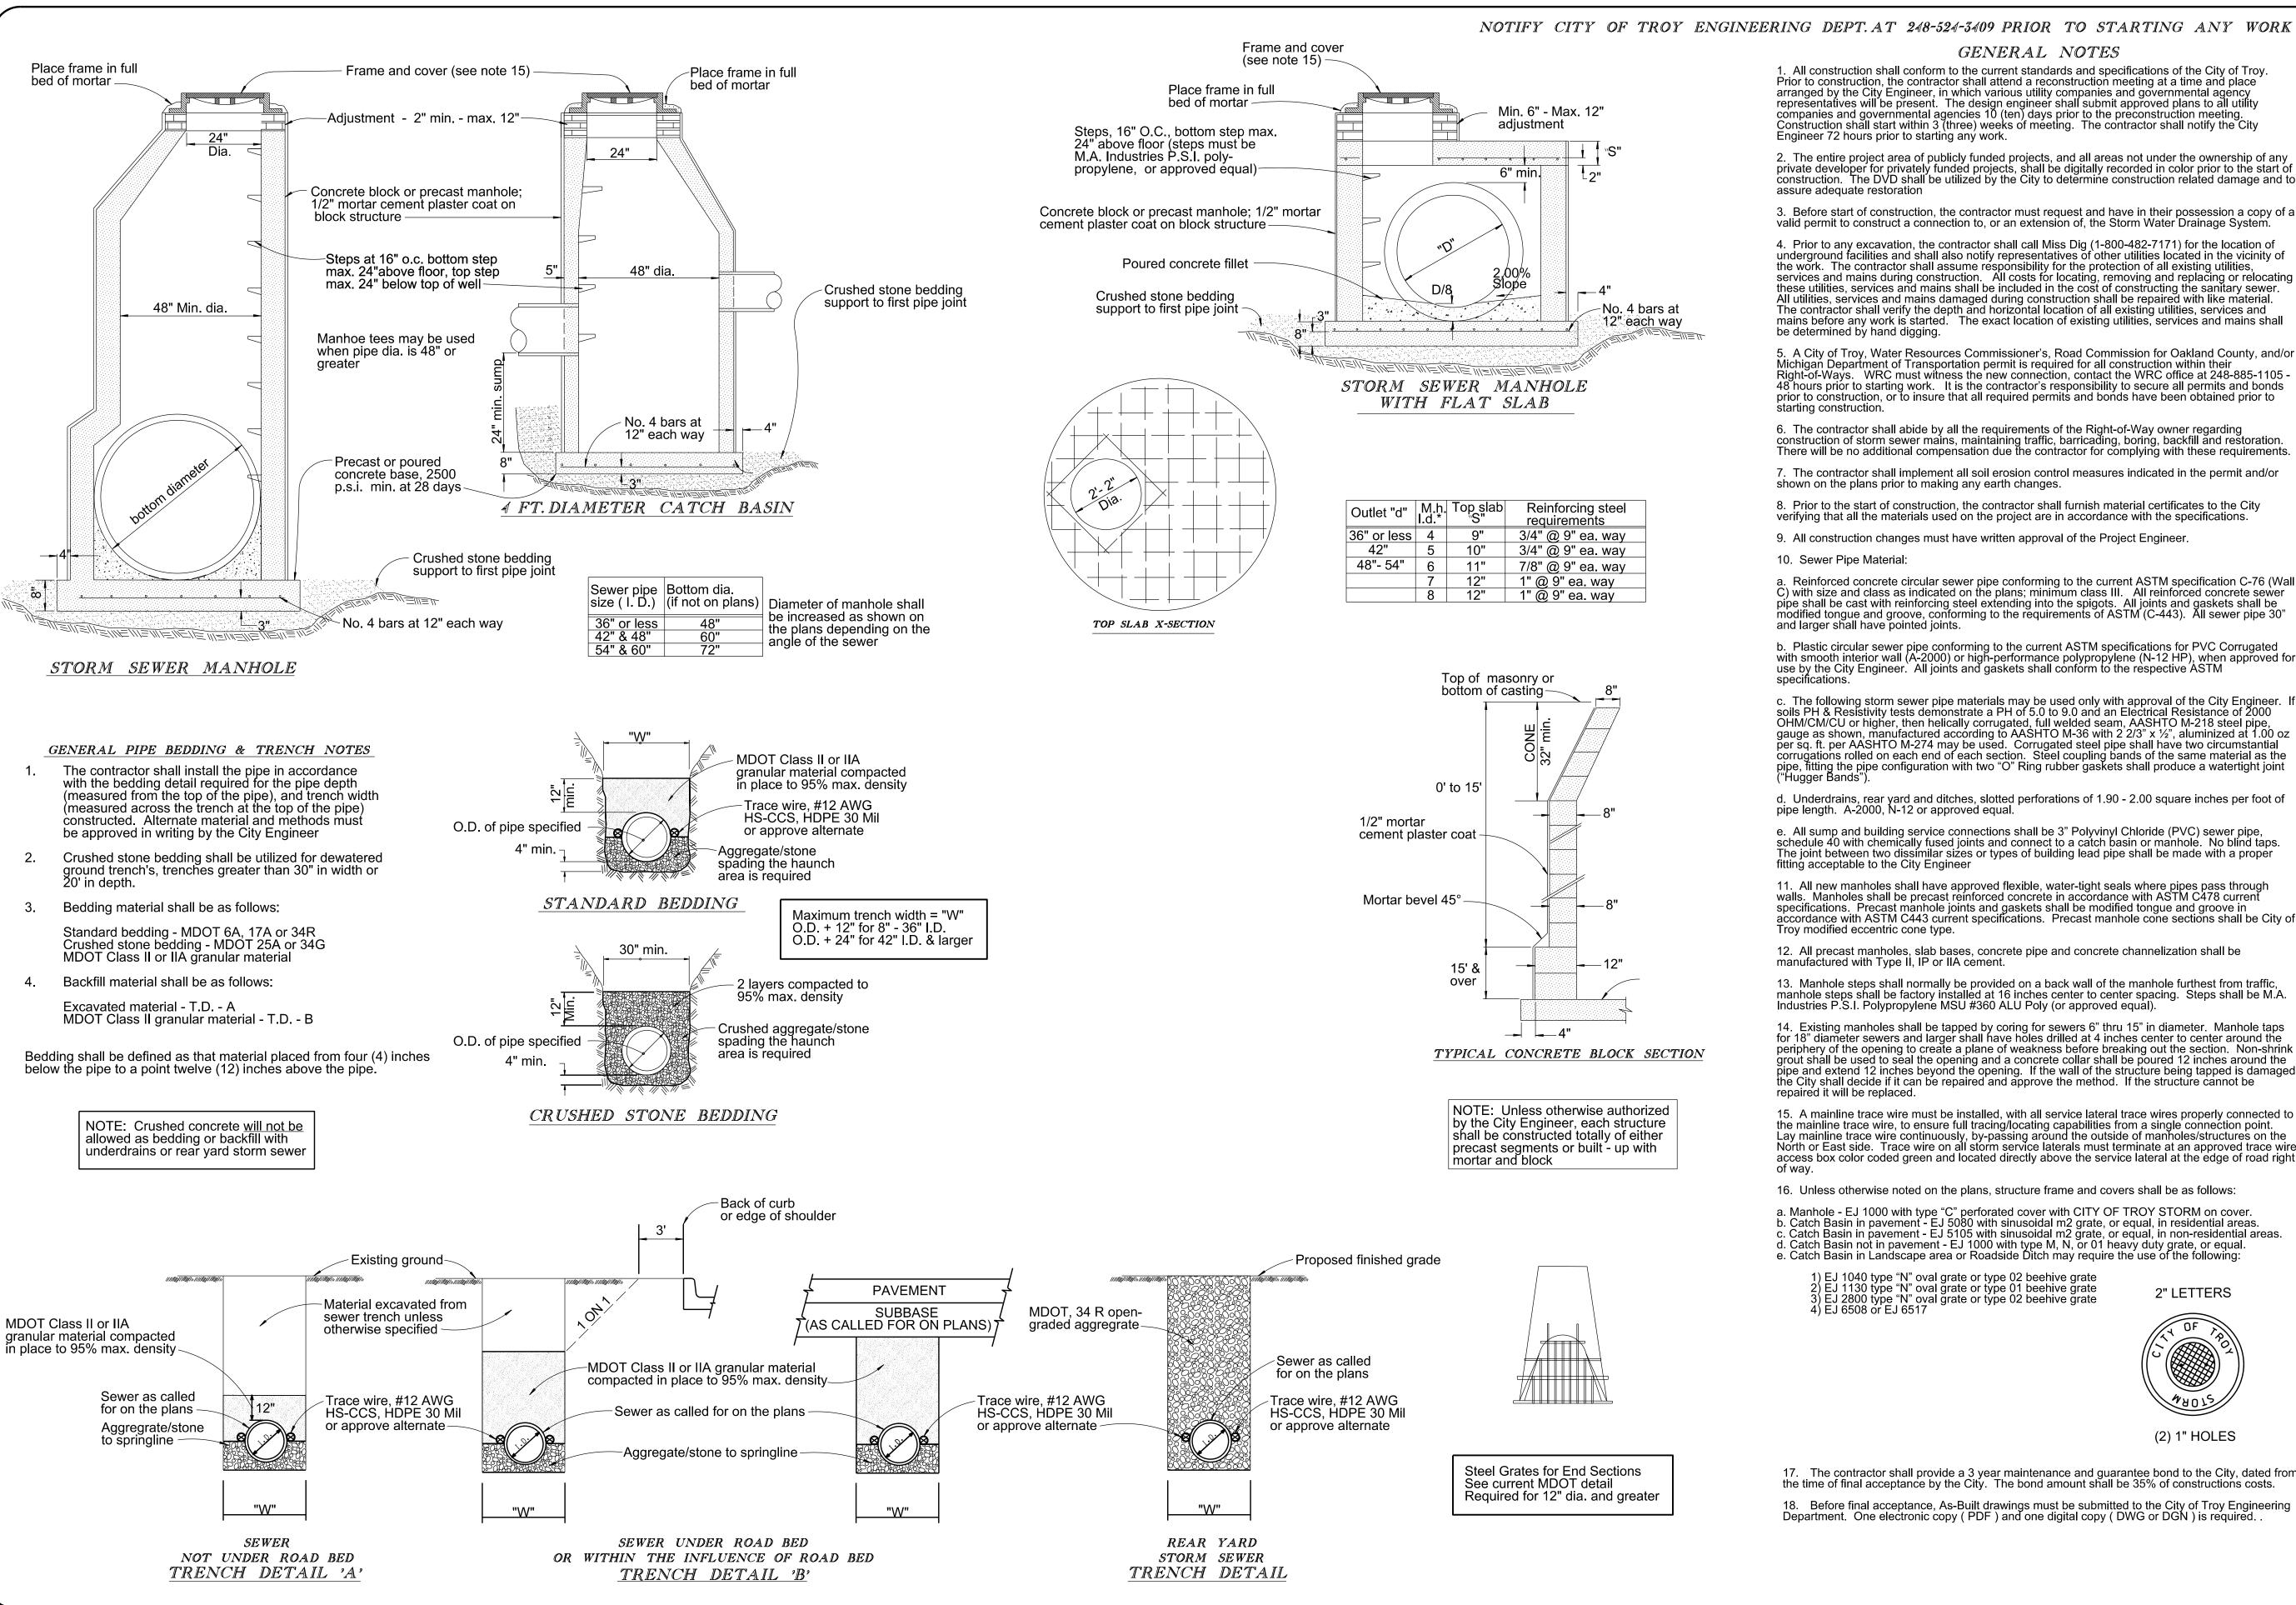



Prior to construction, the contractor shall attend a reconstruction meeting at a time and place arranged by the City Engineer, in which various utility companies and governmental agency representatives will be present. The design engineer shall submit approved plans to all utility companies and governmental agencies 10 (ten) days prior to the preconstruction meeting. Construction shall start within 3 (three) weeks of meeting. The contractor shall notify the City

- 2. The entire project area of publicly funded projects, and all areas not under the ownership of any private developer for privately funded projects, shall be digitally recorded in color prior to the start of construction. The DVD shall be utilized by the City to determine construction related damage and to
- 3. Before start of construction, the contractor must request and have in their possession a copy of a
- 4. Prior to any excavation, the contractor shall call Miss Dig (1-800-482-7171) for the location of underground facilities and shall also notify representatives of other utilities located in the vicinity of the work. The contractor shall assume responsibility for the protection of all existing utilities, services and mains during construction. All costs for locating, removing and replacing or relocating these utilities, services and mains shall be included in the cost of constructing the sanitary sewer.

 All utilities, services and mains damaged during construction shall be repaired with like material. The contractor shall verify the depth and horizontal location of all existing utilities, services and mains before any work is started. The exact location of existing utilities, services and mains shall
- 5. A City of Troy, Water Resources Commissioner's, Road Commission for Oakland County, and/or Michigan Department of Transportation permit is required for all construction within their Right-of-Ways. WRC must witness the new connection, contact the WRC office at 248-885-1105 -48 hours prior to starting work. It is the contractor's responsibility to secure all permits and bonds prior to construction, or to insure that all required permits and bonds have been obtained prior to

6. The contractor shall abide by all the requirements of the Right-of-Way owner regarding construction of storm sewer mains, maintaining traffic, barricading, boring, backfill and restoration. There will be no additional compensation due the contractor for complying with these requirements.

a. Reinforced concrete circular sewer pipe conforming to the current ASTM specification C-76 (Wall C) with size and class as indicated on the plans; minimum class III. All reinforced concrete sewer pipe shall be cast with reinforcing steel extending into the spigots. All joints and gaskets shall be modified tongue and groove, conforming to the requirements of ASTM (C-443). All sewer pipe 30"

b. Plastic circular sewer pipe conforming to the current ASTM specifications for PVC Corrugated with smooth interior wall (A-2000) or high-performance polypropylene (N-12 HP), when approved for use by the City Engineer. All joints and gaskets shall conform to the respective ASTM

c. The following storm sewer pipe materials may be used only with approval of the City Engineer. If soils PH & Resistivity tests demonstrate a PH of 5.0 to 9.0 and an Electrical Resistance of 2000 OHM/CM/CU or higher, then helically corrugated, full welded seam, AASHTO M-218 steel pipe, gauge as shown, manufactured according to AASHTO M-36 with 2 2/3" x ½", aluminized at 1.00 oz per sq. ft. per AASHTO M-274 may be used. Corrugated steel pipe shall have two circumstantial corrugations rolled on each end of each section. Steel coupling bands of the same material as the pipe, fitting the pipe configuration with two "O" Ring rubber gaskets shall produce a watertight joint

d. Underdrains, rear yard and ditches, slotted perforations of 1.90 - 2.00 square inches per foot of pipe length. A-2000, N-12 or approved equal.

e. All sump and building service connections shall be 3" Polyvinyl Chloride (PVC) sewer pipe, schedule 40 with chemically fused joints and connect to a catch basin or manhole. No blind taps. The joint between two dissímilar sizes or types of building lead pipe shall be made with a proper

11. All new manholes shall have approved flexible, water-tight seals where pipes pass through walls. Manholes shall be precast reinforced concrete in accordance with ASTM C478 current specifications. Precast manhole joints and gaskets shall be modified tongue and groove in accordance with ASTM C443 current specifications. Precast manhole cone sections shall be City of


13. Manhole steps shall normally be provided on a back wall of the manhole furthest from traffic, manhole steps shall be factory installed at 16 inches center to center spacing. Steps shall be M.A. Industries P.S.I. Polypropylene MSU #360 ALU Poly (or approved equal).

14. Existing manholes shall be tapped by coring for sewers 6" thru 15" in diameter. Manhole taps for 18" diameter sewers and larger shall have holes drilled at 4 inches center to center around the periphery of the opening to create a plane of weakness before breaking out the section. Non-shrink grout shall be used to seal the opening and a concrete collar shall be poured 12 inches around the pipe and extend 12 inches beyond the opening. If the wall of the structure being tapped is damaged, the City shall decide if it can be repaired and approve the method. If the structure cannot be

15. A mainline trace wire must be installed, with all service lateral trace wires properly connected to the mainline trace wire, to ensure full tracing/locating capabilities from a single connection point. Lay mainline trace wire continuously, by-passing around the outside of manholes/structures on the North or East side. Trace wire on all storm service laterals must terminate at an approved trace wire access box color coded green and located directly above the service lateral at the edge of road right


16. Unless otherwise noted on the plans, structure frame and covers shall be as follows:

a. Manhole - EJ 1000 with type "C" perforated cover with CITY OF TROY STORM on cover. b. Catch Basin in pavement - EJ 5080 with sinusoidal m2 grate, or equal, in residential areas. c. Catch Basin in pavement - EJ 5105 with sinusoidal m2 grate, or equal, in non-residential areas. d. Catch Basin not in pavement - EJ 1000 with type M, N, or 01 heavy duty grate, or equal. e. Catch Basin in Landscape area or Roadside Ditch may require the use of the following:

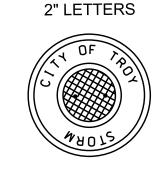


(2) 1" HOLES


17. The contractor shall provide a 3 year maintenance and guarantee bond to the City, dated from the time of final acceptance by the City. The bond amount shall be 35% of constructions costs.

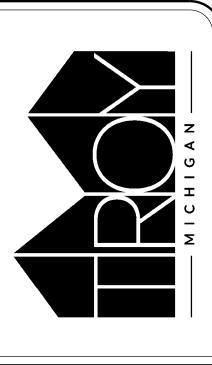


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Site Landscape Plan

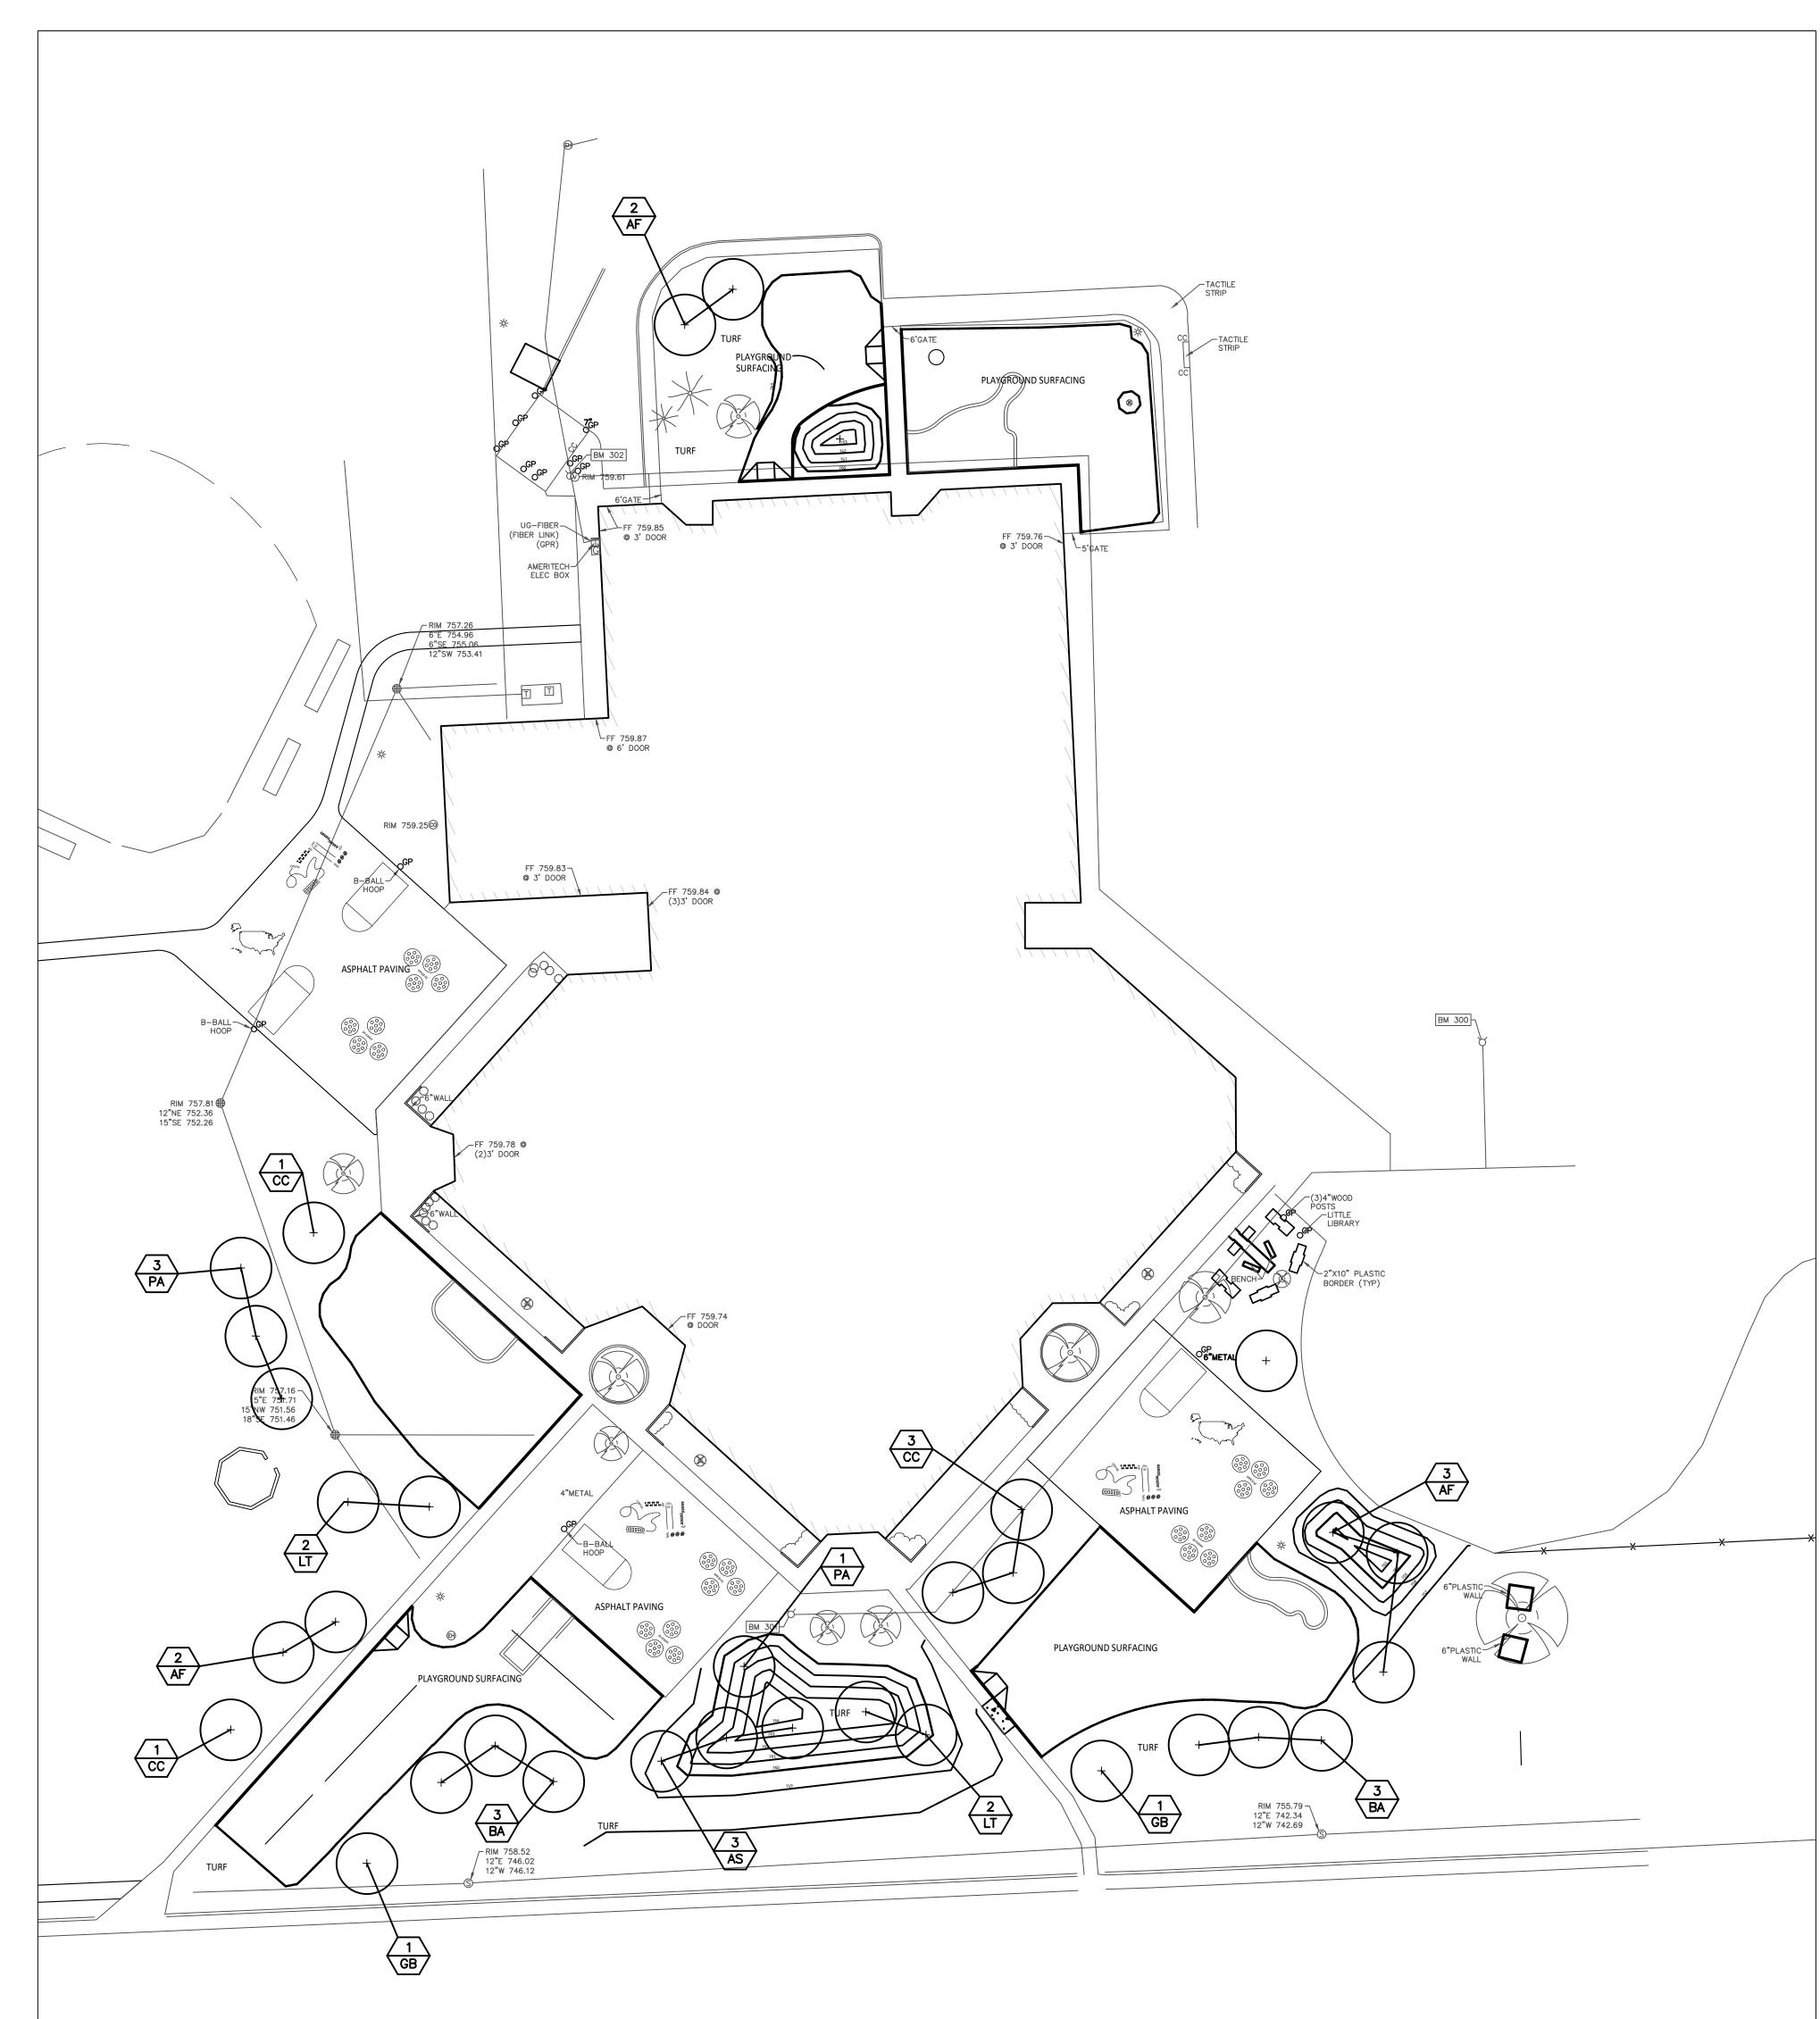

PROPOSED FEATURES LEGEND:

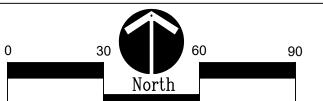

PLANT TAG- REFERS TO TYPE AND NUMBER OF PLANTINGS

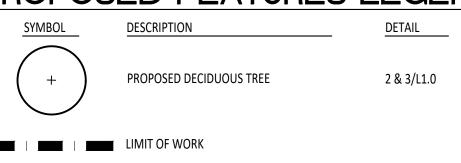PROPERTY LINE

TO BE PROVIDED AND MAINTAINED BY CONTRACTOR.

LANDSCAPE NOTES:

- 1. SURVEY OF EXISTING CONDITIONS PROVIDED BY PEA GROUP, 1849 POND RUN, AUBURN HILLS, MICHIGAN, 48326, (248)689-9090.
- 2. CALL "MISS DIG" AND VERIFY ALL UNDERGROUND UTILITIES PRIOR TO BEGINNING WORK. 72 HOURS BEFORE YOU DIG CALL "MISS DIG" AT 1-800-482-7171. ANY UTILITIES DISTURBED BY CONSTRUCTION SHALL BE REPAIRED AT CONTRACTOR'S EXPENSE.
- BE REPAIRED AT CONTRACTOR'S EXPENSE.

 ANY DISCREPANCIES BETWEEN THESE PLANS AND ACTUAL FIELD CONDITIONS SHOULD BE REPORTED TO THE CONSTRUCTION MANAGER IMMEDIATELY FOR RESOLUTION.
- 4. IN AREAS OF NEW TURF PLACE 4" MINIMUM TOPSOIL, FINE GRADE & ESTABLISH TURF WITHIN SEED LIMIT
- LINES.
- 5. PLACE SHREDDED HARDWOOD MULCH TO A 3" DEPTH IN ALL TREE & SHRUB BEDS & TO A 2" DEPTH IN ALL GROUND COVER BEDS.
- UNLESS OTHERWISE NOTED, TOPSOIL, FINE GRADE AND SEED ALL DISTURBED AREAS WITHIN THE SEEDING LIMIT SHOWN AND AREAS DISTURBED BY CONSTRUCTION.
- REPAIR AND RESTORE ANY DAMAGE OUTSIDE OF LIMIT OF WORK LINE TO ORIGINAL CONDITION.


B. PROTECT ALL TREES AND EXISTING FEATURES TO REMAIN AS SPECIFIED.

- 9. ALL TOPSOIL AND EXCESS FILL MATERIAL SHALL BE STOCKPILED ON SITE SEPARATELY FOR LATER RE-USE.

 LOCATE STOCKPILES IN AREAS AS DIRECTED BY CONSTRUCTION MANAGER AND PROTECT FROM EFFECTS OF
- 10. ALL NURSERY STOCK SHALL BE TRUE TO TYPE AND NAME. ALL STOCK SHALL BE FIRST CLASS QUALITY WITH WELL DEVELOPED BRANCH SYSTEMS AND VIGOROUS HEALTHY ROOT SYSTEMS. ALL STOCK SHALL BE WELL FORMED AND THE TRUNKS OF TREES SHALL BE UNIFORM AND STRAIGHT.
- 1. CONTRACTOR RESPONSIBLE TO LOCATE SITE LIGHTING SERVICES. CONTRACTOR RESPONSIBLE TO NOTIFY CONSTRUCTION MANAGER IF DAMAGE TO LIGHTING ELECTRICAL DISTRIBUTION OCCURS.
- 12. ALL AREAS OF TREE CLEARING SHALL BE STAKED FOR ARCHITECTS APPROVAL PRIOR TO CLEARING.
- UNLESS OTHERWISE SPECIFIED, ALL PERENNIALS, GRASSES AND GROUNDCOVERS SHALL BE GROWN IN THEIR CONTAINER FOR ONE YEAR PRIOR TO INSTALLATION.


PLANT LIST:

	SYM.	BOTANICAL NAME	COMMON NAME	SIZE	ROOT	SPACING	STATUS
	AF	Acer x freemanii 'Marmo'	Marmo Freeman Maple	2" CAL.	B&B	PER PLANS	NATIVAR
	AS	Acer saccharum 'Commemoration'	Commemoration Sugar Maple	2" CAL.	B&B	PER PLANS	NATIVE
	BA	Betula alleghaniensis	Yellow Birch	2" CAL.	B&B	PER PLANS	NATIVE
TREES	CC	Carpinus caroliniana	Hornbeam	2" CAL.	B&B	PER PLANS	NATIVE
	GB	Ginkgo biloba 'Autumn Gold'	Autumn Gold Gingko Tree (no female)	2" CAL.	B&B	PER PLANS	NON-NATIVE
	PA	Platanus x acerifolia 'Bloodgood'	London Planetree	2" CAL.	B&B	PER PLANS	NON-NATIVE
	LT	Liriodendron tulipfera	Tulip Tree	2" CAL.	B&B	PER PLANS	NATIVE

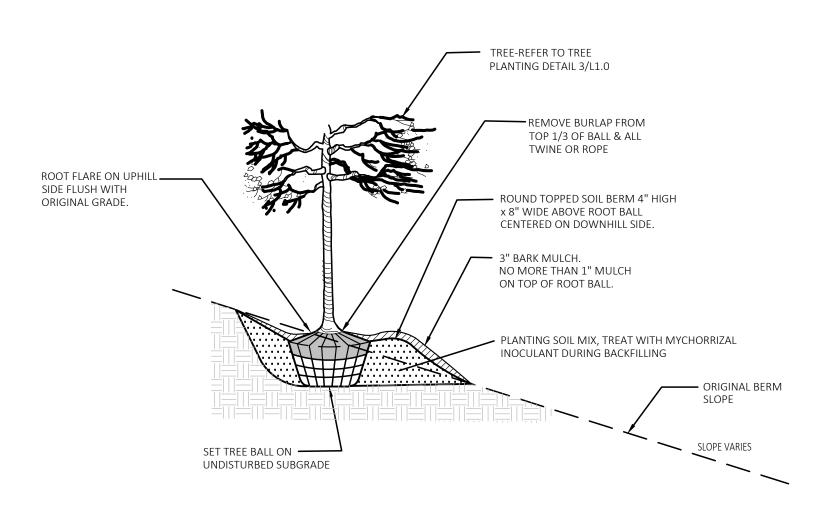

Tree On Berm Detail 1/4 Slope or Greater

NOT TO SCAL

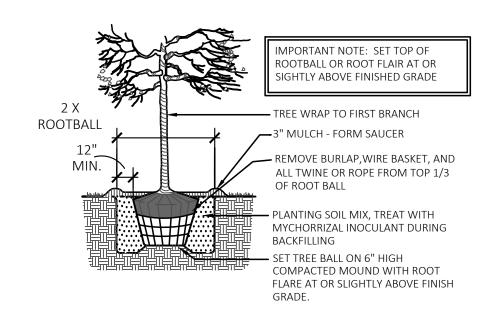

Tree Planting Detail



T M P A R C H I T E C T U R E I N C

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REGISTRATION SEAL

CONSULTANT



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PROJECT TITLE

Bemis Elementary School Playground Renovation Bid Package No.01A

Troy School District Troy, Michigan

DRAWING TITLE
Site Landscape Plan

DATE:	ISSUED FOR:	
11-09-23	CONSTRUCTION DOCUMENTS	
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ISSUE DATES		

PROJECT NO.

22087B

DRAWING NO.

L1.0

CHECKED

APPROVED ...

