


LODI UNIFIED SCHOOL DISTRICT MILLSWOOD MIDDLE SCHOOL PORTABLES RELOCATION DSA APP NO. 02-121945

FILE NO. 39-50
PROJECT TRACKING NO. 68585-261

SYMBOLS

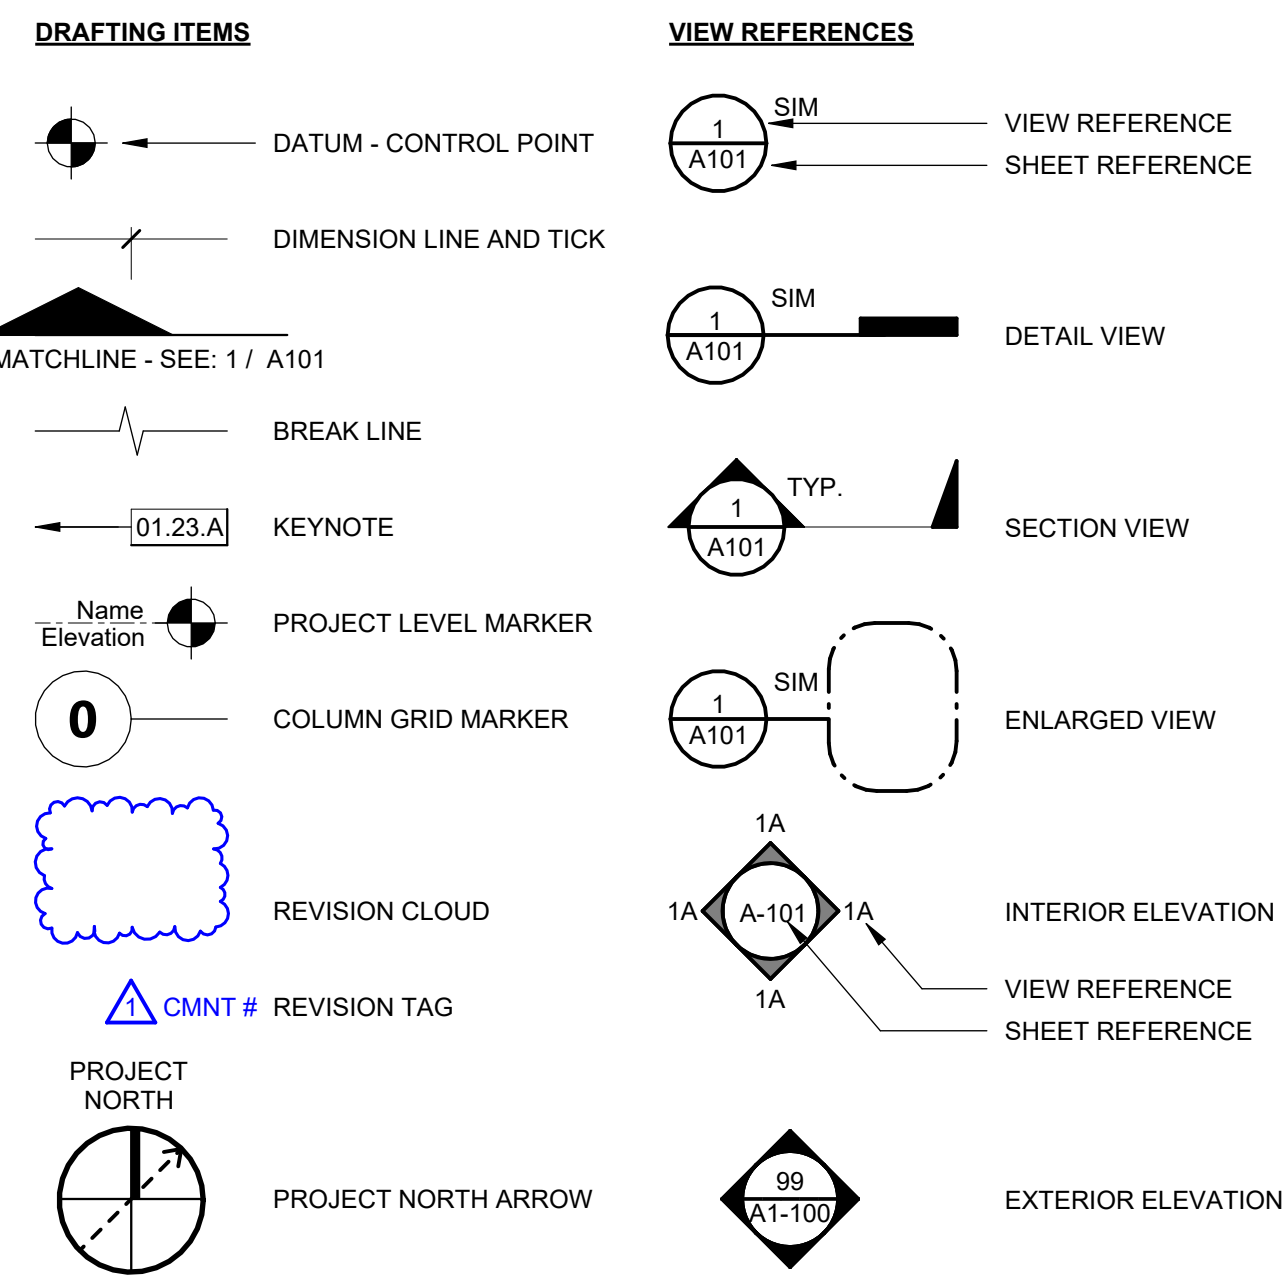

APPLICABLE CODES AND STANDARDS

PARTIAL LIST OF APPLICABLE CODES AS OF JANUARY 1, 2023
ALL PARTS OF THE TITLE 24 CODE SHOWN BELOW HAVE AN EFFECTIVE DATE OF **JANUARY 1, 2023**.
EXCEPT:
• CALIFORNIA ADMINISTRATIVE CODE - EFFECTIVE **MARCH 5, 2022**

CALIFORNIA ADMINISTRATIVE CODE (CAC) - CCR, TITLE 24, PART 1
CALIFORNIA BUILDING CODE (CBC) - CCR, TITLE 24, PART 2
(2021 INTERNATIONAL BUILDING CODE, VOL. 1 & 2, AND 2022 CALIFORNIA AMENDMENTS)
CALIFORNIA ELECTRICAL CODE (CEC) - CCR, TITLE 24, PART 3
(2020 NATIONAL ELECTRICAL CODE AND 2022 CALIFORNIA AMENDMENTS)
CALIFORNIA MECHANICAL CODE (CMC) - CCR, TITLE 24, PART 4
(2021 IAPMO UNIFORM MECHANICAL CODE AND 2022 CALIFORNIA AMENDMENTS)
CALIFORNIA PLUMBING CODE (CPC) - CCR, TITLE 24, PART 5
(2021 IAPMO UNIFORM PLUMBING CODE AND 2022 CALIFORNIA AMENDMENTS)
CALIFORNIA ENERGY CODE (CEC) - CCR, TITLE 24, PART 6
CALIFORNIA FIRE CODE (CFC) - CCR, TITLE 24, PART 9
(2021 INTERNATIONAL FIRE CODE AND 2022 CALIFORNIA AMENDMENTS)
CALIFORNIA EXISTING BUILDING CODE (CEBC) - CCR, TITLE 24, PART 10
CALIFORNIA GREEN BUILDING STANDARDS CODE (CALGREEN) - CCR, TITLE 24, PART 11
CALIFORNIA REFERENCED STANDARDS CODE - CCR, TITLE 24, PART 12
(PUBLIC SAFETY, STATE FIRE MARSHAL REGULATIONS)
ASME A17.1/CSA B44-13 SAFETY CODE FOR ELEVATORS AND ESCALATORS PER 2022 CBC
PART 2 CH 39 - CALIFORNIA ELEVATOR UNIT ENFORCES CCR TITLE 8 AND USES THE 2004
ASME A17.1 BY ADOPTION

PARTIAL LIST OF APPLICABLE STANDARDS AS OF JANUARY 1, 2023
FOR A COMPLETE LIST OF APPLICABLE NFPA STANDARDS REFER TO 2022 CBC (SFM) CHAPTER 35 AND CALIFORNIA FIRE CODE CHAPTER 60. SEE CALIFORNIA BUILDING CODE CHAPTER 35 FOR STATE OF CALIFORNIA AMENDMENTS TO THE NFPA STANDARDS.

NFPA 10-21 - STANDARD FOR PORTABLE FIRE EXTINGUISHERS
NFPA 12-15 - STANDARD ON CARBON DIOXIDE EXTINGUISHING SYSTEMS
NFPA 12A-18 - STANDARD ON HALON 1301 FIRE EXTINGUISHING SYSTEMS
NFPA 13-22 - STANDARD FOR THE INSTALLATION OF SPRINKLER SYSTEMS (AS AMENDED)
NFPA 14-12 - STANDARD FOR THE INSTALLATION OF STANDPIPE AND HOSE SYSTEMS
NFPA 17-21 - STANDARD FOR DRY CHEMICAL EXTINGUISHING SYSTEMS
NFPA 17A-21 - STANDARD FOR WET CHEMICAL EXTINGUISHING SYSTEMS
NFPA 20-19 - STANDARD FOR THE INSTALLATION OF STATIONARY PUMPS FOR FIRE PROTECTION
NFPA 24-19 - STANDARD FOR THE INSTALLATION OF PRIVATE FIRE SERVICE MAINS AND THEIR APPURTENANCES (AS AMENDED)
NFPA 72-22 - NATIONAL FIRE ALARM AND SIGNALING CODE (AS AMENDED)
NFPA 800-19 - STANDARD FOR FIRE DOORS AND OTHER OPENING PROTECTIVES
ICC 300-17 - STANDARD FOR BLEACHERS, FOLDING AND TELESCOPIC SEATING, AND GRANDSTANDS
UL 300-2005(R2010) - STANDARD FOR FIRE TESTING OF FIRE EXTINGUISHING SYSTEMS FOR PROTECTION OF COMMERCIAL COOKING EQUIPMENT
UL 464-03 - AUDIBLE SIGNALING DEVICES FOR FIRE ALARM AND SIGNALING SYSTEMS, INCLUDING ACCESSORIES
UL 521-99 - STANDARD FOR HEAT DETECTORS FOR FIRE PROTECTIVE SIGNALING SYSTEMS
UL 1971-2002(R2010) - STANDARD FOR SIGNALING DEVICES FOR THE HEARING IMPAIRED

GENERAL PROJECT NOTES - K12

- ALL WORK SHALL CONFORM TO 2022 TITLE 24 CALIFORNIA CODE OF REGULATIONS (CCR).
- THE PROJECT MANUAL AND SPECIFICATIONS IN CONJUNCTION WITH THESE DRAWINGS AND REFERENCES SHALL FORM A PART OF THE CONTRACT AND SHALL BE REFERRED TO AS THE "DOCUMENTS". THE DOCUMENTS DEFINE THE WORK TO BE PERFORMED AS AGREED TO IN THE CONTRACT.
- CHANGES TO APPROVED DRAWINGS AND SPECIFICATIONS SHALL BE MADE BY AN ADDENDUM OR A CONSTRUCTION CHANGE DOCUMENT (CCD) APPROVED BY THE DIVISION OF THE STATE ARCHITECT AS REQUIRED BY SECTION 4-336, PART 1, T24 CCR.
- A DSA CERTIFIED **INSPECTOR CLASS 3** SHALL BE EMPLOYED BY THE DISTRICT AND SHALL PROVIDE CONTINUOUS INSPECTION OF THE WORK. THE DUTIES OF THE INSPECTION ARE DEFINED IN SECTION 4-342, PART 1, T24 CCR.
- APPARENT DISCREPANCIES ON DRAWINGS AND/OR SPECIFICATIONS SHALL BE REPORTED TO THE ARCHITECT BEFORE PROCEEDING WITH THE WORK.
- ANY DIFFERENCE BETWEEN THE EXISTING CONSTRUCTION AS OBSERVED IN THE FIELD AND AS SHOWN ON THE DRAWING SHALL BE REPORTED TO THE ARCHITECT BEFORE PROCEEDING WITH THE WORK.
- THE CONTRACTOR SHALL VERIFY ALL DIMENSIONS PRIOR TO STARTING WORK. THE ARCHITECT SHALL BE NOTIFIED OF ANY DISCREPANCIES OR INCONSISTENCIES. THE CONTRACTOR IS RESPONSIBLE FOR CHECKING AND COORDINATING DIMENSIONS.
- IT SHALL BE THE RESPONSIBILITY OF THE GENERAL CONTRACTOR TO ENSURE THAT ALL APPLICABLE SAFETY LAWS ARE STRICTLY ENFORCED AND TO MAINTAIN A SAFE CONSTRUCTION PROJECT.
- IT SHALL BE THE RESPONSIBILITY OF THE GENERAL CONTRACTOR TO PROVIDE SUPERVISION OF THE CONSTRUCTION WORK TO ENSURE THAT IT IS BUILT IN CONFORMANCE WITH THE APPROVED PLANS AND SPECIFICATIONS. THE ARCHITECT WILL PROVIDE ONLY PERIODIC OBSERVATION OF THE WORK. SEE NOTE 4 FOR DSA INSPECTION REQUIREMENTS.
- ANY DAMAGE DONE TO THE EXISTING CONSTRUCTION DURING THE COURSE OF THIS WORK SHALL BE REPLACED BY THE CONTRACTOR AT THE CONTRACTOR'S EXPENSE WITH NO ADDITIONAL COST TO THE OWNER.
- GRADING PLANS, DRAINAGE IMPROVEMENTS, ROAD & ACCESS REQUIREMENTS AND ENVIRONMENTAL HEALTH CONSIDERATIONS SHALL COMPLY WITH ALL LOCAL ORDINANCES.
- THE SEISMIC ANCHORAGE OF MECHANICAL AND ELECTRICAL EQUIPMENT SHALL CONFORM TO CCR TITLE 24, 2022 CBC SECTION 1616A.1.18 AND ASCE 7-16 SECTION 13.8 ANCHORAGE DETAILS FOR ROOF/FLOOR MOUNTED EQUIPMENT SHALL BE SHOWN ON PLANS.
- CUTTING, BORING, SAW CUTTING OR DRILLING THROUGH THE NEW OR EXISTING STRUCTURAL ELEMENTS TO BE DONE ONLY WHEN SO DETAILED IN THE DRAWINGS OR ACCEPTED BY THE ARCHITECT AND THE STRUCTURAL ENGINEER WITH THE APPROVAL OF DSA REPRESENTATIVE. ALL WELDING SHALL BE SPECIALLY INSPECTED BY AN AWS-CWI QUALIFIED INSPECTOR APPROVED BY DSA. ALL BRACING OF DUCTS AND PIPING SHALL BE INSTALLED AS APPROVED BY DSA. WHERE BRACING DETAILS ARE NOT SHOWN ON THE DRAWINGS, THE FIELD INSTALLATION SHALL BE SUBJECT TO THE APPROVAL OF THE ARCHITECT, MECHANICAL ENGINEER AND FIELD ENGINEER. A COPY OF THE DRAWINGS APPROVED BY DSA SHALL BE PROVIDED BY THE CONTRACTOR AND KEPT ON THE JOB AT ALL TIMES.
- THE INTENT OF THESE DRAWINGS AND SPECIFICATIONS IS THAT THE WORK OF THE ALTERATION, REHABILITATION OR RECONSTRUCTION IS TO BE IN ACCORDANCE WITH TITLE 24, CALIFORNIA CODE OF REGULATIONS. SHOULD ANY EXISTING CONDITIONS SUCH AS DETERIORATION OR NON-COMPLYING CONSTRUCTION BE DISCOVERED WHICH IS NOT COVERED BY THE CONTRACT DOCUMENTS WHEREIN THE FINISHED WORK WILL NOT COMPLY WITH TITLE 24, CALIFORNIA CODE OF REGULATIONS, A CONSTRUCTION CHANGE DOCUMENT, OR A SEPARATE SET OF PLANS AND SPECIFICATIONS, DETAILING AND SPECIFYING THE REQUIRED WORK SHALL BE SUBMITTED TO AND APPROVED BY THE DIVISION OF THE STATE ARCHITECT BEFORE PROCEEDING WITH THE WORK.
- A DSA ACCEPTED TESTING LABORATORY DIRECTLY EMPLOYED BY THE SCHOOL DISTRICT (OWNER) SHALL CONDUCT ALL THE REQUIRED TESTS AND INSPECTIONS FOR THE PROJECT.
- IT SHALL BE THE RESPONSIBILITY OF THE GENERAL CONTRACTOR TO COMPLY WITH CFC CHAPTER 33 - FIRE SAFETY DURING CONSTRUCTION AND DEMOLITION.
- DO NOT SCALE DRAWINGS. DIMENSIONS SHOWN SHALL TAKE PRECEDENCE OVER DRAWING SCALE. WHENEVER DSA FINDS ANY CONSTRUCTION WORK IS BEING PERFORMED IN A MANNER CONTRARY TO THE PROVISIONS OF THE CALIFORNIA BUILDING CODE AND THAT WOULD COMPROMISE THE STRUCTURAL INTEGRITY OF THE BUILDING, THE DEPARTMENT OF GENERAL SERVICES, STATE OF CALIFORNIA, IS AUTHORIZED TO ISSUE A STOP WORK ORDER PER SECTION 4-334.1 CALIFORNIA ADMINISTRATIVE CODE (PART 1, TITLE 24, CCR).
- TITLE 24 PARTS 1-5 AND 9 MUST BE KEPT ON SITE DURING CONSTRUCTION
- ALL STRUCTURAL, ARCHITECTURAL, MECHANICAL, ELECTRICAL, AND PLUMBING MATERIALS INSTALLATION TO COMPLY WITH APPLICABLE CODES, STANDARDS, AND MANUFACTURER'S RECOMMENDATIONS.
- PROJECT INSPECTION (PI) SHALL WITNESS AND VERIFY GROUNDING.
- DETERIORATION OR EXISTING NON-COMPLIANT CONSTRUCTION:** IF ANY CONDITION IS DISCOVERED WHICH, IF LEFT UNCORRECTED, WOULD MAKE THE BUILDING NON-COMPLIANT WITH THE REQUIREMENTS OF THE EDITION OF CBC IN FORCE AT THE TIME OF ORIGINAL CONSTRUCTION, THE CONDITION MUST BE CORRECTED IN ACCORDANCE WITH CURRENT CODE REQUIREMENTS. A CONSTRUCTION CHANGE DOCUMENT (CCD-TYPE A), OR A SEPARATE SET OF PLANS AND SPECIFICATIONS DETAILING AND SPECIFYING THE REQUIRED REPAIR WORK SHALL BE SUBMITTED TO AND APPROVED BY DSA BEFORE PROCEEDING WITH THE REPAIR WORK.
- NEW BUILDINGS SHALL BE PROVIDED WITH EMERGENCY RESPONDER RADIO COVERAGE IN ACCORDANCE WITH CALIFORNIA FIRE CODE SECTION 510. THE PROJECT ARCHITECT (AOR) SHALL CONTACT THE LOCAL FIRE DEPARTMENT AND/OR EMERGENCY COMMUNICATIONS AUTHORITY TO OBTAIN DESIGN, EQUIPMENT SPECIFICATIONS, TESTING AND ACCEPTANCE CRITERIA. PLANS AND REQUESTED DOCUMENTATION SHALL BE SUBMITTED TO THE LOCAL AUTHORITY HAVING JURISDICTION FOR REVIEW AND APPROVAL. UPON COMPLETION, COPIES OF THE APPROVED PLANS, EQUIPMENT DATE SHEETS, TESTING AND ACCEPTANCE DOCUMENTATION SHALL BE PROVIDED TO THE SCHOOL DISTRICT.

PROJECT DESCRIPTION

- RELOCATION OF (2) 24'X40' PORTABLE BUILDINGS ON WOOD FOUNDATIONS:
AMS PC RELOCATABLE BUILDING, DSA #88145, SERIAL #97-R286-017A, 97-R286-017B, AND MODTECH PC RELOCATABLE BUILDING, DSA #02-106169, SERIAL #5288-51267
- REMOVAL, PROTECTION AND TRANSPORTATION OF PORTABLE BUILDINGS FROM M&O YARD LOCATED AT 880 N. GUILD AVE., LODI, CA 95240 TO THE MILLSWOOD CAMPUS
- ASSOCIATED SITE WORK CORRESPONDING TO PORTABLE RELOCATION INCLUDING BUT NOT LIMITED TO NEWPATCH CONCRETE, NEWPATCH AC PAVING, ELECTRICAL AND FIRE ALARM CONNECTIONS TO EXISTING SITE.

DEFERRED APPROVALS

NONE

ABBREVIATIONS

AT	CENTER LINE	ID	INSIDE DIAMETER
INSUL	INSULATION OR INSULATED	INVERT	INVERT
LAV	LAVATORY	MATL	MATERIAL
MAX	MAXIMUM	MB	MACHINE BOLT
MECH	MECHANICAL	MFR	MANUFACTURE OR MANUFACTURER
MH	MAN HOLE	MIN	MINIMUM
MISC	MISCELLANEOUS	MO	MASONRY OPENING
N	NORTH	NEW	NEW
NOT IN CONTRACT	NUMBER	NO OR #	NOT TO SCALE
ON CENTER	OUTSIDE DIAMETER	OPNG	OPENING
PL	PLATE OR PROPERTY LINE	PLAM	PLASTIC LAMINATE
PLAS	PLASTER (NUMBER - SEE SPECS)	PLYWOD	PLYWOOD
PNT	PAINT (NUMBER - SEE SPECS)	PTDF	PRESSURE TREATED DOUGLAS FIR
QUARRY TILE	QUARRY TILE	REF	REFRIGERATOR
REINFORCING	REINFORCE OR REINFORCING	RH	ROOM HEAD
ROOM	ROUGH OPENING	RWD	REDWOOD
S	SOUTH	SCH	SCHEDULE
SD	STORM DRAIN	SHR	SHOWER
SHT	SHEET	SHTG	SHEATHING
SIM	SIMILAR	SMACNA SPEC	THE ARCH SHEET METAL MANUAL SPEC
SQ	SQUARE	SSTL	STAINLESS STEEL
STD	STANDARD	STL	STEEL
SUSP	SUSPENDED	SYM	SYMMETRICAL
TOB	TOP OF BEAM	TOC	TOP OF CURB OR TOP OF CONCRETE
TCB	TOP OF CATCH BASIN	TEL	TELEPHONE
TEMP	TEMPERATURE OR TEMPERED	T&G	TONGUE & GROOVE
TP	TOP OF PAVING	TS	STRUCTURAL TUBING
TV	TELEVISION	TOW	TOP OF WALL
TYP	TYPICAL (ITEMS TYPICAL UNLESS SHOWN OR NOTED OTHERWISE)	UON	UNLESS OTHERWISE NOTED
VCT	VINYL COMPOSITION TILE	VERT	VERTICAL
VDOF	VERTICAL GRAIN DOUGLAS FIR	VTR	VENT THRU ROOF
W	WEST	WC	WATER CLOSET
W	WHEELCHAIR ACCESSIBLE	W	WOOD
WF	WIDE FLANGE	WH	WATER HEATER
WP	WOOD SCREW	WSC	WELDED WIRE FABRIC
W	WITH	W	WITHOUT

SHEET INDEX

SHEET # **SHEET NAME**
1. OVERALL GENERAL INFORMATION
G-001 TITLE SHEET
G-002 FIRE AUTHORITY SITE PLAN
GENERAL SHEETS TOTAL: 2

2. CIVIL ENGINEERING
C-0.0 GENERAL NOTES AND ABBREVIATIONS
C-0.1 TOPOGRAPHIC SURVEY
C-1.1 DEMOLITION PLAN
C-2.1 GRADING, PAVING, AND DRAINAGE PLAN
CIVIL SHEETS TOTAL: 4


3. ARCHITECTURAL DRAWINGS
A-101 OVERALL SITE PLAN
A-102 ENLARGED SITE PLAN AND CODE ANALYSIS
A-301 EXTERIOR ELEVATIONS
ARCHITECTURAL SHEETS TOTAL: 3

4. ELECTRICAL ENGINEERING
E-0.1 SYMBOLS & SHEET INDEX
E-0.2 POWER ONE-LINE DIAGRAM, RISERS & SCHEDULES
E-1.1 OVERALL ELECTRICAL SITE PLAN
E-2.1 POWER AND SIGNAL PLAN
E-3.1 FIRE ALARM DETAILS, SCHEDULES & NOTES
E-3.2 FIRE ALARM RISER DIAGRAM & CALCULATIONS
E-4.1 ELECTRICAL DETAILS
ELECTRICAL SHEETS TOTAL: 7


5. PC RELOCATABLE BUILDING AMS #88145 DRAWINGS - FOR REFERENCE ONLY
TS-1.1 TITLE AND BUILDING DATA NOTES
N-1 GENERAL NOTES
1 FLOOR PLAN AND NOTES
2 EXTERIOR ELEVATIONS
3 CEILING GRID, DETAILS, AND NOTES
S1 FOUNDATION PLAN WOOD, DETAILS & NOTES 50#
S2 FLOOR FRAMING PLAN & BUILDING SECTIONS
S2B BUILDING SECTIONS AND WALL DETAILS
S3 ROOF FRAMING PLAN & DETAILS
S4 FRAMING ELEVATIONS & DETAILS
SSR.1 RAMP PLAN, ELEVATION & DETAILS
M1 MECHANICAL PLAN, DETAILS & NOTES
E1 ELECTRICAL PLAN, DETAILS & NOTES
PC RELOCATABLE BUILDING AMS #88145 DRAWINGS SHEETS TOTAL: 13

6. PC RELOCATABLE BUILDING MODTECH #02-106169 DRAWINGS - FOR REFERENCE ONLY
A.0 TITLE SHEET
A.0 FLOOR PLAN 24'X40'
A.0 ROOF PLAN (DUAL PITCH) 24'X40'
A.01 EXTERIOR ELEVATIONS (DUAL PITCH) 24'X40' W/O FASCIA
A.02 INTERIOR ELEVATIONS - (NOTE: SHEET TITLE DIFFERS FROM PC TITLE SHEET)
A.03 SCHEDULE SHEET - (NOTE: SHEET TITLE DIFFERS FROM PC TITLE SHEET)
A.0 ARCHITECTURAL DETAILS (WOOD STUDS)
A.01 ARCHITECTURAL DETAILS (WOOD STUDS)
A.0M ARCHITECTURAL DETAILS (METAL STUDS)
A.01 ARCHITECTURAL DETAILS (METAL STUDS)
A.01 REFLECTED CEILING PLAN (24'X40') (10 LIGHTS)
A.01 REFLECTED CEILING DETAILS
A.01 SPECIFICATIONS
F.1 FOUNDATION PLAN (24'X40') 50 PSF LL (WOOD)
F.01 FOUNDATION DETAILS (WOOD)
S.1 FLOOR FRAMING PLAN 50 PSF LL
S.1.2 STRUCTURAL DETAILS - (NOTE: SHEET TITLE DIFFERS FROM PC TITLE SHEET)
S.2.01 FLOOR FRAMING PLAN
S.2.1 STRUCTURAL DETAILS - (NOTE: SHEET TITLE DIFFERS FROM PC TITLE SHEET)
S.3.01 STRUCTURAL ELEVATIONS & DETAILS (DUAL PITCH)
S.4.0 WALL FRAMING (WOOD)
S.5.0 WALL FRAMING DETAILS (WOOD)
S.5.1 WALL FRAMING DETAILS (METAL)
S.5.1M WALL FRAMING DETAILS (METAL)
M.01 MECHANICAL (HVAC) PLAN 24'X40' - 5 TON
E.1 ELECTRICAL PLAN 24'X40'
R.1 RAMP/LANDING PLAN W/ 12' RAMP
R.02 RAMP/STAIRS DETAILS
PC RELOCATABLE BUILDING MODTECH #02-106169 DRAWINGS SHEETS TOTAL: 31

7. PC 04-122029 ACCESSIBLE RAMP LANDING STAIR PC
R-1 COVER SHEET
R-2 DSA 103 TEST & SPECIAL INSPECTIONS SAMPLE
R-3 CONSTRUCTION SPECIFICATIONS & NOTES
R-4 STANDARD RAMP & LANDING (ATTACHED HANDRAIL TO BUILDING)
R-9 RAMP & LANDING DETAILS
PC 04-122029 ACCESSIBLE RAMP LANDING STAIR PC SHEETS TOTAL: 5
OVERALL SHEET TOTAL: 65

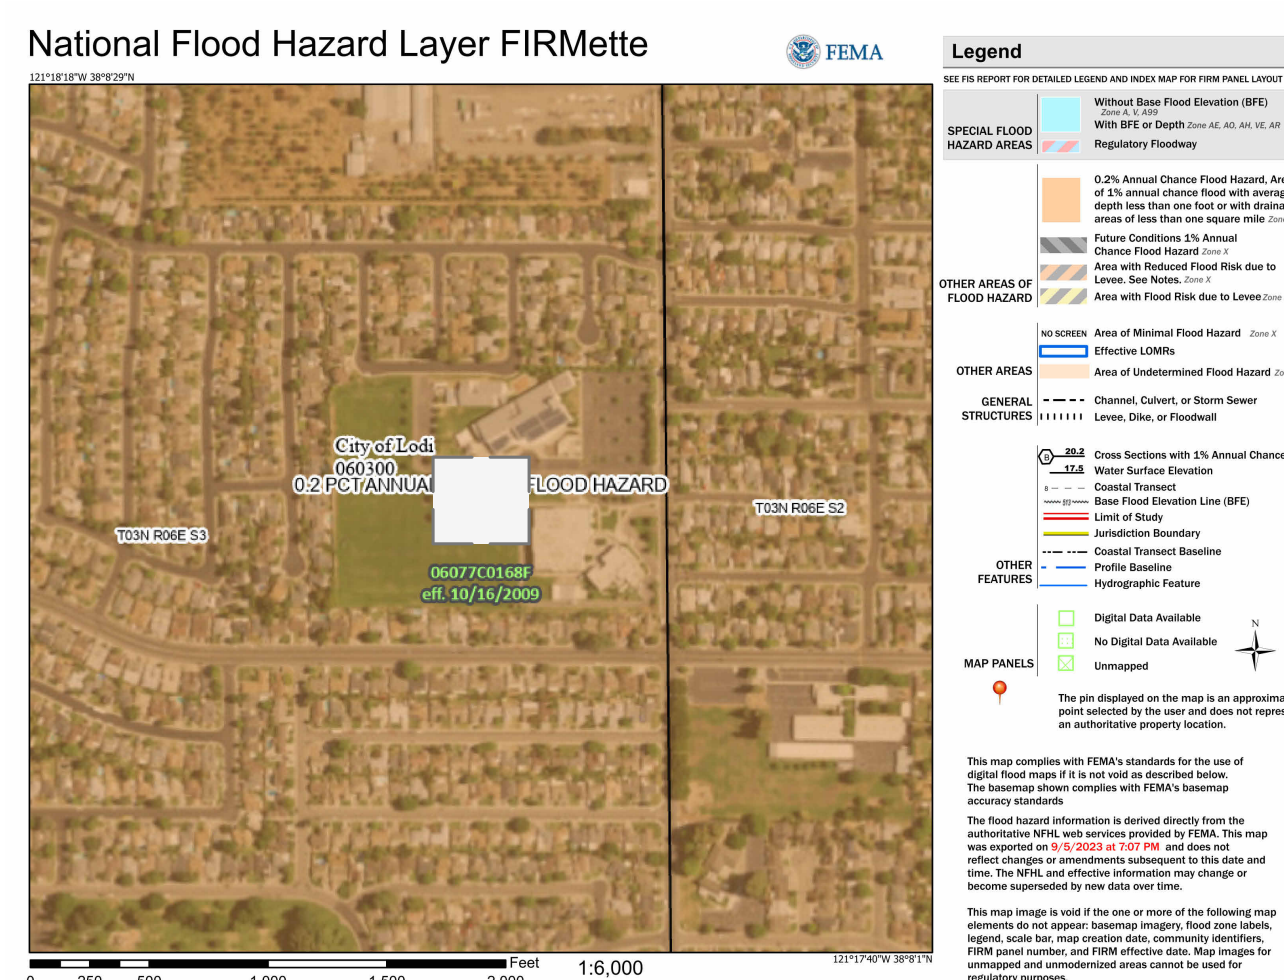

VICINITY MAP

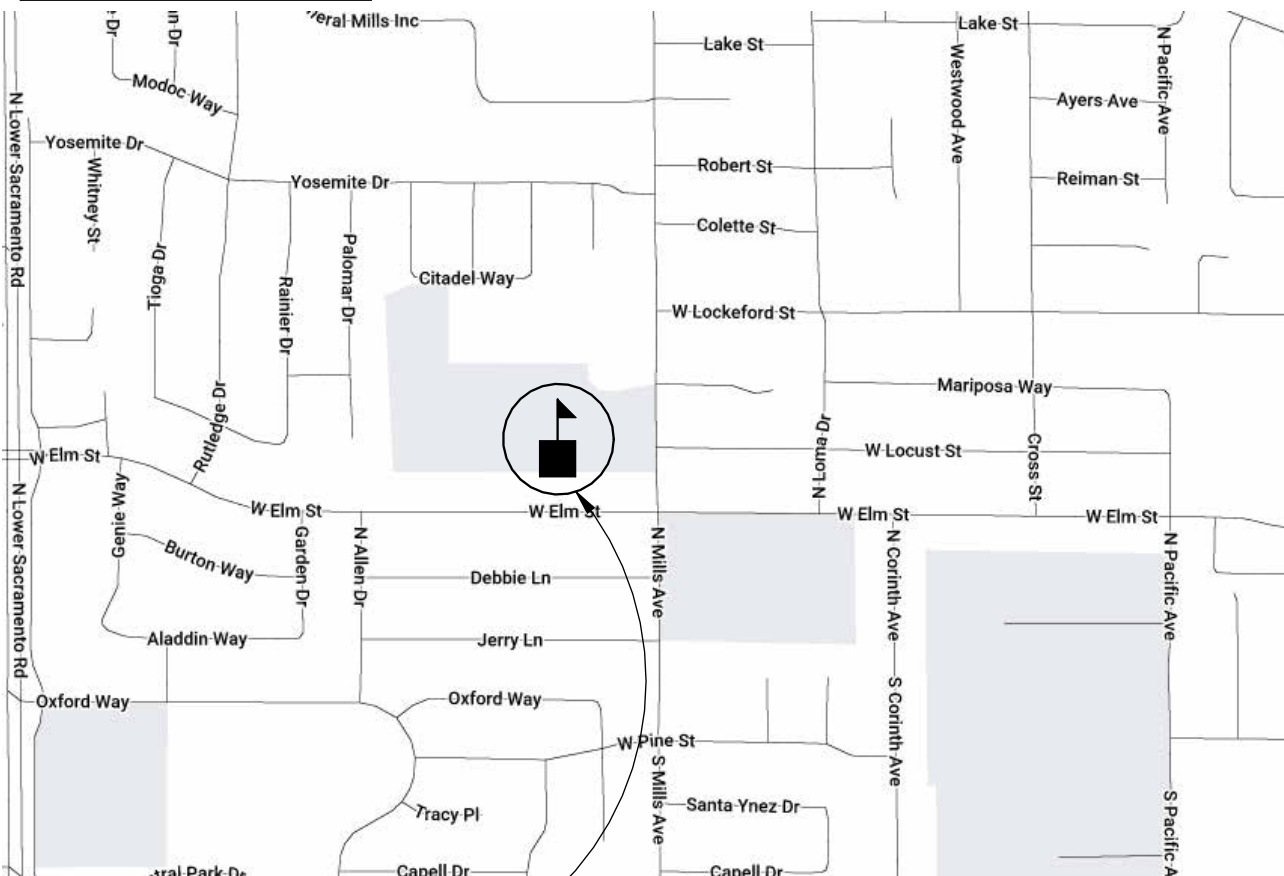

PROJECT LOCATION

MILLSWOOD MIDDLE SCHOOL

STATEMENT OF GENERAL CONFORMANCE

THE PC DRAWINGS SHEETS LISTED BELOW ON THE SHEET INDEX OF THIS COVER HAVE BEEN PREPARED BY OTHER DESIGN PROFESSIONALS OR CONSULTANTS WHO ARE LICENSED AND/OR AUTHORIZED TO PREPARE SUCH DRAWINGS IN THIS STATE. IT HAS BEEN EXAMINED BY ME FOR:

- DESIGN INTENT, AND IT APPEARS TO MEET THE APPROPRIATE REQUIREMENTS OF TITLE 24, CALIFORNIA CODE OF REGULATIONS, AND THE PROJECT SPECIFICATIONS PREPARED BY ME, AND
- COORDINATION WITH MY PLANS AND SPECIFICATIONS, AND IS ACCEPTABLE FOR INCORPORATION INTO THE CONSTRUCTION OF THIS PROJECT.

THE STATEMENT OF GENERAL CONFORMANCE "SHALL NOT BE CONSTRUED AS RELIEVING ME OF MY RIGHTS, DUTIES, AND RESPONSIBILITIES UNDER SECTIONS 17302 AND 81138 OF EDUCATION CODE, AND SECTIONS 4-336, 4-341 AND 4-354 OF TITLE 24, PART 1 (TITLE 24, SECTION 4-317 (B)).

I FIND THAT: ☒ ALL DRAWINGS OR SHEETS LISTED ON THE COVER OR INDEX SHEET

☒ THIS DRAWING OR PAGE
☒ IS/ARE IN GENERAL CONFORMANCE WITH THE PROJECT DESIGN, AND
☒ HAS/HAVE BEEN COORDINATED WITH THE PROJECT PLANS AND SPECIFICATIONS.

SIGNATURE *M. Alvarez* DATE *01-31-25*
ARCHITECT OR ENGINEER DESIGNATED TO BE IN GENERAL RESPONSIBLE CHARGE
PRINT NAME **MARIANA ALVAREZ-PARGA**
C-36107 EXPIRATION DATE
LICENSE NUMBER

AGENCY APPROVAL DSA# 02-121945 39-50

IDENTIFICATION STAMP
DIV. OF THE STATE ARCHITECT
APP: 02-121945 INC:
REVIEWED FOR
SS ☒ FLS ☒ ACS ☒
DATE: 12/12/2023

19.6
ARCHITECTS

1715 R STREET, SUITE 200
SACRAMENTO, CA 95811
TEL (916) 786-8178

CONSULTANTS

CIVIL ENGINEER
Warren Consulting Engineers, Inc.
1117 Windfield Way, Suite 110
El Dorado Hills, CA 95762
TEL (916) 965-1870

ELECTRICAL ENGINEER
The Engineering Enterprise
1125 High Street
Auburn, CA 95603
TEL (530) 886-8556

PROFESSIONAL STAMP



REVISIONS

NO.	DATE	DESCRIPTION
1		
2		
3		
4		
5		
6		
7		
8		
9		
10		

THE ARCHITECT DOES NOT REPRESENT THAT THESE PLANS OR THE SPECIFICATIONS ARE SUITABLE FOR ANY SITE OTHER THAN THE ONE FOR WHICH THEY WERE SPECIFICALLY PREPARED. THE ARCHITECT DISCLAIMS RESPONSIBILITY FOR THESE PLANS AND SPECIFICATIONS IF THEY ARE USED IN WHOLE OR IN PART AT ANY OTHER SITE. WRITTEN DIMENSIONS ON THESE DRAWINGS SHALL HAVE PRECEDENCE OVER SCALED DIMENSIONS.

PROJECT OWNER & TITLE

LODI UNIFIED SCHOOL DISTRICT
1305 E. Vine St
Lodi, CA 95240

MILLSWOOD MIDDLE SCHOOL PORTABLES RELOCATION

233 N Mills Ave
Lodi, CA 95242

SHEET TITLE


TITLE SHEET

DRAWN BY: CV, BI JOB NUMBER: 23219

SHEET NO.

G-001
DATE: DECEMBER 12, 2023

DATE PLOTTED: 12/12/2023 11:05:44 AM FILE LOCATION: C:\Users\lindhoff\Documents\BIM\23219_LUSD_Millswood Middle School Portables Relocation_A22_bimhoff\CK8v.rvt

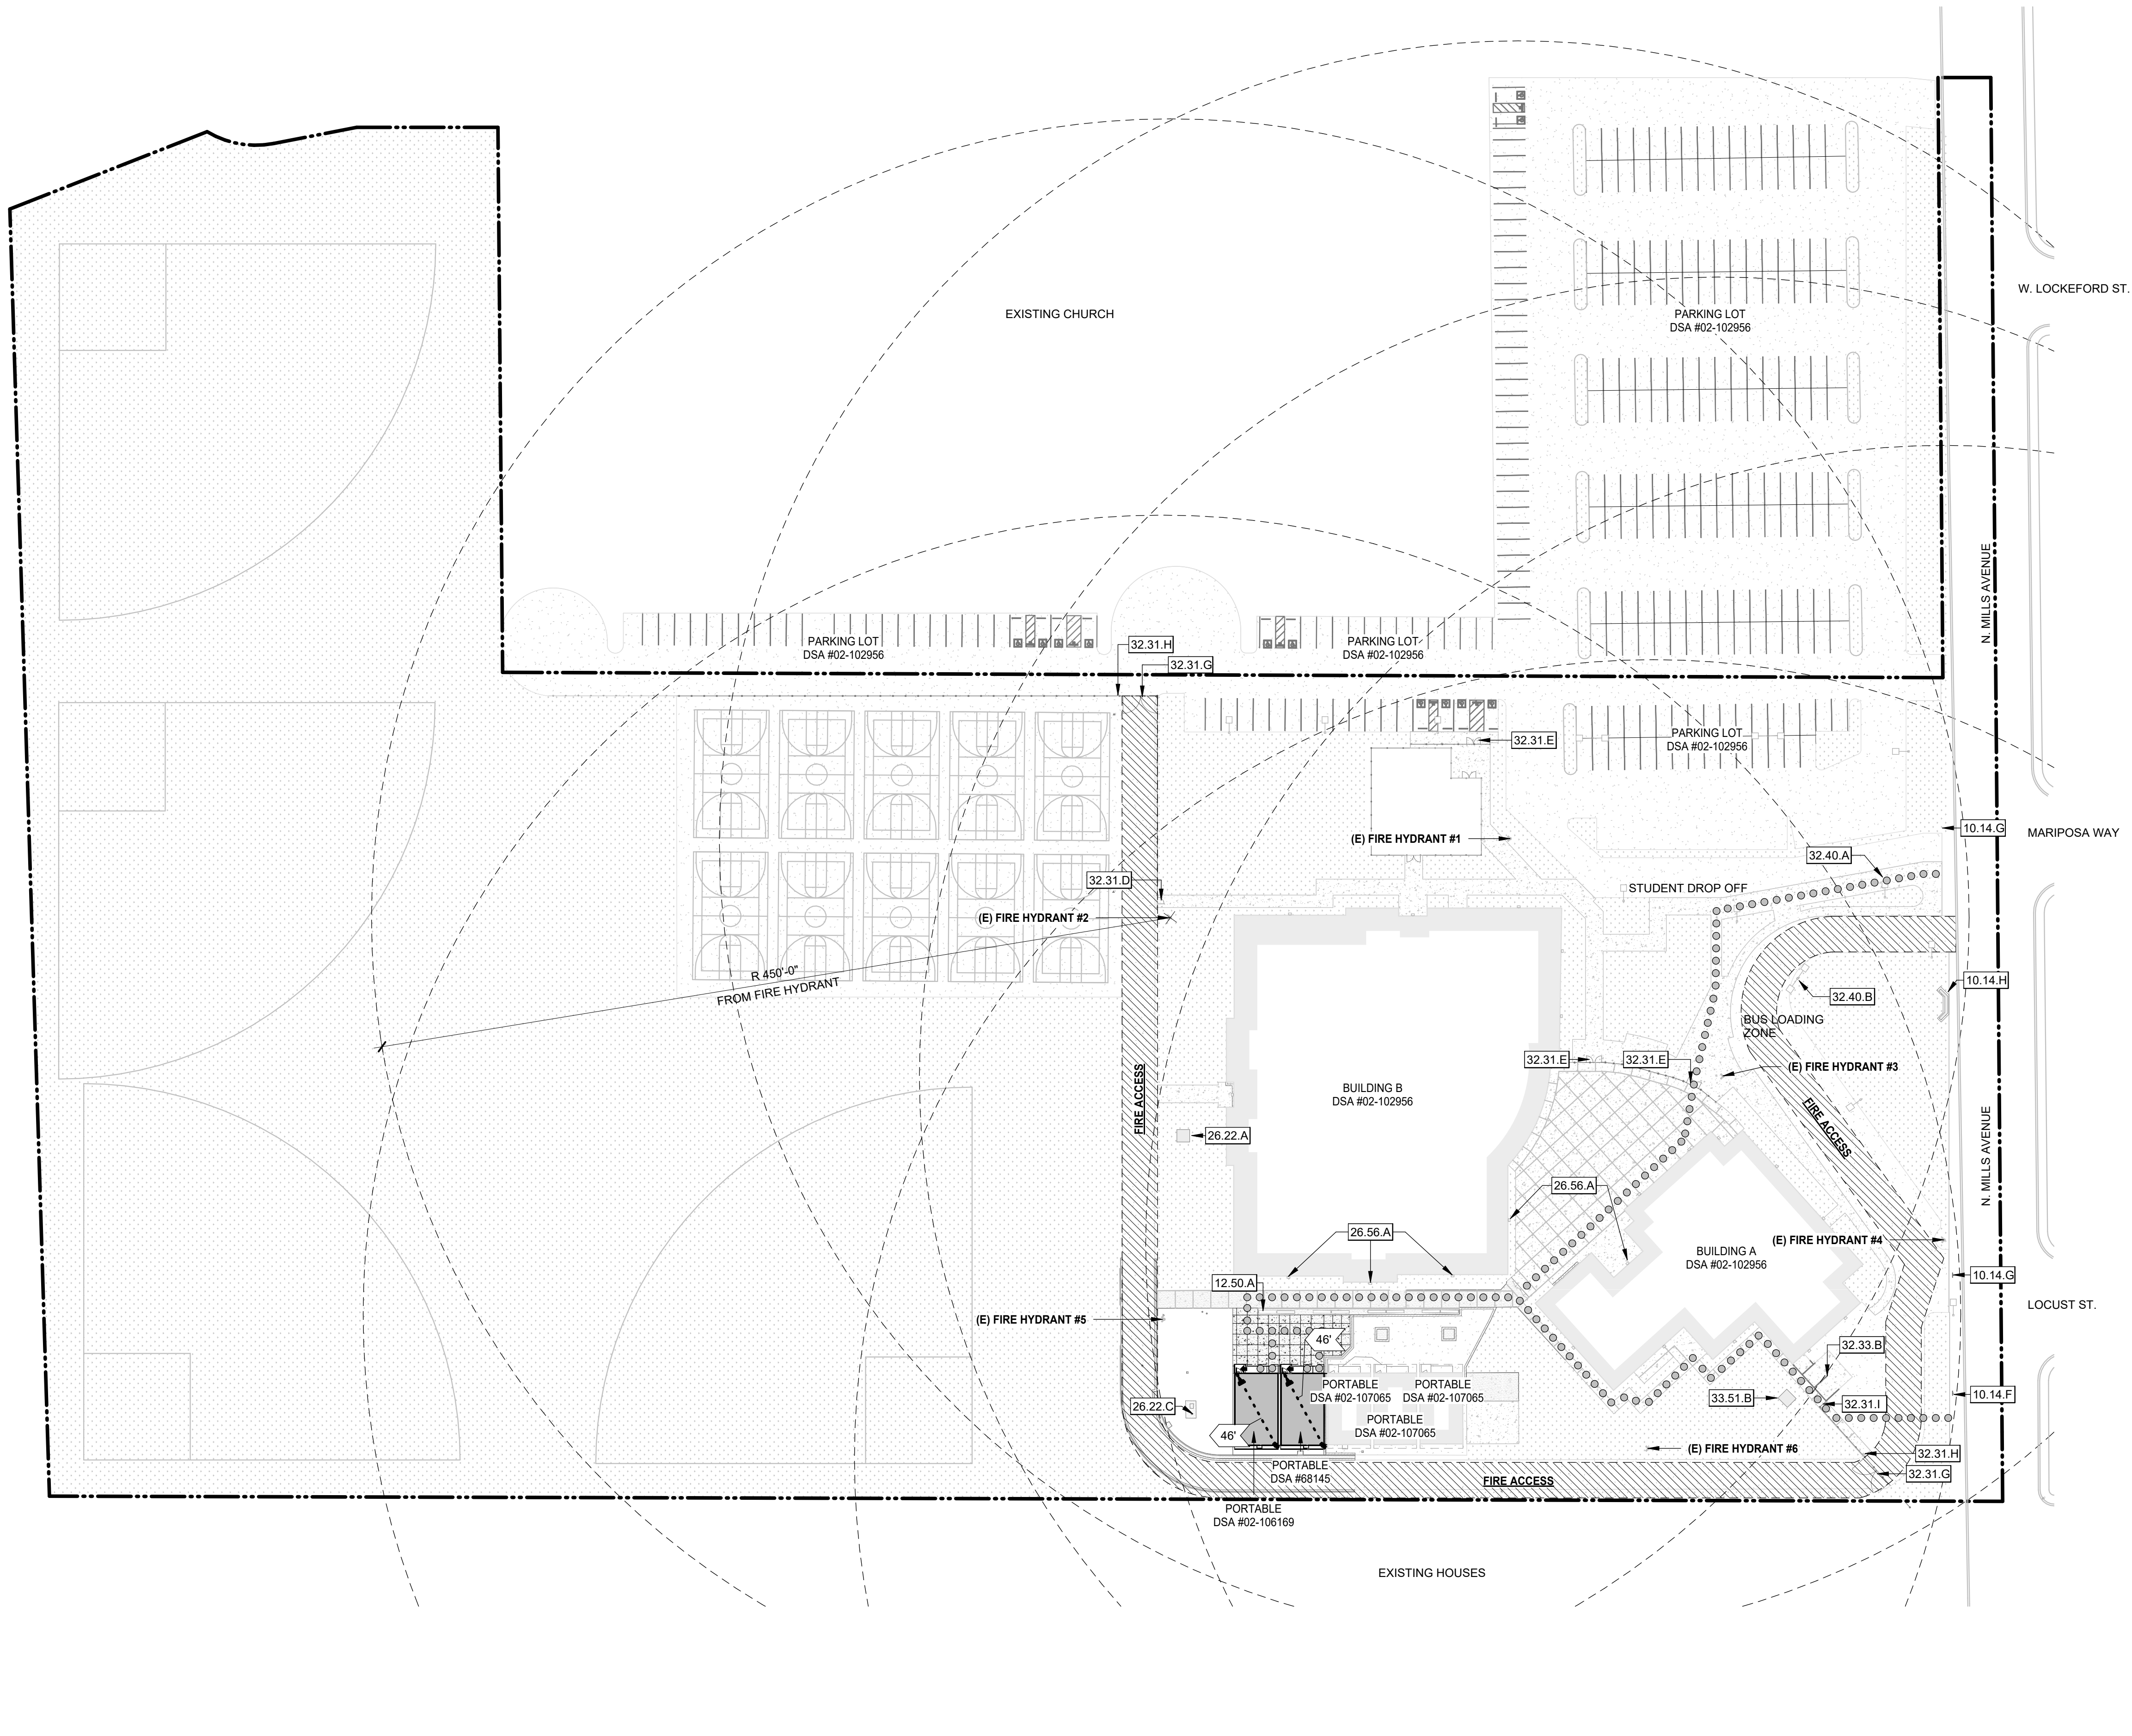

KEYNOTES

- NOTE: NOT ALL KEYNOTES ARE USED ON EVERY SHEET
- 10.14.F (E) SCHOOL SPEED LIMIT SIGN
 - 10.14.G (E) ACCESS SIGN
 - 10.14.H (E) SCHOOL SIGN
 - 12.50.A (E) SITE BENCH
 - 26.22.A (E) ELECTRICAL TRANSFORMER
 - 26.22.C (E) DISTRIBUTOR PANEL
 - 26.56.A (E) EXTERIOR LIGHT FIXTURE
 - 32.31.D (E) SINGLE 3'-0" WIDE CHAIN LINK GATE WITH PANIC HARDWARE
 - 32.31.E (E) DOUBLE 3'-6" WIDE CHAIN LINK GATE WITH PANIC HARDWARE
 - 32.31.G (E) 20' WIDE DOUBLE SWING GATES
 - 32.31.H (E) KNOX BOX
 - 32.31.I (E) 4' WIDE MAN GATE WITH PANIC HARDWARE
 - 32.33.B (E) TRASH ENCLOSURE
 - 32.40.A (E) SINGLE FIXTURE LIGHT STANDARD
 - 32.40.B (E) DOUBLE FIXTURE LIGHT STANDARD
 - 33.51.B (E) GAS METER

FIRE ACCESS LEGEND

- ASSUMED PROPERTY LINE
- PROJECT BUILDING
- (E) BUILDING
- X-X-X-X FENCE LINE
- EGRESS PATH TO PUBLIC RIGHT OF WAY AND/OR SAFE DISPERSAL AREA
- (E) FIRE HYDRANT
- FDC
- (E) FIRE DEPARTMENT CONNECTION

- FIRE ACCESS ROUTE-ALL WEATHER SURFACE (OR BETTER) MAINTAINED TO SUPPORT FIRE APPARATUS WEIGHING 60,000 LBS. HAVING A 15% MAXIMUM GRADE 20'-0" MIN WIDTH PER 2019 CFC 505.2.1
- (E) EXTERIOR LIGHT FIXTURE
- (E) SINGLE FIXTURE LIGHT STANDARD
- (E) DOUBLE FIXTURE LIGHT STANDARD
- FIRE EXTINGUISHER
- FIRE SPRINKLER RISER
- BUILDING ENTRANCE
- EGRESS DISTANCE

FIRE AUTHORITY SITE PLAN

1" = 50'-0"

1



810

FIRE & LIFE SAFETY SITE CONDITIONS SUBMITTAL

Division of the State Architect (DSA) documents referenced within this publication are available on the [DSA Forms](#) or [DSA Publications](#) webpages.

To facilitate the Division of the State Architect's (DSA) fire and life safety plan review of project site conditions, DSA requires the design professional to provide the following information at time of project submittal for projects consisting of construction of a new campus, construction of new building(s), additions to existing buildings, and for site alternate design means for fire department emergency vehicle access, and fire suppression water supply. Information associated with compliance items 1 through 3 below is to be provided for all project types indicated above. Information associated with items 4 through 7 is to be completed when an alternate means is utilized. Acknowledgement by the school district and signature from the Local Fire Authority (LFA) is only required when an alternate design means is being requested.

The Project Information and Fire & Life Safety Information sections are to be completed for all projects and imaged onto the fire access site plan. When an alternate design means is proposed, all sections on pages 1 and 2 are to be completed and imaged on the fire access site plan.

For additional information refer to the instructions at the end of this form and DSA Policy PL 09-01: Fire Flow for Buildings.

PROJECT INFORMATION			
School District/Owner:	Lodi Unified School District		
Project Name/School:	Millswood Middle School Portable Relocation		
Project Address:	233 N. Mills Ave., Lodi, CA 95242		

FIRE & LIFE SAFETY INFORMATION			
1. Has a fire hydrant flow test been performed within the past 12 months? (If yes, provide a copy of the test data.)	Yes <input checked="" type="checkbox"/>	No <input type="checkbox"/>	
2. Was the fire hydrant water flow test performed as part of this LFA review?	Yes <input checked="" type="checkbox"/>	No <input type="checkbox"/>	
3. Is the project located within a designated fire hazard severity zone (FHSZ) as established by Cal-Fire? (If yes, indicate FHSZ classification below.)	Yes <input type="checkbox"/>	No <input checked="" type="checkbox"/>	
Refer to the following website for FHSZ locations: http://egis.fire.ca.gov/FHSZ/	Moderate <input type="checkbox"/>	High <input type="checkbox"/>	Very High <input type="checkbox"/>
Wildland Interface Area (WIFA) (If any designations are checked, project design must meet the requirements of CBC Chapter 7A.)			WIFA <input type="checkbox"/>

DSA 810 FIRE & LIFE SAFETY SITE CONDITIONS SUBMITTAL

CONDITION MEANS AND METHODS RESOLUTION	ALTERNATE ACCEPTED
4. Emergency vehicle access roadways do not meet CFC requirements.	Yes No N/A N/R
4a. Acceptable Alternate: Emergency vehicle and personnel access as proposed by the project architect is acceptable for providing fire suppression and protection of life and property.	
5. Fire Hydrants: Number and spacing does not meet CFC requirements.	
5a. Acceptable Alternate: Number of fire hydrants and spacing as proposed by the project architect is acceptable for fire suppression and protection of life and property.	
6. Fire Hydrants: Water flow and pressure are less than CFC minimum.	
6a. Acceptable Alternate: The available flow and pressure is acceptable for providing fire suppression and protection of life and property.	
7. Location of fire department connection(s) serving fire sprinkler systems or standpipe systems does not meet CFC requirements.	
7a. Acceptable Alternate: The location of fire department connection serving the fire sprinkler system and/or standpipe system is acceptable for providing fire suppression and protection of life and property.	

School District Acceptance of Acceptable Design Alternates

By signing this form, the school district acknowledges and accepts the proposed design as an alternative to California Building Code (CBC) and California Fire Code (CFC) minimum requirements, as indicated by one or more of the conditions indicated at items 4a, 5a, 6a or 7a, for providing fire and life safety protection of life and property.

Accepted by: _____ Title: _____
Signature: _____ Date: _____

LOCAL FIRE AUTHORITY (LFA) INFORMATION	
LFA Agency Name:	
LFA Review Official:	
Title:	Work Phone:
Work Email:	

LFA Reviewer's Signature: _____ Date: _____

DSA 810



210 W. Elm Street, Lodi, CA 95240
209-333-6739
Fire@Lodi.gov

October 13, 2023

Fire Hydrant Readings for Millswood Middle School, 233 N. Mills Ave., Lodi, CA 95240.

Eastern Hydrant
60# static
52# residual
42# flow with approximately 1100 GPM

Western Hydrant
60# static
54# residual
45# flow with approximately 1130 GPM

*NOTE: # = PSI

Brad Doell,
Battalion Chief/Fire Marshal
City of Lodi Fire Department
210 W. Elm St. Lodi, CA 95240
209.333.6739
bdoell@loji.gov



AGENCY APPROVAL DSA# 02-121945 02-121945 09-50

IDENTIFICATION STAMP		
DIV. OF THE STATE ARCHITECT		
APP: 02-121945 INC:		
SS <input checked="" type="checkbox"/>	FLS <input checked="" type="checkbox"/>	ACS <input checked="" type="checkbox"/>
REVIEWED FOR		
DATE: 12/12/2023		



1715 R STREET, SUITE 200
SACRAMENTO, CA 95811
TEL (916) 786-8178

CONSULTANTS

CIVIL ENGINEER
Warren Consulting Engineers, Inc.
1117 Windfield Way, Suite 110
El Dorado Hills, CA 95762
TEL (916) 985-1870

ELECTRICAL ENGINEER
The Engineering Enterprise
1125 High Street
Auburn, CA 95603
TEL (530) 886-8556

PROFESSIONAL STAMP



REVISIONS

NO.	DATE	DESCRIPTION
1		
2		
3		
4		
5		
6		
7		
8		
9		
10		

THE ARCHITECT DOES NOT REPRESENT THAT THESE PLANS OR THE SPECIFICATIONS ARE SUITABLE FOR ANY SITE OTHER THAN THE ONE FOR WHICH THEY WERE SPECIFICALLY PREPARED. THE ARCHITECT DISCLAIMS RESPONSIBILITY FOR THESE PLANS AND SPECIFICATIONS IF THEY ARE USED IN WHOLE OR IN PART AT ANY OTHER SITE. WRITTEN DIMENSIONS ON THESE DRAWINGS SHALL HAVE PRECEDENCE OVER SCALED DIMENSIONS.

PROJECT OWNER & TITLE

LODI UNIFIED SCHOOL DISTRICT
1305 E. Vine St
Lodi, CA 95240

MILLSWOOD MIDDLE SCHOOL PORTABLES RELOCATION

233 N Mills Ave
Lodi, CA 95242

SHEET TITLE

FIRE AUTHORITY SITE PLAN

DRAWN BY: CV, BI JOB NUMBER: 23219

SHEET NO.

G-002

DATE: DECEMBER 12, 2023

G-002 FIRE FLOW TEST

CONSTRUCTION DOCUMENTS

ABBREVIATIONS


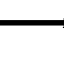

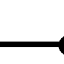
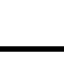
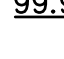
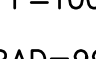

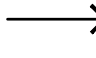






NOTE: NOT ALL ABBREVIATIONS
MAY BE USED ON THESE PLANS.

AB	AGGREGATE BASE
AC	ASPHALTIC CONCRETE
AD	AREA DRAIN
APN	ASSESSOR'S PARCEL NUMBER
ASB	AIR RELEASE VALVE
ASV	AGGREGATE SUB-BASE
BB	BLOW-OFF VALVE
BV	BUTTERFLY VALVE
BW	BACK OF WALK
C/L	CENTERLINE
CB	CATCH BASIN
CL	CLASS
CMP	CORRUGATED METAL PIPE
CATV	CABLE TELEVISION
CO	CLEANOUT
COMM	COMMUNICATION
CONC.	CONCRETE
CONST.	CONSTRUCT
CR	CURB RETURN
CS	CONCRETE SURFACE
DC	DOUBLE CHECK VALVE
DDC	DOUBLE DETECTOR CHECK VALVE
DG	DECOMPOSED GRANITE
DI	DROP INLET
DIA	DIAMETER
DIP	DUCTILE IRON PIPE
DWG	DRAWING
DS	DOWNSPOUT
E	ELECTRIC
EP	EDGE OF PAVEMENT
ESMT	EASEMENT
EX	EXISTING
FS	FIRE SERVICE LINE
FB	FIRE DEPARTMENT CONNECTION
FL	FLOWLINE
FM	SANITARY SEWER FORCE MAIN
FF	FINISHED FLOOR ELEVATION
FH	FIRE HYDRANT
G	GAS
GR	GRATE ELEVATION
GRD	GRADE ELEVATION
GV	GATE VALVE
HB	HOSE BIBB
HBD	HEADER BOARD
HMBE	HIGH POINT POLYETHYLENE PIPE
HP	HIGH POINT
INV	PIPE INVERT ELEVATION
JUP	JOINT UTILITY POLE
LF	LINEAL FEET
LIP	LIP OF GUTTER
LT	LEFT
MS	MOWSTRIP
NTS	NOT TO SCALE
OH	OVERHEAD
PCC	PORTLAND CEMENT CONCRETE
PD	PLANTER DRAIN
PI	POST INDICATOR VALVE
P/L	PROPERTY LINE
PP	POWER POLE
PUE	PUBLIC UTILITY EASEMENT
PVC	POLYVINYL CHLORIDE
RCP	REINFORCED CONCRETE PIPE
R	RADIUS
RM	MANHOLE RIM ELEVATION (SOLID COVER)
RR	REDUCED PRESSURE BACKFLOW PREVENTER
RT	RIGHT OF WAY
SO	SCHEDULE
SD	STORM DRAIN
SDMH	STORM DRAIN MANHOLE
SS	SUBGRADE ELEVATION
SS	SANITARY SEWER
SSMH	SANITARY SEWER MANHOLE
STD	STANDARD
S/W	SIDEWALK
T	TELEPHONE
TC	TOP OF CURB
TD	TRENCH DRAIN
TCDB	TRENCH DRAIN CATCH BASIN
TP	TELEPHONE POLE
TR	TOP OF RETAINING WALL
TSW	TOP OF SEAT WALL
TW	TOP OF WALK ELEVATION
U	UTILITY
UG	UNDERGROUND
UON	UNLESS OTHERWISE NOTED
VCP	VITRIFIED CLAY PIPE
W	WATER
W	WITH
W/O	WITHOUT
WV	WATER VALVE


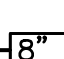
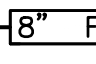
LEGEND

NOTE: NOT ALL SYMBOLS MAY BE USED ON THESE PLANS.
















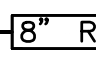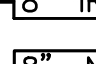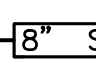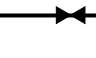


PROPOSED GRADING & DRAINAGE SYMBOLS:

	STORM DRAIN LINE (SIZE AND FLOW SHOWN)
	STORM DRAIN MANHOLE (SDMH)
	CATCH BASIN (CB)
	DROP INLET (DI)
	AREA DRAIN (AD)
	PLANTER DRAIN (PD) OR FLOOR DRAIN (FD)
	STORM DRAIN CLEANOUT ELEVATION
	FINISHED FLOOR ELEVATION
	BUILDING PAD ELEVATION
	CONCRETE SIDEWALK
	GRADED DIRECTION FOR DRAINAGE FLOW
	SWALE
	SLOPE
	TREE TO BE REMOVED
	RETAINING WALL

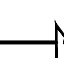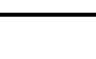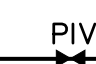PROPOSED SANITARY SEWER SYMBOLS:

	SANITARY SEWER LINE (SIZE AND FLOW SHOWN)
	SANITARY SEWER MANHOLE (SSMH)
	SEWER CLEANOUT FLUSHER BRANCH

PROPOSED WATER SYMBOLS:

	WATER LINE & SIZE
	FIRE LINE & SIZE
	DOMESTIC WATER LINE & SIZE
	RECLAIMED WATER LINE & SIZE
	IRRIGATION SERVICE LINE & SIZE
	NON POTABLE WATER LINE & SIZE
	FIRE SPRINKLER SERVICE LINE & SIZE
	GATE VALVE
	WATER METER
	FIRE HYDRANT ASSEMBLY
	FIRE DEPARTMENT CONNECTION
	DETECTOR CHECK VALVE
	DOUBLE DETECTOR CHECK VALVE
	REDUCED PRESSURE BACKFLOW PREVENTER
	BUTTERFLY VALVE
	AIR RELEASE VALVE & SIZE
	BLOW-OFF VALVE & SIZE
	POST INDICATOR VALVE

GENERAL NOTES:

- THE TYPES, LOCATIONS, SIZES, AND/OR DEPTHS OF EXISTING UNDERGROUND UTILITIES AS SHOWN ON THESE PLANS WERE OBTAINED FROM SOURCES OF VARYING RELIABILITY. THE CONTRACTOR IS CAUTIONED THAT ONLY ACTUAL EXCAVATION WILL REVEAL THE TYPES, EXTENT, SIZES, LOCATIONS AND DEPTHS OF SUCH UNDERGROUND UTILITIES. A REASONABLE EFFORT HAS BEEN MADE TO LOCATE AND DELINEATE ALL KNOWN UNDERGROUND UTILITIES. HOWEVER, WARREN CONSULTING ENGINEERS CAN ASSUME NO RESPONSIBILITY FOR THE COMPLETENESS OR ACCURACY OF ITS DELINEATION OF SUCH UNDERGROUND UTILITIES, NOR FOR THE EXISTENCE OF OTHER BURIED OBJECTS OR UTILITIES WHICH MAY BE ENCOUNTERED BUT WHICH ARE NOT SHOWN ON THESE PLANS. THE CONTRACTOR OR ANY SUBCONTRACTOR FOR THIS CONTRACT SHALL NOTIFY THE CITY OF UNIFORM STANDARD SPECIFICATIONS (A) TWO (2) WORKING DAYS IN ADVANCE OF PERFORMING ANY EXCAVATION WORK BY CALLING TOLL FREE 1-800-227-2600, OR 811.
2. WARREN CONSULTING ENGINEERS, INC. (WCE) ASSUMES NO RESPONSIBILITY FOR ERRORS IN PHYSICAL LOCATION OF IMPROVEMENTS, HORIZONTAL OR VERTICAL, IF STAKED BY OTHERS. IN ADDITION, ANY SUCH ERRORS IN PHYSICAL LOCATION MAY AFFECT THE INTENDED DESIGN OF SUCH IMPROVEMENTS AND WCE CANNOT BE HELD RESPONSIBLE FOR SUCH CONDITIONS WHICH ARE A RESULT OF ERRORS IN SURVEYING, OR IMPROPER CONSTRUCTION.
3. IF SUBSURFACE CULTURAL RESOURCES, REMAINS, AND/OR ARTIFACTS ARE UNCOVERED DURING PROJECT CONSTRUCTION, ALL WORK IN THE VICINITY SHALL BE STOPPED UNTIL SUCH ITEMS CAN BE ASSESSED BY AN APPROPRIATE MEMBER OF THE COUNTY ENVIRONMENTAL IMPACT SECTION STAFF.
4. CONTRACTOR AGREES THAT HE/SHE SHALL ASSUME SOLE AND COMPLETE RESPONSIBILITY FOR JOB SITE CONDITIONS DURING THE COURSE OF CONSTRUCTION OF THIS PROJECT, INCLUDING SAFETY OF ALL PERSONS AND PROPERTY. THAT THIS REQUIREMENT SHALL APPLY CONTINUOUSLY AND SHALL NOT BE LIMITED TO NORMAL WORKING HOURS; AND THAT THE CONTRACTOR SHALL DEFEND, INDEMNIFY AND HOLD THE OWNER AND ENGINEER HARMLESS FROM ANY AND ALL LIABILITY, REAL OR ALLEGED, IN CONNECTION WITH THE PERFORMANCE OF WORK ON THIS PROJECT, EXCEPTING FOR LIABILITY ARISING FROM THE SOLE NEGLIGENCE OF THE OWNER OR ENGINEER.
5. THE CONTRACTOR SHALL OBTAIN AN EXCAVATION PERMIT FROM THE STATE OF CALIFORNIA DEPARTMENT OF INDUSTRIAL SAFETY FOR ALL EXCAVATIONS OF 5 FEET OR MORE IN DEPTH.
6. IT SHALL BE THE CONTRACTOR'S RESPONSIBILITY TO MAKE ALL NECESSARY PRE-BID AND PRE-CONSTRUCTION SITE INSPECTION, AND/OR OBSERVATIONS ON THE SITE TO PRE-DETERMINE ALL HIS/HER MEANS AND METHODS NECESSARY TO COMPLETE THE IMPROVEMENTS SHOWN ON THESE PLANS AND PER THE PROJECT SPECIFICATIONS. IT IS THE CONTRACTORS RESPONSIBILITY TO DETERMINE, AND INCLUDE IN HIS/HER CONTRACT, ALL MEANS AND METHODS NECESSARY TO PERFORM A COMPLETE AND ACCEPTABLE JOB.
7. WHERE IMPROVEMENTS LIE WITHIN AN EXISTING DEVELOPED AREA, CONTRACTOR SHALL USE CAUTION WHEN ENTERING THE SITE TO AVOID EXISTING IMPROVEMENTS. IT IS THE CONTRACTORS RESPONSIBILITY TO PROTECT ANY SUCH EXISTING IMPROVEMENTS OUTSIDE THE PROJECT BOUNDARY, OR EXISTING IMPROVEMENTS WITHIN THE BOUNDARY WHICH ARE TO REMAIN. PROPER PRECAUTIONS SHALL BE PROVIDED AND MAINTAINED THROUGHOUT CONSTRUCTION. ANY DAMAGE SHALL BE REPAIRED OR REPLACED TO THE SATISFACTION OF THE OWNER.
8. IT IS THE RESPONSIBILITY OF THE CONTRACTOR TO KEEP DETAILED RECORDS OF MINOR CHANGES OR ADJUSTMENTS MADE DURING CONSTRUCTION (WHICH WERE NOT FORMALLY ISSUED). UPON PROJECT COMPLETION, THE CONTRACTOR AND/OR INFORMATION SHALL BE PROVIDED TO THE OWNER AND, WARREN CONSULTING ENGINEERS, INC. UNLESS AN OFFICIAL "AS-BUILT" SET OF PLANS IS A REQUIREMENT OF THE CONTRACT. IF AS-BUILT PLANS ARE A REQUIREMENT OF THE CONTRACT, REFER TO SPECIFICATIONS FOR AS-BUILT DELIVERABLE REQUIREMENTS.
9. IN VEHICULAR PATHWAYS, EXISTING ASPHALTIC AND/OR CONCRETE SURFACES SHALL BE CUT OUT TO A NEAT AND STRAIGHT LINE, PARALLEL OR PERPENDICULAR TO THE VEHICULAR TRAVELED PATH. THIS IS TYPICALLY THE ROADWAY CENTERLINE, BUT MAY VARY. THAT SAWCUT EDGE SHALL BE PROTECTED FROM DAMAGE DURING CONSTRUCTION SO A CLEAN EDGE REMAINS FOR PATCH BACK. IF EDGE IS DAMAGED, A NEW SAW CUT WILL BE REQUIRED. THE EXPOSED EDGE SHALL BE "TACKED" WITH EMULSION PRIOR TO PAVING.
10. NO BURNING OR BLASTING SHALL BE ALLOWED ONSITE UNLESS SPECIFICALLY ADDRESSED ON PLANS, OR SPECIFICALLY APPROVED AND COORDINATED WITH THE ARCHITECT, ENGINEER, AND LOCAL AGENCY OR OTHER ADMINISTRATIVE AUTHORITY.
11. SUBGRADE AND RESULTING FINISHED GRADE SHALL BE CONSTRUCTED SMOOTH AND UNIFORM BETWEEN SPOT ELEVATIONS. CONSTRUCTION OF EITHER SPOT ELEVATIONS SHOWN ON PLANS OR OTHER PLANS, NO MOUNDS, RUTS, DEPRESSIONS OR OTHER GRADING DEFICIENCIES WILL BE ALLOWED UNLESS SPECIFICALLY SHOWN ON PLANS.
12. ON NEW WATER SYSTEMS, SERVICE LATERALS SHALL BE MADE USING APPROPRIATE "TEE" AND "WYE" FITTINGS. SADDLE TAPS WILL ONLY BE ALLOWED WHEN MAKING CONNECTIONS TO EXISTING WATER MAINS.
13. CURING COMPOUND SHALL BE APPLIED IN A CONTINUOUS SOLID WET FLOWING COAT. ANY "SPOTTY" APPLIED APPLICATIONS SHALL BE RECOATED IMMEDIATELY. APPLICATION SHALL BE INSPECTED BY PROJECT INSPECTOR DURING APPLICATION.
14. EMBEDMENT OF FEATURES IN CONCRETE PAVING, CURBS, OR WALLS, SUCH AS SQUARE OR ROUND TUBING, POSTS, OR COLUMNS, STEEL BOLTED PLATES, OR OTHER STRUCTURES, SHALL REQUIRE ADDITIONAL SCORE OR EXPANSION JOINTS TO PREVENT UNCONTROLLED CRACKING. THOSE ADDITIONAL JOINTS MAY OR MAY NOT BE SPECIFICALLY SHOWN ON PLANS BUT SHALL BE PROVIDED BY THE CONTRACTOR.
15. EMBEDMENT OF FEATURES IN CONCRETE PAVING, CURBS, OR WALLS, SUCH AS SQUARE OR ROUND TUBING, POSTS, OR COLUMNS, STEEL BOLTED PLATES, OR OTHER STRUCTURES, SHALL REQUIRE A MINOR ADJUSTMENT OF REBAR WITHIN CONCRETE TO ALLOW FOR SUCH STRUCTURE. THAT REBAR ADJUSTMENT MAY NOT BE SPECIFICALLY SHOWN ON PLANS.
16. NO MORE THAN 1 GALLON OF WATER PER YARD OF CONCRETE CAN BE ADDED TO THE TRUCK AFTER ARRIVAL TO PROJECT SITE. THE ADDITION OF WATER CAN ONLY BE ADDED UNDER THE SUPERVISION OF THE CONCRETE INSPECTOR OR LABORATORY TECHNICIAN.
17. WHEN PUMPING CONCRETE FOR PLACEMENT, ABSOLUTELY NO WATER IS TO BE ADDED TO PUMP HOPPER. ANY WATER ADDED TO HOPPER WILL BE REASON FOR CONCRETE REJECTION AT THE CONTRACTORS EXPENSE.
18. ALL CONSTRUCTION/CONSTRUCTION JOINTS "CJ" SHALL BE 1/4" THE SLAB THICKNESS DEEP, BUT NO LESS THAN 1" FOR CONTROLLING OF CRACKING. CONTRACTOR SHALL EXERCISE CAUTION WHEN FINAL TROWELING OF CONCRETE SO AS NOT TO FILL IN THESE JOINTS WITH CONCRETE CREAM. ANY CRACKS OUTSIDE OF JOINTS WHICH WERE CONSTRUCTED LESS THAN 1" DEEP, SHALL BE CAUSE FOR CONCRETE SLAB(S) TO BE REMOVED AND REPLACE AT CONTRACTORS EXPENSE.
19. ANY SCREED BOARDS SET WITHIN CONCRETE SLABS SHALL BE AN "OVERHEAD SCREED" SO THERE IS NO INTERFERENCE WITH THE PLACEMENT AND ALIGNMENT OF SLAB REINFORCING.
20. 3-1/2" FELT JOINTS WILL NOT BE ACCEPTED. PROVIDE A FULL 4" FELT JOINT FOR 4" SLAB CONSTRUCTION, AND A 6" FELT JOINT FOR A 6" SLAB CONSTRUCTION.
21. SHOULD ANY SHRINKAGE CRACKS OCCUR OUTSIDE OF EITHER THE EXPANSION JOINTS OR CRACK CONTROL JOINTS, THEN THE CONCRETE SLAB SHALL BE SAWCUT AT THE NEAREST JOINTS ON EACH SIDE OF THE CRACK AND THE CONCRETE SECTION SHALL BE, REMOVED AND REPLACED. NEW CONCRETE SHALL BE DOWELED INTO EXISTING CONCRETE PER DRAWING DETAIL.
22. ALL AREAS DISTURBED BY GRADING OPERATIONS WHETHER SHOWN ON THE DRAWINGS OR NOT SHALL BE HYDRO SEEDDED UNLESS OTHERWISE NOTED. HYDRO SEEDING SHALL CONFORM TO LOCAL CITY/COUNTY STANDARDS.
23. REPAIR OR PATCHING OF GALVANIZED METALS, SUCH AS AFTER FLOWING GALVANIZED COMPONENTS, SHALL BE MADE USING A ZINC COMPOSITION "HOT STICK" APPLICATION PER ASTM A 780-01. GALVANIZING PAINTS WILL NOT BE ALLOWED.
- 811**
Know what's below.
Call before you dig.

GENERAL PAVING SURFACE NOTES:

1. PROVIDE EQUIVALENT OF MEDIUM BROOM FINISH AT SLOPES UP TO 5.99%, TYPICAL. PROVIDE EQUIVALENT OF HEAVY BROOM FINISH AT SLOPES 6% AND GREATER. REFER TO SPECIFICATIONS.
2. ALL NEW PEDESTRIAN WALKWAYS (NON-RAMP) SHALL BE SLOPED NO GREATER THAN 2.0% AND NO LESS THAN 0.75% IN ANY DIRECTION, UNLESS SPECIFICALLY LABELED OTHERWISE. ALL CONCRETE SHALL MEET THE FOLLOWING SLOPE REQUIREMENTS:
 - NO GREATER THAN 5% SLOPE IN THE DIRECTION OF TRAVEL.
 - NO GREATER THAN 2% SLOPE CROSSING THE DIRECTION OF TRAVEL.
 - NO GREATER THAN 2% SLOPE IN ANY DIRECTION IN COURTYARD OR PLAZA AREAS.

SHEET INDEX

C0.0	GENERAL NOTES AND ABBREVIATIONS
C0.1	TOPOGRAPHIC SURVEY
C1.1	DEMOLITION PLAN
C2.1	GRADING, PAVING AND DRAINAGE PLAN

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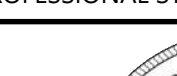
ELECTRICAL ENGINEER
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
WC

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PROFESSIONAL STAMP



ANTHONY J. TASSANO
NO. C74696
STATE OF CALIFORNIA

REVISIONS		
	NO.	DESCRIPTION
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-		

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PROJECT OWNER & TITLE
LODI UNIFIED SCHOOL DISTRICT
1305 E. Vine St
Lodi, CA 95240

**MILLSWOOD MIDDLE SCHOOL
PORTABLES RELOCATION**
233 N Mills Ave
Lodi, CA 95242

SHEET TITLE

GENERAL NOTES
AND
ABBREVIATIONS

DRAWN BY: GV JOB NUMBER: 23219

SHEET NO.

C0.0

DATE: DECEMBER 5, 2023

EXISTING TOPOGRAPHY

- PROPERTY LINE
- CENTERLINE
- EASEMENT
- PROPERTY CORNER FOUND AS NOTED
- PROPERTY CORNER NOTHING FOUND OR SET
- TEMPORARY BENCHMARK (SEE TBM LIST FOR INFO)
- SWALE OR DRAINAGE FLOW
- DRAINAGE FLOW
- FENCE (TYPE NOTED)
- TREE (SIZE/TYPE INDICATED)
- SLOPE
- CONTOUR
- CONCRETE SURFACE
- EDGE OF ASPHALT
- EDGE OF BUILDING
- SIGN
- POST OR BOLLARD
- GROUND ELEVATION
- HARD SURFACE ELEVATION

EXISTING UTILITIES

- STORM DRAIN LINE (SIZE + DIRECTION OF FLOW)
- STORM DRAIN LINE (RECORD INFORMATION)
- STORM DRAIN LINE (UNDERGROUND LOCATING)
- STORM DRAIN MANHOLE
- DROP INLET
- AREA DRAIN
- RAIN WATER LEADER
- DOWNSPOUT
- SANITARY SEWER LINE (SIZE + DIRECTION OF FLOW)
- SANITARY SEWER LINE (RECORD INFORMATION)
- SANITARY SEWER LINE (UNDERGROUND LOCATING)
- SANITARY SEWER MANHOLE
- SANITARY SEWER CLEANOUT
- WATER LINE (SIZE INDICATED)
- WATER LINE (RECORD INFORMATION)
- WATER LINE (UNDERGROUND LOCATING)
- WATER MANHOLE
- WATER VALVE
- WATER METER
- WATER BOX
- IRRIGATION CONTROL VALVE
- FIRE HYDRANT
- BACKFLOW PREVENTER
- SPRINKLER
- HOSE BIBB
- OVERHEAD ELECTRIC LINE
- UNDERGROUND ELECTRIC LINE
- UNDERGROUND ELECTRIC LINE (RECORD INFORMATION)
- UNDERGROUND ELECTRIC LINE (UNDERGROUND LOCATING)
- ELECTRIC MANHOLE
- UTILITY POLE (WITH GUY WIRE)
- ELECTRIC METER
- ELECTRIC BOX
- STREET LIGHTING BOX
- LIGHT STANDARD
- SIGNAL LIGHT
- FLOOD LIGHT
- ELECTRICAL OUTLET
- GAS LINE (SIZE INDICATED)
- GAS LINE (RECORD INFORMATION)
- GAS LINE (UNDERGROUND LOCATING)
- GAS MANHOLE
- GAS VALVE
- GAS METER
- TELEPHONE LINE
- TELEPHONE LINE (RECORD INFORMATION)
- TELEPHONE LINE (UNDERGROUND LOCATING)
- STORM DRAIN BOX
- TRAFFIC SIGNAL BOX

ABBREVIATIONS

- NOTE: NOT ALL ABBREVIATIONS MAY BE USED ON THESE PLANS.
- | | | | | | | | |
|-------|-------------------------|------|----------------------------|------|-------------------------|-------|-------------------------|
| ?? | UNKNOWN | DF | DRINKING FOUNTAIN | INV | PIPE INVERT ELEVATION | SIG | SIGNAL |
| AC | ACCESSIBLE | DG | DECOMPOSED GRANITE | IRR | IRRIGATION | SL | STREET LIGHT |
| ACU | AIR CONDITIONING UNIT | DI | DROP INLET | JP | JOINT UTILITY POLE | SLB | STREET LIGHT BOX |
| AD | AREA DRAIN | DRWY | DRIVEWAY | JT | JOINT TRENCH | SS | SANITARY SEWER CLEANOUT |
| ADN | ASSESSORS PARCEL NUMBER | DS | DOWNGROUT | LNDG | LANDING | SSCO | SANITARY SEWER MANHOLE |
| ARV | AIR RELEASE VALVE | DWG | DRAWING | LVE | LOW VOLTAGE ELECTRIC | STL | STREET LIGHT |
| BSHLL | BASKETBALL POLE | E | ELECTRIC | M | METAL | T | TELEPHONE |
| BCM | BRASS CAP MONUMENT | EP | EDGE OF PAVEMENT | MH | MANHOLE | TD | TOP OF CURB |
| BFP | BACK FLOW PREVENTER | ESMT | EASEMENT | NSC | NOT TO SCALE | TD | TRENCH DRAIN |
| BL | BLOCK | FA | FIRE ALARM | OH | OVERHEAD | TP | TELEPHONE POLE |
| BLDG | BUILDING | FDC | FIRE DEPARTMENT CONNECTION | OIP | OPEN IRON PIPE | TRW | TOP OF RETAINING WALL |
| BOL | BOLLARD | FFC | FINISHED FLOOR ELEVATION | PA | PLANTER AREA | US | UNDERGROUND |
| BOV | BLOW-OFF VALVE | FH | FIRE HYDRANT | PH | POSTHOLE | UNK | UNKNOWN |
| BR | BRICK | FL | FLOWLINE | PIV | POST INDICATOR VALVE | UN | UNLESS OTHERWISE NOTED |
| DWF | DARDED WIRE FENCE | FD | FIBER OPTIC | PAL | PROPERTY LINE | VBALL | VOLLEYBALL |
| G | GRATE | FS | FIRE SERVICE | PP | POWER POLE | W | WATER |
| GR | GRASS | GB | GRACE DRAIN | PR | PER RECORD INFORMATION | WD | WOOD |
| CATV | CABLE TELEVISION | GRB | GROUND ROD BOX | PRI | PUBLIC UTILITY EASEMENT | WF | WOOD FENCE |
| CIP | CAPPED IRON PIPE | GRD | GROUND ROD | PVC | POLYVINYL CHLORIDE | WIF | WROUGHT IRON FENCE |
| CLF | CHAIN LINK FENCE | GV | GAS VALVE | R | RUBBER | XP | TRANSFORMER |
| CAP | CAP | HB | HOSE BIBB BOX | RIM | MANHOLE RIM ELEVATION | XWALK | CROSSWALK |
| CO | CORRUGATED METAL PIPE | HBO | HEADER BOARD | ROW | RIGHT OF WAY | YD | YARD DRAIN |
| COL | COLUMN | HP | HIGH PRESSURE | RW | RETAINING WALL | | |
| COND | CONDENSATE | HVE | HIGH VOLTAGE ELECTRIC | RWL | RAIN WATER LEADER | | |
| CPS | CONTROL POINT FOUND | IC | IRIGATION CONTROL PANEL | SB | SIGNAL BOX | | |
| CS | CONCRETE SURFACE | ICV | IRIGATION CONTROL VALVE | SD | STORM DRAIN | | |
| | | | | SDMH | STORM DRAIN MANHOLE | | |

TBM LIST

NUMBER	DESCRIPTION	NORTHING	EASTING	ELEVATION
1	CPS CHISELED "S"	10000.46	9999.72	43.81
2	CPS CHISELED "S"	9999.25	10487.64	43.44
4	CPS CHISELED "S"	10033.81	9987.87	43.82
5	CPS CHISELED "S"	10332.85	9983.94	43.80
6	CPS CHISELED "S"	10432.80	9984.20	43.70
7	CPS CHISELED "S"	9999.11	10494.45	43.74

BASIS OF BEARINGS:


ASSUMED

FEMA INFORMATION:


THE SUBJECT PROPERTY IS LOCATED IN "ZONE X" (SHADED) -- AREAS OF 0.2% ANNUAL CHANCE FLOOD. AREAS OF 1% ANNUAL CHANCE FLOOD WITH AVERAGE DEPTHS OF LESS THAN 1 FOOT OR WITH DRAINAGE AREAS LESS THAN 1 SQUARE MILE. AND AREAS PROTECTED BY LEVEES FROM 1% ANNUAL CHANCE FLOOD. PER FLOOD INSURANCE RATE MAP 06077C008F DATED OCTOBER 16, 2009.

NOTE:

EXISTING UTILITIES BASED ON VISIBLE SURFACE STRUCTURES AND RECORD INFORMATION.

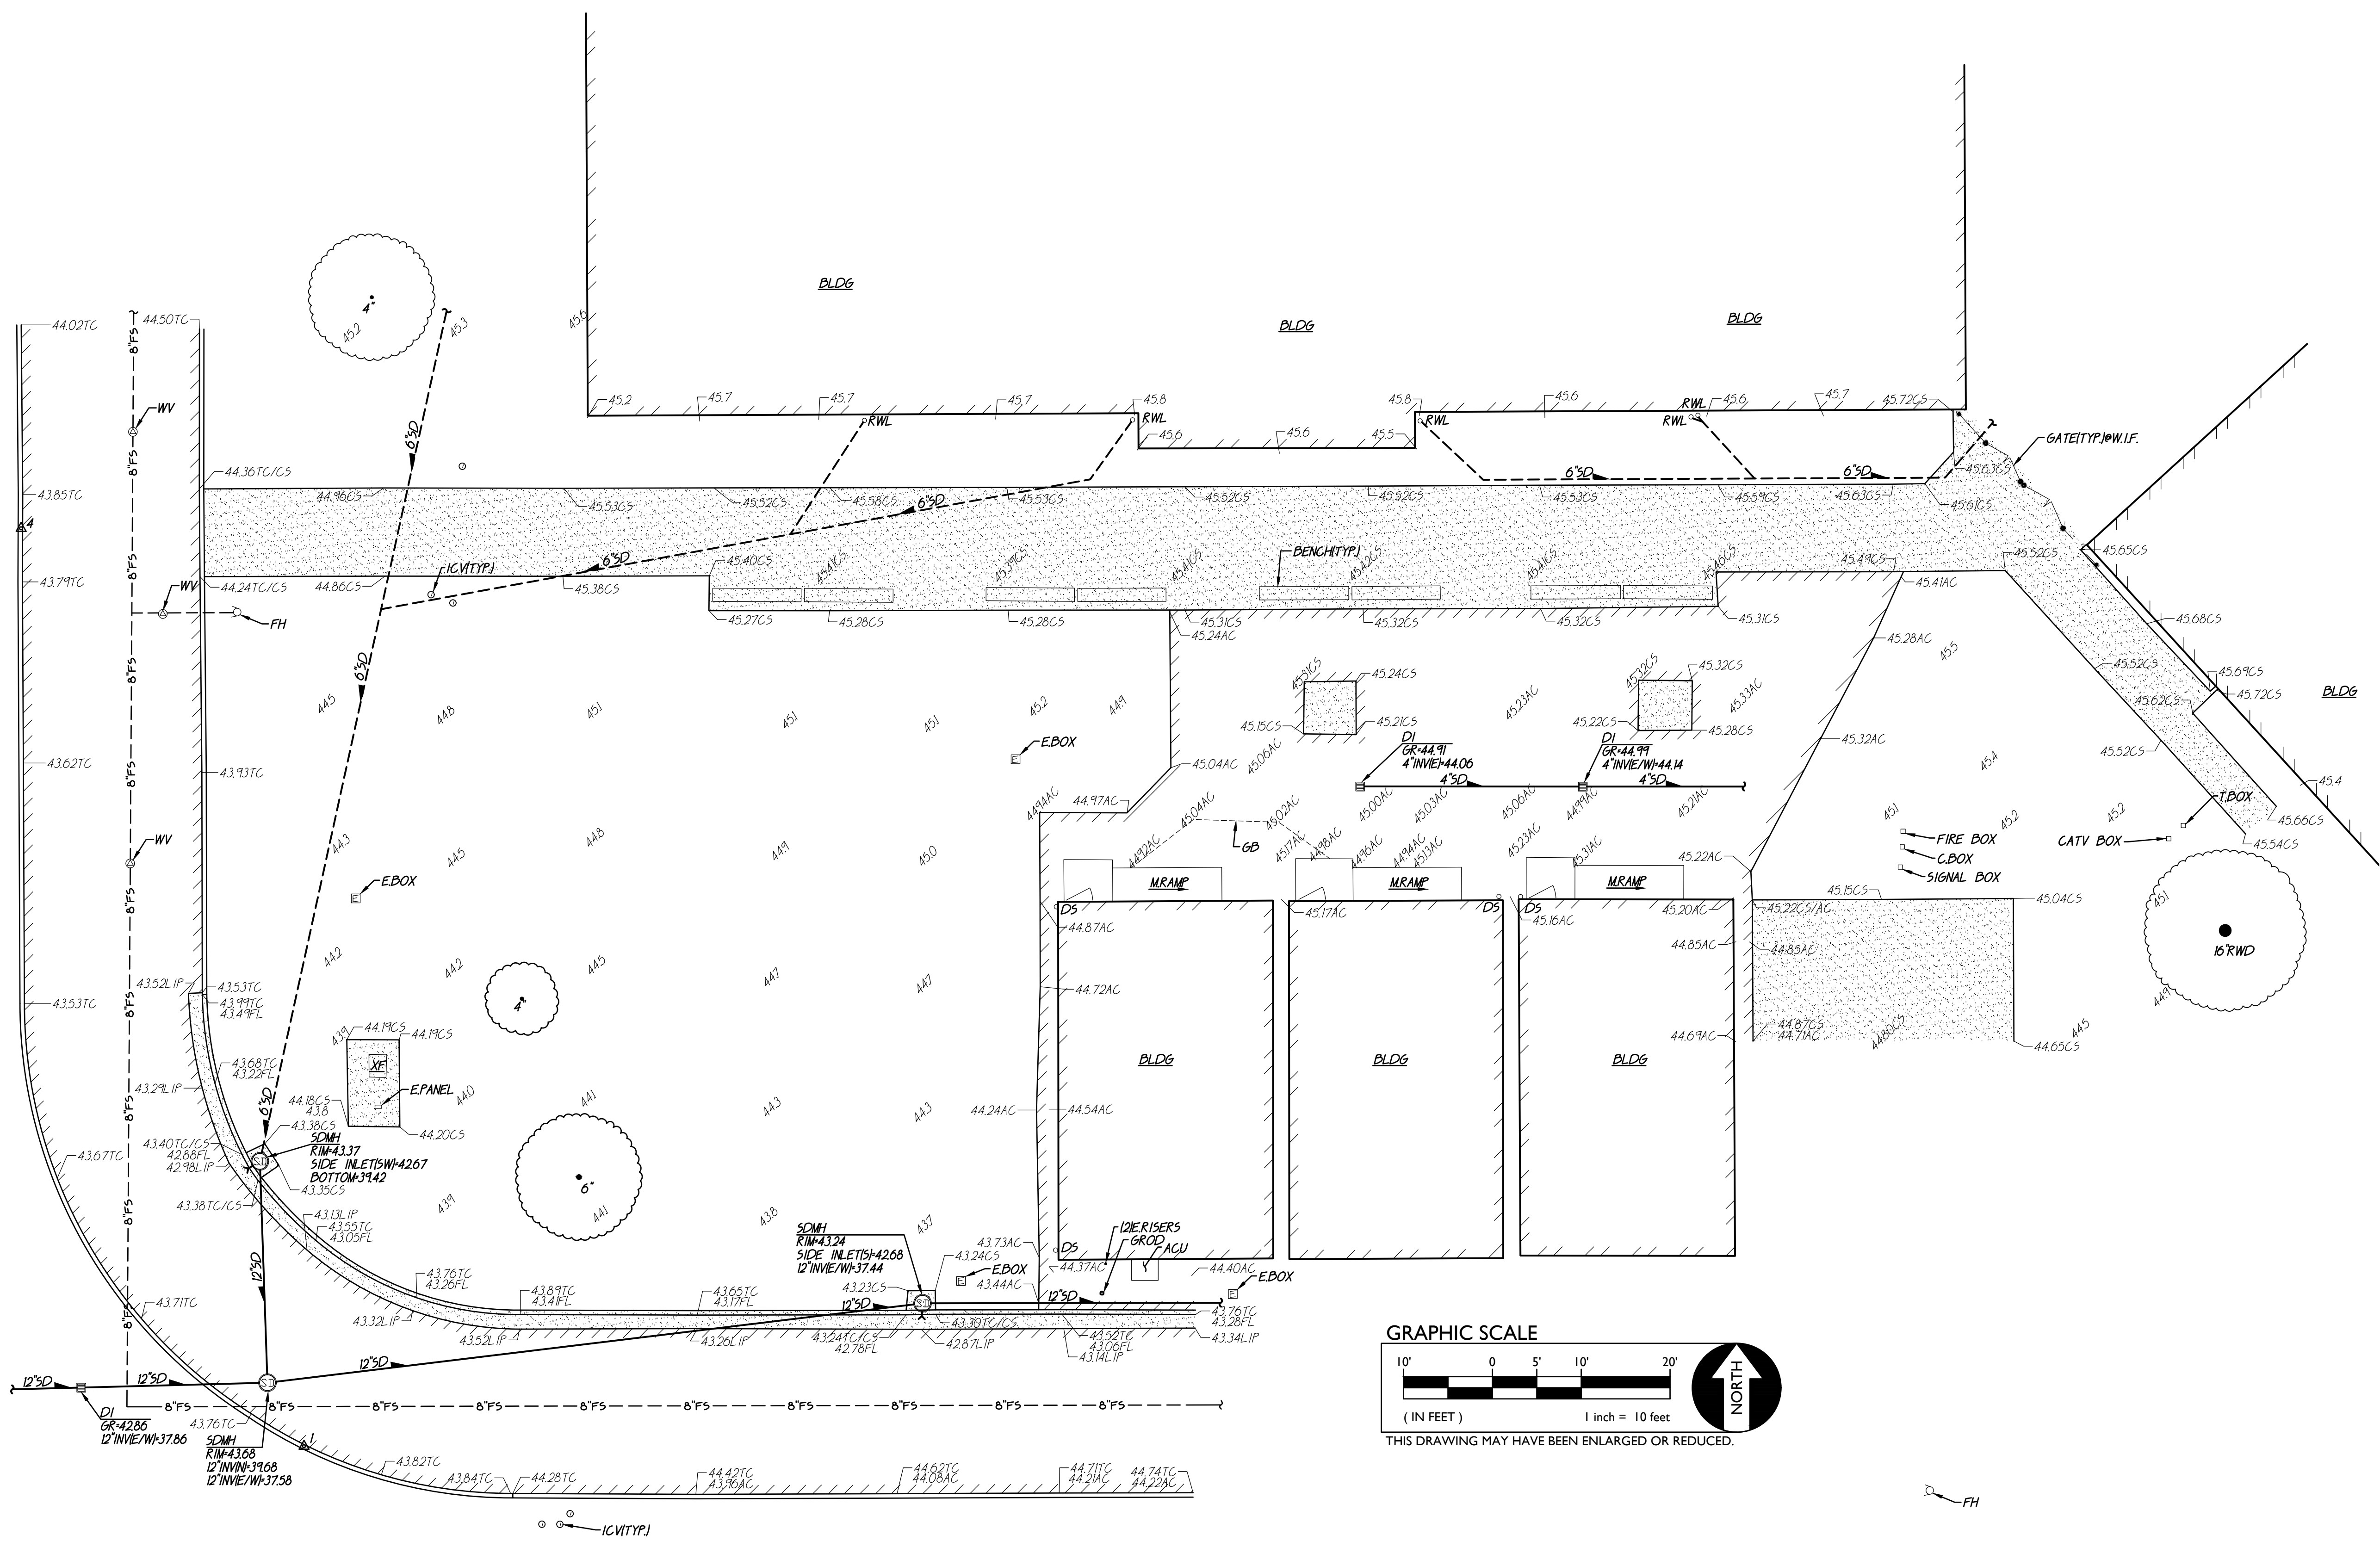


GRAPHIC SCALE

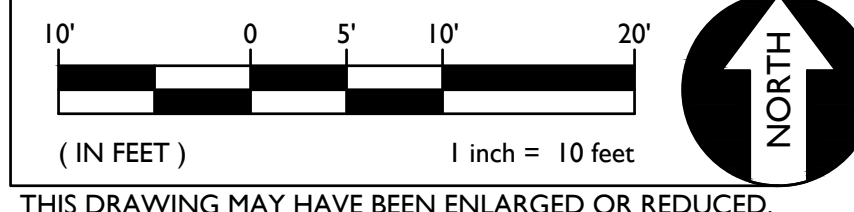

THIS DRAWING MAY HAVE BEEN ENLARGED OR REDUCED.

A.P.N.	029-400-040
BENCHMARK NO.	BM 1207 ELEV. 43.328
SOUTHWEST CORNER ELM ST. + MILLS AVE. 10.2' W/ CL OF CURB RETURN ON ELM ST. 0.5' BEHIND BOC	

AGENCY APPROVAL DSA# 02-121945

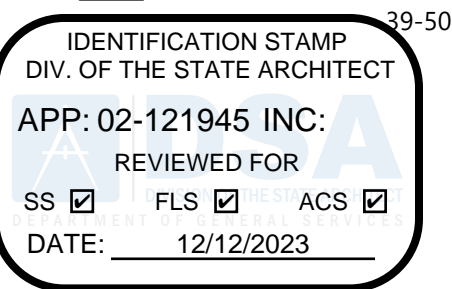

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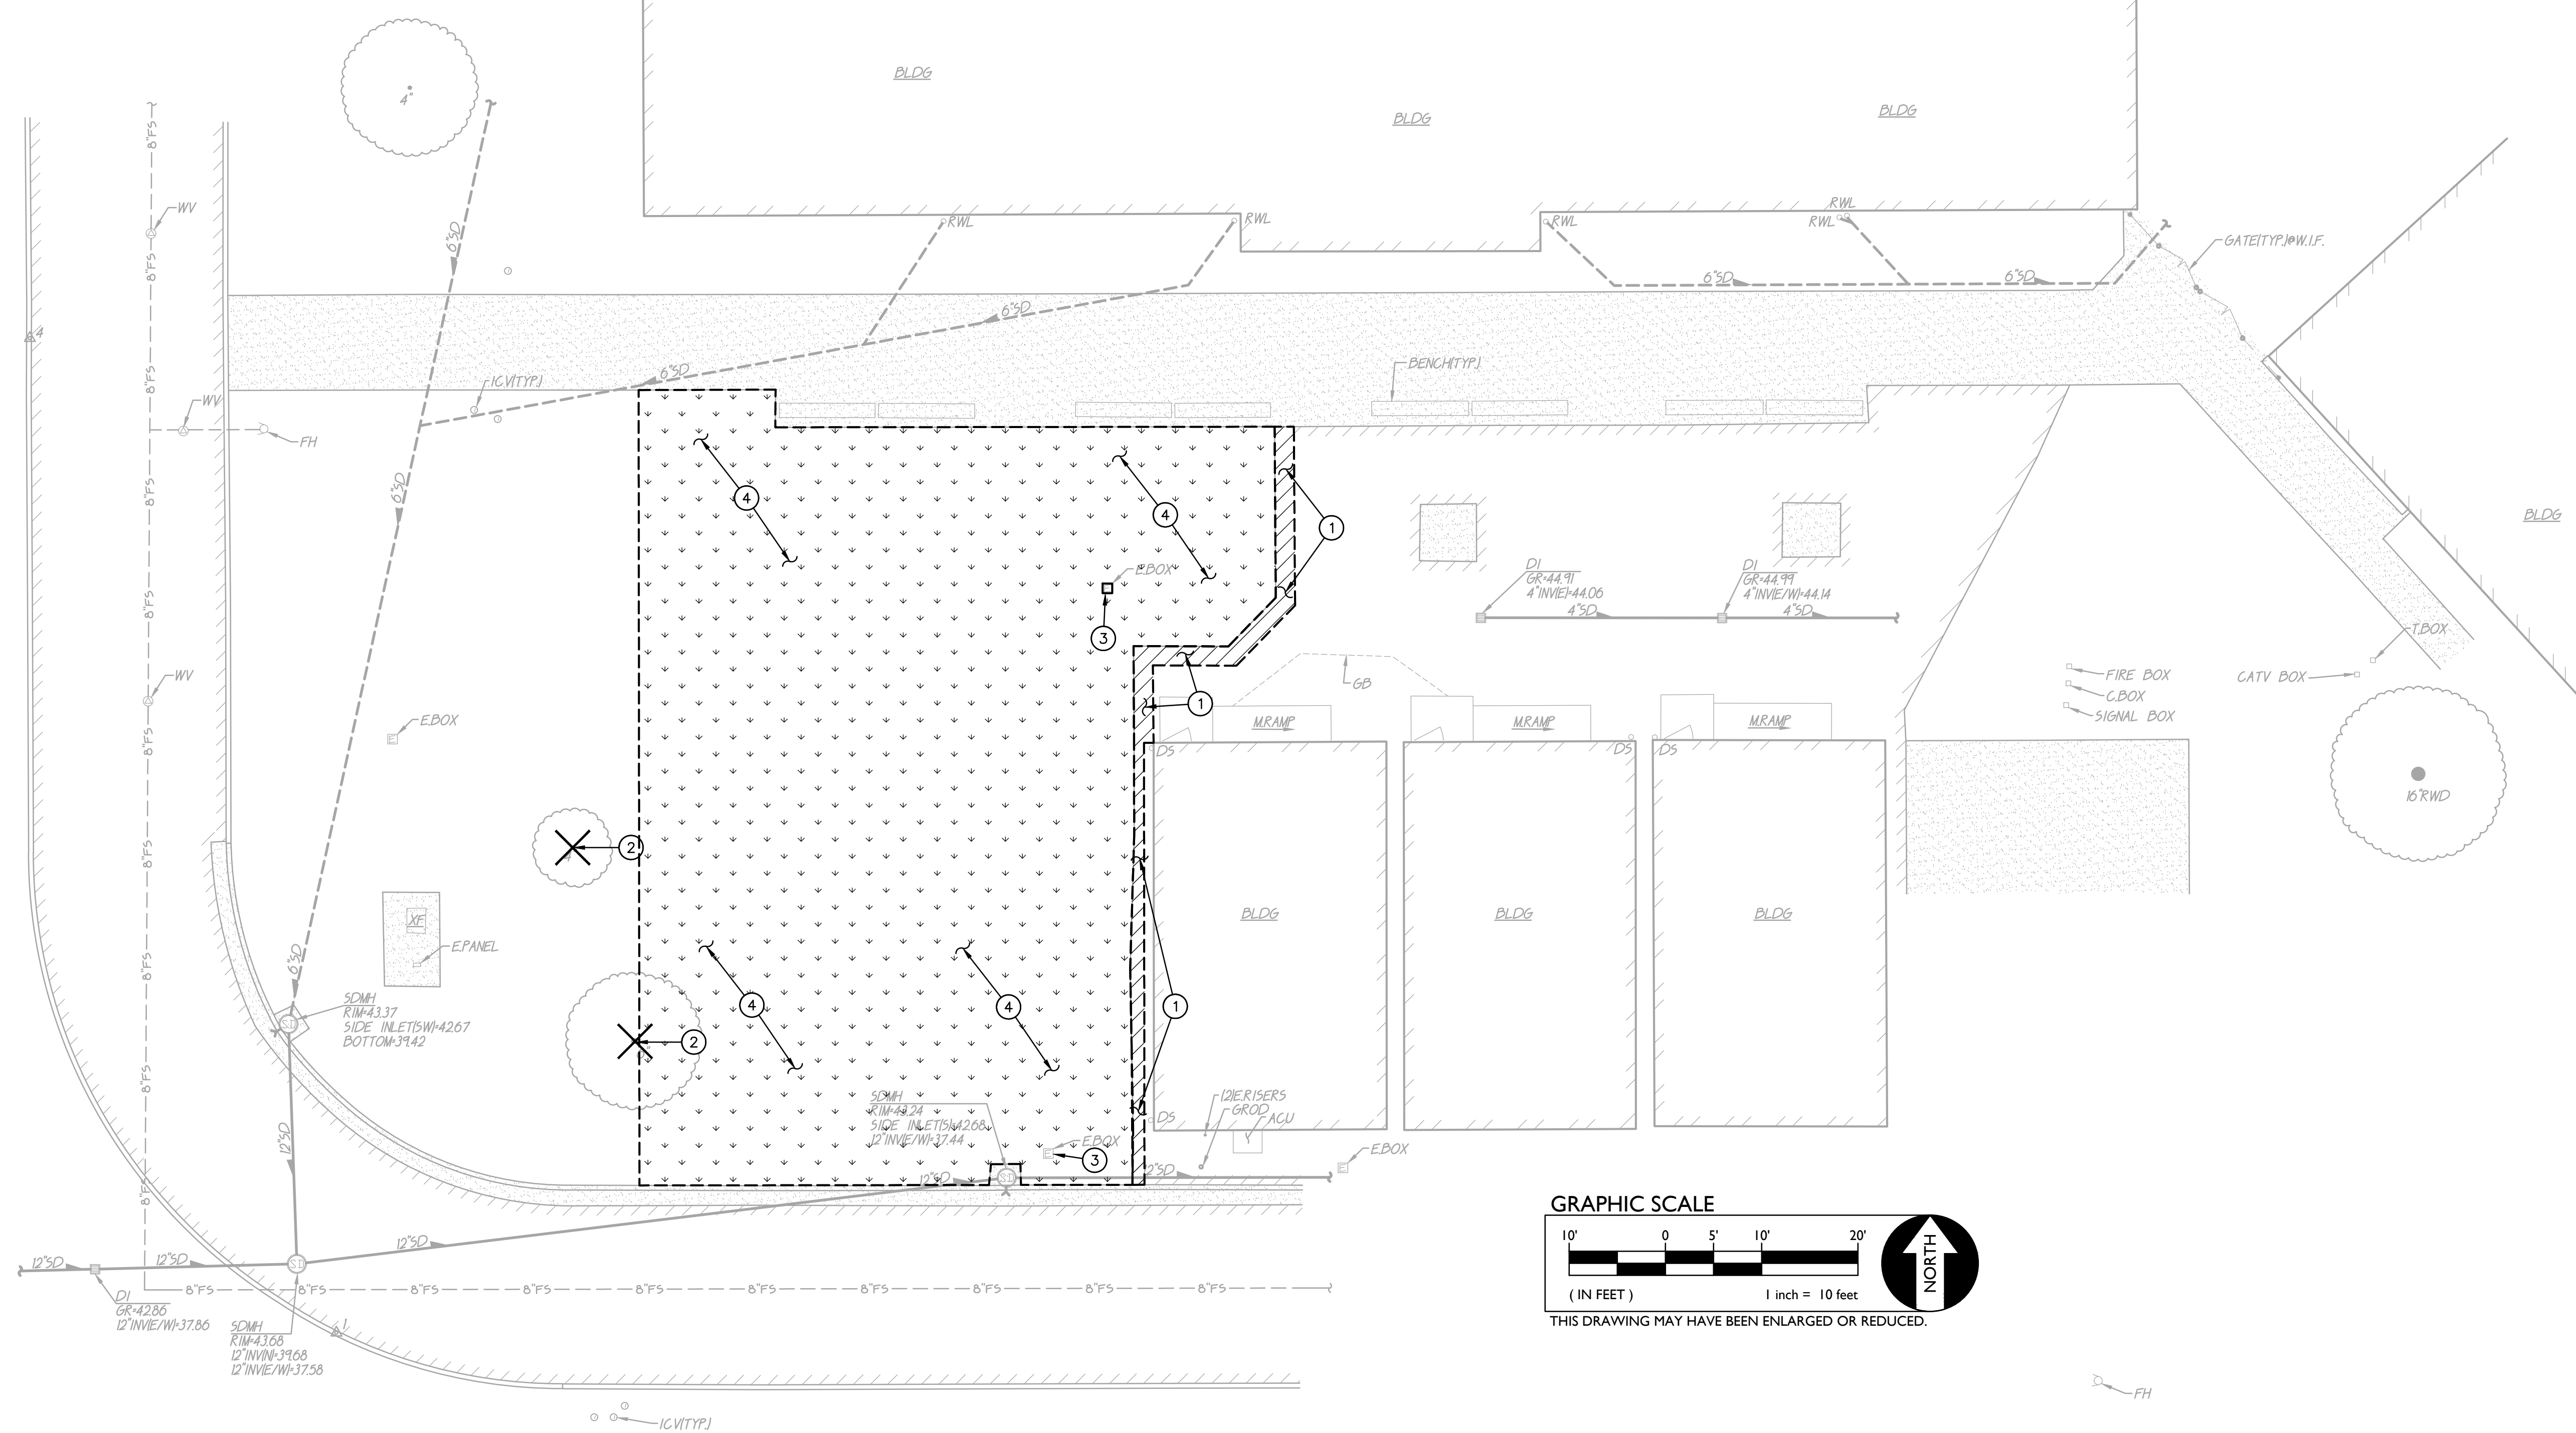
SHEET TITLE
TOPOGRAPHIC
SURVEY


DRAWN BY: GV JOB NUMBER: 23219

SHEET NO.

C0.1

DATE: DECEMBER 5, 2023




-  **DEMOLITION NOTES**

 1. SAWCUT, REMOVE AND DISPOSE OF EXISTING ASPHALT PAVING AND ASSOCIATED AGGREGATE BASE.
 2. REMOVE AND DISPOSE OF EXISTING TREE/STUMP, TRUNK AND ROOTS.
 3. EXISTING ELECTRICAL BOX TO REMAIN AND BE PROTECTED.
 4. REMOVE AND DISPOSE OF TURF/VEGETATION AS REQUIRED TO ALLOW FOR PROPOSED CONSTRUCTION. IRRIGATION DRAINAGE AND SPRINKLER HEADS IN CONFLICT WITH PROPOSED CONSTRUCTION SHALL BE REMOVED.

DEMOLITION GENERAL NOTES

1. IN THE EVENT THAT ANY UNUSUAL CONDITIONS NOT COVERED BY THE GEOTECHNICAL INVESTIGATION REPORT ARE ENCOUNTERED DURING GRADING OPERATIONS, THE GEOTECHNICAL ENGINEER AND THE ENGINEER SHALL BE IMMEDIATELY NOTIFIED FOR DIRECTIONS.
2. NO BURNING OR BLASTING SHALL BE PERMITTED.
3. ADDITIONAL DEMOLITION INFORMATION MAY BE SHOWN ON THE GRADING, DRAINAGE, AND UTILITY PLANS, AND THOSE PLANS PREPARED BY OTHER DISCIPLINES FOR THIS PROJECT.
4. ALL DEMOLISHED ITEMS SHALL BE DISPOSED OF OFFSITE AT A SUITABLE, LEGAL, DUMP SITE OR OTHER FACILITY.
5. ALL DISPOSED OF MATERIALS SHALL BE RECYCLED IF POSSIBLE.
6. THE TYPES, LOCATIONS, SIZES AND/OR DEPTHS OF EXISTING UNDERGROUND UTILITIES AS SHOWN IN THESE PLANS ARE OBTAINED FROM SOURCES OF VARYING RELIABILITY. THE CONTRACTOR IS CAUTIONED THAT ONLY ACTUAL EXCAVATION WILL REVEAL THE TYPES, EXTENT, SIZES, LOCATIONS, AND DEPTHS OF SUCH UNDERGROUND UTILITIES. IF A CASUALTY OR ACCIDENT HAS BEEN MADE TO LOCATE AND DELINEATE ALL KNOWN UNDERGROUND UTILITIES. HOWEVER, WARREN CONSULTING ENGINEERS CAN ASSUME NO RESPONSIBILITY FOR THE COMPLETENESS OR ACCURACY OF ITS DELINEATION OF SUCH UNDERGROUND UTILITIES, NOR FOR THE CONSEQUENCE OF OTHER BURIED OBJECTS OR UTILITIES WHICH MAY BE ENCOUNTERED BUT WHICH ARE NOT SHOWN ON THESE DRAWINGS. THE CONTRACTOR OR ANY SUBCONTRACTOR FOR THIS CONTRACT SHALL NOTIFY THE DISTRICT TWO (2) WORKING DAYS IN ADVANCE OF PERFORMING ANY EXCAVATION WORK. ORDER TO VERIFY THE GREATEST EXTENT OF THE EXISTING UTILITY LINES, CONFLICTS AND PROPOSED UTILITY CONNECTION POINTS.
7. THE SCHOOL DISTRICT SHALL HAVE SALVAGE RIGHTS TO ANY DEMOLISHED ITEMS SHOWN HEREON. THE CONTRACTOR SHALL GIVE THE DISTRICT NOTICE 7 DAYS PRIOR TO THE START OF DEMOLITION. THE DISTRICT SHALL MOVE ANY RETAINED ITEMS OUT OF THE CONTRACTORS WORK AREA, UNLESS ANOTHER ARRANGEMENT IS MADE WITH THE CONTRACTOR. ANY REMAINING ITEMS BECOME THE PROPERTY OF THE CONTRACTOR AND SHALL BE REMOVED FROM THE SITE. ANY ITEMS NOT SHOWN FOR REMOVAL SHALL REMAIN AND SHALL BE PROTECTED FROM DAMAGE DURING CONSTRUCTION TO A REASONABLE EXTEND.
8. EXISTING UTILITY STRUCTURES IN AREAS OF NEW PAVING SHALL BE REMOVED, REPAIRED, OR REPLACED AT NEW GRADE UNLESS SPECIFICALLY NOTED OTHERWISE.
9. ITEMS OUTSIDE THE LIMITS OF DEMOLITION SHALL REMAIN AND BE PROTECTED FROM DAMAGE DURING CONSTRUCTION.
10. CONTRACTOR SHALL COMPLY WITH CHAPTER 33 OF THE 2022 CFC, "FIRE SAFETY DURING CONSTRUCTION AND DEMOLITION" AT ALL TIMES DURING CONSTRUCTION.
11. CONTRACTOR SHALL HIRE A UTILITY LOCATING COMPANY AND SHALL SCAN THE ENTIRE AREA WITHIN THE LIMITS OF NEW WORK. ALL UTILITIES LOCATED SHALL BE RECORDED AND PROTECTED DURING DEMOLITION. THE CONTRACTOR SHALL BE RESPONSIBLE FOR ANY UTILITY DAMAGED WITHIN THE LIMITS OF WORK WILL BE THE RESPONSIBILITY OF THE CONTRACTOR TO REPAIR.
12. ALL DEMOLITION SHALL BE APPROPRIATELY SUPPORTED AND REINFORCED DURING REMOVAL TO PREVENT INJURY FROM FALLING, PROJECTILE, OR OTHERWISE MOVING DEBRIS OR OTHER DESTRUCTIVE MATERIAL. ONSITE SAFETY WITHIN THE LIMITS OF WORK IS THE CONTRACTORS SOLE RESPONSIBILITY.
13. SAWCUTS AND SUBSEQUENT PATCH BACK OF CONCRETE WALKS, SHALL BE TO THE EXISTING CONCRETE JOINT BEYOND NEAREST THE LOCATION OF DEMOLITION. WHEN A PATCH IS REQUIRED DUE TO DAMAGE MADE TO LOCAL SHOW AND COORDINATE WITH EXISTING JOINTS, HOWEVER IF FIELD CONDITIONS ARE OTHERWISE, IT IS UNDERSTOOD TO REMOVE AND PATCH BACK TO THE NEAREST JOINTS BEYOND DEMOLITION.
14. CONTRACTOR SHALL AVOID DAMAGE TO EXISTING PLANTING AND IRRIGATION ALONG EDGES OF DEMOLITION AND NEW PAVEMENT. CONTRACTOR SHALL REPAIR ANY DAMAGE, TO INCLUDE NEW IRRIGATION LINES, NEW HEADS, NEW BARK/MULCH AND NEW SOD TURF WHERE NECESSARY.

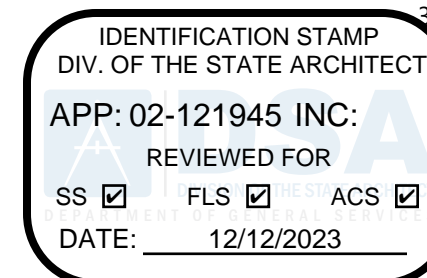

196
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**MILLSWOOD MIDDLE SCHOOL
PORTABLES RELOCATION**

Lodi, CA 95242

SHEET TITLE

DEMOLITION PLAN






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DRAWN BY: GV JOB NUMBER: 23219

SHEET NO.

C1.1

DATE: DECEMBER 5, 2023

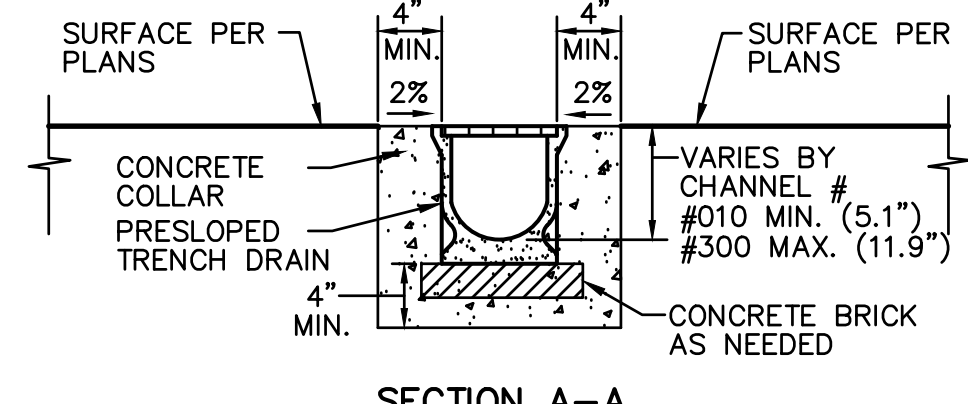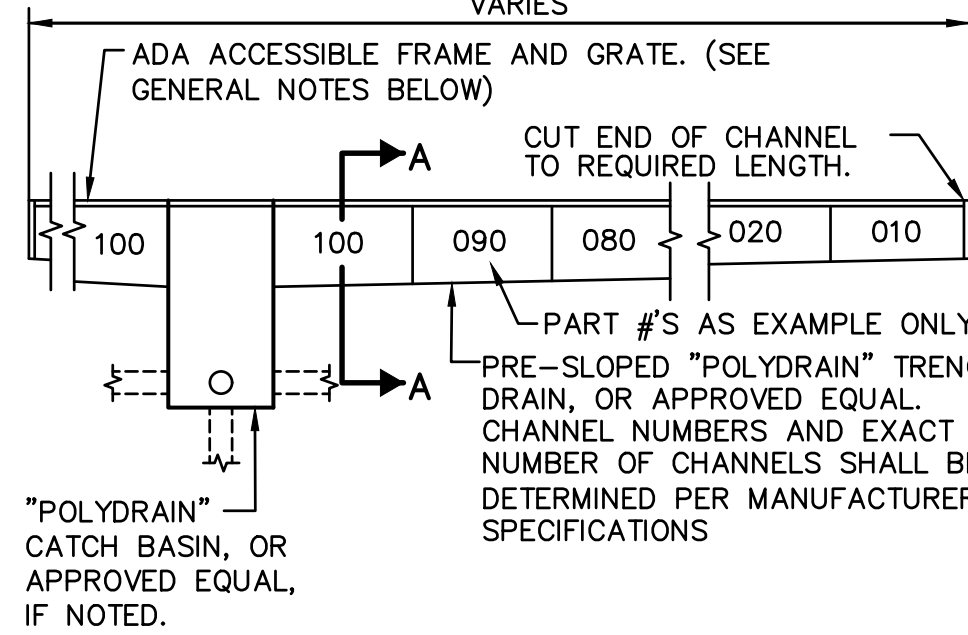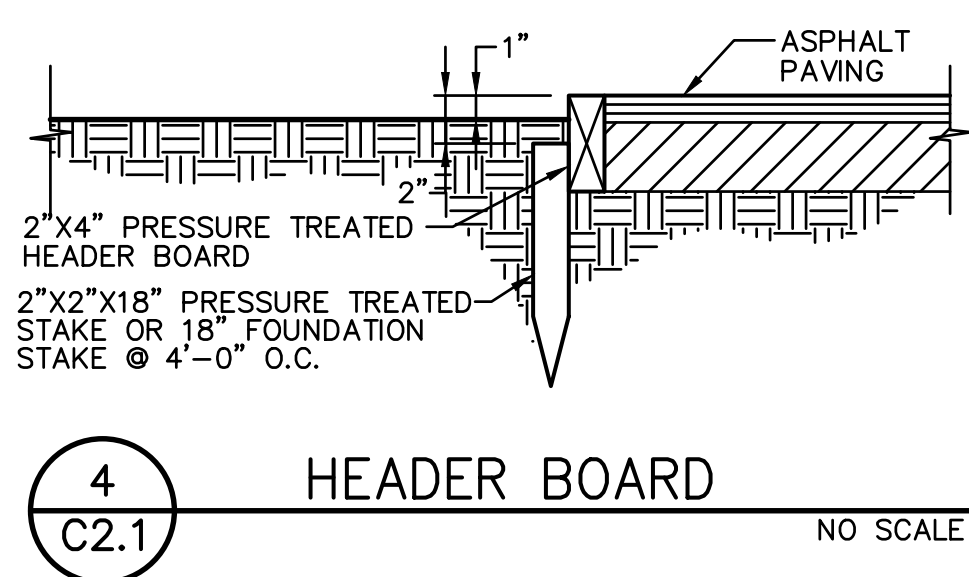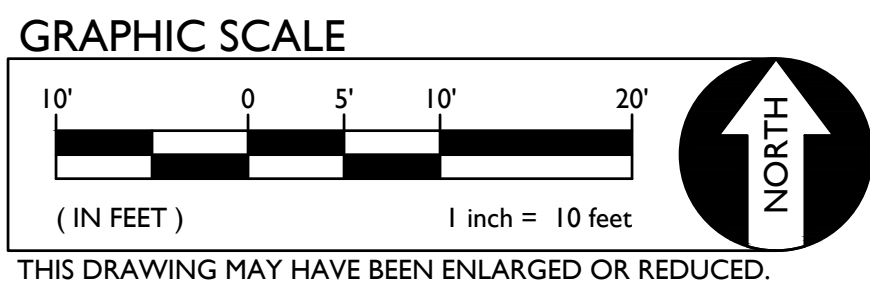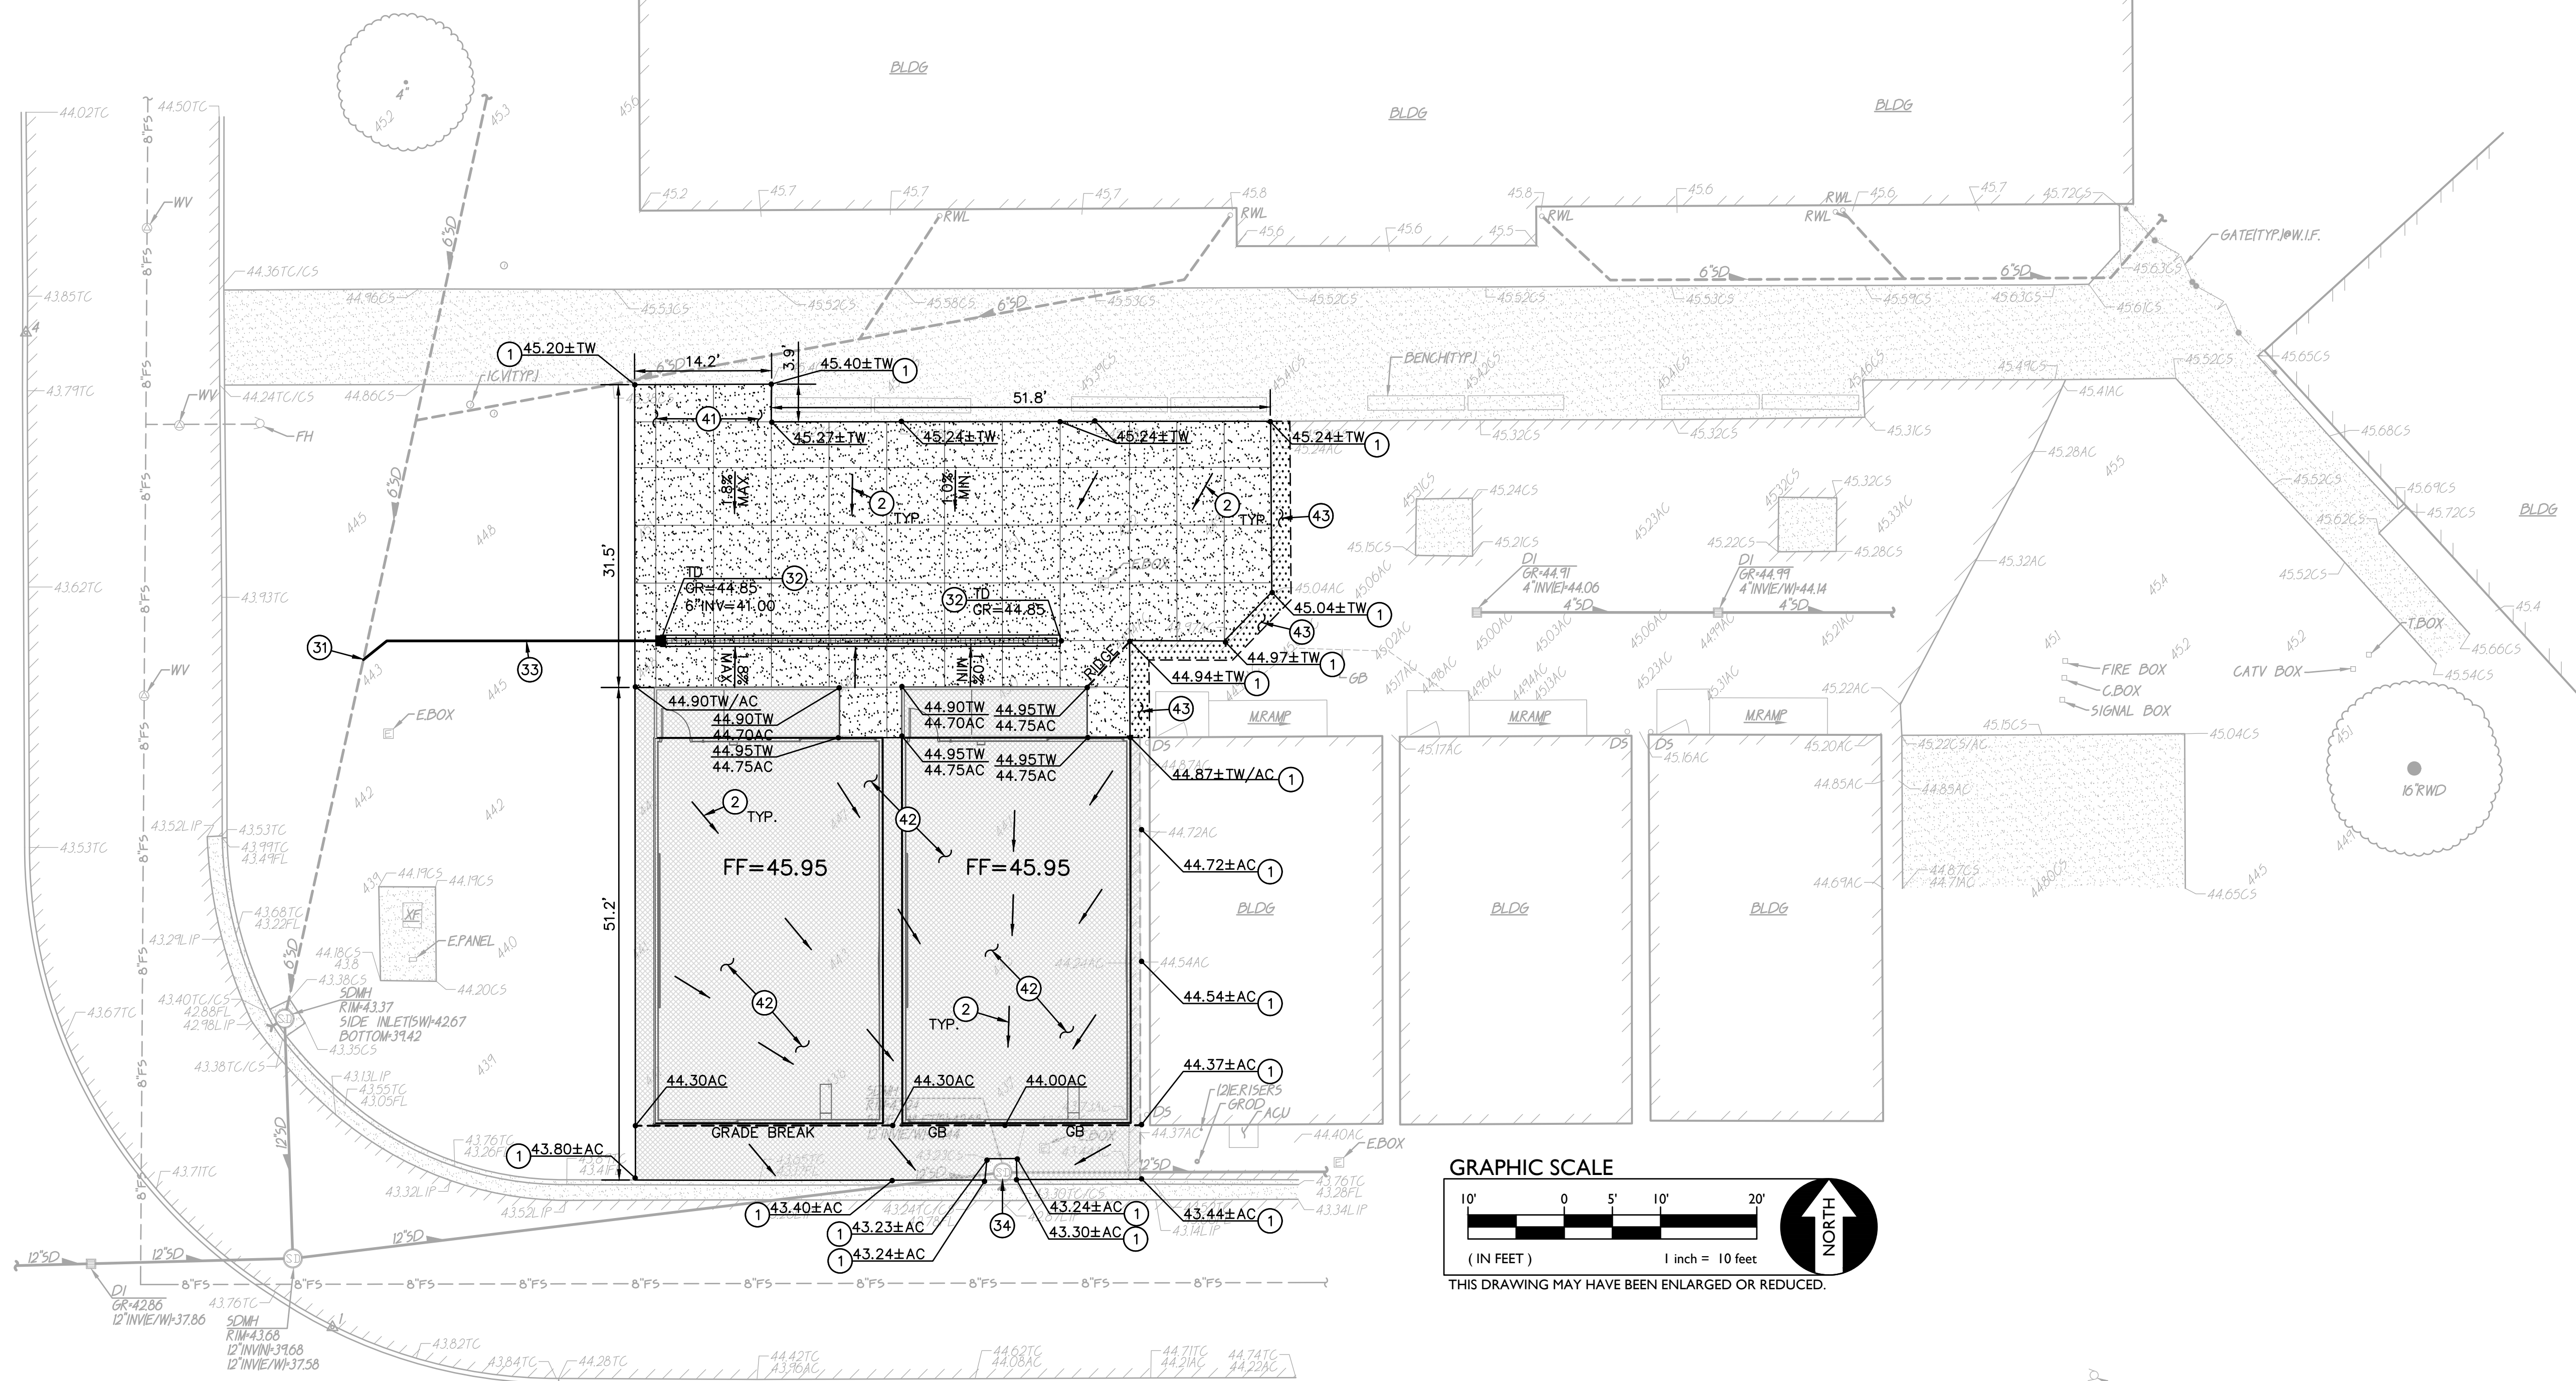

- GENERAL NOTES:**
- GRATE SHALL ADA ACCESSIBLE, POLYDRAIN MODEL 2410 OR APPROVED EQUAL. IF PLACED IN FIRE LANE OR AREA DESIGNATED FOR VEHICLE TRAFFIC PROVIDE POLYDRAIN MODEL 2506.
 - IF TRENCH DRAIN IS PLACED IN FIRE LANE OR AREA DESIGNATED FOR VEHICLE TRAFFIC PROVIDE GALVANIZED STEEL "OVERLAY RAILS" AS SUPPLIED BY POLYDRAIN, OR APPROVED EQUAL.
 - CONTRACTOR SHALL FURNISH AND INSTALL A MODEL 2811B LOCKING DEVICE, OR APPROVED EQUAL, FOR ALL TRENCH DRAIN GRATES.
 - CONTRACTOR SHALL FURNISH AND INSTALL A TRASH BUCKET, MODEL 2900, IN ALL TRENCH DRAIN CATCH BASINS.
 - CONTRACTOR SHALL PURCHASE AND FURNISH THE MAINTENANCE/OPERATIONS DEPARTMENT OF THE SCHOOL WITH 2 MODEL 2231 TRENCH DRAIN SHOVEL HEADS, WITH STANDARD WOOD, OR COMPOSITE HANDLES.
 - ALL MITERED JOINTS SHALL BE SEALED WITH POLYDRAIN "POLYSEAL" CAULKING OR APPROVED EQUAL.





3 C2.1 TRENCH DRAIN DETAIL
NO SCALE

- GRADING NOTES**
- MATCH EXISTING GRADE/ELEVATION.
 - UNIFORMLY GRADE TOWARDS INLET/SWALE

- DRAINAGE NOTES:**
- CONNECT TO EXISTING STORM DRAIN LINE OR STRUCTURE. POT HOLE TO VERIFY DEPTH AND LOCATION PRIOR TO TRENCHING.
 - CONSTRUCT TRENCH DRAIN PER **3 C2.1**
 - PLACE 6" STORM DRAIN PER **2 C2.1**
 - REPLACE MANHOLE COVER WITH GRATED TOP.


PAVING LEGEND

- 1 C2.1**
- 4 C2.1**
- 4 C2.1**
- 4 C2.1**

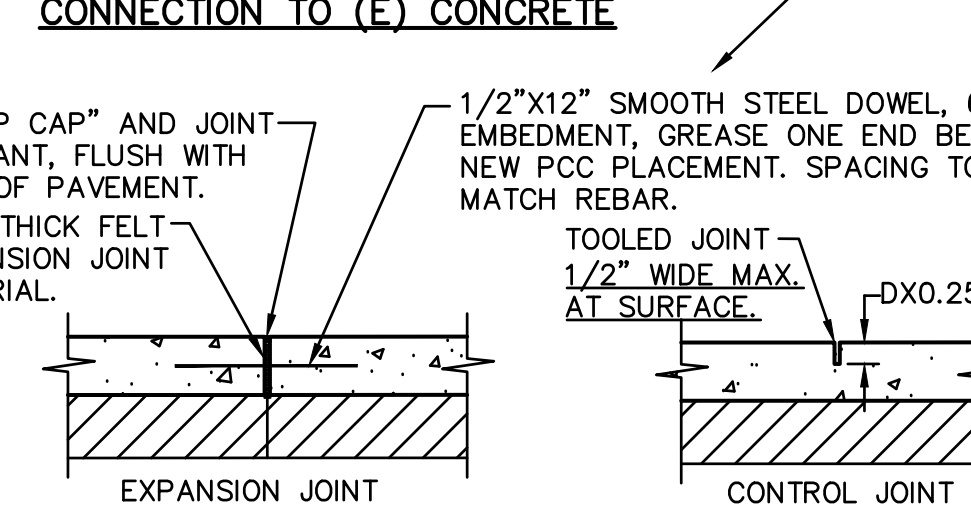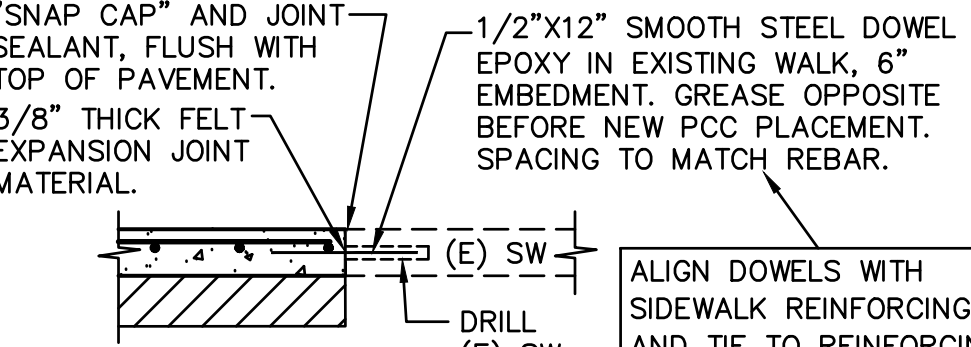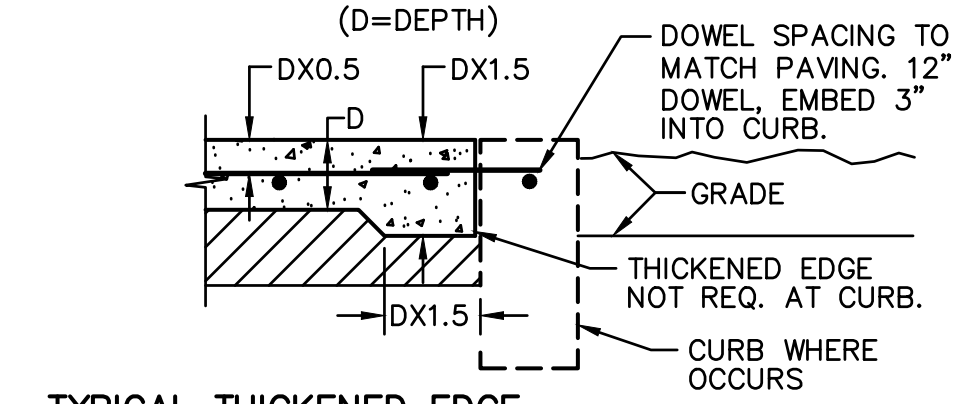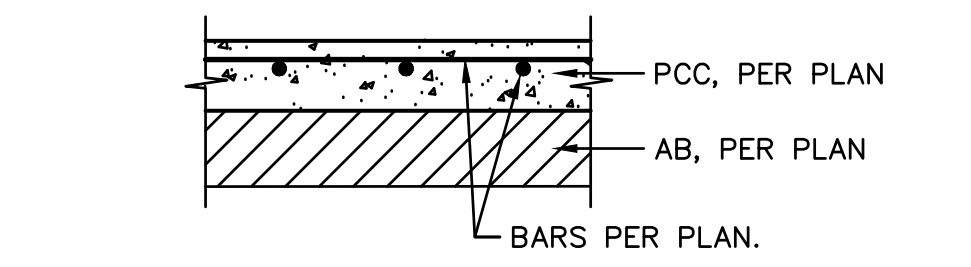

- NOTES:**
- PROVIDE FELT EXPANSION JOINTS AT 20 FEET O.C. MAX. SEE PLAN FOR LAYOUT.
 - PROVIDE CONTROL JOINTS AT 10 FEET O.C. MAX. SEE PLAN FOR LAYOUT.
 - EXPANSION OR CONTROL JOINTS SHALL NOT EXCEED 1/2" IN SURFACE WIDTH.

1 C2.1 CONCRETE SIDEWALK
NO SCALE

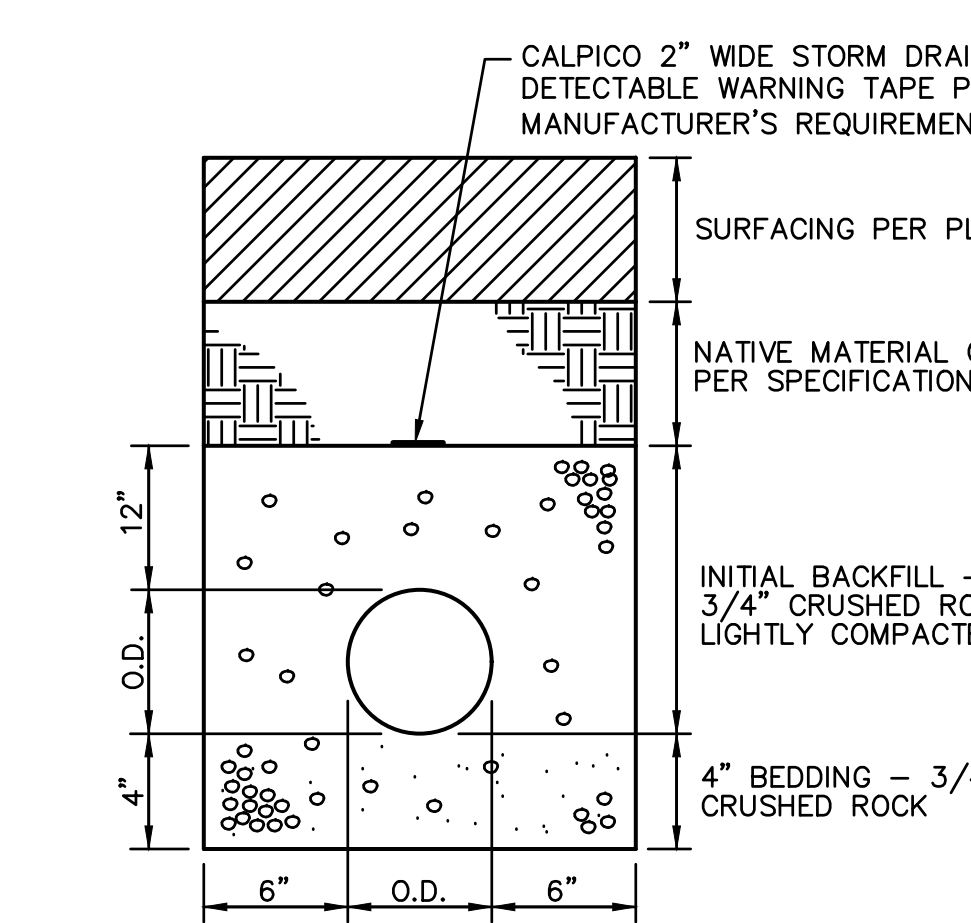

2 C2.1 STORM DRAIN TRENCH
NO SCALE

AGENCY APPROVAL

DSAP

02-121945

09-50

IDENTIFICATION STAMP

DIV. OF THE STATE ARCHITECT

APP: 02-121945 INC:

REVIEWED FOR

SS ☒ FLS ☒ ACS ☒

DATE: 12/12/2023

196

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ANTHONY J. TASSANO

REGISTERED PROFESSIONAL ENGINEER

NO. C74659

STATE OF CALIFORNIA

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GRADING, PAVING, AND DRAINAGE PLAN

DRAWN BY: GV


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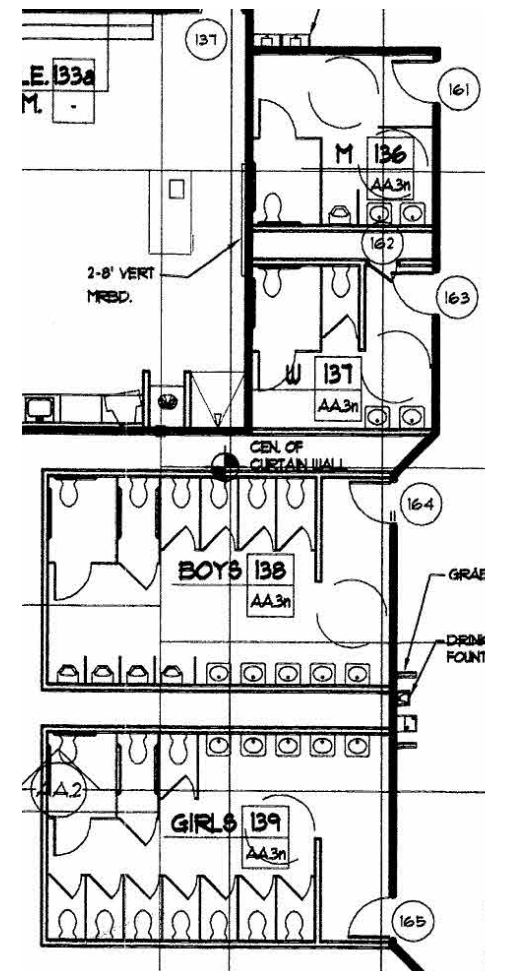
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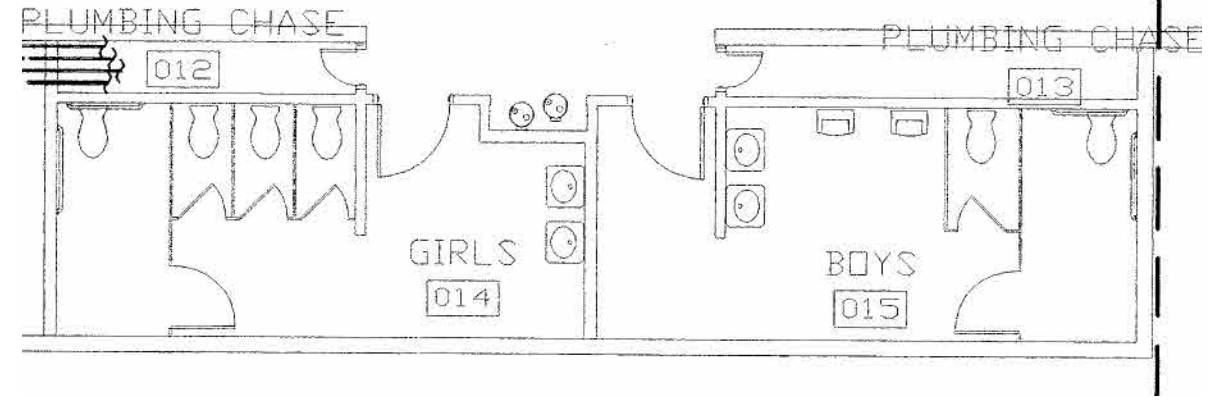
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SITE PLAN 1" = 50'-0" 1



REFERENCE BUILDING A RESTROOMS



REFERENCE BUILDING B RESTROOMS

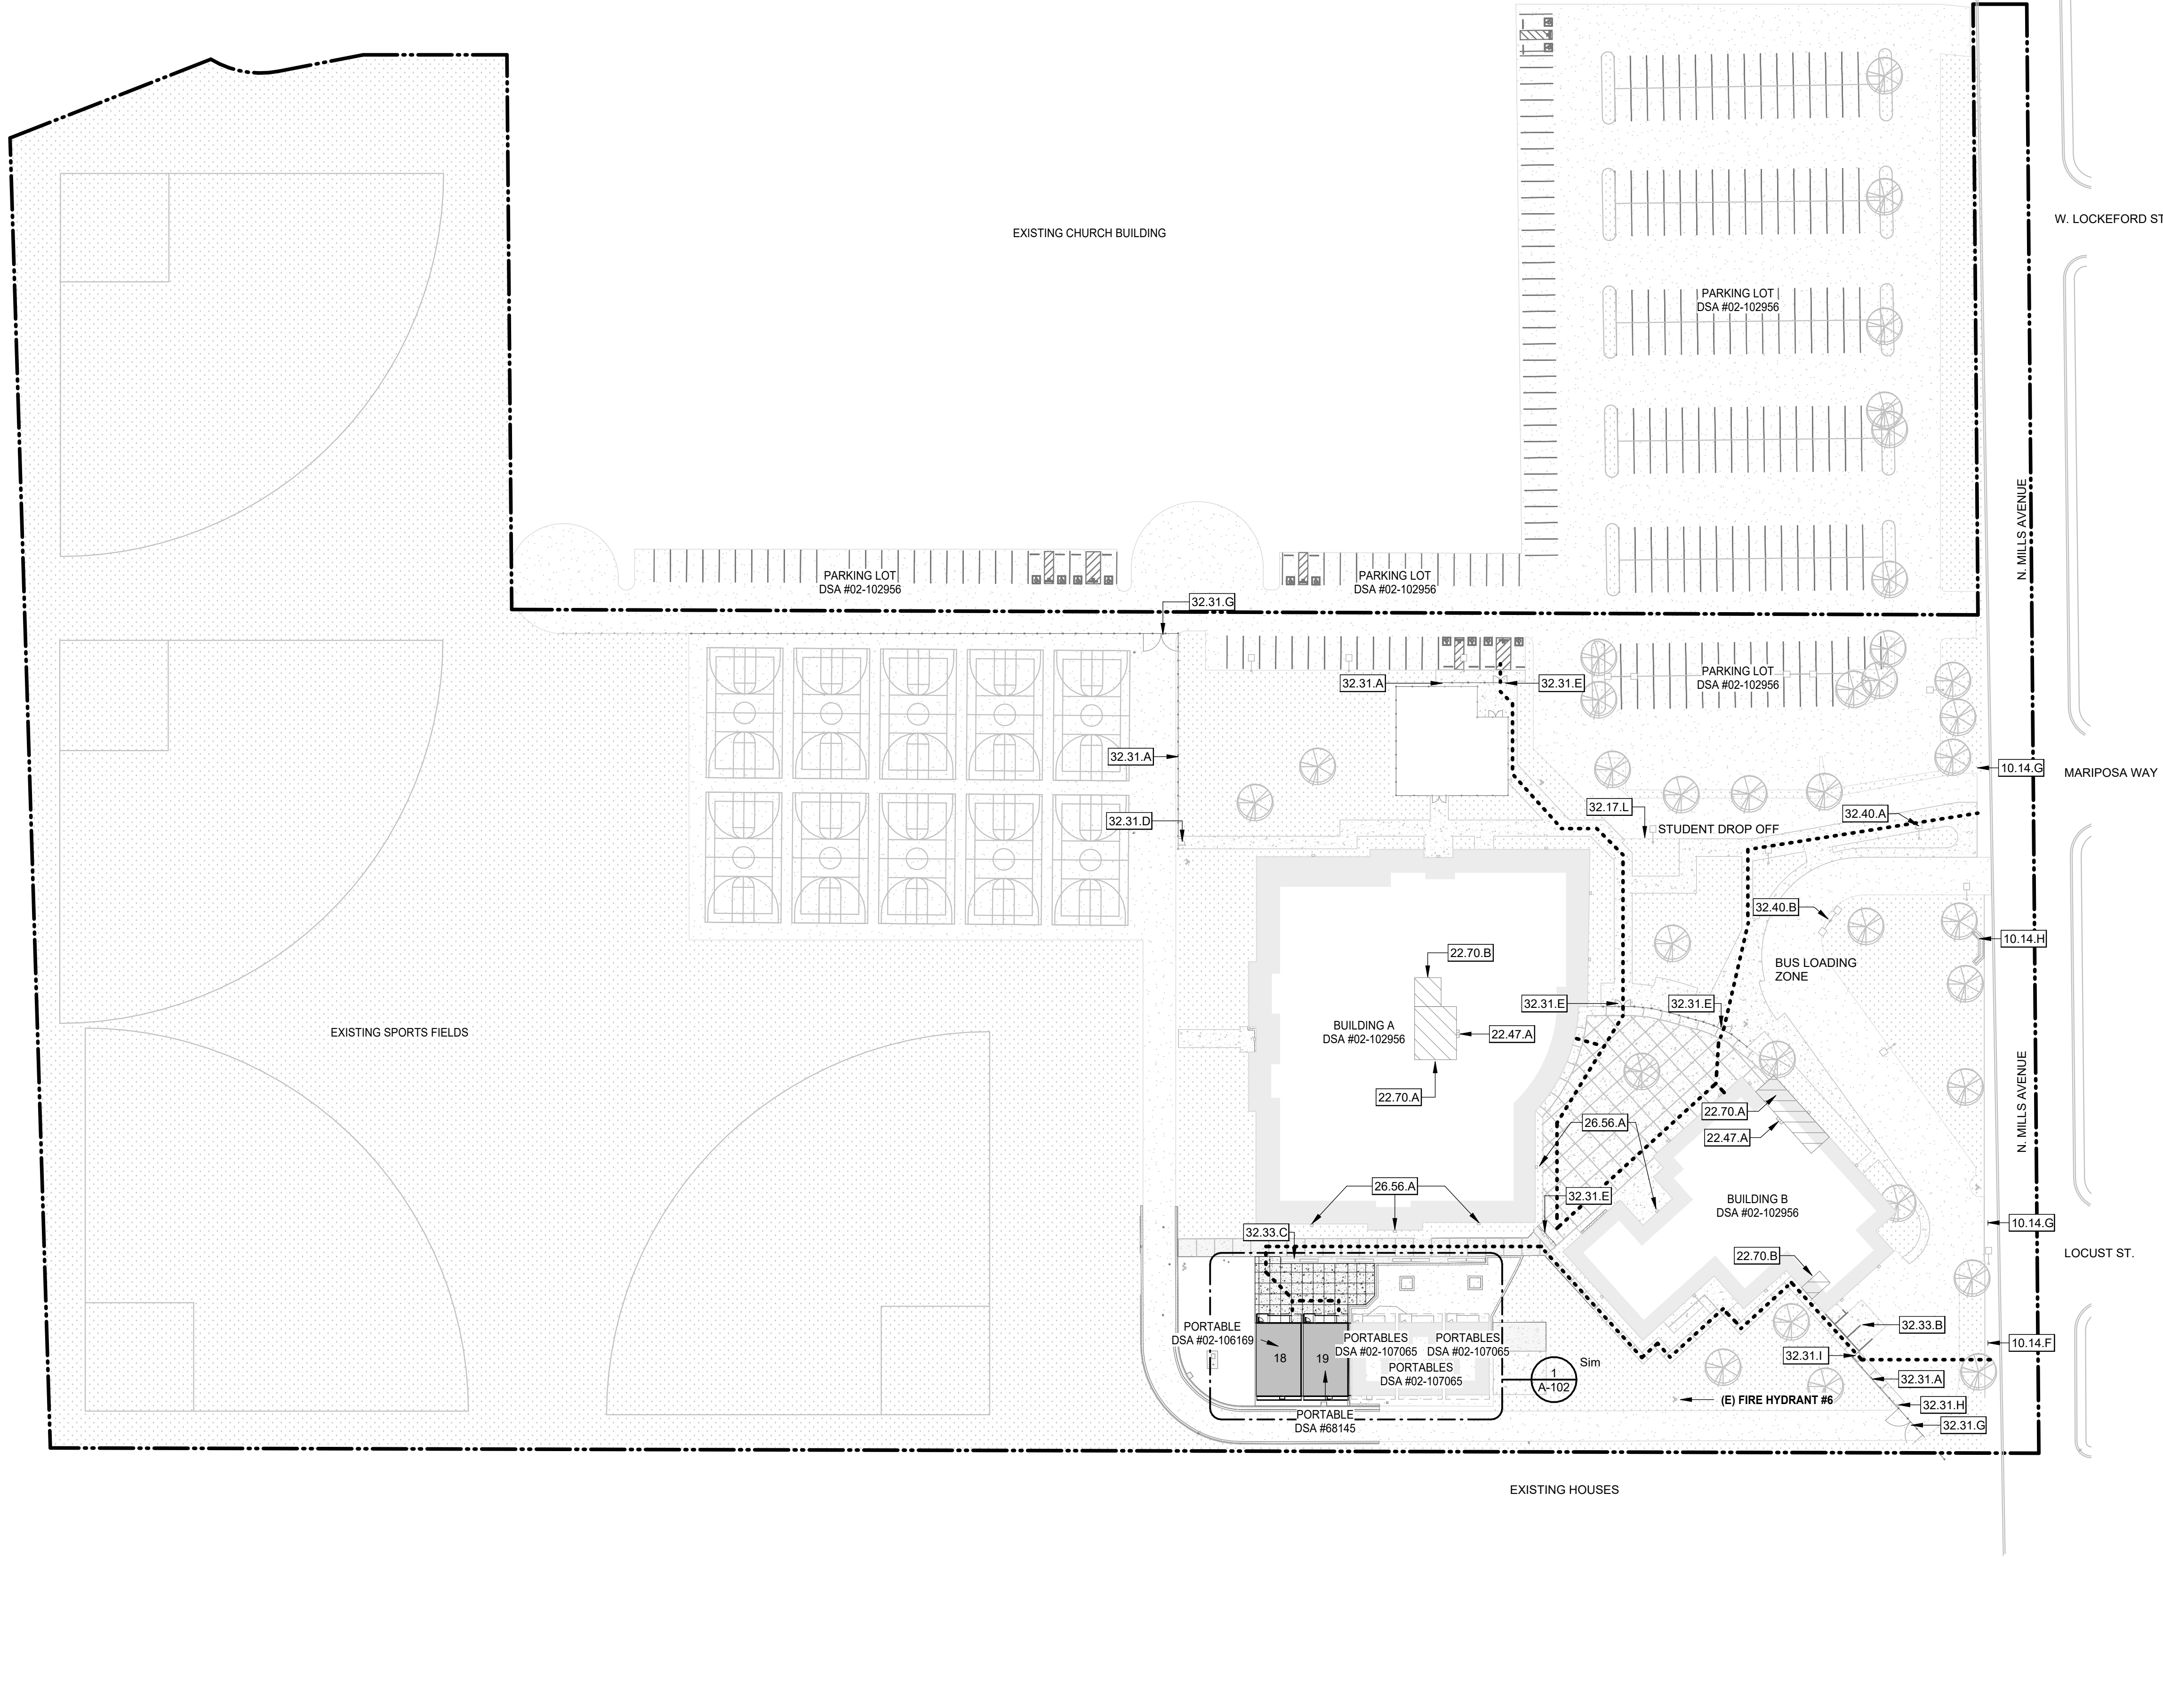- KEYNOTES**
- NOTE: NOT ALL KEYNOTES ARE USED ON EVERY SHEET
- 10.14.F (E) SCHOOL SPEED LIMIT SIGN
 - 10.14.G (E) ACCESS SIGN
 - 10.14.H (E) SCHOOL SIGN
 - 22.47.A HI-LOW DRINKING FOUNTAIN
 - 22.70.A (E) STUDENT RESTROOM LOCATED WITHIN (E) BUILDING DSA #02-102956
 - 22.70.B (E) STAFF RESTROOM LOCATED WITHIN (E) BUILDING DSA #02-102956
 - 26.56.A (E) EXTERIOR LIGHT FIXTURE
 - 32.17.L VERIFY (E) STRIPING AT STUDENT DROP OFF. IF NOT, STRIPE AREA
 - 32.31.A (E) 6'-0" TALL CHAIN LINK FENCE
 - 32.31.D (E) SINGLE 3'-0" WIDE CHAIN LINK GATE WITH PANIC HARDWARE
 - 32.31.E (E) DOUBLE 3'-0" WIDE CHAIN LINK GATE WITH PANIC HARDWARE
 - 32.31.G (E) 20' WIDE DOUBLE SWING GATES
 - 32.31.H (E) KNOX BOX
 - 32.31.I (E) 4' WIDE MAN GATE WITH PANIC HARDWARE
 - 32.33.B (E) TRASH ENCLOSURE
 - 32.33.C (E) FIXED BENCH WITH METAL LEGS
 - 32.40.A (E) SINGLE FIXTURE LIGHT STANDARD
 - 32.40.B (E) DOUBLE FIXTURE LIGHT STANDARD

- LEGEND -**
- 1. SEE ELECTRICAL AND CIVIL DRAWINGS FOR UTILITIES.

- CODE SITE GENERAL NOTES**
- ALL NEW CONCRETE AND AC PAVING IN P.O.T. SHALL HAVE 2% MAX. SLOPE IN ALL DIRECTIONS U.N.O. AND SHALL HAVE FLUSH TRANSITIONS TO ALL ADJACENT NEW AND EXISTING WALK SURFACES IN P.O.T.
 - ALL LANDSCAPE EDGES ALONG ALL NEW OR EXISTING WALK SURFACES IN P.O.T. SHALL BE PER CIVIL DRAWINGS.
 - FOR GRATINGS OR STRAINERS LOCATED IN THE SURFACE OF ANY PEDESTRIAN WAY OR IN P.O.T., THE MAXIMUM GRATE OR STRAINER OPENINGS SHALL NOT EXCEED 1/2" IN THE DIRECTION OF TRAFFIC FLOW.
 - THE P.O.T. IDENTIFIED IN THESE CONSTRUCTION DOCUMENTS IS COMPLIANT WITH THE CURRENT APPLICABLE CALIFORNIA BUILDING CODE ACCESSIBILITY PROVISIONS FOR THE PATH OF TRAVEL REQUIREMENTS FOR ALTERATIONS, ADDITIONS, AND STRUCTURAL REPAIRS. AS PART OF THE DESIGN OF THIS PROJECT, THE P.O.T. WAS EXAMINED AND ANY ELEMENTS, COMPONENTS OR PORTIONS OF THE P.O.T. THAT WERE DETERMINED TO BE NON-COMPLIANT 1) HAVE BEEN IDENTIFIED AND 2) THE CORRECTIVE WORK NECESSARY TO BRING THEM INTO COMPLIANCE HAS BEEN INCLUDED WITHIN THE SCOPE OF THIS PROJECT'S WORK NECESSARY DETAILS, DRAWINGS AND SPECIFICATIONS INCORPORATED INTO THESE CONSTRUCTION DOCUMENTS. ANY NON-COMPLIANT ELEMENTS, COMPONENTS, OR PORTIONS OF THE P.O.T. THAT WILL NOT BE CORRECTED BY THIS PROJECT BASED ON VALUATION THRESHOLD LIMITATIONS OR A FINDING OF UNREASONABLE HARDSHIP ARE SO INDICATED IN THESE CONSTRUCTION DOCUMENTS. DURING CONSTRUCTION, IF POT ITEMS WITHIN THE SCOPE OF THE PROJECT REPRESENTED AS CODE COMPLIANT ARE FOUND TO BE NON-COMFORMING BEYOND REASONABLE CONSTRUCTION TOLERANCES, THEY SHALL BE BROUGHT INTO COMPLIANCE WITH THE CBC AS PART OF THIS PROJECT BY MEANS OF A CONSTRUCTION CHANGE DOCUMENT.

- SITE PLAN LEGEND**
- ASSUMED PROPERTY LINE
 - LIMITS OF WORK
 - PROJECT BUILDING
 - (N) CONCRETE PAVING
EXPANSION JOINT PER
CONTROL JOINT PER
 - (E) CONCRETE PAVING
 - (E) BUILDING
 - (E) LANDSCAPING
 - (E) ASPHALT
 - (E) CHAIN LINK FENCE LINE
 - FH
(E) FIRE HYDRANT
 - (E) EXTERIOR LIGHT FIXTURE
 - (E) SINGLE FIXTURE LIGHT STANDARD
 - (E) DOUBLE FIXTURE LIGHT STANDARD
 - OVERHANG
 - PATH OF TRAVEL (P.O.T.)**
 - AS INDICATED, IS A COMMON BARRIER FREE ACCESS ROUTE
 - IS AT LEAST 48" WIDE
 - NO ABRUPT VERTICAL CHANGES EXCEEDING 1/2" BEVELED AT 1:2 MAXIMUM SLOPE, EXCEPT THAT LEVEL CHANGES DO NOT EXCEED 1/4" VERTICAL
 - THE PATH SURFACE IS SLIP RESISTANT, STABLE, FIRM, AND SMOOTH. PASSING SPACES (11B-403.2) AT LEAST 60"x60" ARE LOCATED NOT MORE THAN 200' APART.
 - PARTS OF P.O.T. WITH CONTINUOUS GRADIENTS HAVE 60" LEVEL AREAS (11B-403.7) NOT MORE THAN 400' APART.
 - THE CROSS-SLOPE DOES NOT EXCEED 2% AND SLOPE IN THE DIRECTION OF TRAVEL IS LESS THAN 5% UNLESS OTHERWISE INDICATED.
 - (POT) SHALL BE MAINTAINED FREE OF OVERHANGING OBSTRUCTIONS TO 80" MINIMUM (11B-307.4) AND PROTRUDING OBJECTS GREATER THAN 4" PROJECTION FROM WALL AND ABOVE 27" AND LESS THAN 80" (11B-307).
 - ARCHITECT SHALL VERIFY PATH OF TRAVEL CONFORMS WITH THE ABOVE.

AGENCY APPROVAL DSA# 02-121945 02-121945 19-50

IDENTIFICATION STAMP
DIV. OF THE STATE ARCHITECT
APP: 02-121945 INC:
REVIEWED FOR
SS ☒ FLS ☒ ACS ☒
DATE: 12/12/2023

19.6
ARCHITECTS

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ELECTRICAL ENGINEER
The Engineering Enterprise
1125 High Street
Auburn, CA 95603
TEL (530) 886-8556

PROFESSIONAL STAMP

REVISIONS

NO.	DATE	DESCRIPTION
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PROJECT OWNER & TITLE
LODI UNIFIED SCHOOL DISTRICT
1305 E. Vine St
Lodi, CA 95240


**MILLSWOOD MIDDLE SCHOOL
PORTABLES RELOCATION**
233 N Mills Ave
Lodi, CA 95242

SHEET TITLE
OVERALL SITE PLAN

DRAWN BY: CV, BI JOB NUMBER: 23219
SHEET NO.
A-101
DATE: DECEMBER 12, 2023

CONSTRUCTION DOCUMENTS

DATE PLOTTED: 12/12/2023 11:05:41 AM FILE LOCATION: C:\Users\blimhorf\Documents\BIM\2321\B_LUSD_Millwood Middle School Portables Relocation_A22_bimhorf\CK8V.rvt

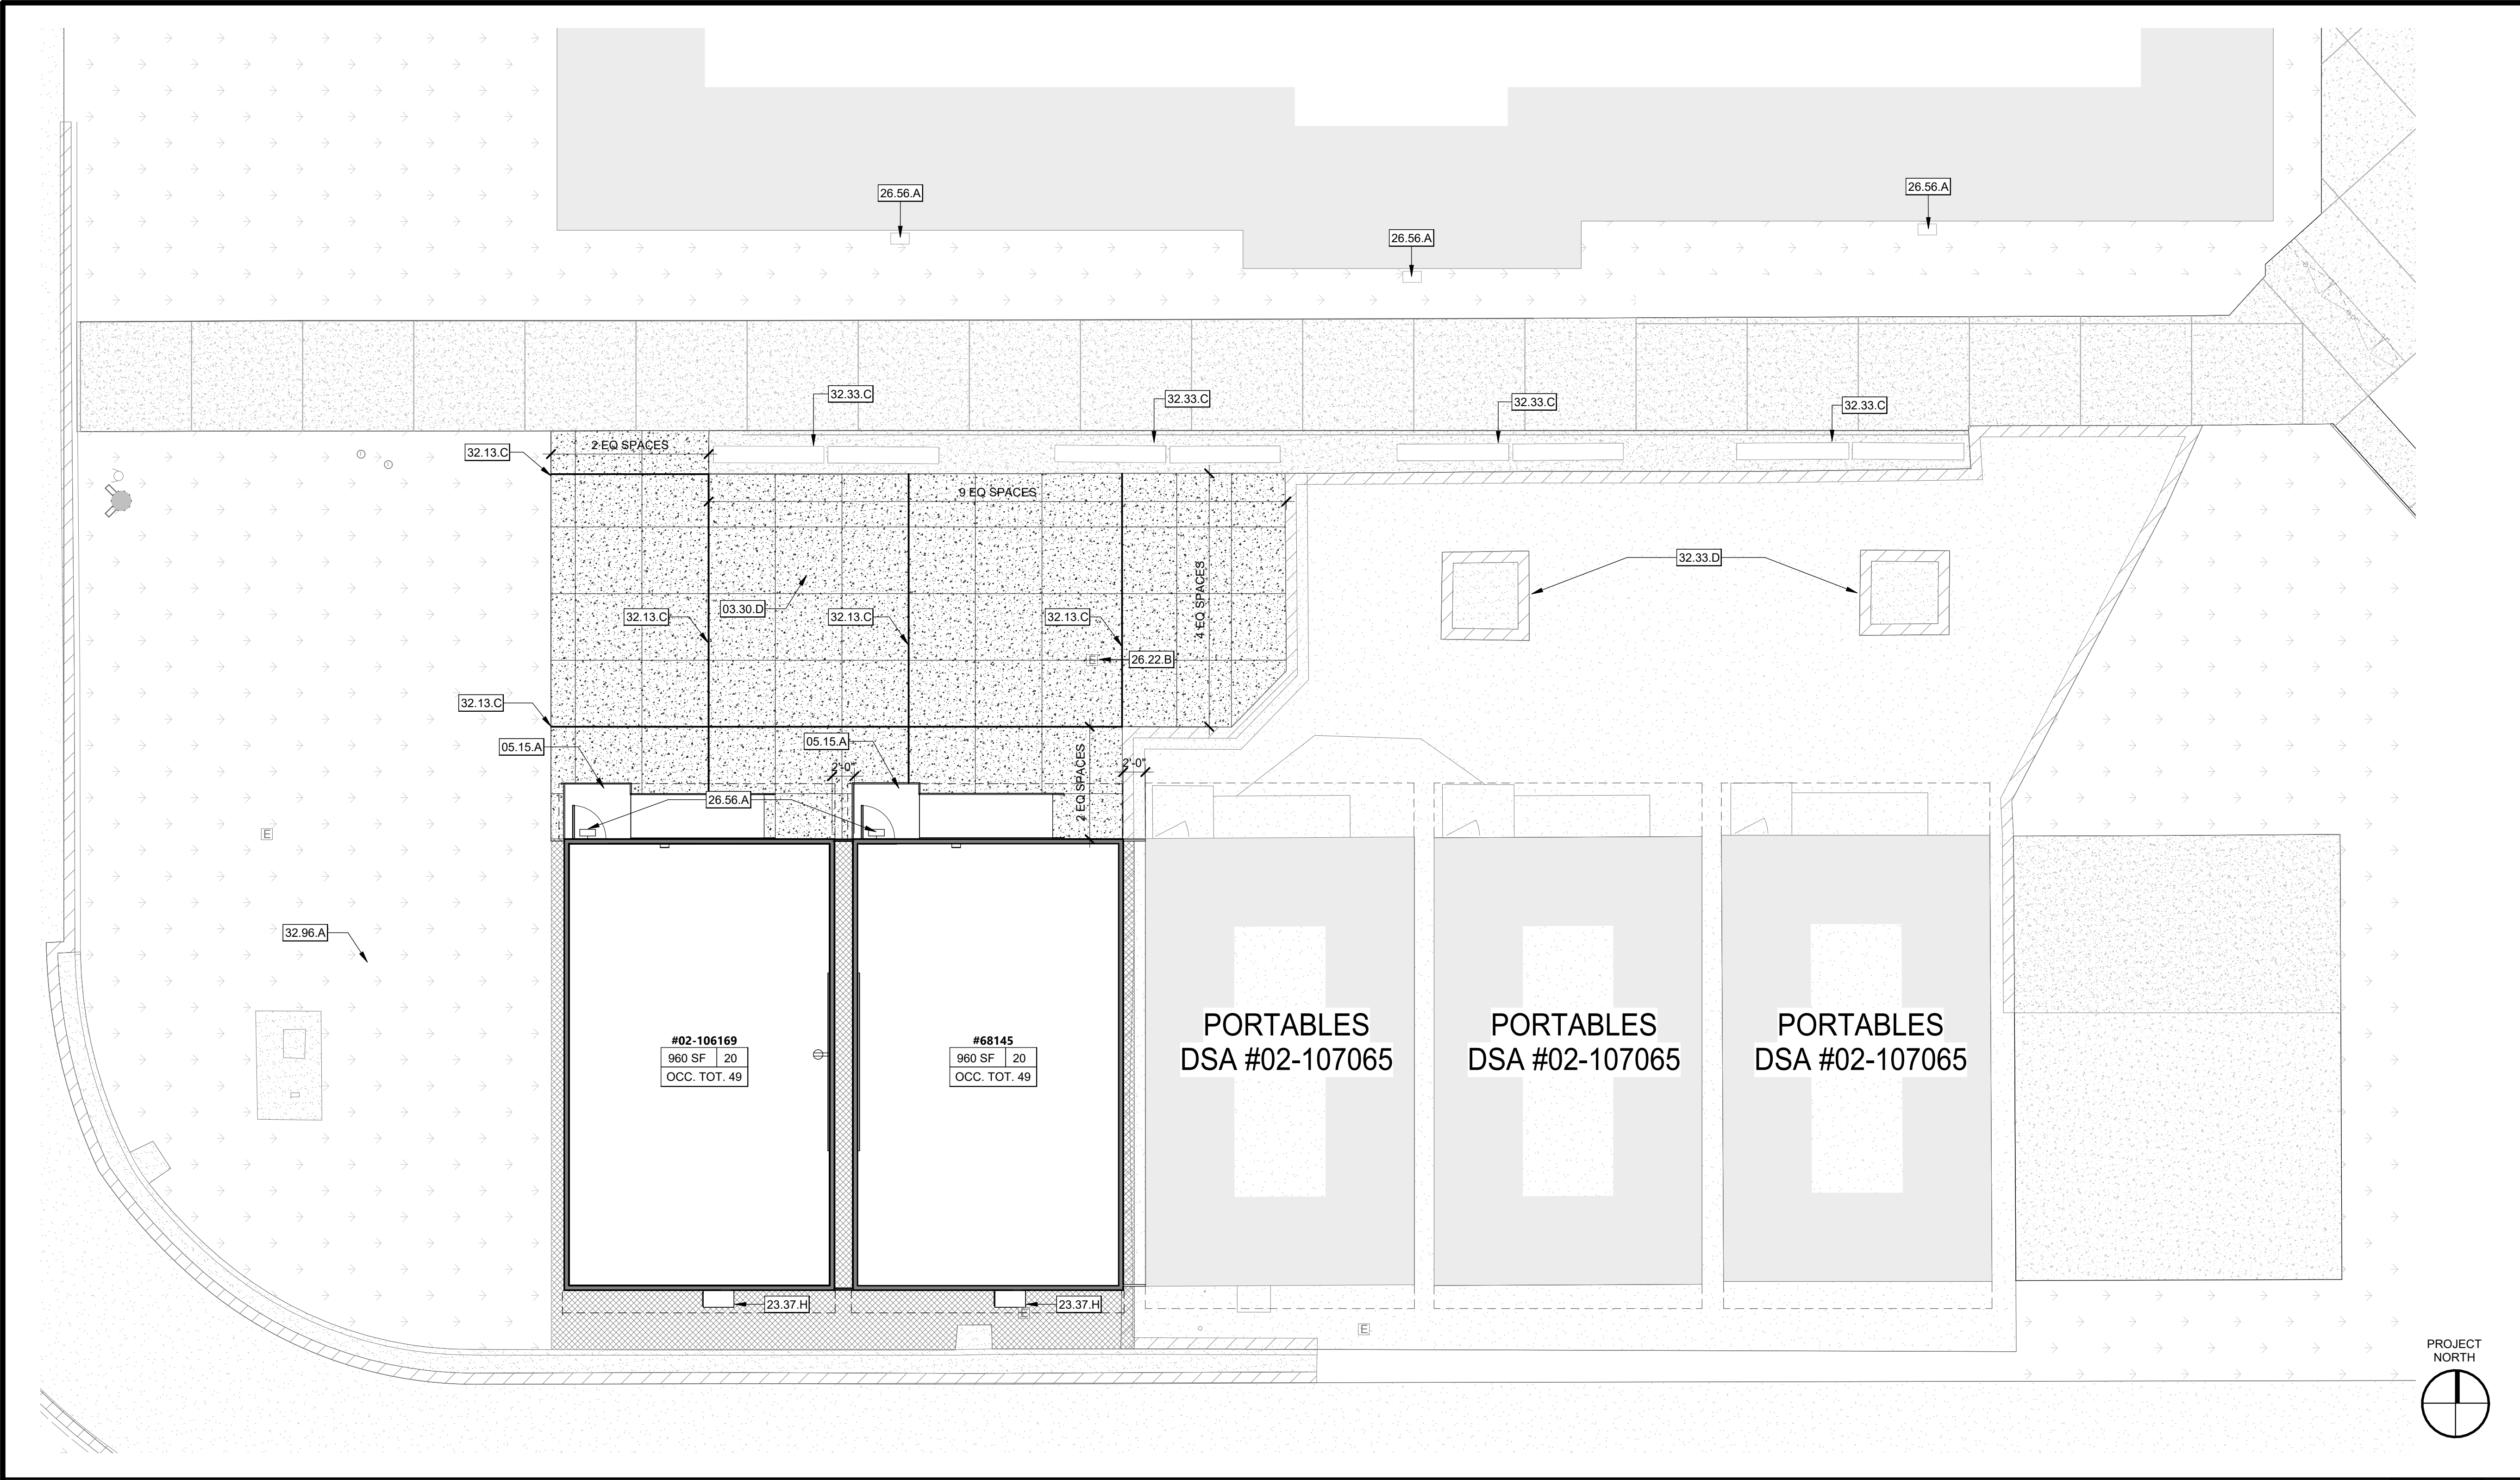

ENLARGED SITE PLAN 1/8" = 1'-0" 1

OCCUPANT CHART PER 2022 CBC TABLE 1004.5


DSA APP. #	FUNCTION	N SF	SF/OCC.	OCC. #	OCCUPANCY TYPE	MAXIMUM OCCUPANT LOAD W/ 1 EXIT TABLE 1006.2.1	MIN. CLR. DOOR EXIT WIDTH	# EXITS REQUIRED	# EXITS PROVIDED
#02-106169	EDUCATIONAL CLASSROOM AREA	960 SF	20 SF	49	E	49	2'-8"	1	1
#68145	EDUCATIONAL CLASSROOM AREA	960 SF	20 SF	49	E	49	2'-8"	1	1
#02-107065	EDUCATIONAL CLASSROOM AREA	960 SF	20 SF	49	E	49	2'-8"	1	1
#02-107065	EDUCATIONAL CLASSROOM AREA	960 SF	20 SF	49	E	49	2'-8"	1	1
#02-107065	EDUCATIONAL CLASSROOM AREA	960 SF	20 SF	49	E	49	2'-8"	1	1
OCCUPANT TOTAL:		245							

602 CONSTRUCTION TYPE:

■ TYPE V-B

TOTAL AREA OF FIVE PORTABLES INCLUDING OVERHANG AND PROJECTIONS EQUALS 4,920 SF

ALLOWABLE AREA: 9,500 SF

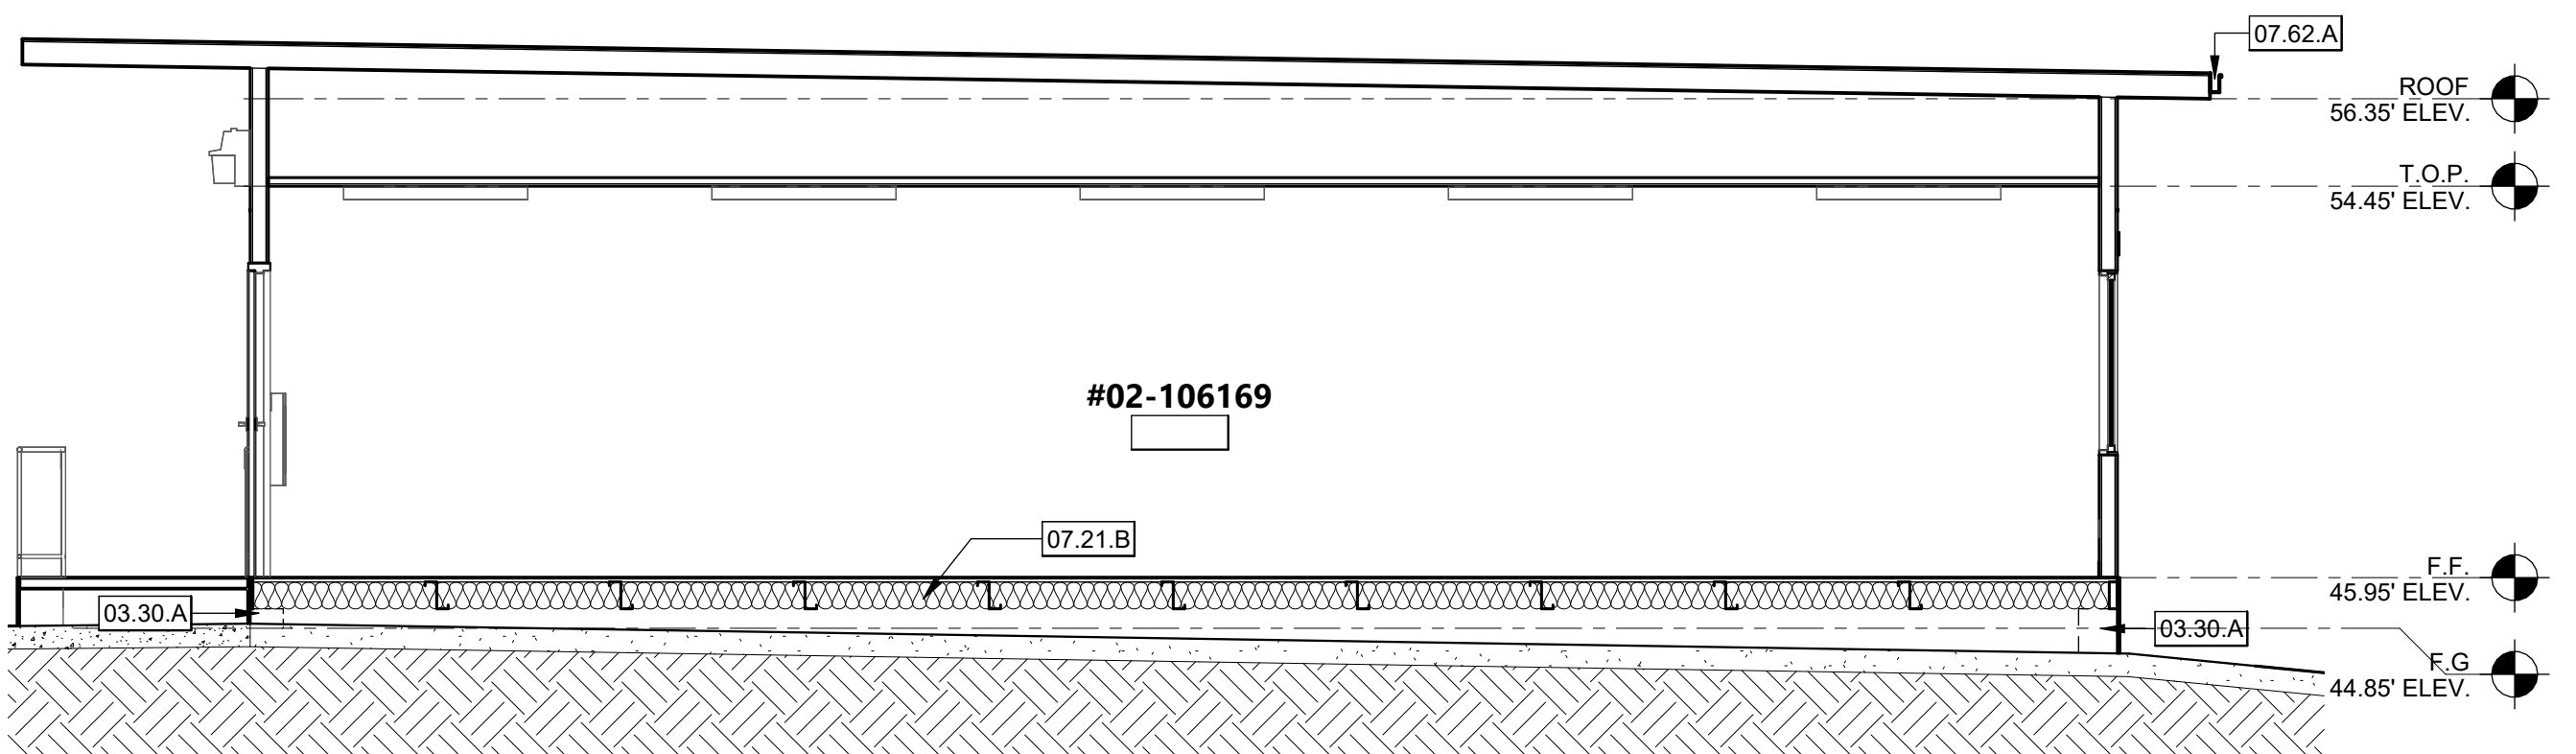

SECTION 1/4" = 1'-0" 2

KEYNOTES

NOTE: NOT ALL KEYNOTES ARE USED ON EVERY SHEET

03.30.A (N) WOOD FOOTING PER PC STRUCTURAL DRAWINGS. SEE AMS S1 AND MODTECH F2.01.

03.30.D (N) CONCRETE PAVING. S.C.D.

05.15.A (N) METAL RAMP PC #04-122029

07.21.B (N) R-11 INSULATION TO BE INSTALLED. SEE SECTION A/S2B AND B/S2B FOR AMS PORTABLE. SEE A8.1 FOR MODTECH.

07.62.A (E) 5" BOX GALV. PRE-FINISHED GUTTER

23.37.H (E) WALL MOUNTED HVAC UNIT

26.22.B (E) ELECTRICAL BOX

26.56.A (E) EXTERIOR LIGHT FIXTURE

32.13.C EXPANSION JOINTS

32.33.C (E) FIXED BENCH WITH METAL LEGS

32.33.D (E) TREE PLANTERS

32.96.A PATCH AND REPAIR GRASS, LANDSCAPE, AND IRRIGATION SURROUNDING (N) PORTABLES

LEGEND -

1. SEE ELECTRICAL AND CIVIL DRAWINGS FOR UTILITIES.

SITE PLAN LEGEND

- ASSUMED PROPERTY LINE
- LIMITS OF WORK
- PROJECT BUILDING
- (N) CONCRETE PAVING
EXPANSION JOINT PER
CONTROL JOINT PER
- (E) CONCRETE PAVING
- (E) BUILDING
- LANDSCAPING
- (E) ASPHALT

- X-X-X-X CHAIN LINK FENCE LINE
- OVERHANG
- FH EXISTING FIRE HYDRANT
- (E) EXTERIOR LIGHT FIXTURE
- (E) SINGLE FIXTURE LIGHT STANDARD
- (E) DOUBLE FIXTURE LIGHT STANDARD


OCCUPANCY TYPE



LEGEND - CODE ANALYSIS

ROOM NAME			OCCUPANCY TAG	EGRESS WIDTH TAG		
101	ROOM NUMBER	150 SF	15	EXIT 01	EXIT LOCATION	
123	OCCUPANT LOAD FACTOR	123	OCC	123	TOTAL OCCUPANTS CALCULATED	
36"	TOTAL OCCUPANCY CALCULATED	36"	MIN	36"	MINIMUM EXIT WIDTH CALCULATED	
36"	ROOM AREA	36"	PROVIDED	36"	EXIT WIDTH PROVIDED	

AGENCY APPROVAL DSA# 02-121945 09-50

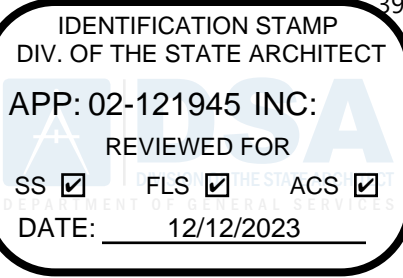

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TEL (916) 985-1870

ELECTRICAL ENGINEER
The Engineering Enterprise
1125 High Street
Auburn, CA 95603
TEL (530) 886-8556

PROFESSIONAL STAMP



REVISIONS

NO.	DATE	DESCRIPTION
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PROJECT OWNER & TITLE

LODI UNIFIED SCHOOL DISTRICT
1305 E. Vine St
Lodi, CA 95240

MILLSWOOD MIDDLE SCHOOL
PORTABLES RELOCATION

233 N Mills Ave
Lodi, CA 95242

SHEET TITLE

ENLARGED SITE PLAN AND CODE
ANALYSIS


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JOB NUMBER: 23219


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A-102


DATE: DECEMBER 12, 2023


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$$1/4'' = 1'-0''$$


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$$1/4'' = 1'-0''$$
$$1/4'' = 1'-0''$$

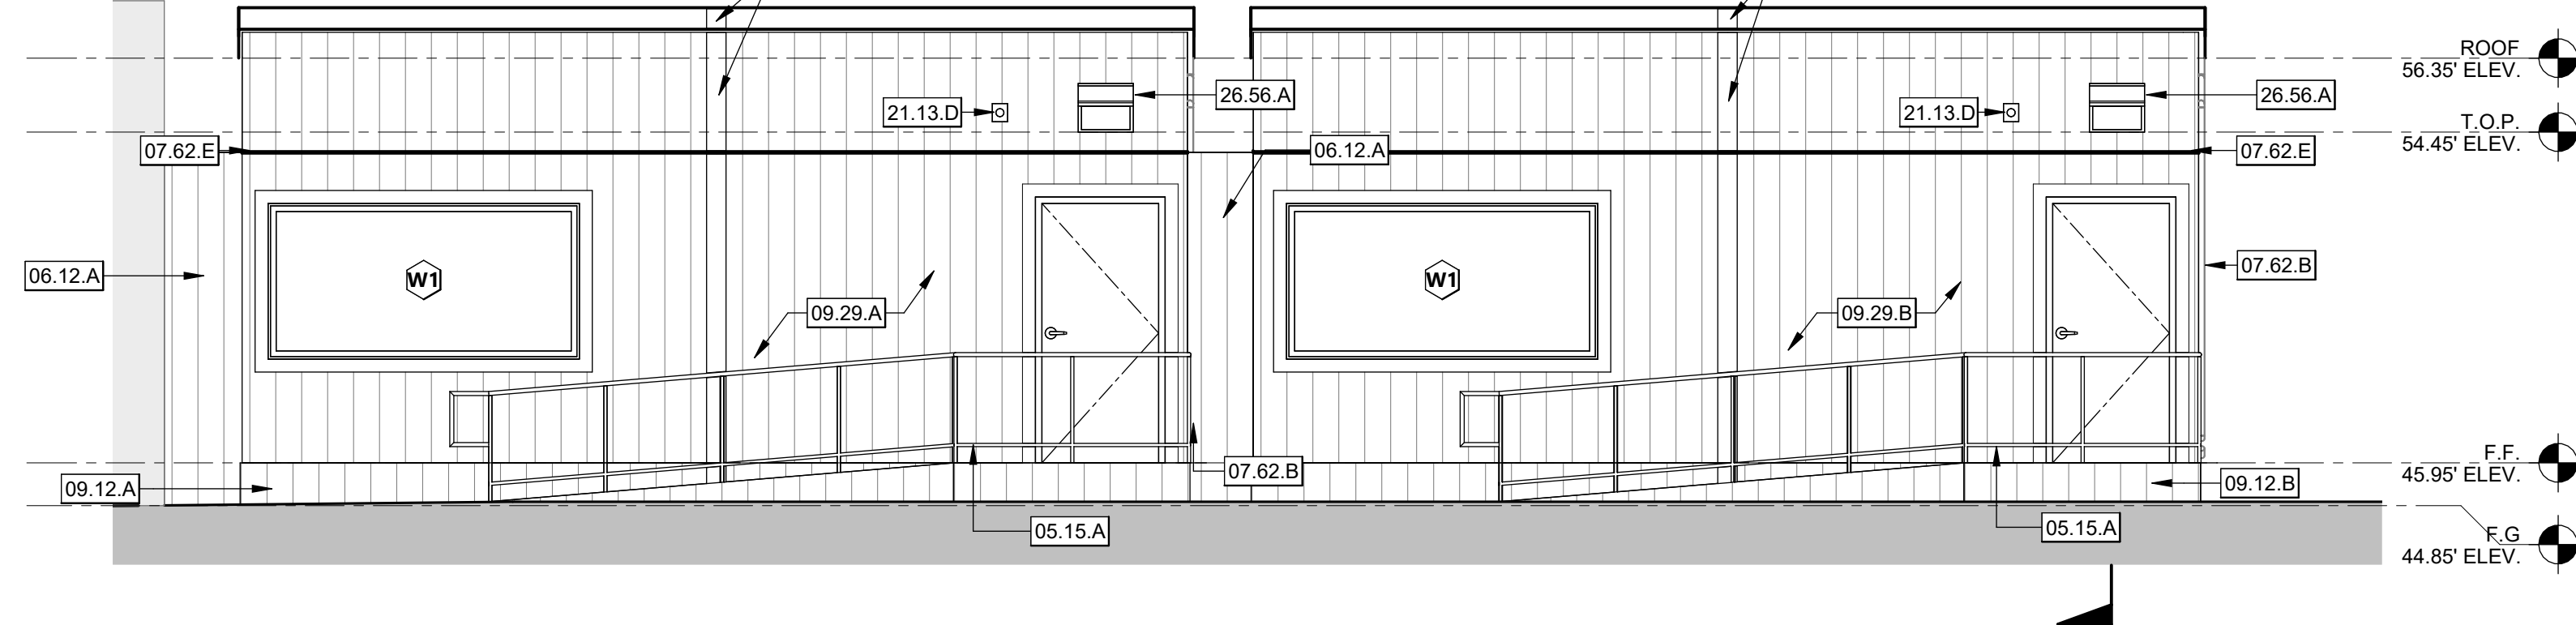2

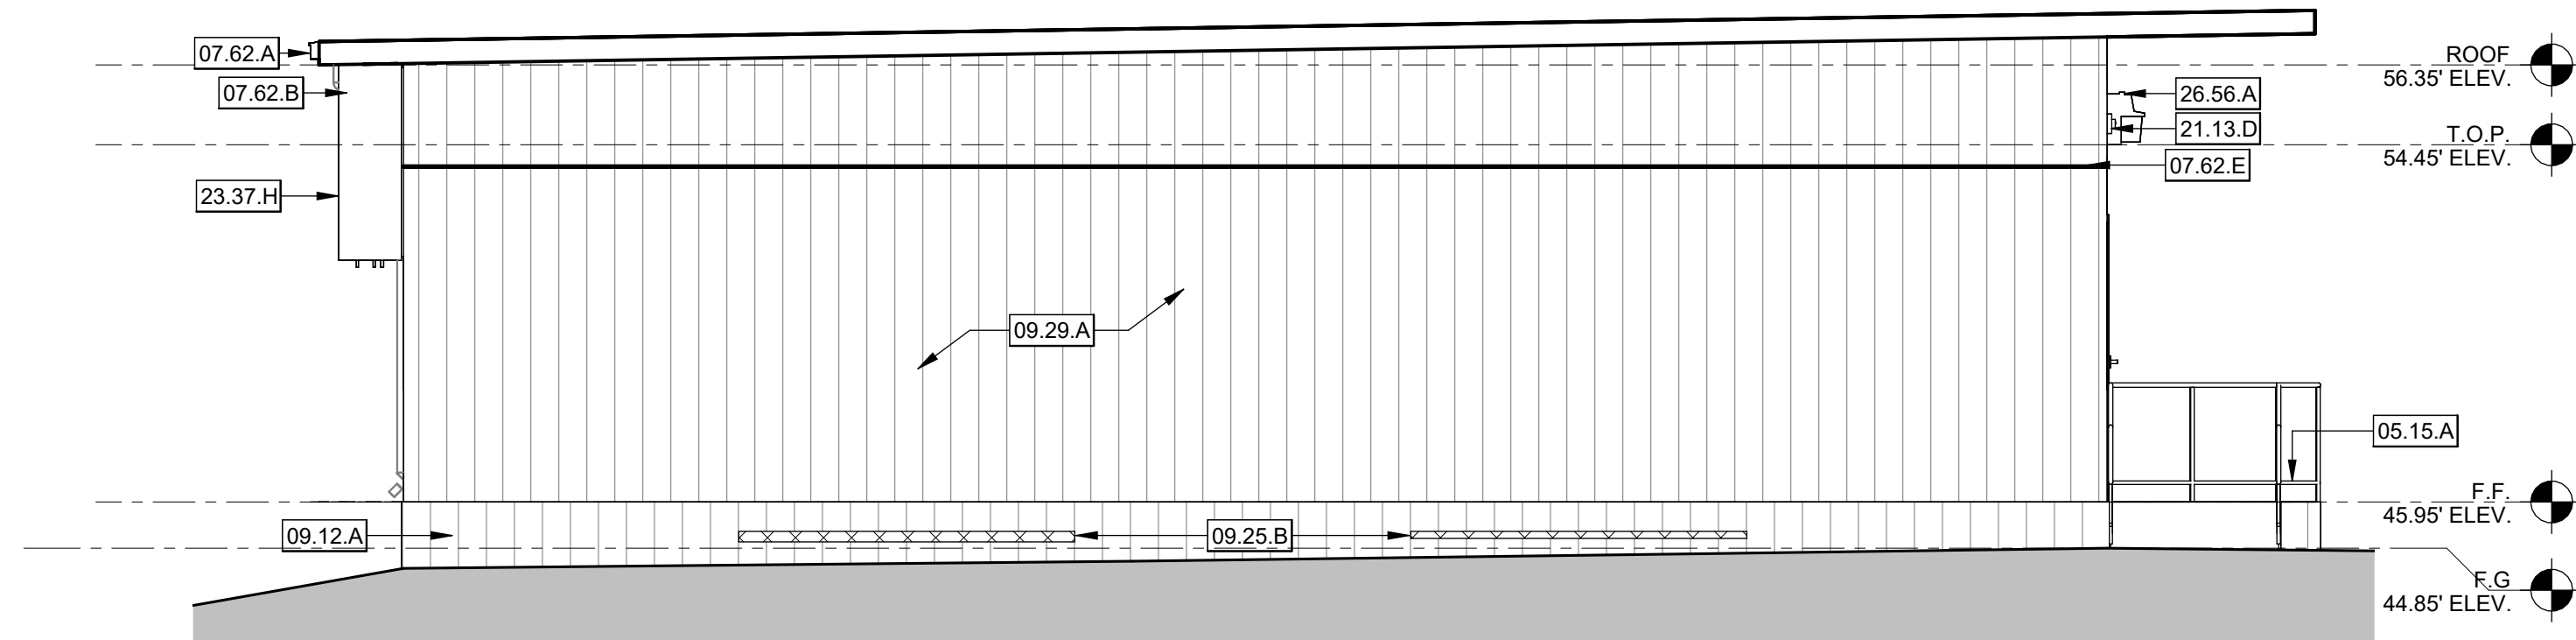
$$1/4" = 1'-0"$$
$$1/4" = 1'-0"$$

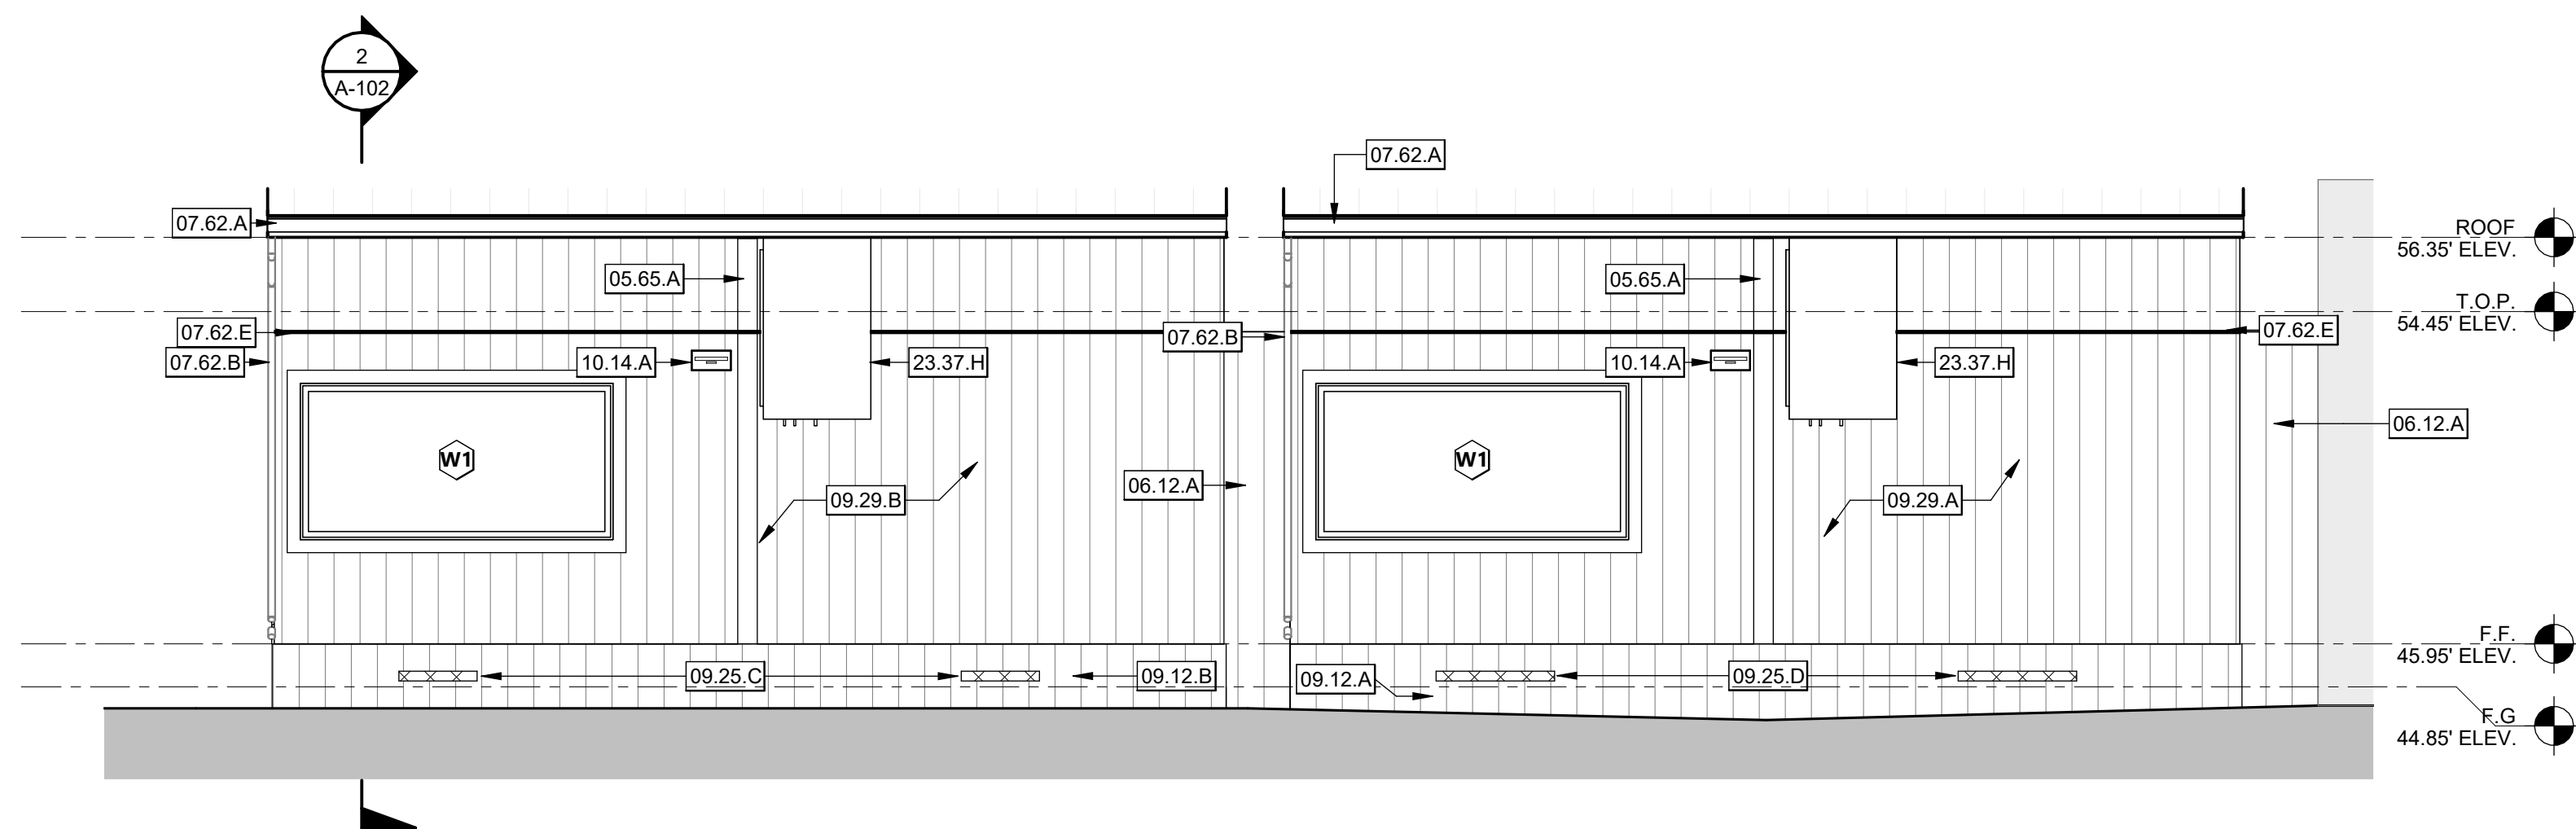3


$$1/4'' = 1'-0''$$
$$1/4'' = 1'-0''$$

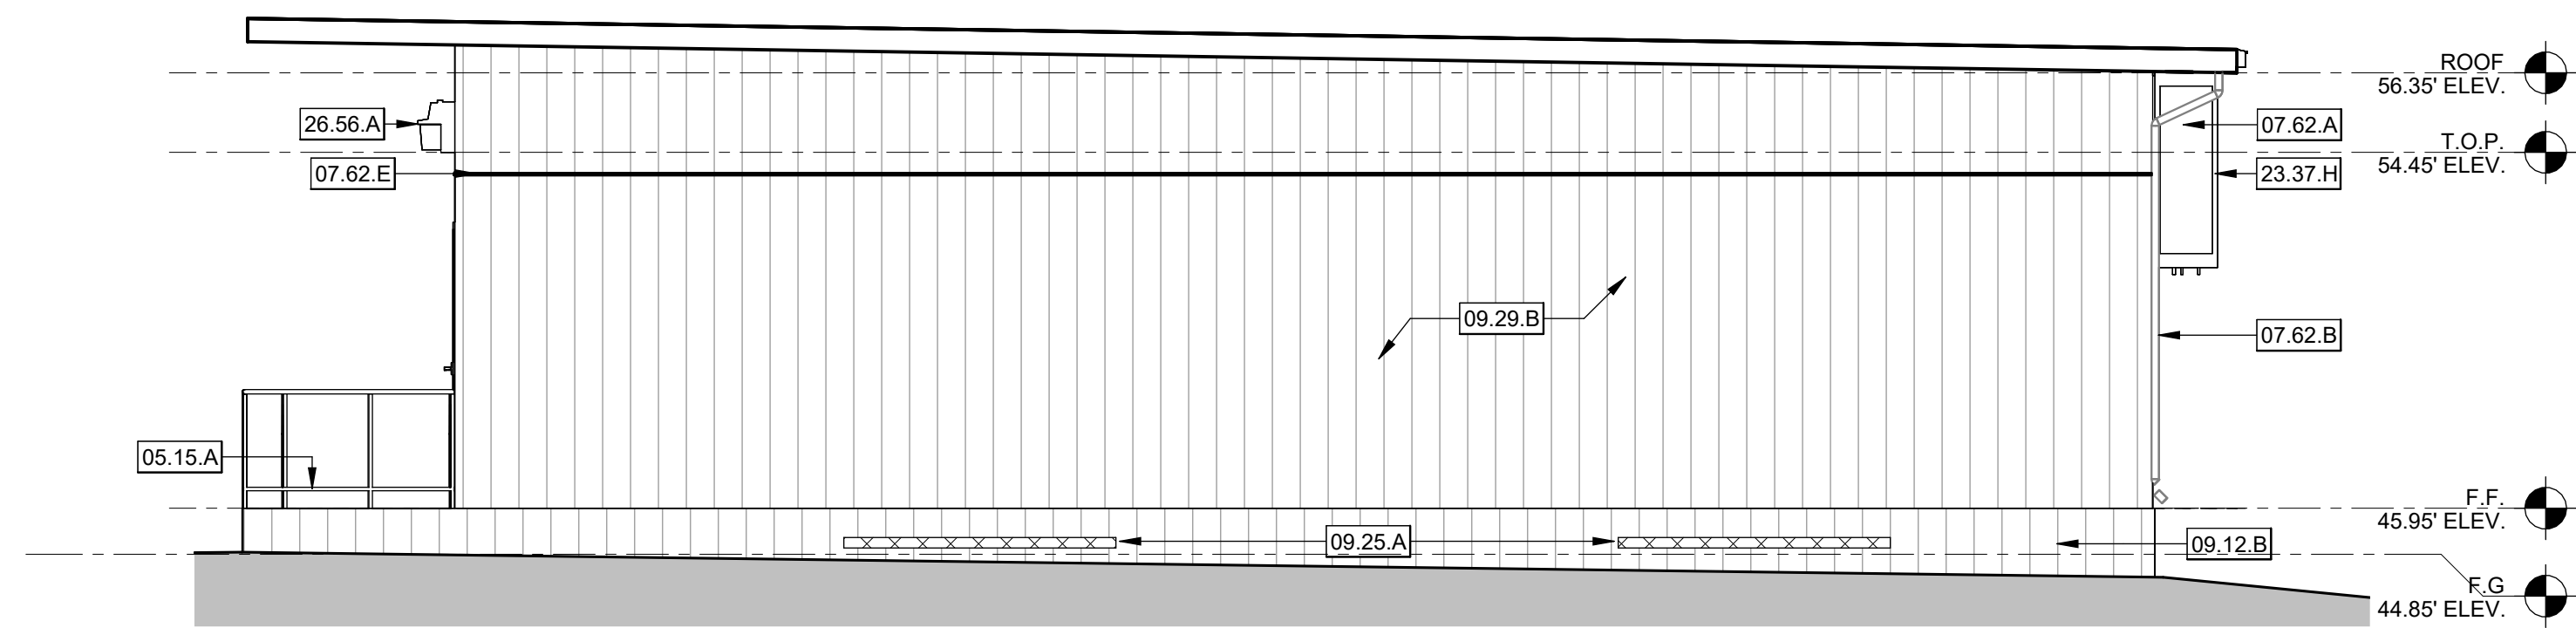4

KEYNOTES

NOTE: NOT ALL KEYNOTES ARE USED ON EVERY SHEET

05.15A	(N) METAL RAMP PK #04-122029
05.65A	SHEET METAL, CLOSURE ANGLE, TYPICAL AT MOD-LINE TO BE INSTALLED BY CONTRACTOR PER AMS DRAWINGS SHEET 2 DETAILS A AND D AND DETAIL 25S
06.12A	(N) 3"X3" SODS BUILDING CLOSURE PANEL. SEE AMS B/2. ADJUST OR REPLACE GALVANIZED 2 FLASHING AS NECESSARY
07.62A	(E) 5" BOX GALV. PRE-FINISHED GUTTER
07.62B	(E) 2" DIA. SCHEDULE 40 DOWNSPOUT
07.62E	(E) Z BAR FLASHING
09.12A	(N) 5/8"X3" SODS BUILDING SKIRT TO BE INSTALLED. SEE AMS B/2. ADJUST OR REPLACE GALVANIZED 2 FLASHING AS NECESSARY
09.12B	(N) BUILDING SKIRT TO BE INSTALLED. SEE MODTECH A8.0.
09.25A	(E) 2 @ 1"x7/8" VENT ON SKIRT @ BOTH SIDEWALLS OF MODTECH PORTABLE #02-106169. SEE KEYNOTE 15 F2.01
09.25B	(E) 1 @ 3"x9/8" VENT (REAR) AND 1 @ 2"x9/8" VENT (FRONT) ON SKIRT @ BOTH SIDEWALLS OF MODTECH #688145. SEE VENT DETAIL 3/2.
09.25C	(E) 3/4"X2" VENT ON SKIRT @ ENDWALL OF MODTECH PORTABLE #02-106169. SEE KEYNOTE 15 F2.01
09.25D	(E) 2 @ 3"x3/8" VENT ON SKIRT @ ENDWALL OF AMS PORTABLE #688145. SEE VENT DETAIL 3/2.
09.29A	(E) 5/8" A.P.A. PLYWOOD 303 SODING. SEE AMS B/2
09.29B	(E) PLYWOOD SODING. SEE MODTECH A8.0.
10.14A	(E) MODULAR IDENTIFICATION TAG
21.13D	(E) FIRE ALARM HORN.
23.37H	(E) WALL MOUNTED HVAC UNIT
26.56A	(E) EXTERIOR LIGHT FIXTURE

EXTERIOR ELEVATION GENERAL NOTES

1. REPAIR DAMAGED AREAS, TOUCH UP PAINT AS REQUIRED TO COVER ALL REPAIRED DAMAGE
SCRATCHES, AND SCRAPES CAUSED BY THE RELOCATION PROCESS. MATCH EXISTING COLORS
UNLESS DIRECTED TO USE NEW COLORS.

DSA# 02-121945

IDENTIFICATION STAMP
DIV. OF THE STATE ARCHITECT
APP: 02-121945 INC:
REVIEWED FOR
SS ☒ FLS ☒ ACS ☒
DATE: 12/12/2023

196
ARCHITECTS

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CONSULTANTS

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PROFESSIONAL STAMP



REVISIONS

[illegible]

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PROJECT OWNER & TITLE

LODI UNIFIED SCHOOL DISTRICT
1305 E. Vine St
Lodi, CA 95240

MILLSWOOD MIDDLE SCHOOL PORTABLES RELOCATION

233 N Mills Ave
Lodi, CA 95242

SHEET TITL

EXTERIOR ELEVATIONS


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SHEET NO.

A-301

DATE: DECEMBER 12, 202

DATE PLOTTED: 12/12/2023 11:16:41 AM FILE LOCATION: C:\Users\morgan.sheehy\Documents\23219_LUSD_Milwood Middle School Portables Relocation_E22_Morgan Sheehy.rvt

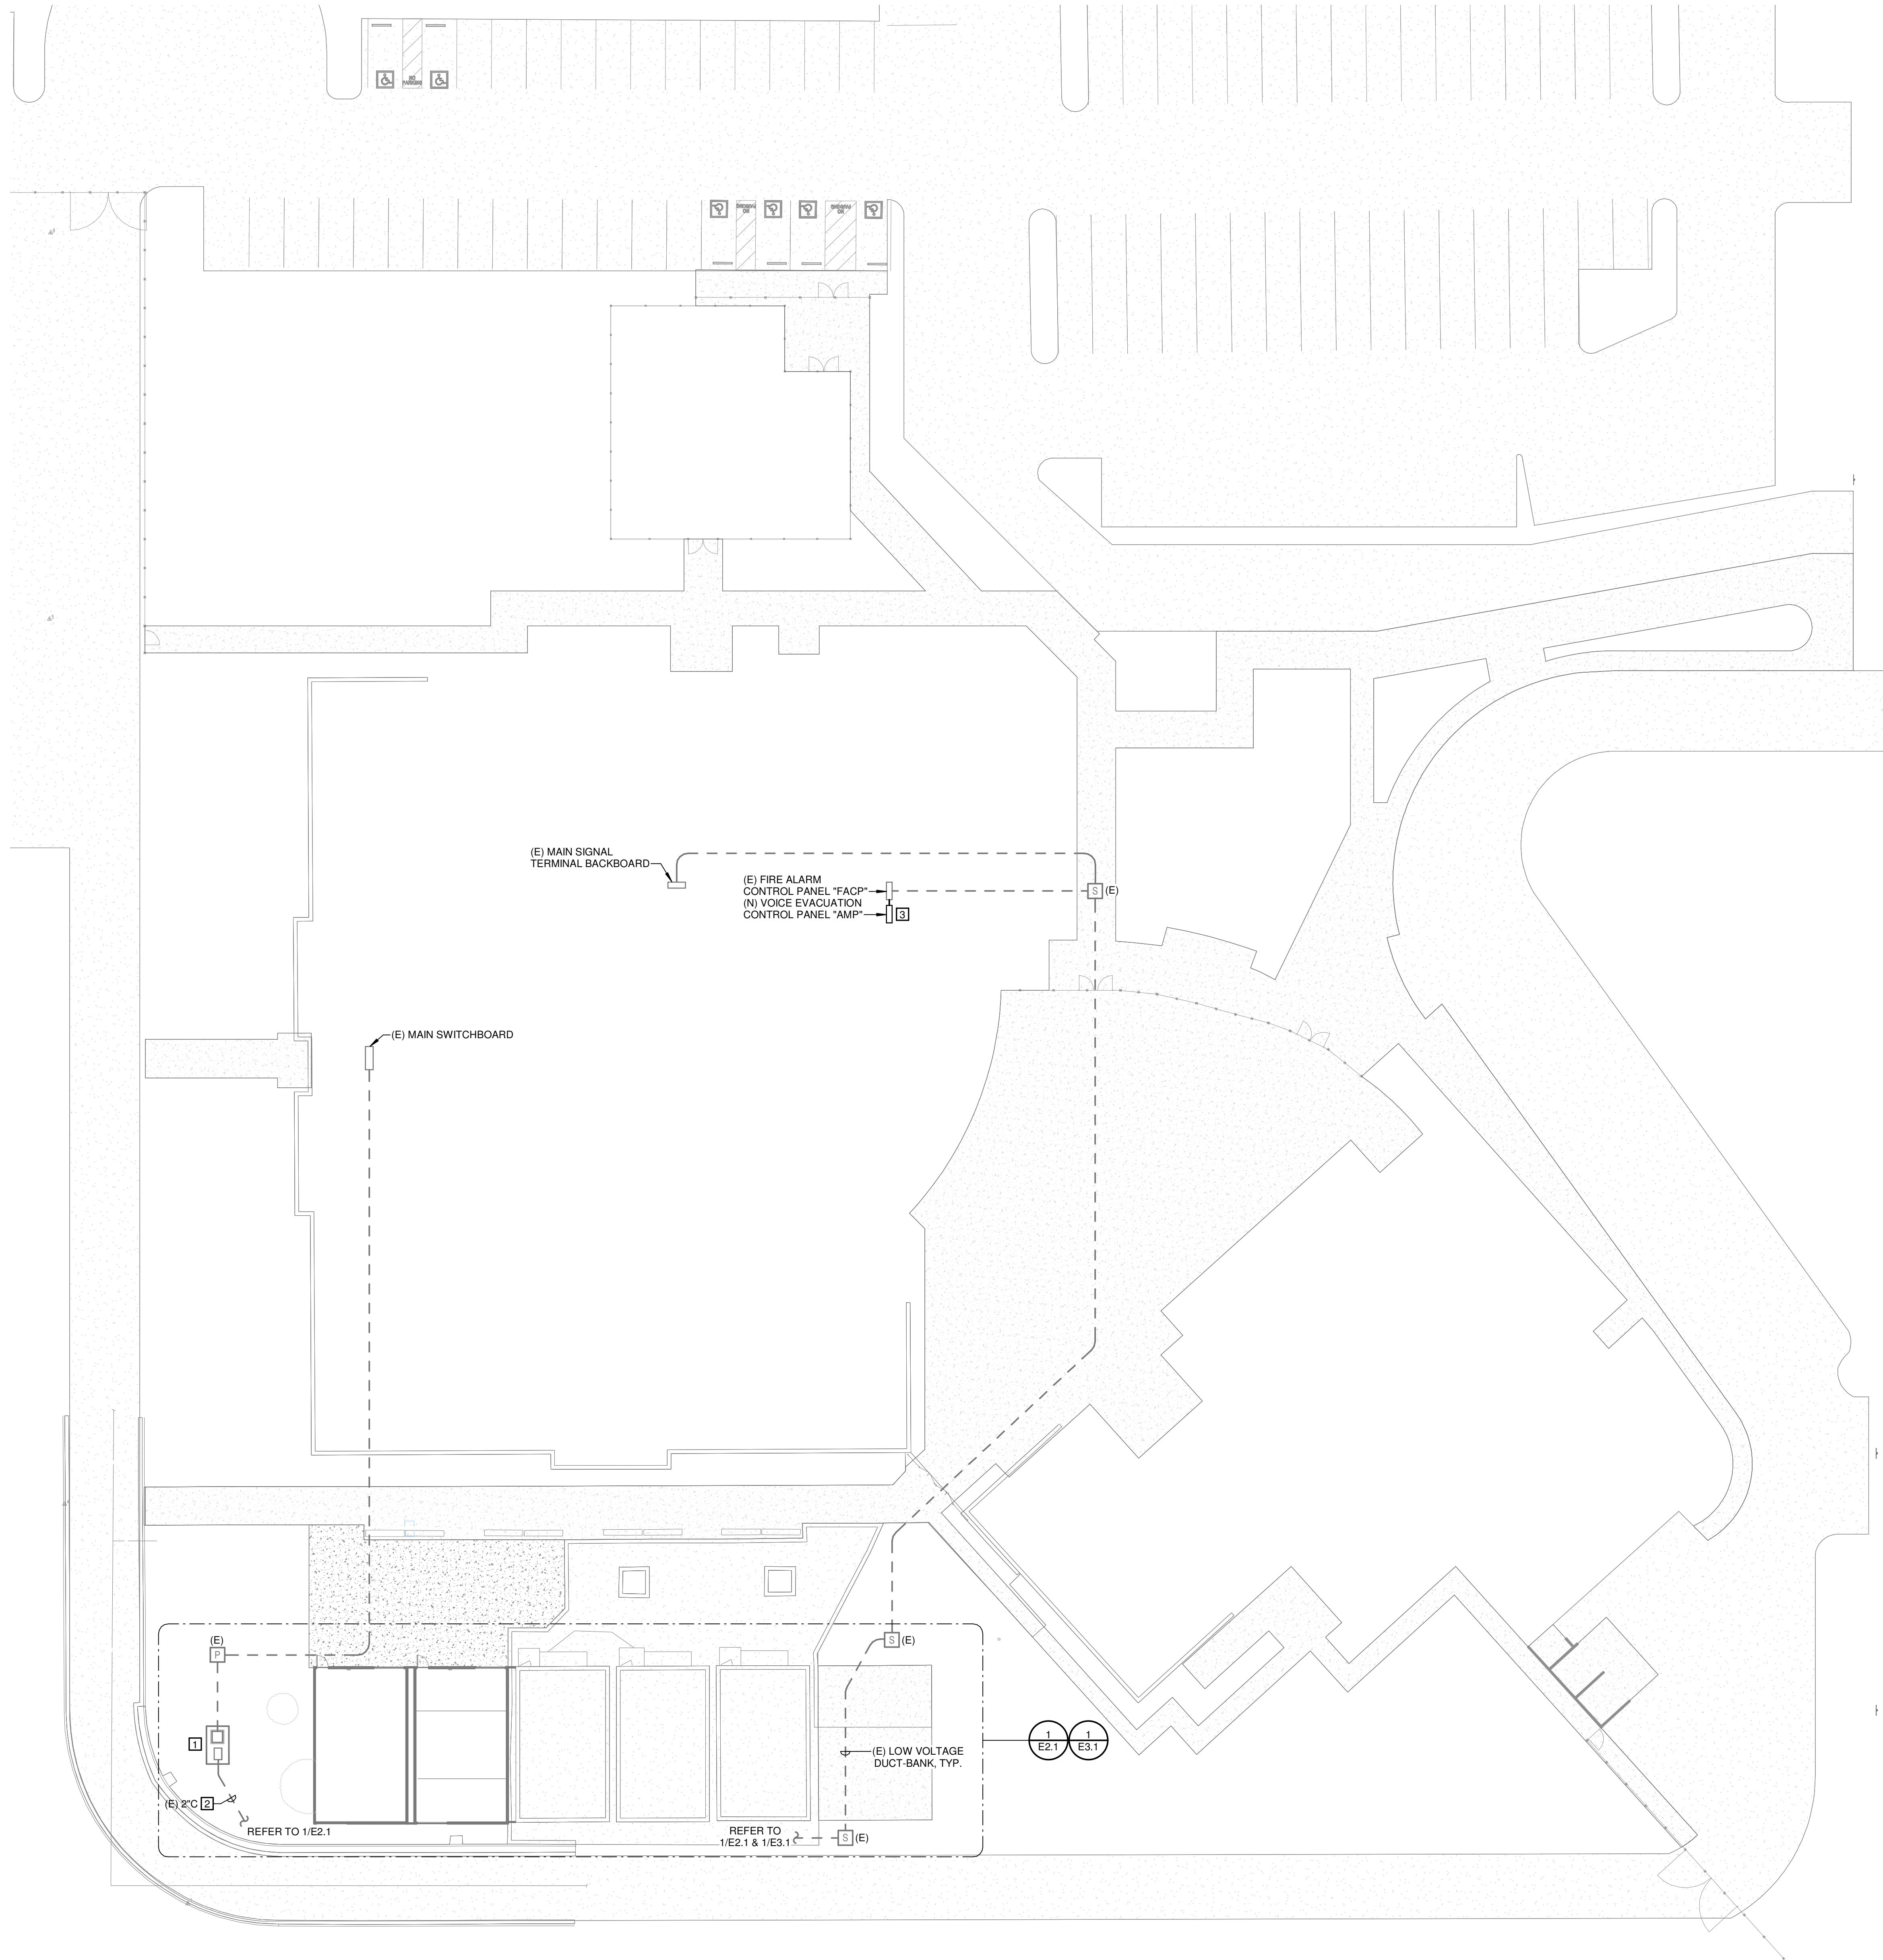

1 OVERALL ELECTRICAL SITE PLAN
SCALE: 1" = 20'-0"

GENERAL SHEET NOTES

- A. CALL U.S.A. PRIOR TO UNDERGROUND WORK, 1-800-227-2600.
B. CONTRACTOR SHALL VERIFY ALL EXISTING CONDITIONS PRIOR TO COMMENCEMENT OF NEW WORK.
C. PROVIDE A 1/2" MULE TAPE IN ALL EMPTY CONDUITS.
D. PROVIDE 6-INCH WIDE UNDERGROUND WARNING TAPE ABOVE ALL NEW UNDERGROUND CONDUITS/CABLES. INSTALL AT 12-INCHES ABOVE THE CONDUITS/CABLES. PROVIDE RED TAPE FOR POWER APPLICATIONS. PROVIDE ORANGE TAPE FOR LOW VOLTAGE APPLICATIONS. PROVIDE BOTH RED AND ORANGE TAPES FOR JOINT TRENCH APPLICATIONS.

NUMBERED SHEET NOTES

- 1 (E) DISTRIBUTION CENTER "DO1" WITH TOTALLY ENCLOSED NON-VENTILATED 112.5KVA TRANSFORMER "T1" AND DISTRIBUTION PANEL "DP1".
2 POWER FEEDERS, REFER TO POWER ONE-LINE DIAGRAM FOR CONDUIT AND WIRING REQUIREMENTS.
3 MOUNT (N) VOICE EVACUATION CONTROL PANEL "AMP" ADJACENT TO (E) FACP. ROUTE CABLING THROUGH EXISTING SITE PATHWAY TO NEW PORTABLES. PROVIDE 120V CONNECTION TO "AMP" FROM EXISTING DEDICATED 120V CIRCUIT USE FOR EXISTING FACP. CONTRACTOR TO PROVIDE LOCKING HARDWARE AND PAINT CIRCUIT BREAKER TRIP HANDLE RED AS REQUIRED.

AGENCY APPROVAL

IDENTIFICATION STAMP
DIV. OF THE STATE ARCHITECT
APP: 02-121945 INC:
REVIEWED FOR
SS ☒ FLS ☒ ACS ☒
DATE: 12/12/2023



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CONSULTANTS

The Engineering Enterprise
CONSULTING ENGINEERS
ALAMEDA | AUBURN | LOS ANGELES
NEOSHO | SAN DIEGO | SANTA BARBARA
<https://www.aengine.com>

PROFESSIONAL STAMP



REVISIONS

NO.	DATE	DESCRIPTION
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PROJECT OWNER & TITLE

LODI UNIFIED SCHOOL DISTRICT
1305 E. Vine St
Lodi, CA 95240

233 N Mills Ave
Lodi, CA 95242

SHEET TITLE

OVERALL ELECTRICAL SITE PLAN

DRAWN BY: Author

JOB NUMBER: 23219


SHEET NO.

E1.1

DATE: DECEMBER 12, 2023

CONSTRUCTION DOCUMENTS

DATE PLOTTED: 12/12/2023 11:16:42 AM FILE LOCATION: C:\Users\morgan.sheehy\Documents\23219_LUSD_Millwood Middle School Portables Relocation_E22_Morgan Sheehy.rvt

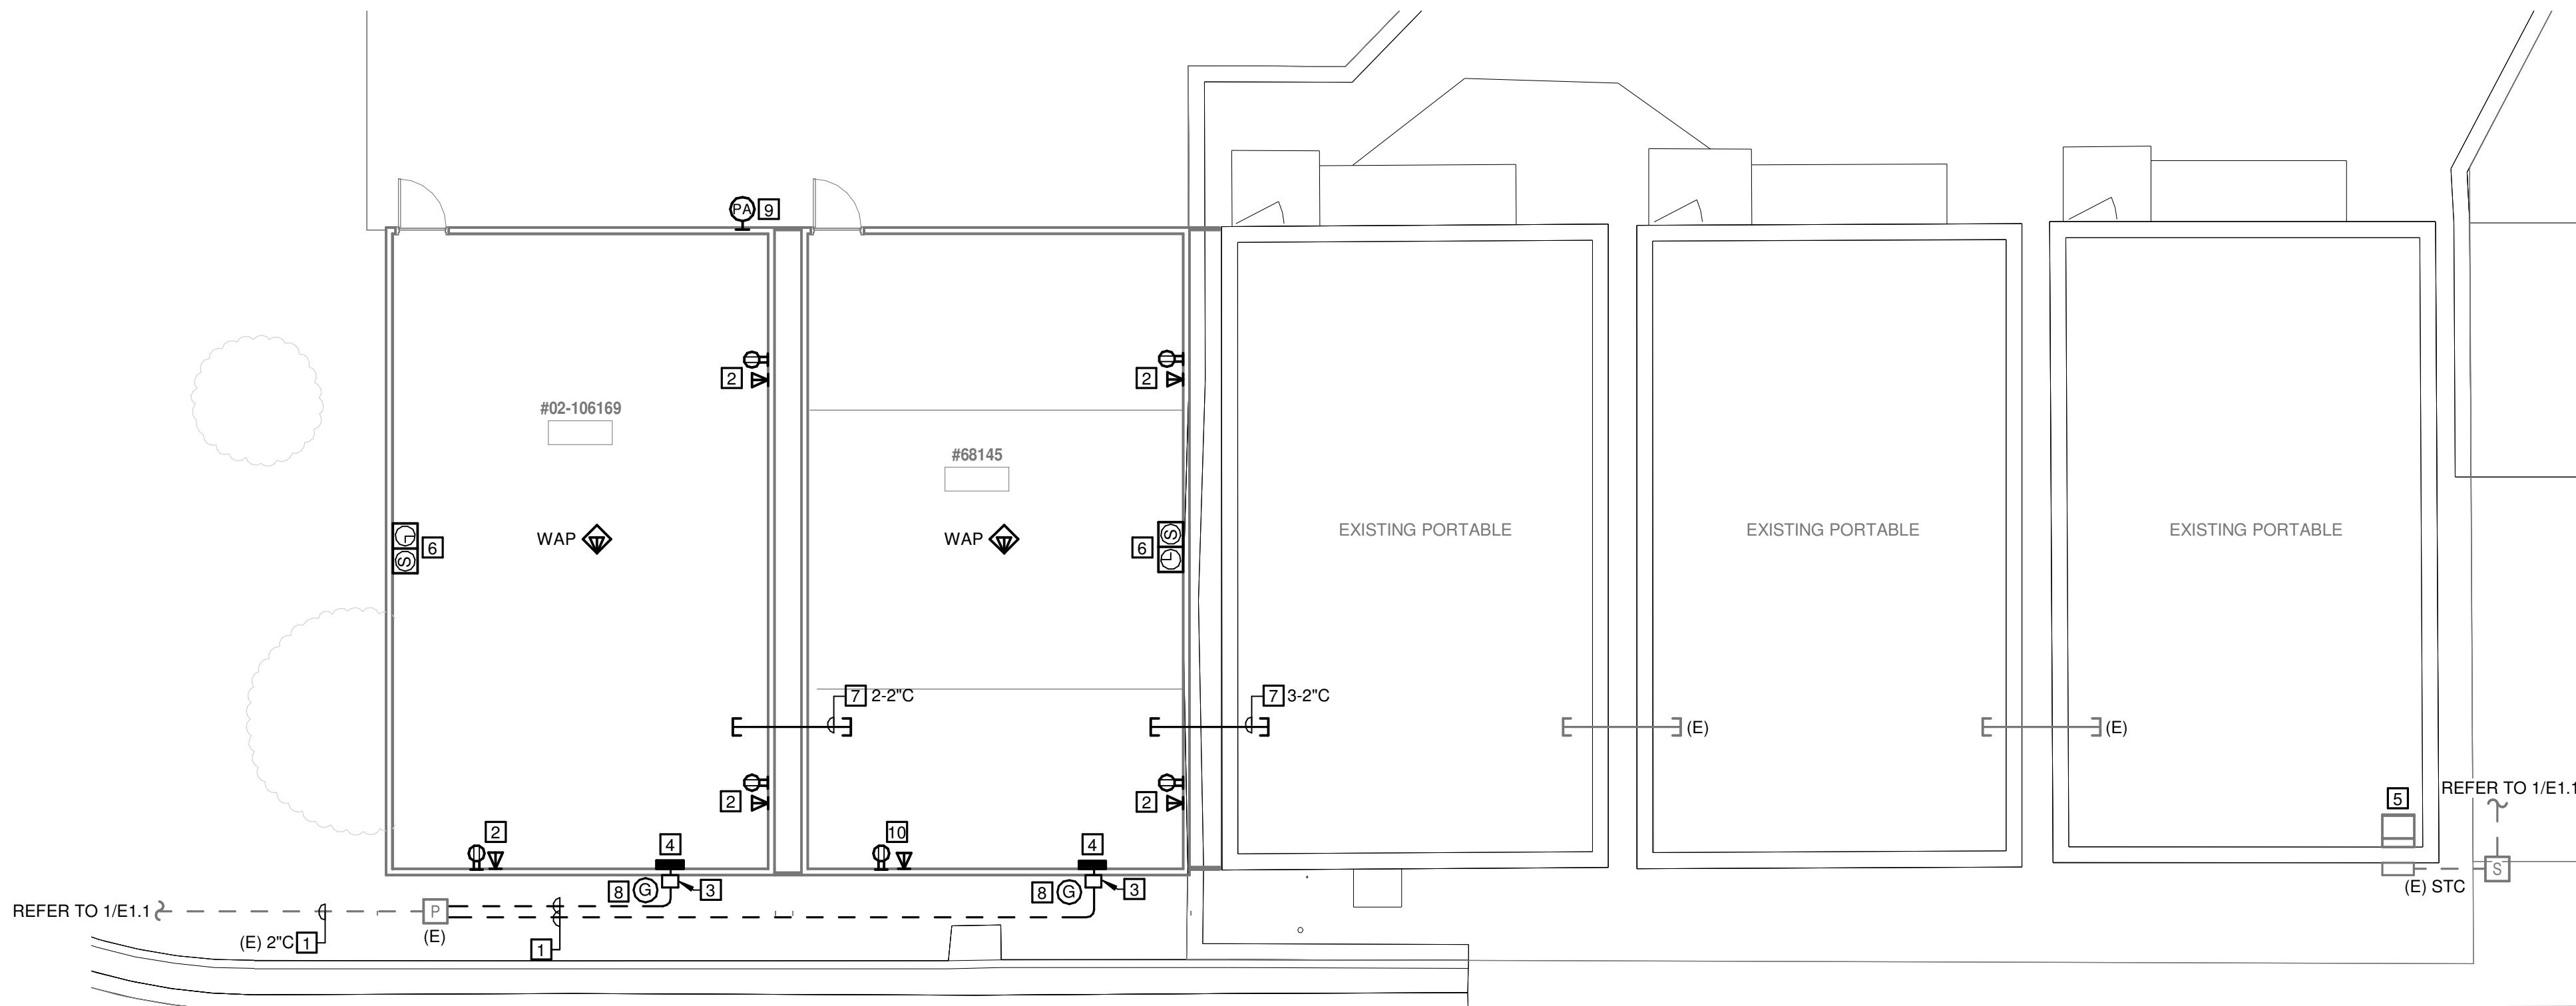

1 POWER & SIGNAL PLAN
SCALE: 1/8" = 1'-0"


GENERAL SHEET NOTES

- A. EXISTING MODULAR BUILDINGS TO BE RELOCATED FROM ANOTHER CAMPUS, REFER TO ARCHITECTURAL AND CIVIL PLANS. EXISTING PANELBOARD, BRANCH CIRCUIT POWER, LIGHTING AND LIGHTING CONTROL TO REMAIN. EXISTING LOW VOLTAGE EQUIPMENT, CABLING, AND DEVICES TO BE REMOVED, PROVIDE NEW DEVICES AND CABLING PER PLANS.
- B. PROVIDE NEW TELECOMMUNICATIONS INFRASTRUCTURE SYSTEM PER DISTRICT STANDARDS AND THE SPECIFICATIONS. COORDINATE WITH THE DISTRICT IT REPRESENTATIVE.
- C. INTRUSION ALARM SYSTEM TO BE INSTALLED BY THE OWNER'S CONTRACTED VENDOR, PROVIDE CONDUIT PATHWAY TO THE NEW PORTABLE BUILDINGS AND COORDINATE AS REQUIRED.

NUMBERED SHEET NOTES


- 1 POWER FEEDERS, REFER TO POWER ONE-LINE DIAGRAM FOR CONDUIT AND WIRING REQUIREMENTS.
- 2 AT TYPICAL WORKSTATION, PROVIDE PANOUT T-70 SURFACE RACEWAY WITH DIVIDER TO ACCESSIBLE CEILING. PROVIDE PANOUT WORKSTATION OUTLET CENTER OFFSET BOX. T70WC2IW. CONNECT POWER RECEPTACLE TO SPARE 20A CIRCUIT AT EXISTING MODULAR BUILDING LOAD CENTER. TELECOM OUTLET WITH 2-BEIGE JACKS AND 1 BLUE JACK (COMPUTER & PHONE).
- 3 AT MODULAR BUILDING WITH FLUSH, INTERIOR LOAD CENTER; PROVIDE A N3R PULL CAN AT EXTERIOR OF BUILDING AND NIPPLE INTO LOAD CENTER.
- 4 POWER PANEL PROVIDED BY MODULAR BUILDING MANUFACTURER, PROVIDE CONNECTION PER 1/E4.1.
- 5 EXISTING WALL MOUNTED IDF CABINET.
- 6 PROVIDE CABLING AND INFRASTRUCTURE FOR OWNER FURNISHED CLOCK/PA SPEAKER.
- 7 SLEEVES BETWEEN BUILDINGS FOR LOW VOLTAGE CABLING REFER TO DETAIL 4/E4.1. FOR INSTALLATION.
- 8 GROUND ROD IN GROUND WELL, INSTALL PER 3/E4.1 AND BOND TO MODULAR BUILDING PER 5/E4.1.
- 9 PROVIDE CABLING AND INFRASTRUCTURE FOR OWNER FURNISHED OUTDOOR PA SPEAKER.

AGENCY APPROVAL

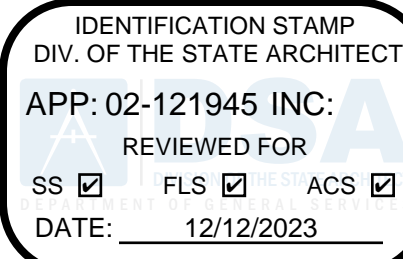

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CONSULTANTS

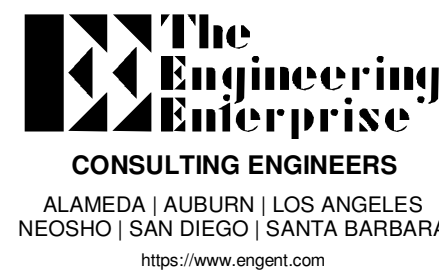

PROFESSIONAL STAMP



REVISIONS

NO.	DATE	DESCRIPTION
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233 N Mills Ave
Lodi, CA 95242

SHEET TITLE

POWER & SIGNAL PLAN

DRAWN BY: Author JOB NUMBER: 23219

SHEET NO.

E2.1

DATE: DECEMBER 12, 2023

DATE PLOTTED: 12/12/2023 11:16:42 AM FILE LOCATION: C:\Users\morgan.sheehy\Documents\23219_LUSD_Millwood Middle School Portables Relocation_E22_Morgan Sheehy.rvt

FIRE ALARM SYSTEM MATRIX							
	SMOKE DETECTOR	HEAT DETECTOR	OPENS/SHORT CIRCUIT	GROUND FAULT	A/C LOSS	BATTERY TROUBLE	SYSTEM SILENCE
ALARM AT FACP & REMOTE ANNUNCIATOR(S)	X	X					
SUPERVISORY AT FACP & REMOTE ANNUNCIATOR(S)							
TROUBLE AT FACP & REMOTE ANNUNCIATOR(S)			X	X	X	X	
REPORT EVENT TO OFFSITE SUPERVISING STATION	X	X	X	X	X	X	
ACTIVATE EVACUATION SIGNALS	X	X					
DEACTIVATE VOICE MESSAGES							X
DEACTIVATE VISUAL SIGNALS							X
RESET FACP TO NORMAL CONDITION							X

FIRE ALARM SYSTEM COMPONENT SCHEDULE				
SYMBOL	EQUIPMENT DESCRIPTION	MODEL NO.	MANUFACTURER	CSFM LISTING
(E) [FACP]	FIRE ALARM CONTROL PANEL	QS4	EDWARDS	-----
(N) [AMP]	SPEAKER AMPLIFIER PANEL	EVAX25	POTTER	6912-1446/0100
(E) [BPS]	NOTIFICATION BOOSTER PANEL	FCPS-2456	EDWARDS	-----
[IM]	ISOLATOR MODULE	SIGA-IM	EDWARDS	7300-1657/0121
[SM]	SINGLE INPUT MONITOR MODULE	SIGA-CT1	EDWARDS	7300-1657/0121
[?]	ADDRESSABLE SMOKE DETECTOR	SIGA-PS	EDWARDS	7272-1657/0331
[AH]	CONVENTIONAL HEAT DETECTOR AH = ATTIC HEAT (ie. ABOVE CEILING)	5604	SYSTEM SENSOR	7270-1653/0167
[15/30/75/110]	CEILING MOUNTED SPEAKER/STROBE	SPSCRL	SYSTEM SENSOR	7320-1653/0505
[WP]	WEATHERPROOF WALL MOUNTED SPEAKER	SPRK	SYSTEM SENSOR	7320-1653/0201

NOTE: CONTRACTOR IS RESPONSIBLE FOR REPLACEMENT OF COMPONENTS SHOWN ON THE FLOOR PLANS. REFER TO SPECIFICATION FOR SPARE DEVICE QUANTITY REQUIREMENTS

FIRE ALARM SYSTEM CABLE SCHEDULE					
CABLE TAG	CIRCUIT DESCRIPTION	CABLE TYPE	GAUGE	CONDUCTORS	COLOR
A	SIGNAL LINE CIRCUIT (SLC)	FPL	#18	2	RED JACKET
B	NOTIFICATION APPLIANCE CIRCUIT (NAC)	FPL	#12	2	RED JACKET
C	CONVENTIONAL SUPERVISED CIRCUIT / 24VDC	FPL	#14	2	RED JACKET
F	UNDERGROUND SLC	WATER TIGHT	#14	2	BLACK JACKET
G	UNDERGROUND NAC	WATER TIGHT	#12	2	BLACK JACKET
H	UNDERGROUND SPEAKER CIRCUIT	WATER TIGHT SHIELDED	#14	2	BLACK JACKET
S	SPEAKER CIRCUIT	FPL OVERALL SHIELDED	#14	2	RED JACKET


FIRE ALARM NOTES	
1. WORK SHALL BE PERFORMED IN ACCORDANCE WITH THE APPLICABLE REGULATIONS, INCLUDING BUT NOT LIMITED TO THE FOLLOWING: STATE CALIFORNIA CODE OF REGULATIONS (CCR) 2022 TITLE 24 CALIFORNIA BUILDING CODE PART 2, 2022 CALIFORNIA BUILDING CODE (CBC) PART 3, 2022 CALIFORNIA ELECTRICAL CODE (CEC) PART 4, 2022 CALIFORNIA MECHANICAL CODE (CMC) PART 5, 2022 CALIFORNIA PLUMBING CODE (CPC) PART 6, 2022 CALIFORNIA FIRE CODE (CFC) 2022 NATIONAL FIRE PROTECTION ASSOCIATION (NFPA) 13 & 72, 2019 NFPA 80, 2018 NFPA 90A, 2021 NFPA 99 & 101.	
2. INSTALLATION OF THE SYSTEMS SHALL NOT BE STARTED UNTIL DETAILED DESIGN DOCUMENTATION AND SPECIFICATION, INCLUDING STATE FIRE MARSHALL LISTING SHEETS FOR EACH COMPONENT OF THE SYSTEM HAS BEEN APPROVED BY DSA.	
3. UPON COMPLETION OF INSTALLATION OF THE SYSTEMS, A SATISFACTORY TEST OF THE ENTIRE SYSTEM SHALL BE MADE IN THE PRESENCE OF A DSA PROJECT INSPECTOR.	
4. A STAMPED SET OF APPROVED FIRE ALARM DESIGN DOCUMENTS SHALL BE ON THE JOB SITE AND USED FOR INSTALLATION.	
5. ANY DISCREPANCIES BETWEEN THE DRAWINGS AND THE CODE OR RECOGNIZED STANDARDS SHALL BE BROUGHT TO THE ATTENTION OF DSA AND THE ARCHITECT/ENGINEER OF RECORD.	
6. DSA, ARCHITECT/ENGINEER AND OWNER SHALL BE NOTIFIED A MINIMUM OF 48 HOURS PRIOR TO THE FINAL INSPECTION AND/ OR TESTING.	
7. ALL PENETRATIONS THROUGH RATED ASSEMBLIES, REQUIRING OPENING PROTECTION SHALL BE PROVIDED WITHIN THE SPECIFICATION WITHIN THE FIRE ALARM SECTION.	
8. AUDIBLE DEVICES SHALL PROVIDE A SOUND PRESSURE LEVEL OF 15 DECIBELS (Dba) ABOVE THE AVERAGE AMBIENT SOUND LEVEL OR 5 Dba ABOVE THE MAXIMUM SOUND LEVEL, HAVING A DURATION AT LEAST 60 SECONDS, WHICHEVER IS GREATER, IN EVERY OCCUPIED SPACE WITHIN THE BUILDING.	
9. AUDIBLE DEVICES SHALL BE SYNCHRONIZED TEMPORAL CODE 3 PATTERN.	
10. THE CONTRACTOR SHALL ADJUST/INSTALL DEVICES TO MAXIMIZE PERFORMANCE AND TO MINIMIZE FALSE ALARMS.	
11. VISUAL DEVICES SHOULD NOT EXCEED 2 FLASHES PER SECOND AND SHOULD NOT BE SLOWER THAN 1 FLASH EVERY SECOND. THE DEVICE SHALL HAVE A PULSING LIGHT SOURCE NOT LESS THAN 15 CANDELA. VISUAL DEVICES WITHIN 55' FROM EACH OTHER SHALL BE SYNCHRONIZED.	
12. UNDERGROUND AND EXTERIOR CONDUIT SHALL HAVE WATERTIGHT FITTINGS AND WIRE TO BE APPROVED FOR WET LOCATIONS.	
13. ALL FIRE ALARM WIRING SHALL BE FPL (FIRE POWER LIMITED) OR FPLP (FIRE POWER LIMITED PLENUM) AS REQUIRED FOR APPLICATION. WIRING IN CONDUIT ABOVE GROUND MAY BE THIN OR THWN.	
14. PER CEC STANDARDS, ALL WIRING IS TO BE PULLED THROUGH EACH JUNCTION BOX AND CONNECTED DIRECTLY TO EACH FIRE DEVICE. DO NOT SPLICE THE WIRE. ALL BOXES TO BE SIZED PER CEC.	
15. IN AREA OF CONSTRUCTION OR POSSIBLE DAMAGE/CONTAMINATION OF NEWLY INSTALLED FIRE ALARM DEVICES SHALL BE COVERED UNTIL AREA IS READY TO BE TURNED OVER TO THE OWNER.	
16. ALL FIRE ALARM CIRCUITS ARE TO BE IN CONDUIT, SURFACE RACEWAY OR OPEN RUN ABOVE THE CEILINGS, UNDER FLOORS AND IN WALLS IN A NEAT AND PROTECTED MANNER AS INDICATED ON THE DESIGN DOCUMENTS. EXPOSED CIRCUITS ARE ONLY PERMITTED WHEN NOTED AS EXPOSED ON DESIGN DOCUMENTS.	
17. FIRE ALARM PANEL, REMOTES, AND COMPONENTS SHALL BE SECURED TO MOUNTING SURFACES PER MANUFACTURERS SPECIFICATIONS. NO DEVICE SHALL EXCEED THE WEIGHT OF 20 LBS. WITHOUT SPECIAL MOUNTING DETAILS.	
18. A DEDICATED BRANCH CIRCUIT SHALL BE PROVIDED FOR FIRE ALARM EQUIPMENT. THIS CIRCUIT SHALL BE ENERGIZED FROM A COMMON USE AREA PANEL AND SHALL HAVE NO OTHER OUTLETS. THE BREAKER SHALL HAVE A RED LOCKING DEVICE TO BLOCK THE HANDLE IN THE "ON" POSITION. THE CIRCUIT BREAKER SHALL BE LABELED "FIRE ALARM CIRCUIT CONTROL". CIRCUIT ID TO BE LABELED AT FIRE PANEL/EXPANDERS.	
19. THE INSTALLER CONTRACTOR SHALL PROVIDE A RECORD OF COMPLETION PER NFPA 72, FIGURE 10.16.2.1.1.	
20. CONTROL PANELS, REMOTE ANNUNCIATORS SHALL BE MOUNTED WITH THE TOP OF THE CONTROL DEVICE OR KEYPAD TO BE A MAXIMUM OF 48".	
21. THE INSTALLING CONTRACTOR SHALL PROVIDE SYSTEM PROGRAMMING FOR SUPERVISORY MONITORING PER CBC SECTION 901.6.2.	
22. SUPERVISORY MONITORING SHALL BE TESTED AND VERIFIED AS SENDING CORRECT SIGNALS IN CONJUNCTION WITH FINAL ACCEPTANCE TEST.	
23. OWNER SHALL BE RESPONSIBLE FOR ESTABLISHING A FIRE SYSTEM MONITORING CONTRACT OR PROVISIONS.	
24. THE FIRE ALARM SYSTEM SHALL CONFORM TO 2022 CALIFORNIA ELECTRICAL CODE (CEC) ARTICLE 760 AND 2022 CALIFORNIA FIRE CODE (CFC) SECTION 907.	
25. BEFORE REQUESTING FINAL APPROVAL OF THE INSTALLATION THE INSTALLING CONTRACTOR SHALL FURNISH A WRITTEN STATEMENT TO THE DSA PROJECT INSPECTOR TO THE EFFECT THAT THE SYSTEM HAS BEEN INSTALLED AND TESTED IN ACCORDANCE WITH THE 2019 NFPA 72 SECTION 14.4.1	
26. UPON COMPLETION OF THE INSTALLATION OF THE FIRE ALARM SYSTEM, A SATISFACTORY TEST OF THE SYSTEM SHALL BE MADE IN THE PRESENCE OF THE DSA PROJECT INSPECTOR.	
27. PROVIDE A RECORD OF COMPLETION PER NFPA 72 CHAPTER 7.5.6.	
28. AUTOMATIC FIRE ALARM SYSTEM SHALL TRANSMIT THE ALARM, SUPERVISORY AND TROUBLE SIGNALS TO AN APPROVED SUPERVISING STATION AS REQUIRED BY NFPA 72 AND CBC 907.6.5.2. THE SUPERVISING STATION SHALL BE LISTED AS EITHER UUXF OR UUIS BY UL OR SHALL MEET THE REQUIREMENTS OF FM STANDARDS 3011.	
29. TEST, INSPECTION AND MAINTENANCE SHALL COMPLY WITH NFPA 72 CHAPTER 14 REQUIREMENTS.	
30. EACH BUILDING TO BE A SEPARATE SPEAKER ZONE. (CFC 907.63).	

FIRE ALARM SYSTEM DESCRIPTION	
SCOPE OF THIS PROJECT IS TO EXTEND EXISTING FIRE ALARM SYSTEM TO NEW CLASSROOM BUILDINGS. PROVIDE NEW VOICE EVACUATION, NOTIFICATION APPLIANCES, INITATION DEVICES, WIRING, AND BACK BOXES.	
FIRE ALARM SYSTEM: CLASS B IDC: CLASS B SLC CIRCUIT: CLASS B NOTIFICATION CIRCUIT: CLASS B	

GENERAL SHEET NOTES	
A. FIRE ALARM CIRCUITS AND CIRCUIT ROUTING ARE SHOW SCHEMATICALLY FOR CLARITY ILLUSTRATING THE WIRING CONFIGURATION NECESSARY FOR PROPER SUPERVISION.	
B. FIRE ALARM STROBES SHALL BE SYNCHRONIZED PER NFPA 72.	
C. ALL OUTDOOR FIRE ALARM EQUIPMENT SHALL BE LISTED FOR EXTERIOR USE.	
D. DO NOT INSTALL FIRE ALARM DEVICES BACK TO BACK IN STUD WALLS.	
E. IN AREAS WHERE DEVICES ARE TO BE CEILING MOUNTED COORDINATE LOCATIONS TO AVOID CONFLICTS WITH EXISTING LIGHT FIXTURES.	
F. FIRE ALARM INSTALLATION SHALL COMPLY WITH ALL REQUIREMENTS OF APPLICABLE CODES, STANDARDS AND STATE REGULATIONS.	

NUMBERED SHEET NOTES	
1 PROVIDE MONITOR MODULE TO SUPERVISE ATTIC HEAT DETECTORS (TYP).	


FIRE ALARM DEVICE MOUNTING DETAIL NOTES	
1 MOUNT DOOR HOLDER SMOKE DETECTOR MAXIMUM 3' FROM DOOR AND A MINIMUM OF 1' FROM DOOR. 2 NFPA 72 17.7.3.2.3.1 ON SMOOTH CEILINGS, SPACING FOR SMOKE DETECTORS SHALL BE IN ACCORDANCE WITH ONE OF THE FOLLOWING REQUIREMENTS: 1. THE DISTANCE BETWEEN SMOKE DETECTORS SHALL NOT EXCEED SPACING OF 30'. 2. ALL POINTS ON THE CEILING SHALL HAVE A DETECTOR WITHIN A DISTANCE EQUAL TO OR LESS THAN 21'. 3 NFPA 72 17.7.4.1 MOUNT SMOKE DETECTOR MINIMUM OF 3' AWAY FROM DIFFUSER VENT. 4 MOUNT SMOKE DETECTOR FOR FIRE SMOKE DAMPER (FSD) WITHIN 3' OF SUPPLY VENT. 5 DUCT SMOKE DETECTOR SHALL BE MOUNTED 6 TO 10 TIMES THE DIAMETER OF DUCT FROM BEND OR OBSTRUCTION. 6 NFPA 72 17.4.7 WHERE FIRE DETECTORS ARE INSTALLED IN CONCEALED LOCATIONS MORE THAN 10' AFF OR IN ARRANGEMENTS WHERE THE DETECTORS ALARM OR SUPERVISORY INDICATOR IS NOT VISIBLE TO RESPONDING PERSONNEL, DETECTORS SHALL BE PROVIDED WITH A REMOTE INDICATOR OR SUPERVISORY INDICATION ACCEPTABLE WITH AUTHORITY HAVING JURISDICTION (AHJ). 7 NFPA 72 17.7.3.2.4.2 BEAM POCKET SPOT DETECTOR ARE REQUIRED FOR BEAMS GREATER THAN 18" BELOW CEILING AND SPACED MORE THAN 8' ON CENTER. EACH BAY FORMED BY BEAM SHALL BE TREATED AS A SEPARATE AREA. BEAMS LESS THAN 12" IN DEPTH AND SPACED LESS THAN 8' ON CENTER SHALL HAVE DETECTORS INSTALLED ON THE BOTTOM OF THE BEAM. OR, CEILINGS WITH BEAM DEPTHS LESS THAN 10 PERCENT OF THE CEILING HEIGHT, SMOOTH CEILING SPACING IS PERMITTED AND DETECTORS PLACED ON THE BOTTOM OF THE BEAM. BEAMS EQUAL TO OR GREATER THAN 10 PERCENT OF CEILING HEIGHT WITH BEAM SPACING GREATER THAN 40 PERCENT OF CEILING HEIGHT, SPOT DETECTORS SHALL BE LOCATED IN EACH CELL. 8 NFPA 72 17.6.3.3.1.1 BEAMS PROJECTING LESS THAN 4" SHALL BE TREATED AS A SMOOTH CEILING. 9 NFPA 72 17.6.3.1.3.1 SMOKE DETECTORS SHALL BE MOUNTED ON THE CEILING MINIMUM 4" FROM WALL, AND 4" MINIMUM TO 12" MAXIMUM FROM CEILING MOUNTED ON WALL. 10 NFPA 72 17.14.5 THE OPERABLE PART OF A MANUALLY ACTUATED ALARM-INITIATING DEVICE SHALL NOT BE LESS THAN 42" AFF AND NOT MORE THAN 48" AFF. NFPA 72 17.14.8.4 MANUAL FIRE ALARM BOXES SHALL BE LOCATED WITHIN 5' OF EACH EXIT DOORWAY ON EACH FLOOR. 11 NFPA 72 18.4.8.1 MOUNT EXTERIOR HORN AT 90° MINIMUM AND 100° MAXIMUM TO THE TOP OF THE DEVICE. 12 NFPA 72 18.5.5.2 WHERE LOW CEILING HEIGHTS DO NOT PERMIT WALL MOUNTING AT A MINIMUM OF 80", WALL MOUNTED VISIBLE APPLIANCES SHALL BE MOUNTED WITHIN 6" OF THE CEILING. 13 NFPA 72 18.5.5.1 INTERIOR WALL MOUNTED APPLIANCES SHALL BE MOUNTED SUCH THAT THE ENTIRE LENS IS NOT LESS THAN 80° AFF AND NOT GREATER THAN 96° AFF. 14 CBC 1117B.0 (3) MOUNT FIRE ALARM CONTROL PANELS AND ANNUNCIATORS AT A MAXIMUM OF 48" TO THE TOP OF THE CONTROL PANEL OR KEY BOARDS. 15 CEILING MOUNTED HORN / SPEAKER STROBE 16 MONITOR MODULE 17 RATE OF RISE HEAT DETECTOR, MOUNTED IN ABOVE CEILING / ATTIC SPACE. 18 APPROVED WIRE MANAGEMENT, ie J-HOOK OR D-RING. 19 ABOVE CEILING CIRCUITS ROUTING IN AN ACCESSIBLE ATTIC SPACE. 20 NON-ACCESSIBLE CEILINGS MUST USE EITHER EMT OR APPROVED WIREMOLD RACEWAY, AS SHOWN ON PLANS. 21 MULTI-CRITERIA PHOTOELECTRIC SMOKE / CO DETECTOR WITH SOUNDER BASE, MOUNT IN AREAS WHERE FOSSIL FUEL IS USED. 23 NFPA 72 17.5.3.1.4 DETECTION FOR CONCEALED ACCESSIBLE SPACES ABOVE SUSPENDED CEILING USED AS A RETURN PLENUM SHALL BE PROVIDED AT EACH CONNECTION FROM RETURN AIR PLENUM AT CENTRAL AIR HANDLING UNIT. 24 NFPA 72 7.2.2 WITH EVERY NEW FIRE ALARM SYSTEM A DOCUMENTATION CABINET SHALL BE INSTALLED AT THE FIRE ALARM CONTROL PANEL OR AT ANOTHER LOCATION APPROVED BY AHJ. THE CABINET SHALL BE PROMINENTLY LABELED "SYSTEM RECORD DOCUMENTS". 25 NFPA 90A 6.4.2.1 SMOKE DETECTORS LISTED FOR USE IN AIR DISTRIBUTION SYSTEMS SHALL BE LOCATED AS FOLLOWS: DOWNSTREAM OF THE AIR FILTERS AND AHEAD OF ANY BRANCH CONNECTIONS IN AIR SUPPLY SYSTEMS HAVING A CAPACITY GREATER THAN 2000 CFM. 26 SMOKE DETECTORS SHALL NOT BE CLOSER THAN 1' FROM SPRINKLERS.	

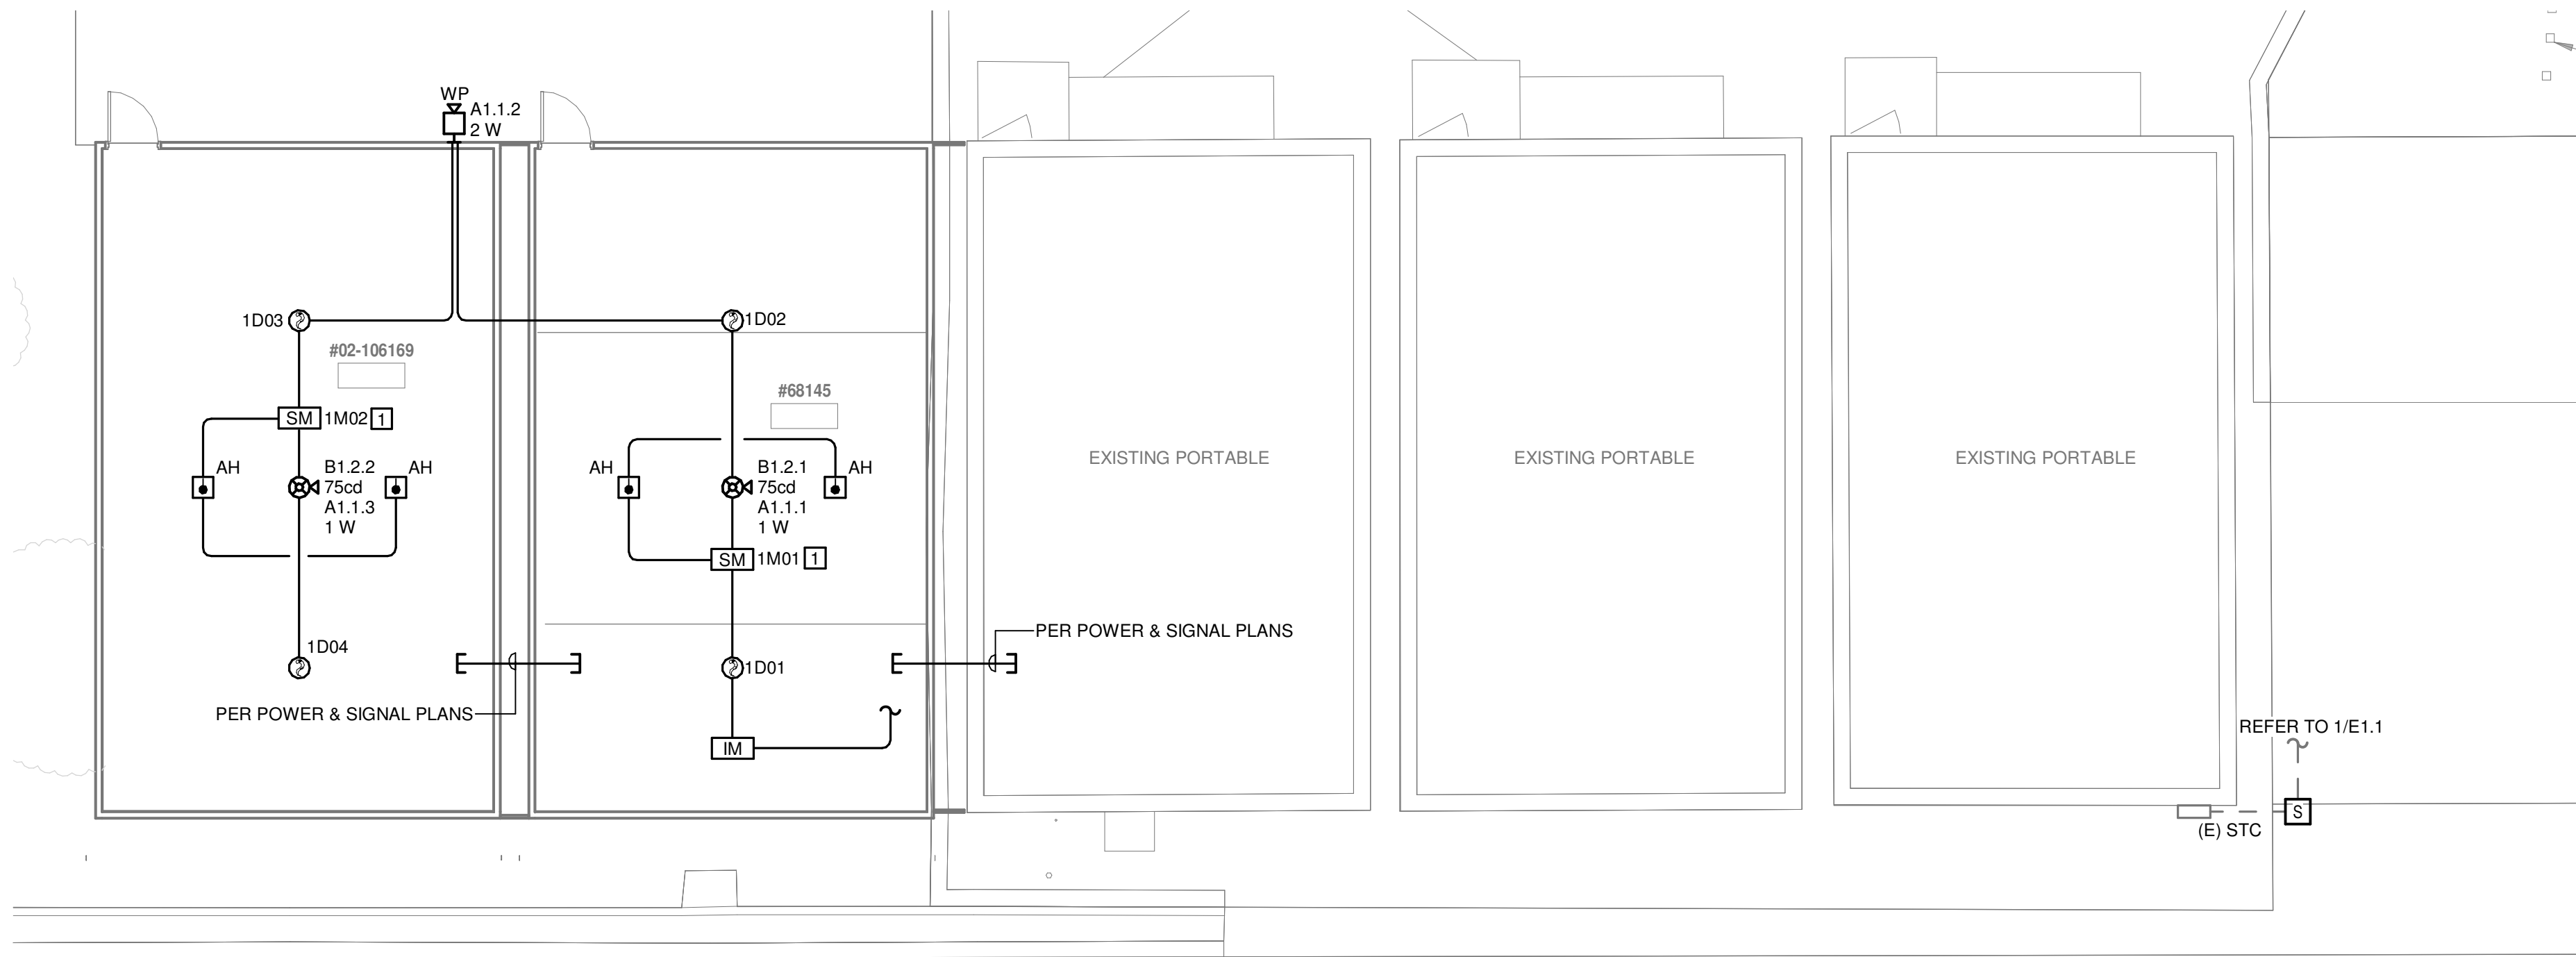

1 FIRE ALARM PLAN


SCALE: 1/8" = 1'-0"

AGENCY APPROVAL

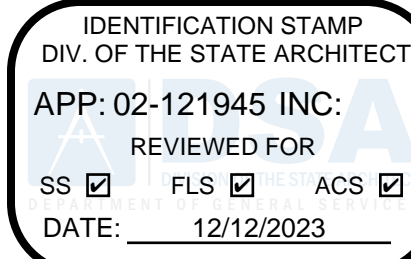

1715 R STREET, SUITE 200
SACRAMENTO, CA 95811
TEL TEL (916) 786-8178

CONSULTANTS

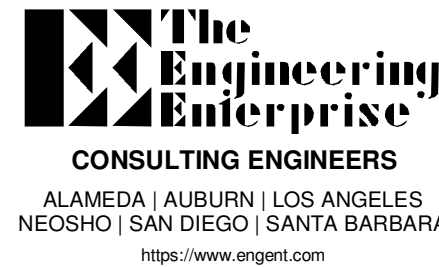

PROFESSIONAL STAMP



REVISIONS

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PROJECT OWNER & TITLE
LODI UNIFIED SCHOOL DISTRICT
1305 E. Vine St
Lodi, CA 95240

233 N Mills Ave
Lodi, CA 95242

SHEET TITLE

FIRE ALARM DETAILS, SCHEDULES & NOTES

DRAWN BY: Author

JOB NUMBER: 23219

SHEET NO.

E3.1

DATE: DECEMBER 12, 2023

CONSTRUCTION DOCUMENTS

MILLSWOOD AMP A1									
		Standby Current (amps)				Alarm Current (amps)			
Device Type	QTY	Watts	Current Draw	Total		Qty	Current Draw	Total	
1. System									
EVAX 25	1	25	X	0.0860	=	0.0860	0	X	2.2060
			X		=		0	X	= 0.0000
			X		=		0	X	= 0.0000
2. Speakers									
Total Speaker Watts @ 25Vrms		0					0.0000	=	0.0000
Total Speaker Watts @ 70.7Vrms		4					0.0566	=	0.0566
		Total Standby Load		0.0860		Total Alarm Load		2.2626	
0									
Standby Load Current (Amps)						Required Standby Time in Hours			
0.0860 Amps						X 24 = 2.064 AH			
Alarm Load Current (Amps)						Required Alarm Time in Hours			
2.2626 Amps						X 15 = 0.566 AH			
						Total Current Load 2.63 AH			
						*Multiply by the Derating Factor = x 0.25			
						Total Ampere Hours Required 3.29 AH			
Recommended Batteries:						7AH BATTERIES			


*Derating Factor required to compensate for the non-linear discharge characteristic of a battery.

(E) FACP CALCULATIONS

Signaling Line Circuit Loading

Qty	Device	DEVICE		SUBTOTAL	
		Standby	Alarm	Standby	Alarm
1	FIRE ALARM CONTROL PANEL	0.081000	0.150000	0.081000	0.150000
5	MONITOR MODULE	0.012000	0.002000	0.060000	0.010000
0	SMOKE DETECTOR	0.000300	0.000000	0.000000	0.000000
1	ISOLATION MODULE	0.000300	0.000000	0.000300	0.000000


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NOTE: COORDINATE PANEL LOCATION WITH EXISTING CONDITIONS FOR PLACEMENT OF IN-GROUND PULLBOX TO ENSURE MINIMAL ABOVE-GROUND RISER.

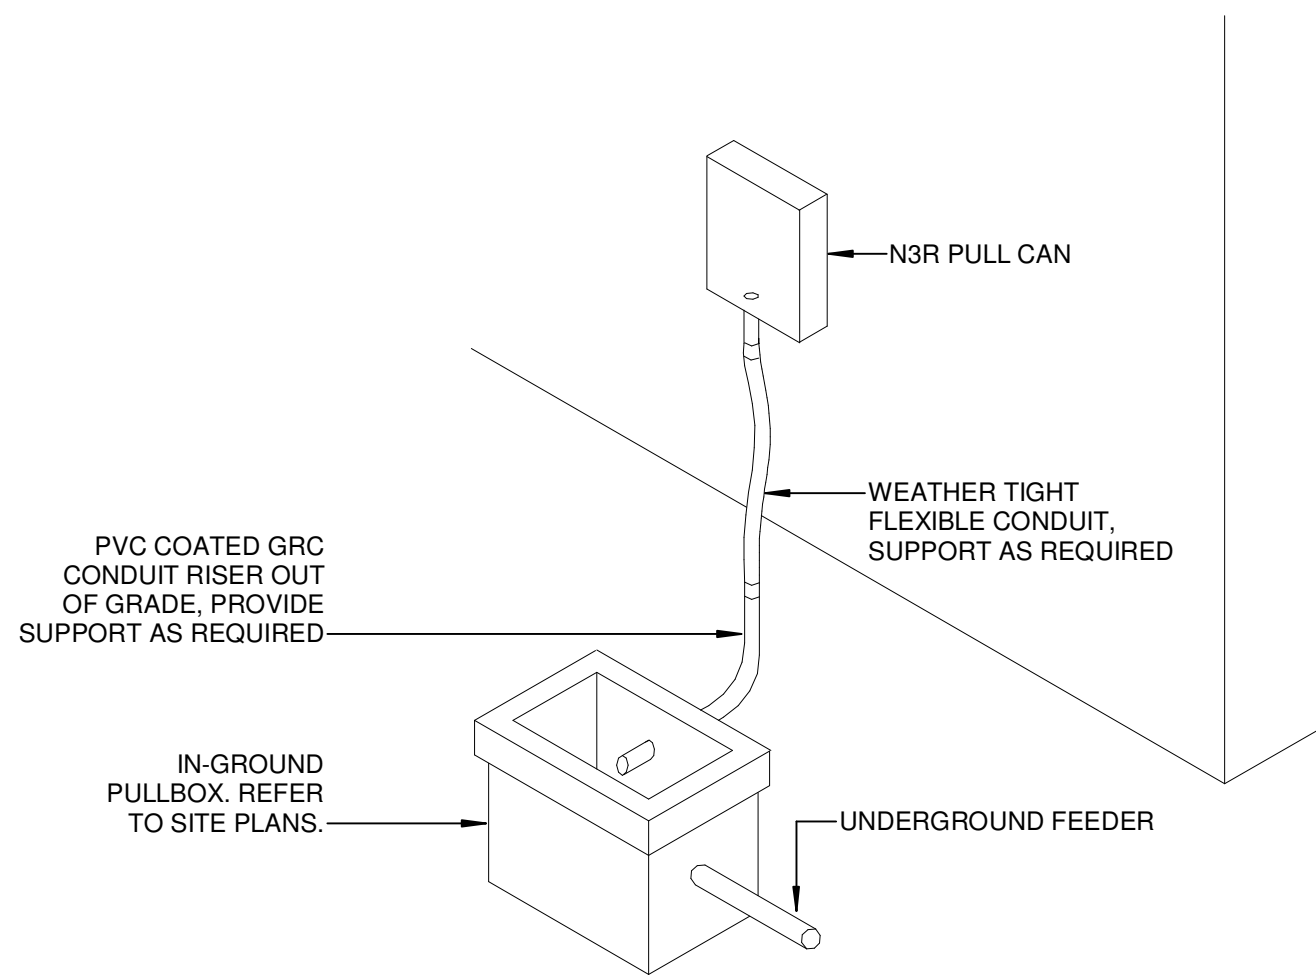
1 MODULAR BUILDING FEEDERS

SCALE: NTS




3 GROUND ROD INSTALLATION

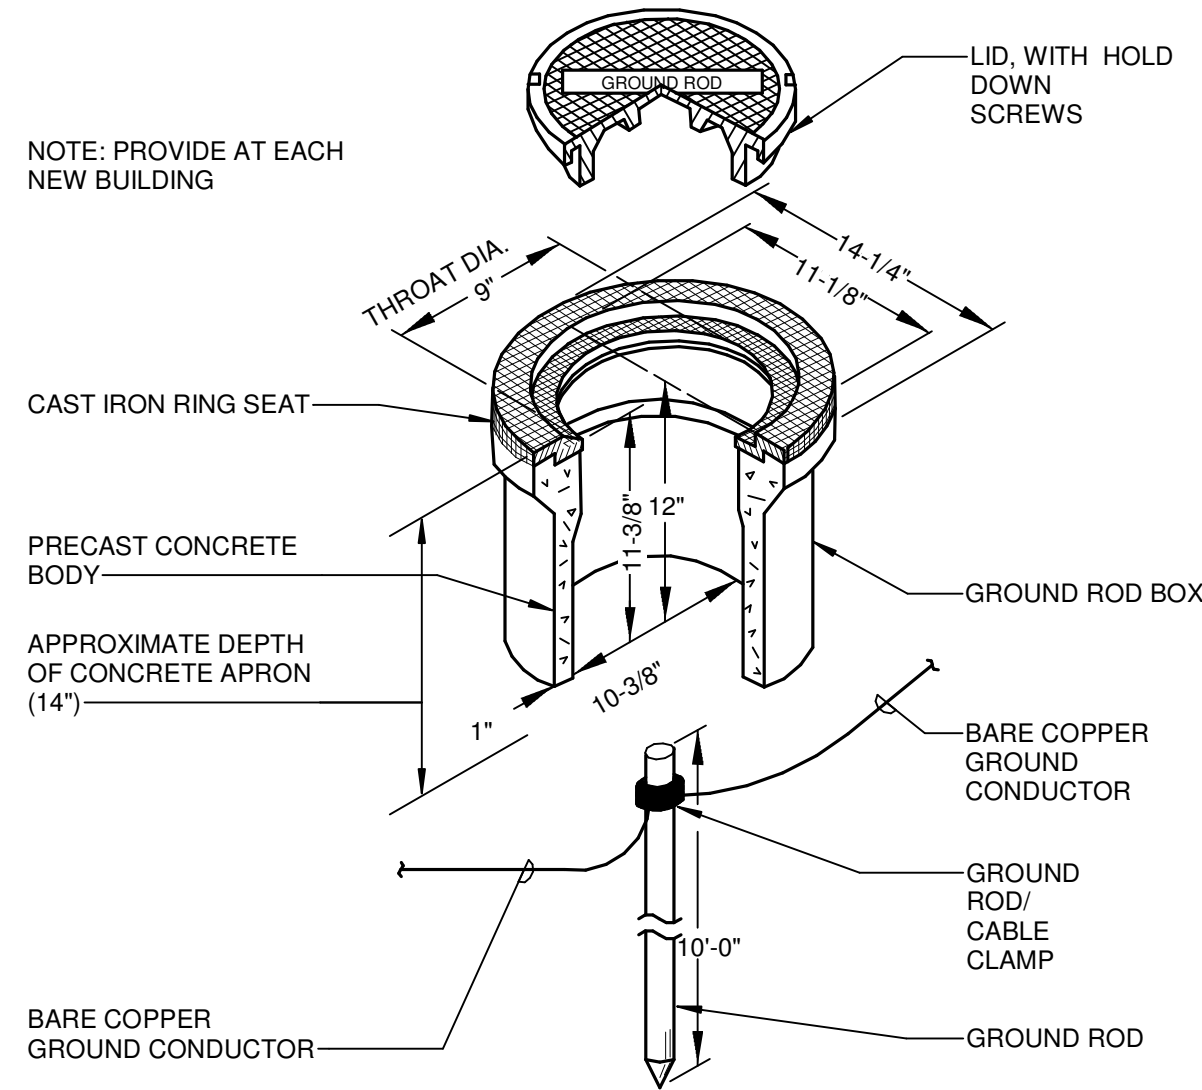SCALE: NTS

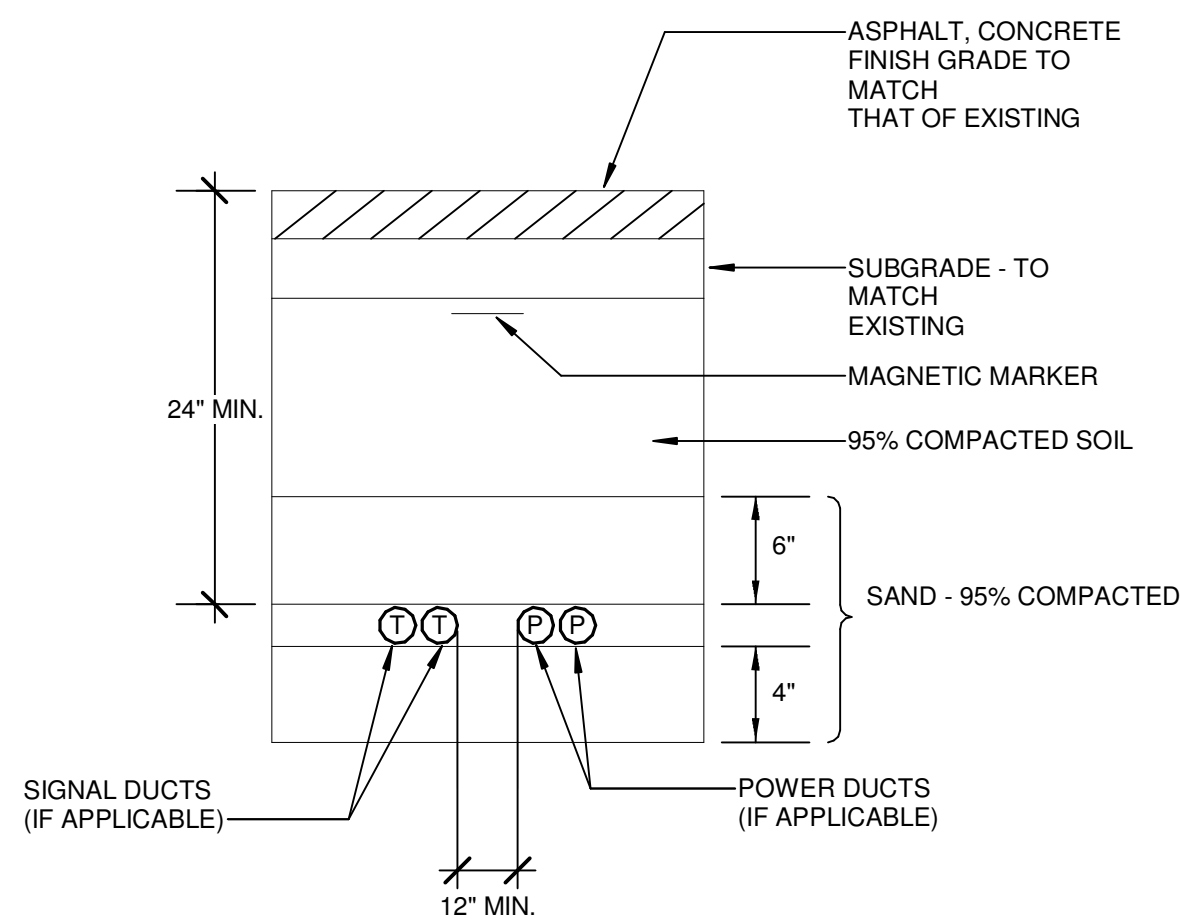

2 JOINT TRENCH

SCALE: NTS

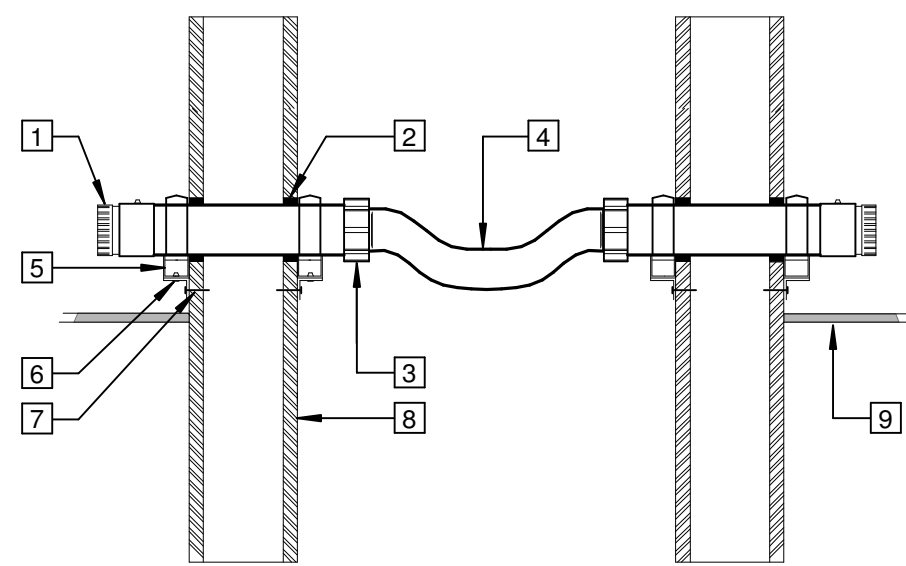


DETAIL NOTES:

- 1 PLASTIC BUSHING ON SET-SCREW CONNECTOR
- 2 CAULKING ACCORDING TO FIRE RATING, TYPICAL PACK 1-HOUR RATED MINERAL WOOL IN CONDUIT SLEEVE
- 3 WATER-TIGHT CONNECTORS IN ACCORDANCE WITH SPECIFICATIONS
- 4 WATER-TIGHT FLEXIBLE CONDUIT WITH ENOUGH SLACK TO ALLOW BUILDING TO MOVE 12' WITHOUT OVER STRESSING CONDUIT. REFER TO PLANS FOR CONDUIT SIZES AND QUANTITY.
- 5 CHANNEL STRUT BOLTED TO HEAVY ELL BRACKET
- 6 3/8" X 1-1/2" MACHINE BOLT WITH WASHERS BOTH SIDES AND HEX NUT
- 7 3/8" LAG SCREW, MIN. 2-1/2" EMBED
- 8 EXTERIOR OF BUILDING
- 9 DROP CEILING INSIDE BUILDING

4 CONDUIT PENETRATION BETWEEN PORTABLES

SCALE: 12" = 1'-0"

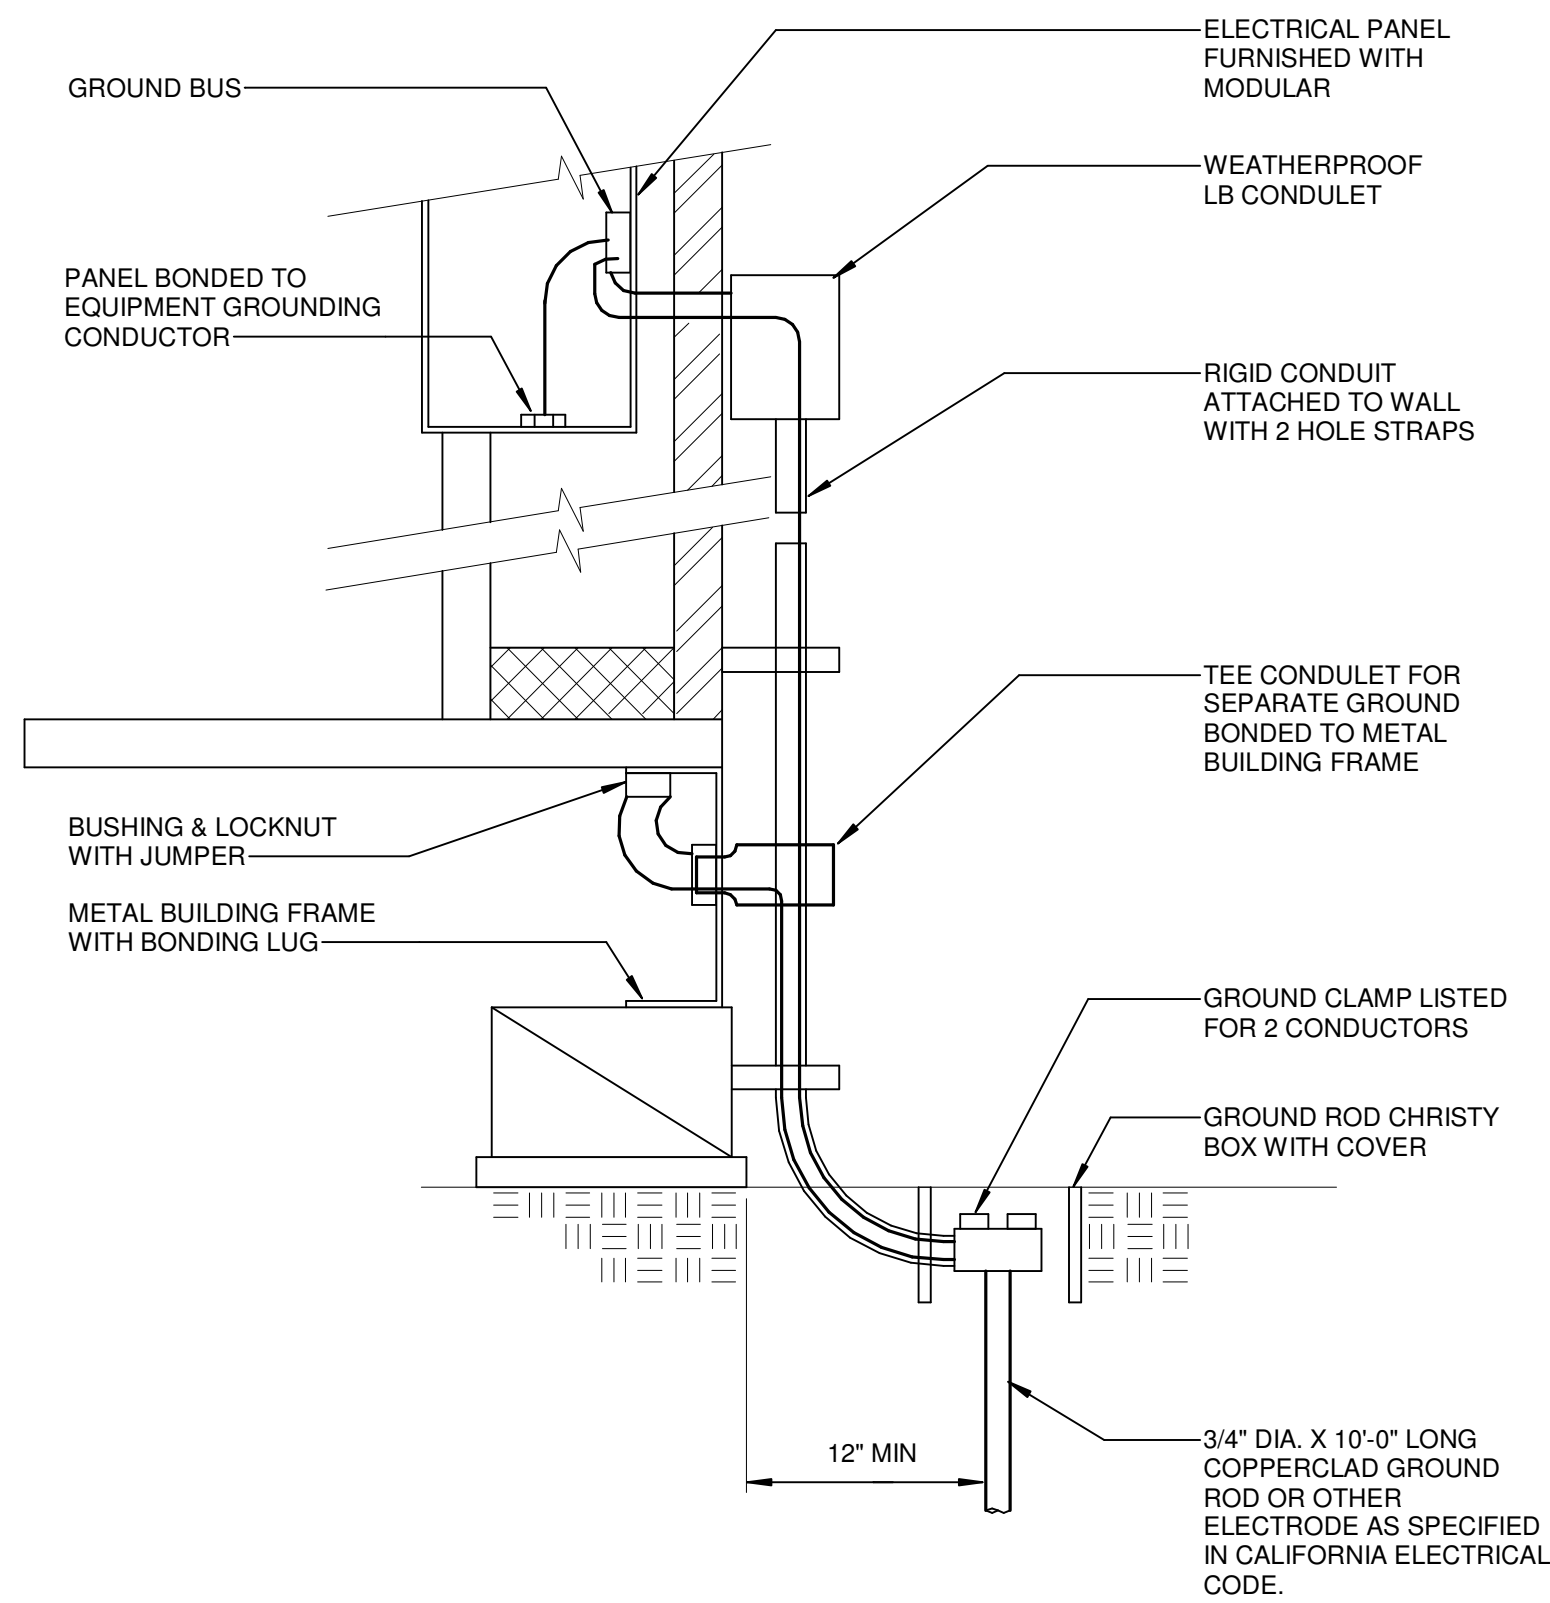

NOTES:

1. SIZE OF CONDUCTORS SHALL COMPLY WITH C.E.C. TABLE 250-66.
2. BOND SEPARATE CONDUCTORS FROM GROUND ROD TO GROUNDING POINT IN ELECTRICAL PANEL AND TO METAL BUILDING FRAME IF APPLICABLE. BOND THE ELECTRICAL GROUND TO THE METAL WATER PIPE EMBEDDED AT LEAST 10 FT. INTO THE SOIL (C.E.C. 250-52)
3. ALL MODULES OF METAL FRAME BUILDINGS SHALL BE ELECTRICALLY BONDED TOGETHER (BOLTING ONLY IS NOT ACCEPTABLE), USING #8 AWG CU.
4. CHECK RESISTANCE TO GROUND. IF RESISTANCE EXCEEDS 25 OHMS, INSTALL ADDITIONAL GROUND RODS WITH CONDUCTORS AS SHOWN, SEPARATED AT LEAST 6'-0" UNTIL RESISTANCE IS REDUCED TO 25 OHMS OR LESS (C.E.C. 250-53).
5. TESTS SHALL BE CONDUCTED IN THE PRESENCE OF THE PROJECT INSPECTOR.

5 TYP. GROUNDING FOR MODULAR CLASSROOMS

SCALE: NTS

AGENCY APPROVAL

IDENTIFICATION STAMP
DIV. OF THE STATE ARCHITECT
APP: 02-121945 INC:
REVIEWED FOR
SS ☒ FLS ☒ ACS ☒
DATE: 12/12/2023

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ARCHITECTS

1715 R STREET, SUITE 200
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CONSULTANTS

The Engineering Enterprise
CONSULTING ENGINEERS
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NO.	DATE	DESCRIPTION
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PROJECT OWNER & TITLE
LODI UNIFIED SCHOOL DISTRICT
1305 E. Vine St
Lodi, CA 95240

233 N Mills Ave
Lodi, CA 95242

SHEET TITLE

ELECTRICAL DETAILS

DRAWN BY: Author JOB NUMBER: 23219

SHEET NO.

E4.1

DATE: DECEMBER 12, 2023



24 X 40 RELOCATABLE CLASSROOMS

TEST AND INSPECTION LIST

TESTING LABORATORY: _____ DATE: _____
NAME: _____
DISTRICT/OWNER: _____
DIVISION-FILE NO. _____ APPLICATION NO. _____
ARCHITECT: _____
STRUCTURAL ENGINEER: _____

STATE OF CALIFORNIA
DEPT. OF GENERAL SERVICES
DIVISION OF THE
STATE ARCHITECT
STRUCTURAL
TESTS
AND
INSPECTIONS
ORS 103-1 (R 11/85)

the following tests and inspections, as checked, will be required as detailed in:

COMPACTED FILL	CONCRETE	GROUT	MORTAR
FW materials, acceptance tests	<input checked="" type="checkbox"/>	<input checked="" type="checkbox"/>	<input checked="" type="checkbox"/>
Compaction control, acceptance tests	<input checked="" type="checkbox"/>	<input checked="" type="checkbox"/>	<input checked="" type="checkbox"/>
Compaction tests, acceptance tests	<input checked="" type="checkbox"/>	<input checked="" type="checkbox"/>	<input checked="" type="checkbox"/>
Reinforcing steel, acceptance tests	<input checked="" type="checkbox"/>	<input checked="" type="checkbox"/>	<input checked="" type="checkbox"/>
REINFORCING STEEL	<input checked="" type="checkbox"/>	<input checked="" type="checkbox"/>	<input checked="" type="checkbox"/>
Reinforcing steel, acceptance tests	<input checked="" type="checkbox"/>	<input checked="" type="checkbox"/>	<input checked="" type="checkbox"/>
Reinforcing steel, acceptance tests	<input checked="" type="checkbox"/>	<input checked="" type="checkbox"/>	<input checked="" type="checkbox"/>
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BRICK AND BLOCK	<input checked="" type="checkbox"/>	<input checked="" type="checkbox"/>	<input checked="" type="checkbox"/>
Brick and block, acceptance tests	<input checked="" type="checkbox"/>	<input checked="" type="checkbox"/>	<input checked="" type="checkbox"/>
GLUED LAMINATED STRUCTURAL LUMBER	<input checked="" type="checkbox"/>	<input checked="" type="checkbox"/>	<input checked="" type="checkbox"/>
Glued laminated structural lumber, acceptance tests	<input checked="" type="checkbox"/>	<input checked="" type="checkbox"/>	<input checked="" type="checkbox"/>
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Glued laminated structural lumber, acceptance tests	<input checked="" type="checkbox"/>	<input checked="" type="checkbox"/>	<input checked="" type="checkbox"/>

TESTING MAY BE WAIVED IF STEEL HAS BEEN PROPERLY IDENTIFIED BY MFR'S MILL ANALYSIS AND TEST REPORTS PER TITLE 24, C.C.R., SECTION 2212.A.1

Other Tests and Inspections, together with special instructions:

GROUNDING TEST
EXPANSION ANCHORS

COPIES OF REPORTS TO:
DSA/ORS
AMERICAN MODULAR SYSTEMS, INC.
SCHOOL DISTRICT
ARCHITECT

By: _____
AUTHORIZED REPRESENTATIVE

INDEX

SHEET No.	DESCRIPTION
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2	EXTERIOR ELEVATIONS
3	CEILING GRID, DETAILS & NOTES
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S1A	FOUNDATION PLAN WOOD, DETAILS & NOTES 125#
S1B	FOUNDATION PLAN CONCRETE, DETAILS & NOTE 50#
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BUILDING DATA

CLASSROOMS

OCCUPANCY	E-2
TYPE OF CONSTRUCTION	V - NON-RATED
WIND LOAD (80 MPH EXPOSURE C)	21 LBS/SQ FT
FLOOR LIVE LOAD	50 LBS/SQ FT OR 125 LBS./SQ. FT.
ROOF LIVE LOAD	20 LBS/SQ FT (REDUCIBLE)
RAMP LIVE LOAD	100 LBS/SQ FT
BUILDING AREA	960 SQ FT
FIRE MARSHAL - CALIFORNIA BUILDING CODE (CBC)	TITLE 24, PART 2, CCR (1994 UBC W/ CAL. AMENDS) TITLE 24, PART 3, CCR (1993 NEC W/ CAL. AMENDS) TITLE 24, PART 4, CCR (1994 UMC W/ CAL. AMENDS) TITLE 24, PART 5, CCR (1994 UPC W/ CAL. AMENDS) TITLE 24, PART 6, CCR (1994 UFC W/ CAL. AMENDS) TITLE 24, PART 12, CCR (1994 STD. W/ CAL. AMENDS) TITLE 19
STRUCTURAL - 1995 CALIFORNIA BUILDING CODE (CBC)	TITLES 24 PARTS 1 AND 2
MODULES	MOMENT-RESISTANT
SYSTEM	(2) 12' X 40' MODULES
FOUNDATION	PRESSURE TREATED WOOD OR CONCRETE
SEISMIC	ZONE 4



3" STANDING SEAM ROOF

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AC: _____
APPL. NO. 68445
DATE: 5/12/98

FILE NO.
IDENTIFICATION STAMP
DIV. OF THE STATE ARCHITECT
OFFICE OF REGULATION SERVICES
APPL. NO. 328
AC: 6/12/98
DATE: 4/9/97

JOB NO.
DATE: APRIL 8, 1997
SHEET NUMBER
TS-1.1
BINDING ORDER 1

AGENCY APPROVAL DSA# 02-121945

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APP: 02-121945 INC:
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PROJECT OWNER & TITLE
LODI UNIFIED SCHOOL DISTRICT
1305 E. Vine St
Lodi, CA 95240

MILLSWOOD MIDDLE SCHOOL
PORTABLES RELOCATION
233 N Mills Ave
Lodi, CA 95242



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TITLE & BUILDING DATA NOTES

DRAWN BY: XXXXXX JOB NUMBER: 23219

SHEET NO.

TS-1.1
DATE: DECEMBER 5, 2023

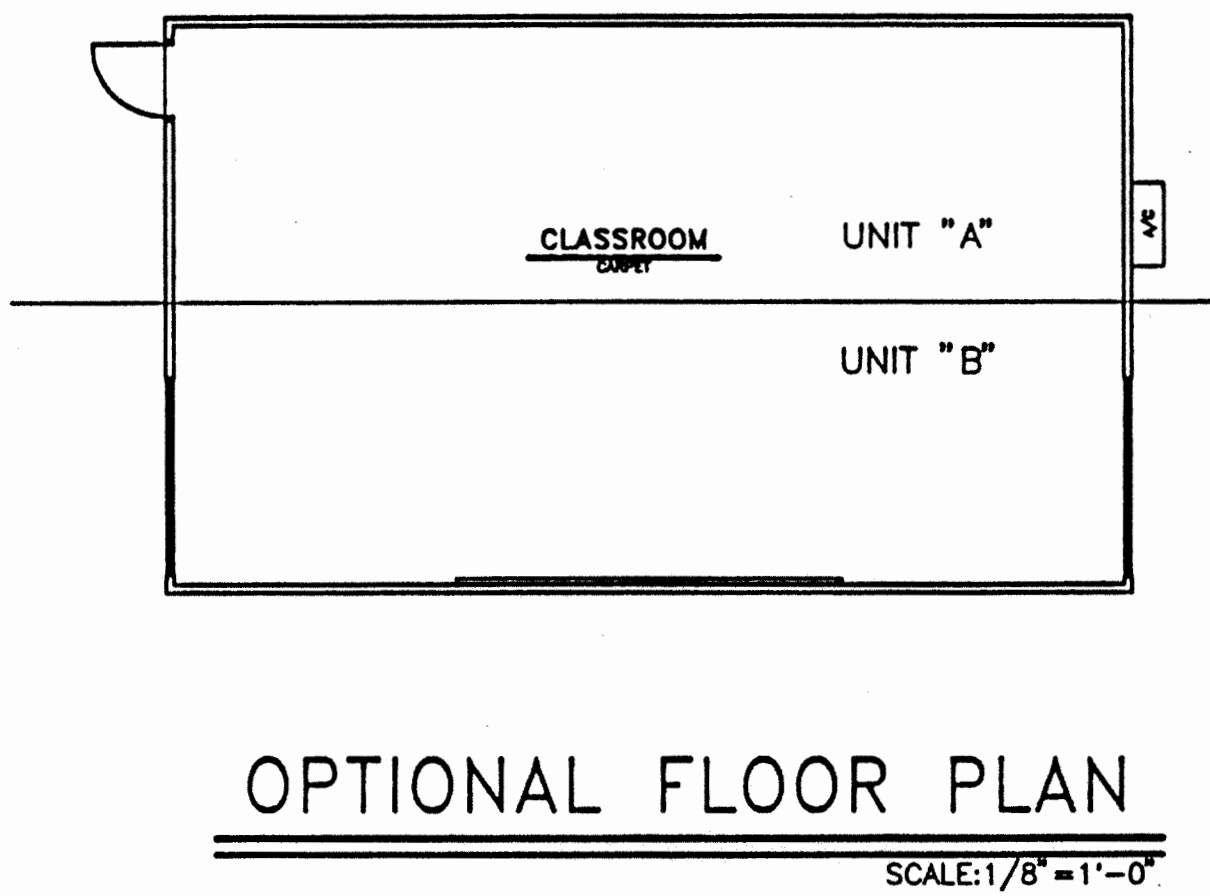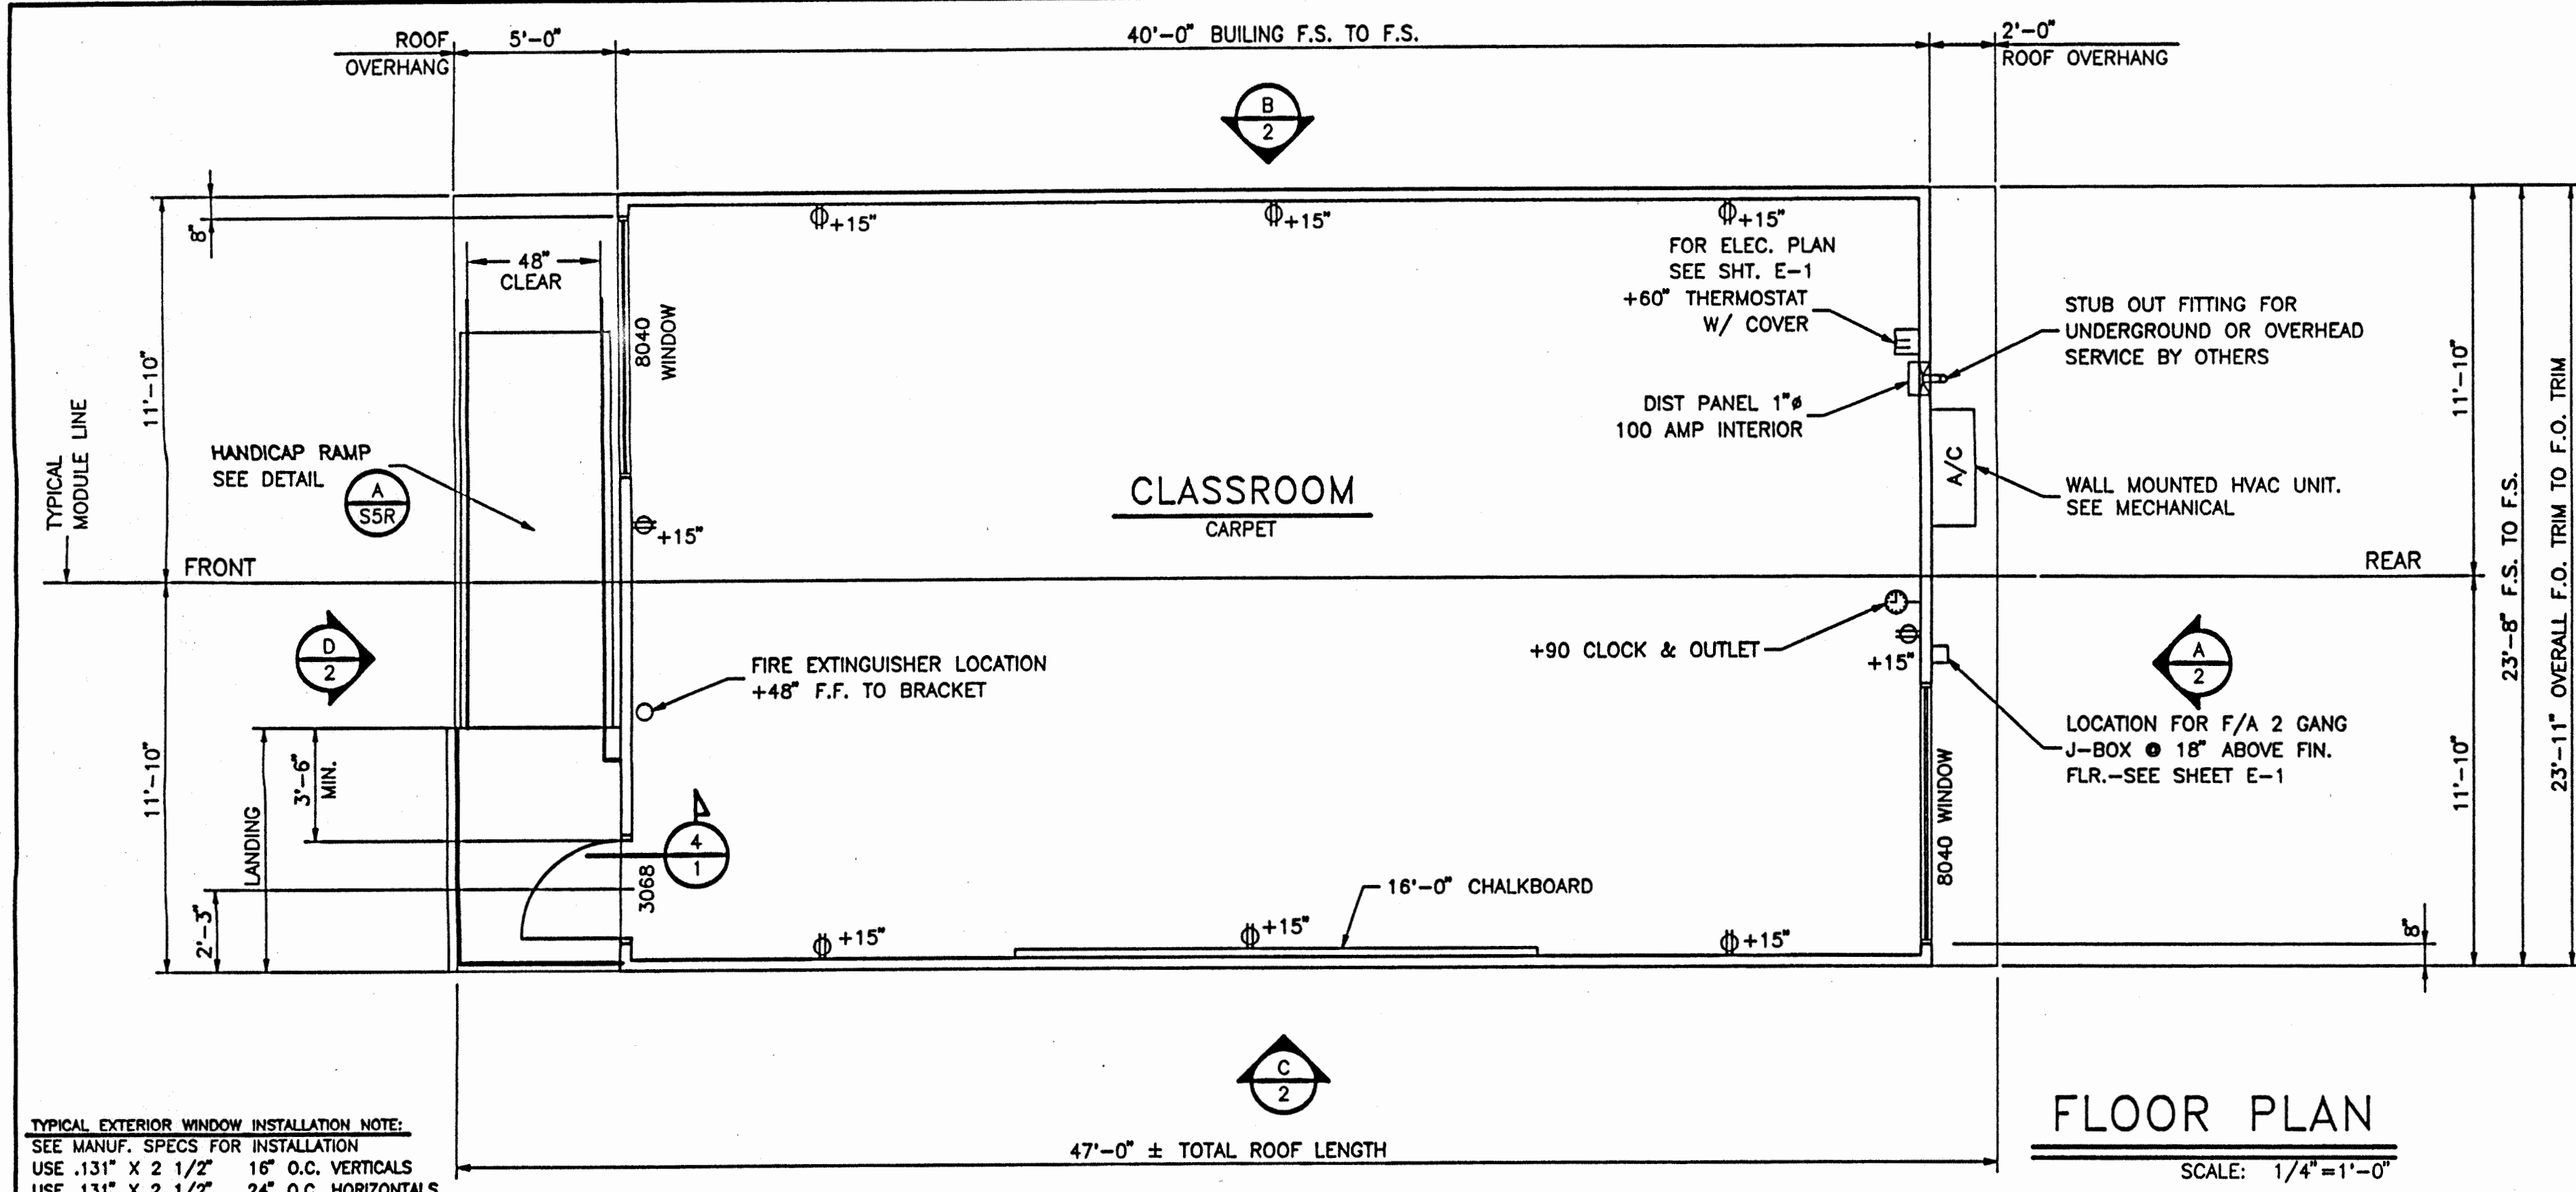



- NOTES
- Interior Floor Carpets - Units shall be carpeted as indicated on floor plan with direct glue down type per State of California Specification 7220-XXX-01, Group 1, Type A, Class 18. Color will be selected by District after award of bid. The carpet density shall be 4600 minimum. The pile yarn shall be branded nylon. No cross seams shall be allowed.
 - Base: Resilient Cove Base - Best quality, moulded rubber, 1/8" thick, 4" high, moulded top set. Cove: Provide preformed base for square external corners and preformed end stops where base does not butt. Solid color as manufactured by Johnsonite Co., Flexco, or equal. Apply cove to complete perimeter of classroom.
 - Interior walls shall be vinyl covered lockboard U.N.D. applied in one continuous length from floor to ceiling. The lockboard shall be industrial insulation board manufactured specifically as a substitute for vinyl covered wall panels. The board shall be asphalt free, shall have an iron-on coating and shall have a minimum density of 18 lbs. per ft. The vinyl coating shall be made of virgin vinyl calendared base color, weighing a minimum of 8 oz. per square yard. The coating backing shall be sheathing or non-woven fabric. The vinyl coating shall be mechanically laminated, with the long edges wrapped, to the lockboard. Lockboard shall be applied over 1/2" sheetrock or 3/8" plywood sheathing. The vinyl wall covered panel shall have a Class II flame spread rating. The panel shall be approved for classroom use by The California State Fire Marshal. Reference brand: Vinyl covered lockboard as manufactured by Chatfield-Clarke or comparable. Care shall be taken in mounting the lockboard so that the texture of all panels will have the same orientation and color match.
 - CEILING: Suspend T-Bar System, see sheet 3 for details etc. Materials and installation per CCR 2501A.5 and IR #47-4 inclusive as applicable to classrooms.

- DOORS & WINDOWS
- Exterior Doors: Metal Doors - 3'0"X6'8" hollow metal door construction of 1 sheet of 18 ga. steel assembled per CS242 min and reinforced with 20 ga. min. continuous vertical steel stiffeners spaced @ 2' O.C. Fill spaces between stiffeners with mineral wool or other insulation. (Reinforce both faces for closure) provide flush top on doors. Hardware reinforcement shall be 10 ga. min for hinges, door frame shall be 18 ga. pressed steel frame ASTM A36 & C5242. Hardware reinforcement shall be 10 ga. plate. Frames shall be designed with integral stop and trim. Provide (3) anchors per jamb.
- Exterior Windows: Provide anodized aluminum frame 5/8" minimum dual pane window units, as shown on floor plans. The 5/8" dimension is the minimum thickness for the dual glazed window panel consisting of two lights of glass and the air space. Glazing material shall be:
- Exterior Lite - 3/16" minimum tempered glass or laminated as - 1 glass of solar gray glass reducing type with a light transmission factor of 45% maximum.
- Interior Lite - 1/8" minimum clear tempered.
- Minimum air space shall be 1/4".
- Space - Bent or sealed corner aluminum with desiccant fill
- Sealer - Butyl primary seal and polysulfide of silicone secondary seal.
- Certification - All glazing to be certified in accordance with ASTM E-773, E-774.
- Header height shall be the same as the door. All operable sash shall have aluminum screens. Windows shall not be mounted to the exterior plowed surface. All windows shall meet the AAMA GS101-88 voluntary spec. For aluminum prime windows and sliding glass (ANSI), commercial grade.




- HARDWARE
- Exterior Door
 - Hinges: HAGER 4-1/2X4-1/2 butts, BB1271 US260, 1-1/2 pair each door with set screw in barrel and ball bearing design, or approved equal.
 - Lockset: Classroom lever handle lockset, mortise or cylindrical type, Schlage D70PD (Roses) or equal, US260 finish.
 - Closer: Norton 85000A or 8500BF series, LCN 1460 Del series or equal.
 - Weatherstripping: All exterior doors shall be weatherstripped with Pemko 299D, Ultra WS007, or door jambs and head or equal.
 - Threshold: Threshold shall be Pemko 271 AV 5" aluminum with Pemko 216 AV Ultra TH042 door bottom.
 - Doorstop: Quality #44, or equal.

- FIRE EXTINGUISHER
- Each portable classroom shall be equipped with pressure type fire extinguishers with 2A0BC UL rating. To be mounted on the interior wall of the building near the doorway(s) at a height of 4 feet to mounting bracket. Fire extinguishers shall be totally charged and have a dial indicating the state of charge.

- CHALKBOARD SPECIFICATIONS
- Chalkboards(standard) shall have green facing sheet. Markerboards(extra cost option). Markerboards shall be 5 mil thick melamine facing sheet suitable to accept dry erase felt markers. The facing sheet shall be laminated, using hot melt adhesive, to a medium density particleboard substrate with a minimum density of 45#/c. ft. The panel shall have a full backing. The panels shall have extruded aluminum molding and channel with a minimum of 2-15/16" projection from the face of the panel. A full length map rail shall be provided with cork insert and end stops. The map rail and chalkroll are to incorporate a channel to wrap around the panel. Three (3) map hooks, with clips, per panel shall be provided. One flag holder, 1/2" size, shall be provided for each classroom. Each classroom shall be 2 ea. 4x8 panels installed side by side to make a 4x16 panel, centered on what the long wall is. Referenced brand: Chatfield-Clarke series 500. Attach directly to studs and blocking w/18x3" oval head wood screw @ 32" o.c. horizontally and @ 24" o.c. vertically.

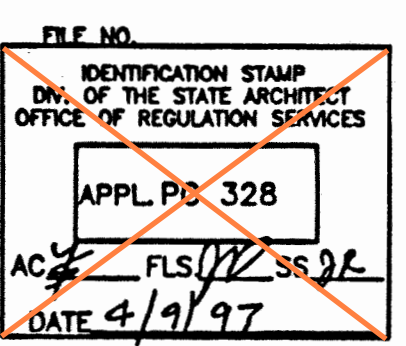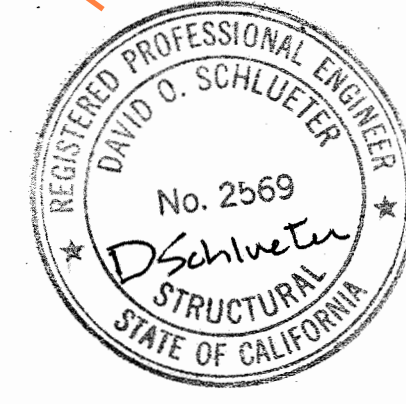

TYPICAL EXTERIOR WINDOW INSTALLATION NOTE:
SEE MANUF. SPECS FOR INSTALLATION
USE .131" X 2 1/2" 16" O.C. VERTICALS
USE .131" X 2 1/2" 24" O.C. HORIZONTALS

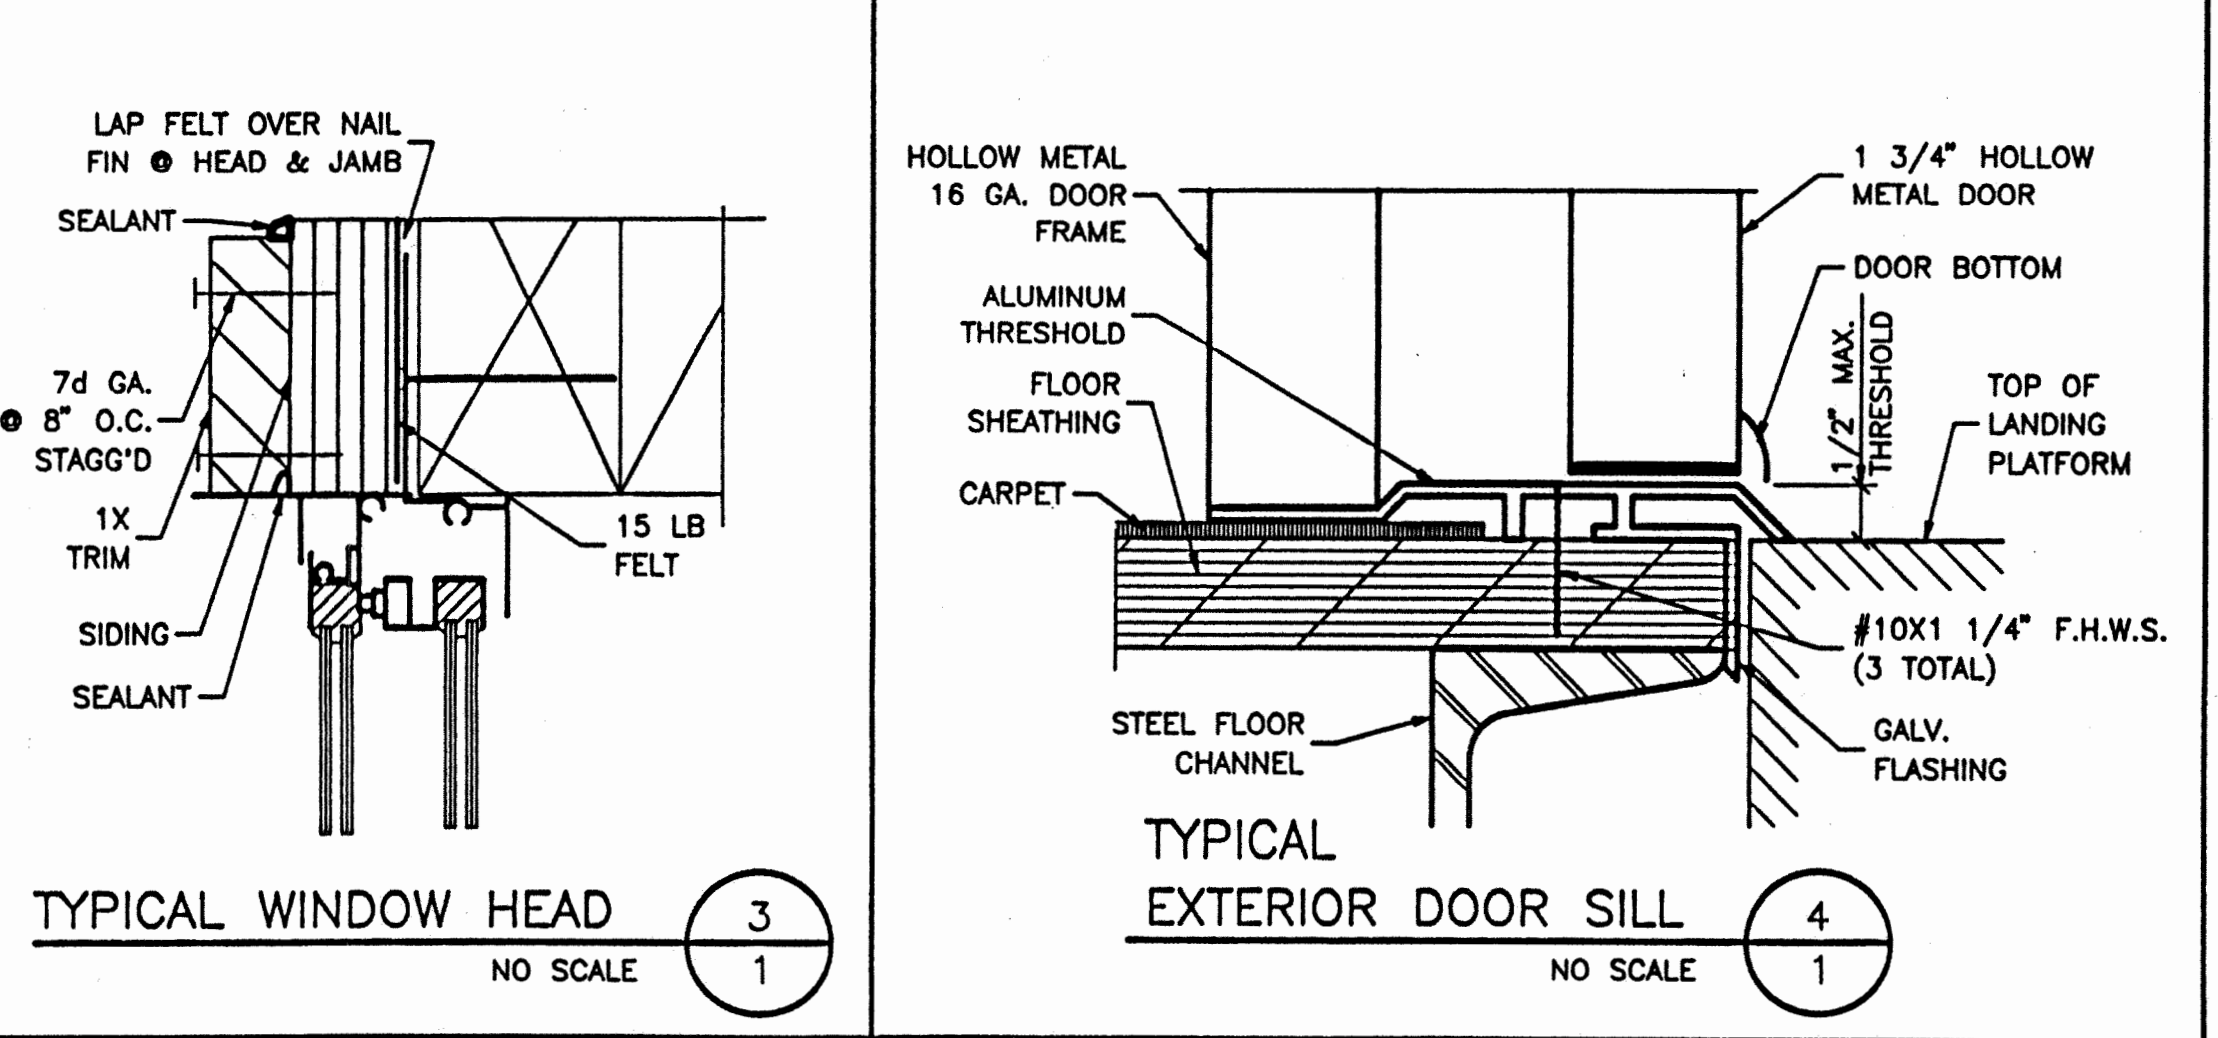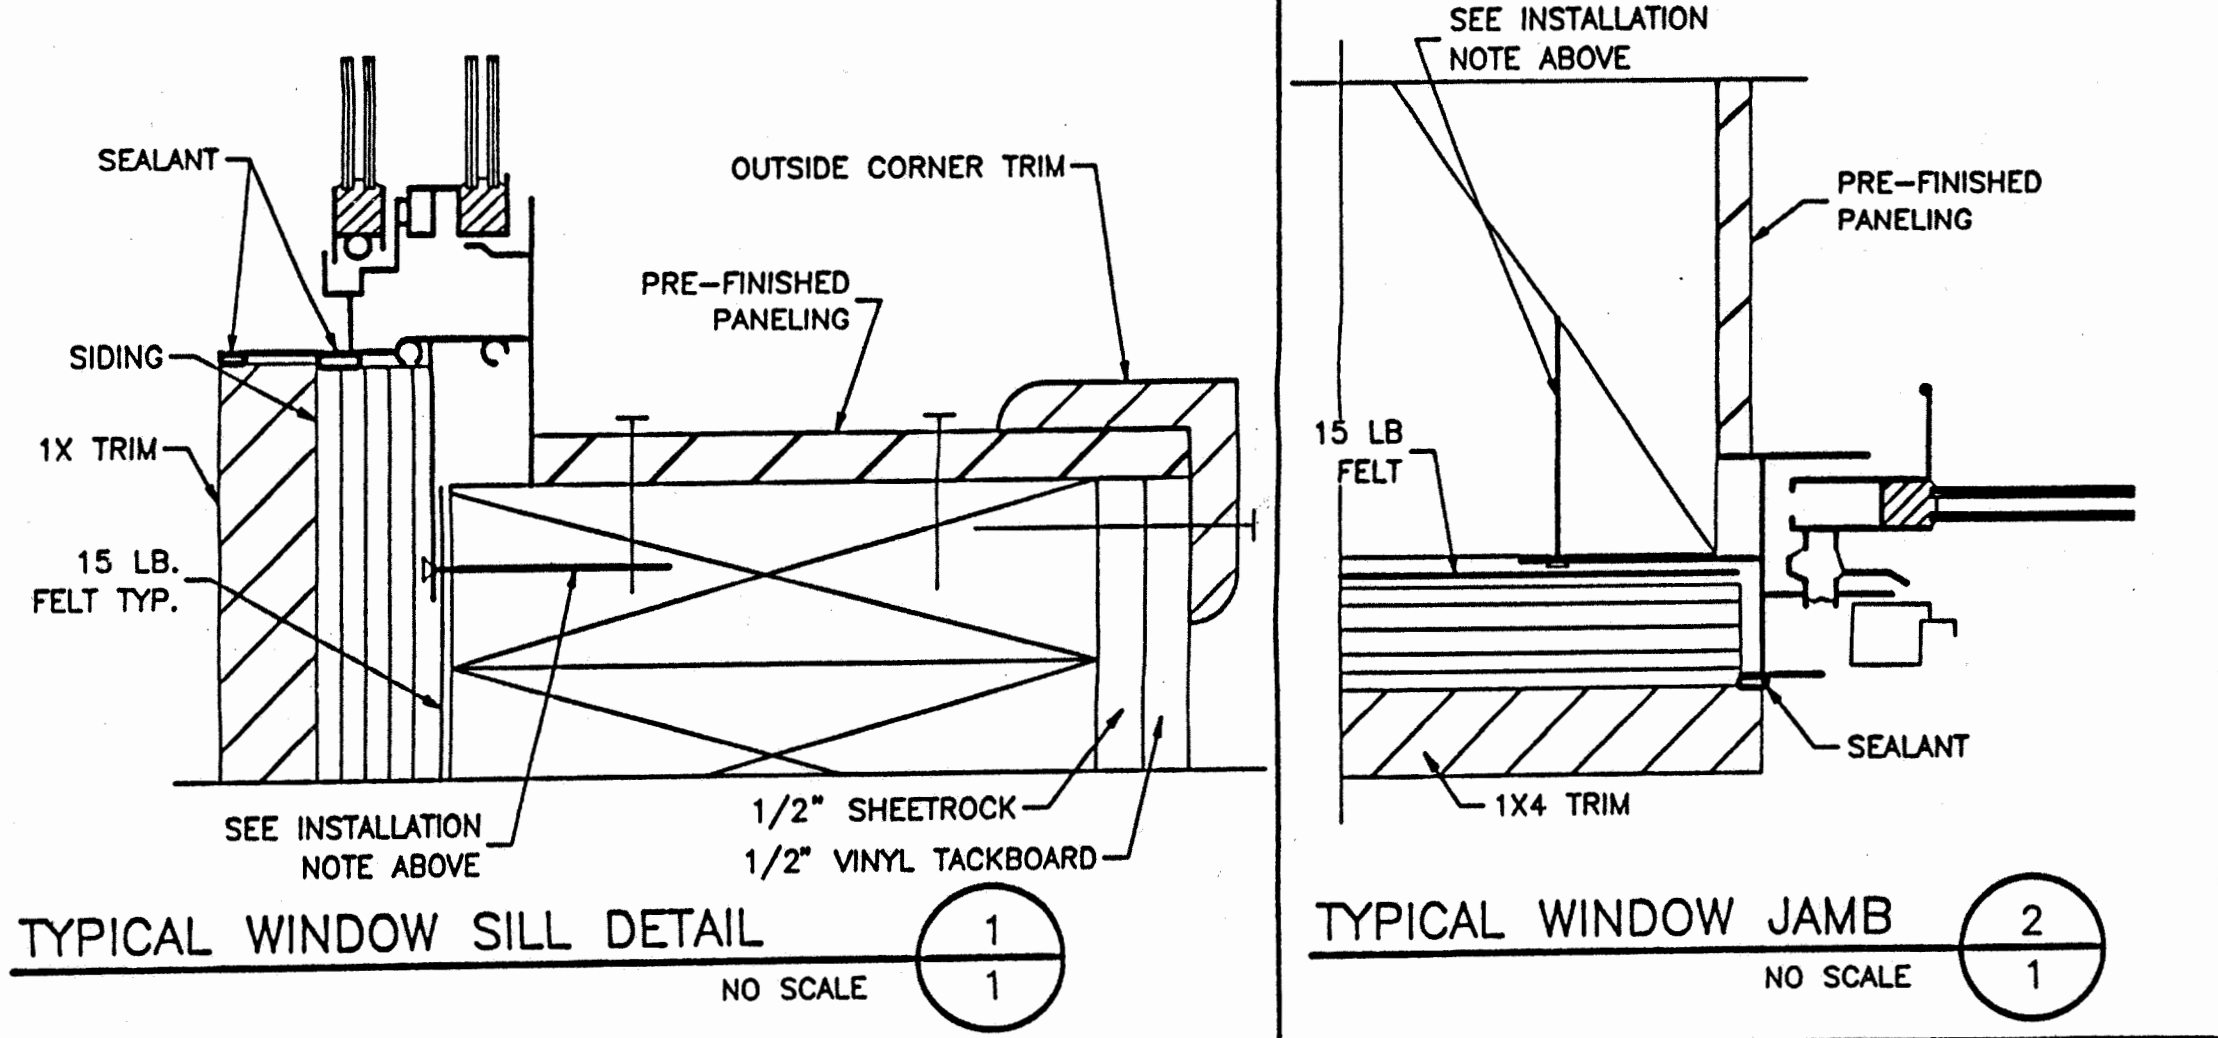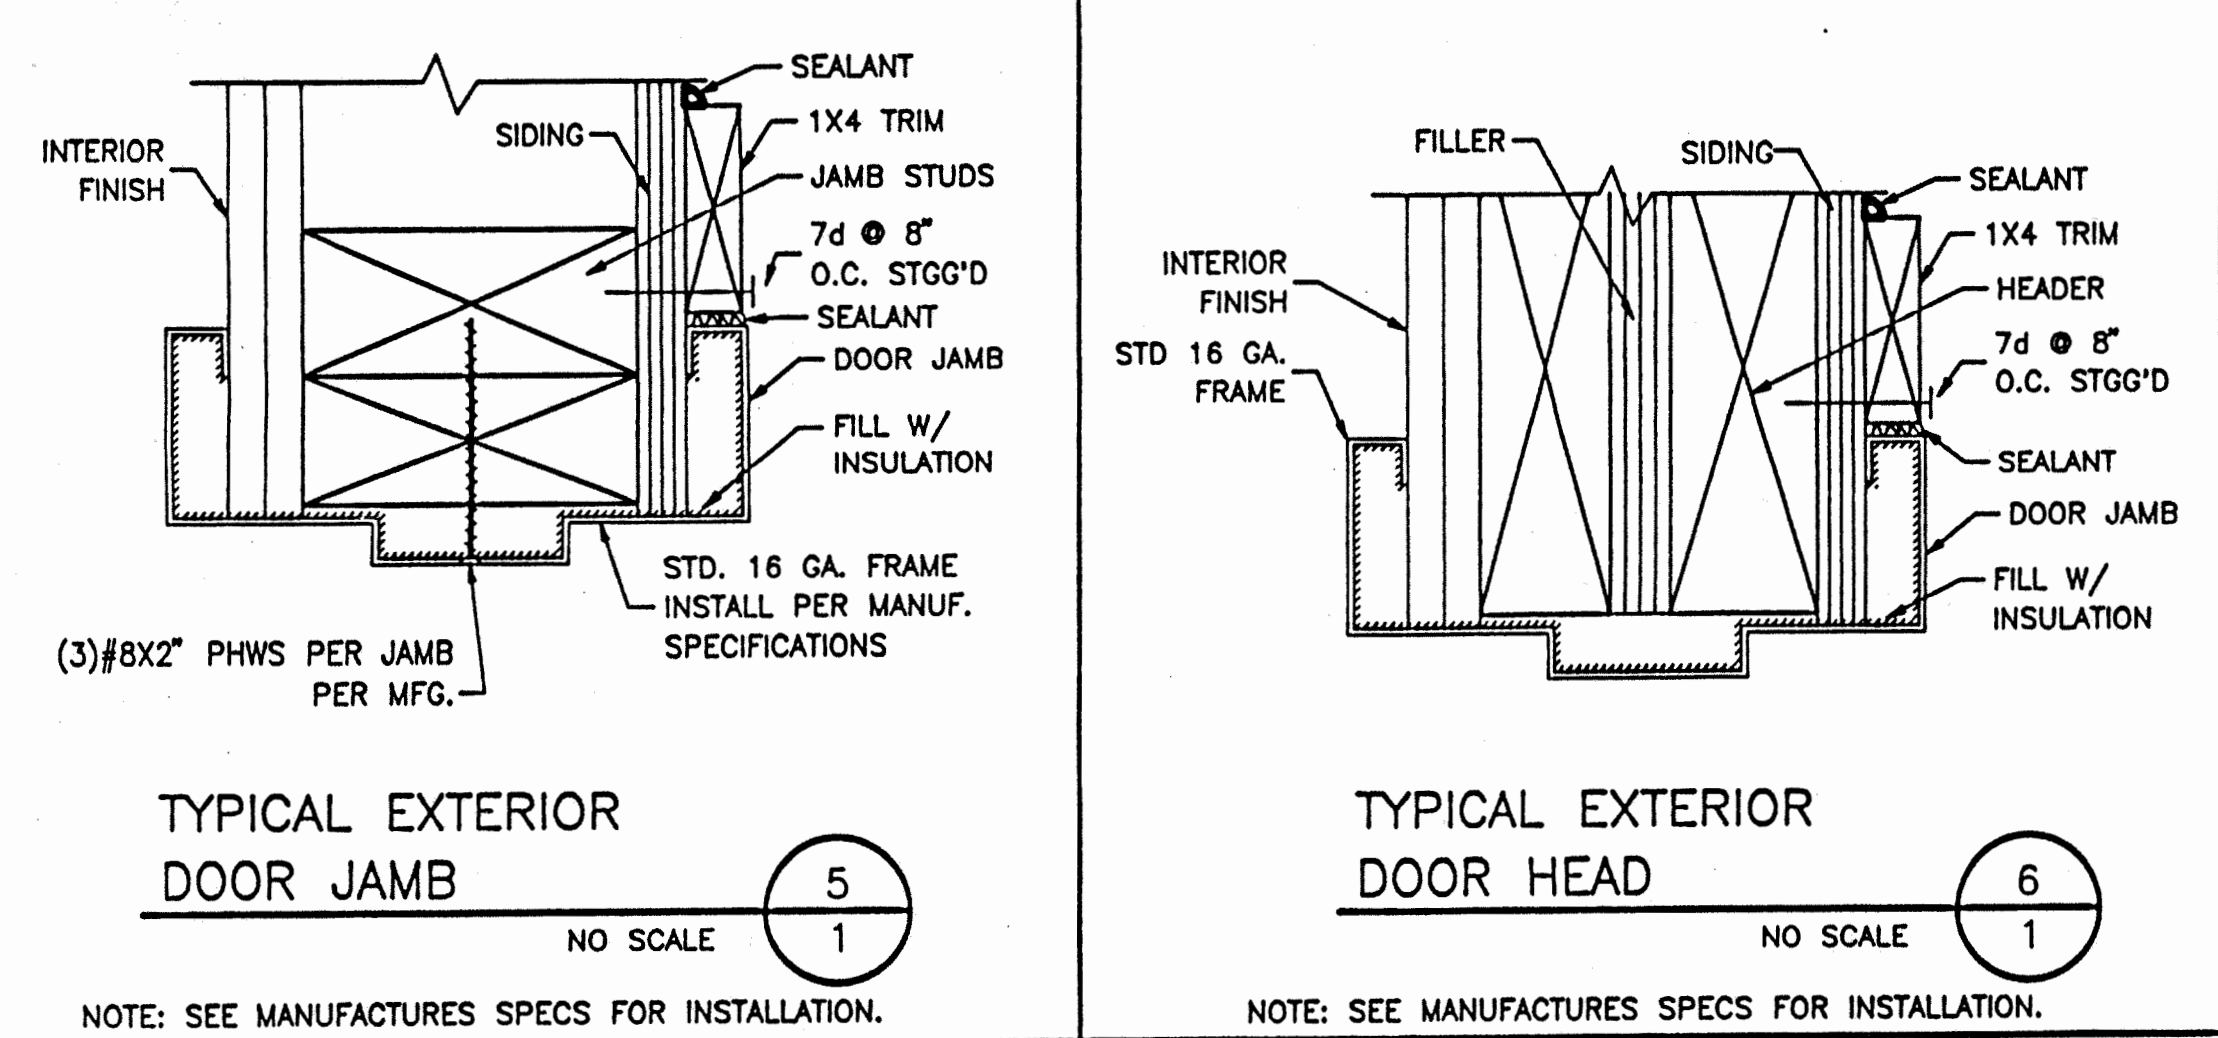

24 X 40
RELOCATABLE
CLASSROOMS

**American
Modular Systems**

CUSTOMER: _____
FLOOR PLAN & NOTES

DATE: 4-8-97	REVISIONS					PROJECT No.
SCALE: NONE	NO	DATE	DESCRIPTION	NO	DATE	DESCRIPTION
DRAWN BY: R.S.	▲			▲		
CHECKED BY:	▲			▲		
CHECKED BY:	▲			▲		
SERIAL NO.	▲			▲		

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1305 E. Vine St
Lodi, CA 95240






MILLSWOOD MIDDLE SCHOOL
PORTABLES RELOCATION
233 N Mills Ave
Lodi, CA 95242

SHEET TITLE
FLOOR PLAN AND NOTES

DRAWN BY: XXXXXX JOB NUMBER: 23219
SHEET NO.
1
DATE: DECEMBER 5, 2023

CONSTRUCTION DOCUMENTS

DATE PLOTTED: 11/28/2023 9:11:51 AM
FILE LOCATION: C:\Users\jimhorff\Documents\BIM\23219_LUSD_Millswood Middle School Portables Relocation_A22_jimhorff\CK8V.rvt

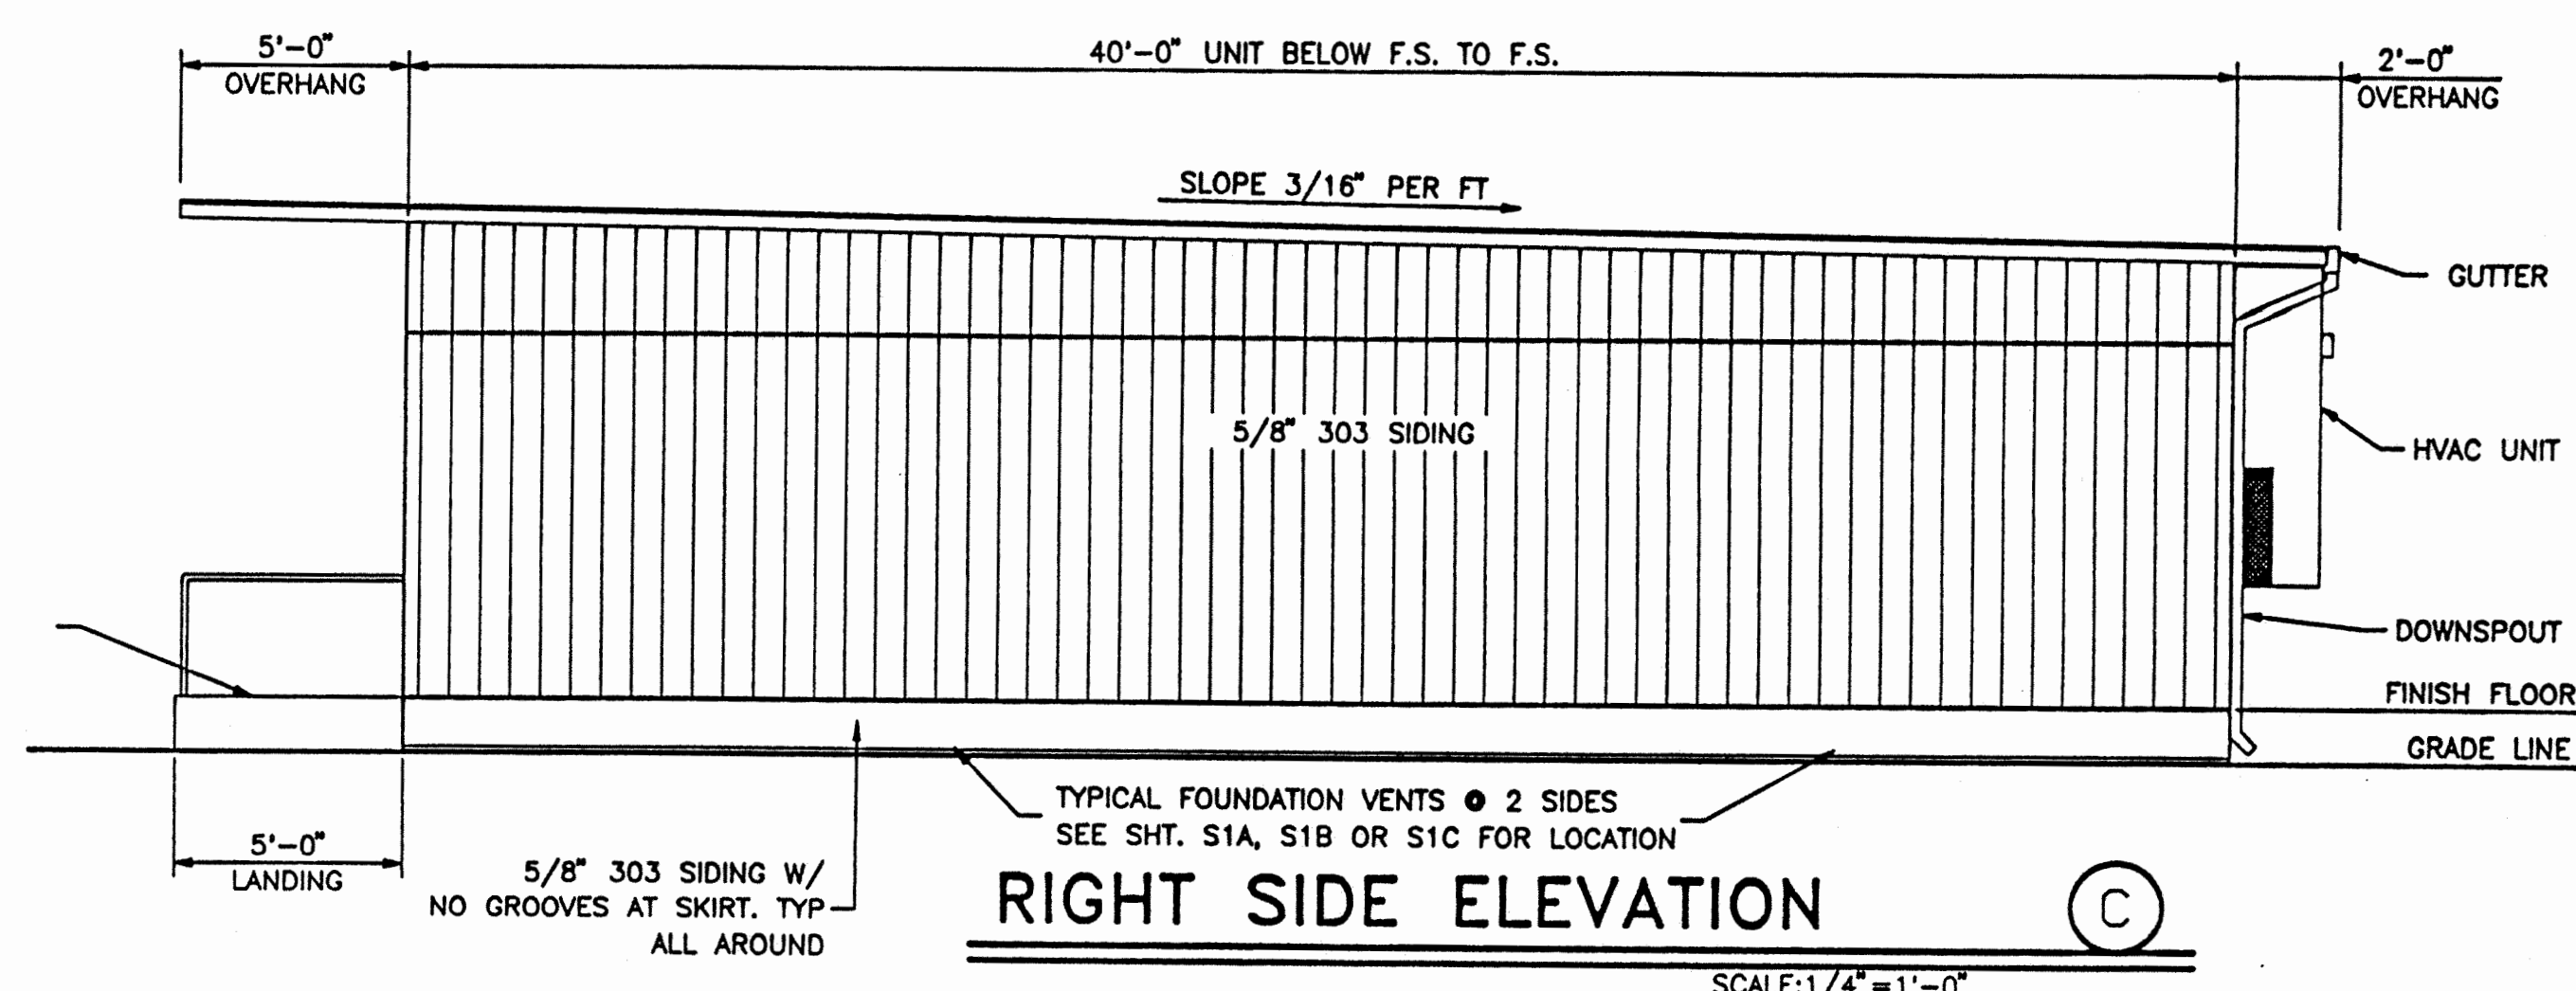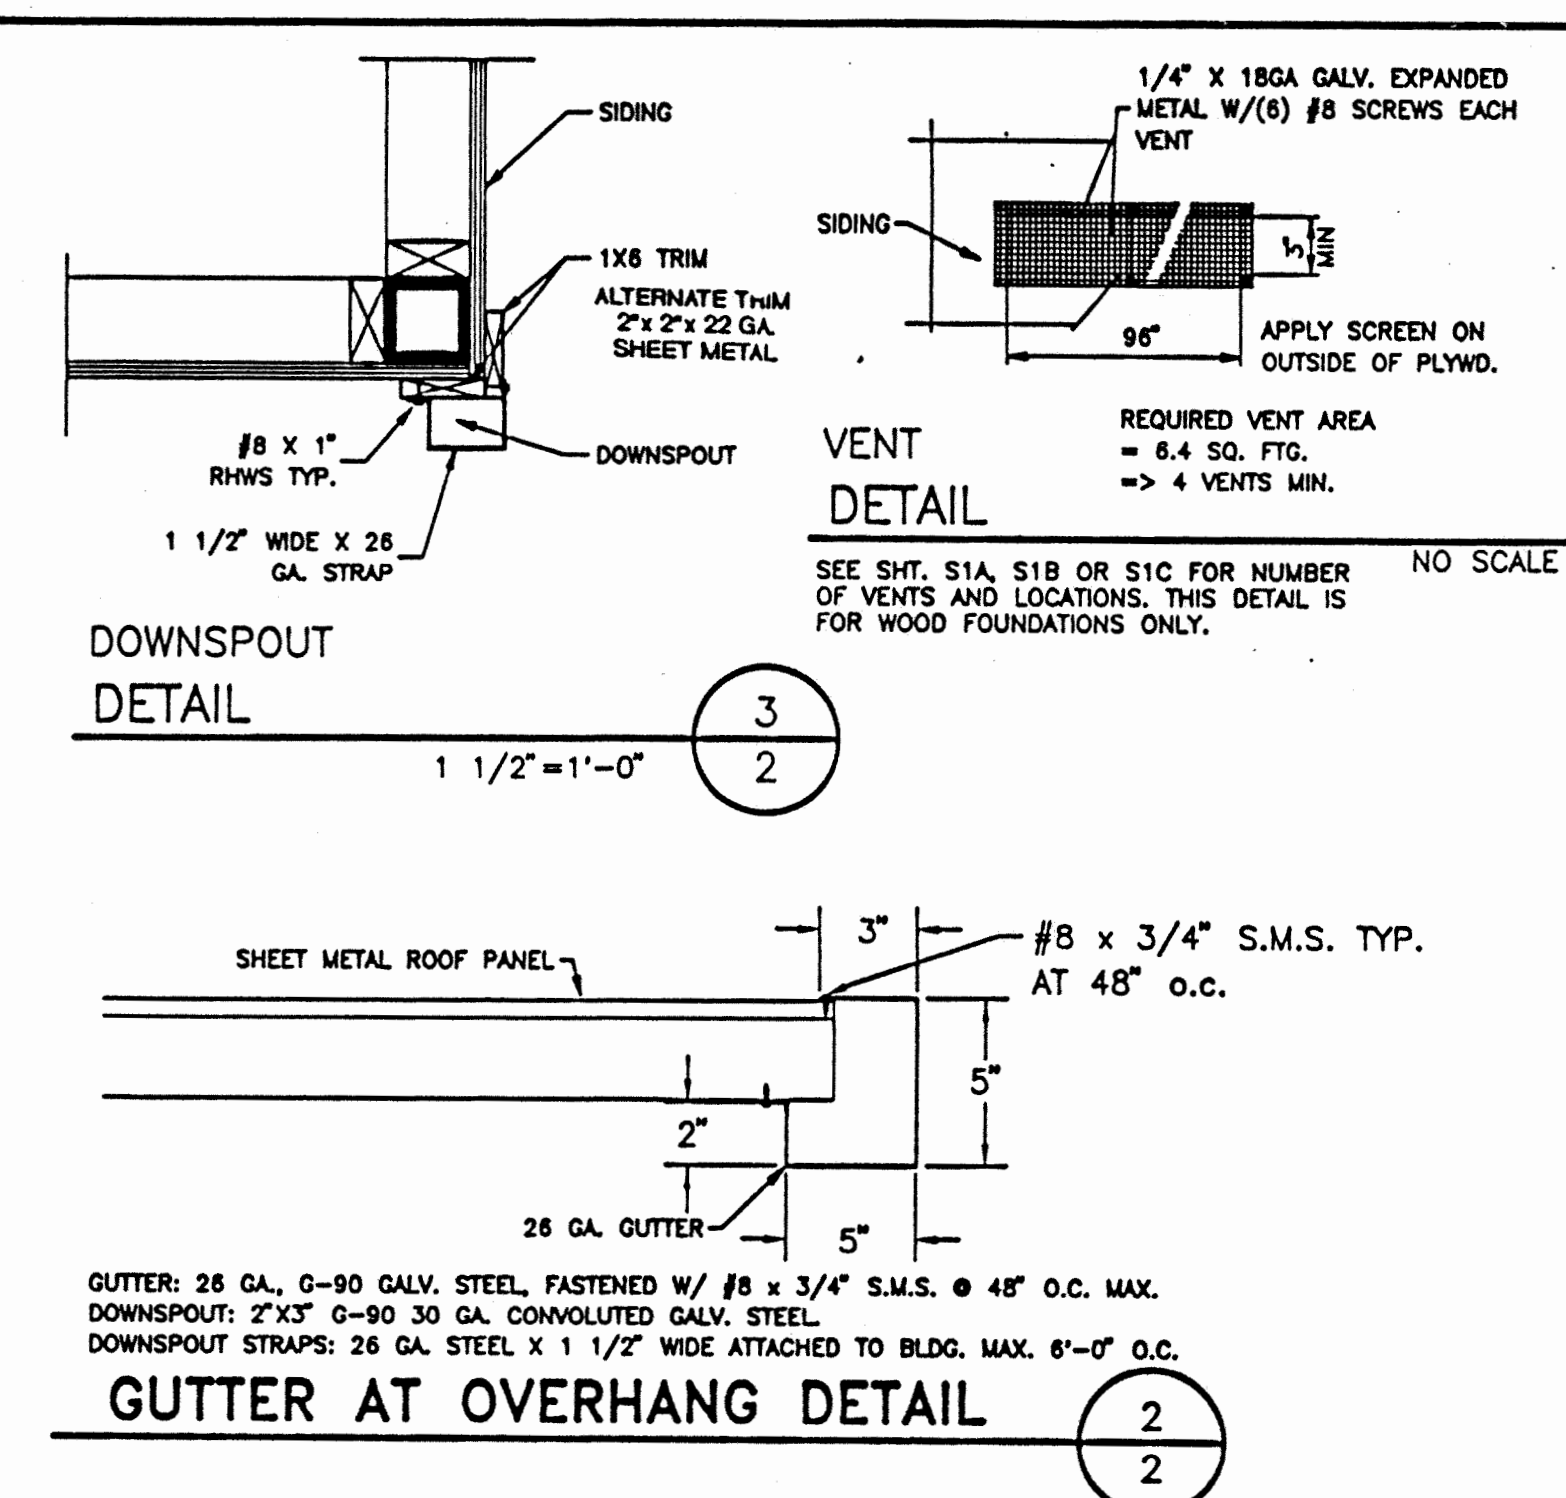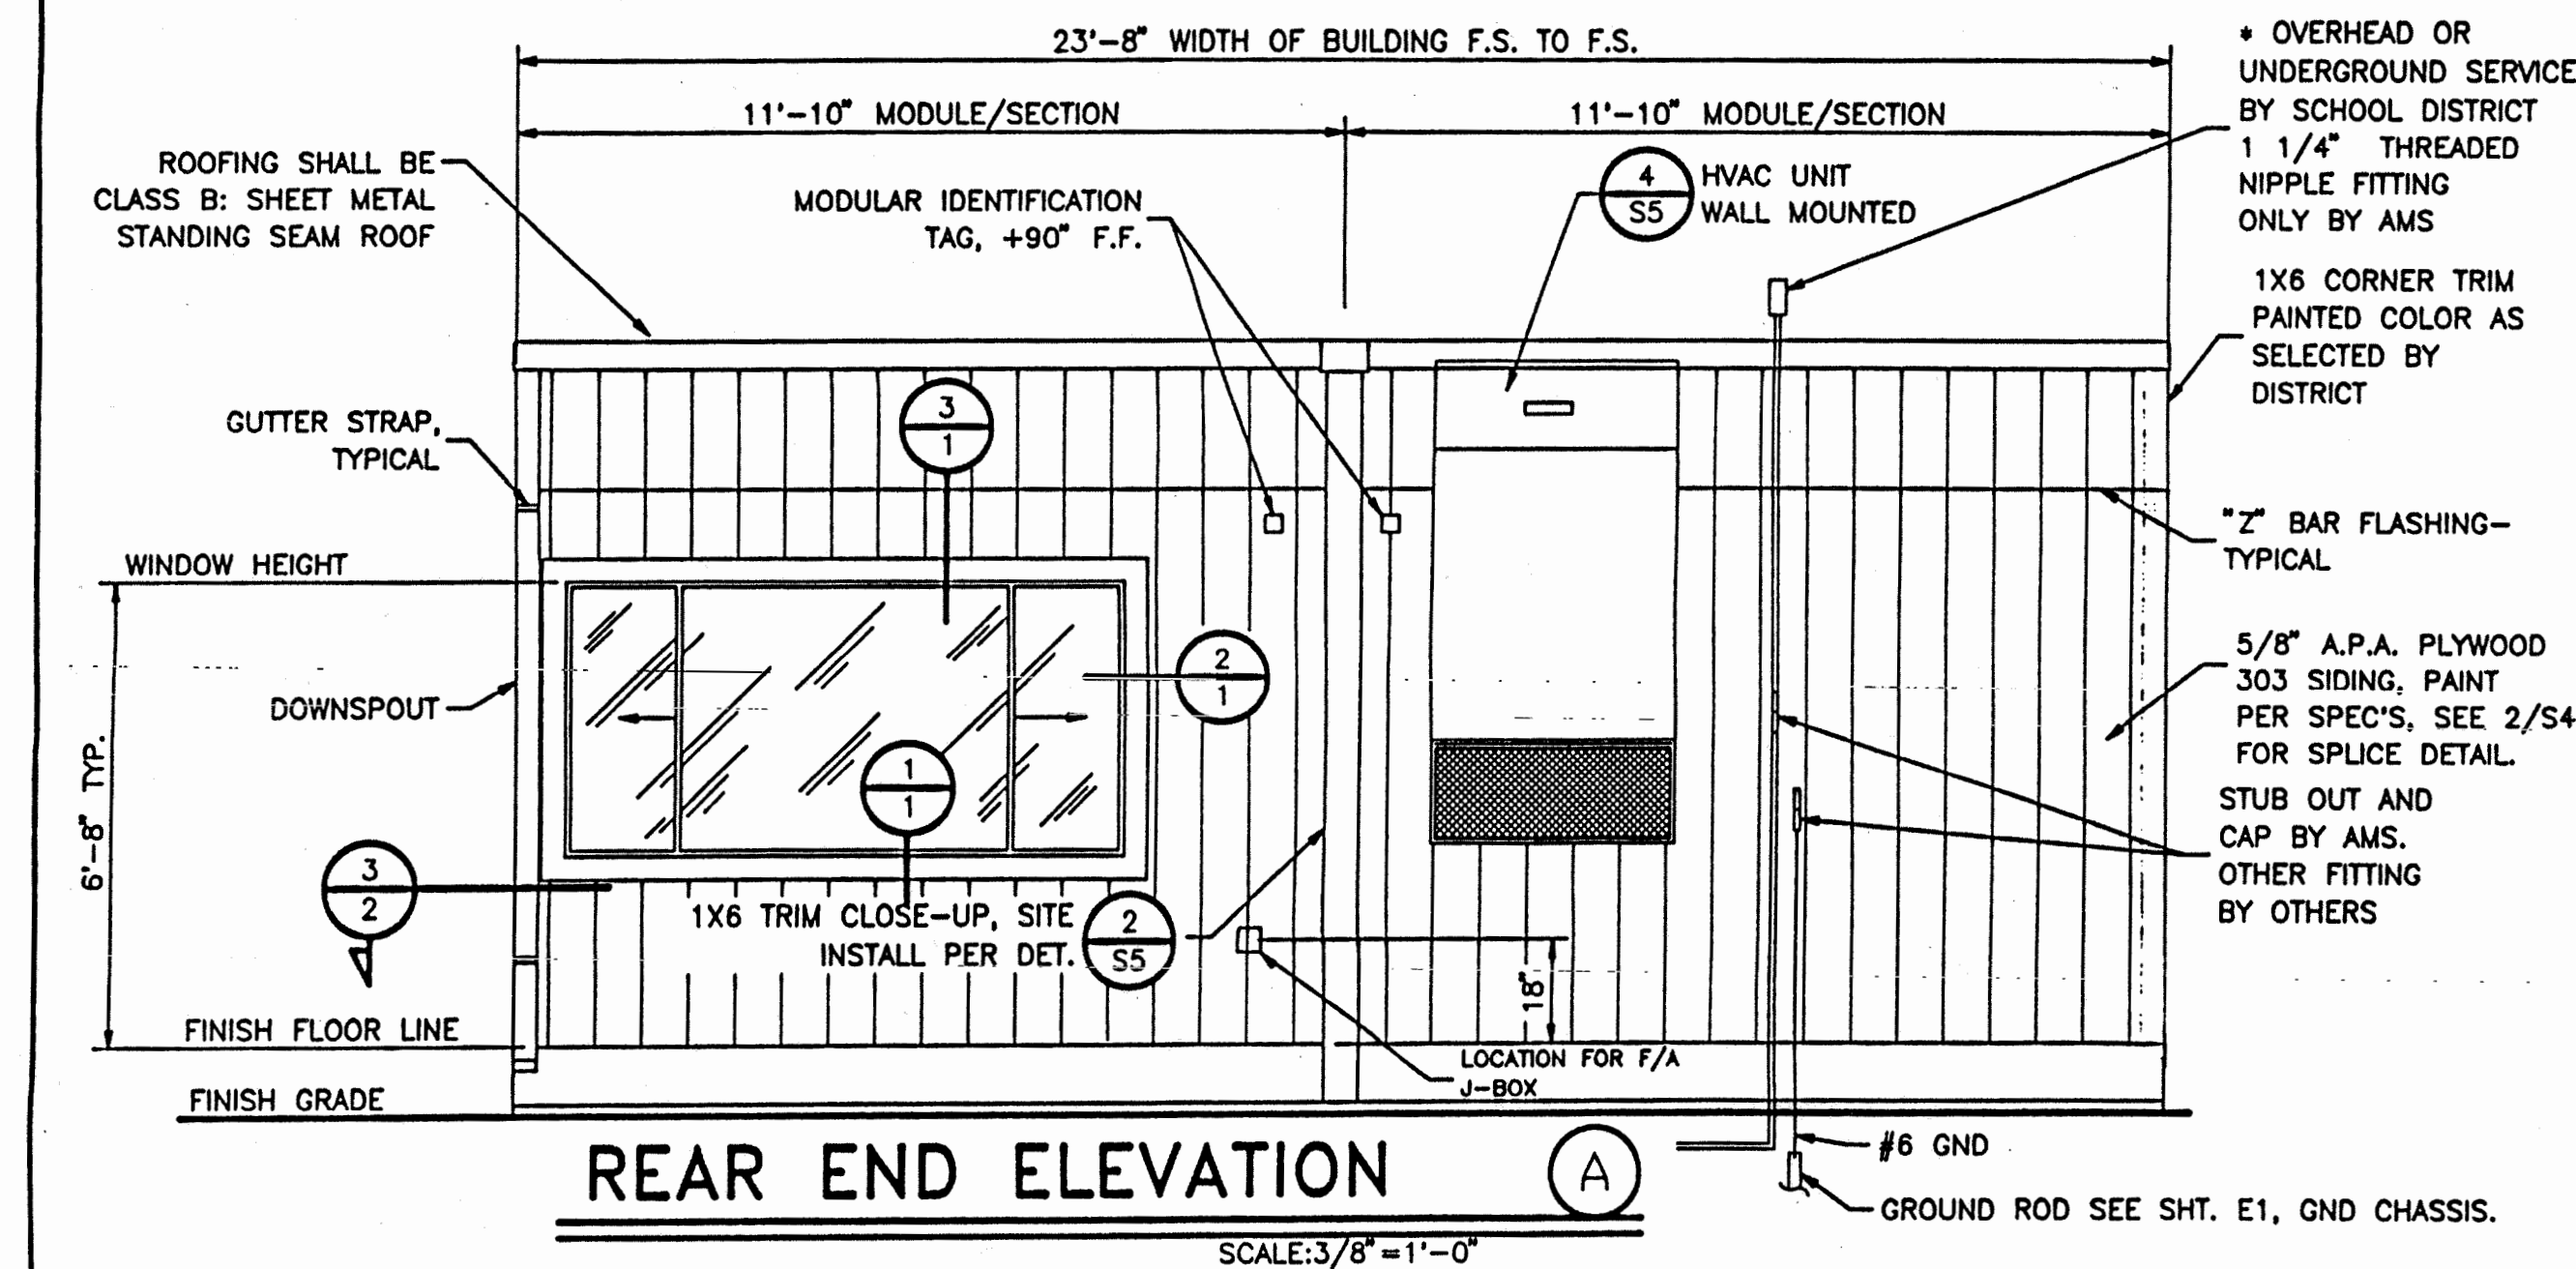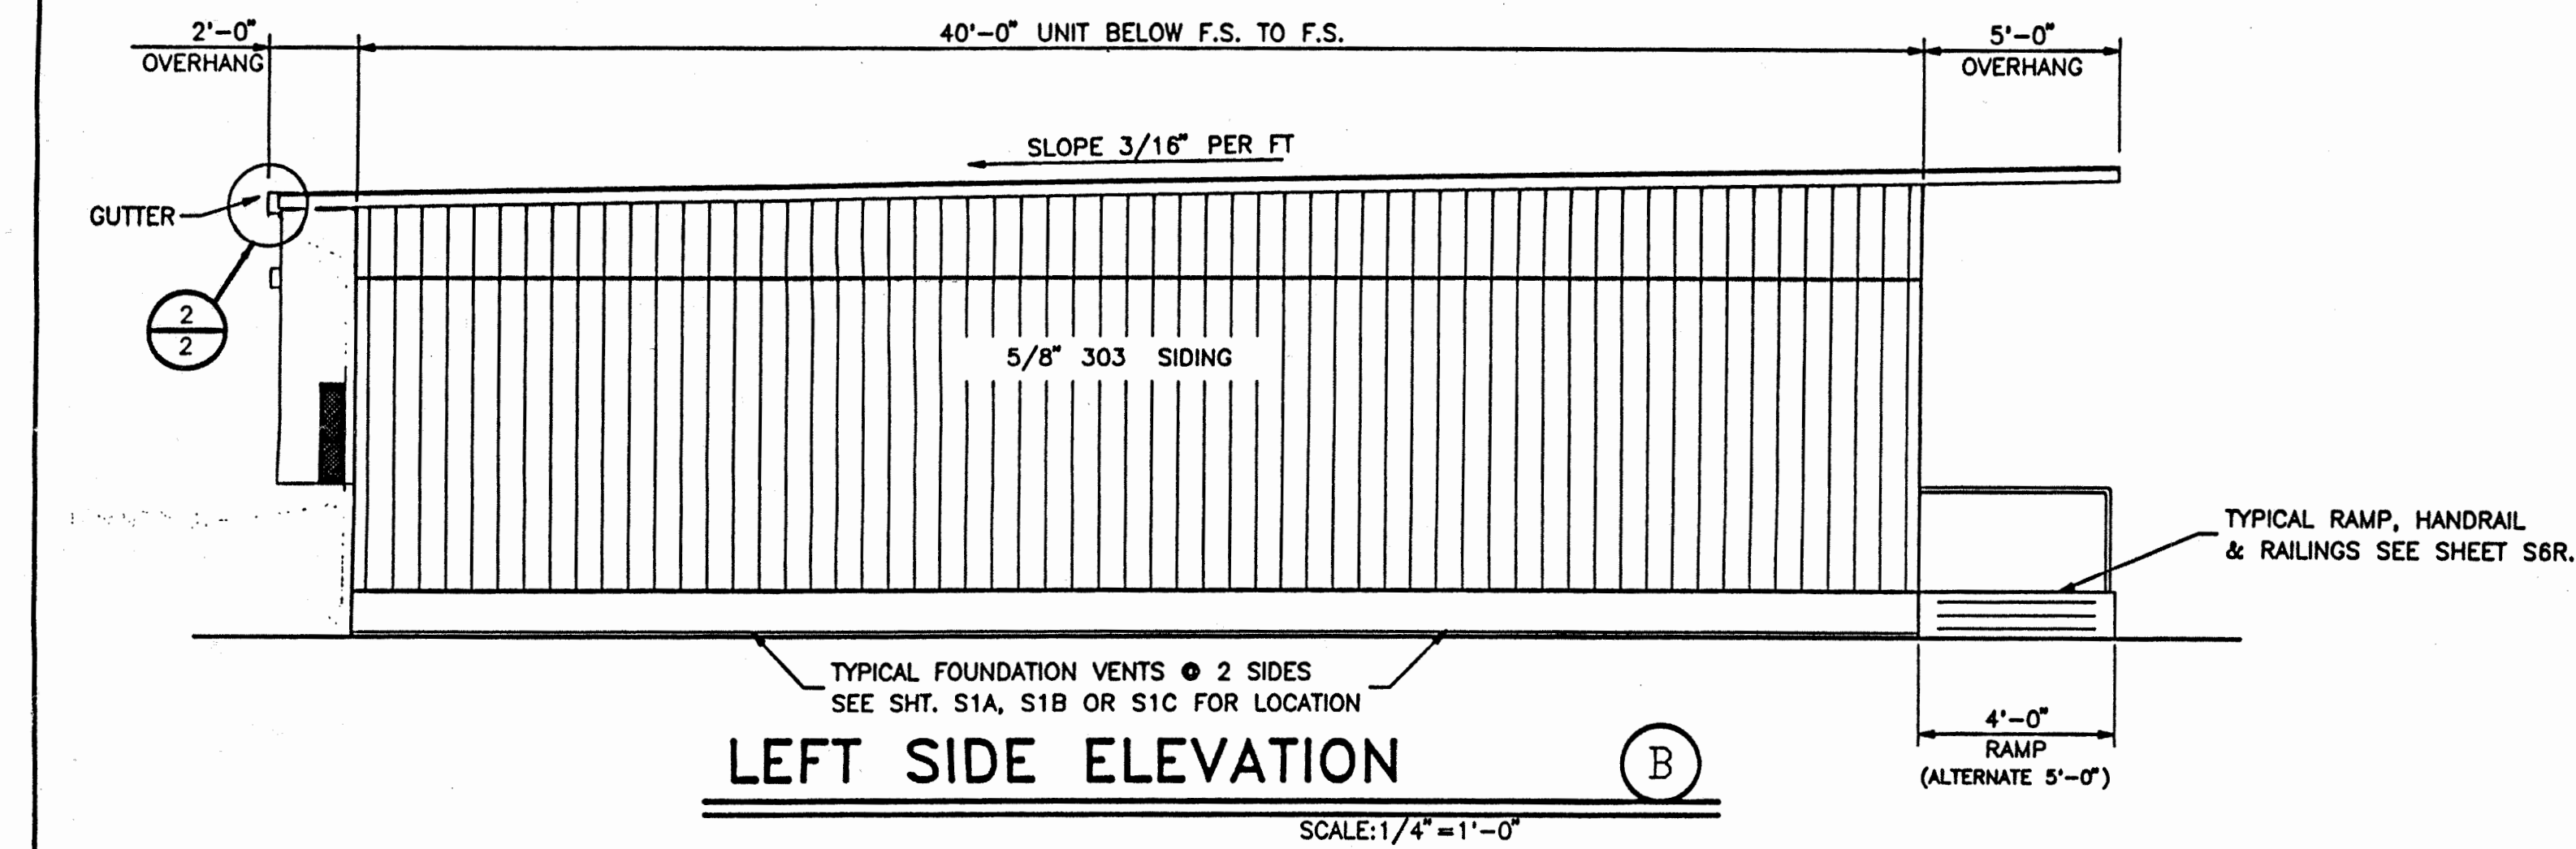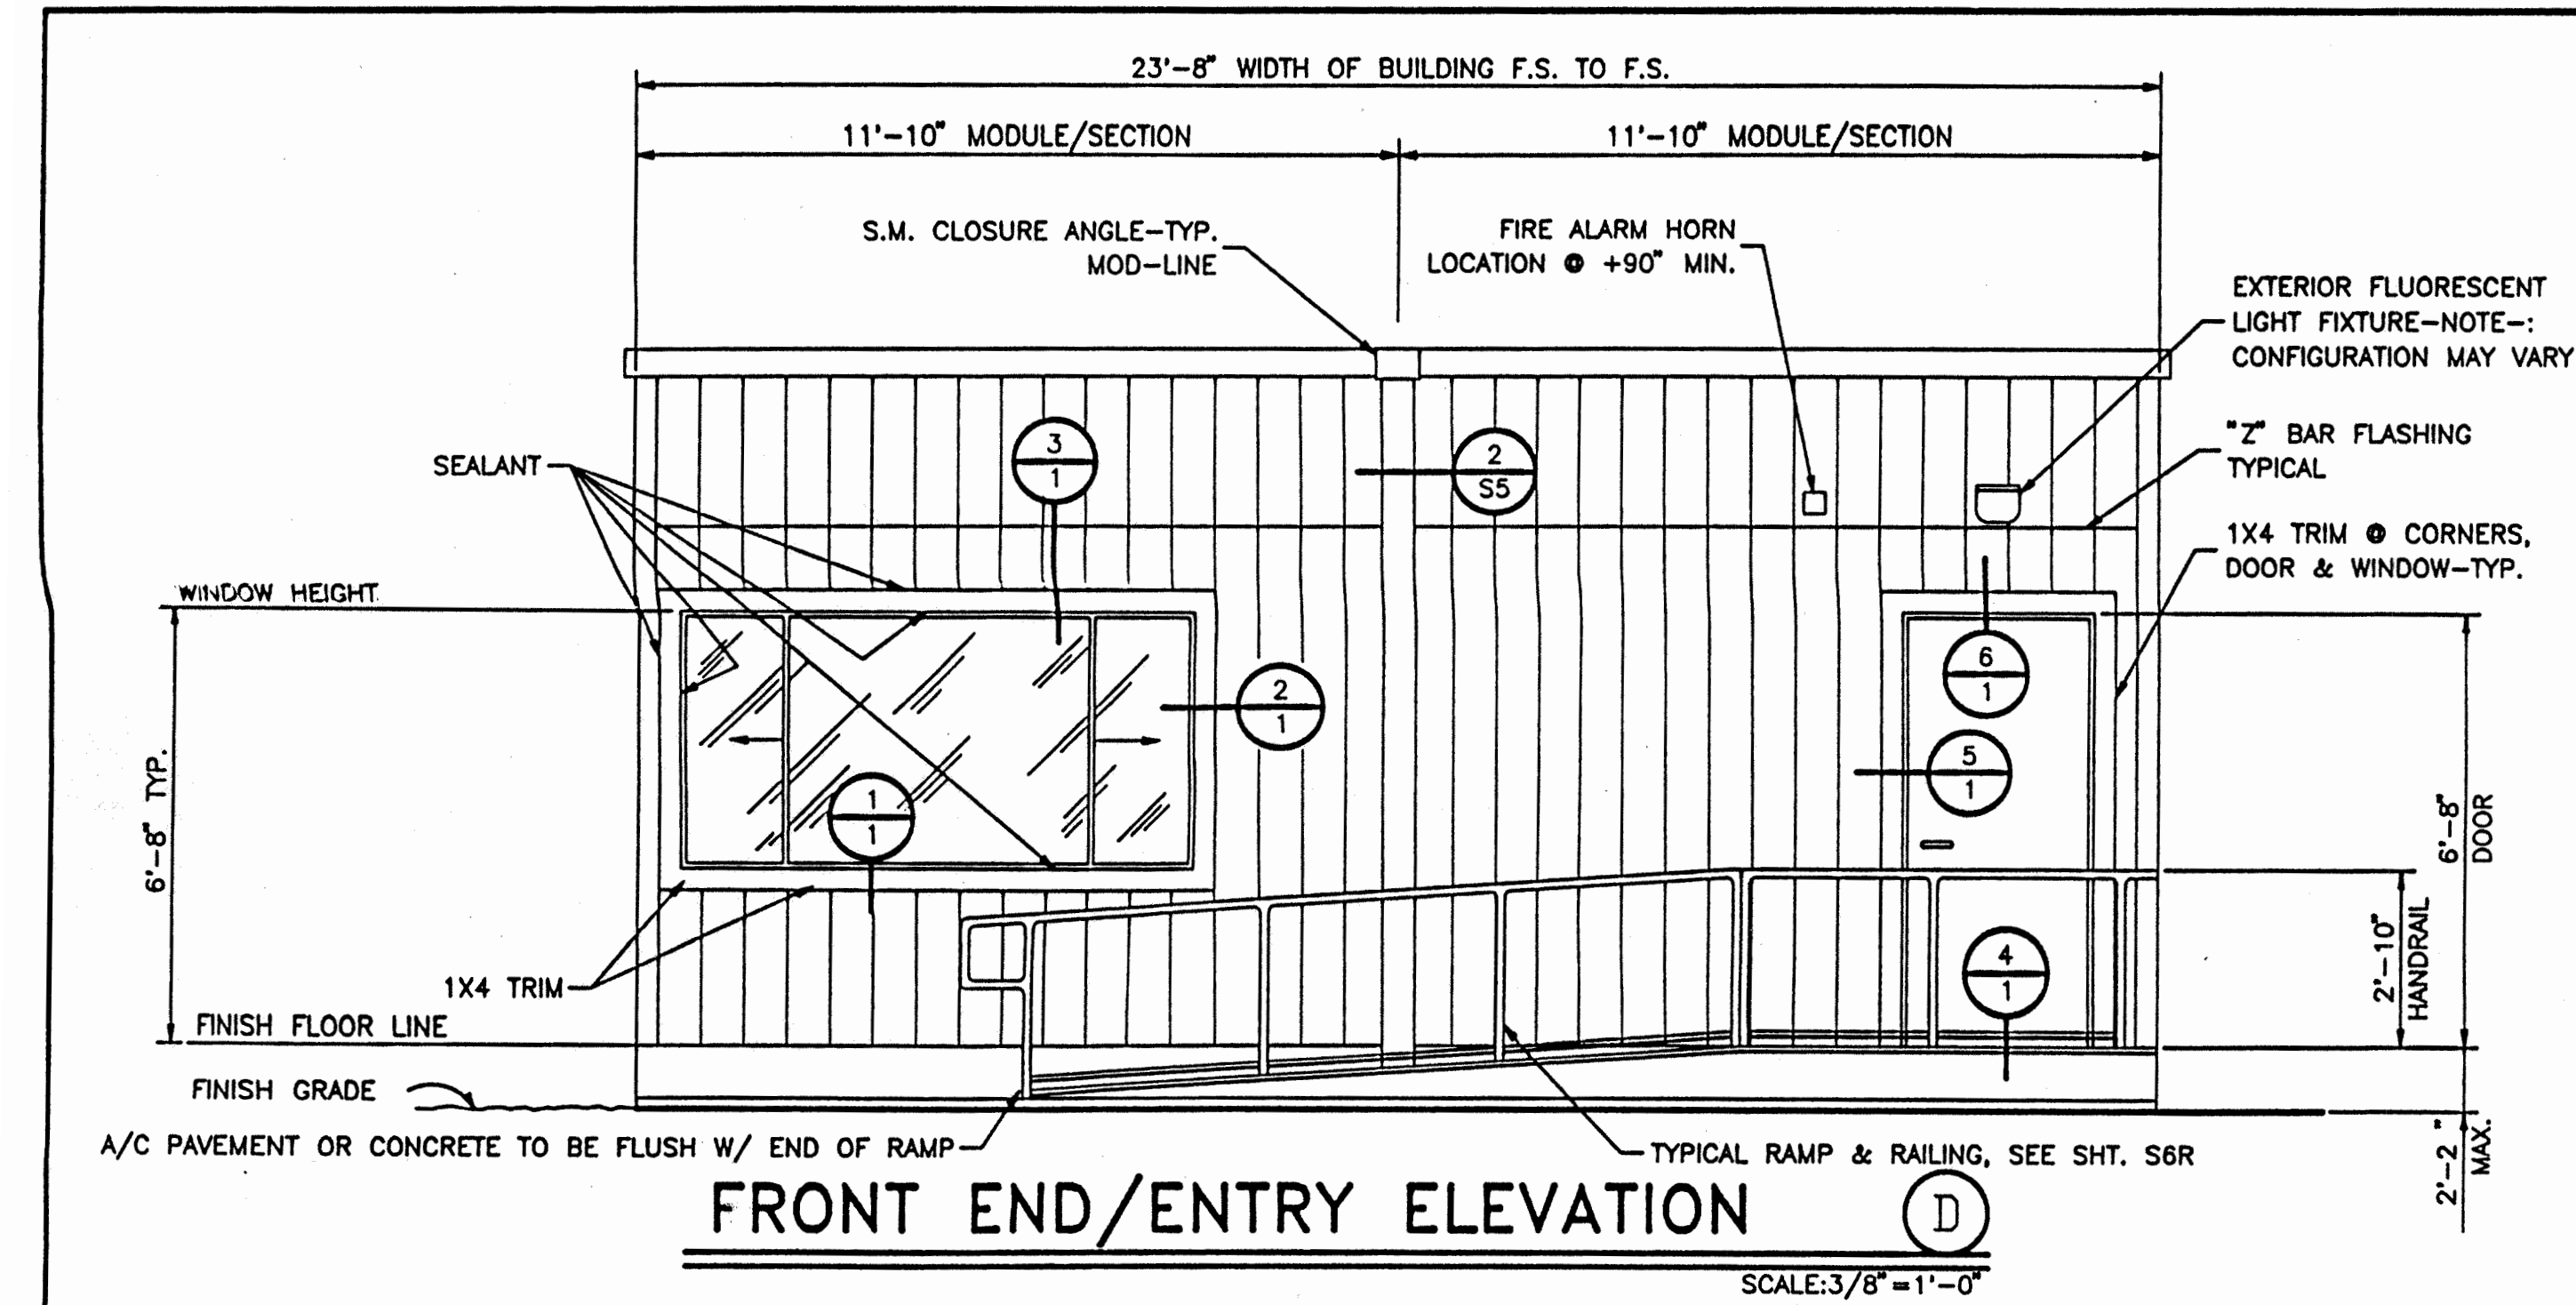

24 X 40
RELOCATABLE
CLASSROOMS

**American
Modular Systems**

CUSTOMER:

EXTERIOR ELEVATIONS

DATE: 4-8-97
SCALE: NONE
DRAWN BY: R.S.
CHECKED BY:
SERIAL NO.

REVISIONS					
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2

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1305 E. Vine St
Lodi, CA 95240

**MILLSWOOD MIDDLE SCHOOL
PORTABLES RELOCATION**
233 N Mills Ave
Lodi, CA 95242

SHEET TITLE

EXTERIOR ELEVATIONS

DRAWN BY: XXXXXX JOB NUMBER: 23219

SHEET NO.

2

DATE: DECEMBER 5, 2023

AGENCY APPROVAL DSA# 02-121945 02-121945

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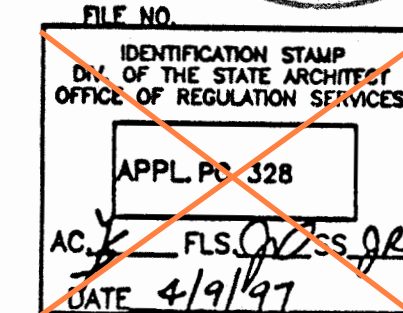
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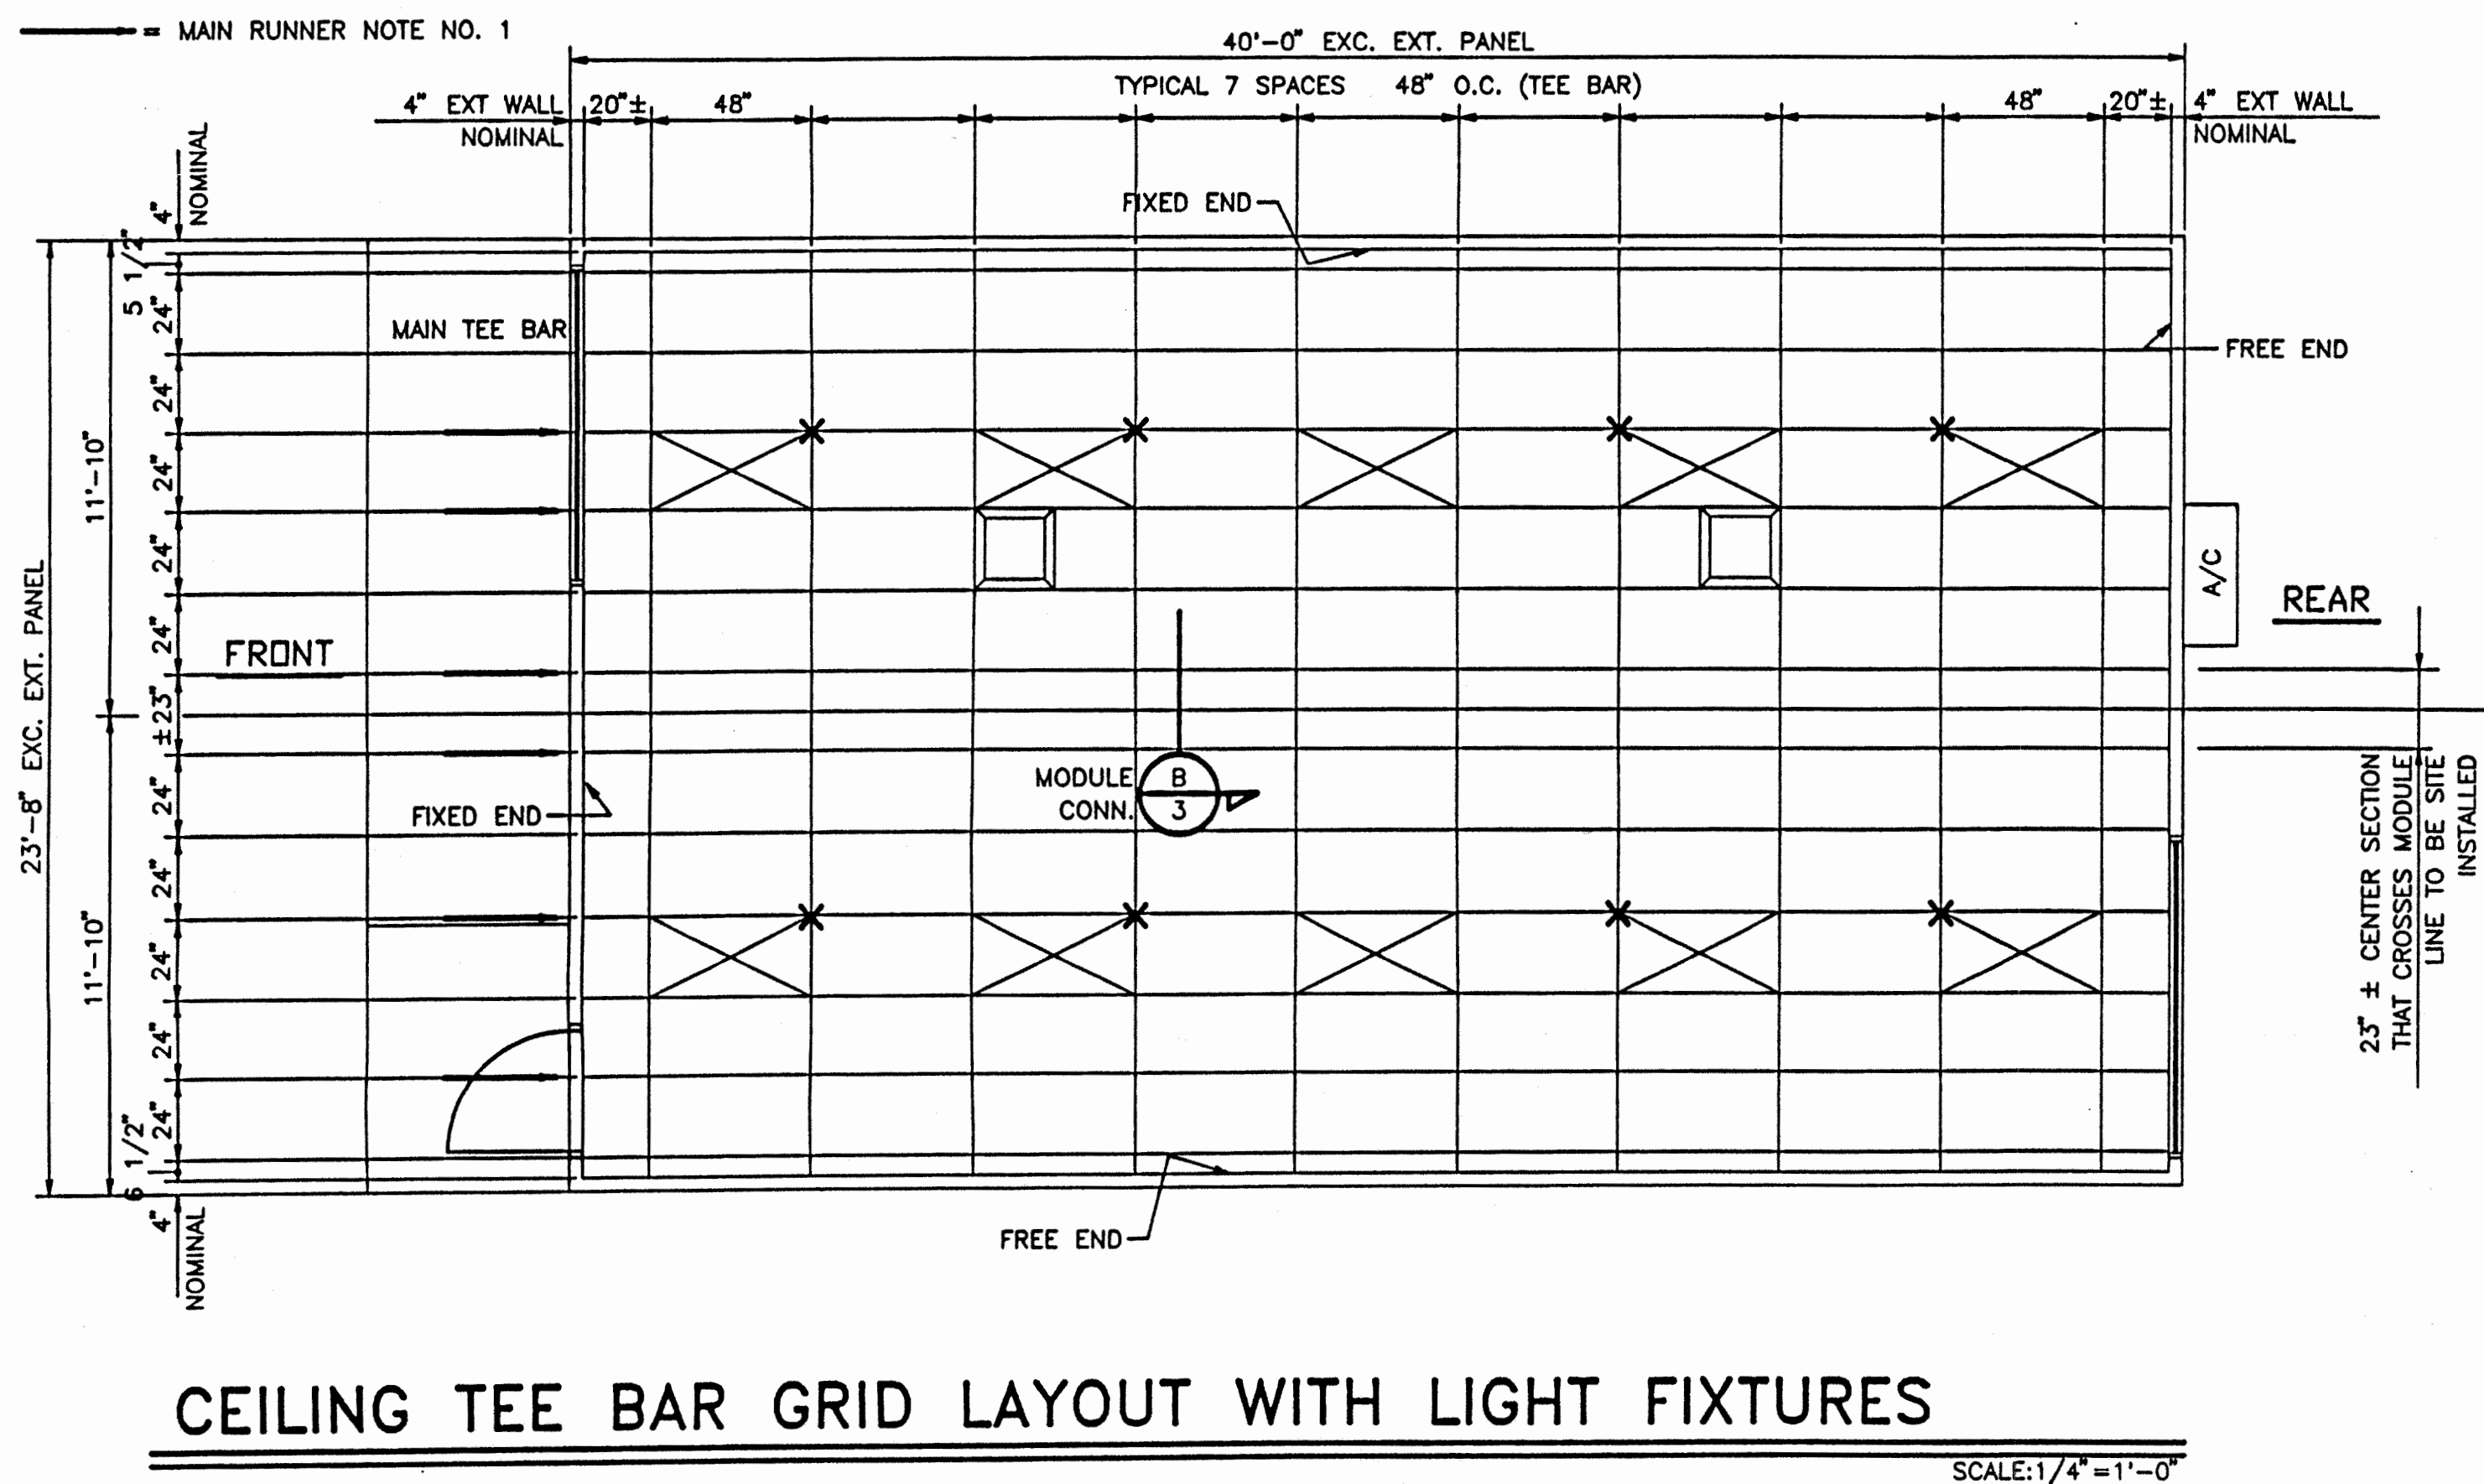
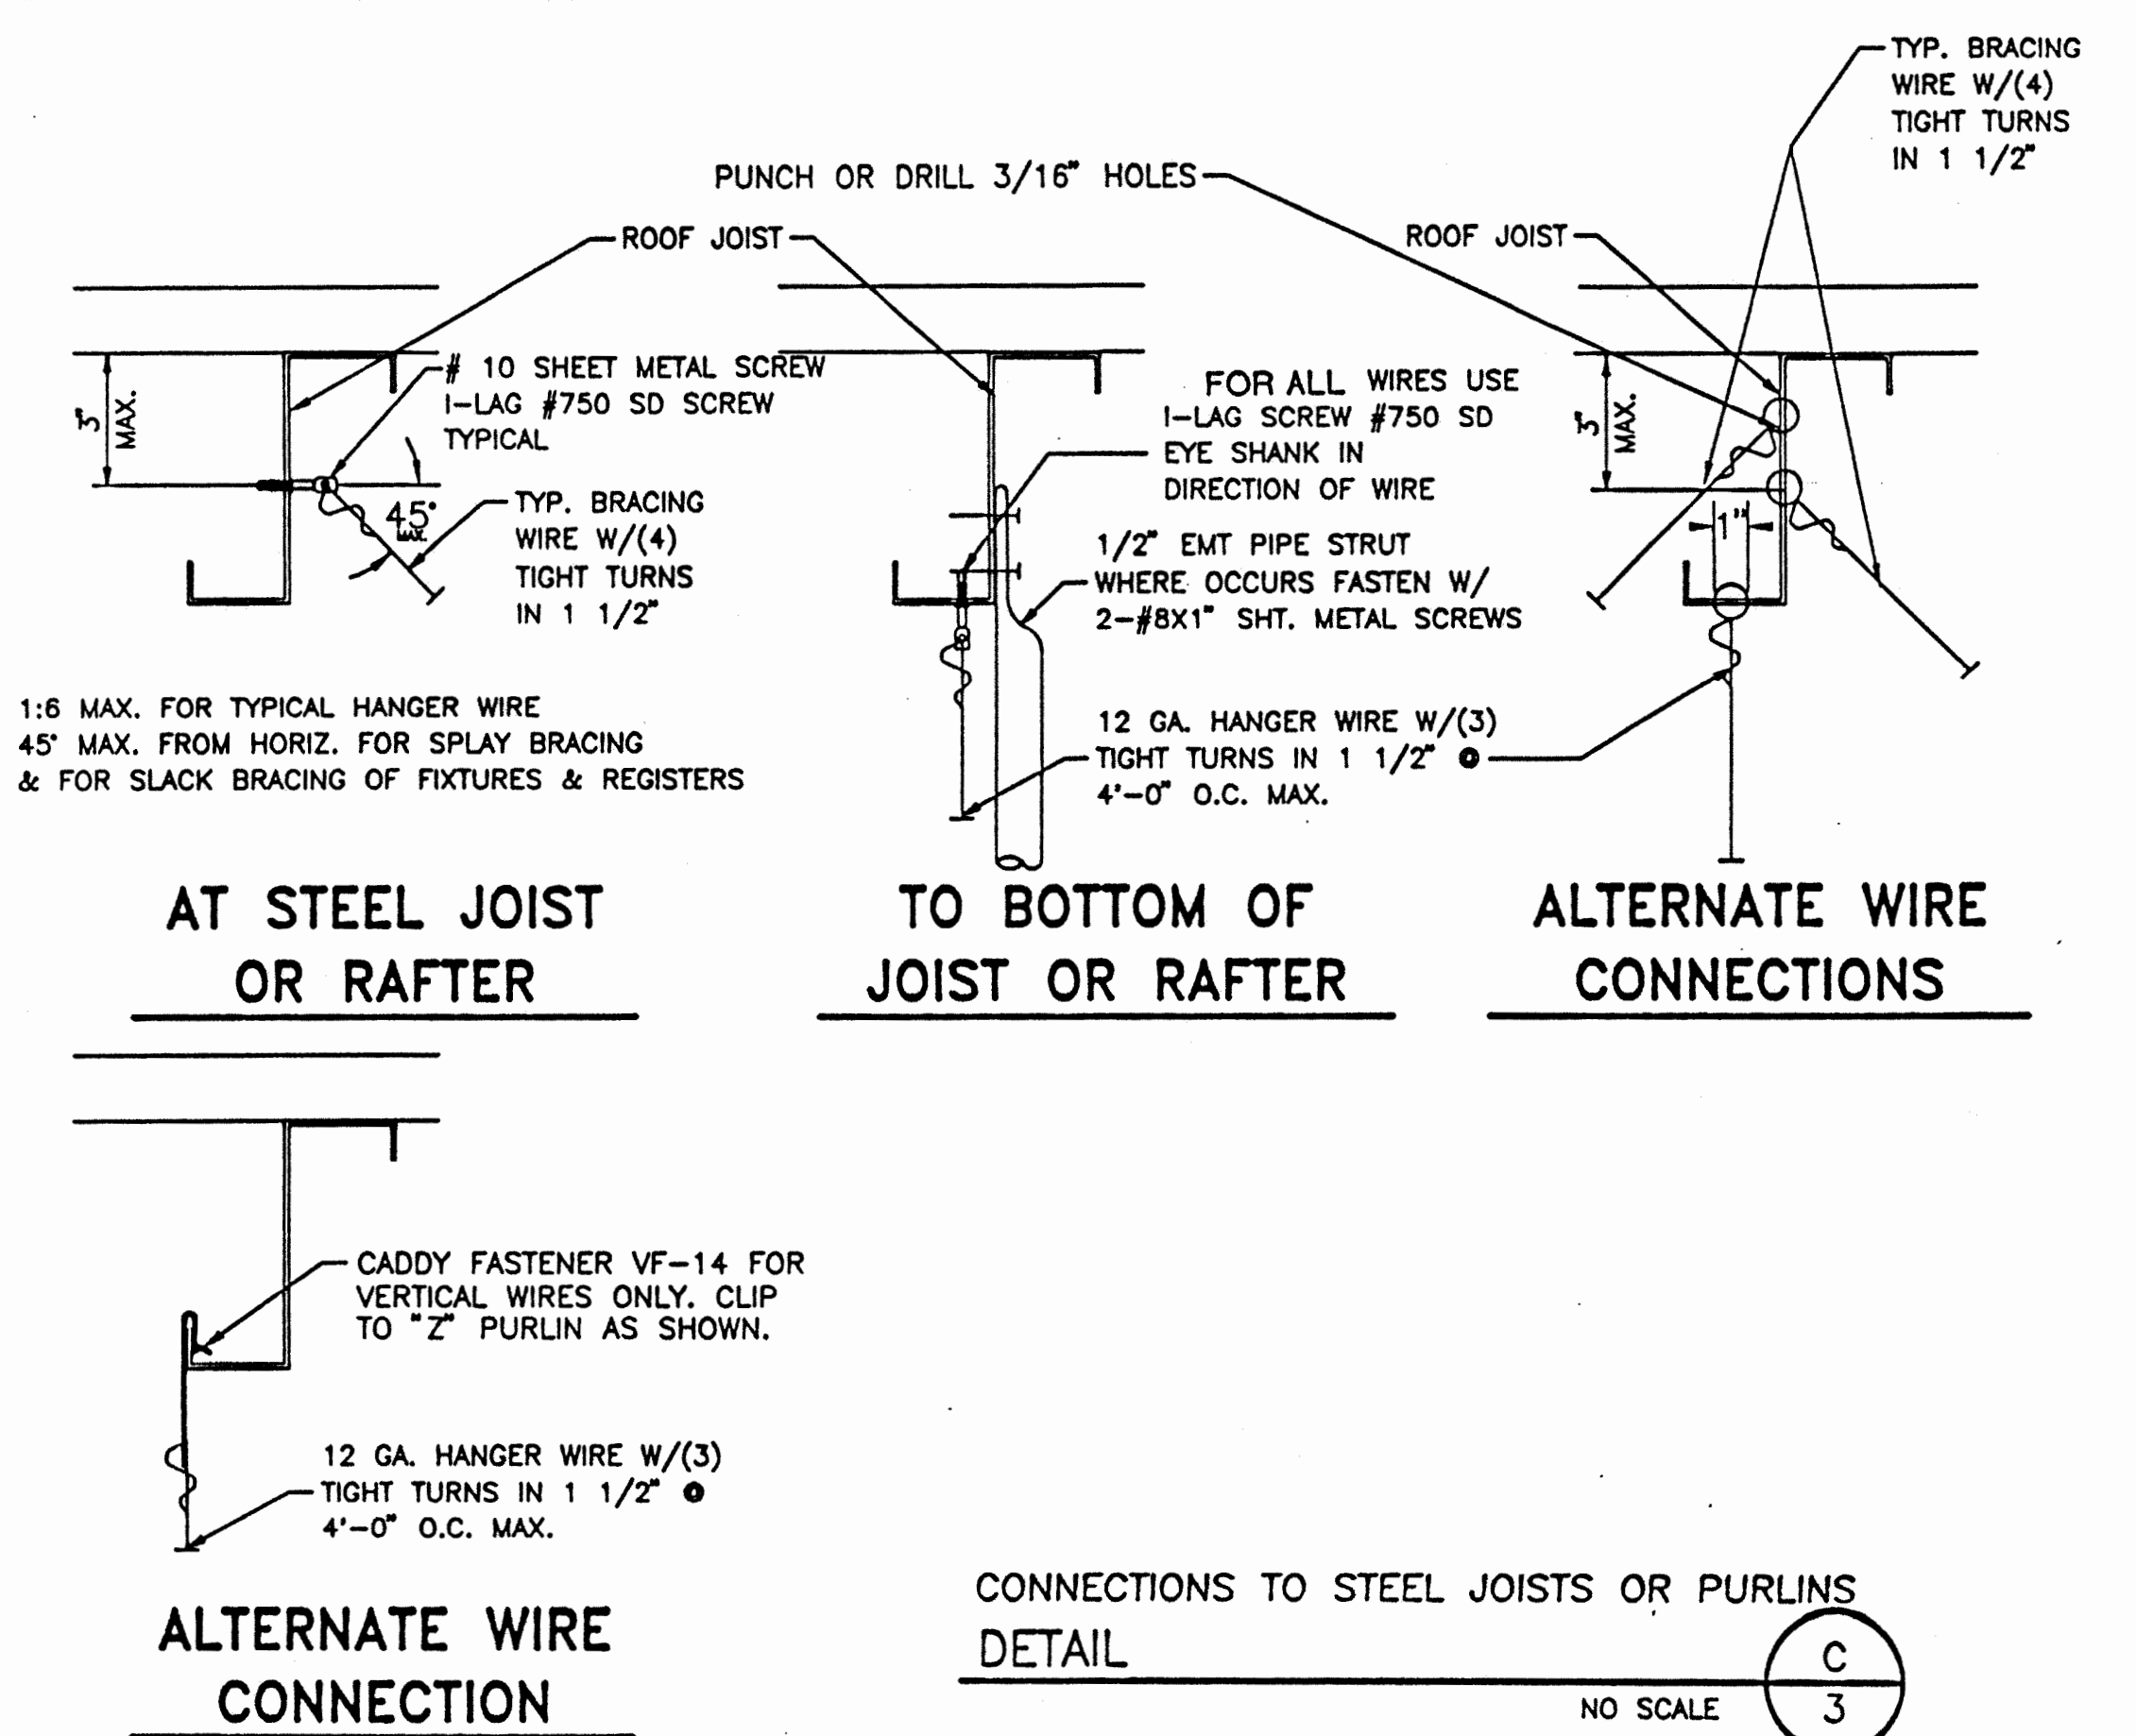
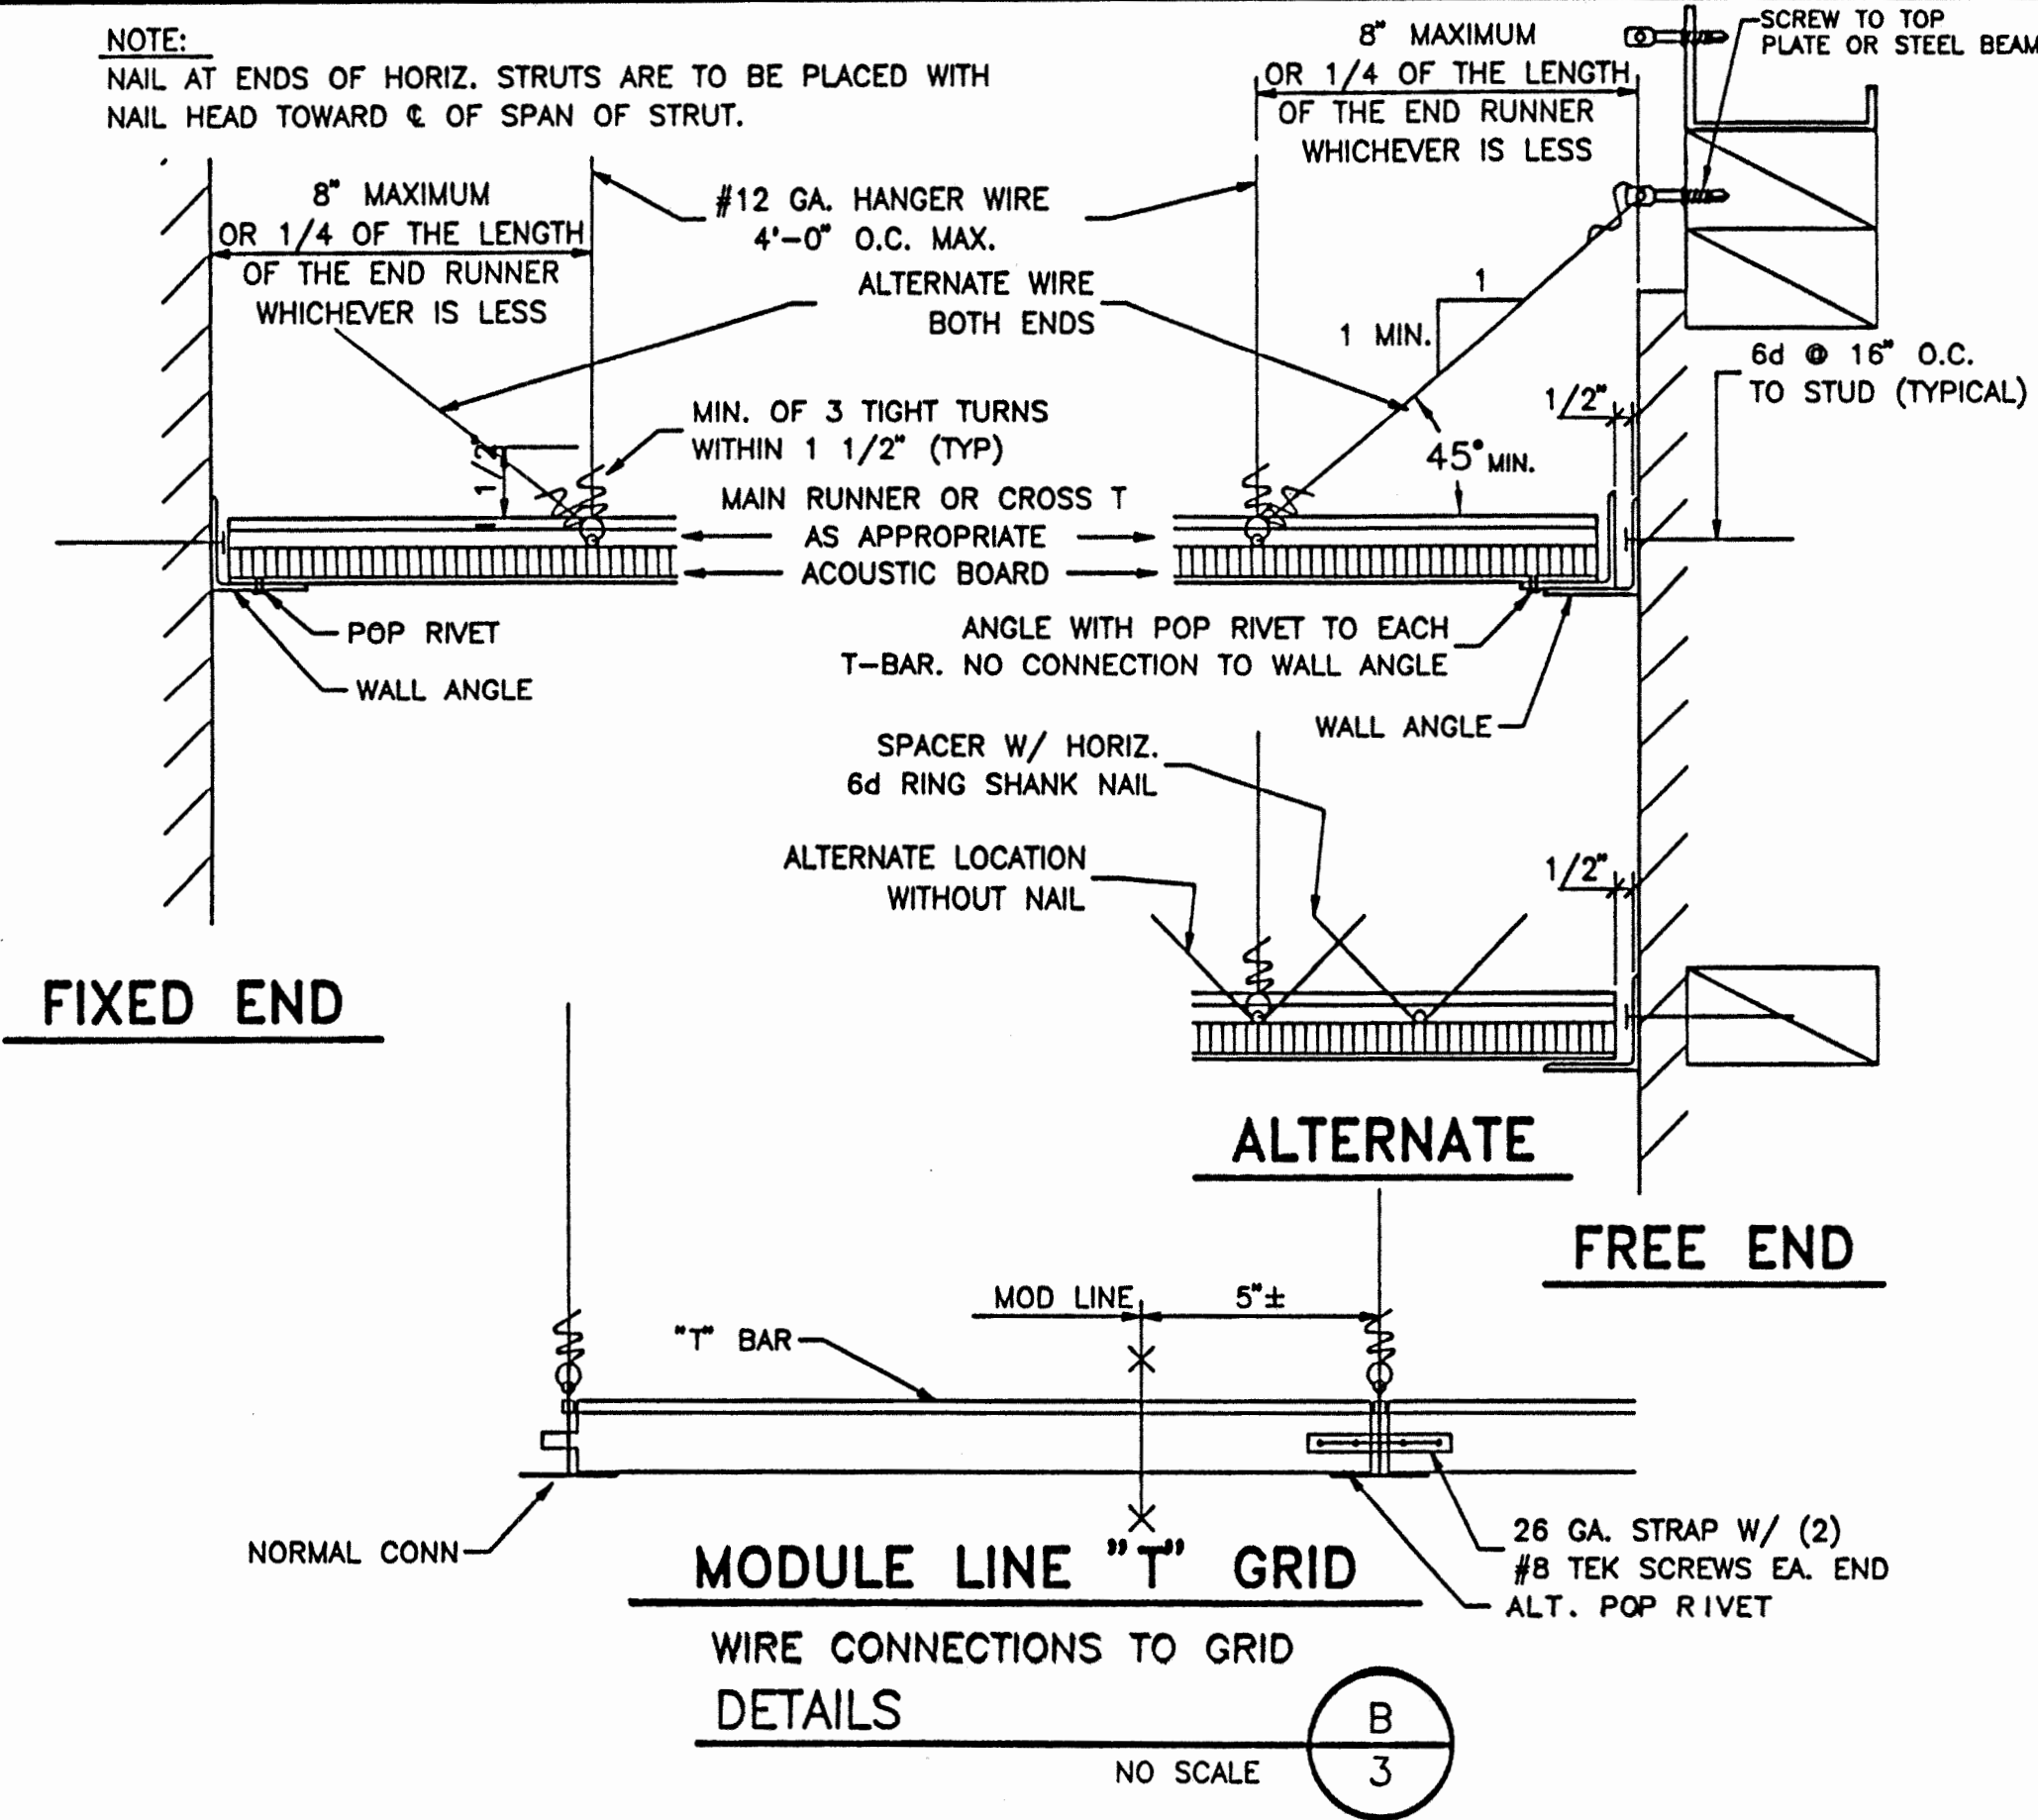
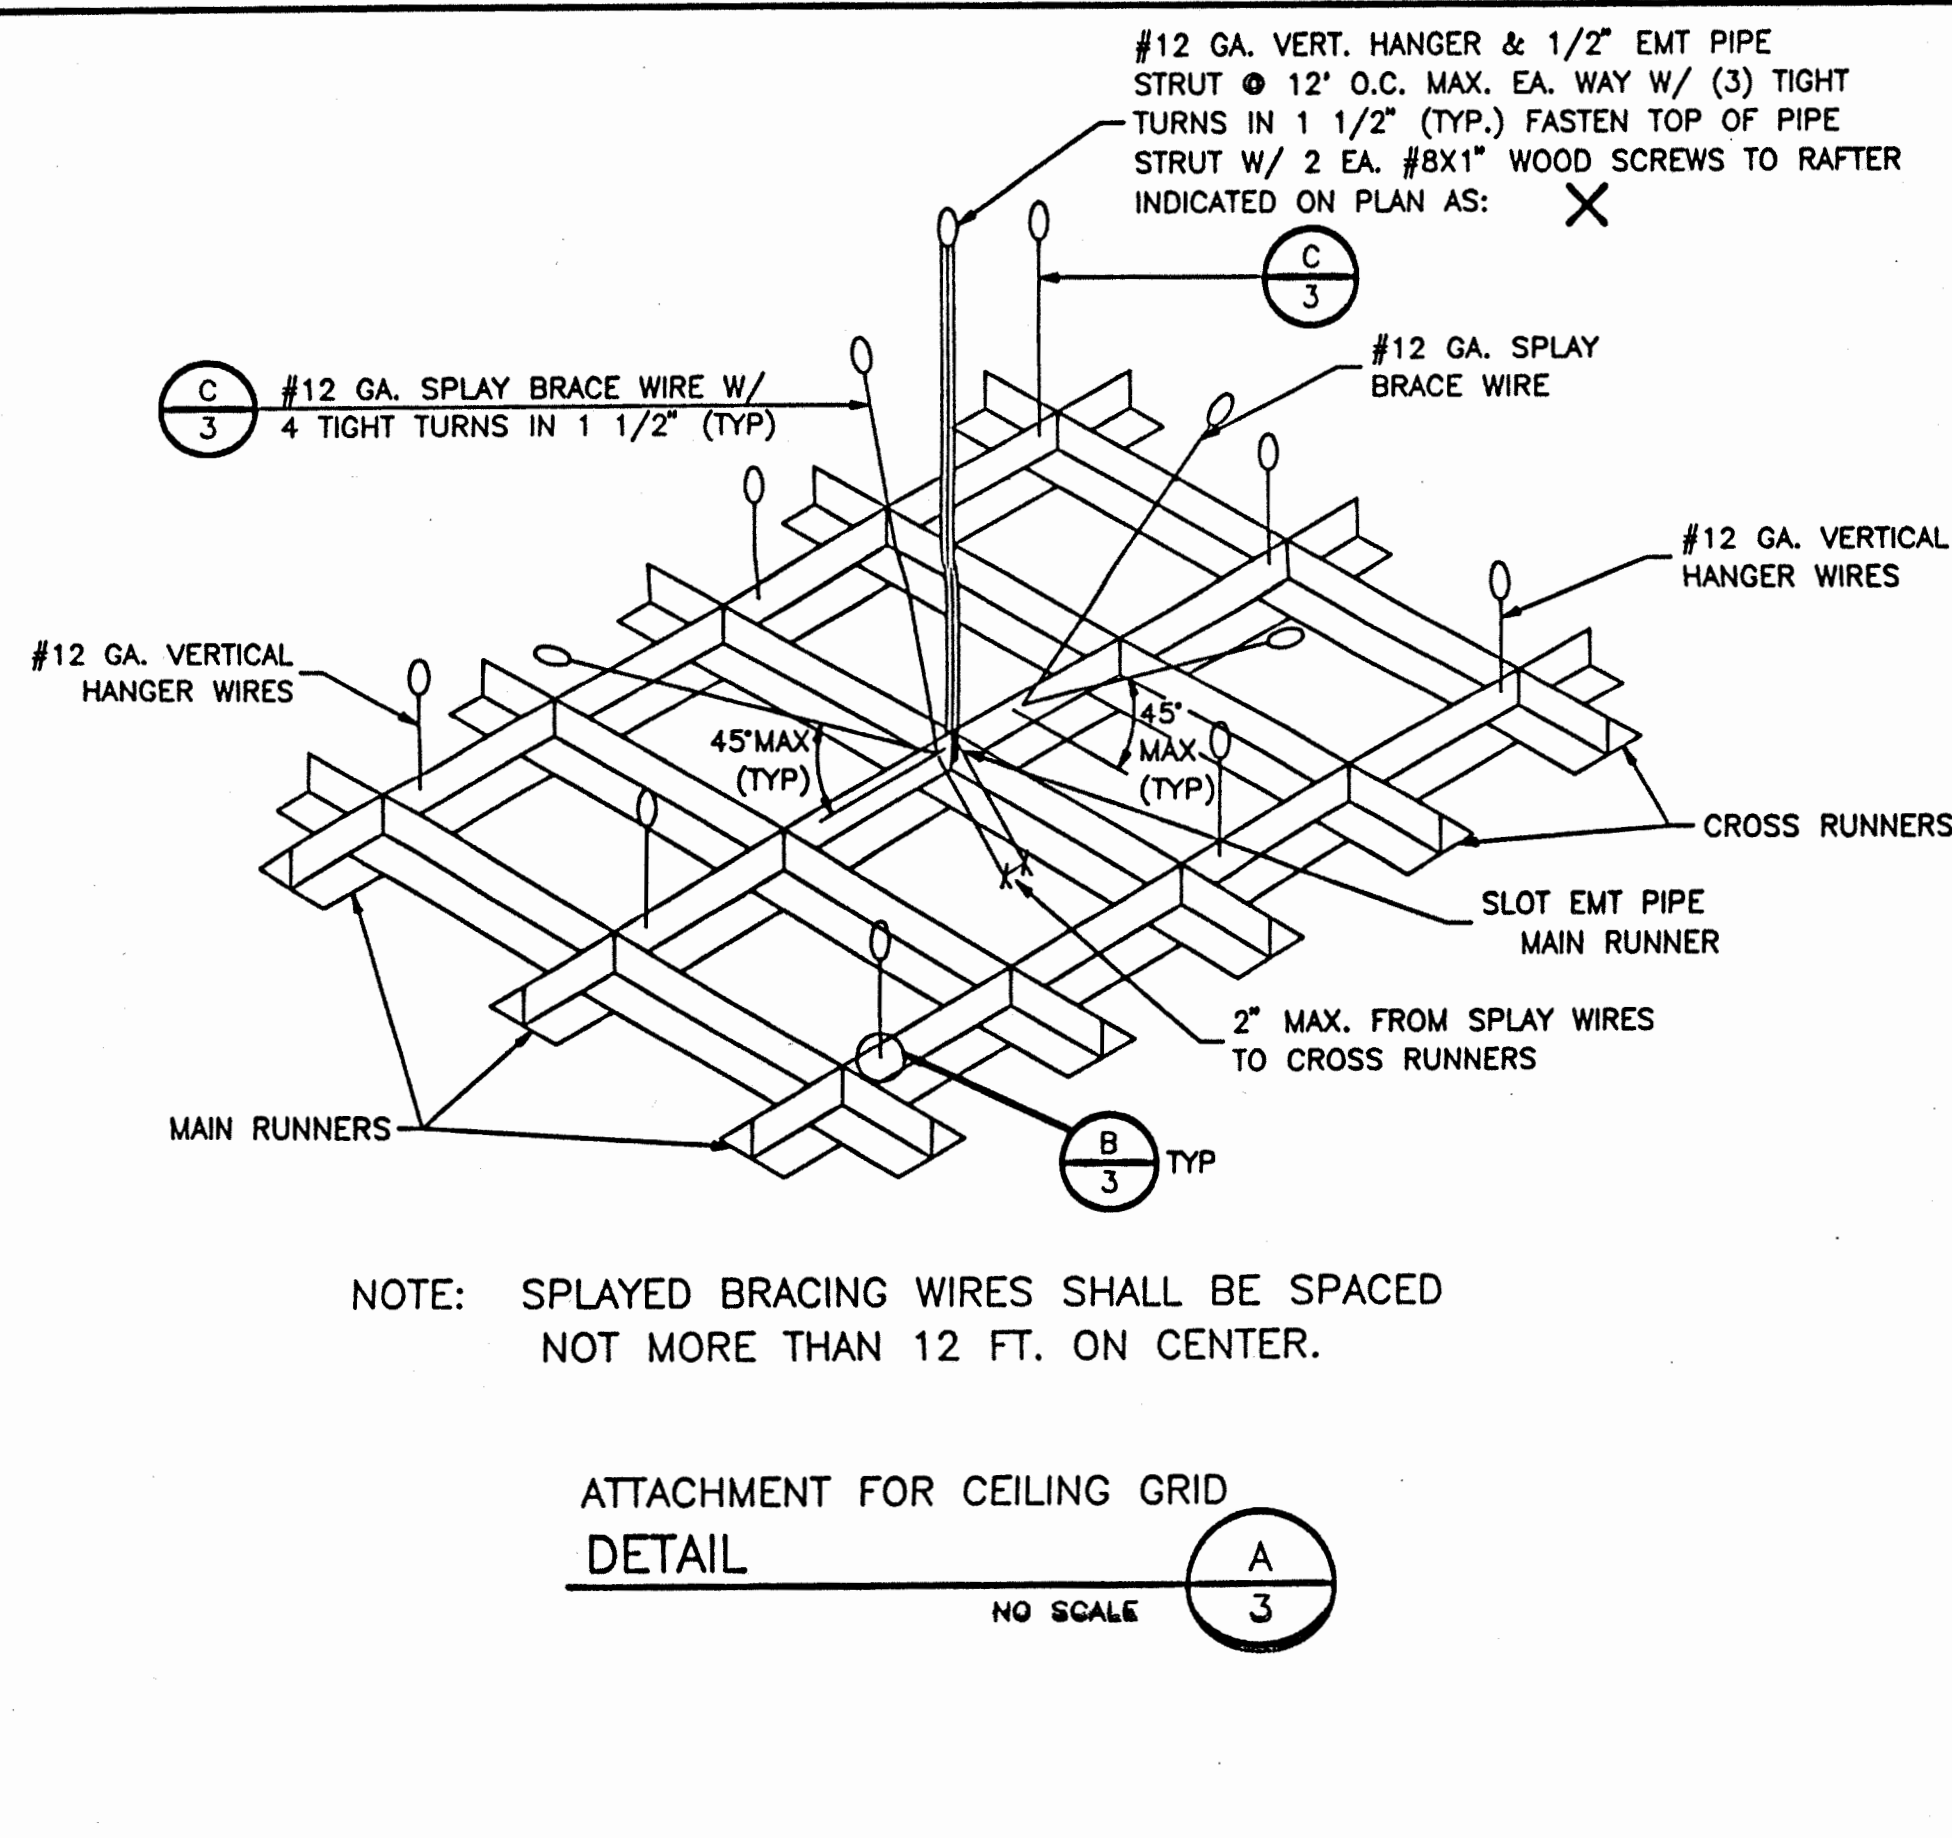


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METAL SUSPENSION SYSTEMS FOR LAY IN PANEL CEILING


- 12 GA. (MIN) HANGER WIRES MAY BE USED FOR UP TO AND INCLUDING 4'-0" x 4'-0" GRID SPACING, ALONG MAIN RUNNER. SPICES WILL NOT BE PERMITTED IN ANY HANGER WIRES UNLESS SPECIFICALLY APPROVED BY DSA/ORS.
- PROVIDE 12 GA HANGER WIRES WITHIN 8" OF THE ENDS OF ALL MAIN AND CROSS RUNNERS OR AT 1/4 OF THE LENGTH OF THE END TEE, WHICHEVER IS LESS AT THE PERIMETER OF THE CEILING AREA.
- PROVIDE TRAPEZE OR OTHER SUPPLEMENTARY SUPPORT MEMBERS AT OBSTRUCTIONS TO MAINTAIN HANGER SPACING. PROVIDE ADDITIONAL HANGERS, STRUTS OR BRACES AS REQUIRED AT ALL CEILING BREAKS, SOFFITS OR DISCONTINUOUS AREA. HANGER WIRES THAT ARE MORE THAN 1 IN 6 OUT OF PLUMB ARE TO HAVE COUNTERBRACED WIRES.
- CEILING GRID MEMBERS MAY BE ATTACHED TO NOT MORE THAN 2 ADJACENT WALLS. CEILING GRID MEMBERS SHOULD BE AT LEAST 1/2 INCH FREE OF OTHER WALLS. RUNNERS, ONE END OF MAIN AND CROSS RUNNERS SHOULD IF WALLS RUN DIAGONALLY TO CEILING GRID SYSTEM BE FREE AND A MINIMUM OF 1/2 INCH CLEAR OF WALL.
- AT THE PERIMETER OF THE CEILING AREA WHERE MAIN OR CROSS RUNNERS ARE NOT CONNECTED TO THE ADJACENT WALL, PROVIDE INTERCONNECTION BETWEEN THE RUNNERS AT THE FREE END TO PREVENT LATERAL SPREADING. A METAL STRUT OR A 16 GA WIRE WITH A POSITIVE MECHANICAL CONNECTION TO THE RUNNERS MAY BE USED, WHERE THE PERPENDICULAR DISTANCE FROM THE WALL TO THE FIRST PARALLEL RUNNERS IS 12" OR LESS, THIS INTERLOCK IS NOT REQUIRED.
- PROVIDE SETS OF 4-#12 GA. SPLAYED BRACING WIRES ORIENTED 90 DEGREES FROM EACH OTHER AT THE FOLLOWING SPACING:
(A) FOR SCHOOL BUILDINGS, PLACE SETS OF SPLAY WIRES AT A SPACING NOT MORE THAN 12 FEET BY 12 FEET ON CENTER.
(B) PROVIDE SPLAY WIRES AT LOCATIONS NOT MORE THAN 1/2 THE ABOVE SPACING FROM EACH PERIMETER WALL OR AT THE EDGE OF VERTICAL CEILING OFFSETS
- FASTEN HANGER WIRES WITH NOT LESS THAN 3 TIGHT TURNS. FASTEN SPLAY WIRES WITH 4 TIGHT TURNS. MAKE ALL TIGHT TURNS WITHIN A DISTANCE OF 1 1/2 INCHES. HANGER OR BRACING WIRE ANCHORS TO THE STRUCTURE SHOULD BE INSTALLED IN SUCH A MANNER THAT THE DIRECTION OF THE WIRE ALIGNS AS CLOSELY AS POSSIBLE WITH THE DIRECTION OF THE FORCES ACTING ON THE WIRE.
- SEPARATE ALL CEILING HANGING AND BRACING WIRES AT LEAST 6 INCHES FROM ALL UNBRACED DUCTS, PIPES, CONDUIT ETC.. IT IS ACCEPTABLE TO ATTACH LIGHT-WEIGHT ITEMS, SUCH AS SINGLE ELECTRICAL CONDUIT NOT EXCEEDING 3/4" NOMINAL DIAMETER, TO HANGER WIRES USING CONNECTORS ACCEPTABLE TO DSA/ORS.
- ATTACH ALL LIGHT FIXTURES AND AIR TERMINALS TO THE CEILING GRID RUNNERS TO RESIST A HORIZONTAL FORCE EQUAL TO THE WEIGHT OF THE FIXTURES.
- FLUSH OR RECESSED LIGHT FIXTURES AND AIR TERMINALS OR SERVICES WEIGHING LESS THAN 56 POUNDS MAY BE SUPPORTED DIRECTLY ON THE RUNNERS OF A HEAVY DUTY GRID SYSTEM BUT, IN ADDITION, THEY MUST HAVE A MINIMUM OF 2-#12 GA. SLACK SAFETY WIRES ATTACHED AT DIAGONAL CORNERS AND ANCHORED TO THE STRUCTURE ABOVE.
- CLASSIFICATION OF CEILING GRID:
CLASSIFICATION OF CEILING GRID IS "HEAVY DUTY" PER ASTM C635
MANUFACTURER'S CATALOG NUMBER - MAIN RUNNER HEAVY DUTY MAIN TEE OR EQUAL PER TABLE A.
MANUFACTURER'S CATALOG NUMBER - CROSS RUNNER PER TABLE A.

MANUFACTURER'S CATALOG NUMBER OF DETAIL FOR RUNNER SPICE N/A.
ACOUSTICAL PANELS SHALL BE 5/8" MINIMUM THICK, MINERAL FIBERBOARD OR VINYL-FACED FIBERGLASS LAY-IN PANELS SQUARE EDGE ASTM FLAME SPREAD CLASS 1, 24" x 48" MODULAR SIZE, LIGHT REFLECTION 75% MINIMUM, NOISE REDUCTION COEFFICIENT OF 0.65 MINIMUM. MAXIMUM SMOKE DENSITY NOT TO EXCEED 450.

TABLE A HEAVY DUTY GRID COMPONENTS			
MANUFACTURER	MAIN TEE	H.D. 4" CROSS TEE	H.D. 2" CROSS TEE
JOHN/USG	DX-28	DX-422	DX-218
ARMSTRONG	7301	7341	7323
CHICAGO MET.	200-01	1204-01	1226-01

NOTE: ALL GRID COMPONENTS SHALL BE BY SAME MANUFACTURER

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APPL NO. 22445 DATE 5/2/90

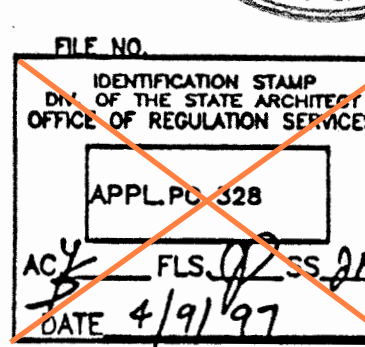

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LODI UNIFIED SCHOOL DISTRICT
1305 E. Vine St
Lodi, CA 95240

MILLSWOOD MIDDLE SCHOOL PORTABLES RELOCATION
233 N Mills Ave
Lodi, CA 95242

SHEET TITLE

CEILING, GRID, DETAILS, AND NOTES

DRAWN BY: XXXXXX JOB NUMBER: 23219

SHEET NO.

3

DATE: DECEMBER 5, 2023

24 X 40
RELOCATABLE
CLASSROOMS

American Modular Systems

CUSTOMER:

CEILING GRID, DETAILS AND NOTES


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SCALE: NONE
DRAWN BY: R.S.
CHECKED BY:
SERIAL NO.

REVISIONS					
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PROJECT No.

SHEET No.

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DATE: 12/12/2023

PROFESSIONAL STAMP
No. 2569
D. Schluter
REGISTERED PROFESSIONAL ENGINEER
STRUCTURAL
STATE OF CALIFORNIA

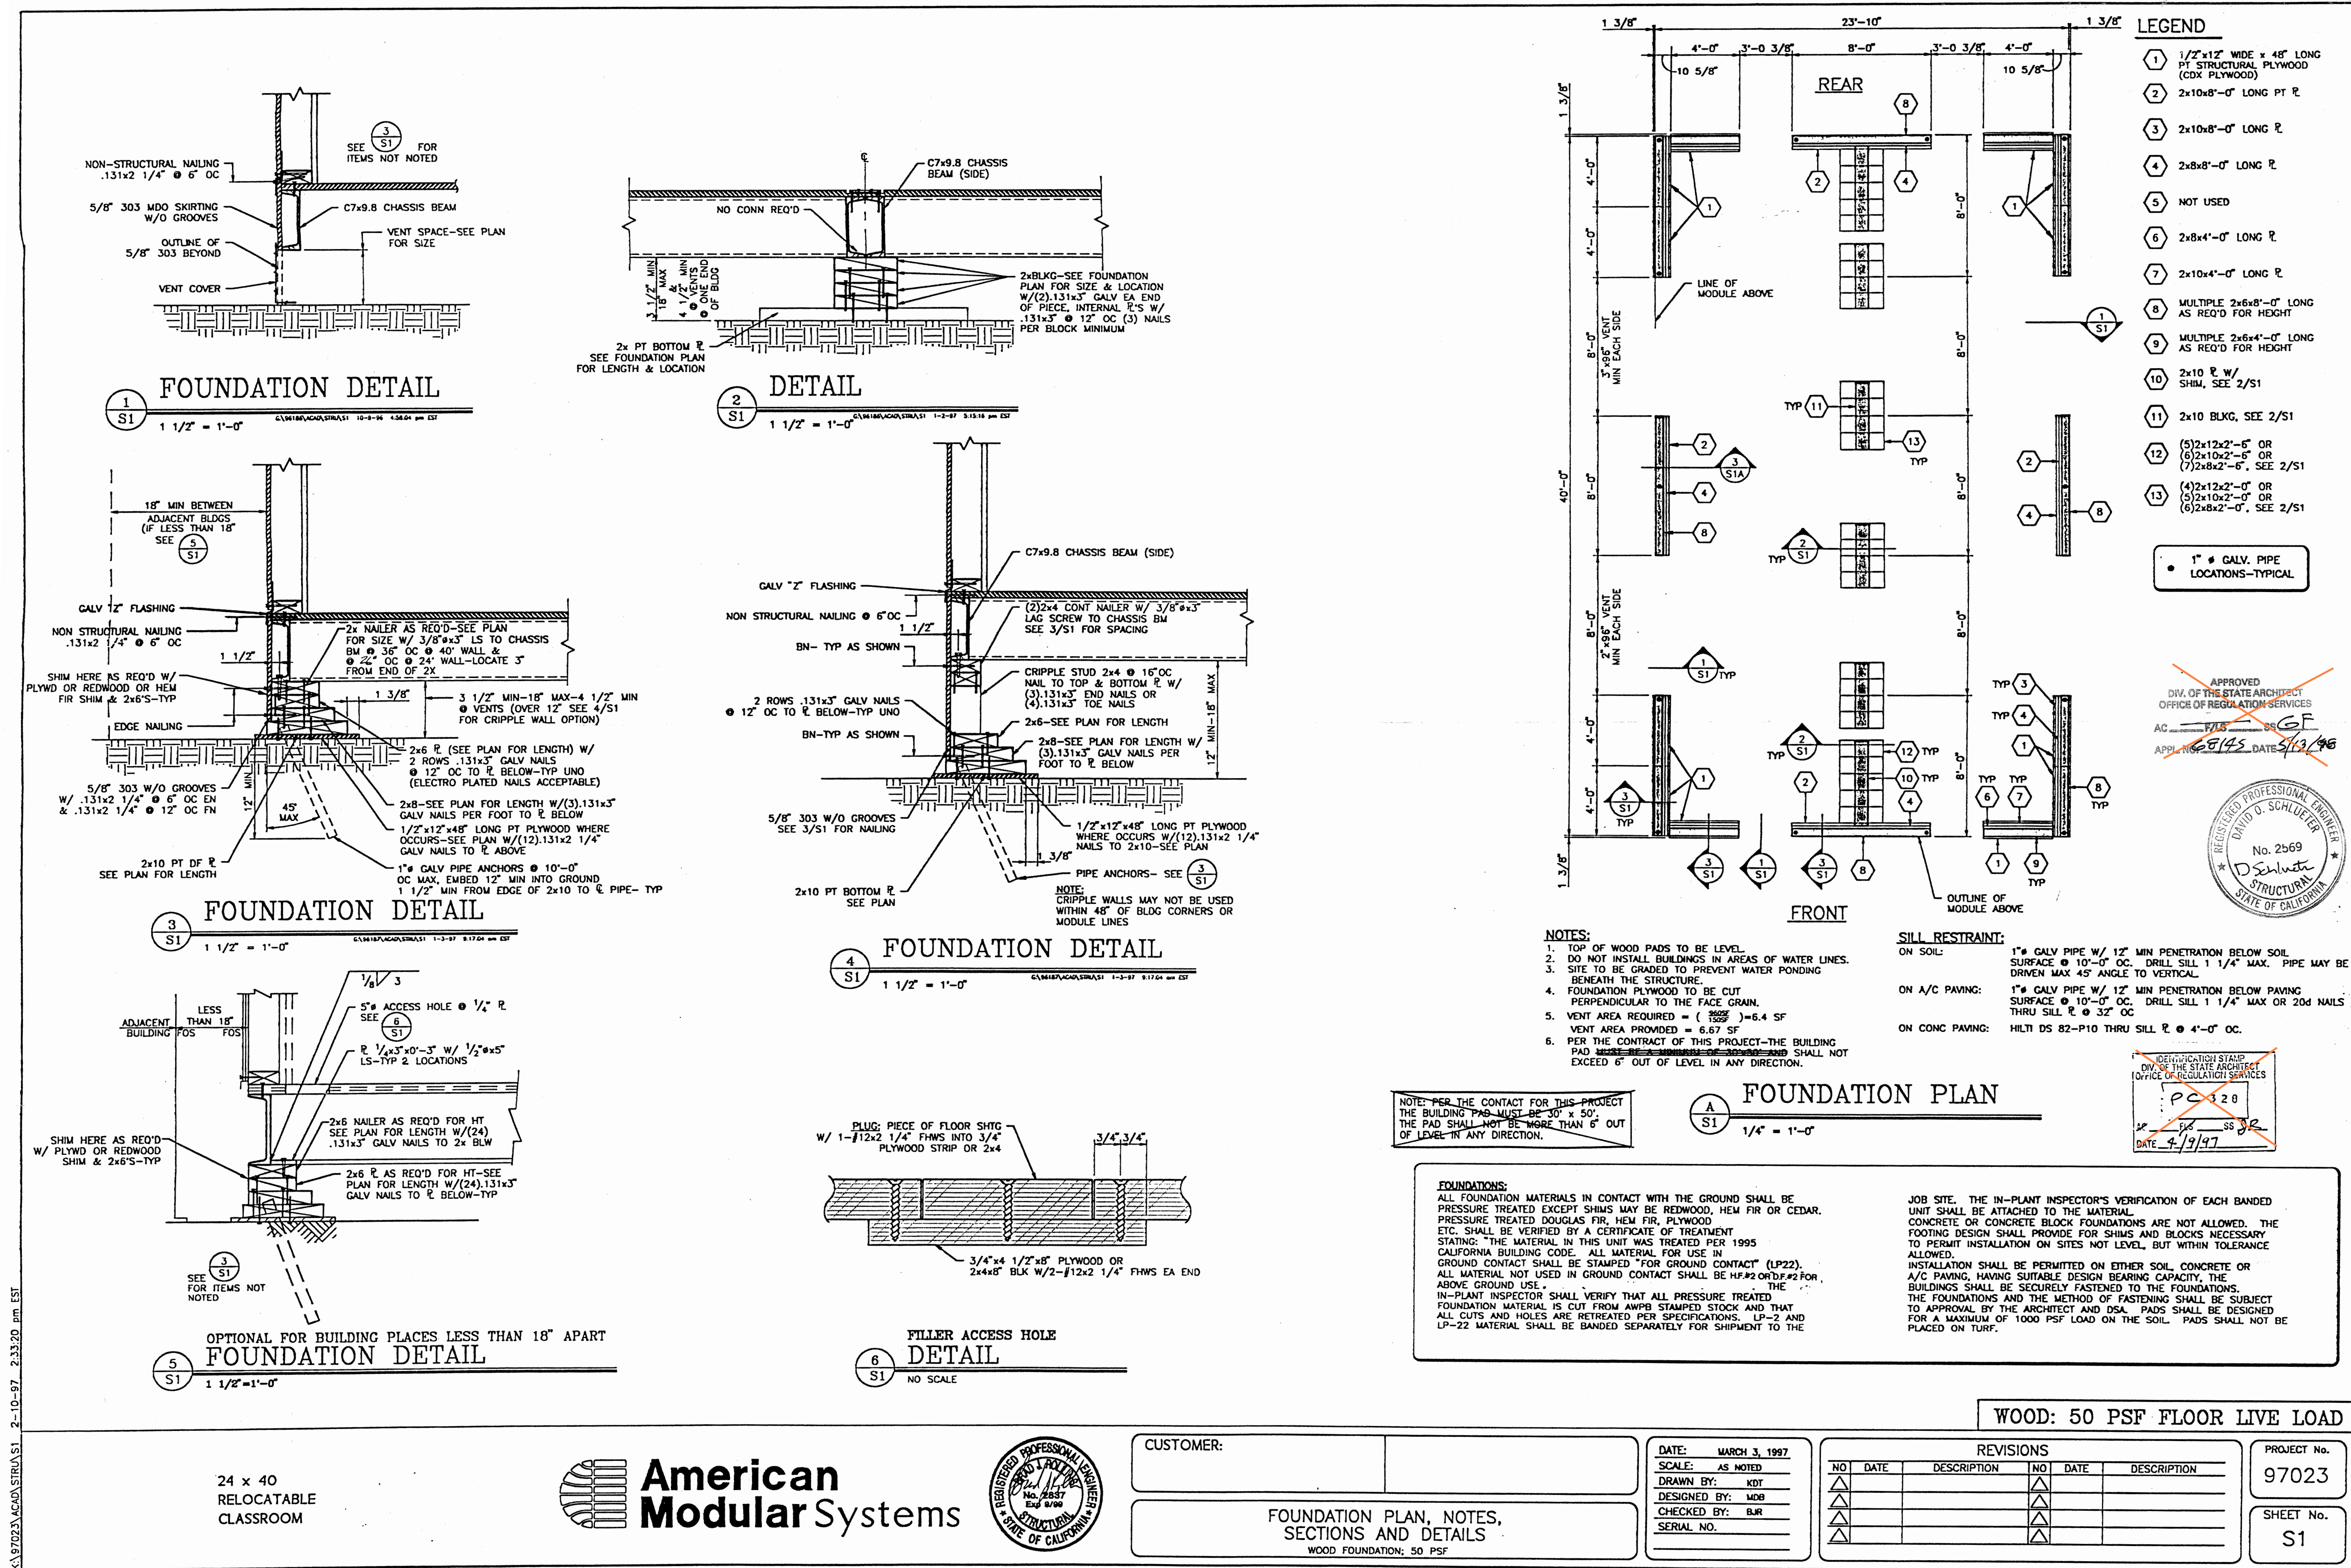REVISIONS

NO.	DATE	DESCRIPTION

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PROJECT OWNER & TITLE
LODI UNIFIED SCHOOL DISTRICT
1305 E. Vine St
Lodi, CA 95240

MILLSWOOD MIDDLE SCHOOL PORTABLES RELOCATION
233 N Mills Ave
Lodi, CA 95242

SHEET TITLE
DETAILS & NOTES 50#

DRAWN BY: XXXXXX JOB NUMBER: 23219
SHEET NO.
S1
DATE: DECEMBER 5, 2023

1
S2

DETAIL

NO SCALE

1A
S2

DETAIL

NO SCALE

2
S2

PLAN DETAIL

NO SCALE

DETAIL

3
S2

1 1/2" = 1'-0"

6
S2

5
S2

DETAIL


1 1/2" = 1'-0"

4
S2

TYPICAL SIDING JOINT
DETAIL

NO SCALE

FLOOR FRAMING PLAN

FOR TYPICAL CHASSIS BEAM
TO CHASSIS BEAM CONN.
● CORNER SEE 

- NOTES:**
1. SEE SHEET S4 FOR
TYPICAL WALL FRAMING


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DIV. OF THE STATE ARCHITECT
OFFICE OF REGULATION SERVICES
AC F/L SS 6F
APPL. NO. 68145 DATE 5/13/98~~

IDENTIFICATION STAMP
OFFICE OF THE STATE ARCHITECT
OFFICE OF REGULATION SERVICES
PC 328
FILE SS JR
DATE 4/9/97



50 PSF FLOOR LIVE LOAD

24 x 40
RELOCATABLE
CLASSROOM

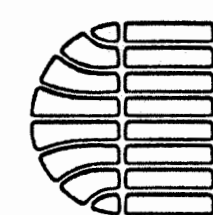

American Modular Systems



CUSTOMER:

FLOOR FRAMING PLAN
AND DETAILS
50 PSF FLOOR LOAD

DATE:	MARCH 3, 1997
SCALE:	AS NOTED
DRAWN BY:	KDT
DESIGNED BY:	MOB
CHECKED BY:	BJR
SERIAL NO.	

REVISIONS

PROJECT No.

97023

SHEET No.
S2

[illegible]

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1305 E. Vine St
Lodi, CA 95240

**MILLSWOOD MIDDLE SCHOOL
PORTABLES RELOCATION**

233 N Mills Ave
Lodi, CA 95242

SHEET TITLE

FLOOR FRAMING PLAN & BUILDING SECTIONS














DRAWN BY: XXXXXX JOB NUMBER: 23219

SHEET NO.

S2

DATE: DECEMBER 5, 2023

S2B 2-10-97 4:16:49 pm EST

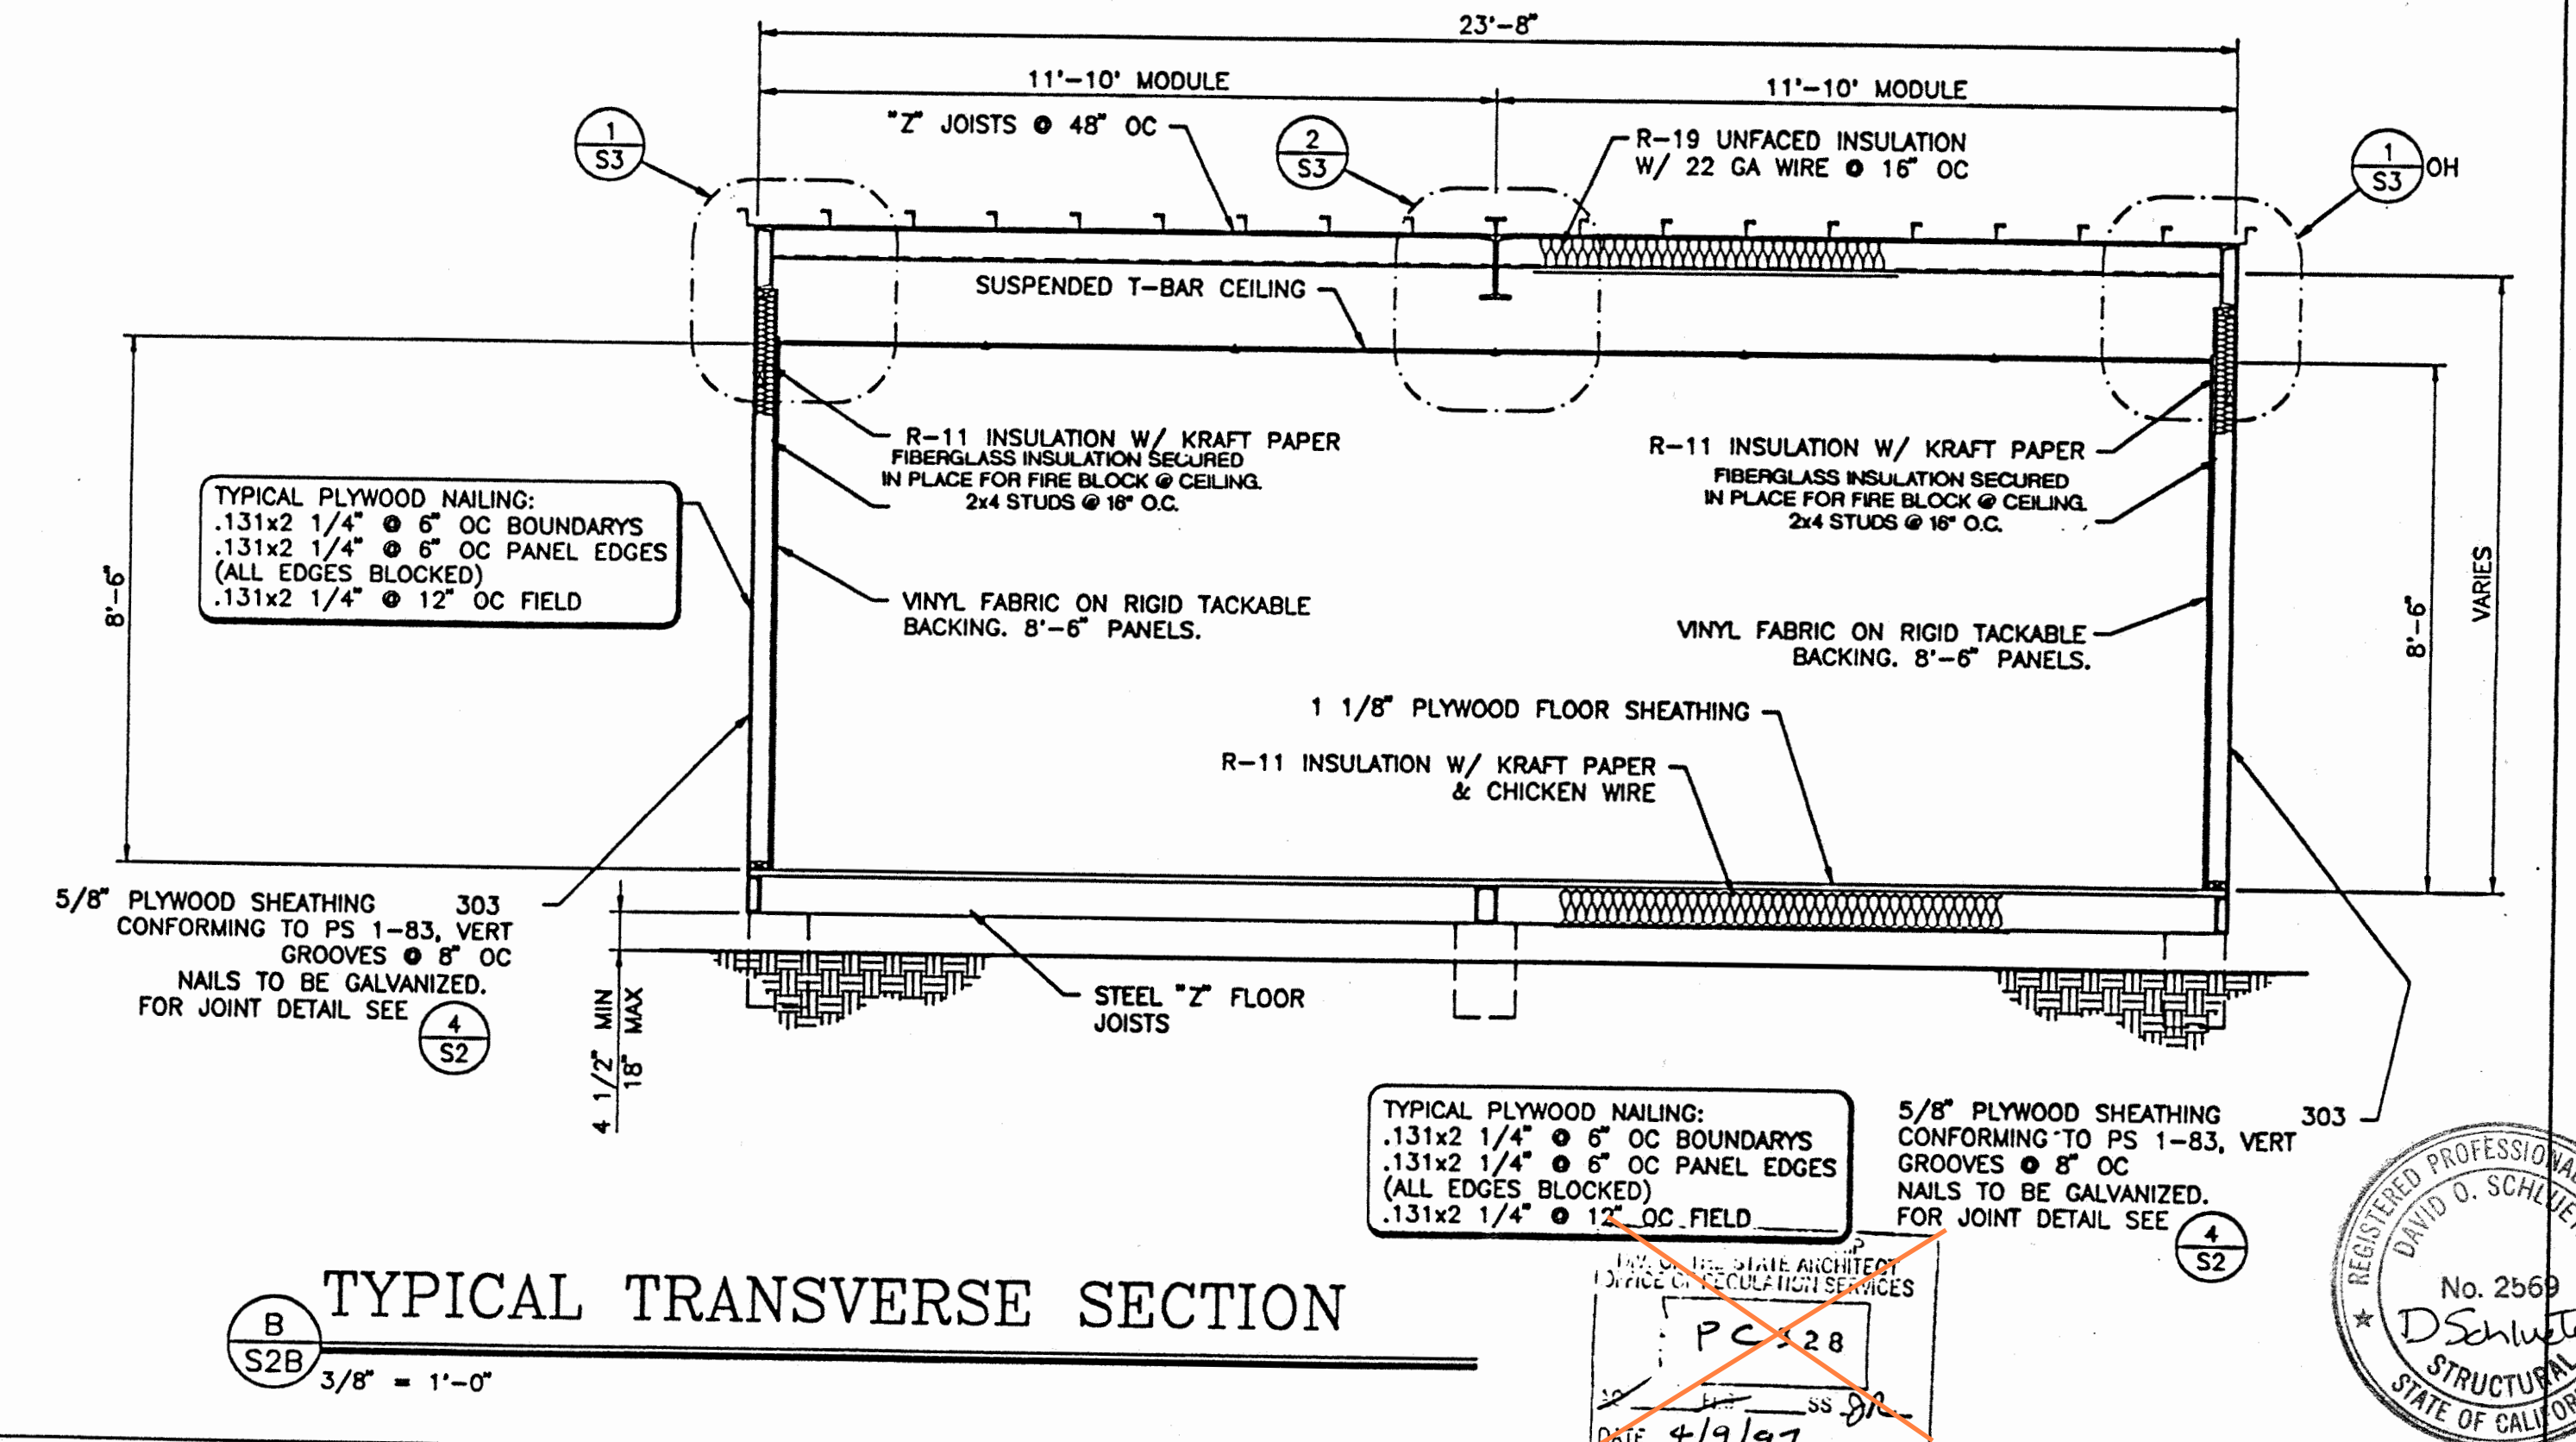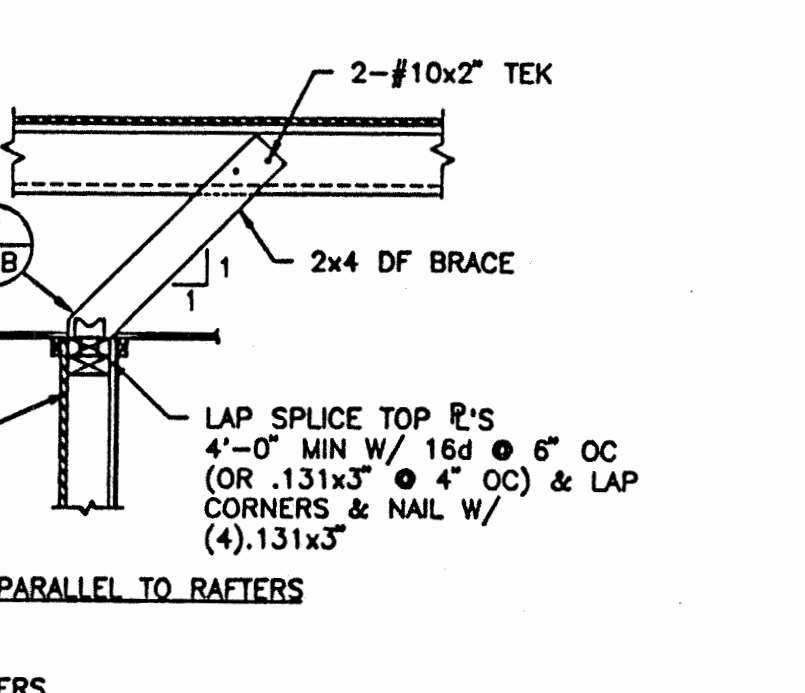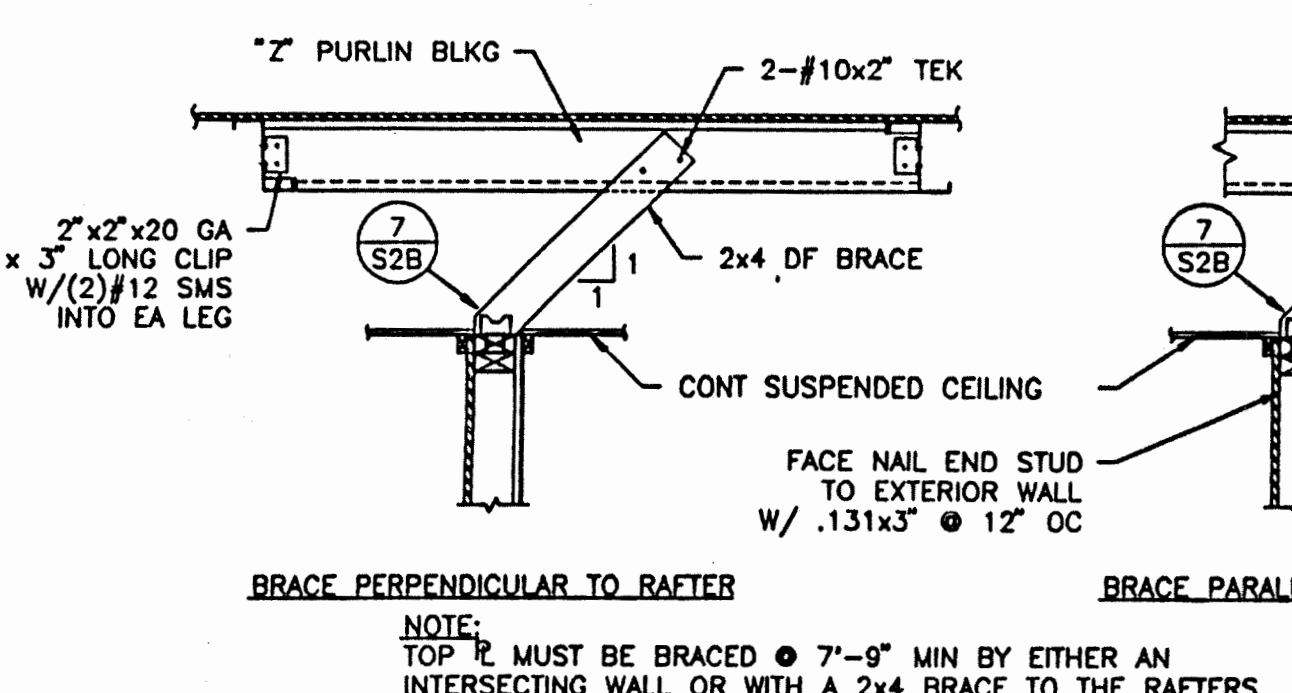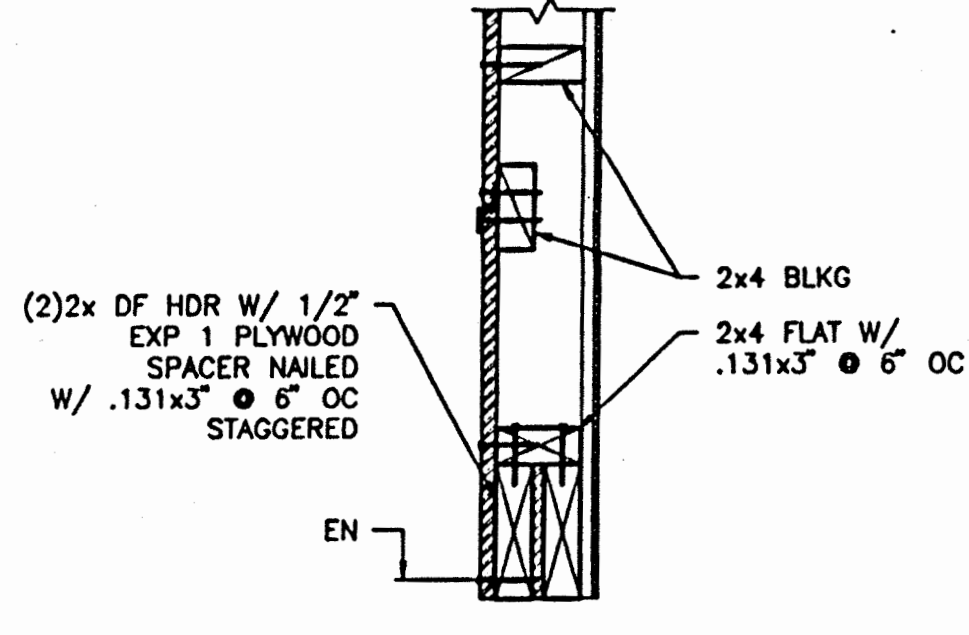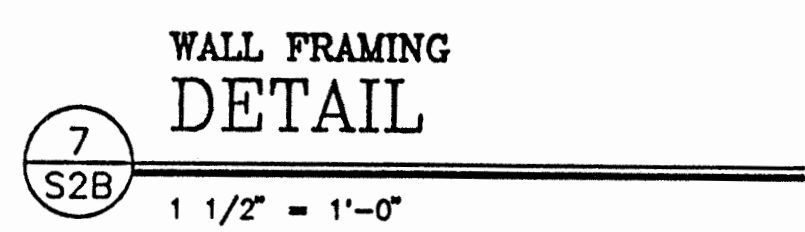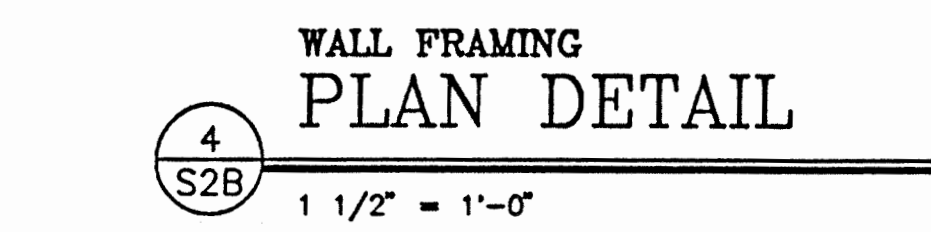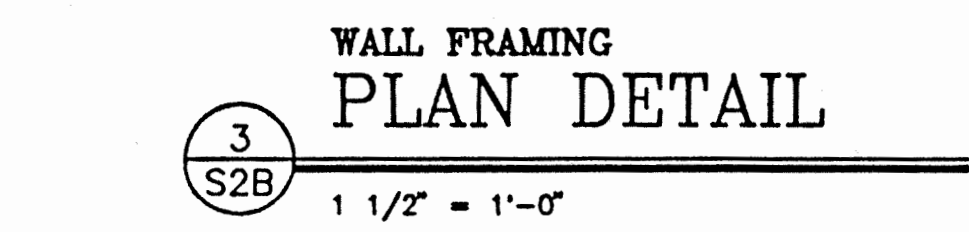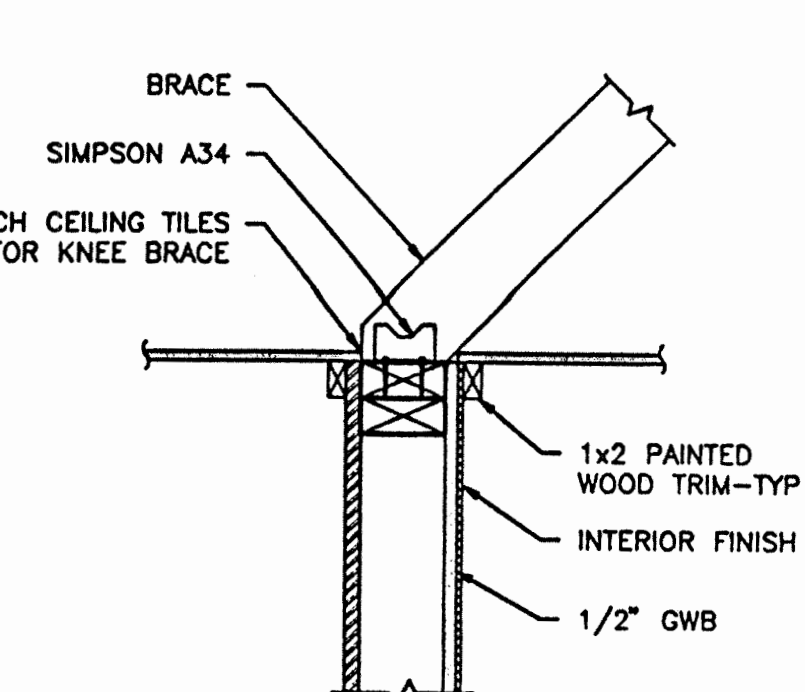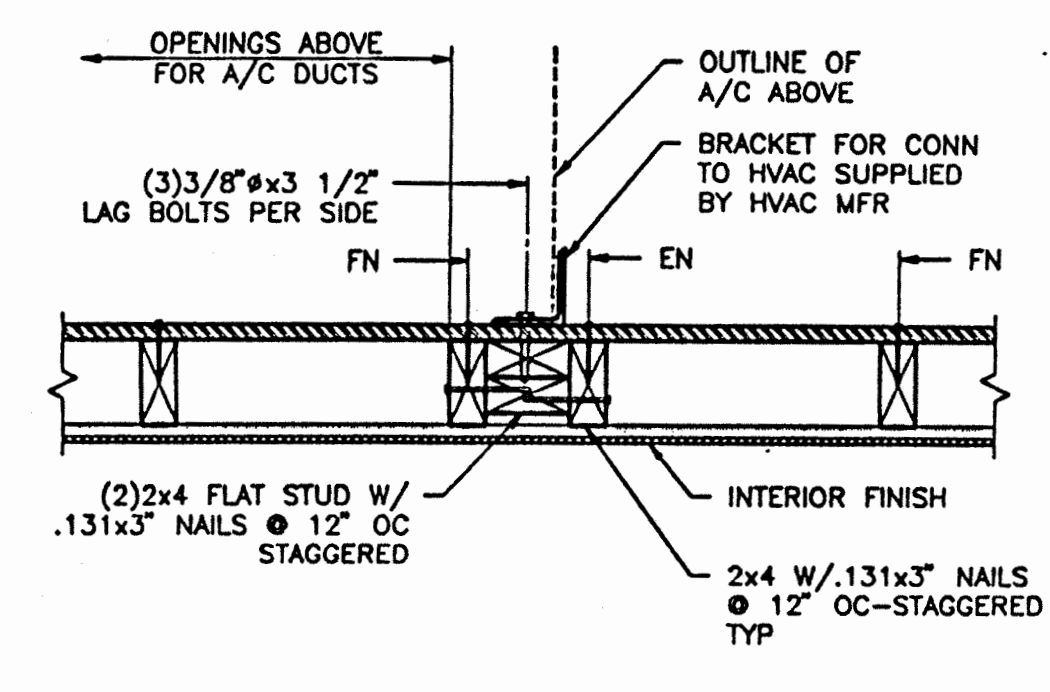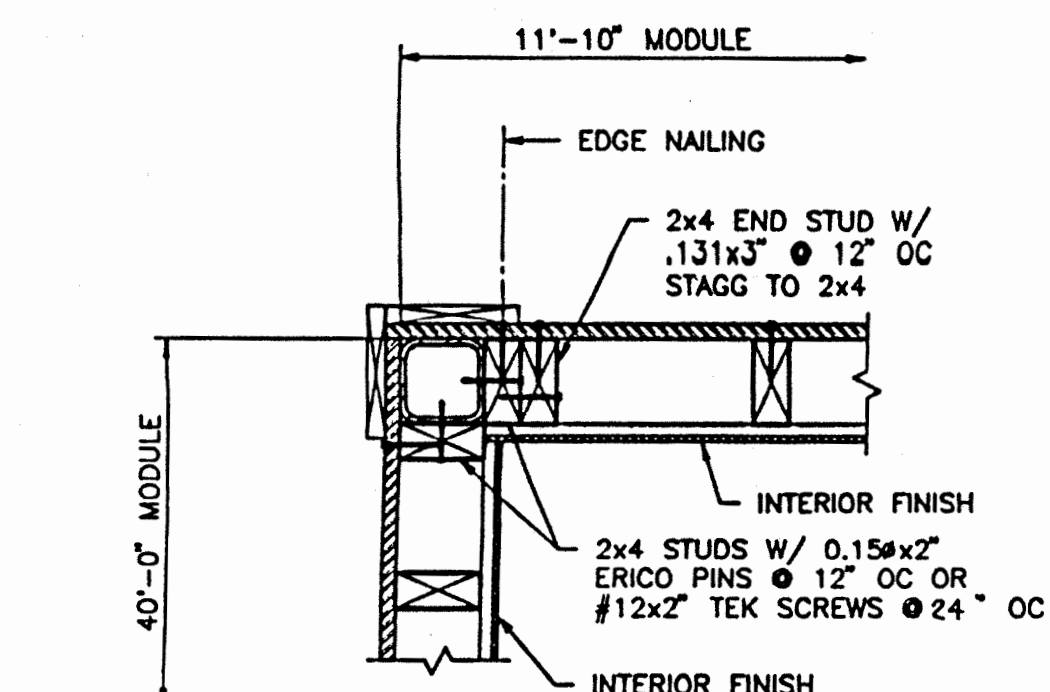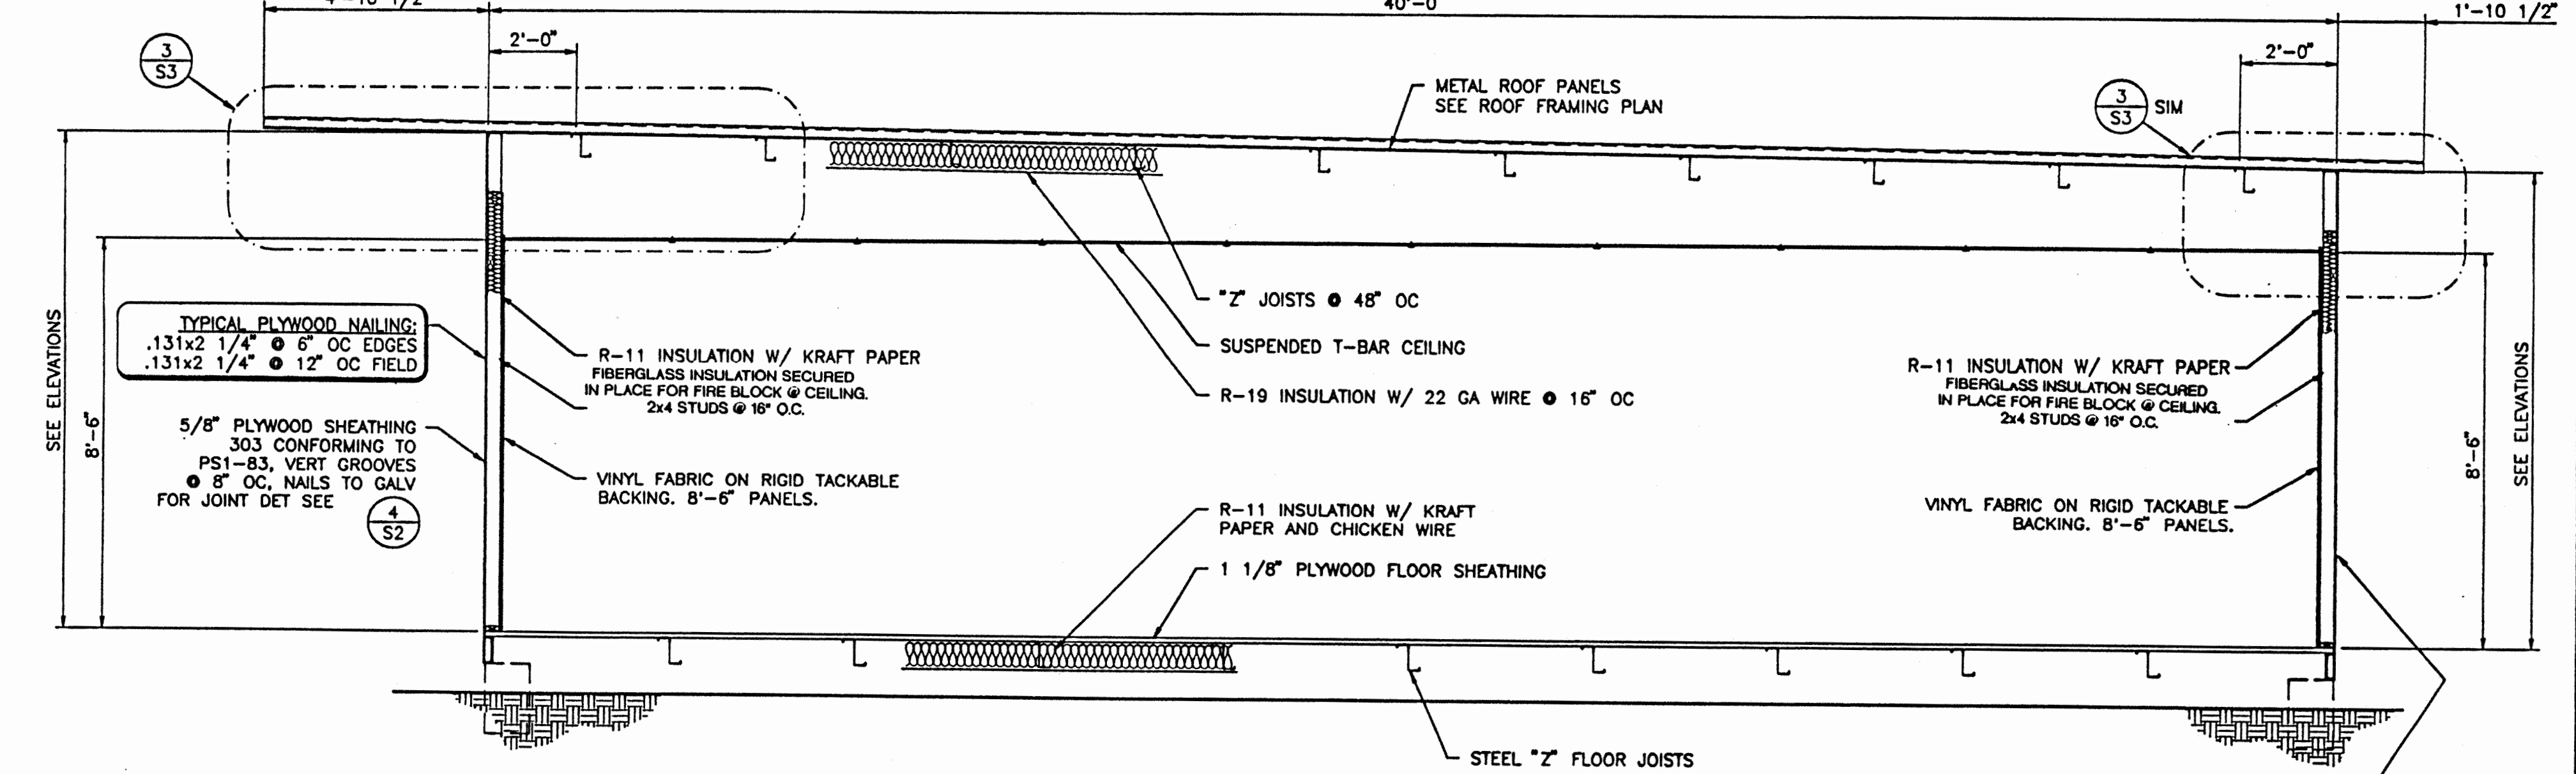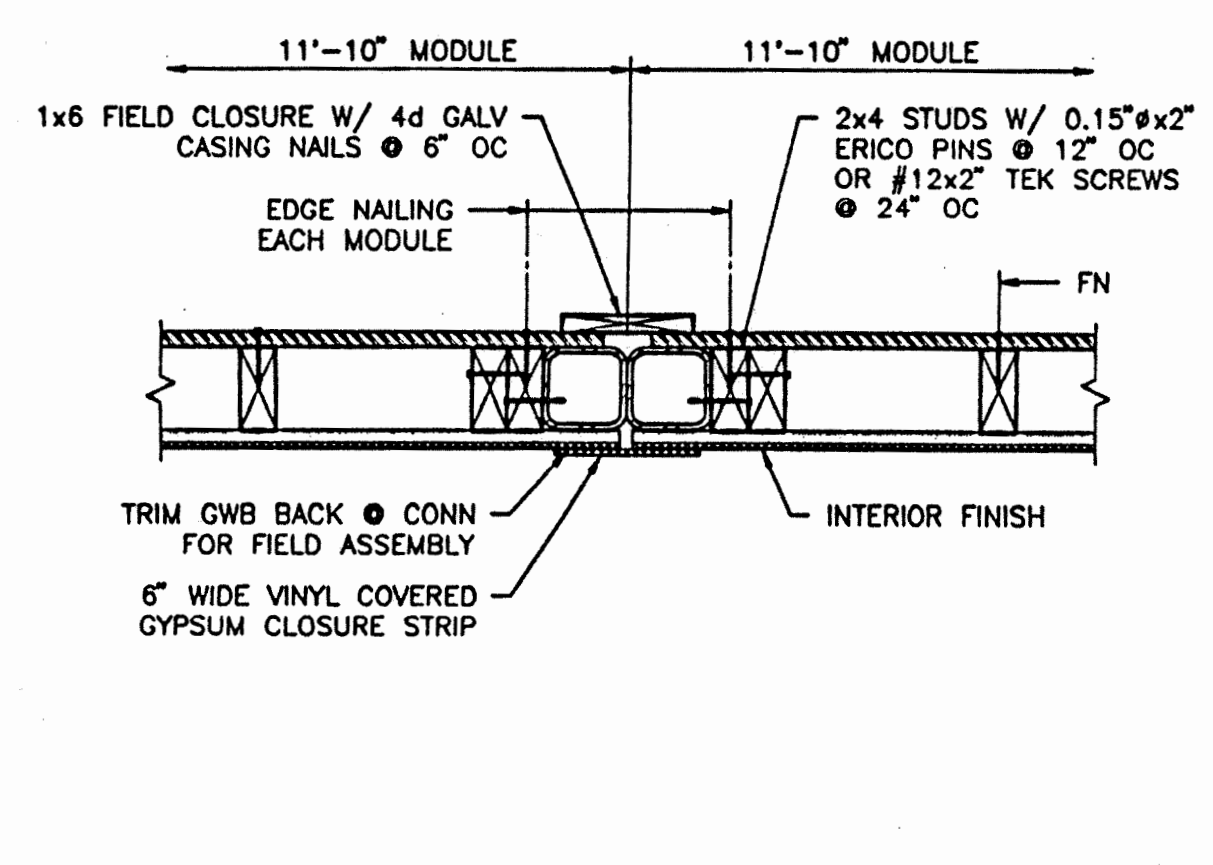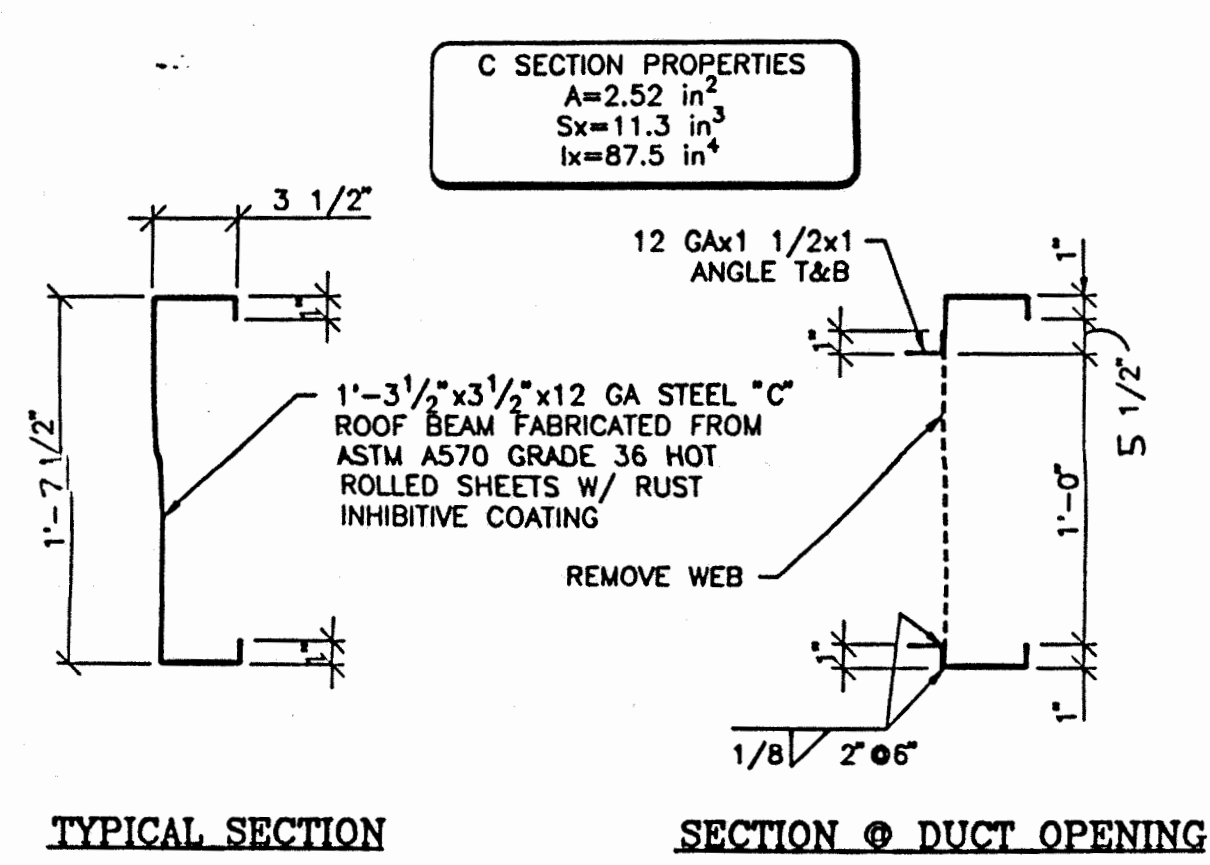

24 x 40
RELOCATABLE
CLASSROOM

**American
Modular Systems**



CUSTOMER: _____

BUILDING SECTIONS
AND WALL DETAILS

DATE: MARCH 3, 1997
SCALE: AS NOTED
DRAWN BY: KDT
DESIGNED BY: MDB
CHECKED BY: BUR
SERIAL NO. _____

REVISIONS			
NO.	DATE	DESCRIPTION	

PROJECT No.
97023

SHEET No.
S2B

AGENCY APPROVAL
DIV. OF THE STATE ARCHITECT
OFFICE OF REGULATION SERVICES
APPROVED
AC: [Signature]
DATE: 5/13/98

IDENTIFICATION STAMP
DIV. OF THE STATE ARCHITECT
APP: 02-121945 INC.
REVIEWED FOR:
SS ☒ FLS ☒ ACS ☒
DATE: 12/12/2023

NO.	DATE	DESCRIPTION

PROJECT OWNER & TITLE
LODI UNIFIED SCHOOL DISTRICT
1305 E. Vine St
Lodi, CA 95240





PROJECT OWNER & TITLE
**MILLSWOOD MIDDLE SCHOOL
PORTABLES RELOCATION**
233 N Mills Ave
Lodi, CA 95242

SHEET TITLE
**BUILDING SECTIONS AND WALL
DETAILS**


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SHEET NO.
S2B

DATE: DECEMBER 5, 2023

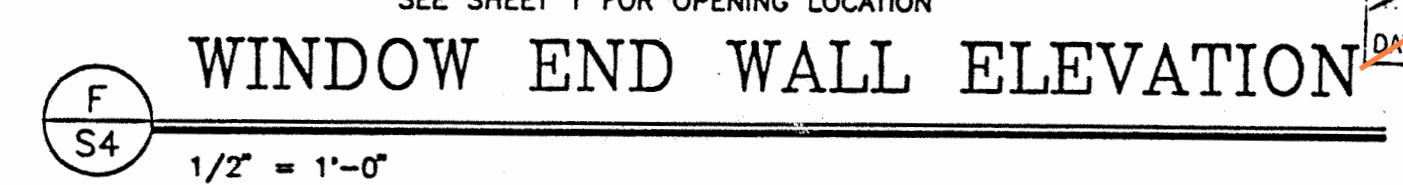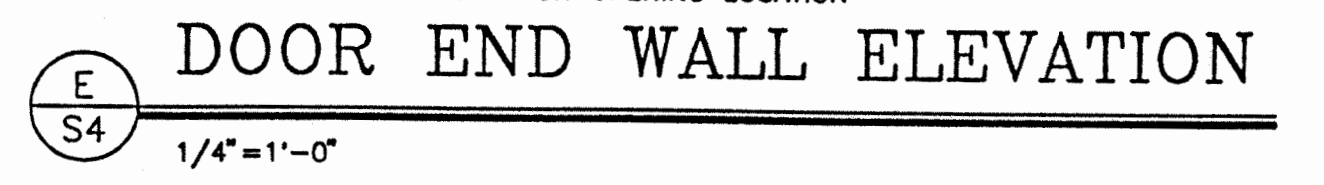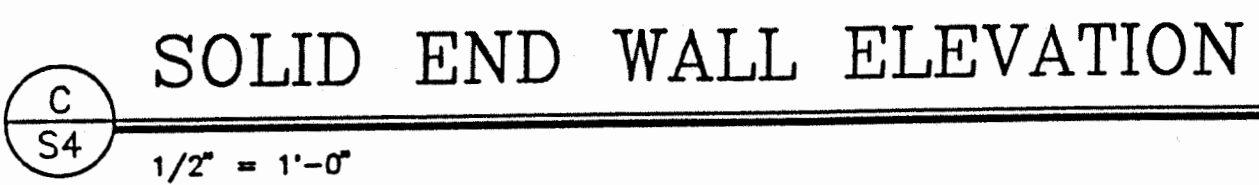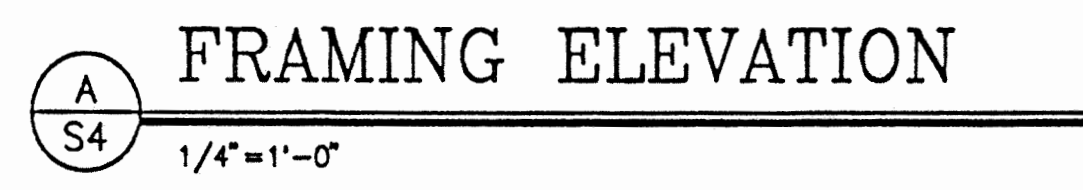

APPL. NO. ~~68145~~ DATE ~~5/13/98~~

[illegible]
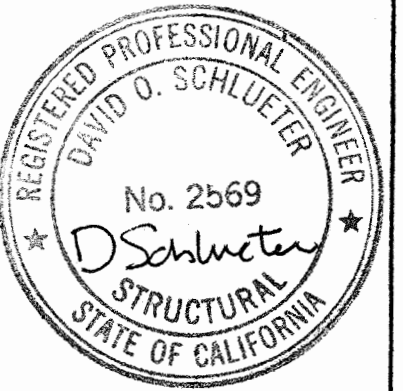
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PROJECT OWNER & TITLE
LODI UNIFIED SCHOOL DISTRICT
1305 E. Vine St
Lodi, CA 95240

**MILLSWOOD MIDDLE SCHOOL
PORTABLES RELOCATION**
233 N Mills Ave
Lodi, CA 95242

SHEET TITLE

FRAMING ELEVATIONS & DETAILS

DRAWN BY: XXXXXX JOB NUMBER: 23219

SHEET NO.

STREET NO.


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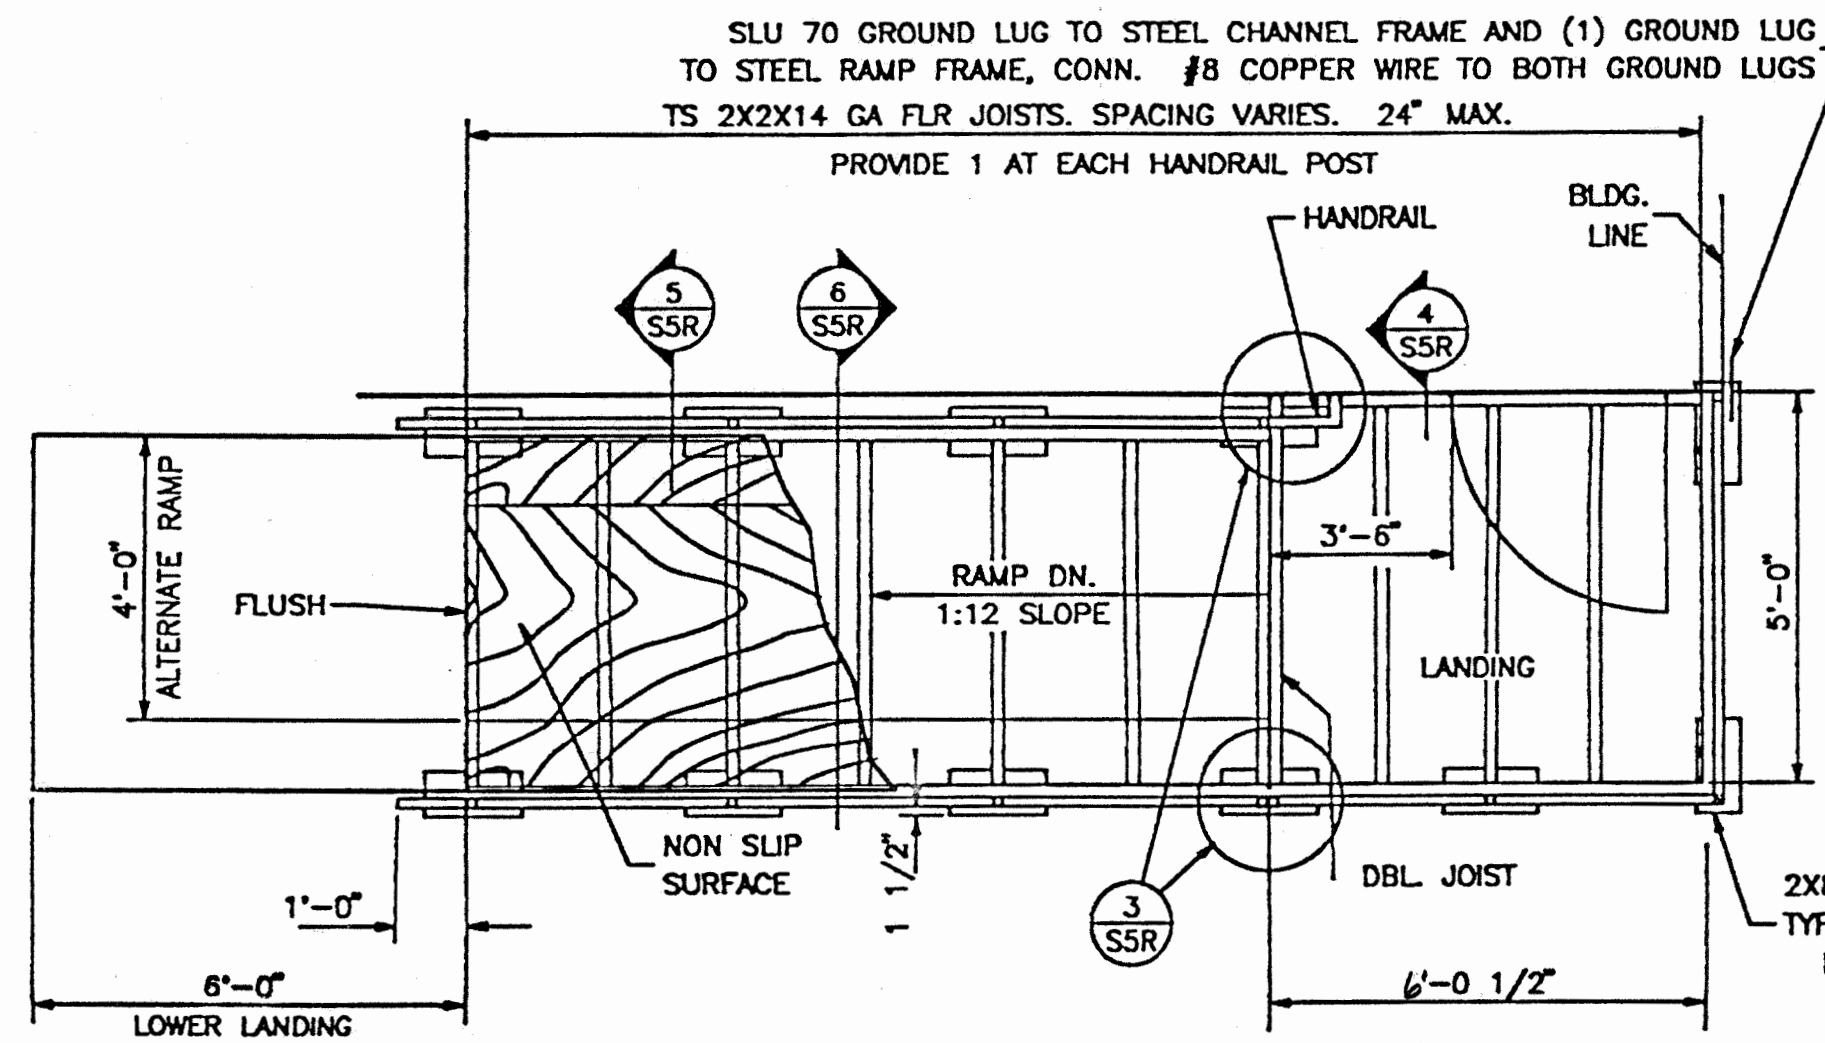
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CONSTRUCTION DOCUMENTS

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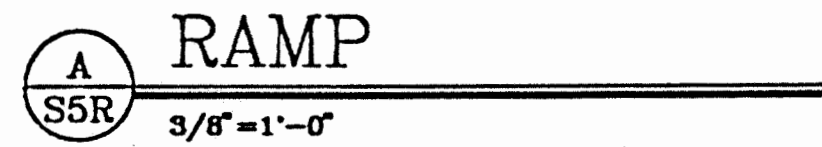


RAMP ELEVATION



RAMP PLAN

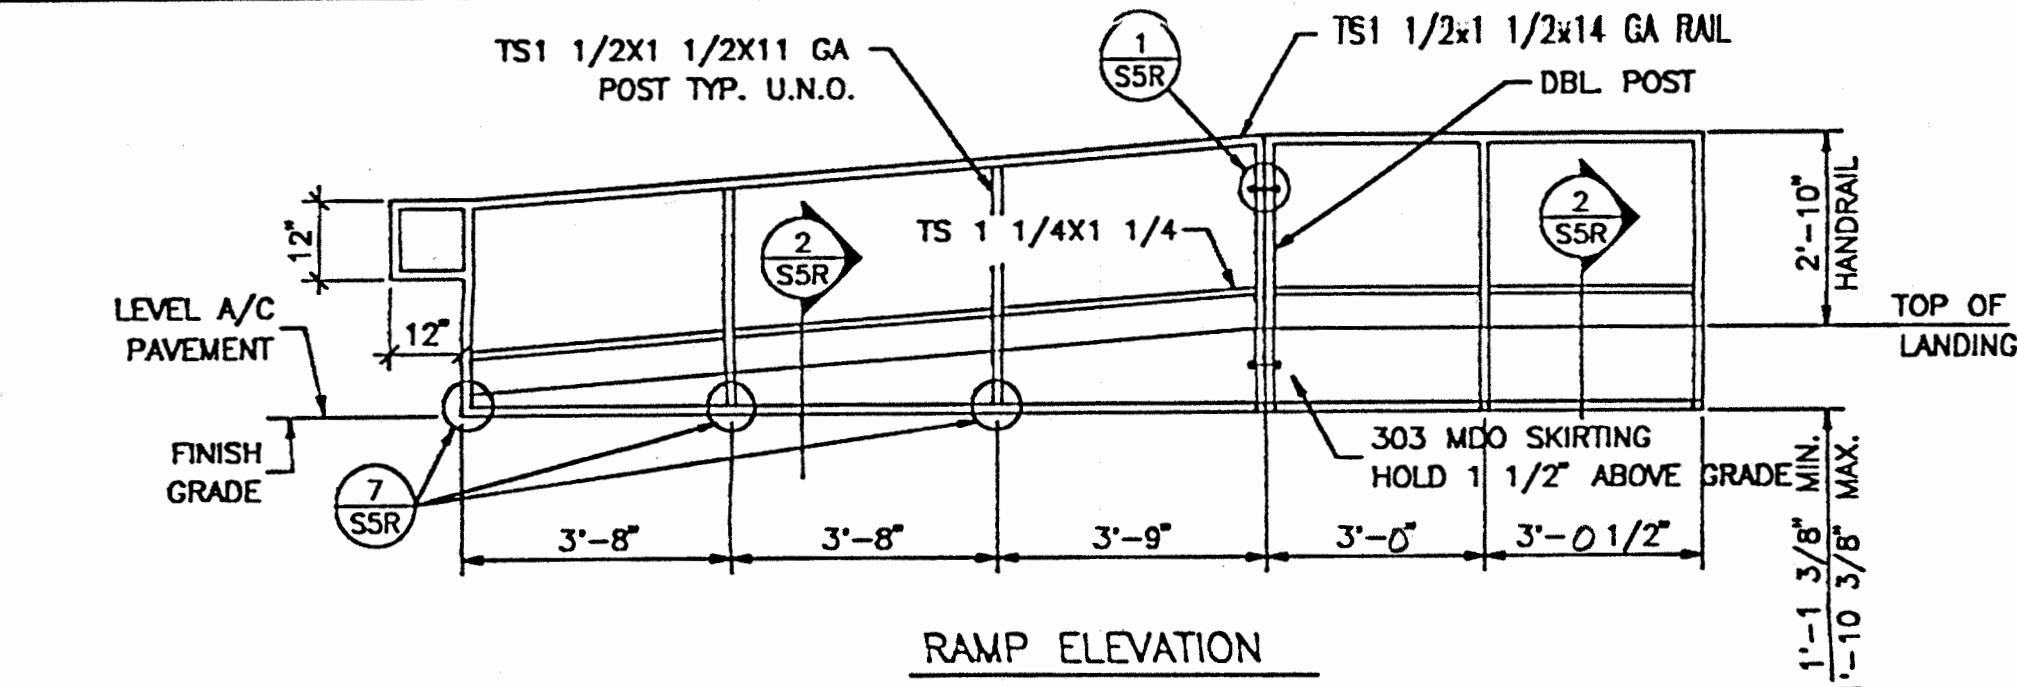NOTE: RAMP & LANDING TO BE FABRICATED IN SECTIONS (2 MIN) FOR MOVING



RAMP


ENTRY RAMP AND LANDING SPECIFICATIONS

EACH BUILDING SHALL HAVE A RAMP AND LANDING TO CONFORM TO TITLE 24 COR SECTIONS 1006 AND 1007. THE RAMP AND LANDING STRUCTURES INCLUDING HANDRAIL AND WHEEL GUIDES ARE TO BE PREFABRICATED METAL IN SECTIONS THAT ARE DEMOUNTABLE FOR MOVING AND REINSTALLATION AT A NEW SITE. DESIGN SHALL BE SUCH THAT HEIGHT ADJUSTMENT CAN BE MADE AT THE INSTALLATION SITE. TUBING SHALL BE STEEL CONFORMING TO ASTM A500 GRADE B. THE RAMP SURFACE SHALL BE 3/4" MARINE GRADE PLYWOOD. RAMP AND LANDING SHALL HAVE A NON-SKID SURFACE FINISH APPLIED. NON-SKID FINISH SHALL BE AMOCO GRIP II MANUFACTURED BY AMERICAN CHEMICAL CO. OR EQUIVALENT. ALL RAMP SURFACES SHALL BE PAINTED AS INDICATED IN SECTION 3.3.19. RAMP SHALL HAVE HANDRAILS ON BOTH SIDES. WALL MOUNTED HANDRAILS SHALL BE OF SIMILAR CONSTRUCTION TO THE INTEGRAL RAMP HANDRAIL. RAMP AND LANDING SHALL BE FULLY SKIRTED WITH THE SAME MATERIAL USED FOR BUILDING SKIRT. SIDES OF RAMP AND LANDING THAT DO NOT ADJOIN BUILDING WALL SHALL BE SKIRTED. ALL EDGES OF THE PLYWOOD SKIRT SHALL BE SUPPORTED AND PROTECTED FROM WEATHER. FOUNDATION MEMBERS SHALL BE AS FOR BUILDING FOUNDATION. ONLY THE FOUNDATION PAD RESTING ON GRADE MAY EXTEND BEYOND THE OUTSIDE FACE OF THE SKIRT 1" MAXIMUM

FLOOR DECKING:
3/4" MARINE EXT. APA 48/24 PLYWOOD W/ NON-SKID SURFACE. (SEE ALTERNATE) DECK SURFACES SHALL BE SEALED ON ALL SIDES. FASTENED TO STEEL FLOOR MEMBERS WITH #10-24 X 1 1/4" LONG PLY-METAL TYPE SCREWS @ 12" O.C.
ALT. FLOOR DECKING:
1. 11 GA SHEET METAL WITH NON-SKID SURFACE.

GROUNDING OF BUILDING COMPONENTS:
CONTRACTOR SHALL BE RESPONSIBLE FOR PROVIDING NECESSARY CONNECTORS TO GROUND THE METAL PORTIONS OF THE BUILDING (I.E. FRAME, RAMP, ETC.) GROUNDING ROD, WIRES AND TESTING SHALL BE PROVIDED BY OTHERS AND MEET THE REQUIREMENTS OF I.R. #8-1 ISSUED BY DSA.

24 x 40
RELOCATABLE
CLASSROOM

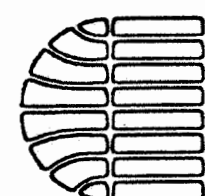

American
Modular Systems



CUSTOMER:

RAMP PLAN, ELEVATIONS
AND DETAILS

DATE: MARCH 3, 1997
SCALE: AS NOTED
DRAWN BY: KDT
DESIGNED BY: MDR
CHECKED BY: BJR
SERIAL NO.

REVISIONS				REVISIONS			
NO	DATE	DESCRIPTION	NO	DATE	DESCRIPTION	NO	DATE

PROJECT NO.
97023
SHEET NO.
S5R.1

PROJECT OWNER & TITLE
LODI UNIFIED SCHOOL DISTRICT
1305 E. Vine St
Lodi, CA 95240

MILLWOOD MIDDLE SCHOOL
PORTABLES RELOCATION
233 N Mills Ave
Lodi, CA 95242

SHEET TITLE

RAMP PLAN, ELEVATION & DETAILS


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SHEET NO.


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DATE: DECEMBER 5, 2023


IDENTIFICATION STAMP
DIV. OF THE STATE ARCHITECT
APP: 02-121945 INC:
REVIEWED FOR:
SS ☒ FLS ☒ ACS ☒
DATE: 12/12/2023



RAMP SKIRT
DETAIL

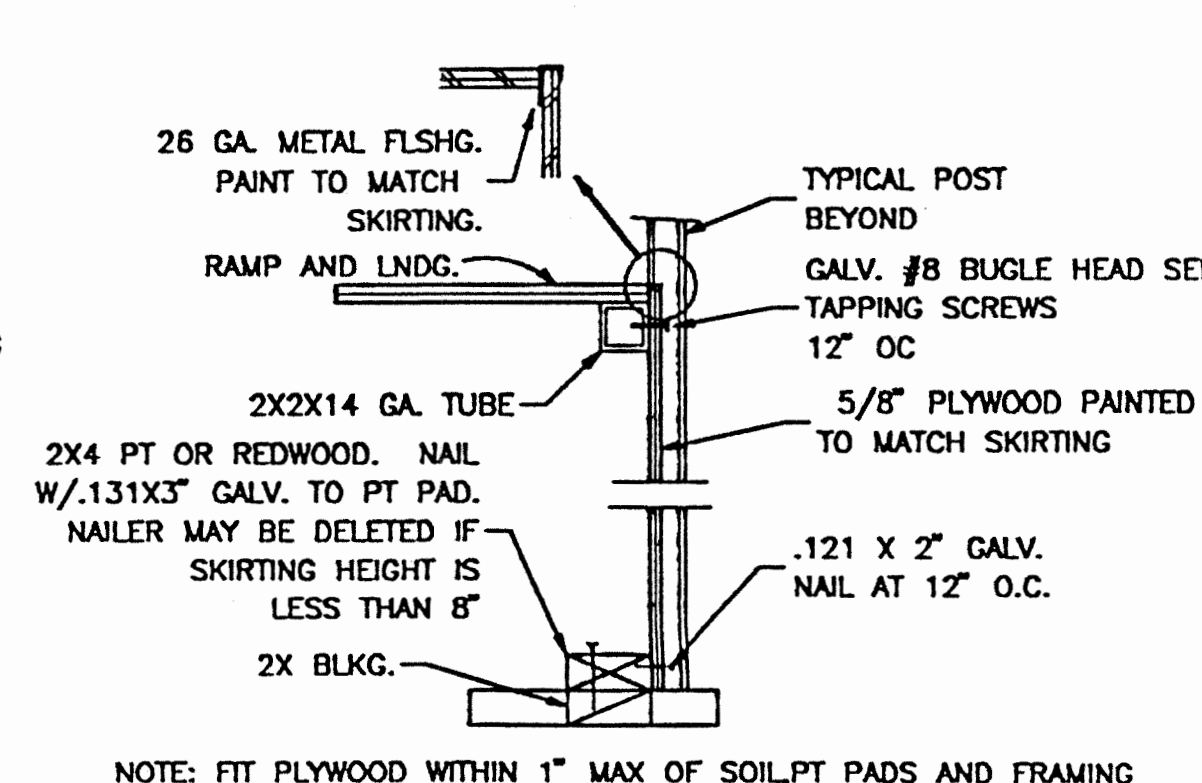

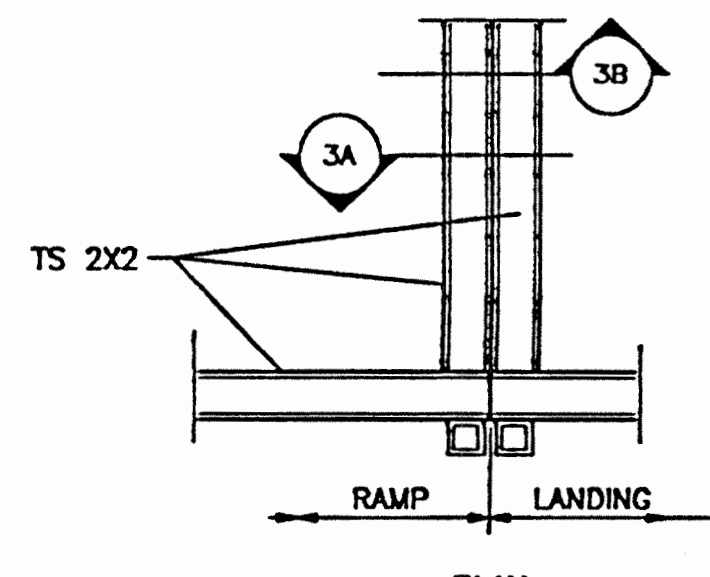
PLAN

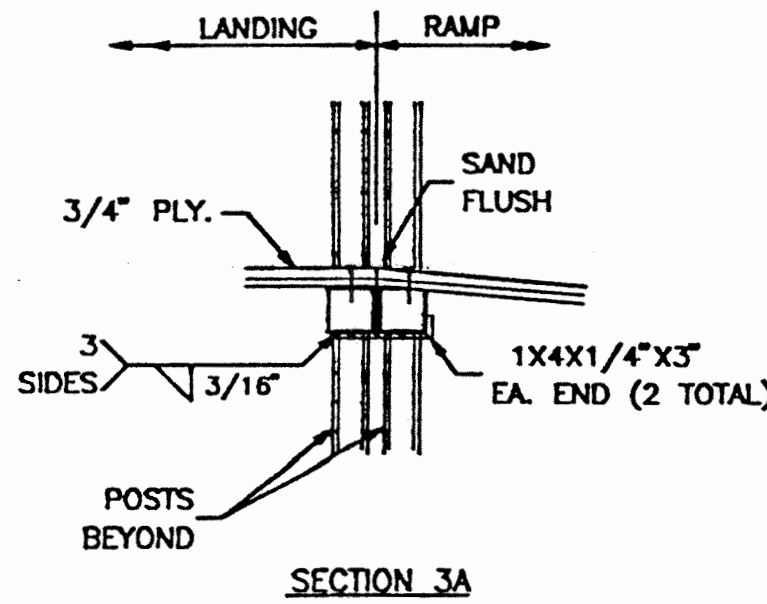

SECTION 3A


HANDRAIL
DETAIL

NO SCALE

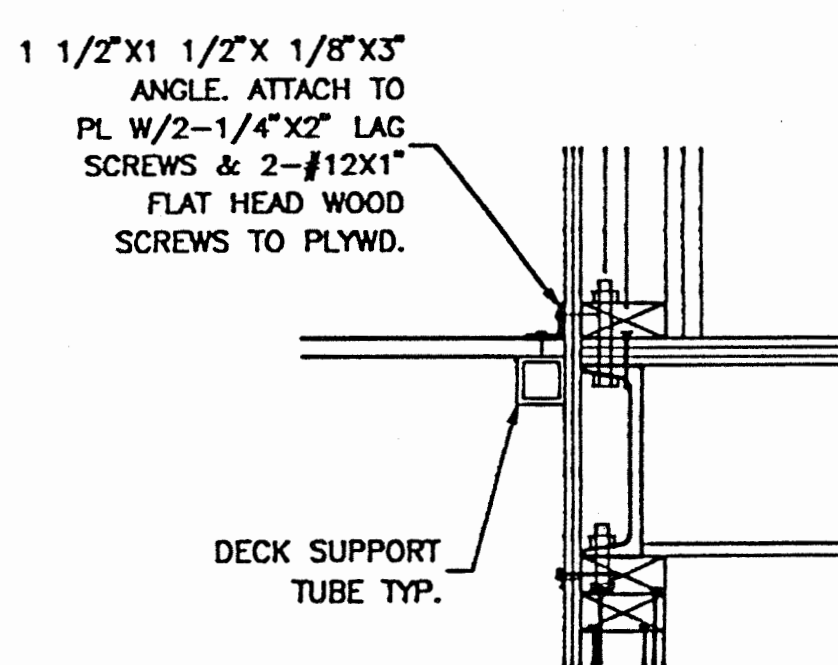


LANDING ATTACHMENT
DETAIL

NO SCALE

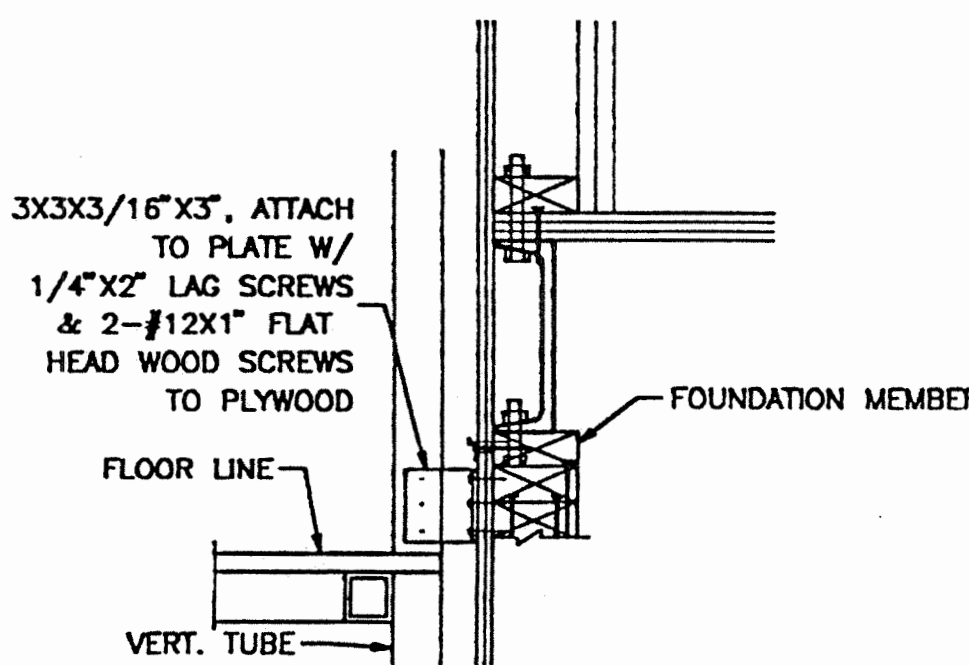


RAMP CONNECTION
DETAIL

NO SCALE

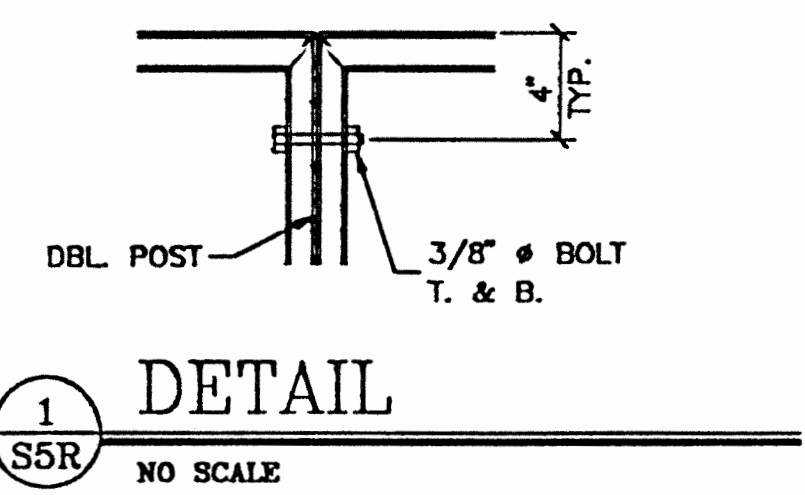


DETAIL


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PLAN @ WALL

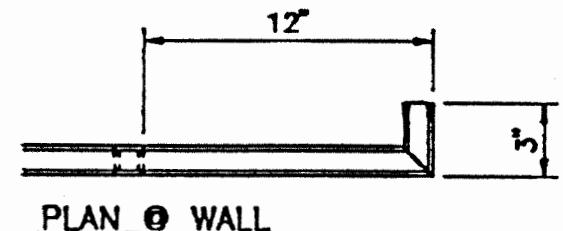


SECTION 3B

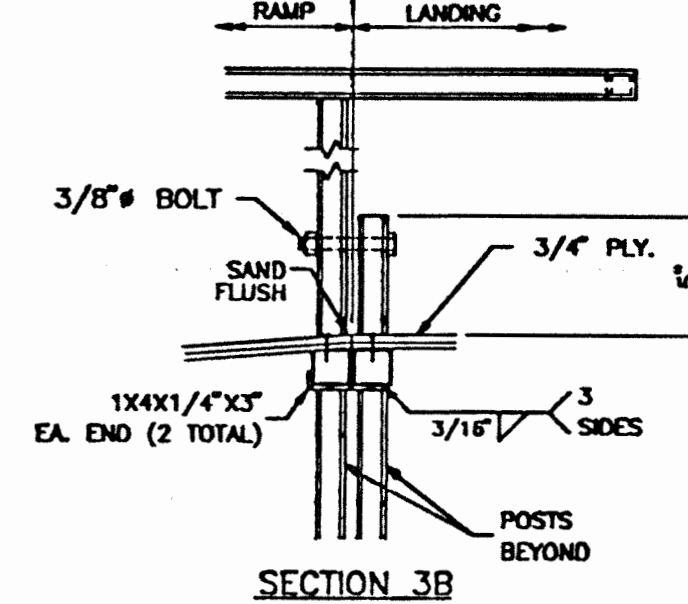


HANDRAIL AND RAMP
DETAIL

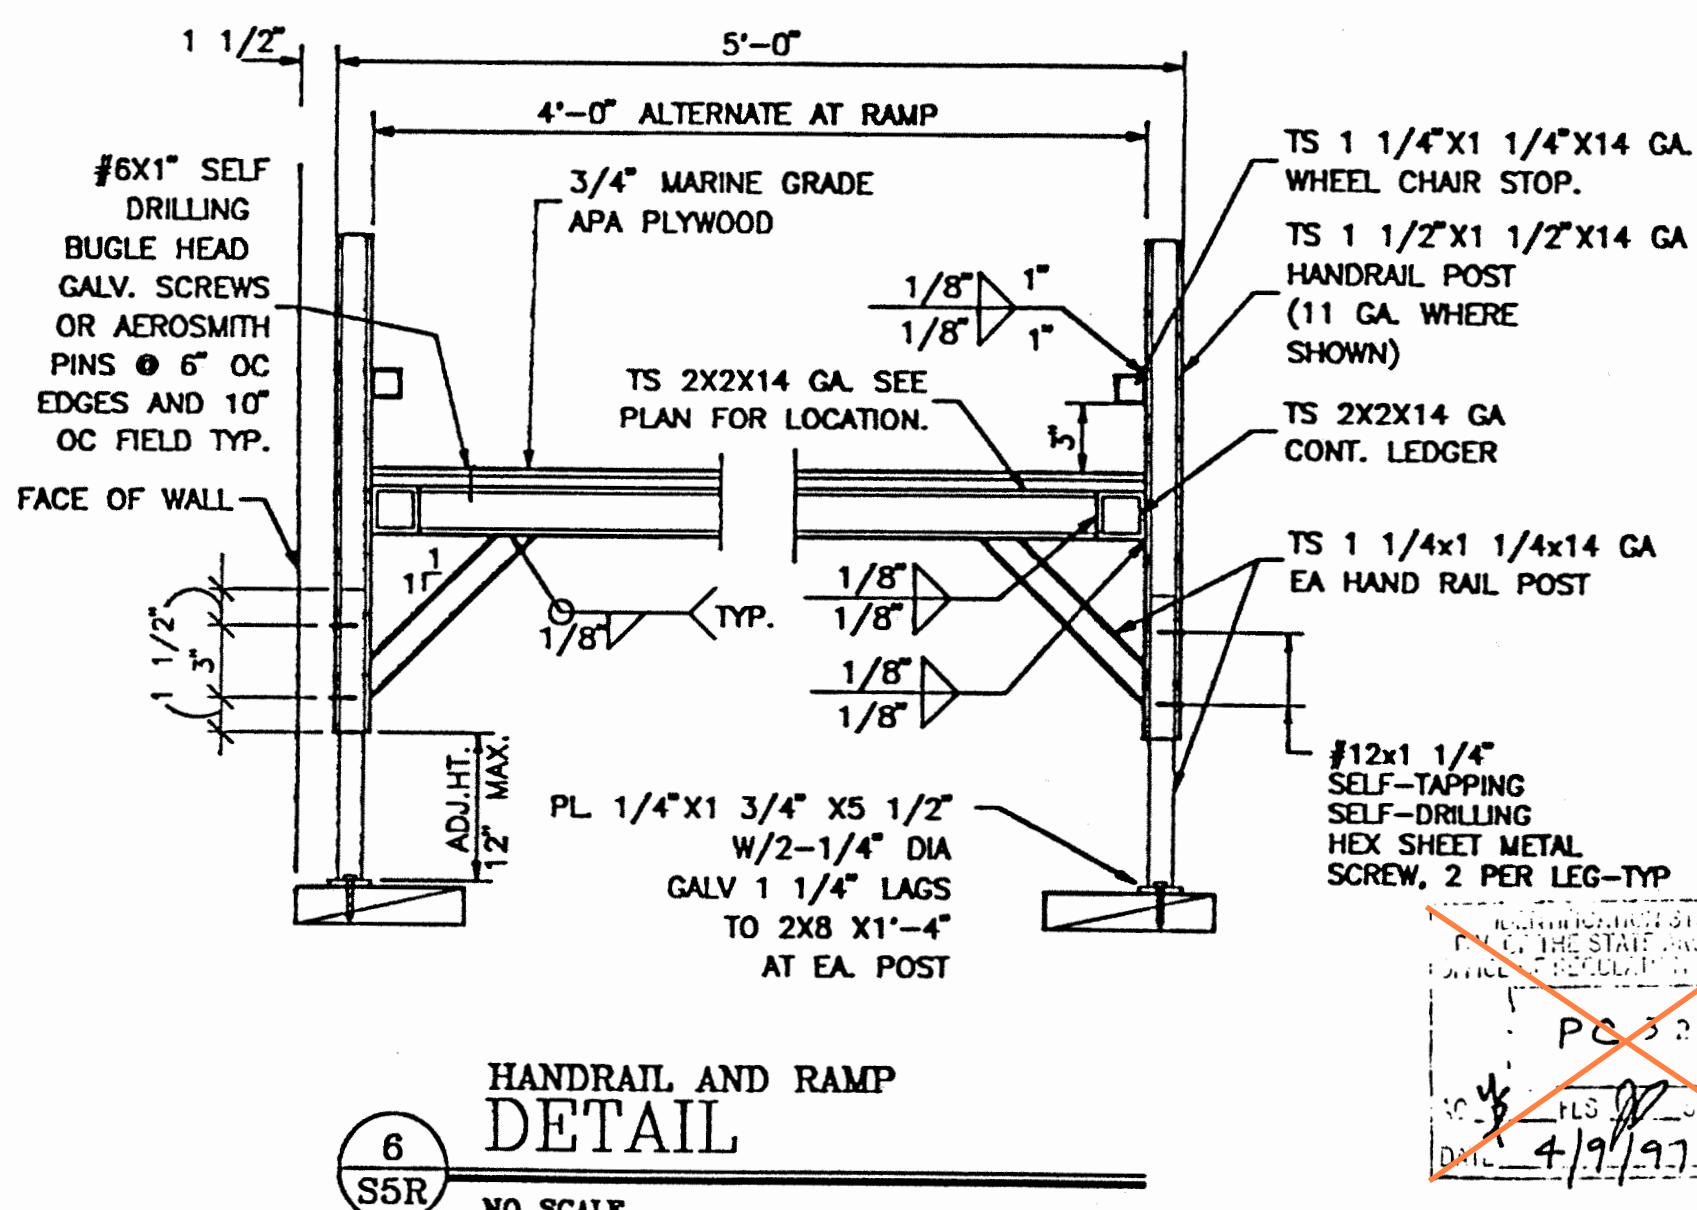NO SCALE

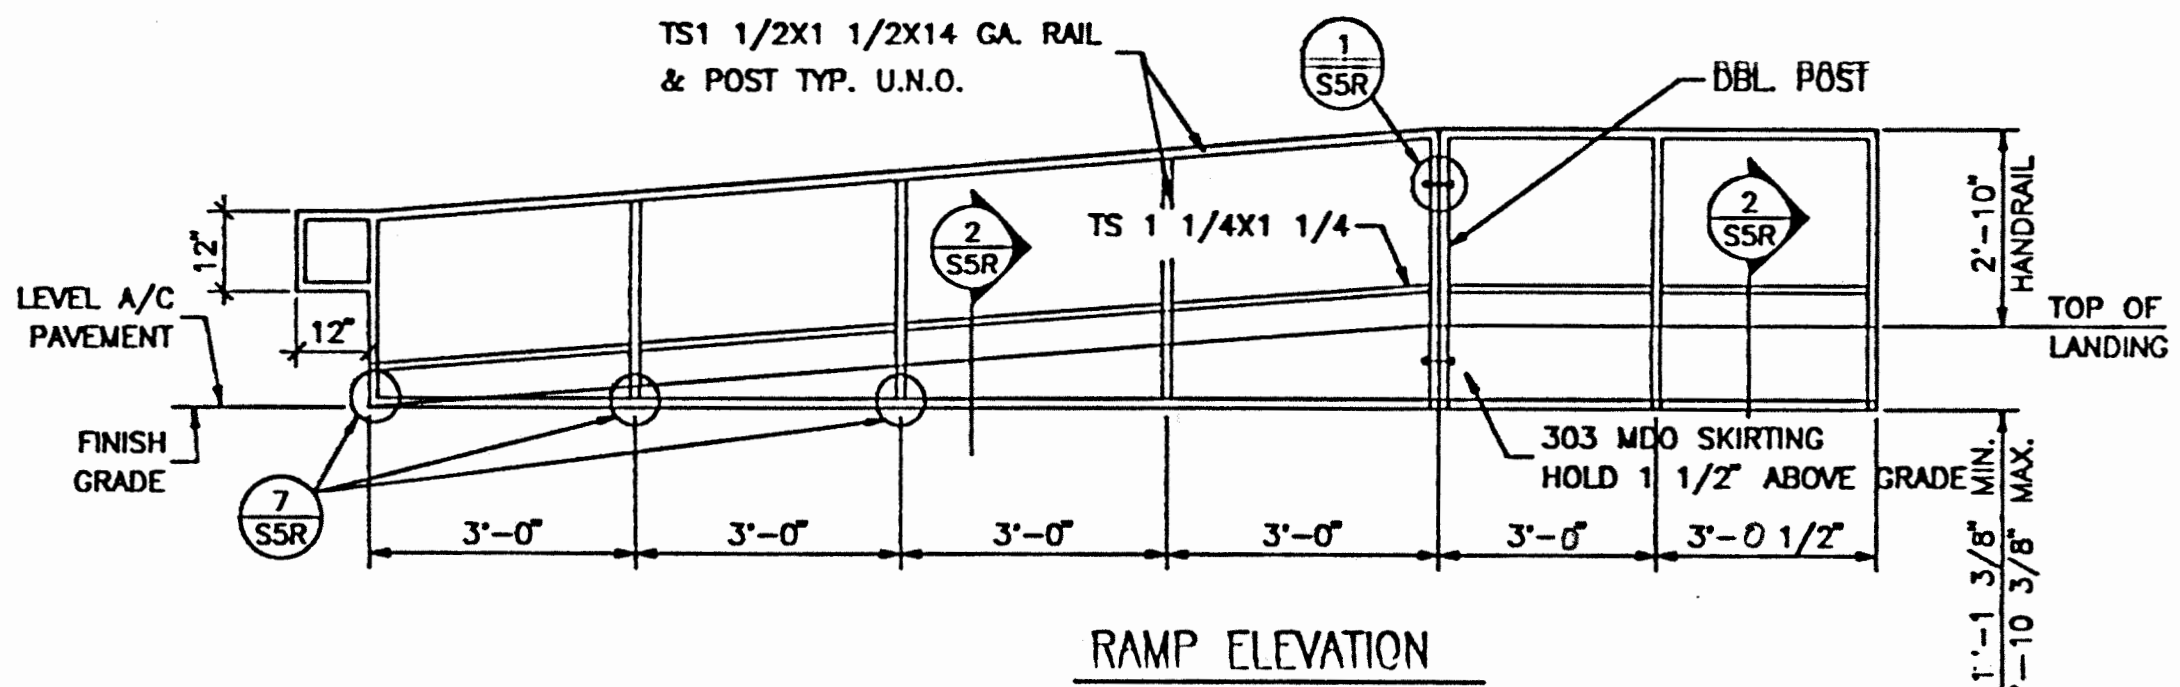

RAMP ELEVATION

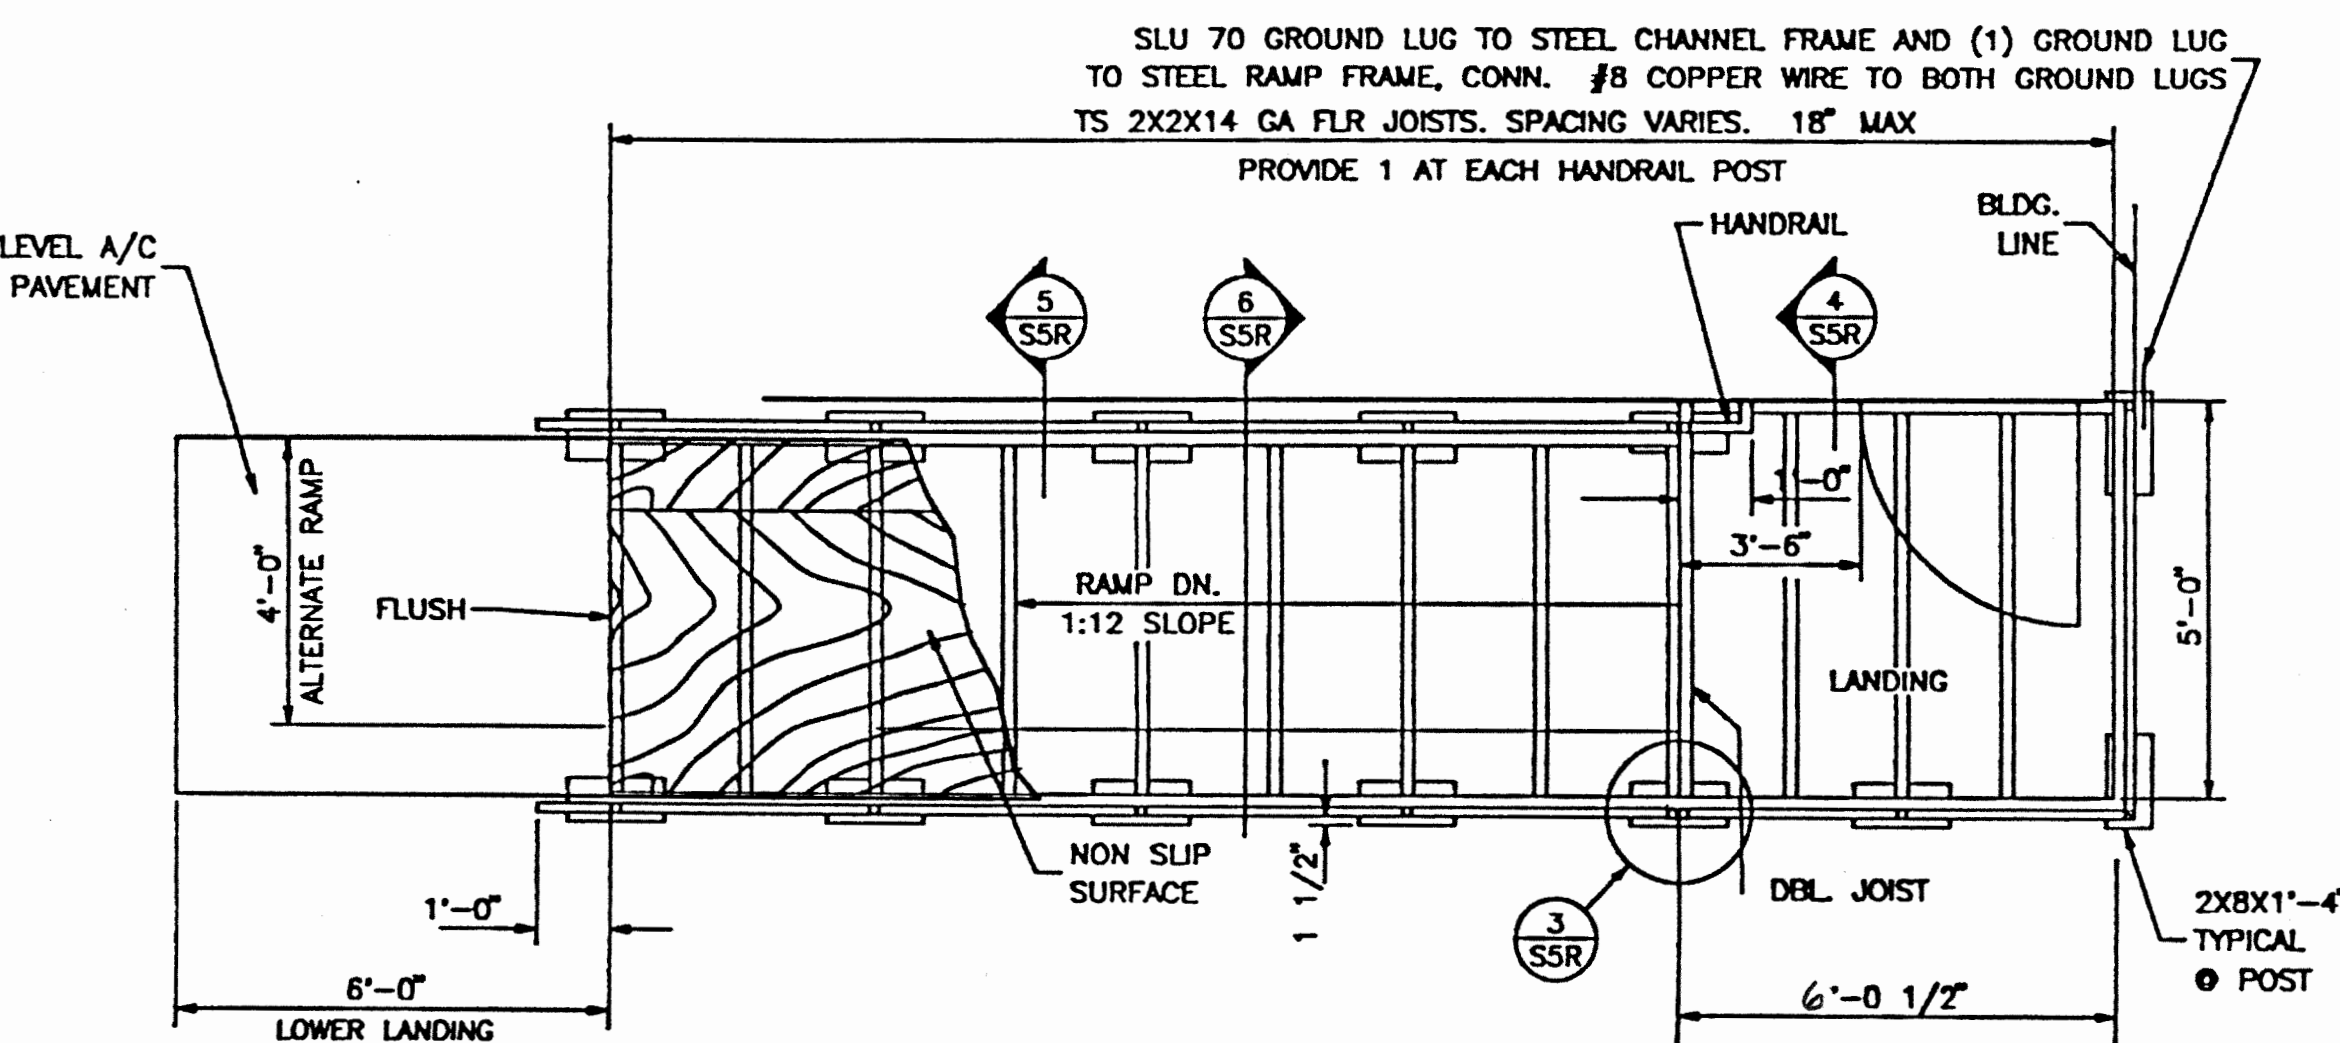


RAMP PLAN

NOTE: RAMP & LANDING TO BE FABRICATED IN SECTIONS (2 MIN) FOR MOVING


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NO SCALE

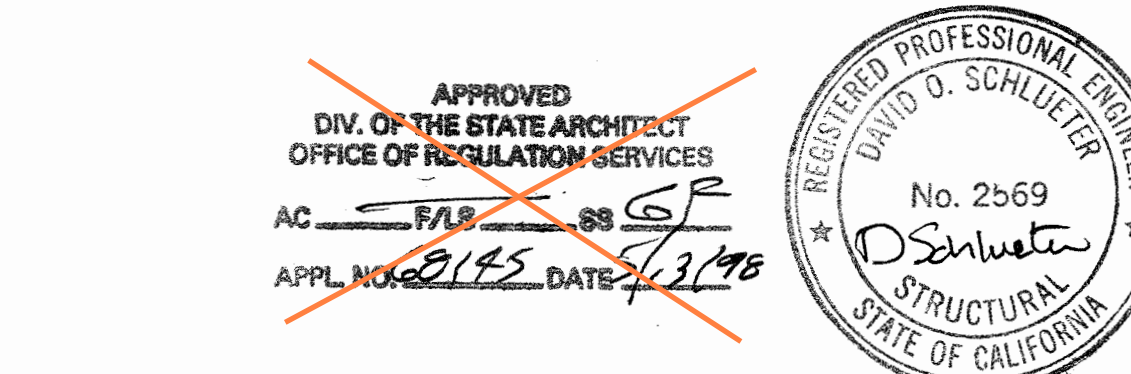


DETAIL

NO SCALE

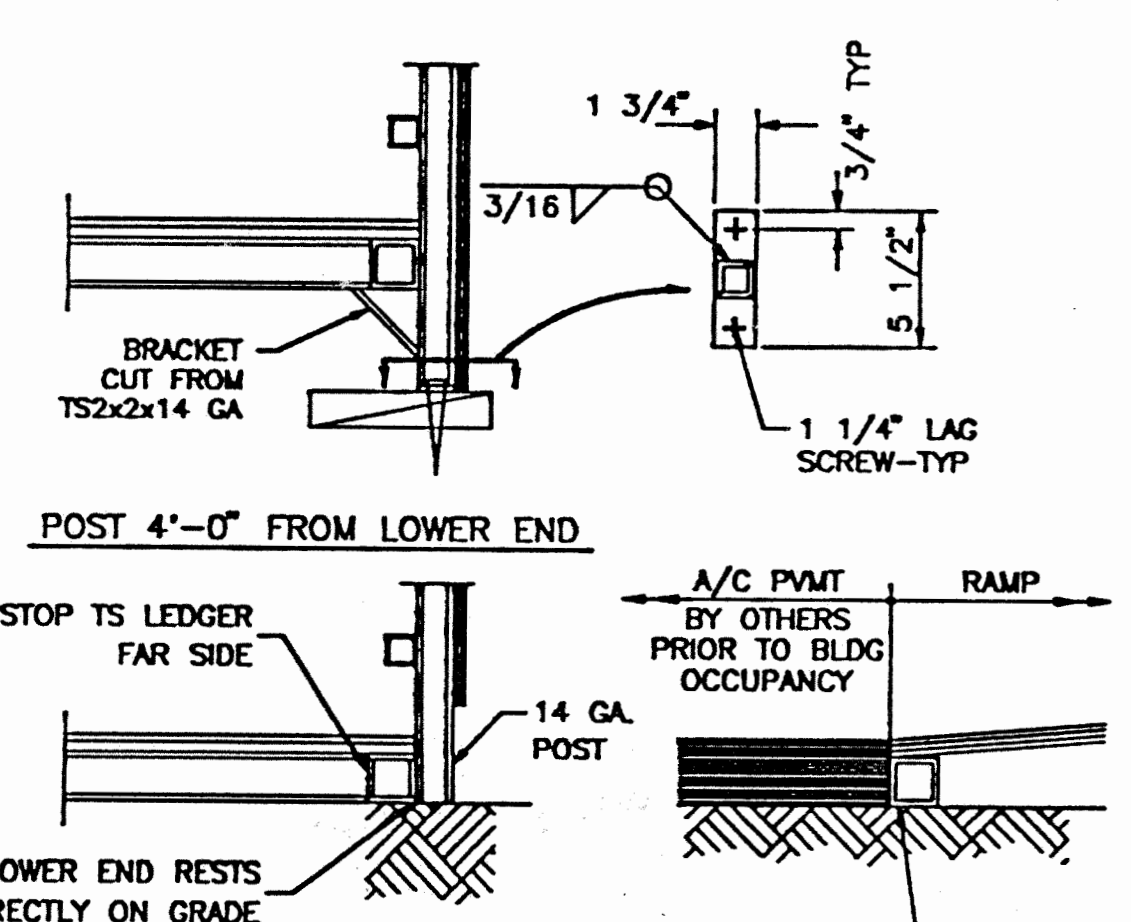

LOWER END POST
DETAIL

NO SCALE

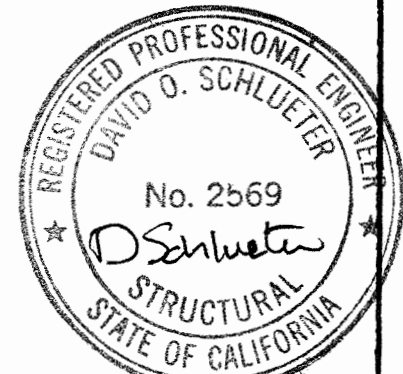


PROFESSIONAL STAMP

REVISIONS

NO	DATE	DESCRIPTION


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DATE PLOTTED: 11/28/2023 9:11:51 AM
FILE LOCATION: C:\Users\blimhof\Documents\BIM\23219_LUSD_Millwood Middle School Portables Relocation_A22_bimhof\CK8V.rvt

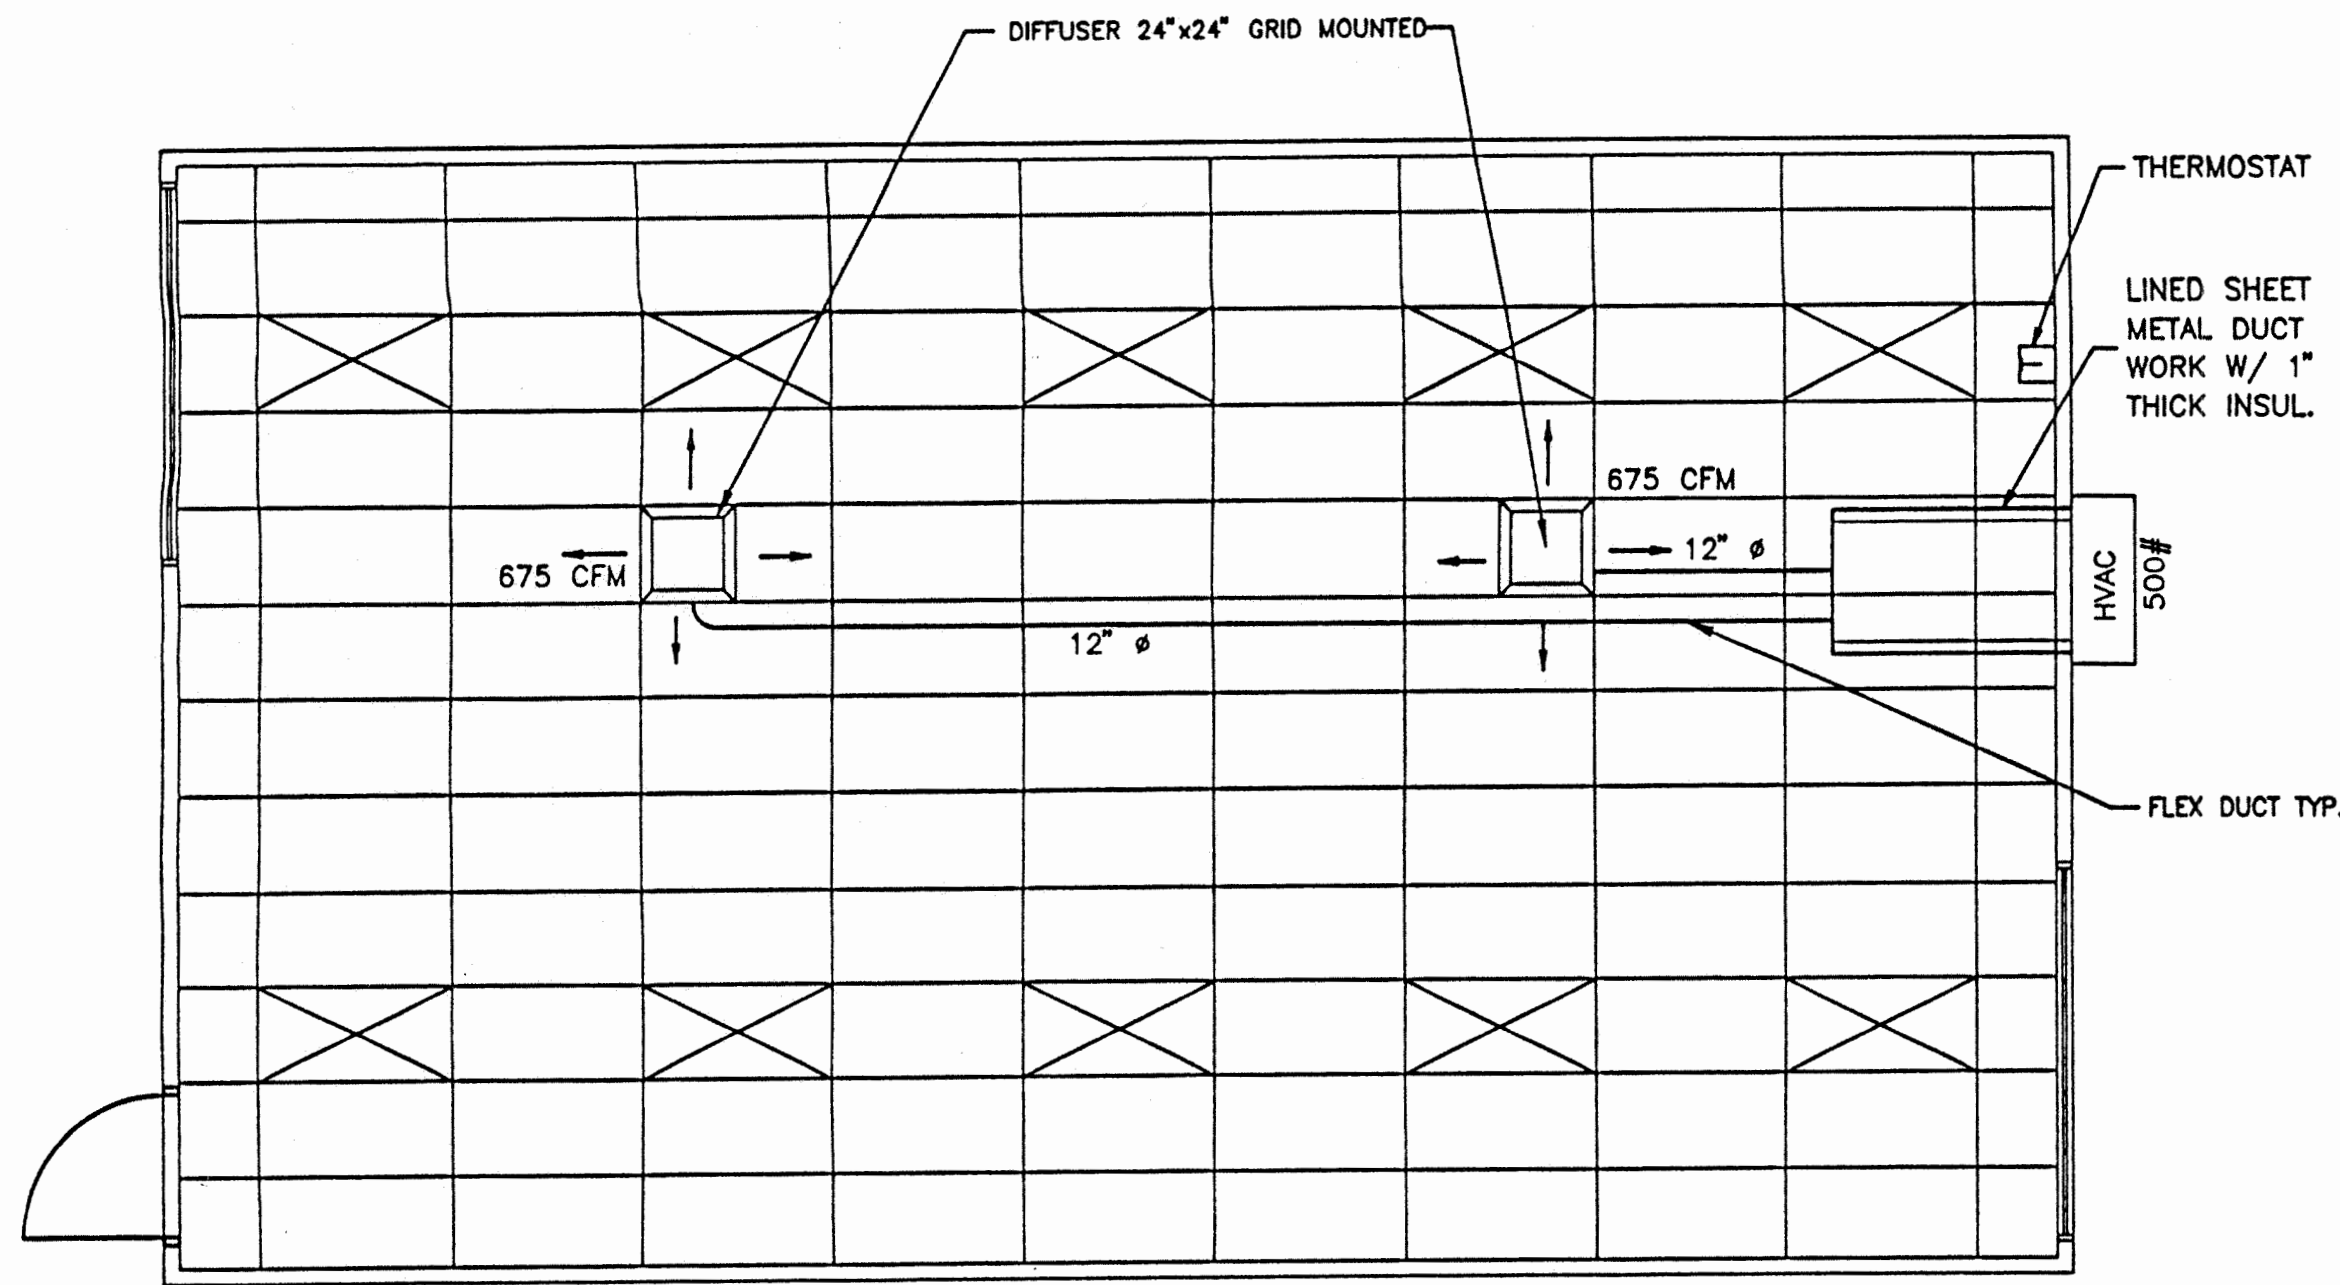

HEAT/SUPPLY AIR DUCT LAYOUT

SCALE: 1/4"=1'-0"

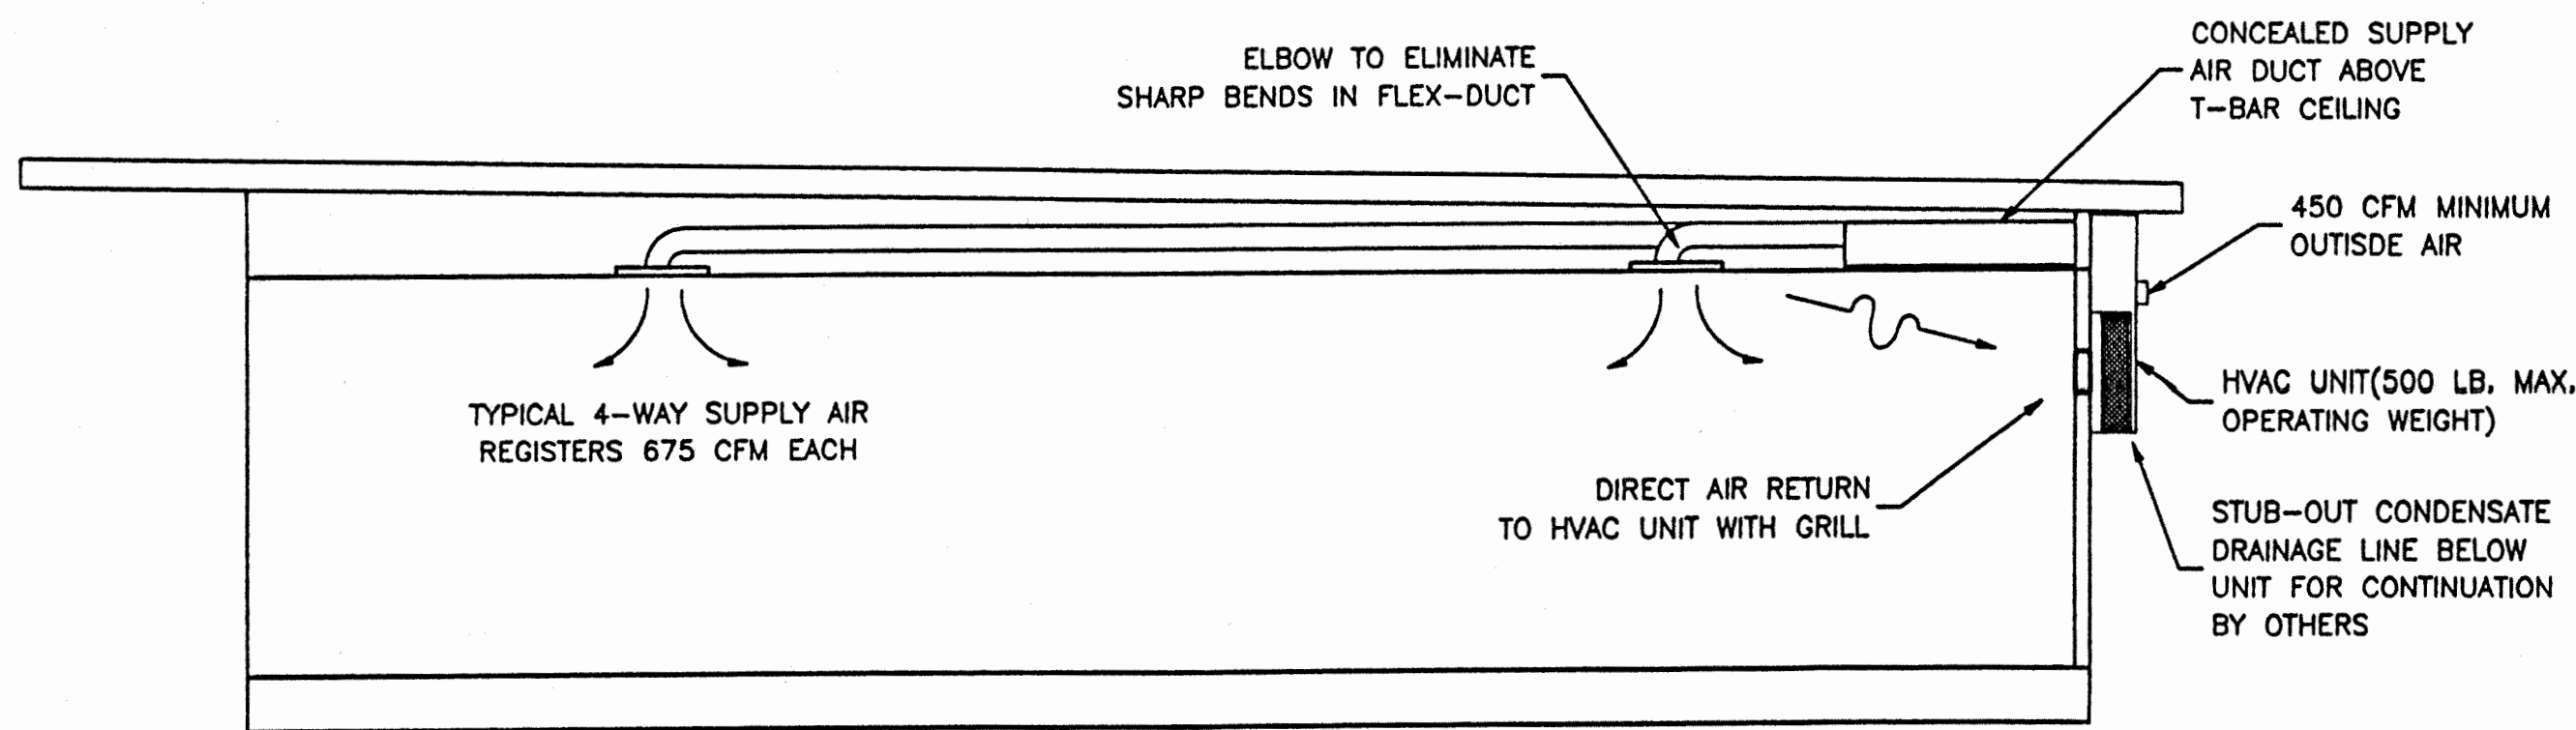

HEAT/SUPPLY AIR DUCT CROSS SECTION


SCALE: 1/4"=1'-0"

DUCT SUPPORT
Flex duct to be supported with 1-1/2" wide x 26 ga. galv. strap @ max 6'-0" o.c. Attach to rafter W/2 #8 SMS @ each end.
Supply air plenum to be supported with 1-1/2" wide x 26 ga. galv. straps min. 2 per plenum.
Supply air box and diffusers to be supported with (2) 12 ga. hanger wires to box @ opposite corners.
Supply air box and diffusers to be braced with (2) 12 ga. slack wires to box @ opposite corners. Attach supply air diffusers to ceiling grid to resist a lateral load equal to the weight of the diffuser and supply air box W/2 #8 SMS.

THESE DRAWINGS COMPLY
WITH THE ENERGY CONSERVATION REQUIREMENTS
OF TITLE 24 OF THE STATE OF CALIFORNIA

- GENERAL NOTES**
HEATING VENTILATING AND AIR CONDITIONING (HVAC)
- Heat Pump: Single package wall mounted air to air electric heat pump unit shall be rated in accordance with ARI Standard 240-77.
Reference Brands: BARD WH42A-XXXXXX MARVAIR AVP 42 HPA-08S
 - All units shall be 230/208 volt, 1 phase system, UL tested & approved or comparable and meet current energy standards.
A.) The system shall maintain an automatically controlled indoor classroom temperature of 78 degrees F. When the outdoor dry bulb temperature varies between 100 degrees F. in the summer
B.) The system must maintain the above temperature when the damper is adjusted to use approximately one third fresh air.
 - Duckwork.
A.) Construct all ductwork of galvanized sheet metal in accordance with U.M.C., Ashrae Guide Equipment volume and Smacna Low Velocity Duct Construction manual latest editions. All ductwork shall be insulated with 1" thick fiberglass duct wrap with vapor barrier. Provide 1" duct attenuation at all ductwork within 5'0" of HVAC unit.
B.) Non-metallic ductwork option: In accessible concealed portions of duct system rigid 1" fiberglass or insulated flex-duct with vapor barrier may be substituted for sheet metal ductwork. All ductwork within 5' of the HVAC unit and all interface connections shall be metal. Ductwork and reinforcement shall be designed for 2" static pressure.
Reference Brands: Owens-Corning fiberglass ductboard, 1" thick, and Micro-aire, TYPE 475.
Non-metallic ductwork shall conform to NFPA 90-A and SMACNA Class 1 rating.
 - Air duct insulation and linings shall comply with flame spread less than or equal to 25, smoke generation less than or equal to 50.
 - Supply air diffusers shall be 675 CFM max. 15"x15" neck, steel, rigid 1" fiberglass or flexduct ductwork specifically designed to provide air thermal cooling systems. 24"x8"x1" Micro-Aire type #475 Owens-Corning, Knauf, Certainteed, or equal and 90- B: UL #131 test, class 1 rating with "SMACNA".
 - Registers and diffusers: Provide three (Min) 4-way throw air diffusers as manufactured Carnes, Titus, Hart and Cooley, Metalaire, Shoemaker, Barber-Coleman or Krueger commercial grade grills and registers
 - Air conditioning controls.
Thermostat: Provide electronic programmable thermostat. Thermostat shall have the following functions.
A.) 5 and 2 weekday/weekend programming with 4 separate time/temperature setting for 24-hour period.
B.) Key board lockout switch.
C.) Programmable display.
D.) 2-hour override minimum.
E.) Status Indicated Led's.
F.) Battery back-up.
Provide locking clear thermostat cover with thermostat cover with access hole for program override. White Rodgers IF92.
 - Thermal Insulation
A.) Roof Insulation: R-19 Unfaced.
B.) Walls Insulation: R-11 Kraft Faced.
C.) Floors Insulation: R-11 Kraft Faced.
Flame spread and smoke development shall conform to California Building Code sec. 707.
 - Factory-made air ducts. Factory-made air ducts shall be approved for the use intended or shall conform to the requirements of U.M.C. Standard No. 6-1. Each portion of a factory-made air duct system shall be identified by the manufacturer with a label or other suitable identification indicating compliance with U.M.C. Standard No. 6-1 and its class designation. These ducts shall be listed and shall be installed in accordance with the terms of their listing and the requirements of UMC STD. 6-1.

APPROVED
DIV. OF THE STATE ARCHITECT
OFFICE OF REGULATION SERVICES
AG 7/15/96
APPL NO. 8145 DATE 2/12/96

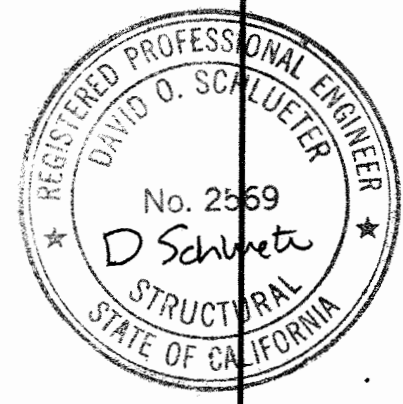

FILE NO.
IDENTIFICATION STAMP
DIV. OF THE STATE ARCHITECT
OFFICE OF REGULATION SERVICES
APPL NO. 328
DATE 4/9/97

3" STANDING SEAM ROOF

24 X 40
RELOCATABLE
CLASSROOMS



CUSTOMER:

MECHANICAL PLAN & NOTES

DATE: 4-8-97
SCALE: NONE
DRAWN BY: R.S.
CHECKED BY:
SERIAL NO.

REVISIONS					
NO	DATE	DESCRIPTION	NO	DATE	DESCRIPTION

PROJECT No.

SHEET No.

M 1

AGENCY APPROVAL DSA# 02-121945

IDENTIFICATION STAMP
DIV. OF THE STATE ARCHITECT
APP: 02-121945 INC:
REVIEWED FOR:
SS ☒ FLS ☒ ACS ☒
DATE: 12/12/2023

PROFESSIONAL STAMP

REVISIONS

NO	DATE	DESCRIPTION

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PROJECT OWNER & TITLE
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1305 E. Vine St
Lodi, CA 95240

**MILLSWOOD MIDDLE SCHOOL
PORTABLES RELOCATION**
233 N Mills Ave
Lodi, CA 95242

SHEET TITLE

MECHANICAL PLAN, DETAILS & NOTES



DRAWN BY: XXXXXX JOB NUMBER: 23219

SHEET NO.

M1


DATE: DECEMBER 5, 2023

CONSTRUCTION DOCUMENTS

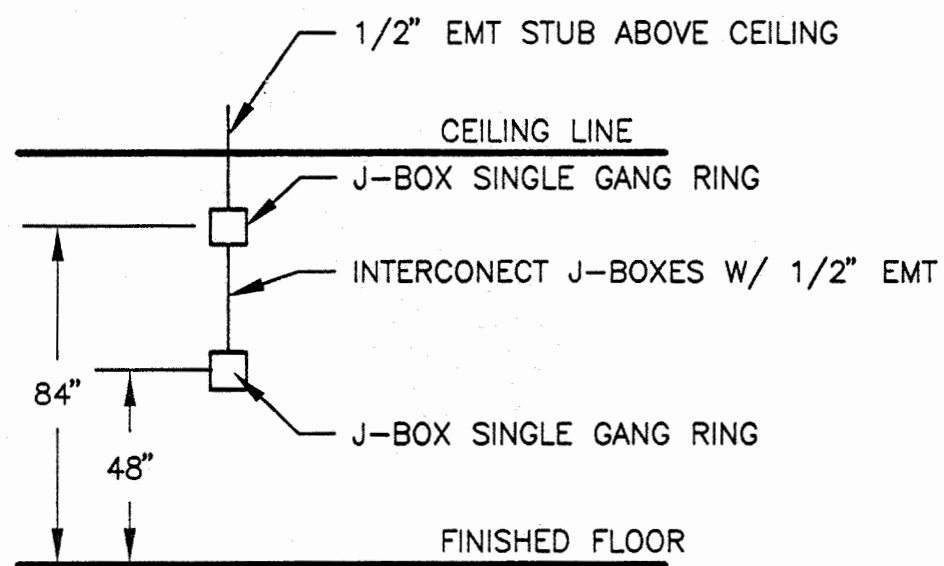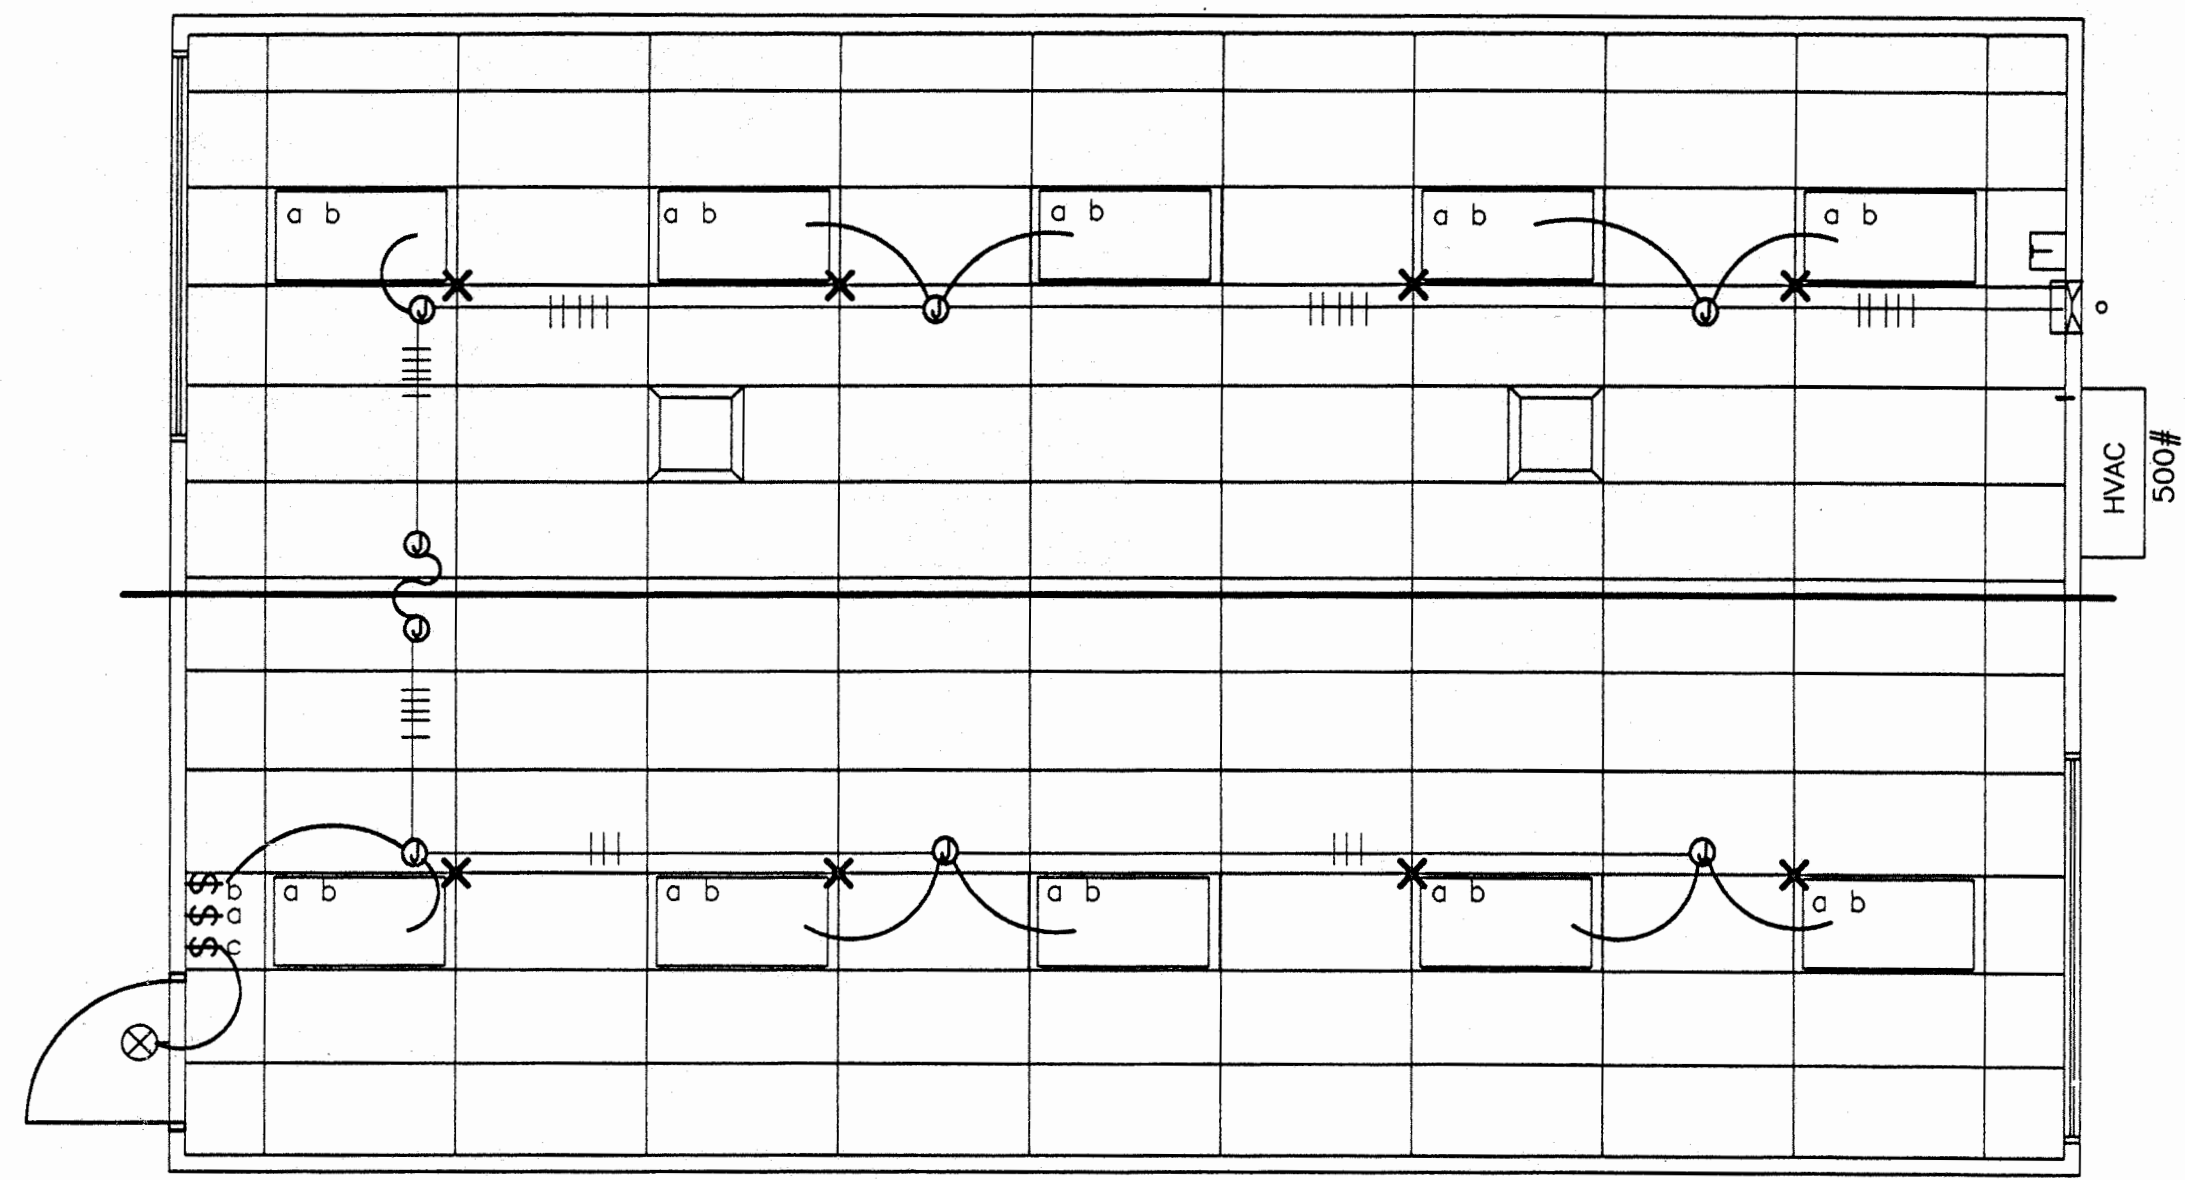

F.A. : STUB-UP ALL FIRE ALARM JUNCTION BOXES WITH 1/2" MIN. GALV. THIN WALL TUBING (EMT); DO NOT CONNECT FIRE ALARM CONDUIT WITH ANY OTHER ELECTRICAL CONDUIT


FIRE ALARM HORN @ +90" MIN. J-BOX WITH BLANK WEATHERPROOF COVER ONLY DEVICE N.I.C. FIRE ALARM PULL STATION +48", J-BOX AND COVER ONLY, DEVICE N.I.C.

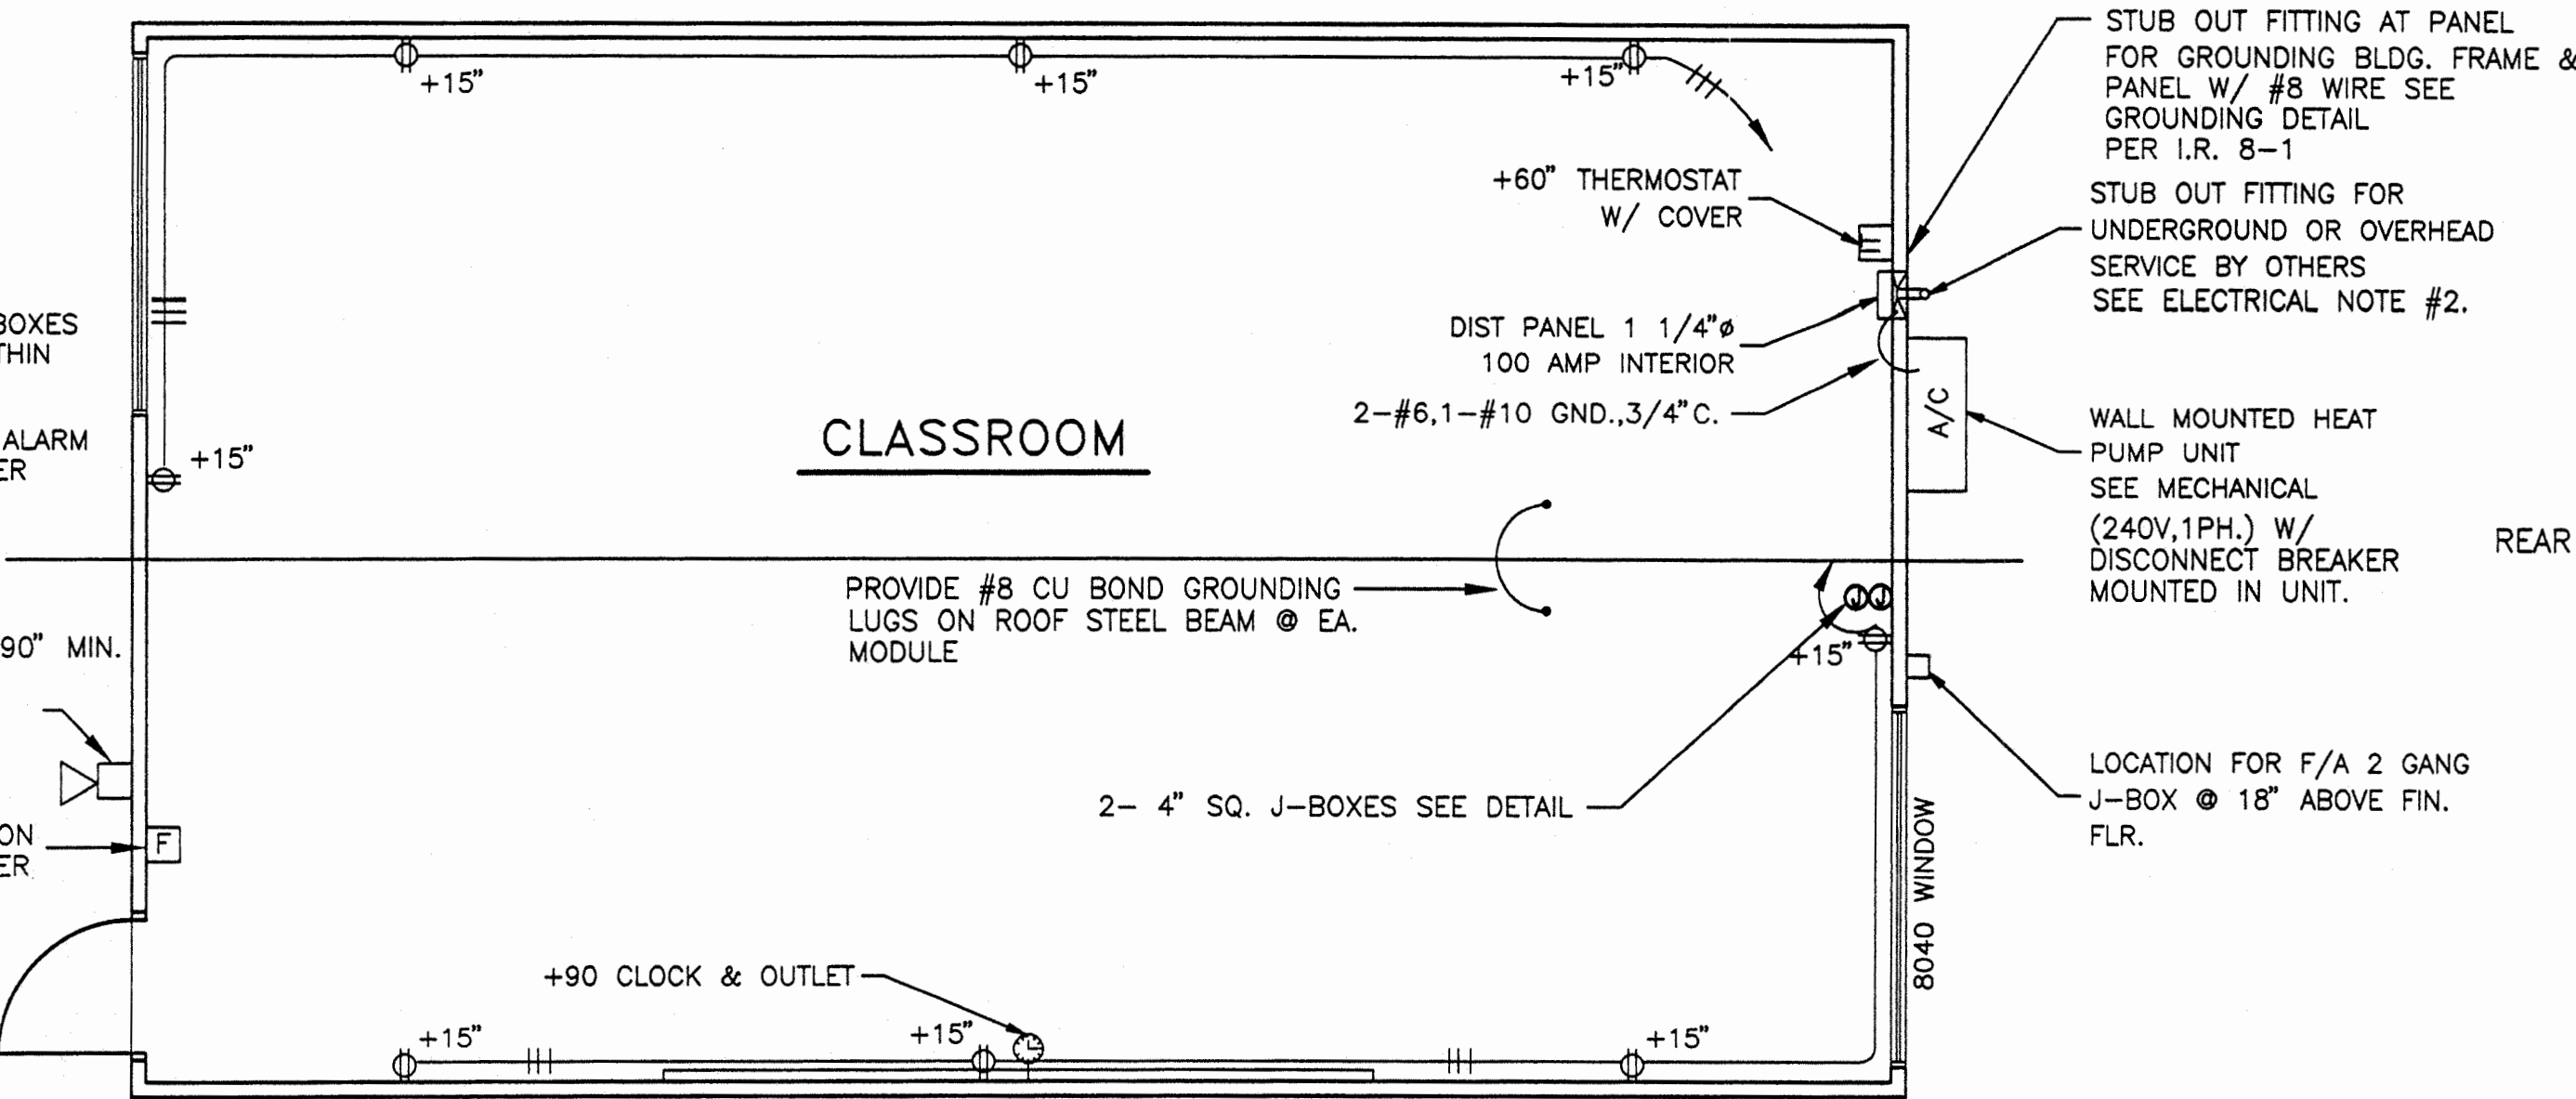

FIRE ALARM Junction boxes - Galvanized sheet metal, square or rectangular with blank covers. Locate one box at rear of building near main electrical panel at +18" above finish floor for future connection. Covers - Install gasketed, metal, waterproof, finish covers at exterior locations. Install finish covers at interior locations.

If testing results determine fire alarm audibility does not meet 15db over ambient noise levels, additional fire alarm signaling devices may be required by the enforcing agency


24 X 40
RELOCATABLE
CLASSROOMS

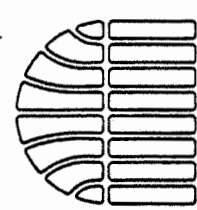

**American
Modular Systems**

STANDARD ELECTRICAL SYMBOLS

- FLUORESCENT LIGHTING FIXTURE - SURFACE MOUNTED.
FLUORESCENT LIGHTING FIXTURE - RECESSED.
FLUORESCENT LIGHTING FIXTURE - WALL MOUNTED (EXTERIOR)
INCANDESCENT LIGHTING FIXTURE - WALL MOUNTED (INTERIOR).
DUPLEX WALL CONVENIENCE OUTLETS +15".
SINGLE POLE LIGHT SWITCHES +48", HUBBELL PREMIUM, BRYANT HEAVY DUTY, OR LEVITON SPECIFICATIONS GRADE.
LECTRICAL CROSSOVER J-BOXES ABOVE T-BAR CEILING #1-4"X1 " #22 4"X2 "
WALL CLOCK OUTLET WITH POWER OUTLET +84".
SWITCH SUBSCRIPTS - a=DEVICE CONTROLLED.
15 AMP DUPLEX RECEPTACLE +15", HOSPITAL GRADE.
JUNCTION BOX - SIZE AND TYPE AS REQUIRED.
PANELBOARD - SEE SCHEDULE.
TERMINAL CABINET - SIZE AND TYPE AS NOTED.
CONDUIT CONCEALED IN CEILING OR WALL.
CONDUIT CONCEALED BELOW FLOOR OR GRADE.
HOMERUN TO RESPECTIVE PANEL TO TERMINAL.
INDICATES 1#14 (GREEN) GROUND WIRE, OTHER SIZES AS INDICATED.
BRANCH CIRCUIT WITHOUT FURTHER DESIGNATION IS A 2#14 WIRE CIRCUIT, FOR MORE THAN 2#14 WIRES AS FOLLOWS, -#1-3#14, -#1-4#14 ETC. FOR OTHER SIZES AS FOLLOWS, -#1-3#10, -#1-4#6 ETC.
NOTE
Ⓐ FIXTURE IDENTIFICATION - LETTER INDICATES TYPE.
N.I.E.S. ABBREV. FOR NOT IN ELECTRICAL SECTION OF THESE PLANS AND SPEC'S.
MT ABBREV. FOR EMPTY CONDUIT WITH POLY PULL CORD.
FUSED DISCONNECT SWITCH SIZE AS REQUIRED. PROVIDE FUSES AS RECOMMENDED BY EQUIPMENT SUPPLIER.
[W.E.F.] WALL MOUNTED EXHAUST FAN N.I.E.S. CONNECT AS REQUIRED.
50 AMP 250 VOLT RANGE RECEPTACLE.
FIRE ALARM STATION - OUTLET ONLY, 4" SQ. BOX W/ SINGLE DEVICE RING AND COVER +48" CENTERLINE
FIRE ALARM HORN - OUTLET ONLY - 4" SQ. BOX W/ SINGLE DEVICE RING AND COVER +90" MIN. AND NOT LESS THAN 6" BELOW FINISHED CEILING.
FIRE ALARM VISUAL ALARM - OUTLET ONLY - 4" SQ. BOX W/ SINGLE DEVICE RING AND COVER BOTTOM +80". A.F.F. BUT NO GREATER THAN +95". IF CEILING MOUNTED PER NFPA72 TABLE 6-4.4.1(d).
SPEAKER - OUTLET ONLY - 4" SQ. BOX W/ SINGLE DEVICE RING AND COVER +84".
INTERCOM TELEPHONE - OUTLET ONLY - 4" SQ. BOX W/ SINGLE DEVICE RING AND COVER +48".
FIRE ALARM MINI HORN - OUTLET ONLY - 4" SQ. BOX W/ SINGLE DEVICE RING AND COVER +90" MIN. AND NOT LESS THAN 6" BELOW FINISHED CEILING.

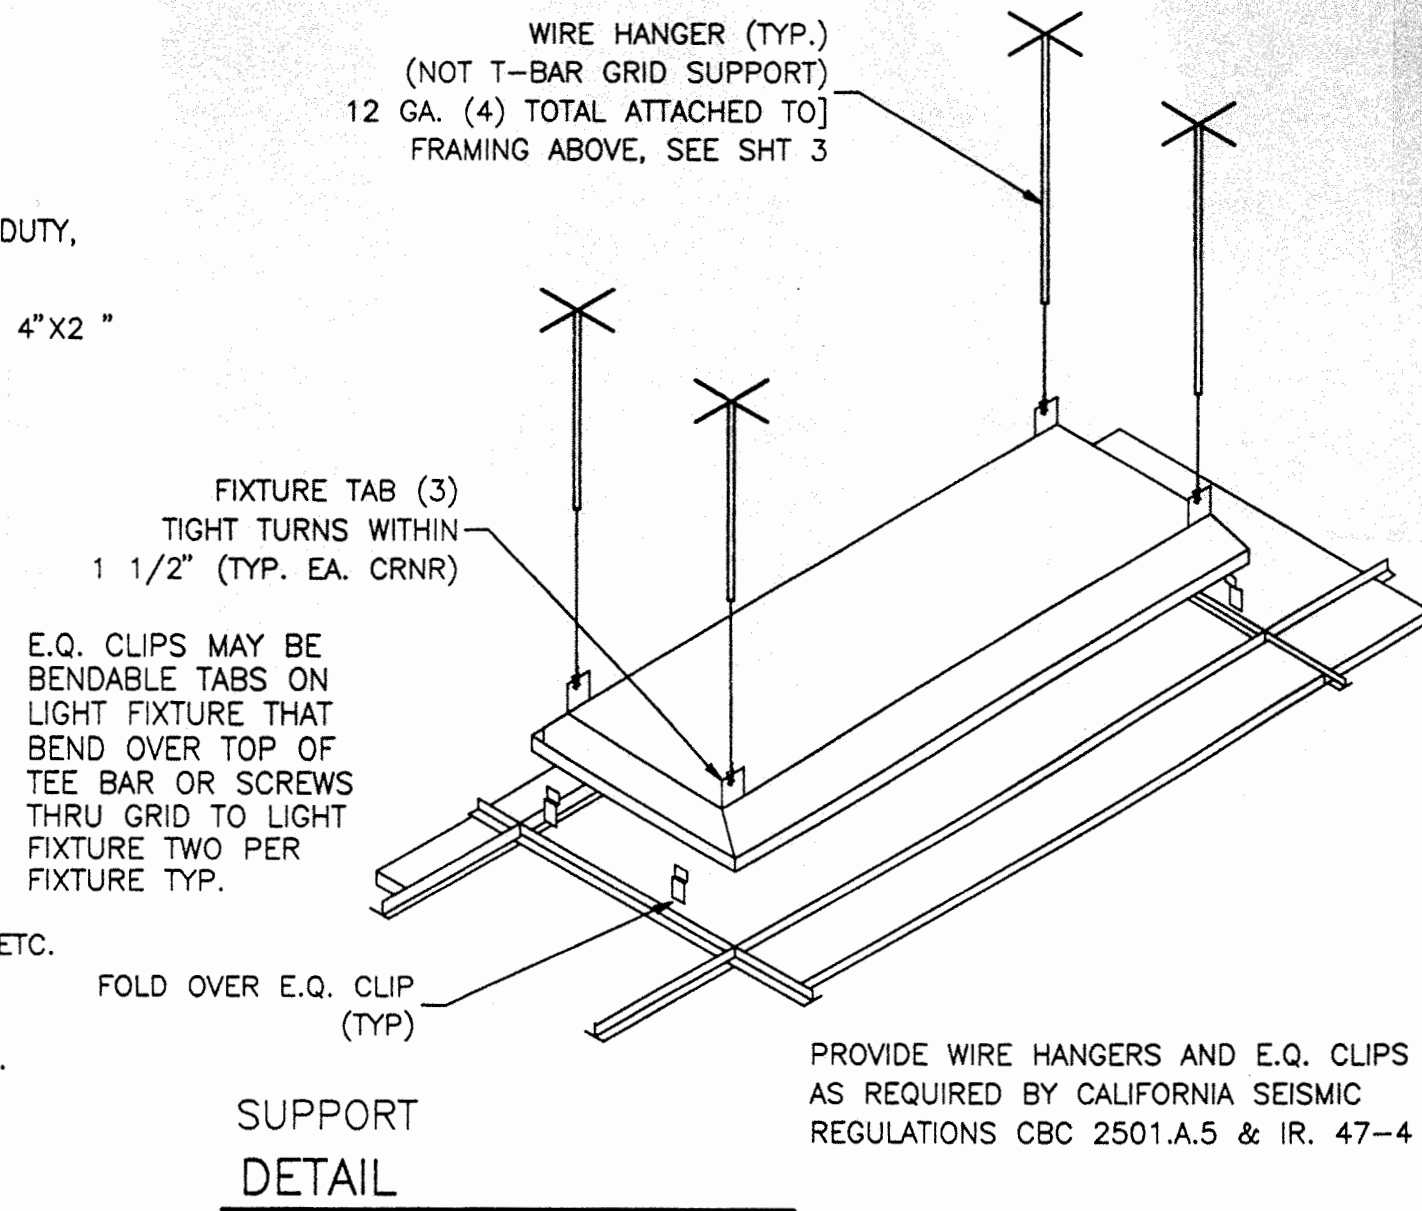

SYMBOL	DESCRIPTION	WATTS	MANUFACTURER
	2'x4' FLOURESCENT DROP IN FIXTURE, ACRYLIC PRISMATIC LENS, ENERGY SAVING BALLAST, (4)35 WATT TUBES, WT. 27 LBS.	156 W	CRESCENT 24TF440DLA
	FLOURESCENT SURFACE MOUNTED EXTERIOR LIGHT WITH IMPACT RESISTANT ENCLOSURE, .125 THICK CLEAR PRISMATIC ONE PIECE LENS W/ NEOPRENE GASKET & "POSIGRIP" STAINLESS STEEL SCREWS.	(2) 7W TT 2700 K	KENALL 3714 OR LITHONIA 202 2/7PL LP
	INCANDESCENT WALL MOUNTED	150W	PROGRESS P3011x30"

SEE TYPICAL CLASSROOM LAYOUT FOR LOCATIONS OF ALL DEVICES. FIXTURE MOUNTING SHALL COMPLY WITH CALIFORNIA SEISMIC REGULATIONS.

FIRE ALARM SYSTEM

1. THE FIRE ALARM SYSTEM SHALL CONFORM TO THE CALIFORNIA ELECTRICAL CODE, ARTICLE 760 & C.A. FIRE CODE ART. 10.
2. INSTALLATION OF THE FIRE ALARM SYSTEM SHALL NOT BE STARTED UNTIL DETAILED PLANS AND SPECIFICATIONS, INCLUDING CALIFORNIA STATE FIRE MARSHAL LISTING NUMBERS FOR EACH COMPONENT OF THE SYSTEM HAVE BEEN APPROVED BY THE DIVISION OF THE STATE ARCHITECT.
3. UPON COMPLETION OF THE INSTALLATION OF THE FIRE ALARM SYSTEM, A SATISFACTORY TEST OF THE ENTIRE SYSTEM SHALL BE MADE IN THE PRESENCE OF THE ENFORCING AGENCY.

GENERAL NOTES

1. GROUNDING ELECTRODE CONDUCTOR SIZED PER CEC 250-94 & 95.
2. ALLOW FOR 12" MOVEMENT IN ANY DIRECTION IF PAD FOUNDATION IS USED.
3. PROVIDE BONDS TO BLDG. STEEL & PANEL (#8 CU)
4. PANEL TO LISTED FOR USE AS SERVICE EQUIPMENT.

FIXTURE NOTES:

1. ALL FLUORESCENT LIGHT FIXTURES SHALL HAVE ENERGY SAVING LAMPS AND BALLASTS.
2. LUMINATES/BALLASTS SHALL BE CERTIFIED PER CALIFORNIA BUILDING CODE TITLE 24.
3. FLUORESCENT LIGHT FIXTURE TYPE "A" SHALL BE CONTROLLED TO PROVIDE TWO LEVELS OF LIGHTING. SWITCH (SA) SHALL CONTROL THE TWO OUTER LAMPS AND SWITCH (SB) SHALL CONTROL THE TWO INNER LAMPS.

ELECTRICAL

1. Electrical service drop and connections supplied by others.
2. Manufacturer to provide stub-out from back of electrical panel through the exterior wall for receiving either underground or overhead service & fitting for grounding cable.
3. Electrical panel board shall be recess mounted inside the building. Sized to accommodate all connected loads including spaces as shown. Overcurrent protective devices in the panel boards have adequate short circuit interrupting capacity. All buses including bus shall be copper or aluminum.
4. 2x4 fluorescent fixtures shall be steel frame, lens shall be hinged and locked in place by two locking devices. The lens diffusers shall be KHS, Inc. #KSH-12, Carolite, Inc. #C-12 or Plaskolite, Inc. #PL21A. Minimum lens thickness shall be .125 inch.
5. Fluorescent ballast shall be energy saver while maintaining full light output, class "P" equipped with thermal protectors, guaranteed against failure for (2) years and be replaced from inside the fixture.
6. Clock - 12" dial clock on clock outlet.
A) Clock shall be General Electric model 2912 129V 60 cycle
B) Clock outlet shall be Bryant #2828 or equal with seperable hanging clip & app'd recept.

APPROVED
DIV. OF THE STATE ARCHITECT
OFFICE OF REGULATION SERVICES
AC DATE 11/23/23
APPL NO. 6145

VOLTS: 120/240 SINGLE PHASE				PANEL: A				FEED: EXTERIOR LB			
MAIN: 100 AMP MAIN BKR.				LOCATION: INTERIOR				MOUNTING: FLUSH			
LOAD				WATTS	BRK.	C	A	WATTS	BRK.	C	A
LIGHTS, FLUORESCENT	960	15	1	1	2	2,50	4476				
LIGHTS, FLUORESCENT	960	15	1	3	4	2,50	4476				
EXTERIOR LIGHT & CLOCK	100	15	1	5	6						
DUPLEX RECEPT.	720	15	1	7	8						
DUPLEX RECEPT.	720	15	1	9	10						
SPACE					11						
					12						
					13						
					14						
					15						
					16						
PHASE WATTAGE	1880	1680	17	18	4476	4476		PHASE WATTAGE			
TOTAL WATTS "A" LEG: 6556					TOTAL WATTS A+B=2743			TOTAL WATTS "B" LEG 6156			
TOTAL WATTS: 15455	65	AMPS	120/240V	SINGLE PHASE				100AMP BUS.			
FEEDERS: TO BE RUN BY THE DISTRICT EITHER UNDERGROUND OR OVERHEAD, SEE SITE ELEC. PLAN.											

3 ELECTRICAL DISTRIBUTION PLAN E1 1/4" = 1'-0"

NOTE: THIS PAGE IS BASED ON PC264 CHANGES INCLUDE NOTE ON LIGHT DETAIL AND ADDED J-BOXES AT REAR OF CLASSROOM.

FILE NO.
IDENTIFICATION STAMP
DIV. OF THE STATE ARCHITECT
OFFICE OF REGULATION SERVICES
APPL. DATE 11/23/23
AC DATE 11/23/23

CUSTOMER:
RELOCATABLE CLASSROOMS AT VARIOUS SITES
LODI UNIFIED SCHOOL DISTRICT
LODI, CALIFORNIA

DATE: 3-6-97
SCALE: NONE
DRAWN BY: R.S.
CHECKED BY:
CHECKED BY:
SERIAL NO.

REVISIONS

NO	DATE	DESCRIPTION	NO	DATE	DESCRIPTION
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PROJECT No.

SHEET No.
E 1

IDENTIFICATION STAMP
DIV. OF THE STATE ARCHITECT
APP: 02-121945 INC.
REVIEWED FOR
SS ☒ FLS ☒ ACS ☒
DATE: 12/12/2023

PROFESSIONAL STAMP

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NO	DATE	DESCRIPTION
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PROJECT OWNER & TITLE
LODI UNIFIED SCHOOL DISTRICT
1305 E. Vine St
Lodi, CA 95240

**MILLSWOOD MIDDLE SCHOOL
PORTABLES RELOCATION**
233 N Mills Ave
Lodi, CA 95242

SHEET TITLE


ELECTRICAL PLAN, DETAILS & NOTES

DRAWN BY: XXXXXX JOB NUMBER: 23219

SHEET NO.

E1

DATE: DECEMBER 5, 2023

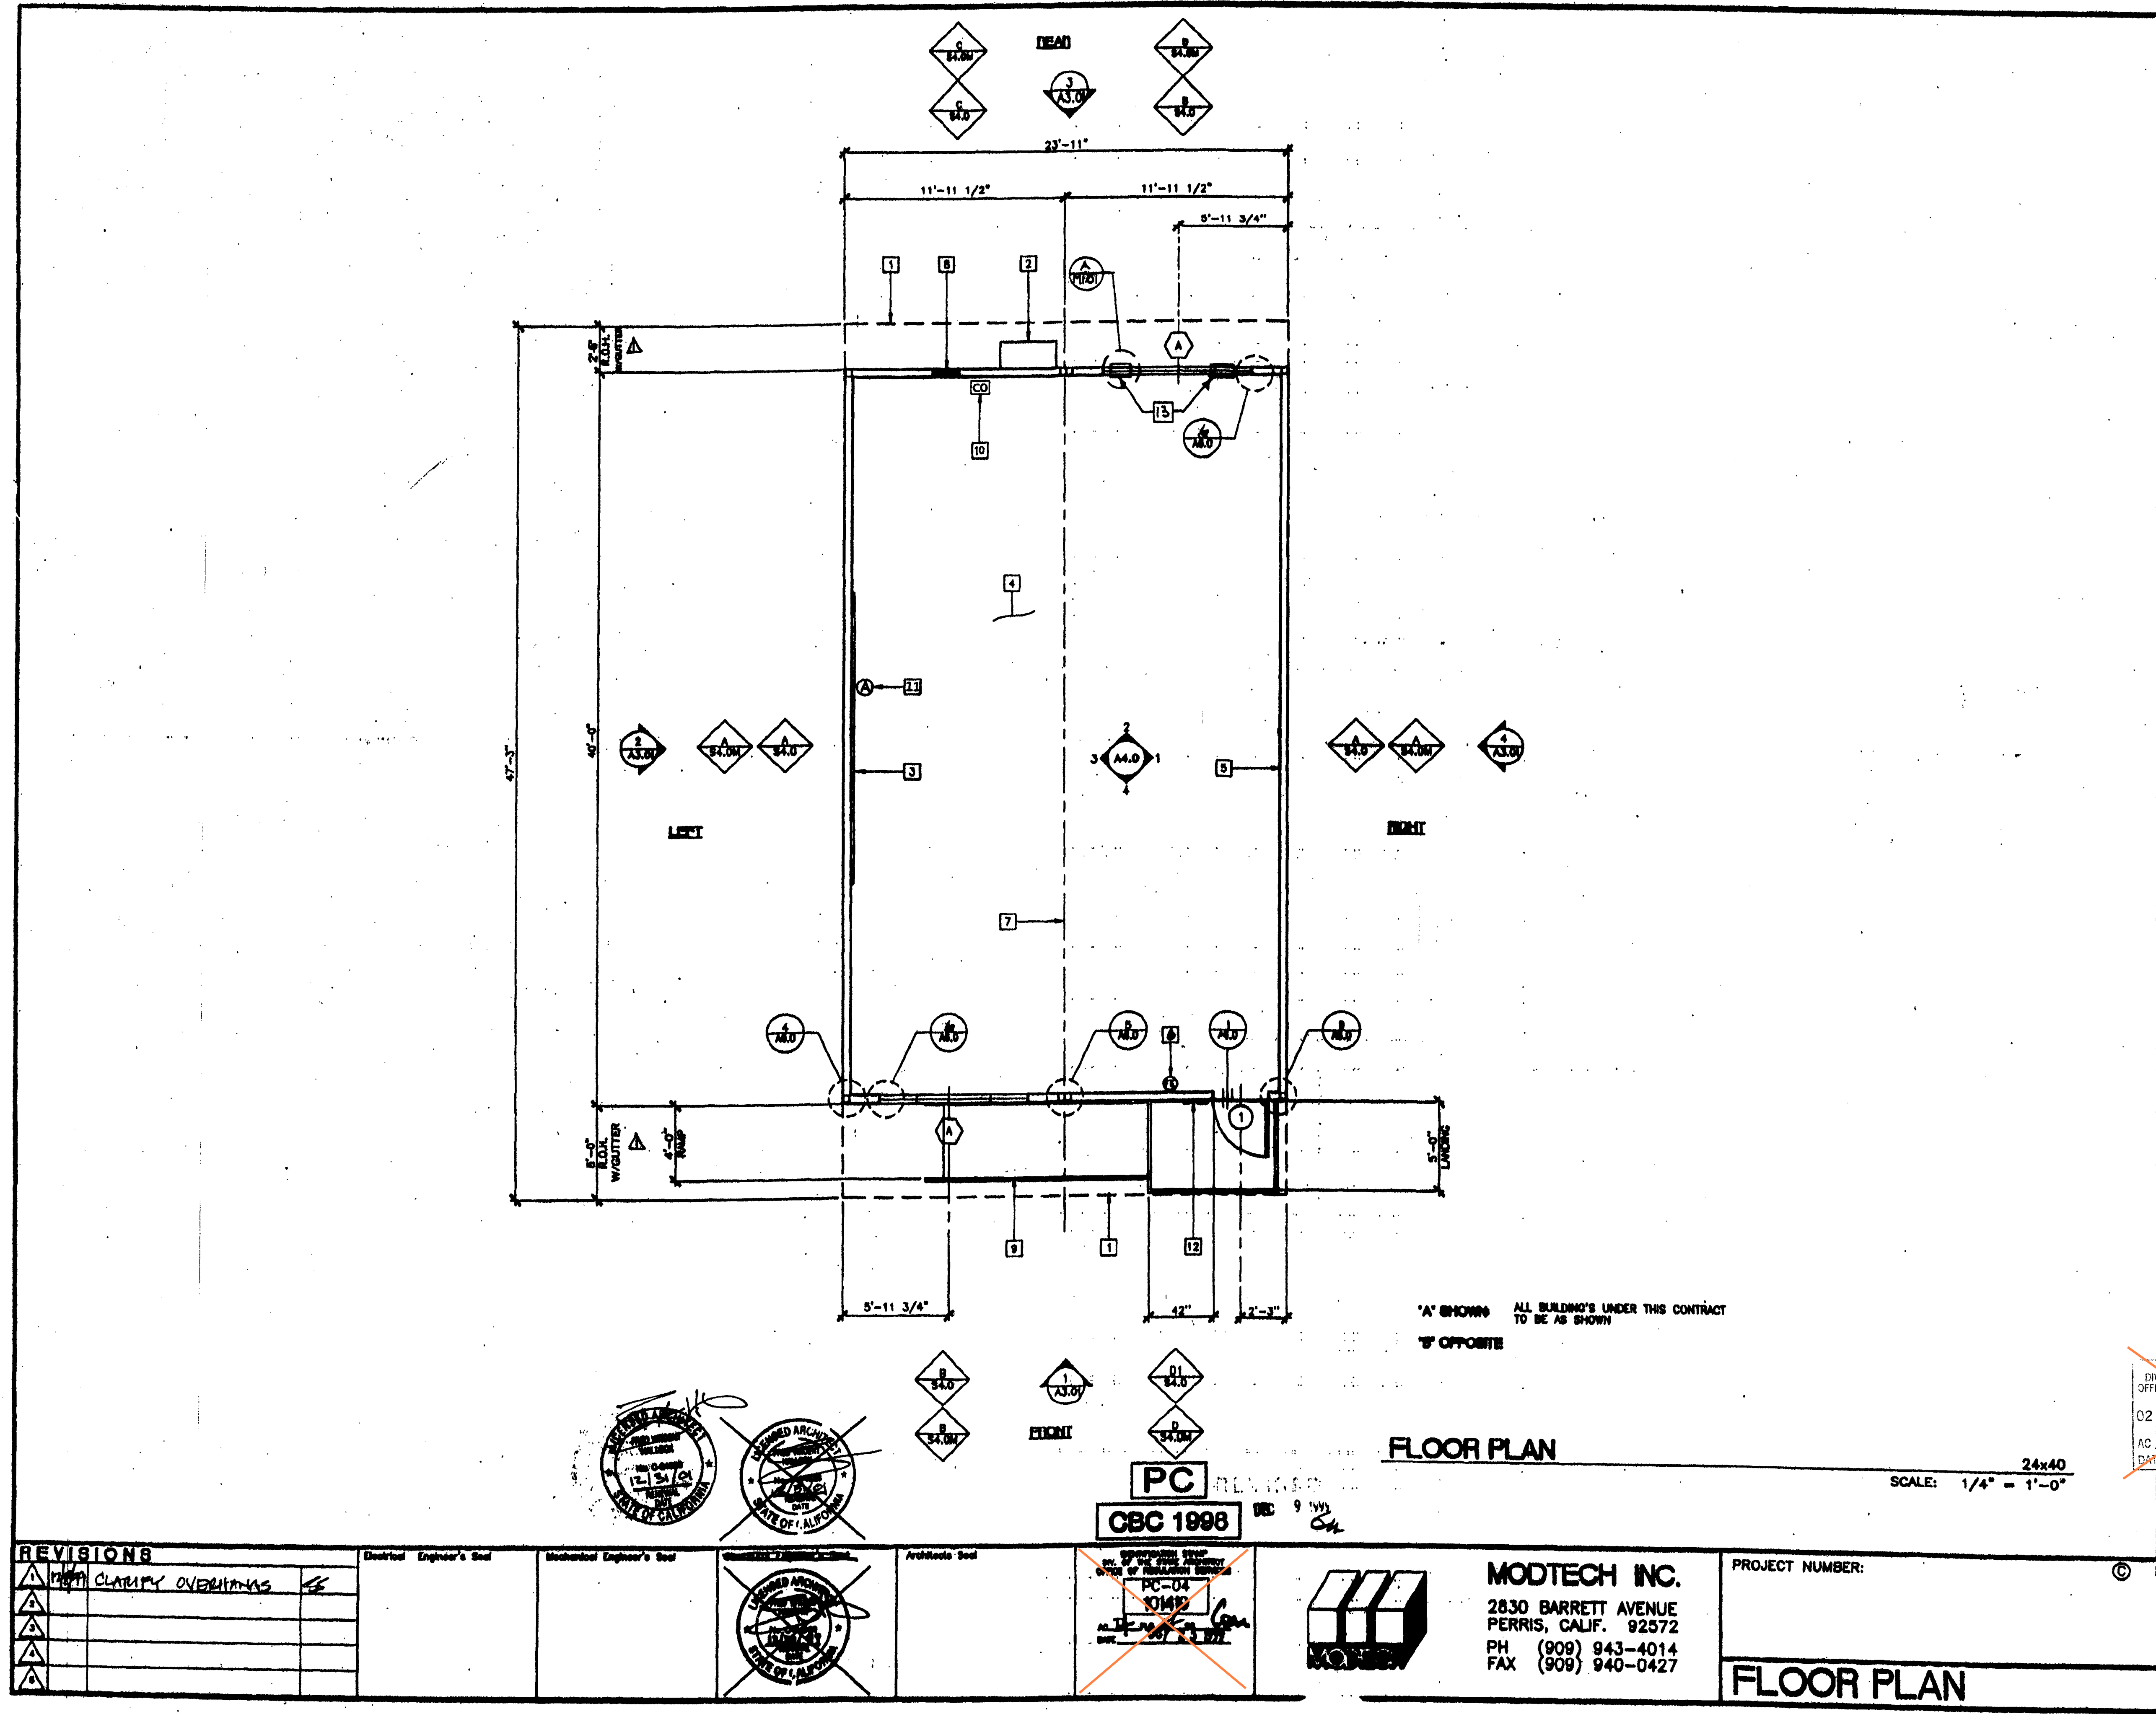

- KEY NOTES**
- 1 ROOF OVERHANG
 - 2 HVAC UNIT (HV)
 - 3 2 - 8"x4" MARKER BONDS (SEE SPEC'S FOR TYPE)
 - 4 FINISH FLOORING (FN)
 - 5 INTERIOR FINISH (FN)
 - 6 FIRE EXTINGUISHER - 5 LBS DRY CHEMICAL WITH 2A-10BC UL RATING WALL MOUNTED BRACKET, HANDLE AT 48" AFF
 - 7 MODULINE (M)
 - 8 ELECTRICAL PANEL
 - 9 RAMP/LANDING (RM)
 - 10 GAS SENSOR AT +8'-0" WFF (EL)
 - 11 INTRUSION ALARM DETECTOR AT +7'-6" WFF (EL)
 - 12 SIGNAGE PROVIDED AND INSTALLED BY DISTRICT PRIOR TO OCCUPANCY, SEE A.G.O.
 - 13 2"X4" METRIC RELIEF DAMPER (1/4"X1/4") 2" TOP-L BUILT IN BASE AS HIGH AS POSSIBLE ON WALL, FRAMED OPENING 4.15-14 1/2"X14 1/2"

- NOTES**
- 1. METAL TAG ON ALL MODULES, MECHANICALLY ATTACHED TO REAR EXTERIOR OF BUILDING SHOW D.S.A. APPLICATION NUMBER, MANUFACTURER'S NAME AND SERIAL NUMBER.
 - 2. METAL TAG MIN. 3 1/2"x1 1/2" STAMPED METAL I.D. W/
 - 1. OPSC BUILDING NUMBER
 - 2. DESIGN WIND LOAD
 - 3. DESIGN ROOF LOAD
 - 3. PROVIDE MIN. 3 1/2"x1 1/2" METAL TAG INSTALLED INSIDE THE ELECTRICAL PANEL SHOWING OPSC NUMBER AND DSA NUMBER.

Professional stamps and seals, including the State of California seal and the Modtech Inc. seal. The stamps include the following information:

- IDENTIFICATION STAMP, DIV. OF THE STATE ARCHITECT, OFFICE OF REGULATION SERVICES
- 02 103677
- AC 10/23/2004
- DATE 10/23/2004
- 04 103216
- AC 10/23/2004
- DATE 10/23/2004
- 02 103169
- AC 10/23/2004
- DATE 10/23/2004
- 04 103190
- AC 10/23/2004
- DATE 10/23/2004

PROJECT NO. 200019.31 BSH PROJECT NO. 200019.31

REVISIONS	
1	CLARIFY OVERLAYS
2	
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Electrical Engineer's Seal	Mechanical Engineer's Seal	Architect's Seal	PC 1998
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MODTECH INC.
2830 BARRETT AVENUE
PERRIS, CALIF. 92572
PH (909) 943-4014
FAX (909) 940-0427

PROJECT NUMBER: © MODTECH, INC. 1999

DRAWN BY: J. J. J. J.
CHECKED BY: S. S.
DATE: 10/22/2023

AGENCY APPROVAL DSA# 02-121945 19-50

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DIV. OF THE STATE ARCHITECT
APP: 02-121945 INC.
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1305 E. Vine St
Lodi, CA 95240


MILLSWOOD MIDDLE SCHOOL PORTABLES RELOCATION
233 N Mills Ave
Lodi, CA 95242

SHEET TITLE
FLOOR PLAN 24'X40

DRAWN BY: XXXXXX JOB NUMBER: 23219

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A1.0
DATE: DECEMBER 5, 2023

CONSTRUCTION DOCUMENTS

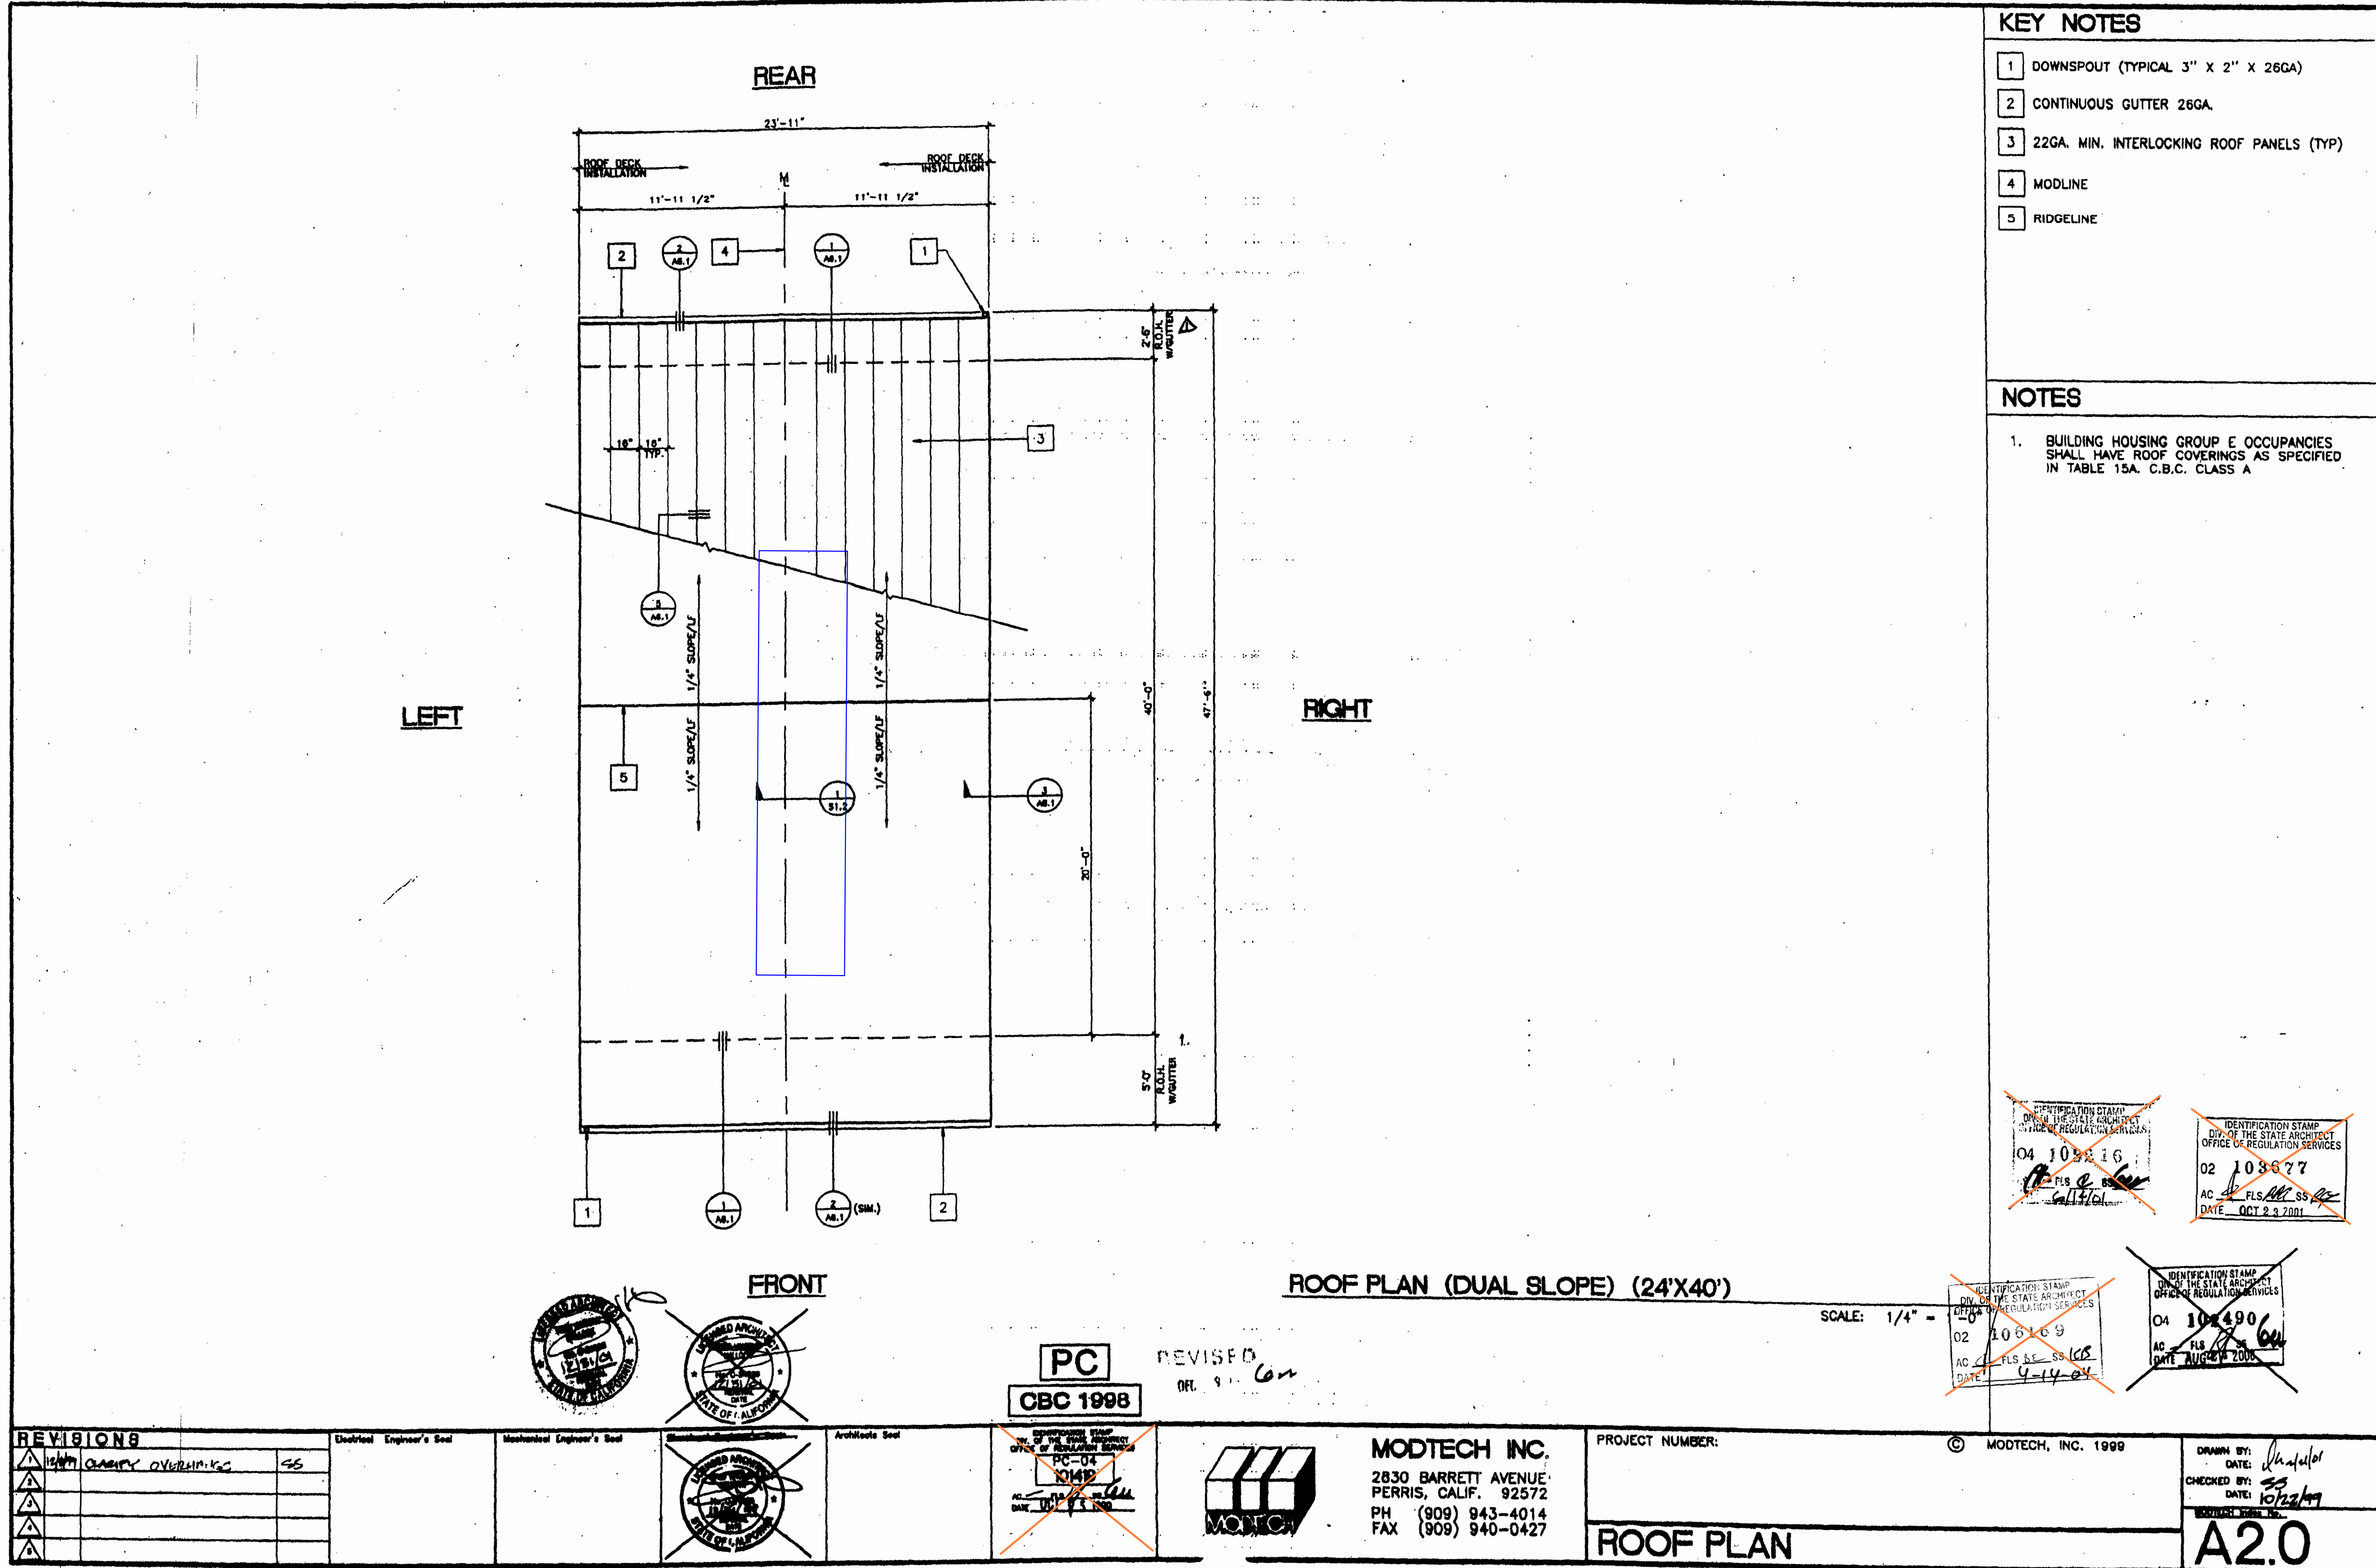

AGENCY APPROVAL

DSAE

02-121945

12-12-2023

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DIV. OF THE STATE ARCHITECT

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LODI UNIFIED SCHOOL DISTRICT

1305 E. Vine St

Lodi, CA 95240

MILLSWOOD MIDDLE SCHOOL

PORTABLES RELOCATION

233 N Mills Ave

Lodi, CA 95242

SHEET TITLE

ROOF PLAN (DUAL PITCH) 24'X40'

DRAWN BY: XXXXXX


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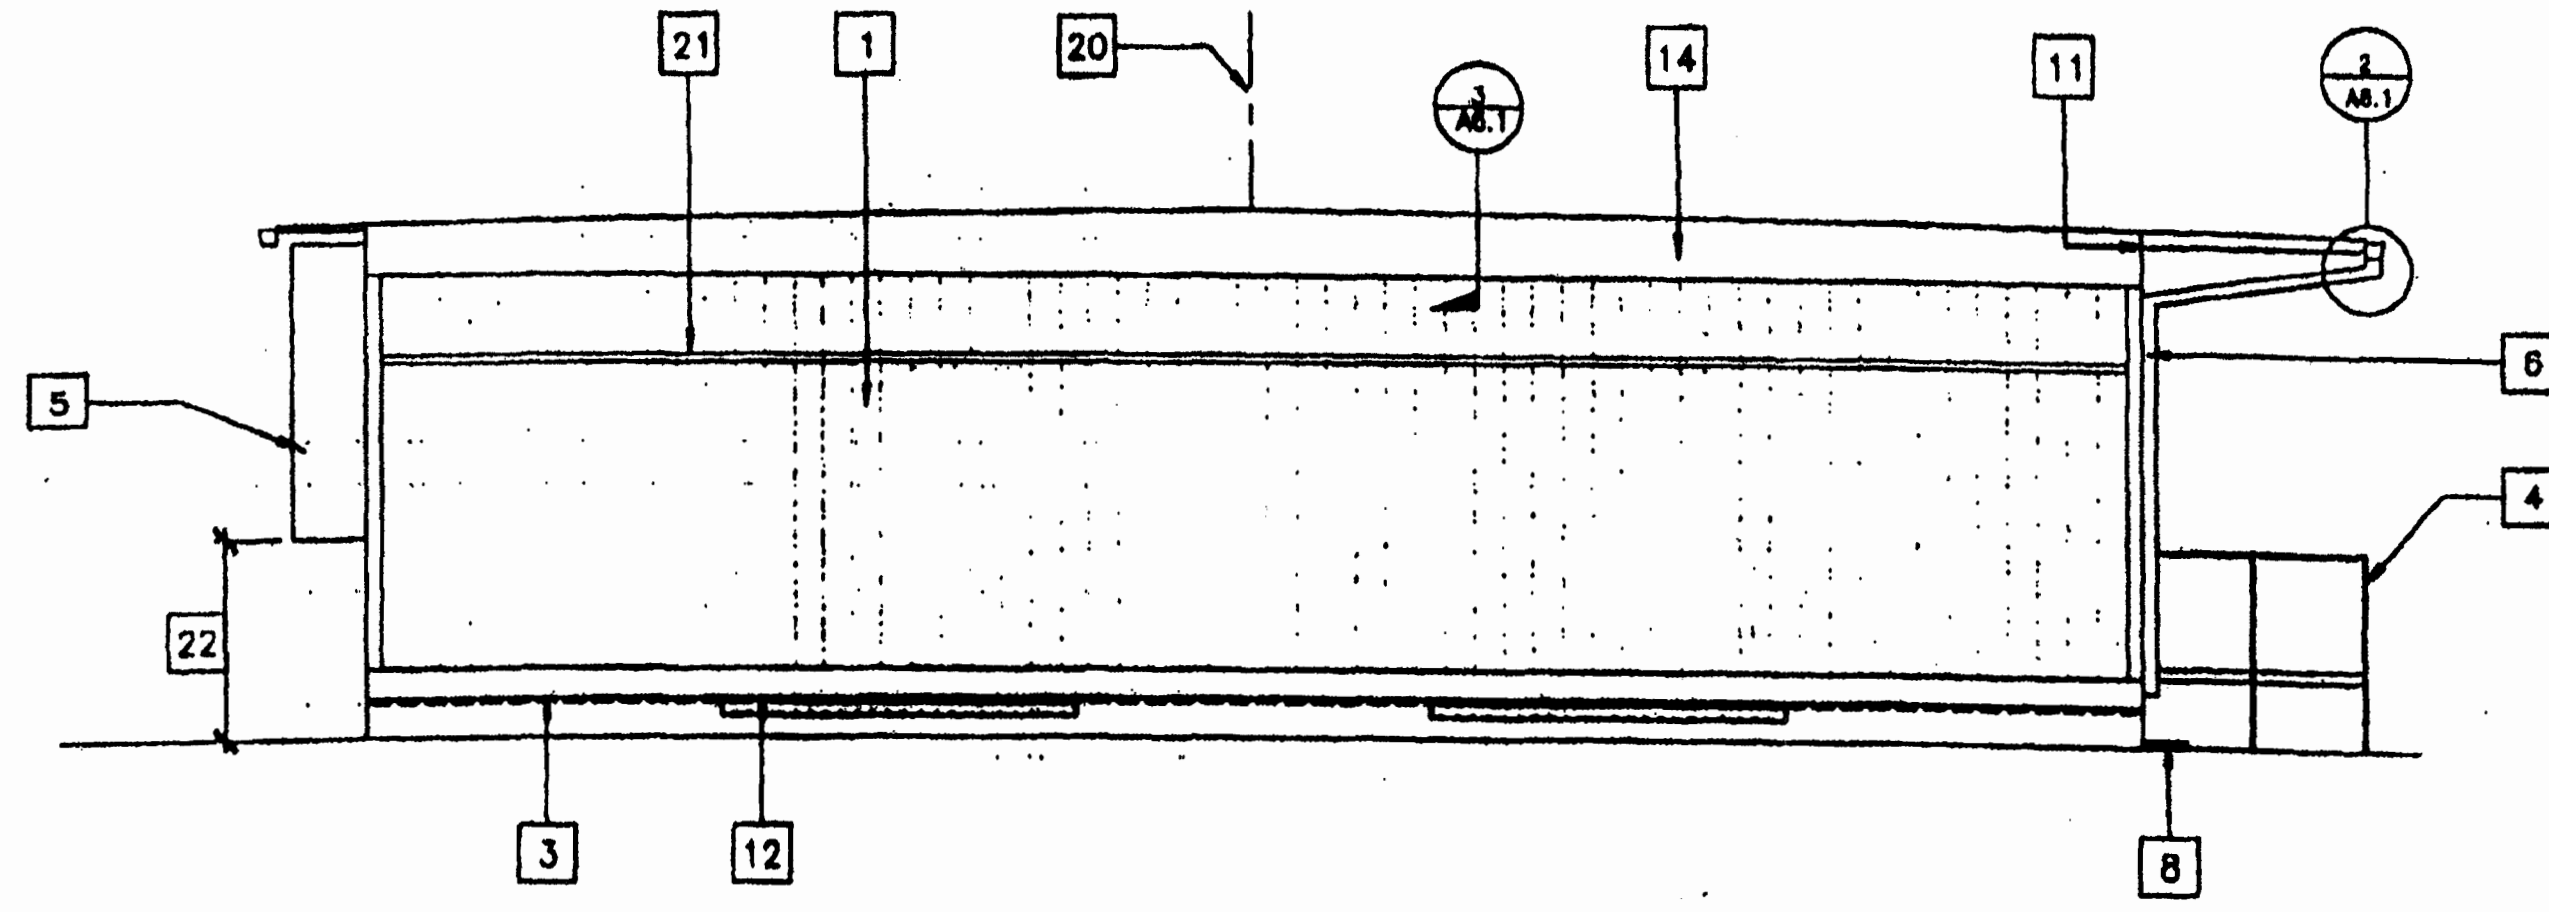
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DATE: DECEMBER 5, 2023


CONSTRUCTION DOCUMENTS




1 FRONT ELEVATION 1/4" = 1'-0"

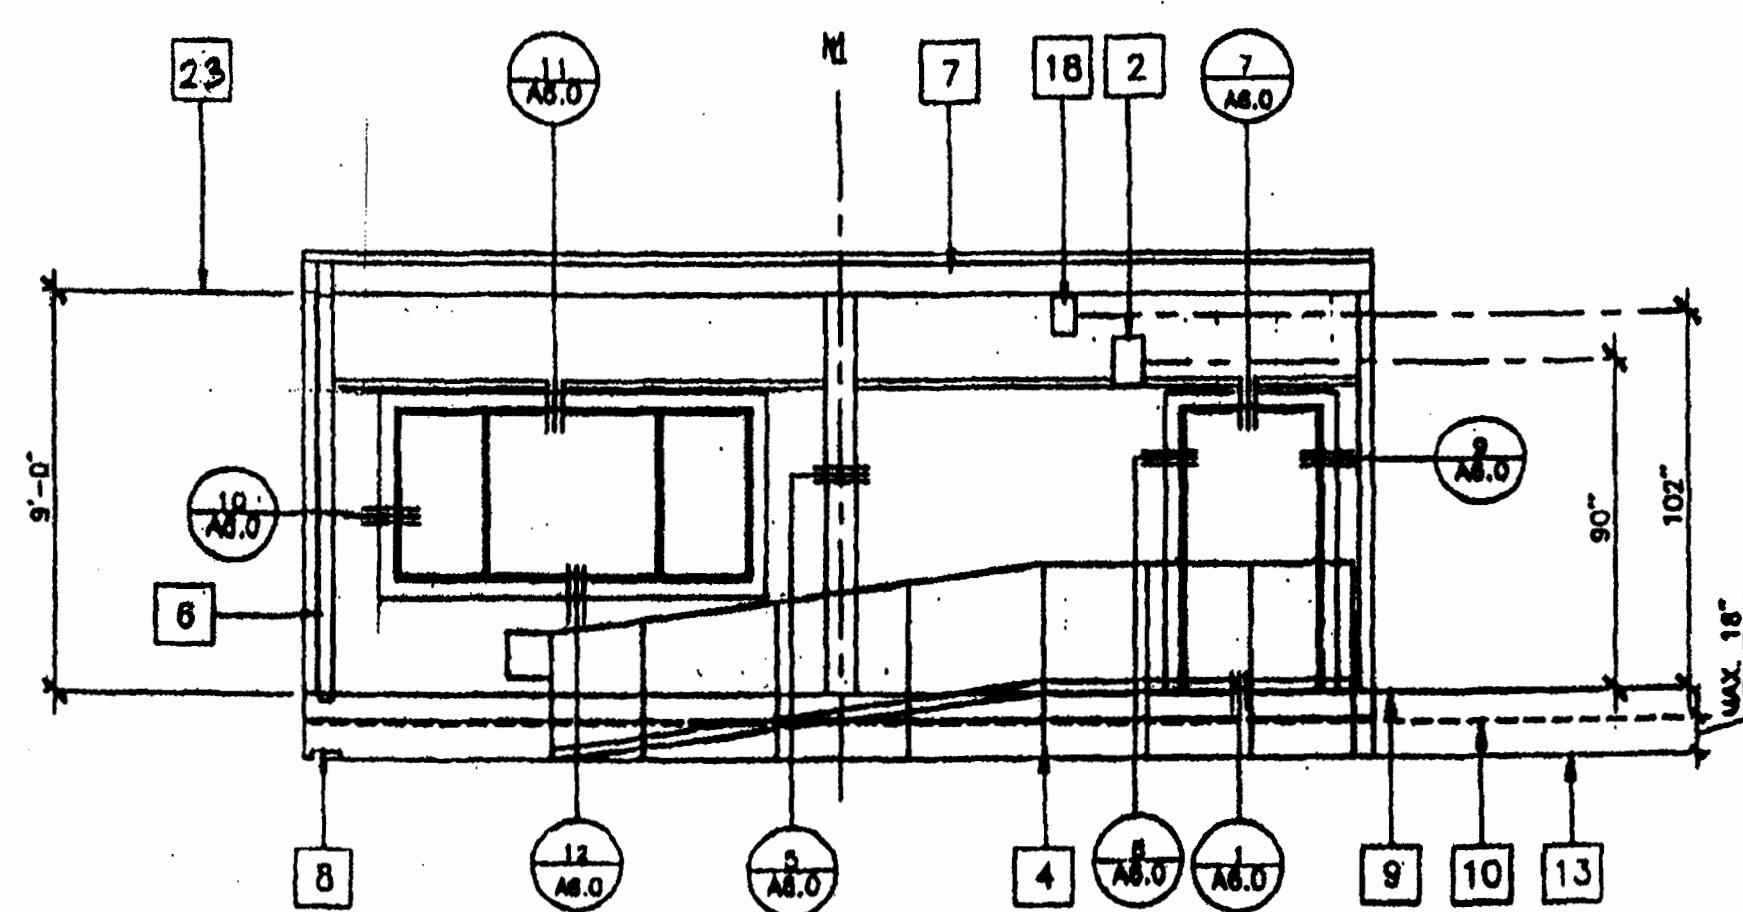

2 LEFT ELEVATION 1/4" = 1'-0"

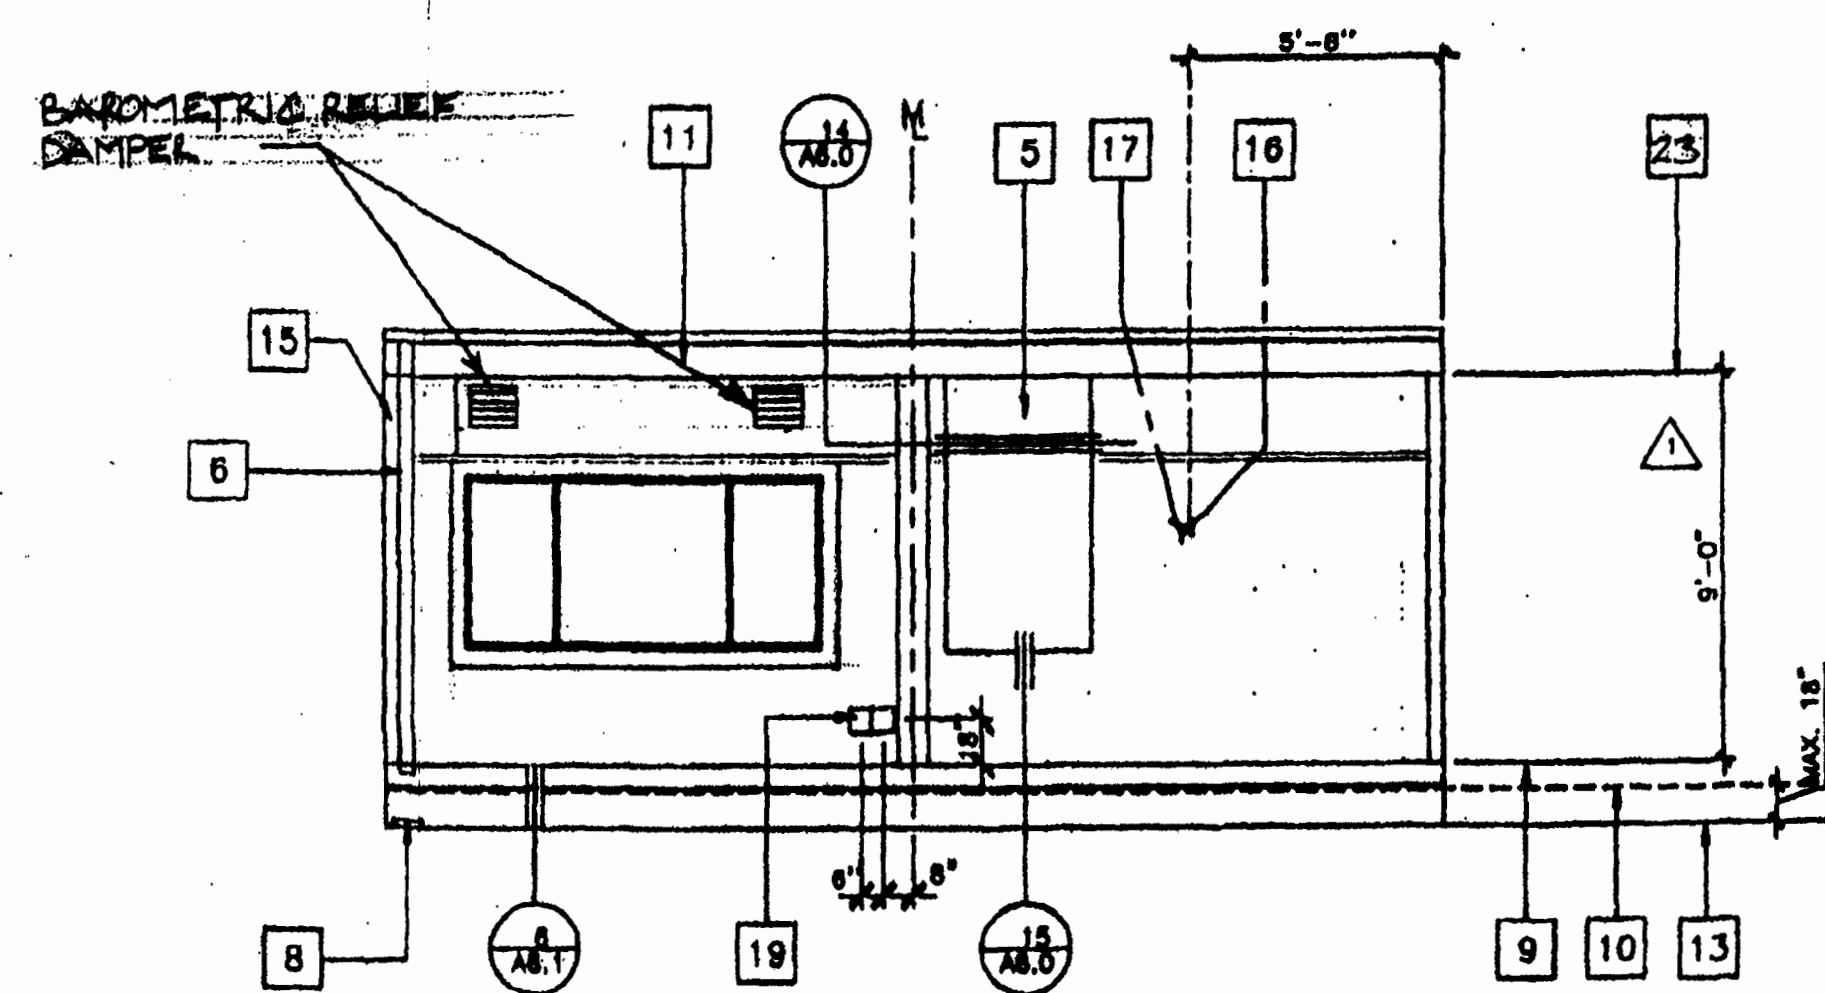

3 REAR ELEVATION 1/4" = 1'-0"

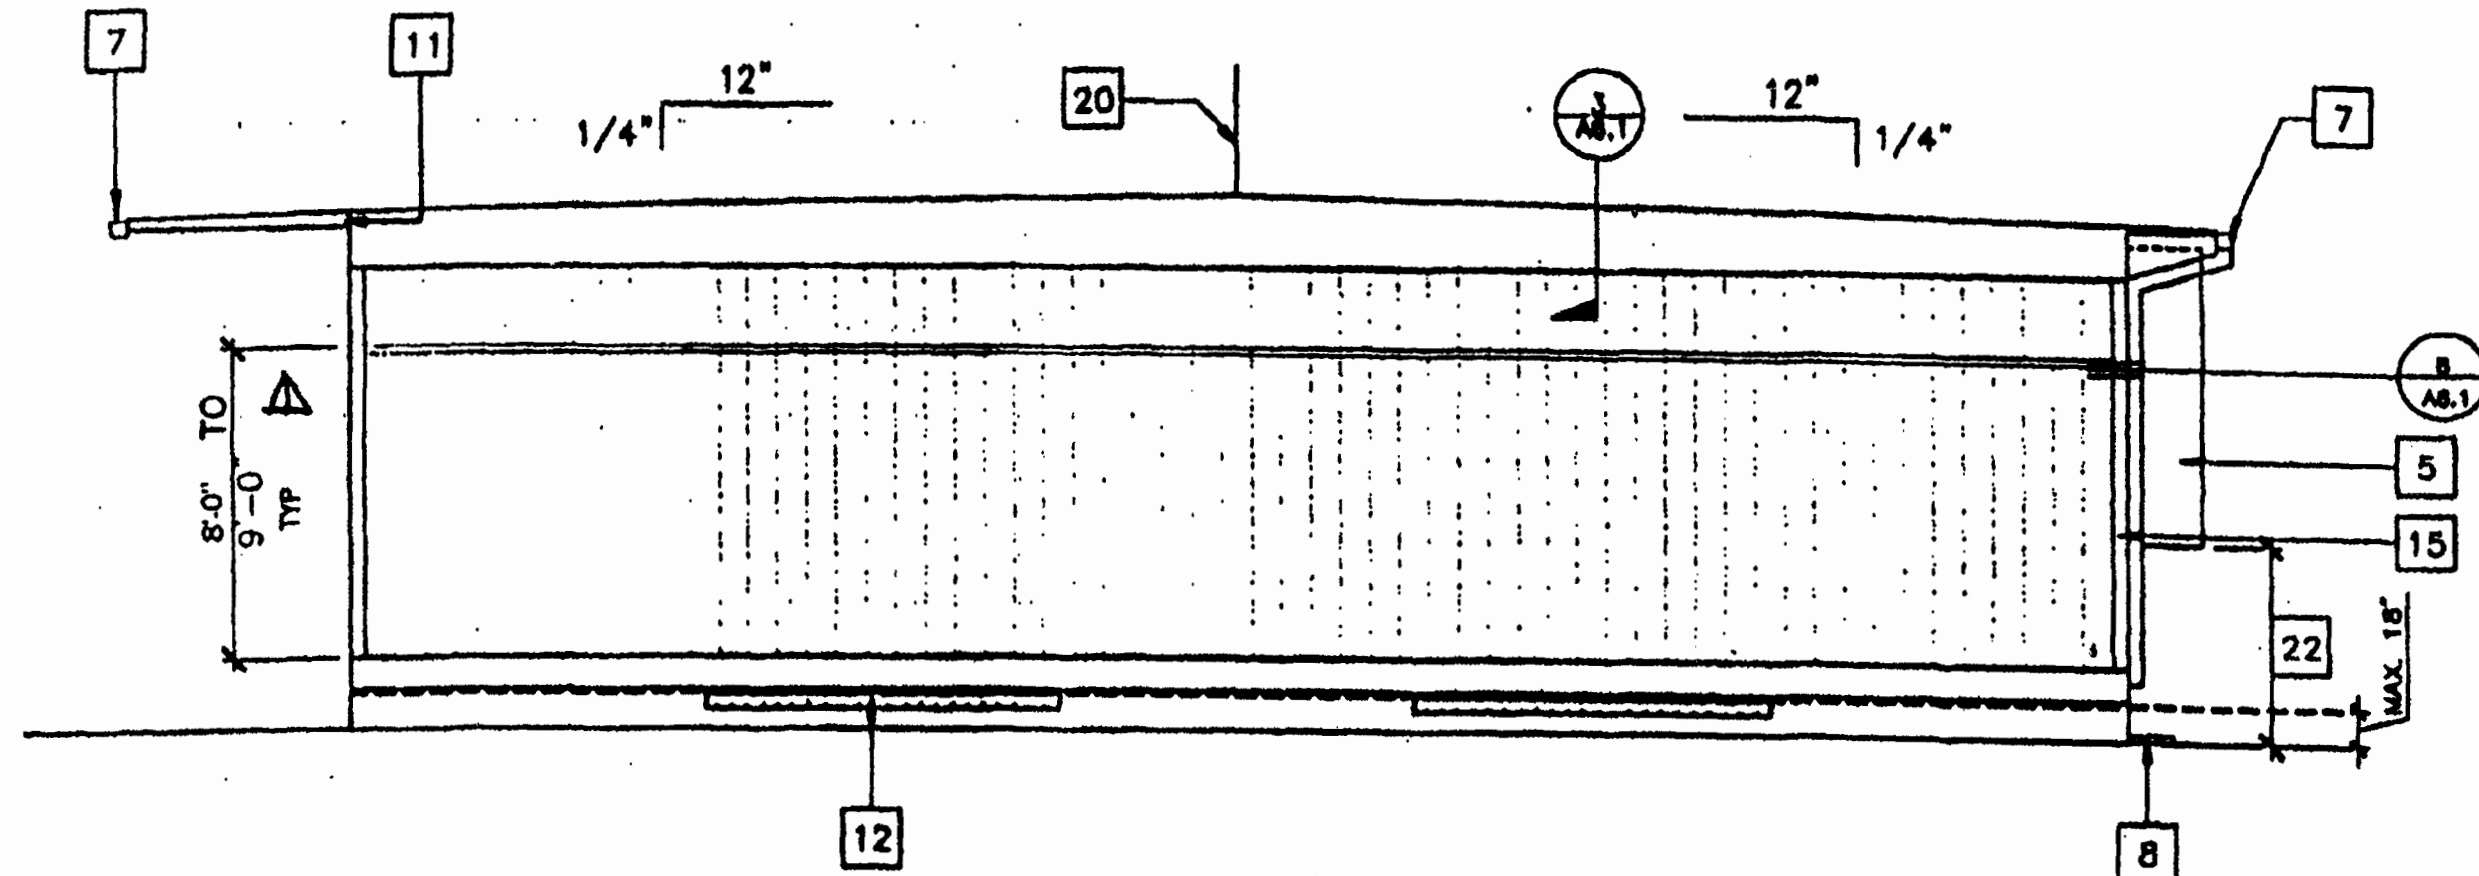

4 RIGHT ELEVATION 1/4" = 1'-0"


'A' = SHOWN
'B' = OPPOSITE

KEY NOTES

- 1 TYPICAL EXTERIOR SIDING (SEE A5.0)
- 2 EXTERIOR LIGHT FIXTURE (SEE SPEC'S)
- 3 TOP OF SKIRTING
- 4 RAMP AND LANDING SEE SHT. R-1
- 5 HVAC UNIT. SEE (H)
- 6 DOWNSPOUT (TYP.) FOR (2). FASTEN TO BLD'G. TYP 3 PLACES (SEE 6/A6.1)
- 7 CONTINUOUS GUTTER WITH DOWNSPOUT (LOCATION OF DOWNSPOUT SHOWN ON ROOF PLAN) SEE A2.
- 8 SPLASH BLOCK (BY OTHERS)
- 9 FINISH FLOOR LINE
- 10 BOTTOM FLANGE OF FLOOR BEAM
- 11 ROOF HEADER
- 12 VENT. SEE FOUNDATION PLAN
- 13 FINISH GRADE
- 14 ROOF BEAM SEE (B)
- 15 COLUMN SEE (B)
- 16 ELECTRICAL STUB-OUT SEE (E)
- 17 GROUND STUB-OUT SEE (E)
- 18 J BOX FOR EXT. FA HORN SEE (E)
- 19 NEMA 6" X 8" GUTTER BOX SEE (E)
- 20 RIDGE
- 21 G I Z FLASHING
- 22 IF HVAC UNIT IS LOCATED IN ANY PATH OF TRAVEL OR CIRCULATION AREA AND HEIGHT FROM GRADE TO BOTTOM OF UNIT EXCEEDS 27" THEN PROTECTION MUST BE PROVIDED.
- 23 TOP OF COLUMN

NOTES

1. SEE FOUNDATION PLAN FOR SIZE AND LOCATION OF UNDER FLOOR VENTS.

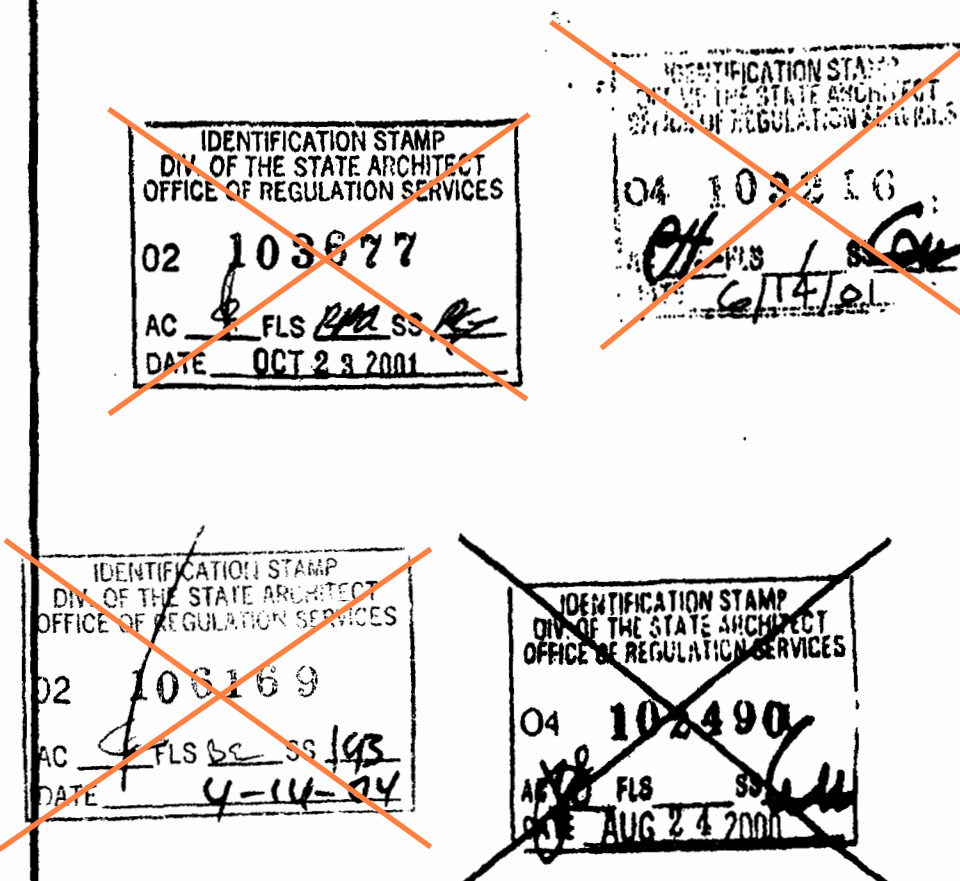

REVISIONS

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Dist'd Engineer's Seal

Mechanical Engineer's Seal

Architectural Seal

Structural Seal

PC
CBC 1998



MODTECH INC.
2830 BARRETT AVENUE
PERRIS, CALIF. 92572
PH (909) 943-4014
FAX (909) 940-0427

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CHECKED BY: *ss*
DATE: 11/22/23

EXTERIOR ELEVATIONS W/O FASCIA

A3.01

IDENTIFICATION STAMP
DIV. OF THE STATE ARCHITECT
APP: 02-121945 INC.
REVIEWED FOR
SS ☒ FLS ☒ ACS ☒
DATE: 12/12/2023

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PROJECT OWNER & TITLE
LODI UNIFIED SCHOOL DISTRICT
1305 E. Vine St
Lodi, CA 95240

**MILLSWOOD MIDDLE SCHOOL
PORTABLES RELOCATION**
233 N Mills Ave
Lodi, CA 95242

SHEET TITLE


EXTERIOR ELEVATIONS (DUAL
PITCH) 24"X40" W/O FASCIA

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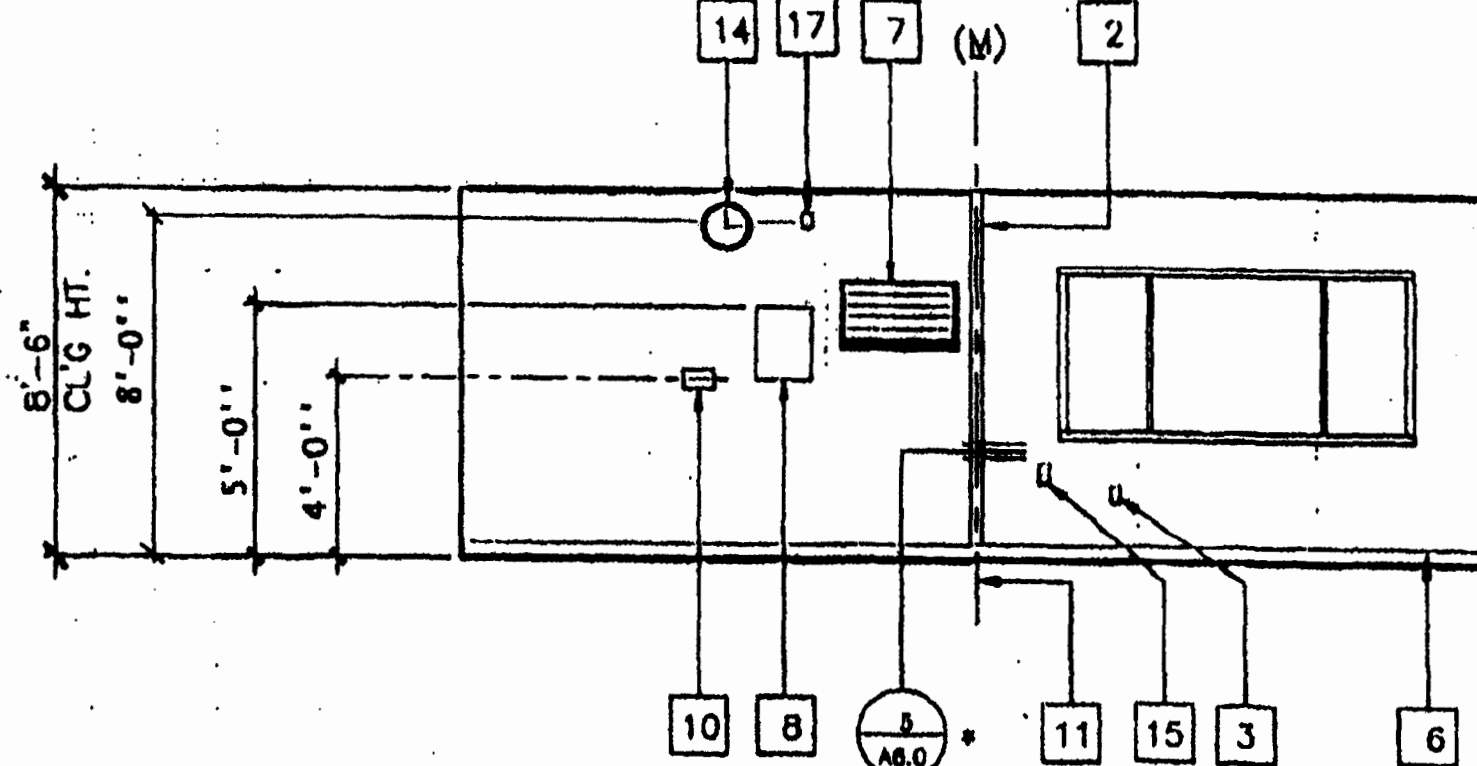
SHEET NO.

A3.01
DATE: DECEMBER 5, 2023


DATE PLOTTED: 11/28/2023 9:11:51 AM FILE LOCATION: C:\Users\lmmh\Documents\BIM\23219_LUSD_Millswood Middle School Portables Relocation_A22_bim\lmmh\A22.dwg

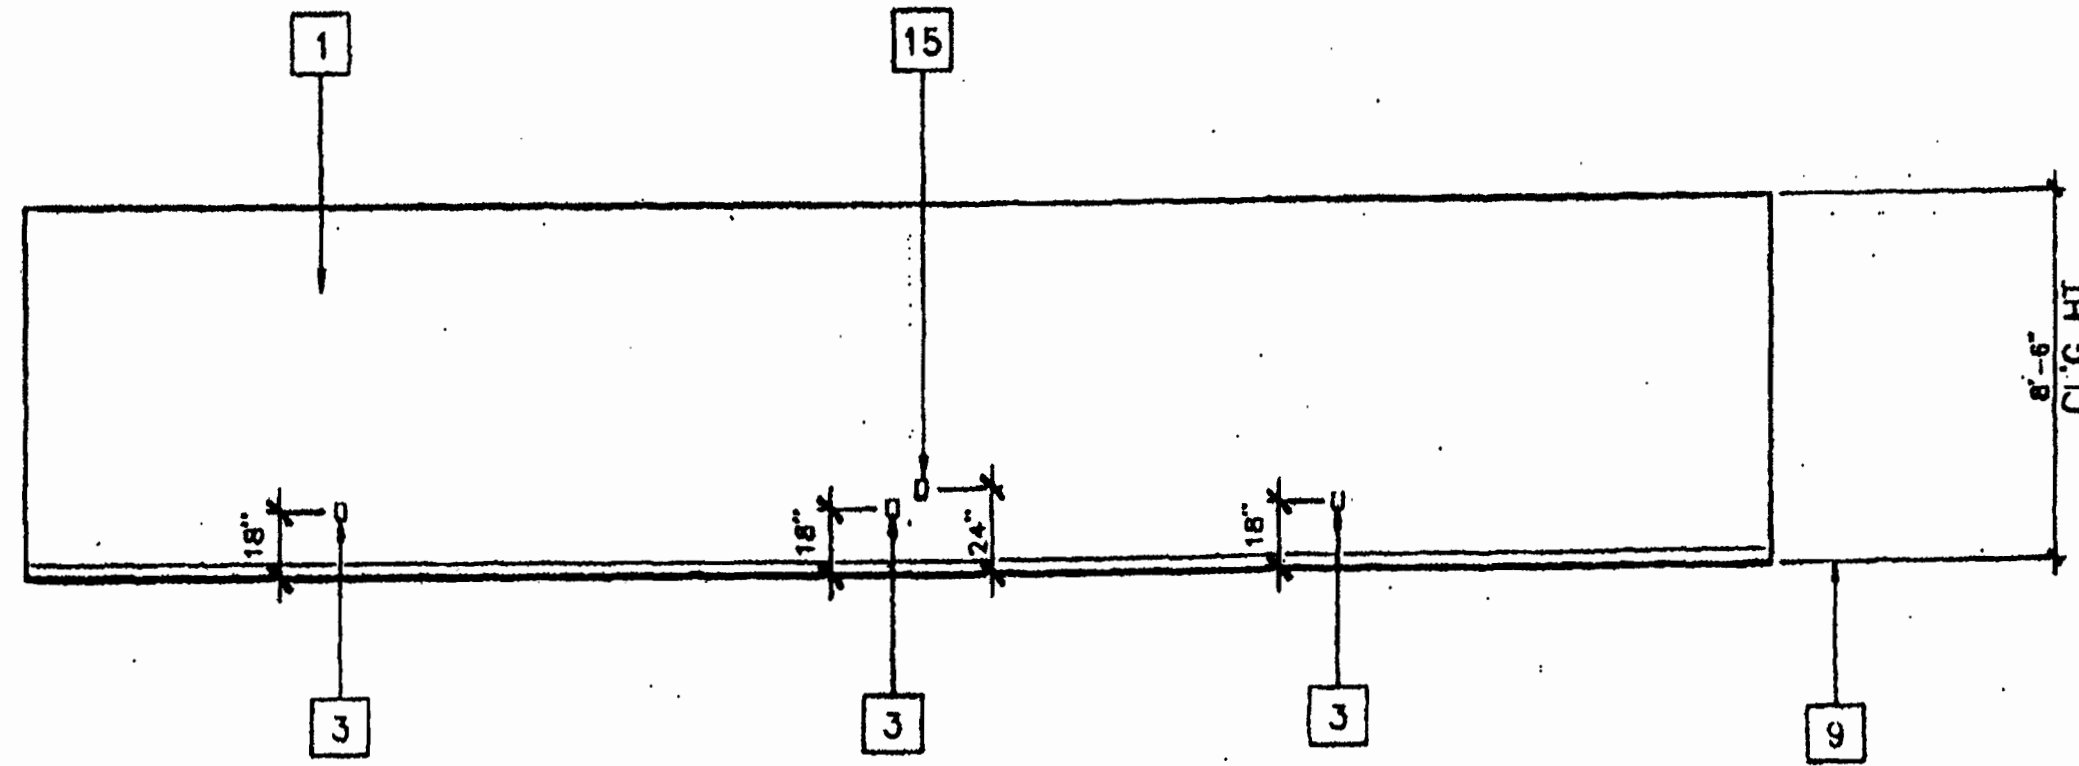


1 RIGHT ELEVATION



2 REAR ELEVATION

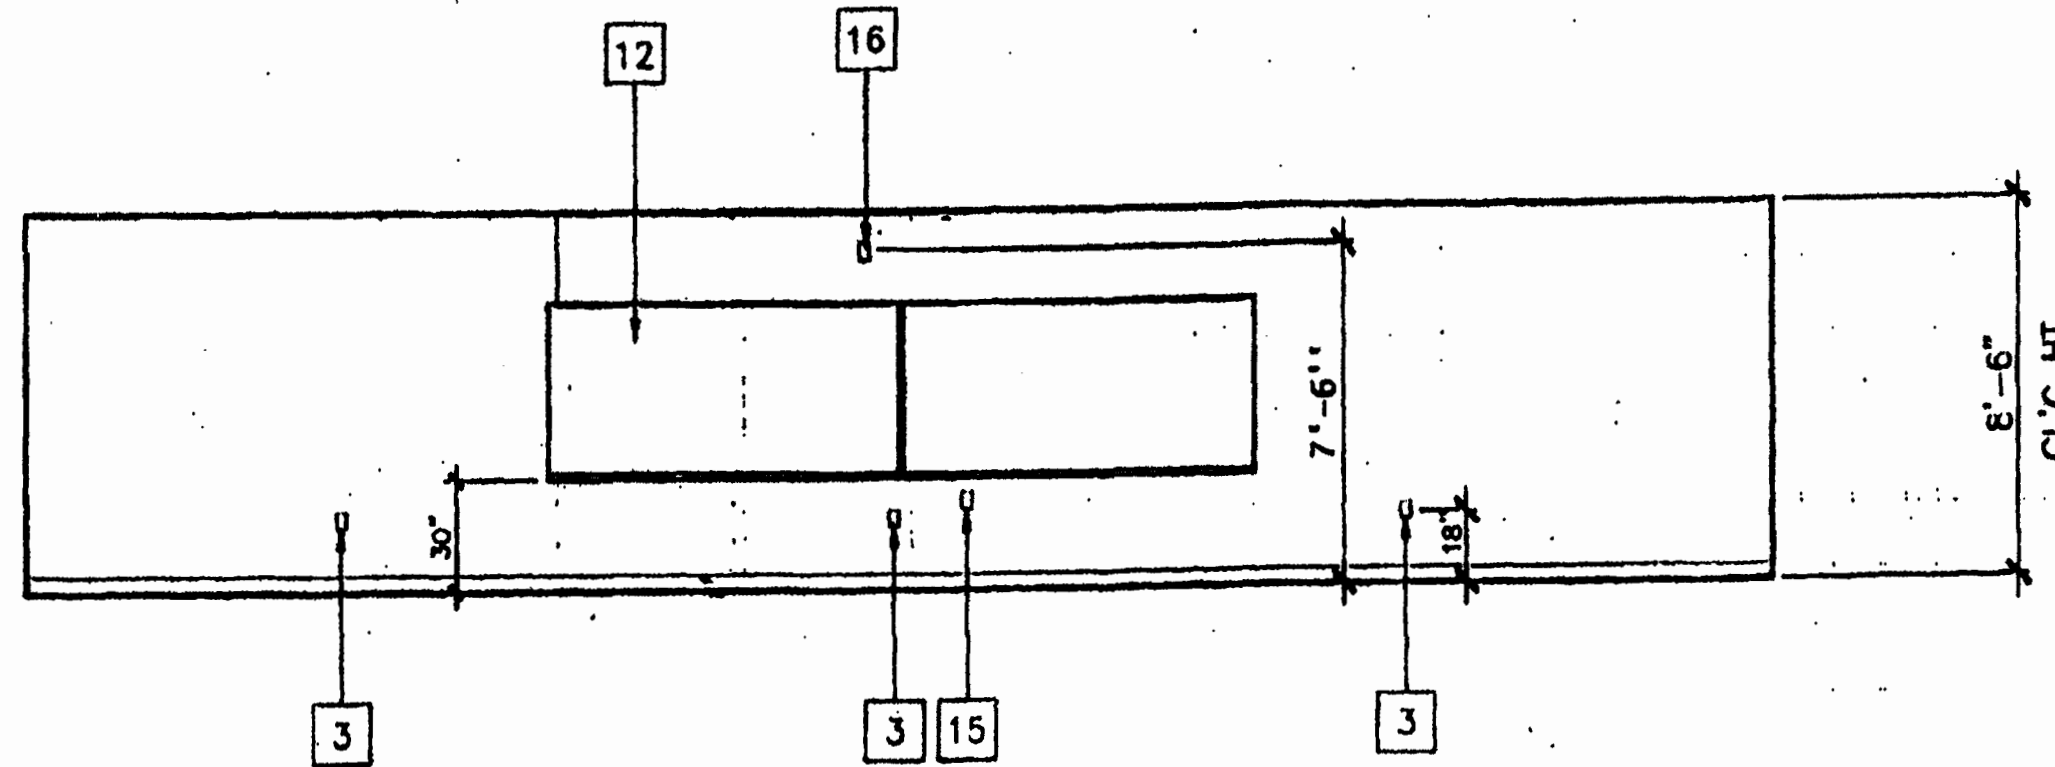

3 LEFT ELEVATION

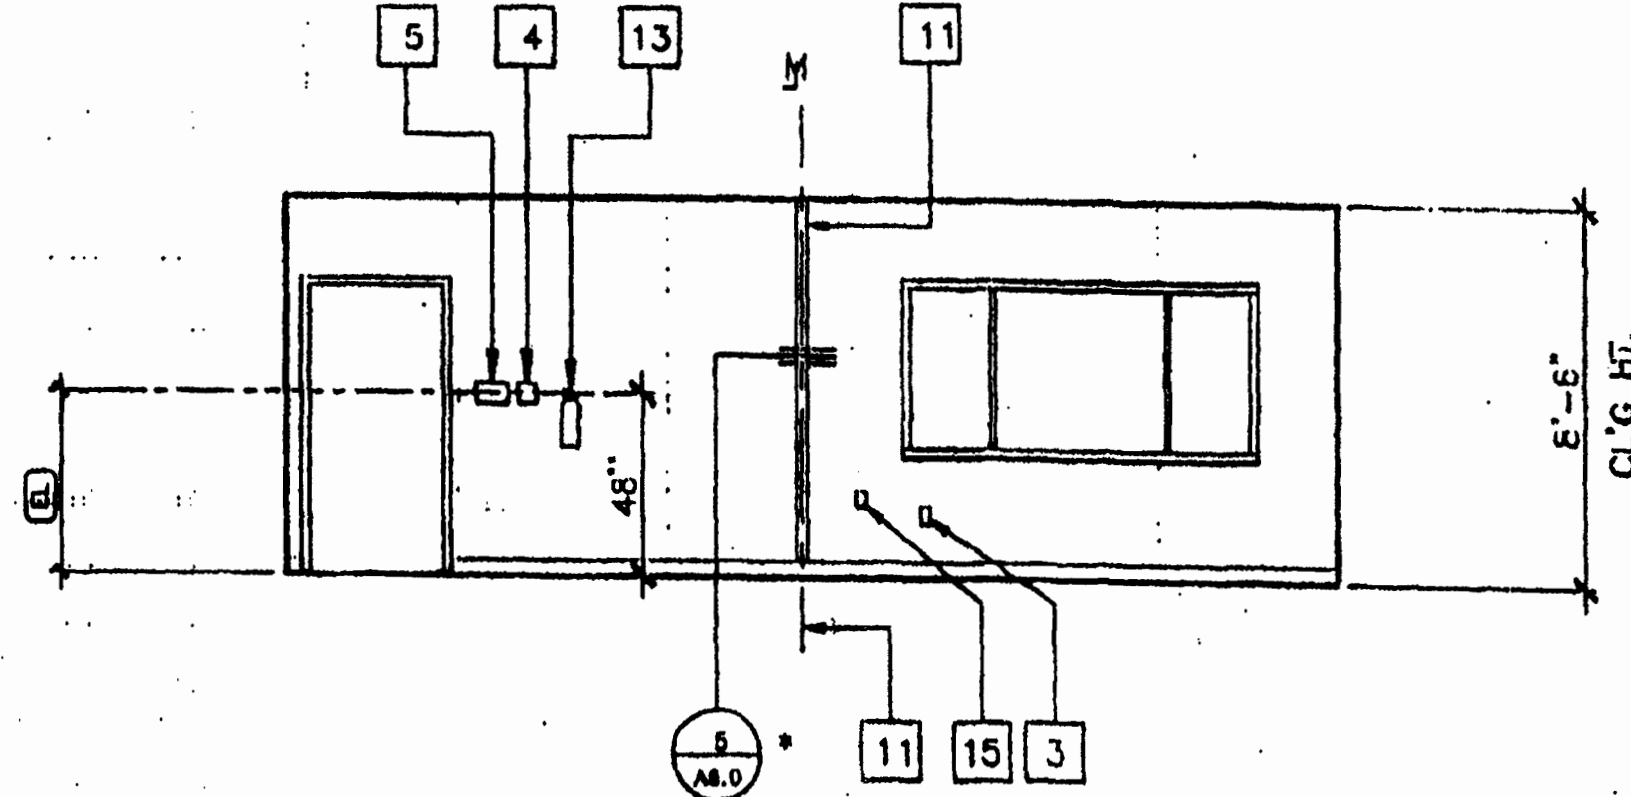

4 FRONT ELEVATION

A = SHOWN
B = OPPOSITE

INTERIOR ELEVATIONS
24' x 40'

SCALE 1/4"=1'-0"

REVISIONS

NO.	DATE	DESCRIPTION


Electrical Engineer's Seal

Mechanical Engineer's Seal

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MODTECH INC.
2830 BARRETT AVENUE
PERRIS, CALIF. 92572
PH (909) 943-4014
FAX (909) 940-0427

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DATE: 10/23/99
CHECKED BY: SS
DATE: 10/23/99

INTERIOR ELEVATIONS




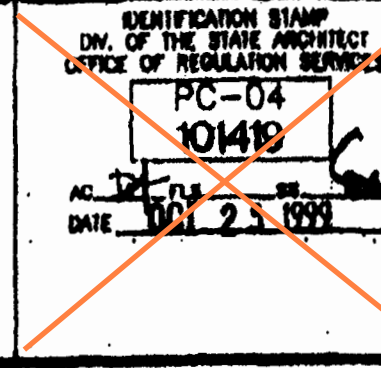
A4.0

KEY NOTES

- 1 TYPICAL INTERIOR FINISH (SEE A5.0)
- 2 CLOSURE AT MODULAR JOINT
- 3 FOURPLEX WALL RECEPTACLE SEE (EL)
- 4 J BOX FOR INT FA PULLSTATION SEE (EL)
- 5 LIGHT SWITCH SEE (EL)
- 6 TOP SET BASE (TYPICAL) SEE FINISH SCHED.
- 7 RETURN AIR GRILL SEE (HW)
- 8 ELECTRICAL PANEL SEE (EL)
- 9 LINE OF FINISH FLOOR
- 10 THERMOSTAT SEE (HW)
- 11 MODULAR JOINT
- 12 8040 MARKBOARD, TYPICAL FOR (2) SEE SPEC'S
- 13 FIRE EXTINGUISHER: 5LBS. DRY CHEMICAL WITH 2A-10BC U.L. RATING ON WALL MTD. BRACKET, HANDLE AT 48" A.F.F.
- 14 12" DIA. ELECTRIC CLOCK SEE (EL)
- 15 DATA J BOX SEE (EL)
- 16 INTRUSION ALARM J BOX SEE (EL) (OPTIONAL)
- 17 CO₂ SENSOR SEE (HW) (EL)

NOTES

1. FOR MOUNTING HEIGHTS SEE (EL)
2. *DETAIL 5/A6.0 FOR WOOD STUDS. SEE ALT. DET. 9/A6.0M FOR USE WITH METAL STUDS.

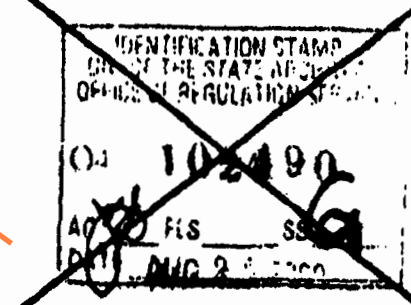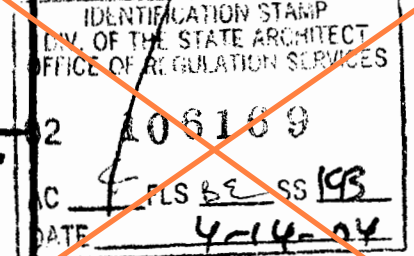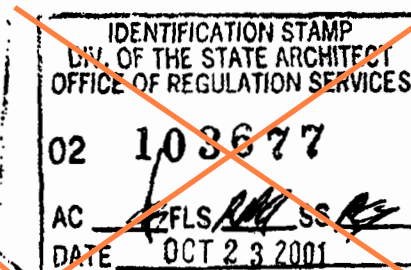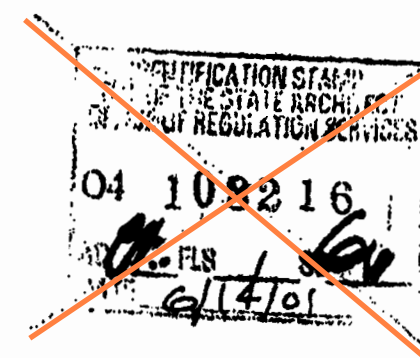

FILE PATH: 2440-0-A-0.DWG

PROJECT NO. 200019.31
BGH PROJECT NO. 200019.31

PROJECT NO. 2440-0

AGENCY APPROVAL DSA# 02-121945

IDENTIFICATION STAMP
DIV. OF THE STATE ARCHITECT
APP: 02-121945 INC.
REVIEWED FOR
SS ☒ FLS ☒ ACS ☒
DATE: 12/12/2023

PROFESSIONAL STAMP

REVISIONS

NO.	DATE	DESCRIPTION

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PROJECT OWNER & TITLE
LODI UNIFIED SCHOOL DISTRICT
1305 E. Vine St
Lodi, CA 95240

MILLSWOOD MIDDLE SCHOOL
PORTABLES RELOCATION
233 N Mills Ave
Lodi, CA 95242

SHEET TITLE

EXTERIOR ELEVATIONS 24'x40'


DRAWN BY: XXXXXX JOB NUMBER: 23219

SHEET NO.

A4.0

DATE: DECEMBER 5, 2023

CONSTRUCTION DOCUMENTS

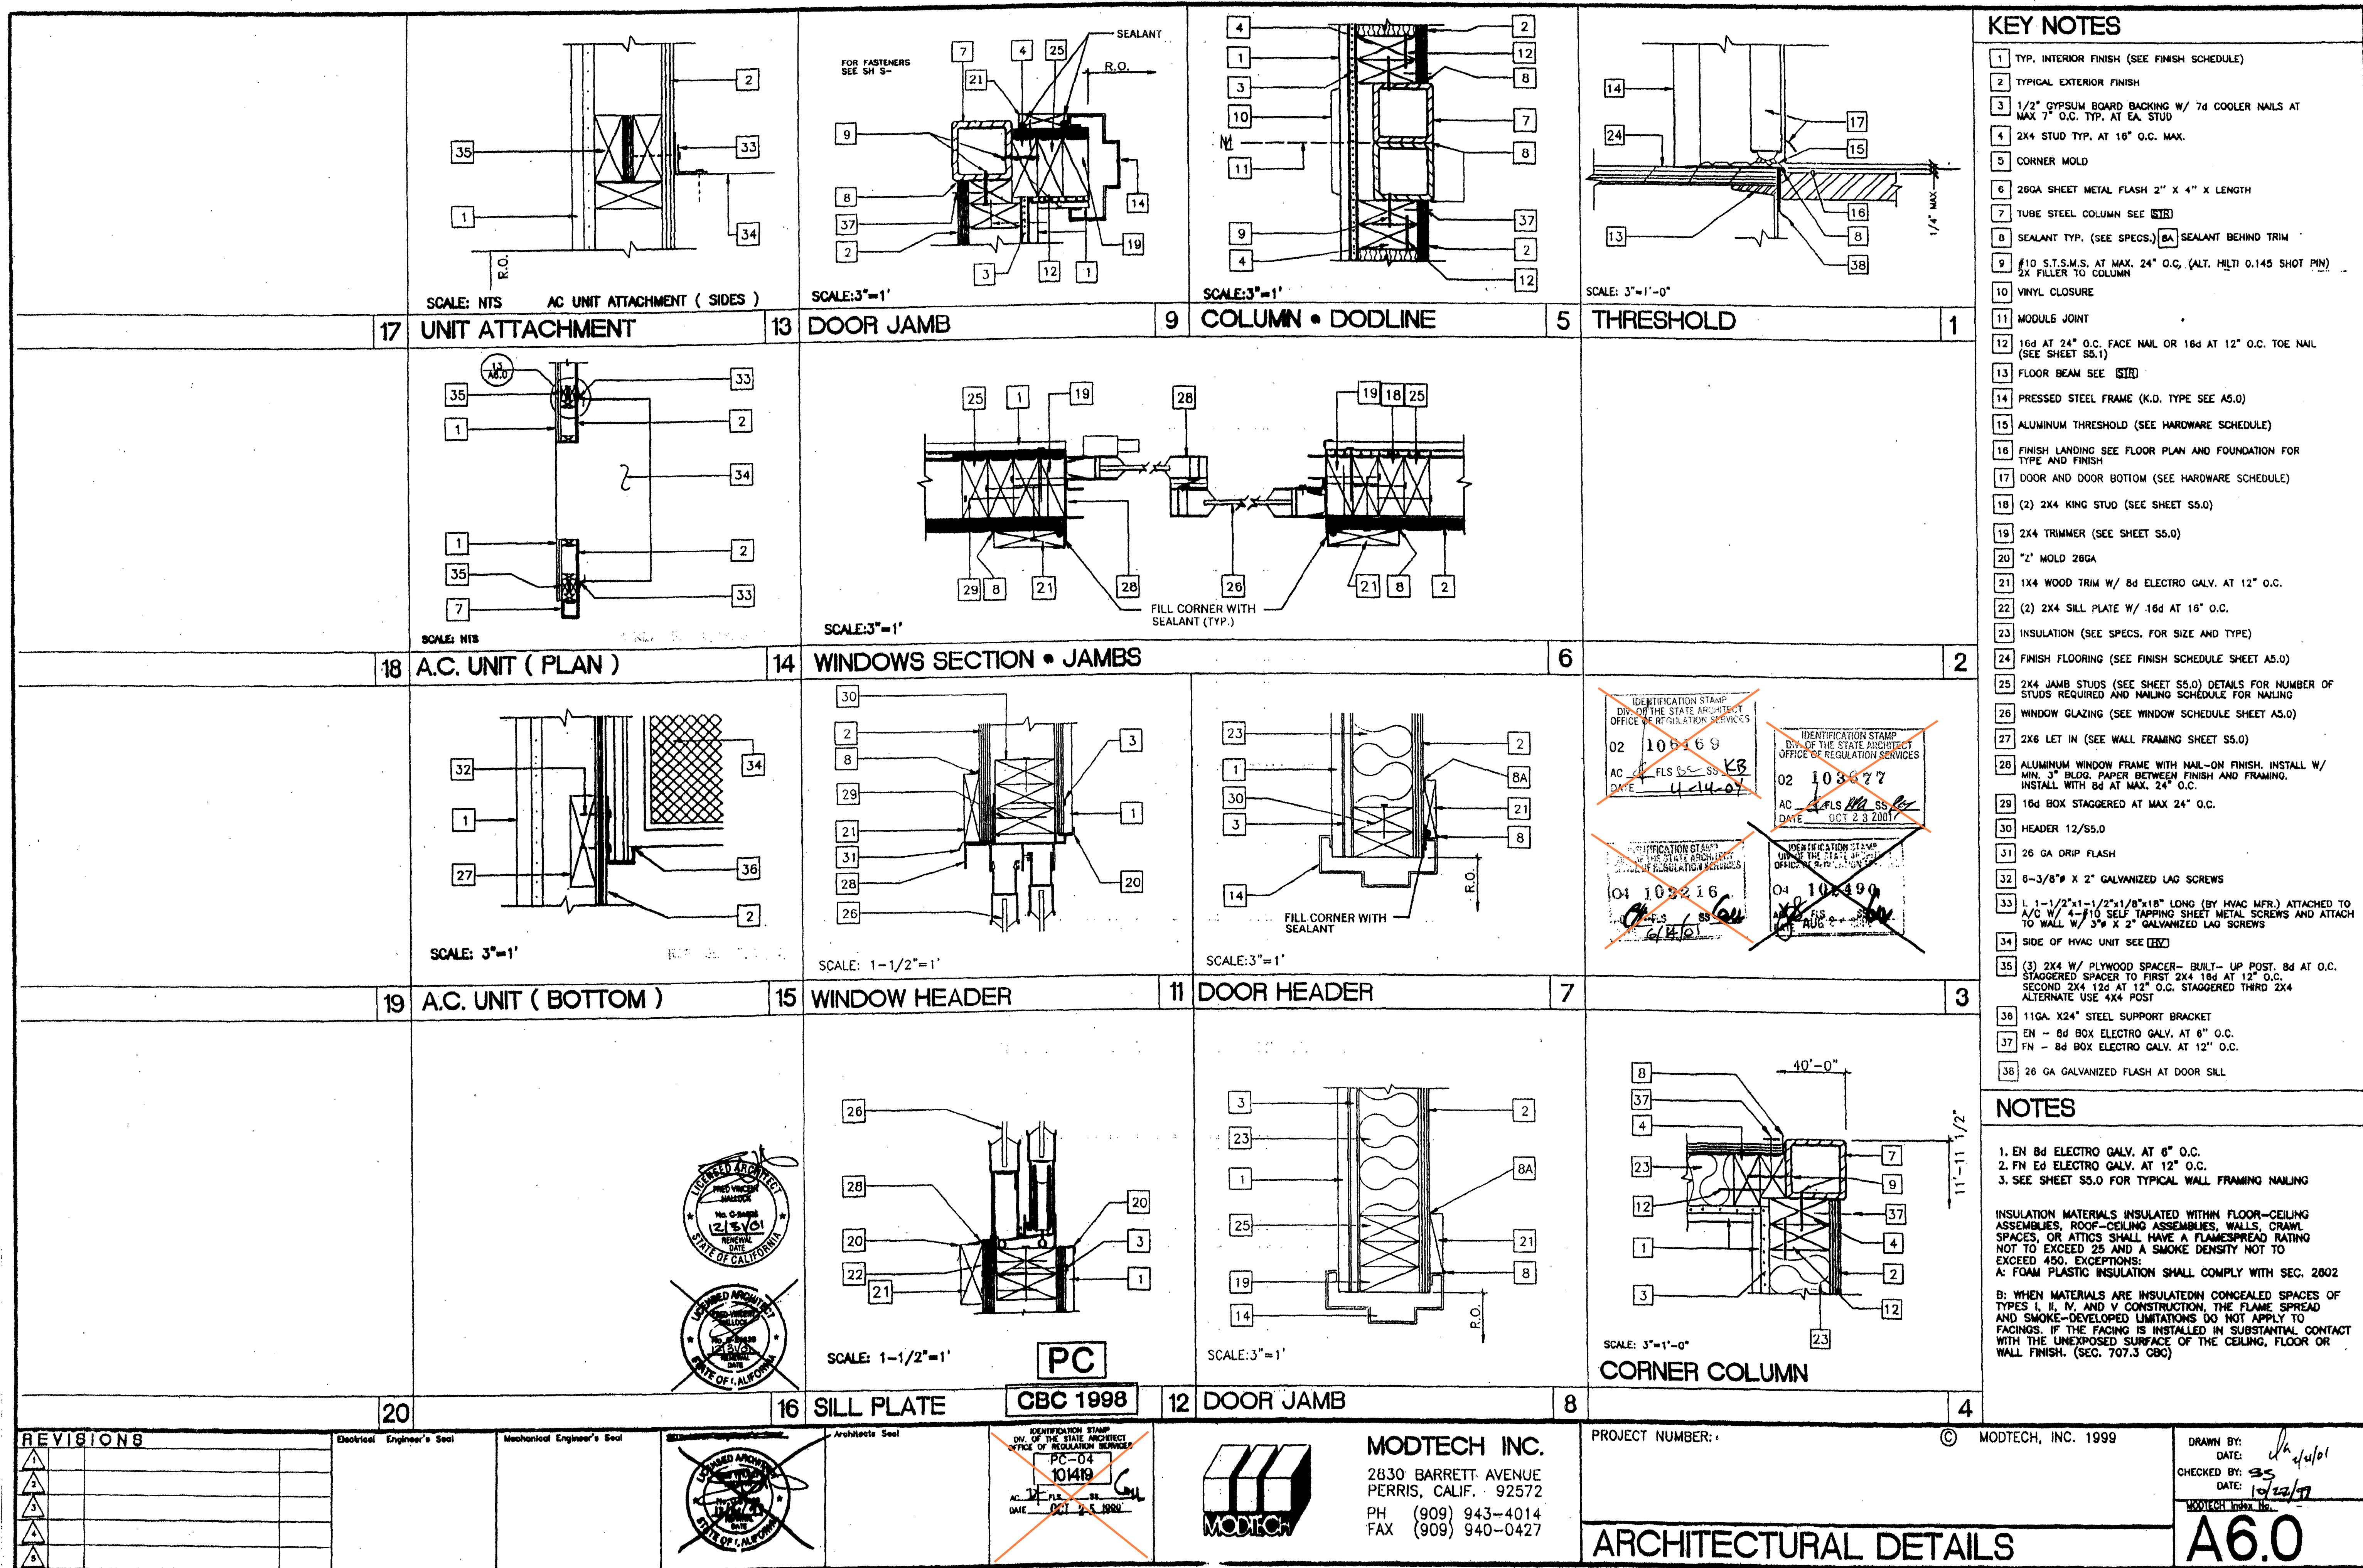


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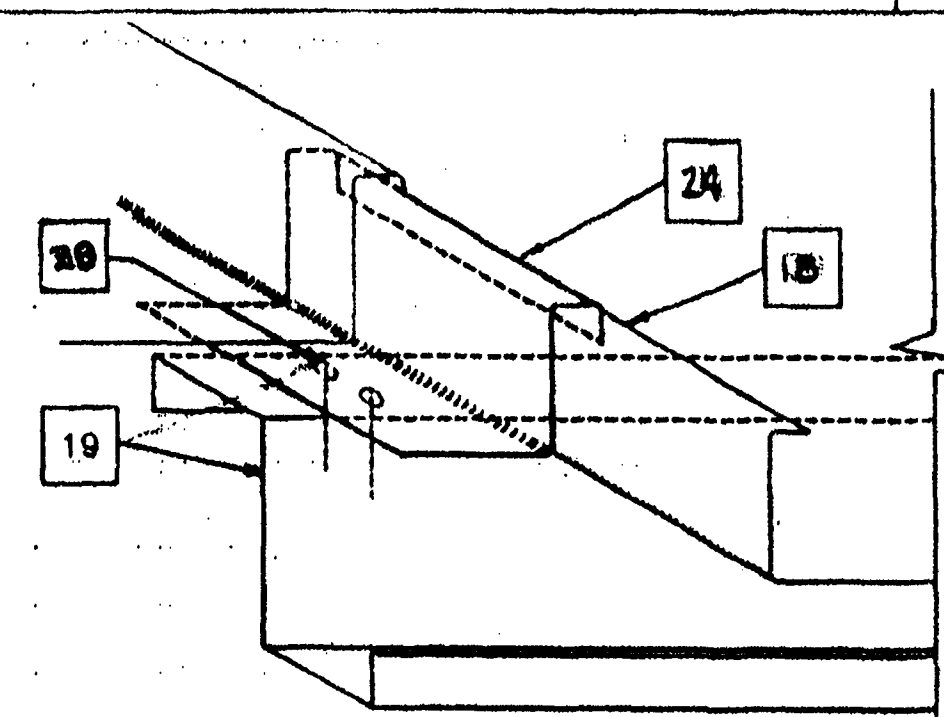
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SHEET NO.


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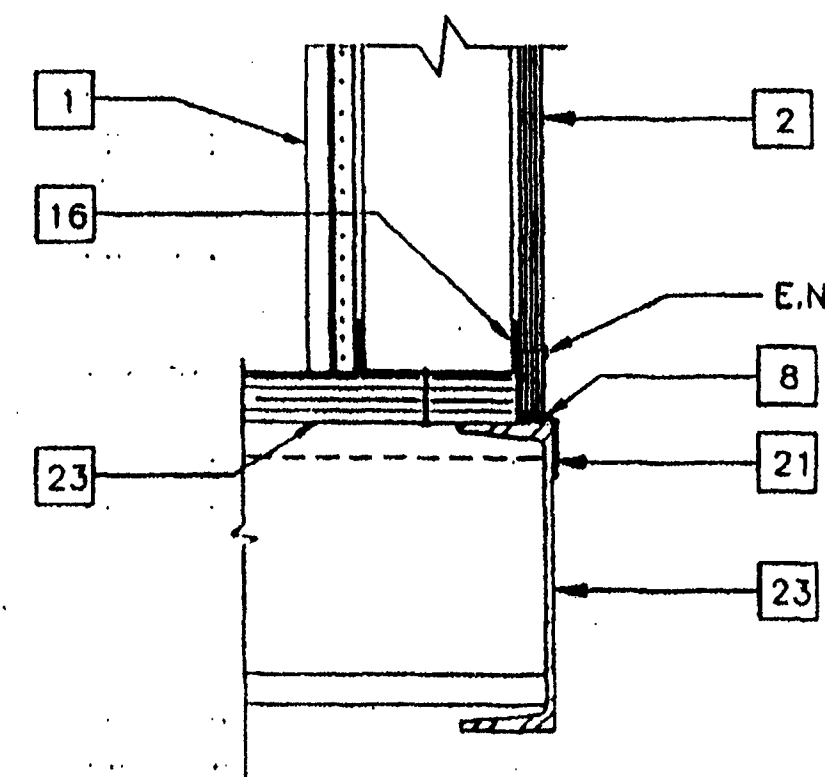
DOWNSPOUT ATTACHMENT




ROOF STANDING SEAM	△	5
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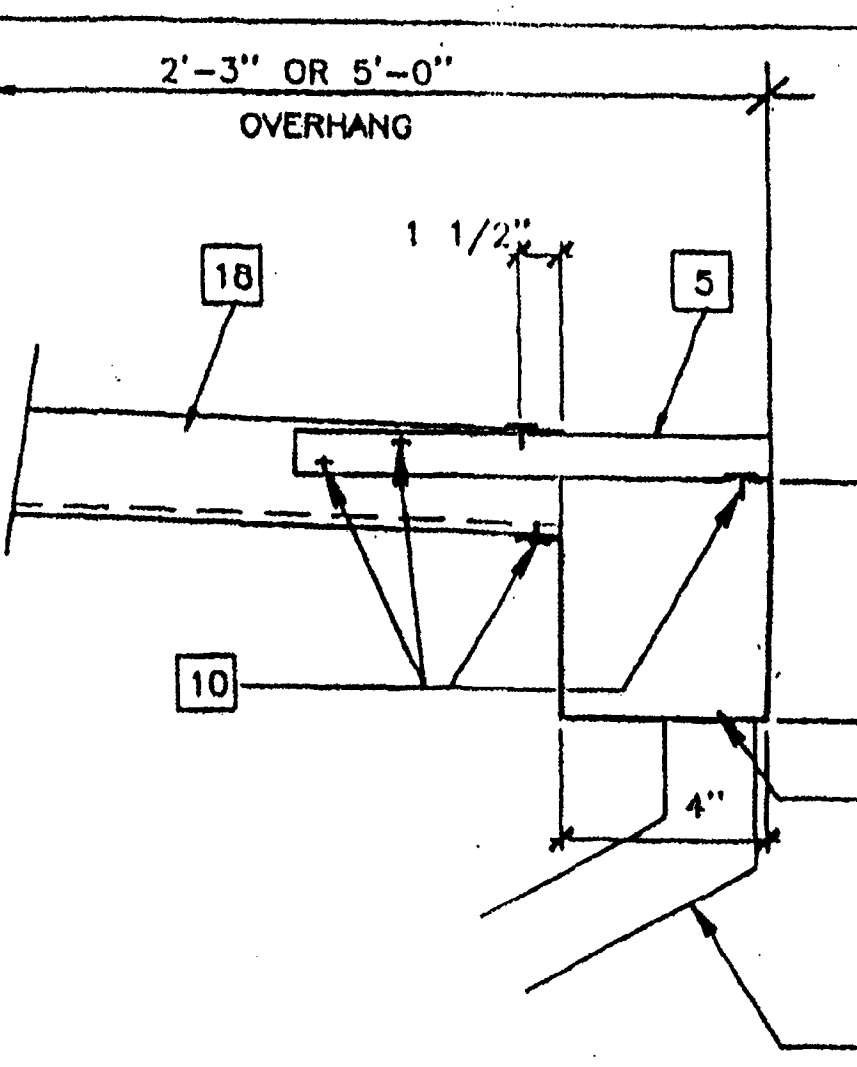
CONT. GUTTER/CLOSURE

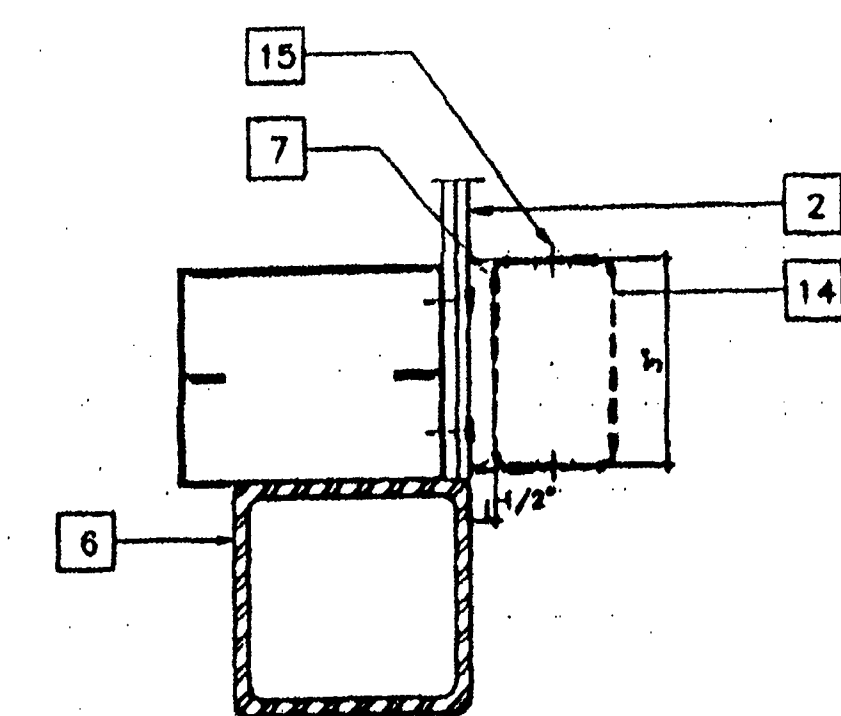


NOTE: FLASHING AS SHOWN SUPPLIED BY
MODTECH. SEE NOTE #21 ANY OTHER
FLASHING OR EXTENSION IS THE
RESPONSIBILITY OF THE SITE CONTRACTOR
OR SCHOOL DISTRICT

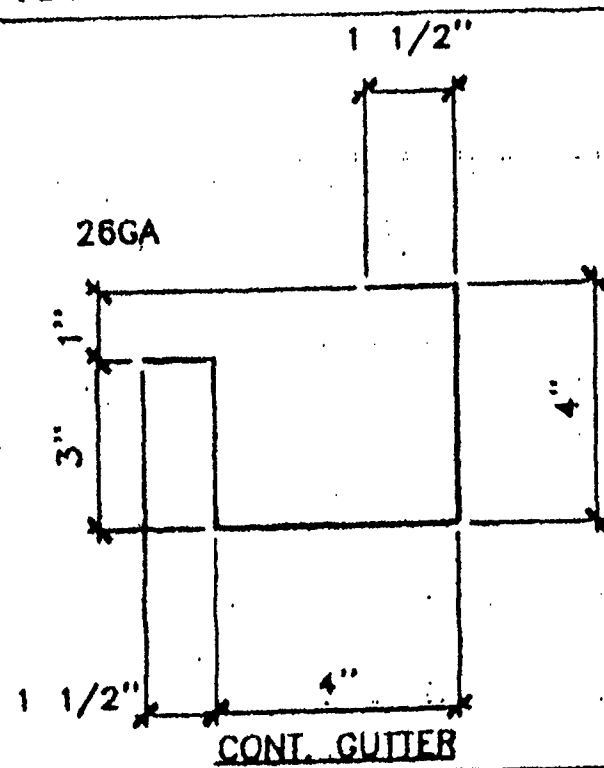

END WALL • ROOF

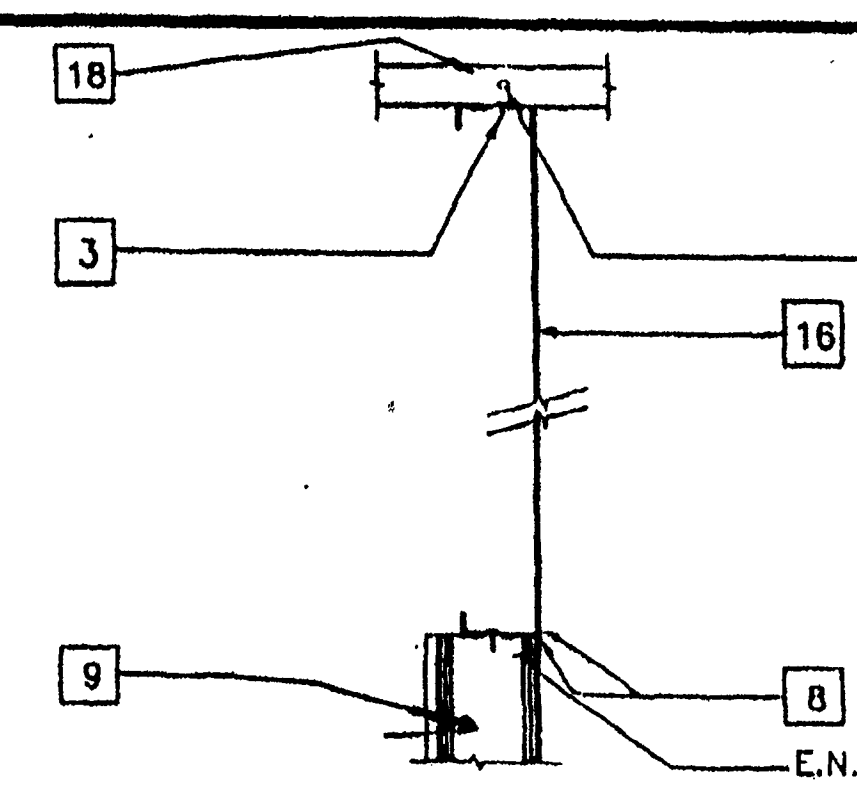

GUTTER • ROOF HEADER

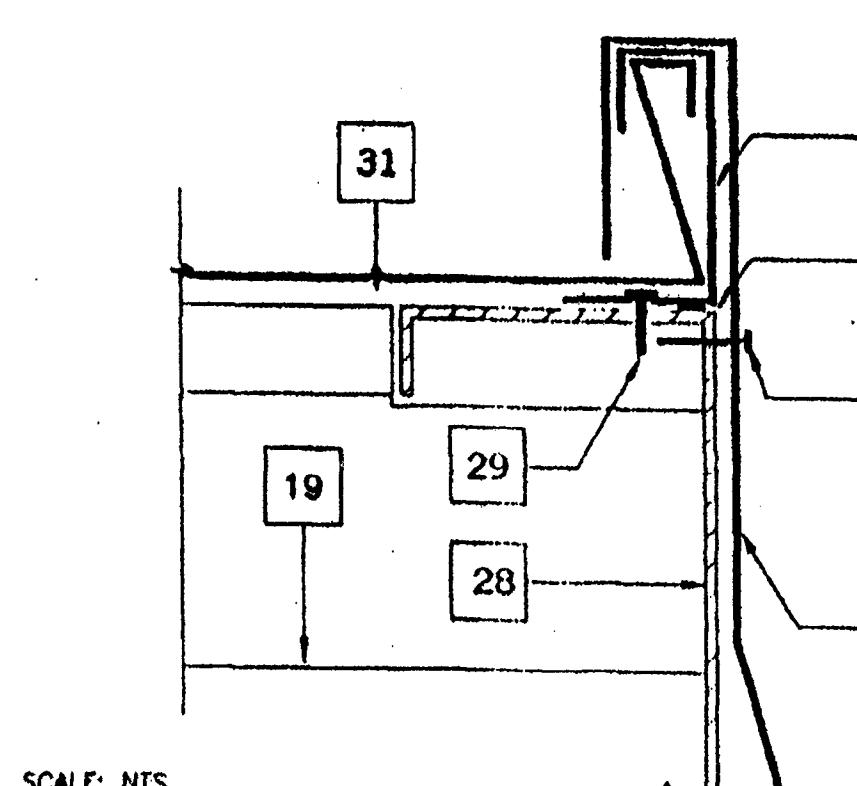

SCALE: NT:

KEY NOTES

- 1 TYP. INTERIOR FINISH (SEE FINISH SCHED.)
- 2 TYP. EXTERIOR FINISH
- 3 #14 STMS X 3/4" W/NEOPRENE WASHER 3 PER PAN MAX. 6" O.C.
- 4 20 GA X 3 1/2" MT'L STUD @ 16" O.C.
- 5 1 1/2X1 1/2X22GA L CLIP @ 32" O.C.
- 6 TUBE STEEL COLUMN (SEE STRUCTURAL)
- 7 ATTACHMENT BRACKET(TYP-3 PLACES/TOP, BOTTOM & MIDSPAN) W/2-#10 STMS. BRACKET TO STUD
- 8 SEALANT TYP. (SEE SPECIFICATIONS)
- 9 EXTERIOR WALL (SEE S5.2 FOR CONNECTIONS)
- 10 #14 STMS @ EA STANDING RIB (16" O.C.)
- 11 ROOF BEAM (SEE STRUCTURAL)
- 12 1 1/2X1 1/2X20GA COPED ANGLE W/2-#10 STMS TO PURLIN (TYP) @ 8'-0" O.C.
- 13 1-#14 X 3/4" STMS W/NEOPRENE WASHER THRU RIB
- 14 DOWNSPOUT
- 15 #8 STMS 1 @ EA SIDE OF DOWNSPOUT TO BRACKET
- 16 ROOF HEADER (SEE STRUCTURAL)
- 17 G.I. FLASHING 28GA
- 18 STANDING SEAM ROOF (SEE A2.0 FOR GA)
- 19 ROOF PURLIN (SEE STRUCTURAL)
- 20 CONT. SILL TRACK
- 21 28GA GALV. FLASHING (ONLY AT BELOW GRADE CONC. FOUNDATIONS (Z FLASH)
- 22 CONTINUOUS 28GA GUTTER (SEE 9/A.6.1)
- 23 FLOOR BEAM (SEE STRUCTURAL)
- 24 22 GA STARTER/END ROOF CLIP-3/A.6.1
- 25 1/4" CONTINUOUS BEAD OF SEALANT AROUND ENTIRE PERIMETER OF FRAME
- 26 #10X3/4" STMS THREE FLASHING INTO ROOF BEAM W/NEOPRENE WASHER-24" OC
- 27 26 GA GALVANIZED IRON FLASHING AT SIDE WALL
- 28 C 14x12 GA HEADER
- 29 (2) AKN .144 KNURLED DRIVE PINS-ROOF CLIP TO PURLIN ROOF BEAM OR HEADER
- 30 6"x2 1/2"x14 GA ROOF PURLIN SEE PLAN FOR SPACING
- 31 22 GA STANDING SEAM ROOF 1/4"

FILE PATH: 2440-0-A8-1M.0WG

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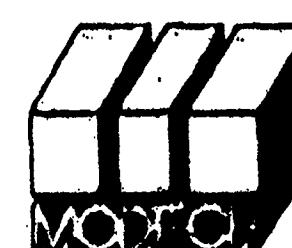
Electrical Engineer's Seal

Mechanical Engineer's Sec

Architects Sec

PC
CBC 1998

REVISED
DEC 9 1944



MODTECH INC
2830 BARRETT AVENUE
PERRIS, CALIF. 92572
PH (909) 943-4014
FAX (909) 940-0427

PROJECT NUMBER:

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DATE: 4/4/0
CHECKED BY: SS
DATE: 10/22/9

A6.1M

PROFESSIONAL STAMPS

REVISIONS

[illegible]

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PROJECT OWNER & TITLE
LODI UNIFIED SCHOOL DISTRICT
1305 E. Vine St
Lodi, CA 95240

**MILLSWOOD MIDDLE SCHOOL
PORTABLES RELOCATION**

Lodi, CA 95242

SHEET TITL


ARCHITECTURAL DETAILS (METAL STUDS)

DRAWN BY: XXXXXX JOB NUMBER: 23219

SHEET NO.

A6.1 M

DATE: DECEMBER 5, 2023

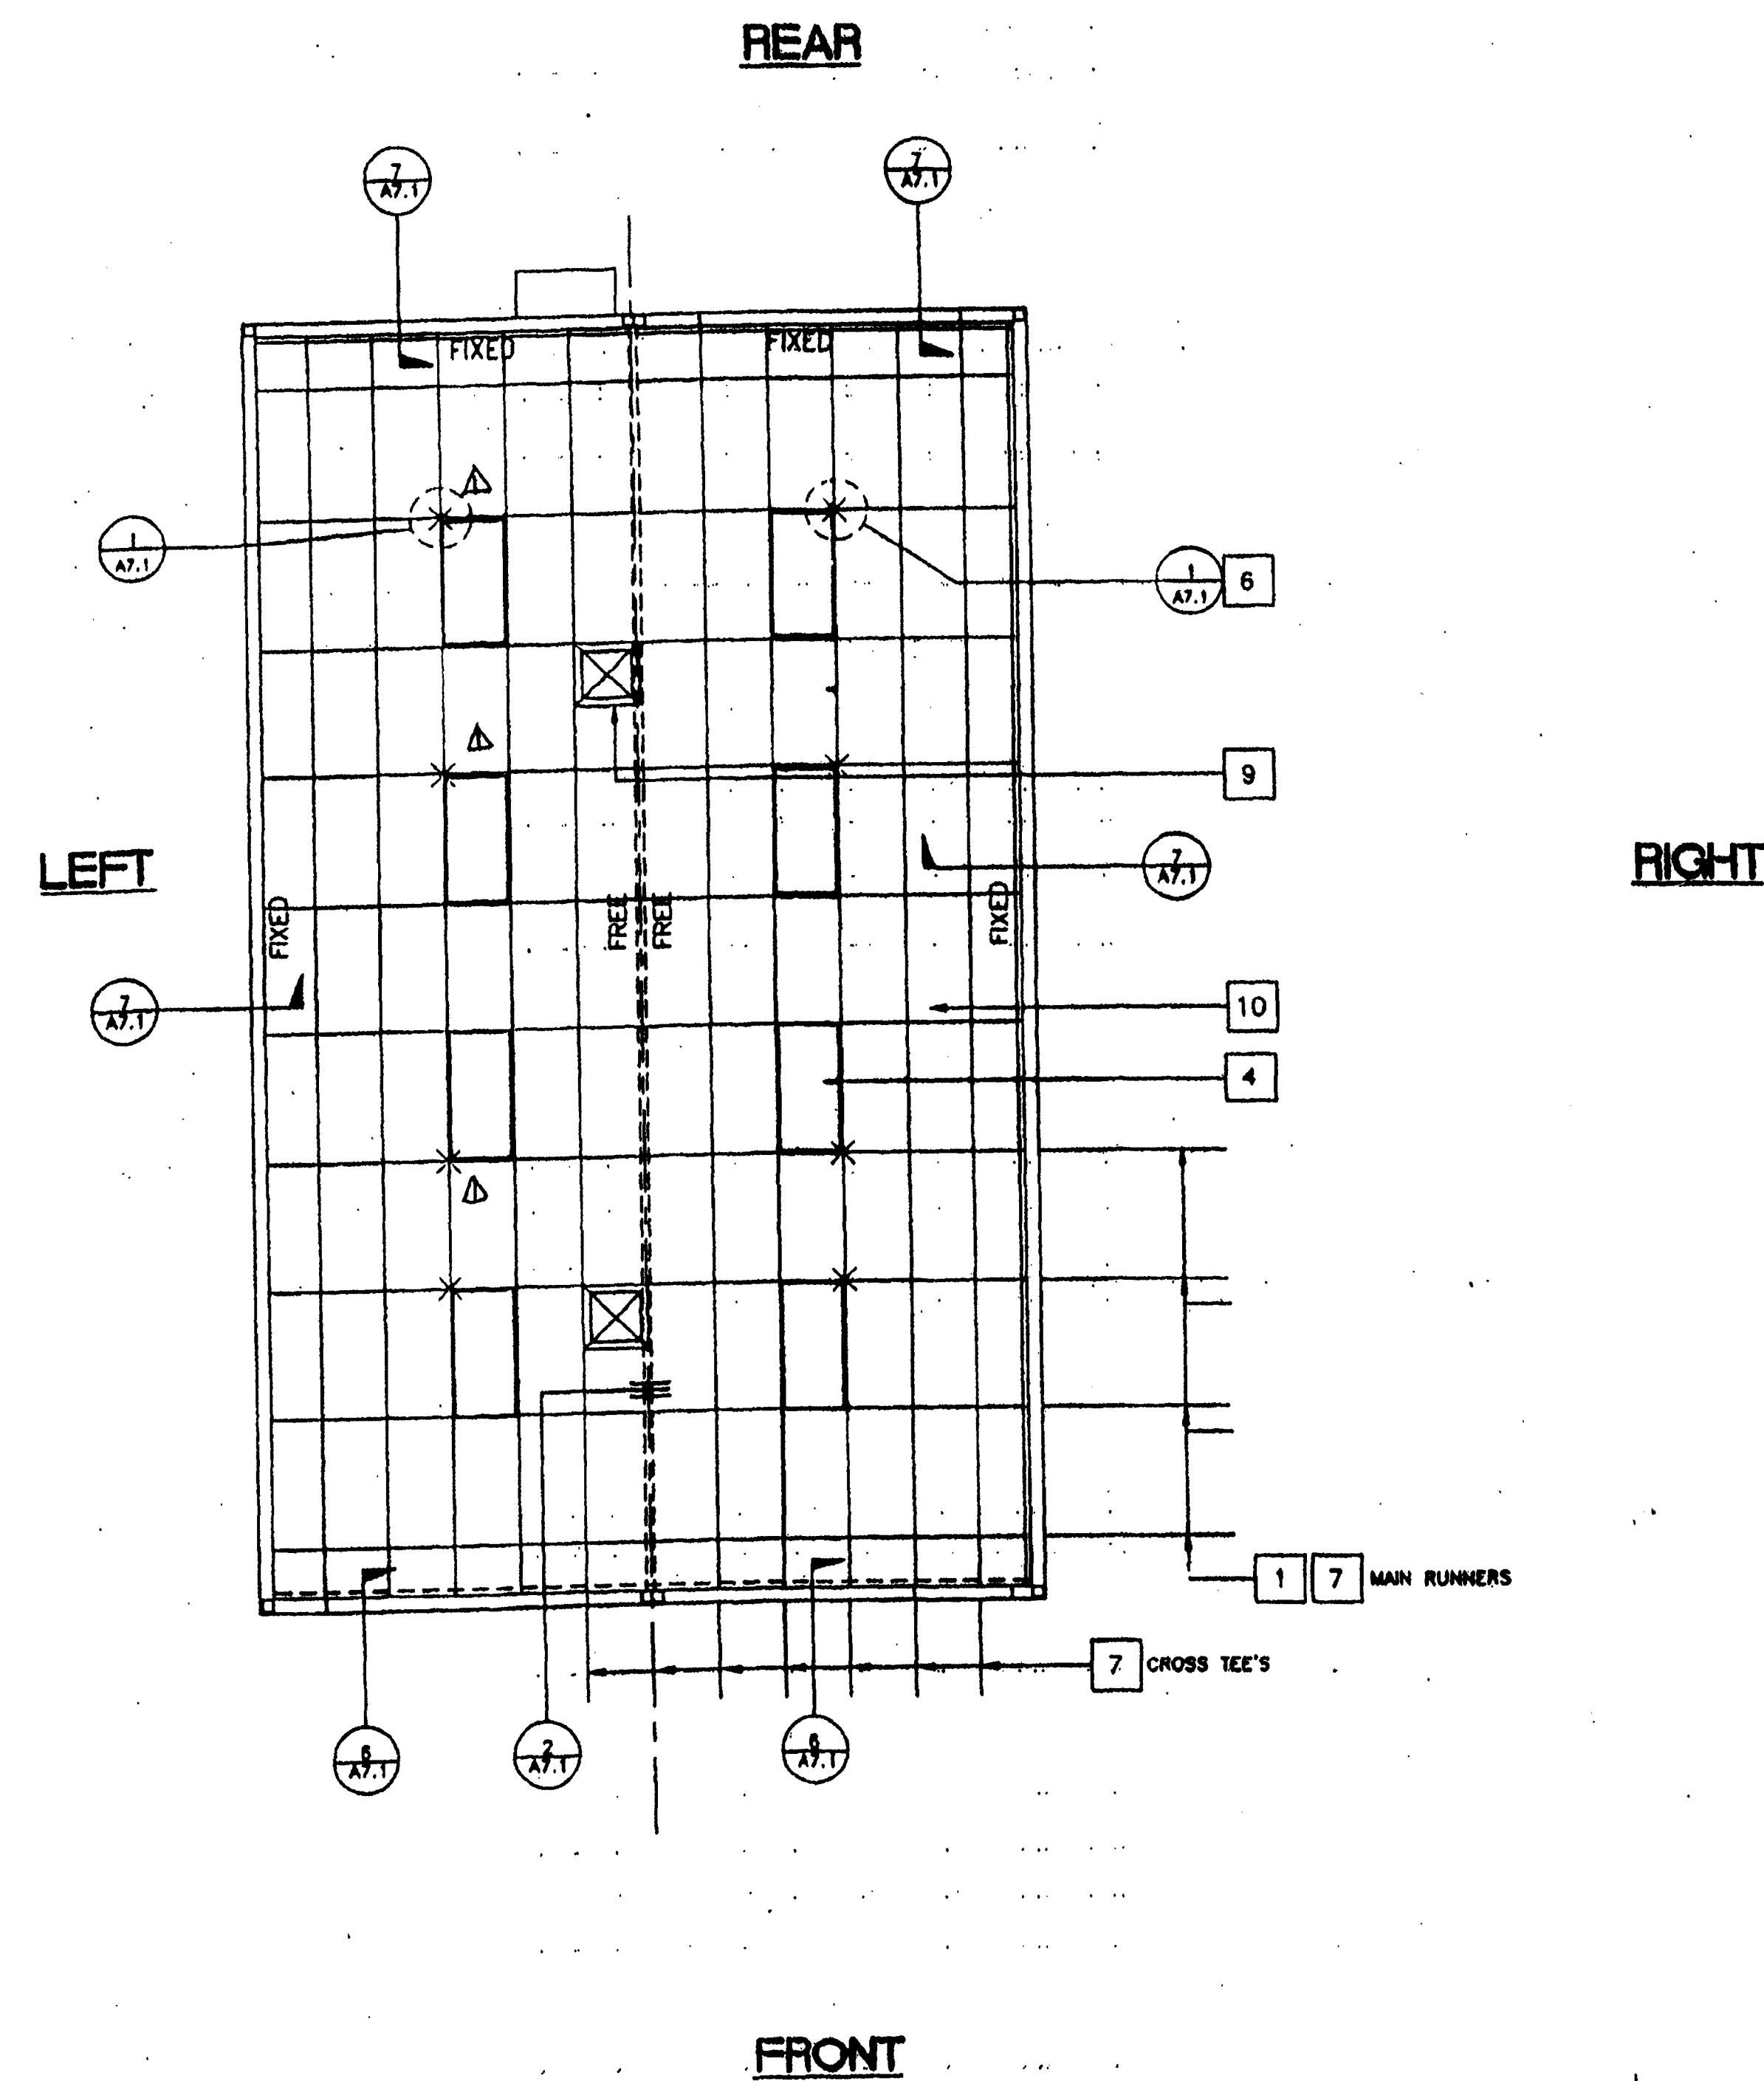

REFLECTED CEILING PLAN (24'X40')

SCALE: $1/4" = 1'-0"$

KEY NOTES

- 1 MAIN RUNNERS @ 4'-0" W/12GA. HANGER WIRES @ END OF EACH RUNNER.
 - 2 AT THE END OF ROWS OF RUNNERS A 12GA. HANGER WIRE SHALL BE ATTACHED WITHIN 8" OF WALL OR SOFFIT.
 - 3 VERTICAL WIRES MORE THAN 1-IN-6 OUT OF PLUMB SHALL HAVE COUNTERBRACING WIRES.
 - 4 PROVIDE 2-12GA. SLACK WIRES TO HOUSING OF ALL LIGHT FIXTURES AT DIAGONAL CORNERS. WIRES SHALL BE ATTACHED TO STRUCTURE OF LIGHT FIXTURES: 2 X 4 RECESSED. ATTACH FIXTURE TO GRID W/1-#8 SHEET METAL SCREW AT EACH CORNER.
 - 5 RUNNERS MAY BE ATTACHED TO WALLS OR MOLD AT 2-ADJACENT WALLS, OTHER WALLS NO. ATTACHMENT. CLEARANCE OF 1/2" BETWEEN END OF RUNNERS AND FACE OF WALL.
 - 6 CEILING AREAS SHALL HAVE 2/4-WAY WAYS PER DETAIL 1 ON SHEET A7.1 IN LOCATIONS INDICATED ON DRAWINGS. WIRES TAUT BUT NOT TO DISTORT GRID.


7

T-BAR PART NUMBERS	
	AFMETRONIC PA-081
RUNNER MAIN	7301D
4' CROSS TEE	7343
2' CROSS TEE	7328
WALL ANGLE	7800D

 - 8 DUCTWORK SHALL BE RIGIDLY ATTACHED TO BUILDING AND SHALL NOT BE CLOSER THAN 6" TO HANGER WIRES.
 - 9 REGISTERS SHALL BE POSITIVELY ATTACHED W/4-10GA. SHEET METAL SCREWS. (TYP. 1- @ EA. CORNER) PROVIDE SLACK SAFETY WIRES AT ALL HVAC REGISTERS
 - 10 CEILING PANELS: 2 X 4 LAY-IN PANELS. ASTM FLAME SPREAD CLASS 1 (0-25). FLAME SPREAD SMOKE DEVELOPMENT DENSITY LESS THAN 450 (TYP.)

T-BAR PART NUMBERS	
	ARMSTRONG PA-041
RUNNER MAIN	73010
4" CROSS TEE	7343
2" CROSS TEE	7328
WALL ANGLE	78000

LEGEND

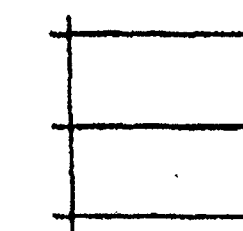

T & T BAR CEILING



2'X 4' ELEC. FIXTURE RECESSED



SUPPLY AIR DIFFUSER



RETURN AIR DIFFUSER



SPLAY WIRE 4 WAY

INDICATES FIXED SIDE
(SEE DETAIL 7/A7.1)

INDICATES FREE SIDE
(SEE DETAIL 6/A7.1)

REVISIONS


1	12/27/77	MOVE SPRINGS	SS
2			
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Electrical Engineer's Soc

Mechanical Engineer's Son

Architects See

PC
CBC 1998

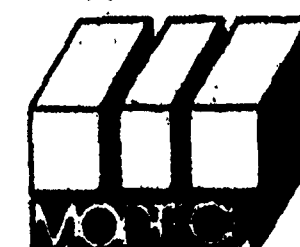

MODTECH INC.
2830 BARRETT AVENUE
PERRIS, CALIF. 92572
PH (909) 943-4014
FAX (909) 940-0427

PROJECT NUMBER:

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DRAWN BY: *[Signature]*
DATE: 4/21/01
CHECKED BY: SS
DATE: 10/22/99

REFLECTED CEILING PLAN 18 LIGHTS

A7.01

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PROJECT OWNER & TITLE
LODI UNIFIED SCHOOL DISTRICT
1305 E. Vine St
Lodi, CA 95240

**MILLSWOOD MIDDLE SCHOOL
PORTABLES RELOCATION**

233 N Mills Ave
Lodi, CA 95242

SHEET TITLE

REFLECTED CEILING PLAN (24'X40')

DRAWN BY: XXXXXX JOB NUMBER: 23219

SHEET NO.

A7.01

DATE: DECEMBER 5, 2023

DATE PLOTTED: 11/28/2023 9:11:51 AM
FILE LOCATION: C:\Users\lindhoff\Documents\BIM\23219_LUSD_Millwood Middle School Portables Relocation_A22_lindhoff\CK8V.rvt

ALTERNATE

TYPICAL FIXED SIDE

7

NOTE: CONDUIT MAY BE CRIMPED ON EITHER SIDE OF T-BAR, DEPENDING UPON CONDITION & LOCATION

ALT. CONN. AT BOTTOM

4

SEE DETAIL 3

SIESMIC SPLAY - 4 WAY

1

5

NOTE: LAY-IN CEILING TILE NOT SHOWN FOR CLARITY.

SCALE 3"=1'

GRID AT MOD LINE

2

ALTERNATE

TYPICAL FREE SIDE

6

NOTE: CONDUIT MAY BE CRIMPED ON EITHER SIDE OF T-BAR DEPENDING UPON CONDITION & LOCATION

3

KEY NOTES

- 12GA. HANGER OR DIAGONAL SPLAY WIRE IN PUNCHED OR DRILLED HOLE
- 12GA. WIRE WITH 4 WRAPS IN 1 1/2" (TYP.) WIRE TO RUN PERPENDICULAR TO MAIN TEE
- MAIN RUNNER
- 1/8" Ø POP RIVET TO EACH T-BAR
- WALL ANGLE
- 6d 16" Ø FRAMING TO WALL STUD #8 S.T.S.M.S. WHEN METAL STUDS ARE USED
- ANGLE WITH 1/8" Ø POP RIVET TO EACH T-BAR NO CONNECTION TO WALL ANGLE
- TOP PLATE
- #10 S.T.S.M.S. Ø 4" O.C.
- 3" X 1/4" EYED SCREW, 1/8" Ø X 2" JIF-E SCREW WHEN METAL STUDS ARE USED
- HANGER TO WALL WHERE NO RAFTER ABOVE MAX SLOPE 1" IN 6"
- 28 GA. JETCOAT
- CROSS TEE
- 12GA. HANGER WIRE AT THE END ON EACH RUNNER MIN. 4 WRAPS IN MAX 1-1/2" - SEE DETAIL #5 FOR WIRE TO PURLIN ATTACHMENT
- MAIN RUNNERS OR CROSS TEES
- ACOUSTICAL BOARD
- FINISH WALL
- HORIZONTAL STRUTS SHALL RUN CONTINUOUS AT ALL PERIMETERS, NOT POP RIVETED TO THE WALL ANGLE ARMSTRONG #7425 OR #7445 WITH SPRING STEEL SNAP TO RUNNER PER IR 47-4
- 3/4" EMT CONDUIT - MAX 5'-2" (COMPRESSION STRUT)
- CRIMP CONDUIT AND ATTACH TO RAFTER WITH (2) #8 TEK SCREW
- PROVIDE SPACE AT ALL MEMBERS AT OPPOSITE WALL WITH #8 TEK SCREW
- CRIMP CONDUIT AND ATTACH TO T-BAR GRID WITH #8 TEK SCREW
- ROOF BEAM SEE (6TH)
- ROOF PURLIN SEE (6TH)
- RUN GYP BOARD TO TOP PLATE FOR FIRE BLOCKING

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CBC 1998

MODTECH INC.

2830 BARRETT AVENUE
PERRIS, CALIF. 92572
PH (909) 943-4014
FAX (909) 940-0427

PROJECT NUMBER:

© MODTECH, INC. 1999

DRAWN BY: *lindhoff*
DATE: *9/5*
CHECKED BY: *SS*
DATE: *10/22/99*

REFLECTED CEILING DETAILS

A7.1

AGENCY APPROVAL DSA# 02-121945

IDENTIFICATION STAMP
DIV. OF THE STATE ARCHITECT
APP: 02-121945 INC.
REVIEWED FOR
SS ☒ FLS ☒ ACS ☒
DATE: 12/12/2023

PROFESSIONAL STAMP

REVISIONS

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Lodi, CA 95240

MILLSWOOD MIDDLE SCHOOL
PORTABLES RELOCATION

233 N Mills Ave
Lodi, CA 95242

SHEET TITLE

REFLECTED CEILING DETAILS


DRAWN BY: XXXXXX JOB NUMBER: 23219

SHEET NO.


A7.1

DATE: DECEMBER 5, 2023

CONSTRUCTION DOCUMENTS

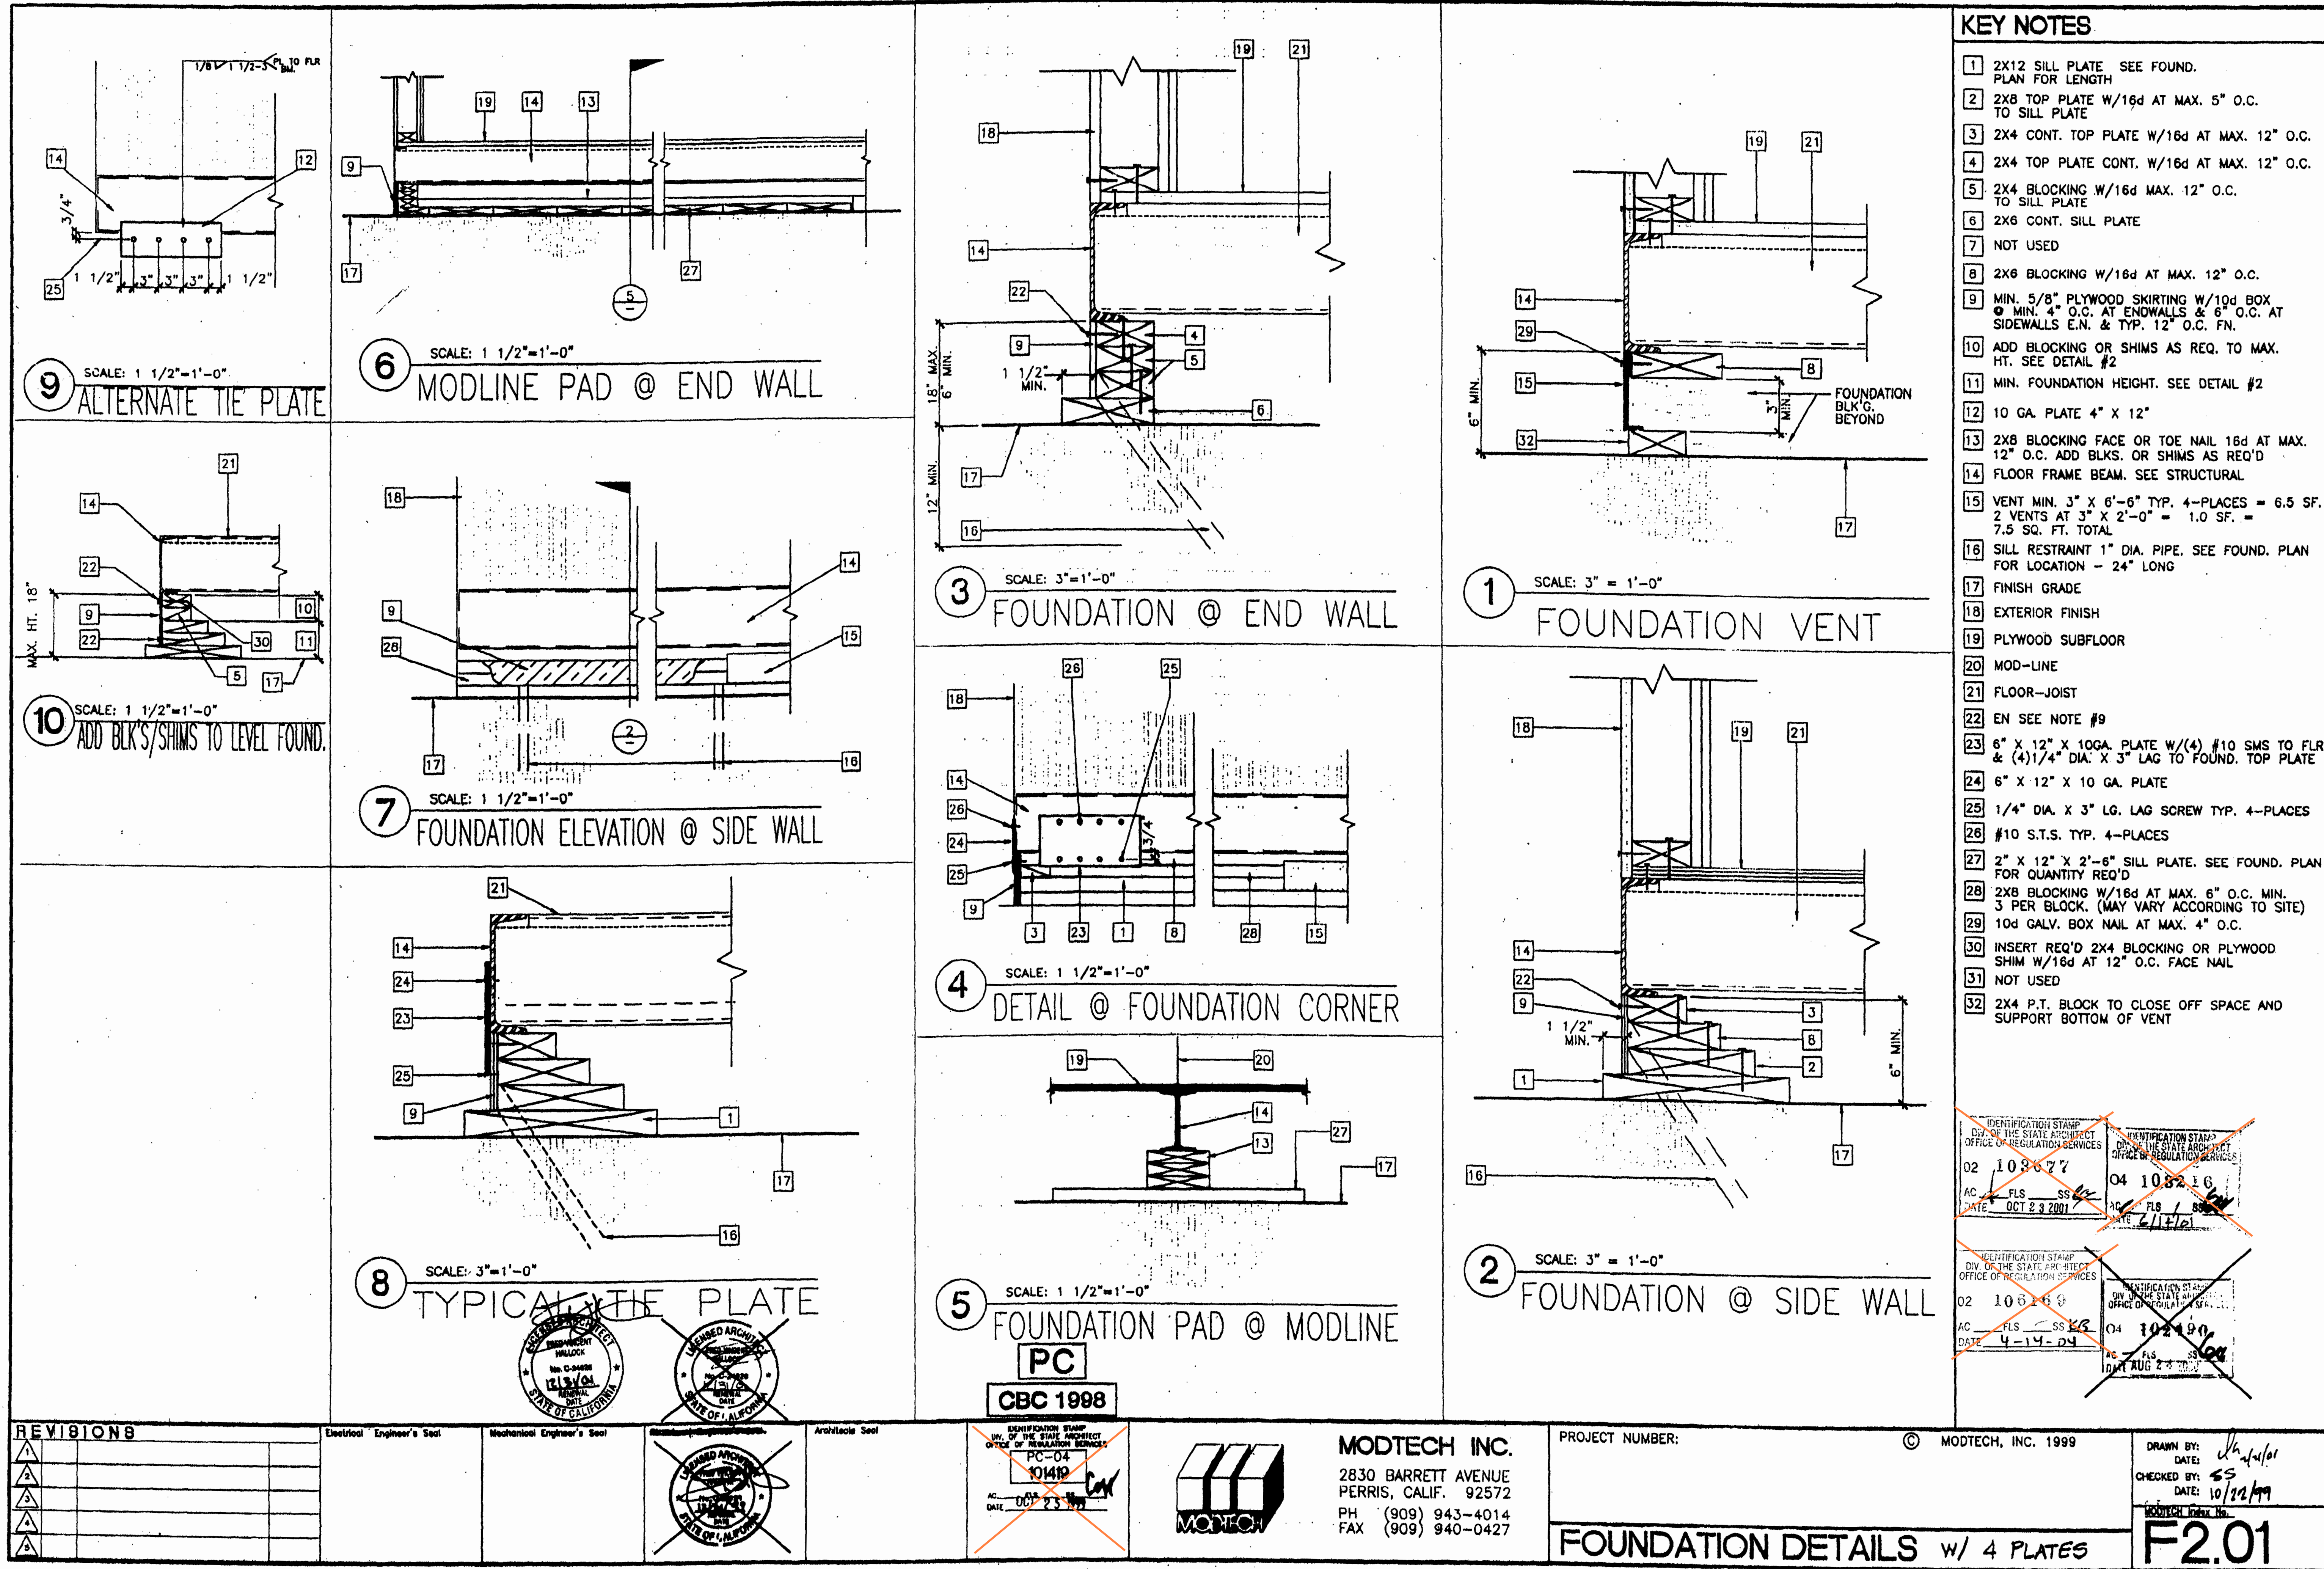

FILE PATH: 240-0-F2-0.DWG
PROJECT NO. 200019.31
BCH-PROJECT-NO-200019.31
PC-04-101419

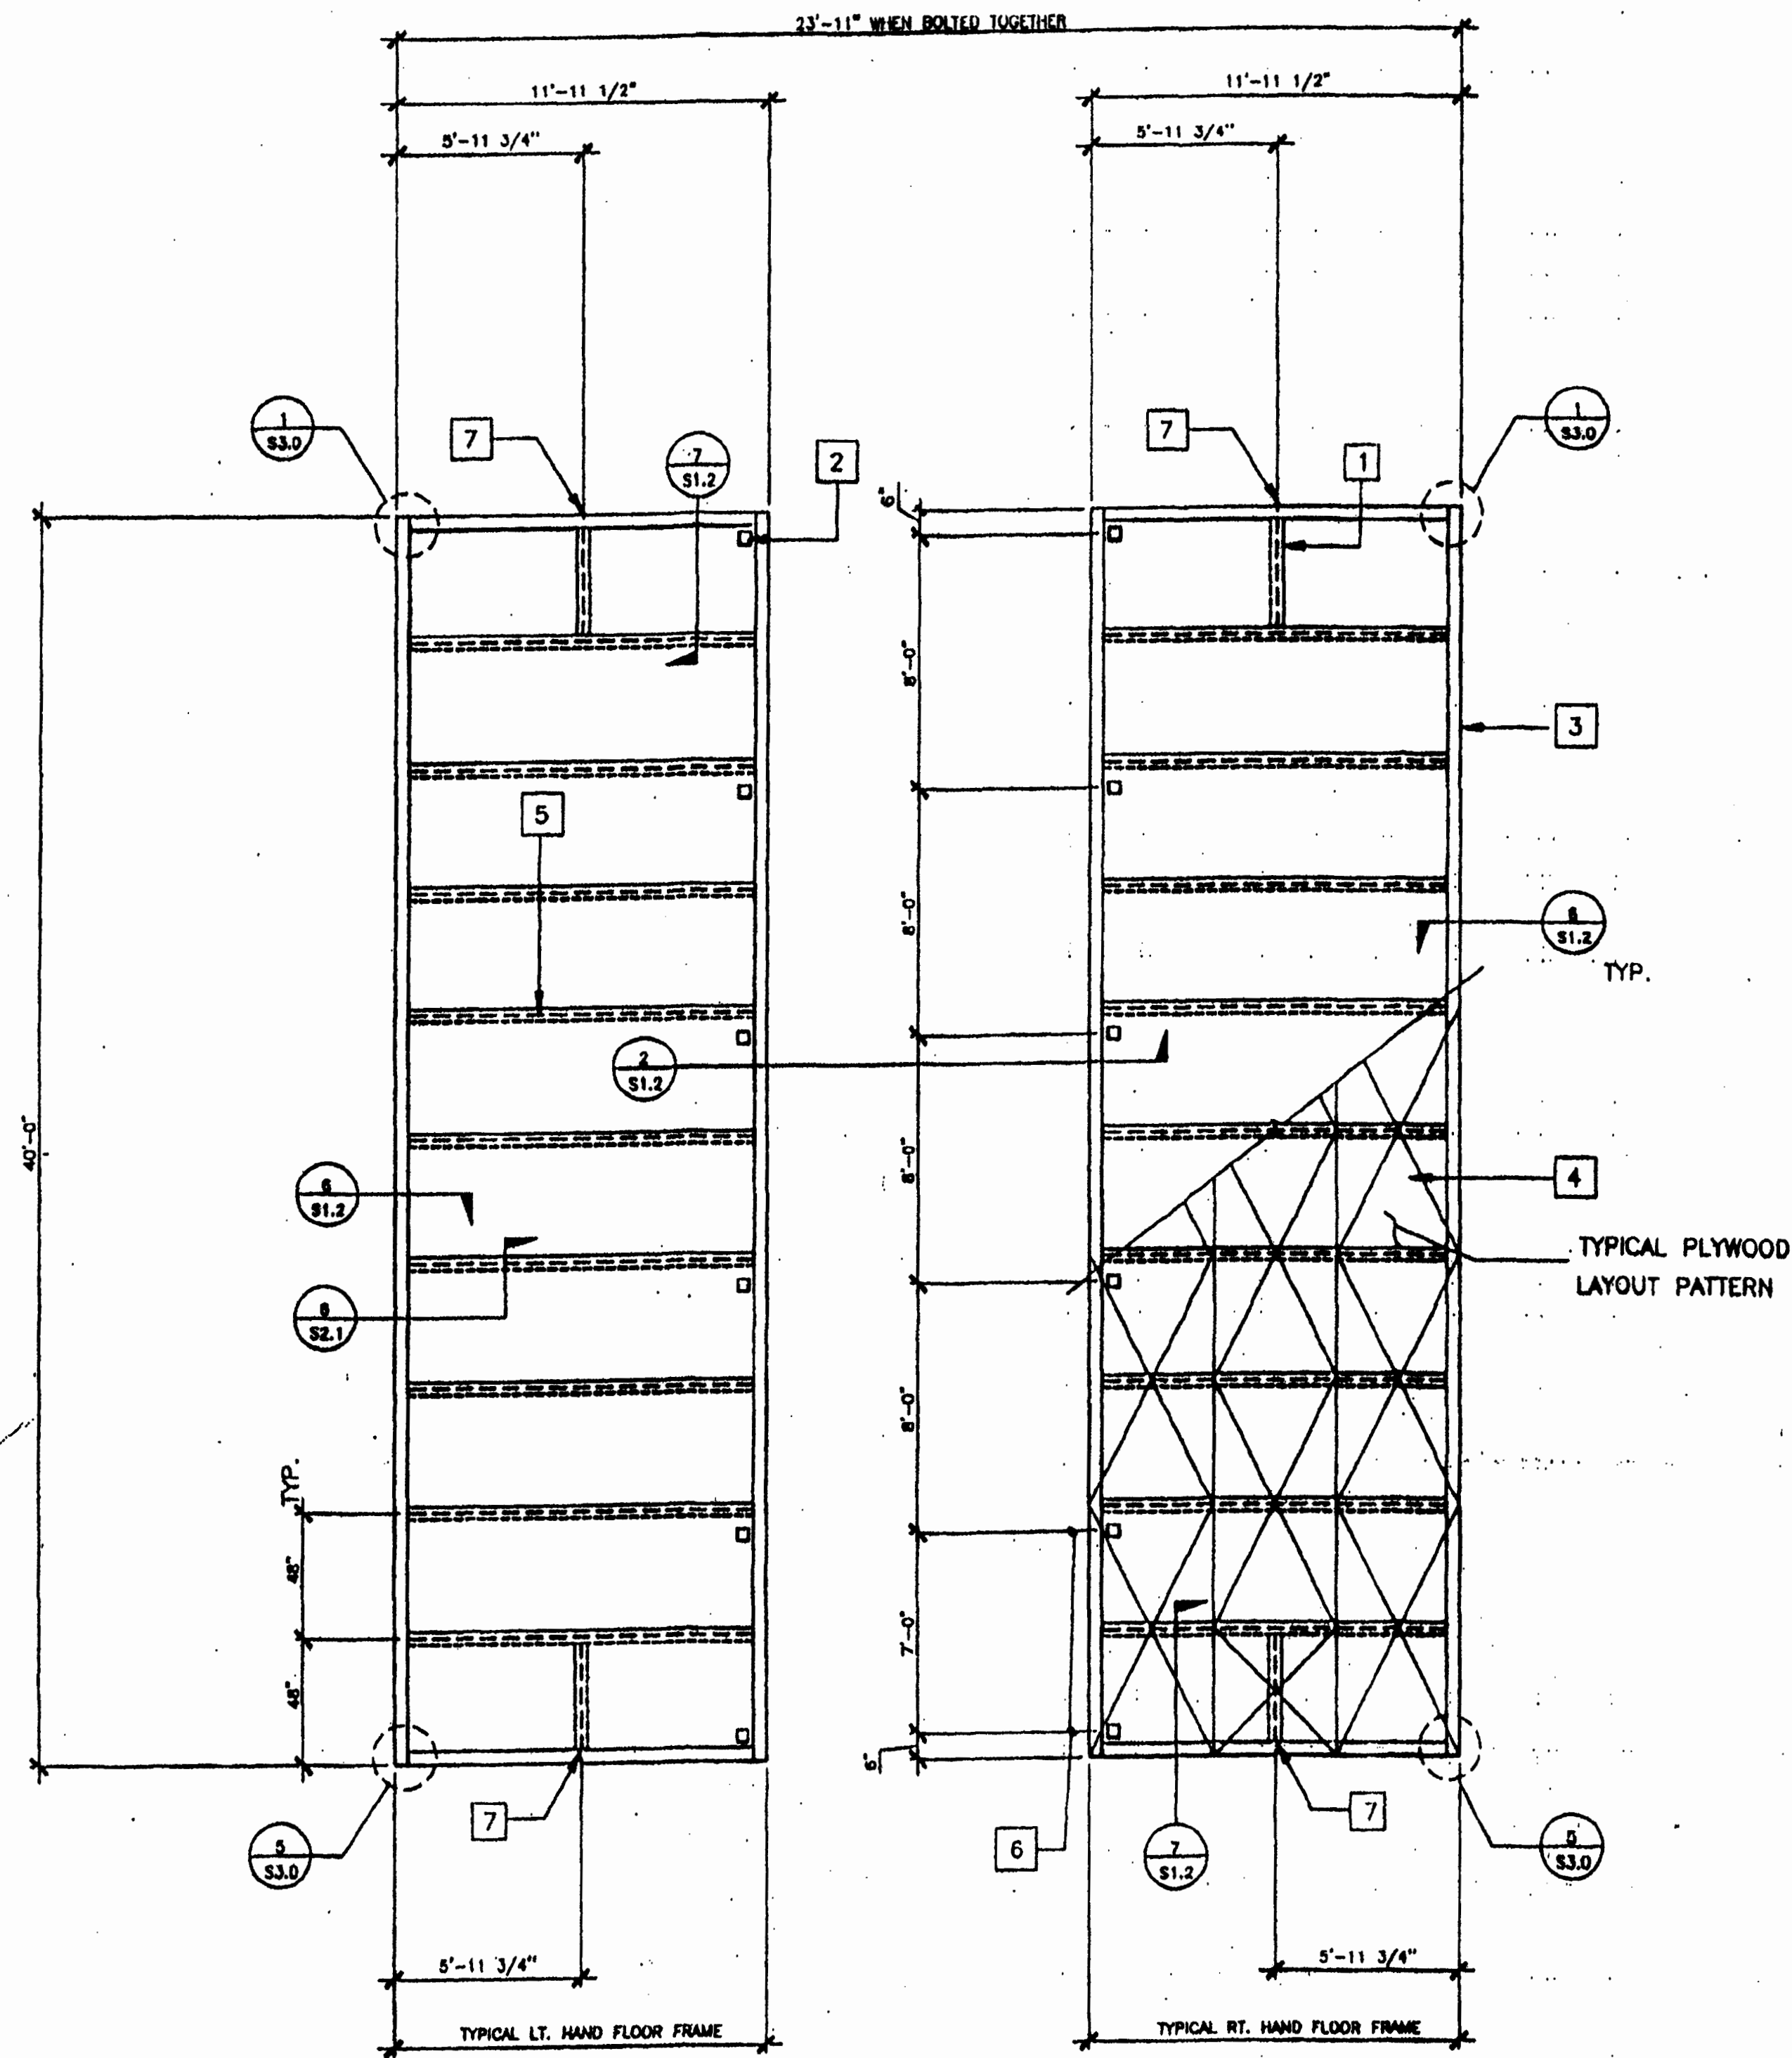

FLOOR FRAMING PLAN

FLOOR LIVE LOAD - 50 PSF



SCALE 1/4"=1'-0"




FLOOR JOIST TABLE	
LIVE LOAD	$\int 6 \frac{3}{8}" \times 2 \frac{1}{2}"$ 12GA.
50 P.S.F.	48" O.C.

KEY NOTES

- 1 6 3/8 X 2 1/2 X 12GA. BLOCKING AT MIDSPAN OF FLOOR HDR. TYPICAL
- 2 5" DIA HAND HOLES AT BOLT BM TO BM (12 PLACES) OPTIONAL 5" SQUARE HOLE
- 3 C 7X9.8 PERIMETER CHANNEL (TYPICAL) SEE 2/S2.1
- 4 PLYWOOD FLOOR SHEATHING: APA PS 1-B3 1 1/8" THICK, STURD-I-FLOOR OR EQUAL W/48" O.C. SPAN RATING, ATTACHED W/ #10 X 1 3/4" SELF-TAPPING FLAT HEAD SCREW AT 6" O.C. TO PERIMETER FRAME, AEROSMIT AKN 144-0175 DRIVE PINK AT 6" O.C. SUPPORTED EDGES AND 6" O.C. FIELD TO JOIST. (TYPICAL) SEE 10/S2.1
- 5 6 3/8 X 2 1/2 X 12GA. FLOOR JOIST AT 48" O.C.
- 6 TYPICAL BOLT LOCATION (SEE 2/S1.2)
- 7 1"Ø HOLE @ MID-DEPTH FOR HANDLING

NOTES

1. FOR L HAND & R HAND FRAME SEE S1.0
2. WELDING FIT-UP: OPENINGS = $\frac{1}{2}$ OR $\frac{1}{8}$ " MIN
FOR FULL PEN  AND 
t = BASE METAL THICKNESS

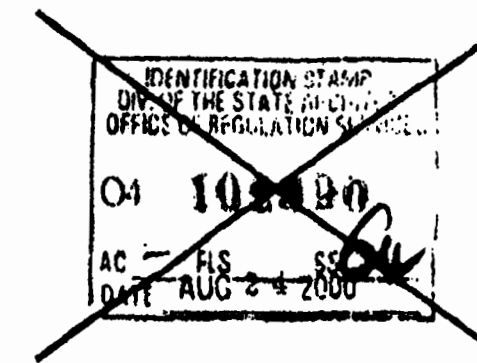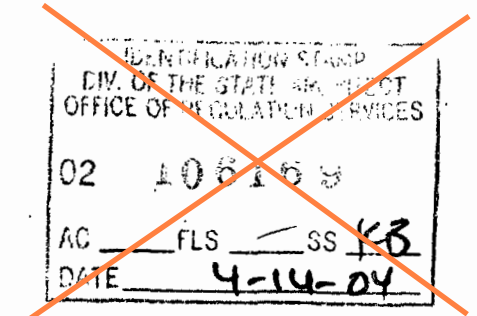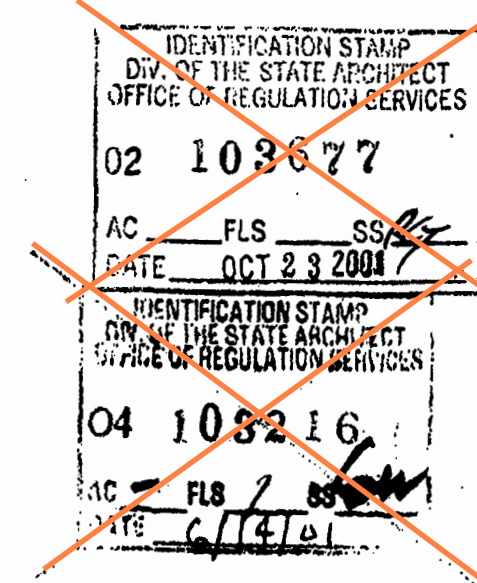[illegible]

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PROJECT OWNER & TITLE
LODI UNIFIED SCHOOL DISTRICT
1305 E. Vine St
Lodi, CA 95240

**MILLSWOOD MIDDLE SCHOOL
PORTABLES RELOCATION**
233 N Mills Ave
Lodi, CA 95242

SHEET TITLE

FLOOR FRAMING PLAN 50 PSF LL


DRAWN BY: XXXXXX JOB NUMBER: 23219

SHEET NO.

S1.0

DATE: DECEMBER 5, 2023

CONSTRUCTION DOCUMENTS

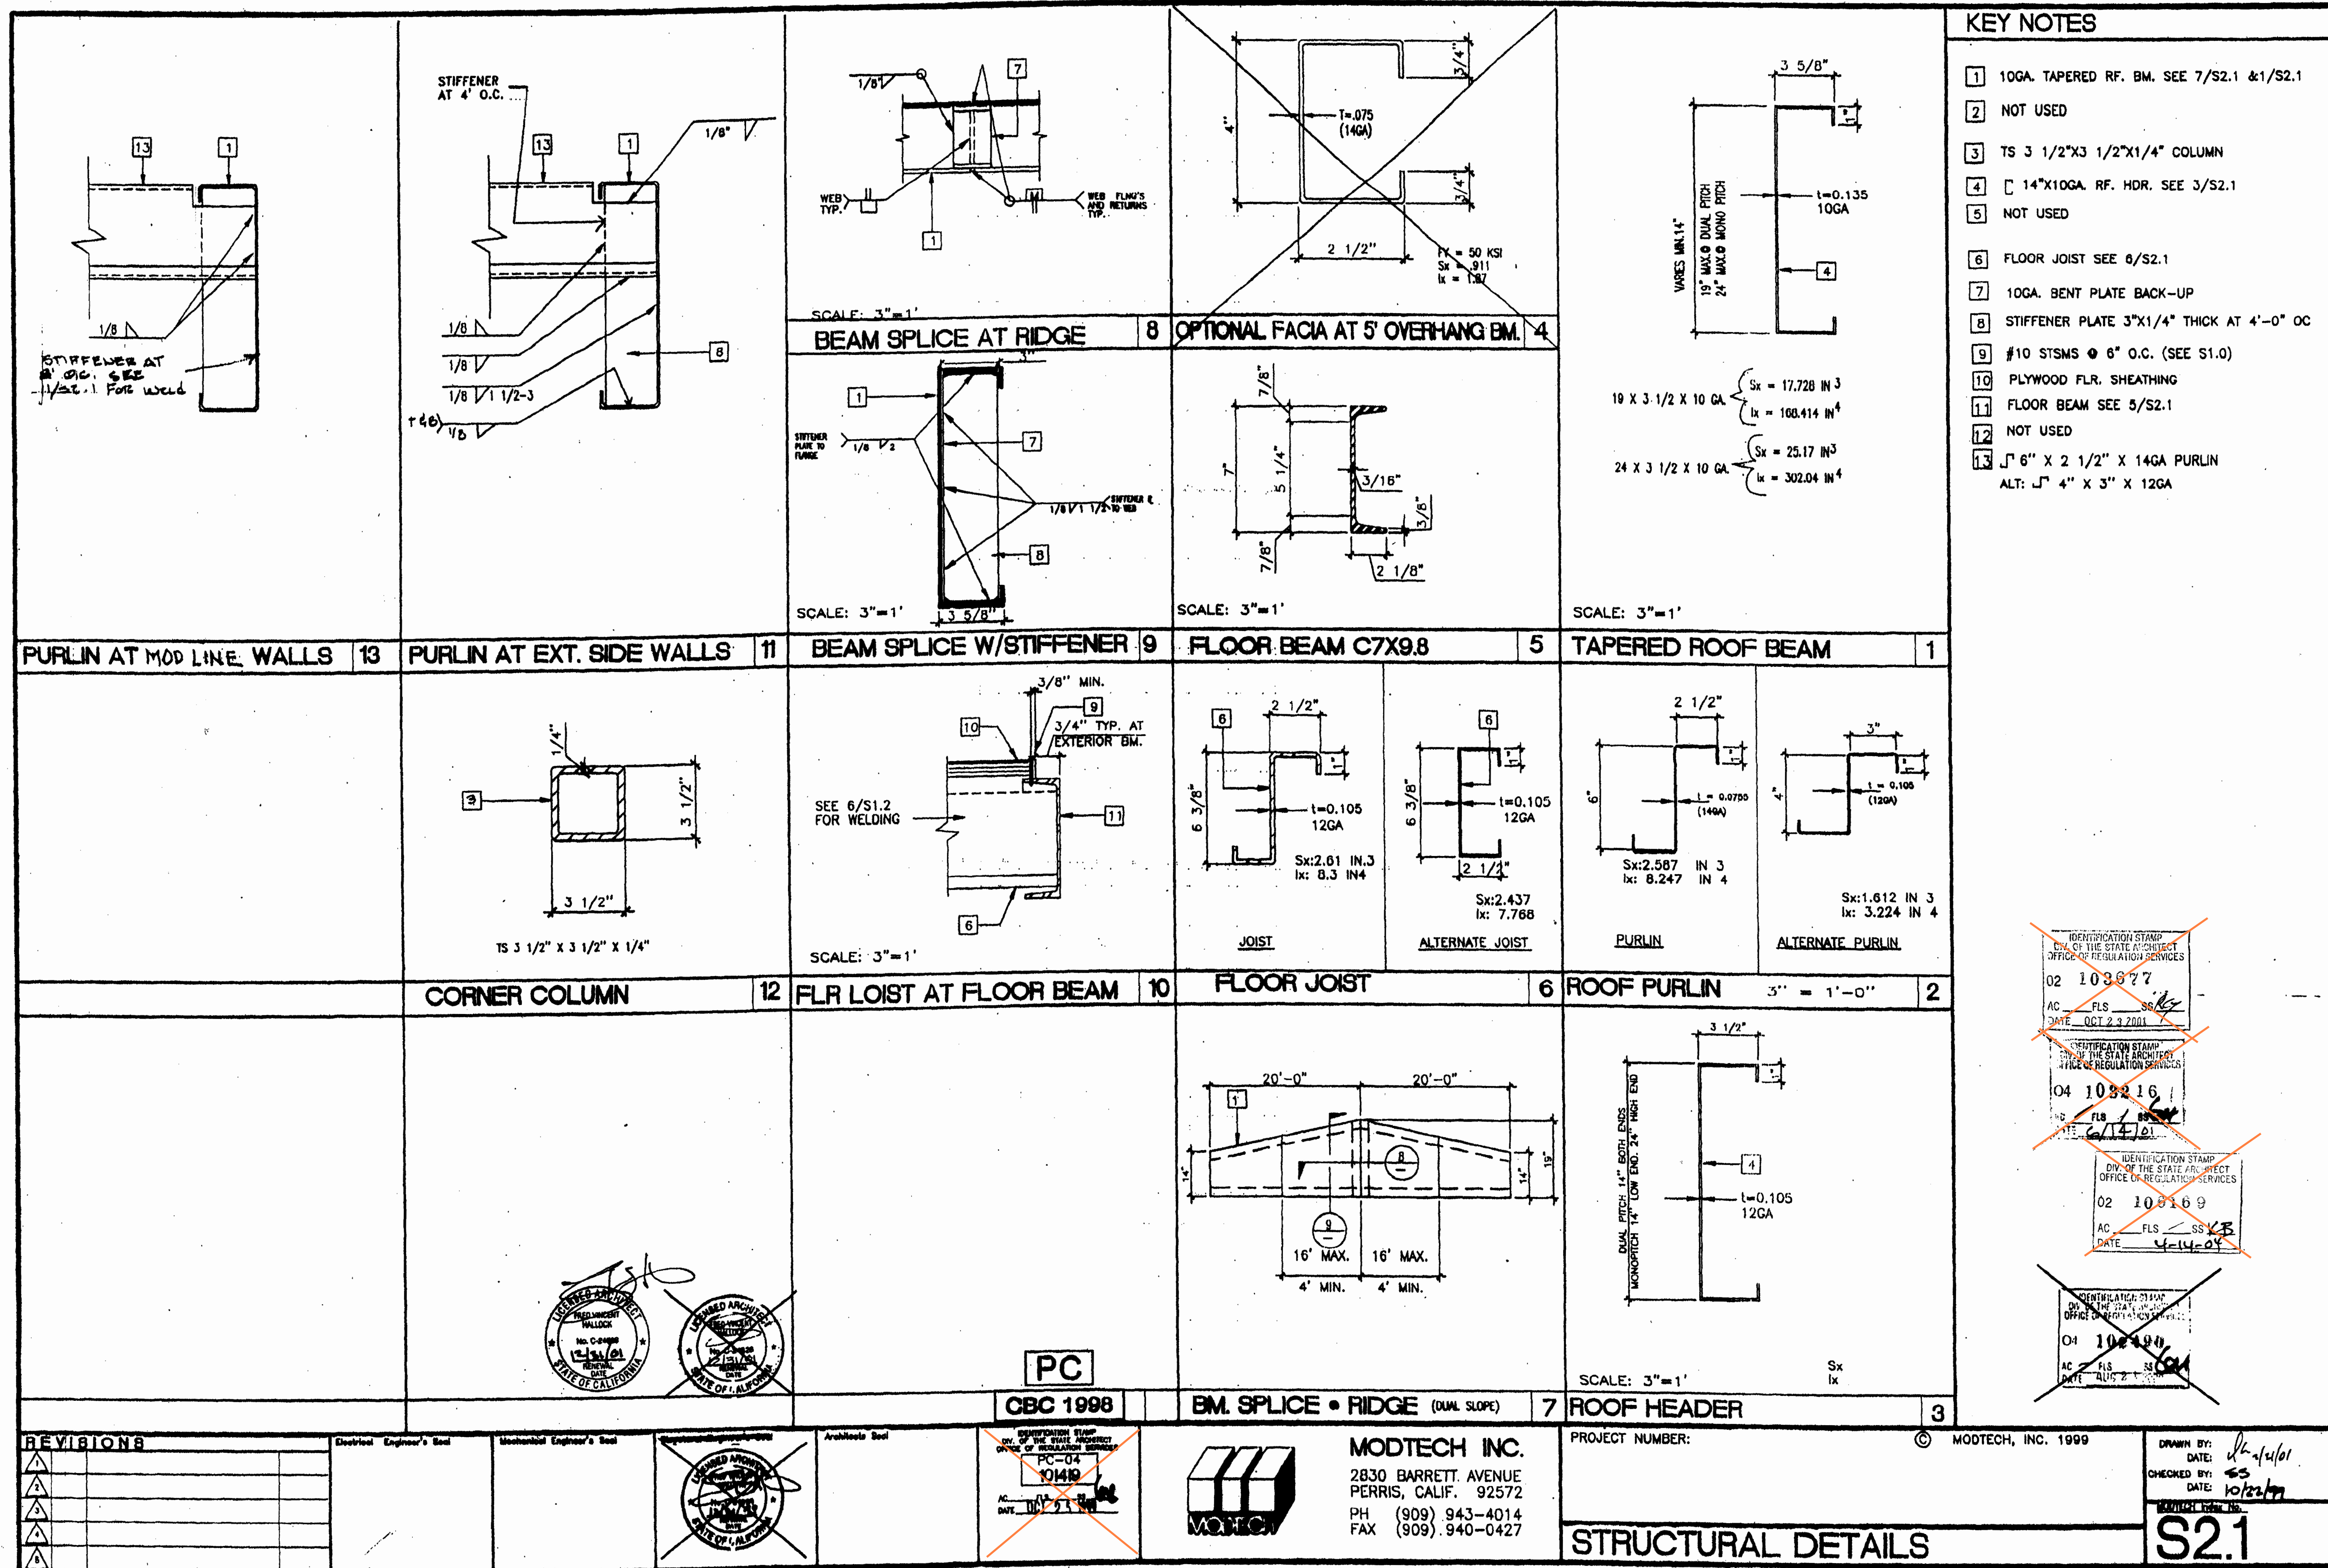

FILE PATH: 2440-O-S2-1.DWG

~~BGH PROJECT NO. 200019.21~~
BGH PROJECT NO. 200019.31

PC-04-101419 PROJECT NO.

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PROJECT OWNER & TITLE
LODI UNIFIED SCHOOL DISTRICT
1305 E. Vine St
Lodi, CA 95240

**MILLSWOOD MIDDLE SCHOOL
PORTABLES RELOCATION**
233 N Mills Ave
Lodi, CA 95242

SHEET TITLE


FLOOR FRAMING DETAILS (TYP.)

DRAWN BY: XXXXXX JOB NUMBER: 23219

SHEET NO.

S2.1

CONSTRUCTION DOCUMENTS

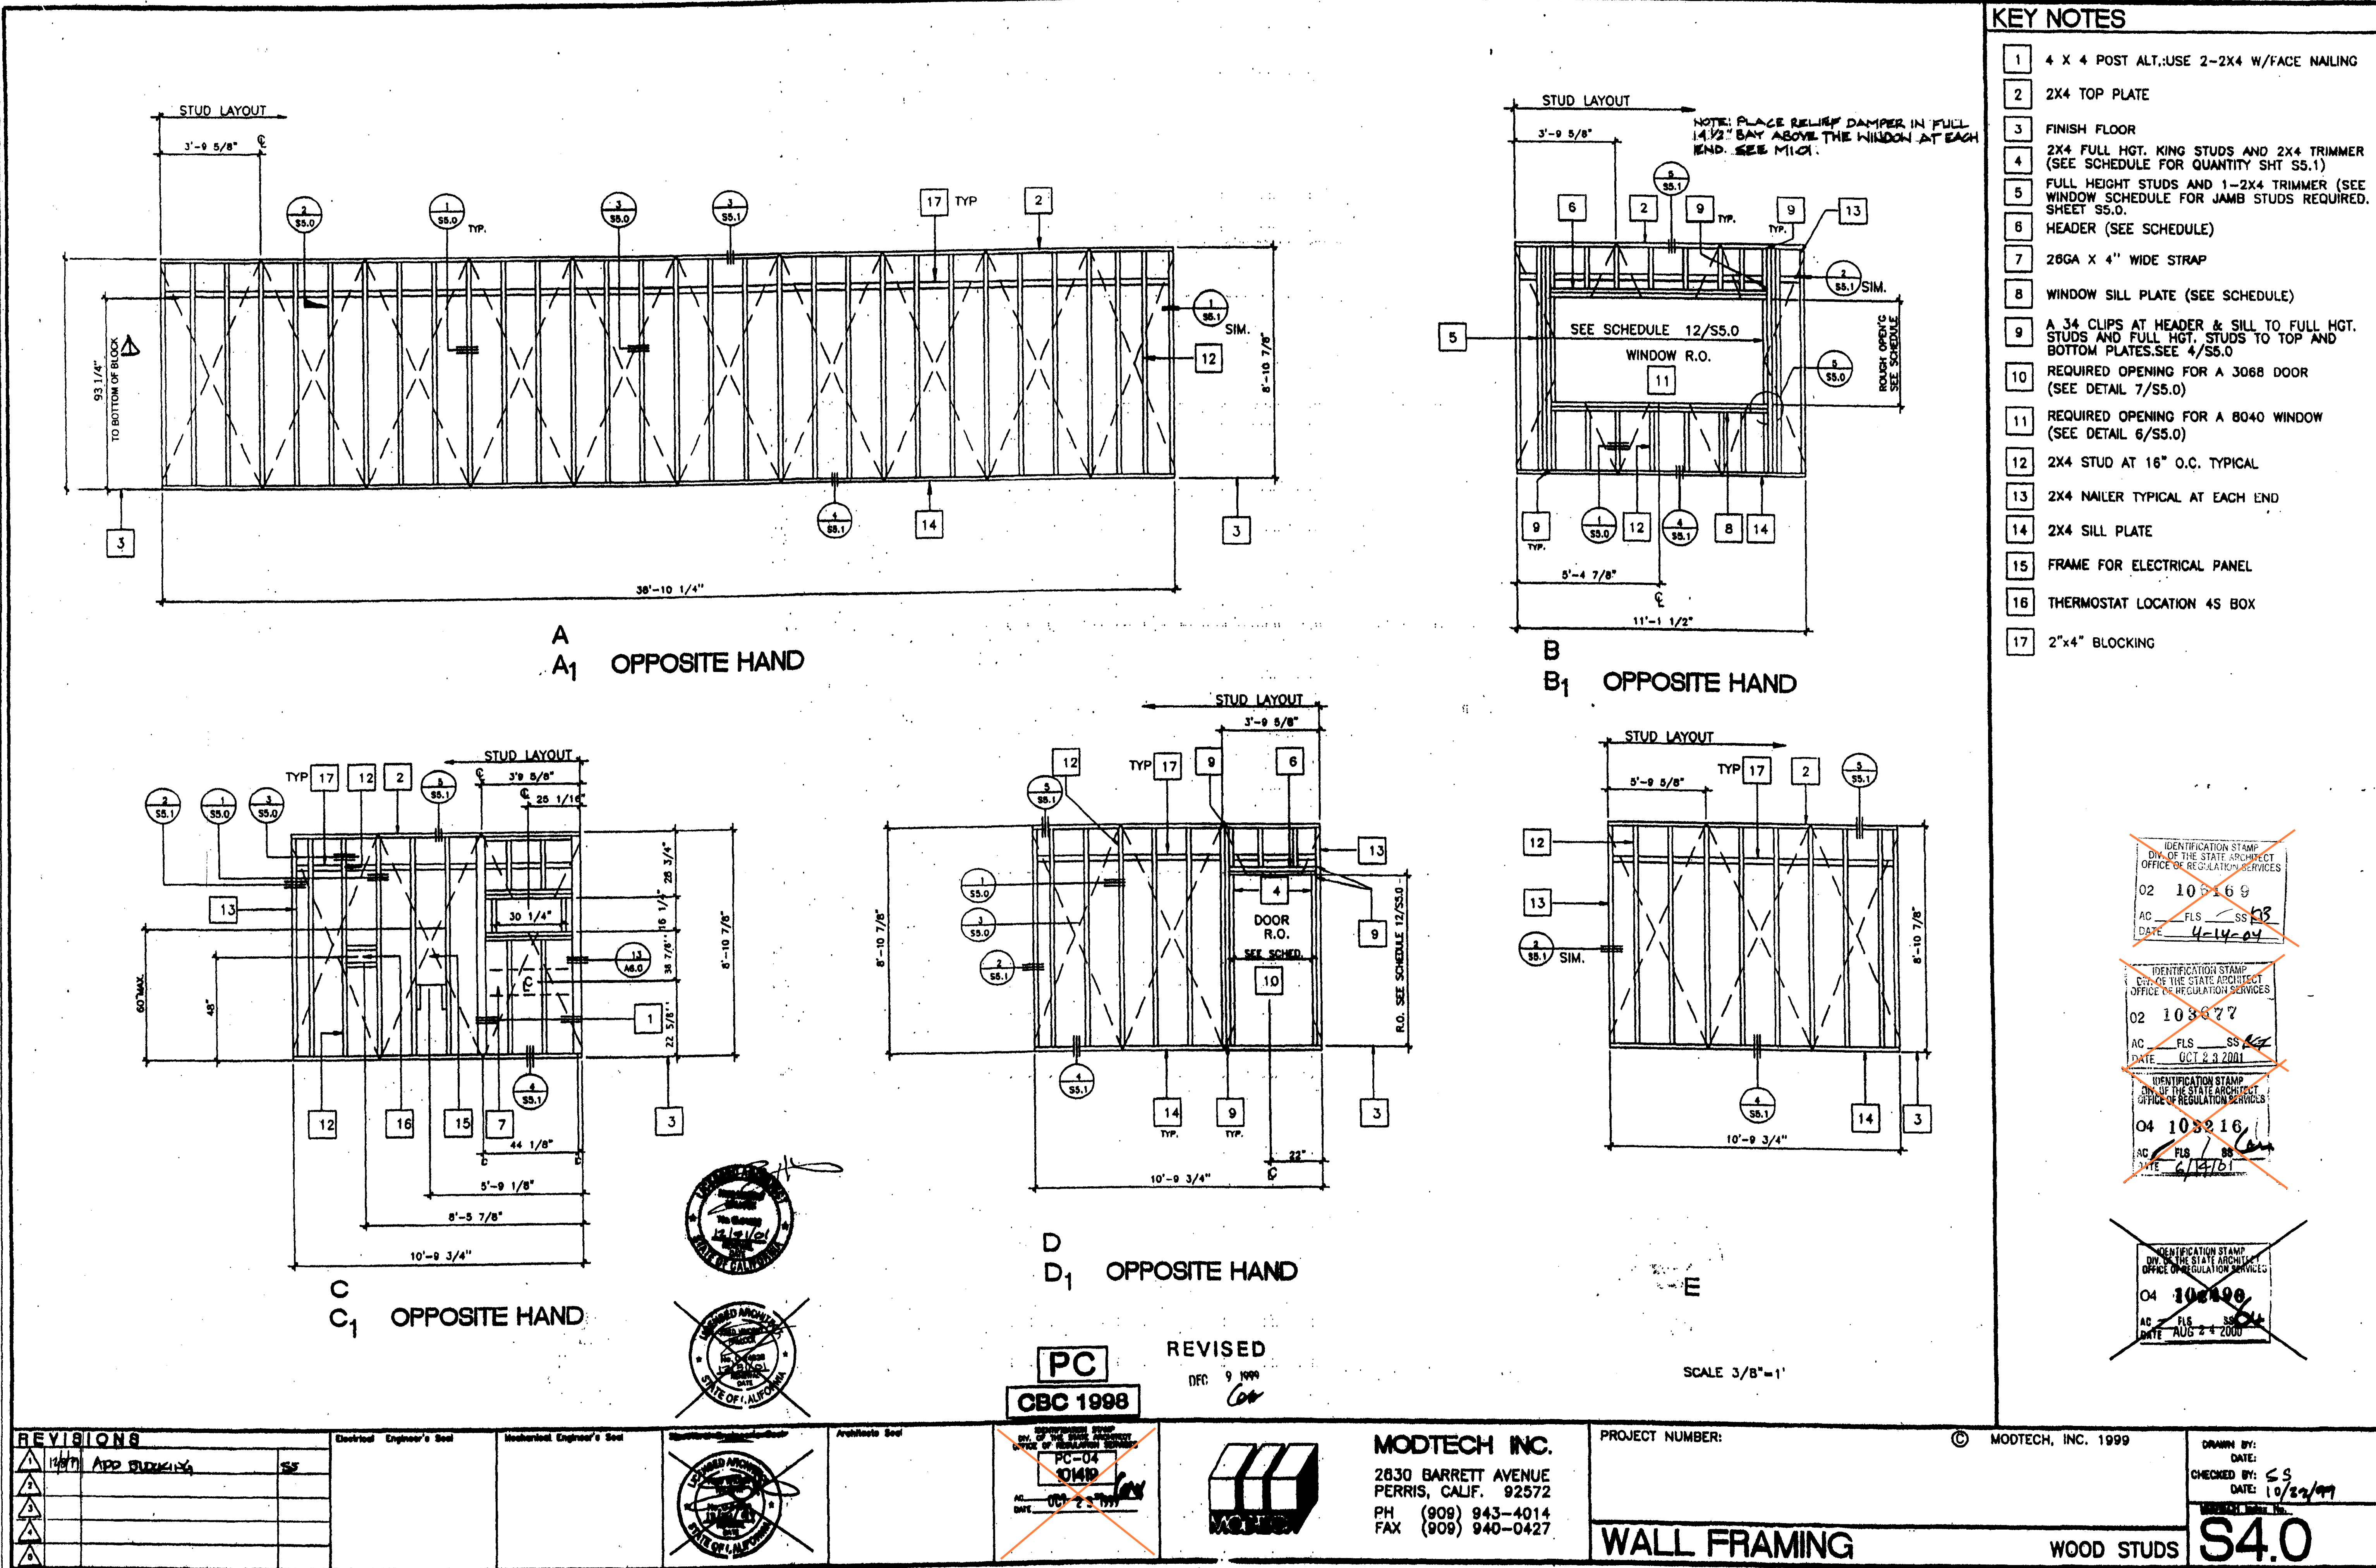

AGENCY APPROVAL DSA# 02-121945 02-121945 02-121945

IDENTIFICATION STAMP
DIV. OF THE STATE ARCHITECT
APP: 02-121945 INC:
REVIEWED FOR
SS ☒ FLS ☒ ACS ☒
DATE: 12/12/2023

PROFESSIONAL STAMP

REVISIONS

NO.	DATE	DESCRIPTION
1	10/16/09	
2	10/16/09	
3	10/16/09	
4	10/16/09	
5	10/16/09	
6	10/16/09	
7	10/16/09	
8	10/16/09	
9	10/16/09	
10	10/16/09	
11	10/16/09	
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16	10/16/09	
17	10/16/09	


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PROJECT OWNER & TITLE
LODI UNIFIED SCHOOL DISTRICT
1305 E. Vine St
Lodi, CA 95240


MILLWOOD MIDDLE SCHOOL PORTABLES RELOCATION
233 N Mills Ave
Lodi, CA 95242

SHEET TITLE
WALL FRAMING (WOOD)


DRAWN BY: XXXXXX JOB NUMBER: 23219
SHEET NO.
S4.0
DATE: DECEMBER 5, 2023

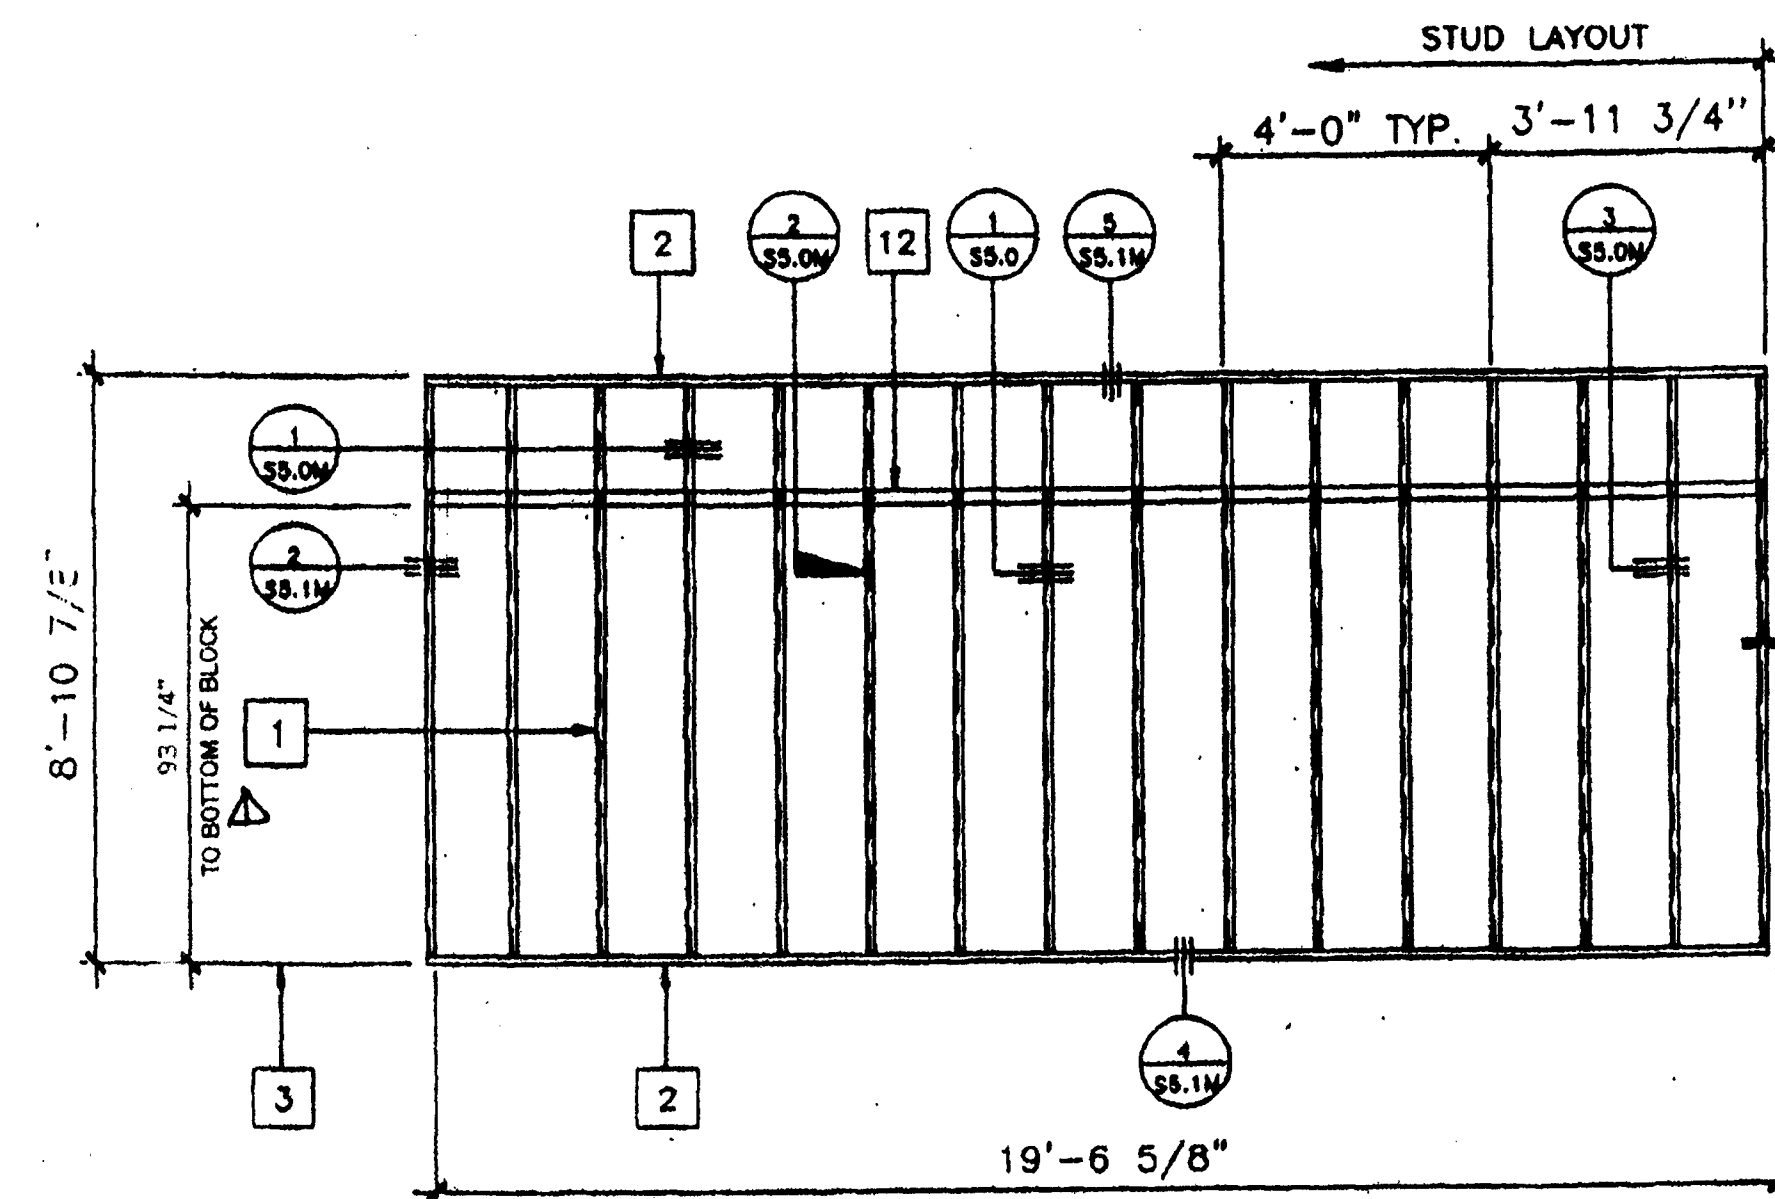


PANEL A,
PANEL 'A' 2 OPOSITE HD

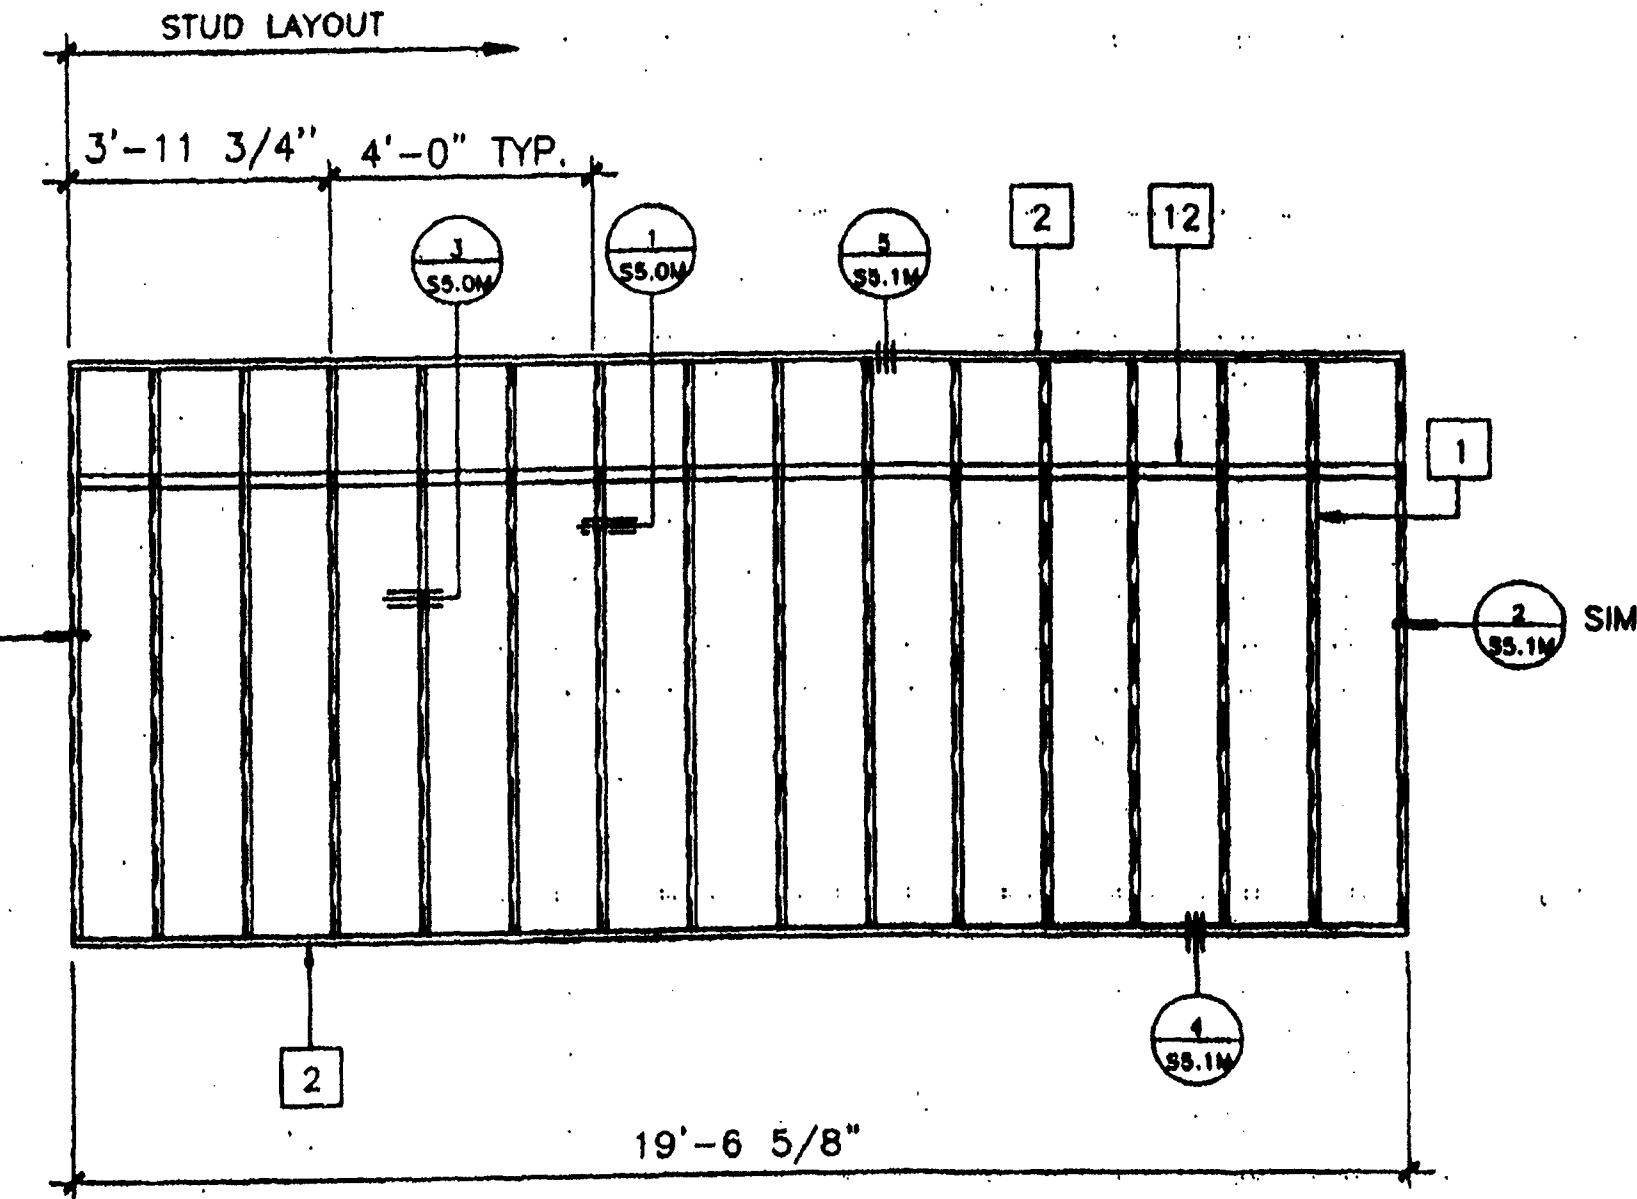


PANEL A,
PANEL 'A' 3 OPOSITE HD

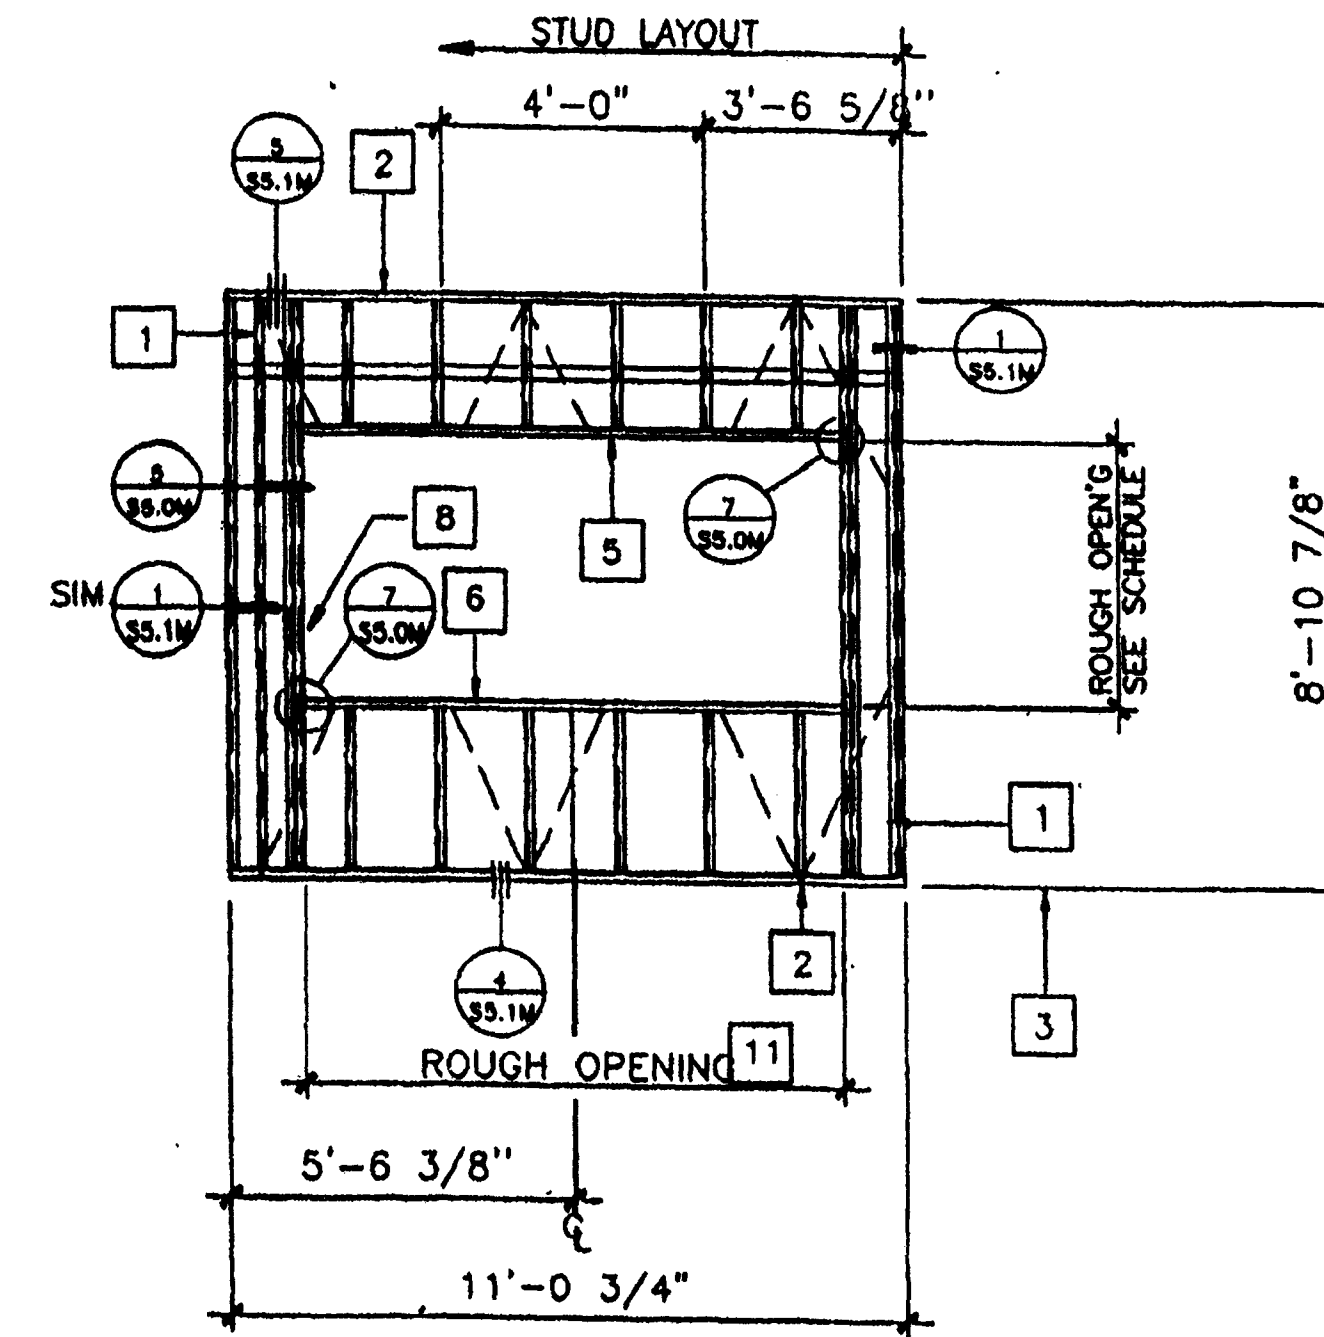


B
B₁ OPPOSITE HAND

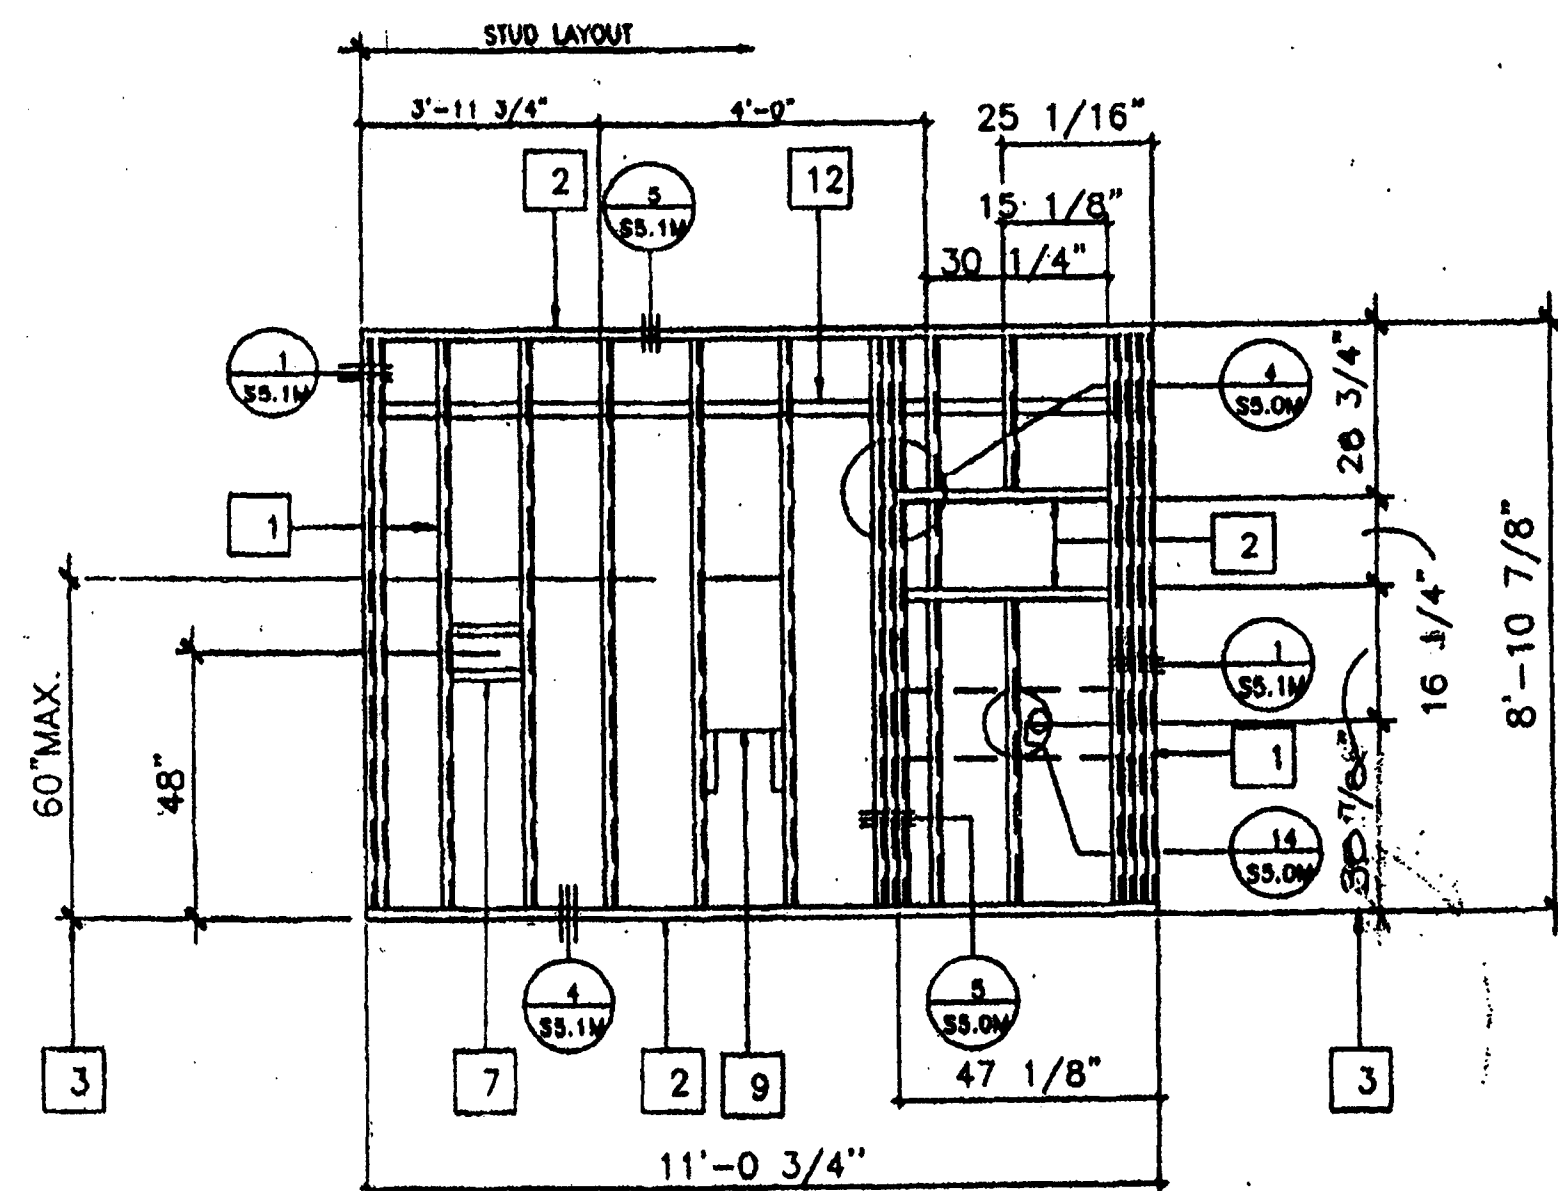

C
C₁ OPPOSITE HAND

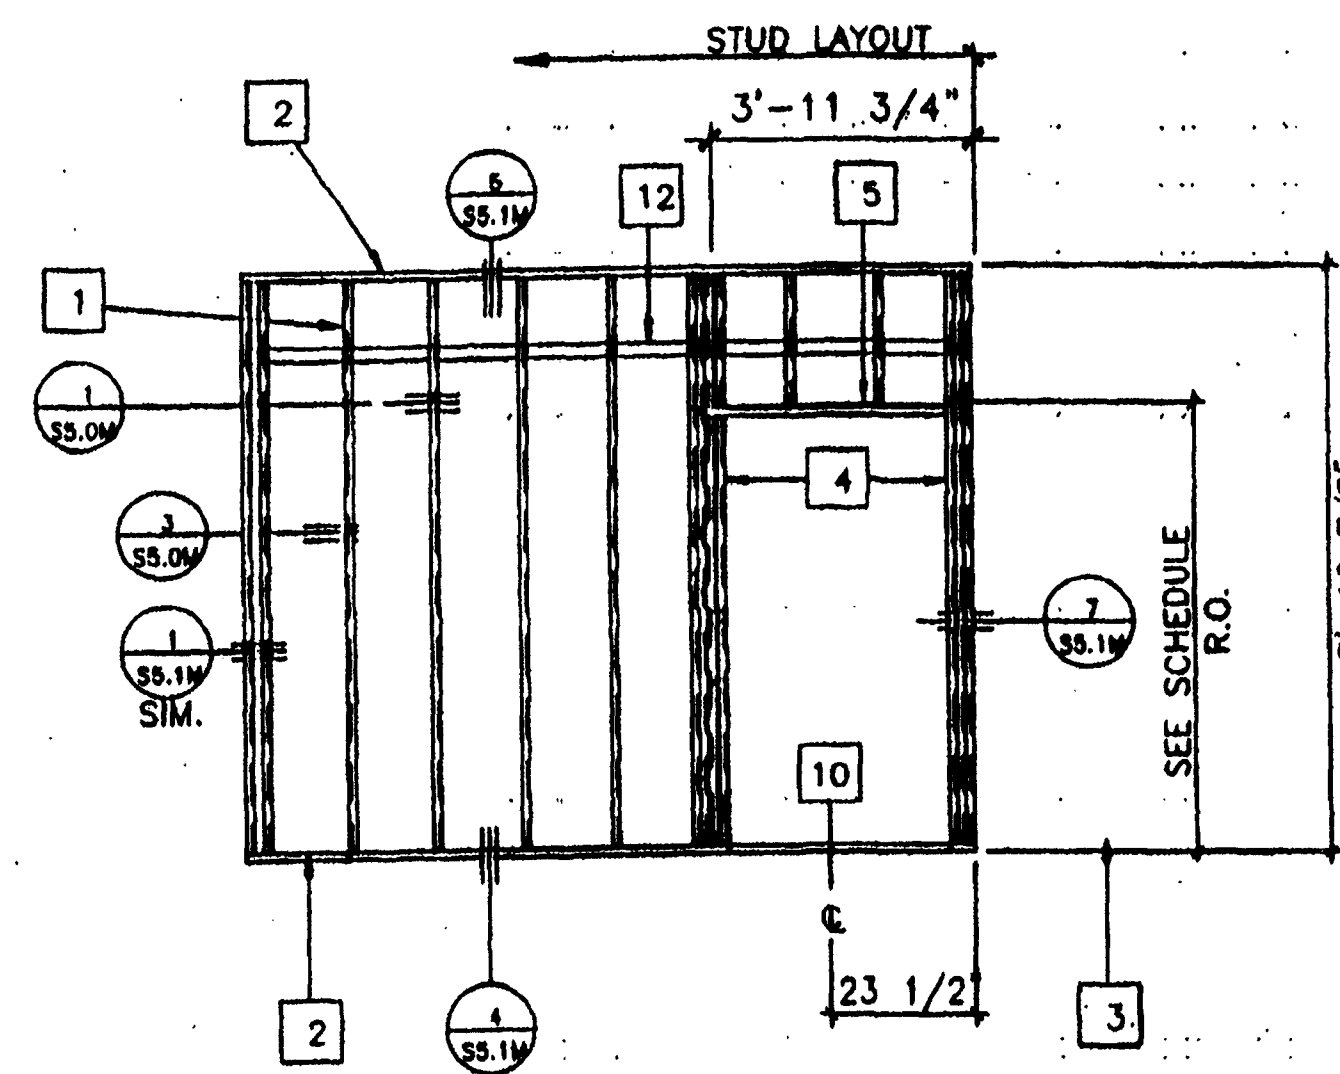


D
D₁ OPPOSITE HAND

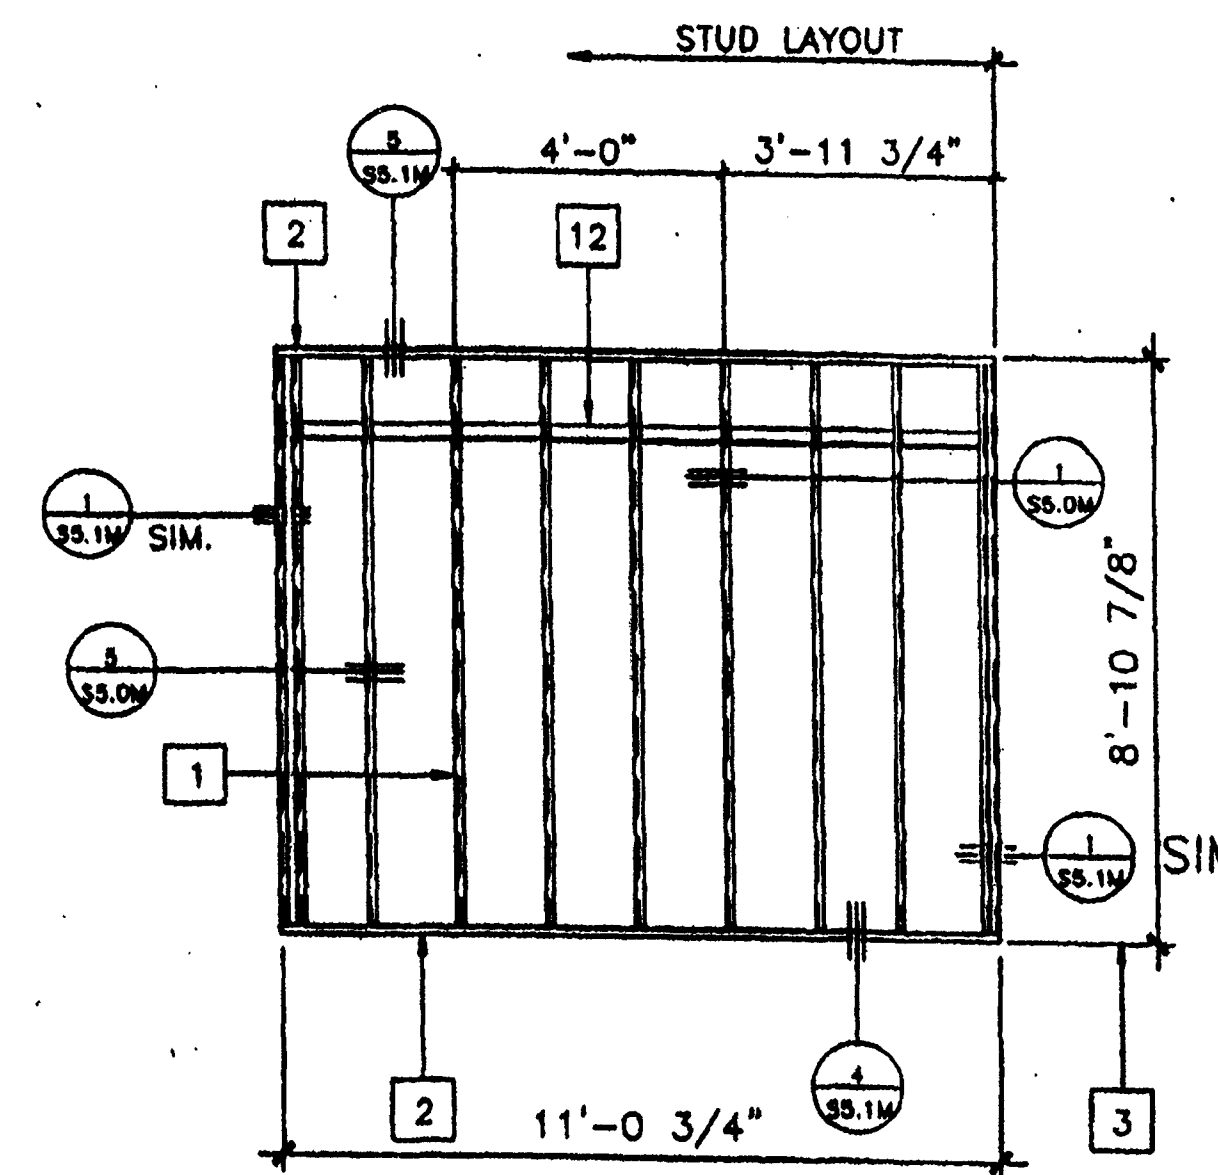

E

KEY NOTES

- 1 1 1/2" X 3 1/2" 20GA METAL STUD
● MAX 16" O.C.
- 2 1 1/2" X 3 1/2" X 18GA TRACK
- 3 FINISH FLOOR
- 4 FULL HGT. KING STUDS
(SEE SCHEDULE FOR QUANTITY SHT \$5.0M)
- 5 HEADER (SEE SCHEDULE SHT. \$5.0M) . . .
- 6 WINDOW SILL PLATE (SEE SCHED.SHT \$5.0M)
- 7 THERMOSTAT BOX
- 8 FULL HEIGHT STUDS AND JAMB STUDS (SEE
WINDOW SCHEDULE FOR TYPE AND QUANTITY
OF JAMB STUDS - SHT. \$5.0M)
- 9 FRAME FOR ELECTRICAL PANEL
- 10 REQUIRED OPENING FOR A 3068
DOOR (SEE DETAIL 7/55.0M)
- 11 REQUIRED OPENING FOR A 8040
WINDOW (SEE DETAIL 7/55.0M)
- 12 20GA X 2 1/2" STRAP (OPTIONAL FOR 8'
SIDING ONLY)

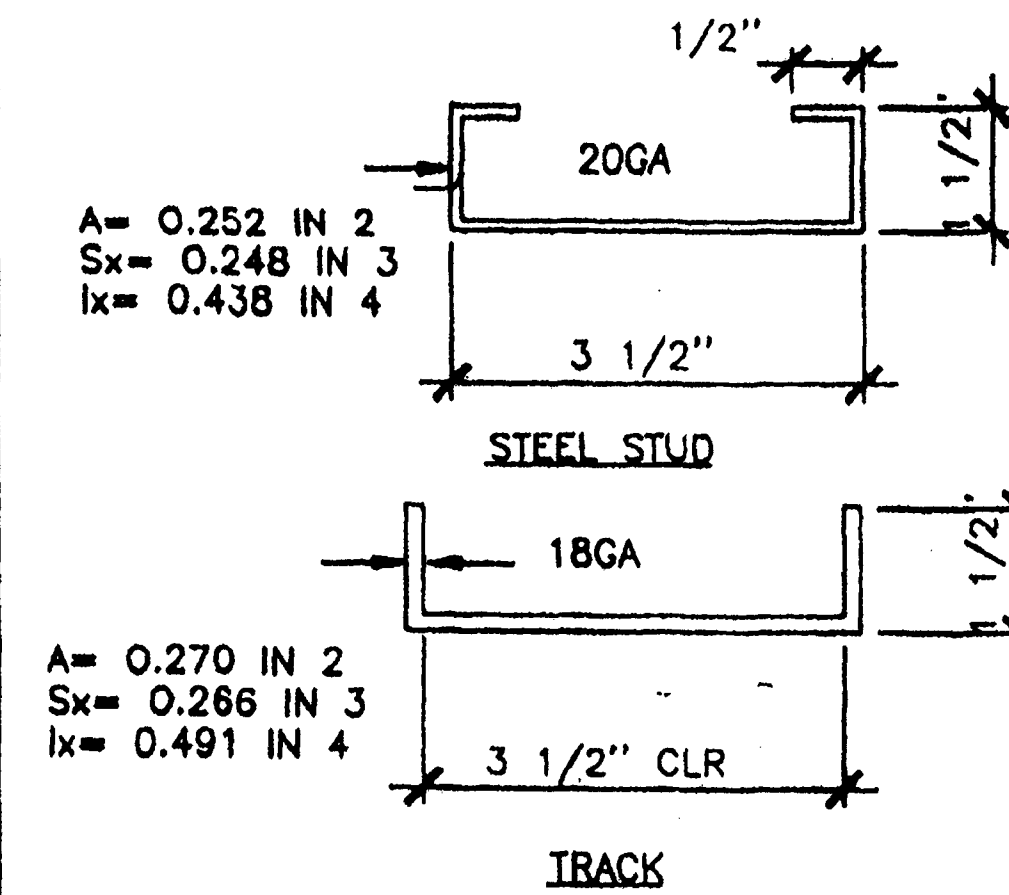

CONNECTIONS:
TOP TRACK TO ROOF BEAM/HEADER
0.145" SHOT PINS OR
#10 STMS AT 24" O.C.
TRACK TO FLOOR PLYWOOD:
16d BOX @ 10" O.C. OR
#10 X 1 1/2 W.S AT 10" O.C.
4'-0" HEADER:
(1) 5 1/2"x1 1/2"x18GA TRACK AS HEADER
(1) 5 1/2"x1 1/2"x20GA STUDS AS JAMB
8'-0" HEADER:
(1) 5 1/2"x1 1/2"x18GA TRACK AS HEADER
(2) 5 1/2"x1 1/2"x20GA STUDS AS JAMB

NOTES

ALL STEEL STUDS ARE 3 1/2" X 1 1/2" X 20GA
CHANNEL @ 16" O.C.
ALL STEEL SECTIONS CONFORM TO ASTM A446
GALVANIZED SHEETS HAVE BASE METAL THICKNESS
AS INDICATED WITH COATINGS PER ASTM A525.

[illegible]

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PROJECT OWNER & TITLE
LODI UNIFIED SCHOOL DISTRICT
1305 E. Vine St
Lodi, CA 95240

**MILLSWOOD MIDDLE SCHOOL
PORTABLES RELOCATION**

233 N Mills Ave
Lodi, CA 95242

SHEET TITLE

WALL FRAMING (METAL)

DRAWN BY: XXXXXX JOB NUMBER: 23219

SHEET NO.

S4.0M

DATE: DECEMBER 5, 2023

CONSTRUCTION DOCUMENTS

[illegible]

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LODI UNIFIED SCHOOL DISTRICT
1305 E. Vine St
Lodi, CA 95240

**MILLSWOOD MIDDLE SCHOOL
PORTABLES RELOCATION**
233 N Mills Ave
Lodi, CA 95242

SHEET TITLE

WALL FRAMING DETAILS (WOOD)


DRAWN BY: XXXXXX JOB NUMBER: 23219

SHEET NO.



S5.1



DATE: DECEMBER 5, 2023

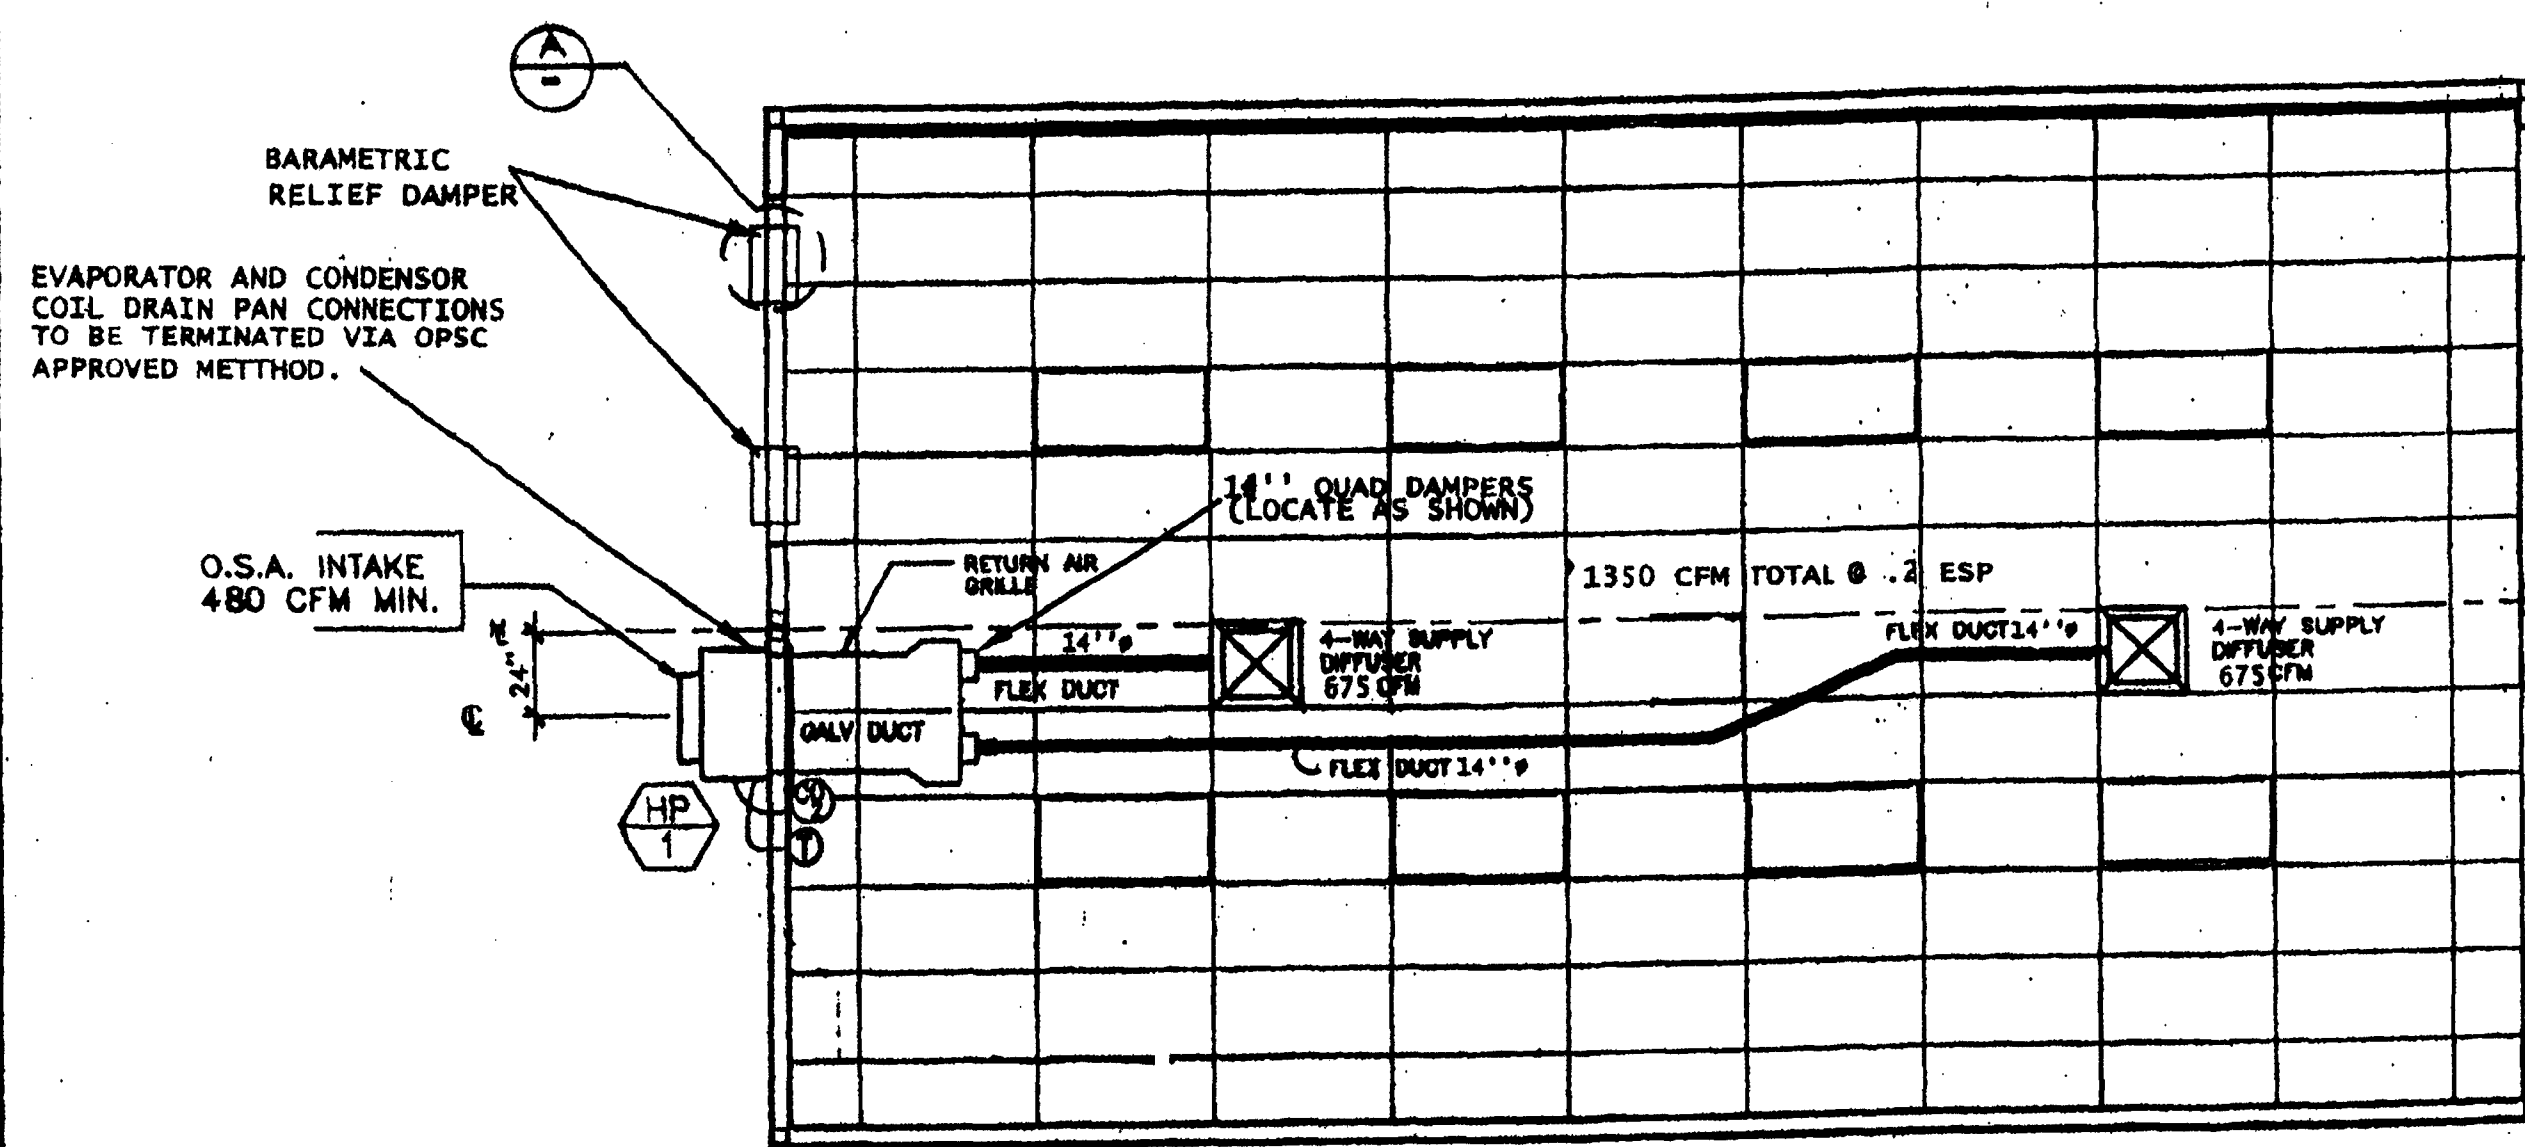

AIR CONDITIONING FLOOR PLAN - TYPE 1 BUILDING
1/4" = 1'-0"

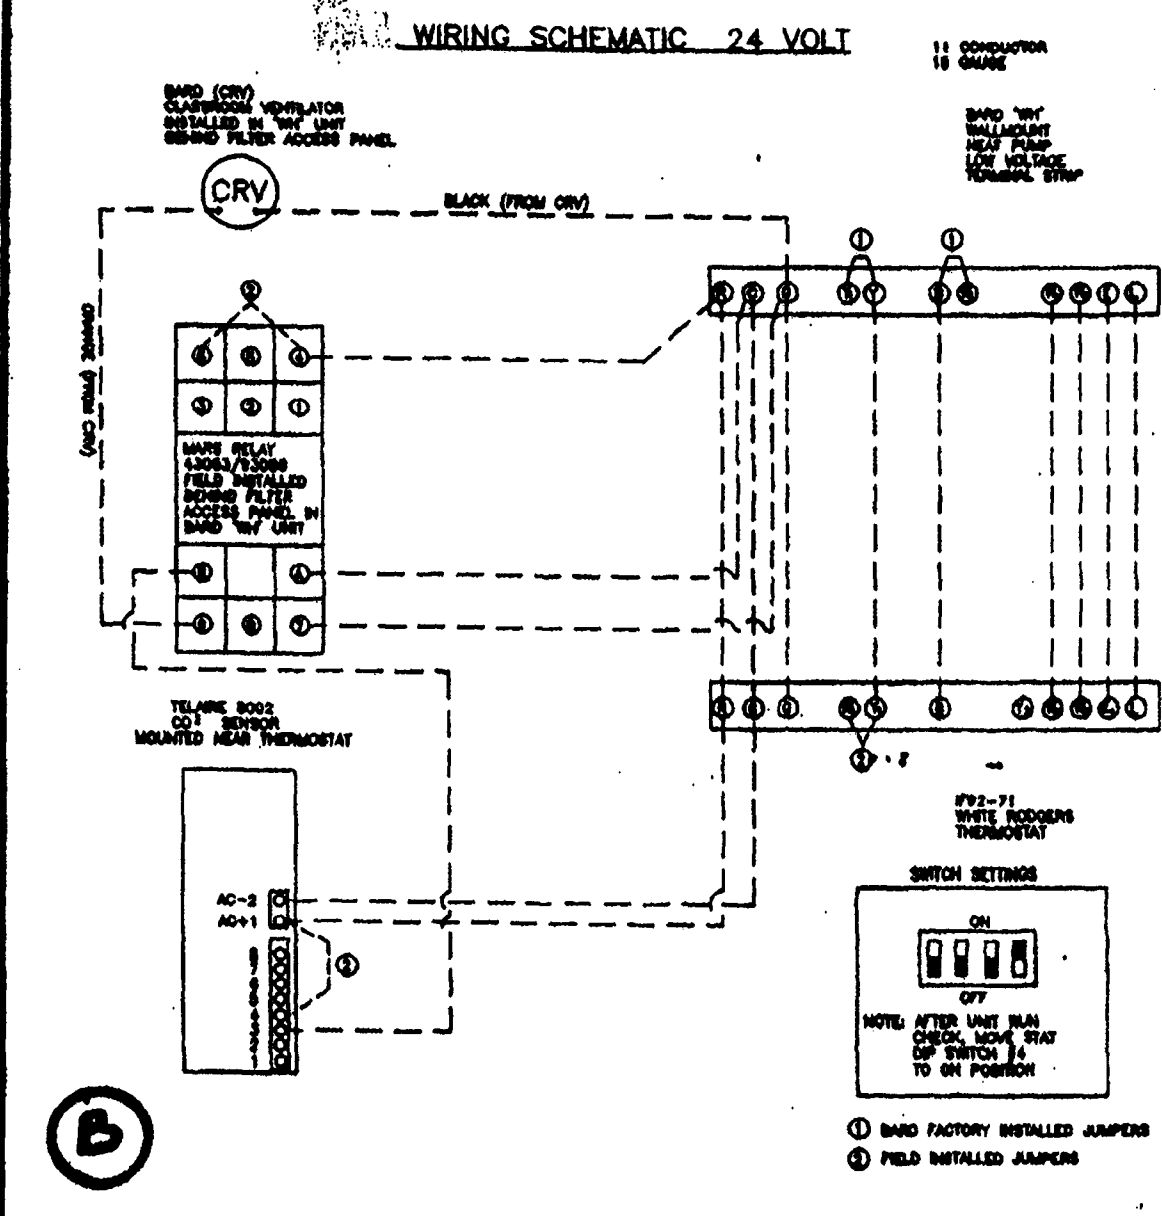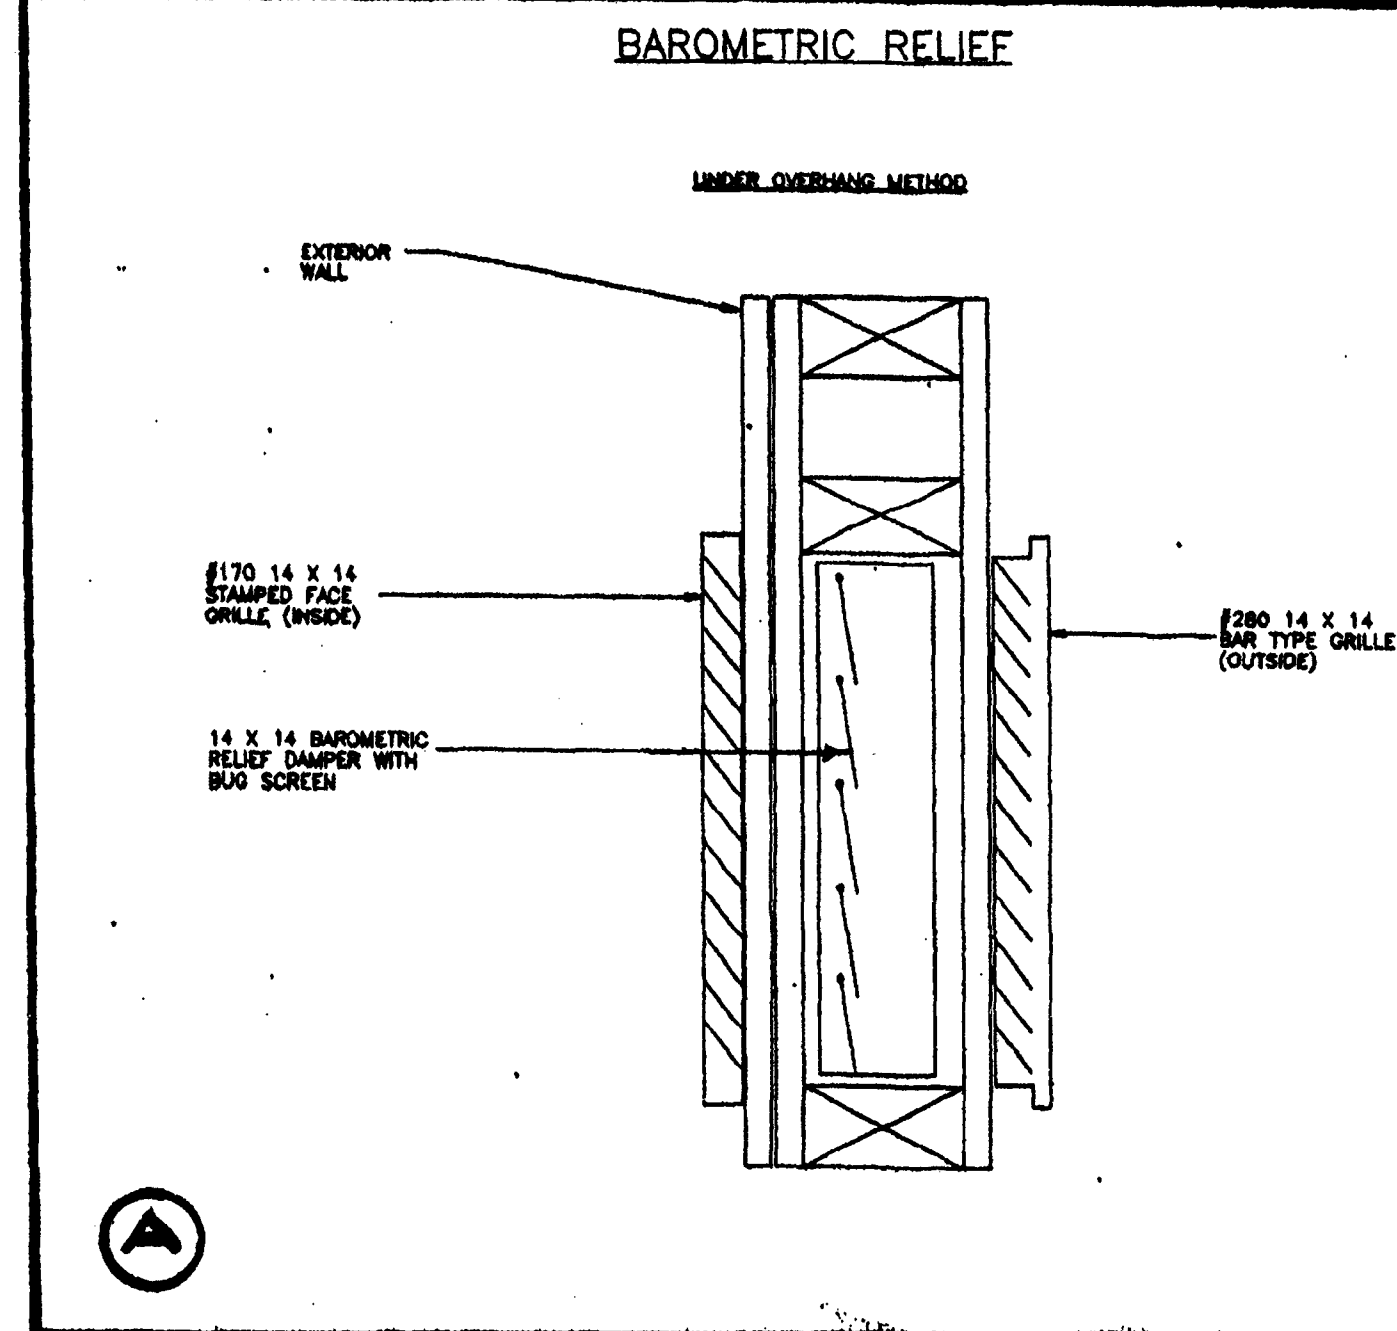

INSULATION APPLIED TO EXTERIOR SURFACE OF DUCTS LOCATED IN BLDGS SHALL HAVE A FLAME SPREAD OF NOT MORE THAN 25 & A SMOKE-DENSITY NOT EXCEEDING 50 WHEN TESTED AS A COMPOSITE INSTALLATION, INCLUDING INSULATION, FACING MATERIALS, TAPES & ADHESIVES AS NORMALLY APPLIED.

HEAT PUMP, 12 SEER, BARD WALL MOUNT, WH61-A10CP4 10 KW
58,000 NOMINAL BTUH COOLING CAPACITY @ 90 F OUTDOORS /67°F INDOORS
58,000 NOMINAL BTUH HEATING CAPACITY FROM COMPRESSOR
ANOMINAL 34,370 NOMINAL BTUH HEATING FROM 10 KW AUX. HEAT STRIP
@ 240V.
DUAL CIRCUIT:
CIRCUIT A: MCA 52 MDCP 60 WIRE SIZE #6
CIRCUIT B: MCA 52 MDCP 60 WIRE SIZE #6
1350 CFM @ .2 ESP, UNIT WT. 510lbs.
230V, 60 CYCLE, SINGLE PHASE

DUCTWORK: GALV. IRON PLENUM 60" WITH
GALV. IRON REGISTER BOXES
GAGE PER ASHRAE CODE REQUIREMENTS
FLEX DUCT PER CODE AND
SIZING PER .1" S.P.
INSULATE WITH 1" LINER INSULATION
PER: SPECIFICATIONS SECTION #3.23.2.1



CONTROLS: PER SPECIFICATION AND TITLE 24

AIR BALANCE: PER SPECIFICATIONS

OUTSIDE AIR INTAKE: PROVIDE 15 CFM x 32 = 480 CFM MINIMUM


① THERMOSTAT: WHITE RODGERS IF92 PROGRAMMABLE OR EQUAL
W/LOCKABLE COVER, OPSC INSTRUCTION PLATE INSTALLED ON STAT

CO₂ CO2 SENSOR: TELAIRE, 8002 PROGRAMMABLE W/WIRE GUARD

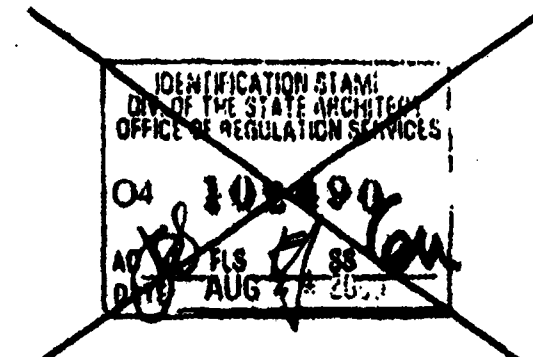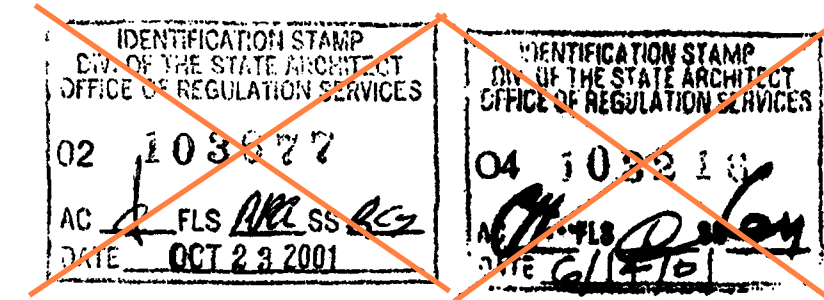

NOTES

1. INSULATION APPLIED TO EXTERIOR SURFACE OF DUCTS LOCATED IN BUDOS SHALL HAVE A FLAME SPREAD OF NOT MORE THAN 25 AND A SMOKE-DENSITY NOT EXCEEDING 50 WHEN TESTED AS A COMPLETE INSULATION SYSTEM. INSULATION, FACING MATERIALS, TAPES AND ADHESIVES AS NORMALLY APPLIED.
2. SCHOOL EQUIPMENT ANCHORAGE
- THE FOLLOWING IS FOR THE MECHANICAL ENGINEER'S INFORMATION ONLY:
- THE SEISING ANCHORAGE OF MECHANICAL EQUIPMENT SHALL CONFORM TO THE TITLE AND SECTION OF THE TABLE LISTED BELOW FOR ROOF/ FLOOR MOUNTED EQUIPMENT WEIGHING LESS THAN 400 LBS. AND FLOOR EQUIPMENT WEIGHING LESS THAN 20 LBS. MAY BE OMITTED FROM THE PLANS.
- ALL MECHANICAL EQUIPMENT SHALL BE BRACED OR ANCHORED TO RESIST A CENTRAL FORCE ACTING IN ANY DIRECTION USING THE FOLLOWING CRITERIA:
- | | |
|------------------------------|--------------------------------|
| _____ EQUIPMENT ON GRADE | _____ JOBS OF OPERATING WEIGHT |
| _____ EQUIPMENT ON STRUCTURE | _____ JOBS OF OPERATING WEIGHT |
- FOR FLOOR MOUNTED EQUIPMENT USE 4 TIMES THE ABOVE VALUES AND FOR SIMILARLY MOUNTED VERTICAL EQUIPMENT USE 1/3 TIMES THE HORIZONTAL FORCE.
- THE ABOVE VALUES ARE FOR AN IMPORTANCE FACTOR, $I = 1.0$ AND SEISMIC ZONE, $Z = 4$
- WHERE ANCHORAGE DETAILS ARE NOT SHOWN ON THE DRAWINGS THE FIELD ENGINEER SHALL BE SUBJECT TO THE APPROVAL OF THE MECHANICAL ENGINEER AND THE FIELD ENGINEER OF THE OFFICE OF THE STATE ARCHITECT.

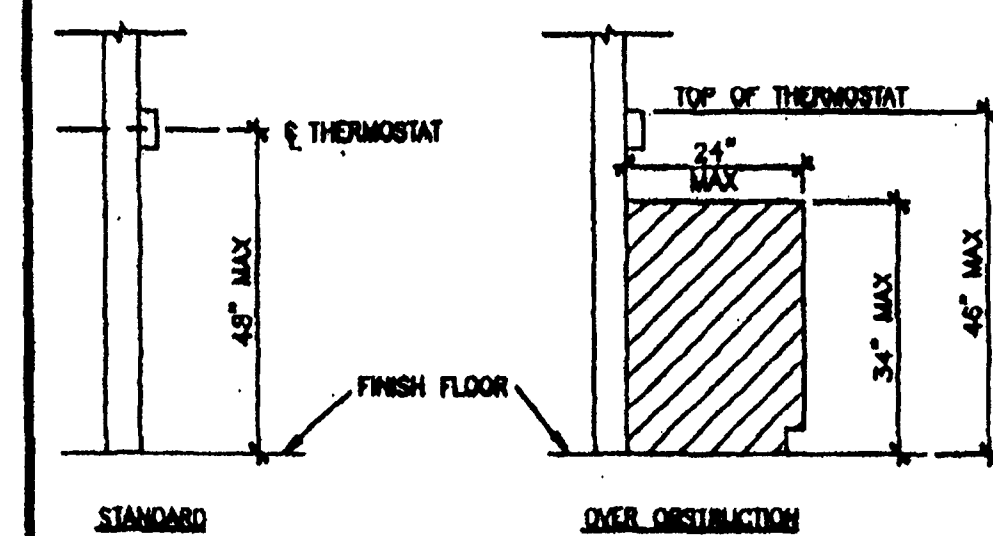

THERMOSTAT ACCESS

[illegible]

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PROJECT OWNER & TITLE
LODI UNIFIED SCHOOL DISTRICT
1305 E. Vine St
Lodi, CA 95240

**MILLSWOOD MIDDLE SCHOOL
PORTABLES RELOCATION**

Lodi, CA 95242

SHEET TITLE

MECHANICAL (HVAC) PLAN 24'X40'
5 TON

DRAWN BY: XXXXXX JOB NUMBER: 23219

SHEET NO.

M1.01

DATE: DECEMBER 5, 2023

ELECTRICAL PANEL SCHEDULE

MAIN: 150 AMP			PANEL: A										FEED: REAR					
			LOCATION: REAR/INTERIOR										MOUNTING: FLUSH					
LOAD			WATTS		BREAKER		C		O		BREAKER		WATTS		LOAD			
	As	Bs	Amps	1	2	3	4	5	6	7	8	9	As	Bs				
HEAT PUMP			6240	60	2	1				2	1	20	720			RECEPTS		
HEAT PUMP		6240	-	-	3				4	1	20		900			RECEPTS/CLOCK		
HEAT STRIP - 10 KW		6240	60	2	5				6	1	20	1000				COMPUTER		
HEAT STRIP - 10 KW		6240	-	-	7				8	1	20		1000			COMPUTER		
LIGHTS		760	20	1	9				10	1	20	1000				COMPUTER		
LIGHTS		700	20	1	11				12	1	20		1000			COMPUTER		
									13									
									14									
									15									
									16									
									17				2720	2900				
WATTS/PHASE			A = 15,960		13240	13180									B = 16,080		WATTS/PHASE	
TOTAL			32,040		WATTS	134	AMPS		120/240 VOLTS				SINGLE #		THREE WIRE			

10 K.A.I.C. MIN


NOTES

1. PROVIDE MIN. 3" x 1 1/2" METAL TAG INSIDE
ELEC. PANEL INDICATING OPSC NUMBER AND
DSA NUMBER.
2. SCHOOL EQUIPMENT ANCHORAGE
- THE FOLLOWING IS FOR THE ELECTRICAL ENGINEER'S INFORMATION ONLY:
- THE SEISMIC DESIGN OF ELECTRICAL EQUIPMENT SHALL CONFORM
TO THE FOLLOWING: (SEE SECTION 1203.03.2) THE SEISMIC DESIGN
FOR ROOF/FLOOR INSULATED EQUIP. WINDING LESS THAN 400 LBS. & HUNG
EQUIPMENT WINDING LESS THAN 200 LBS. MAY BE OMITTED FROM THE PLANS.
- FOR ELECTRICAL DRAWINGS:
- ALL ELECTRICAL EQUIPMENT SHALL BE BRACED OR ANCHORED TO RESIST A
HORIZONTAL FORCE ACTING IN ANY DIRECTION USING THE FOLLOWING CRITERIA:
- | | |
|-------------------------------|-------------------------|
| <u>EQUIPMENT ON GRADE</u> | 20% OF OPERATING WEIGHT |
| <u>EQUIPMENT ON STRUCTURE</u> | 30% OF OPERATING WEIGHT |
- FOR FLUENTLY MOUNTED EQUIPMENT USE 4 X THE ABOVE VALUES, AND FOR
SIMULTANEOUS VERTICAL FORCE USE 1/3 X THE HORIZONTAL FORCE.
- THE ABOVE VALUES ARE FOR AN IMPORTANCE FACTOR, $I = 1.0$ AND SEISMIC
ZONE, $Z = 0.4$.
- WHERE ANCHORAGE DETAILS ARE NOT SHOWN ON THE DRAWINGS, THE FIELD
INSTALLATION SHALL BE SUBJECT TO THE APPROVAL OF THE ARCHITECT AND
THE FIELD ENGINEER OF THE OFFICE OF THE STATE ARCHITECT.


* SMOKE & HEAT DETECTORS SHOWN ARE FOR OPTIONAL AUTOMATIC DETECTION. IF ELECTED AS AN OPTION THEY MUST BE PROVIDED BY DISTRICT. NO PROVISIONS WILL BE MADE UNDER THIS CONTRACT.

GENERAL GROUNDING NOTES


1. EACH RAIL SHALL BE SEPARATELY GROUNDED WITH A 3/4" ROD, X 8" COPPERCLAD STEEL GROUND ROD, WHERE THE BOTTOM IS ENCOUNTERED. ROO SHALL BE DRIVEN TO A DEPTH OF 10' TO BE EXCEED AS DEGREE'S FROM THE VERTICAL OR SHALL BE BURIED IN A TRENCH THAT IS AT LEAST 18" DEEP. (BY SITE ELECTRICAL)
2. TESTING: TEST FOR RESISTANCE TO GROUND. IF RESISTANCE EXCEEDS 25 OHMS, INSTALL ADDITIONAL GROUND RODS SEPARATED AT LEAST 6'-0" UNTIL RESISTANCE IS REDUCED TO 25 OHMS OR LESS. (BY SITE ELECTRICAL)
3. PROVIDE EQUIPMENT ANCHORAGE PER TABLE 24, TABLE 19.4, PART B.
4. APPROVAL OF THIS PLAN DOES NOT CONSTITUTE APPROVAL OF THIS FINE ALARM FOR ALL SITES. THE FINE ALARM SYSTEM AND/OR COMPONENTS MAYBE REQUIRED TO BE CHANGED DUE TO SITE LOCATION, EXISTING CONDITIONS OR INADEQUATE COMPONENTS.
5. GROUND MG TEST SHALL BE DONE IN THE PRESENCE OF THE PROJECT INSPECTOR. ALL DEGREE'S SHALL BE IN ACCORDANCE WITH C.E.C. ARTICLE 250.
6. TO ASSURE A QUALITY GROUND FOR COMPUTER OUTLETS AN EQUIPMENT GROUNDING CONDUCTOR SHALL BE RUN THROUGH THE RECEPTACLE CIRCUITS FROM THE PANEL GROUNDING BUS AND SHOWN TO THE EQUIPMENT GROUND TERMINAL OF EACH RECEPTACLE PER CEC ART. 250

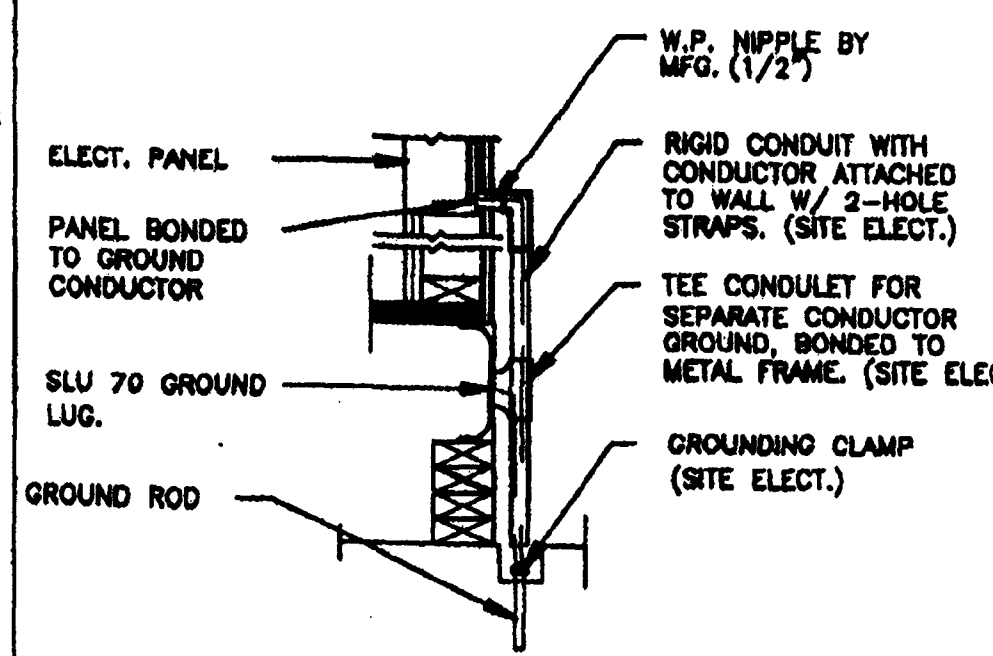

TYP GROUNDING DETAIL

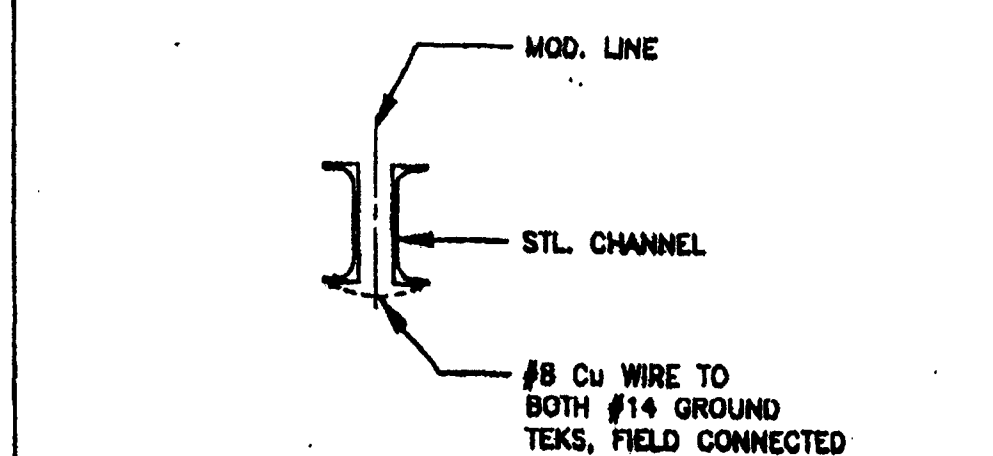



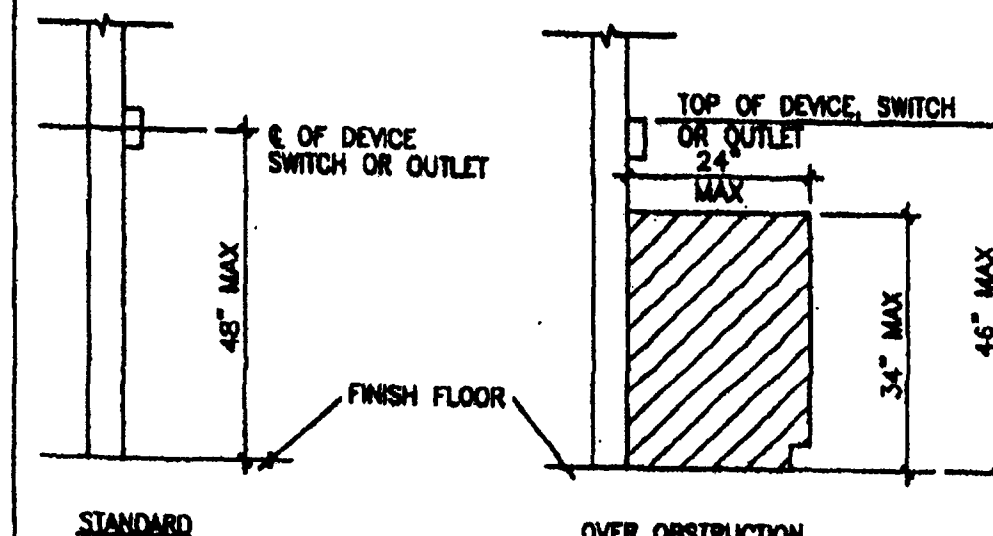




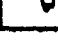












GROUND JUMPER • MOD LINE

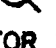


DEVICE MOUNTING

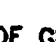

ELECTRICAL LEGEND


-  2 X 4 TUBE 20 FLUORESCENT LIGHT FIXTURE
 W/ELC.BALAST. SELECT (SEE SPEC. FOR LABELING INSIDE
 FIXTURE 0
 EXTERIOR LIGHT, 13" WATT FLOUR. WITH PHOTO CELL AND
 SWITCH CONTROL, AT +90° AFF. (SEE SPECS)
 SWITCH AT +48" AFF (SEE SPECS)
 RECEPTACLE, FOURPLEX (2 DUPLEX RECEPTACLES IN TWO
 GANG BOX) COLORS: COMMEUNE - IVORY (1)
 COMPUTER - GREY (G)
 WALL MOUNT AT +81" AFF - UNG. COVG PLATES - IVORY
 SEE GROUNDING NOTE #6
 JUNCTION BOX, 4" SQ X 2 1/8" W/SINGLE DEVISE RAISED
 RING AND 3/4" CONDUIT W/BUSHING TO ATTIC. MOUNT AT
 7'-6" AFF AND PROVIDE S&L GANG BLANK COVG. PLATE.
 JUNCTION BOX, 2 GANG. S&L GANG BLANK COVG. PLATE.
 MOUNT +24" AFF. 1" CONDUIT TO ATTIC. PULLSTRING.
 HVAC UNIT - SEE MECH PLAN
 THERMOSTAT - #F92 W/LOCKABLE COVER, 48" AFF
 4SD J-BOX FOR FIRE ALARM PULL STATION AT +48" AFF. TO @
 3/4" CO TO  OR  . PULLSTRING
 4SD J-BOX FOR FIRE ALARM STROBE AT +80" AFF
 3/4" CO TO  PULLSTRING
 4SD J-BOX FOR FIRE ALARM HORN AT +98" AFF
 3/4" CO TO  . PULLSTRING
 WEATHER PROOF GUTTER BOX (6"6"x4") AT
 +18" AFF RECEIVE 3/4" CO FROM FA DEXIVE, PULLSTRING
 ELECTRICAL PANEL AT +60" AFF TO CENTERLINE 1 1/4" POWER
 NIPPLE POC, QND JUMPER BY SITE SELECT
 CLOCK AT +90° AFF
 CARBON DIOXIDE DETECTOR, SGL QNG. BOX WIRED TO
 FRESH AIR DAMPER, CONTROLLER W/ WIRE GROUND AT 66" AFF

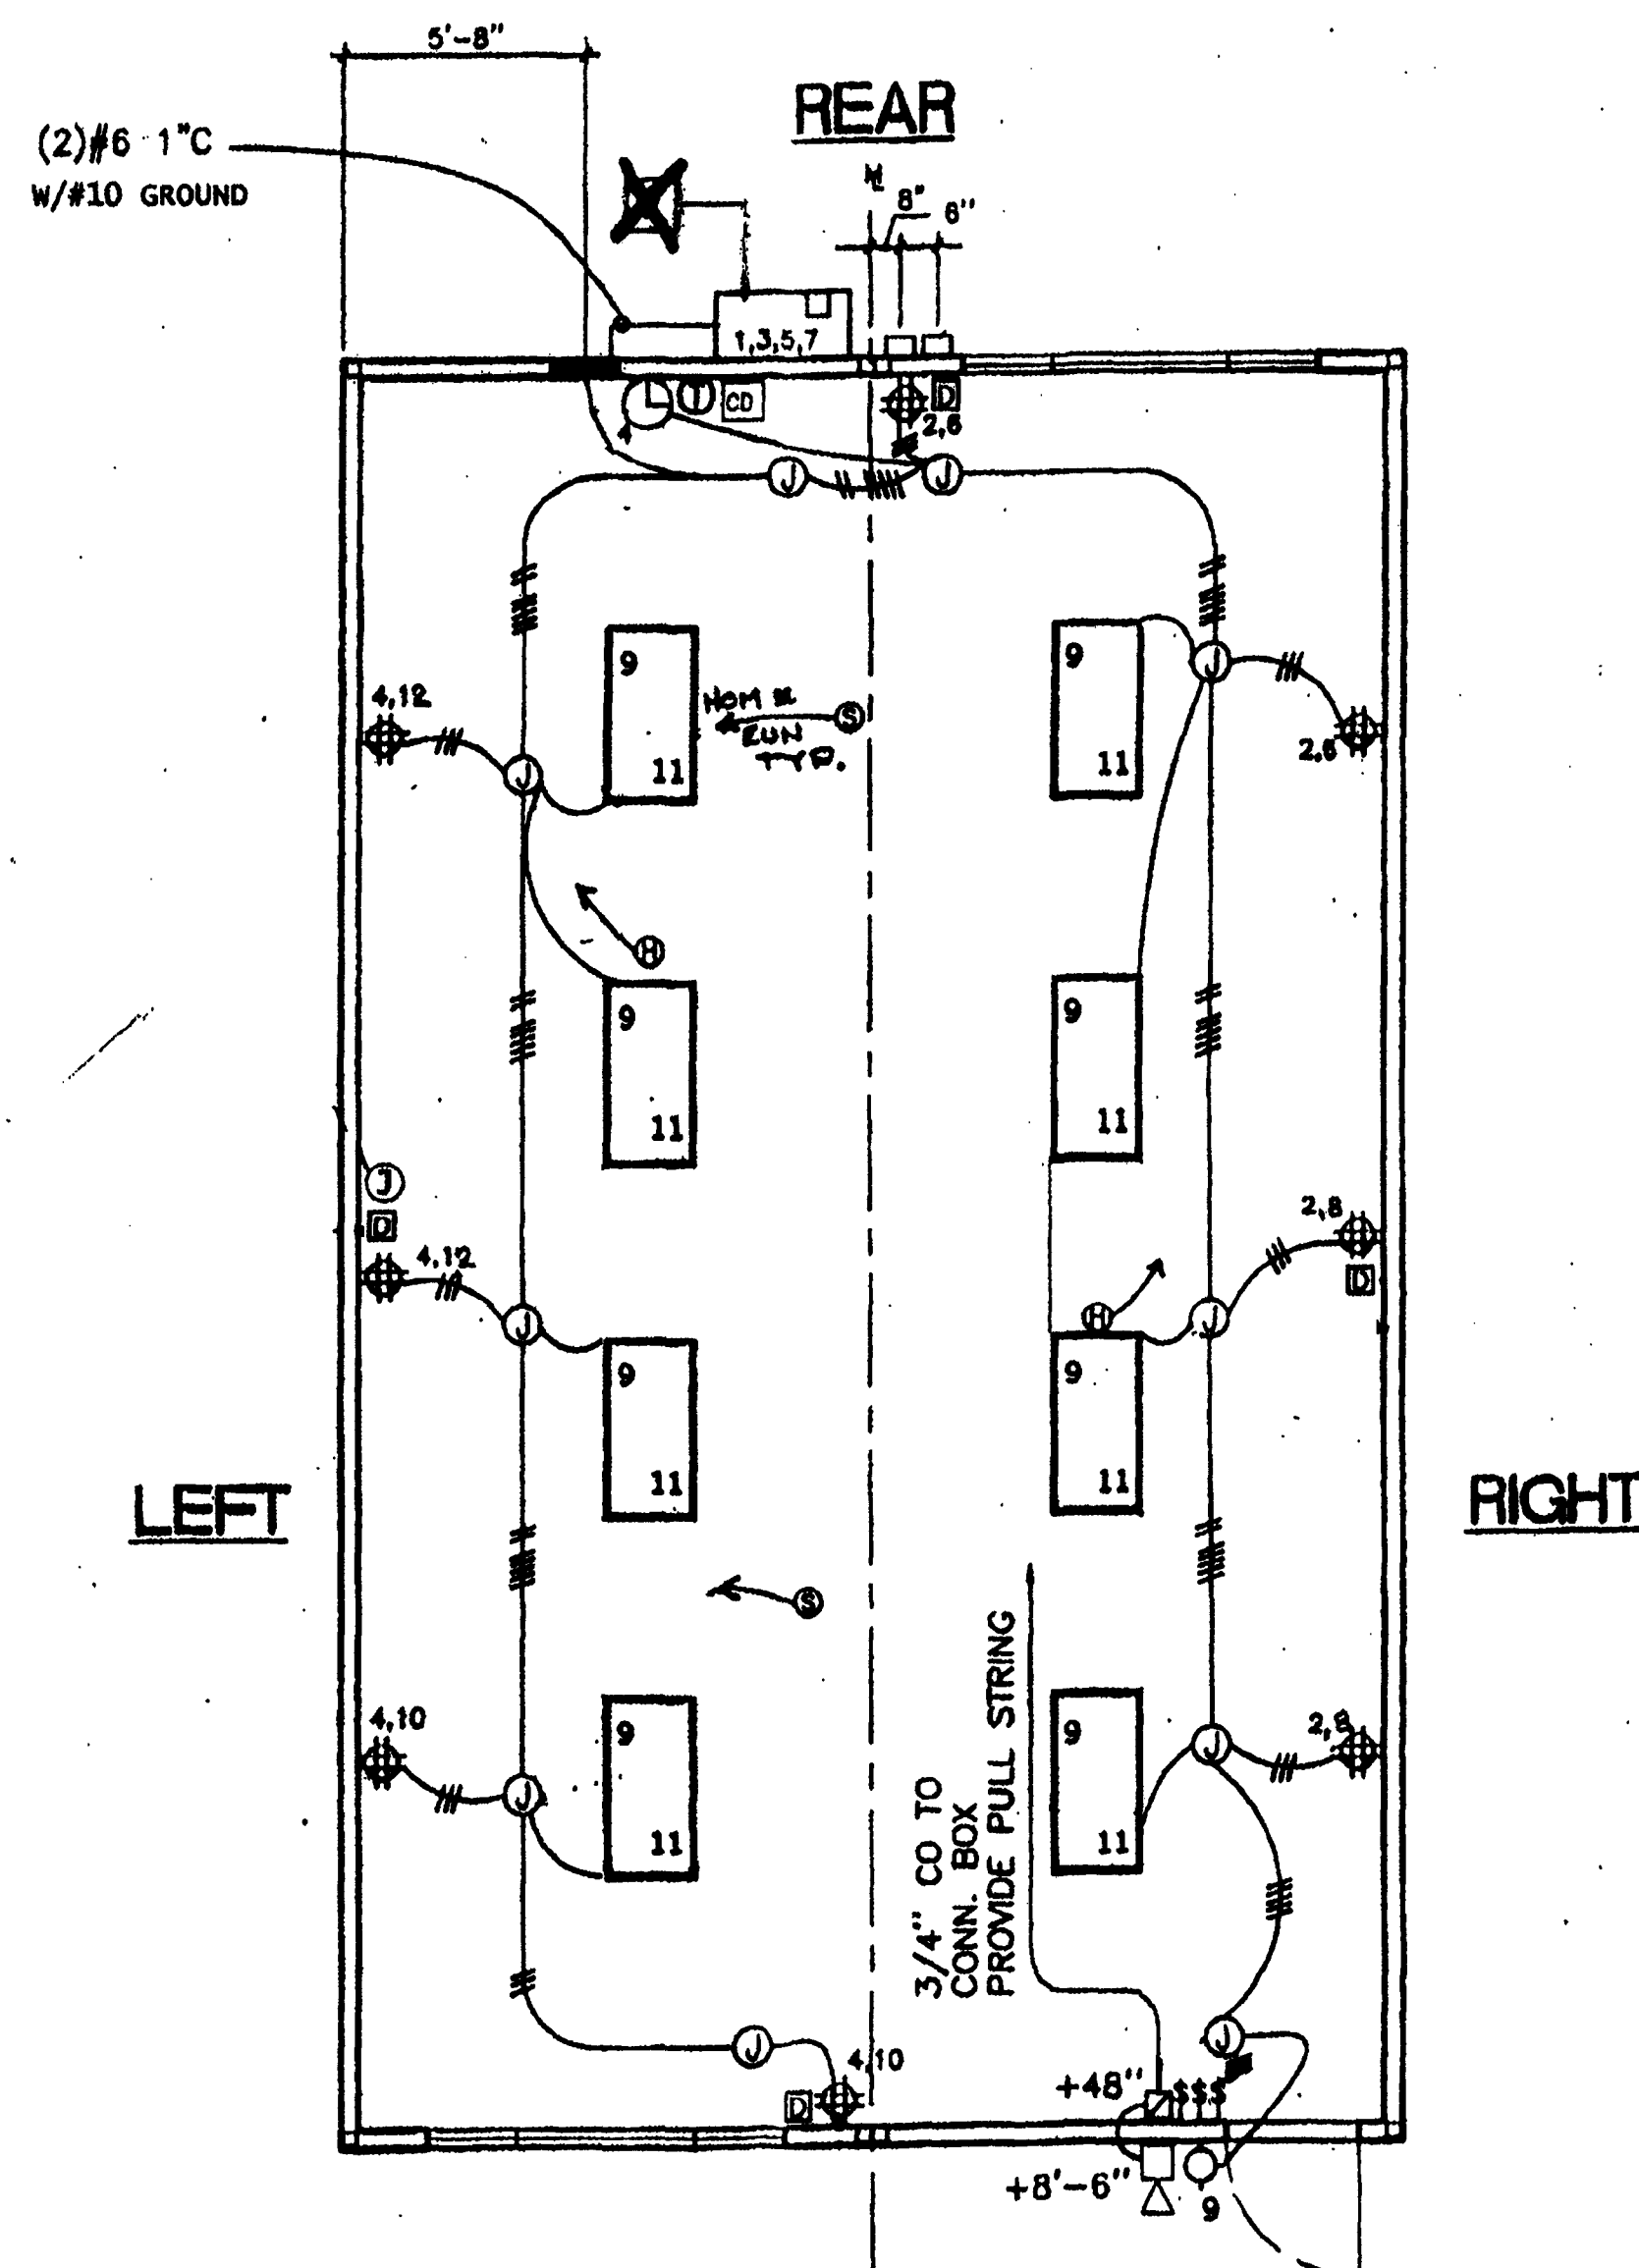


ELECTRICAL PLAN (24'X40')

"A" SHOWN
"B" OPPOSITE

SCALE: $1/4" = 1'-0"$

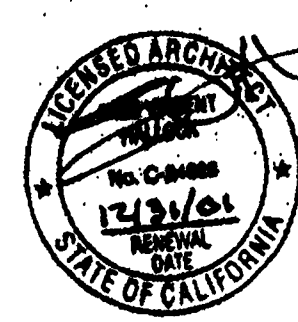

PC
CBC 1998

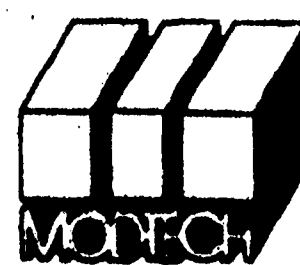

MODTECH INC.
2830 BARRETT AVENUE
PERRIS, CALIF. 92572
PH (909) 943-4014
FAX (909) 940-0427

PROJECT NUMBER:

© MODTECH, INC. 1999

DRAWN BY: *dk*
DATE: *4/24/00*
CHECKED BY: *SS*
DATE: *10/22/99*

PROFESSIONAL STAMP

REVISIONS

[illegible]

THE ARCHITECT DOES NOT REPRESENT THAT THESE PLANS OR THE SPECIFICATIONS ARE SUITABLE FOR ANY SITE OTHER THAN THE ONE FOR WHICH THEY WERE SPECIFICALLY PREPARED. THE ARCHITECT DISCLAIMS RESPONSIBILITY FOR THESE PLANS AND SPECIFICATIONS IF THEY ARE USED IN WHOLE OR IN PART AT ANY OTHER SITE. WRITTEN DIMENSIONS ON THESE DRAWINGS SHALL HAVE PRECEDENCE OVER SCALED DIMENSIONS.

PROJECT OWNER & TITLE
LODI UNIFIED SCHOOL DISTRICT
1305 E. Vine St
Lodi, CA 95240

**MILLSWOOD MIDDLE SCHOOL
PORTABLES RELOCATION**

233 N Mills Ave
Lodi, CA 95242

SHEET TITLE


ELECTRICAL PLAN 24'X40

DRAWN BY: XXXXXX JOB NUMBER: 23219

SHEET NO.

E1.01

DATE: DECEMBER 5, 2023

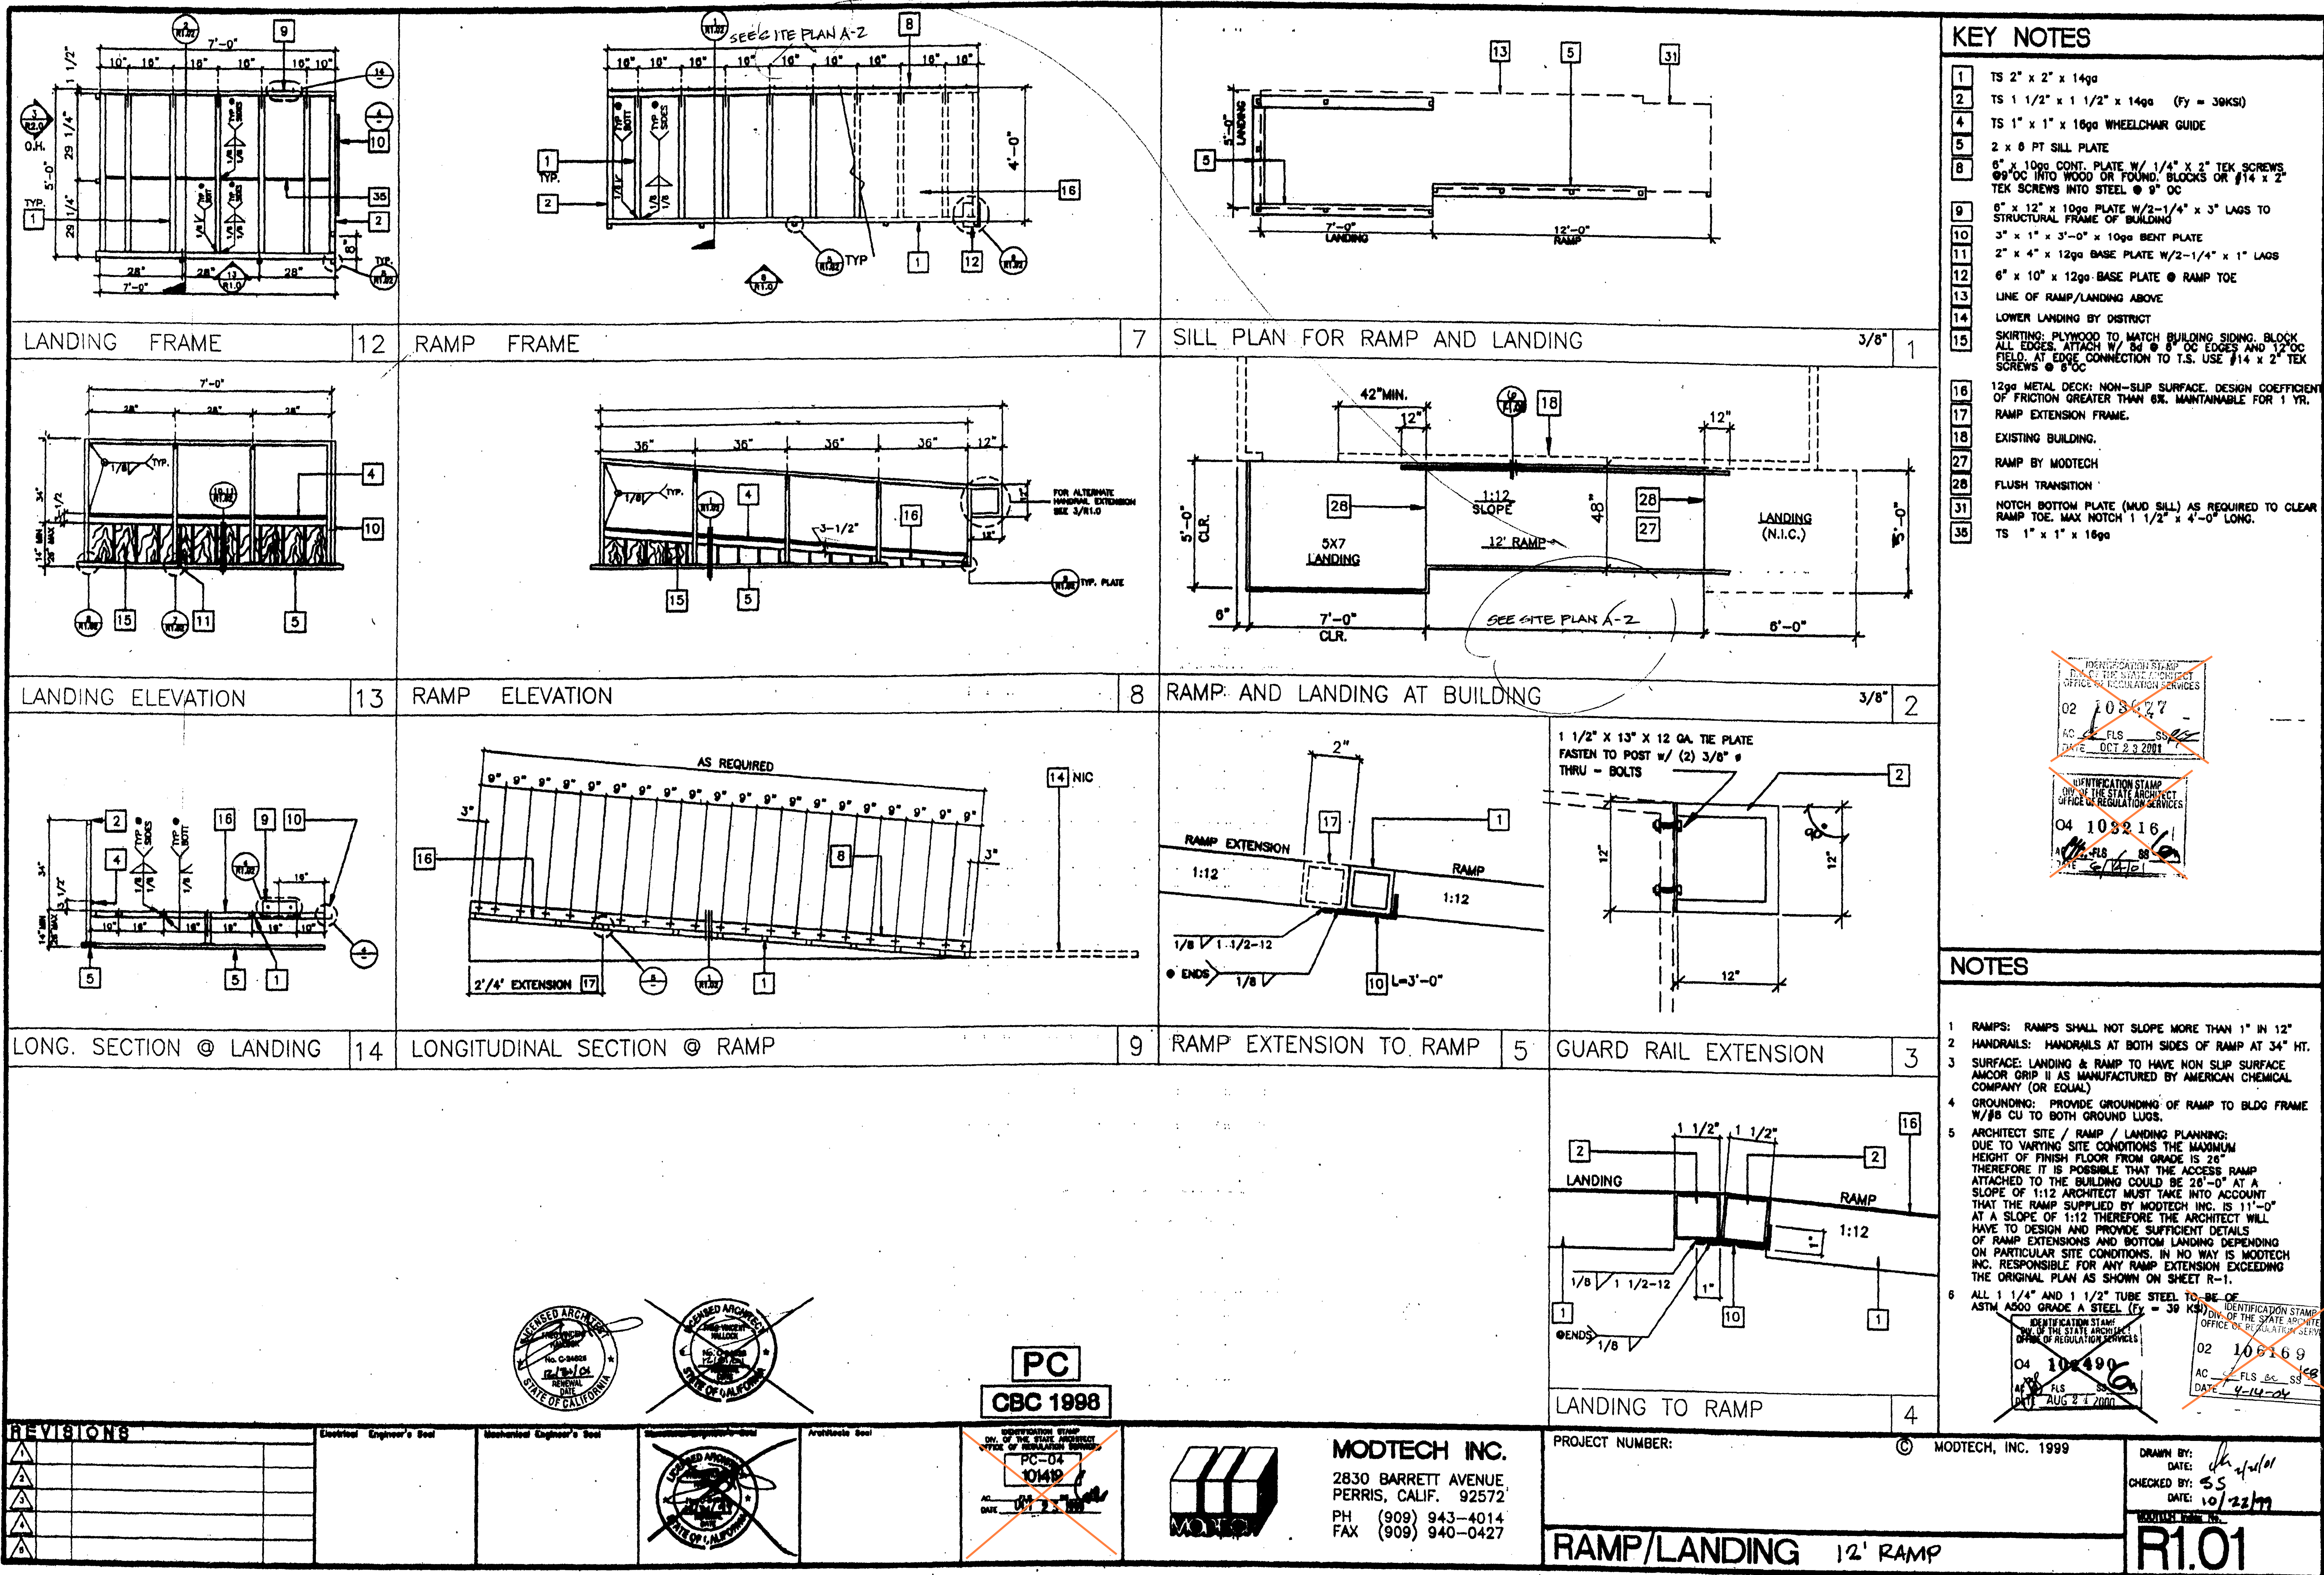

REVISIONS

NO.	DATE	DESCRIPTION
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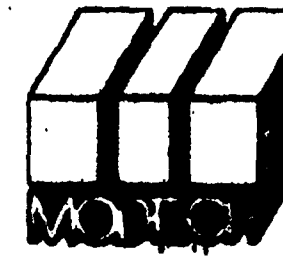
Electrical Engineer's Seal

Mechanical Engineer's Seal

Structural Engineer's Seal

Architect's Seal

PC
CBC 1998



MODTECH INC.
2830 BARRETT AVENUE
PERRIS, CALIF. 92572
PH (909) 943-4014
FAX (909) 940-0427

PROJECT NUMBER:

© MODTECH, INC. 1999

DRAWN BY: *SS*
CHECKED BY: *SS*
DATE: 10/23/99

RAMP/LANDING 12' RAMP

R1.01

KEY NOTES

- 1 TS 2" x 2" x 14ga
- 2 TS 1 1/2" x 1 1/2" x 14ga (Fy = 36KSI)
- 3 TS 1" x 1" x 16ga WHEELCHAIR GUIDE
- 4 2 x 6 PT SILL PLATE
- 5 6" x 10ga CONT. PLATE W/ 1/4" x 2" TEK SCREWS @ 9" OC INTO WOOD OR FOUND. BLOCKS OR #14 x 2" TEK SCREWS INTO STEEL @ 9" OC
- 6 6" x 12" x 10ga PLATE W/ 2-1/4" x 3" LAGS TO STRUCTURAL FRAME OF BUILDING
- 7 3" x 1" x 3'-0" x 10ga BENT PLATE
- 8 2" x 4" x 12ga BASE PLATE W/ 2-1/4" x 1" LAGS
- 9 6" x 10" x 12ga BASE PLATE @ RAMP TOE
- 10 LINE OF RAMP/LANDING ABOVE
- 11 LOWER LANDING BY DISTRICT
- 12 SKIRTING: PLYWOOD TO MATCH BUILDING SIDING. BLOCK ALL EDGES. ATTACH W/ 8d @ 6" OC EDGES AND 12" OC FIELD. MAKE CONNECTION TO S.I. USE #14 x 2" TEK SCREWS @ 6" OC
- 13 12ga METAL DECK: NON-SLIP SURFACE. DESIGN COEFFICIENT OF FRICTION GREATER THAN 0.6. MAINTAINABLE FOR 1 YR. RAMP EXTENSION FRAME.
- 14 EXISTING BUILDING.
- 15 RAMP BY MODTECH
- 16 FLUSH TRANSITION
- 17 NOTCH BOTTOM PLATE (MUD SILL) AS REQUIRED TO CLEAR RAMP TOE. MAX NOTCH 1 1/2" x 4'-0" LONG.
- 18 TS 1" x 1" x 16ga

NOTES

- 1 RAMP: RAMP SHALL NOT SLOPE MORE THAN 1" IN 12"
- 2 HANDRAILS: HANDRAILS AT BOTH SIDES OF RAMP AT 34" HT.
- 3 SURFACE: LANDING & RAMP TO HAVE NON SLIP SURFACE. AMCOR GRIP II AS MANUFACTURED BY AMERICAN CHEMICAL COMPANY (OR EQUAL)
- 4 GROUNDING: PROVIDE GROUNDING OF RAMP TO BLDG FRAME W/ 8 CU TO BOTH GROUND LUGS.
- 5 ARCHITECT SITE / RAMP / LANDING PLANNING: DUE TO VARYING SITE CONDITIONS THE MAXIMUM HEIGHT OF FINISH FLOOR FROM GRADE IS 26" THEREFORE IT IS POSSIBLE THAT THE ACCESS RAMP ATTACHED TO THE BUILDING COULD BE 26'-0" AT A SLOPE OF 1:12 ARCHITECT MUST TAKE INTO ACCOUNT THAT THE RAMP SUPPLIED BY MODTECH INC. IS 11'-0" AT A SLOPE OF 1:12 THEREFORE THE ARCHITECT WILL HAVE TO DESIGN AND PROVIDE SUFFICIENT DETAILS OF RAMP EXTENSIONS AND BOTTOM LANDING DEPENDING ON PARTICULAR SITE CONDITIONS. IN NO WAY IS MODTECH INC. RESPONSIBLE FOR ANY RAMP EXTENSION EXCEEDING THE ORIGINAL PLAN AS SHOWN ON SHEET R-1.
- 6 ALL 1 1/4" AND 1 1/2" TUBE STEEL TO BE OF ASTM A500 GRADE A STEEL (Fy = 36 KSI)

AGENCY APPROVAL
DIV. OF THE STATE ARCHITECT
APP: 02-121945 INC.
REVIEWED FOR:
SS ☒ FLS ☒ ACS ☒
DATE: 12/12/2023

PROJECT OWNER & TITLE
LODI UNIFIED SCHOOL DISTRICT
1305 E. Vine St
Lodi, CA 95240

PROJECT NUMBER: 23219
JOB NUMBER: 23219

SHEET TITLE
RAMP/LANDING PLAN W/ 12' RAMP


DATE: DECEMBER 5, 2023

REVISIONS
NO. DATE DESCRIPTION

THE ARCHITECT DOES NOT REPRESENT THAT THESE PLANS OR THE SPECIFICATIONS ARE SUITABLE FOR ANY SITE OTHER THAN THE ONE FOR WHICH THEY WERE SPECIFICALLY PREPARED. THE ARCHITECT DISCLAIMS RESPONSIBILITY FOR THESE PLANS AND SPECIFICATIONS IF THEY ARE USED IN WHOLE OR IN PART AT ANY OTHER SITE. WRITTEN DIMENSIONS ON THESE DRAWINGS SHALL HAVE PRECEDENCE OVER SCALED DIMENSIONS.

CONSTRUCTION DOCUMENTS

R1.01

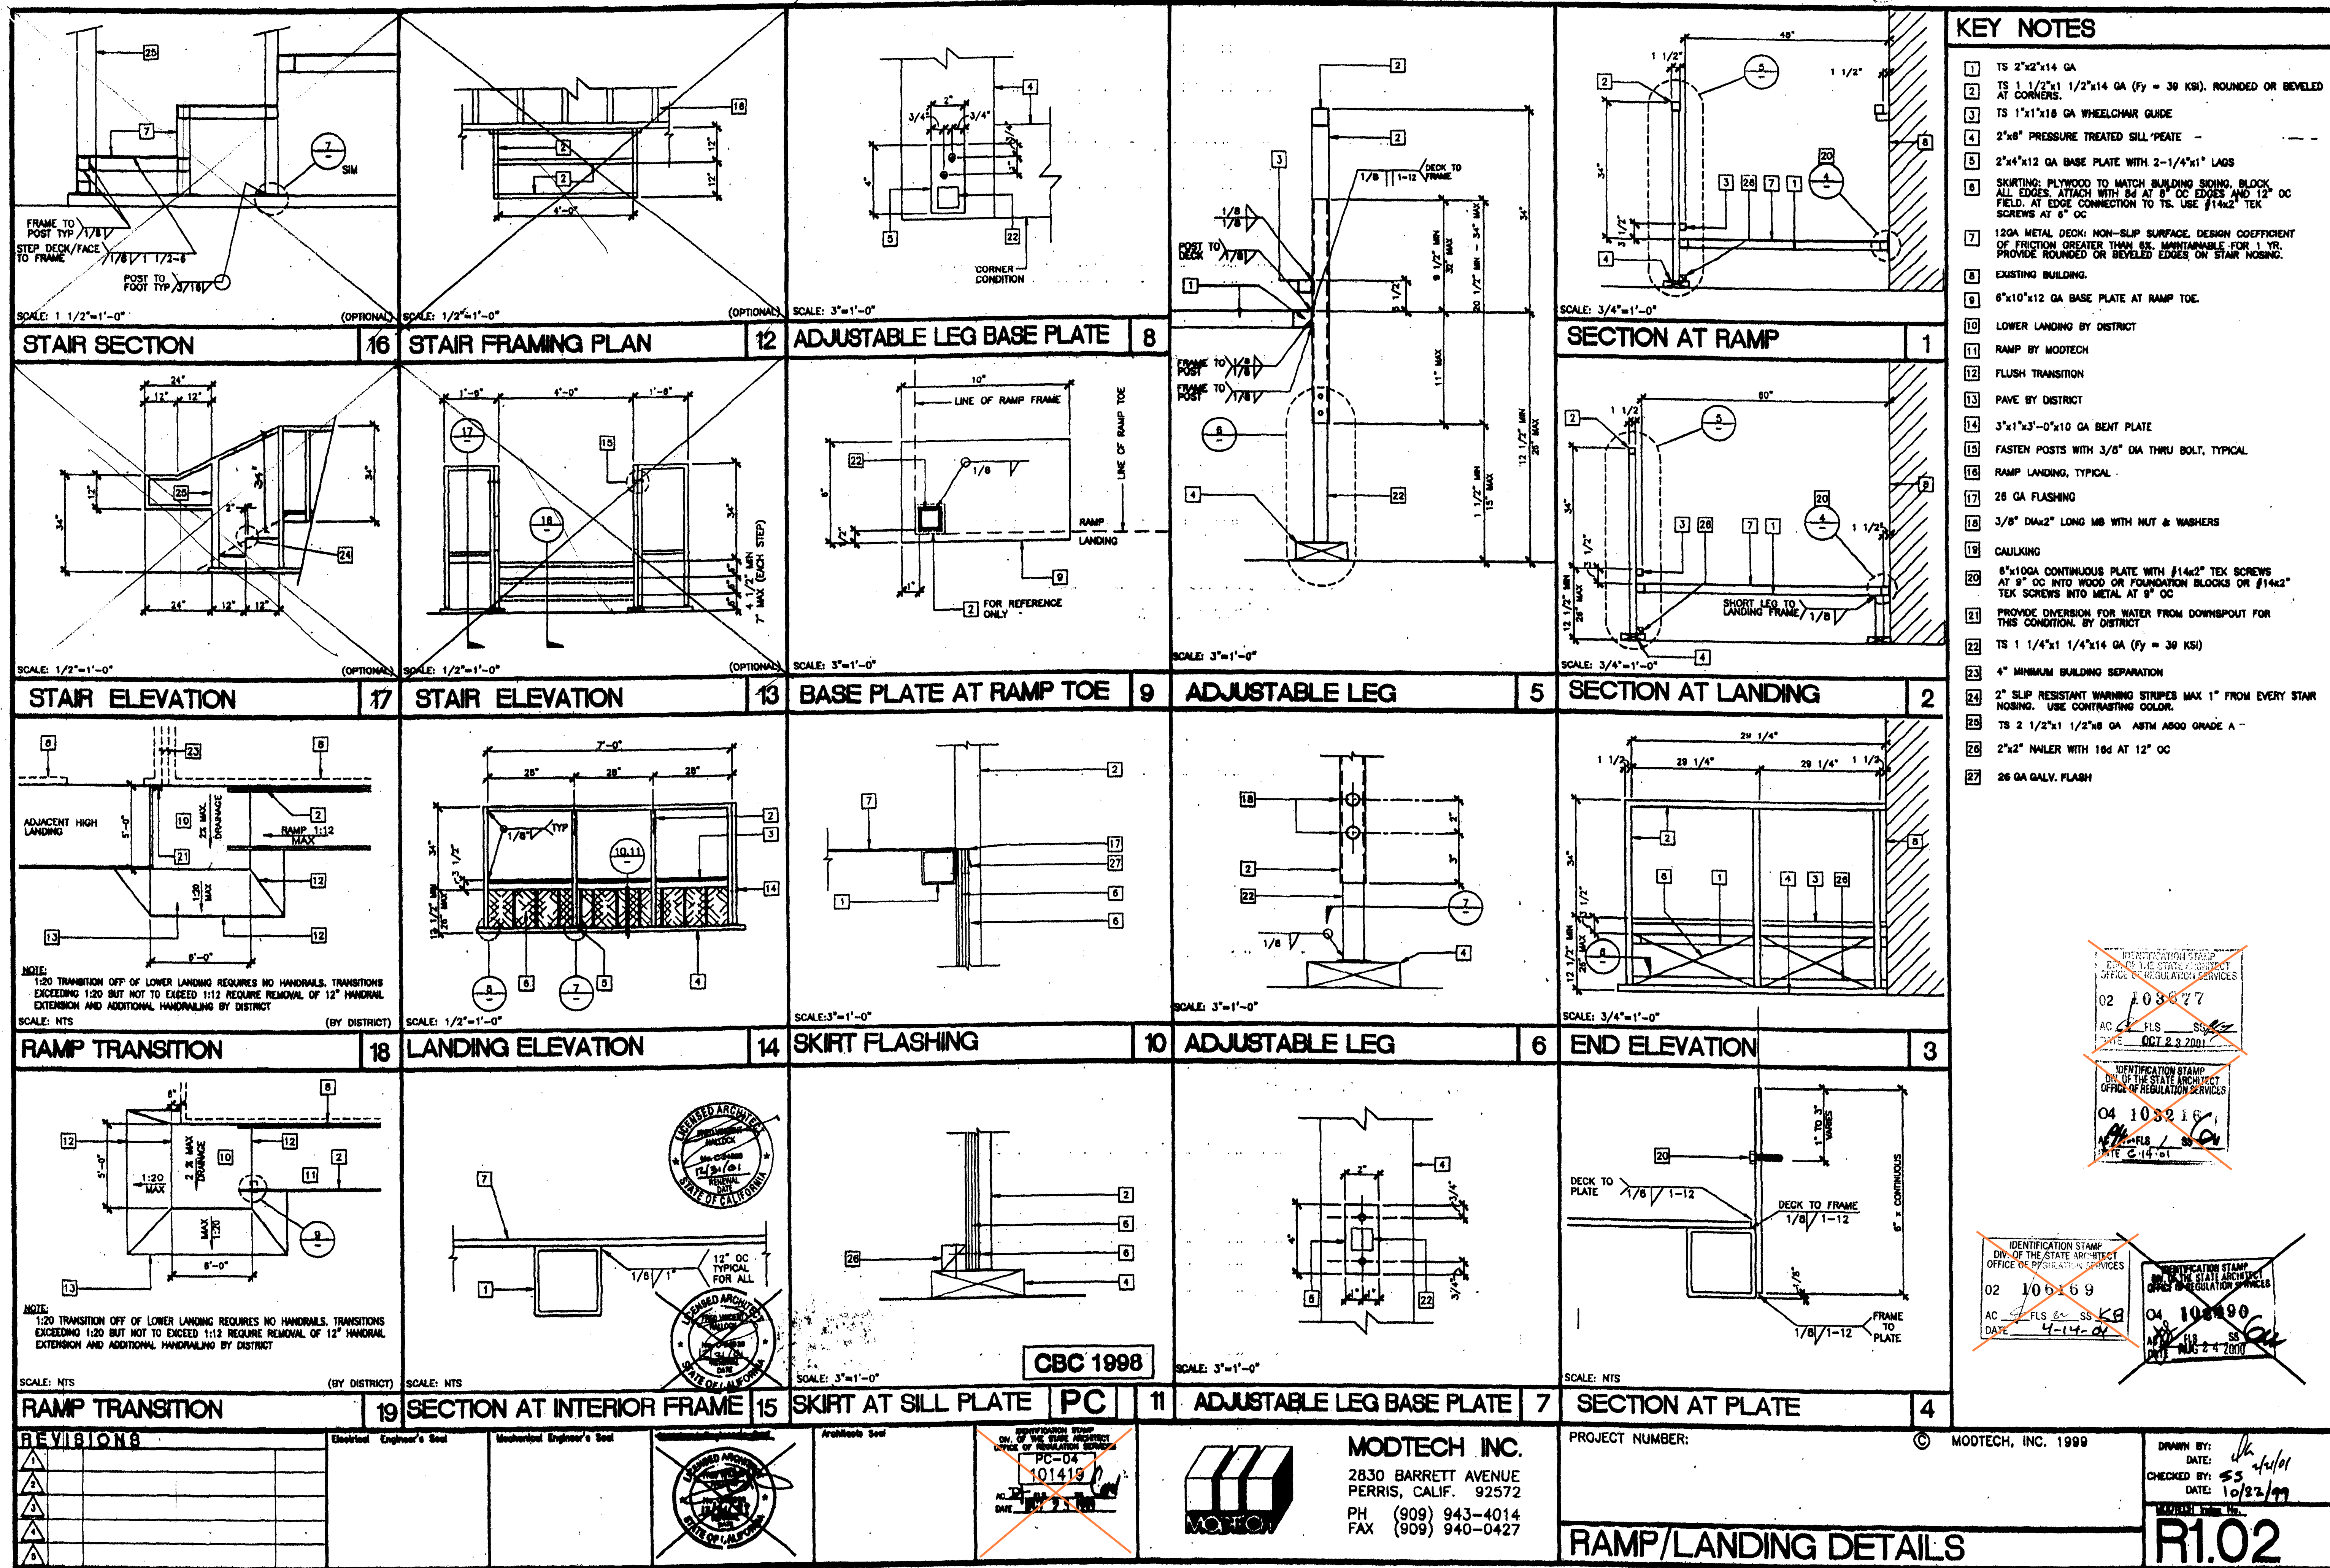

FILE PATH: 240-0-R1.02.DWG
PROJECT NO. 200019.21
BGH PROJECT NO. 200019.31

AGENCY APPROVAL
DIV. OF THE STATE ARCHITECT
APP: 02-121945 INC.
REVIEWED FOR:
SS ☒ FLS ☒ ACS ☒
DATE: 12/12/2023

PROFESSIONAL STAMP
02 108827
AC FLS SS
DATE OCT 2 3 2001

IDENTIFICATION STAMP
DIV. OF THE STATE ARCHITECT
OFFICE OF REGULATION SERVICES
02 106669
AC FLS SS KB
DATE 4-14-02

IDENTIFICATION STAMP
DIV. OF THE STATE ARCHITECT
OFFICE OF REGULATION SERVICES
04 108890
AC FLS SS KB
DATE 10-24-2001

REVISIONS
NO. DATE DESCRIPTION

NO.	DATE	DESCRIPTION

THE ARCHITECT DOES NOT REPRESENT THAT THESE PLANS OR THE SPECIFICATIONS ARE SUITABLE FOR ANY SITE OTHER THAN THE ONE FOR WHICH THEY WERE SPECIFICALLY PREPARED. THE ARCHITECT DISCLAIMS RESPONSIBILITY FOR THESE PLANS AND SPECIFICATIONS IF THEY ARE USED IN WHOLE OR IN PART AT ANY OTHER SITE. WRITTEN DIMENSIONS ON THESE DRAWINGS SHALL HAVE PRECEDENCE OVER SCALED DIMENSIONS.

PROJECT OWNER & TITLE
LODI UNIFIED SCHOOL DISTRICT
1305 E. Vine St
Lodi, CA 95240

MILLSWOOD MIDDLE SCHOOL
PORTABLES RELOCATION
233 N Mills Ave
Lodi, CA 95242

SHEET TITLE
RAMP/STAIRS DETAILS

DRAWN BY: XXXXXX JOB NUMBER: 23219
SHEET NO.
R1.02
DATE: DECEMBER 5, 2023

GENERAL NOTES

1.

ALL WORK SHALL CONFORM TO 2022 TITLE 24, CALIFORNIA CODE OF REGULATIONS (CCR)

2.

CHANGES TO THE APPROVED DRAWINGS AND SPECIFICATIONS SHALL BE MADE BY AN ADDENDUM OR A CONSTRUCTION CHANGE DOCUMENT (CCD) APPROVED BY THE DIVISIONS OF THE STATE ARCHITECT, AS REQUIRED BY SECTION 4-338, PART 1, TITLE 24, CCR

3.

A "DSA CERTIFIED" PROJECT INSPECTOR EMPLOYED BY THE DISTRICT (OWNER) AND APPROVED BY THE DSA SHALL PROVIDE CONTINUOUS INSPECTION OF THE WORK. THE DUTIES OF THE INSPECTOR ARE DEFINED IN SECTION 4-342, PART 1, TITLE 24, CCR

4.

A DSA ACCEPTED TESTING LABORATORY DIRECTLY EMPLOYED BY THE DISTRICT (OWNER) SHALL CONDUCT ALL THE REQUIRED TEST AND INSPECTIONS FOR THE PROJECT

5.

THIS PC IS NOT APPROVED FOR CHAPTER 7A WILDLAND URBAN AREAS. WHEN THIS PC IS SITE ADAPTED FOR PROJECT SPECIFIC, THE REQUIREMENTS IS TO BE REVIEWED AND APPROVED BY THE PROJECT SPECIFIC PLAN REVIEWER

BUILDING CODES AND STANDARDS

2022 CALIFORNIA ADMINISTRATIVE CODE (CAC), PART 1, TITLE 24, CCR

2022 CALIFORNIA BUILDING CODE (CBC), PART 2, TITLE 24, CCR

2022 CALIFORNIA ELECTRICAL CODE (CEC), PART 3, TITLE 24, CCR

2022 CALIFORNIA MECHANICAL CODE (CMC), PART 4, TITLE 24, CCR

2022 CALIFORNIA PLUMBING CODE (CPC), PART 5, TITLE 24, CCR

2022 CALIFORNIA ENERGY CODE (CEC), PART 6, TITLE 24, CCR

2022 CALIFORNIA FIRE CODE (CFC), PART 9, TITLE 24, CCR

2022 CALIFORNIA EXISTING BUILDING STANDARDS CODE (CEBC), PART 10, TITLE 24

2022 CALIFORNIA GREEN BUILDING STANDARD CODE (CALGREEN), PART 11, TITLE 24 CCR

2022 CALIFORNIA REFERENCED STANDARDS CODE, PART 12, TITLE 24, CCR

TITLE 19 CCR, PUBLIC SAFETY, STATE FIRE MARSHALL REGULATIONS

DRAWING SYMBOLS & LEGEND

KEY NOTE SYMBOL

INDICATES DETAIL #

INDICATES SHEET #

INDICATES EXTERIOR ELEVATION #

INDICATES SHEET #

INDICATES CUT SECTION DETAIL#

INDICATES SHEET #

SHEET INDEX

SHEET NO.

ARCHITECTURAL

R-1

COVER SHEET

R-2

DSA 103 TEST & SPECIAL INSPECTIONS SAMPLE

R-3

CONSTRUCTION SPECIFICATIONS & NOTES

R-4

STANDARD RAMP & LANDING (ATTACHED HANDRAIL TO BUILDING)

R-9

RAMP & LANDING DETAILS

TOTAL SHEET COUNT: 5

DESIGN PARAMETERS

1.

RAMP LIVE LOAD: 100 PSF

2.

NO SNOW LOAD (GROUND SNOW LOAD Pg= 0 psf)

3.

NO FLOOD LOADING

4.

WIND:

WIND DESIGN PER ASCE 7-16, CHAPTER 29

SEE SCHEDULE BELOW FOR SITE SPECIFIC PARAMETERS

5.

SEISMIC:

RISK CATEGORY=II

R = 1.25 (ASCE 7-16 TABLE 15.4-2)

Ie = 1.0

SITE CLASS = A,B, OR D

Ss = 2.41

Fa = 1.0

Sds = 1.61

Si = 1.4

SITE CLASS = C, OR D (DEFAULT)

Ss = 2.01

Fa = 1.2

Sds = 1.61

Si =1.4

Cs = 1.93

6.

ALLOWABLE SOIL BEARING = 1000 PSF

SITE SPECIFIC PARAMETERS

INSTRUCTIONS: DESIGN PROFESSIONAL SHALL CHECK THE APPROPRIATE SELECTION BOXES BELOW AND ENTER THE DESIGN PARAMETERS APPLICABLE TO THE SPECIFIC PROJECT SITE

WIND

V = 93 MPH < 95 MPH BASIC DESIGN WIND SPEED

Kzt = ≤ 1.0

EXPOSURE: ☒ C ☐ D

SEISMIC

☒

DESIGN BASED ON SITE CLASS D DEFAULT

NO GEOTECHNICAL INVESTIGATION REQUIRED

Ss = 0.627 Fa = 1.2

☐

DESIGN BASED ON SITE CLASS DETERMINED PER CHAPTER 20 OF ASCE 7-16

GEOTECHNICAL INVESTIGATION PROVIDED

SITE CLASS: ☐ C ☐ D ☐ E

Ss = Fa = PER ASCE 7-16 SUPPL 3 TABLE 11.4-1

☐

DESIGN BASED ON SITE CLASS GROUND MOTION HAZARD ANALYSIS PER CHAPTER 21 OF ASCE 7-16

SHORT-PERIOD DESIGN SPECTRAL RESPONSE PARAMETER, Sds, SHALL BE AS SPECIFIED IN GEOTECHNICAL INVESTIGATION

CGS APPROVAL REQUIRED

NOT ELIGIBLE FOR OTC REVIEW

SITE CLASS: ☐ C ☐ D ☐ E

Ss = Fa =

Sds = 2/3 Fa Ss= ≤ 1.607

Cs = 1.607 USED IN DESIGN

SEISMIC DESIGN CATEGORY: ☒ D ☐ E

ASCE 7-16 12.8.1.3 HAS NOT BEEN USED IN CALCULATION OF Sds

PC LIMITATIONS

1.

THE MAXIMUM DECK HEIGHT DESIGNED ON THIS PC IS 30". VERIFY WITH BUILDING MANUFACTURER MAXIMUM FINISH FLOOR HEIGHT FOR ABOVE GRADE FOUNDATIONS. THE MAXIMUM DECK HEIGHT SHALL BE SET FORTH PER THE BUILDING MANUFACTURER MAXIMUM FINISH FLOOR HEIGHT HOWEVER NOT TO EXCEED 30" MAX

2.

THE MAXIMUM RAMP HANDRAIL DESIGN ON THIS PC IS 34" AFF

3.

THIS PC IS NOT DESIGNED FOR DECKS HIGHER THAN 30" OR A GUARDRAIL DESIGN AT 42" MIN WHEN DECK HEIGHT EXCEEDS 30"

4.

THE MINIMUM POINT LOAD DESIGNED ON THE HANDRAILS IS 200#

5.

THE RAMP CLEAR WIDTH SET FORTH ON THIS PC IS DESIGNED FOR OCCUPANCIES LESS THAN 100 (OR NO GREATER THAN 48" CLEAR WIDTH)

6.

THE STAIRS MAXIMUM CLEAR WIDTH SET FORTH ON THIS PC IS 48" MAX

7.

THE MAXIMUM RAMP LENGTH SET FORTH ON THIS PC IS 30'-0" MAX

8.

THE MAXIMUM SINGLE DECK SECTION SET FORTH ON THIS PC IS 6'-6" X 19'-10 1/2". ADDITIONAL DECK SECTIONS CAN BE ADDED TOGETHER (SEE #9/R-9) ON ANY SIDE OF THE DECK. THE MINIMUM DECK SECTION IS SHALL BE NO LESS THAN 4'-0" X 1'-0"

9.

THE DESIGN PROFESSIONAL HAS EXEMPTED THIS RAMP FROM SPECIAL INSPECTION REQUIREMENTS FOR MATERIAL IDENTIFICATION AND STRUCTURAL WELDING. RAMP SHALL NOT BE MODIFIED NOR HAVE SHIMS ADDED CAUSING THE DISTANCE BETWEEN THE HIGHEST RAMP WALKING SURFACE AND THE ADJACENT GRADE TO BE MORE THAN 30" INCHES. IF THIS CONDITION IS NOT MET, STRUCTURAL TESTING AND/OR INSPECTION WILL BE REQUIRED TO VERIFY MATERIALS AND STRUCTURAL WELDING. THIS APPLIES TO SCOPE OF WORK INCLUDING NEW CONSTRUCTION, ALTERATION, OR RELOCATION OF RAMP. REFER TO DSA 103 APPENDIX, IR PC-2 AND IR PC-6

10.

RAMP SLOPE SHALL NOT BE LESS THAN 1:12 (OR GREATER THAN 8.33% MAX). RAMP SLOPE GRATER THAN 1:20 (OR LESS THAN 5.0%) DOES NOT NEED TO COMPLY WITH HANDRAIL REQUIREMENTS

2022 CBC

ACCESSIBLE RAMP / LANDING / STAIR PC DESIGN (LESS THAN 30" SYSTEM)

RISK CATEGORY II

PC 04-122029

STATE AGENCY APPROVAL

IDENTIFICATION STAMP

DIV. OF THE STATE ARCHITECT

APP: 02-121945 INC:

REVIEWED FOR

SS ☒ FLS ☒ ACS ☒

DATE: 12/12/2023

SKSCOMPANY

15345 FAIRFIELD RANCH RD - SUITE 160 CHINO HILLS, CA 91709

OFFICE: (909) 740-3120, FAX: (909) 726-9470

WEBSITE: WWW.SKCCOMPANY.COM

MANUFACTURER #MF1279666 DEALER # DL1279666

GC LIC # 992118 SBE CERTIFIED

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DISTRICT/CUSTOMER NAME:

SCHOOL/SITE NAME:

SHEET TITLE:

COVER SHEET

PRE-CHECK (PC) DOCUMENT

CODE: 2022 CBC

A SEPARATE PROJECT APPLICATION FOR CONSTRUCTION IS REQUIRED

APPROVED

DIV. OF THE STATE ARCHITECT

APP: 04-122029 PC

REVIEWED FOR

SS ☒ FLS ☒ ACS ☒ SG ☐

DATE: 09/27/2023

PROFESSIONAL OF RECORD ON PC

ORION

ORION STRUCTURAL ENGINEERING, INC.

11305 RANCHO BERNARDO ROAD, SUITE 121

SAN DIEGO, CA 92127

(619) 575-1974

FIRM:

ADDRESS:

CITY:

PHONE:

PROJECT SPECIFIC PROFESSIONAL OF RECORD

LODI UNIFIED SCHOOL DISTRICT

MILLSWOOD MIDDLE SCHOOL

PORTABLE RELOCATION

DSA APP# 02-121945

FILE No.: 39-50

PTN: 68585-261

FIRM:

ADDRESS:

CITY:

PHONE:

REVISIONS

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PROJECT NO.: 00-0000

DRAFTER: 00

SCALE: AS NOTED

DATE: 00-00-00

SHEET NUMBER

R-1

9/26/2023 9:27:23 AM

DSA 103-22: LISTING OF STRUCTURAL TESTS & SPECIAL INSPECTIONS, 2022 CBC

Application Number: 04-122029	School Name: Accessible Ramp Landing Stair PC	School District: SKC Company
DSA File Number: PC-116	Increment Number:	Date Created: 2023-02-20 13:43:59

2022 CBC

IMPORTANT: This form is only a summary list of structural tests and some of the special inspections required for the project. Generally, the structural tests and special inspections noted on this form are those that will be performed by the Geotechnical Engineer of Record, Laboratory of Record, or Special Inspector. The actual complete test and inspection program must be performed as detailed on the DSA approved documents. The appendix at the bottom of this form identifies work NOT subject to DSA requirements for special inspection or structural testing. The project inspector is responsible for providing inspection of all facets of construction, including but not limited to, special inspections not listed on this form such as structural wood framing, high-load wood diaphragms, cold-formed steel framing, anchorage of non-structural components, etc., per Title 24, Part 2, Chapter 17A (2022 CBC).

**NOTE: Undefined section and table references found in this document are from the CBC, or California Building Code.

KEY TO COLUMNS

1. TYPE	2. PERFORMED BY
Continuous – Indicates that a continuous special inspection is required	GE (Geotechnical Engineer) – Indicates that the special inspection shall be performed by a registered geotechnical engineer or his or her authorized representative.
Periodic – Indicates that a periodic special inspection is required	LOR (Laboratory of Record) – Indicates that the test or special inspection shall be performed by a testing laboratory accepted in the DSA Laboratory Evaluation and Acceptance (LEA) Program. See CAC Section 4-335.
Test – Indicates that a test is required	PI (Project Inspector) – Indicates that the special inspection may be performed by a project inspector when specifically approved by DSA.
	SI (Special Inspection) – Indicates that the special inspection shall be performed by an appropriately qualified/approved special inspector.

DIVISION OF THE STATE ARCHITECT
DGS DSA 103-22 (Revised 12/01/2022)

DEPARTMENT OF GENERAL SERVICES
Page 1 of 6

STATE OF CALIFORNIA

Appendix: Work Exempt from DSA Requirements for Structural Tests / Special Inspections

Application Number: 04-122029	School Name: Accessible Ramp Landing Stair PC	School District: SKC Company
DSA File Number: PC-116	Increment Number:	Date Created: 2023-02-20 13:43:59

CONCRETE/MASONRY:

- ☐ 5. Testing of reinforcing bars is not required for items given in CBC Section 1910A.2 subject to the requirements and limitations in that section.

WELDING:

- ☐ 1. Solid-clad and open-mesh fences, gates with maximum leaf span of 10', and gates with a maximum rolling section of 10' all having an apex height less than 8'-0" above lowest adjacent grade. When located above circulation or occupied space below, these gates/fences are not located within 1.5x gate/fence height (max 8'-0") to the edge of floor or roof.
- ☒ 2. Handrails, guardrails, and modular or relocatable ramps associated with walking surfaces less than 30" above adjacent grade (excluding post base connections per the 'Exception' language in Section 1705A.2.1); fillet welds shall not be ground flush.
- ☐ 3. Non-structural interior cold-formed steel framing spanning less than 15'-0", such as in interior partitions, interior soffits, etc. supporting only self weight and light-weight finishes or adhered tile, masonry, stone, or terra cotta veneer no more than 5/8" thickness and apex less than 20'-0" in height and not over an exit way. Maximum tributary load to a member shall not exceed the equivalent of that occurring from a 10'x10' opening in a 15' tall wall for a header or king stud.
- ☐ 4. Manufactured support frames and curbs using hot rolled or cold-formed steel (i.e., light gauge) for mechanical, electrical, or plumbing equipment weighing less than 2000# (equipment only) (connections of such frames to superstructure elements using welding will require special inspection as noted in selected item(s) for Sections S/A3, S/A4 and/or S/A5 of listing above).
- ☐ 5. Manufactured components (e.g., Tolco, B-Line, Afcon, etc.) for mechanical, electrical, or plumbing hanger support and bracing (connections of such components to superstructure elements using welding will require special inspection as noted in selected item(s) for Sections S/A3, S/A4 and/or S/A5 of listing above).
- ☐ 6. TV Brackets, projector mounts with a valid listing (see DSA IR A-5) and recreational equipment (e.g., playground structures, basketball backstops, etc.) (connections of such elements to superstructure elements using welding will require special inspection as noted in selected item(s) for sections S/A3, S/A4 and/or S/A5 located in the Steel/Aluminum category of listing above).
- ☐ 7. Any support for exempt non-structural components given in CBC Section 1617A.1.18 (which replaces ASCE 7-16, Section 13.1.4) meeting the following: A) when supported on a floor/roof, <400# and resulting composite center of mass (including component's center of mass) ≤4' above supporting floor/roof, B) when hung from a wall or roof/floor, <20# for discrete units or <5 pcf for distributed systems.

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DSA 103-22: LISTING OF STRUCTURAL TESTS & SPECIAL INSPECTIONS (OTHER), 2022 CBC

Application Number: 04-122029	School Name: Accessible Ramp Landing Stair PC	School District: SKC Company
DSA File Number: PC-116	Increment Number:	Date Created: 2023-02-20 13:43:59

X1. OTHER:				
Test or Special Inspection	Type	Performed By	Code References and Notes	
<input type="checkbox"/> a. Load test for identified product(s):	Test	LOR	1709A.2, 1709A.3. Testing is not required for: 1) a product with a valid evaluation service report per DSA IR A-5, or 2) a product that can be justified by structural calculation.	
<input type="checkbox"/> b. Installation torque for non-HS bolts	Continuous	SI*	Applicable to communication towers identified as Essential Service Facility Projects (ESFP). Calibrated wrench use required, verified by SI during installation. DSA Policy PL 18-01: Communication Towers, Poles and Buildings Utilized by State Agencies for Essential Services Communications. *EXCEPTION: Non-ESFP may use PI without need for notification to DSA.	
<input type="checkbox"/> c.				

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STATE OF CALIFORNIA

DSA 103-22: LISTING OF STRUCTURAL TESTS & SPECIAL INSPECTIONS (SIGNATURE), 2022 CBC

Application Number: 04-122029	School Name: Accessible Ramp Landing Stair PC	School District: SKC Company
DSA File Number: PC-116	Increment Number:	Date Created: 2023-02-20 13:43:59

Name of Architect or Engineer in general responsible charge:

Name of Structural Engineer (When structural design has been delegated):

Signature of Architect or Structural Engineer: _____ Date: _____

Note: To facilitate DSA electronic mark-ups and identification stamp application, DSA recommends against using secured electronic or digital signatures.

DSA STAMP

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Appendix: Work Exempt from DSA Requirements for Structural Tests / Special Inspections

Application Number: 04-122029	School Name: Accessible Ramp Landing Stair PC	School District: SKC Company
DSA File Number: PC-116	Increment Number:	Date Created: 2023-02-20 13:43:59

Exempt items given in DSA IR A-22 or the 2019 CBC (including DSA amendments) and those items identified below with a check mark by the design professional are NOT subject to DSA requirements for the structural tests / special inspections noted. Items marked as exempt shall be identified on the approved construction documents. The project inspector shall verify all construction complies with the approved construction documents.

SOILS:
<input type="checkbox"/> 1. Deep foundations acting as a cantilever footing with a design based on minimum allowable pressures per CBC Table 1806A.2 and without a geotechnical report for the following cases: A) free standing sign or scoreboard, B) cell or antenna towers and poles less than 35'-0" tall (e.g., lighting poles, flag poles, poles supporting open mesh fences, etc.), C) single-story structure with dead load less than 5 psf (e.g., open fabric shade structure) or D) covered walkway structure with an apex height less than 10'-0" above adjacent grade.
<input type="checkbox"/> 2. Shallow foundations, etc. are exempt from special inspections and testing by a Geotechnical Engineer for the following cases: A) buildings without a geotechnical report and meeting the exception item #1 criteria in CBC Section 1803A.2 supported by native soil (any excavation depth) or fill soil (not exceeding 12" depth per CBC Section 1804A.6), B) soil scarification/recompaction not exceeding 12" depth, C) native or fill soil supporting exterior non-structural flatwork (e.g., sidewalks, site concrete ramps, site stairs, parking lots, driveways, etc.), D) unpaved landscaping and playground areas, or E) utility trench backfill.

CONCRETE/MASONRY:
<input type="checkbox"/> 1. Post-installed anchors for the following: A) exempt non-structural components (e.g., mechanical, electrical, plumbing equipment - see item 7 for "Welding" in the Appendix below) given in CBC Section 1617A.1.18 (which replaces ASCE 7-16, Section 13.1.4) or B) interior nonstructural wall partitions meeting criteria listed in exempt item 3 for "Welding" in the Appendix below.
<input type="checkbox"/> 2. Concrete batch plant inspection is not required for items given in CBC Section 1705A.3.3.2 subject to the requirements and limitations in that section.
<input type="checkbox"/> 3. Non-bearing non-shear masonry walls may be exempt from certain DSA masonry testing and special inspection items as allowed per DSA IR 21-1. Refer to construction documents for specific exemptions accordingly for each applicable wall condition.
<input type="checkbox"/> 4. Epoxy shear dowels in site flatwork and/or other non-structural concrete.

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DSA 103-22: LIST OF REQUIRED VERIFIED REPORTS, CBC 2022

Application Number: 04-122029	School Name: Accessible Ramp Landing Stair PC	School District: SKC Company
DSA File Number: PC-116	Increment Number:	Date Created: 2023-02-20 13:43:59

DIVISION OF THE STATE ARCHITECT
DGS DSA 103-22 (Revised 12/01/2022)

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STATE OF CALIFORNIA

STATE AGENCY APPROVAL

IDENTIFICATION STAMP
DIV. OF THE STATE ARCHITECT
APP: 02-121945 INC:
REVIEWED FOR
SS ☒ FLS ☒ ACS ☒
DATE: 12/12/2023

SKC
COMPANY

15345 FAIRFIELD RANCH RD., SUITE 160 CHINO HILLS, CA 91709
OFFICE: (909) 740-3120, FAX: (909) 726-9470
WEBSITE: WWW.SKCCOMPANY.COM
MANUFACTURER MAP 1279566 DEALER # DL1279566
CSC LIC# 90218 HBC CERTIFIED

ALL DESIGNS INDICATED ON THESE PLANS/DRAWINGS ARE PROPERTY OF SKC, INC AND ARE FOR THE USE BY SKC IN THE SPECIFIED JOB ONLY. THEY SHALL NOT BE USED AND/OR DUPLICATED OR TRANSMITTED IN ANY FORM, FOR ANY PURPOSE WITHOUT THE PRIOR WRITTEN CONSENT OF SKC, INC. ANY UNAUTHORIZED USE OF THESE PLANS SHALL SUBJECT THE OWNER OF SAID PROPERTY TO LIQUIDATED DAMAGES OF \$75,000.00. THESE PLANS ARE PROTECTED UNDER THE PROVISIONS OF THE 1976 COPYRIGHT ACT. COPYRIGHT SKC, © ALL RIGHTS RESERVED.

DISTRICT/CUSTOMER NAME:

SCHOOL/SITE NAME:

SHEET TITLE:

DSA 103
TEST & SPECIAL INSPECTIONS
SAMPLE

PRE-CHECK (PC) DOCUMENT
CODE: 2022 CBC
A SEPARATE PROJECT APPLICATION FOR
CONSTRUCTION IS REQUIRED

APPROVED
DIV. OF THE STATE ARCHITECT
APP: 04-122029 PC
REVIEWED FOR
SS ☒ FLS ☒ ACS ☒ CG ☐
DATE: 09/27/2023

PROFESSIONAL OF RECORD ON PC



FIRM:
ADDRESS:
CITY:
PHONE:

ORION STRUCTURAL ENGINEERING, INC.
11308 RANCHO BERNARDO ROAD, SUITE 121
SAN DIEGO, CA 92127
(658) 979-1974

PROJECT SPECIFIC PROFESSIONAL OF RECORD

LODI UNIFIED SCHOOL DISTRICT
MILLSWOOD MIDDLE SCHOOL
PORTABLE RELOCATION
DSA APP# 02-121945
FILE No.: 39-50
PTN: 68585-261

FIRM:
ADDRESS:
CITY:
PHONE:

REVISIONS

Δ -
Δ -
Δ -
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PROJECT NO.: 00-0000
DRAFTER: 00
SCALE: AS NOTED
DATE: 00-00-00

SHEET NUMBER

R-2

9/26/2023 9:27:48 AM

THE SAMPLE DSA 103 FORMS SHOWN ON THIS SHEET ARE FOR ILLUSTRATION PURPOSES ONLY. A SEPARATE DSA 103 FORM IS TO BE COMPLETED FOR EACH PROJECT SPECIFIC APPLICATION THAT THIS PC IS BEING INCORPORATED INTO. THE DSA 103 FORM IS TO BE COMPLETED BY THE ARCHITECT OF RECORD FOR THE OVERALL SCOPE OF WORK ON THE PROJECT SPECIFIC APPLICATION. MODULAR BUILDING MANUFACTURER (OR DESIGN BUILD CONTRACTOR) IS ONLY RESPONSIBLE FOR COMPLETING DSA103 FORM ON STOCKPILE PROJECTS. THE SAMPLE DSA 103 FORM SHALL BE CROSSED OUT ON THIS DRAWING.

GENERAL NOTES

GENERAL NOTES:

1. ALL CONSTRUCTION SHALL COMPLY WITH THE 2022 EDITION OF THE CALIFORNIA BUILDING CODE, CCR TITLE 24, PART 2 (CBC) AND CCR TITLE 24, PART 1, CHAPTER 4, GROUP 1, LATEST REVISIONS.
2. THE CONTRACTOR SHALL BE RESPONSIBLE FOR THE SAFETY OF THE BUILDING DURING CONSTRUCTION AND SHALL PROVIDE ADEQUATE SHORING AND BRACING DURING CONSTRUCTION. CONTRACTOR SHALL COMPLY WITH APPLICABLE SAFETY REGULATIONS.
3. DETAILS NOT SPECIFICALLY SHOWN SHALL BE CALLED TO THE ATTENTION OF THE MANUFACTURER OR DESIGN PROFESSIONAL AND DSA.
4. THE CONTRACTOR SHALL COORDINATE THE WORK OF ALL TRADES AND SHALL CHECK ALL DIMENSIONS. ANY DISCREPANCIES SHALL BE CALLED TO THE ATTENTION OF THE OWNER AND BE RESOLVED BEFORE PROCEEDING WITH THE WORK.
5. NO STRUCTURAL MEMBERS SHALL BE CUT, NOTCHED OR OTHERWISE PENETRATED UNLESS SPECIFICALLY APPROVED BY THE STRUCTURAL ENGINEER IN ADVANCE OR SHOWN ON THESE DRAWINGS.
6. TYPICAL DETAILS SHALL APPLY UNLESS SHOWN OTHERWISE ON THE DRAWINGS.
7. WHERE THESE GENERAL NOTES AND TYPICAL DETAILS ARE IN CONFLICT WITH THE CUSTOMER SPECIFICATIONS, THESE GENERAL NOTES AND TYPICAL DETAILS SHALL GOVERN.
8. NOT USED
9. REFER TO ARCHITECTURAL DRAWINGS FOR DIMENSIONS AND OTHER INFORMATION NOT SPECIFICALLY SHOWN ON STRUCTURAL DRAWINGS
10. ALL ELEVATIONS ARE REFERENCED FROM TOP OF FINISHED FIRST FLOOR ELEVATION = 0'-0"
11. NOT USED
12. NOT USED
13. DIMENSIONS AND ELEVATIONS SHOWN ARE APPROXIMATE AND ARE PROVIDED AS AN AID IN INTERPRETING THE DRAWINGS ONLY. DIMENSIONS AND ELEVATIONS MUST BE VERIFIED WITH ARCHITECTURAL DRAWINGS. IN THE EVENT OF CONFLICT, DIMENSIONS AND ELEVATIONS SHOWN ON ARCHITECTURAL DRAWINGS SHALL GOVERN. DRAWING SCALES GIVEN ARE APPROXIMATE - DO NOT SCALE PLANS OR DETAILS
14. NOT USED

STRUCTURAL STEEL:

1. NOT USED
2. NOT USED
3. NOT USED
4. ALL WELDING SHALL BE IN ACCORDANCE WITH THE REQUIREMENTS OF THE CALIFORNIA BUILDING CODE (CBC) AND THE STRUCTURAL WELDING CODE - STEEL, AWS D1.1, 2015 EDITION OF THE AMERICAN WELDING SOCIETY. WELDING DONE BY SHIELDING ELECTRIC-ARC OR FLUX-CORED PROCESS COMPLYING WITH AWS.
5. FABRICATION AND ERECTION OF STRUCTURAL AND MISCELLANEOUS STEEL SHALL BE IN ACCORDANCE WITH THE REQUIREMENTS OF THE 2016 EDITION OF THE SPECIFICATION FOR STRUCTURAL STEEL BUILDINGS OF THE AMERICAN INSTITUTE OF STEEL CONSTRUCTION (AISC) (CBC CHAPTER 22A). ALSO COMPLY WITH REQUIREMENTS OF THE AISC CODE OF STANDARD PRACTICE FOR STEEL BUILDINGS AND BRIDGES. TEMPORARY BRACING IS REQUIRED AS NEEDED UNTIL ALL ELEMENTS SHOWN ON STRUCTURAL DRAWINGS ARE IN PLACE.
6. PRIME ALL STEEL SURFACES WITH AN APPROVED PRIMER, EXCEPT SURFACES TO BE EMBEDDED IN CONCRETE AND SURFACES TO RECEIVE FIELD WELDS. TOUCH-UP FIELD WELDS AND OTHER EXPOSED STEEL SURFACES AFTER ERECTION. ALTERNATE: PROVIDE GALVANIZED PER ASTM A-123.
7. N/A
8. QUALIFIED AND CERTIFIED WELDERS SHALL BE USED FOR ALL WELDING. ALL WELDING TO CONFORM TO THE 2015 EDITION OF THE AMERICAN WELDING SOCIETY STRUCTURAL WELDING CODE AWS D1.1
9. MATERIALS:
- | | |
|--------------------------------|----------------------------------|
| ANGLES, MISC STEEL | ASTM A36 |
| PLATES | ASTM A-572 GRADE 50 |
| WELDING ELECTRODES | AWS STRUCTURAL STEEL E70XX. |
| TYPICAL STEEL CONNECTION BOLTS | ASTM A307 GRADE A |
| RUSH-INHIBITING PRIMER | TT-P-645 |
| RECTANGULAR HSS MEMBERS | ASTM A-500 GRADE B (Fy = 46 KSI) |
10. CONNECTED MEMBERS SHALL BEAR ONLY UPON UNTHREADED PORTIONS OF BOLTS
11. BURNING OF HOLES IS NOT ALLOWED
12. NOT USED
13. THE STRUCTURAL STEEL FABRICATOR SHALL SUBMIT SHOP DRAWINGS TO THE ENGINEER FOR APPROVAL PRIOR TO FABRICATION
14. BOLT HOLES SHALL BE 1/16" LARGER IN DIAMETER THAN NOMINAL SIZE OF BOLTS USED, UNO

COLD FORMED STRUCTURAL STEEL:

1. NOT USED
2. NOT USED
3. CORROSION PROTECT PER TABLE A4-1 BELOW
4. GALVANIZED COATINGS MUST MEET ASTM A-525 SPECIFICATIONS
5. CARBON SHEET STEEL MUST MEET THE MINIMUM REQUIREMENTS OF ASTM A-1011 SS GRADE 55 & 33 GRADE 55 KSI FOR 10, 12, 14, AND 16 GAUGE AND GRADE 33 KSI FOR 18 GAUGE AND LIGHT MEMBERS UNO. CARBON SHEET STEEL PRODUCTS MUST BE THOROUGHLY COATED WITH A RUST INHIBITIVE PAINT.
6. ALL STRUCTURAL MEMBERS SHALL BE DESIGNED IN ACCORDANCE WITH AMERICAN IRON AND STEEL INSTITUTE (AISI) NORTH AMERICAN SPECIFICATION FOR THE DESIGN OF COLD-FORMED STRUCTURAL STEEL MEMBERS LATEST ADOPTED EDITION AISI S100-16 (2020) W/S2-20.
7. NOT USED
8. NOT USED
9. FASTENINGS OF COMPONENTS SHALL BE WITH SELF-DRILLINGS SCREWS OR WELDING. SCREWS OR WELDS SHALL BE SUFFICIENT SIZE TO INSURE THE STRENGTH OF THE CONNECTION. ALL WELDS OF GALVANIZED STEEL SHALL BE TOUCHED UP WITH ZINC-RICH PAINT. ALL WELDS OF CARBON SHEET STEEL SHALL BE TOUCHED UP WITH PAINT
10. NOT USED
11. PROVIDE SHOP DRAWINGS INDICATING MEMBERS GAUGES, SHAPES, SIZES, SPACING, LOCATIONS AND CONNECTIONS
12. STUDS SHALL BE INSTALLED WITH THEIR BEARING ENDS POSITIONED FLUSH AGAINST THE INSIDE TRACK WEB.
13. NOT USED
14. NOT USED
15. N/A
16. NOT USED
17. ALL SHEET METAL SCREWS SHALL BE THREAD FORMING OR THREAD CUTTING, WITH OR WITHOUT A SELF-DRILLING POINT PER AISI
18. ALL WELDING OR MATERIAL LESS THAN 0.18 INCHES IN THICKNESS SHALL BE MADE IN ACCORDANCE WITH THE AWS D1.3 WELDERS AND WELDING PROCEDURES AND SHALL BE QUALIFIED AS SPECIFIED IN AWS D1.3
19. TOUCH UP COLD GALVANIZING USING ZRC CHEMICAL PRODUCTS CO.M, ZRC COLD GALVANIZING COMPOUND OR EQUAL
20. SPLICES IN STUDS SHALL NOT BE PERMITTED

CORROSION PROTECTION:

1. STRUCTURAL MEMBERS UTILIZED IN COLD-FORMED STEEL FRAMED CONSTRUCTION SHALL HAVE A PROTECTIVE COATING AS SPECIFIED IN TABLE A4-1

COATING CLASSIFICATION	COATING DESIGNATOR	MINIMUM COATING REQUIREMENTS			
		ZINC COATED ^a OZ/FT ² (G/M ²)	ZINC IRON ^b OZ/FT ² (G/M ²)	55% AL-ZINC ^c OZ/FT ² (G/M ²)	ZINCE-5% ^d OZ/FT ² (G/M ²)
METALLIC COATED	CP 80	G60 [2180]	A60 [1780]	AZ50 [AZM1850]	CF30 [ZGF90]
	CP 90	G90 [2275]	NOT APPLICABLE	AZ50 [AZM1850]	CF45 [ZGF135]
PAINTED METALLIC	PM	THE METALLIC COATED SUBSTRATE SHALL MEET THE REQUIREMENTS OF METALLIC COATED. IN ADDITION, THE PAINT FILM SHALL HAVE A MINIMUM THICKNESS OF 0.5 MIL PER SIDE (PRIMER PLUS TOPCOAT) WITH A MINIMUM PRIMER THICKNESS OF 0.1 MIL PER SIDE			

^a ZINC-COATED STEEL SHEET AS DESCRIBED IN ASTM A653/A653M
^b ZINC-IRON ALLOY-COATED STEEL SHEET AS DESCRIBED IN ASTM A653/A653M
^c 55% ALUMINUM-ZINC ALLOY COATED STEEL SHEET AS DESCRIBED IN ASTM A792/A792M
^d ZINCE-5% ALUMINUM ALLOY-COATED STEEL SHEET AS DESCRIBED IN ASTM A875/A875M
^e IN ACCORDANCE WITH THE REQUIREMENTS OF ASTM A1002A/1002M

2. ADDITIONAL CORROSION PROTECTION SHALL NOT BE REQUIRED ON EDGES OF METALLIC-COATED STEEL FRAMING MEMBERS, SHOP OR FIELD CUT, PUNCHED OR DRILLED
3. UNLESS ADDITIONAL CORROSION PROTECTION IS PROVIDED, FRAMING MEMBERS SHALL BE LOCATED WITHIN THE BUILDING ENVELOPE AND SHIELDED FROM DIRECT CONTACT WITH MOISTURE FROM THE GROUND OR THE OUTDOOR CLIMATE

WOOD:

1. STRUCTURAL FRAMING SHALL BE HEM FIR GRADED IN ACCORDANCE WITH THE STANDARD GRADING RULES OF THE WESTERN WOOD PRODUCTS ASSOCIATION OR STANDARD GRADING RULES #17 OF THE WEST COAST LUMBER INSPECTION BUREAU, LATEST EDITIONS. GRADES SHALL BE AS FOLLOWS UNLESS NOTED OTHERWISE ON THE DRAWINGS. (HEM FIR NORTH IS NOT ALLOWED.) EACH PIECE SHALL BE GRADE MARKED AND NO PIECE MAY FALL BELOW GRADES INDICATED.
2. ALL FRAMING EXCEPT AS NOTED HEM FIR #2
3. PLYWOOD SHALL BE AS SHOWN ON THESE DRAWINGS WITH EXTERIOR GLUE IN ACCORDANCE WITH U.S. PRODUCT STANDARD PS 1-19. ALL PANELS SHALL BE MARKED WITH AN APA GRADE MARK WITH AN IDENTIFICATION INDEX AS SHOWN ON DRAWINGS.
4. LAG SCREWS SHALL BE STEEL AND CONFORM TO ANSI/ASME STANDARD B18.2.1 AND THE REQUIREMENTS OF THE 2018 NATIONAL DESIGN SPECIFICATION FOR WOOD CONSTRUCTION (NDS). HOLES FOR LAG SCREW SHANKS SHALL BE BORED THE SAME DEPTH AND DIAMETER AS THE SHANK. THE REMAINING DEPTH OF PENETRATION OF THE SCREW SHALL BE BORED TO 70% OF THE SHANK DIAMETER. ONE QUARTER INCH (1/4") DIAMETER LAG SCREWS NEED NOT HAVE PRE-DRILLED HOLES IF IT CAN BE SHOWN THAT THE WOOD MEMBERS ARE NOT DAMAGED DURING INSTALLATION. PROVIDE FULL BODY DIAMETER LAG SCREWS WITH BENDING YIELD STRENGTHS PER THE 2018 NDS.
5. PROVIDE MALLEABLE IRON WASHERS OR EQUIVALENT CUT PLATE WASHERS (NOT LESS THAN A STANDARD CUT WASHER) UNDER NUTS AND BOLT OR LAG SCREW HEADS WHICH BEAR ON WOOD.
6. WOOD SCREWS SHALL CONFORM TO ANSI/ASME STANDARD B18.6.1 AND THE REQUIREMENTS OF THE 2018 NATIONAL DESIGN SPECIFICATION FOR WOOD CONSTRUCTION (NDS). GALVANIZED OR OTHER CORROSION RESISTANT COATING WHERE EXPOSED TO WEATHER OR USED IN FOUNDATIONS. SCREWS SHALL BE STEEL WITH CUT THREADS AND BENDING YIELD STRENGTHS NDS.
7. WOOD MEMBERS SHALL BE CUT OR NOTCHED ONLY AS SHOWN ON STRUCTURAL DRAWINGS.
8. WHEN REQUIRED NAILING TENDS TO SPLIT WOOD MEMBERS, NAIL HOLES SHALL BE PRE-BORED TO 3/4 OF THE NAIL DIAMETER.
9. STRUCTURAL NAILING SHALL BE WITH FULL HEAD COMMON NAILS PER ALL REQUIREMENTS OF THE 2018 NDS. NAILING NOT SPECIFICALLY INDICATED SHALL COMPLY WITH CCR TITLE 24, PART 2, TABLE 2304.10.2. ALL NAILS SHALL BE GALVANIZED OR OTHER CORROSION RESISTANT COATING WHERE EXPOSED TO WEATHER, IN FOUNDATIONS AND AS NOTED ON PLANS, PER THE REQUIREMENTS OF CCR TITLE 24, PART 2, WITH MINIMUM BENDING YIELDS PER THE 2018 NDS. (SEE NAIL EQUIVALENCE BELOW.)
10. NAIL EQUIVALENCE: (PROVIDE MINIMUM NAIL LENGTHS AS REQUIRED FOR SPECIFIED PENETRATION, TYP UNO) 6d EQUALS .113"Ø - PROVIDE 1.36" MIN POINT PENETRATION 8d EQUALS .131"Ø - PROVIDE *1.57" MIN POINT PENETRATION 10d EQUALS .148"Ø - PROVIDE *1.78" MIN POINT PENETRATION 16d EQUALS .162"Ø - PROVIDE *1.94" MIN POINT PENETRATION * 1 1/2" AT 2x MEMBERS
11. EXCEPT WHERE MORE STRINGENT CONSTRUCTION IS SHOWN ON THE DRAWINGS, WOOD CONSTRUCTION SHALL COMPLY WITH TITLE 24, PART 2, SECTION 2308, CONVENTIONAL LIGHT-FRAME CONSTRUCTION PROVISIONS, AS A MINIMUM PRESSURE PRESERVATIVE TREATMENT SHALL BE PER SECTION 2303.1.9, CCR TITLE 24, PART 2. PROVIDE QUALITY MARK ON ALL TREATED FOUNDATION MEMBERS FROM AGENCY LISTED BY AN ACCREDITATION BODY THAT COMPLIES WITH THE REQUIREMENTS OF THE AMERICAN LUMBER STANDARDS TREATED WOOD PROGRAM. ALL FOUNDATION MEMBERS SHALL BE IDENTIFIED PER SECTION 2303.1.9.1. TREAT ALL CUT ENDS OF PRESSURE TREATED MEMBERS WITH AN APPROVED PRESERVATIVE. (WILLARD W/B COPPER GREEN 2% OR AN APPROVED EQUIVALENT).
12. MACHINE NAILING IS SUBJECT TO APPROVAL BY THE STRUCTURAL ENGINEER OR ARCHITECT AND THE DIVISION OF THE STATE ARCHITECT.
13. POWDER DRIVEN FASTENERS SHALL BE BY HILTI, INC. HILTI FASTENING SYSTEMS - OR EQUAL. INSTALL IN ACCORDANCE WITH DRAWINGS AND THE MANUFACTURER'S RECOMMENDATIONS AND ICC APPROVALS
14. FASTENERS FOR PRESSURE-PRESERVATIVE TREATED WOOD SHALL COMPLY WITH SECTION 2304.10.6 OF CBC
15. NAILS AND SPIKES USED IN WET OR EXTERIOR LOCATIONS SHALL COMPLY WITH SECTION 2304.10.2.1 OF CBC

ACCEPTABLE FASTENERS:

SELF-TAPPING SCREWS	SECT 3.2.12 ASTM C1513
SELF-DRILLING SCREWS	SECT 3.2.9 ASTM C1513
SELF-PIERCING SCREWS	SECT 3.2.9 ASTM C1513

REFERENCE ASTM C1513, STANDARD SPECIFICATION FOR TAPPING SCREWS FOR COLD-FORMED STEEL FRAMING CONNECTION

REFERENCE AISI S400-20 , NORTH AMERICAN STANDARD FOR SEISMIC DESIGN

FASTENERS MANUFACTURED WITH CARBON STEEL WIRE SHALL CONFORM TO ASTM A510

TESTING - THE OPERATOR, TOOL, AND FASTENER SHALL BE PRE-QUALIFIED BY THE PROJECT INSPECTOR. HE SHALL OBSERVE THE TESTING OF THE FIRST 10 FASTENER INSTALLATIONS. A TEST "PULL-OUT" LOAD OF NOT LESS THAN TWICE THE DESIGN LOAD SHALL BE APPLIED TO THE PIN IN SUCH A MANNER AS NOT TO RESIST THE SPALLING TENDENCY OF THE CONCRETE SURROUNDING THE PIN. THEREAFTER, RANDOM TEST UNDER THE PROJECT INSPECTOR'S SUPERVISION SHALL BE MADE OF APPROXIMATELY 1 IN 10 PINS. IF ANY PIN FAILS TESTING, TEST ALL PINS OF THE SAME CATEGORY NOT PREVIOUSLY TESTED UNTIL TWENTY (20) CONSECUTIVE PASS, THEN RESUME THE INITIAL TESTING FREQUENCY.

ACCESS NOTES

1. RAMPS HAVING SLOPES STEEPER THAN 1 VERTICAL TO 20 HORIZONTAL SHALL HAVE LANDINGS AT TOP AND BOTTOM AND AT LEAST ONE INTERMEDIATE LANDING SHALL BE PROVIDED FOR EACH 30" RISE OF RISE PER CBC 11B-405.7
2. LOCATION OF LANDINGS - LANDINGS SHALL BE PROVIDED AT THE TOP AND BOTTOM OF EACH RAMP. INTERMEDIATE LANDINGS SHALL BE PROVIDED A INTERVALS NOT EXCEEDING 30" OF VERTICAL RISE AND AT EACH CHANGE OF DIRECTION. LANDINGS ARE NOT CONSIDERED IN DETERMINING THE MAXIMUM HORIZONTAL DISTANCE OF EACH RAMP

EXAMPLES OF RAMP DIMENSIONS:

SLOPE:	MAX RISE (INCHES):	MAX HORIZONTAL PROJECTION:
1:12	30	30'-0"
1:15	30	37'-6"
1:16	30	40'-0"

SIZE OF LANDINGS SHALL NOT BE LESS THAN 60" WIDE AND SHALL HAVE A LENGTH OF NOT LESS THAN 60" IN THE DIRECTION OF THE RAMP RUN PER CBC 11B-405.7.2 & 11B-405.7.3. AT THE BOTTOM LANDING OR LANDING AT CHANGE OF RAMP DIRECTION, THE LANDING SHALL SLOPE 1:48 MAX AND EXTEND MIN 72" IN THE DIRECTION OF THE RAMP

3. DOORS IN ANY POSITION SHALL NOT BE REDUCE THE MINIMUM DIMENSIONS OF THE LANDING TO LESS THAN 42" AND SHALL NOT REDUCE THE REQUIRED WIDTH BY MORE THAN 3" WHEN FULLY OPENED PER CBC 11B-405.7.5
4. RAMPS SHALL BE CONSTRUCTED AS REQUIRED. ALL REQUIREMENTS SHALL CONFORM TO CBC 11B-405
5. THE SURFACE OF RAMPS, LANDING & STAIRS SHALL BE ROUGHED OR SHALL BE OF SLIP-RESISTANT MATERIAL WITH A COEFFICIENT OF FRICTION OF 0.6 FOR LANDINGS AND 0.8 FOR RAMP AND STAIRS
6. RAMPS AND STAIRWAY USED AS THE EXIT REQUIRED WIDTH SHALL CONFORM TO CBC SECTION 1009, 1010, CHAPTER 11B & 11B-405.5
7. HANDRAILS SHALL CONFORM TO CBC SECTION 11B-405.8 (RAMPS) AND 11B-504.6 (STAIRS)
8. STRIKE EDGE EXTENSION THE WIDTH OF THE LANDING SHALL EXTEND 24" PAST THE STRIKE EDGE OF ANY DOOR OR GATE FOR EXTERIOR RAMPS AND 18" PAST THE STRIKE EDGE FOR INTERIOR RAMPS. FOR DOOR SWINGING INTO LANDING, 42" MIN IS REQUIRED PER 11B-405.7.5
9. CHANGE IN DIRECTION - RAMPS THAT CHANGE DIRECTION BETWEEN RUNS AT LANDING SHALL HAVE A CLEAR LANDING 60" MINIMUM BY 72" MINIMUM IN THE DOWNWARD DIRECTION OF TRAVEL PER CBC 11B-405.7.4 AND 72" MIN REQUIRED AT THE BOTTOM LANDING
10. THE WIDTH OF RAMPS SHALL HAVE A MINIMUM WIDTH OF 48" OR AS WIDE AS REQUIRED EXIT WIDTH IF LARGER REQUIRED PER STAIRWAY AND EXITS PER CBC 11B-405.5
11. LANDINGS AND RAMPS SHALL BE SLOPED AT 1:48 MAX TO PREVENT THE ACCUMULATION OF WATER ON WALKING SURFACES PER CBC 11B-405.10. SEE CBC 11B-504.7 FOR STAIRS
12. SITE CONDITION: DUE TO VARIES SITE CONDITIONS, THE MAXIMUM HEIGHT OF FINISH FLOOR FROM GRADE IS 26". THEREFORE IT IS POSSIBLE THAT THE ACCESS RAMP ATTACHED TO THE COMMON LANDING COULD BE 26'-0". AT A SLOPE OF 1:12, THE ARCHITECT MUST TAKE INTO ACCOUNT THAT THE RAMP SUPPLIED BY SKC COMPANY IS 11'-0". AT A SLOPE OF 1:12 THE ARCHITECT WILL HAVE TO DESIGN AND PROVIDE SUFFICIENT DETAILS OF RAMP EXTENSIONS AND BOTTOM LANDING DEPENDING ON PARTICULAR SITE CONDITIONS ICS WILL NOT BE RESPONSIBLE FOR ANY RAMP EXTENSION EXCEEDING ORIGINAL PLAN AS SHOWN ON PLANS

STATE AGENCY APPROVAL

IDENTIFICATION STAMP
DIV. OF THE STATE ARCHITECT
APP: 02-121945 INC:
REVIEWED FOR
SS ☒ FLS ☒ ACS ☒
DATE: 12/12/2023

SKC COMPANY

15345 FAIRFIELD RANCH RD., SUITE 180 CHINO HILLS, CA 91709
OFFICE: (909) 740-3120, FAX: (909) 726-9470
WEBSITE: WWW.SKCCOMPANY.COM

MANUFACTURER REF: RMF1279606 DEALER # DL1279606
CS-112-190218 SEE CERTIFIED


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DISTRICT/CUSTOMER NAME:

SCHOOL/SITE NAME:

SHEET TITLE:

CONSTRUCTION SPECIFICATIONS AND NOTES

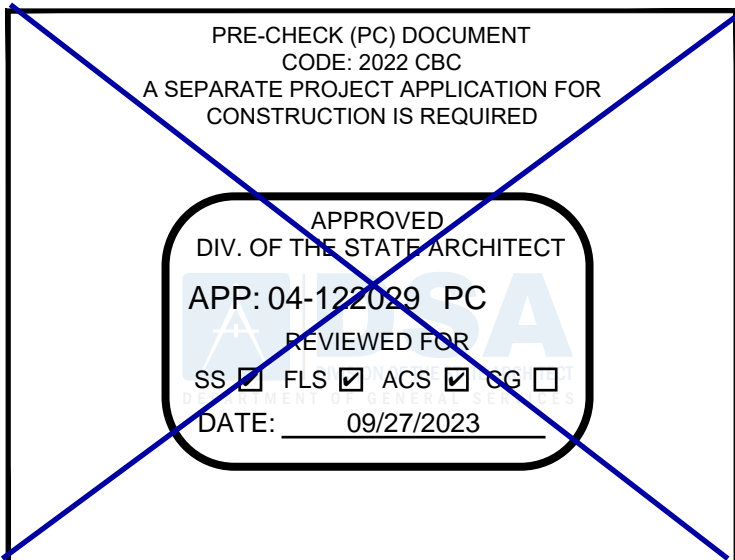

PROFESSIONAL OF RECORD ON PC



FIRM: ORION STRUCTURAL ENGINEERING, INC.
ADDRESS: 11305 RANCHO BERNARDO ROAD, SUITE 121
CITY: SAN DIEGO, CA 92127
PHONE: (619) 579-1974


PROJECT SPECIFIC PROFESSIONAL OF RECORD

**LODI UNIFIED SCHOOL DISTRICT
MILLSWOOD MIDDLE SCHOOL
PORTABLE RELOCATION**
DSA APP# 02-121945
FILE No.: 39-50
PTN: 68585-261

FIRM: ORION STRUCTURAL ENGINEERING, INC.
ADDRESS: 11305 RANCHO BERNARDO ROAD, SUITE 121
CITY: SAN DIEGO, CA 92127
PHONE: (619) 579-1974

REVISIONS	
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PROJECT NO.: 00-0000	
DRAFTER: 00	
SCALE: AS NOTED	
DATE: 00-00-00	
SHEET NUMBER	

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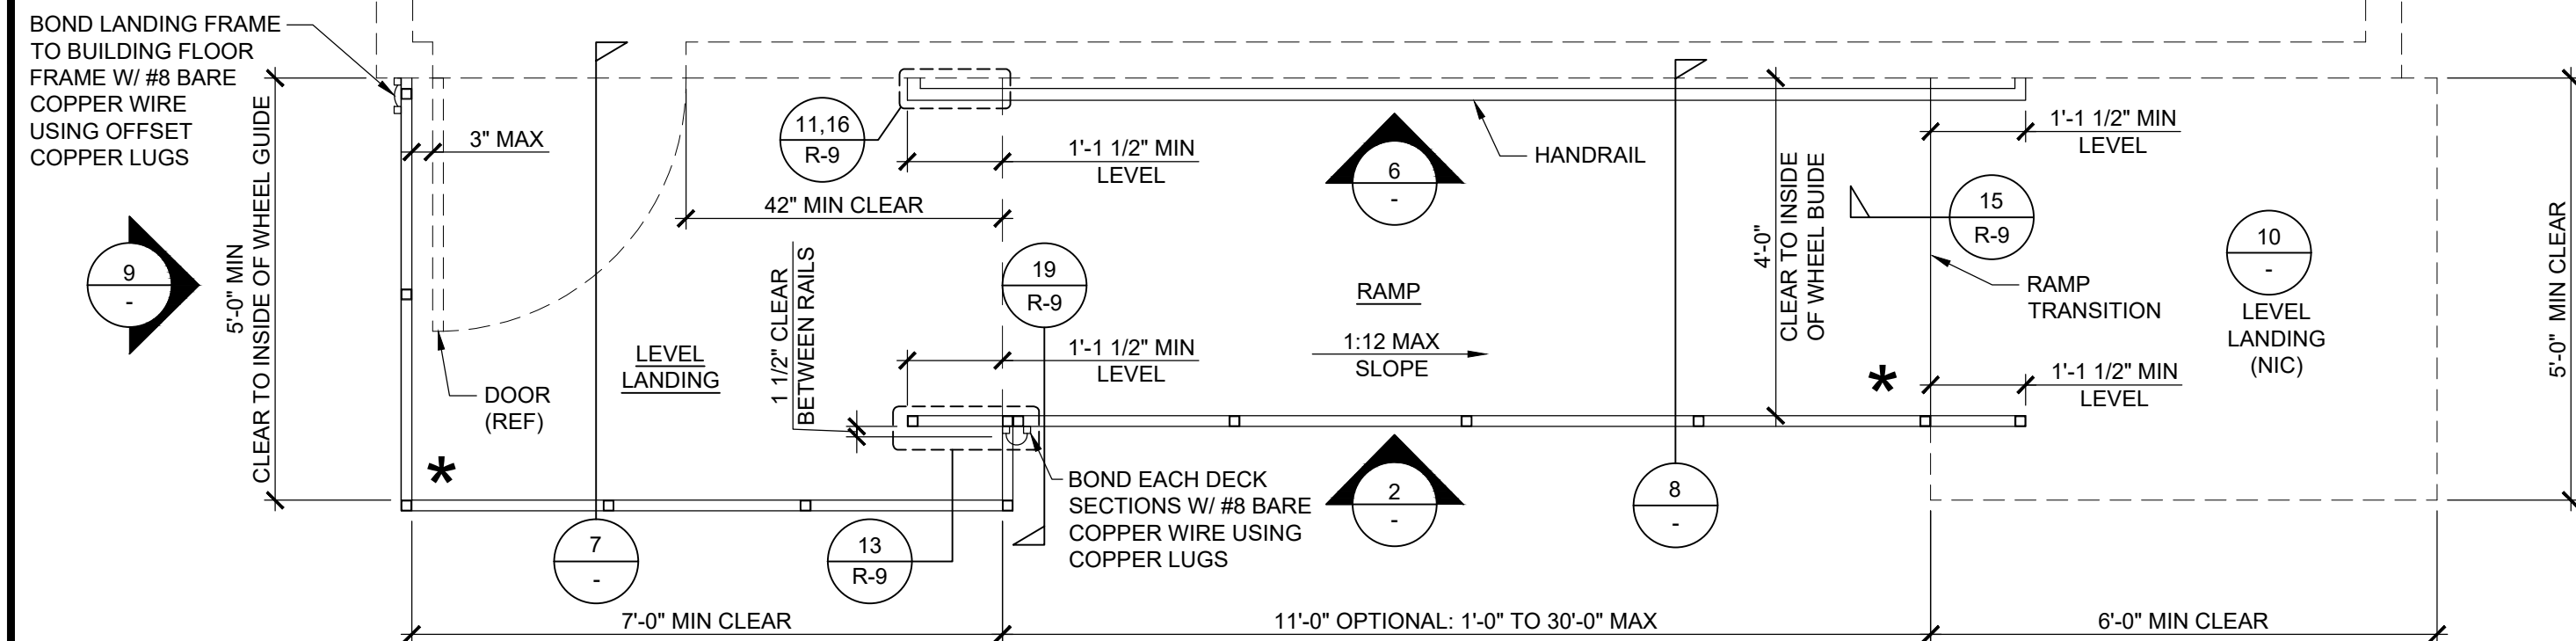
HANDRAIL ATTACHMENT TO BUILDING

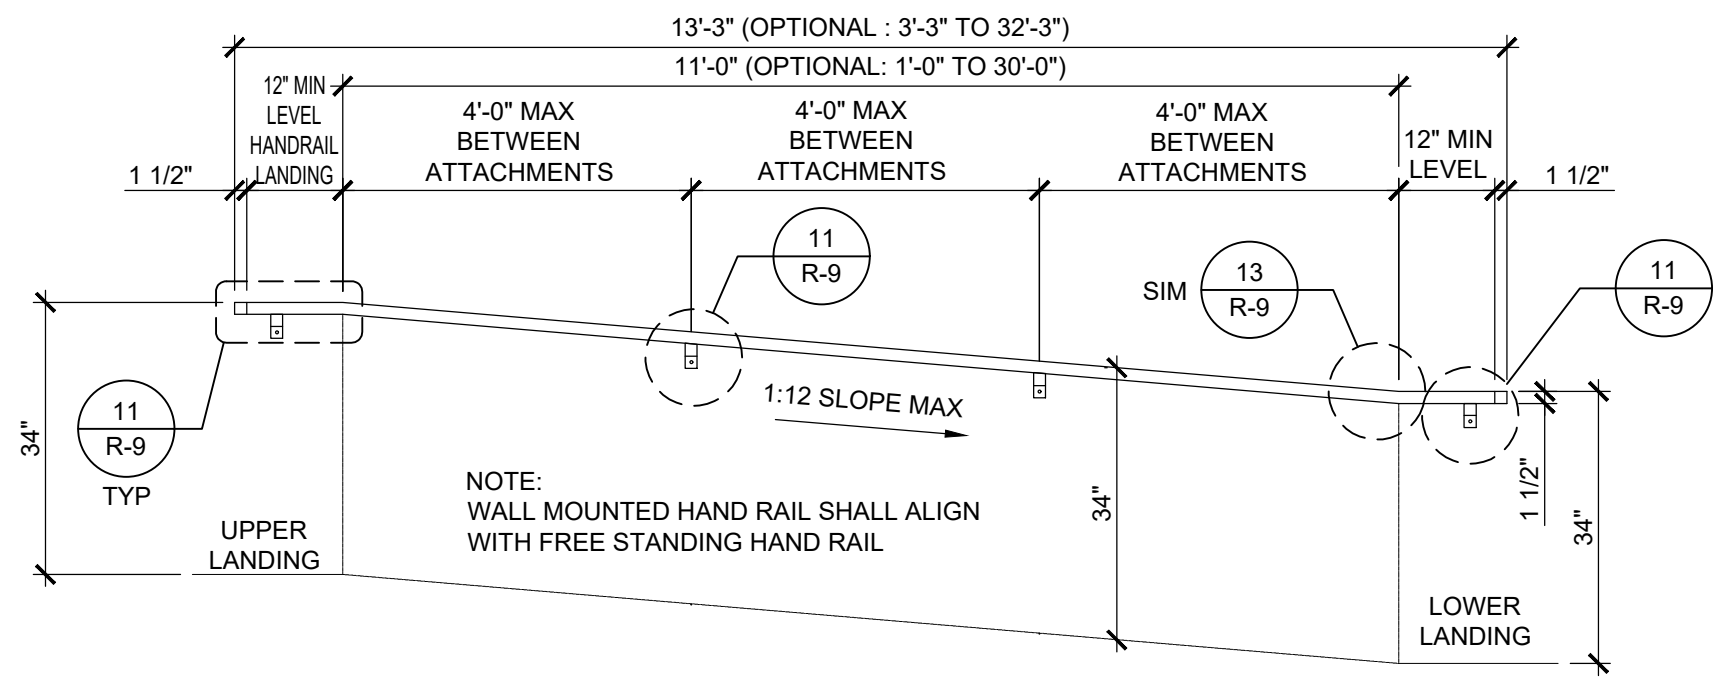SCALE: 1/2" = 1'-0"

NOTE(*): ALL HAND RAILS SURFACES SHALL BE SMOOTH WITH NO SHARP CORNER. PER CBC 11B-505.8 WALL TO BE SMOOTH AND TO EXTEND 18" ABOVE HANDRAIL.

ATTACHED TO BUILDING MEMBER BY OTHERS.

6




RAMP AND LANDING AT BUILDING

SCALE: 1/2" = 1'-0"

* RAMPS AND LANDINGS TO BE SLOPED SO AS NOT TO RETAIN STANDING WATER, 1:48 (2.083%) MAX SLOPE


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SECTION AT LANDING

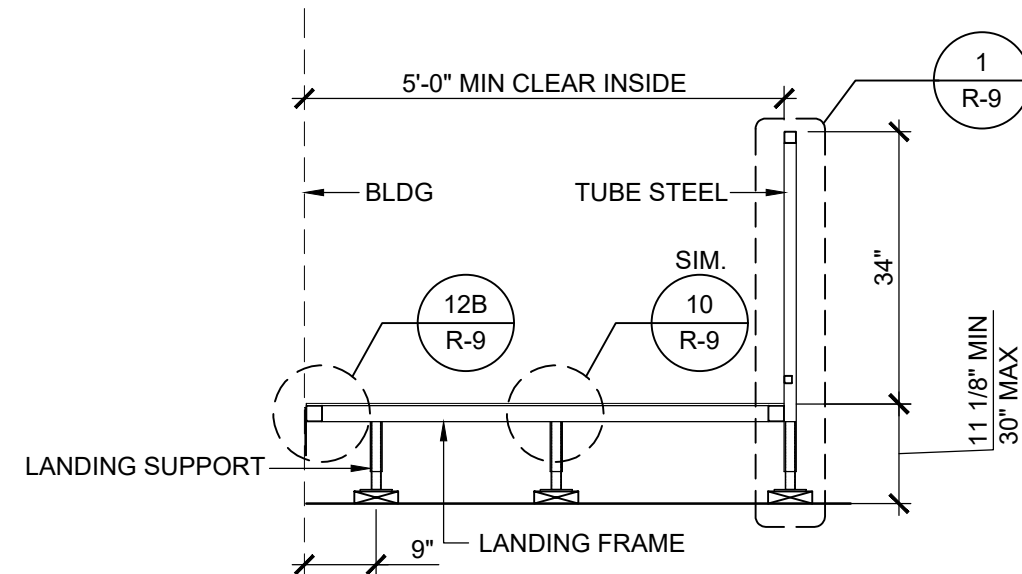SCALE: 1/2" = 1'-0"


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RAMP AND LANDING ELEVATION

SCALE: 1/2" = 1'-0"

2

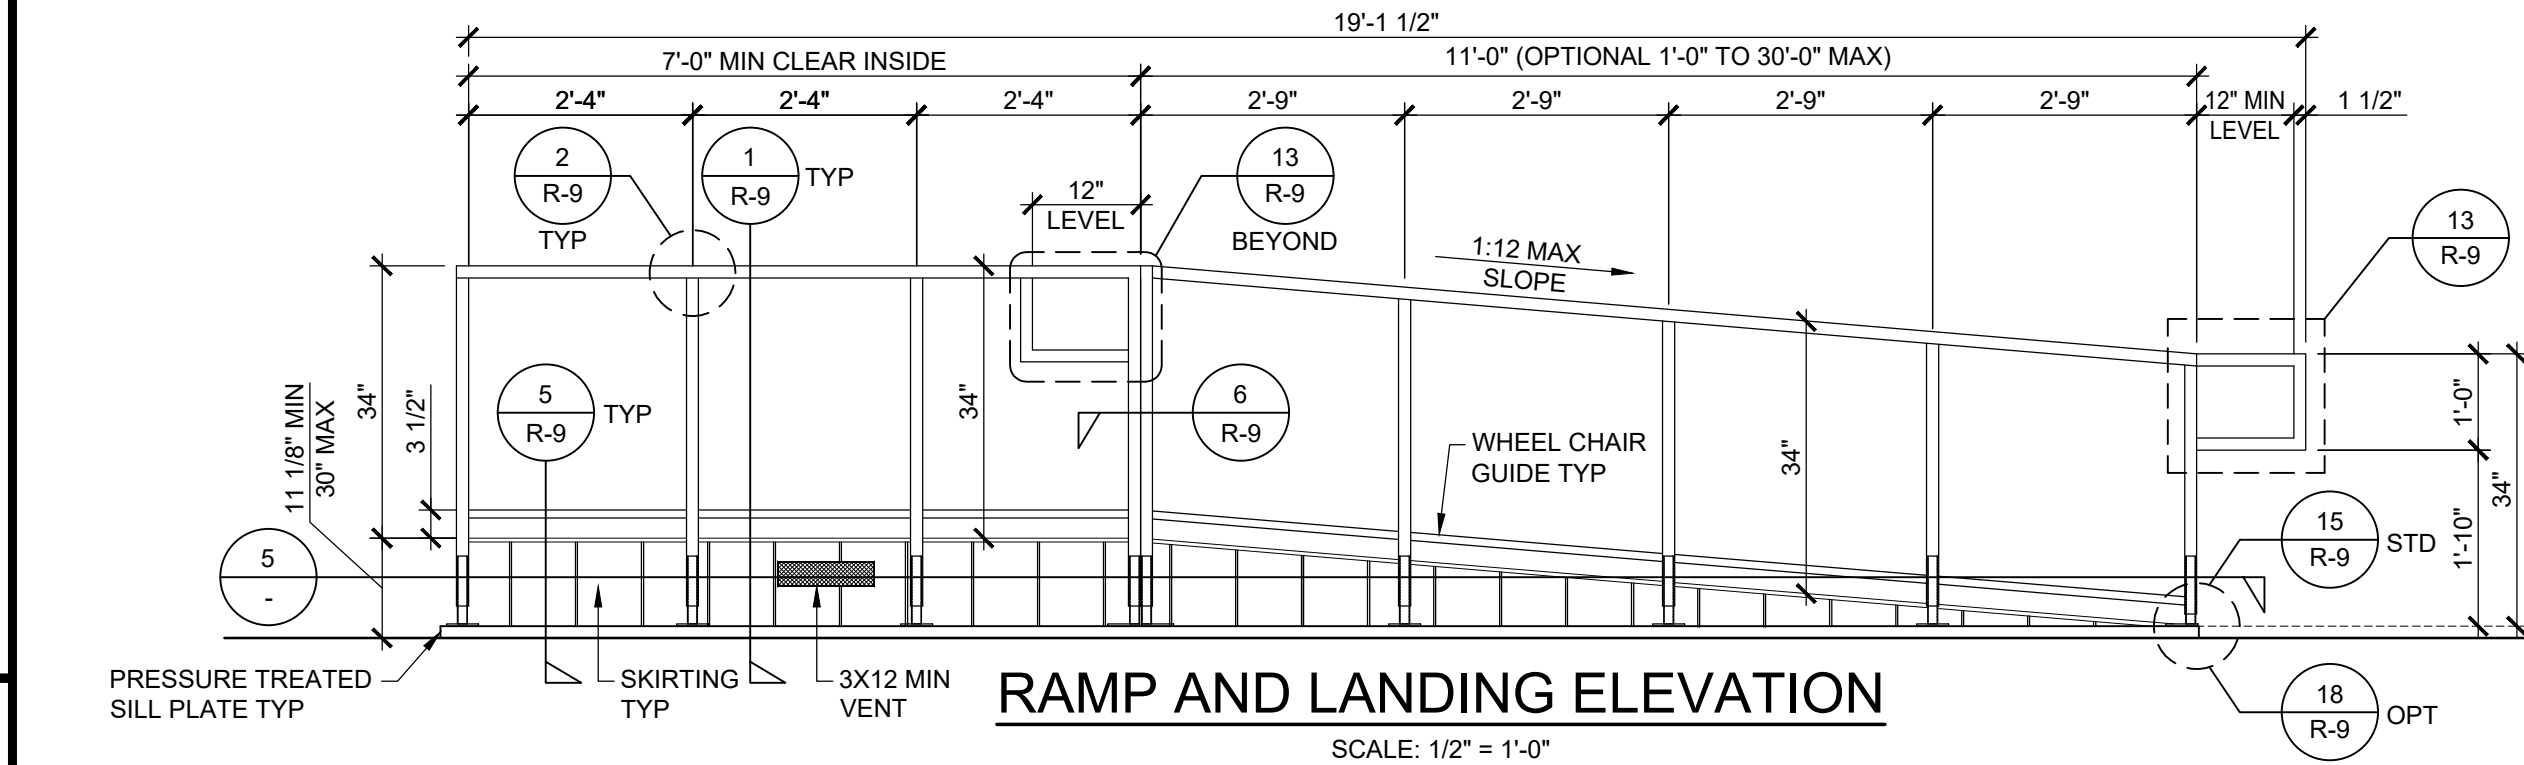


SECTION AT RAMP

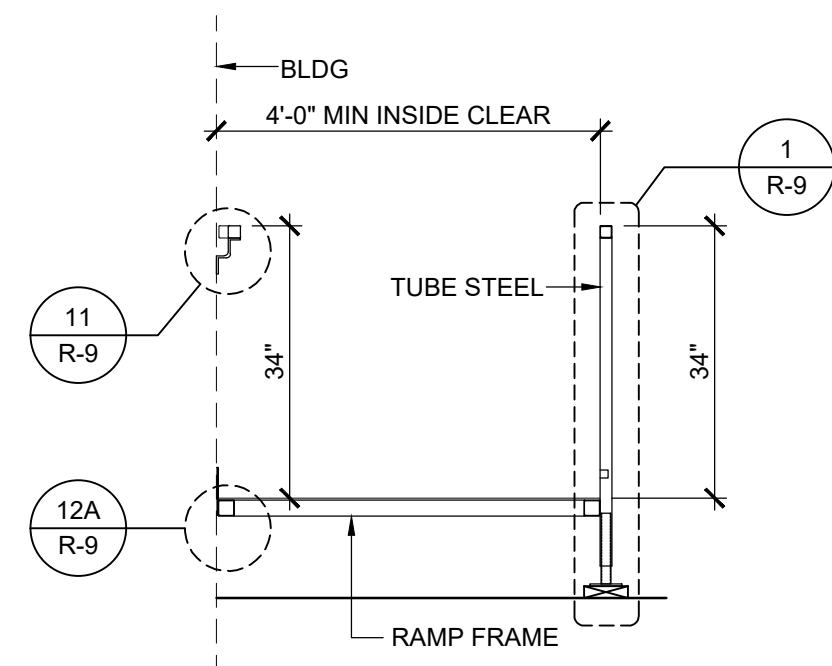SCALE: 1/2" = 1'-0"

8

NOTE(*): ALL HAND RAILS SURFACES SHALL BE SMOOTH WITH NO SHARP CORNER. PER CBC 11B-505.8 WALL TO BE SMOOTH AND TO EXTEND 8" ABOVE HANDRAIL.

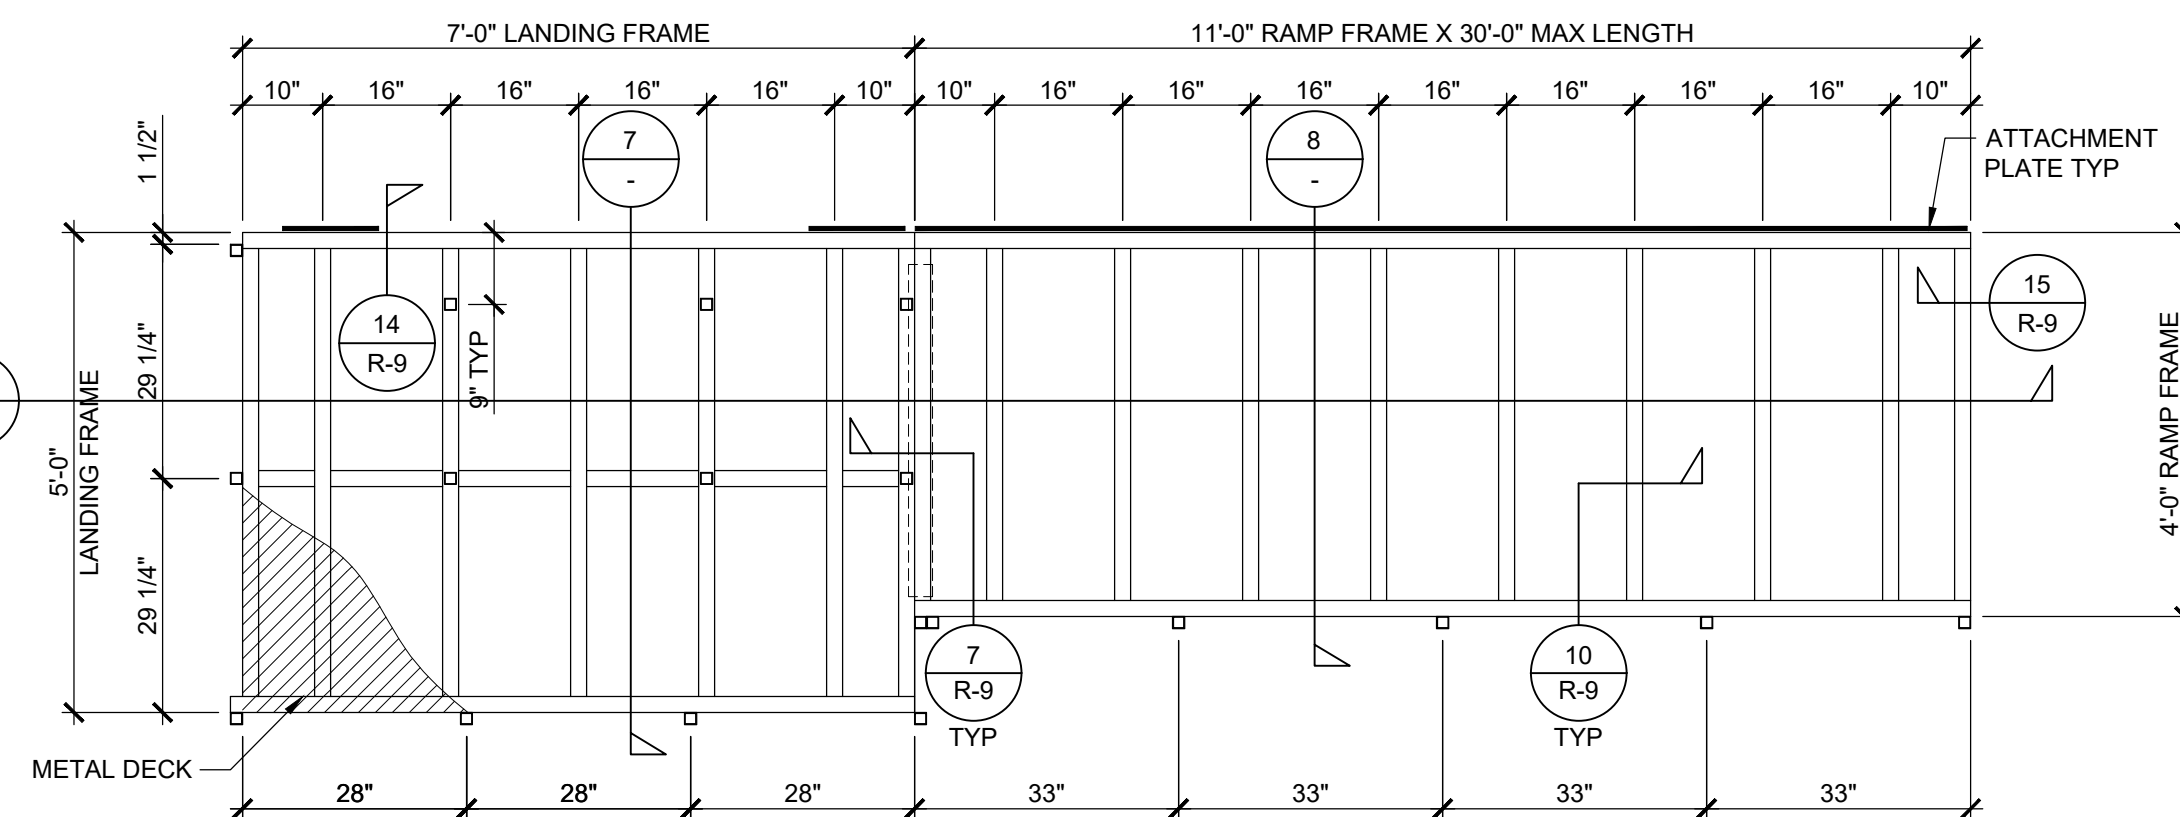


RAMP AND LANDING FRAMING PLAN

SCALE: 1/2" = 1'-0"

3

NOTE:
PER CBC 1012.5.1 MINIMUM EGRESS WIDTH SHALL COMPLY WITH CBC 1020.3 (CORRIDORS)


1020.3
THE MIN WIDTH OF CORRIDORS SPECIFIED IN TABLE 1020.3 SHALL BE DETERMINED BY SECTION 1005.3, PER OCCUPANT. HOWEVER FOR GROUP E IF THERE ARE 100 OR MORE OCCUPANTS REQ'D TO EXIT THE RAMP SHALL BE 72" MIN WIDTH. THIS WILL REQUIRE A NEW DESIGN.

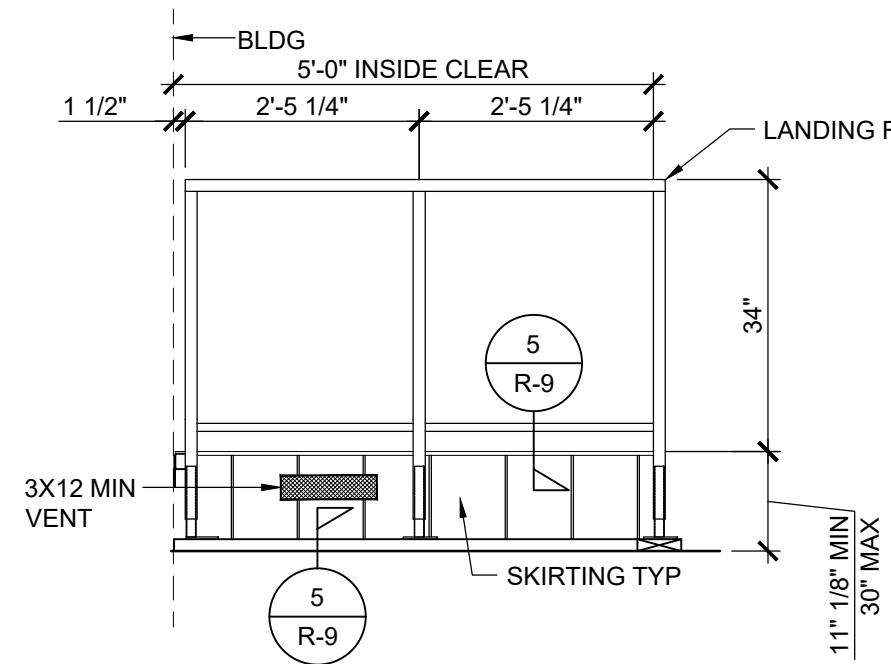

LANDING ELEVATION (REAR)

SCALE: 1/2" = 1'-0"


9

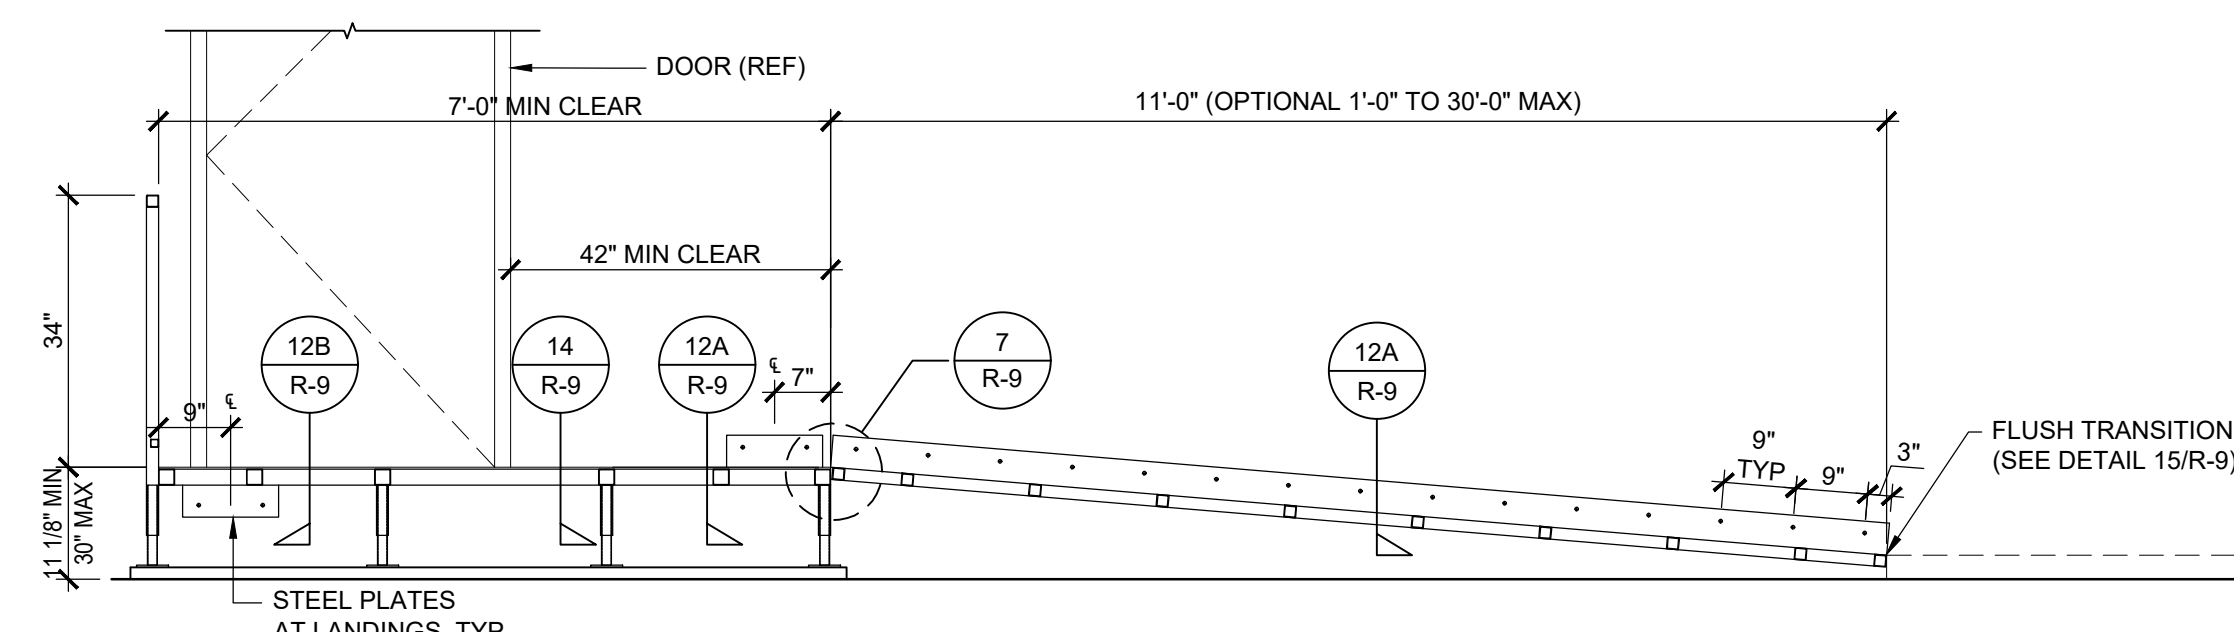

SECTION AT RAMP AND LANDING

SCALE: 1/2" = 1'-0"

4

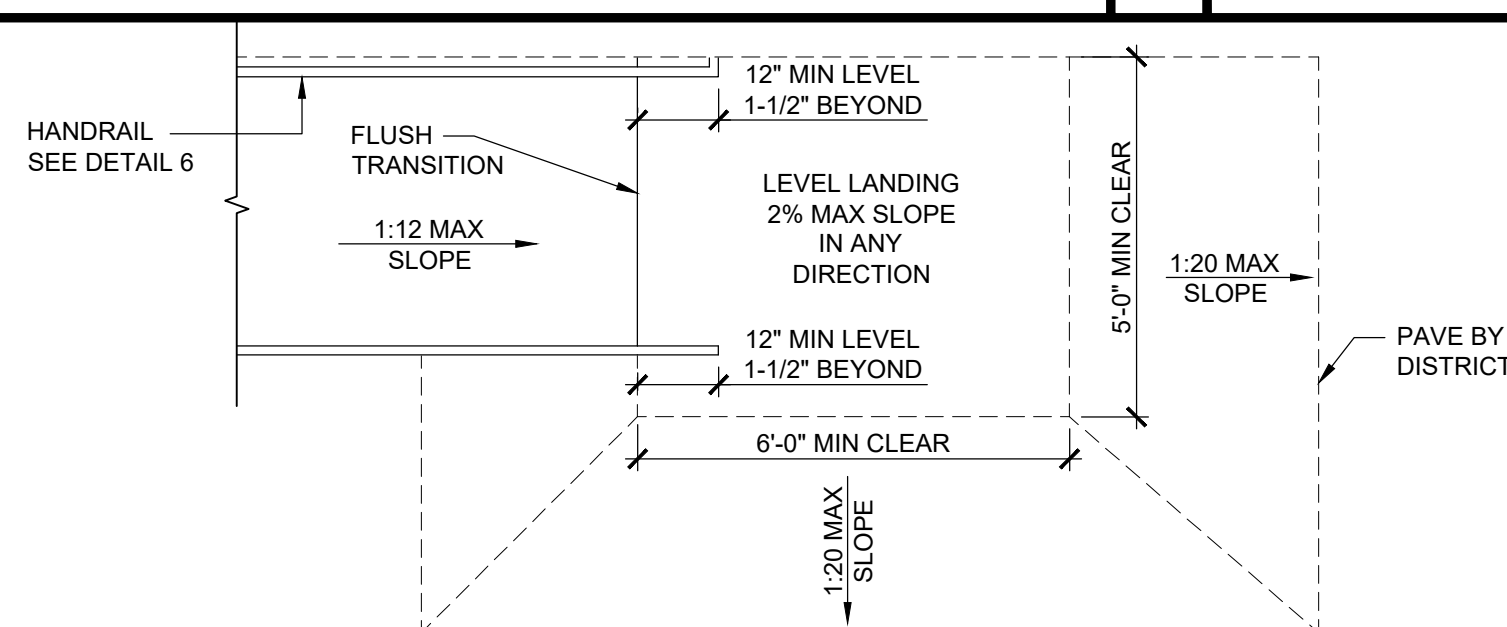


CLEAR LANDING SPACE

SCALE: 3/8" = 1'-0"

10

NOTE:
1. 1:20 TRANSITIONS OFF OF LOWER LANDING REQUIRES NO HANDRAILS.
2. TRANSITIONS EXCEEDING 1:20 BUT NOT TO EXCEED 1:12 REQUIRE REMOVAL OF 12" HANDRAIL EXTENSION AND ADDITIONAL HANDRAILING ALSO REQUIRES ADDITIONAL RAMP LENGTH BY DISTRICT. (THIS CONDITION REQUIRES A SITE SPECIFIC DETAIL PROVIDED BY ARCHITECT TO DEMONSTRATE ACCESSIBLE RAMP.)

* RAMPS AND LANDINGS TO BE SLOPED SO AS NOT TO RETAIN STANDING WATER, 1:48 (2.083%) MAX SLOPE.

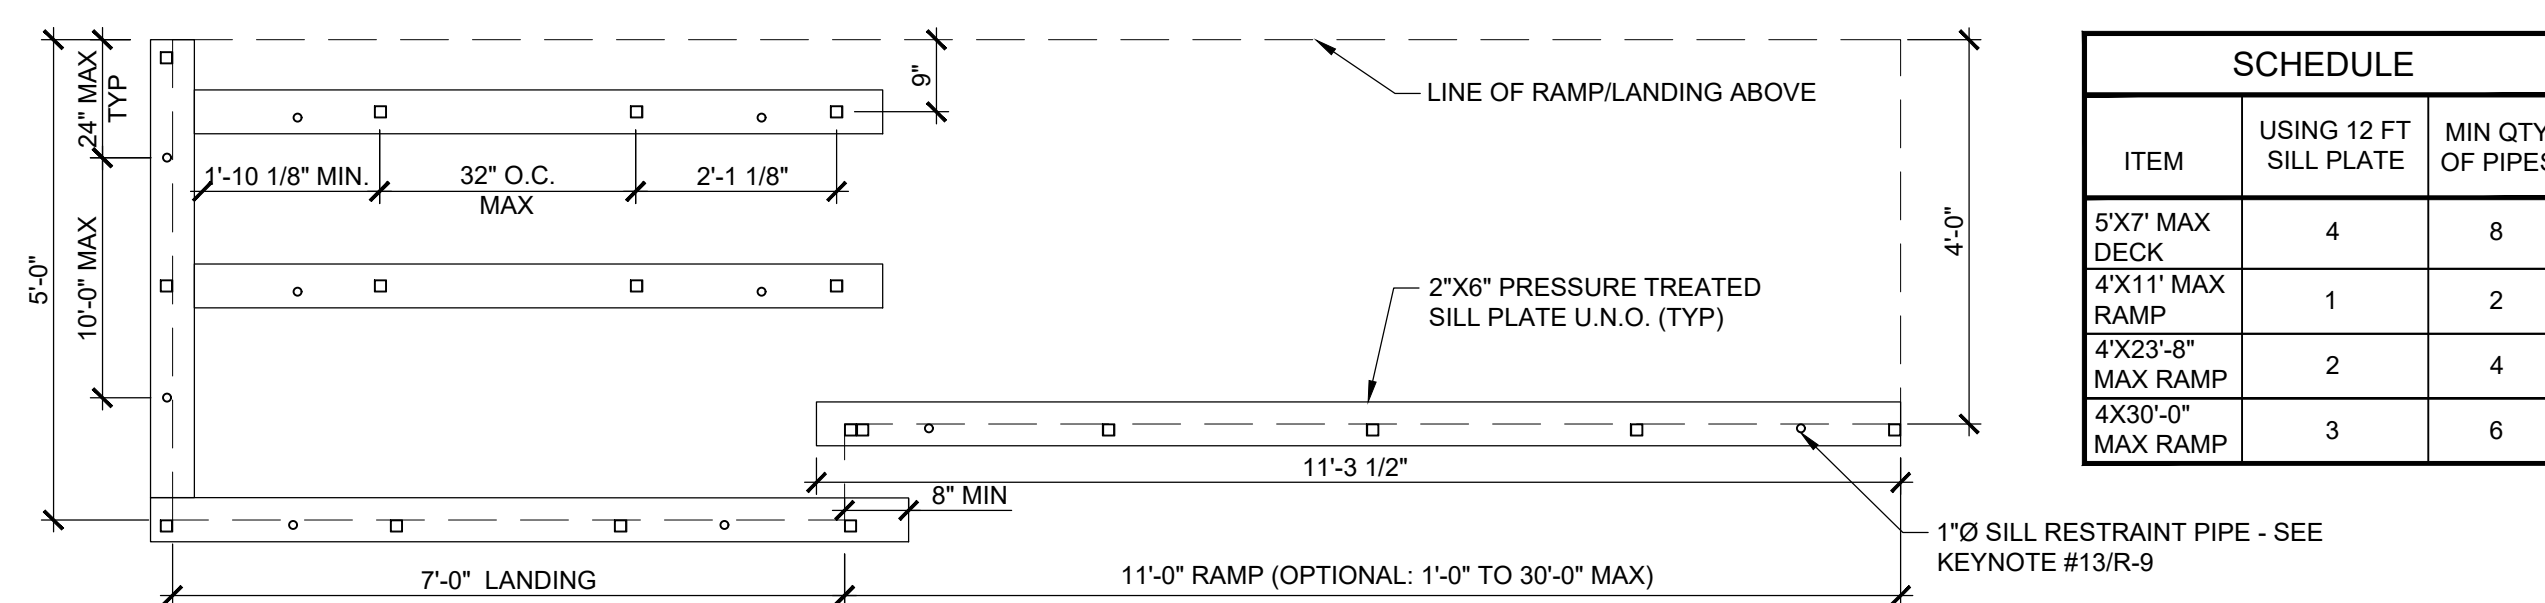

SILL PLAN FOR RAMP AND LANDING

SCALE: 1/2" = 1'-0"

5

SCHEDULE		
ITEM	USING 12 FT SILL PLATE	MIN QTY OF PIPES
5'X7' MAX DECK	4	8
4'X11' MAX RAMP	1	2
4'X23'-8" MAX RAMP	2	4
4'X30'-0" MAX RAMP	3	6

STATE AGENCY APPROVAL

IDENTIFICATION STAMP
DIV. OF THE STATE ARCHITECT
APP: 02-121945 INC:
REVIEWED FOR
SS ☒ FLS ☒ ACS ☒
DATE: 12/12/2023

SKSC COMPANY

15345 FAIRFIELD RANCH RD., SUITE 180 CHINO HILLS, CA 91709
OFFICE: (909) 740-3120, FAX: (909) 726-9470
WEBSITE: WWW.SKSCOMPANY.COM

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DISTRICT/CUSTOMER NAME:

SCHOOL/SITE NAME:

SHEET TITLE:

STANDARD RAMP & LANDING
(ATTACHED HANDRAIL TO BUILDING)

PRE-CHECK (PC) DOCUMENT
CODE: 2022 CBC
A SEPARATE PROJECT APPLICATION FOR CONSTRUCTION IS REQUIRED

APPROVED
DIV. OF THE STATE ARCHITECT
APP: 04-122029 PC
REVIEWED FOR
SS ☒ FLS ☒ ACS ☒ SG ☐
DATE: 09/27/2023

PROFESSIONAL OF RECORD ON PC



FIRM: ORION STRUCTURAL ENGINEERING, INC.
ADDRESS: 11305 RANCHO BERNARDO ROAD, SUITE 121
CITY: SAN DIEGO, CA 92127
PHONE: (619) 579-1974

PROJECT SPECIFIC PROFESSIONAL OF RECORD

LODI UNIFIED SCHOOL DISTRICT
MILLSWOOD MIDDLE SCHOOL
PORTABLE RELOCATION
DSA APP# 02-121945
FILE No.: 39-50
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ADDRESS: 11305 RANCHO BERNARDO ROAD, SUITE 121
CITY: SAN DIEGO, CA 92127
PHONE: (619) 579-1974

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9/26/2023 9:28:19 AM

