DSA APP NO. 02-121945

FILE NO. 39-50 PROJECT TRACKING NO. 68585-261 AGENCY APPROVAL IDENTIFICATION STAMP DIV. OF THE STATE ARCHITE APP: 02-121945 INC: REVIEWED FOR SS 🗹 FLS 🗹 ACS 🗹

1715 R STREET, SUITE 200 SACRMENTO, CA 95811 TEL (916) 786-8178

## **SYMBOLS DRAFTING ITEMS** VIEW REFERENCES DIMENSION LINE AND TICK MATCHLINE - SEE: 1 / A10<sup>-</sup> **→** 01.23.A KEYNOT **ENLARGED VIEW REVISION CLOUD** INTERIOR ELEVATION VIEW REFERENCE /1\ CMNT # REVISION TAG SHEET REFERENCE EXTERIOR ELEVATION PROJECT NORTH ARROW

### **GENERAL PROJECT NOTES - K12**

- ALL WORK SHALL CONFORM TO 2022 TITLE 24 CALIFORNIA CODE OF REGULATIONS (CCR). THE PROJECT MANUAL AND SPECIFICATIONS IN CONJUNCTION WITH THESE DRAWINGS AND REFERENCES SHALL FORM A PART OF THE CONTRACT AND SHALL BE REFERRED TO AS THE
- OR A CONSTRUCTION CHANGE DOCUMENT (CCD) APPROVED BY THE DIVISION OF THE STATE ARCHITECT AS REQUIRED BY SECTION 4-338, PART 1, T24 CCR.
- PROVIDE CONTINUOUS INSPECTION OF THE WORK. THE DUTIES OF THE INSPECTION ARE DEFINED IN SECTION 4-342. PART 1, T24, CCR.
- ANY DIFFERENCE BETWEEN THE EXISTING CONSTRUCTION AS OBSERVED IN THE FIELD AND
- WITH THE WORK.
- ARCHITECT SHALL BE NOTIFIED OF ANY DISCREPANCIES OR INCONSISTENCIES. THE
- : IT SHALL BE THE RESPONSIBILITY OF THE GENERAL CONTRACTOR TO ENSURE THAT AL APPLICABLE SAFETY LAWS ARE STRICTLY ENFORCED AND TO MAINTAIN A SAFE
- 9. IT SHALL BE THE RESPONSIBILITY OF THE GENERAL CONTRACTOR TO PROVIDE SUPERVISION OF THE CONSTRUCTION WORK TO ENSURE THAT IT IS BUILT IN CONFORMANCE WITH THE APPROVED PLANS AND SPECIFICATIONS. THE ARCHITECT WILL PROVIDE ONLY PERIODIC OBSERVATION OF THE WORK. SEE NOTE 4 FOR DSA INSPECTION REQUIREMENTS.
- 10. ANY DAMAGE DONE TO THE EXISTING CONSTRUCTION DURING THE COURSE OF THIS WORK SHALL BE REPLACED BY THE CONTRACTOR AT THE CONTRACTOR'S EXPENSE WITH NO
- 11. GRADING PLANS, DRAINAGE IMPROVEMENTS, ROAD & ACCESS REQUIREMENTS AND ENVIRONMENTAL HEALTH CONSIDERATIONS SHALL COMPLY WITH ALL LOCAL ORDINANCES.
- 12. THE SEISMIC ANCHORAGE OF MECHANICAL AND ELECTRICAL EQUIPMENT SHALL CONFORM TO CCR TITLE 24, 2022 CBC SECTION 1616A.1.18 AND ASCE-7-16 SECTION 13.6 ANCHORAGE DETAILS FOR ROOF/FLOOR MOUNTED EQUIPMENT SHALL BE SHOWN ON PLANS.
- 13. CUTTING, BORING, SAW CUTTING OR DRILLING THROUGH THE NEW OR EXISTING STRUCTURAL ELEMENTS TO BE DONE ONLY WHEN SO DETAILED IN THE DRAWINGS OR ACCEPTED BY THE ARCHITECT AND THE STRUCTURAL ENGINEER WITH THE APPROVAL OF DSA REPRESENTATIVE. ALL WELDING SHALL BE SPECIALLY INSPECTED BY AN AWS-CWI QUALIFIED INSPECTOR APPROVED BY DSA. ALL BRACING OF DUCTS AND PIPING SHALL BE INSTALLED AS APPROVED BY DSA. WHERE BRACING DETAILS ARE NOT SHOWN ON THE DRAWINGS, THE FIELD INSTALLATION SHALL BE SUBJECT TO THE APPROVAL OF THE ARCHITECT, MECHANICAL ENGINEER AND FIELD ENGINEER. A COPY OF THE DRAWINGS APPROVED BY DSA SHALL BE PROVIDED BY THE CONTRACTOR AND KEPT ON THE JOB AT ALL
- 14. THE INTENT OF THESE DRAWINGS AND SPECIFICATIONS IS THAT THE WORK OF THE ALTERATION, REHABILITATION OR RECONSTRUCTION IS TO BE IN ACCORDANCE WITH TITLE 24, CALIFORNIA CODE OF REGULATIONS. SHOULD ANY EXISTING CONDITIONS SUCH AS DETERIORATION OR NON-COMPLYING CONSTRUCTION BE DISCOVERED WHICH IS NOT COVERED BY THE CONTRACT DOCUMENTS WHEREIN THE FINISHED WORK WILL NOT COMPLY WITH TITLE 24, CALIFORNIA CODE OF REGULATIONS, A CONSTRUCTION CHANGE DOCUMENT OR A SEPARATE SET OF PLANS AND SPECIFICATIONS, DETAILING AND SPECIFYING THE REQUIRED WORK SHALL BE SUBMITTED TO AND APPROVED BY THE DIVISION OF THE STATE
- 15. A DSA ACCEPTED TESTING LABORATORY DIRECTLY EMPLOYED BY THE SCHOOL DISTRICT (OWNER) SHALL CONDUCT ALL THE REQUIRED TESTS AND INSPECTIONS FOR THE PROJECT.
- 16. IT SHALL BE THE RESPONSIBILITY OF THE GENERAL CONTRACTOR TO COMPLY WITH CFC CHAPTER 33 - FIRE SAFETY DURING CONSTRUCTION AND DEMOLITION.
- 17. DO NOT SCALE DRAWINGS, DIMENSIONS SHOWN SHALL TAKE PRECEDENCE OVER DRAWING SCALE. WHENEVER DSA FINDS ANY CONSTRUCTION WORK IS BEING PERFORMED IN A MANNER CONTRARY TO THE PROVISIONS OF THE CALIFORNIA BUILDING CODE AND THAT WOULD COMPROMISE THE STRUCTURAL INTEGRITY OF THE BUILDING, THE DEPARTMENT OF GENERAL SERVICES, STATE OF CALIFORNIA, IS AUTHORIZED TO ISSUE A STOP WORK ORDER PER SECTION 4-334.1 CALIFORNIA ADMINISTRATIVE CODE (PART 1, TITLE 24, CCR).
- 18. TITLE 24 PARTS 1-5 AND 9 MUST BE KEPT ON SITE DURING CONSTRUCTION
- 19. ALL STRUCTURAL, ARCHITECTURAL, MECHANICAL, ELECTRICAL, AND PLUMBING MATERIALS INSTALLATION TO COMPLY WITH APPLICABLE CODES, STANDARDS, AND MANUFACTURER'S
- 20. PROJECT INSPECTION (PI) SHALL WITNESS AND VERIFY GROUNDING.
- 21. DETERIORATION OR EXISTING NON-COMPLIANT CONSTRUCTION: IF ANY CONDITION IS DISCOVERED WHICH, IF LEFT UNCORRECTED, WOULD MAKE THE BUILDING NON-COMPLIANT WITH THE REQUIREMENTS OF THE EDITION OF CBC IN FORCE AT THE TIME OF ORIGINAL CONSTRUCTION. THE CONDITION MUST BE CORRECTED IN ACCORDANCE WITH CURRENT CODE REQUIREMENTS. A CONSTRUCTION CHANGE DOCUMENT (CCD-TYPE A), OR A SEPARATE SET OF PLANS AND SPECIFICATIONS DETAILING AND SPECIFYING THE REQUIRED REPAIR WORK SHALL BE SUBMITTED TO AND APPROVED BY DSA BEFORE PROCEEDING WITH
- 22. NEW BUILDINGS SHALL BE PROVIDED WITH EMERGENCY RESPONDER RADIO COVERAGE IN ACCORDANCE WITH CALIFORNIA FIRE CODE SECTION 510. THE PROJECT ARCHITECT (AOR) SHALL CONTACT THE LOCAL FIRE DEPARTMENT AND/OR EMERGENCY COMMUNICATIONS AUTHORITY TO OBTAIN DESIGN, EQUIPMENT SPECIFICATIONS, TESTING AND ACCEPTANCE CRITERIA. PLANS AND REQUESTED DOCUMENTATION SHALL BE SUBMITTED TO THE LOCAL AUTHORITY HAVING JURISDICTION FOR REVIEW AND APPROVAL. UPON COMPLETION, COPIES OF THE APPROVED PLANS, EQUIPMENT DATE SHEETS, TESTING AND ACCEPTANCE DOCUMENTATION SHALL BE PROVIDED TO THE SCHOOL DISTRICT.

### **PROJECT DESCRIPTION**

RELOCATION OF (2) 24'X40' PORTABLE BUILDINGS ON WOOD FOUNDATIONS: AMS PC RELOCATABLE BUILDING, DSA #68145, SERIAL #97-R286-017A, 97-R286-017B, AND REMOVAL. PROTECTION AND TRANSPORTATION OF PORTABLE BUILDINGS FROM M&O YAR LOCATED AT 880 N. GUILD AVE., LODI, CA 95240 TO THE MILLSWOOD CAMPUS ASSOCIATED SITE WORK CORRESPONDING TO PORTABLE RELOCATION INCLUDING BUT NO LIMITED TO NEW/PATCH CONCRETE, NEW/PATCH AC PAVING, ELECTRICAL AND FIRE ALARM

INSIDE DIAMETER

LAVATORY

MATERIAL

MAXIMUM

MINIMUM

NORTH

MACHINE BOLT

MISCELLANEOUS

NOT IN CONTRACT

**OUTSIDE DIAMETER** 

PLASTIC LAMINATE

PLATE OR PROPERTY LINE

PLASTER (NUMBER - SEE SPECS)

PRESSURE TREATED DOUGLAS FUR

PAINT (NUMBER - SEE SPECS)

REINFORCE OR REINFORCING

NOT TO SCALE

ON CENTER

PLYWOOD

QUARRY TILE

ROOF DRAIN

ROUND HEAD

REDWOOD

SCHEDULE

SHTHG

STORM DRAIN

SHEATHING

STANDARD

SUSPENDED

SYMMETRICAL

TELEPHONE

TOP OF CATCH BASIN

TONGUE & GROOVE

STRUCTURAL TUBING

NOTED OTHERWISE)

VENT THRU ROOF

WATER CLOSET

WATER HEATER

WATERPROOF

WOOD SCREW

WELDED WIRE FABRIC

WAINSCOT

WITHOUT

UNLESS OTHERWISE NOTED

VERTICAL GRAIN DOUGLAS FIR

VINYL COMPOSITION TILE

WHEELCHAIR ACCESSIBLE

TOP OF PAVING

TOP OF WALL

SMACNA SPEC THE ARCH SHEET METAL MANUAL SPEC

TOP OF CURB OR TOP OF CONCRETE

TYPICAL (ITEMS TYPICAL UNLESS SHOWN OR

TEMPERATURE OR TEMPERED

STAINLESS STEEL

ROUGH OPENING

REFRIGERATOR

MASONRY OPENING

MECHANICAL

INSULATION OR INSULATED

MANUFACTURE OR MANUFACTURER

### **DEFERRED APPROVALS**

CONNECTIONS TO EXISTING SITE

**ABBREVIATIONS** 

**CENTER LINE** 

**PERPENDICULAR** 

ASPHALTIC CONCRETE

ABOVE FINISH FLOOR

ACOUSTICAL CEILING TILE

ARCHITECT OR ARCHITECTURAL

**ANCHOR BOLT** 

ALUMINUM

BLOCK(ING)

CATCH BASIN

CEILING

CLEAN OUT

CONCRETE

**CONTINUOUS** 

**COLD WATER** 

DEPARTMEN

DIAGONAL

DOWNSPOU

DRAWING

**EXISTING** 

**FLEVATION** 

FLFCTRIC(AL

**EQUIPMENT** 

FLOW LINE

FLASHING

FI OOR

**FLOOR DRAIN** 

EXPANSION BOLT

**EXPANSION JOINT** 

**EDGE OF PAVING** 

FINISHED GRADE

FACE OF CONCRETE

FACE OF MASONRY

GRAB BAR, GRADE BREAK

GLUE LAMINATED BEAM

GYPSUM WALL BOARD

HEATING/VENTILATING/AIR

FACE OF FINISH

FACE OF STUD

FOOT OR FEFT

**FOOTING** 

GAL VANIZED

HOSE BIBB

HORIZONTAL

HEIGHT

HORIZ

HVAC

FIRE EXTINGUISHER (& CABINET) TOC

FIBERGLASS REINFORCED PANEL VCT

FLAT HEAD OR FIRE HYDRANT

DRINKING FOUNTAIN

DOUBL F

COUNTERSINK

**BOTTOM OF BEAM** 

CONSTRUCTION JOINT

CONCRETE MASONRY UNIT

ANOD APPROX ANODIZED APPROXIMATE

### 2. CIVIL ENGINEERING GENERAL NOTES AND ABREVIATIONS

G-002

**SHEET INDEX** 

SHEET # SHEET NAME

**GENERAL SHEETS TOTAL: 2** 

1. OVERALL GENERAL INFORMATION

TITLE SHEET

TOPOGRAPHIC SURVEY DEMOLITION PLAN GRADING, PAVING, AND DRAINAGE PLAN CIVIL SHEETS TOTAL: 4 3. ARCHITECTURAL DRAWINGS

FIRE AUTHORITY SITE PLAN

### OVERALL SITE PLAN

**ENLARGED SITE PLAN AND CODE ANALYSIS EXTERIOR ELEVATIONS** ARCHITECTURAL SHEETS TOTAL: 3

### 4. ELECTRICAL ENGINEERING SYMBOLS & SHEET INDEX POWER ONE-LINE DIAGRAM, RISERS & SCHEDULES OVERALL ELECTRICAL SITE PLAN

POWER AND SIGNAL PLAN FIRE ALARM DETAILS, SCHEDULES & NOTES FIRE ALARM RISER DIAGRAM & CALCULATIONS

### ELECTRICAL DETAILS

PC RELOCATABLE BUILDING AMS #68145 DRAWINGS - FOR REFERENCE ONLY TITLE AND BUILDING DATA NOTES

### GENERAL NOTES FLOOR PLAN AND NOTES **EXTERIOR ELEVATIONS**

CEILING GRID, DETAILS, AND NOTES FOUNDATION PLAN WOOD, DETAILS & NOTES 50# FLOOR FRAMING PLAN & BUILDING SECTIONS **BUILDING SECTIONS AND WALL DETAILS** ROOF FRAMING PLAN & DETAILS FRAMING ELEVATIONS & DETAILS

### MECHANICAL PLAN, DETAILS & NOTES ELECTRICAL PLAN, DETAILS & NOTES

RAMP PLAN, ELEVATION & DETAILS

PC RELOCATABLE BUILDING AMS #68145 DRAWINGS SHEETS TOTAL: 13 6. PC RELOCATABLE BUILDING MODTECH #02-106169 DRAWINGS - FOR REFERENCE ONLY

# FLOOR PLAN 24'X40'

ROOF PLAN (DUAL PITCH) 24'X40' EXTERIOR ELEVATIONS (DUAL PITCH) 24'X40' W/O FASCIA INTERIOR ELEVATIONS - (NOTE. SHEET TITLE DIFFERES FROM PC TITLE SHEET) SCHEDULE SHEET - (NOTE. SHEET TITLE DIFFERES FROM PC TITLE SHEET)

### ARCHITECTURAL DETAILS (WOOD STUDS) ARCHITECTURAL DETAILS (WOOD STUDS) ARCHITECTURAL DETAILS (METAL STUDS)

A6.0M ARCHITECTURAL DETAILS (METAL STUDS) REFLECTED CEILING PLAN (24'X40') (10 LIGHTS)

### REFLECTED CEILING DETAILS SPECIFICATIONS SPECIFICATIONS

FOUNDATION PLAN (24'X40') 50 PSF LL (WOOD) FOUNDATION DETAILS (WOOD)

### FLOOR FRAMING PLAN 50 PSF LL STRUCTURAL DETAILS - (NOTE. SHEET TITLE DIFFERES FROM PC TITLE SHEET)

S2.01 FLOOR FRAMING PLAN STRUCTURAL DETAILS - (NOTE. SHEET TITLE DIFFERES FROM PC TITLE SHEET) STRUCTURAL ELEVATIONS & DETAILS (DUAL PITCH)

### WALL FRAMING (WOOD) WALL FRAMING (METAL) WALL FRAMING DETAILS (WOOD)

WALL FRAMING DETAILS (METAL S5.1M WALL FRAMING DETAILS (METAL MECHANICAL (HVAC) PLAN 24'X40' - 5 TON ELECTRICAL PLAN 24'X40' RAMP/LANDING PLAN W/ 12' RAMP

WALL FRAMING DETAILS (WOOD)

### RAMP/STAIRS DETAILS PC RELOCATABLE BUILDING MODTECH #02-106169 DRAWINGS SHEETS TOTAL: 31

7. PC 04-122029 ACCESSIBLE RAMP LANDING STAIR PC COVER SHEET

DSA 103 TEST & SPECIAL INSPECTIONS SAMPLE CONSTRUCTION SPECIFICATIONS & NOTES STANDARD RAMP & LANDING (ATATCHED HANDRAIL TO BUILDING)

RAMP & LANDING DETAILS PC 04-122029 ACCESSIBLE RAMP LANDING STAIR PC SHEETS TOTAL: 5 OVERALL SHEET TOTAL: 65

National Flood Hazard Laver FIRMe

<u>CIVIL ENGINEER</u> Warren Consulting Engineers, Inc 1117 Windfield Way, Suite 110 El Dorado Hills, CA 95762 TEL (916) 985-1870

LECTRICAL ENGINEER The Engineering Enterprise 1125 High Street

Auburn, CA 95603 ΓEL (530) 886-8556



THE ARCHITECT DOES NOT REPRESENT THAT THESE PLANS OR THE SPECIFICATIONS ARE FOR WHICH THEY WERE SPECIFICALLY PREPARED. THE ARCHITECT DISCLAIMS RESPONSIBILITY FOR THESE PLANS AND SPECIFICATIONS IF THEY ARE USED IN WHOLE OR IN PART AT ANY OTHER SITE. WRITTEN DIMENSIONS ON THESE DRAWINGS SHALL HAVE PRECEDENCE OVER SCALED DIMENSIONS.

# LODI UNIFIED SCHOOL DISTRICT

1305 E. Vine St Lodi, CA 95240

233 N Mills Ave

Lodi, CA 95242

SHEET TITLE

TITLE SHEET

**EXPIRATION DATE** 

### l MILLSWOOD MIDDLE SCHOOL PORTABLES RELOCATION

2) COORDINATION WITH MY PLANS AND SPECIFICATIONS, AND IS ACCEPTABLE FOR INCORPORATION INTO THE CONSTRUCTION OF THIS PROJECT. THE STATEMENT OF GENERAL CONFORMANCE "SHALL NOT BE CONSTRUED AS RELIEVING ME OF M RIGHTS, DUTIES, AND RESPONSIBILITIES UNDER SECTIONS 17302 AND 81138 OF EDUCATION CODE.

AND SECTIONS 4-336, 4-341 AND 4-334 OF TITLE 24, PART 1 (TITLE 24, PART 1, SECTION 4-317 (B)).

STATEMENT OF GENERAL CONFORMANCE

THE PC DRAWINGS SHEETS LISTED BELOW ON THE SHEET INDEX OF THIS COVER HAVE BEEN

PREPARED BY OTHER DESIGN PROFESSIONALS OR CONSULTANTS WHO ARE LICENSED AND/OR

AUTHORIZED TO PREPARE SUCH DRAWINGS IN THIS STATE. IT HAS BEEN EXAMINED BY ME FOR:

1) DESIGN INTENT, AND IT APPEARS TO MEET THE APPROPRIATE REQUIREMENTS OF TITLE 24,

CALIFORNIA CODE OF REGULATIONS, AND THE PROJECT SPECIFICATIONS PREPARED BY ME, AN

- I FIND THAT: ALL DRAWINGS OR SHEETS LISTED ON THE COVER OR INDEX SHEET
- THIS DRAWING OR PAGE ■ IS/ARE IN GENERAL CONFORMANCE WITH THE PROJECT DESIGN, AND
- HAS/HAVE BEEN COORDINATED WITH THE PROJECT PLANS AND SPECIFICATIONS.

**SIGNATURE** ARCHITECT OR ENGINEER DESIGNATED TO BE IN GENERAL RESPONSIBLE CHARGE

MILLSWOOD MIDDLE SCHOOL

LICENSE NUMBER

MARIANA ALVAREZ-PARGA 01-31-25

DATE: DECEMBER 12, 2023

### **APPLICABLE CODES AND STANDARDS** PARTIAL LIST OF APPLICABLE CODES AS OF JANUARY 1, 2023

ALL PARTS OF THE TITLE 24 CODE SHOWN BELOW HAVE AN EFFECTIVE DATE OF **JANUARY 1, 2023** CALIFORNIA ADMINISTRATIVE CODE - EFFECTIVE MARCH 5, 2022 CALIFORNIA ADMINISTRATIVE CODE (CAC) - CCR, TITLE 24, PART 1 CALIFORNIA BUILDING CODE (CBC) - CCR, TITLE 24, PART 2

CALIFORNIA ELECTRICAL CODE (CEC) - CCR, TITLE 24, PART 3 (2020 NATIONAL ELECTRICAL CODE AND 2022 CALIFORNIA AMENDMENTS) CALIFORNIA MECHANICAL CODE (CMC) - CCR, TITLE 24, PART 4 (2021 IAPMO UNIFORM MECHANICAL CODE AND 2022 CALIFORNIA AMENDMENTS CALIFORNIA PLUMBING CODE (CPC) - CCR, TITLE 24, PART 5 (2021 IAPMO UNIFORM PLUMBING CODE AND 2022 CALIFORNIA AMENDMENTS)

(2021 INTERNATIONAL BUILDING CODE, VOL. 1 & 2, AND 2022 CALIFORNIA AMENDMENTS)

CALIFORNIA ENERGY CODE (CEC) - CCR, TITLE 24, PART 6 CALIFORNIA FIRE CODE (CFC) - CCR, TITLE 24, PART 9 (2021 INTERNATIONAL FIRE CODE AND 2022 CALIFORNIA AMENDMENTS) CALIFORNIA EXISTING BUILDING CODE (CEBC) - CCR, TITLE 24, PART 10 CALIFORNIA GREEN BUILDING STANDARDS CODE (CALGREEN) - CCR, TITLE 24, PART 11 CALIFORNIA REFERENCED STANDARDS CODE - CCR, TITLE 24, PART 12

(PUBLIC SAFETY, STATE FIRE MARSHAL REGULATIONS) ASME A17.1/CSA B44-13 SAFETY CODE FOR ELEVATORS AND ESCALATORS PER 2022 CBC PART 2 CH 35) - CAL/OSHA ELEVATOR UNIT ENFORCES CCR TITLE 8 AND USES THE 2004 ASME A17.1 BY ADOPTION

### PARTIAL LIST OF APPLICABLE STANDARDS AS OF JANUARY 1, 2023\* FOR A COMPLETE LIST OF APPLICABLE NFPA STANDARDS REFER TO 2022 CBC (SFM) CHAPTER 35 AND CALIFORNIA FIRE CODE CHAPTER 80. SEE CALIFORNIA BUILDING CODE CHAPTER 35 FOR

- STATE OF CALIFORNIA AMENDMENTS TO THE NFPA STANDARDS. NFPA 10-21 - STANDARD FOR PORTABLE FIRE EXTINGUISHERS
- NFPA 12-15 STANDARD ON CARBON DIOXIDE EXTINGUISHING SYSTEMS NFPA 12A-18 - STANDARD ON HALON 1301 FIRE EXTINGUISHING SYSTEMS NFPA 13-22 - STANDARD FOR THE INSTALLATION OF SPRINKLER SYSTEMS (AS AMENDED)

NFPA 14-19 - STANDARD FOR THE INSTALLATION OF STANDPIPE AND HOSE SYSTEMS

- NFPA 17-21 STANDARD FOR DRY CHEMICAL EXTINGUISHING SYSTEMS NFPA 17A-21 - STANDARD FOR WET CHEMICAL EXTINGUISHING SYSTEMS NFPA 20-19 - STANDARD FOR THE INSTALLATION OF STATIONARY PUMPS FOR FIRE PROTECTION
- NFPA 24-19 STANDARD FOR THE INSTALLATION OF PRIVATE FIRE SERVICE MAINS AND THEIR APPURTENANCES (AS AMENDED) NFPA 72-22 - NATIONAL FIRE ALARM AND SIGNALING CODE (AS AMENDED) NFPA 80-19 - STANDARD FOR FIRE DOORS AND OTHER OPENING PROTECTIVES
- ICC 300-17 STANDARD FOR BLEACHERS, FOLDING AND TELESCOPIC SEATING. AND UL 300-2005(R2010) - STANDARD FOR FIRE TESTING OF FIRE EXTINGUISHING SYSTEMS FOR PROTECTION OF COMMERCIAL COOKING EQUIPMENT
- UL 521-99 STANDARD FOR HEAT DETECTORS FOR FIRE PROTECTIVE SIGNALING SYSTEMS UL 1971-2002(R2010) - STANDARD FOR SIGNALING DEVICES FOR THE HEARING IMPAIRED

UL 464-03 - AUDIBLE SIGNALING DEVICES FOR FIRE ALARM AND SIGNALING SYSTEMS,

DRAWN BY: CV, BI JOB NUMBER: 23219

(E) DOUBLE FIXTURE LIGHT STANDARD

FIRE EXTINGUISHER

FIRE SPRINKLER RISER

**BUILDING ENTRANCE** 

0' •••• EGRESS DISTANCE

**ADSA** 

### FIRE & LIFE SAFETY SITE CONDITIONS SUBMITTAL

Division of the State Architect (DSA) documents referenced within this publication are available on the DSA Forms or DSA Publications webpages.

To facilitate the Division of the State Architect's (DSA) fire and life safety plan review of project site conditions, DSA requires the design professional to provide the following information at time of project submittal for projects consisting of construction of a new campus, construction of new building(s), additions to existing buildings, and for site alternate design means for fire department emergency vehicle access, and fire suppression water supply. Information associated with compliance items 1 through 3 below is to be provided for all project types indicated above. Information associated with items 4 through 7 is to be completed when an alternate means is utilized. Acknowledgement by the school district and signature from the Local Fire Authority (LFA) is only required when an alternate design means is being requested.

The Project Information and Fire & Life Safety Information sections are to be completed for all projects and imaged onto the fire access site plan. When an alternate design/means is proposed, all sections on pages 1 and 2 are to be completed and imaged on the fire access site plan.

For additional information refer to the instructions at the end of this form and DSA Policy PL 09-01: Fire Flow for

PROJECT INFORMATION School District/Owner: Lodi Unified School District Project Name/School: Millswood Middle School Portable Relocation Project Address: 233 N. Mills Ave., Lodi, CA 95242 FIRE & LIFE SAFETY INFORMATION 1. Has a fire hydrant flow test been performed within the past 12 months? Yes 🗹 (If yes, provide a copy of the test data.) 2. Was the fire hydrant water flow test performed as part of this LFA (FHSZ) as established by Cal-Fire? (If yes, indicate FHSZ classification Refer to the following website for FHSZ locations: | Moderate □ | High □ | Very High □ http://egis.fire.ca.gov/FHSZ/ | Wildland Interface Area (WIFA) (If any designations are checked, project design must meet the | WIFA | requirements of CBC Chapter 7A.)

### FIRE & LIFE SAFETY SITE CONDITIONS SUBMITTAL

	NOITION MEANS AND METHODS RESOLUTION	ALTE	RNATE A	ACCEPT
	Emergency vehicle access roadways do not meet CFC requirements.	Yes	No	N/A
4.	Emergency vehicle decess roadways do not meet or o requirements.			
4a.	Acceptable Alternate: Emergency vehicle and personnel access as proposed by the project architect is acceptable for providing fire suppression and protection of life and property.			
5.	Fire Hydrants: Number and spacing does not meet CFC requirements.			~
5a.	<b>Acceptable Alternate:</b> Number of fire hydrants and spacing as proposed by the project architect is acceptable for fire suppression and protection of life and property.			
6.	Fire Hydrants: Water flow and pressure are less than CFC minimum.			
6a.	Acceptable Alternate: The available flow and pressure is acceptable for providing fire suppression and protection of life and property.			
7.	Location of fire department connection(s) serving fire sprinkler systems or standpipe systems does not meet CFC requirements.			~
7a.	Acceptable Alternate: The location of fire department connection serving the fire sprinkler system and/or standpipe system is acceptable for providing fire suppression and protection of life and property.			

LOCAL FIRE AUTHORITY (LFA) INFORMATION LFA Agency Name: LFA Review Official: Work Phone:

LFA Reviewer's Signature

**DSA 810** 

# LODI FIRE DEPARTMENT

210 W. Elm Street, Lodi, CA 95240 209-333-6739

October 13, 2023

Fire Hydrant Readings for Millswood Middle School, 233 N. Mills Ave., Lodi CA 95240.

**Eastern Hydrant** 60 # static 52# Residual

42# flow with approximately 1100 GPM

60# static 54# residual

45# flow with approximately 1130 GPM

Brad Doell, Battalion Chief/Fire Marshal City of Lodi Fire Department 210 W. Elm St. Lodi, CA 95240



IDENTIFICATION STAMP DIV. OF THE STATE ARCHITEC APP: 02-121945 INC: REVIEWED FOR SS 🗹 FLS 🗹 ACS 🗹 DATE: 12/12/2023

AGENCY APPROVAL DSA#

A R C H I T E C T S


1715 R STREET, SUITE 200 SACRMENTO, CA 95811 TEL (916) 786-8178

CONSULTANTS <u>CIVIL ENGINEER</u> Warren Consulting Engineers, Inc 1117 Windfield Way, Suite 110

El Dorado Hills, CA 95762

TEL (916) 985-1870 ELECTRICAL ENGINEER
The Engineering Enterprise 1125 High Street

Auburn, CA 95603 TEL (530) 886-8556

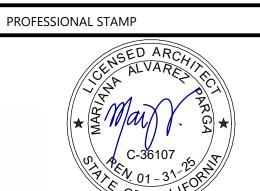

DESCRIPTION

THE ARCHITECT DOES NOT REPRESENT THA THESE PLANS OR THE SPECIFICATIONS ARE FOR WHICH THEY WERE SPECIFICALLY PREPARED. THE ARCHITECT DISCLAIMS RESPONSIBILITY FOR THESE PLANS AND SPECIFICATIONS IF THEY ARE USED IN WHOLE OR IN PART AT ANY OTHER SITE. WRITTEN DIMENSIONS ON THESE DRAWINGS SHALL HAVE PRECEDENCE OVER SCALED DIMENSIONS.

PROJECT OWNER & TITLE LODI UNIFIED SCHOOL DISTRICT 1305 E. Vine St Lodi, CA 95240

MILLSWOOD MIDDLE SCHOOL

PORTABLES RELOCATION 233 N Mills Ave Lodi, CA 95242

SHEET TITLE

FIRE AUTHORITY SITE PLAN

DRAWN BY: CV, BI JOB NUMBER: 23219

**G-002** 

G-002 FIRE FLOW TEST DATE: DECEMBER 12, 2023

32.31.E (E) DOUBLE 3'-6" WIDE CHAIN LINK GATE WITH PANIC HARDWARE

X—X—X—X FENCE LINE

O O O O O O O O EGRESS PATH TO PUBLIC RIGHT OF WAY AND/OR SAFE DISPERSAL AREA

(E) FIRE DEPARTMENT CONNECTION

(E) FIRE HYDRANT

32.31.G (E) 20' WIDE DOUBLE SWING GATES

32.40.A (E) SINGLE FIXTURE LIGHT STANDARD 32.40.B (E) DOUBLE FIXTURE LIGHT STANDARD

32.31.I (E) 4' WIDE MAN GATE WITH PANIC HARDWARE

32.31.H (E) KNOX BOX

33.51.B (E) GAS METER

32.33.B (E) TRASH ENCLOSURE


CONSTRU

BLOW-OFF VALVE + SIZE

POST INDICATOR VALVE

### **GENERAL NOTES:**

1. THE TYPES, LOCATIONS, SIZES, AND/OR DEPTHS OF EXISTING UNDERGROUND UTILITIES AS SHOWN ON THESE PLANS WERE OBTAINED FROM SOURCES OF VARYING RELIABILITY. THE CONTRACTOR IS CAUTIONED THAT ONLY ACTUAL EXCAVATION WILL REVEAL THE TYPES, EXTENT, SIZES, LOCATIONS AND DEPTHS OF SUCH UNDERGROUND UTILITIES. A REASONABLE EFFORT HAS BEEN MADE TO LOCATE AND DELINEATE ALL KNOWN UNDERGROUND UTILITIES. HOWEVER, WARREN CONSULTING ENGINEERS CAN ASSUME NO RESPONSIBILITY FOR THE COMPLETENESS OR ACCURACY OF ITS DELINEATION OF SUCH UNDERGROUND UTILITIES, NOR FOR THE EXISTENCE OF OTHER BURIED OBJECTS OR UTILITIES WHICH MAY BE ENCOUNTERED BUT WHICH ARE NOT SHOWN ON THESE PLANS. THE CONTRACTOR OR ANY SUBCONTRACTOR FOR THIS CONTRACT SHALL NOTIFY MEMBERS OF UNDERGROUND SERVICE ALERT (USA) TWO (2) WORKING DAYS IN ADVANCE OF PERFORMING ANY EXCAVATION WORK BY CALLING TOLL FREE 1-800-227-2600, OR 811.

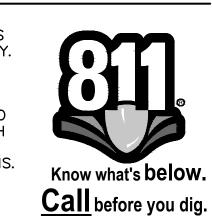

WARREN CONSULTING ENGINEERS, INC. (WCE) ASSUMES NO RESPONSIBILITY FOR ERRORS IN PHYSICAL LOCATION OF IMPROVEMENTS, HORIZONTAL OR VERTICAL, IF STAKED BY OTHERS. IN ADDITION, ANY SUCH ERRORS IN PHYSICAL LOCATION MAY AFFECT THE INTENDED DESIGN OF SUCH IMPROVEMENTS AND WCE CANNOT BE HELD RESPONSIBLE FOR SUCH CONDITIONS WHICH ARE A RESULT OF ERRORS IN SURVEYING, OR IMPROPER

3. IF SUBSURFACE CULTURAL RESOURCES, REMAINS, AND/OR ARTIFACTS ARE UNCOVERED DURING PROJECT CONSTRUCTION, ALL WORK IN THE VICINITY SHALL BE STOPPED UNTIL SUCH ITEMS CAN BE ASSESSED BY AN APPROPRIATE MEMBER OF THE COUNTY ENVIRONMENTAL IMPACT SECTION STAFF.

4. CONTRACTOR AGREES THAT HE/SHE SHALL ASSUME SOLE AND COMPLETE RESPONSIBILITY FOR JOB SITE CONDITIONS DURING THE COURSE OF CONSTRUCTION OF THIS PROJECT. INCLUDING SAFETY OF ALL PERSONS AND PROPERTY: THAT THIS REQUIREMENT SHALL APPLY CONTINUOUSLY AND SHALL NOT BE LIMITED TO NORMAL WORKING HOURS: AND THAT THE CONTRACTOR SHALL DEFEND, INDEMNIFY AND HOLD THE OWNER AND ENGINEER HARMLESS FROM ANY AND ALL LIABILITY, REAL OR ALLEGED, IN CONNECTION WITH THE PERFORMANCE OF WORK ON THIS PROJECT, EXCEPTING FOR LIABILITY ARISING FROM THE SOLE NEGLIGENCE OF THE OWNER OR ENGINEER.

5. THE CONTRACTOR SHALL OBTAIN AN EXCAVATION PERMIT FROM THE STATE OF CALIFORNIA DEPARTMENT OF INDUSTRIAL SAFETY FOR ALL EXCAVATIONS OF 5 FEET OR MORE IN DEPTH.

6. IT SHALL BE THE CONTRACTOR'S RESPONSIBILITY TO MAKE ALL NECESSARY PRE-BID AND PRE-CONSTRUCTION SITE INSPECTION, AND/OR OBSERVATIONS ON THE SITE TO PRE-DETERMINE ALL HIS/HER MEANS AND METHODS NECESSARY TO COMPLETE THE IMPROVEMENTS SHOWN ON THESE PLANS AND PER THE PROJECT SPECIFICATIONS. IT IS THE CONTRACTORS RESPONSIBILITY TO DETERMINE, AND INCLUDE IN HIS/HER CONTRACT, ALL MEANS AND METHODS NECESSARY TO PERFORM A COMPLETE AND ACCEPTABLE JOB.

WHERE IMPROVEMENTS LIE WITHIN AN EXISTING DEVELOPED AREA, CONTRACTOR SHALL USE CAUTION WHEN ACCESSING THE SITE THROUGH THESE EXISTING IMPROVEMENTS. IT IS THE CONTRACTORS RESPONSIBILITY TO PROTECT ANY SUCH EXISTING IMPROVEMENTS OUTSIDE THE PROJECT BOUNDARY, OR EXISTING IMPROVEMENTS WITHIN THE BOUNDARY WHICH ARE TO REMAIN. PROPER PRECAUTIONS SHALL BE PROVIDED AND MAINTAINED THROUGHOUT CONSTRUCTION. ANY DAMAGE SHALL BE REPAIRED OR REPLACED TO THE SATISFACTION OF THE

8. IT IS THE RESPONSIBILITY OF THE CONTRACTOR TO KEEP DETAILED RECORDS OF MINOR CHANGES OR ADJUSTMENTS MADE DURING CONSTRUCTION (WHICH WERE NOT FORMALLY ISSUED). UPON PROJECT COMPLETION, THESE RECORDS AND/OR INFORMATION SHALL BE PROVIDED TO THE OWNER AND WARREN CONSULTING ENGINEERS, INC. UNLESS AN OFFICIAL "AS-BUILT" SET OF PLANS IS A REQUIREMENT OF THE CONTRACT. IF AS-BUILT PLANS ARE A REQUIREMENT OF THE CONTRACT, REFER TO SPECIFICATIONS FOR AS-BUILT DELIVERABLE REQUIREMENTS.

9. IN VEHICULAR PATHWAYS, EXISTING ASPHALTIC AND/OR CONCRETE SURFACES SHALL BE CUT TO A NEAT AND STRAIGHT LINE. PARALLEL OR PERPENDICULAR TO THE VEHICULAR TRAVELED PATH. THIS IS TYPICALLY THE ROADWAY CENTERLINE, BUT MAY VARY. THAT SAWCUT EDGE SHALL BE PROTECTED FROM DAMAGE DURING CONSTRUCTION SO A CLEAN EDGE REMAINS FOR PATCH BACK.. IF EDGE IS DAMAGED, A NEW SAW CUT WILL BE REQUIRED. THE EXPOSED EDGE SHALL BE "TACKED" WITH EMULSION PRIOR TO PAVING.

10. NO BURNING OR BLASTING SHALL BE ALLOWED ONSITE UNLESS SPECIFICALLY ADDRESSED ON PLANS, OR SPECIFICALLY APPROVED AND COORDINATED WITH THE ARCHITECT, ENGINEER, AND LOCAL AGENCY OR OTHER ADMINISTRATIVE AUTHORITY.

11. SUBGRADE AND RESULTING FINISHED GRADE SHALL BE CONSTRUCTED SMOOTH AND UNIFORM BETWEEN SPOT ELEVATIONS, CONTOURS OR OTHER STRUCTURE ELEVATIONS SHOWN ON GRADING OR OTHER PLANS. NO MOUNDS, RUTS, DEPRESSIONS OR OTHER GRADING DEFICIENCIES WILL BE ALLOWED UNLESS SPECIFICALLY SHOWN ON

12. ON NEW WATER SYSTEMS. SERVICE LATERALS SHALL BE MADE USING APPROPRIATE "TEE" AND "WYE" FITTINGS. SADDLE TAPS WILL ONLY BE ALLOWED WHEN MAKING CONNECTIONS TO EXISTING WATER MAINS.

13. CURING COMPOUND SHALL BE APPLIED IN A CONTINUOUS SOLID WET FLOWING COAT. ANY "SPOTTY" APPLICATIONS SHALL BE RECOATED IMMEDIATELY. APPLICATION SHALL BE INSPECTED BY PROJECT INSPECTOR DURING APPLICATION.

14. EMBEDMENT OF FEATURES IN CONCRETE PAVING, CURBS, OR WALLS, SUCH AS SQUARE OR ROUND TUBING, POSTS, OR COLUMNS, STEEL BOLTED PLATES, OR OTHER STRUCTURES, SHALL REQUIRE ADDITIONAL SCORE OR EXPANSION JOINTS TO PREVENT UNCONTROLLED CRACKING. THOSE ADDITIONAL JOINTS MAY OR MAY NOT BE SPECIFICALLY SHOWN ON PLANS BUT SHALL BE PROVIDED BY THE CONTRACTOR.

15. EMBEDMENT OF FEATURES IN CONCRETE PAVING, CURBS, OR WALLS, SUCH AS SQUARE OR ROUND TUBING. POSTS, OR COLUMNS, STEEL BOLTED PLATES, OR OTHER STRUCTURES, SHALL REQUIRE A MINOR ADJUSTMENT OF REBAR WITHIN CONCRETE TO ALLOW FOR SUCH STRUCTURE. THAT REBAR ADJUSTMENT MAY NOT BE SPECIFICALLY SHOWN ON PLANS.

16. NO MORE THAN 1 GALLON OF WATER PER YARD OF CONCRETE CAN BE ADDED TO THE TRUCK AFTER ARRIVAL TO PROJECT SITE. THE ADDITION OF WATER CAN ONLY BE ADDED UNDER THE SUPERVISION OF THE CONCRETE INSPECTOR OR LABORATORY TECHNICIAN.

17. WHEN PUMPING CONCRETE FOR PLACEMENT, ABSOLUTELY NO WATER IS TO BE ADDED TO PUMP HOPPER. ANY WATER ADDED TO HOPPER WILL BE REASON FOR CONCRETE REJECTION AT THE CONTRACTORS EXPENSE.

18. ALL CONTRACTION/CONSTRUCTION JOINTS "CJ" SHALL BE 1/4 THE SLAB THICKNESS DEEP, BUT NO LESS THAN 1" FOR CONTROLLING OF CRACKING. CONTRACTOR SHALL EXERCISE CAUTION WHEN FINAL TROWELING OF CONCRETE SO AS NOT TO FILL IN THESE JOINTS WITH CONCRETE CREAM. ANY CRACKS OUTSIDE OF JOINTS WHICH WERE CONSTRUCTED LESS THAN 1" DEEP, SHALL BE CAUSE FOR CONCRETE SLAB(S) TO BE REMOVED

19. ANY SCREED BOARDS SET WITHIN CONCRETE SLABS SHALL BE AN "OVERHEAD SCREED" SO THERE IS NO

INTERFERENCE WITH THE PLACEMENT AND ALIGNMENT OF SLAB REINFORCING.

20. 3-1/2" FELT JOINTS WILL NOT BE ACCEPTED. PROVIDE A FULL 4" FELT JOINT FOR 4" SLAB CONSTRUCTION, AND A 6" FELT JOINT FOR A 6" SLAB SLAB CONSTRUCTION.

21. SHOULD ANY SHRINKAGE CRACKS OCCUR OUTSIDE OF EITHER THE EXPANSION JOINTS OR CRACK CONTROL JOINTS, THEN THE CONCRETE SLAB SHALL BE SAWCUT AT THE NEAREST JOINTS ON EACH SIDE OF THE CRACK AND THE CONCRETE SECTION SHALL BE, REMOVED AND REPLACED. NEW CONCRETE SHALL BE DOWELED INTO EXISTING CONCRETE PER DRAWING DETAIL.

22. ALL AREAS DISTURBED BY GRADING OPERATIONS WHETHER SHOWN ON THE DRAWINGS OR NOT SHALL BE HYDRO SEEDED UNLESS OTHERWISE NOTED. HYDRO SEEDING SHALL CONFORM TO LOCAL CITY/COUNTY STANDARDS.

23. REPAIR OR PATCHING OF GALVANIZED METALS, SUCH AS AFTER WELDING GALVANIZED COMPONENTS, SHALL BE MADE USING A ZINC COMPOSITION "HOT STICK" APPLICATION PER ASTM A 780-01. GALVANIZING PAINTS WILL NOT BE ALLOWED.

### **GENERAL PAVING SURFACE NOTES:**

AND REPLACE AT CONTRACTORS EXPENSE.

PROVIDE EQUIVALENT OF MEDIUM BROOM FINISH AT SLOPES UP TO 5.99%, TYPICAL. PROVIDE EQUIVALENT OF HEAVY BROOM FINISH AT SLOPES 6% AND GREATER. REFER TO SPECIFICATIONS.

2. ALL NEW PEDESTRIAN WALKWAYS (NON-RAMP) SHALL BE SLOPED NO GREATER THAN 2.0%. AND NO LESS THAN 0.75% IN ANY DIRECTION, UNLESS SPECIFICALLY LABELED OTHERWISE. ALL CONCRETE SHALL MEET THE FOLLOWING SLOPE REQUIREMENTS: - NO GREATER THAN 5% SLOPE IN THE DIRECTION OF TRAVEL

- NO GREATER THAN 2% SLOPE CROSSING THE DIRECTION OF TRAVEL. - NO GREATER THAN 2% SLOPE IN ANY DIRECTION IN COURTYARD OR PLAZA AREAS.

### SHEET INDEX

GENERAL NOTES AND ABBREVIATIONS

TOPOGRAPHIC SURVEY

DEMOLITION PLAN

GRADING, PAVING AND DRAINAGE PLAN

AGENCY APPROVAL DSA# IDENTIFICATION STAMP DIV. OF THE STATE ARCHITEC APP: 02-121945 INC: REVIEWED FOR

SS 🗹 FLS 🗹 ACS 🗹 DATE: 12/12/2023

1715 R STREET, SUITE 200 SACRMENTO, CA 95811 TEL (916) 786-8178

ARCHITECTS


CONSULTANTS

CIVIL ENGINEER
Warren Consulting Engineers, Inc 117 Windfield Way, Suite 110 El Dorado Hills, CA 95762 TEL (916) 985-1870

ELECTRICAL ENGINEER The Engineering Enterprise

1125 High Street Auburn, CA 95603 TEL (530) 886-8556



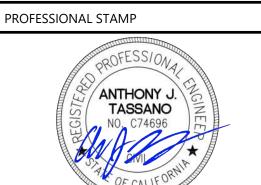

REVISI	ONS	
NO.	DATE	DESCRIPTION
-		
-		

THE ARCHITECT DOES NOT REPRESENT THAT THESE PLANS OR THE SPECIFICATIONS ARE SUITABLE FOR ANY SITE OTHER THAN THE ONE FOR WHICH THEY WERE SPECIFICALLY PREPARED THE ARCHITECT DISCLAIMS RESPONSIBILITY FOR THESE PLANS AND SPECIFICATIONS IF THEY ARE USED IN WHOLE OR IN PART AT ANY OTHER SITE. WRITTEN DIMENSIONS ON THESE DRAWINGS

SHALL HAVE PRECEDENCE OVER SCALED

PROJECT OWNER & TITLE **LODI UNIFIED SCHOOL DISTRICT** 1305 E. Vine St

Lodi, CA 95240

MILLSWOOD MIDDLE SCHOOL | PORTABLES RELOCATION

233 N Mills Ave

Lodi, CA 95242

**GENERAL NOTES** AND **ABBREVIATIONS** 

CONSTRI

JOB NUMBER: 23219 DRAWN BY: GV

**C0.0** 

DATE: DECEMBER 5, 2023

VCP

W/O


VITRIFIED CLAY PIPE

WATER

WITHOUT

WATER VALVE

WITH

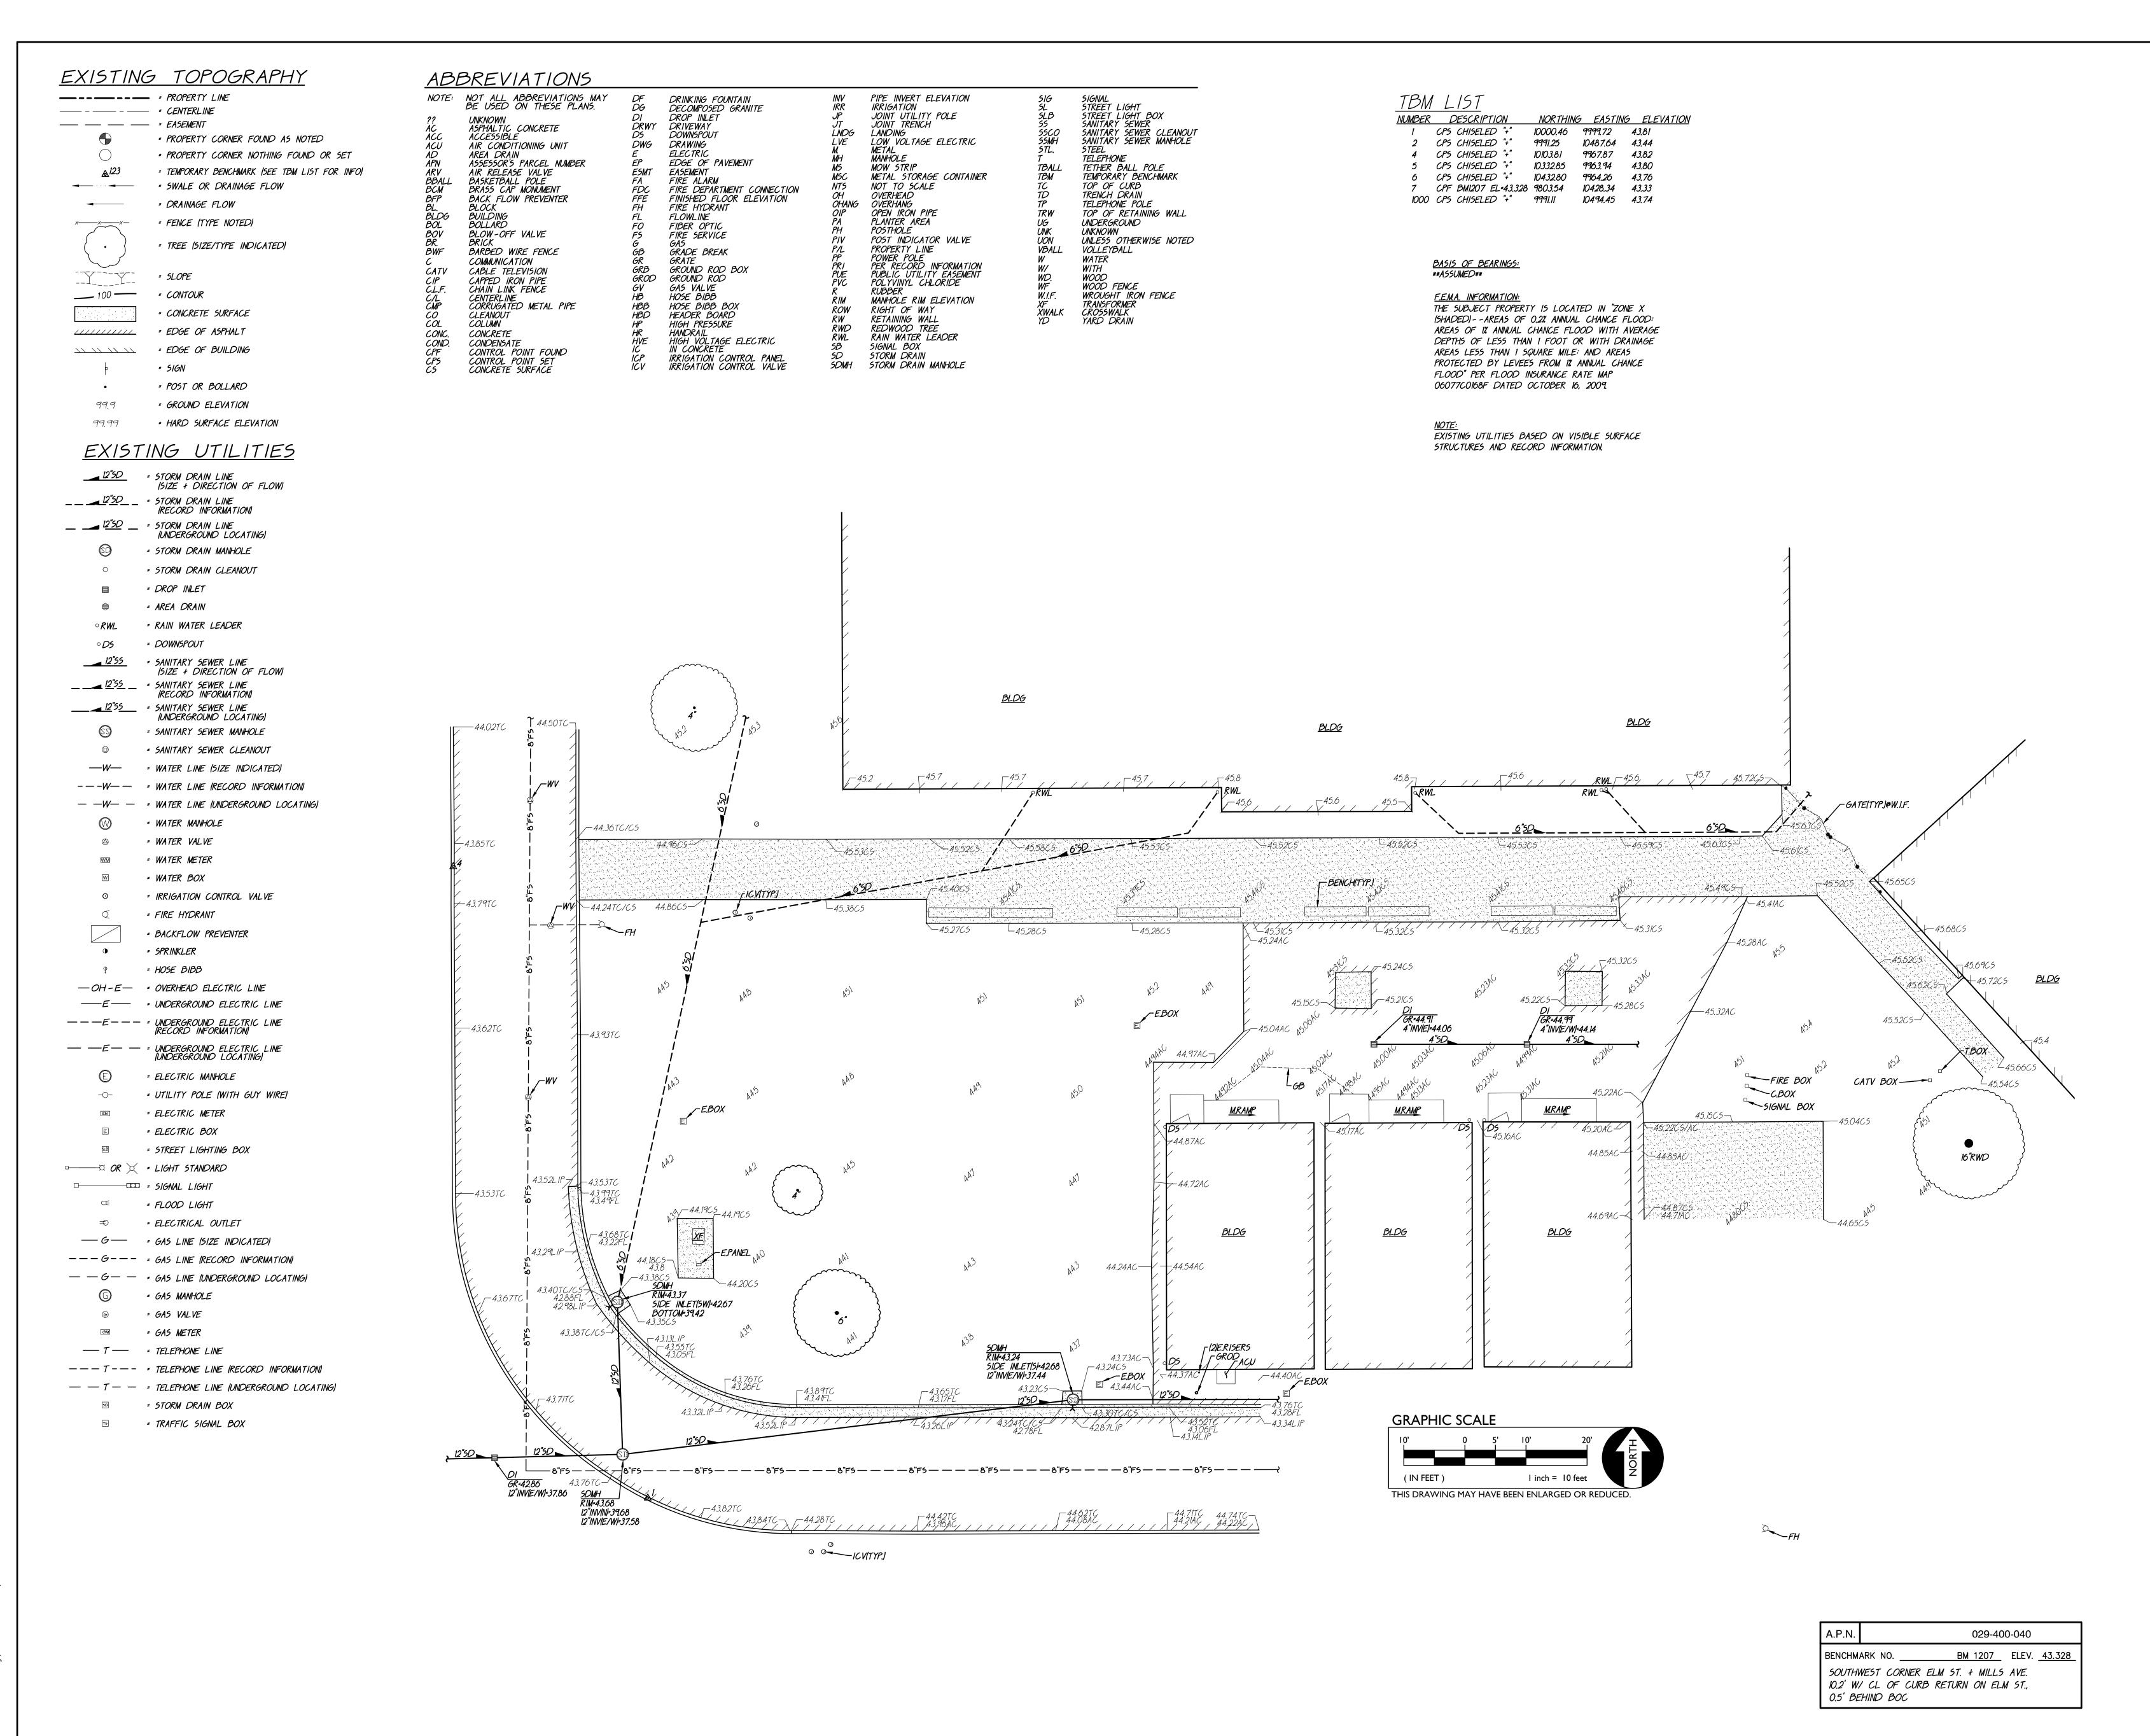

AGENCY APPROVAL

DSA#

IDENTIFICATION STAMP
DIV. OF THE STATE ARCHITECT

APP: 02-121945 INC:

REVIEWED FOR
SS FLS ACS D

DATE: 12/12/2023

ARCHITECTS

1715 R STREET, SUITE 200 SACRMENTO, CA 95811 TEL (916) 786-8178

CONSULTANTS

TEL (530) 886-8556

CIVIL ENGINEER
Warren Consulting Engineers, Inc
1117 Windfield Way, Suite 110
El Dorado Hills, CA 95762
TEL (916) 985-1870

ELECTRICAL ENGINEER
The Engineering Enterprise
1125 High Street
Auburn, CA 95603

1117 WINDFIELD WAY, SUITE 110 EL DORADO HILLS, CA 95762 | (916) 985-1870

PROFESSIONAL STAMP

ANTHONY J.

TASSANO

NO. C74696

OF CALLE OR THE OR

REVISIONS

#

NO. DATE DESCRIPTION

-

THE ARCHITECT DOES NOT REPRESENT THAT THESE PLANS OR THE SPECIFICATIONS ARE SUITABLE FOR ANY SITE OTHER THAN THE ONE FOR WHICH THEY WERE SPECIFICALLY PREPARED THE ARCHITECT DISCLAIMS RESPONSIBILITY FOR THESE PLANS AND SPECIFICATIONS IF THEY ARE USED IN WHOLE OR IN PART AT ANY OTHER SITE. WRITTEN DIMENSIONS ON THESE DRAWINGS SHALL HAVE PRECEDENCE OVER SCALED

PROJECT OWNER & TITLE

LODI UNIFIED SCHOOL DISTRICT

1305 E. Vine St

MILLSWOOD MIDDLE SCHOOL

| PORTABLES RELOCATION

233 N Mills Ave Lodi, CA 95242

Lodi, CA 95240

Lodi, CA 9524


TOPOGRAPHIC SURVEY

DRAWN BY: GV JOB NUMBER: 23219
SHEET NO.

C0.1

DATE: DECEMBER 5, 2023

CONSTRU

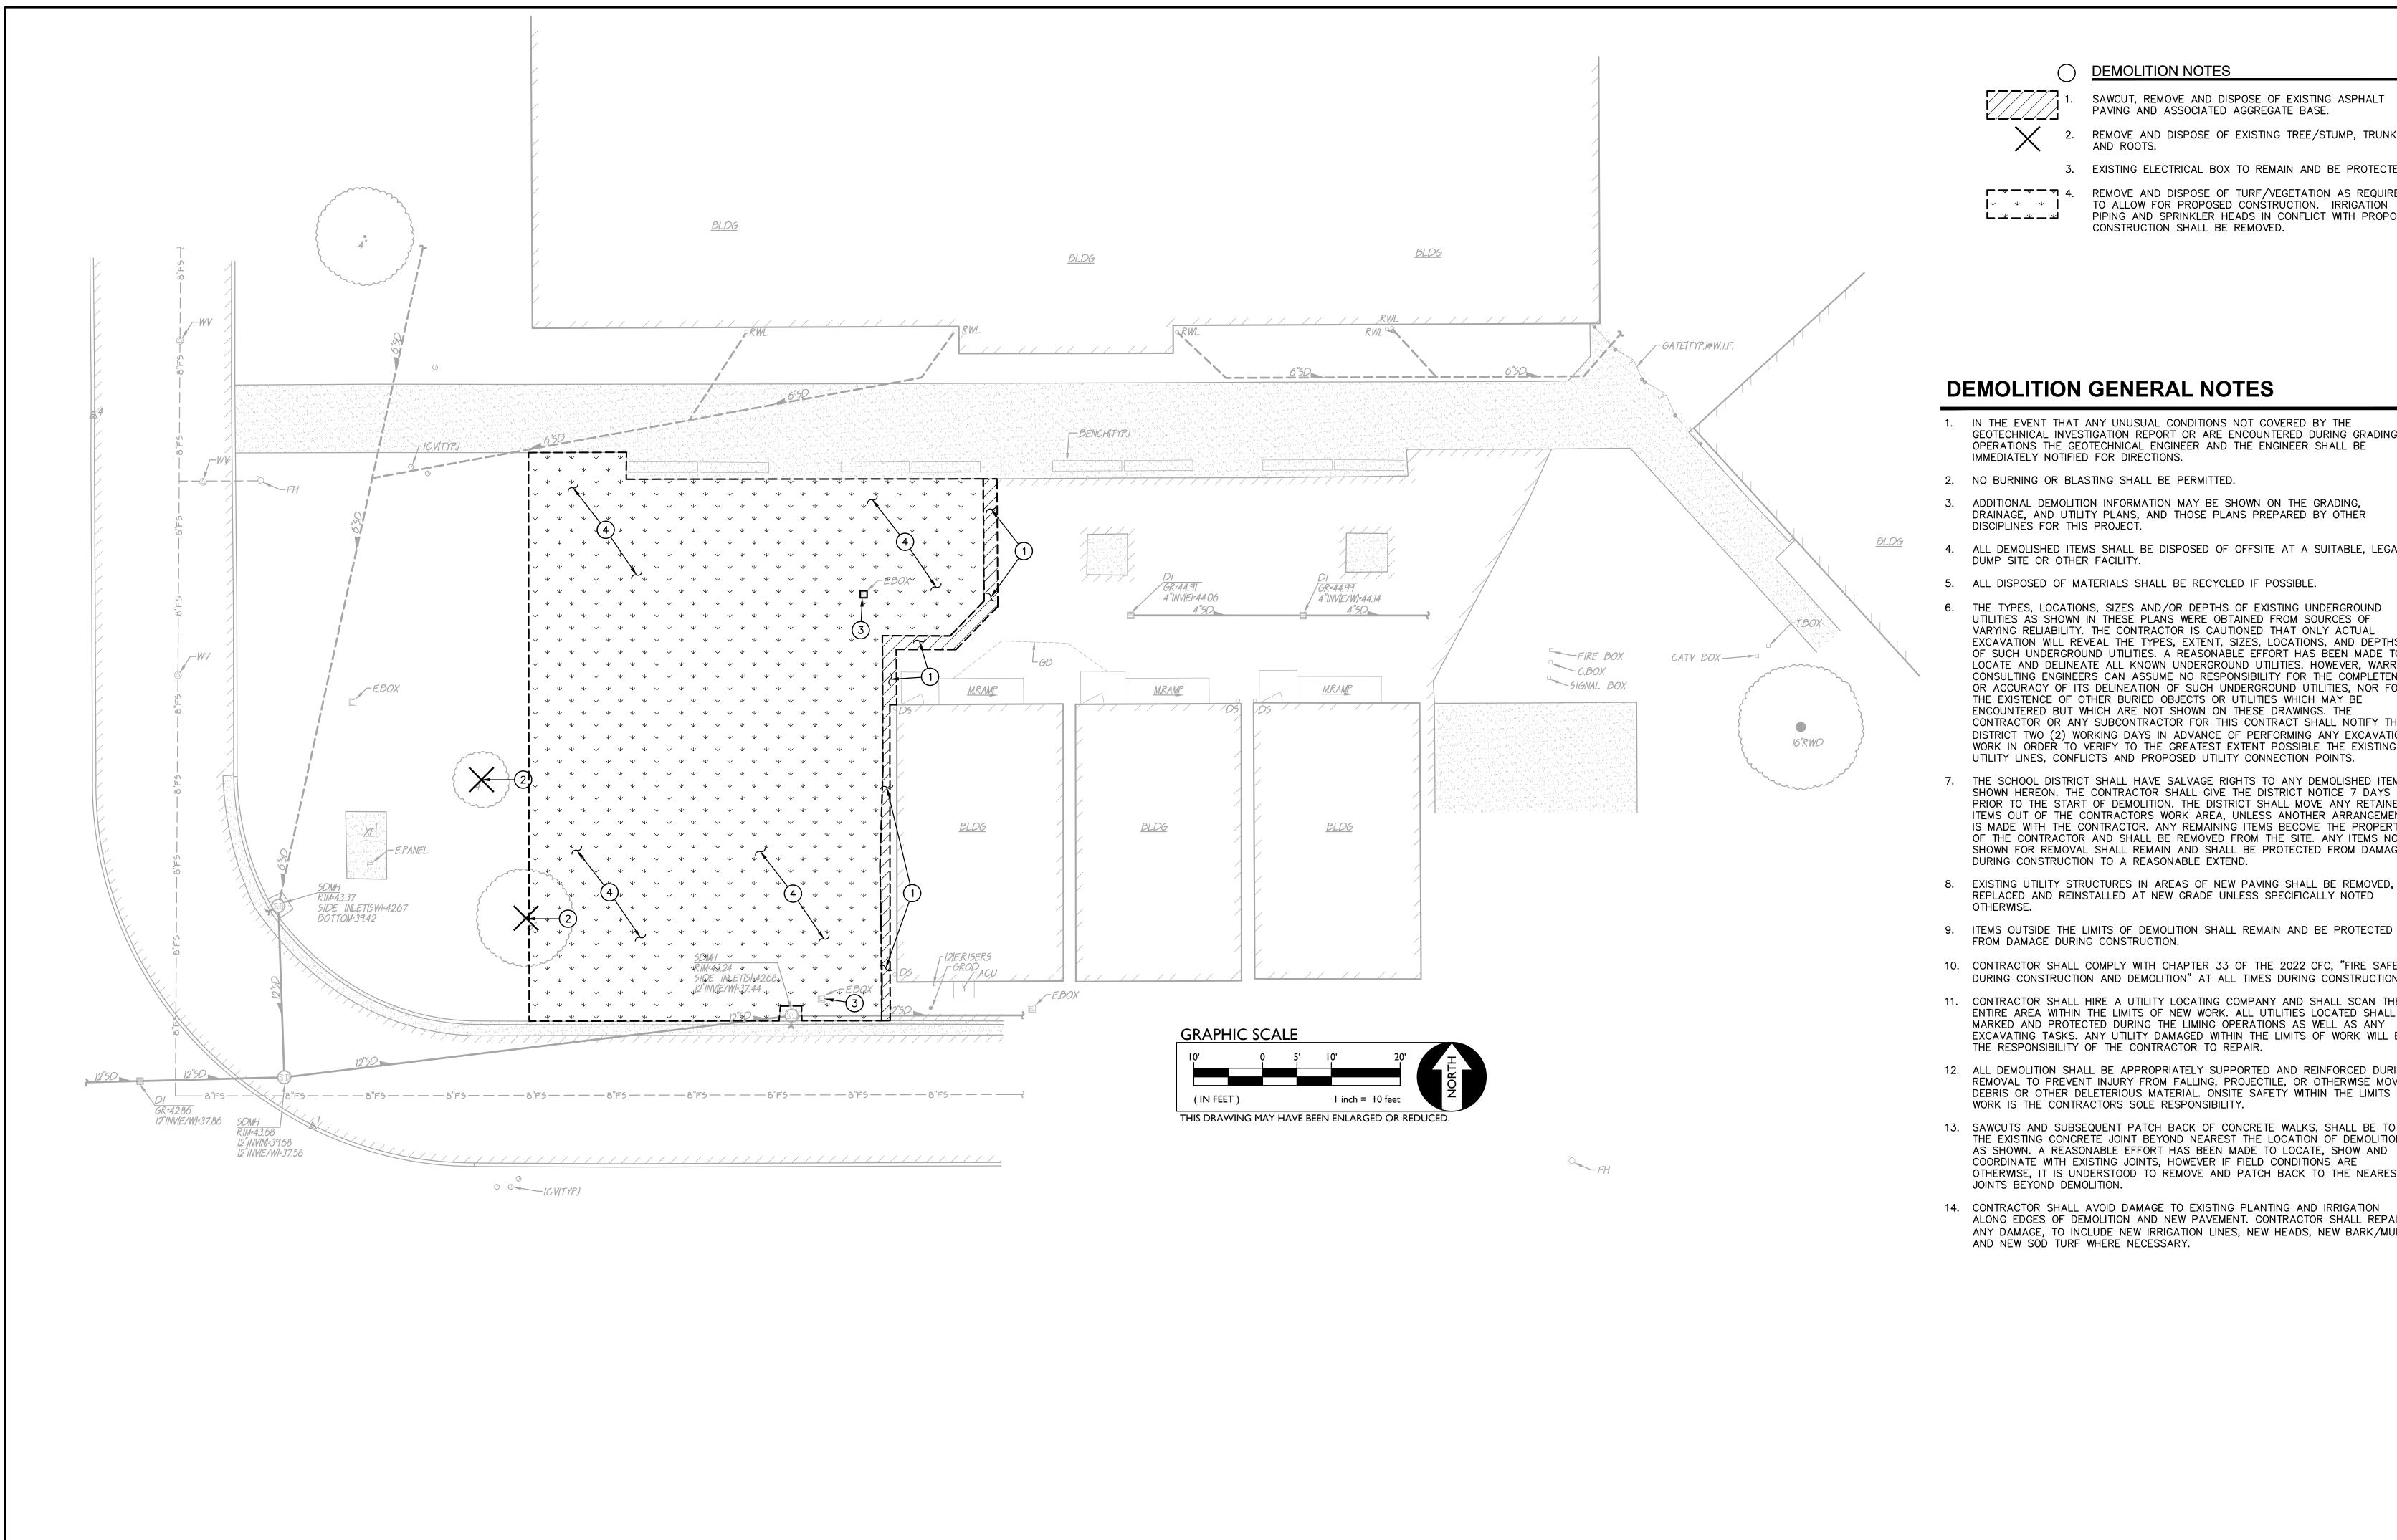

DEMOLITION NOTES

SAWCUT, REMOVE AND DISPOSE OF EXISTING ASPHALT PAVING AND ASSOCIATED AGGREGATE BASE.

REMOVE AND DISPOSE OF EXISTING TREE/STUMP, TRUNK AND ROOTS.

3. EXISTING ELECTRICAL BOX TO REMAIN AND BE PROTECTED.

T 4. REMOVE AND DISPOSE OF TURF/VEGETATION AS REQUIRED PIPING AND SPRINKLER HEADS IN CONFLICT WITH PROPOSED CONSTRUCTION SHALL BE REMOVED.

### **DEMOLITION GENERAL NOTES**

- 1. IN THE EVENT THAT ANY UNUSUAL CONDITIONS NOT COVERED BY THE GEOTECHNICAL INVESTIGATION REPORT OR ARE ENCOUNTERED DURING GRADING OPERATIONS THE GEOTECHNICAL ENGINEER AND THE ENGINEER SHALL BE IMMEDIATELY NOTIFIED FOR DIRECTIONS.
- 2. NO BURNING OR BLASTING SHALL BE PERMITTED.
- 3. ADDITIONAL DEMOLITION INFORMATION MAY BE SHOWN ON THE GRADING, DRAINAGE, AND UTILITY PLANS, AND THOSE PLANS PREPARED BY OTHER DISCIPLINES FOR THIS PROJECT.
- 4. ALL DEMOLISHED ITEMS SHALL BE DISPOSED OF OFFSITE AT A SUITABLE, LEGAL,
- DUMP SITE OR OTHER FACILITY.
- 6. THE TYPES, LOCATIONS, SIZES AND/OR DEPTHS OF EXISTING UNDERGROUND UTILITIES AS SHOWN IN THESE PLANS WERE OBTAINED FROM SOURCES OF VARYING RELIABILITY. THE CONTRACTOR IS CAUTIONED THAT ONLY ACTUAL EXCAVATION WILL REVEAL THE TYPES, EXTENT, SIZES, LOCATIONS, AND DEPTHS OF SUCH UNDERGROUND UTILITIES. A REASONABLE EFFORT HAS BEEN MADE TO LOCATE AND DELINEATE ALL KNOWN UNDERGROUND UTILITIES. HOWEVER, WARREN CONSULTING ENGINEERS CAN ASSUME NO RESPONSIBILITY FOR THE COMPLETENESS OR ACCURACY OF ITS DELINEATION OF SUCH UNDERGROUND UTILITIES, NOR FOR THE EXISTENCE OF OTHER BURIED OBJECTS OR UTILITIES WHICH MAY BE ENCOUNTERED BUT WHICH ARE NOT SHOWN ON THESE DRAWINGS. THE CONTRACTOR OR ANY SUBCONTRACTOR FOR THIS CONTRACT SHALL NOTIFY THE DISTRICT TWO (2) WORKING DAYS IN ADVANCE OF PERFORMING ANY EXCAVATION WORK IN ORDER TO VERIFY TO THE GREATEST EXTENT POSSIBLE THE EXISTING UTILITY LINES, CONFLICTS AND PROPOSED UTILITY CONNECTION POINTS.
- THE SCHOOL DISTRICT SHALL HAVE SALVAGE RIGHTS TO ANY DEMOLISHED ITEMS SHOWN HEREON. THE CONTRACTOR SHALL GIVE THE DISTRICT NOTICE 7 DAYS PRIOR TO THE START OF DEMOLITION. THE DISTRICT SHALL MOVE ANY RETAINED ITEMS OUT OF THE CONTRACTORS WORK AREA, UNLESS ANOTHER ARRANGEMENT IS MADE WITH THE CONTRACTOR. ANY REMAINING ITEMS BECOME THE PROPERTY OF THE CONTRACTOR AND SHALL BE REMOVED FROM THE SITE. ANY ITEMS NOT SHOWN FOR REMOVAL SHALL REMAIN AND SHALL BE PROTECTED FROM DAMAGE DURING CONSTRUCTION TO A REASONABLE EXTEND.
- REPLACED AND REINSTALLED AT NEW GRADE UNLESS SPECIFICALLY NOTED
- FROM DAMAGE DURING CONSTRUCTION. 10. CONTRACTOR SHALL COMPLY WITH CHAPTER 33 OF THE 2022 CFC, "FIRE SAFETY
- DURING CONSTRUCTION AND DEMOLITION" AT ALL TIMES DURING CONSTRUCTION.
- 11. CONTRACTOR SHALL HIRE A UTILITY LOCATING COMPANY AND SHALL SCAN THE ENTIRE AREA WITHIN THE LIMITS OF NEW WORK. ALL UTILITIES LOCATED SHALL BE MARKED AND PROTECTED DURING THE LIMING OPERATIONS AS WELL AS ANY EXCAVATING TASKS. ANY UTILITY DAMAGED WITHIN THE LIMITS OF WORK WILL BE THE RESPONSIBILITY OF THE CONTRACTOR TO REPAIR.
- 12. ALL DEMOLITION SHALL BE APPROPRIATELY SUPPORTED AND REINFORCED DURING REMOVAL TO PREVENT INJURY FROM FALLING, PROJECTILE, OR OTHERWISE MOVING DEBRIS OR OTHER DELETERIOUS MATERIAL. ONSITE SAFETY WITHIN THE LIMITS OF WORK IS THE CONTRACTORS SOLE RESPONSIBILITY.
- 13. SAWCUTS AND SUBSEQUENT PATCH BACK OF CONCRETE WALKS, SHALL BE TO THE EXISTING CONCRETE JOINT BEYOND NEAREST THE LOCATION OF DEMOLITION AS SHOWN. A REASONABLE EFFORT HAS BEEN MADE TO LOCATE, SHOW AND COORDINATE WITH EXISTING JOINTS, HOWEVER IF FIELD CONDITIONS ARE OTHERWISE, IT IS UNDERSTOOD TO REMOVE AND PATCH BACK TO THE NEAREST JOINTS BEYOND DEMOLITION.
- 14. CONTRACTOR SHALL AVOID DAMAGE TO EXISTING PLANTING AND IRRIGATION ALONG EDGES OF DEMOLITION AND NEW PAVEMENT. CONTRACTOR SHALL REPAIR ANY DAMAGE, TO INCLUDE NEW IRRIGATION LINES, NEW HEADS, NEW BARK/MULCH AND NEW SOD TURF WHERE NECESSARY.

AGENCY APPROVAL DSA#

IDENTIFICATION STAMP DIV. OF THE STATE ARCHITEC APP: 02-121945 INC: REVIEWED FOR SS 🗹 FLS 🗹 ACS 🗹 DATE: 12/12/2023

ARCHITECTS

1715 R STREET, SUITE 200 SACRMENTO, CA 95811 TEL (916) 786-8178


CONSULTANTS

17 Windfield Way, Suite 110 El Dorado Hills, CA 95762 TEL (916) 985-1870

LECTRICAL ENGINEER The Engineering Enterprise

1125 High Street Auburn, CA 95603 TEL (530) 886-8556



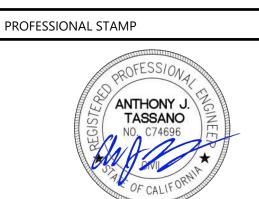

REVISI	ONS	
VO.	DATE	DESCRIPTION
-		
-		

THE ARCHITECT DOES NOT REPRESENT THAT THESE PLANS OR THE SPECIFICATIONS ARE SUITABLE FOR ANY SITE OTHER THAN THE ONE FOR WHICH THEY WERE SPECIFICALLY PREPARED.

THE ARCHITECT DISCLAIMS RESPONSIBILITY FOR THESE PLANS AND SPECIFICATIONS IF THEY ARE USED IN WHOLE OR IN PART AT ANY OTHER SITE. WRITTEN DIMENSIONS ON THESE DRAWINGS SHALL HAVE PRECEDENCE OVER SCALED DIMENSIONS.

LODI UNIFIED SCHOOL DISTRICT 1305 E. Vine St Lodi, CA 95240

| MILLSWOOD MIDDLE SCHOOL PORTABLES RELOCATION

233 N Mills Ave Lodi, CA 95242


PROJECT OWNER & TITLE

**DEMOLITION PLAN** 

DRAWN BY: GV JOB NUMBER: 23219

C1.1

CONSTRU

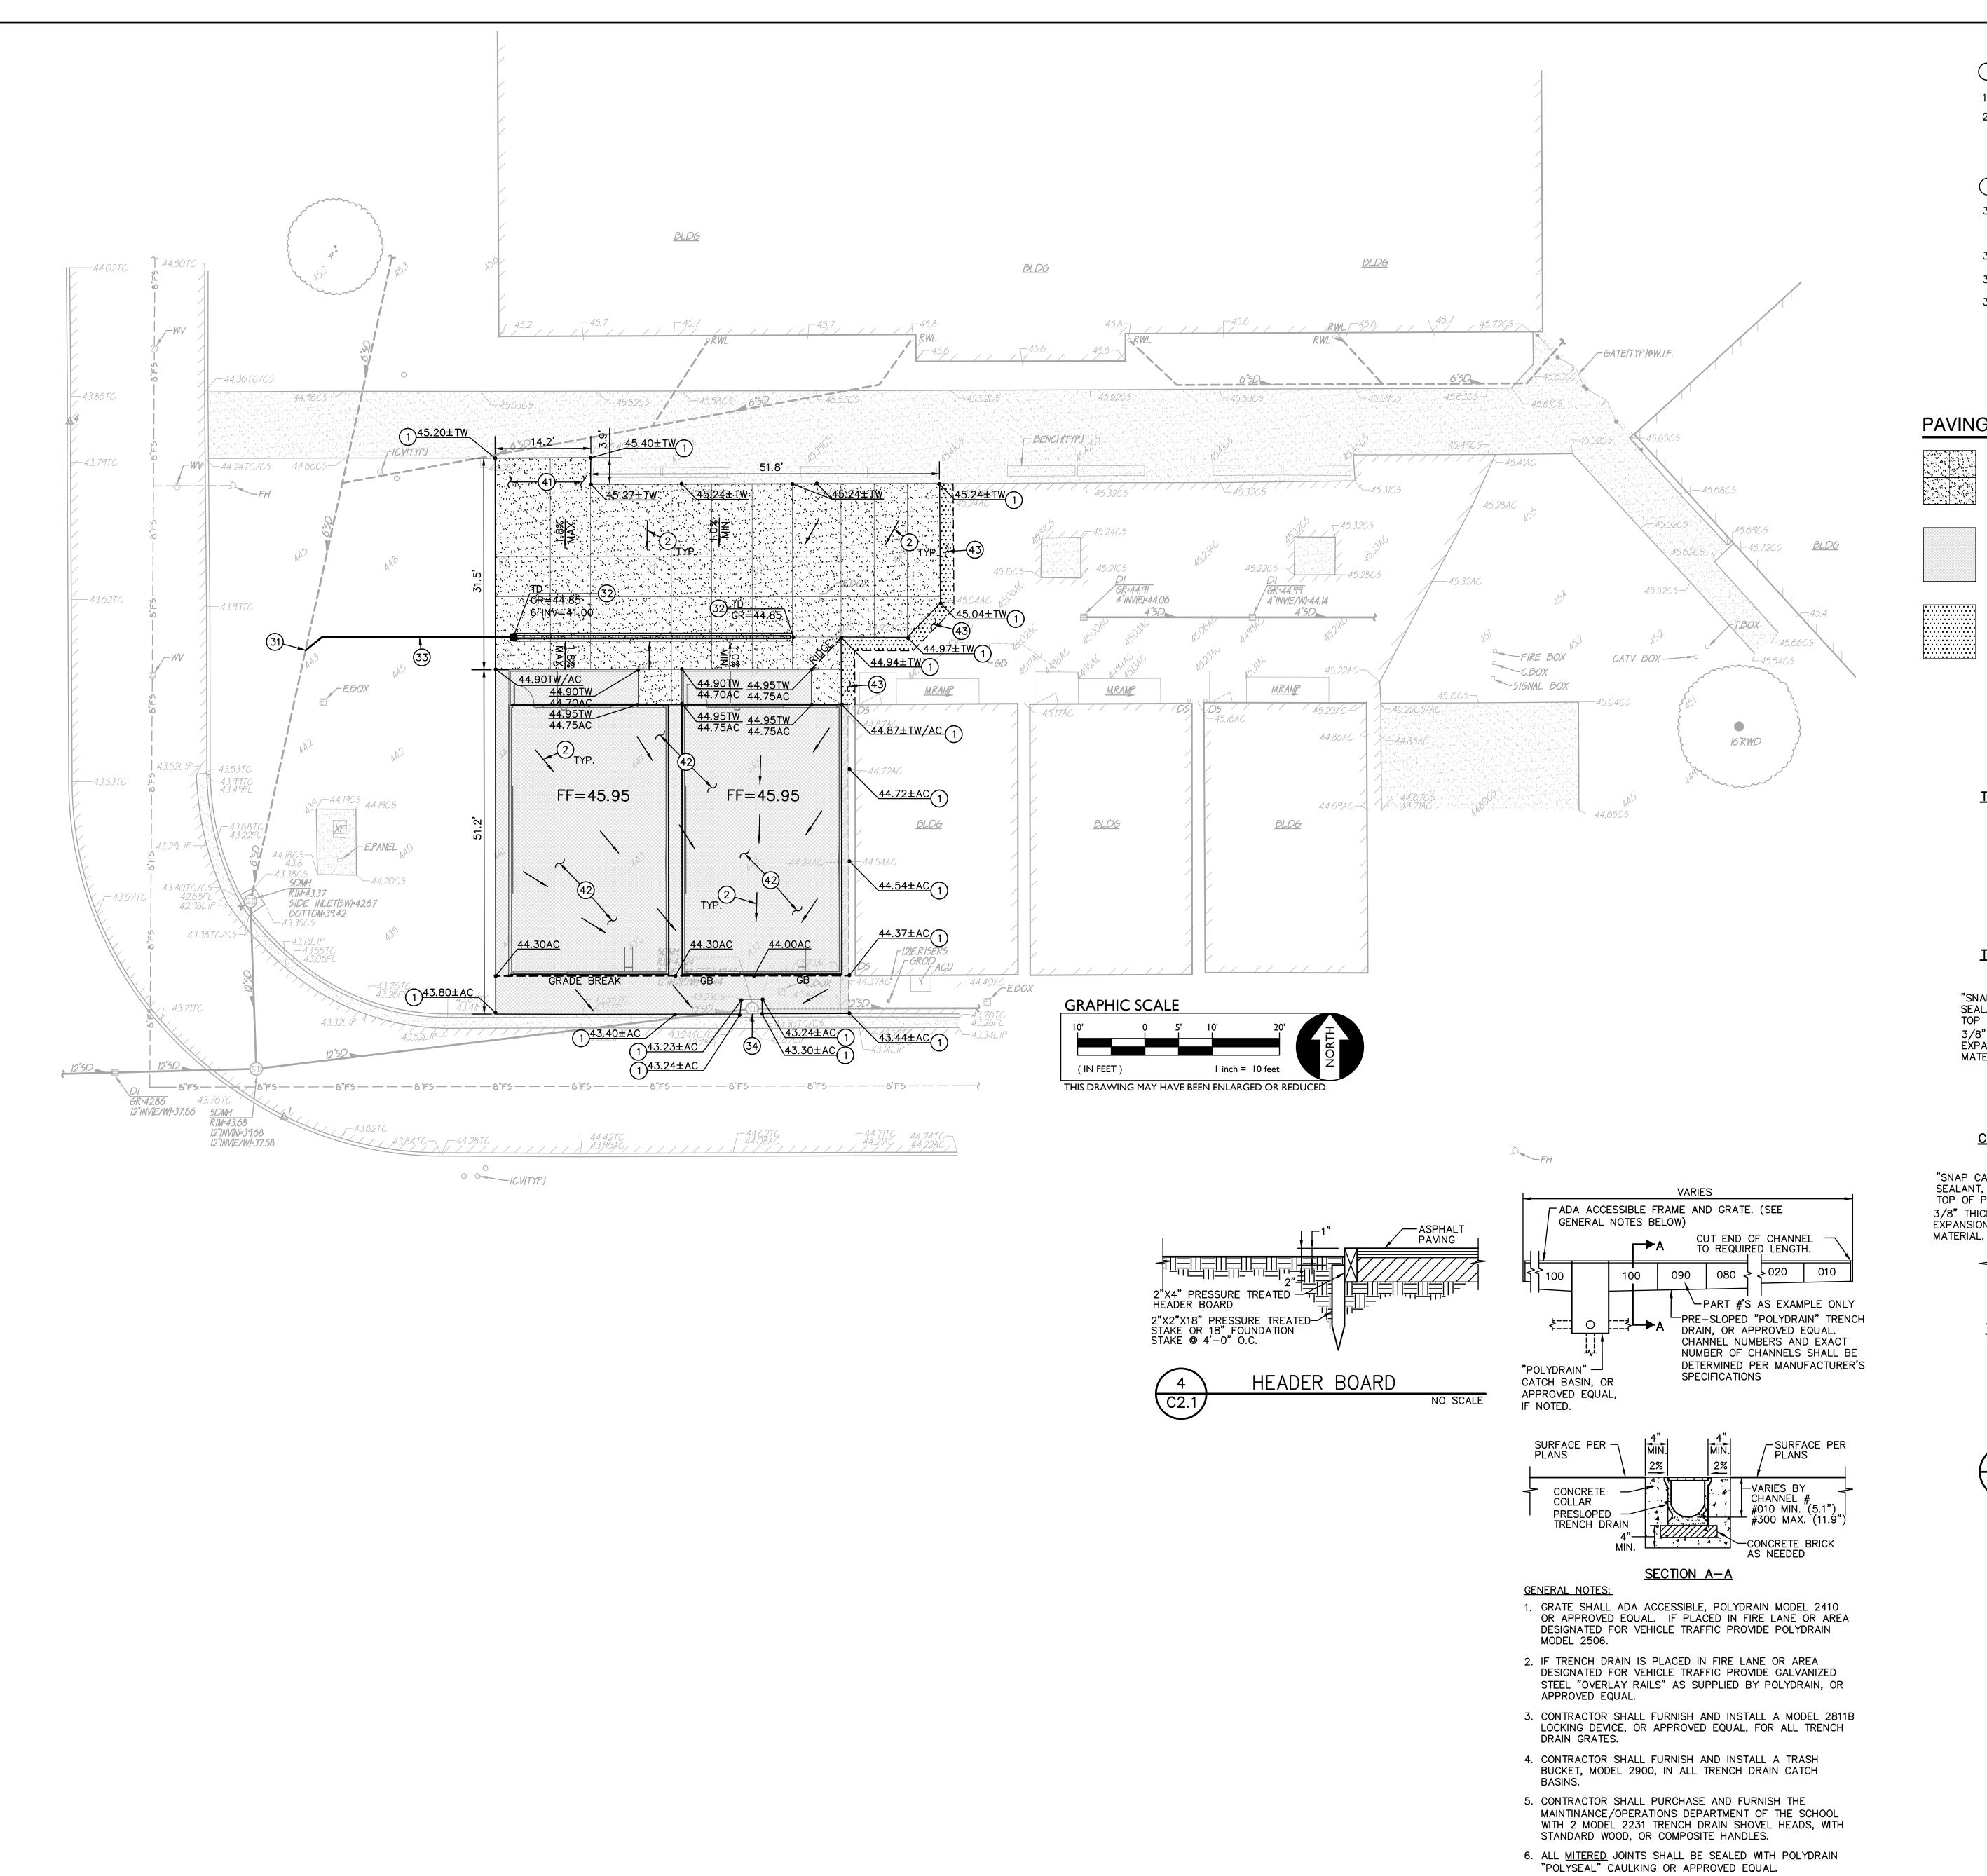

**GRADING NOTES** 

1. MATCH EXISTING GRADE/ELEVATION.

2. UNIFORMLY GRADE TOWARDS INLET/SWALE

**DRAINAGE NOTES:** 

31. CONNECT TO EXISTING STORM DRAIN LINE OR STRUCTURE. POTHOLE TO VERIFY DEPTH AND LOCATION PRIOR TO TRENCHING.

32. CONSTRUCT TRENCH DRAIN PER

33. PLACE 6" STORM DRAIN PER


34. REPLACE MANHOLE COVER WITH GRATED TOP.


### PAVING LEGEND

(41) TYPE 1 PAVING

PLACE <u>5"</u> PCC WITH #4 REBAR @ 24" O.C.E.W. OVER 12" CLASS II AB ON COMPACTED SUBGRADE C2.1 PER SPECIFICATIONS.

PLACE 3" AC OVER 12" CLASS II AB COMPACTED WITH HEADER BOARD PER, ON COMPACTED SUBGRADE, COMPACTION TO BE PER SPECIFICATIONS.

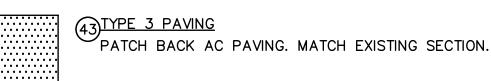

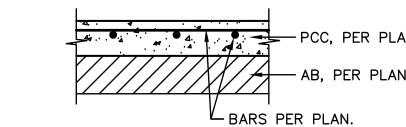

TYPICAL SECTION - DOWEL SPACING TO ┌ DX1.5 MATCH PAVING. 12 DOWEL, EMBED 3" INTO CURB. 4 4 4 4

- THICKENED EDGE

NOT REQ. AT CURB.


CURB WHERE OCCURS

TYPICAL THICKENED EDGE

"SNAP CAP" AND JOINT-\_1/2"X12" SMOOTH STEEL DOWEL SEALANT, FLUSH WITH EPOXY IN EXISTING WALK, 6" TOP OF PAVEMENT. EMBEDMENT. GREASE OPPOSITE 3/8" THICK FELT BEFORE NEW PCC PLACEMENT. EXPANSION JOINT SPACING TO MATCH REBAR. MATERIAL. ALIGN DOWELS WITH SIDEWALK REINFORCING AND TIE TO REINFORCING.

CONNECTION TO (E) CONCRETE

1/2" IN SURFACE WIDTH.

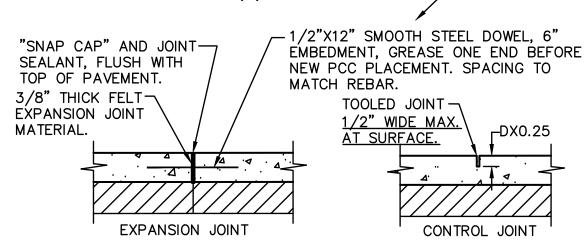


TYPICAL JOINTS

1. PROVIDE FELT EXPANSION JOINTS AT 20 FEET O.C. MAX. SEE PLAN FOR LAYOUT. 2. PROVIDE CONTROL JOINTS AT 10 FEET O.C. MAX. SEE PLAN FOR LAYOUT.

3. EXPANSION OR CONTROL JOINTS SHALL NOT EXCEED

CONCRETE SIDEWALK

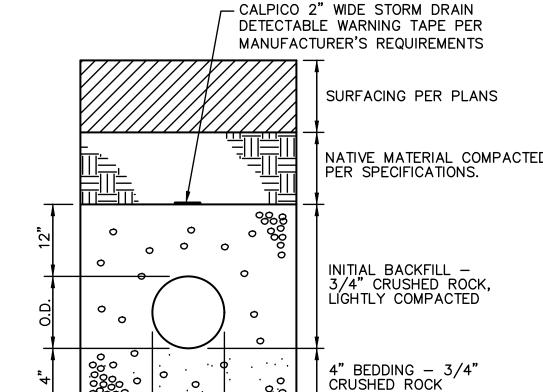

TRENCH DRAIN DETAIL

STORM DRAIN TRENCH

AGENCY APPROVAL DSA# IDENTIFICATION STAMP DIV. OF THE STATE ARCHITEC APP: 02-121945 INC: REVIEWED FOR SS 🗹 FLS 🗹 ACS 🗹 DATE: 12/12/2023

ARCHITECTS

1715 R STREET, SUITE 200 SACRMENTO, CA 95811 TEL (916) 786-8178


CONSULTANTS

1117 Windfield Way, Suite 110 El Dorado Hills, CA 95762 TEL (916) 985-1870

ELECTRICAL ENGINEER
The Engineering Enterprise 1125 High Street Auburn, CA 95603 TEL (530) 886-8556



PROFESSIONAL STAMP ANTHONY J.

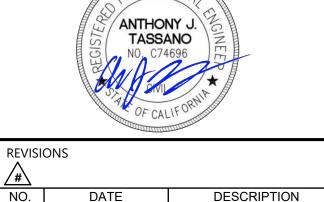

DESCRIPTION

THE ARCHITECT DOES NOT REPRESENT THAT THESE PLANS OR THE SPECIFICATIONS ARE SUITABLE FOR ANY SITE OTHER THAN THE ONE FOR WHICH THEY WERE SPECIFICALLY PREPARED THE ARCHITECT DISCLAIMS RESPONSIBILITY FOR THESE PLANS AND SPECIFICATIONS IF THEY ARE USED IN WHOLE OR IN PART AT ANY OTHER SITE. WRITTEN DIMENSIONS ON THESE DRAWINGS SHALL HAVE PRECEDENCE OVER SCALED DIMENSIONS.

PROJECT OWNER & TITLE LODI UNIFIED SCHOOL DISTRICT 1305 E. Vine St

NATIVE MATERIAL COMPACTED | MILLSWOOD MIDDLE SCHOOL

| PORTABLES RELOCATION

233 N Mills Ave Lodi, CA 95242

SHEET NO.

Lodi, CA 95240


SHEET TITLE GRADING, PAVING, AND DRAINAGE

PLAN JOB NUMBER: 23219 DRAWN BY: GV

DATE: DECEMBER 5, 2023

ONSTRU

TION

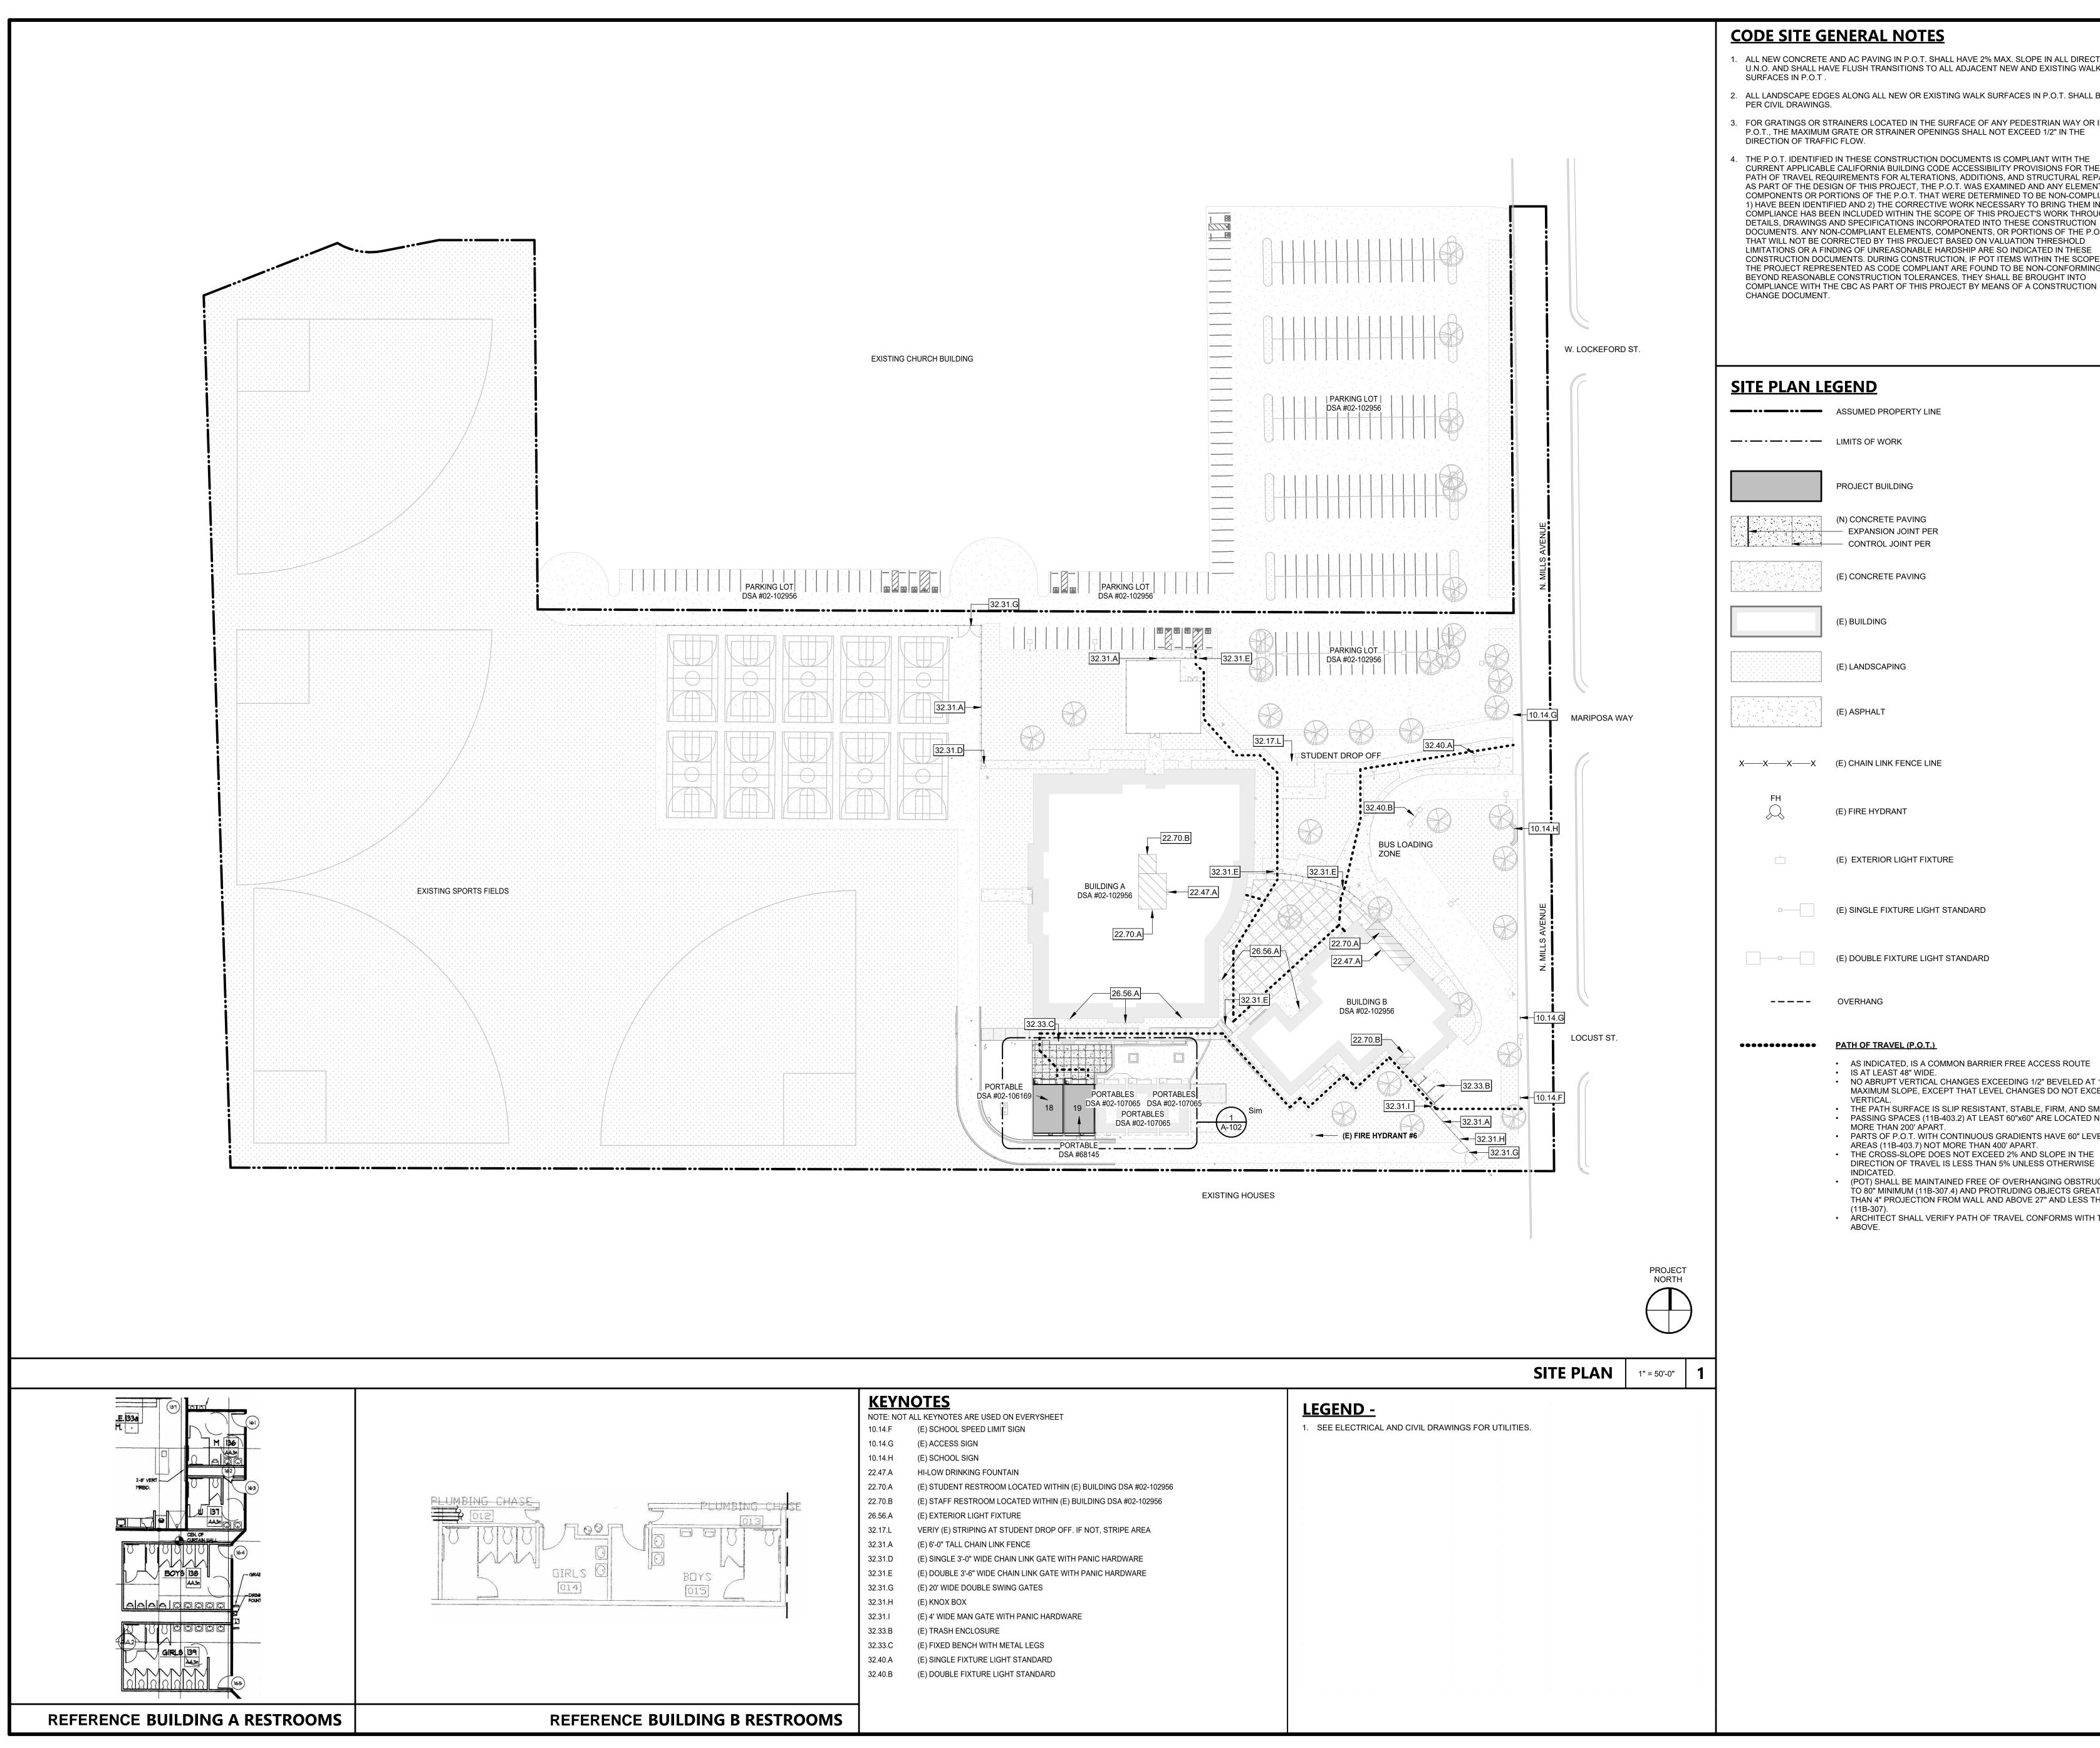

ALL NEW CONCRETE AND AC PAVING IN P.O.T. SHALL HAVE 2% MAX. SLOPE IN ALL DIRECTIONS U.N.O. AND SHALL HAVE FLUSH TRANSITIONS TO ALL ADJACENT NEW AND EXISTING WALK

ALL LANDSCAPE EDGES ALONG ALL NEW OR EXISTING WALK SURFACES IN P.O.T. SHALL BE

B. FOR GRATINGS OR STRAINERS LOCATED IN THE SURFACE OF ANY PEDESTRIAN WAY OR IN P.O.T., THE MAXIMUM GRATE OR STRAINER OPENINGS SHALL NOT EXCEED 1/2" IN THE

. THE P.O.T. IDENTIFIED IN THESE CONSTRUCTION DOCUMENTS IS COMPLIANT WITH THE CURRENT APPLICABLE CALIFORNIA BUILDING CODE ACCESSIBILITY PROVISIONS FOR THE PATH OF TRAVEL REQUIREMENTS FOR ALTERATIONS, ADDITIONS, AND STRUCTURAL REPAIRS. AS PART OF THE DESIGN OF THIS PROJECT, THE P.O.T. WAS EXAMINED AND ANY ELEMENTS, COMPONENTS OR PORTIONS OF THE P.O.T. THAT WERE DETERMINED TO BE NON-COMPLIANT 1) HAVE BEEN IDENTIFIED AND 2) THE CORRECTIVE WORK NECESSARY TO BRING THEM INTO COMPLIANCE HAS BEEN INCLUDED WITHIN THE SCOPE OF THIS PROJECT'S WORK THROUGH DETAILS, DRAWINGS AND SPECIFICATIONS INCORPORATED INTO THESE CONSTRUCTION DOCUMENTS. ANY NON-COMPLIANT ELEMENTS, COMPONENTS, OR PORTIONS OF THE P.O.T. THAT WILL NOT BE CORRECTED BY THIS PROJECT BASED ON VALUATION THRESHOLD LIMITATIONS OR A FINDING OF UNREASONABLE HARDSHIP ARE SO INDICATED IN THESE CONSTRUCTION DOCUMENTS. DURING CONSTRUCTION, IF POT ITEMS WITHIN THE SCOPE OF THE PROJECT REPRESENTED AS CODE COMPLIANT ARE FOUND TO BE NON-CONFORMING BEYOND REASONABLE CONSTRUCTION TOLERANCES, THEY SHALL BE BROUGHT INTO

IDENTIFICATION STAMP DIV. OF THE STATE ARCHITEC APP: 02-121945 INC: REVIEWED FOR SS 🗹 FLS 🗹 ACS 🗹 DATE: 12/12/2023

AGENCY APPROVAL DSA#

ARCHITECTS

1715 R STREET, SUITE 200 SACRMENTO, CA 95811 TEL (916) 786-8178

CONSULTANTS

<u>CIVIL ENGINEER</u> Warren Consulting Engineers, Inc 1117 Windfield Way, Suite 110 El Dorado Hills, CA 95762 TEL (916) 985-1870

ELECTRICAL ENGINEER The Engineering Enterprise 1125 High Street Auburn, CA 95603 TEL (530) 886-8556

 AS INDICATED, IS A COMMON BARRIER FREE ACCESS ROUTE IS AT LEAST 48" WIDE. NO ABRUPT VERTICAL CHANGES EXCEEDING 1/2" BEVELED AT 1:2

MAXIMUM SLOPE, EXCEPT THAT LEVEL CHANGES DO NOT EXCEED 1/4" THE PATH SURFACE IS SLIP RESISTANT, STABLE, FIRM, AND SMOOTH. PASSING SPACES (11B-403.2) AT LEAST 60"x60" ARE LOCATED NOT

• PARTS OF P.O.T. WITH CONTINUOUS GRADIENTS HAVE 60" LEVEL AREAS (11B-403.7) NOT MORE THAN 400' APART. THE CROSS-SLOPE DOES NOT EXCEED 2% AND SLOPE IN THE

DIRECTION OF TRAVEL IS LESS THAN 5% UNLESS OTHERWISE (POT) SHALL BE MAINTAINED FREE OF OVERHANGING OBSTRUCTIONS TO 80" MINIMUM (11B-307.4) AND PROTRUDING OBJECTS GREATER THAN 4" PROJECTION FROM WALL AND ABOVE 27" AND LESS THAN 80"

ARCHITÉCT SHALL VERIFY PATH OF TRAVEL CONFORMS WITH THE

PROFESSIONAL STAMP

**REVISIONS** 

DESCRIPTION

THE ARCHITECT DOES NOT REPRESENT THAT THESE PLANS OR THE SPECIFICATIONS ARE SUITABLE FOR ANY SITE OTHER THAN THE ONE FOR WHICH THEY WERE SPECIFICALLY PREPARED. THE ARCHITECT DISCLAIMS RESPONSIBILITY FOR THESE PLANS AND SPECIFICATIONS IF THEY ARE USED IN WHOLE OR IN PART AT ANY OTHER SITE. WRITTEN DIMENSIONS ON THESE DRAWINGS SHALL HAVE

PROJECT OWNER & TITLE LODI UNIFIED SCHOOL DISTRICT 1305 E. Vine St

PRECEDENCE OVER SCALED DIMENSIONS.

MILLSWOOD MIDDLE SCHOOL PORTABLES RELOCATION

233 N Mills Ave Lodi, CA 95242

Lodi, CA 95240

SHEET TITLE


OVERALL SITE PLAN

JOB NUMBER: 23219


DATE: DECEMBER 12, 2023

DRAWN BY: CV, BI

CONSTRI

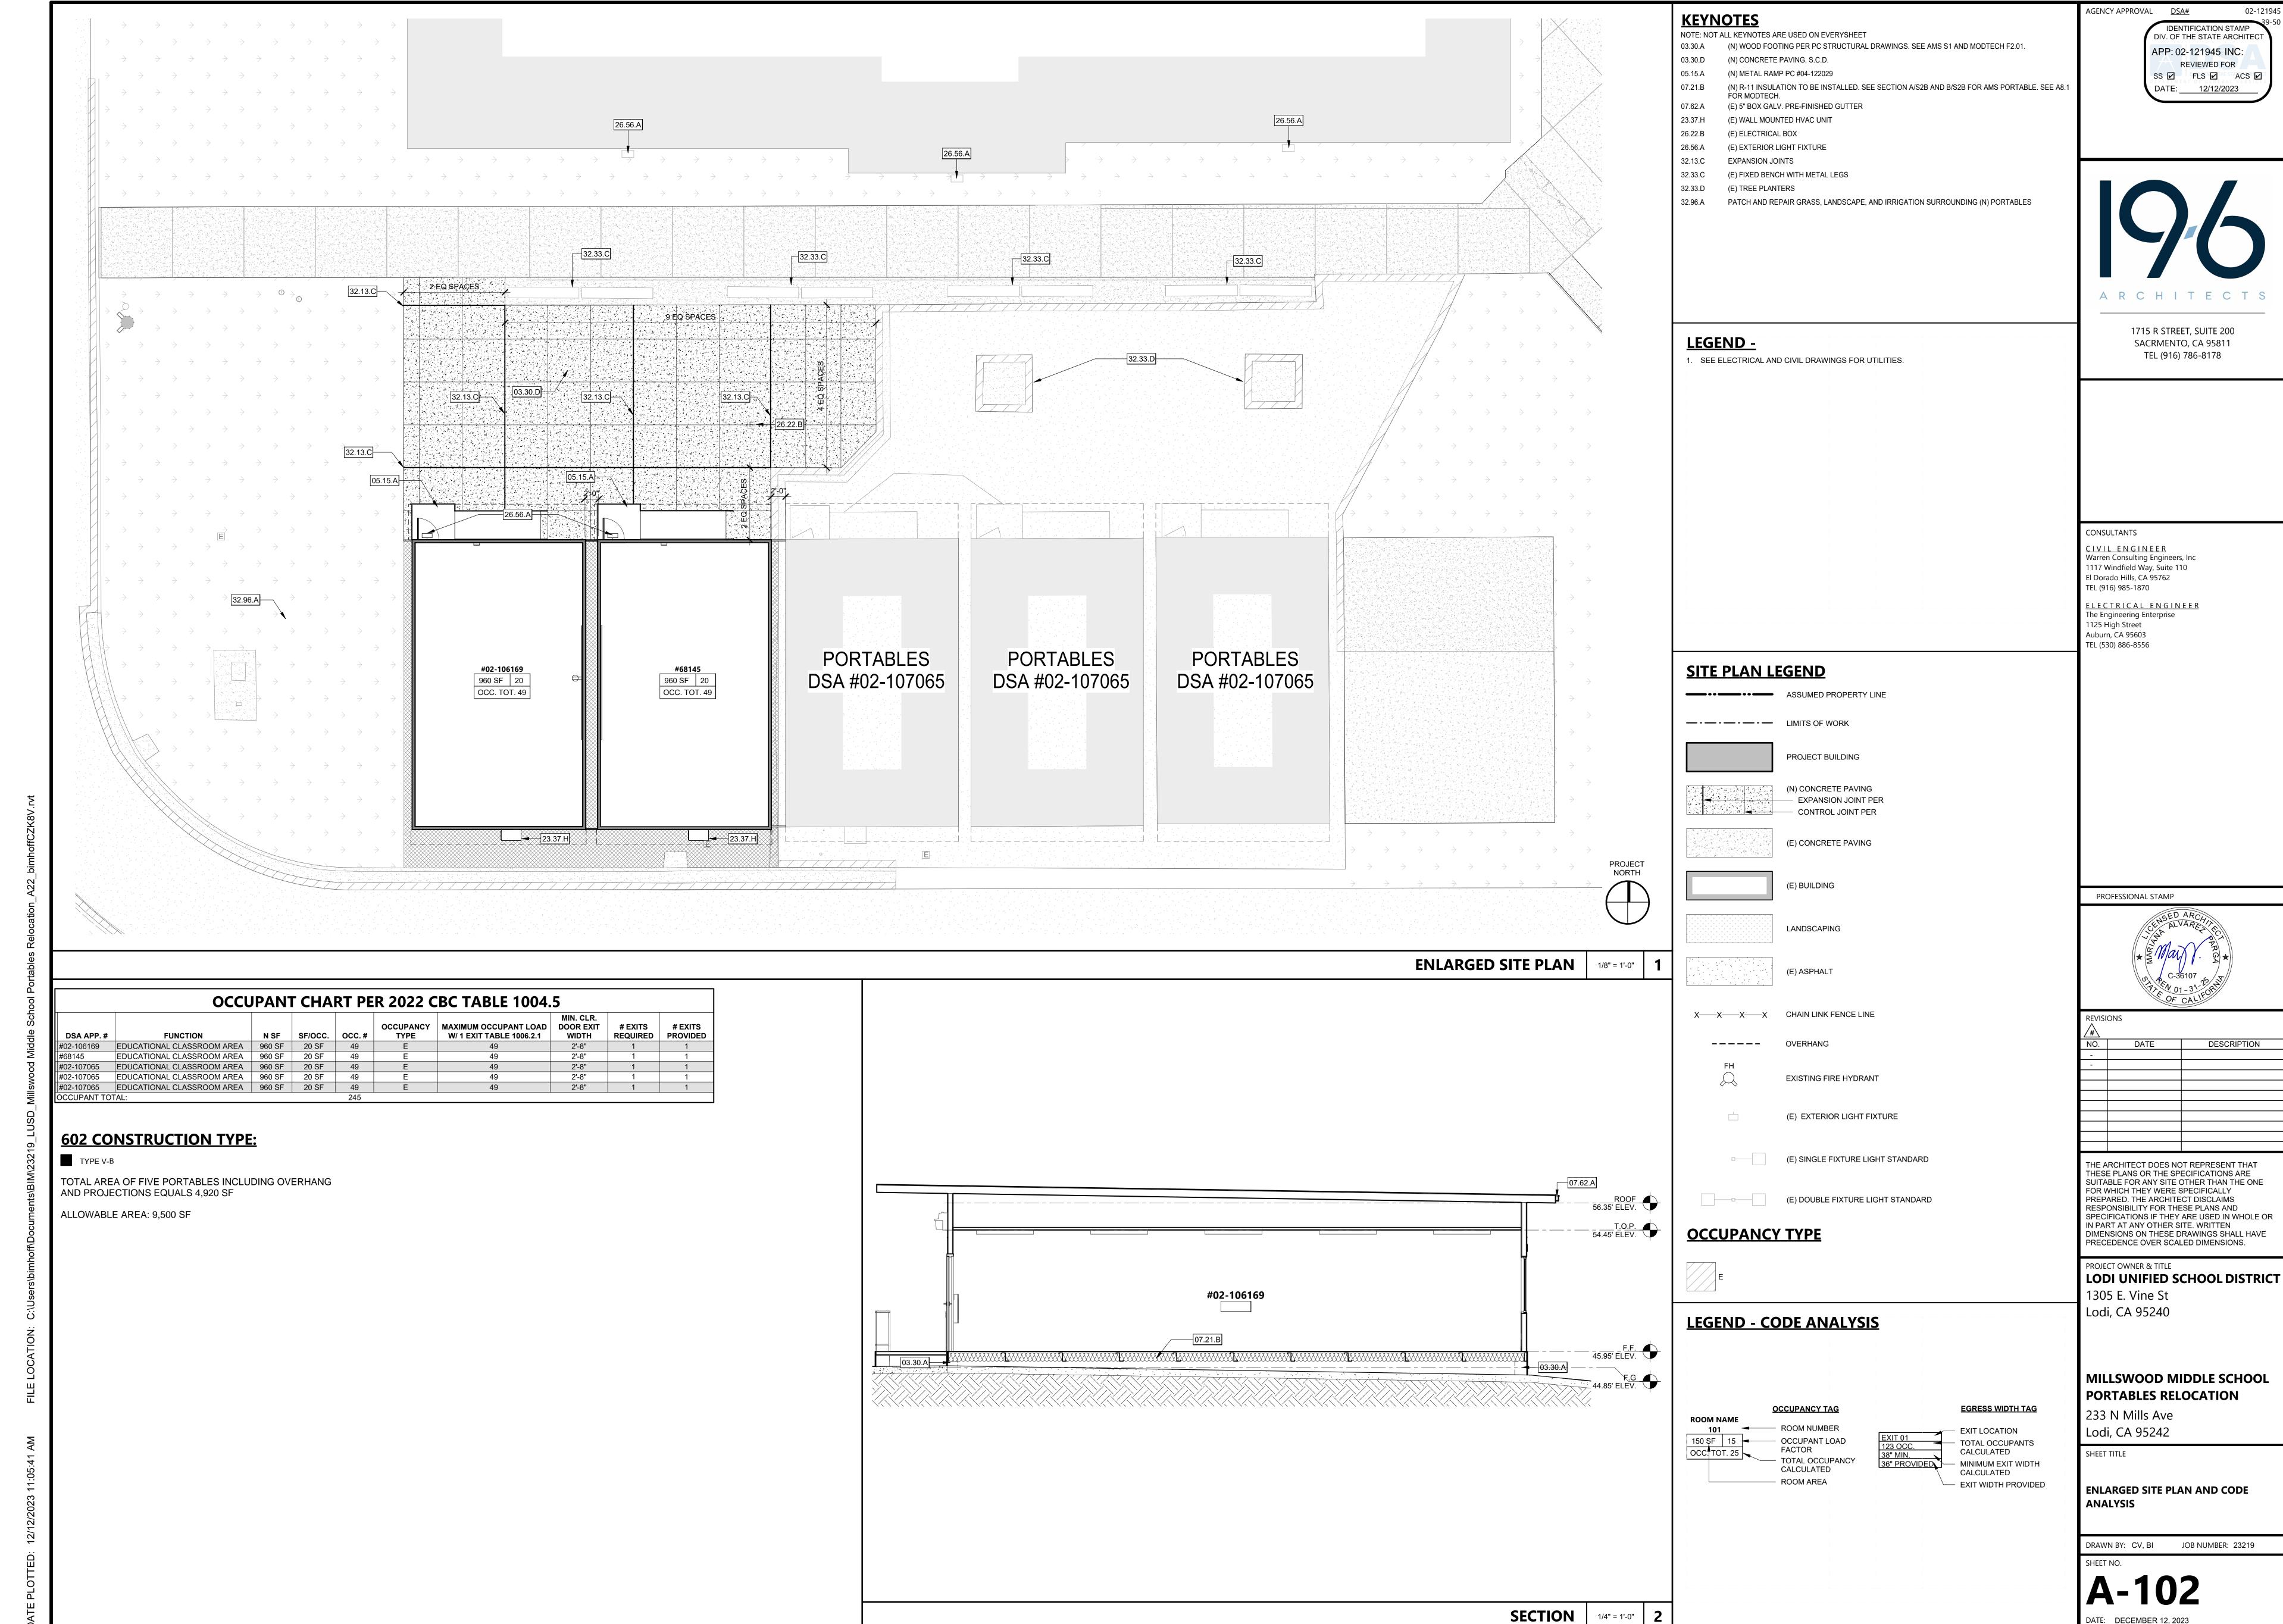

CONSTRUCTION

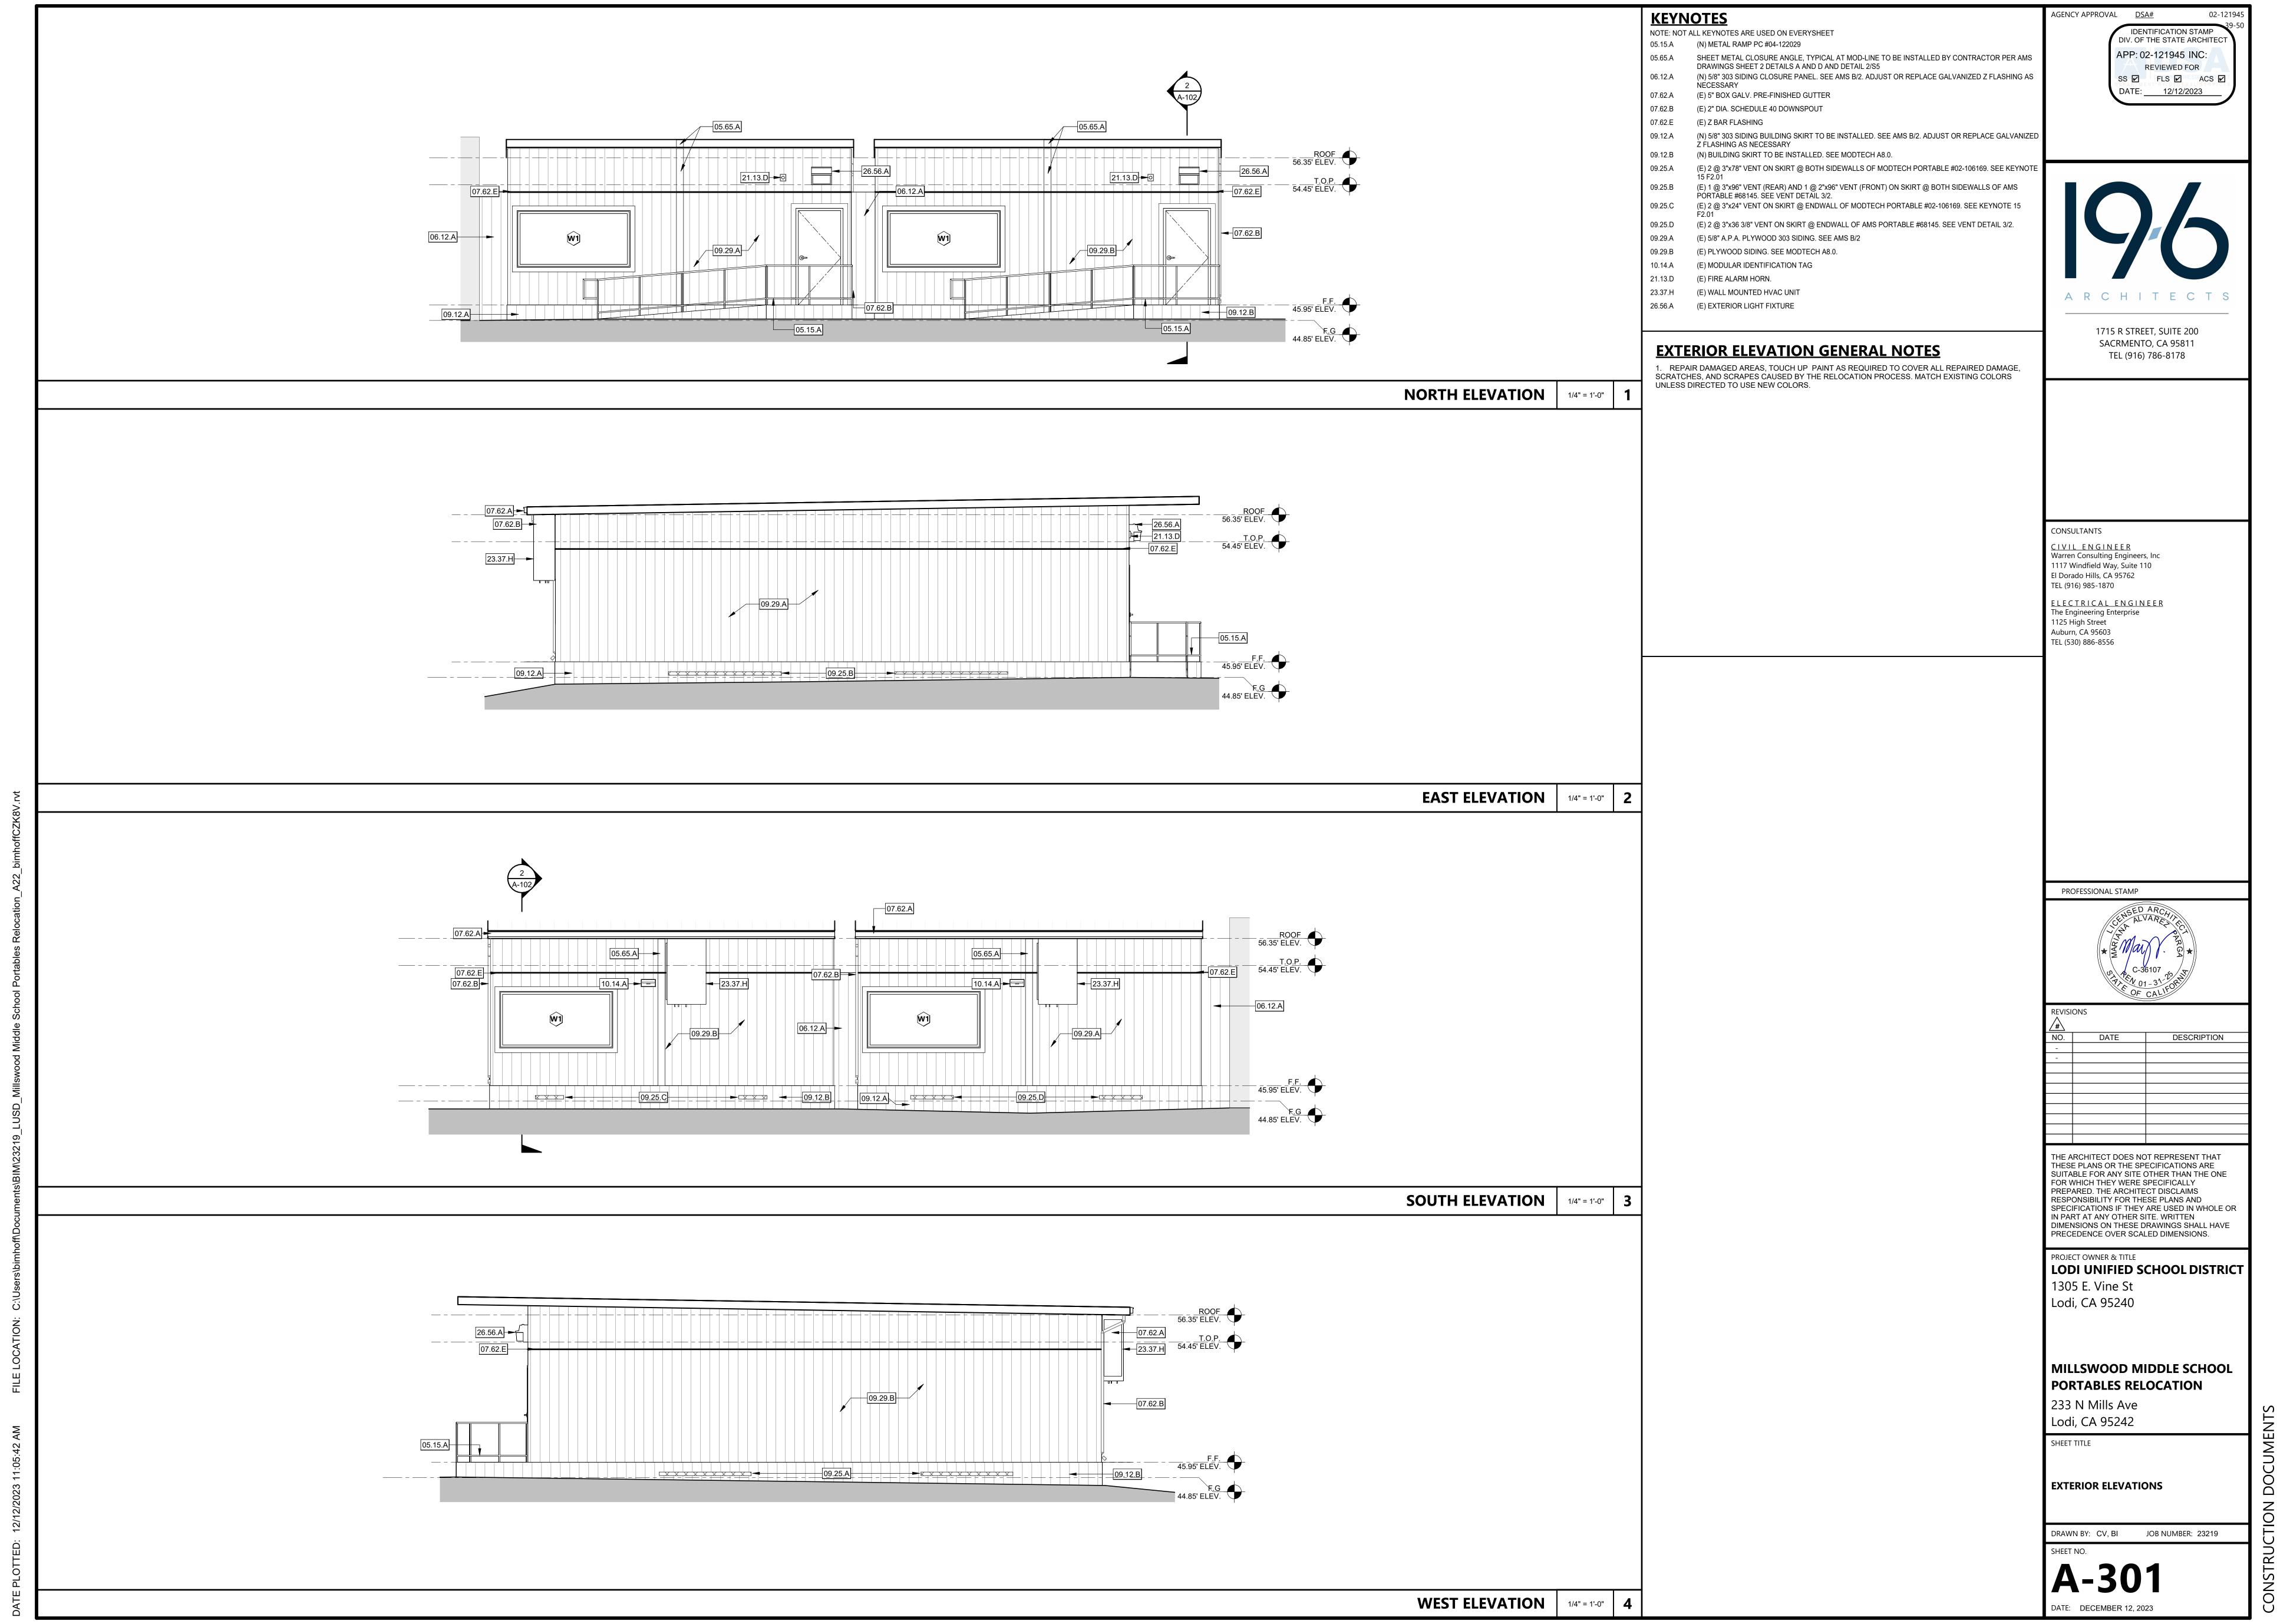

DATE: DECEMBER 12, 2023

ONSTRU

- 1. COPPER FEEDER SIZES SHOWN IN THIS SCHEDULE ARE BASED ON CONDUCTORS WITH THHN/THWN-2 INSULATION IN EMT CONDUIT.
- 2. ALUMINUM FEEDER SIZES SHOWN IN THIS SCHEDULE ARE BASED ON CONDUCTORS WITH XHHW-2 INSULATION IN EMT CONDUIT. 3. FEEDER SIZES SHOWN IN THIS SCHEDULE ARE BASED ON AN AMBIENT TEMPERATURE OF 30 DEGREES C (86 DEGREES F).
- 4. FEEDERS CONSISTING OF MULTIPLE SETS OF CONDUCTORS AND CONDUITS ARE TO BE PROVIDED WITH THE INDICATED SIZE GROUND CONDUCTOR
- 5. PER CEC ARTICLE 110.14, ALL FEEDERS SIZED AT #2 AWG OR LESS ARE CALCULATED PER 60 DEGREE TABLE. FEEDERS GREATER THAN #2 AWG
- ARE RATED 75 DEGREE. FEEDER SCHEDULE REMARKS
- A. OVERSIZED 150% NEUTRAL, SUITABLE FOR SERVICE FROM K-13 RATED TRANSFORMERS.
- B. FEEDER APPROVED FOR USE WITH SEPARATELY DERIVED SYSTEM; GROUNDING AS REQUIRED BY CEC ARTICLES 240 AND 250.
- C. FEEDER GROUND AND BONDING JUMPER SHALL HAVE AN AREA NOT LESS THAN 12.5% OF THE AREA OF THE LARGEST PHASE CONDUCTOR. D. INCREASE CONDUIT TO THE NEXT LARGER TRADE SIZE WHEN USING SCHEDULE 40 OR 80 PVC CONDUIT.
- E. PER CEC SECTION 240.4(B), FOR OVERCURRENT DEVICES RATED 800A OR LESS, THE NEXT HIGHER STANDARD OVERCURRENT DEVICE RATING (ABOVE THE
- AMPACITY OF THE CONDUCTORS) CAN BE USED. RULE CAN NOT BE APPLIED IF 100% RATED BREAKERS ARE USED. F. PER CEC 240.21(C), THE PROVISIONS OF 240.4(B) SHALL NOT BE PERMITTED FOR TRANSFORMER SECONDARY CONDUCTORS.

FEEDER	FEEDER FEEDER		CONDUCT	TORS	SEPARATELY SYSTI		DEMADIZO
TAG	TAG DESCRIPTION	CONDUIT	PHASE/NEUTRAL	GROUND	GROUNDING ELECTRODE	BONDING JUMPER	REMARKS
1503	150 AMP, 3 WIRE	1-1.50"	3 #1/0 CU	1 #6 CU	-	-	-

### DSA ANCHORAGE SCHEDULE

APPLICABLE CODE: 2022 CBC

MEP COMPONENT ANCHORAGE NOTE

ALL MECHANICAL, PLUMBING, AND ELECTRICAL COMPONENTS SHALL BE ANCHORED AND INSTALLED PER THE DETAILS ON THE DSA-APPROVED CONSTRUCTION DOCUMENTS. THE FOLLOWING COMPONENTS SHALL BE ANCHORED OR BRACED TO MEET THE FORCE AND DISPLACEMENT REQUIREMENTS PRESCRIBED IN THE 2022 CBC SECTIONS 1617A.1.18 THROUGH 1617A.1.26 AND ASCE 7-16 CHAPTERS 13, 26, AND 30:

- 1. ALL PERMANENT EQUIPMENT AND COMPONENTS. 2. TEMPORARY, MOVABLE OR MOBILE EQUIPMENT THAT IS PERMANENTLY ATTACHED (E.G., HARD WIRED) TO THE BUILDING UTILITY SERVICES SUCH AS ELECTRICITY, GAS OR WATER. "PERMANENTLY ATTACHED" SHALL INCLUDE ALL ELECTRICAL CONNECTIONS EXCEPT
- PLUGS FOR 110/220 VOLT RECEPTACLES HAVING A FLEXIBLE CABLE. 3. TEMPORARY, MOVABLE OR MOBILE EQUIPMENT WHICH IS HEAVIER THAN 400 POUNDS OR HAS A CENTER OF MASS LOCATED 4 FEET OR MORE ABOVE THE ADJACENT FLOOR OR ROOF LEVEL THAT DIRECTLY SUPPORT THE COMPONENT IS REQUIRED TO BE RESTRAINED IN A MANNER APPROVED

THE FOLLOWING MECHANICAL AND ELECTRICAL COMPONENTS SHALL BE POSITIVELY ATTACHED TO THE STRUCTURE BUT NEED NOT DEMONSTRATE DESIGN COMPLIANCE WITH THE REFERENCES NOTED ABOVE. THESE COMPONENTS SHALL HAVE FLEXIBLE CONNECTIONS PROVIDED BETWEEN THE COMPONENT AND ASSOCIATED DUCTWORK, PIPING, AND CONDUIT. FLEXIBLE CONNECTIONS MUST ALLOW MOVEMENT IN BOTH TRANSVERSE AND LONGITUDINAL DIRECTIONS:

- A. COMPONENTS WEIGHING LESS THAN 400 POUNDS AND HAVING A CENTER OF MASS LOCATED 4 FEET OR LESS ABOVE THE ADJACENT FLOOR OR ROOF LEVEL THAT DIRECTLY SUPPORT THE
- B. COMPONENTS WEIGHING LESS THAN 20 POUNDS, OR IN THE CASE OF DISTRIBUTED SYSTEMS, LESS THAN 5 POUNDS PER FOOT, WHICH ARE SUSPENDED FROM A ROOF OR FLOOR OR HUNG FROM A

THE ANCHORAGE OF ALL MECHANICAL, ELECTRICAL AND PLUMBING COMPONENTS SHALL BE SUBJECT TO THE APPROVAL OF THE DESIGN PROFESSIONAL IN GENERAL RESPONSIBLE CHARGE OR STRUCTURAL ENGINEER DELEGATED RESPONSIBILITY AND ACCEPTANCE BY DSA. THE PROJECT INSPECTOR WILL VERIFY THAT ALL COMPONENTS AND EQUIPMENT HAVE BEEN ANCHORED IN ACCORDANCE WITH THE ABOVE REQUIREMENTS.

APPLICABLE CODE: 2022 CBC

PIPING, DUCTWORK, AND ELECTRICAL DISTRIBUTION SYSTEM BRACING NOTE

PIPING. DUCTWORK. AND ELECTRICAL DISTRIBUTION SYSTEMS SHALL BE BRACED TO COMPLY WITH THE FORCES AND DISPLACEMENTS PRESCRIBED IN ASCE 7-16 SECTION 13.3 AS DEFINED IN ASCE 7-16 SECTIONS 13.6.5, 13.6.6, 13.6.7, 13.6.8; AND 2022 CBC, SECTIONS 1617A.1.24, 1617A.1.25 AND 1617A.1.26. THE METHOD OF SHOWING BRACING AND ATTACHMENTS TO THE STRUCTURE FOR THE IDENTIFIED DISTRIBUTION SYSTEM ARE AS NOTED BELOW. WHEN BRACING AND ATTACHMENTS ARE BASED ON A PREAPPROVED INSTALLATION GUIDE (E.G., HCAI OPM FOR 2013 CBC OR LATER), COPIES OF THE BRACING SYSTEM INSTALLATION GUIDE OR MANUAL SHALL BE AVAILABLE ON THE JOBSITE PRIOR TO THE START OF AND DURING THE HANGING AND BRACING OF THE DISTRIBUTION SYSTEMS. THE STRUCTURAL ENGINEER OF RECORD SHALL VERIFY THE ADEQUACY OF THE STRUCTURE TO SUPPORT THE HANGER AND BRACE

ELECTRICAL DISTRIBUTION SYSTEMS, OPTION 1: DETAILED ON THE APPROVED DRAWINGS WITH PROJECT SPECIFIC NOTES AND DETAILS.

### NUMBERED SHEET NOTES


- PROVIDE NEW CIRCUIT BREAKER IN EXISTING PREPARED SPACE AT EXISTING DISTRIBUTION PANELBOARD. NEW BREAKER TO MATCH MANUFACTURER, TYPE, AIC RATING OF EXISTING BREAKERS. PROVIDE ALL REQUIRED MOUNTING HARDWARE AND FILLER PLATES. PROVIDE ENGRAVED NAMEPLATE.
- POWER PANEL PROVIDED BY MODULAR BUILDING MANUFACTURER, PROVIDE CONNECTION PER 1/E4.1. REFER TO 5/E4.1 FOR PANELBOARD GROUNDING.
- ROUTE (6) 1/0 CU AWG (3 PER PORTABLE) WITH (2) #6 CU GROUND WIRE IN EXISTING 2"C TO EXISTING PULLBOX.
- PROVIDE PANDUIT MINI-COM PATCH PANEL AND PANDUIT DOUBLE-SIDED 2U WIRE MANAGER PER DISTRICT IT STANDARDS FOR NEW HORIZONTAL CABLING.
- ROUTE NEW STATION HORIZONTAL CABLING PER DISTRICT STANDARDS TO NEW PORTABLE BUILDINGS. USE EXISTING SPARE CONDUIT SLEEVES BETWEEN EXISTING PORTABLE BUILDINGS, AND PROVIDE NEW SLEEVES TO NEW BUILDINGS PER 1/E2.1.

### PROJECT GENERAL NOTES

- ELECTRICAL SCOPE SHALL COMPLY WITH THE LATEST ADOPTED EDITIONS OF THE CALIFORNIA ELECTRIC CODE (CEC), CALIFORNIA BUILDING CODE (CBC), CALIFORNIA FIRE CODE (CFC), CALIFORNIA MECHANICAL CODE (CMC), NATIONAL FIRE PROTECTION ASSOCIATION (NFPA 72) AND THE CALIFORNIA ENERGY CODE.
- THE CONTRACTOR SHALL VISIT THE JOBSITE AND VERIFY ALL EXISTING CONDITIONS PRIOR TO BIDDING THE PROJECT AND SHALL INCLUDE IN THEIR BID THE NECESSARY COSTS TO CONSTRUCT THIS PROJECT IN ACCORDANCE WITH THE ELECTRICAL DRAWINGS, SPECIFICATIONS, AND ALL APPLICABLE CODES.
- DRAWINGS INDICATE GENERAL ARRANGEMENT OF ELECTRICAL SYSTEMS AND WORK. FOLLOW THE DRAWINGS IN LAYING OUT WORK AND VERIFY EXACT LOCATIONS WITH ARCHITECTURAL FLOOR PLAN AND RCP DRAWINGS. ALSO, CHECK DRAWINGS OF OTHER TRADES TO VERIFY LOCATIONS OF EQUIPMENT REQUIRING ELECTRICAL CONNECTIONS AND COORDINATE SPACE CONDITIONS WITH THEIR INSTALLATION. FINAL LOCATIONS SHALL BE ADJUSTED TO MEET FIELD CONDITIONS.
- NOT EVERY ELECTRICAL RACEWAY, BOX, CONDUCTOR, ETC., FOR A COMPLETE ELECTRICAL INSTALLATION, IS SHOWN ON THESE DRAWINGS. THIS IS DONE FOR CLARITY PURPOSES AND EASE OF INTERPRETING DRAWINGS. PROVIDE ALL ADDITIONAL ITEMS REQUIRED TO MAKE THE ELECTRICAL SYSTEMS COMPLETE AND OPERATIONAL.
- WORK PERFORMED UNDER THIS CONTRACT SHALL CONFORM TO THESE DRAWINGS AND SHALL ALSO COMPLY WITH THE ELECTRICAL SPECIFICATIONS. IN THE EVENT THAT THERE IS A DISCREPANCY BETWEEN THE DRAWINGS AND SPECIFICATIONS, THE MORE STRINGENT OF THE REQUIREMENTS SHALL TAKE PRECEDENT.
- ALL NEW ELECTRICAL MATERIALS AND EQUIPMENT SHALL BE UNDERWRITER'S LABORATORIES (UL) LISTED OR ELECTRICAL TESTING LABORATORIES (ETL) LISTED AND BEAR THEIR LABELS.
- ALL ELECTRICAL MATERIALS SHALL BE NEW AND UNUSED, AND OF THE SAME MANUFACTURER OF LIKE EQUIPMENT AND/OR SYSTEMS.
- CONTRACTOR SHALL REMOVE ALL LEFTOVER CONDUIT, WIRE, SCRAPS, ETC. AND LEAVE PREMISES CLEAN AND FREE OF TRASH AND DEBRIS RESULTING FROM THEIR WORK.
- PRIOR TO COMMENCING ANY TRENCHING SCOPE ON-SITE, CONTACT THE UTILITIES UNDERGROUND SERVICE ALERT TO DETERMINE THE EXACT LOATIONS OF ANY EXISTING UNDERGROUND UTILITY LINES, WHICH MIGHT GET DAMAGED DURING EXCAVATION. WHERE INTERFERENCE IS POSSIBLE, TRENCHING SHALL BE DONE MANUALLY.
- 10. MINIMUM CONDUIT TRADE SIZE FOR EXTERIOR APPLICATIONS SHALL BE 1.0", UNLESS OTHERWISE
- 1. ALL UNDERGROUND FEEDER CONDUITS SHALL HAVE A MINIMUM COVER OF 24". WHERE FEEDER CONDUITS ARE INSTALLED UNDER ROADS OR PAVED SURFACE WITH VEHICLE TRAFFIC. THE MINIMUM COVER SHALL INCREASE TO 36". INCLUDE A MINIMUM 12" HORIZONTAL SEPARATION BETWEEN LOW-VOLTAGE AND LINE-VOLTAGE CONDUITS INSTALLED IN SAME TRENCH. INSTALL A WARNING/MARKER TAPE 12" OVER THE CONDUITS.
- 2. ALL UNDERGROUND CONDUITS ORIGINATING FROM BUILDING EXTERIOR AND TERMINATING IN ELECTRICAL EQUIPMENT WITHIN THE BUILDING INTERIOR SHALL BE SEALED AT BOTH ENDS AFTER CONDUCTORS ARE INSTALLED, TO PREVENT MOISTURE FROM COMING IN CONTACT WITH
- 3. SITE PULLBOXES FOR BRANCH CIRCUITING SHALL BE SIZED TO CODE MINIMUM REQUIREMENTS. OBTAIN APPROVAL FROM LANDSCAPE ARCHITECT FOR ANY PULLBOXES NEEDED TO FACILITATE SITE CONDUIT REQUIREMENTS.
- 4. ALL GROUNDING ELECTRODES WITHIN BUILDING OR STRUCTURE SHALL BE BONDED TOGETHER TO FORM A SINGLE GROUNDING ELECTRODE SYSTEM. 15. ALL SEPARATELY DERIVED SYSTEMS SHALL COMPLY WITH CODE, CEC 250.104, FOR BONDING TO
- METAL WATER PIPING AND STRUCTURAL METAL.
- 16. FURNISH, INSTALL, AND CONNECT A CODE SIZED INSULATED OR BARE COPPER GROUND CONDUCTOR IN ALL BRANCH CIRCUITS AND FEEDER CONDUITS.
- 7. WHERE UNGROUNDED CONDUCTORS ARE INCREASED IN SIZE TO ACCOMMODATE VOLTAGE DROP. THE EQUIPMENT GROUND CONDUCTOR SHALL ALSO BE INCREASED IN SIZE PROPORTIONATELY, ACCORDING TO THE CIRCULAR MIL AREA OF UNGROUNDED CONDUCTORS.
- 18. ALL EQUIPMENT CONNECTED BY PERMANENT WIRING METHODS SHALL BE GROUNDED.
- 9. BRANCH CIRCUIT CONDUCTORS SHALL BE SIZED TO PREVENT VOLTAGE DROP EXCEEDING 3% AT THE FARTHEST OUTLET OR DEVICE. THE MAXIMUM VOLTAGE DROP ALLOWED ON COMBINED FEEDERS AND BRANCH CIRCUITS SHALL NOT EXCEED 5% TO THE FARTHEST OUTLET OR DEVICE.
- 20. ALL CONDUCTORS ON THIS PROJECT SHALL BE STRANDED COPPER.
- 21. MULTIWIRE BRANCH CIRCUITS SHALL BE PROVIDED WITH A MEANS TO SIMULTANEOUSLY DISCONNECT ALL UNGROUNDED CONDUCTORS AT THE POINT WHERE THE BRANCH CIRCUIT ORIDINATES, I.E. HANDLE TIES OR MULTIPOLE CIRCUIT BREAKERS.
- 22. CONDUIT ROUTING ON DRAWINGS IS ESSENTIALLY DIAGRAMMATIC. CONTRACTOR SHALL LAYOUT RUNS TO SUIT FIELD CONDITIONS, LIMITING BENDS AND BOXES, AND SHALL COORDINATE INSTALLATION WITH WORK OF OTHER TRADES.
- 23. PROVIDE INSULATING BUSHINGS OR INSULATED THROAT CONNECTORS AT BOTH ENDS OF ALL CONDUIT SLEEVES.
- 24. ALL JUNCTION AND PULL BOXES SHALL BE SIZED PER CODE TO ACCOMMODATE NUMBER OF CONDUITS AND/OR CONDUCTORS ROUTED TO AND FROM BOXES.
- 25. PROVIDE A PULL WIRE/TAPE IN ALL EMPTY CONDUIT RUNS OVER 15' IN LENGTH.
- 26. NO PIPING, DUCTWORK, OR EQUIPMENT FOREIGN TO ELECTRICAL EQUIPMENT SHALL BE ALLOWED WITHIN THE DEDICATED SPACE ABOVE ELECTRICAL EQUIPMENT.
- 27. PROVIDE ENGRAVED NAMEPLATES FOR ALL ELECTRICAL PANELBOARDS, SWITCHBOARDS, SWITCHGEAR, TRANSFORMERS, AND DISCONNECT SWITCHES, AS DESCRIBED IN THE
- 28. CONTRACTOR SHALL ENSURE THAT THE ELECTRICAL EQUIPMENT PROVIDED UNDER THEIR CONTRACTOR WILL FIT WITHIN THE SPACES PROVIDED IN THE BID DOCUMENTS. WHETHER PROVIDED BY THE SPECIFIED EQUIPMENT MANUFACTURER OR NOT. NO ADDITIONAL COMPENSATION WILL BE CONSIDERED IF CONTRACTOR NEEDS TO ADJUST EQUIPMENT PACKAGE TO OBTAIN REDUCED DIMENISONS.
- 29. CONTRACTOR IS RESPONSIBLE FOR SUBMITTING REVISED LAYOUTS OF DISTRIBUTION EQUIPMENT IN SPACES, FOR APPROVAL BY ENGINEER, IF PROPOSED INSTALLATION DIFFERS FROM CONSTRUCTION DOCUMENTS. SUBMISSION MUST BE REVIEWED PRIOR TO RELEASE OF
- 30. ALL FLOOR AND/OR FREE-STANDING ELECTRICAL EQUIPMENT SHALL BE MOUNTED ON A 4" HIGH CONCRETE HOUSEKEEPING PAD, U.O.N.
- 31. ALL OUTDOOR ELECTRICAL EQUIPMENT SHALL BE WEATHERPROOF (NEMA 3R RATED, MINIMUM) AND LISTED FOR EXTERIOR APPLICATIONS.

EQUIPMENT AND PRIOR TO INSTALLATION.

- 32. ALL CIRCUIT BREAKERS SERVING THE FIRE ALARM CONTROL PANEL AND FIRE ALARM SYSTEM COMPONENTS SHALL HAVE LOCKABLE HANDLES AND SHALL BE RED IN COLOR, FOR EASE IN
- 33. MOUNTING HEIGHTS OF ALL WIRING DEVICES ARE DIMENSIONED TO THE CENTER OF THE DEVICE, UNLESS OTHERWISE NOTED.
- 34. PROVIDE GFCI TYPE RECEPTACLES WITH WEATHERPROOF "WHILE-IN-USE" COVERPLATES WITHIN 25' OF ALL EXTERIOR HVAC AND PLUMBING EQUIPMENT.
- 35. WHERE RECEPTACLES ARE LOCATED OUTSIDE OR IN WET/DAMP LOCATIONS, PROVIDE WEATHERPROOF WHILE-IN-USE COVERPLATES.
- INDICATING THE PANELBOARD AND CIRCUIT NUMBER(S) SERVING EACH DEVICE.
- 37. CONTRACTOR SHALL SIZE ALL JUNCTION AND PULL BOXES PER THE MINIMUM CODE REQUIREMENTS OF CEC ARTICLE 314, UNLESS OTHERWISE NOTED ON DRAWINGS.

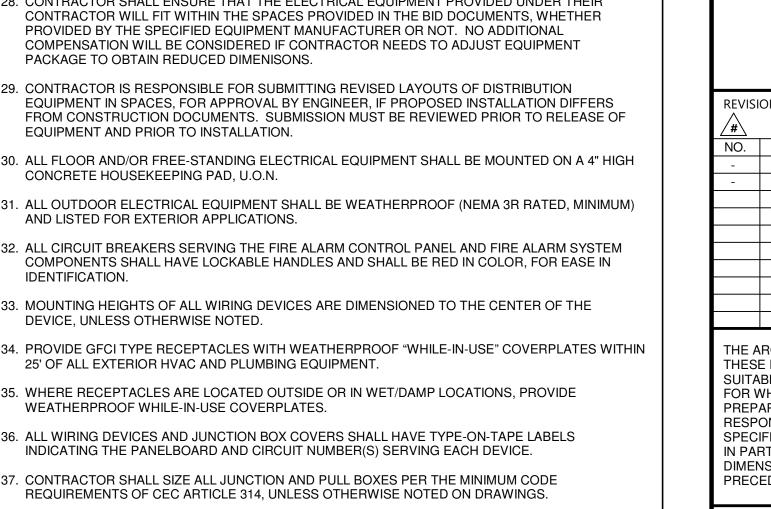

AGENCY APPROVAL

IDENTIFICATION STAMP DIV. OF THE STATE ARCHITE APP: 02-121945 INC: REVIEWED FOR SS 🗹 FLS 🗹 ACS 🗹 DATE: 12/12/2023


1715 R STREET, SUITE 200 SACRMENTO, CA 95811 TEL TEL (916) 786-8178

ARCHITECTS

CONSULTANTS

ALAMEDA | AUBURN | LOS ANGELES NEOSHO | SAN DIEGO | SANTA BARBARA https://www.engent.com

PROFESSIONAL STAMP

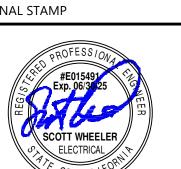

REVISI	ONS	
NO.	DATE	DESCRIPTION
-		
-		

THE ARCHITECT DOES NOT REPRESENT THAT THESE PLANS OR THE SPECIFICATIONS ARE SUITABLE FOR ANY SITE OTHER THAN THE ONE FOR WHICH THEY WERE SPECIFICALLY PREPARED. THE ARCHITECT DISCLAIMS RESPONSIBILITY FOR THESE PLANS AND SPECIFICATIONS IF THEY ARE USED IN WHOLE OR IN PART AT ANY OTHER SITE. WRITTEN DIMENSIONS ON THESE DRAWINGS SHALL HAVE PRECEDENCE OVER SCALED DIMENSIONS.

PROJECT OWNER & TITLE LODI UNIFIED SCHOOL DISTRICT 1305 E. Vine St Lodi, CA 95240

233 N Mills Ave


Lodi, CA 95242

SHEET TITLE


**POWER ONE-LINE DIAGRAM, RISERS & SCHEDULES** 

DRAWN BY: Author

**E0.2** DATE: DECEMBER 12, 2023

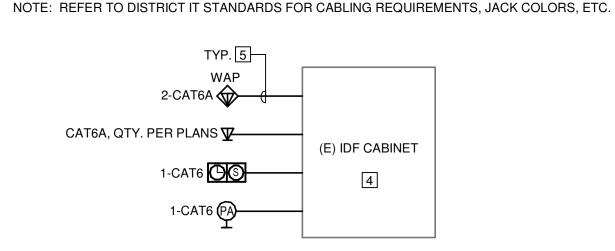

PARTIAL TELECOMMUNICATIONS RISER DIAGRAM SCALE:NTS

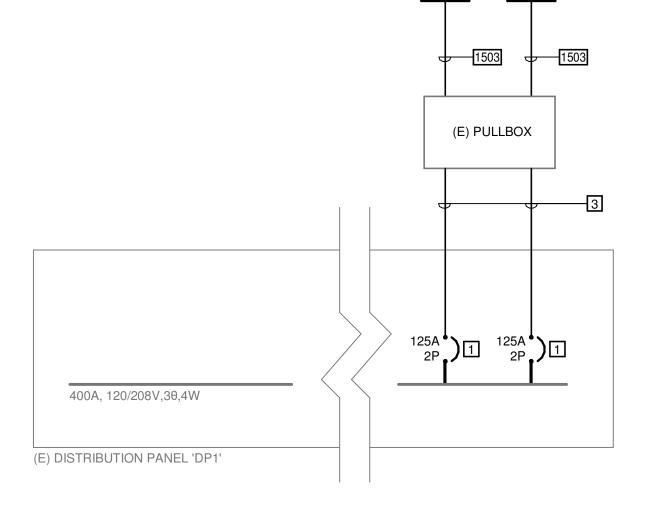

PARTIAL POWER ONE-LINE DIAGRAM SCALE: 12" = 1'-0"

CONSTRI

### GENERAL SHEET NOTES

- A. CALL U.S.A. PRIOR TO UNDERGROUND WORK, 1-800-227-2600. B. CONTRACTOR SHALL VERIFY ALL EXISTING CONDITIONS PRIOR TO COMMENCEMENT OF NEW
- C. PROVIDE A 1/2" MULE TAPE IN ALL EMPTY CONDUITS.
- D. PROVIDE 6-INCH WIDE UNDERGROUND WARNING TAPE ABOVE ALL NEW UNDERGROUND CONDUITS/CABLES. INSTALL AT 12-INCHES ABOVE THE CONDUITS/CABLES. PROVIDE RED TAPE FOR POWER APPLICATIONS. PROVIDE ORANGE TAPE FOR LOW VOLTAGE APPLICATIONS. PROVIDE BOTH RED AND ORANGE TAPES FOR JOINT TRENCH APPLICATIONS.

### NUMBERED SHEET NOTES

- (E) DISTRIBUTION CENTER "DO1" WITH TOTALLY ENCLOSED NON-VENTILATED 112.5KVA TRANSFORMER "T1" AND DISTRIBUTION PANEL "DP1".
- 2 POWER FEEDERS, REFER TO POWER ONE-LINE DIAGRAM FOR CONDUIT AND WIRING
- MOUNT (N) VOICE EVACUATION CONTROL PANEL "AMP" ADJACENT TO (E) FACP. ROUTE CABLING THROUGH EXISTING SITE PATHWAY TO NEW PORTABLES. PROVIDE 120V CONNECTION TO "AMP" FROM EXISTING DEDICATED 120V CIRCUIT USE FOR EXISTING FACP. CONTRACTOR TO PROVIDE LOCKING HARDWARE AND PAINT CIRCUIT BREAKER TRIP HANDLE RED AS REQUIRED.

AGENCY APPROVAL

IDENTIFICATION STAMP DIV. OF THE STATE ARCHITEC APP: 02-121945 INC: REVIEWED FOR SS 🗸 FLS 🗹 ACS 🗸 DATE: 12/12/2023

ARCHITECTS


1715 R STREET, SUITE 200 SACRMENTO, CA 95811 TEL TEL (916) 786-8178

CONSULTANTS

**CONSULTING ENGINEERS** ALAMEDA | AUBURN | LOS ANGELES NEOSHO | SAN DIEGO | SANTA BARBARA

https://www.engent.com

PROFESSIONAL STAMP

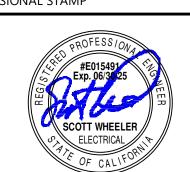

REVISI	ONS	
NO.	DATE	DESCRIPTION
-		
-		
	_	_

THE ARCHITECT DOES NOT REPRESENT THAT THESE PLANS OR THE SPECIFICATIONS ARE SUITABLE FOR ANY SITE OTHER THAN THE ONE FOR WHICH THEY WERE SPECIFICALLY PREPARED. THE ARCHITECT DISCLAIMS RESPONSIBILITY FOR THESE PLANS AND SPECIFICATIONS IF THEY ARE USED IN WHOLE OR IN PART AT ANY OTHER SITE. WRITTEN DIMENSIONS ON THESE DRAWINGS SHALL HAVE PRECEDENCE OVER SCALED DIMENSIONS.

PROJECT OWNER & TITLE LODI UNIFIED SCHOOL DISTRICT 1305 E. Vine St Lodi, CA 95240

233 N Mills Ave Lodi, CA 95242

SHEET TITLE

OVERALL ELECTRICAL SITE PLAN

DRAWN BY: Author JOB NUMBER: 23219

CONSTRUCTION

### GENERAL SHEET NOTES

- A. EXISTING MODULAR BUILDINGS TO BE RELOCATED FROM ANOTHER CAMPUS, REFER TO ARCHITECTURAL AND CIVIL PLANS. EXISTING PANELBOARD, BRANCH CIRCUIT POWER, LIGHTING AND LIGHTING CONTROL TO REMAIN. EXISTING LOW VOLTAGE EQUIPMENT, CABLING, AND DEVICES TO BE REMOVED, PROVIDE NEW DEVICES AND CABLING PER PLANS.
- B. PROVIDE NEW TELECOMMUNICATIONS INFRASTRUCTURE SYSTEM PER DISTRICT STANDARDS AND THE SPECIFICATIONS. COORDINATE WITH THE DISTRICT IT REPRESENTATIVE.
- C. INTRUSION ALARM SYSTEM TO BE INSTALLED BY THE OWNER'S CONTRACTED VENDOR, PROVIDE CONDUIT PATHWAY TO THE NEW PORTABLE BUILDINGS AND COORDINATE AS REQUIRED.

### NUMBERED SHEET NOTES

- REQUIREMENTS.
- 1 POWER FEEDERS, REFER TO POWER ONE-LINE DIAGRAM FOR CONDUIT AND WIRING 2 AT TYPICAL WORKSTATION, PROVIDE PANDUIT T-70 SURFACE RACEWAY WITH DIVIDER TO
- ACCESSIBLE CEILING. PROVIDE PANDUIT WORKSTATION OUTLET CENTER OFFSET BOX,
  T70WC2IW. CONNECT POWER RECEPTACLE TO SPARE 20A CIRCUIT AT EXISTING MODULAR BUILDING LOAD CENTER. TELECOM OUTLET WITH 2-BEIGE JACKS AND 1 BLUE JACK (COMPUTER
- 3 AT MODULAR BUILDING WITH FLUSH, INTERIOR LOAD CENTER; PROVIDE A N3R PULL CAN AT EXTERIOR OF BUILDING AND NIPPLE INTO LOAD CENTER.
- 4 POWER PANEL PROVIDED BY MODULAR BUILDING MANUFACTURER, PROVIDE CONNECTION PER
- 5 EXISTING WALL MOUNTED IDF CABINET.
- 6 PROVIDE CABLING AND INFRASTRUCTURE FOR OWNER FURNISHED CLOCK/PA SPEAKER.
- 7 SLEEVES BETWEEN BUILDINGS FOR LOW VOLTAGE CABLING REFER TO DETAIL 4/E4.1. FOR INSTALLATION.
- 8 GROUND ROD IN GROUND WELL, INSTALL PER 3/E4.1 AND BOND TO MODULAR BUILDING PER
- 9 PROVIDE CABLING AND INFRASTRUCTURE FOR OWNER FURNISHED OUTDOOR PA SPEAKER.

IDENTIFICATION STAMP DIV. OF THE STATE ARCHITECT APP: 02-121945 INC: REVIEWED FOR SS 🗹 FLS 🗹 ACS 🗹 DATE: 12/12/2023

AGENCY APPROVAL


ARCHITECTS

1715 R STREET, SUITE 200 SACRMENTO, CA 95811 TEL TEL (916) 786-8178

CONSULTANTS



PROFESSIONAL STAMP

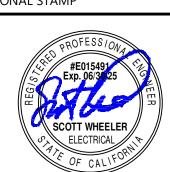

REVISION	S	
NO.	DATE	DESCRIPTION
-		
-		

THE ARCHITECT DOES NOT REPRESENT THAT THESE PLANS OR THE SPECIFICATIONS ARE SUITABLE FOR ANY SITE OTHER THAN THE ONE FOR WHICH THEY WERE SPECIFICALLY PREPARED. THE ARCHITECT DISCLAIMS RESPONSIBILITY FOR THESE PLANS AND SPECIFICATIONS IF THEY ARE USED IN WHOLE OR IN PART AT ANY OTHER SITE. WRITTEN DIMENSIONS ON THESE DRAWINGS SHALL HAVE PRECEDENCE OVER SCALED DIMENSIONS.

PROJECT OWNER & TITLE LODI UNIFIED SCHOOL DISTRICT 1305 E. Vine St Lodi, CA 95240


233 N Mills Ave Lodi, CA 95242

SHEET TITLE

POWER & SIGNAL PLAN

DRAWN BY: Author JOB NUMBER: 23219

CONSTRUCTION

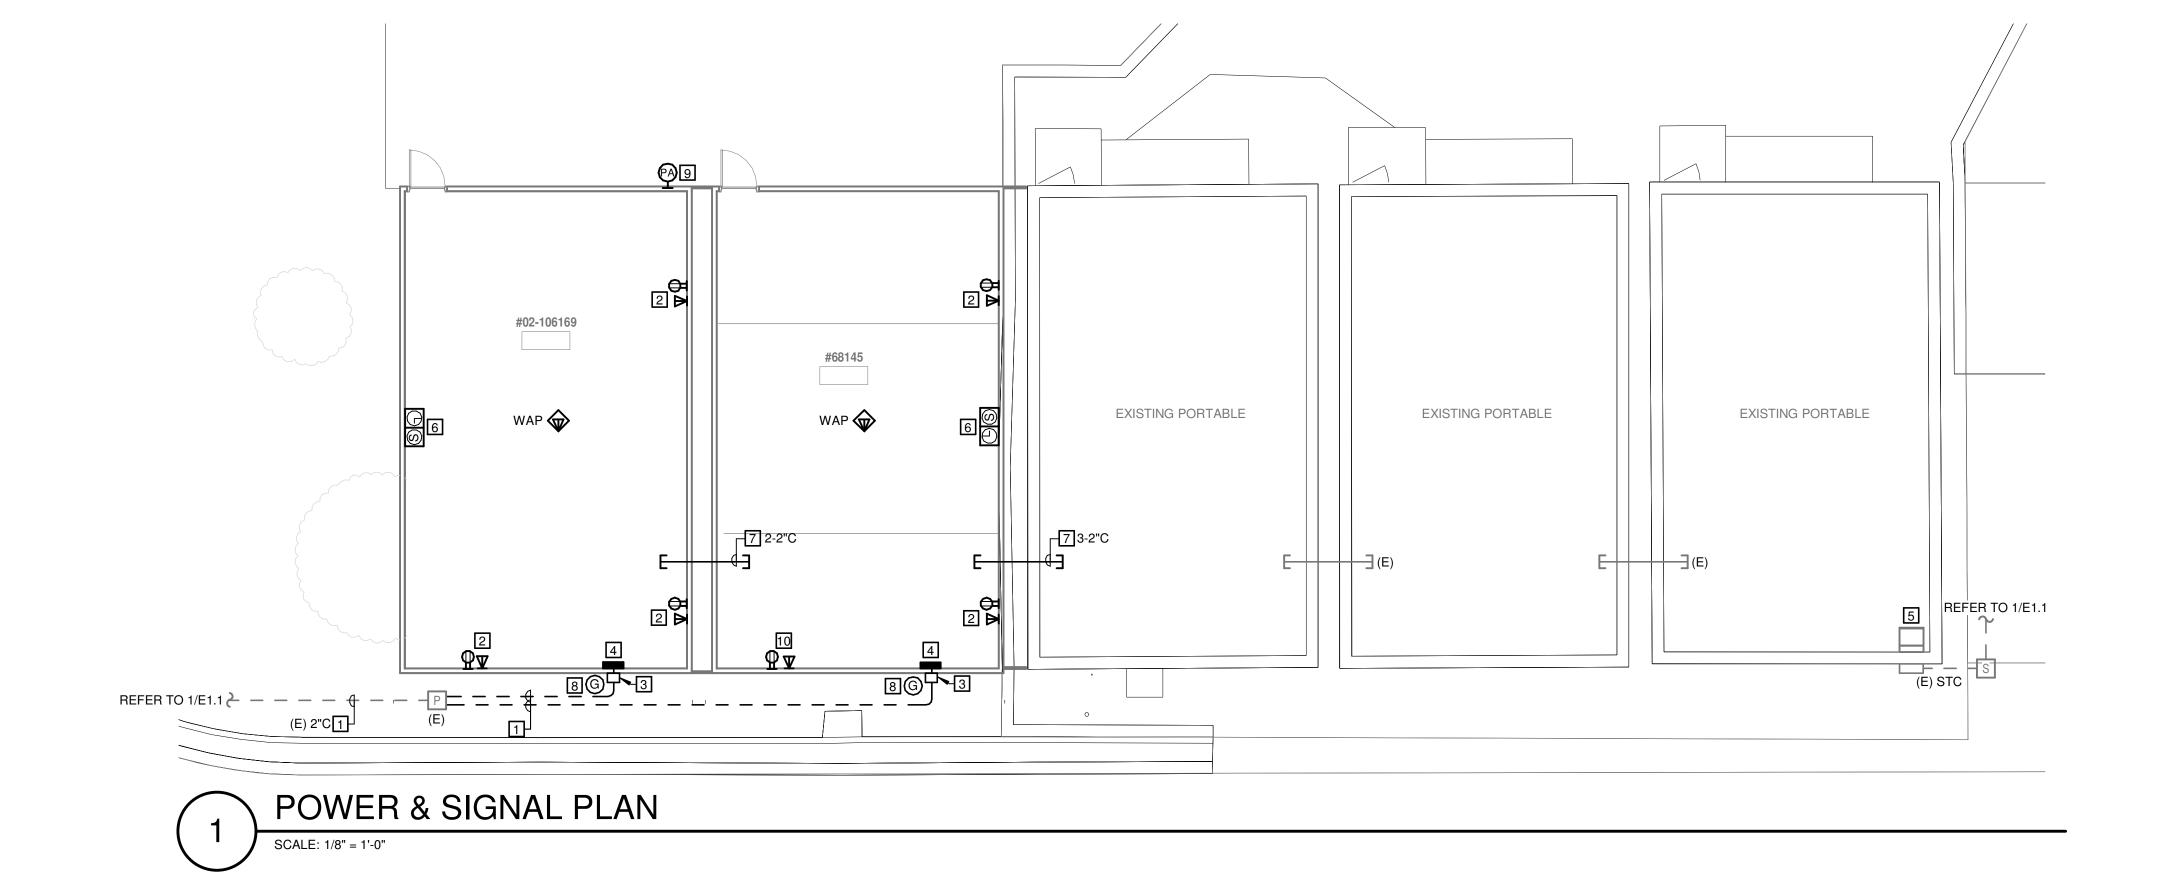

MOUNT DOOR HOLDER SMOKE DETECTOR MAXIMUM 3' FROM DOOR AND A MINIMUM OF 1' FROM DOOR.

2 NFPA 72 17.7.3.2.3.1 ON SMOOTH CEILINGS, SPACING FOR SMOKE DETECTORS SHALL BE IN

2. ALL POINTS ON THE CEILING SHALL HAVE A DETECTOR WITHIN A DISTANCE EQUAL TO

5 DUCT SMOKE DETECTOR SHALL BE MOUNTED 6 TO 10 TIMES THE DIAMETER OF DUCT FROM BEND

6 NFPA 72 17.4.7 WHERE FIRE DETECTORS ARE INSTALLED IN CONCEALED LOCATIONS MORE THAN

OR SUPERVISORY INDICATION ACCEPTABLE WITH AUTHORITY HAVING JURISDICTION (AHJ).

10' AFF OR IN ARRANGMENTS WHERE THE DETECTOR'S ALARM OR SUPERVISORY INDICATOR IS NOT

7 NFPA 72 17.7.3.2.4.2 BEAM POCKET SPOT DETECTOR ARE REQUIRED FOR BEAMS GREATER THAN 18"

BELOW CEILING AND SPACED MORE THAN 8' ON CENTER. EACH BAY FORMED BY BEAM SHALL BE

TREATED AS A SEPARATE AREA. BEAMS LESS THAN 12" IN DEPTH AND SPACED LESS THAN 8' ON

8 NFPA 72 17.6.3.3.1.1 BEAMS PROJECTING LESS THAN 4" SHALL BE TREATED AS A SMOOTH CEILING.

AND 4" MINIMUM TO 12" MAXIMUM FROM CEILING MOUNTED ON WALL.

IS NOT LESS THAN 80" AFF AND NOT GREATER THAN 96" AFF.

17 RATE OF RISE HEAT DETECTOR, MOUNTED IN ABOVE CEILING / ATTIC SPACE.

19 ABOVE CEILING CIRCUITS ROUTING IN AN ACCESSIBLE ATTIC SPACE.

THE TOP OF THE CONTROL PANEL OR KEY BOARDS.

18 APPROVED WIRE MANAGEMENT, ie J-HOOK OR D-RING.

15 CEILING MOUNTED HORN / SPEAKER STROBE

AREAS WHERE FOSSIL FUEL IS USED.

AT CENTRAL AIR HANDLING UNIT.

16 MONITOR MODULE

BOXES SHALL BE LOCATED WITHIN 5' OF EACH EXIT DOORWAY ON EACH FLOOR.

WALL MOUNTED VISIBLE APPLIANCES SHALL BE MOUNTED WITHIN 6" OF THE CEILING.

20 NON-ACCESSIBLE CEILINGS MUST USE EITHER EMT OR APPROVED WIREMOLD RACEWAY, AS

21 MULTI-CRITERIA PHOTOELECTRIC SMOKE / CO DETECTOR WITH SOUNDER BASE. MOUNT IN

24 NFPA 72 7.7.2 WITH EVERY NEW FIRE ALARM SYSTEM A DOCUMENTATION CABINET SHALL BE

25 NFPA 90A 6.4.2.1 SMOKE DETECTORS LISTED FOR USE IN AIR DISTRIBUTION SYSTEMS SHALL BE LOCATED AS FOLLOWS: DOWNSTREAM OF THE AIR FILTERS AND AHEAD OF ANY BRANCH CONNECTIONS IN AIR SUPPLY SYSTEMS HAVING A CAPACITY GREATER THAN 2000 CFM.

THE CABINET SHALL BE PROMINENTLY LABELED "SYSTEM RECORD DOCUMENTS".

#02-106169

PER POWER & SIGNAL PLANS

26 SMOKE DETECTORS SHALL NOT BE CLOSER THAN 1' FROM SPRINKLERS.

23 NFPA 72 17.5.3.1.4 DETECTION FOR CONCEALED ACCESSIBLE SPACES ABOVE SUSPENDED CEILING

INSTALLED AT THE FIRE ALARM CONTROL PANEL OR AT ANOTHER LOCATION APPROVED BY AHJ.

USED AS A RETURN PLENUM SHALL BE PROVIDED AT EACH CONNECTION FROM RETURN AIR PLENUM

9 NFPA 72 17.6.3.1.3.1 SMOKE DETECTORS SHALL BE MOUNTED ON THE CEILING MINIMUM 4" FROM WALL,

10 NFPA 72 17.14.5 THE OPERABLE PART OF A MANUALLY ACTUATED ALARM-INITIATING DEVICE SHALL

NOT BE LESS THAN 42" AFF AND NOT MORE THAN 48" AFF. NFPA 72 17.14.8.4 MANUAL FIRE ALARM

NFPA 72 18.5.5.2 WHERE LOW CEILING HEIGHTS DO NOT PERMIT WALL MOUNTING AT A MINIMUM OF 80",

14 CBC 1117B.0 (3) MOUNT FIRE ALARM CONTROL PANELS AND ANNUNCIATORS AT A MAXIMUM OF 48" TO

VISIBLE TO RESPONDING PERSONNEL. DETECTORS SHALL BE PROVIDED WITH A REMOTE INDICATOR

1. THE DISTANCE BETWEEN SMOKE DETECTORS SHALL NOT EXCEED SPACING OF 30'.

3 NFPA 72 17.7.4.1 MOUNT SMOKE DETECTOR MINIMUM OF 3' AWAY FROM DIFFUSER VENT.

4 MOUNT SMOKE DETECTOR FOR FIRE SMOKE DAMPER (FSD) WITHIN 3' OF SUPPLY VENT.

ACCORDANCE WITH ONE OF THE FOLLOWING REQUIREMENTS:

OR OBSTRUCTION.

SHALL BE LOCATED IN EACH CELL.

SYMBOL	EQUIPMENT DESCRIPTION	MODEL NO.	MANUFACTURER	CSFM LISTING
E) FACP	FIRE ALARM CONTROL PANEL	QS4	EDWARDS	
(N) AMP	SPEAKER AMPLIFIER PANEL	EVAX25	POTTER	6912-1446:0100
E)BPS	NOTIFICATION BOOSTER PANEL	FCPS-24S6	EDWARDS	
IM	ISOLATOR MODULE	SIGA-IM	EDWARDS	7300-1657:012
SM	SINGLE INPUT MONITOR MODULE	SIGA-CT1	EDWARDS	7300-1657:012
2	ADDRESSABLE SMOKE DETECTOR	SIGA-PS	EDWARDS	7272-1657:033
<b></b> AH	CONVENTIONAL HEAT DETECTOR AH = ATTIC HEAT (ie. ABOVE CEILING)	5604	SYSTEM SENSOR	7270-1653:0167
©⊲cd 15/30/75/110	CEILING MOUNTED SPEAKER/STROBE	SPSCRL	SYSTEM SENSOR	7320-1653:050
WP⊡⊲	WEATHERPROOF WALL MOUNTED SPEAKER	SPRK	SYSTEM SENSOR	7320-1653:020

EXISTING PORTABLE

PER POWER & SIGNAL PLANS

B1.2.1

**(**2)1D01

**EXISTING PORTABLE** 

**EXISTING PORTABLE** 

REFER TO 1/E1.1

(E) STC

FIRE ALARM SYSTEM CABLE SCHEDULE							
CABLE TAG	CIRCUIT DESCRIPTION	CABLE TYPE	GAUGE	CONDUCTORS	COLOR		
Α	SIGNAL LINE CIRCUIT (SLC)	FPL	#18	2	RED JACKET		
В	NOTIFICATION APPLIANCE CIRCUIT (NAC)	FPL	#12	2	RED JACKET		
С	CONVENTIONAL SUPERVISED CIRCUIT / 24VDC	FPL	#14	2	RED JACKET		
F	UNDERGROUND SLC	WATER TIGHT	#14	2	BLACK JACKE		
G	UNDERGROUND NAC	WATER TIGHT	#12	2	BLACK JACKE		
Н	UNDERGROUND SPEAKER CIRCUIT	WATER TIGHT SHIELDED	#14	2	BLACK JACKE		
S	SPEAKER CIRCUIT	FPL OVERALL SHIELDED	#14	2	RED JACKET		

- WORK SHALL BE PERFORMED IN ACCORDANCE WITH THE APPLICABLE REGULATIONS, INCLUDING BUT NOT LIMITED TO THE FOLLOWING:
- STATE CALIFORNIA CODE OF REGULATIONS (CCR) 2022 TITLE 24 CALIFORNIA BUILDING CODE
- PART 2, 2022 CALIFORNIA BUILDING CODE (CBC) PART 3, 2022 CALIFORNIA ELECTRICAL CODE (CEC)
- PART 5, 2022 CALIFORNIA PLUMBING CODE (CPC)
- INSTALLATION OF THE SYSTEMS SHALL NOT BE STARTED UNTIL DETAILED DESIGN DOCUMENTATION AND SPECIFICATION, INCLUDING STATE FIRE MARSHALL LISTING SHEETS FOR EACH COMPONENT OF THE
- SHALL BE MADE IN THE PRESENCE OF A DSA PROJECT INSPECTOR.
- FOR INSTALLATION. ANY DISCREPANCIES BETWEEN THE DRAWINGS AND THE CODE OR RECOGNIZED STANDARDS SHALL BE
- BROUGHT TO THE ATTENTION OF DSA AND THE ARCHITECT/ENGINEER OF RECORD.
- PROVIDED WITHIN THE SPECIFICATION WITHIN THE FIRE ALARM SECTION. AUDIBLE DEVICES SHALL PROVIDE A SOUND PRESSURE LEVEL OF 15 DECIBLES (Dba) ABOVE THE AVERAGE AMBIENT SOUND LEVEL OR 5 Dba ABOVE THE MAXIMUM SOUND LEVEL HAVING A DURATION AT
- AUDIBLE DEVICES SHALL BE SYNCHRONIZED TEMPORAL CODE 3 PATTERN.
- D. THE CONTRACTOR SHALL ADJUST/INSTALL DEVICES TO MAXIMIZE PERFORMANCE AND TO MINIMIZE
- VISUAL DEVICES SHOULD NOT EXCEED 2 FLASHES PER SECOND AND SHOULD NOT BE SLOWER THAN 1 FLASH EVERY SECOND. THE DEVICE SHALL HAVE A PULSING LIGHT SOURCE NOT LESS THAN 15 CANDELA.
- 12. UNDERGROUND AND EXTERIOR CONDUIT SHALL HAVE WATERTIGHT FITTINGS AND WIRE TO BE
- 13. ALL FIRE ALARM WIRING SHALL BE FPL (FIRE POWER LIMITED) OR FPLP (FIRE POWER LIMITED
- 4. PER CEC STANDARDS, ALL WIRING IS TO BE PULLED THROUGH EACH JUNCTION BOX AND CONNECTED DIRECTLY TO EACH FIRE DEVICE. DO NOT SPLICE THE WIRE. ALL BOXES TO BE SIZED PER CEC.
- 5. IN AREA OF CONSTRUCTION OR POSSIBLE DAMAGE/CONTAMINATION OF NEWLY INSTALLED
- FIRE ALARM DEVICES SHALL BE COVERED UNTIL AREA IS READY TO BE TURNED OVER TO THE OWNER. 6. ALL FIRE ALARM CIRCUITS ARE TO BE IN CONDUIT, SURFACE RACEWAY OR OPEN RUN ABOVE THE
- FIRE ALARM PANEL, REMOTES, AND COMPONENTS SHALL BE SECURED TO MOUNTING SURFACES PER MANUFACTURERS SPECIFICATIONS. NO DEVICE SHALL EXCEED THE WEIGHT OF 20 LBS. WITHOUT
- . A DEDICATED BRANCH CIRCUIT SHALL BE PROVIDED FOR FIRE ALARM EQUIPMENT. THIS CIRCUIT SHALL BE ENERGIZED FROM A COMMON USE AREA PANEL AND SHALL HAVE NO OTHER OUTLETS. THE BREAKER SHALL HAVE A RED LOCKING DEVICE TO BLOCK THE HANDLE IN THE "ON" POSITION. THE
- 20. CONTROL PANELS, REMOTE ANNUNCIATORS SHALL BE MOUNTED WITH THE TOP OF THE CONTROL
- THE INSTALLING CONTRACTOR SHALL PROVIDE SYSTEM PROGRAMMING FOR SUPERVISORY
- 22. SUPERVISORY MONITORING SHALL BE TESTED AND VERIFIED AS SENDING CORRECT SIGNALS IN
- 23. OWNER SHALL BE RESPONSIBLE FOR ESTABLISHING A FIRE SYSTEM MONITORING CONTRACT OR
- 760 AND 2022 CALIFORNIA FIRE CODE (CFC) SECTION 907.
- 26. UPON COMPLETION OF THE INSTALLATION OF THE FIRE ALARM SYSTEM, A SATISFACTORY TEST OF
- THE SYSTEM SHALL BE MADE IN THE PRESENCE OF THE DSA PROJECT INSPECTOR.
- 28. AUTOMATIC FIRE ALARM SYSTEM SHALL TRANSMIT THE ALARM, SUPERVISORY AND TROUBLE SIGNALS TO AN APPROVED SUPERVISING STATION AS REQUIRED BY NFPA 72 AND CBC 907.6.5.2. THE SUPERVISING STATION SHALL BE LISTED AS EITHER UUFX OR UUIS BY UL OR SHALL MEET THE

FIRE ALARM SYSTEM DESCRIPTION

SCOPE OF THIS PROJECT IS TO EXTEND EXISTING FIRE ALARM SYSTEM TO NEW CLASSROOM BUILDINGS. PROVIDE NEW VOICE EVACUATION, NOTIFICATION APPLIANCES, INITATION DEVICES, WIRING, AND BACK BOXES.

FIRE ALARM SYSTEM: CLASS B IDC: CLASS B SLC CIRCUIT: CLASS B NOTIFICATION CIRCUIT: CLASS B

### **GENERAL SHEET NOTES**

- A. FIRE ALARM CIRCUITS AND CIRCUIT ROUTING ARE SHOW SCHEMATICALLY FOR CLARITY ILLUSTRATING THE WIRING CONFIGURATION NECESSARY FOR PROPER SUPERVISION.
- B. FIRE ALARM STROBES SHALL BE SYNCHRONIZED PER NFPA 72.
- C. ALL OUTDOOR FIRE ALARM EQUIPMENT SHALL BE LISTED FOR EXTERIOR USE.
- D. DO NOT INSTALL FIRE ALARM DEVICES BACK TO BACK IN STUD WALLS.
- E. IN AREAS WHERE DEVICES ARE TO BE CEILING MOUNTED COORDINATE LOCATIONS TO AVOID CONFLICTS WITH EXISTING LIGHT FIXTURES.
- F. FIRE ALARM INSTALLATION SHALL COMPLY WITH ALL REQUIREMENTS OF APPLICABLE CODES, STANDARDS AND STATE REGULATIONS.

### NUMBERED SHEET NOTES

PART 4, 2022 CALIFORNIA MECHANICAL CODE (CMC)

PART 9, 2022 CALIFORNIA FIRE CODE (CFC)

2022 NATIONAL FIRE PROTECTION ASSOCIATION (NFPA) 13 &72. 2019 NFPA 80. 2018 NFPA 90A. 2021

SYSTEM HAS BEEN APPROVED BY DSA. UPON COMPLETION OF INSTALLATION OF THE SYSTEMS, A SATISFACTORY TEST OF THE ENTIRE SYSTEM

A STAMPED SET OF APPROVED FIRE ALARM DESIGN DOCUMENTS SHALL BE ON THE JOB SITE AND USED

DSA, ARCHITECT/ENGINEER AND OWNER SHALL BE NOTIFIED A MINIMUM OF 48 HOURS PRIOR TO THE FINAL INSPECTION AND/ OR TESTING.

ALL PENETRATIONS THROUGH RATED ASSEMBLIES, REQUIRING OPENING PROTECTION SHALL BE

LEAST 60 SECONDS, WHICHEVER IS GREATER, IN EVERY OCCUPIED SPACE WITHIN THE BUILDING.

VISUAL DEVICES WITHIN 55' FROM EACH OTHER SHALL BE SYNCHRONIZED.

APPROVED FOR WET LOCATIONS.

PLENUM) AS REQUIRED FOR APPLICATION. WIRING IN CONDUIT ABOVE GROUND MAY BE THHN OR THWN.

CEILINGS, UNDER FLOORS AND IN WALLS IN A NEAT AND PROTECTED MANOR AS INDICATED ON THE DESIGN DOCUMENTS. EXPOSED CIRCUITS ARE ONLY PERMITTED WHEN NOTED AS EXPOSED ON DESIGN

SPECIAL MOUNTING DETAILS.

CIRCUIT BREAKER SHALL BE LABELED "FIRE ALARM CIRCUIT CONTROL". CIRCUIT ID TO BE LABELED AT FIRE PANEL/EXPANDERS.

9. THE INSTALLER CONTRACTOR SHALL PROVIDE A RECORD OF COMPLETION PER NFPA 72, FIGURE

DEVICE OR KEYPAD TO BE A MAXIMUM OF 48".

MONITORING PER CBC SECTION 901.6.2.

CONJUNCTION WITH FINAL ACCEPTANCE TEST.

24. THE FIRE ALARM SYSTEM SHALL CONFORM TO 2022 CALIFORNIA ELECTRICAL CODE (CEC) ARTICLE

5. BEFORE REQUESTING FINAL APPROVAL OF THE INSTALLATION THE INSTALLING CONTRACTOR SHALL FURNISH A WRITTEN STATEMENT TO THE DSA PROJECT INSPECTOR TO THE EFFECT THAT THE SYSTEM HAS BEEN INSTALLED AND TESTED IN ACCORDANCE WITH THE 2019 NFPA 72 SECTION 14.4.1

7. PROVIDE A RECORD OF COMPLETION PER NFPA 72 CHAPTER 7.5.6.

REQUIREMENTS OF FM STANDARDS 3011.

29. TEST, INSPECTION AND MAINTENANCE SHALL COMPLY WITH NFPA 72 CHAPTER 14 REQUIREMENTS. 30. EACH BUILDING TO BE A SEPARATE SPEAKER ZONE. (CFC 907.63).

PROFESSIONAL STAMP

ALAMEDA | AUBURN | LOS ANGELES

NEOSHO | SAN DIEGO | SANTA BARBARA

https://www.engent.com

AGENCY APPROVAL

IDENTIFICATION STAMP DIV. OF THE STATE ARCHITE

REVIEWED FOR

SS 🗹 FLS 🗹 ACS 🗹

APP: 02-121945 INC:

DATE: 12/12/2023

ARCHITECTS

1715 R STREET, SUITE 200

SACRMENTO, CA 95811

TEL TEL (916) 786-8178

CONSULTANTS

DESCRIPTION

THE ARCHITECT DOES NOT REPRESENT THAT THESE PLANS OR THE SPECIFICATIONS ARE SUITABLE FOR ANY SITE OTHER THAN THE ONE FOR WHICH THEY WERE SPECIFICALLY PREPARED. THE ARCHITECT DISCLAIMS RESPONSIBILITY FOR THESE PLANS AND SPECIFICATIONS IF THEY ARE USED IN WHOLE OR IN PART AT ANY OTHER SITE. WRITTEN DIMENSIONS ON THESE DRAWINGS SHALL HAVE PRECEDENCE OVER SCALED DIMENSIONS.

PROJECT OWNER & TITLE **LODI UNIFIED SCHOOL DISTRICT** 1305 E. Vine St Lodi, CA 95240

233 N Mills Ave


Lodi, CA 95242 SHEET TITLE

FIRE ALARM DETAILS, SCHEDULES &


JOB NUMBER: 23219 DRAWN BY: Author


DATE: DECEMBER 12, 2023

FIRE ALARM PLAN SCALE: 1/8" = 1'-0"

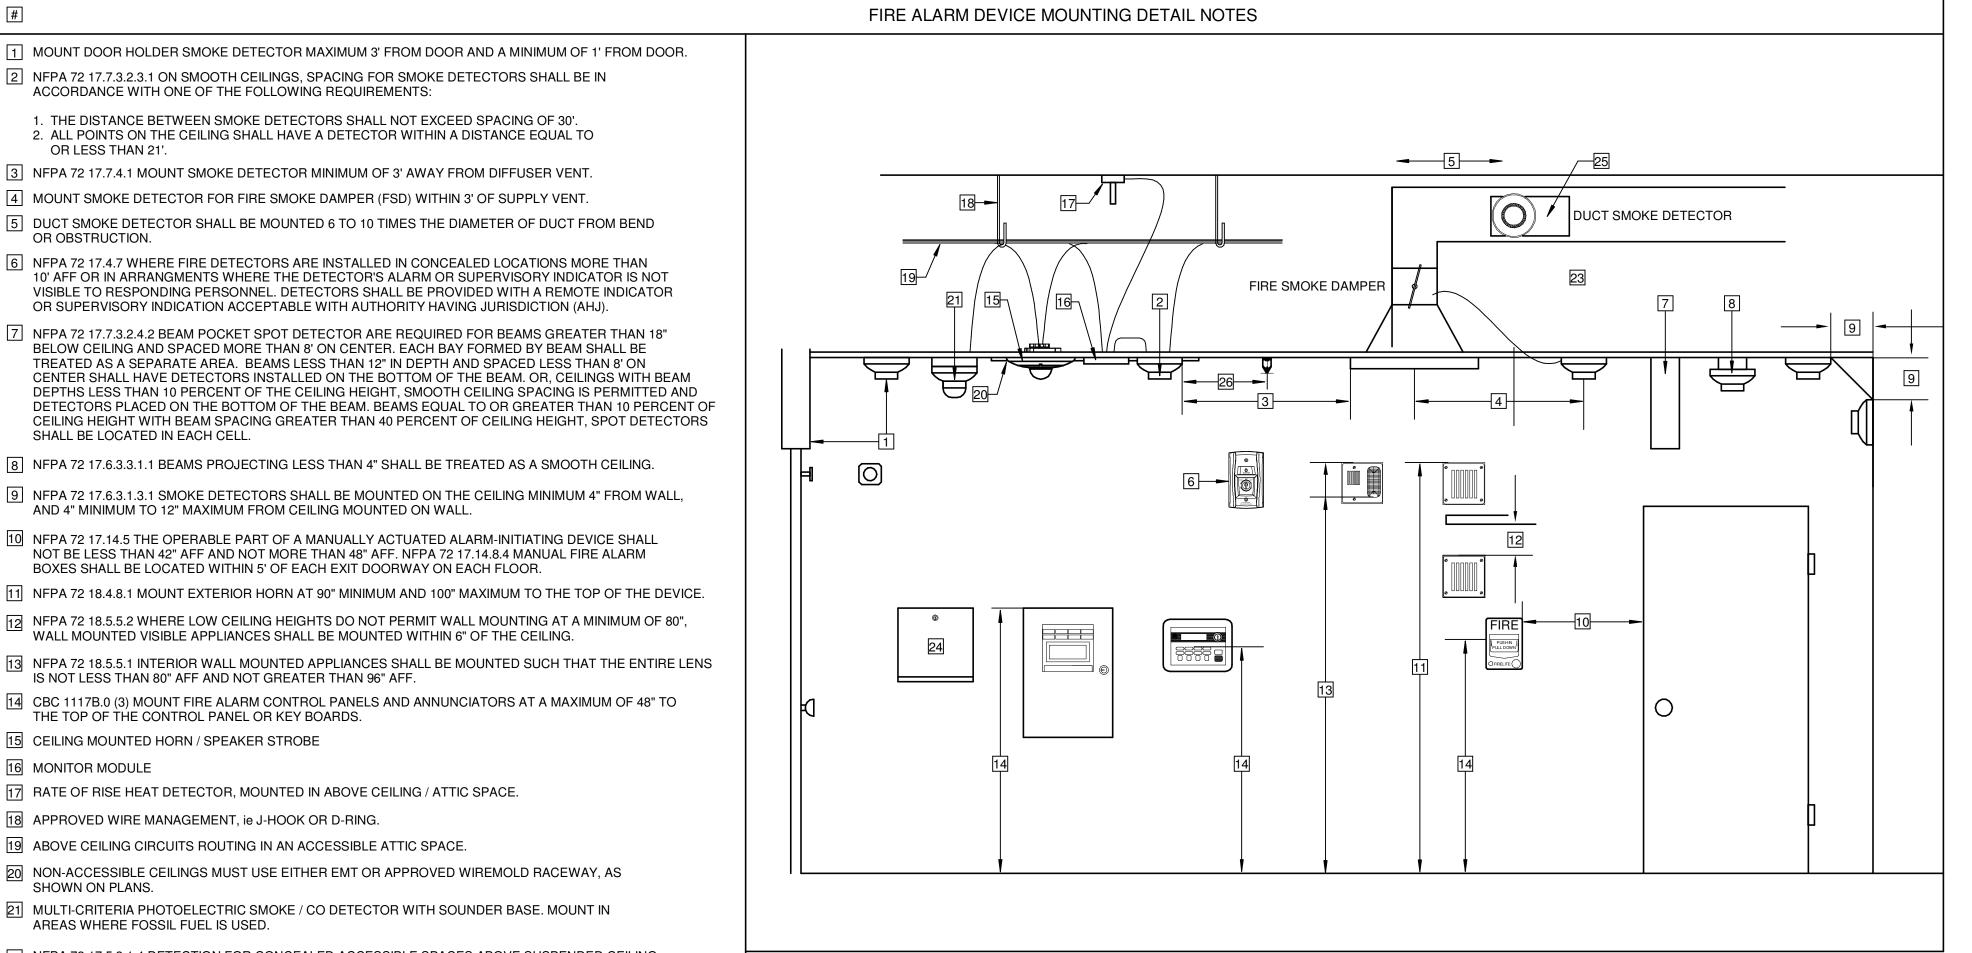

		Standb	y Cu	rrent (amps)			Alar	m C	urrent (amp	s)	
Device Type	QTY	Watts	Cu	rrent Draw		Total	Qty	Cu	rrent Draw		Total
1. System											
EVAX 25	1	25	X	0.0860	=	0.0860	0	Х	2.2060	=	2.2060
			X		=		0	X		=	0.0000
			X		=		0	X		=	0.0000
2. Speakers											
Total Speaker Watts	@ 25Vrms	0	(C) (C)						0.0000	=	0.0000
Total Speaker Watts	@ 70.7Vrms	4	(4) 2						0.0566	=	0.0566
		To	tal S	Standby Loa	ıd	0.0860		Tot	al Alarm Lo	ad	2.2626
				0	12.44		12.400				
				100 000 000			Req	uire	d Standby T	ime i	in Hours
Standby Load Curre	nt (Amps)			0.08	60 A	mps	X		24	=	2.064 AF
							Req	uire	d Alarm Tim	e in l	Hours
Alarm Load Current	(Amps)			2.26	26 A	mps	Х		15	=	0.566 AH
							T	otal	Current Lo	ad	2.63 Al
						*Multiply	by the	Der	ating Factor	=	x 0.25
						Total Am	pere l	lour	s Required		3.29 AH
				Recomme	nded	d Batteries			7AH BAT	<b>TERI</b>	ES

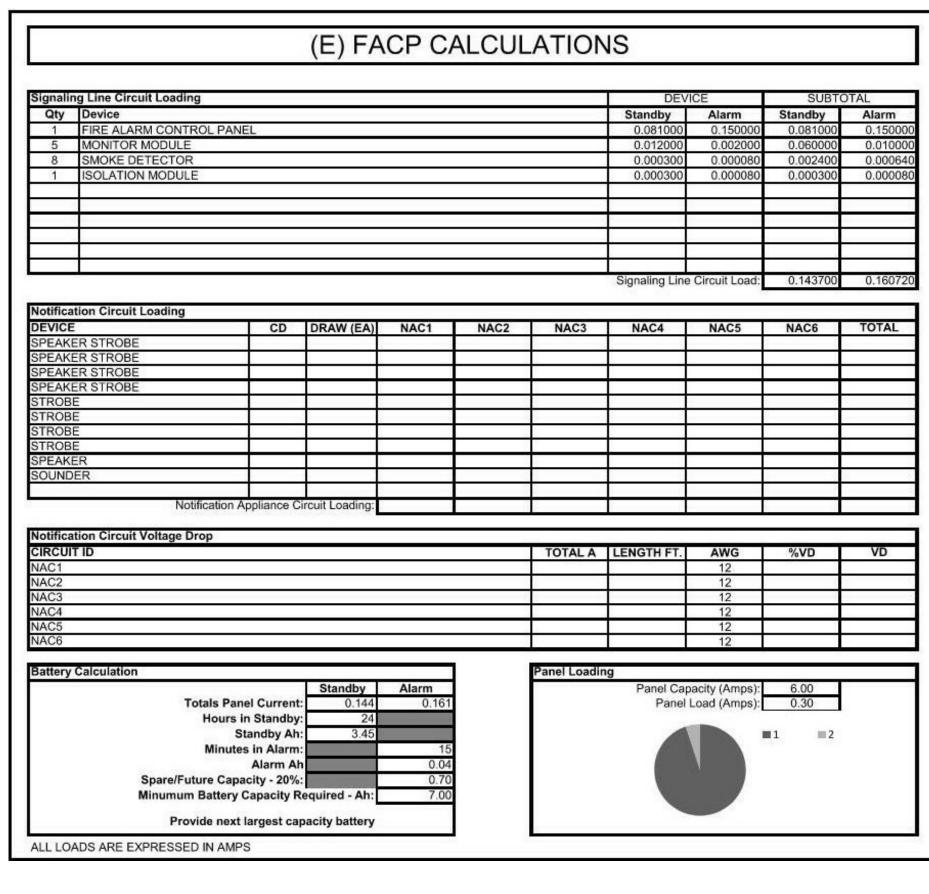

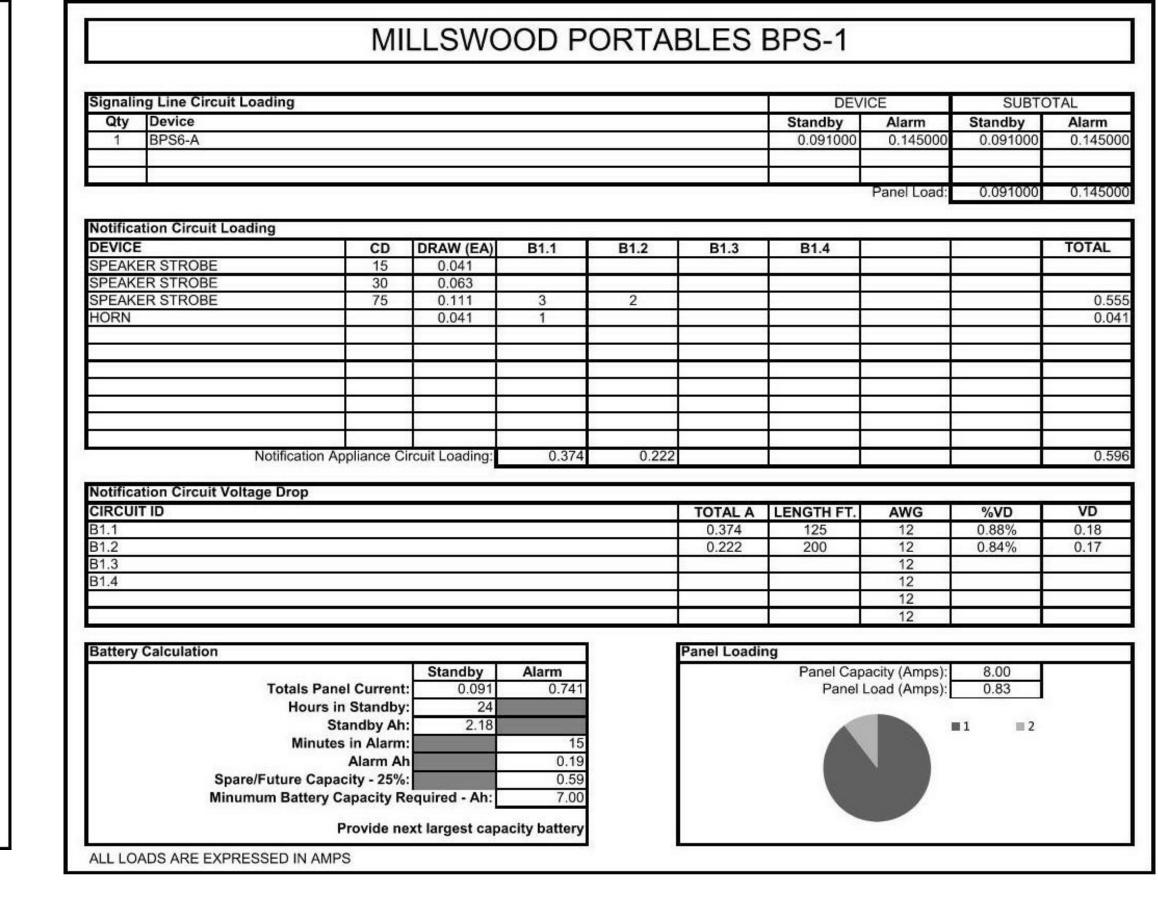



CONSULTANTS


AGENCY APPROVAL

IDENTIFICATION STAMP DIV. OF THE STATE ARCHITECT

APP: 02-121945 INC:



PROFESSIONAL STAMP

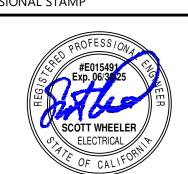

REVISI	ONS	
NO.	DATE	DESCRIPTION
-		
-		
	ARCHITECT DOES NO	OT REPRESENT THAT ECIFICATIONS ARE

THE ARCHITECT DOES NOT REFRESENT THAT
THESE PLANS OR THE SPECIFICATIONS ARE
SUITABLE FOR ANY SITE OTHER THAN THE ONE
FOR WHICH THEY WERE SPECIFICALLY
PREPARED. THE ARCHITECT DISCLAIMS
RESPONSIBILITY FOR THESE PLANS AND
SPECIFICATIONS IF THEY ARE USED IN WHOLE OR
IN PART AT ANY OTHER SITE. WRITTEN
DIMENSIONS ON THESE DRAWINGS SHALL HAVE
PRECEDENCE OVER SCALED DIMENSIONS.

PROJECT OWNER & TITLE

LODI UNIFIED SCHOOL DISTRICT

1305 E. Vine St
Lodi, CA 95240

233 N Mills Ave Lodi, CA 95242


SHEET TITLE

FIRE ALARM RISER DIAGRAM & CALCULATIONS


DRAWN BY: Author JOB NUMBER: 23219

3.2

DATE: DECEMBER 12, 2023

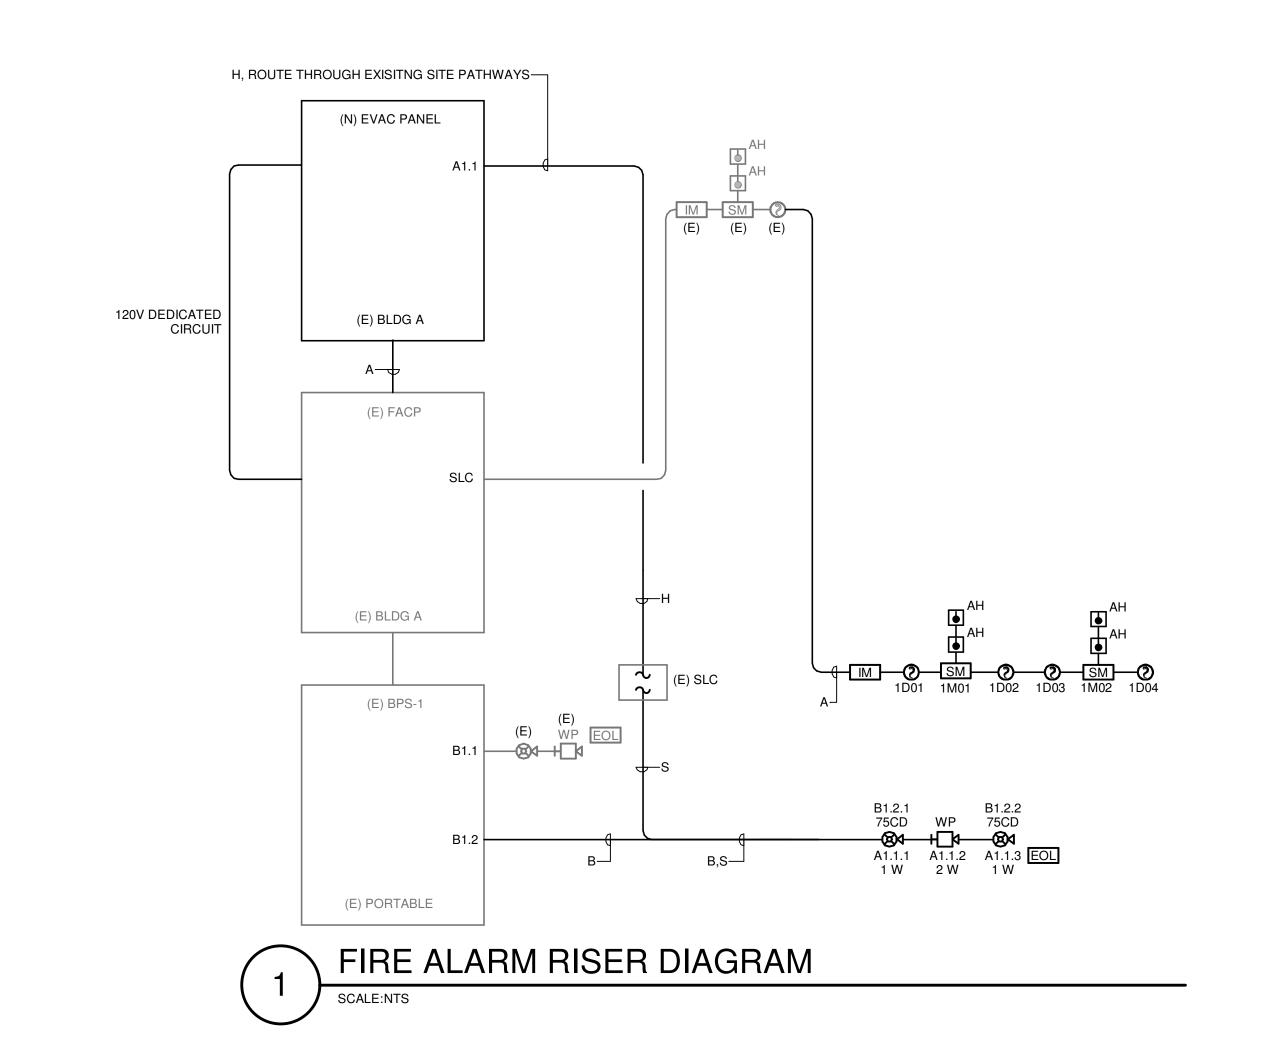


CONSTRUCTION DOCUMENTS

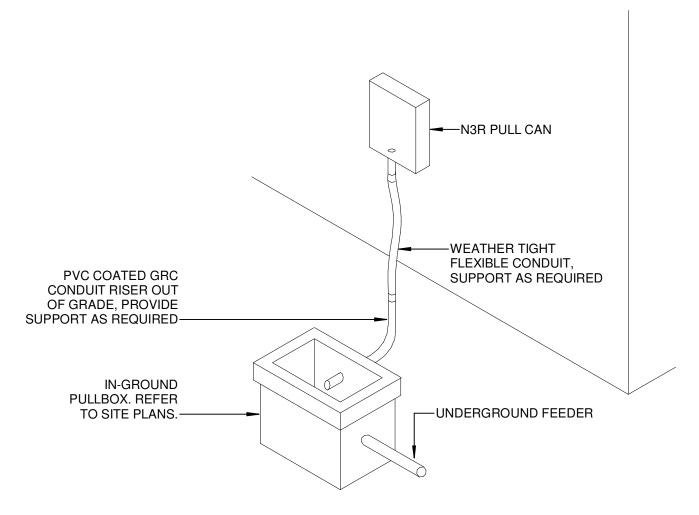



NOTE: COORDINATE PANEL LOCATION WITH EXISTING CONDITIONS FOR PLACEMENT OF IN-GROUND PULLBOX TO ENSURE MINIMAL ABOVE-GROUND RISER.



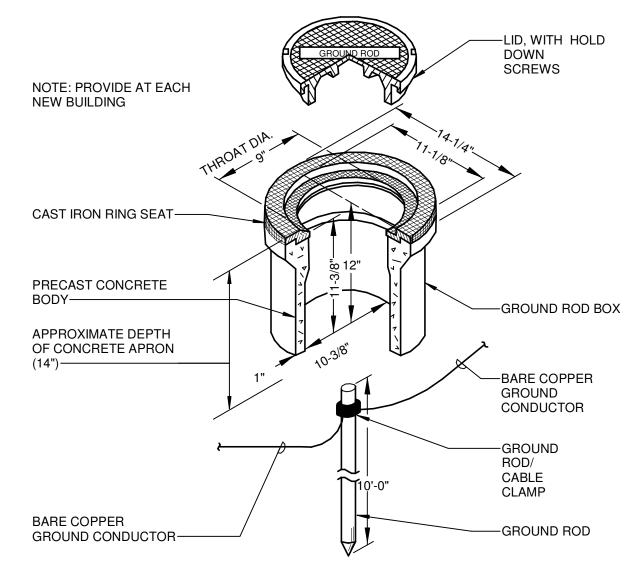

GROUND ROD INSTALLATION SCALE: NTS

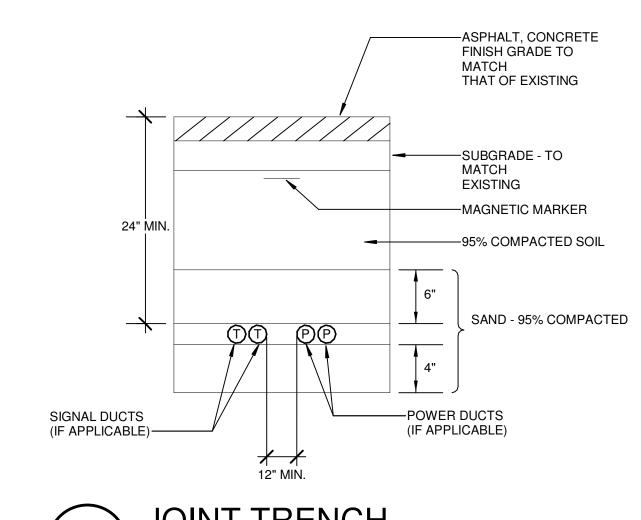

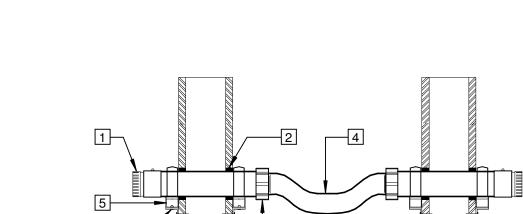

**DETAIL NOTES**: 1 PLASTIC BUSHING ON SET-SCREW CONNECTOR 2 CAULKING ACCORDING TO FIRE RATING, TYPICAL. PACK 1-HOUR RATED MINERAL WOOL IN CONDUIT SLEEVE.

WATER-TIGHT CONNECTORS IN ACCORDANCE WITH SPECIFICATIONS 4 WATER-TIGHT FLEXIBLE CONDUIT WITH ENOUGH SLACK TO ALLOW BUILDING TO MOVE 12" WITHOUT


OVER STRESSING CONDUIT. REFER TO PLANS FOR CONDUIT SIZES AND QUANTITY.

5 CHANNEL STRUT BOLTED TO HEAVY ELL BRACKET 3/8" X 1-1/2" MACHINE BOLT WITH WASHERS BOTH

SIDES AND HEX NUT 7 3/8" LAG SCREW, MIN. 2-1/2" EMBED

8 EXTERIOR OF BUILDING 9 DROP CEILING INSIDE BUILDING

CONDUIT PENETRATION BETWEEN PORTABLES SCALE: 12" = 1'-0"

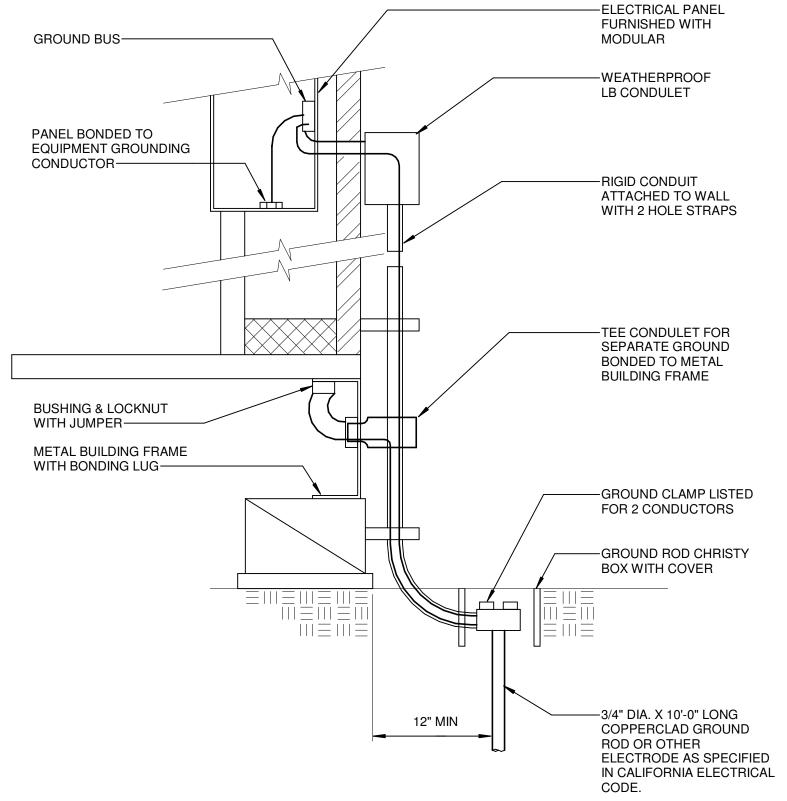

### NOTES:

- 1. SIZE OF CONDUCTORS SHALL COMPLY WITH C.E.C. TABLE 250-66.
- 2. BOND SEPARATE CONDUCTORS FROM GROUND ROD TO GROUNDING POINT IN ELECTRICAL PANEL AND TO METAL BUILDING FRAME IF APPLICABLE. BOND THE ELECTRICAL GROUND TO THE METAL WATER PIPE EMBEDDED AT LEAST 10 FT. INTO THE SOIL (C.E.C. 250-52)
- 3. ALL MODULES OF METAL FRAME BUILDINGS SHALL BE ELECTRICALLY BONDED TOGETHER (BOLTING ONLY IS NOT ACCEPTABLE). USING #8 AWG CU.
- 4. CHECK RESISTANCE TO GROUND. IF RESISTANCE EXCEEDS 25 OHMS, INSTALL ADDITIONAL GROUND RODS WITH CONDUCTORS AS SHOWN, SEPARATED AT LEAST 6'-0" UNTIL RESISTANCE IS REDUCED TO 25 OHMS OR
- LESS (C.E.C. 250-53). 5. TESTS SHALL BE CONDUCTED IN THE PRESENCE OF THE PROJECT INSPECTOR.



TYP. GROUNDING FOR MODULAR CLASSROOMS

ARCHITECTS

IDENTIFICATION STAMP DIV. OF THE STATE ARCHITE

REVIEWED FOR SS 🗹 FLS 🗹 ACS 🗹

APP: 02-121945 INC:

AGENCY APPROVAL


1715 R STREET, SUITE 200 SACRMENTO, CA 95811 TEL TEL (916) 786-8178

CONSULTANTS

**CONSULTING ENGINEERS** ALAMEDA | AUBURN | LOS ANGELES NEOSHO | SAN DIEGO | SANTA BARBARA

https://www.engent.com

PROFESSIONAL STAMP

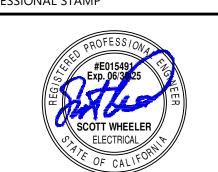

REVISION AND THE PROPERTY OF T	ONS	
NO.	DATE	DESCRIPTION
-		
-		
	·	

THE ARCHITECT DOES NOT REPRESENT THAT THESE PLANS OR THE SPECIFICATIONS ARE SUITABLE FOR ANY SITE OTHER THAN THE ONE FOR WHICH THEY WERE SPECIFICALLY PREPARED. THE ARCHITECT DISCLAIMS RESPONSIBILITY FOR THESE PLANS AND SPECIFICATIONS IF THEY ARE USED IN WHOLE OR IN PART AT ANY OTHER SITE. WRITTEN DIMENSIONS ON THESE DRAWINGS SHALL HAVE PRECEDENCE OVER SCALED DIMENSIONS.

PROJECT OWNER & TITLE LODI UNIFIED SCHOOL DISTRICT 1305 E. Vine St Lodi, CA 95240

233 N Mills Ave Lodi, CA 95242

SHEET TITLE

**ELECTRICAL DETAILS** 

DRAWN BY: Author JOB NUMBER: 23219

CONSTRUCTION

# 24 X 40 RELOCATABLE CLASSROOMS

# TEST AND INSPECTION LIST

TESTING LABORATORY:				DAIE: _			DEPT. O	e of Calfornia f general serv vision of the	
NAME:								ATE ARCHITECT	
DISTRICT/OWNER:	·			<u>,,,,</u>		·	SI	RUCTURAL	
							•	TESTS	
DMSION-FILE NO.		APPLICA	MON NO.	-			,	AND	
ARCHITECT:							. IN	INSPECTIONS	
STRUCTURAL ENGINEER:							ORS	103-1 (R 11/8	
he following tests and inspections, as the				,	7				
COMPACTED FILL	CON- CRETE	GUNITE	GROUT	MORTA					
FIII moterial, ecceptance tests					Test of	eggregates for	mbs deelan enty		
Compaction control, continuous					Sultablik	y tooto of eagre	ogates as detailed be	low	
Compection tests only an cocared					Mix deal				
Bearing capacity of compacted fill	-	<b> </b>			Continue	we batch plant	Inepection		
REINFORCING STEEL	_	<b> </b>	-		inesest.	pleaking			
Sample and test bar steel		<del> </del>	-		Somele				
Semple and test mesh	-  <del> -</del> X-				1	olve teste			
Inspect placing at lob	-	<del> </del>	-						
STRUCTURAL STEEL	_	<del> </del>			1	delivered to let remple forme to			
Sample and test as detailed below	_	<del>                                     </del>	-			and test comen			
Shop febrication inspection	-			CON	RETE				
Field erection inepection	SUITA	BILITY T	ESIS	MATE	WLS .	GUNITE	MORTAR	GROUT	
Inspection of weide - Shep		um autohat							
Inspection of wolds - Field Inspection of rhyting or beiling - Shop	1	Structural strength							
Inspection of riveting or bolting - Field	1	Angeles re	er method)			-			
Sample and test high strength bolts and washers	1	thity tools							
BRICK AND BLOCK		ne change							
Sample and test	MIX C	ESIGNS	: CONCR	ETE. GR	OUT. N	ORTAR OR	GUNITE		
Tool only								ENGTH, PSI, MINIMUM	
Inspection of placing	MATER	HAL	MAXIMUM S	1ZE 28	DAYS				
Core drill samples	CONCR	ETE	1 1/2	30					
GLUED LAMINATED STRUCTURAL LUMBER									
Fabrication inspection			·						
Sample and test steel accessories	_								
Inspect febrication of steel eccessories							<u> </u>		
į .			members to						
0740.0							BEEN PROF		
C7X9.8							D TEST REP	ORTS	
C12X20.7	PER 1	TITLE 2	24, C.C.	R., SE	CTION	l 2212.A.	1		
6 3/4"X14 GA. JOISTS				•		•			
2"x18 ga. STRAPS	*			***		·			
Other Teets and inspections, together with special inst	ructions:				DC1 /0		of Reports to:		
GROUNDING TEST					DSA/C	CAN MODUL	AR SYSTEMS,	INC.	
EXPANSION ANCHORS	SCHOOL DISTRICT								
					ARCHII	FCI			
				}					
·									
			*	ì					
•				Į.	Bv:				

## INDEX DESCRIPTION SHEET No.

	TS-1.1	TITLE & BUILDING DATA NOTES
	N-1	GENERAL NOTES
	1	FLOOR PLAN & NOTES
	2	EXTERIOR ELEVATIONS
	3	CEILING GRID, DETAILS & NOTES
	S1	FOUNDATION PLAN WOOD, DETAILS & NOTES 50# (APPLIES TO UNITS 97-R286-017 AND 97-R286-018 ONLY)
	-S1A	FOUNDATION PLAN WOOD, DETAILS & NOTES 125#
	<del>-S1B</del>	FOUNDATION PLAN CONCRETE, DETAILS & NOTE 50#
	<del>-\$10</del>	FOUNDATION PLAN CONCRETE, DETAILS & NOTE 125#S
	<del>S1D</del>	FOUNDATION BELOW GR. CONCRETE, DETAILS & NOTES 50#
4	<del>-\$1</del> E	FOUNDATION BELOW CR. CONCRETE, DETAILS & NOTES 125#
	S2	FLOOR FRAMING PLAN & BUILDING SECTIONS
	-S2A	
	S2B	BUILDING SECTIONS AND WALL DETAILS
	<b>S3</b>	ROOF FRAMING PLAN & DETAILS
	S4	FRAMING ELEVATIONS & DETAILS
	S5R.1	RAMP PLAN, ELEVATION & DETAILS
F	M1	MECHANICAL PLAN, DETAILS & NOTES
	E1	ELECTRICAL PLAN, DETAILS & NOTES

# BUILDING DATA CLASSROOMS

21 LBS/SQ FT

100 LBS/SQ FT

FLOOR LIVE LOAD

50 LBS/SQ FT OR 125 LBS./SQ. FT.

ROOF LIVE LOAD

20 LBS/SQ FT (REDUCIBLE)

BUILDING AREA

RAMP LIVE LOAD

960 SQ FT

FIRE MARSHAL- CALIFORNIA BUILDING CODE (CBC)

STRUCTURAL - 1995 CALIFORNIA BUILDING CODE (CBC)

TITLES 24 PARTS 1 AND 2

MODULES

MOMENT-RESISTANT

SYSTEM

SEISMIC


(2) 12' X 40' MODULES

FOUNDATION

PRESSURE TREATED WOOD OR CONCRETE

ZONE 4

39-50
APPROVED
DIV. OF THE STATE ARCHITECT
OFFICE OF REGULATION SERVICES

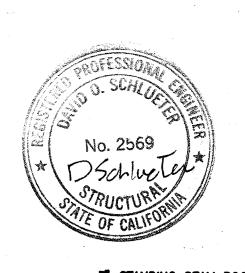

3" STANDING SEAM ROOF

	IDENTIFICATION STAMP OF THE STATE ARCHITECT OF REGULATION SERVICES
	APPL. PC 328
OAT	E 4/9/97
	JOB NO.
l	DATE: APRIL 8,1997
ľ	SHEET NUMBER

BINDING ORDER

TS-1.1

PROJECT OWNER & TITLE **LODI UNIFIED SCHOOL DISTRICT** 1305 E. Vine St

THESE PLANS OR THE SPECIFICATIONS ARE SUITABLE FOR ANY SITE OTHER THAN THE ONE

SPECIFICATIONS IF THEY ARE USED IN WHOLE OR

DIMENSIONS ON THESE DRAWINGS SHALL HAVE PRECEDENCE OVER SCALED DIMENSIONS.

FOR WHICH THEY WERE SPECIFICALLY PREPARED. THE ARCHITECT DISCLAIMS RESPONSIBILITY FOR THESE PLANS AND

IN PART AT ANY OTHER SITE. WRITTEN

DESCRIPTION

Lodi, CA 95240

PROFESSIONAL STAMP

MILLSWOOD MIDDLE SCHOOL PORTABLES RELOCATION

233 N Mills Ave Lodi, CA 95242

SHEET TITLE

TITLE & BUILDING DATA NOTES

DRAWN BY: XXXXXX JOB NUMBER: 23219

TS-1.1

GENERAL NOTES AND SPECIFICATIONS SECTION 1A 1. GENERAL A. THE REQUIREMENTS OF THE GENERAL CONDITIONS OF THE AGREEMENT AND THIS GENERAL REQUIREMENT APPLY TO THE SEVERAL TRADE SECTIONS WITH THE SAME FORCE AS THOUGH FULLY REPEATED IN EACH TRADE SECTION. B. NAME BRANDS ARE INDICATED TO ESTABLISH A STANDARD OF QUALITY. ITEMS OF EQUAL OR BETTER QUALITY MAY BE SUBSTITUTED FOR THE LISTED BRAND NAMED PRODUCTS WITH THE WRITTEN APPROVAL OF D.S.A. AND THE C. ALL WORK SHALL COMPLY WITH THE REQUIREMENTS OF TITLES 19 AND 24 CALIFORNIA CODE OF REGULATIONS. NO CHANGES SHALL BE MADE FROM D.S.A. APPROVED DRAWINGS OR SPECIFICATIONS WITHOUT PRIOR WRITTEN APPROVAL OF D.S.A. AND THE ARCHITECT. SCOPE OF WORK THE WORK CONSISTS OF MANUFACTURING OFF-SITE IN A PLANT AND INSTALLING ON-SITE, MODULAR RELOCATABLE BUILDINGS AS DEFINED HEREIN AND SHOWN AND DETAILED ON DRAWINGS. ALL REQUIREMENTS OF TITLES 24 OF THE STATE OF CALIFORNIA CODE OF REGULATIONS RELATING TO INSPECTIONS AND VERIFIED REPORTS SHALL BE COMPLIED WITH AND SHALL GENERAL RESPONSIBLE CHARGE OF FIELD ADMINISTRATION BY THE ARCHITECT OF RECORD. INSPECTION IN-PLANT DURING THE COURSE OF CONSTRUCTION BY AN INSPECTOR APPROVED BY THE DIVISION OF THE STATE ARCHITECT AND THE DISTRICT ARCHITECT. THE INSPECTOR SHALL BE RESPONSIBLE FOR AND APPROVED TO INSPECT THE GENERAL CONSTRUCTION WELDING, MECHANICAL, AND ELECTRICAL WORK. COST OF THESE INSPECTIONS SHALL BE BORNE BY THE SCHOOL ON-SITE INSPECTION OF THE BUILDING INSTALLATION ELECTRICAL AND UTILITY INSTALLATION OR CONNECTIONS BY AN INSPECTOR APPROVED BY THE DMISION OF THE STATE ARCHITECT AND THE DISTRICT ARCHITECT AND RETAINED BY THE SCHOOL DISTRICT. OTHER SPECIAL TESTS OR INSPECTIONS AS MAY BE REQUIRED BY THE DIMISION OF THE STATE ARCHITECT. ADDENDUMS SHALL BE SIGNED BY THE ARCHITECT & APPROVED BY D.S.A. CHANGE ORDERS SHALL BE SIGNED BY THE OWNER & ARCHITECT & APPROVED BY D.S.A. THE TESTING LAB SHALL BE IN THE EMPLOY OF THE 8. ALL CONTRACTORS SHALL VERIFY ALL WORK CONDITIONS, "DIMENSIONS AND DETAILS AND REPORT ANY OR ALL OMISSIONS AND DISCREPANCIES TO THE DESIGNER/OWNER IMMEDIATELY BEFORE COMMENCING WORK. 9. EACH CONTRACTOR TO BE RESPONSIBLE TO SEE THAT THEIR WORK CONFORMS TO ALL GOVERNMENTAL CODES WHETHER OR NOT SO STATED ON THE DRAWINGS. 10. ALL MATERIALS AND WORKMANSHIP TO CONFORM TO THE LATEST REQUIREMENTS OF THE GOVERNING BUILDING CODES IN EFFECT AT TIME OF DSA APPLICATION. 11. ALL MANUFACTURED ARTICLES, MATERIALS AND EQUIPMENT SHALL BE APPLIED, INSTALLED, CONNECTED AND ERECTED PER MANUFACTURER'S DIRECTIONS AND INSTRUCTIONS 12. SHOP DRAWINGS MAY BE REQUIRED. IF SO, THEY WILL BE ACCURATELY DRAWN TO A LARGE ENOUGH SCALE TO SHOW ALL RELATED WORK. 13. THE MANUFACTURER OF BUILDING IS TO PLACE A PERMANENT METAL IDENTIFICATION LABEL ON EACH MODULE, MECHANICALLY FASTENED TO THE FRAME AND VISIBLE FROM THE EXTERIOR OF THE END OF THE MODULE. SEE "GENERAL DESIGN REQUIREMENTS", THIS PAGE. FOR PROJECTS MANUFACTURED OFF-SITE, THE PLANT INSPECTOR IS TO INDICATE THE MANUFACTURER'S NAME AND SERIAL NUMBER OF EACH MODULE ON THE VERIFIED REPORT AND D.S.A. APP. NUMBER. 14. ALL TESTS AND INSPECTIONS REQUIRED BY DSA SHALL BE COMPLIED WITH. ALL TESTS REQ. BY FIRE AND LIFE SAFETY REGULATIONS SHALL BE BY A NATIONALY RECOGNIZED TESTING LABORATORY. FOUNDATION ASSUMED ALLOWABLE SOIL BEARING: 1000 PSF. FOOTINGS SHALL BE LOCATED ON UNDISTURBED FIRM NATURAL SOIL, APPROVED COMPACTED FILL OR ON AN APPROVED PAVED NOTE: THE FOUNDATION SYSTEM PRESENTED HEREIN COMPLIES WITH INTERPRETATION OF REGULATIONS, IR 23-6, ISSUED BY DIVISION OF THE STATE ARCHITECT FOR TEMPORARY BUILDINGS. THIS FOUNDATION SYSTEM IS NON-CONVENTIONAL AND THE STRUCTURAL ENGINEER TAKES NO RESPONSIBILITY FOR ITS CONSTRUCTION OR LONGEVITY. WORK NOT INCLUDED A. ALL ON-SITE OR OFF-SITE UTILITIES AND THE CONNECTION OF THEM TO THE BUILDING UNLESS INDICATED ON THE DRAWINGS. ALL LEVELING, GRADING OR OTHER SITE PREPARATION EXCEPT CONCRETE OR WOOD LEVELING STRIPS WHERE REQUIRED, UNLESS OTHERWISE INDICATED ON THE DRAWINGS. FIRE ALARM SYSTEM, PROGRAM BELL, PUBLIC ADDRESS SYSTEM, INTERCOM SYSTEM, TV, TELEPHONE SYSTEM UNLESS OTHERWISE INDICATED ON THE DRAWINGS OR MODIFIED BY CHANGE ORDER. WHEELS AND HITCH SHALL REMAIN THE PROPERTY OF THE CONTRACTOR. ACCESSIBILITY OF SITE THE SCHOOL DISTRICT SHALL PROVIDE ACCESS TO THE SITE

FOR THE INSTALLATION OF BUILDINGS. REMOVAL OF TREES SHRUBS, FENCING, SPRINKLERS ETC. NECESSARY FOR THE MOVE-IN OF BUILDINGS SHALL BE THE RESPONSIBILITY OF THE SCHOOL DISTRICT. TRIM/ FINISH NAILING .131 2 1/4" GALV INT. CORNER TRIM .131 3 GALV 2X FASCIA .131 2 1/4" GALV 1X EXT. TRIM, WINDOWS, EXT. DOORS, EXT. TRIM

24 X 40

RELOCATABLE

CLASSROOMS

SECTION 6 WORKMANSHIP GENERAL - ALL WORK SHALL CONFORM TO THE REQUIREMENTS OF AISC STANDARD SPECIFICATIONS, TITLE 24 OF CALIFORNIA CODE OF REGULATIONS AND THE AMERICAN IRON AND STEEL INSTITUTE SPECIFICATIONS FOR DESIGN OF STEEL STRUCTURAL MEMBERS. A COPY OF TITLE 24 SHALL BE KEPT AT THE JOBSITE AT ALL TIMES.

GENERAL REQUIREMENTS

WELDING - ALL WELDING DONE BY SHIELDED ELECTRIC-ARC OR FLUX CORED-ARC PROCESS COMPLYING WITH REQUIREMENTS OF THE "STRUCTURAL WELDING CODE" OF THE AMERICAN WELDING SOCIETY. WELDING DONE BY OPERATORS QUALIFIED BY TESTS ACCEPTABLE TO THE DIVISION OF THE STATE ARCHITECT. WELDING INSPECTION PER TITLE 24,PART 2,CCR, SECTION 2212.A.5 WELDING ELECTRODE SHALL BE E70XX.

1. STRUCTURAL STEEL SHALL CONFORM TO A.S.T.M. A-38 & A-570 GR.36. 2. PIPE COLUMNS SHALL COMFORM TO A.S.T.M. A-53 WITH SULFUR CONTENT NOT EXCEEDING 0.05%.

3. STEEL TUBING SHALL CONFORM TO A.S.T.M. A-500 GRADE B OR A.S.T.M. A579 GRADE 50 FOR GAUGE TUBING-TYP. U.N.O. 4. STRUCTURAL WELDS ARE DESIGNED FOR FULL ALLOWABLE STRESS UNLESS OTHERWISE NOTED. ERECTION - STRUCTURAL STEEL ERECTED TRUE, STRAIGHT,

CONNECTIONS BOLTED OR WELDED AS INDICATED ON THE NAILS, BOLTS, SCREWS AND NUTS ETC .- FOR EXTERIOR WORK SHALL BE CADMIUM PLATED OR GALVANIZED

PLUMB AND TO ITS DESIGNATED LOCATIONS. FIELD

1. BOLTS FOR STRUCTURAL STEEL JOINTS SHALL CONFORM TO A.S.T.M. A-307 UNLESS OTHERWISE NOTED. ALL HOLES FOR MACHINE AND CARRIAGE BOLTS THROUGH STEEL TO BE DRILLED, OR TORCH PILOT HOLE AND REAM MIN. 1/16" TO CORRECT SIZE. NELSON STUDS (WELDED TO STEEL) MAY BE SUBSTITUTED FOR BOLTS SAME LENGTH AND DIAMETER EXCEPT AT SIMPSON MTT28B. E. HANDRAILS - FABRICATED, AS DETAILED, WELDS GROUND

SMOOTH. EXPOSED STEEL COATED WITH ONE SHOP COAT OF RED OXIDE PRIMER.

NON-EXPOSED STEEL COATED WITH ONE SHOP COAT OF RED OXIDE PRIMER. ALL SURFACES THOROUGHLY CLEANED BY EFFECTIVE MEANS PRIOR TO APPLICATION OF SHOP COATS.PRIME ALL EXPOSED STEEL SURFACES AFTER FIELD WELDING.

PROVIDE MILL CERTIFICATES OR TEST ALL STEEL MEMBERS PER T-24 PART 2,CCR SECTION 2212.A.1.

CONTRACTOR SHALL PROVIDE ALL LABOR, MATERIALS AND SERVICES TO INSTALL CARPENTRY

MATERIALS LUMBER GRADE MARKED IN ACCORDANCE WITH "STANDARD GRADING AND DRESSING RULE NO. 17 OF WEST COAST LUMBER INSPECTION BUREAU, OR "GRADING RULES FOR LUMBER, 3RD EDITION OF WESTERN WOOD PRODUCTS ASSOCIATION OR W.C.L.I.B.. PLYWOOD GRADE MARKED IN ACCORDANCE WITH PRODUCT STANDARD PS 1-95 FOR SOFTWOOD PLYWOOD, OF AMERICAN PLYWOOD ASSOCIATION, COMPLYING WITH CBC EACH SHEET SHALL BEAR THE STAMP OF

APA, PITTSBURGH TESTING, OR TECO. A. JOISTS, RAFTERS, PLATES, STUDS-DOUGLAS FIR OR HEM FIR S4S #2 U.N.O. NOTE: MSR 1650 E1.5 MAY BE SUBSTITUTED FOR #2 GRADE IF IT MEETS THE STRUCTURAL REQUIREMENTS FOR FLOOR AND ROOF MEMBERS. HEADERS, POSTS AND TIMBERS-DOUGLAS FIR S4S #1

BLOCKING - DOUG FIR #3,OR HEM FIR #3,OR STD. & BET D. SILLS AND LUMBER & SHIM PLATES IN CONTACT WITH CONCRETE, MASONRY OR EARTH, DOUG FIR #2 PRESSURE TREATED IN ACCORDANCE WITH CBC 1811.7. EACH PIECE SHALL BEAR AWPB STAMP. LP-22 GROUND CONTACT, D.F. \$2 ABOVE GROUND. E. PLYWOOD ROOF DECKING - NOT USED.

F. PLYWOOD FLOOR DECKING - APA STURD-I-FLOOR 2-4-1 OR UNI-FLOOR BY PITTSBURGH TESTING LAB. 1-1/8"NOM. TONGUE AND GROOVE FLOOR SHEATHING, WITH EXTERIOR GLUE G. EXTERIOR SIDING/SHEATHING - APA TYPE 303, EXTERIOR.

MOISTURE BARRIER - KRAFT WATERPROOF BUILDING PAPER, OR 15 LB. FELT, UBC STANDARD 14-1 FOR KRAFT, 15-1 FOR FELT. STUDS - DOUG FIR #2. OR HEM FIR. #2. FASTENERS - ALL NAILS SHALL BE CORROSION RESISTANT PER

UBC STANDARD 25-17. ELECTROGALVANIZED COMMON NAILS U.N.O. BUILDING TRIM - 2X RESAWN SELECT D.F., H.F., OR CEDAR M. DOOR/WINDOW TRIM - 1X4 REWAWN D.F.,H.F.,OR

N. FRAMING CONNECTORS SHALL BE FROM SIMPSON CATALOG LATEST ED. FIRE BLOCKS SHALL CONFORM TO CBC SECTION 708.

ALL NAILS SHALL BE COMMON NAILS UNLESS OTHERWISE NOTED. FOUNDATION LUMBER: ALL CUT ENDS AND HOLES IN PRESSURE TREATED LUMBER SHALL BE TREATED WITH "CUPRINOL". WORKMANSHIP FRAMING - SECURELY NAILED, BRIDGED AND BLOCKED TO FORM

RIGID STRUCTURE. WORK CUT, FITTED AND ASSEMBELED LEVEL PLUMB AND TRUE TO LINE. TRIM IN AS LONG LENGTHS AS POSSIBLE WITH ALL STANDING TRIM IN ONE PIECE. TRIM SEALED AT ALL EDGES. NAILING - IN ACCORDANCE WITH TITLE 24, PART 2, CALIFORNIA CODE OF REGULATIONS, TABLE 23-1-Q

C. EXTERIOR WALLS - FACTORY FABRICATED. CAULKING PROVIDED BETWEEN PERIMETER OF WALL AND STRUCTURAL MEMBERS PROVIDING WEATHER-PROOF AND WATER-TIGHT SEAL. NECESSARY CLOSERS, SEALS, AND FLASHINGS PLACED AT TOP AND BASE SUPPORT OF PANELS AND AROUND OPENINGS. MACHINE APPLIED NAILING:

USE OF MACHINE NAILING IS SUBJECT TO A SATISFACTORY JOBSITE DEMONSTRATION FOR EACH PROJECT AND THE APPROVAL BY THE PROJECT ARCHITECT OR STRUCTURAL ENGINEER AND THE DIMSION OF THE STATE ARCHITECT. THE APPROVAL IS SUBJECT TO CONTINUED SATISFACTORY PERFORMANCE. MACHINE NAILING WILL NOT BE APPROVED IN 5/16" PLYWOOD. IF NAILHEADS PENETRATE THE OUTER PLY MORE THAN WOULD BE NORMAL FOR A HAND HAMMER OR IF MINIMUM ALLOWABLE EDGE DISTANCES ARE NOT MAINTAINED THE PERFORMANCE WILL BE

DEEMED UNSATISFACTORY. MOISTURE BARRIER - APPLIED TO STUDS WEATHER-BOARD FASHION, HORIZONTAL JOINTS LAPPED MIN 6" INCLUDING BUILDING CORNERS. SHEATHING APPLIED OVER MOISTURE BARRIER. F. TRIM SEALED AT ALL EDGES. SEALANT PAINTED TO MATCH

TRIM OR SIDING UNLESS TRANSPARENT TYPE.

SHEET METAL

SCOPE OF WORK CONTRACTOR SHALL PROVIDE ALL LABOR, MATERIALS AND SERVICES TO INSTALL INDICATED SHEET METAL.

A. SHEET METAL - STEEL SHEETS HOT DIP GALVANIZED WITH 1.25 OZ. PER SQUARE FOOT ZINC COATING CONFORMING TO ASTM A526. MINIMUM 26 GA. UNLESS OTHERWISE NOTED ON THE SOLDER - OF STAND, GRADE "A" OF EQUAL PARTSARD BRAND

LEAD AND TIN ASTM B32. FLUX - ZINC SATURATED MURIATIC ACID. GUTTERS: 26 GA. G-90 GALV. STEEL. DOWNSPOUTS: 2"X3" CONVOLUTED 30 GA. G-90 GALV. STEEL. GUTTER ENDCAPS: 26 GA. G-90 GALV. STEEL. GUTTER CLIPS: 18 GA. G-90 GALV. STEEL

WORKMANSHIP SHEET METAL ACCURATELY FORMED TO DIMENSIONS AND SHAPES DETAILED WITH TRUE STRAIGHT LINES, CORNERS AND ANGLES. FLASHING INSTALLED IN LONGEST LENGTHS POSSIBLE. EXTERIOR WORK FORMED, FABRICATED AND INSTALLED SO THAT IT ADEQUATELY PROVIDES FOR EXPANSION AND CONTRACTION IN THE COMPLETED WORK AND FINISHES WATER AND WEATHER TIGHT. ALUMINUM SHALL BE SEPARATED FROM FERROUS METAL BY POLYETHYLENE TAPE OR FLOOD COAT OF ASPHALTIC PAINT.

METAL ROOFING

CONTRACTOR SHALL PROVIDE ALL LABOR, MATERIALS AND SERVICES TO INSTALL METAL ROOFING. TEST RESULTS SHOWING THE ROOFING SYSTEM WILL WITHSTAND THE UPLIFT OF A 80 MPH WIND SHALL BE SUBMITTED WITH THE PLANS AND SPECIFICATIONS. MATERIALS

ROOFING - 3" INCH STANDING SEAM 22-GAUGE G-90 GALV. INTERLOCKING SHEET STL PANELS (G90).

CONTRACTOR SHALL PROVIDE ALL LABOR, MATERIAL AND SERVICES TO SEAL BUILDINGS. MATERIALS

VULKEM SEALANT, POLYURETHANE, MANUFACTURED BY MAMECO INTERNATIONAL FOR ROOFS. "GEOCEL" SILICONIZED CAULK, GE, DUPONT, EAGLESEAL OR DAP FOR ALL OTHER APPLICATIONS, OR EQUAL. SEALANT APPLIED TO DRY CLEAN SURFACES, WHEREVER INDICATED ON DETAILS AND AS NEEDED TO MAKE BUILDING WATERTIGHT IN ACCORDANCE WITH MANUFACTURER'S SPECIFICATIONS.

CONCRETE (IF USED) SECTION CONCRETE

. CONCRETE MORTAR AND RELATED MATERIALS TO CONFORM TO APPLICABLE PROVISIONS OF TITLE 24 EXCEPT AS MODIFED HEREIN. . REINFORCEING BARS:ASTM A615 OR ASTM A706 DEFORMED GRADE 40 BILLET STEEL 3. EXPANSION JOINT FILLER: ASTM D994 . FORM MATERIALS: SIDE FORMS DOUGLAS FIR. CONSTRUCTION GRADE OR BETTER: OR METAL . PLACING REINFORCEMENT, PLACING CONCRETE SUFACE FINISHES, CURING AND REMOVAL OF FORMS SHALL BE IN ACCORDANCE WITH APPLICABLE PROVISIONS OF TITLE 24, PART 2.

HOLLOW METAL DOORS AND FRAMES

CONTRACTOR SHALL PROVIDE ALL LABOR, MATERIALS AND SERVICES TO INSTALL HOLLOW METAL DOORS AND FRAMES. 2. MATERIALS A. DOORS - TYPE L FULL FLUSH, MANUFACTURED BY AMWELD MANUFACTURING COMPANY, 18 GA. 1 3/4" THICK PER CS242

MIN, REINFORCE FOR HARDWARE-BOTH FACES FOR CLOSER,

SOUND DEADEN INTERIOR. FRAMES - 16 GA COLD ROLLED,2" FACES, CS242 MIN.3 ANCHORS PER JAMB + ADJUSTABLE FLOOR ANCHOR EACH JAMB REINFORCE FOR HARDWARE. PROVIDE STRIKE BOX, PROVIDE SOUND DEADENING: 1/8" UNDERCOATING OR INSULATING FILL.

ALL WORK FABRICATED IN SHOP TO REQUIRED PROFILES BY FORMING AND WELDING, WITH ARISES AND EDGES STRAIGHT, SHARDP FIT FABRICATED ACCURATELY WITH SQUARE CORNERS, HAIRLINE JOINTS AND SURFACES FREE FROM WARP, WAVE, BUCKLE OR OTHER DEFECTS AFTER FABRICATION, DOORS AND FRAMES CLEANED THOUROUGHLY, ALL WELDS GROUND SMOOTH AND GIVEN PRIME COAT.

SCOPE OF WORK CONTRACTOR SHALL SUPPLY AND INSTALL FINISH HARDWARE AS SPECIFIED AND AS REQUIRED.

2. SCHEDULE FOR EXTERIOR DOORS SEE NOTE ON FLOOR PLAN.

8.5 LBS. PRESSURE.

3. SPECIAL REQUIREMENTS EXIT DOORS SHALL BE OPENABLE FROM THE INTERIOR WITHOUT KEY OR SPECIAL KNOWLEDGE OR EFFORT. CLOSER SHALL BE SET FOR A MAXIMUM OPENING PRESSURE OF

SECTION 98 CONTRACTOR SHALL PROVIDE ALL LABOR, MATERIALS AND SERVICES TO PAINT BUILDING. ALL EXPOSED SURFACES OF BUILDING AND RAMPS SHALL BE PAINTED EXCEPT ALUMINUM WINDOW FRAMES, THRESHOLDS, AND ROOFING. MATERIALS

FOR EXTERIOR WOOD: SHERWIN MOORE WILLIAMS 1240 Y24W20 42-9M 1240-XXX B54WZ102 GE2-NXX FINISH QD-60-XX B. FOR INTERIOR TRIM SHERWIN SINCLAIR DUNN KELLY MOORE EDWARDS WILLIAMS

W450-XX 1650-XXX A26W11 C. FOR METAL KELLY REF. BRAND **EDWARDS** MOORE WILLIAMS PRIMER 1710 43-4 1700-XXX B54WZ102

3. WORKMANSHIP ALL EXPOSED SURFACES SHALL BE PAINTED EXCEPT ALUMINUM WINDOW FRAMES AND THRESHOLDS. MATERIAL SHALL BE OF THE GRADE

SPECIFIED OR EQUAL. A. EXTERIOR - WOOD SIDING, TRIM AND SKIRTING FLAT OR SEMI-GLOSS LATEX - APPLY ONE COAT OF PRIME AND AT LEAST ONE FINISH COAT. PRIME COAT SHALL BE BRUSHED ON OR SPRAYED AND BACK BRUSHED INTO ALL GROOVES IN THE SIDING. IF NECESSARY, IN THE OPINION OF THE INSPECTOR, AN EXTRA COAT SHALL BE APPLIED TO ALL GROOVES SO THAT THE FINISH COAT WILL HAVE A UNIFORM APPEARANCE. ALLOW PRIME COAT TO DRY ACCORDING TO MANUFACTURER'S RECOMMENDATION. PRIME AND FINISH COATS SHALL BE COMPATIBLE AND MANUFACTURED BY THE SAME COMPANY. B. INTERIOR TRIM - TRIM NOT PRECOATED SHALL BE PAINTED WITH TWO

COATS OF SEMI-GLOSS LATEX OVER PRIMER. INTERIOR HARDWOOD CABINETS - TWO COATS LOW LUSTER POLYURETHANE FINISH. APPLY FIRST COAT THINNED WITH ONE QUART MINERAL SPIRITS PER GALLON. APPLY SECOND COAT AS RECOMMENDED BY MANUFACTURER.

D. METAL - ALL METAL SURFACES SHALL BE PAINTED WITH TWO COATS OF ALKYD FINISH COAT OVER ZINC CHROMATE OR EQUAL RUST INHIBITING PRIMER. E. RAMP - ONE COAT OF FERROX NON-SKID SURFACING AS MANUFACTURED

BY AMERICAN ABRASIVE METALS OR COMPARABLE. ALL PAINTS OF THE TYPE INDICATED SHALL BE LISTED ON THE STATE OF CALIFORNIA QUALIFIED PRODUCTS LIST FOR MAINTENANCE PAINTS 8010-91G-98A DATED JULY 1989. OR EQIAL.

P. SUBMIT ONE SET COLOR SAMPLES TO ARCHITECT FOR EACH PRODUCT TO ASSIST IN SELECTION.

SITE ASSEMBLY

SCOPE OF WORK CONTRACTOR SHALL PROVIDE ALL LABOR MATERIALS AND SERVICES TO PREPARE THE BUILDING ELEMENTS, TRANSPORT THEM FROM THE PLANT TO THE SITE AND TO COMPLETE THE ASSEMBLY AT THE SITE. THE CONDITION OF THE SITE, SUCH AS DRAINAGE AND SOIL BEARING CAPACITY. SHALL BE THE RESPONSIBILITY OF THE SCHOOL DISTRICT UNLESS SPECIFICALLY CALLED FOR IN THE CONTRACT, STEPS, RAMPS, OR HANDRAILS SHALL BE THE RESPONSIBILITY OF THE CONTRACTOR.

ASSEMBLY OF ELEMENTS A. IN A LOCATION ON THE SITE AS DETERMINED BY THE SCHOOL DISTRICT, (APPROVED BY DSA) THE CONTRACTOR SHALL PLACE WOOD LEVELING STRIPS OR OTHER SUITABLE SUPPORTS AS DETAILED ON THE DRAWINGS.

B. THE ELEMENTS SHALL BE BROUGHT TO THE SITE ON WHEEL ASSEMBLY AND TRANSFERRED TO THE PREPARED SITE. GREAT CARE SHALL BE TAKEN TO AVOID DAMAGE TO THE ELEMENTS BY RACKING OR BUMPING

EACH OTHER. CONNECTION OF THE ELEMENTS TOGETHER SHALL, BE DONE ACCORDING TO INSTRUCTION ON THE DRAWINGS. FLASHINGS, TRIM AND OTHER LOOSE ITEMS SHALL BE INSTALLED PER DETAILS ON THE DRAWINGS.

NOTE:

**CUSTOMER:** 

WALL FINISH MATERIAL FLAME SPREAD MAX = 200 SMOKE DENSITY MAX = 450

BUILDING INSULATION FLAME SPREAD MAX = 25 SMOKE DENSITY MAX = 450

PIPE INSULATION FLAME SPREAD MAX = 25 SMOKE DENSITY MAX = 450

DUCT INSULATION

FLAME SPREAD MAX = 25

SMOKE DENSITY MAX = 50

1. SCOPE OF WORK (SEE SHEET M-1 FOR HVAC SPEC. AND NOTES) CONTRACTOR SHALL PROVIDE ALL LABOR, MATERIALS AND SERVICES TO INSTALL THE AIR CONDITIONING SYSTEM AS SHOWN ON THE DRAWINGS AND SPECIFICATIONS, INCLUDING A/C UNITS AND ACCESSORIES, REMOTE THERMOSTAT, GRILLS AND POWER WIRING

COMPLETE TO LOAD CENTER. CONTRACTOR SHALL INSTRUCT OWNER'S

OPERATORS ON OPERATION AND MAINTENANCE OF A/C SYSTEM. EQUIPMENT SEE NOTE ON FLOOR PLAN FOR SIZE AND TYPE.

WORKMANSHIP UNITS SHALL BE INSTALLED COMPLETE AND OPERATING WITH ALL ACCESSORIES IN ACCORDANCE WITH THE MANUFACTURER'S INSTRUCTIONS.

SCOPE OF WORK

CONTRACTOR SHALL PROVIDE ALL LABOR, MATERIALS AND SERVICES FOR ELECTRICAL INSTALLATION COMPLETE WITH ASSOCIATED EQUIPMENT AND FIXTURES, IN OPERATING CONDITION READY FOR USE. THE WORK INCLUDES: LIGHT AND POWER SYSTEMS, LIGHTING FIXTURES COMPLETE WITH LAMPS, CONNECTIONS AND DISCONNECTS TO A/C EQUIPMENT. MATERIALS

ALL NEW COMPLYING WITH REQUIREMENTS OF CALIFORNIA ELECTRICAL CODE AND NATIONAL FIRE PROTECTION ASSOCIATION

A. ELECTRIC METALLIC TUBING - COUPLING AND FLEX CONDUIT GALVANIZED OR SHERARDIZED, EXTERIOR FLEX- GALV. STEEL W/ FACTORY APPLIED P.V.C. JACKET.

PANELBOARDS - FLUSH MOUNTED. CONDUCTORS - COPPER, INSULATED FOR 600 VOLTS, TYPE THHN FOR SIZES #12 TO #6, TYPE THW FOR LARGER SIZES.MINIMUM SIZE-

RECEPTACLES - AS NOTED. +15" A.F.F. MIN.

CLOCK RECEPTACLE - AS NOTED. SWITCHES - AS NOTED. +48" A.F.F. MAX. LIGHTING FIXTURES - AS NOTED ON THE DRAWINGS.

WORKMANSHIP MATERIALS AND EQUIPMENT INSTALLED IN A SECURE, NEAT WORKMANLIKE MANNER IN ACCORDANCE WITH CODE REQUIREMENTS. PANELBOARD CARDS FILLED OUT. CONDUIT AND CABLE INSTALLED IN WALL AND CEILING SPACES. WORK PIERCING WATERPROOFED AREAS FLASHED AND SEALED TO A WATERTIGHT CONDITION.

BUILDING CONDUIT/WIRING FROM FACE OF BLDG TO SITE TERMINATION

BY SITE CONTRACTOR(N.I.C.).(FLEXIBLE CONDUIT S-BEND SEALTITE)

INSPECTION OF PREFABRICATED BUILDINGS IS DIVIDED INTO TWO SEPARATE FUNCTIONS.

1. IN-PLANT INSPECTION. 2. ON-SITE INSPECTION.

THE CONTRACTOR SHALL ALLOW UP TO SEVEN (7) DAYS FROM THE DATE OF PLAN APPROVAL TO OBTAIN AN IN PLANT INSPECTOR APPROVED BY D.S.A.

IN-PLANT INSPECTION AND MATERIAL TESTING SHALL BE ACCOMPLISHED UNDER THE SUPERVISION OF THE DISTRICT ARCHITECT THE CONTRACTOR SHALL NOTIFY THE DISTRICT ARCHITECT, DSA, AND THE DESIGNATED INSPECTOR/INSPECTION AGENCY AT LEAST 48 HOURS PRIOR TO COMMENCING WORK. THE MANUFACTURER SHALL PROVIDE THE INSPECTOR WITH FULL ACCESS TO ALL PLANT OPERATIONS INVOLVING WORK UNDER THIS CONTRACT AND SHALL ADVISE THE INSPECTOR IN ADVANCE OF THE TIME AND PLACE WHEN OPERATIONS THAT THE INSPECTOR WANTS TO OBSERVE TAKE PLACE. BEFORE THE BUILDING(S) ARE REMOVED FROM THE PLANT FOR DELIVERY TO THE STORAGE FACILITY OR FROM THE STORAGE FACILITY TO THE SITE THE INSPECTOR SHALL DETERMINE THAT THEY

ARE ACCEPTABLE AND ISSUE A WRITTEN RELEASE WHICH SHALL BE IN THE FORM OF A VERIFIED REPORT (FORM SSS-6). A COPY OF THE NSPECTOR'S VERIFIED REPORT SHALL ACCOMPANY EACH BUILDING TO STORAGE OR TO THE SITE. THE INSPECTOR SHALL PUT ONE COPY IN EACH BUILDING.

COORDINATION OF WORK IT SHALL BE THE CONTRACTOR'S RESPONSIBILITY TO MAKE ALL NECESSARY ARRANGEMENTS WITH THE SCHOOL DISTRICT AUTHORIZED REPRESENTATIVE FOR ACCESS TO GROUNDS AND REMOVAL OF EQUIPMENT.IF NECESSARY. THIS CONTACT SHALL BE MADE AT LEAST 48 HOURS PRIOR TO DELIVERY OF AY MODULE. ON-SITE INSPECTION SHALL BE DONE BY THE SITE INSPECTOR. ALL

WORK WHICH THE MANUFACTURER OR HIS SUBCONTRACTORS PERFORM AT THE SITE SHALL BE SUBJECT TO THE INSPECTION OF THE SITE INSPECTOR. THE MANUFACTURER WILL FURNISH THE SITE INSPECTOR WITH SUCH INFORMATION AS MAY BE NECESSARY TO KEEP HIM FULLY INFORMED AS TO PROGRESS OF WORK AND DATES WHEN SITE WORK WILL OCCUR. THE CONTRACTOR SHALL NOTIFY THE INSPECTION AGENCY AT LEAST 48 HOURS PRIOR TO COMMENCING WORK.

THE CONTRACTOR SHALL VERIFY THAT THE DISTRICT'S SITE IS READY TO RECEIVE THE CLASSROOM(S) PRIOR TO THE DELIVERY OF ANY CLASSROOM(S) BY VISITING EACH SITE (THIS MAY BE DONE BY THE INSPECTOR).

MATERIALS AND WORKMANSHIP ALL CONTRACTORS SHALL CERTIFY THAT NO ASBESTOS-CONTAINING BUILDING MATERIALS WHICH EXCEED STATE AND FEDERAL MANDATED SAFE ASBESTOS LEVELS HAVE BEEN USED IN THE CONSTRUCTION OF RELOCATABLE FACILITIES.

ALL WORKMEN SHALL BE SKILLED AND QUALIFIED FOR THE WORK WHICH THEY PERFORM. ALL MATERIALS USED, UNLESS OTHERWISE SPECIFIED, SHALL BE NEW AND OF THE TYPES AND GRADES SPECIFIED. THE CONTRACTOR SHALL, IF REQUESTED, FURNISH EVIDENCE SATISFACTORY TO THE ARCHITECT THAT SUCH IS THE CASE.

CONTRACTOR'S CREWS ASSIGNED TO ANY WORK PERFORMED UNDER THIS CONTRACT SHALL INCLUDE ONE COMPETENT AND FULLY EXPERIENCED PERSON DESIGNATED AS THE RESPONSIBLE PERSON IN CHARGE. SUCH PERSON MUST BE IDENTIFIED BY NAME TO THE DISTRICT IN ADVANCE OF ANY WORK. UPON REQUEST, THE CONTRACTOR SHALL PROMPTLY FURNISH TO THE DISTRICT INFORMATION RELATING TO THIS EMPLOYEE'S EXPERIENCE.

WORKMANSHIP SHALL BE EQUAL OR BETTER IN QUALITY TO THAT REQUIRED BY THE CONSTRUCTION TRADES FOR A FINISHED PRODUCT. A QUALITY CONTROL SUPERVISOR, DESIGNATED BY THE MANUFACTURER, SHALL REVIEW ALL WORK IN PROGRESS AND SHALL REVIEW THE FINISHED BUILDING PRIOR TO FINAL INSPECTION TO ASSURE IT IS COMPLETE AND CORRECT. THE QUALITY CONTROL SUPERVISOR SHALL HAVE THE AUTHORITY TO HAVE MATERIALS REPLACED AND WORK REDONE IN ORDER TO CORRECT FAULTY MATERIALS OR WORKMANSHIP.

GENERAL DESIGN REQUIREMENTS:

TWO (2) APPROXIMATELY 12' X 40' MODULES DESIGNED SO THAT TWO MODULES MAY BE JOINED TOGETHER TO FORM A COMPLETE STRUCTURE TO MAINTAIN A POSITIVE ALIGNMENT OF FLOORS, WALLS, AND ROOF AND TO PERMIT SIMPLE NON-DESTRUCTIVE DETACHMENT FOR FUTURE RELOCATION.

EACH MODULE SHALL BE PERMANENTLY IDENTIFIED WITH AN IMPRINTED (STAMPED NOT ENGRAVED) METAL IDENTIFICATION TAG 3"X1 -1/2" MINIMUM SIZE WITH THE FOLLOWING INFORMATION

MANUFACTURER'S BUILDING NUMBER.

DESIGN WIND LOAD DESIGN ROOF LIVE LOAD

D.S.A. APPLICATION NUMBER.

EACH MODULE SHALL BE CAPABLE OF RESISTING ALL VERTICAL AND LATERAL LOADS DURING TRANSPORTATION AND RELOCATION. (NORMAL INDUSTRY PRACTICE FOR BRACING MODULES DURING TRANSPORTATION AND RELOCATIONS IS ACCEPTABLE.) WHEN MODULES ARE ASSEMBLED JOINTS SHALL BE SEALED WITH REMOVABLE CLOSING STRIPS OR OTHER METHOD TO PRESENT A FINISHED APPEARANCE AND BE PERMANENTLY WATERPROOF.

EACH 12' X 40' MODULE SHALL BE SUFFICIENTLY RIGID TO BE JACKED UP AT THE FRONT AND BACK CORNERS FOR RELOCATION WITHOUT DAMAGE OR THE MODULE SHALL HAVE LIFT LUGS AT FRONT AND BACK LOCATED AS REQUIRED SO THAT THE MODULE MAY BE JACKED UP FOR RELOCATION IN ONE PIECE WITHOUT ADDITIONAL SUPPORTS OF ANY TYPE. EMDENCE OF EXCESSIVE BOWING DURING THE INSTALLATION OF THE MODULES WHICH, IN THE OPINION OF THE AGENCY ARCHITECT OR STRUCTURAL ENGINEER. CAUSES EXCESSIVE WORKING AT ANY JOINT OR COMPROMISES THE STRUCTURAL INTEGRITY OF THE MODULE SHALL BE SUFFICIENT REASON FOR REJECTION OF THE MODULE.


FINISH AND BASE MATERIALS AT EACH MODULE SHALL TERMINATE AT INTERIOR MODULE JOINTS IN A MANNER TO JOIN FLUSH AND TIGHT WITH SAME MATERIAL IN ADJACENT MODULE SO THE MODULE MAY BE RELOCATED WITH MINIMUM CUTTING AND PATCHING.

THE BUILDINGS SHALL OCCUPY AN AREA OF 960 SQUARE FEET WITH A TOLERANCE OF MINUS 5 SQUARE FEET. THE BUILDINGS SHALL BE 24' X 40'. ALL BUILDINGS SHALL MEET THE SQUARE FOOTAGE REQUIREMENT. LINEAR DIMENSIONS SHALL BE VERTICAL TRIM FINISH

LINE TO VERTICAL TRIM FINISH LINE. FASCIA AND REQUIRED OVERHANGS ARE NOT INCLUDED IN THE CALCULATION OF THE SQUARE FOOTAGE THE BUILDING OCCUPIES. THE ENTRANCE WALL SHALL HAVE A 5' MINIMUM ROOF OVERHANG. THE REAR WALL SHALL HAVE A MINIMUM 2' OVERHANG. FULL LENGTH GUTTERS AND DOWNSPOUTS SHALL BE FURNISHED ON THE SIDES OF EACH OVERHANG AND EACH ROOF EDGE WHERE DRAINAGE OCCURS. THE INTERIOR HEIGHT, FLOOR TO CEILING SHALL BE 8'-6" U.O.N. THE MODULE SHALL BE CLEAR SPAN TYPE EXCEPT AS PROMDED FOR IN THE BID SPECIFICATIONS NOTHING SHALL

PROTRUDE MORE THAN 1" BELOW THE CEILING LEVEL. ITEMS NOTED AS N.I.C. (NOT IN CONTRACT) OR "BY OTHERS" IS THE RESPONSIBILITY OF THE SCHOOL

DISTRICT DEPENDING ON THE AGGREEMENT WITH DISTRICT. IN THE EVENT OF CONFLICT BETWEEN THESE SPECIFICATIONS AND THE DISTRICT BID SPECIFICATIONS, THE DISTRICT SPECIFICATIONS SHALL PREVAIL.

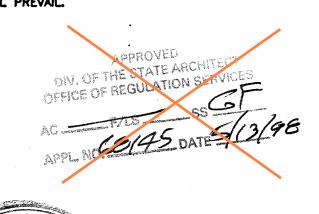



IDENTIFICATION STAMP
DIV. OF THE STATE ARCHITECT
OFFICE OF REGULATION SERVICES FLS JOSS JR DATE 4/9/97

PROJECT No.

1305 E. Vine St Lodi, CA 95240

PROJECT OWNER & TITLE

THE ARCHITECT DOES NOT REPRESENT THAT

SUITABLE FOR ANY SITE OTHER THAN THE ONE

SPECIFICATIONS IF THEY ARE USED IN WHOLE OR

LODI UNIFIED SCHOOL DISTRICT

DIMENSIONS ON THESE DRAWINGS SHALL HAVE

PRECEDENCE OVER SCALED DIMENSIONS.

THESE PLANS OR THE SPECIFICATIONS ARE

FOR WHICH THEY WERE SPECIFICALLY

PREPARED. THE ARCHITECT DISCLAIMS

RESPONSIBILITY FOR THESE PLANS AND

IN PART AT ANY OTHER SITE. WRITTEN

PROFESSIONAL STAMP

AGENCY APPROVAL DSA#

IDENTIFICATION STAMP DIV. OF THE STATE ARCHITEC

REVIEWED FOR

SS 🗹 FLS 🗹 ACS 🗹

APP: 02-121945 INC:

DATE: 12/12/2023

MILLSWOOD MIDDLE SCHOOL PORTABLES RELOCATION 233 N Mills Ave Lodi, CA 95242 SHEET TITLE **GENERAL NOTES** DRAWN BY: XXXXXX JOB NUMBER: 23219

American

Modular Systems

GENERAL NOTES

CHECKED BY: CHECKED BY: SERIAL NO.

SCALE: NONE DRAWN BY: R.S.

DATE: 4-8-97


REVISIONS NO DATE DESCRIPTION NO DATE DESCRIPTION

3" STANDING SEAM ROOF


SHEET No. N-1

DATE: DECEMBER 5, 2023

DESCRIPTION

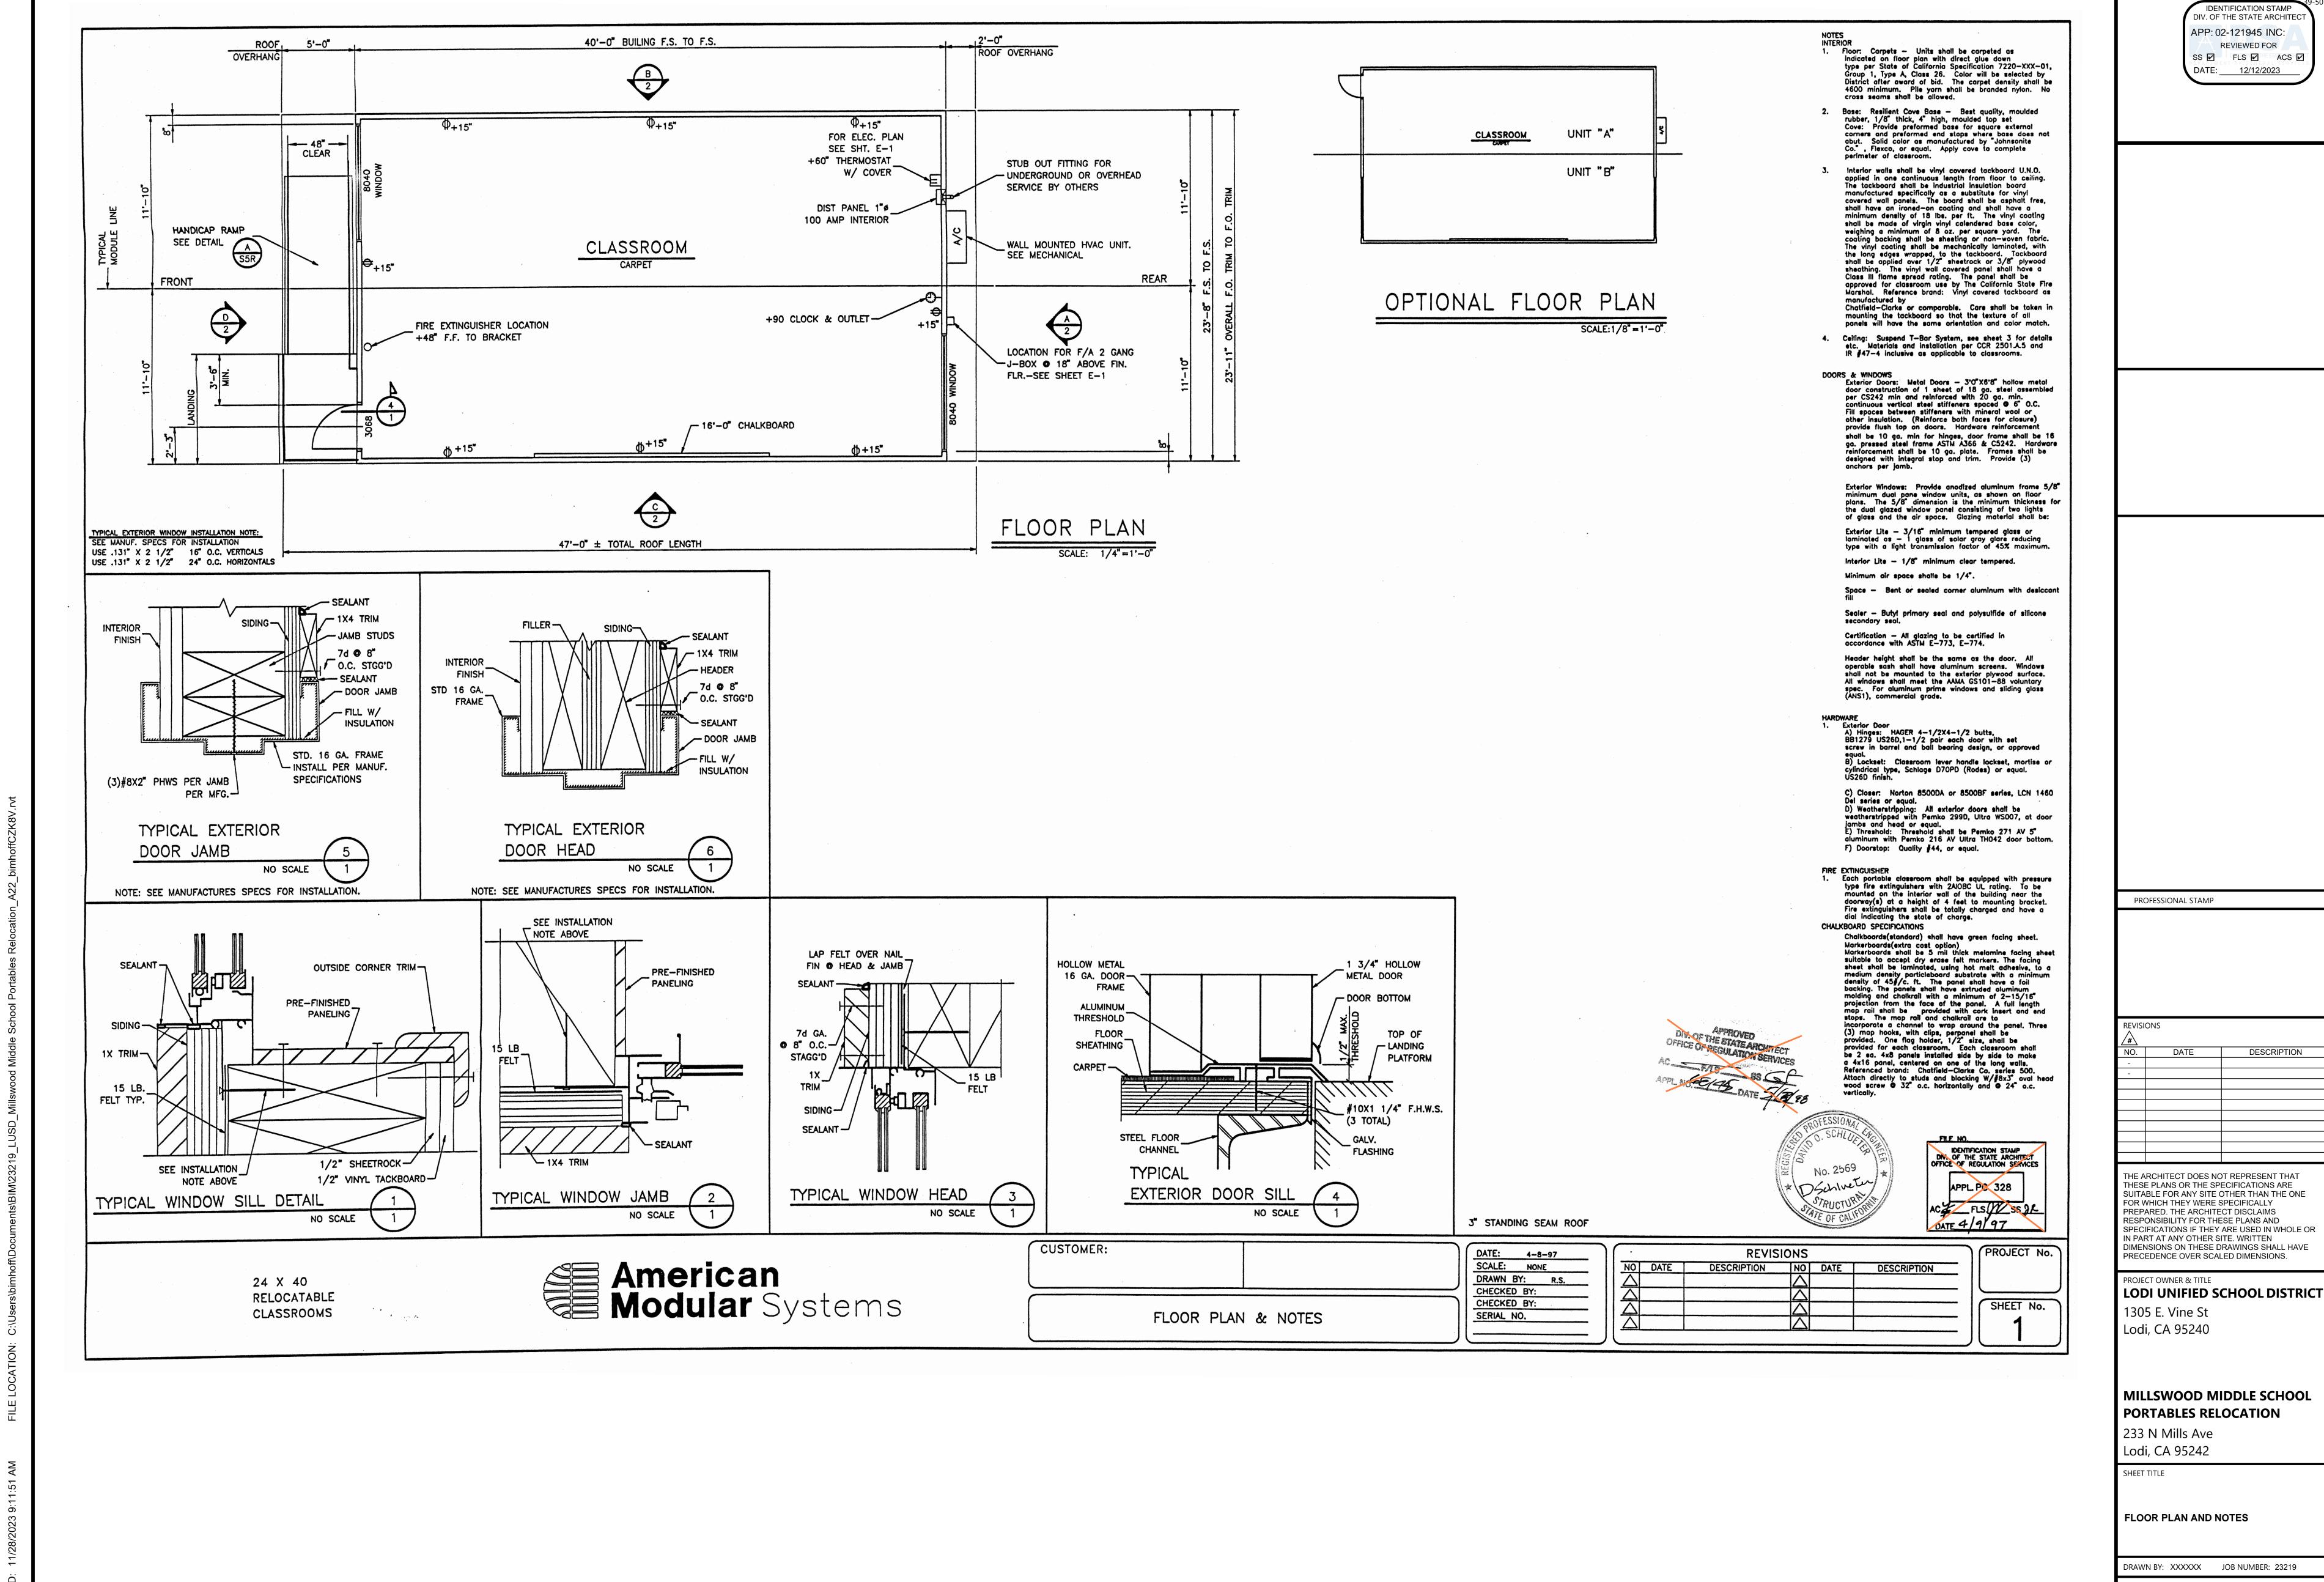



AGENCY APPROVAL DSA#

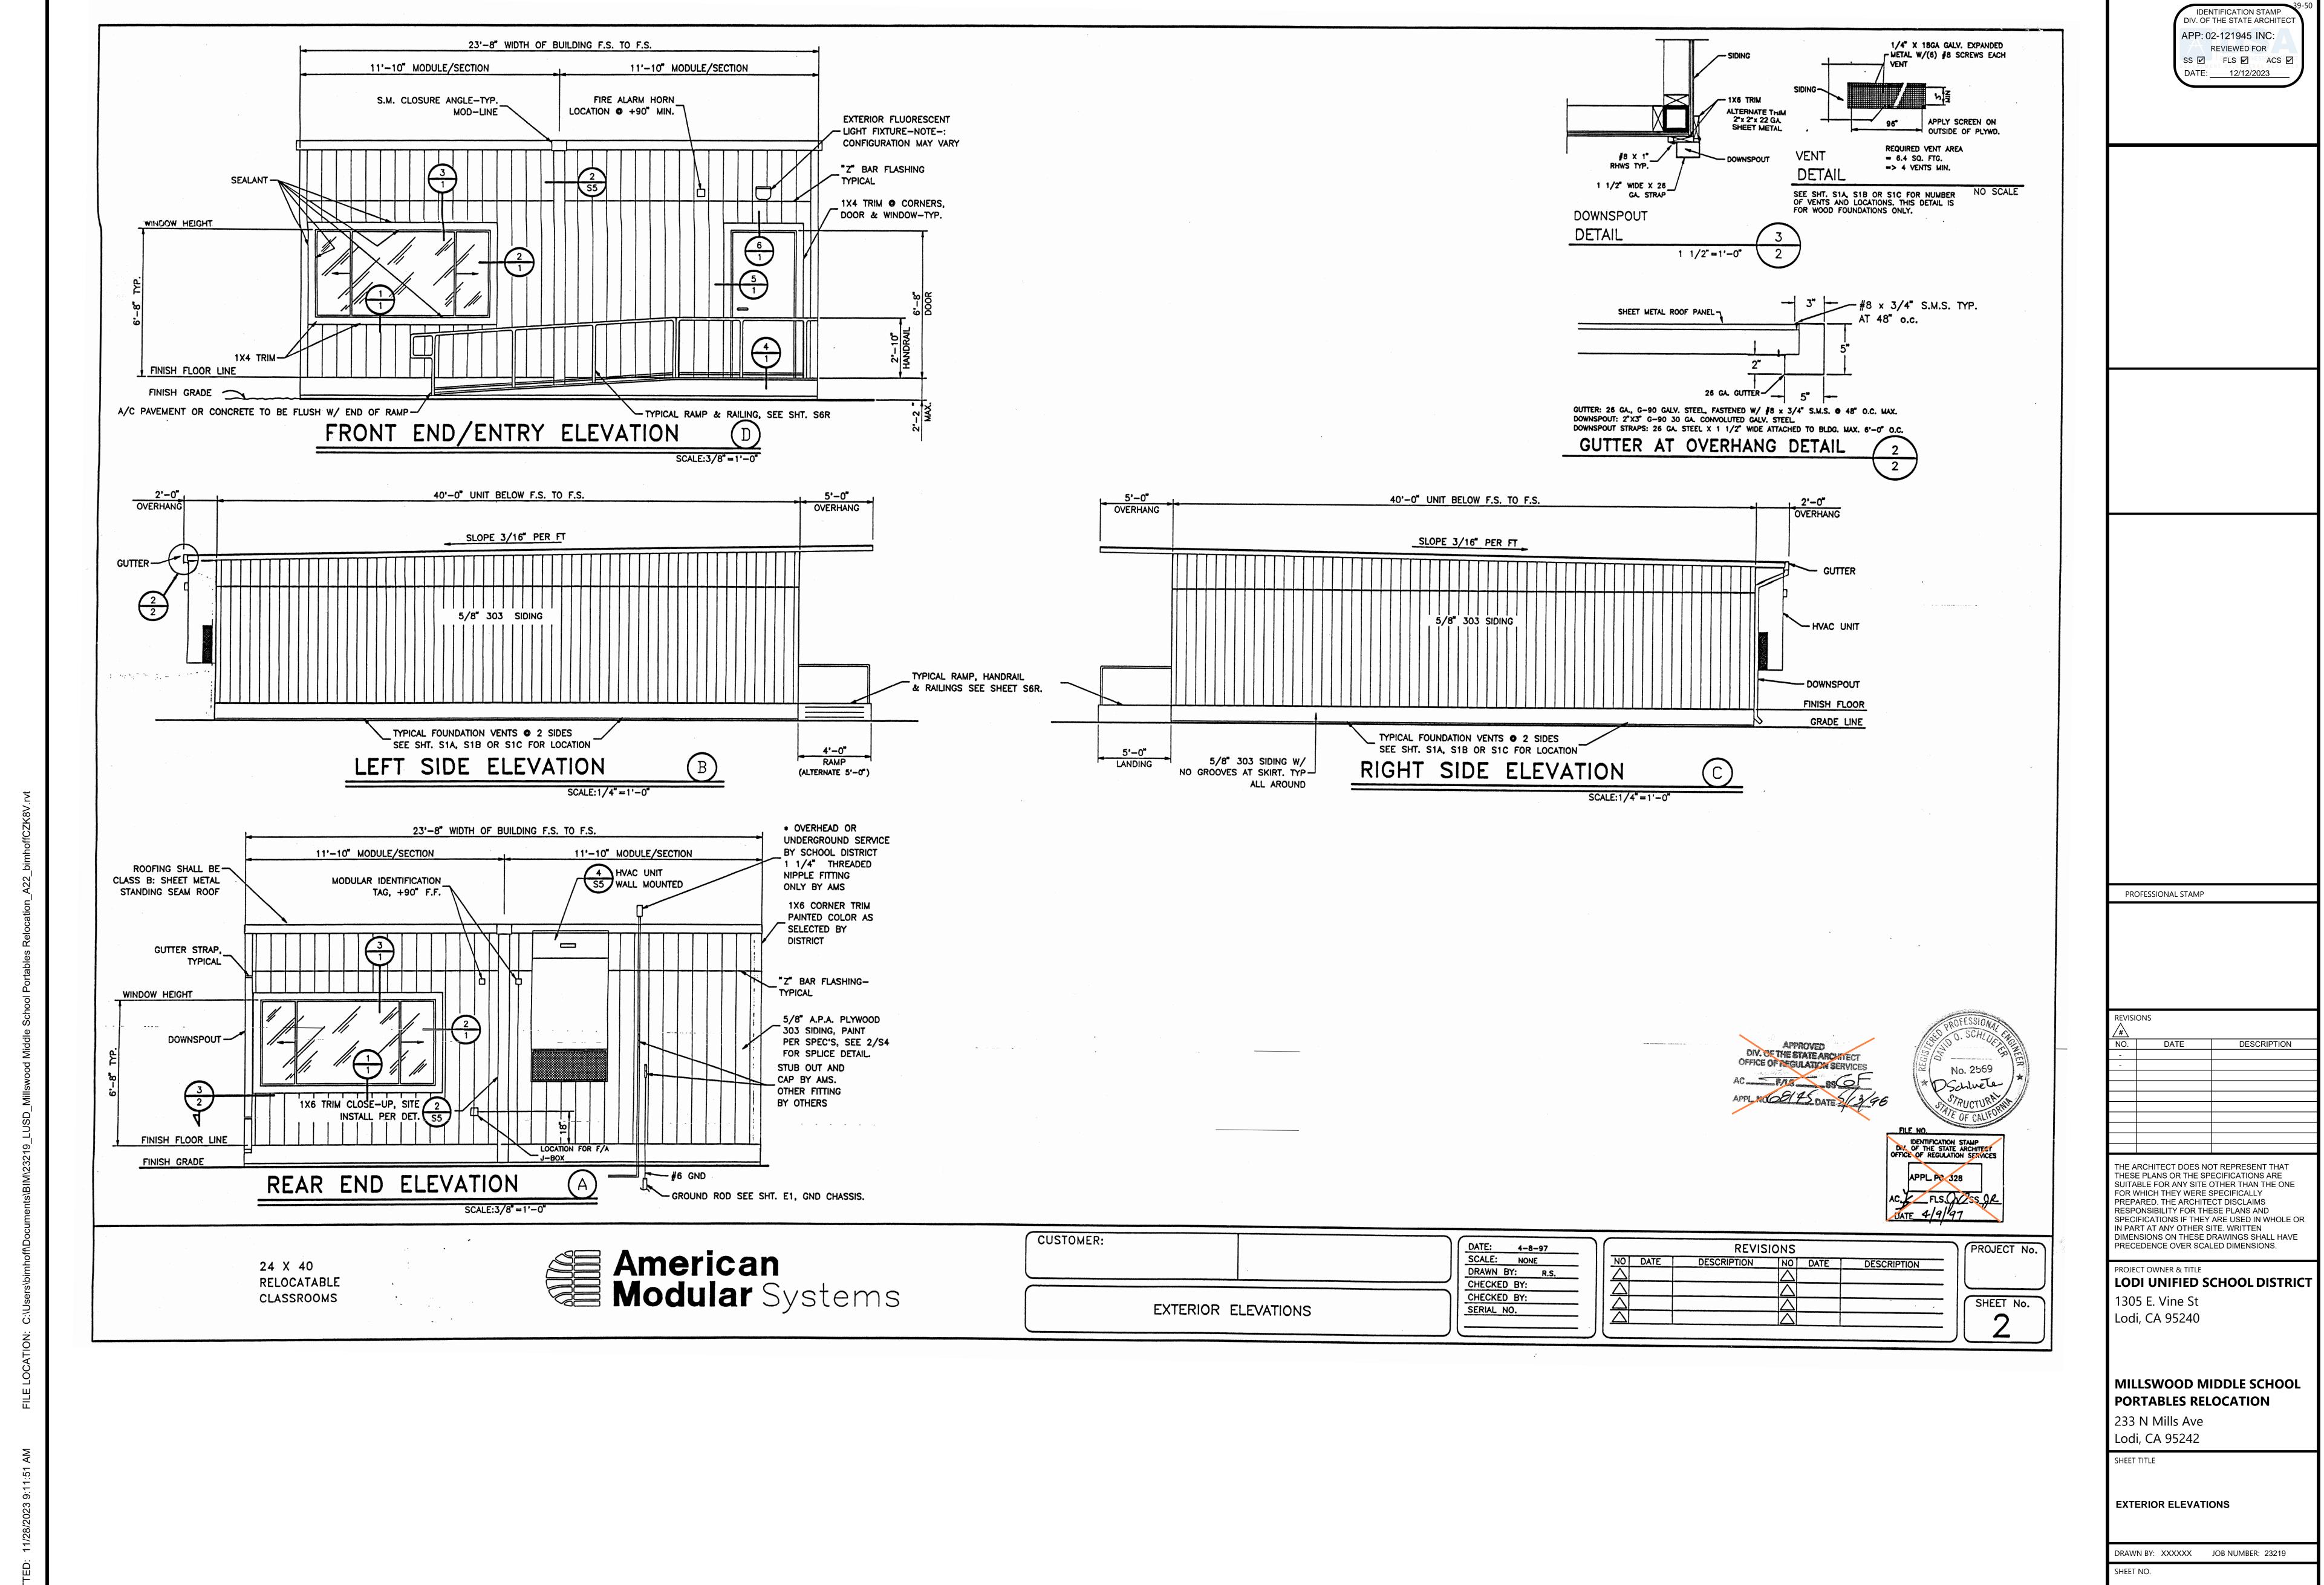

ONSTRUCTION DOCUMENTS

DATE: DECEMBER 5, 2023

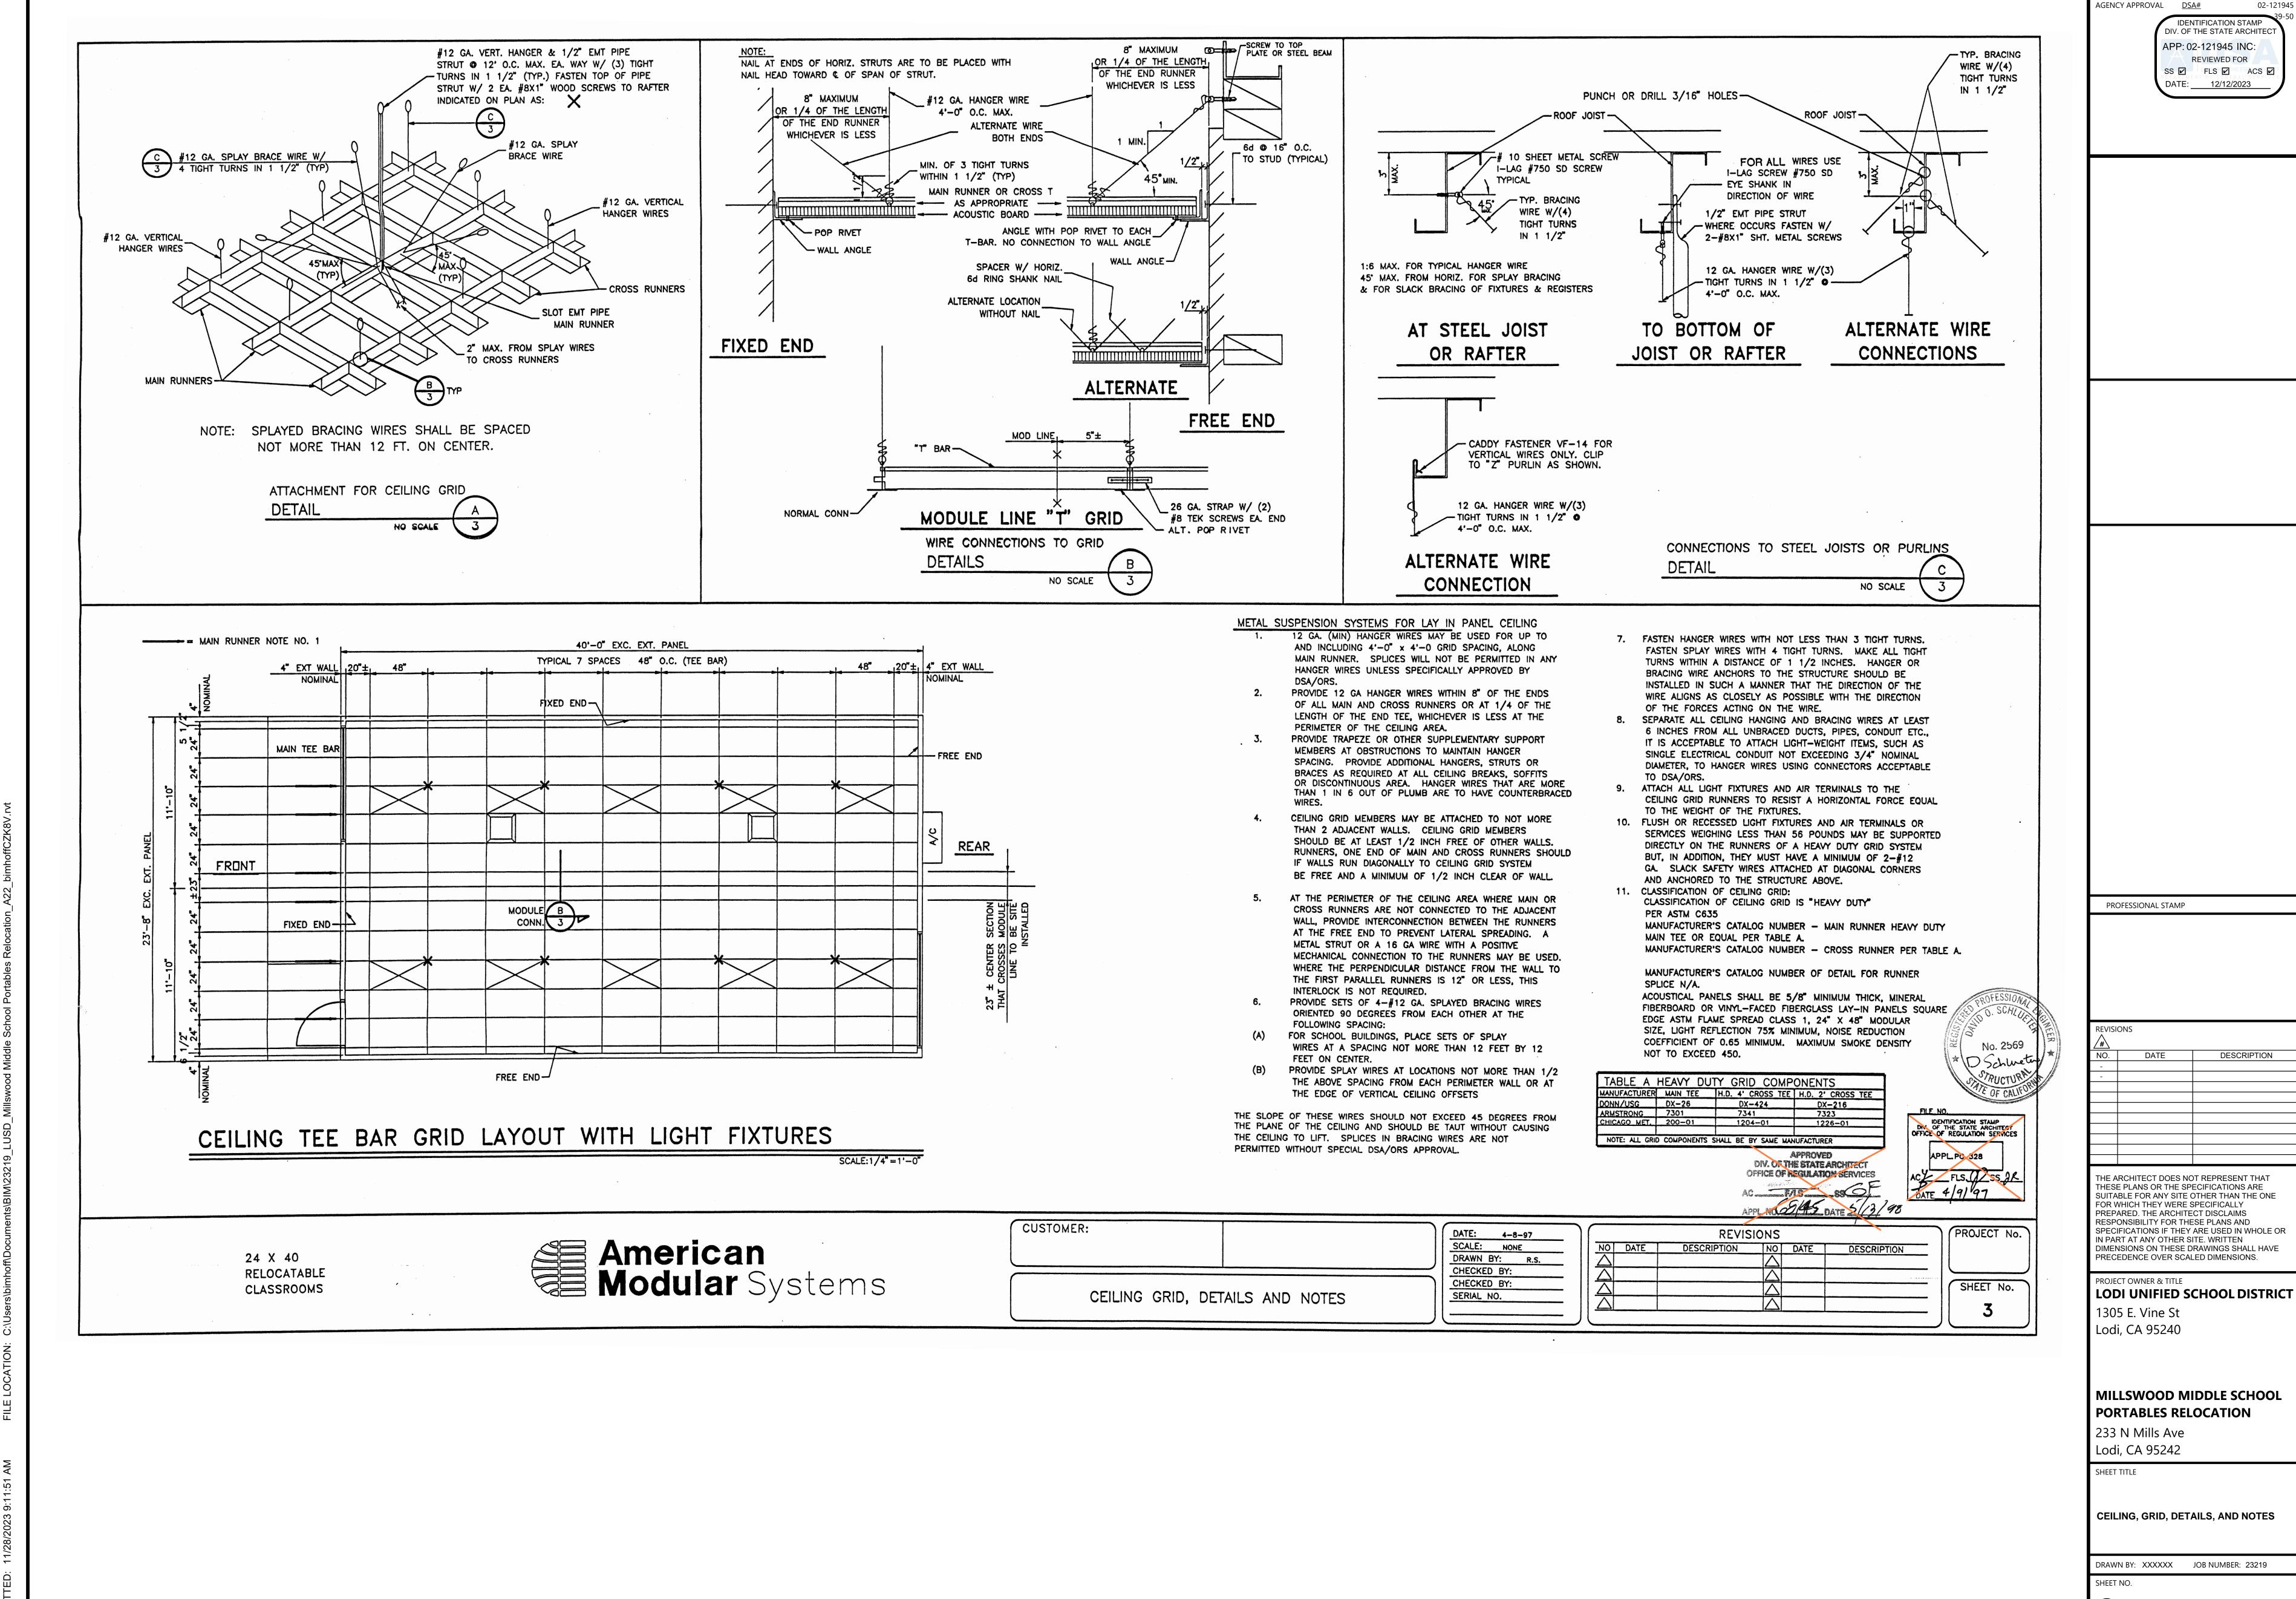

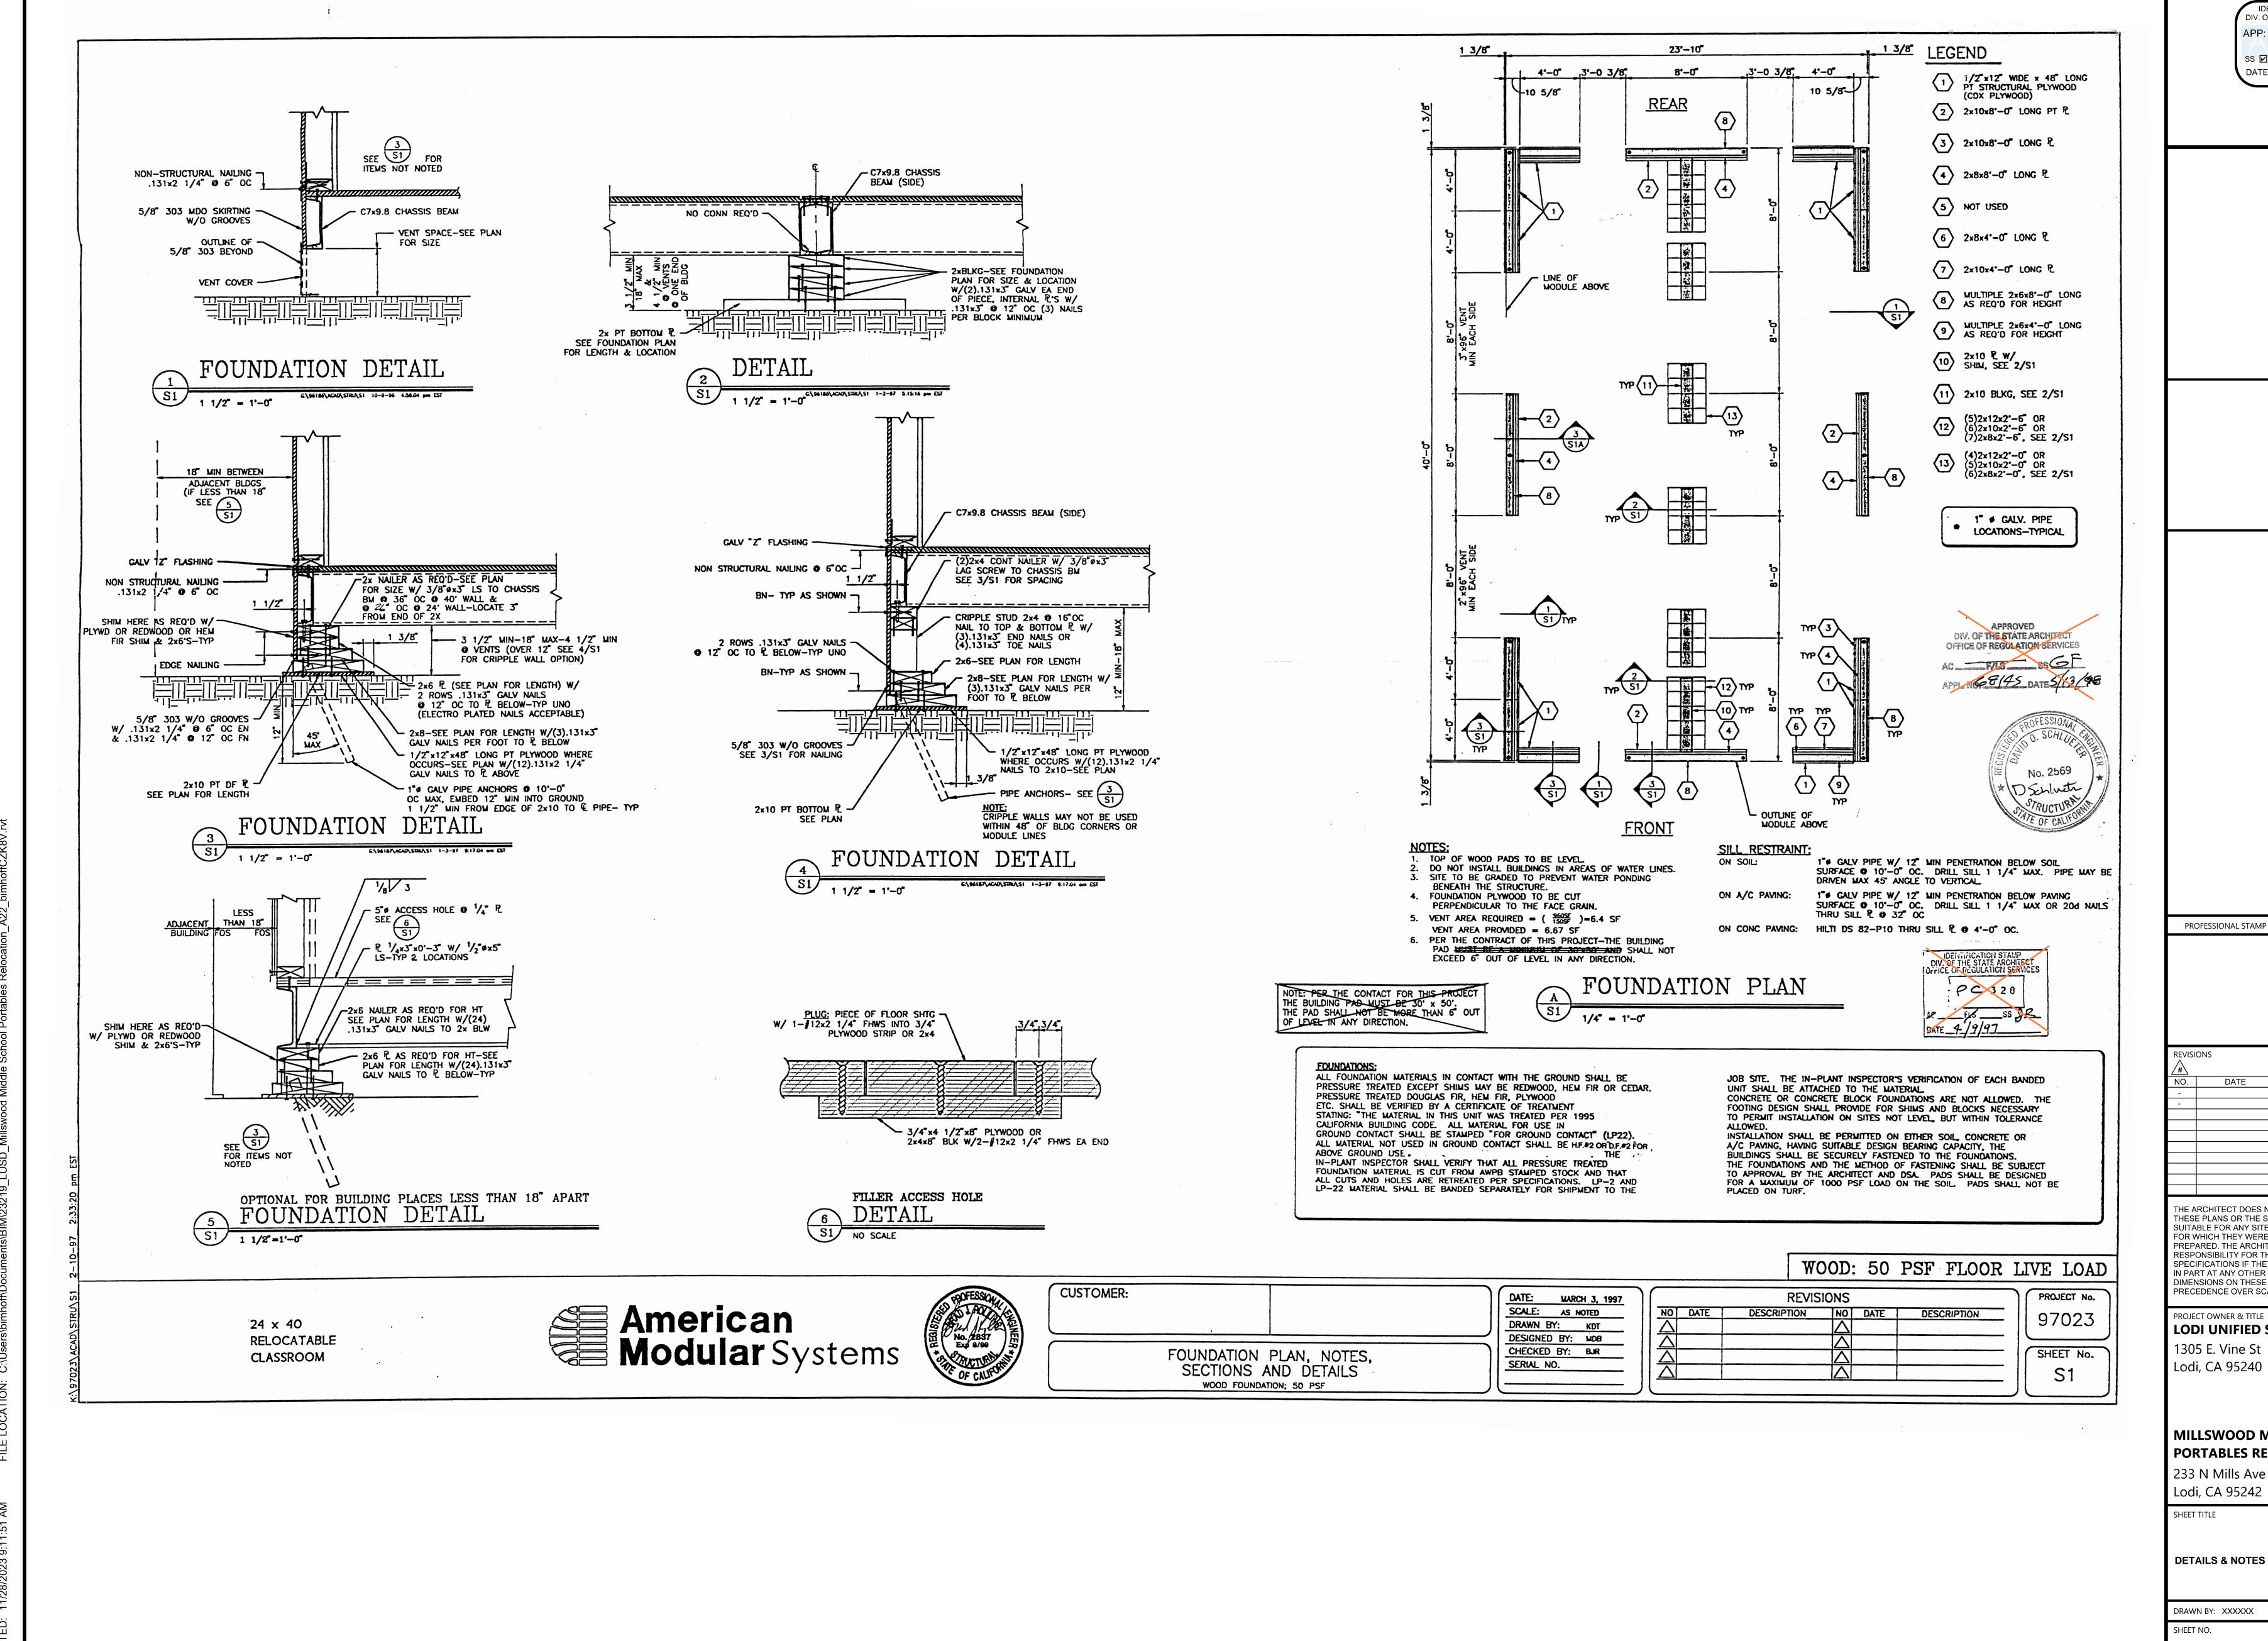

AGENCY APPROVAL DSA# IDENTIFICATION STAMP DIV. OF THE STATE ARCHITE APP: 02-121945 INC: REVIEWED FOR SS 🗹 FLS 🗹 ACS 🗹 DATE: 12/12/2023

DESCRIPTION

THE ARCHITECT DOES NOT REPRESENT THAT THESE PLANS OR THE SPECIFICATIONS ARE SUITABLE FOR ANY SITE OTHER THAN THE ONE FOR WHICH THEY WERE SPECIFICALLY PREPARED. THE ARCHITECT DISCLAIMS RESPONSIBILITY FOR THESE PLANS AND SPECIFICATIONS IF THEY ARE USED IN WHOLE OR IN PART AT ANY OTHER SITE. WRITTEN DIMENSIONS ON THESE DRAWINGS SHALL HAVE PRECEDENCE OVER SCALED DIMENSIONS.

PROJECT OWNER & TITLE **LODI UNIFIED SCHOOL DISTRICT** 


1305 E. Vine St Lodi, CA 95240

MILLSWOOD MIDDLE SCHOOL PORTABLES RELOCATION

233 N Mills Ave Lodi, CA 95242

DETAILS & NOTES 50#


DRAWN BY: XXXXXX JOB NUMBER: 23219

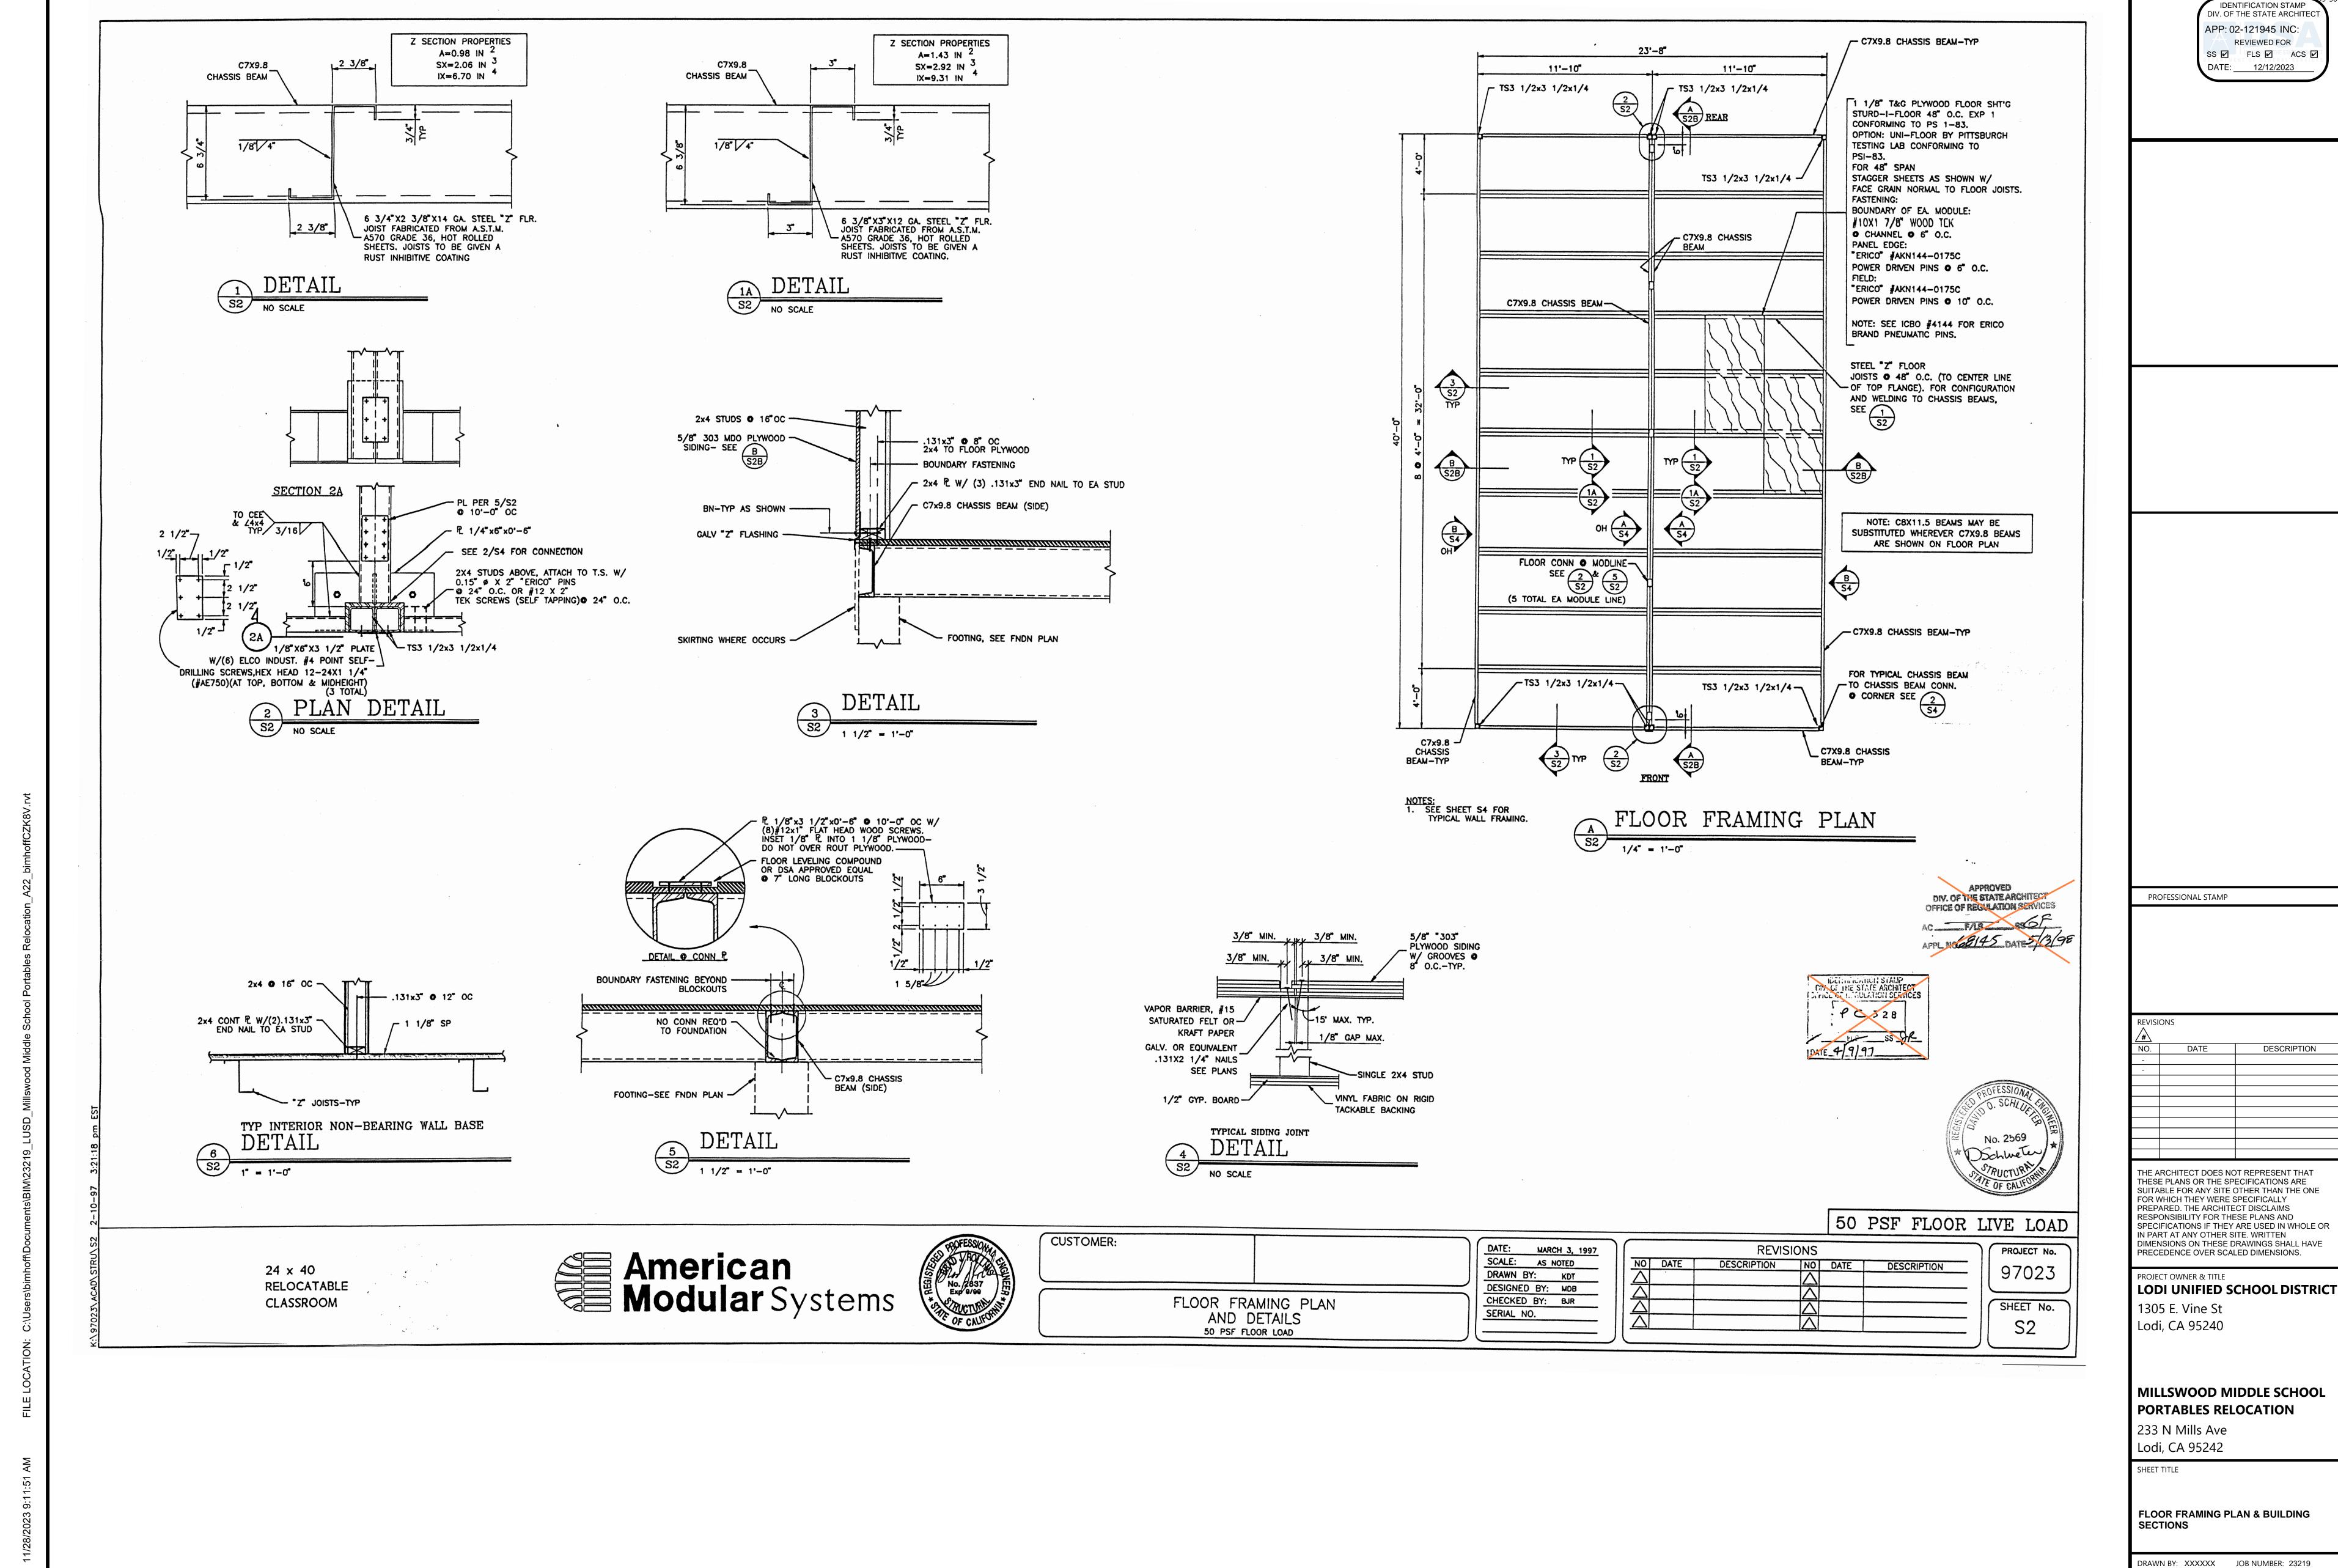

CONSTRI


**S2** 

DATE: DECEMBER 5, 2023

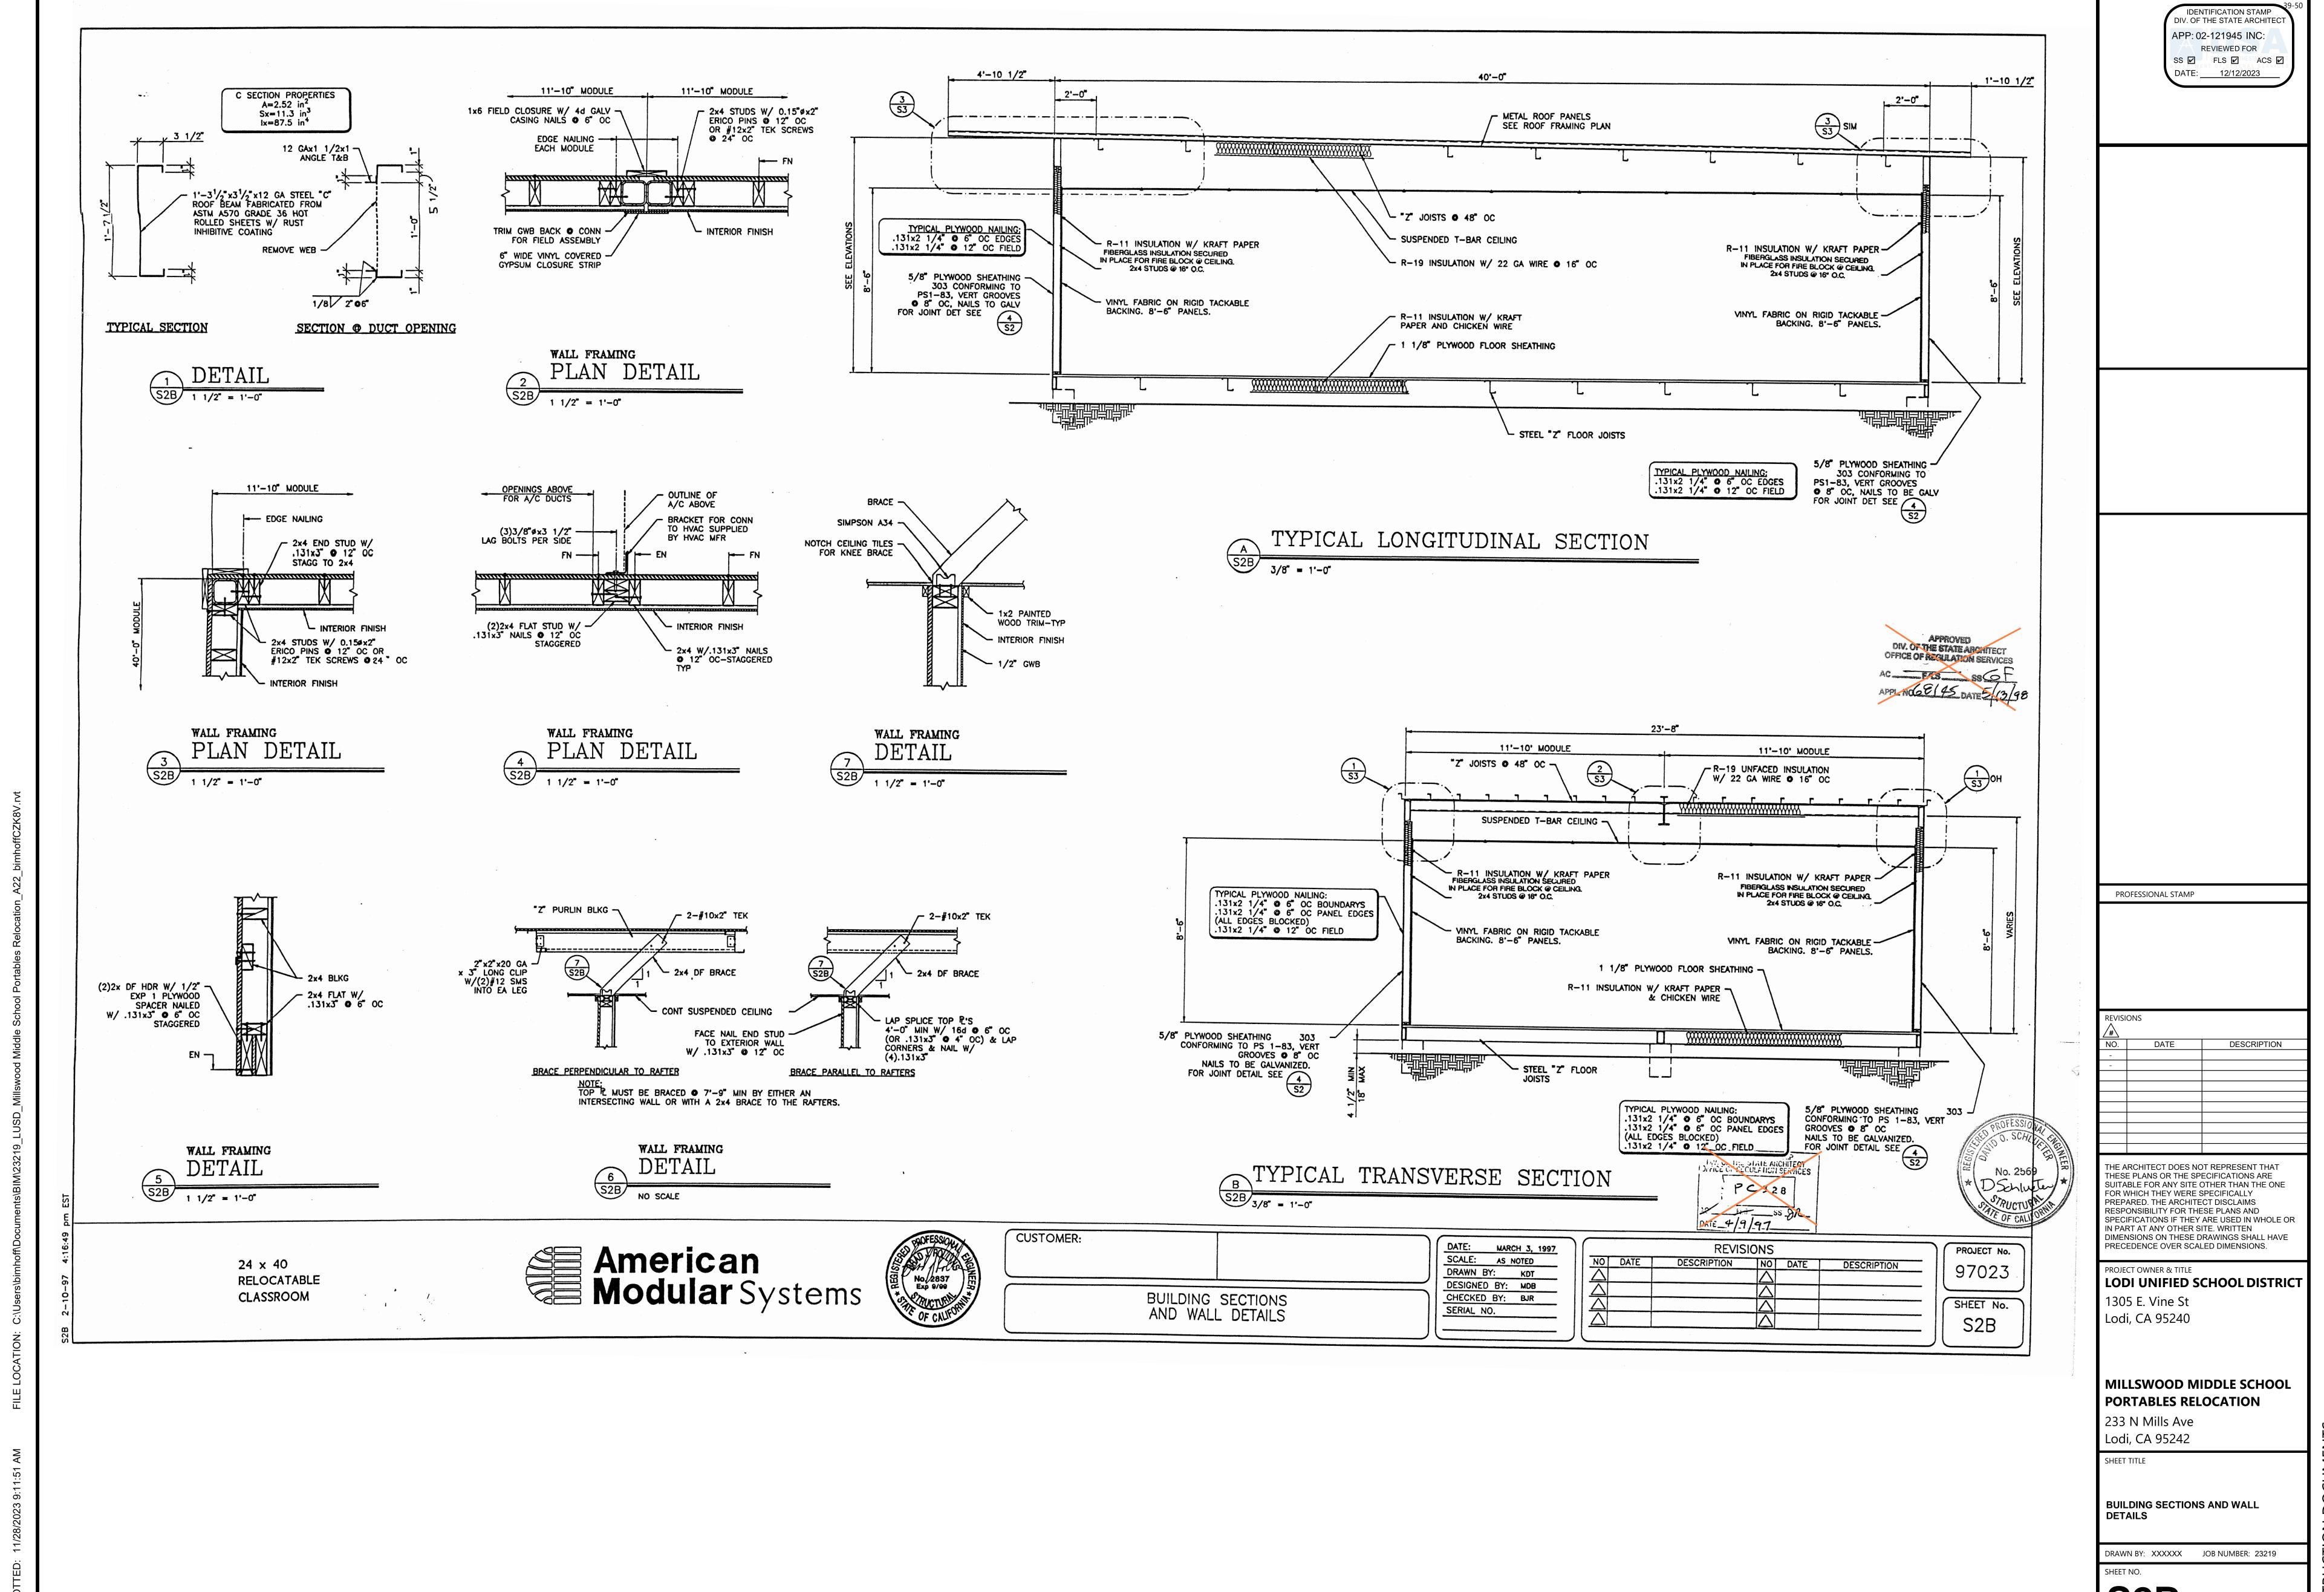


CONSTRI


AGENCY APPROVAL DSA#

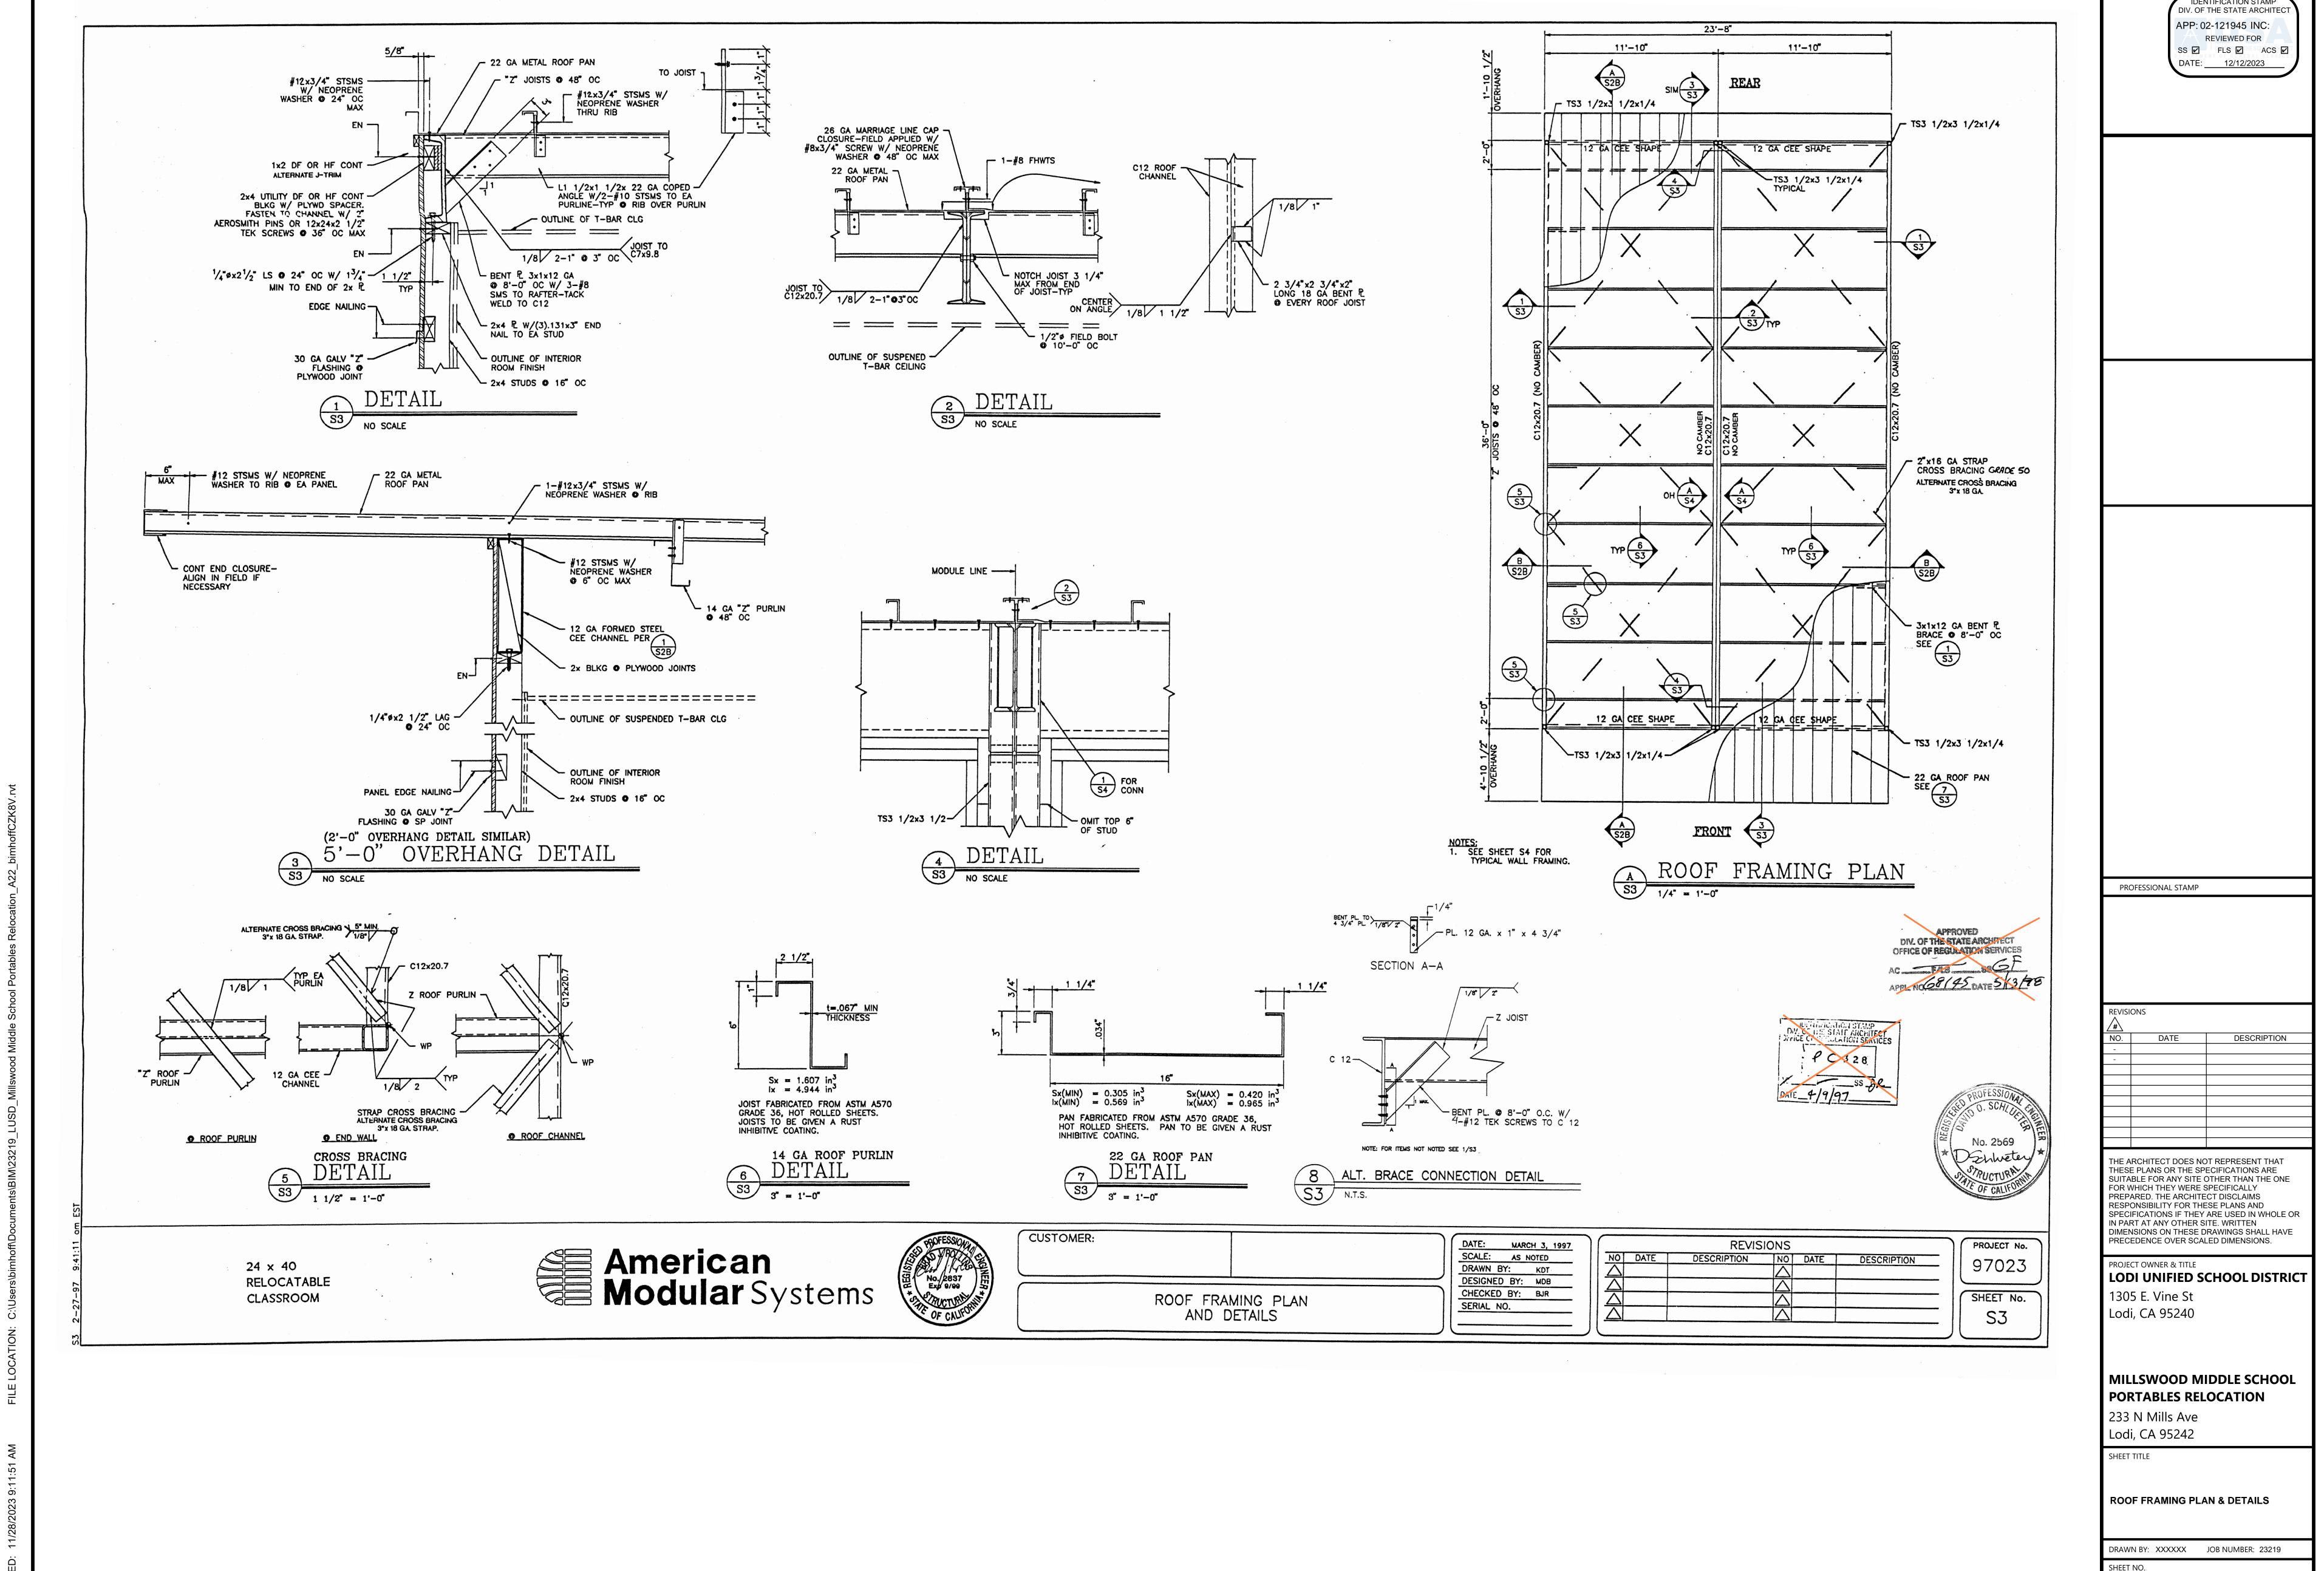

AGENCY APPROVAL DSA# IDENTIFICATION STAMP

**S3** DATE: DECEMBER 5, 2023 CONSTRI

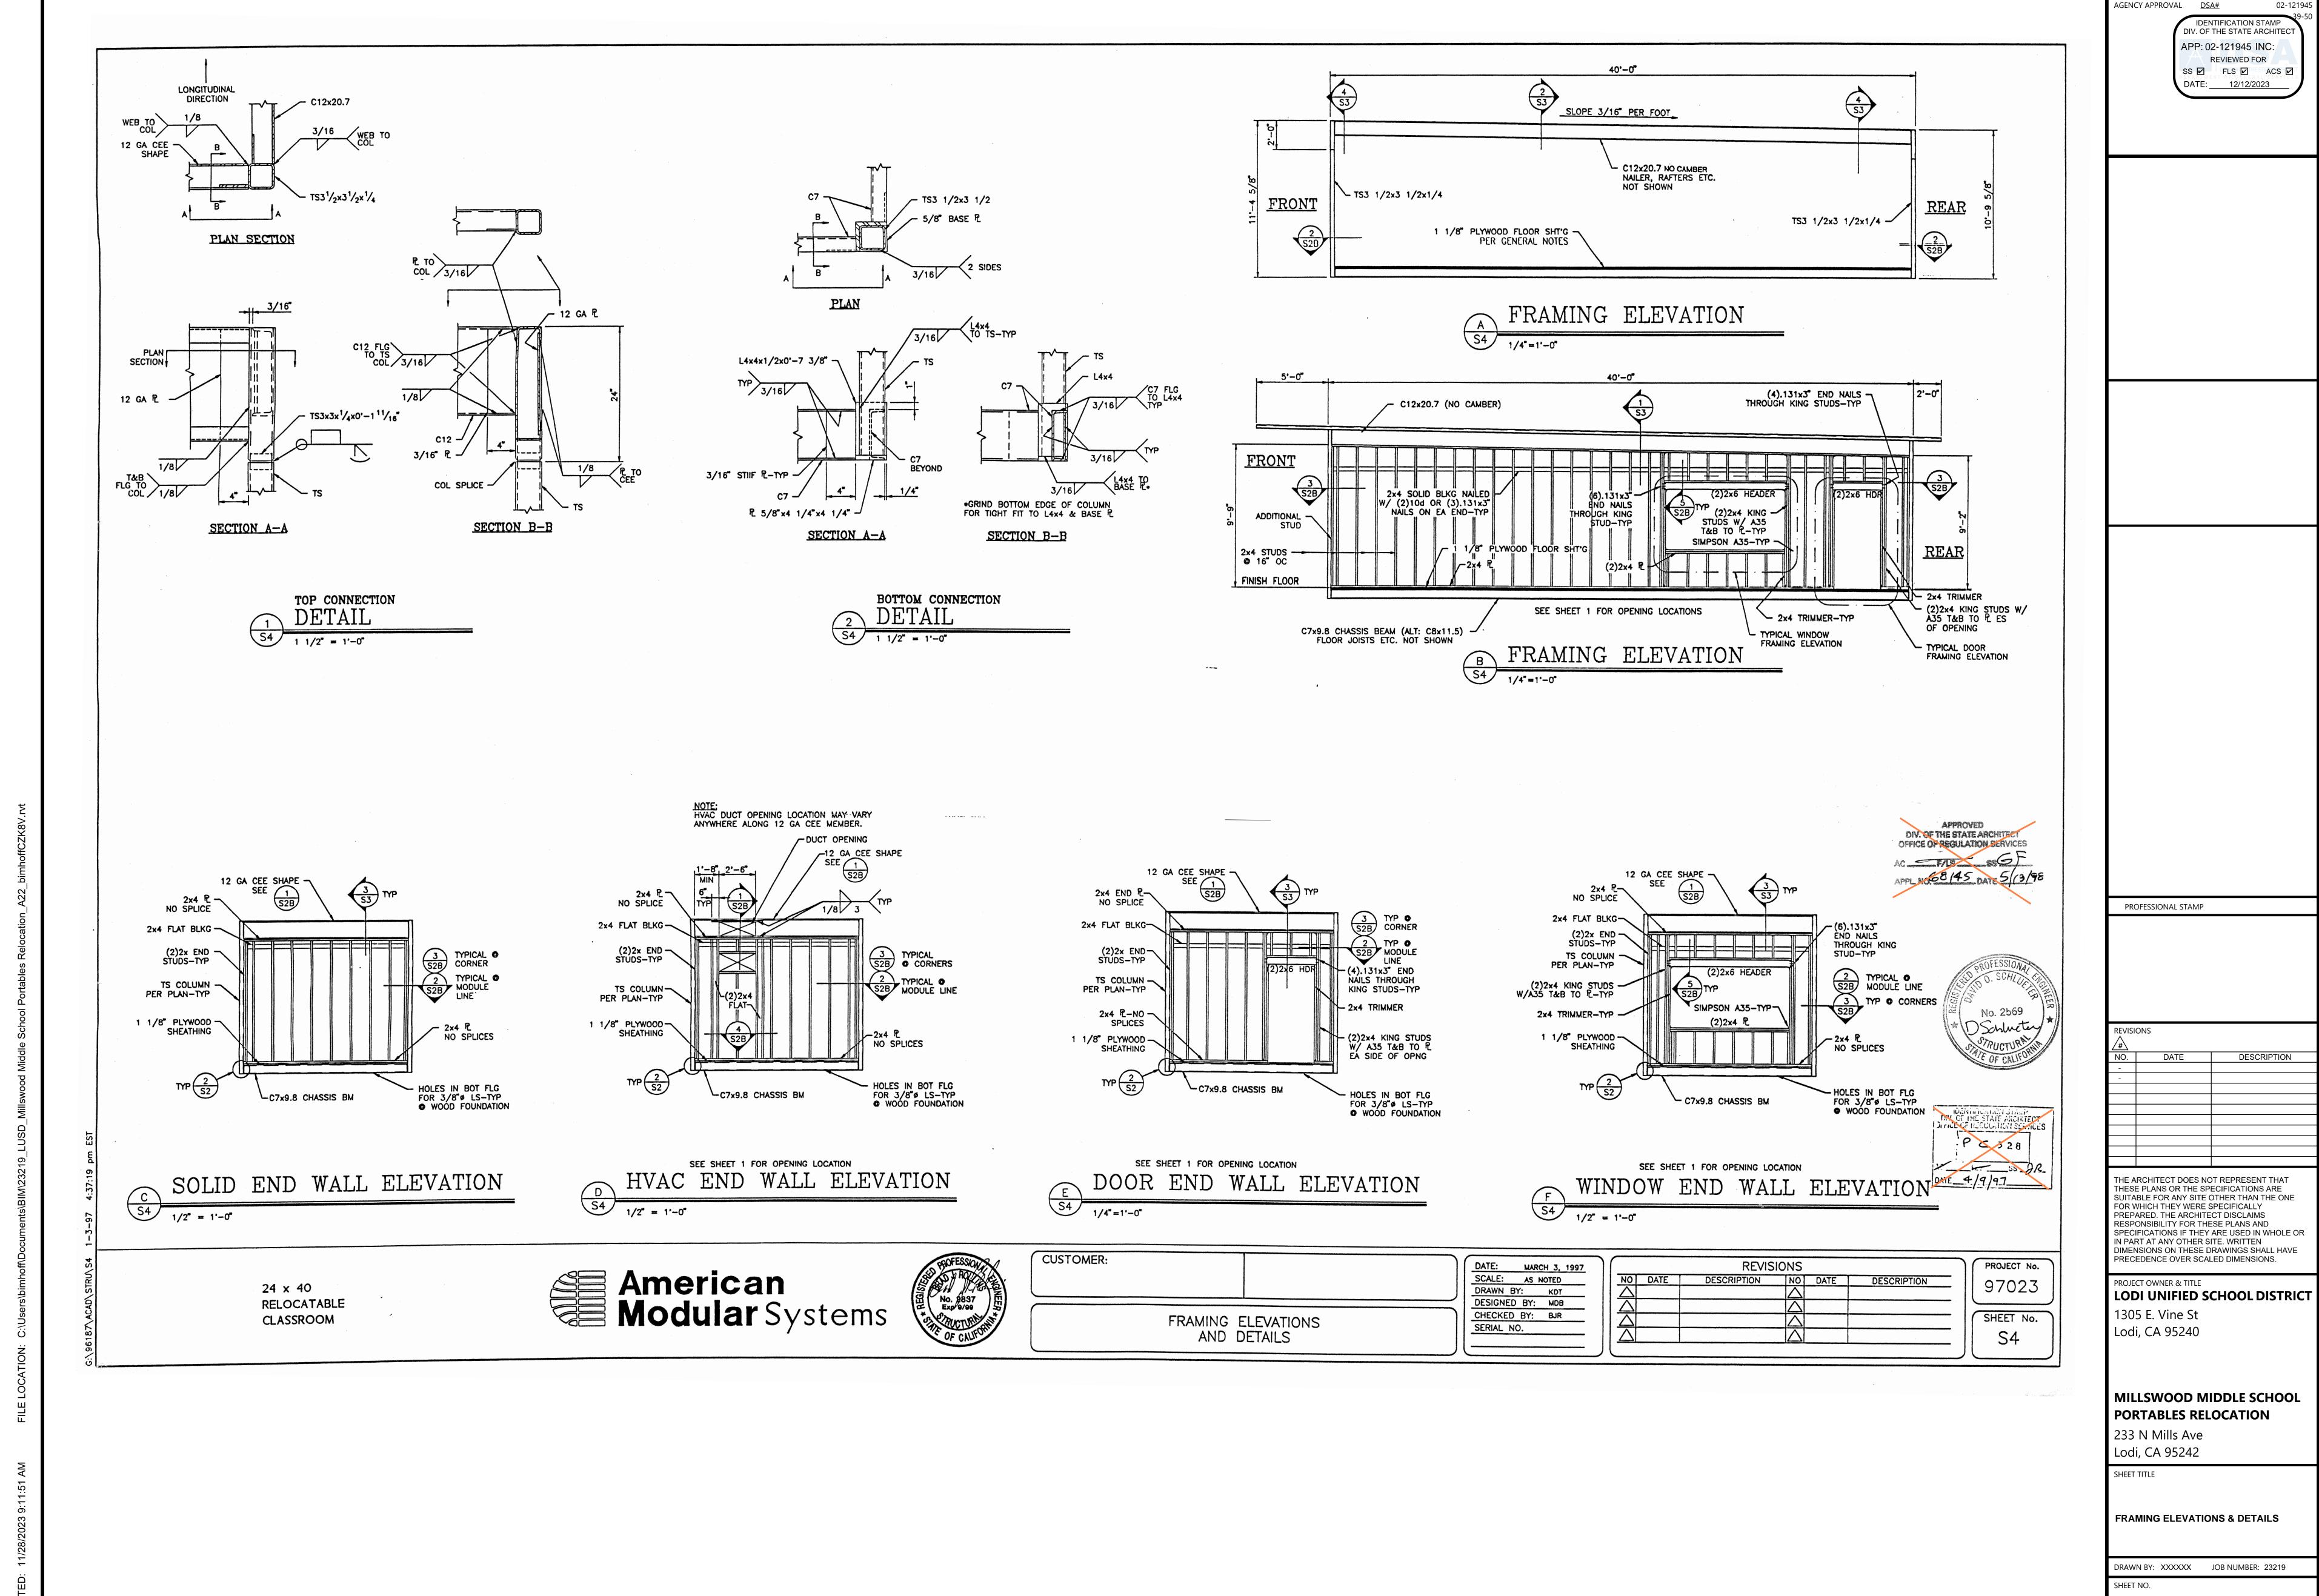

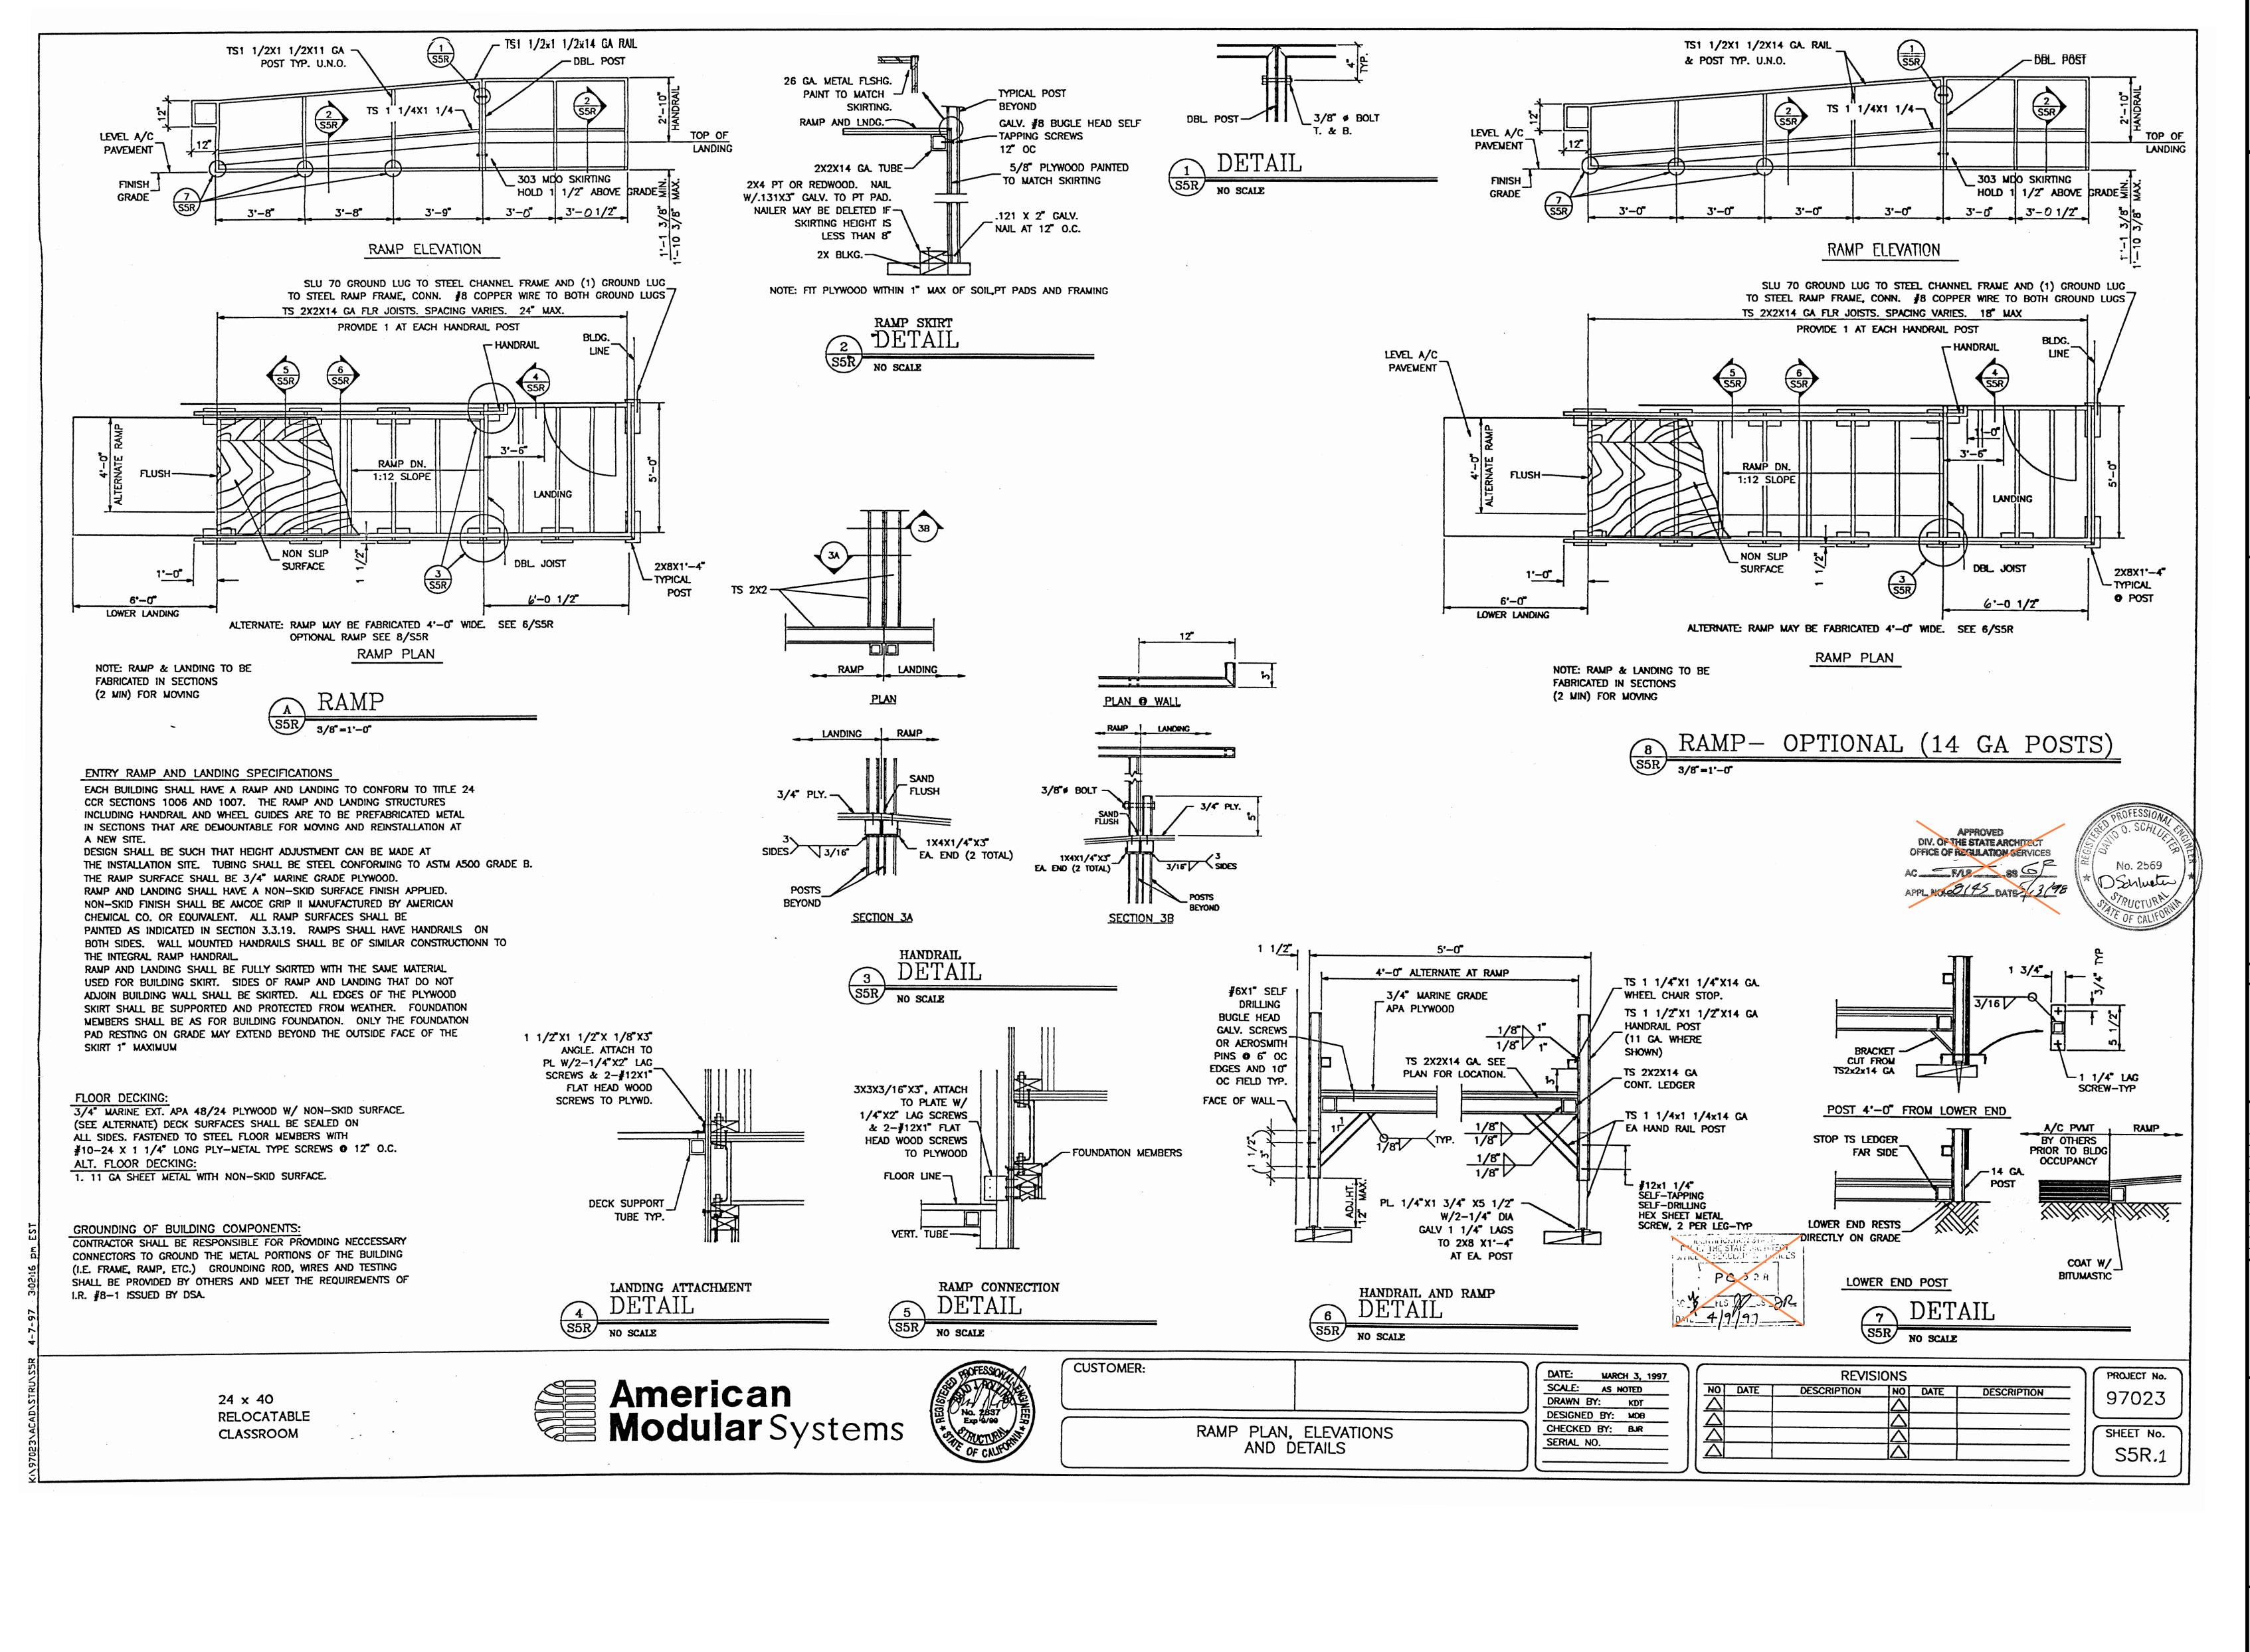

IDENTIFICATION STAMP DIV. OF THE STATE ARCHITE APP: 02-121945 INC: REVIEWED FOR SS 🗹 FLS 🗹 ACS 🗹 DATE: 12/12/2023

AGENCY APPROVAL DSA#

PROFESSIONAL STAMP

THE ARCHITECT DOES NOT REPRESENT THAT THESE PLANS OR THE SPECIFICATIONS ARE SUITABLE FOR ANY SITE OTHER THAN THE ONE FOR WHICH THEY WERE SPECIFICALLY PREPARED. THE ARCHITECT DISCLAIMS RESPONSIBILITY FOR THESE PLANS AND SPECIFICATIONS IF THEY ARE USED IN WHOLE OR

DESCRIPTION

PRECEDENCE OVER SCALED DIMENSIONS. PROJECT OWNER & TITLE LODI UNIFIED SCHOOL DISTRICT

DIMENSIONS ON THESE DRAWINGS SHALL HAVE

1305 E. Vine St Lodi, CA 95240

IN PART AT ANY OTHER SITE. WRITTEN

MILLSWOOD MIDDLE SCHOOL PORTABLES RELOCATION

233 N Mills Ave Lodi, CA 95242

SHEET TITLE


RAMP PLAN, ELEVATION & DETAILS

ONSTRI

DRAWN BY: XXXXXX JOB NUMBER: 23219

S5R.1 DATE: DECEMBER 5, 2023



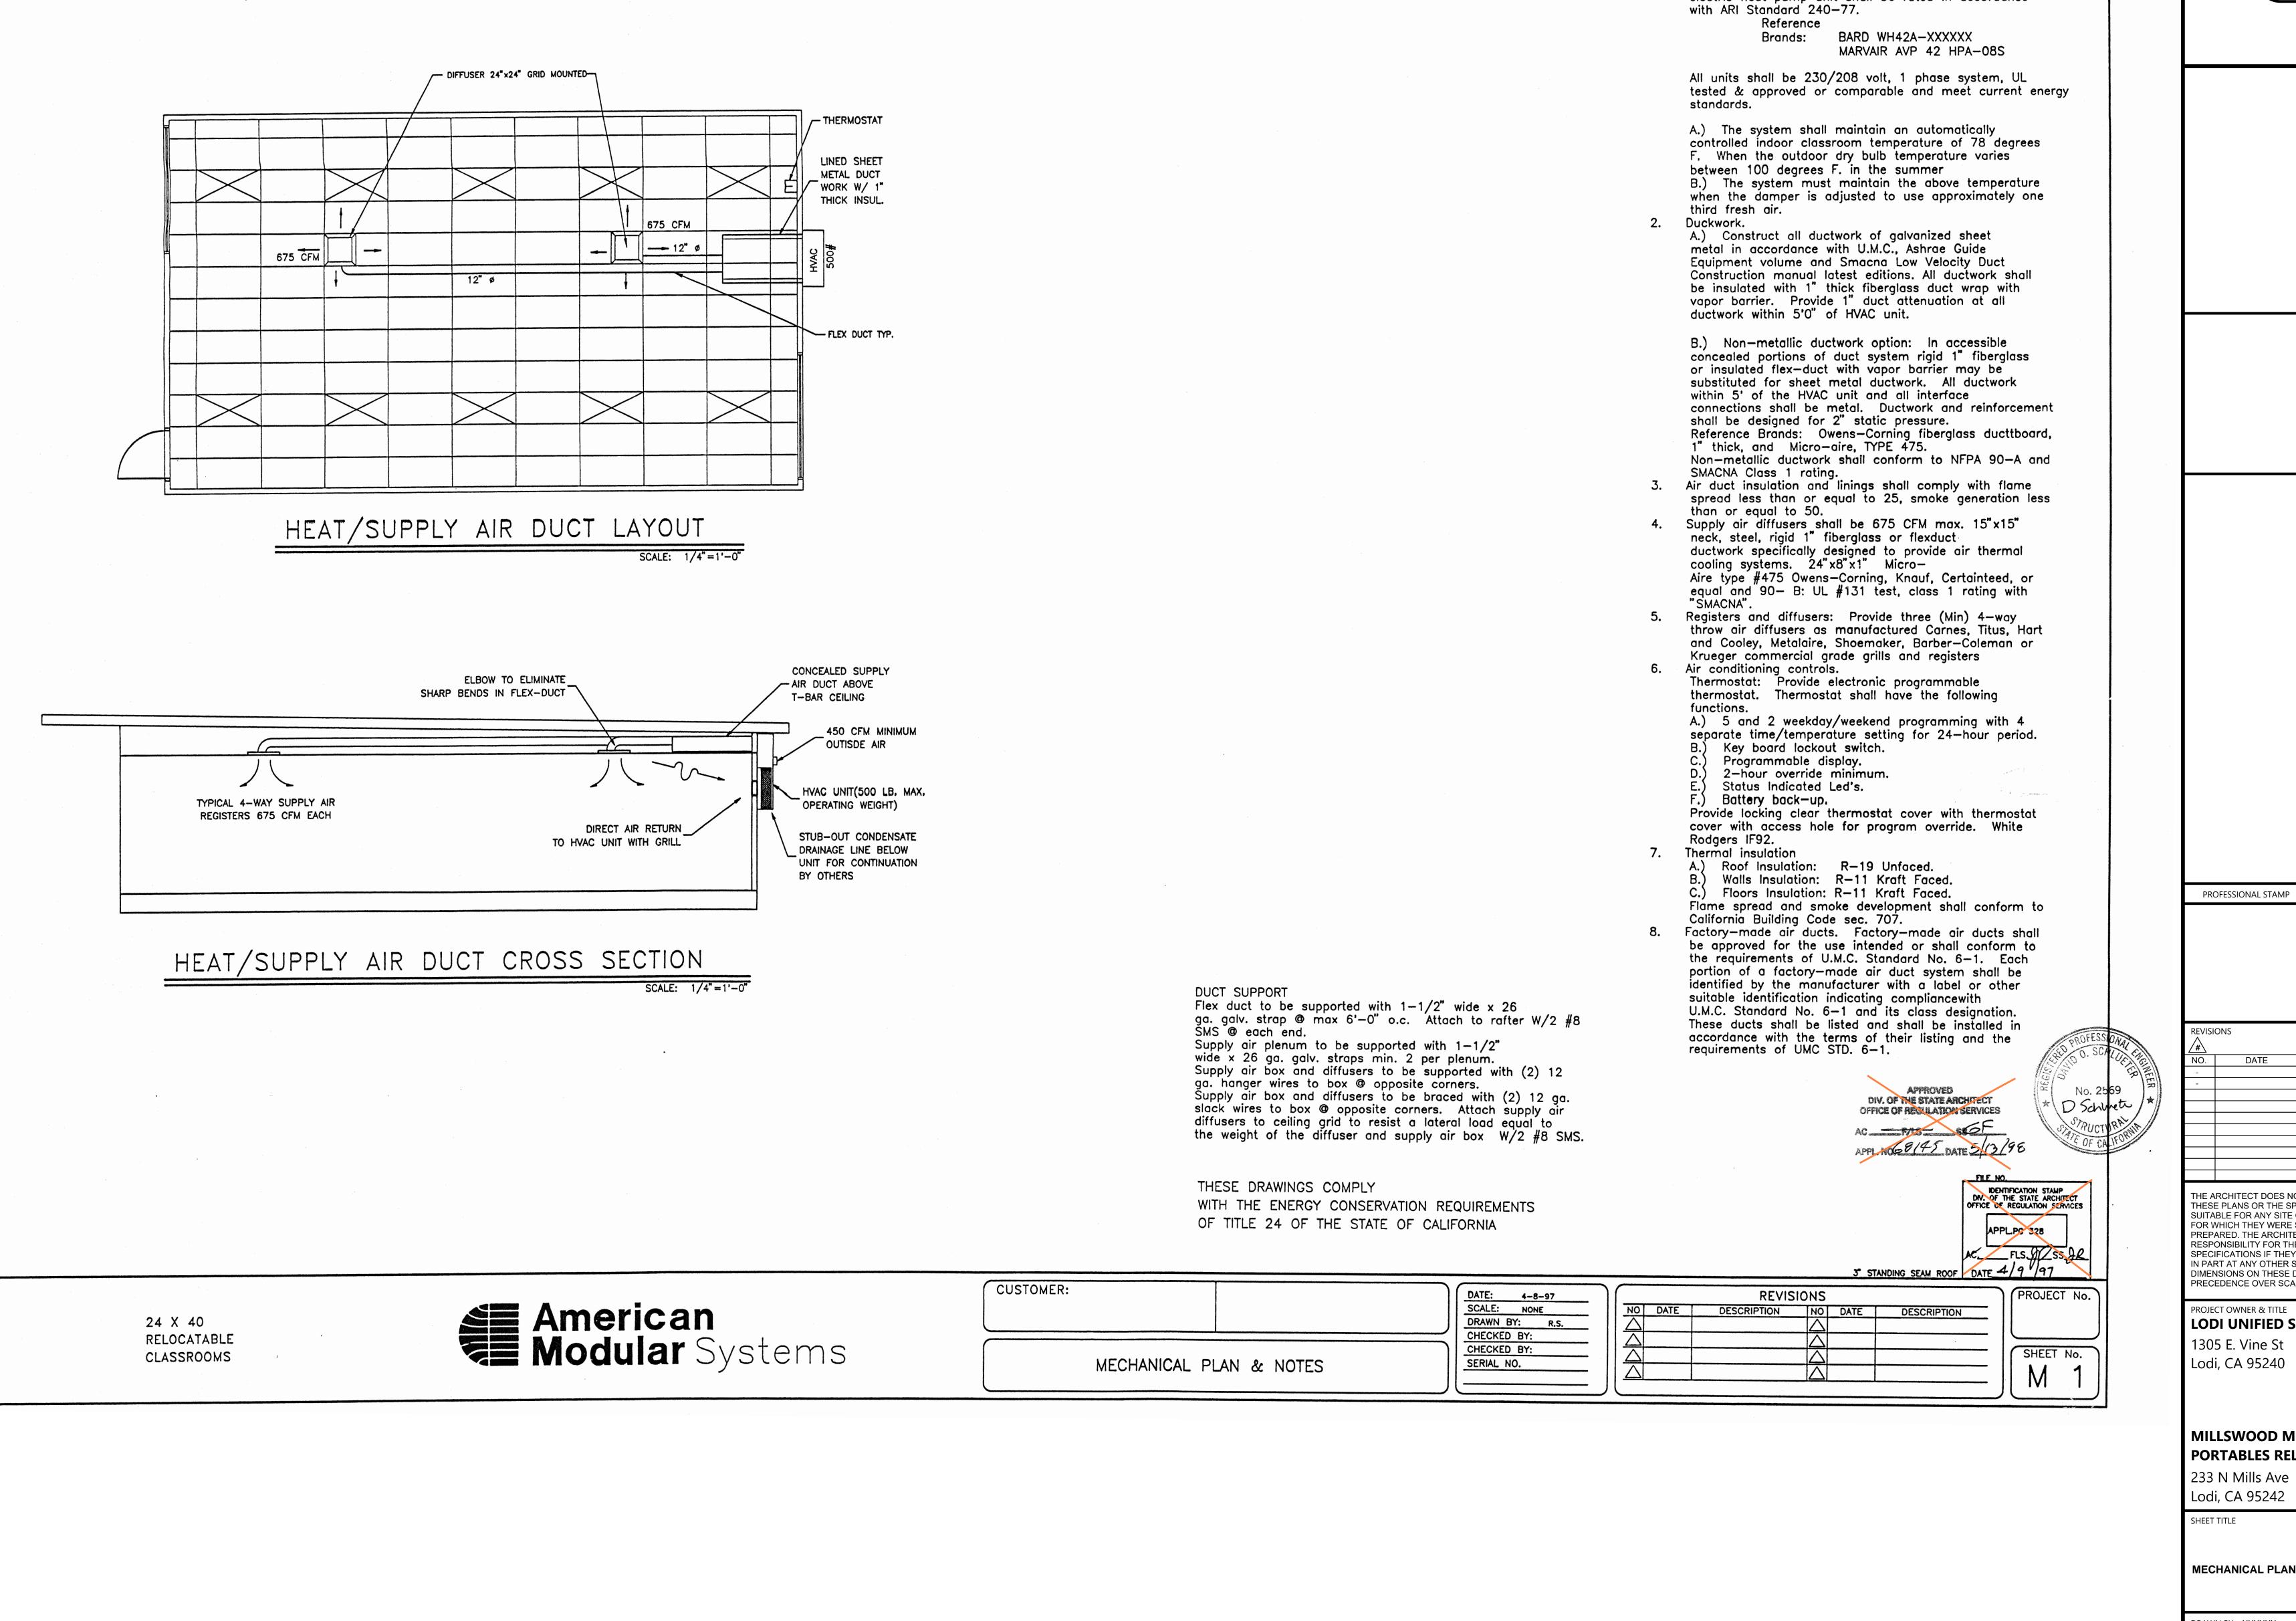

AGENCY APPROVAL DSA# IDENTIFICATION STAMP DIV. OF THE STATE ARCHITEC APP: 02-121945 INC: REVIEWED FOR SS 🗹 FLS 🗹 ACS 🗹 DATE: 12/12/2023

GENERAL NOTES

HEATING VENTILATING AND AIR CONDITIONING (HVAC)

1. Heat Pump: Single package wall mounted air to air

electric heat pump unit shall be rated in accordance

DESCRIPTION

THE ARCHITECT DOES NOT REPRESENT THAT


THESE PLANS OR THE SPECIFICATIONS ARE SUITABLE FOR ANY SITE OTHER THAN THE ONE FOR WHICH THEY WERE SPECIFICALLY PREPARED. THE ARCHITECT DISCLAIMS RESPONSIBILITY FOR THESE PLANS AND SPECIFICATIONS IF THEY ARE USED IN WHOLE OR IN PART AT ANY OTHER SITE. WRITTEN DIMENSIONS ON THESE DRAWINGS SHALL HAVE PRECEDENCE OVER SCALED DIMENSIONS.

LODI UNIFIED SCHOOL DISTRICT

MILLSWOOD MIDDLE SCHOOL PORTABLES RELOCATION

MECHANICAL PLAN, DETAILS & NOTES

DRAWN BY: XXXXXX JOB NUMBER: 23219

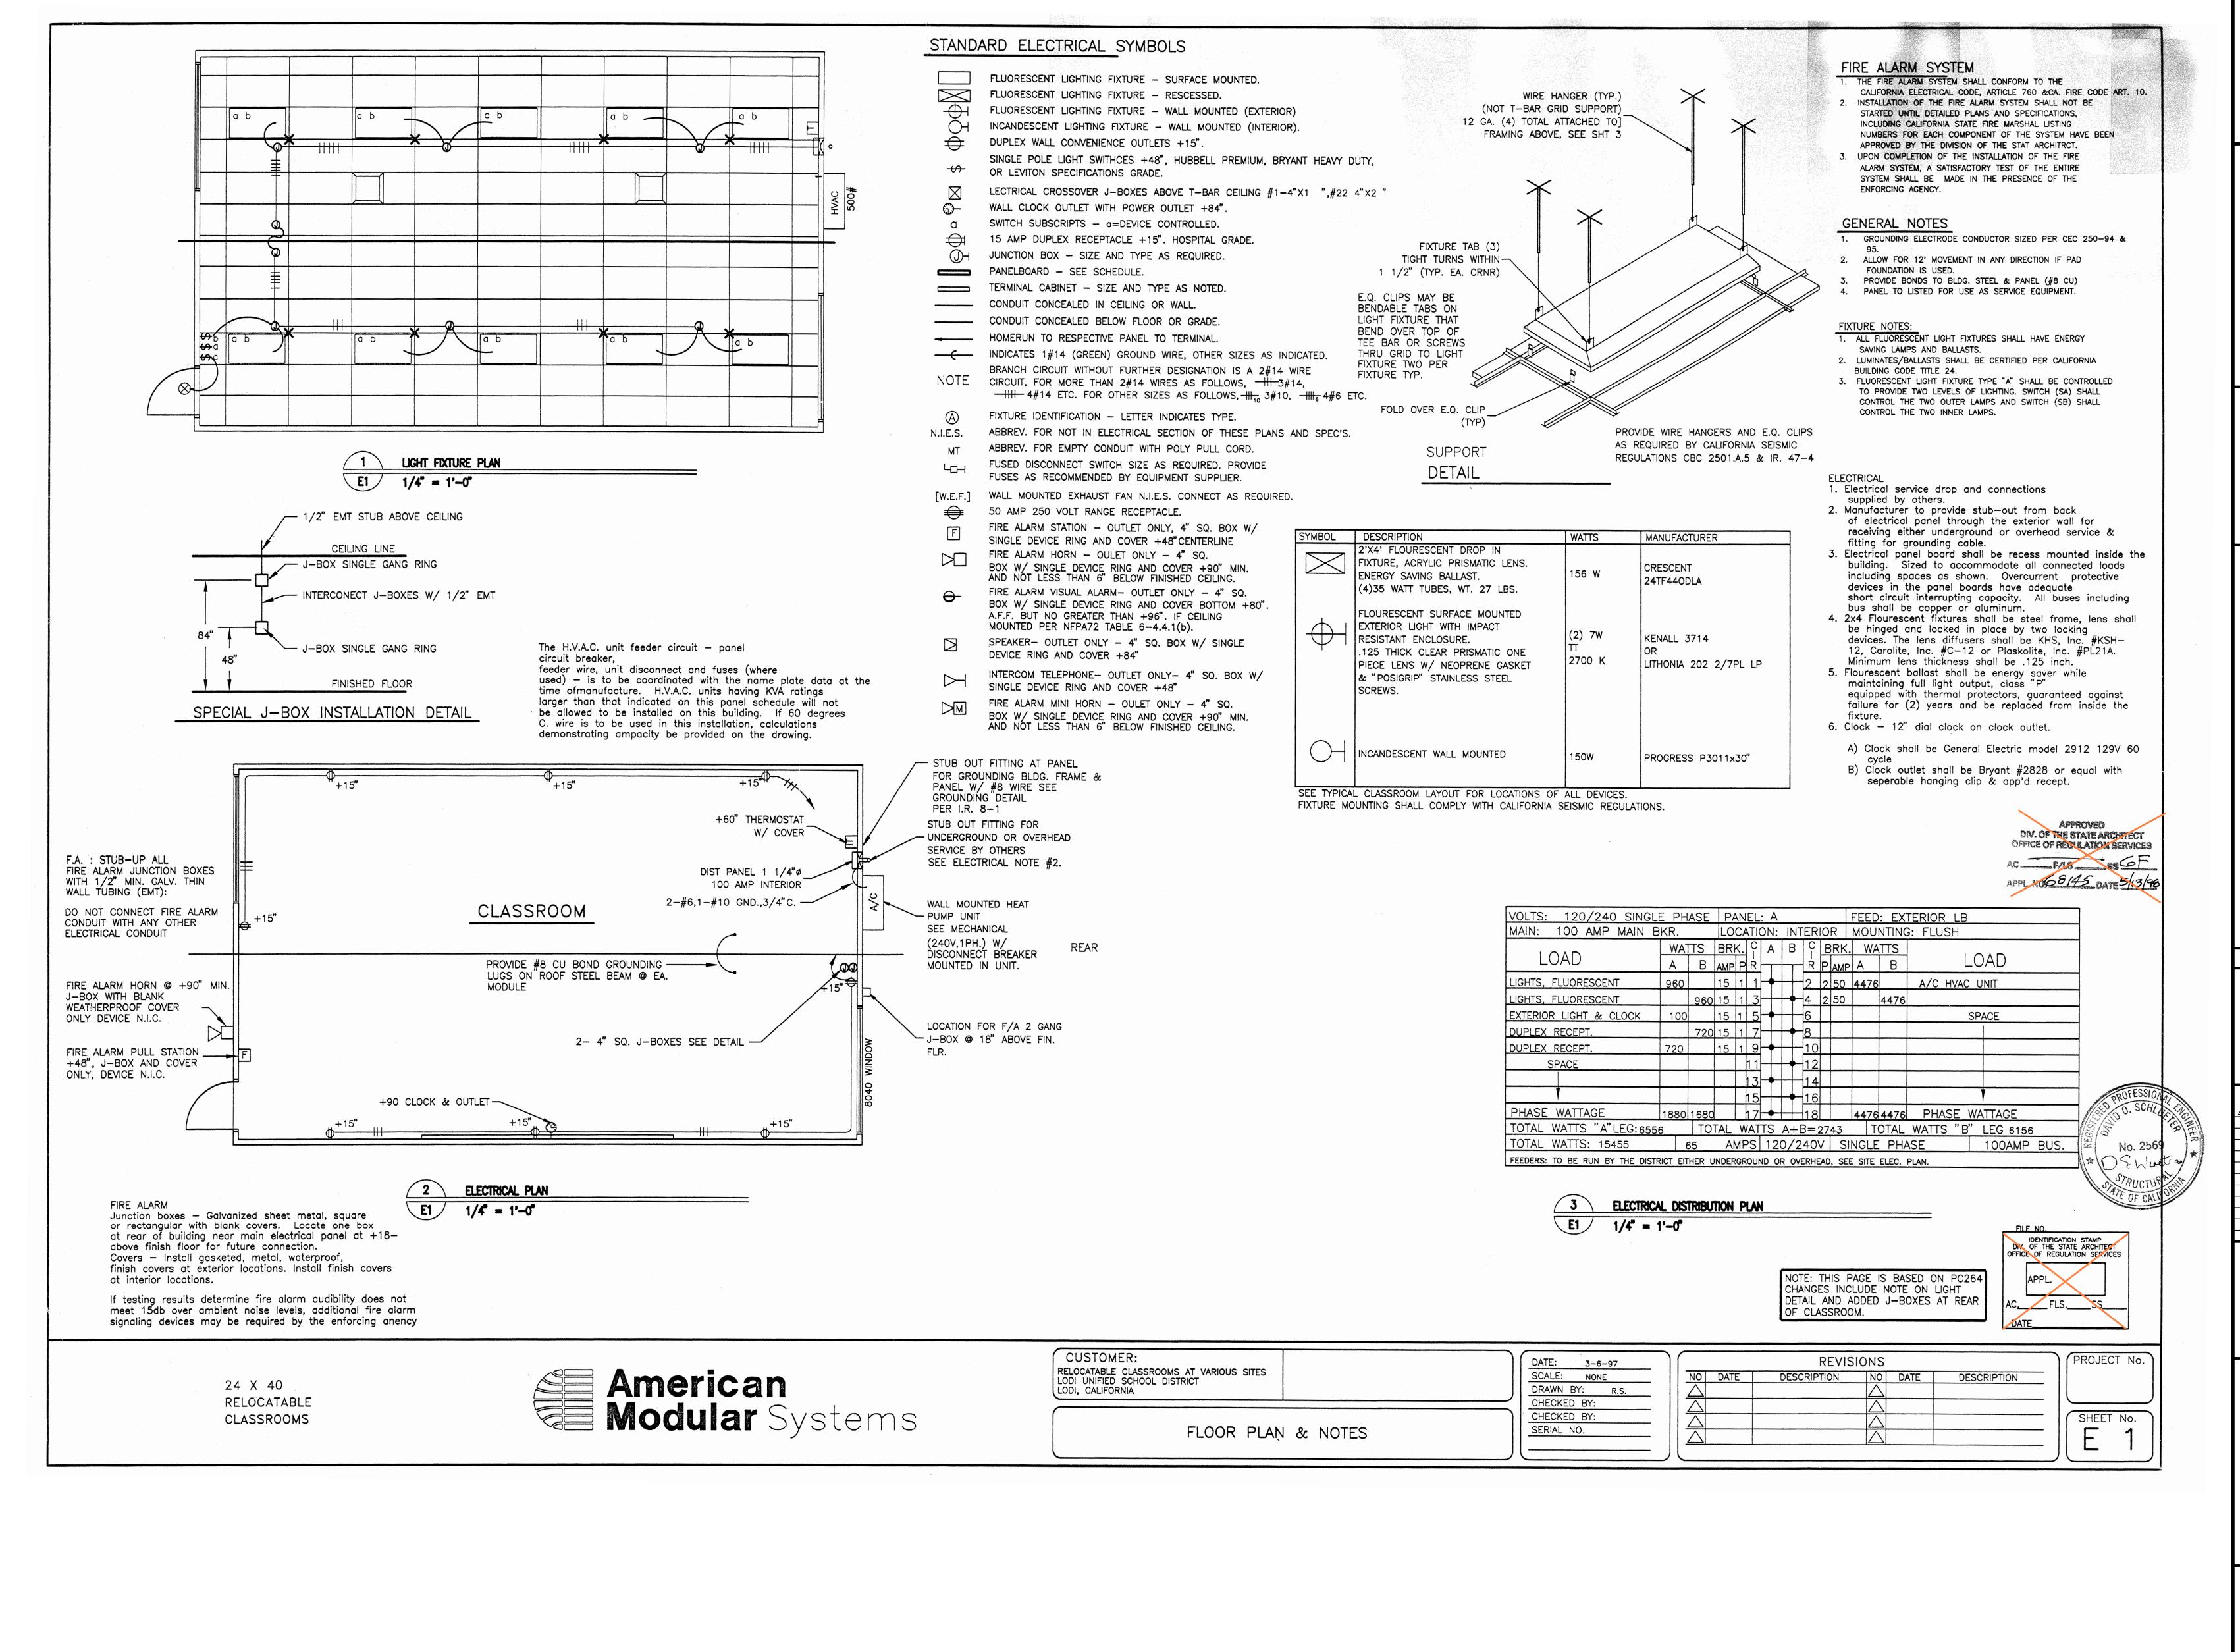

AGENCY APPROVAL

DSA#

02-12194

IDENTIFICATION STAMP
DIV. OF THE STATE ARCHITECT

APP: 02-121945 INC:

REVIEWED FOR
SS FLS ACS D

DATE: 12/12/2023

PROFESSIONAL STAMP

VISIONS

DATE DESCRIPTION

THE ARCHITECT DOES NOT REPRESENT THAT
THESE PLANS OR THE SPECIFICATIONS ARE
SUITABLE FOR ANY SITE OTHER THAN THE ONE
FOR WHICH THEY WERE SPECIFICALLY
PREPARED. THE ARCHITECT DISCLAIMS
RESPONSIBILITY FOR THESE PLANS AND
SPECIFICATIONS IF THEY ARE USED IN WHOLE OR
IN PART AT ANY OTHER SITE. WRITTEN
DIMENSIONS ON THESE DRAWINGS SHALL HAVE
PRECEDENCE OVER SCALED DIMENSIONS.

PROJECT OWNER & TITLE

LODI UNIFIED SCHOOL DISTRICT

1305 E. Vine St Lodi, CA 95240

MILLSWOOD MIDDLE SCHOOL PORTABLES RELOCATION


233 N Mills Ave Lodi, CA 95242

SHEET TITLE

ELECTRICAL PLAN, DETAILS & NOTES

DRAWN BY: XXXXXX JOB NUMBER: 23219


E1

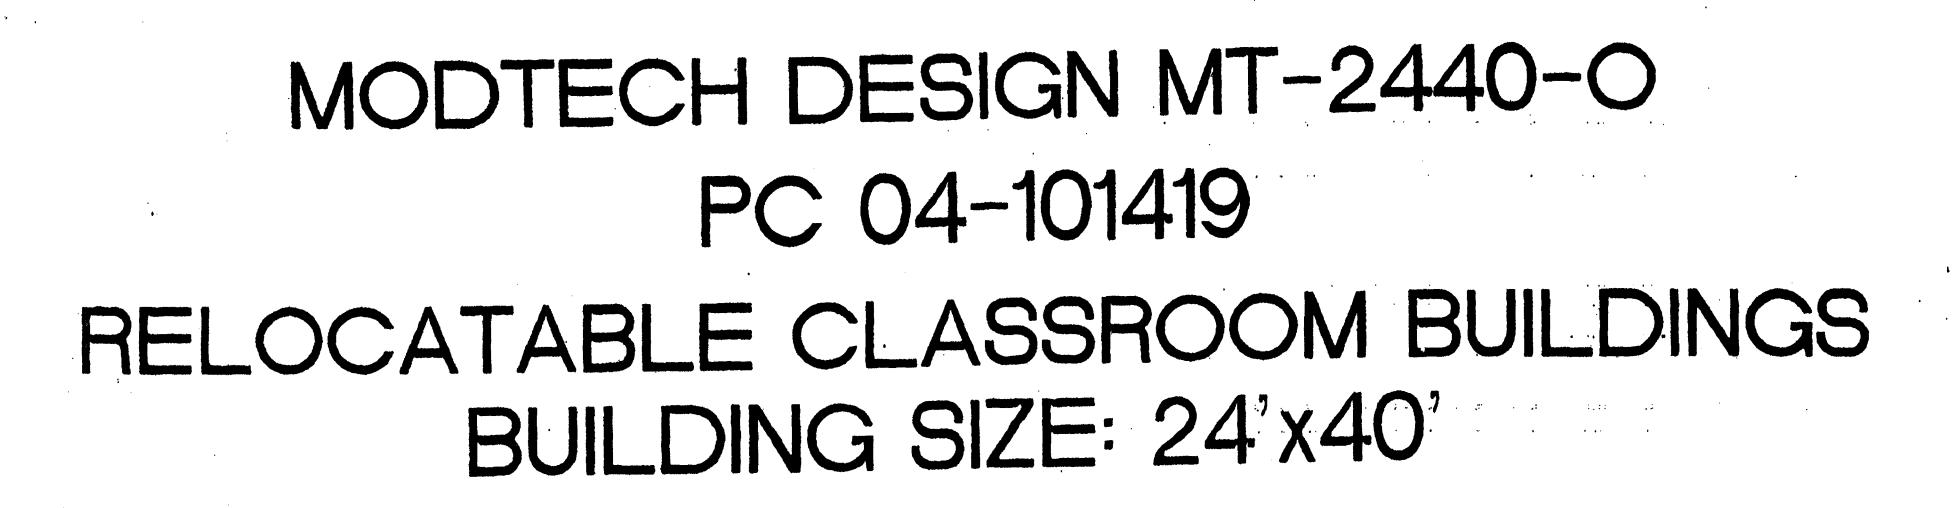


OFFICE OF PUBLIC SCHOOL CONSTRUCTION


**BUILDING TYPE 1** 


STOCKPILE

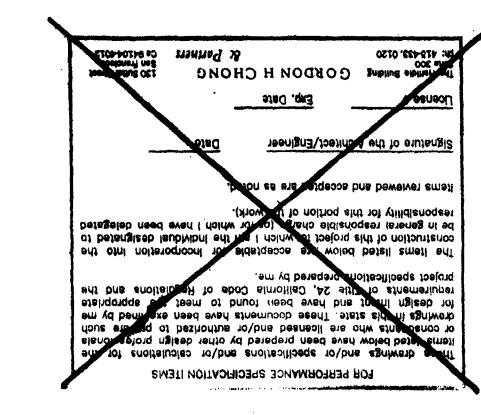

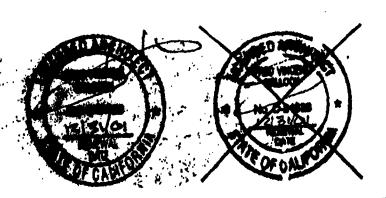



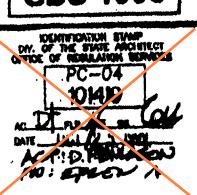

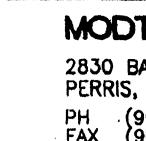

2830 BARRETT AVENUE PERRIS, CALIF. 92572 PH (909) 943-4014 FAX (909) 940-0427

	BUILDIN	IG DATA	SHEET				
	STRUCTURAL DESIGN: RIGID FRAME TYPE OF CONSTRUCTION: Y-N		ANCHITECTUR				
•	WIND LOAD (EXP FLOOR LIVE LOAD	: 50 PSF	A0 A1.0	TITLE SHEET FLOOR PLAN24"X40"			
	ROOF LIVE LOAD: OCCUPANCY: 24'	20 PSF x40' CLASSROOM: E-2	<b>A2</b> .0	ROOF PLAN (DUAL PITCH) 24'X40'			
			A3.01	EXTENOR ELEVATIONS (DEAL PITCH) _24140, W/O FARGA			
	BUILDING AREA: 24'x40' BUI	LDING - 960 SF	A4.0 A5.0	INTERIOR ELEVATIONS <u>24'X40'</u> DOOR, WINDOW, FINISH, HANDWARE SCHEDULES			
			A6.0	ARCHITECTI MAI DETAILS (MOCH) STLIPS)	·		
			A6.1 A6.0M A6.1M	ARCHITECTURAL DETAILS (WOOD STUDS) ARCHITECTURAL DETAILS (METAL STUDS) ARCHITECTURAL DETAILS (METAL STUDS)	·		
	APPLIC	ABLE CODES					
-		PART 2. 1996 CBC (97 UBC W/98 CA AMENDMENTS)	A7.01 A7.1	REFLECTED CEILING PLAN (24"N46") (10 LIGHTS) REFLECTED CEILING DETAILS			
		P8 CA AMENDMENTS (98 CBC - PART 2, TITLE 24, CCR)	AB.0 AB.1	SPECIFICATIONS SPECIFICATIONS	<b>5</b>		
-	<del></del>	98 CA AMENDMENTS (98 CEC - PART 3, TITLE 24, CCR) 98 CA AMENDMENTS (98 CMC - PART 4, TITLE 24, CCR)			0.0-		
		98 CA AMENOMENTS (98 CPC - PART 5 TITLE 24, CCR)			<b>Y</b> -		
	1997 UFC & 191	98 CA AMENDMENTS (98 CFC - PART 9, TITLE 24, CCR)	STRUCTURAL		07		
-	1998 CA BUILDIN	G STANDARDS CODE	F1.0	FOUNDATION PLAN (24 x 40) SO PSF LL (WOOD)	: 24		
-		PUBLIC SAFETY, STATE FIRE MARSHALL REGULATIONS.	\$1.0 \$1.2				
	LEGEN		\$2.01	ASSE FRANKS FLAN (BUAL PITCH) W/O FARCA	T. T		
	8YMBOL	DESCRIPTION	\$2.1	ROOF FRAMING DETAILS (TYP.)	E		
	( <del>1</del> )	DETAIL (1) ON SAME SHEET AS SYMBOL	\$3.0 \$4.0	STRUCTURAL ELEVATIONS & DETAILS (DUAL PITCH)			
		· · · · · · · · · · · · · · · · · · ·	\$4.0M	WALL FRANING (WOOD) WALL FRANING (METAL)			
I		DETAIL (1) ON SHEET (2)	\$5.0 \$5.1 \$5.0M	WALL FRAMING BETALS (W888) WALL FRAMING BETALS (METAL) WALL FRAMING BETALS (METAL)			
	1	KEY NOTE (1) ON SAME SHEET AS SYMBOL	\$5.1M	WALL FRAMING DETALS (METAL)	:		
			MECHANICAL				
	$\frac{\wedge}{2}$	SECTION "A" ON SHEET (2)	M1.01	MECHANICAL (HVAC) PLAN 24'X40' - 8 TON			
	$\wedge$	REVISION/CHANGE IN DHAWING. (1) IS FIRST REVISION					
	(1)	•	ELECTRICAL				
	(arono)	HIGHLIGHTS CHANGED AREA	E1.01	ELECTRICAL PLAN 28'X40'			
	(1)	DOOR REFERENCE					
	lack	WINDOW REFERENCE	RAMP				
	(EL)	ELECTRICAL ITEM(S) SEE ELECTRICAL DRAWINGS	R1.01 R1.02	RAMP/LANDING PLAN W/ 12' RAMP RAMP/STARS DETAILS			
	HV	HEATING/VENTILATING & AIR CONDITIONING ITEM(S) SEE MECHANICAL DRAWINGS	-P0-04				
	PLG	PLUMBING ITEM(S) SEE MECHANICAL DRAWINGS	-B4-04-				
	STR	STRUCTURAL ITEM(S) SEE STRUCTURAL DRAWINGS		A contract of the contract of			
	FIN	FINISH ITEM(S) SEE FINISH SCHEDULE	These draw	FOR PERFORMANCE SPECIFICATION ITEMS ings and/or specifications and/or calculations for the			
	RAMP	RAMP - SEE RAMP DRAWINGS	or consultan drawings in	below have been prepared by other design professionals its who are licensed and/or suthorized to prepare such this state. These documents have been examined by me			
	ABBRE	EVIATIONS	tequirement:	intent and have been found to meet the appropriate of Title 24, California Code of Regulations and the lifestions prepared by me.			
	ACC ARC	WE GRADE CONCRETE	The items	listed below are acceptable for incorporation into the of this project for which I am the individual designated to	·		
	BGC = BEL	OW GRADE CONCRETE METER  FILE 39-50	ye in genera	it responsible charge (or for which I have been delegated by for this position of the work).	·		
	CLR = CLE GA = GAU	AR IDENTIFICATION STAMP DIV. OF THE STATE ARCHITECT	items (see	100 1 1 1 1 1 1 1 1 1 1 1 1 1 1 1 1 1 1	# = .		
	SIM = SIM	ILAR  (IMUM 02 , 103677	Signature of	the Architect/Engineer, Date	19.3		
		IMUM IN CONTRACT  ACCE FLS MC SS CC	License #	Exp. Date C. 977	<b>200019</b>		
	NTS - NOT	TO SCALE DATE OCT 2 3 2001	The Halildle Bi Suite 300 ph: 415-433.0	allding GORDON H CHONG 130 Surter Street Sen Francisco Ca 94104-4012			
		TSIDE DIAMETER ENTED STRAND BOARD		· · · · · · · · · · · · · · · · · · ·	ON I		
		OF OVERHANG		·	ROJECT ROJECT		
	STSMS - SEL	F TAPPING SCREW F TAPPING SHEET METAL SCREW			PRC PRC		
	TYP = TYP UON = UNI	PICAL LESS OTHERWISE NOTED	e teatransaceann ar a E. referense en el	OF STATE AND A STATE OF THE STA	96H		
,	WITH THE SIGNI	ing of these drawings, we acknowledge that we have		order of the state	IT /		
	I KENEMED THES	E PLANS AND SPECIFICATIONS AND HAVE FOUND THEM TO COMPLIANCE WITH THE BID DRAWINGS, SPECIFICATIONS AND DENDA. WHEN THE PLANS AND SPECIFICATIONS HAVE BEEN THE DIVISION OF THE STATE ARCHITECT. THEY SHALL PRESIDENCE OF THE STATE ARCHITECT.	4	OFFICE OF T	FIGURION STAMP IE DIATE ARCHITECT INCLATION SERVICES		
	CACK COMETICE	ING AREAS IN 1912 BID DRAWINGS AND SPECIFICATIONS, AND	)	A STATE OF THE STA	0 2 6 9		
	ANT ADDENUA	IMERETU.	5/5/2/6	SANTE SCHAPE	ELSURESS ICR		
	ARE THE PROPE OR OTHER LINE	- THIS DOCUMENT AND THE INFORMATION CONTAINED HEREIL ERTY OF MODTECH, "INC, UNAUTHORIZED COPYING, DISCLOSURE AUTHORIZED USES ARE PROHIBITED.	36.6.1	MS JAC CO. HANK	S T		
	PROJECT N		MODTECH, INC				
•			•	CHECKED BY:	£19		
•		•••		DATE: 10/22/99	101		
•				MODILOH Irolan He.			

FOR WHICH THEY WERE SPECIFICALLY

1305 E. Vine St

Lodi, CA 95240

233 N Mills Ave

Lodi, CA 95242

SHEET TITLE

TITLE SHEET

DATE: DECEMBER 5, 2023


IN PART AT ANY OTHER SITE. WRITTEN
DIMENSIONS ON THESE DRAWINGS SHALL HAVE
PRECEDENCE OVER SCALED DIMENSIONS.

**LODI UNIFIED SCHOOL DISTRICT** 

MILLSWOOD MIDDLE SCHOOL


DRAWN BY: XXXXXX JOB NUMBER: 23219

PORTABLES RELOCATION

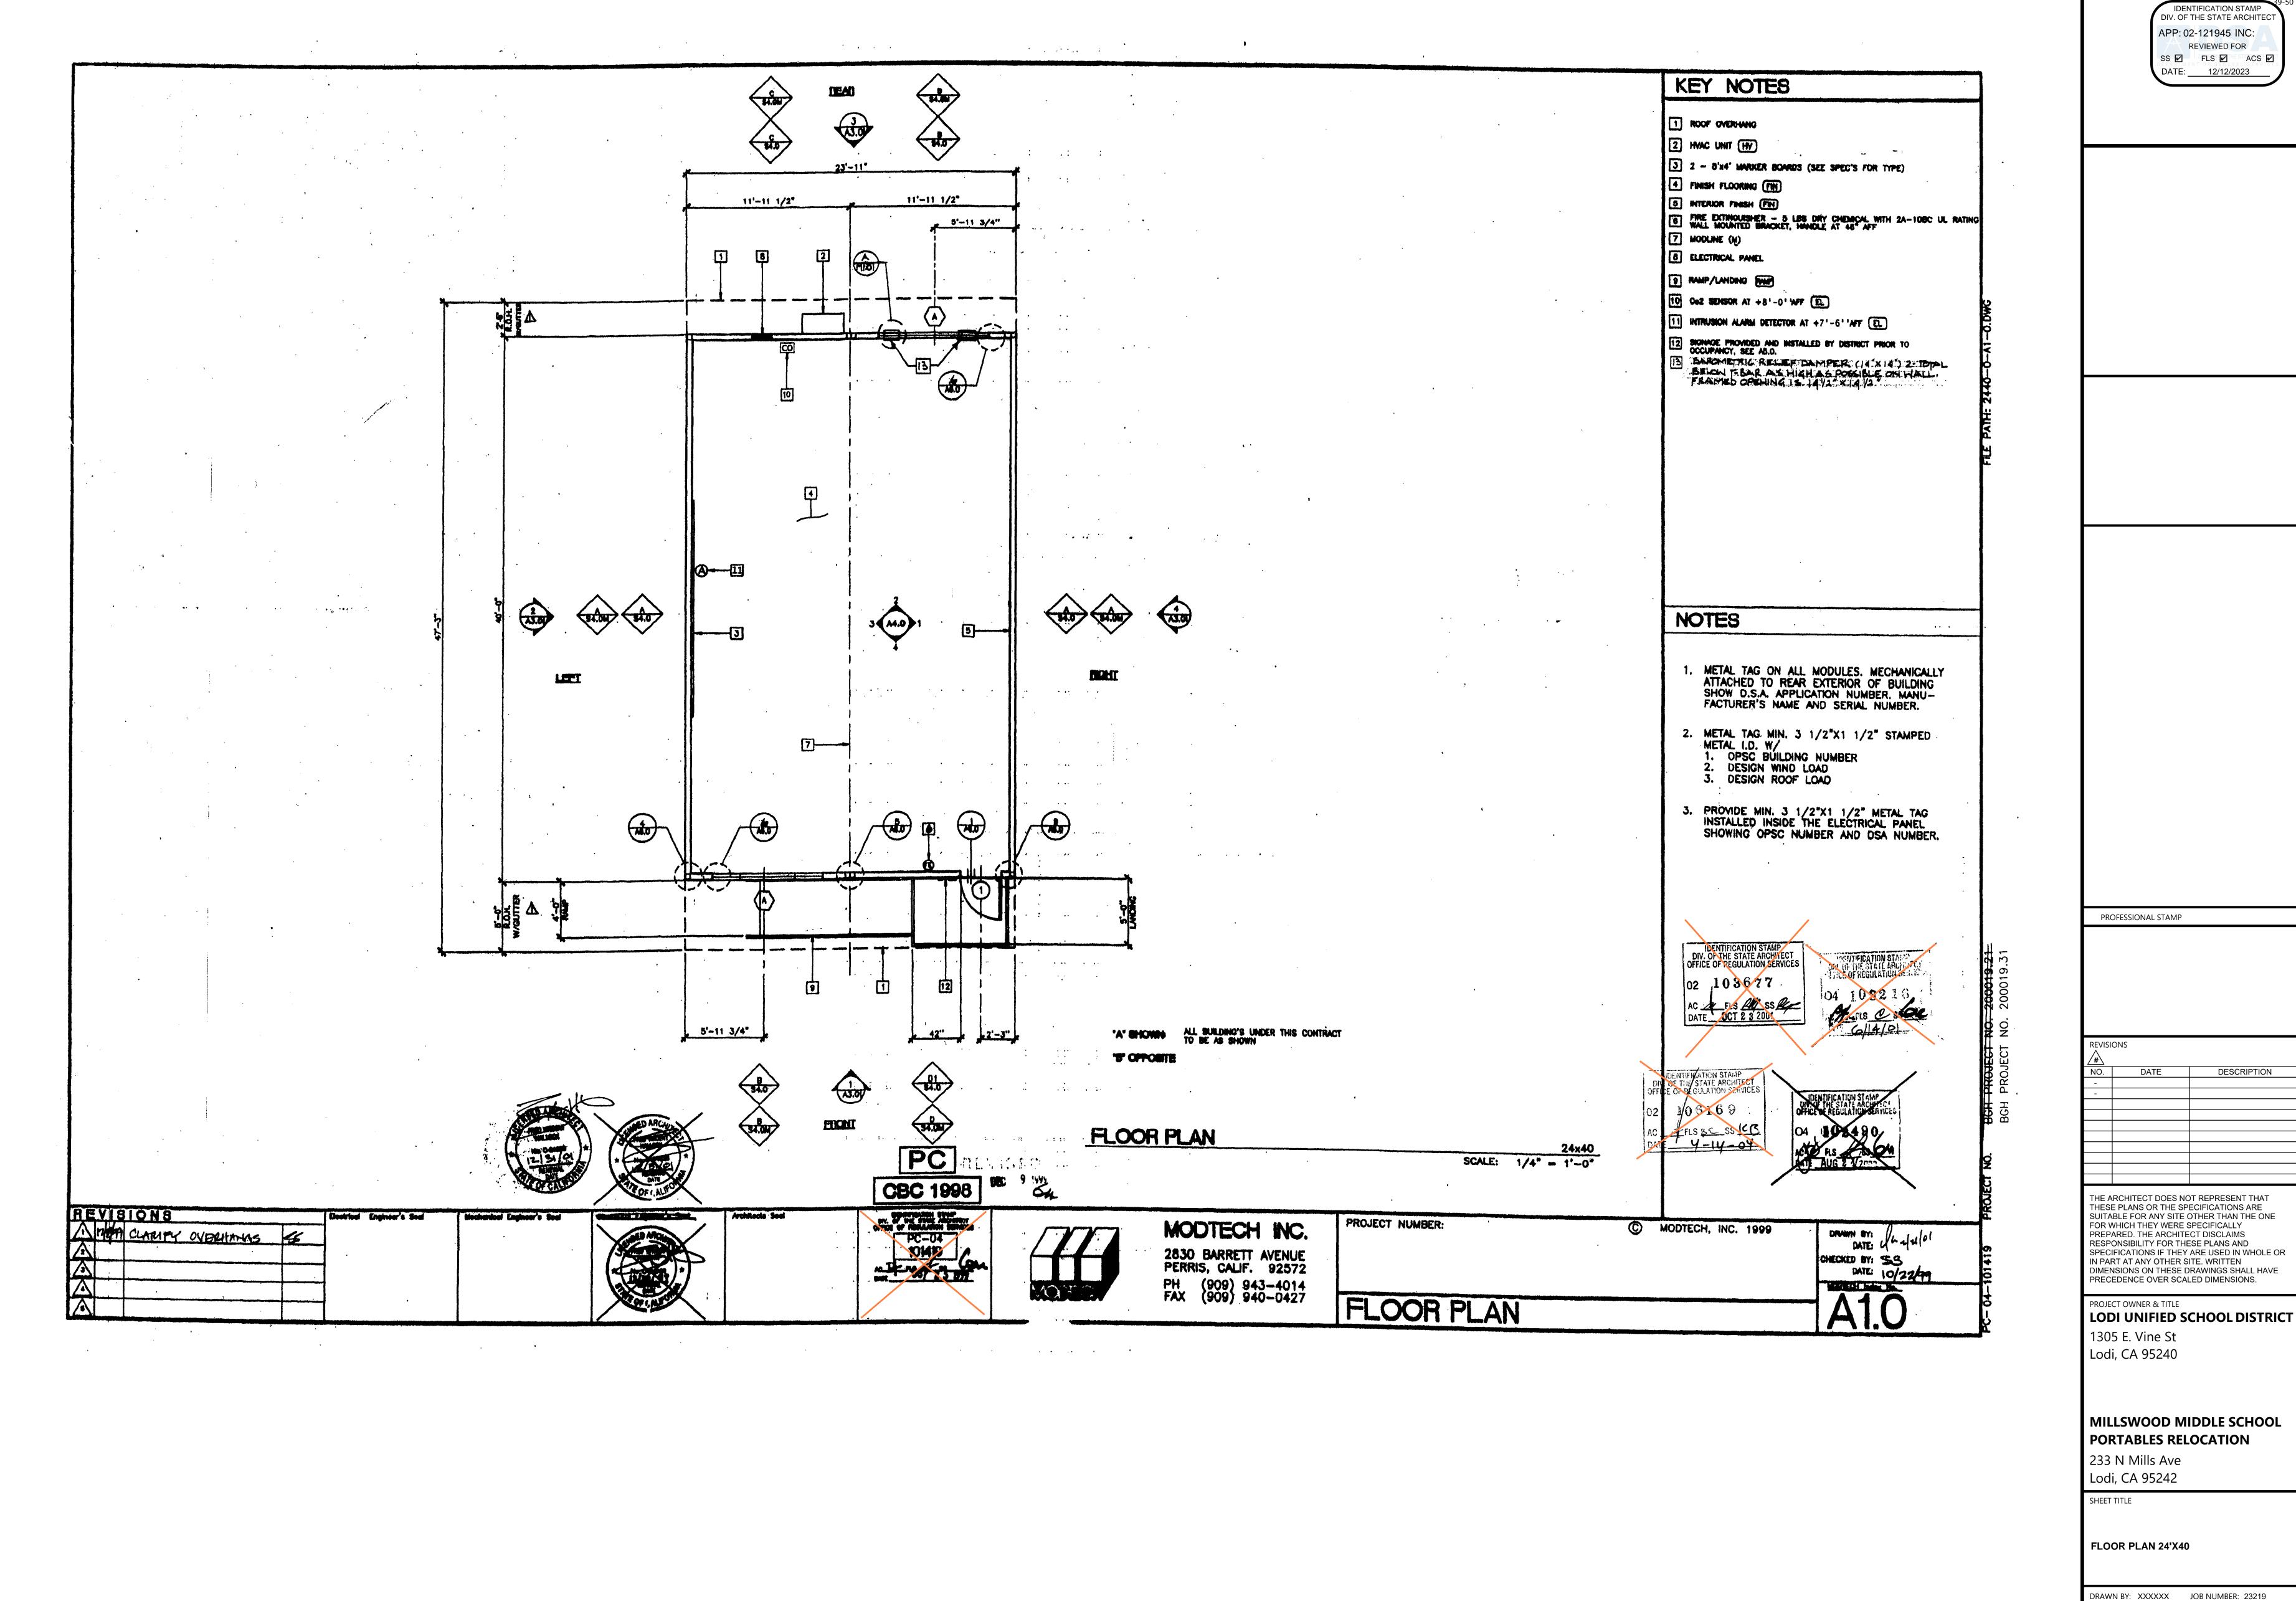


CONSTRUC

DATE: DECEMBER 5, 2023

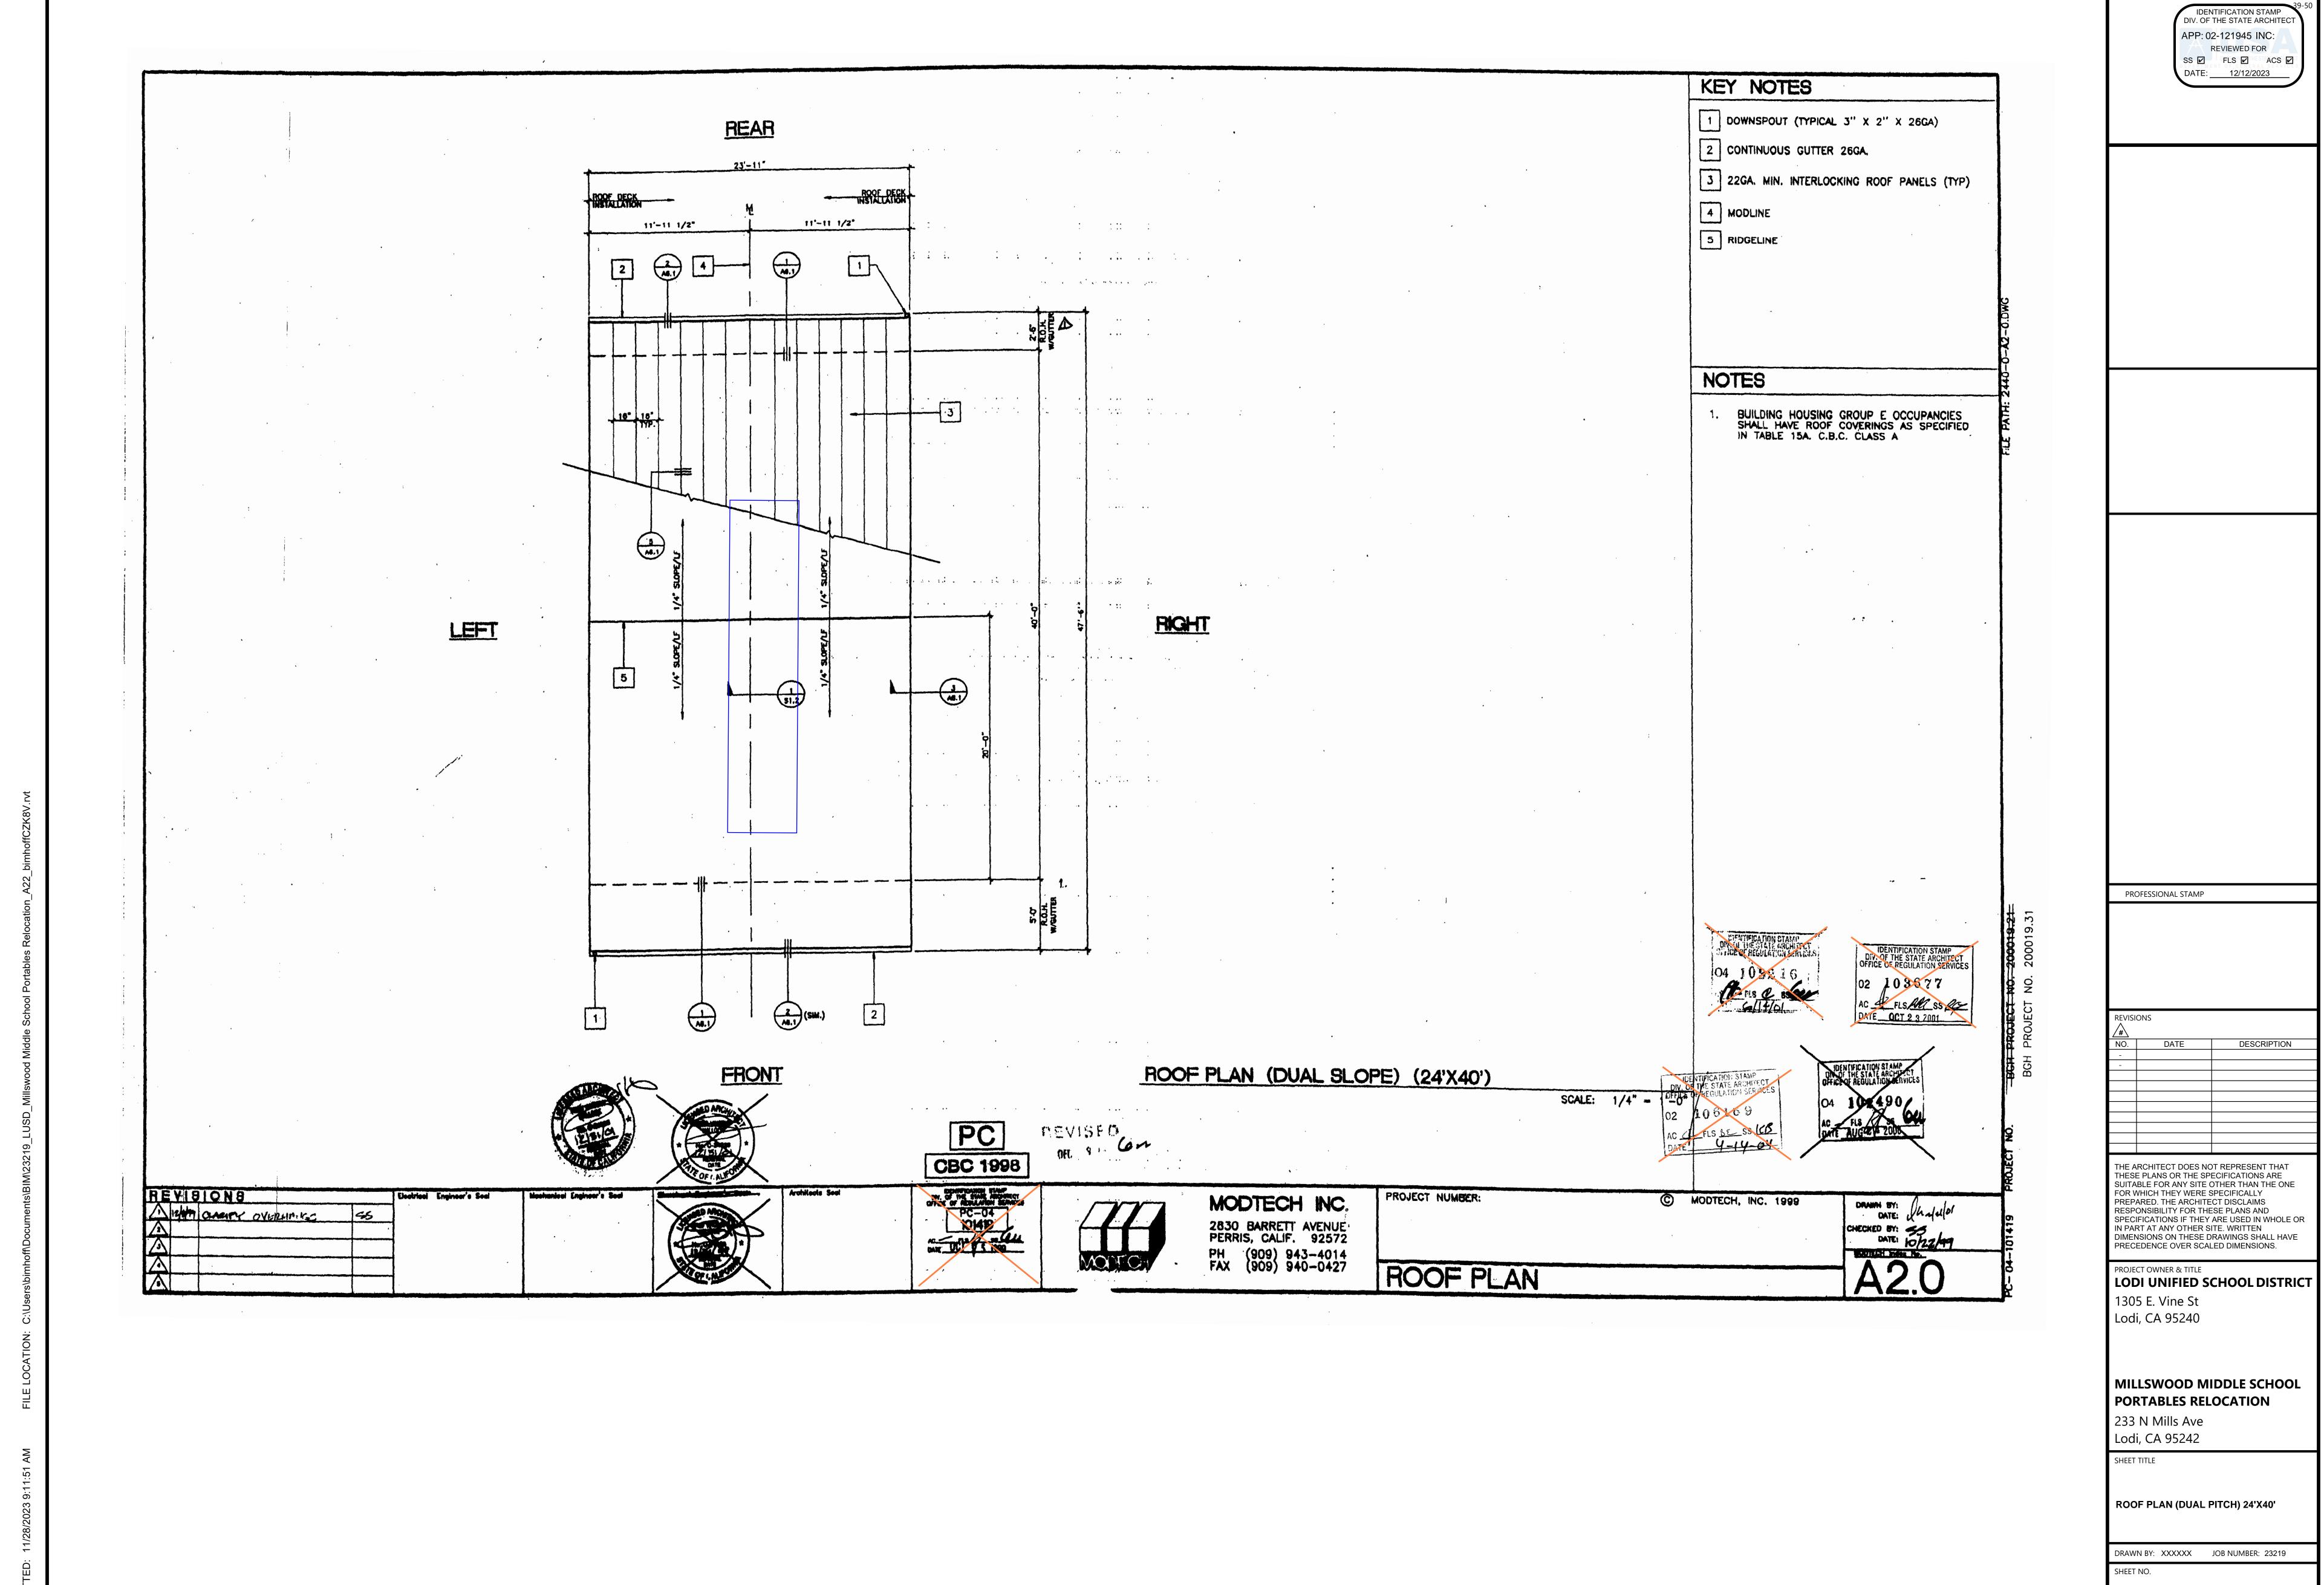

CONSTRUCTION


DATE: DECEMBER 5, 2023

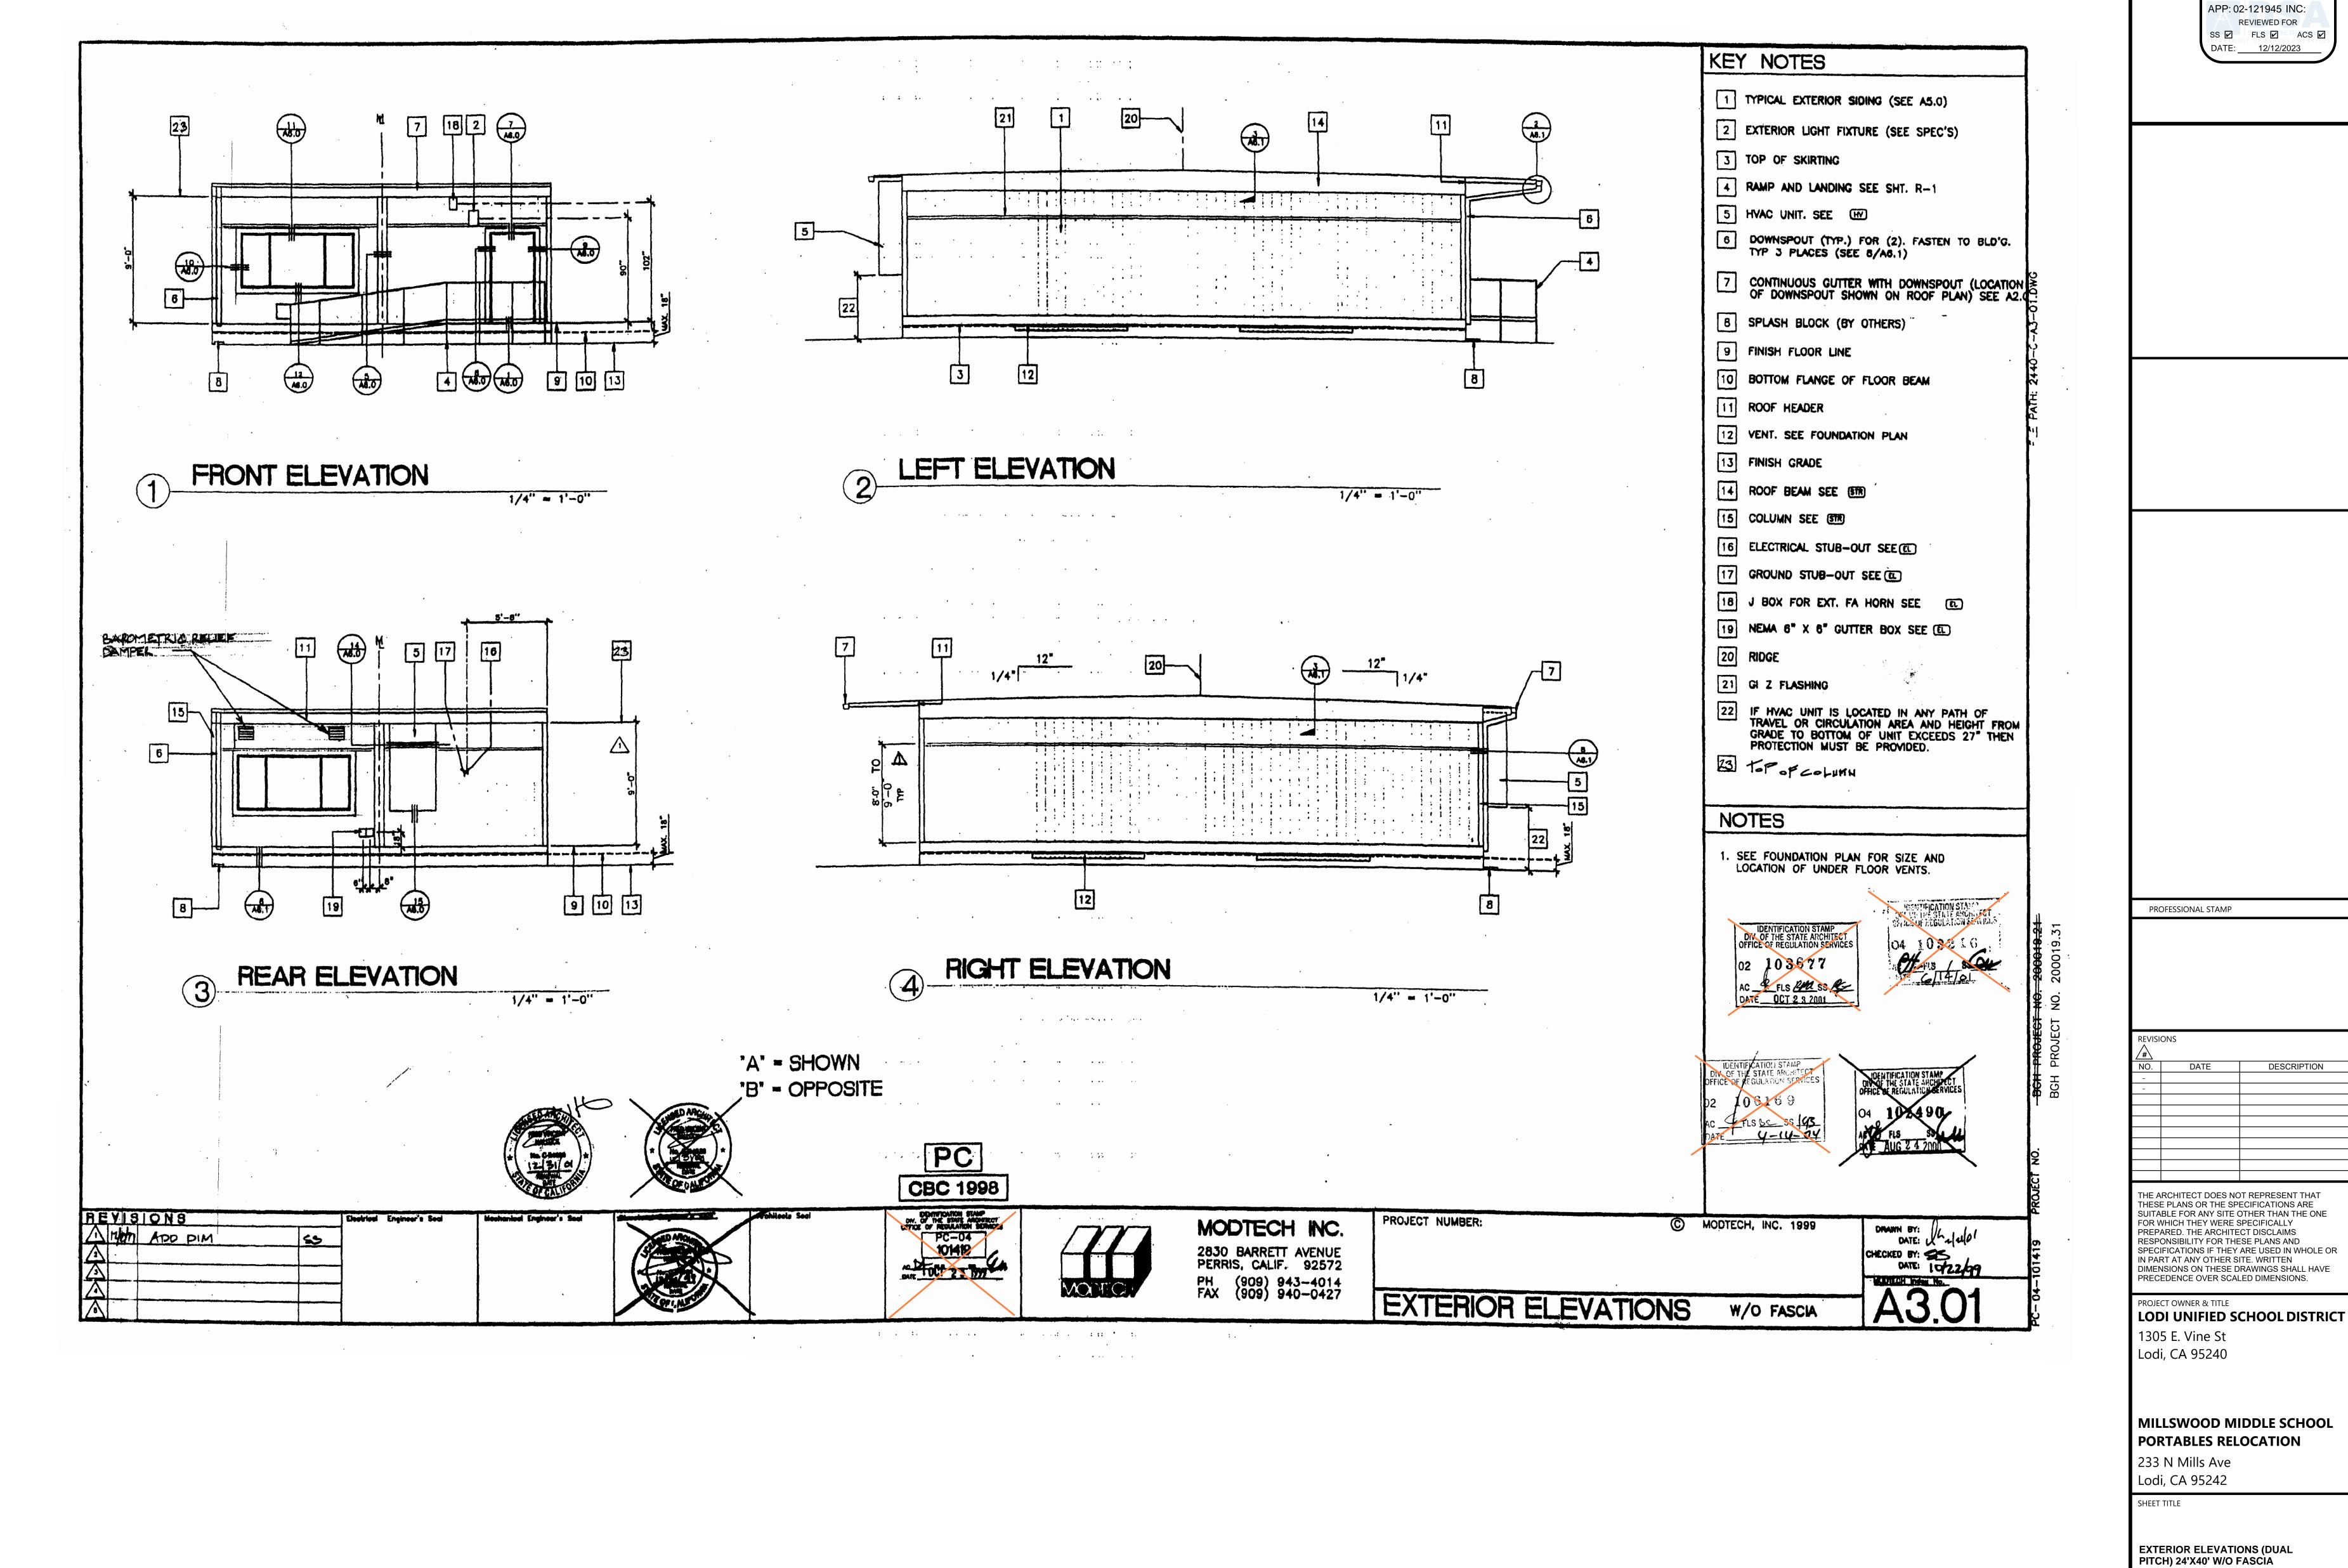

CONSTRU

DRAWN BY: XXXXXX JOB NUMBER: 23219 A3.01

DATE: DECEMBER 5, 2023

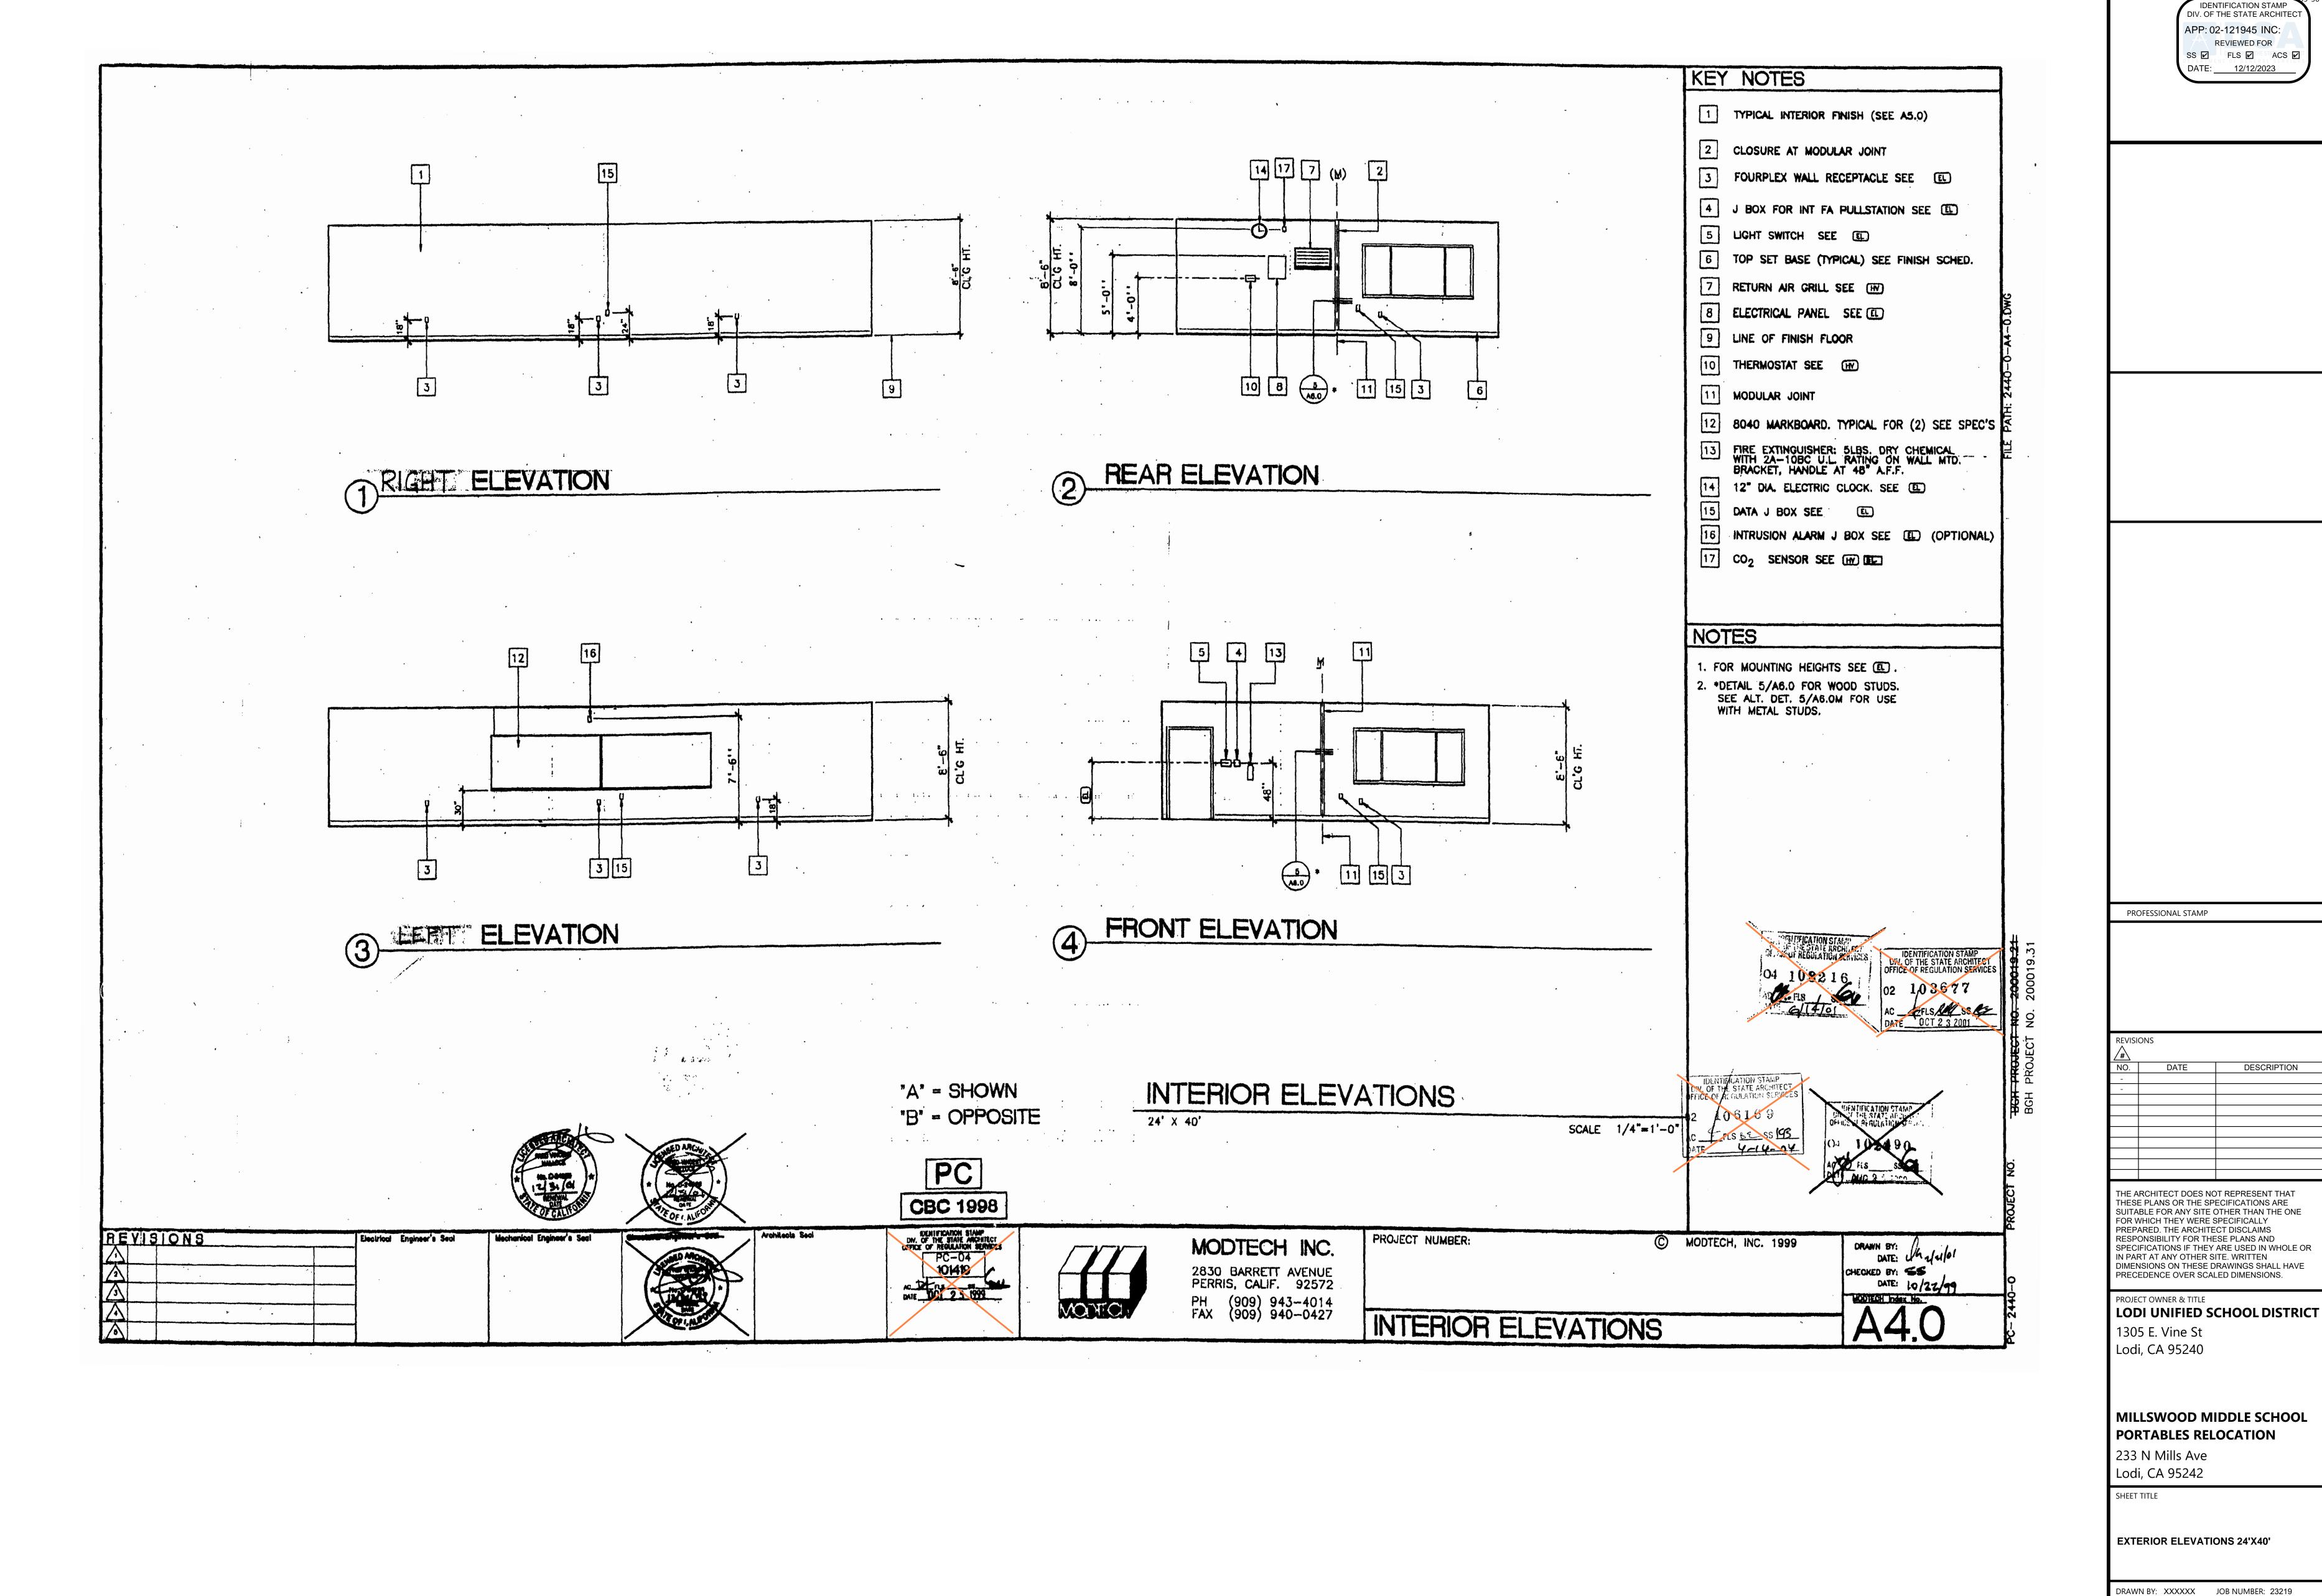

AGENCY APPROVAL <u>DSA#</u>

ROOM FINISH SCHEDULE

NOTES

WINDOW SCHEDULE

AGENCY APPROVAL DSA# IDENTIFICATION STAMP DIV. OF THE STATE ARCHITEC APP: 02-121945 INC: REVIEWED FOR SS 🗹 FLS 🗹 ACS 🗹 DATE: 12/12/2023 PROFESSIONAL STAMP DESCRIPTION THE ARCHITECT DOES NOT REPRESENT THAT THESE PLANS OR THE SPECIFICATIONS ARE SUITABLE FOR ANY SITE OTHER THAN THE ONE FOR WHICH THEY WERE SPECIFICALLY PREPARED. THE ARCHITECT DISCLAIMS RESPONSIBILITY FOR THESE PLANS AND

SPECIFICATIONS IF THEY ARE USED IN WHOLE OR IN PART AT ANY OTHER SITE. WRITTEN DIMENSIONS ON THESE DRAWINGS SHALL HAVE PRECEDENCE OVER SCALED DIMENSIONS.

PROJECT OWNER & TITLE LODI UNIFIED SCHOOL DISTRICT 1305 E. Vine St

Lodi, CA 95240

MILLSWOOD MIDDLE SCHOOL PORTABLES RELOCATION

233 N Mills Ave Lodi, CA 95242


SHEET TITLE

DOOR, WINDOW, FINISH, HARDWARE SCHEDULES

CONSTRI

DRAWN BY: XXXXXX JOB NUMBER: 23219

A5.0 DATE: DECEMBER 5, 2023

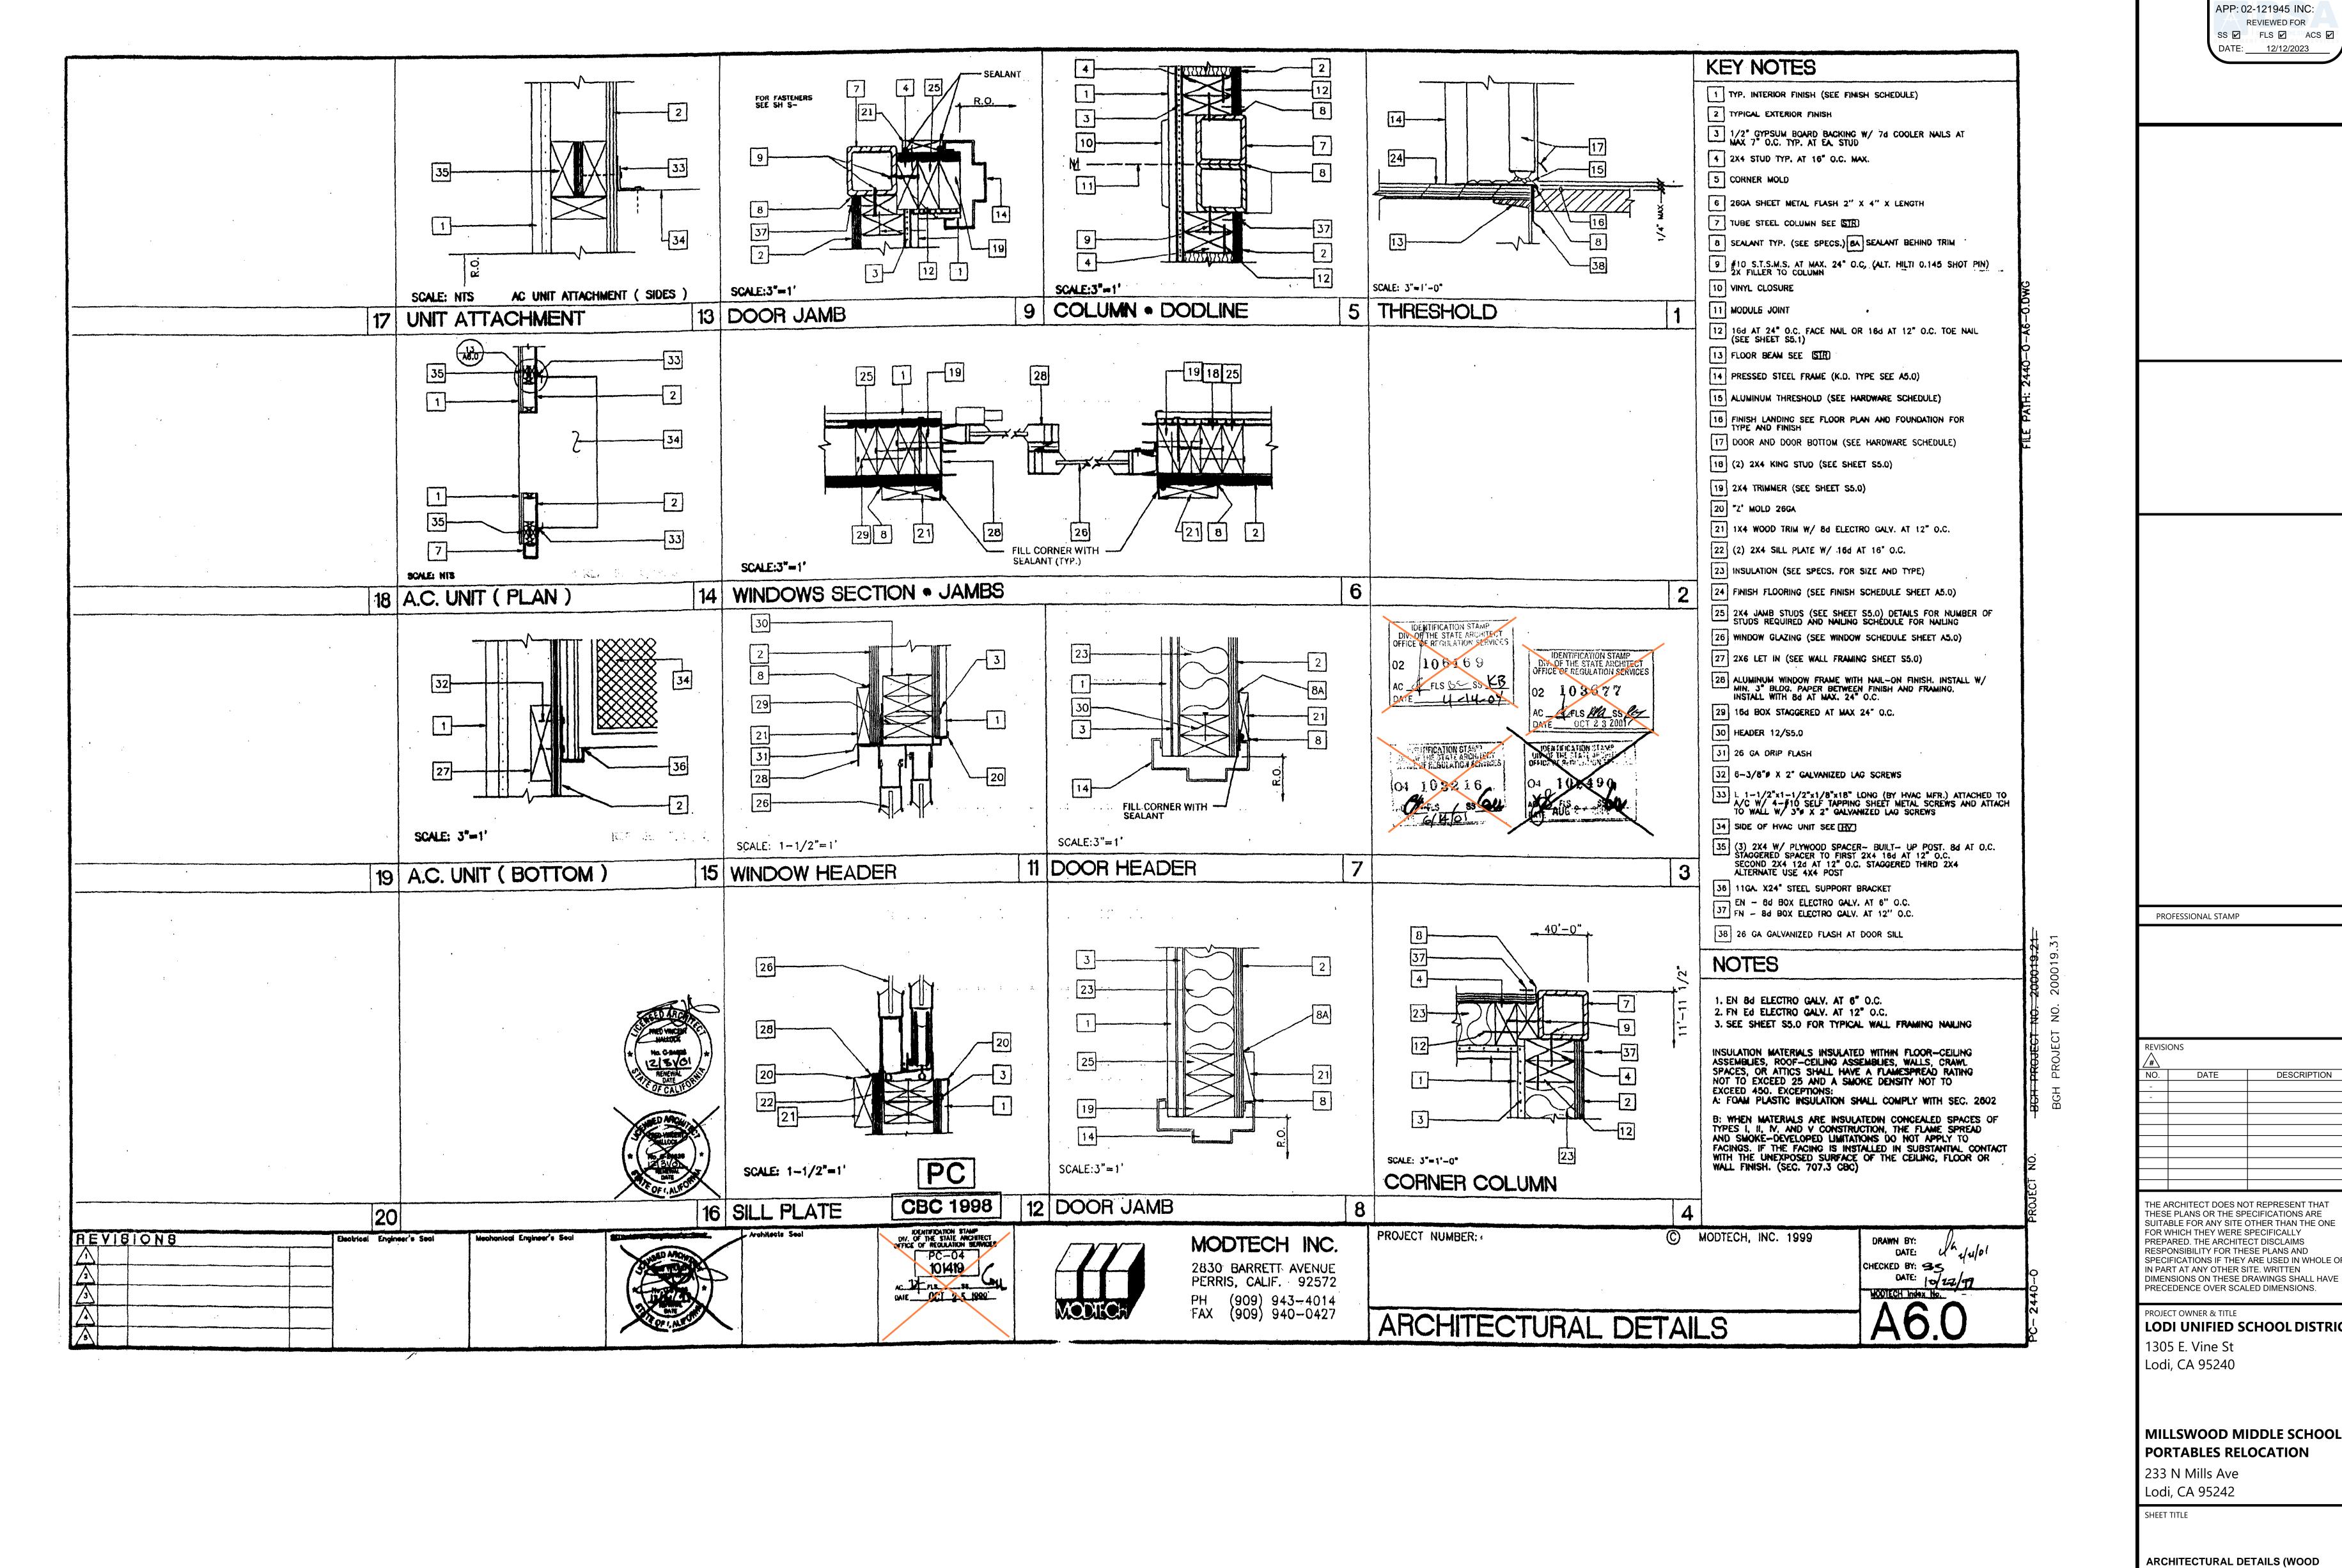

AGENCY APPROVAL <u>DSA#</u> IDENTIFICATION STAMP DIV. OF THE STATE ARCHITE


SUITABLE FOR ANY SITE OTHER THAN THE ONE SPECIFICATIONS IF THEY ARE USED IN WHOLE OR

LODI UNIFIED SCHOOL DISTRICT

CONSTRI


DRAWN BY: XXXXXX JOB NUMBER: 23219

A6.0 DATE: DECEMBER 5, 2023

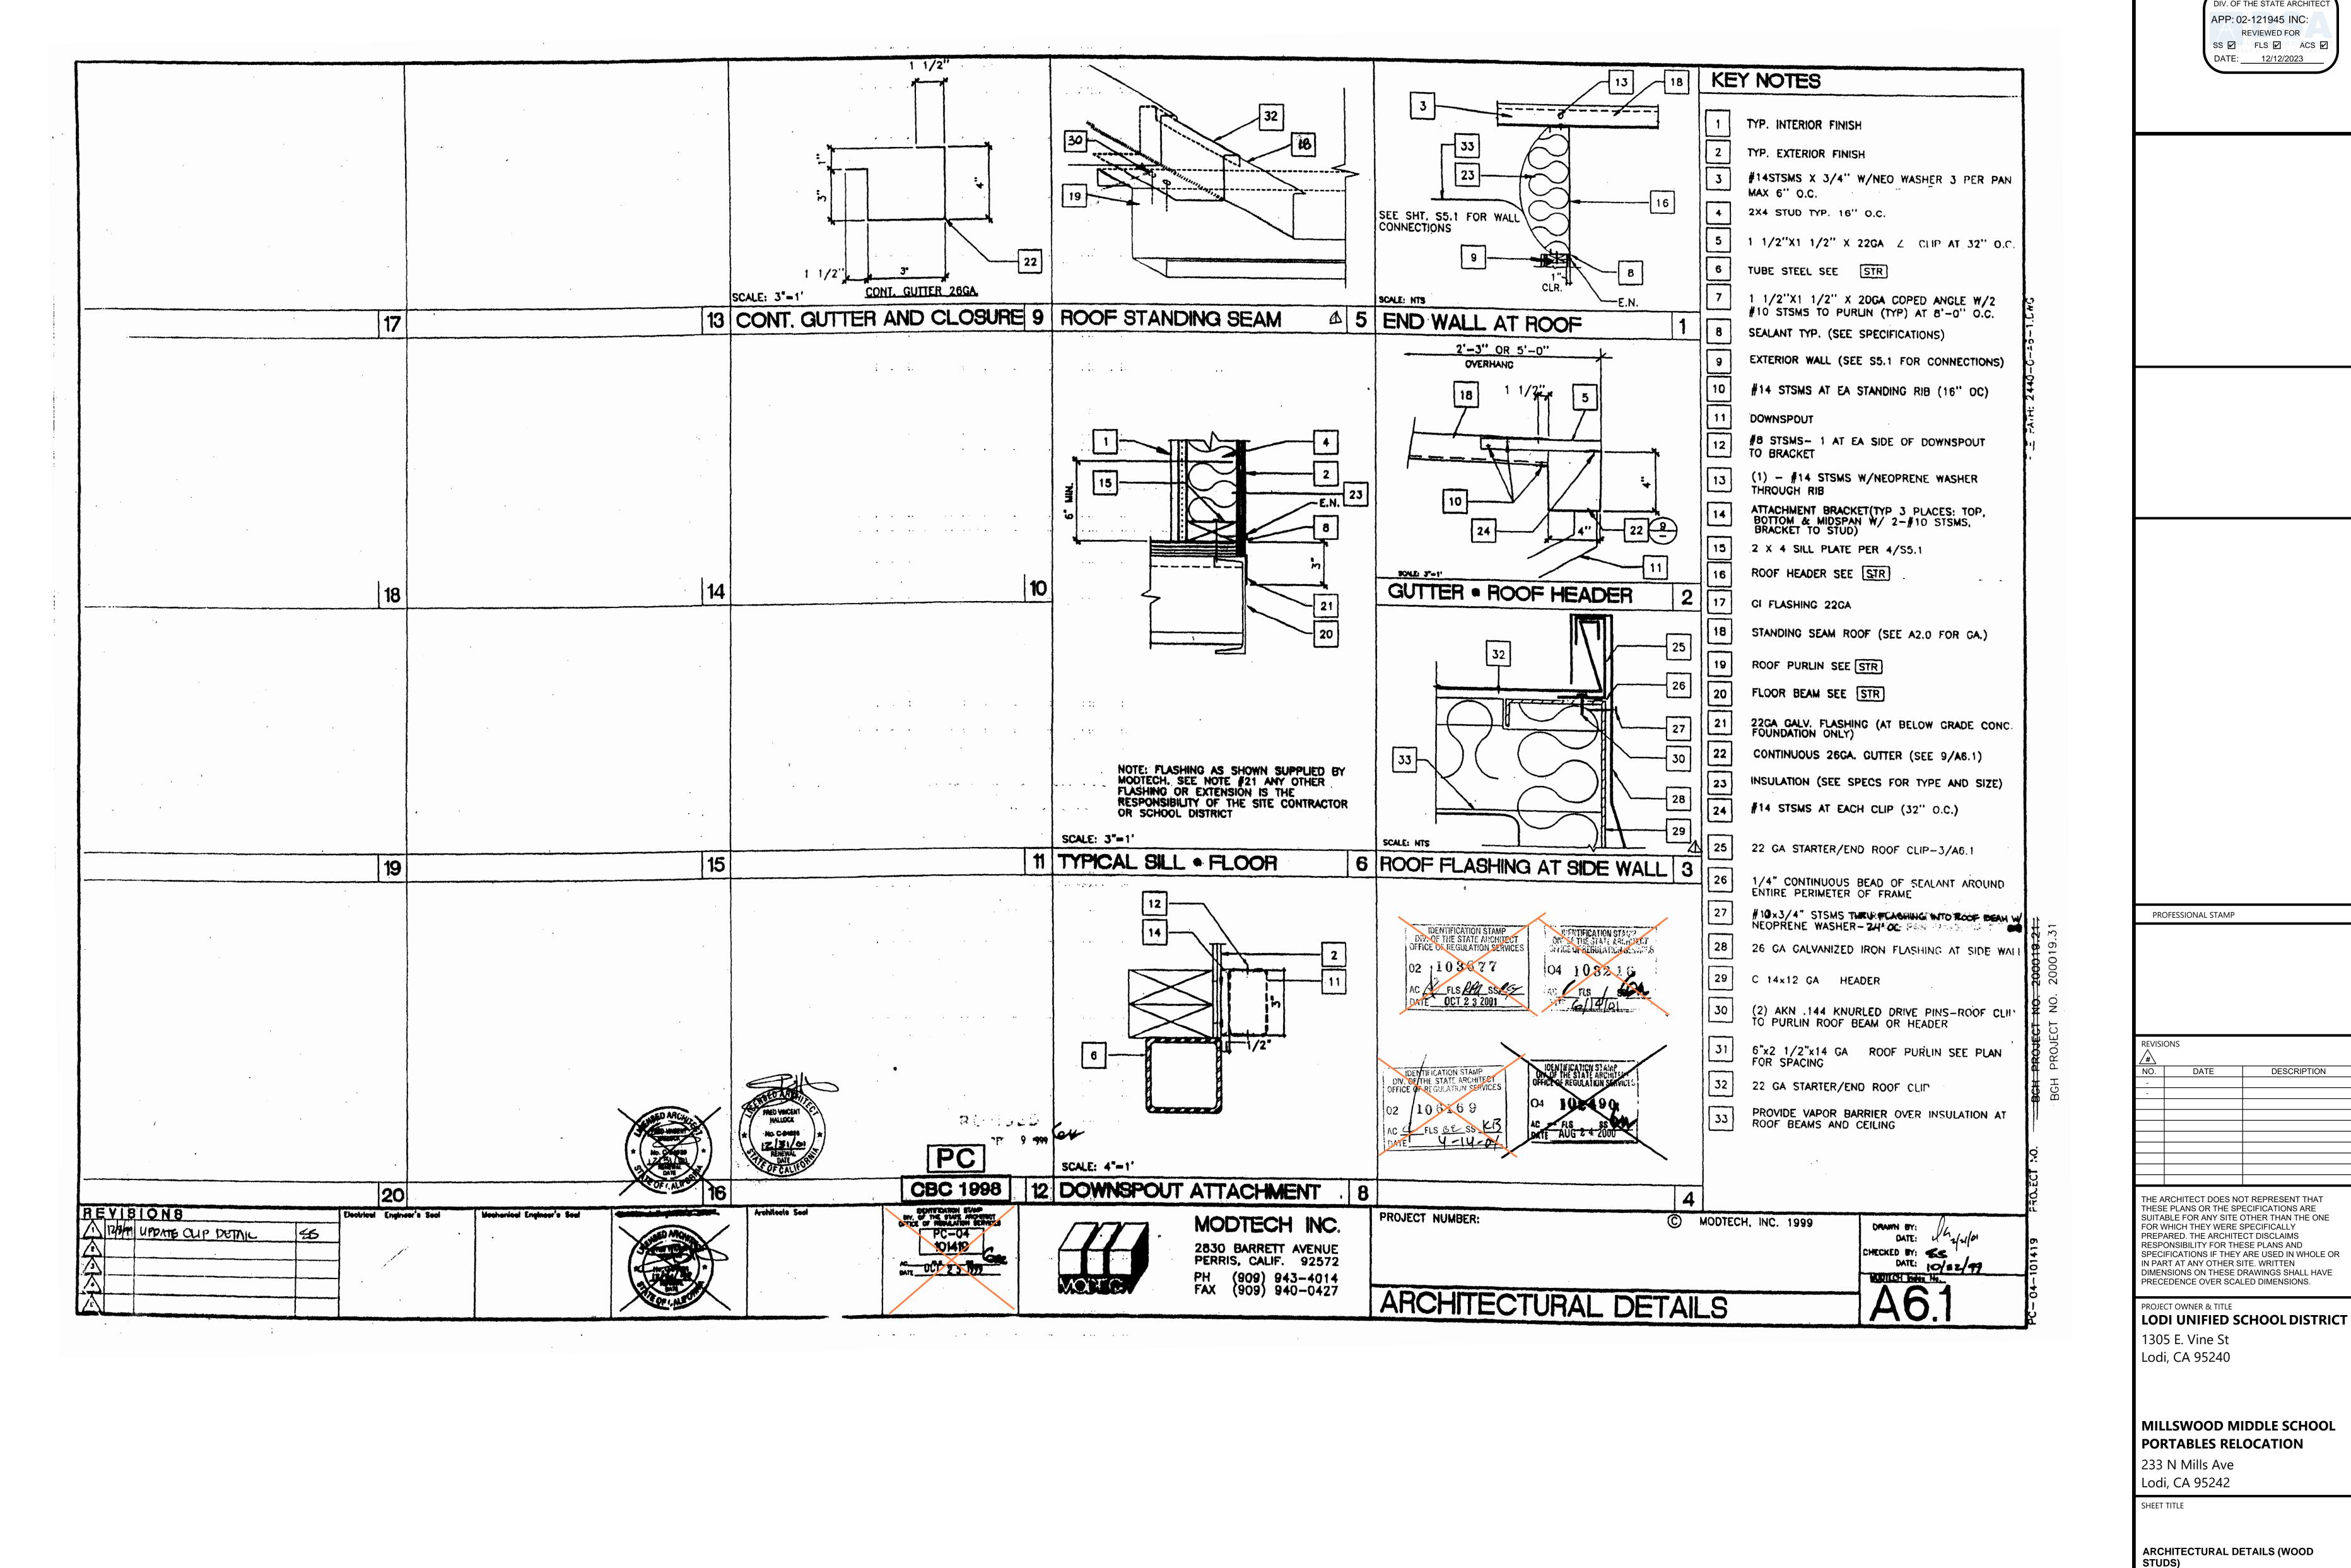

AGENCY APPROVAL <u>DSA#</u> IDENTIFICATION STAMP

DRAWN BY: XXXXXX JOB NUMBER: 23219

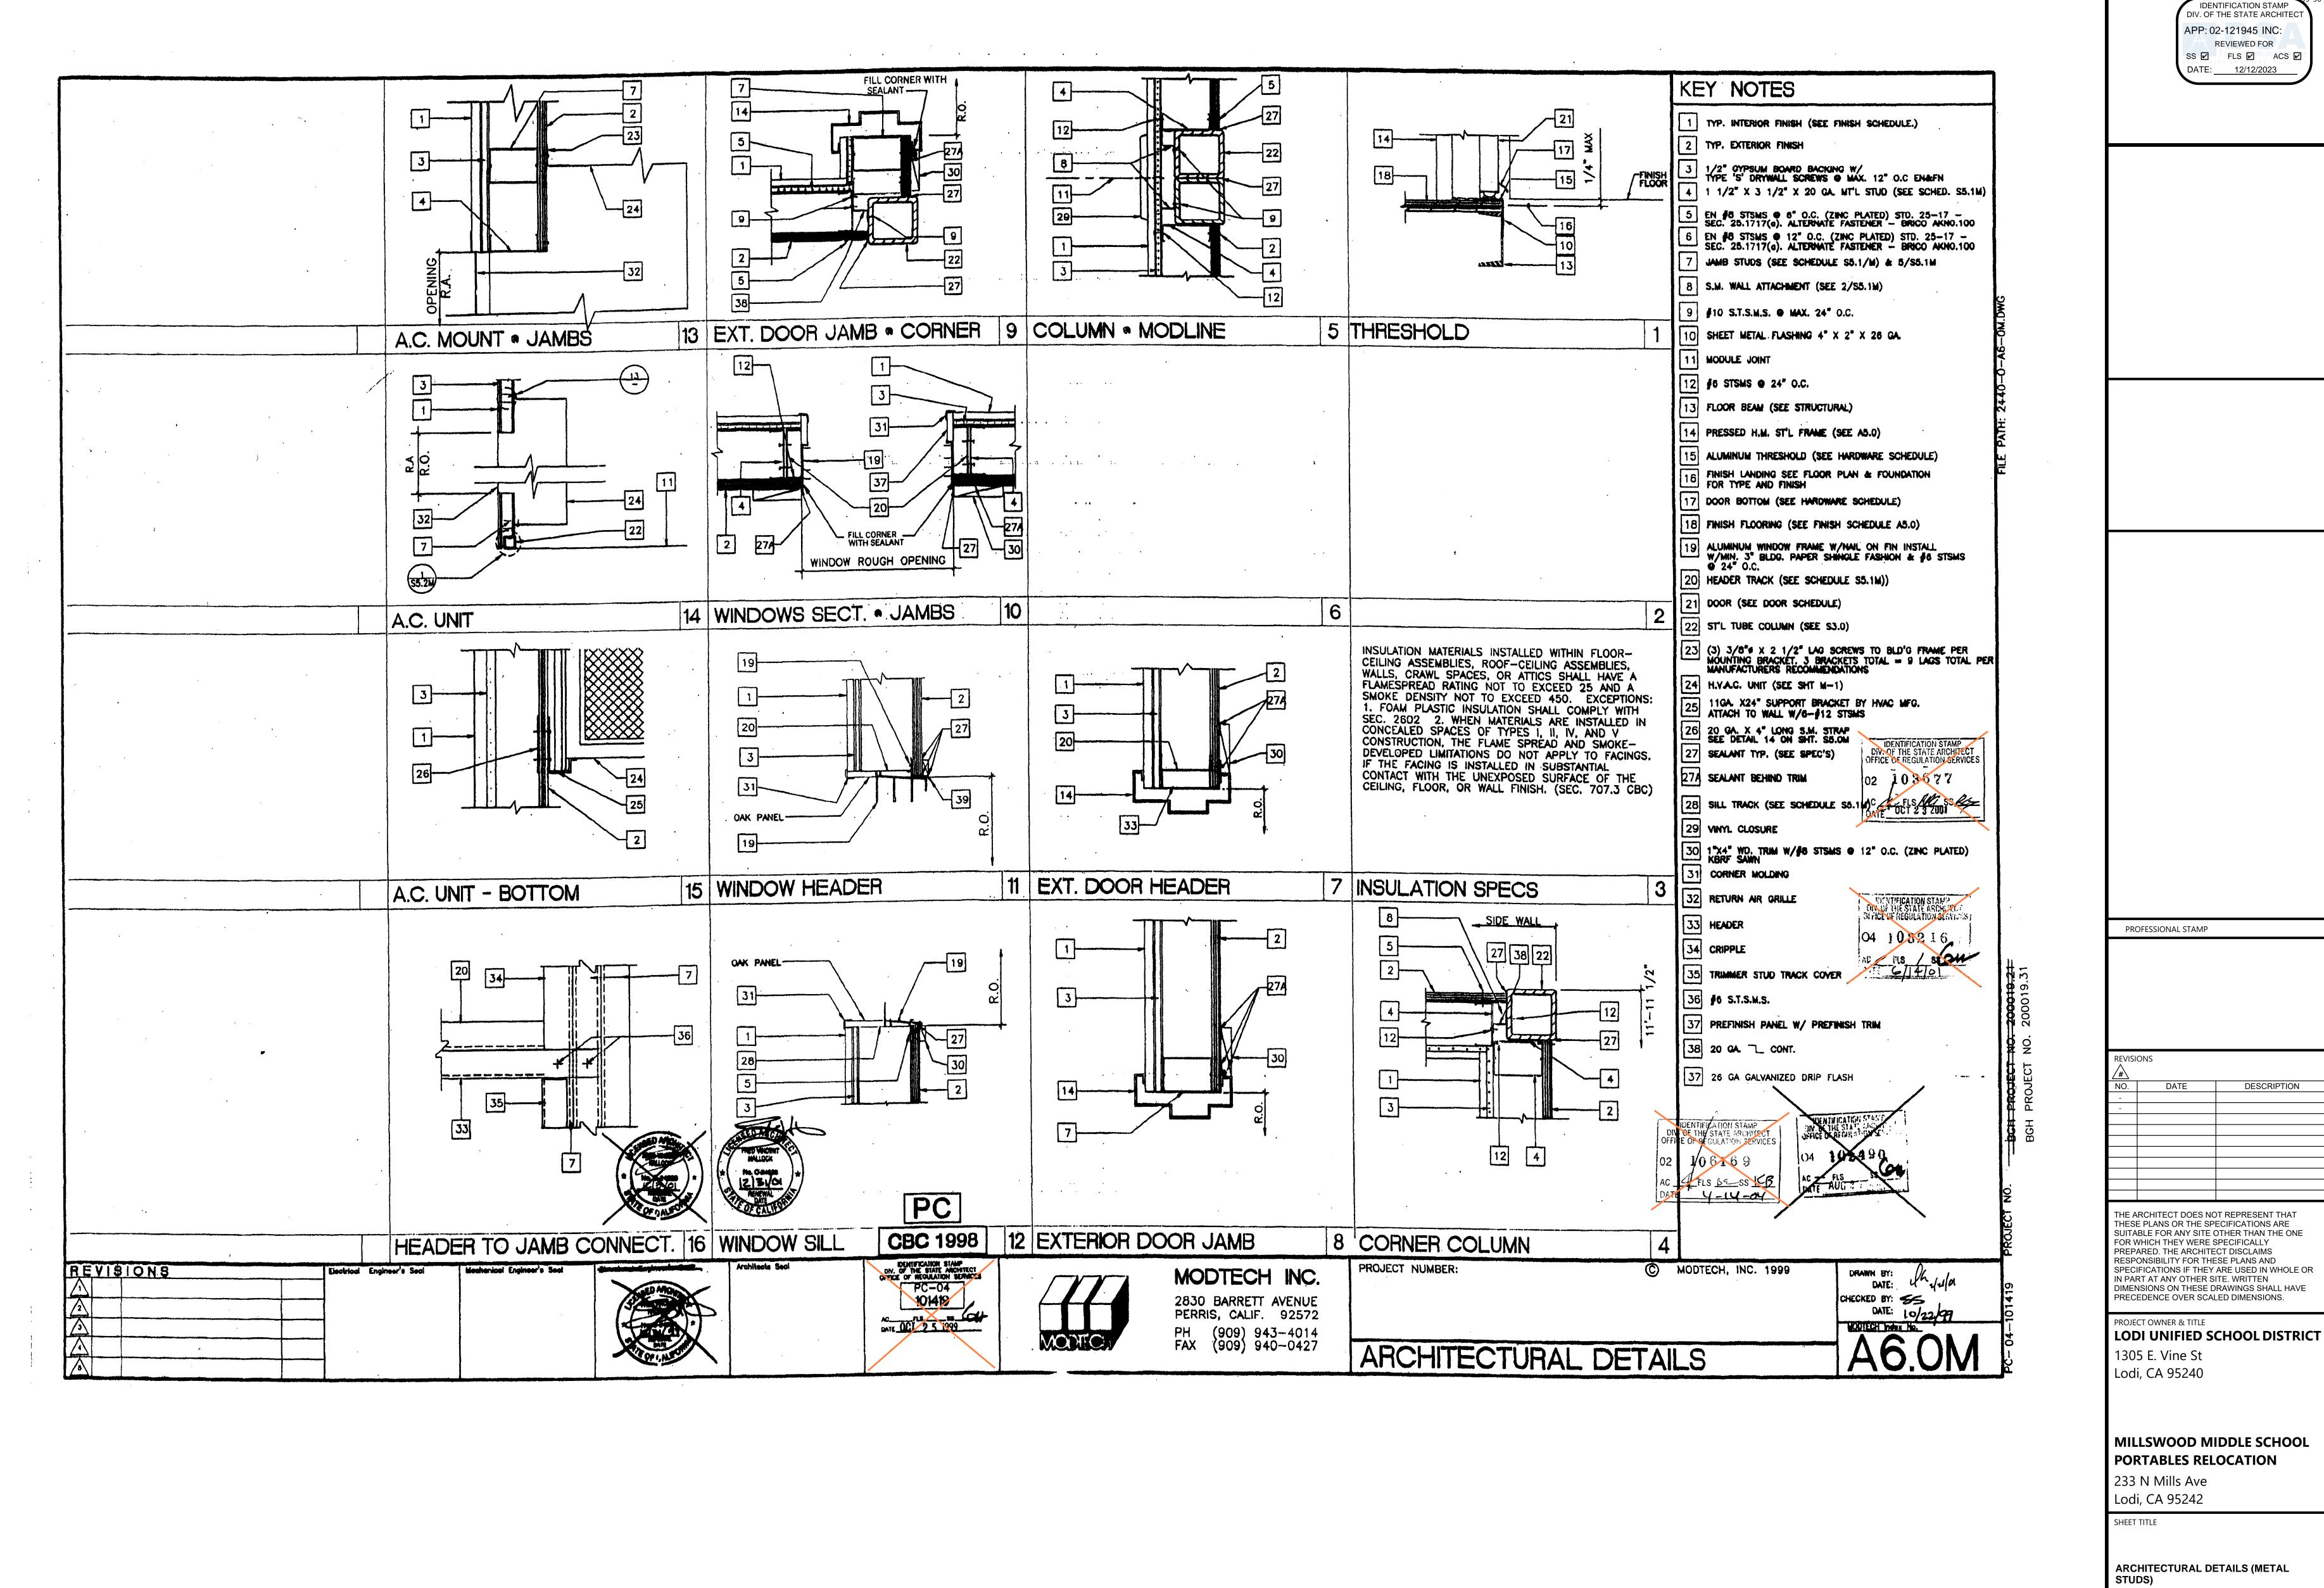


AGENCY APPROVAL DSA#

CONSTRU

DRAWN BY: XXXXXX JOB NUMBER: 23219

A6.0M

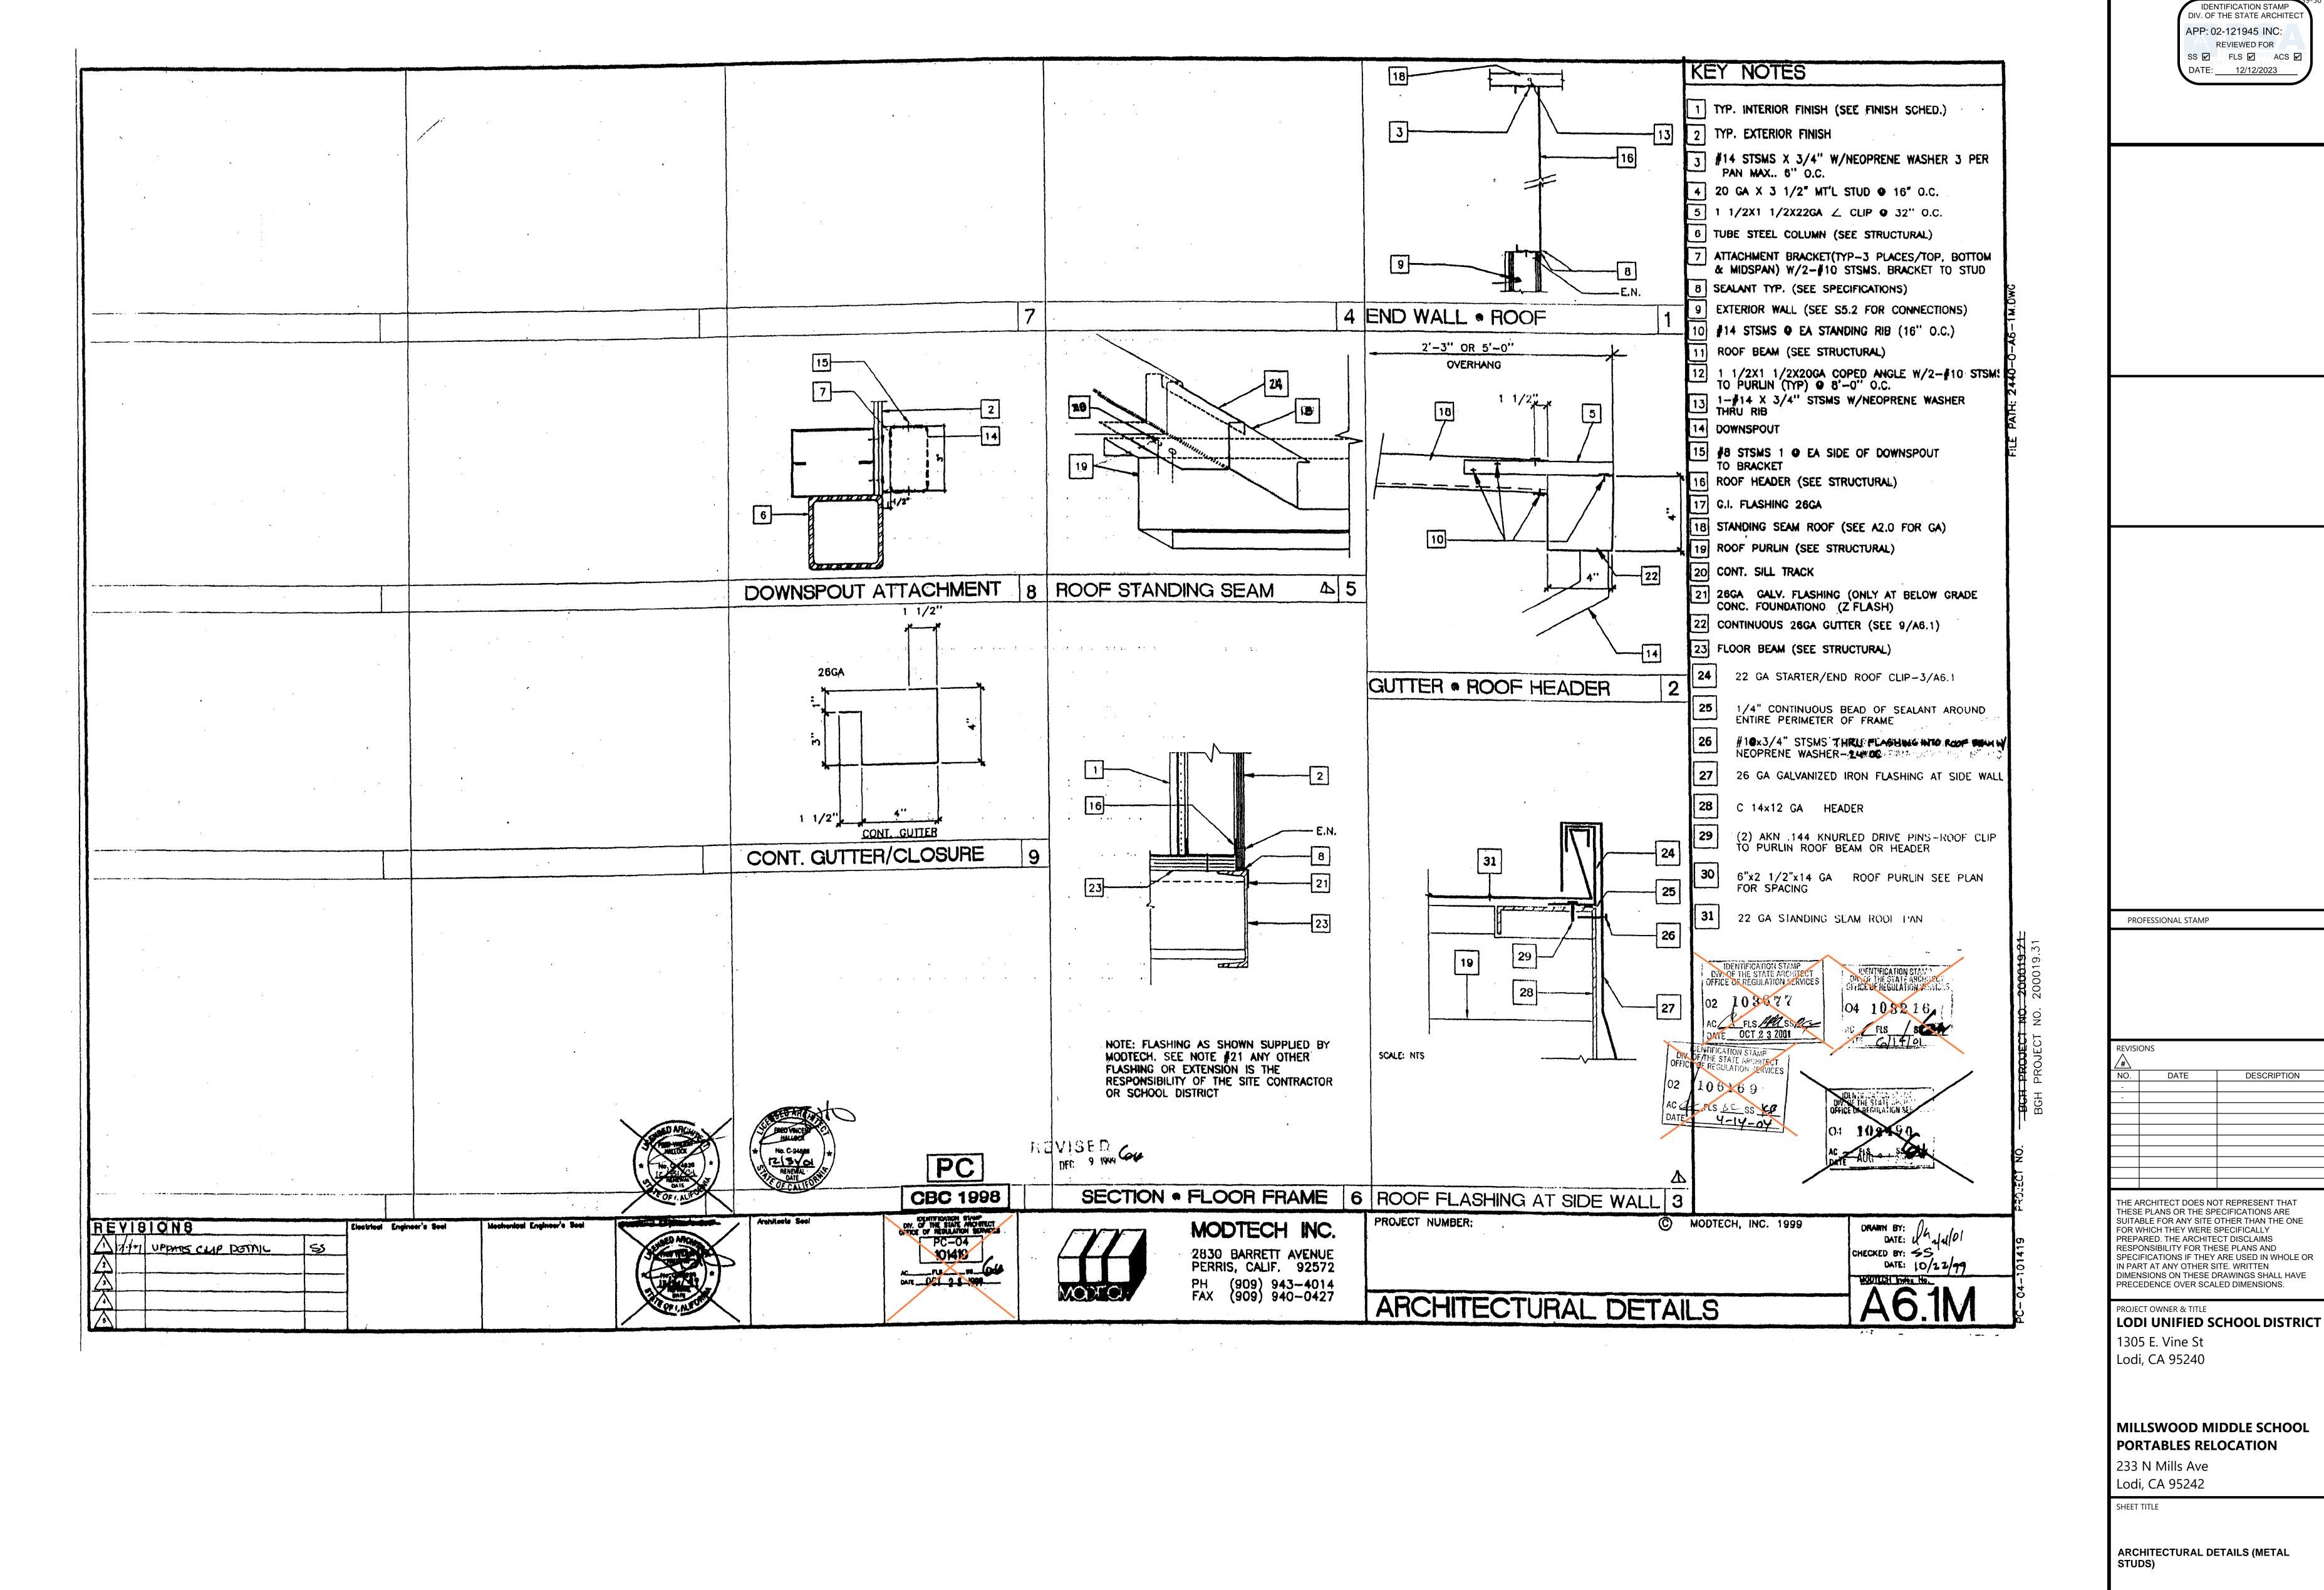


CONSTRU

DRAWN BY: XXXXXX JOB NUMBER: 23219


A6.1M

DATE: DECEMBER 5, 2023

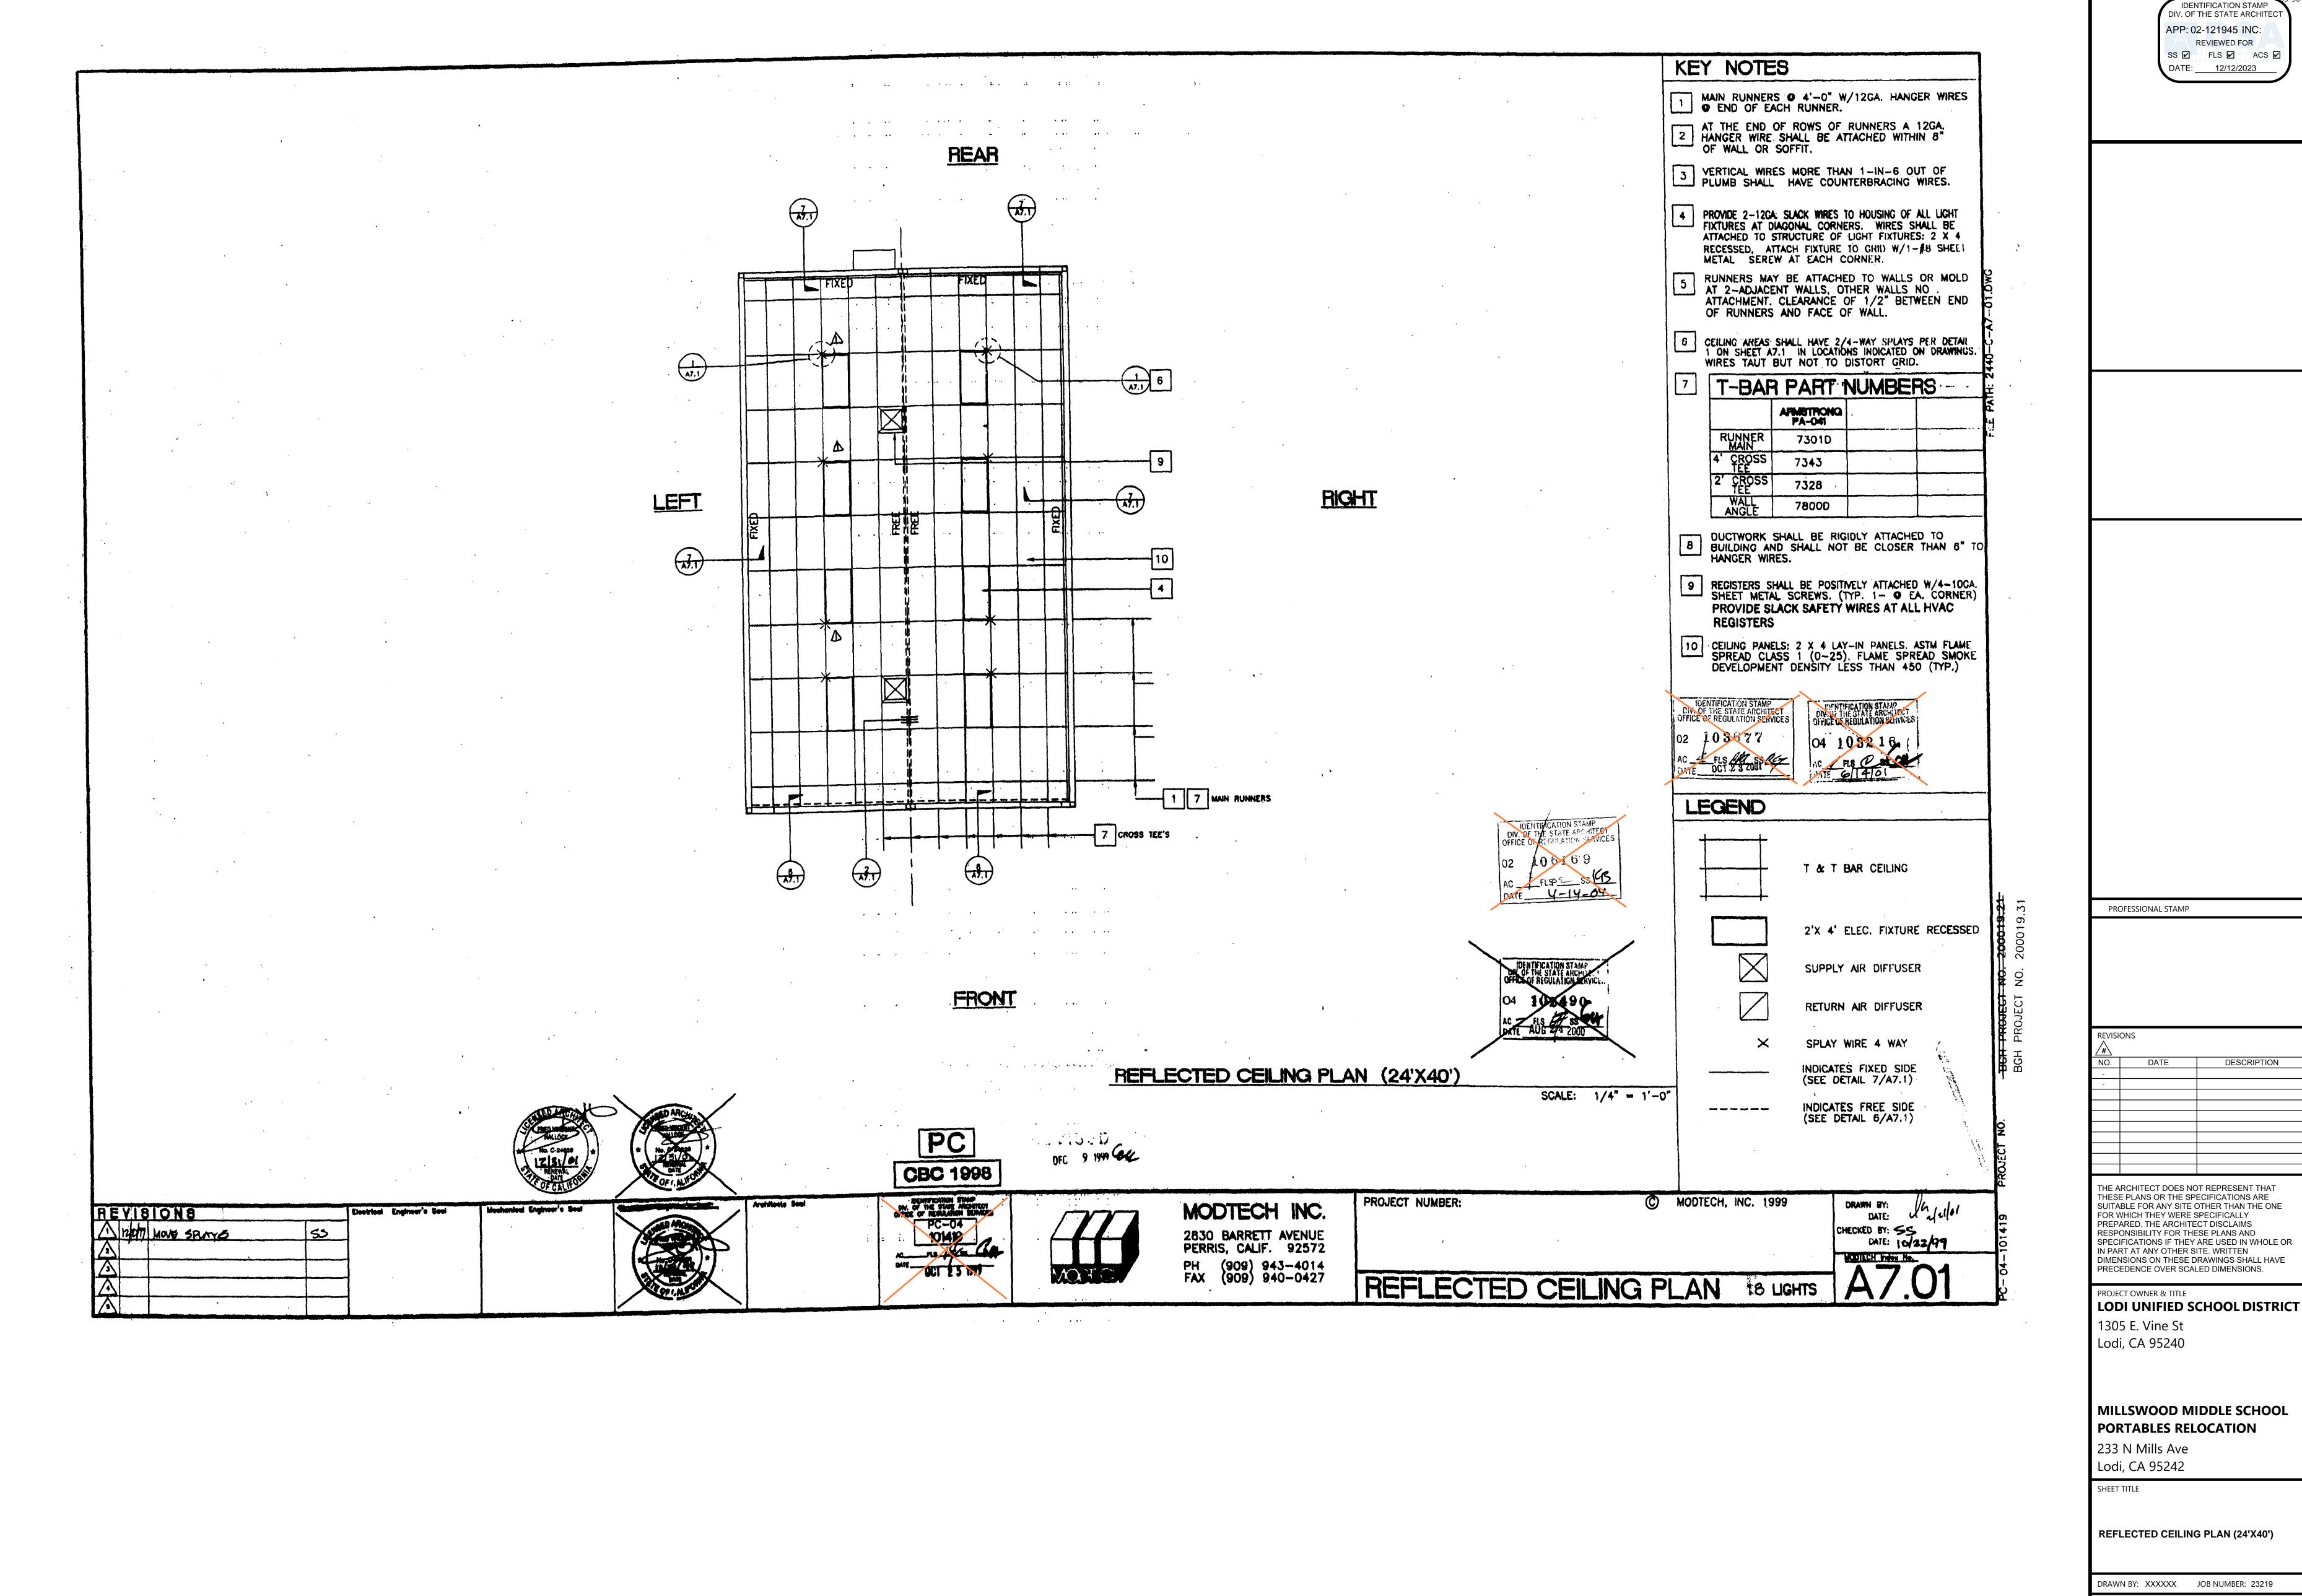

CONSTRUCTION DOCUMENTS

SHEET NO. **A7.01**DATE: DECEMBER 5, 2023

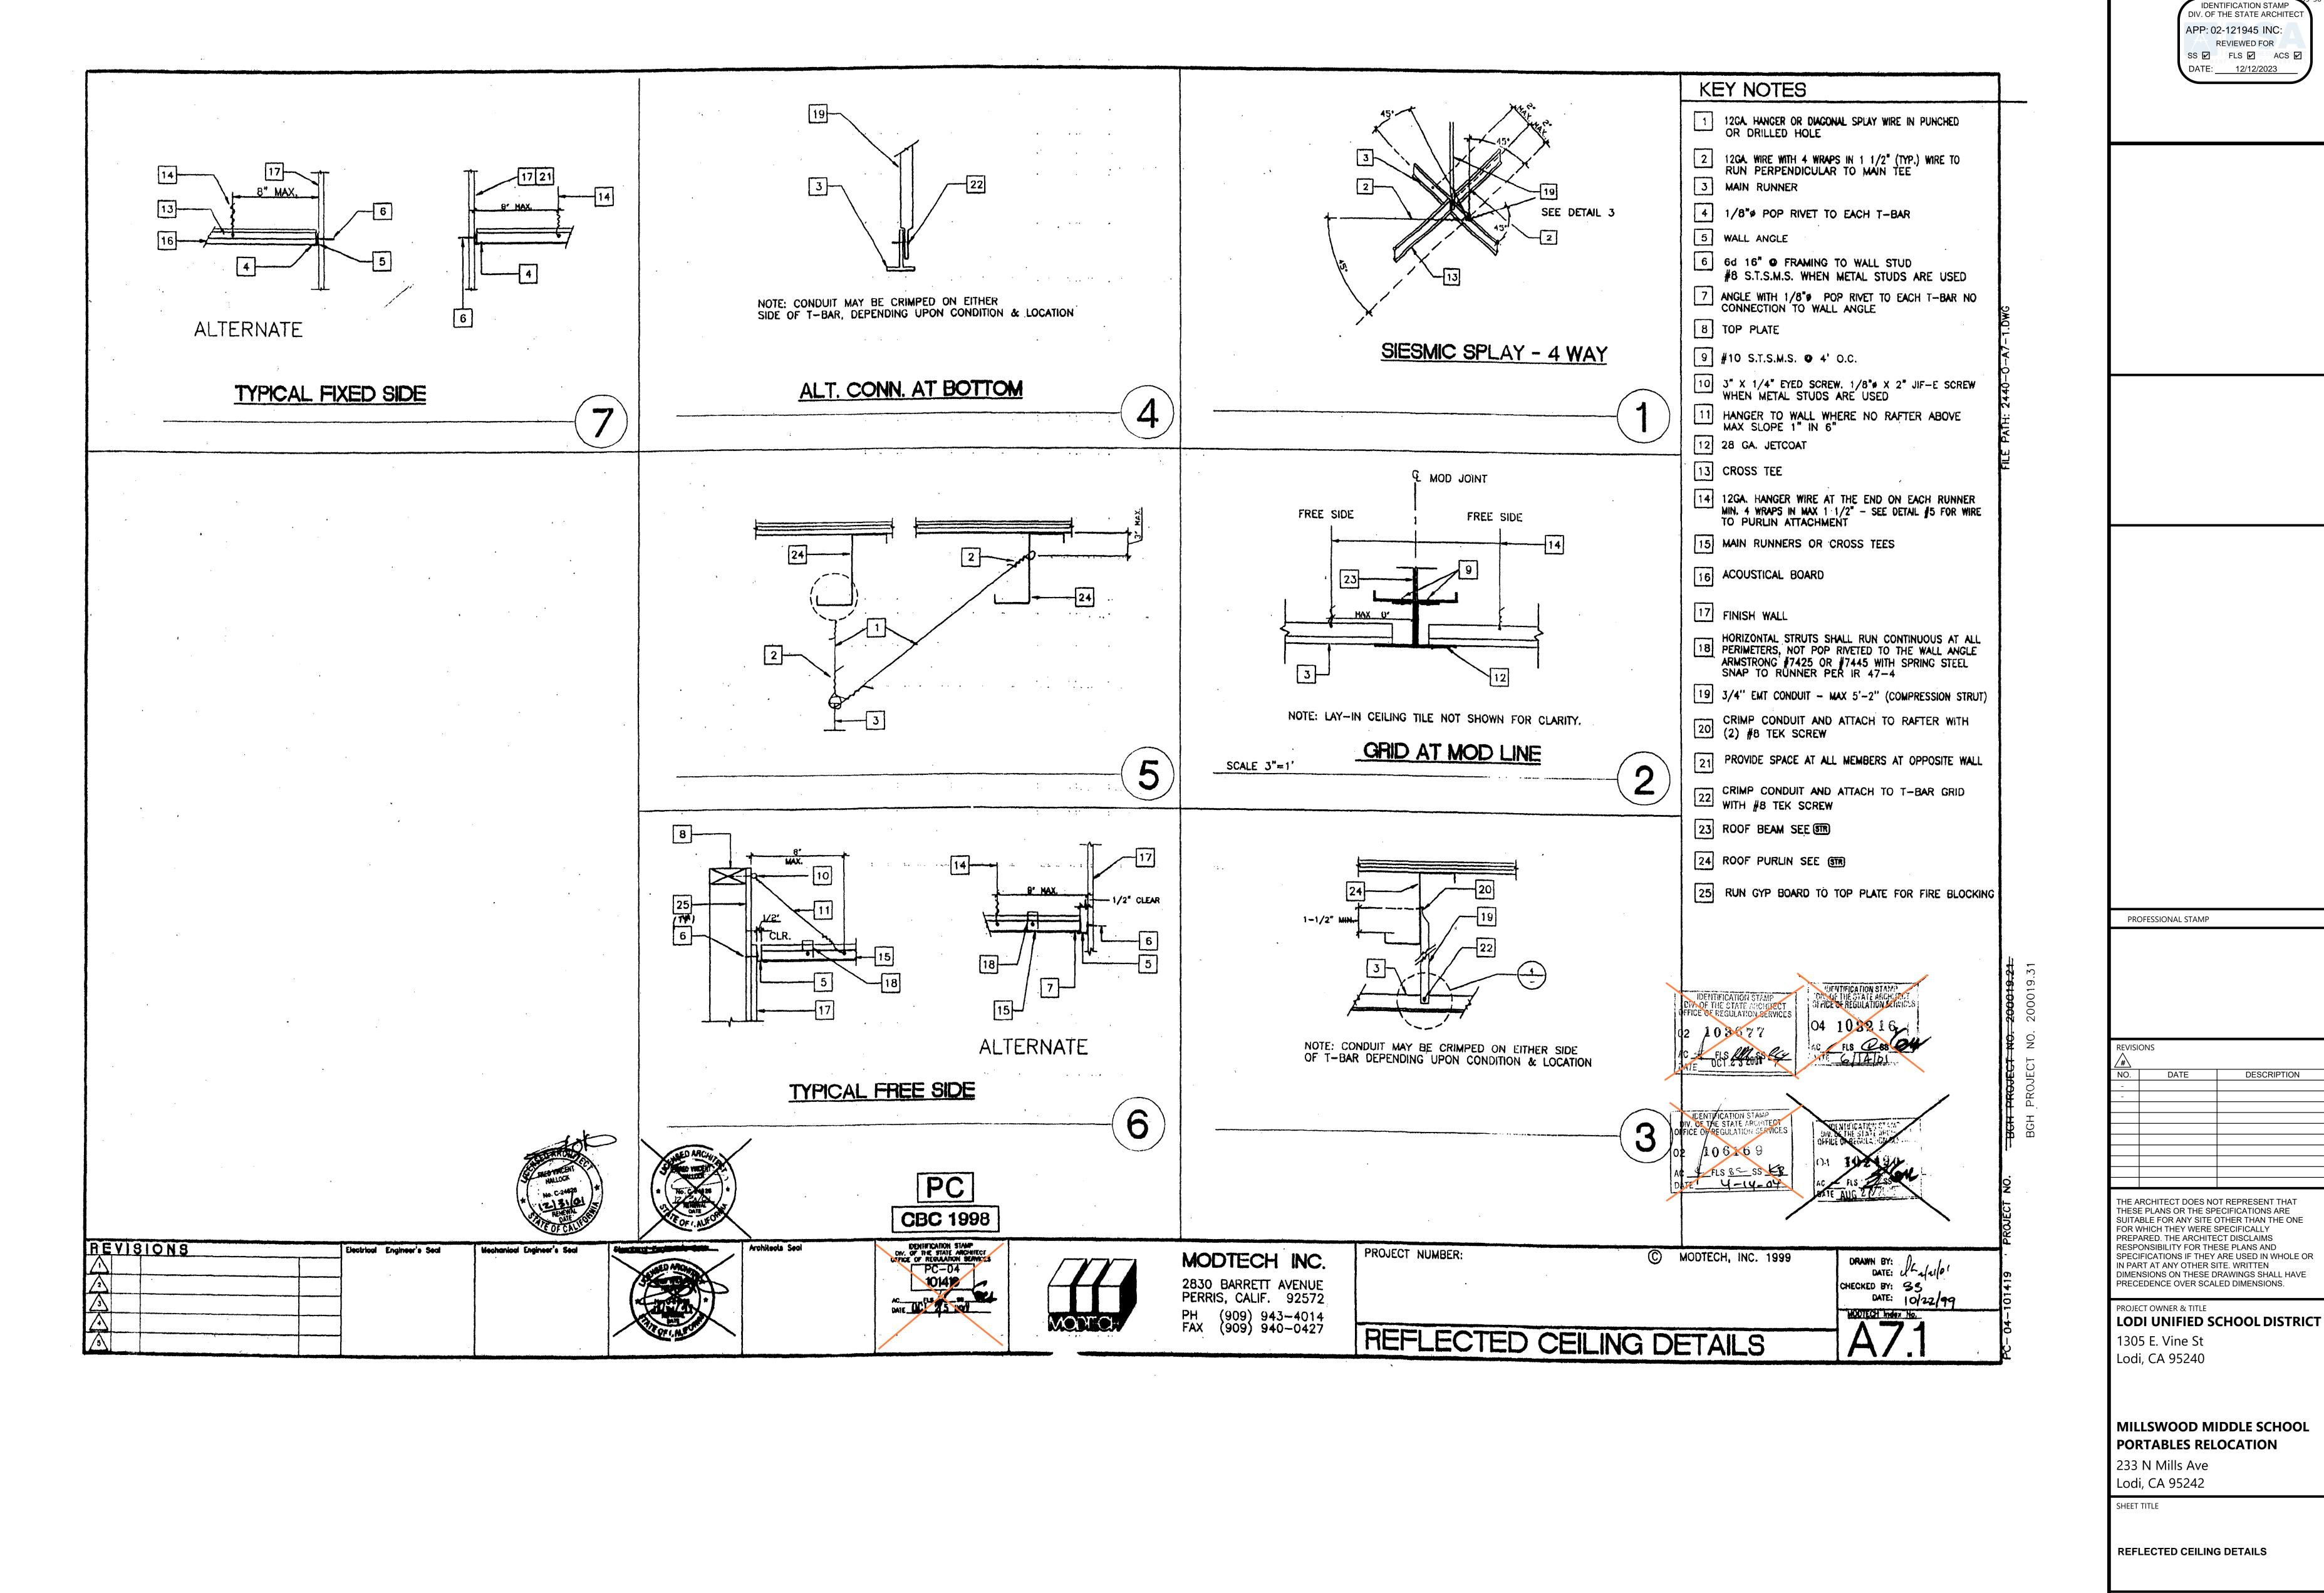

DRAWN BY: XXXXXX JOB NUMBER: 23219

DATE: DECEMBER 5, 2023

ONSTRUCTION DOCUMENTS

DRAWN BY: XXXXXX JOB NUMBER: 23219

**A8.0** 

DATE: DECEMBER 5, 2023

AGENCY APPROVAL DSA#

IDENTIFICATION STAMP
DIV. OF THE STATE ARCHITEC

REVIEWED FOR

SS FLS ACS

APP: 02-121945 INC:

DATE: 12/12/2023

Workmanship shall be equal or better in quality to that required by the construction trades for a finished product. A quality control supervisor, designated by the manufacturer, shall review all work in progress and shall review the finished building prior to final inspection to assure it is complete and correct. The quality control supervisor shall have the authority to have materials. replaced and work redone in order to correct faulty materials or workmanship

Buildings To Be Constructed After Bid Opening Date: In-plant inspection services shall be provided by independent contractors retained by OPSC. In-plant inspection and material testing enall be accomplished under the supervision of the Agency Architect. The contractor shall notify OPSC at (916) 445-3160 and the Agency Architect at least 5 working days prior to beginning of production on each building. Payment will not be made on buildings where this requirement is not met. The Agency Architect and inspector shall have full access to all plant operations involving work under this contract. The inspector shall be notified in advance of the time and place of operations that the inspector wants to observe. Before the building is removed from the plant for delivery to the storage lacility or from the storage facility to the site, the inspector and Agency Architect shall determine that they are acceptable and issue a written release which shall be in the form of a Verified Report (Form SSS-6). A COPY OF THE INSPECTOR'S VERIFIED REPORT INDICATING THERE ARE NO PUNCH LIST ITEMS SHALL ACCOMPANY EACH BUILDING TO STORAGE OR TO THE SITE.

3.13 General

Energy Conservation: Building shall comply with Title 24, Part 2, and Chapter 2-53 of the elifornia Code of Regulations. These regulations are also contained in California Energy Commission Publication P400-82-001 (Building Energy Efficiency Standards for New Buildings). Title 24 documentation shall be provided for planchack and submittel to DSA.

Tagging, Each module shall be permanently identified with a minimum 3" x 1-1/2" slamped metal not foil) identification tag with the following information: 1) OPSC building number. 2) Design wind load, and 3) Design roof live load. This leg may be in addition to or to be combined with the identification tog required by the Division of the State Architect. An additional tag indicaling the OPSC number and the DSA number shall be installed inside the electrical penel.

3,13.3 Finish and base materials at each module, except fooling, carpet and suspended ceiling shall terminate at interior module joints in a manner to join flush and light with same material in adjacent module so that modules may be relocated with minimum cutting and patching

3,13.4 Each module placed in slorage for ANY length of time (either in storage yard or on site) shall be closed up in a secure and weatherlight manner protecting them from all damage. Modules shall be maintained in this manner until State acceptance at designated achool site.

Submittel of engineering data or strewings by the Contractor and subsequent authorization to proceed by the owner or owner's representative shall not relieve the Contractor from responsibility for compliance with all applicable specifications. Deviations from any specification is acceptable only where authorized in advance in writing by the owner or owner's representatives. Where deviations were agreed to on an earlier contract, it shall not be assumed that these deviations will be accepted on the current contract.

Color Semple Submittale: Color samples shall be submitted to OPSC for selection for all items for which there are color options. Samples shall be submitted at an appropriate time so those color requirements are incorporated into drawings or reference documents prior to construction

Special Permits or Fees: Any special loss required by city, county, or State agencies for the delivery and/or installation of these modules shall be the responsibility of the contractor

Once modules are delivered at the sits, installation shall commence immediately and be pursued in a timely manner until complete. All modules called for at that site shall be scheduled for delivery and metaliation in one continuous time frame, at least two per week (Saturdays, Sundays and Holidays excepted). Feiture to begin installation within 24 hours after delivery (Saturdays, Sundays and Holidays excepted) or failure to complete building installation to the approval of the State within ten calendar days after building delivery shall be considered a default of the Contract The contractor shall furnish materials and equipment in simple quantities and at such times to assure uninterrupted progress of the work. Faiture to provide edequate working force or material of proper quality, or failure in any other respect to prosecute the work specified herein shell be grounds for decising default on the contract.

Security of the buildings against vandalism is the sole responsibility of the contractor until installation of the buildings, according to the terms of this contract, has been completed and the buildings have been accepted by the State or accepted for occupancy by the School District with State approval. The Contractor shall lock up all materials and equipment at the end of the day's work. All screp material shall be removed from the site at the end of each day's work. The building site and the building shall be clean and ready for occupancy prior to acceptance by the

4.3 Coordination of Work and On-Bite Inspection: It shall be the Contractor's responsibility to make all necessary arrangements with the School District's Authorized Representative for access to grounds and removal of equipment, if necessary. The representative's name and address is available from OPSC. This contact shall be made at least 48 hours prior to delivery of any module. The site inspector hired by the district shall do on-site inspection. All work, which the manufacturer or his subcontractors perform at the site, shall be subject to the inspection of the site inspector. The manufacturer shall furnish the site inspector with a full set of approved plans and such information as may be necessary to keep him fully informed as to progress of work and dates when alle work will occur. The contractor shall notify DSA and the District's designated Inspector/Inspection Agency at least 48 hours prior to commencing work. THE CONTRACTOR SHALL VERIFY THAT THE DISTRICT'S SITE IS READY TO RECEIVE THE CLASSROOM (S) PRIOR TO THE DELIVERY OF ANY CLASSROOM (8) BY VISITING EACH SITE. In the event buildings are delivared to any site that is not in condition to receive buildings, the contractor shall be responsible for all costs incurred including, but not limited to, INSPECTOR'S time

Temporary Facilities: Contractor shalf make arrangements for and provide his own temporary water, electric light and power, field office, corporation yard, parking and tollet (scilities as may be required for each of the sites.

GUARANTEE: Contractor shall unconditionally guarantee that work will be done in accordance th requirements of contract, and that the work will remain free of detects in workmanship and materials for a period of one year from date of ecceptance by the State. Contractor shall agree to repair or replace any and all work, together with any other adjacent work which may have been damaged or displaced in so doing, that may prove to be not in accordance with requirements of contract or that may be delective in its workmanship or material within guarantee period specified. without any expense whatevover to the State. Contract bonds shell be in full force and effect during guarantee period. Within ten calendar days after being notified in writing by the agency of any work not in accordance with requirements of contract or any detects in the work, contractor shall commence and prosecute with due diligence all work necessary to fulfill terms of this guarantee, and to complete the work within a reseanable period of time. In the event the contractor falls to comply, the agency shall proceed to have such work done at contractor's expense and contractor shall pay cost thereof upon demand. State shall be entitled to all costs.

including reasonable attorney's less, necessarily incurred upon contractor's refusal to pay above

STATE OF CALIFORNIA Bid Specification

Building, Cisesroom, Prolabricated, Relecatable, Type I (Standard Without Restrooms)

Office of Public School Construction (OPSC)

5410-985-029 MARCH 2000

SCOPE: This specification establishes the apacific requirements for standard relocatable prefabricated cleasrooms without restrooms. Building shall also comply with general requirements contained in State of California Bid Specification 5410-X88-028, Building, Classroom.

SPECIFICATIONS AND STANDARDS: Specifications and standards referenced in this document in effect on the opening of the invitation for Bid form a part of this specification where referenced REQUIREMENTS

3.1.1 Anodized sluminum (8040) frame 5/5" minimum dual pane window units shall be provided on oppose walls. One window shall be in the same well and a minimum of two feet from the door. interior window opening shall be completely cased with solid wood molding or prefinished paneling with prefinished from. Window frame shall be the 50%, double sliding sesh type (XOX). Glazing materials shall be

Extenor He - 3/16" minimum tempered gless or teminated AS-1 LOW-E GLASS (CARDINAL GLASS COMPANY, LO-E! 172, OR EQUIVALENT) type with a maximum light transmission factor of 48% Interior life - 1/8" minimum clear tempered. Space - Bent or sealed corner aluminum with designant fill. Sealer - Bulyl primary seal and polysulfide or allicone secondary sea

3.1.2 Certification-All glazing shall be certified in accordance with ASTM E-773 (Test Method for Seal Durability of Sealed Insulating Glass Units) and E-774 (Specification for Sealed insulating Glass

3.1.3 Header height shall be the same as the door. All operable each shall have aluminum screens. Windows shall not be mounted to the exterior plywood surface. 3.1.4 Windows shall be dual-commercial type (HS-C20) meeting requirements of American National

Standard Institute (ANSI)/American Architectural Manufacturers Associate (AAMA) Standard 101 Voluntary-Specification for Aluminum Prime Windows and Stiding Glass Doors.

3.1.5 A minimum of 6' of sharple style last paper fisshing shall be installed around all windows. Minimum 26 gauge Q I, flashing shall be installed at head.

Floor Covering: All units shall be carpeted with direct glue down type per State of California Spacification 7220-XXX-04 (Garpet, Broadloom, Nylon, TuRed, Commercial grade, 26 Ounce. Level or Multilevel Loop Pild), Type 1. Color will be selected by agency after award of bid. Cross seams are unacceptable. Realient cove base shall be solid salor, molded rubber, minimum 1/8" thick, minimum 4" high. Prefermed base pieces shall be used for corners. Cove shall be applied to complete perimeter of classroom. Cove best shall be Burke Rubber #802-P or equivalent approved in advance and in writing by PD. Adhesives shall be water based and shall be applied per manufacturer's written instructions.

Well and floor insulation shall have a rating of R13. Celliny insulation shall have a rating of R22. On buildings where a mater roof deak, mater beares or other metal elements are exposed above the celling, an interior mointure barrier shall be provided on the worn in winter of the insulation in the celling are to prevent condensation on any metal authores. The moleture barrier shall corrupt with 25/50 Fire Hazard Classification Rating per ASTM E-64 and at seams or openings shall be seated. Moleture barrier to be Convex CW800 flame spread 0-25 and a smalle detailly rating not to exceed 450 when tested in accordance with U.B.C. Standard No. 8-1.

3.3.2 Floor insulation shall be secure with a permanble material in a manner approved by the Agency Architect. The insulation support material shall prevent movement of the insulation during transportation. The insulation and support material shall be integt upon delivery to the site and shall completely cover the floor cavity.

3.4 Merkerbeards: Each classroom shell have two 4' x 8' panels installed side by side centered on one of the lone walls.

3.5 OPSC/DSA Approval and Document Distribution

3.5.1 After notice of sward, the successful bidder shall prepare plans, specifications, and calculations and submit two copies of them to the Agency Architect within 30 calender days of receipt of the order. All plans, specifications and osiculations shall be signed by an architech(s), structural engineer(s), electrical engineer(s) and mechanical engineer(s) licensed by the State of California. The material sections of this specification and bid specification 5410-XBS-028 shall be incorporated into the bidder's plans and printed on the appropriate pages prior to submission to the Agency Architect for specification

3.5.2 The Agency Architect shall return one set of the plans, specifications for corrections or issue a letter of compliance showing approval within 10 working days of receipt. Any notations or corrections required by the Agency Architect shall be incorporated into the piens and specifications and they shall be returned to the Agency Architect within 5 working days in the firm of one complete set of reproducibiles and two complete set of prints. contractor shall have only one opportunity to correct plans at the Agency Architect level, resubmittels shall be delivered by express mail or may be delivered in person.

3.5.3 Once Agency Architect approval has been obtained, Contractor shall submit to the Agency Architect two complete .sets of approved plans for each lot of buildings offered within 3 working days. The Agency Architect shall then submit to DSA for project approval and obtain a stockpile approval number for the specified number of buildings to be provided under the current contract. Final DSs approved plans shall be expressed mailed or hand delivered to Contractor within three working days. THE SUCCESSFUL BIDDER SHALL BE RESPONSIBLE FOR ALL COSTS ASSOCIATED WITH MEETING THE REQUIREMENTS OF THE CALIFORNIA BUILDING CODE IN EFFECT AT THE TIME OF SUBMISSION TO DSA FOR FINAL APPROVAL. The Department of General Services will pay any charges from DSA which are incurred white obtaining final DSA building approvals.

3.5.4 The Contractor shall provide one set of reproducible approved plans for each school site listed within 5 working days after receiving the "Plan Letter". Plans shall be sent to each school district architect for use in obtaining site plan approval, proof of mailing shall be sent to OPSC within 3 working days.

3.5.5 Contractor shall not begin construction of the buildings until a written notice to proceed by the OPSC representative lias been received. Notice will be provided within thirty days of project approval.

STATE OF CALIFORNIA Specification

Paint, Latex Maintenance

procured by the State of California. SPECIFICATIONS AND STANDARDS Specifications and standards referenced in this document in effect on the opening of the invitation for Bid form a part of this specification where referenced.

Scope This specification covers the requirements for latex based maintenance pain

REQUIREMENTS

FORMULATION: The manufactuer shall include in his formulation the necessary additives for control of sagging, leveling, excessive settlement and skin formatiom, drier absorption and other requisite qualities of a satisfactory working material.

district regulatoins and federal lead and mercury content laws. CONDITION IN CONTAINER: Paint shall show no evidence of putrelection, skinning, hard settled pigment or corrosion of the container. The paint shall be easily dispersible to a uniform condition by hand stirring.

REGULATORY REQUIREMENTS: This product must comply with local air pollution control

COLOR: The paint shall be svallable in all colors.

The paint shall have no objectionable edor.

PERFORMANCE: Must be a high quality point with a minimum ten (10) year manufacturers warranty

The paint shall have acceptable one coat coverage.

The paint shall brush, roll and be sprayable (airless) without filtering. The material shall have no objectionable pulling and the resulting film shall not sag , or run, and shall level to a smooth surface of satisfactory appearance with no coarse particles, bilstering, fish eyes, orange peel, pitting or pinholes after drying. Drytime shell not be more than one (1) hour, set to touch.

Dry opacity of white paint shall not be less than 0.97, 3 mil wat film.

MANUFACTURERS QUALITY CONTROL PROGRAM: The manufacturer shall maintain a Quality Control laboratory sufficiently equipped and staffed for the control of all the requirements in this specification.

QUALITY ASSURANCE PROVISIONS

Sampling and Inspection; This commodity will be sampled and inspected for compliance to this specification as deemed necessary. Sampling and inspection by attributes will be in accordance with Military Standard, MIL-STD-105 Sampling Procedures and Tables for Inspection by Attributes. An inspection lot is defined as one delivery to one agency

PREPARATION FOR DELIVERY

Containers: Each container shall be clearly labeled with the following information:

s. The descriptive name of paint (e.g. Latex Interior Wall Paint, Semiglost, Exterior, Finish Coat, etc.)

. Batch number and data code. The manufacturers standard batch and data code are acceptable for this item if clearly marked and the key to any code is provided to the customer. c. The manufacturers name.

d. Full instructions for surface preparation, application, thinning and equipment cleanup. e. Recommended use of the product on various types of surfaces.

f. The approximate area covered per gallon (liter)

g. All paints containing flammable solvents shall have a caution warning on the label,

The vendors standard label is acceptable if it contains the above data. Those items unique to State Precurement may be added with small stick-on labels at the option of the vendor. The stick-on labels must not obscure other required data.

Labels for one- gallon (4 liter) cans and smaller shall be of the complete wrap-around type. Labels for the five gallon (19 liter) cans shall be at least seven (7) by eight (8) inches (18x20 cm) and shall be permanenty attached with permanent glue.

CARTONS: Each shipping carton shall be clearly labeled with the following information: Purchase Order Number, State Commodity Item Code Number, Descriptive Name of the Paint, Color, Batch Number, Data of Manufacture (Month and Year),


SHIPPING: All packaging and shipping shall conform to applicable Federal and State Regulations and conform to good

commercial practices. The groce weight of each shipping carton shall not exceed 55 pounds.

WARRANTY: The shelf life of all protective coatings manufactured under this specification shelf be not less than one year. Some 'soft settling' will be allowed, but the materials shall be easily redispersed with a hand paddle.

The State reserves the right, at any time within one year from date of acceptance, to check for conformance to specification any paint delivered under this specification. Any material failing to comply will be returned to the vendor for replacement and all expenses, including re-inspection and re-testing, shall be paid for by the vendor.



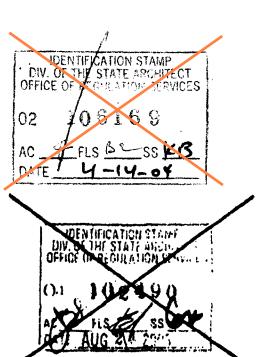

CHECKED BY: 45

MODIFICH Index No.

0

DATE: 10/22/19

THE ARCHITECT DOES NOT REPRESENT THAT THESE PLANS OR THE SPECIFICATIONS ARE SUITABLE FOR ANY SITE OTHER THAN THE ONE FOR WHICH THEY WERE SPECIFICALLY PREPARED. THE ARCHITECT DISCLAIMS RESPONSIBILITY FOR THESE PLANS AND SPECIFICATIONS IF THEY ARE USED IN WHOLE OR IN PART AT ANY OTHER SITE. WRITTEN DATE: . UM 2/2/0

DIMENSIONS ON THESE DRAWINGS SHALL HAVE PRECEDENCE OVER SCALED DIMENSIONS. PROJECT OWNER & TITLE LODI UNIFIED SCHOOL DISTRICT 1305 E. Vine St

**DESCRIPTION** 

PROFESSIONAL STAMP

AGENCY APPROVAL

IDENTIFICATION STAMP DIV. OF THE STATE ARCHITE

REVIEWED FOR SS 🗹 FLS 🗹 ACS 🗹

APP: 02-121945 INC:

DATE: 12/12/2023

MILLSWOOD MIDDLE SCHOOL

PORTABLES RELOCATION 233 N Mills Ave Lodi, CA 95242

Lodi, CA 95240


SHEET TITLE

**SPECIFICATIONS** 

DRAWN BY: XXXXXX JOB NUMBER: 23219

DATE: DECEMBER 5, 2023

**CBC** 1998

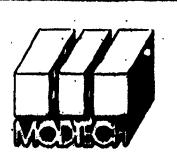

MODTECH INC. 2830 BARRETT AVENUE PERRIS, CALIF. 92572 PH (909) 943-4014 FAX (909) 940-0427

PROJECT NUMBER:


SPECIFICATIONS

DENIFICATION STAMP

OF THE STATE ANCHIEGT


OFFICE OF REQULATION SERVICES 1014.19 ME SS 00

•

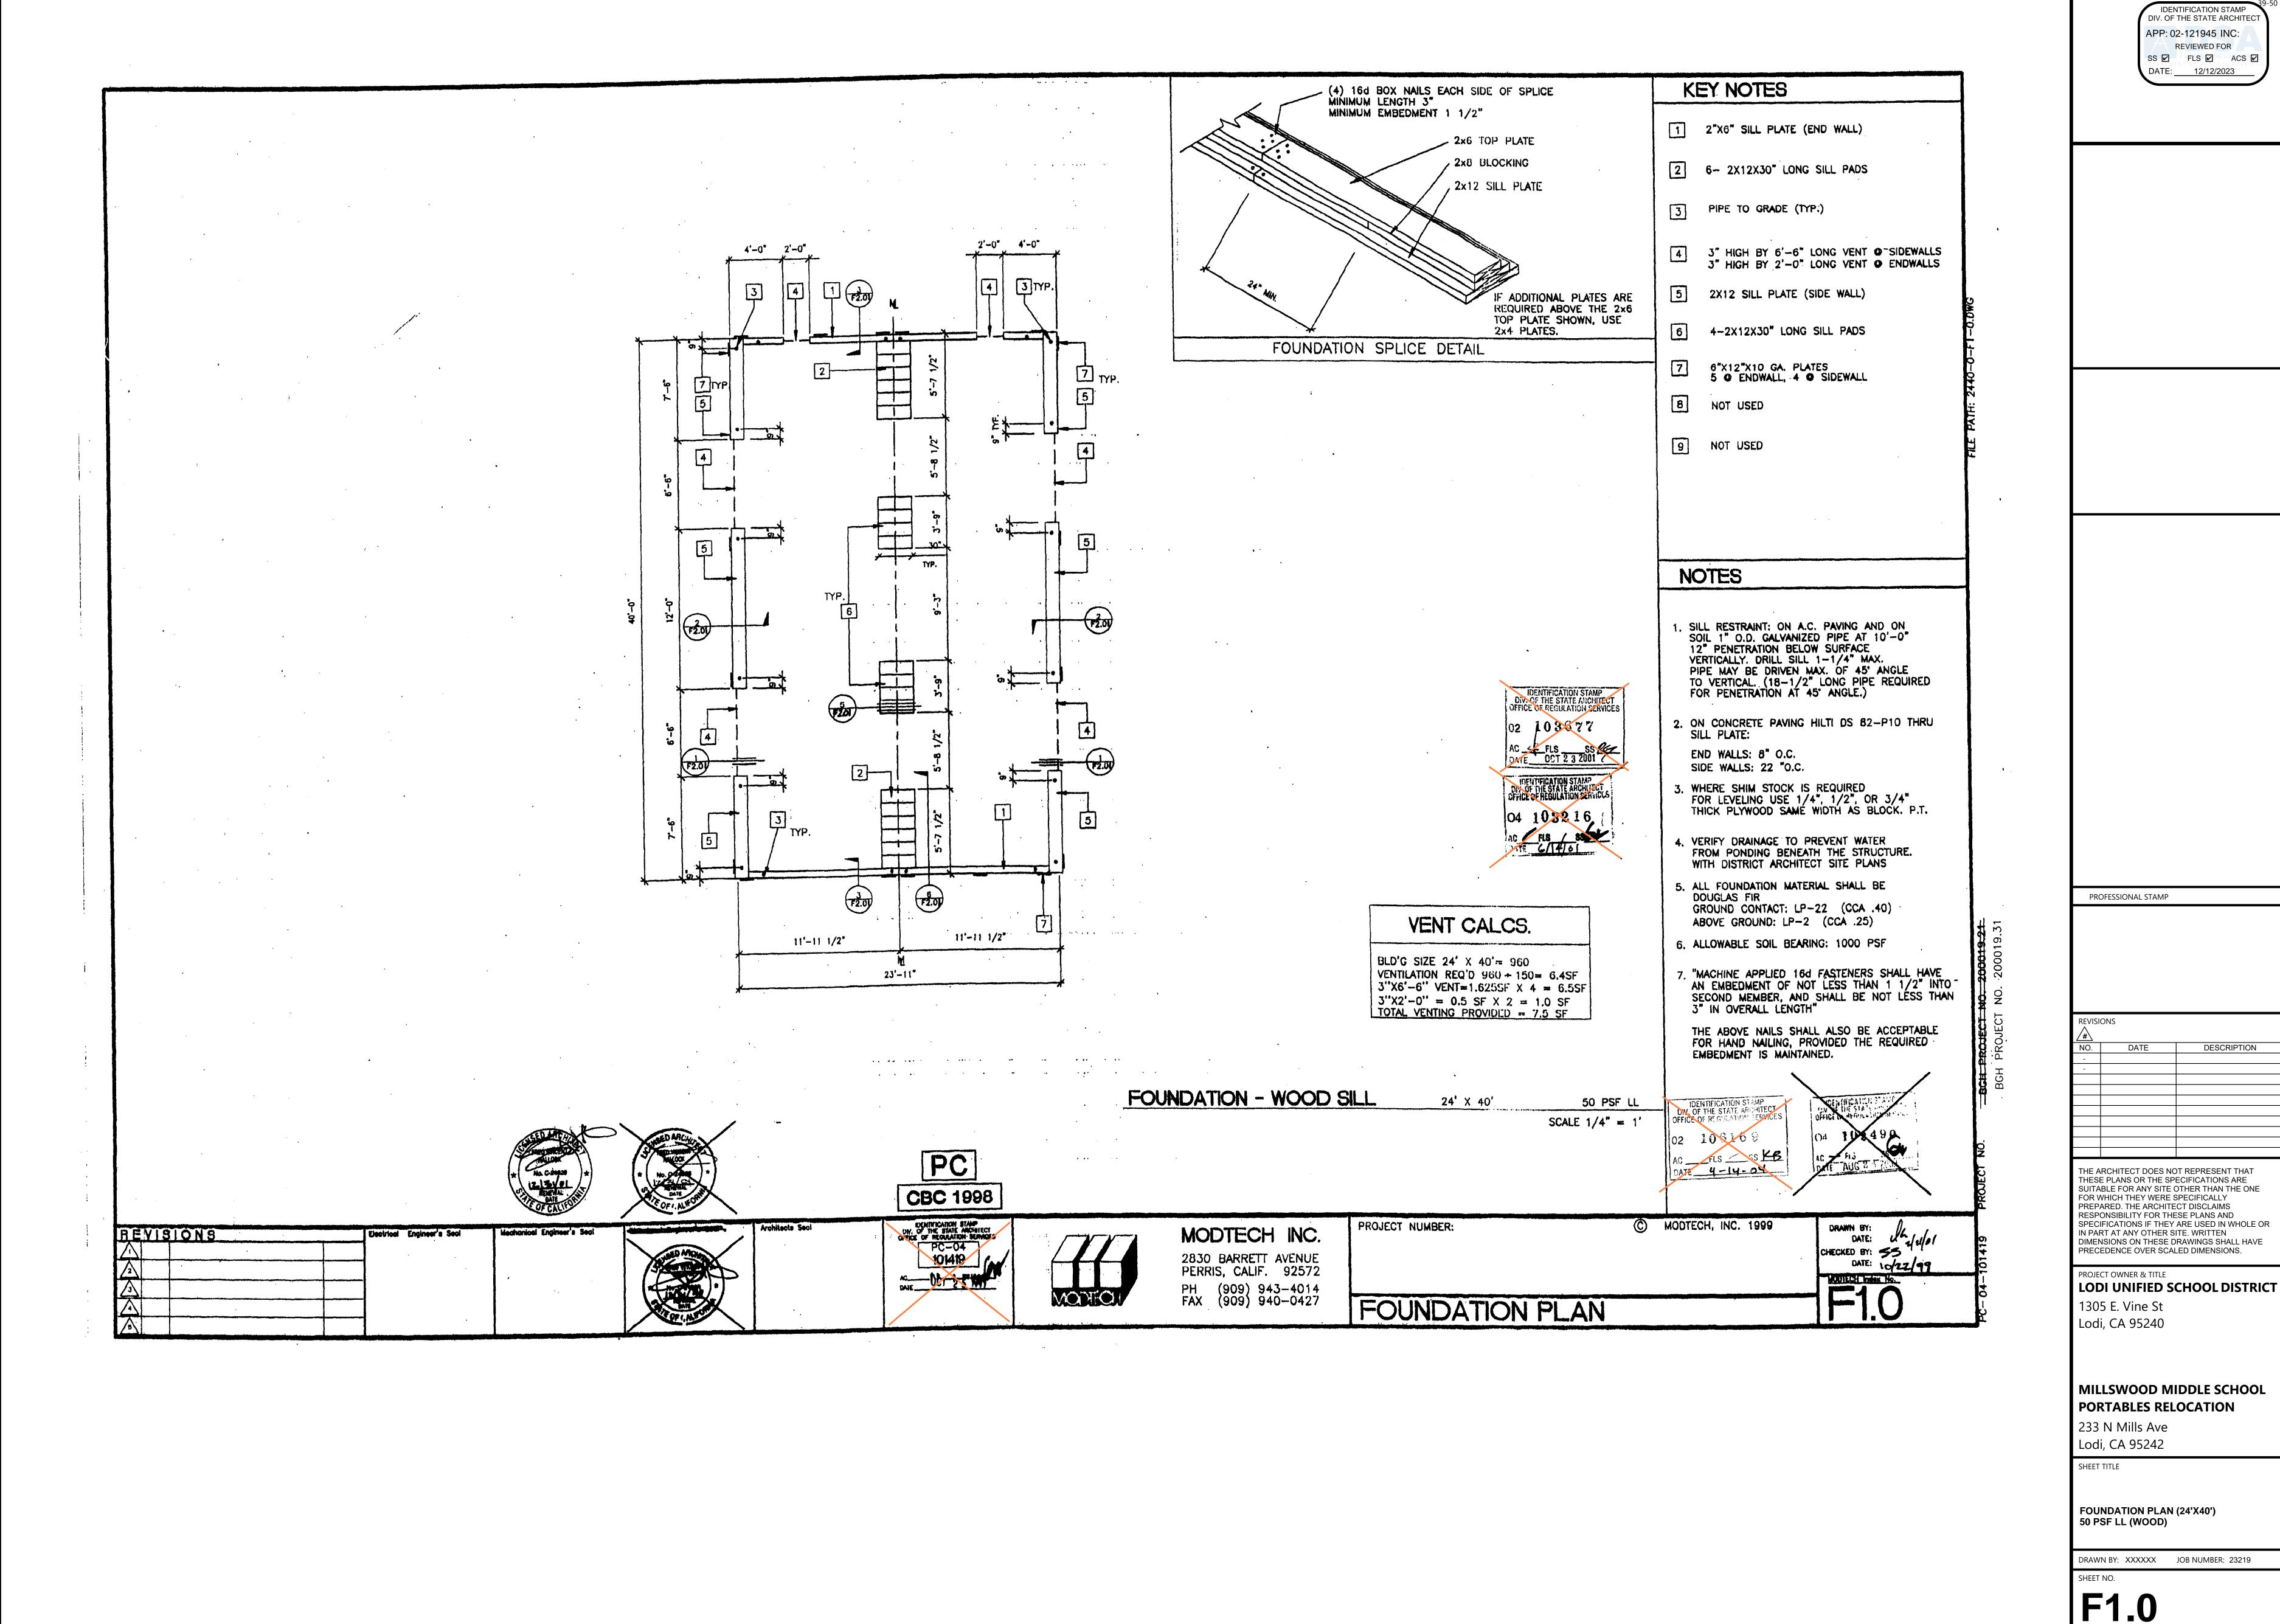

AGENCY APPROVAL DSA#

CONSTRU

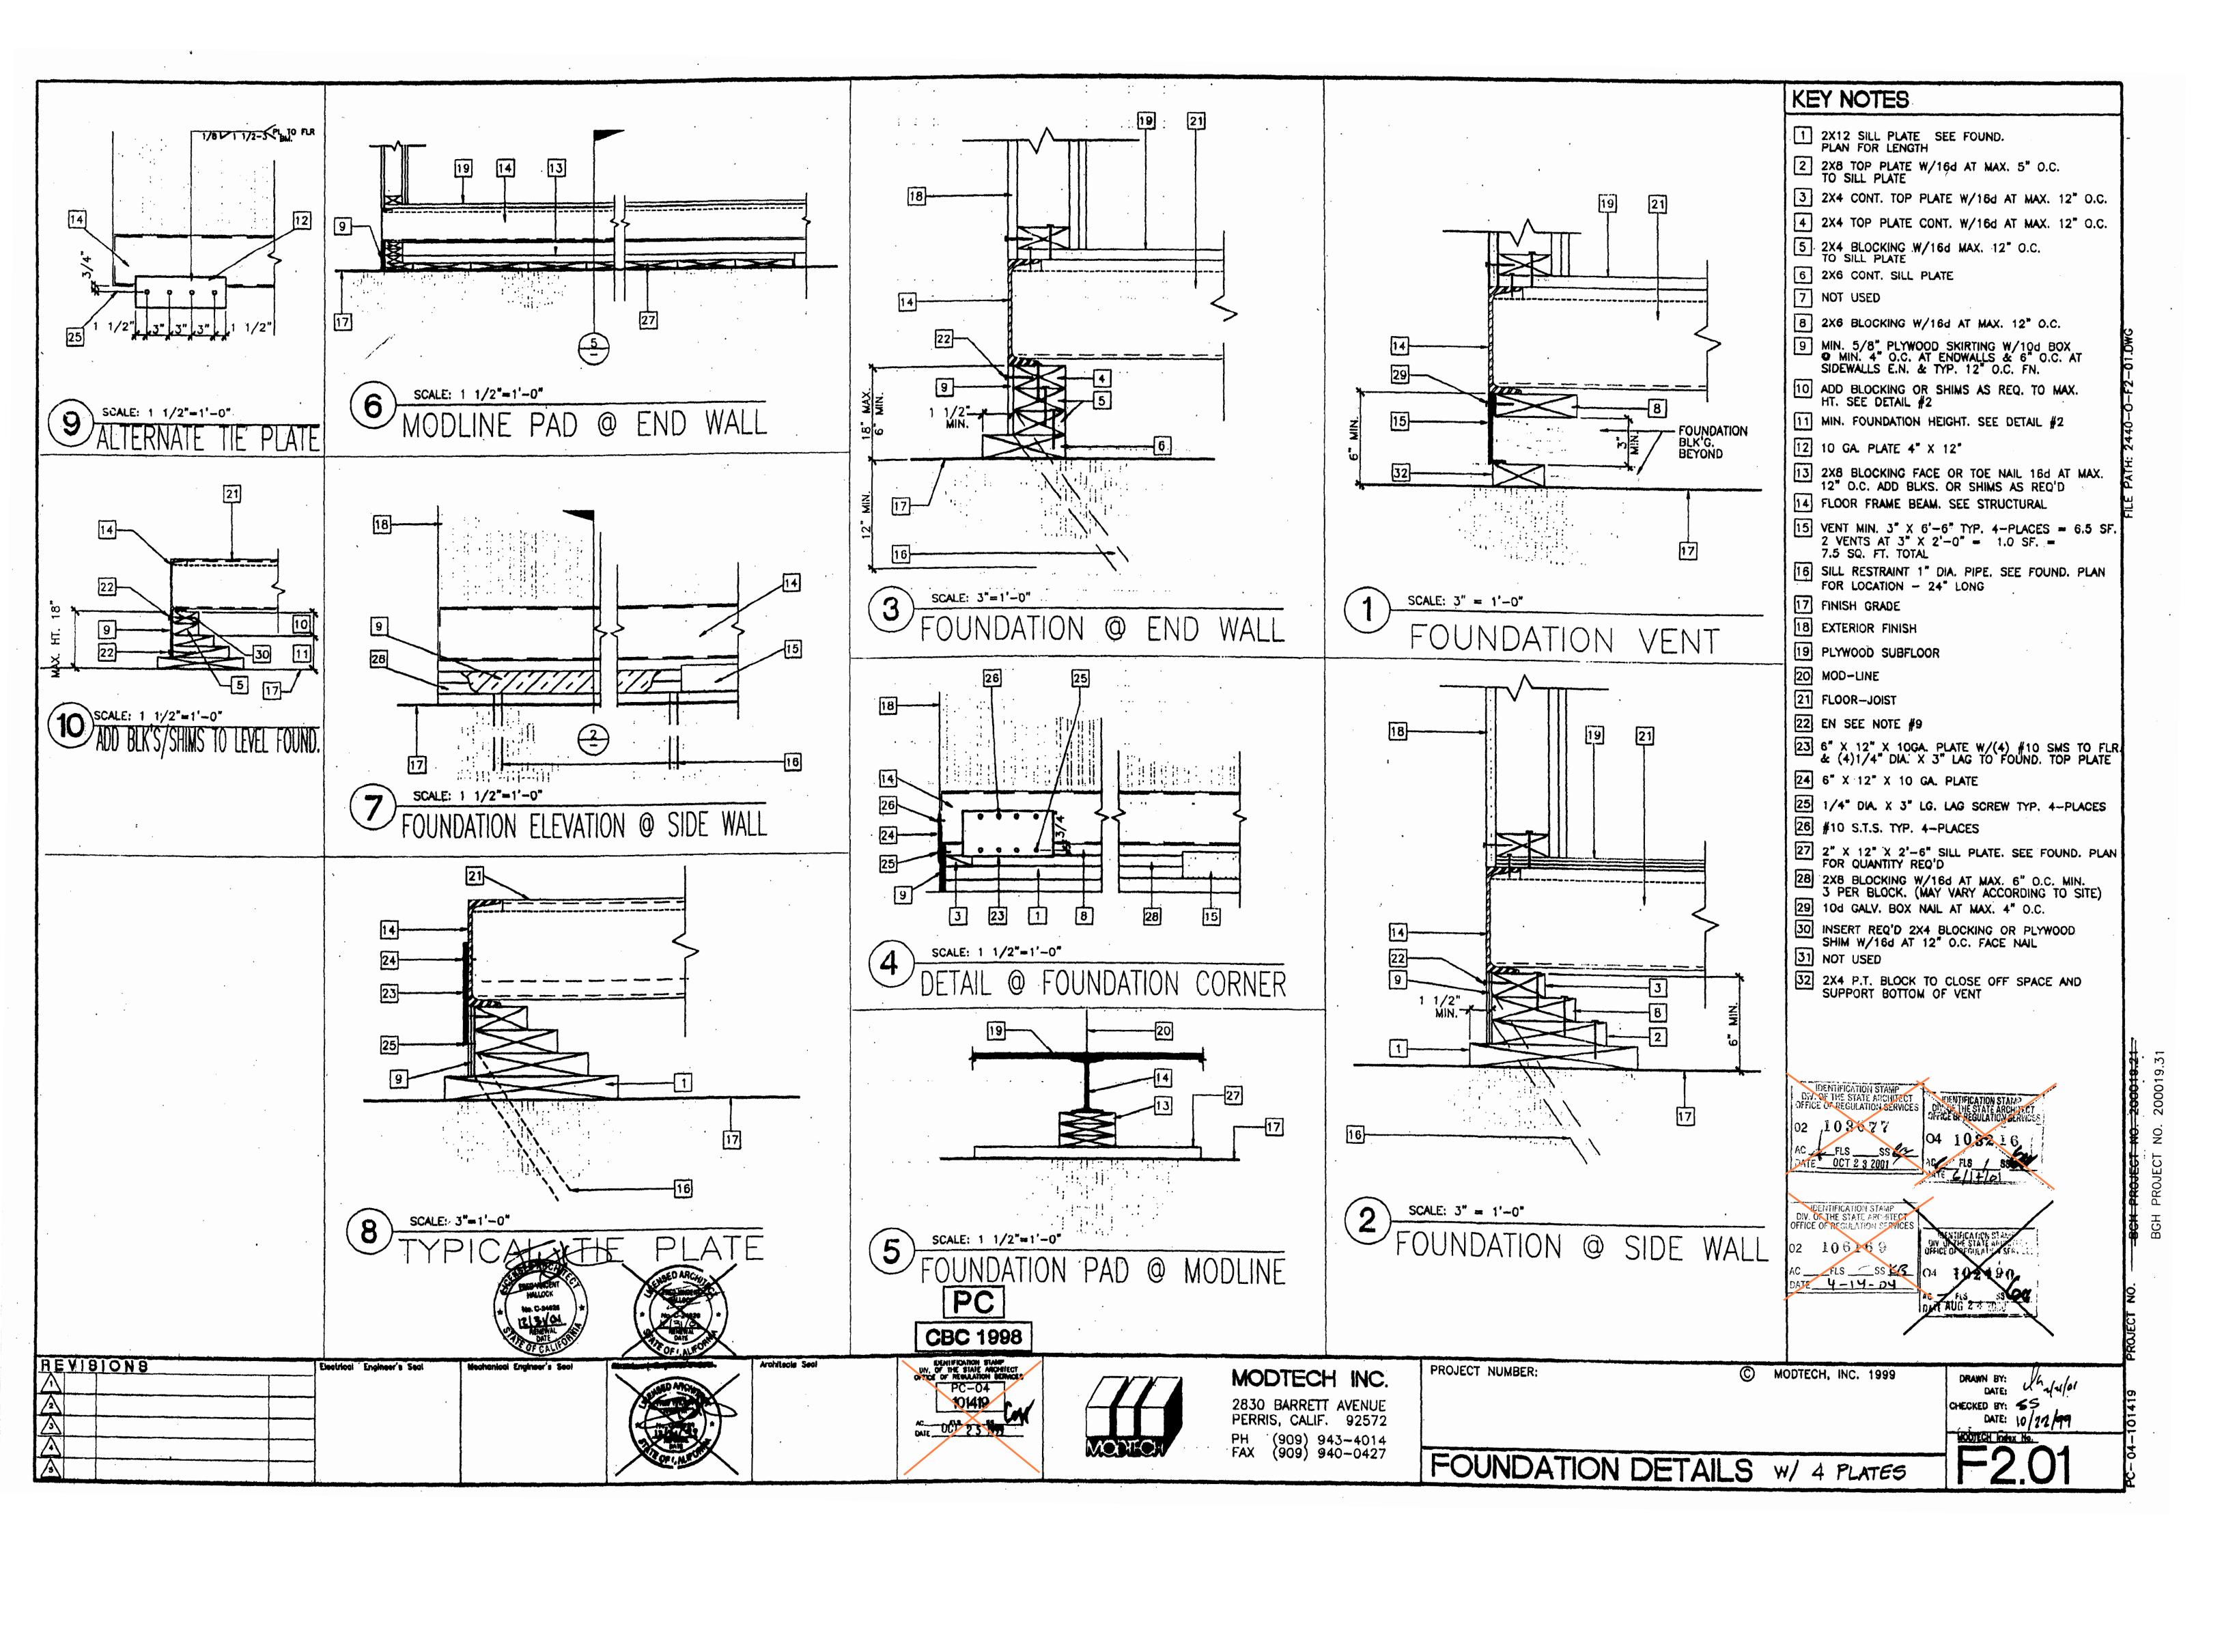

DIV. OF THE STATE ARCHITE APP: 02-121945 INC: REVIEWED FOR SS 🗹 FLS 🗹 ACS 🗹 DATE: 12/12/2023 PROFESSIONAL STAMP DESCRIPTION SUITABLE FOR ANY SITE OTHER THAN THE ONE FOR WHICH THEY WERE SPECIFICALLY PREPARED. THE ARCHITECT DISCLAIMS RESPONSIBILITY FOR THESE PLANS AND

AGENCY APPROVAL <u>DSA#</u>

SPECIFICATIONS IF THEY ARE USED IN WHOLE OR IN PART AT ANY OTHER SITE. WRITTEN DIMENSIONS ON THESE DRAWINGS SHALL HAVE PRECEDENCE OVER SCALED DIMENSIONS.

PROJECT OWNER & TITLE LODI UNIFIED SCHOOL DISTRICT 1305 E. Vine St

MILLSWOOD MIDDLE SCHOOL PORTABLES RELOCATION 233 N Mills Ave


Lodi, CA 95242 SHEET TITLE

Lodi, CA 95240

FOUNDATION DETAILS (WOOD)

DRAWN BY: XXXXXX JOB NUMBER: 23219


F2.01

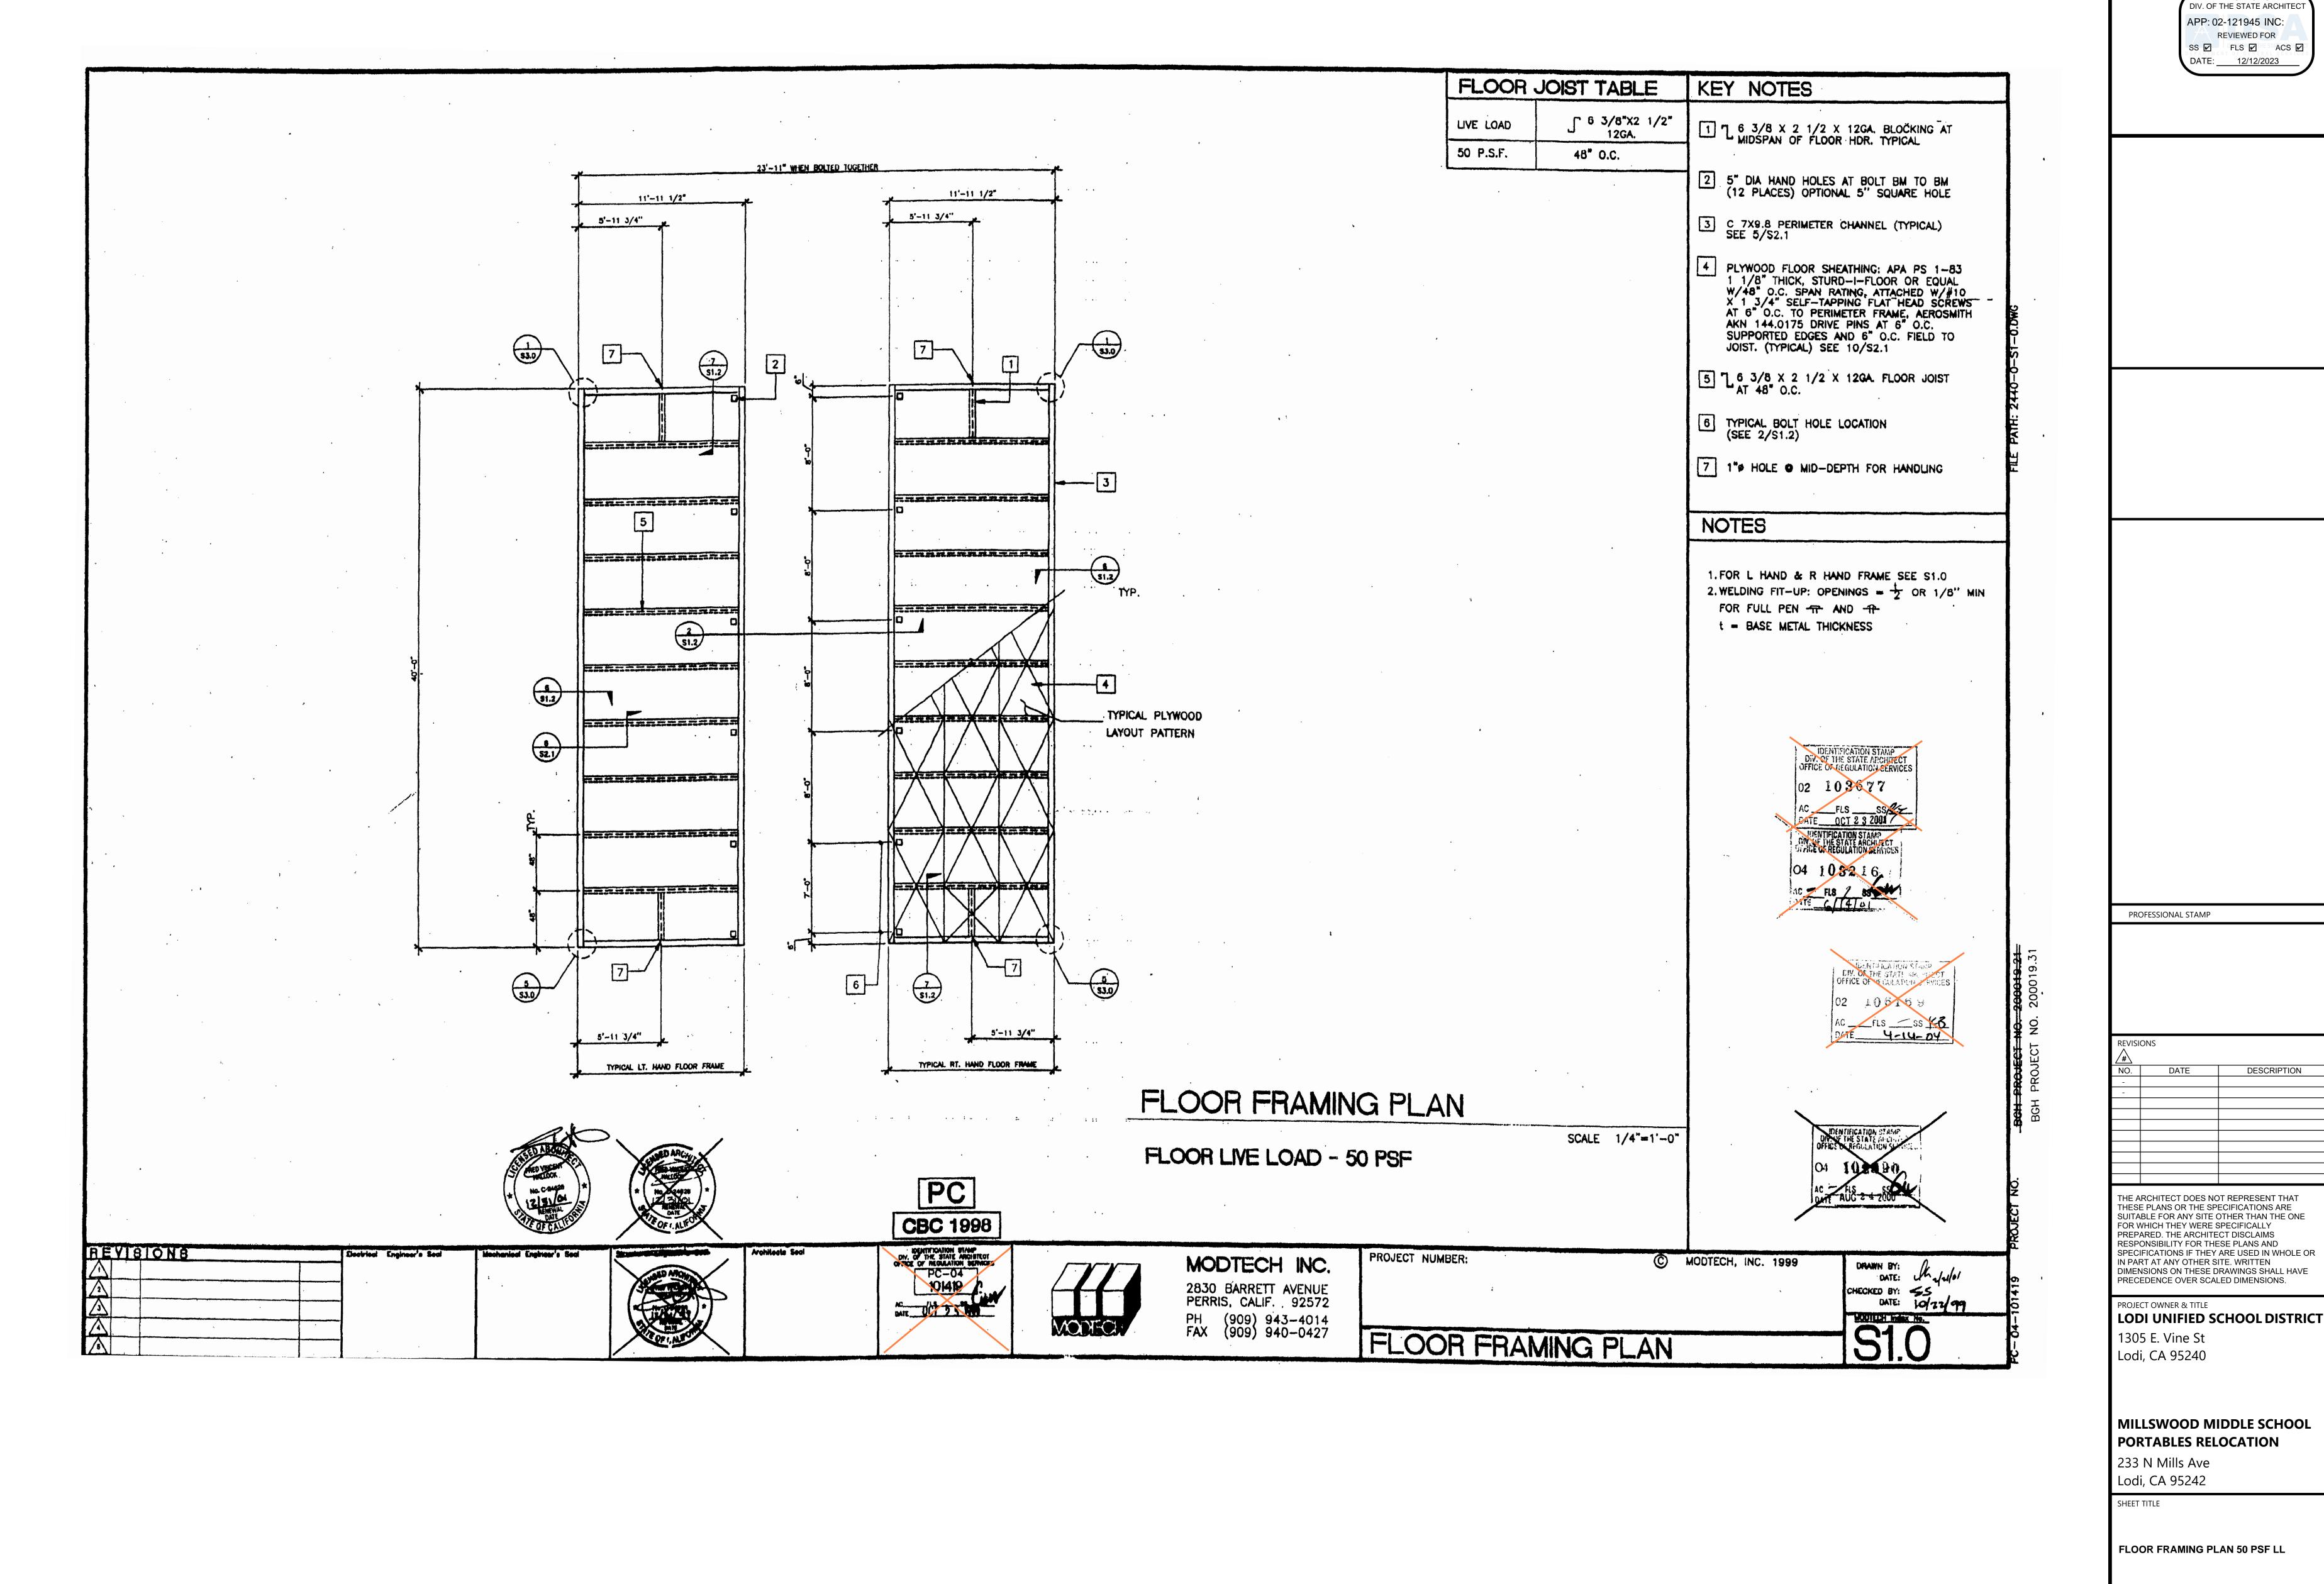

AGENCY APPROVAL DSA#

IDENTIFICATION STAMP


DRAWN BY: XXXXXX JOB NUMBER: 23219

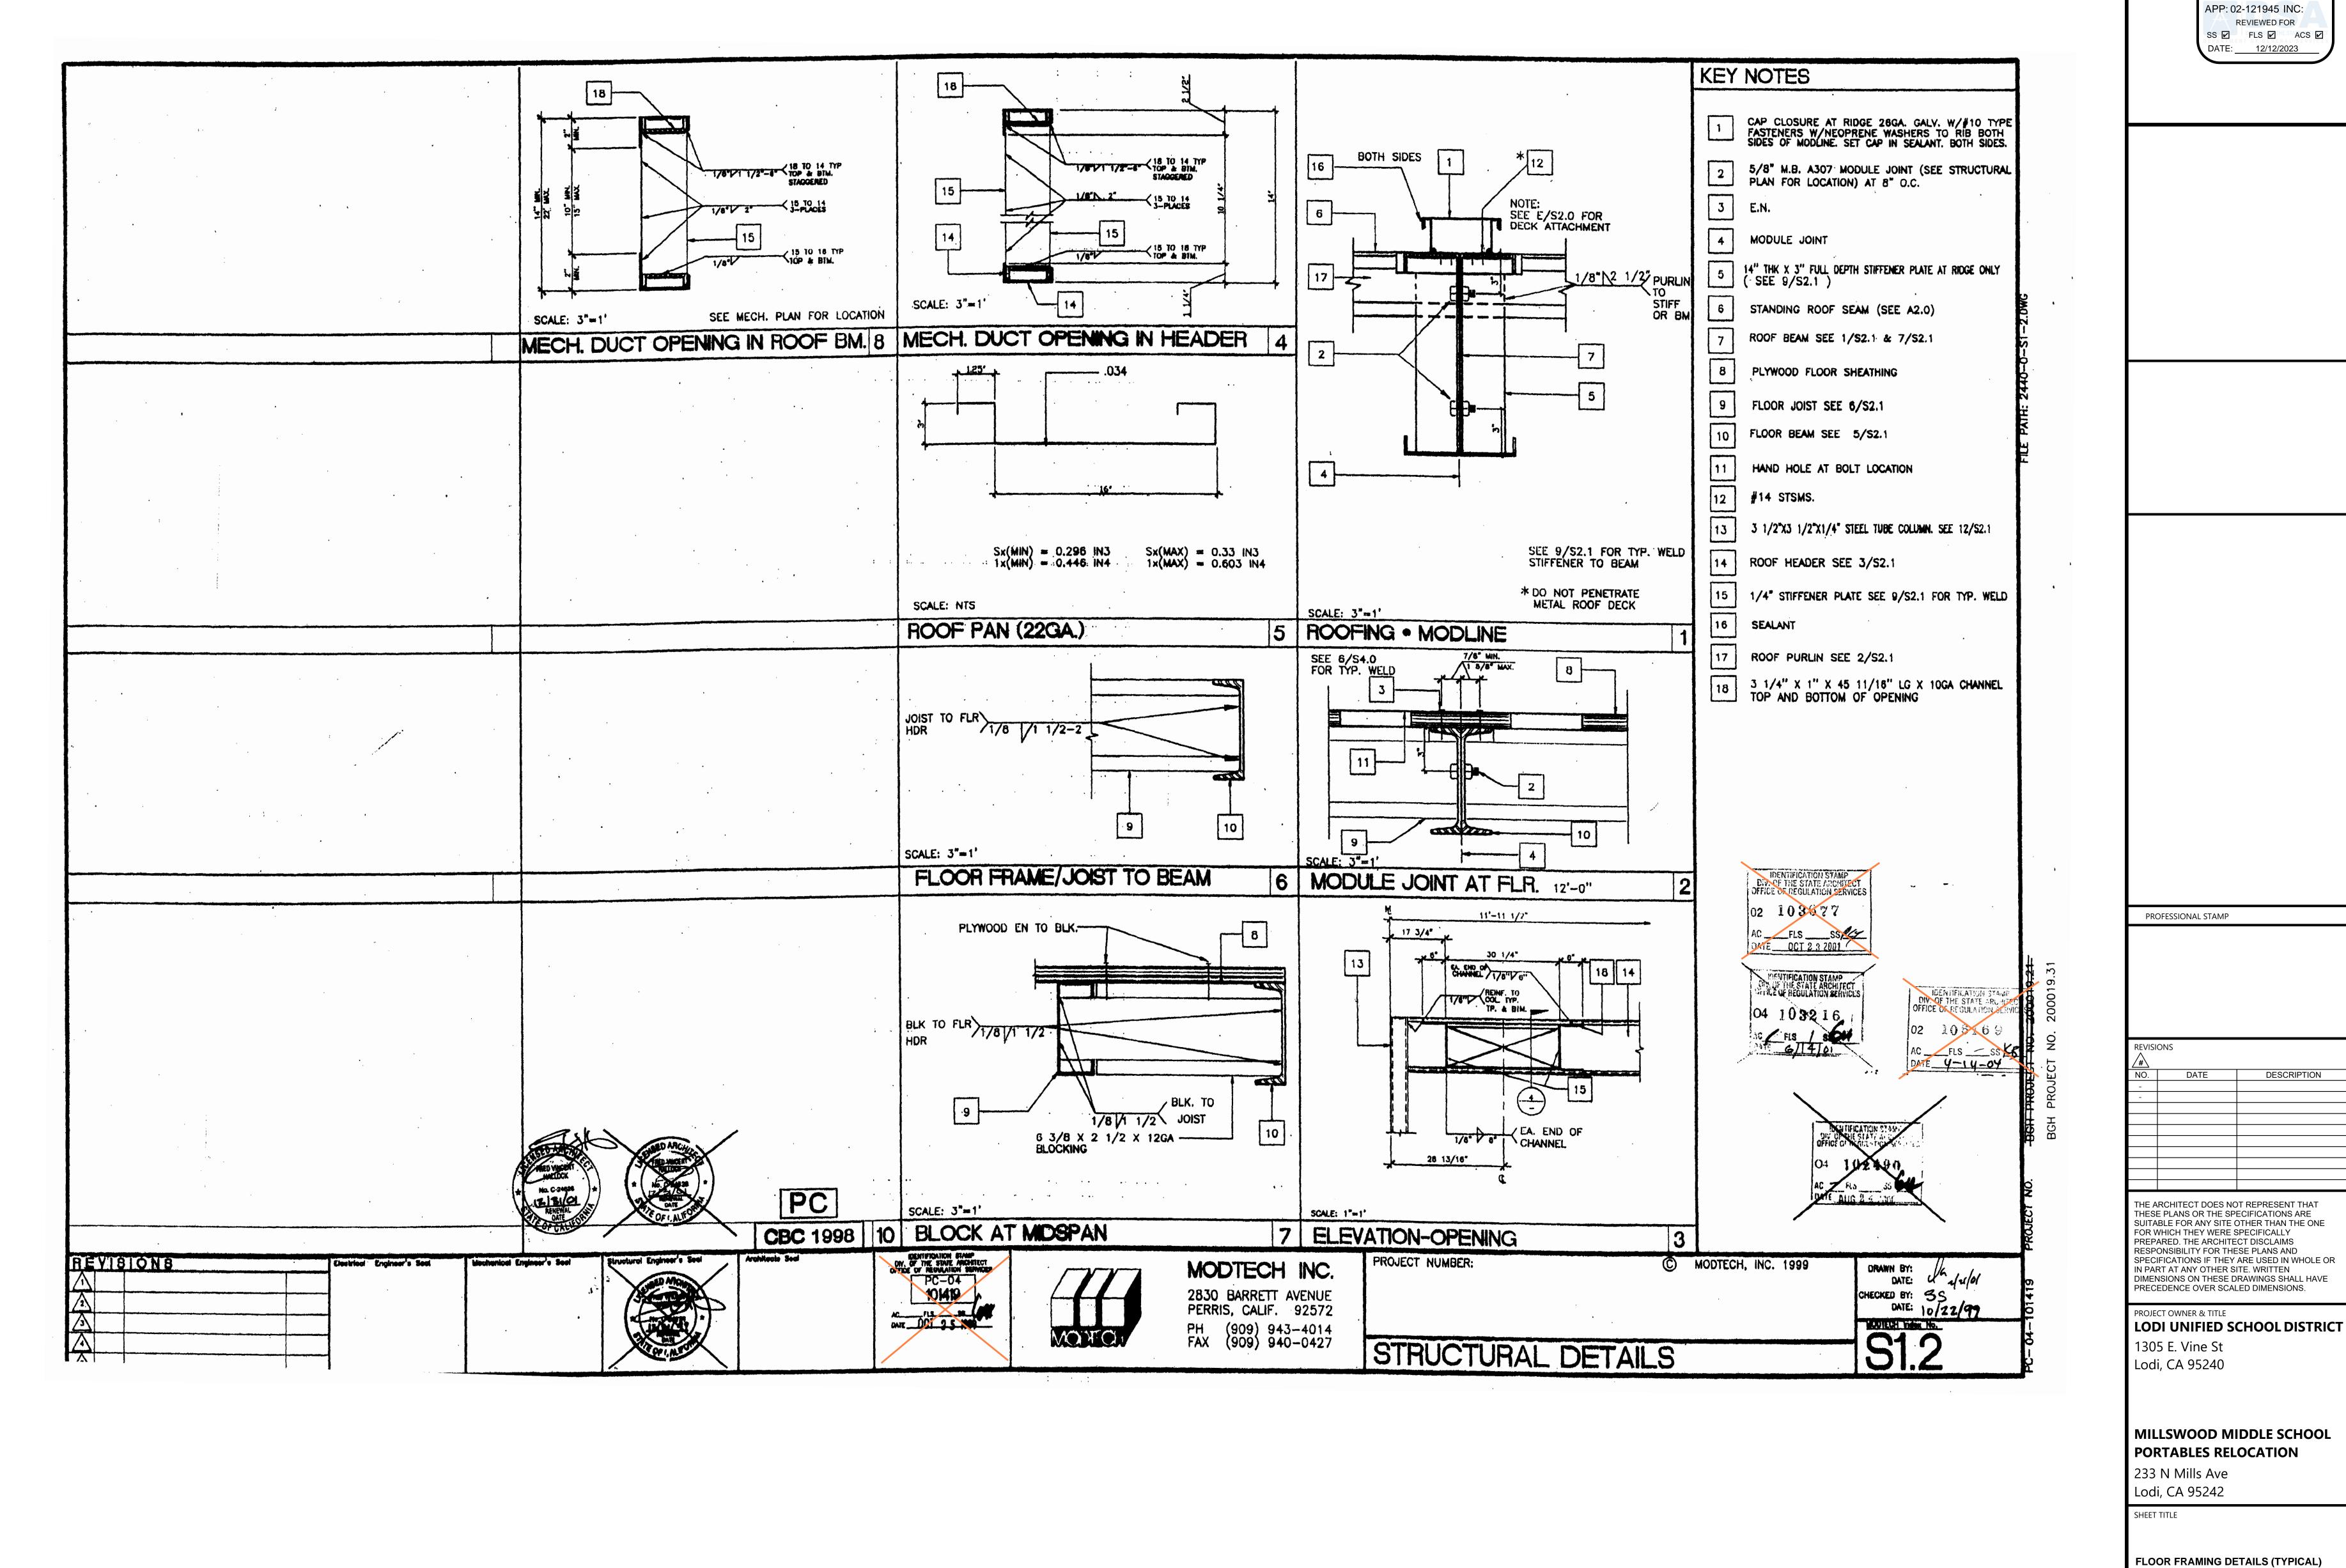

AGENCY APPROVAL <u>DSA#</u> IDENTIFICATION STAMP DIV. OF THE STATE ARCHITEC

FLOOR FRAMING DETAILS (TYPICAL)


DRAWN BY: XXXXXX JOB NUMBER: 23219

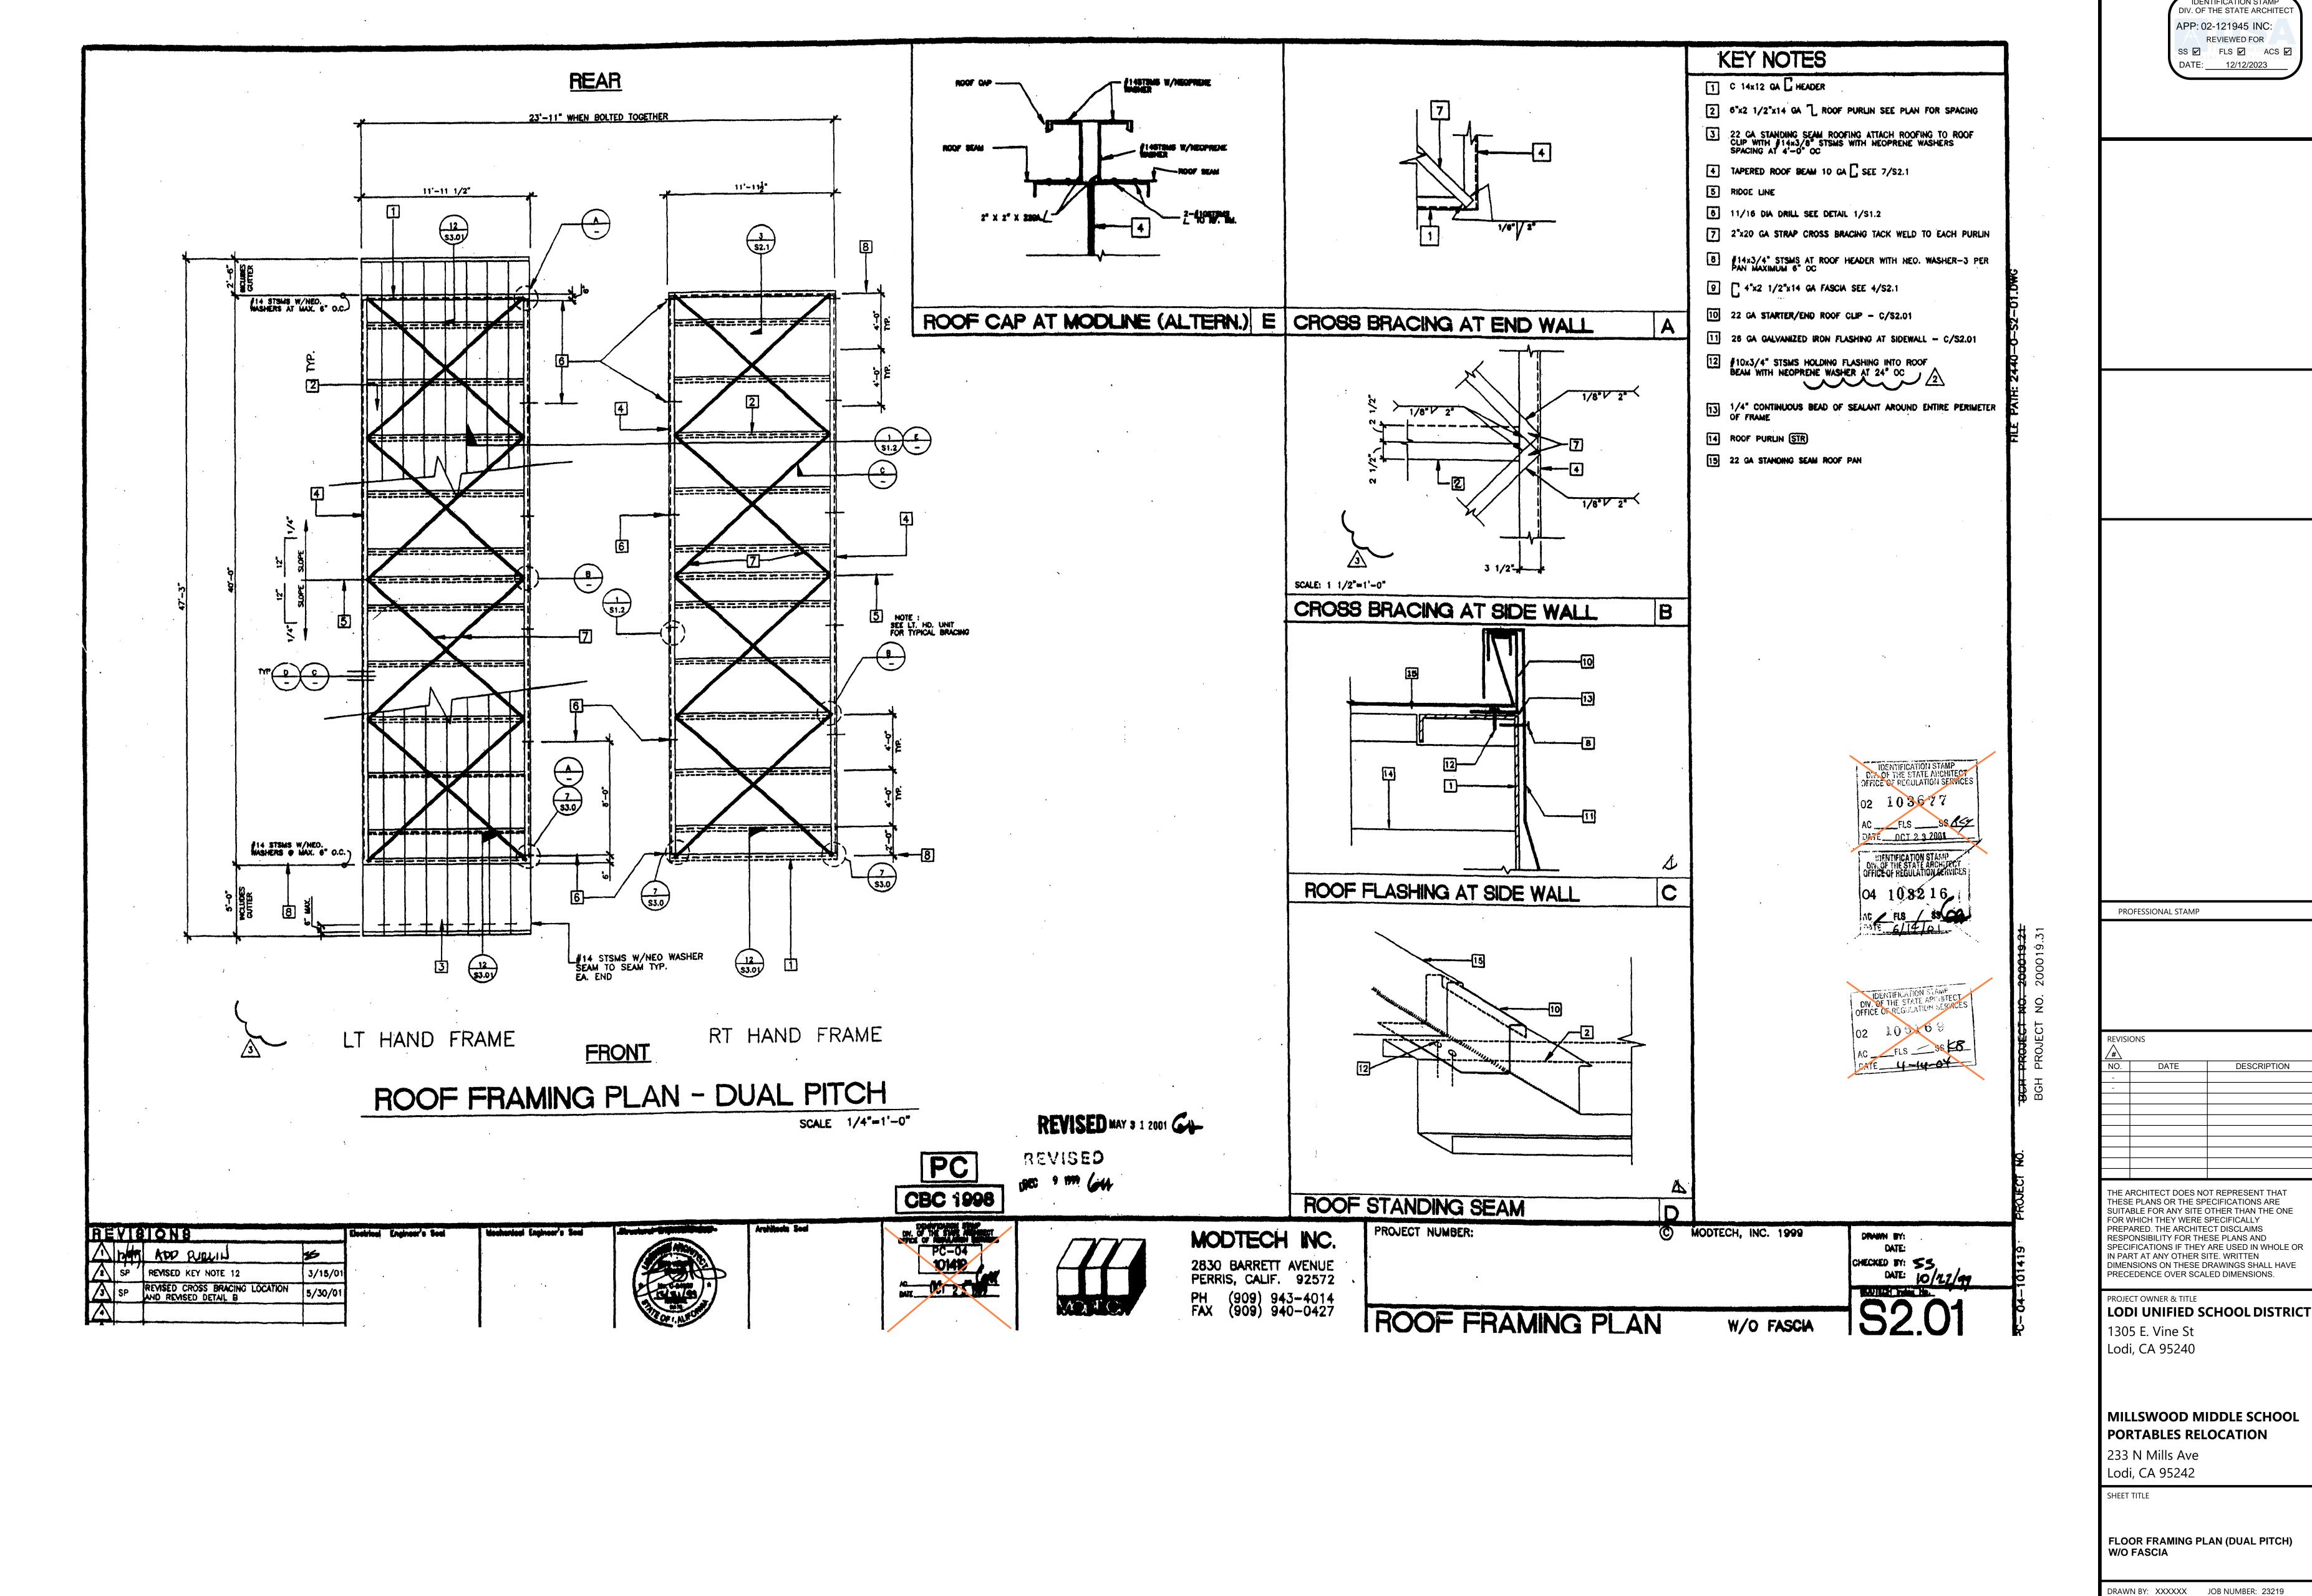

CONSTRU


**S2.01** 

DATE: DECEMBER 5, 2023

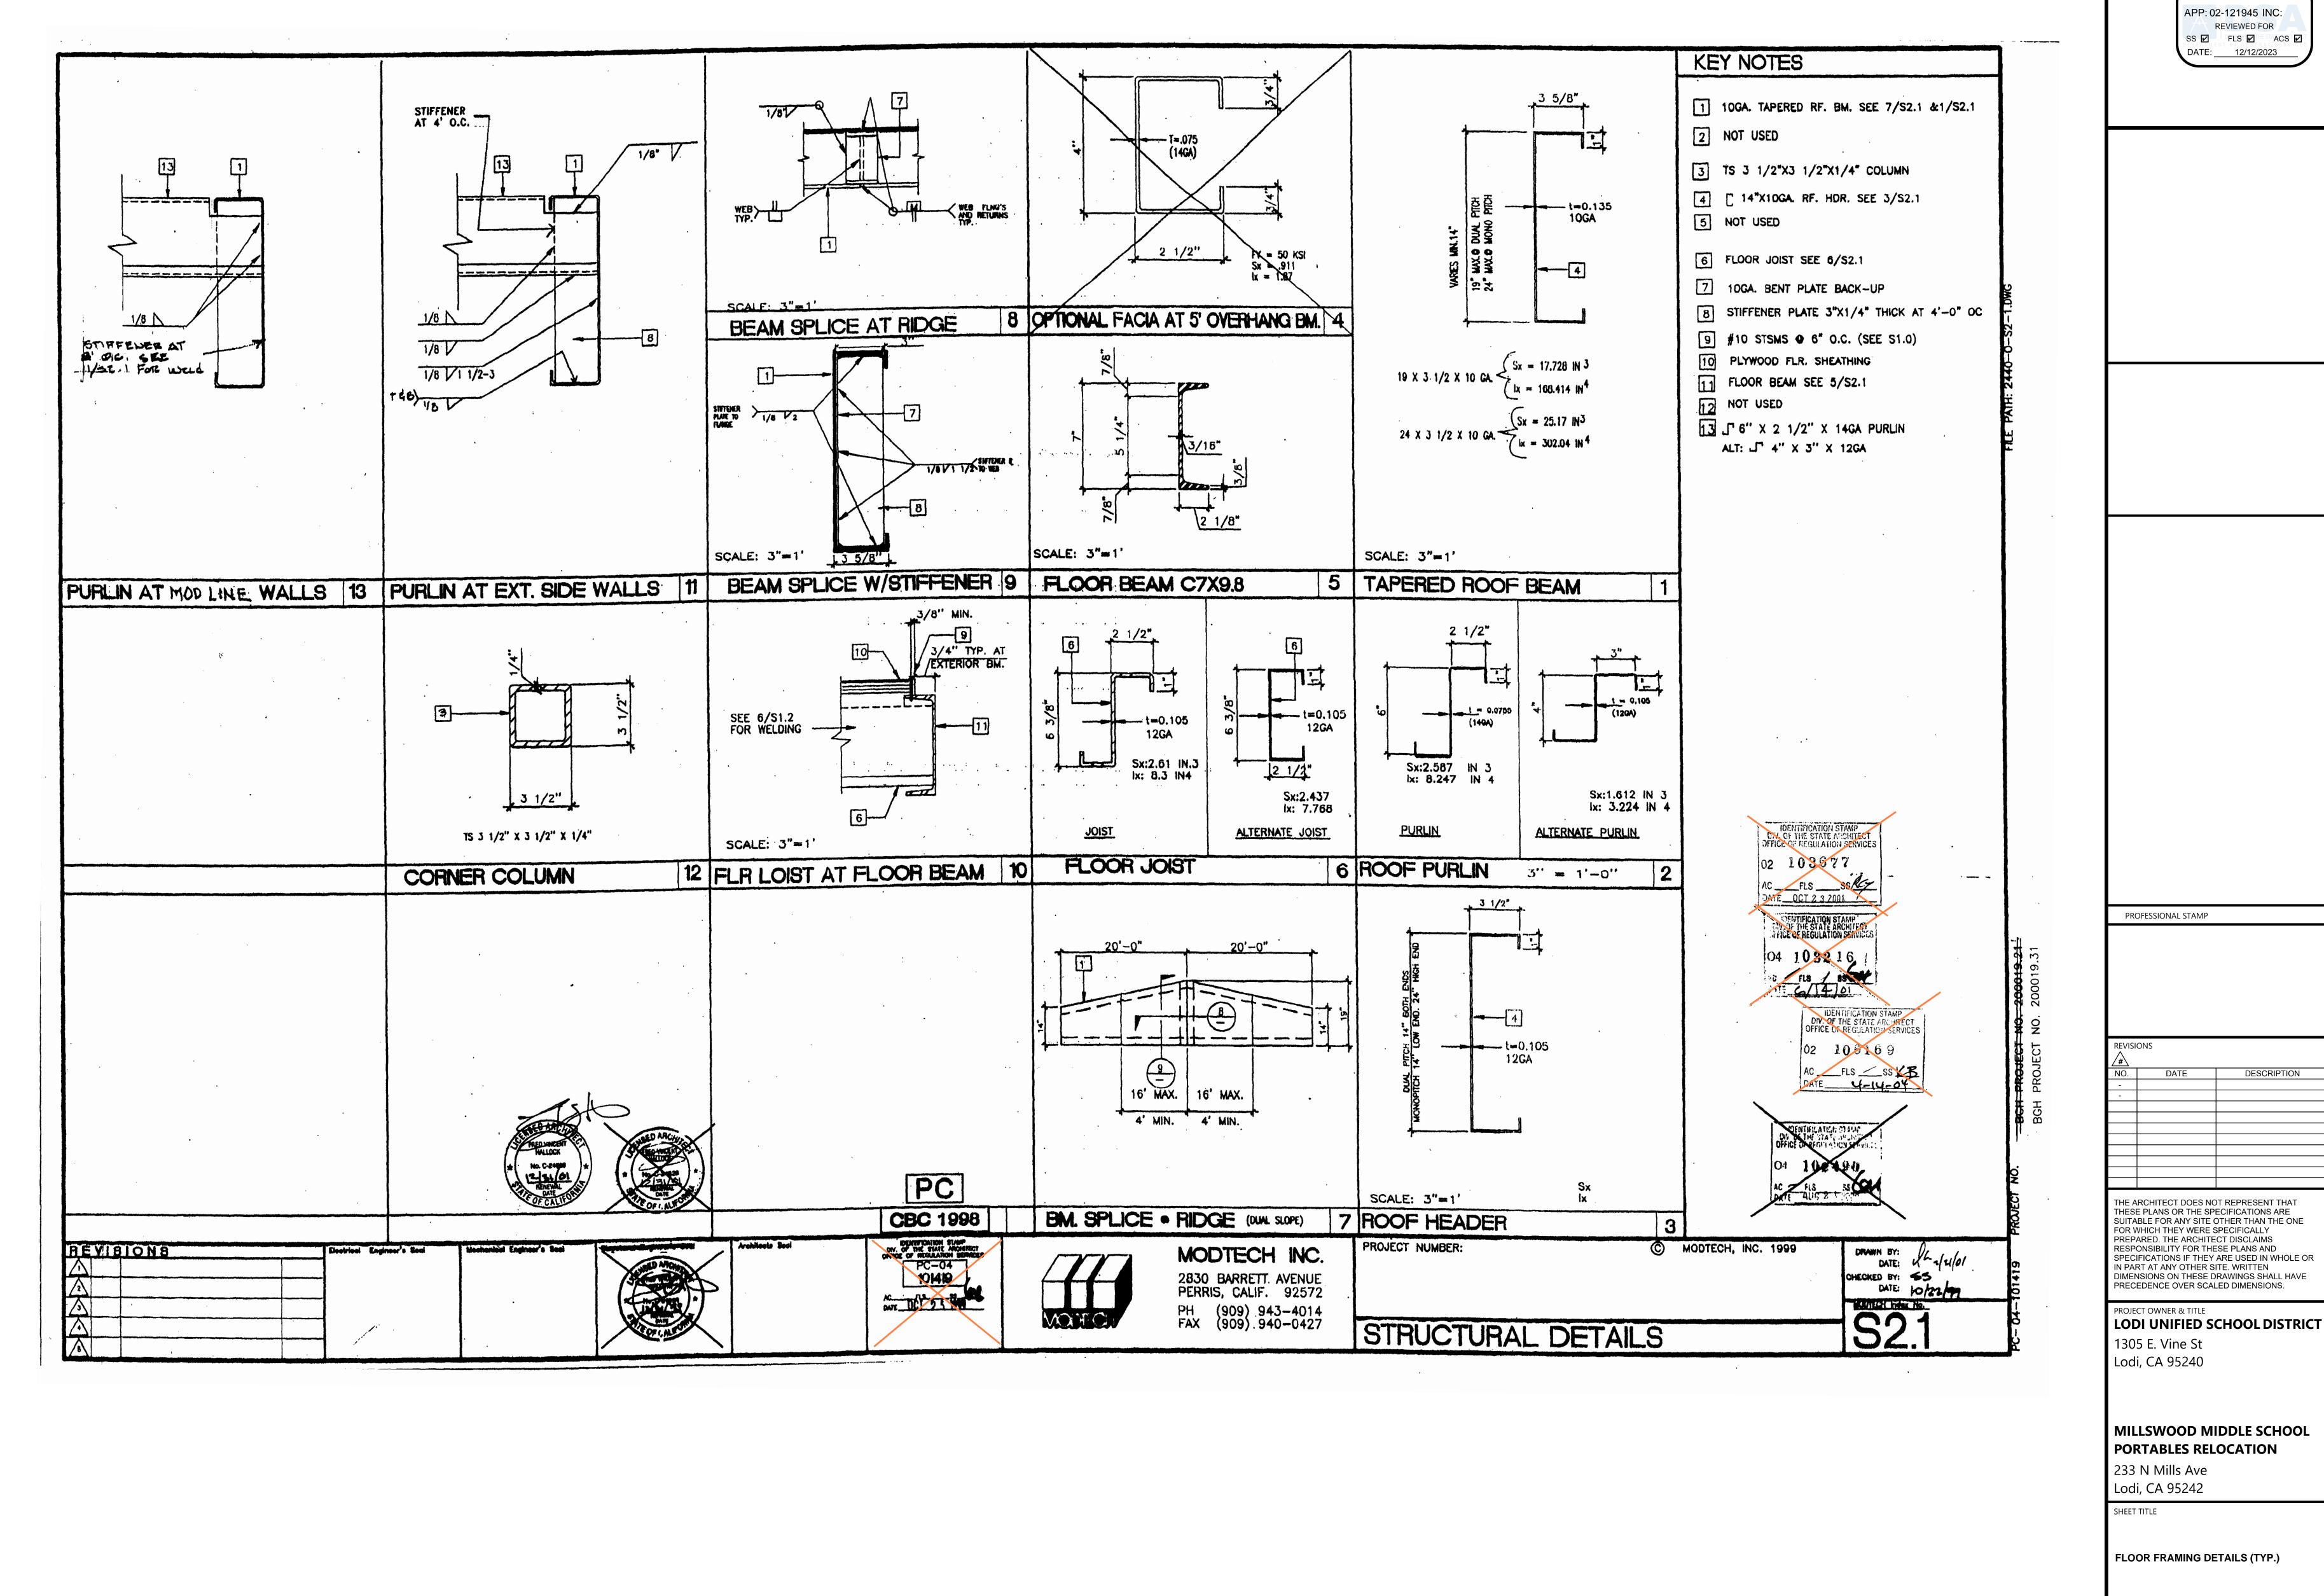

DRAWN BY: XXXXXX JOB NUMBER: 23219

DATE: DECEMBER 5, 2023

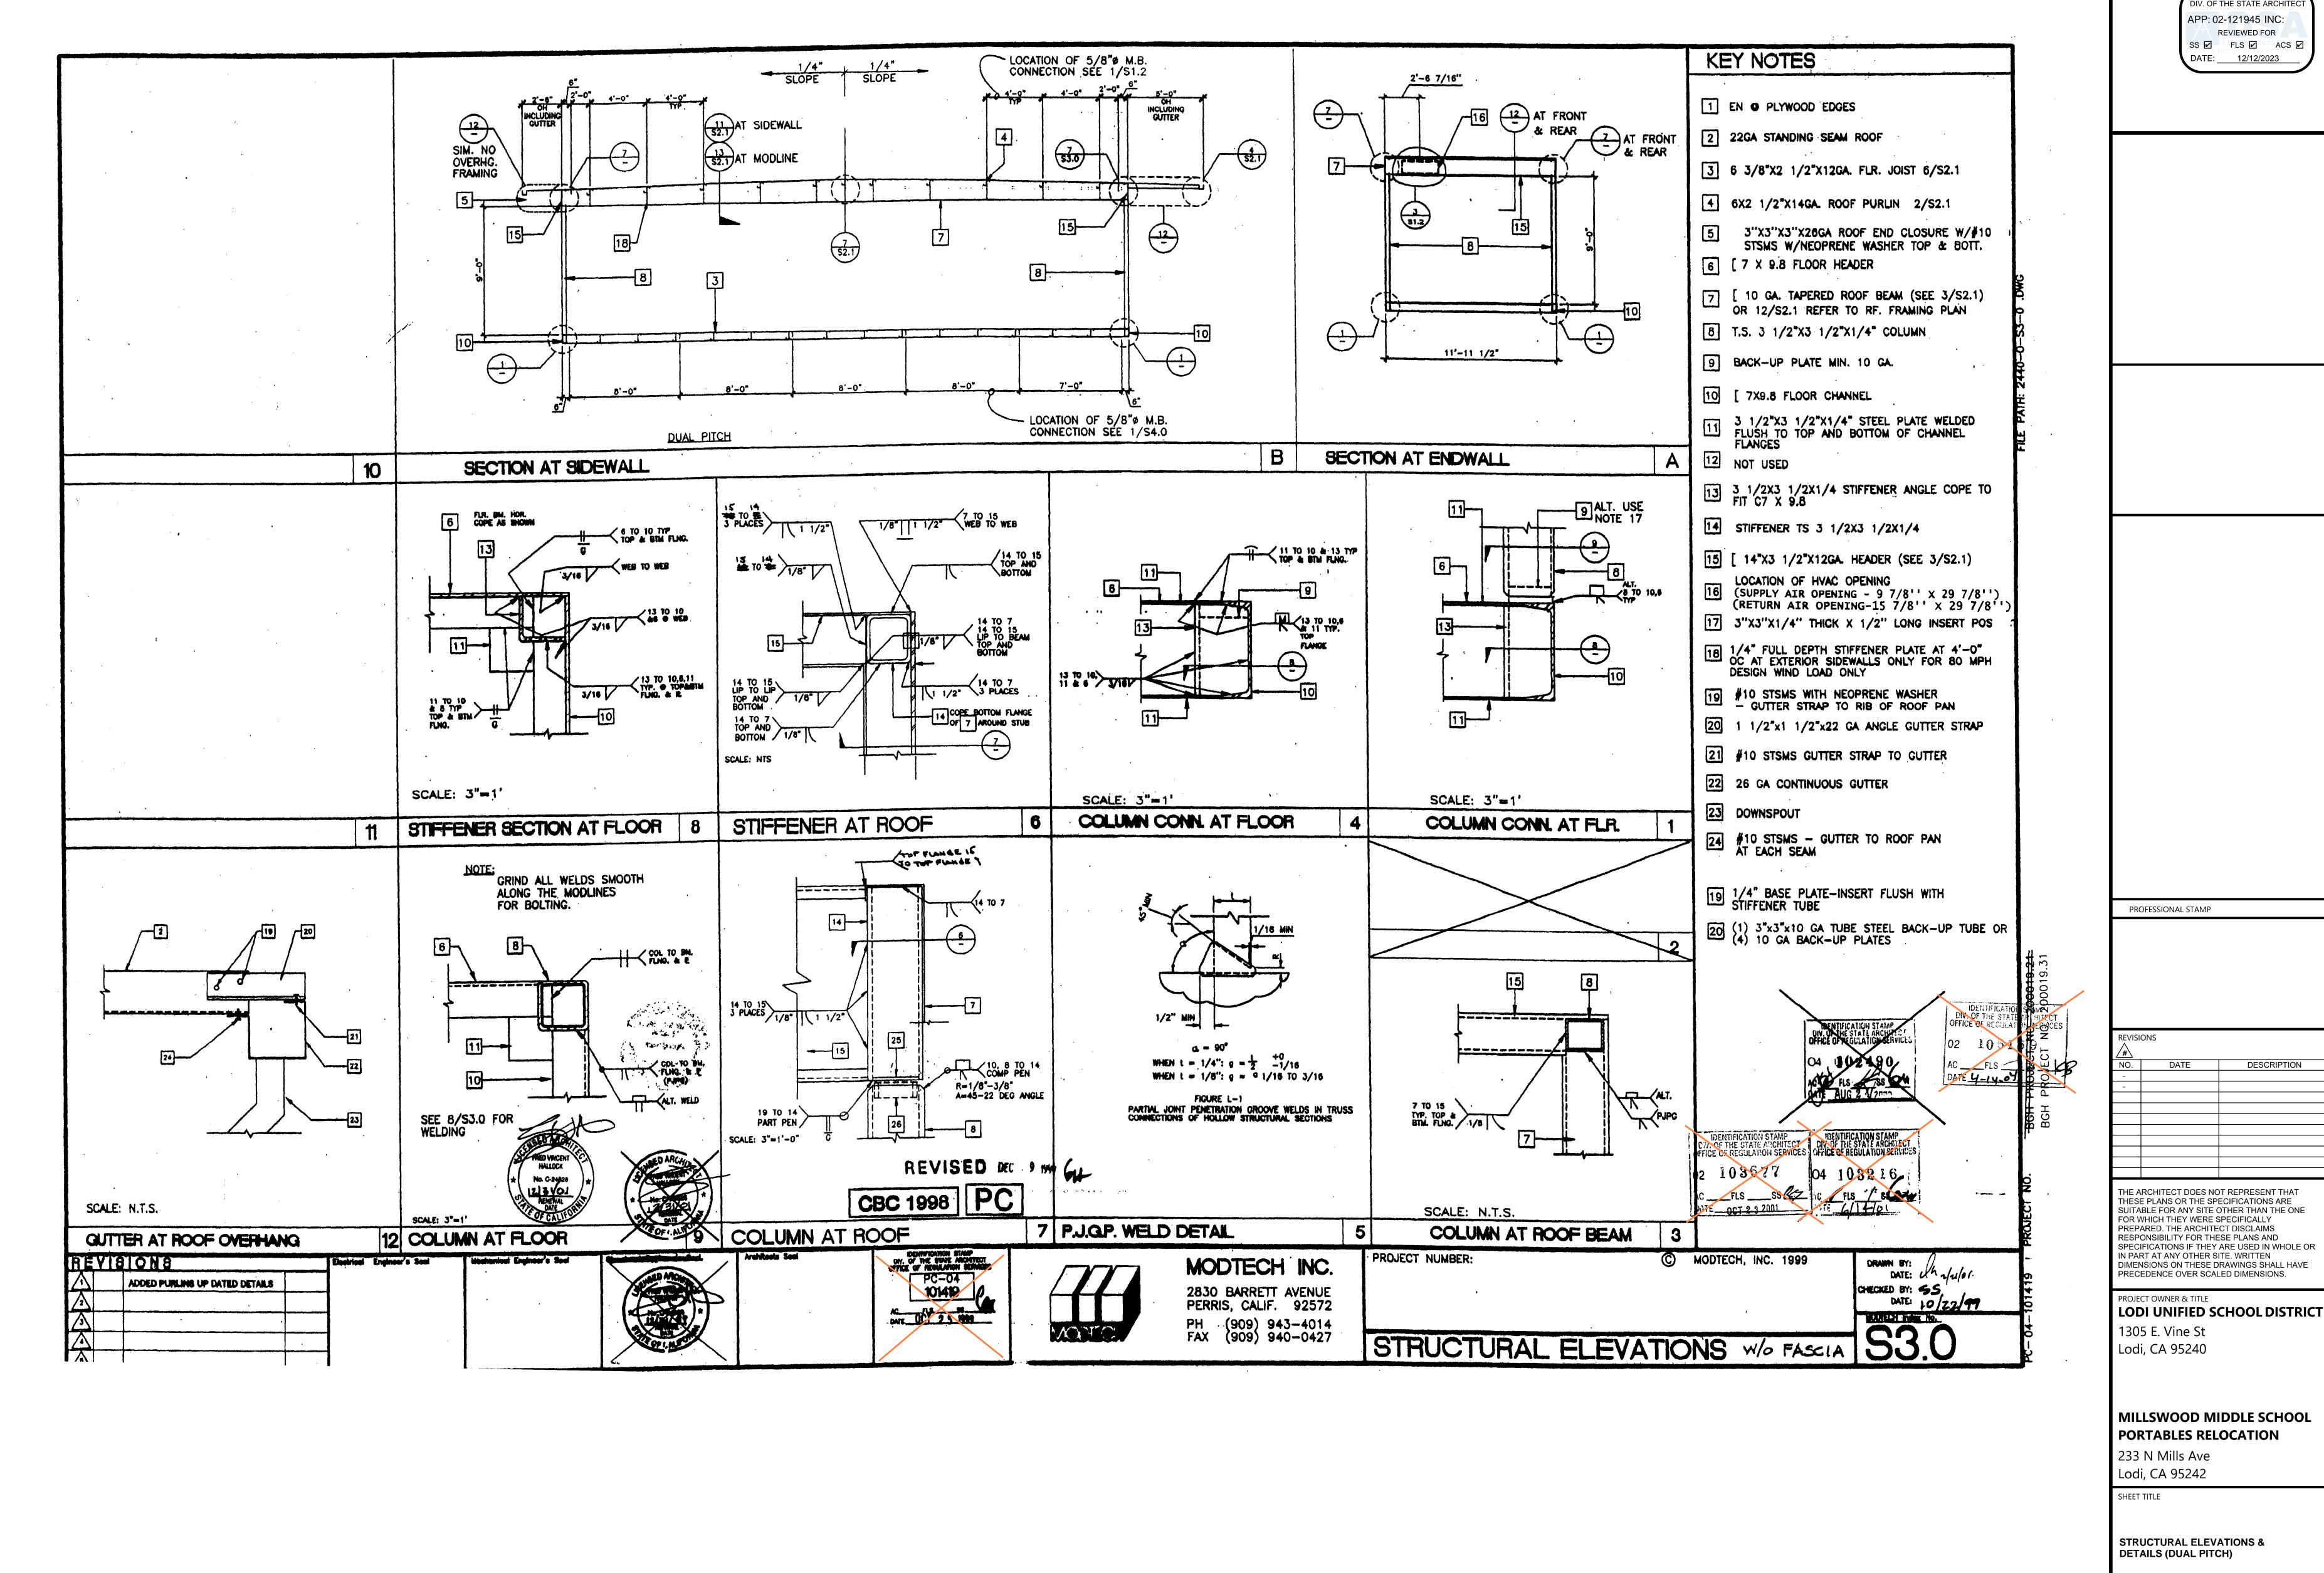


AGENCY APPROVAL DSA#

IDENTIFICATION STAMP

CONSTRI

DRAWN BY: XXXXXX JOB NUMBER: 23219

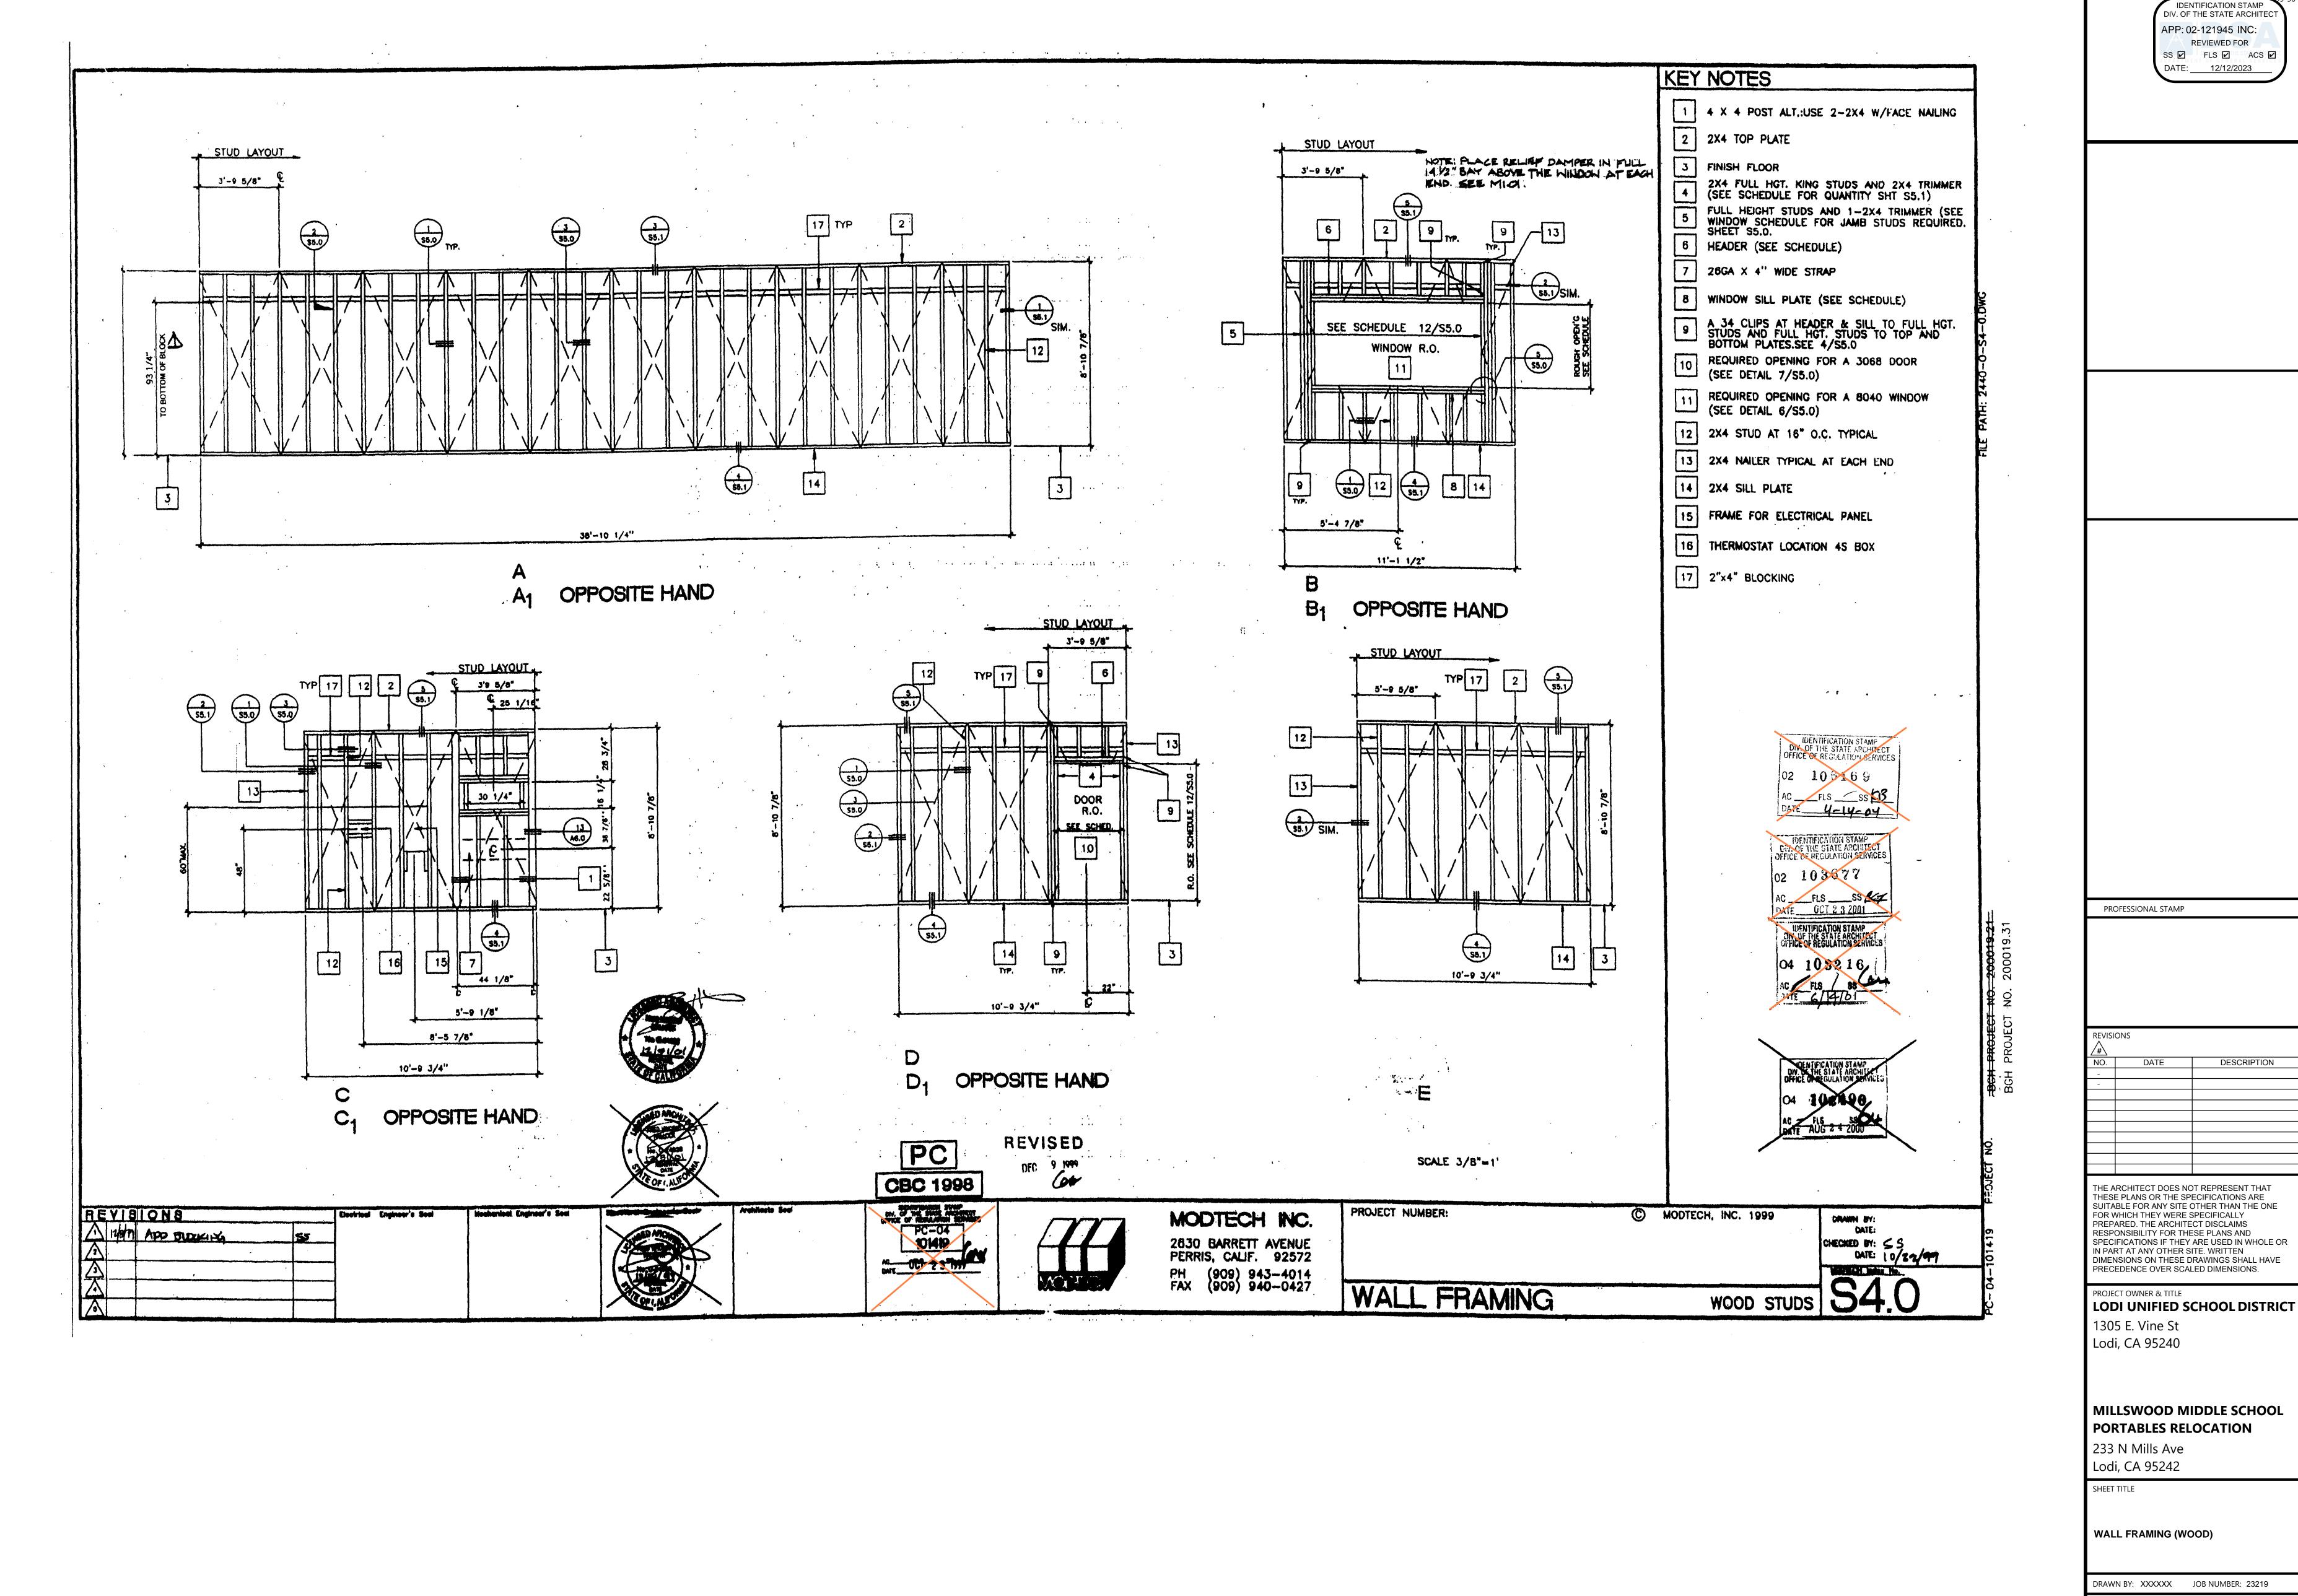


**S4.0** 

DATE: DECEMBER 5, 2023

AGENCY APPROVAL DSA#

CONSTRU

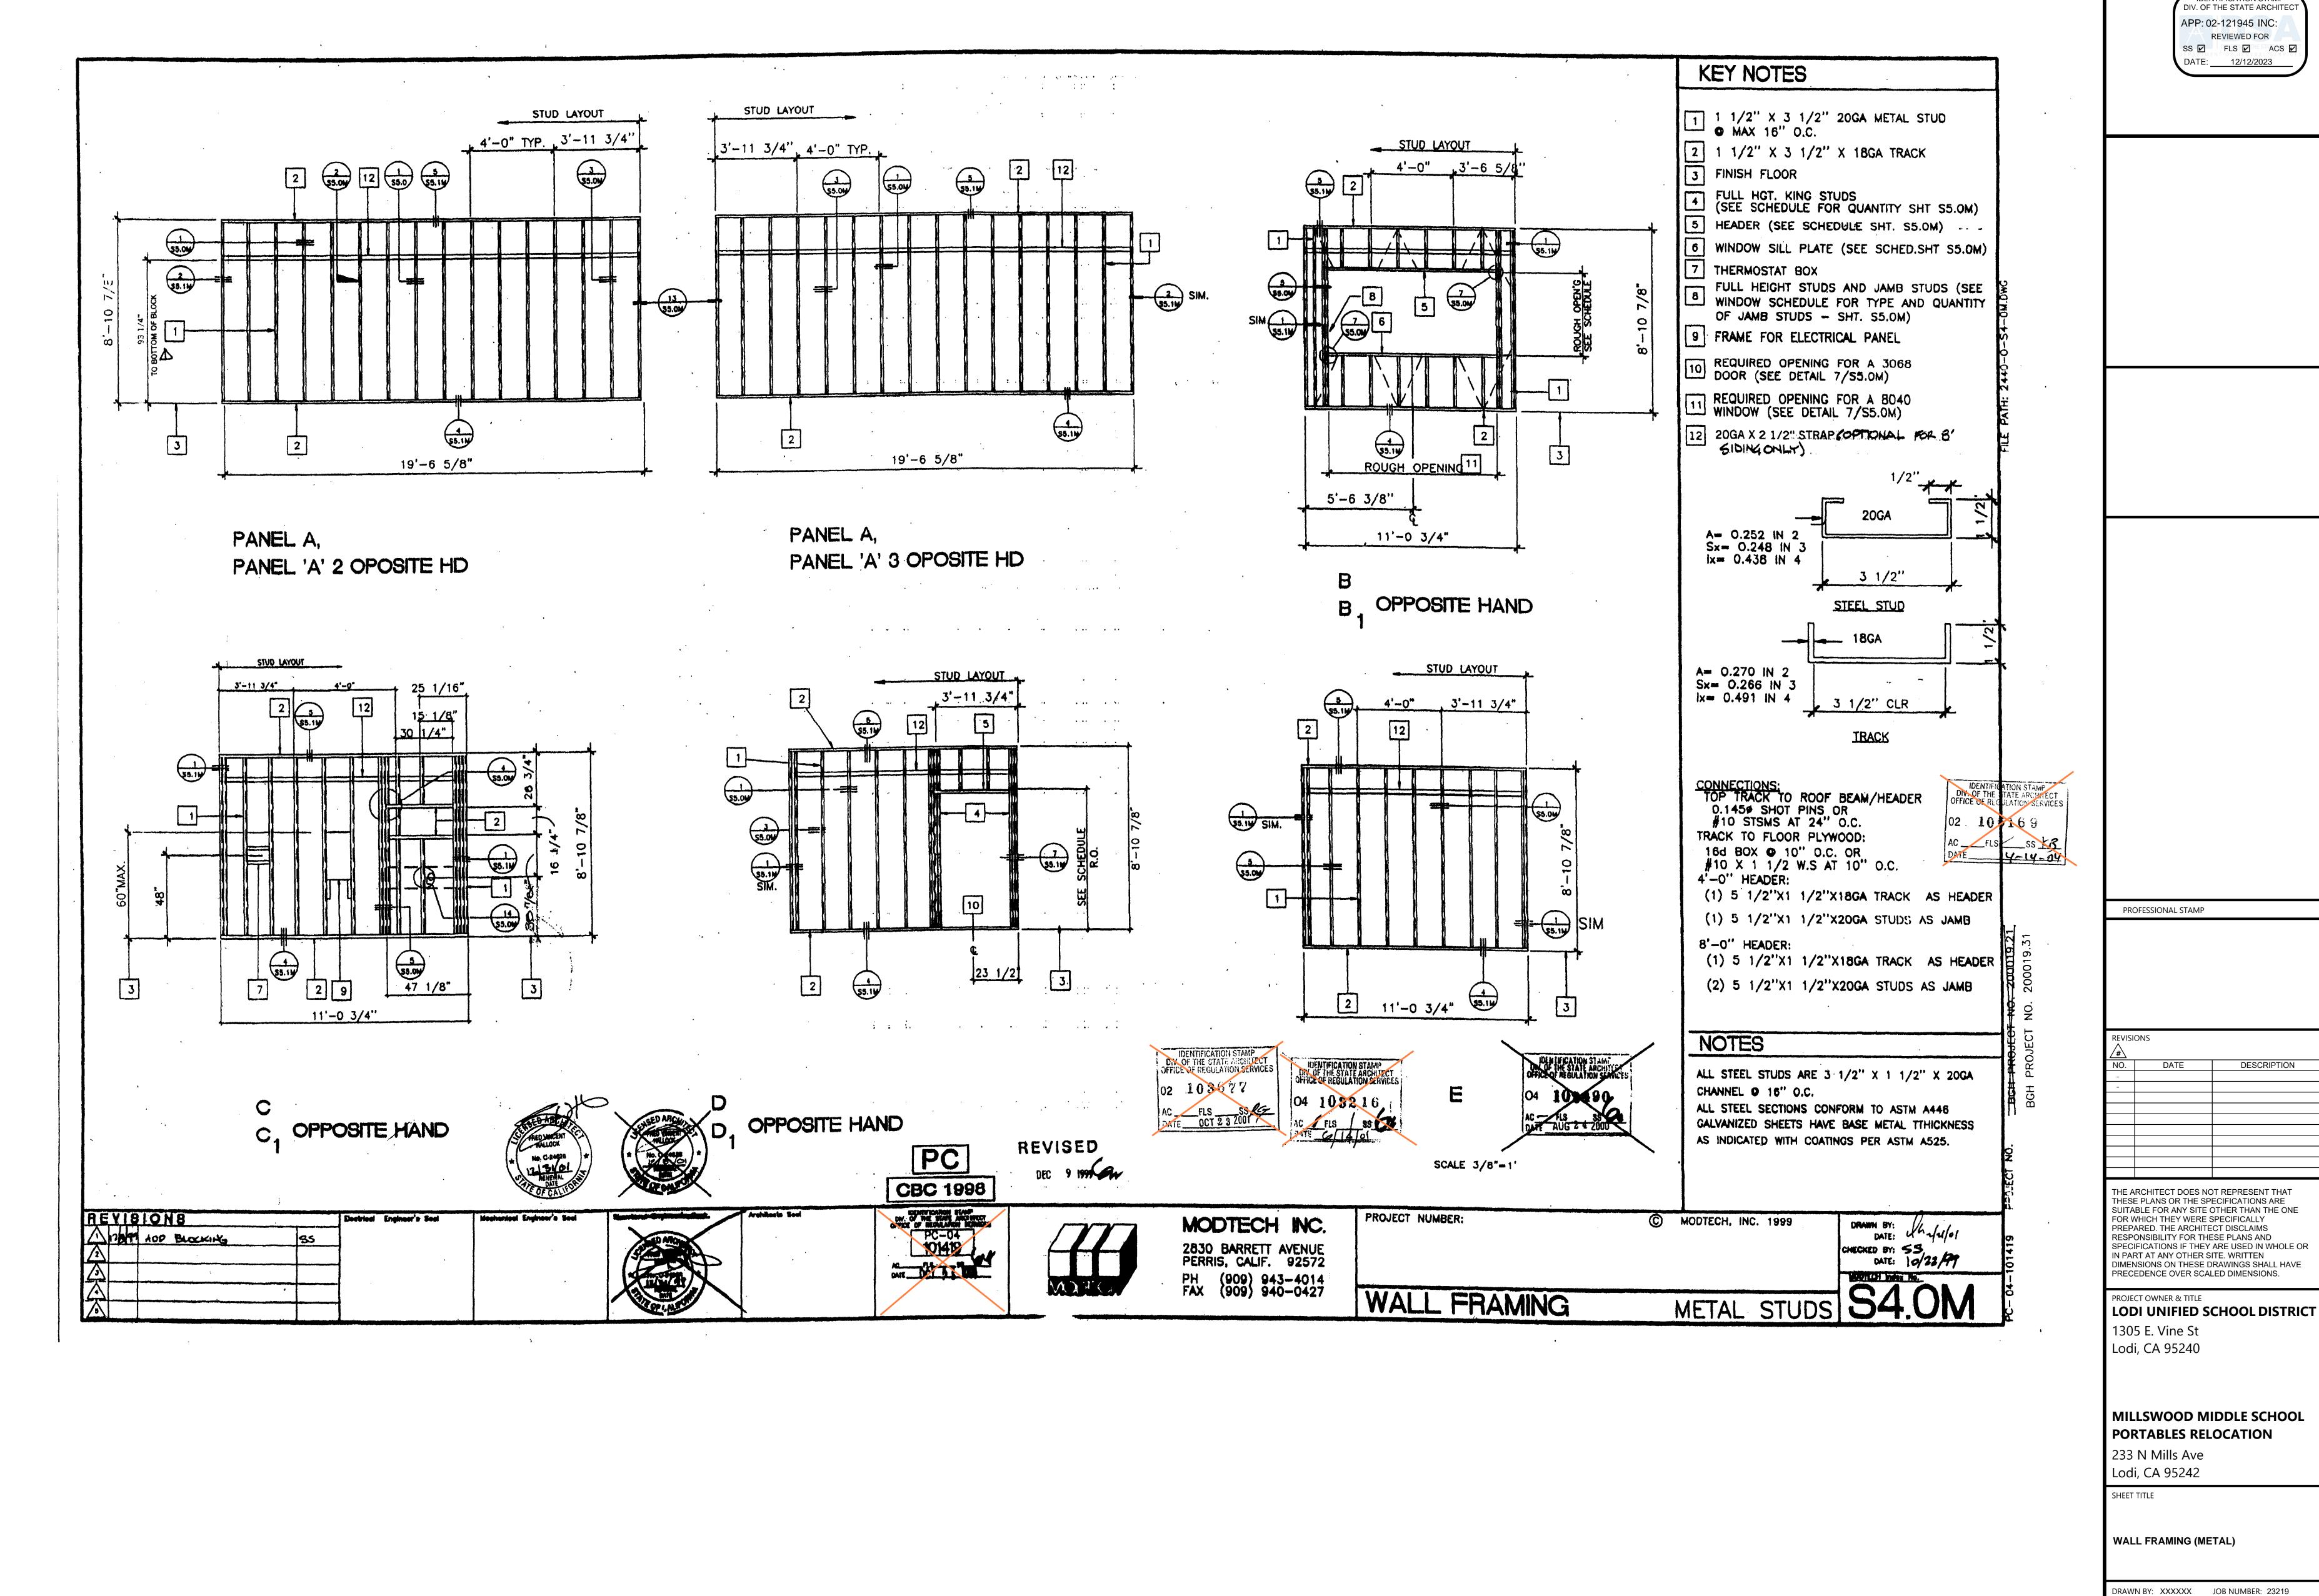

CONSTRU

AGENCY APPROVAL <u>DSA#</u>

**S4.0M** 

AGENCY APPROVAL DSA# IDENTIFICATION STAMP DIV. OF THE STATE ARCHITE APP: 02-121945 INC: REVIEWED FOR SS 🗹 FLS 🗹 ACS 🗹 DATE: 12/12/2023 PROFESSIONAL STAMP DESCRIPTION THESE PLANS OR THE SPECIFICATIONS ARE SUITABLE FOR ANY SITE OTHER THAN THE ONE FOR WHICH THEY WERE SPECIFICALLY PREPARED. THE ARCHITECT DISCLAIMS RESPONSIBILITY FOR THESE PLANS AND SPECIFICATIONS IF THEY ARE USED IN WHOLE OR IN PART AT ANY OTHER SITE. WRITTEN DIMENSIONS ON THESE DRAWINGS SHALL HAVE PRECEDENCE OVER SCALED DIMENSIONS.

PROJECT OWNER & TITLE

LODI UNIFIED SCHOOL DISTRICT

1305 E. Vine St

Lodi, CA 95240

MILLSWOOD MIDDLE SCHOOL PORTABLES RELOCATION

233 N Mills Ave Lodi, CA 95242

SHEET TITLE

WALL FRAMING DETAILS


DRAWN BY: XXXXXX JOB NUMBER: 23219

**S5.0**DATE: [ DECEMBER 5, 2023

AGENCY APPROVAL DSA# IDENTIFICATION STAMP DIV. OF THE STATE ARCHITE APP: 02-121945 INC: LODI UNIFIED SCHOOL DISTRICT

DRAWN BY: XXXXXX JOB NUMBER: 23219

CONSTRUCTION

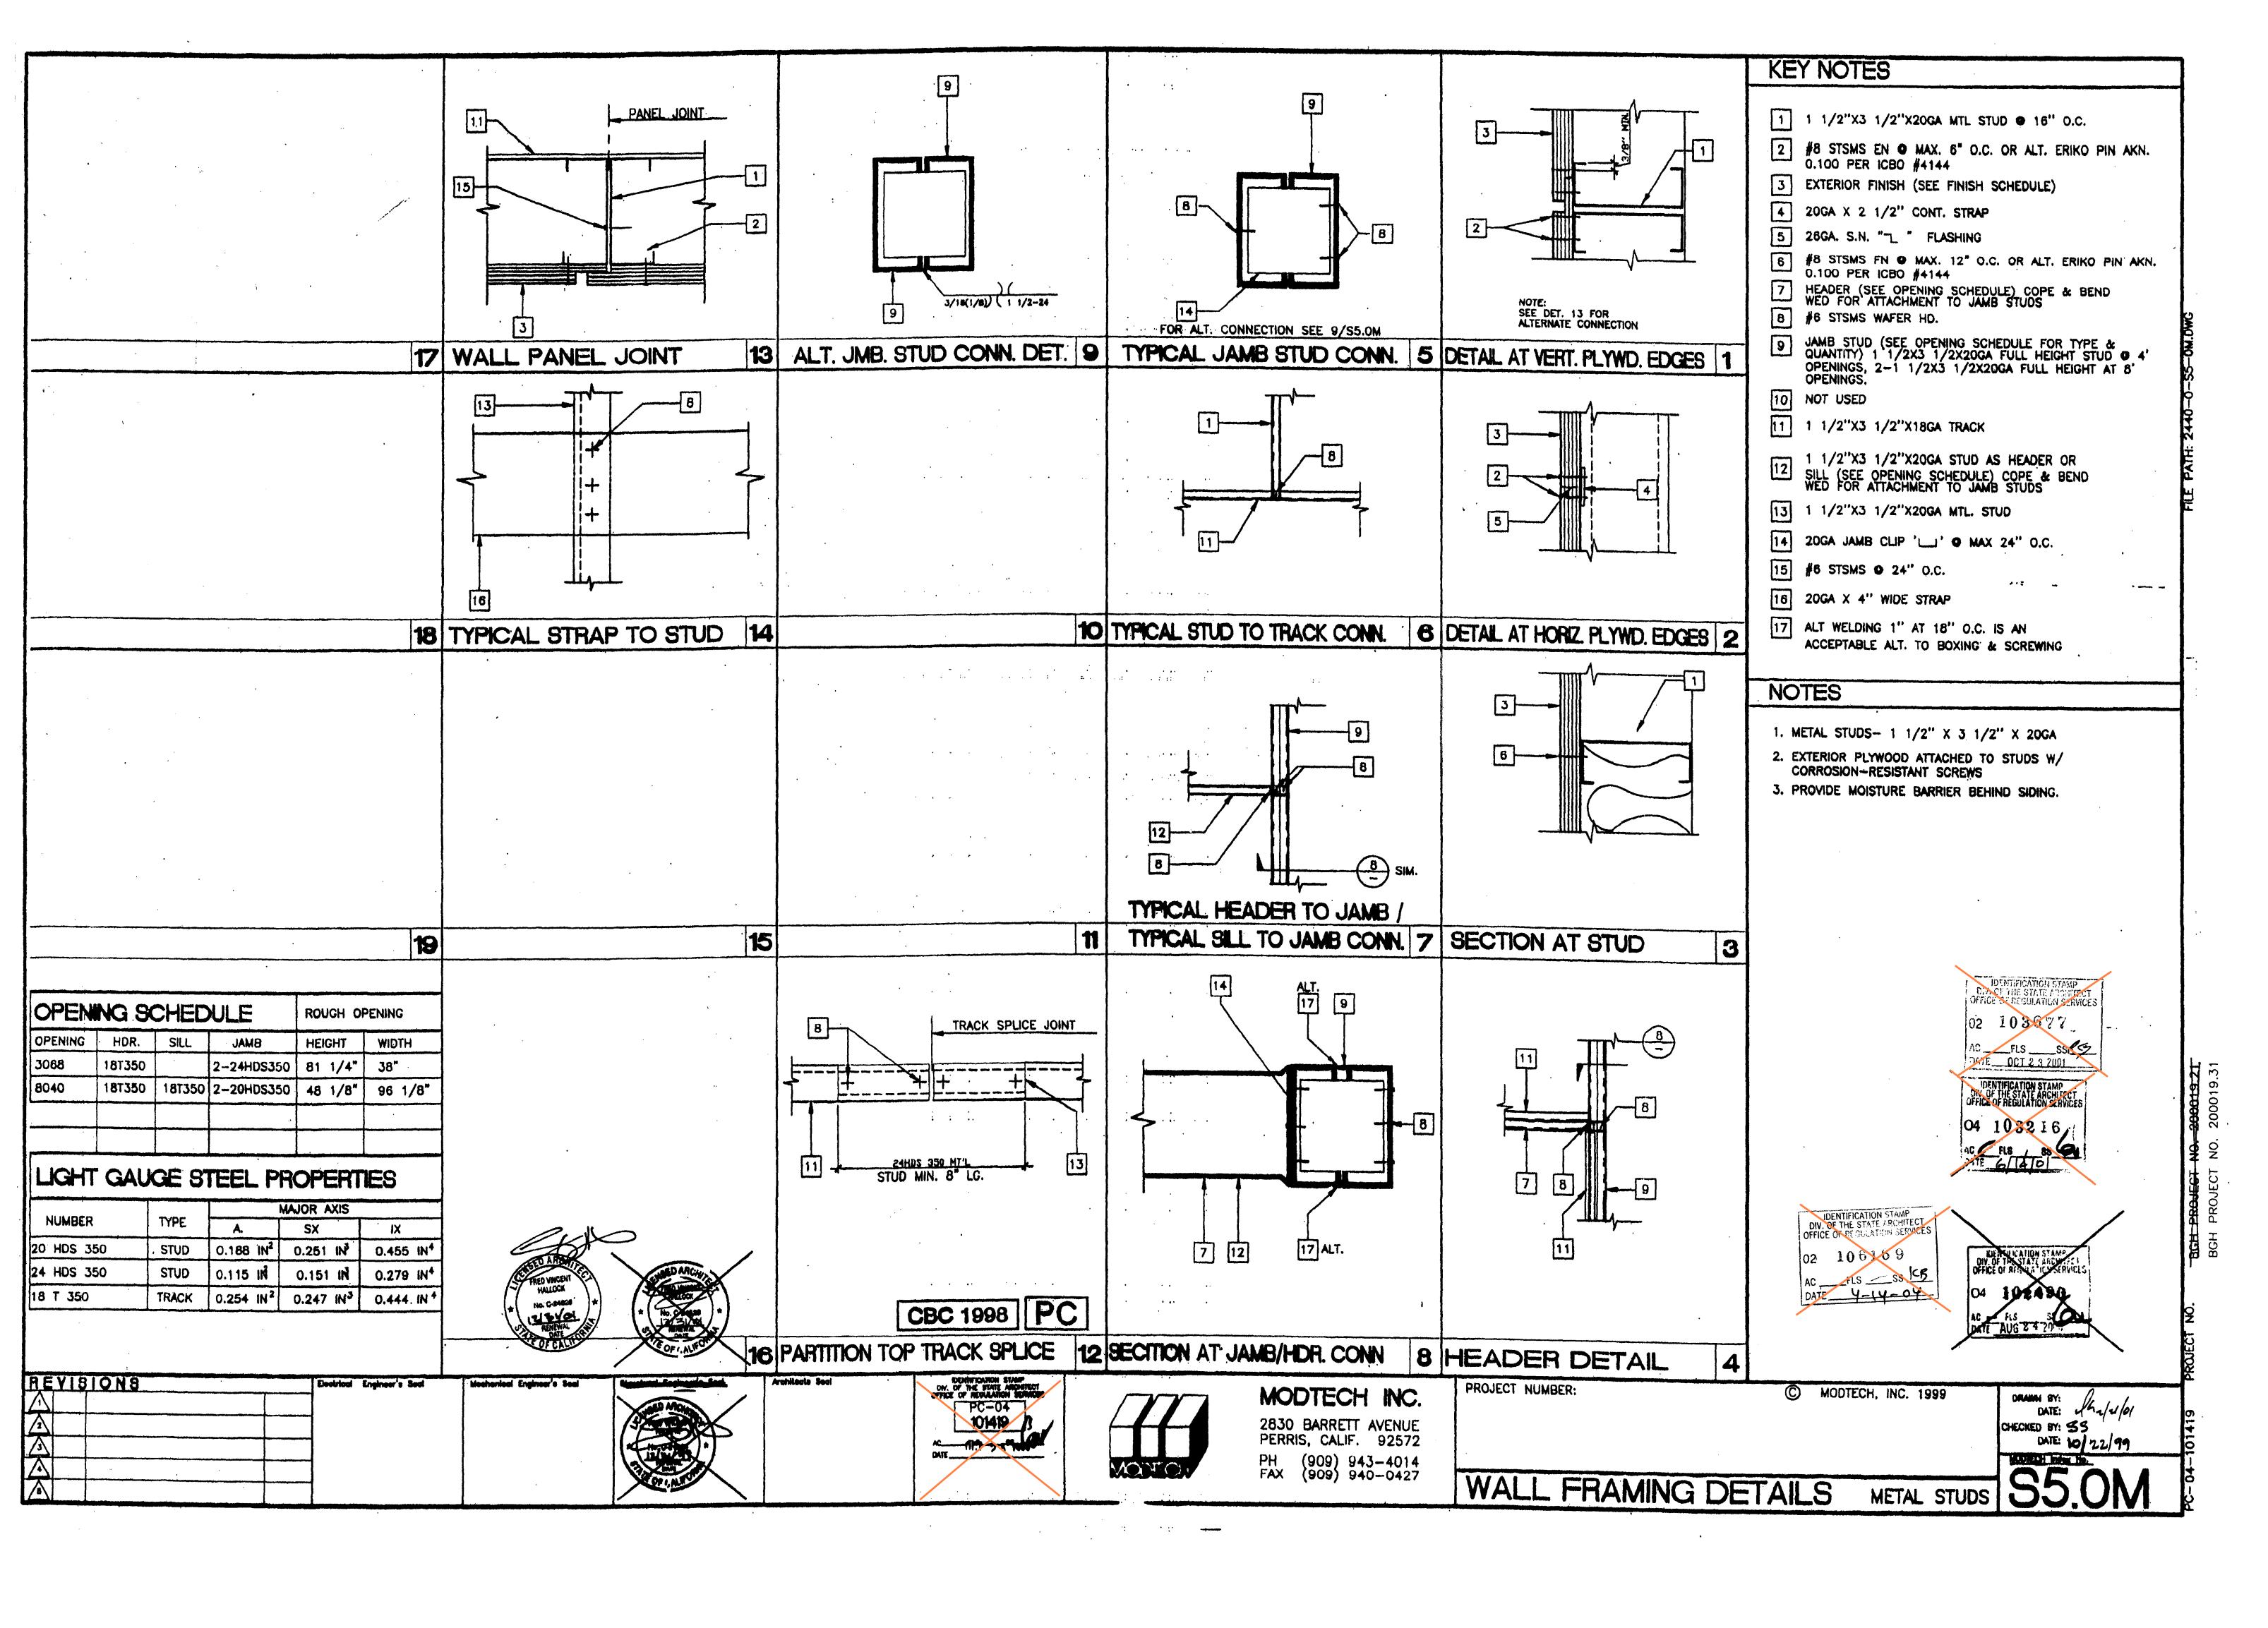

AGENCY APPROVAL DSA# IDENTIFICATION STAMP APP: 02-121945 INC: REVIEWED FOR SS 🗹 FLS 🗹 ACS 🗹 DATE: 12/12/2023 PROFESSIONAL STAMP

IN PART AT ANY OTHER SITE. WRITTEN
DIMENSIONS ON THESE DRAWINGS SHALL HAVE
PRECEDENCE OVER SCALED DIMENSIONS.

DESCRIPTION

PROJECT OWNER & TITLE LODI UNIFIED SCHOOL DISTRICT

1305 E. Vine St Lodi, CA 95240

MILLSWOOD MIDDLE SCHOOL PORTABLES RELOCATION


233 N Mills Ave Lodi, CA 95242

SHEET TITLE

WALL FRAMING DETAILS (METAL)

DRAWN BY: XXXXXX JOB NUMBER: 23219

S5.0M

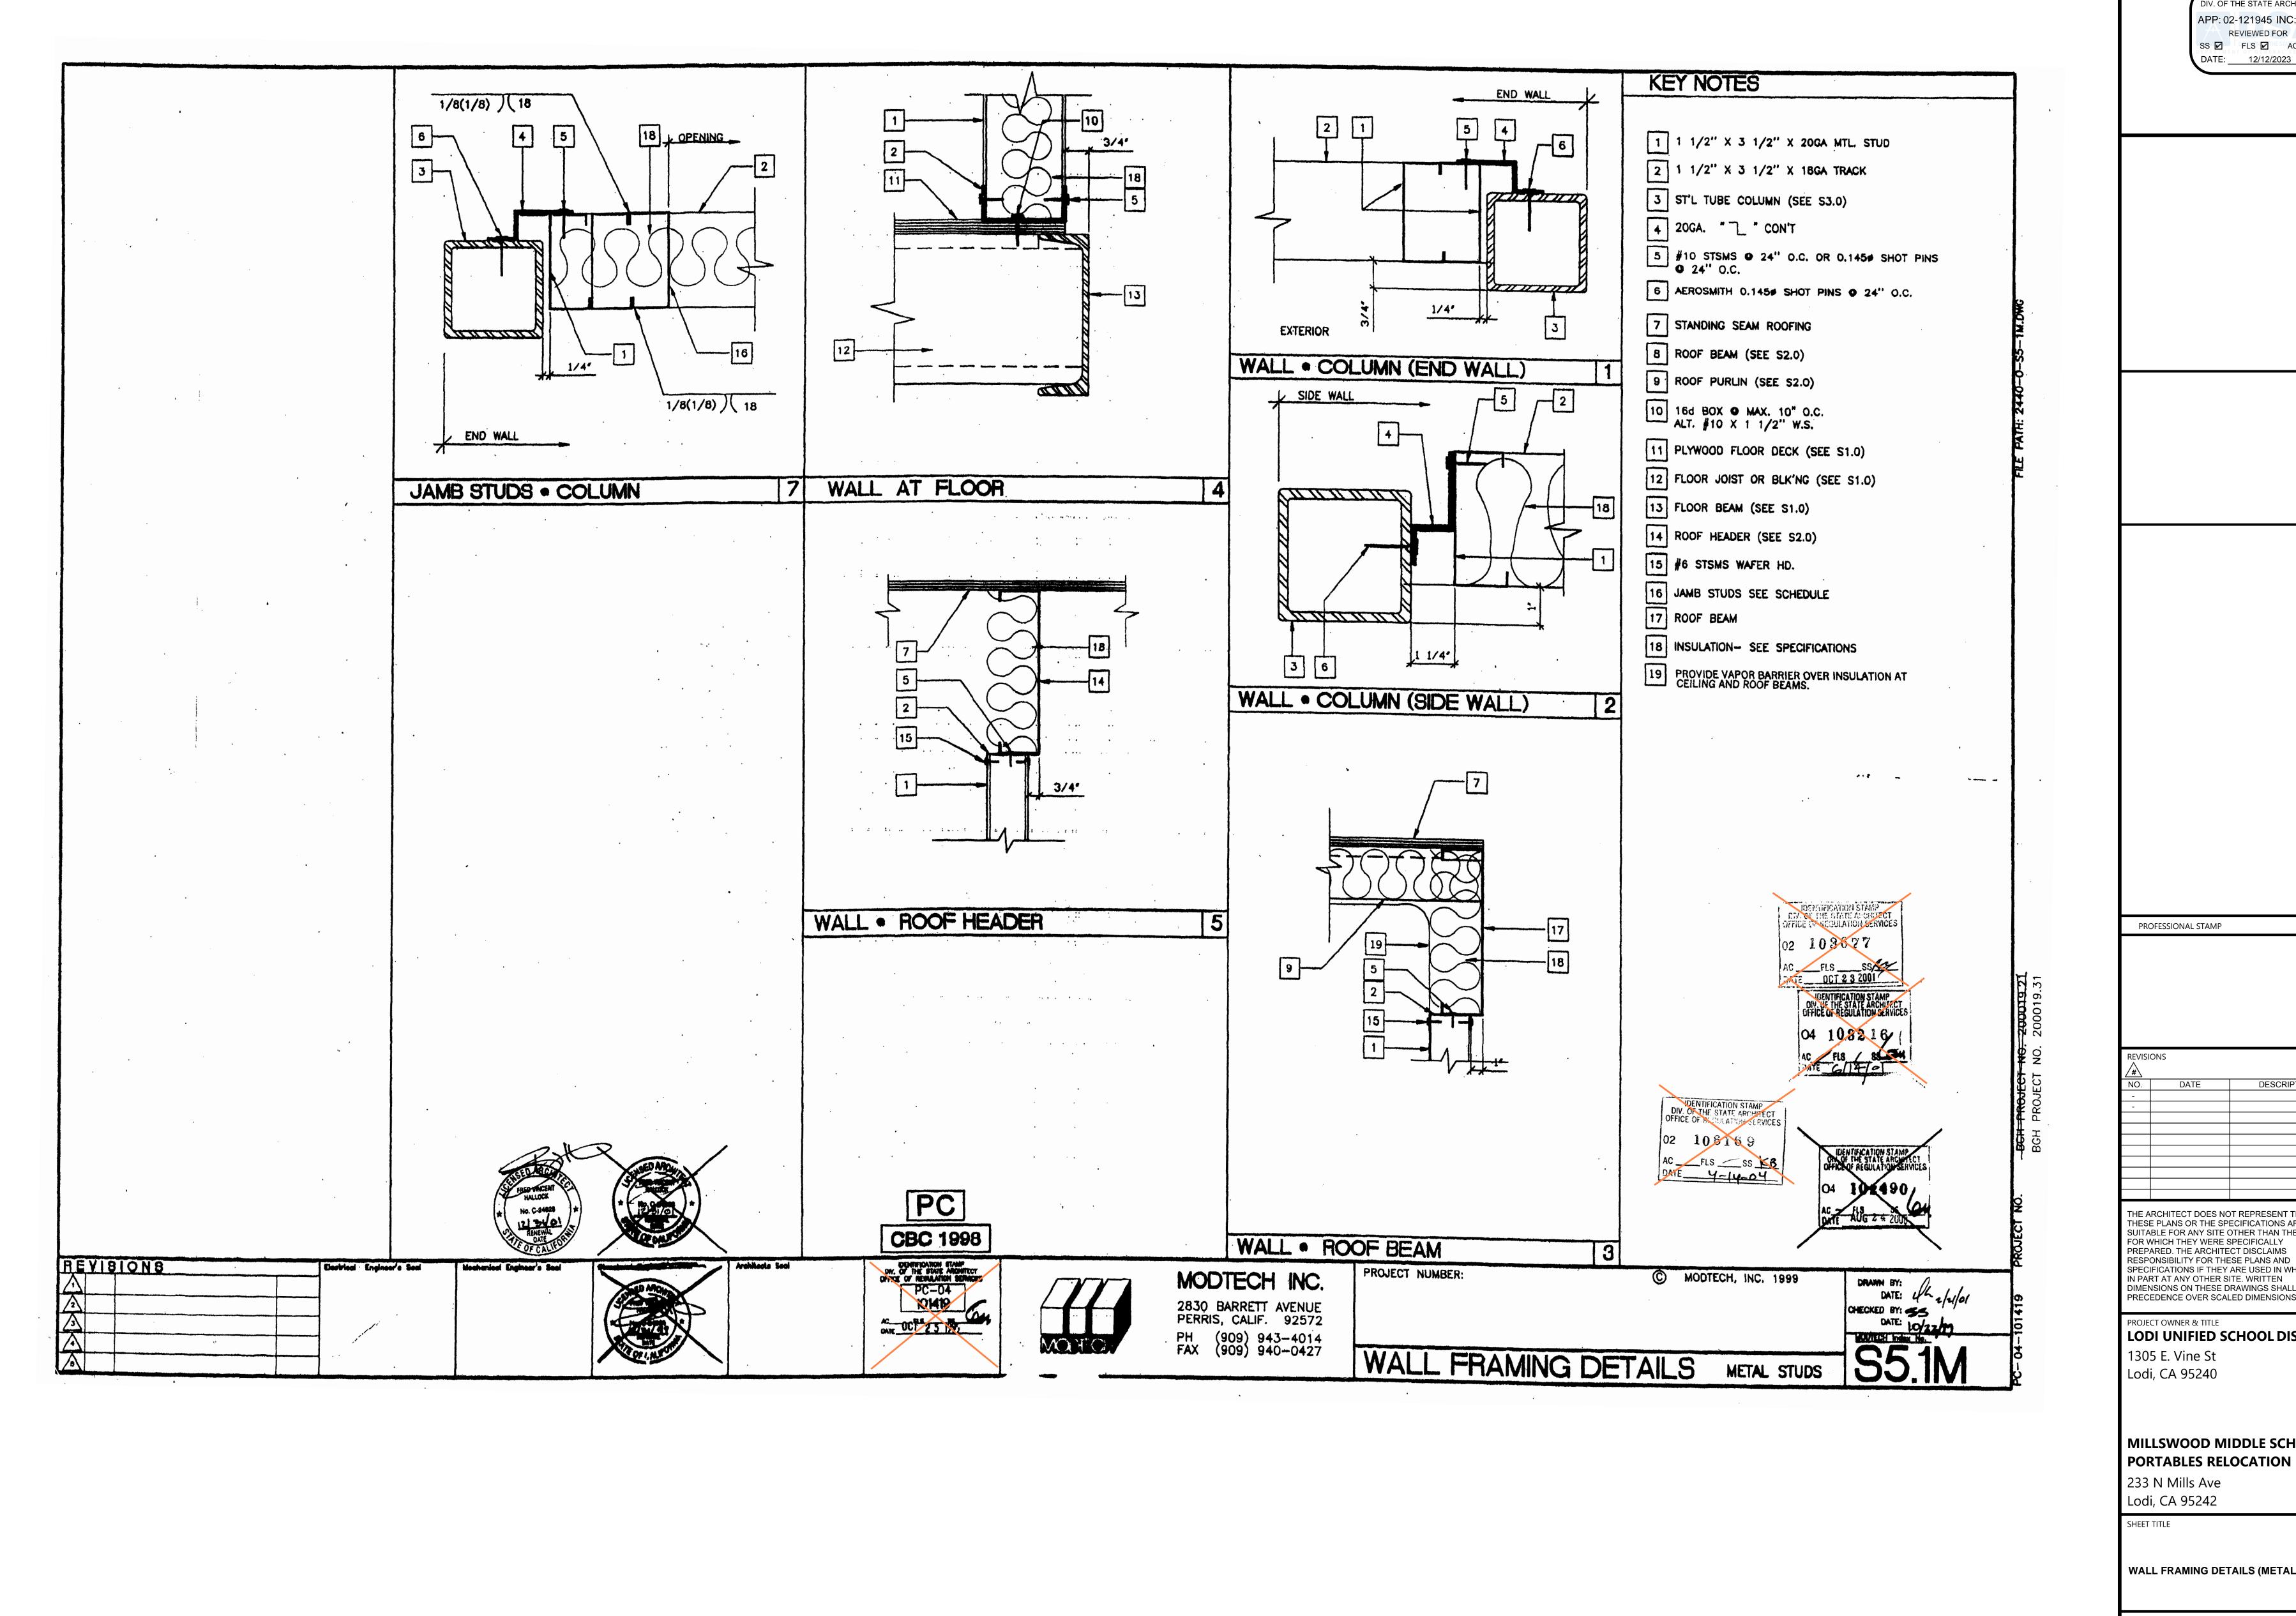

AGENCY APPROVAL DSA# APP: 02-121945 INC: REVIEWED FOR SS 🗹 FLS 🗹 ACS 🗹 DATE: <u>12/12/2023</u> DESCRIPTION

IN PART AT ANY OTHER SITE. WRITTEN
DIMENSIONS ON THESE DRAWINGS SHALL HAVE
PRECEDENCE OVER SCALED DIMENSIONS.


LODI UNIFIED SCHOOL DISTRICT

MILLSWOOD MIDDLE SCHOOL

WALL FRAMING DETAILS (METAL)

DRAWN BY: XXXXXX JOB NUMBER: 23219

**S5.1M** 

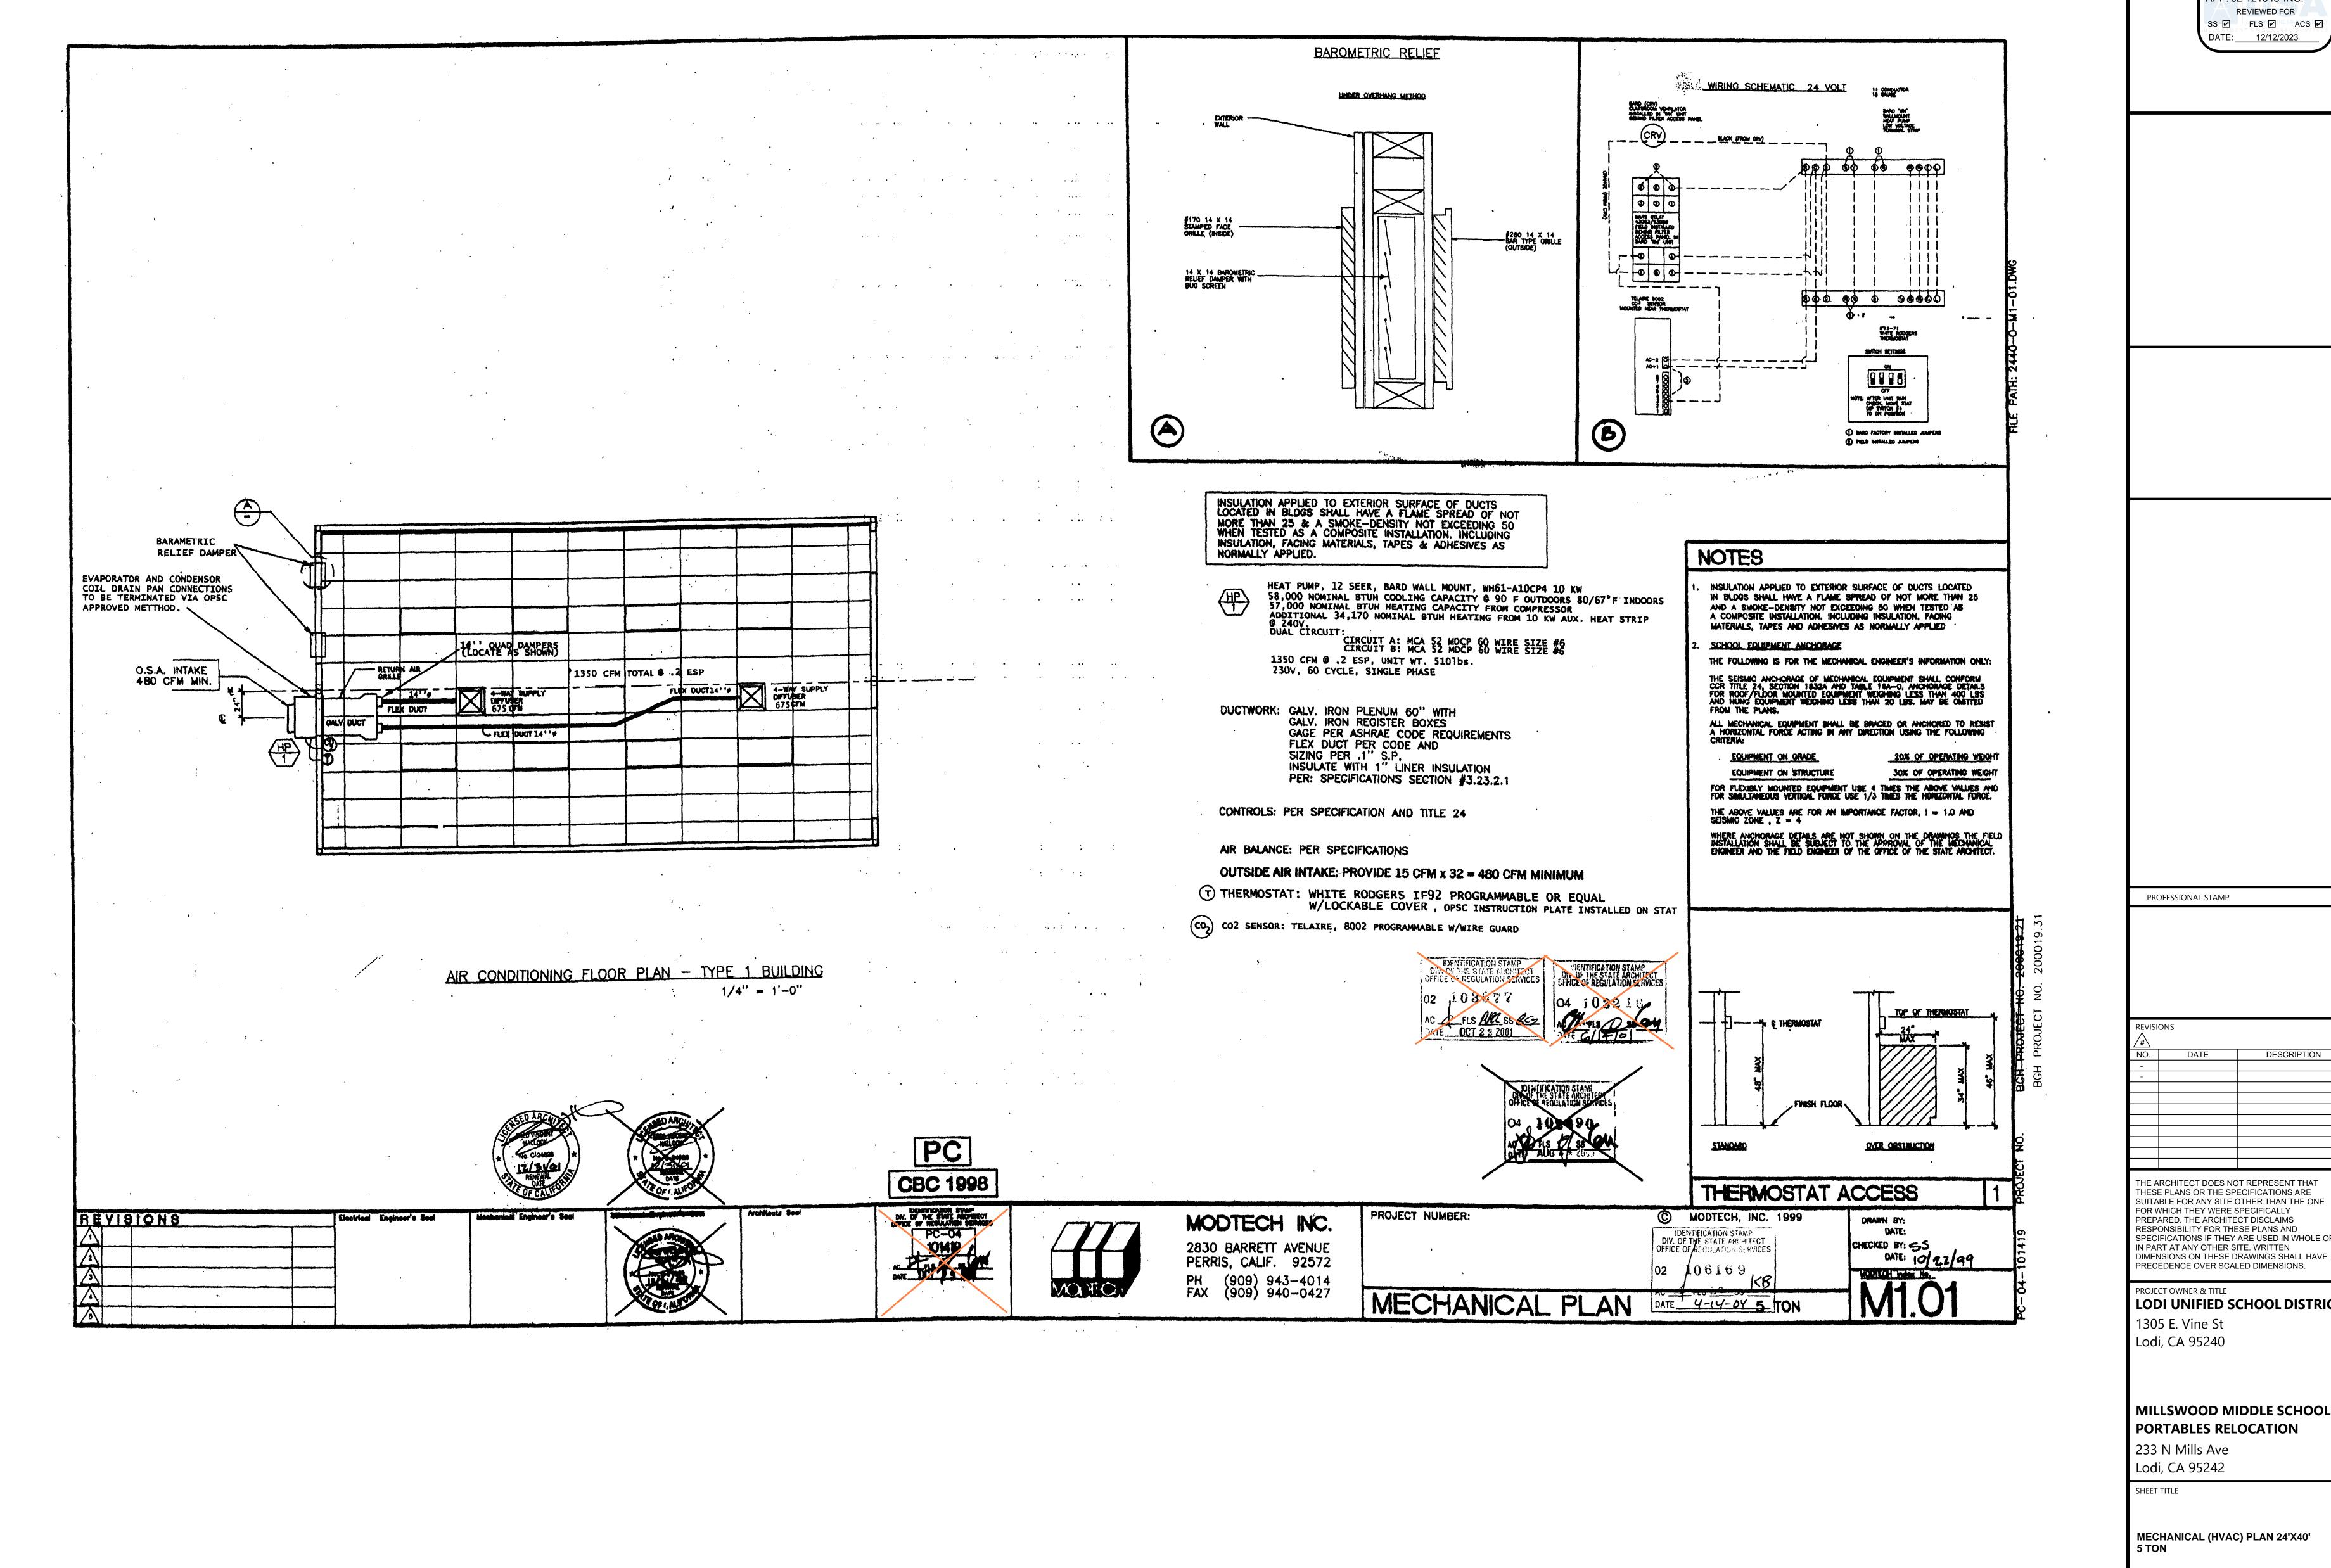

AGENCY APPROVAL DSA# IDENTIFICATION STAMP APP: 02-121945 INC: SS 🗹 FLS 🗹 ACS 🗹


SUITABLE FOR ANY SITE OTHER THAN THE ONE FOR WHICH THEY WERE SPECIFICALLY

LODI UNIFIED SCHOOL DISTRICT

MILLSWOOD MIDDLE SCHOOL


DRAWN BY: XXXXXX JOB NUMBER: 23219

M1.01

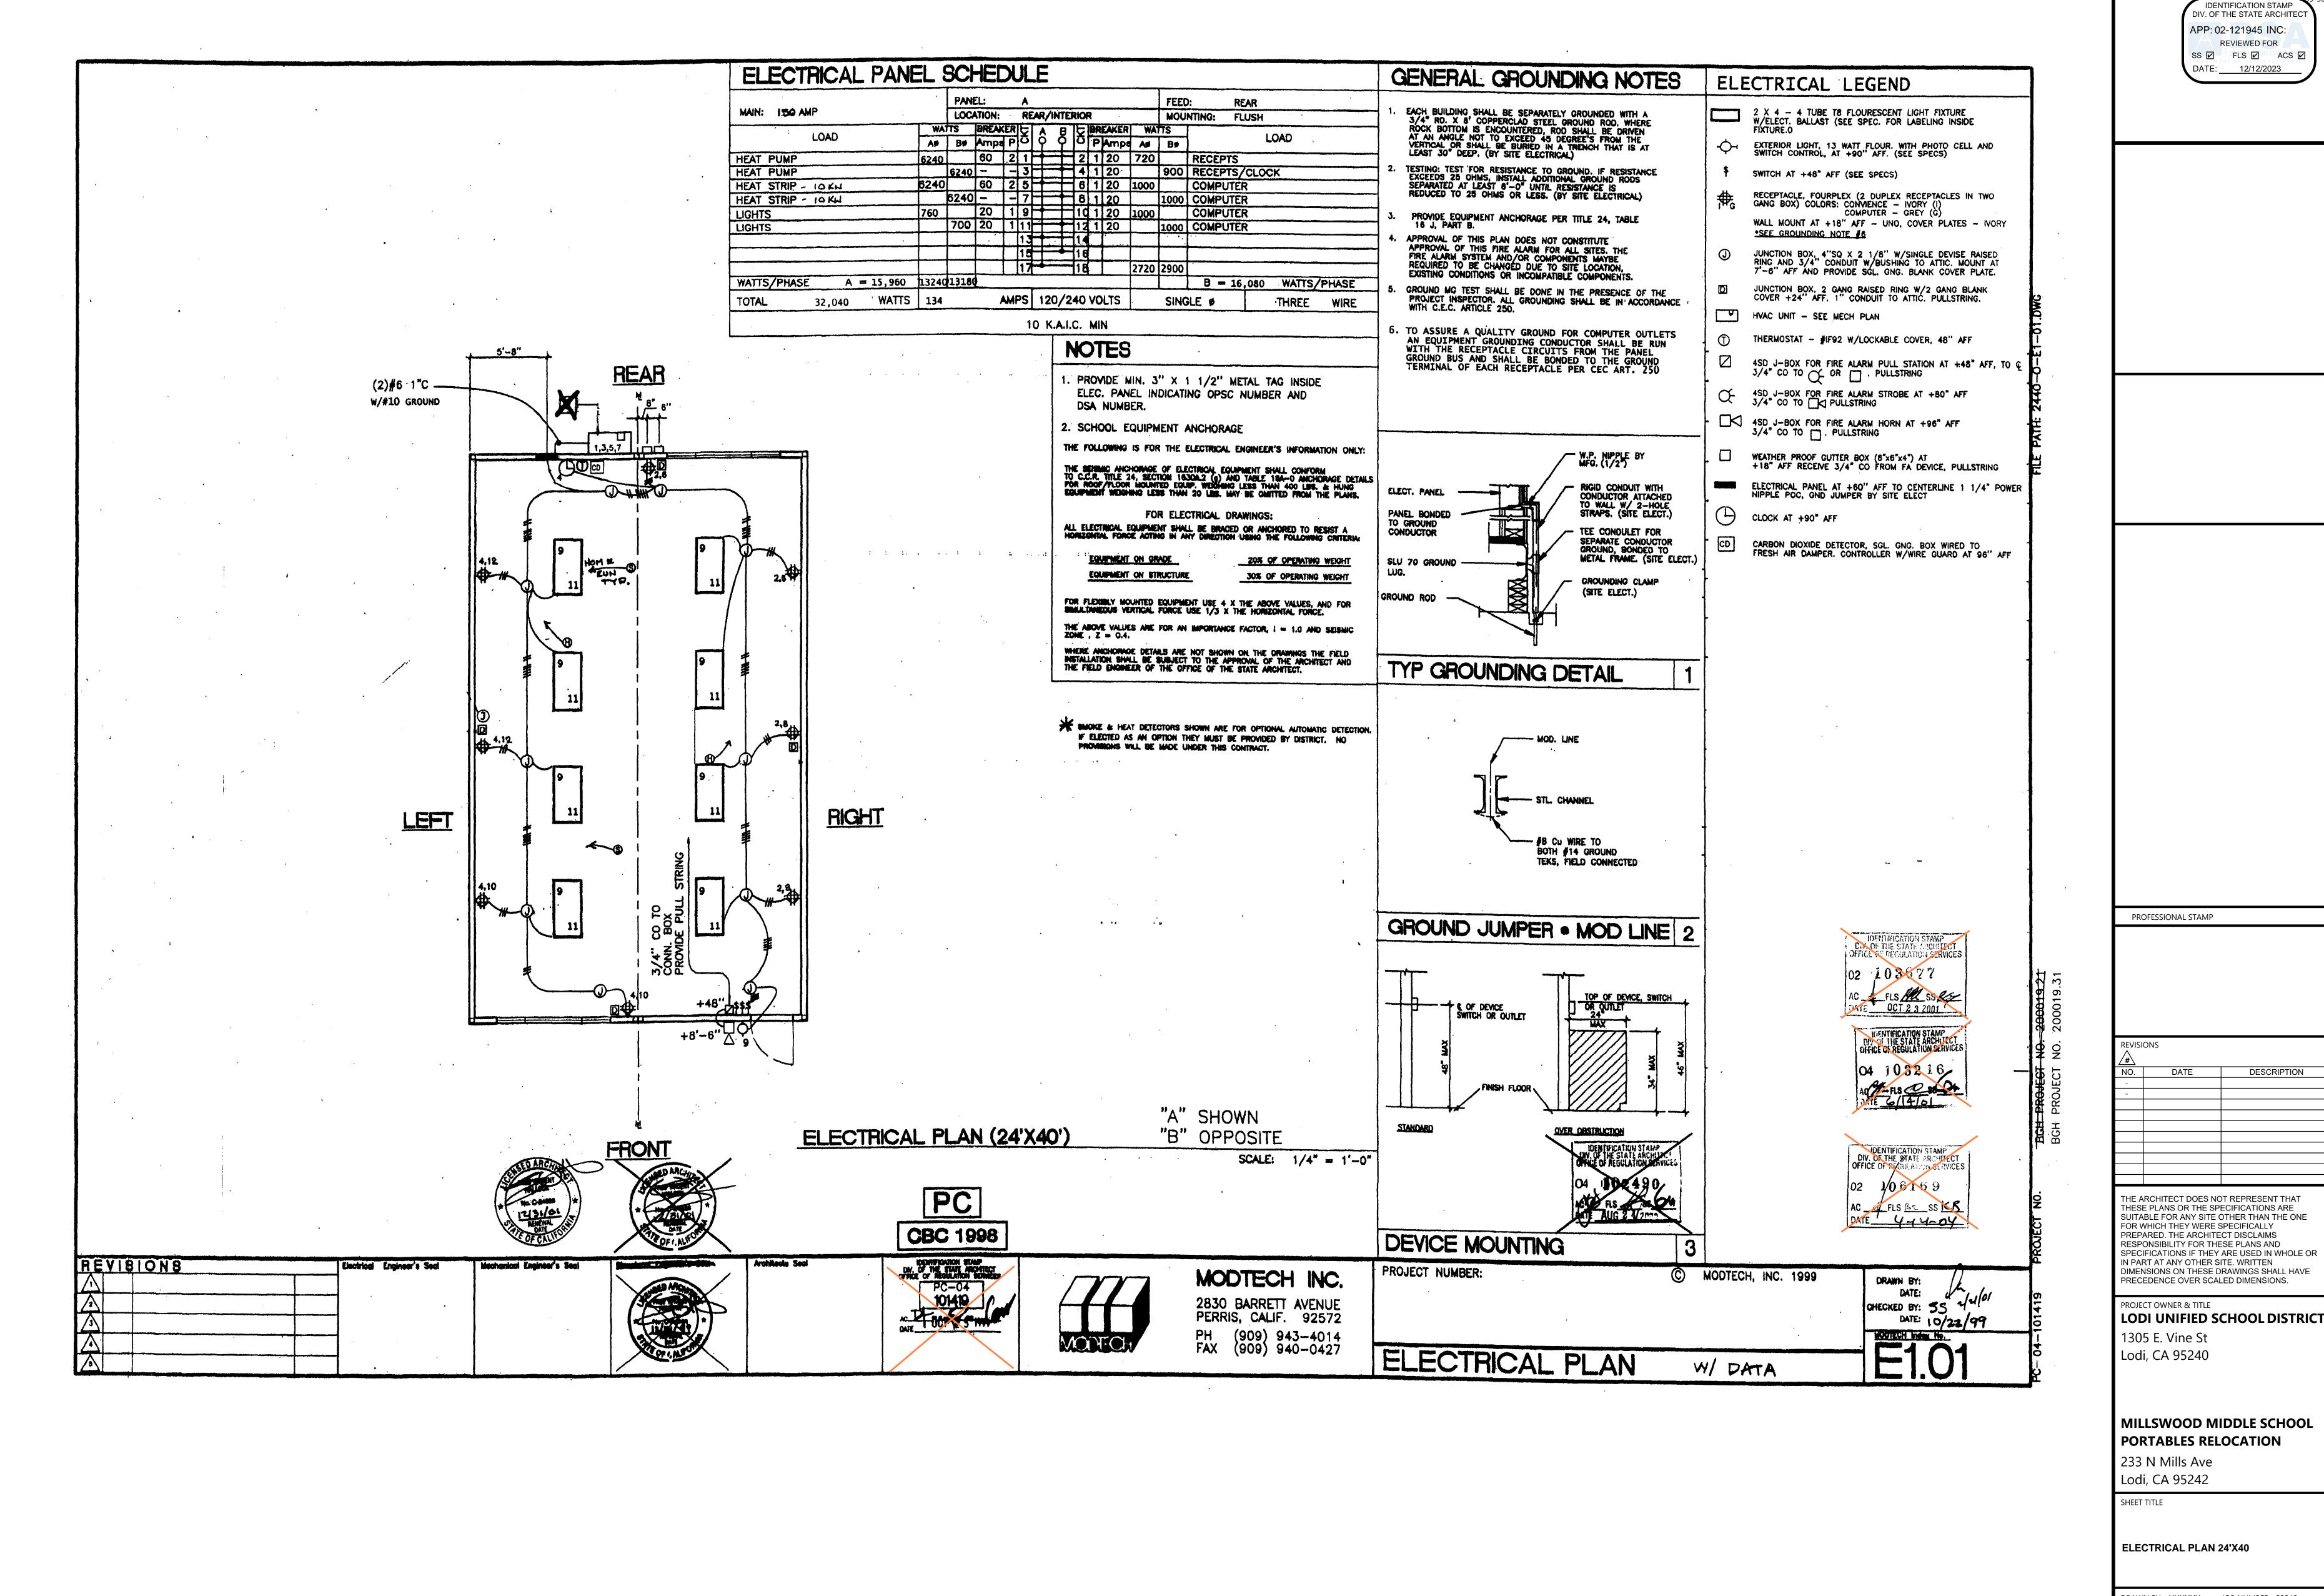

CONSTRI

DRAWN BY: XXXXXX JOB NUMBER: 23219 E1.01 DATE: DECEMBER 5, 2023

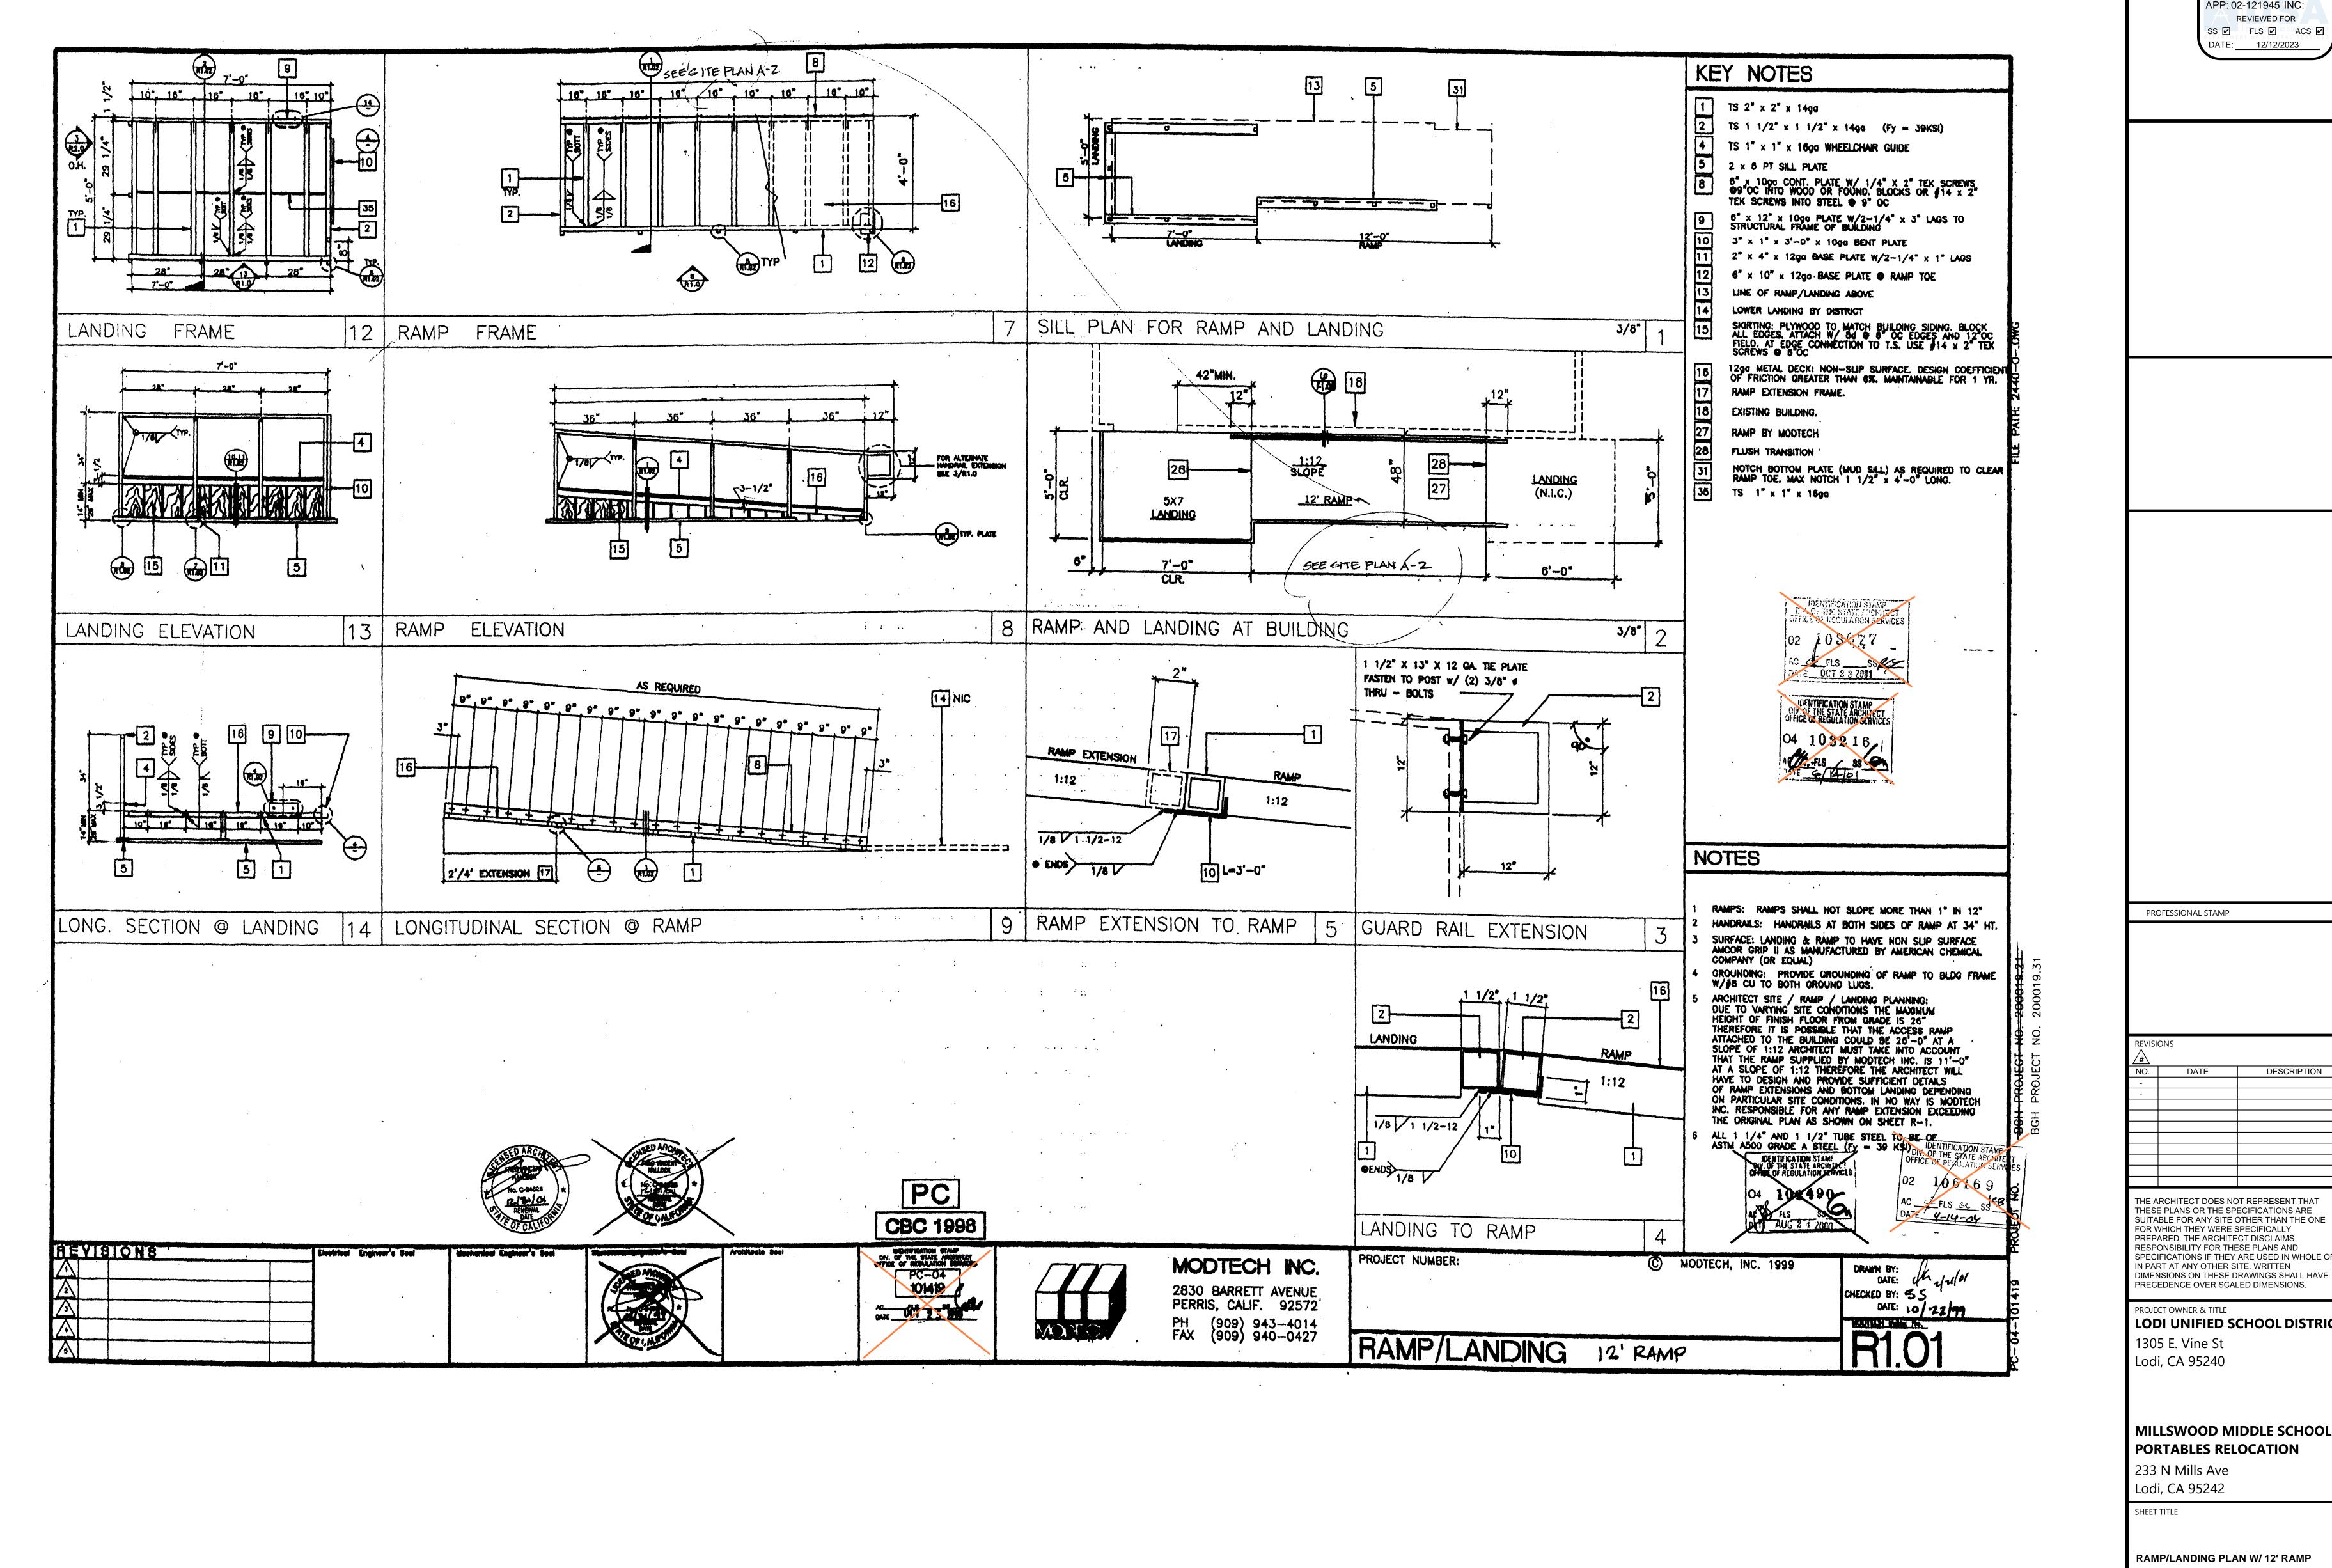

AGENCY APPROVAL DSA# IDENTIFICATION STAMP APP: 02-121945 INC: REVIEWED FOR SS 🗹 FLS 🗹 ACS 🗹 DATE: 12/12/2023

THE ARCHITECT DOES NOT REPRESENT THAT THESE PLANS OR THE SPECIFICATIONS ARE SUITABLE FOR ANY SITE OTHER THAN THE ONE FOR WHICH THEY WERE SPECIFICALLY PREPARED. THE ARCHITECT DISCLAIMS RESPONSIBILITY FOR THESE PLANS AND SPECIFICATIONS IF THEY ARE USED IN WHOLE OR


LODI UNIFIED SCHOOL DISTRICT

MILLSWOOD MIDDLE SCHOOL

CONSTRU

DRAWN BY: XXXXXX JOB NUMBER: 23219

R1.01

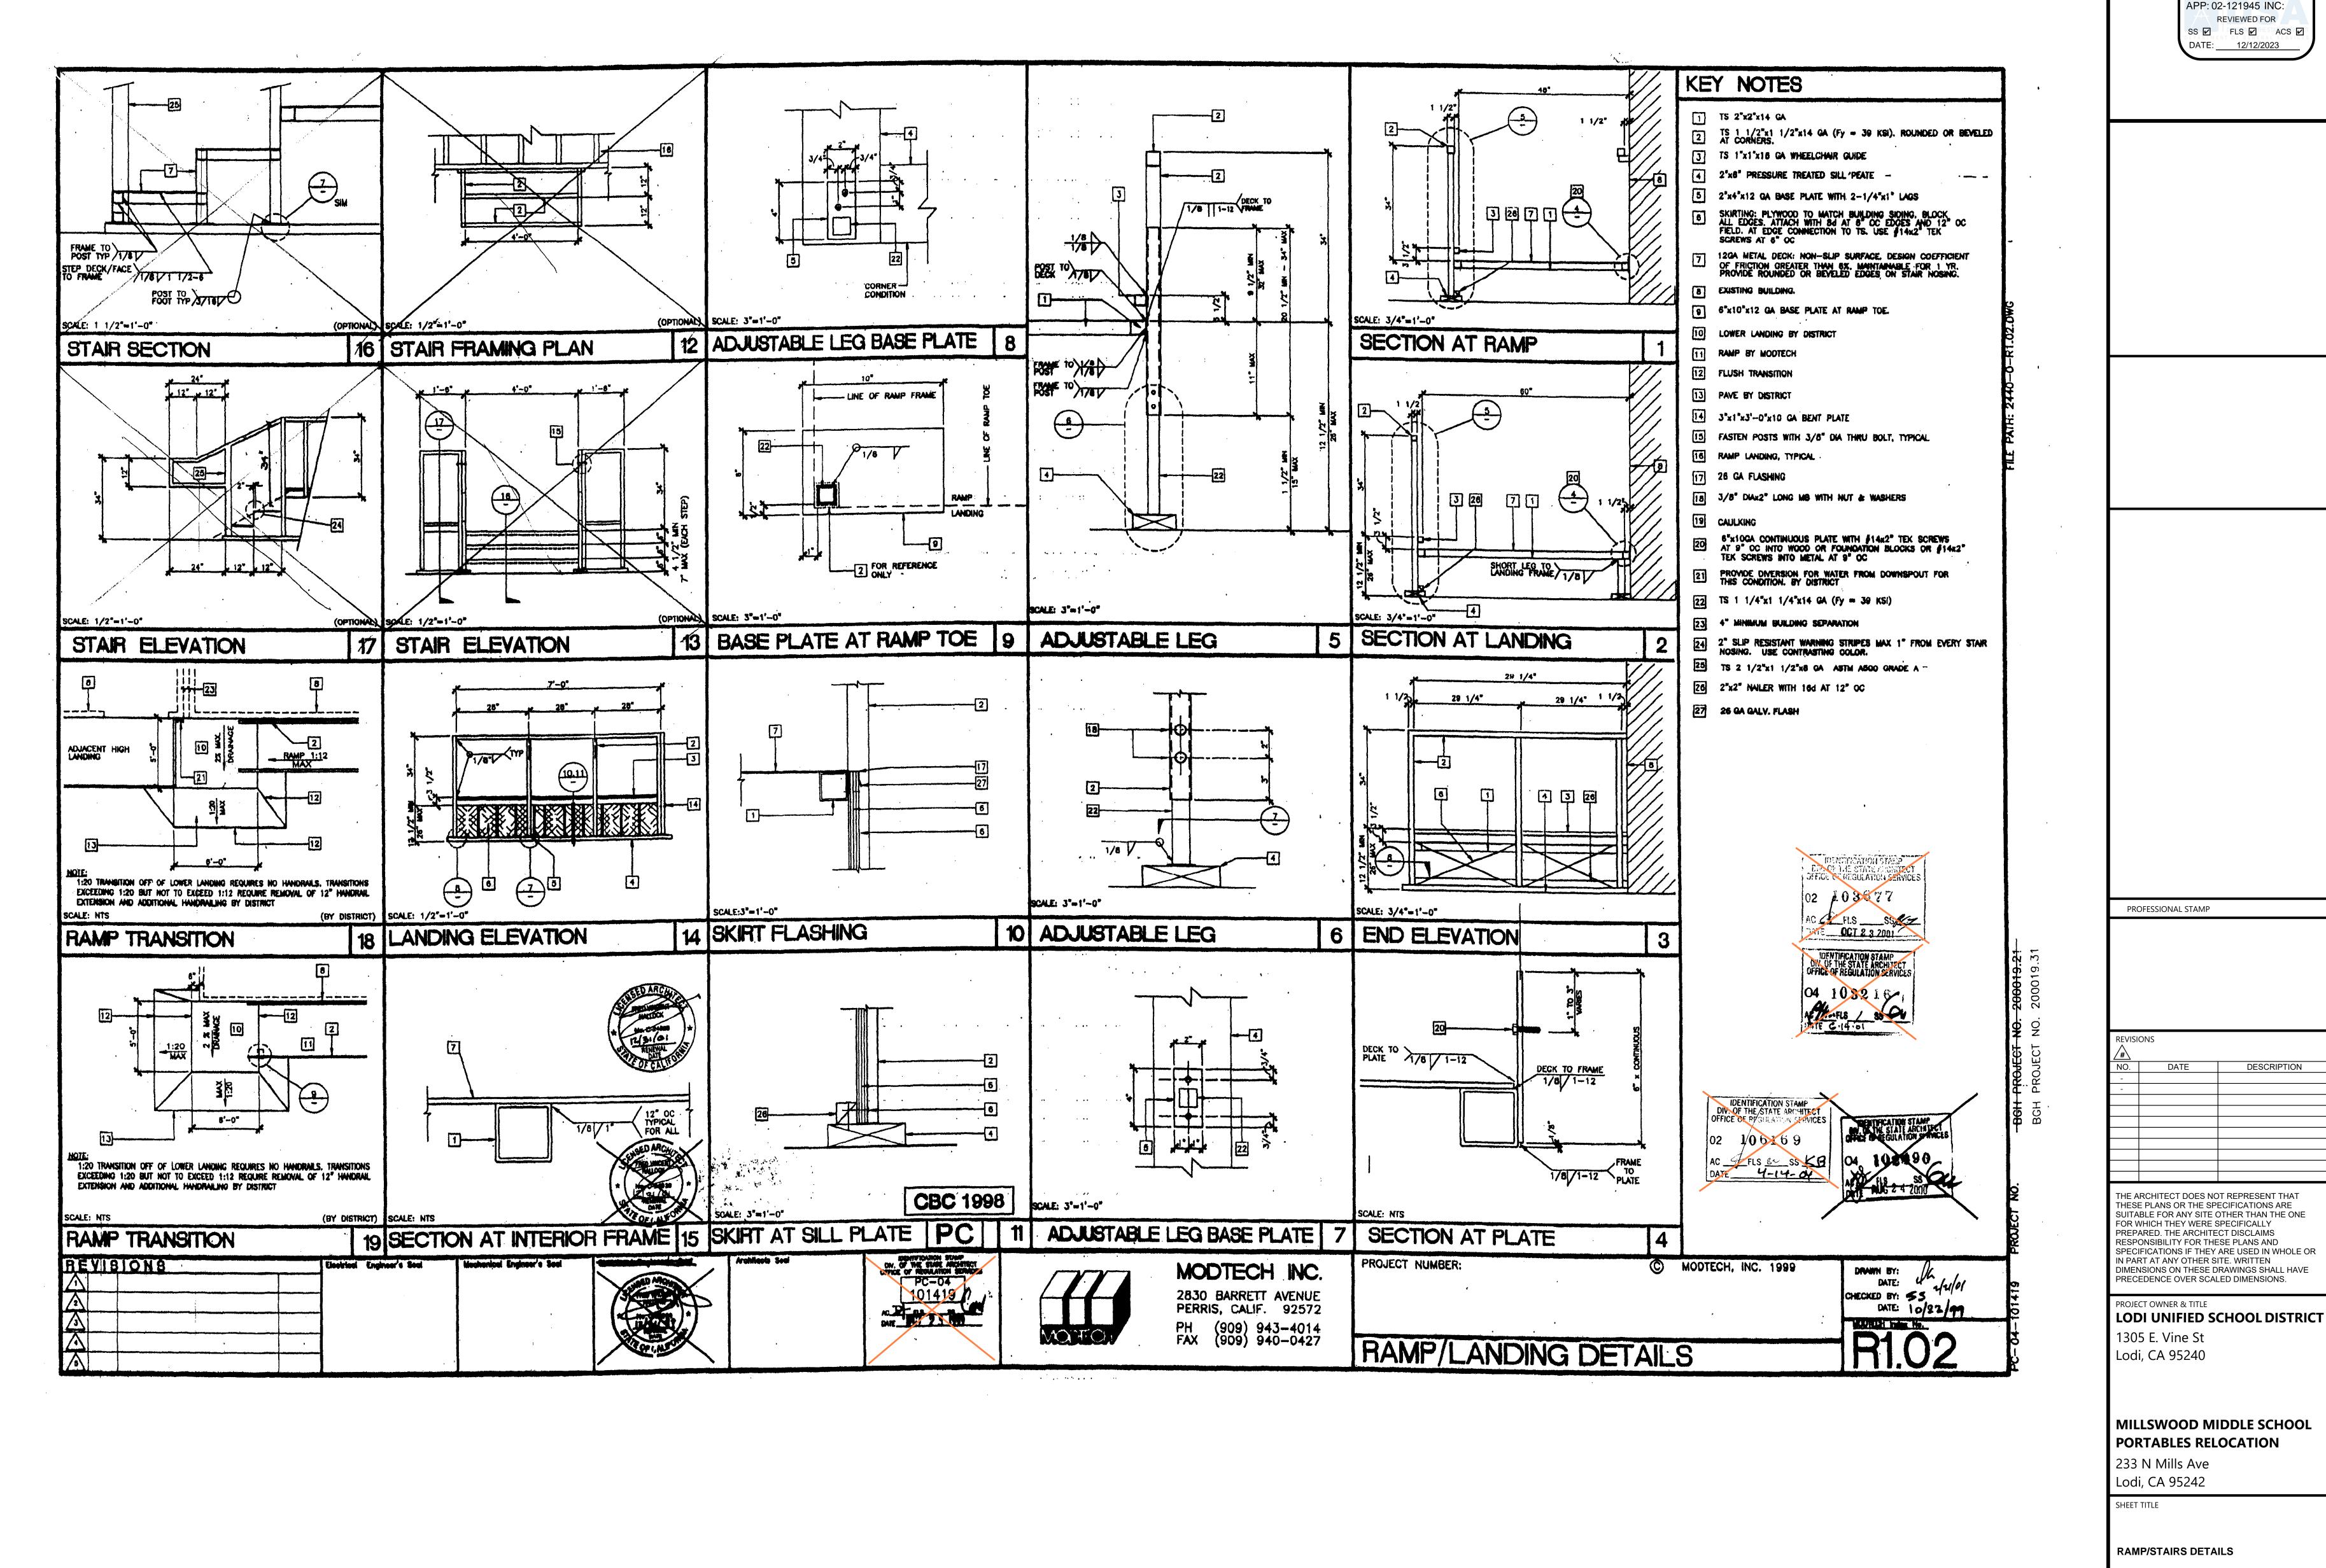


AGENCY APPROVAL DSA#

IDENTIFICATION STAMP DIV. OF THE STATE ARCHITE

CONSTRI

DRAWN BY: XXXXXX JOB NUMBER: 23219

R1.02

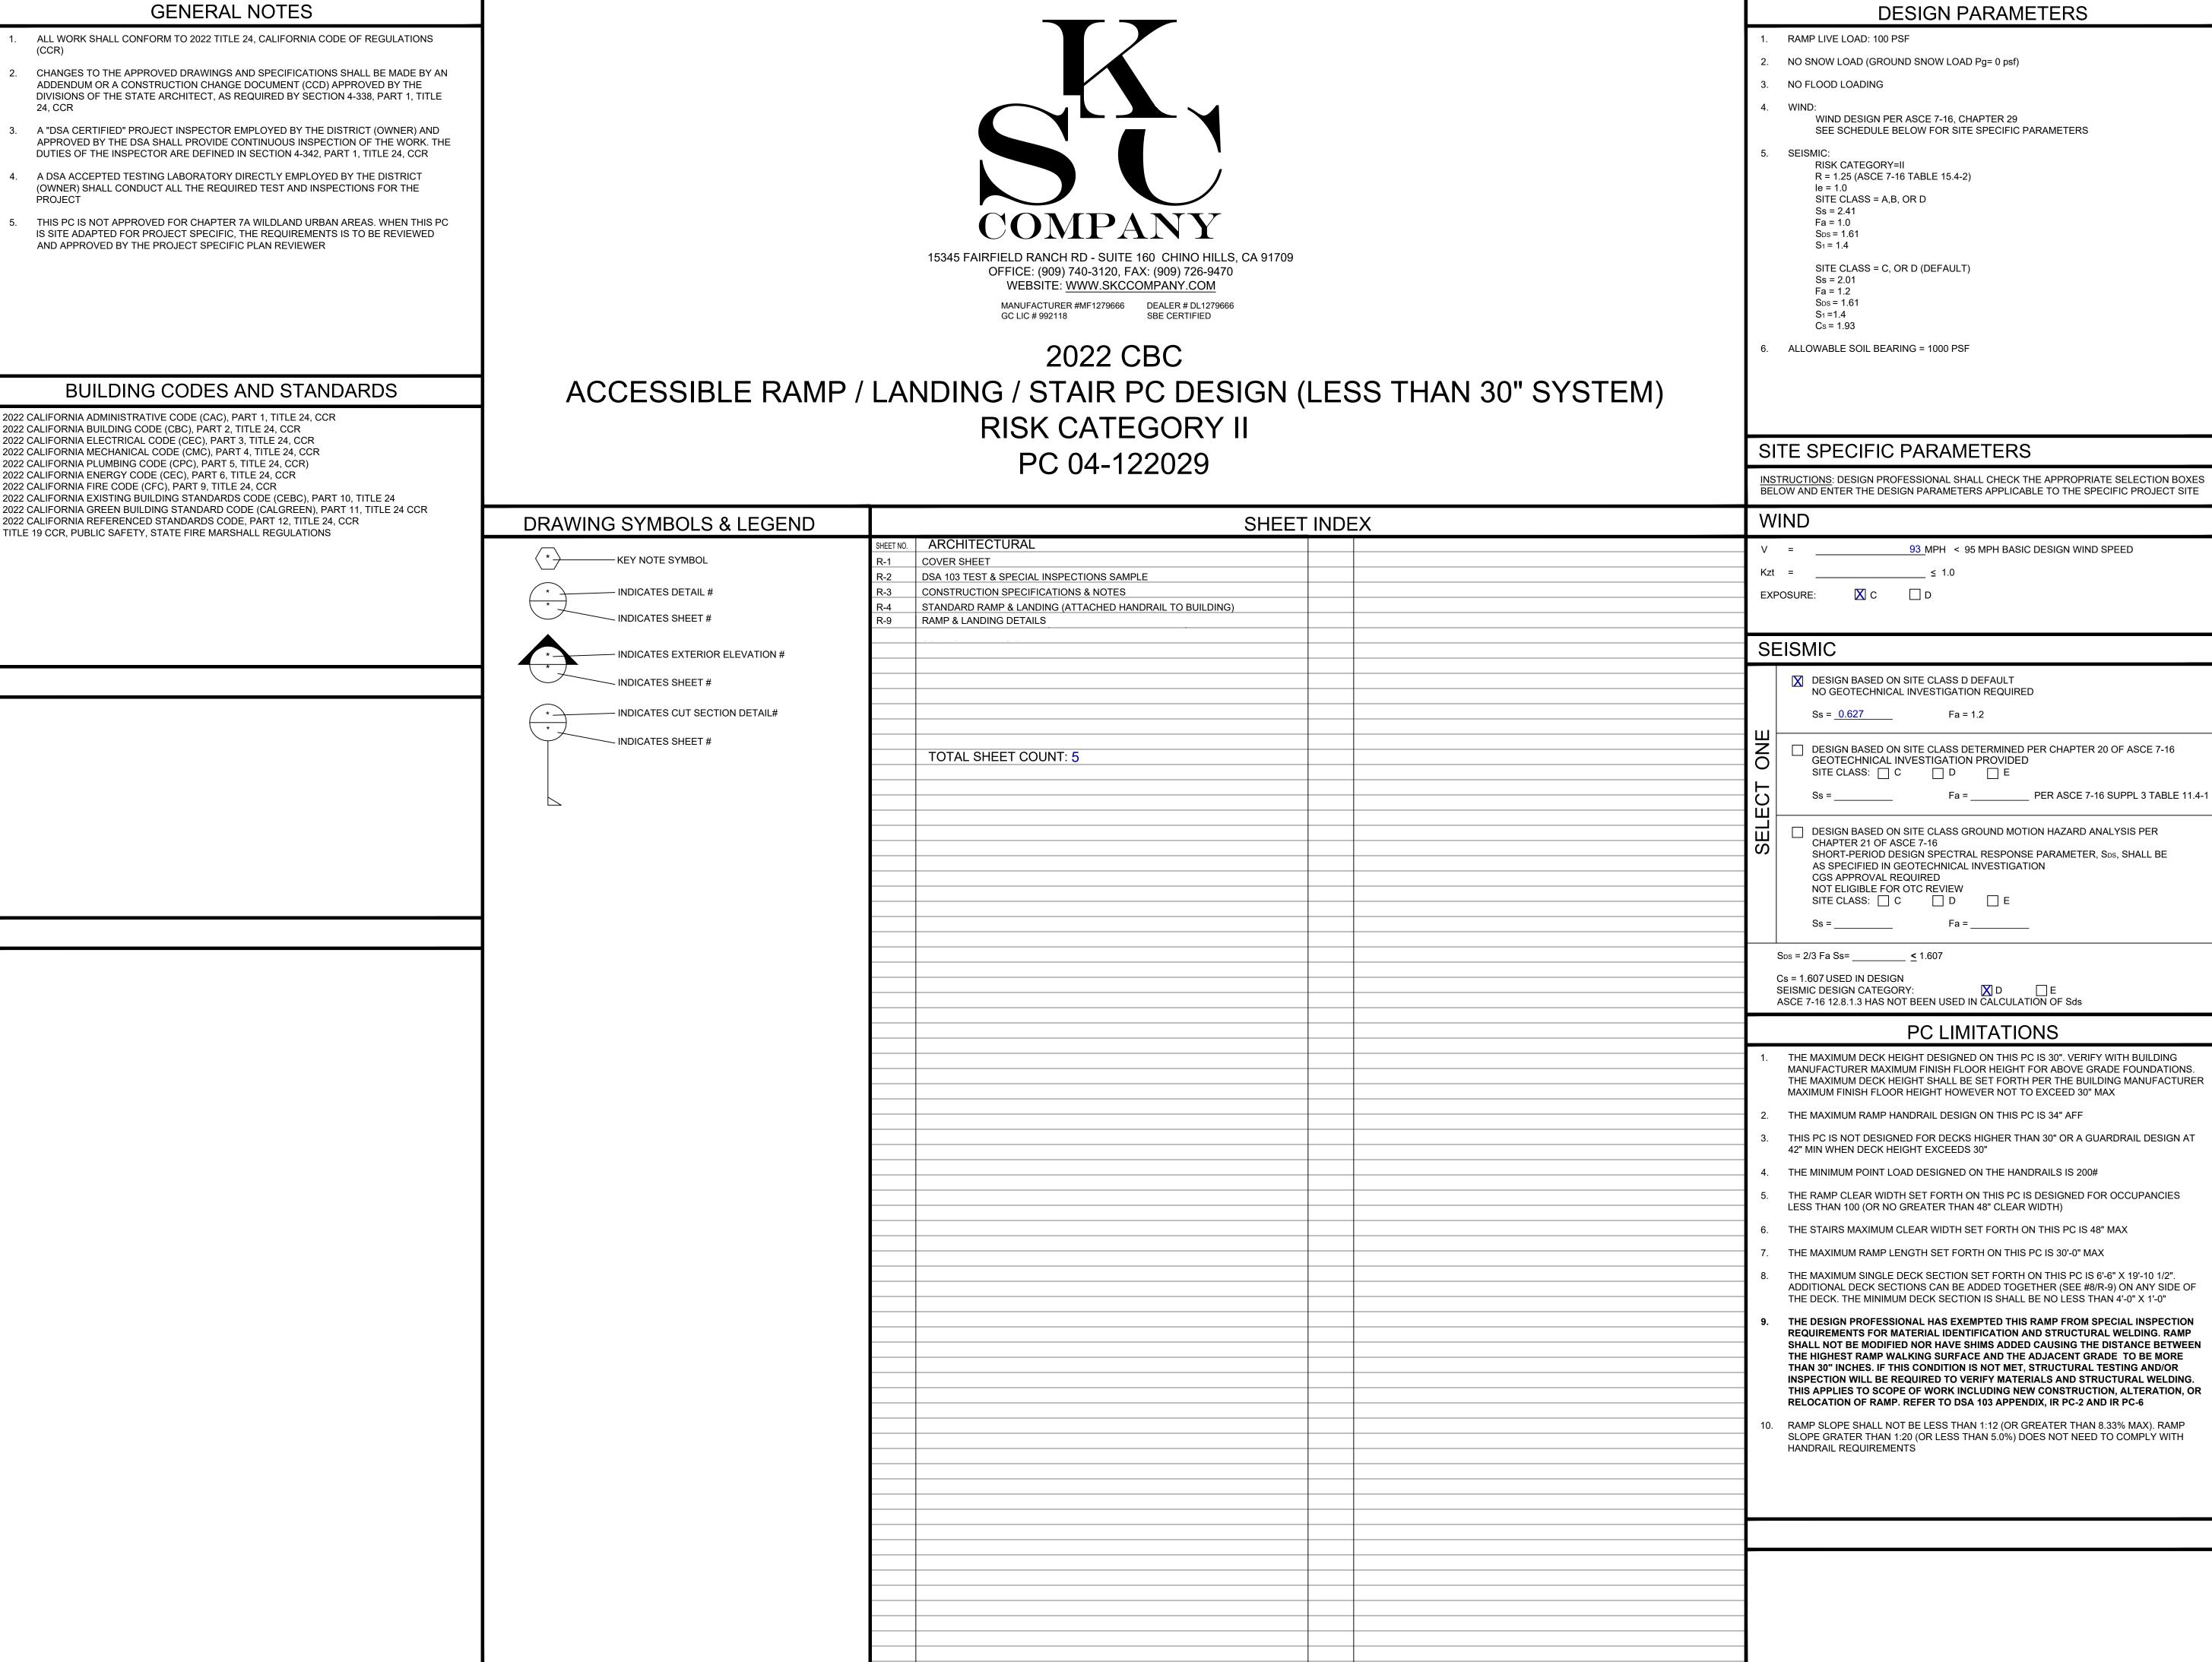

INSTRUCTIONS: DESIGN PROFESSIONAL SHALL CHECK THE APPROPRIATE SELECTION BOXES BELOW AND ENTER THE DESIGN PARAMETERS APPLICABLE TO THE SPECIFIC PROJECT SITE

INC AND ARE FOR THE USE BY SKC IN THE SPECIFIED JOB ONLY. THEY SHALL  $\,$ NOT BE USED AND/OR DUPLICATED OR TRANSMITTED IN ANY FORM, FOR ANY UNAUTHORIZED USE OF THESE PLANS SHALL SUBJECT THE OWNER OF SAID PROPERTY TO LIQUIDATED DAMAGES OF \$75,000.00. THESE PLANS ARE COPYRIGHT SKC, © ALL RIGHTS RESERVED.

DISTRICT/CUSTOMER NAME:

SCHOOL/SITE NAME:

SHEET TITLE:

**COVER SHEET** 

15345 FAIRFIELD RANCH RD - SUITE 160 CHINO HILLS, CA 91709

OFFICE: (909) 740-3120, FAX: (909) 726-9470

WEBSITE: WWW.SKCCOMPANY.COM MANUFACTURER #MF1279666 DEALER # DL1279666 GC LIC # 992118 DEALER # DL1279666 SBE CERTIFIED

STATE AGENCY APPROVAL

IDENTIFICATION STAMP DIV. OF THE STATE ARCHITEC

**REVIEWED FOR** 

SS 🗹 FLS 🗹 ACS 🗹

APP: 02-121945 INC:

DATE: 12/12/2023

PRE-CHECK (PC) DOCUMENT CODE: 2022 CBC SEPARATE PROJECT APPLICATION FOR CONSTRUCTION IS REQUIRED APP: 04-122089 PC EVIEWED FOR FLS 🗹 ACS 🗹

PROFESSIONAL OF RECORD ON PC



ORION STRUCTURAL ENGINEERING, INC. 11305 RANCHO BERNARDO ROAD, SUITE 121 SAN DIEGO, CA 92127

PROJECT SPECIFIC PROFESSIONAL OF RECORD

LODI UNIFIED SCHOOL DISTRICT MILLSWOOD MIDDLE SCHOOL PORTABLE RELOCATION DSA APP# 02-121945

FILE No.: 39-50 PTN: 68585-261

DDRESS: ITY: HONE:		
	REVISIONS	
1 -		
2 -		
3 -		
4 -		
5 -		
PROJECT NO.:	00-0000	
DRAFTER:	00	
SCALE:	AS NOTED	
DATE:	00-00-00	
	SHEET NUMBER	

DSA 103-22: LISTING OF STRUCTURAL TESTS & SPECIAL INSPECTIONS, 2022 CBC		G OF STRUCTURAL TESTS & SPECIAL			mpt from DSA Requirements for Stru	
Application Number: School Name: School District: 04-122029 Accessible Ramp Landing Stair PC SKC Company	Application Number: 04-122029	School Name: Accessible Ramp Landing Stair PC	School District: SKC Company	Application Number: 04-122029	School Name: Accessible Ramp Landing Stair PC	School District: SKC Company
DSA File Number: Date Created: PC-116 2023-02-20 13:43:59	DSA File Number: PC-116	Increment Number:	Date Created: 2023-02-20 13:43:59	DSA File Number: PC-116	Increment Number:	Date Created: 2023-02-20 13:43:59
	10110		2023 02 20 13.43.35			
2022 CBC	X1. OTHER:					endments) and those items identified below with a check mark by the
IMPORTANT: This form is only a summary list of structural tests and some of the special inspections required for the project.  Generally, the structural tests and special inspections noted on this form are those that will be performed by the Geotechnical Engineer	Test or Special Inspec	ction Type	Performed By Code References and Notes			tural tests / special inspections noted. <u>Items marked as exempt shall</u> t inspector shall verify all construction complies with the approved
of Record, Laboratory of Record, or Special inspection. The actual complete test and inspection program must be performed as detailed	a. Load test for identifi	ied product(s): Test	LOR 1709A.2, 1709A.3. Testing is not required for: 1) a product with a			
on the DSA approved documents. The appendix at the bottom of this form identifies work NOT subject to DSA requirements for special		*	valid evaluation service report per DSA IR A-5, or 2) a product that can be justified by structural calculation.	SOILS:		
inspection or structural testing. The project inspector is responsible for providing inspection of all facets of construction, including but not limited to, special inspections not listed on this form such as structural wood framing, high-load wood diaphragms, cold-formed steel	□ b. Installation torque f	for non-HS bolts Continuous	SI* Applicable to communication towers identified as Essential Servi		acting as a cantilever footing with a design based	on minimum allowable pressures per CBC Table 1806A.2 and without a
framing, anchorage of non-structural components, etc., per Title 24, Part 2, Chapter 17A (2022 CBC).			Facility Projects (ESFP). Calibrated wrench use required, verified by	by SI geotechnical report for	for the following cases: A) free standing sign or sco	oreboard, B) cell or antenna towers and poles less than 35'-0" tall (e.g., lighting
			during installation. DSA Policy PL 18-01: Communication Towers, and Buildings Utilized by State Agencies for Essential Services	or D) covered walkwa	es supporting open mesh fences, etc.), C) single-st ay structure with an apex height less than 10'-0" a	tory structure with dead load less than 5 psf (e.g., open fabric shade structure)
**NOTE: Undefined section and table references found in this document are from the CBC, or California Building Code.			Communications.*EXCEPTION: Non-ESFP may use PI without nee notification to DSA.	eed for	. 150	esting by a Geotechnical Engineer for the following cases: A) buildings without
KEY TO COLUMNS			Thomas and the bark.	a geotechnical report	t and meeting the exception item #1 criteria in CB	C Section 1803A.2 supported by native soil (any excavation depth) or fill soil
1. TYPE 2. PERFORMED BY	□ c.					n/recompaction not exceeding 12" depth, C) native or fill soil supporting te stairs, parking lots, driveways, etc.), D) unpaved landscaping and playground
GE (Geotechnical Engineer) – Indicates that the special inspection shall be performed by a registered geotechnical engineer or his or her authorized				areas, or E) utility tren		te stairs, parking lots, anveways, etc.,, b, anpavea land scaping and playground
Continuous – Indicates that a continuous special inspection is representative.						
required  LOR (Laboratory of Record) – Indicates that the test or special inspection shall				CONCRETE/MASOI	NRY:	
be performed by a testing laboratory accepted in the DSA Laboratory Evaluation and Acceptance (LEA) Program. See CAC Section 4-335.						omponents (e.g., mechanical, electrical, plumbing equipment - see
Periodic – Indicates that a periodic special inspection is required					in the Appendix below) given in CBC Section 1617 ng criteria listed in exempt item 3 for "Welding" in	7A.1.18 (which replaces ASCE 7-16, Section 13.1.4) or B) interior nonstructural
PI (Project Inspector) – Indicates that the special inspection may be performed by a project						BC Section 1705 A.3.3.2 subject to the requirements and limitations
inspector when specifically approved by DSA.				in that section.		2. Section 17 of 1.5.5.2 subject to the requirements and inflications
Test – Indicates that a test is required  SI (Special Inspection) – Indicates that the special inspection shall be performed				☐ 3. Non-bearing non-s	shear masonry walls may be exempt from certain	DSA masonry testing and special inspection items as allowed per DSA
by an appropriately qualified/approved special inspector.				IR 21-1. Refer to const	truction documents for specific exemptions accor	raingly for each applicable wall condition.
				4. Epoxy shear dowels	ls in site flatwork and/or other non-structural cond	crete.
DIVISION OF THE STATE ARCHITECT DEPARTMENT OF GENERAL SERVICES STATE OF CALIFORNIA	DIVISION OF THE STATE ARCHITEC		OF GENERAL SERVICES STATE OF CALI	LIFORNIA DIVISION OF THE STATE ARCHITECT DGS DSA 103-22 (Revised 12/01/20		GENERAL SERVICES STATE OF CALIFORNIA e 3 of 6
DGS DSA 103-22 (Revised 12/01/2022) Page 1 of 6	DGS DSA 103-22 (Revised 12/01/2	2022) Pa	age 2 of 6	DGS DSA 103-22 (Revised 12/01/20	1 ag	
					/	
Appendix: Work Exempt from DSA Requirements for Structural Tests / Special Inspections	DSA 103-22: LISTING	G OF STRUCTURAL TESTS & SPECIAL	. INSPECTIONS(SIGNATURE), 2022 CBC	DSA 103-22; LIST OF	REQUIRED VERIFIED REPORTS, CBC 2	2022
Application Number: School Name: School District: 04-122029 Accessible Ramp Landing Stair PC SKC Company	Application Number:	School Name:	School District:	Application Number:	School Name:	School District: SKC Company
DSA File Number: Date Created:	04-122029 DSA File Number:	Accessible Ramp Landing Stair PC Increment Number:	SKC Company  Date Created:	04-122 <b>02</b> 9 DSA File Number:	Accessible Ramp Landing Stair PC Increment Number:	Date Created:
PC-116 2023-02-20 13:43:59	PC-116		2023-02-20 13:43:59	PC-116		2023-02-20 13:43:59
CONCRETE/MASONRY:	Name of Architect or Engineer in g	eneral responsible charge:				
5. Testing of reinforcing bars is not required for items given in CBC Section 1910A.2 subject to the requirements and limitations						
in that section.	N 65: 15: 011					
	Name of Structural Engineer (Whel	n structural design has been delegated):				
WELDING:						
1. Solid-clad and open-mesh fences, gates with maximum leaf span of 10', and gates with a maximum rolling section of 10' all having an apex height less than 8'-0" above lowest adjacent grade. When located above circulation or occupied space below, these gates/fences are not located within 1.5x	5	15.				
gate/fence height (max 8'-0") to the edge of floor or roof.	Signature of Architect or Structura	al Engineer: Date:				
2. Handrails, guardrails, and modular or relocatable ramps associated with walking surfaces less than 30" above adjacent grade (excluding post base						
connections per the 'Exception' language in Section 1705A.2.1); fillet welds shall not be ground flush.	Note: To facilitate DSA ele	ectronic mark-ups and identification stamp applicatio	on, DSA recommends against using secured electronic or digital signatures.			
3. Non-structural interior cold-formed steel framing spanning less than 15'-0", such as in interior partitions, interior soffits, etc. supporting only self						
weight and light-weight finishes or adhered tile, masonry, stone, or terra cotta veneer no more than 5/8" thickness and apex less than 20'-0" in height and not over an exit way. Maximum tributary load to a member shall not exceed the equivalent of that occurring from a 10'x10' opening in a 15' tall			DSA STAMP			
wall for a header or king stud.						
4. Manufactured support frames and curbs using hot rolled or cold-formed steel (i.e., light gauge) for mechanical, electrical, or plumbing equipment						
weighing less than 2000# (equipment only) (connections of such frames to superstructure elements using welding will require special inspection as noted in selected item(s) for Sections S/A3, S/A4 and/or S/A5 of listing above).						
5. Manufactured components (e.g., Tolco, B-Line, Afcon, etc.) for mechanical, electrical, or plumbing hanger support and bracing (connections of such						
components to superstructure elements using welding will require special inspection as noted in selected item(s) for Sections S/A3, S/A4 and/or S/A5						
of listing above).						
6. TV Brackets, projector mounts with a valid listing (see DSA IR A-5) and recreational equipment (e.g., playground structures, basketball backstops, etc.) (connections of such elements to superstructure elements using welding will require special inspection as noted in selected item(s) for sections			<u> </u>			
S/A3, S/A4 and/or S/A5 located in the Steel/Aluminum category of listing above).						
7. Any support for exempt non-structural components given in CBC Section 1617A.1.18 (which replaces ASCE 7-16, Section 13.1.4) meeting the						
following: A) when supported on a floor/roof, <400# and resulting composite center of mass (including component's center of mass) ≤4' above supporting floor/roof, B) when hung from a wall or roof/floor, <20# for discrete units or <5 plf for distributed systems.						
supporting floor, both both a wall of foot, floor, 120% for discrete arms of 13 ph for distributed systems.						
DIVISION OF THE STATE ARCHITECT DEPARTMENT OF GENERAL SERVICES STATE OF CALIFORNIA	DIVISION OF THE STATE ARCHITEC		OF GENERAL SERVICES STATE OF CALI			GENERAL SERVICES STATE OF CALIFORNIA
DGS DSA 103-22 (Revised 12/01/2022) Page 4 of 6	DGS DSA 103-22 (Revised 12/01/2	2022) P:	age 5 of 6	DGS DSA 103-22 (Revised 12/01/20	022) Pag	e 6 of 6
		<b></b>	00A 400 FORMO CUIONAL CUI			
			SA 103 FORMS SHOWN ON			
			RE FOR ILLUSTRATION			
			LY. A SEPARATE DSA 103 FORM			
			LETED FOR EACH PROJECT			
		SPECIFIC APPLI	CATION THAT THIS PC IS BEING			

INCORPORATED INTO. THE DSA 103 FORM IS TO BE COMPLETED BY THE ARCHITECT OF RECORD FOR THE OVERALL SCOPE OF WORK ON THE PROJECT SPECIFIC APPLICATION. MODULAR BUILDING MANUFACTURER (OR DESIGN BUILD CONTRACTOR) IS ONLY RESPONSIBLE FOR COMPLETING DSA103 FORM ON STOCKPILE PROJECTS. THE SAMPLE DSA 103 FORM SHALL BE CROSSED OUT ON THIS DRAWING.

STATE AGENCY APPROVAL IDENTIFICATION STAMP DIV. OF THE STATE ARCHITECT APP: 02-121945 INC: REVIEWED FOR SS 🗹 FLS 🗹 ACS 🗹 DATE: 12/12/2023



15345 FAIRFIELD RANCH RD - SUITE 160 CHINO HILLS, CA 91709 OFFICE: (909) 740-3120, FAX: (909) 726-9470 WEBSITE: WWW.SKCCOMPANY.COM MANUFACTURER #MF1279666 DEALER # DL1279666 GC LIC # 992118 DEALER # DL1279666 SBE CERTIFIED


ALL DESIGNS INDICATED ON THESE PLANS/DRAWINGS ARE PROPERTY OF SKC, INC AND ARE FOR THE USE BY SKC IN THE SPECIFIED JOB ONLY. THEY SHALL NOT BE USED AND/OR DUPLICATED OR TRANSMITTED IN ANY FORM, FOR ANY PURPOSE WITHOUT THE PRIOR WRITTEN CONSENT OF SKC, INC. ANY UNAUTHORIZED USE OF THESE PLANS SHALL SUBJECT THE OWNER OF SAID PROPERTY TO LIQUIDATED DAMAGES OF \$75,000.00. THESE PLANS ARE PROTECTED UNDER THE PROVISIONS OF THE 1976 COPYRIGHT ACT COPYRIGHT SKC, © ALL RIGHTS RESERVED.

DISTRICT/CUSTOMER NAME:

SCHOOL/SITE NAME:

SHEET TITLE:

DSA 103 TEST & SPECIAL INSPECTIONS SAMPLE

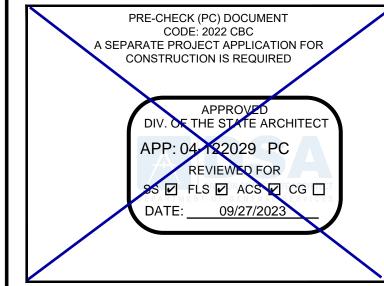

PROFESSIONAL OF RECORD ON PC



PROJECT SPECIFIC PROFESSIONAL OF RECORD

LODI UNIFIED SCHOOL DISTRICT MILLSWOOD MIDDLE SCHOOL PORTABLE RELOCATION DSA APP# 02-121945 FILE No.: 39-50 PTN: 68585-261

FIRM:		
ADDRESS: CITY:		
PHONE:		
	REVISIONS	
_1 -		
<u></u>		
_4 -		
5 -		
PROJECT NO.:	00-0000	
DRAFTER:	00	
SCALE:	AS NOTED	
DATE:	00-00-00	
	SHEET NOMBER	

# **GENERAL NOTES**

### **GENERAL NOTES**

- ALL CONSTRUCTION SHALL COMPLY WITH THE 2022 EDITION OF THE CALIFORNIA BUILDING CODE, CCR TITLE 24, PART 2 (CBC) AND CCR TITLE 24, PART 1, CHAPTER 4, GROUP 1. LATEST REVISIONS.
- THE CONTRACTOR SHALL BE RESPONSIBLE FOR THE SAFETY OF THE BUILDING DURING CONSTRUCTION AND SHALL PROVIDE ADEQUATE SHORING AND BRACING DURING CONSTRUCTION. CONTRACTOR SHALL COMPLY WITH APPLICABLE SAFETY REGULATIONS
- DETAILS NOT SPECIFICALLY SHOWN SHALL BE CALLED TO THE ATTENTION OF THE MANUFACTURER OR DESIGN PROFESSIONAL AND DSA.
- THE CONTRACTOR SHALL COORDINATE THE WORK OF ALL TRADES AND SHALL CHECK ALL DIMENSIONS. ANY DISCREPANCIES SHALL BE CALLED TO THE ATTENTION
- OF THE OWNER AND BE RESOLVED BEFORE PROCEEDING WITH THE WORK. NO STRUCTURAL MEMBERS SHALL BE CUT, NOTCHED OR OTHERWISE PENETRATED UNLESS SPECIFICALLY APPROVED BY THE STRUCTURAL ENGINEER IN ADVANCE OR SHOWN ON THESE DRAWINGS
- TYPICAL DETAILS SHALL APPLY UNLESS SHOWN OTHERWISE ON THE DRAWINGS. WHERE THESE GENERAL NOTES AND TYPICAL DETAILS ARE IN CONFLICT WITH THE
- CUSTOMER SPECIFICATIONS, THESE GENERAL NOTES AND TYPICAL DETAILS SHALL GOVERN.
- NOT USED REFER TO ARCHITECTURAL DRAWINGS FOR DIMENSIONS AND OTHER INFORMATION
- NOT SPECIFICALLY SHOWN ON STRUCTURAL DRAWINGS 10. ALL ELEVATIONS ARE REFERENCED FROM TOP OF FINISHED FIRST FLOOR ELEVATION
- 11. NOT USED
- 12. NOT USED
- 13. DIMENSIONS AND ELEVATIONS SHOWN ARE APPROXIMATE AND ARE PROVIDED AS AN AID IN INTERPRETING THE DRAWINGS ONLY. DIMENSIONS AND ELEVATIONS MUST BE VERIFIED WITH ARCHITECTURAL DRAWINGS. IN THE EVENT OF CONFLICT, DIMENSIONS AND ELEVATIONS SHOWN ON ARCHITECTURAL DRAWINGS SHALL GOVERN. DRAWING SCALES GIVEN ARE APPROXIMATE - DO NOT SCALE PLANS OR DETAILS
- 14. NOT USED

- 1. STRUCTURAL FRAMING SHALL BE HEM FIR GRADED IN ACCORDANCE WITH THE STANDARD GRADING RULES OF THE WESTERN WOOD PRODUCTS ASSOCIATION OR STANDARD GRADING RULES #17 OF THE WEST COAST LUMBER INSPECTION BUREAU, LATEST EDITIONS. GRADES SHALL BE AS FOLLOWS UNLESS NOTED OTHERWISE ON THE DRAWINGS. (HEM FIR NORTH IS NOT ALLOWED.) EACH PIECE SHALL BE GRADE MARKED AND NO PIECE MAY FALL BELOW GRADES INDICATED. ALL FRAMING EXCEPT AS NOTED HEM FIR #2
- PLYWOOD SHALL BE AS SHOWN ON THESE DRAWINGS WITH EXTERIOR GLUE IN ACCORDANCE WITH U.S. PRODUCT STANDARD PS 1-19, ALL PANELS SHALL BE MARKED WITH AN APA GRADE MARK WITH AN IDENTIFICATION INDEX AS SHOWN ON DRAWINGS.
- LAG SCREWS SHALL BE STEEL AND CONFORM TO ANSI/ASME STANDARD B18.2.1 AND THE REQUIREMENTS OF THE 2018 NATIONAL DESIGN SPECIFICATION FOR WOOD CONSTRUCTION (NDS). HOLES FOR LAG SCREW SHANKS SHALL BE BORED THE SAME DEPTH AND DIAMETER AS THE SHANK. THE REMAINING DEPTH OF PENETRATION OF THE SCREW SHALL BE BORED TO 70% OF THE SHANK DIAMETER. ONE QUARTER INCH (1/4") DIAMETER LAG SCREWS NEED NOT HAVE PRE-DRILLED HOLES IF IT CAN BE SHOWN THAT THE WOOD MEMBERS ARE NOT DAMAGED DURING INSTALLATION. PROVIDE FULL BODY DIAMETER LAG SCREWS WITH BENDING YIELD STRENGTHS PER THE 2018 NDS.
- PROVIDE MALLEABLE IRON WASHERS OR EQUIVALENT CUT PLATE WASHERS (NOT LESS THAN A STANDARD CUT WASHER) UNDER NUTS AND BOLT OR LAG SCREW HEADS WHICH BEAR ON WOOD.
- WOOD SCREWS SHALL CONFORM TO ANSI/ASME STANDARD B18.6.1 AND THE REQUIREMENTS OF THE 2018 NATIONAL DESIGN SPECIFICATION FOR WOOD CONSTRUCTION (NDS). GALVANIZED OR OTHER CORROSION RESISTANT COATING WHERE EXPOSED TO WEATHER OR USED IN FOUNDATIONS. SCREWS SHALL BE STEEL WITH CUT THREADS AND BENDING YIELD STRENGTHS NDS.
- WOOD MEMBERS SHALL BE CUT OR NOTCHED ONLY AS SHOWN ON STRUCTURAL DRAWINGS
- WHEN REQUIRED NAILING TENDS TO SPLIT WOOD MEMBERS, NAIL HOLES SHALL BE PRE-BORED TO 3/4 OF THE NAIL DIAMETER.
- STRUCTURAL NAILING SHALL BE WITH FULL HEAD COMMON NAILS PER ALL REQUIREMENTS OF THE 2018 NDS. NAILING NOT SPECIFICALLY INDICATED SHALL COMPLY WITH CCR TITLE 24, PART 2, TABLE 2304.10.2. ALL NAILS SHALL BE GALVANIZED OR OTHER CORROSION RESISTANT COATING WHERE EXPOSED TO WEATHER, IN FOUNDATIONS AND AS NOTED ON PLANS, PER THE REQUIREMENTS OF CCR TITLE 24, PART 2, WITH MINIMUM BENDING YIELDS PER THE 2018 NDS. (SEE NAIL EQUIVALENCE BELOW.)
- NAIL EQUIVALENCE: (PROVIDE MINIMUM NAIL LENGTHS AS REQUIRED FOR SPECIFIED PENETRATION, TYP UNO) 6d EQUALS .113"Ø - PROVIDE 1.36" MIN POINT PENETRATION 8d EQUALS .131"Ø - PROVIDE \*1.57" MIN POINT PENETRATION 10d EQUALS .148"Ø -PROVIDE \*1.78" MIN POINT PENETRATION 16d EQUALS .162"Ø - PROVIDE \*1.94" MIN POINT PENETRATION \* 1 1/2" AT 2x MEMBERS
- EXCEPT WHERE MORE STRINGENT CONSTRUCTION IS SHOWN ON THE DRAWINGS, WOOD CONSTRUCTION SHALL COMPLY WITH TITLE 24, PART 2, SECTION 2308, CONVENTIONAL LIGHT-FRAME CONSTRUCTION PROVISIONS, AS A MINIMUM
- PRESSURE PRESERVATIVE TREATMENT SHALL BE PER SECTION 2303.1.9, CCR TITLE 24, PART 2. PROVIDE QUALITY MARK ON ALL TREATED FOUNDATION MEMBERS FROM AGENCY LISTED BY AN ACCREDITATION BODY THAT COMPLIES WITH THE REQUIREMENTS OF THE AMERICAN LUMBER STANDARDS TREATED WOOD PROGRAM. ALL FOUNDATION MEMBERS SHALL BE IDENTIFIED PER SECTION 2303.1.9.1. TREAT ALL CUT ENDS OF PRESSURE TREATED MEMBERS WITH AN APPROVED PRESERVATIVE. (WILLARD W/B COPPER GREEN 2% OR AN APPROVED EQUIVALENT).
- 12. MACHINE NAILING IS SUBJECT TO APPROVAL BY THE STRUCTURAL ENGINEER OR ARCHITECT AND THE DIVISION OF THE STATE ARCHITECT.
- 13. POWDER DRIVEN FASTENERS SHALL BE BY HILTI, INC, HILTI FASTENING SYSTEMS OR EQUAL. INSTALL IN ACCORDANCE WITH DRAWINGS AND THE MANUFACTURER'S RECOMMENDATIONS AND ICC APPROVALS
- 14. FASTENERS FOR PRESSURE-PRESERVATIVE TREATED WOOD SHALL COMPLY WITH SECTION 2304.10.6 OF CBC
- 15. NAILS AND SPIKES USED IN WET OR EXTERIOR LOCATIONS SHALL COMPLY WITH SECTION 2304.10.2.1 OF CBC

## STRUCTURAL STEEL:

- NOT USED
- NOT USED
- NOT USED ALL WELDING SHALL BE IN ACCORDANCE WITH THE REQUIREMENTS OF THE CALIFORNIA BUILDING CODE (CBC) AND THE STRUCTURAL WELDING CODE - STEEL, AWS D1.1, 2015 EDITION OF THE AMERICAN WELDING SOCIETY. WELDING DONE BY SHIELDING ELECTRIC-ARC OR FLUX-CORED PROCESS COMPLYING WITH AWS.
- FABRICATION AND ERECTION OF STRUCTURAL AND MISCELLANEOUS STEEL SHALL BE IN ACCORDANCE WITH THE REQUIREMENTS OF THE 2016 EDITION OF THE SPECIFICATION FOR STRUCTURAL STEEL BUILDINGS OF THE AMERICAN INSTITUTE OF STEEL CONSTRUCTION (AISC) (CBC CHAPTER 22A). ALSO COMPLY WITH REQUIREMENTS OF THE AISC CODE OF STANDARD PRACTICE FOR STEEL BUILDINGS AND BRIDGES. TEMPORARY BRACING IS REQUIRED AS NEEDED UNTIL ALL ELEMENTS SHOWN ON STRUCTURAL DRAWINGS ARE IN
- PRIME ALL STEEL SURFACES WITH AN APPROVED PRIMER, EXCEPT SURFACES TO BE EMBEDDED IN CONCRETE AND SURFACES TO RECEIVE FIELD WELDS. TOUCH-UP FIELD WELDS AND OTHER EXPOSED STEEL SURFACES AFTER ERECTION. ALTERNATE: PROVIDE GALVANIZED PER ASTM A-123.

## ANGLES, MISC STEEL

RUSH-INHIBITING PRIMER

WEDLING CODE AWS D1.1

MATERIALS:

ASTM A36

ASTM A-572 GRADE 50 WELDING ELECTRODES AWS STRUCTURAL STEEL E70XX.

8. QUALIFIED AND CERTIFIED WELDERS SHALL BE USED FOR ALL WELDING. ALL WELDING TO

CONFORM TO THE 2015 EDITION OF THE AMERICAN WELDING SOCIETY STRUCTURAL

TYPICAL STEEL CONNECTION BOLTS

ASTM A307 GRADE A

ASTM A-500 GRADE B (Fv = 46 KSI)

**RECTANGULAR HSS MEMBERS** 

- 10. CONNECTED MEMBERS SHALL BEAR ONLY UPON UNTHREADED PORTIONS OF BOLTS
- 11. BURNING OF HOLES IS NOT ALLOWED 12. NOT USED
- 13. THE STRUCTURAL STEEL FABRICATOR SHALL SUBMIT SHOP DRAWINGS TO THE ENGINEER
- FOR APPROVAL PRIOR TO FABRICATION
- 14. BOLT HOLES SHALL BE 1/16" LARGER IN DIAMETER THAN NOMINAL SIZE OF BOLTS USED, UNO

## COLD FORMED STRUCTURAL STEEL

- NOT USED
- NOT USED
- CORROSION PROTECT PER TABLE A4-1 BELOW GALVANIZED COATINGS MUST MEET ASTM A-525 SPECIFICATIONS
- CARBON SHEET STEEL MUST MEET THE MINIMUM REQUIREMENTS OF ASTM A-1011 SS GRADE 55 & 33 GRADE 55 KSI FOR 10, 12, 14, AND 16 GAUGE AND GRADE 33 KSI FOR 18 GAUGE AND LIGHT MEMBERS UON. CARBON SHEET STEEL PRODUCTS MUST BE THOROUGHLY COATED WITH A RUST INHIBITIVE PAINT.
- 6. ALL STRUCTURAL MEMBERS SHALL BE DESIGNED IN ACCORDANCE WITH AMERICAN IRON AND STEEL INSTITUTE (AISI) NORTH AMERICAN SPECIFICATION FOR THE DESIGN OF COLD-FORMED STRUCTURAL STEEL MEMBERS LATEST ADOPTED EDITION AISI S100-16 (2020) W/S2-20.
- NOT USED NOT USED
- FASTENINGS OF COMPONENTS SHALL BE WITH SELF-DRILLINGS SCREWS OR WELDING. SCREWS OR WELDS SHALL BE SUFFICIENT SIZE TO INSURE THE STRENGTH OF THE CONNECTION. ALL WELDS OF GALVANIZED STEEL SHALL BE TOUCHED UP WITH ZINC-RICH PAINT. ALL WELDS OF CARBON SHEET STEEL SHALL BE TOUCHED UP
- NOT USED
- PROVIDE SHOP DRAWINGS INDICATING MEMBERS GAUGES, SHAPES, SIZES, SPACING,
- LOCATIONS AND CONNECTIONS 12. STUDS SHALL BE INSTALLED WITH THEIR BEARING ENDS POSITIONED FLUSH AGAINST THE INSIDE TRACK WEB.
- 13. NOT USED 14. NOT USED
- 15. N/A
- 16. NOT USED
- ALL SHEET METAL SCREWS SHALL BE THREAD FORMING OR THREAD CUTTING, WITH OR WITHOUT A SELF-DRILLING POINT PER AISI
- 18. ALL WELDING OR MATERIAL LESS THAN 0.18 INCHES IN THICKNESS SHALL BE MADE IN ACCORDANCE WITH THE AWS D1.3 WELDERS AND WELDING PROCEDURES AND SHALL BE QUALIFIED AS SPECIFIED IN AWS D1.3
- 19. TOUCH UP COLD GALVANIZING USING ZRC CHEMICAL PRODUCTS CO.M, ZRC COLD GALVANIZING COMPOUND OR EQUAL
- 20. SPLICES IN STUDS SHALL NOT BE PERMITTED

STRUCTURAL MEMBERS UTILIZED IN COLD-FORMED STEEL FRAMED CONSTRUCTION SHALL HAVE A PROTECTIVE COATING AS SPECIFIED IN TABLE A4-1

### TABLE A4-1 COATING DESIGNATIONS

00471110	COATING	MINIMUM COATING REQUIREMENTS			
COATING CLASSIFICATION	COATING DESIGNATOR	ZINC COATED <sup>A</sup> OZ/FT <sup>2</sup> (G/M <sup>2</sup> )	ZINC IRON <sup>B</sup> OZ/FT <sup>2</sup> (G/M <sup>2</sup> )	55% AL-ZINC° OZ/FT²(G/M²)	ZINCE-5% <sup>D</sup> OZ/FT <sup>2</sup> (G/M <sup>2</sup> )
METALLIC	CP 60	G60 [Z180]	A60 [F180]	AZ50 [AZM1850]	CF30 [ZGF90]
COATED	CP 90	G90 [Z275]	NOT APPLICABLE	AZ50 [AZM1850]	CF45 [ZGF135]
PAINTED METALLIC	PM	THE METALLIC COATED SUBSTRATE SHALL MEET THE REQUIREMENTS OF METALLIC COATED. IN ADDITION, THE PAINT FILM SHALL HAVE A MINIMUM THICKNESS OF 0.5 MIL PER SIDE (PRIMER PLUS TOPCOAT) WITH A MINIMUM PRIMER THICKNESS OF 0.1 MIL PER SIDE			

- A ZINC-COATED STEEL SHEET AS DESCRIBED IN ASTM A653/A653M <sup>B</sup> ZINC-IRON ALLOY-COATED STEEL SHEET AS DESCRIBED IN ASTM A653/A653M
- © 55% ALLIMINUM-ZINCE ALLOY COATED STEEL SHEET AS DESCRIBED IN ASTM A792/A792M ZINCE-5% ALUMINUM ALLOY-COAED STEEL SHEET AS DESCRIBED IN ASTM A875/A875M
- E IN ACCORDANCE WITH THE REQUIREMENTS OF ASTM A1003/A1003M
- ADDITIONAL CORROSION PROTECTION SHALL NOT BE REQUIRED ON EDGES OF METALLIC-COATED STEEL FRAMING MEMBERS, SHOP OR FIELD CUT, PUNCHED OR DRILLED
- UNLESS ADDITIONAL CORROSION PROTECTION IS PROVIDED, FRAMING MEMBERS SHALL BE LOCATED WITHIN THE BUILDING ENVELOPE AND SHIELDED FROM DIRECT CONTACT WITH MOISTURE FROM THE GROUND OR THE OUTDOOR CLIMATE

15345 FAIRFIELD RANCH RD - SUITE 160 CHINO HILLS, CA 91709 OFFICE: (909) 740-3120, FAX: (909) 726-9470 WEBSITE: WWW.SKCCOMPANY.COM MANUFACTURER #MF1279666 DEALER # DL1279666 GC LIC # 992118 DEALER # DL1279666 SBE CERTIFIED

STATE AGENCY APPROVAL

**IDENTIFICATION STAMP** DIV. OF THE STATE ARCHITEC

REVIEWED FOR

SS 🗹 FLS 🗹 ACS 🗹

12/12/2023

APP: 02-121945 INC:


ALL DESIGNS INDICATED ON THESE PLANS/DRAWINGS ARE PROPERTY OF SKC, INC AND ARE FOR THE USE BY SKC IN THE SPECIFIED JOB ONLY. THEY SHALL NOT BE USED AND/OR DUPLICATED OR TRANSMITTED IN ANY FORM. FOR ANY PURPOSE WITHOUT THE PRIOR WRITTEN CONSENT OF SKC, INC. ANY UNAUTHORIZED USE OF THESE PLANS SHALL SUBJECT THE OWNER OF SAID PROPERTY TO LIQUIDATED DAMAGES OF \$75,000,00. THESE PLANS ARE PROTECTED UNDER THE PROVISIONS OF THE 1976 COPYRIGHT ACT COPYRIGHT SKC, © ALL RIGHTS RESERVED.

DISTRICT/CUSTOMER NAME:

SCHOOL/SITE NAME

SHEET TITLE:

## CONSTRUCTION SPECIFICATIONS AND NOTES

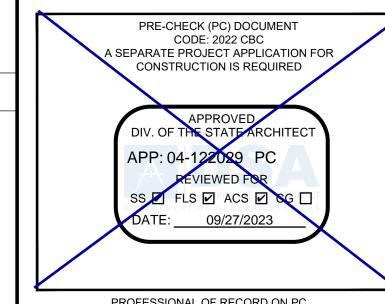

PROFESSIONAL OF RECORD ON PC



PHONE: (858) 679-1974 PROJECT SPECIFIC PROFESSIONAL OF RECORD

LODI UNIFIED SCHOOL DISTRICT MILLSWOOD MIDDLE SCHOOL PORTABLE RELOCATION DSA APP# 02-121945 FILE No.: 39-50

FIRM: ADDRESS:		
CITY: PHONE:		
	REVISIONS	
1 -		
_2 -		
<u></u>		
4 -		
5 -		
PROJECT NO.:	00-0000	
DRAFTER:	00	
SCALE:	AS NOTED	
DATE:	00-00-00	
	SHEET NUMBER	

# **ACCEPTABLE FASTENERS:**

SELF-TAPPING SCREWS SECT 3.2.12 ASTM C1513 SELF-DRILLING SCREWS SECT 3.2.9 ASTM C1513 SELF-PIERCING SCREWS SECT 3.2.9 ASTM C1513

REFERENCE ASTM C1513, STANDARD SPECIFICATION FOR TAPPING SCREWS FOR COLD-FORMED STEEL FRAMING

REFERENCE AISI S400-20, NORTH AMERICAN STANDARD FOR SEISMIC DESIGN

FASTENERS MANUFACTURED WITH CARBON STEEL WIRE SHALL CONFORM TO ASTM A510

TESTING - THE OPERATOR, TOOL, AND FASTENER SHALL BE PRE-QUALIFIED BY THE PROJECT INSPECTOR. HE SHALL OBSERVE THE TESTING OF THE FIRST 10 FASTENER INSTALLATIONS. A TEST "PULL-OUT" LOAD OF NOT LESS THAN TWICE THE DESIGN LOAD SHALL BE APPLIED TO THE PIN IN SUCH A MANNER AS NOT TO RESIST THE SPALLING TENDENCY OF THE CONCRETE SURROUNDING THE PIN. THEREAFTER, RANDOM TEST UNDER THE PROJECT INSPECTOR'S SUPERVISION SHALL BE MADE OF APPROXIMATELY 1 IN 10 PINS. IF ANY PIN FAILS TESTING, TEST ALL PINS OF THE SAME CATEGORY NOT PREVIOUSLY TESTED UNTIL TWENTY (20) CONSECUTIVE PASS, THEN RESUME THE INITIAL TESTING FREQUENCY.

# **ACCESS NOTES**

- RAMPS HAVING SLOPES STEEPER THAN 1 VERTICAL TO 20 HORIZONTAL SHALL HAVE LANDINGS AT TOP AND BOTTOM AND AT LEAST ONE INTERMEDIATE LANDING SHALL BE PROVIDED FOR EACH 30" RISE OF RISE PER CBC 11B-405.7
- 2. LOCATION OF LANDINGS LANDINGS SHALL BE PROVIDED AT THE TOP AND BOTTOM OF EACH RAMP. INTERMEDIATE LANDINGS SHALL BE PROVIDED A INTERVALS NOT EXCEEDING 30" OF VERTICAL RISE AND AT EACH CHANGE OF DIRECTION. LANDINGS ARE NOT CONSIDERED IN DETERMINING THE MAXIMUM HORIZONTAL DISTANCE OF EACH RAMP EXAMPLES OF RAMP DIMENSIONS:

SLOPE:	MAX RISE (INCHES):	MAX HORIZONTAL PROJECTION:
1:12	30	30'-0"
1:15	30	37'-6"
1:16	30	40'-0"

SIZE OF LANDINGS SHALL NOT BE LESS THAN 60" WIDE AND SHALL HAVE A LENGTH OF NOT LESS THAN 60" IN THE DIRECTION OF THE RAMP RUN PER CBC 11B-405.7.2 & 11B-405.7.3. AT THE BOTTOM LANDING OR LANDING AT CHANGE OF RAMP DIRECTION, THE LANDING SHALL SLOPE 1:48 MAX AND EXTEND MIN 72" IN THE DIRECTION OF THE RAMP

- 3. DOORS IN ANY POSITION SHALL NOT BE REDUCE THE MINIMUM DIMENSIONS OF THE LANDING TO LESS THAN 42" AND SHALL NOT REDUCE THE REQUIRED WIDTH BY MORE THAN 3" WHEN FULLY OPENED PER CBC 11B-405.7.5

4. RAMPS SHALL BE CONSTRUCTED AS REQUIRED. ALL REQUIREMENTS SHALL CONFORM TO CBC 11B-405

- 5. THE SURFACE OF RAMPS, LANDING & STAIRS SHALL BE ROUGHED OR SHALL BE OF SLIP-RESISTANT MATERIAL WITH A COEFFICIENT OF FRICTION OF 0.6 FOR LANDINGS AND 0.8 FOR RAMP AND
- 6. RAMPS AND STAIRWAY USED AS THE EXIT REQUIRED WIDTH SHALL CONFORM TO CBC SECTION 1009, 1010, CHAPTER 11B & 11B-405.5
- 7. HANDRAILS SHALL CONFORM TO CBC SECTION 11B-405.8 (RAMPS) AND 11B-504.6 (STAIRS)
- 8. STRIKE EDGE EXTENSION THE WIDTH OF THE LANDING SHALL EXTEND 24" PAST THE STRIKE EDGE OF ANY DOOR OR GATE FOR EXTERIOR RAMPS AND 18" PAST THE STRIKE EDGE FOR INTERIOR RAMPS. FOR DOOR SWINGING INTO LANDING, 42" MIN IS REQUIRED PER 11B-405.7.5
- 9. CHANGE IN DIRECTION RAMPS THAT CHANGE DIRECTION BETWEEN RUNS AT LANDING SHALL HAVE A CLEAR LANDING 60" MINIMUM BY 72" MINIMUM IN THE DOWNWARD DIRECTION OF TRAVEL PER CBC 11B-405.7.4 AND 72" MIN REQUIRED AT THE BOTTOM LANDING
- 10. THE WIDTH OF RAMPS SHALL HAVE A MINIMUM WIDTH OF 48" OR AS WIDE AS REQUIRED EXIT WIDTH IF LARGER REQUIRED PER STAIRWAY AND EXITS PER CBC 11B-405.5
- 11. LANDINGS AND RAMPS SHALL BE SLOPED AT 1:48 MAX TO PREVENT THE ACCUMULATION OF WATER ON WALKING SURFACES PER CBC 11B-405.10. SEE CBC 11B-504.7 FOR STAIRS
- 12. SITE CONDITION: DUE TO VARIES SITE CONDITIONS, THE MAXIMUM HEIGHT OF FINISH FLOOR FROM GRADE IS 26". THEREFORE IT IS POSSIBLE THAT THE ACCESS RAMP ATTACHED TO THE COMMON LANDING COULD BE 26'-0". AT A SLOPE OF 1:12, THE ARCHITECT MUST TAKE INTO ACCOUNT THAT THE RAMP SUPPLIED BY SKC COMPANY IS 11'-0". AT A SLOPE OF 1:12 THE ARCHITECT WILL HAVE TO DESIGN AND PROVIDE SUFFICIENT DETAILS OF RAMP EXTENSIONS AND BOTTOM LANDING DEPENDING ON PARTICULAR SITE CONDITIONS ICS WILL NOT BE RESPONSIBLE FOR ANY RAMP EXTENSION EXCEEDING ORIGINAL PLAN AS SHOWN ON PLANS

