


# TOMBALL HIGH SCHOOL CTE & MISC. RENOVATIONS



Texas ARCADIS Inc.

10205 Westheimer Suite 800  
Houston, TX 77042 USA  
tel 281.286.6605, fax 713.977.4620



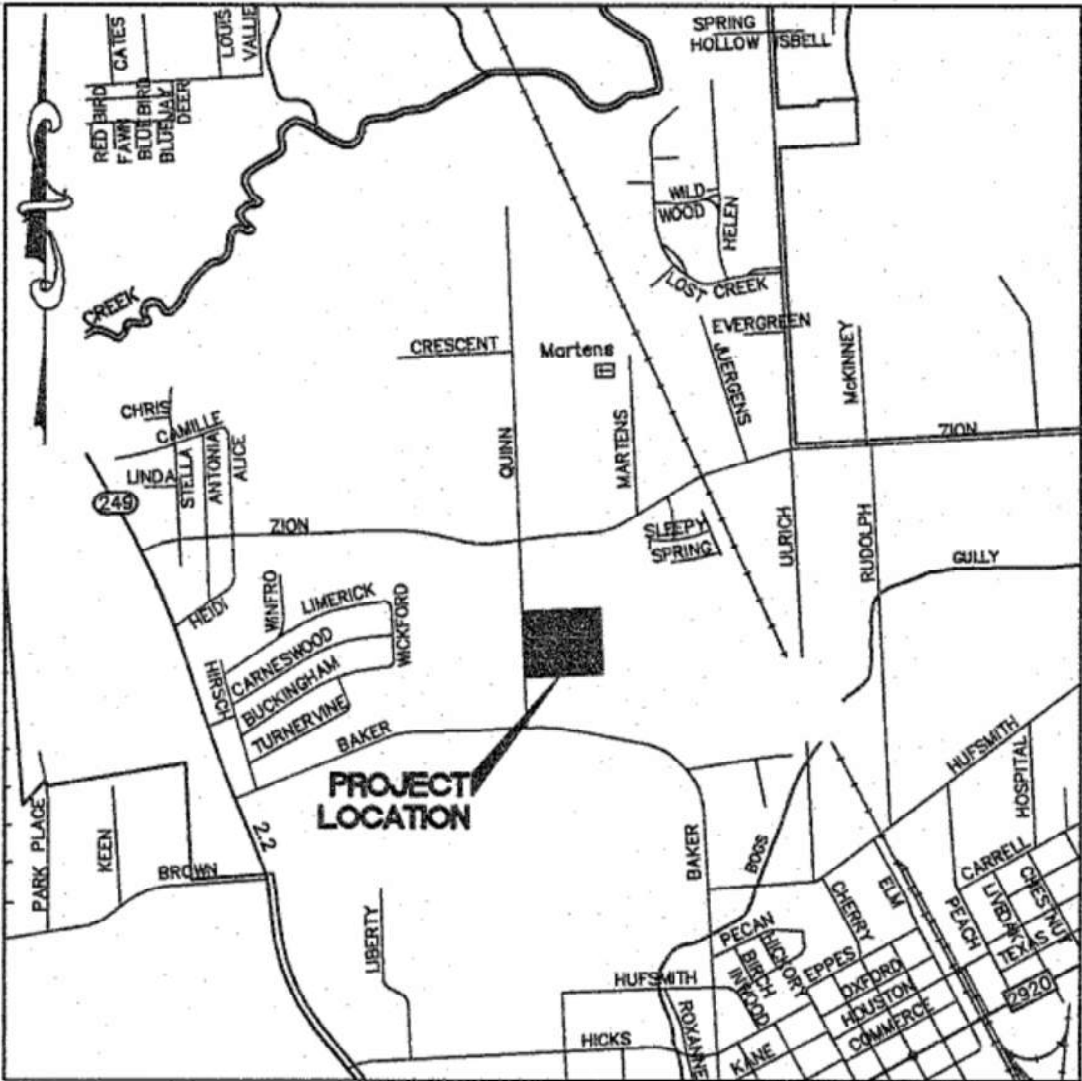
SHEET INDEX	
SHEET #	SHEET NAME
G1.00	GENERAL CODE INFORMATION
G1.01	CODE ANALYSIS
G1.02	1ST FLOOR LIFE SAFETY PLAN
SV0.01	TOPOGRAPHIC SURVEY
CA0.01	SITE DEMO PLAN
CA1.01	SITE DETAILS
CA1.02	SITE PLAN
C1.00	GENERAL NOTES
C1.01	PLAT
C1.03	SITE DEMOLITION PLAN
C1.04	SITE DIMENSIONAL PLAN
C2.01	CIVIL SITE PLAN
C2.02	SITE EROSION CONTROL PLAN
C2.03	SITE PAVING AND JOINTING PLAN
C2.04	FIRE APPARATUS ACCESS PLAN
C3.00	SITE GRADING PLAN
C4.00	DRAINAGE AND UTILITY PLAN
C7.01	CIVIL DETAILS
C7.02	CIVIL DETAILS
C7.03	CIVIL DETAILS
S0.00	GENERAL NOTES
S0.01	GENERAL NOTES
S0.02	TEST NOTES
S0.03	UPLIFT KEYPLAN
SD1.01	DEMO FOUNDATION PLAN
S1.00	COMPOSITE FOUNDATION PLAN
S1.01	AREA 'A' FOUNDATION PLAN
S1.02	AREA 'B' FOUNDATION PLAN
S2.01	ROOF FRAMING DETAILS
S2.02	FOUNDATION DETAILS
S3.01	FRAMING DETAILS
A0.01	DEMO PLAN
A1.01	1ST FLOOR COMPOSITE PLAN
A2.01	AREA 'A1' 1ST FLOOR PLAN
A2.02	AREA 'B1' 1ST FLOOR PLAN, SCHEDULES, & ENLARGED RESTROOMS
A4.00	ROOF PLAN
A6.00	PARTITION TYPES & WALL SECTIONS
A7.01	ELEVATIONS
A8.00	CASEWORK ELEVATIONS & SECTIONS
A8.01	FRAME ELEVATIONS & OPENING DETAILS
A10.01	AREA 'A' 1ST FLOOR RCP
A10.02	AREA 'B' 1ST FLOOR RCP
A11.00	INTERIOR FINISH PLAN & LEGEND
A12.00	SIGNAGE FLOOR PLAN
A12.01	SIGNAGE DETAILS
M1.01	MECHANICAL DEMOLITION AREA 'A1' 1ST FLOOR PLAN
M2.01	MECHANICAL AREA 'A1' 1ST FLOOR PLAN
M2.02	MECHANICAL AREA 'B1' 1ST FLOOR PLAN
M3.01	MECHANICAL DETAILS AND LEGENDS
M3.02	MECHANICAL DETAILS AND LEGENDS
M4.01	MECHANICAL SCHEDULES
E1.00	ELECTRICAL SITE PLAN
E1.01	ELECTRICAL DEMOLITION AREA 'A1' 1ST FLOOR PLAN
E1.02	ELECTRICAL DEMOLITION AREA 'B1' 1ST FLOOR PLAN
E2.01	ELECTRICAL LIGHTING AREA 'A1' 1ST FLOOR PLAN
E2.02	ELECTRICAL LIGHTING AREA 'B1' 1ST FLOOR PLAN
E3.01	ELECTRICAL POWER AREA 'A1' 1ST FLOOR PLAN
E3.02	ELECTRICAL POWER AREA 'B1' 1ST FLOOR PLAN
E4.01	ELECTRICAL ONE-LINE DIAGRAM
E5.01	ELECTRICAL PANEL SCHEDULES
E5.02	ELECTRICAL PANEL SCHEDULES
E6.01	ELECTRICAL DETAILS AND SCHEDULES
P1.00	PLUMBING SITE PLAN
P1.01	PLUMBING DEMOLITION AREA 'A1' 1ST FLOOR PLAN
P2.01	PLUMBING UNDERFLOOR AREA 'A1' 1ST FLOOR PLAN
P2.02	PLUMBING UNDERFLOOR AREA 'B1' 1ST FLOOR PLAN
P3.01	PLUMBING AREA 'A1' 1ST FLOOR PLAN
P3.02	PLUMBING AREA 'B1' 1ST FLOOR PLAN
P5.01	PLUMBING DETAILS
P6.02	PLUMBING DETAILS
P6.01	PLUMBING SCHEDULES
T0.00	TECHNOLOGY NOTES AND LEGENDS
T1.01	TECHNOLOGY DEMOLITION AREA 'A1' 1ST FLOOR PLAN
T1.02	TECHNOLOGY DEMOLITION AREA 'B1' 1ST FLOOR PLAN
T2.01	TECHNOLOGY AREA 'A1' 1ST FLOOR PLAN
T2.02	TECHNOLOGY AREA 'B1' 1ST FLOOR PLAN
T3.01	TECHNOLOGY ENLARGED PLANS
T4.01	TECHNOLOGY DETAILS
T4.02	TECHNOLOGY DETAILS
T4.03	TECHNOLOGY DETAILS
T4.04	TECHNOLOGY DETAILS

## BOARD OF TRUSTEES


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Mark Lewandowski	Assistant Secretary
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Matt Schiel	Trustee


## ADMINISTRATION

Dr. Martha Salazar-Zamora	Superintendent of Schools
Dr. Amy Schindewolf	Chief of Staff
Dr. Steven Gutierrez	Chief Operating Officer
Dr. Michael Webb	Chief Academic Officer
Jim Ross	Chief Financial Officer
Dr. Mindy Munoz	Asst. Superintendent of Secondary Schools
Dr. George Flores	Asst. Superintendent of Elementary Schools
Dr. Lee Wright	Asst. Superintendent of Stategic Innovation
Mark White	Asst. Superintendent of Accountability
Zachery Boles	Asst. Superintendent of Finance



SITE LOCATION MAP

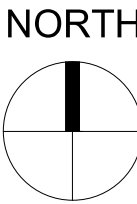

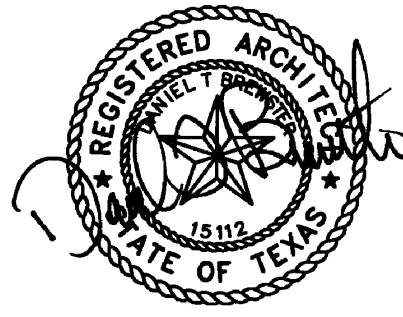

2023-11-06

BID SET

PROJECT #:

202311

DATE:

2023-11-06

DATE:

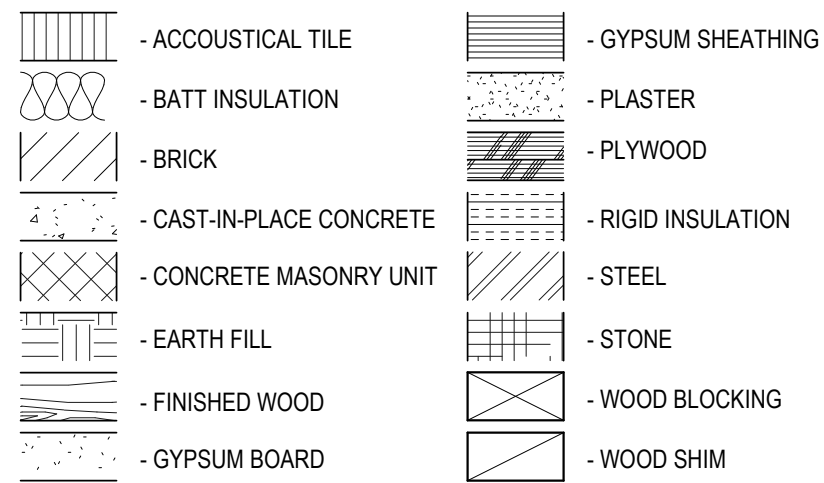
2023-11-06

ISSUE:

BID SET


TOMBALL HIGH SCHOOL CTE & MISC. RENOVATIONS





## 18 GEN - DRAWING LEGEND

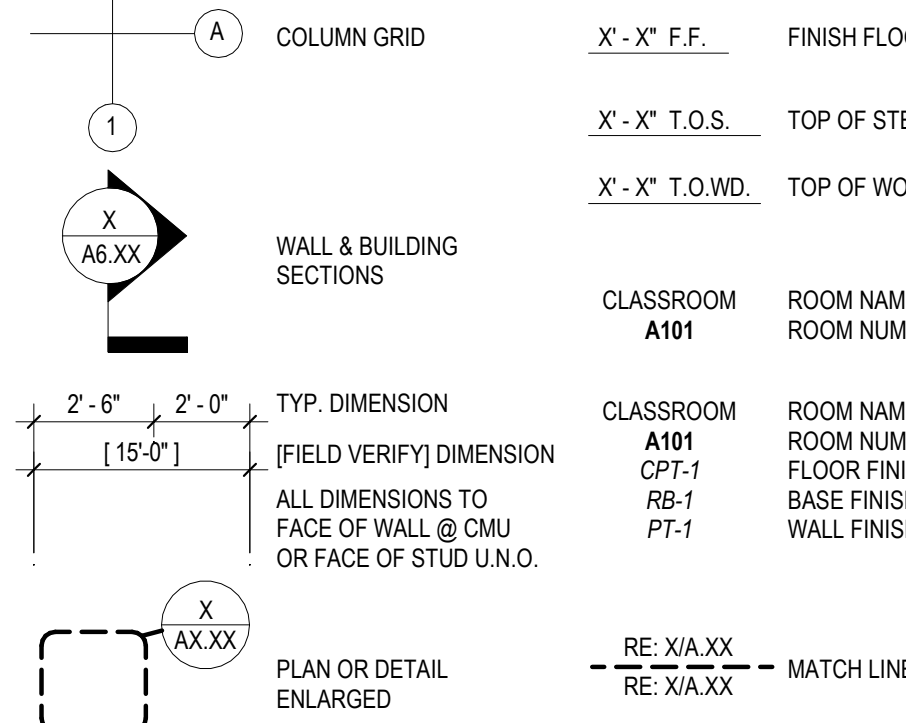3/4" = 1'-0"



## 15 GEN - DRAWING CONVENTIONS

1/4" = 1'-0"

NUMBER OF SEATS	MIN NUMBER OF REQ'D WHEELCHAIR SPACES
4 - 25	1
26 - 50	2
51 - 100	3
101 - 150	4
151 - 200	5
9951 - 10000	201

## 14 ADA - 221 ASSEMBLY AREA

1/4" = 1'-0"

### 219. ASSISTED LISTENING SYSTEMS

CAPACITY OF SEATING IN ASSEMBLY AREA	MIN NUMBER OF REQ'D RECEIVERS	MIN NUMBER OF REQ'D RECEIVERS REQ'D TO BE HEARING-AID COMPATIBLE
50 OR LESS	2	2
51 - 200	2 PLUS 1 PER 25 SEATS OVER 50 SEATS	2
201 - 500	2 PLUS 1 PER 25 SEATS OVER 50 SEATS	1 PER 4 RECEIVERS
501 - 1000	20 PLUS 1 PER 33 SEATS OVER 500 SEATS	1 PER 4 RECEIVERS
1001 - 2000	35 PLUS 1 PER 50 SEATS OVER 1000 SEATS	1 PER 4 RECEIVERS
2001 AND OVER	55 PLUS 1 PER 100 SEATS OVER 2000 SEATS	1 PER 4 RECEIVERS

TABLE 219.3 RECEIVERS FOR ASSISTIVE LISTENING SYSTEMS

## 13 ADA - 219 ASSISTIVE LISTENING SYSTEMS

1/4" = 1'-0"

REACH RANGES	ACCESSIBLE MOUNTING HEIGHTS BY AGE GROUP			
	ADULT	AGE: 9 - 12	AGE: 5 - 8	AGE: 2 - 3
HIGH (MAX)	48"	44"	40"	36"
LOW (MIN)	15"	18"	18"	20"
RAMP AND STAIRS				
TOP OF HANDRAIL GRIPPING SURFACE	34" - 38"	SECOND SET 28" MAX	SECOND SET 28" MAX	SECOND SET 28" MAX
ELEVATORS				
EMERGENCY CONTROL BUTTONS	35" TO C.L.			
CONTROL BUTTONS	48" MAX			
DRINKING FOUNTAINS & WATER COOLERS				
HEIGHT TO SPOUT WHEELCHAIR STANDING	36" - 43"	30" MAX	30" MAX	30" MAX
WATER CLOSETS				
CENTERLINE - WALL HUNG	16" - 18"	15" - 18"	12" - 15"	12"
TOP OF SEAT	17" - 19"	15" - 17"	12" - 15"	11" - 12"
GRAB BARS	33" - 38"	25" - 29"	20" - 25"	18" - 20"
DISPENSER HEIGHT	15" MIN	17" - 19"	14" - 17"	14"
URINALS				
CENTERLINE - WALL HUNG	15" MIN			
TOP OF RIM	17" MAX			
FLUSH CONTROLS	46" MAX	44" MAX		
LAVATORIES AND SINKS				
RIM OR COUNTER SURFACE	34" MAX	31" MAX	31" MAX	
KNEE CLEARANCE	PER 308.2	24" MIN	24" MIN	
SHOWER STALLS				
TOP OF SEAT	17" - 19"	15" - 17"	12" - 15"	11" - 12"
GRAB BARS	33" - 38"	25" - 29"	20" - 25"	18" - 20"
HAND SHOWER HEAD MOUNTING	59" MIN HOSE			
FIXED OR BUILT-IN SEATING & TABLES				
HIGHEST OPERABLE PART	28" - 34"	26" - 30"	26" - 30"	
DRESSING AND FITTING ROOMS				
HANDICAP BENCH MOUNT	17" - 19"			
TOP OF RIM	20" - 24"			
FLUSH CONTROLS	42" MIN			
FOOD SERVICE LINES				
TOP OF TRY SLIDE				
EMERGENCY EYEWASH				
TOP OF COUNTER				
ACTUATOR				

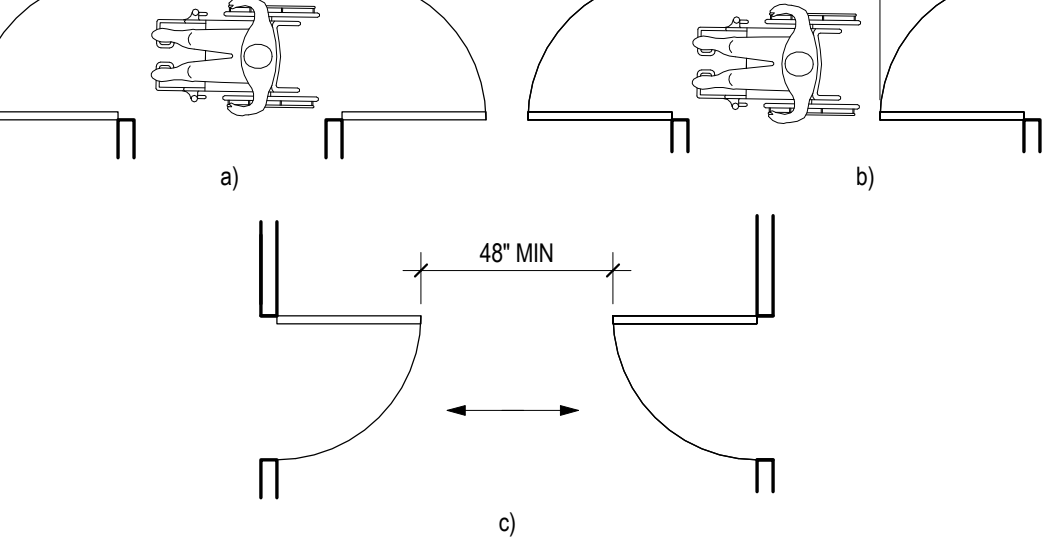
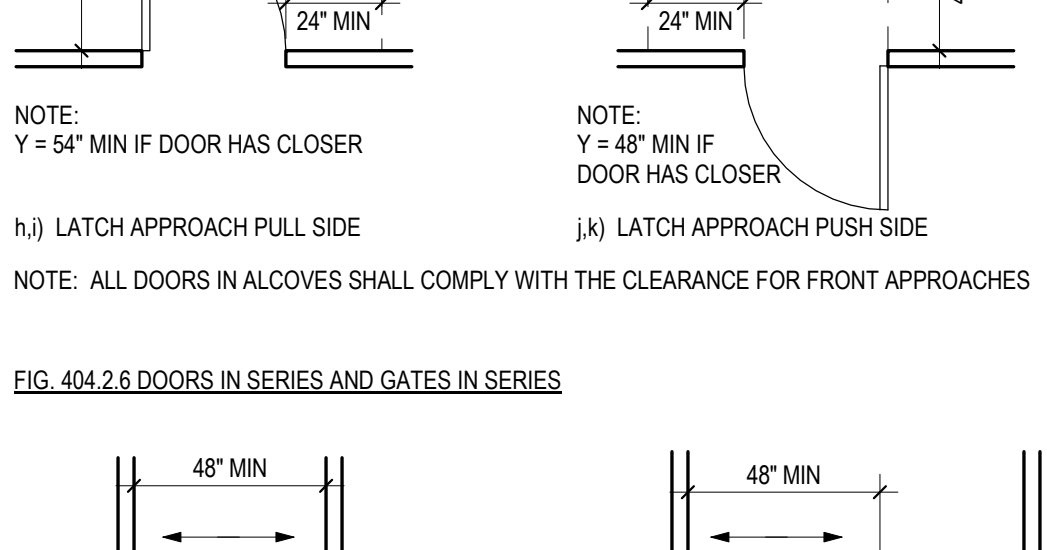
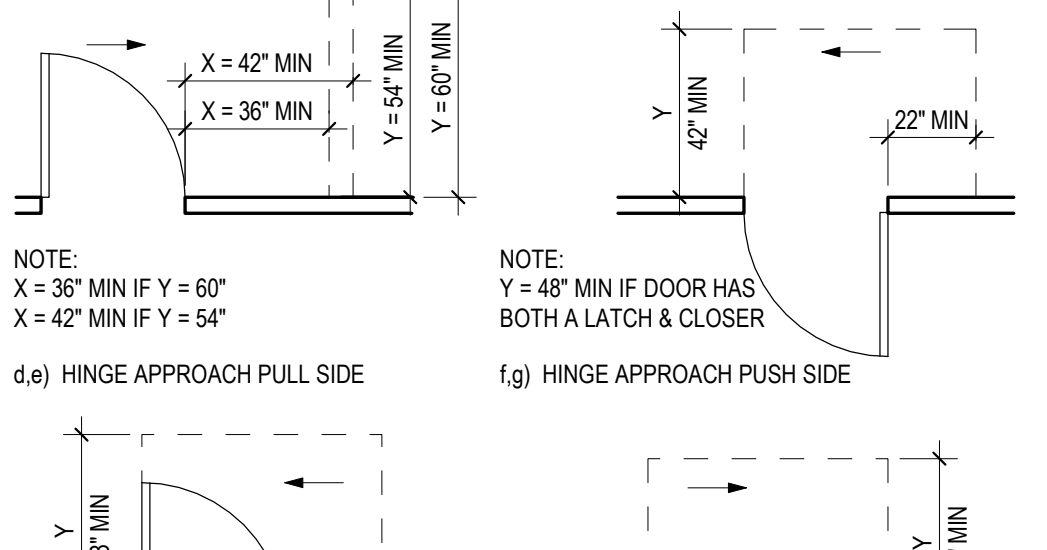
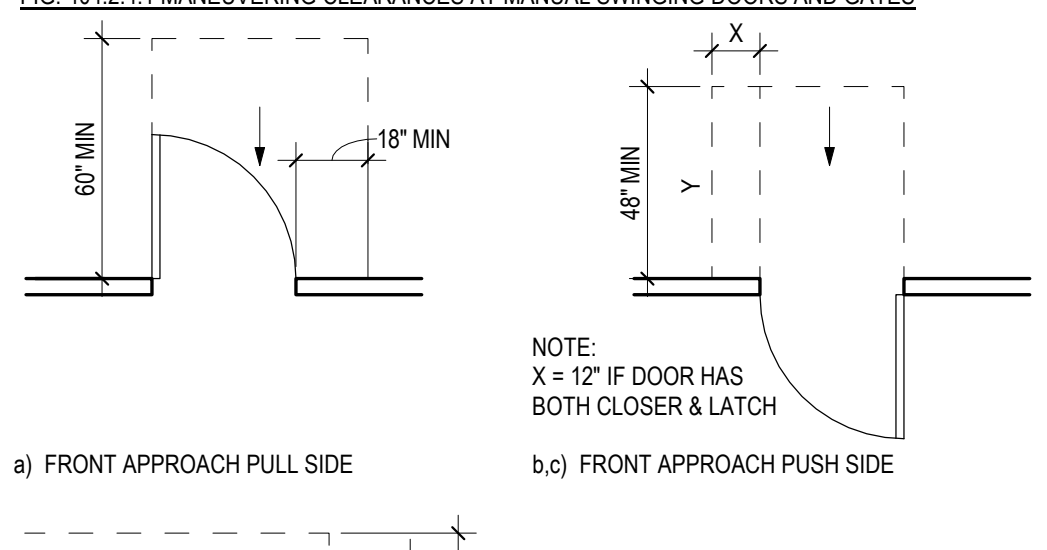
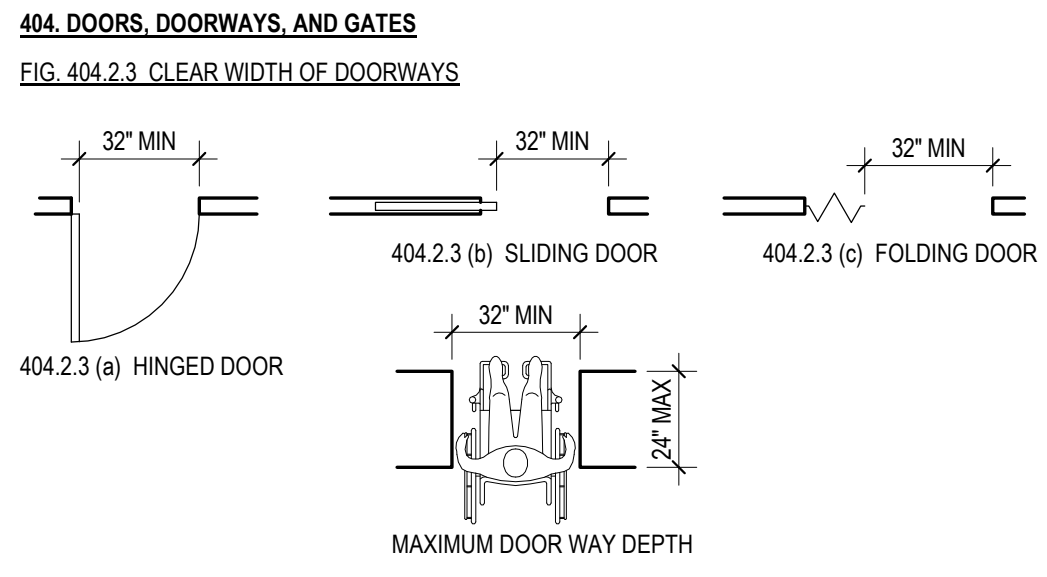
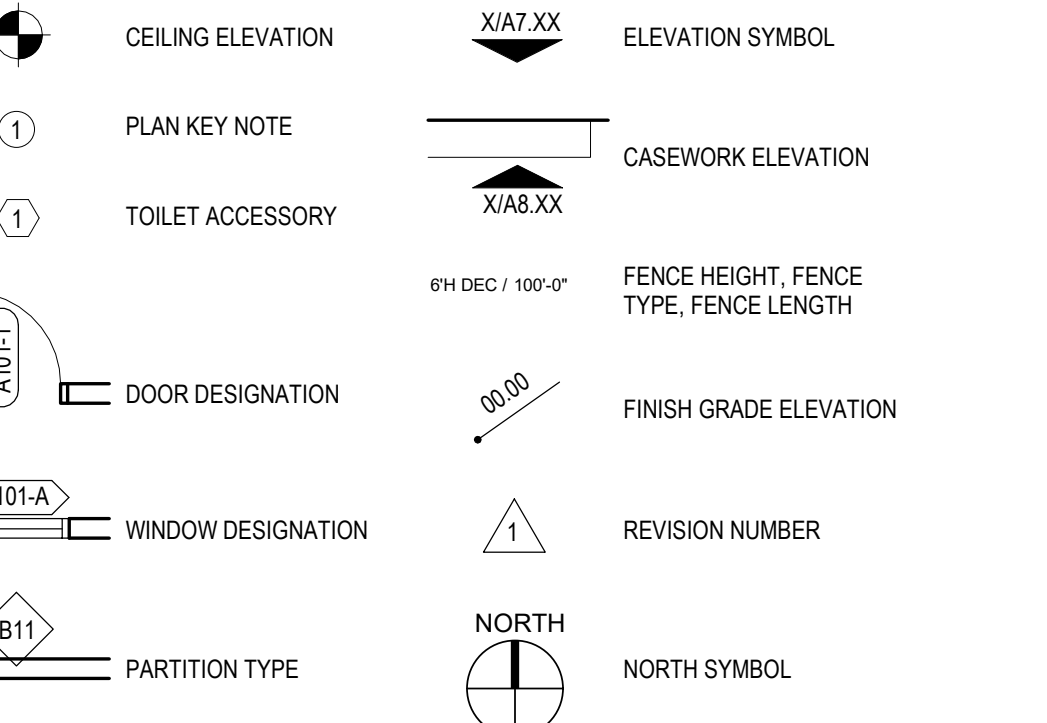
## 6 ADA - ACCESS. MNT. HTS BY AGE

1/4" = 1'-0"

ACT	AED	MEP	LOCKER
A.F.F.	MEP	MEP	MECHANICAL ELECTRICAL PLUMBING
AMP	MEP	MEP	MECHANICAL ELECTRICAL PLUMBING
CC	MEP	MEP	MECHANICAL ELECTRICAL PLUMBING
C.J.	MEP	MEP	MECHANICAL ELECTRICAL PLUMBING
CORR	MEP	MEP	MECHANICAL ELECTRICAL PLUMBING
CPT	MEP	MEP	MECHANICAL ELECTRICAL PLUMBING
CT	MEP	MEP	MECHANICAL ELECTRICAL PLUMBING
C.R.D.	MEP	MEP	MECHANICAL ELECTRICAL PLUMBING
CUST.	MEP	MEP	MECHANICAL ELECTRICAL PLUMBING
D	MEP	MEP	MECHANICAL ELECTRICAL PLUMBING
DW	MEP	MEP	MECHANICAL ELECTRICAL PLUMBING
DWG(S)	MEP	MEP	MECHANICAL ELECTRICAL PLUMBING
EIS	MEP	MEP	MECHANICAL ELECTRICAL PLUMBING
ELEV.	MEP	MEP	MECHANICAL ELECTRICAL PLUMBING
EPK	MEP	MEP	MECHANICAL ELECTRICAL PLUMBING
EQ	MEP	MEP	MECHANICAL ELECTRICAL PLUMBING
FE	MEP	MEP	MECHANICAL ELECTRICAL PLUMBING
FEC	MEP	MEP	MECHANICAL ELECTRICAL PLUMBING
F.R.P.	MEP	MEP	MECHANICAL ELECTRICAL PLUMBING
GALV.	MEP	MEP	MECHANICAL ELECTRICAL PLUMBING
G.F.R.C.	MEP	MEP	MECHANICAL ELECTRICAL PLUMBING
GYP. BD	MEP	MEP	MECHANICAL ELECTRICAL PLUMBING
HC	MEP	MEP	MECHANICAL ELECTRICAL PLUMBING
I.M.	MEP	MEP	MECHANICAL ELECTRICAL PLUMBING
INFO	MEP	MEP	MECHANICAL ELECTRICAL PLUMBING
K.S.	MEP	MEP	MECHANICAL ELECTRICAL PLUMBING
LB.	MEP	MEP	MECHANICAL ELECTRICAL PLUMBING
LVT	MEP	MEP	MECHANICAL ELECTRICAL PLUMBING


## 17 GEN - ABBREVIATIONS

1/4" = 1'-0"



## 5 ADA - 404 DRS, DRWAYS, & GATES

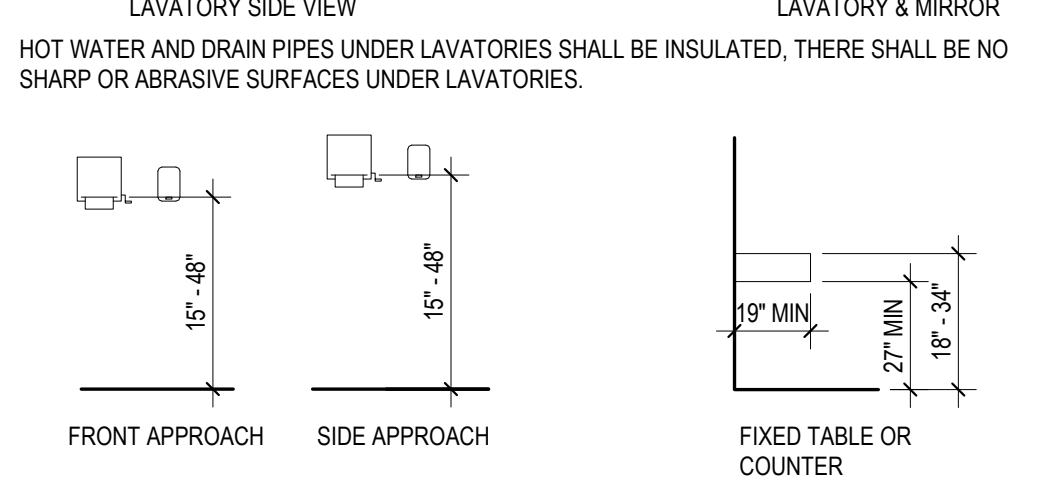1/4" = 1'-0"



### 604. WATER CLOSETS AND TOILET COMPARTMENTS

FIG. 604.3.1 SIZE OF CLEARANCES AT WATER CLOSETS



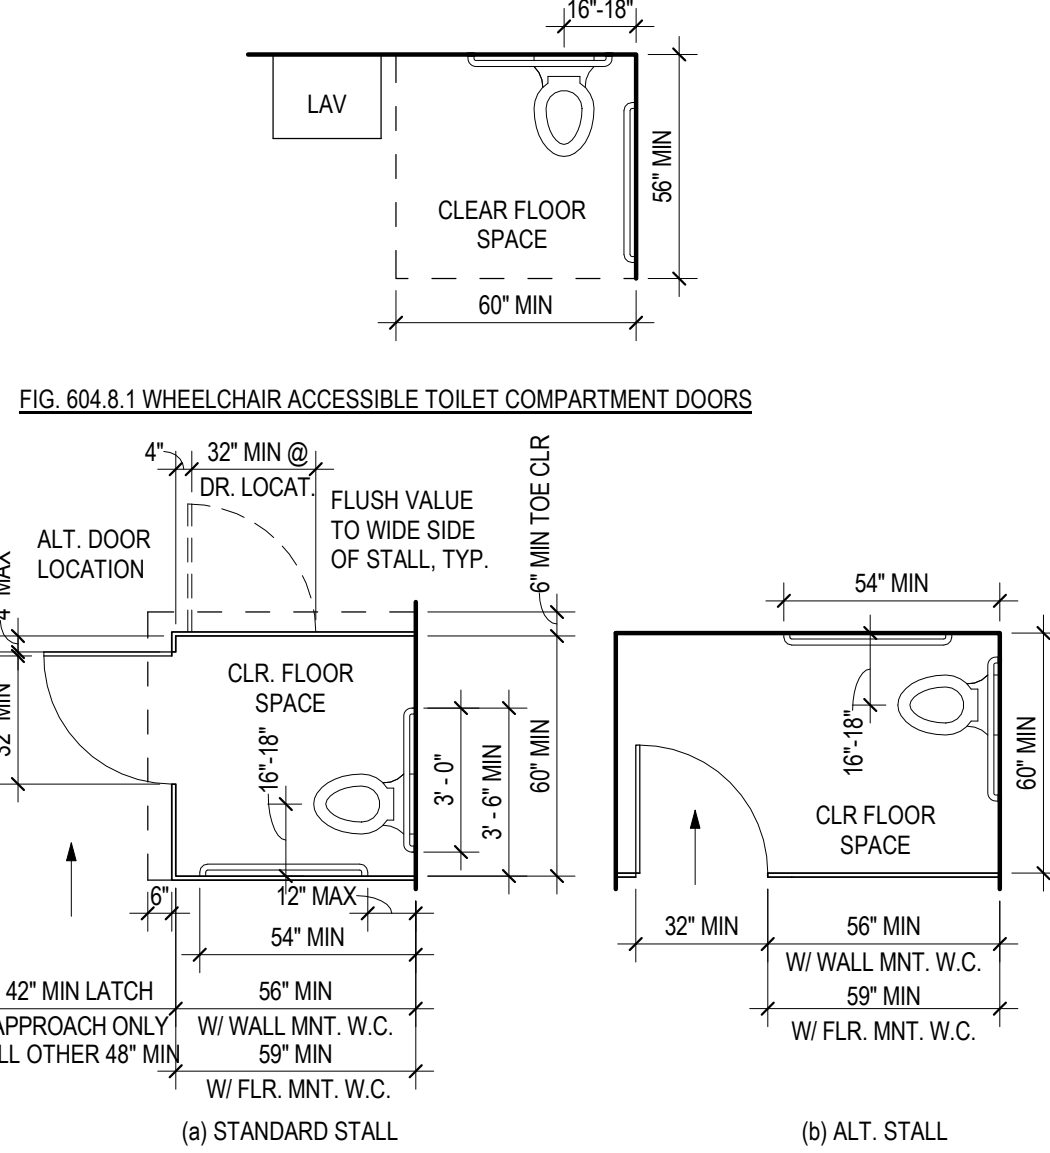
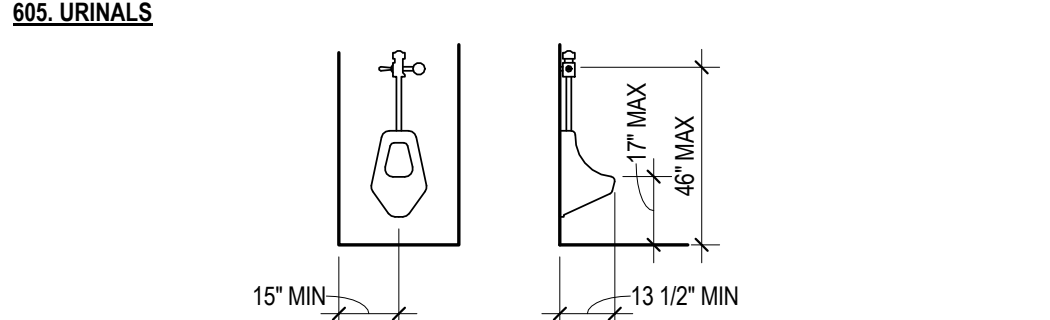
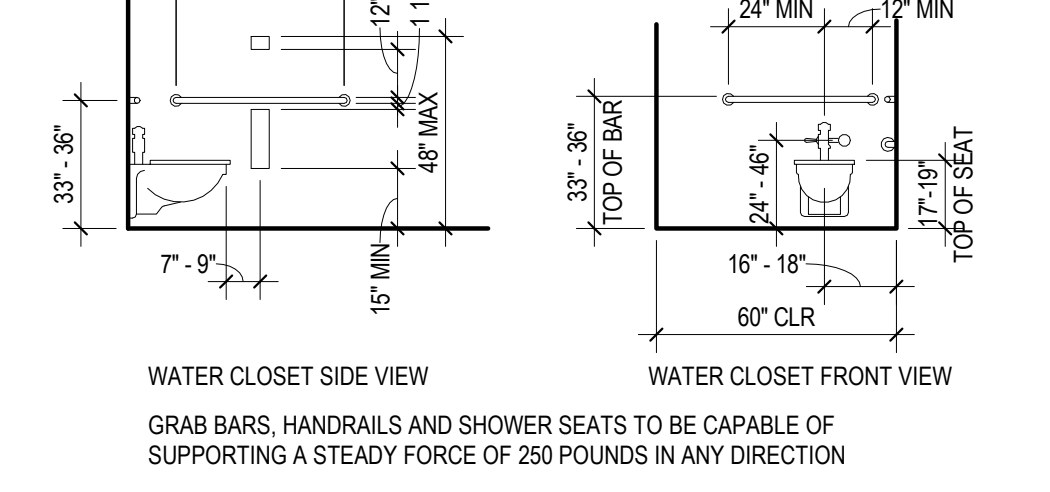
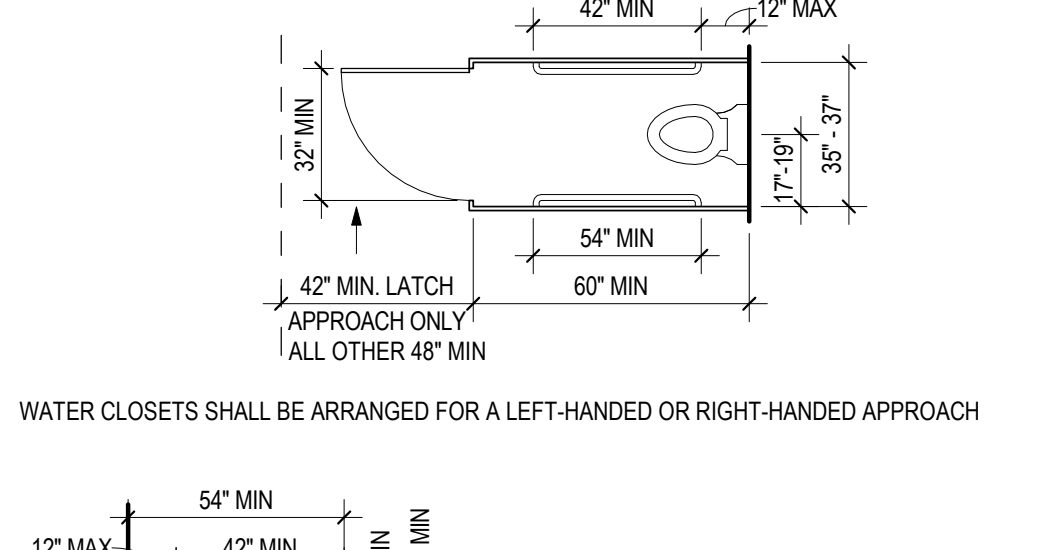


FIG. 604.3.2 AMBULATORY ACCESSIBLE TOILET COMPARTMENT

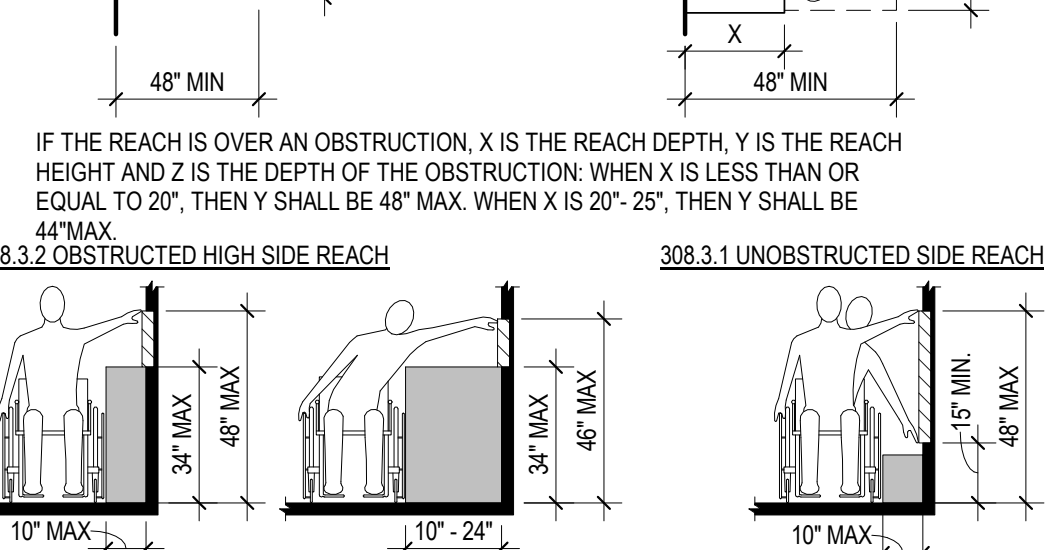


## 9 ADA - 603, 604, 605 - TLT CMPRTMNTS

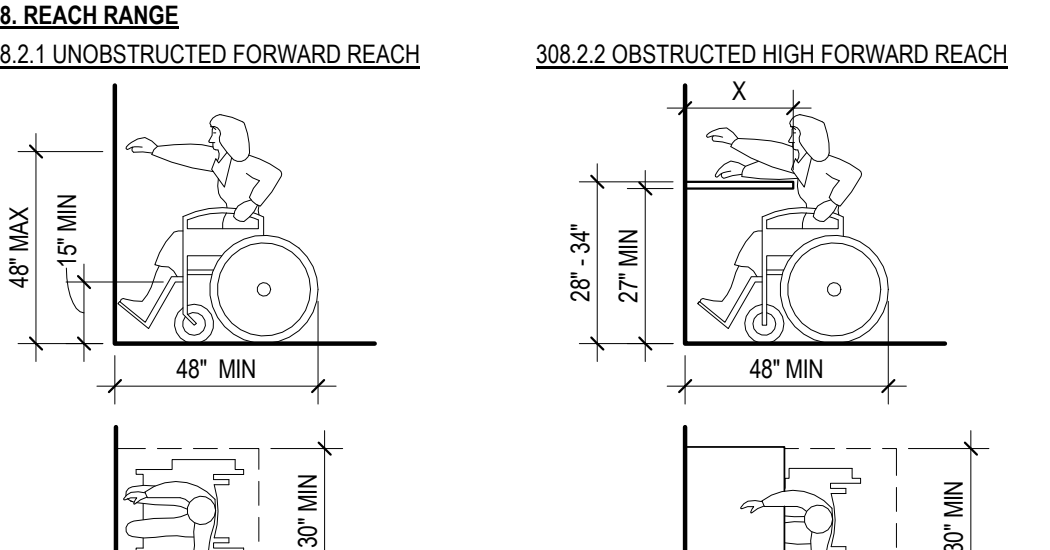1/4" = 1'-0"










## 4 ADA - 308 REACH RANGE

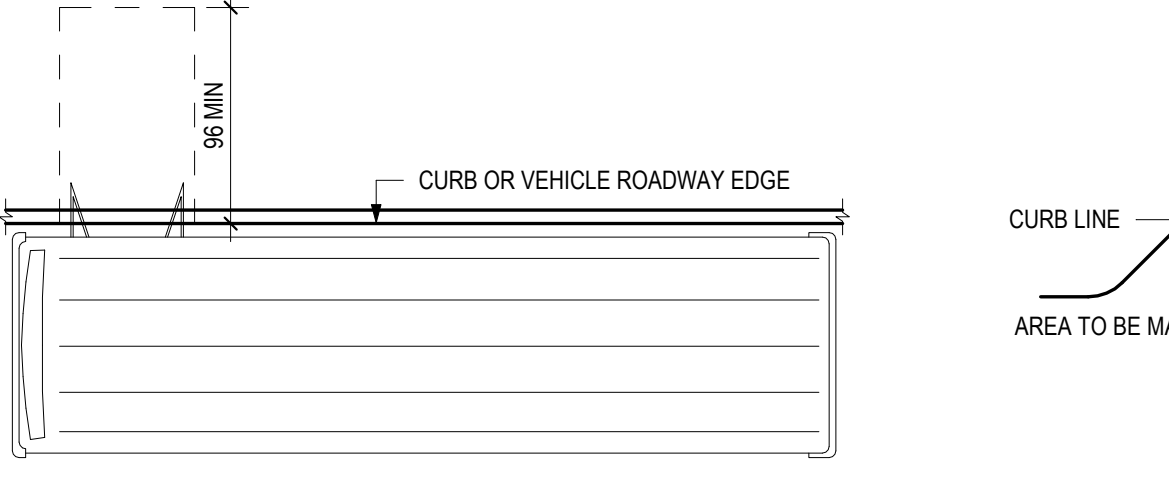1/4" = 1'-0"




## 16 ADA - 503 PARKING & PASSENGER LOADING ZONES

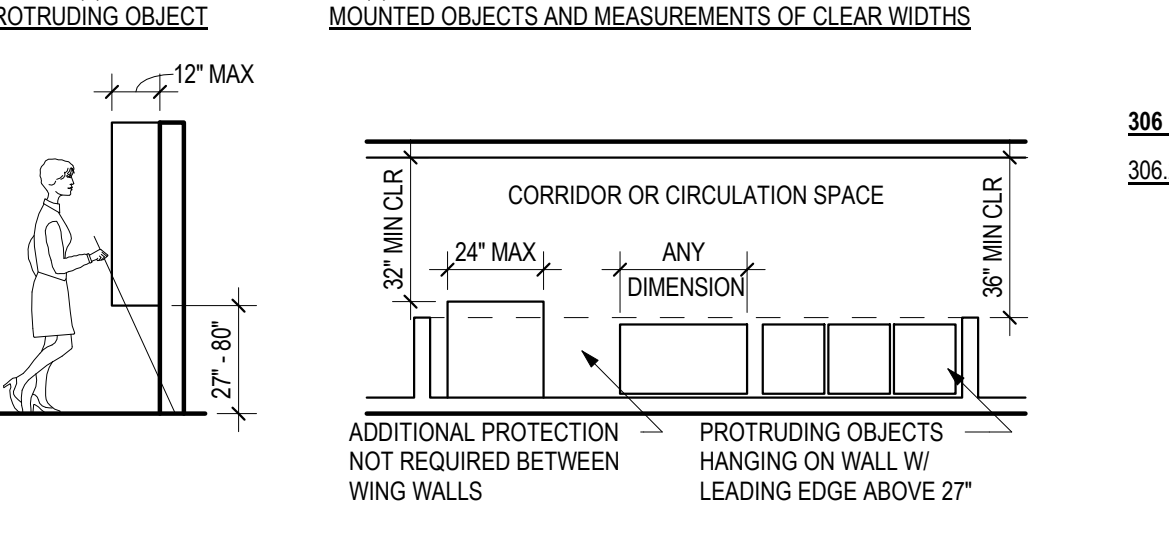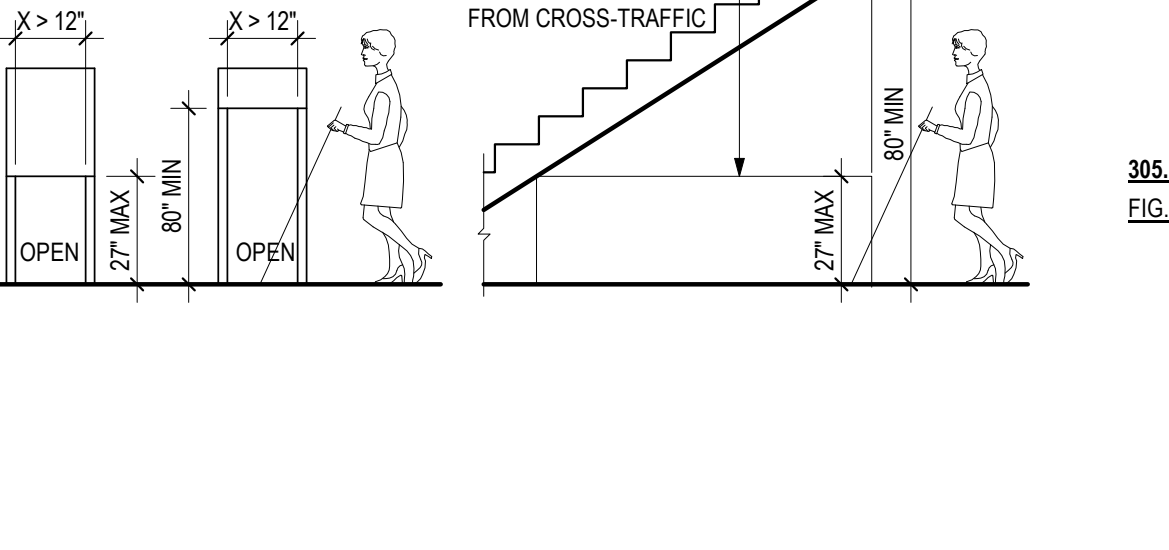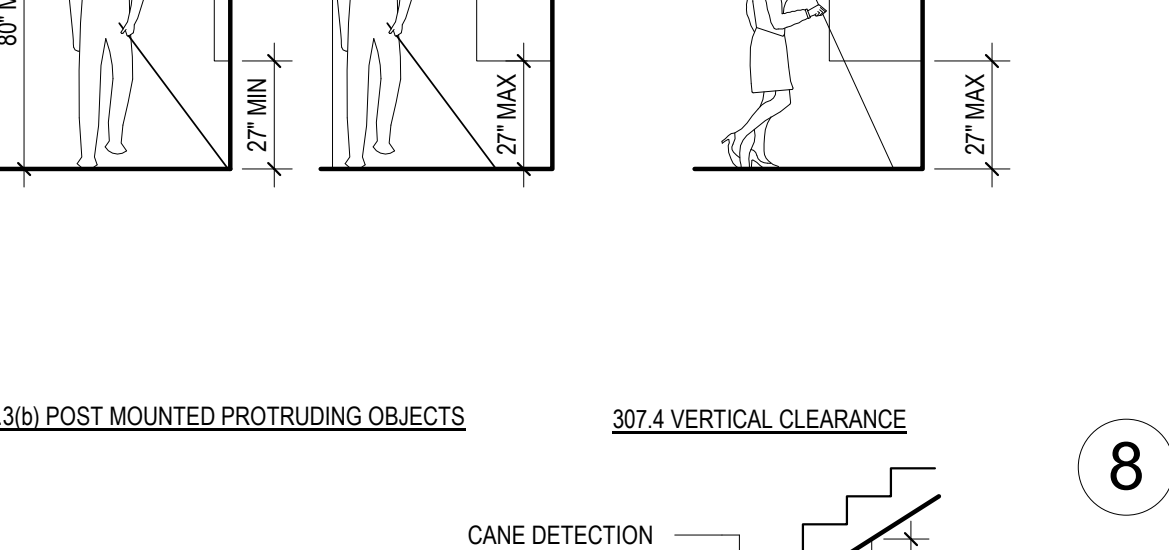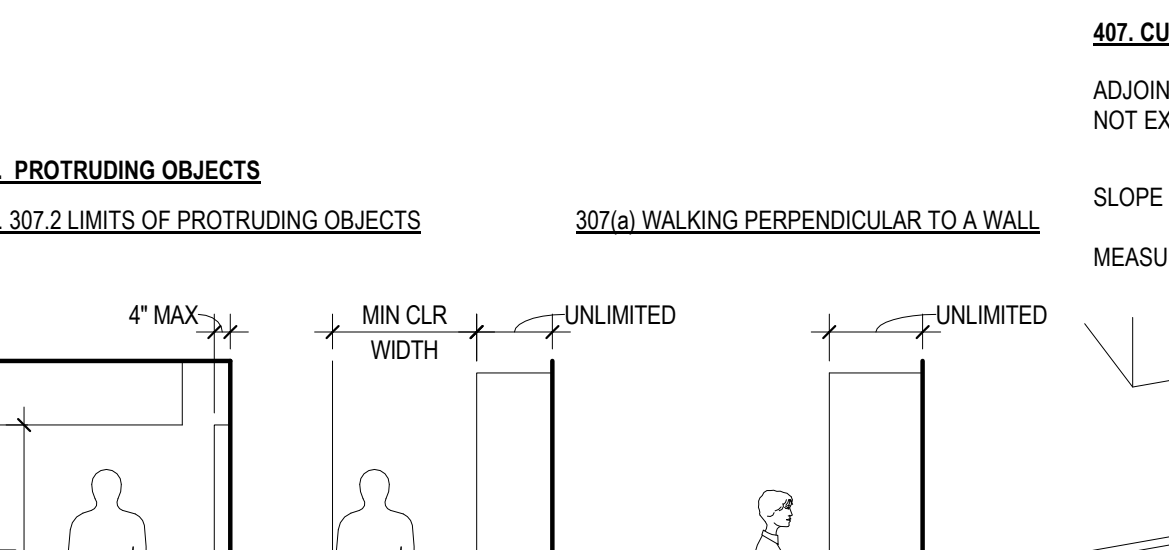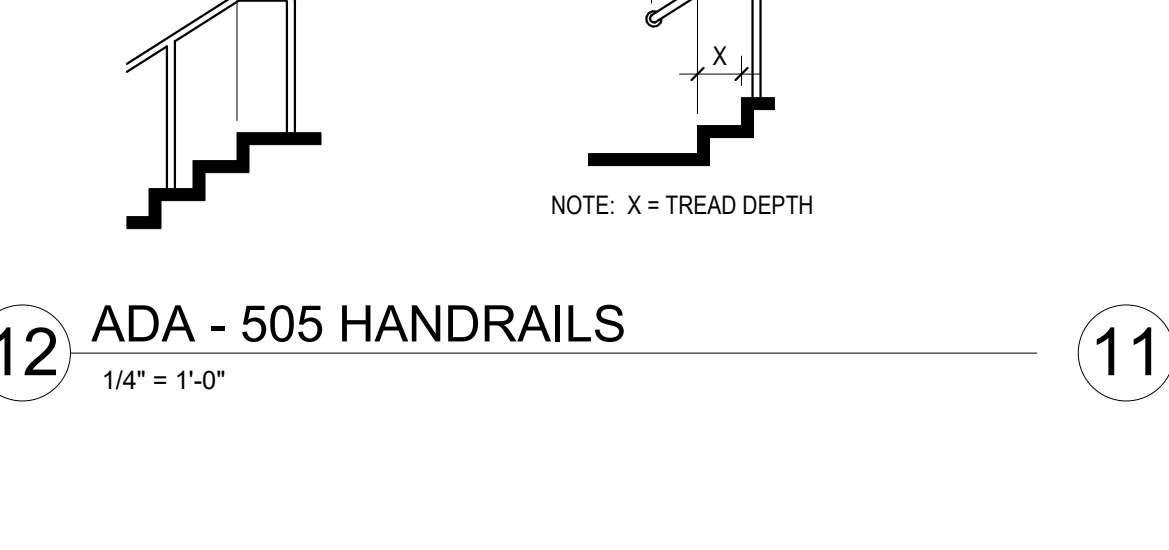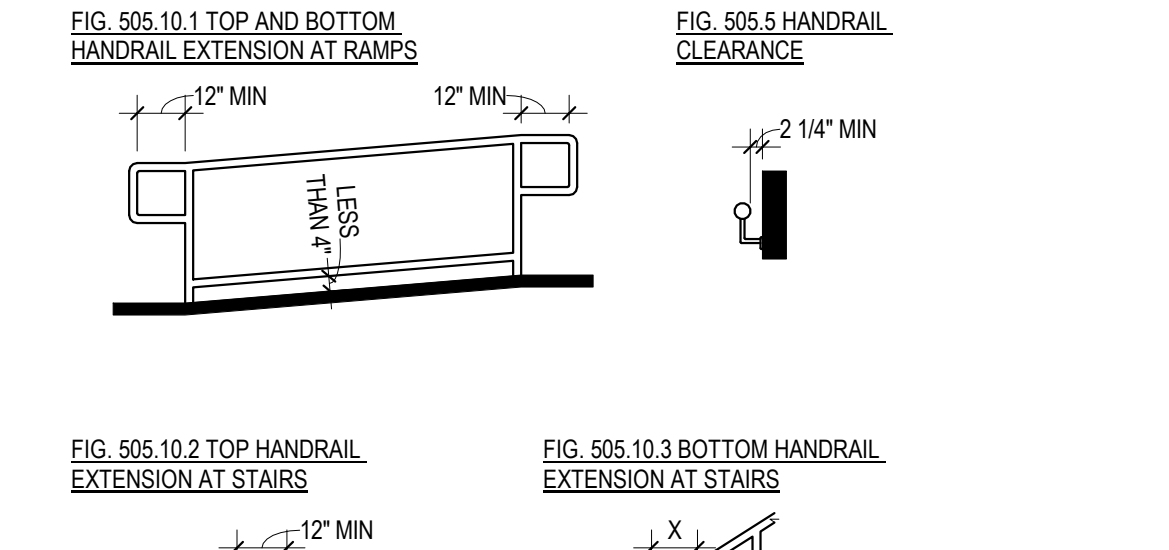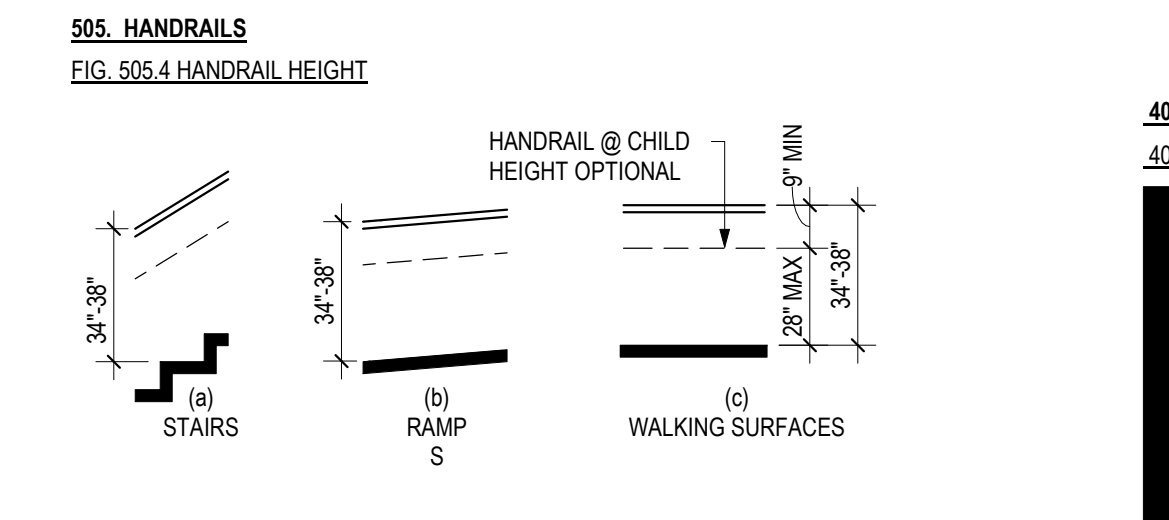1/4" = 1'-0"




## 3 ADA - 307 PROTRUDING OBJECTS

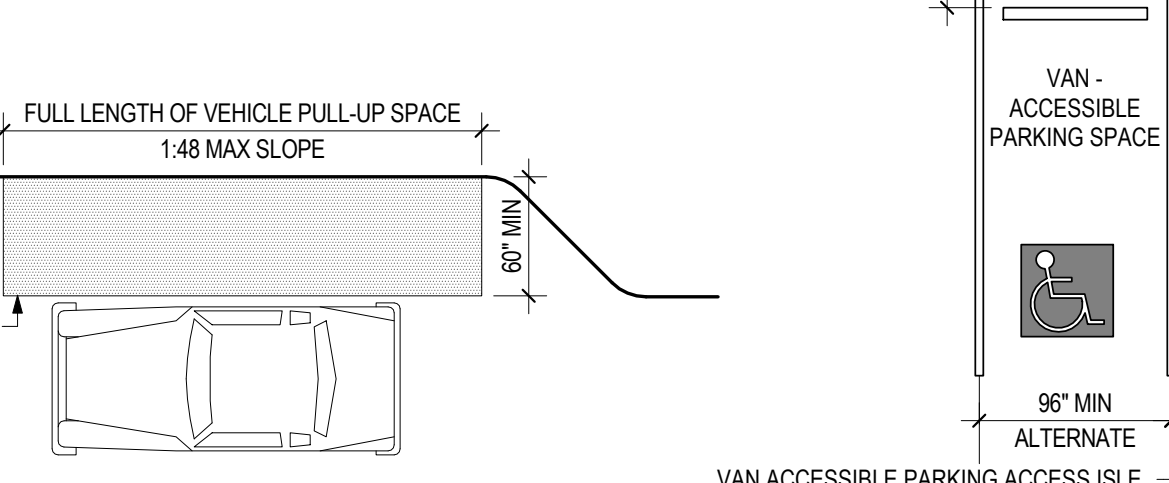1/4" = 1'-0"



## 11 ADA - 407 ELEVATOR CAB

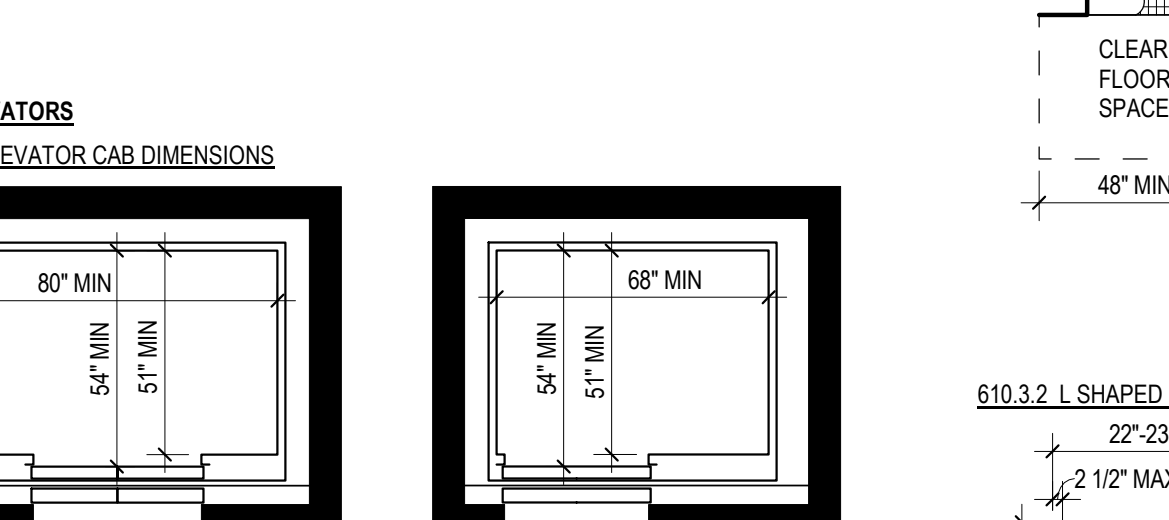1/4" = 1'-0"



I. GENERAL DESCRIPTION

- PROJECT NAME: TOMBALL HIGH SCHOOL CTE RENOVATIONS
- PROJECT LOCATION: 30330 QUINN RD. TOMBALL, TX 77375
- APPLICABLE CODES
  - INTERNATIONAL BUILDING CODE, 2015 ED.
  - INTERNATIONAL MECHANICAL CODE, 2015 ED. WITH ADOPTED AMENDMENTS
  - INTERNATIONAL PLUMBING CODE, 2015 ED. WITH ADOPTED AMENDMENTS
  - NATIONAL ELECTRICAL CODE, 2017 ED. WITH ADOPTED AMENDMENTS
  - INTERNATIONAL FIRE CODE, 2015 ED.
  - INTERNATIONAL ENERGY CONSERVATION CODE, 2015 ED.
  - ASHRAE 90.1-2007
  - THE STANDARDS OF THE STATE BOARD OF INSURANCE
  - TEXAS ACCESSIBILITY STANDARDS - (TAS) 2012
  - NFPA 101

II. USE AND OCCUPANCY CLASSIFICATION (IBC CH.3, CH.4 AND CH.5)

- USE AND OCCUPANCY CLASSIFICATION (IBC SECTION 302.303, AND 304)

- GENERAL BUILDING: TYPE E - EDUCATIONAL

ACCESSORY OCCUPANCIES (IBC SECTION 508.2)  
ACCESSORY OCCUPANCIES THAT ARE ANCILLARY TO THE MAIN OCCUPANCY OF THE BUILDING OR PORTION THEREOF. ACCESSORY OCCUPANCIES SHALL COMPLY WITH THE PROVISIONS OF SECTIONS 508.2.1 THROUGH 508.2.4.

GENERAL (IBC SECTION 508.1)  
EACH PORTION OF A BUILDING SHALL BE INDIVIDUALLY CLASSIFIED IN ACCORDANCE WITH SECTION 302.1. WHERE A BUILDING CONTAINS MORE THAN ONE OCCUPANCY GROUP, THE BUILDING OR PORTION THEREOF SHALL COMPLY WITH THE APPLICABLE PROVISIONS OF SECTION 508.2, 508.3 OR 508.4, OR A COMBINATION OF THESE SECTIONS.

OCCUPANCY CLASSIFICATION (IBC SECTION 508.2.1)  
ACCESSORY OCCUPANCIES SHALL BE INDIVIDUALLY CLASSIFIED IN ACCORDANCE WITH SECTION 302.1. THE REQUIREMENTS OF THIS CODE SHALL APPLY TO EACH PORTION OF THE BUILDING BASED ON THE OCCUPANCY CLASSIFICATION OF THAT SPACE.

ALLOWABLE BUILDING HEIGHT (IBC SECTION 508.2.2)  
THE ALLOWABLE HEIGHT AND NUMBER OF STORIES OF THE BUILDING CONTAINING ACCESSORY OCCUPANCIES SHALL BE IN ACCORDANCE WITH SECTION 504 FOR THE MAIN OCCUPANCY OF THE BUILDING.

ALLOWABLE BUILDING AREA (IBC SECTION 508.2.3)  
THE ALLOWABLE AREA OF THE BUILDING SHALL BE BASED ON THE APPLICABLE PROVISIONS OF SECTION 506 FOR THE MAIN OCCUPANCY OF THE BUILDING. AGGREGATE ACCESSORY OCCUPANCIES SHALL NOT OCCUPY MORE THAN 10 PERCENT OF THE FLOOR AREA OF THE STORY IN WHICH THEY ARE LOCATED AND SHALL NOT EXCEED THE TABULAR VALUES FOR NON-SPRINKLED BUILDINGS IN THE TABLE 506.2 FOR EACH SUCH ACCESSORY OCCUPANCY.

SEPERATION OF OCCUPANCIES (IBC SECTION 508.2.4)  
NO SEPERATION IS REQUIRED BETWEEN ACCESSORY OCCUPANCIES AND THE MAIN OCCUPANCY.

REQUIRED SEPERATION OF OCCUPANCIES (IBC TABLE 508.4)  
OCCUPANCIES "B" AND "A": NO SEPERATION REQUIRED.

- INCIDENTAL USES (IBC SECTION 509)

OCCUPANCY CLASSIFICATION (IBC SECTION 509.2)  
INCIDENTAL USES SHALL NOT BE INDIVIDUALLY CLASSIFIED IN ACCORDANCE WITH SECTION 302.1. INCIDENTAL USES SHALL BE INCLUDED IN THE BUILDING OCCUPANCIES WITHIN WHICH THEY ARE LOCATED.

- INCIDENTAL USES (IBC TABLE 509)
  - FURNACE ROOM WHERE ANY PIECE OF EQUIPMENT IS OVER 400,000 BTU PER HOUR INPUT: 1 HOUR OR AUTOMATIC SPRINKLER SYSTEM
  - ROOMS WITH BOILERS WHERE THE LARGEST PIECE OF EQUIPMENT IS OVER 15 PSI AND 10 HORSEPOWER: 1 HOUR OR PROVIDE AUTOMATIC SPRINKLER SYSTEM
  - REFRIGERANT MACHINERY ROOM: 1 HOUR OR PROVIDE AUTOMATIC SPRINKLER SYSTEM

III. CONSTRUCTION CLASSIFICATION

- CONSTRUCTION TYPE (IBC TABLE 506.2)  
TYPE II-B, FULLY SPRINKLED

IV. ALLOWABLE HEIGHT AND BUILDING AREA

- ALLOWABLE NUMBER OF STORIES (IBC TABLE 404.4)  
BUSINESS GROUP "E": 3 STORIES
- ALLOWABLE HEIGHT (IBC TABLE 504.3)  
BUSINESS GROUP "E": 75 FEET
- ALLOWABLE AREA FACTOR (IBC TABLE 506.2)  
EDUCATIONAL GROUP "E": 58,000 S.F. = PER STORY

V. ACTUAL HEIGHT AND BUILDING AREA

- ACTUAL HEIGHT: 1 STORY
- ACTUAL GROSS BUILDING AREA:  
TOTAL AIA SQUARE FEET = **34,670 S.F.**

VI. SEPERATION AND/OR PROTECTION

- FIRE RESISTANCE RATING REQUIREMENTS (IBC TABLE 601)  
CONSTRUCTION TYPE II-A

BUILDING ELEMENT	FIRE-RESISTANCE RATING	PROVIDED
PRIMARY STRUC. FRAME	0 HOUR	N/A
BEARING WALLS		
EXTERIOR	0 HOUR	N/A
INTERIOR	0 HOUR	N/A
NONBEARING WALLS & PARTITIONS (EXTERIOR)	0 HOURS	N/A
NONBEARING WALLS & PARTITIONS (INTERIOR)	0 HOURS	N/A
FLOOR CONSTRUCTION	0 HOUR	N/A
ROOF CONSTRUCTION	0 HOUR	N/A

- FIRE BARRIERS (IBC SECTION 707)

FIRE RESISTANCE RATING (IBC SECTION 707.3)  
THE FIRE-RESISTANCE RATINGS OF FIRE BARRIERS SHALL COMPLY WITH THIS SECTION.

SHAFT ENCLOSURES (IBC SECTION 707.3.1)  
SHAFT ENCLOSURES REQUIRED TO BE 1 HOUR FIRE RATED

FIRE-RESISTANCE RATING (IBC SECTION 713.4)  
SHAFT ENCLOSURES REQUIRED TO BE 1 HOUR FIRE RATED

- INTERIOR WALL AND CEILING FINISH REQUIREMENTS BY OCCUPANCY (IBC TABLE 803.1.1)

GROUP	SPRINKLERED		
	INTERIOR EXIT STAIRWAYS, INTERIOR EXIT RAMPS & EXIT PASSAGEWAYS	CORRIDORS & ENCLOSURE FOR EXIT ACCESS STAIRWAYS & EXIT ACCESS RAMPS	ROOMS & ENCLOSED SPACES
BUSINESS "B"	B	C	C

- MACHINE ROOMS (IBC SECTION 3005)

MACHINE ROOMS, CONTROL ROOMS, MACHINERY SPACES, AND CONTROL SPACES (IBC SECTION 3005.4)  
ELEVATOR MACHINE ROOMS, CONTROL ROOMS, CONTROL SPACES AND MACHINERY SPACES OUTSIDE OF BUT ATTACHED TO A HOISTWAY THAT HAVE OPENINGS INTO THE HOISTWAY SHALL BE ENCLOSED WITH FIRE BARRIERS CONSTRUCTED IN ACCORDANCE WITH SECTION 707 OR HORIZONTAL ASSEMBLIES CONSTRUCTED IN ACCORDANCE WITH SECTION 711, OR BOTH. THE FIRE-RESISTANCE RATING SHALL BE NOT LESS THAN THE REQUIRED RATING OF THE HOISTWAY ENCLOSURE SERVED BY THE MACHINERY. OPENINGS IN THE FIRE BARRIERS SHALL BE PROTECTED WITH ASSEMBLIES HAVING A FIRE PROTECTION RATING NOT LESS THAN THAT REQUIRED FOR THE HOISTWAY ENCLOSURE DOORS. (ELEVATOR IS MACHINE ROOM-LESS)

VII. FIRE PROTECTION SYSTEMS

- AUTOMATIC SPRINKLER SYSTEMS (IBC SECTION 903): PROVIDED
- PORTABLE FIRE EXTINGUISHERS (IBC SECTION 906)  
PORTABLE FIRE EXTINGUISHERS SHALL BE INSTALLED IN ALL OF THE FOLLOWING LOCATIONS:

- IN GROUP A,B,E,F,H,I,M,R-1,R-2,R-4 AND S OCCUPANCIES
- WITHIN 30 FEET (9144 MM) OF COMMERCIAL COOKING EQUIPMENT
- ON EACH FLOOR OF STRUCTURES UNDER CONSTRUCTION, EXCEPT GROUP R-3 OCCUPANCIES, IN ACCORDANCE WITH SECTION 3315.1 OF INTERNATIONAL FIRE CODE
- WHERE REQUIRED BY THE INTERNATIONAL FIRE CODE SECTIONS INDICATED IN THE TABLE 906.1
- SPECIAL-HAZARD AREAS, INCLUDING BUT NOT LIMITED TO LABORATORIES, COMPUTER ROOMS AND GENERATOR ROOMS, WHERE REQUIRED BY THE FIRE CODE OFFICIAL

MAXIMUM TRAVEL DISTANCE TO EXTINGUISHER (IBC TABLE 906.3): 75 FEET

- FIRE ALARM SYSTEM (IBC SECTION 907): PROVIDED

VIII. FIRE APPARATUS ACCESS ROADS

- REQUIRED ACCESS (IBC SECTION D102.1)

ACCESS AND LOADING (IBC SECTION D102.1)  
FACILITIES, BUILDINGS OR PORTIONS OF BUILDINGS HEREAFTER CONSTRUCTED SHALL BE ACCESSIBLE TO FIRE DEPARTMENT APPARATUS BY WAY OF AN APPROVED FIRE APPARATUS ACCESS ROAD WITH AN ASPHALT, CONCRETE OR OTHER APPROVED DRIVING SURFACE CAPABLE OF SUPPORTING THE IMPOSED LOAD OF FIRE APPARATUS WEIGHING AT LEAST 75,000 POUNDS.

ACCESS ROAD WIDTH WITH A HYDRANT (IBC SECTION D103.1)  
WHERE FIRE HYDRANT IS LOCATED ON A FIRE APPARATUS ACCESS ROAD, THE MINIMUM ROAD WIDTH SHALL BE 26 FEET, EXCLUSIVE OF SHOULDERS. PROVIDED

BUILDINGS EXCEEDING THREE STORIES OR 30 FEET IN HEIGHT (IBC SECTION D104.1)  
BUILDINGS OR FACILITIES EXCEEDING 30 FEET OR THREE STORIES IN HEIGHT SHALL HAVE ATLEAST TWO MEANS OF FIRE APPARATUS ACCESS ROADS. PROVIDED

BUILDINGS EXCEEDING 62,000 SQUARE FEET IN AREA (IBC SECTION D104.2)  
BUILDINGS OR FACILITIES HAVING A GROSS BUILDING AREA OF MORE THAN 62,000 SQUARE FEET SHALL BE PROVIDED WITH TWO SEPERATE AND APPROVED FIRE APPARATUS ACCESS ROADS.

IX. EGRESS REQUIREMENTS

- MAXIMUM FLOOR AREA ALLOWANCES PER OCCUPANT (IBC TABLE 1004.1.2)

FUNCTION SPACE	FLOOR AREA (SF PER OCCUPANT)
ACCESSORY STORAGE AREAS, MECHANICAL EQUIPMENT ROOM	300 GROSS
ASSEMBLY WITHOUT FIXED SEATS	
CONCENTRATED (CHAIRS ONLY - NOT FIXED)	7 NET
STANDING SPACE	5 NET
UNCONCENTRATED (TABLES AND CHAIRS)	16 NET
BUSINESS AREAS	100 GROSS
EDUCATIONAL	
CLASSROOM AREA	20 NET
SHOPS AND OTHER VOCATIONAL ROOM AREAS	50 NET
KITCHENS, COMMERCIAL	200 GROSS
LOCKER ROOMS	50 GROSS

- MEANS OF EGRESS SIZING (IBC SECTION 1005)

OTHER EGRESS COMPONENTS (IBC SECTION 1005.3.2)

OTHER EGRESS COMPONENTS (WITH SPRINKLER SYSTEM)  
3'-0" DOOR @ .15' PER OCCUPANT = 240 OCCUPANTS  
4'-0" DOOR @ .15' PER OCCUPANT = 320 OCCUPANTS  
PAIR 3'-0" DOORS @ .15' PER OCCUPANT = 480 OCCUPANTS

- ADJACENT STORIES (IBC SECTION 1004.1.1.3)  
OTHER THAN FOR THE EGRESS COMPONENTS DESIGNED FOR CONVERGENCE IN ACCORDANCE WITH SECTION 1005.6, THE OCCUPANT LOAD FROM SEPERATE STORIES SHALL NOT BE ADDED.

- EXIT ACCESS TRAVEL DISTANCE (IBC SECTION 1017)

LIMITATIONS (IBC SECTION 1017.2)  
EXIT ACCESS TRAVEL DISTANCE SHALL NOT EXCEED THE VALUES GIVEN IN TABLE 1017.2.

EXIT ACCESS TRAVEL DISTANCE (IBC TABLE 1017.2)  
EDUCATION "E" WITH SPRINKLER SYSTEM: 250 FEET

EGRESS FROM STORIES OR OCCUPIED ROOFS (IBC SECTION 1006.3)  
THE MEANS OF EGRESS SYSTEM SERVING ANY STORY OR OCCUPIED ROOF SHALL BE PROVIDED WITH THE NUMBER OF EXITS OR ACCESS TO EXITS BASED ON THE AGGREGATE OCCUPANT LOAD SERVED IN ACCORDANCE WITH THIS SECTION. THE PATH OF EGRESS TRAVEL TO AN EXIT SHALL NOT PASS THROUGH MORE THAN ONE ADJACENT STORY.

WHERE THREE OR MORE EXITS OR ACCESS TO EXITS ARE REQUIRED, NOT LESS THAN 50 PERCENT OF THE REQUIRED EXITS SHALL BE INTERIOR OR EXTERIOR EXIT STAIRWAYS.

- CORRIDORS SECTION 1020

WIDTH AND CAPACITY (IBC SECTION 1020.2)  
THE REQUIRED CAPACITY OF CORRIDORS SHALL BE DETERMINED AS SPECIFIED IN SECTION 1005.1, BUT THE MINIMUM WIDTH SHALL BE NOT LESS THAN THAT SPECIFIED IN TABLE 1020.2.

\*OCCUPANCY "B" MINIMUM WIDTH 44 INCHES

DEAD ENDS (IBC SECTION 1020.4)

EXCEPTION 2: IN OCCUPANCIES IN GROUPS B,E,F,H,I,M,R-1,R-2,R-4,S,AND U, WHERE THE BUILDING IS EQUIPPED THROUGHOUT WITH AN AUTOMATIC SPRINKLER SYSTEM IN ACCORDANCE WITH SECTION 903.3.1.1, THE LENGTH OF THE DEAD-END CORRIDORS SHALL NOT EXCEED 50 FEET.

X. MINIMUM PLUMBING FIXTURE COUNT

NOTE: PLUMBING FIXTURE COUNT IS BASED ON STUDENT CAPACITY AS SET BY THE TEXAS EDUCATION AGENCY

- MINIMUM NUMBER OF REQUIRES PLUMBING FIXTURES (UPC TABLE 422.1)

USE GROUP	DESCRIPTION	WATER CLOSETS/ URINALS		LAVATORIES		BATHTUBS/ SHOWERS	DRINKING FOUNTAIN (1:100)	SERVICE SINK (1)
		MALE (1:50)	FEMALE (1:50)	MALE (1:50)	FEMALE (1:50)			
E	325 OCCUPANTS	2/2	4	4	4	0	4	1

FIXTURE CALCULATIONS (IBC SECTION 2902.1.1)

TO DETERMINE THE OCCUPANT LOAD OF EACH SEX, THE TOTAL OCCUPANT LOAD SHALL BE DIVIDED IN HALF. TO DETERMINE THE REQUIRES NUMBER OF FIXTURES, THE FIXTURE RATIO OR RATIOS FOR EACH FIXTURE TYPE SHALL BE APPLIED TO THE OCCUPANT LOAD OF EACH SEX IN ACCORDANCE WITH TABLE 2902.1. FRACTIONAL NUMBERS RESULTING FROM APPLYING THE FIXTURE RATIOS OF TABLE 2902.1 SHALL BE ROUNDED UP TO THE NEXT WHOLE NUMBER. FOR CALCULATIONS INVOLVING MULTIPLE OCCUPANCIES, SUCH FRACTIONAL NUMBERS FOR EACH OCCUPANCY SHALL FIRST BE SUMMED AND THEN ROUNDED TO THE NEXT WHOLE NUMBER.

XI. ACTUAL PLUMBING FIXTURE COUNT


USE GROUP	DESCRIPTION	WATER CLOSETS/URINALS		LAVATORIES		BATHTUBS/ SHOWERS	DRINKING FOUNTAIN	SERVICE SINK
		MALE	FEMALE	MALE	FEMALE			
E	325 OCCUPANTS	5/2	11	5	7	2	2	1

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TOMBALL HIGH SCHOOL  
CTE & MISC. RENOVATIONS


TOMBALL INDEPENDENT SCHOOL DISTRICT  
30330 QUINN ROAD, TOMBALL, TX 77375



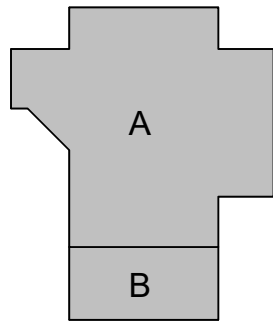TEXAS ARCADIS INC.

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tel 713.953.4897, fax 713.977.4620

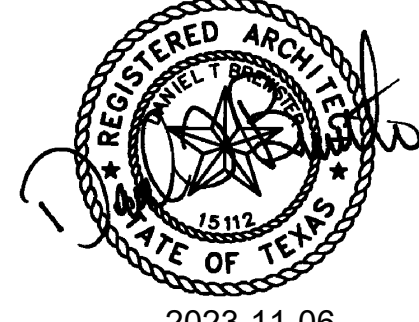

PROJECT #: 202311

DATE: 2023-11-06

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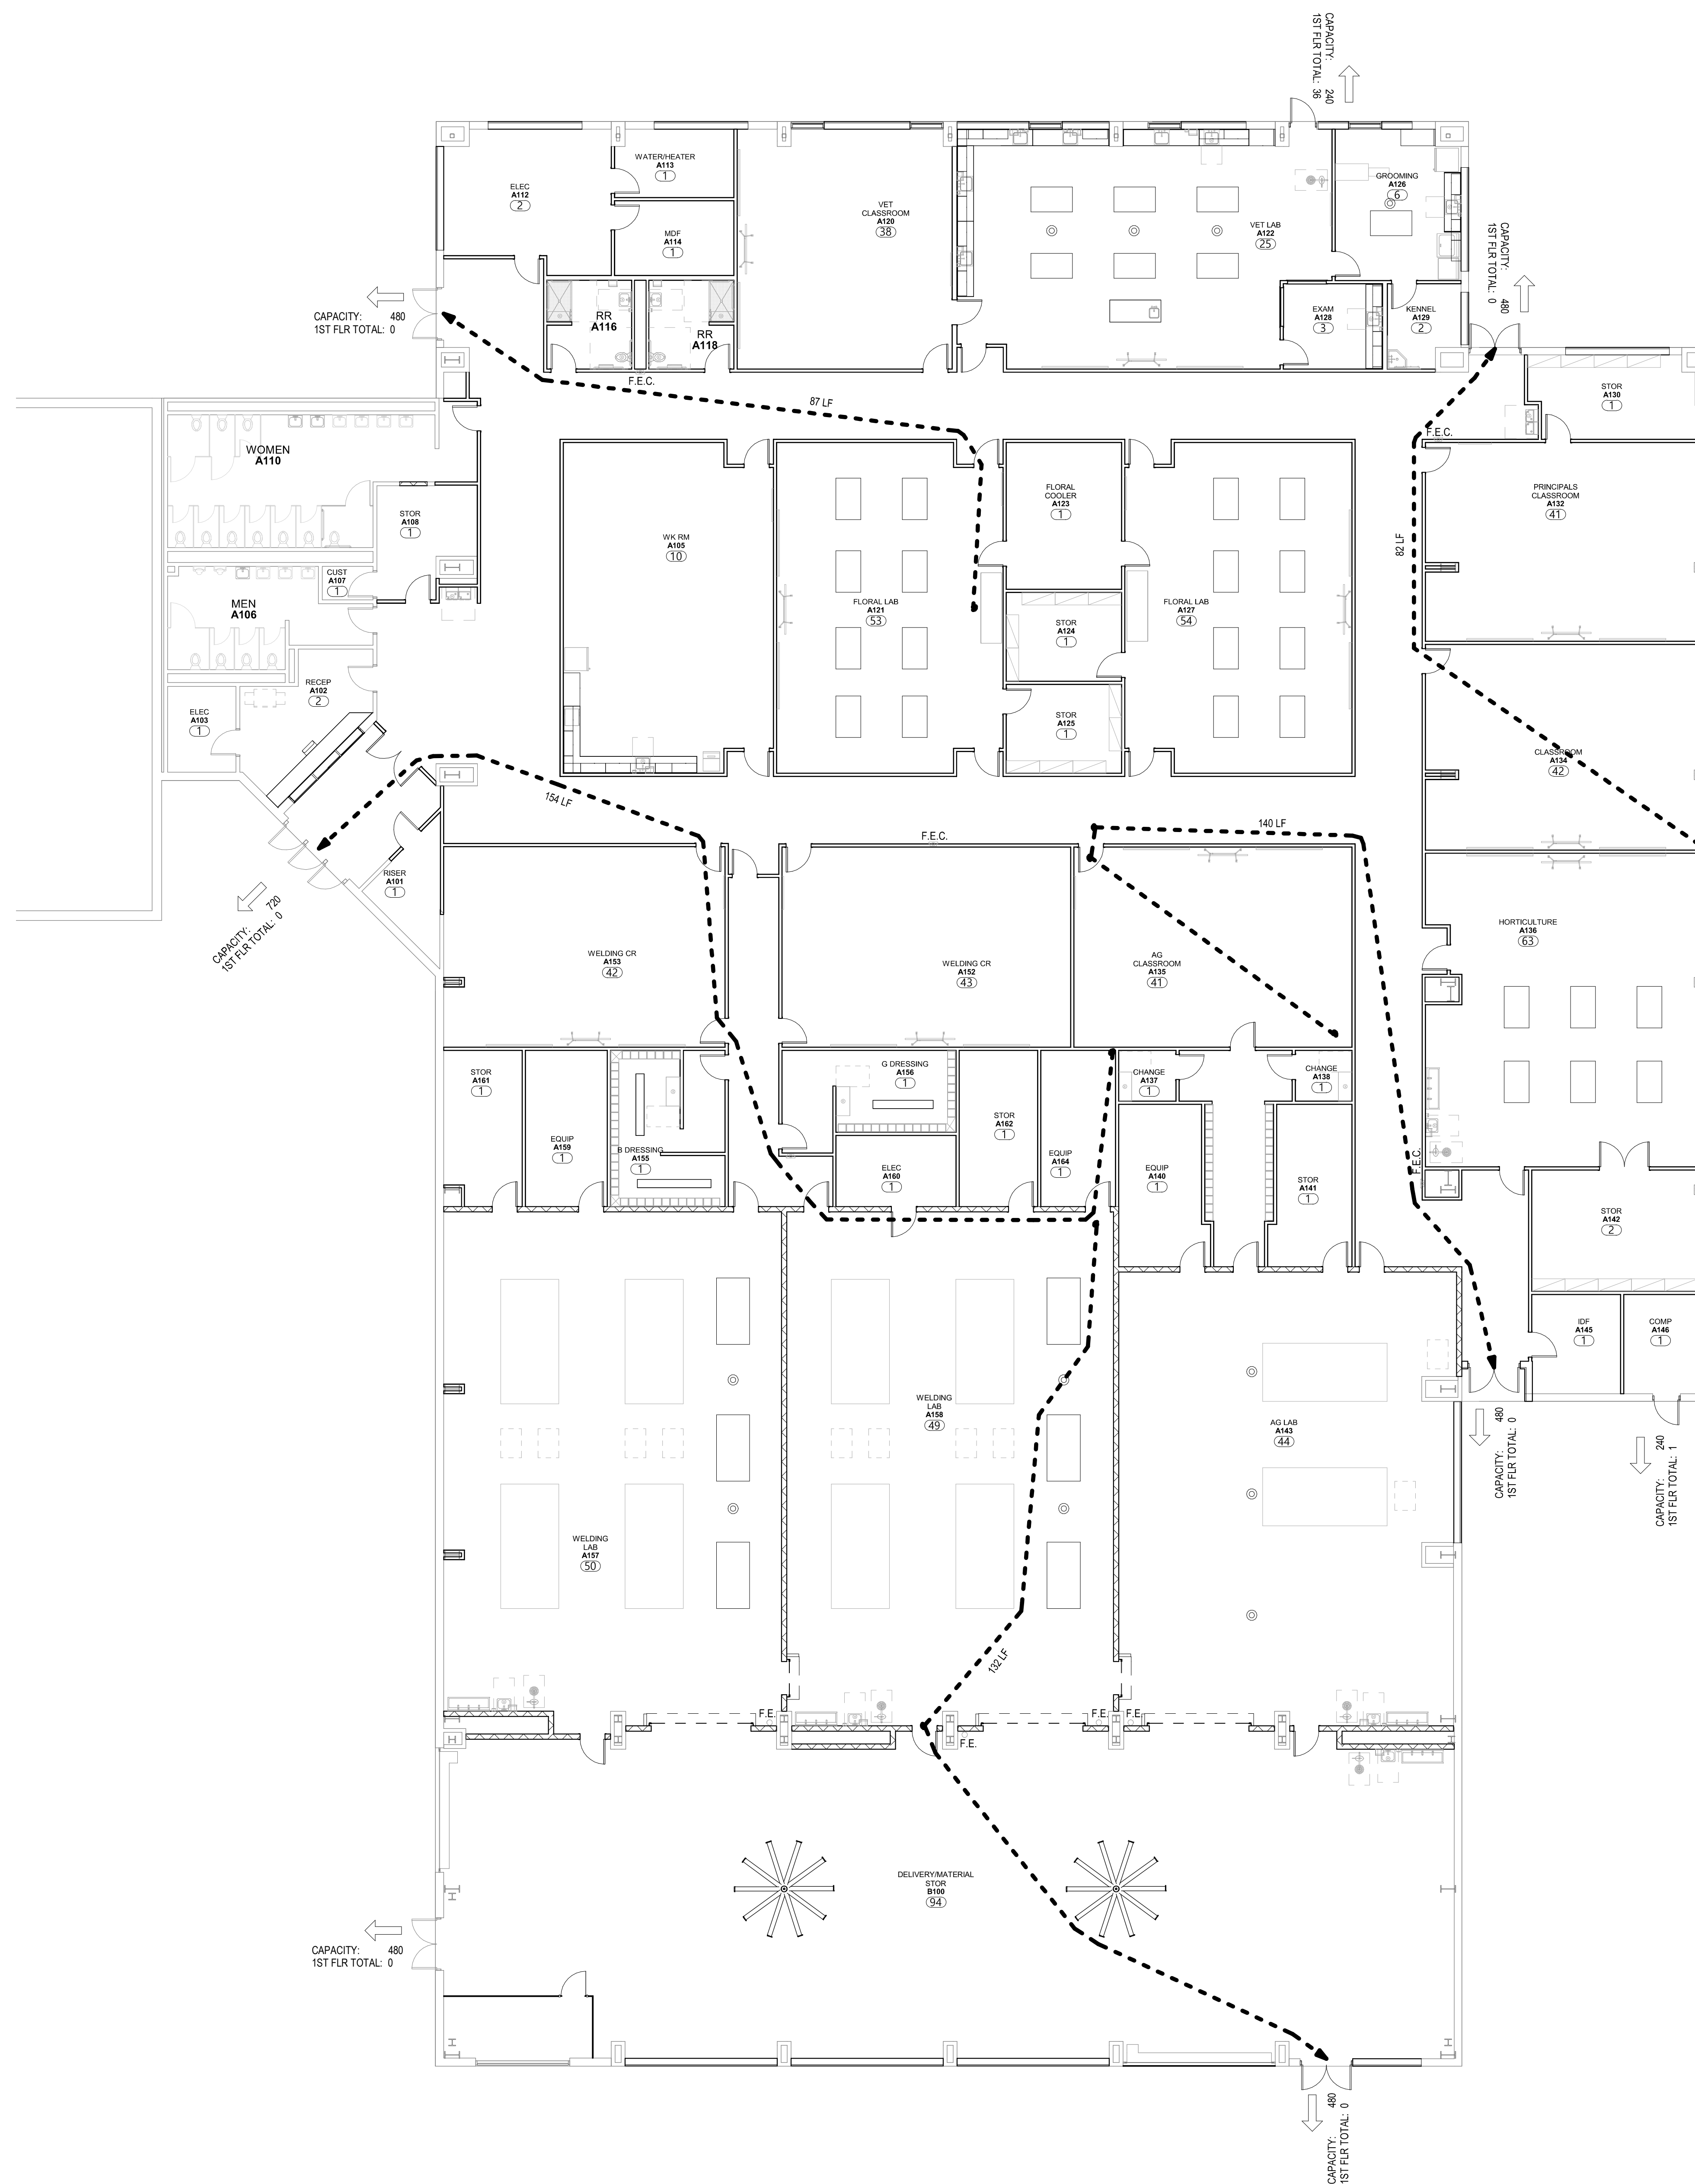
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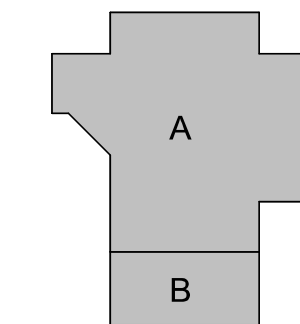
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CODE ANALYSIS






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**TOMBALL HIGH SCHOOL  
CTE & MISC. RENOVATIONS**
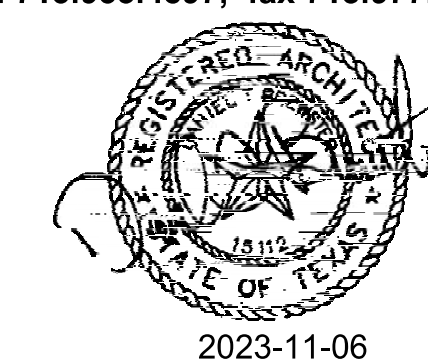
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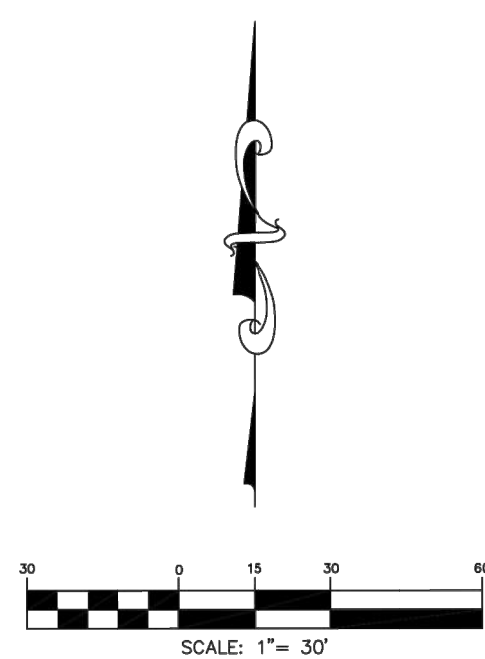
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1ST FLOOR LIFE  
SAFETY PLAN



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B.L.—BUILDING LINE  
C.L.F.—CHAIN LINK FENCE  
ESMT—EASEMENT  
CF—FILM CODE  
FF—FINISH FLOOR  
FL—FLOW LINE  
H.C.C.F.—HARRIS COUNTY CLERK'S FILE  
H.C.M.—HARRIS COUNTY MAP RECORDS  
HDP—HIGH DENSITY POLYETHYLENE PIPE  
MH—MANHOLE  
OHE—OVERHEAD ELECTRIC  
PGE—PLAYGROUND EQUIPMENT  
PVC—POLYVINYL CHLORIDE PIPE  
R.C.—REINFORCED CONCRETE PIPE  
R.O.W.—RIGHT-OF-WAY  
SAN.—SANITARY  
STM.—STORM  
SWR.—SEWER  
TRF.—PAD MOUNTED TRANSFORMER  
TG—TOP OF GRADE  
TG—TOP OF RIM  
U.E.—UTILITY EASEMENT  
UGV—UNDERGROUND VAULT  
W.I.F.—WROUGHT IRON FENCE  
W.L.E.—WATER LINE EASEMENT

SURVEYOR'S NOTES:

1. THE BEARINGS SHOWN HEREON ARE BASED ON THE TEXAS COORDINATE SYSTEM, SOUTH MAGNETIC DECLINATION 10° 00' 00" E.

2. ACCORDING TO F.L.R.M. MAP NO. 48021021010, (COMMUNITY-PANEL NO. 10), THE PROPERTY LIES WITHIN THE 15th JUNE 1980, THE SUBJECT PROPERTY LIES WITHIN THE AREA DESIGNATED AS ZONE "X".

3. THE PROPERTY LIES WITHIN THE 0.2% ANNUAL CHANCE FLOOD.

THIS STATEMENT IS BASED ON SCALING THE MAP TO THE BEARING OF THE LINE IN THE ABOVE REFERENCED MAP. THIS INFORMATION IS NOT TO BE USED AS A BASIS FOR SUIT ONLY AND IS NOT INTENDED TO INDICATE SPECIFIC FLOODING CONDITIONS.

3. ALL UTILITIES SHOWN HEREON ARE BASED ON "AS SHOWN" AND NOT BASED ON ON-SITE OBSERVATION UNLESS NOTED OTHERWISE.

4. THE SUBJECT TRACT IS AFFECTED BY THE CITY OF HOUSTON ORDINANCE NO. 85-1878, AMENDED BY ORDINANCE NO. 199-262.

5. -INDICATES AN UNDERGROUND SEWER OR WATER MAIN LOCATING, OR A POSSIBLE LOCATION OR A POSSIBLE SUB-UT.

6. UNDERGROUND UTILITY LOCATIONS ARE SHOWN BY DOTTED LINES. LOCATING MARKS WITH NUMERIC VALUES ARE SHOWN BY DOTTED LINES WITH NUMERIC VALUES IN PARENTHESES. LOCATIONS DETERMINED BY ELECTRONIC TUNING.

REFERENCE BENCHMARK:  
RM100395 - BRASS DISK STAMPED  
"RM100395" LOCATED ON THE SOUTHEAST  
CORNER OF A 5' X 8' CONCRETE BOX  
CULVERT UNDER RUDOLPH RD.  $\pm 0.4$  MILE  
SOUTH OF ZION RD.  
ELEVATION = 171.59' (NAVD 88, 2001 ADJ.)

TEMPORARY BENCHMARKS:

TBM "F" - BOX CUT ON 24" RCP LOCATED ON THE EAST SIDE OF QUINN ROAD ON THE SOUTH SIDE OF THE MOST SOUTHERLY DRIVEWAY TO THE AG FACILITY.

ELEVATION = 228.14'

TBM "G" - BOX CUT ON THE SOUTHWEST CORNER OF THE "E" INLET LOCATED  $\pm 40'$  SOUTHWEST OF THE MOST SOUTHERLY SOUTHEAST CORNER OF THE AG BARN.  
ELEVATION = 198.84'

TBM "H" - BOX CUT ON CONCRETE BASE OF  
LIGHT STANDARD LOCATED  $\pm 105'$  NORTHEAST  
OF THE NORTHEAST CORNER OF THE JUNIOR  
ROTC BUILDING.  
ELEVATION = 207.60'

TBM "1" - BOX CUT ON BACK OF CURB  
LOCATED AT THE SOUTHWEST CORNER OF THE  
JUNIOR ROTC BUILDING.  
ELEVATION = 206.96'

TBM "J" - BOX CUT ON BACK OF CURB PI  
LOCATED  $\pm 110'$  NORTHWEST OF THE  
NORTHEAST CORNER OF THE JUNIOR ROTC  
BUILDING.  
ELEVATION = 206.96'

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TOMBALL INDEPENDENT

SCHOOL DISTRICT

---

TOPOGRAPHIC SURVEY

---

TOMBALL HIGH SCHOOL  
AG FACILITY  
OUT OF THE  
JOSEPH HOUSE SURVEY

ABSTRACT NO. 34  
CITY OF TOMBALL  
HARRIS COUNTY, TEXAS

WEST  BELT  
SURVEYING, INC.

21020 PARK ROW  
KATY, TX. 77449

PHONE: (281) 599-8200  
FAX: (281) 402-0020

CERTIFIED FIRM NO. 10073800


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DRAWN BY: MDL	CHECKED BY: KMH
SCALE: 1"=30'	APPROVED BY: JOW
PROJECT NO. S866-0029C	DATE: JUNE 8, 2023
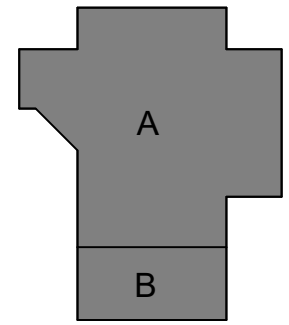
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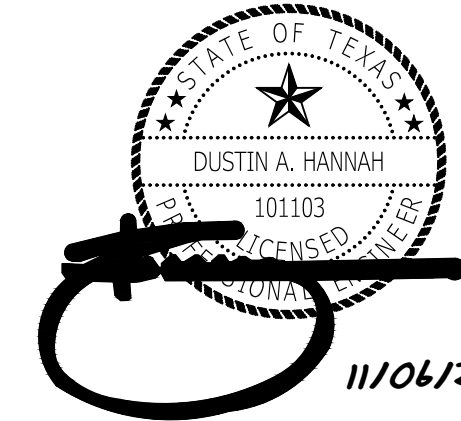


TOMBALL INDEPENDENT SCHOOL DISTRICT  
30330 QUINN ROAD, TOMBALL, TX 77375



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11/06/2023

DATE	ISSUE
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HORIZ:  
VERT:

[illegible]

520 POST OAK BLVD SU

HOUSTON, TEXAS 77007  
AURICENGINEERS.COM

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SV0.01

## TOPOGRAPHIC SURVEY



- ① EXISTING CURB TO BE DEMOLISHED AND REMOVED  
② EXISTING WALK TO BE DEMOLISHED AND REMOVED  
③ EXISTING PAVING TO BE DEMOLISHED AND REMOVED  
④ REMOVE AND RELOCATE EXIST'G EQUIPMENT  
⑤ EXISTING RAMP & RAILING TO BE DEMOLISHED AND REMOVED  
⑥ EXISTING BOLLARDS TO BE DEMOLISHED AND REMOVED  
⑦ EXISTING FENCING TO BE DEMOLISHED AND REMOVED

KEYNOTES - SITE PLAN - DEMO

1/4" = 1'-0"

QUINN RD

EXISTING STRUCTURE

EXISTING STRUCTURE

EXISTING AG FACILITY

EXIST'G  
GREENHOUSE

GC LAYOUT AREA  
& ACCESS

1. CONTRACTOR SHALL BE RESPONSIBLE FOR VERIFYING ALL EXISTING SITE CONDITIONS, DIMENSIONS, UTILITIES, ETC. WHERE NEW CONSTRUCTION JOINS EXISTING CONDITIONS, THE EXISTING CONDITIONS SHALL CONTROL. ALL DISCREPANCIES SHALL BE SUBMITTED TO THE ARCHITECT FOR CONSIDERATION BEFORE PROCEEDING W/ THE WORK.
2. CONTRACTOR SHALL BE RESPONSIBLE FOR MAINTAINING & MODIFYING EXISTING UTILITY LINES ABOVE & BELOW GRADE DURING THE ENTIRE CONSTRUCTION PERIOD INCLUDING ALL NECESSARY TIE-INS & ELEVATION ADJUSTMENTS, RELOCATION OF ALL UTILITY POLES, LINES & OTHER EXISTING SERVICES. CONTRACTOR SHALL BE RESPONSIBLE FOR ALL COSTS ASSOCIATED W/ THE WORK INCLUDING VERIFICATION & COORDINATION W/ THE APPROPRIATE AGENCIES. CONTRACTOR SHALL BE RESPONSIBLE FOR REPAIRING ANY DAMAGE TO EXISTING UTILITIES IMMEDIATELY TO INSURE NO INTERRUPTION OF SERVICE. CONTRACTOR SHALL BE RESPONSIBLE FOR COORDINATING W/ APPROPRIATE AGENCIES ALL BURIED LINES THAT APPROACH THE CONSTRUCTION AREA.
3. CONTRACTOR SHALL BE RESPONSIBLE FOR THE DESIGN & IMPLEMENTATION OF THE STORM WATER POLLUTION PREVENTION PLAN & SHALL ACQUIRE ALL NECESSARY PERMITS FROM THE APPROPRIATE AGENCIES.
4. CONTRACTOR SHALL BE RESPONSIBLE FOR PROTECTING ALL VEGETATION, SHRUBS, TREES, ETC. INDICATED TO REMAIN FROM ALL CONSTRUCTION ACTIVITIES. DAMAGED LANDSCAPING SHALL BE REPLACED W/ LIKE MATERIALS & SIZE(S) AT THE DIRECTION OF THE ARCHITECT.
5. THE OWNER HAS NEED TO OCCUPY THE FACILITIES DURING THE ENTIRE CONSTRUCTION PROCESS. CONTRACTOR SHALL BE RESPONSIBLE FOR COORDINATING W/ THE OWNER & TAKE ALL NECESSARY MEANS TO ISOLATE OCCUPANTS FROM CONSTRUCTION AREA. NO DISRUPTIVE WORK WILL BE PERMITTED INSIDE THE FACILITY DURING SCHOOL HOURS. CONTRACTOR SHALL BE RESPONSIBLE FOR KEEPING THE CONSTRUCTION AREA CLEAN OF DEBRIS & EXCESSIVE DUST. CONTRACTOR SHALL BE RESPONSIBLE FOR IMMEDIATELY CORRECTING ANY INTERRUPTED USE TO THE FACILITY AT NO COST TO THE OWNER. CONTRACTOR SHALL BE RESPONSIBLE FOR REPLACEMENT OF ANY DAMAGE TO EXISTING FACILITY MATERIALS AT THE DIRECTION OF THE ARCHITECT & AT NO COST TO THE OWNER.
6. CONTRACTOR SHALL BE RESPONSIBLE FOR PROVIDING ANY & ALL MEANS OF SECURITY FOR THE PORTION OF THE FACILITY UNDER CONSTRUCTION OR BEING RENOVATED.
7. CONTRACTOR SHALL BE RESPONSIBLE FOR PROVIDING ANY & ALL MEANS OF ACCESSING THE CONSTRUCTION AREA REQUIRED. CONTRACTOR SHALL BE RESPONSIBLE FOR THE REMOVAL AND RESTORATION OF THE EXISTING AREA(S) UPON COMPLETION OF THE CONSTRUCTION. THE OWNER RESERVES THE RIGHT TO APPROVE ALL CROSSINGS.
8. CONTRACTOR SHALL BE RESPONSIBLE FOR MAINTAINING ALL EXISTING UNDERGROUND STORM LINES DURING ALL CONSTRUCTION INCLUDING NEW TIE-INS. CONTRACTOR SHALL REPAIR DAMAGE TO EXISTING SYSTEM (PIPE, GRATES, ETC.) IMMEDIATELY TO INSURE NO INTERRUPTION. CONTRACTOR SHALL BE RESPONSIBLE TO PROTECT AGAINST SEDIMENT INFILTRATION AND SHALL JET CLEAN ALL LINES AS NECESSARY & UPON COMPLETION OF CONSTRUCTION.
9. CONTRACTOR SHALL BE RESPONSIBLE FOR MODIFYING EXISTING SWALES AND/OR CREATING NEW TEMPORARY WALES OR BERMS AS REQUIRED TO PROVIDE POSITIVE DRAINAGE AWAY FROM DRAINAGE ARE(S). NO FLOODING OF ADJACENT AREAS WILL BE ALLOWED.

NOTES - GENERAL SITE PLAN - DEMO

1/4" = 1'-0"

1 SITE DEMO PLAN - AREA '1'

1" = 20'-0"

CONSULTANTS

MEP

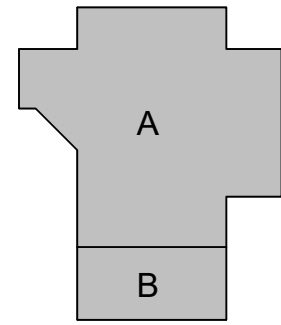
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TOMBALL HIGH SCHOOL  
CTE & MISC. RENOVATIONS

TOMBALL INDEPENDENT SCHOOL DISTRICT  
30330 QUINN ROAD, TOMBALL, TX 77375




TEXAS ARCADIS INC.

10205 WESTHEIMER SUITE 800

HOUSTON, TX 77042

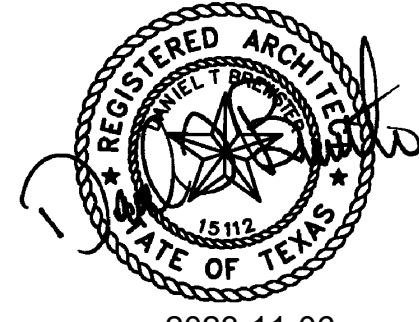tel 713.953.4897, fax 713.977.4620



2023-11-06

PROJECT #: 202311  
DATE: 2023-11-06  
DRAWN: Author  
CHECKED: Checker


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ISSUE: BID SET

CA0.01

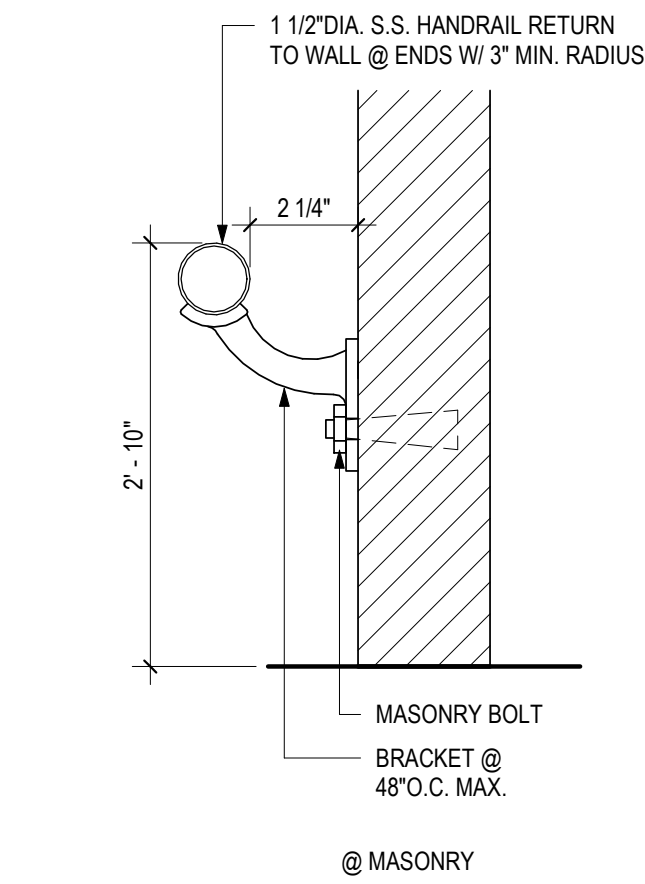
SITE DEMO PLAN









6 RAIL - HANDRAIL @ MAS  
3" = 1'-0"

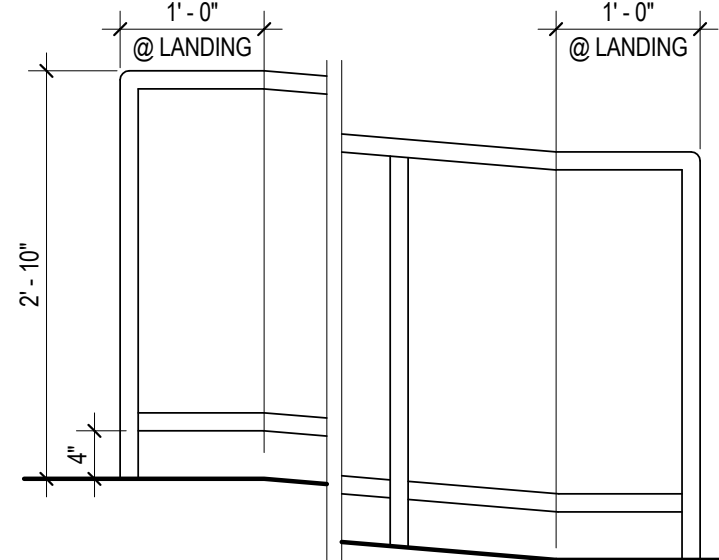

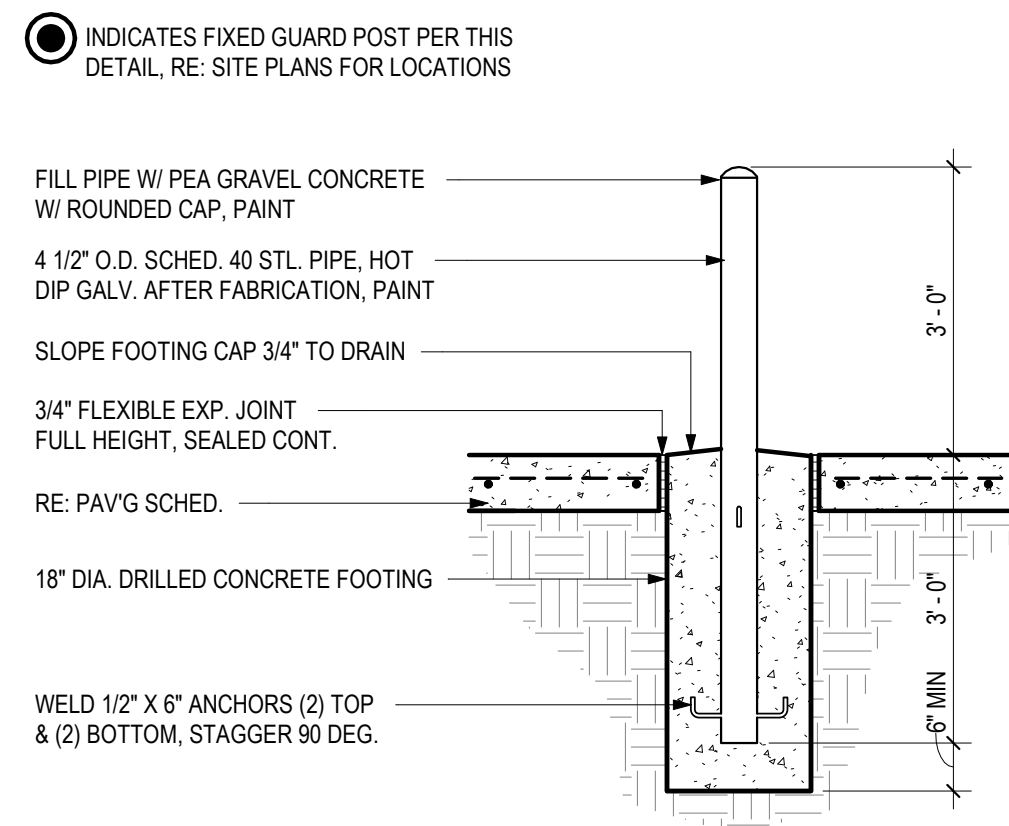
5 RAIL - RAMP ELEV - PIPE  
3/4" = 1'-0"



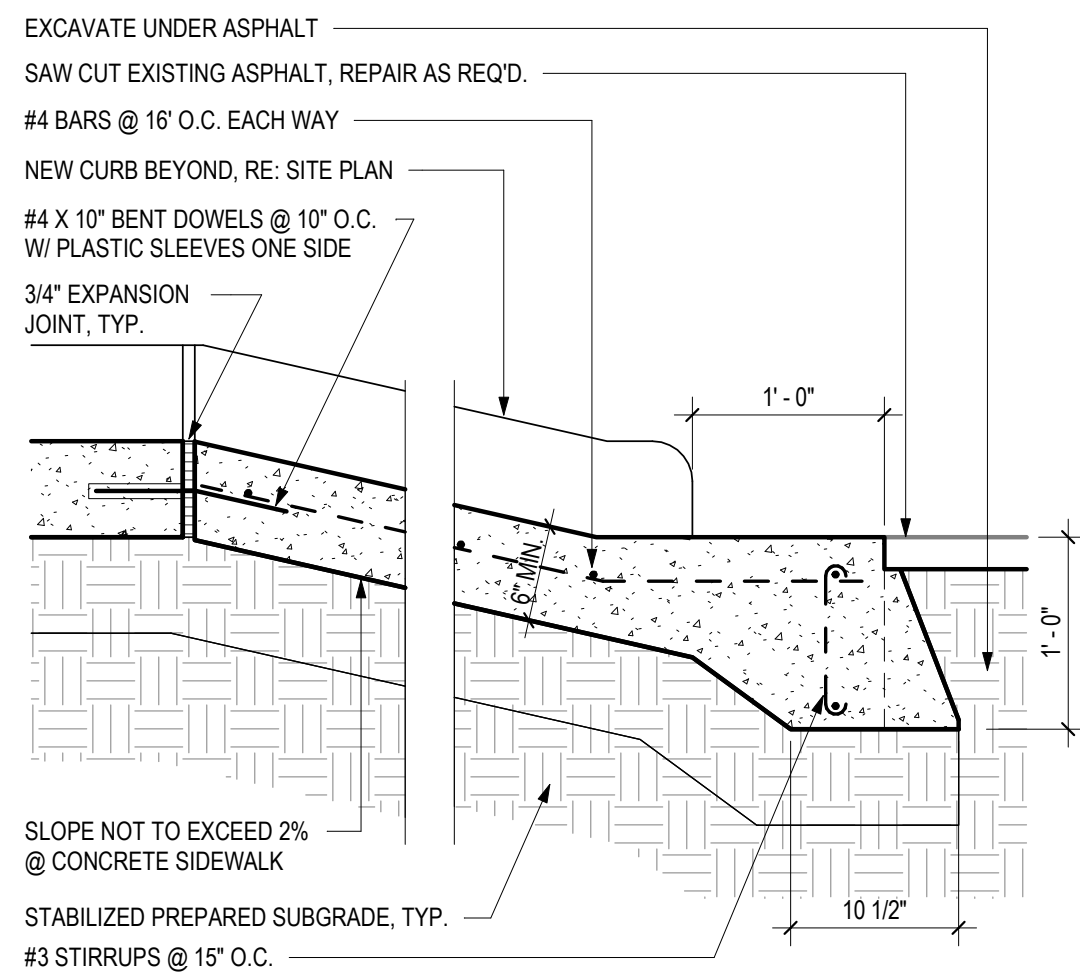
4 MISC - FIXED GUARD POST  
1/2" = 1'-0"




3 PAV'G - CONC DRIVE APPROACH  
1" = 1'-0"

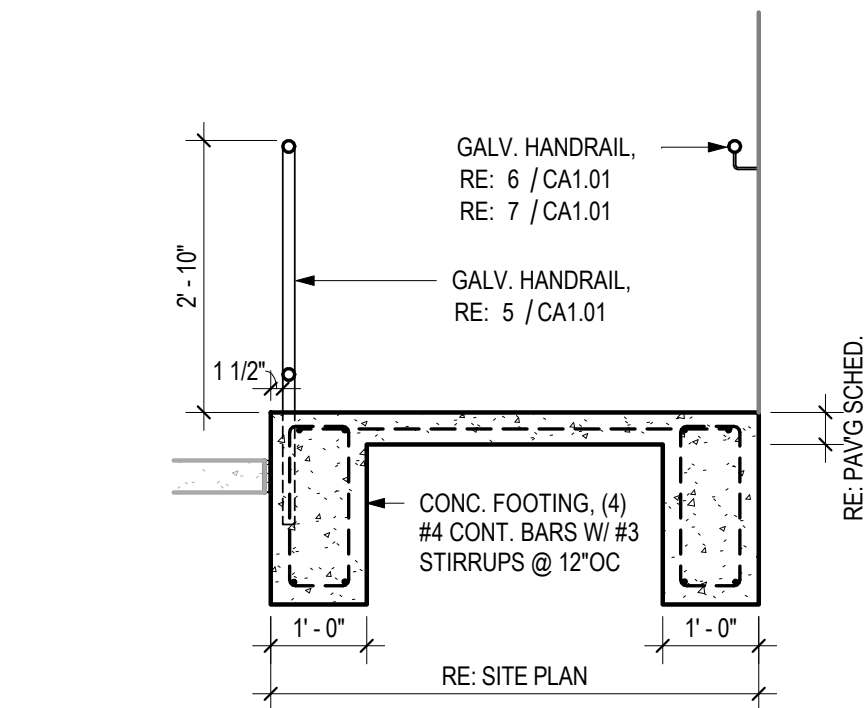


8 RAMP - SECTION - SITE  
1/2" = 1'-0"

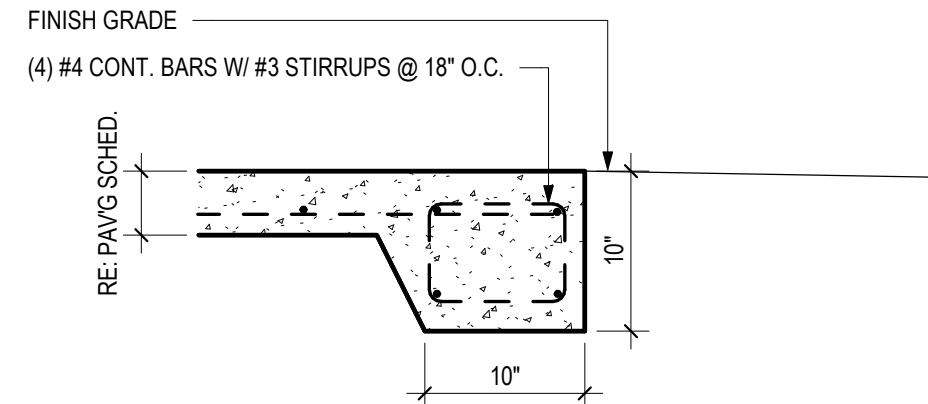

2 PAV'G - CONC PAV'G @ GRADE  
1" = 1'-0"

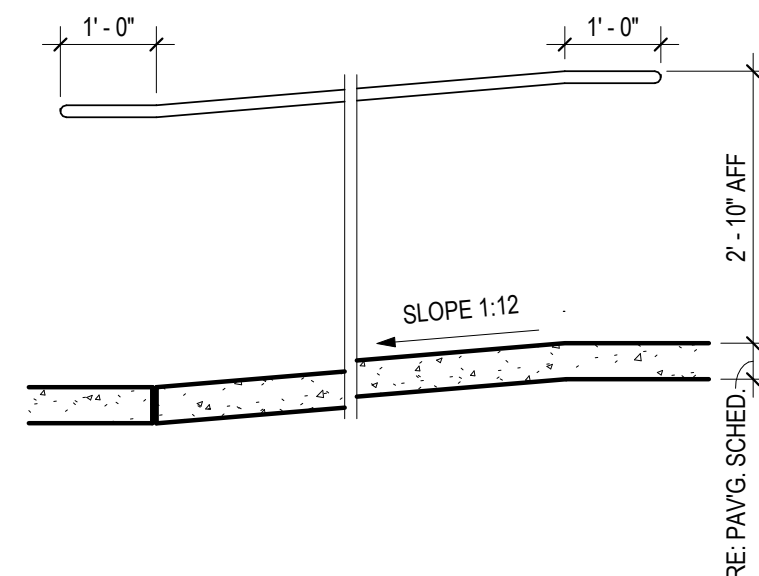

7 RAMP - SECTION @ LNDG  
1/2" = 1'-0"

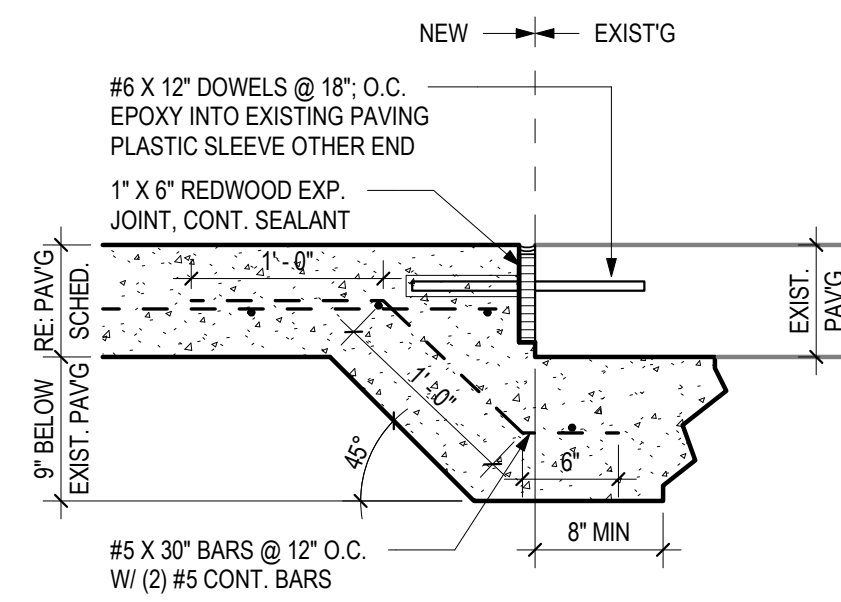


1 PAV'G - CONC PAV'G TO EXIST  
1" = 1'-0"
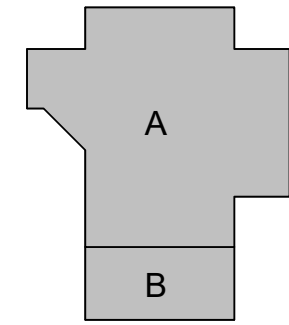
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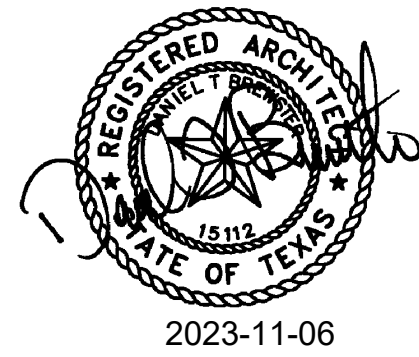


**TOMBALL HIGH SCHOOL  
CTE & MISC. RENOVATIONS**

TOMBALL INDEPENDENT SCHOOL DISTRICT  
30330 QUINN ROAD, TOMBALL, TX 77375

**ARCADIS**

**TEXAS ARCADIS INC.**  
10205 WESTHEIMER SUITE 800  
HOUSTON, TX 77042  
tel 713.953.4897, fax 713.977.4620



PROJECT #: 202311  
DATE: 2023-11-06  
DRAWN: Author  
CHECKED: Checker

DATE: 2023-11-06  
ISSUE: BID SET

**CA1.01**  
SITE DETAILS

GATE SCHEDULE							
MARK	WIDTH	HEIGHT	GATE		ELEV.	FRAME MAT	COMMENTS
			S/ PR	MATERIAL			
GATE-1	3'-0"	6'-0"	S	C.L. MESH	C1	GALV.	EGRESS GATE
GATE-2	6'-0"	6'-0"	PR	C.L. MESH	CC1	GALV.	EGRESS GATE
GATE-3	3'-0"	6'-0"	S	C.L. MESH	C1	GALV.	EGRESS GATE
GATE-4	6'-0"	6'-0"	PR	C.L. MESH	CC1	GALV.	EGRESS GATE

- 1

SIDEWALK EXPANSION JT., RE: C1.01
- 2

SIDEWALK CONTROL JT., RE: C1.01
- 3

18" WIDE MOW STRIP
- 4

ACCESSIBLE RAMP, RE: C1.01
- 5

VAN ACCESSIBLE PARKING SPACES RE: C1.01
- 6

CAR ACCESSIBLE PARKING SPACES RE: C1.01
- 7

FIXED BOLLARD, RE: C1.01
- 8

PEDESTRIAN LIGHT, RE: C1.01
- 9

ALUM. WALKWAY COVER, RE: ROOF PLAN & SECTIONS FOR ADDITIONAL SCOPE
- 10

FLAGPOLE, RE: C1.01
- 11

SITE LIGHT POLE, RE: C1.01
- 12

PEDESTRIAN LIGHT POLE, RE: C1.01
- 13

DIRECTIONAL ARROW, RE: C1.01
- 14

4" PAINT STRIPING
- 15

6'-0" HIGH DECORATIVE FENCE
- 16

6'-0" HIGH CHAIN LINK FENCE
- 17

DUMPSTERS
- 18

4" PVC IRRIGATION SLEEVE

KEYNOTES - SITE PLAN

1/4" = 1'-0"

DESCRIPTION	GRAPHIC	MATERIAL	REINFORCING
SIDEWALKS/ FLATWORK		4" THICK CONCRETE	#3 BARS @ 15" O.C. EACH WAY
STANDARD DUTY PARKING AREAS & DRIVES		5" THICK CONCRETE	#4 BARS @ 15" O.C. EACH WAY
MEDIUM DUTY PARKING AREAS & DRIVES		6" THICK CONCRETE	#4 BARS @ 15" O.C. EACH WAY
HEAVY DUTY PARKING AREAS, DRIVES, & SERVICE YARDS		7" THICK CONCRETE	#4 BARS @ 12" O.C. EACH WAY

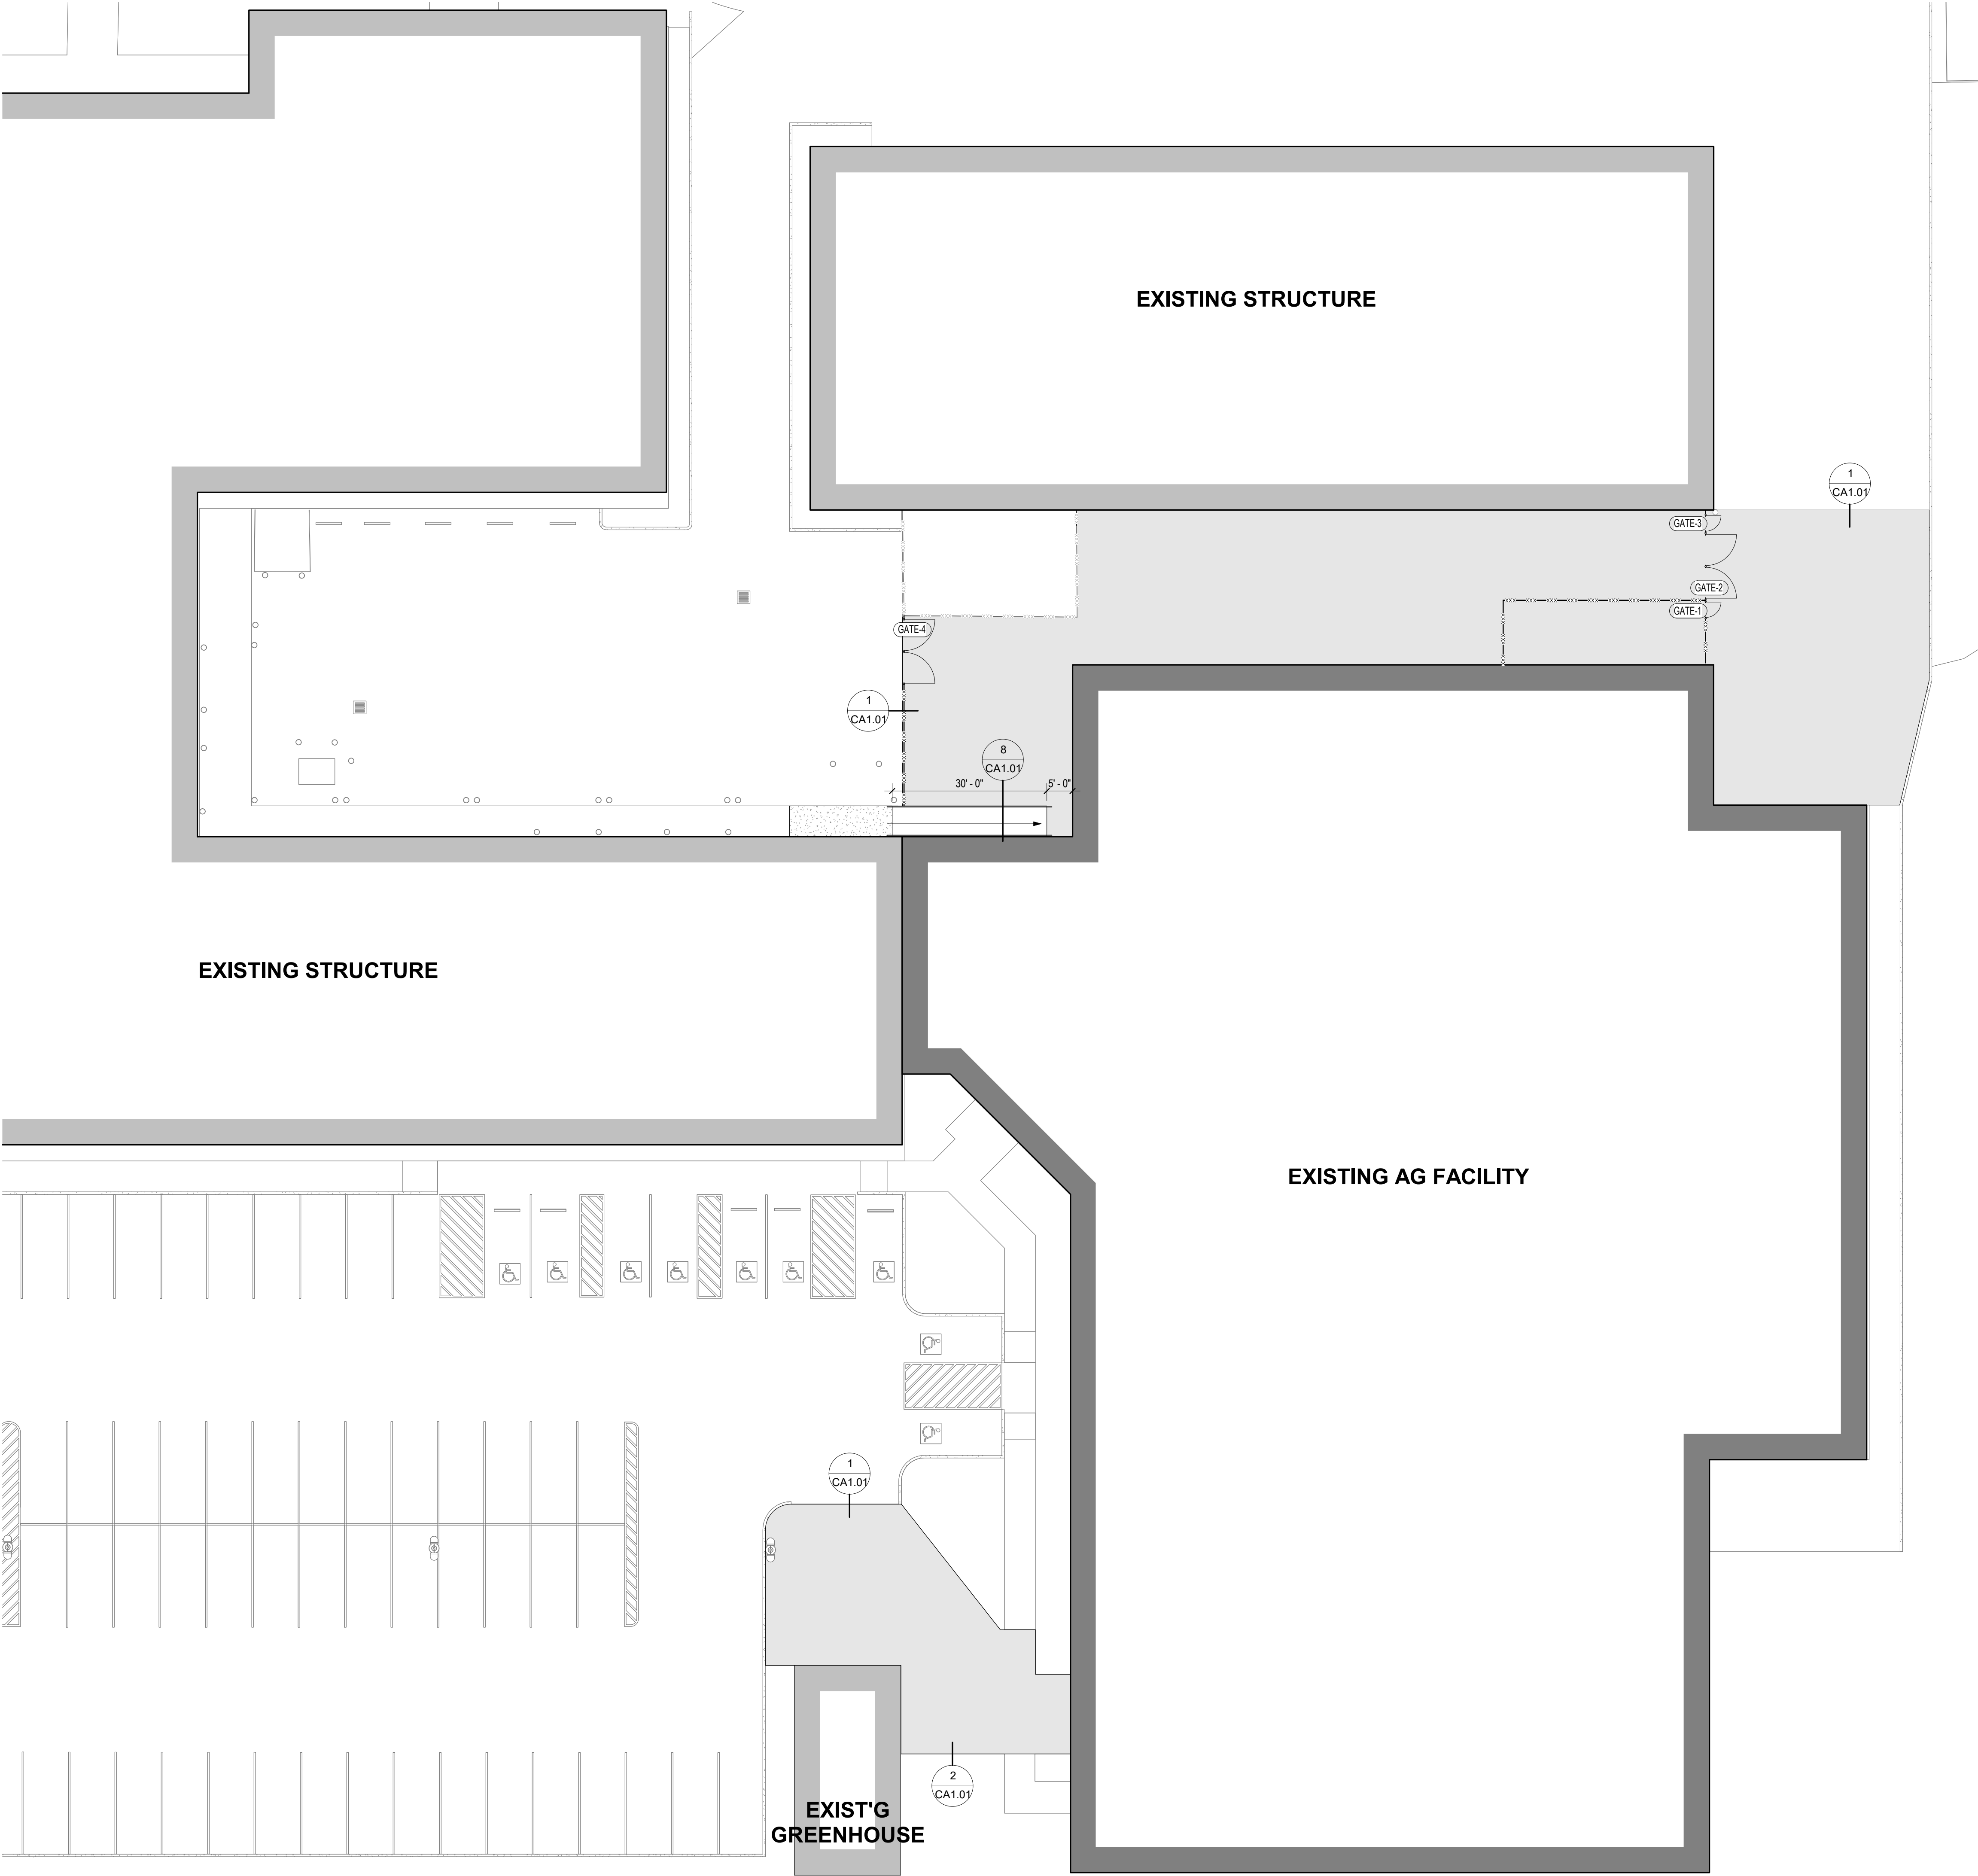
LEGEND - PAVING/ FLATWORK

1" = 1'-0"

1. CONTRACTOR SHALL BE RESPONSIBLE FOR VERIFYING ALL EXISTING SITE CONDITIONS, DIMENSION, UTILITIES, ETC. WHERE NEW CONSTRUCTION JOINS EXISTING CONDITIONS, THE EXISTING CONDITIONS SHALL CONTROL. ALL DISCREPANCIES SHALL BE SUBMITTED TO THE ARCHITECT FOR CONSIDERATION BEFORE PROCEEDING W/ THE WORK.
2. CONTRACTOR SHALL BE RESPONSIBLE FOR MAINTAINING & MODIFYING EXISTING UTILITY LINES ABOVE & BELOW GRADE DURING THE ENTIRE CONSTRUCTION PERIOD, INCLUDING ALL NECESSARY TIE-INS & ELEVATION ADJUSTMENTS, RELOCATION OF ALL UTILITY POLES, LINES & OTHER EXISTING SERVICES. CONTRACTOR SHALL BE RESPONSIBLE FOR ALL COSTS ASSOCIATED W/ THE WORK INCLUDING VERIFICATION & COORDINATION W/ THE APPROPRIATE AGENCIES. CONTRACTOR SHALL BE RESPONSIBLE FOR REPAIRING ANY DAMAGE TO EXISTING UTILITIES IMMEDIATELY TO INSURE NO INTERRUPTION OF SERVICE. CONTRACTOR SHALL BE RESPONSIBLE FOR COORDINATING WITH APPROPRIATE AGENCIES ALL BURIED LINES THAT APPROACH THE CONSTRUCTION AREA.
3. CONTRACTOR SHALL BE RESPONSIBLE FOR THE DESIGN, ACQUIREMENT OF ALL NECESSARY PERMITS, ETC. & IMPLEMENTATION OF THE STORM WATER POLLUTION PREVENTION PLAN W/ THE APPROPRIATE AGENCIES.
4. CONTRACTOR SHALL BE RESPONSIBLE FOR PROTECTING ALL VEGETATION, SHRUBS, TREES, ETC. INDICATED TO REMAIN FROM ALL CONSTRUCTION ACTIVITIES. DAMAGED LANDSCAPING SHALL BE REPLACED W/ LIKE MATERIALS AND SIZE(S) AT THE DIRECTION OF THE ARCHITECT.
5. THE OWNER HAS NEED TO OCCUPY THE FACILITIES DURING THE ENTIRE CONSTRUCTION. CONTRACTOR SHALL BE RESPONSIBLE FOR COORDINATING W/ THE CONSTRUCTION AREA. NO DISRUPTIVE WORK WILL BE PERMITTED INSIDE THE FACILITY DURING SCHOOL HOURS. CONTRACTOR SHALL BE RESPONSIBLE FOR KEEPING THE CONSTRUCTION AREA CLEAN OF DEBRIS & EXCESSIVE DUST. CONTRACTOR SHALL BE RESPONSIBLE FOR IMMEDIATELY CORRECTING ANY INTERRUPTED USE TO THE FACILITY AT NO COST TO THE OWNER. CONTRACTOR SHALL BE RESPONSIBLE FOR REPLACEMENT OF ANY DAMAGE TO EXISTING FACILITY MATERIALS AT THE DIRECTION OF THE ARCHITECT & AT NO COST TO THE OWNER.
6. CONTRACTOR SHALL BE RESPONSIBLE FOR PROVIDING ANY & ALL MEANS OF SECURITY INSIDE & OUTSIDE REQUIRED & APPROVED BY THE OWNER.
7. CONTRACTOR SHALL BE RESPONSIBLE FOR PROVIDING ANY & ALL MEANS OF ACCESSING THE CONSTRUCTION AREA REQUIRED & APPROVED BY THE OWNER. CONTRACTOR SHALL BE RESPONSIBLE FOR THE REMOVAL & RESTORATION OF THE EXISTING AREA(S) UPON COMPLETION OF THE CONSTRUCTION.
8. CONTRACTOR SHALL BE RESPONSIBLE FOR MAINTAINING ALL EXISTING UNDERGROUND STORM LINES DURING ALL CONSTRUCTION, INCLUDING NEW TIES-INS. CONTRACTOR SHALL REPAIR DAMAGE TO EXISTING SYSTEM (PIPE, GRATES, ETC.) IMMEDIATELY TO INSURE NO INTERRUPTION. CONTRACTOR SHALL BE RESPONSIBLE TO PROTECT SEDIMENT INFILTRATION & SHALL JET CLEAN ALL LINES AS NECESSARY UPON COMPLETION OF CONSTRUCTION.
9. CONTRACTOR SHALL BE RESPONSIBLE FOR MODIFYING EXISTING SWALES AND/OR CREATING NEW TEMPORARY SWALES OR BERMS AS REQUIRED TO PROVIDE POSITIVE DRAINAGE AWAY FROM CONSTRUCTION AREA(S).
10. CONTRACTOR SHALL BE RESPONSIBLE FOR PROVIDING THE FOLLOWING AMERICANS W/ DISABILITIES ACT (A.D.A.) & TEXAS ACCESSIBILITY STANDARDS (T.A.S.) ACCESSIBLE ROUTE REQUIREMENTS:  
\*ACCESSIBLE ROUTE (PARKING LOT & WALKS):  
SLOPE SHALL NOT EXCEED 5% (5/101 FOOT)  
CROSS-SLOPE SHALL NOT EXCEED 2% (1/4" PER 1')  
\*ACCESSIBLE APPROACH TO EXTERIOR DOOR(S)  
IMMEDIATELY OUTSIDE OF DOOR & FOR A DISTANCE OF 5'-0" MIN. SHALL NOT EXCEED A SLOPE OF 2% (1/4" PER 1')  
MAXIMUM RISE AT THRESHOLD SHALL NOT EXCEED 1/2".
11. CONTRACTOR SHALL BE RESPONSIBLE FOR PROVIDING CONCRETE WALKS AS INDICATED ON THE SITE PLAN & DETAILED ON THE DETAIL SHEET (EXPANSION JOINTS AT 20'-0" MAX. W/ CONTROL JOINTS AT 5'-0" MAX. & EQUAL SPACES). CONTRACTOR SHALL BE RESPONSIBLE FOR VERIFYING JOINT LAYOUT W/ ARCHITECT IN THE FIELD PRIOR TO FORMING.
12. CONTRACTOR SHALL BE RESPONSIBLE FOR PROVIDING HYDROMULCH AT ALL LANDSCAPE & PLANNING AREA, ETC. DISTURBED DURING CONSTRUCTION & AT ALL AREAS NOTED AS FILL & GRADE, UNLESS NOTED OTHERWISE ON PLANS. PROVIDE TEMPORARY BARRICADE ALONG MAIN ACCESS PATHS TO BUILDING UNTIL SUCH TIME THE GRASS HAS STABILIZED THE FINISH GRADE.
13. CONTRACTOR SHALL PROVIDE EXPANSION JOINTS AT THE PROPERTY LINE AT ALL DRIVES.
14. CONTRACTOR SHALL GRADE ALL LANDSCAPE ISLAND TO AVOID WATER PONDING INSIDE OF CURBS.
15. CONTRACTOR SHALL PROVIDE FILL & SOLID SOD AT 5'-0" MIN. FROM ALL CONSTRUCTION AREAS UNLESS NOTED OTHERWISE.
16. CONTRACTOR SHALL REFER TO CIVIL DRAWINGS FOR ALL SITE GRADING & SUB-SURFACE DRAINAGE SYSTEMS, MODIFICATIONS TO EXISTING SYSTEMS AND UTILITIES.
17. CONTRACTOR SHALL REFER TO PAVING SCHEDULE FOR THICKNESS OF SURFACES.
18. ALL DIMENSIONS ARE TO EDGE OF WALK OR PAVING, BACK OF CURB, FACE OF BUILDING OR PROPERTY LINE, UNLESS NOTED OTHERWISE.
19. PARKING LOT PAINTING STANDARDS:  
\*TYPICAL PARKING LINE SHALL BE 4" WIDE x 18'-0" LONG PER STALL, UNLESS NOTED OTHERWISE.  
\*TYPICAL A.D.A. SYMBOL & LOADING AREA SHALL BE PER DETAIL ON DETAIL SHEET.  
\*TYPICAL FIRE LANE CURB SHALL BE OF APPROVED COLOR W/ STENCILED CONTRASTING GRAPHICS AT 50'-0" SPACING THAT READS:  
"FIRE LANE - NO PARKING - TOW AWAY ZONE"
20. AT ALL FIRE LANE CURBS, PROVIDE FIRE LANE SIGNS, SIMILAR TO ACCESSIBLE SIGN ON C1.00, EXCEPT LOCATION EVERY 50'-0" O.C. ALONG FIRE LANE CURBS. SIGN TO READ: "FIRE LANE", "NO PARKING", "TOW AWAY ZONE". COORDINATE THE LOCATIONS IN THE FIELD W/ ARCHITECT.

NOTES - GENERAL SITE PLAN

1/4" = 1'-0"



SITE PLAN

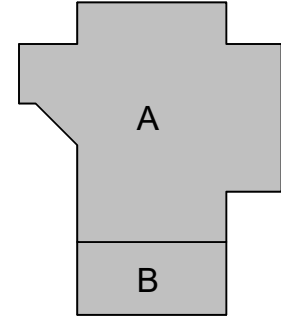
1/16" = 1'-0"

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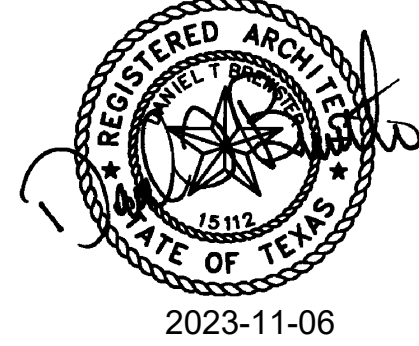
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Fax: 713.780.3712



**TOMBALL HIGH SCHOOL  
CTE & MISC. RENOVATIONS**


TOMBALL INDEPENDENT SCHOOL DISTRICT  
30330 QUINN ROAD, TOMBALL, TX 77375

**ARCADIS**  
TEXAS ARCADIS INC.  
10205 WESTHEIMER SUITE 800  
HOUSTON, TX 77042  
tel 713.953.4897, fax 713.977.4620



PROJECT #: 202311  
DATE: 2023-11-06  
DRAWN: Author  
CHECKED: Checker  
DATE: 2023-11-06  
ISSUE: BID SET

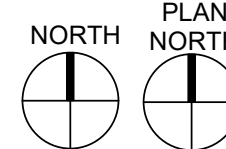**CA1.02**  
SITE PLAN









UNOFFICIAL COPY

STATE OF TEXAS  
COUNTY OF HARRIS  
I, [Name], County Clerk of Harris County, Texas, do hereby certify that the foregoing is a true and correct copy of the plat as recorded in the Public Records of Harris County, Texas, on [Date].  
WITNESS MY HAND AND SEAL OF OFFICE, at Houston, the day and date first above written.

STATE OF TEXAS  
COUNTY OF HARRIS  
I, [Name], County Clerk of Harris County, Texas, do hereby certify that the foregoing is a true and correct copy of the plat as recorded in the Public Records of Harris County, Texas, on [Date].  
WITNESS MY HAND AND SEAL OF OFFICE, at Houston, the day and date first above written.

STATE OF TEXAS  
COUNTY OF HARRIS  
I, [Name], County Clerk of Harris County, Texas, do hereby certify that the foregoing is a true and correct copy of the plat as recorded in the Public Records of Harris County, Texas, on [Date].  
WITNESS MY HAND AND SEAL OF OFFICE, at Houston, the day and date first above written.

STATE OF TEXAS  
COUNTY OF HARRIS  
I, [Name], County Clerk of Harris County, Texas, do hereby certify that the foregoing is a true and correct copy of the plat as recorded in the Public Records of Harris County, Texas, on [Date].  
WITNESS MY HAND AND SEAL OF OFFICE, at Houston, the day and date first above written.

FINAL - PLAT  
OF  
TOMBALL I.S.D.  
SENIOR HIGH SCHOOL  
&  
BECKENDORF SCHOOL SUBDIVISION

BEING 62.5376 ACRES OUT OF THE JOSEPH  
HOUSE SURVEY, A-34, CITY OF TOMBALL  
HARRIS COUNTY, TEXAS.

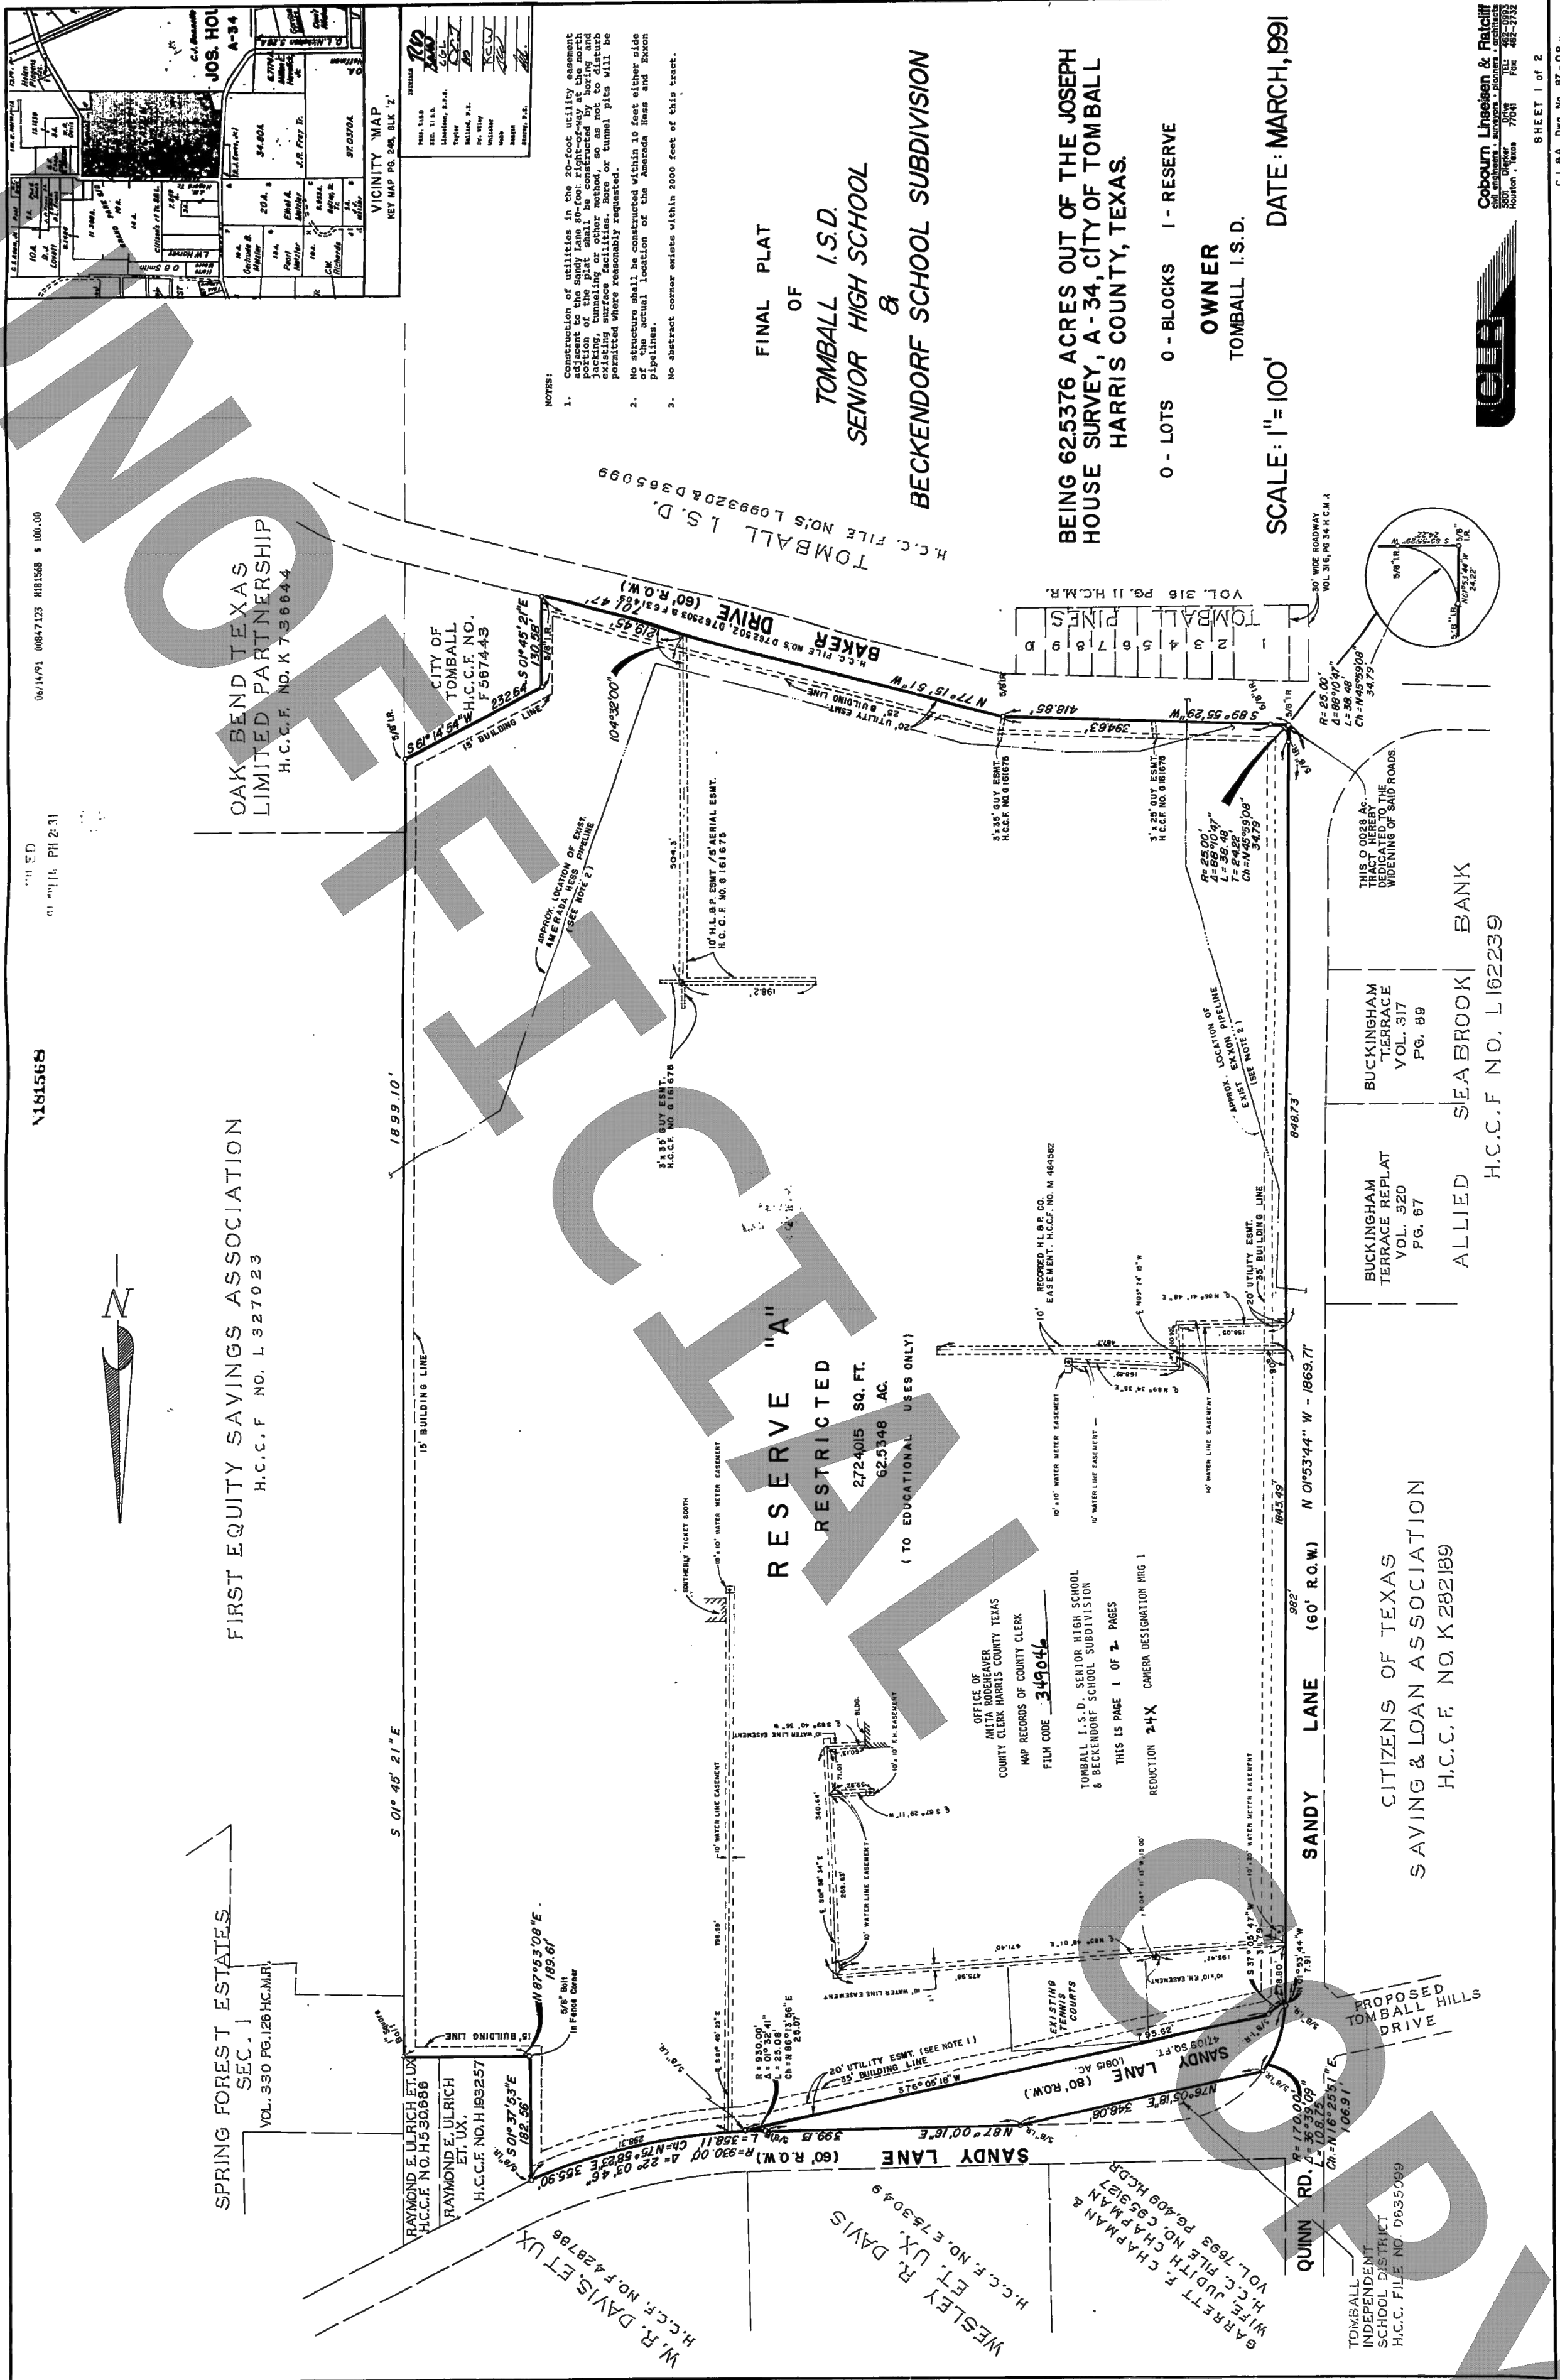
0 - LOTS 0 - BLOCKS 1 - RESERVE  
OWNER  
TOMBALL I.S.D.

SCALE: 1"=100'  
DATE: MARCH, 1991

Copcon Limited & Related  
Companies  
10000  
10000  
10000

C.L.A. Reg. No. 87-08

SHEET 2 OF 2



**Texas 811**  
Know what's below.  
Call before you dig.

DRAWING SCALE  
HORIZ: N/A  
VERT: N/A


PROJECT NUMBER  
0104.0117

**auric**  
ENGINEERS  
TEXAS ENGINEERING FIRM 20740  
520 POST OAK BLVD., SUITE 895  
HOUSTON, TEXAS 77007  
AURICENGINEERS.COM


PROJECT #:	202311
DATE:	11/06/2023
DRAWN:	DAH
CHECKED:	DAH
DATE	ISSUE
11/06/2023	BID SET

C1.01  
PLAT

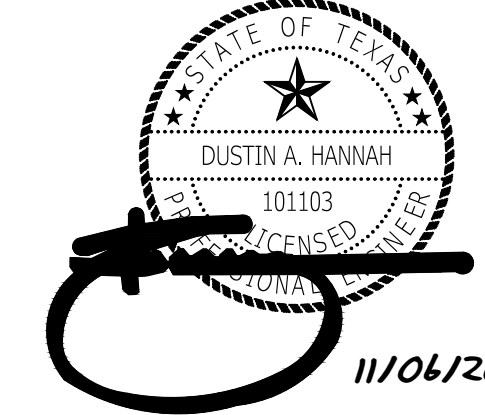**ARCADIS**  
TEXAS ARCADIS INC.  
10205 WESTHEIMER SUITE 800  
HOUSTON, TX 77042  
tel 281.286.6605, fax 713.977.4620



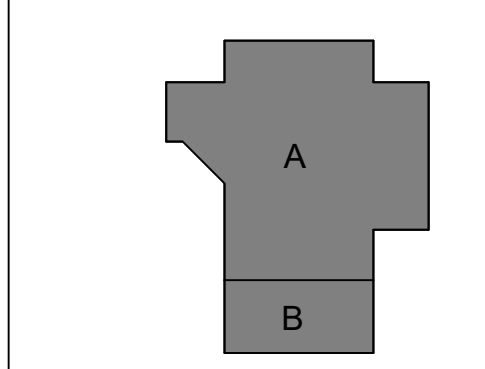
**TOMBALL HIGH SCHOOL  
CTE & MISC. RENOVATIONS**  
TOMBALL INDEPENDENT SCHOOL DISTRICT  
30330 QUINN ROAD, TOMBALL, TX 77375



**CONSULTANTS**  
MEP  
Salas O'Brien  
10930 W. Sam Houston Pkwy N  
Suite 900  
Houston, TX 77064  
Tel: 281.664.1900  
Fax: 281.664.1912  
CIVIL  
Auric Engineers, LLC  
520 Post Oak Blvd., Suite 895  
Houston, TX 77007  
Tel: 713.405.1901  
**STRUCTURAL**  
CJG Engineers  
3200 Wilcrest Drive, Suite 305  
Houston, TX 77042  
Tel: 713.780.3345  
Fax: 713.780.3712

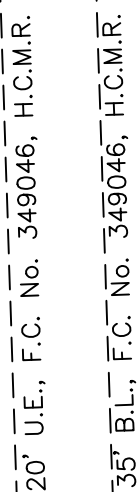**BENCHMARK AND FLOODPLAIN INFORMATION**  
PROJECT BENCHMARK:  
DESCRIPTION  
RM100395 - BRASS DISK STAMPED "RM100395" LOCATED ON THE SOUTHEAST CORNER OF A 5' X 8' CONCRETE BOX CULVERT UNDER RUDOLPH RD. 40.4 MILE SOUTH OF 210N RD.  
ELEVATION = 171.59' (NAVD 88, 2001 ADJ.)  
FLOODPLAIN INFORMATION:  
ACCORDING TO F.I.R.M. MAP NO. 48201C0210L (COMMUNITY-PANEL NO. 480150210L), MAP REVISED DATE: JUNE 18, 2007, THE SUBJECT PROPERTY LIES WITHIN THE AREA DESIGNATED AS ZONE "V" UNSHADED, DETERMINED TO BE OUTSIDE THE 0.2% ANNUAL CHANCE FLOOD.  
NEAREST 1%(100-YR) FLOOD ELEVATION = 179.10 FT





**TOMBALL HIGH SCHOOL  
CTE & MISC. RENOVATIONS**

TOMBALL INDEPENDENT SCHOOL DISTRICT  
30330 QUINN ROAD, TOMBALL, TX 77375



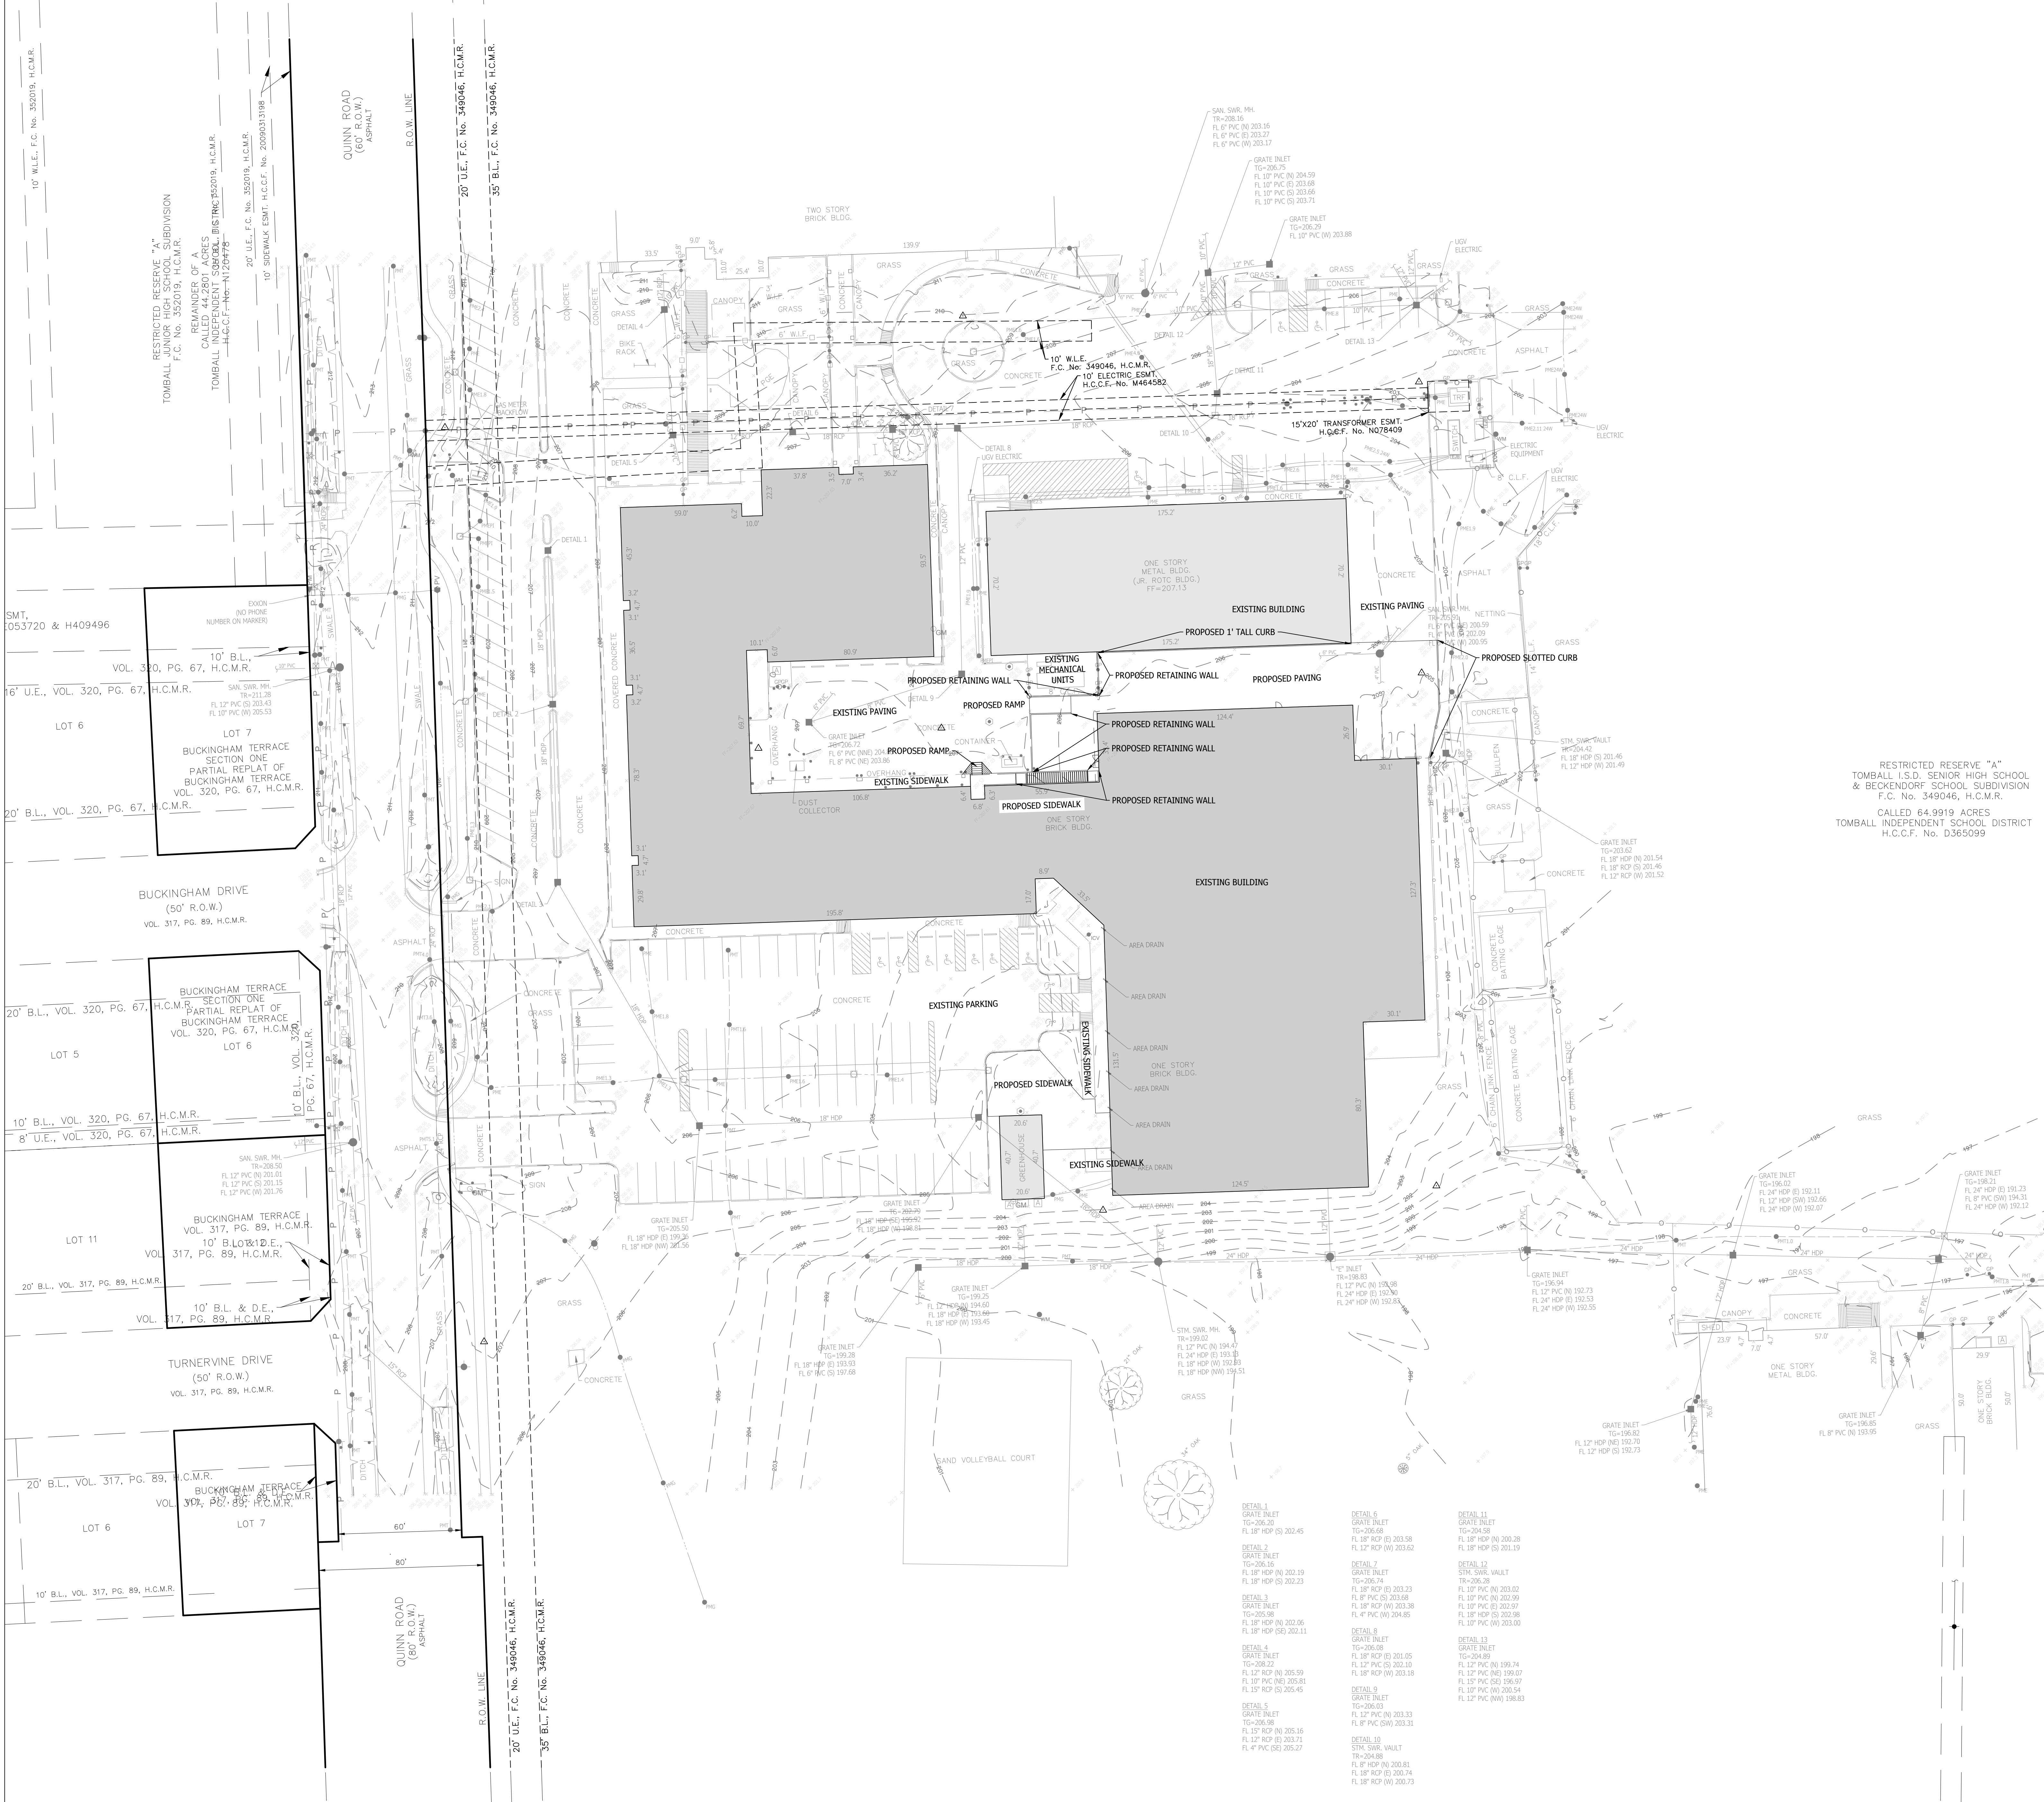




PLOTTED: 11/03/2023 12:58 PM

PLOT STYLE: AURIC.AUT

FILE PATH: C:\USERS\JSTANHAN\APP\CAD\DWG\PROJECTS\TOMBALL\TOMBALL ISD HS (REVISED) FILES\CIVIL\DWG\DRAWINGS\DSHETS\CD\CD SITE PLAN.DWG



**BENCHMARK AND FLOODPLAIN INFORMATION**

**PROJECT BENCHMARK:**  
DESCRIPTION: BRASS DISK STAMPED "RM100399" LOCATED ON THE SOUTHEAST CORNER OF A 5' X 8' CONCRETE BOX CULVERT UNDER RUDOLPH RD. +0.4 MILE SOUTH OF 20th RD.  
ELEVATION = 171.59' (NAVD 88, 2001 ADJ.)

**FLOODPLAIN INFORMATION:**  
DESCRIPTION: ACCORDING TO F.I.R.M. MAP NO. 48201C0210L (COMMUNITY-PANEL NO. 4803150210L), MAP REVISED DATE: JUNE 18, 2007. THE SUBJECT PROPERTY LIES WITHIN THE AREA DESIGNATED AS ZONE "X" UNSHADED, DETERMINED TO BE OUTSIDE THE 0.2% ANNUAL CHANCE FLOOD.  
NEAREST 1%(100-YR) FLOOD ELEVATION = 179.10 FT



RESTRICTED RESERVE "A"  
TOMBALL I.S.D. SENIOR HIGH SCHOOL  
& BECKENDORF SCHOOL SUBDIVISION  
F.C. No. 349046, H.C.M.R.  
CALLED 64.9919 ACRES  
TOMBALL INDEPENDENT SCHOOL DISTRICT  
H.C.C.F. No. D365099

LOT 6  
10' W.L.E., F.C. No. 352019, H.C.M.R.  
TOMBALL JUNIOR HIGH SCHOOL SUBDIVISION  
F.C. No. 352019, H.C.M.R.  
REMAINDER OF A  
CALLED 44.2801 ACRES  
TOMBALL INDEPENDENT SCHOOL DISTRICT  
H.C.C.F. No. N129472

LOT 7  
10' B.L., VOL. 320, PG. 67, H.C.M.R.  
BUCKINGHAM TERRACE  
SECTION ONE  
PARTIAL REPLAT OF  
BUCKINGHAM TERRACE  
VOL. 320, PG. 67, H.C.M.R.

LOT 5  
20' B.L., VOL. 320, PG. 67, H.C.M.R.  
LOT 6  
10' B.L., VOL. 320, PG. 67, H.C.M.R.

LOT 11  
20' B.L., VOL. 317, PG. 89, H.C.M.R.  
LOT 7  
10' B.L. & D.E., VOL. 317, PG. 89, H.C.M.R.


LOT 6  
20' B.L., VOL. 317, PG. 89, H.C.M.R.  
LOT 7  
10' B.L., VOL. 317, PG. 89, H.C.M.R.

**CONSULTANTS**

MEP  
Salas O'Brien  
10930 W. Sam Houston Pkwy N  
Suite 900  
Houston, TX 77064  
Tel: 281.664.1900  
Fax: 281.664.1912

CIVIL  
Auric Engineers, LLC  
520 Post Oak Blvd., Suite 895  
Houston, TX 77042  
Tel: 281.780.3345  
Fax: 281.780.3712

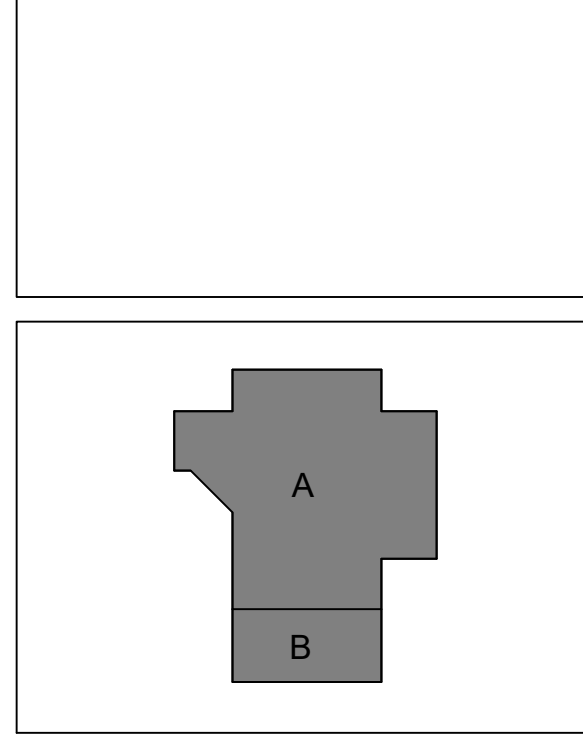**STRUCTURAL**  
CJG Engineers  
3200 Wilcrest Drive, Suite 305  
Houston, TX 77042  
Tel: 281.780.3345  
Fax: 281.780.3712



# TOMBALL HIGH SCHOOL CTE & MISC. RENOVATIONS

TOMBALL INDEPENDENT SCHOOL DISTRICT  
30330 QUINN ROAD, TOMBALL, TX 77375

**ARCADIS**  
TEXAS ARCADIS INC.  
10205 WESTMEIER SUITE 800  
HOUSTON, TX 77042  
tel 281.286.6605, fax 713.977.4620



PROJECT #: 202311  
DATE: 11/06/2023  
DRAWN: DAH  
CHECKED: DAH  
DATE: 11/06/2023  
ISSUE: BID SET

**C2.01**  
CIVIL SITE PLAN



**Texas 811**  
Know what's below.  
Call before you dig.

DRAWING SCALE: 1" = 30'  
HORIZ: N/A  
VERT: N/A

PROJECT NUMBER: 0104.0117

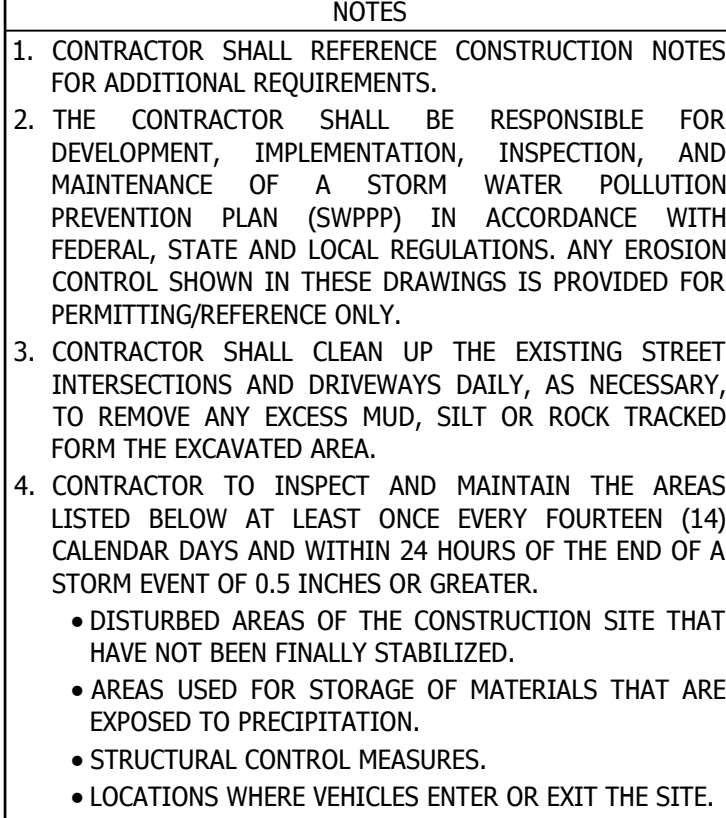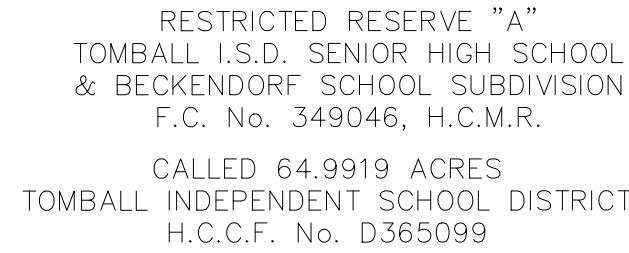
**auric ENGINEERS**  
TEXAS ENGINEERING FIRM 20740  
520 POST OAK BLVD., SUITE 895  
HOUSTON, TEXAS 77007  
AURICENGINEERS.COM





**TOMBALL HIGH SCHOOL  
CTE & MISC. RENOVATIONS**

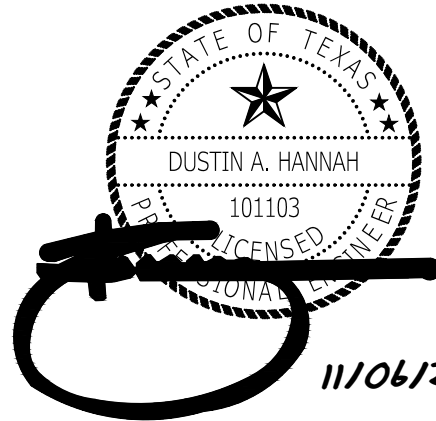TOMBALL INDEPENDENT SCHOOL DISTRICT  
30330 QUINN ROAD, TOMBALL, TX 77375



# C2.02

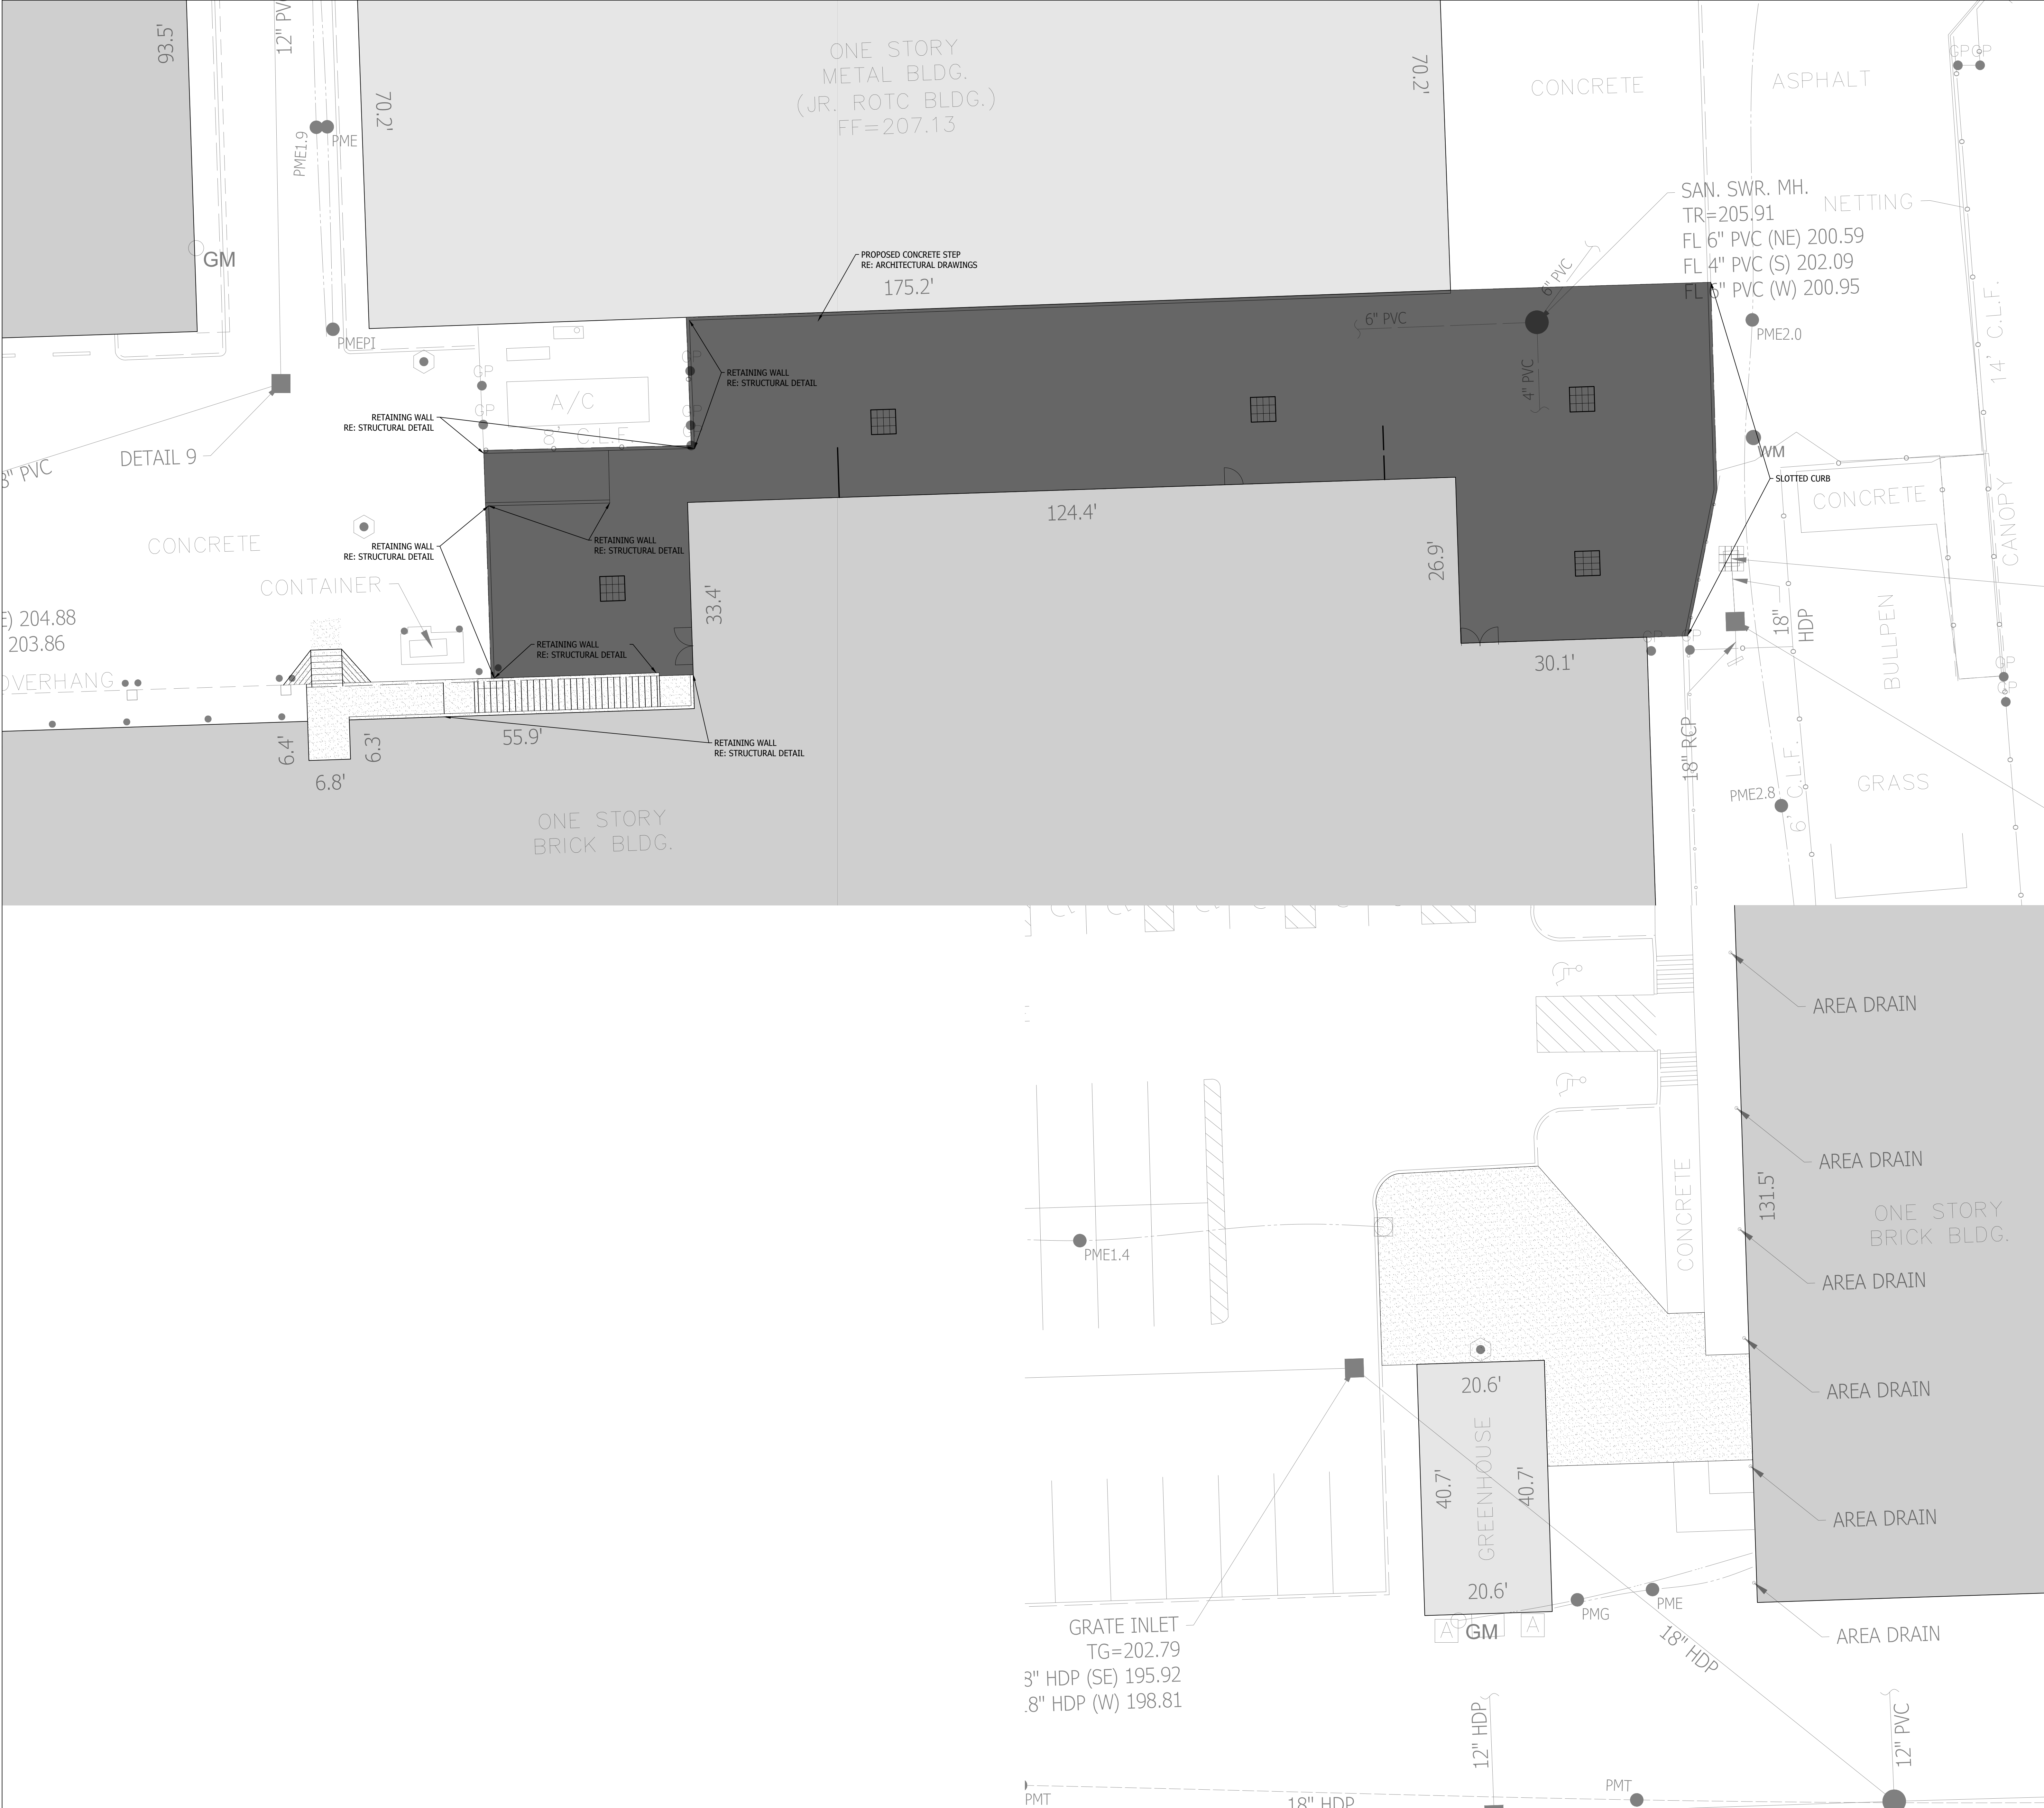
## SITE EROSION CONTROL PLAN



PLOTTED: 11/06/2023 12:57 PM

PLOT STYLE: AURIC.AUT

FILE PATH: C:\USERS\JOSHUA\APPDATA\LOCAL\AUTOCAD\DRAWINGS\TOMBALL\TOMBALL ISD HS (TEVPROJECT FILES)\CIVIL\DWG-DRAWINGS\03-SHET\03-03 SITE PAVING AND JOINTING PLAN.DWG



**BENCHMARK AND FLOODPLAIN INFORMATION**

**PROJECT BENCHMARK:**  
 DESCRIPTION  
 RM100395 - BRASS DISK STAMPED "RM100395" LOCATED ON THE SOUTHEAST CORNER OF A 5' X 8' CONCRETE BOX CULVERT UNDER RUDOLPH RD. +0.4 MILE SOUTH OF ZION RD.  
 ELEVATION = 171.59' (NAVD 88, 2001 ADJ.)

**FLOODPLAIN INFORMATION:**  
 DESCRIPTION  
 ACCORDING TO F.I.R.M. MAP NO. 48201C0210L (COMMUNITY-PANEL NO. 4803150210L), MAP REVISED DATE: JUNE 18, 2007, THE SUBJECT PROPERTY LIES WITHIN THE AREA DESIGNATED AS ZONE "Y" UNSHADED, DETERMINED TO BE OUTSIDE THE 0.2% ANNUAL CHANCE FLOOD.  
 NEAREST 1%/100-YR FLOOD ELEVATION = 179.10 FT

**LEGEND**

- PROP. 7" REINFORCED CONCRETE PAVEMENT WITH 8" STABILIZED SUBGRADE
- PROP. 6" REINFORCED CONCRETE PAVEMENT WITH 6" STABILIZED SUBGRADE
- PROP. 5" REINFORCED CONCRETE PAVEMENT WITH 6" STABILIZED SUBGRADE
- PROP. 2" HMAc PAVEMENT WITH 8" BLACK BASE AND 6" STABILIZED SUBGRADE
- PROP. 4.5" REINFORCED CONCRETE WALK
- PROP. SAWED CONTRACTION JOINT

**KEY NOTES**

**NOTES**

- CONTRACTOR SHALL REFERENCE CIVIL CONSTRUCTION NOTES FOR ADDITIONAL REQUIREMENTS.
- SUBGRADE SHALL BE STABILIZED BY THE ADDITION OF LIME AND FLY ASH AT THE RATE OF 3% LIME AND 8% FLY ASH.
- THE CONTRACTOR SHALL SUBMIT A DRAWING SHOWING THE PROPOSED POURING PLAN AND ANY MODIFICATIONS TO THE PROPOSED JOINT LAYOUT TO THE ENGINEER FOR REVIEW.
- THE PAVEMENT JOINTING PLAN SHALL BE COORDINATED WITH THE LOCATION OF INLETS, MANHOLES LIGHT POLES, ETC. IN PAVED AREAS.
- SAWED JOINTS ARE TO BE EQUALLY SPACED BETWEEN EXPANSION JOINTS.
- REFERENCE THE ARCHITECTURAL SITE PLAN FOR SIDEWALK JOINT PATTERN. SIDEWALK JOINTS SHALL ALIGN WITH PAVING JOINTS WHEN SIDEWALK IS ADJACENT TO PAVING.
- WHERE NEW CONCRETE PAVING MEETS EXISTING CONCRETE PAVING, SAW CUT AND EXPOSE 15" OF EXISTING REINFORCING STEEL. IF NO REINFORCING STEEL EXISTS, USE HORIZONTAL DOWELS (#6 BARS 24" LONG) 24" C-C DRILLED AND EMBEDDED 8" INTO THE CENTER OF THE EXISTING SLAB WITH "PO ROC" OR EQUAL.

DRAWING SCALE

HORIZ: 1" = 10'

VERT: N/A

PROJECT NUMBER

0104.0117

TEXAS ENGINEERING FIRM 20740

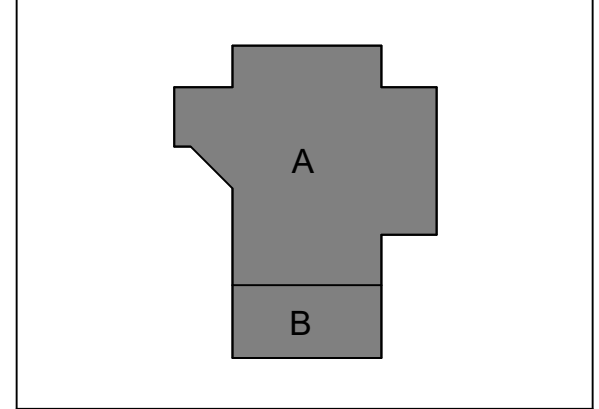
520 POST OAK BLVD., SUITE 895  
 HOUSTON, TEXAS 77007  
 AURICENGINEERS.COM

**CONSULTANTS**

**MEP**  
 Salas O'Brien  
 10930 W. Sam Houston Pkwy N  
 Suite 900  
 Houston, TX 77064  
 Tel: 281.664.1900  
 Fax: 281.664.1912

**CIVIL**  
 Auric Engineers, LLC  
 520 Post Oak Blvd., Suite 895  
 Houston, TX 77027  
 Tel: 713.405.1901

**STRUCTURAL**  
 CJG Engineers  
 3200 Wilcrest Drive, Suite 305  
 Houston, TX 77042  
 Tel: 713.780.3345  
 Fax: 713.780.3712



**TOMBALL HIGH SCHOOL  
 CTE & MISC. RENOVATIONS**

**TOMBALL INDEPENDENT SCHOOL DISTRICT**  
 30330 QUINN ROAD, TOMBALL, TX 77375

**TEXAS ARCADIS INC.**  
 10205 WESTHEIMER SUITE 800  
 HOUSTON, TX 77042  
 tel 281.286.6605, fax 713.977.4620

PROJECT #: 202311

DATE: 11/06/2023

DRAWN: DAH

CHECKED: DAH


DATE: 11/06/2023

ISSUE: BID SET

**C2.03**

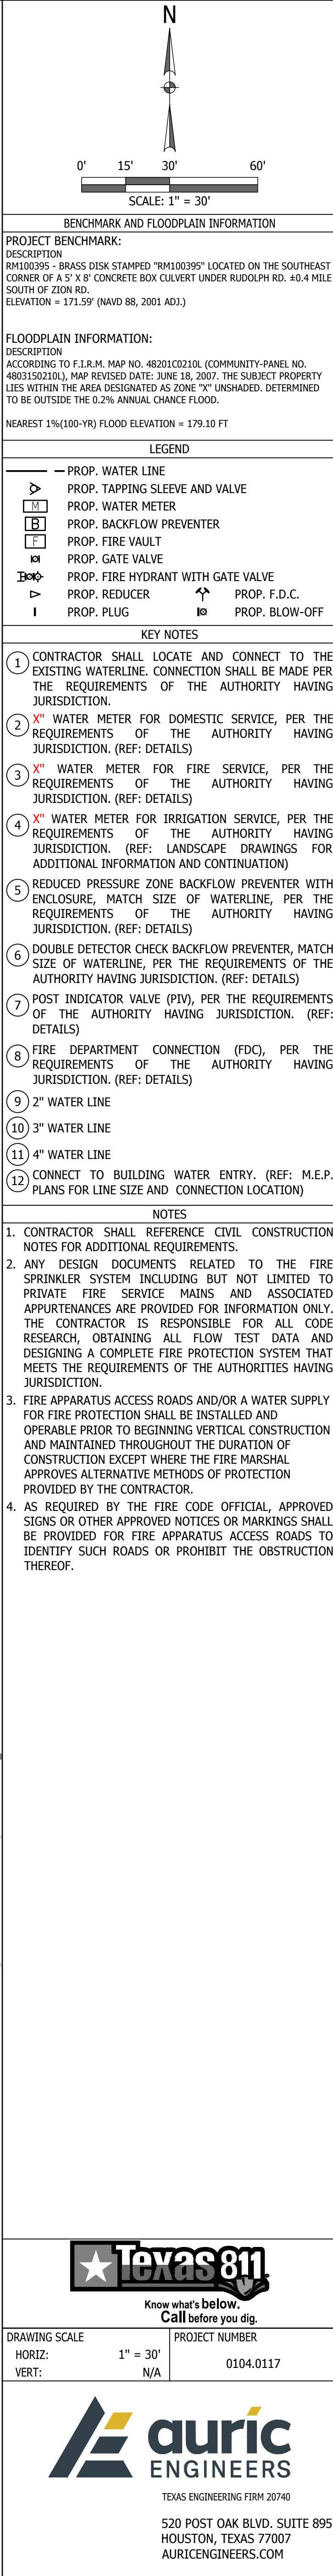
**SITE PAVING AND JOINTING  
 PLAN**






**STRUCTURAL**  
CJG Engineers  
3200 Wilcrest Drive, Suite 305  
Houston, TX 77042  
Tel: 713.780.3345  
Fax: 713.780.3712



PROJECT #: 202311	
DATE: 11/06/2023	
DRAWN: DAH	
CHECKED: DAH	
DATE	ISSUE 
11/06/2023	BID SET

## FIRE APPARATUS ACCESS PLAN



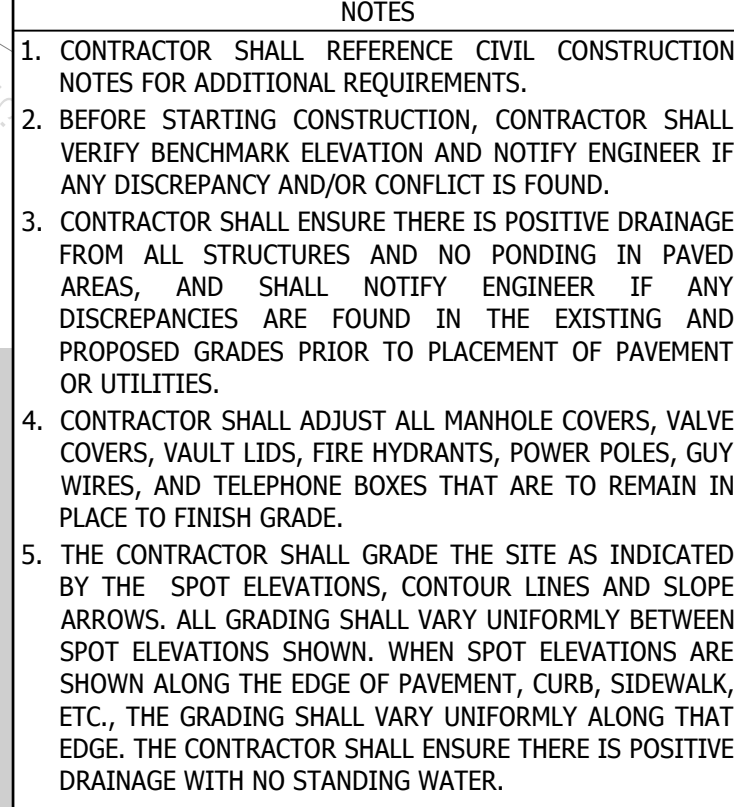


- NOTES**
1. CONTRACTOR SHALL VERIFY ELEVATION, CONSTRUCTION NOTES FOR ADDITIONAL REQUIREMENTS.
  2. BEFORE STARTING CONSTRUCTION, CONTRACTOR SHALL VERIFY BENCHMARK ELEVATION AND NOTIFY ENGINEER IF ANY DISCREPANCY AND/OR CONFLICT IS FOUND.
  3. CONTRACTOR SHALL VERIFY POSITIVE DRAINAGE FROM ALL STRUCTURES AND NO FOUNTAIN IN PAVED AREAS, AND SHALL NOTIFY ENGINEER IF ANY DISCREPANCIES ARE FOUND IN THE EXISTING AND PROPOSED DRAINAGE PRIOR TO PLACEMENT OF PAVEMENT OR UTILITIES.
  4. CONTRACTOR SHALL ADJUST ALL MANHOLE COVERS, VALVE COVERS, VAULT LIDS, FIRE HYDRANTS, POWER POLES, GUY WIRE ANCHORING BOXES THAT ARE TO REMAIN IN PLACE TO FINISH GRADE.
  5. THE CONTRACTOR SHALL GRADE THE SITE AS INDICATED BY THE SPOT ELEVATIONS, CONTOUR LINES AND SLOPED GRADING. GRADING SHALL BE CONFORM TO THE SPECIFIED SPOT ELEVATIONS SHOWN. WHEN SPOT ELEVATIONS ARE SHOWN ALONG THE EDGE OF PAVEMENT, CURB, SIDEWALK, DRIVE, OR WALKING SURFACE, THE CONTRACTOR SHALL GRADE THE EDGE. THE CONTRACTOR SHALL ENSURE THERE IS POSITIVE DRAINAGE WITH NO STANDING WATER.

the 1990s, the number of people in the United States who are 65 years of age or older has increased by 50 percent. The number of people 75 years of age or older has increased by 100 percent. The number of people 85 years of age or older has increased by 200 percent. The number of people 95 years of age or older has increased by 400 percent. The number of people 100 years of age or older has increased by 1,000 percent. The number of people 105 years of age or older has increased by 2,000 percent. The number of people 110 years of age or older has increased by 4,000 percent. The number of people 115 years of age or older has increased by 8,000 percent. The number of people 120 years of age or older has increased by 16,000 percent. The number of people 125 years of age or older has increased by 32,000 percent. The number of people 130 years of age or older has increased by 64,000 percent. The number of people 135 years of age or older has increased by 128,000 percent. The number of people 140 years of age or older has increased by 256,000 percent. The number of people 145 years of age or older has increased by 512,000 percent. The number of people 150 years of age or older has increased by 1,024,000 percent. The number of people 155 years of age or older has increased by 2,048,000 percent. The number of people 160 years of age or older has increased by 4,096,000 percent. The number of people 165 years of age or older has increased by 8,192,000 percent. The number of people 170 years of age or older has increased by 16,384,000 percent. The number of people 175 years of age or older has increased by 32,768,000 percent. The number of people 180 years of age or older has increased by 65,536,000 percent. The number of people 185 years of age or older has increased by 131,072,000 percent. The number of people 190 years of age or older has increased by 262,144,000 percent. The number of people 195 years of age or older has increased by 524,288,000 percent. The number of people 200 years of age or older has increased by 1,048,576,000 percent. The number of people 205 years of age or older has increased by 2,097,152,000 percent. The number of people 210 years of age or older has increased by 4,194,304,000 percent. The number of people 215 years of age or older has increased by 8,388,608,000 percent. The number of people 220 years of age or older has increased by 16,777,216,000 percent. The number of people 225 years of age or older has increased by 33,554,432,000 percent. The number of people 230 years of age or older has increased by 67,108,864,000 percent. The number of people 235 years of age or older has increased by 134,217,728,000 percent. The number of people 240 years of age or older has increased by 268,435,456,000 percent. The number of people 245 years of age or older has increased by 536,870,912,000 percent. The number of people 250 years of age or older has increased by 1,073,741,824,000 percent. The number of people 255 years of age or older has increased by 2,147,483,648,000 percent. The number of people 260 years of age or older has increased by 4,294,967,296,000 percent. The number of people 265 years of age or older has increased by 8,589,934,592,000 percent. The number of people 270 years of age or older has increased by 17,179,869,184,000 percent. The number of people 275 years of age or older has increased by 34,359,738,368,000 percent. The number of people 280 years of age or older has increased by 68,719,476,736,000 percent. The number of people 285 years of age or older has increased by 137,438,953,472,000 percent. The number of people 290 years of age or older has increased by 274,877,906,944,000 percent. The number of people 295 years of age or older has increased by 549,755,813,888,000 percent. The number of people 300 years of age or older has increased by 1,099,511,627,776,000 percent. The number of people 305 years of age or older has increased by 2,199,023,255,552,000 percent. The number of people 310 years of age or older has increased by 4,398,046,511,104,000 percent. The number of people 315 years of age or older has increased by 8,796,093,022,208,000 percent. The number of people 320 years of age or older has increased by 17,592,186,044,416,000 percent. The number of people 325 years of age or older has increased by 35,184,372,088,832,000 percent. The number of people 330 years of age or older has increased by 70,368,744,177,664,000 percent. The number of people 335 years of age or older has increased by 140,737,488,355,328,000 percent. The number of people 340 years of age or older has increased by 281,474,976,710,656,000 percent. The number of people 345 years of age or older has increased by 562,949,953,421,312,000 percent. The number of people 350 years of age or older has increased by 1,125,899,906,842,624,000 percent. The number of people 355 years of age or older has increased by 2,251,799,813,685,248,000 percent. The number of people 360 years of age or older has increased by 4,503,599,627,370,496,000 percent. The number of people 365 years of age or older has increased by 9,007,199,254,740,992,000 percent. The number of people 370 years of age or older has increased by 18,014,398,509,481,984,000 percent. The number of people 375 years of age or older has increased by 36,028,797,018,963,968,000 percent. The number of people 380 years of age or older has increased by 72,057,594,037,927,936,000 percent. The number of people 385 years of age or older has increased by 144,115,188,075,855,872,000 percent. The number of people 390 years of age or older has increased by 288,230,376,151,711,744,000 percent. The number of people 395 years of age or older has increased by 576,460,752,303,423,488,000 percent. The number of people 400 years of age or older has increased by 1,152,921,504,606,846,976,000 percent. The number of people 405 years of age or older has increased by 2,305,843,009,213,693,952,000 percent. The number of people 410 years of age or older has increased by 4,611,686,018,427,387,904,000 percent. The number of people 415 years of age or older has increased by 9,223,372,036,854,775,808,000 percent. The number of people 420 years of age or older has increased by 18,446,744,073,709,551,616,000 percent. The number of people 425 years of age or older has increased by 36,893,488,147,419,103,232,000 percent. The number of people 430 years of age or older has increased by 73,786,976,294,838,206,464,000 percent. The number of people 435 years of age or older has increased by 147,573,952,589,676,412,928,000 percent. The number of people 440 years of age or older has increased by 295,147,905,179,352,825,856,000 percent. The number of people 445 years of age or older has increased by 590,295,810,358,705,651,712,000 percent. The number of people 450 years of age or older has increased by 1,180,591,620,717,411,303,424,000 percent. The number of people 455 years of age or older has increased by 2,361,183,241,434,822,606,848,000 percent. The number of people 460 years of age or older has increased by 4,722,366,482,869,645,213,696,000 percent. The number of people 465 years of age or older has increased by 9,444,732,965,739,290,427,392,000 percent. The number of people 470 years of age or older has increased by 18,889,465,931,478,580,854,784,000 percent. The number of people 475 years of age or older has increased by 37,778,931,862,957,161,709,568,000 percent. The number of people 480 years of age or older has increased by 75,557,863,725,914,323,419,136,000 percent. The number of people 485 years of age or older has increased by 151,115,727,451,828,646,838,272,000 percent. The number of people 490 years of age or older has increased by 302,231,454,903,657,293,676,544,000 percent. The number of people 495 years of age or older has increased by 604,462,909,807,314,587,353,088,000 percent. The number of people 500 years of age or older has increased by 1,208,925,819,614,629,174,706,176,000 percent. The number of people 505 years of age or older has increased by 2,417,851,639,229,258,349,412,352,000 percent. The number of people 510 years of age or older has increased by 4,835,703,278,458,516,698,824,704,000 percent. The number of people 515 years of age or older has increased by 9,671,406,556,917,033,397,649,408,000 percent. The number of people 520 years of age or older has increased by 19,342,813,113,834,066,795,298,816,000 percent. The number of people 525 years of age or older has increased by 38,685,626,227,668,133,590,597,632,000 percent. The number of people 530 years of age or older has increased by 77,371,252,455,336,267,181,195,264,000 percent. The number of people 535 years of age or older has increased by 154,742,504,910,672,534,362,390,528,000 percent. The number of people 540 years of age or older has increased by 309,485,009,821,345,068,724,781,056,000 percent. The number of people 545 years of age or older has increased by 618,970,019,642,690,137,449,562,112,000 percent. The number of people 550 years of age or older has increased by 1,237,940,039,285,380,274,899,124,224,000 percent. The number of people 555 years of age or older has increased by 2,475,880,078,570,760,549,798,248,448,000 percent. The number of people 560 years of age or older has increased by 4,951,760,157,141,521,099,596,496,896,000 percent. The number of people 565 years of age or older has increased by 9,903,520,314,283,042,199,193,993,792,000 percent. The number of people 570 years of age or older has increased by 19,807,040,628,566,084,398,387,9

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<p>DRAWING SCALE</p> <p>HORIZ:</p> <p>VERT:</p>	<p>1" = 10'</p> <p>N/A</p>	<p>PROJECT NUMBER</p> <p>0104.0117</p>



**auric**  
ENGINEERS

TEXAS ENGINEERING FIRM 20740

520 POST OAK BLVD, SUITE 895  
HOUSTON, TEXAS 77007  
AURICENGINEERS.COM

**TOMBALL HIGH SCHOOL  
CTE & MISC. RENOVATIONS**

TOMBALL INDEPENDENT SCHOOL DISTRICT  
30330 QUINN ROAD, TOMBALL, TX 77375



**ARCADIS**  
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10205 WESTHEIMER SUITE 800  
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tel 281.286.6605, fax 713.977.4620

PROJECT #:	202311
DATE:	11/06/2023
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DATE	ISSUE
11/06/2023	BID SET

**C3.00**

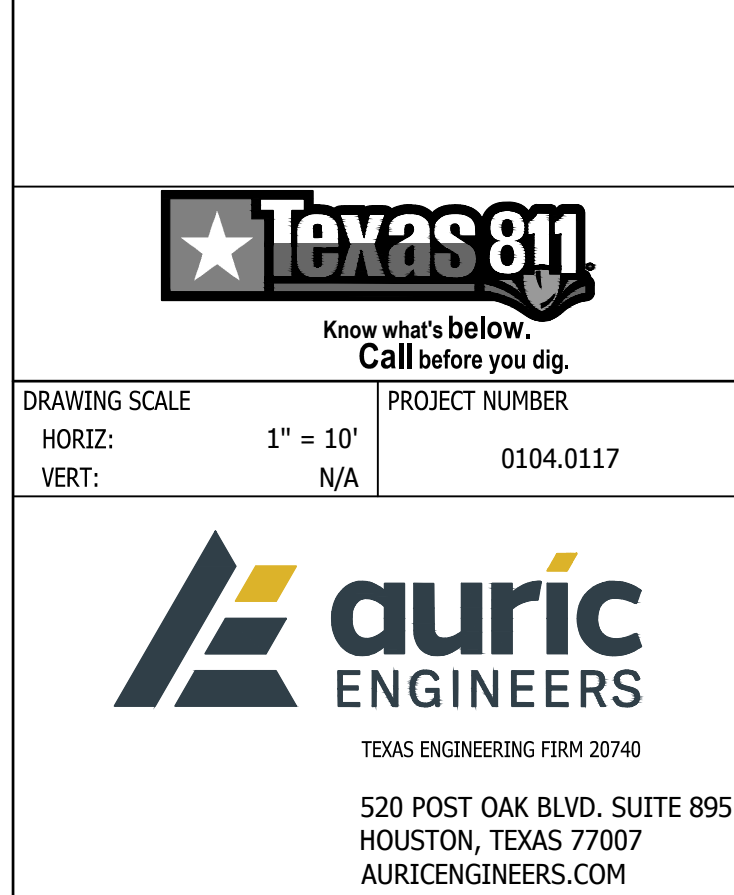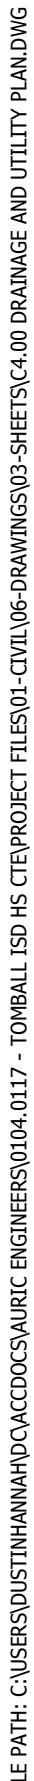SITE GRADING PLAN





**TOMBALL HIGH SCHOOL  
CTE & MISC. RENOVATIONS**

TOMBALL INDEPENDENT SCHOOL DISTRICT  
30330 QUINN ROAD, TOMBALL, TX 77375




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PLOT STYLE: AURIC.ASTB
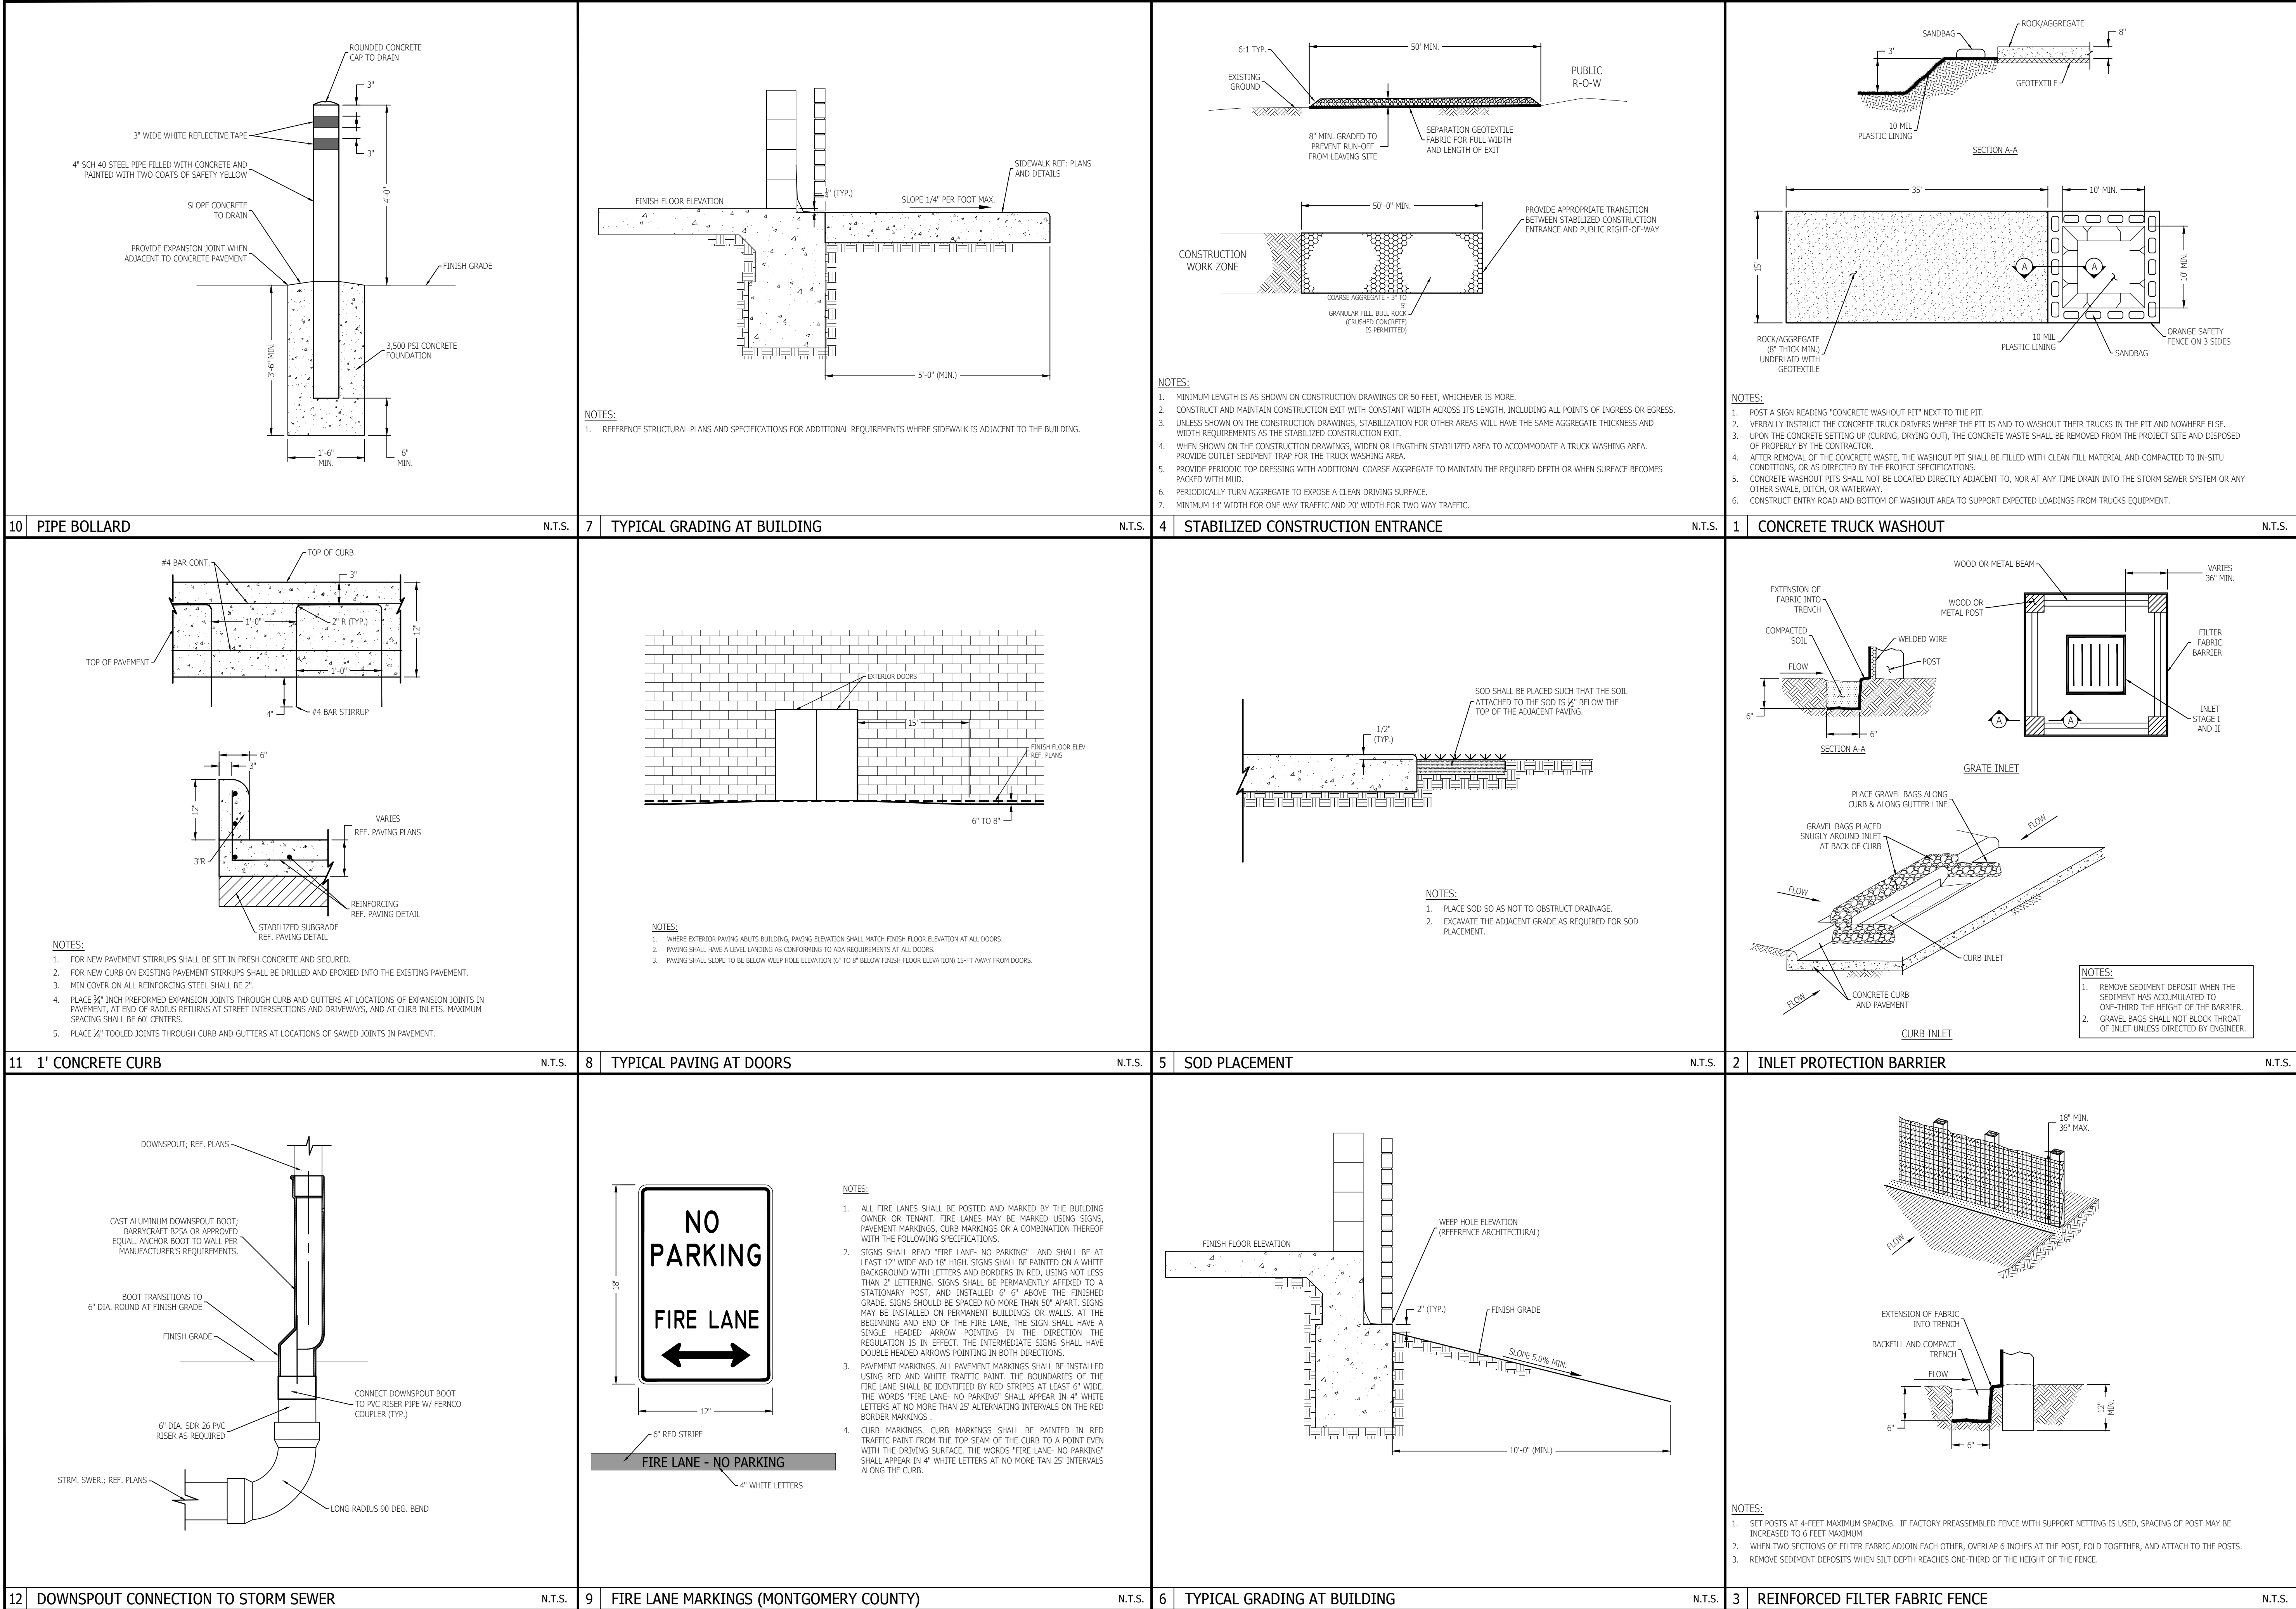
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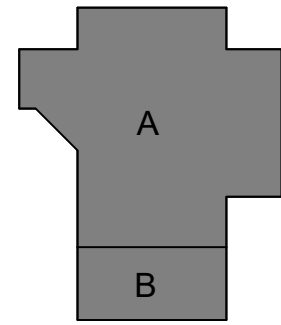


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TOMBALL HIGH SCHOOL  
CTE & MISC. RENOVATIONS

TOMBALL INDEPENDENT SCHOOL DISTRICT


30330 QUINN ROAD, TOMBALL, TX 77375

ARCADIS

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tel 281.286.6605, fax 713.977.4620



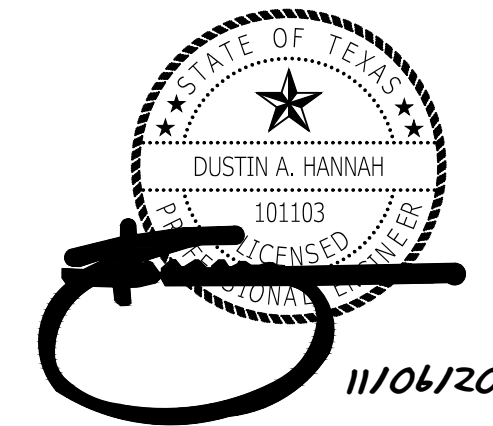PROJECT #: 202311  
DATE: 11/06/2023  
DRAWN: DAH  
CHECKED: DAH

DATE: 11/06/2023  
ISSUE: BID SET



DRAWING SCALE  
HORIZ: N/A  
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PROJECT NUMBER  
0104.0117



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C7.01

CIVIL DETAILS



11/06/2023 12:58 PM

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10

7

STORM SEWER CLEANOUT

N.T.S.

4

SANITARY SEWER SERVICE DROP

N.T.S.

1

SANITARY SEWER BEDDING AND BACKFILL (DRY TRENCH)

N.T.S.

11

8

GRATE INLET

N.T.S.

5

STORM SEWER BEDDING AND BACKFILL (DRY TRENCH)

N.T.S.

2

SANITARY SEWER CLEANOUT

N.T.S.

12

9

SAWTOOTH CURB

N.T.S.

6

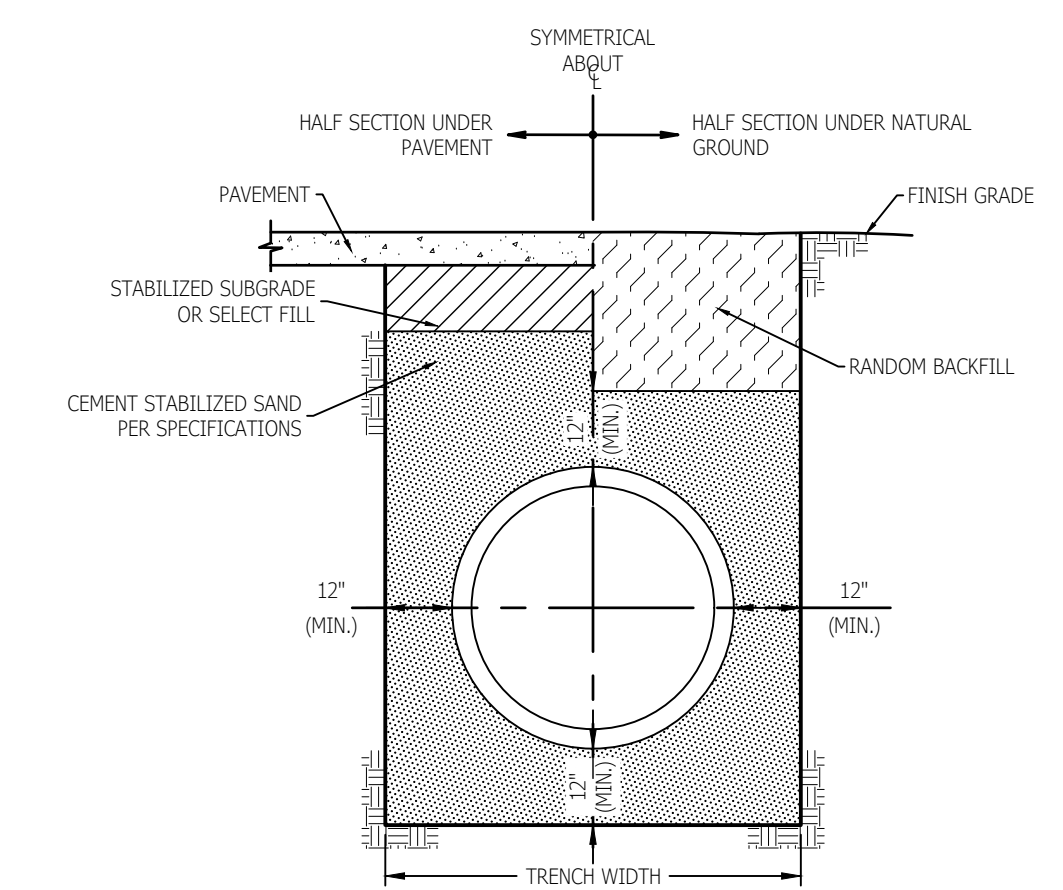
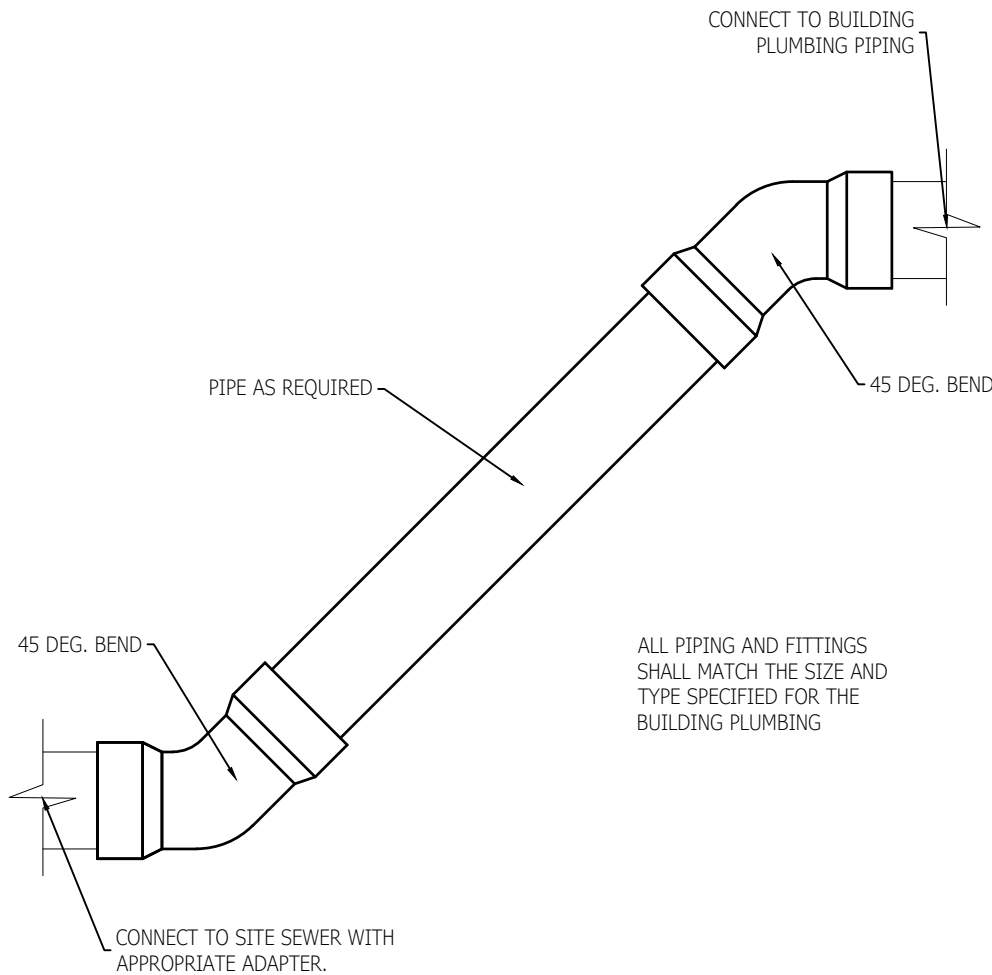
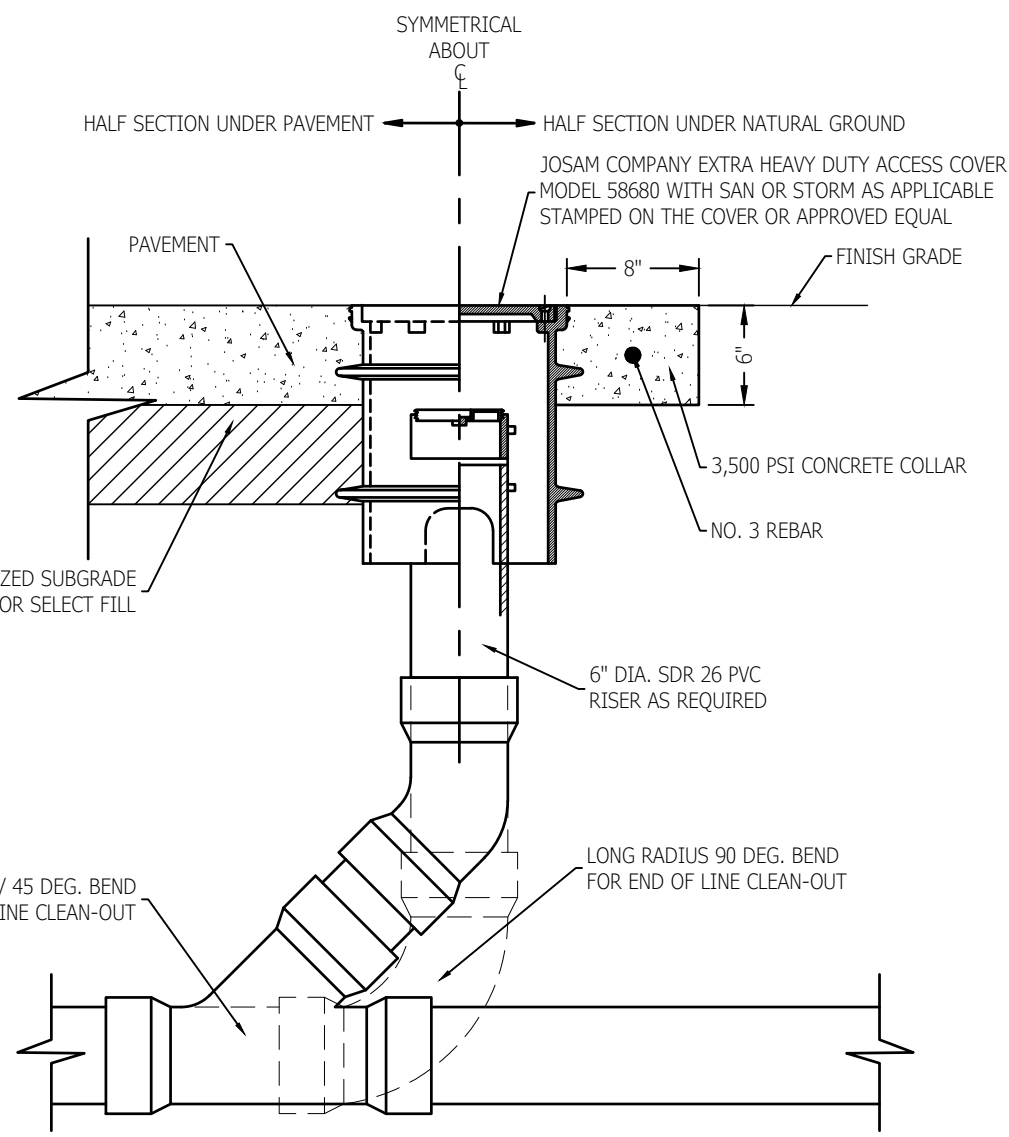
STORM SEWER MANHOLE

N.T.S.


3

SANITARY SEWER MANHOLE

N.T.S.



- NOTES:
1. THIS DETAIL MAY BE USED ONLY FOR DRY STABLE TRENCH CONDITIONS. WHERE WET SAND CONDITIONS ARE ENCOUNTERED SEWERS SHALL BE BACKFILLED PER THE REQUIREMENTS OF THE WET CONDITION BEDDING AND BACKFILLING DETAIL.
  2. ALL BACKFILL SHALL BE PLACED IN 8-INCH THICK LOOSE LIFTS AND COMPACTED AT A MOISTURE CONTENT WITHIN +/- 2% OF THE OPTIMUM MOISTURE CONTENT AS DETERMINED BY ASTM D698 TO AN IN-PLACE DENSITY EQUAL TO AT LEAST 95% OF THE MAXIMUM DRY DENSITY UNDER PAVEMENT/WALKS AND 92% OF THE MAXIMUM DRY DENSITY IN ALL OTHER AREAS.
  3. MIN. TRENCH WIDTH SHALL BE PIPE O.D. PLUS 34-INCHES FOR PIPES WITH A NOMINAL SIZE OF 30-INCHES OR LESS AND O.D. PLUS 36-INCHES FOR PIPES WITH A NOMINAL SIZE GREATER THAN 30-INCHES.

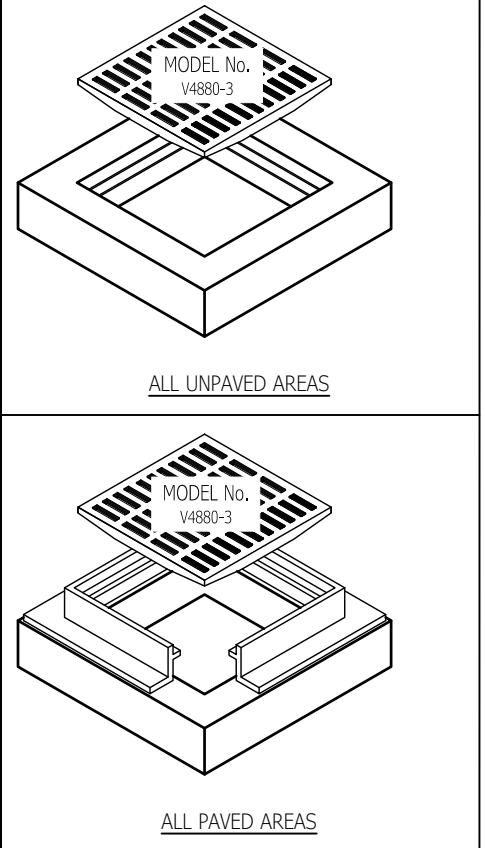

KEYED NOTES	
MARK	DESCRIPTION
1	CAST IN IRON FRAME & GRATE
2	LOOSE FRAME & GRATE
3	TOP SECTION
4	PRECAST CONCRETE BASIN SECTION
5	WITH WALL KNOCKOUT ON ALL 4 SIDES, SEE NO DIMENSION FOR MAXIMUM PIPE O.D.

KO	W1	W2	H1	H2	T1	GRADE
10"	15"	10"	21"	18"	3"	12"x12"x12"
12"	20"	12"	28"	24"	4"	14"x14"x14"
15"	24"	15"	34"	30"	4"	18"x18"x18"
18"	28"	18"	38"	34"	4"	20"x20"x20"
21"	32"	21"	41"	38"	6"	24"x24"x24"
24"	36"	24"	44"	40"	6"	27"x27"x27"
27"	40"	27"	47"	42"	6"	30"x30"x30"
30"	44"	30"	50"	44"	6"	36"x36"x36"
36"	50"	36"	56"	48"	6"	38"x38"x38"
42"	56"	42"	62"	54"	6"	38"x38"x38"
48"	62"	48"	68"	60"	6"	38"x38"x38"
54"	68"	54"	74"	66"	6"	38"x38"x38"
60"	74"	60"	80"	72"	6"	38"x38"x38"
66"	80"	66"	86"	78"	6"	38"x38"x38"
72"	86"	72"	92"	84"	6"	38"x38"x38"

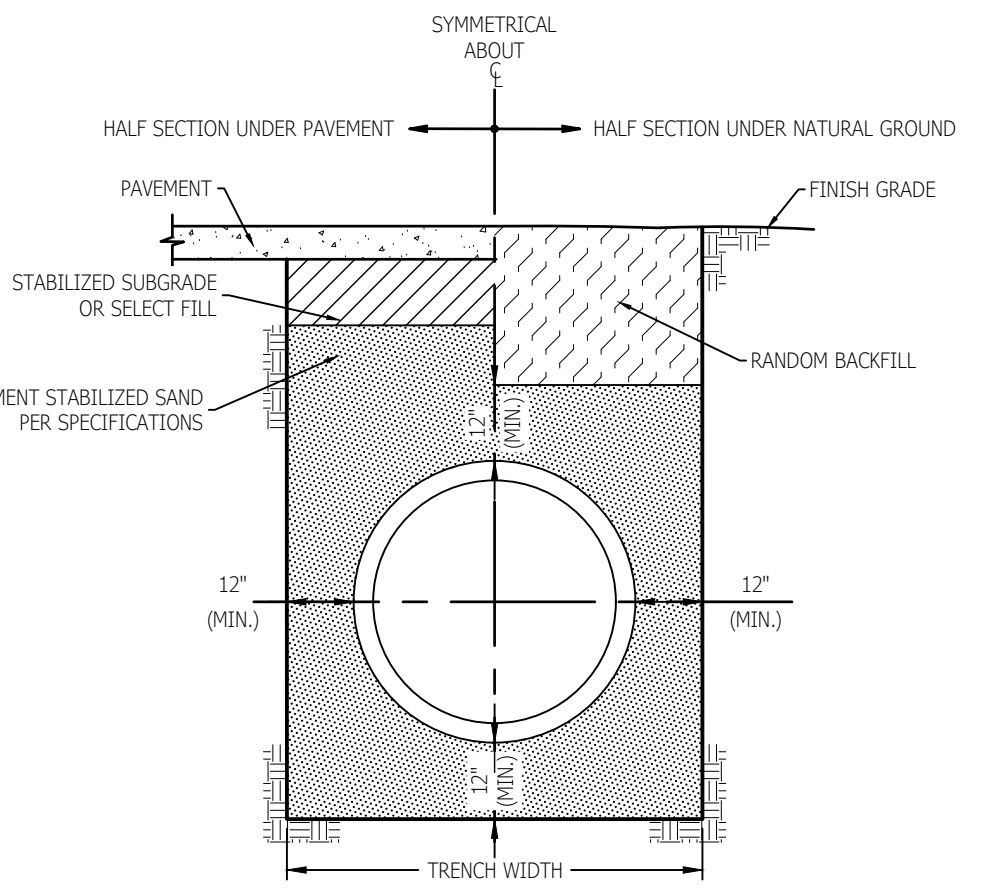
SPECIFICATIONS:

CONCRETE : CLASS 1/1 CONCRETE WITH OF DESIGN STRENGTH OF 4500 PSI AT 28 DAYS.



UNIT IS OF MONOLITHIC CONSTRUCTION AT FLOOR AND FIRST STAGE OF WALL WITH SECTIONAL RISER TO REQUIRED DEPTH. RATED FOR H-20 LOADING.

REINFORCEMENT: REINFORCED WITH STEEL REBAR TO CONFORM TO ASTM A618 ON REQUIRED CENTERS OR EQUAL.


C.I. CASTINGS: CAST IRON FRAMES AND GRATES ARE MANUFACTURED OF GREY CAST IRON CONFORMING TO ASTM A48 (IN CLASS 30).



- NOTES:
1. THIS DETAIL MAY BE USED ONLY FOR DRY STABLE TRENCH CONDITIONS. WHERE WET SAND CONDITIONS ARE ENCOUNTERED SEWERS SHALL BE BACKFILLED PER THE REQUIREMENTS OF THE WET CONDITION BEDDING AND BACKFILLING DETAIL.
  2. ALL BACKFILL SHALL BE PLACED IN 8-INCH THICK LOOSE LIFTS AND COMPACTED AT A MOISTURE CONTENT WITHIN +/- 2% OF THE OPTIMUM MOISTURE CONTENT AS DETERMINED BY ASTM D698 TO AN IN-PLACE DENSITY EQUAL TO AT LEAST 95% OF THE MAXIMUM DRY DENSITY UNDER PAVEMENT/WALKS AND 92% OF THE MAXIMUM DRY DENSITY IN ALL OTHER AREAS.
  3. FOR R.C.P. STORM SEWERS MIN. TRENCH WIDTH SHALL BE PIPE O.D. PLUS 24-INCHES FOR PIPES WITH A NOMINAL SIZE OF 30-INCHES OR LESS AND O.D. PLUS 36-INCHES FOR PIPES WITH A NOMINAL SIZE GREATER THAN 30-INCHES.
  4. FOR H.D.P.E. STORM SEWERS MIN. TRENCH WIDTH SHALL BE PIPE O.D. PLUS 24-INCHES FOR PIPES WITH A NOMINAL SIZE OF 24-INCHES OR LESS AND O.D. PLUS 36-INCHES FOR PIPES WITH A NOMINAL SIZE GREATER THAN 24-INCHES.

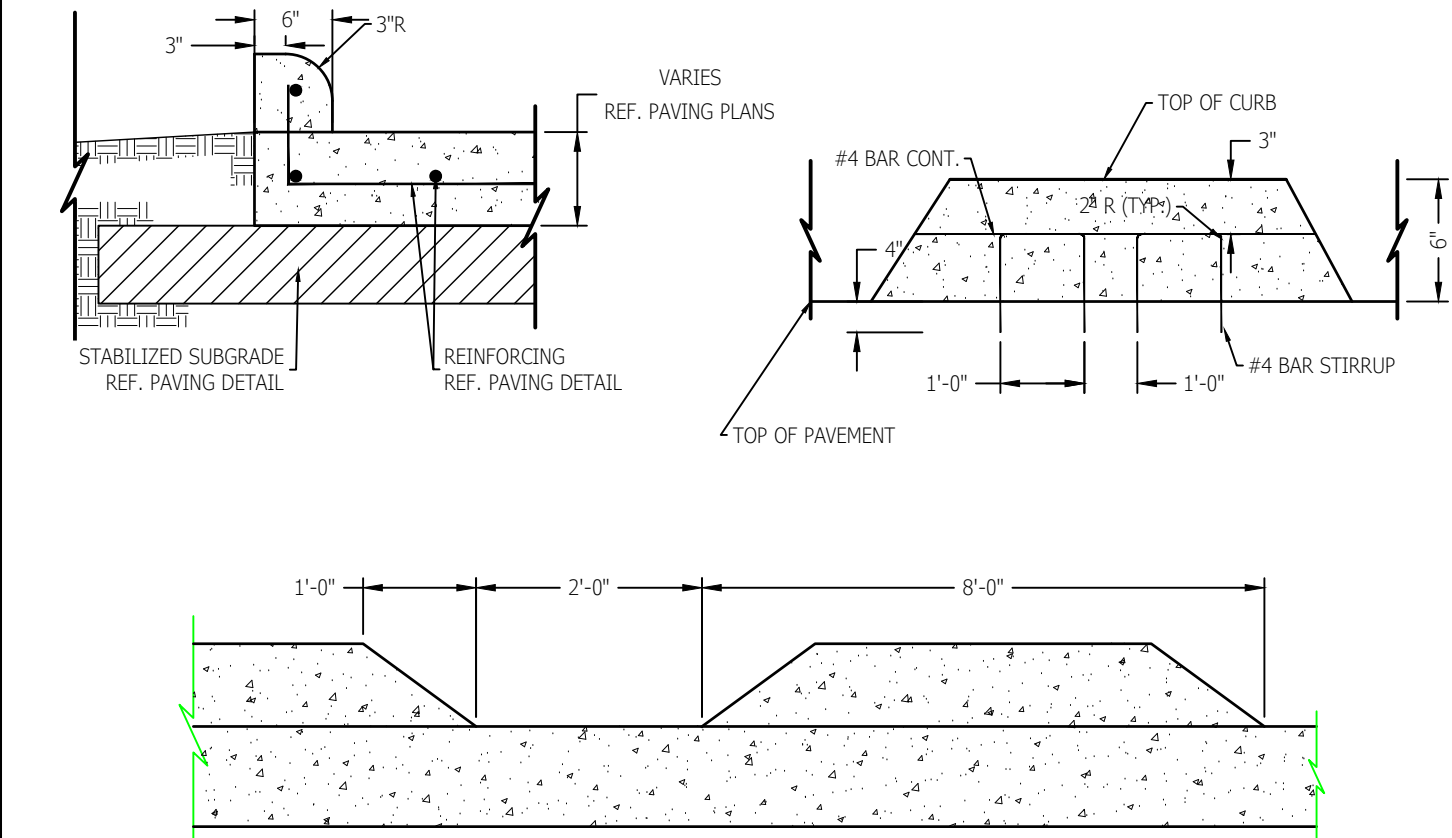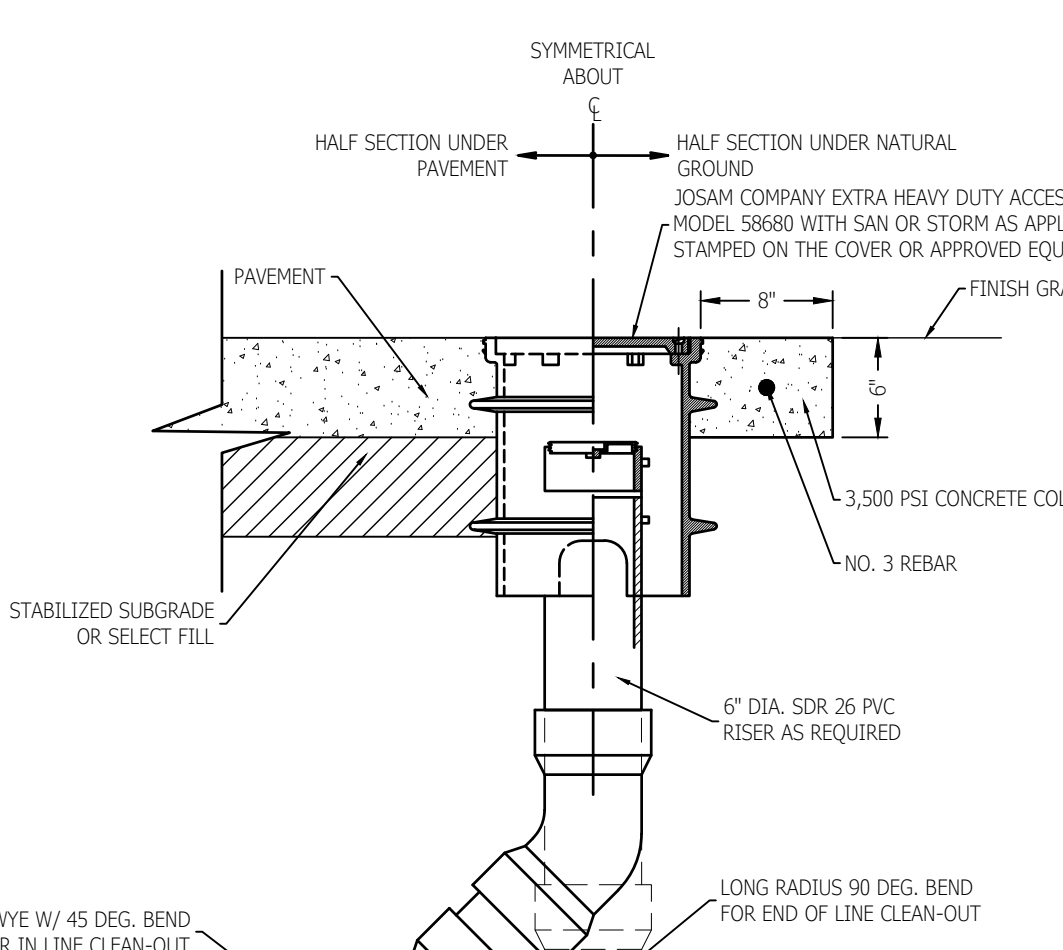


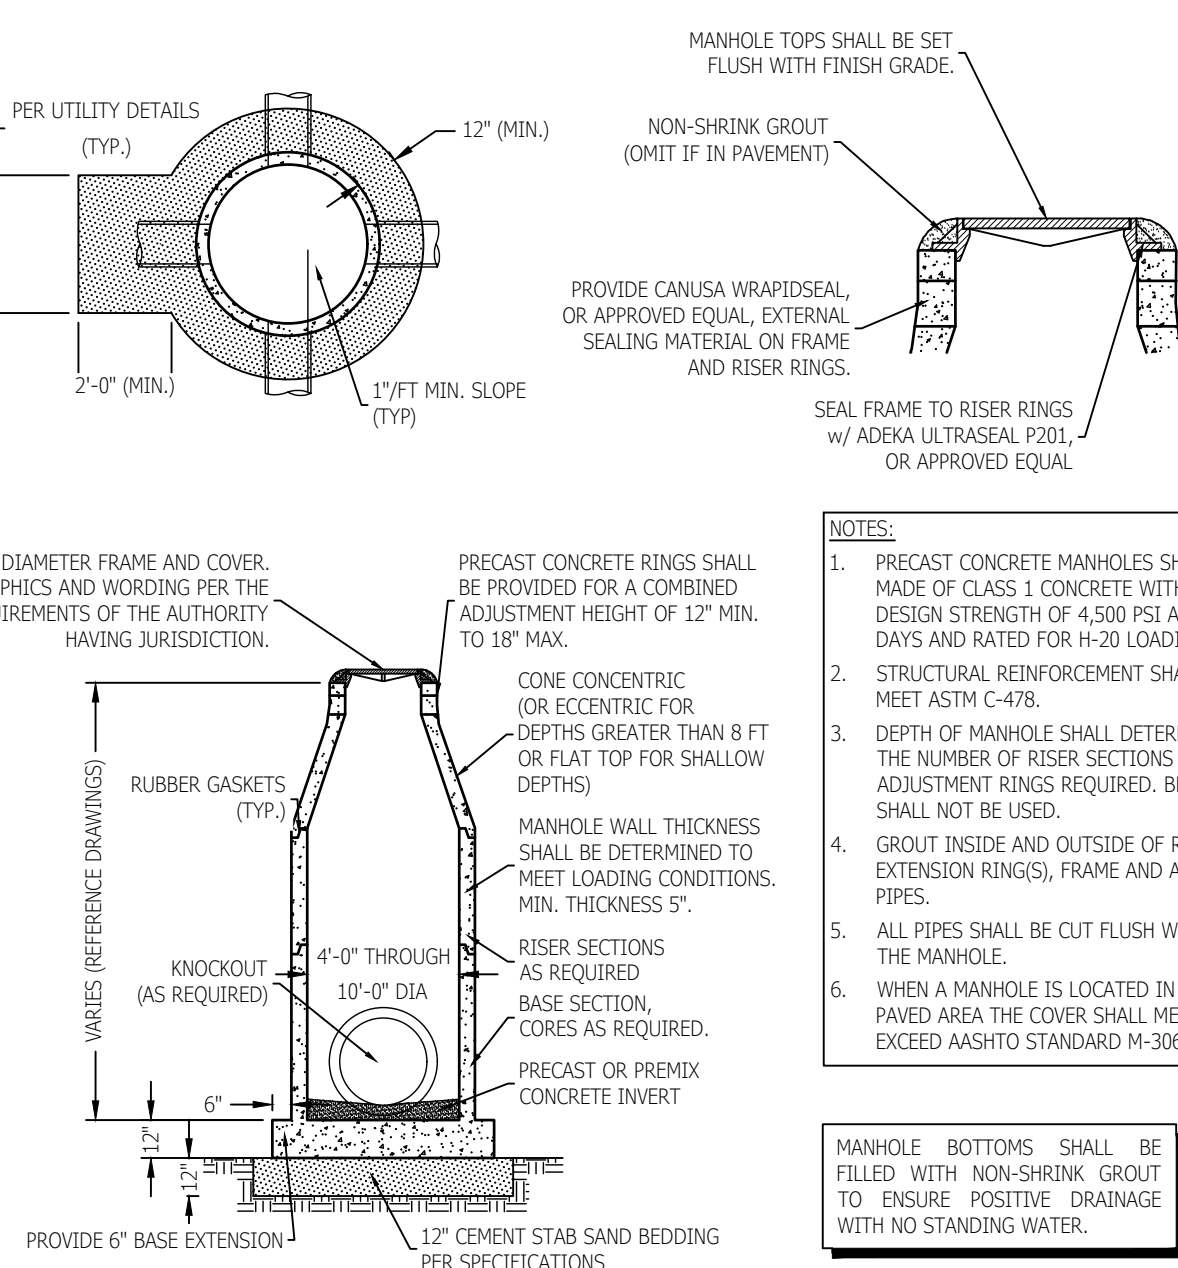- NOTES:
1. FOR NEW PAVEMENT STRIPLIPS SHALL BE SET IN FRESH CONCRETE AND SECURED.
  2. FOR NEW CURB ON EXISTING PAVEMENT STRIPLIPS SHALL BE DRILLED AND EXPLODED INTO THE EXISTING PAVEMENT.
  3. MIN COVER ON ALL REINFORCING STEEL SHALL BE 2\"/>



- NOTES:
1. PRECAST CONCRETE MANHOLES SHALL BE MADE OF CLASS 1 CONCRETE WITH A DESIGN STRENGTH OF 4500 PSI AT 28 DAYS AND RATED FOR H-20 LOADING.
  2. STRUCTURAL REINFORCEMENT SHALL MEET ASTM C-478.
  3. DEPTH OF MANHOLE SHALL DETERMINE THE NUMBER OF RISER SECTIONS AND ADJUSTMENT RINGS REQUIRED. BRICKS SHALL NOT BE USED.
  4. GROUT INSIDE AND OUTSIDE OF RISERS, EXTENSION RINGS, FRAME AND ALL PIPES.
  5. ALL PIPES SHALL BE CUT FLUSH WITH THE MANHOLE.
  6. WHEN A MANHOLE IS LOCATED IN A PAVED AREA THE COVER SHALL MEET OR EXCEED ASHTO STANDARD M-306.

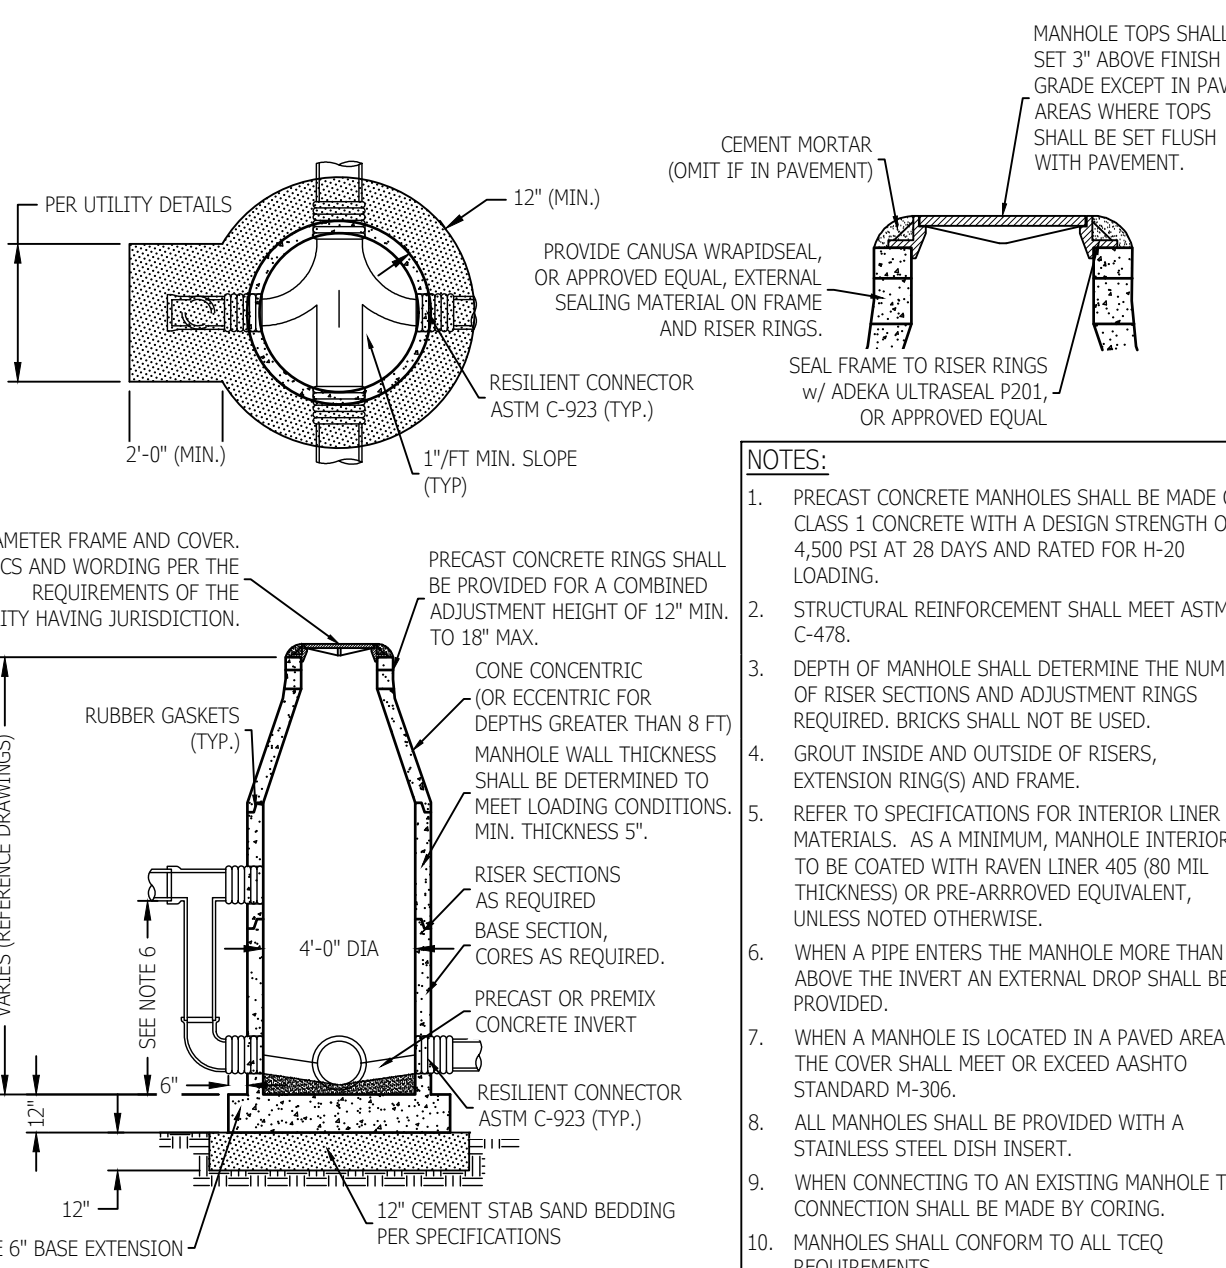MANHOLE BOTTOMS SHALL BE FILLED WITH NON-SHRINK GROUT TO ENSURE POSITIVE DRAINAGE WITH NO STANDING WATER.



- NOTES:
1. PRECAST CONCRETE MANHOLES SHALL BE MADE OF CLASS 1 CONCRETE WITH A DESIGN STRENGTH OF 4500 PSI AT 28 DAYS AND RATED FOR H-20 LOADING.
  2. STRUCTURAL REINFORCEMENT SHALL MEET ASTM C-478.
  3. DEPTH OF MANHOLE SHALL DETERMINE THE NUMBER OF RISER SECTIONS AND ADJUSTMENT RINGS REQUIRED. BRICKS SHALL NOT BE USED.
  4. GROUT INSIDE AND OUTSIDE OF RISERS, EXTENSION RINGS AND FRAME.
  5. REFER TO SPECIFICATIONS FOR INTERIOR LINER MATERIALS. AS A MINIMUM, MANHOLE INTERIOR TO BE COATED WITH RAVEN LINER 405 (80 MIL THICKNESS) OR PRE-APPROVED EQUIVALENT, UNLESS NOTED OTHERWISE.
  6. WHEN A PIPE ENTERS THE MANHOLE MORE THAN 24\"/>



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DRAWING SCALE: N/A  
HORIZ: N/A  
VERT: N/A




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520 POST OAK BLVD., SUITE 895  
HOUSTON, TEXAS 77007  
AURICENGINEERS.COM

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CIVIL  
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Tel: 713.405.1901


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3200 Wilcrest Drive, Suite 305  
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# TOMBALL HIGH SCHOOL CTE & MISC. RENOVATIONS

TOMBALL INDEPENDENT SCHOOL DISTRICT  
30330 QUINN ROAD, TOMBALL, TX 77375

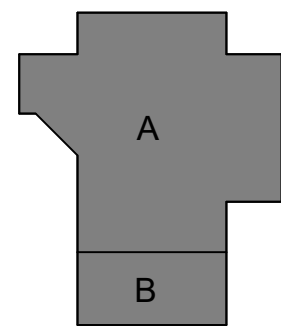ARCADIS  
TEXAS ARCADIS INC.  
10205 WESTMEIER SUITE 800  
HOUSTON, TX 77042  
tel 281.286.6605, fax 713.977.4620



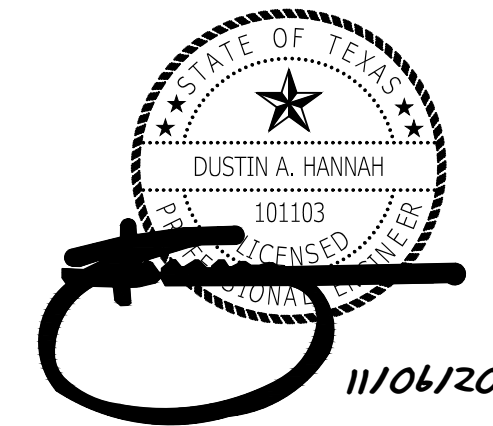
PROJECT #: 202311  
DATE: 11/06/2023  
DRAWN: DAH  
CHECKED: DAH

DATE: 11/06/2023  
ISSUE: BID SET

# C7.02

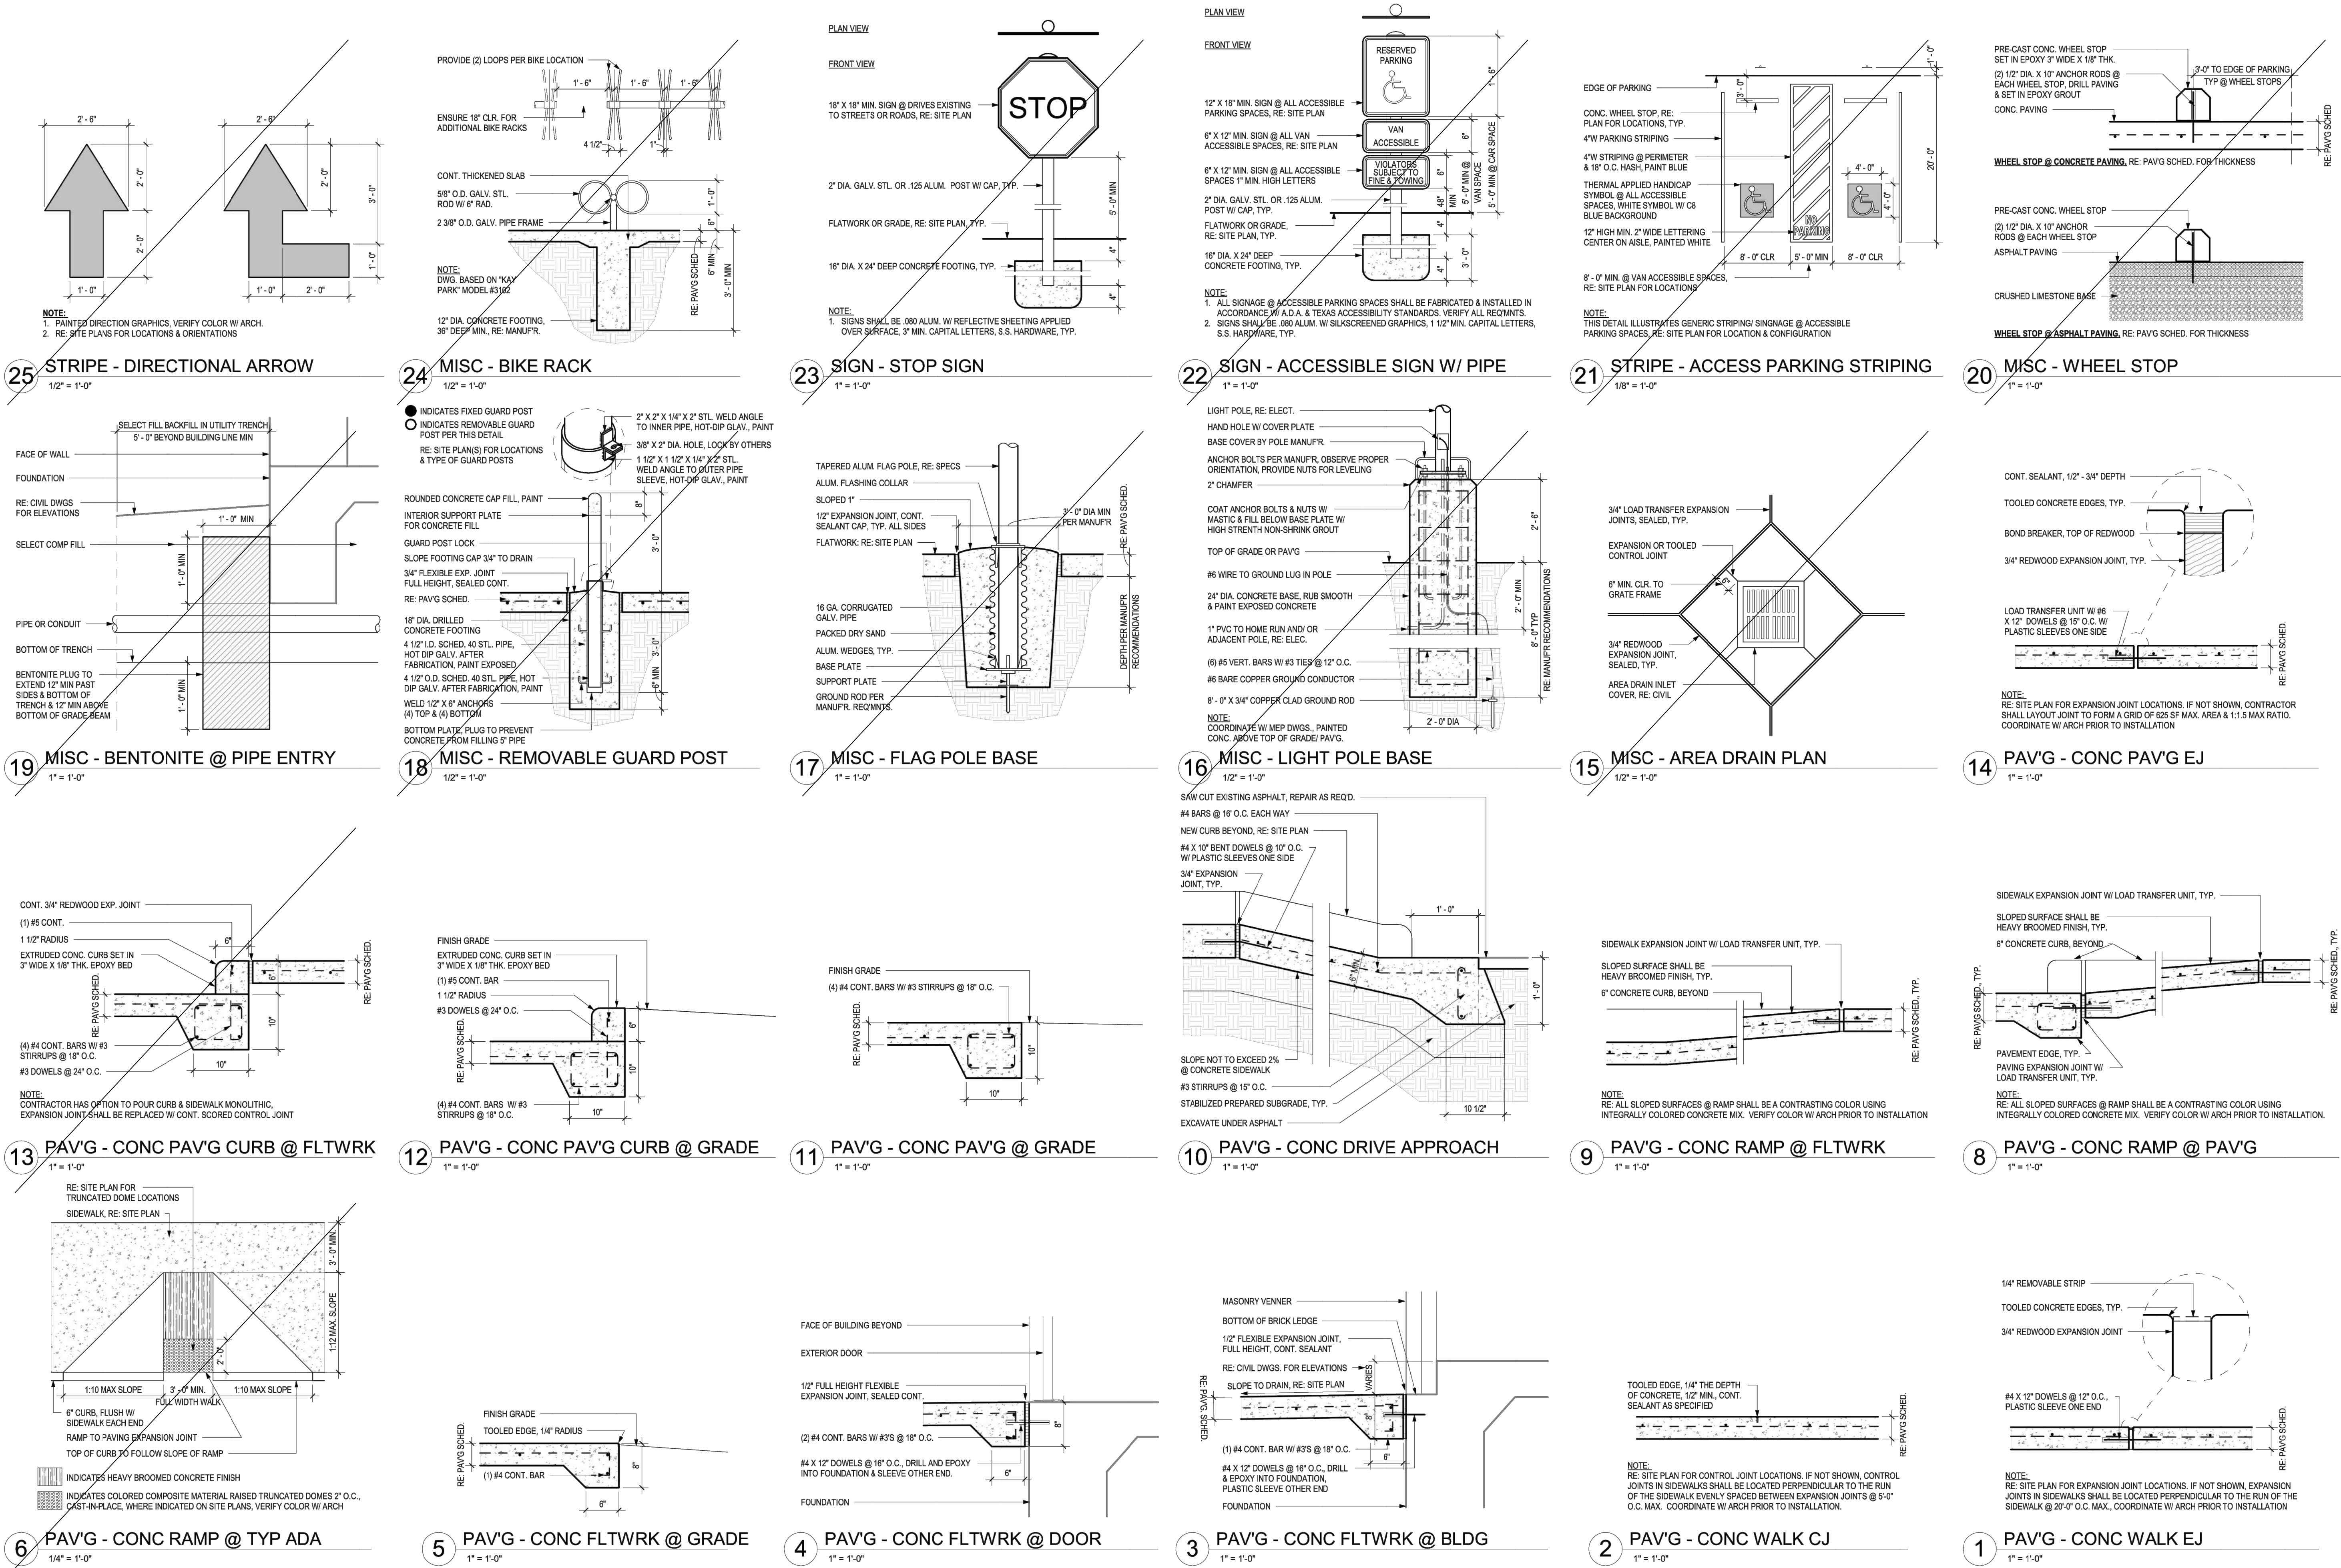CIVIL DETAILS



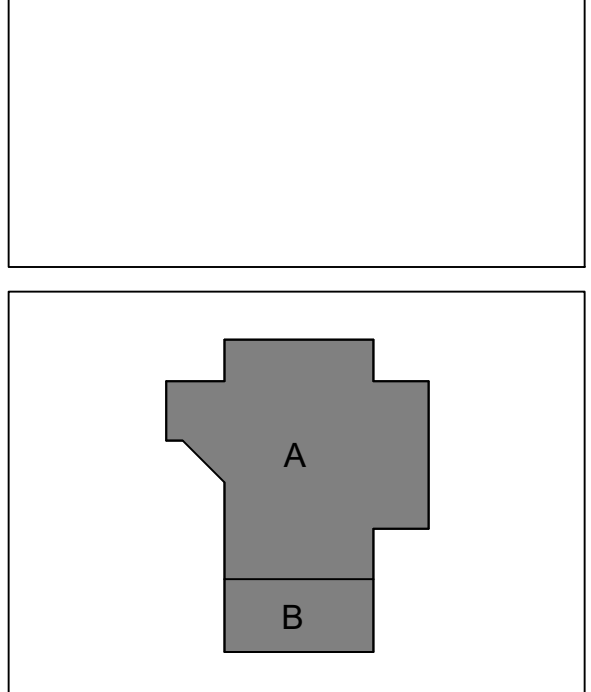


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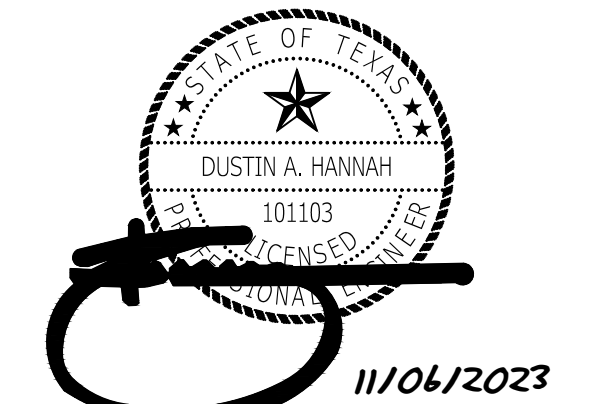


# TOMBALL HIGH SCHOOL CTE & MISC. RENOVATIONS

TOMBALL INDEPENDENT SCHOOL DISTRICT  
30330 QUINN ROAD, TOMBALL, TX 77375

**ARCADIS**

**TEXAS ARCADIS INC.**  
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PROJECT #:	202311
DATE:	11/06/2023
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**C7.03**

CIVIL DETAILS

**Texas 811**  
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DRAWING SCALE  
HORIZ: N/A  
VERT: N/A

PROJECT NUMBER  
0104.0117

**auric ENGINEERS**  
TEXAS ENGINEERING FIRM 20740  
520 POST OAK BLVD., SUITE 895  
HOUSTON, TEXAS 77007  
AURICENGINEERS.COM







STRUCTURAL STEEL

1. ALL GROUT USED UNDER STEEL COLUMN BASE PLATES SHALL BE OF NON-SHRINKABLE TYPE CONFORMING TO ASTM C1090 AND THE CORPS OF ENGINEERS SPECIFICATION CRD-C-681 AND SHALL HAVE A MINIMUM COMPRESSIVE STRENGTH OF 6000 PSI. 100 PERCENT OF VOID UNDER ALL BASE PLATES IS TO BE GROUTED. ALL BASE PLATES WITH A DIMENSION GREATER THAN 24" SHALL HAVE TWO 1" DIAMETER GROUT HOLES. IF THE SPACE UNDER A COLUMN BASE PLATE IS LESS THAN 1/4", A PRESSURE INJECTION SYSTEM SHALL BE USED. PRE-GROUTING OF THE BASE PLATES IS NOT PERMITTED
2. ALL STRUCTURAL STEEL DESIGN, DETAILING, FABRICATION AND ERECTION SHALL CONFORM TO LOAD AND RESISTANCE FACTOR DESIGN (LRFD) ACCORDING TO THE 2005 AISC SPECIFICATION.
3. ALL WELDING SHALL CONFORM TO THE STANDARDS OF THE THIRTEENTH EDITION OF THE MANUAL STEEL CONSTRUCTION OF THE AMERICAN INSTITUTE OF STEEL CONSTRUCTION, AND THE AMERICAN WELDING SOCIETY ANSI/AWS D1.1 STRUCTURAL WELDING CODE-STEEL. WELDING OF REINFORCING BARS SHALL COMPLY TO THE AMERICAN WELDING SOCIETY AWS D1.4. SHORT CIRCUIT TRANSFER FOR THE GAS METAL ARC WELDING PROCESS IS NOT PERMITTED.
4. ELECTRODES FOR ALL FIELD AND SHOP WELDING SHALL BE CLASS E70XX LOW HYDROGEN. ELECTRODES FOR MOMENT CONNECTIONS SHALL BE CLASS E7018 WITH A HADDPY TOUGHNESS OF AT LEAST 20 FT-LBS AT -20 DEGREES FAHRENHEIT.
5. ALL STRUCTURAL STEEL ROLLED SHAPES SHALL CONFORM TO ASTM A992, AND ALL ANGLES, BARS, CHANNELS AND PLATES SHALL CONFORM TO ASTM A36. ALL SQUARE AND RECTANGULAR TUBES (FY 30 KSI) SHALL CONFORM TO ASTM A500 GRADE C AND ROUND PIPES (FY 50 KSI) SHALL CONFORM TO ASTM A500 GR C. ALL COLD-FORMED GIRTS AND PURLINS SHALL CONFORM TO ASTM A570M GR. 55.
6. ALL STRUCTURAL STEEL DETAILS AND CONNECTIONS SHALL CONFORM TO STANDARDS OF THE AISC. DOUBLE CONNECTIONS THROUGH COLUMN WEBS, BEAMS THAT FRAME OVER THE TOP OF COLUMNS, AND BEAM TO BEAM CONNECTIONS SHALL BE HUNG FROM JOIST TOP CHORD OR A STAGGERED CONNECTION WITH AT LEAST ONE INSTALLED BOLT REMAINING IN PLACE TO SUPPORT THE FIRST BEAM WHILE THE SECOND BEAM IS BEING ERECTED.
7. CONNECTIONS NOT DETAILED ON THE DRAWINGS SHALL BE SELECTED FROM THE TABLES IN PART 10 OF THE THIRTEENTH EDITION OF THE MANUAL OF STEEL CONSTRUCTION OF THE AISC. TABLE 10-1 MAY BE USED FOR ALL BOLTED DOUBLE ANGLE CONNECTIONS. TABLE 10-2 MAY BE USED FOR WELDED/BOLTED DOUBLE ANGLE CONNECTIONS. TABLE 10-3 MAY BE USED FOR ALL WELDED DOUBLE ANGLE CONNECTIONS. BEAM REACTIONS USED SHALL BE ONE-HALF THE TOTAL ALLOWABLE UNIFORM LOAD GIVEN IN TABLE 3-6 THROUGH 3-9 IN PART 3 OF THE MANUAL OF STEEL CONSTRUCTION OF THE AISC. CONNECTIONS FOR COMPOSITE BEAMS SHALL HAVE THE STANDARD AISC CAPACITY INCREASED BY 35 PERCENT.
8. ALL MISCELLANEOUS WELDS (FIELD OR SHOP) SHALL BE MINIMUM SIZE FILLET ALL AROUND IN ACCORDANCE WITH AISC. TABLE 10-1 IS ASSUMED TO BE THE PLATE THICKNESS OF THE THINNEST PIECE MINUS 1/16". WELDING OF CONTINUOUS MEMBERS SHALL BE A MINIMUM OF 2 INCHES OF 3/16 INCH FILLET STITCH WELDS AT 12 INCHES O.C., STAGGERED EACH SIDE, UNLESS OTHERWISE NOTED. COLUMN BASE PLATES, CAP PLATES AND STIFFENER PLATES SHALL BE WELDED ALL AROUND.
9. PROVIDE COLUMN CAP PLATES AS FOLLOWS UNLESS NOTED OR DETAILED OTHERWISE:
- A) FOR DECK BEARING — 1/4 INCH THICK FOR ALL HSS SECTIONS AND WIDE FLANGE SECTIONS WHERE BEAMS DO NOT FRAME INTO BOTH SIDES OF THE WEB
- B) FOR BEAM BEARING — SEE TYPICAL DETAILS OF 3/4 INCH MINIMUM UNLESS NOTED OTHERWISE
- C) FOR MOMENT CONNECTS — REFER TO TYPICAL MOMENT CONNECTION DETAILS
- D) ALWAYS PROVIDE CAP PLATES FOR SQUARE, RECTANGULAR, AND ROUND HSS COLUMNS
10. WEB STIFFENERS SHALL BE PROVIDED IN WIDE FLANGE SHAPES AS FOLLOWS:
- A) COLUMN WEBS AT FULLY DEVELOPED MOMENT CONNECTIONS — STIFFENERS SHALL BE COMPLETE PENETRATION GROOVE WELDED WITH SAME THICKNESS AND GRADE AS THE BEAM FLANGES. WHERE MOMENT CONNECTIONS OCCUR ON COLUMN WEBS, STIFFENERS AND COLUMN WEBS, STIFFENER THICKNESS SHALL BE EQUAL THE VECTOR SUMMATION OF THE RESPECTIVE BEAM FLANGE THICKNESSES.
- B) BEAM WEBS WHERE BEAMS BEAR ON A COLUMN — SAME THICKNESS AND STRENGTH AS COLUMN FLANGES.
- C) BEAM WEBS WHERE COLUMN BEARS ON A BEAM (POST UP OR STUB COLUMN) — SAME THICKNESS AND STRENGTH AS COLUMN FLANGES.
11. PROVIDE ALL NECESSARY HOLES IN MISCELLANEOUS STRUCTURAL STEEL MEMBERS FOR ATTACHMENT OF NON-STRUCTURAL ITEMS (IE: HOLES FOR WINDOW HEAD ANCHORS). SEE ARCHITECTURAL DRAWINGS FOR REQUIREMENTS.
12. SPLICING OF STRUCTURAL STEEL MEMBERS WHERE NOT DETAILED IS PROHIBITED WITHOUT PRIOR APPROVAL OF THE STRUCTURAL ENGINEER.
13. ARCHITECTURALLY EXPOSED STRUCTURAL STEEL (AESS): WHERE NOTED ON PLANS OR BY THE ARCHITECT SHALL CONFORM TO AISC 303 SECTION 10
14. ALL CONNECTION BOLTS FOR STRUCTURAL STEEL MEMBERS SHALL CONFORM TO ASTM A325 EXCEPT WHERE NOTED OTHERWISE. MINIMUM SIZE SHALL BE 3/4 INCH DIAMETER UNLESS NOTED OTHERWISE. BOLTS SHALL BE DIRECT TENSION INDICATING BOLTS CONFORMING TO ASTM F1552 WITH HARDENED WASHERS UNDER THE NUT AND SACRIFICIAL SPLINES. HEX NUTS SHALL CONFORM TO ASTM A563 AND WASHERS SHALL CONFORM TO ASTM F436.
15. SHOP BOLTED CONNECTIONS ARE PERMISSIBLE IF SUFFICIENT BOLT CLEARANCE IS AVAILABLE FOR TIGHTENING OF HIGH STRENGTH BOLTS. CLEARANCES SHALL BE IN ACCORDANCE WITH TABLE 7-16 AND 7-17 OF THE THIRTEENTH EDITION OF THE MANUAL OF STEEL CONSTRUCTION OF THE AISC. ALL STEEL MEMBERS AND ASSEMBLIES SHALL BE SHOP FABRICATED TO THE GREATEST EXTENT POSSIBLE. TRUSSES SHALL BE FULLY SHOP ASSEMBLED. FIELD SPLICES FOR SHIPPING SHALL ONLY BE AS APPROVED BY THE ENGINEER OF RECORD. THE STEEL FABRICATOR AND THE STEEL ERECTOR SHALL COORDINATE THE SHOP FABRICATION, SHIPPING AND ERECTION OF ALL STRUCTURAL MEMBERS AND ASSEMBLIES
16. STEEL DECK SHALL ALWAYS BE INSTALLED WITH DIRECTION OF FLUTES PERPENDICULAR TO STEEL FRAMING MEMBERS. DECK SHALL BE CUT TO INSURE A MINIMUM OF THREE SPANS PER DECK WIDTH.
17. HEADED ANCHORS SHALL BE MANUFACTURED FROM COLD DRAWN WIRE CONFORMING TO ASTM A108, GR.50 WITH FLUXED ENDS. STUDS SHALL BE AUTOMATICALLY END WELDED WITH SUITABLE STUD WELDING EQUIPMENT IN ACCORDANCE WITH AWS D1.1. STUDS FOR EMBEDDED PLATES AND OTHER ANCHORS SHALL BE SHOP WELDED. STUDS FOR COMPOSITE BEAMS SHALL BE FIELD WELDED.
18. ALL STRUCTURAL STEEL, WHICH IS OUTSIDE THE BUILDING ENVELOPE SHALL BE HOT DIPPED GALVANIZED. ZINC COATING SHALL MEET THE REQUIREMENTS OF ASTM 123-75, WITH A MINIMUM COATING CLASS OF G100 AND SHALL BE APPLIED AFTER FABRICATION. ALL FIELD WELDS SHALL BE GROUND SMOOTH AND TOUCHED UP WITH A ZINC RICH PAINT.
19. STEEL COLUMNS SHALL BE SPLICED A MINIMUM OF 4'-0" ABOVE THE FINISH FLOOR IN STORIES WHERE SPLICES OCCUR. COLUMNS SHALL BE SPLICED EVERY TWO LEVELS. COLUMNS SHALL HAVE HOLES FOR 3/4" DIAMETER SAFETY CABLES OR PLATES WITH A HOLE WELDED TO THE COLUMN. PROVIDE AN 1.3x3x1/4 DECK SUPPORT ANGLE ON ALL SIDES OF THE COLUMN.
20. THE GENERAL CONTRACTOR AND HIS SUBCONTRACTOR'S SHALL COMPLY TO OSHA 29 CFR 1926 SUBPART R, SAFETY STANDARDS FOR STEEL ERECTION.
21. AS SCOPE AND PERFORMANCE DOCUMENTS, THE DRAWINGS AND SPECIFICATIONS DO NOT INDICATE OR DESCRIBE ALL OF THE WORK REQUIRED FOR THE PERFORMANCE AND COMPLETION OF THIS WORK, THE CONTRACTOR SHALL BE SOLELY RESPONSIBLE FOR THE FABRICATION AND INSTALLATION OF ALL MISCELLANEOUS METAL ITEMS INDICATED, DESCRIBED, OR IMPLIED ON THE STRUCTURAL AND/OR THE ARCHITECTURAL DRAWINGS. MISCELLANEOUS STEEL ITEMS, WITHIN AN ASSEMBLY AND NOT ATTACHED TO THE STRUCTURE, ARE THE RESPONSIBILITY OF THE GENERAL CONTRACTOR AND HIS SUBCONTRACTORS WHETHER THEY ARE SHOWN OR NOT SHOWN ON THE ARCHITECTURAL OR STRUCTURAL DRAWINGS. SUCH ASSEMBLIES INCLUDE BUT ARE NOT LIMITED TO, EXTERIOR AND INTERIOR WALL ASSEMBLIES, CEILING ASSEMBLIES, PARTITION ASSEMBLIES, SHELF AND CABINET ASSEMBLIES AND ALL OTHER SIMILAR ASSEMBLIES. ANY MISCELLANEOUS METAL ITEMS INDICATED ON THE ARCHITECTURAL DRAWINGS AND NOT SHOWN ON STRUCTURAL DRAWINGS SHALL BE A MINIMUM OF 1/4x1/4x1/2", C7x9.8, 3/8" PLATE OR HSS 4x4x3/8" UNLESS OTHERWISE APPROVED BY THE STRUCTURAL ENGINEER.

MECHANICAL UNIT, DUCTWORK, ELECTRICAL CONDUIT AND PIPE SUPPORT FROM STEEL JOISTS AND BEAMS

- I. THE FOLLOWING CRITERIA SHALL APPLY TO HANGING NEW MECHANICAL UNITS, DUCTWORK, ELECTRICAL CONDUITS AND ALL PIPING (MECHANICAL AND PLUMBING) ON STEEL JOIST IN NEW AND EXISTING CONSTRUCTION
- A) ALL SUPPORTS FOR MECHANICAL UNITS AND DUCTWORK SHALL BE PROVIDED SUCH THAT INDIVIDUAL LOADS ARE LIMITED TO 250 LBS. WITH A MAXIMUM OF TWO HANGERS PER JOIST
- B) SUPPORTS FOR MULTIPLE RUNS OF PIPING 4 INCH TO 6 INCH DIAMETER SHALL BE STAGGERED SUCH THAT ONE JOIST SUPPORTS NO MORE THAN TWO PIPES. SPACING OF THE SHALL BE IN ACCORDANCE WITH INDUSTRY STANDARDS, THE MECHANICAL OR PLUMBING CONTRACT DOCUMENTS OR 8 FEET ON CENTER MAXIMUM.
- C) SUPPORTS FOR MULTIPLE RUNS OF PIPING 8 INCH TO 10 INCH DIAMETER SHALL BE STAGGERED SUCH THAT ONE JOIST SUPPORTS NO MORE THAN TWO PIPES. SPACING OF THE SHALL BE IN ACCORDANCE WITH INDUSTRY STANDARDS, THE MECHANICAL OR PLUMBING CONTRACT DOCUMENTS OR 6 FEET ON CENTER MAXIMUM.
- D) FOR PIPING 12 INCHES DIAMETER AND LARGER OR FOR CASES WHERE THE CRITERIA ABOVE CANNOT BE MAINTAINED, SUPPLEMENTARY SHALL BE PROVIDED TO SUPPORT THE PIPES ON NEW OR EXISTING STEEL GIRDERS (WIDE FLANGES BEAMS) AND BEARING WALLS.
2. MECHANICAL UNIT AND PIPING SUPPORTS SHALL NOT OCCUR ON THE SAME JOISTS.
3. IN NO CASE SHALL THE TOTAL WEIGHT SUPPORTED BY A SINGLE JOIST EXCEED 500 LBS. UNLESS THE JOIST IS SPECIFICALLY DESIGNED FOR HIGHER LOADS OR NOTED AS PROVIDING MECHANICAL OR PIPE SUPPORT ON THE PLANS.
4. ALL MECHANICAL PIPING AND LARGE CONDUITS HANGING OF THE STRUCTURE SHALL BE SUPPORTED BY 5/8" DIAMETER ASTM A36 ALL THREAD ROD UNLESS NOTED OTHERWISE IN THE DRAWINGS.
5. ALL PIPES AND CONDUITS SHALL BE HUNG FROM BEAM CLAMPS ON BEAMS OR FROM THE TOP CHORD OF THE JOIST AT A PANEL POINT LOCATIONS. HANGING FROM JOIST BOTTOM CHORD IS NOT ALLOWED ON JOISTS. PIPING AND CONDUITS SHALL BE HUNG FROM JOIST TOP CHORD WITH ALL THREAD ROD WITH NUT AND WASHER TOP AND BOTTOM OF THE JOIST TOP CHORD AT PANEL POINT LOCATIONS OR PROVIDE TRAPEZE UNISTRUT P1000 OR EQUAL BETWEEN TWO JOISTS MINIMUM AT JOIST PANEL POINT LOCATIONS.
6. ALL SUPPORT POINTS SHALL BE LOCALLY REINFORCED ACCORDING TO THE TYPICAL DETAILS
7. DO NOT USE BEAM CLAMPS TO SUPPORT DUCTWORK, CONDUIT OR PIPING FROM STEEL JOISTS.
8. ALL THREAD HANGERS SHALL BE PLACED AT OR WITHIN 3 INCHES OF PANEL POINT AND BETWEEN THE JOIST TOP CHORDS. USE PROPER WASHERS OR PLATES TO SUPPORT THE WEIGHT
9. HANGERS LOCATED AT JOIST TOP CHORD LOCATIONS OTHER THAN THE PANEL POINTS SHALL BE LOCALLY REINFORCED ACCORDING TO THE TYPICAL DETAILS.
10. DO NOT SUPPORT PIPING FROM JOIST BRIDGING.
11. PIPE HANGER REQUIREMENTS:

SIZE	WEIGHT	MAX. SPACING OF HANGERS
4" DIA.	16 PLF	10'
6" DIA.	32 PLF	10'
8" DIA.	50 PLF	10'
10" DIA.	75 PLF	5'
12" DIA.	100 PLF	5'

PLF = POUNDS PER LINEAR FOOT

PIPES OR (2) TWO OR MORE IN NUMBER AND LARGER THAN 4" INCH DIAMETER SHALL BE HUNG AT 5'-0" ON CENTER MAXIMUM

MASONRY WALL NOTES

1. THE STRUCTURAL PLANS ONLY SHOW THE LOAD BEARING "STRUCTURAL" MASONRY.
2. MASONRY CONSTRUCTION SHALL BE PERFORMED IN ACCORDANCE WITH PART 3 OF ACI 531 "BUILDING CODE REQUIREMENTS FOR CONCRETE MASONRY CONSTRUCTION".
3. ALL CONCRETE MASONRY UNITS SHALL BE HOLLOW LOAD BEARING UNITS CONFORMING TO THE REQUIREMENTS OF ASTM C90, TYPE I AND THE QUALITY CONTROL STANDARDS OF THE CONCRETE MASONRY ASSOCIATION.
4. NORMAL WEIGHT CONCRETE MASONRY UNITS (CMU) SHALL CONFORM TO ASTM C90, TYPE II, WITH A MINIMUM DESIGN COMPRESSIVE STRENGTH OF 3,750 PSI. CONCRETE MASONRY UNITS USED BELOW GRADE SHALL BE COMPOSED OF NORMAL WEIGHT AGGREGATE. LIGHT WEIGHT CONCRETE MASONRY UNITS SHALL CONFORM TO ASTM C531 WITH A MINIMUM DESIGN COMPRESSIVE STRENGTH OF 3,750 PSI. CONCRETE MASONRY UNITS USED ABOVE GRADE SHALL BE COMPOSED OF LIGHTWEIGHT AGGREGATE.
5. ALL MASONRY UNITS SHALL HAVE A MINIMUM NET COMPRESSIVE STRENGTH OF 3,750 PSI AND A MINIMUM NET TENSILE STRENGTH OF NOT LESS THAN 125 PSI. WHEN TESTED IN ACCORDANCE WITH THE METHODS SET FORTH IN THE QUALITY CONTROL STANDARDS OF THE CONCRETE MASONRY ASSOCIATION.
6. MASONRY UNITS SHALL HAVE CURED FOR NOT LESS THAN 28 DAYS WHEN PLACED IN THE STRUCTURE.
7. ALL MASONRY UNITS SHALL HAVE A MAXIMUM LINEAR SHRINKAGE OF .065 OF 1% FROM THE SATURATED TO THE OVEN DRY CONDITION, WHEN TESTED IN ACCORDANCE WITH THE METHODS SET FORTH IN THE QUALITY CONTROL STANDARDS OF THE CONCRETE MASONRY ASSOCIATION.
8. MASONRY MORTAR SHALL BE FRESHLY PREPARED, UNIFORMLY MIXED AND SHALL CONFORM TO ASTM C270, TYPE 'S' WITH A MINIMUM COMPRESSIVE STRENGTH OF 1,800 PSI AT 28 DAYS. MASONRY CEMENT AND MORTAR CEMENT SHALL NOT BE USED. USE ASTM C270 TYPE 'M' MORTAR WITH A MINIMUM COMPRESSIVE STRENGTH OF 3,000 PSI AT 28 DAYS IS REQUIRED IN BELOW GRADE APPLICATIONS. FOR MULTI WYTHE WALLS USE THE SAME TYPE OF MORTAR FOR EACH WYTHE.
9. BRICK MORTAR SHALL BE FRESHLY PREPARED, UNIFORMLY MIXED, AND SHALL CONFORM TO ASTM C270, TYPE 'N' WITH A MINIMUM COMPRESSIVE STRENGTH OF 1,800 PSI AT 28 DAYS.
10. GROUT MIXTURES SHALL CONFORM TO ASTM C476 WITH A 28 DAY COMPRESSIVE STRENGTH OF 2500 PSI AND A MAXIMUM 28 DAY COMPRESSIVE STRENGTH OF 4,000 PSI.
11. CONCRETE MASONRY CONSTRUCTION SHALL HAVE A MINIMUM COMPRESSIVE STRENGTH OF THE MASONRY (Fm) SHALL BE 2500 PSI ON THE NET CROSS SECTIONAL AREA AT 28 DAYS.
12. ALL CELLS WITH REINFORCING BARS SHALL BE GROUTED SOLID AND CONCRETE MASONRY UNITS LOCATED BELOW GRADE SHALL HAVE ALL CELLS FULLY GROUTED. REINFORCING STEEL SHALL CONSIST OF DEFORMED GRADE 60 BARS CONFORMING TO ASTM A618. BARS SHALL BE NEW BILLET STEEL OF A DOMESTIC MANUFACTURE. ALL CELLS TO BE GROUTED SHALL BE CLEAN AND FREE OF EXCESS MORTAR AND FOREIGN MATERIALS.
13. ALL CELLS SHOWN TO HAVE DRILLED EXPANSION ANCHORS, EMBEDDED HEADS OR OTHER EMBEDDED ANCHORS SHALL BE GROUTED SOLID.
14. HORIZONTAL JOINT REINFORCEMENT SPACED AT 16 INCHES ON CENTER MAX. VERTICALLY SHALL CONFORM TO ASTM A981 WITH A MINIMUM YIELD STRENGTH OF 70,000 PSI AND A MINIMUM SIZE OF 9 GAGE FOR SIDE RODS AND 9 GAGE FOR TRUSS RODS.
15. BOND BEAM BLOCKS SHALL BE OPEN BOTTOM UNITS AND ARE TO BE USED AT THE TOPS OF WALLS AND AT THE MID-HEIGHT OF WALL OR AT 8'-0" ON CENTER VERTICALLY MAXIMUM UNLESS NOTED OTHERWISE ON THE DRAWINGS. PROVIDE (2) NO. 4 BARS IN A SOLID GROUTED BOND BEAM UNLESS NOTED OTHERWISE. LINTEL BLOCKS SHALL NOT BE USED IN PLACE OF BOND BEAM BLOCKS. BOND BEAMS TO STOP AND START AT EVERY THIRD VERTICAL CONTROL JOINT. BOND BEAM TO BE CUT AT EVERY VERTICAL CONTROL JOINT BUT REINFORCING TO REMAIN CONTINUOUS.
16. OPENINGS IN MASONRY WALLS SHALL HAVE EITHER MASONRY OR STEEL LINTELS AS DETAILED ON THE DRAWINGS. WHEN NO LINTEL IS DETAILED A MINIMUM OF (2) NO. 4 BARS IN A SOLID GROUTED LINTEL BLOCK SHALL BE INSTALLED. THE BARS SHALL EXTEND A MINIMUM OF EIGHT INCHES BEYOND THE TOP AND BOTTOM OF THE OPENING AND THE MID-HEIGHT OF THE OPENING SHALL BE GROUTED SOLID FOR A DISTANCE OF EIGHT INCHES WITH A NO. 5 VERTICAL MINIMUM AT EACH JAMB. LAP BARS 2'-0" MIN. OR 40 BAR DIAMETERS AT SPLICES, INTERSECTIONS AND CORNERS
17. LINTEL BLOCKS SHALL BE "U" SHAPED UNITS WITH SOLID BOTTOMS AND ARE TO BE USED OVER WINDOW AND DOOR OPENINGS. BOND BEAM BLOCKS SHALL BE OPEN BOTTOM UNITS AND ARE TO BE USED AT THE TOPS OF WALLS AND AT THE MID-HEIGHT OF WALL OR AT 8'-0" ON CENTER VERTICALLY MAXIMUM UNLESS NOTED OTHERWISE ON THE DRAWINGS. PROVIDE (2) NO. 4 BARS IN A SOLID GROUTED BOND BEAM UNLESS NOTED OTHERWISE. LINTEL BLOCKS SHALL NOT BE USED IN PLACE OF BOND BEAM BLOCKS. VERTICAL REINFORCING SHALL EXTEND THROUGH ALL BOND BEAMS. BOND BEAMS TO STOP AND START AT EVERY THIRD VERTICAL CONTROL JOINT. BOND BEAM TO BE CUT AT EVERY VERTICAL CONTROL JOINT BUT REINFORCING TO REMAIN CONTINUOUS THRU THE CONTROL JOINT.
18. STEEL LINTELS SHALL BEAR 8 INCHES MINIMUM AT EACH END ON FLASHING ABOVE AND BELOW THE ANGLE. VERTICAL CONTROL JOINTS SHALL EXTEND UP FROM THE END OF THE STEEL LINTEL, UNLESS 15# FELL T OR FLASHING IS PROVIDED TOP AND BOTTOM OF LINTEL ANGLE WHERE ANGLE BEARS ON BRICK.
19. MASONRY WALLS SHALL HAVE VERTICAL CONTROL JOINTS AT APPROXIMATELY SIXTEEN (16) FEET TO TWENTY-FOUR (24) FEET ON CENTER AND FOUR (4) FEET MAXIMUM FROM CORNERS OR AT A MAXIMUM HEIGHT/LENGTH RATIO OF 1.5 FOR UNREINFORCED WALLS AND H/L OF 2 FOR REINFORCED WALLS. COORDINATE THE LOCATION OF JOINTS WITH THE ARCHITECT. PROVIDE HECKMANN NO. 351 CONTROL JOINT ANCHORS AT 16 INCHES ON CENTER VERTICALLY AT BRICK MASONRY AND HECKMANN NO. 350 CONTROL JOINT ANCHORS AT 16 INCHES ON CENTER VERTICALLY AT CONCRETE MASONRY UNITS.
20. AT FREE VERTICAL EDGES, CORNERS AND INTERSECTIONS OF WALLS PROVIDE AT LEAST (1) NO. 5 VERTICAL IN GROUT FILLED END CORE, UNLESS NOTED OTHERWISE ON THE DRAWINGS.
21. PROVIDE A MINIMUM OF NO. 4 AT 48 INCHES ON CENTER VERTICAL WALL REINFORCING AND DOWELS IN FULLY GROUTED CELLS AT ALL EXTERIOR AND INTERIOR WALLS UNLESS A GREATER REINFORCING IS SHOWN ON THE PLANS OR IN THE DETAILS. PROVIDE 1/2 INCH DIAMETER DEFORMED BAR ANCHORS AT 48 INCHES ON CENTER WELDED TO STEEL MEMBERS SUPPORTING MASONRY ABOVE UNLESS NOTED OTHERWISE ON THE DRAWINGS.
22. PROVIDE HOHMAN AND BARNARD RB-8 REBAR POSITIONERS OR EQUAL AT EVERY THIRD COURSE AND AT SPLICE LOCATIONS.
23. ALL MASONRY TIES TO BACKUP STRUCTURE SHALL BE HOT DIP GALVANIZED, PROVIDE A HECKMANN NO. 315 ANCHOR WITH NO. 316 TRIANGULAR TIE-ON COLUMNS AT 16 INCHES (15 INCHES AT KING SIZE BRICK) ON CENTER VERTICALLY AND A HECKMANN NO. 191 OR 192 ANCHORS ON EACH SIDE OF ALL BEAMS AT 16 INCHES ON CENTER HORIZONTALLY UNLESS NOTED OTHERWISE ON THE DRAWINGS. MASONRY TIES TO WALL STUDS SHALL BE A HECKMANN NO. 316 TRIANGULAR TIE WITH A HECKMANN NO. 315-C SCREW ON ANCHOR STRAP OR HECKMANN #77 WING NUT POS-I-TIE ANCHOR SPACED 16 INCHES (15 INCHES AT KING SIZE BRICK) ON CENTER HORIZONTALLY AND 16 INCHES ON CENTER VERTICALLY. AT TOP OF WALLS AND AT WALL CORNERS AND INTERSECTIONS PROVIDE TWO VERTICAL ROWS OF ANCHORS SPACED 16 INCHES APART AND 16 INCHES ON CENTER VERTICALLY. TRIANGULAR TIES SHALL EXTEND 3/4 INCH FROM FACE OF MASONRY. ANCHOR STRAPS SHALL BE ATTACHED TO METAL STUDS WITH TWO (2) #40-16x 1/2 INCHES CADMIUM PLATED HEX HEAD SHEET METAL SCREWS WITH NEOPRENE WASHER.
24. ANCHOR WOOD SILL (PRESSURE TREATED) TO CMU WITH 1/2 INCH DIA. x 9 INCHES LONG HOT-DIP GALVANIZED, HOOKED ANCHOR BOLTS WITH 9/16-INCH-WIDE TYPE "B" HOT-DIP GALVANIZED WASHERS EMBEDDED 7 INCH MINIMUM AT 24 INCHES MAX. ON CENTER. AT CORNERS AND DOOR OPENINGS PROVIDE ONE ANCHOR BOLT AT 8 INCHES IN EACH DIRECTION FROM CORNER. PROVIDE TWO BOLTS MINIMUM PER PIECE OF SILL PLATE.
25. ALL MASONRY DESIGN IS BASED CHAPTER 21 OF INTERNATIONAL BUILDING CODE, LATEST EDITION AND ACI 530/TMS 402, LATEST EDITION.
26. TOPS OF ALL NON-LOAD BEARING INTERIOR WALLS SHALL BE BRACED ACCORDING TO THE SPECIFIC SECTION INDICATED ON PLAN OR THE TYPICAL DETAILS.

CONSULTANTS

MEP

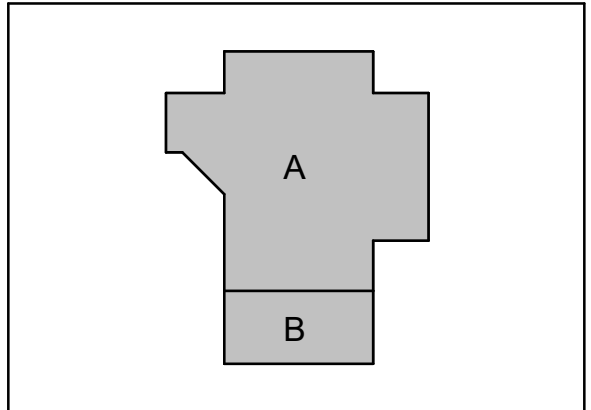
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06 November 2023	
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DATE:	2023-11-06
DRAWN:	JG
CHECKED:	HK
DATE:	ISSUE
2023-11-06	BID SET

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GENERAL  
NOTES



STRUCTURAL TESTING AND INSPECTIONS

EARTHWORK TESTING

1. DURING EARTHWORK OPERATIONS KEEP A COMPETENT TRAINED TECHNICIAN ASSIGNED TO THE PROJECT. SERVICES PROVIDED SHALL INCLUDE:
- A) OBSERVE STRIPPING OPERATIONS AND EVALUATE THE REQUIRED STRIPPING DEPTH DURING THESE OPERATIONS.
- B) OBSERVE PROOFROLLING OPERATIONS AFTER SITE STRIPPING. DETERMINE IF ANY SOFT SPOTS NEED TO BE UNDERCUT TO FIRM SOILS, REPLACED WITH SELECT FILL AND RECOMPACTED.
- C) VERIFY THAT THE SUBGRADE SHALL THEN BE SCARIFIED AND MOISTURE CONDITIONED TO A SIX (6) INCH DEPTH AND THEN RECOMPACTED TO BETWEEN 95 AND 100 PERCENT OF THE MAXIMUM DRY DENSITY AS DETERMINED BY THE STANDARD PROCTOR DENSITY TEST (ASTM D698). THE MOISTURE CONTENT SHALL BE BETWEEN OPTIMUM AND +3 PERCENT OF THE OPTIMUM MOISTURE CONTENT. PROVIDE A MINIMUM OF (4) FIELD DENSITY TESTS ON THE SUBGRADE OR ONE (1) FOR EVERY 2,500 SQUARE FEET WHICHEVER IS GREATER.
- D) STRUCTURAL SELECT FILL PAD MATERIAL SHALL BE TESTED FOR ACCEPTABILITY AND A MOISTURE DENSITY CURVE SHALL BE ESTABLISHED. SELECT FILL MATERIAL SHALL BE AN INORGANIC SANDY CLAY WITH LIQUID LIMIT BETWEEN 26 AND 40 AND PLASTICITY INDEX BETWEEN 10 AND 20.
- E) SELECT FILL SHALL BE PLACED IN EIGHT INCH LOOSE LIFTS AND COMPACTED TO BETWEEN 95 AND 100 PERCENT OF THE MAXIMUM DRY DENSITY AS DETERMINED BY THE STANDARD PROCTOR DENSITY TEST (ASTM D698). THE MOISTURE CONTENT SHALL BE BETWEEN OPTIMUM AND +3 PERCENT OF THE OPTIMUM MOISTURE CONTENT FOR SELECT FILL.
- F) SELECT FILL MATERIAL SHALL BE TESTED DURING PLACEMENT OF EACH LIFT FOR THE ATTERBERG LIMITS IN ACCORDANCE WITH ASTM D4318-98 METHOD 8 "STANDARD TEST METHOD FOR LIQUID LIMIT, PLASTIC LIMIT AND PLASTICITY INDEX OF SOILS" TO VERIFY THAT THE SELECT FILL MATERIAL IS IN ACCORDANCE WITH THE ORIGINALLY APPROVED SELECT FILL MATERIAL. PROVIDE A MINIMUM OF ONE (1) TEST PER LIFT OR ONE (1) FOR EVERY 2,500 SQUARE FEET WHICHEVER IS GREATER WITH A MAXIMUM OF TEN (10) PER LIFT.
- G) OBSERVE THE EXCAVATION DAILY AND ENSURE THAT THE CONTRACTOR MAINTAINS A CLEAN EXCAVATION THAT IS FREE OF WATER 100% OF THE TIME. CONTRACTOR SHALL PROVIDE PUMPS AS REQUIRED TO REMOVE ANY WATER AT ALL TIMES.
- H) OBSERVE GRADING OPERATIONS TO ENSURE THAT PROPER DRAINAGE AWAY FROM THE BUILDING PAD IS PROVIDED.

DRILLED FOOTINGS TESTING

1. DURING DRILLED FOOTING OPERATIONS KEEP A COMPETENT TRAINED TECHNICIAN ASSIGNED TO THE PROJECT. SERVICES PROVIDED SHALL INCLUDE:
- A) OBSERVING THE BOTTOM OF SHAFT FOR CLEANLINESS.
- B) CHECKING SHAFT FOR CONFORMANCE TO REQUIRED TOLERANCES. FOOTINGS SHALL BE WITHIN 3" OF THEIR REQUIRED LOCATIONS AND SHAFTS SHALL NOT BE OUT OF PLUMB BY MORE THAN 2 PERCENT OF THE SHAFT LENGTH.
- C) CHECKING SHAFT BOTTOM FOR PROPER BEARING MATERIAL.
- D) NOTING DEPTH AND DIAMETER OF ALL FOOTINGS.
- E) VERIFY QUANTITY, SIZE AND LOCATION OF REINFORCEMENT.
- F) CHECK FOR CAVING OF SHAFT OR BELL WALLS.
- G) CHECKING THAT THE BELL IS CONCENTRIC WITH THE SHAFT.

2. ENSURE THAT THE SPILLS FROM THE DRILLED FOOTING EXCAVATIONS ARE REMOVED FROM THE BUILDING PAD AND THAT THE PAD IS MOISTURE CONDITIONED AND RECOMPACTED AS SPECIFIED.

CONCRETE TESTING

1. CONCRETE MIX DESIGNS SHALL BE SUBMITTED FOR REVIEW INDICATING CONFORMANCE WITH ACI 318, LATEST EDITION, CHAPTER 5, SECTION 5.3.
2. SLUMP TESTS, CONFORMING TO ASTM C143, SHALL BE TAKEN AT THE POINT OF DISCHARGE AT THE SAME RATE AS NOTED BELOW IN NOTE NUMBER 5.
3. AIR CONTENT TESTS CONFORMING TO ASTM C173, VOLUMETRIC METHOD FOR LIGHTWEIGHT OR NORMAL WEIGHT CONCRETE; ASTM C231 PRESSURE METHOD FOR NORMAL WEIGHT CONCRETE; SHALL BE TAKEN FOR EACH DAY'S POUR OF EACH TYPE OF AIR-ENTRAINED CONCRETE.
4. CONCRETE TEMPERATURE SHALL BE TESTED HOURLY WHEN AIR TEMPERATURE IS 40 DEG F (4 DEG C) AND BELOW, WHEN 80 DEG F (27 DEG C) AND ABOVE, AND EACH TIME A SET OF COMPRESSION TEST SPECIMENS IS MADE.
5. ONE SET OF FOUR COMPRESSION TEST SPECIMENS CONFORMING TO ASTM C31 SHALL BE MOLDED AND STORED FOR LABORATORY-CURED SPECIMENS. COMPRESSIVE STRENGTH TESTS SHALL CONFORM TO ASTM C39 AND SHALL CONSIST OF ONE SET FOR EACH DAY'S POUR EXCEEDING 5 CU YDS. PLUS ADDITIONAL SETS FOR EACH 50 CU YDS. MORE THAN THE FIRST 25 CU YDS OF EACH CONCRETE CLASS PLACED IN ANY ONE DAY. ONE SPECIMEN SHALL BE TESTED AT 7 DAYS. TWO SPECIMENS SHALL BE TESTED AT 28 DAYS, AND ONE SPECIMEN SHALL BE RETAINED FOR LATER TESTING AS REQUIRED.
6. VERIFY CONCRETE IS BEING CONSOLIDATED IN ACCORDANCE WITH THE RECOMMENDATIONS OF ACI 318 AND ACI 308R, LATEST EDITION.
7. VERIFY THAT POST INSTALLED ANCHORS ARE AS SPECIFIED AND THAT THE ANCHORS ARE INSTALLED PER THE MANUFACTURER'S RECOMMENDATIONS AND REQUIREMENTS.

REINFORCING STEEL INSTALLATION

1. DURING CAST-IN-PLACE CONCRETE STRUCTURAL MEMBER REINFORCING PLACEMENT OPERATIONS KEEP A COMPETENT TRAINED TECHNICIAN ASSIGNED TO THE PROJECT. INSPECT REINFORCING UTILIZING ACI 311.4R "GUIDE FOR CONCRETE INSPECTION" AS A GUIDE. SERVICES PROVIDED SHALL INCLUDE:
- A) VERIFY TYPE AND GRADE OF ALL REINFORCING STEEL.
- B) VERIFY REBAR IS FREE OF OIL, DIRT, EXCESSIVE RUST AND FROM DAMAGE IN SHIPMENT TO SITE.
- C) VERIFY REINFORCING IS ADEQUATELY TIED, CHAIRED AND SUPPORTED TO PREVENT DISPLACEMENT DURING CONCRETE PLACEMENT.
- D) VERIFY MINIMUM AND MAXIMUM CLEAR DISTANCES BETWEEN BARS AND MINIMUM STRUCTURAL DISTANCE TO OUTSIDE OF CONCRETE.
- E) VERIFY QUANTITY, SIZE AND LOCATION OF REINFORCEMENT.
- F) VERIFY MINIMUM CONCRETE COVER IS MAINTAINED BETWEEN REBAR AND SURFACE OF CONCRETE.
- G) VERIFY SIZE AND PLACEMENT OF REBAR. VERIFY LAP LENGTHS, LOCATIONS AND STAGGERS AND VERIFY BENDS FOR MINIMUM DIAMETER, SLOPE AND LENGTH. VERIFY HOOKED BAR LENGTHS AND LOCATIONS.

POST INSTALLED ANCHORS — FIELD QUALITY CONTROL

1. THE INTERNATIONAL BUILDING CODE (IBC 2018) REQUIRES SPECIAL INSPECTION OF ALL POST-INSTALLED ANCHORS. ACI 308-R SECTIONS 26.13.1.5 AND 26.13.1.6 REQUIRE THAT ALL INSPECTIONS OF MECHANICAL AND ADHESIVE ANCHORS, RESPECTIVELY, ARE PERFORMED BY A CERTIFIED FIELD INSPECTOR SPECIFICALLY APPROVED FOR THAT PURPOSE BY THE SER AND THE BUILDING OFFICIAL. CERTIFICATION IS ESTABLISHED THROUGH AN INDEPENDENT ASSESSMENT SUCH AS THE ACI POST-INSTALLED CONCRETE ANCHOR INSTALLATION INSPECTOR PROGRAM OR SIMILAR PROGRAM WITH EQUIVALENT REQUIREMENTS. ADHESIVE ANCHORS INSTALLED IN HORIZONTAL OR UPWARDLY INCLINED ORIENTATIONS TO RESIST SUSTAINED TENSION LOADS SHALL BE CONTINUOUSLY INSPECTED DURING INSTALLATION BY A CERTIFIED INSPECTOR.
2. POST-INSTALLED EXPANSION AND ADHESIVE ANCHORS SHALL BE PROOF LOADED AS REQUIRED IN THE CONTRACT DOCUMENTS. A PERCENTAGE OF EACH TYPE AND SIZE OF EACH TYPE OF SIZE OF ANCHOR ASSEMBLY SHALL BE PROOF LOADED IN TENSION BY AN INDEPENDENT TESTING LABORATORY UNLESS OTHERWISE SHOWN ON THE CONTRACT DOCUMENTS.
- A) PROOF LOADING SHALL BE CONDUCTED AS CONFINED TENSION TESTING FOR ADHESIVE ANCHORS USING A CENTER-HOLE CYLINDER.
- B) THE INDEPENDENT TESTING LABORATORY SHALL SUBMIT AN ANCHORAGE TESTING PLAN TO THE SER TO ENSURE THE TESTING REQUIREMENTS ARE FULFILLED.
- C) PROOF LOAD RANDOM SAMPLE RATES AS FOLLOWS:

TYPE OF ANCHOR	SAMPLE RATE (PERCENT)
REINFORCING FOR SLAB ON GROUND	5
REINFORCING — GRADE BEAMS	30
REINFORCING — CONCRETE BEAMS	50
REINFORCING — CONCRETE COLUMNS	50
ANCHOR BOLTS NEW OR REPLACEMENT — SHEAR ONLY	25
ANCHOR BOLTS NEW OR REPLACEMENT — MOMENT FRAMES	50
ANCHORS FOR SHEAR TABS/PLATES OR ANGLES	30
ANCHORS IN TENSION — STRUCTURAL MEMBERS	50
ANCHORS IN TENSION — NON-STRUCTURAL MEMBERS	25
ANCHORS SUPPORTING LIFE SAFETY DEVICES	100

3. POST-INSTALLED EXPANSION AND ADHESIVE ANCHORS SHALL BE PROOF LOADED TO LOAD LEVELS AS SHOWN ON THE CONTRACT DOCUMENTS, OR AS INDICATED ON THE STRUCTURAL DRAWINGS FOR THE SPECIFIC ANCHOR TYPES ABOVE. PROOF LOADING OF ADHESIVE ANCHORS SHALL BE PERFORMED AFTER A MINIMUM CURING PERIOD SPECIFIED BY THE MANUFACTURER.
4. ANCHORS SHALL HAVE NO VISIBLE INDICATIONS OF DISPLACEMENT OR DAMAGE DURING OR AFTER PROOF LOAD APPLICATION. CONCRETE CRACKING IN THE VICINITY OF THE ANCHOR AFTER LOADING SHALL BE CONSIDERED A FAILURE.
5. IF AN ANCHOR FAILS, MODIFY ALL INSTALLATIONS OF THE SAME TYPE AND RETEST UNTIL SATISFACTORY RESULTS ARE ACHIEVED.
6. IF MORE THAN 5 PERCENT OF THE TESTED ANCHORS FAIL TO ACHIEVE THE SPECIFIED PROOF LOAD WITHIN THE LIMITS DEFINED ON THESE DRAWINGS, THEN 100 PERCENT OF THE ANCHORS OF THE SAME DIAMETER AND TYPE AS THE FAILED ANCHOR SHALL BE PROOF TESTED, UNLESS OTHERWISE DIRECTED BY THE SER.
7. PROVIDE WRITTEN FASTENER LOAD TEST REPORTS AND INTERMITTENT SPECIAL INSPECTION REPORTS OF POST INSTALLED FASTENERS AS THE WORK PROGRESSES.

STRUCTURAL STEEL TESTING

1. CERTIFY WELDERS FOR THE WELD TYPES IN THE PROJECT AND CONDUCT INSPECTIONS AND TESTS AS REQUIRED, AS A MINIMUM, WELDERS SHALL BE AISC CERTIFIED, RECORD TYPES AND LOCATIONS OF DEFECTS FOUND IN WORK. RECORD WORK REQUIRED AND PERFORMED TO CORRECT DEFICIENCIES.
2. VISUALLY INSPECT 100% OF ALL FILLET WELDS.
3. VISUALLY INSPECT 100% OF ALL FULL PENETRATION WELDS. TEST 20% OF ALL FULL PENETRATION WELDS BY ONE OF THE FOLLOWING METHODS: LIQUID PENETRANT INSPECTION (ASTM E165), MAGNETIC PARTICLE INSPECTION (ASTM E709; PERFORMED ON THE ROOT PASS AND ON THE FINISHED WELD; CRACKS AND ZONES OF INCOMPLETE FUSION OR PENETRATION IS NOT ACCEPTABLE), RADIOGRAPHIC INSPECTION (ASTM E94 AND ASTM E146; MINIMUM QUALITY LEVEL OF "2-2T"), OR ULTRASONIC INSPECTION (ASTM E164). IF FAILURE RATE IS 20% OR GREATER, TEST 100% OF WELDS AT CONTRACTOR'S EXPENSE UNTIL FAILURE RATE FALLS BELOW 20%.
4. ALL WELDS THAT FAIL SHALL BE REWELDED AND RETESTED UNTIL THEY PASS THE TEST. TEST TWO ADDITIONAL WELDS AT THE CONTRACTOR'S EXPENSE FOR EVERY WELD FAILURE.
5. VISUALLY INSPECT WELDS ON 100% OF ALL STUDS AND TEST 10% BY THE METHOD DESCRIBED BELOW IN COMPLIANCE WITH AWS D11. HEADED STUD SHALL BE TESTED BY ALTERNATELY BENDING 30 DEG. IN OPPOSITE DIRECTIONS FROM ITS ORIGINAL AXIS BY EITHER STRIKING THE STUDS WITH A HAMMER ON THE UNWELDED END OR PLACING A PIPE OR OTHER SUITABLE HOLLOW DEVICE OVER THE STUD AND MANUALLY OR MECHANICALLY BENDING THE STUD. IF FAILURE RATE IS 10% OR GREATER, TEST 100% OF STUDS AT CONTRACTOR'S EXPENSE UNTIL FAILURE RATE FALLS BELOW 10%. IF A VISUAL INSPECTION REVEALS ANY STUD THAT DOES NOT SHOW A FULL 360 DEG. FLASH (AS DEFINED IN AWS D11) OR ANY STUD THAT HAS BEEN REPAIRED BY WELDING, SUCH STUD SHALL BE BENT TO AN ANGLE OF APPROXIMATELY 15 DEGREES FROM ITS ORIGINAL AXIS. THE DIRECTION OF BENDING FOR STUDS WITH LESS THAN 360 DEGREES FLASH SHALL BE OPPOSITE TO THE MISSING PORTION OF FLASH.
6. BOLTS SHALL BE VISUALLY INSPECTED WHEN TWIST-OFF SPLINES ARE USED, OTHERWISE BOLTS SHALL BE SNUG TIGHT.
7. ALL FULL PENETRATION WELDS AT MOMENT CONNECTIONS REQUIRING TESTING SHALL BE TESTED AND CERTIFIED BY AN INDEPENDENT TESTING LABORATORY USING NON-DESTRUCTIVE TESTING METHODS. FOR SHOP WELDS, CERTIFICATION SHALL BE SUBMITTED PRIOR TO SHIPPING TO THE JOB SITE. FOR FIELD WELDS, CERTIFICATION SHALL BE SUBMITTED PRIOR FLOOR DECK INSTALLATION AND CONCRETE PLACEMENT AND PRIOR TO COVERING CONNECTIONS WITH FIREPROOFING OR ARCHITECTURAL FINISHES.

MASONRY TESTING

1. MASONRY TESTING SHALL CONSIST OF A QUALIFIED TESTING LABORATORY PROVIDING THE FOLLOWING SERVICES:
- A) VERIFY QUANTITY, SIZE AND SPACING OF REQUIRED REINFORCING SHOWN ON THE DRAWINGS.
- B) OBSERVE THE INSTALLATION OF MASONRY UNITS.
- C) INSPECTION OF GROUT SPACE, IMMEDIATELY PRIOR TO CLOSING OF CLEANOUTS AND PRIOR TO ALL GROUTING OPERATIONS. VERIFY THAT THE SPECIFIED CELLS HAVE BEEN FULLY GROUTED.
- D) MONITOR THE PROPORTIONING, MIXING AND CONSISTENCY OF MORTAR AND GROUT. PROVIDE 28 DAY COMPRESSIVE STRENGTH TESTS ON EACH GROUT MIX IN ACCORDANCE WITH ASTM C1019. COMPRESSION TEST MASONRY PRISMS FOR EACH TYPE OF WALL CONSTRUCTION IN ACCORDANCE WITH ASTM C1314. CONTRACTOR SHALL PREPARE ONE SET OF PRISMS FOR TESTING AT 28 DAYS. TESTS ARE TO BE CONDUCTED FOR EACH 2000 SQUARE FEET OF WALL INSTALLED, BUT NOT LESS THAN TWO TESTS.

SPECIAL INSPECTIONS AND STRUCTURAL TESTING

SPECIAL INSPECTION WORK AND THE FINAL LETTER OF COMPLIANCE HAVE NOT BEEN INCLUDED IN THE STRUCTURAL ENGINEER OF RECORD'S SCOPE OF SERVICES. THE OWNER IS RESPONSIBLE FOR OBTAINING THE SERVICES OF THE SPECIAL INSPECTOR AND THE TESTING LABORATORY. SPECIAL INSPECTIONS CAN BE PROVIDED BY AN INDEPENDENT SPECIAL INSPECTOR APPROVED AUTHORITY BY THE SER AUTHORITY. THE SPECIAL INSPECTOR DOES NOT INCLUDE THE TESTING LABORATORY SERVICES AS CALLED FOR ON THE DRAWINGS. ARRANGEMENTS FOR SPECIAL INSPECTIONS SHOULD BE MADE PRIOR TO THE COMMENCEMENT OF CONSTRUCTION. THE CONTRACTOR IS RESPONSIBLE FOR NOTIFYING THE TESTING LABORATORY AND SPECIAL INSPECTOR IN A TIMELY MANNER PRIOR TO PROCEEDING WITH CONSTRUCTION OPERATIONS. THE CONTRACTOR SHALL NOT PROCEED WITH ANY WORK REQUIRING INSPECTIONS WITHOUT THE TESTING LABORATORY'S OR SPECIAL INSPECTOR'S PRESENCE.

STRUCTURAL STATEMENT OF SPECIAL INSPECTIONS

THE STRUCTURAL SPECIAL INSPECTOR SHALL KEEP RECORDS OF ALL STRUCTURAL INSPECTIONS AND SHALL FURNISH INSPECTION REPORTS TO THE OWNER AND THE STRUCTURAL REGISTERED DESIGN PROFESSIONAL IN RESPONSIBLE CHARGE (SDRP). DISCOVERED DISCREPANCIES SHALL BE BROUGHT TO THE ATTENTION OF THE CONTRACTOR FOR CORRECTION. IF SUCH DISCREPANCIES ARE NOT CORRECTED, THE DISCREPANCIES SHALL BE BROUGHT TO THE ATTENTION OF THE OWNER AND THE SDRP. THE SPECIAL INSPECTION PROGRAM DOES NOT RELIEVE THE CONTRACTOR OF HIS RESPONSIBILITIES.

A FINAL REPORT OF SPECIAL INSPECTION DOCUMENTING COMPLETION OF ALL SPECIAL INSPECTIONS, TESTING AND CORRECTION OF ANY DISCREPANCIES NOTED IN THE INSPECTIONS SHALL BE SUBMITTED TO THE OWNER AND THE SDRP PRIOR TO ISSUANCE OF A CERTIFICATE OF OCCUPANCY AND USE.

STRUCTURAL SCHEDULE OF SPECIAL INSPECTIONS

QUALIFICATIONS OF INSPECTORS AND TESTING TECHNICIANS

THE QUALIFICATIONS OF ALL PERSONNEL PERFORMING SPECIAL INSPECTION AND TESTING ACTIVITIES ARE SUBJECT TO THE APPROVAL OF THE OWNER. THE CREDENTIALS OF ALL INSPECTORS AND TESTING TECHNICIANS SHALL BE PROVIDED TO THE SPECIAL INSPECTOR FOR THEIR RECORDS.

KEY FOR MINIMUM QUALIFICATION OF INSPECTION AGENTS

WHEN THE REGISTERED DESIGN PROFESSION IN RESPONSIBLE CHARGE OR SPECIAL INSPECTOR OF RECORD DEEMS APPROPRIATE THAT THE INDIVIDUAL PERFORMING THE STIPULATED TEST OR INSPECTION HAVE A SPECIFIC CERTIFICATION, LICENSE OR EXPERIENCE AS INDICATED BELOW. SUCH REQUIREMENT SHALL BE LISTED BELOW AND SHALL BE CLEARLY IDENTIFIED WITHIN THE SCHEDULE UNDER THE AGENT QUALIFICATION DESIGNATION.

PE/SE STRUCTURAL ENGINEER  
A LICENSED SE OR PE SPECIALIZING IN THE DESIGN OF BUILDING STRUCTURES

PE/SE GEOTECHNICAL ENGINEER  
A LICENSED PE SPECIALIZING IN SOIL, MECHANICS AND FOUNDATIONS

EIT OR ENGINEER IN TRAINING  
A GRADUATE ENGINEER WHO HAS PASSED THE FUNDAMENTALS OF ENGINEERING EXAM

EXPERIENCED TESTING TECHNICIAN

ETT OR EXPERIENCED TESTING TECHNICIAN  
AN EXPERIENCED TESTING TECHNICIAN WITH A MINIMUM OF 5 YEARS EXPERIENCE WITH THE STIPULATED TEST OR INSPECTION

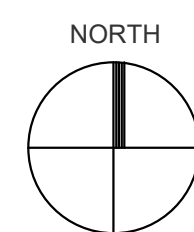
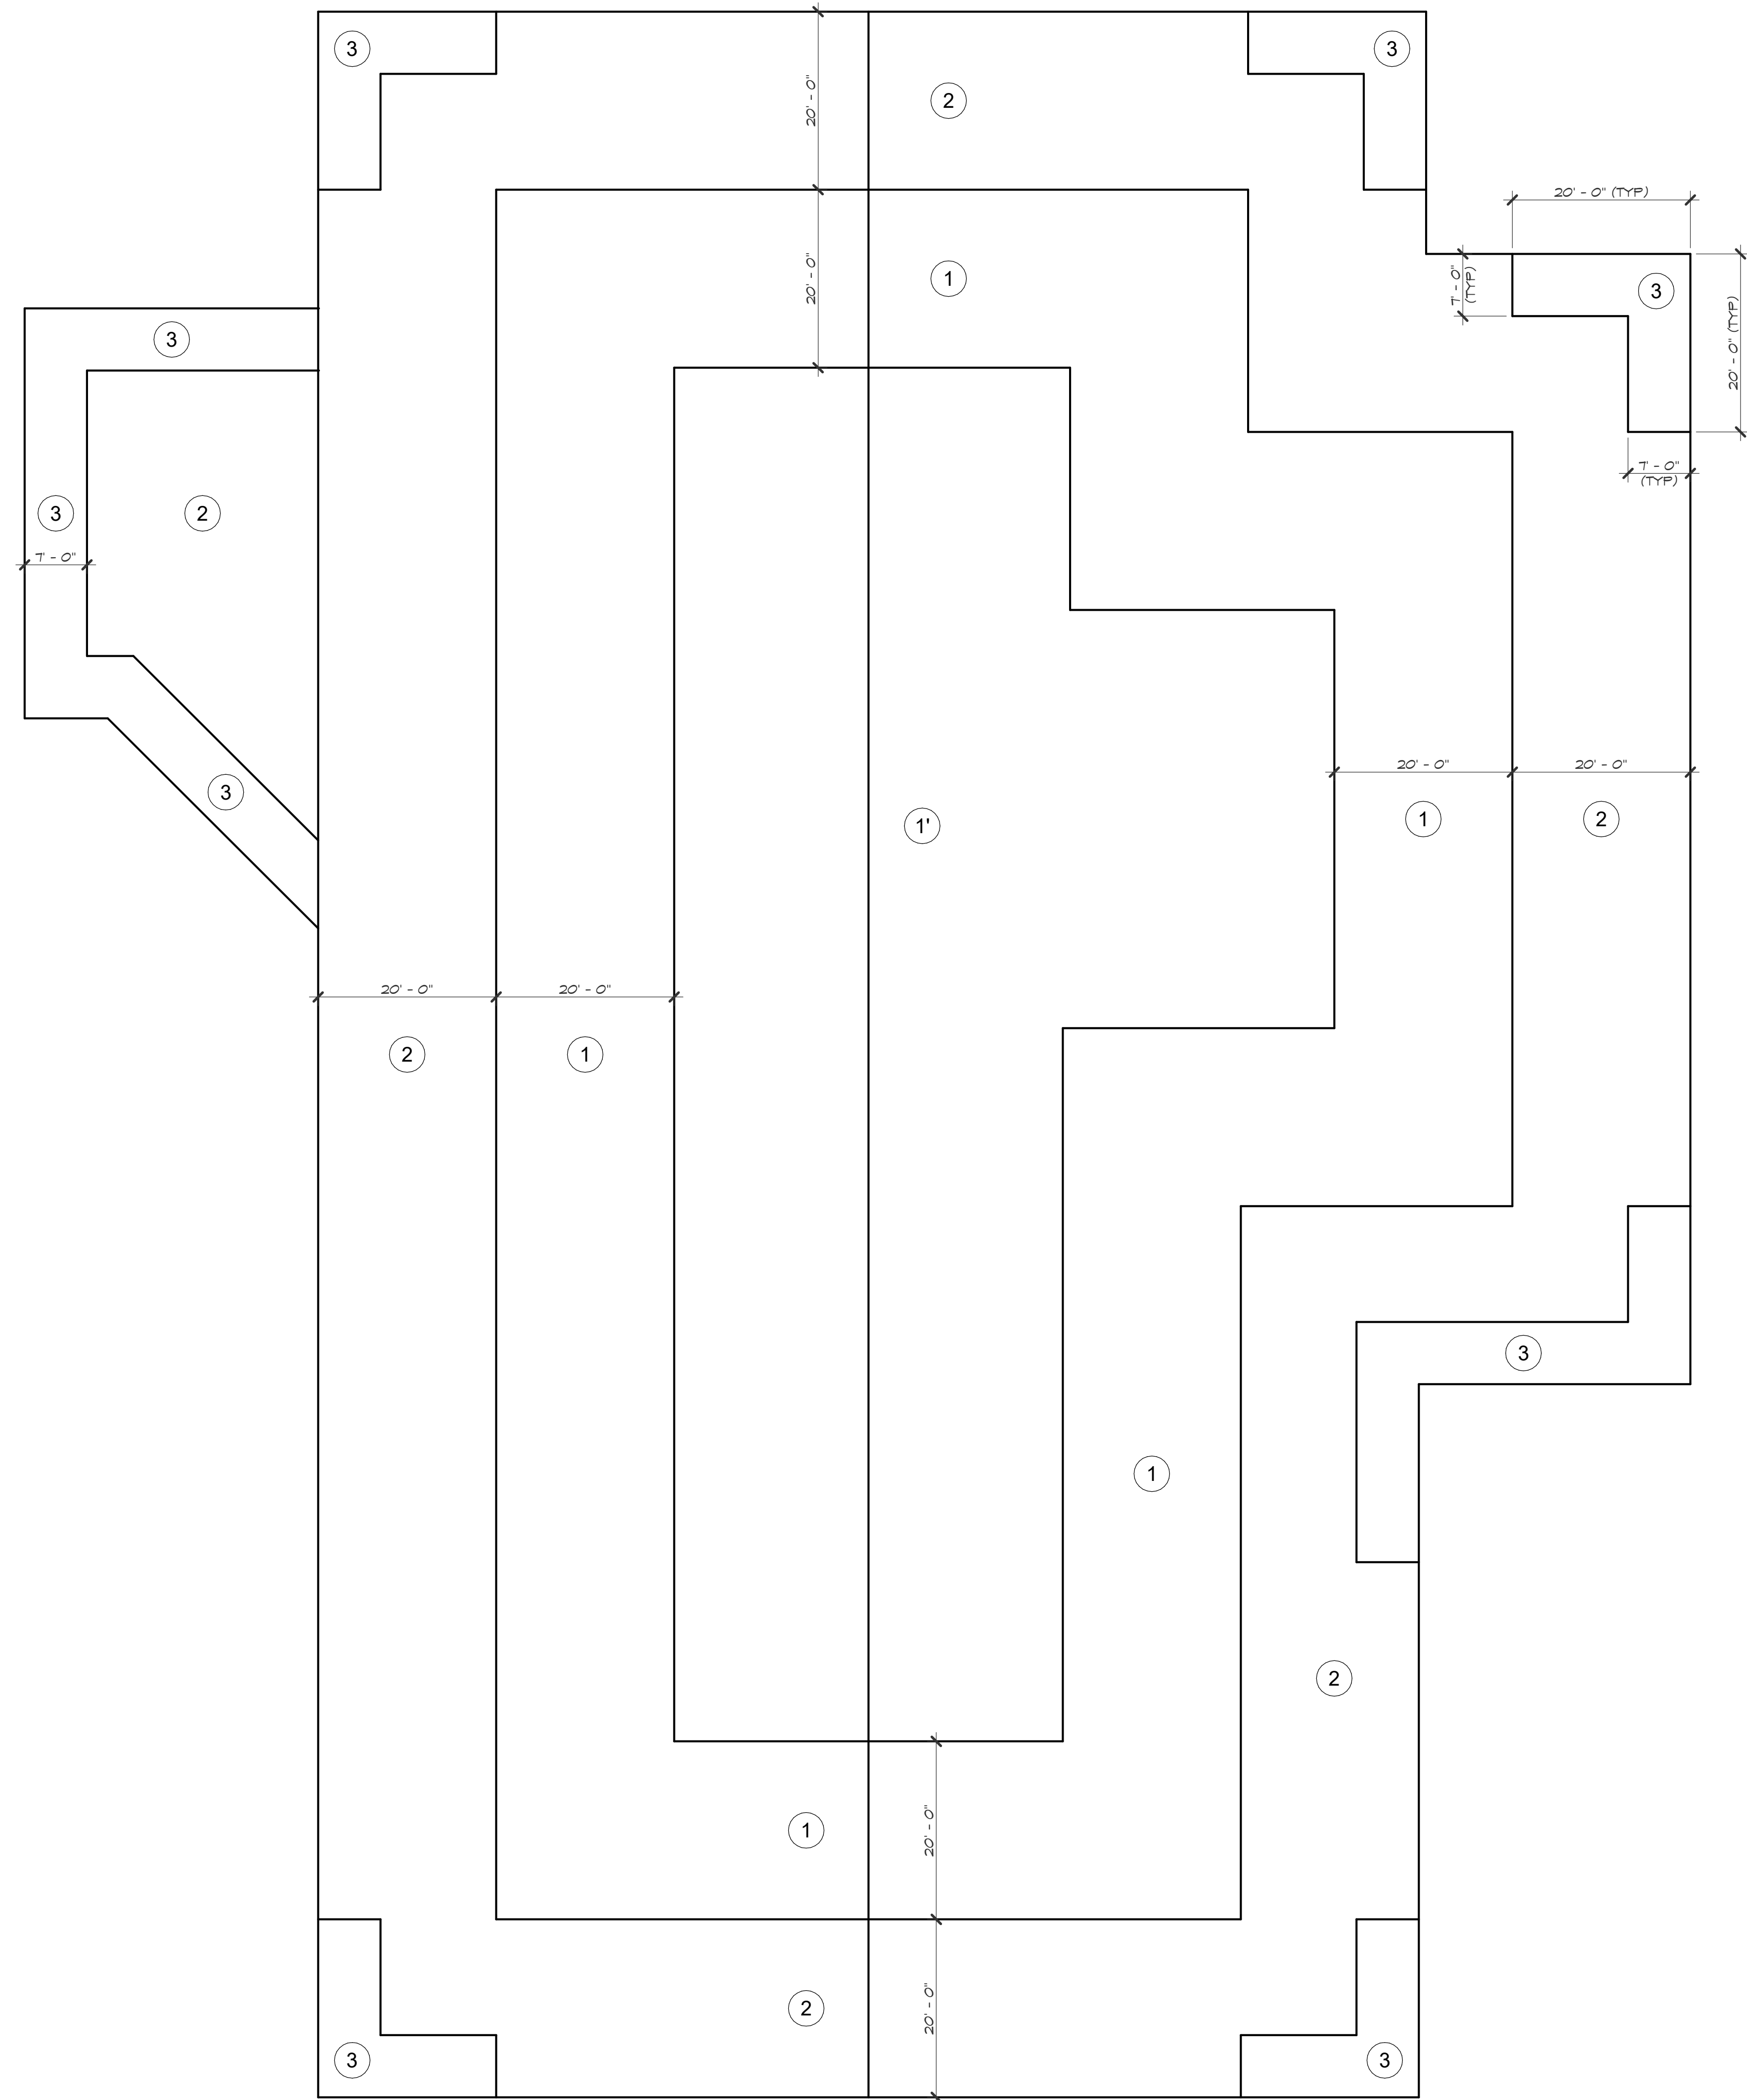
AMERICAN CONCRETE INSTITUTE (ACI) CERTIFICATION  
ACI-CFT CONCRETE FIELD TESTING TECHNICIAN - GRADE I  
ACI-CCI CONCRETE CONSTRUCTION INSPECTOR  
ACI-LTT LABORATORY TESTING TECHNICIAN - GRADE I/2  
ACI-STT STRENGTH TESTING TECHNICIAN

AMERICAN WELDING SOCIETY (AWS) CERTIFICATION  
AWS-CWI CERTIFIED WELDING INSPECTOR  
AWS-AISC-SSI CERTIFIED STRUCTURAL STEEL INSPECTOR

CHAPTER 17 OF THE [2015] INTERNATIONAL BUILDING CODE IS INTERPRETED TO REQUIRE SPECIAL INSPECTION FOR THE FOLLOWING ITEMS IN THE FOLLOWING TABLES:

SCHEDULE OF SPECIAL INSPECTIONS				
VERIFICATION/INSPECTION	EXTENT	COMMENTS	AGENT	
IBC SECTION 1706.8, TABLE 1706.8	CONTINUOUS, PERIODIC		PE/GE, ETT OR ETT	
1. INSPECT REINFORCEMENT, INCLUDING PRESTRESSING TENDONS, AND VERIFY PLACEMENT	PERIODIC	ACI 318-19 CH. 20, 25.2, 25.3, 25.4, 25.5, 25.6, 25.7, 25.8, 25.9, 25.10, 25.11, 25.12, 27.73, 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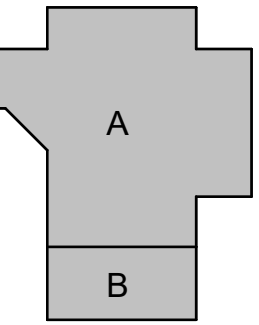
UPLIFT KEY PLAN  
SCALE: NTS

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**TOMBALL HIGH SCHOOL  
CTE & MISC. RENOVATIONS**  
TOMBALL INDEPENDENT SCHOOL DISTRICT  
30330 QUINN ROAD, TOMBALL, TX 77375



TEXAS ARCADIS INC.  
10205 WESTHEIMER SUITE 800  
HOUSTON, TX 77042  
tel 713.953.4897, fax 713.977.4620



06 November 2023


PROJECT #: 202311  
DATE: 2023-11-06  
DRAWN: JG  
CHECKED: HK

DATE: 2023-11-06  
ISSUE: BID SET

**S0.03**

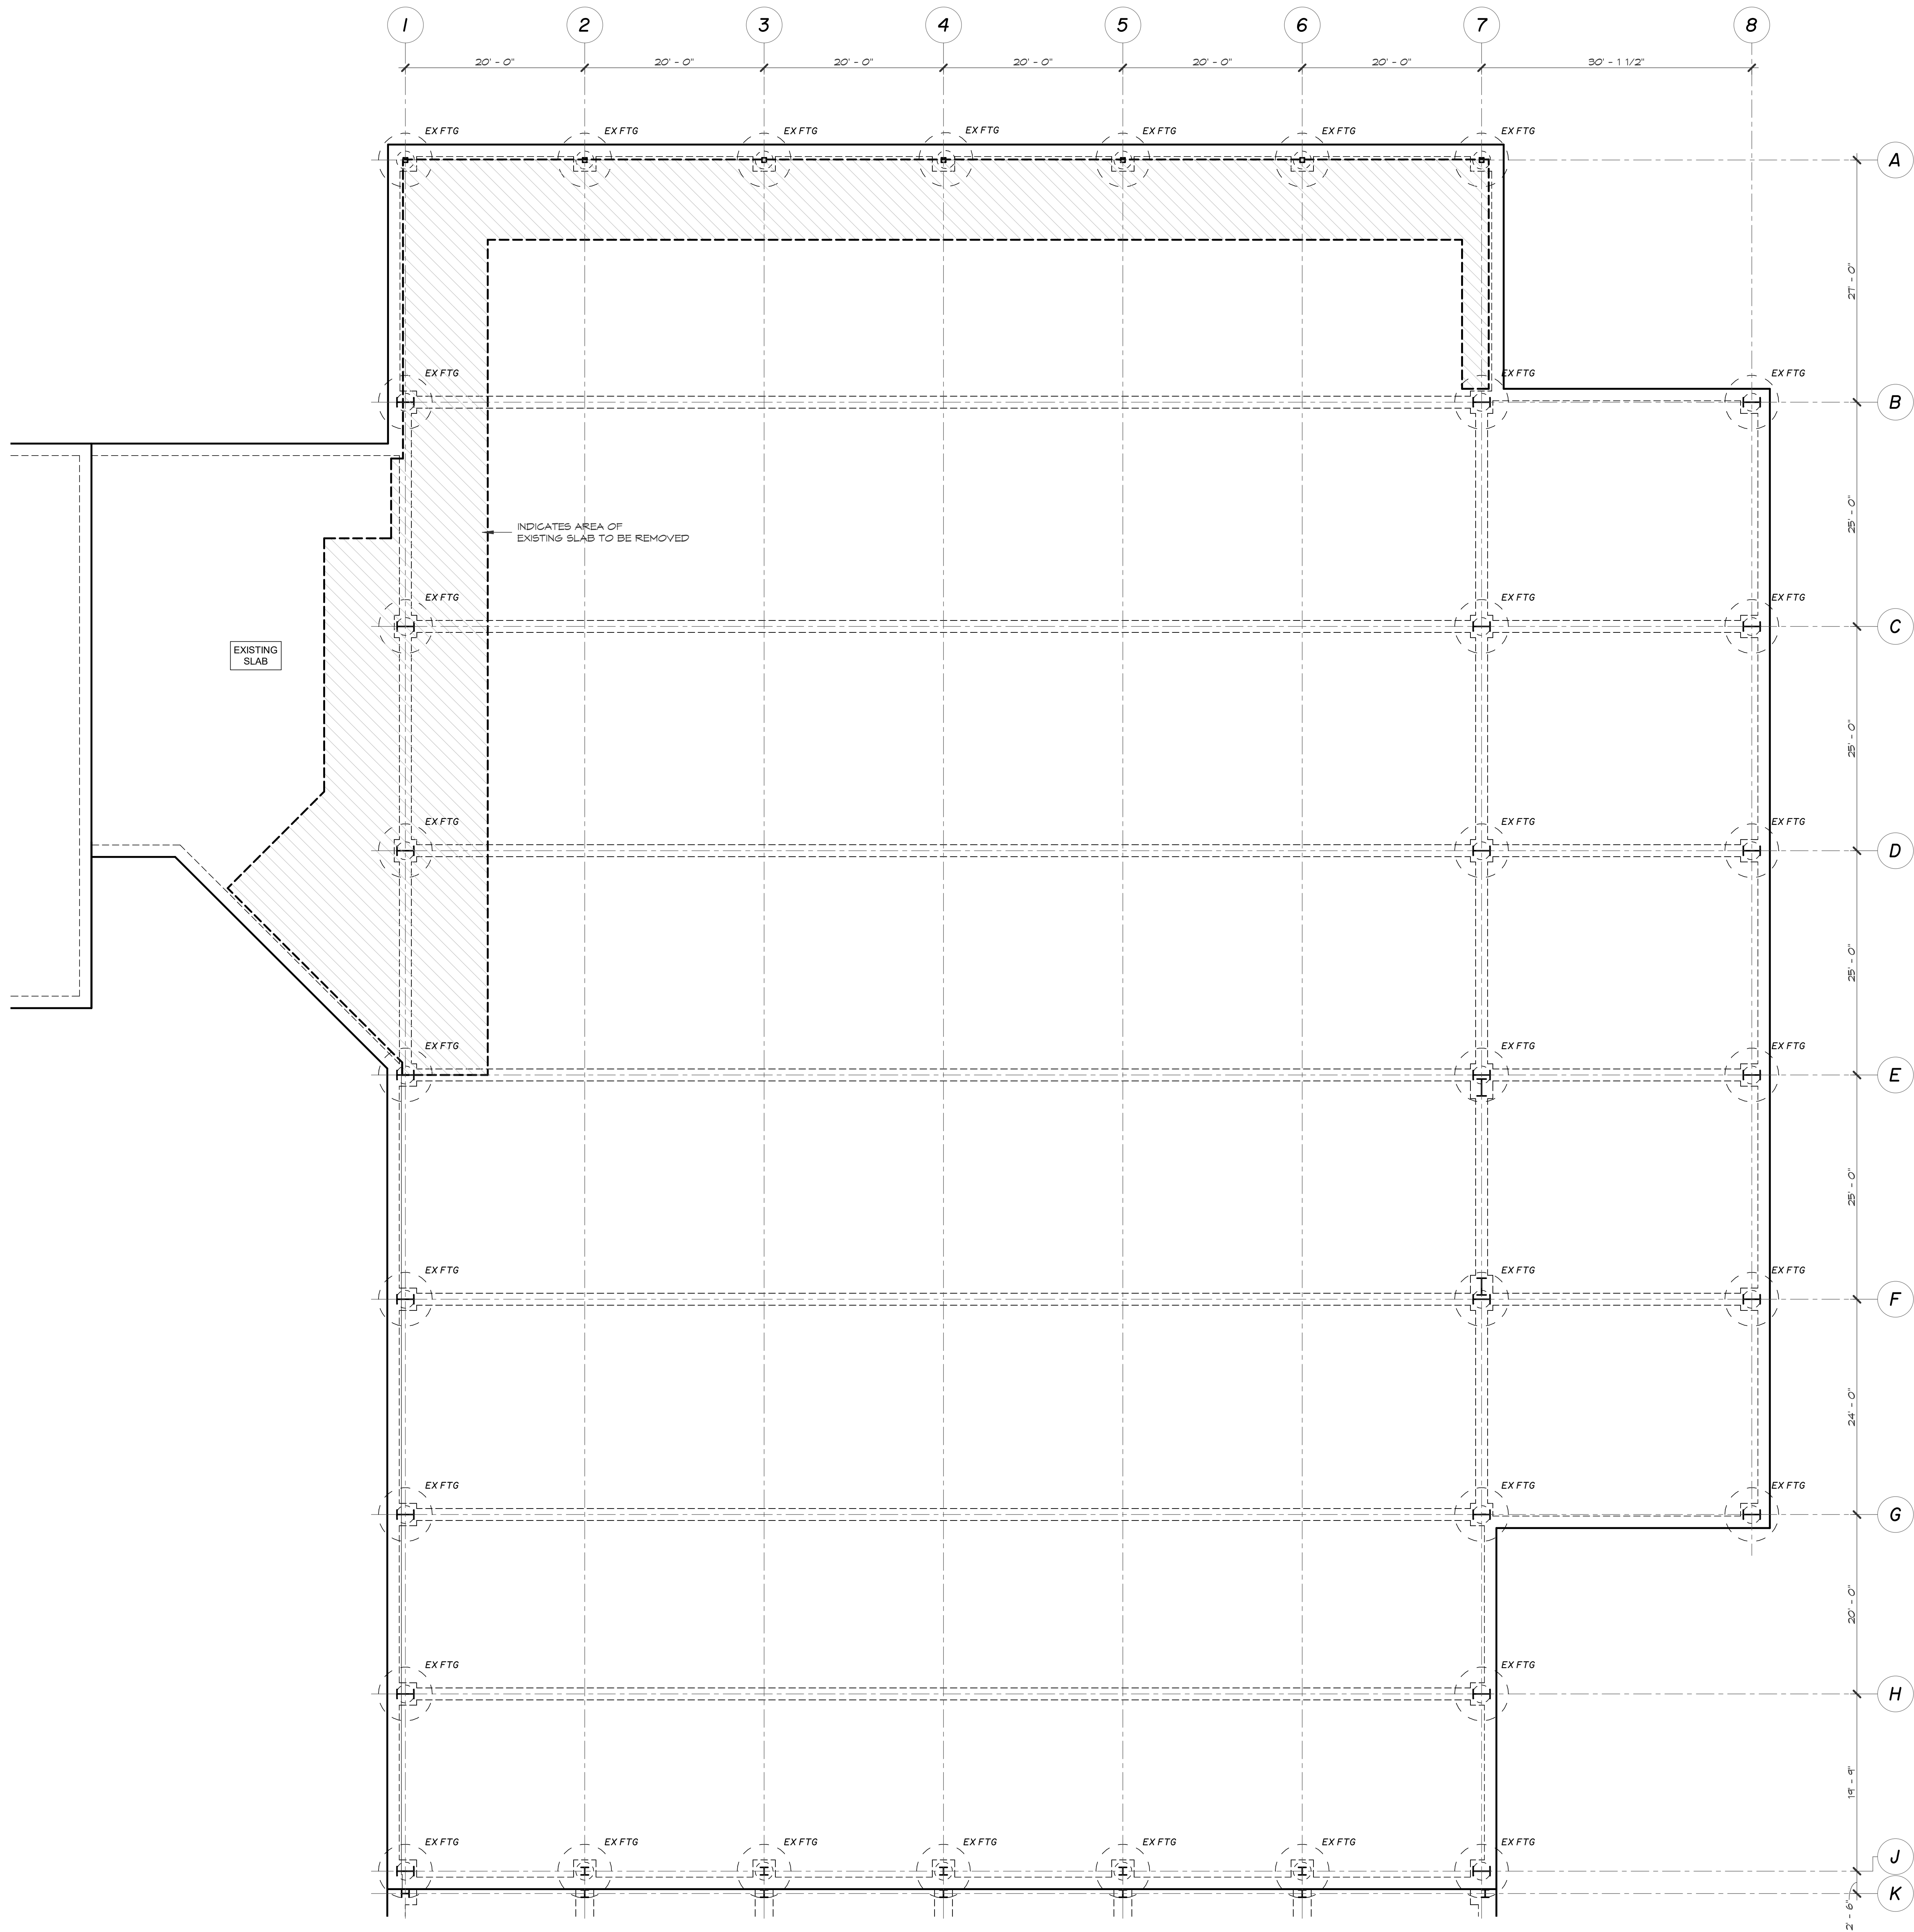UPLIFT KEY  
PLAN






NORTH  
  
**DEMO  
FOUNDATION PLAN**  
SCALE: 1/8" = 1'-0"

**CONSULTANTS**
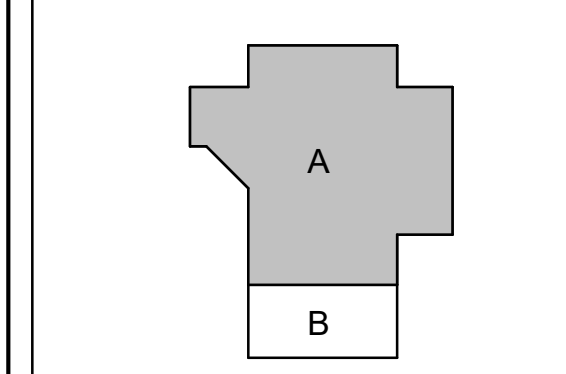
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CTE & MISC. RENOVATIONS**

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**TEXAS ARCADIS INC.**  
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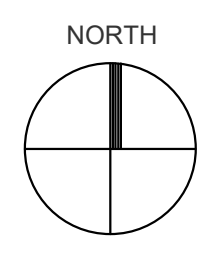
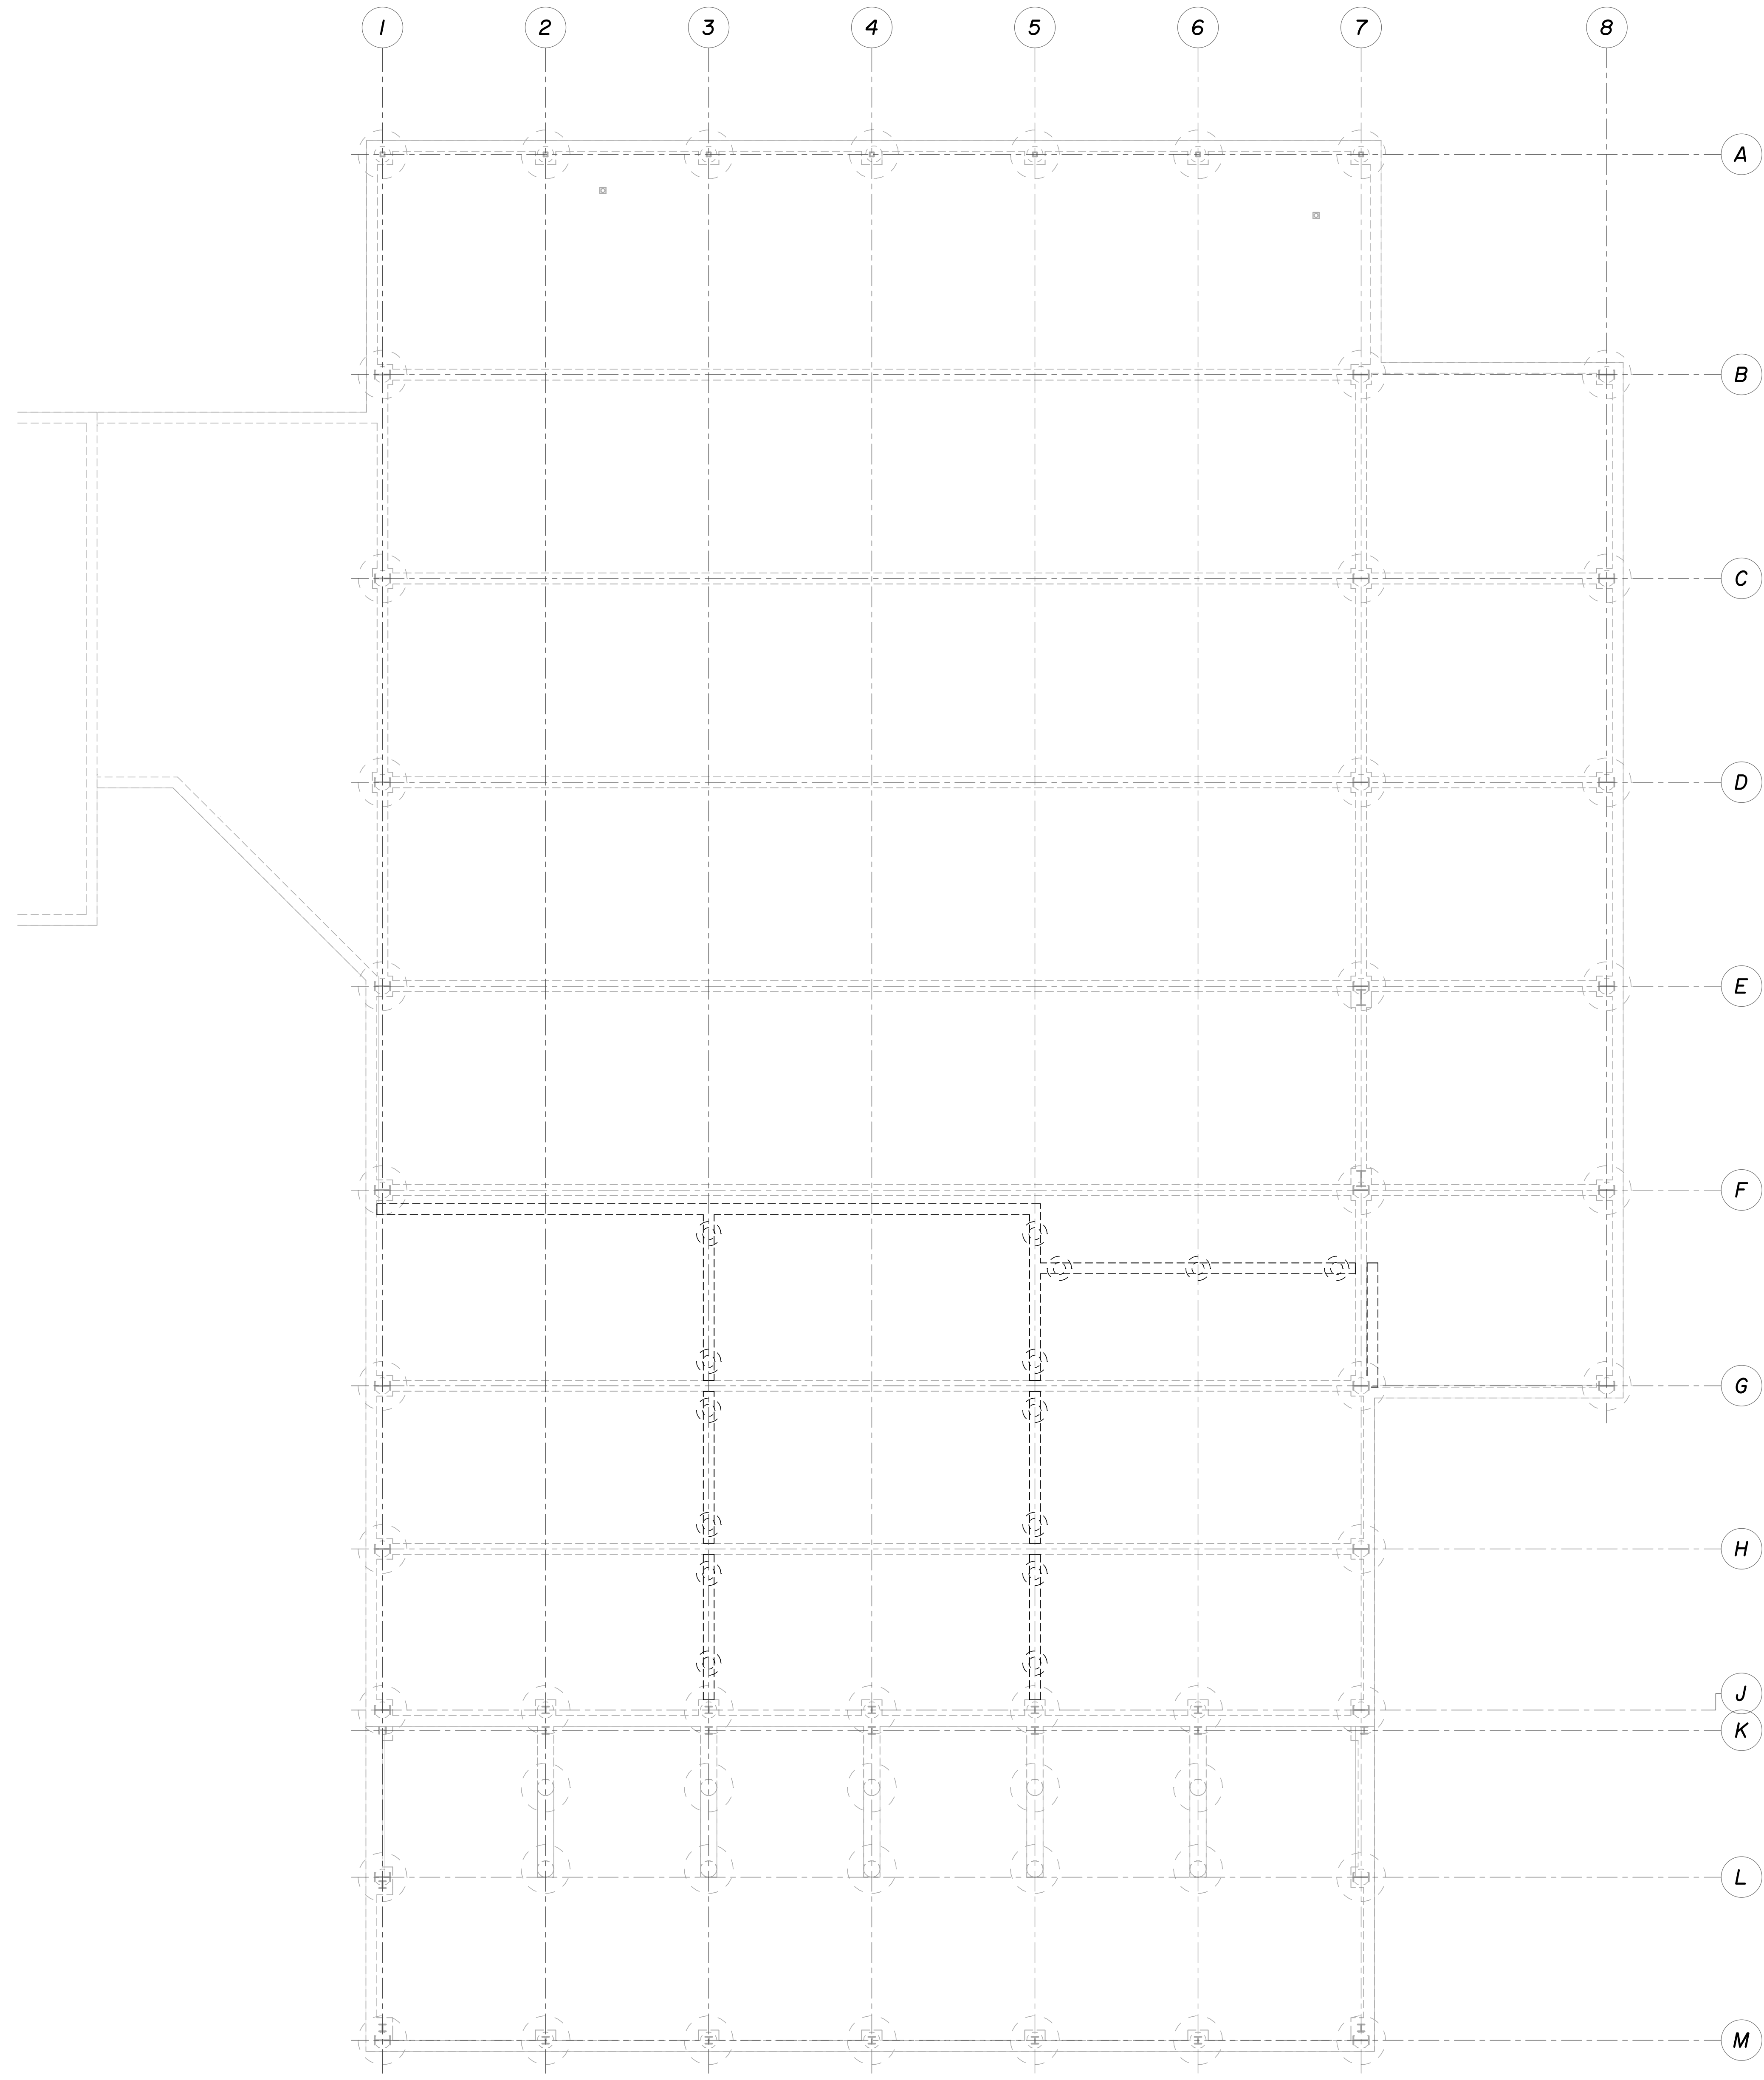


PROJECT #: 202311	
DATE: 2023-11-06	
DRAWN: JG	
CHECKED: HK	
DATE	ISSUE
2023-11-06	BID SET

**SD1.01**

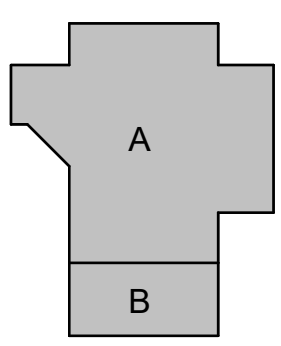
DEMO  
FOUNDATION  
PLAN





**COMPOSITE  
FOUNDATION PLAN**  
SCALE: 1" = 10'-0"

**CONSULTANTS**  
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**TOMBALL HIGH SCHOOL  
CTE & MISC. RENOVATIONS**  
TOMBALL INDEPENDENT SCHOOL DISTRICT  
30330 QUINN ROAD, TOMBALL, TX 77375


**ARCADIS**  
**TEXAS ARCADIS INC.**  
10205 WESTHEIMER SUITE 800  
HOUSTON, TX 77042  
tel 713.953.4897, fax 713.977.4620



PROJECT #: 202311	
DATE: 2023-11-06	
DRAWN: JG	
CHECKED: HK	
DATE	ISSUE
2023-11-06	BID SET

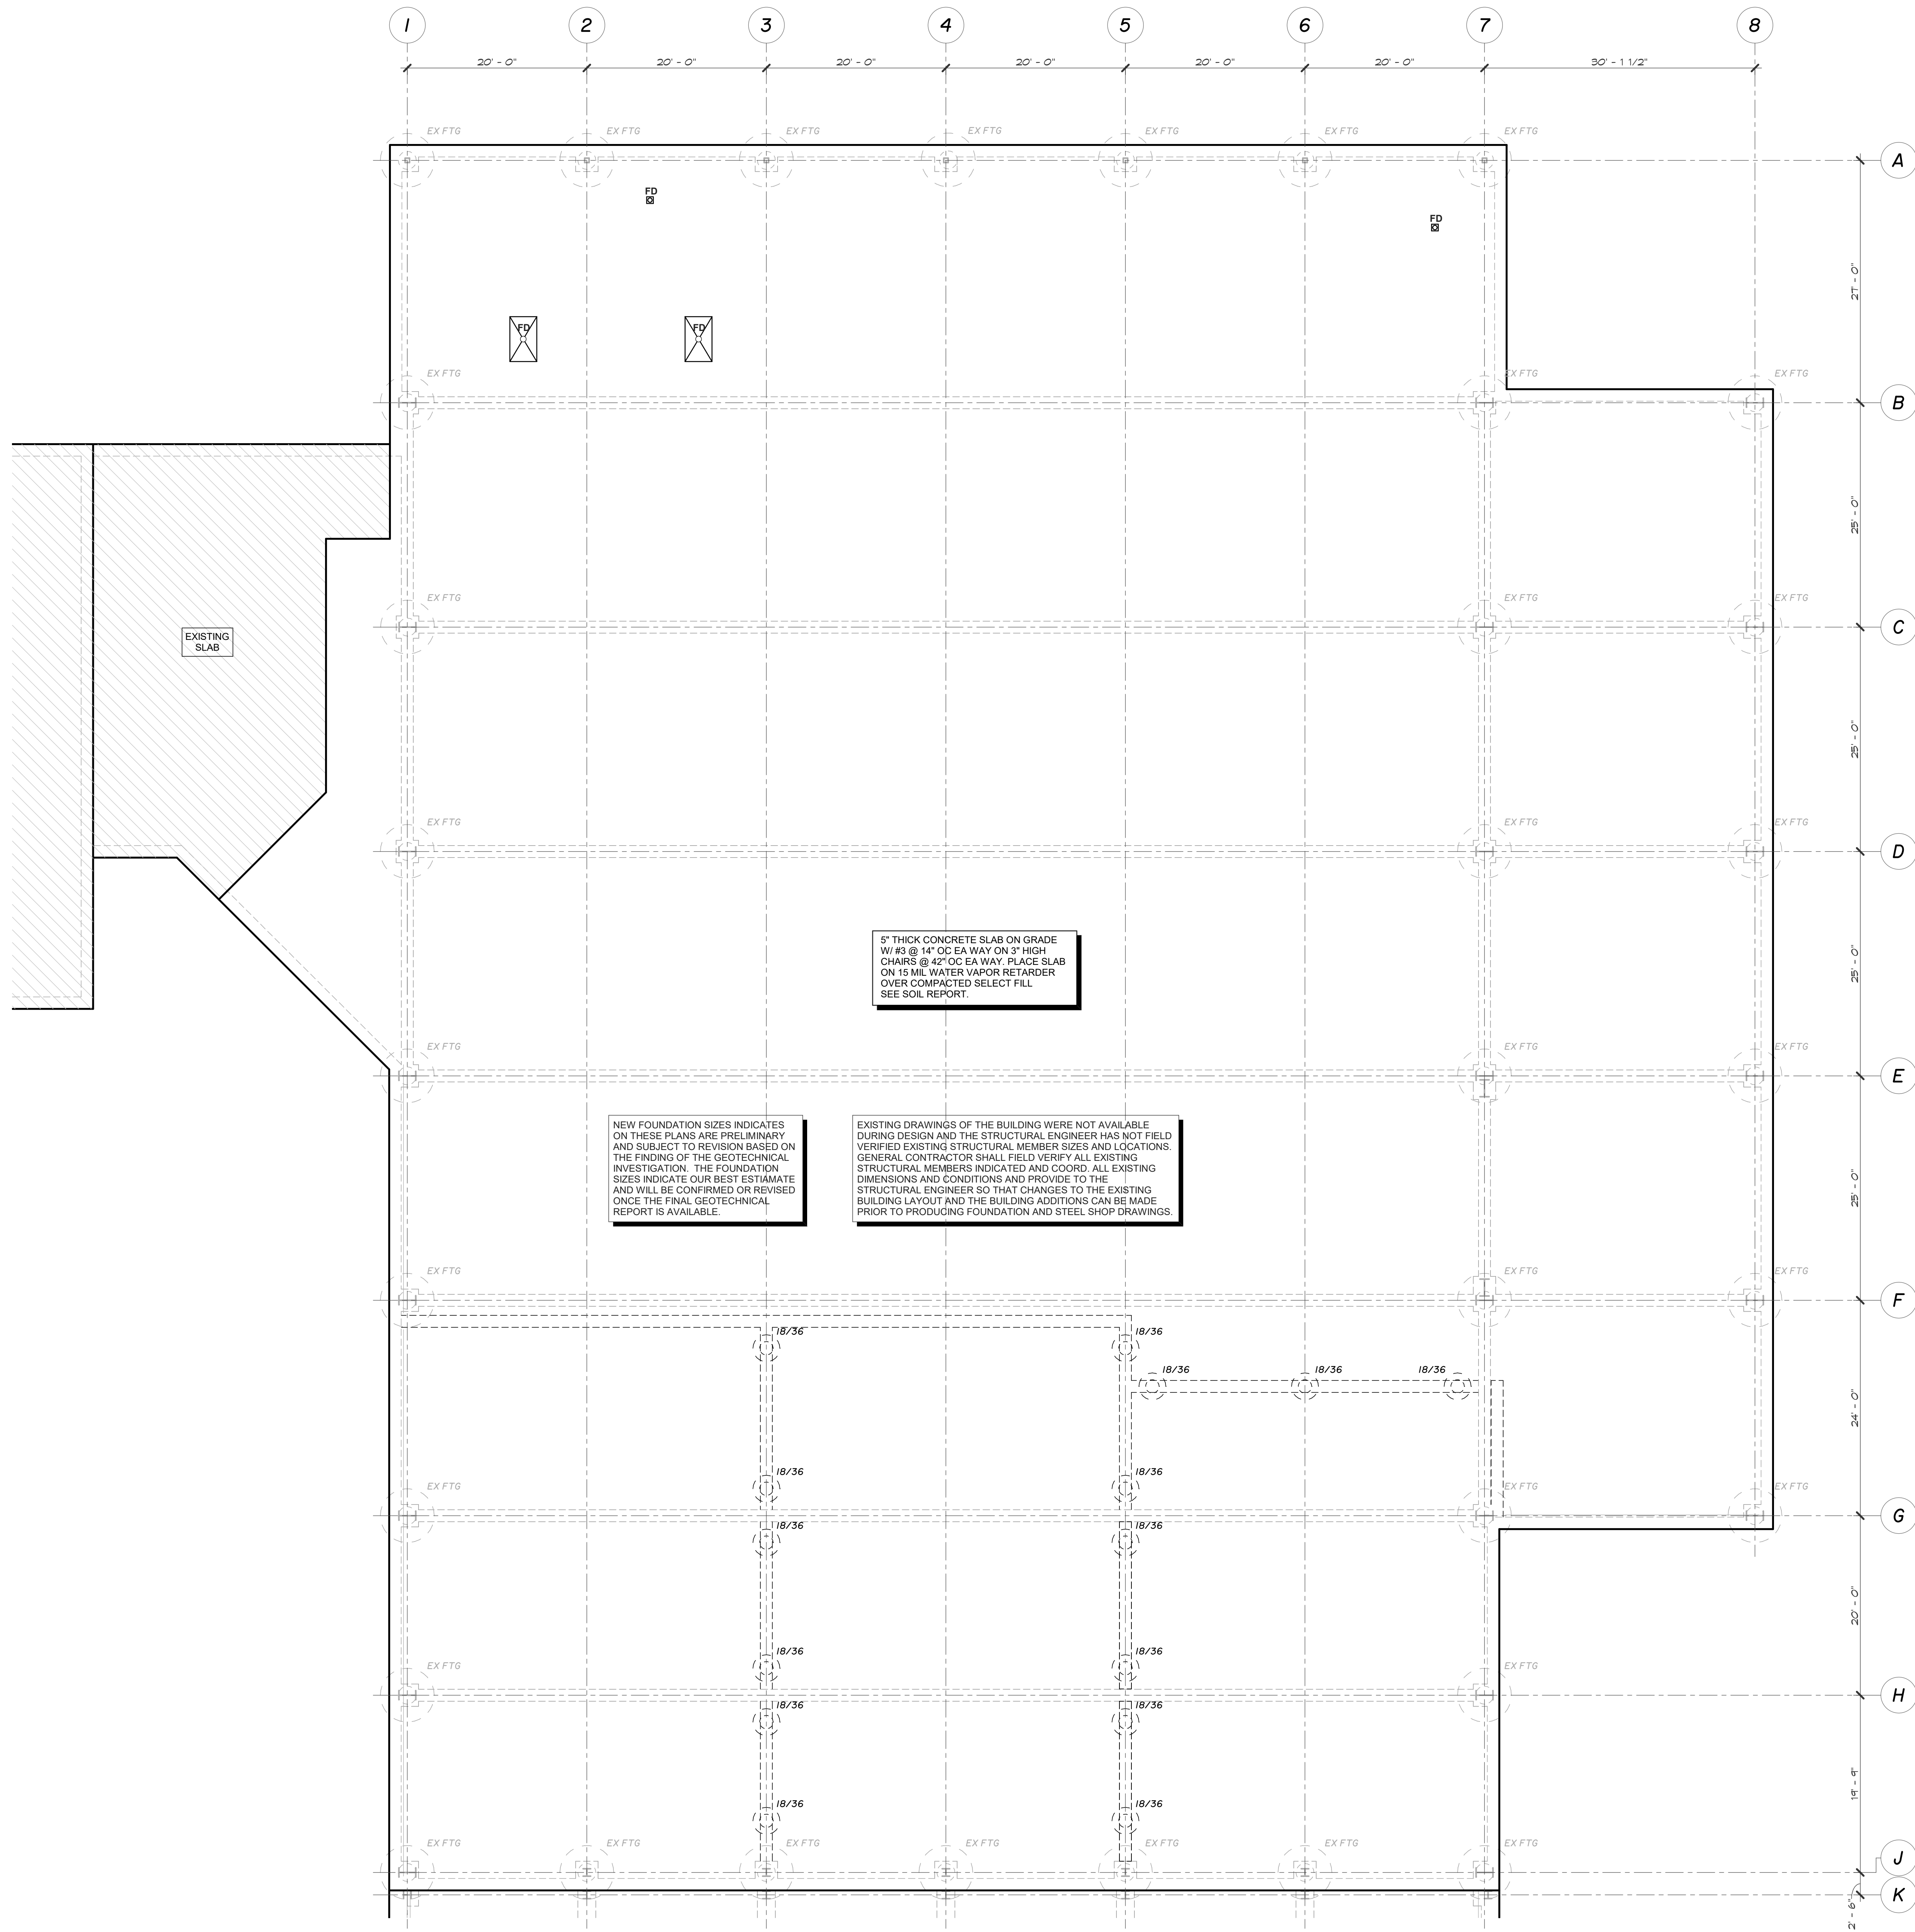**S1.00**  
COMPOSITE  
FOUNDATION  
PLAN






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**TOMBALL HIGH SCHOOL  
CTE & MISC. RENOVATIONS**

TOMBALL INDEPENDENT SCHOOL DISTRICT  
30330 QUINN ROAD, TOMBALL, TX 77375

**ARCADIS**

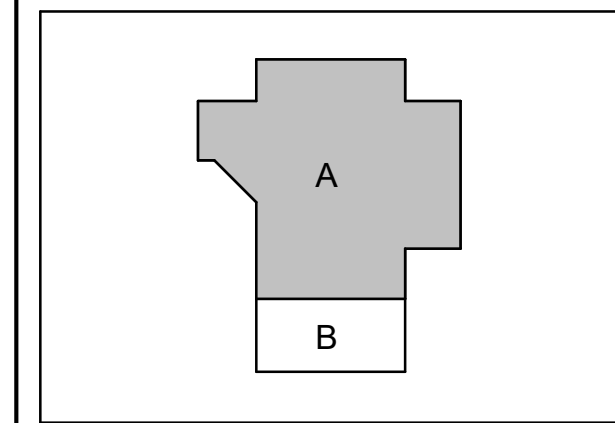TEXAS ARCADIS INC.

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PROJECT #: 202311	
DATE: 2023-11-06	
DRAWN: JG	
CHECKED: HK	
DATE: 2023-11-06	ISSUE: BID SET

**S1.01**

AREA 'A'  
FOUNDATION  
PLAN

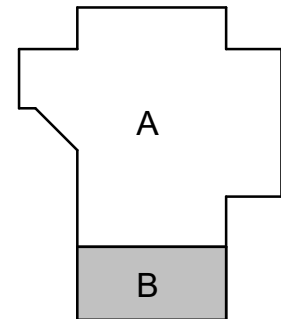


CONSULTANTS

MEP  
Salas O'Brien  
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Tel: 281.664.1900  
Fax: 281.664.1912



CIVIL  
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STRUCTURAL  
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**TOMBALL HIGH SCHOOL  
CTE & MISC. RENOVATIONS**

TOMBALL INDEPENDENT SCHOOL DISTRICT  
30330 QUINN ROAD, TOMBALL, TX 77375



**AREA 'B'**  
**FOUNDATION PLAN**  
SCALE: 1/8" = 1'-0"

**ARCADIS**  
**TEXAS ARCADIS INC.**  
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HOUSTON, TX 77042  
tel 713.953.4897, fax 713.977.4620

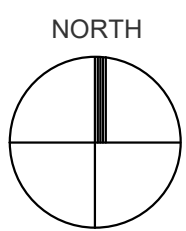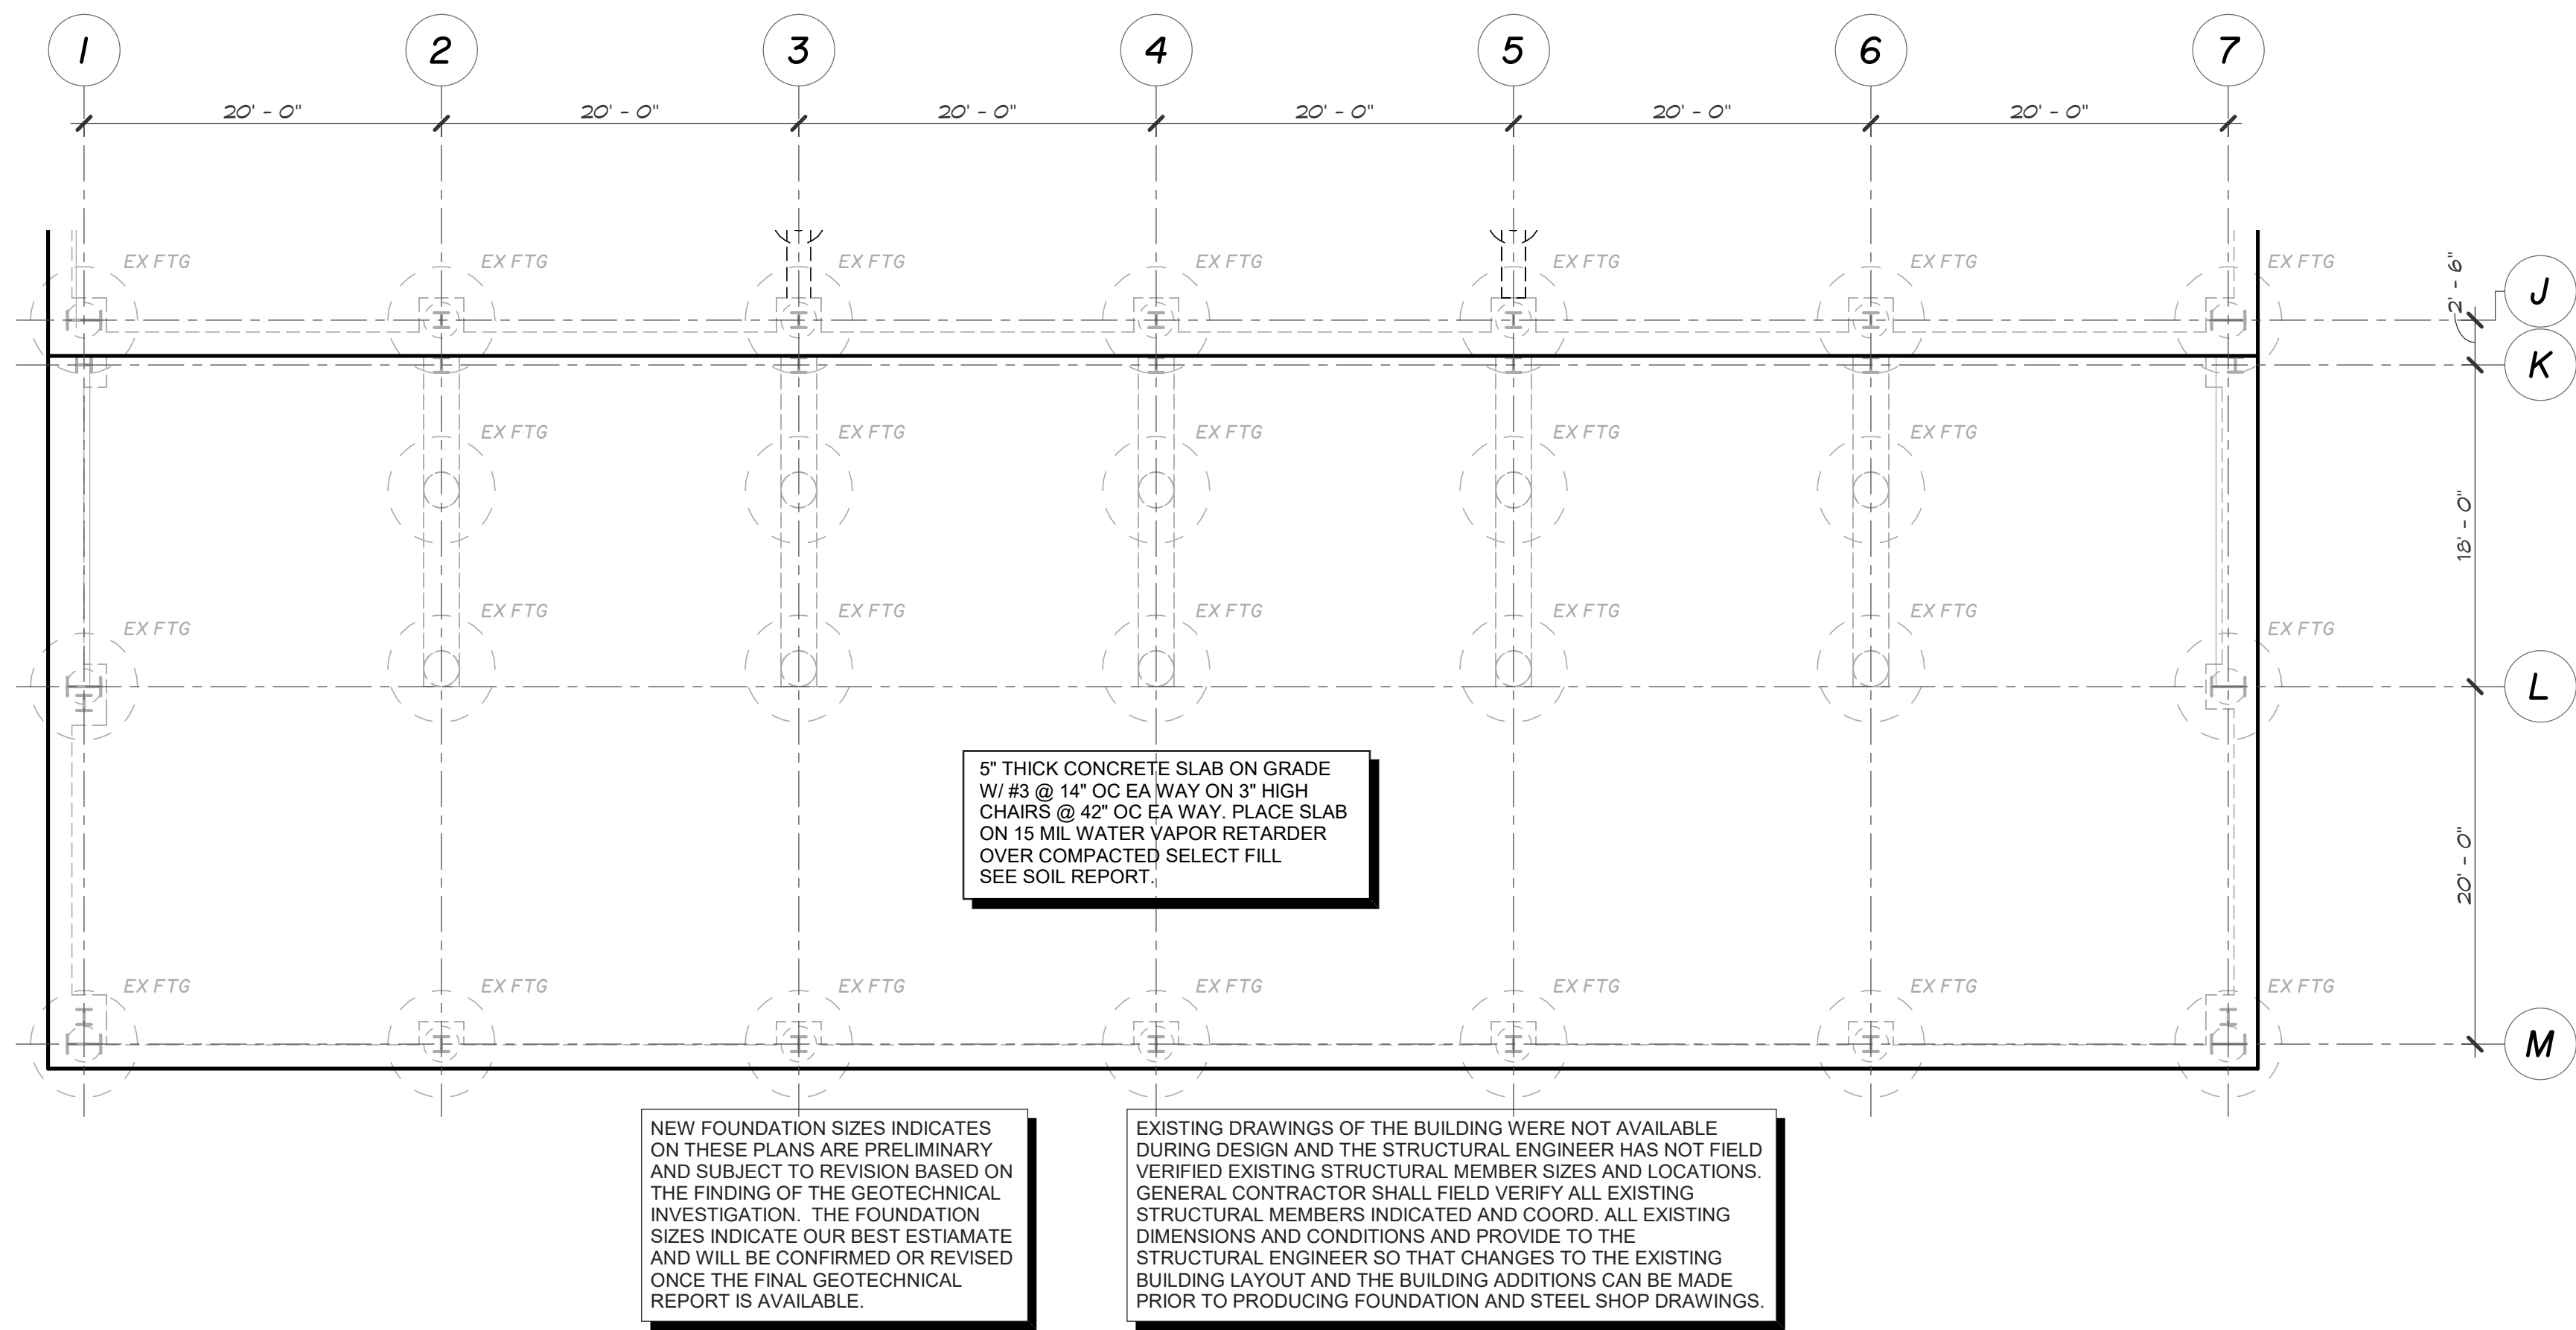

06 November 2023

PROJECT #:	202311
DATE:	2023-11-06
DRAWN:	JG
CHECKED:	HK
DATE	ISSUE
2023-11-06	BID SET

**S1.02**  
**AREA 'B'**  
**FOUNDATION**  
**PLAN**




**CONSULTANTS**
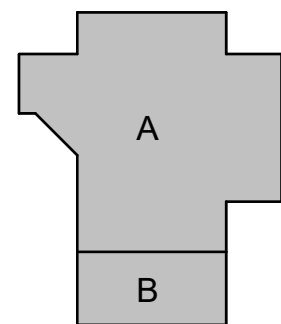
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**TOMBALL HIGH SCHOOL  
CTE & MISC. RENOVATIONS**


TOMBALL INDEPENDENT SCHOOL DISTRICT  
30330 QUINN ROAD, TOMBALL, TX 77375



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10205 WESTHEIMER SUITE 800  
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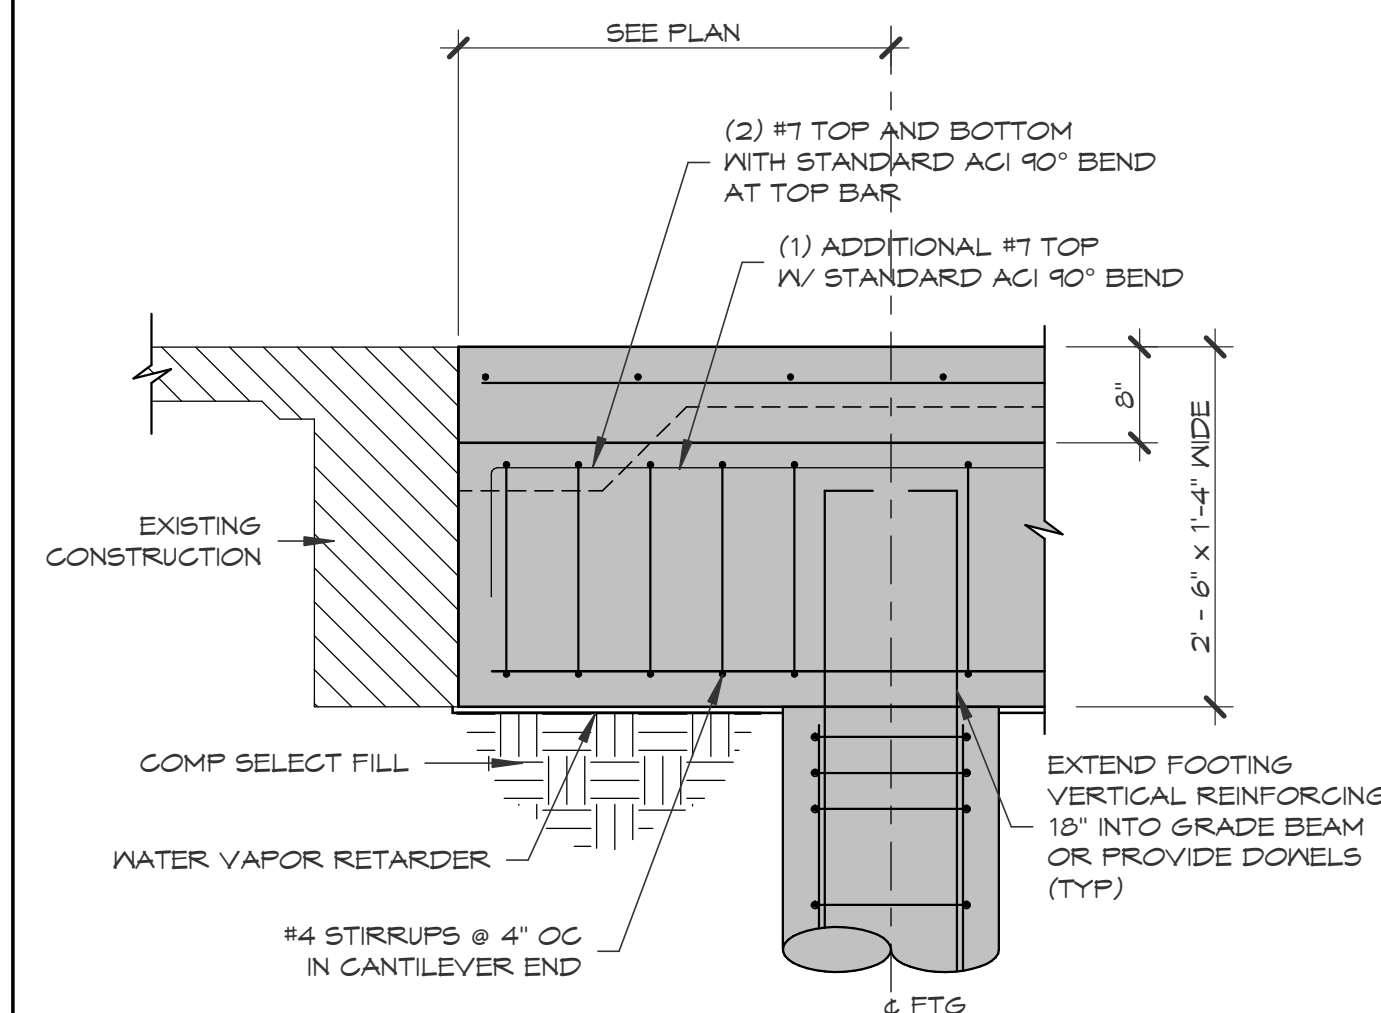


06 November 2023


PROJECT #: 202311		
DATE: 2023-11-06		
DRAWN: JG		
CHECKED: HK		
DATE	ISSUE	
2023-11-06	BID SET	

# S2.01

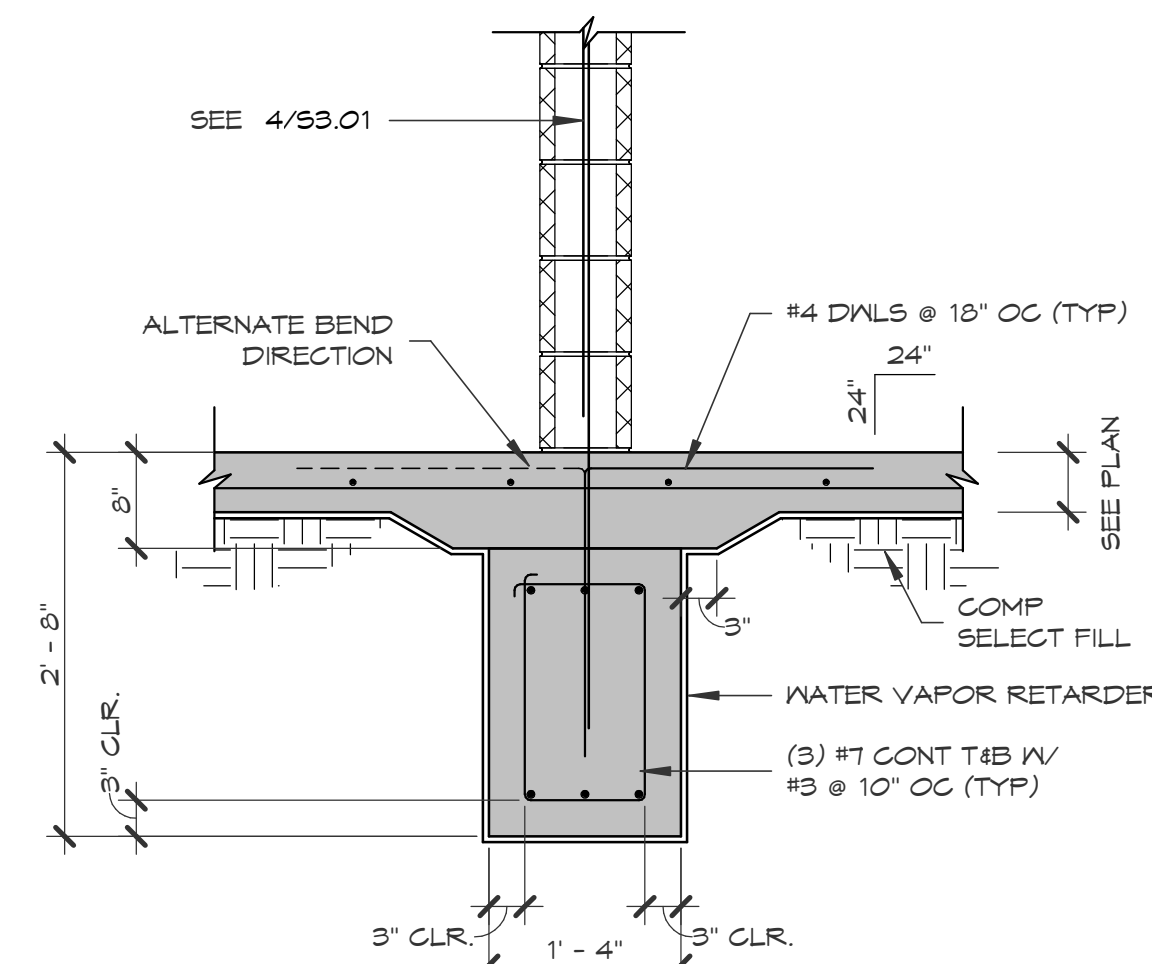
## ROOF FRAMING DETAILS



3 CANTILEVER GRADE BEAM  
SCALE: 3/4" = 1'-0"




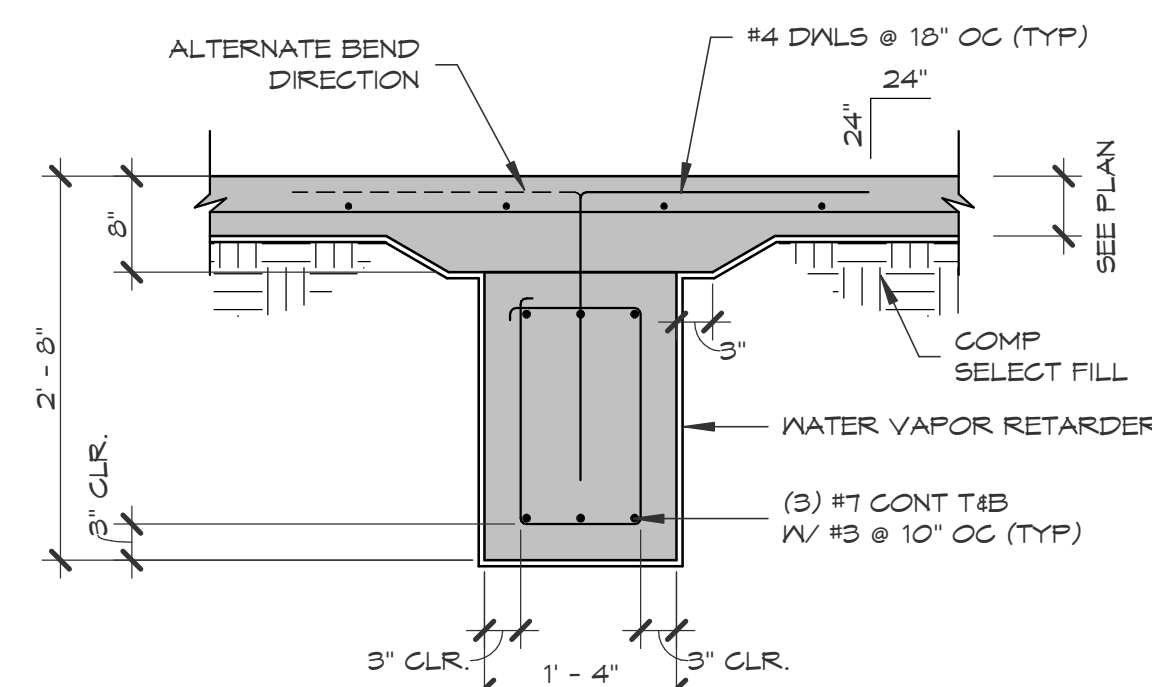2 INTERIOR  
GRADE BEAM AT CMU WALL  
SCALE: 3/4" = 1'-0"




1 INTERIOR GRADE BEAM  
SCALE: 3/4" = 1'-0"


FOOTING SCHEDULE		
SHAFT DIA.	VERT. BARS	TIES
12"	4 - #5	#3 @ 10"
14"	4 - #5	#3 @ 10"
16"	4 - #5	#3 @ 10"
18"	4 - #6	#3 @ 12"
20"	4 - #6	#3 @ 12"
22"	6 - #6	#3 @ 14"
24"	6 - #6	#3 @ 14"
26"	6 - #7	#3 @ 16"
28"	6 - #7	#3 @ 16"
30"	6 - #8	#3 @ 18"
32"	6 - #8	#3 @ 18"
34"	8 - #8	#3 @ 18"
36"	8 - #10	#3 @ 18"
42"	8 - #9	#3 @ 18"
48"	8 - #10	#3 @ 18"

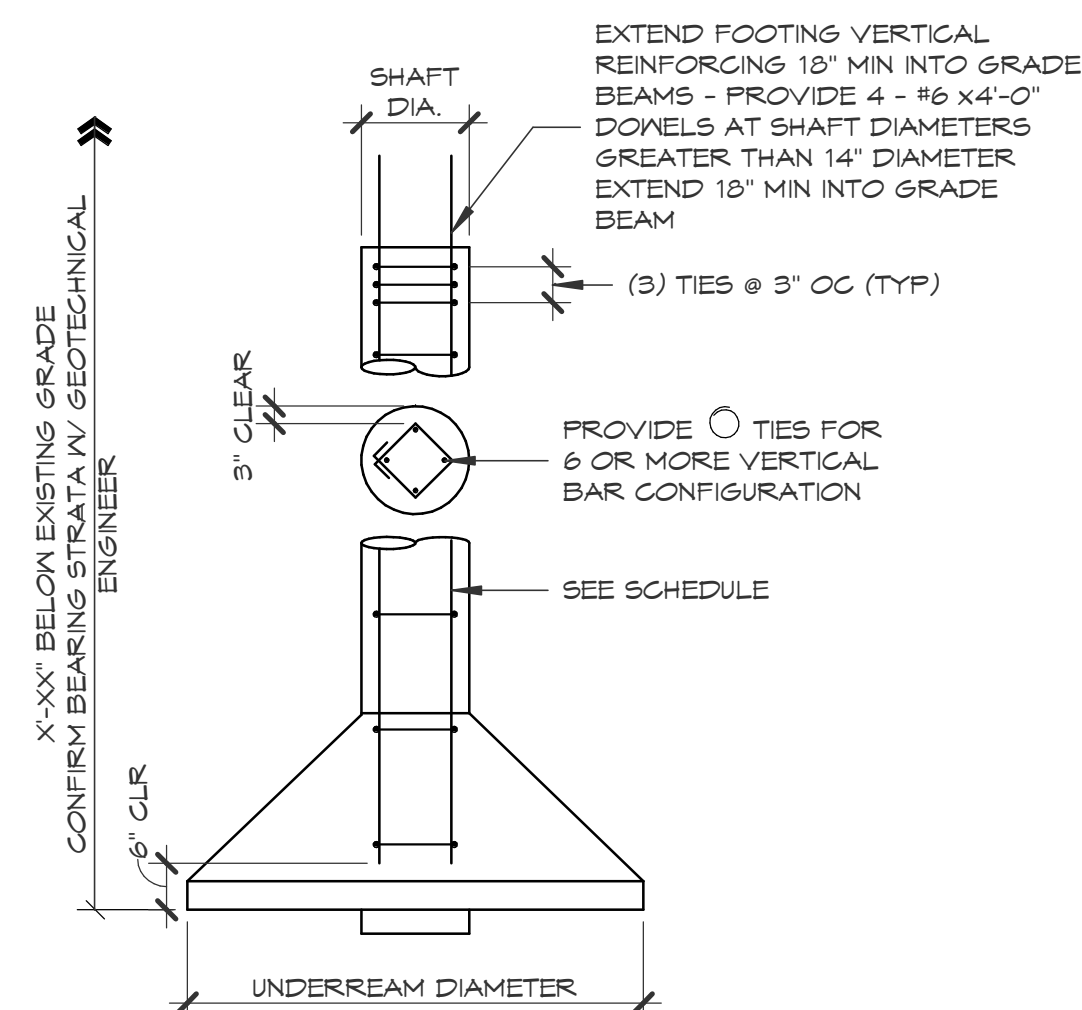

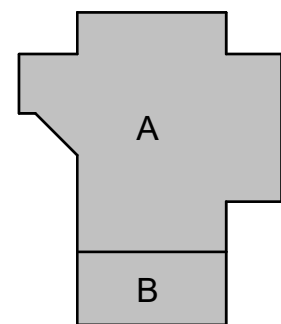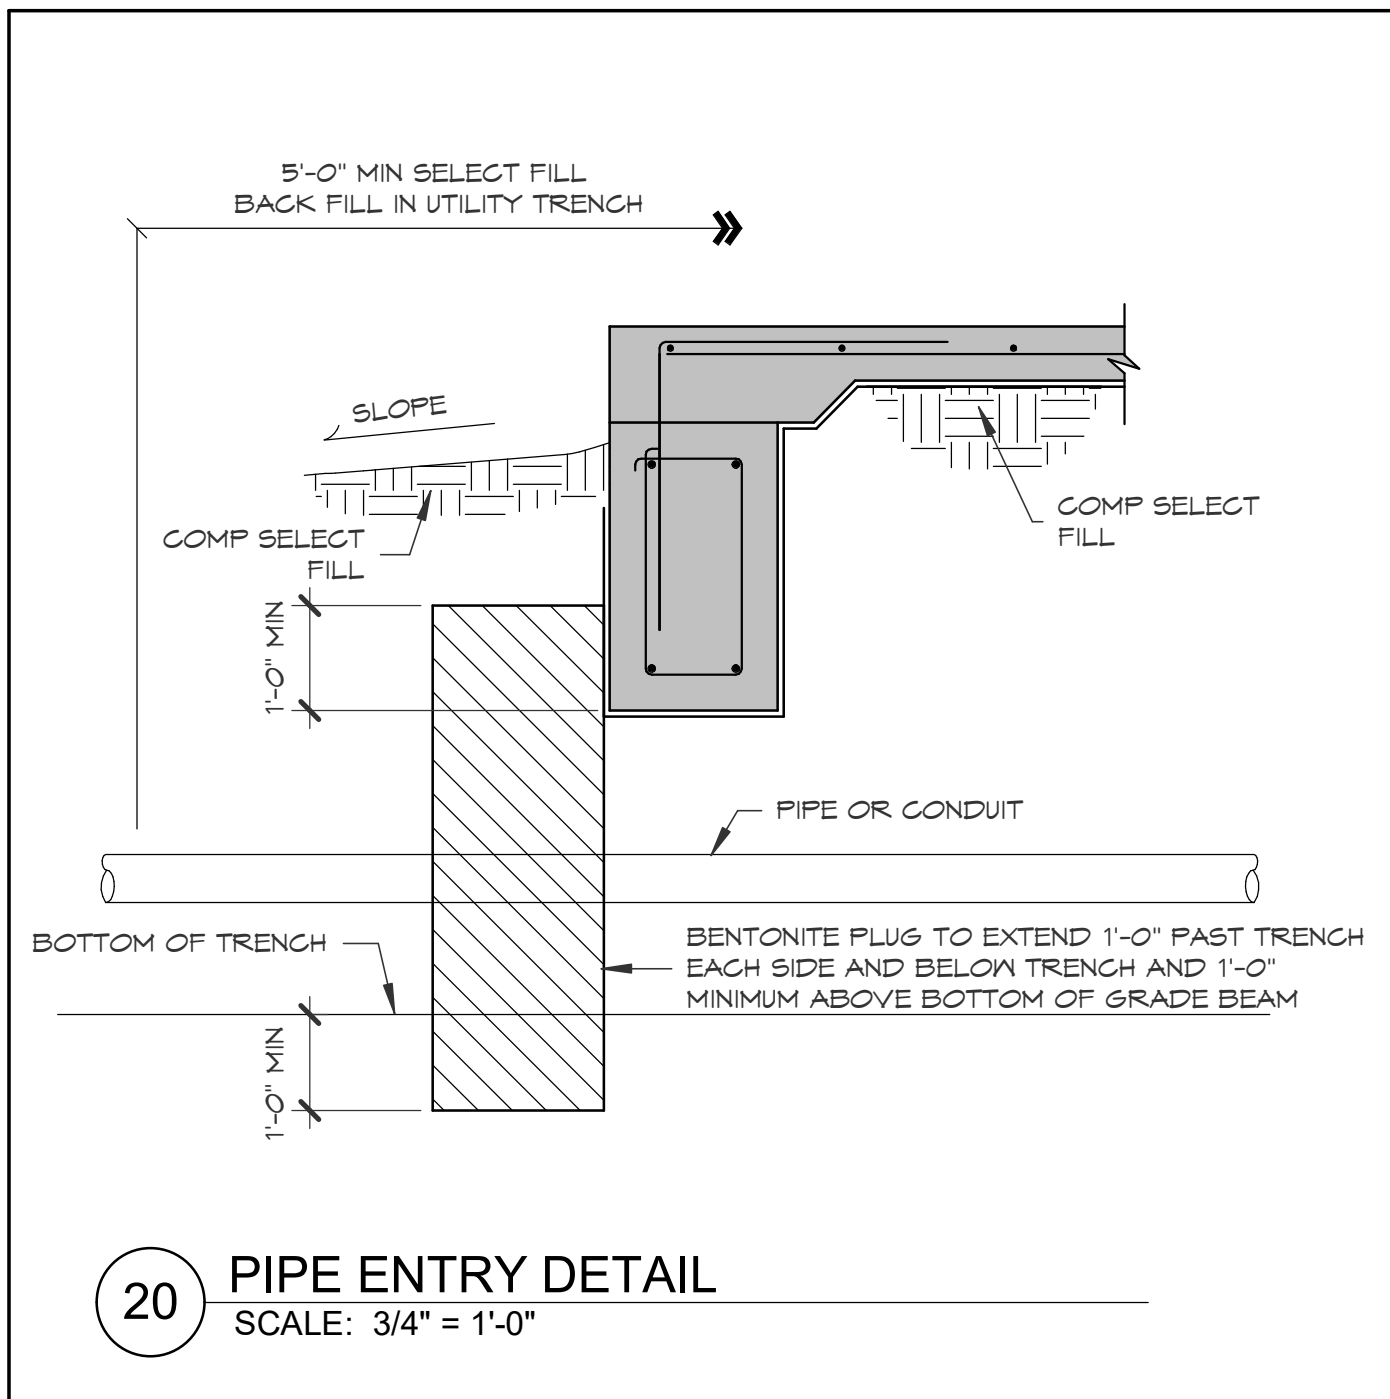
5 DRILLED FOOTING DETAIL  
SCALE: 3/4" = 1'-0"








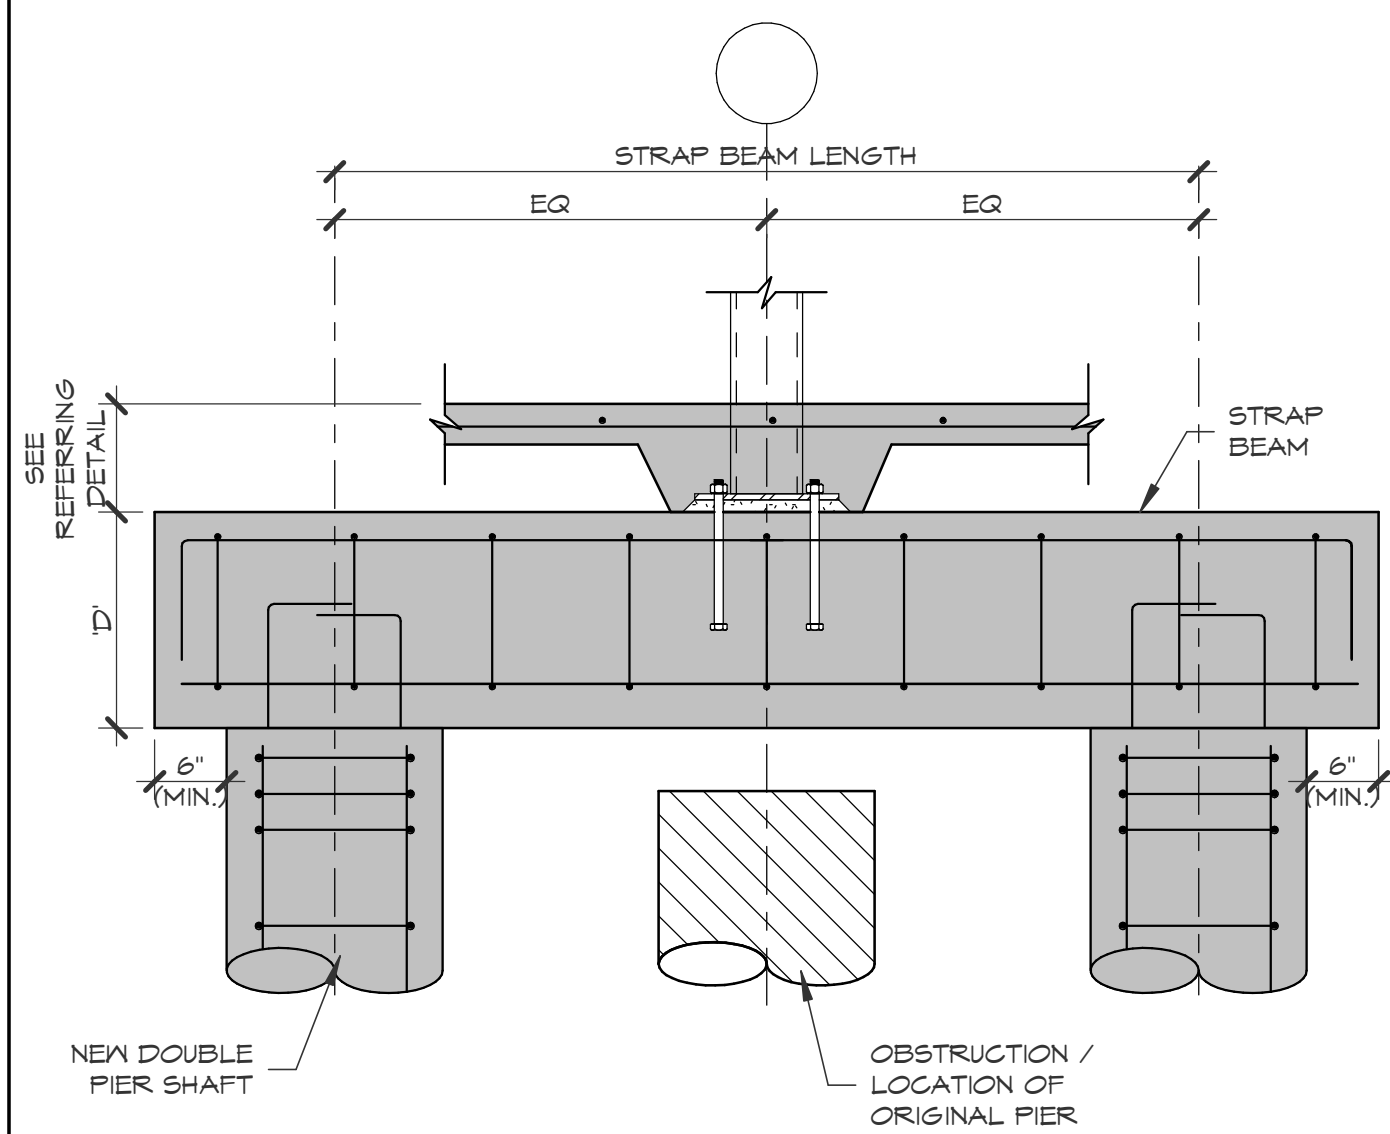20 PIPE ENTRY DETAIL  
SCALE: 3/4" = 1'-0"




18 OBSTRUCTION DETAIL  
SCALE: 3/4" = 1'-0"


STRAP BEAM SCHEDULE					
ORIG SINGLE BELL DIAM	DBL PIER BELL SIZE	DBL PIER SHAFT SIZE	STRAP BEAM LENGTH (L)	STRAP BEAM (WxD)	STRAP BEAM REINFORCING
24", 36"	30"	12"	5'-0"	30"x24"	(5) #7 T&B #4 @ 9" OC
42", 48"	36"	12"	6'-0"	30"x24"	(5) #7 T&B #4 @ 9" OC
54", 60"	48"	18"	8'-0"	30"x24"	(6) #7 T&B #4 @ 9" OC
66", 72"	54"	18"	9'-0"	30"x24"	(6) #7 T&B #4 @ 9" OC
72", 80"	60"	24"	10'-0"	30"x24"	(6) #7 T&B #4 @ 9" OC

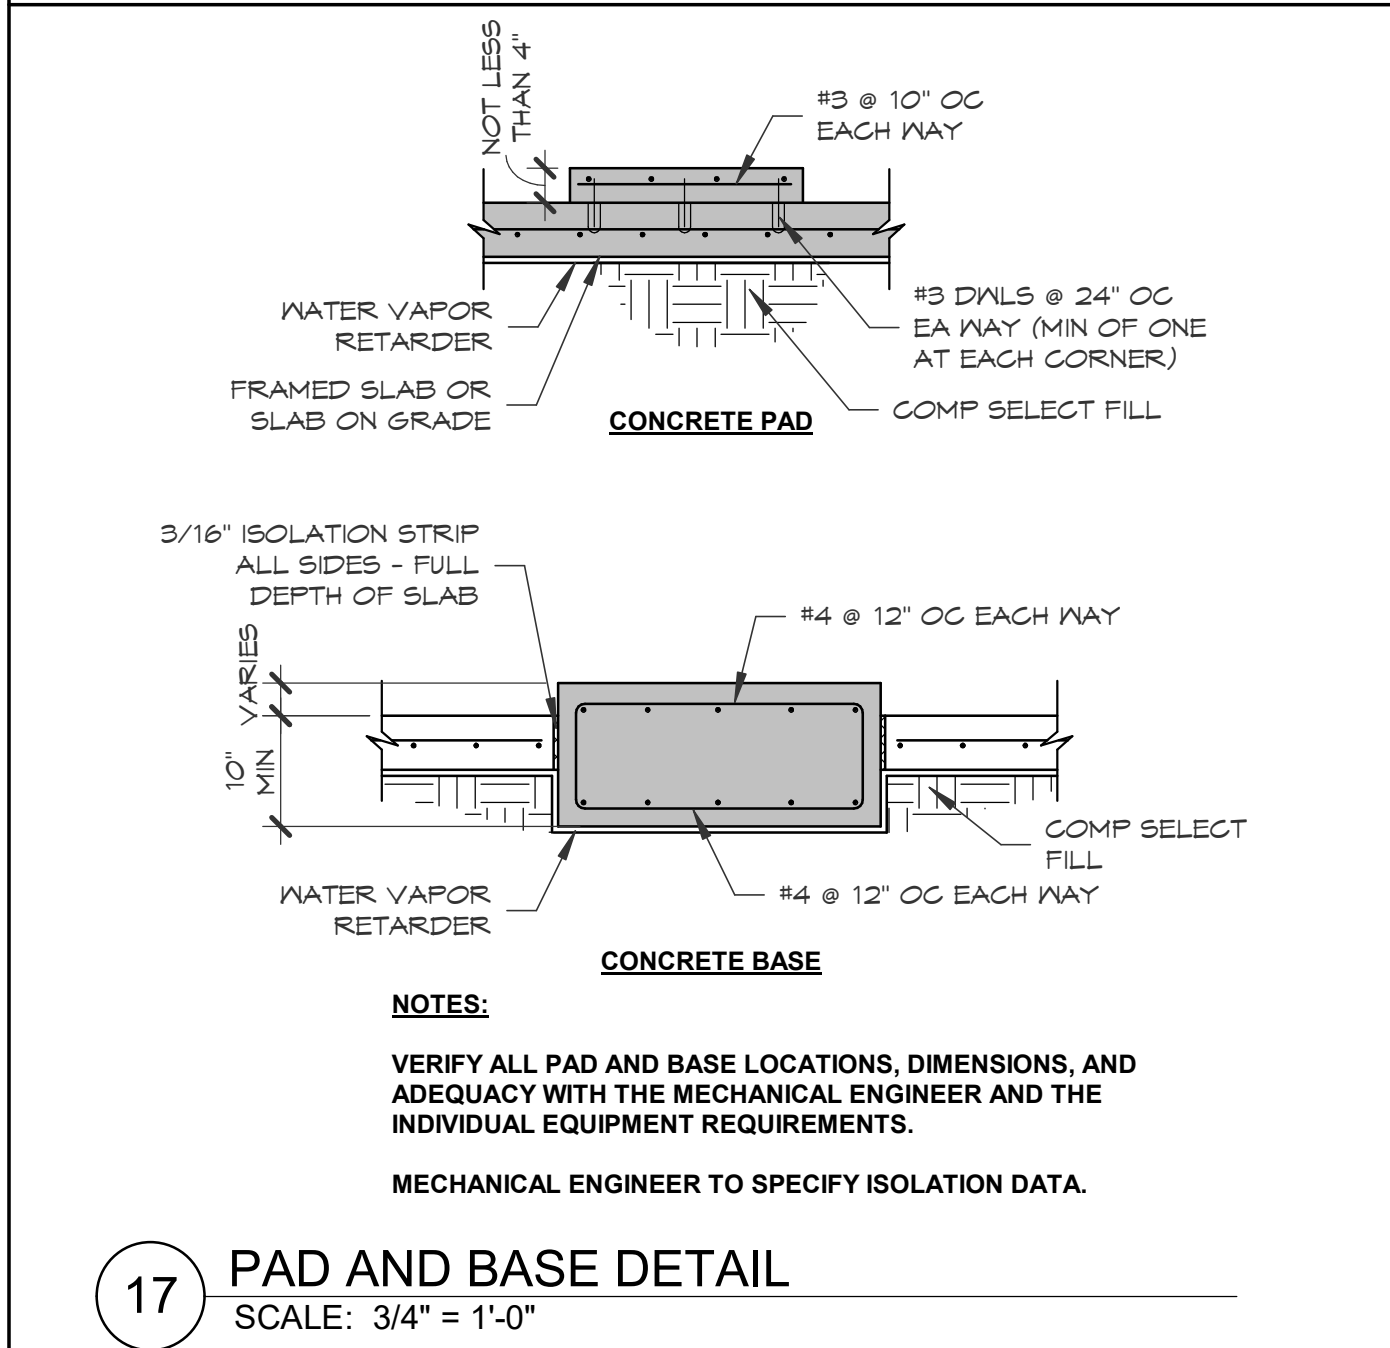

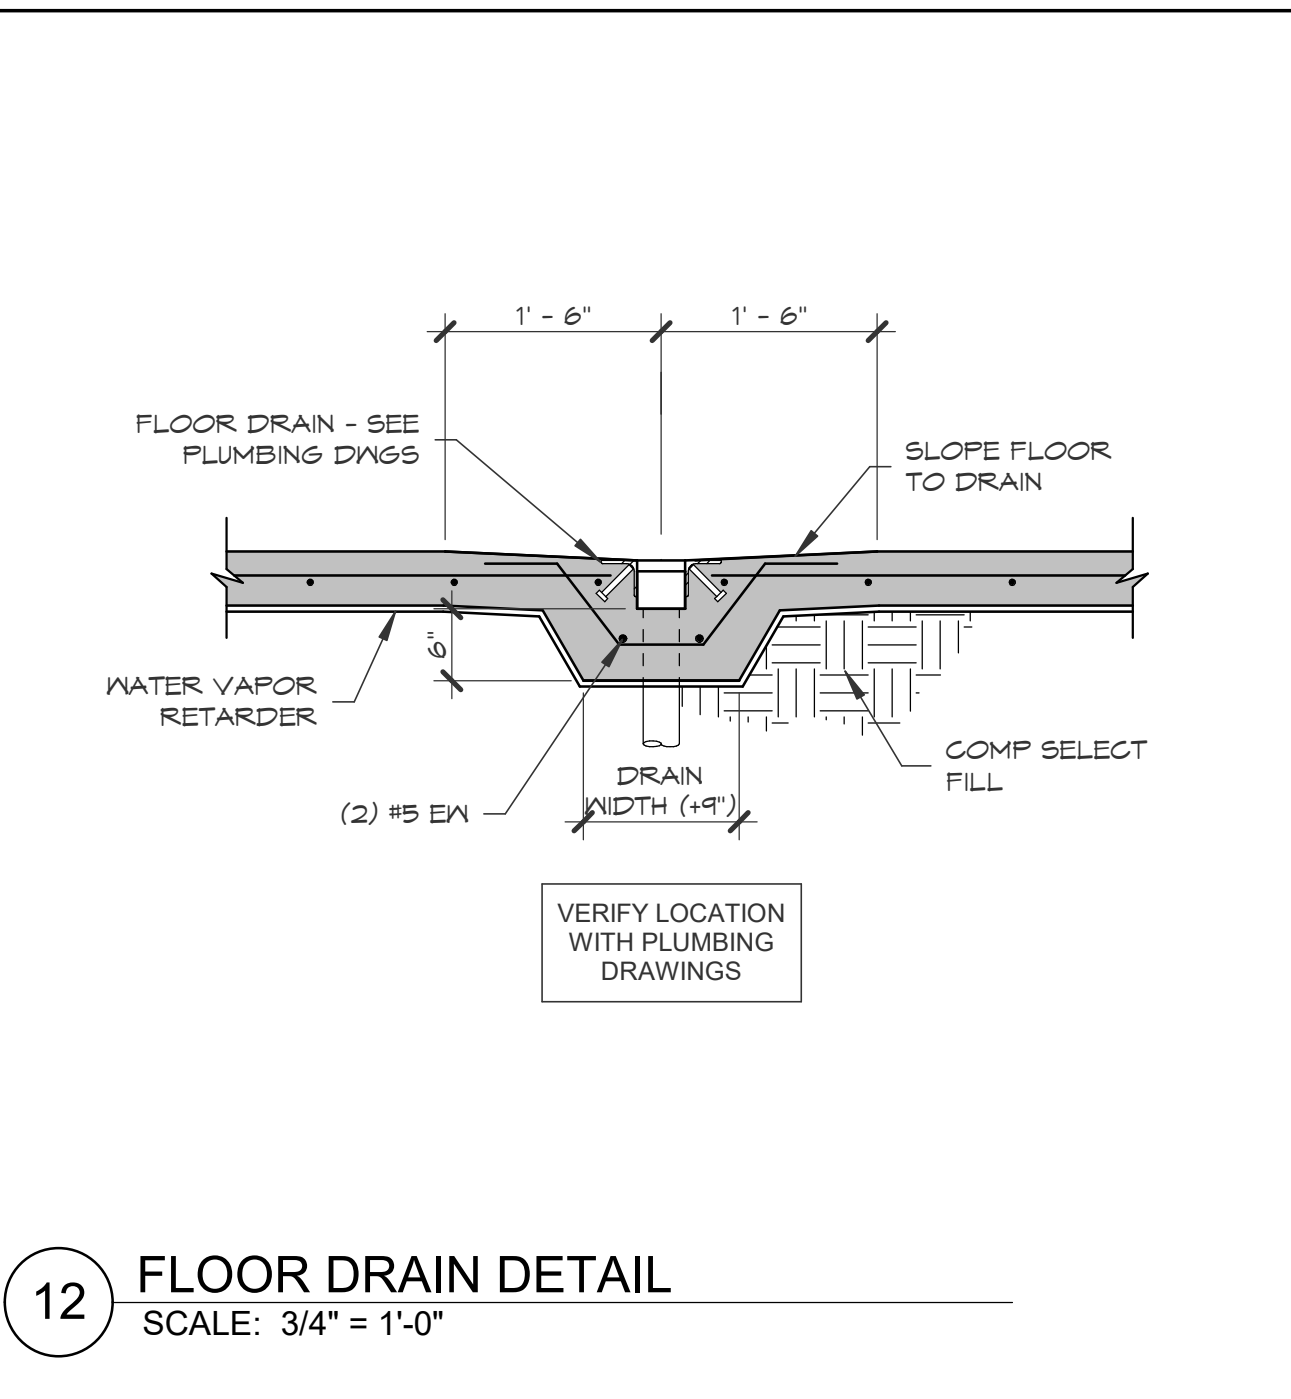
17 PAD AND BASE DETAIL  
SCALE: 3/4" = 1'-0"



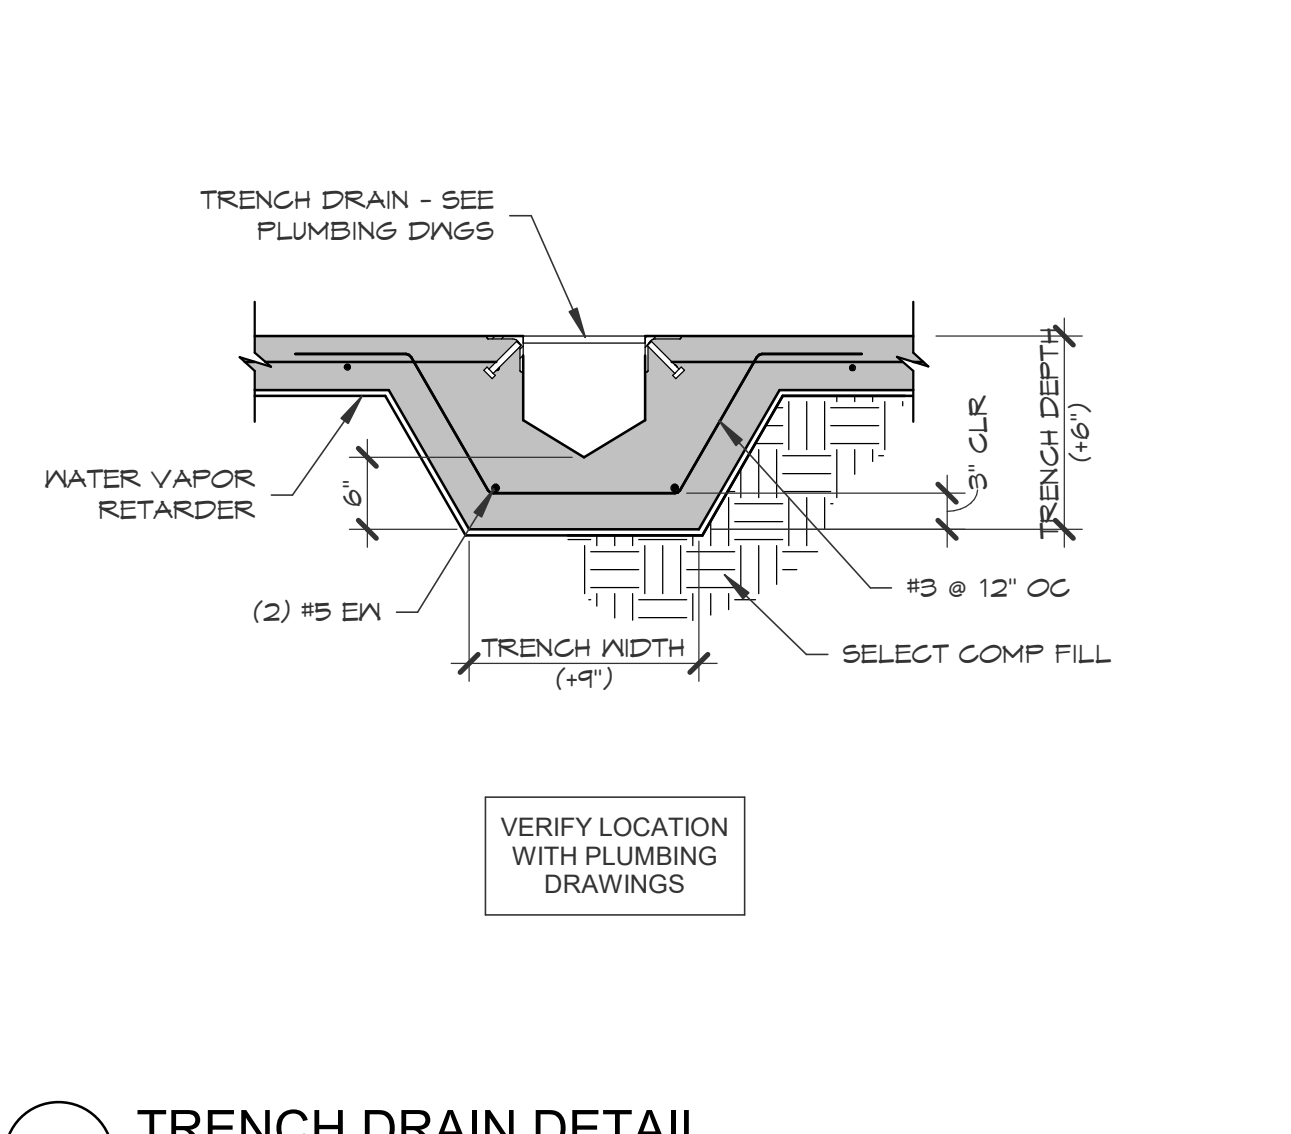
12 FLOOR DRAIN DETAIL  
SCALE: 3/4" = 1'-0"



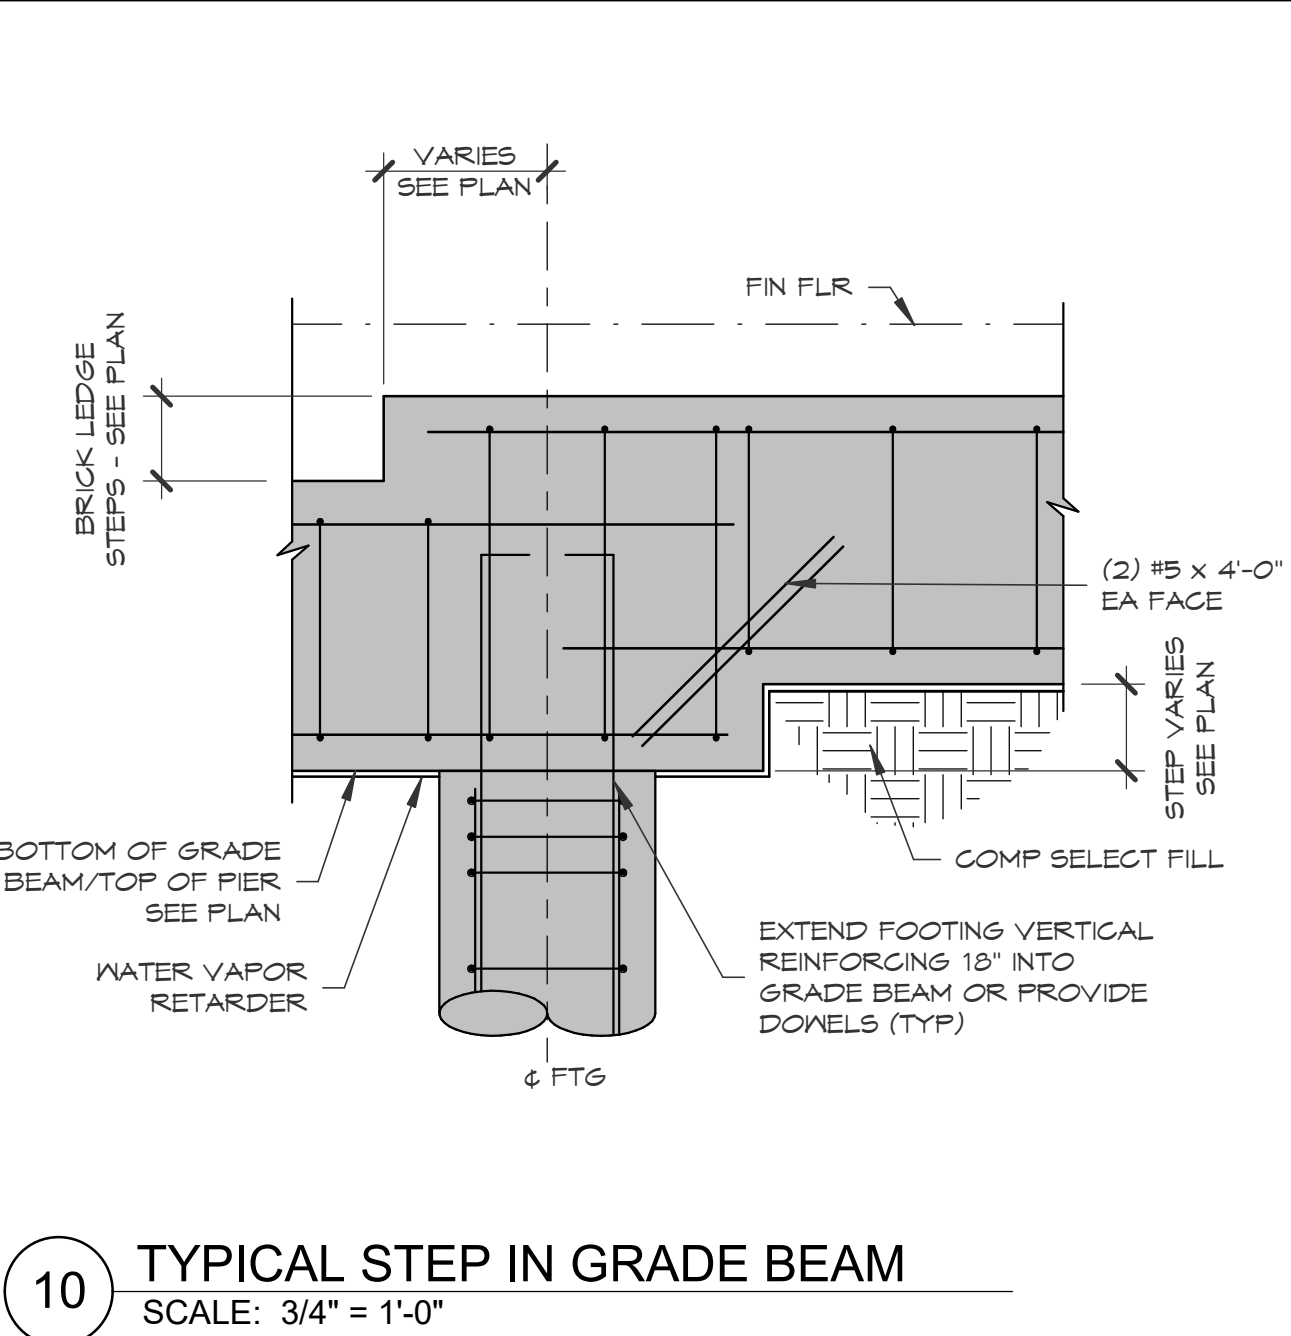
11 TRENCH DRAIN DETAIL  
SCALE: 3/4" = 1'-0"



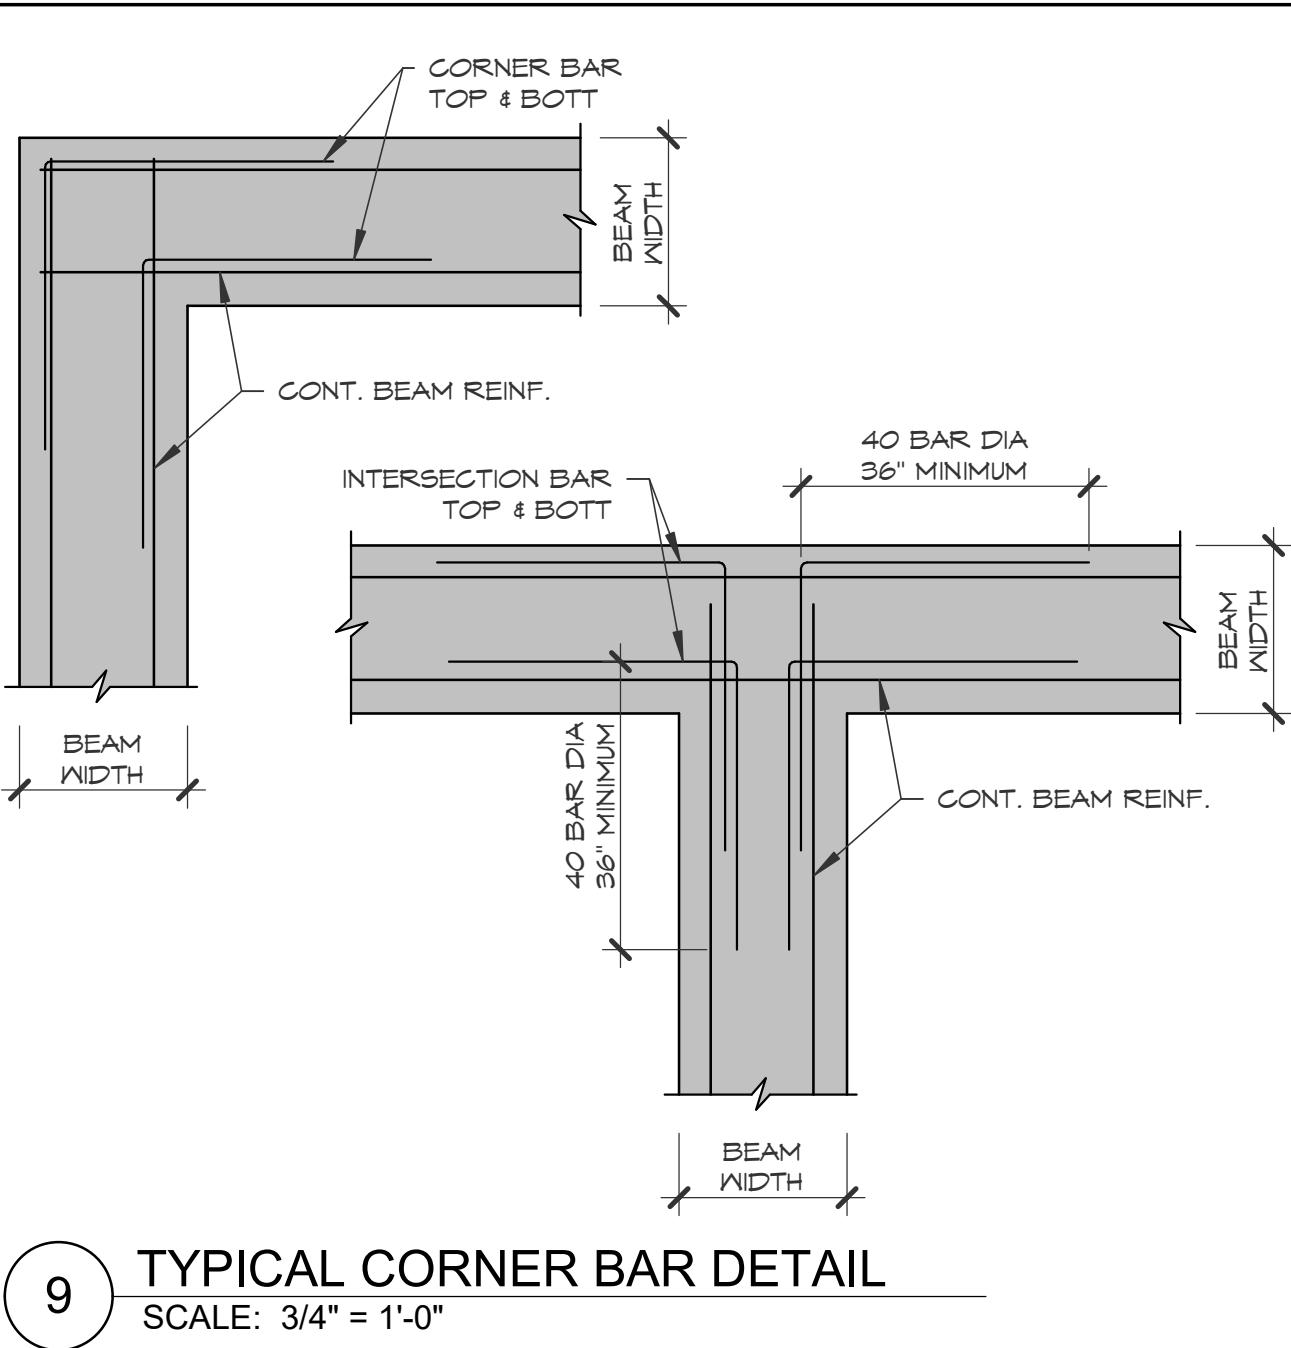
10 TYPICAL STEP IN GRADE BEAM  
SCALE: 3/4" = 1'-0"



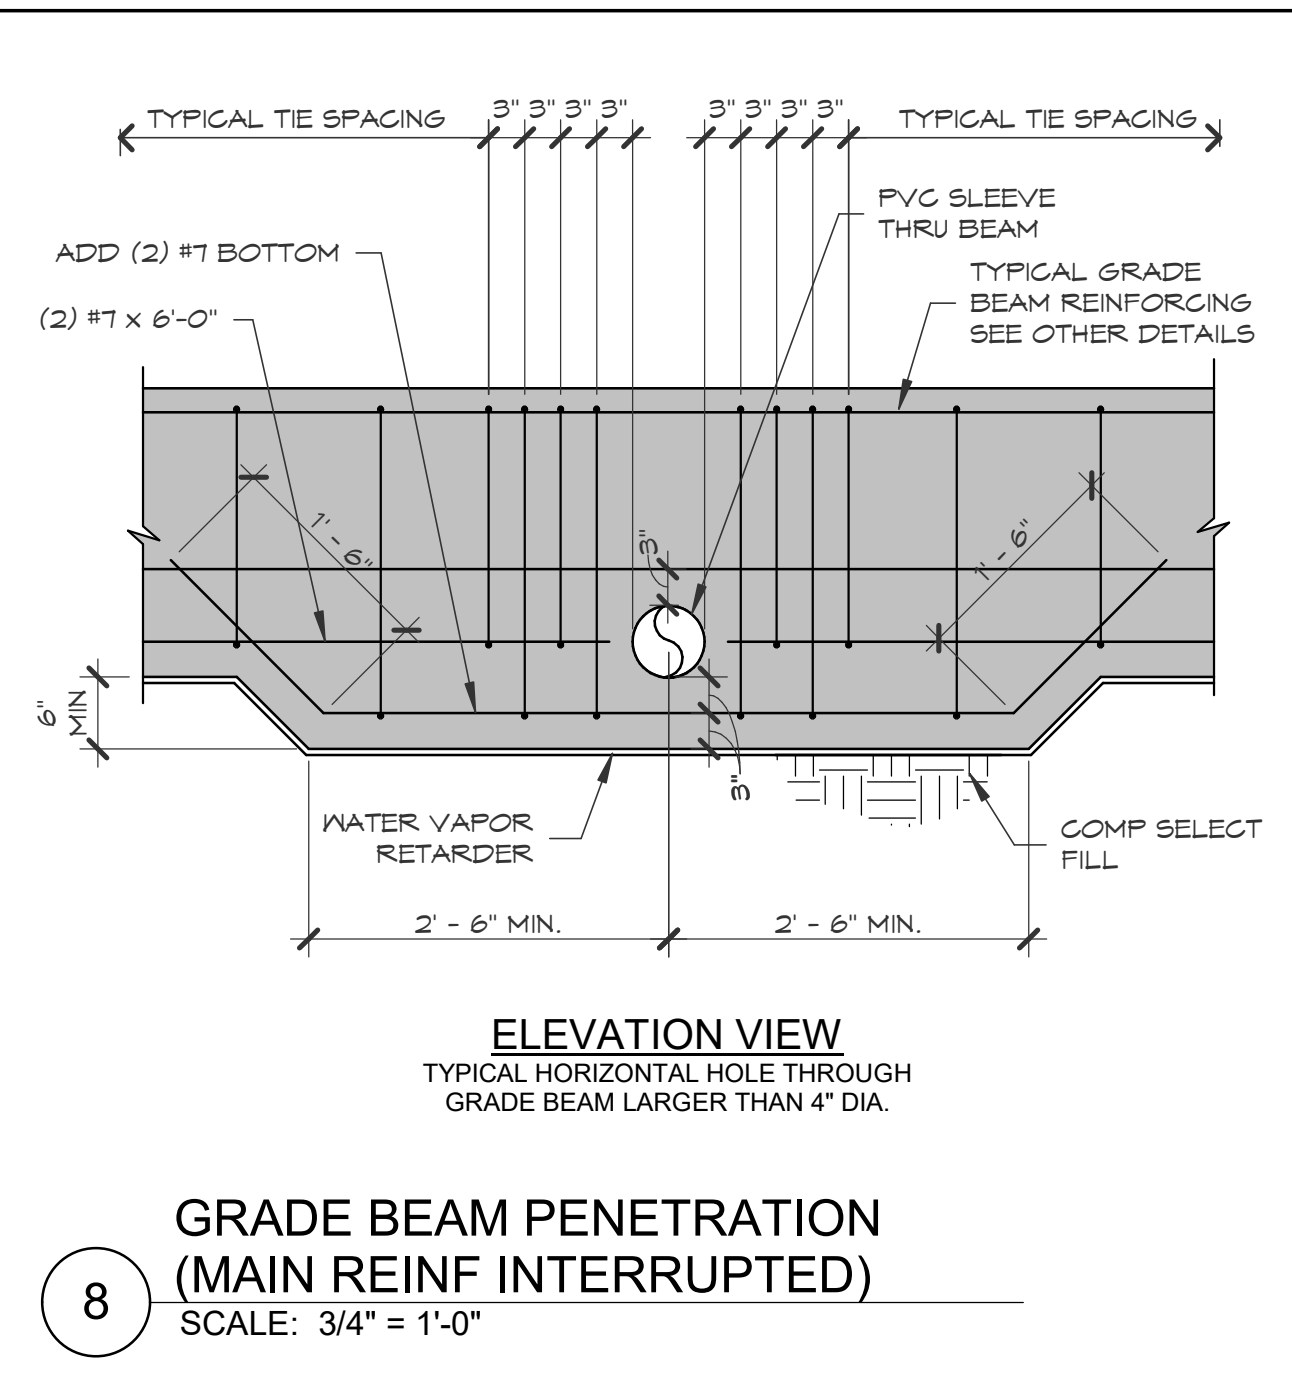
9 TYPICAL CORNER BAR DETAIL  
SCALE: 3/4" = 1'-0"



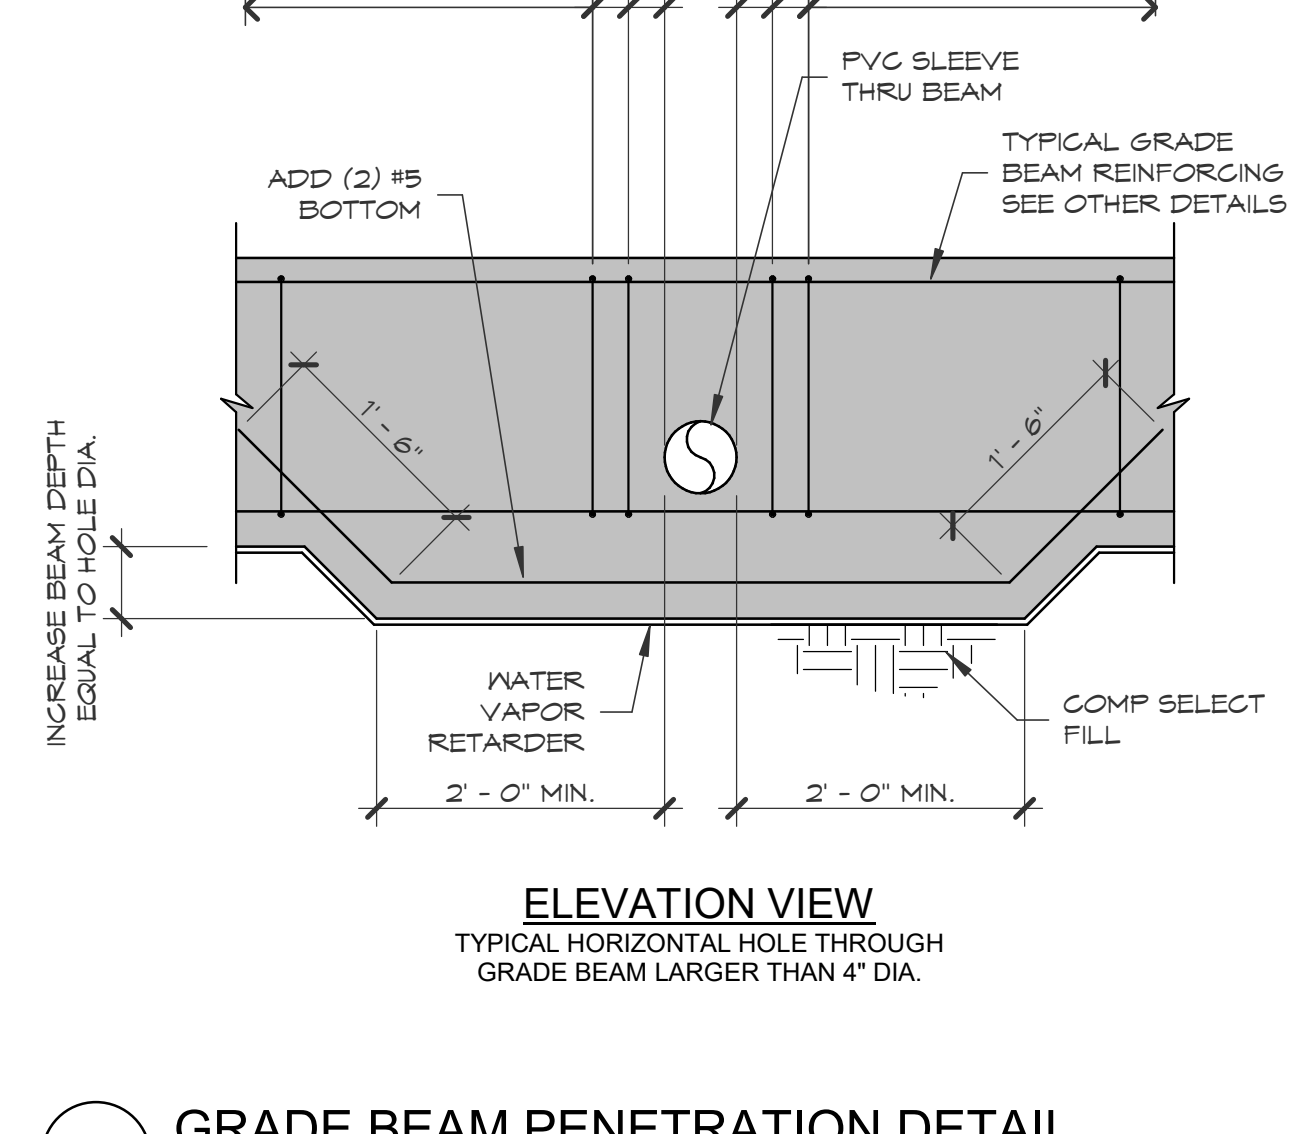
8 GRADE BEAM PENETRATION (MAIN REINF INTERRUPTED)  
SCALE: 3/4" = 1'-0"



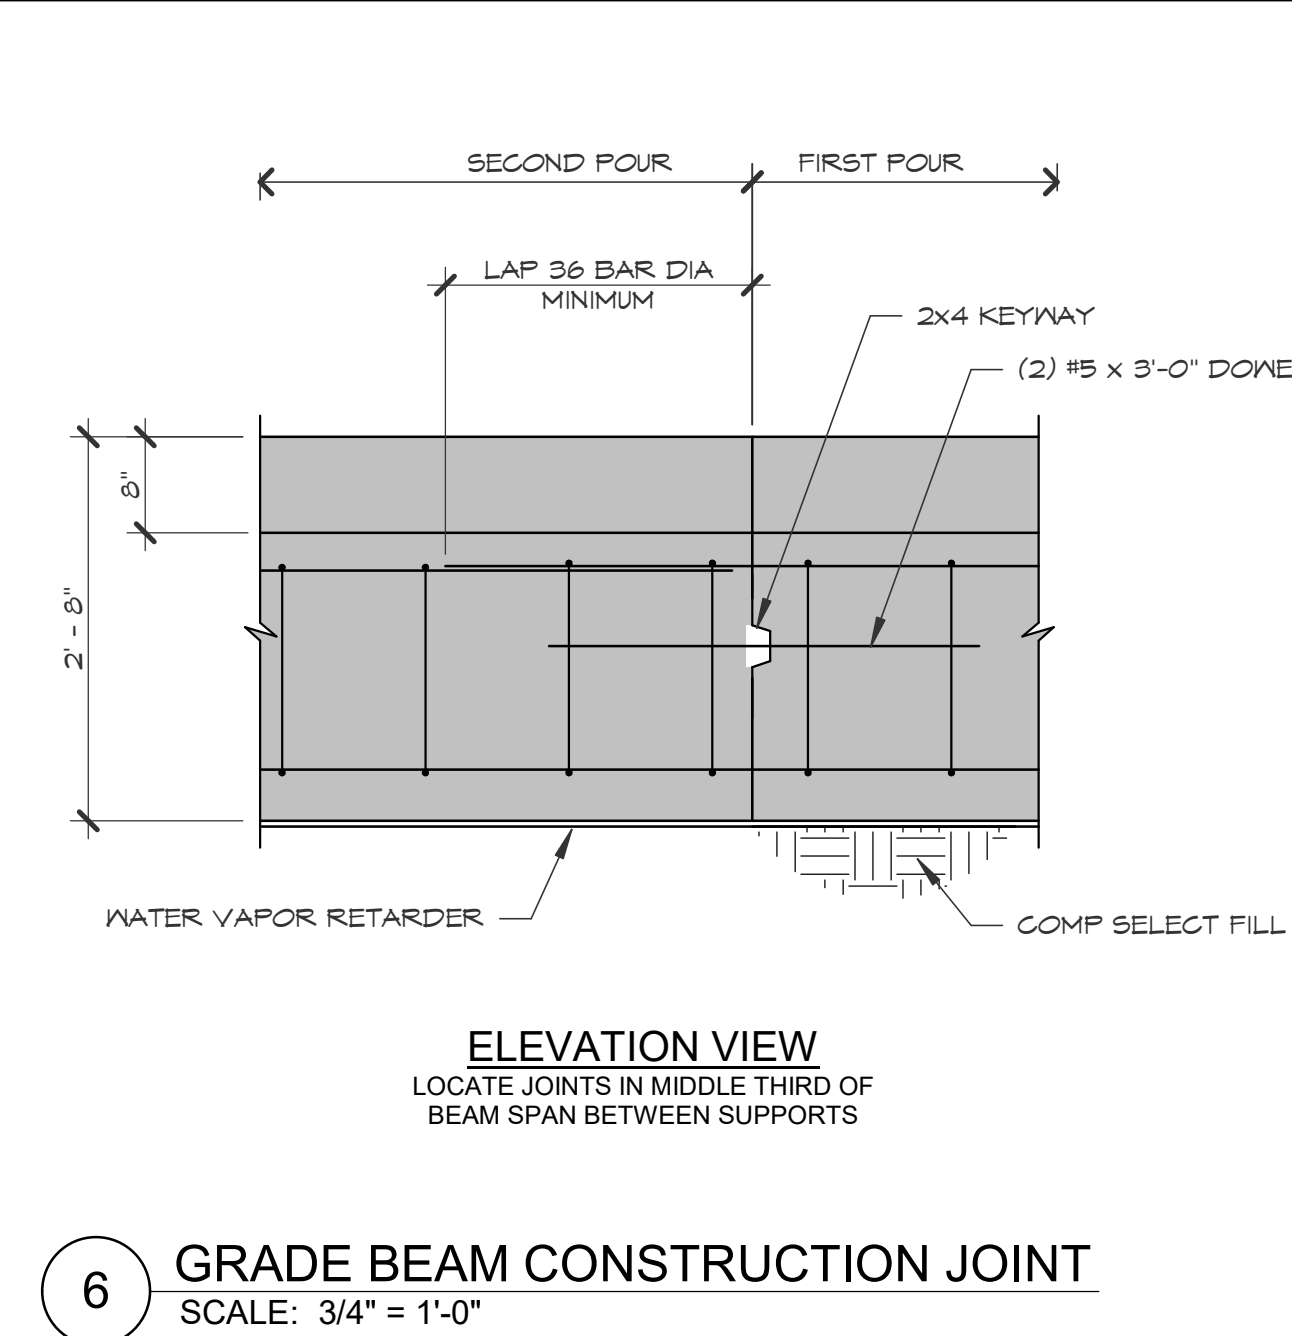
7 GRADE BEAM PENETRATION DETAIL  
SCALE: 3/4" = 1'-0"



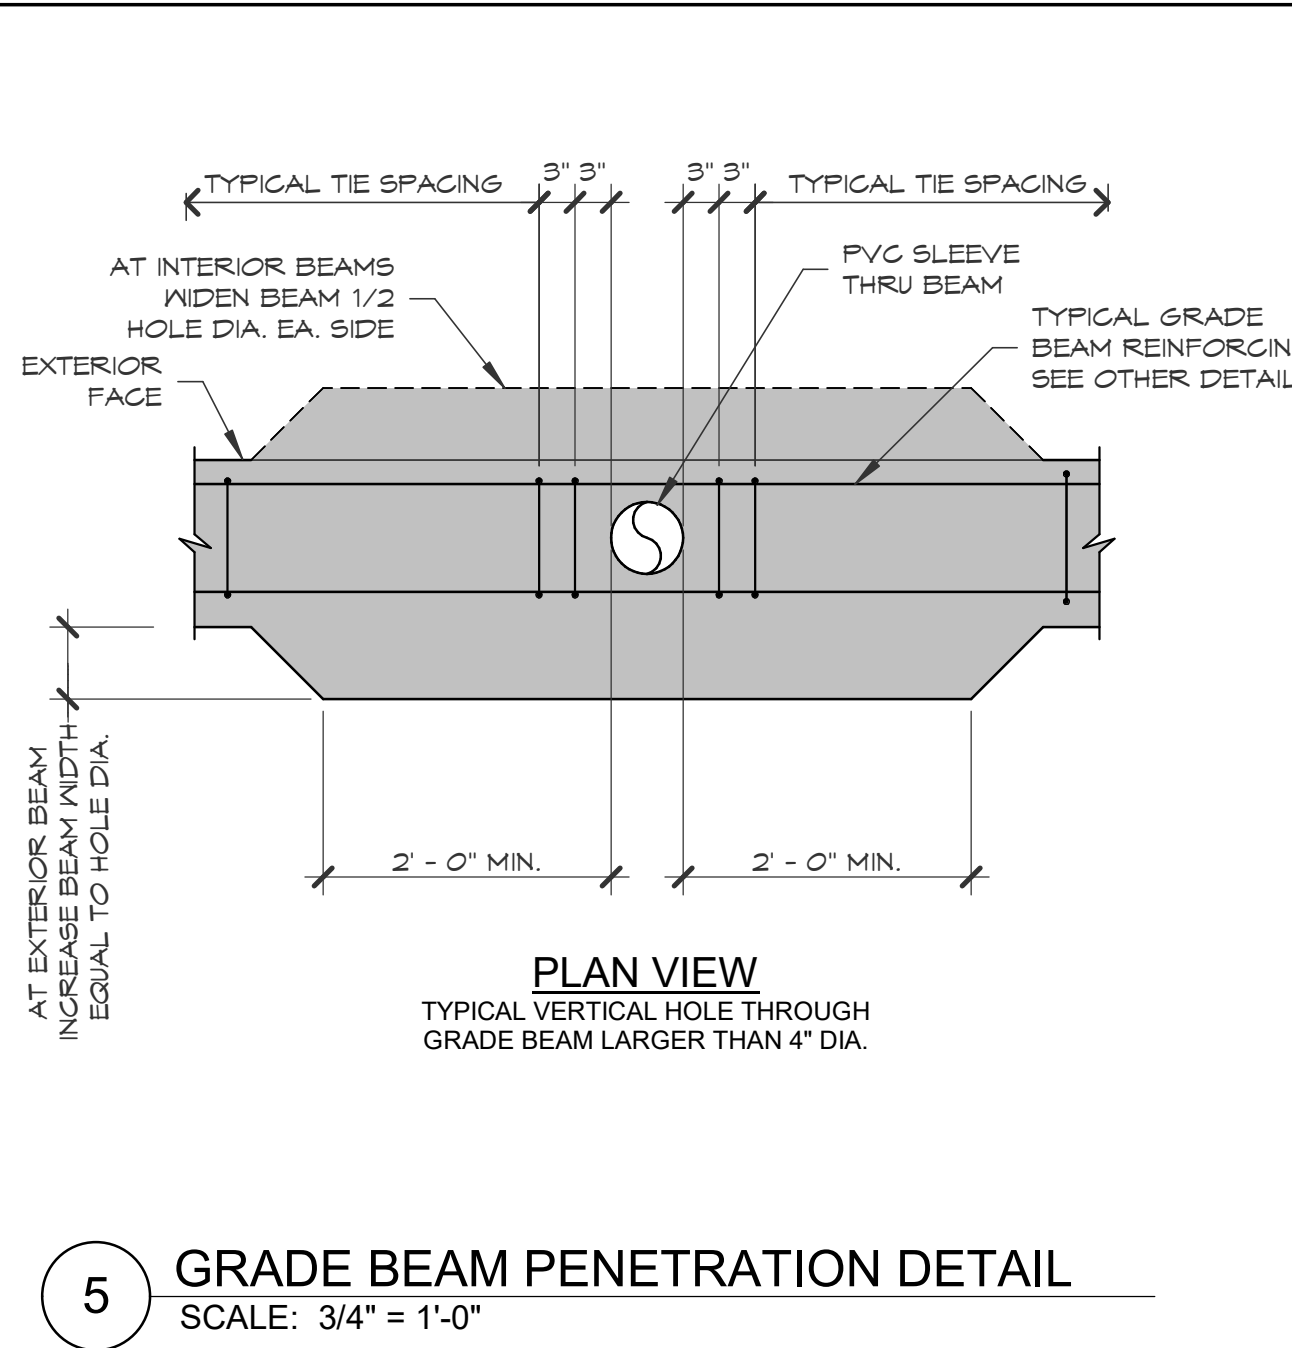
6 GRADE BEAM CONSTRUCTION JOINT  
SCALE: 3/4" = 1'-0"



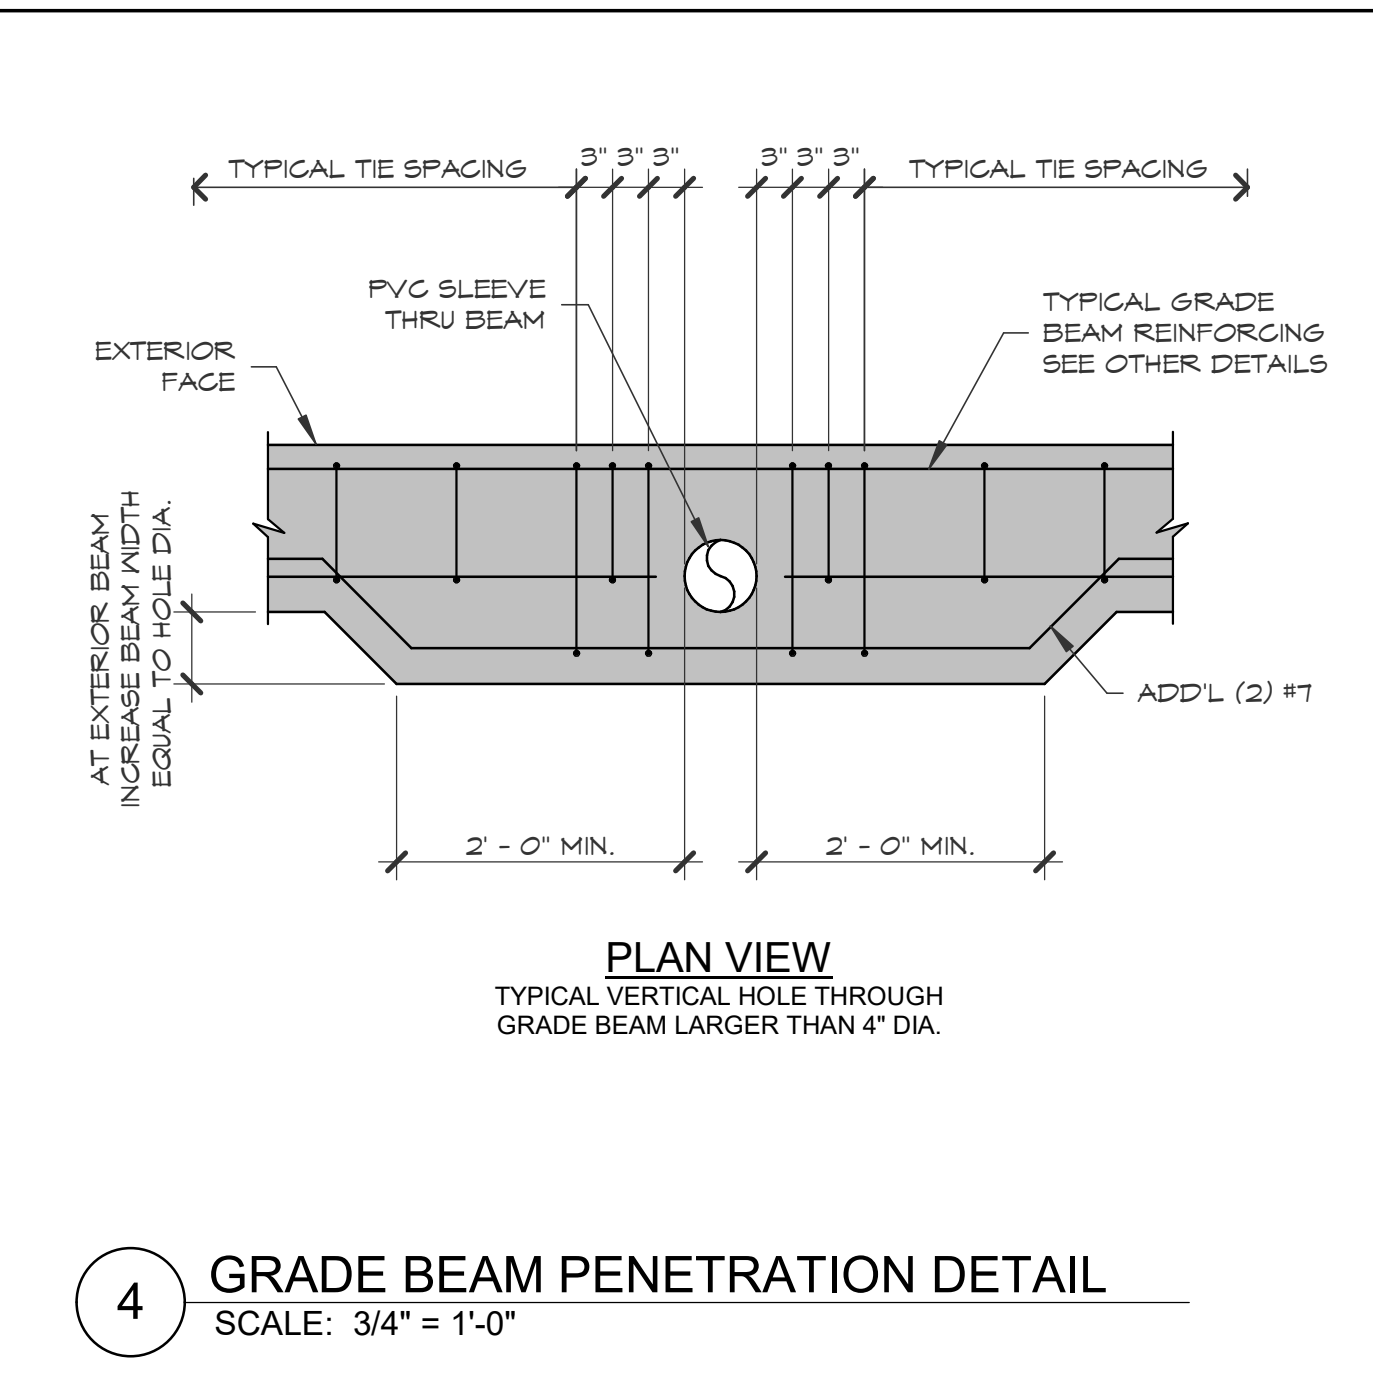
5 GRADE BEAM PENETRATION DETAIL  
SCALE: 3/4" = 1'-0"



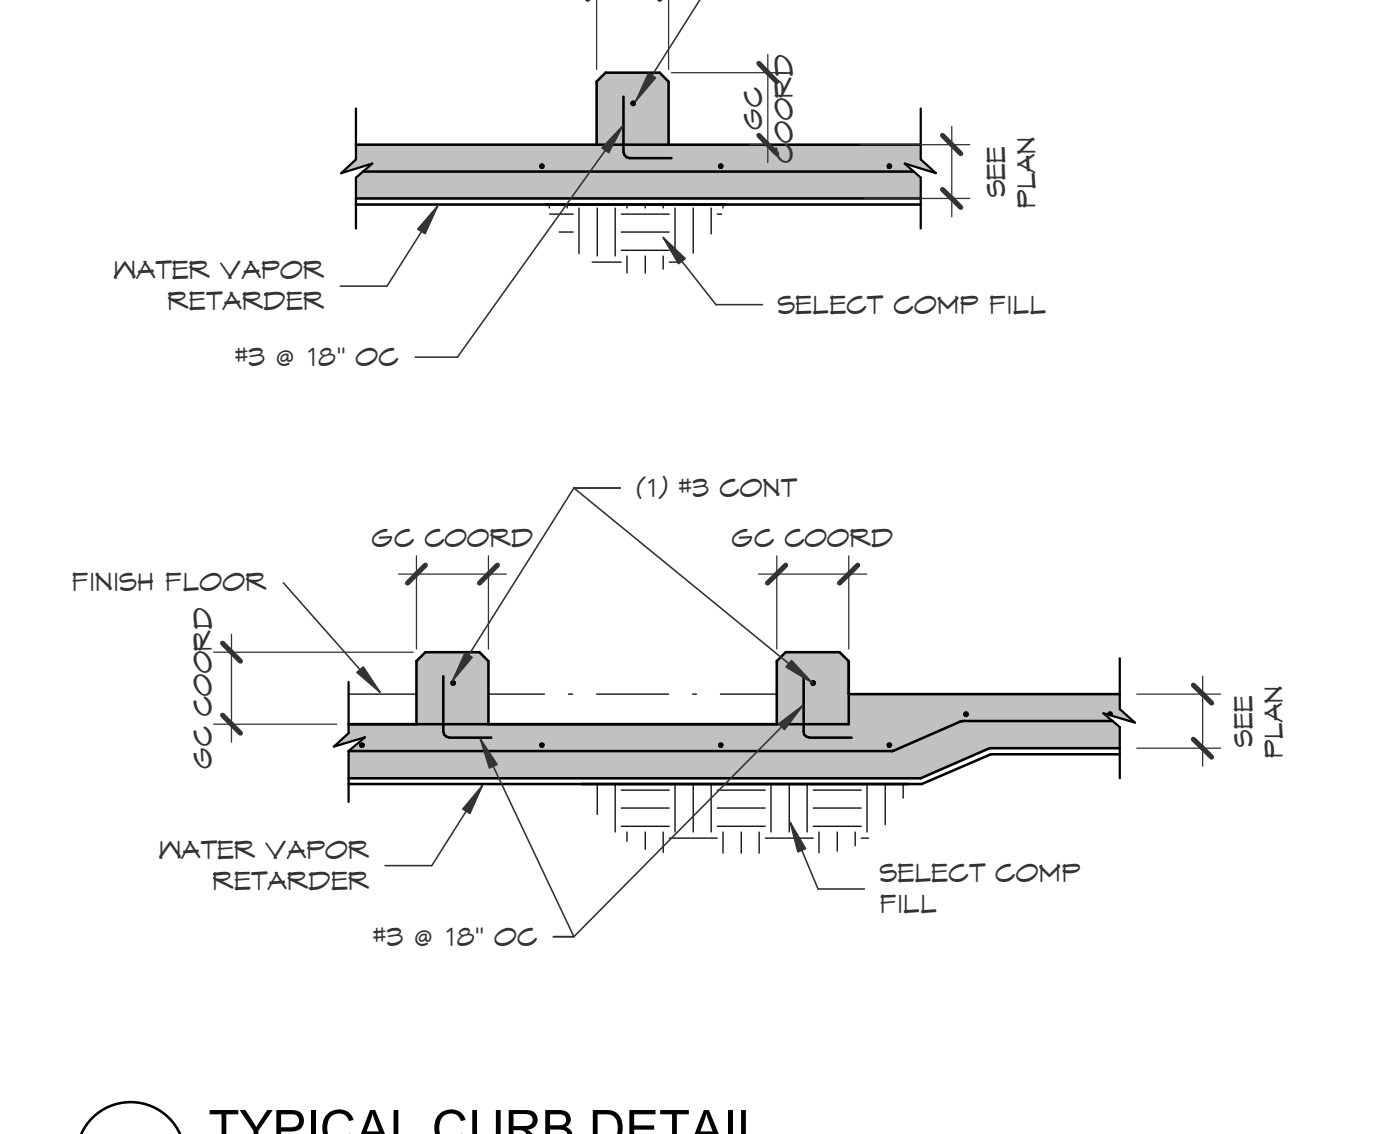
4 GRADE BEAM PENETRATION DETAIL  
SCALE: 3/4" = 1'-0"



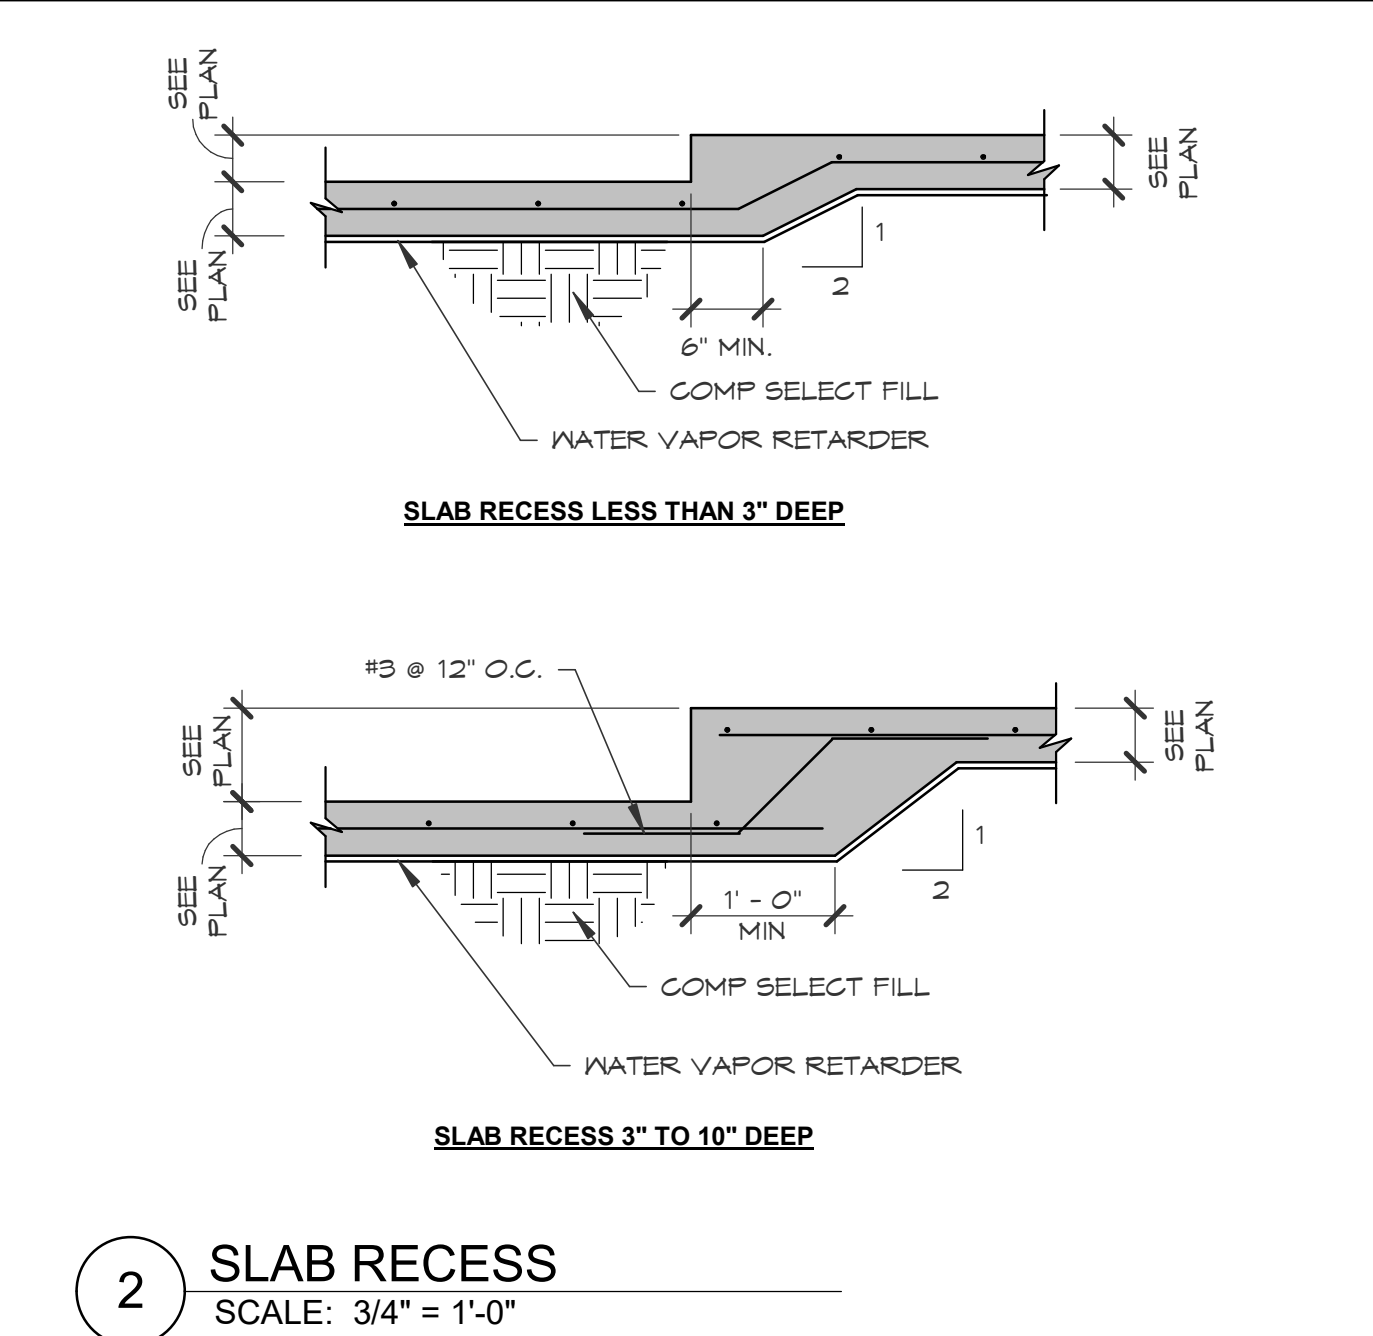3 TYPICAL CURB DETAIL  
SCALE: 3/4" = 1'-0"




2 SLAB RECESS  
SCALE: 3/4" = 1'-0"

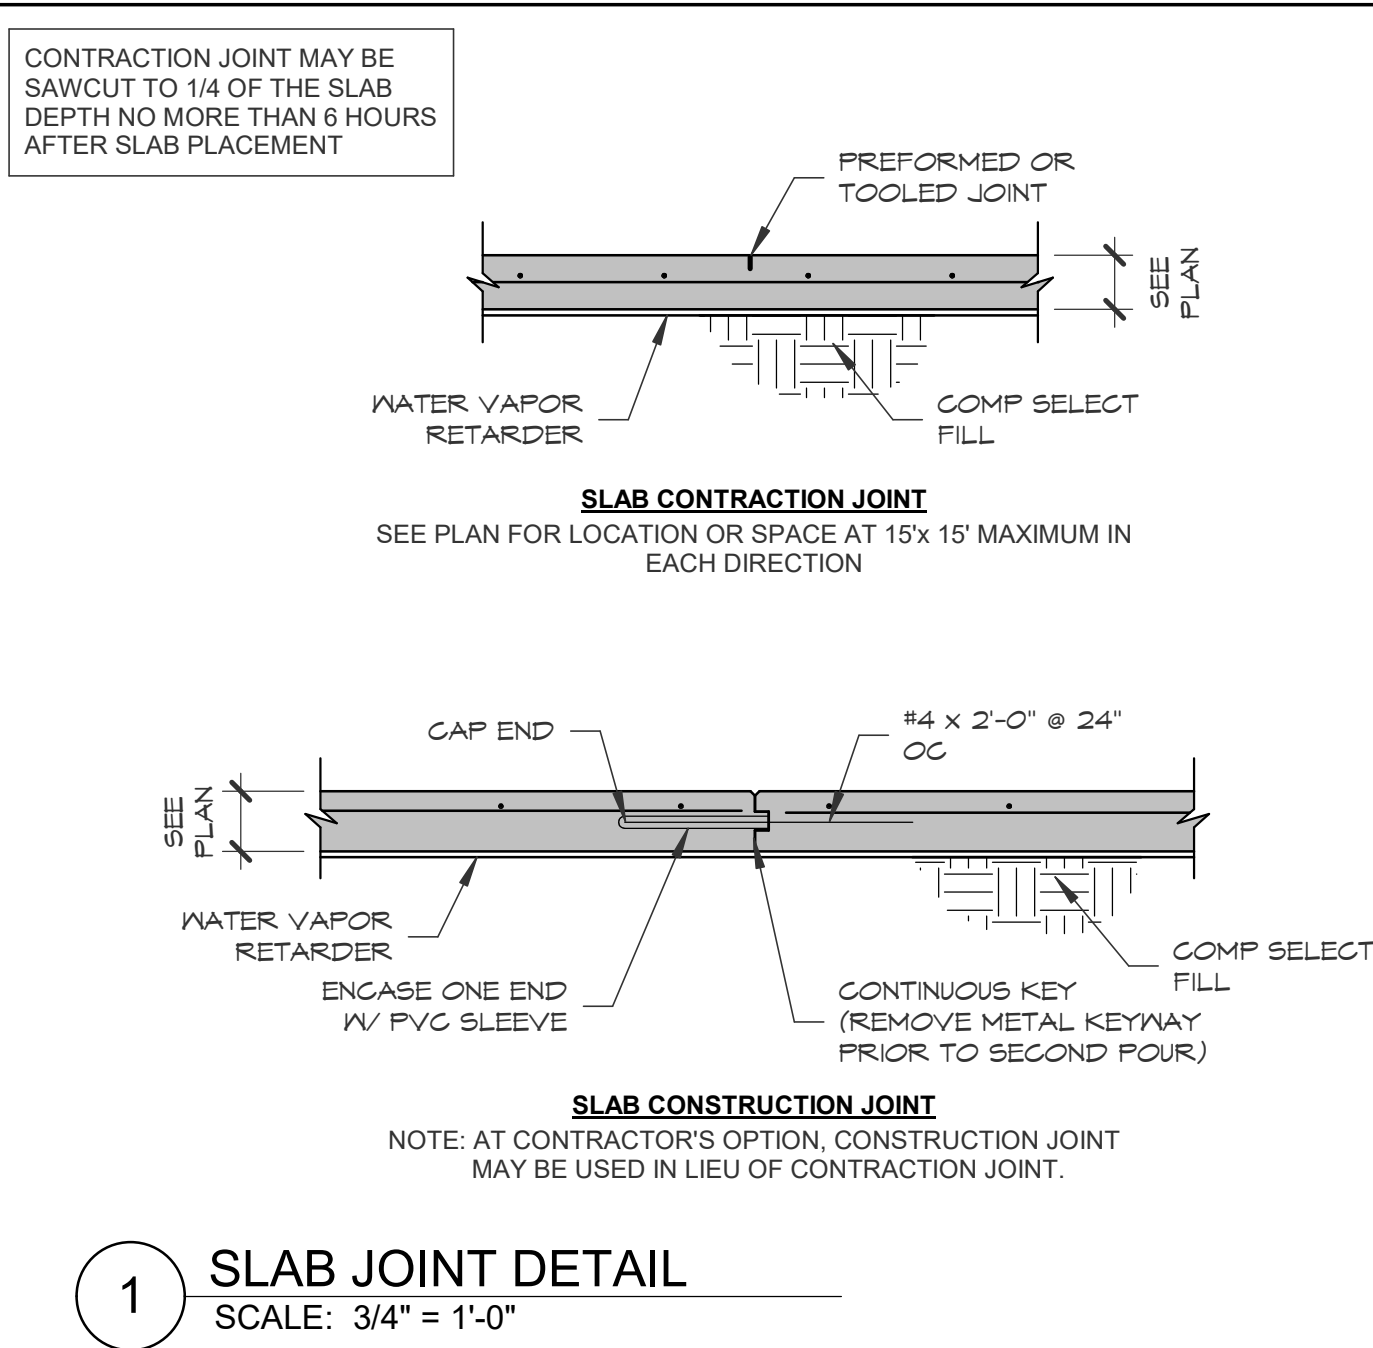

1 SLAB JOINT DETAIL  
SCALE: 3/4" = 1'-0"

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**TOMBALL HIGH SCHOOL  
CTE & MISC. RENOVATIONS**  
TOMBALL INDEPENDENT SCHOOL DISTRICT  
30330 QUINN ROAD, TOMBALL, TX 77375

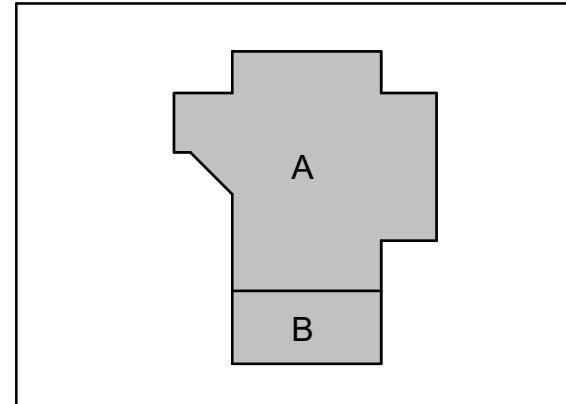**ARCADIS**  
TEXAS ARCADIS INC.  
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06 November 2023  
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**S2.02**  
FOUNDATION  
DETAILS







- DEMOLITION DWGS. INDICATE GENERAL DEMOLITION REQD., HOWEVER, THEY DO NOT SHOW SPECIFIC DETAILS OF DEMOLITION. CONTRACTOR SHALL VISIT PROJECT SITE / BLDG. PRIOR TO BIDDING TO ASCERTAIN EXISTING CONDITIONS & SPECIFIC REQMENTS. FOR DEMOLITION WORK & SHALL INCLUDE ALL COSTS ASSOCIATED W/ DEMOLITION, EXCEPTING CONDITIONS THAT COULD NOT BE DETERMINED WITHOUT DESTRUCTIVE INVESTIGATION. COORDINATE W/ ARCH. & OWNER W/ RESPECT TO VISITATION SCHEDULE.
- RE. CIVIL, STRUC. & MEP DWGS. FOR DEMOLITION REQMENTS. PARTICULAR TO THE OTHER CONSULTING DISCIPLINES, THE CONTRACTOR SHALL BE RESPONSIBLE TO ASCERTAIN THE INTERRELATIONSHIPS OF ALL REQD. DEMOLITION & INCLUDE ALL ASSOCIATED COSTS IN THE PROPOSAL.
- PRIOR TO STARTING DEMOLITION WORK, FIELD VERIFY ALL EXISTING CONDITIONS. NOTIFY THE ARCH. OF ANY ISSUES AND/ OR CONCEALED CONDITIONS THAT MAY PREVENT IMPLEMENTATION & PROGRESS OF DEMOLITION WORK. DO NOT PROCEED UNTIL SUCH ISSUES ARE FULLY RESOLVED.
- FOR DEMOLITION CONDUCTED WITHIN AN OPERATIONAL BLDG., CONTRACTOR SHALL COORD. W/ ARCH. & OWNER REGARDING SCHEDULING AND/ OR DISRUPTIVE NOISE ISSUES. IF REQD. TO MAINTAIN ONGOING OPERATION OF THE BLDG., CONTRACTOR SHALL BE PREPARED TO PERFORM DISRUPTIVE DEMOLITION OUTSIDE NORMAL HOURS OF OPERATION.
- IF NOT INDICATED IN THE CONTRACT DOCUMENTS, COORD. W/ ARCH. & OWNER FOR DISPOSITION OF EXISTING FIXTURES, FURNITURE & EQUIP. (FFE).
- OWNER SHALL RETAIN THE RIGHT TO RECEIVE & SALVAGE ANY EXISTING WORK SHOWN TO BE DEMOLISHED AND/ OR REMOVED. CONFIRM W/ OWNER IF ANY MATERIALS ARE TO BE SALVAGED PRIOR TO THE START OF ANY DEMOLITION WORK. COORD. W/ OWNER FOR TRANSFER OF SALVAGED MATERIALS.
- CONTRACTOR SHALL USE ALL MEANS NECESSARY TO PROTECT EXISTING WORK INDICATED TO REMAIN, IN CASE OF DAMAGE DURING DEMOLITION AND/ OR NEW WORK CONSTRUCTION, CONTRACTOR SHALL REPAIR AND/ OR REPLACE SUCH EXISTING WORK BACK TO ORIGINAL CONDITION, SUBJECT TO ACCEPTANCE BY THE ARCH. SIMILARLY, CONTRACTOR SHALL PROVIDE ADEQUATE MEANS OF RESTRICTING DISTRIBUTION OF DUST & OTHER DEMOLITION CONTAMINANTS FROM SPREADING INTO AREAS OUTSIDE OF DEMOLITION AREA(S).
- WHERE EXISTING WORK IS INDICATED TO BE REMOVED & REINSTALLED, CONTRACTOR SHALL USE ALL MEANS NECESSARY TO REMOVE THE WORK WITHOUT DAMAGE. SUFFICIENTLY STORE THE WORK TO PREVENT LOSS OR DAMAGE & CAREFULLY REINSTALL THE WORK AS INDICATED ON THE DWGS. IN CASE OF DAMAGE, CONTRACTOR SHALL REPAIR AND/ OR REPLACE SUCH EXISTING WORK BACK TO ORIGINAL CONDITION, SUBJECT TO ACCEPTANCE BY THE ARCH.
- ALL EXISTING CONCRETE SLABS TO BE REMOVED IN ORDER FOR DEMOLITION OF UNDER-SLAB WORK SHALL BE SAW-CUT, MAINTAIN INTEGRITY OF EXISTING VAPOR MEMBRANE AS REQD. FOR RECONNECTION TO NEW VAPOR BARRIERS UNDER SAW-CUT AREA.
- ALL EXISTING PLUMBING WORK SHOWN TO BE ABANDONED SHALL BE REMOVED & CAPPED 2" BELOW SLAB OR BACK TO WITHIN A WALL. SLABS & WALLS SHALL BE REPAIRED FLUSH W/ ADJACENT SURFACES.
- WHERE NEW OPENING ARE TO BE INSTALLED IN EXISTING WALLS / PARTITIONS, LIMITS OF DEMOLITION SHALL BE BEYOND OPENING SIZE AS REQD. TO PROPERLY CONSTRUCT ROUGH OPENINGS IN ACCORDANCE W/ NEW OPENING DETAILS INDICATED ON THE DWGS. REBUILD & OR PATCH ADJACENT AREAS TO NEW OPENING AS REQD. FOR FLUSH INTERFACE W/ EXISTING WORK TO REMAIN.
- IN AREAS WHERE EXISTING FINISH FLOORING IS TO BE REMOVED, REMOVE FLOORING MATERIALS, & ANY ADHESIVES DOWN TO THE CONCRETE SLAB. MAINTAIN SLAB IN A SUITABLE CONDITION FOR INSTALLATION OF NEW SCHEDULED FLOORING MATERIALS.
- IN AREAS WHERE EXISTING WORK IS TO RECEIVE A NEW FINISH, CONTRACTOR SHALL REPAIR, PATCH AND/ OR PREP EXISTING WORK AS REQD. FOR PROPER INSTALLATION OF NEW FINISHES IN ACCORDANCE W/ NEW FINISH MANUFACTURER'S REQMENTS. VERIFY ALL CONDITIONS & COORD. AS REQD.

#### NOTES - GENERAL FLOOR PLAN - DEMO

1/4" = 1'-0"

- REMOVE EXISTING OVERHEAD DOOR, CLEAN/PREP/ FINISH REMAINING SURFACES & INSTALL NEW FINISHES TO MATCH ADJACENT CONDITIONS
- REMOVE EXISTING WATERFOUNTAIN, CLEAN/PREP/ FINISH REMAINING SURFACES TO MATCH ADJACENT CONDITIONS, CAP PLUMB. AS REQD. BY MEP
- CAREFULLY DEMOLISH AND REMOVE EXISTING CONCRETE WALK AND PADS. FIELD VERIFY EXACT LOCATION AND QUANTITY. CONTACT OWNER AND ARCHITECT IF THERE ARE QUESTIONS OR POTENTIAL CONFLICTS AT STRUCTURAL FRAMING OR EXTERIOR WALLS. PROPERLY DISPOSE OF MATERIALS
- REMOVE EXISTING PLUMB. FIXTURE IN ITS ENTIRETY. CLEAN/ PREP/ FINISH REMAINING SURFACES TO MATCH ADJACENT CONDITIONS. CAP PLUMB. AS REQD. BY MEP
- REMOVE EXISTING WALL FOR NEW OPENING, RE: #11 UNDER GENERAL DEMO PLAN NOTES
- REMOVE PORTION OF EXISTING TOILET PARTITIONS IN THEIR ENTIRETY. CLEAN/ PREP/ FINISH REMAINING SURFACES TO MATCH ADJACENT CONDITIONS.
- REMOVE EXISTING LOUVER PANELS IN THEIR ENTIRETY. CLEAN/ PREP/ FINISH REMAINING SURFACES TO MATCH ADJACENT CONDITIONS
- REMOVE EXISTING METAL PANELS TO TRANSITION POINT (V.I.F.). CLEAN/ PREP/ FINISH REMAINING SURFACES TO MATCH ADJACENT CONDITIONS

#### KEYNOTES - FLOOR PLAN - DEMO

1/4" = 1'-0"

DEMOLISH WINDOW, CLEAN/ PREP/ FINISH REMAINING SURFACES TO MATCH ADJACENT CONDITIONS

DEMOLISH DOOR/ FRAME, CLEAN/ PREP/ FINISH REMAINING SURFACES TO MATCH ADJACENT CONDITIONS

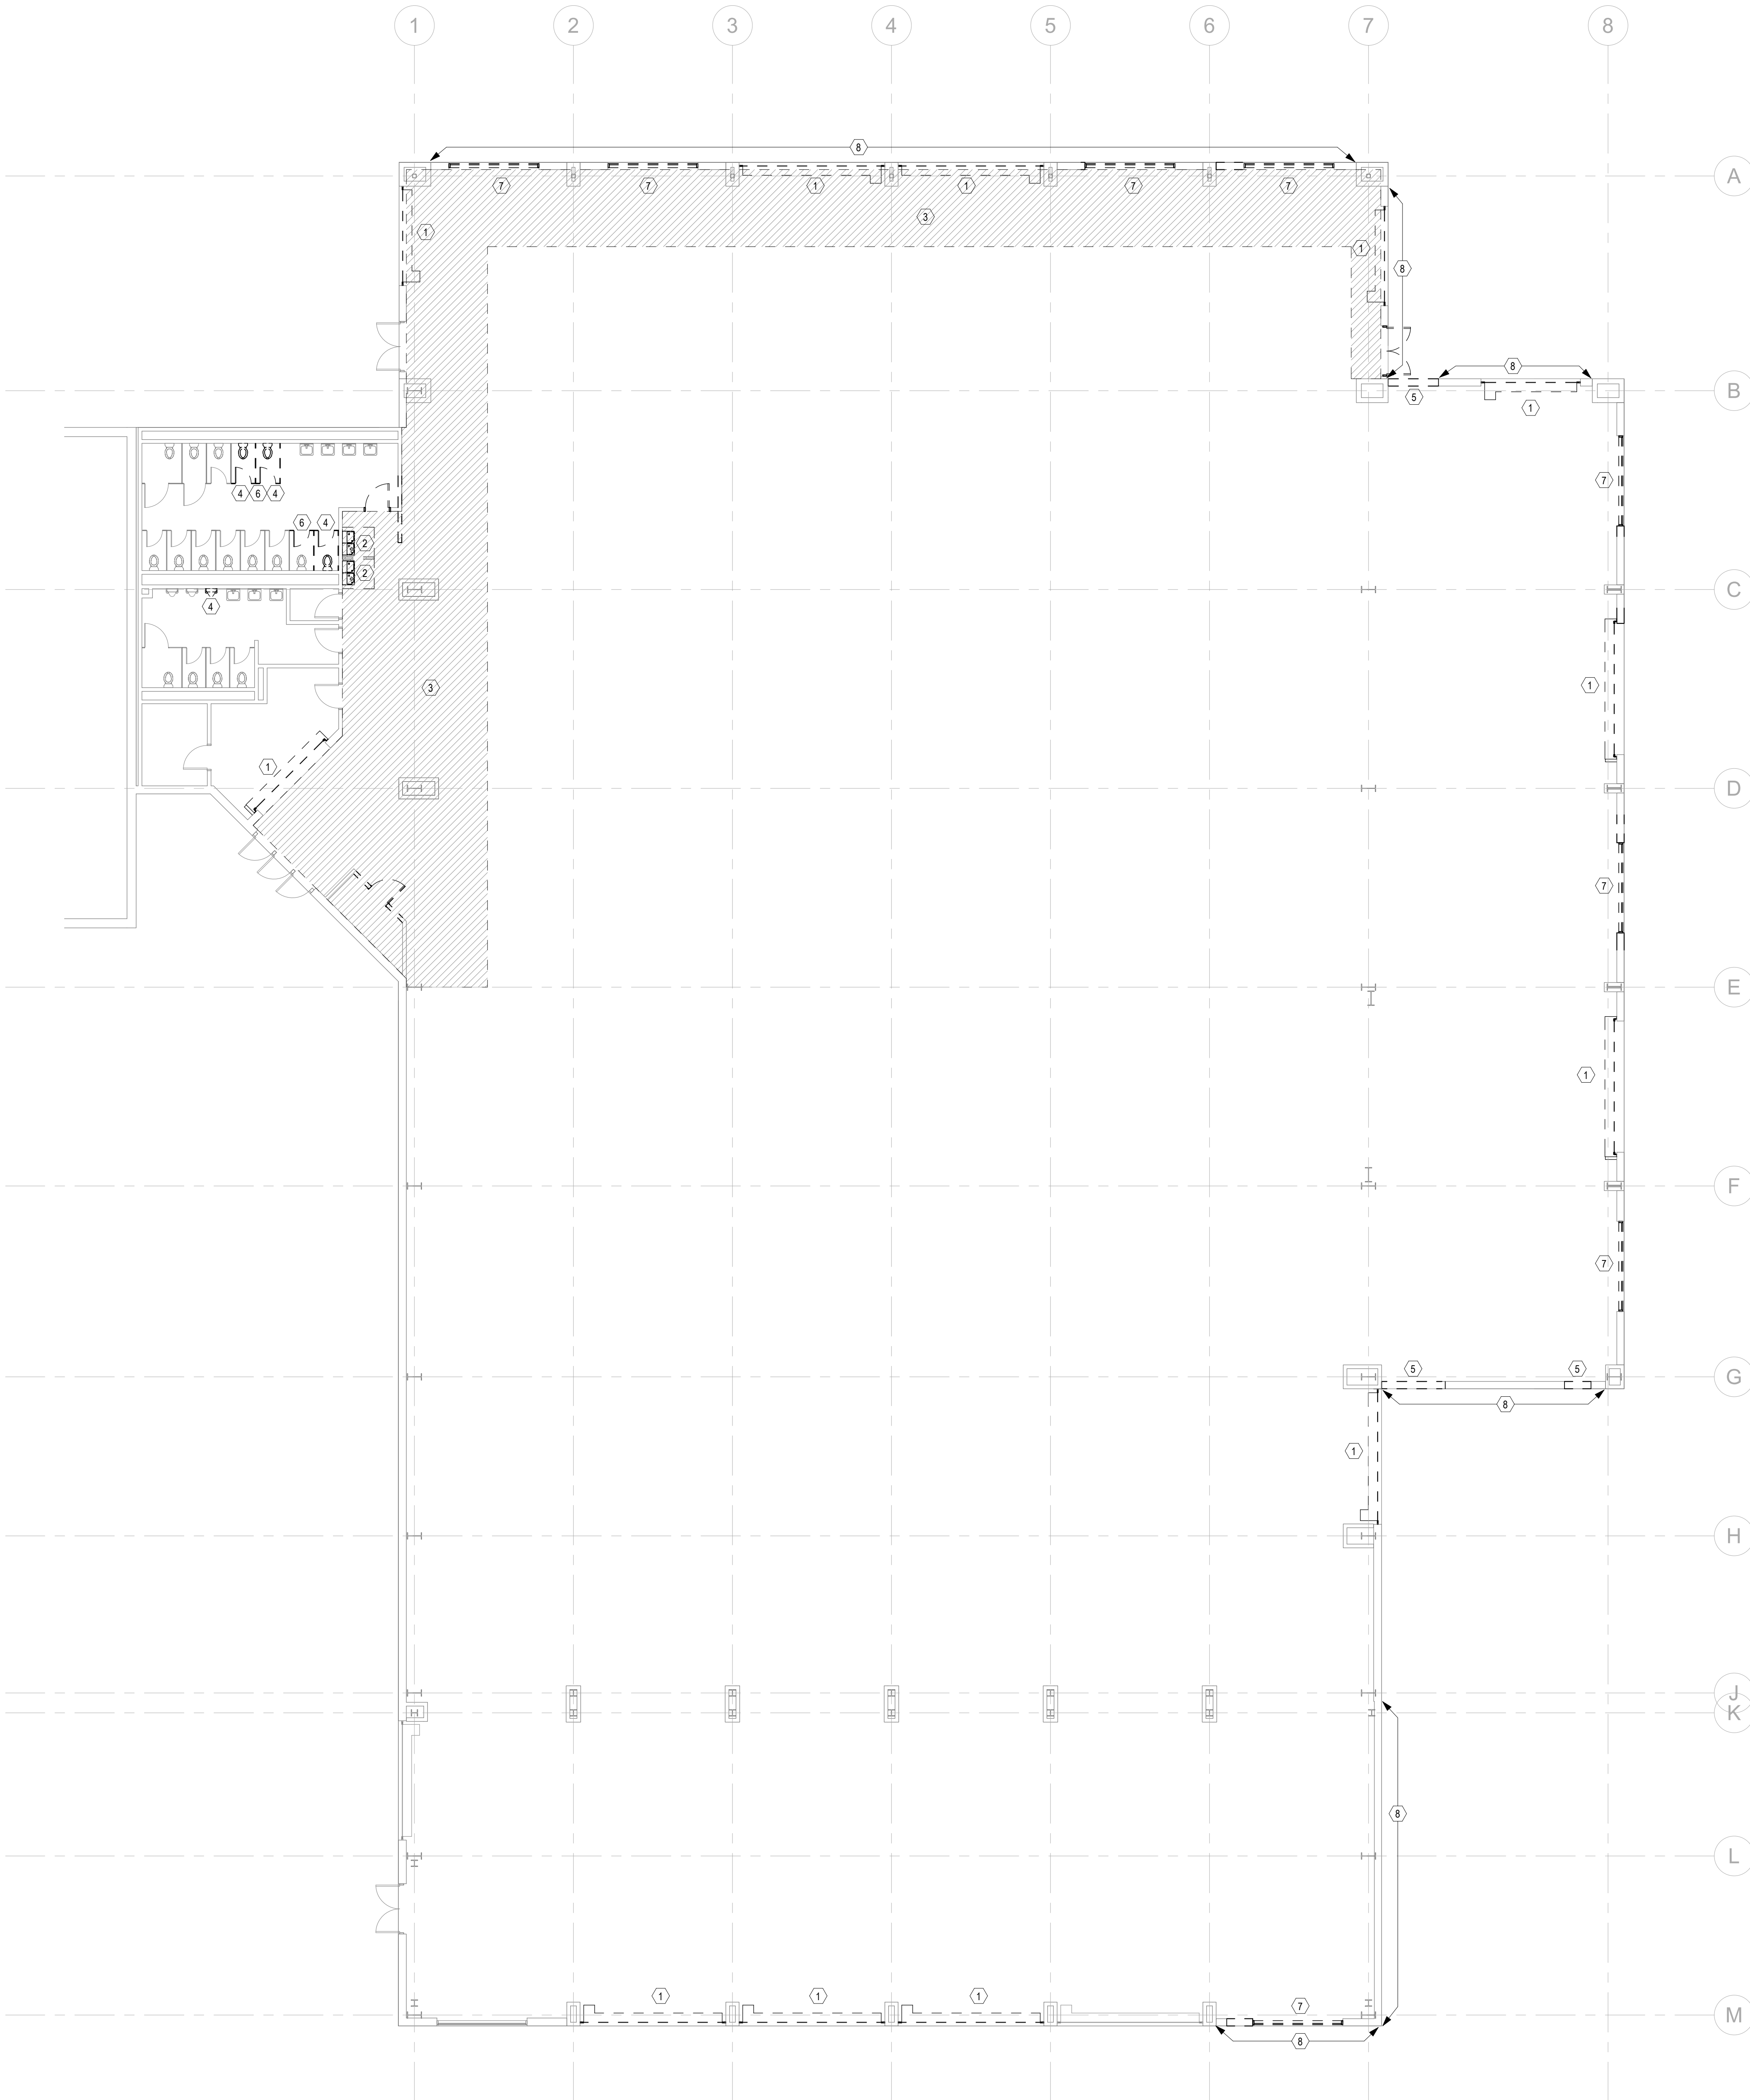
DEMOLISH WALL, CLEAN/ PREP/ FINISH REMAINING SURFACES TO MATCH ADJACENT CONDITIONS

EXISTING CONCRETE WALKS TO BE DEMOLISHED

NO WORK DONE IN THIS AREA

#### LEGEND - FLOOR PLAN - DEMO

1/4" = 1'-0"



#### 1 DEMO PLAN

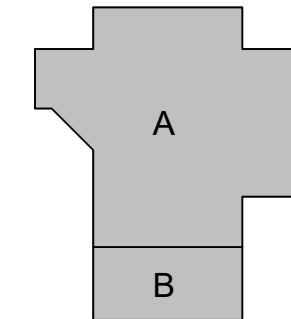
1/4" = 1'-0"

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# TOMBALL HIGH SCHOOL CTE & MISC. RENOVATIONS

TOMBALL INDEPENDENT SCHOOL DISTRICT  
30330 QUINN ROAD, TOMBALL, TX 77375




#### TEXAS ARCADIS INC.

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2023-11-06
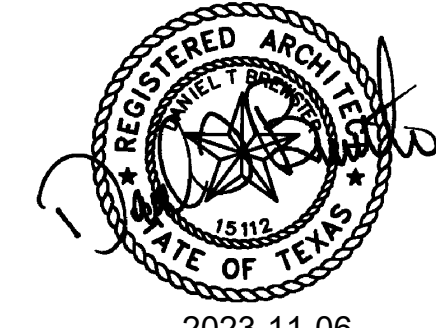
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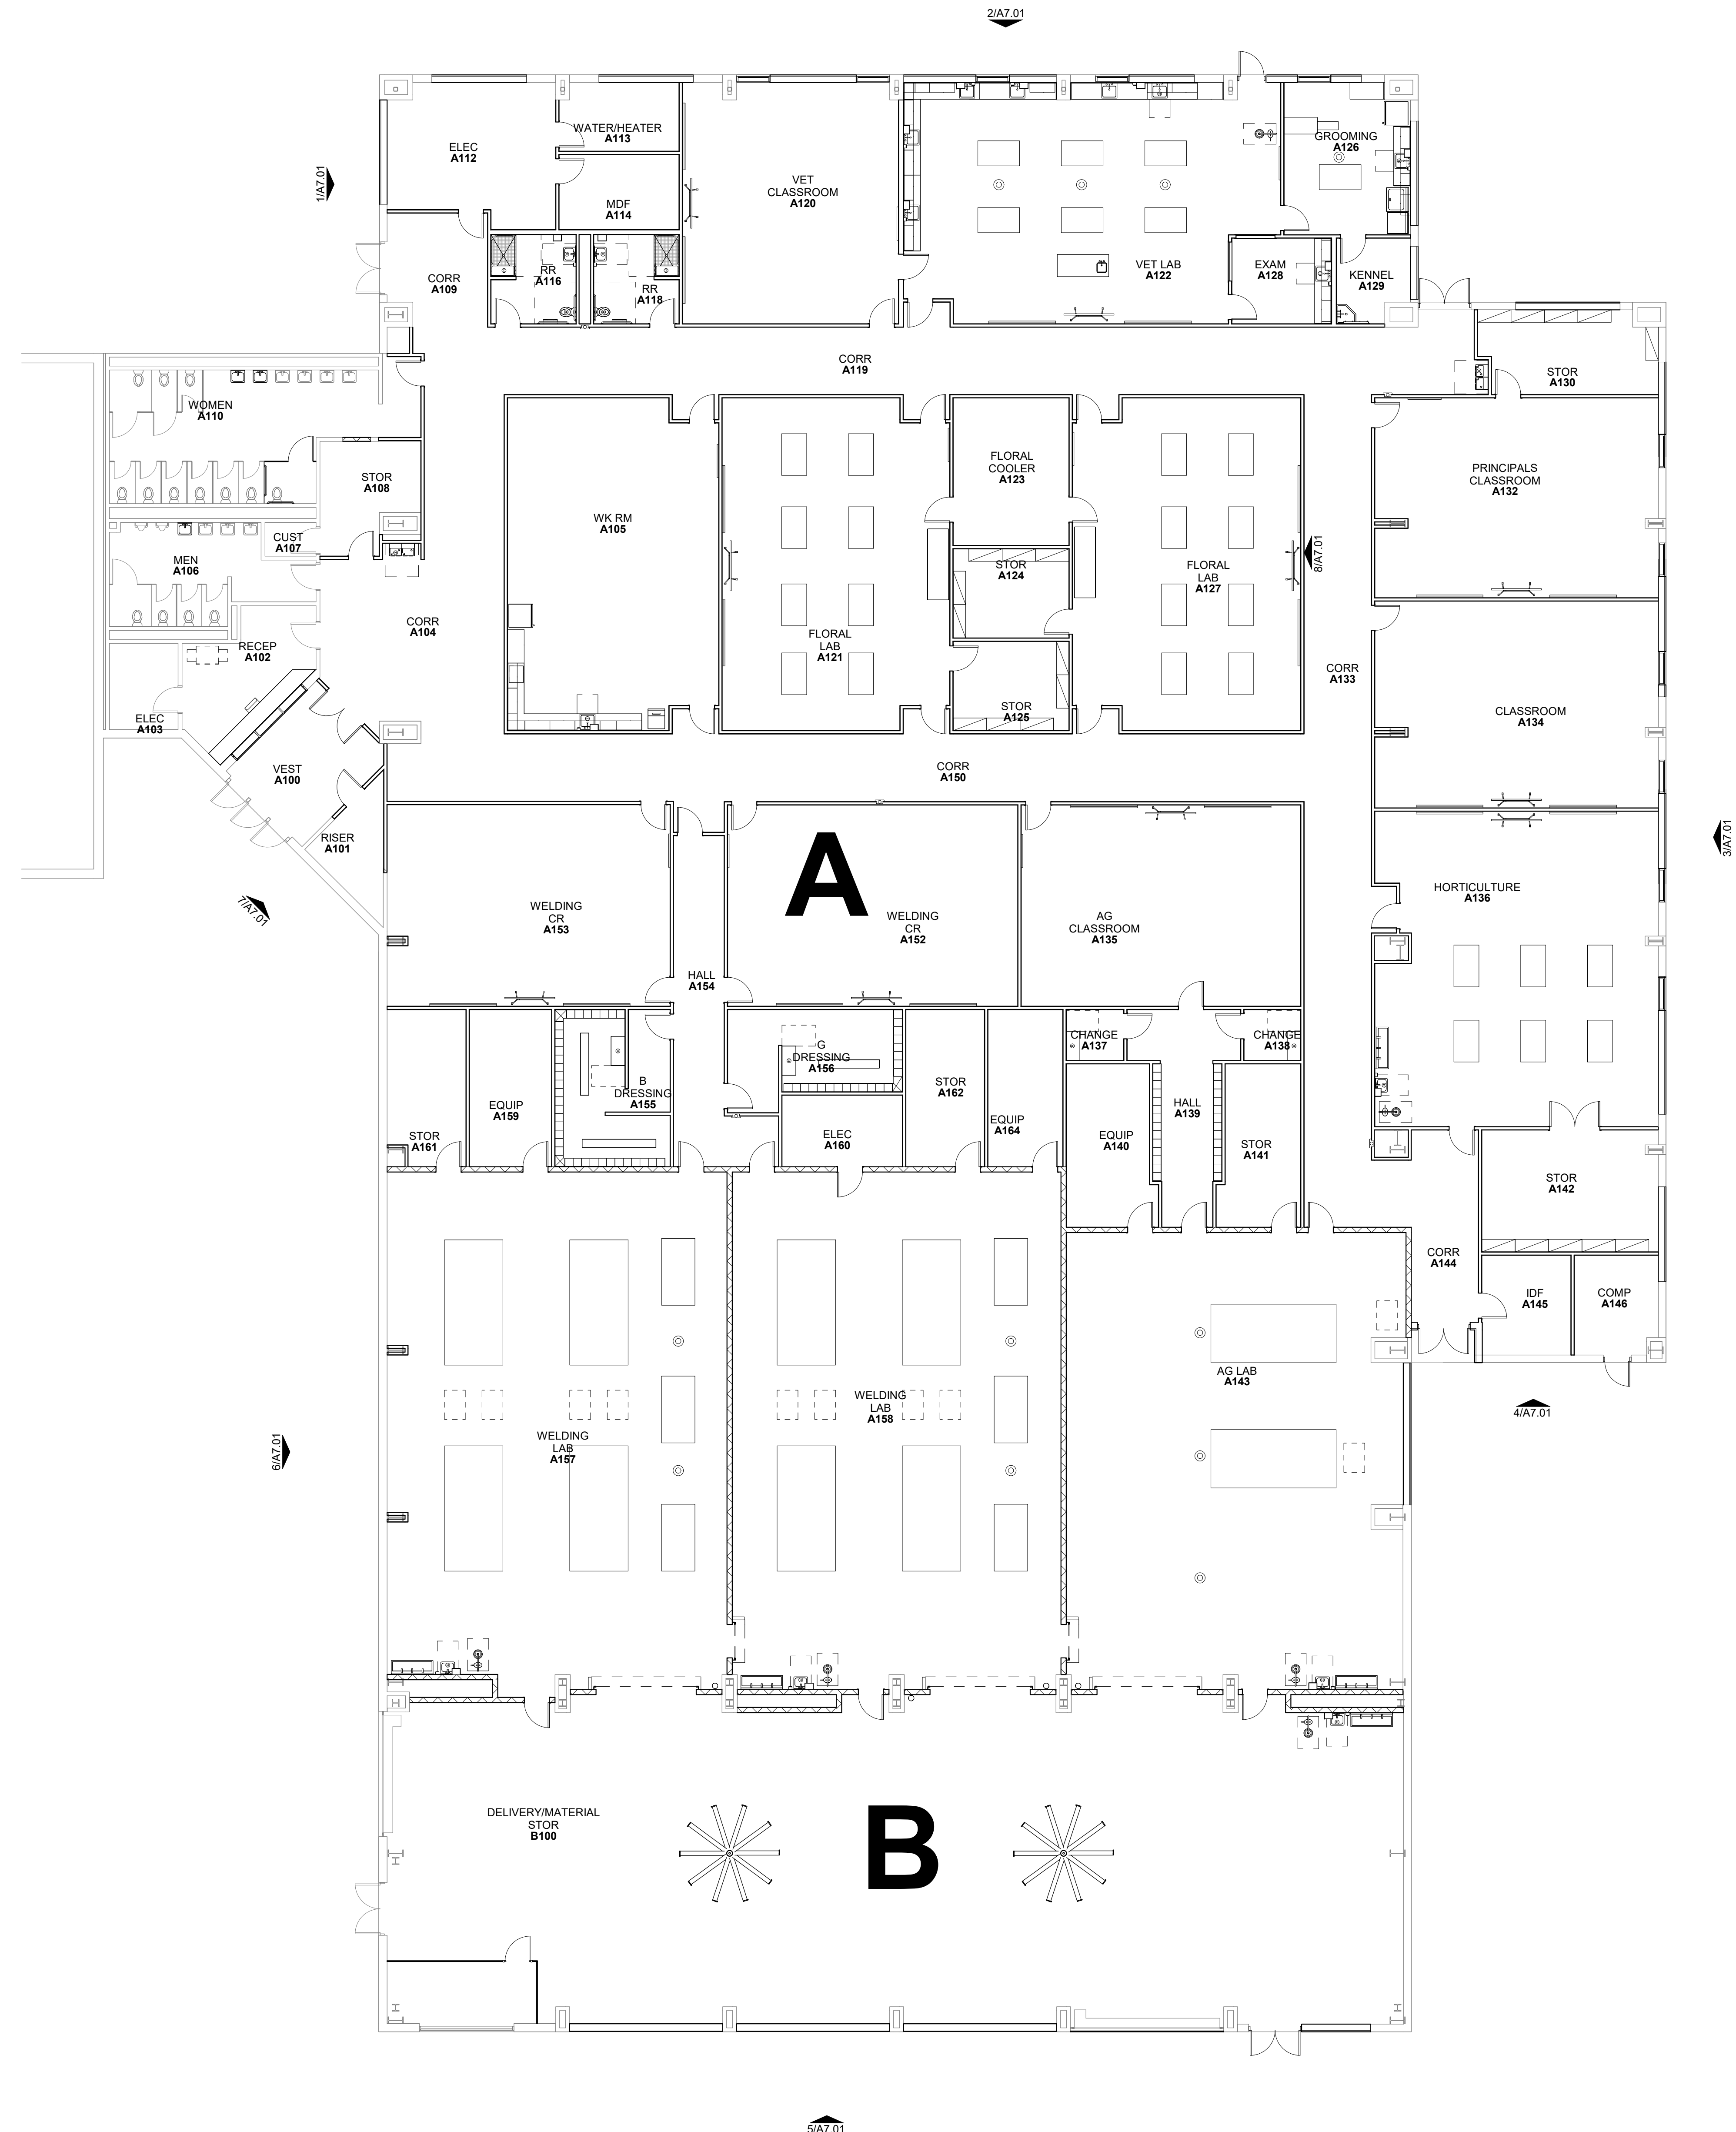
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DEMO PLAN








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**A1.01**  
1ST FLOOR  
COMPOSITE  
PLAN





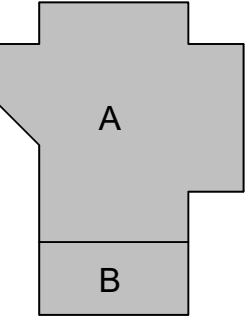- RE: G1 SERIES SHEETS FOR ACCESSIBLE MOUNTING HEIGHTS
- RE: A6 SERIES SHEETS FOR PARTITION TYPES
- RE: A6 SERIES SHEETS FOR DOOR & FRAME ELEVATIONS
- RE: A11 SERIES SHEETS COLOR SELECTIONS IN FINISH LEGEND
- ALL INTERIOR STUD PARTITIONS ARE TYPE B11, UNLESS OTHERWISE NOTED
- ALL MTL. STUD COLUMN/FURROUTS ARE TO BE 10" OFF COLUMN CENTER LINE & ALL CMU COLUMN FURROUTS ARE TO BE 1'-0" OFF COLUMN CENTER LINE, UNLESS NOTED OTHERWISE
- MASONRY DIMENSIONS ARE NOMINAL
- ALL DIMENSIONS ARE TO FACE OF STUD @ INTERIOR PARTITIONS UNLESS OTHERWISE NOTED
- ALL DIMENSIONS ARE TO FINISH FACE OF EXTERIOR WALLS, FOUNDATION, MASONRY, OR TO CENTER LINE OF COLUMN, UNLESS NOTED OTHERWISE
- ALL WALL FINISH GOES TO DECK IN ROOMS WITHOUT CEILING
- ALL EXTERIOR WALLS EXTEND TO BOTTOM OF ROOF DECK
- PROVIDE EXPANSION JOINT COVERS ON INTERIOR WALLS @ BUILDING EXPANSION JOINTS
- ALL SPACES W/ FLOOR DRAINS SHALL HAVE FINISHED FLOOR SLOPE TO DRAIN. VERIFY W/ ARCH. IN FIELD
- ALL EQUIP. PADS SHALL BE AS PER STRUC. DWGS. COORDINATE SIZES, THICKNESS & LOCATIONS W/ MECH. CHAMBER EDGES
- ALL EXTERIOR DOORS SHALL RECEIVE A THRESHOLD. THRESHOLD TO BE OF SUFFICIENT WIDTH TO COVER SIDEWALK TO FOUNDATION EXPANSION JOINT TO MAINTAIN ONLY 1/2" RISE & STAY ADA COMPLIANT
- PROVIDE TRANSITION STRIPS @ ALL FLOOR FINISH TRANSITIONS PER SPECS., UNLESS NOTED OTHERWISE
- ALL FLOOR MATERIAL CHANGES SHALL OCCUR @ CENTERLINE OF DOOR, UNLESS NOTED OTHERWISE
- F.E.C. DENOTES FIRE EXTINGUISHER & CABINET
- DASHED EQUIPMENT/FURNITURE IS NOT IN CONTRACT (N.I.C.)
- PROVIDE HORIZONTAL BLINDS @ ALL EXTERIOR WINDOWS, EXCEPT WINDOWS ADJACENT TO EXIT/ ENTRY DOORS. PROVIDE HORIZONTAL BLINDS @ ALL INTERIOR WINDOW LOCATIONS
- PROVIDE SOAP (TA-1) & PAPER TOWEL (TA-3) DISPENSERS PER SPECS @ ALL SINK LOCATIONS

## NOTES - GENERAL FLOOR PLAN

1/4" = 1'-0"

- MILQ ELECTRONIC DRINKING FOUNTAIN, RE: MEP
- SOAP DISPENSER, (N.I.C.)
- PAPER TOWEL DISPENSER, (N.I.C.)
- FLOWER DISPLAY
- DRYER, RE: SPECS
- WASHER, RE: SPECS
- REFRIGERATOR
- ICE MACHINE
- DISHWASHER
- MICROWAVE, (N.I.C.)
- 20"X42" ACCESSIBLE BENCH
- COPYER/PRINTER, (N.I.C.)
- VENDING, (N.I.C.)
- STAINLESS STEEL TABLES
- CURTAIN TRACK (ABOVE)
- EMERGENCY EYE WASH / SHOWER, RE: PLUMB.
- PEG BOARD DRYING RACK
- (3) DOUBLE WELDING BOOTHS
- PET WASH W/ RAMP
- CORD REEL
- LOCKERS, RE: 2 / A2.01
- WOOD BENCH, RE: 4 / A2.01

## KEYNOTES - FLOOR PLAN

1/4" = 1'-0"

1 1/2" HDPE BENCH W/ EASED EDGES, SECURE W/ S.S. VANDAL PROOF COUNTERSUNK FASTENERS @ 16" O.C.  
CONT. BACKER ROD & SEALANT  
TREATED SHIM ON TREATED 2X4 WOOD BLOCKING  
FULLY GROUTED 8" CMU W/ #4 BARS @ 48"  
EPOXY 3" INTO SLAB PAINT EXP. SURFACE  
RE: WALL SECTION FOR STARTER COURSE  
SCHED. BASE, TYP.

## 4 LCKR - BENCH HDPE-CMU

1" = 1'-0"

RE: PLAN FOR PARTITION TYPE  
WING WALL BEYOND  
SUPPORT ANGLE PER MANUFR., FASTEN TO WALL W/ 1/4" EXP. BOLT @ 24" O.C.  
20 GA. SLOPED PRE-FIN. MTL. TOP  
SUPPORT ANGLE PER MANUFR.  
CONT. TREATED 1X4  
LOCKER, RE: SPECS

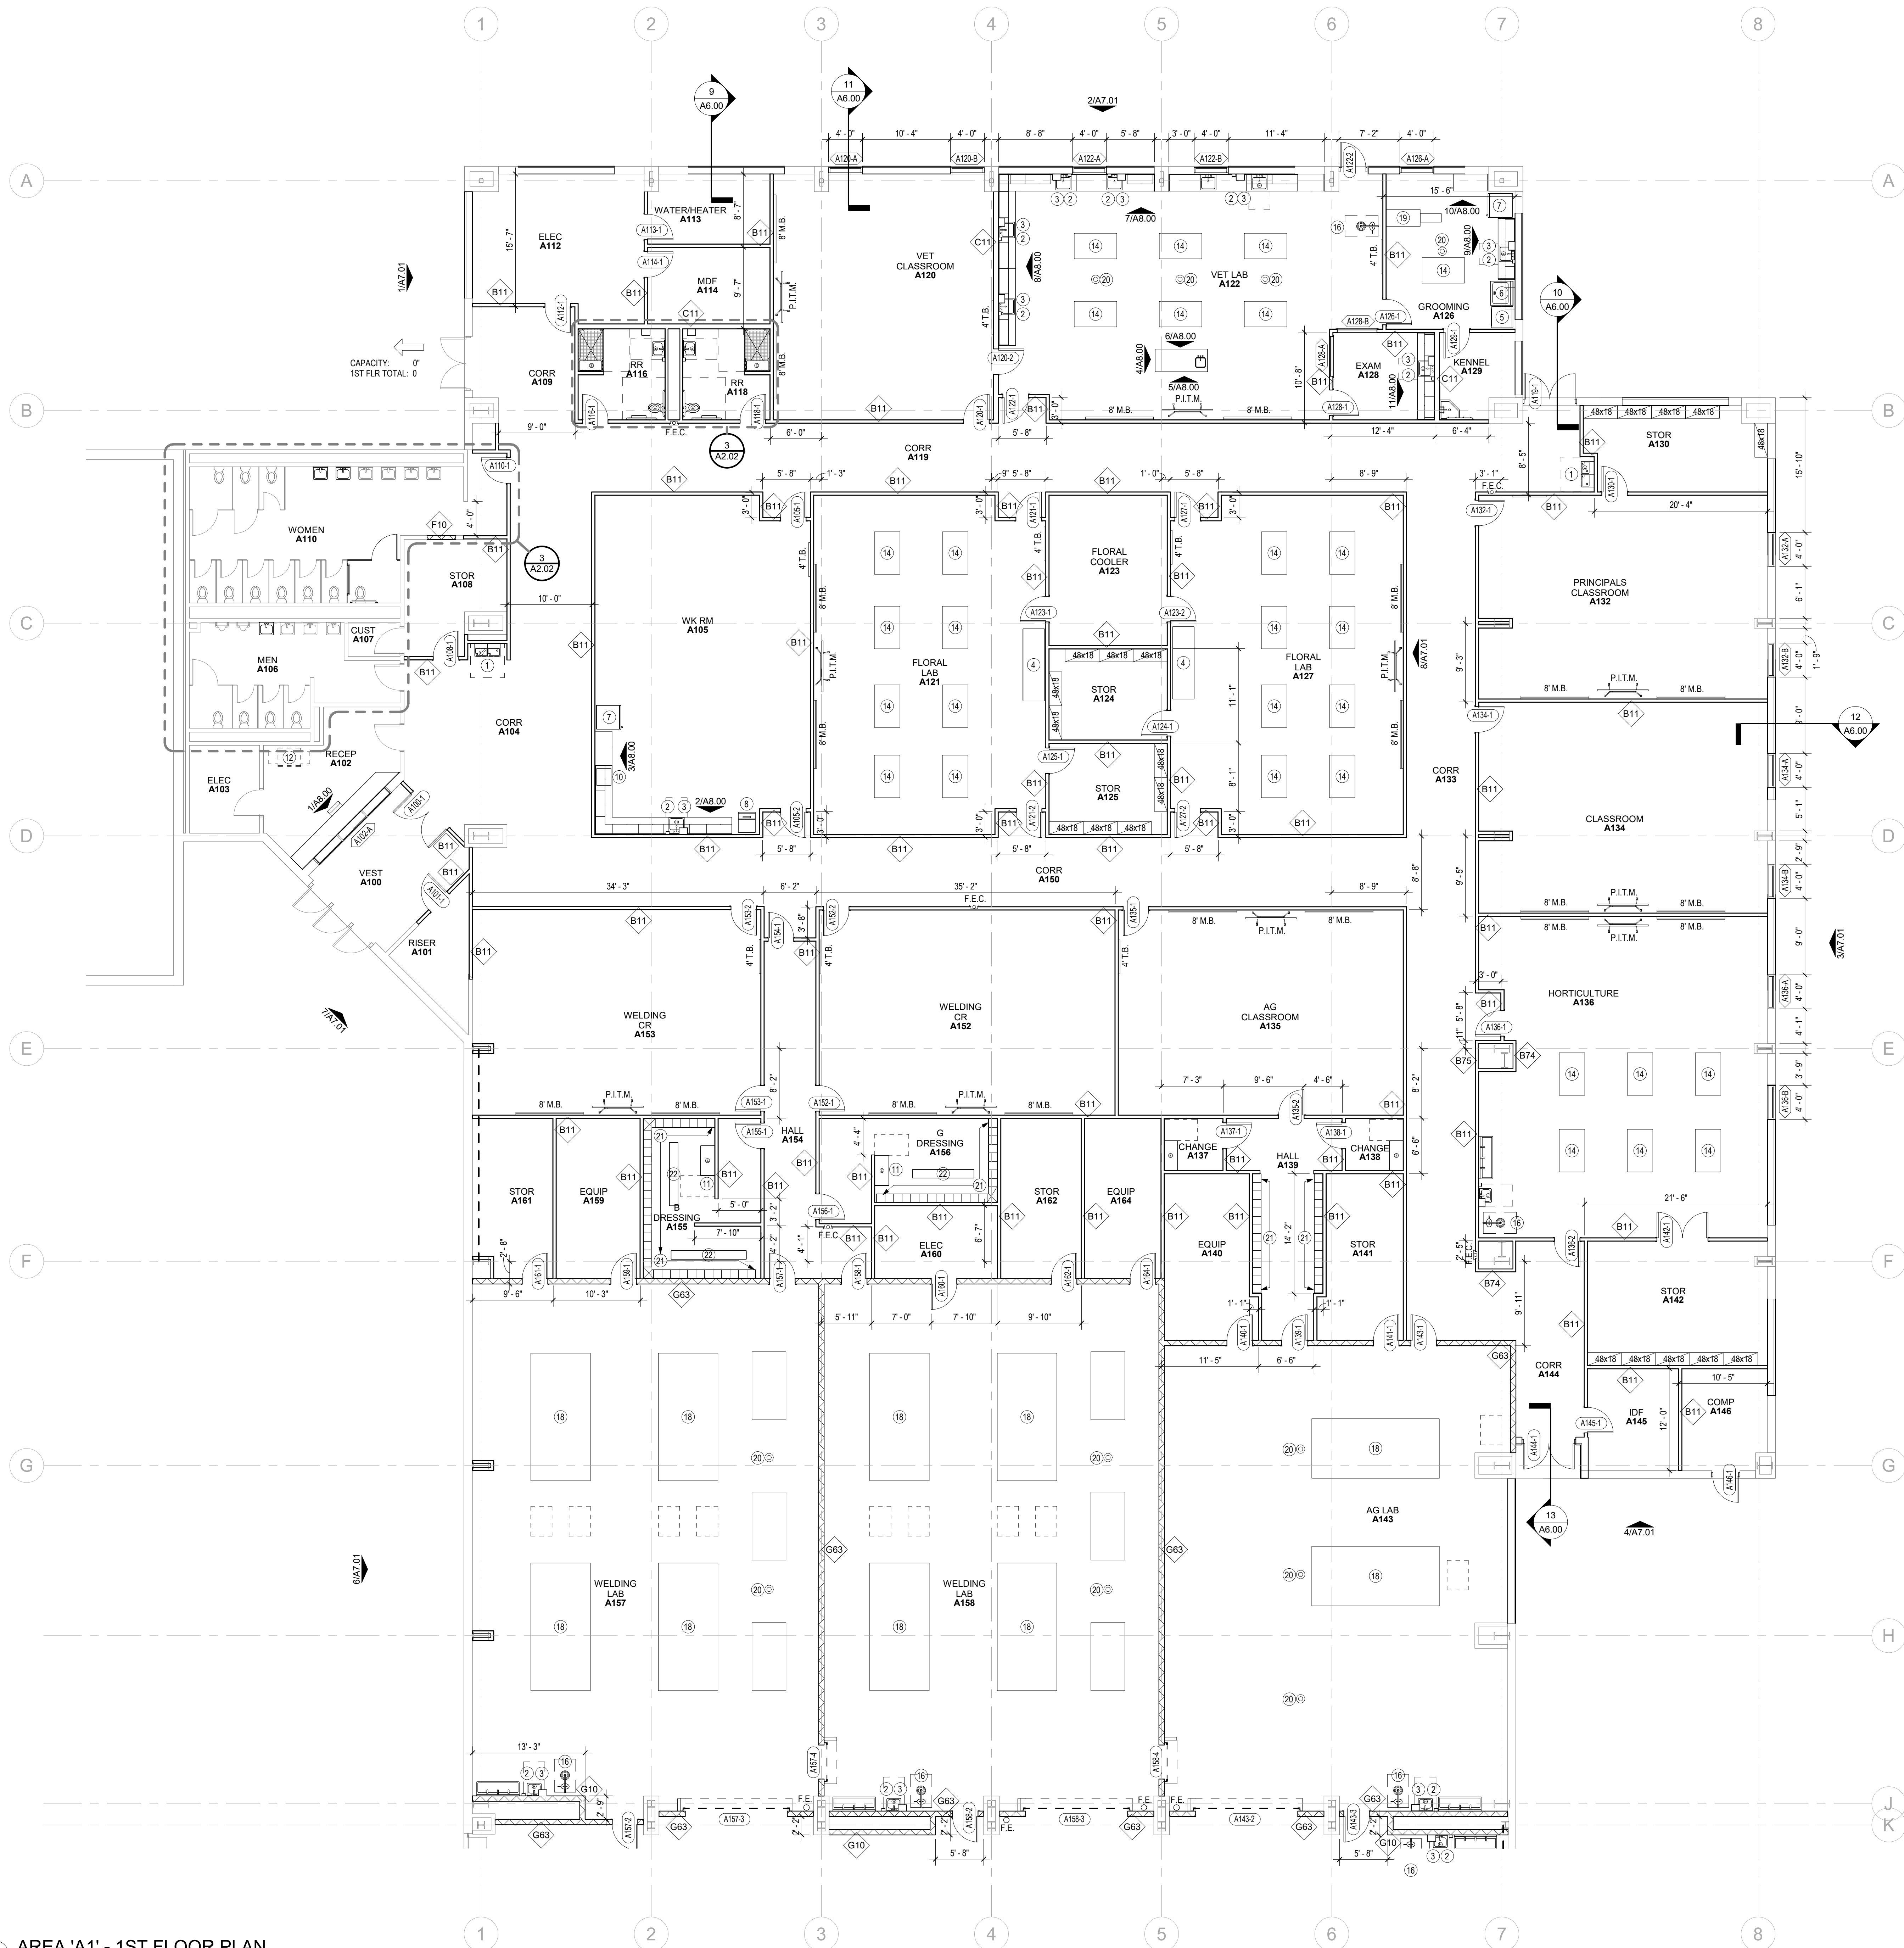
## 3 LCKR - HEAD @ PARTITION

1" = 1'-0"

TYPE	E
SIZE	12'W x 12'D 2-TIER 72" HIGH
BASE/TOP	4" CONC. BASE & SLOPED TOP

## 2 LCKR - TYPES

1/4" = 1'-0"



## 1 AREA 'A1' - 1ST FLOOR PLAN

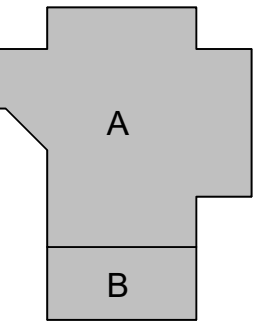
1/8" = 1'-0"

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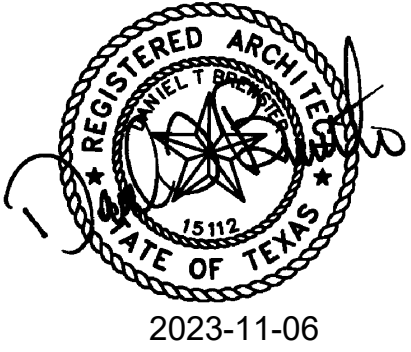
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DRAWN: Author  
CHECKED: Checker

DATE: 2023-11-06  
ISSUE: BID SET

# A2.01

AREA 'A1' 1ST  
FLOOR PLAN



AREA 'B1' - DOOR SCHEDULE													
MARK	DOOR SLAB					DOOR FRAME					FIRE R.	COMMENTS	MARK
	WIDTH	HEIGHT	S/ PR	ELEV.	MATERIAL	GLASS	WIDTH	DEPTH	ELEV.	MATERIAL			
B100-1	3'-0"	7'-0"	PR	BB	H.M.		2"	6"	1.4E	H.M.			B100-1

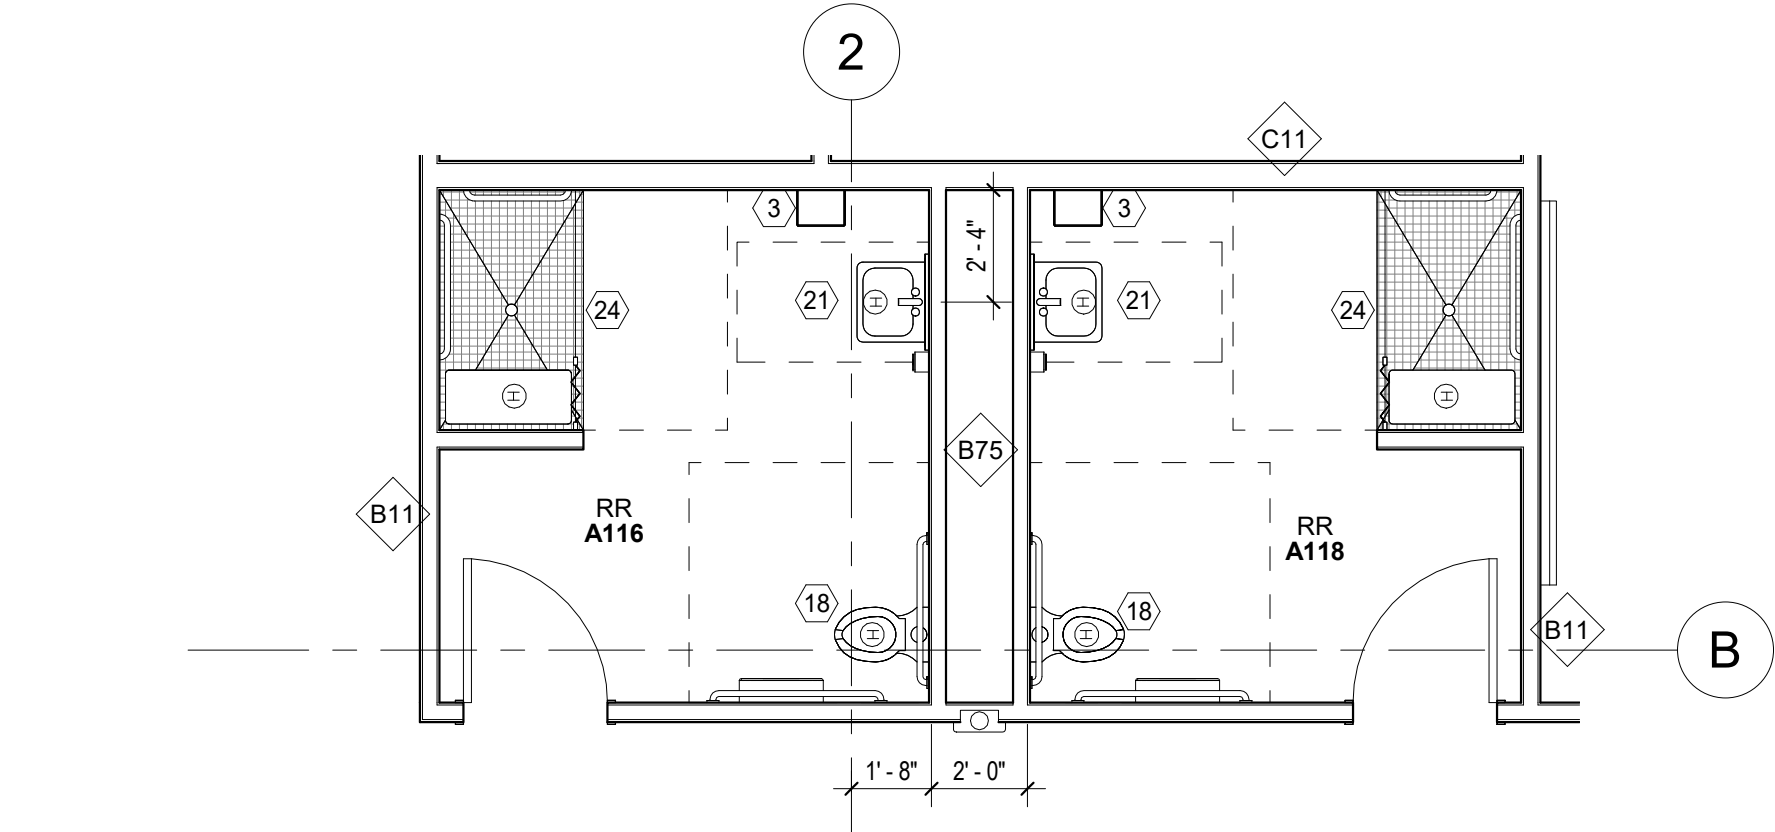
AREA 'B1' - ROOM FINISH SCHEDULE							
ROOM #	ROOM NAME	FLOOR FINISHES		WALL FINISH(S) COORD. W/ A7 & A11	CEILING FINISH(S) COORD. W/A10	COMMENTS	ROOM #
		FLOOR	BASE				
B100	DELIVERY/MATERIAL STOR	SC-1	RB-1	PTW-1	ACT-1		B100

AREA 'B1' - WINDOW SCHEDULE				
MARK	WIDTH	DEPTH	ELEV.	MATERIAL
MARK	WIDTH	DEPTH	ELEV.	MATERIAL

MARK	DESCRIPTION	SPEC REF.	TYP. TLT. ROOM LAYOUTS
(1)	SOAP DISPENSER	TA-1	
(2)	MIRROR	TA-2	
(3)	PAPER TOWEL DISPENSER	TA-3	
(4)	RECESSED WASTE RECEPTACLE	TA-4	
(5)	TOILET TISSUE DISPENSER	TA-5	
(6)	GRAB BARS	TA-6	
(7)	MOP & BROOM HOLDER	TA-7	
(8)	CLOTHES/ TOWEL HOOKS	TA-8	
(9)	FEMININE NAPKIN DISPENSER	TA-9	
(10)	FEMININE NAPKIN DISPOSAL	TA-10	
(11)	SHOWER GRAB BARS	TA-11	
(12)	FOLDING BENCH - SHOWER COMPARTMENTS	TA-12	
(13)	SHOWER CURTAINS & RODS	TA-13	
(14)	ELECTRIC HAIR DRYERS	TA-14	
(15)	ELECTRIC HAND DRYERS	TA-15	
(16)	BABY CHANGING STATION	TA-16	
(17)	SHOWER WATER RETAINER	TA-17	
(18)	ACCESSIBLE TOILET STALL	TA-18	
(19)	AMBULATORY TOILET STALL	TA-19	
(20)	STANDARD TOILET STALL	TA-20	
(21)	ACCESSIBLE SINK	TA-21	
(22)	STANDARD SINK	TA-22	
(23)	TRANSFER TYPE SHOWER COMPARTMENTS	TA-23	
(24)	ROLL-IN SHOWER COMPARTMENTS	TA-24	
(25)	MARBLE THRESHOLD		


#### LEGEND - TOILET ACCESSORIES

1/4" = 1'-0"



3 A101 - RESTROOM

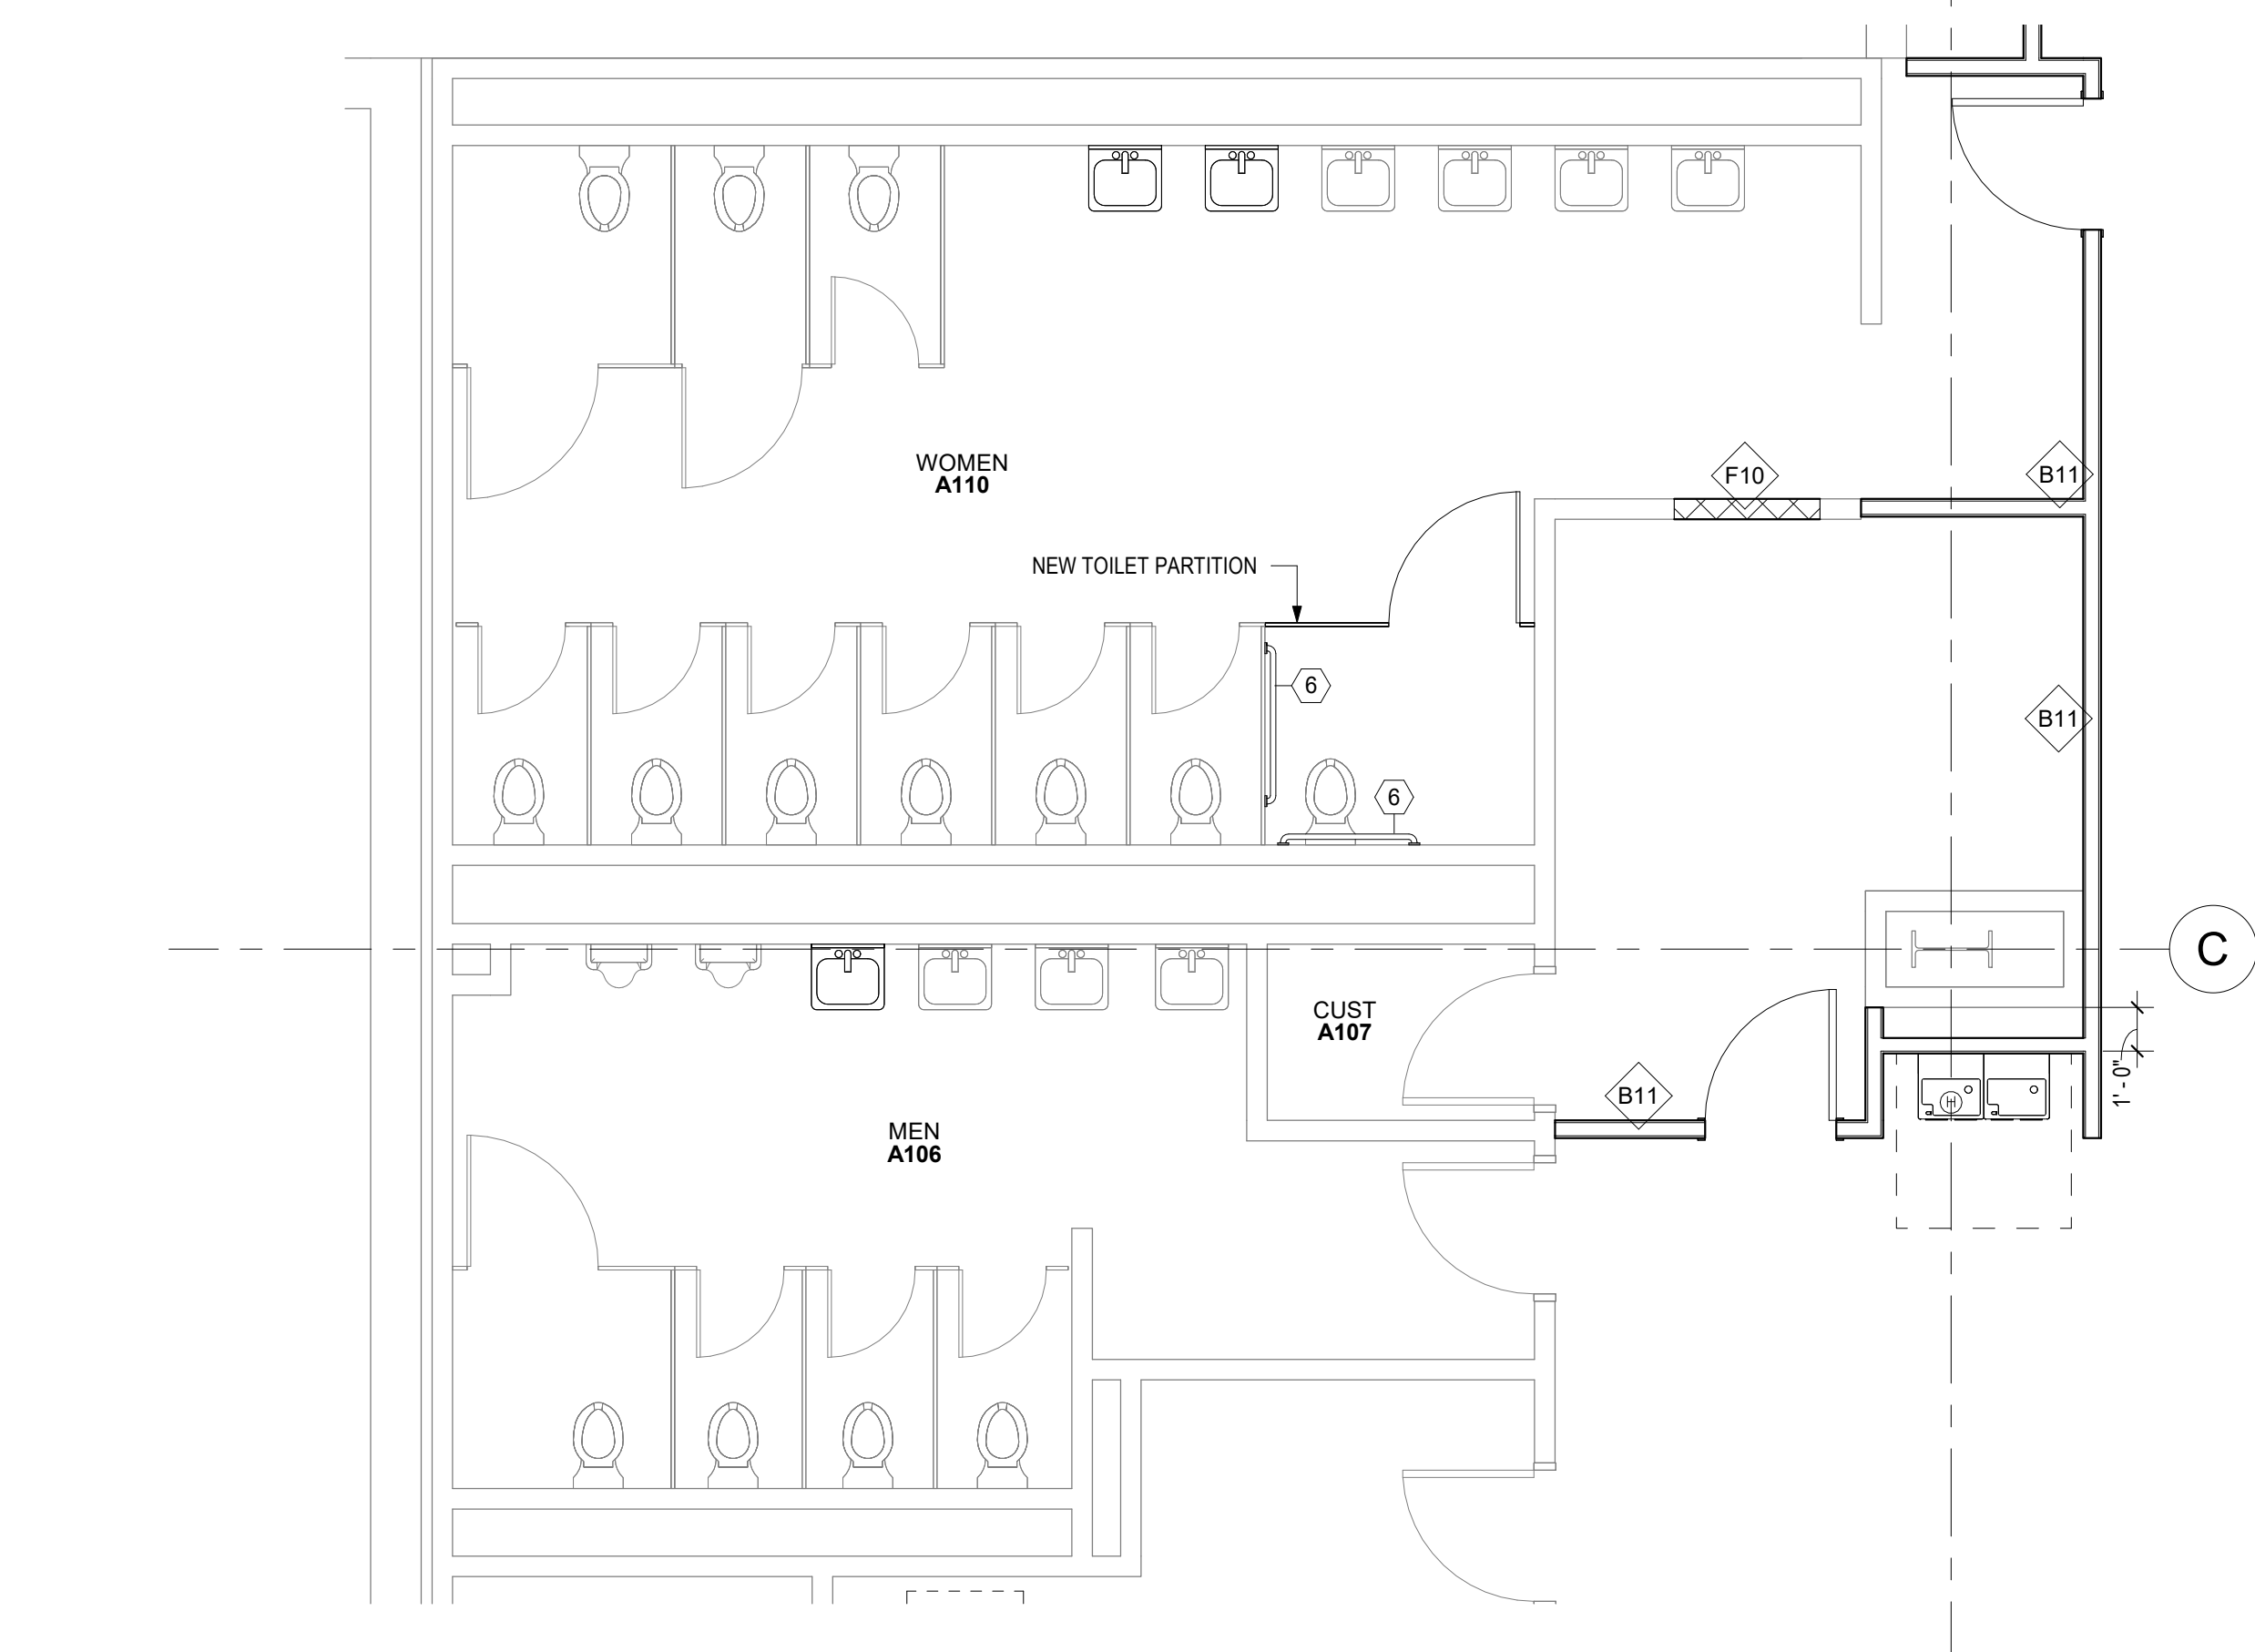1/4" = 1'-0"



2 A100 - RESTROOM

1/4" = 1'-0"

AREA 'A1' - DOOR SCHEDULE													
MARK	DOOR SLAB					DOOR FRAME					FIRE R.	COMMENTS	MARK
	WIDTH	HEIGHT	S/ PR	ELEV.	MATERIAL	GLASS	WIDTH	DEPTH	ELEV.	MATERIAL			
A100-1	3'-0"	7'-0"	PR	BB	SC.P.L.	-	2"	6"	1	H.M.	-	-	A100-1
A101-1	3'-0"	7'-0"	S	B	SC.P.L.	-	2"	6"	1	H.M.	-	-	A101-1
A105-1	3'-0"	7'-0"	S	C	SC.P.L.	G2	2"	6"	1	H.M.	-	-	A105-1
A105-2	3'-0"	7'-0"	S	C	SC.P.L.	G2	2"	6"	1	H.M.	-	-	A105-2
A108-1	3'-0"	7'-0"	S	B	SC.P.L.	-	2"	6"	1	H.M.	-	-	A108-1
A110-1	3'-0"	7'-0"	S	B	SC.P.L.	-	2"	6"	1	H.M.	-	-	A110-1
A112-1	3'-0"	7'-0"	S	B	SC.P.L.	-	2"	6"	1	H.M.	-	-	A112-1
A113-1	3'-0"	7'-0"	S	B	SC.P.L.	-	2"	6"	1	H.M.	-	-	A113-1
A114-1	3'-0"	7'-0"	S	B	SC.P.L.	-	2"	6"	1	H.M.	-	-	A114-1
A116-1	3'-0"	7'-0"	S	B	SC.P.L.	-	2"	6"	1	H.M.	-	-	A116-1
A118-1	3'-0"	7'-0"	S	B	SC.P.L.	-	2"	6"	1	H.M.	-	-	A118-1
A119-1	3'-0"	7'-0"	PR	BB	H.M.	-	2"	6"	1.4E	H.M.	-	-	A119-1
A120-1	3'-0"	7'-0"	S	C	SC.P.L.	G2	2"	6"	1	H.M.	-	-	A120-1
A120-2	3'-0"	7'-0"	S	C	SC.P.L.	G2	2"	8 3/8"	1	H.M.	-	-	A120-2
A121-1	3'-0"	7'-0"	S	C	SC.P.L.	G2	2"	6"	1	H.M.	-	-	A121-1
A121-2	3'-0"	7'-0"	S	C	SC.P.L.	G2	2"	6"	1	H.M.	-	-	A121-2
A122-1	3'-0"	7'-0"	S	C	SC.P.L.	G2	2"	6"	1	H.M.	-	-	A122-1
A122-2	3'-0"	7'-0"	S	B	H.M.	-	2"	6"	1.4E	H.M.	-	-	A122-2
A122-5	3'-0"	6'-0"	S	C1	CL MESH	-	-	-	-	GALV.	-	EGRESS GATE	A122-5
A123-1	3'-0"	7'-0"	S	C	SC.P.L.	G2	2"	6"	1	H.M.	-	-	A123-1
A123-2	3'-0"	7'-0"	S	C	SC.P.L.	G2	2"	6"	1	H.M.	-	-	A123-2
A124-1	3'-0"	7'-0"	S	C	SC.P.L.	G2	2"	6"	1	H.M.	-	-	A124-1
A125-1	3'-0"	7'-0"	S	C	SC.P.L.	G2	2"	6"	1	H.M.	-	-	A125-1
A126-1	3'-0"	7'-0"	S	C	SC.P.L.	G2	2"	6"	1	H.M.	-	-	A126-1
A127-1	3'-0"	7'-0"	S	C	SC.P.L.	G2	2"	6"	1	H.M.	-	-	A127-1
A127-2	3'-0"	7'-0"	S	C	SC.P.L.	G2	2"	6"	1	H.M.	-	-	A127-2
A128-1	3'-0"	7'-0"	S	D	SC.P.L.	G2	2"	6"	1	H.M.	-	-	A128-1
A129-1	3'-0"	7'-0"	S	C	SC.P.L.	G2	2"	6"	1	H.M.	-	-	A129-1
A130-1	3'-0"	7'-0"	S	C	SC.P.L.	G2	2"	6"	1	H.M.	-	-	A130-1
A132-1	3'-0"	7'-0"	S	C	SC.P.L.	G2	2"	6"	1	H.M.	-	-	A132-1
A134-1	3'-0"	7'-0"	S	C	SC.P.L.	G2	2"	6"	1	H.M.	-	-	A134-1
A135-1	3'-0"	7'-0"	S	C	SC.P.L.	G2	2"	6"	1	H.M.	-	-	A135-1
A135-2	3'-0"	7'-0"	S	C	SC.P.L.	G2	2"	6"	1	H.M.	-	-	A135-2
A136-1	3'-0"	7'-0"	S	C	SC.P.L.	G2	2"	6"	1	H.M.	-	-	A136-1
A136-2	3'-0"	7'-0"	S	C	SC.P.L.	G2	2"	6"	1	H.M.	-	-	A136-2
A137-1	3'-0"	7'-0"	S	B	SC.P.L.	-	2"	6"	1	H.M.	-	-	A137-1
A138-1	3'-0"	7'-0"	S	B	SC.P.L.	-	2"	6"	1	H.M.	-	-	A138-1
A139-1	3'-0"	7'-0"	S	C	SC.P.L.	G2	2"	8 3/4"	1	H.M.	-	-	A139-1
A140-1	3'-0"	7'-0"	S	C	SC.P.L.	G2	2"	8 3/4"	1	H.M.	-	-	A140-1
A141-1	3'-0"	7'-0"	S	C	SC.P.L.	G2	2"	8 3/4"	1	H.M.	-	-	A141-1
A142-1	3'-0"	7'-0"	PR	CC	SC.P.L.	G2	2"	6"	1	H.M.	-	-	A142-1
A143-1	3'-0"	7'-0"	S	C	SC.P.L.	G2	2"	8 3/4"	1	H.M.	-	-	A143-1
A143-2	12'-0"	12'-0"	-	Q	GRILLE MESH	-	-	-	-	GALV.	-	MANUAL COILING GRILLE	A143-2
A143-3	3'-0"	7'-0"	S	C	SC.P.L.	G2	2"	8 3/4"	1	H.M.	-	-	A143-3
A144-1	3'-0"	7'-0"	PR	BB	H.M.	-	2"	6"	1.4E	H.M.	-	-	A144-1
A145-1	3'-0"	7'-0"	S	B	SC.P.L.	-	2"	6"	1	H.M.	-	-	A145-1
A146-1	3'-0"	7'-0"	S	B	H.M.	-	2"	6"	1.4E	H.M.	-	-	A146-1
A152-1	3'-0"	7'-0"	S	C	SC.P.L.	G2	2"	6"	1	H.M.	-	-	A152-1
A152-2	3'-0"	7'-0"	S	C	SC.P.L.	G2	2"	6"	1	H.M.	-	-	A152-2
A153-1	3'-0"	7'-0"	S	C	SC.P.L.	G2	2"	6"	1	H.M.	-	-	A153-1
A153-2	3'-0"	7'-0"	S	C	SC.P.L.	G2	2"	6"	1	H.M.	-	-	A153-2
A154-1	3'-0"	7'-0"	S	C	SC.P.L.	G2	2"	6"	1	H.M.	-	-	A154-1
A155-1	3'-0"	7'-0"	S	B	SC.P.L.	-	2"	6"	1	H.M.	-	-	A155-1
A156-1	3'-0"	7'-0"	S	B	SC.P.L.	-	2"	6"	1	H.M.	-	-	A156-1
A157-1	3'-0"	7'-0"	S	C	SC.P.L.	G2	2"	8 3/4"	1	H.M.	-	-	A157-1
A157-2	3'-0"	7'-0"	S	C	SC.P.L.	G2	2"	8 3/4"	1	H.M.	-	-	A157-2
A157-3	12'-0"	12'-0"	-	Q	GRILLE MESH	-	-	-	-	GALV.	-	MANUAL COILING GRILLE	A157-3
A157-4	4'-0"	12'-0"	-	Q	GRILLE MESH	-	-	-	-	GALV.	-	MANUAL COILING GRILLE	A157-4
A158-1	3'-0"	7'-0"	S	C	SC.P.L.	G2	2"	8 3/4"	1	H.M.	-	-	A158-1
A158-2	3'-0"	7'-0"	S	C	SC.P.L.	G2	2"	8 3/4"	1	H.M.	-	-	A158-2
A158-3	12'-0"	12'-0"	-	Q	GRILLE MESH	-	-	-	-	GALV.	-	MANUAL COILING GRILLE	A158-3
A158-4	4'-0"	12'-0"	-	Q	GRILLE MESH	-	-	-	-	GALV.	-	MANUAL COILING GRILLE	A158-4
A159-1	3'-0"	7'-0"	S	C	SC.P.L.	G2	2"	8 3/4"	1	H.M.	-	-	A159-1
A160-1	3'-0"	7'-0"	S	C	SC.P.L.	G2	2"	8 3/4"	1	H.M.	-	-	A160-1
A161-1	3'-0"	7'-0"	S	C	SC.P.L.	G2	2"	8 3/4"	1	H.M.	-	-	A161-1
A162-1	3'-0"	7'-0"	S	C	SC.P.L.	G2	2"	8 3/4"	1	H.M.	-	-	A162-1
A164-1	3'-0"	7'-0"	S	C	SC.P.L.	G2	2"	8 3/4"	1	H.M.	-	-	A164-1

AREA 'A1' - ROOM FINISH SCHEDULE							
ROOM #	ROOM NAME	FLOOR FINISHES		WALL FINISH(S)	CEILING FINISH(S)	COMMENTS	ROOM #
		FLOOR	BASE	COOR. W/ A7 & A11	COOR. W/ A10		
A100	VEST	SC-1	RB-1	PTW-1	ACT-1		A100
A101	RISER	SC-1	RB-1	PTW-1	ACT-1		A101
A102	ELEC	LV1-1	RB-1	PTW-1	ACT-1		A102
A103	ELEC	SC-1	RB-1	PTW-1	ACT-1		A103
A104	CORR	SC-1	RB-1	AWC-1PTW-1	ACT-1		A104
A105	WK RM	LV1-1	RB-1	PTW-1	ACT-1		A105
A106	MEN	SC-1	RB-1	PTW-1	ACT-2		A106
A107	CUST	SC-1	RB-1	PTW-1	ACT-1		A107
A108	STOR	RB-1	RB-1	PTW-1	ACT-1		A108
A109	CORR	SC-1	RB-1	PTW-1	ACT-1		A109
A110	WOMEN	SC-1	RB-1	PTW-1	ACT-2		A110
A112	ELEC	SC-1	RB-1	PTW-1	EXP. TO STRUC.		A112
A113	WATERHEATER	SC-1	RB-1	PTW-1	EXP. TO STRUC.		A113
A114	MDF	SC-1	RB-1	PTW-1	EXP. TO STRUC.		A114
A116	RR	SC-1	RB-1	PTW-1	ACT-2		A116
A118	RR	SC-1	RB-1	PTW-1	ACT-2		A118
A119	CORR	SC-1	RB-1	AWC-1PTW-1	ACT-1		A119
A120	VET CLASSROOM	SC-1	RB-1	PTW-1	ACT-1		A120
A121	FLORAL LAB	SC-1	RB-1	PTW-1	ACT-1		A121
A122	VET LAB	SC-1	RB-1	PTW-1	ACT-1		A122
A123	FLORAL COOLER	SC-1	RB-1	PTW-1	ACT-1		A123
A124	STOR	SC-1	RB-1	PTW-1	ACT-1		A124
A125	STOR	SC-1	RB-1	PTW-1	ACT-1		A125
A126	GROOMING	SC-1	RB-1	PTW-1	ACT-1		A126
A127	FLORAL LAB	SC-1	RB-1	PTW-1	ACT-1		A127
A128	EXAM	SC-1	RB-1	PTW-1	ACT-1		A128
A129	KENNEL	SC-1	RB-1	PTW-1	ACT-1		A129
A130	STOR	SC-1	RB-1	PTW-1	ACT-1		A130
A132	PRINCIPALS CLASSROOM	SC-1	RB-1	PTW-1	ACT-1		A132
A133	CORR	SC-1	RB-1	AWC-1PTW-1	ACT-1		A133
A134	CLASSROOM	SC-1	RB-1	PTW-1	ACT-1		A134
A135	AG CLASSROOM	SC-1	RB-1	PTW-1	ACT-1		A135
A136	HORTICULTURE	SC-1	RB-1	PTW-1	ACT-1		A136
A137	CHANGE	SC-1	RB-1	PTW-1	ACT-1		A137
A138	CHANGE	SC-1	RB-1	PTW-1	ACT-1		A138
A139	HALL	SC-1	RB-1	PTW-1	ACT-1		A139
A140	EQUIP	SC-1	RB-1	PTW-1	ACT-1		A140
A141	STOR	SC-1	RB-1	PTW-1	ACT-1		A141
A142	STOR	SC-1	RB-1	PTW-1	ACT-1		A142
A143	AG LAB	SC-1	RB-1	PTW-1	EXP. TO STRUC.		A143
A144	CORR	RB-1	RB-1	PTW-1	ACT-1		A144
A145	IDF	SC-1	RB-1	PTW-1	EXP. TO STRUC.		A145
A146	COMP	SC-1	RB-1	PTW-1	EXP. TO STRUC.		A146
A150	CORR	SC-1	RB-1	AWC-1PTW-1	ACT-1		A150
A152	WELDING CR	SC-1	RB-1	PTW-1	ACT-1		A152
A153	WELDING CR	SC-1	RB-1	PTW-1	ACT-1		A153
A154	HALL	SC-1	RB-1	AWC-1PTW-1	ACT-1		A154
A155	B DRESSING	SC-1	RB-1	PTW-1	ACT-1		A155
A156	G DRESSING	SC-1	RB-1	PTW-1	ACT-1		A156
A157	WELDING LAB	SC-1	RB-1	PTW-1	EXP. TO STRUC.		A157
A158	WELDING LAB	SC-1	RB-1	PTW-1	EXP. TO STRUC.		A158
A159	EQUIP	SC-1	RB-1	PTW-1	ACT-1		A159
A160	ELEC	SC-1	RB-1	PTW-1	ACT-1		A160
A161	STOR	SC-1	RB-1	PTW-1	ACT-1		A161
A162	STOR	SC-1	RB-1	PTW-1	ACT-1		A162
A164	EQUIP	SC-1	RB-1	PTW-1	ACT-1		A164



SLOPE

HIGH ROOF

LOW ROOF

REMOVE VENT AND REPLACE WITH METAL ROOF PANELS

REMOVE EXISTING HVAC UNITS, PROVIDE NEW ROOF PANELS

ADDITIONAL RIGID INSULATION SLOPE (DOWN), SLOPE TO DRAIN MIN 1/4" PER FOOT, TYP.

STRUCTURE SLOPE (DOWN), SLOPE TO DRAIN MIN 1/4" PER FOOT, TYP.

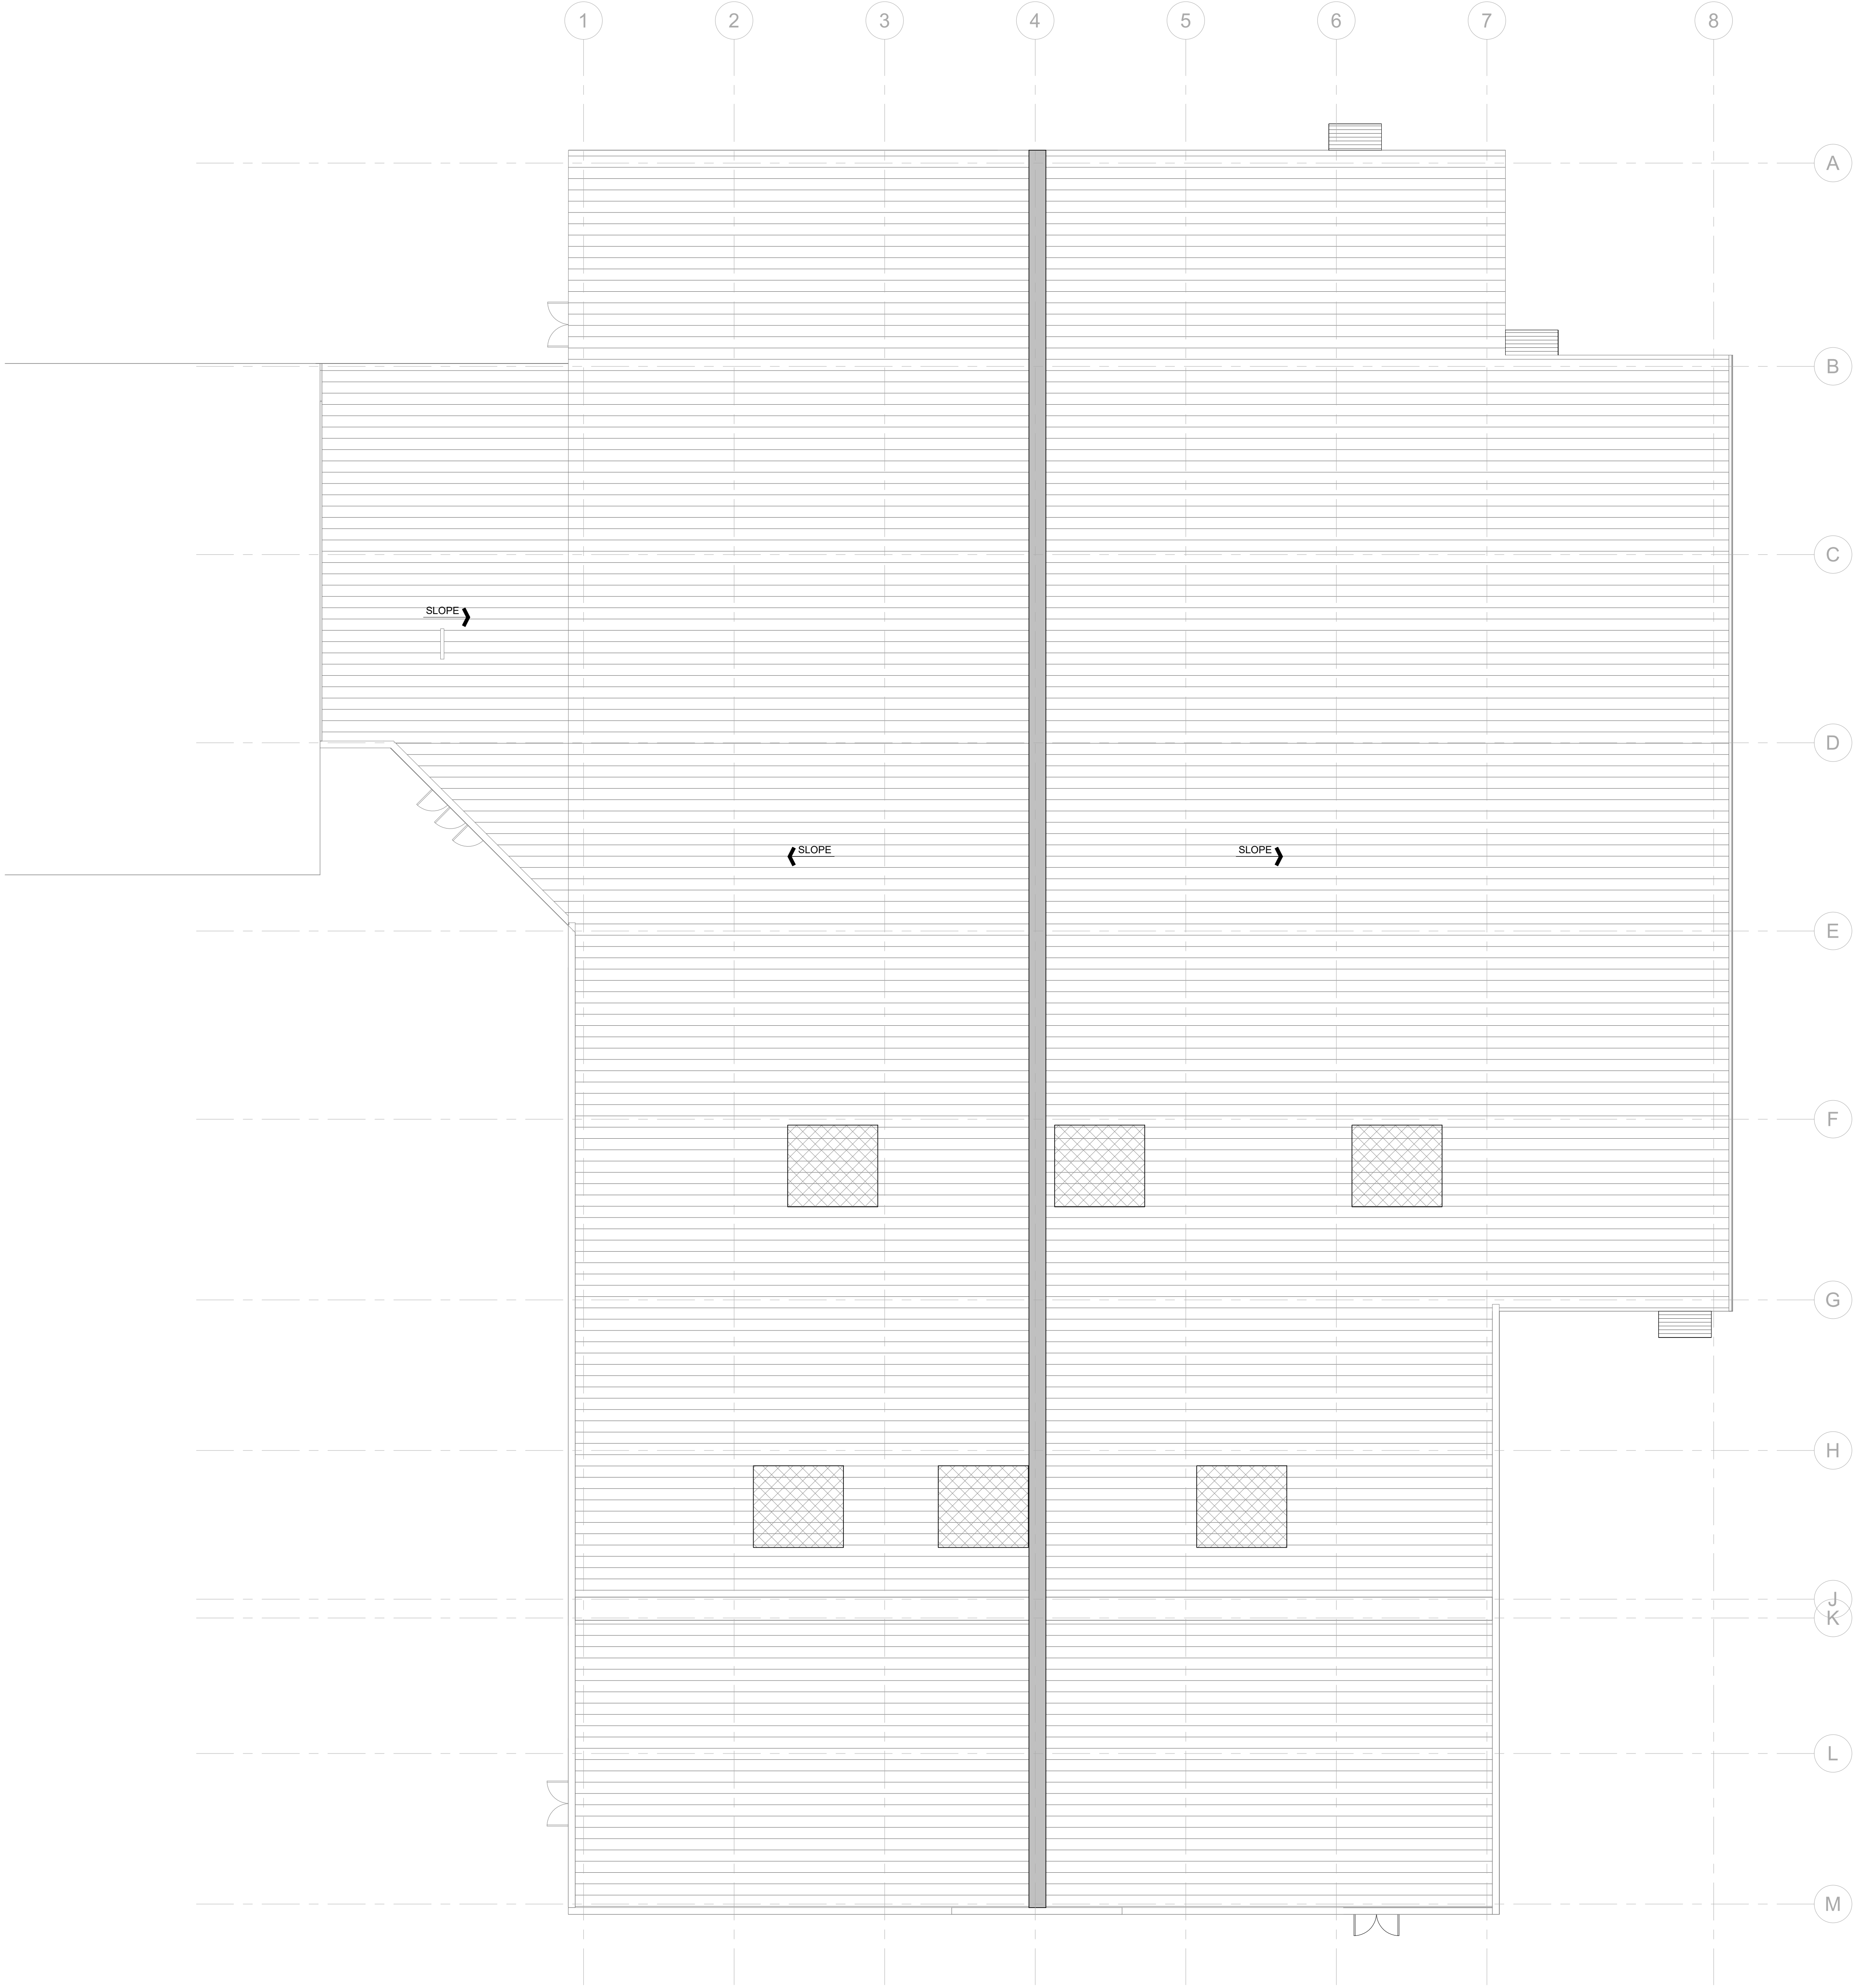
HIGH TO LOW ROOF TRANSITION

REMOVE VENT AND REPLACE WITH METAL ROOF PANELS

REMOVE EXISTING HVAC UNITS, PROVIDE NEW ROOF PANELS

LEGEND - ROOF PLAN

1/4" = 1'-0"



1 ROOF PLAN  
1" = 10'-0"

CONSULTANTS

MEP

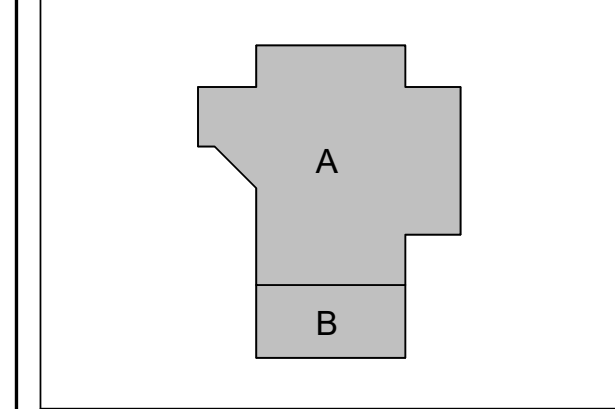
Salas O'Brien  
10930 W. Sam Houston Pkwy N  
Suite 900  
Houston, TX 77064  
Tel: 281.664.1900  
Fax: 281.664.1912

CIVIL

Auric Engineers, LLC  
520 Post Oak Blvd., Suite 895  
Houston, TX 77027  
Tel: 713.405.1901

STRUCTURAL

CJG Engineers  
3200 Wilcrest Drive, Suite 305  
Houston, TX 77042  
Tel: 713.780.3345  
Fax: 713.780.3712



TOMBALL HIGH SCHOOL  
CTE & MISC. RENOVATIONS

TOMBALL INDEPENDENT SCHOOL DISTRICT  
30330 QUINN ROAD, TOMBALL, TX 77375

ARCADIS

TEXAS ARCADIS INC.  
10205 WESTHEIMER SUITE 800  
HOUSTON, TX 77042  
tel 713.953.4897, fax 713.977.4620

REGISTERED ARCHITECT  
STATE OF TEXAS  
2023-11-06


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DATE:	2023-11-06
DRAWN:	Author
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DATE:	ISSUE
2023-11-06	BID SET

A4.00

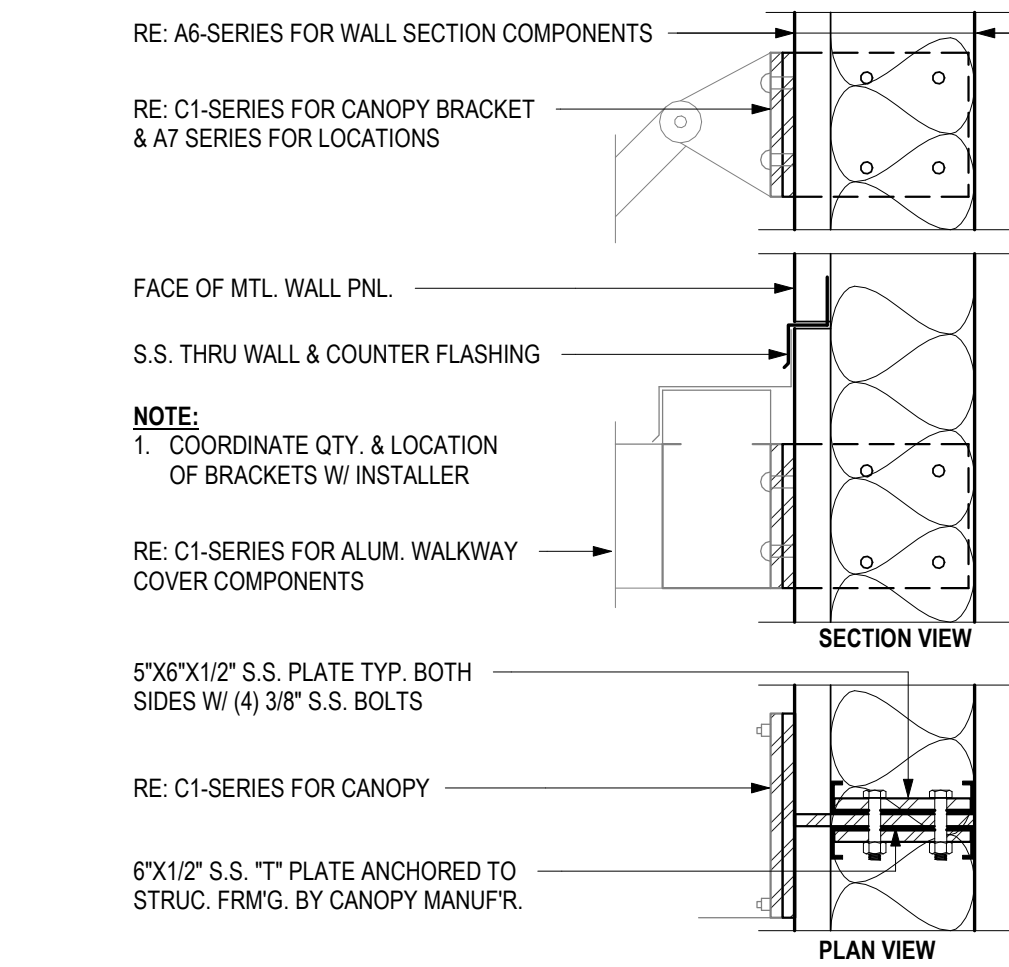
ROOF PLAN








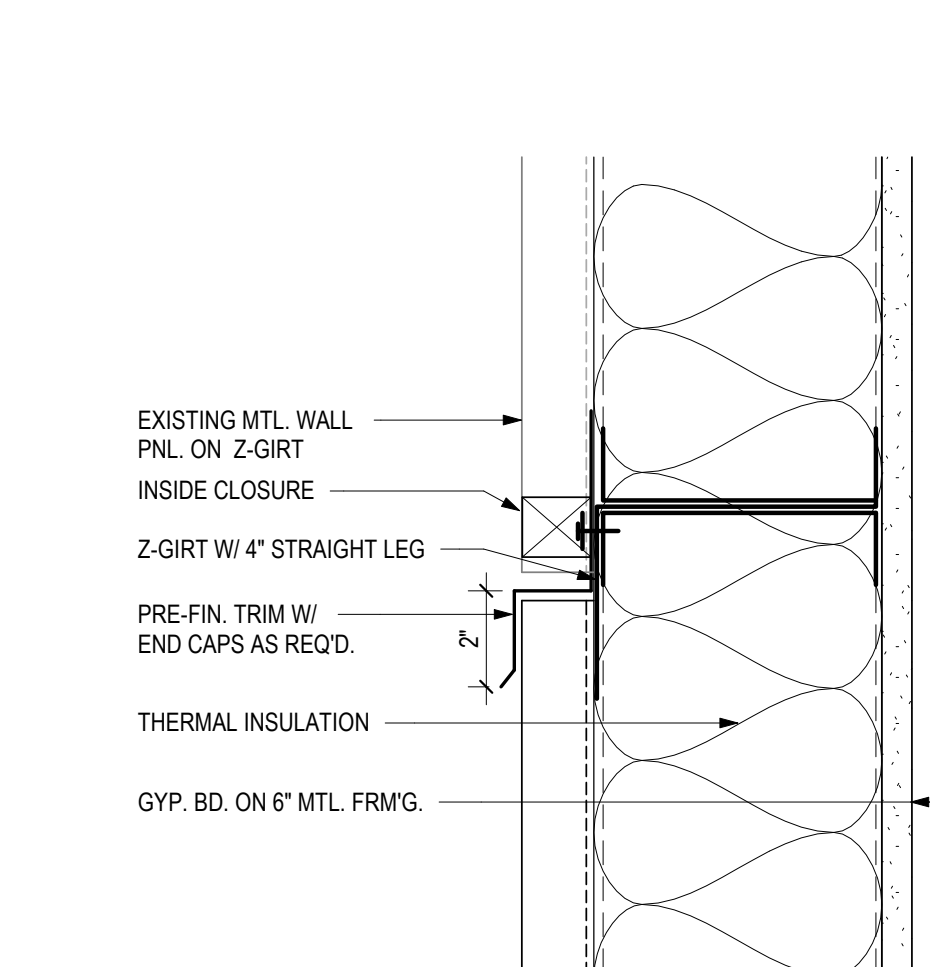
**16 WALL - EXT CNPY @ MTL BLDG**  
1 1/2" = 1'-0"



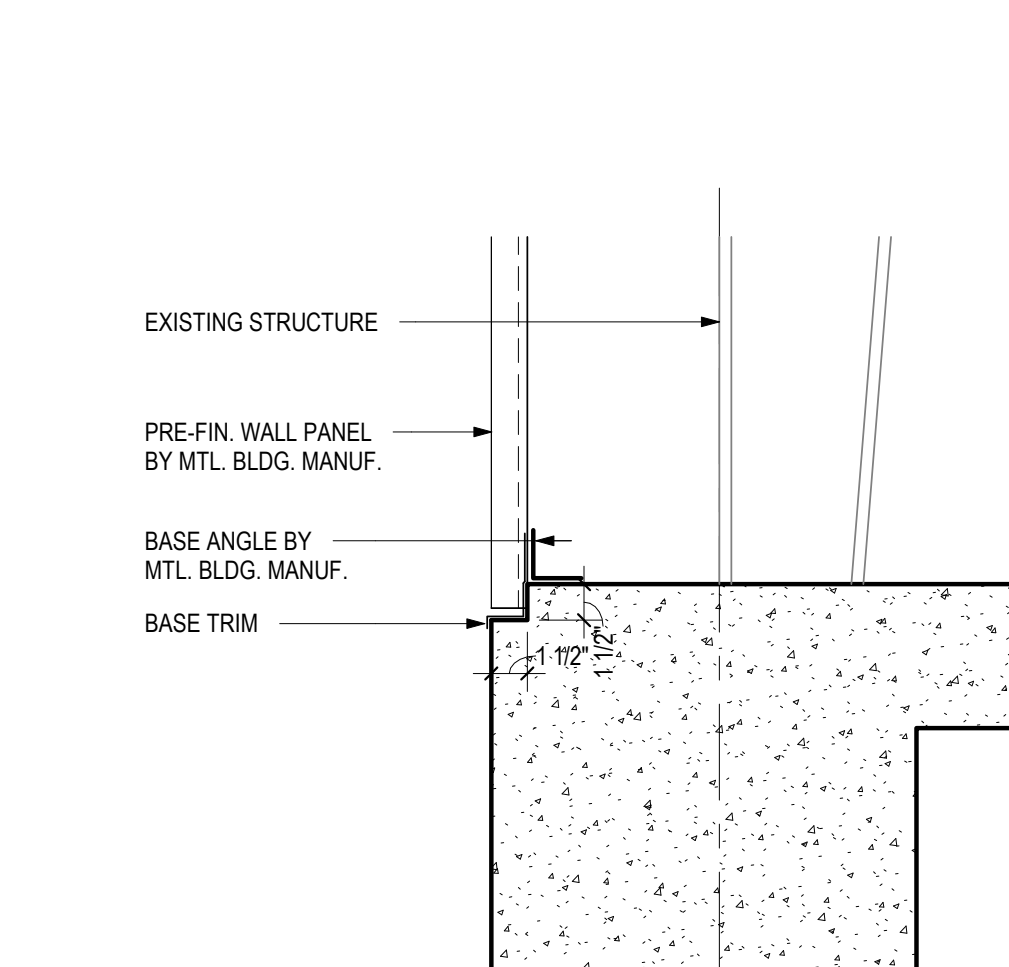**15 WALL - EXT MTL TO MAS @ MTL**  
3" = 1'-0"



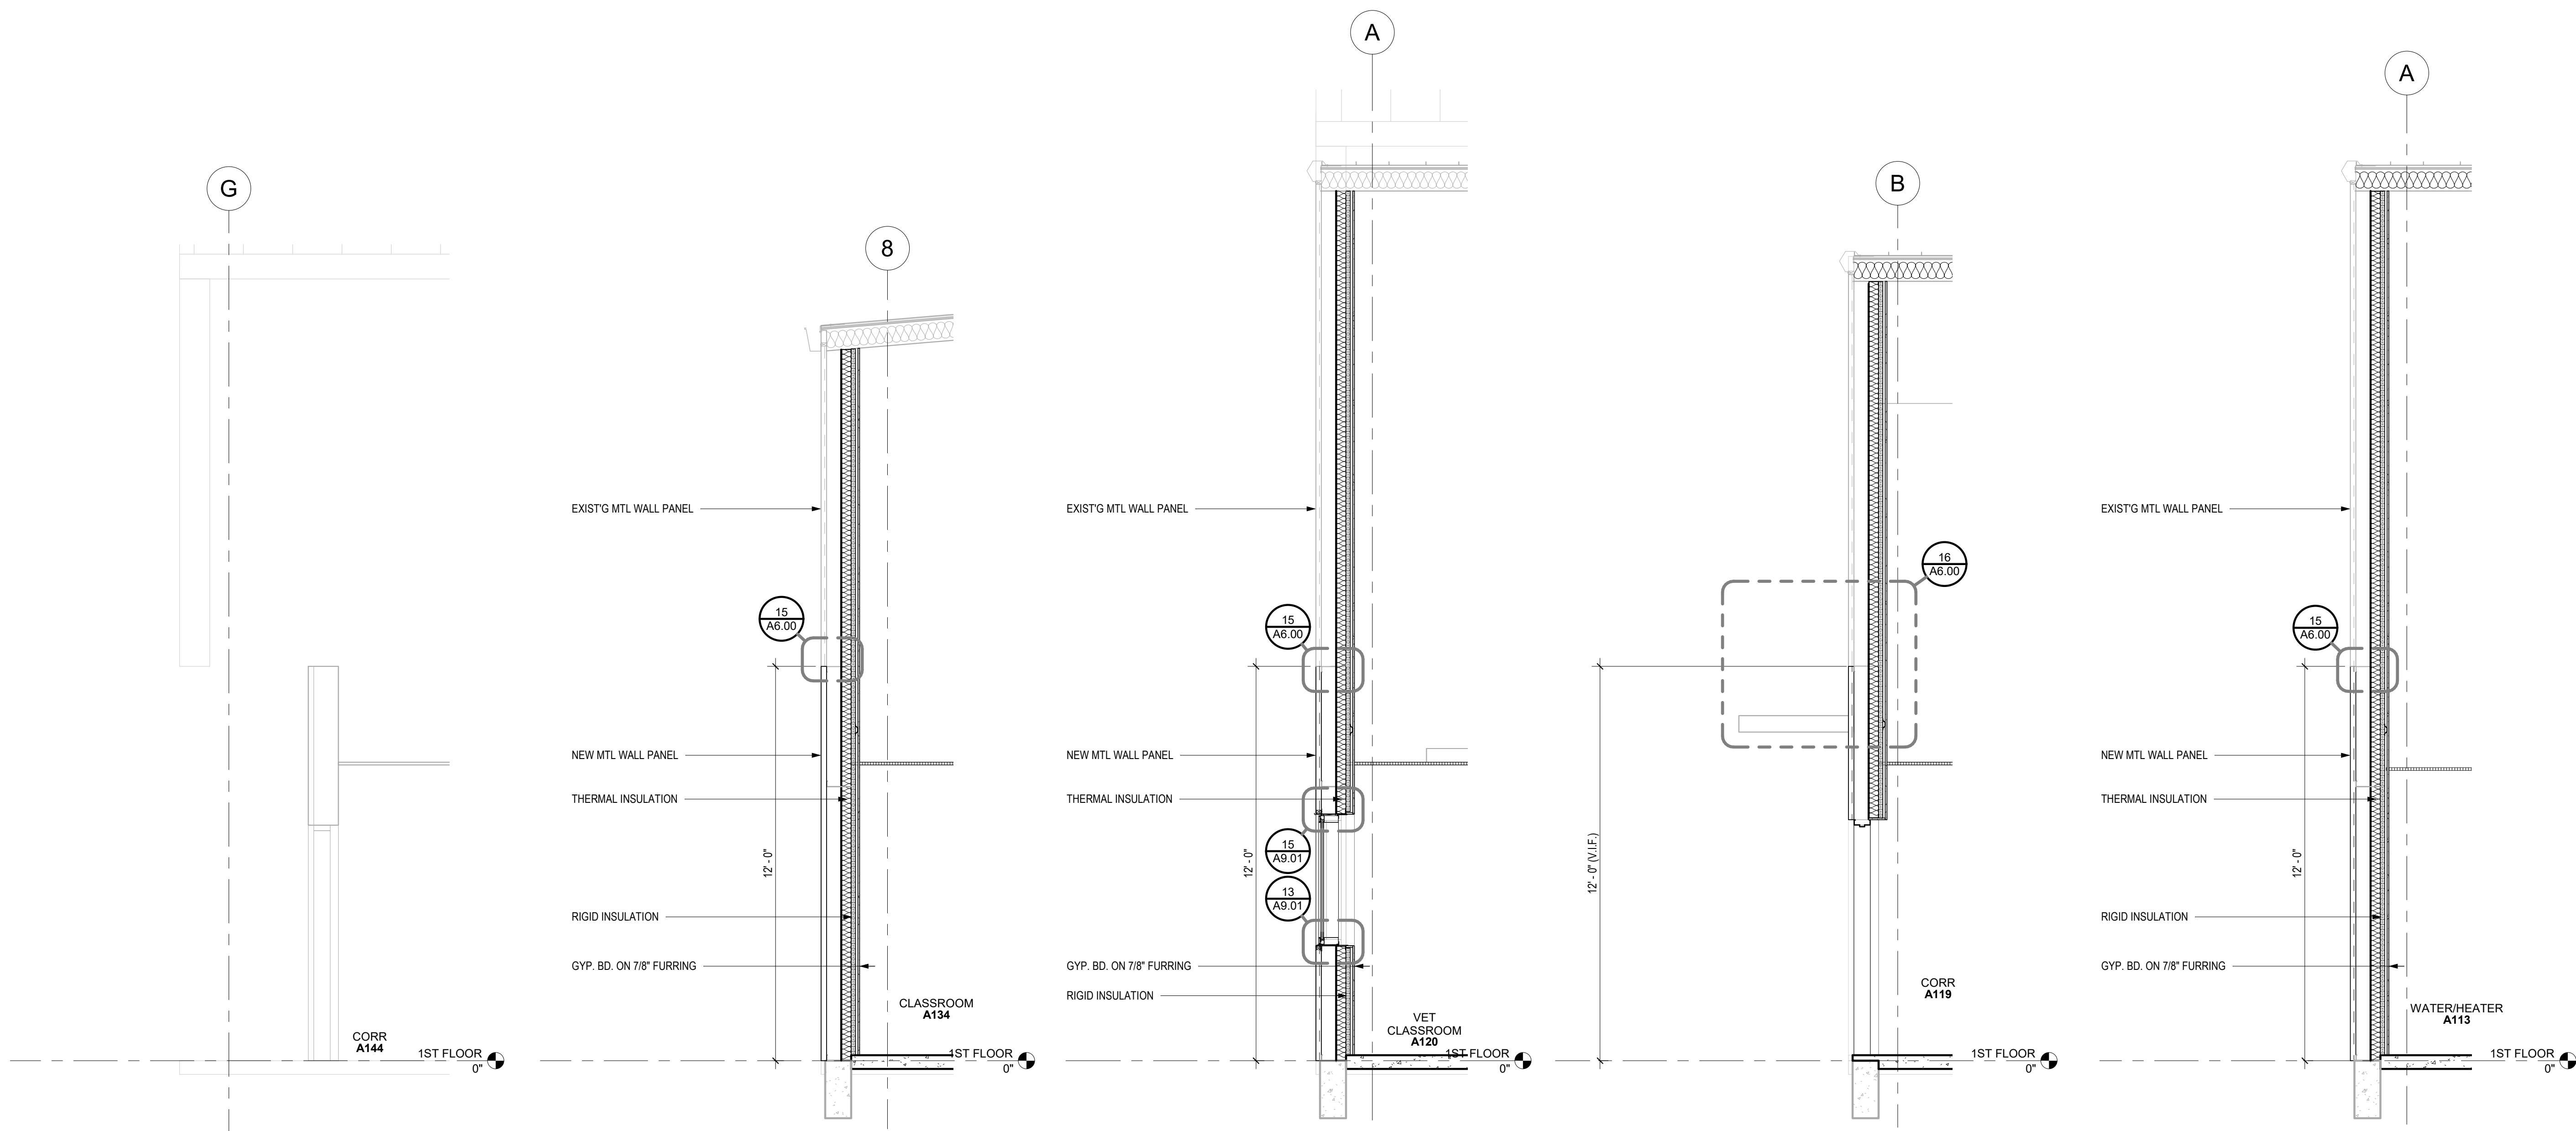**14 WALL - EXT - MTL BLDG LEDGE**  
1 1/2" = 1'-0"




**13 MTL GYP -A144-S**  
3/8" = 1'-0"

**12 MTL GYP -A134-E**  
3/8" = 1'-0"


**11 MTL GYP -A120-N**  
3/8" = 1'-0"

**10 MTL GYP -A119-N**  
3/8" = 1'-0"

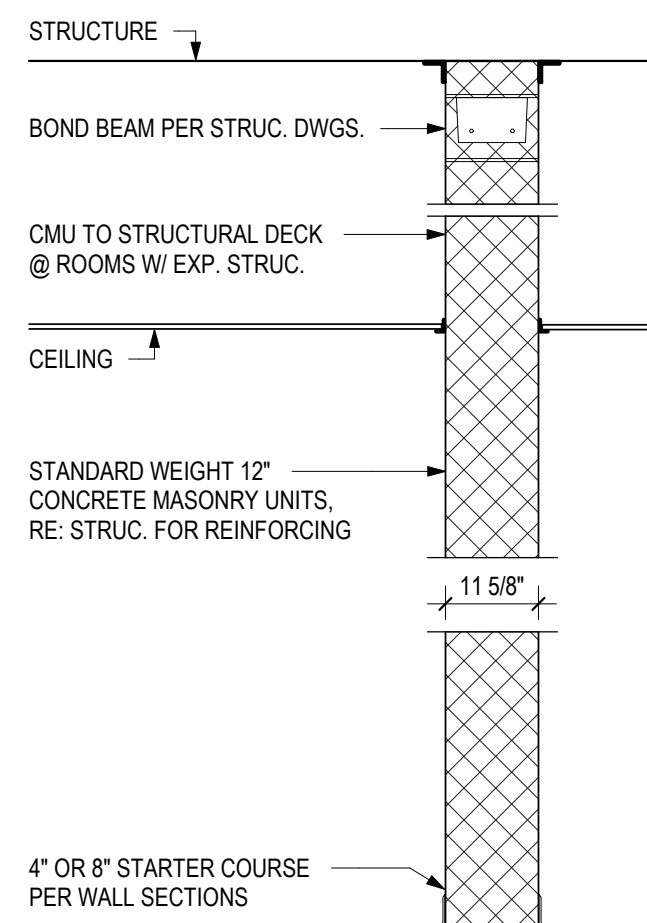
**9 MTL GYP -A113-N**  
3/8" = 1'-0"




**8 PARTITION H10**  
1/2" = 1'-0"

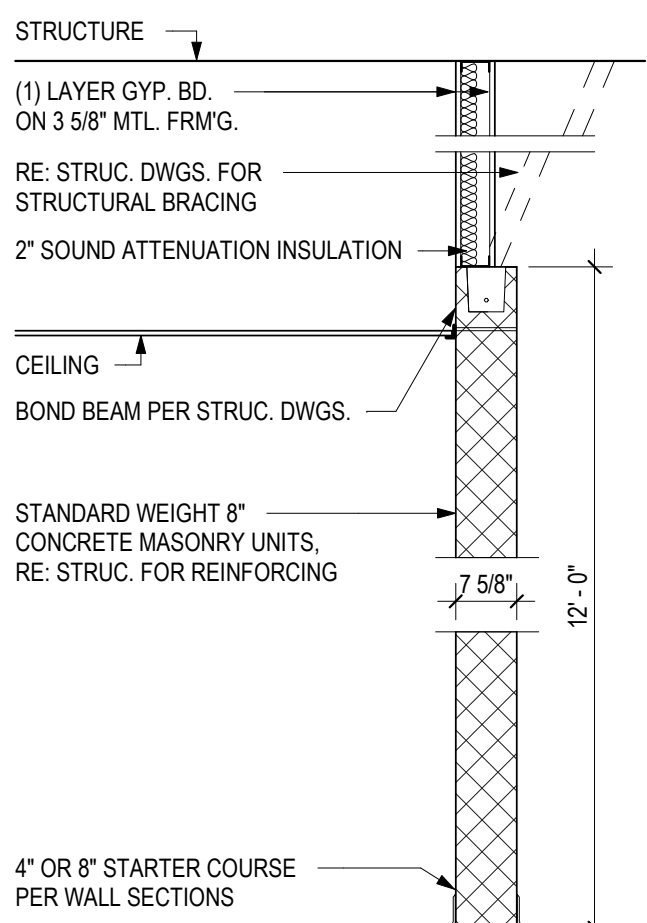


**7 PARTITION G63**  
1/2" = 1'-0"

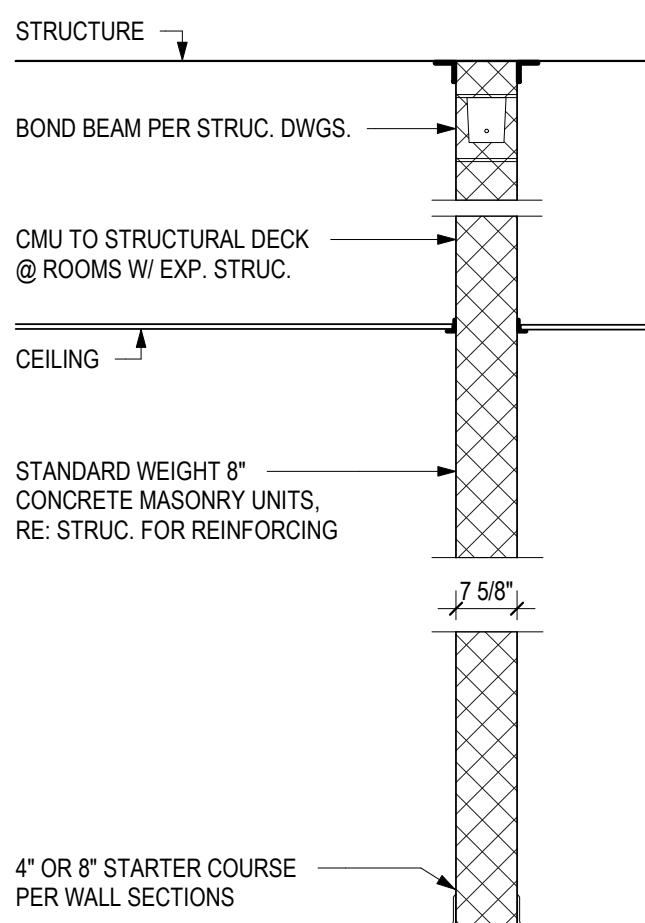


**6 PARTITION G10**  
1/2" = 1'-0"

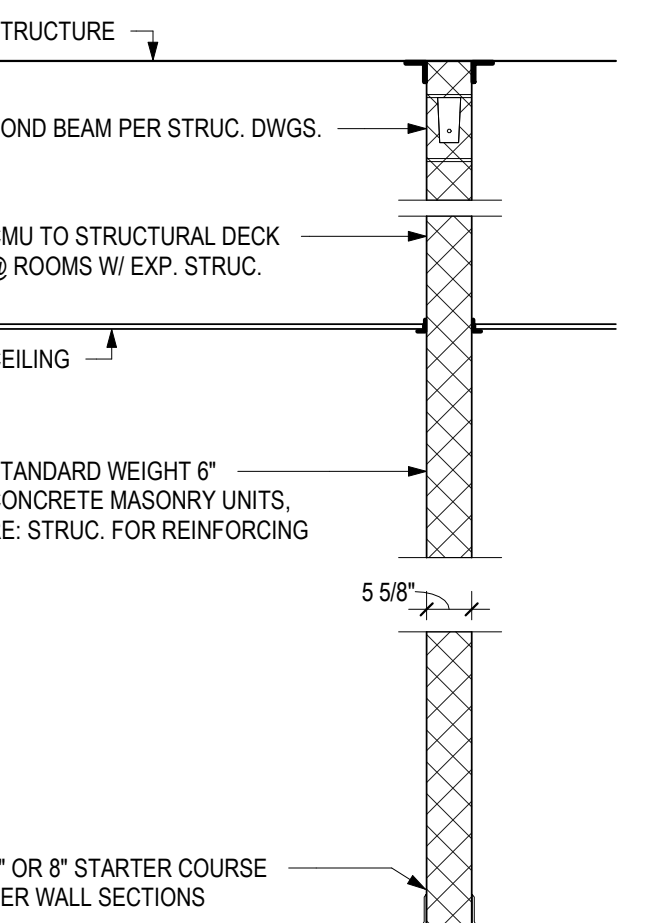


**5 PARTITION F10**  
1/2" = 1'-0"

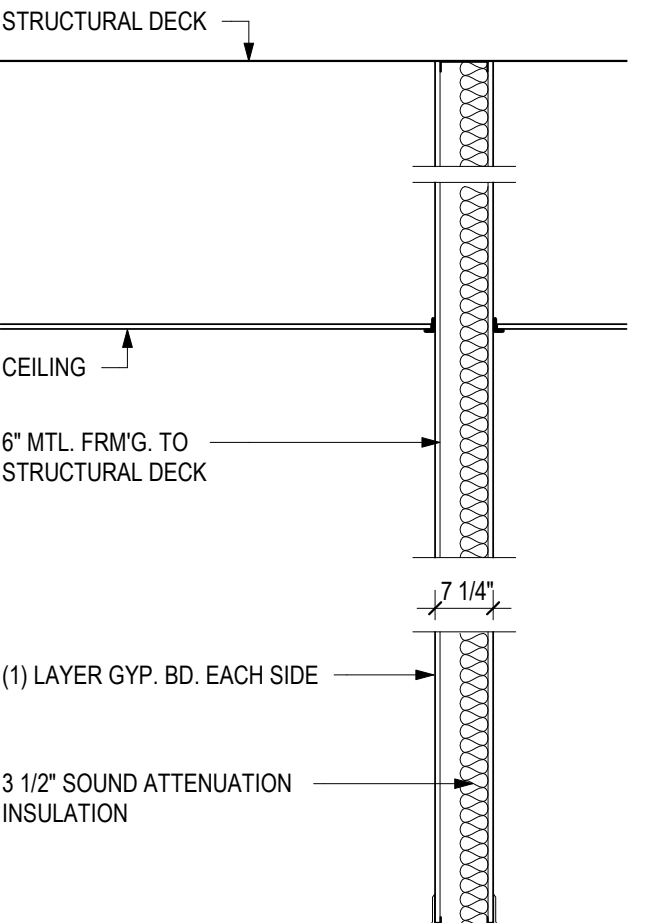


**4 PARTITION C11**  
1/2" = 1'-0"

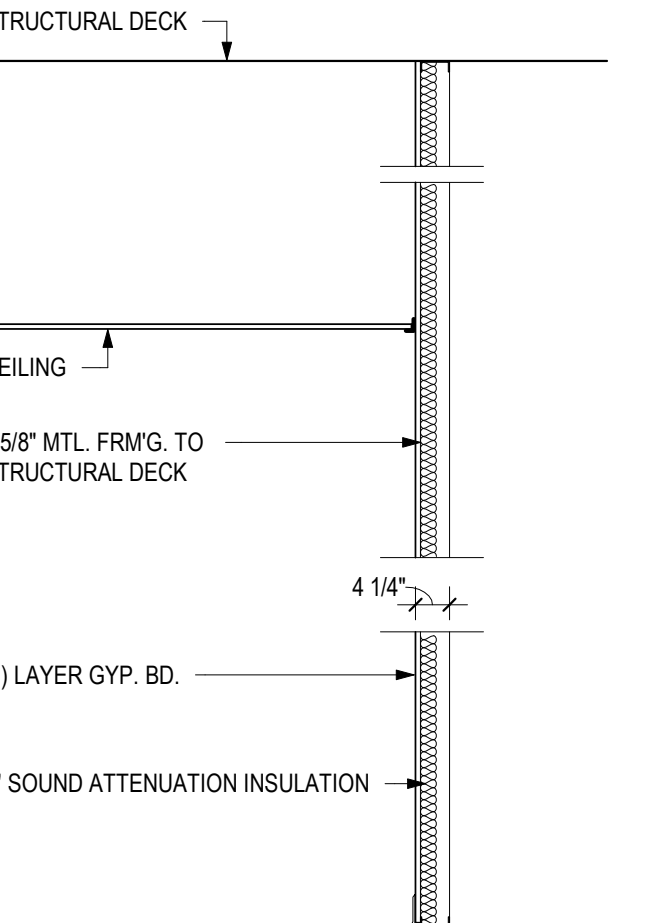

**3 PARTITION B75**  
1/2" = 1'-0"

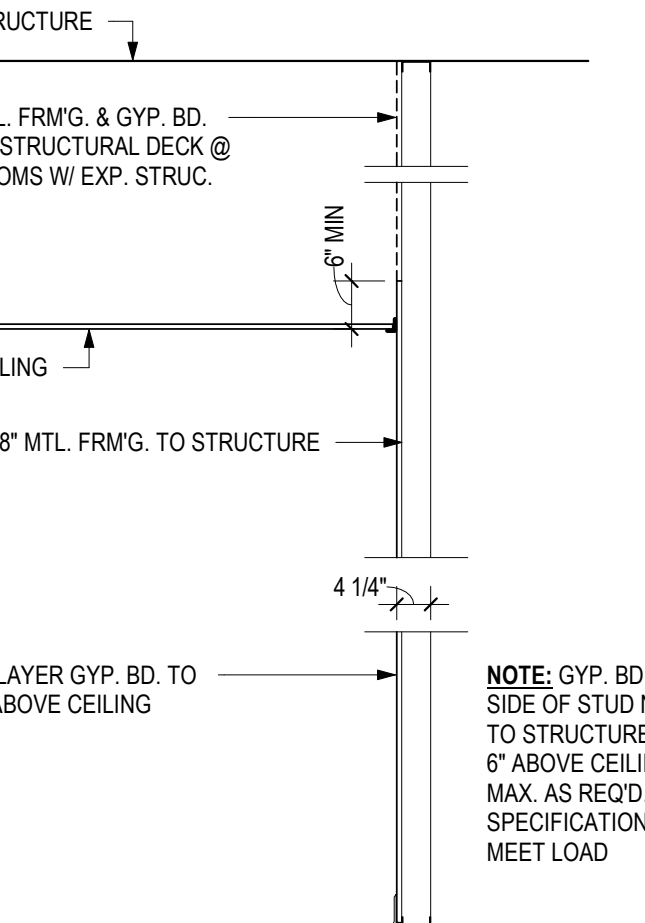


**2 PARTITION B74**  
1/2" = 1'-0"

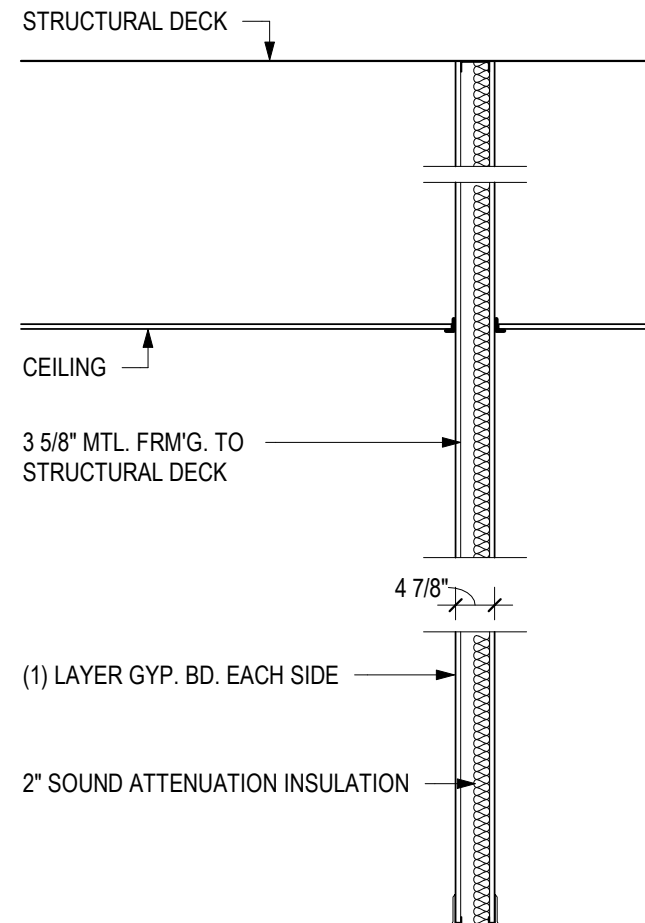

**1 PARTITION B11**  
1/2" = 1'-0"

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**TOMBALL HIGH SCHOOL  
CTE & MISC. RENOVATIONS**  
TOMBALL INDEPENDENT SCHOOL DISTRICT  
30330 QUINN ROAD, TOMBALL, TX 77375

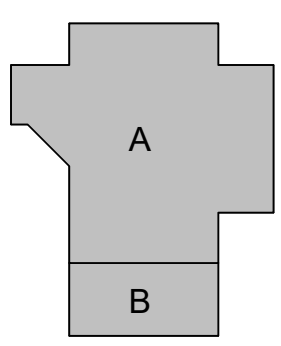**ARCADIS**  
**TEXAS ARCADIS INC.**  
10205 WESTHEIMER SUITE 800  
HOUSTON, TX 77042  
tel 713.953.4897, fax 713.977.4620  
  
2023-11-06

PROJECT #: 202311  
DATE: 2023-11-06  
DRAWN: Author  
CHECKED: Checker  
DATE: 2023-11-06  
ISSUE: BID SET

**A6.00**  
PARTITION  
TYPES & WALL  
SECTIONS

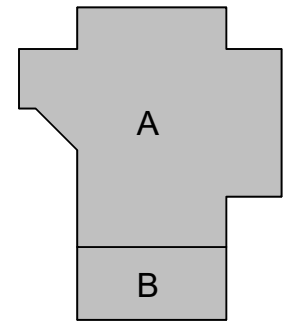


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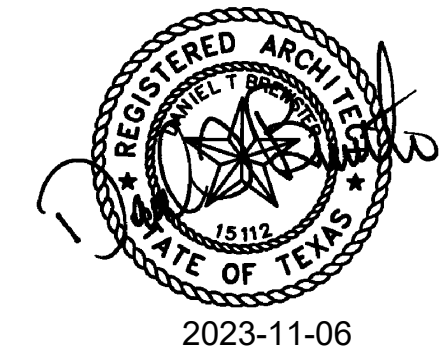


**TOMBALL HIGH SCHOOL  
CTE & MISC. RENOVATIONS**

TOMBALL INDEPENDENT SCHOOL DISTRICT  
30330 QUINN ROAD, TOMBALL, TX 77375


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PROJECT #: 202311  
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**A7.01**  
ELEVATIONS








1. PROVIDE LOCKS ON ALL DOORS & DRAWERS. LOCKS ARE TO BE MASTER KEYED PER SPECS.  
2. PROVIDE KEYBOARD TRAY & 2" GROMMET @ ALL KNEESPACES  
3. RE: MEP DWGS. FOR OTHER DEVICES, ONLY UNIQUE CONDITIONS ARE SHOWN ON THESE DRAWINGS.  
4. FINISH TOE SPACE OF ALL CABINETS W/ SCHEDULED BASE FINISH  
5. ALL COUNTERTOPS ARE 24" DEEP UNLESS INDICATED OTHERWISE  
6. PROVIDE REMOVABLE BACK PANEL ON ALL SINK CASEWORK & FUME HOOD CASEWORK  
7. ALL CASEWORK IS EDUCATIONAL CASEWORK UNLESS NOTED OTHERWISE  
8. ALL SINKS IN CASEWORK SHOULD BE SUPPLIED & INSTALLED BY PLUMB. CONTRACTOR & SHOULD INCLUDE STRAINER & TAIL PIECE, RE: PLUMB. DWGS. FOR SINK TYPES  
9. ALL COUNTERTOPS ARE 1 1/2" THK PLASTIC LAMINATE W/ 4" HIGH BACKSPLASH & SPLASH RETURN UNLESS NOTED OTHERWISE  
10. ALL EXPOSED BACKS & ENDS SHALL BE FINISHED W/ LAMINATE  
11. PROVIDE FILLER & CLOSER PANELS AS REQD. TO MATCH UNITS  
12. PROVIDE RADIUS EDGE @ ALL OUTSIDE COUNTERTOP CORNERS  
13. FILE DRAWERS TO INCLUDE INTEGRAL FILE HANGING SYSTEM  
14. "H" INDICATES ACCESSIBLE PLUMBING FIXTURE @ ACCESSIBLE MOUNTING HEIGHT, RE: G1 SERIES  
15. ALL UPPER WALL CABINETS ARE 14" DEEP UNLESS NOTED OTHERWISE  
16. TEACHERS CABINET TO INCLUDE: (1) FIXED SHELF & ROD, (2) ADJUSTABLE SHELVES, (2) LETTER SIZE FILE DRAWERS, & (1) 10"X12" MIRROR & PIN TRAY  
17. CASEWORK ELEVATIONS ARE INTENDED TO SHOW CASEWORK & MILLWORK ONLY. ANY OTHER ELEMENTS SUCH AS WALLS, WINDOWS, & DOORS ARE FOR REFERENCE ONLY. RE: FLOOR PLANS, SCHEDULES & RELATED ELEVATIONS FOR SPECIFIC INFO RELATED TO THESE ELEMENTS.

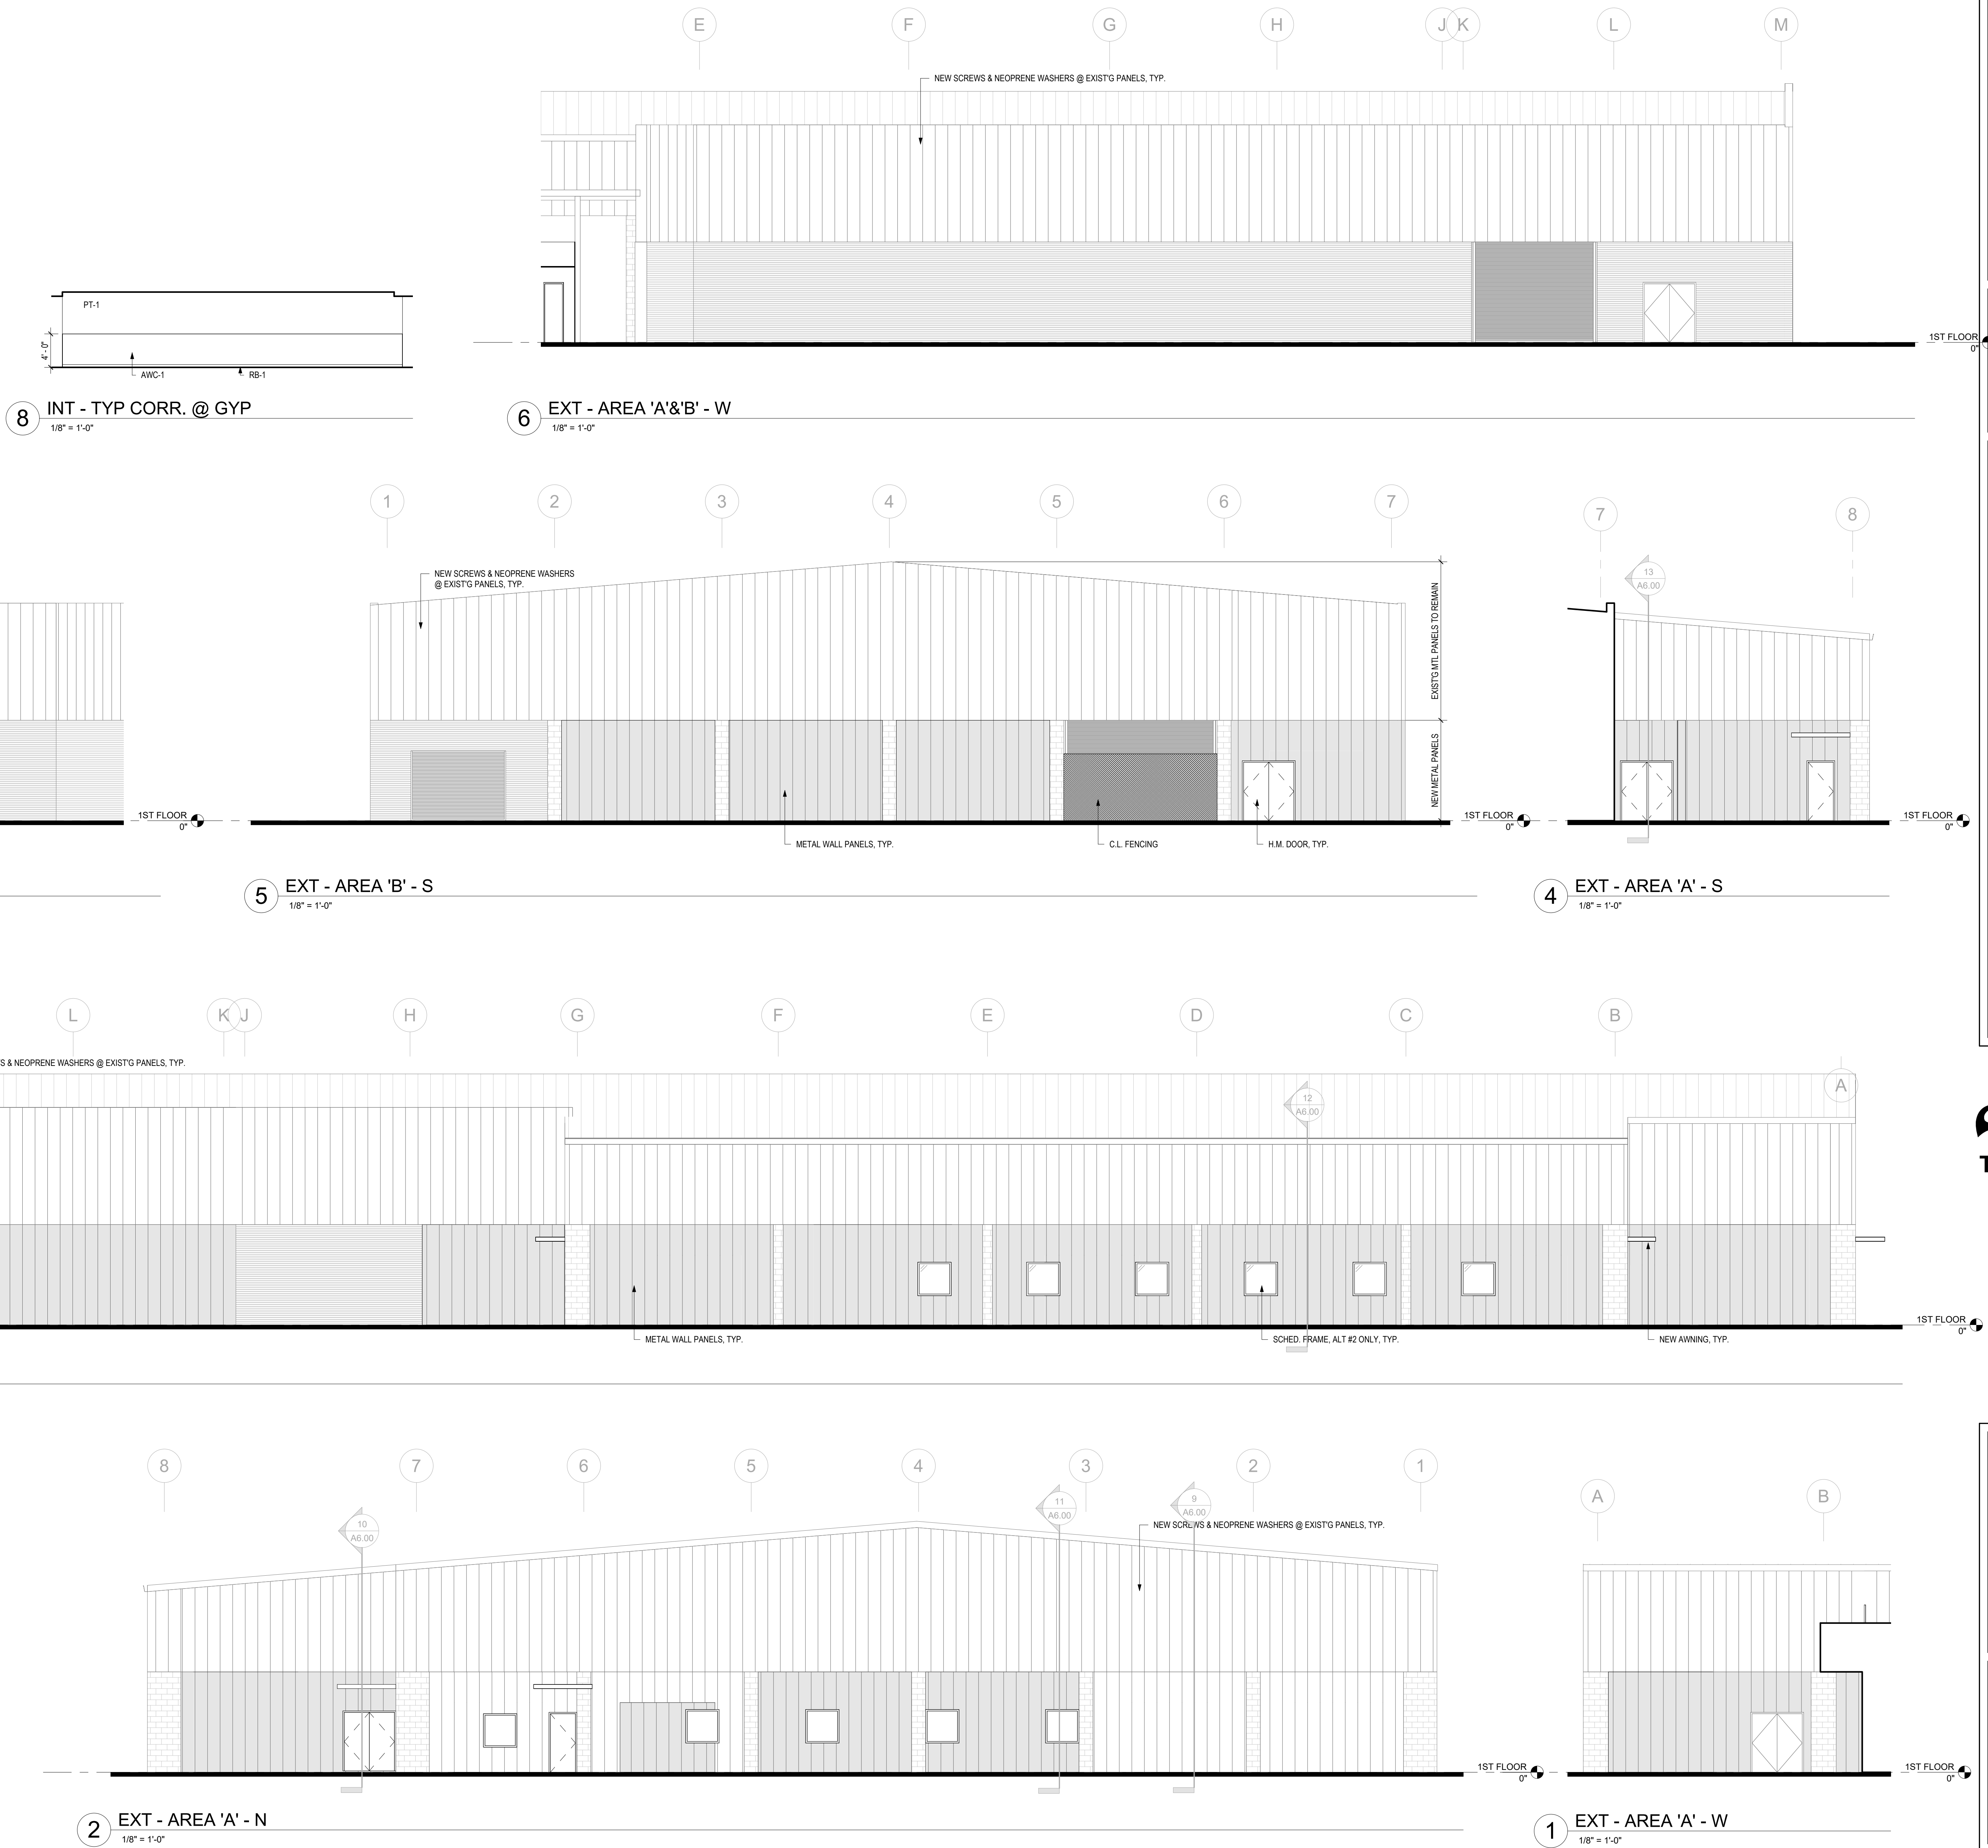NOTES - GENERAL CASEWORK


1/4" = 1'-0"

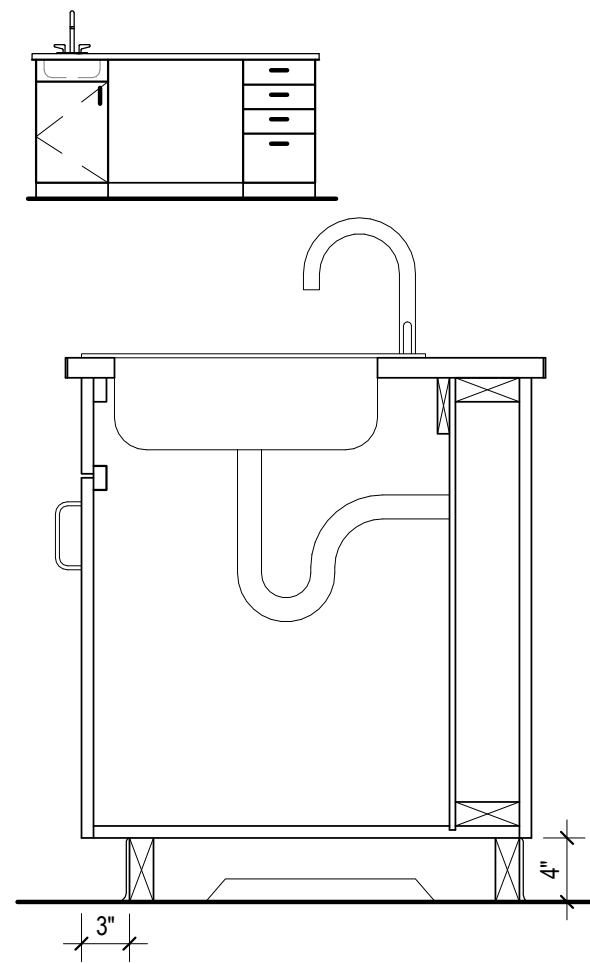


18 CSK "D801"  
1" = 1'-0"

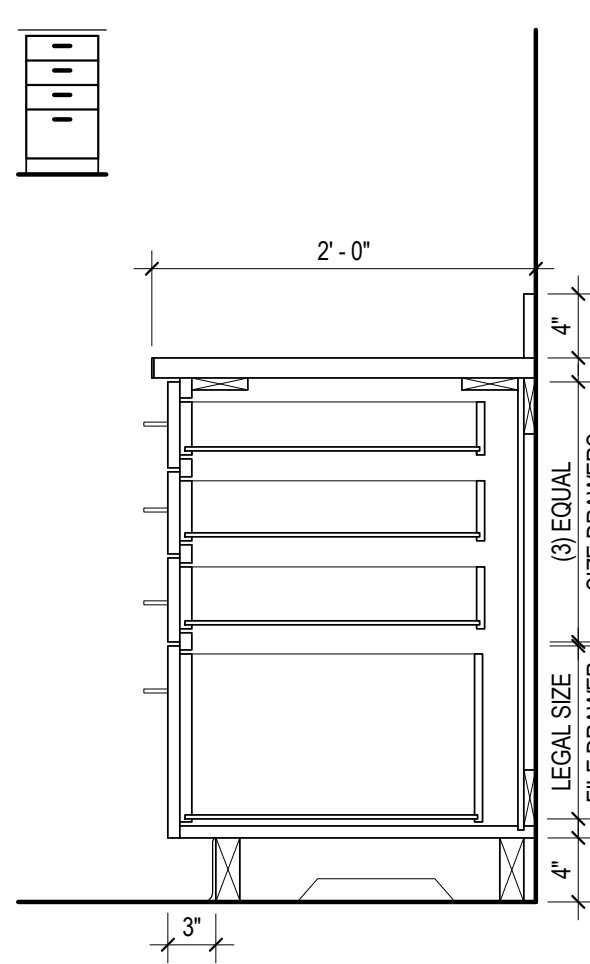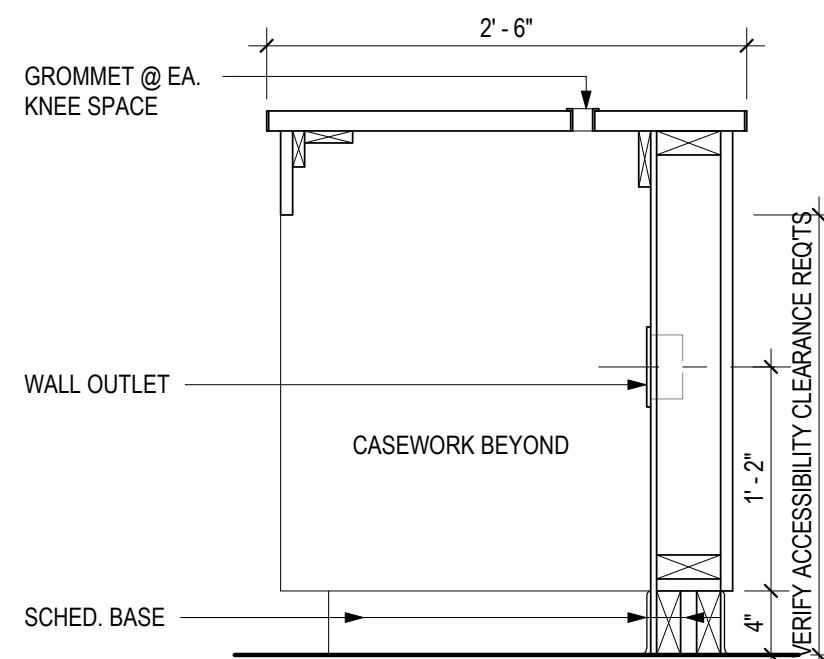


17 CSK "B256"  
1" = 1'-0"

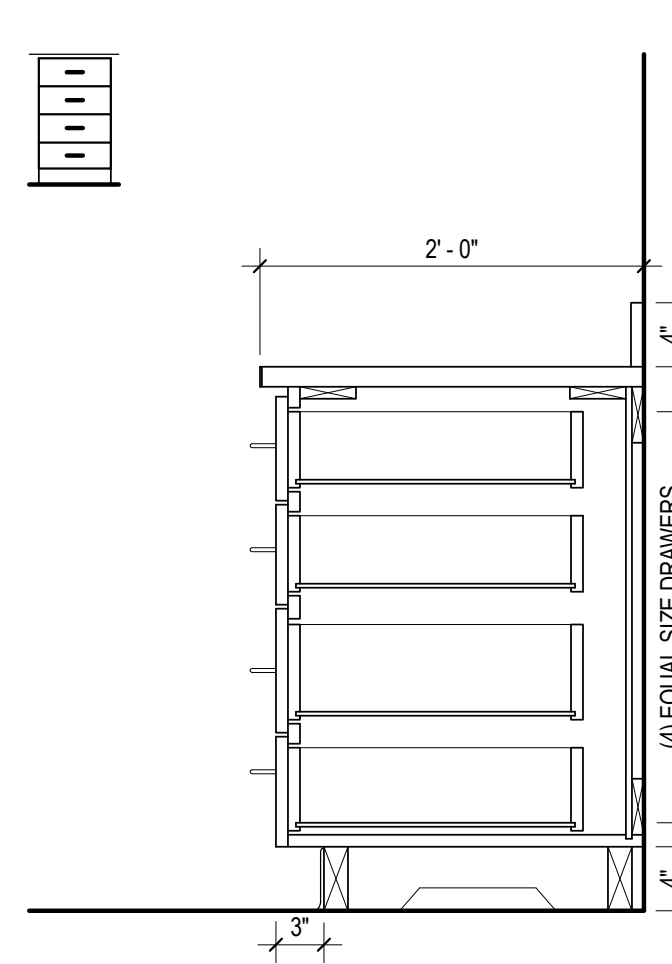


15 CSK "B232"  
1" = 1'-0"

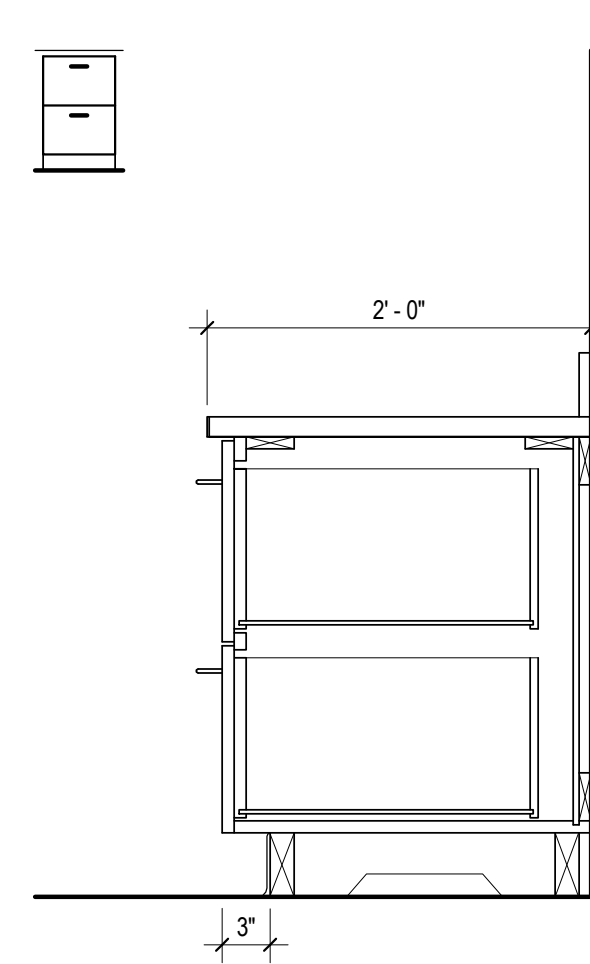


14 CSK "B221"  
1" = 1'-0"

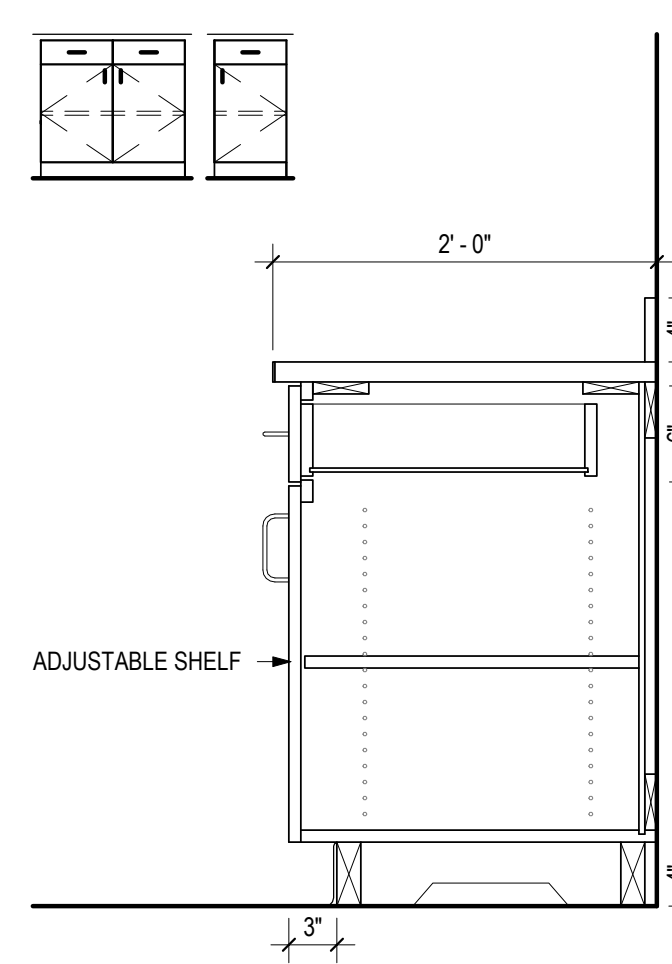


13 CSK "B201"  
1" = 1'-0"

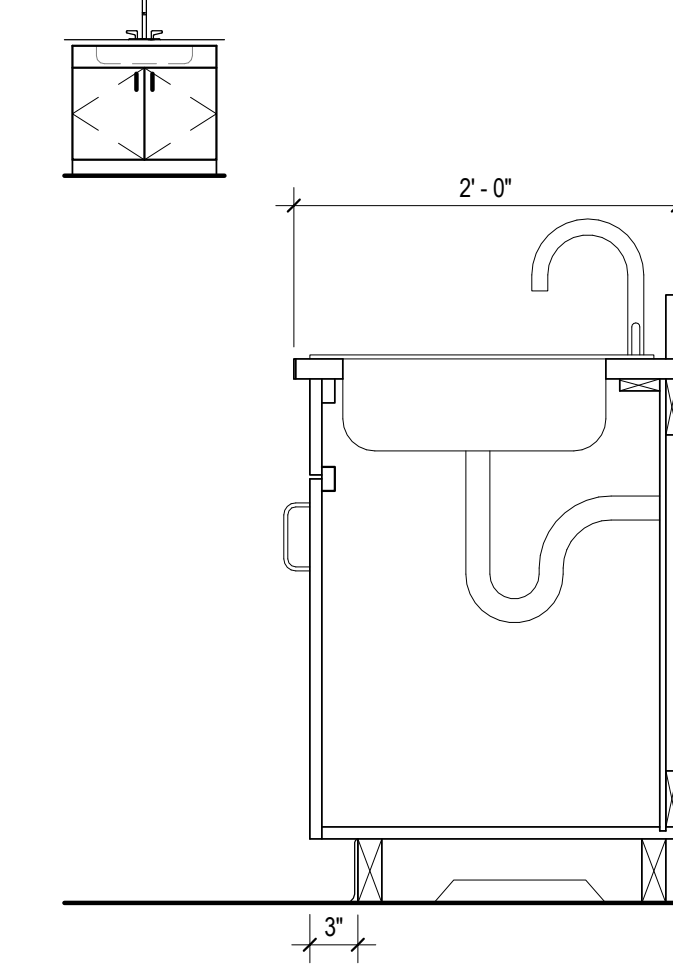


12 CSK "B152"  
1" = 1'-0"

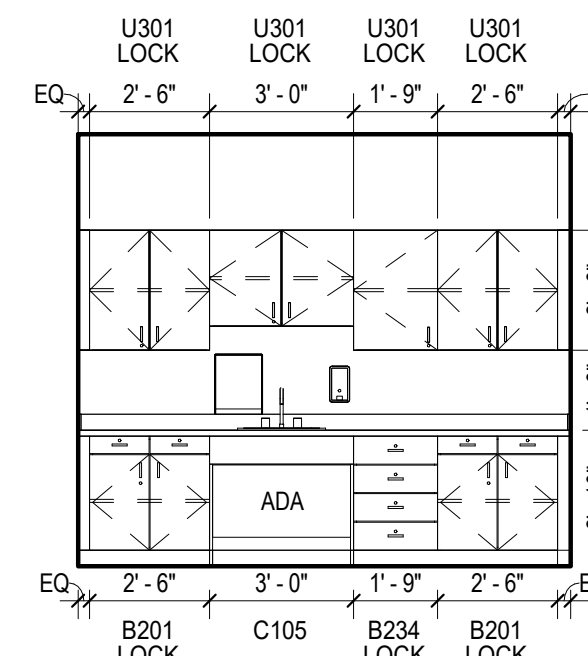


11 A128 - EXAM-E  
1/4" = 1'-0"

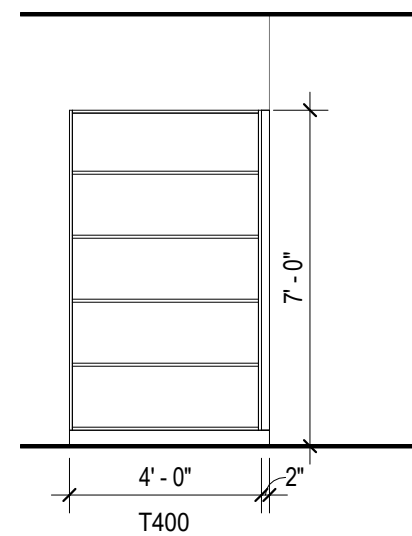


10 A126 - GROOMING-N  
1/4" = 1'-0"

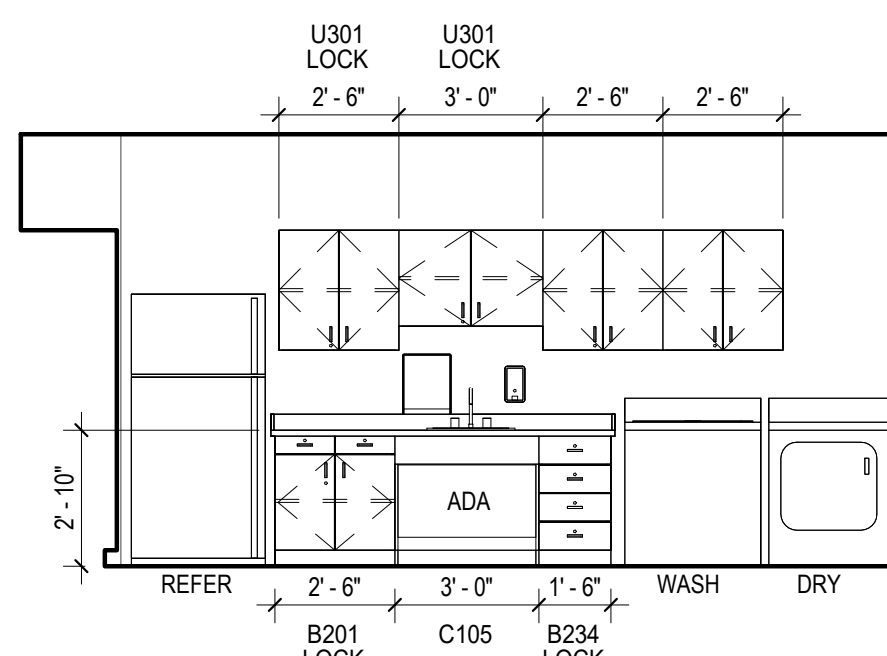


9 A126 - GROOMING-E  
1/4" = 1'-0"

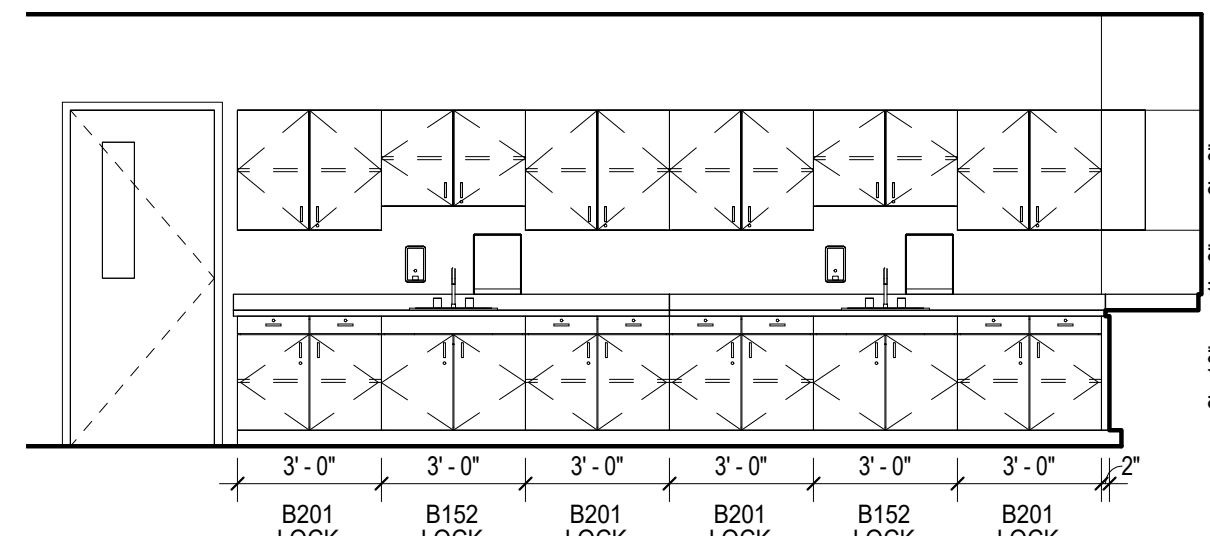


8 A122 - VET LAB-W  
1/4" = 1'-0"

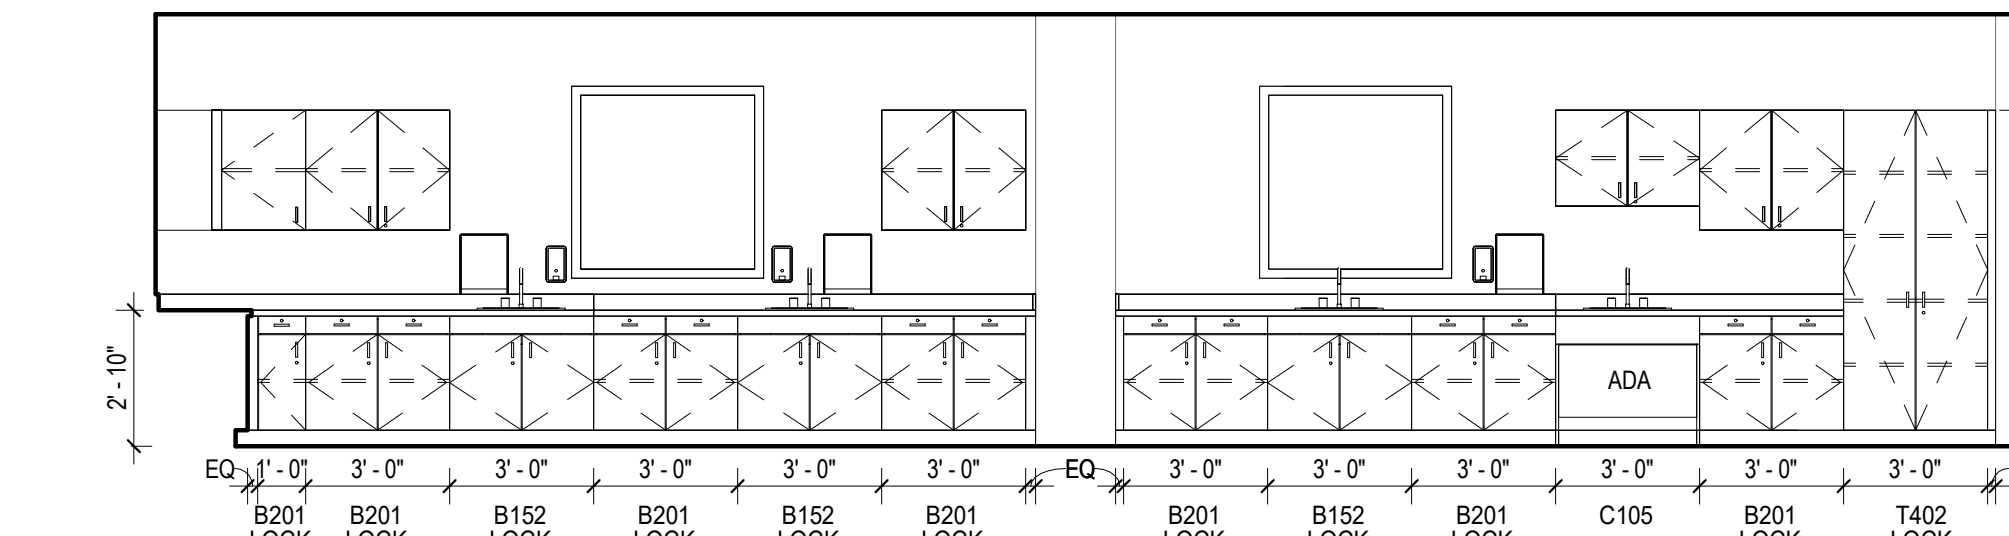


7 A122 - VET LAB-N  
1/4" = 1'-0"

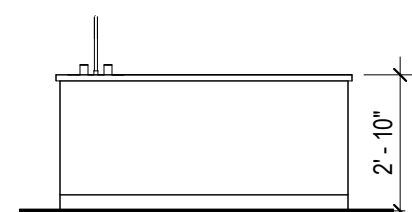


6 A122 - DEMO-S  
1/4" = 1'-0"

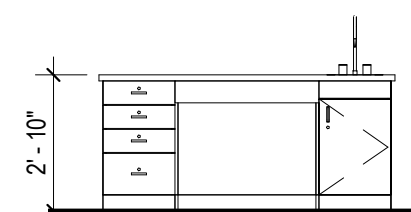


5 A122 - DEMO-N  
1/4" = 1'-0"

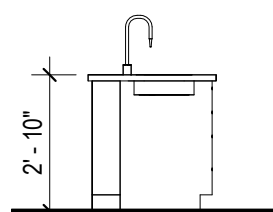


4 A122 - DEMO-E  
1/4" = 1'-0"

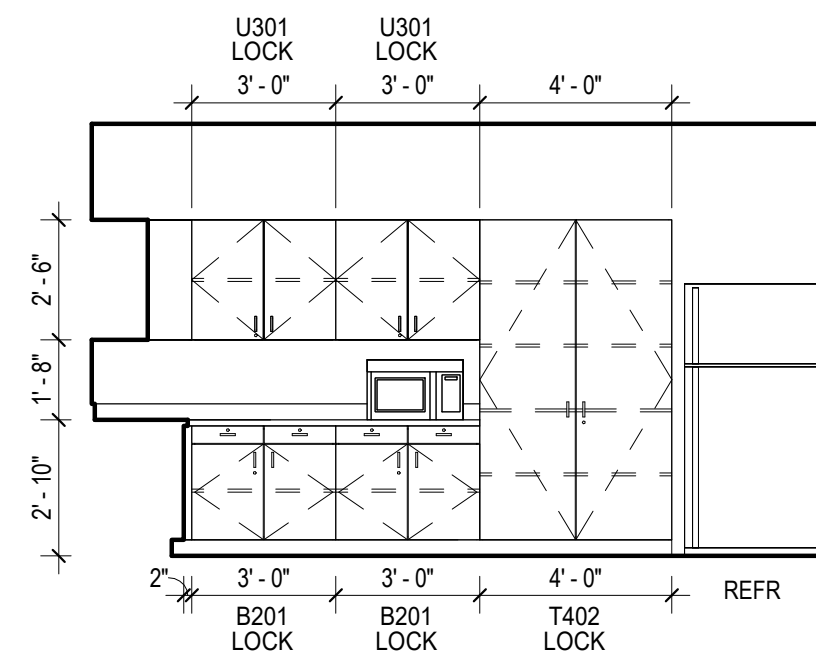

3 A105 - WK RM-W  
1/4" = 1'-0"

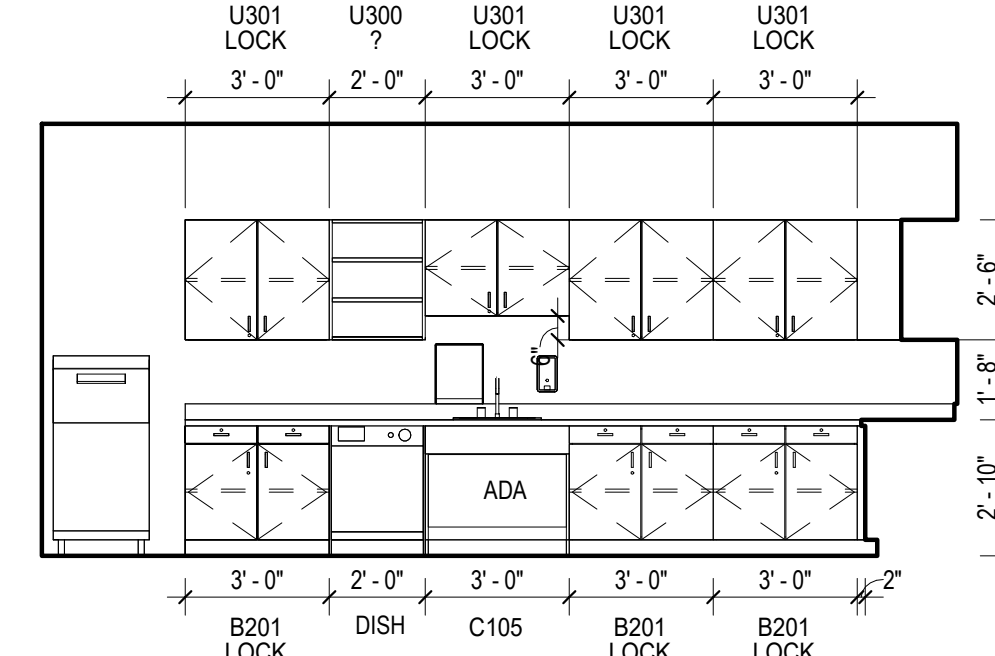

2 A105 - WK RM-S  
1/4" = 1'-0"

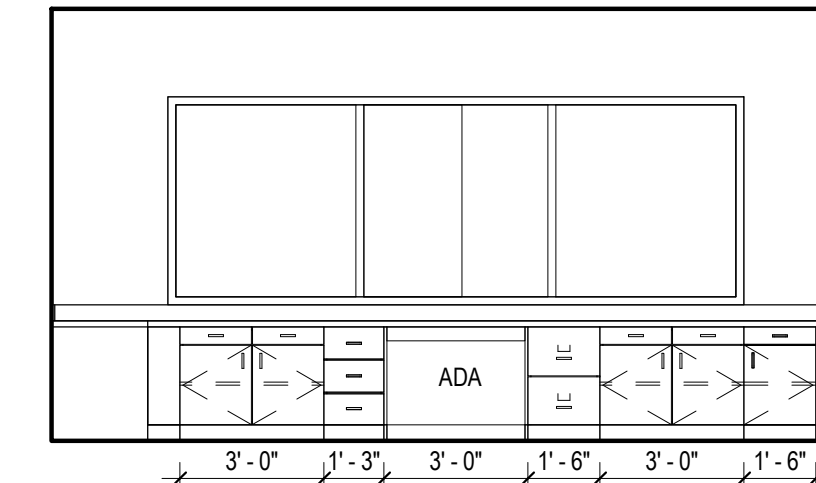


1 A102 - RECEP-SE  
1/4" = 1'-0"
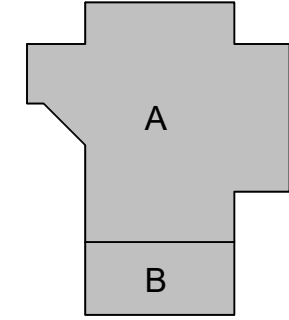
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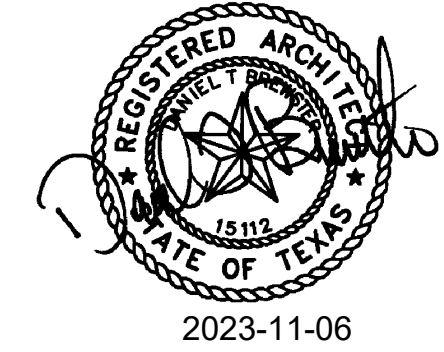


TOMBALL HIGH SCHOOL  
CTE & MISC. RENOVATIONS  
TOMBALL INDEPENDENT SCHOOL DISTRICT  
30330 QUINN ROAD, TOMBALL, TX 77375



TEXAS ARCADIS INC.

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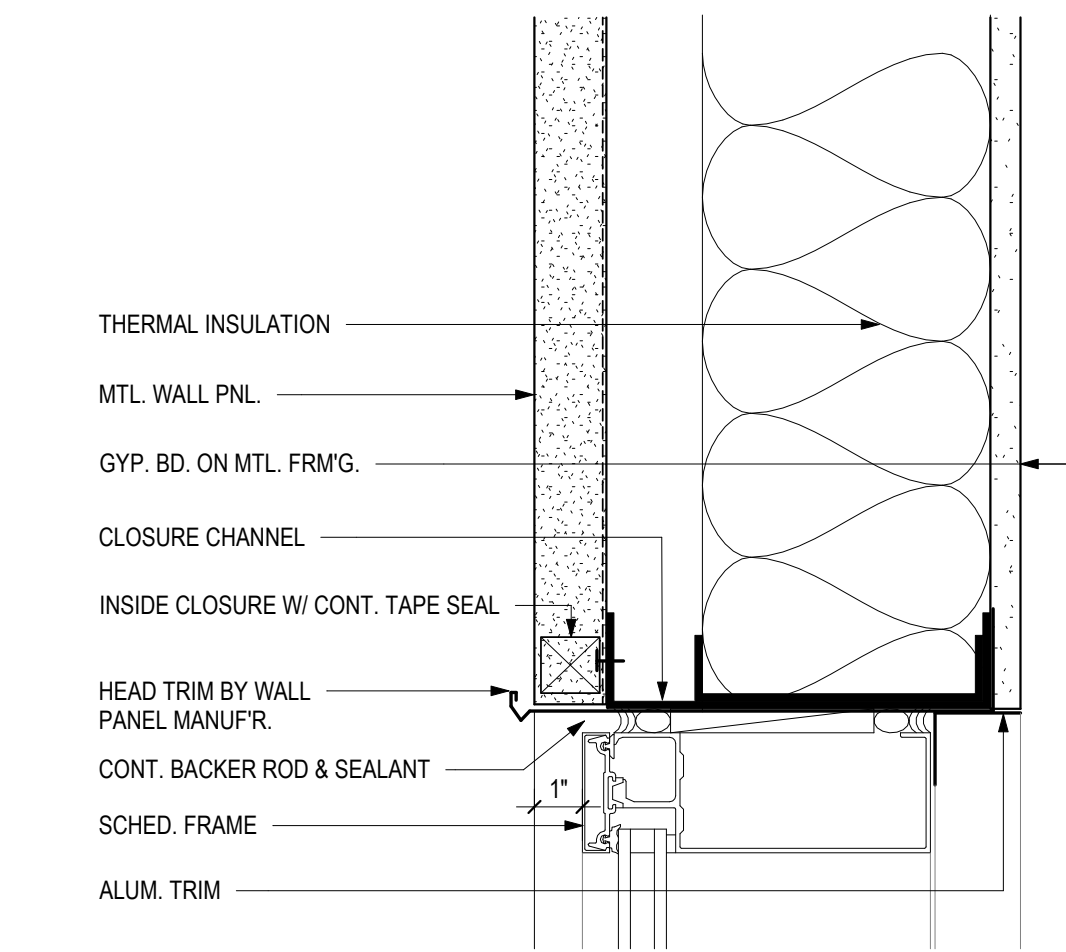


PROJECT #: 202311  
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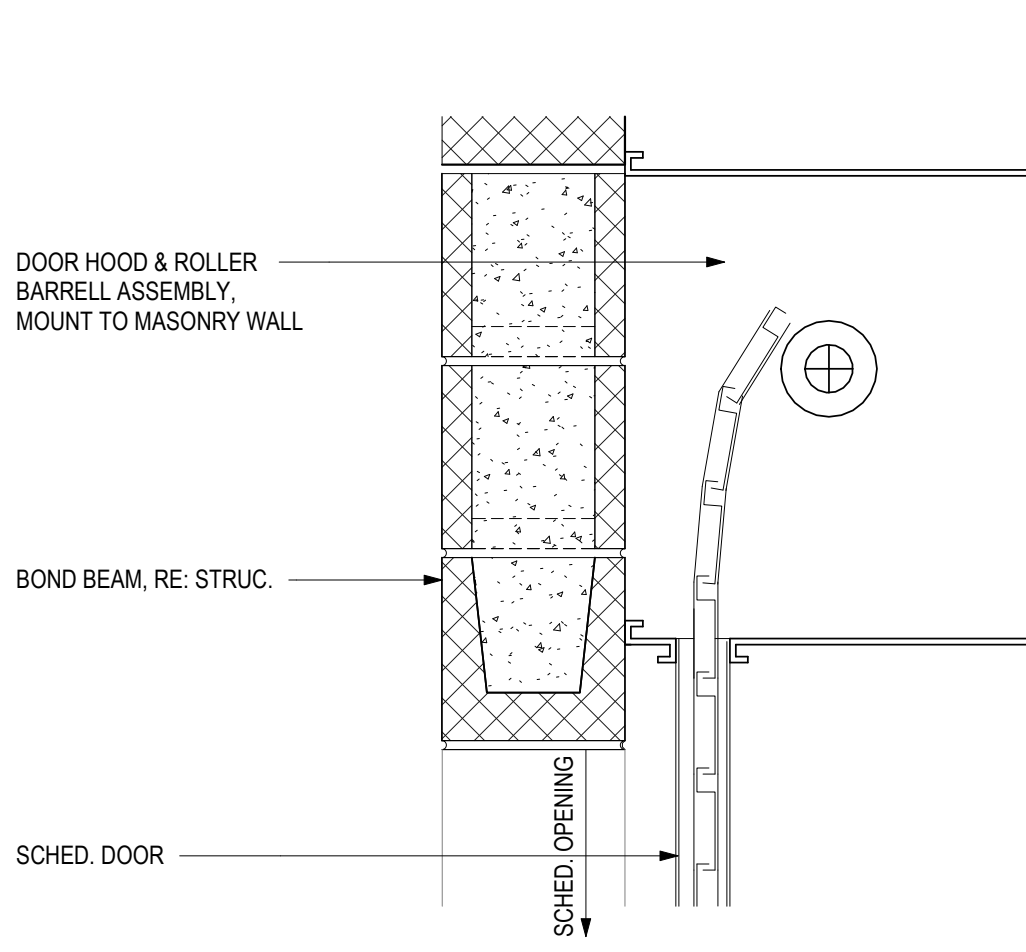
DATE: 2023-11-06  
ISSUE: BID SET

A8.00  
CASEWORK  
ELEVATIONS &  
SECTIONS

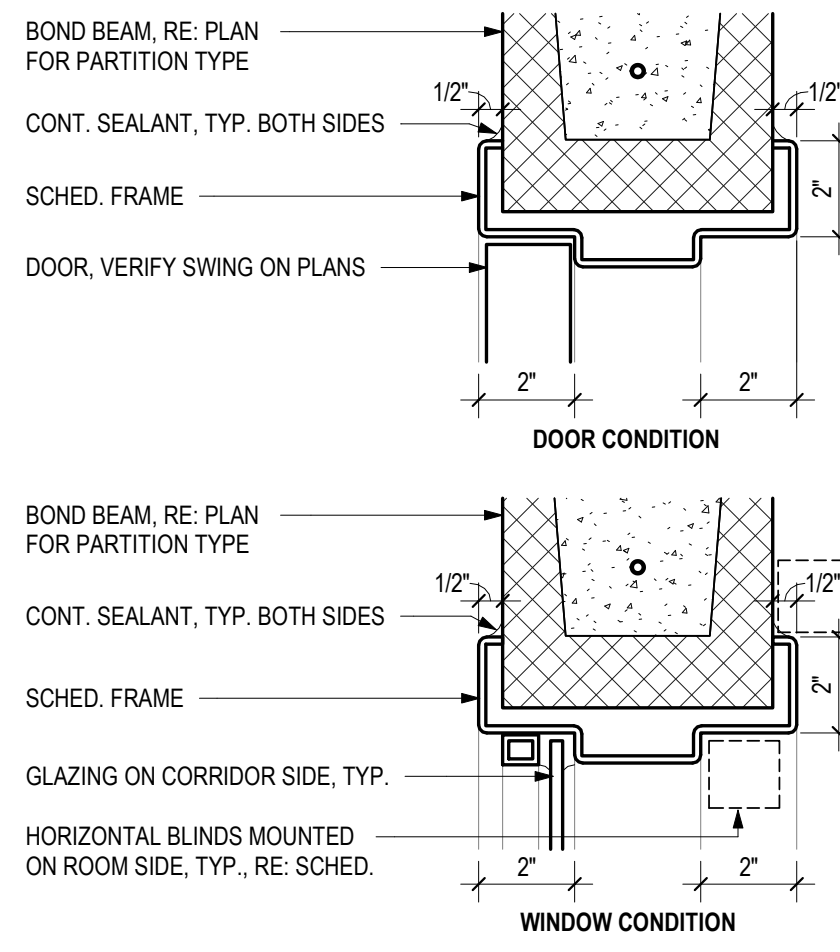





15 EXT ALUM WND HEAD @ MTL B-GYP  
3" = 1'-0"




12 INT OVRHD DOOR HEAD @ CMU  
1 1/2" = 1'-0"




9 INT HM WRP HEAD @ CMU  
3" = 1'-0"

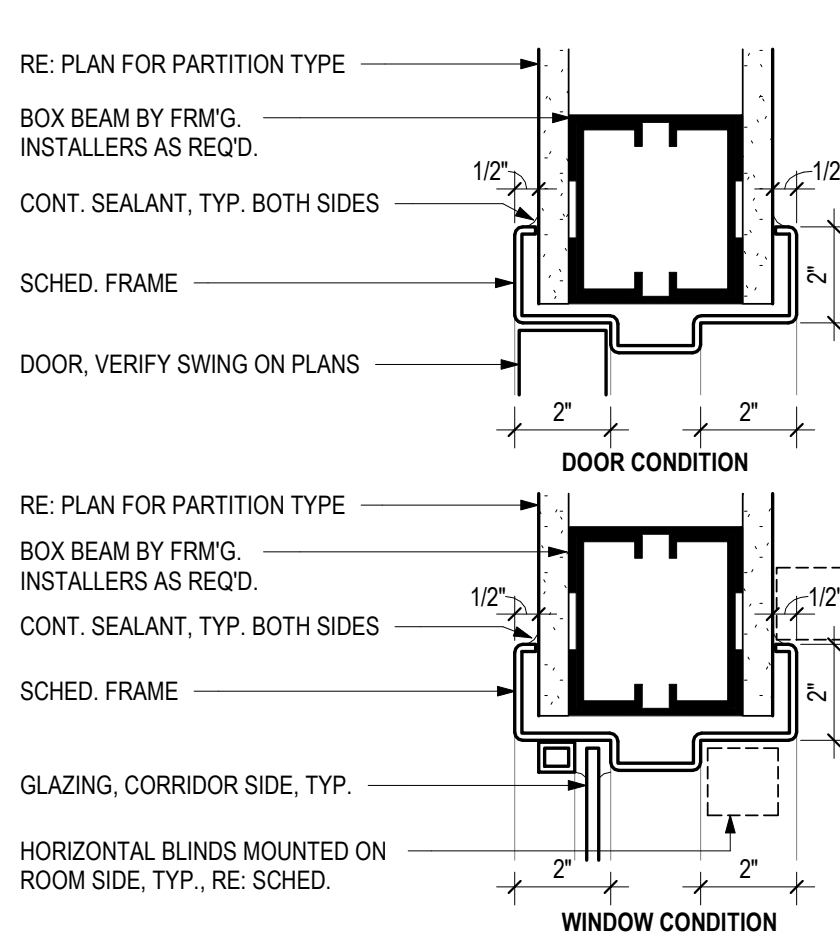


6 INT HM WRP HEAD @ GYP  
3" = 1'-0"

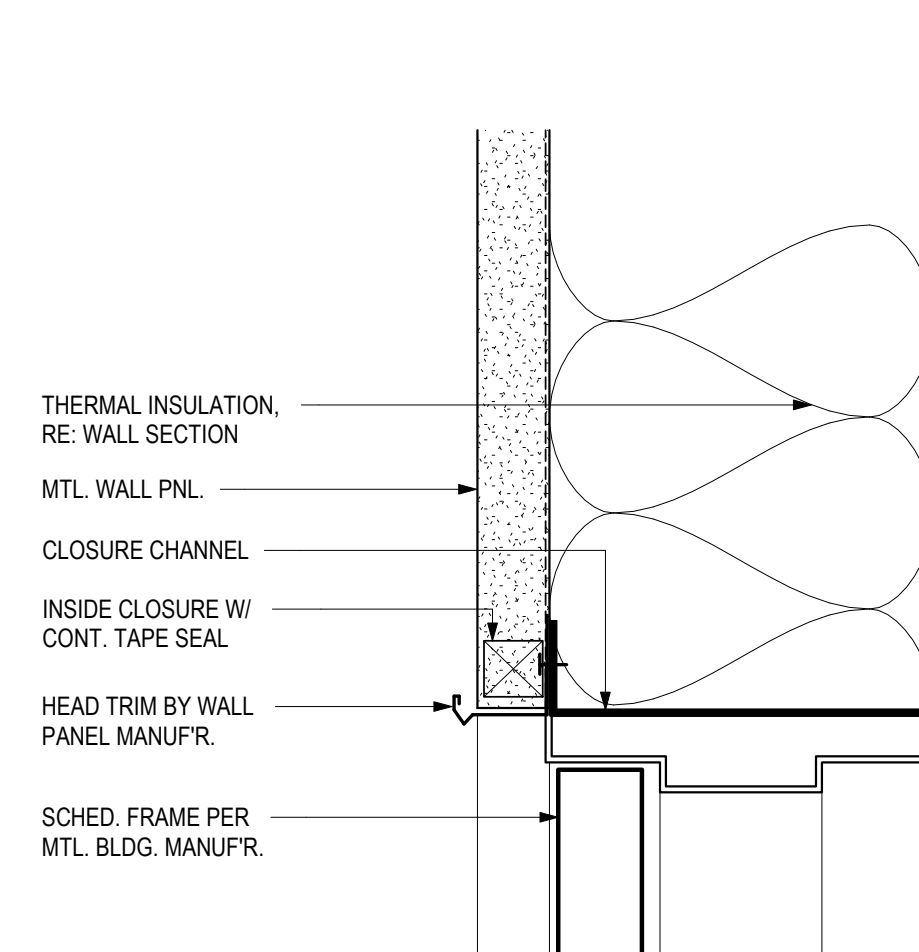

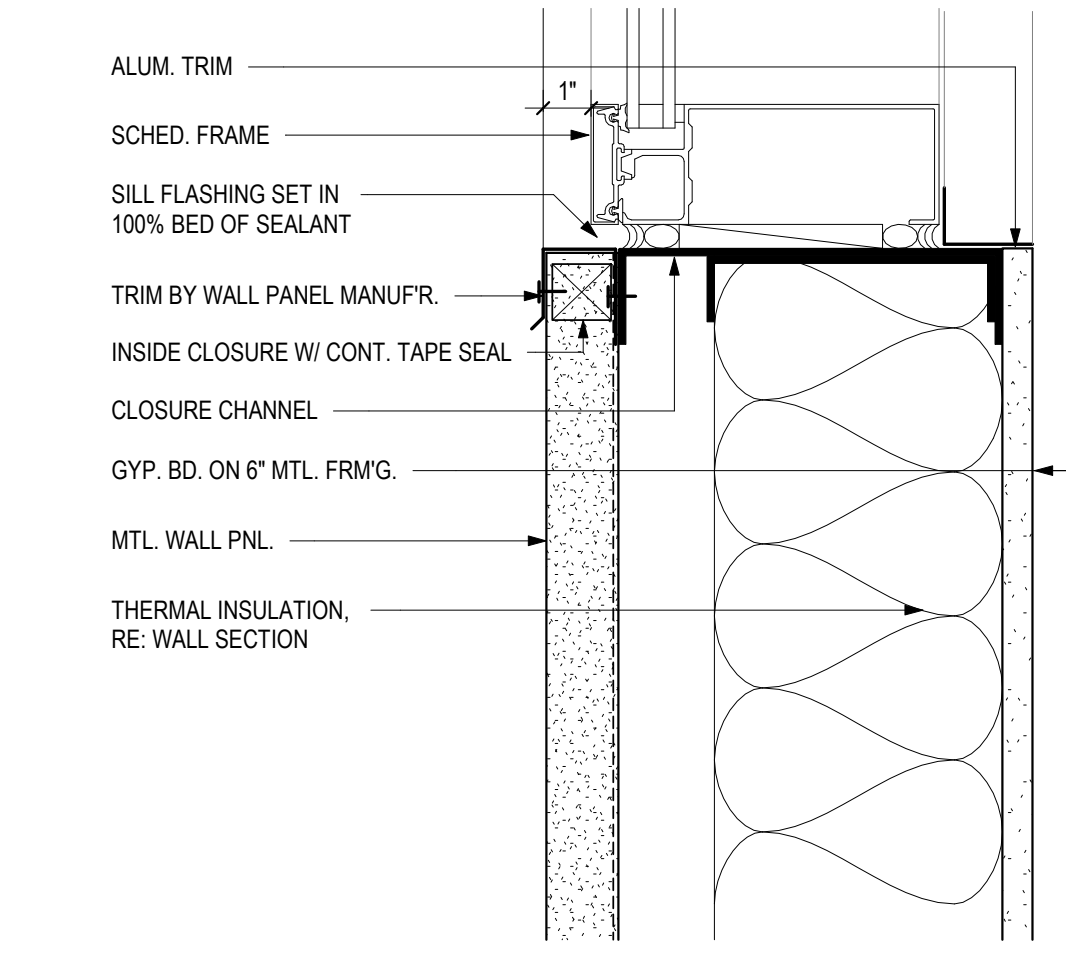
3 EXT HM DR HEAD @ MTL BLDG  
3" = 1'-0"



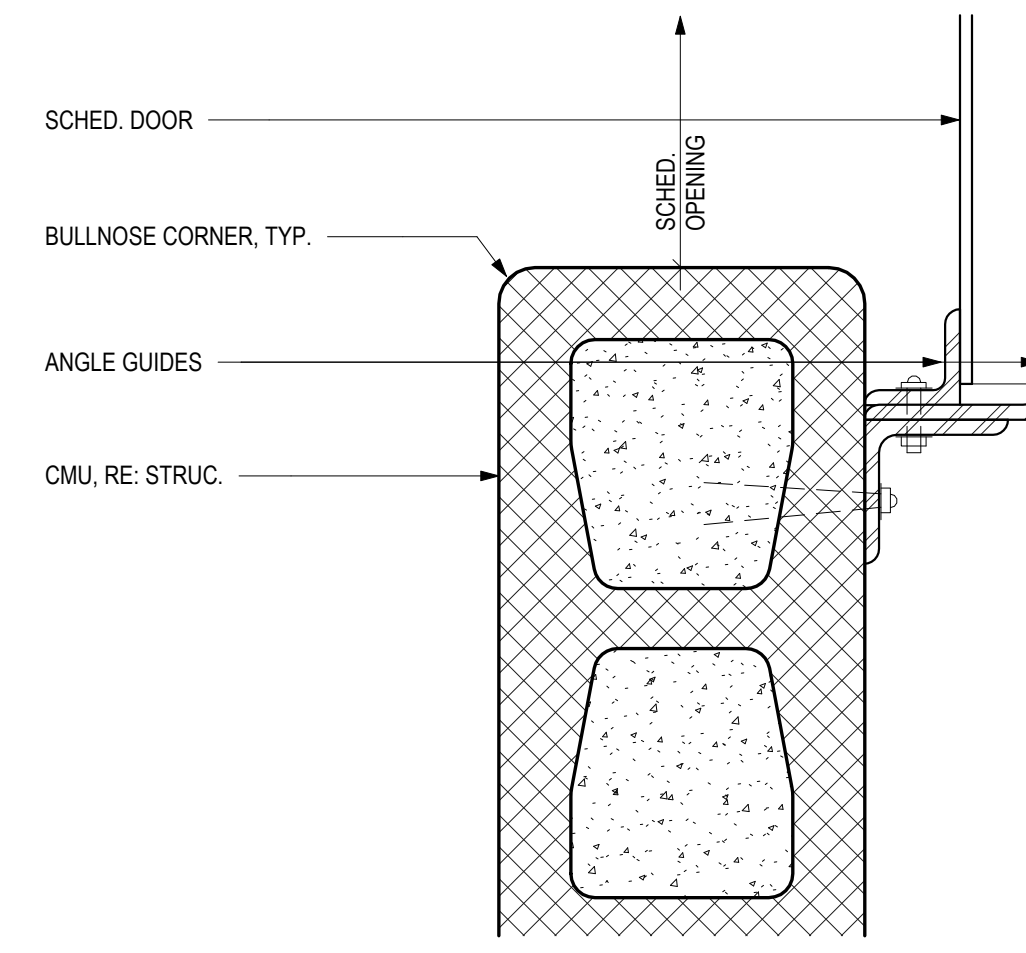
14 EXT ALUM WND JAMB @ MTL B-GYP  
3" = 1'-0"



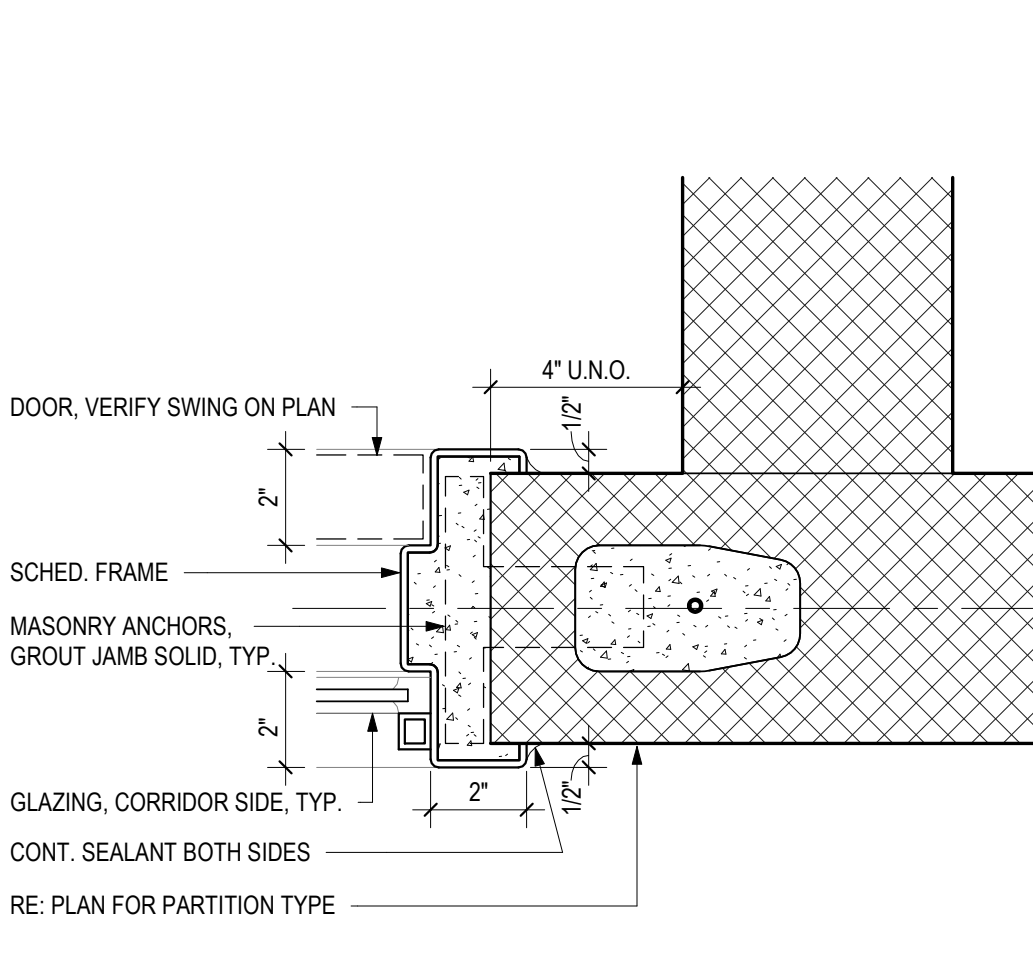
11 INT OVRHD DOOR JAMB @ CMU  
3" = 1'-0"




8 INT HM WRP JAMB @ CMU  
3" = 1'-0"

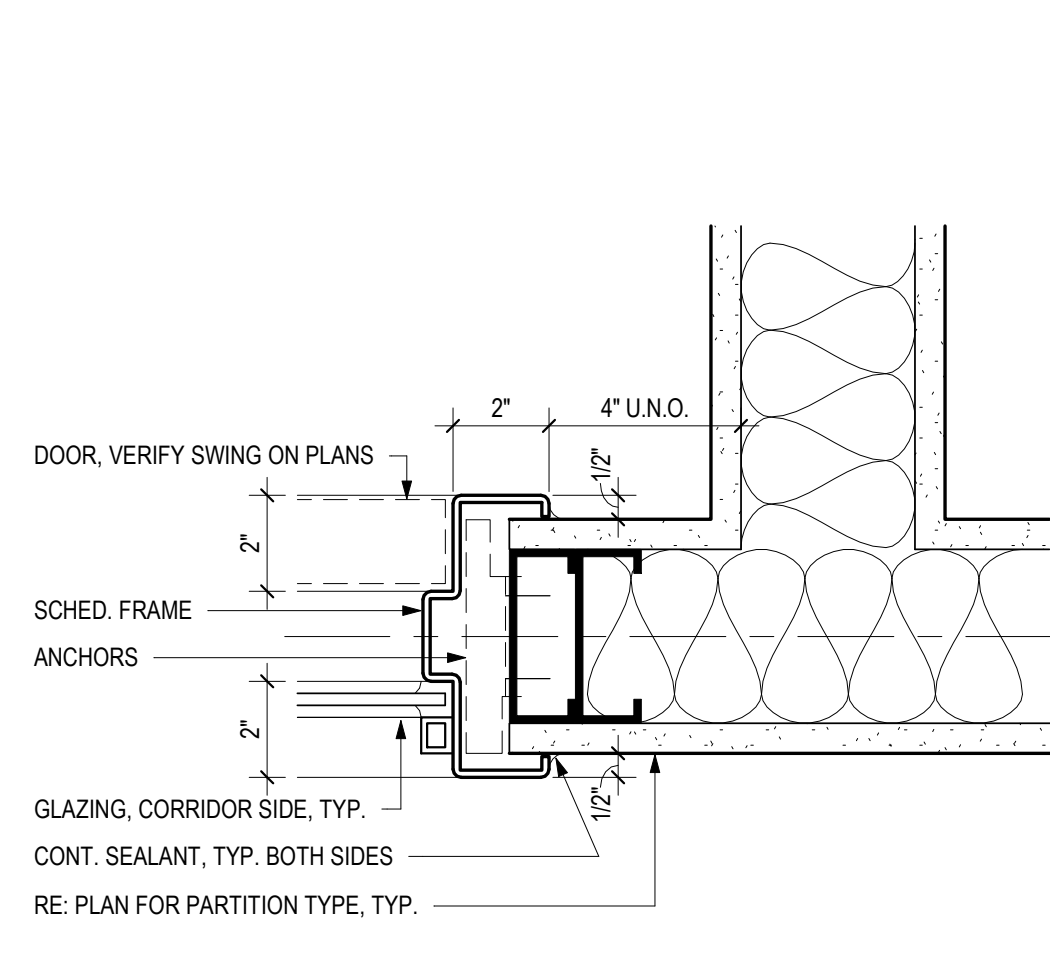


5 INT HM WRP JAMB @ GYP  
3" = 1'-0"

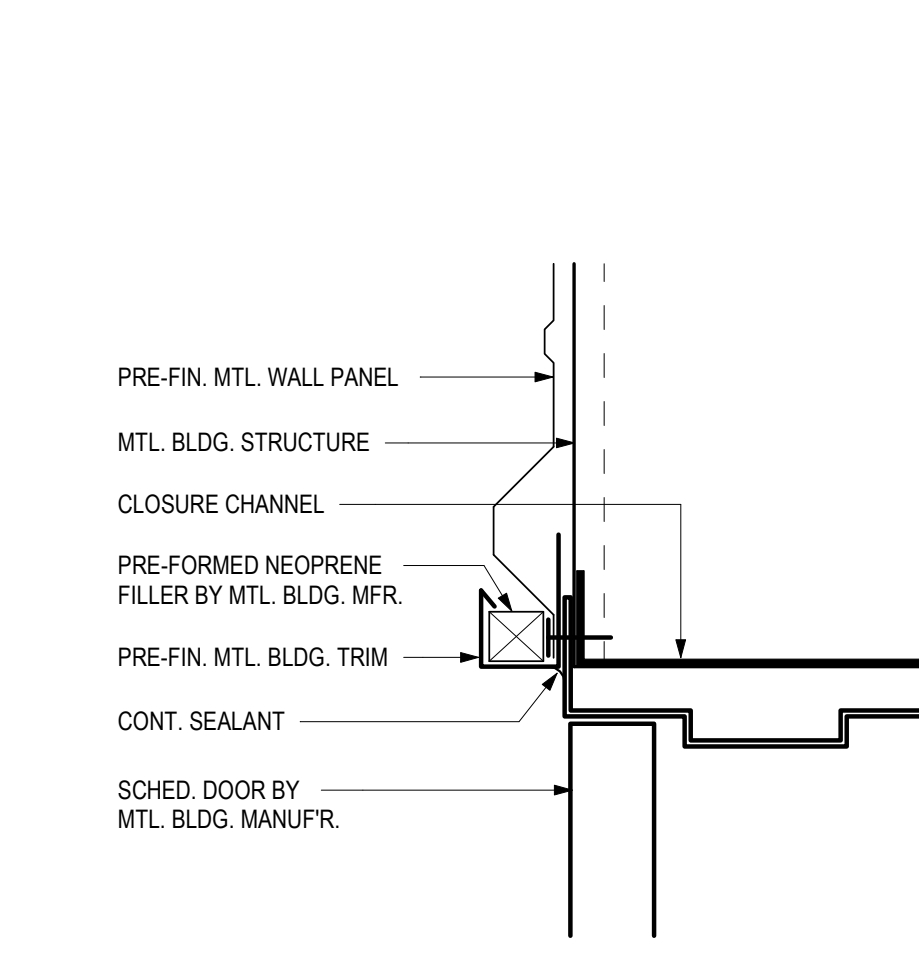

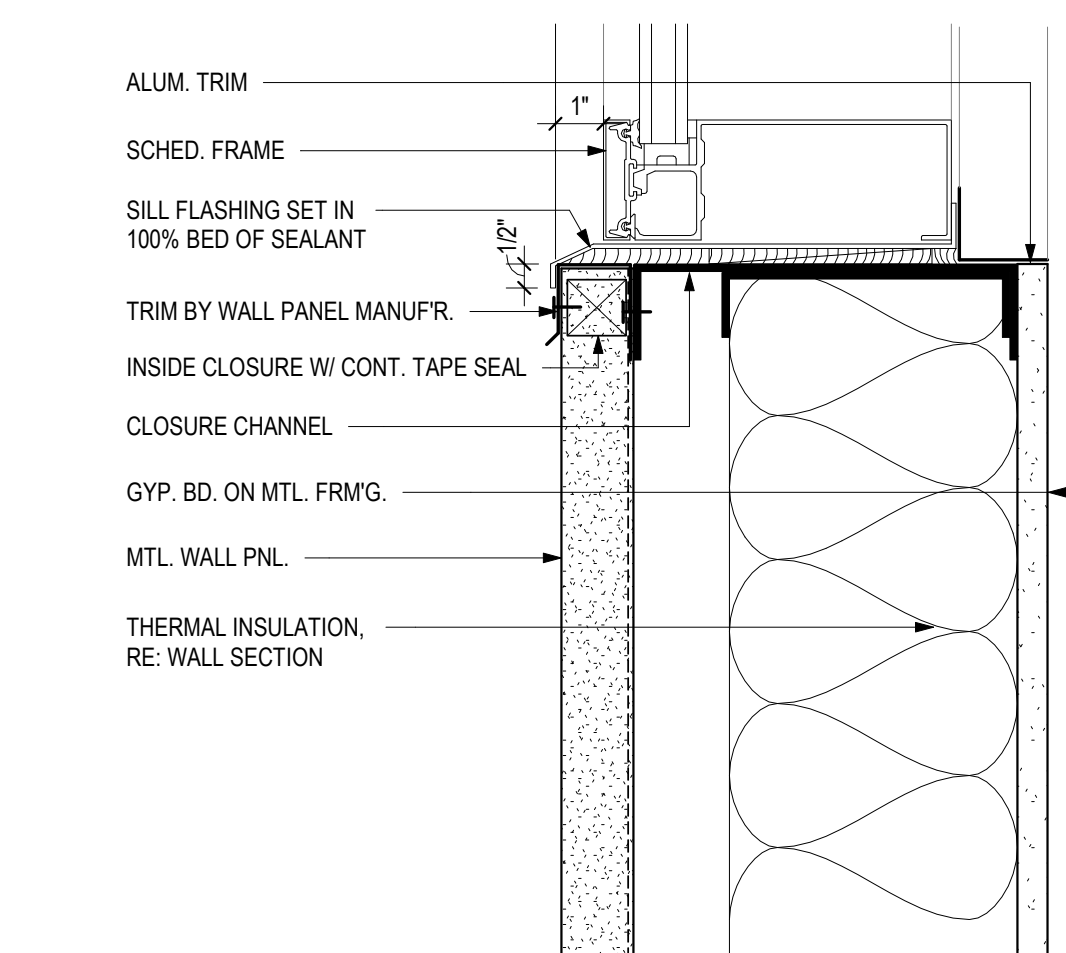
2 EXT HM DR JAMB @ MTL BLDG  
3" = 1'-0"



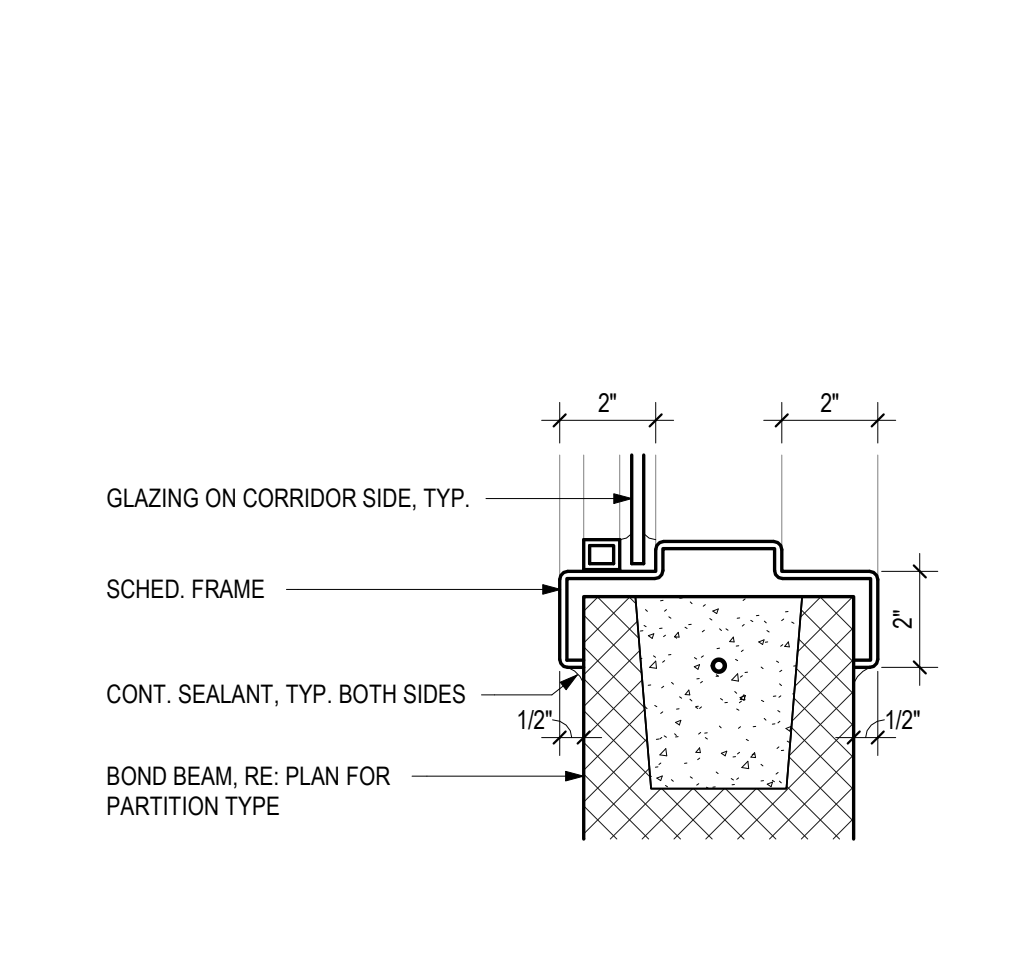
13 EXT ALUM WND SILL @ MTL B-GYP  
3" = 1'-0"



7 INT HM WRP SILL @ CMU  
3" = 1'-0"

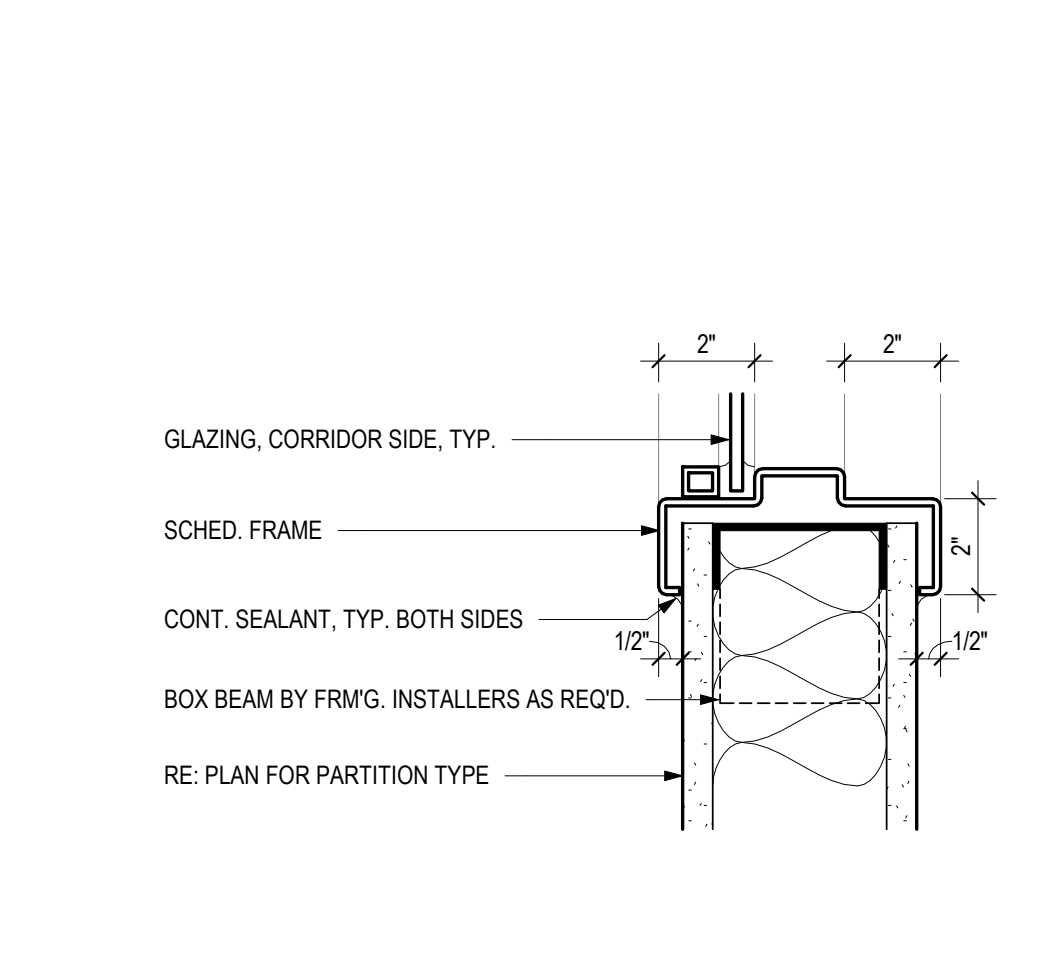

4 INT HM WRP SILL @ GYP  
3" = 1'-0"

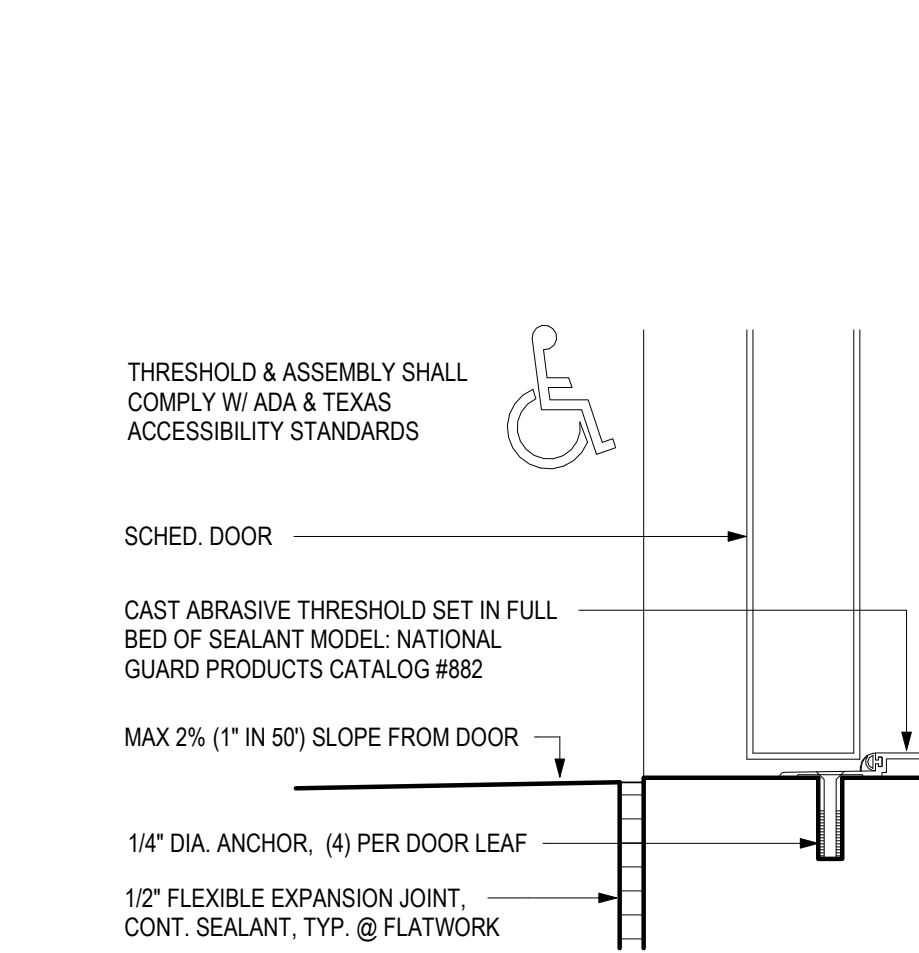

1 EXT DOOR THRSOLD @ FOUND  
3" = 1'-0"

2-E - ALT 2				1-E			
SILL	JAMB	HEAD	CONDITION	SILL	JAMB	HEAD	CONDITION
13 / A9.01	14 / A9.01	15 / A9.01	@ MTL BLDG	1 / A9.01	2 / A9.01	3 / A9.01	@ MTL BLDG

ELEVATIONS - EXTERIOR FRAMES  
1/4" = 1'-0"

3				2				1			
SILL	JAMB	HEAD	CONDITION	SILL	JAMB	HEAD	CONDITION	SILL	JAMB	HEAD	CONDITION
7 / A9.01	8 / A9.01	9 / A9.01	@ CMU	4 / A9.01	5 / A9.01	6 / A9.01	@ GYP	-	5 / A9.01	6 / A9.01	@ GYP
								-	8 / A9.01	9 / A9.01	@ CMU

GENERAL NOTES: 1. "00-E" DESIGNATES EXTERIOR FRAMES  
2. RE: WINDOW ELEVATIONS FOR DOOR FRAMES WHICH ARE PART OF A WINDOW ASSEMBLY

ELEVATIONS - INTERIOR FRAMES  
1/4" = 1'-0"

- LEGEND - GLAZING
- C1 - INSULATED FIRE RATED GLASS
  - G2 - TEMPERED GLASS
  - G3 - CLEAR WIRE SAFETY GLASS
  - G4 - INSULATED GLASS
  - G5 - INSULATED SPANDREL GLASS
  - G6 - ACOUSTIC GLASS
  - G7 - HURRICANE RESISTANT GLASS
  - G8 - HURRICANE RESISTANT SPANDREL GLASS

LEGEND - GLAZING  
1/4" = 1'-0"

P OVERHEAD COILING DOOR SOLID W/ HOOD				L WIRE MESH DOOR				H FLUSH DOOR				D FLUSH DOOR				C FLUSH DOOR				B FLUSH DOOR				A STOREFRONT DOOR			
SILL	JAMB	HEAD	CONDITION	SILL	JAMB	HEAD	CONDITION	SILL	JAMB	HEAD	CONDITION	SILL	JAMB	HEAD	CONDITION	SILL	JAMB	HEAD	CONDITION	SILL	JAMB	HEAD	CONDITION	SILL	JAMB	HEAD	CONDITION
-	11 / A9.01	12 / A9.01	@ CMU	-	-	-	-	-	-	-	-	-	-	-	-	-	-	-	-	-	-	-	-	-	-	-	-

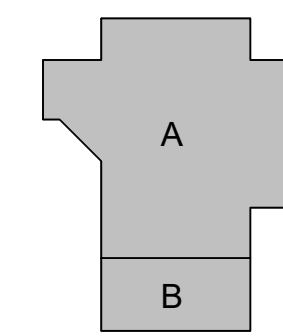
ELEVATIONS - DOORS  
1/4" = 1'-0"

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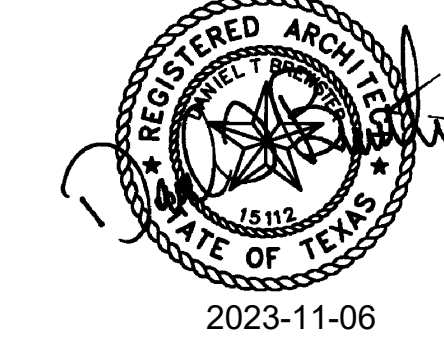


# TOMBALL HIGH SCHOOL CTE & MISC. RENOVATIONS

TOMBALL INDEPENDENT SCHOOL DISTRICT  
30330 QUINN ROAD, TOMBALL, TX 77375

ARCADIS

TEXAS ARCADIS INC.  
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PROJECT #: 202311  
DATE: 2023-11-06  
DRAWN: Author  
CHECKED: Checker

DATE: 2023-11-06  
ISSUE: BID SET

# A9.01

FRAME  
ELEVATIONS &  
OPENING  
DETAILS



1'-0" X 4'-0" LIGHT FIXTURE

2'-0" X 4'-0" LIGHT FIXTURE

SUSPENDED GRID W/ ACOUSTICAL  
CEILING TILE, RE: SCHED. & SPECS.

GYP. BD., PAINTED

LEGEND - RCP

1/4" = 1'-0"

2

FURR DN - ACT-GYP-ACT

1 1/2" = 1'-0"

1

AREA 'A' - RCP

1/8" = 1'-0"

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A

B

TOMBALL HIGH SCHOOL

CTE & MISC. RENOVATIONS

TOMBALL INDEPENDENT SCHOOL DISTRICT

30330 QUINN ROAD, TOMBALL, TX 77375

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REGISTERED ARCHITECT  
STATE OF TEXAS

2023-11-06

PROJECT #: 202311

DATE: 2023-11-06

DRAWN: Author

CHECKED: Checker

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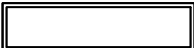
ISSUE: BID SET

A10.01

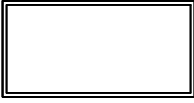
AREA 'A' 1ST  
FLOOR RCP

PLAN  
NORTH







1'-0" X 4'-0" LIGHT FIXTURE




2'-0" X 4'-0" LIGHT FIXTURE

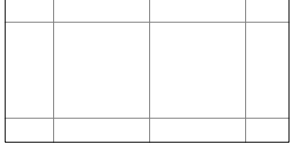

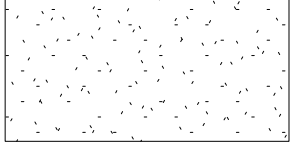SUSPENDED GRID W/ ACOUSTICAL  
CEILING TILE, RE: SCHED. & SPECS.




GYP. BD., PAINTED

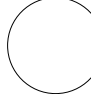

LEGEND - RCP

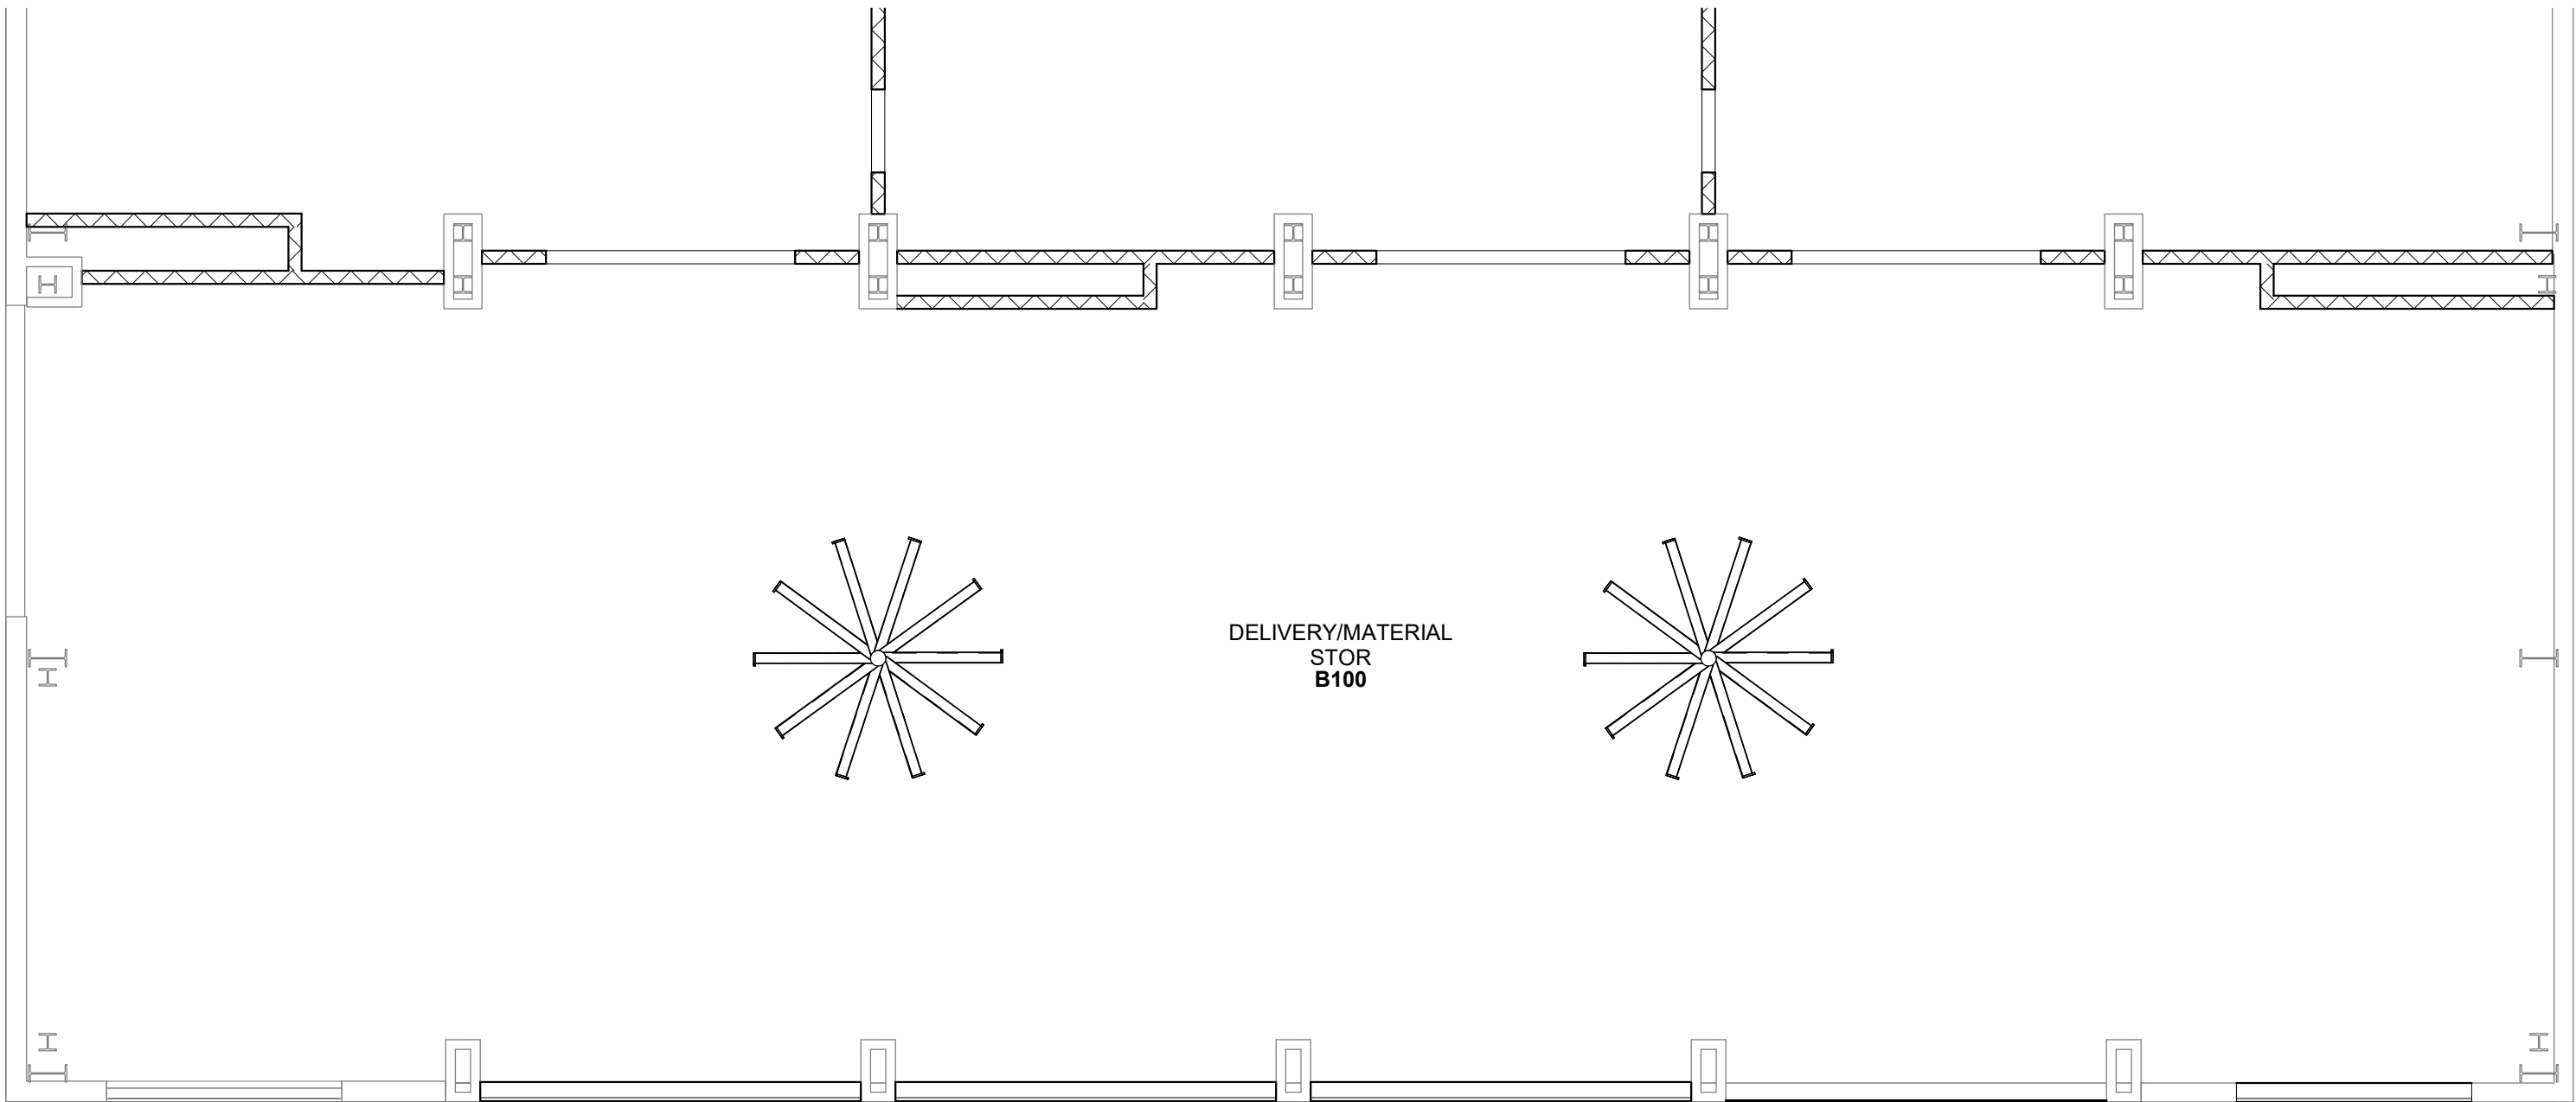1/4" = 1'-0"



1

AREA 'B' - RCP

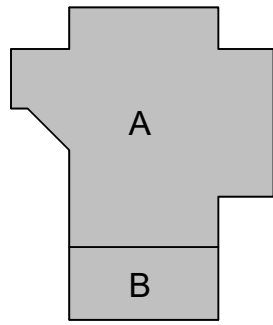
1/8" = 1'-0"

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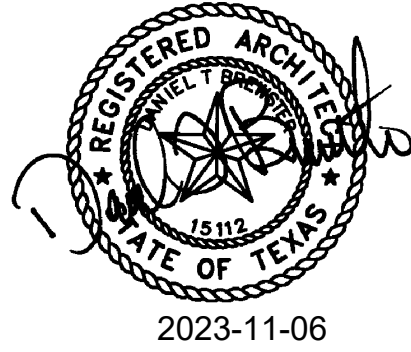


**TOMBALL HIGH SCHOOL  
CTE & MISC. RENOVATIONS**

TOMBALL INDEPENDENT SCHOOL DISTRICT  
30330 QUINN ROAD, TOMBALL, TX 77375

**ARCADIS**

**TEXAS ARCADIS INC.**  
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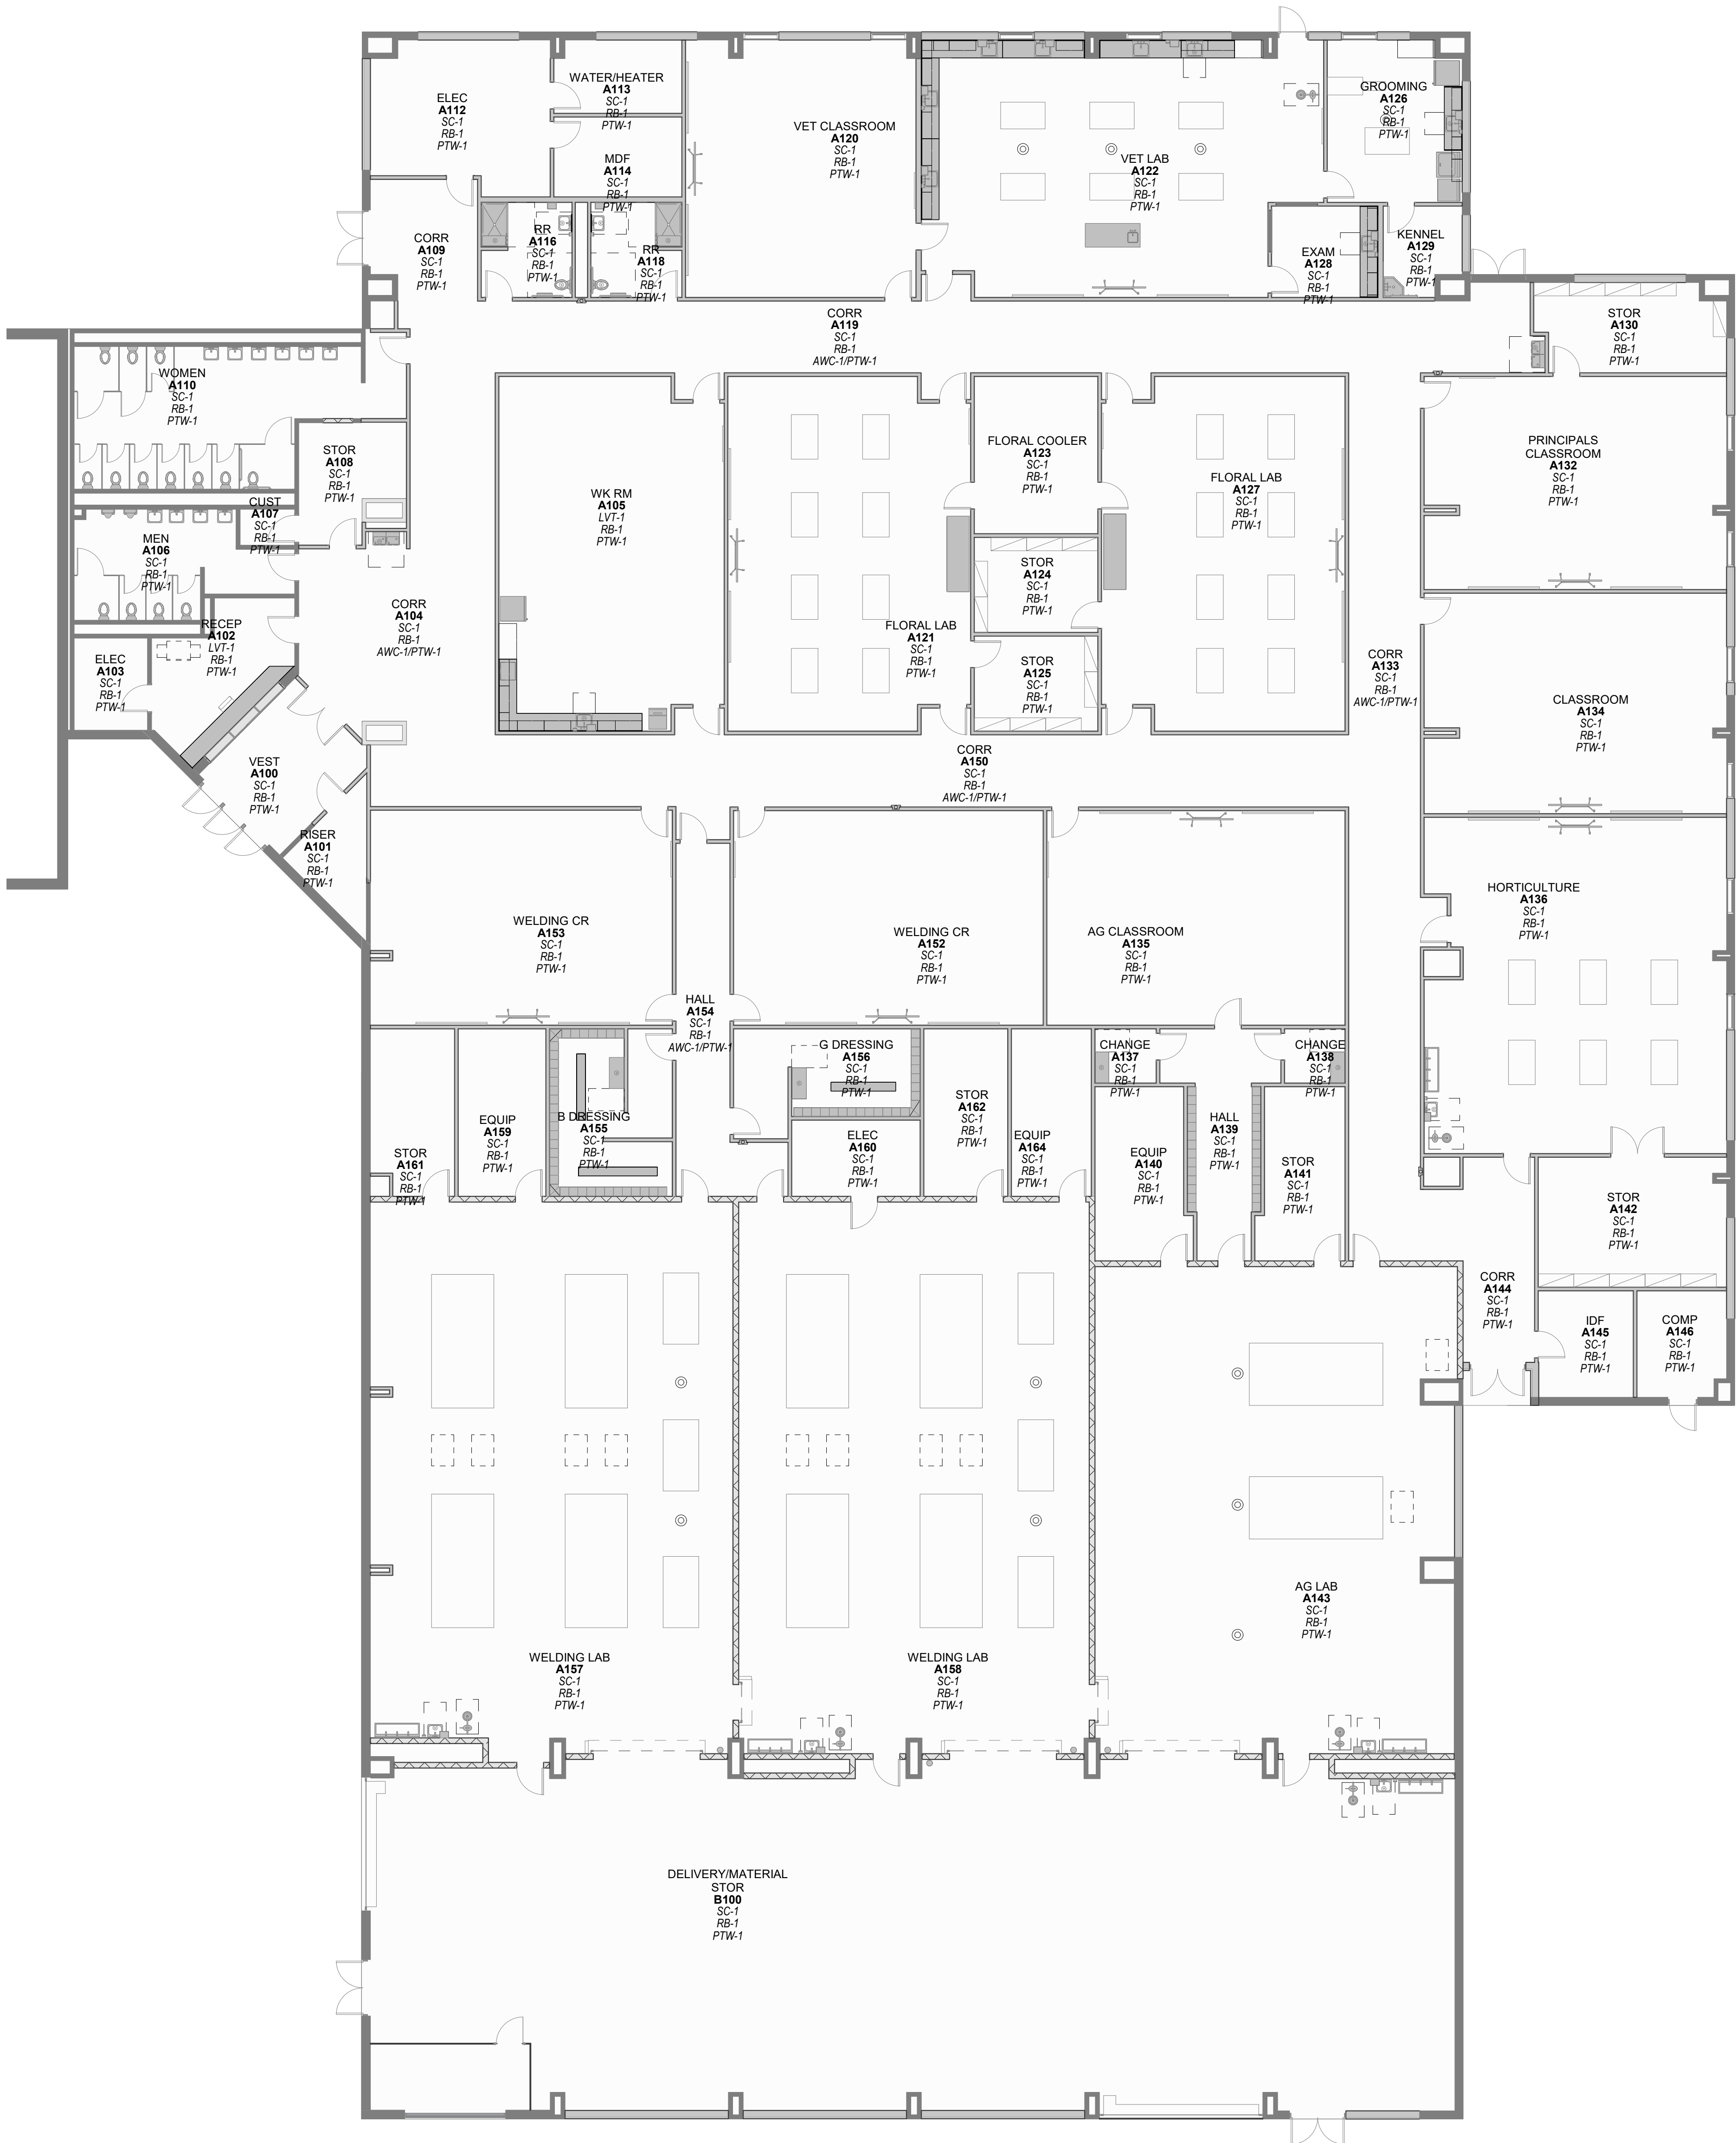
PROJECT #:	202311
DATE:	2023-11-06
DRAWN:	Author
CHECKED:	Checker
DATE:	ISSUE
2023-11-06	BID SET

**A10.02**

AREA 'B' 1ST  
FLOOR RCP







FLOORS		WALLS		CEILINGS		MISC.	
CT F-1	CERAMIC TILE MFR: XX SERIES: XX COLOR: XX SIZES: XX	AWC-1	RIGID STAIN RESISTANT WALL COVERING MFR: XX SERIES: XX COLOR: XX SIZES: XX	ACT-1	ACOUSTICAL CEILING TILE (TYPE A) MFR: XX SERIES: XX COLOR: XX SIZES: XX	GRT-1	GROUT MFR: XX SERIES: XX COLOR: XX SIZES: XX
CT F-2	CERAMIC TILE MFR: XX SERIES: XX COLOR: XX SIZES: XX	AWP-1	ACOUSTICAL WALL PANEL MFR: TECTUM SERIES: XX COLOR: XX SIZES: XX	ACT-2	ACOUSTICAL CEILING TILE (TYPE B) MFR: XX SERIES: XX COLOR: XX SIZES: XX	GRT2	GROUT MFR: XX SERIES: XX COLOR: XX SIZES: XX
LVT-1	RESILIENT FLOOR MFR: XX SERIES: XX COLOR: XX SIZES: XX	CTW-1	CERAMIC TILE MFR: XX SERIES: XX COLOR: XX SIZES: XX	PT C-1	PAINT (GYP. BD. CEILING) MFR: XX SERIES: XX COLOR: XX SIZES: XX	LCK-1	LOCKER MFR: XX SERIES: XX COLOR: XX SIZES: XX
SC-1	SEALED CONCRETE MFR: XX SERIES: XX COLOR: XX SIZES: XX	CTW-2	CERAMIC TILE MFR: XX SERIES: XX COLOR: XX SIZES: XX			PT M-1	PAINT (DOOR FRAMES) MFR: XX SERIES: XX COLOR: XX SIZES: XX
WM-1	WALK-OFF MAT MFR: XX SERIES: XX COLOR: XX SIZES: XX	CG-1	CORNER GUARD MFR: XX SERIES: XX COLOR: XX SIZES: XX			PL-1	PLASTIC LAMINATE (DOORS) MFR: XX SERIES: XX COLOR: XX SIZES: XX
		PT W-1	PAINT MFR: XX SERIES: XX COLOR: XX SIZES: XX			PL-2	PLASTIC LAMINATE (CASEWORK) MFR: XX SERIES: XX COLOR: XX SIZES: XX
		PT W-2	PAINT MFR: XX SERIES: XX COLOR: XX SIZES: XX			PL-3	PLASTIC LAMINATE (COUNTERTOPS) MFR: XX SERIES: XX COLOR: XX SIZES: XX
		PT W-3	PAINT MFR: XX SERIES: XX COLOR: XX SIZES: XX			PL-4	PLASTIC LAMINATE (TOILET PARTITIONS) MFR: XX SERIES: XX COLOR: XX SIZES: XX
		RB-1	RUBBER BASE MFR: XX SERIES: XX COLOR: XX SIZES: XX			SS-1	SOLID SURFACE MFR: XX SERIES: XX COLOR: XX SIZES: XX

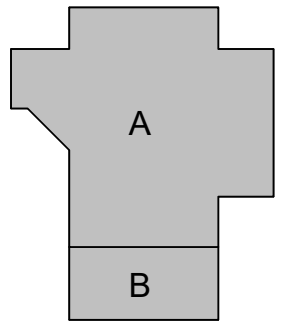
NOTE: ALL OPTIONS, SIZES, AND PATTERNS ARE SUBJECT TO CHANGE UPON OWNER APPROVAL.

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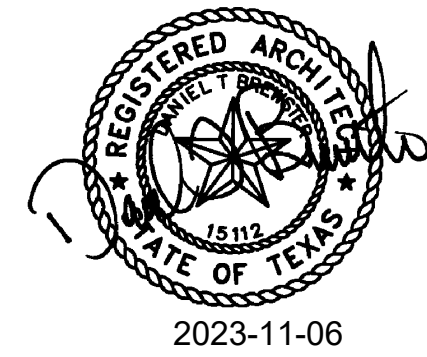
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# TOMBALL HIGH SCHOOL CTE & MISC. RENOVATIONS

TOMBALL INDEPENDENT SCHOOL DISTRICT  
30330 QUINN ROAD, TOMBALL, TX 77375

ARCADIS  
TEXAS ARCADIS INC.  
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PROJECT #: 202311  
DATE: 2023-11-06  
DRAWN: Author  
CHECKED: Checker  
DATE: 2023-11-06  
ISSUE: BID SET

## A11.00

INTERIOR FINISH  
PLAN & LEGEND



AREA 'A1' - GRAPHIC SCHEDULE										
ROOM #	ROOM NAME	GRAPHIC #	GRAPHIC NAME	PLAQUE TYPE	SEX ID	ADA SYMBOL	QTY	BCKR PLT(S)	COMMENTS	
A100	VEST	1650		B			1			
A101	RISER	1650A		B			1			
A102	RECEP	1652		B			1			
A103	ELEC	1652A		B			1			
A104	CORR	1651		B			1			
A105	WK RM	1661		A			1			
A106	MEN	1654		A			1			
A107	CUST	-					0			
A108	STOR	1656		B			1			
A109	CORR	1651A		B			1			
A110	WOMEN	1658		D			1			
A112	ELEC	1600		B			1			
A113	WATERHEATER	1660A		B			1			
A114	MDF	1660B		B			1			
A116	RR	1662		D			1			
A118	RR	1664		D			1			
A119	CORR	1651B		B			1			
A120	VET CLASSROOM	1666		A			1			
A121	FLORAL LAB	1663		A			1			
A122	VET LAB	1668		A			1			
A123	FLORAL COOLER	1665		B			1			
A124	STOR	1667A		B			1			
A125	STOR	1663A		B			1			
A126	GROOMING	1668B		A			1			
A127	FLORAL LAB	1667		A			1			
A128	EXAM	1668A		B			1			
A129	KENNEL	1668C		B			1			
A130	STOR	1670A		B			1			
A132	PRINCIPALS CLASSROOM	1670		A			1			
A133	CORR	1651C		B			1			
A134	CLASSROOM	1672		A			1			
A135	AG CLASSROOM	1680		A			1			
A136	HORTICULTURE	1674		A			1			
A137	CHANGE	1680C		B			1			
A138	CHANGE	1680B		B			1			
A139	HALL	1680A		B			1			
A140	EQUIP	1681B		B			1			
A141	STOR	1681A		B			1			
A142	STOR	1674A		B			1			
A143	AG LAB	1681		A			1			
A144	CORR	1651E		B			1			
A145	IDF	1676		B			1			
A146	COMP	1678		B			1			
A150	CORR	1651D		B			1			
A152	WELDING CR	1682		A			1			
A153	WELDING CR	1686		A			1			
A154	HALL	1684		B			1			
A155	B DRESSING	1684B		B			1			
A156	G DRESSING	1684A		B			1			
A157	WELDING LAB	1685		A			1			
A158	WELDING LAB	1683		A			1			
A159	EQUIP	1685A		B			1			
A160	ELEC	1683C		B			1			
A161	STOR	1685B		B			1			
A162	STOR	1683B		B			1			
A164	EQUIP			B			1			

AREA 'B1' - GRAPHIC SCHEDULE										
ROOM #	ROOM NAME	GRAPHIC #	GRAPHIC NAME	PLAQUE TYPE	SEX ID	ADA SYMBOL	QTY	BCKR PLT(S)	COMMENTS	
B100	DELIVERYMATERIAL STOR	1688								

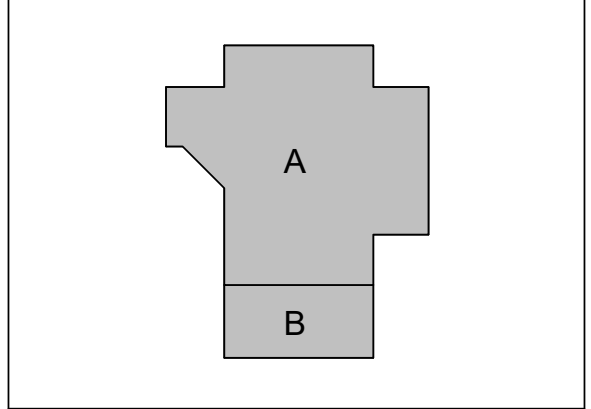


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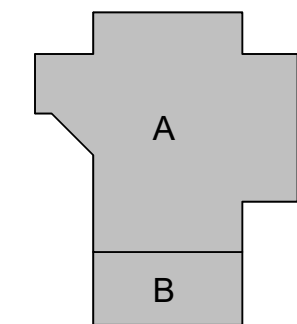
A12.00

SIGNAGE FLOOR  
PLAN





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**TOMBALL HIGH SCHOOL  
CTE & MISC. RENOVATIONS**


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30330 QUINN ROAD, TOMBALL, TX 77375



**TEXAS ARCADIS INC**

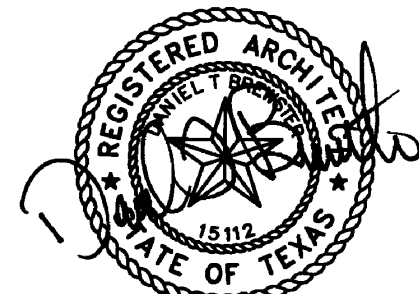10205 WESTHEIMER SUITE 800

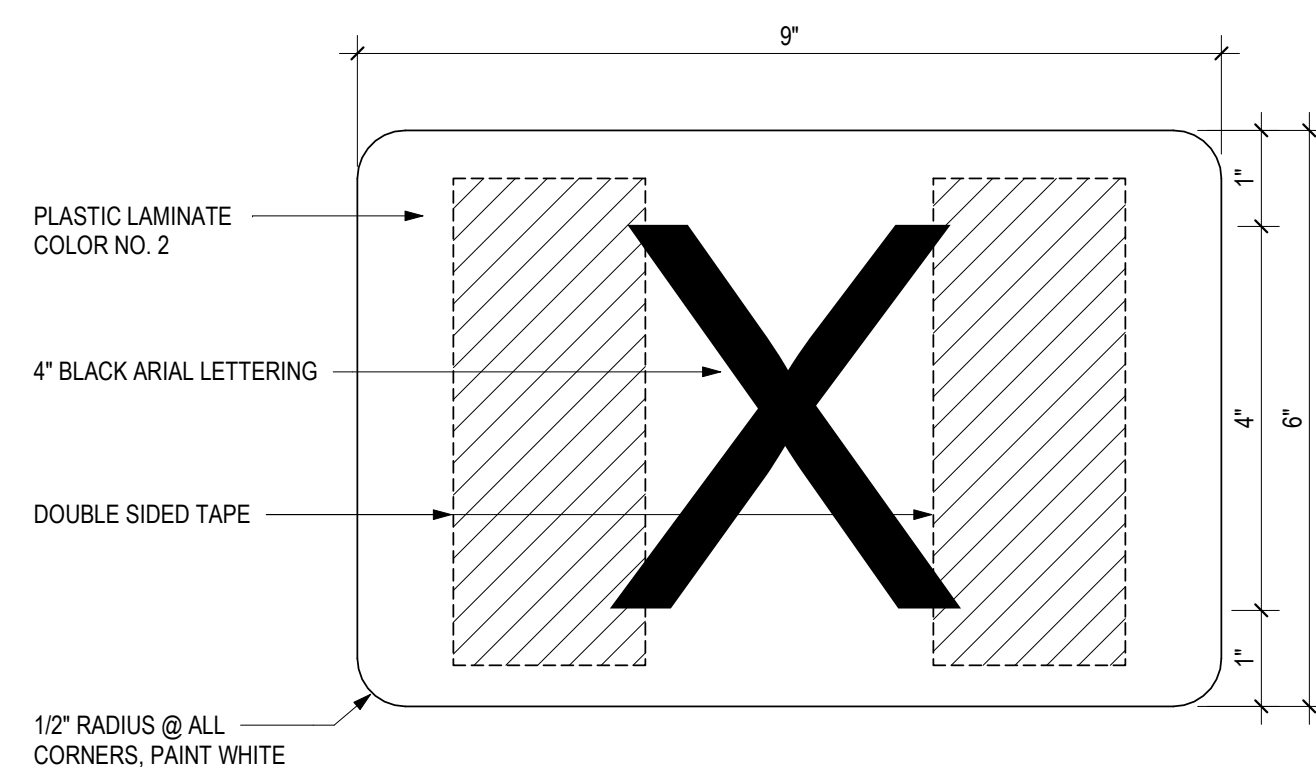
HOUSTON, TX 77042



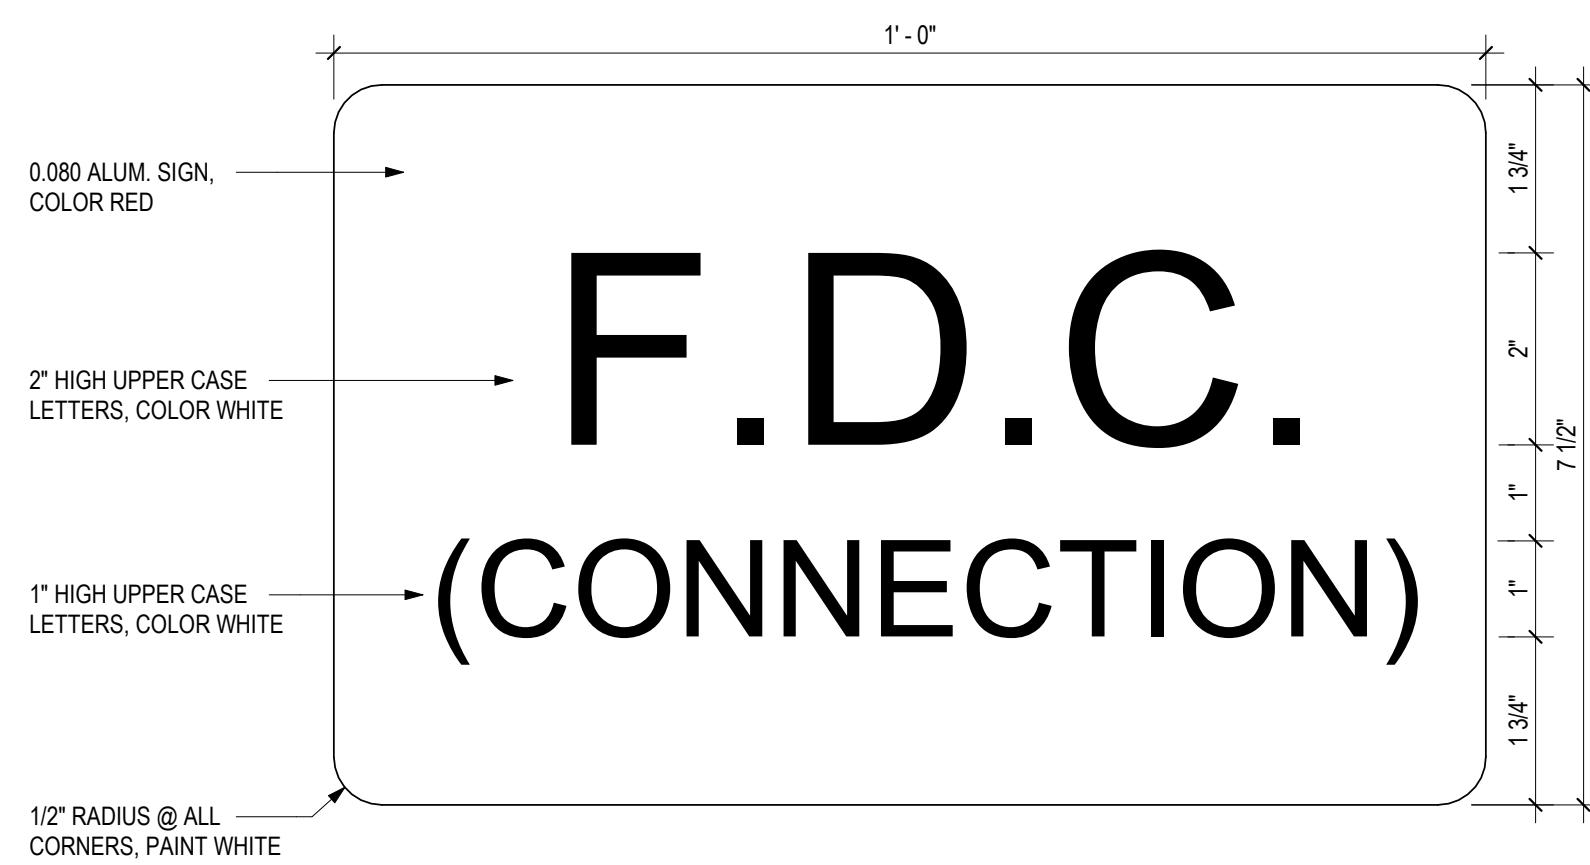
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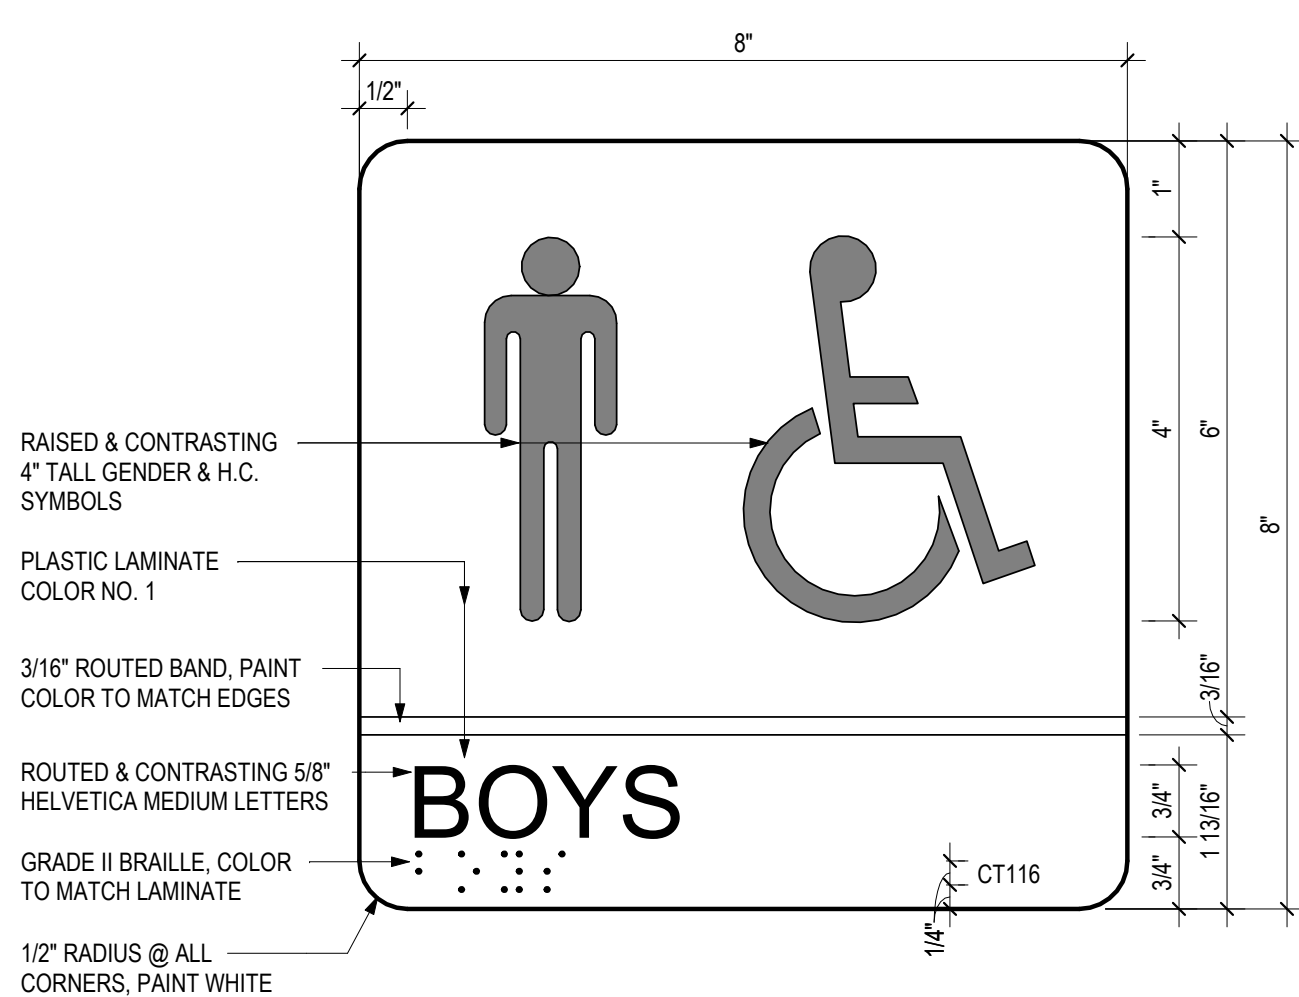
**7** SIGN - TYPE 'V'




6 SIGN - TYPE 'Q'  
6" = 1'-0"




5 SIGN - TYPE 'K'  
6" = 1'-0"



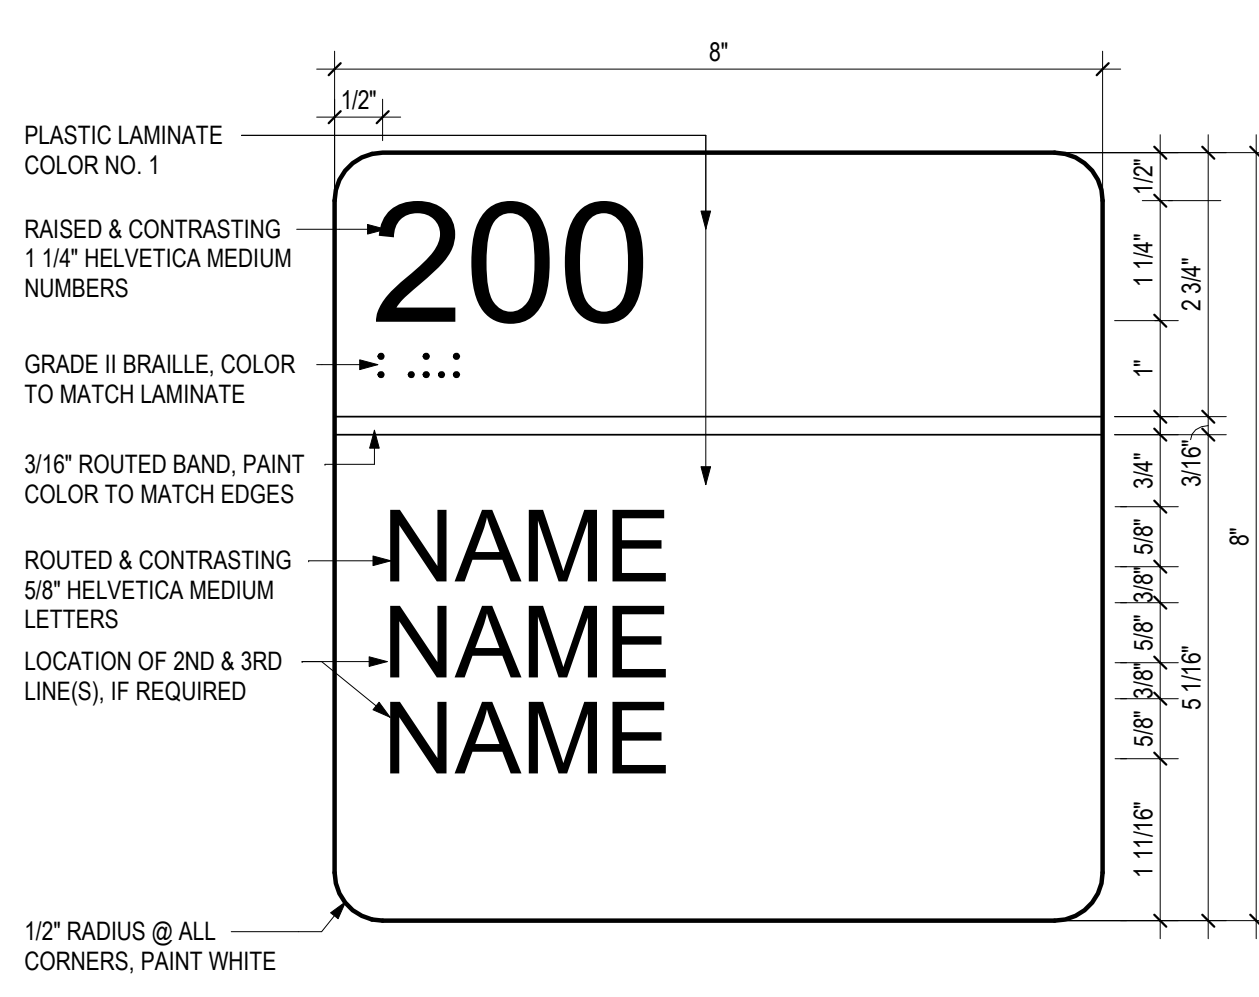
4 SIGN - TYPE 'D'  
6" = 1'-0"



3 SIGN - TYPE 'B'  
6" = 1'-0"

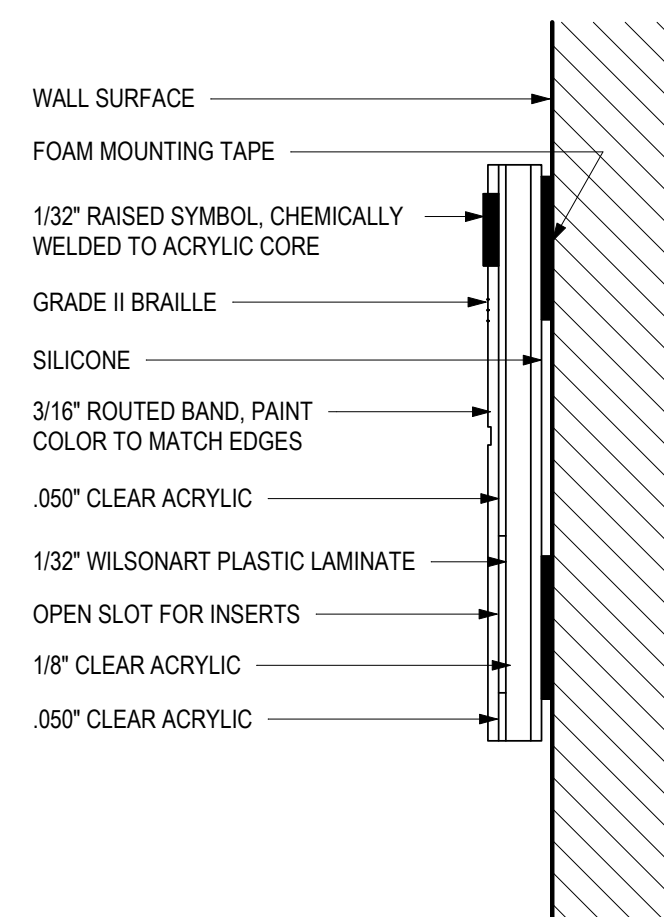

2 SIGN - TYPE 'A' SECTION  
6" = 1'-0"

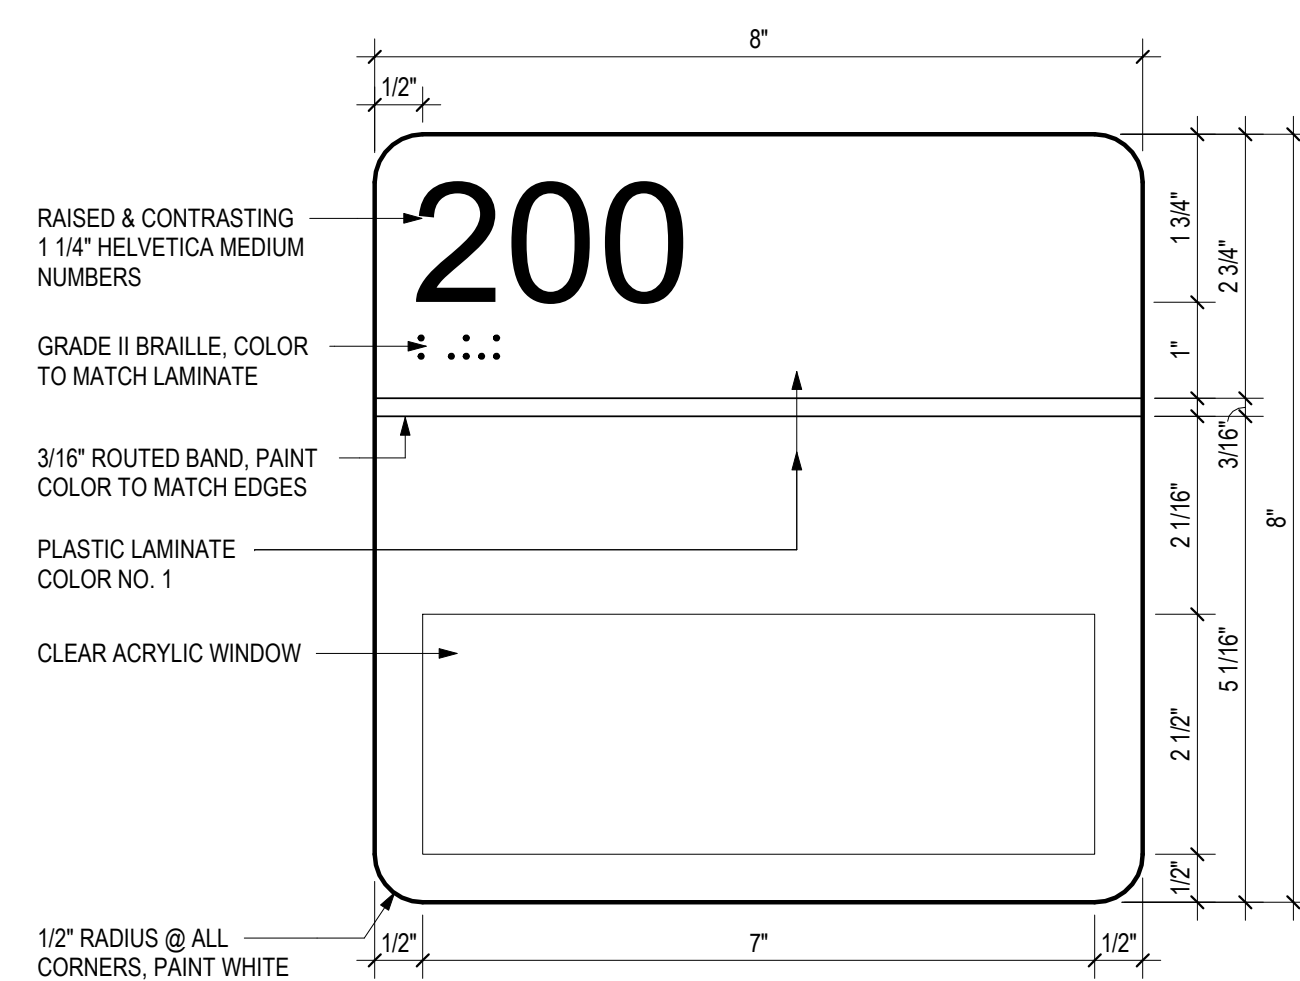

PLASTIC LAMINATE		RAISED LETTERING
#	WILSONART COLOR/ NUMBER	
1	HUNTINGTON MAPLE / 7929-38	BLACK


1 SIGN - TYPE 'A'  
6" = 1'-0"

PROJECT #:	202311
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CHECKED:	Checker
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2023-11-06	BID SET

## A12.01

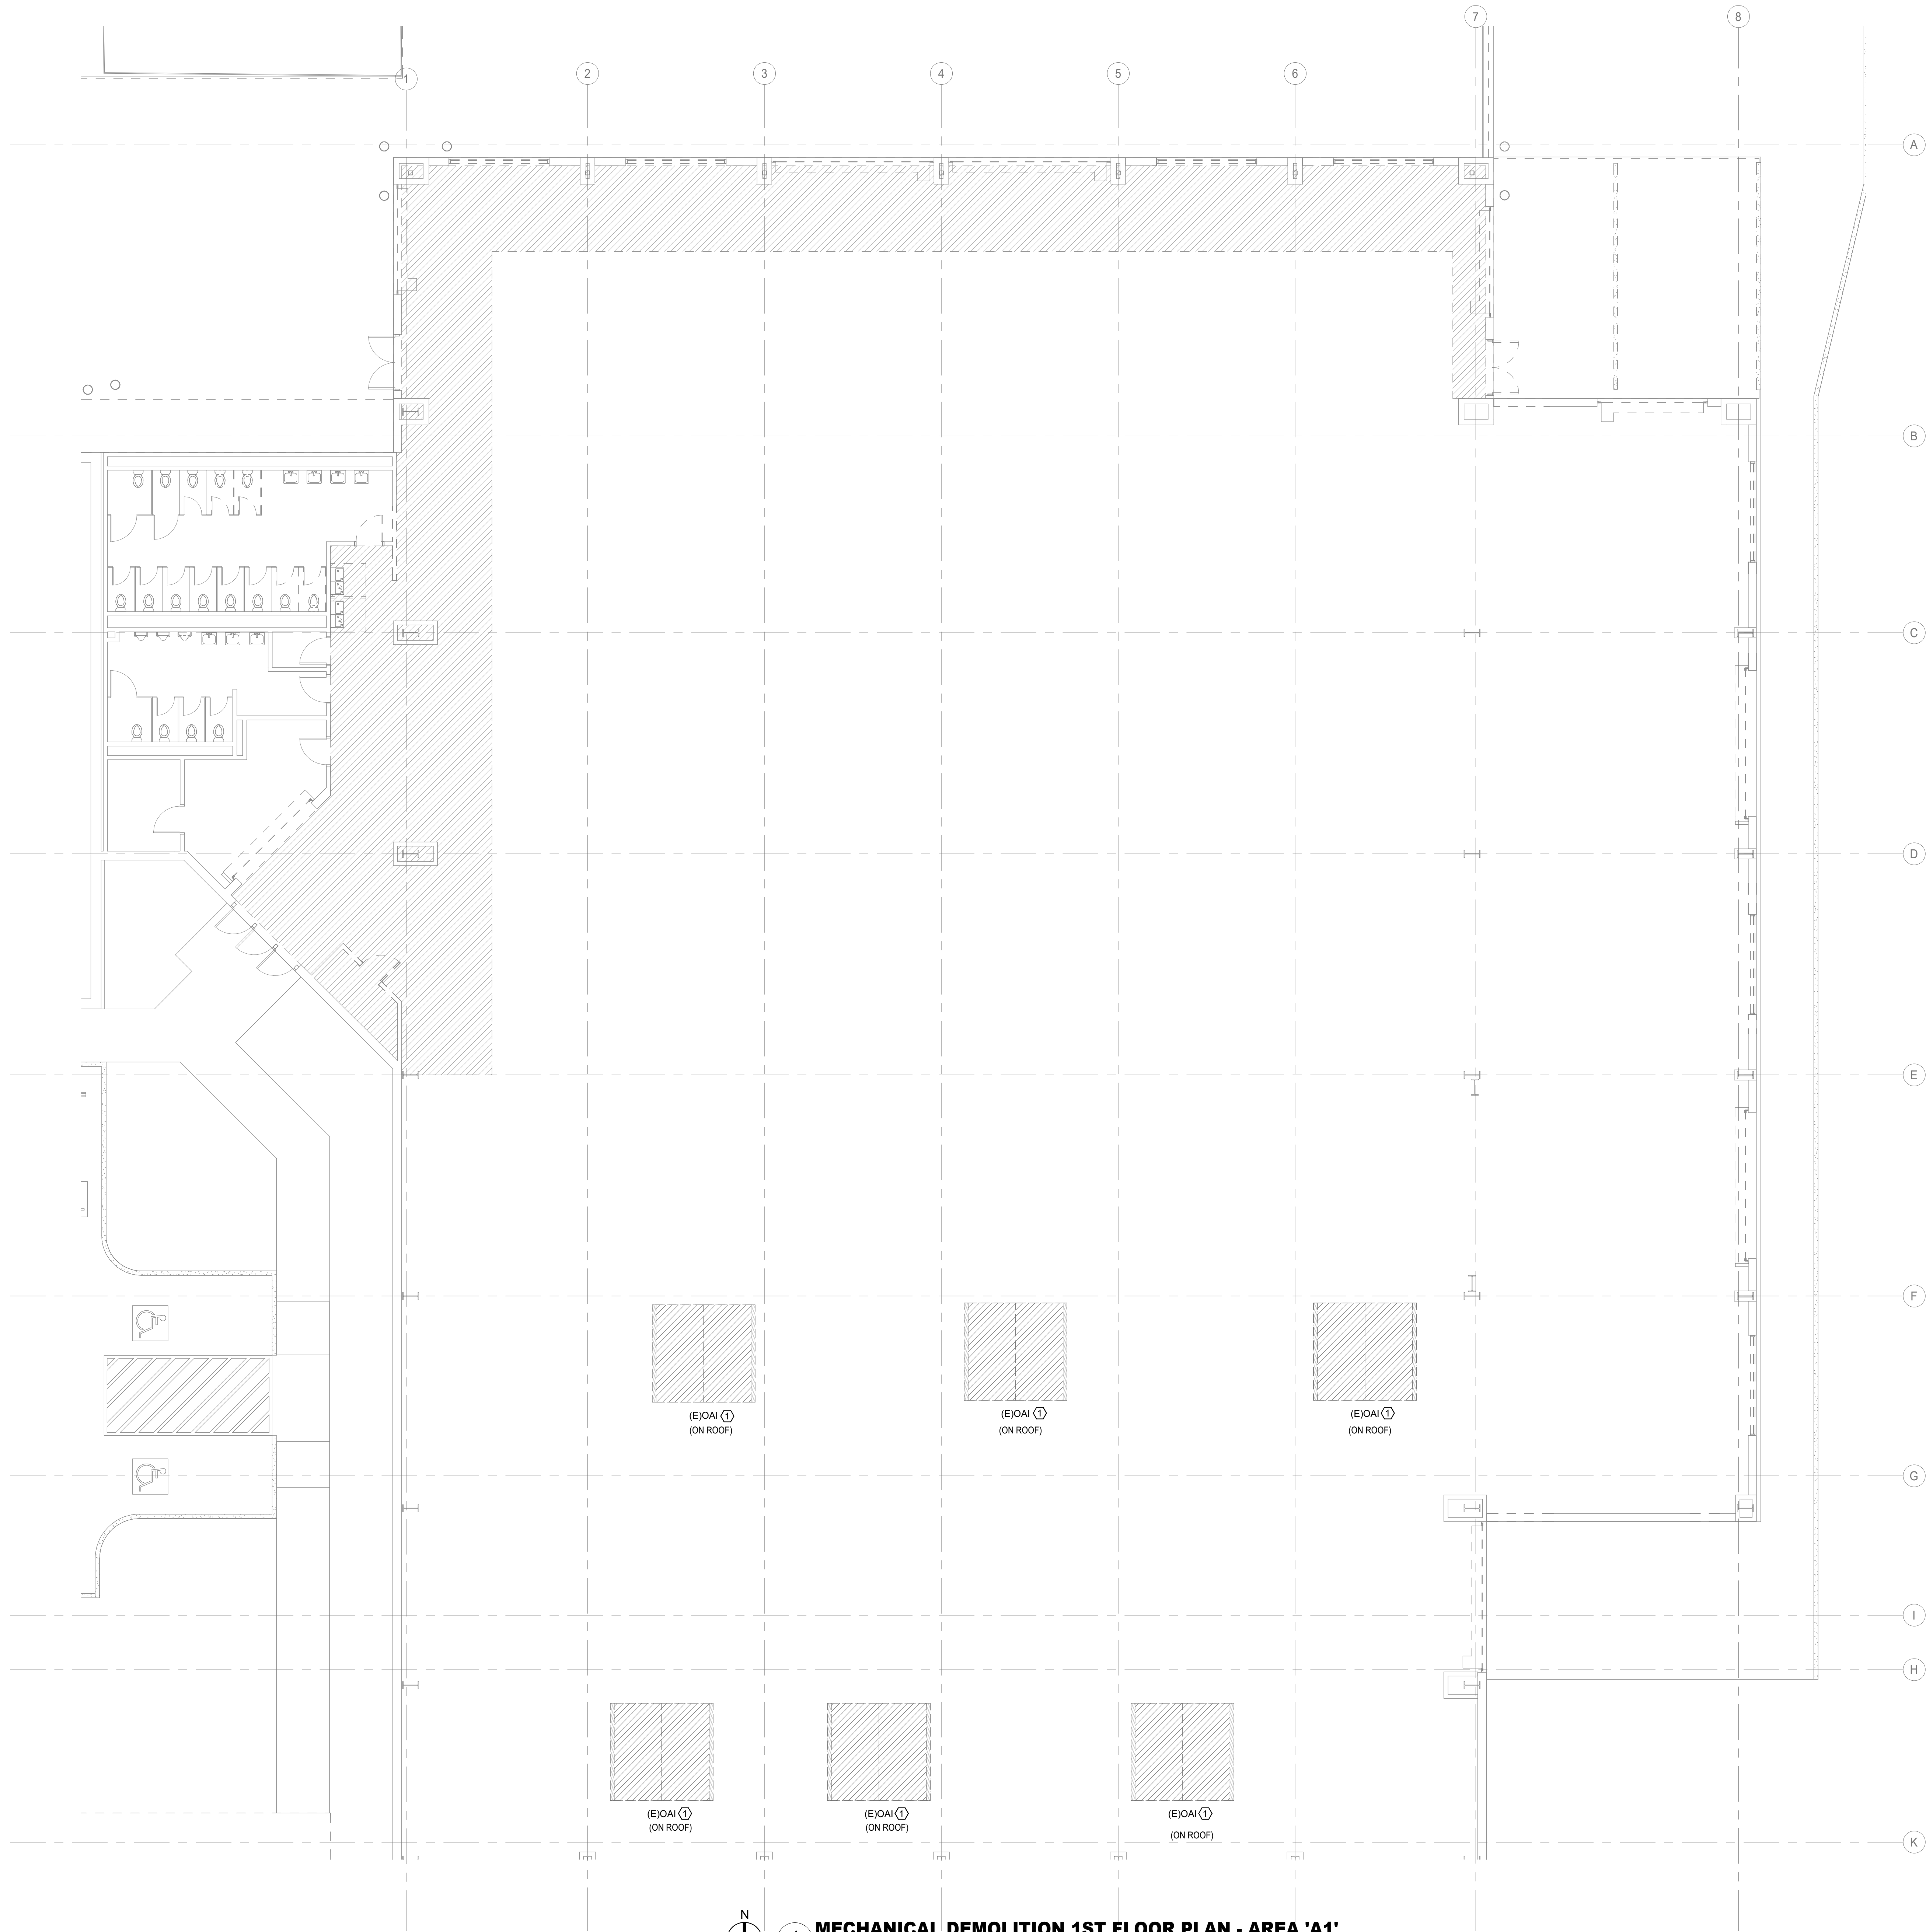SIGNAGE  
DETAILS





**MECHANICAL DEMOLITION GENERAL NOTES:**

1. THESE CONSTRUCTION DRAWINGS ARE DIAGRAMMATIC, AND DO NOT NECESSARILY REFLECT ACTUAL DIMENSIONS. IT IS THE RESPONSIBILITY OF THE CONTRACTOR TO FIELD-VERIFY ALL DIMENSIONS AND COORDINATE PLACEMENT OF ALL EQUIPMENT AND ROUTING OF ALL PIPING AND/OR DUCT SYSTEMS.
2. ALL MECHANICAL SYSTEMS SHOWN ON THIS PLAN ARE FROM EXISTING PRELIMINARY FIELD WORK. CONTRACTOR IS RESPONSIBLE FOR FIELD-VERIFYING ALL LOCATIONS AND SIZES OF MECHANICAL SYSTEMS PRIOR TO THE START OF WORK.
3. MECHANICAL CONTRACTOR SHALL COORDINATE WITH THE REMOVE ALL EXISTING SPACE MOUNTED TEMPERATURE AND HUMIDITY SENSORS NOT BEING REUSED. PROVIDE STAINLESS STEEL COVER PLATES. CONTRACTOR FOR ALL ELECTRICAL POWER REQUIREMENTS.
4. OWNER SHALL HAVE FIRST RIGHT OF REFUSAL ON ALL HVAC EQUIPMENT BEING REMOVED FROM THIS PROJECT. THIS INCLUDES BUT NOT LIMITED TO CONDENSING UNITS, AIR HANDLING UNITS, CONTROLS, AND OUTSIDE AIR INTAKE VENTS.

**MECHANICAL DEMOLITION KEYED NOTES:**

① EXISTING ROOF MOUNTED FAN / ROOF VENT SHALL BE REMOVED. ROOF OPENING SHALL BE CAPPED AND PATCHED. REFER TO ARCHITECTURAL DRAWINGS FOR MORE INFORMATION.

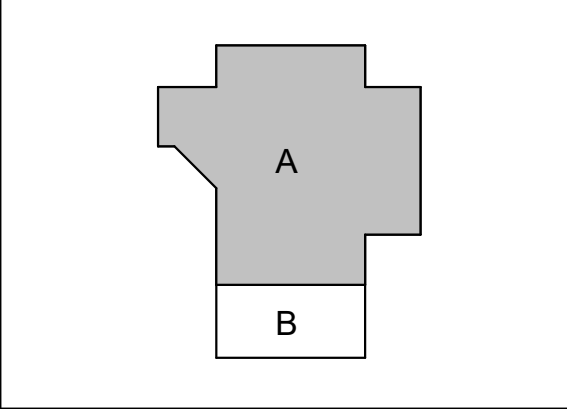
SYMBOL LEGEND	
	POINT OF CONNECTION TO EXISTING
	ITEM TO REMAIN
	ITEM TO BE REMOVED

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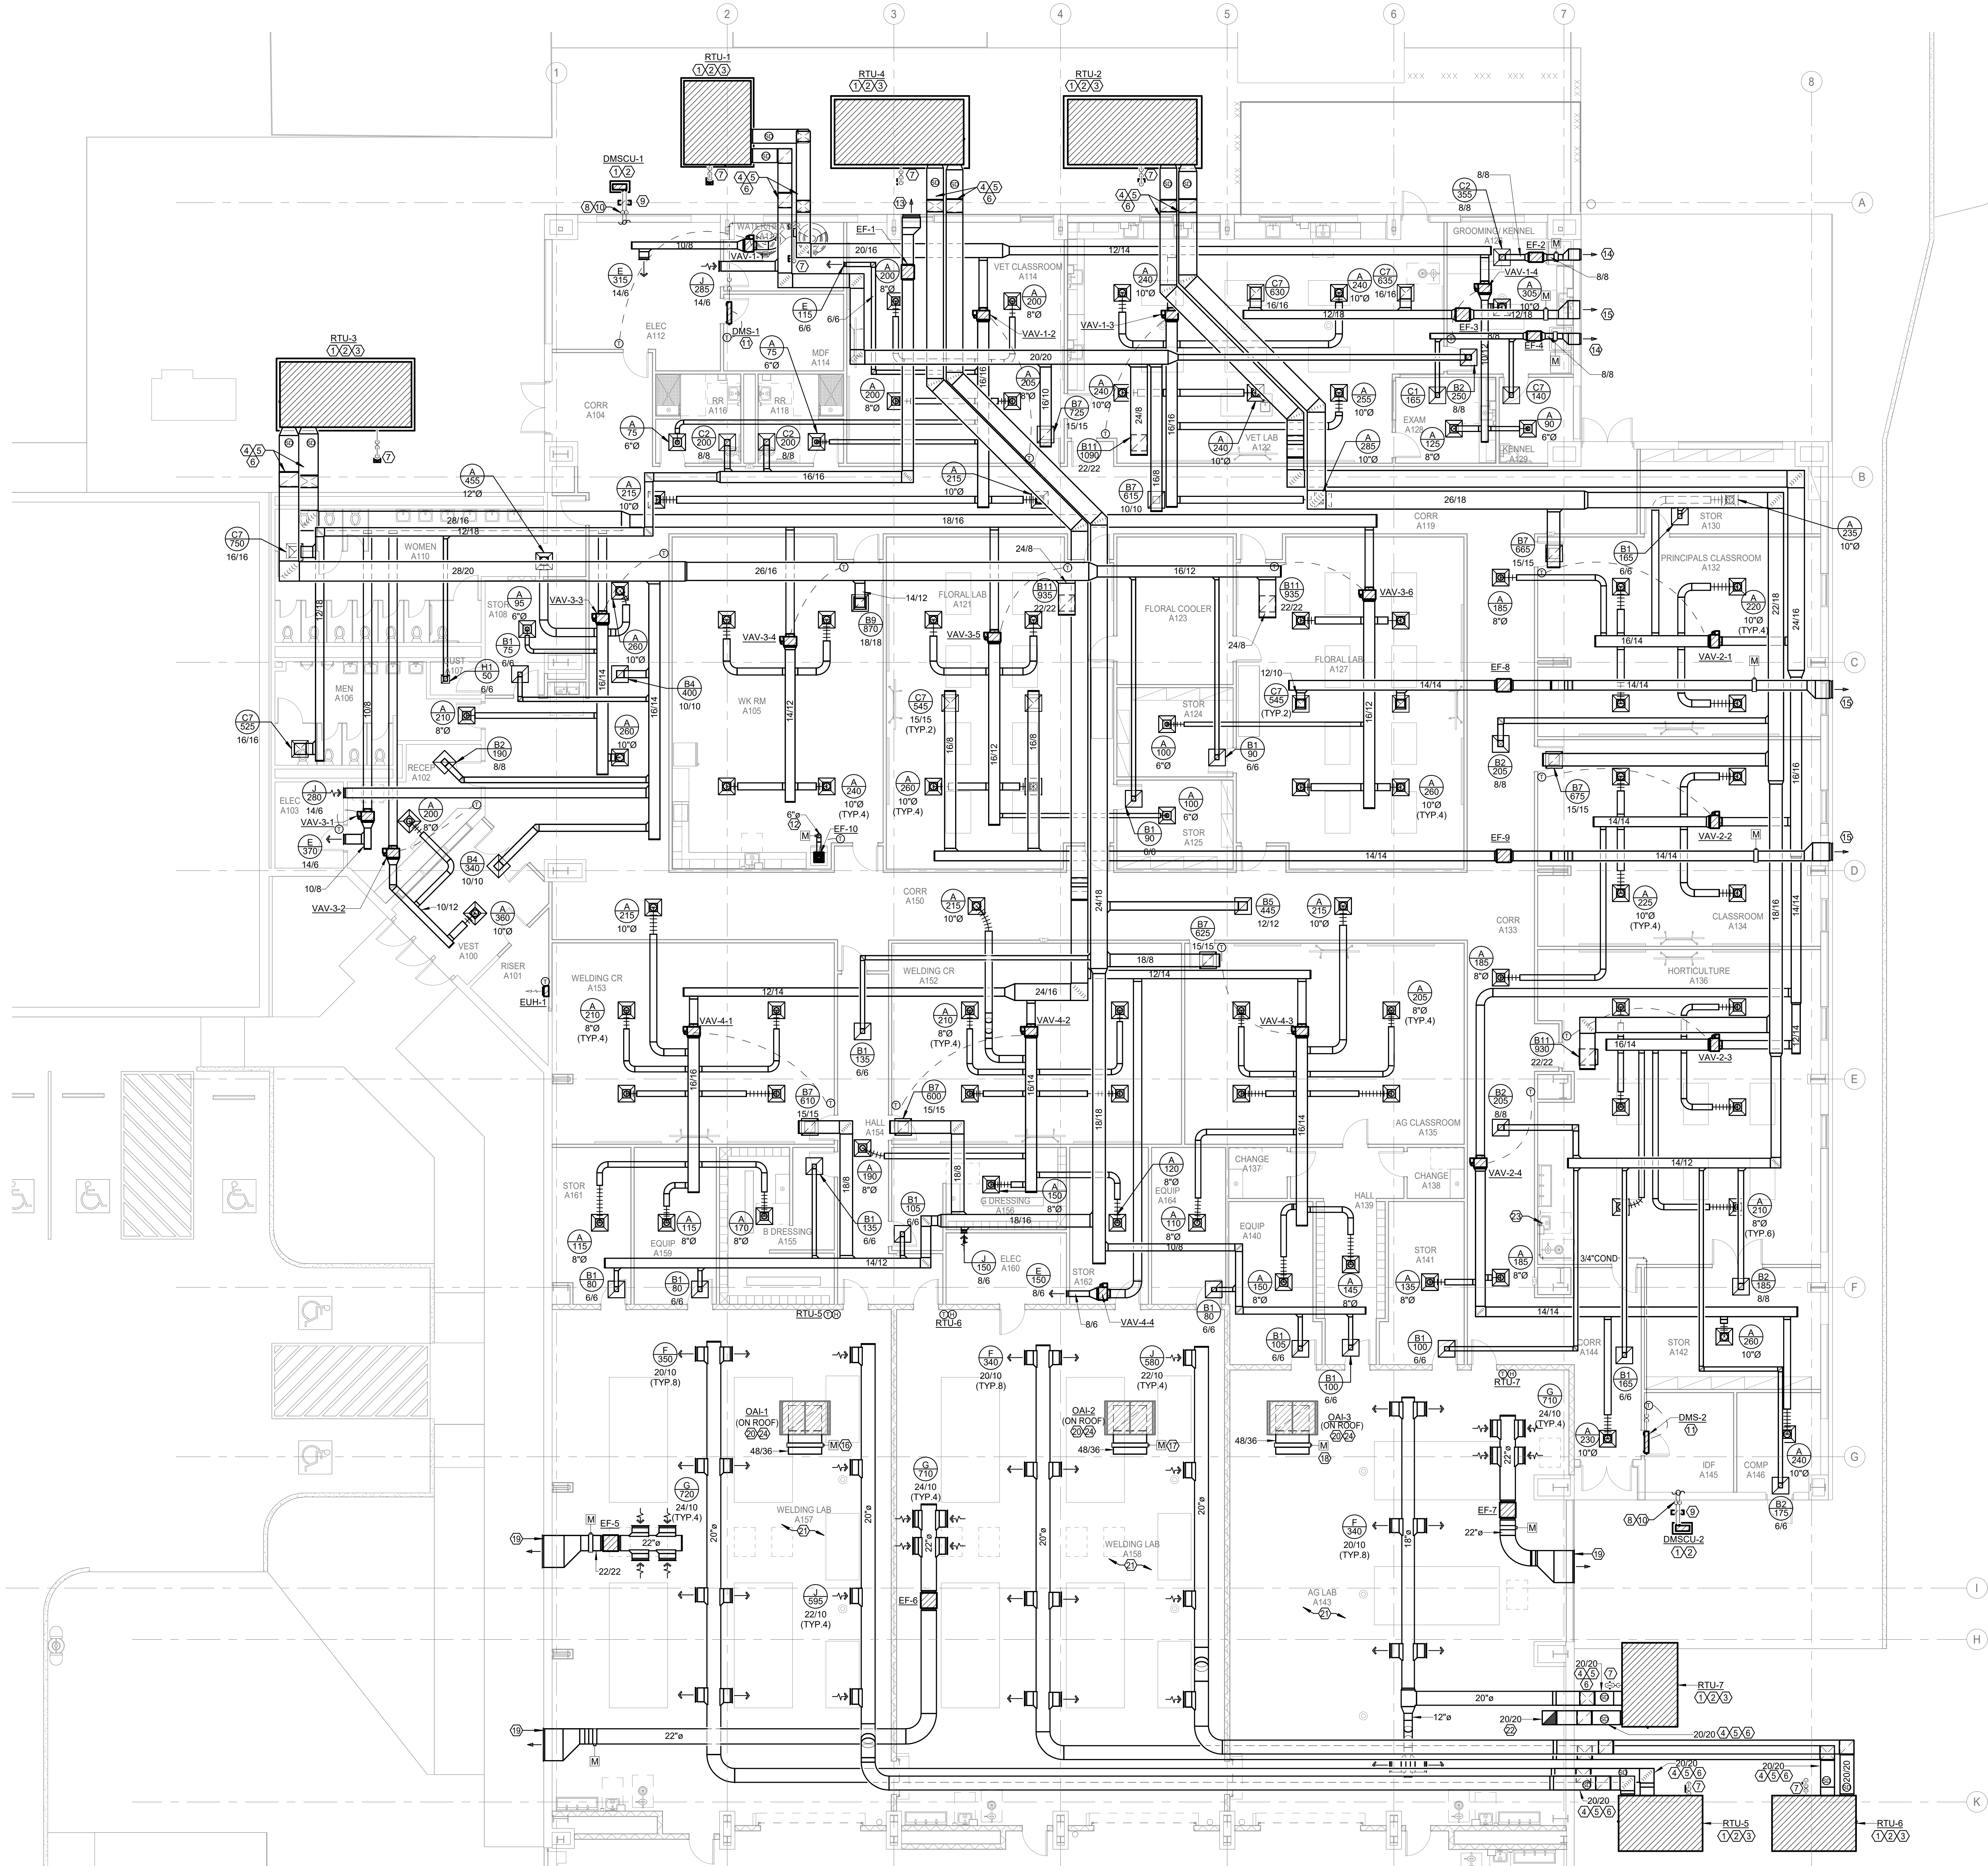


PROJECT #:	202311
DATE:	2023-11-03
DRAWN:	AA
CHECKED:	SH
DATE:	ISSUE
2023-11-03	BID SET

**M1.01**

MECHANICAL  
DEMOLITION  
AREA 'A1' 1ST  
FLOOR PLAN





1 MECHANICAL 1ST FLOOR PLAN - AREA 'A1'  
Scale: 1/8" = 1'-0"

MECHANICAL GENERAL NOTES:

- COORDINATE IN THE FIELD THE EXACT LOCATION OF MECHANICAL EQUIPMENT WITH CONTRACTOR AND ALL TRADES.
- SENSORS SHALL BE MOUNTED AT 48" AFF (ABOVE FINISHED FLOOR), UNLESS OTHERWISE NOTED.
- MECHANICAL CONTRACTOR SHALL COORDINATE WITH THE ELECTRICAL CONTRACTOR FOR ALL ELECTRICAL POWER REQUIREMENTS.
- THESE CONSTRUCTION DRAWINGS ARE DIAGRAMMATIC AND DO NOT NECESSARILY REFLECT ACTUAL DIMENSIONS. IT IS THE RESPONSIBILITY OF THE CONTRACTOR TO FIELD-VERIFY ALL DIMENSIONS AND COORDINATE PLACEMENT OF ALL EQUIPMENT AND ROUTING OF ALL PIPING AND/OR HVAC SYSTEMS.

MECHANICAL KEYED NOTES:

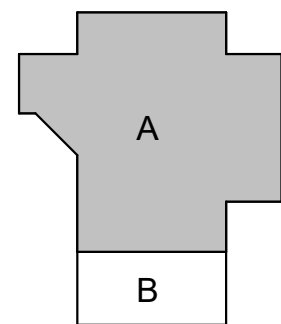
- VERIFY SERVICE CLEARANCE WITH EQUIPMENT MANUFACTURER. COORDINATE WITH ALL TRADES NOT TO OBSTRUCT.
- MOUNT PACKAGED UNIT ON 4" THICK HOUSE KEEPING CONCRETE PAD.
- PACKAGED UNIT SHALL MAINTAIN MANUFACTURER'S RECOMMENDED UNOBSTRUCTED CLEARANCE ON ALL SIDES FOR SERVICING AND AIR FLOW.
- REFER TO SPECIFICATIONS FOR OUTDOOR DUCTWORK MATERIAL AND INSULATION.
- SUPPORT DUCTWORK FROM EXTERIOR WALL BY SECURING GALVANIZED UNISTRUT SUPPORT CHANNELS TO WALL AND ATTACH DUCTWORK TO UNISTRUT WITH GALVANIZED DUCT STRAPS. ALL FASTENERS SHALL BE STAINLESS STEEL.
- PROVIDE PHP DUCT SUPPORT OR APPROVED EQUAL AT LOCATION SHOWN.
- ROUTE FULL SIZE CONDENSATE PIPE TO FLOOR SINK. REFER TO PLUMBING DRAWINGS FOR FLOOR SINK EXACT LOCATION.
- INSULATE OUTDOOR REFRIGERANT PIPING PER SPECIFICATION.
- PROVIDE PHP PIPE SUPPORT AND ATTACH TO CONCRETE SLAB WITH STRUT CLAMPS.
- ROUTE REFRIGERANT PIPE UP WALL.
- ROUTE REFRIGERANT LINES TO ASSOCIATED AIR COOLED CONDENSING UNIT.
- ROUTE EXHAUST DUCT AT SIZE INDICATED UP TO GOOSENECK ON ROOF. REFER TO 12M3.01 FOR DETAIL.
- PROVIDE 26" X 28" RUSKIN MODEL EME520MD WIND-DRIVEN RAIN RESISTANT STATIONARY LOUVER OR APPROVED EQUAL WITH MINIMUM FREE AREA OF 2.05 SQ. FT. PROVIDE WITH BIRD SCREEN AND PAINT TO MATCH WALL OR AS SPECIFIED BY ARCHITECT. COORDINATE FINAL LOCATION WITH ARCHITECT.
- PROVIDE 16" X 14" RUSKIN MODEL EME520MD WIND-DRIVEN RAIN RESISTANT STATIONARY LOUVER OR APPROVED EQUAL WITH MINIMUM FREE AREA OF 0.49 SQ. FT. PROVIDE WITH BIRD SCREEN AND PAINT TO MATCH WALL OR AS SPECIFIED BY ARCHITECT. COORDINATE FINAL LOCATION WITH ARCHITECT.
- PROVIDE 26" X 26" RUSKIN MODEL EME520MD WIND-DRIVEN RAIN RESISTANT STATIONARY LOUVER OR APPROVED EQUAL WITH MINIMUM FREE AREA OF 1.88 SQ. FT. PROVIDE WITH BIRD SCREEN AND PAINT TO MATCH WALL OR AS SPECIFIED BY ARCHITECT. COORDINATE FINAL LOCATION WITH ARCHITECT.
- INTERLOCK MOTORIZED DAMPER WITH EF-5.
- INTERLOCK MOTORIZED DAMPER WITH EF-6.
- INTERLOCK MOTORIZED DAMPER WITH EF-7.
- PROVIDE 48" X 24" RUSKIN MODEL EME520MD WIND-DRIVEN RAIN RESISTANT STATIONARY LOUVER OR APPROVED EQUAL WITH MINIMUM FREE AREA OF 3.3 SQ. FT. PROVIDE WITH BIRD SCREEN AND PAINT TO MATCH WALL OR AS SPECIFIED BY ARCHITECT. COORDINATE FINAL LOCATION WITH ARCHITECT.
- FULL SIZE DUCTWORK DOWN THROUGH ROOF FROM OUTSIDE AIR INTAKE ON ROOF. PROVIDE TRANSITION AS REQUIRED TO SIZE INDICATED.
- PROVIDE SPIRAL DOUBLE WALL ACOUSTICAL DUCTWORK AT THIS AREA.
- PROVIDE INTERNALLY LINED RETURN AIR ELBOW.
- ROUTE CONDENSATE PIPE AT SIZE INDICATED TO WYE TAIL PIECE. REFER TO PLUMBING DRAWINGS AT SIZE INDICATED.
- MOUNT OUTSIDE AIR INTAKE ON WIND RESISTANT ROOF CURB RE: 14M3.02 FOR MORE INFORMATION.

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CTE & MISC. RENOVATIONS**  
TOMBALL INDEPENDENT SCHOOL DISTRICT  
30330 QUIN ROAD, TOMBALL, TX 77375




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PROJECT #: 202311  
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CHECKED: SH

DATE: 2023-11-03  
ISSUE: BID SET

**M2.01**

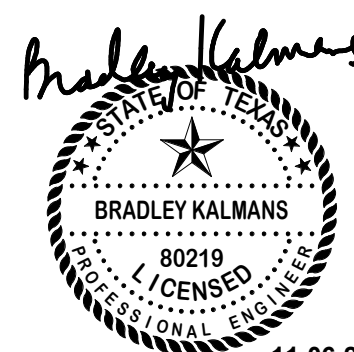MECHANICAL  
AREA 'A1' 1ST  
FLOOR PLAN





MECHANICAL GENERAL NOTES:

- COORDINATE IN THE FIELD THE EXACT LOCATION OF MECHANICAL EQUIPMENT WITH CONTRACTOR AND ALL TRADES.
- SENSORS SHALL BE MOUNTED AT +48" AFF (ABOVE FINISHED FLOOR), UNLESS OTHERWISE NOTED.
- MECHANICAL CONTRACTOR SHALL COORDINATE WITH THE ELECTRICAL CONTRACTOR FOR ALL ELECTRICAL POWER REQUIREMENTS.
- THESE CONSTRUCTION DRAWINGS ARE DIAGRAMMATIC AND DO NOT NECESSARILY REFLECT ACTUAL DIMENSIONS. IT IS THE RESPONSIBILITY OF THE CONTRACTOR TO FIELD-VERIFY ALL DIMENSIONS AND COORDINATE PLACEMENT OF ALL EQUIPMENT AND ROUTING OF ALL PIPING AND/OR HVAC SYSTEMS.

MECHANICAL KEYED NOTES:


- VERIFY SERVICE CLEARANCE WITH EQUIPMENT MANUFACTURER. COORDINATE WITH ALL TRADES NOT TO OBSTRUCT.
- MAINTAIN A MINIMUM OF 30" FT. BETWEEN FAN BLADE AND HOIST CRANE.
- ROUTE FLUE AT SIZE INDICATED UP TO GOOSENECK ON ROOF. REFER TO DETAILS FOR MORE INFORMATION.
- ROUTE INTAKE AT SIZE INDICATED UP TO ROOF.
- INTERLOCK MOTORIZED DAMPER WITH EF-11.
- INTERLOCK MOTORIZED DAMPER WITH EF-12.
- PROVIDE 48"X 24" RUSKIN MODEL EME520MD WIND-DRIVEN RAIN RESISTANT STATIONARY LOUVER OR APPROVED EQUAL WITH MINIMUM FREE AREA OF 3.3 SQ. FT. PROVIDE WITH BIRD SCREEN AND PAINT TO MATCH WALL OR AS SPECIFIED BY ARCHITECT. COORDINATE FINAL LOCATION WITH ARCHITECT.
- FULL SIZE DUCTWORK DOWN THROUGH ROOF FROM OUTSIDE AIR INTAKE ON ROOF. PROVIDE TRANSITION AS REQUIRED TO SIZE INDICATED.
- PROVIDE DOUBLE WALL ACOUSTICAL DUCTWORK AT THIS AREA.
- MOUNT OUTSIDE AIR INTAKE ON WIND RESISTANT ROOF CURB RE: 14/M3.02 FOR MORE INFORMATION.

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TOMBALL HIGH SCHOOL  
CTE & MISC. RENOVATIONS

TOMBALL INDEPENDENT SCHOOL DISTRICT  
30330 QUIN ROAD, TOMBALL, TX 77375

ARCADIS

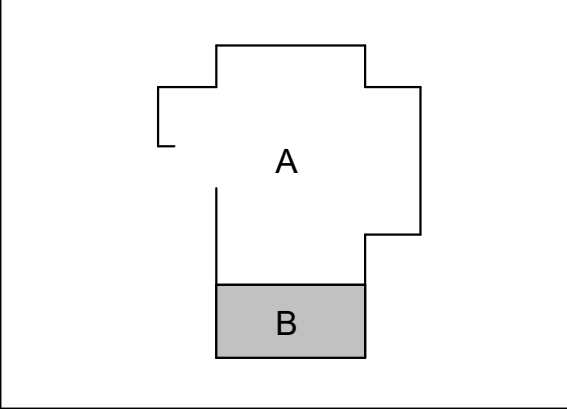TEXAS ARCADIS INC.


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PROJECT #:	202311
DATE:	2023-11-03
DRAWN:	AA
CHECKED:	SH
DATE:	ISSUE
2023-11-03	BID SET

M2.02

MECHANICAL  
AREA 'B1' 1ST  
LOOR PLAN



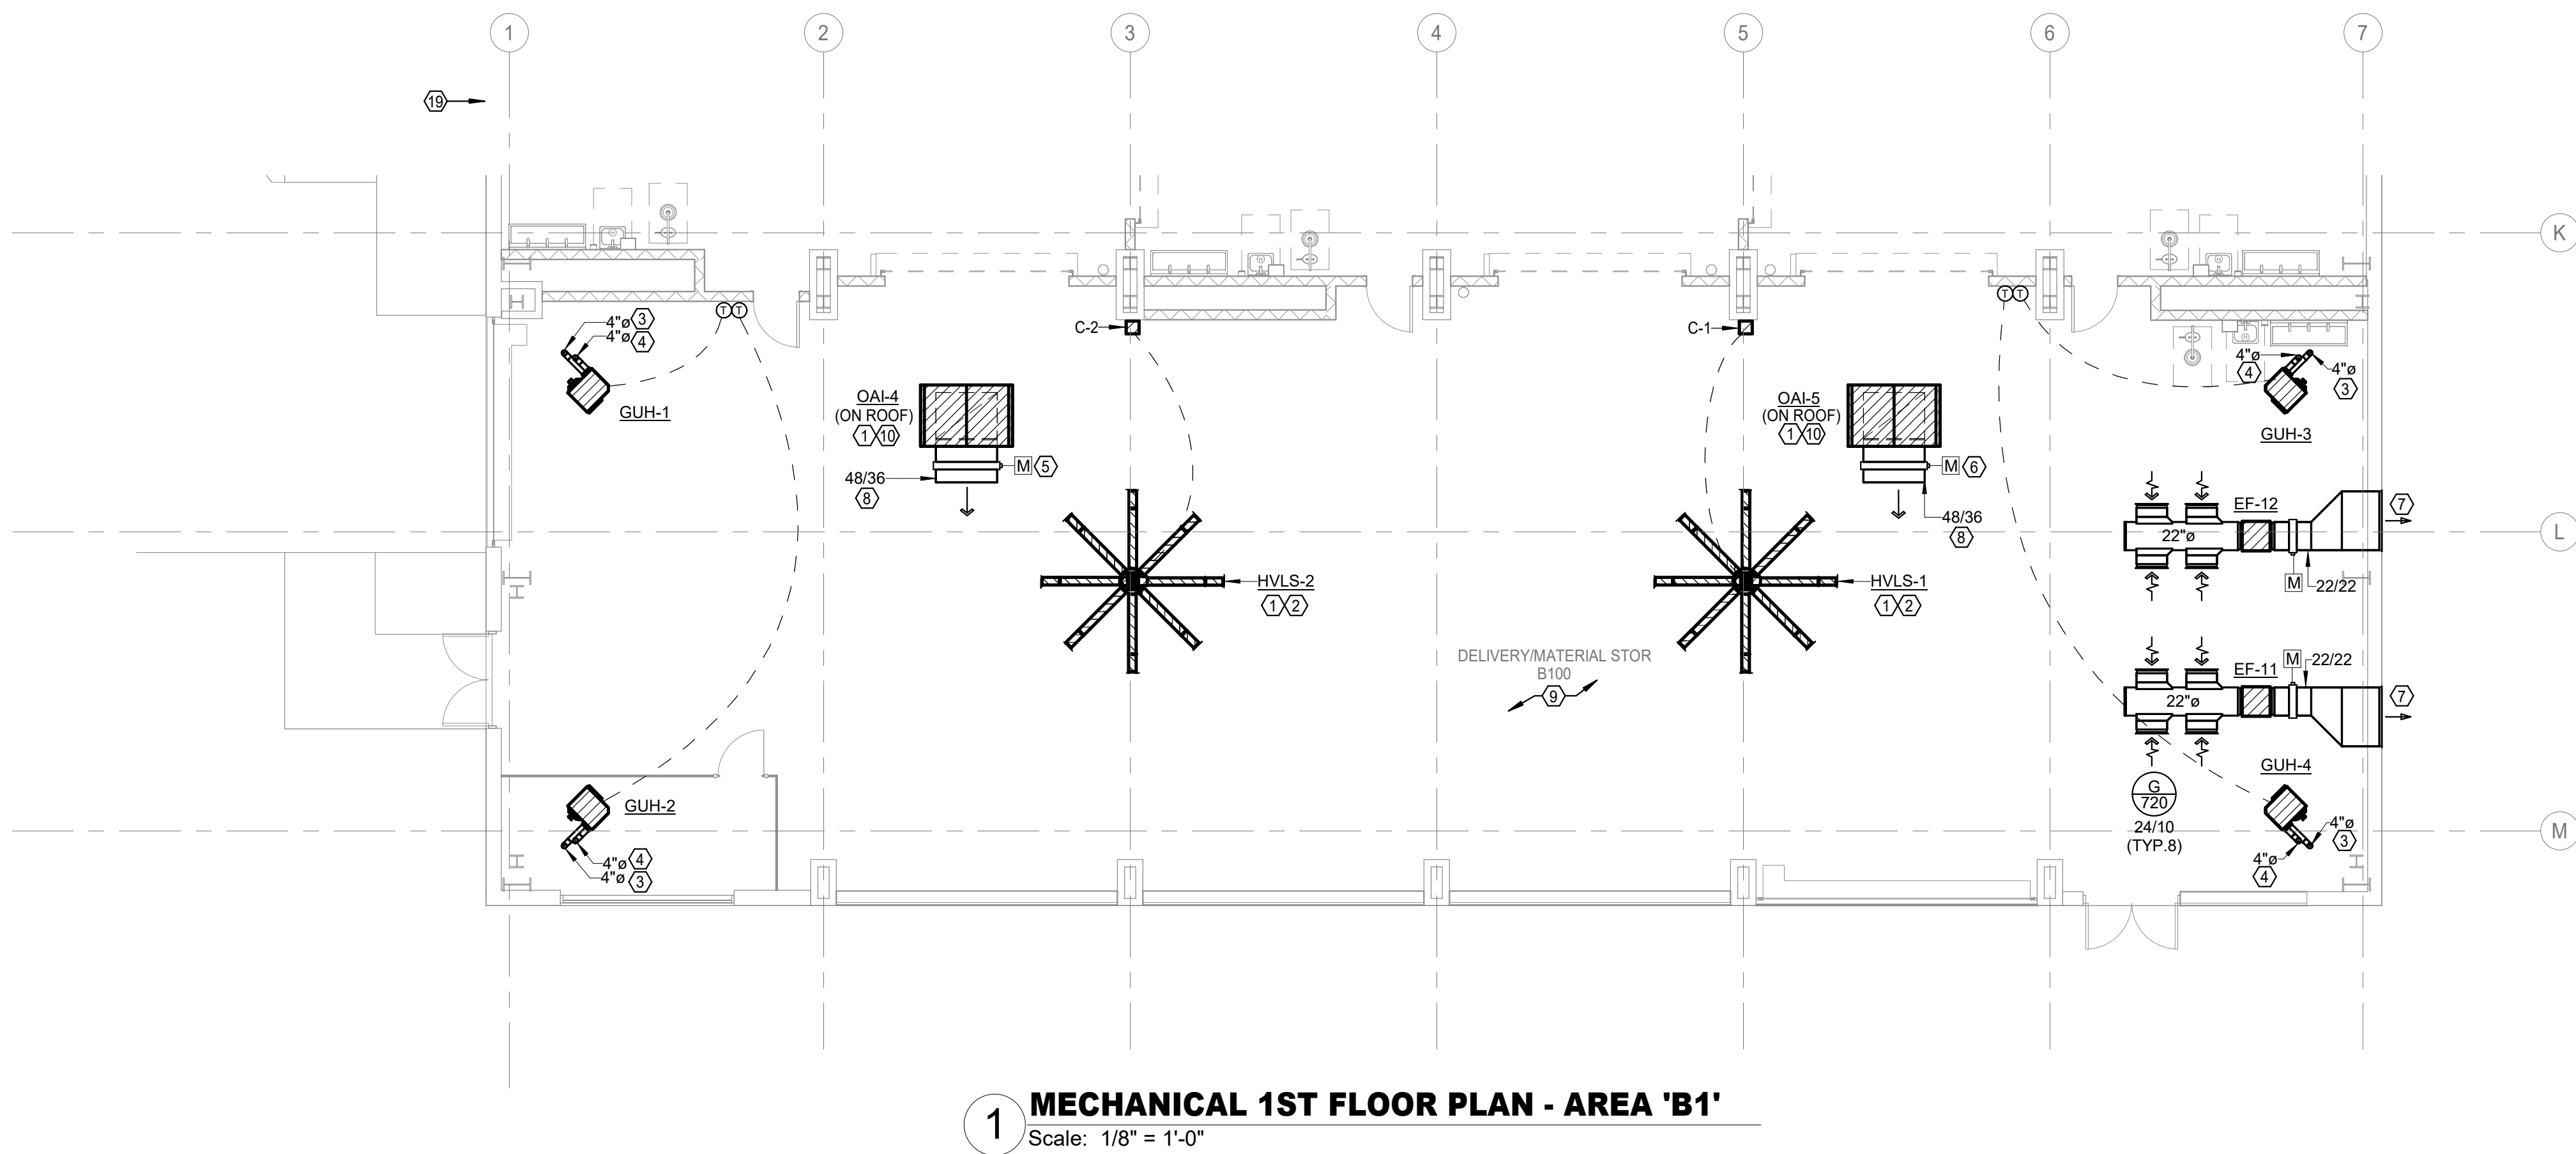1 MECHANICAL 1ST FLOOR PLAN - AREA 'B1'

Scale: 1/8" = 1'-0"



SYMBOL LEGEND	
SYMBOL	DESCRIPTION (DISREGARD ITEMS NOT SHOWN ON PLANS)
GENERAL	
	KEY NOTE TAG
	REVISION TAG
	NEW EQUIPMENT
DUCTWORK	
	SUPPLY AIR DUCTWORK
	RETURN AIR AND OUTSIDE AIR DUCTWORK
	EXHAUST AIR DUCTWORK
	FLEXIBLE DUCTWORK
	SUPPLY AIR DUCTWORK THROUGH HORIZONTAL PARTITION
	EXHAUST AIR DUCTWORK THROUGH HORIZONTAL PARTITION
	FIRE DAMPER (VERTICAL)
	FIRE DAMPER (HORIZONTAL)
	SMOKE DAMPER (VERTICAL)
	SMOKE DAMPER (HORIZONTAL)
	COMBINATION FIRE & SMOKE DAMPER (VERTICAL)
	COMBINATION FIRE & SMOKE DAMPER (HORIZONTAL)
	MANUAL BALANCING DAMPER (SEE DAMPER SCHEDULE)
	MOTORIZED DAMPER (SEE DAMPER SCHEDULE)
SENSORS	
	THERMOSTAT AND TEMPERATURE SENSOR
	HUMIDISTAT
	SMOKE DETECTOR
	HEAT DETECTOR
AIR DEVICES	
	GRILLE SIZE TAG (REFER TO GRILLE SIZE LEGEND)
	SUPPLY AIR GRILLE WITH FOUR-WAY THROW
	SUPPLY AIR GRILLE WITH THREE-WAY THROW
	SUPPLY AIR GRILLE WITH TWO-WAY THROW
	SUPPLY AIR GRILLE WITH TWO-WAY CORNER THROW
	SUPPLY AIR GRILLE WITH ONE-WAY THROW
	RETURN AIR GRILLE
	RETURN AIR GRILLE WITH SOUND BOOT
	EXHAUST AIR GRILLE
	SUPPLY AIR SIDEWALL GRILLE
	RETURN AIR SIDEWALL GRILLE
	RETURN AIR OPENING ABOVE CEILING
PIPING	
	CONDENSER WATER SUPPLY & RETURN (TOTAL OF TWO PIPES, ONLY ONE PIPE SHOWN FOR DRAWING CLARITY)
	CONDENSER WATER SUPPLY
	CONDENSER WATER RETURN
	CHILLED WATER SUPPLY & RETURN (TOTAL OF TWO PIPES, ONLY ONE PIPE SHOWN FOR DRAWING CLARITY)
	CHILLED WATER SUPPLY
	CHILLED WATER RETURN
	HOT WATER FOR HYDRONIC HEATING SUPPLY & RETURN (TOTAL OF TWO PIPES, ONLY ONE PIPE SHOWN FOR DRAWING CLARITY)
	HOT WATER FOR HYDRONIC HEATING SUPPLY
	HOT WATER FOR HYDRONIC HEATING RETURN
	CONDENSATE DRAIN LINE
	AUXILIARY CONDENSATE DRAIN LINE
	REFRIGERANT LIQUID & GAS RECIRCULATION LINE (TOTAL OF TWO PIPES, ONLY ONE PIPE SHOWN FOR DRAWING CLARITY)
	REFRIGERANT LIQUID LINE
	REFRIGERANT HOT GAS LINE
	REFRIGERANT SUCTION LINE
	ELBOW UP
	ELBOW DOWN
	90° ELBOW
	45° ELBOW
	TEE
	TEE DOWN
	TEE UP
	TOP BRANCH CONNECTION
	BOTTOM BRANCH CONNECTION
	FLANGE
	CAP
	CONTINUATION
	FLOOR DRAIN (REFER TO PLUMBING DRAWINGS)
	GAUGE COCK
	SITE GLASS
	DIFFERENTIAL PRESSURE SENSOR
	TURBINE FLOW METER
	ANCHOR
	PIPE GUIDE
SUBSCRIPTS AND ABBREVIATIONS	
AFF	ABOVE FINISHED FLOOR
BBS	BELOW BOTTOM OF STRUCTURE
BOD	BOTTOM OF DUCT
BOP	BOTTOM OF PIPE
CA	COMBUSTION AIR
CFM	CUBIC FEET PER MINUTE
EA	EXHAUST AIR
FPM	FEET PER MINUTE
NC	NORMALLY CLOSED
NO	NORMALLY OPEN
OA	OUTSIDE AIR
RA	RETURN AIR
SA	SUPPLY AIR
RENOVATIONS	
	POINT OF CONNECTION FROM NEW TO EXISTING
	ITEM TO REMAIN
	ITEM TO BE REMOVED

DUCTWORK CONSTRUCTION DETAILS	
<p>① DAMPER ABOVE INACCESSIBLE CEILING ② DAMPER ABOVE LIFT-OUT CEILING</p>	
<p>NOTES: 1. MAX. WIDTH OF DUCT TAP SHALL BE 48". PROVIDE BOTTOM BRACKET FOR SUPPORT WHERE EXTRACTOR EXCEEDS 16". 2. MAX. HEIGHT OF DUCT TAP SHALL BE 12" (MIN. 4").</p>	

DUCT LINER AND INSULATION	
PACKAGED ROOFTOP UNIT	
MAKE-UP/VENTILATION AIR SYSTEMS	

EXHAUST AIR SYSTEMS	
KEYED NOTES: ① SHEETMETAL DUCTWORK WITH EXTERNAL DUCTWORK INSULATION AS SPECIFIED. ② SHEETMETAL DUCTWORK RETURN AIR PLENUM WITH EXTERNAL DUCTWORK INSULATION AS SPECIFIED. ③ FLEXIBLE DUCTWORK WITH EXTERNAL DUCTWORK INSULATION AS SPECIFIED. ④ SHEETMETAL DUCTWORK WITH EXTERNAL DUCTWORK INSULATION AS SPECIFIED AND 1" THICK 1-1/2 LB LINER AS SPECIFIED FROM AIR HANDLING UNIT DISCHARGE TO 10'-0" DOWNSTREAM. ⑤ SHEETMETAL DUCTWORK WITH EXTERNAL DUCTWORK INSULATION AS SPECIFIED AND 1" THICK 1-1/2 LB LINER AS SPECIFIED FROM AIR HANDLING UNIT INLET TO 10'-0" UPSTREAM. ⑥ EXHAUST DUCTWORK AS SPECIFIED WITH FIREBOARD INSULATION AS SPECIFIED. ⑦ SHEETMETAL DUCTWORK ONLY, NO INSULATION REQUIRED.	

DUCTWORK SYMBOLS LEGEND	

GRILLE SIZING SCHEDULE	
ALL GRILLES SHOWN SHALL BE FOUR-WAY THROW UNLESS OTHERWISE SHOWN.	
REGISTER OR NONSTANDARD GRILLE	
ALL GRILLES SHOWN SHALL BE FOUR-WAY THROW UNLESS OTHERWISE SHOWN. ALL REGISTERS SHALL HAVE A 45° HORIZONTAL DEFLECTION UNLESS OTHERWISE SHOWN.	
GRILLE SIZE DESIGNATION	GRILLE NECK SIZE
1	6" x 6"
2	8" x 8"
3	9" x 9"
4	10" x 10"
5	12" x 12"
6	14" x 14"
7	15" x 15"
8	16" x 16"
9	18" x 18"
10	20" x 20"
11	22" x 22"
12	24" x 24"

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A
B

TOMBALL HIGH SCHOOL CTE & MISC. RENOVATIONS
TOMBALL INDEPENDENT SCHOOL DISTRICT 30330 QUIN ROAD, TOMBALL, TX 77375

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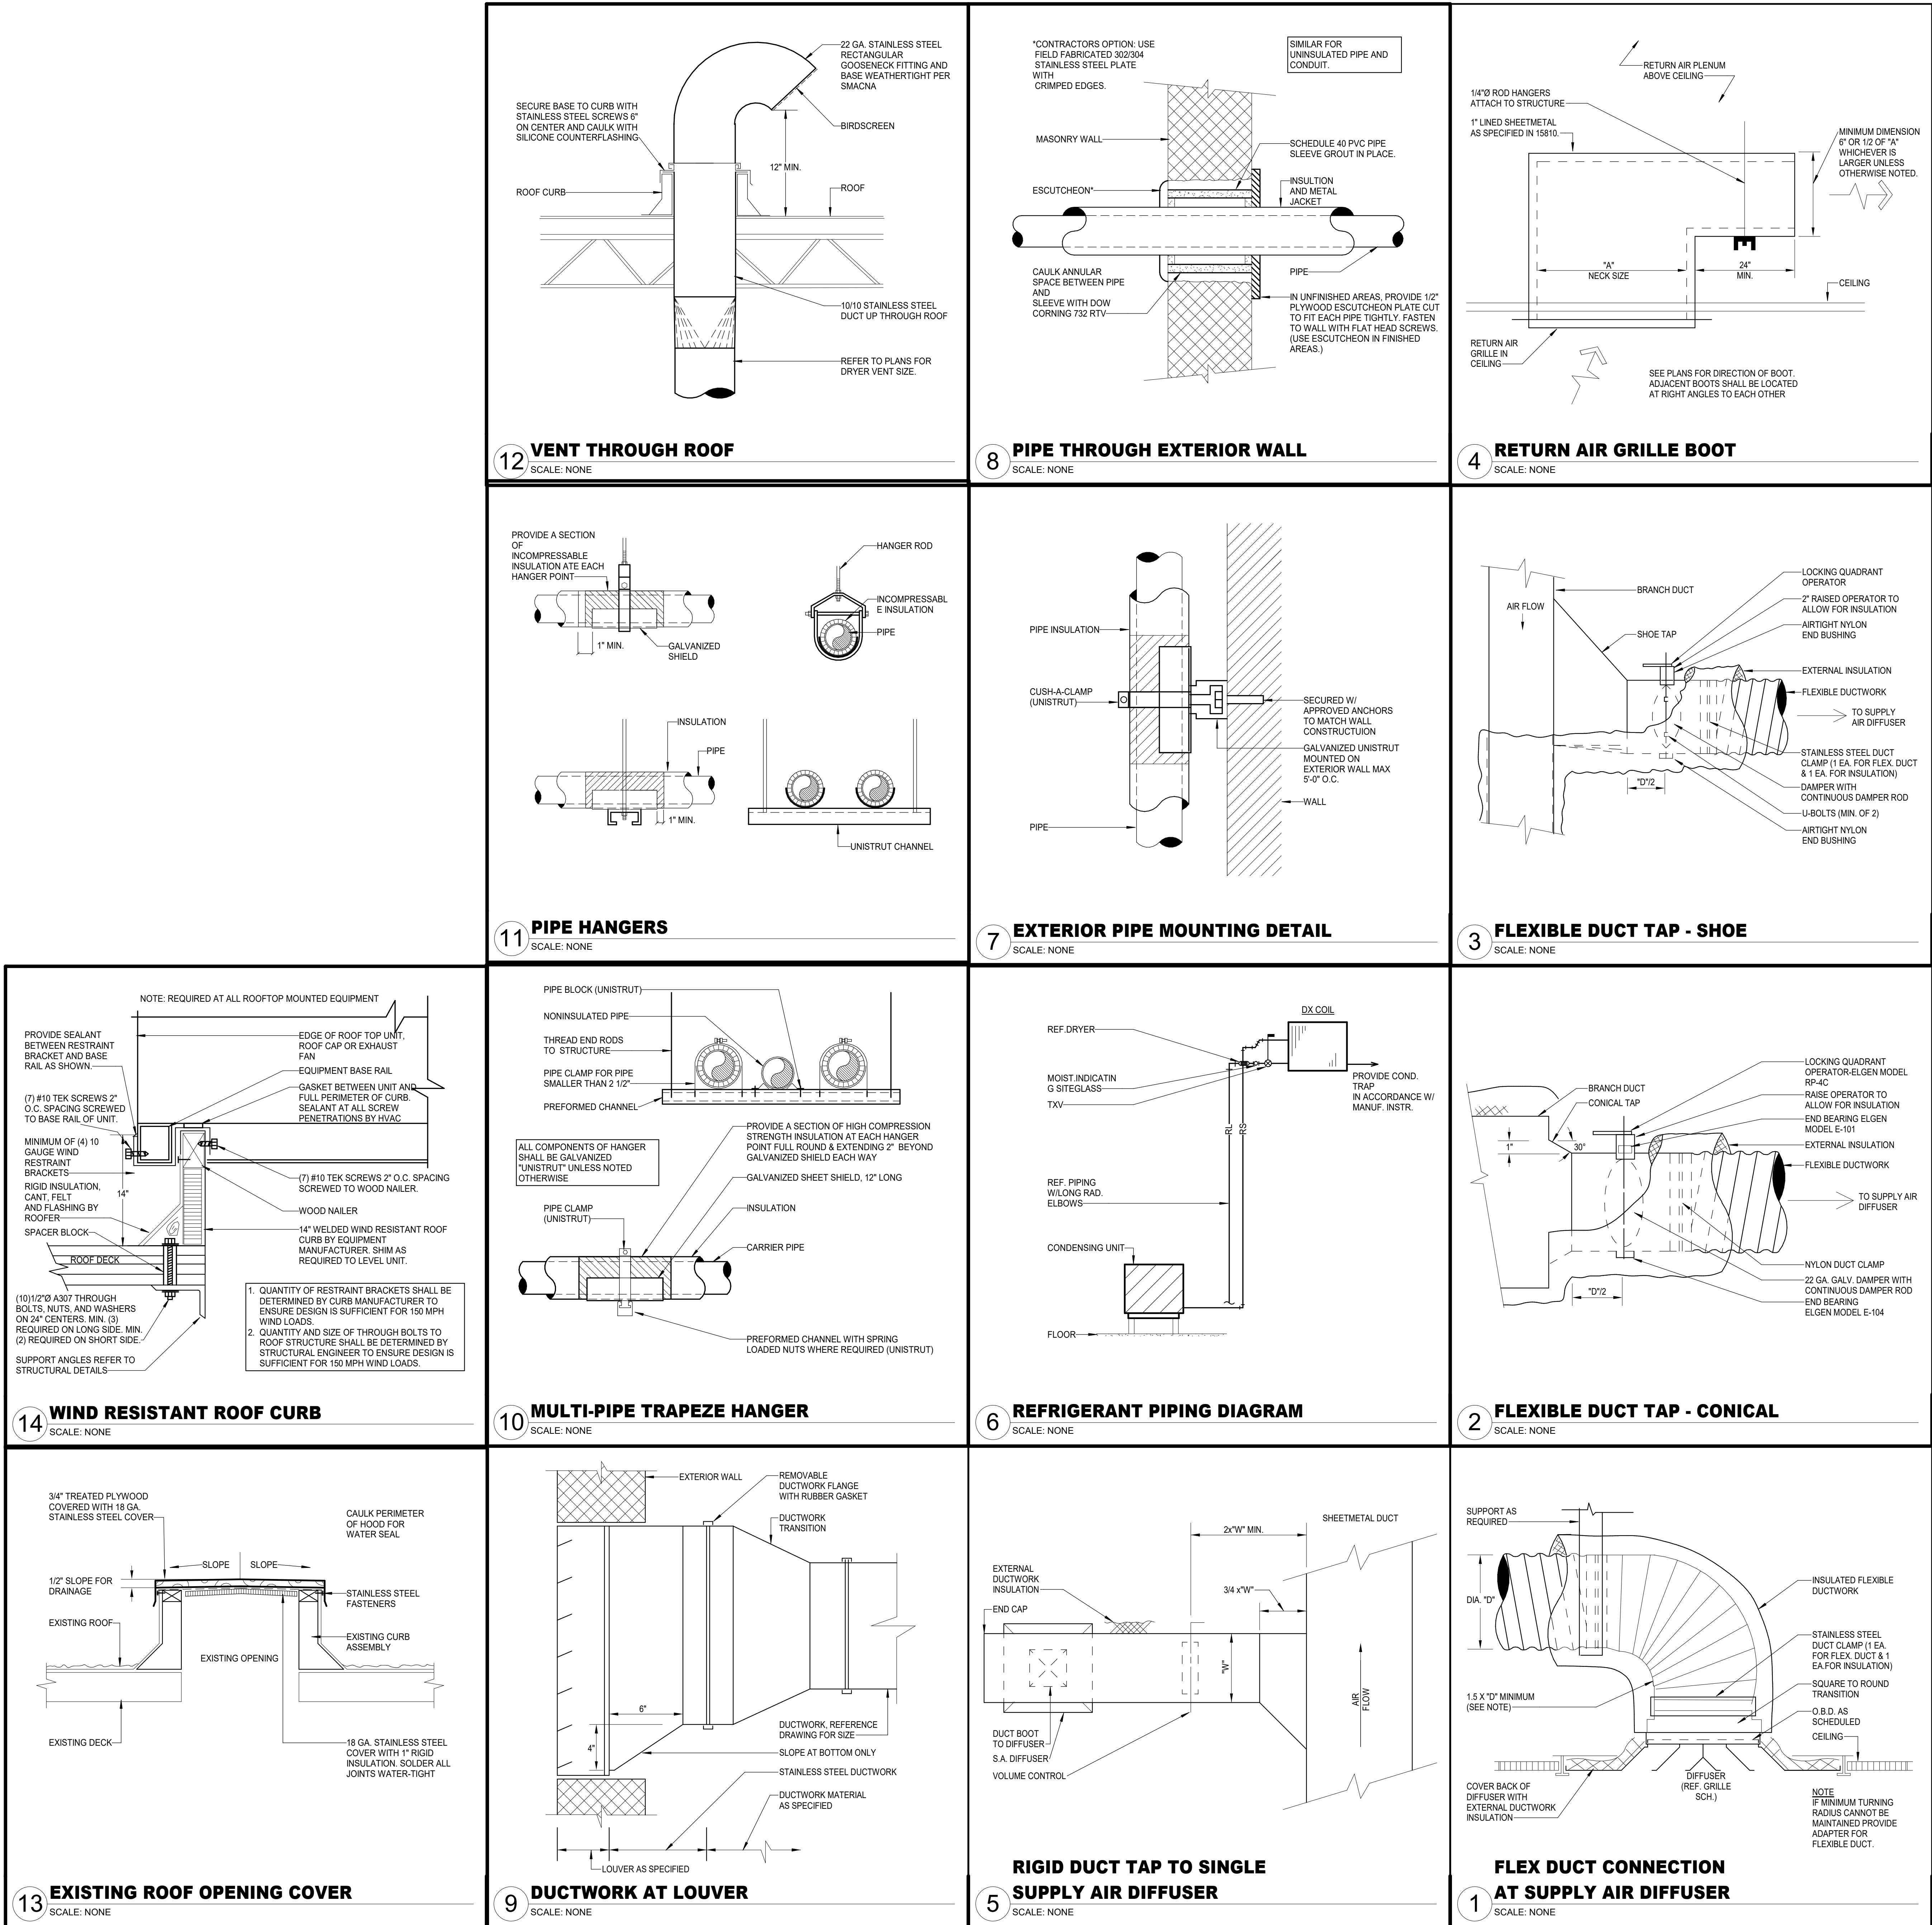
BRADLEY KALMANS 80219 CENSER
11-06-23

PROJECT #:	202311
DATE:	2023-11-03
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2023-11-03	BID SET

M3.01
MECHANICAL DETAILS AND LEGENDS





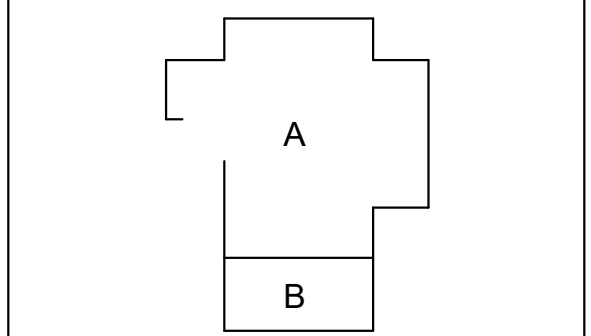


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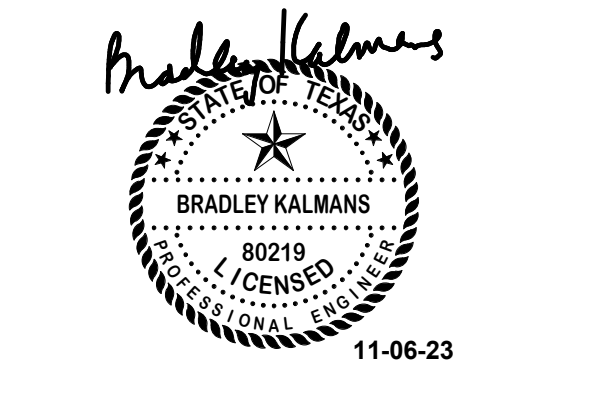


**TOMBALL HIGH SCHOOL  
CTE & MISC. RENOVATIONS**

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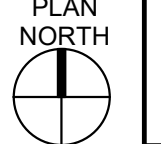


**PROJECT #:** 202311  
**DATE:** 2023-11-03  
**DRAWN:** Author  
**CHECKED:** Checker

**DATE:** 2023-11-03  
**ISSUE:** BID SET

**M3.02**

MECHANICAL  
DETAILS AND  
LEGENDS





UNIT HEATER - GAS FIRED									
TAG	MINIMUM INPUT CAPACITY (BTUH)	AGA EFFICIENCY (%)	CURRENT CHARAC.		CFM	MANUFACTURER	MODEL		REMARKS
			V	PH					
GUH-1	30,000	80	120	1	60	450	REZNOR	UDAS	1,2
GUH-2	30,000	80	120	1	60	450	REZNOR	UDAS	1,2
GUH-3	30,000	80	120	1	60	450	REZNOR	UDAS	1,2
GUH-4	30,000	80	120	1	60	450	REZNOR	UDAS	1,2
REMARKS: 1. PROVIDE WITH WALL MOUNTED THERMOSTAT. 2. REFER TO MANUFACTURER FOR INSTALLATION GUIDE.									

FAN															
MARK	LOCATION	CFM	EXT. STATIC PRESSURE (IN. W.C.)	MAX FAN RPM	HORSE POWER	CURRENT CHARAC.			LOCALLY SWITCHED BY	INTERLOCKED WITH	FAN TYPE	DRIVE TYPE	MANUFACTURER	MODEL NUMBER	REMARKS
						V	P	F							
EF-1	VET CLASSROOM A114	1,725	0.90	1,114	0.5	120	1	60	-	RTU-3	INLINE	DIRECT	COOK	SQND	1,2,3,4,6
EF-2	GROOMING KENNEL A126	355	0.50	1,725	0.5	120	1	60	TIMER	-	INLINE	DIRECT	COOK	SQND	1,2,3,4,5,6
EF-3	GROOMING KENNEL A126	1,265	0.50	1,725	0.5	120	1	60	TIMER	-	INLINE	DIRECT	COOK	SQND	1,2,3,4,5,6
EF-4	GROOMING KENNEL A126	305	0.50	1,725	0.5	120	1	60		RTU-1	INLINE	DIRECT	COOK	SQND	1,2,3,4
EF-5	WELDING LAB A157	2,880	0.80	1,725	1	480	3	60	SWITCH	-	INLINE	DIRECT	COOK	SQN	1,2,3,4
EF-6	WELDING LAB A158	2,840	0.80	1,725	1	480	3	60	SWITCH	-	INLINE	DIRECT	COOK	SQN	1,2,3,4
EF-7	AG LAB A143	2,840	0.80	1,725	1	480	3	60	SWITCH	-	INLINE	DIRECT	COOK	SQN	1,2,3,4
EF-8	GROOMING KENNEL A126	1,090	0.50	1,725	0.5	120	1	60	TIMER	-	INLINE	DIRECT	COOK	SQND	1,2,3,4,5,6
EF-9	GROOMING KENNEL A126	1,090	0.50	1,725	0.5	120	1	60	TIMER	-	INLINE	DIRECT	COOK	SQND	1,2,3,4,5,6
EF-10	WK RM A105	150	0.20	1,160	0.1	120	1	60		TSTAT	CEILING	DIRECT	COOK	GC	1,3,6,10,11
EF-11	DELIVERYMATE RIAL STOR B100	2,880	0.80	1,725	1	480	3	60	SWITCH	-	INLINE	DIRECT	COOK	SQN	1,2,3,4,6
EF-12	DELIVERYMATE RIAL STOR B100	2,880	0.80	1,725	1	480	3	60	SWITCH	-	INLINE	DIRECT	COOK	SQN	1,2,3,4,6
HVLS-1	DELIVERYMATE RIAL STOR B100	0	0.00	145	1	480	3	60	CONTROLE R	-	CEILING MOUNTED	DIRECT	Big Ass Fans	PFD 12	7,8,9
HVLS-2	DELIVERYMATE RIAL STOR B100	0	0.00	145	1	480	3	60	CONTROLE R	-	CEILING MOUNTED	DIRECT	Big Ass Fans	PFD 12	7,8,9
REMARKS: 1. PROVIDE WITH DISCONNECT SWITCH. 2. PROVIDE WITH BIRD SCREEN. 3. PROVIDE WITH MOTORIZED DAMPER. 4. SUSPEND UNIT WITH FOR HANGER RODS ATTACHED TO TWO UNISTRUT RUNNERS SECURED TO STRUCTURE. PROVIDE SPRING ISOLATION. REFER TO MANUFACTURER FOR MORE INFORMATION. 5. PROVIDE WITH 60 MINUTE TIMER WITHOUT HOLD FEATURE. 6. PROVIDE WITH SPEED CONTROLLER. 7. PROVIDE WITH FAN CONTROLLER. 8. MOUNT FAN TO STRUCTURAL BEAMS. REFER TO MANUFACTURER'S INSTRUCTION FOR MOUNTING OPTIONS AND REQUIRED CLEARANCES. 9. INCLUDE AUTOMATIC FIRE SPRINKLER RELAY. 10. PROVIDE WITH MANUFACTURER GRILLE. 11. PROVIDE WITH LINE VOLTAGE THERMOSTAT.															

PACKAGED ROOFTOP UNIT - GAS HEAT															
MARK	SUPPLY AIR CFM	OUTSIDE AIR CFM	FAN			HORSE POWER	CURRENT CHARAC.			COOLING			HEATING		
			EXT. STATIC PRESSURE (IN. W.C.)	DRY BULB	WET BULB		V	PH	F	AIR TEMP. (°F)	ENTERING DRY BULB	ENTERING WET BULB	MIN. TOTAL CAPACITY (BTUH)	MIN. SENS. CAPACITY (BTUH)	MINIMUM EER/SEER
RTU-5	2,800	420	1.50	5.0	480	3	60			78.3	65.5	95 °F	108,173	76,507	11.2+
RTU-6	2,720	405	1.50	5.0	480	3	60			78.3	65.5	95 °F	105,083	74,321	11.2+
RTU-7	2,720	405	1.50	5.0	480	3	60			78.3	65.5	95 °F	105,083	74,321	11.2+
REMARKS: 1. PROVIDE UNIT WITH DISCONNECT SWITCH, ROOF CURB AND MOTORIZED OUTSIDE AIR DAMPER. 2. PROVIDE UNIT WITH FACTORY MOUNTED GFCI RECEPTACLE FOR ELECTRICIAN TO WIRE TO SEPARATE CIRCUIT. 3. PROVIDE UNIT WITH LOW AMBIENT CONTROL. 4. PROVIDE UNIT WITH TEMPERATURE AND HUMIDITY SENSOR. 5. PROVIDE WITH SIDE DISCHARGE OR TRANSITION PLENUM CURB. 6. PROVIDE A WATER LEVEL SENSING DEVICE (FLOW SWITCH) IN THE PRIMARY DRAIN PAN. THIS DEVICE SHALL SHUT OFF THE APPLIANCE IN THE EVENT THE PRIMARY DRAIN LINE BECOMES RESTRICTED. 7. PROVIDE UNIT WITH DIFFERENTIAL ENTHALPY CONTROLLED ECONOMIZER AND POWERED EXHAUST. ECONOMIZER DAMPER SHALL BE ULTRA LOW LEAK EQUIVALENT TO RUSKIN CDO60 OR BETTER. 8. MECHANICAL CONTRACTOR IS RESPONSIBLE FOR ALL ELECTRICAL COSTS IF ALTERNATE UNIT IS PROVIDED WITH GREATER ELECTRICAL CHARACTERISTICS THEN SHOWN. 9. PROVIDE WITH EVAPORATOR COIL LEAVING AIR TEMPERATURE SENSOR. 10. PROVIDE WITH MULTIPLE ZONE VAV UNIT CONTROLS WITH VFD ON SUPPLY FAN. 11. PROVIDE WITH HOT GAS REHEAT. 12. PROVIDE UNIT WITH DEMAND CONTROLLED VENTILATION.															

PACKAGED ROOFTOP UNIT - VAV NO HEAT															
MARK	SUPPLY AIR CFM	OUTSIDE AIR CFM	FAN			HORSE POWER	CURRENT CHARAC.			COOLING			MIN. SENS. CAPACITY (BTUH)	MINIMUM EER/SEER	REMARKS
			EXT. STATIC PRESSURE (IN. W.C.)	DRY BULB	WET BULB		V	PH	F	AIR TEMPERATURE (°F)	ENTERING DRY BULB	ENTERING WET BULB	MIN. TOTAL CAPACITY (BTUH)	MIN. SENS. CAPACITY (BTUH)	
RTU-1	3,835	870	2.50	5.0	480	3	60			81.0	67.9	95 °F	175,440	118,041	11+
RTU-2	4,695	1,225	2.50	5.0	480	3	60			81.3	67.9	95 °F	214,730	146,033	11+
RTU-3	5,450	1,245	2.50	7.5	480	3	60			80.7	67.9	95 °F	249,382	165,985	10+
RTU-4	4,660	1,310	2.50	5.0	480	3	60			81.7	67.9	95 °F	208,487	143,884	11+
REMARKS: 1. PROVIDE UNIT WITH DISCONNECT SWITCH, ROOF CURB AND MOTORIZED OUTSIDE AIR DAMPER. 2. PROVIDE UNIT WITH FACTORY MOUNTED GFCI RECEPTACLE FOR ELECTRICIAN TO WIRE TO SEPARATE CIRCUIT. 3. PROVIDE UNIT WITH LOW AMBIENT CONTROL. 4. PROVIDE UNIT WITH OUTSIDE AIR FLOW MONITORING STATION. 5. PROVIDE WITH HORIZONTAL DISCHARGE. 6. PROVIDE WITH MULTIPLE ZONE VAV UNIT CONTROLS WITH VFD ON SUPPLY FAN. 7. PROVIDE UNIT WITH DIFFERENTIAL ENTHALPY CONTROLLED ECONOMIZER AND POWERED EXHAUST. ECONOMIZER DAMPER SHALL BE ULTRA LOW LEAK EQUIVALENT TO RUSKIN CDO60 OR BETTER. 8. MECHANICAL CONTRACTOR IS RESPONSIBLE FOR ALL ELECTRICAL COSTS IF ALTERNATE UNIT IS PROVIDED WITH GREATER ELECTRICAL CHARACTERISTICS THEN SHOWN. 9. PROVIDE WITH EVAPORATOR COIL LEAVING AIR TEMPERATURE SENSOR. 10. PROVIDE WITH MULTIPLE ZONE VAV UNIT CONTROLS WITH VFD ON SUPPLY FAN. 11. PROVIDE WITH VARIABLE CAPACITY COMPRESSOR. 12. PROVIDE WITH DUCT STATIC PRESSURE SENSOR.															

DUCTLESS MINI-SPLIT - INDOOR UNIT															
MARK	FAN					COOLING					REMARKS				
	SUPPLY AIR CFM	OUTSIDE AIR CFM	EXT. STATIC PRESSURE (IN. W.C.)	POWER (WATTS)	CURRENT CHARGE			AIR TEMPERATURE (°F)		MIN. TOTAL CAPACITY (BTU/H)		MIN. SENS. CAPACITY (BTU/H)	MINIMUM EER/ SEER	NUMBER OF STAGES	
					V	PH	F	ENTERING DRY BULB	ENTERING WET BULB						
DMS-1	705	0	0.10	75.0	208	1	60	75.0	62.5	34,200	27,880	-J14	1	(1,2,3,4,5)	
DMS-2	370	0	0.10	40.0	208	1	60	75.0	62.5	17,100	13,680	-J15.2	1	(1,2,3,4,5)	
GENERAL NOTES:															
1. EXTERNAL STATIC PRESSURE INCLUDES LOSSES DUE TO DUCTWORK, AIR DEVICES, DAMPERS, AND DUCT MOUNTED HOT WATER COILS WHERE APPLICABLE. DUCTY AIR AND GASING MAY BE ADDED TO EXTERNAL STATIC PRESSURE TO OBTAIN TOTAL PRESSURE LOSS. INCREASE HORSEPOWER AS REQUIRED TO MEET YOUR TOTAL PRESSURE LOSS.															
2. MAINTAIN MINIMUM CLEARANCE FOR COIL PULL AS RECOMMENDED BY UNIT MANUFACTURER. MAINTAIN MINIMUM CLEARANCE AS REQUIRED TO OPEN ACCESS AND CONTROL DOORS ON UNIT FOR SERVICE, MAINTENANCE, AND INSPECTION. MAINTAIN MINIMUM ELECTRICAL CLEARANCE AS REQUIRED BY NEC.															
REMARKS:															
1. UNIT TO BE INSTALLED PER MANUFACTURER'S INSTALLATION INSTRUCTIONS.															
2. CONTROLLED BY PROGRAMMABLE WIRED THERMOSTAT.															
3. REFRIGERANT LINES TO BE SIZED PER MANUFACTURER'S REQUIREMENTS.															
4. INDOOR UNIT IS POWERED FROM OUTDOOR UNIT.															
5. PROVIDE INTEGRAL MINI SPLIT CONDENSATE PUMP KIT ASP-MA-UNI MINI AQUA BY ASPEN PUMPS OR EQUAL. CONDENSATE PUMP SHALL BE INSTALLED INSIDE HIGH WALL UNIT. REFER TO MANUFACTURER INSTALLATION INSTRUCTIONS.															

AIR COOLED CONDENSING UNIT							
MARK	MIN. TOTAL CAPACITY (BTUH)	OUTDOOR AIR TEMP (°F)	MINIMUM EER/SEER	CURRENT CHARAC. V P F	RELATED UNIT MARK		REMARKS
DMSCU-1	34,200	95	-J14	208 1 60	DMS-1	(1,2,3)	
DMSCU-2	17,100	95	-J15.2	208 1 60	DMS-2	(1,2,3)	
REMARKS: 1. PROVIDE WITH LOW AMBIENT CONTROL DOWN TO 20°F. 2. PROVIDE WITH DISCONNECT SWITCH. 3. REFRIGERANT LINES TO BE SIZED PER MANUFACTURER'S REQUIREMENTS.							

UNIT HEATER - ELECTRIC							
MARK	MINIMUM CAPACITY (BTUH)	KW	NUMBER OF STAGES	CURRENT CHARAC. V P F	CFM	MANUFACTURER	MODEL
EUH-1	17,060	5	1	208 1 60	310	REZNOR	EGEB
REMARKS: 1. PROVIDE WITH DISCONNECT SWITCH AND PENDANT MOUNTED THERMOSTAT. 2. REFER TO MANUFACTURER INSTALLATION GUIDE FOR CLEARANCES AND MOUNTING HEIGHTS.							

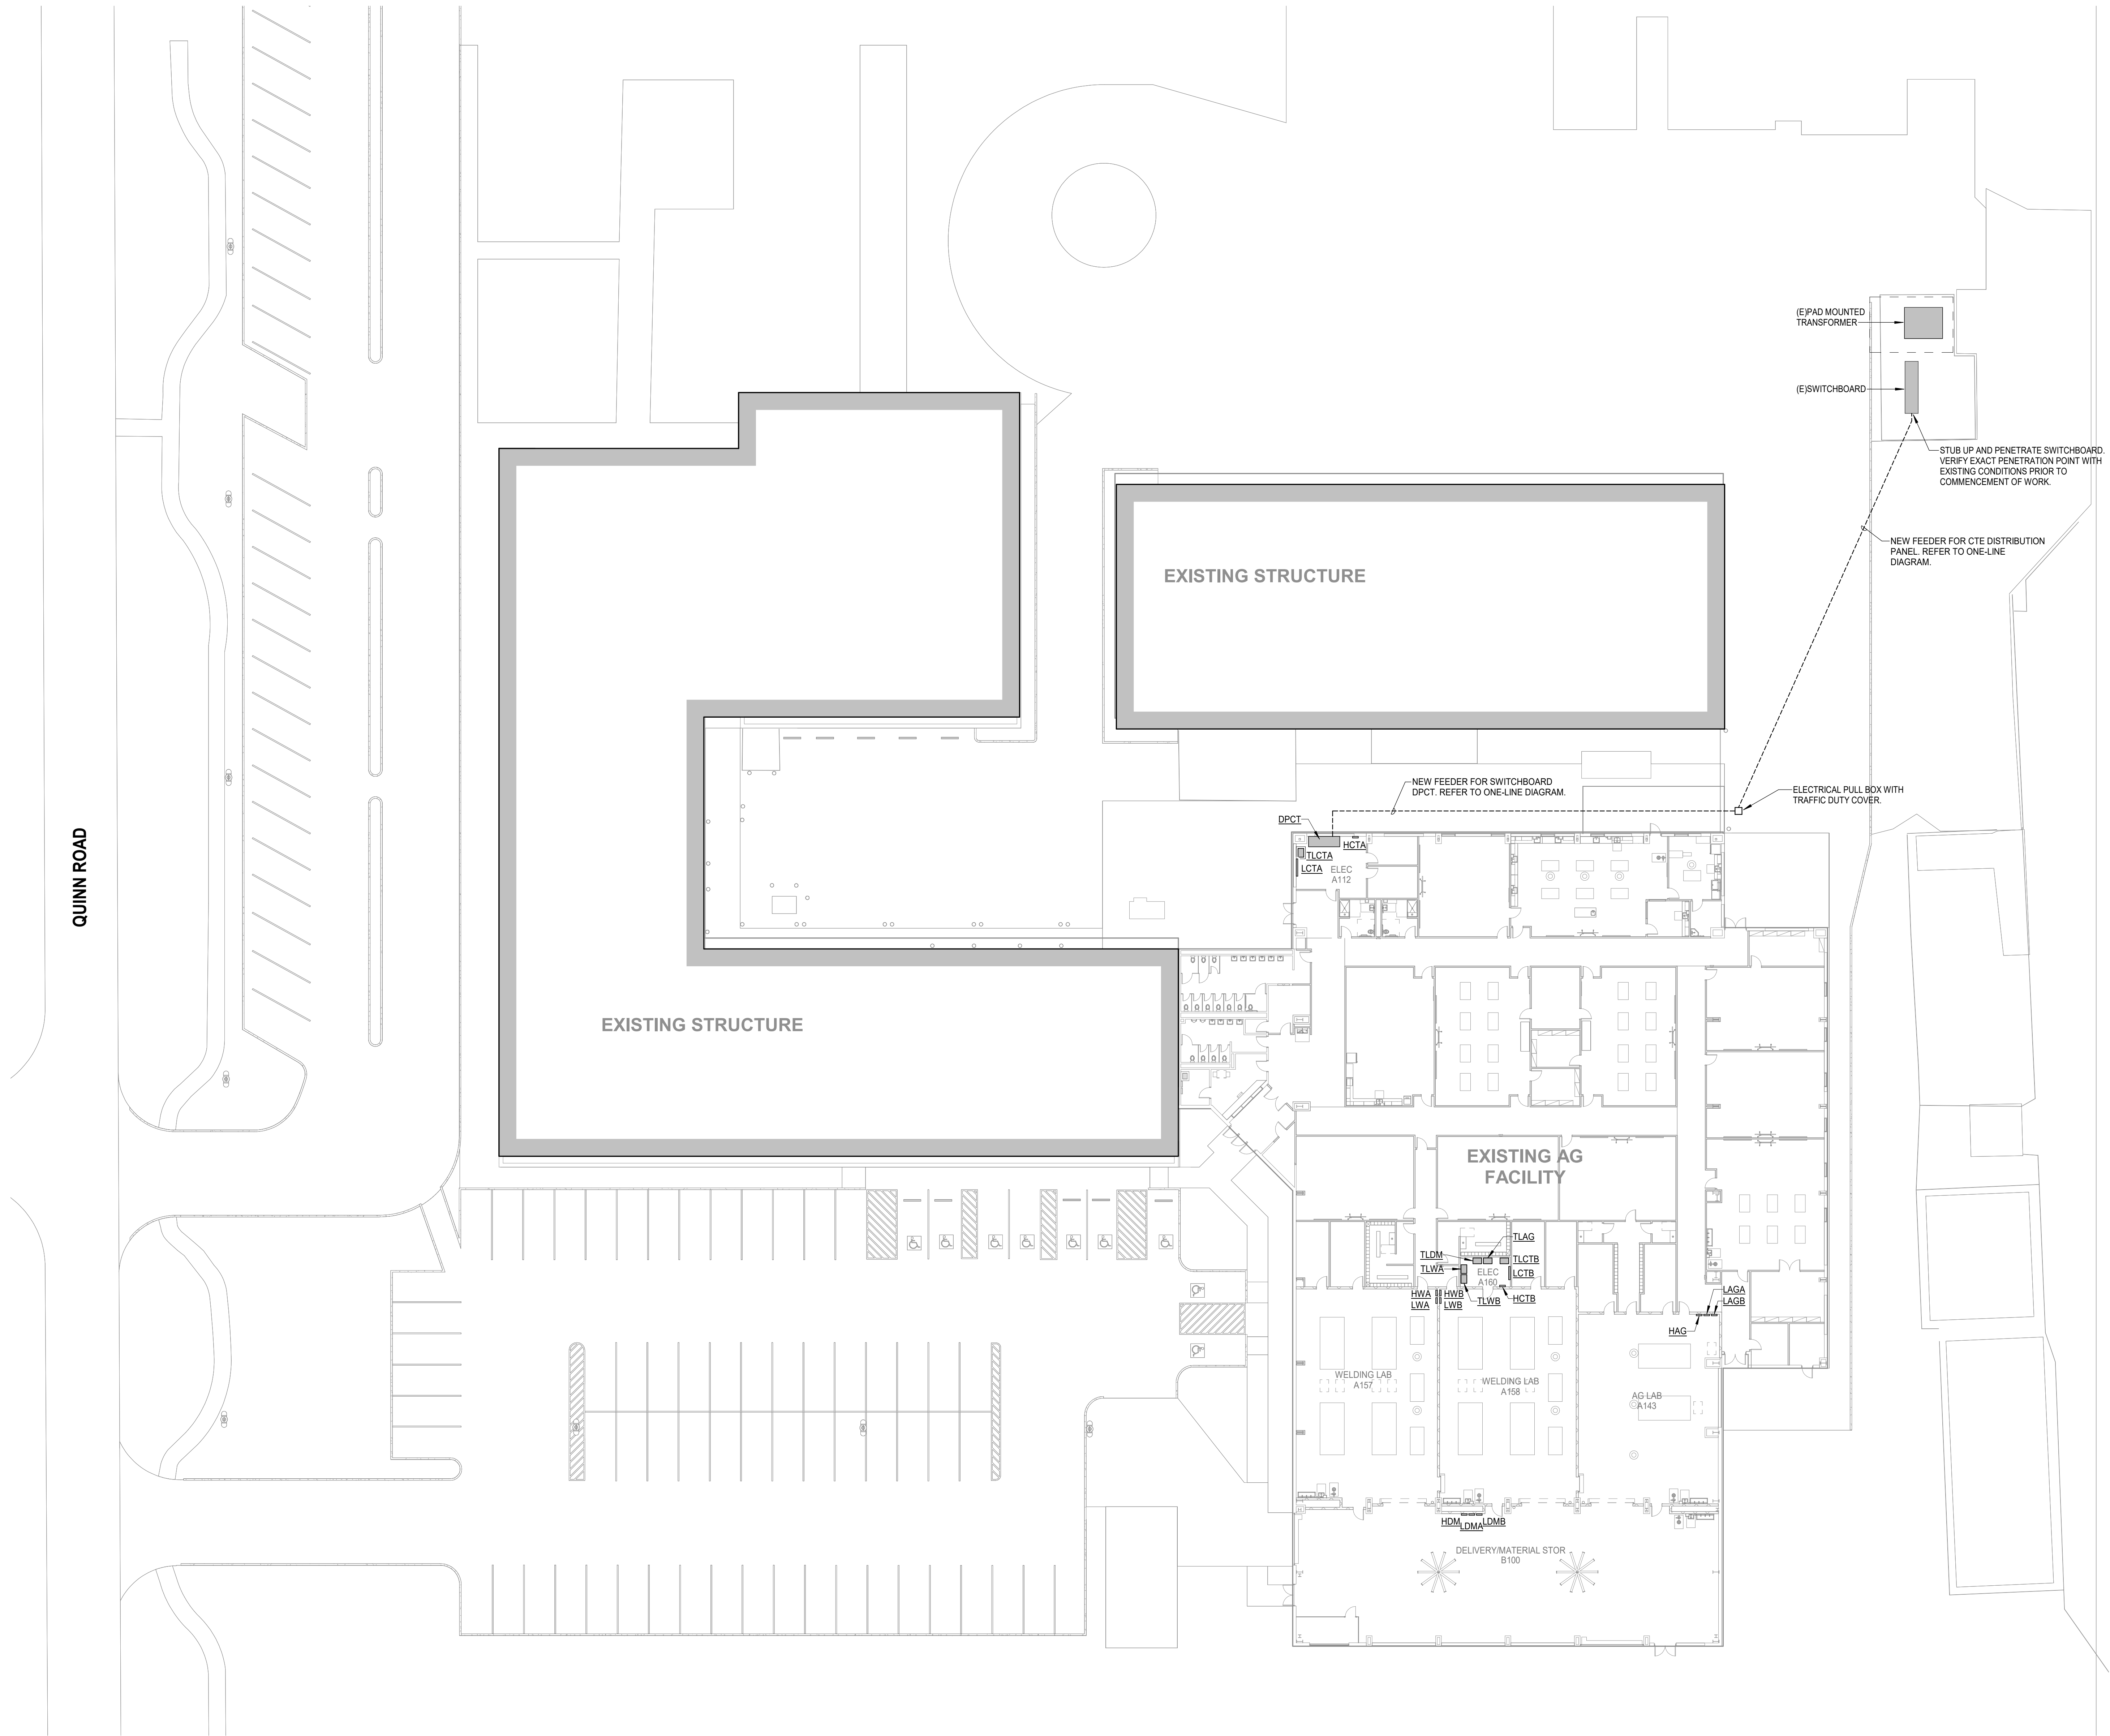
VARIABLE VOLUME TERMINAL BOX (ELECTRIC HEAT)									
MARK	MAXIMUM CFM	MINIMUM CFM	INLET DIAMETER SIZE (IN.)	KW	CURRENT CHARAC. V P F				REMARKS
VAV-1-1	315	315	6						-
VAV-1-2	1,500	575	12	16.6	480 3 60	-			-
VAV-1-3	1,500	645	12	16.6	480 3 60	-			-
VAV-1-4	520	365	8	5.8	480 3 60	-			-
VAV-2-1	1,300	640	12	14.4	480 3 60	-			-
VAV-2-2	1,085	400	10	12.0	480 3 60	-			-
VAV-2-3	1,260	450	12	14.0	480 3 60	-			-
VAV-2-4	1,050	550	10	11.6	480 3 60	-			-
VAV-3-1	370	370	6			-			-
VAV-3-2	560	290	8	6.2	480 3 60	-			-
VAV-3-3	1,280	720	12	14.2	480 3 60	-			-
VAV-3-4	960	360	10	10.6	480 3 60	-			-
VAV-3-5	1,140	360	12	12.6	480 3 60	-			-
VAV-3-6	1,140	360	12	12.6	480 3 60	-			-
VAV-4-1	1,455	455	12	16.1	480 3 60	-			-
VAV-4-2	1,515	420	12	16.8	480 3 60	-			-
VAV-4-3	1,440	360	12	16.0	480 3 60	-			-
VAV-4-4	150	150	4			-			-
REMARKS: 1. MAXIMUM STATIC PRESSURE DROP OF AIR THROUGH THE TERMINAL BOX SHALL BE 0.2" W.G. 2. MAXIMUM VELOCITY THROUGH DUCT INLET SHALL BE 2,000 FPM. 3. SUSPEND UNIT WITH FOUR THREADED HANGER RODS ATTACHED TO TWO UNISTRUT RUNNERS SECURED TO STRUCTURE. REFER TO MANUFACTURER FOR MORE DETAILS. 4. UNITS TO BE MOUNTED BETWEEN BEAMS AND 18" MAXIMUM ABOVE CEILING. AVOID MOUNTING OVER LIGHTS WHEREVER POSSIBLE.									

GRILLE									
MARK	SERVICE	TYPE	DAMPER	CONSTRUCTION MATERIAL	FINISH COLOR	MANUFACTURER	MODEL NUMBER		DESCRIPTION
A	SUPPLY AIR	DIFFUSER	-	STEEL	-	TITUS	OMNI		EXPOSED T-BAR CEILING FRAME STYLE WITH 24"x24" OR 12"x12" FACE.
B	RETURN AIR	DIFFUSER	-	STEEL	-	TITUS	PAR		EXPOSED T-BAR CEILING FRAME STYLE WITH A 24"x24" FACE. PERFORATED.
C	EXHAUST AIR	DIFFUSER	-	STEEL	-	TITUS	PAR		EXPOSED T-BAR CEILING FRAME STYLE WITH A 24"x24" OR 12"x12" FACE. PERFORATED FACE.
E	SUPPLY AIR	SUPPLY AIR	-	STEEL	-	TITUS	300RL		DOUBLE DEFLECTION SIDEWALL GRILLE WITH HORIZONTAL FRONT BARS. SURFACE MOUNTED
F	SUPPLY AIR	GRILLE	-	STEEL	-	TITUS	DL		DRUM LOUVER
G	EXHAUST AIR	GRILLE	-	STEEL	-	TITUS	350RL		SINGLE DEFLECTION SIDEWALL GRILLE WITH HORIZONTAL FRONT BARS. SURFACE MOUNTED
H	EXHAUST AIR	DIFFUSER	-	STEEL	-	TITUS	PAR		SURFACE MOUNT CEILING FRAME STYLE WITH 24"x24" OR 12"x12" FACE. PERFORATED FACE.
J	RETURN AIR	GRILLE	-	STEEL	-	TITUS	350RL		SINGLE DEFLECTION SIDEWALL GRILLE WITH HORIZONTAL FRONT BARS. SURFACE MOUNTED
REMARKS: 1. DAMPERS NOTED AS U.L. SHALL BE A 'U.L.' CLASSIFIED CEILING RADIATION DAMPER WITH THERMAL BLANKET. 2. COORDINATE FINAL AIR DEVICE LOCATION AND FINISH COLOR WITH ARCHITECT.									

DAMPER					
MARK	ACTUATOR	DUTY	BLADE ACTION	MANUFACTURER	REMARKS
D-1	MANUAL BALANCING	UNDER 9" WIDE	N/A	N/A	SEE SMACNA CONSTRUCTION DETAILS REFERENCED "TYPICAL CONSTRUCTION DETAILS FOR LOW VELOCITY DUCTS."
D-2	MANUAL BALANCING	OVER 9" WIDE	OPPOSED	RUSKIN	MANUAL DAMPER WITH STANDARD CONSTRUCTION FEATURES AND VENTLOCK #639 LOCKING REGULATOR
D-3	MOTORIZED	OVER 9" WIDE	OPPOSED	RUSKIN	LOW LEAKAGE DAMPER WITH BLADE SEALS
NOTES: N/A - NOT APPLICABLE					

RELIEF VENT & O.A. INTAKE						
MARK	CFM	MAX. S.P. (IN.W.C.)	MIN. THROAT AREA	COOK MODEL NUMBER	SERVES	REMARKS
OAI-1	2,880	0.17	8.75	GI	EF-5	1,2,3
OAI-2	2,840	0.17	8.75	GI	EF-6	1,2,3
OAI-3	2,840	0.17	8.75	GI	EF-7	1,2,3
OAI-4	2,880	0.17	8.75	GI	EF-8	1,2,3
OAI-5	2,880	0.17	8.75	GI	EF-9	1,2,3
REMARKS:						
1. PROVIDE WITH ROOF CURB.						
2. PROVIDE WITH BIRD SCREEN.						
3. PROVIDE WITH MOTORIZED DAMPER.						






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**TOMBALL HIGH SCHOOL  
CTE & MISC. RENOVATIONS**

TOMBALL INDEPENDENT SCHOOL DISTRICT  
30330 QUINN ROAD, TOMBALL, TX 77375

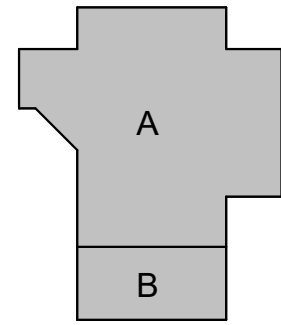**ARCADIS**  
TEXAS ARCADIS INC.  
10205 WESTHEIMER SUITE 800  
HOUSTON, TX 77042  
tel 713.953.4897, fax 713.977.4620



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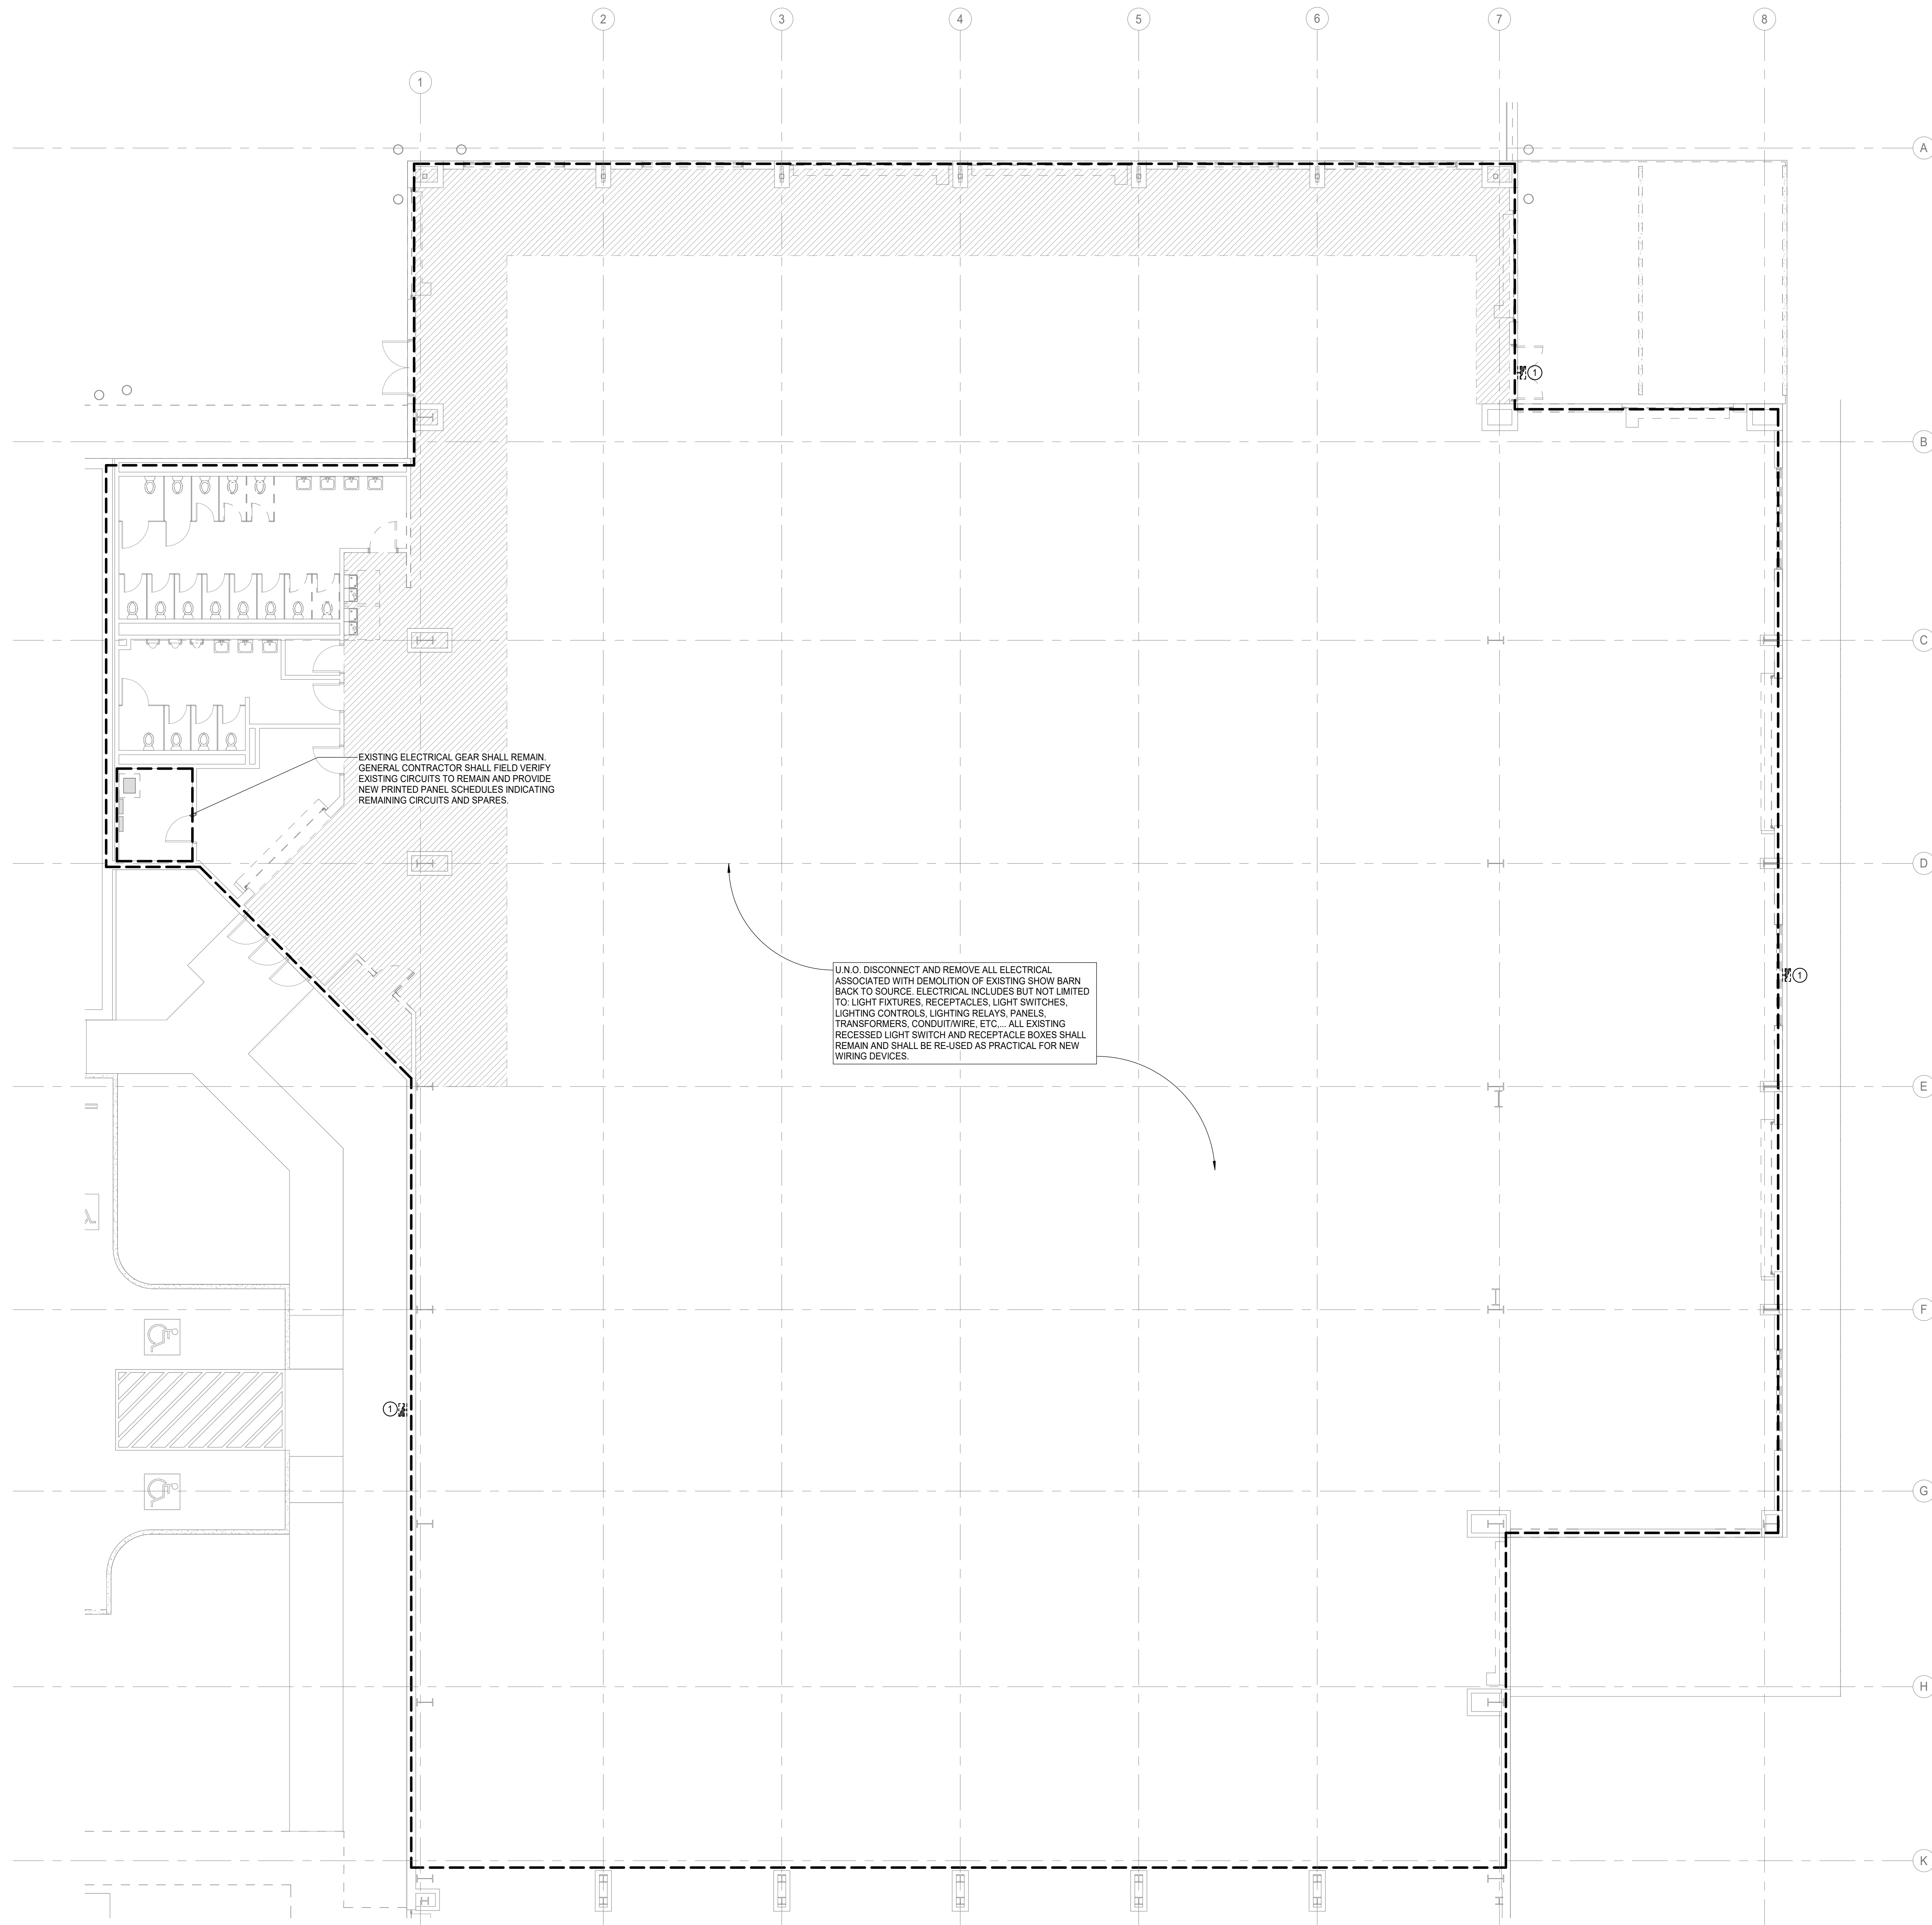
DATE: 2023-11-03  
ISSUE: BID SET

**E1.00**  
ELECTRICAL  
SITE PLAN

**1 ELECTRICAL SITE PLAN**  
Scale: 1" = 20'-0"







**ELECTRICAL GENERAL NOTES:**

1. DISCONNECT AND REMOVE ALL ABANDONED WIRING AND CONDUIT.
2. DISCONNECT AND REMOVE ALL CONDUIT, WIRE, AND DISCONNECTING MEANS ASSOCIATED WITH HVAC EQUIPMENT BEING REMOVED.
3. DISCONNECT AND REMOVE ALL ELECTRICAL FROM WALLS SCHEDULED TO BE DEMOLISHED. REMOVE BACK TO SOURCE. REFER TO ARCHITECTURAL DRAWINGS FOR EXACT WALL DEMOLITION.

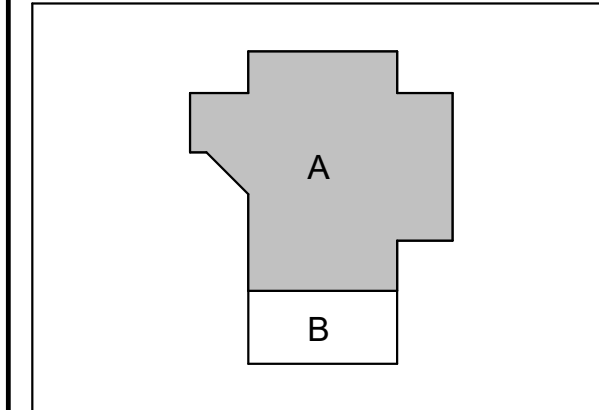
LINETYPE LEGEND	
	EXISTING TO REMAIN
	DISCONNECT AND REMOVE

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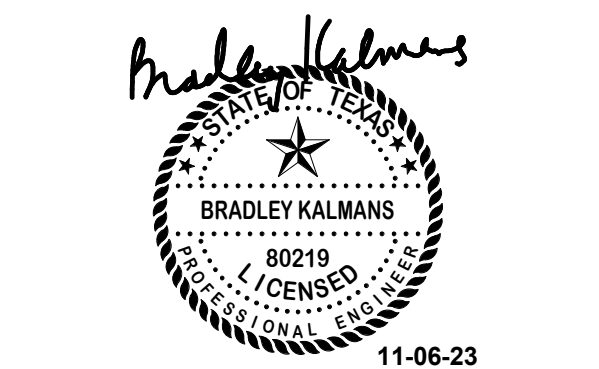
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**E1.01**

ELECTRICAL  
DEMOLITION  
AREA 'A1' 1ST  
FLOOR PLAN

**1 ELECTRICAL DEMOLITION 1ST FLOOR PLAN - AREA 'A1'**  
Scale: 1/8" = 1'-0"





ELECTRICAL GENERAL NOTES:

1. DISCONNECT AND REMOVE ALL ABANDONED WIRING AND CONDUIT.
2. DISCONNECT AND REMOVE ALL CONDUIT, WIRE, AND DISCONNECTING MEANS ASSOCIATED WITH HVAC EQUIPMENT BEING REMOVED.
3. DISCONNECT AND REMOVE ALL ELECTRICAL FROM WALLS SCHEDULED TO BE DEMOLISHED. REMOVE BACK TO SOURCE. REFER TO ARCHITECTURAL DRAWINGS FOR EXACT WALL DEMOLITION.

LINETYPE LEGEND


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<div></div>	DISCONNECT AND REMOVE

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TOMBALL HIGH SCHOOL  
CTE & MISC. RENOVATIONS

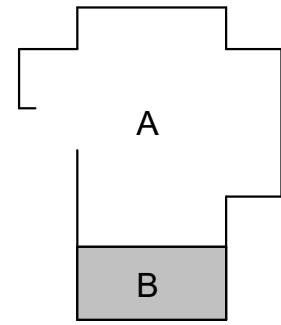TOMBALL INDEPENDENT SCHOOL DISTRICT  
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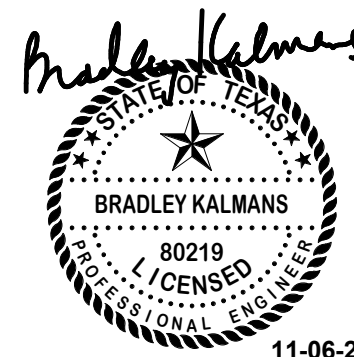


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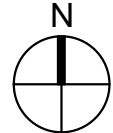
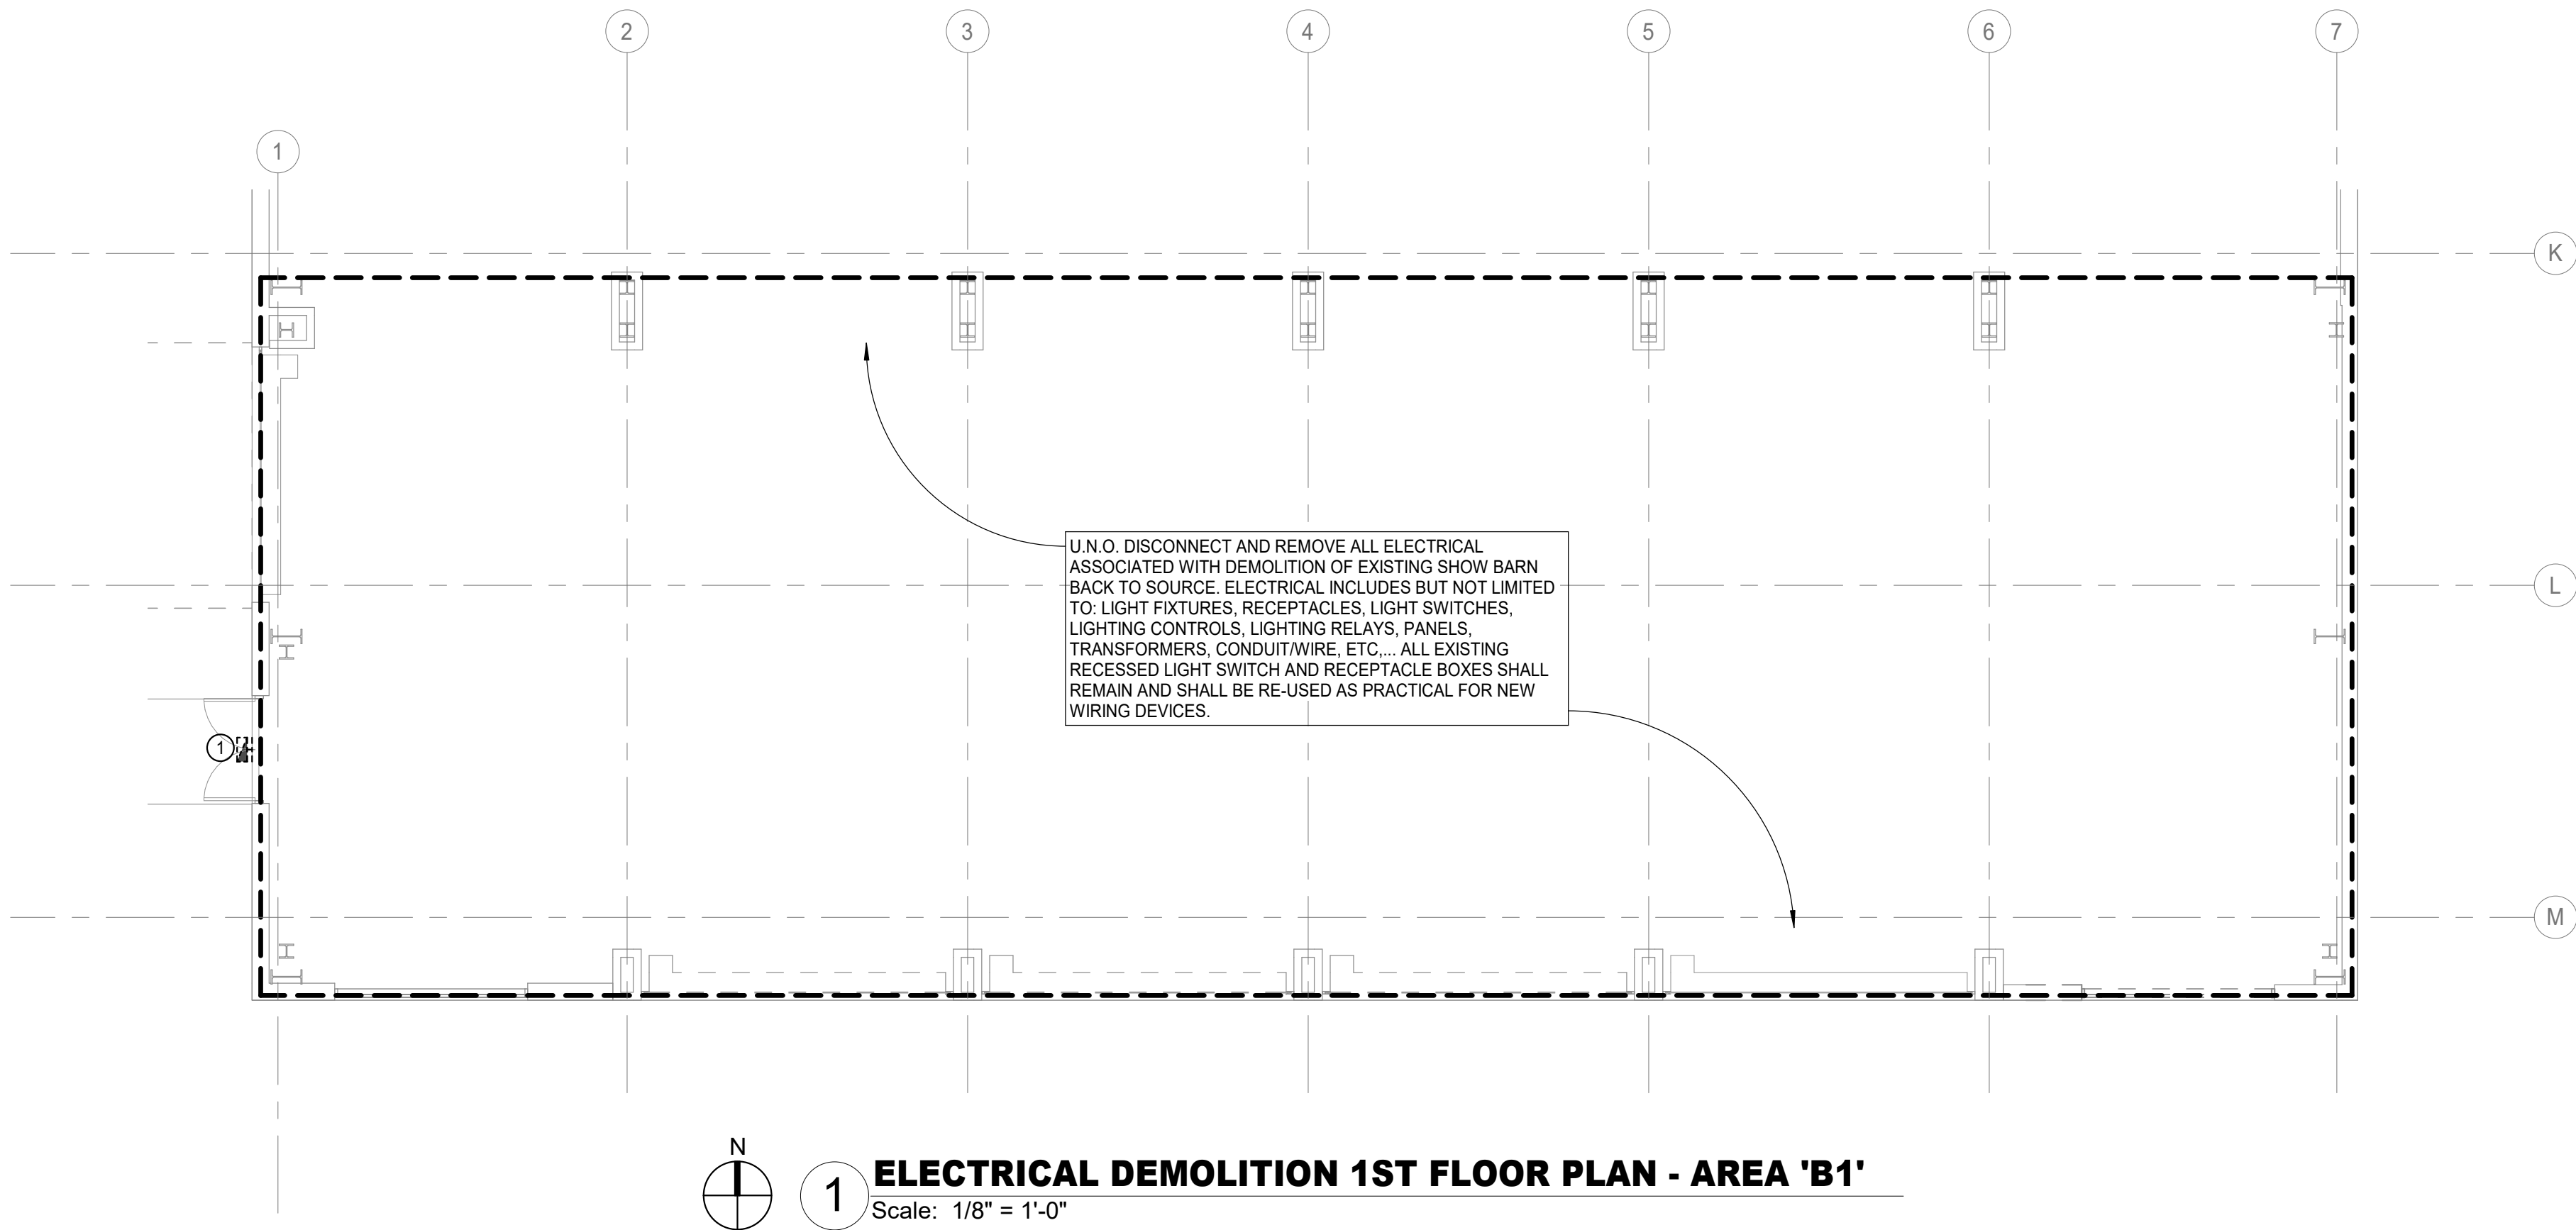


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E1.02

ELECTRICAL  
DEMOLITION  
AREA 'B1' 1ST  
FLOOR PLAN




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ELECTRICAL DEMOLITION 1ST FLOOR PLAN - AREA 'B1'

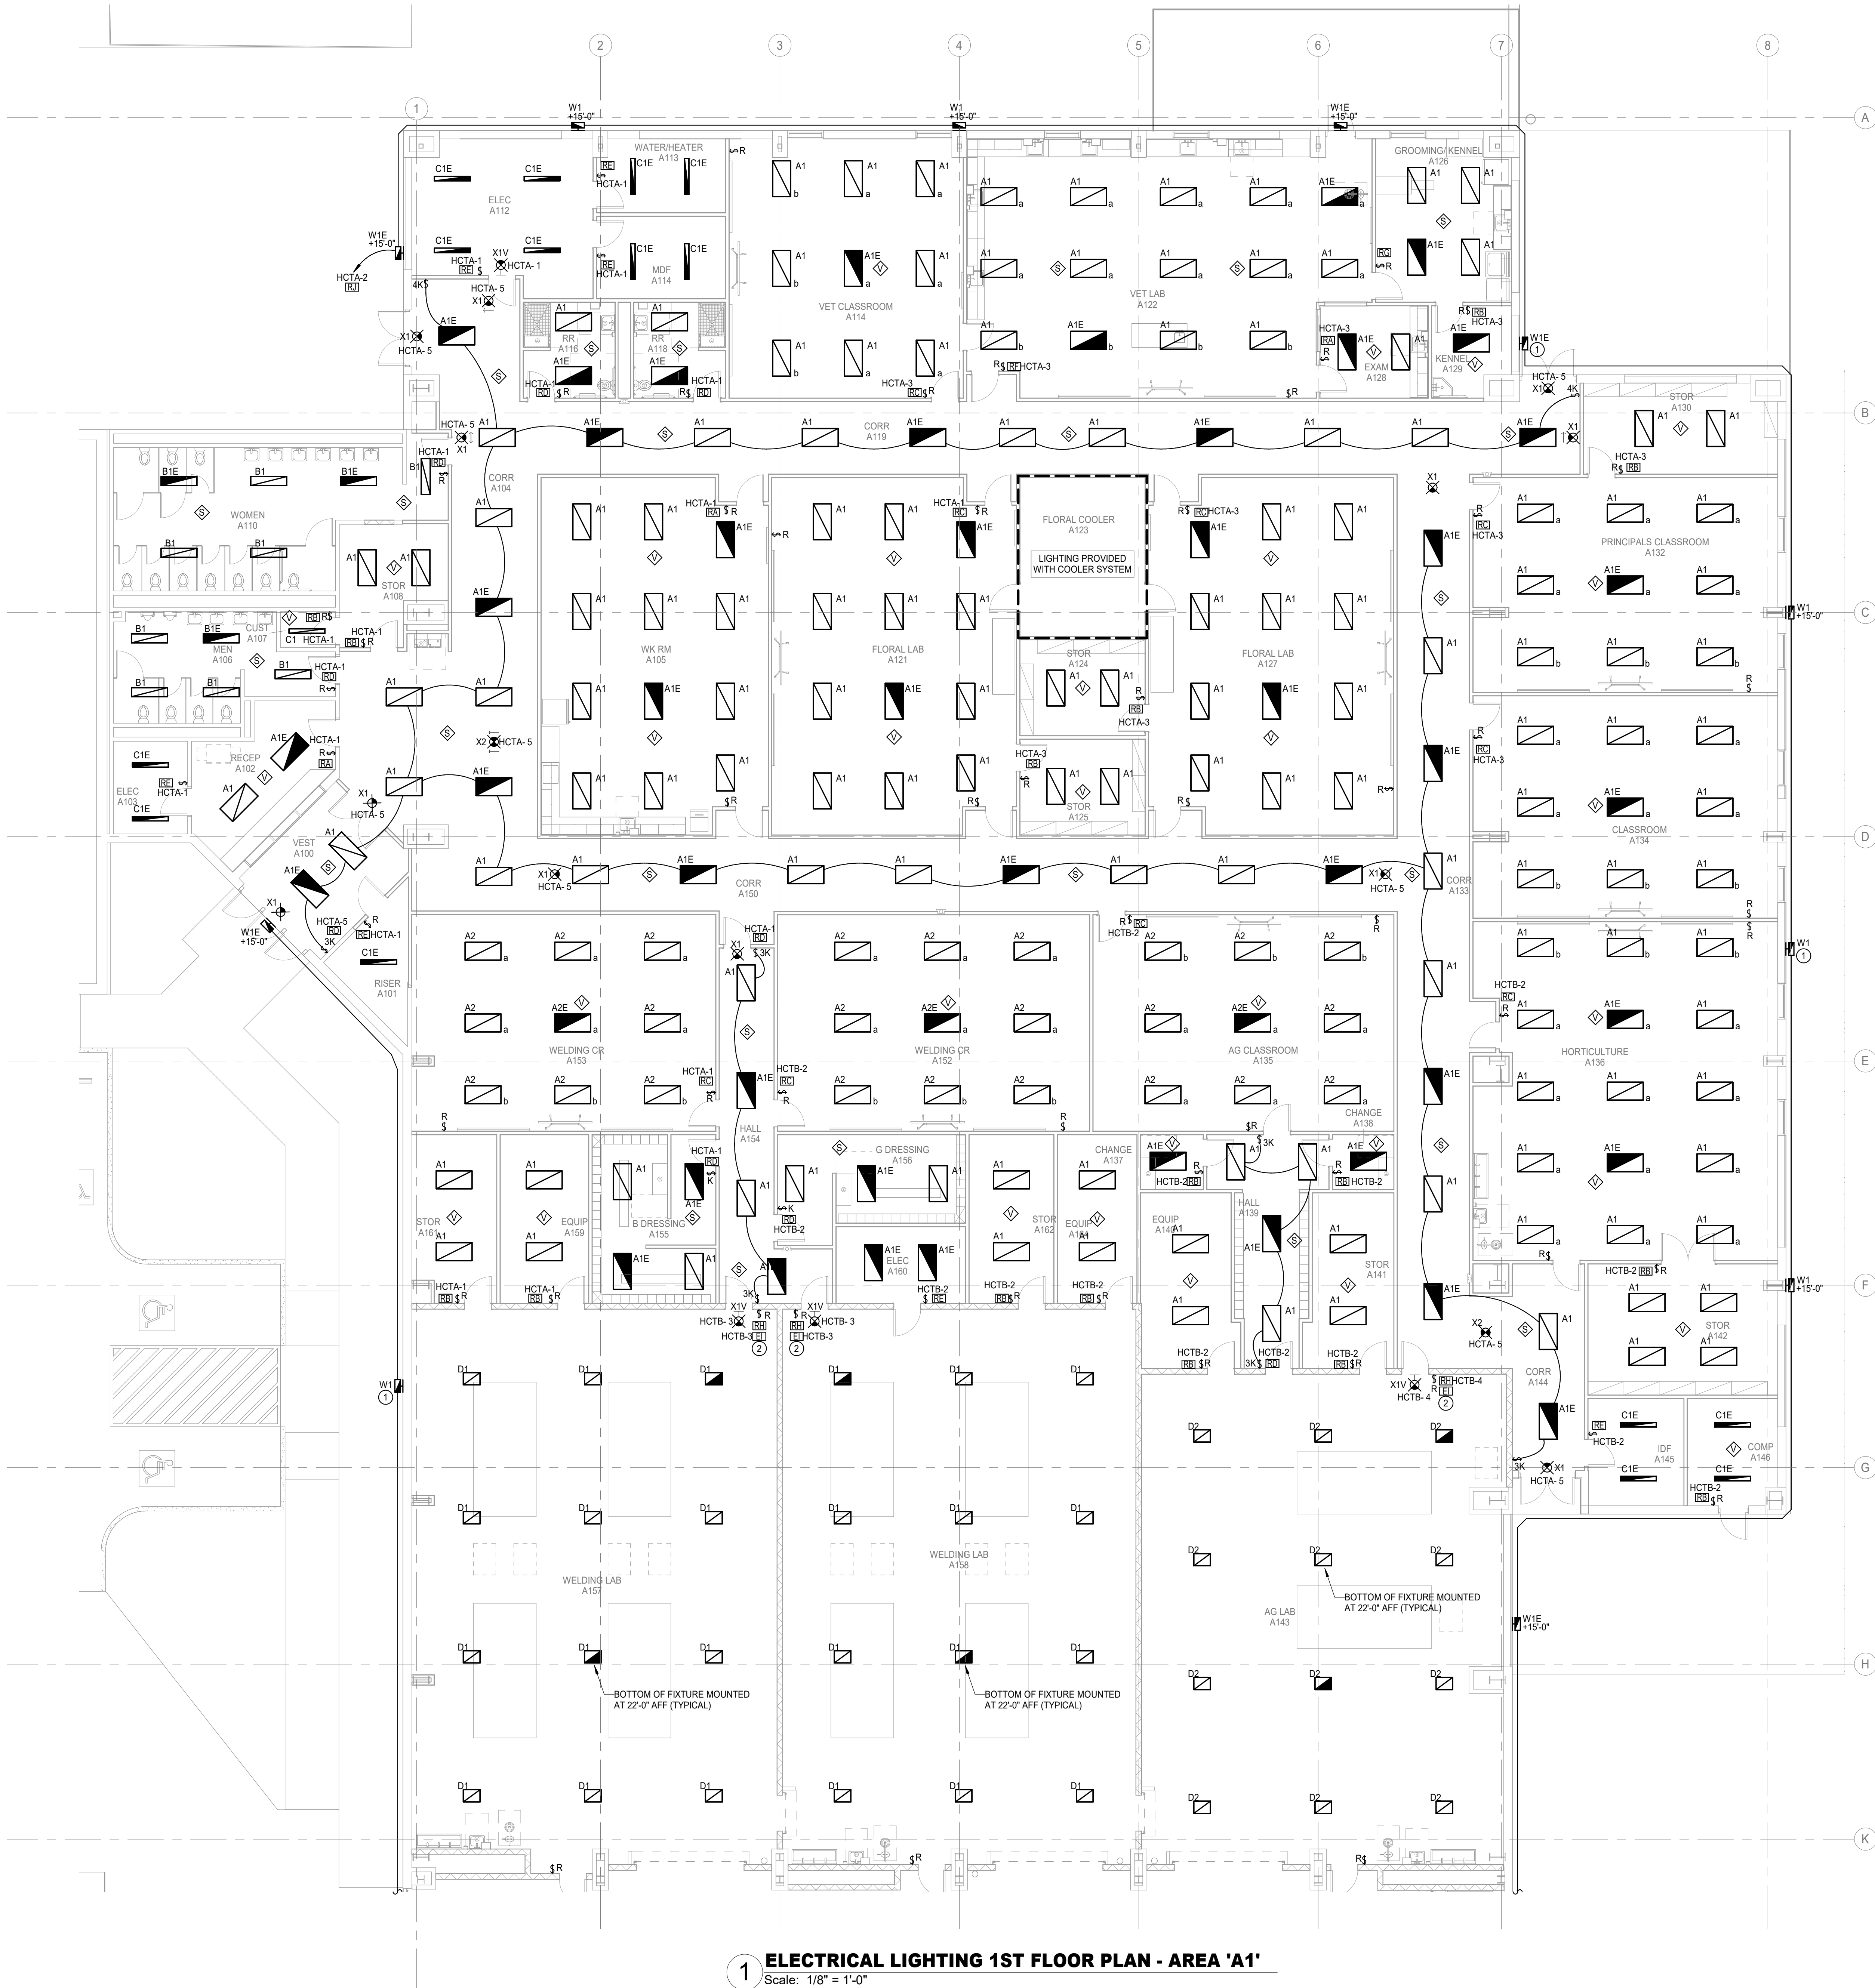Scale: 1/8" = 1'-0"







1 ELECTRICAL LIGHTING 1ST FLOOR PLAN - AREA 'A1'  
Scale: 1/8" = 1'-0"

#### ELECTRICAL GENERAL NOTES:

1. LIGHTING CONTROLS SHALL COMPLY WITH IEC 2015. REFER TO CONTROLS SCHEDULE FOR ALL LIGHTING CONTROLS, SENSORS, AND SWITCHING SCHEMES THROUGHOUT FACILITY.
2. CONTRACTOR SHALL MAINTAIN CONSTANT UNSWITCHED POWER FOR EMERGENCY LOAD CONTROL RELAYS AND EXIT SIGNS.
3. LOCATE DIGITAL LIGHTING CONTROLLER AND / OR EMERGENCY LOAD CONTROL RELAY ABOVE ACCESSIBLE CEILING 12-FEET AFF OR BELOW ADJACENT TO SWITCH CONTROLLING THE SPACE. IN NON-ACCESSIBLE AND / OR HIGH CEILING AREAS, LOCATE DIGITAL LIGHTING CONTROLLER IN ADJACENT ANCILLARY AREA WITH ACCESSIBLE CEILING. IN AREAS WITH NO CEILING AND / OR IN EXTERIOR APPLICATIONS LOCATE ADJACENT TO PANEL SERVING THE LOAD. PROVIDE PLASTIC TAPE MACHINE TYPED NAME PLATE TO BOTTOM OF CEILING T-GRID BELOW RELAY LOCATION. WHITE LETTERS ON BLACK BACKGROUND WITH 1/4" HIGH LETTERS ON 1/2" TALL LABEL FOR DIGITAL MODULE, INDICATE AS LGT RELAYS.
4. OCCUPANCY / VACANCY SENSOR AND DAYLIGHTING SENSOR LOCATIONS INDICATE SPACE OR AREA CONTROLLED. CONTRACTOR TO PROVIDE ACTUAL QUANTITIES, TYPES, AND MOUNTING LOCATIONS AS RECOMMENDED BY MANUFACTURER.
5. SPACES WITH MULTIPLE OCCUPANCY / VACANCY SENSORS OR WHERE LINE OF SIGHT MAY BE OBSCURED, SHALL BE LINKED TOGETHER FOR SIMULTANEOUS OPERATION WITHIN THE SPACE.
6. COORDINATE LOCATION OF LIGHT FIXTURES IN ALL MEPT ROOMS WITH MECHANICAL EQUIPMENT, PIPING, AND ALL OTHER TRADES.

#### ELECTRICAL KEYED NOTES:

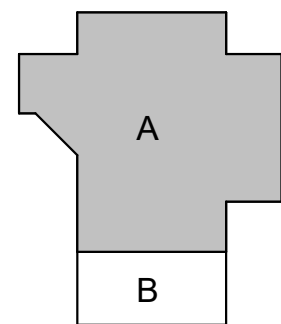
1. EXISTING EXTERIOR LIGHT FIXTURE LOCATION. PROVIDE NEW LIGHT FIXTURE IN SAME LOCATION. CONNECT TO NEW CIRCUITRY/CONTROLS.
2. PROVIDE EMERGENCY POWER INVERTER FOR CONNECTION OF EMERGENCY HATCHED FIXTURES IN SHOP. LOCATE INVERTER IN ELECTRICAL A160 AND MAKE FINAL CONNECTION TO LIGHT FIXTURES.

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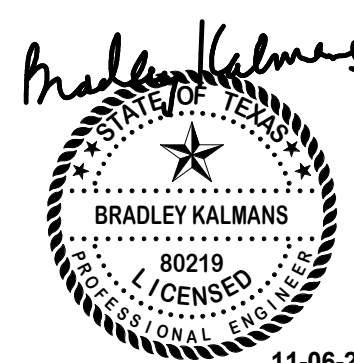


**TOMBALL HIGH SCHOOL  
CTE & MISC. RENOVATIONS**  
TOMBALL INDEPENDENT SCHOOL DISTRICT  
30330 QUIN ROAD, TOMBALL, TX 77375



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**E2.01**

ELECTRICAL  
LIGHTING AREA  
'A1' 1ST FLOOR  
PLAN





ELECTRICAL GENERAL NOTES:

1. LIGHTING CONTROLS SHALL COMPLY WITH IECC 2015. REFER TO CONTROLS SCHEDULE FOR ALL LIGHTING CONTROLS, SENSORS, AND SWITCHING SCHEMES THROUGHOUT FACILITY.
2. CONTRACTOR SHALL MAINTAIN CONSTANT UNSWITCHED POWER FOR EMERGENCY LOAD CONTROL RELAYS AND EXIT SIGNS.
3. LOCATE DIGITAL LIGHTING CONTROLLER AND / OR EMERGENCY LOAD CONTROL RELAY ABOVE ACCESSIBLE CEILING 12-FEET AFF OR BELOW ADJACENT TO SWITCH CONTROLLING THE SPACE. IN NON-ACCESSIBLE AND / OR HIGH CEILING AREAS, LOCATE DIGITAL LIGHTING CONTROLLER IN ADJACENT ANCILLARY AREA WITH ACCESSIBLE CEILING. IN AREAS WITH NO CEILING AND / OR IN EXTERIOR APPLICATIONS LOCATE ADJACENT TO PANEL SERVING THE LOAD. PROVIDE PLASTIC TAPE MACHINE TYPED NAME PLATE TO BOTTOM OF CEILING T-GRID BELOW RELAY LOCATION. WHITE LETTERS ON BLACK BACKGROUND WITH 1/4" HIGH LETTERS ON 1/2" TALL LABEL FOR DIGITAL MODULE, INDICATE AS LGT RELAYS.
4. OCCUPANCY / VACANCY SENSOR AND DAYLIGHTING SENSOR LOCATIONS INDICATE SPACE OR AREA CONTROLLED. CONTRACTOR TO PROVIDE ACTUAL QUANTITIES, TYPES, AND MOUNTING LOCATIONS AS RECOMMENDED BY MANUFACTURER.
5. SPACES WITH MULTIPLE OCCUPANCY / VACANCY SENSORS OR WHERE LINE OF SIGHT MAY BE OBSCURED, SHALL BE LINKED TOGETHER FOR SIMULTANEOUS OPERATION WITHIN THE SPACE.
6. COORDINATE LOCATION OF LIGHT FIXTURES IN ALL MEPT ROOMS WITH MECHANICAL EQUIPMENT, PIPING, AND ALL OTHER TRADES.

ELECTRICAL KEYED NOTES:

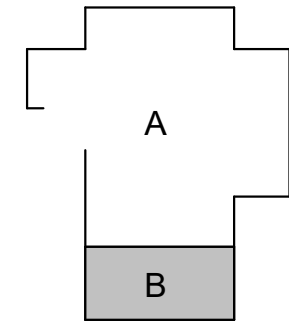
- ① EXISTING EXTERIOR LIGHT FIXTURE LOCATION. PROVIDE NEW LIGHT FIXTURE IN SAME LOCATION. CONNECT TO NEW CIRCUITRY/CONTROLS.
- ② PROVIDE EMERGENCY POWER INVERTER FOR CONNECTION OF EMERGENCY HATCHED FIXTURES IN SHOP. LOCATE INVERTER IN ELECTRICAL A160 AND MAKE FINAL CONNECTION TO LIGHT FIXTURES.

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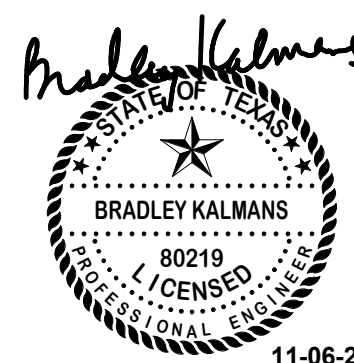
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CTE & MISC. RENOVATIONS**

TOMBALL INDEPENDENT SCHOOL DISTRICT  
30330 QUIN ROAD, TOMBALL, TX 77375



TEXAS ARCADIS INC.

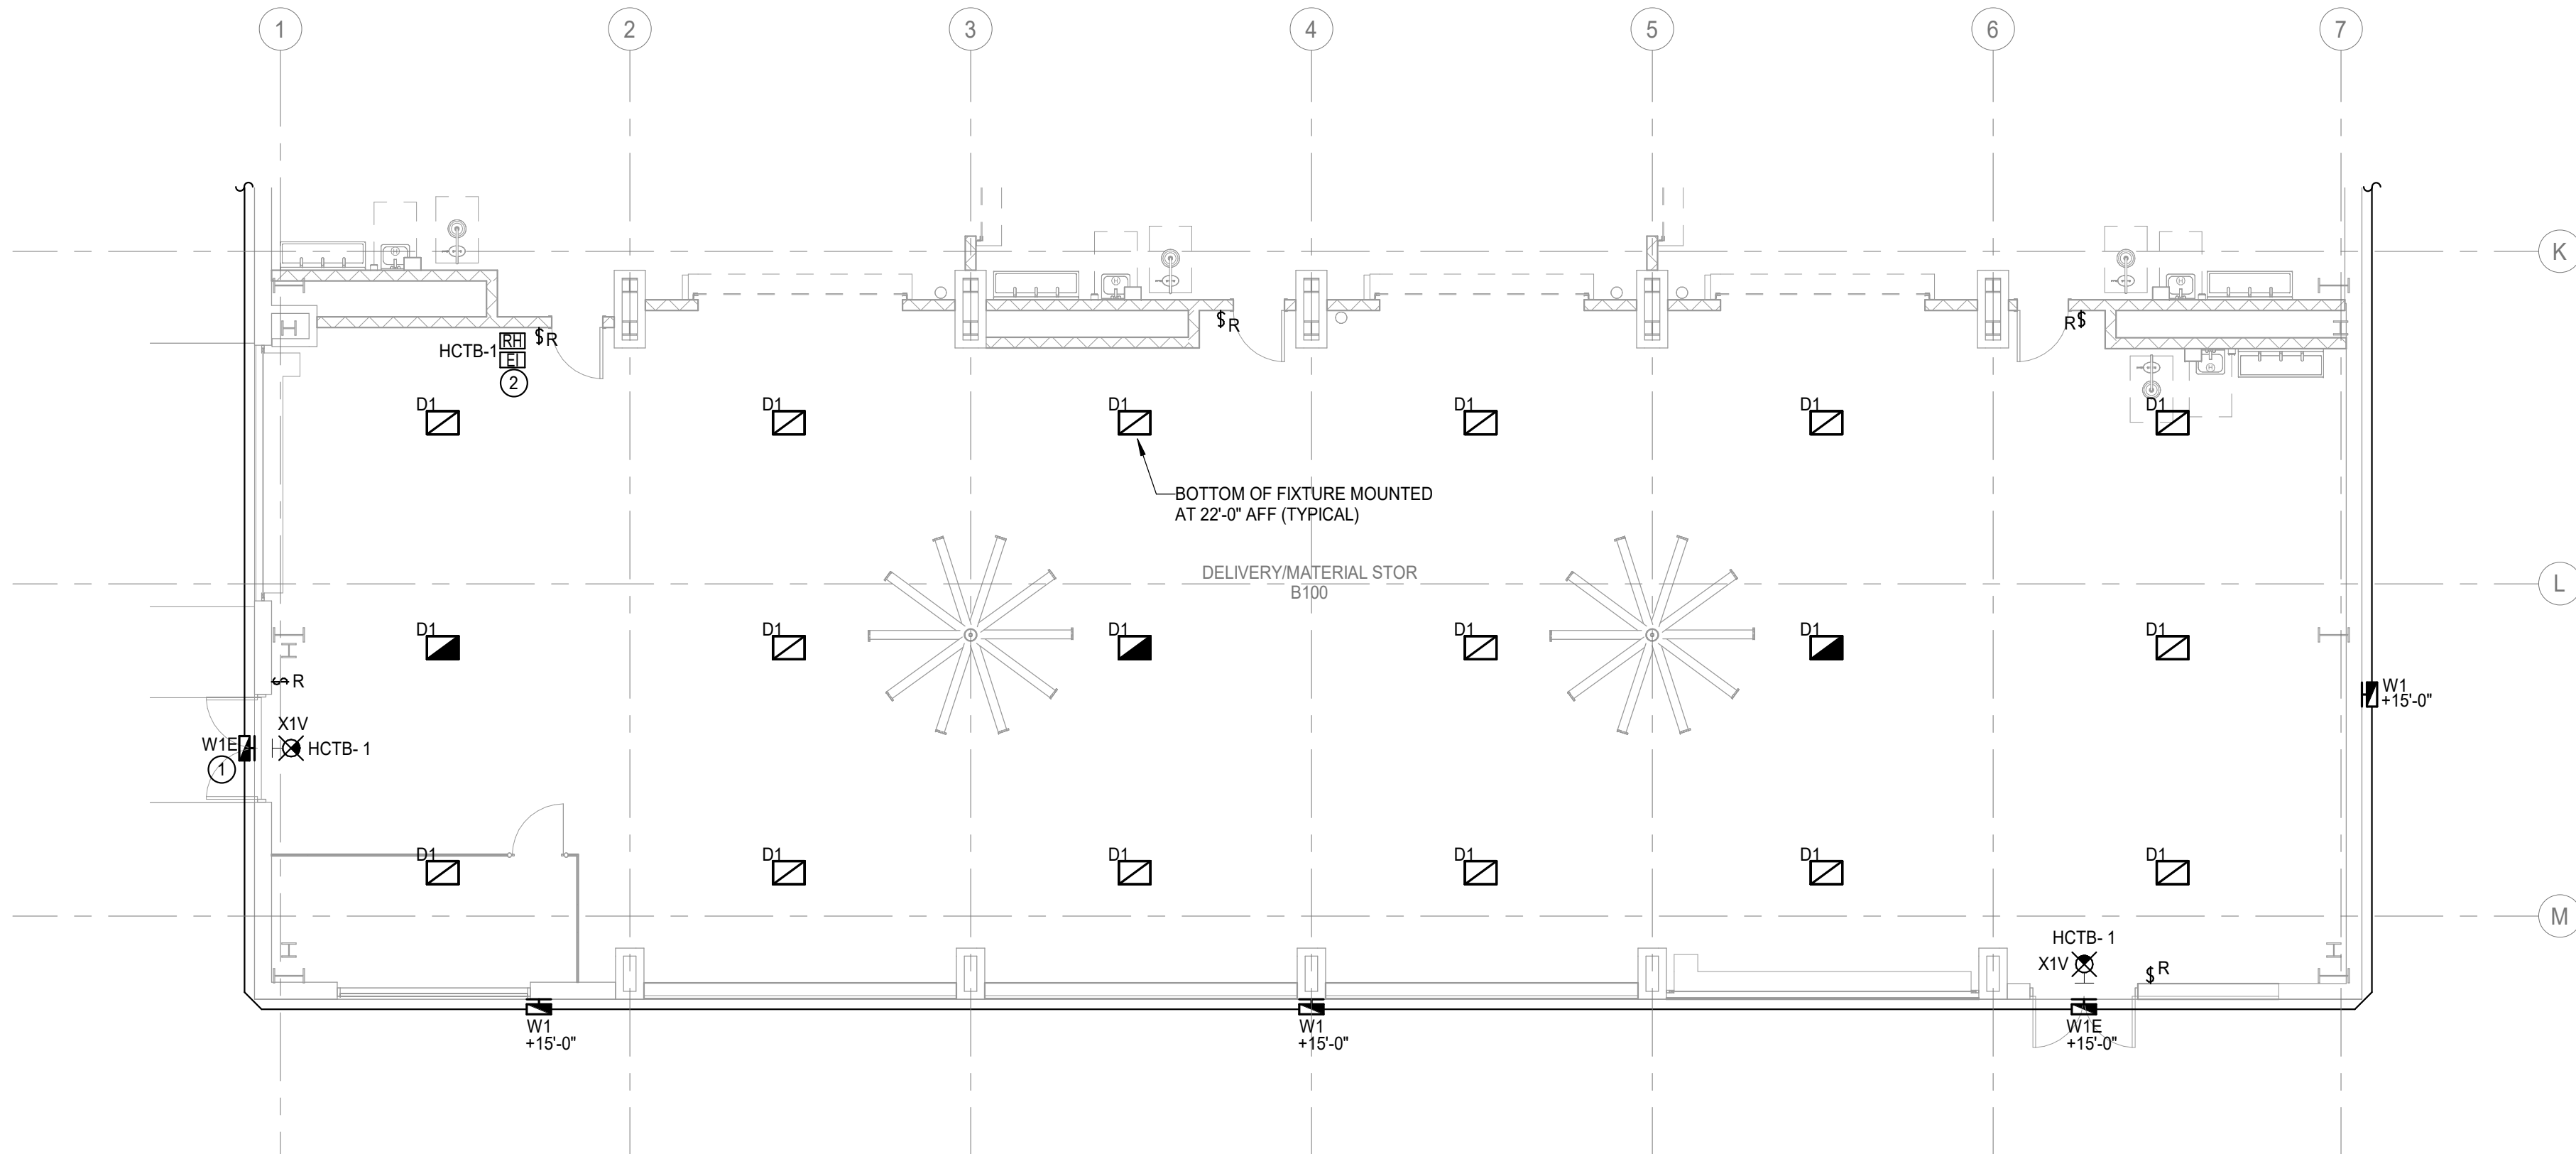
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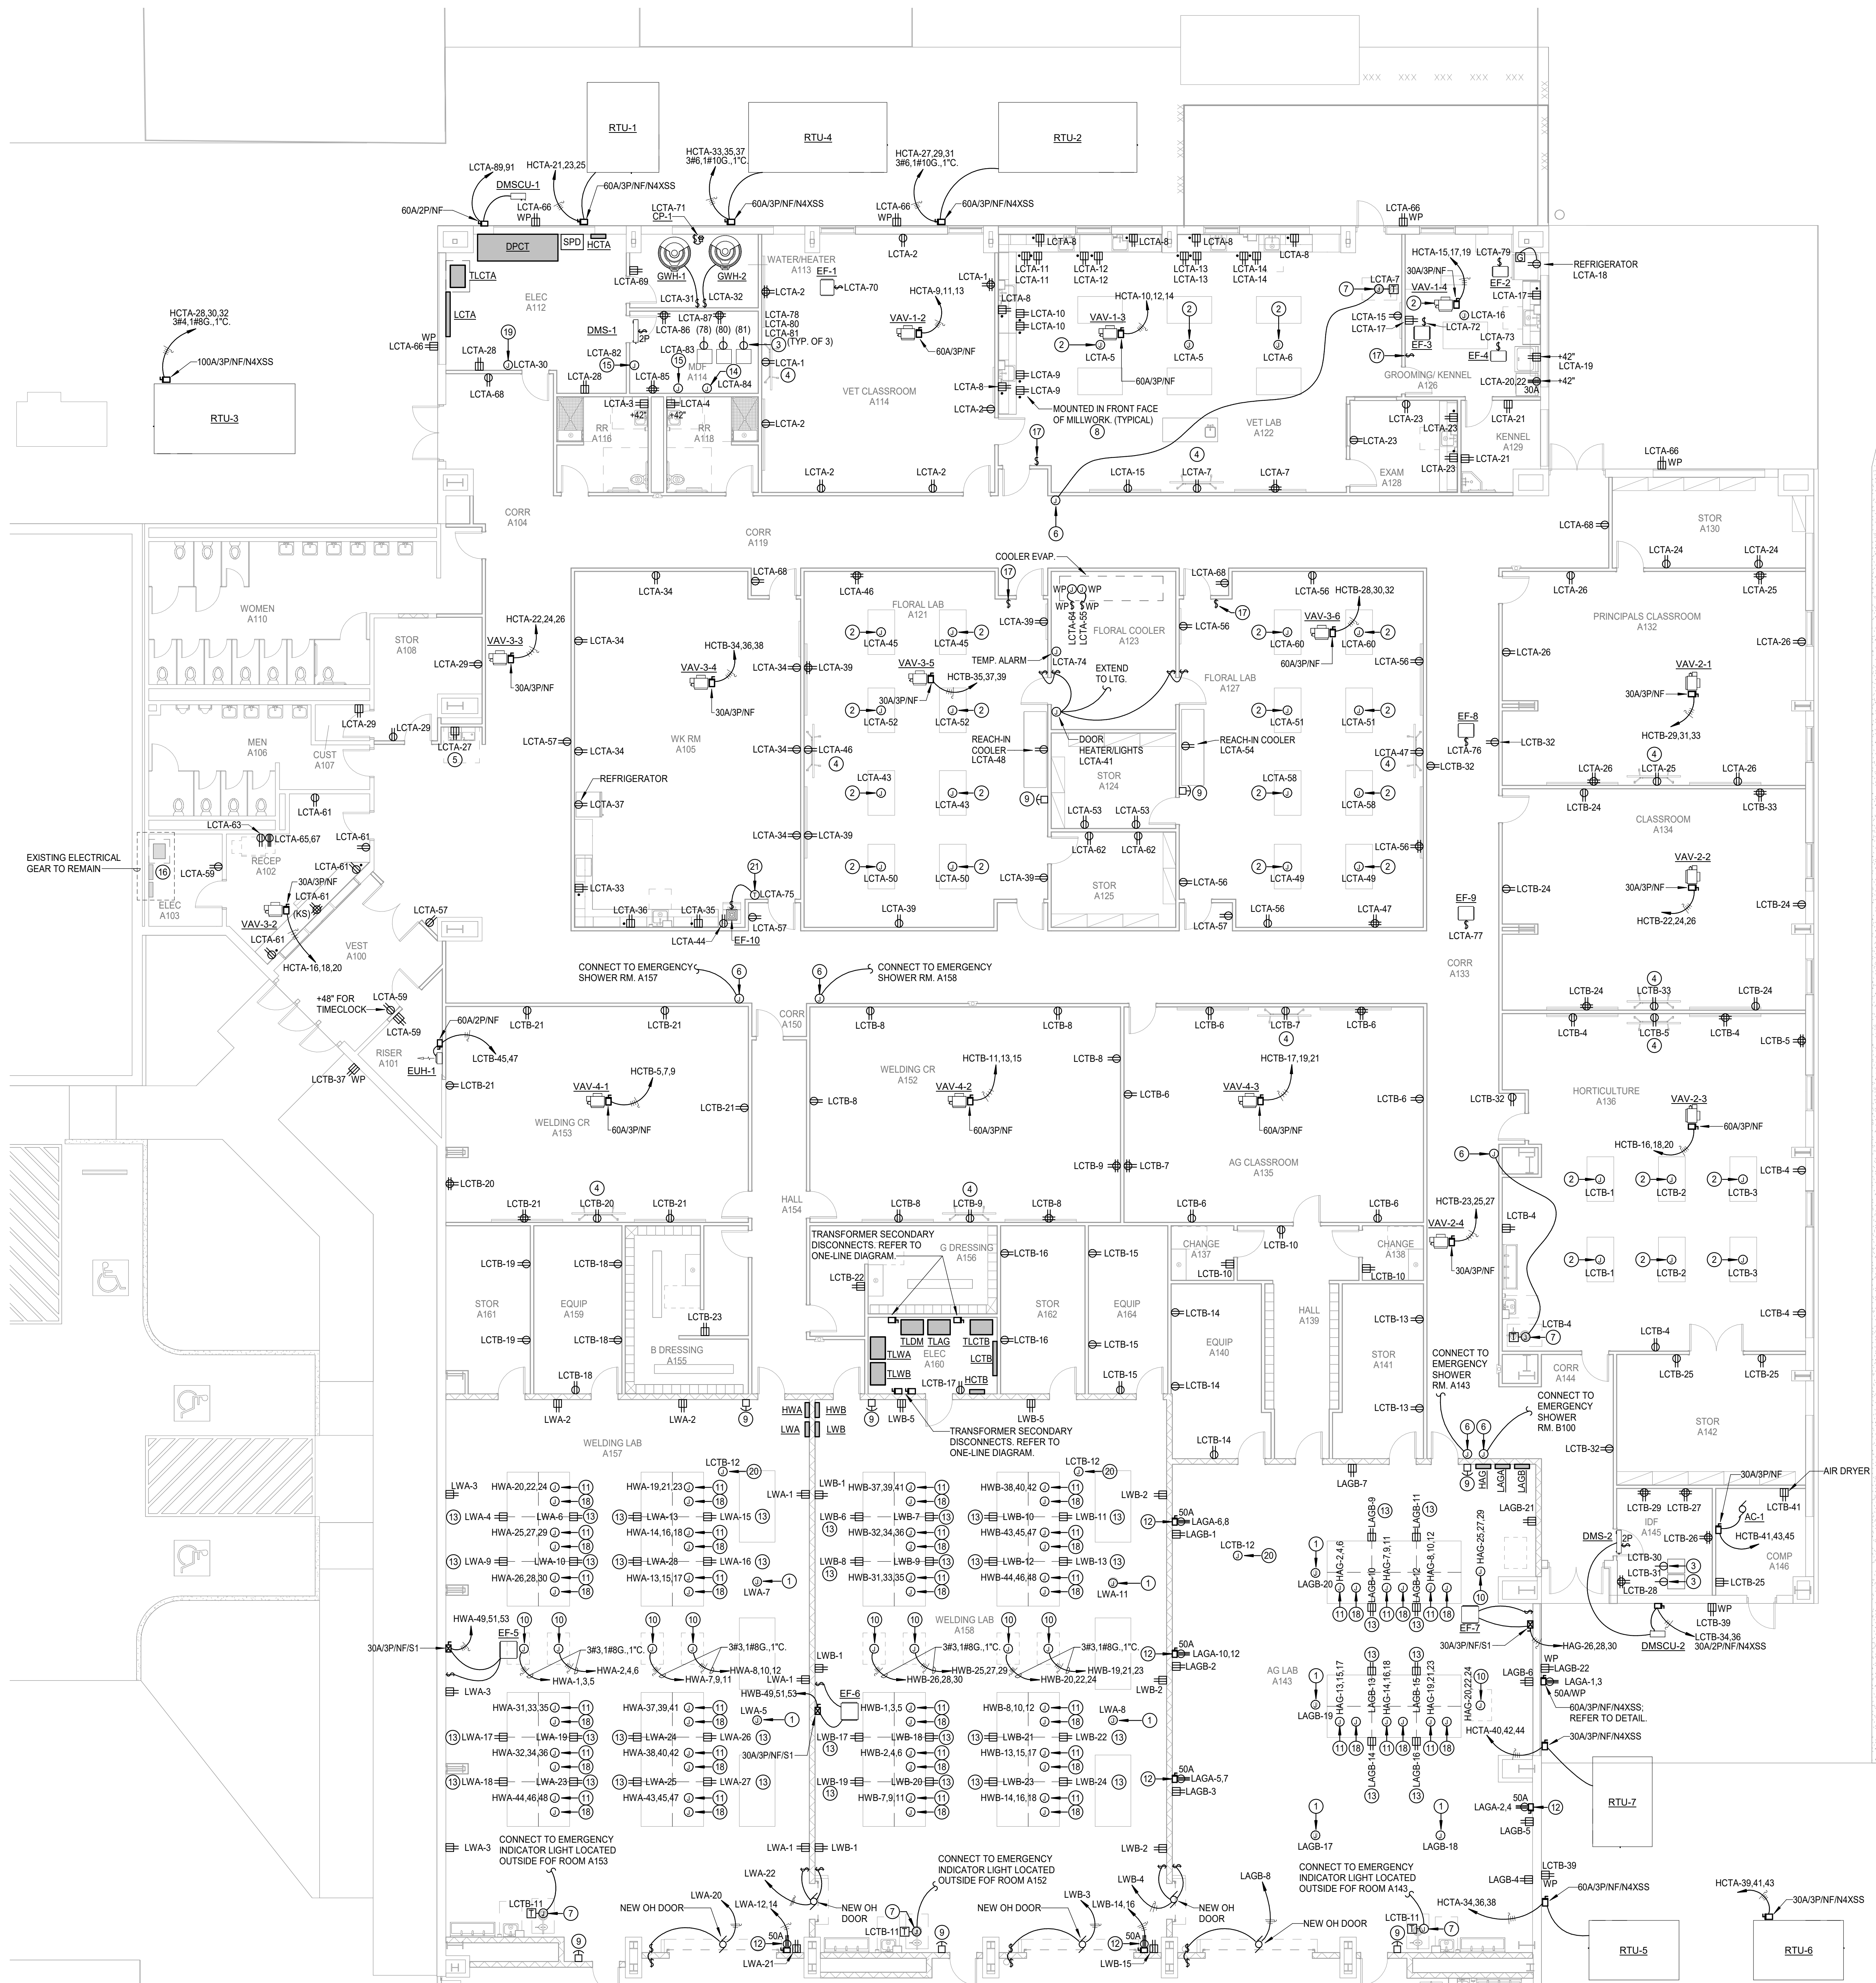
**E2.02**

ELECTRICAL  
LIGHTING AREA  
'B1' 1ST FLOOR  
PLAN



**1 ELECTRICAL LIGHTING 1ST FLOOR PLAN - AREA 'B1'**  
Scale: 1/8" = 1'-0"





1 ELECTRICAL POWER 1ST FLOOR PLAN - AREA 'A1'  
Scale: 1/8" = 1'-0"

**ELECTRICAL GENERAL NOTES:**

1. REFER TO TECHNOLOGY DRAWINGS (T-SERIES) FOR ADDITIONAL WORK REQUIRED BY DIVISION 26.
2. GENERAL CONTRACTOR SHALL VERIFY ALL ELECTRICAL REQUIREMENTS TO SHOP/LAB EQUIPMENT TO BE INSTALLED IN CTE BUILDING PRIOR TO ANY ELECTRICAL INSTALLATION.

**ELECTRICAL KEYED NOTES:**

1. PROVIDE 125V, 20-AMP DOUBLE DUPLEX ELECTRIC CORD REEL WITH GFCI PROTECTION. MOUNT TO BOTTOM OF STRUCTURE.
2. PROVIDE 125V, 20-AMP DOUBLE DUPLEX ELECTRIC CORD REEL WITH GFCI PROTECTION. LOCATE WITHIN RECESSED PLENUM RATED CORD REEL ENCLOSURE.
3. PROVIDE NEMA L5-30R 125V RECEPTACLE FOR DATA RACK UPS. VERIFY EXACT LOCATION WITH OWNER AND DIVISION 27 PRIOR TO ROUGH-IN.
4. RECEPTACLE FOR INTERACTIVE VIDEO DISPLAY. MOUNT AT +18" ABOVE FINISHED FLOOR OR AS DIRECTED BY DISTRICT REPRESENTATIVE. VERIFY EXACT LOCATION WITH ARCHITECT/OWNER PRIOR TO ROUGH-IN.
5. RECEPTACLE FOR DRINKING FOUNTAIN. LOCATE IN READILY ACCESSIBLE LOCATION BELOW DRINKING FOUNTAIN UNDER LOWER BASIN.
6. PROVIDE WHEELLOCK® RSSR-2475C-NW EMERGENCY SHOWER WATER FLOW INDICATOR LIGHT OR APPROVED EQUAL. COORDINATE LOCATION OF FLOW SWITCH WITH DIVISION 22. COORDINATE LOCATION OF LIGHT FIXTURE WITH ARCHITECT/OWNER.
7. PROVIDE 120V/24V LOW VOLTAGE TRANSFORMER FOR CONNECTION OF EMERGENCY SHOWER WATER FLOW DETECTION EQUIPMENT AND STROBE LIGHT. COORDINATE INSTALLATION WITH DIVISION 22.
8. RECEPTACLES MOUNTED IN VERTICAL FRONT FACE OF MILLWORK. COORDINATE EXACT LOCATION WITH ARCHITECT AND MILLWORK DRAWINGS PRIOR TO ROUGH-IN.
9. PROVIDE EMERGENCY POWER OFF (EPO) MUSHROOM PUSH BUTTON WITH COVER AND KEY RESET (STI H852-SERIES OR EQUAL). EPO SHALL CONTROL SHUNT TRIP BREAKER(S) FOR PANEL/EQUIPMENT SERVING ROOM.
10. PROVIDE A JUNCTION BOX WITH 50' DROP CORD MOUNTED TO BOTTOM OF STRUCTURE FOR CONNECTION OF WELDING INVERTER BANK. VERIFY EXACT ELECTRICAL REQUIREMENTS AND MAKE FINAL CONNECTION. DROP CORD SHALL BE 20'-0" IN LENGTH WITH A 100-AMP 3POLE PIVOTSLEEVE CONNECTION. PROVIDE CORD WITH STRAIN RELIEF GRIP.
11. PROVIDE A JUNCTION BOX MOUNTED TO BOTTOM OF STRUCTURE FOR CONNECTION OF WELDING BOOTH BLOWER AND INTEGRATED DISCONNECT SWITCH. MOTOR STARTER, OVERLOAD, AND START/STOP BUTTON. VERIFY EXACT CONNECTION POINT AND MAKE FINAL CONNECTION.
12. PROVIDE 60A/3P/NF/1 DISCONNECT SWITCH FOR SHOP EQUIPMENT WITH TWIST LOCK RECEPTACLE MOUNTED BELOW. REFER TO DETAIL.
13. MOUNT RECEPTACLE ON FRONT FACE OF WELDING BOOTH. MOUNT AT +45" AFF UNLESS DIRECTED OTHERWISE BY ARCHITECT/OWNER.
14. PROVIDE JUNCTION BOX AT +54" FOR CONNECTION OF ACCESS CONTROL PANEL. VERIFY EXACT LOCATION WITH DIVISION 27 CONTRACTOR AND MAKE FINAL CONNECTION.
15. PROVIDE JUNCTION BOX AT +54" FOR CONNECTION OF INTRUSION DETECTION PANEL. VERIFY EXACT LOCATION WITH DIVISION 27 CONTRACTOR AND MAKE FINAL CONNECTION.
16. INTERCEPT EXISTING 277/480V 3PH FEEDER AND EXTEND CONDUIT TO NEW PANEL DPCT; PULL NEW CONDUCTORS. REFER TO ONE-LINE DIAGRAM.
17. FAN CONTROL SWITCH PROVIDED BY DIVISION 23. INSTALLED BY DIVISION 26. REFER TO MECHANICAL SCHEDULE FOR MORE INFO.
18. PROVIDE A JUNCTION BOX MOUNTED TO BOTTOM OF STRUCTURE WITH 3/4" C. TO WELDING BOOTHS FOR DATA CABLING. VERIFY EXACT CONNECTION POINT AND MAKE FINAL CONNECTION.
19. PROVIDE JUNCTION BOX AT +54" FOR CONNECTION OF BMCS PANEL. VERIFY EXACT LOCATION WITH DIVISION 27 CONTRACTOR AND MAKE FINAL CONNECTION.
20. PROVIDE A JUNCTION BOX FOR CONNECTIN OF MOTORIZED DAMPER. VERIFY EXACT LOCATION AND MAKE FINAL CONNECTION.
21. LINE VOLTAGE THERMOSTAT PROVIDED BY DIVISION 23. INSTALLED BY DIVISION 26.

**CONSULTANTS**

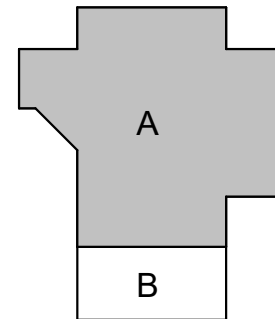
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**E3.01**

ELECTRICAL  
POWER AREA  
'A1' 1ST FLOOR  
PLAN





ELECTRICAL GENERAL NOTES:

1. REFER TO TECHNOLOGY DRAWINGS (T-SERIES) FOR ADDITIONAL WORK REQUIRED BY DIVISION 28.
2. GENERAL CONTRACTOR SHALL VERIFY ALL ELECTRICAL REQUIREMENTS TO SHOP/LAB EQUIPMENT TO BE INSTALLED IN CTE BUILDING PRIOR TO ANY ELECTRICAL INSTALLATION.

ELECTRICAL KEYED NOTES:

- ① PROVIDE 125V, 20-AMP DOUBLE DUPLEX ELECTRIC CORD REEL WITH GFCI PROTECTION. MOUNT TO BOTTOM OF STRUCTURE.
- ② PROVIDE 60A/3P/NF/N1 DISCONNECT SWITCH FOR SHOP EQUIPMENT WITH TWIST LOCK RECEPTACLE MOUNTED BELOW. REFER TO DETAIL.
- ③ PROVIDE EMERGENCY POWER OFF (EPO) MUSHROOM PUSH BUTTON WITH COVER AND KEY RESET (S11) RSS2-SERIES OR EQUAL. EPO SHALL CONTROL SHUNT TRIP BREAKER(S) FOR PANEL/EQUIPMENT SERVING ROOM.
- ④ PROVIDE 120V/24V LOW VOLTAGE TRANSFORMER FOR CONNECTION OF EMERGENCY SHOWER WATER FLOW DETECTION EQUIPMENT AND STROBE LIGHT. COORDINATE INSTALLATION WITH DIVISION 22.
- ⑤ PROVIDE A JUNCTION BOX FOR CONNECTIN OF MOTORIZED DAMPER. VERIFY EXACT LOCATION AND MAKE FINAL CONNECTION.

CONSULTANTS


MEP  
Salas O'Brien  
10930 W. Sam Houston Pkwy N  
Suite 900  
Houston, TX 77064  
Tel: 281.664.1900  
Fax: 281.664.1912

CIVIL

Auric Engineers, LLC  
520 Post Oak Blvd., Suite 895  
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Tel: 713.405.1901

STRUCTURAL

CJG Engineers  
3200 Wilcrest Drive, Suite 305  
Houston, TX 77042  
Tel: 713.780.3345  
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TOMBALL HIGH SCHOOL  
CTE & MISC. RENOVATIONS

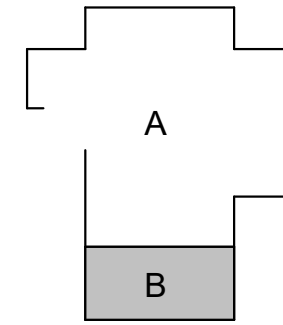TOMBALL INDEPENDENT SCHOOL DISTRICT  
30330 QUIN ROAD, TOMBALL, TX 77375




TEXAS ARCADIS INC.

10205 WESTHEIMER SUITE 800

HOUSTON, TX 77042

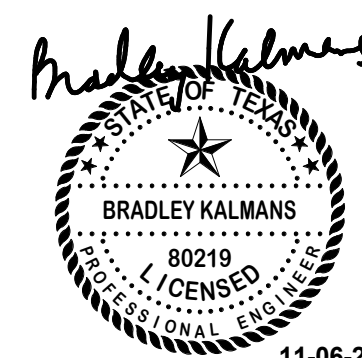tel 713.953.4897, fax 713.977.4620




PROJECT #: 202311  
DATE: 2023-11-03  
DRAWN: DES  
CHECKED: JZ

DATE: 2023-11-03  
ISSUE: BID SET

E3.02

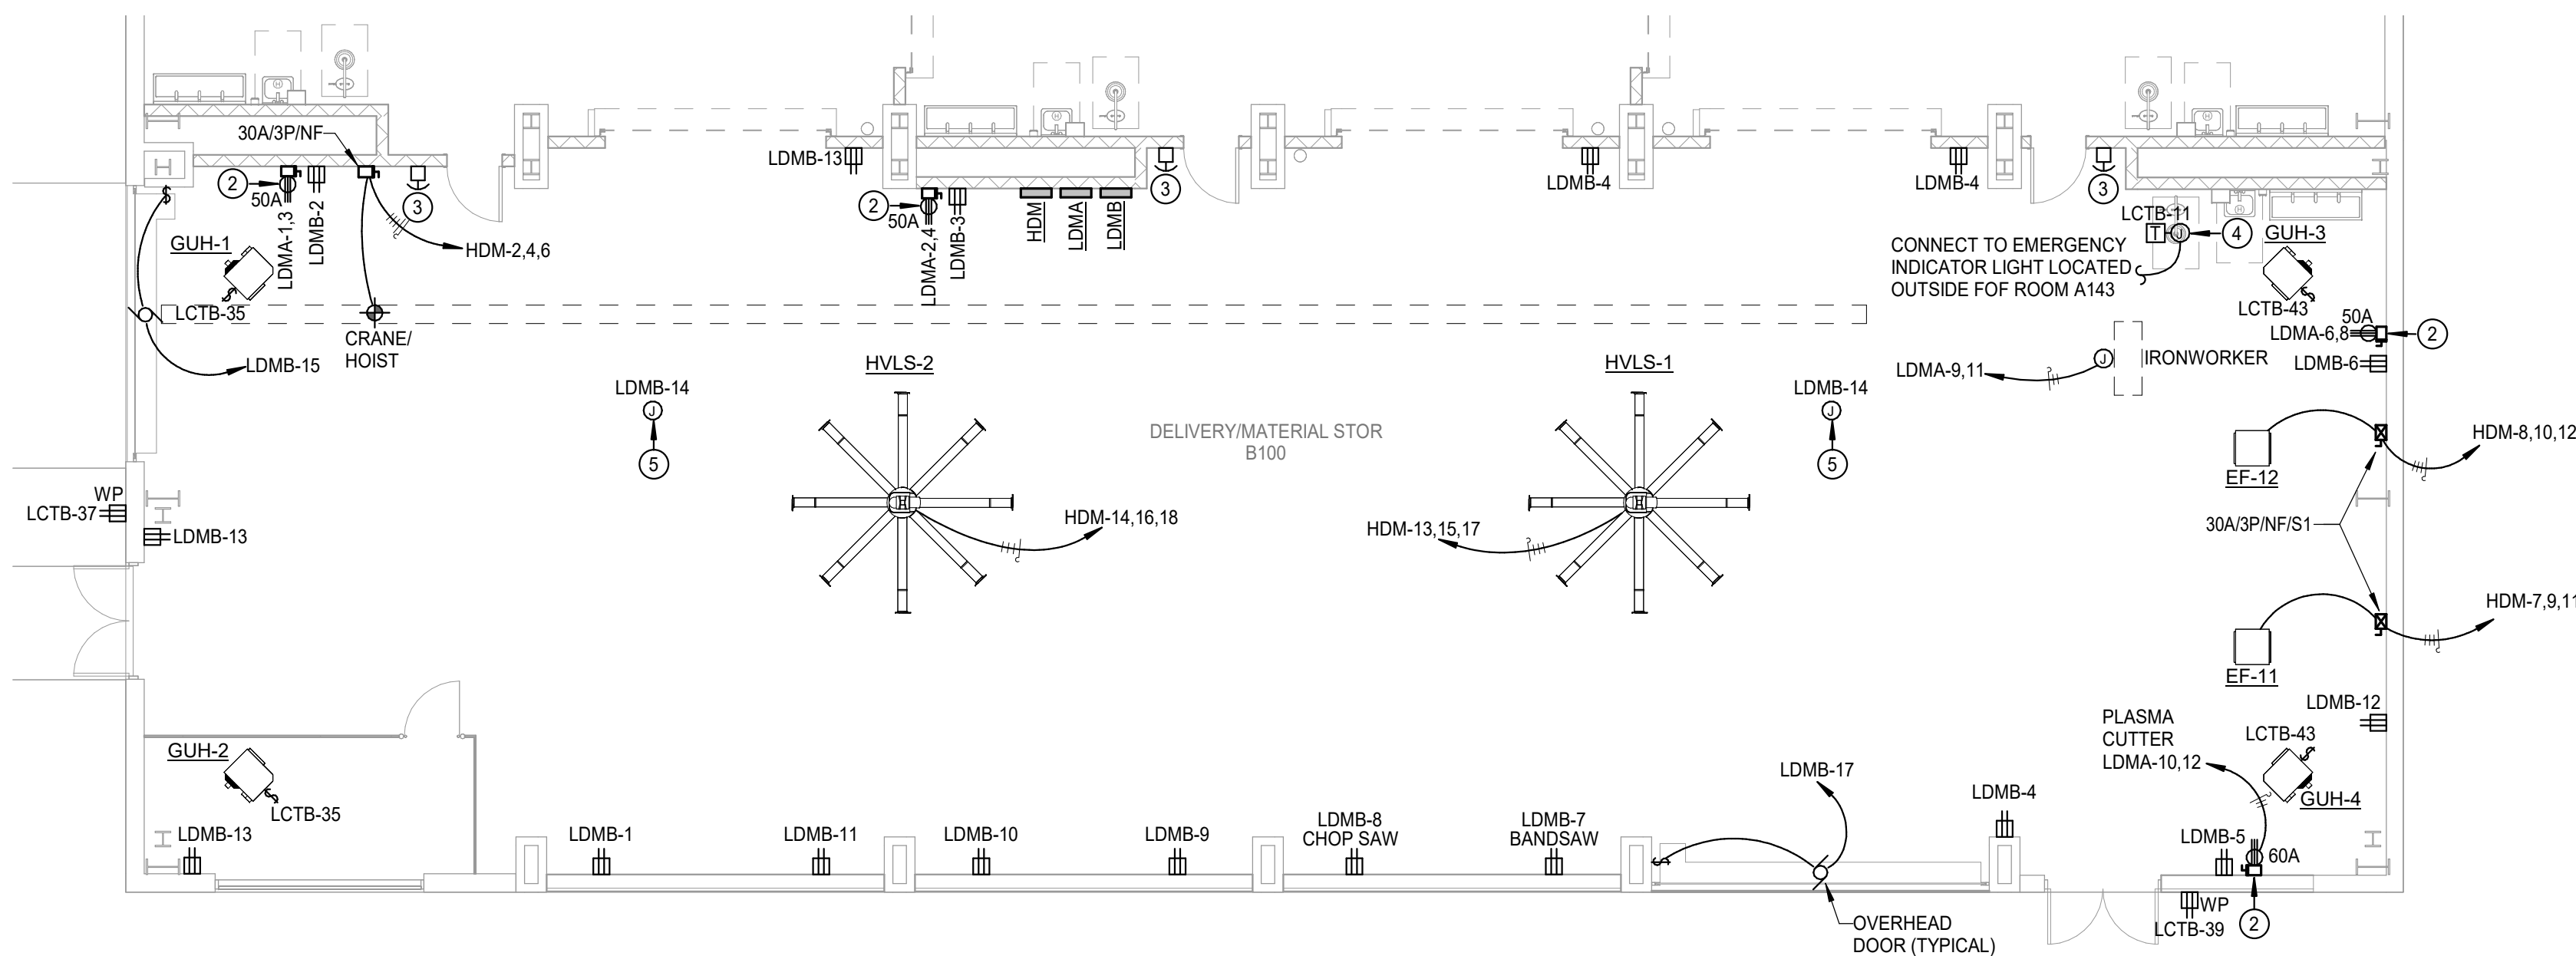ELECTRICAL  
POWER AREA  
'B1' 1ST FLOOR  
PLAN




1 ELECTRICAL POWER 1ST FLOOR PLAN - AREA 'B1'

Scale: 1/8" = 1'-0"







<b>CONSULTANTS</b>
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**TOMBALL HIGH SCHOOL  
CTE & MISC. RENOVATIONS**

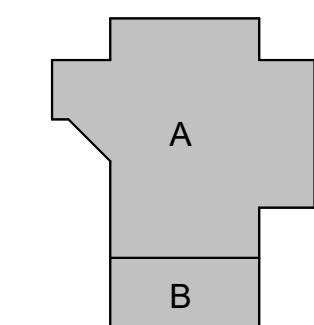
TOMBALL INDEPENDENT SCHOOL DISTRICT  
30330 QUIN ROAD, TOMBALL, TX 77375



PROJECT #: 202311		
DATE: 2023-11-03		
DRAWN: DES		
CHECKED: JZ		
DATE	ISSUE	
2023-11-03	BID SET	
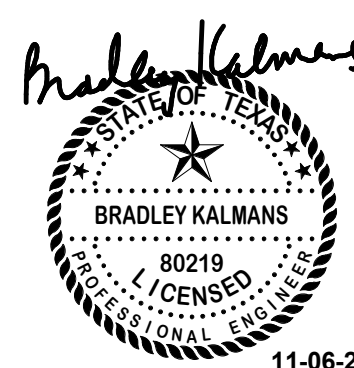
# E4.01

## ELECTRICAL ONE-LINE DIAGRAM

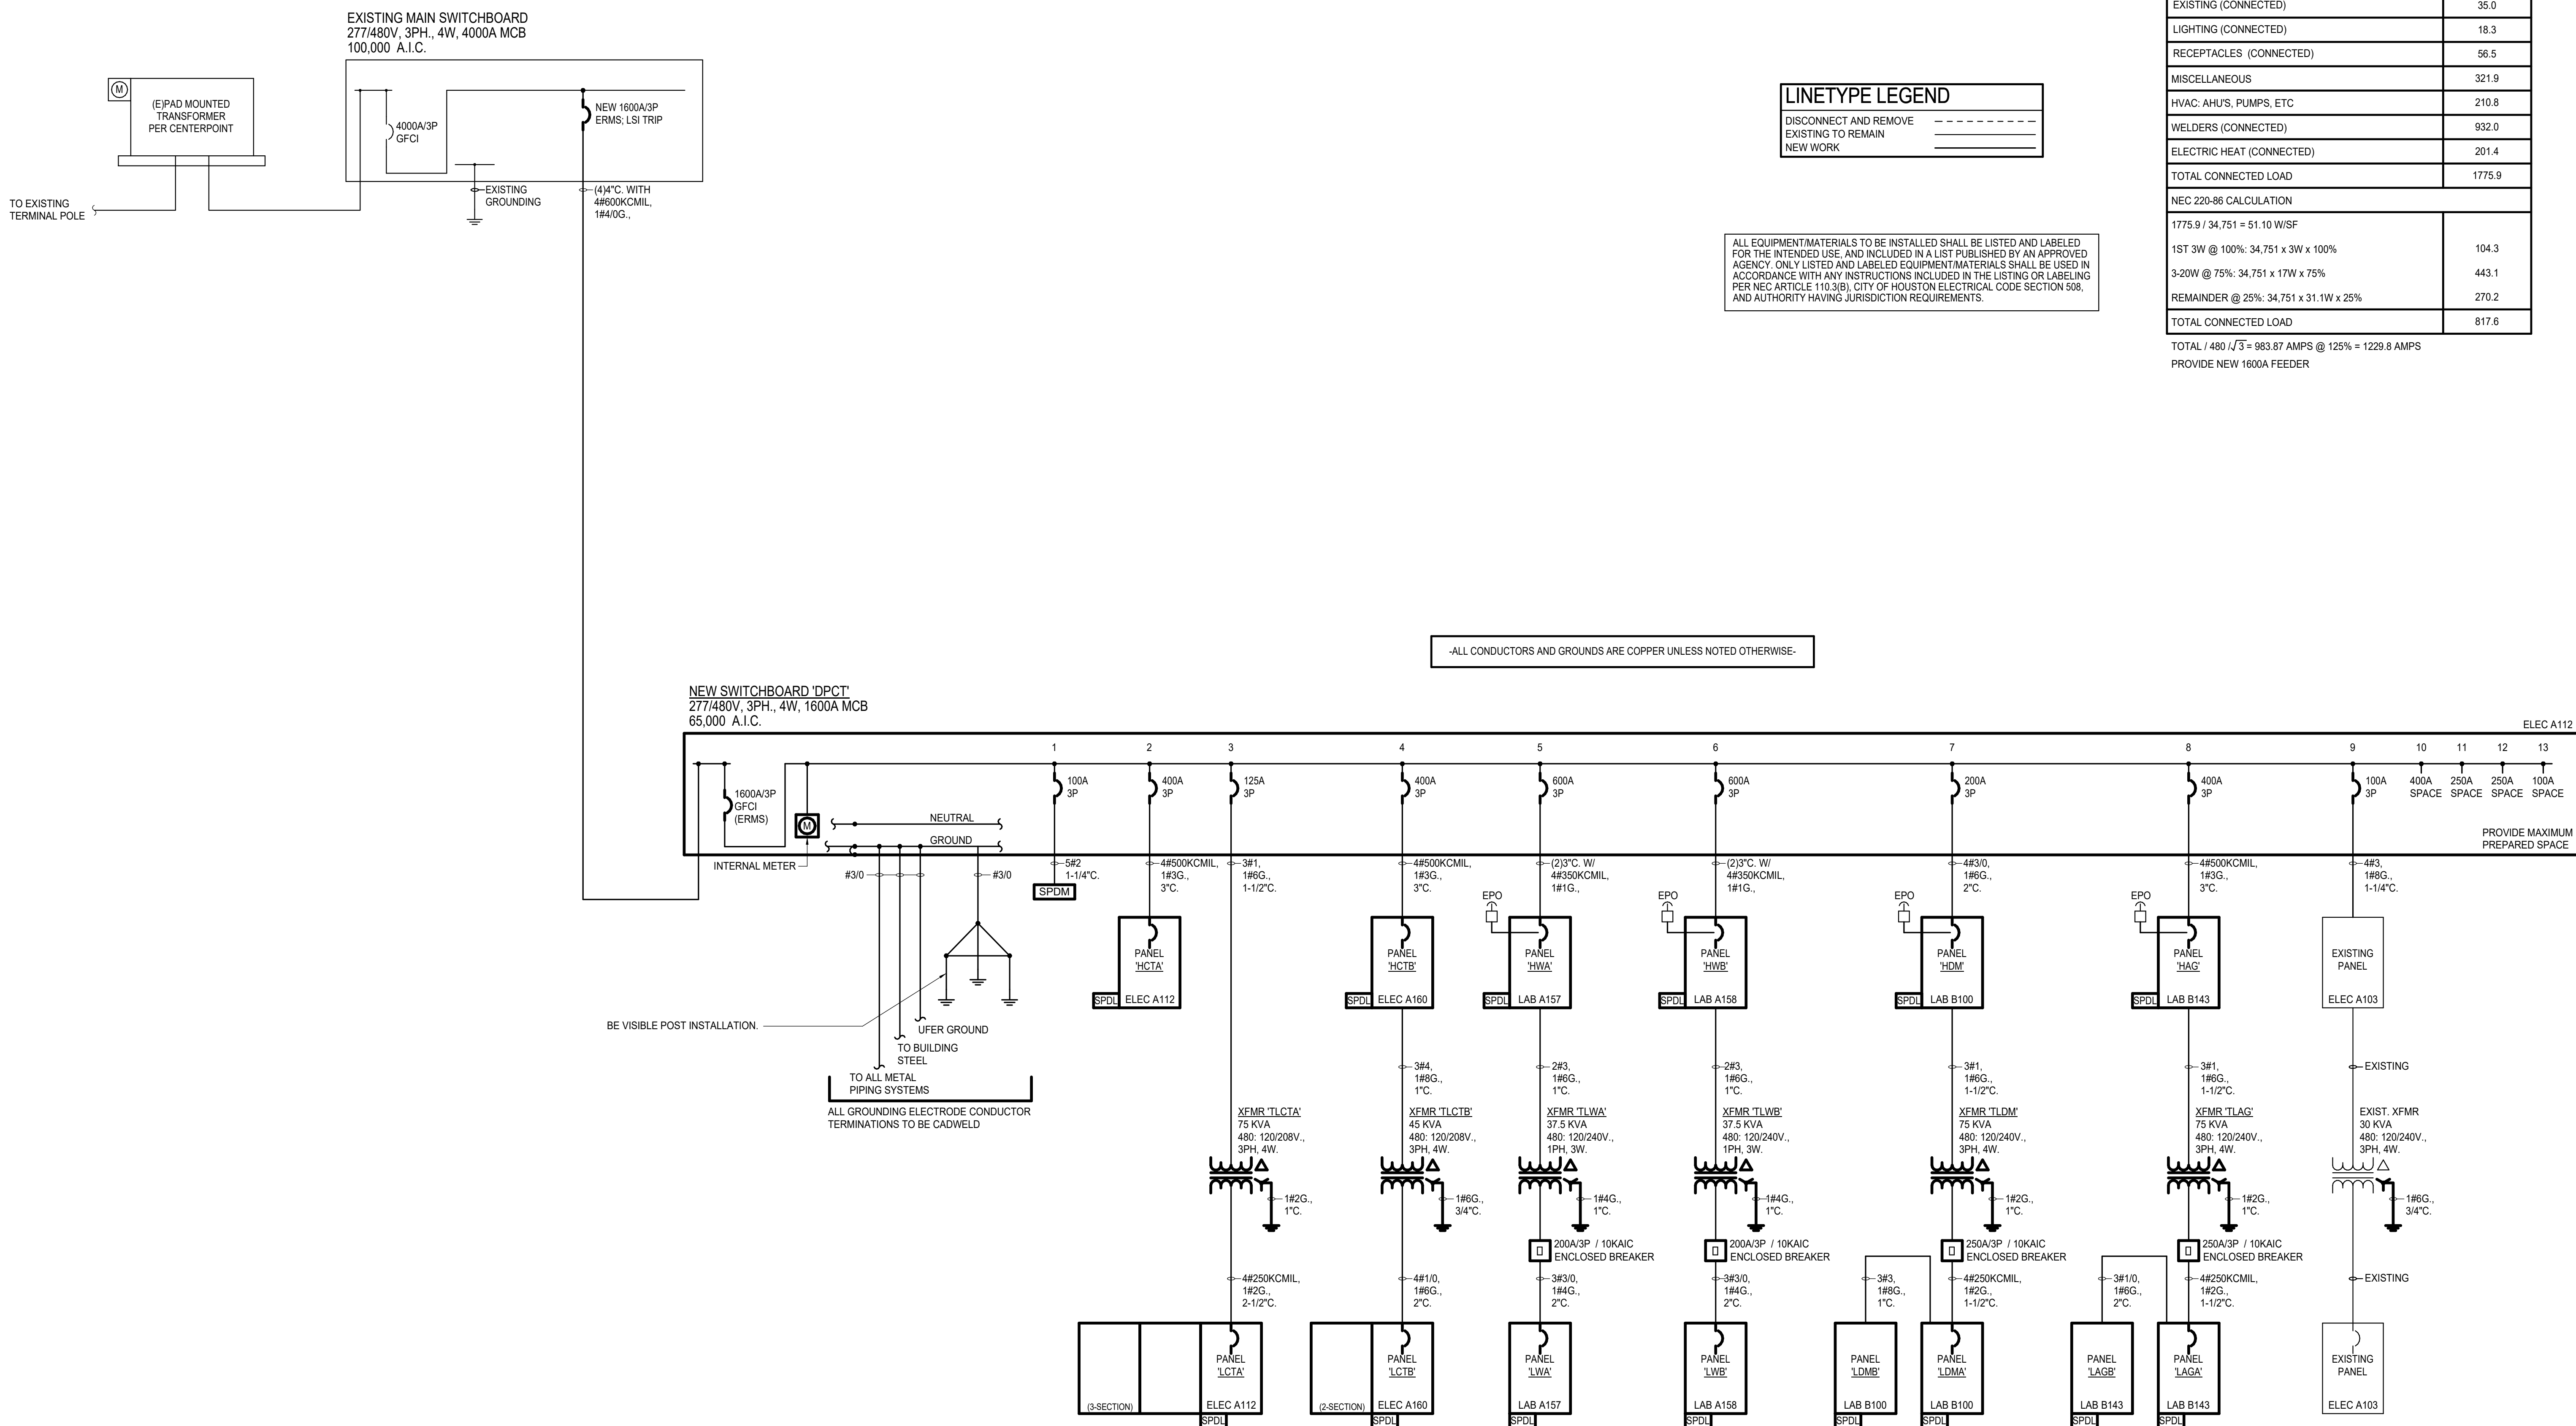

1 ELECTRICAL ONE-LINE DIAGRAM  
SCALE: NONE



Branch Panel: HWA													
Location: WELDING LAB A157					Volts: 277/480V					A.I.C. Rating: 18,000			
Supply From: DPCT					Phases: 3					Enclosure: Type 1			
Mounting: Surface					Wires: 4					Mains: 600A MCB			
					Phase in kVA					Shunt Trip			
Not e	CK T	Circuit Description	Wir e	Breaker	A	B	C	Breaker	Wir e	Circuit Description	CK T	Not e	
	1				28.4 /...	28.4 /...			3	100	#3	Welder Rack	
	3	Welder Rack	#3	100	3				3	100	#3	Welder Rack	
	5												
	7				28.4 /...	28.4 /...			3	100	#3	Welder Rack	
	9	Welder Rack	#3	100	3				3	100	#3	Welder Rack	
	11												
	13				2.0 /2.0				3	20	#12	Welding Booth	
	15	Welding Booth	#12	20	3				3	20	#12	Welding Booth	
	17					2.0 /2.0							
	19				2.0 /2.0				3	20	#12	Welding Booth	
	21	Welding Booth	#12	20	3				3	20	#12	Welding Booth	
	23					2.0 /2.0							
	25				2.0 /2.0				3	20	#12	Welding Booth	
	27	Welding Booth	#12	20	3				3	20	#12	Welding Booth	
	29					2.0 /2.0							
	31				2.0 /2.0				3	20	#12	Welding Booth	
	33	Welding Booth	#12	20	3				3	20	#12	Welding Booth	
	35					2.0 /2.0							
	37				2.0 /2.0				3	20	#12	Welding Booth	
	39	Welding Booth	#12	20	3				3	20	#12	Welding Booth	
	41					2.0 /2.0							
	43				2.0 /2.0				3	20	#12	Welding Booth	
	45	Welding Booth	#12	20	3				3	20	#12	Welding Booth	
	47					2.0 /2.0							
	49					2.0 /2.0			3	20	#12	Welding Booth	
	51	EF-5	#12	20	3	0.3/0.0			1	--	--	Space	
	53					0.3/0.0			1	--	--	Space	
--	55	Space	--	--	1	0.0/0.0	0.3/0.0	1	--	--	Space		
--	57	Space	--	--	1			1	--	--	Space		
--	59	Space	--	--	1	0.0/0.0		1	--	--	Space		
--	61	Space	--	--	1	0.0/0.0	0.0/0.0	1	--	--	Space		
LF	63	TLWA											
	65		1-L	100	2	153.0/0.0	152.5/0.0		3	30	--	SPDL	
Total Load:					138.3 /...	153.6 /...	152.5 /...						
Total Amps:					499 A	562 A	558 A						
Load Classification			Connected Load		Demand Factor		Estimated...		Panel Totals				
HVAC			1.0 kVA		100.00%		1.0 kVA						
Miscellaneous			91.7 kVA		100.00%		91.7 kVA		Total Conn. Load: 444.4 kVA				
Receptacles			2.9 kVA		100.00%		2.9 kVA		Total Est. Demand: 367.7 kVA				
Welders (60% Duty)			348.8 kVA		78.00%		272.1 kVA		Total Conn. Current: 535 A				
									Total Est. Demand... 442 A				
Notes:													
Abbreviations:													
G - PROVIDE GFCI CIRCUIT BREAKER													
LF - PROVIDE PERMANENT LOCK-OFF DEVICE													
LO - PROVIDE PERMANENT LOCK-ON DEVICE													

Branch Panel: LCTA														
Location: ELEC A112				Volts: 120/208V Wye				A.I.C. Rating: 10,000						
Supply From: TLCTA				Phases: 3				Enclosure: Type 1						
Mounting: Surface				Wires: 4				Mains: 250A MCB						
Phase in kVA														
Not e	CK T	Circuit Description	Wir e	Breaker	A	B	C	Breaker	Wir e	Circuit Description	CK T	Not e		
	1	Convenience Recept. RM. A114	#12	20	1	0.5/1.3			1	20	#12	Convenience Recept. RM. A114	2	
	3	Convenience Recept. RR. A116	#12	20	1		0.2/0.2		1	20	#12	Convenience Recept. RR. A116	4	
	5	Cord Reel RM. A122	#12	20	1			0.7/0.4	1	20	#12	Cord Reel RM. A122	6	
	7	Emergency Shower RM. A122	#12	20	1	0.7/1.1			1	20	#12	Receptacles VET Lab A122	8	
	9	Recept. Lab Station RM. A122	#12	20	1		0.4/0.4		1	20	#12	Recept. Lab Station RM. A122	10	
	11	Recept. Lab Station RM. A122	#12	20	1			0.4/0.4	1	20	#12	Recept. Lab Station RM. A122	12	
	13	Recept. Lab Station RM. A122	#12	20	1	0.4/0.4			1	20	#12	Recept. Lab Station RM. A122	14	
	15	Receptacles RM. A122	#12	20	1		0.4/0.4		1	20	#12	Cord Reel RM. A126	16	
	17	Convenience Recept. RM. A126	#12	20	1			0.4/0.6	1	20	#12	Refrigerator	18	
	19	Washer RM. A126	#12	20	1	1.5/1.6			2	30	#12	Dryer	20	
	21	Convenience Recept. RM. A128	#12	20	1		0.4/1.6		0.7/0.4	1	20	#12	Convenience Recept. RM. A130	24
	23	Convenience Recept. RM. A129	#12	20	1				1	20	#12	Convenience Recept. RM. A132	26	
	25	Receptacles RM. A132	#12	20	1	0.5/1.1			1	20	#12	Convenience Recept. RM. A112	28	
	27	Drinking Fountain	#12	20	1		0.4/0.4		1	20	#12	Receptacles FLORAL Lab A121	30	
	29	Receptacles Room A107, A108	#12	20	1		0.5/0.5	1	20	#12	BMCS		32	
	31	Gas Water Heater (GWH)	#12	20	1	0.6/0.6			1	20	#12	Gas Water Heater (GWH)	34	
	33	Convenience Recept. RM. A105	#12	20	1		0.2/1.1		1	20	#12	Receptacles WK RM A105	36	
	35	Convenience Recept. RM. A105	#12	20	1			0.2/0.2	1	20	#12	Receptacles WK RM A105	38	
	37	Refrigerator	#12	20	1	0.6/0.0							40	
	39	Receptacles RM. A121	#12	20	1		1.1/7.0		3	30	--	SPD	42	
	41	Cooler Heater/Lights	#12	20	1			0.5/0.0					44	
	43	Cord Reel RM. A121	#12	20	1	0.7/1.5			1	20	#12	Ice Machine	46	
	45	Cord Reel RM. A121	#12	20	1		0.7/0.5		1	20	#12	Receptacles	48	
	47	Receptacles RM. A127	#12	20	1			0.5/0.2	1	20	#12	Receptacles FLORAL Lab A121	50	
	49	Cord Reel RM. A127	#12	20	1	0.7/0.7			1	20	#12	Receptacles	52	
	51	Cord Reel RM. A127	#12	20	1		0.7/0.7		0.4/0.2	1	20	#12	Receptacles FLORAL Lab A127	54
	53	Convenience Recept. RM. A124	#12	20	1				1	20	#12	Receptacles FLORAL Lab A127	56	
	55	Evaporator Heater	#12	20	1	0.5/1.3			1	20	#12	Receptacles FLORAL Lab A127	58	
	57	Convenience Recept. Corr. A150	#12	20	1		0.7/0.7		0.5/0.7	1	20	#12	Receptacles	60
	59	Convenience Recept. Vest A100	#12	20	1				1	20	#12	Receptacles	62	
	61	Receptacles Recept. A102	#12	20	1	1.1/0.4			1	20	#12	Convenience Recept. RM. A125	64	
	63	Copier	#12	20	1	1.5/0.5			1	20	#12	Cooler Evaporator	66	
	65		#12	20	1			1.0/0.9					68	
	67	Copier	#12	20	2	1.0/0.7			1	20	#12	Convenience Recept. Corr. A119	70	
	69	Convenience Recept. A113	#12	20	1		0.2/0.5		1	20	#12	EF-1	72	
	71	Circulation Pump (GP-1)	#12	20	1			0.1/0.5	1	20	#12	EF-3	74	
	73	EF-4	#12	20	1	0.5/0.5			1	20	#12	Temp. Alarm	76	
	75	EF-10	#12	20	1		0.1/0.5		1	20	#12	EF-8	78	
	77	EF-9	#12	20	1			0.5/2.5	1	30	#10	UPS Receptacle	80	
	79	EF-2	#12	20	1	0.5/2.5			1	30	#10	UPS Receptacle	82	
	81	UPS Receptacle	#10	30	1		2.5/0.5		1	20	#12	Fire Alarm Panel	84	
LO	83	Intrusion Detection Panel	#12	20	1			0.5/0.5	1	20	#12	Access Control Panel	86	
	85	Receptacles MDT A114	#12	20	1	0.4/0.4			1	20	#12	Receptacles MDT A114	88	
	87	Receptacles MDT A114	#12	20	1		0.4/0.0		1	20	--	Spare	90	
	89	DMSCU-1 / DMS-1	#8	40	2	1.8/0.0		1.8/0.0	1	20	--	Spare	92	
	91		--	20	1		0.0/0.0		1	20	--	Spare	94	
	--	93 Spare	--	20	1		0.0/0.0		1	20	--	Spare	96	
	--	95 Spare	--	20	1			0.0/0.0	1	20	--	Spare	98	
	--	97 Spare	--	20	1	0.0/0.0			1	20	--	Spare	100	
	--	99 Spare	--	20	1		0.0/0.0		1	20	--	Spare	102	
	--	101 Spare	--	20	1			0.0/0.0	1	20	--	Spare	104	
	--	103 Spare	--	20	1	0.0/0.0			1	20	--	Spare	106	
	--	105 Spare	--	1	1		0.0/0.0		1	20	--	Spare	108	
	--	107 Spare	--	1	1			0.0/0.0	1	20	--	Spare	110	
	--	109 Spare	--	1	1	0.0/0.0			1	--	--	Spare	112	
	--	111 Spare	--	1	1		0.0/0.0		1	--	--	Spare	114	
	--	113 Spare	--	1	1		0.0/0.0		1	--	--	Spare	116	
	--	115 Spare	--	1	1	0.0/0.0			1	--	--	Spare	118	
	--	117 Spare	--	1	1		0.0/0.0		1	--	--	Spare	120	
	--	119 Spare	--	1	1			0.0/0.0	1	--	--	Spare	122	
	--	121 Spare	--	1	1	0.0/0.0			1	--	--	Spare	124	
	--	123 Spare	--	1	1		0.0/0.0		1	--	--	Spare	126	
	--	125 Spare	--	1	1			0.0/0.0	1	--	--	Spare	128	
Total Load:					26.0 kVA 17.6 kVA 16.7 kVA									
Total Amps:					216 A 148 A 139 A									
Load Classification					Connected Load		Demand Factor		Estimated...		Panel Totals			
HVAC					7.0 kVA		100.00%		7.0 kVA		60.3 kVA			
Miscellaneous					20.5 kVA		100.00%		20.5 kVA		Total Conn. Load: 60.3 kVA			
Receptacles					32.8 kVA		65.26%		21.4 kVA		Total Est. Demand: 48.9 kVA			
											Total Conn. Current: 167 A			
											Total Est. Demand... 136 A			
Notes:														
~Provide (3) 42-circuit sections.														
Abbreviations:														
G - PROVIDE GFCI CIRCUIT BREAKER														
LF - PROVIDE PERMANENT LOCK-OFF DEVICE														
LO - PROVIDE PERMANENT LOCK-ON DEVICE														

Branch Panel: HCTB													
Location: ELEC A160				Volts: 277/480V				A.I.C. Rating: 18,000					
Supply From: DPCT				Phases: 3				Enclosure: Type 1					
Mounting: Surface				Wires: 4				Mains: 400A MLO					
Phase in KVA													
Not e	CK T	Circuit Description	Wir e	Breaker	A	B	C	Breaker	Wir e	Circuit Description	CK T	Not e	
	1	Lighting	#12	20	1	2.3/2.8		1	20	#12	Lighting	2	
	3	Lighting	#12	20	1		3.0/1.5	1	20	#12	Lighting	4	
	5						5.4/0.0	1	20	--	Spare	6	
	7	VAV-4-1	#8	40	3	5.4/0.0		1	20	--	Spare	8	
	9					5.4/0.0		1	20	--	Spare	10	
	11						5.6/0.0	1	20	--	Spare	12	
	13	VAV-4-2	#8	40	3	5.6/0.0		1	20	--	Spare	14	
	15					5.6/4.7						16	
	17						5.3/4.7	3	30	#10	VAV-2-3	18	
	19	VAV-4-3	#8	40	3	5.3/4.7						20	
	21					5.3/4.0						22	
	23						3.9/4.0	3	30	#10	VAV-2-2	24	
	25	VAV-2-4	#10	60	3	3.9/4.0						26	
	27					3.9/4.2		4.8/4.2	3	30	#10	VAV-3-6	
	29											30	
	31	VAV-2-1	#10	30	3	4.8/4.2						32	
	33					4.8/3.6		4.2/3.6	3	30	#10	VAV-3-4	
	35											36	
	37	VAV-3-5	#10	30	3	4.2/3.6						38	
	39					4.2/0.0		0.0/0.0	1	--	Space	40	
	41						3.0/0.0	1	--	--	Space	42	
	43	Air Compressor (7-1/2HP)	#12	20	3	3.0/0.0			1	--	Space	44	
	45					3.0/0.0			1	--	Space	46	
--	47	Space	--	--	1			0.0/0.0	1	--	Space	48	
--	49	Space	--	--	1	0.0/0.0			1	--	Space	50	
--	51	Space	--	--	1	0.0/0.0			1	--	Space	52	
--	53	Space	--	--	1		0.0/0.0	1	--	Space	54		
--	55	Space	--	--	1			0.0/0.0	1	--	Space	56	
--	57	Space	--	--	1	0.0/0.0			1	--	Space	58	
--	59	Space	--	--	1		0.0/0.0	1	--	Space	60		
	61					9.9/0.0						62	
	63	XFMR TLCTB	1-L	70	3		9.9/0.0	3	30	--	SPDL	64	
	65						11.1/1.0/0					66	
Total Load:					63.7 KVA	63.1 KVA	59.8 KVA						
Total Amps:					232 A	230 A	216 A						
Load Classification			Connected Load		Demand Factor		Estimated...		Panel Totals				
HVAC			0.0 KVA		0.00%		0.0 KVA						
Heating			142.0 KVA		100.00%		142.0 KVA		Total Conn. Load: 186.7 KVA				
Lighting			9.6 KVA		125.00%		12.0 KVA		Total Est. Demand: 184.9 KVA				
Miscellaneous			16.7 KVA		100.00%		16.7 KVA		Total Conn. Current: 225 A				
Receptacles			18.4 KVA		77.23%		14.2 KVA		Total Est. Demand... 222 A				
Notes:				Abbreviations: G - PROVIDE GFCI CIRCUIT BREAKER LF - PROVIDE PERMANENT LOCK-OFF DEVICE LO - PROVIDE PERMANENT LOCK-ON DEVICE									



Branch Panel: LAGA													
Location: AG LAB A143				Volts: 120/240V 3Ph				A.I.C. Rating: 10,000					
Supply From: TLAG				Phases: 3				Enclosure: Type 1					
Mounting: Surface				Wires: 4				Mains: 250A MCB					
Phase in kVA													
Not e	CK T	Circuit Description	Wir e	Breaker	A	B	C	Breaker	Wir e	Circuit Description	CK T	Not e	
	1	Welder	#8	50	2	4.0 / 4.0			2	50	#8	Welder	2
	3					4.0 / 4.0							4
	5	Welder	#8	50	2	4.0 / 4.0		4.0 / 4.0	2	50	#8	Welder	6
	7												8
	9	Panel LAGB	14-L	150	2	13.7 / 4.0			2	50	#8	Welder	10
	11							9.7 / 4.0	2	50	#8	Welder	12
--	13	Spare	--	50	2	0.0 / 0.0			1	--	--	Space	14
	15					0.0 / 0.0			1	--	--	Space	16
	17						0.0 / 0.0		1	--	--	Space	18
	19	Spare	--	50	2	0.0 / 0.0			1	--	--	Space	20
	21	Space	--	--	--	0.0 / 0.0			1	--	--	Space	22
	23	Space	--	--	--		0.0 / 0.0		1	--	--	Space	24
	25	Space	--	--	--	1.0 / 0.0			1	--	--	Space	26
	27	Space	--	--	--	0.0 / 0.0			1	--	--	Space	28
	29	Space	--	--	--		0.0 / 0.0		1	--	--	Space	30
	31	Space	--	--	--	1.0 / 0.0			1	--	--	Space	32
	33	Space	--	--	--	0.0 / 0.0			1	--	--	Space	34
	35	Space	--	--	--			0.0 / 0.0	1	--	--	Space	36
	37	Space	--	--	--	1.0 / 0.0			1	--	--	Space	38
	39	Space	--	--	--	0.0 / 0.0			3	30	--	SPDL	40
	41	Space	--	--	--								42
Total Load:					16.0 kVA	25.7 kVA	21.7 kVA						
Total Amps:					115 A	192 A	163 A						
Load Classification			Connected Load	Demand Factor	Estimated...		Panel Totals						
Miscellaneous			22.0 kVA	100.00%	22.0 kVA		Total Est. Demand: 54.6 kVA						
Receptacles			1.4 kVA	100.00%	1.4 kVA		Total Conn. Load: 63.4 kVA						
Welders (60% Duty)			40.0 kVA	78.00%	31.2 kVA		Total Conn. Current: 153 A						
							Total Est. Demand... 131 A						
Notes:													
1 - CONNECT TO A/C PHASE ONLY													
Abbreviations:													
G - PROVIDE GFCI CIRCUIT BREAKER													
LF - PROVIDE PERMANENT LOCK-OFF DEVICE													
LO - PROVIDE PERMANENT LOCK-ON DEVICE													

Branch Panel: LAGB													
Location: AG LAB A143				Volts: 120/240V 1Ph				A.I.C. Rating: 10,000					
Supply From: LAGA				Phases: 1				Enclosure: Type 1					
Mounting: Surface				Wires: 3				Mains: 225A MLO					
Phase in kVA													
Note	CKT	Circuit Description	Wire	Breaker	B	C	Breaker	Wire	Circuit Description	CKT	Note		
	1	Welder	#12	20	1	1.5 / 1.5	1	20	#12 Welder	2			
	3	Welder	#12	20	1	1.5 / 1.5	1	20	#12 Convenience Recept. RM. A143	4			
	5	Welder	#12	20	1	1.5 / 1.5	1	20	#12 Convenience Recept. RM. A143	6			
	7	Convenience Recept. RM. A143	#12	20	1	1.5 / 0.5	1	20	#12 Overhead Door	8			
	9	Grinder	#12	20	1	1.0 / 1.0	1	20	#12 Grinder	10			
	11	Grinder	#12	20	1	1.0 / 1.0	1	20	#12 Grinder	12			
	13	Grinder	#12	20	1	1.0 / 1.0	1	20	#12 Grinder	14			
	15	Grinder	#12	20	1	1.0 / 1.0	1	20	#12 Grinder	16			
	17	Cord Reel	#12	20	1	0.4 / 0.4	1	20	#12 Cord Reel	18			
	19	Cord Reel	#12	20	1	0.4 / 0.4	1	20	#12 Cord Reel	20			
	21	Convenience Recept. RM. A143	#12	20	1	1.5 / 1.5	1	20	#12 Welder	22			
--	23	Spare	--	20	1	0.0 / 0.0	1	20	-- Spare	24	--		
--	25	Spare	--	20	1	0.0 / 0.0	1	20	-- Spare	26	--		
--	27	Spare	--	20	1	0.0 / 0.0	1	20	-- Spare	28	--		
--	29	Spare	--	20	1	0.0 / 0.0	1	20	-- Spare	30	--		
--	31	Spare	--	20	1	0.0 / 0.0	1	20	-- Spare	32	--		
--	33	Spare	--	20	1	0.0 / 0.0	1	20	-- Spare	34	--		
--	35	Spare	--	20	1	0.0 / 0.0	1	20	-- Spare	36	--		
--	37	Spare	--	20	1	0.0 / 0.0	1	20	-- Spare	38	--		
--	39	Spare	--	20	1	0.0 / 0.0	2	30	-- SPDL	40	--		
--	41	Spare	--	20	1	0.0 / 0.0				42	--		
Total Load:			13.7 kVA		9.7 kVA								
			114 A		61 A								
Load Classification			Connected Load		Demand Factor		Estimated...		Panel Totals				
Miscellaneous			22.0 kVA		100.00%		22.0 kVA						
Receptacles			1.4 kVA		100.00%		1.4 kVA		Total Conn. Load: 23.4 kVA				
									Total Est. Demand: 23.4 kVA				
									Total Conn. Current: 98 A				
									Total Est. Demand... 98 A				
Notes:													
Abbreviations:													
G - PROVIDE GFCI CIRCUIT BREAKER													
LF - PROVIDE PERMANENT LOCK-OFF DEVICE													
LO - PROVIDE PERMANENT LOCK-ON DEVICE													


Branch Panel: LDMB													
Location: DELIVERY/MATERIAL.....						Volts: 120/240V 1Ph				A.I.C. Rating: 10,000			
Supply From: LDMA						Phases: 1				Enclosure: Type 1			
Mounting: Surface						Wires: 3				Mains: 100A MLO			
Phase in kVA													
Note	CKT	Circuit Description	Wire	Breaker	A	C	Breaker	Wire	Circuit Description	CKT	Note		
	1	Miscellaneous Equipment	#12	20	1	1.5 / 1.5	1	20	#12	Miscellaneous Equipment	2		
	3	Miscellaneous Equipment	#12	20	1	1.5 / 0.5	1	20	#12	Rescues	4		
	5	Miscellaneous Equipment	#12	20	1	1.5 / 1.5	1	20	#12	Miscellaneous Equipment	6		
	7	Band saw	#12	20	1	1.5 / 1.5	1	20	#12	Chop Saw	8		
	9	Miscellaneous Equipment	#12	20	1	1.5 / 1.5	1	20	#12	Miscellaneous Equipment	10		
	11	Miscellaneous Equipment	#12	20	1	1.5 / 1.5	1	20	#12	Miscellaneous Equipment	12		
	13	Receptacles	20	1	0.5 / 0.2	1	20	#12	Motorized Dampers	14			
	15	Overhead Door	#12	20	1	0.5 / 0.0	1	20	-- Spare	16	--		
	17	Overhead Door	#1	20	1	0.5 / 0.0	1	20	-- Spare	18	--		
--	19	Spare	--	20	1	0.0 / 0.0	1	20	-- Spare	20	--		
--	21	Spare	--	20	1	0.0 / 0.0	1	20	-- Spare	22	--		
--	23	Spare	--	20	1	0.0 / 0.0	1	20	-- Spare	24	--		
--	25	Spare	--	20	1	0.0 / 0.0	1	20	-- Spare	26	--		
--	27	Spare	--	20	1	0.0 / 0.0	1	20	-- Spare	28	--		
--	29	Spare	--	20	1	0.0 / 0.0	1	20	-- Spare	30	--		
--	31	Spare	--	20	1	0.0 / 0.0	1	20	-- Spare	32	--		
--	33	Spare	--	20	1	0.0 / 0.0	1	20	-- Spare	34	--		
--	35	Spare	--	20	1	0.0 / 0.0	1	20	-- Spare	36	--		
--	37	Spare	--	20	1	0.0 / 0.0	1	20	-- Spare	38	--		
--	39	Spare	--	20	1	0.0 / 0.0	2	30	-- SPDL	40	--		
--	41	Spare	--	20	1	0.0 / 0.0				42	--		
Total Load:			10.2 kVA		8.5 kVA								
Total Amps:			85 A		71 A								
Load Classification			Connected Load		Demand Factor		Estimated...		Panel Totals				
Miscellaneous			18.8 kVA		100.00%		18.8 kVA						
									Total Conn. Load: 18.8 kVA				
									Total Est. Demand: 18.8 kVA				
									Total Conn. Current: 78 A				
									Total Est. Demand... 78 A				
Notes:					Abbreviations:								
					G - PROVIDE GFCI CIRCUIT BREAKER								
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					LO - PROVIDE PERMANENT LOCK-ON DEVICE								




LIGHTING CONTROLS SCHEDULE				
Type	Sensor Operation	# of Lighting Zones	Description	
EI	-	-	UL924 EMERGENCY POWER INVERTER; SINE WAVE OUTPUT, 550-WATTS, 120/277V, IOTA #SS 550-SERIES OR EQUAL.	
RA	VACANCY - MANUAL ON / AUTO OFF	1	DIGITAL KEYPAD, ON/OFF SWITCH WITH RAISE LOWER, 0-10V DIMMING.	
RB	VACANCY - MANUAL ON / AUTO OFF	1	DIGITAL KEYPAD, ON/OFF SWITCH, NO DIMMING.	
RC	VACANCY - MANUAL ON / AUTO OFF	2	DIGITAL KEYPAD WITH MULTIPLE BUTTONS FOR ZONING, RAISE/LOWER; ADDITIONAL KEYPAD FOR TEACHING WALL ZONE; 0-10V DIMMING.	
RD	OCCUPANCY - AUTO ON / AUTO OFF	1	ON/OFF KEYED SWITCH, NO DIMMING.	
RE	NONE	1	ON/OFF SWITCH, NO DIMMING.	
RF	OCCUPANCY - AUTO ON @ 50% / AUTO OFF	2	DIGITAL KEYPAD WITH MULTIPLE BUTTONS FOR ZONING, RAISE/LOWER; ADDITIONAL KEYPAD FOR TEACHING WALL ZONE; 0-10V DIMMING.	
RG	OCCUPANCY - AUTO ON @ 50% / AUTO OFF	1	DIGITAL KEYPAD, ON/OFF SWITCH WITH RAISE LOWER; 0-10V DIMMING.	
RH	NONE	1	DIGITAL KEYPAD, ON/OFF WITH RAISE/LOWER; 0-10V DIMMING. (AUTOMATIC AND TIMESWITCH CONTROLS EXEMPT. IECC 2015 - C405.2.2 EXCEPTION 5)	
RJ	NONE	1	EXTERIOR LIGHTING, CIRCUIT CONTROLLED VIA CONTACTOR, CONTACTOR CONTROLLED VIA BMCS.	

\*\*ALL EGRESS PATHWAYS AND ASSEMBLY SPACES SHALL BE INTEGRATED WITH FIRE ALARM TO FORCE ON EMERGENCY LIGHTING TO 100% OUTPUT DURING A FIRE ALARM OR FIRE DRILL ACTIVATION. EGRESS PATHS SHALL BE CONNECTED TO A NETWORKED LIGHTING SYSTEM.


LIGHTING FIXTURE SCHEDULE									
Type	Manufacturer	Model	Mounting	Driver / Light Engine				Input Voltage	Remarks
				Type/Lumens	Color Temperature	CRI	Voltage		
A1	METALUX	24FP4740C	RECESSED	LED / 4700 LUMENS	4000 K	80+	277 V	42 W	2x4 FLAT PANEL, OPAQUE ACRYLIC LENS, 0-10V DIMMING, DLC LISTED.
A1E	METALUX	24FP470C +EL14W	RECESSED	LED / 4700 LUMENS	4000 K	80+	277 V	42 W	2x4 FLAT PANEL, OPAQUE ACRYLIC LENS, 0-10V DIMMING, DLC LISTED.
A2	METALUX	24FP6440C	RECESSED	LED / 6400 LUMENS	4000 K	80+	277 V	62 W	2x4 FLAT PANEL, OPAQUE ACRYLIC LENS, 0-10V DIMMING, DLC LISTED.
A2E	METALUX	24FP640C +EL14W	RECESSED	LED / 6400 LUMENS	4000 K	80+	277 V	62 W	2x4 FLAT PANEL, OPAQUE ACRYLIC LENS, 0-10V DIMMING, DLC LISTED.
B1	METALUX	14FP4240C	RECESSED	LED / 4200 LUMENS	4000 K	80+	277 V	38 W	1x4 FLAT PANEL, OPAQUE ACRYLIC LENS, 0-10V DIMMING, DLC LISTED.
B1E	METALUX	14FP4240C +EL14W	RECESSED	LED / 4200 LUMENS	4000 K	80+	277 V	38 W	1x4 FLAT PANEL, OPAQUE ACRYLIC LENS, 0-10V DIMMING, DLC LISTED.
C1	METALUX	4SNX-51SL-LW-UNV-L840-CD1-U + AY/CCHAIN-SET-U	CHAIN HANG	LED / 4000 LUMENS	4000 K	80+	277 V	31 W	4-FOOT STRIP, FROSTED ACRYLIC LENS, WIREGUARD, DLC LISTED.
C1E	METALUX	4SNX-51SL-LW-UNV-L840-CD1-EL14W-U + AY/CCHAIN-SET-U	CHAIN HANG	LED / 4000 LUMENS	4000 K	80+	277 V	31 W	4-FOOT STRIP, FROSTED ACRYLIC LENS, WIREGUARD, DLC LISTED.
D1	METALUX	LHBS-1218-UNV-L84050 + LHBS-PMK	PENDANT	LED / 18000 LUMENS	4000 K	80+	277 V	124 W	INDUSTRIAL HIGH BAY, DISFUSED ACRYLIC LENS, SELECTABLE LUMENS/CCT, 0-10V DIMING, DLC LISTED.
D2	METALUX	LHBS-1218-UNV-L84050 + LHBS-PMK	PENDANT	LED / 12000 LUMENS	4000 K	80+	277 V	124 W	INDUSTRIAL HIGH BAY, DISFUSED ACRYLIC LENS, SELECTABLE LUMENS/CCT, 0-10V DIMING, DLC LISTED.
W1	McGRAW EDISON	GWA-SA1-C-740-U-T4W-BK-LCF	WALL	LED / 7502 LUMENS	4000 K	70+	277 V	59 W	ARCHITECTURAL WALL PACK, TYPE IV WIDE DISTRIBUTION, BLACK FINISH, DLC LISTED.
W1E	McGRAW EDISON	GWA-SA1-C-740-U-T4W-BK-LCF + REMOTE EMERGENCY BATTERY	WALL	LED / 7502 LUMENS	4000 K	70+	277 V	59 W	ARCHITECTURAL WALL PACK, TYPE IV WIDE DISTRIBUTION, BLACK FINISH, DLC LISTED. PROVIDE WITH REMOTE EMERGENCY BATTERY PACK. LOCATE BATTERY INDOORS ABOVE ACCESSIBLE CEILING.
X1	SURE-LITES	EUX7RWH	UNIVERSAL	LED			277 V		SINGLE-FACED EDGE-LIT EXIT SIGN, WHITE HOUSING, RED LETTERING, MIRROR BACKGROUND, 90MIN BATTERY. PROVIDE CHEVRON DIRECTIONAL ARROWS PER PLANS OR AS DIRECTED BY AHJ.
X1V	SURE-LITES	UX71WHSD	SURFACE	LED			277 V		SINGLE-FACED VANDAL RESISTANT EXIT SIGN, WHITE HOUSING, RED LETTERING, PROVIDE CHEVRON DIRECTIONAL ARROWS PER PLANS OR AS DIRECTED BY AHJ.
X2	SURE-LITES	EUX7RWH	UNIVERSAL	LED			277 V		DOUBLE-FACED EDGE-LIT EXIT SIGN, WHITE HOUSING, RED LETTERING, MIRROR BACKGROUND, 90MIN BATTERY. PROVIDE CHEVRON DIRECTIONAL ARROWS PER PLANS OR AS DIRECTED BY AHJ.

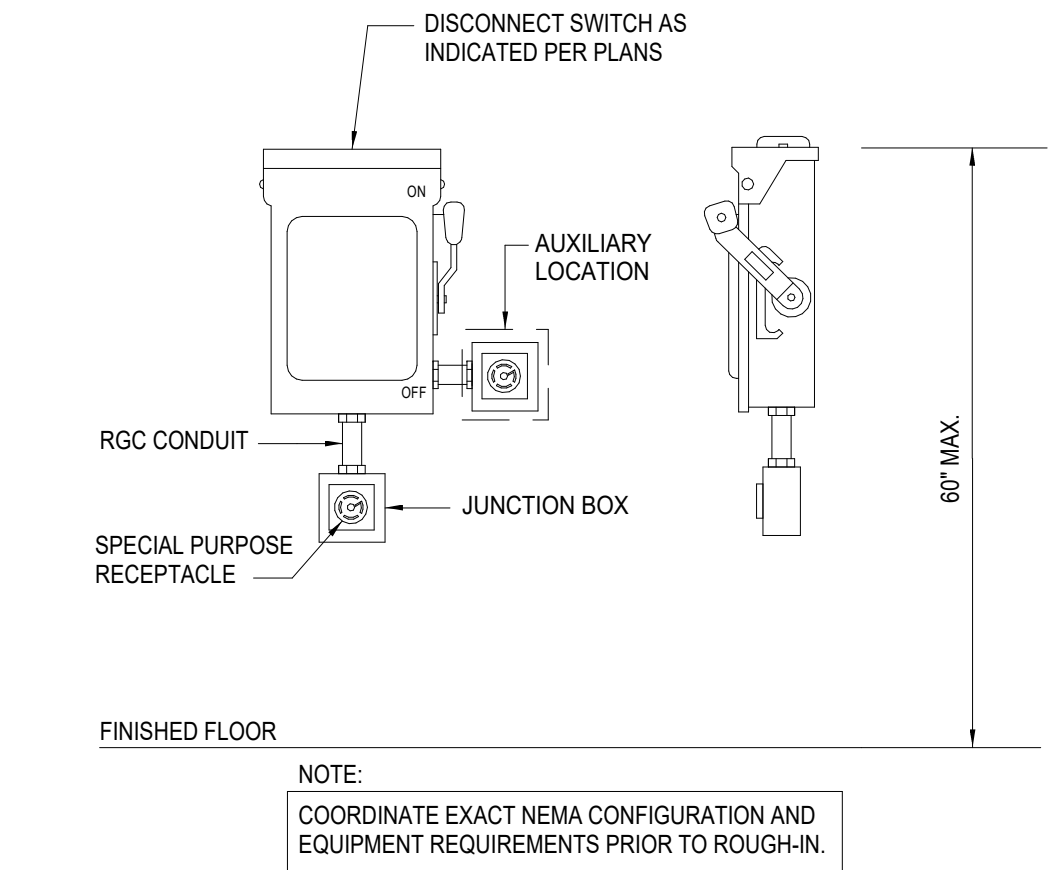

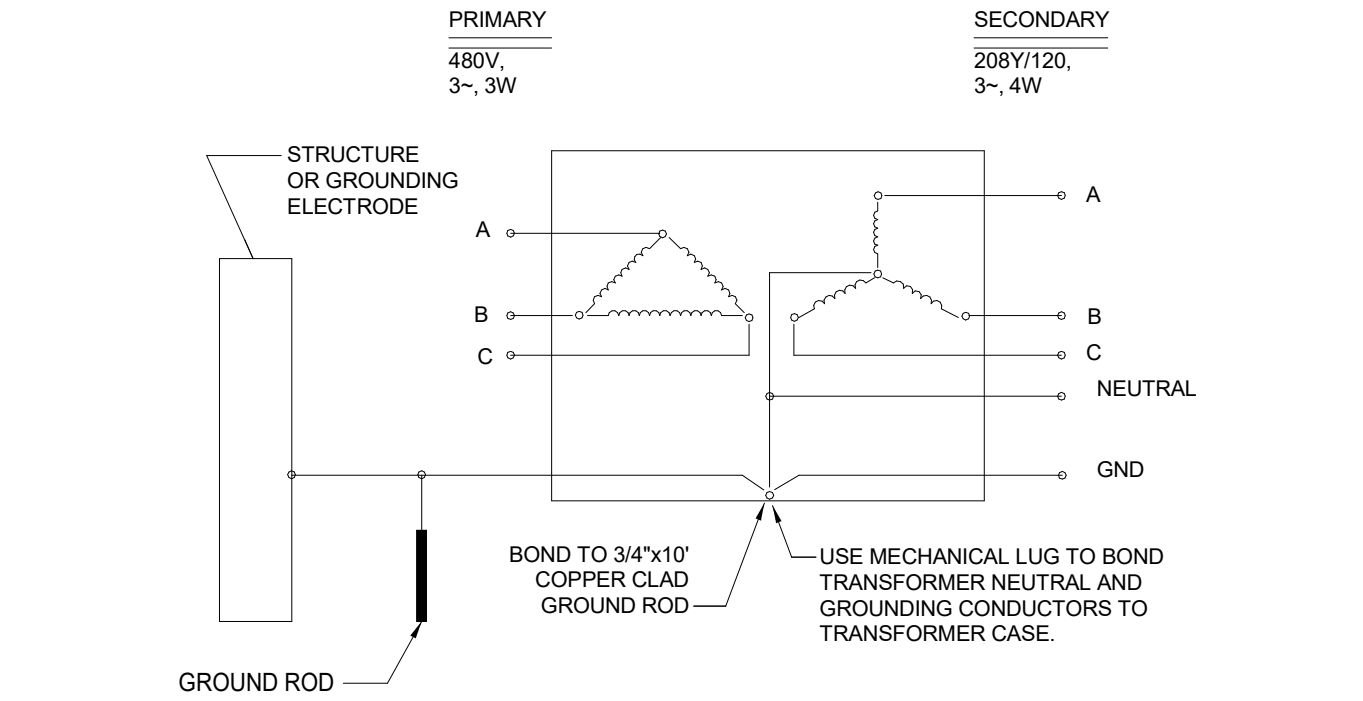
5 SPECIAL PURPOSE RECEPTACLE WITH DISCONNECT SWITCH DETAIL  
SCALE: NONE



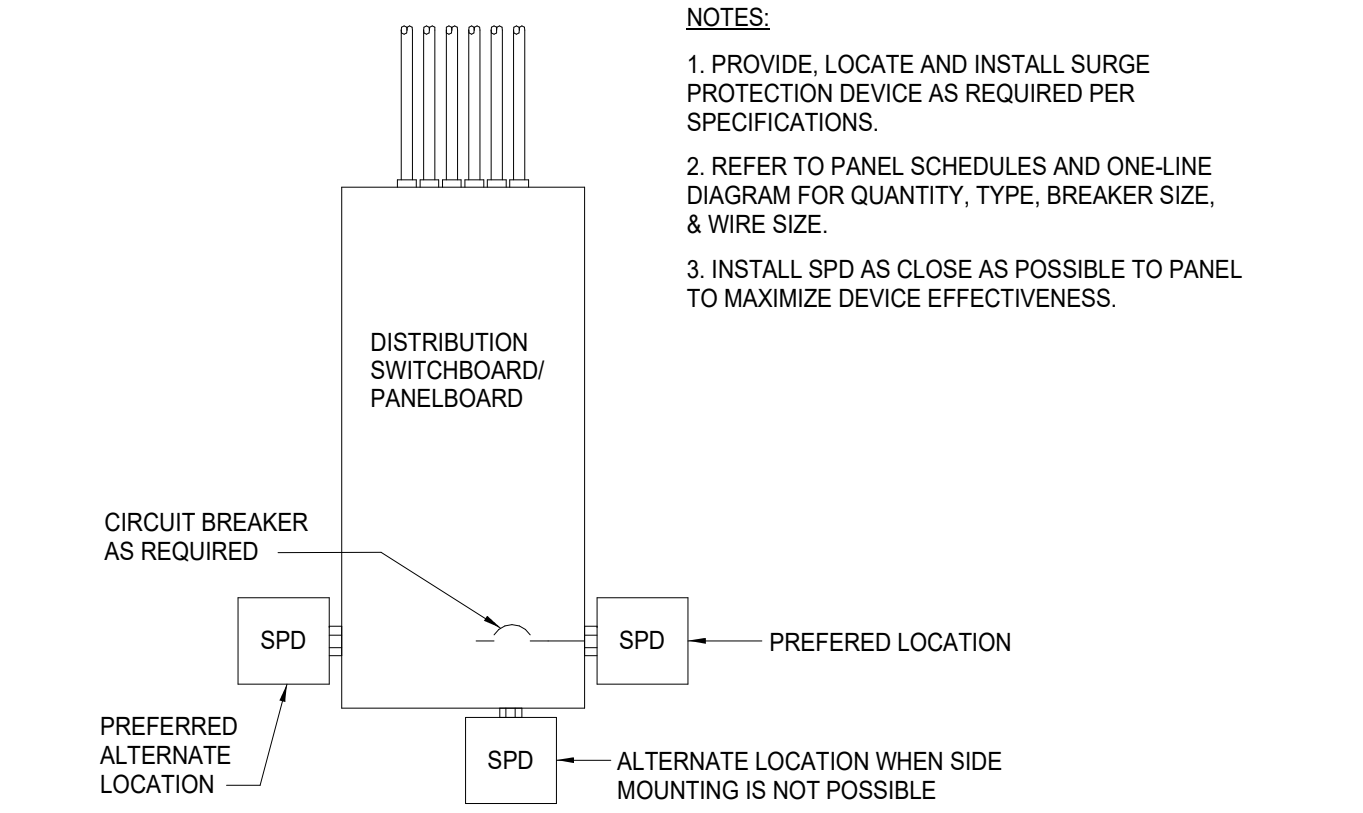
2 TRANSFORMER GROUNDING DETAIL  
SCALE: NONE



3 SURGE PROTECTION DETAIL  
SCALE: NONE

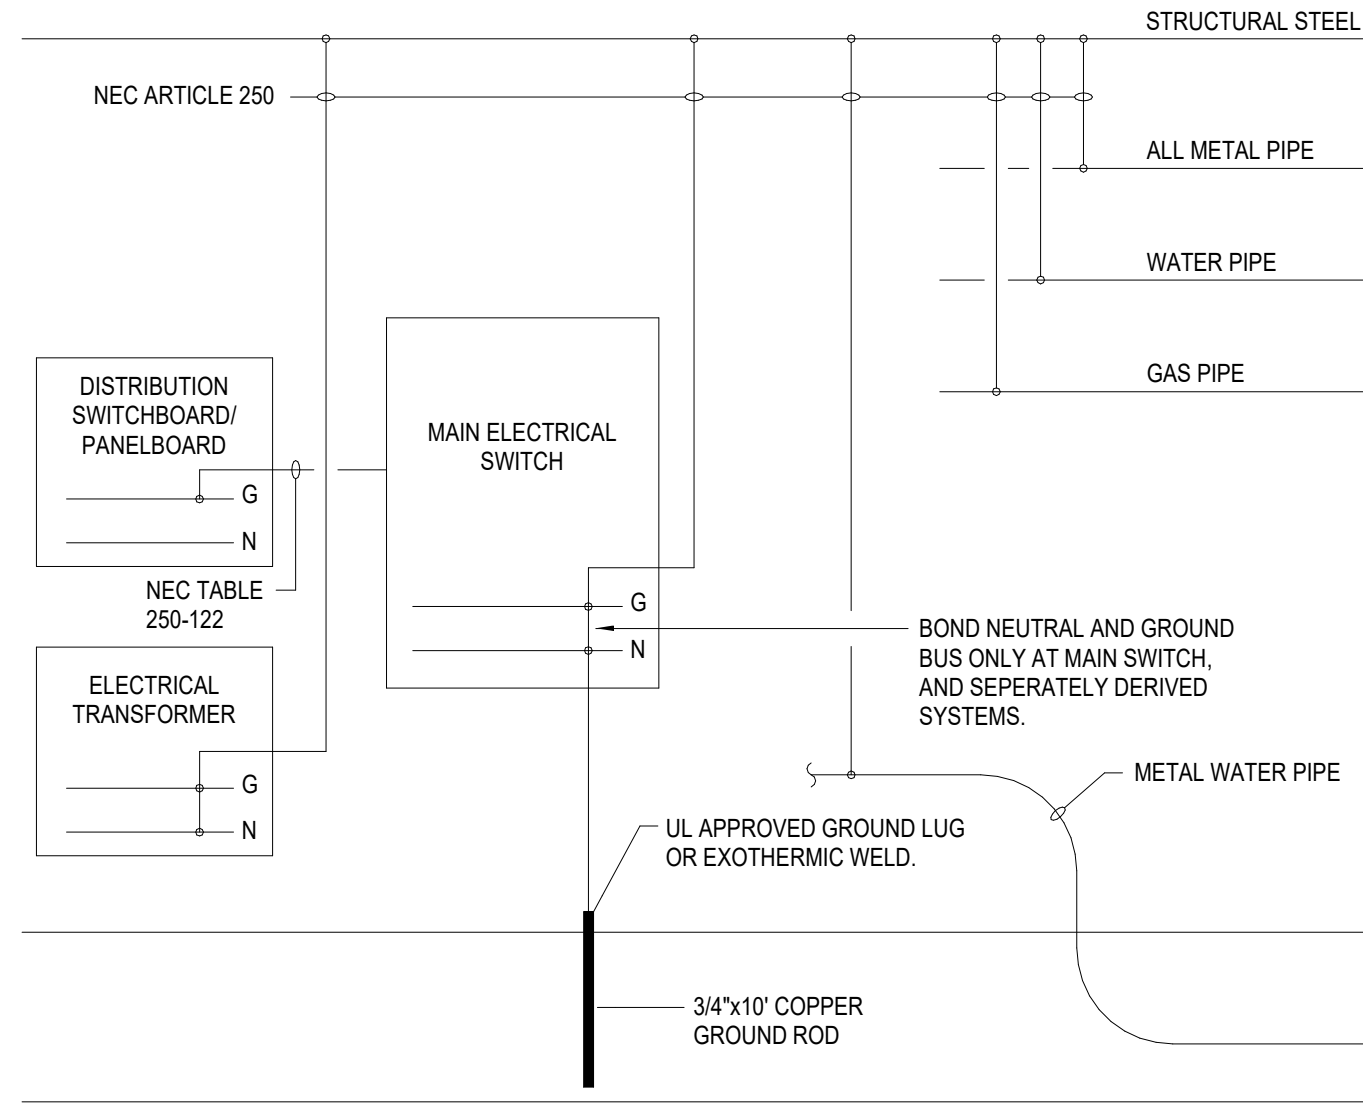

2 GROUNDING DETAIL  
SCALE: NONE

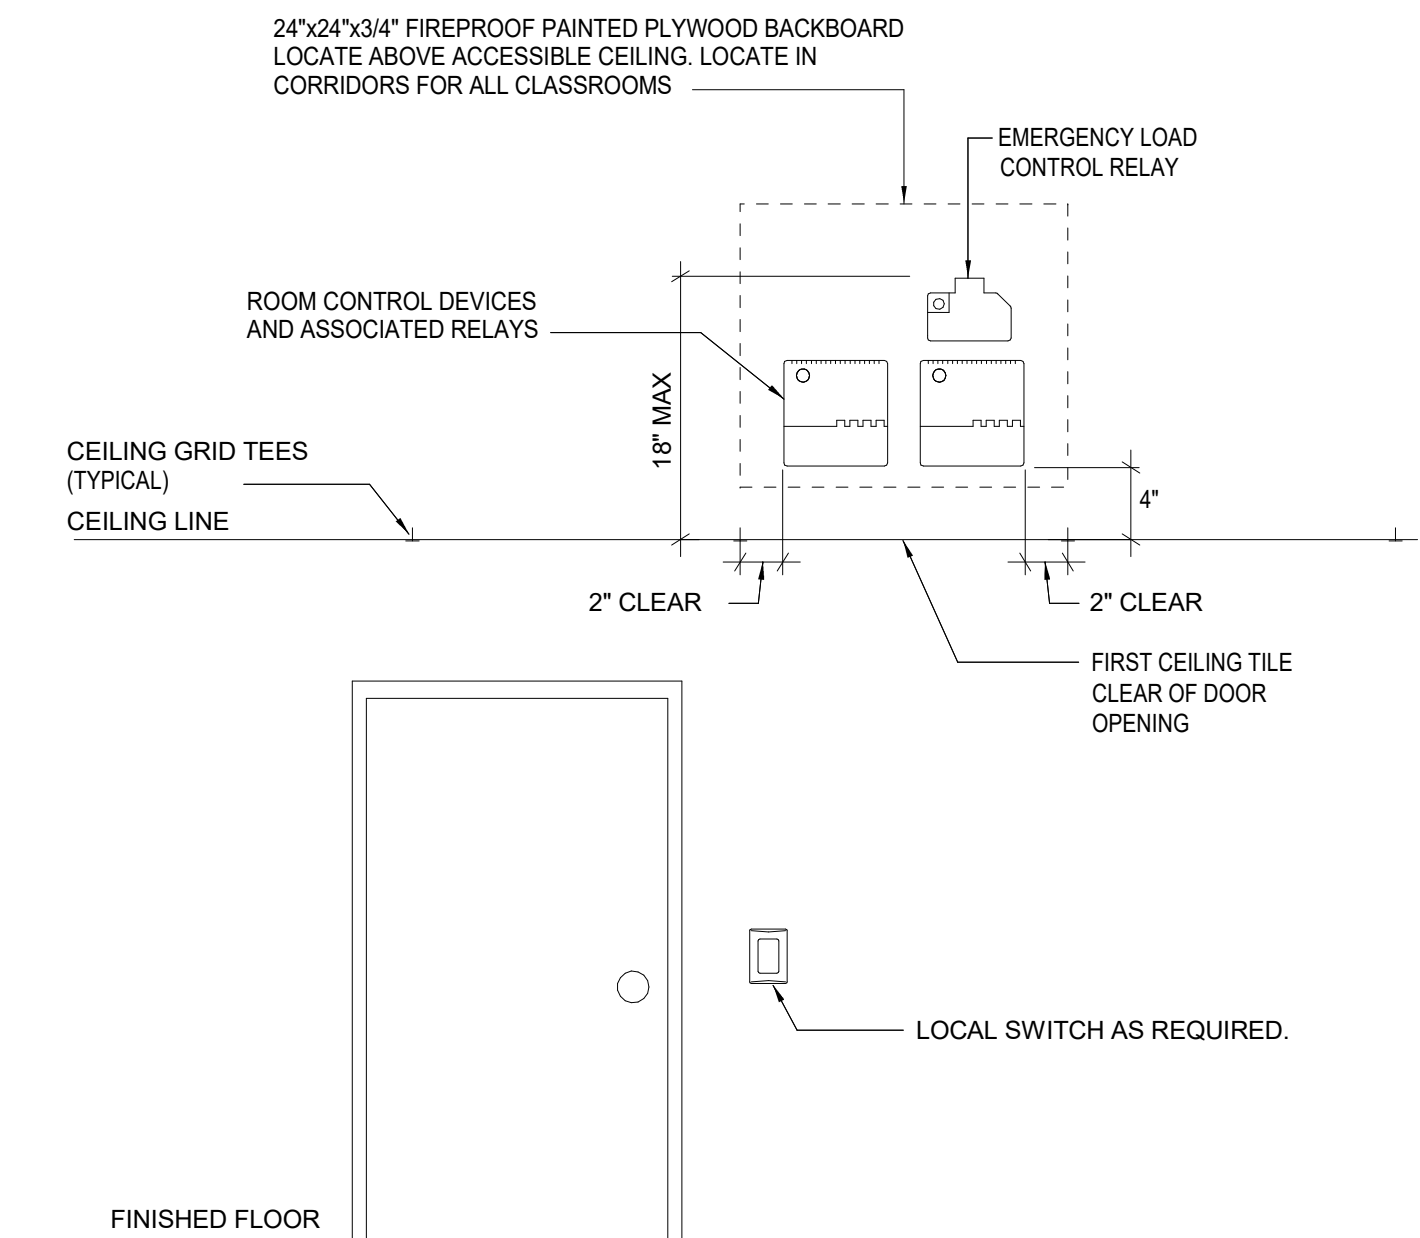

1 TYPICAL LIGHTING CONTROLS ELEVATION  
SCALE: NONE

SYMBOL SCHEDULE	
SYMBOL	DESCRIPTION (DISREGARD ITEMS NOT SHOWN ON PLANS)
LIGHTING (LETTER DENOTES TYPE - SEE LIGHT FIXTURE SCHEDULE)	
○	LIGHT FIXTURE - RECESSED OR SURFACE MOUNTED
⬢	LIGHT FIXTURE - RECESSED OR SURFACE MOUNTED ON EMERGENCY CIRCUIT
○	DOWNLIGHT FIXTURE
●	DOWNLIGHT FIXTURE ON EMERGENCY CIRCUIT
⊖	LIGHT FIXTURE - WALL MOUNTED
●	LIGHT FIXTURE - WALL MOUNTED ON EMERGENCY CIRCUIT
⊖	EXIT LIGHT - CEILING MOUNTED ON EMERGENCY CIRCUIT
⊖	EXIT LIGHT - WALL MOUNTED ON EMERGENCY CIRCUIT
LIGHTING CONTROLS & DEVICES	
\$	LINE VOLTAGE SINGLE POLE SWITCH
\$3	LINE VOLTAGE 3-WAY SWITCH
\$4	LINE VOLTAGE 4-WAY SWITCH
\$K	LINE VOLTAGE MOMENTARY DPST KEYED SWITCH
\$D	LINE VOLTAGE DIMMER SWITCH, SIZE AND TYPE AS REQUIRED
\$P	LINE VOLTAGE SWITCH WITH PILOT LIGHT
\$T	6-HOUR ROTARY TIMER SWITCH WITH NO HOLD U.N.O.
⏏	PUSH BUTTON EPO SWITCH WITH COVER
\$MC	LOW VOLTAGE MOMENTARY CONTACT SWITCH
\$R	LOW VOLTAGE DIGITAL KEYPAD
\$B	LOW VOLTAGE BUILDING MANAGEMENT (BMCS) LOCAL OVERRIDE SWITCH
⊕	OCCUPANCY SENSOR (AUTO ON / AUTO OFF WITHIN 20-MINUTES)
⊖	VACANCY SENSOR (MANUAL ON / AUTO OFF WITHIN 20-MINUTES)
⊕	PHOTOCELL SENSOR
[RF]	LIGHTING CONTROL SYSTEM. ( ' ' ' DENOTES TYPE - SEE LIGHTING CONTROLS SCHEDULE)
[ER]	EMERGENCY LOAD CONTROL RELAY. MINIMUM 16A AND 0-10V COMPATIBLE. PROVIDE U.L. 924 U.N.O.
RECEPTACLES AND OUTLETS	
⊖	SIMPLEX RECEPTACLE
⊖	DUPLEX RECEPTACLE
⊖	DUPLEX RECEPTACLE WITH TWO USB CHARGING PORTS.
⊖	125/250 VOLT, 1 PHASE, 3-WIRE, 20 AMPS UNLESS NOTED OTHERWISE
⊖	DOUBLE DUPLEX IN 2-GANG BOX WITH SINGLE COVER PLATE
⊖	DOUBLE DUPLEX WITH TWO USB CHARGING PORTS IN 2-GANG BOX WITH SINGLE COVER PLATE
⊖	DOUBLE DUPLEX GROUND FAULT CIRCUIT INTERRUPTER RECEPTACLE IN 2-GANG BOX WITH SINGLE COVER PLATE
⊖	DUPLEX GROUND FAULT CIRCUIT INTERRUPTER RECEPTACLE
⊖	FLUSH FLOOR DUPLEX RECEPTACLE OUTLET
⊖	FLUSH FLOOR DOUBLE DUPLEX RECEPTACLE OUTLET
⊖	CONCEALED SERVICE MULTI-ACCESS FLOOR BOX WITH DUPLEX RECEPTACLE AND DATA OUTLET. REFER TO TECHNOLOGY SERIES DRAWINGS FOR DATA CABLE QUANTITIES.
⊖	CONCEALED SERVICE MULTI-ACCESS FLOOR BOX WITH DOUBLE DUPLEX RECEPTACLE AND DATA OUTLET. REFER TO TECHNOLOGY SERIES DRAWINGS FOR DATA CABLE QUANTITIES.
⊖	JUNCTION BOX
⊖	FLUSH REMOTE GFCCI DEVICE (LOCATE IN READILY ACCESSIBLE LOCATION)
MOTOR CONTROLLERS AND EQUIPMENT	
⊖	MOTOR, MAKE FINAL MOTOR CONNECTION
\$	MOTOR-RATED SWITCH, 20A UNLESS INDICATED OTHERWISE.
⊖	DISCONNECT SWITCH AS REQUIRED
⊖	COMBINATION MOTOR STARTER/DISCONNECT SWITCH AS REQUIRED
⊖	MOTOR STARTER
⊖	PREWIRED DEVICE, MAKE ELECTRICAL FINAL CONNECTIONS
[VFD]	VARIABLE FREQUENCY DRIVE MOTOR CONTROLLER FURNISHED BY MECHANICAL CONTRACTOR AND INSTALLED BY ELECTRICAL CONTRACTOR
[HF]	HIGH EFFICIENCY HARMONIC FILTER FURNISHED BY MECHANICAL CONTRACTOR AND INSTALLED BY ELECTRICAL CONTRACTOR
[T]	LOW VOLTAGE TRANSFORMER, SIZE AND TYPE AS REQUIRED.
⊖	CHIME/BUZZER
ELECTRICAL EQUIPMENT	
⊖	ELECTRICAL PANELBOARD; REFER TO FLOOR PLANS FOR VOLTAGE.
⊖	DRY TYPE TRANSFORMER
⊖	PLYWOOD TELEPHONE BACKBOARD
CIRCUITING	
⊖	CONDUIT
⊖	CONDUIT BELOW FLOOR, SLAB, OR GRADE
⊖	3/4\"/>


## ELECTRICAL GENERAL NOTES:

- REFER TO ARCHITECTURAL DRAWINGS FOR EXACT LOCATION AND MOUNTING HEIGHTS OF ALL LIGHTING FIXTURES AND ELECTRICAL DEVICES.
- ALL LIGHT FIXTURES IN MECHANICAL AREAS SHALL BE COORDINATED WITH MECHANICAL AND PLUMBING EQUIPMENT TO AVOID CONFLICTS. LOCATE LIGHT FIXTURES ON PERIMETER WALLS OF MECHANICAL AREAS WHERE PRACTICAL.
- ALL EMPTY CONDUIT SHALL HAVE PULL STRING.
- EACH CONDUIT SHALL BE LIMITED TO (3) CIRCUITS MAXIMUM.
- VERIFY MOUNTING HEIGHTS OF RECEPTACLES WITH CASEWORK ELEVATIONS PRIOR TO ROUGH-IN. REFER TO ARCHITECTURAL DRAWINGS FOR ROOM ELEVATIONS FOR LOCATION AND COORDINATION OF ELECTRICAL OUTLETS. AT KNEESPACE LOCATIONS, LOCATE ELECTRICAL OUTLETS WITHIN KNEESPACE, UNLESS NOTED OTHERWISE. AT COUNTERS WITH OUT KNEESPACE, LOCATE OUTLETS HORIZONTALLY 6" ABOVE BACK SPLASH, UNLESS NOTED OTHERWISE.
- ALL FIRE ALARM DEVICES, RECEPTACLES, SWITCHES, AND WIRING DEVICES IN MECHANICAL AND ELECTRICAL ROOMS ARE TO BE RECESSED IN WALLS.
- ALL LIGHTING, RECEPTACLE, AND EQUIPMENT BRANCH CIRCUITS CONDUITS SHALL CONTAIN A GROUND WIRE USING THE CONDUIT SYSTEM AS THE ONLY GROUND PATH IS NOT ACCEPTABLE.
- CENTER ALL EXIT SIGNS OVER DOORS.
- PROVIDE 120V CIRCUIT FROM NEAREST RECEPTACLE OUTLET TO EACH FAN COIL UNIT. COOLING UNITS ABOVE CEILING TO RECEPTACLE FOR CONDENSATE PUMP.

CONSULTANTS  
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**TOMBALL HIGH SCHOOL**  
**CTE & MISC. RENOVATIONS**  
TOMBALL INDEPENDENT SCHOOL DISTRICT  
30330 QUIN ROAD, TOMBALL, TX 77375

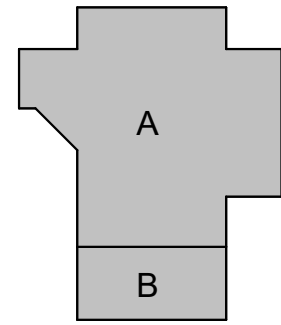**ARCADIS**  
**TEXAS ARCADIS INC.**  
10205 WESTMEIER SUITE 800  
HOUSTON, TX 77042  
tel 713.953.4897, fax 713.977.4620



PROJECT #: 202311  
DATE: 2023-11-03  
DRAWN: DES  
CHECKED: JZ

DATE: 2023-11-03  
ISSUE: BID SET

**E6.01**  
ELECTRICAL  
DETAILS AND  
SCHEDULES



PLUMBING KEYED NOTES


1 CONNECT 2" GAS LINE TO EXISTING METER, 5PSI  
TOTAL DEMAND XXX CFH.

CONSULTANTS

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30330 QUIN ROAD, TOMBALL, TX 77375




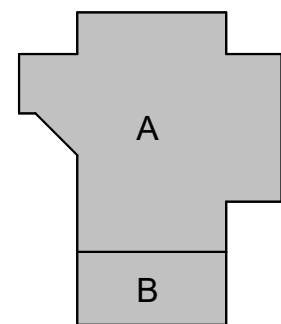TEXAS ARCADIS INC.

10205 WESTHEIMER SUITE 800

HOUSTON, TX 77042

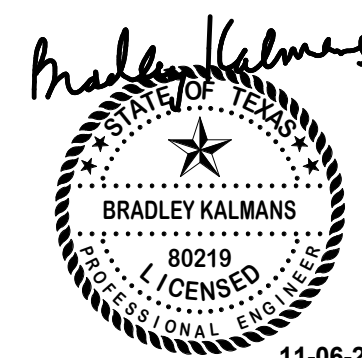tel 713.953.4897, fax 713.977.4620




PROJECT #: 202311  
DATE: 2023-11-03  
DRAWN: PG  
CHECKED: EH

DATE: 2023-11-03  
ISSUE: BID SET

**P1.00**

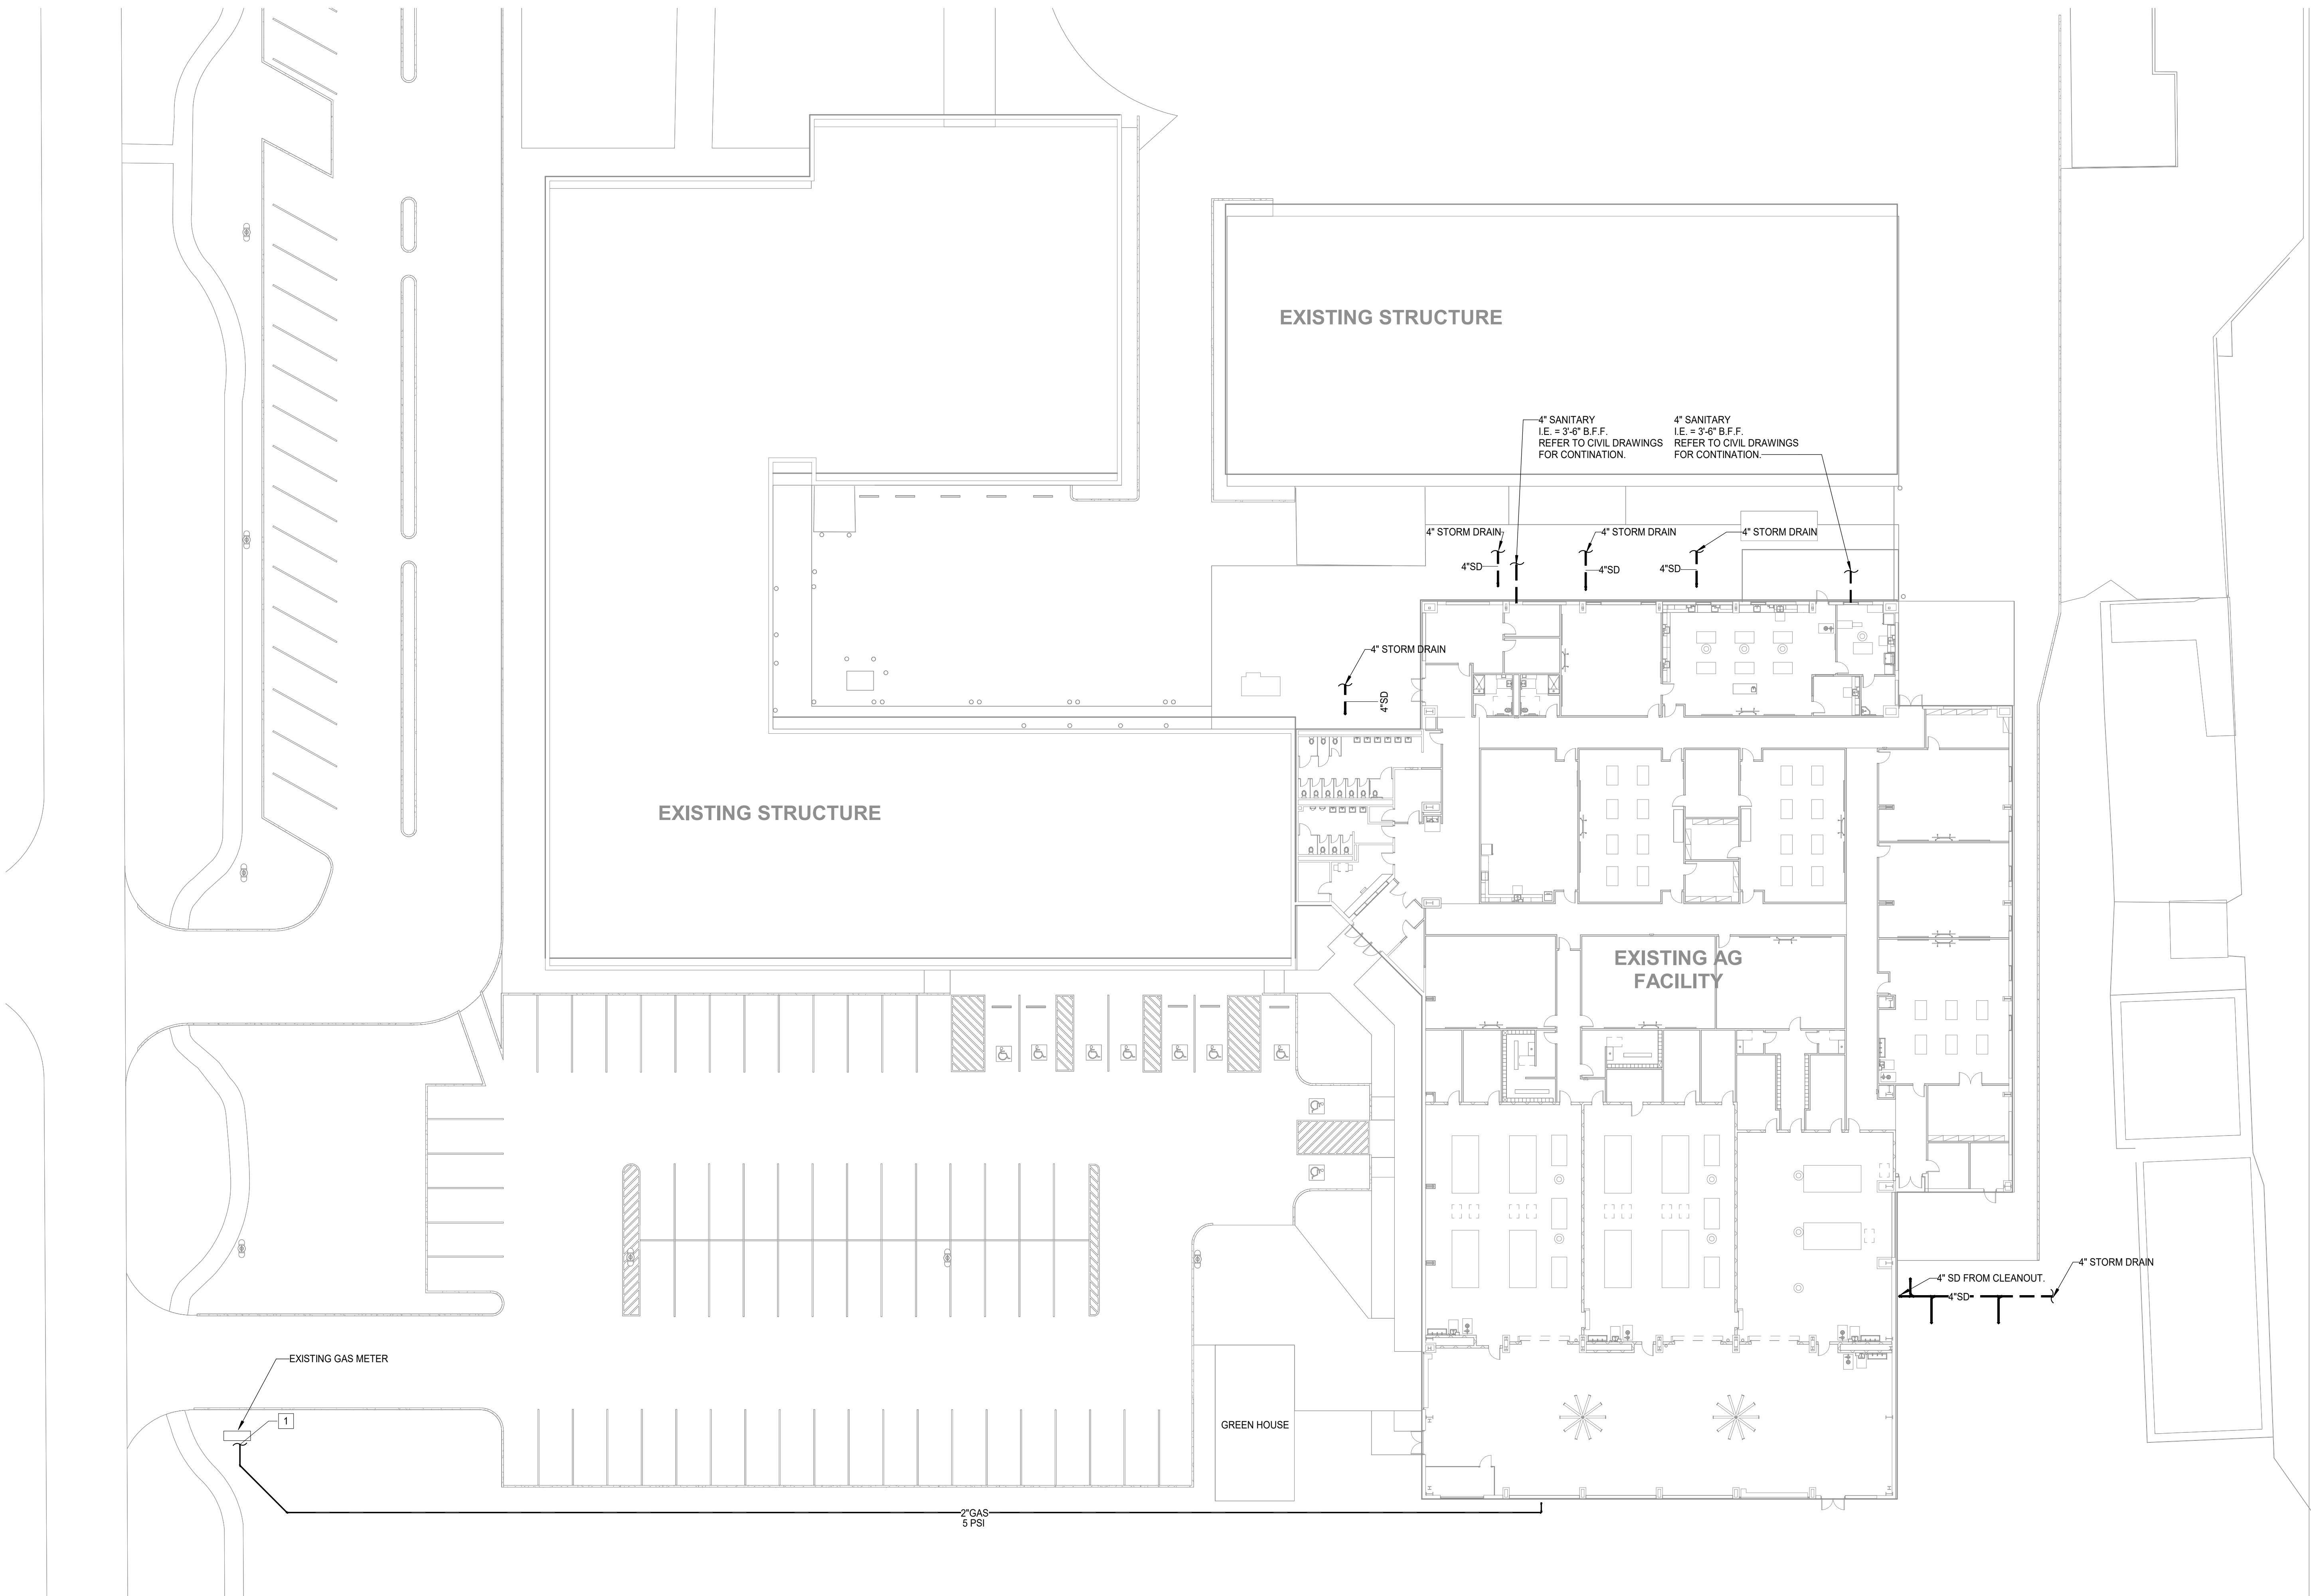PLUMING SITE  
PLAN




**1 PLUMBING SITE PLAN**

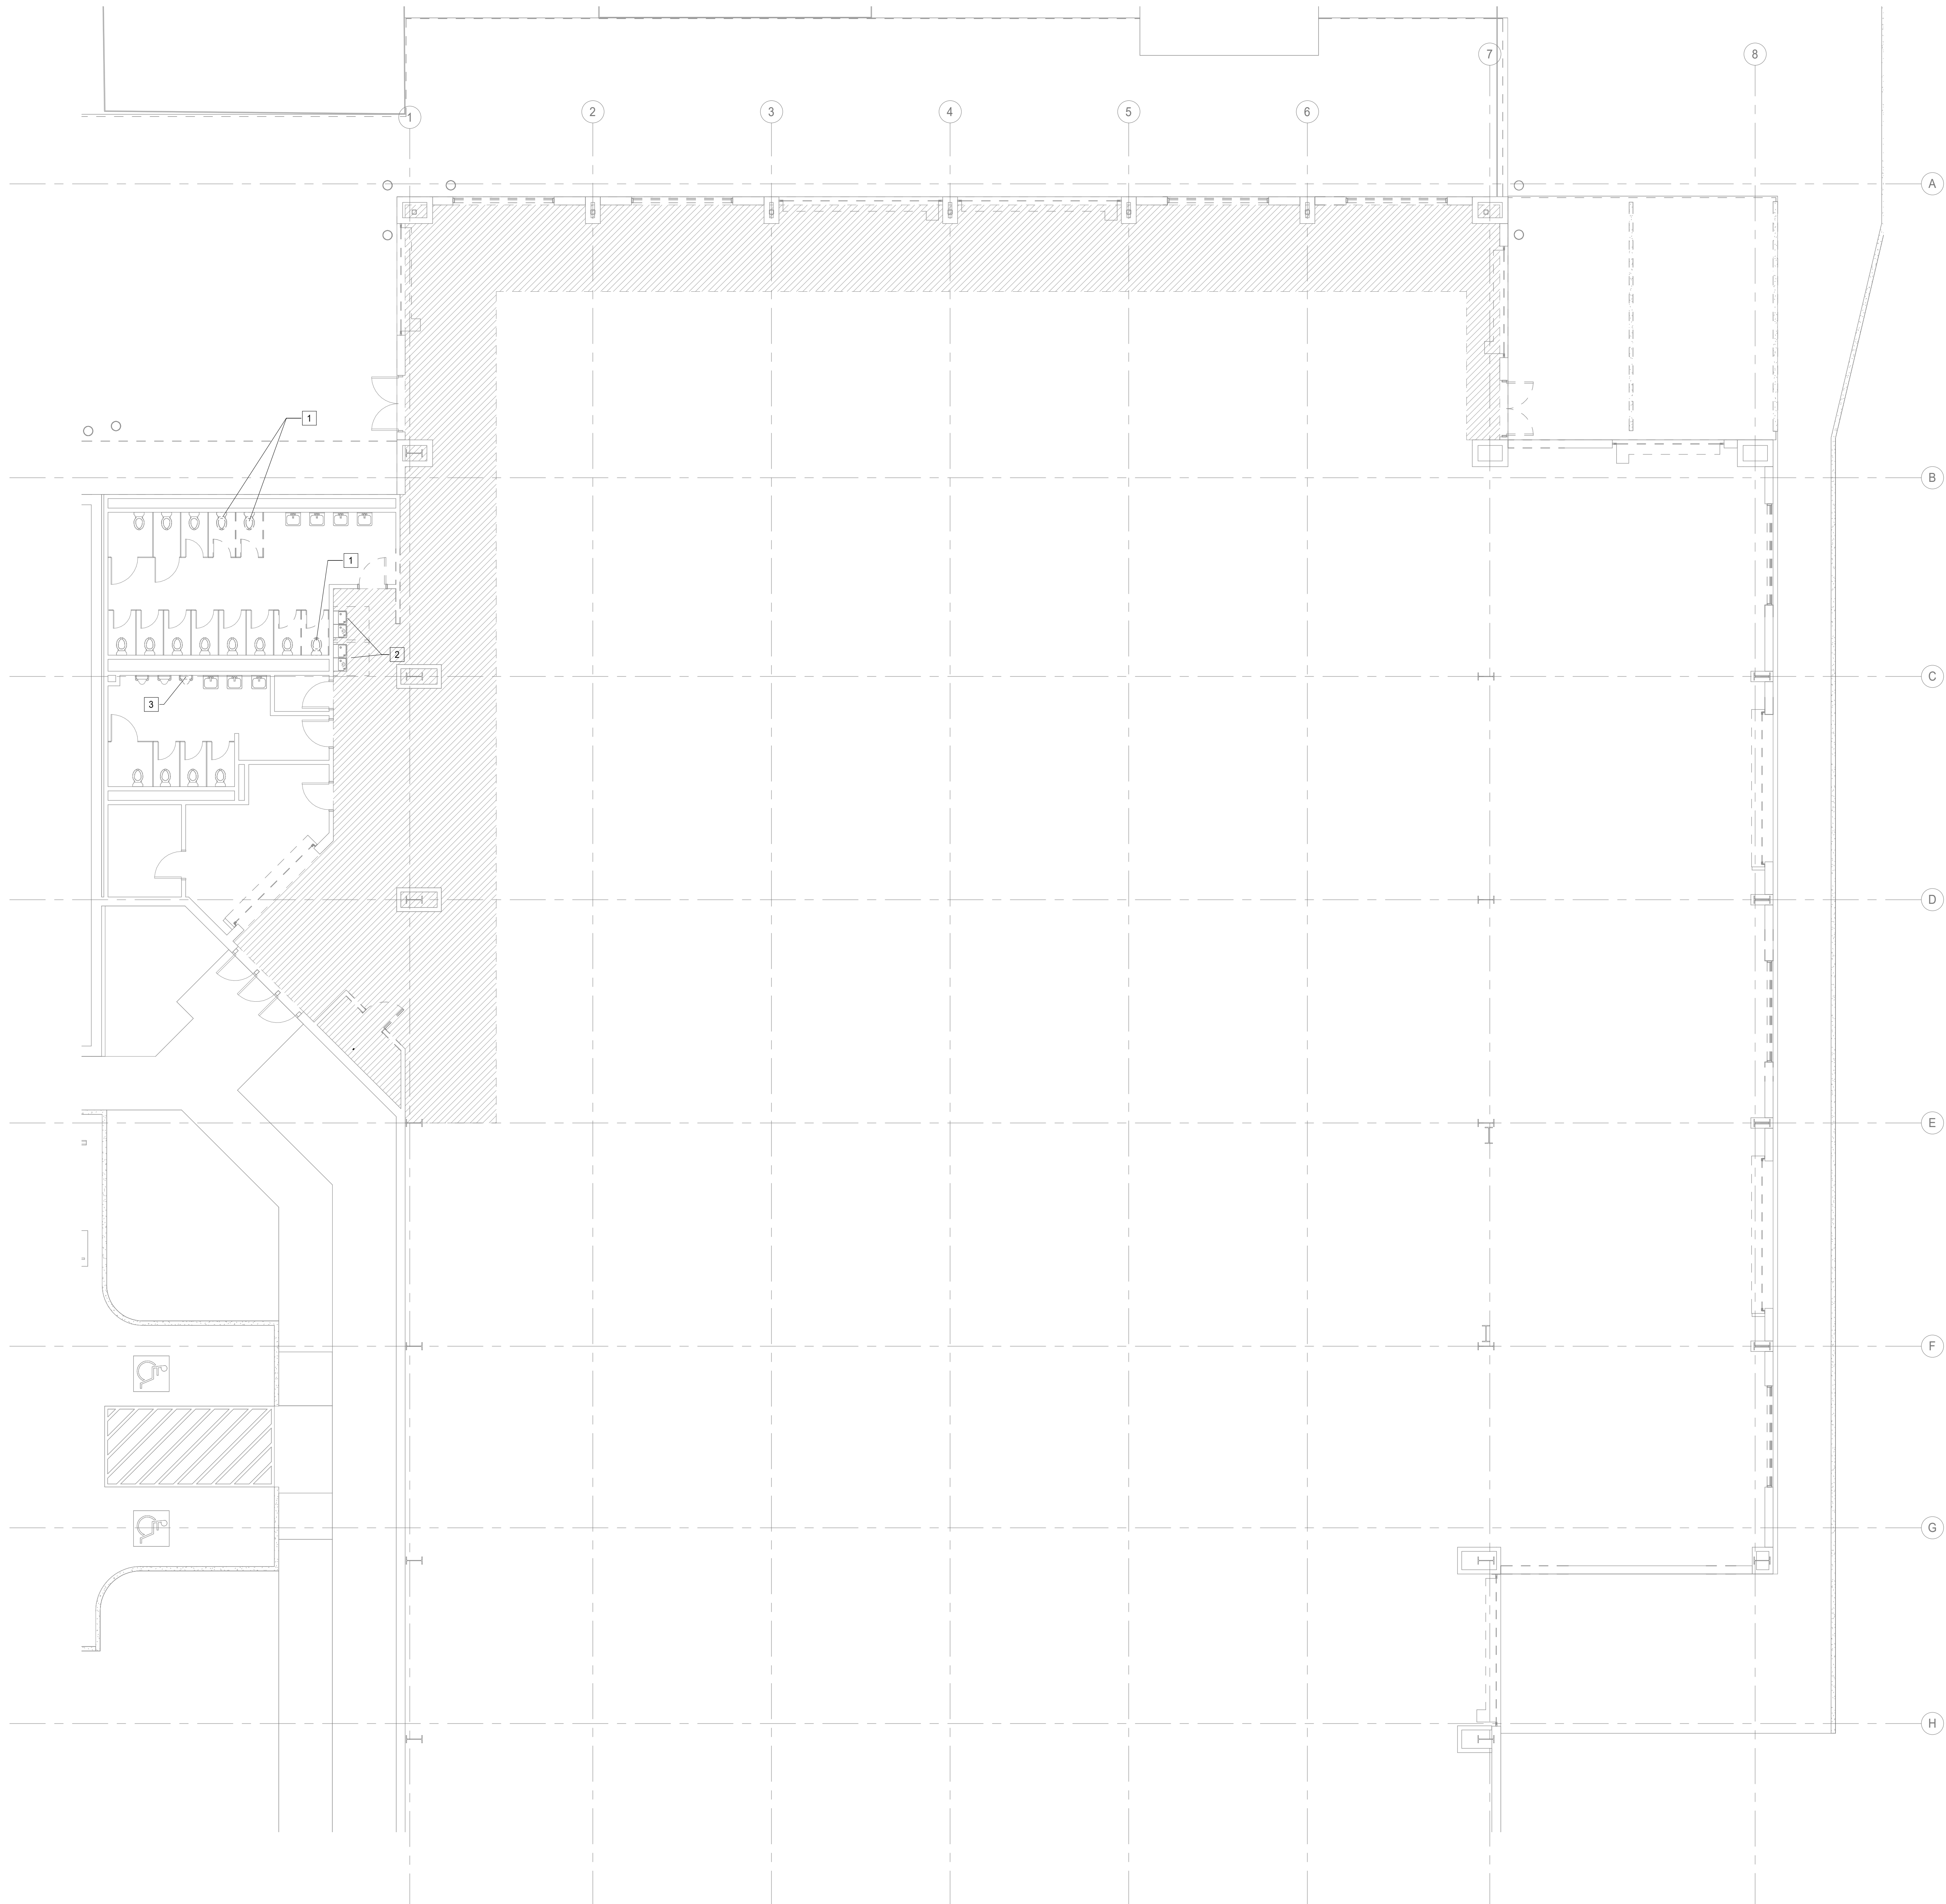Scale: 1" = 20'-0"







**PLUMBING KEYED NOTES**

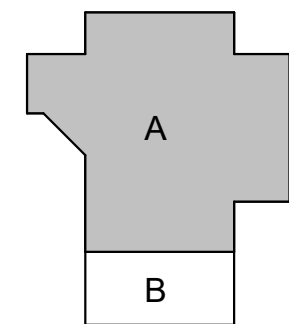
- 1 EXISTING WATER CLOSET TO BE REMOVED. REMOVE SANITARY, DW AND VENT BACK TO MAIN.
- 2 EXISTING ELECTRONIC DRINKING FOUNTAIN TO BE REMOVED. REMOVE SANITARY, DW AND VENT BACK TO MAIN.
- 3 EXISTING URINAL TO BE REMOVED AND REPLACED. CAP UTILITIES FOR FUTURE CONNECTION.

**CONSULTANTS**

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CTE & MISC. RENOVATIONS**  
TOMBALL INDEPENDENT SCHOOL DISTRICT  
30330 QUIN ROAD, TOMBALL, TX 77375

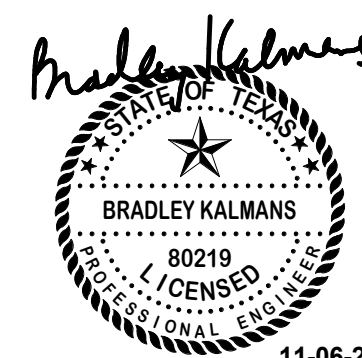


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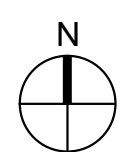


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DATE: 2023-11-03  
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**P1.01**

PLUMBING  
DEMOLITION  
AREA 'A1' 1ST  
FLOOR PLAN




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**PLUMBING DEMOLITION 1ST FLOOR PLAN - AREA 'A1'**

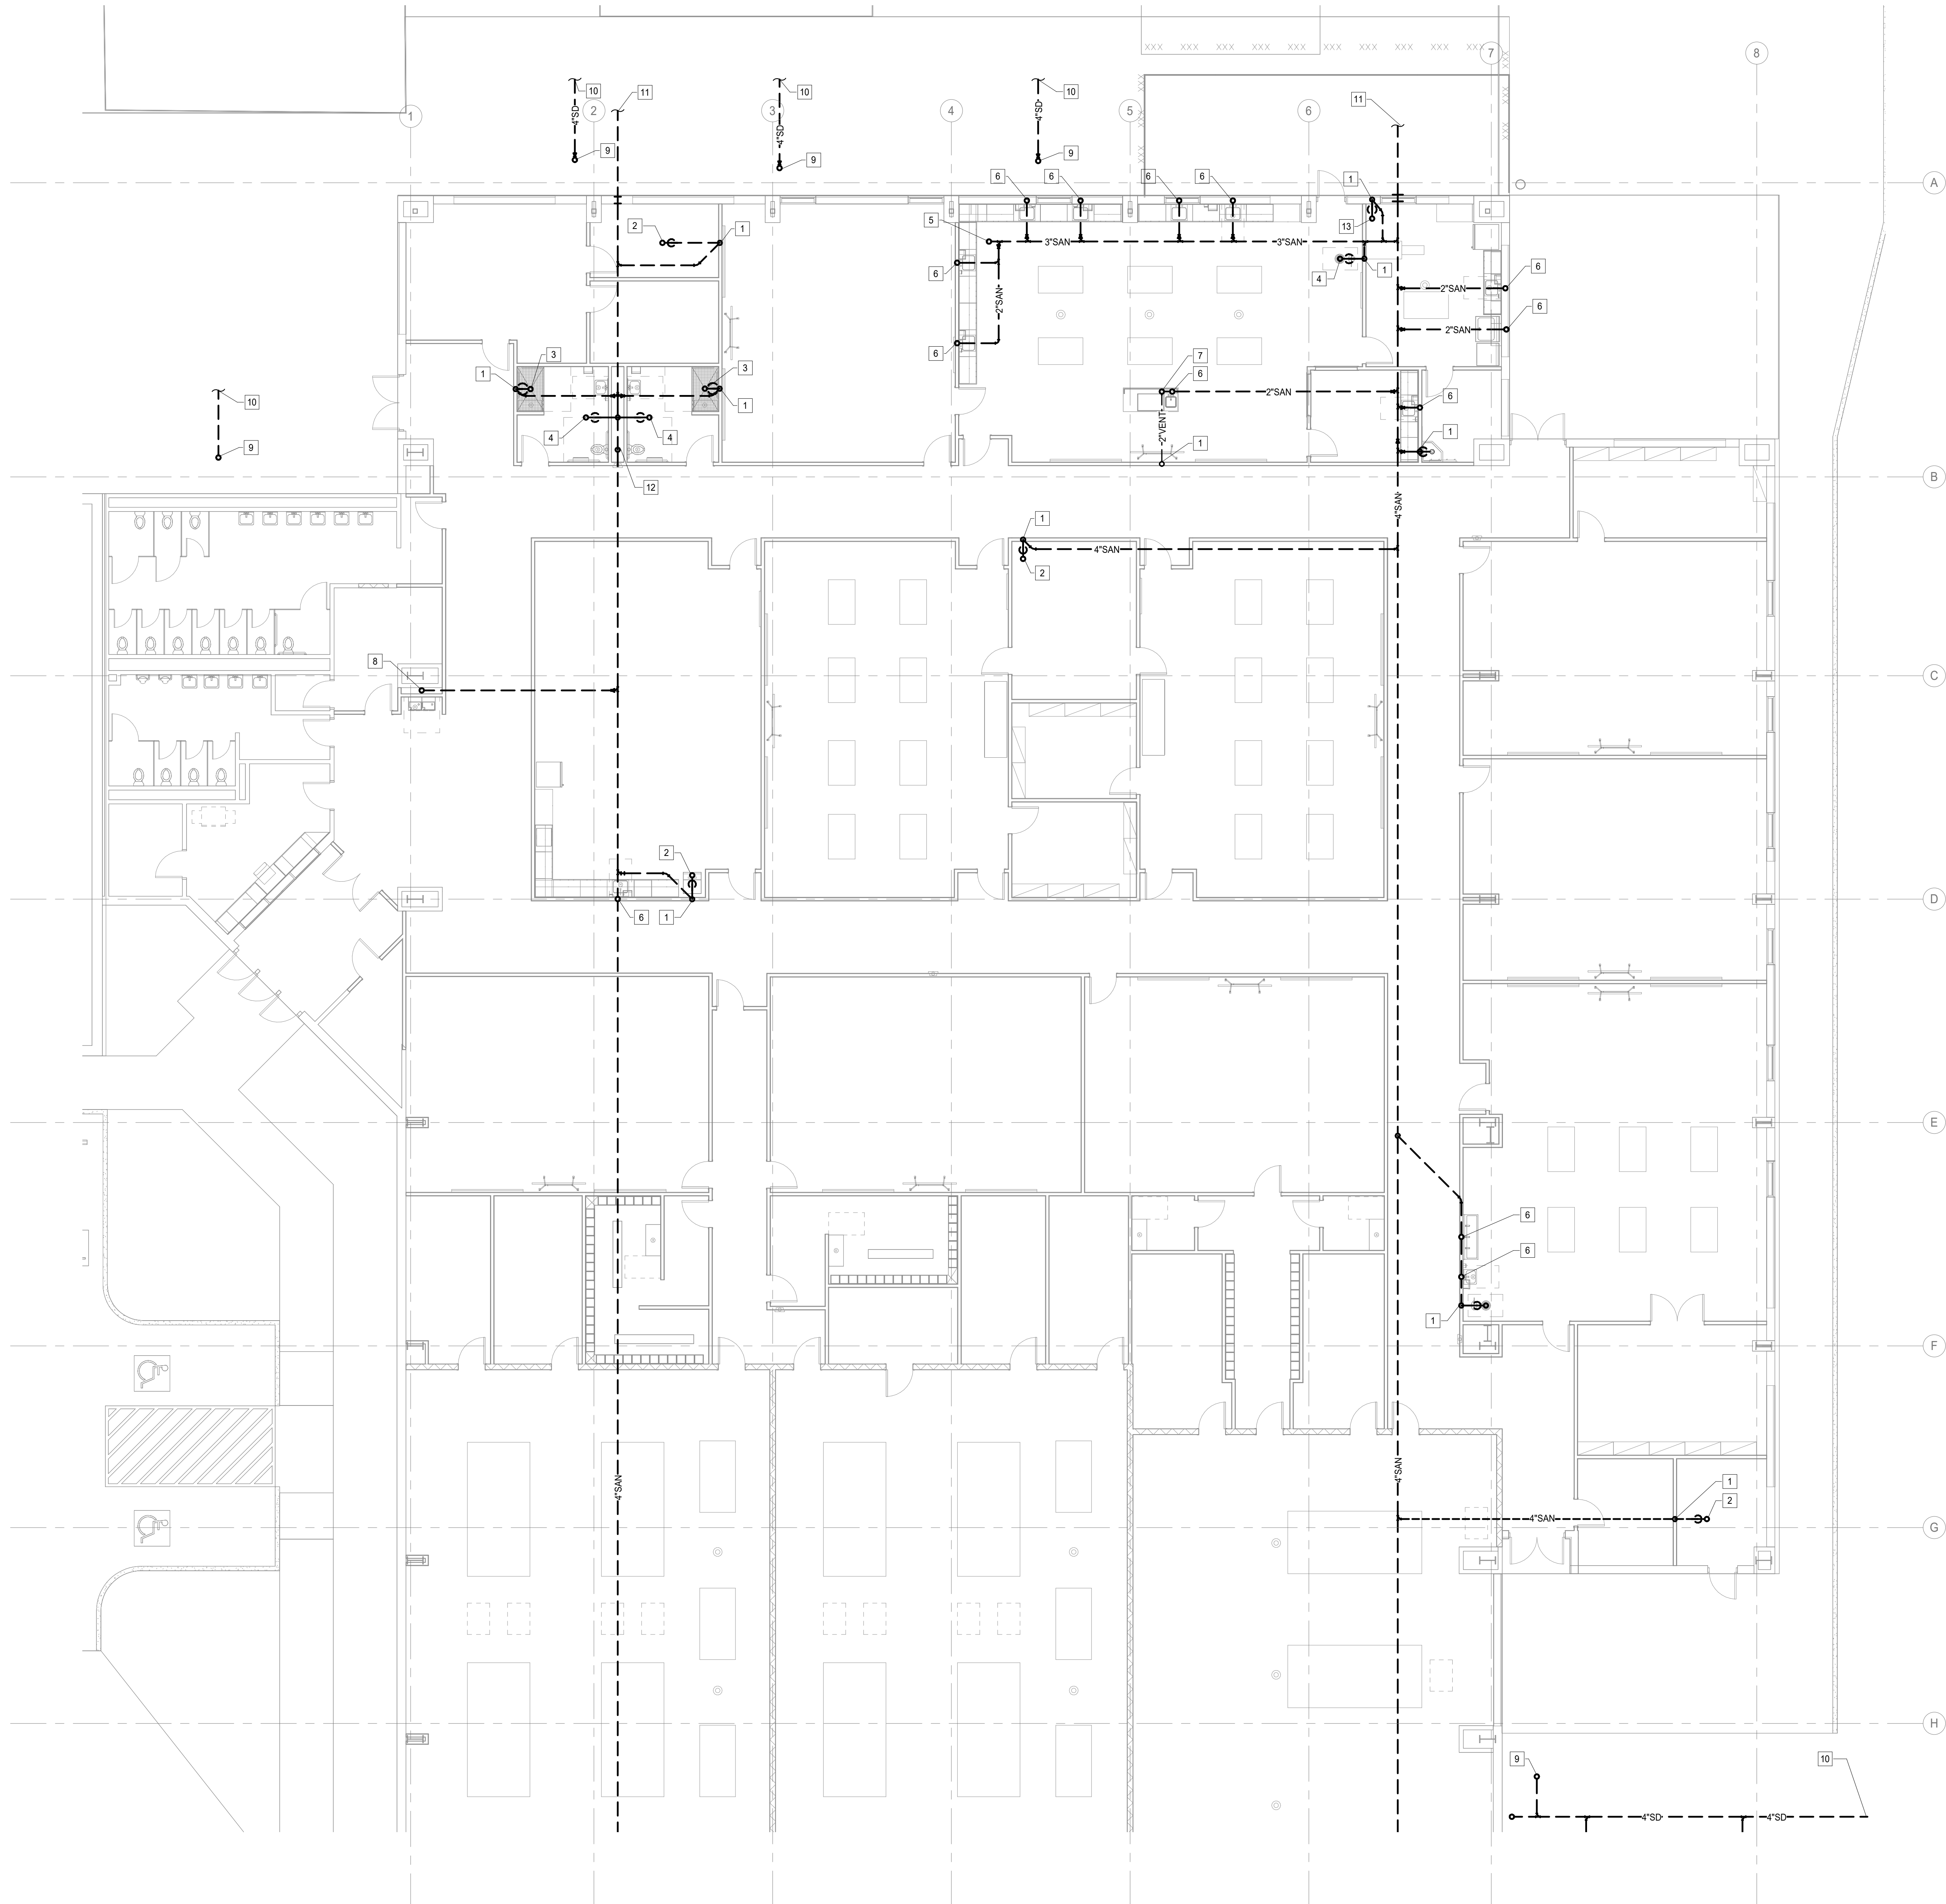Scale: 1/8" = 1'-0"





**1 PLUMBING UNDERFLOOR PLAN - AREA 'A1'**  
Scale: 1/8" = 1'-0"

**PLUMBING KEYED NOTES**

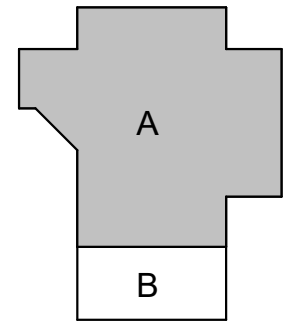
- 1 2" VENT UP.
- 2 4" SANITARY FROM FLOOR SINK ABOVE.
- 3 2" SANITARY FROM SHOWER ABOVE.
- 4 3" SANITARY FROM FLOOR DRAIN ABOVE.
- 5 4" SANITARY FROM CLEANOUT ABOVE.
- 6 2" SANITARY FROM SINK ABOVE.
- 7 2" VENT FROM BELOW.
- 8 2" SANITARY FROM ELECTRONIC DRINKING FOUNTAIN ABOVE.
- 9 4" STORM FROM ABOVE.
- 10 4" STORM, REFER TO PLUMBING SITE PLAN P1.01 FOR CONTINUATION.
- 11 REFER TO SHEET P1.00 FOR CONTINUATION.
- 12 4" SANITARY FROM ABOVE.
- 13 3" SANITARY FROM FLOOR SINK ABOVE.

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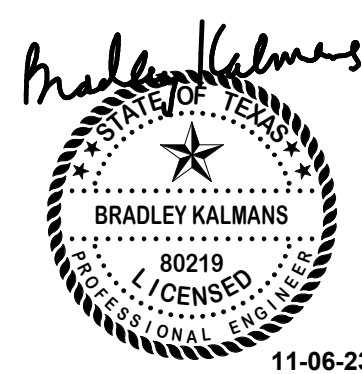
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**TOMBALL HIGH SCHOOL  
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**P2.01**  
PLUMBING  
UNDERFLOOR  
AREA 'A1' 1ST  
FLOOR PLAN





PLUMBING KEYED NOTES

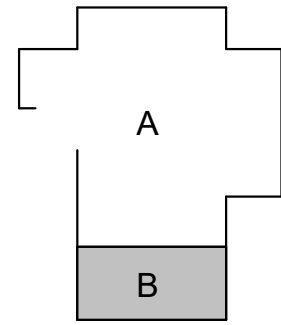
- 1 2" SANITARY FROM SINK ABOVE.  
2 2" VENT UP.  
3 3" SANITARY FROM FLOOR DRAIN ABOVE.  
4 4" STORM FROM ABOVE.  
5 2" GAS UP.  
6 4" SANITARY FROM CLEANOUT ABOVE.

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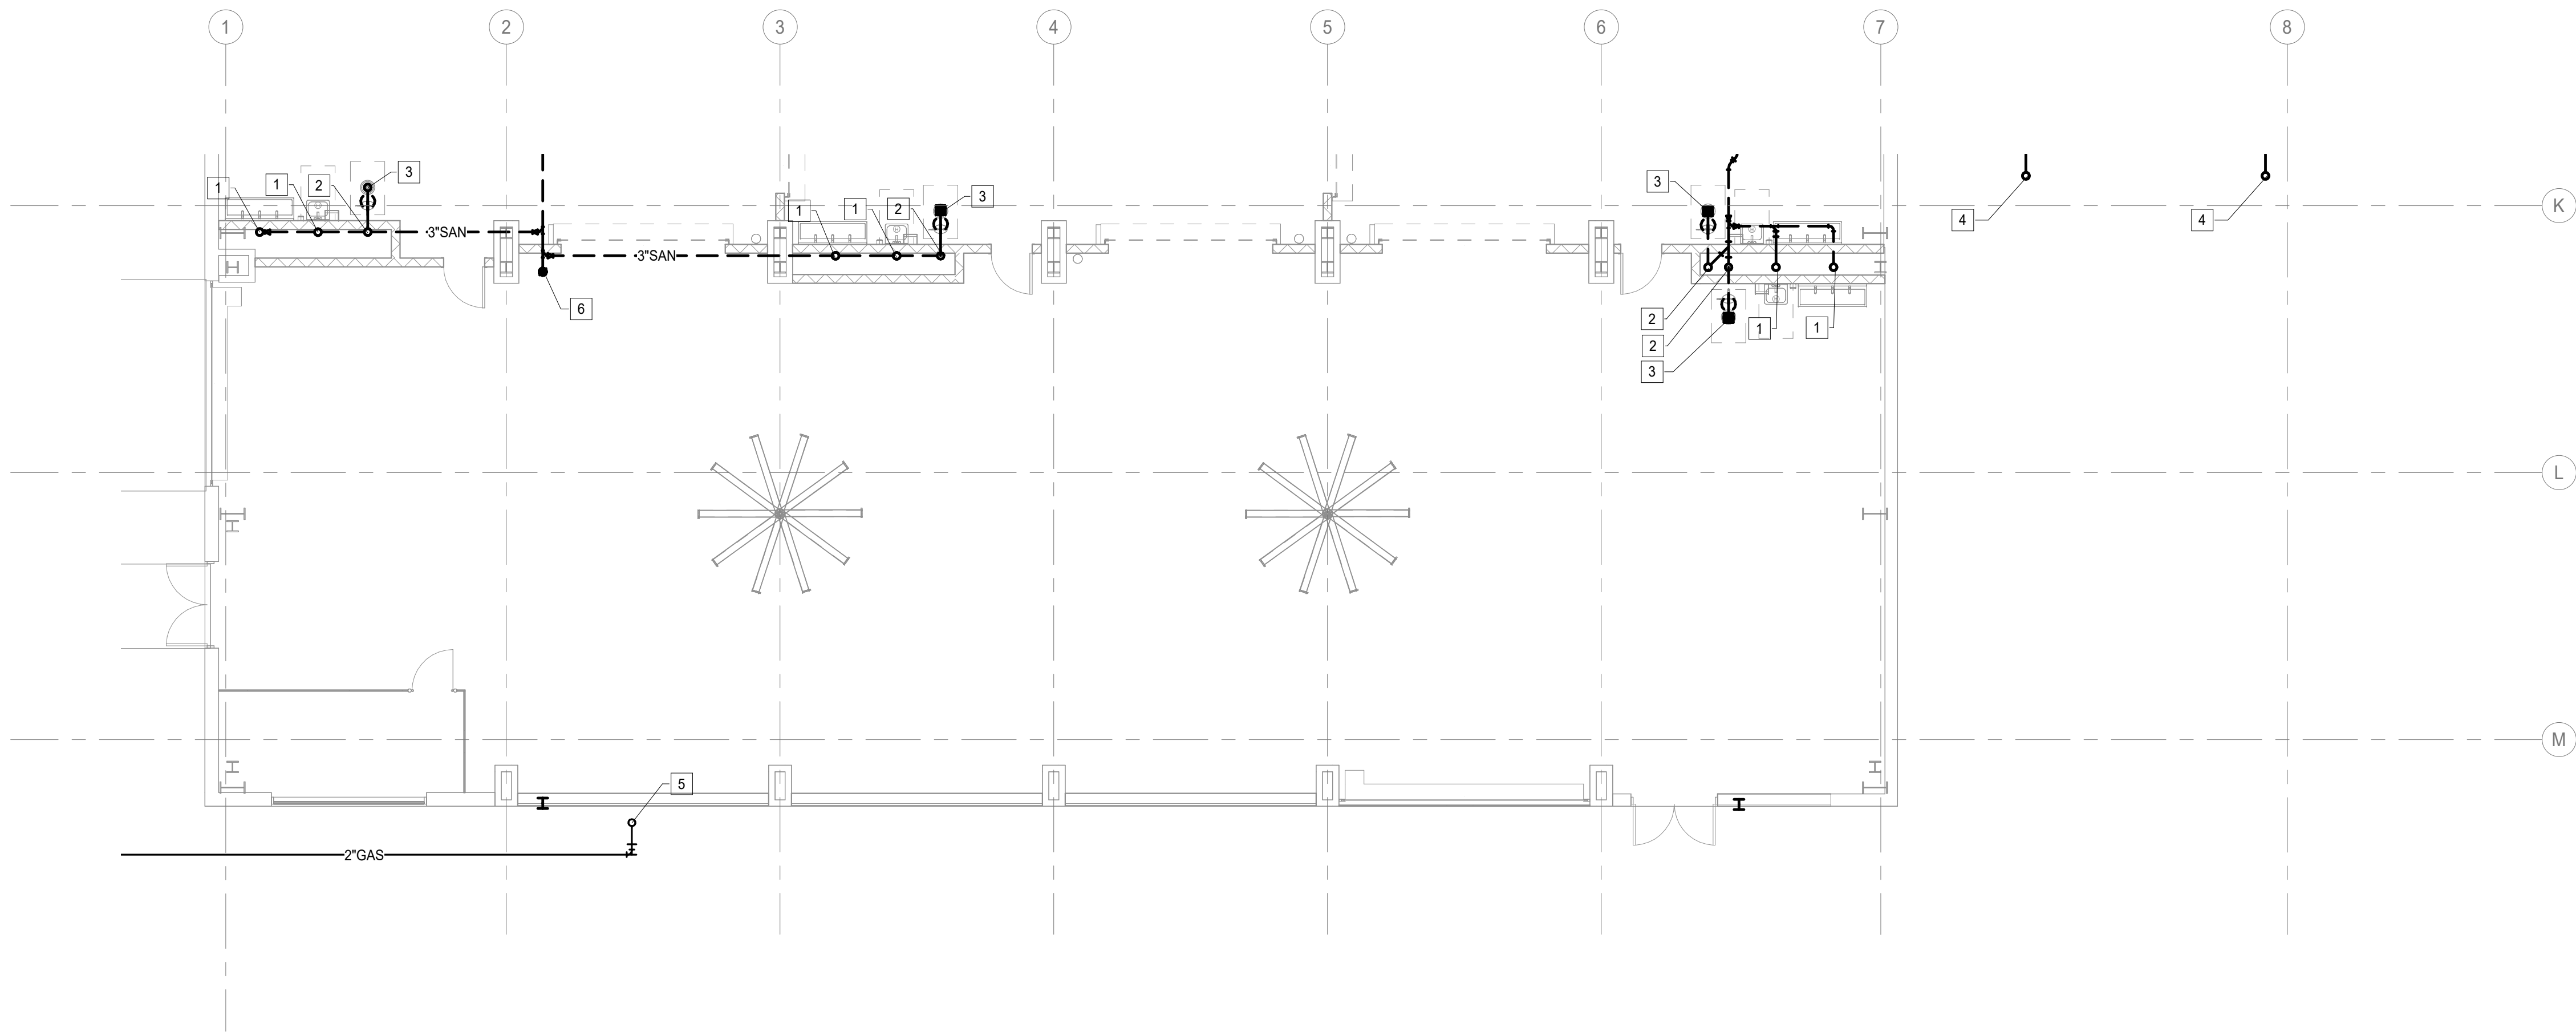
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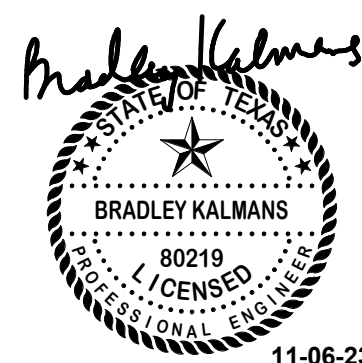


**1 PLUMBING UNDERFLOOR PLAN - AREA 'B1'**  
Scale: 1/8" = 1'-0"



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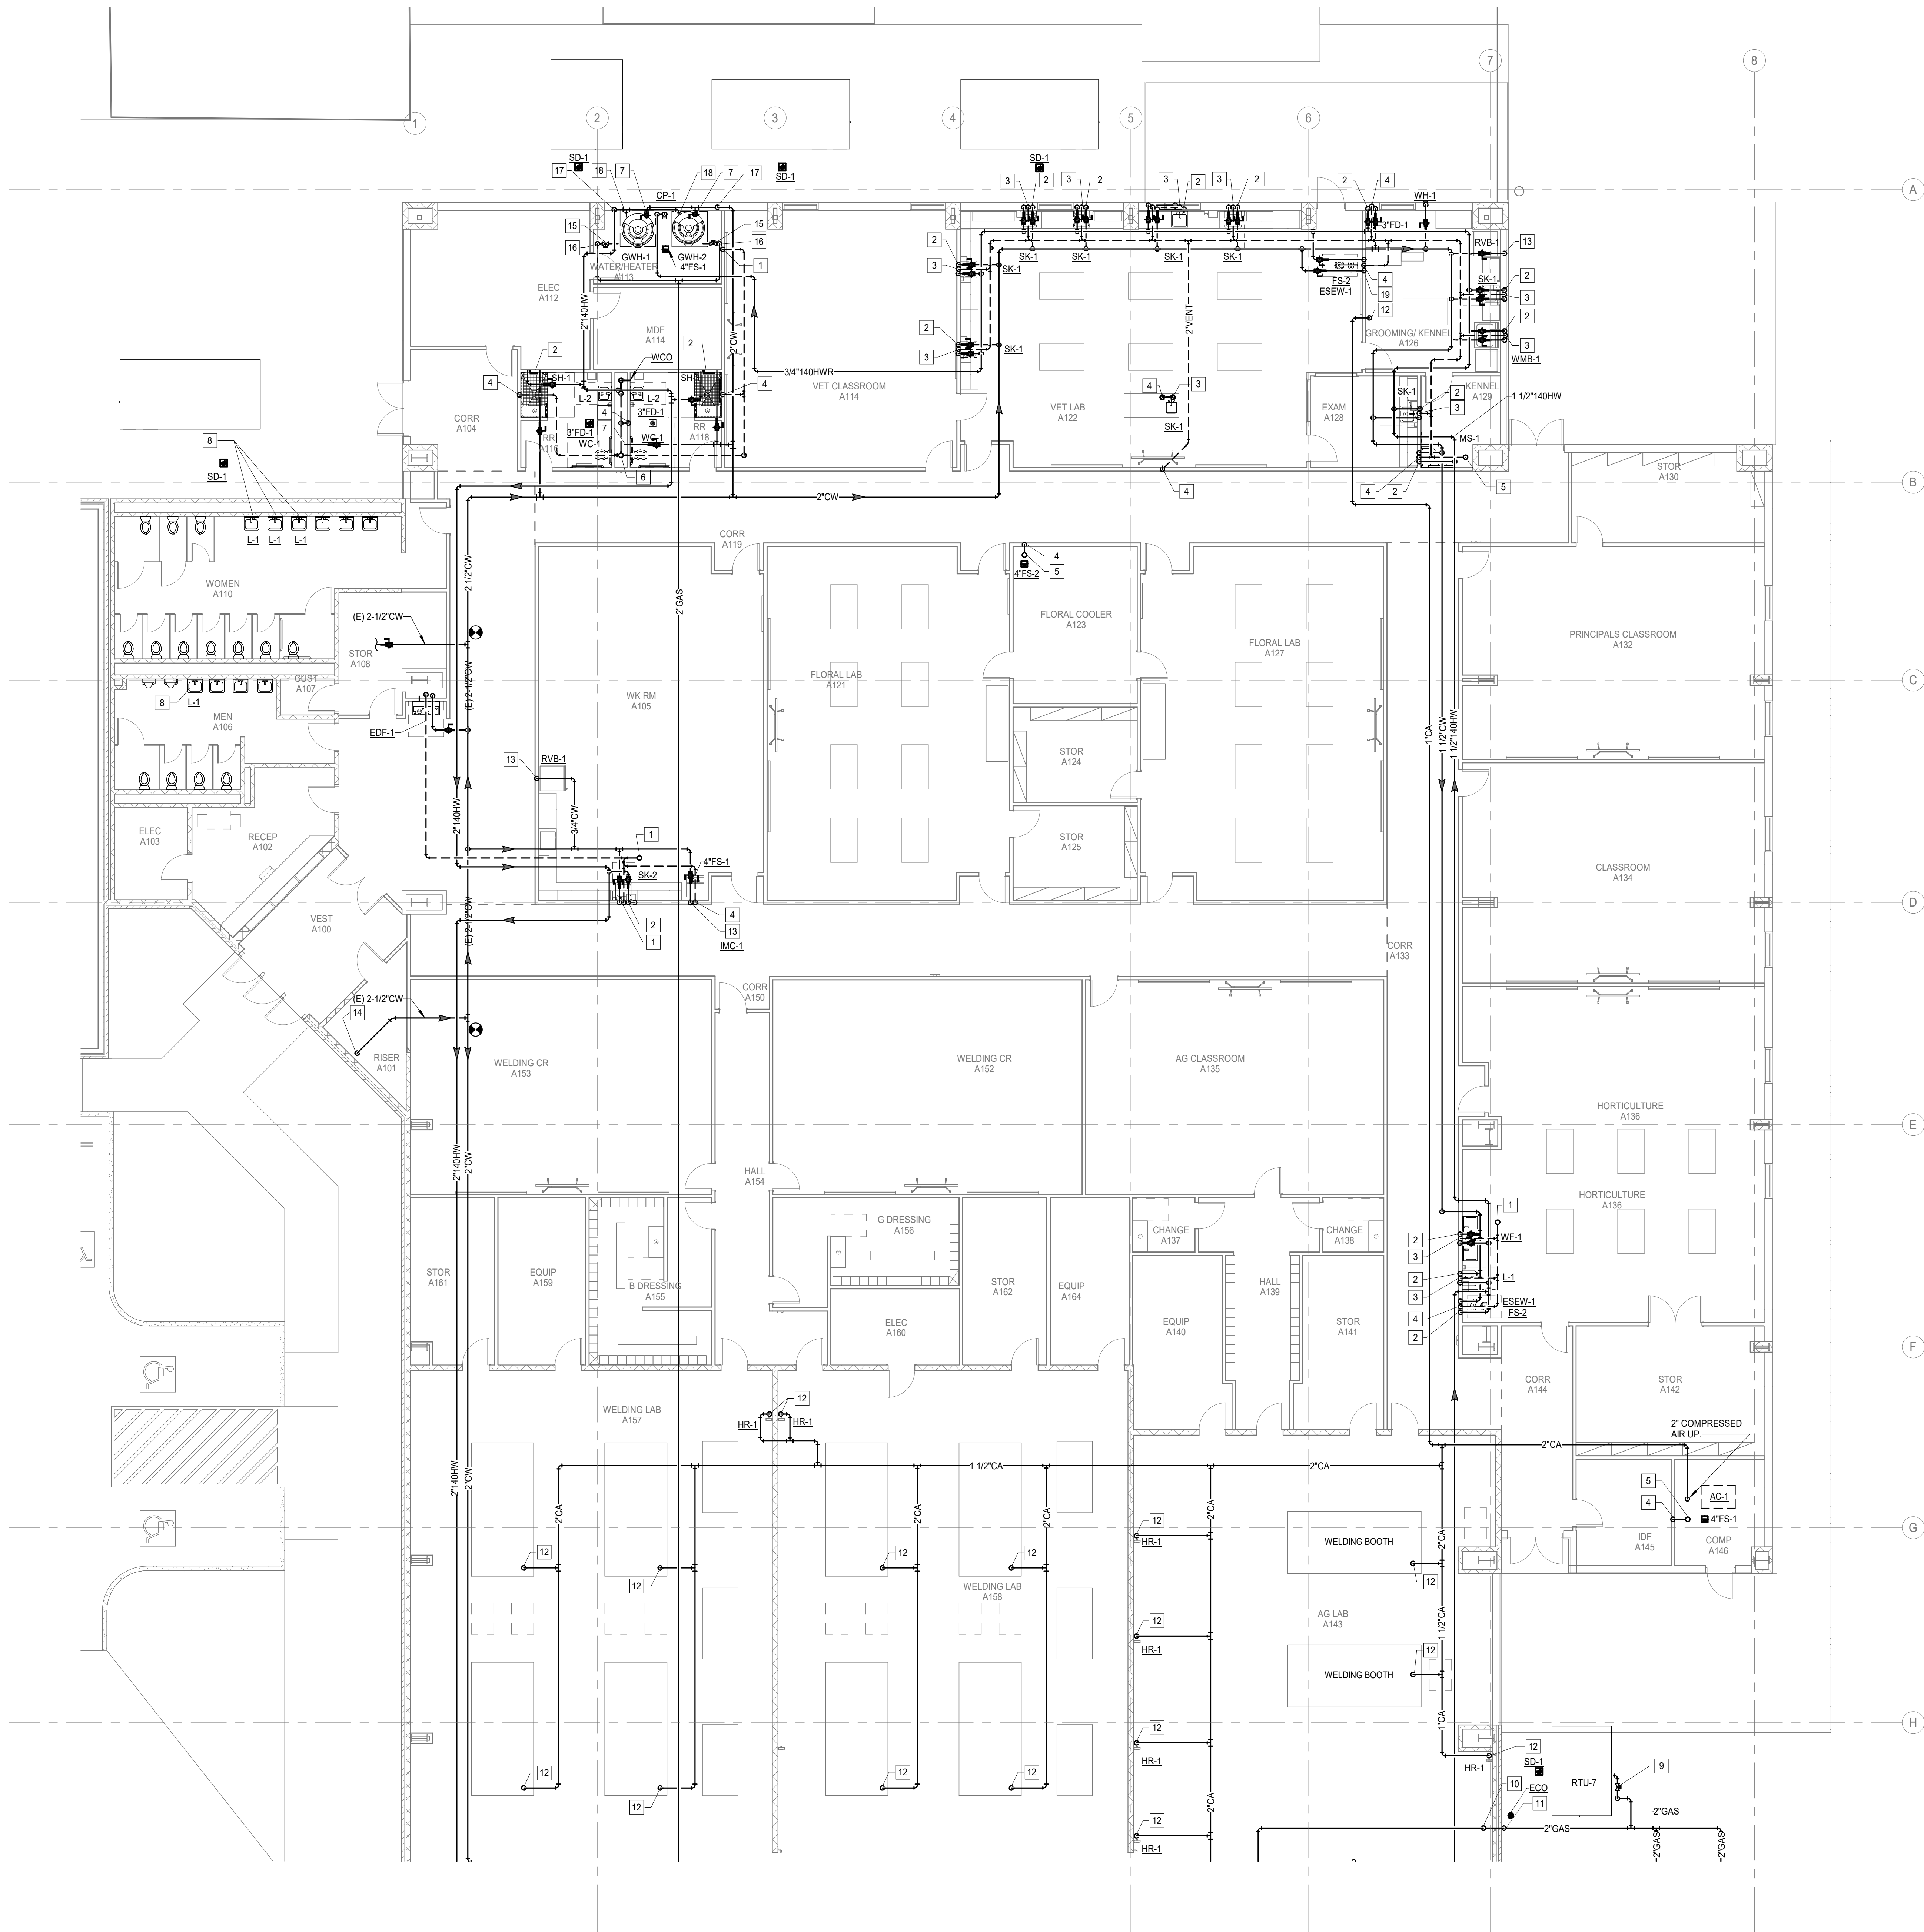
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**P2.02**

PLUMBING  
UNDERFLOOR  
AREA 'B1' 1ST  
FLOOR PLAN







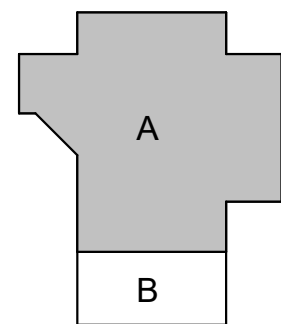
- PLUMBING KEYED NOTES**
- 2" VENT UP.
  - 3/4" CW AND HW DOWN.
  - 2" SANITARY DOWN, 2" VENT UP.
  - 2" VENT FROM BELOW.
  - 2" VENT UP TO 2" VTR.
  - 2" VENT UP TO 4" VTR.
  - 1-1/2" CW DOWN.
  - INSTALL NEW LAVATORIES AND CONNECT TO EXISTING PLUMBING IN CHASE.
  - PRESSURE REGULATOR FROM 5 PSI TO 8 OZ. 150 CFH.
  - 2" GAS DOWN.
  - 2" GAS DOWN MOUNTED ON TOP OF SLAB.
  - 1" COMPRESSED AIR DOWN.
  - 3/4" CW DOWN.
  - 2-1/2" CW FROM BELOW.
  - PRESSURE REGULATOR FROM 5 PSI TO 8 OZ. 199 CFH.
  - 1" GAS DOWN.
  - 2" CW DOWN.
  - 1-1/2" HOT WATER FROM WATER HEATERS BELOW.
  - 1-1/4" CW AND HW DOWN TO SERVE EMERGENCY SHOWER.

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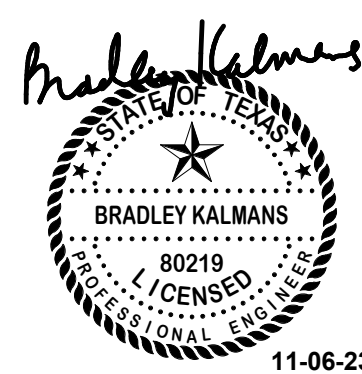
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**TEXAS ARCADIS INC.**  
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**P3.01**  
PLUMBING AREA  
'A1' 1ST FLOOR  
PLAN



PLUMBING KEYED NOTES

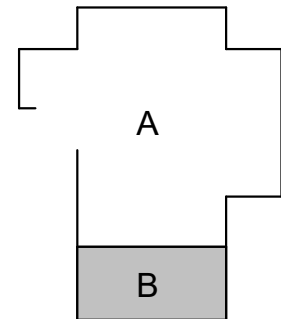
- 1 3/4" CW AND HW DOWN.  
2 2" SANITARY DOWN, 2" VENT UP.  
3 2" VENT FROM BELOW.  
4 2" VENT UP.  
5 3/4" CW DOWN.  
6 PRESSURE REGULATOR FROM 5 PSI TO 8 OZ.  
180 CFH.  
7 PRESSURE REGULATOR FROM 5 PSI TO 8 OZ.  
150 CFH.  
8 2" GAS FROM BELOW  
9 2" GAS UP  
10 1" COMPRESSED AIR DOWN.  
11 3/4" CW DOWN TO SERVE PLUMBING FIXTURES.

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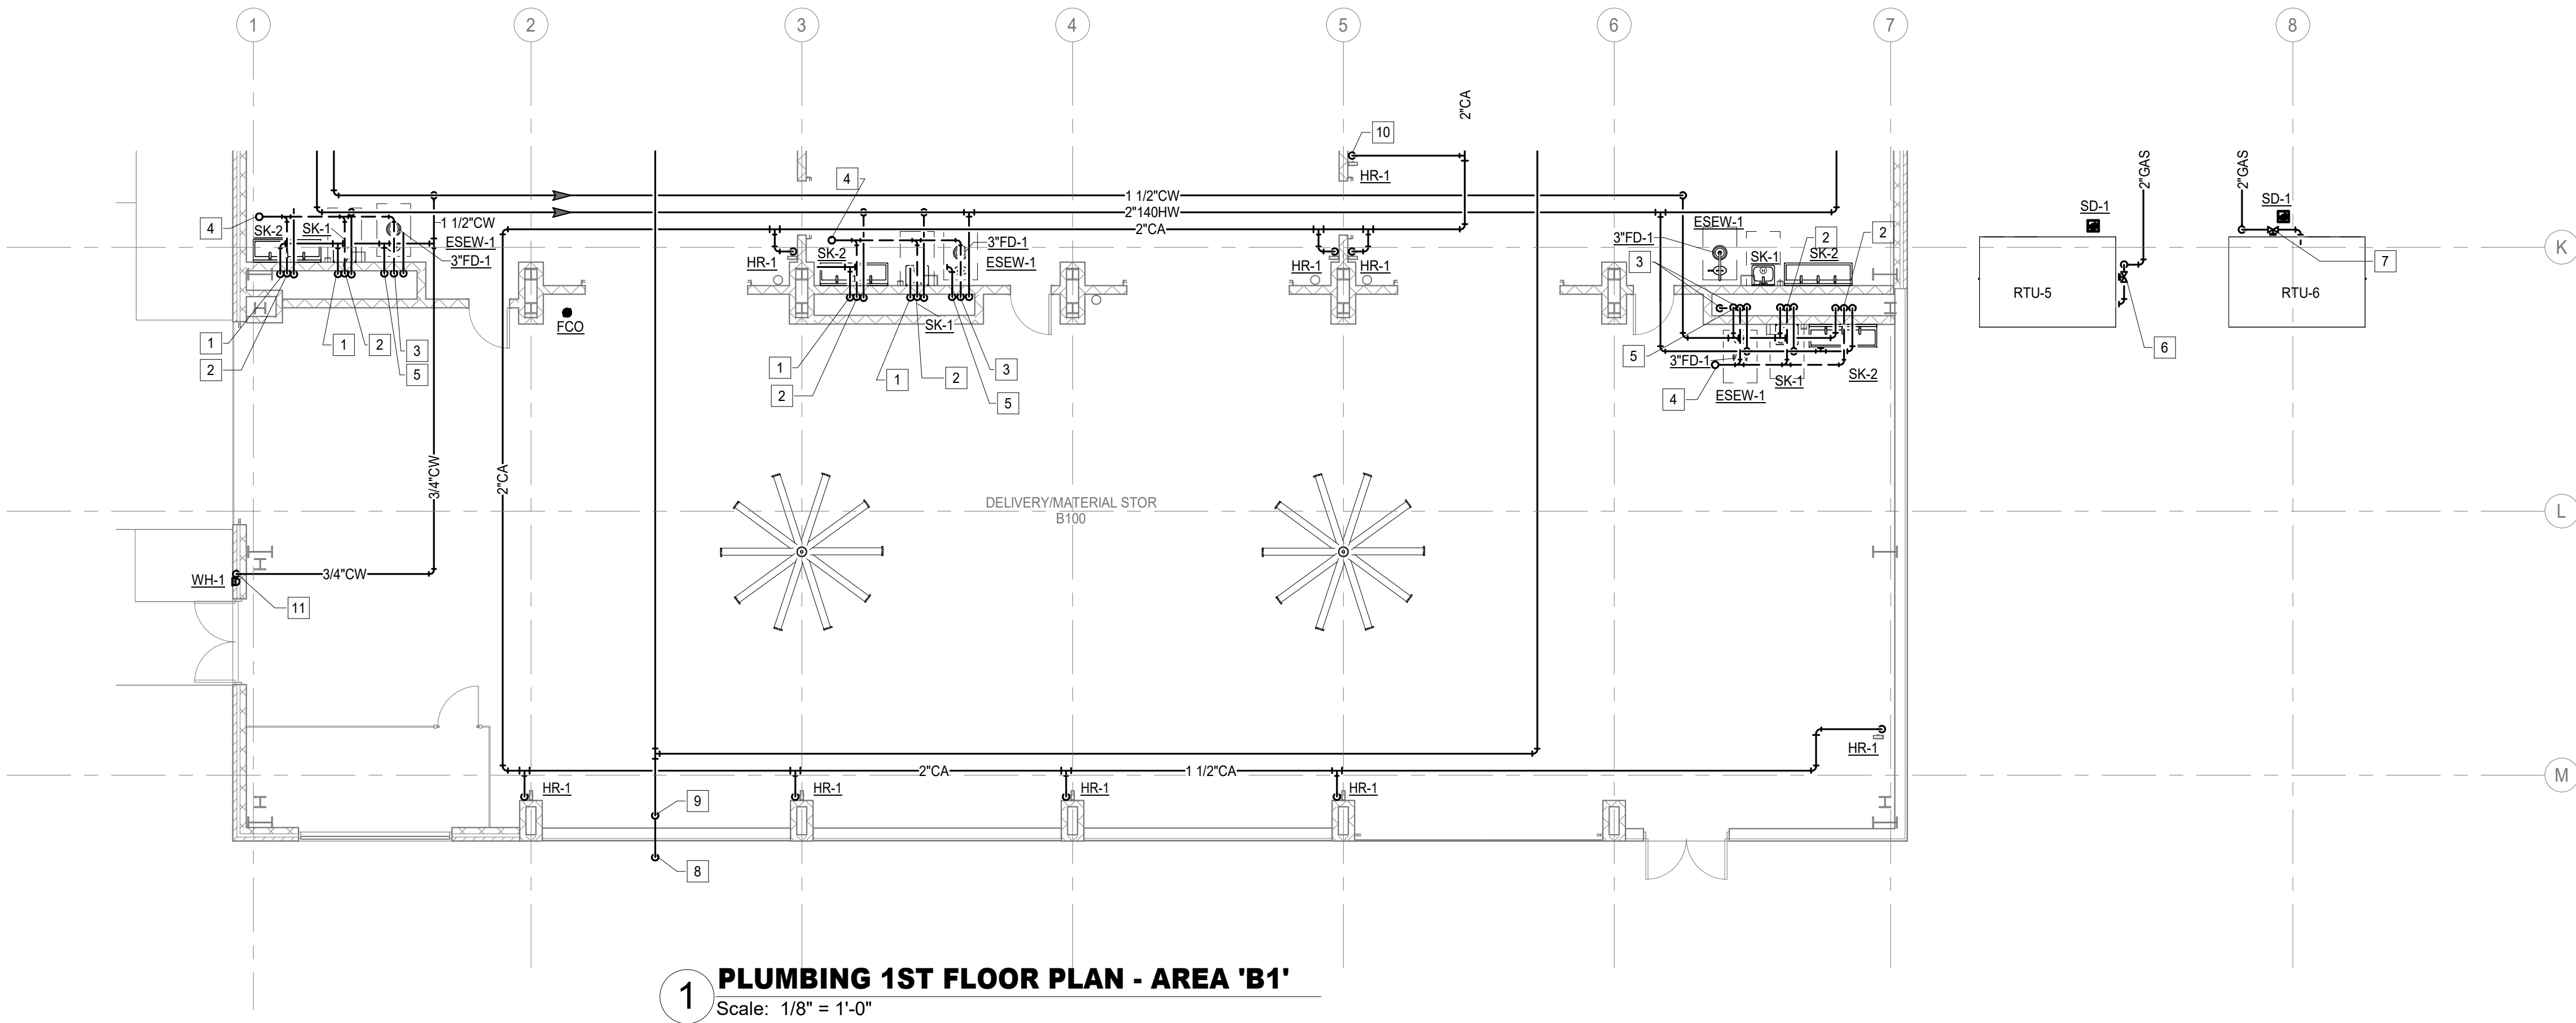
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ARCADIS

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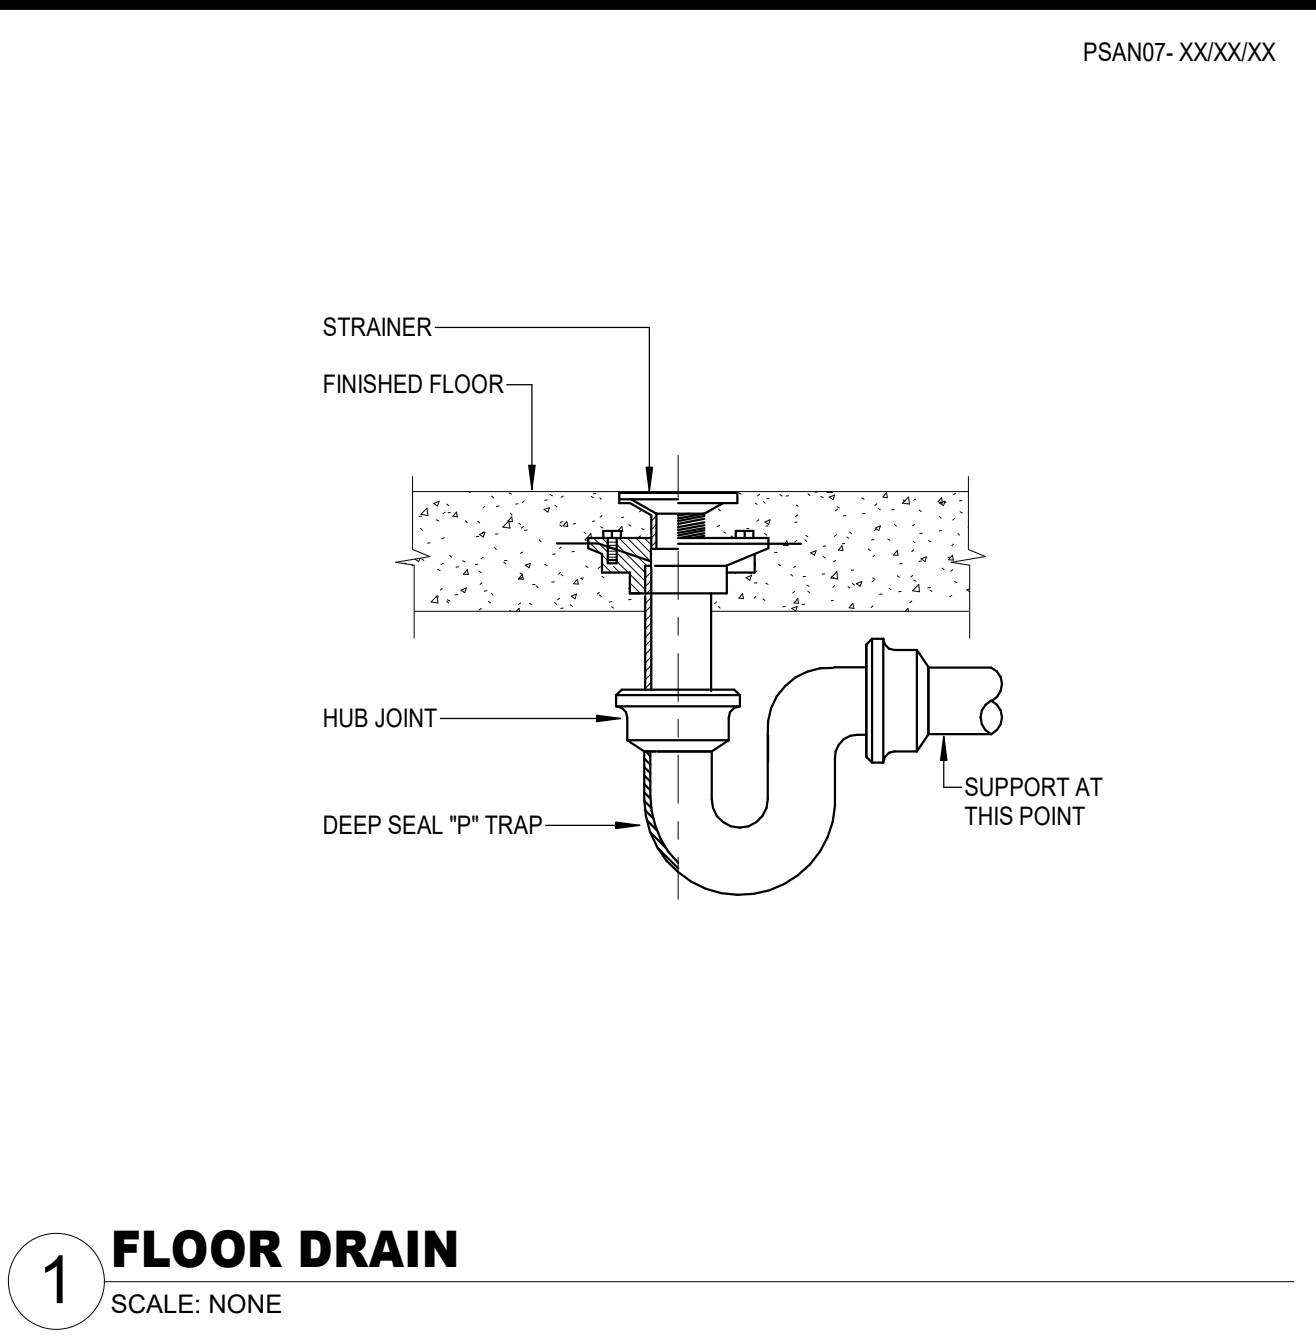
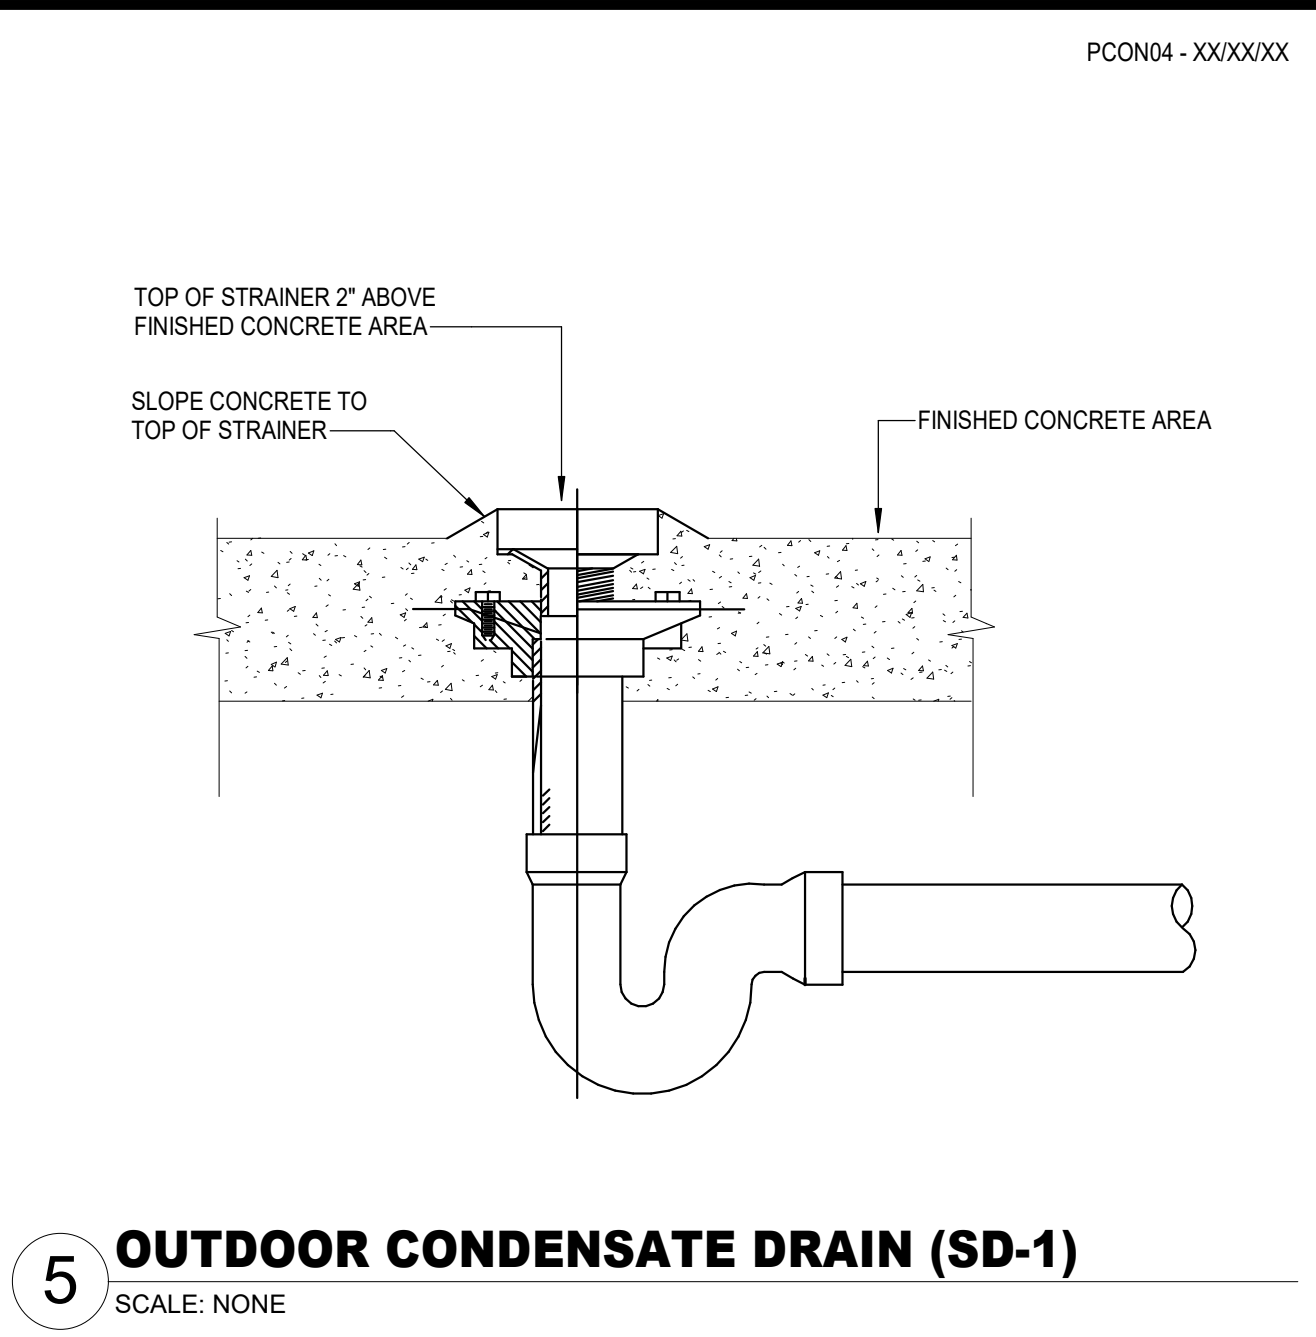
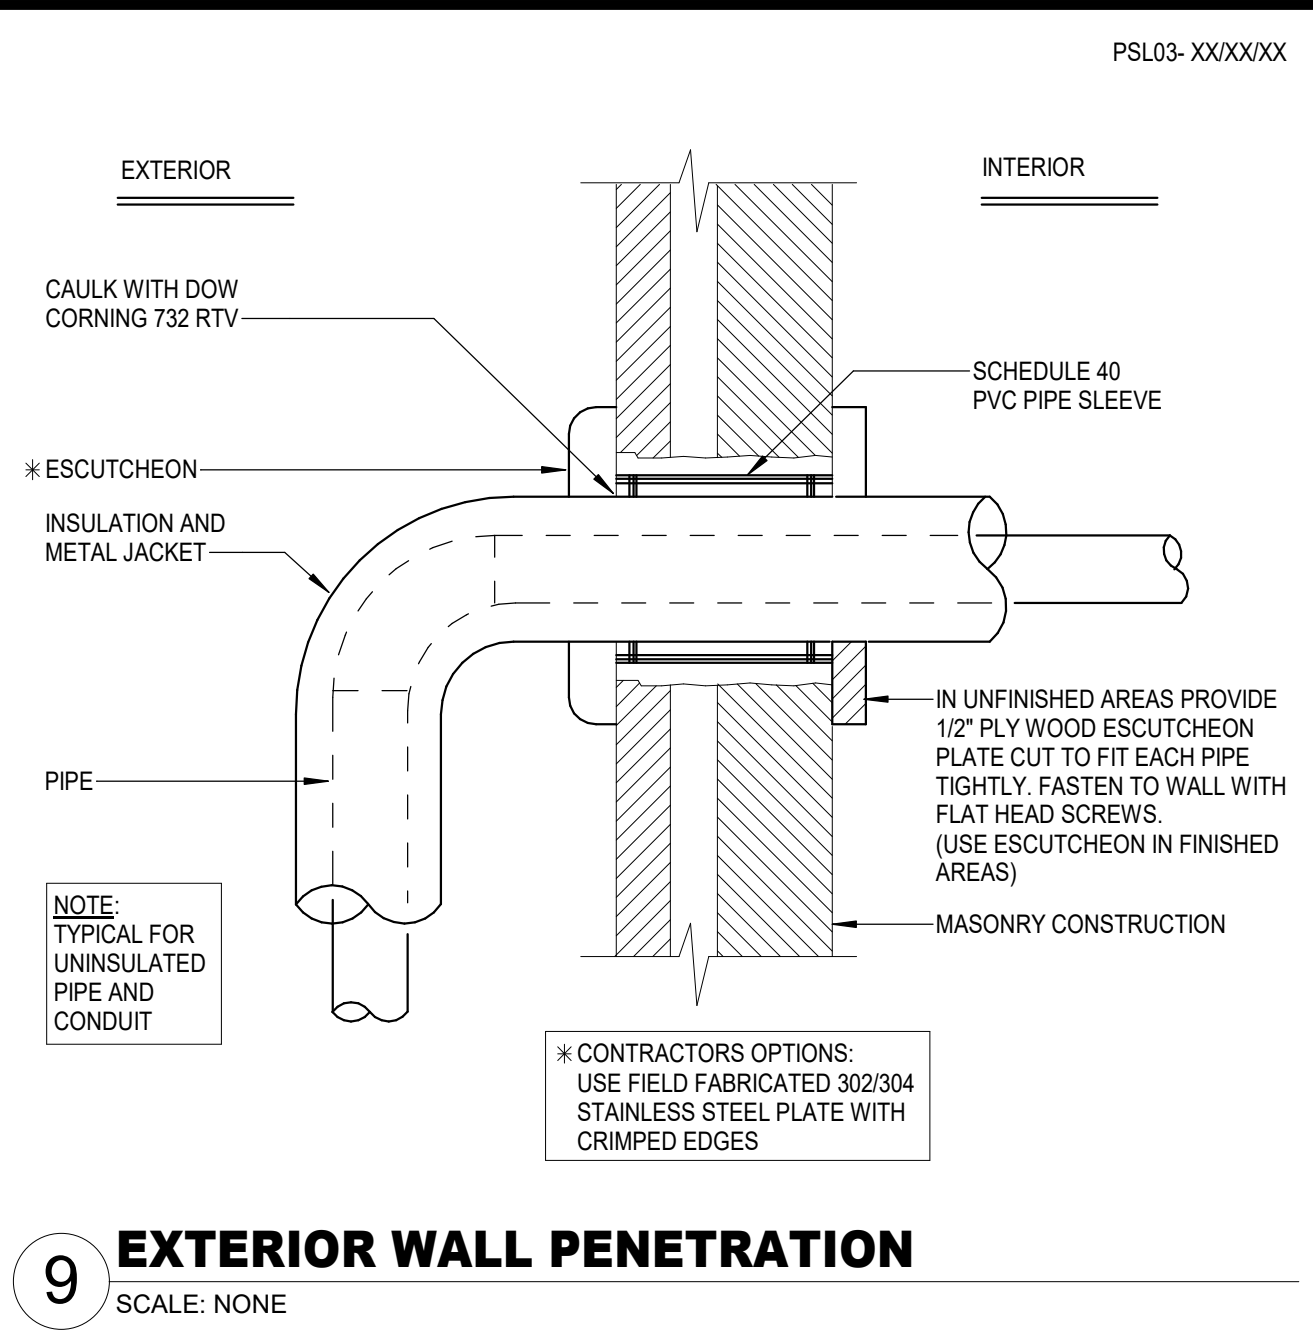
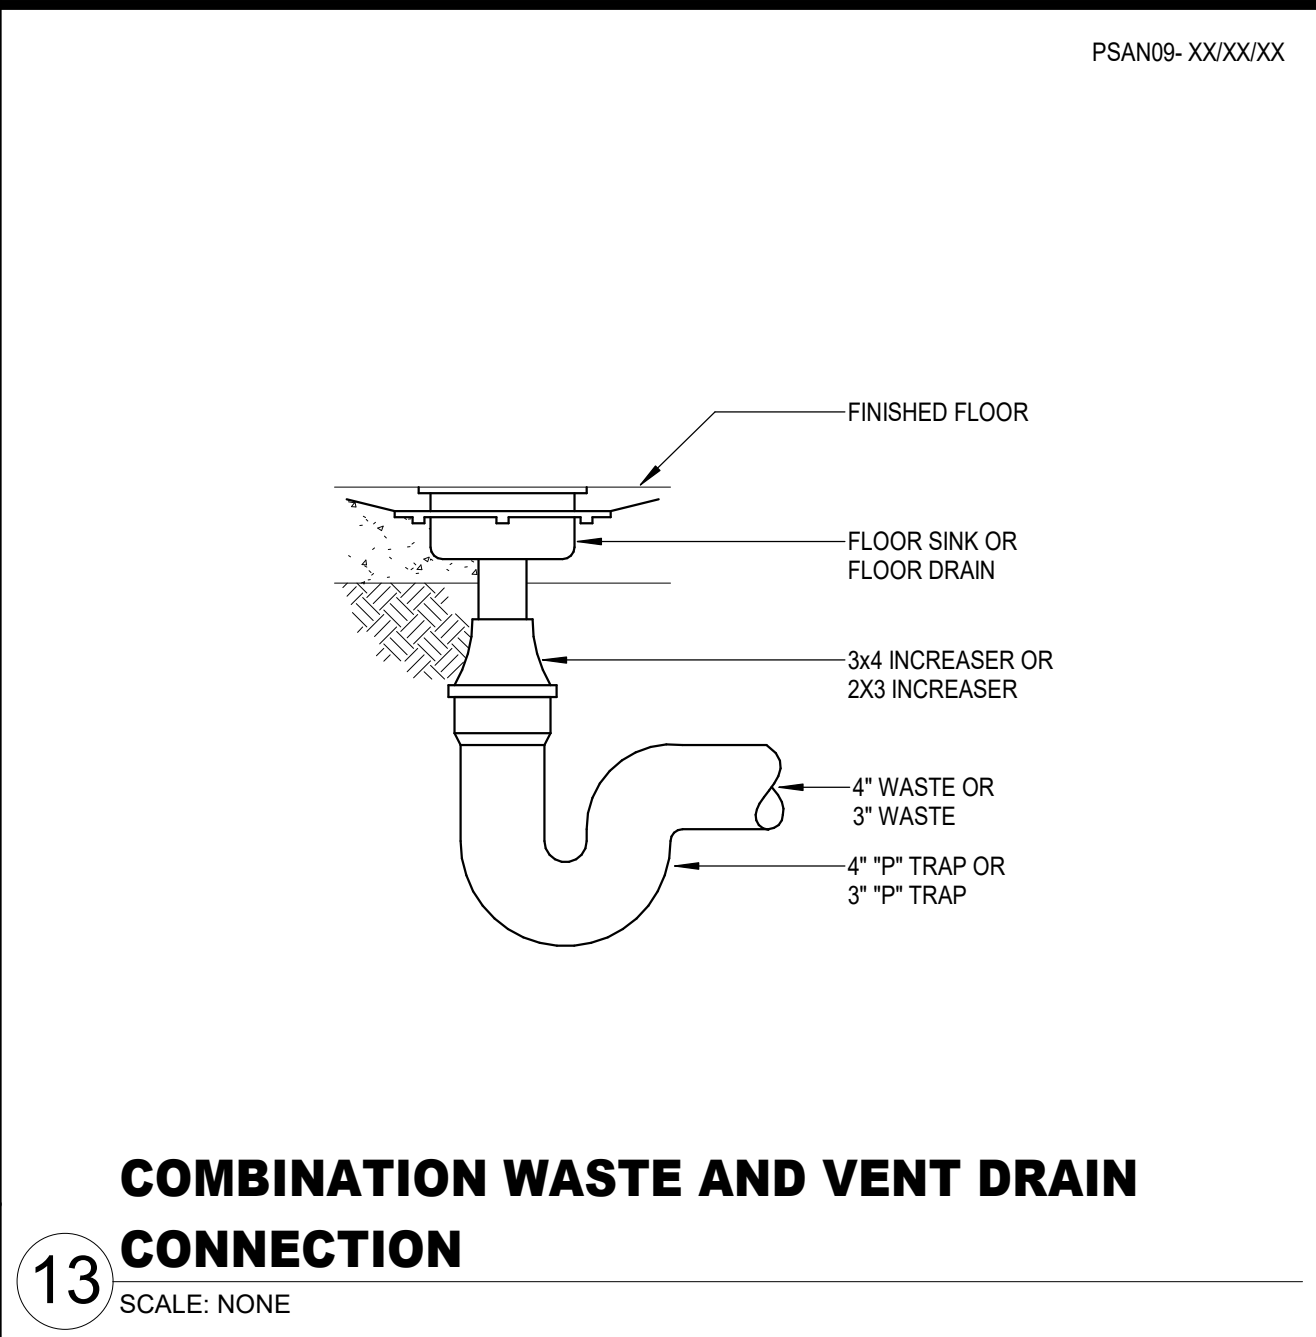
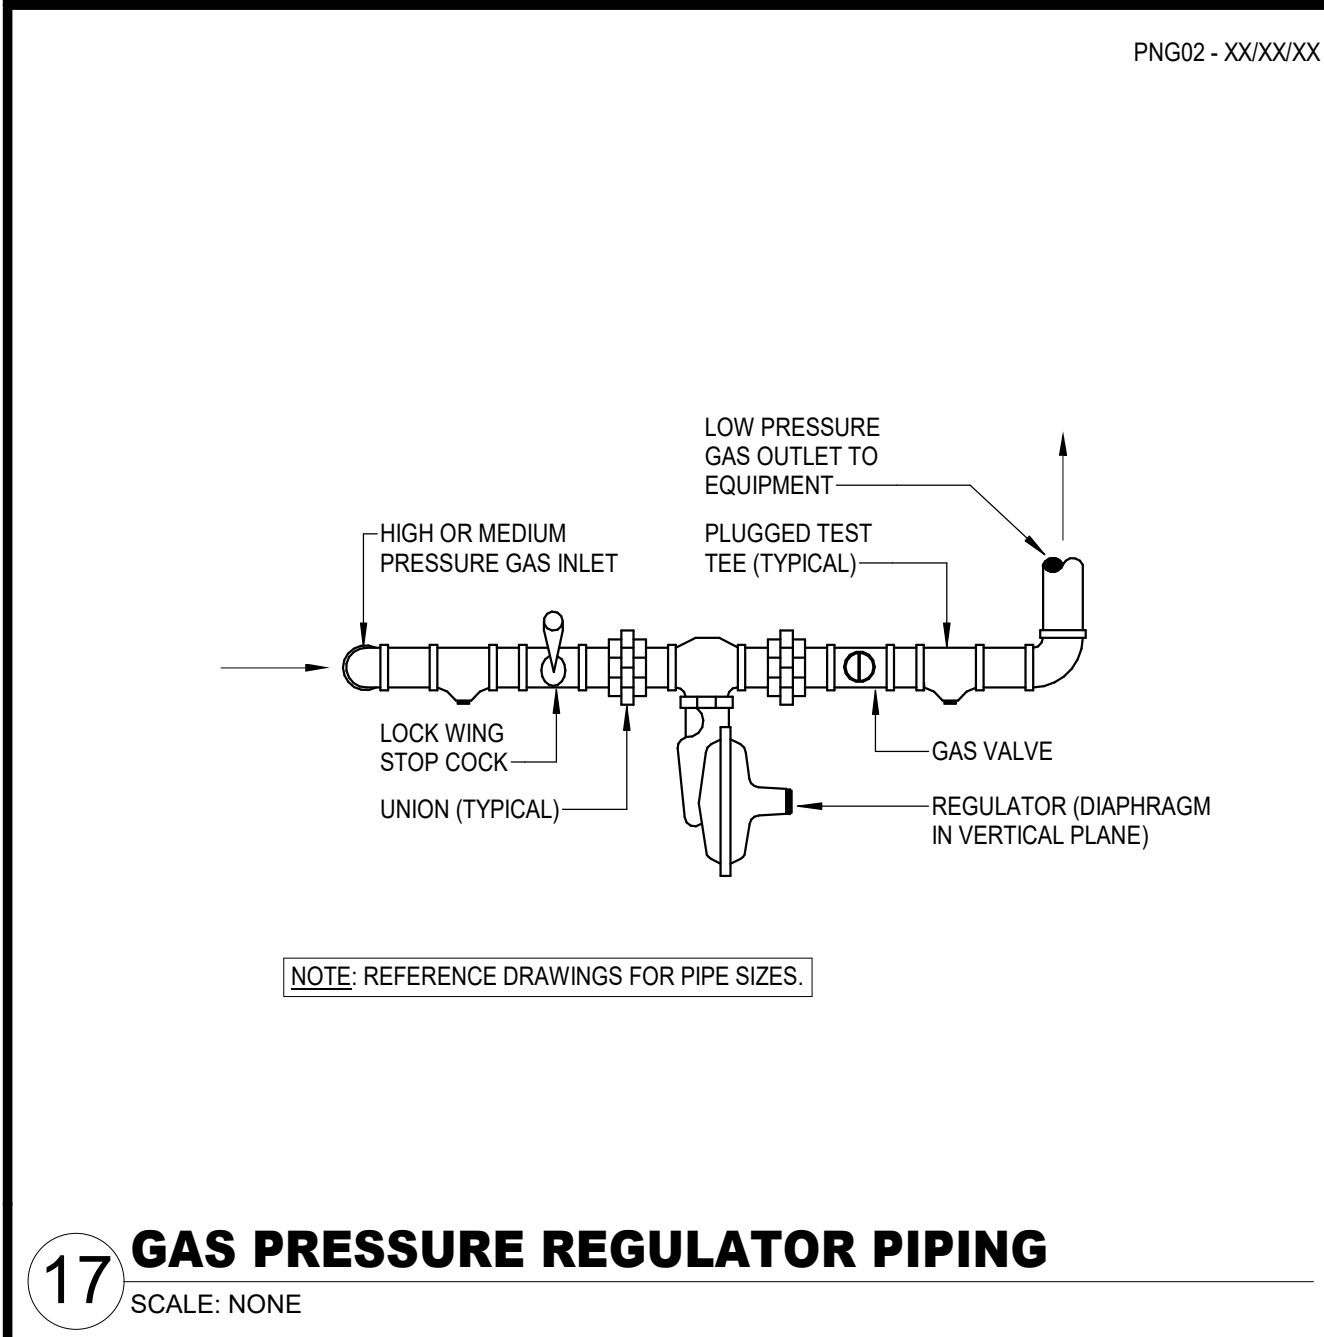
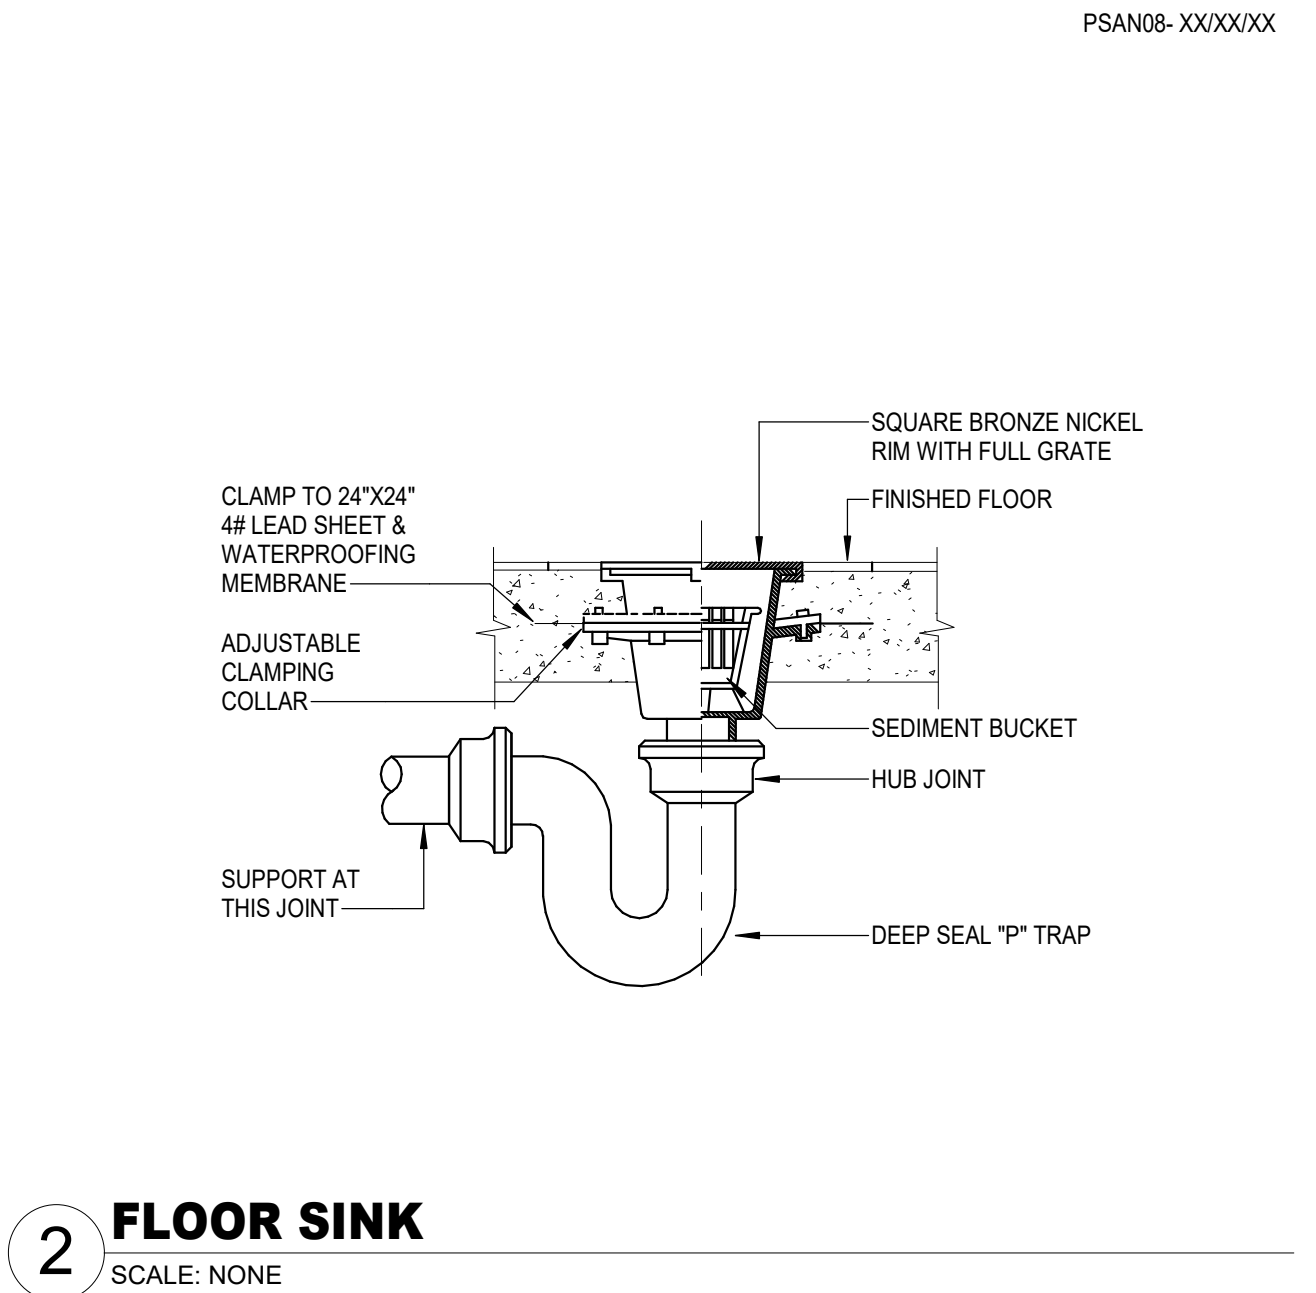
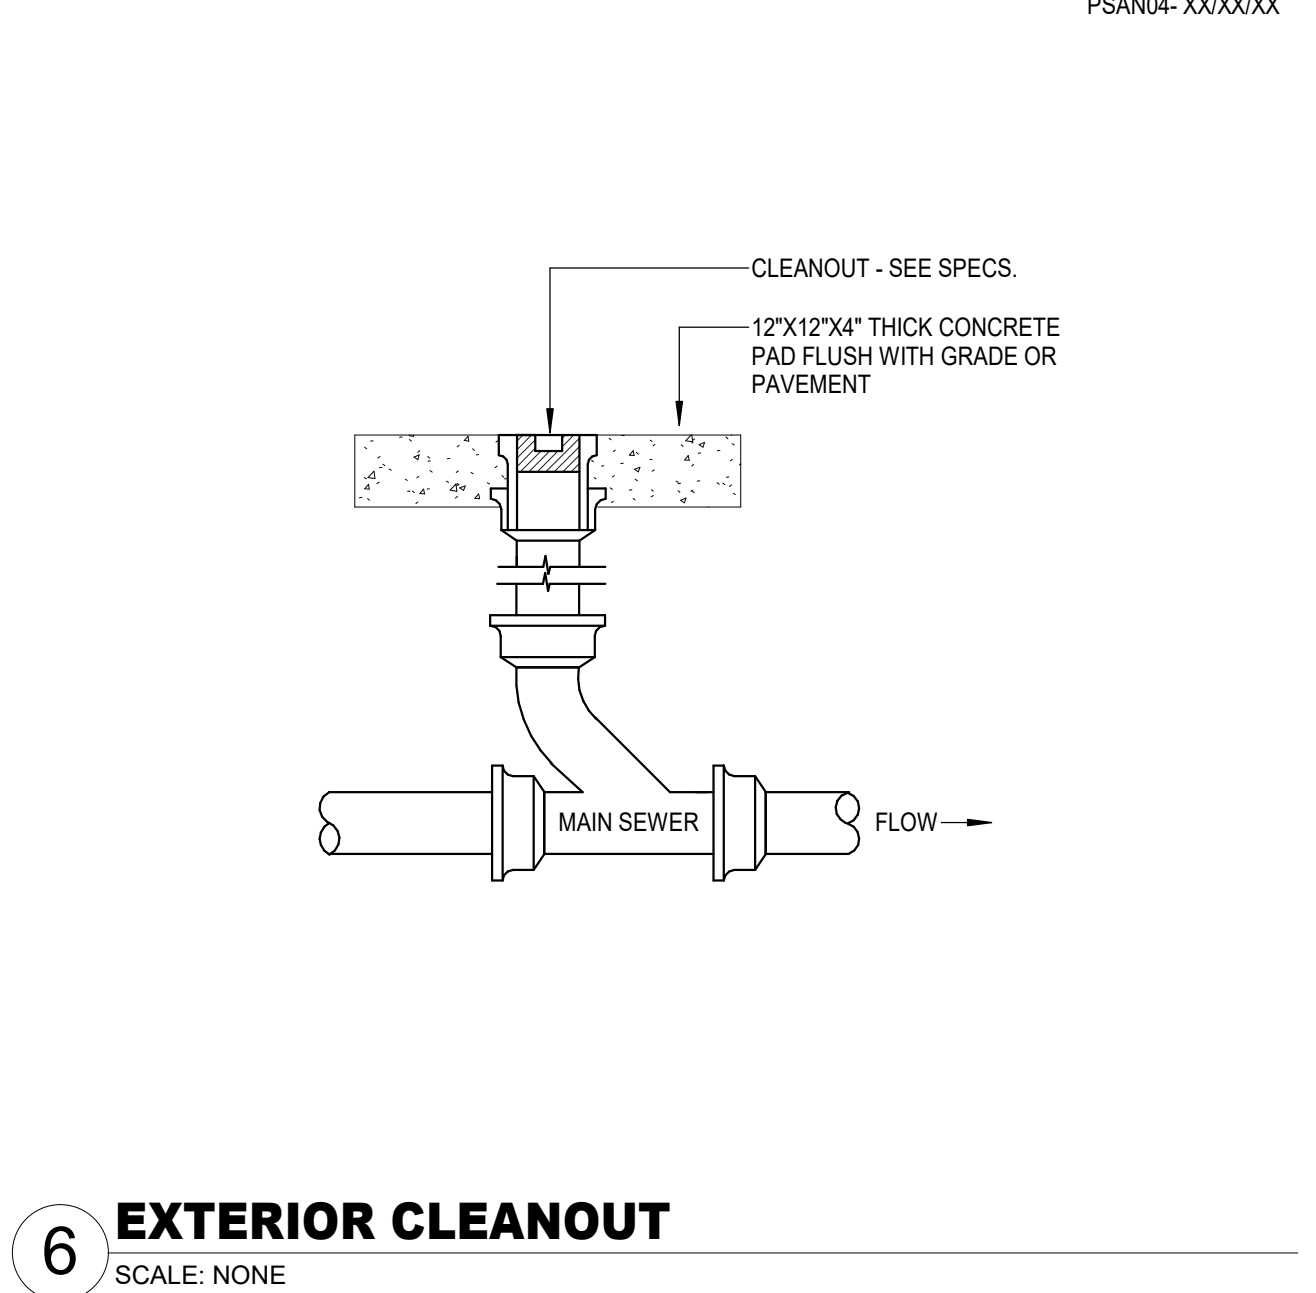
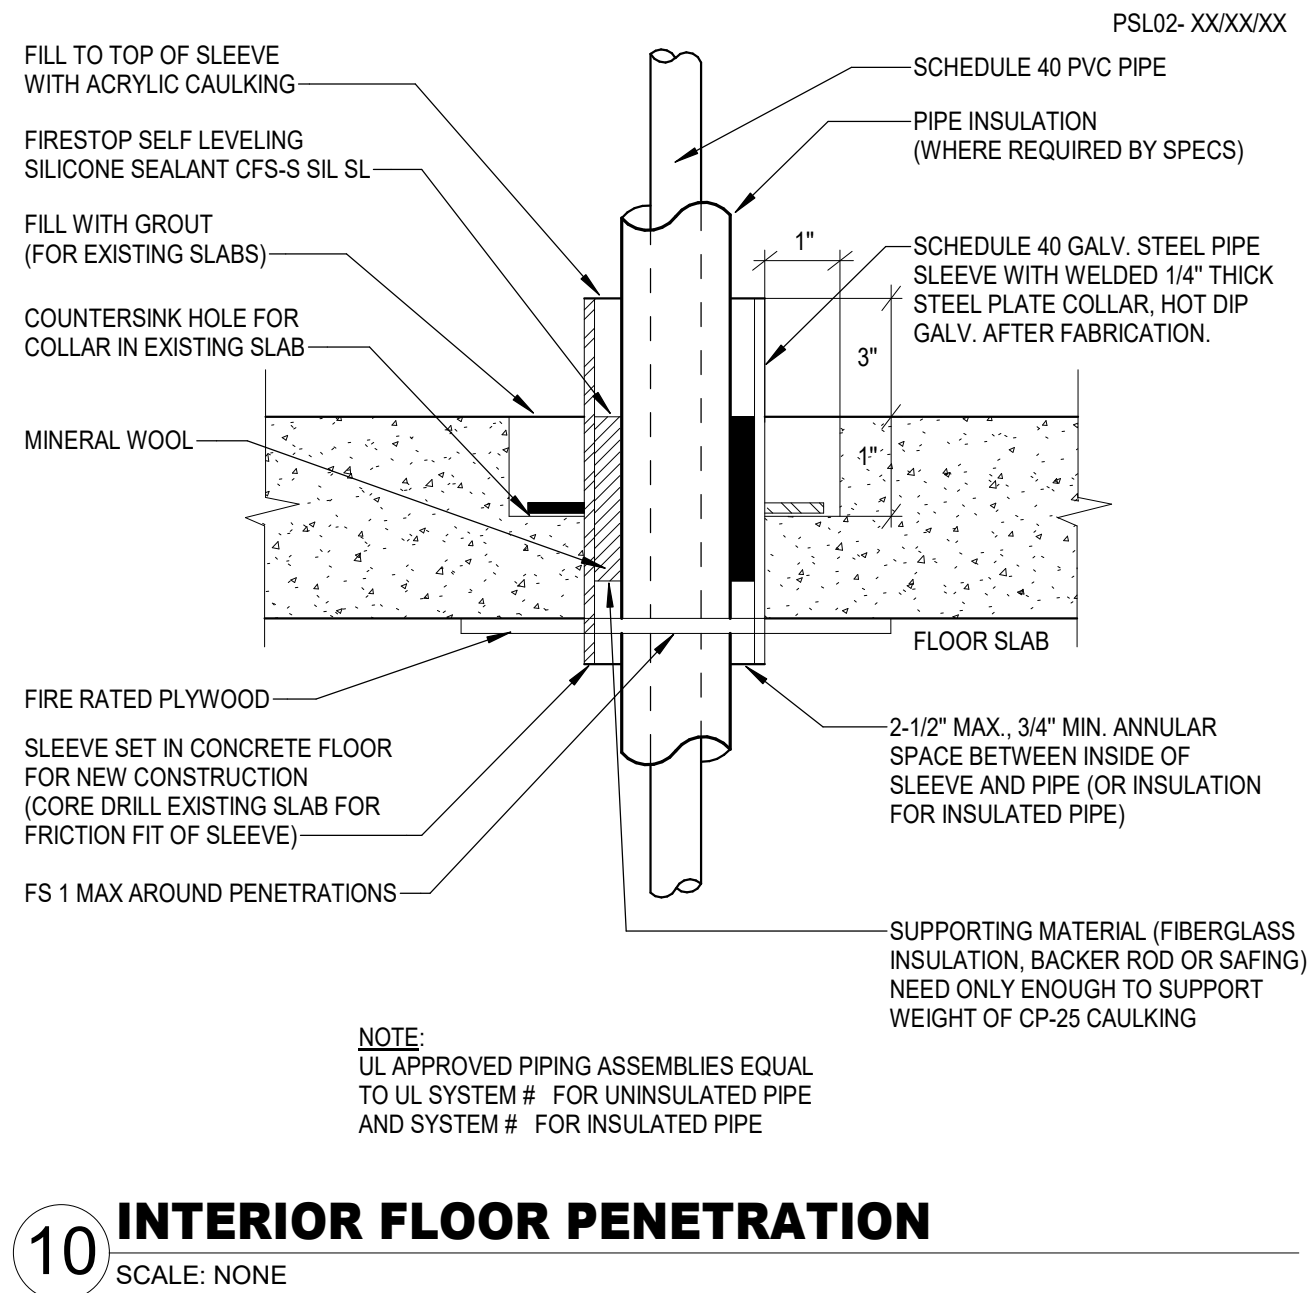
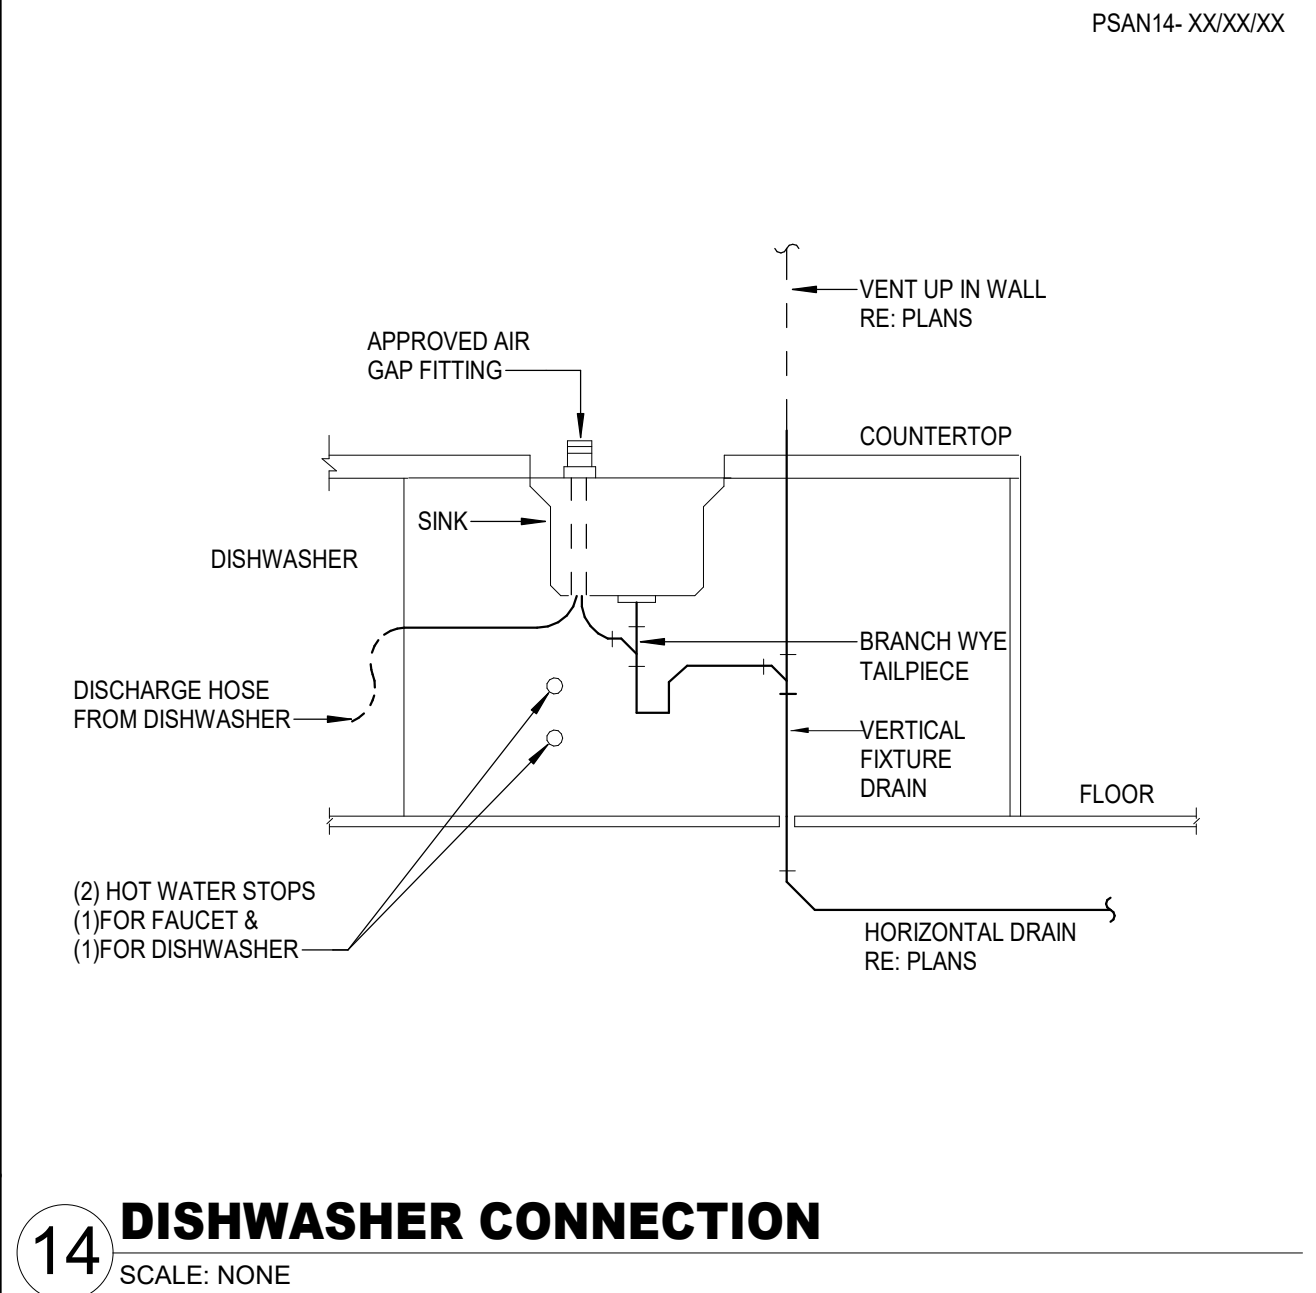
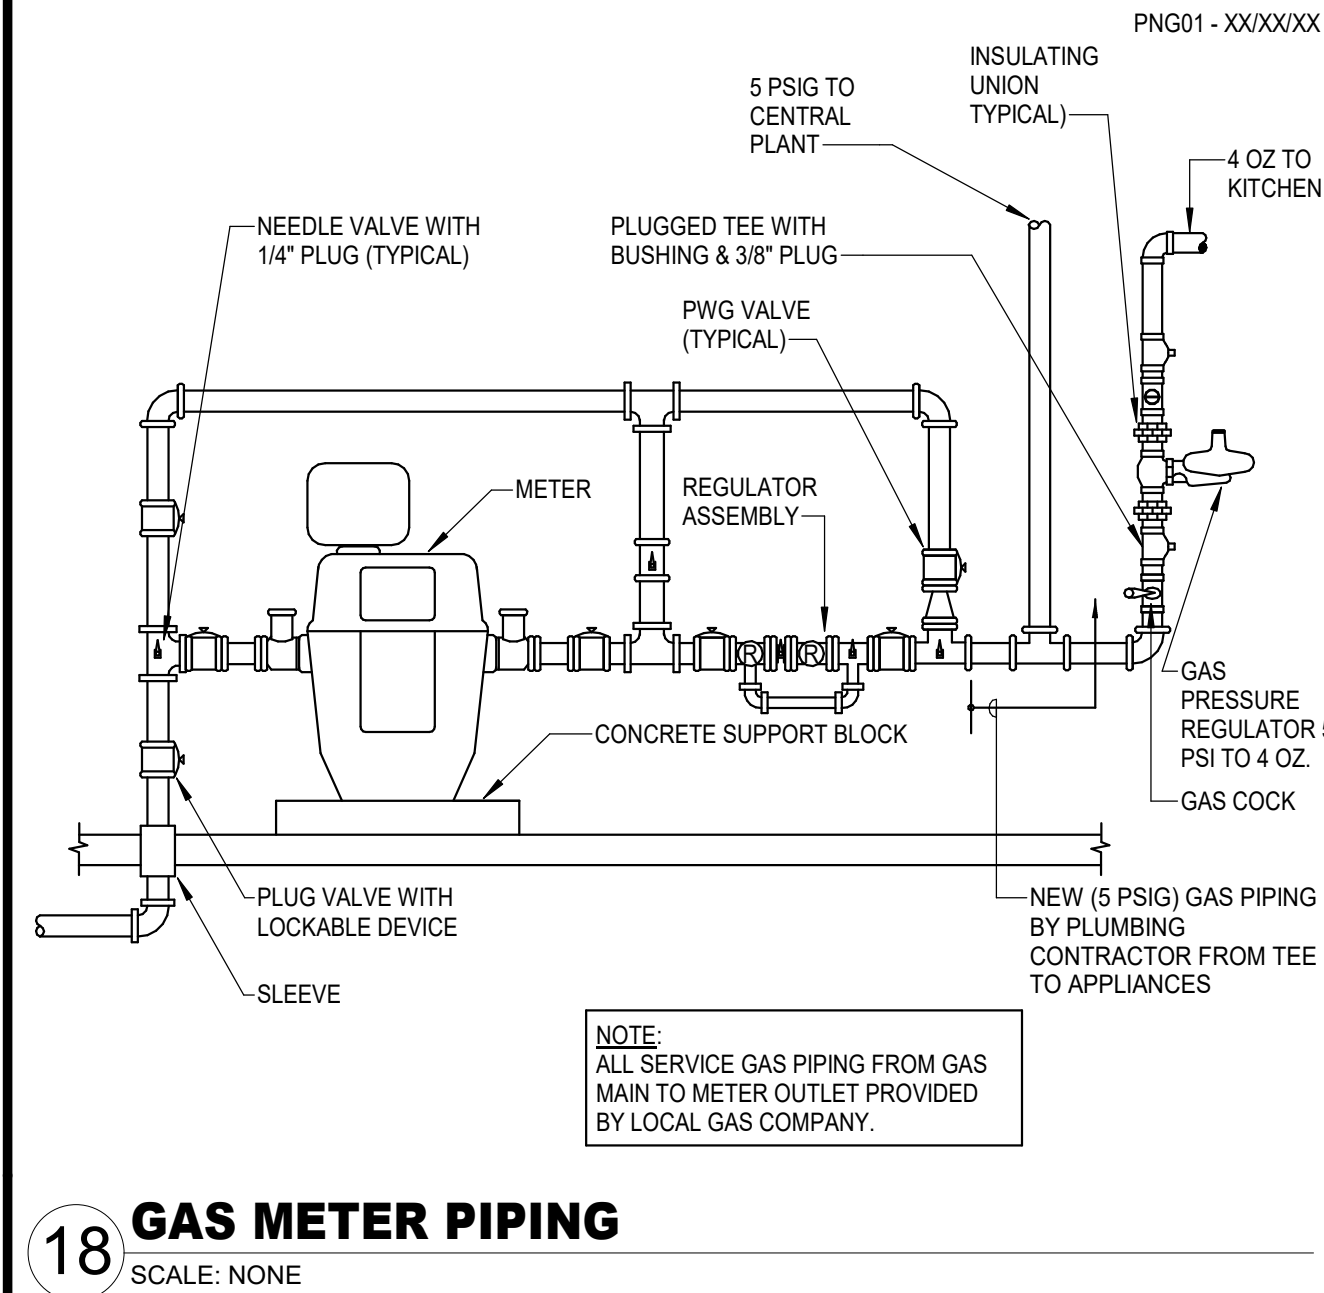
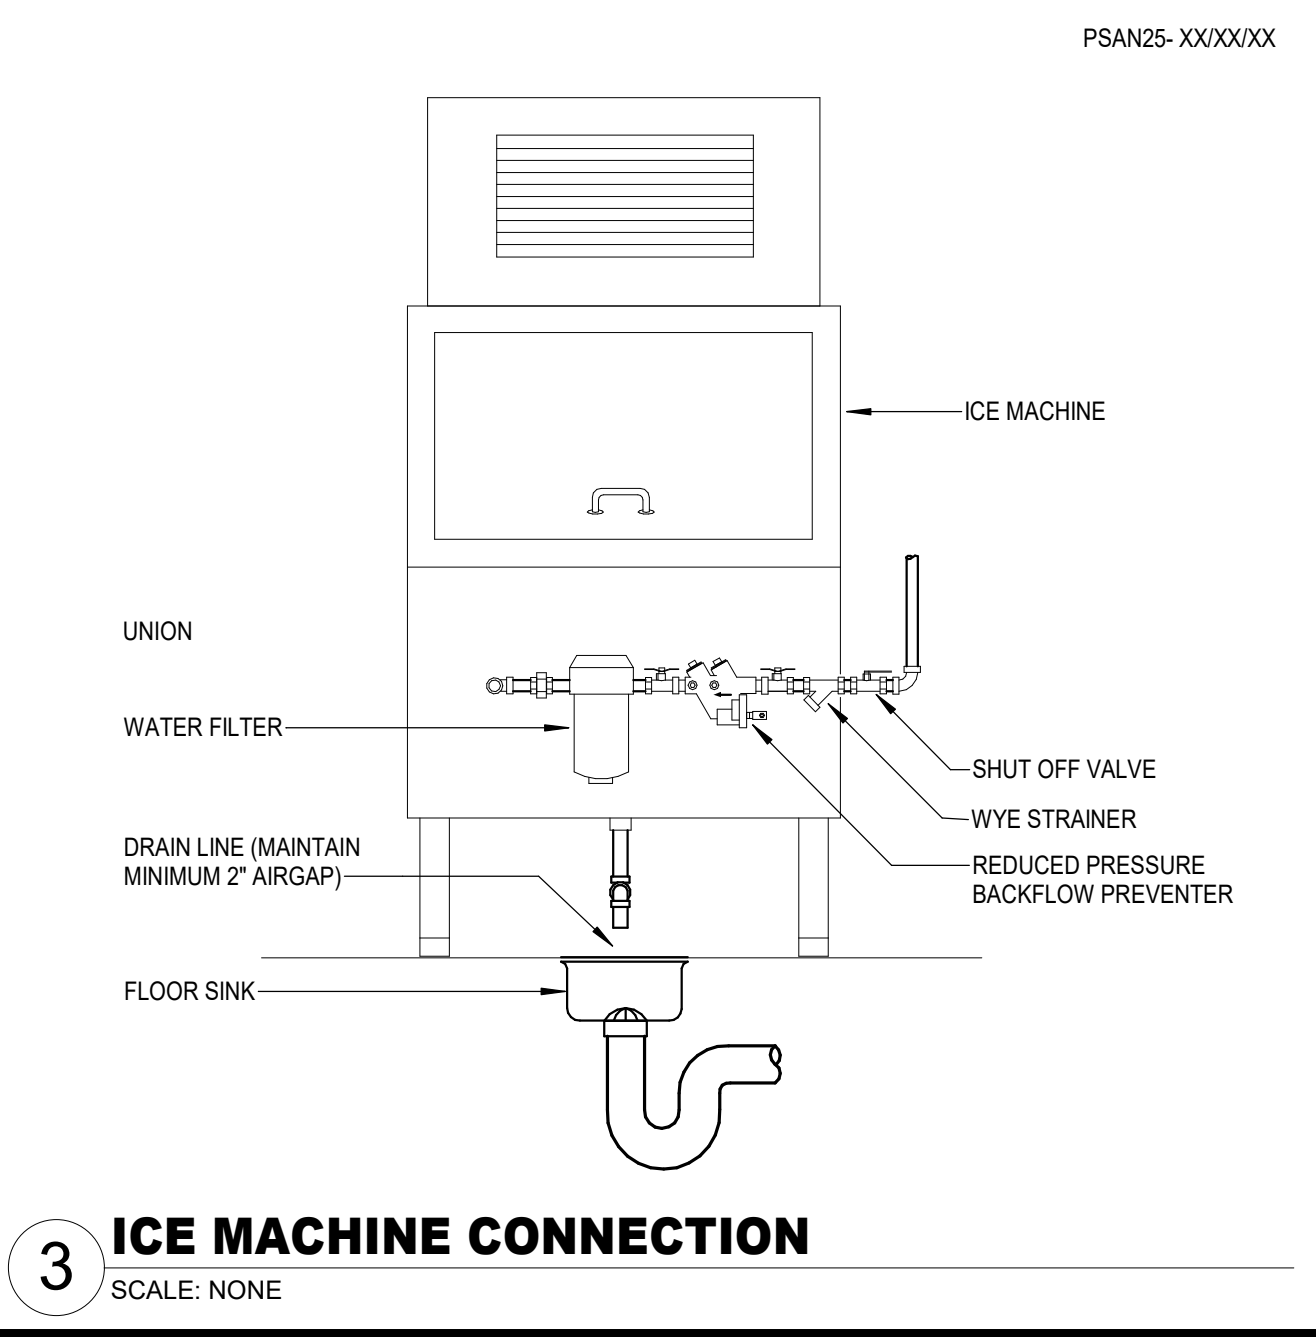
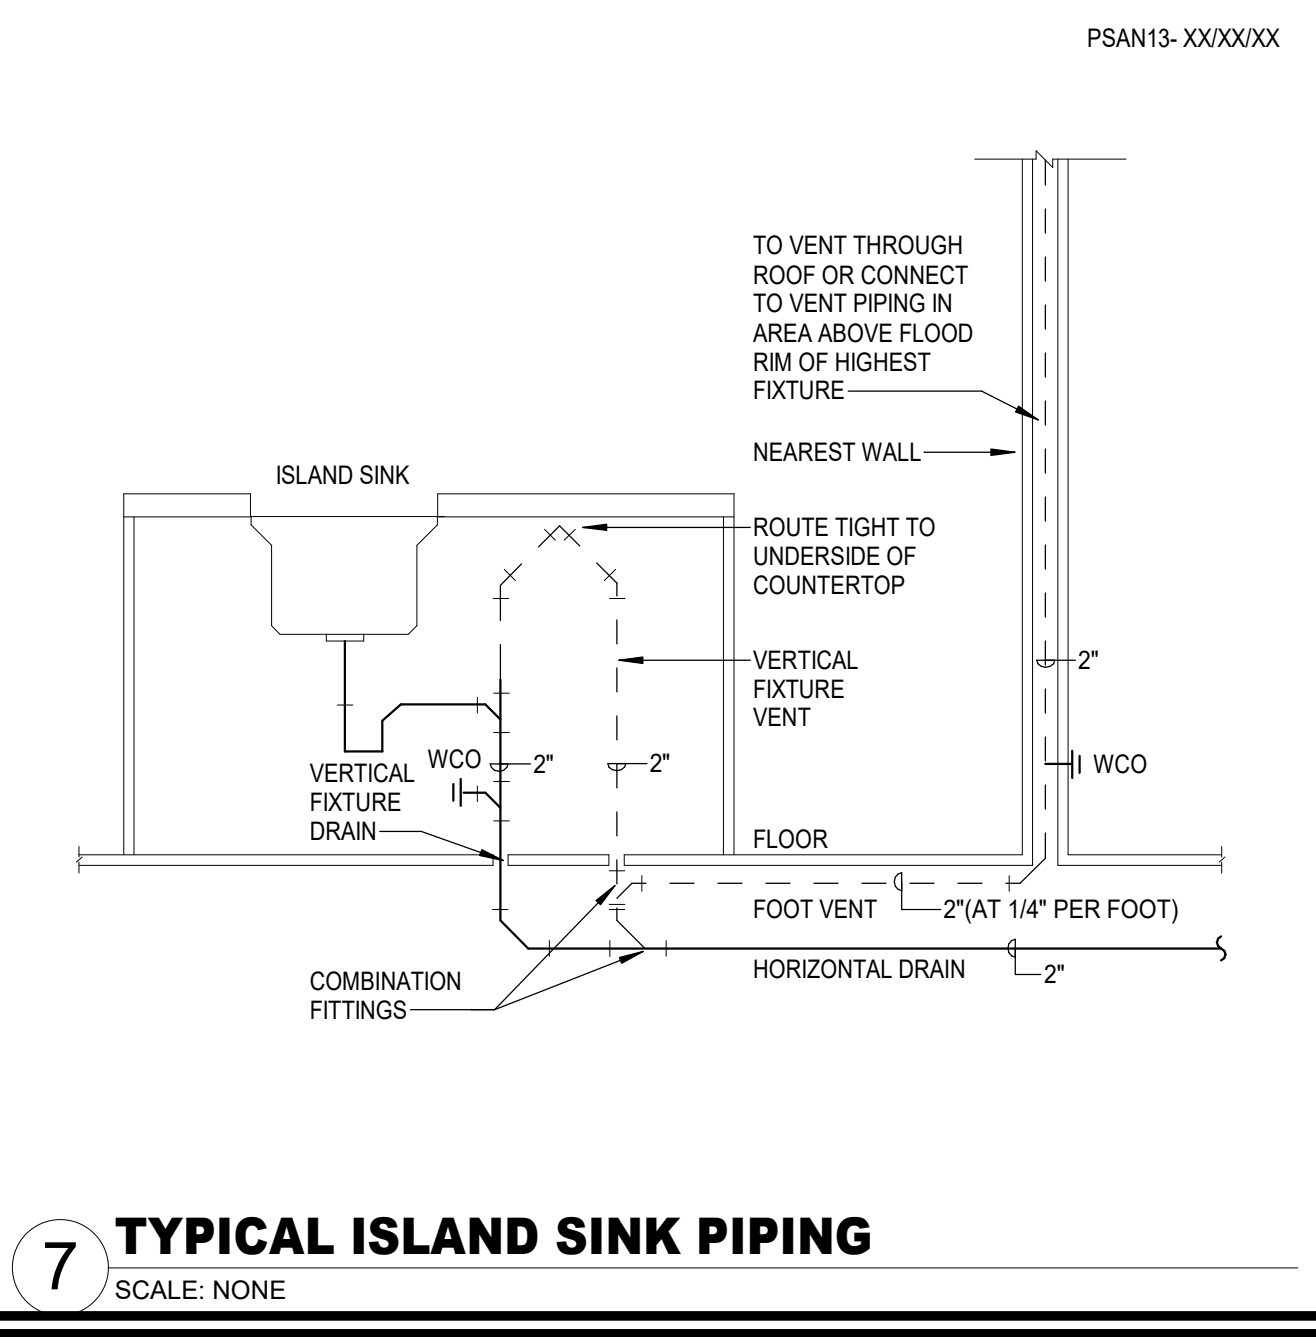
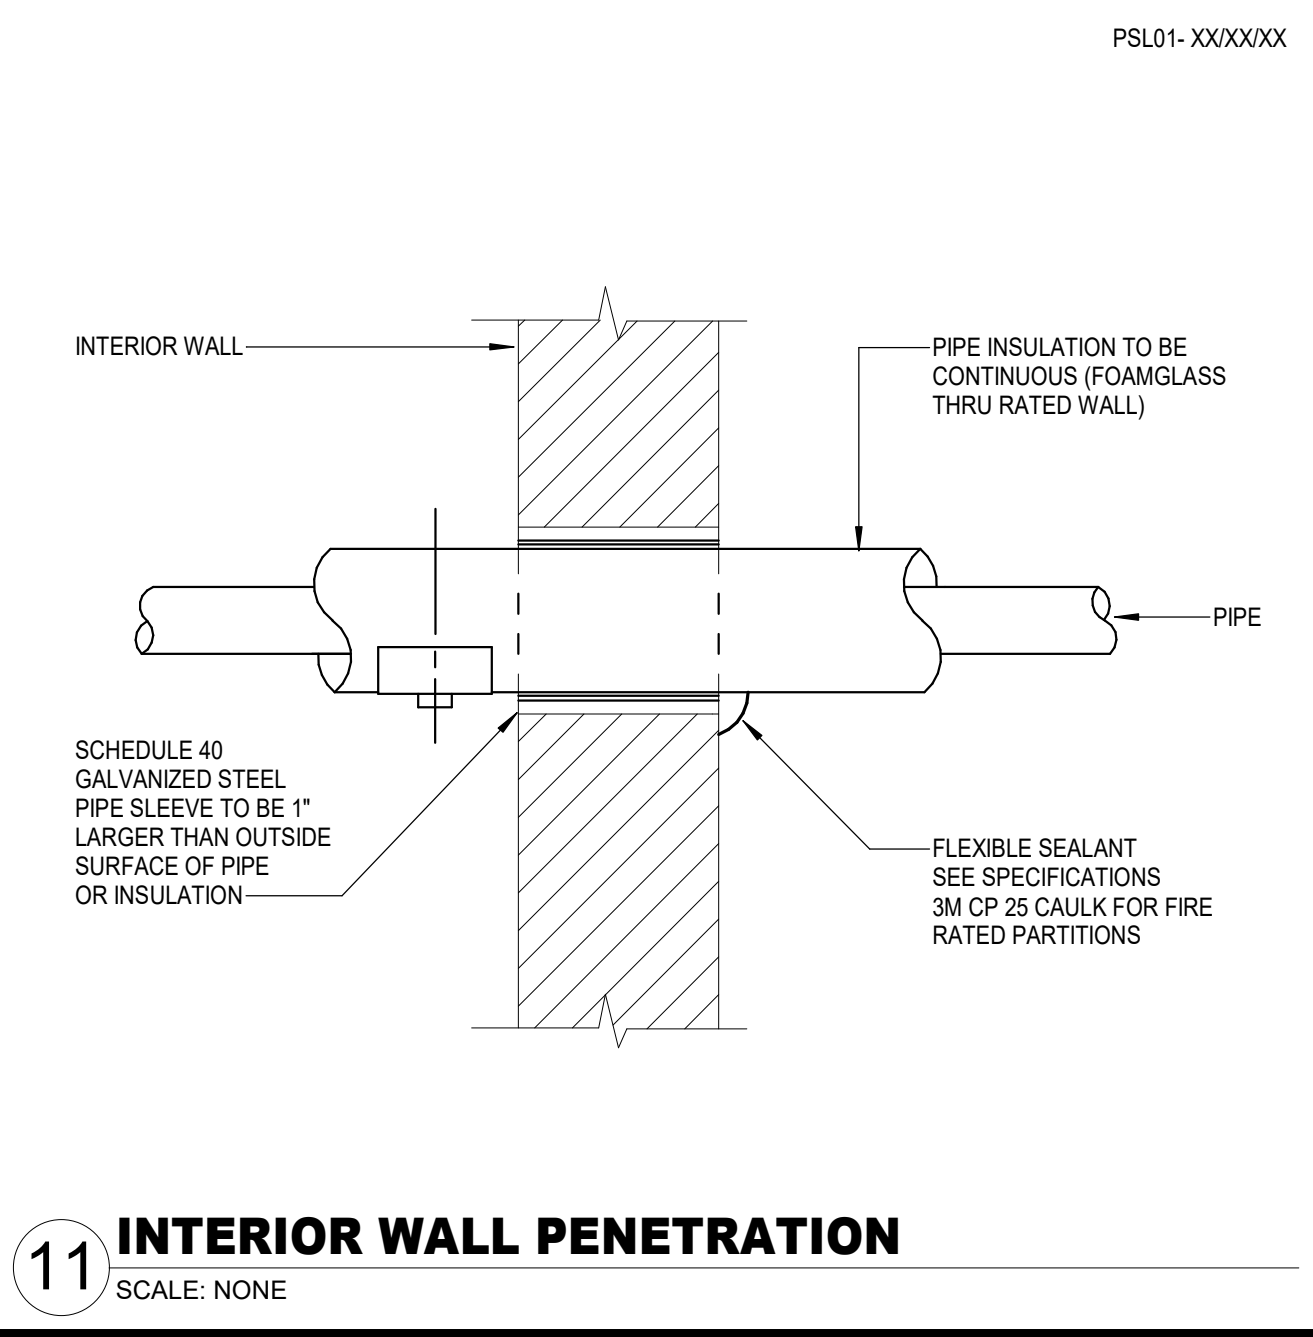
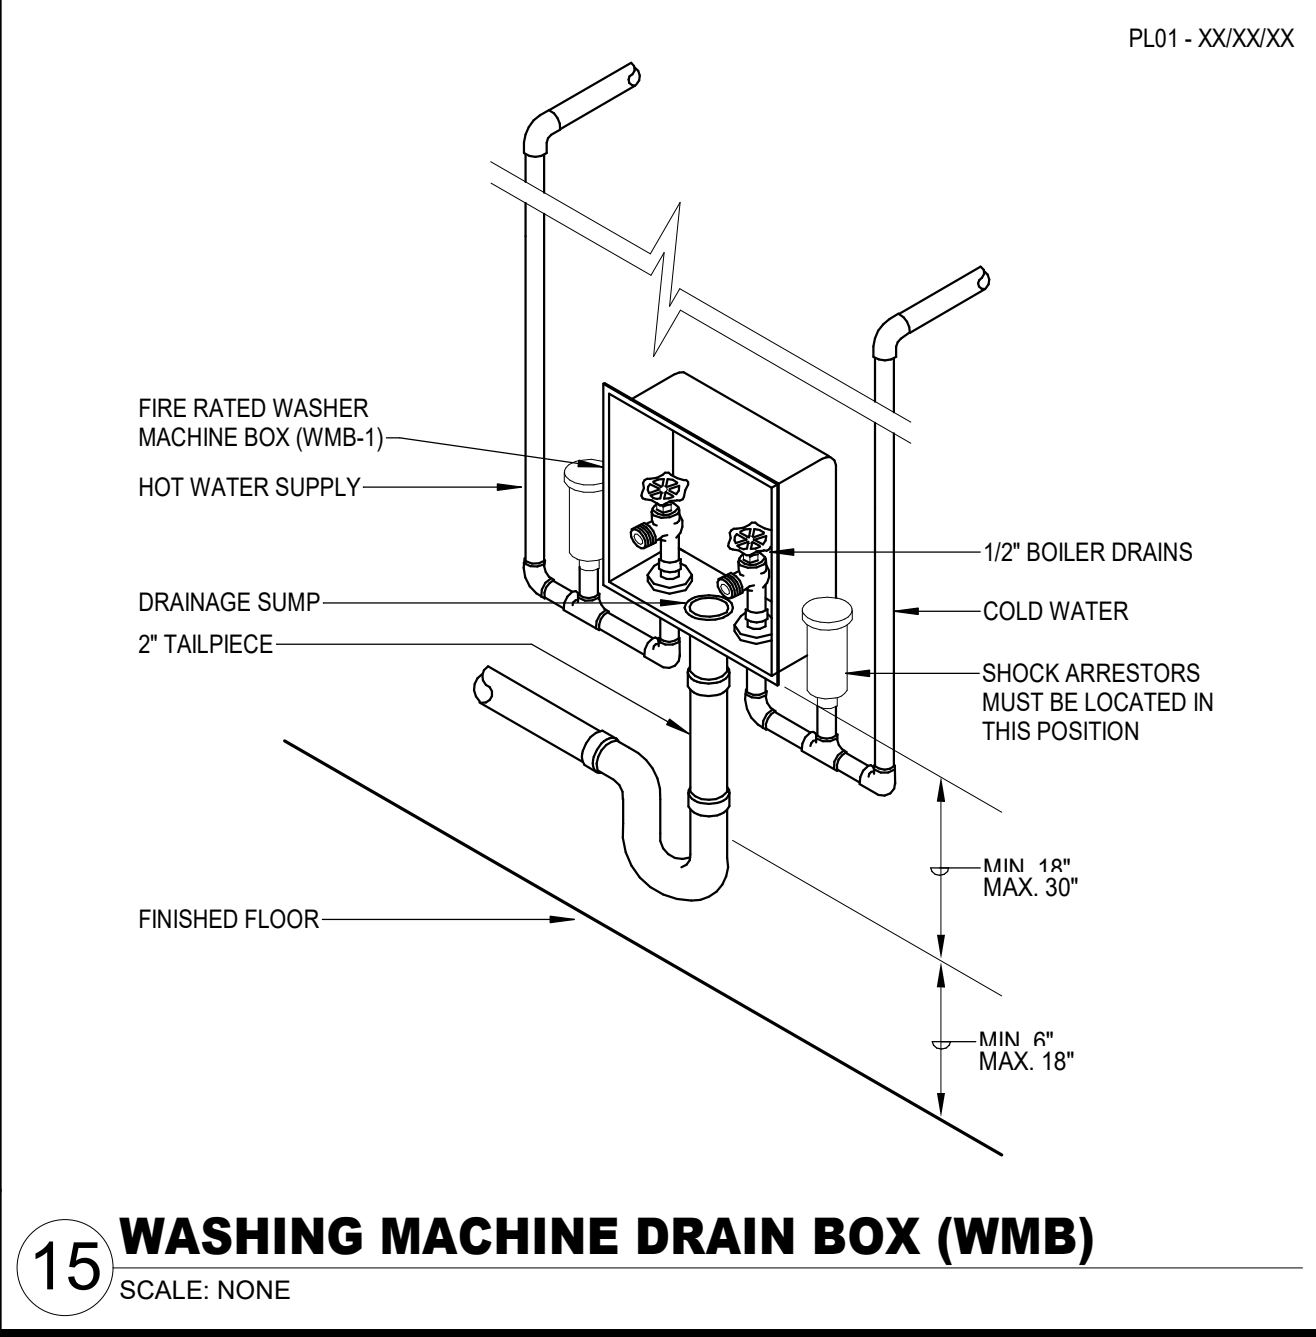
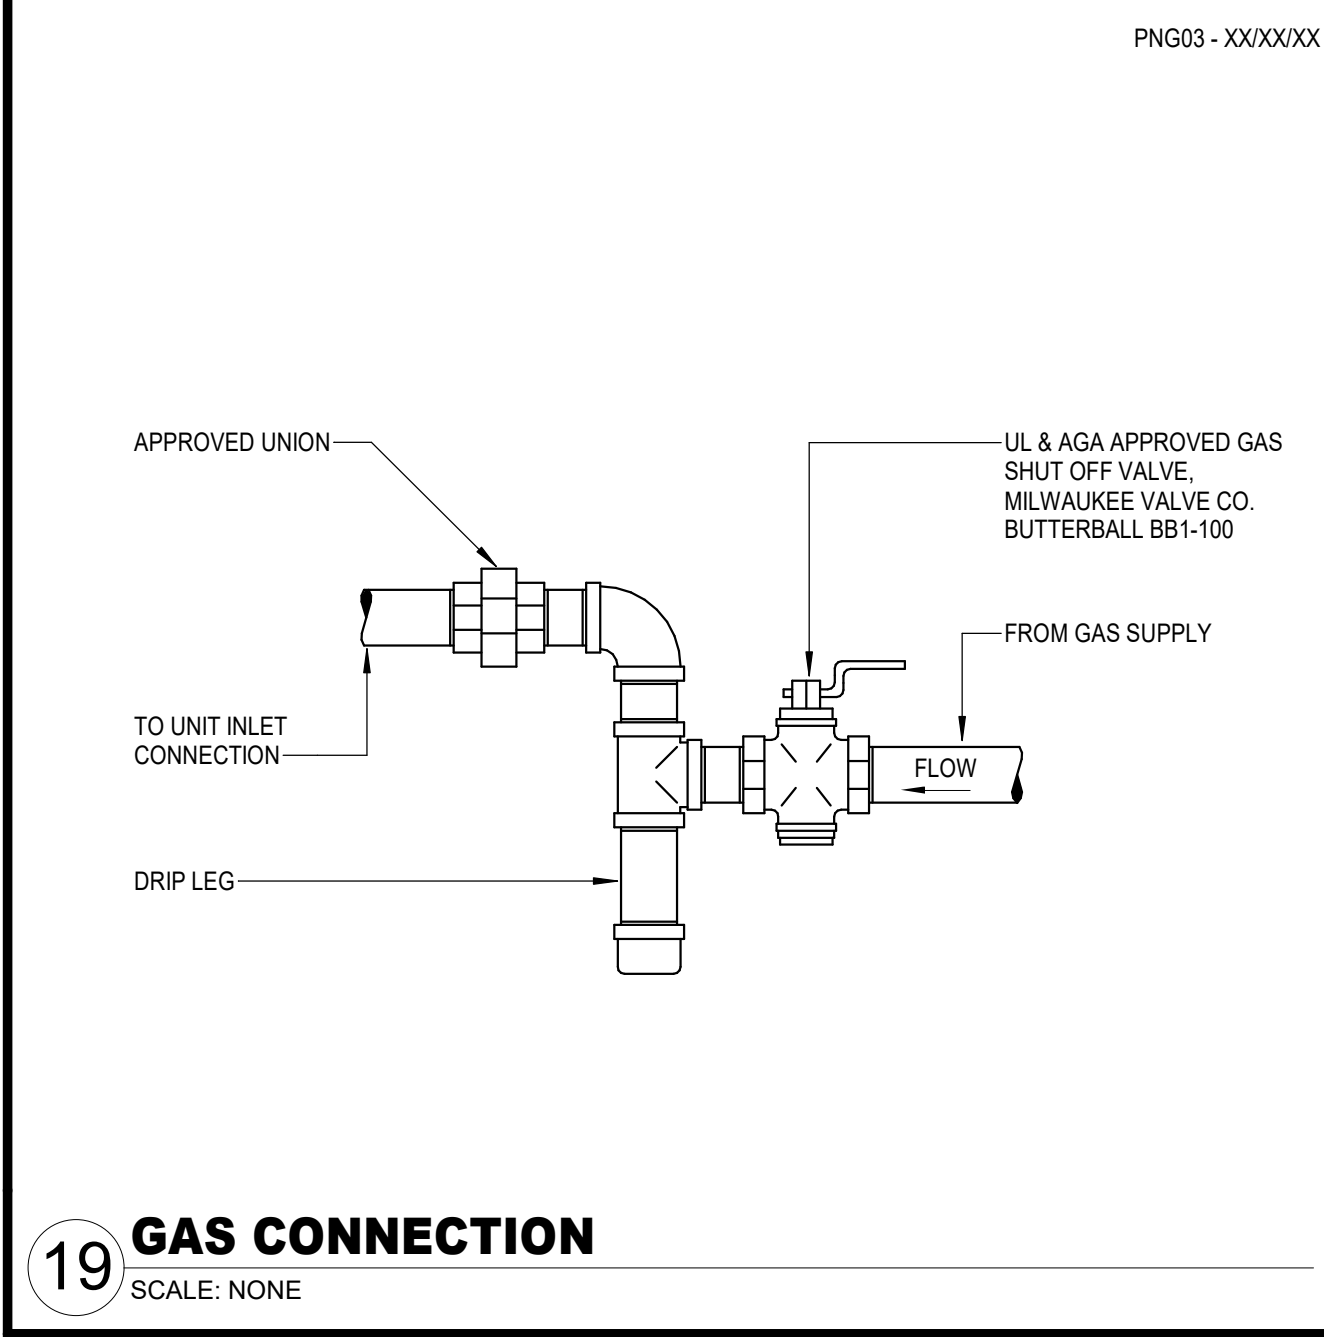
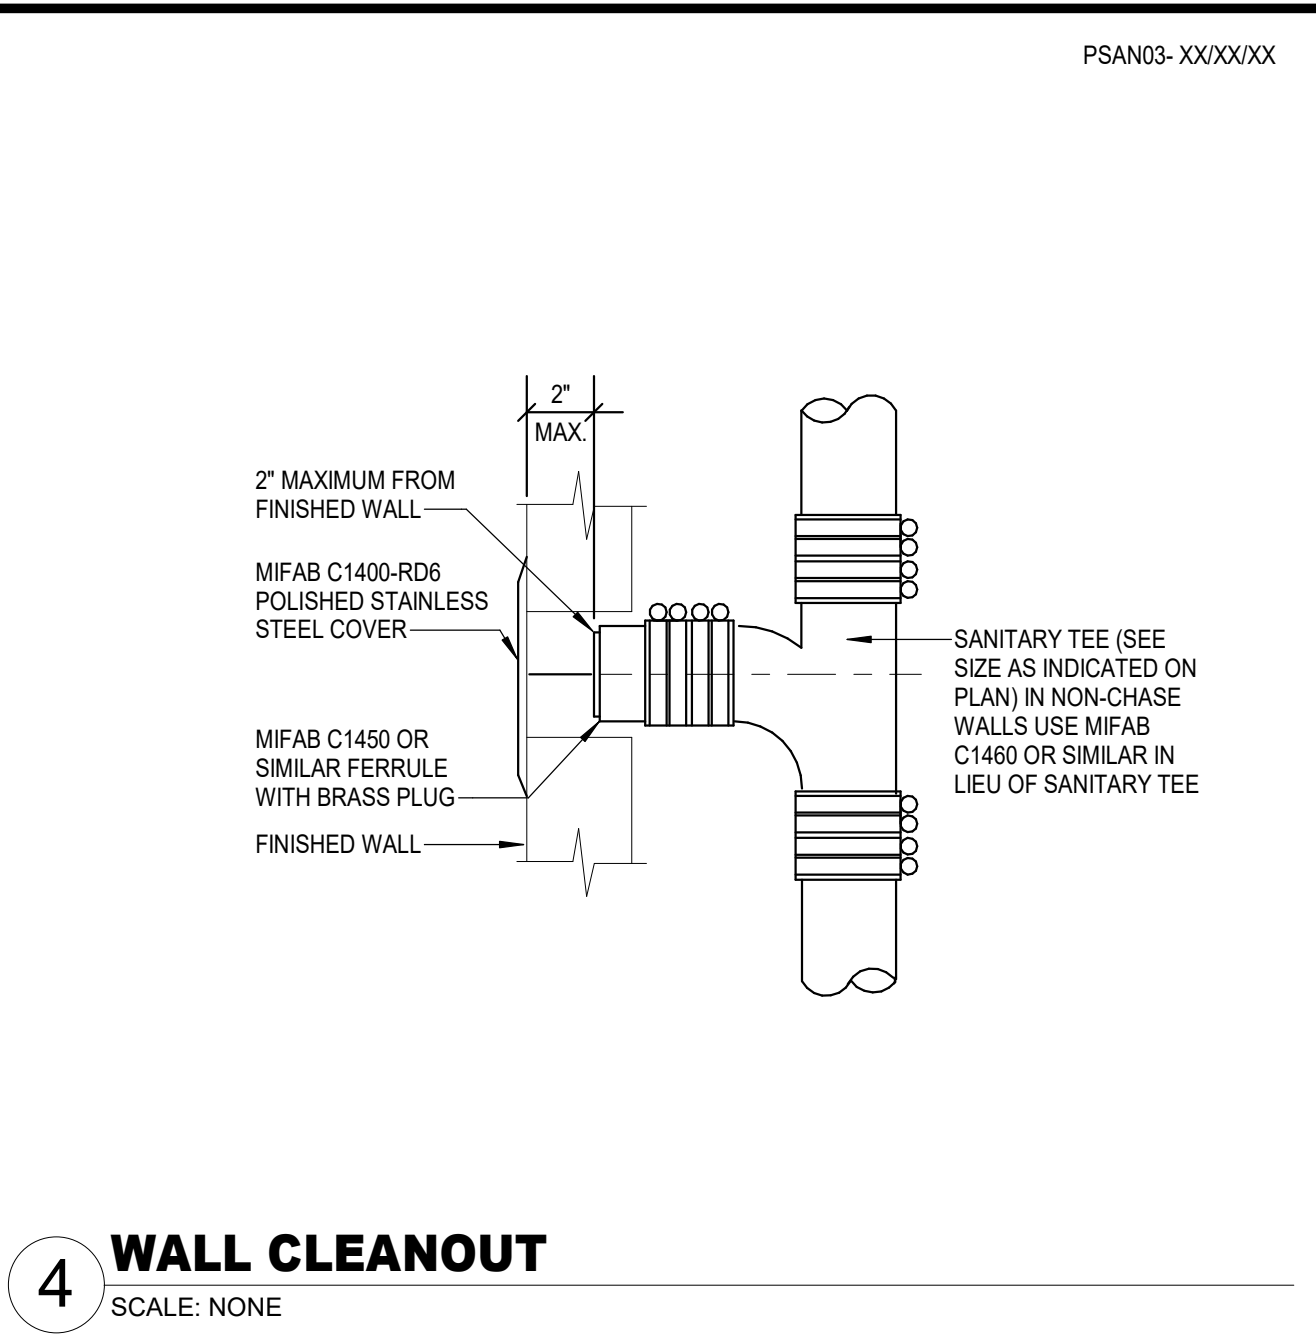
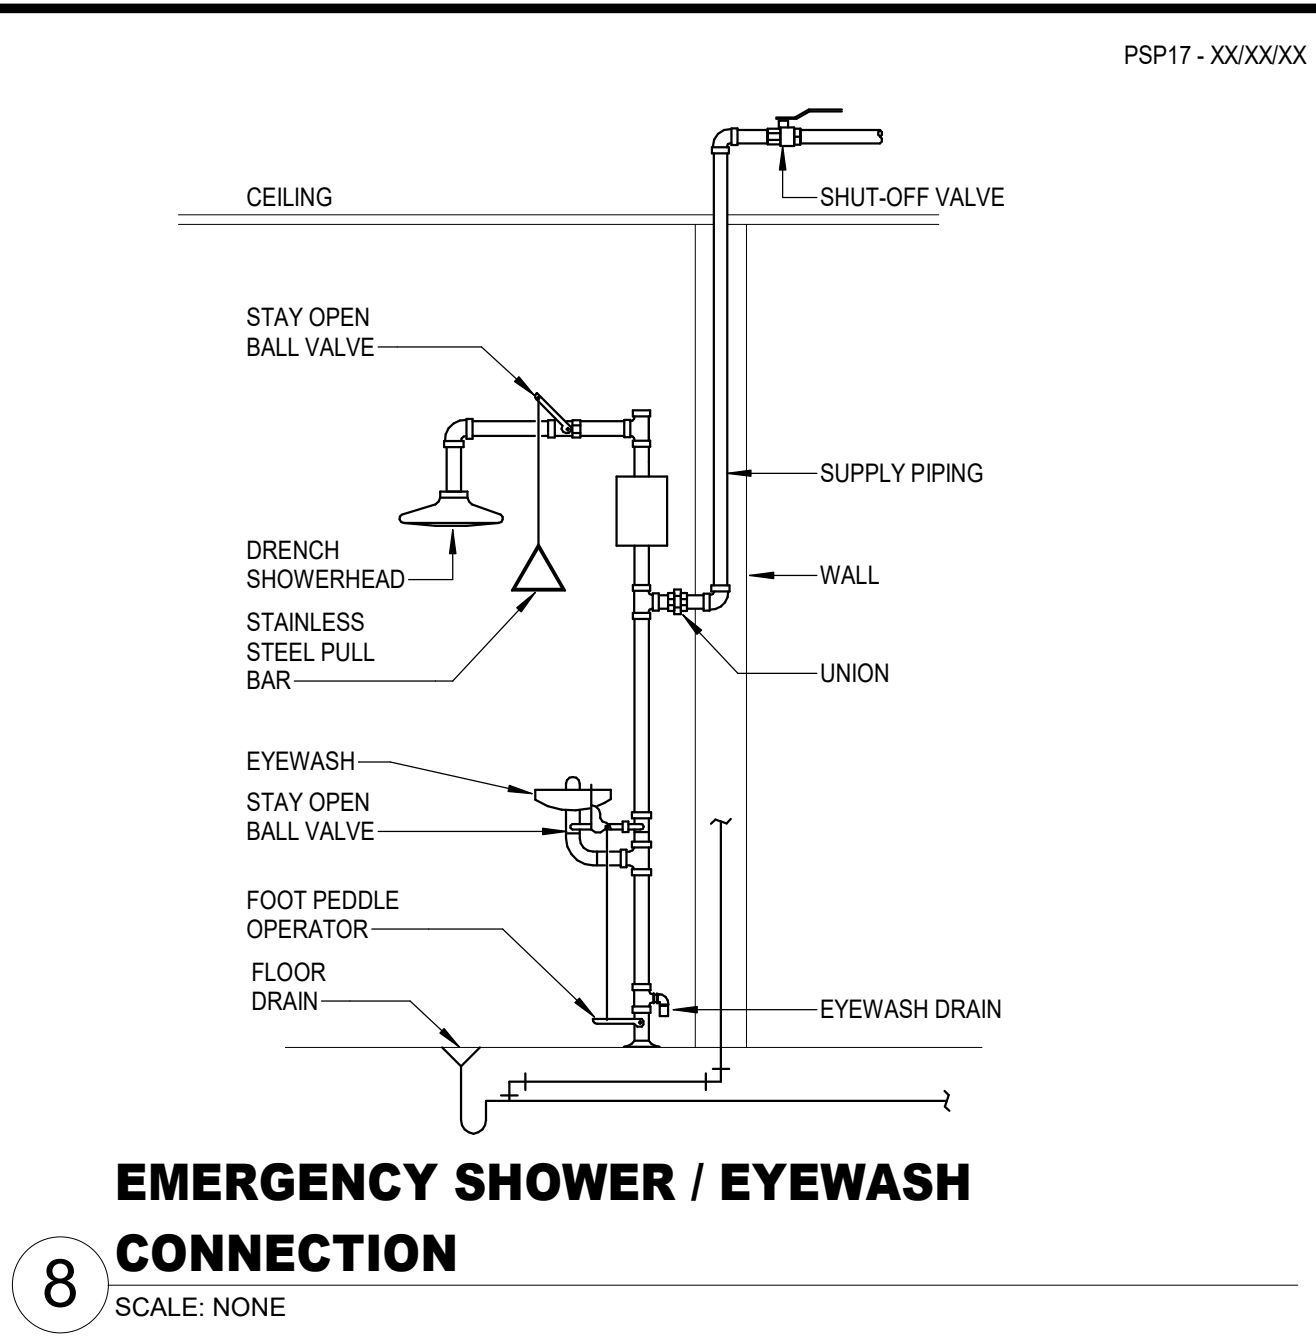
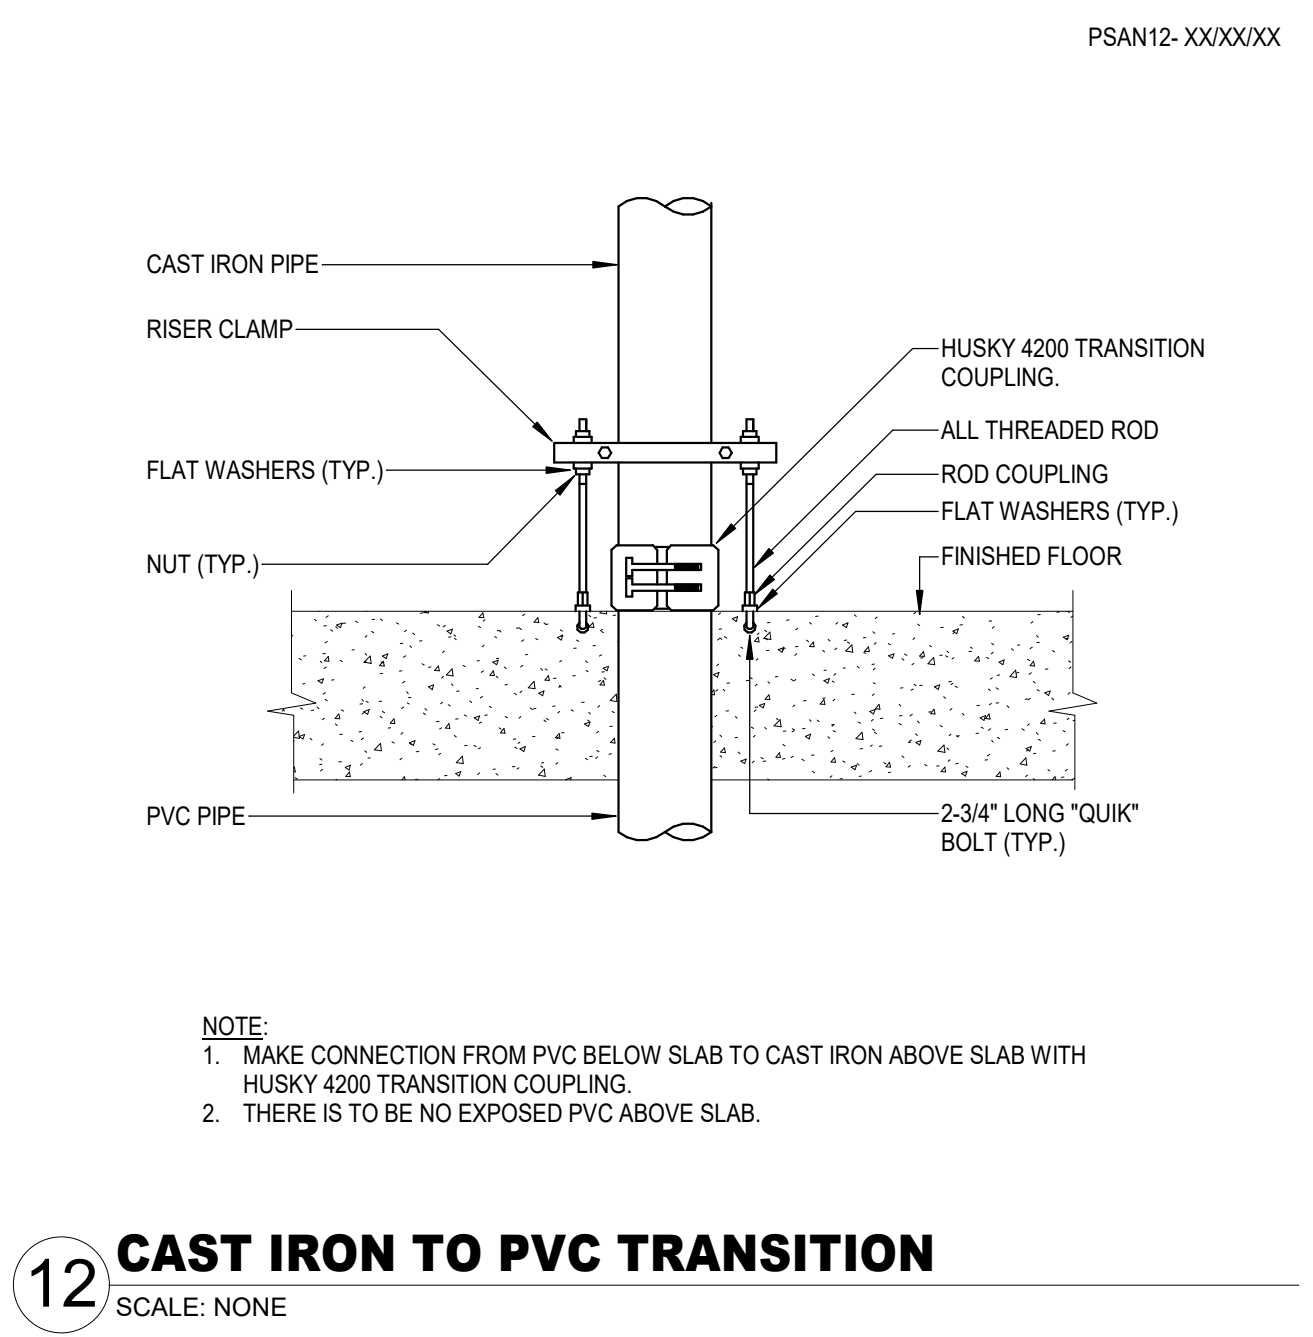
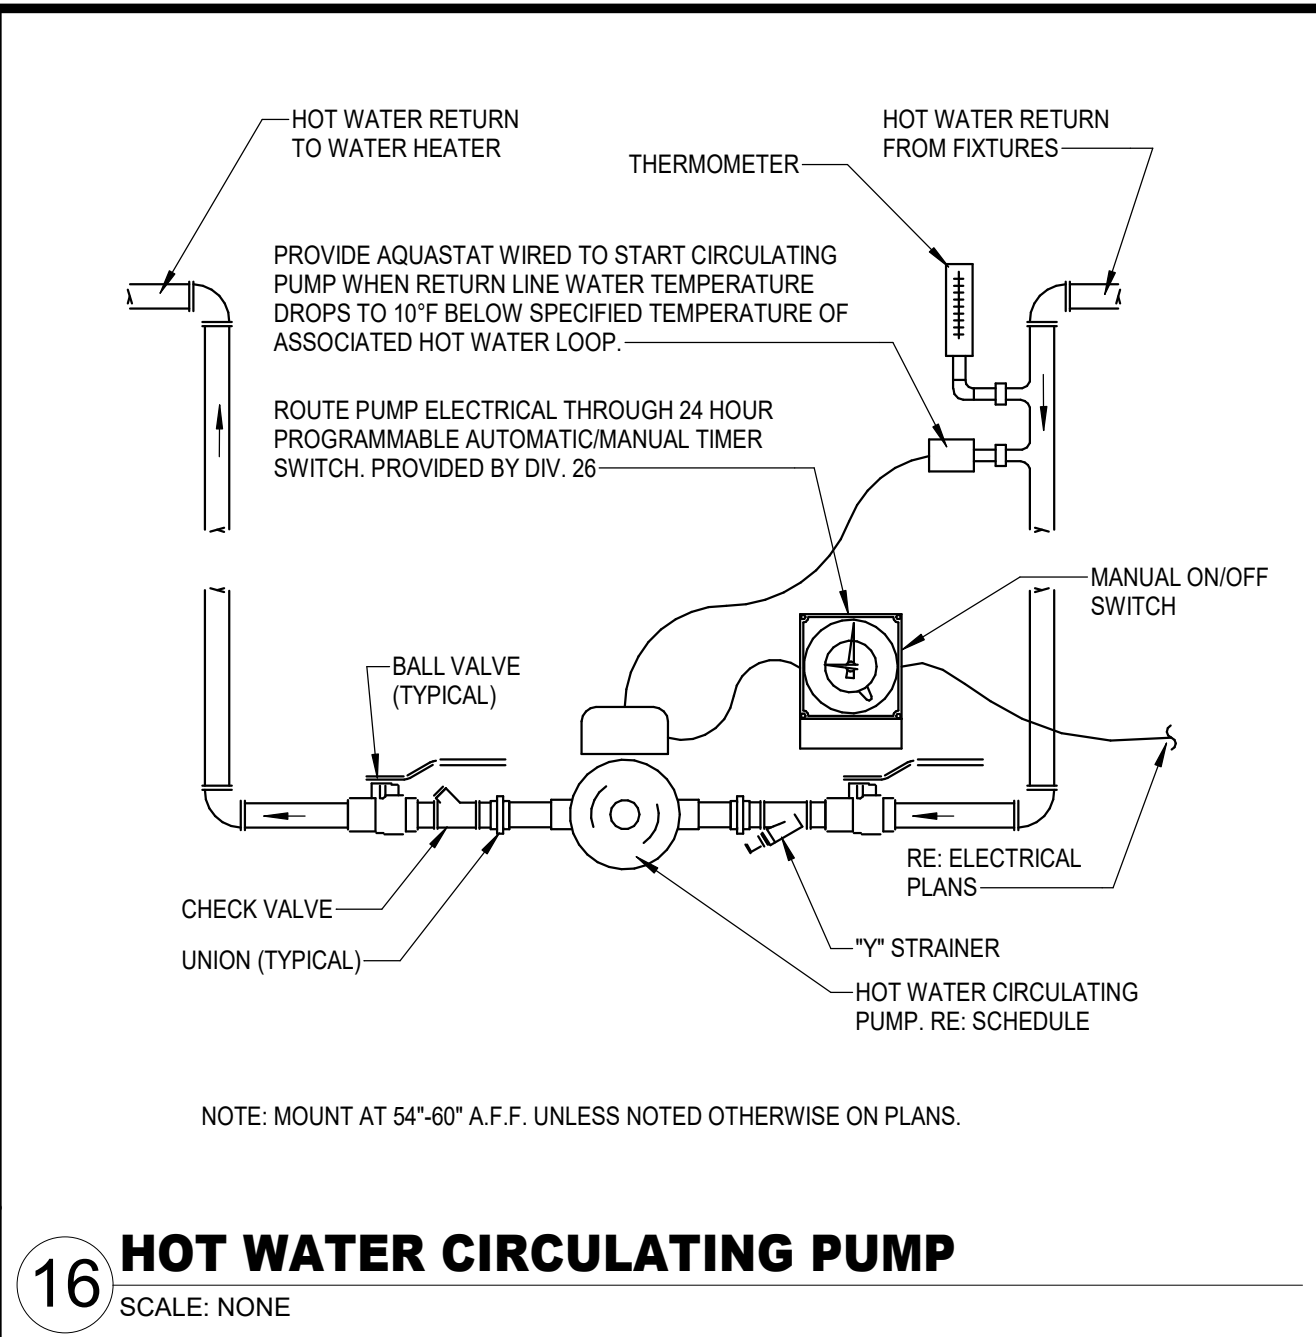
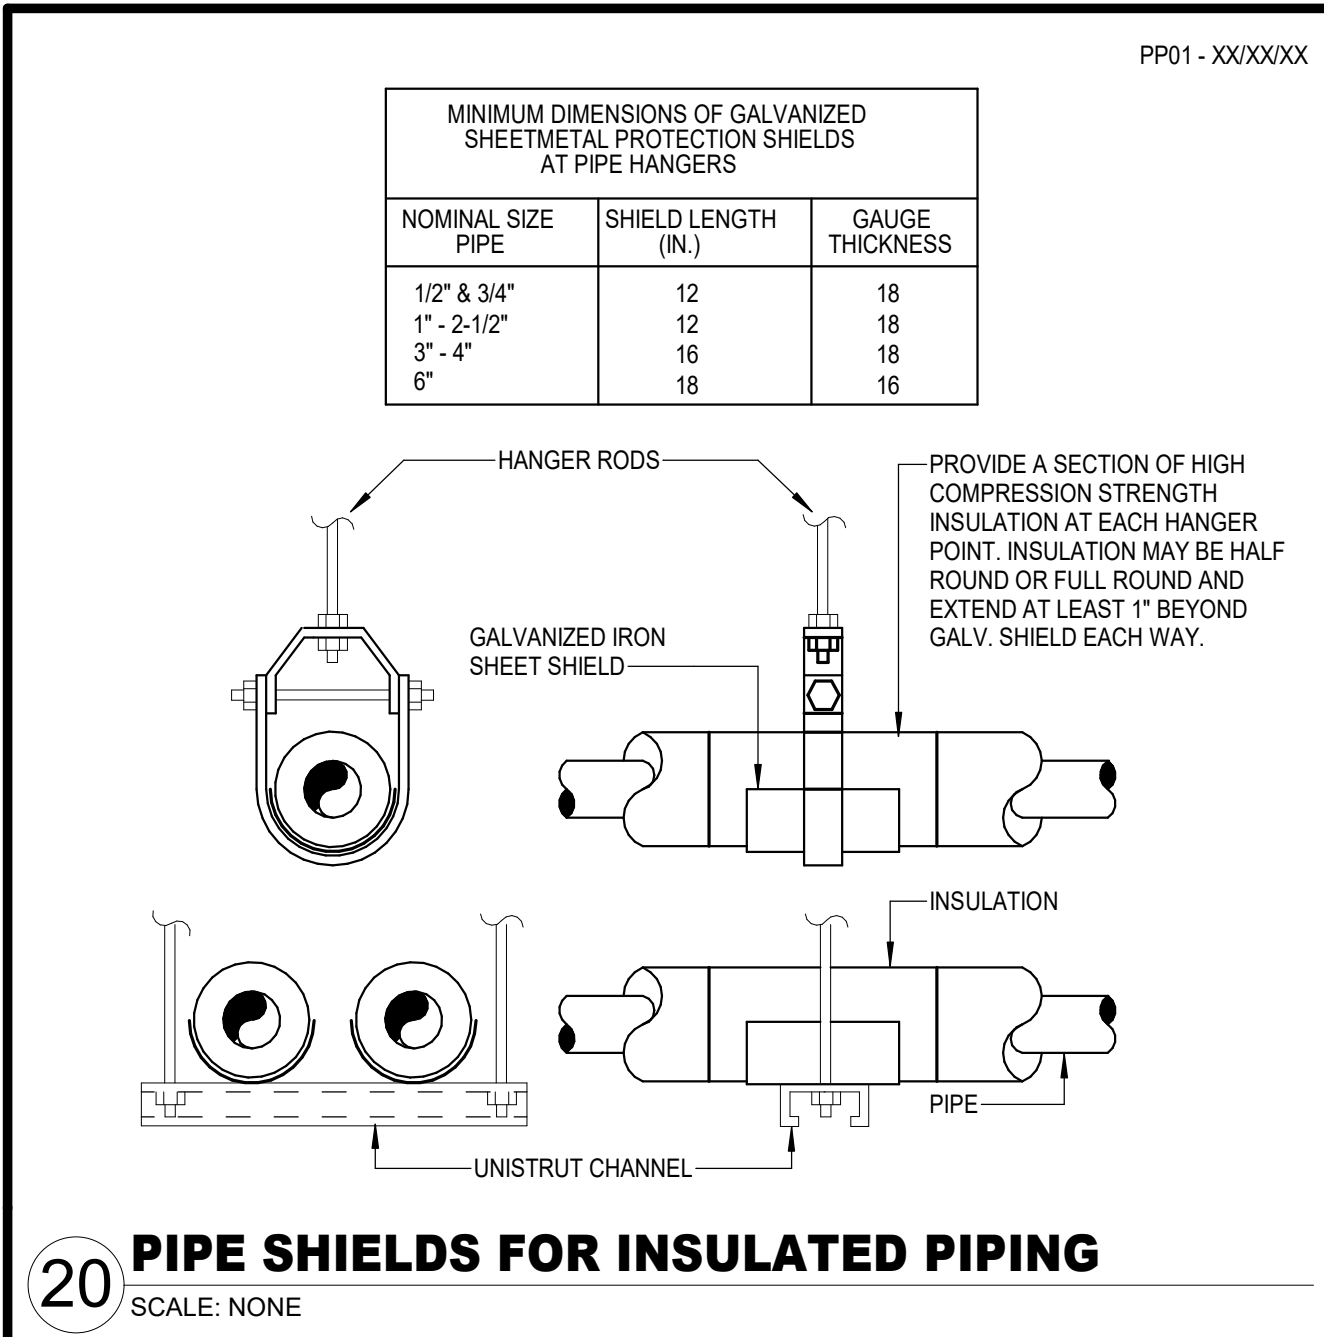
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DATE:	2023-11-03
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P3.02

PLUMBING AREA  
'B1' 1ST FLOOR  
PLAN





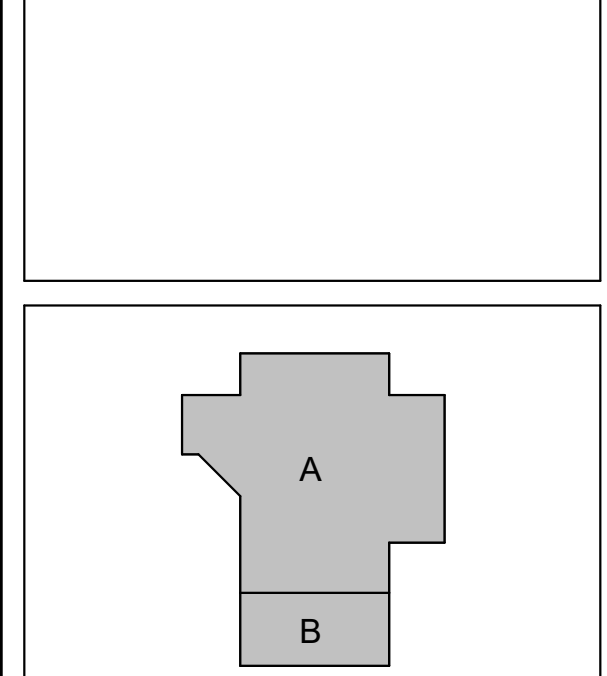


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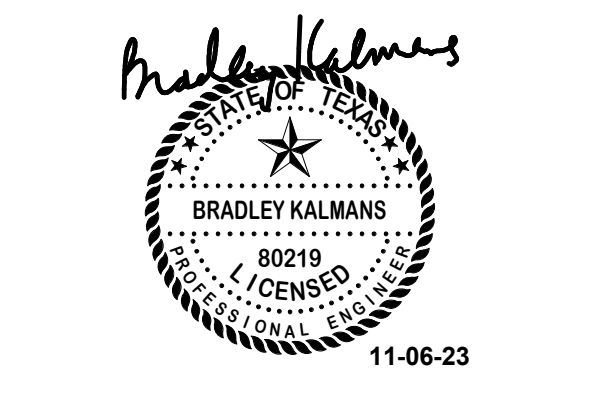


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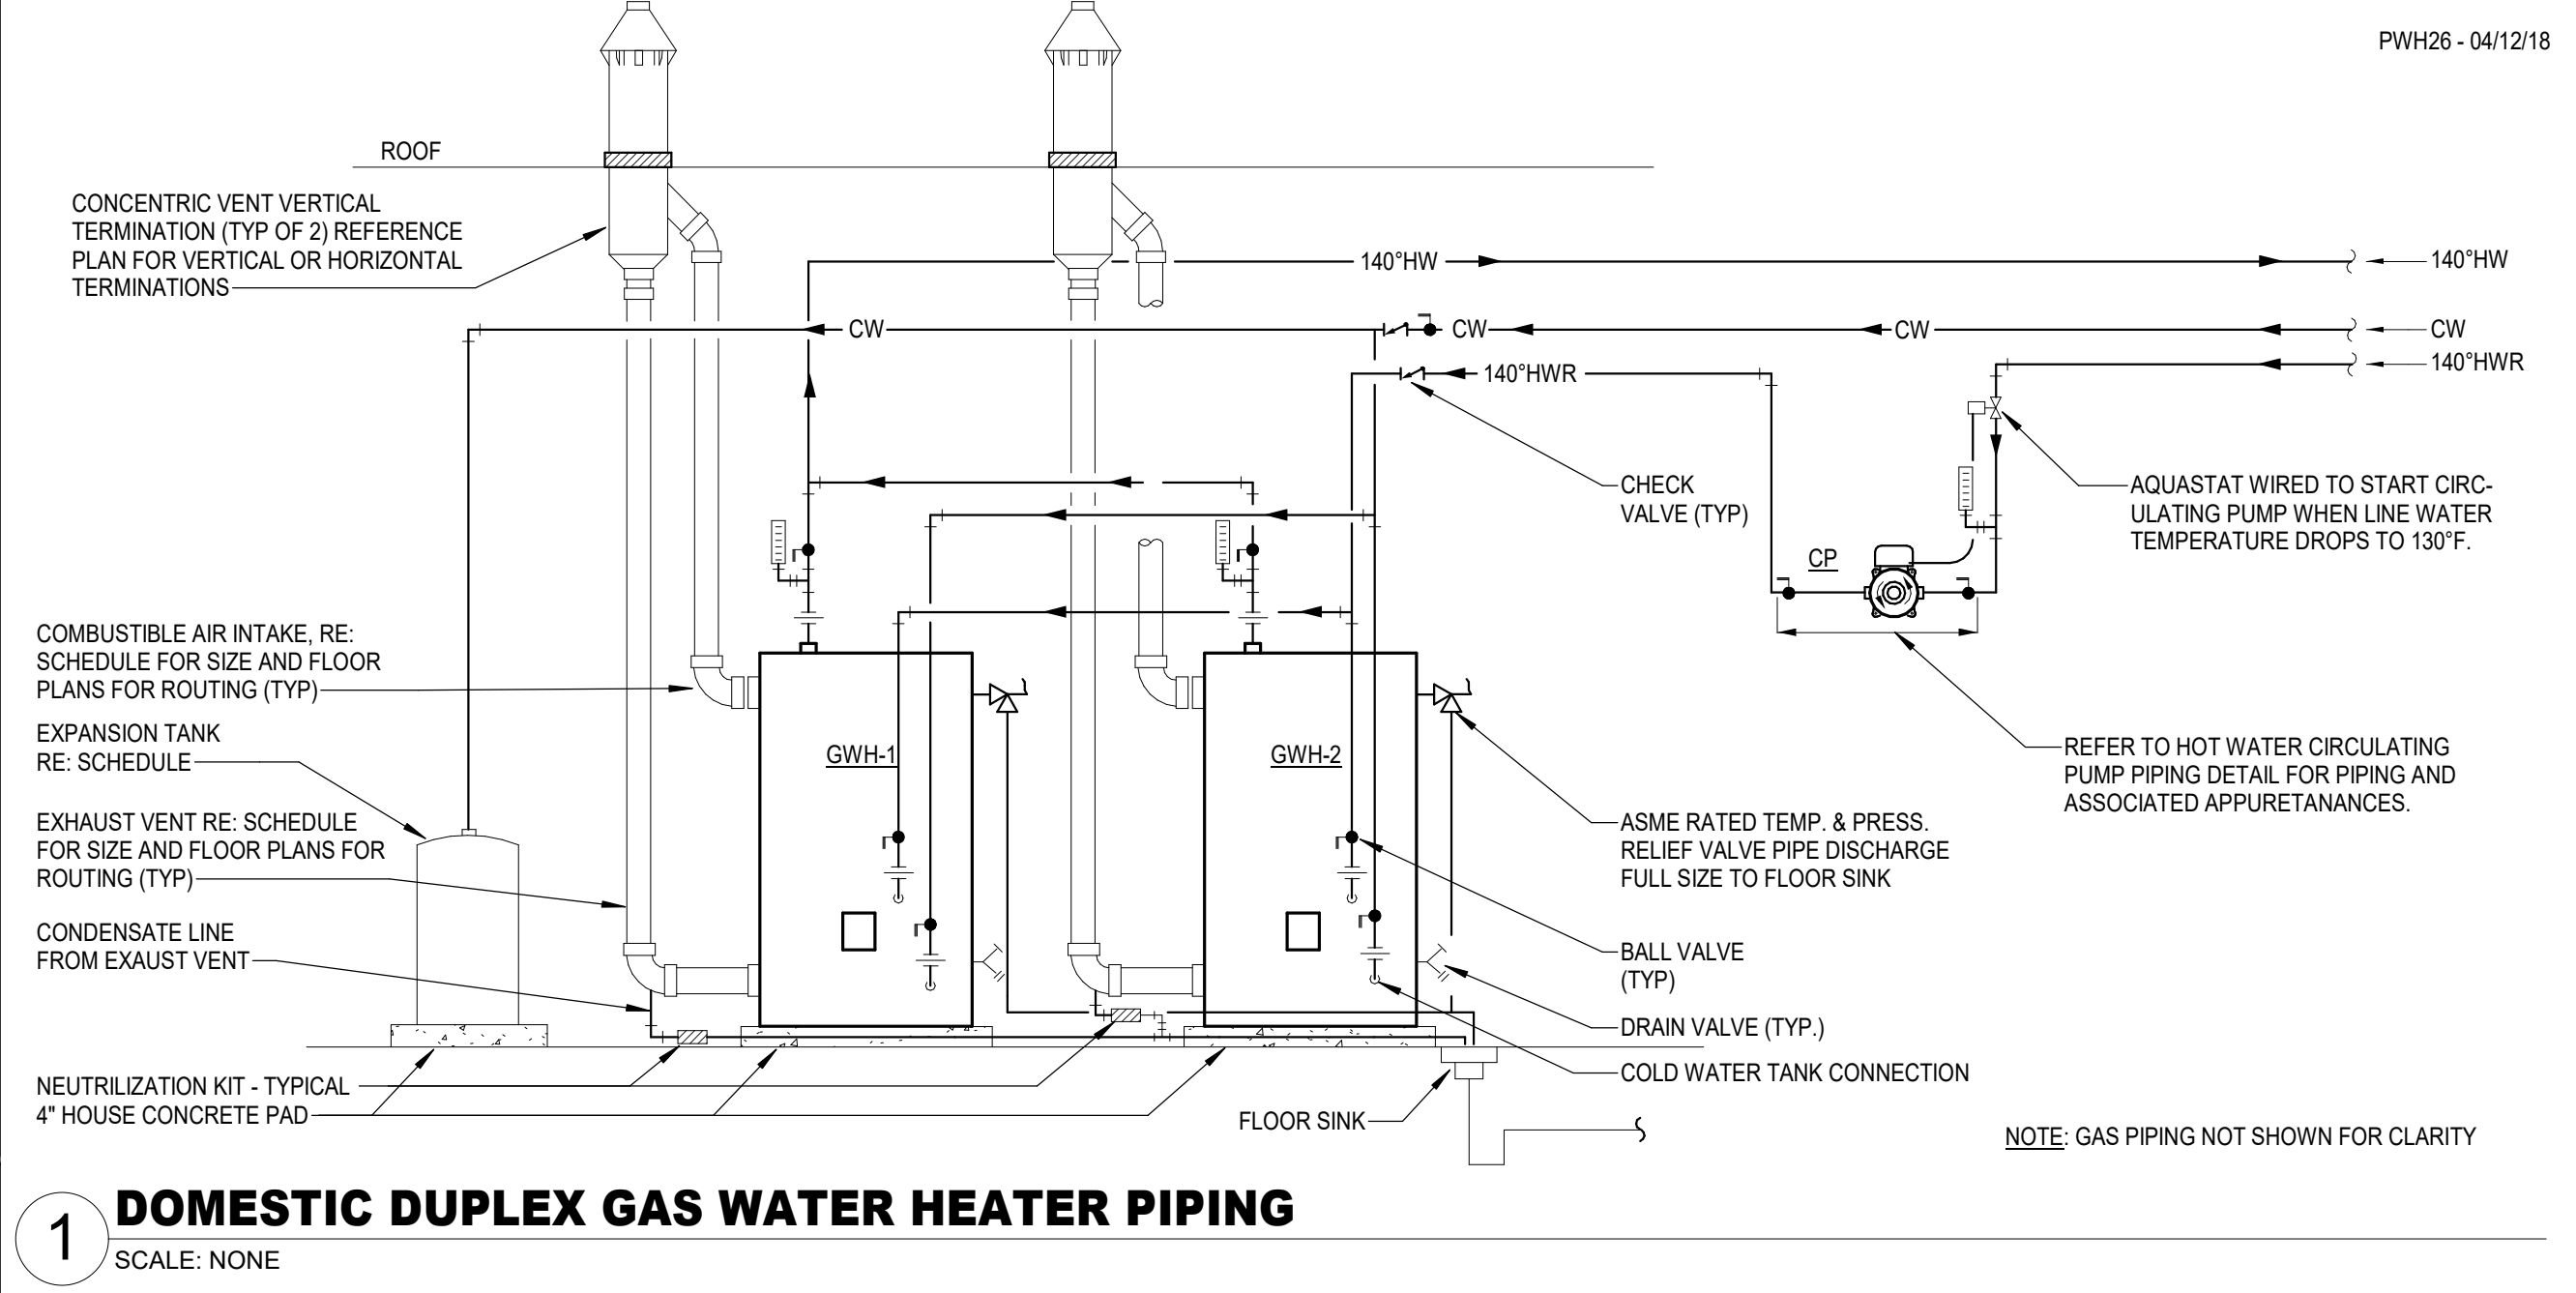
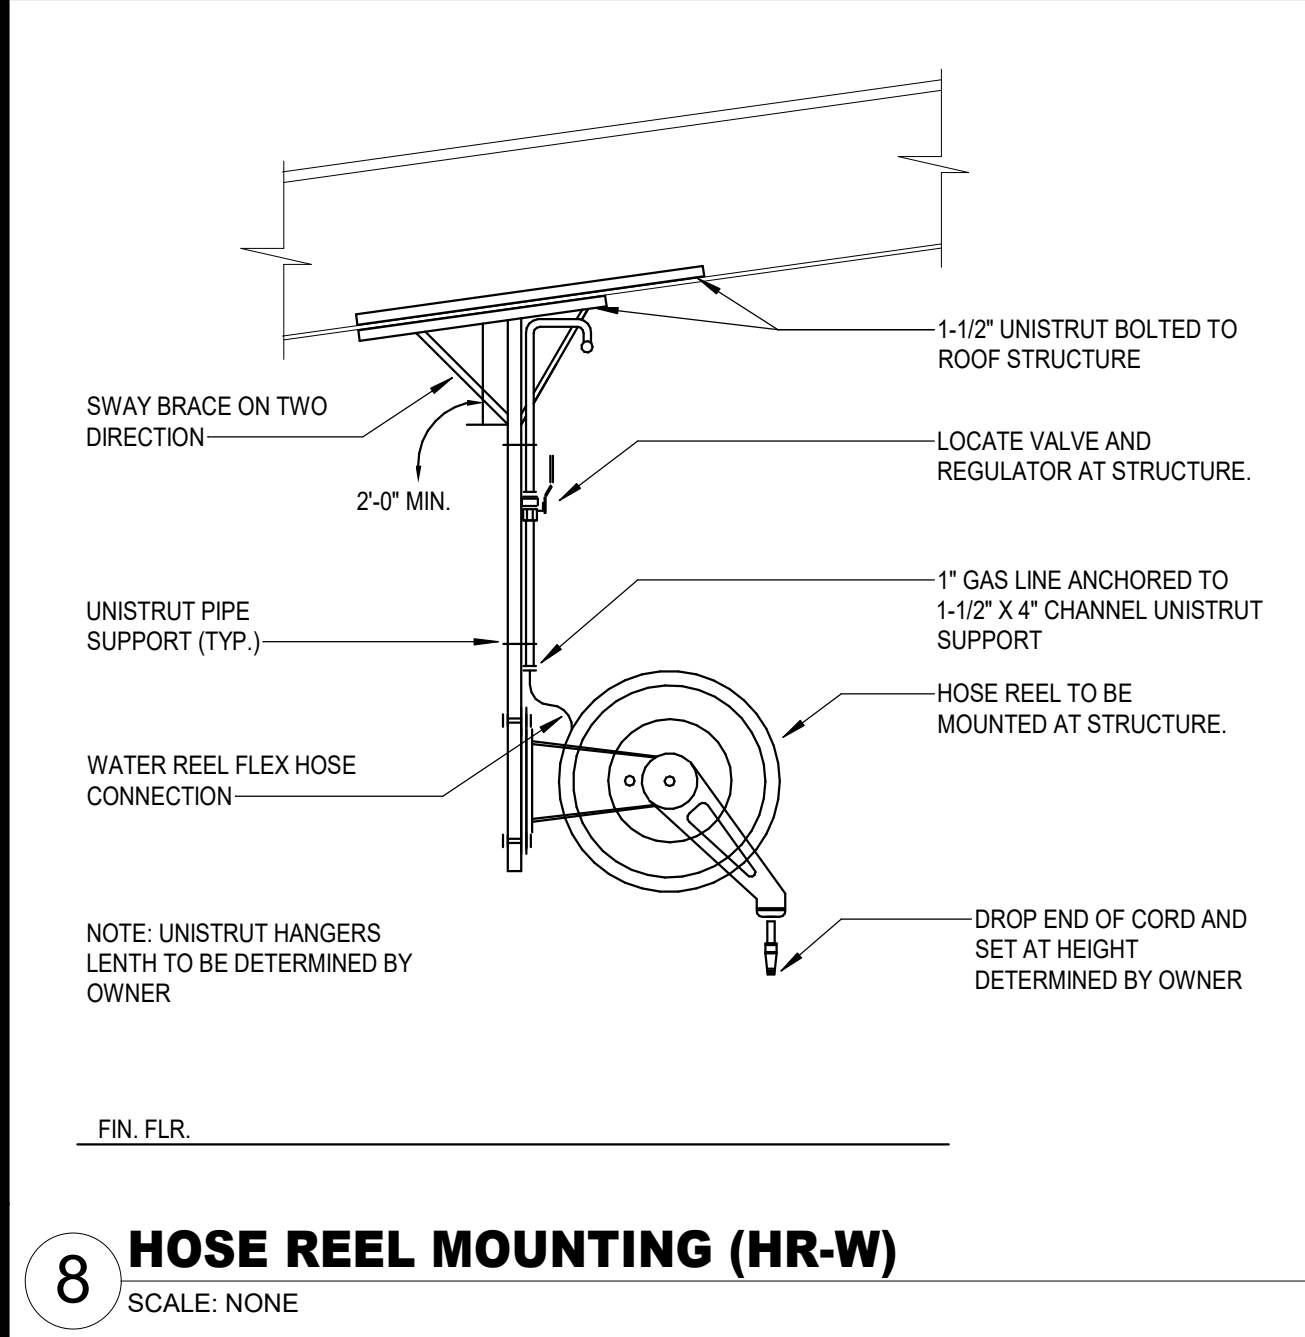
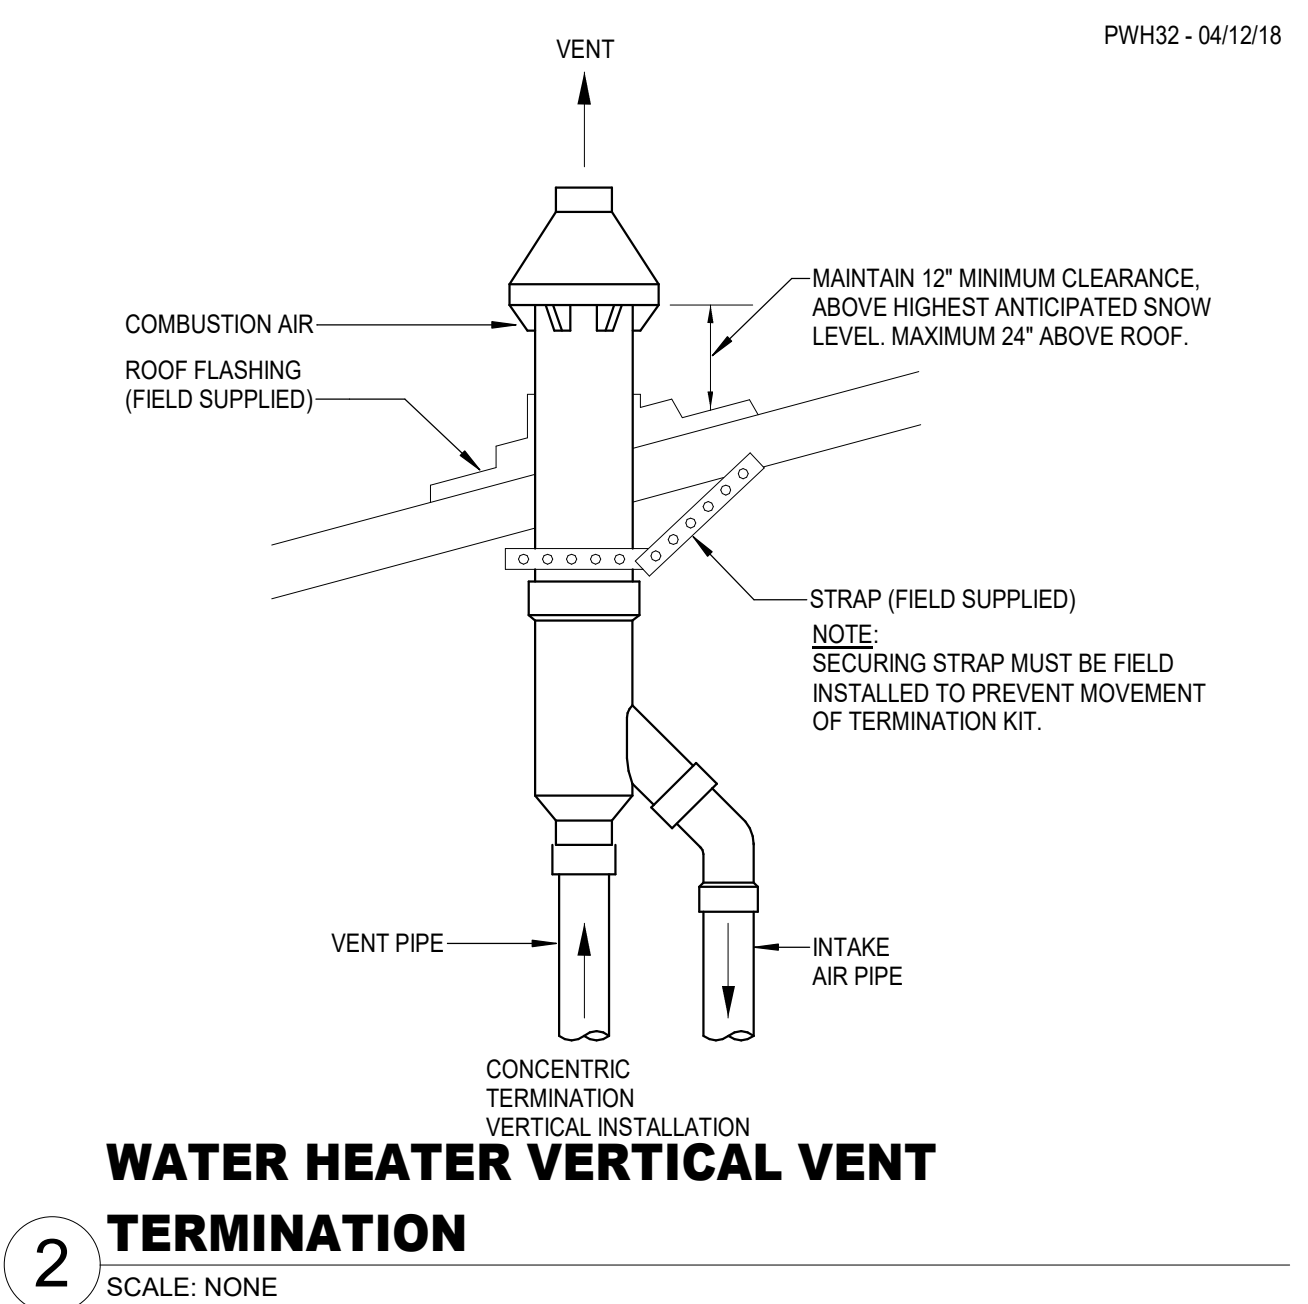
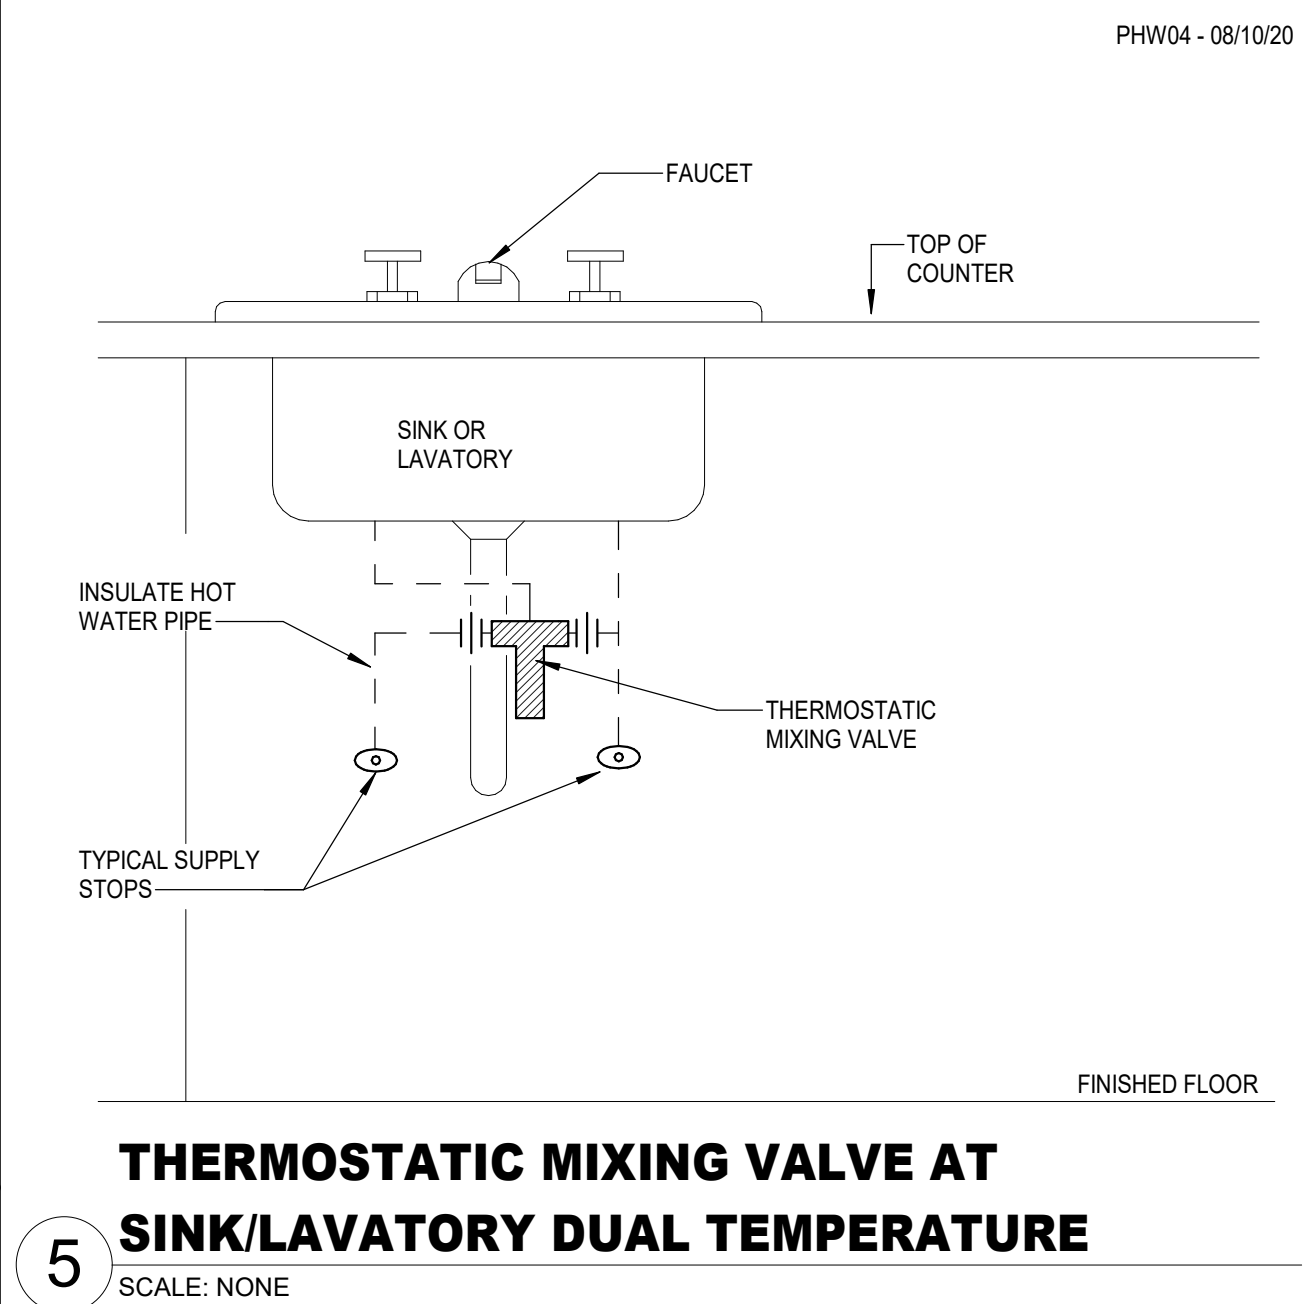
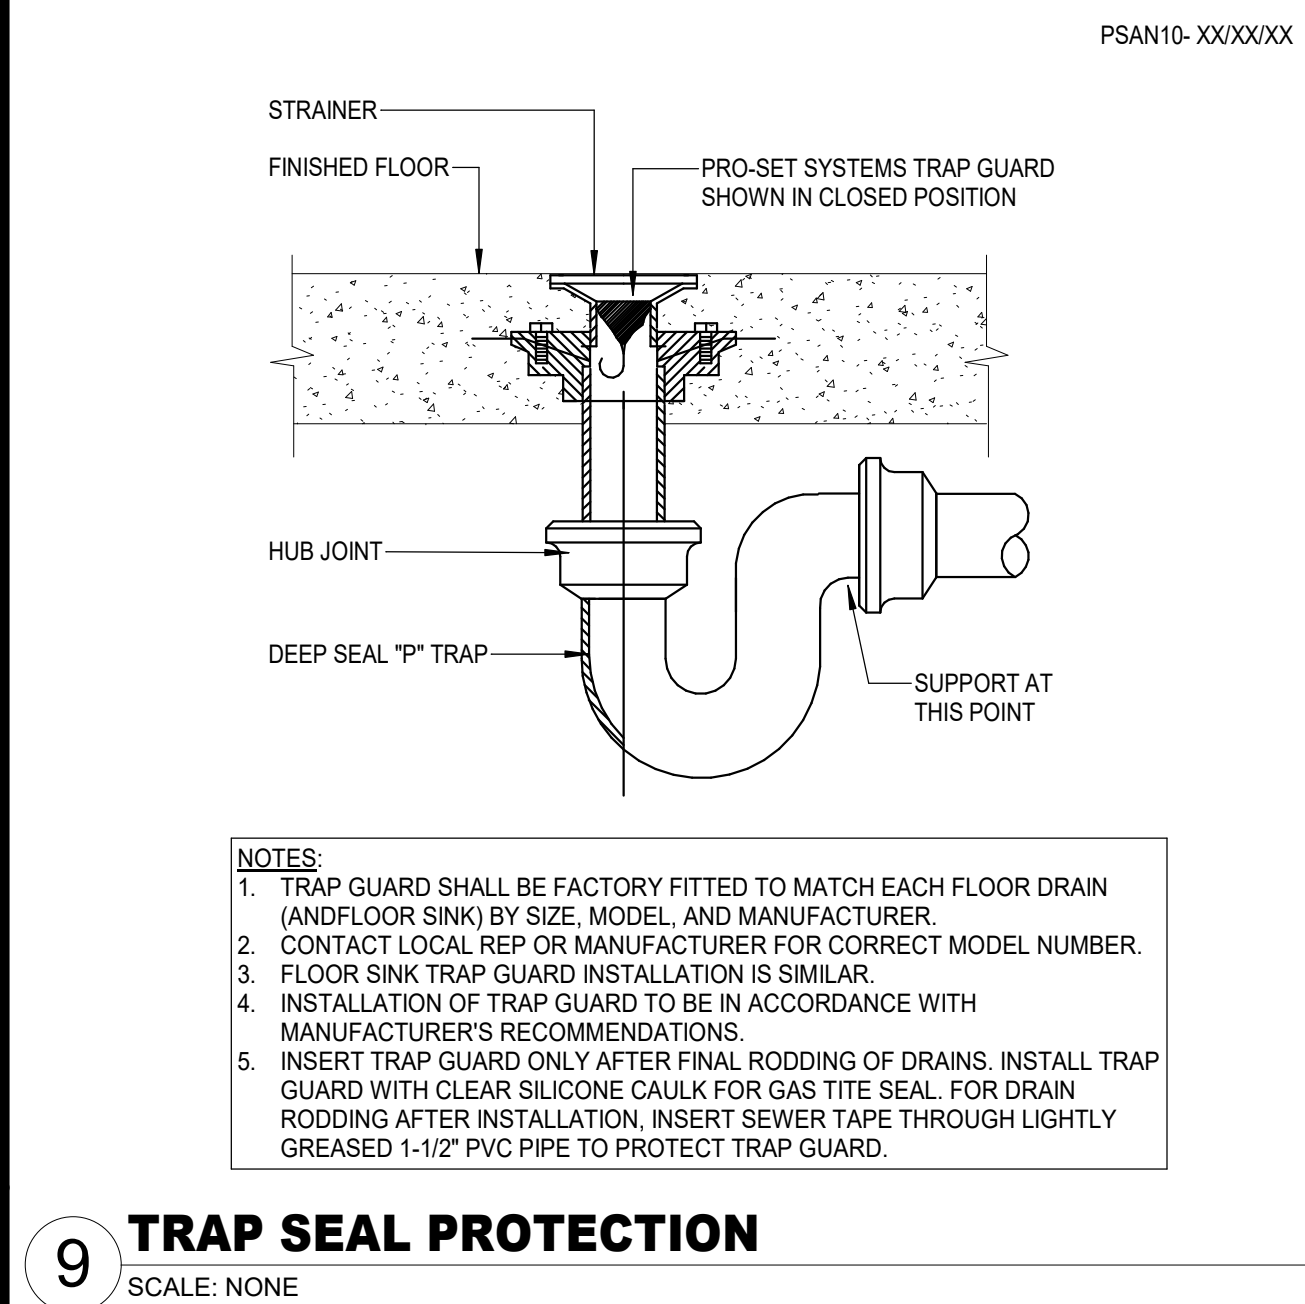
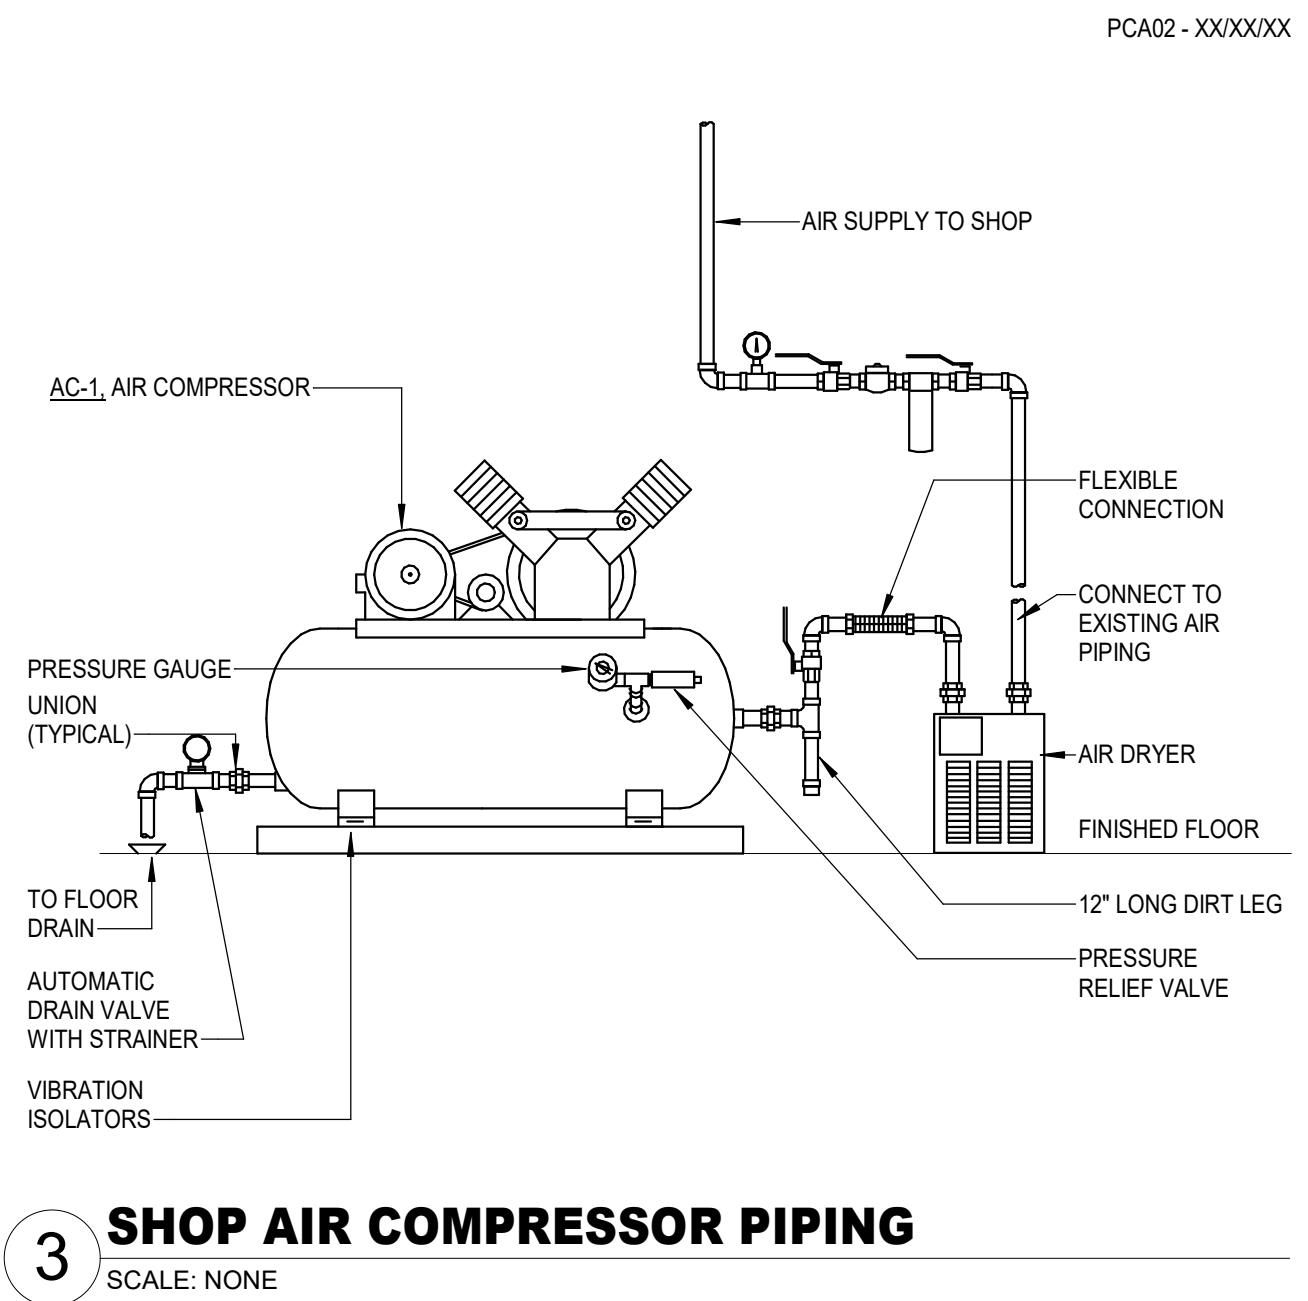
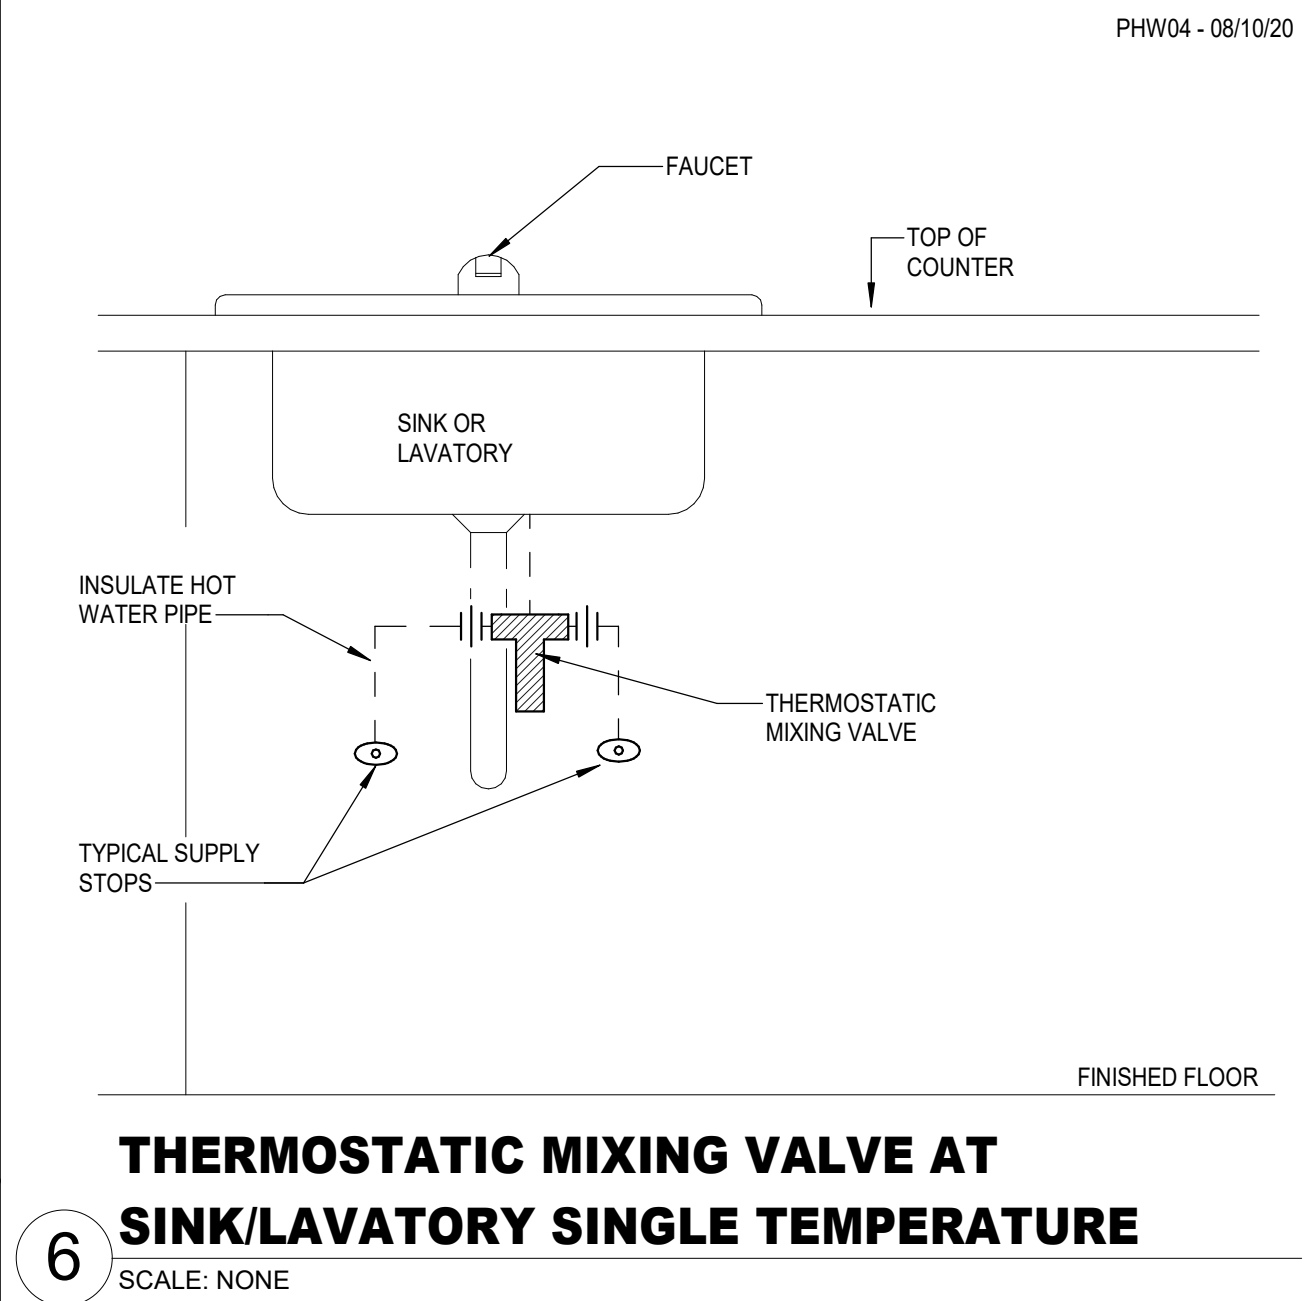
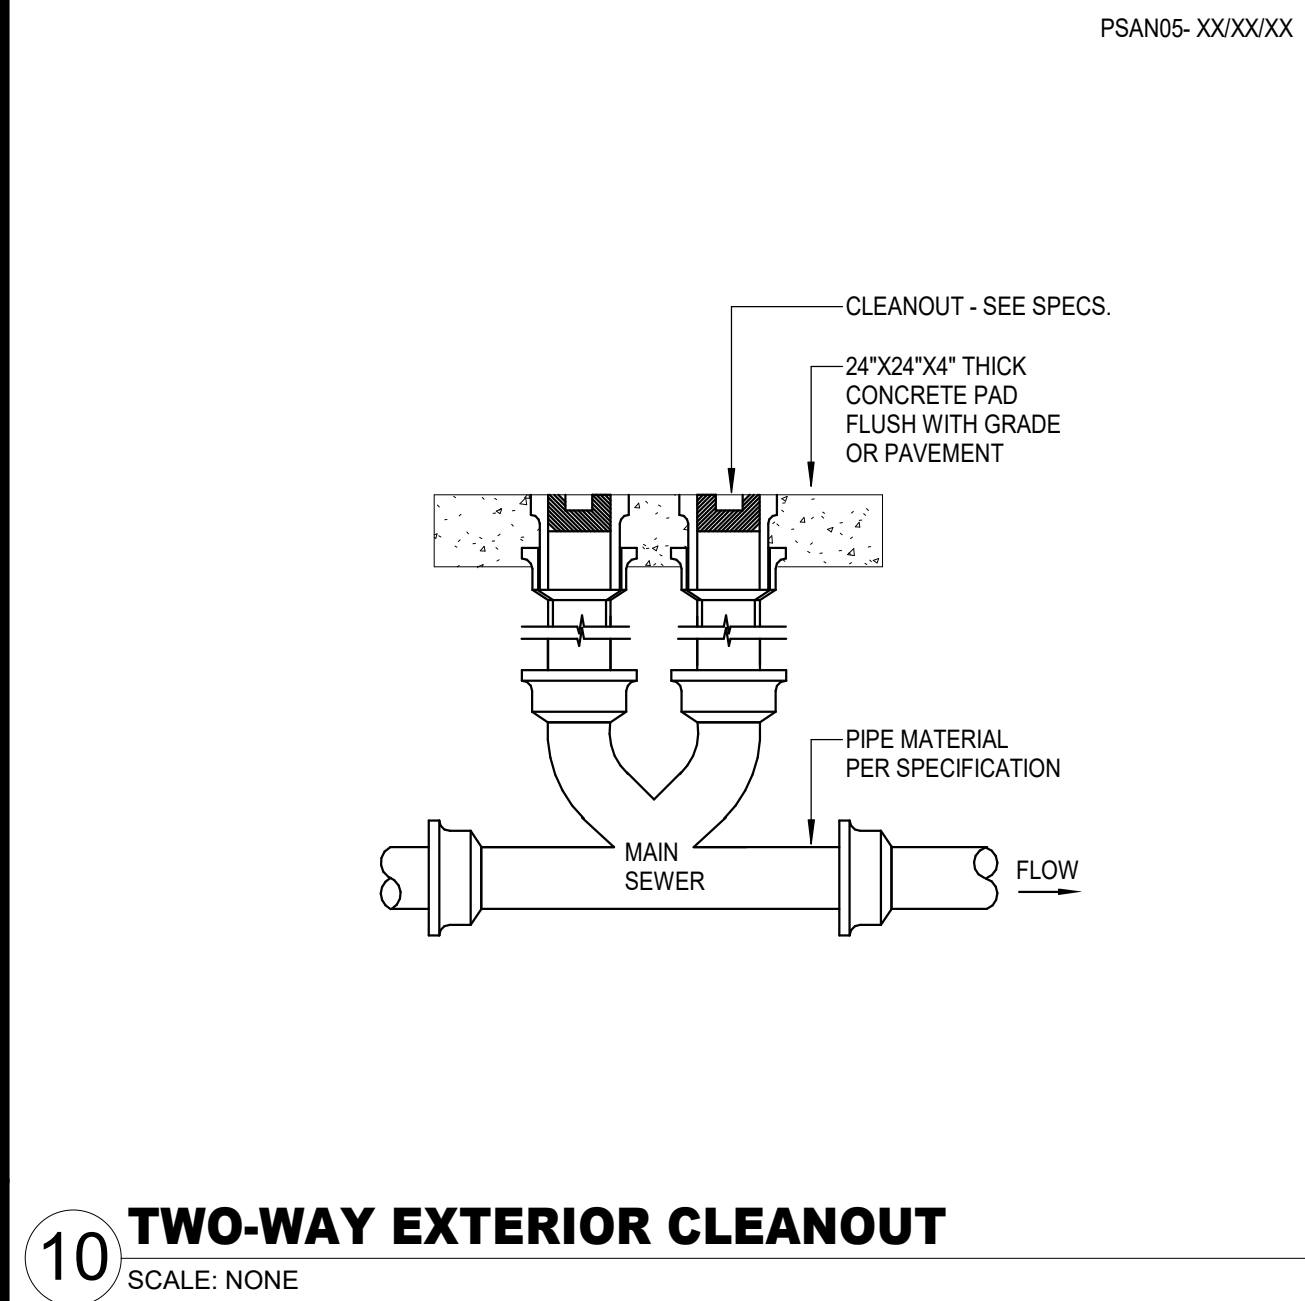
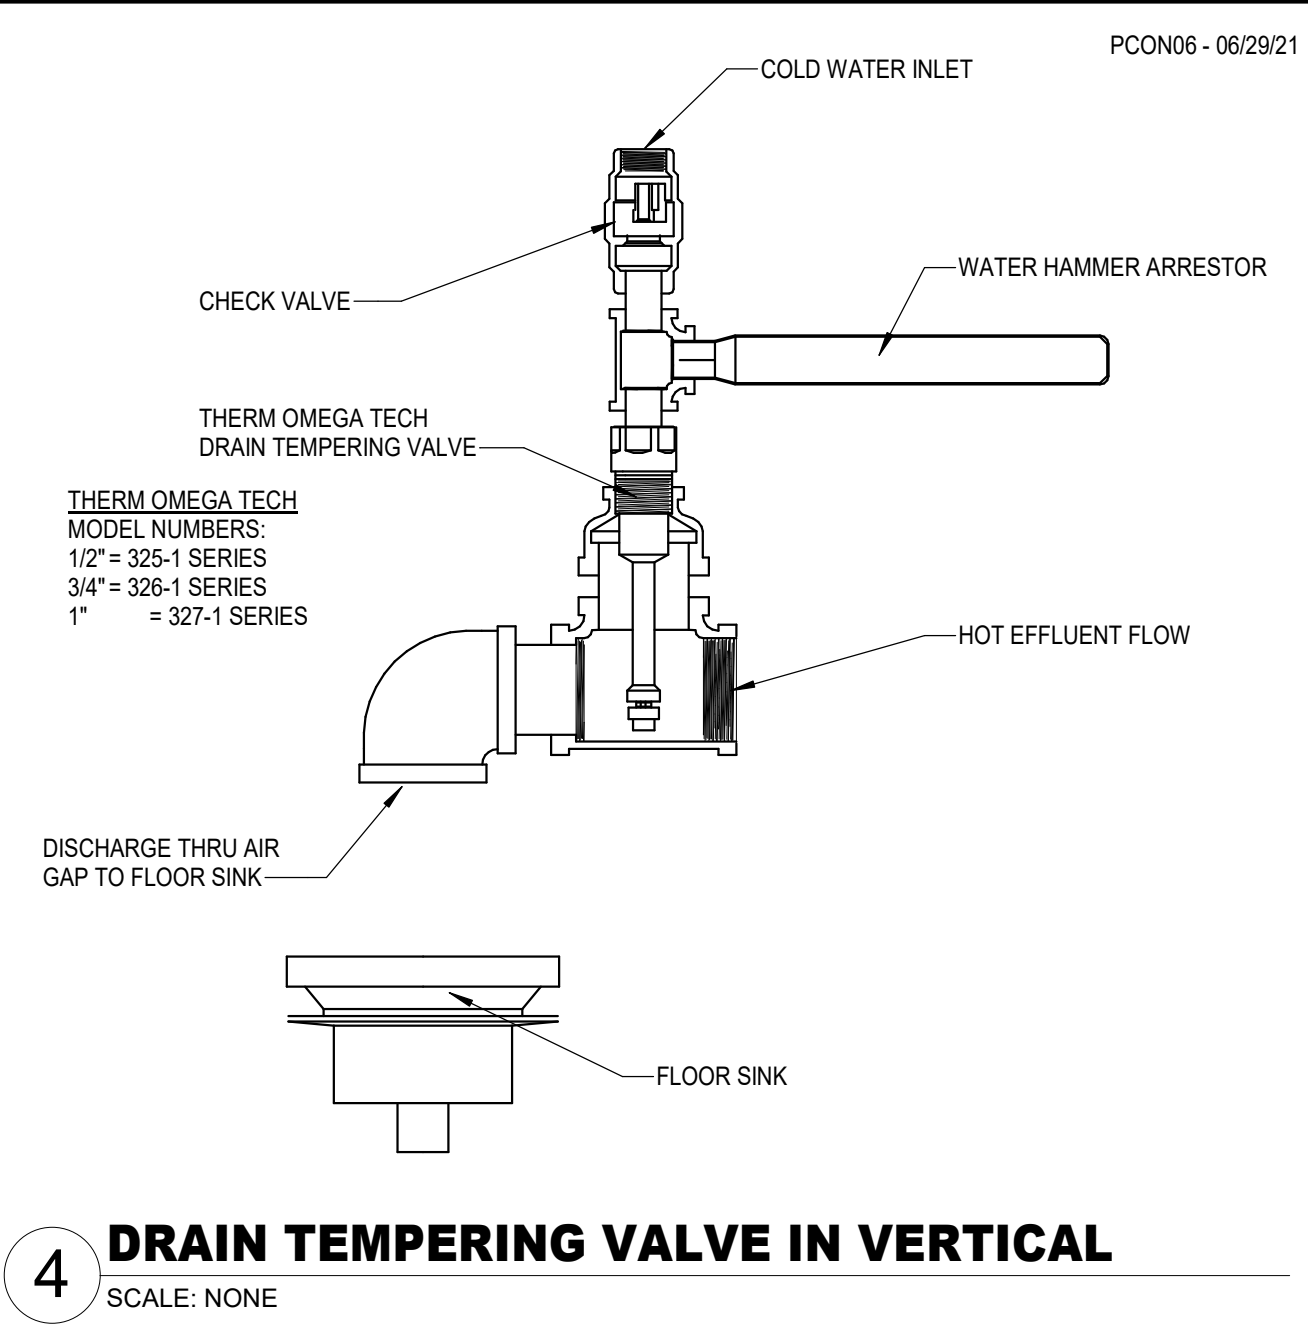
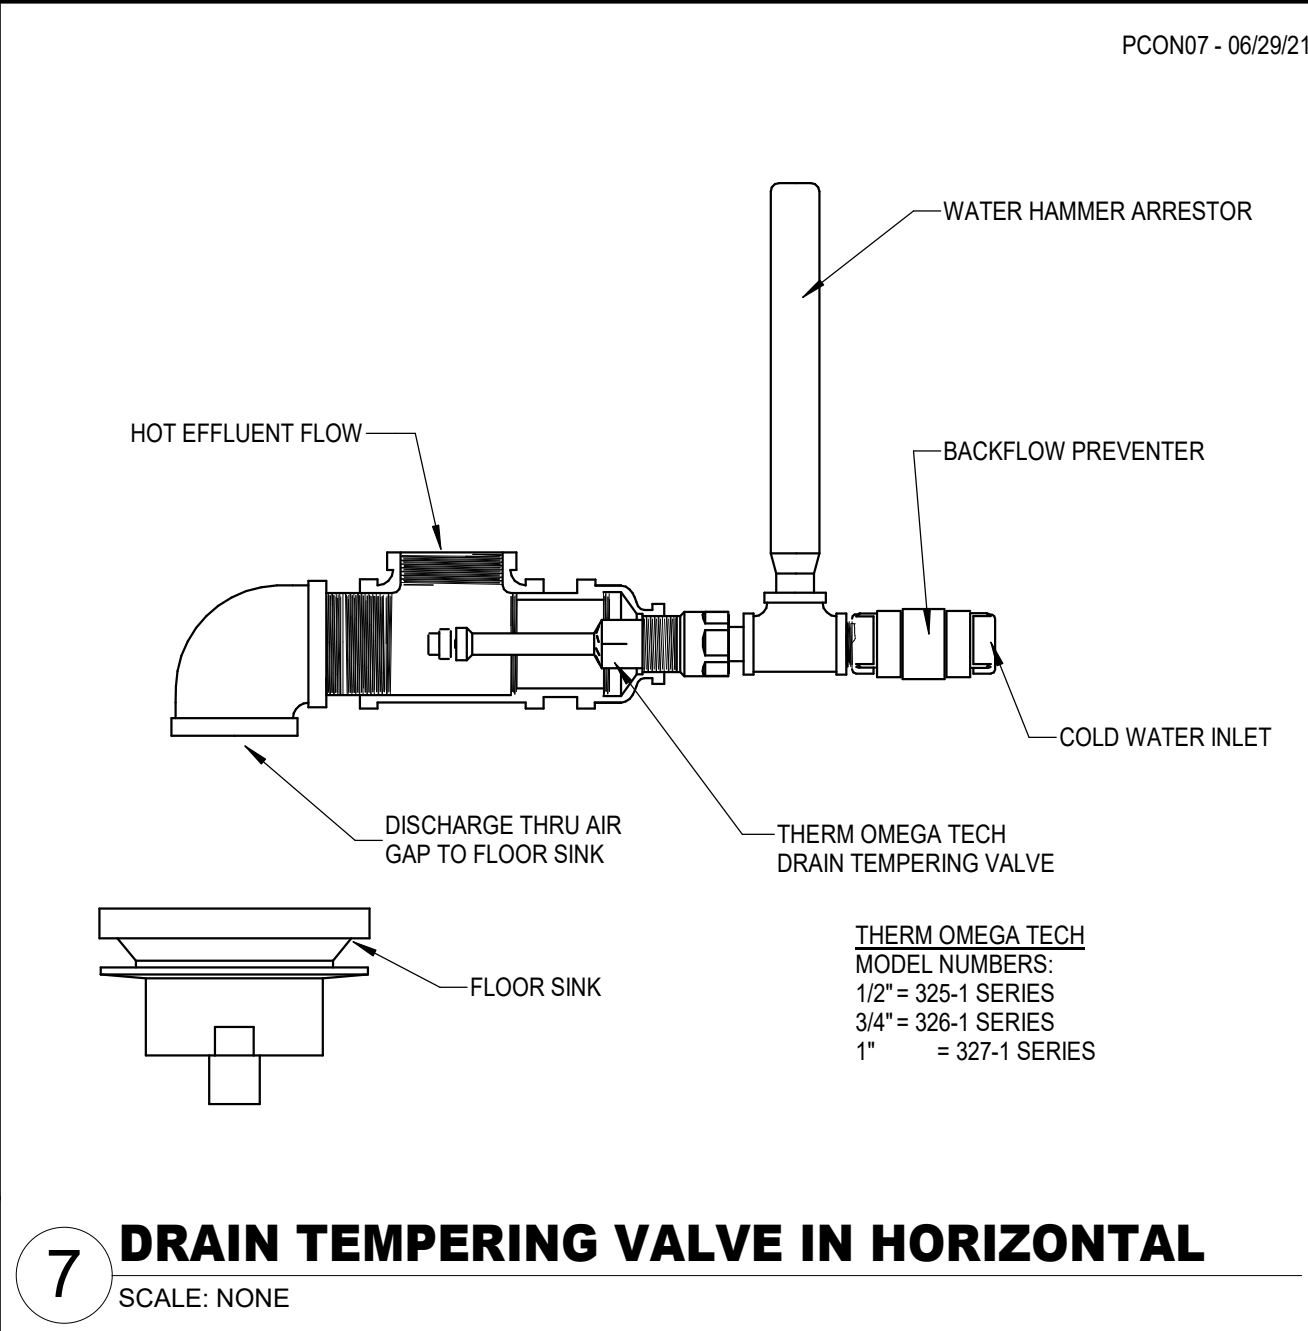
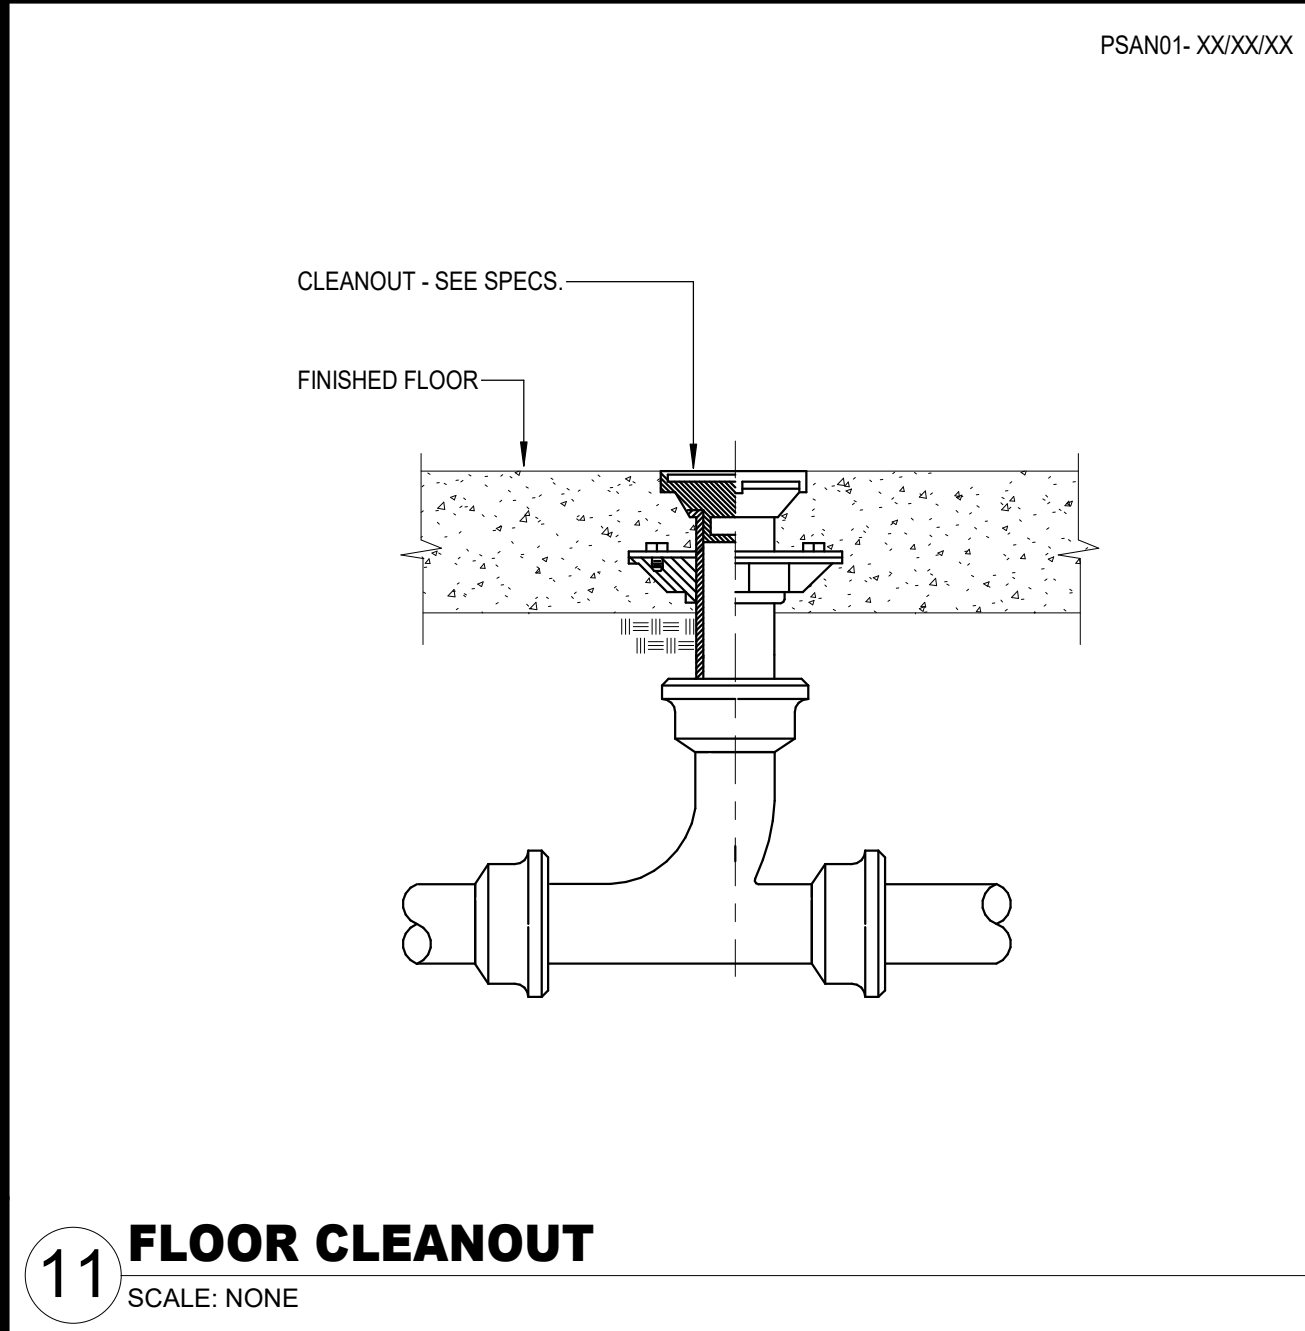
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**P5.01**

PLUMBING  
DETAILS





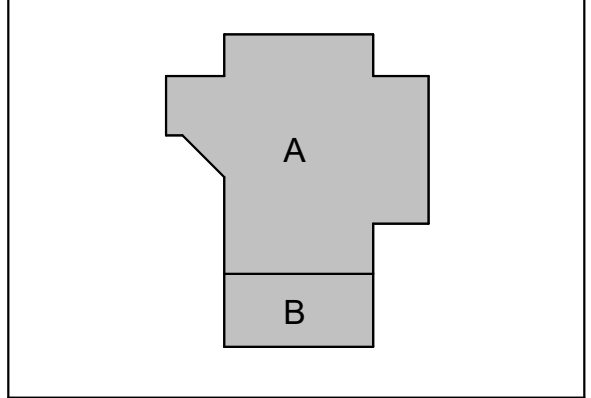


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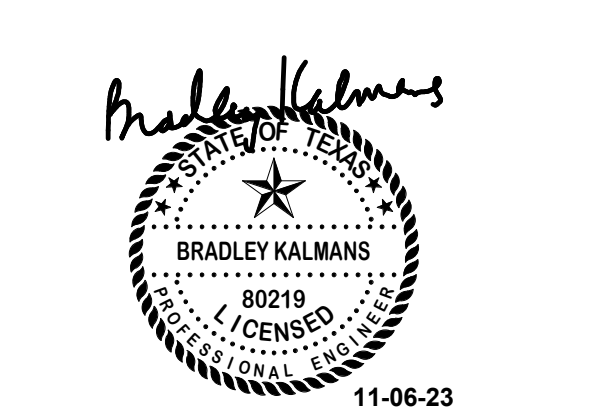


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**P5.02**

PLUMBING  
DETAILS





PLUMBING FIXTURE SCHEDULE					
TYPE: WC-1 (T.A.S. / ADA COMPLIANT) DESCRIPTION: WATER CLOSET, WALL HUNG, WHITE VITREOUS CHINA WITH ANTIMICROBIAL SURFACE. ELONGATED CLOSET BOWL WITH 1- 1/2" TOP SPUD AND BOLT. COVERS: AMERICAN STANDARD AFWALL #3351.101 ELONGATED OPEN FRONT SEAT WITH SELF SUSTAINING CONCEALED CHECK HINGES. REFER TO ARCHITECTURAL DRAWINGS FOR SEAT COLOR, BENCH #16555COT, 1.26 GALLON FLUSH CYCLE. EXPOSED, DIAPHRAGM TYPE, CHROME PLATED CLOSET FLUSHOMETER, VACUUM BREAKER, SPUD COUPLING FOR 1-1/2" TOP SPUD. SLOAN ROYAL II #1111.1.26	TYPE: EDF-1 (T.A.S. COMPLIANT) DESCRIPTION: WALL HUNG, BARRIER FREE, ELECTRIC DRINK FOUNTAIN, ALL STAINLESS STEEL. CHROME PLATED TWO-STREAM MOUND BUILDING TYPE BUBBLER, 8 GPM OF 50 DEGREE WATER AT 90 DEGREE AMBIENT AND 80 DEGREE INLET WATER. PROVIDE CAME TOUCH APRON IN ALL STAINLESS STEEL. ON ALL UNITS MOUNTED WITH A CLEAR KNEE SPACE GREATER THAN 27" HIGH. HALSEY TAYLOR HACRPS-Q WITH APRON #2522.	TYPE: SERVICE: FD-1 TOILET ROOMS AND GENERAL USE DESCRIPTION: FLOOR DRAIN, CAST IRON BODY, ADJUSTABLE 6" DIAMETER STAINLESS STEEL STRAINER WITH VANDAL PROOF SCREWS, INTEGRAL CLAMPING DEVICE, BOTTOM OUTLET. WADE 1100MR6.	TYPE: TRAP SEAL: ROUGH-IN: TYPE: SERVICE: FS-1 ICE MACHINE DRAIN / BACKFLOW PREVENTER DISCHARGE DESCRIPTION: CAST IRON 8" SQUARE FLOOR SINK WITH 6" DEEP SUMP, A.R.E. INTERIOR, ALUMINUM DOME BOTTOM STRAINER, 1/2 STAINLESS STEEL TOP, CLAMPING DEVICE. WADE 9110-15026-27-SS.	TYPE: TRAP SEAL: ROUGH-IN: TYPE: SERVICE: FS-2 MECHANICAL ROOM DESCRIPTION: A.R.E. COATED CAST IRON BODY 12" SQUARE FLOOR SINK WITH 8" DEEP SUMP, BOTTOM OUTLET, LOOSE SET CAST IRON SECONDARY STRAINER, CLAMPING DEVICE, AND HALF TOP GRATE. WADE #140-8-15-26-64.	TYPE: TRAP SEAL: ROUGH-IN: TYPE: DESCRIPTION: ESEW-1 (T.A.S. COMPLIANT) ELEVATED WASH CLOSET AND EYEWASH, FLOOR MOUNTED WITH STAINLESS STEEL BOWL AND SCHEDULE 80, HOT DIP GALVANIZED PIPING, CHROME PLATED STAY-OPEN BALL VALVES, STAINLESS STEEL ACTUATORS, GRAPHICS, YELLOW ABS PLASTIC SHOWER HEAD ACTIVATED BY PULL ROD, 30 GPM FLOW CONTROL. ABS PLASTIC DUAL STREAM EYE-FACEWASH HEADS ACTIVATED BY PUSH PLATE, SELF ADJUSTING 3.5 GPM REGULATOR, FLOAT OFF COVERS SECURED WITH STAINLESS STEEL HEAD CHAINS, IN-LINE STRAINER TEE, ROTATE DRAIN TEE TO FLOOR DRAIN LOCATION, FACTORY PAINTED SAFETY YELLOW, ENCON 01050273 WITH 01-0520-98 STRAINER TEE.
FAUCET: L-1 (T.A.S. COMPLIANT) - METERED - TEMPERED WATER FOR STUDENTS DESCRIPTION: LAVATORY, WALL HUNG, WHITE VITREOUS CHINA, 20-1/2" X 18-1/4" WITH FRONT OVERFLOW AND CONCEALED ARM SUPPORTS, 4" CENTERSET FAUCET HOLES. AMERICAN STANDARD LUCERNE #0355.012.	FAUCET: SK-2 (T.A.S. COMPLIANT) - LOUNGE, WORKROOM, CLINIC DESCRIPTION: SINK, COUNTER MOUNTED, TOP MOUNT, 18 GAUGE TYPE 304 STAINLESS STEEL, STATION, 36" L X 12" D DEEP, SINGLE COMPARTMENT WITH FAUCET DECK, THREE HOLES ON 8" CENTERS. ELKAY #1918.	TYPE: TRAP SEAL: ROUGH-IN: TYPE: DESCRIPTION: TMV THERMOSTATIC MIXING VALVE, SCHEDULED ON DRAWINGS.	TYPE: TRAP SEAL: ROUGH-IN: TYPE: DESCRIPTION: G NATURAL GAS COCK, SINGLE OR DOUBLE, COUNTERTOP OR WALL MOUNTED, FURNISHED BY DIVISION 12 AND INSTALLED BY DIVISION 22.	TYPE: TRAP SEAL: ROUGH-IN: TYPE: DESCRIPTION: HB-1 - COLD WATER HOSE BIBB, EXPOSED TYPE, MILD CLIMATE, WALL-MOUNTED FAUCET WITH 3/4" F.P.T. INLET, 3/4" MALE HOSE THREAD OUTLET AND SELF-DRAINING ANTI-SIPHON VACUUM BREAKER. CHROME PLATED BRASS FINISH WITH REMOVABLE TEE HANDLE.	TYPE: TRAP SEAL: ROUGH-IN: TYPE: DESCRIPTION: HR-1 OVERHEAD AIR HOSE REEL WITH 50 FOOT 2" WITH 1/4" FITTINGS AIR HOSE WITH ADJUSTABLE HOSE STOP AND SNAP-HOOK, BALCRANK MODEL 2110-019.
STRAINER: CHROME PLATED BRASS DECK MOUNTED LAVATORY FAUCET WITH COVER PLATE, 4-1/8" SPOUT, AND PUSH BUTTON HANDLE INDEXED "PUSH", SELF CLOSING METERING CARTRIDGE, VANDAL RESISTANT 0.5 GPM NON-AERATING LAMINAR FLOW OUTLET. CHICAGO MODEL #857-ESBVP-689P#HABOP.	STRAINER: CHROME PLATED WROUGHT BRASS 4-1/2" WIDE GRID SINK STRAINER, 1-1/4" 17 GAUGE CHROME PLATED BRASS GRID STRAINER WITH TAILPIECE. MCGUIRE #152A.	TYPE: TRAP SEAL: ROUGH-IN: TYPE: DESCRIPTION: ECO EXTERIOR CLEANOUT TO GRADE, CAST IRON BODY WITH ADJUSTABLE TOP ASSEMBLY WITH GASKET SEAL, AND ROUND SCORATED STAINLESS STEEL COVER. WADE 6000-Z.	TYPE: TRAP SEAL: ROUGH-IN: TYPE: DESCRIPTION: WCO WALL CLEANOUT, CAST IRON BODY AND ADJUSTABLE TOP ASSEMBLY WITH GASKET SEAL, AND ROUND SCORATED STAINLESS STEEL COVER. WADE 6000-153. FOR CARPETED FLOORS PROVIDE 6000-CM.	TYPE: TRAP SEAL: ROUGH-IN: TYPE: DESCRIPTION: WMB-1 WASHING MACHINE DRAIN BOX, 20 GAUGE STEEL BOX WITH WHITE POWDER COAT FINISH, MALE IRON PIPE WATER SUPPLY CONNECTIONS AND DRAIN FITTING. PROVIDE HAMMER ARRESTOR AT BOTH HOT AND COLD WATER HOSE THREADS.	TYPE: TRAP SEAL: ROUGH-IN: TYPE: DESCRIPTION: WCO WALL CLEANOUT, CAST IRON BODY AND ADJUSTABLE TOP ASSEMBLY WITH GASKET SEAL, AND ROUND SCORATED STAINLESS STEEL COVER. WADE 6000-153. FOR CARPETED FLOORS PROVIDE 6000-CM.
P-TRAP: 1-1/4" 17 GAUGE CHROME PLATED HEAVY CAST BRASS TRAP WITH CLEANOUT AND EXTENSION TO WALL WITH ESCUTCHEON PLATE. MCGUIRE #887C.	P-TRAP: 1-1/2" 17 GAUGE CHROME PLATED CAST BRASS TRAP WITH CLEANOUT AND EXTENSION TO WALL WITH ESCUTCHEON PLATE. MCGUIRE #812.	TYPE: TRAP SEAL: ROUGH-IN: TYPE: DESCRIPTION: WCO WALL CLEANOUT, CAST IRON BODY AND ADJUSTABLE TOP ASSEMBLY WITH GASKET SEAL, AND ROUND SCORATED STAINLESS STEEL COVER. WADE 6000-153. FOR CARPETED FLOORS PROVIDE 6000-CM.	TYPE: TRAP SEAL: ROUGH-IN: TYPE: DESCRIPTION: WCO WALL CLEANOUT, CAST IRON BODY AND ADJUSTABLE TOP ASSEMBLY WITH GASKET SEAL, AND ROUND SCORATED STAINLESS STEEL COVER. WADE 6000-153. FOR CARPETED FLOORS PROVIDE 6000-CM.	TYPE: TRAP SEAL: ROUGH-IN: TYPE: DESCRIPTION: WCO WALL CLEANOUT, CAST IRON BODY AND ADJUSTABLE TOP ASSEMBLY WITH GASKET SEAL, AND ROUND SCORATED STAINLESS STEEL COVER. WADE 6000-153. FOR CARPETED FLOORS PROVIDE 6000-CM.	TYPE: TRAP SEAL: ROUGH-IN: TYPE: DESCRIPTION: WCO WALL CLEANOUT, CAST IRON BODY AND ADJUSTABLE TOP ASSEMBLY WITH GASKET SEAL, AND ROUND SCORATED STAINLESS STEEL COVER. WADE 6000-153. FOR CARPETED FLOORS PROVIDE 6000-CM.
SUPPLIES: 1/2" I.P.S. X 3/8" O.D. CHROME PLATED LOOSE KEY STOP VALVE WITH ESCUTCHEON AND 3/8" COMPRESSION CHROME PLATED FLEXIBLE RISERS. MCGUIRE #1216SK.	SUPPLIES: 1/2" I.P.S. X 3/8" O.D. CHROME PLATED LOOSE KEY STOP VALVE WITH ESCUTCHEON AND 3/8" COMPRESSION CHROME PLATED FLEXIBLE RISERS. MCGUIRE #1216SK.	TYPE: TRAP SEAL: ROUGH-IN: TYPE: DESCRIPTION: WCO WALL CLEANOUT, CAST IRON BODY AND ADJUSTABLE TOP ASSEMBLY WITH GASKET SEAL, AND ROUND SCORATED STAINLESS STEEL COVER. WADE 6000-153. FOR CARPETED FLOORS PROVIDE 6000-CM.	TYPE: TRAP SEAL: ROUGH-IN: TYPE: DESCRIPTION: WCO WALL CLEANOUT, CAST IRON BODY AND ADJUSTABLE TOP ASSEMBLY WITH GASKET SEAL, AND ROUND SCORATED STAINLESS STEEL COVER. WADE 6000-153. FOR CARPETED FLOORS PROVIDE 6000-CM.	TYPE: TRAP SEAL: ROUGH-IN: TYPE: DESCRIPTION: WCO WALL CLEANOUT, CAST IRON BODY AND ADJUSTABLE TOP ASSEMBLY WITH GASKET SEAL, AND ROUND SCORATED STAINLESS STEEL COVER. WADE 6000-153. FOR CARPETED FLOORS PROVIDE 6000-CM.	TYPE: TRAP SEAL: ROUGH-IN: TYPE: DESCRIPTION: WCO WALL CLEANOUT, CAST IRON BODY AND ADJUSTABLE TOP ASSEMBLY WITH GASKET SEAL, AND ROUND SCORATED STAINLESS STEEL COVER. WADE 6000-153. FOR CARPETED FLOORS PROVIDE 6000-CM.
CARRIER: 4" WASTE, 2" VENT, 1" COLD WATER. REFER TO ARCHITECTURAL DRAWINGS FOR MOUNTING HEIGHT REQUIREMENTS.	CARRIER: 4" WASTE, 2" VENT, 1/2" COLD WATER. REFER TO ARCHITECTURAL DRAWINGS FOR HEIGHT REQUIREMENTS.	TYPE: TRAP SEAL: ROUGH-IN: TYPE: DESCRIPTION: WCO WALL CLEANOUT, CAST IRON BODY AND ADJUSTABLE TOP ASSEMBLY WITH GASKET SEAL, AND ROUND SCORATED STAINLESS STEEL COVER. WADE 6000-153. FOR CARPETED FLOORS PROVIDE 6000-CM.	TYPE: TRAP SEAL: ROUGH-IN: TYPE: DESCRIPTION: WCO WALL CLEANOUT, CAST IRON BODY AND ADJUSTABLE TOP ASSEMBLY WITH GASKET SEAL, AND ROUND SCORATED STAINLESS STEEL COVER. WADE 6000-153. FOR CARPETED FLOORS PROVIDE 6000-CM.	TYPE: TRAP SEAL: ROUGH-IN: TYPE: DESCRIPTION: WCO WALL CLEANOUT, CAST IRON BODY AND ADJUSTABLE TOP ASSEMBLY WITH GASKET SEAL, AND ROUND SCORATED STAINLESS STEEL COVER. WADE 6000-153. FOR CARPETED FLOORS PROVIDE 6000-CM.	TYPE: TRAP SEAL: ROUGH-IN: TYPE: DESCRIPTION: WCO WALL CLEANOUT, CAST IRON BODY AND ADJUSTABLE TOP ASSEMBLY WITH GASKET SEAL, AND ROUND SCORATED STAINLESS STEEL COVER. WADE 6000-153. FOR CARPETED FLOORS PROVIDE 6000-CM.
ROUGH-IN: 1-1/4" 17 GAUGE CHROME PLATED BRASS GRID STRAINER WITH TAILPIECE. MCGUIRE #152A.	ROUGH-IN: 1-1/4" 17 GAUGE CHROME PLATED BRASS GRID STRAINER WITH TAILPIECE. MCGUIRE #152A.	TYPE: TRAP SEAL: ROUGH-IN: TYPE: DESCRIPTION: WCO WALL CLEANOUT, CAST IRON BODY AND ADJUSTABLE TOP ASSEMBLY WITH GASKET SEAL, AND ROUND SCORATED STAINLESS STEEL COVER. WADE 6000-153. FOR CARPETED FLOORS PROVIDE 6000-CM.	TYPE: TRAP SEAL: ROUGH-IN: TYPE: DESCRIPTION: WCO WALL CLEANOUT, CAST IRON BODY AND ADJUSTABLE TOP ASSEMBLY WITH GASKET SEAL, AND ROUND SCORATED STAINLESS STEEL COVER. WADE 6000-153. FOR CARPETED FLOORS PROVIDE 6000-CM.	TYPE: TRAP SEAL: ROUGH-IN: TYPE: DESCRIPTION: WCO WALL CLEANOUT, CAST IRON BODY AND ADJUSTABLE TOP ASSEMBLY WITH GASKET SEAL, AND ROUND SCORATED STAINLESS STEEL COVER. WADE 6000-153. FOR CARPETED FLOORS PROVIDE 6000-CM.	TYPE: TRAP SEAL: ROUGH-IN: TYPE: DESCRIPTION: WCO WALL CLEANOUT, CAST IRON BODY AND ADJUSTABLE TOP ASSEMBLY WITH GASKET SEAL, AND ROUND SCORATED STAINLESS STEEL COVER. WADE 6000-153. FOR CARPETED FLOORS PROVIDE 6000-CM.
TYPE: DESCRIPTION: L-2 (T.A.S. COMPLIANT) - HOT AND COLD WATER FOR FACULTY LAVATORY, WALL HUNG, VITREOUS CHINA, 20-1/2" X 18-1/4" WITH FRONT OVERFLOW AND CONCEALED ARM SUPPORTS, FAUCET HOLES ON 4" CENTERS.	TYPE: DESCRIPTION: WF-1 (T.A.S. COMPLIANT) - SHOP AREAS HAND WASH FOUNTAIN, OFF-FLOOR WALL MOUNTED, SEMI-CIRCULAR, FOUR HAND WASH FOUNTAIN, 36" L X 12" W X 4-1/2" DEEP, FACTORY FINISH WITH INDIVIDUAL SECTIONAL CONTROL, BY PUSH BUTTON ACTIVATED METERING NON-HOLD OPEN AIR CONTROL VALVES, TIMING CYCLE TO BE FIELD SET PER OWNER'S INSTRUCTIONS.	TYPE: TRAP SEAL: ROUGH-IN: TYPE: DESCRIPTION: WCO WALL CLEANOUT, CAST IRON BODY AND ADJUSTABLE TOP ASSEMBLY WITH GASKET SEAL, AND ROUND SCORATED STAINLESS STEEL COVER. WADE 6000-153. FOR CARPETED FLOORS PROVIDE 6000-CM.	TYPE: TRAP SEAL: ROUGH-IN: TYPE: DESCRIPTION: WCO WALL CLEANOUT, CAST IRON BODY AND ADJUSTABLE TOP ASSEMBLY WITH GASKET SEAL, AND ROUND SCORATED STAINLESS STEEL COVER. WADE 6000-153. FOR CARPETED FLOORS PROVIDE 6000-CM.	TYPE: TRAP SEAL: ROUGH-IN: TYPE: DESCRIPTION: WCO WALL CLEANOUT, CAST IRON BODY AND ADJUSTABLE TOP ASSEMBLY WITH GASKET SEAL, AND ROUND SCORATED STAINLESS STEEL COVER. WADE 6000-153. FOR CARPETED FLOORS PROVIDE 6000-CM.	TYPE: TRAP SEAL: ROUGH-IN: TYPE: DESCRIPTION: WCO WALL CLEANOUT, CAST IRON BODY AND ADJUSTABLE TOP ASSEMBLY WITH GASKET SEAL, AND ROUND SCORATED STAINLESS STEEL COVER. WADE 6000-153. FOR CARPETED FLOORS PROVIDE 6000-CM.
FAUCET: CHROME PLATED BRASS DECK MOUNTED LAVATORY FAUCET WITH 4" SPOUT AND 4" WRIST BLADE HANDLES ON 4" CENTERS. QUARTER TURN CERAMIC DISC OPERATING CARTRIDGES, VANDAL RESISTANT 2.2 GPM AERATOR. CHICAGO MODEL #820V17X0KCP-612.	FAUCET: CHROME PLATED BRASS DECK MOUNTED LAVATORY FAUCET WITH 4" SPOUT AND 4" WRIST BLADE HANDLES ON 4" CENTERS. QUARTER TURN CERAMIC DISC OPERATING CARTRIDGES, VANDAL RESISTANT 2.2 GPM AERATOR. CHICAGO MODEL #820V17X0KCP-612.	TYPE: TRAP SEAL: ROUGH-IN: TYPE: DESCRIPTION: WCO WALL CLEANOUT, CAST IRON BODY AND ADJUSTABLE TOP ASSEMBLY WITH GASKET SEAL, AND ROUND SCORATED STAINLESS STEEL COVER. WADE 6000-153. FOR CARPETED FLOORS PROVIDE 6000-CM.	TYPE: TRAP SEAL: ROUGH-IN: TYPE: DESCRIPTION: WCO WALL CLEANOUT, CAST IRON BODY AND ADJUSTABLE TOP ASSEMBLY WITH GASKET SEAL, AND ROUND SCORATED STAINLESS STEEL COVER. WADE 6000-153. FOR CARPETED FLOORS PROVIDE 6000-CM.	TYPE: TRAP SEAL: ROUGH-IN: TYPE: DESCRIPTION: WCO WALL CLEANOUT, CAST IRON BODY AND ADJUSTABLE TOP ASSEMBLY WITH GASKET SEAL, AND ROUND SCORATED STAINLESS STEEL COVER. WADE 6000-153. FOR CARPETED FLOORS PROVIDE 6000-CM.	TYPE: TRAP SEAL: ROUGH-IN: TYPE: DESCRIPTION: WCO WALL CLEANOUT, CAST IRON BODY AND ADJUSTABLE TOP ASSEMBLY WITH GASKET SEAL, AND ROUND SCORATED STAINLESS STEEL COVER. WADE 6000-153. FOR CARPETED FLOORS PROVIDE 6000-CM.
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P-TRAP: 1-1/4" 17 GAUGE CHROME PLATED HEAVY CAST BRASS TRAP WITH CLEANOUT AND EXTENSION TO WALL WITH ESCUTCHEON PLATE. MCGUIRE #812.	P-TRAP: 1-1/2" 17 GAUGE CHROME PLATED CAST BRASS TRAP WITH CLEANOUT AND EXTENSION TO WALL WITH ESCUTCHEON PLATE. MCGUIRE #812.	TYPE: TRAP SEAL: ROUGH-IN: TYPE: DESCRIPTION: WCO WALL CLEANOUT, CAST IRON BODY AND ADJUSTABLE TOP ASSEMBLY WITH GASKET SEAL, AND ROUND SCORATED STAINLESS STEEL COVER. WADE 6000-153. FOR CARPETED FLOORS PROVIDE 6000-CM.	TYPE: TRAP SEAL: ROUGH-IN: TYPE: DESCRIPTION: WCO WALL CLEANOUT, CAST IRON BODY AND ADJUSTABLE TOP ASSEMBLY WITH GASKET SEAL, AND ROUND SCORATED STAINLESS STEEL COVER. WADE 6000-153. FOR CARPETED FLOORS PROVIDE 6000-CM.	TYPE: TRAP SEAL: ROUGH-IN: TYPE: DESCRIPTION: WCO WALL CLEANOUT, CAST IRON BODY AND ADJUSTABLE TOP ASSEMBLY WITH GASKET SEAL, AND ROUND SCORATED STAINLESS STEEL COVER. WADE 6000-153. FOR CARPETED FLOORS PROVIDE 6000-CM.	TYPE: TRAP SEAL: ROUGH-IN: TYPE: DESCRIPTION: WCO WALL CLEANOUT, CAST IRON BODY AND ADJUSTABLE TOP ASSEMBLY WITH GASKET SEAL, AND ROUND SCORATED STAINLESS STEEL COVER. WADE 6000-153. FOR CARPETED FLOORS PROVIDE 6000-CM.
SUPPLIES: 1/2" I.P.S. X 3/8" O.D. CHROME PLATED LOOSE KEY STOP VALVE WITH ESCUTCHEON AND 3/8" COMPRESSION CHROME PLATED FLEXIBLE RISERS. MCGUIRE #1216SK.	SUPPLIES: 1/2" I.P.S. X 3/8" O.D. CHROME PLATED LOOSE KEY STOP VALVE WITH ESCUTCHEON AND 3/8" COMPRESSION CHROME PLATED FLEXIBLE RISERS. MCGUIRE #1216SK.	TYPE: TRAP SEAL: ROUGH-IN: TYPE: DESCRIPTION: WCO WALL CLEANOUT, CAST IRON BODY AND ADJUSTABLE TOP ASSEMBLY WITH GASKET SEAL, AND ROUND SCORATED STAINLESS STEEL COVER. WADE 6000-153. FOR CARPETED FLOORS PROVIDE 6000-CM.	TYPE: TRAP SEAL: ROUGH-IN: TYPE: DESCRIPTION: WCO WALL CLEANOUT, CAST IRON BODY AND ADJUSTABLE TOP ASSEMBLY WITH GASKET SEAL, AND ROUND SCORATED STAINLESS STEEL COVER. WADE 6000-153. FOR CARPETED FLOORS PROVIDE 6000-CM.	TYPE: TRAP SEAL: ROUGH-IN: TYPE: DESCRIPTION: WCO WALL CLEANOUT, CAST IRON BODY AND ADJUSTABLE TOP ASSEMBLY WITH GASKET SEAL, AND ROUND SCORATED STAINLESS STEEL COVER. WADE 6000-153. FOR CARPETED FLOORS PROVIDE 6000-CM.	TYPE: TRAP SEAL: ROUGH-IN: TYPE: DESCRIPTION: WCO WALL CLEANOUT, CAST IRON BODY AND ADJUSTABLE TOP ASSEMBLY WITH GASKET SEAL, AND ROUND SCORATED STAINLESS STEEL COVER. WADE 6000-153. FOR CARPETED FLOORS PROVIDE 6000-CM.
CARRIER: 4" WASTE, 2" VENT, 1/2" HOT AND COLD WATER. REFER TO ARCHITECTURAL DRAWINGS FOR HEIGHT REQUIREMENTS.	CARRIER: 4" WASTE, 2" VENT, 1/2" HOT AND COLD WATER. REFER TO ARCHITECTURAL DRAWINGS FOR HEIGHT REQUIREMENTS.	TYPE: TRAP SEAL: ROUGH-IN: TYPE: DESCRIPTION: WCO WALL CLEANOUT, CAST IRON BODY AND ADJUSTABLE TOP ASSEMBLY WITH GASKET SEAL, AND ROUND SCORATED STAINLESS STEEL COVER. WADE 6000-153. FOR CARPETED FLOORS PROVIDE 6000-CM.	TYPE: TRAP SEAL: ROUGH-IN: TYPE: DESCRIPTION: WCO WALL CLEANOUT, CAST IRON BODY AND ADJUSTABLE TOP ASSEMBLY WITH GASKET SEAL, AND ROUND SCORATED STAINLESS STEEL COVER. WADE 6000-153. FOR CARPETED FLOORS PROVIDE 6000-CM.	TYPE: TRAP SEAL: ROUGH-IN: TYPE: DESCRIPTION: WCO WALL CLEANOUT, CAST IRON BODY AND ADJUSTABLE TOP ASSEMBLY WITH GASKET SEAL, AND ROUND SCORATED STAINLESS STEEL COVER. WADE 6000-153. FOR CARPETED FLOORS PROVIDE 6000-CM.	TYPE: TRAP SEAL: ROUGH-IN: TYPE: DESCRIPTION: WCO WALL CLEANOUT, CAST IRON BODY AND ADJUSTABLE TOP ASSEMBLY WITH GASKET SEAL, AND ROUND SCORATED STAINLESS STEEL COVER. WADE 6000-153. FOR CARPETED FLOORS PROVIDE 6000-CM.
ROUGH-IN: 1-1/4" 17 GAUGE CHROME PLATED BRASS GRID STRAINER WITH TAILPIECE. MCGUIRE #152A.	ROUGH-IN: 1-1/4" 17 GAUGE CHROME PLATED BRASS GRID STRAINER WITH TAILPIECE. MCGUIRE #152A.	TYPE: TRAP SEAL: ROUGH-IN: TYPE: DESCRIPTION: WCO WALL CLEANOUT, CAST IRON BODY AND ADJUSTABLE TOP ASSEMBLY WITH GASKET SEAL, AND ROUND SCORATED STAINLESS STEEL COVER. WADE 6000-153. FOR CARPETED FLOORS PROVIDE 6000-CM.	TYPE: TRAP SEAL: ROUGH-IN: TYPE: DESCRIPTION: WCO WALL CLEANOUT, CAST IRON BODY AND ADJUSTABLE TOP ASSEMBLY WITH GASKET SEAL, AND ROUND SCORATED STAINLESS STEEL COVER. WADE 6000-153. FOR CARPETED FLOORS PROVIDE 6000-CM.	TYPE: TRAP SEAL: ROUGH-IN: TYPE: DESCRIPTION: WCO WALL CLEANOUT, CAST IRON BODY AND ADJUSTABLE TOP ASSEMBLY WITH GASKET SEAL, AND ROUND SCORATED STAINLESS STEEL COVER. WADE 6000-153. FOR CARPETED FLOORS PROVIDE 6000-CM.	TYPE: TRAP SEAL: ROUGH-IN: TYPE: DESCRIPTION: WCO WALL CLEANOUT, CAST IRON BODY AND ADJUSTABLE TOP ASSEMBLY WITH GASKET SEAL, AND ROUND SCORATED STAINLESS STEEL COVER. WADE 6000-153. FOR CARPETED FLOORS PROVIDE 6000-CM.
TYPE: DESCRIPTION: SK-1 (T.A.S. COMPLIANT) - HOT AND COLD WATER - VET LAB SINK, COUNTER MOUNTED, SELF-RIMMING, 18 GAUGE TYPE 304 STAINLESS STEEL, 19" X 18" X 4" DEEP, SINGLE COMPARTMENT WITH FAUCET DECK, THREE FAUCET HOLES ON 4" CENTERS. ELKAY LRAD-1918.	TYPE: DESCRIPTION: MS-1 MOP SINK BASIN, 36" X 36" X 12" HIGH CORNER TYPE, PRECAST TERRAZZO WITH 6" DROPPED FRONT, STAINLESS STEEL, THRESHOLD CAP, AND DOUBLE STAINLESS STEEL WALL GUARDS STERN-WILLIAMS "CORLOX" SBC-1750.	TYPE: TRAP SEAL: ROUGH-IN: TYPE: DESCRIPTION: WCO WALL CLEANOUT, CAST IRON BODY AND ADJUSTABLE TOP ASSEMBLY WITH GASKET SEAL, AND ROUND SCORATED STAINLESS STEEL COVER. WADE 6000-153. FOR CARPETED FLOORS PROVIDE 6000-CM.	TYPE: TRAP SEAL: ROUGH-IN: TYPE: DESCRIPTION: WCO WALL CLEANOUT, CAST IRON BODY AND ADJUSTABLE TOP ASSEMBLY WITH GASKET SEAL, AND ROUND SCORATED STAINLESS STEEL COVER. WADE 6000-153. FOR CARPETED FLOORS PROVIDE 6000-CM.	TYPE: TRAP SEAL: ROUGH-IN: TYPE: DESCRIPTION: WCO WALL CLEANOUT, CAST IRON BODY AND ADJUSTABLE TOP ASSEMBLY WITH GASKET SEAL, AND ROUND SCORATED STAINLESS STEEL COVER. WADE 6000-153. FOR CARPETED FLOORS PROVIDE 6000-CM.	TYPE: TRAP SEAL: ROUGH-IN: TYPE: DESCRIPTION: WCO WALL CLEANOUT, CAST IRON BODY AND ADJUSTABLE TOP ASSEMBLY WITH GASKET SEAL, AND ROUND SCORATED STAINLESS STEEL COVER. WADE 6000-153. FOR CARPETED FLOORS PROVIDE 6000-CM.
FAUCET: CHROME PLATED BRASS DECK MOUNTED FITTING WITH 11" HIGH GOOSENECK SPOUT AND 4" WRIST BLADE HANDLES ON 8" CENTERS. QUARTER TURN CERAMIC DISC OPERATING CARTRIDGES, VANDAL RESISTANT 2.2 GPM AERATOR. CHICAGO MODEL #86-ESXK-ESVPJKCP.	FAUCET: CHROME PLATED BRASS DECK MOUNTED FITTING WITH CHECK IN STOPS, ADJUSTABLE SUPPLY ARMS, VACUUM BREAKER SPOUT WITH PAL HOOK AND WALL BRACE, 2-1/2" INDEXED LEVER HANDLES ON 8" CENTERS. QUARTER TURN CARTRIDGES, 3/4" MALE HOSE THREAD OUTLET. CHICAGO 445-897-CP.	TYPE: TRAP SEAL: ROUGH-IN: TYPE: DESCRIPTION: WCO WALL CLEANOUT, CAST IRON BODY AND ADJUSTABLE TOP ASSEMBLY WITH GASKET SEAL, AND ROUND SCORATED STAINLESS STEEL COVER. WADE 6000-153. FOR CARPETED FLOORS PROVIDE 6000-CM.	TYPE: TRAP SEAL: ROUGH-IN: TYPE: DESCRIPTION: WCO WALL CLEANOUT, CAST IRON BODY AND ADJUSTABLE TOP ASSEMBLY WITH GASKET SEAL, AND ROUND SCORATED STAINLESS STEEL COVER. WADE 6000-153. FOR CARPETED FLOORS PROVIDE 6000-CM.	TYPE: TRAP SEAL: ROUGH-IN: TYPE: DESCRIPTION: WCO WALL CLEANOUT, CAST IRON BODY AND ADJUSTABLE TOP ASSEMBLY WITH GASKET SEAL, AND ROUND SCORATED STAINLESS STEEL COVER. WADE 6000-153. FOR CARPETED FLOORS PROVIDE 6000-CM.	TYPE: TRAP SEAL: ROUGH-IN: TYPE: DESCRIPTION: WCO WALL CLEANOUT, CAST IRON BODY AND ADJUSTABLE TOP ASSEMBLY WITH GASKET SEAL, AND ROUND SCORATED STAINLESS STEEL COVER. WADE 6000-153. FOR CARPETED FLOORS PROVIDE 6000-CM.
P-TRAP: 1-1/2" 17 GAUGE CHROME PLATED CAST BRASS TRAP WITH CLEANOUT AND EXTENSION TO WALL WITH ESCUTCHEON PLATE. MCGUIRE #812.	P-TRAP: 1-1/2" 17 GAUGE CHROME PLATED CAST BRASS TRAP WITH CLEANOUT AND EXTENSION TO WALL WITH ESCUTCHEON PLATE. MCGUIRE #812.	TYPE: TRAP SEAL: ROUGH-IN: TYPE: DESCRIPTION: WCO WALL CLEANOUT, CAST IRON BODY AND ADJUSTABLE TOP ASSEMBLY WITH GASKET SEAL, AND ROUND SCORATED STAINLESS STEEL COVER. WADE 6000-153. FOR CARPETED FLOORS PROVIDE 6000-CM.	TYPE: TRAP SEAL: ROUGH-IN: TYPE: DESCRIPTION: WCO WALL CLEANOUT, CAST IRON BODY AND ADJUSTABLE TOP ASSEMBLY WITH GASKET SEAL, AND ROUND SCORATED STAINLESS STEEL COVER. WADE 6000-153. FOR CARPETED FLOORS PROVIDE 6000-CM.	TYPE: TRAP SEAL: ROUGH-IN: TYPE: DESCRIPTION: WCO WALL CLEANOUT, CAST IRON BODY AND ADJUSTABLE TOP ASSEMBLY WITH GASKET SEAL, AND ROUND SCORATED STAINLESS STEEL COVER. WADE 6000-153. FOR CARPETED FLOORS PROVIDE 6000-CM.	TYPE: TRAP SEAL: ROUGH-IN: TYPE: DESCRIPTION: WCO WALL CLEANOUT, CAST IRON BODY AND ADJUSTABLE TOP ASSEMBLY WITH GASKET SEAL, AND ROUND SCORATED STAINLESS STEEL COVER. WADE 6000-153. FOR CARPETED FLOORS PROVIDE 6000-CM.
SUPPLIES: 1/2" I.P.S. X 3/8" O.D. CHROME PLATED LOOSE KEY STOP VALVE WITH ESCUTCHEON AND 3/8" COMPRESSION CHROME PLATED FLEXIBLE RISERS. MCGUIRE #1216SK.	SUPPLIES: 1/2" I.P.S. X 3/8" O.D. CHROME PLATED LOOSE KEY STOP VALVE WITH ESCUTCHEON AND 3/8" COMPRESSION CHROME PLATED FLEXIBLE RISERS. MCGUIRE #1216SK.	TYPE: TRAP SEAL: ROUGH-IN: TYPE: DESCRIPTION: WCO WALL CLEANOUT, CAST IRON BODY AND ADJUSTABLE TOP ASSEMBLY WITH GASKET SEAL, AND ROUND SCORATED STAINLESS STEEL COVER. WADE 6000-153. FOR CARPETED FLOORS PROVIDE 6000-CM.	TYPE: TRAP SEAL: ROUGH-IN: TYPE: DESCRIPTION: WCO WALL CLEANOUT, CAST IRON BODY AND ADJUSTABLE TOP ASSEMBLY WITH GASKET SEAL, AND ROUND SCORATED STAINLESS STEEL COVER. WADE 6000-153. FOR CARPETED FLOORS PROVIDE 6000-CM.	TYPE: TRAP SEAL: ROUGH-IN: TYPE: DESCRIPTION: WCO WALL CLEANOUT, CAST IRON BODY AND ADJUSTABLE TOP ASSEMBLY WITH GASKET SEAL, AND ROUND SCORATED STAINLESS STEEL COVER. WADE 6000-153. FOR CARPETED FLOORS PROVIDE 6000-CM.	TYPE: TRAP SEAL: ROUGH-IN: TYPE: DESCRIPTION: WCO WALL CLEANOUT, CAST IRON BODY AND ADJUSTABLE TOP ASSEMBLY WITH GASKET SEAL, AND ROUND SCORATED STAINLESS STEEL COVER. WADE 6000-153. FOR CARPETED FLOORS PROVIDE 6000-CM.
ROUGH-IN: 1-1/4" 17 GAUGE CHROME PLATED BRASS GRID STRAINER WITH TAILPIECE. MCGUIRE #152A.	ROUGH-IN: 1-1/4" 17 GAUGE CHROME PLATED BRASS GRID STRAINER WITH TAILPIECE. MCGUIRE #152A.	TYPE: TRAP SEAL: ROUGH-IN: TYPE: DESCRIPTION: WCO WALL CLEANOUT, CAST IRON BODY AND ADJUSTABLE TOP ASSEMBLY WITH GASKET SEAL, AND ROUND SCORATED STAINLESS STEEL COVER. WADE 6000-153. FOR CARPETED FLOORS PROVIDE 6000-CM.	TYPE: TRAP SEAL: ROUGH-IN: TYPE: DESCRIPTION: WCO WALL CLEANOUT, CAST IRON BODY AND ADJUSTABLE TOP ASSEMBLY WITH GASKET SEAL, AND ROUND SCORATED STAINLESS STEEL COVER. WADE 6000-153. FOR CARPETED FLOORS PROVIDE 6000-CM.	TYPE: TRAP SEAL: ROUGH-IN: TYPE: DESCRIPTION: WCO WALL CLEANOUT, CAST IRON BODY AND ADJUSTABLE TOP ASSEMBLY WITH GASKET SEAL, AND ROUND SCORATED STAINLESS STEEL COVER. WADE 6000-153. FOR CARPETED FLOORS PROVIDE 6000-CM.	TYPE: TRAP SEAL: ROUGH-IN: TYPE: DESCRIPTION: WCO WALL CLEANOUT, CAST IRON BODY AND ADJUSTABLE TOP ASSEMBLY WITH GASKET SEAL, AND ROUND SCORATED STAINLESS STEEL COVER. WADE 6000-153. FOR CARPETED FLOORS PROVIDE 6000-CM.
TYPE: DESCRIPTION: SK-8 (NON T.A.S. COMPLIANT) - PET GROOMING SINK, FREE STANDING, STAINLESS STEEL, WITH FAUCET AND VACUUM BREAKER MOUNTED ON SIDEWALL OF SINK, FOREVER STAINLESS STEEL ARMBIT WITH DELUXE PLUS FIXTURE PACKAGE AND TWO BACK SPLASH MOUNTED BOTTLE AND TOOL HOLDER TRAYS.	TYPE: DESCRIPTION: SH-1 (T.A.S. COMPLIANT) - INDIVIDUAL SHOWER STATION SHOWER, JOB BUILT BASE INSTALLED PER ARCHITECTURAL DRAWINGS.	TYPE: TRAP SEAL: ROUGH-IN: TYPE: DESCRIPTION: WCO WALL CLEANOUT, CAST IRON BODY AND ADJUSTABLE TOP ASSEMBLY WITH GASKET SEAL, AND ROUND SCORATED STAINLESS STEEL COVER. WADE 6000-153. FOR CARPETED FLOORS PROVIDE 6000-CM.	TYPE: TRAP SEAL: ROUGH-IN: TYPE: DESCRIPTION: WCO WALL CLEANOUT, CAST IRON BODY AND ADJUSTABLE TOP ASSEMBLY WITH GASKET SEAL, AND ROUND SCORATED STAINLESS STEEL COVER. WADE 6000-153. FOR CARPETED FLOORS PROVIDE 6000-CM.	TYPE: TRAP SEAL: ROUGH-IN: TYPE: DESCRIPTION: WCO WALL CLEANOUT, CAST IRON BODY AND ADJUSTABLE TOP ASSEMBLY WITH GASKET SEAL, AND ROUND SCORATED STAINLESS STEEL COVER. WADE 6000-153. FOR CARPETED FLOORS PROVIDE 6000-CM.	TYPE: TRAP SEAL: ROUGH-IN: TYPE: DESCRIPTION: WCO WALL CLEANOUT, CAST IRON BODY AND ADJUSTABLE TOP ASSEMBLY WITH GASKET SEAL, AND ROUND SCORATED STAINLESS STEEL COVER. WADE 6000-153. FOR CARPETED FLOORS PROVIDE 6000-CM.
FAUCET: CHROME PLATED WROUGHT BRASS 4-1/2" WIDE GRID SINK STRAINER, 1-1/4" 17 GAUGE CHROME PLATED BRASS TAILPIECE. MCGUIRE #152.	FAUCET: CHROME PLATED WROUGHT BRASS 4-1/2" WIDE GRID SINK STRAINER, 1-1/4" 17 GAUGE CHROME PLATED BRASS TAILPIECE. MCGUIRE #152.	TYPE: TRAP SEAL: ROUGH-IN: TYPE: DESCRIPTION: WCO WALL CLEANOUT, CAST IRON BODY AND ADJUSTABLE TOP ASSEMBLY WITH GASKET SEAL, AND ROUND SCORATED STAINLESS STEEL COVER. WADE 6000-153. FOR CARPETED FLOORS PROVIDE 6000-CM.	TYPE: TRAP SEAL: ROUGH-IN: TYPE: DESCRIPTION: WCO WALL CLEANOUT, CAST IRON BODY AND ADJUSTABLE TOP ASSEMBLY WITH GASKET SEAL, AND ROUND SCORATED STAINLESS STEEL COVER. WADE 6000-153. FOR CARPETED FLOORS PROVIDE 6000-CM.	TYPE: TRAP SEAL: ROUGH-IN: TYPE: DESCRIPTION: WCO WALL CLEANOUT, CAST IRON BODY AND ADJUSTABLE TOP ASSEMBLY WITH GASKET SEAL, AND ROUND SCORATED STAINLESS STEEL COVER. WADE 6000-153. FOR CARPETED FLOORS PROVIDE 6000-CM.	TYPE: TRAP SEAL: ROUGH-IN: TYPE: DESCRIPTION: WCO WALL CLEANOUT, CAST IRON BODY AND ADJUSTABLE TOP ASSEMBLY WITH GASKET SEAL, AND ROUND SCORATED STAINLESS STEEL COVER. WADE 6000-153. FOR CARPETED FLOORS PROVIDE 6000-CM.
STRAINER: CHROME PLATED BRASS WIDE TOP SINK STRAINER WITH PERFORATED STRAINER, 1-1/2" CHROME PLATED BRASS TAILPIECE. MCGUIRE #152.	STRAINER: CHROME PLATED BRASS WIDE TOP SINK STRAINER WITH PERFORATED STRAINER, 1-1/2" CHROME PLATED BRASS TAILPIECE. MCGUIRE #152.	TYPE: TRAP SEAL: ROUGH-IN: TYPE: DESCRIPTION: WCO WALL CLEANOUT, CAST IRON BODY AND ADJUSTABLE TOP ASSEMBLY WITH GASKET SEAL, AND ROUND SCORATED STAINLESS STEEL COVER. WADE 6000-153. FOR CARPETED FLOORS PROVIDE 6000-CM.	TYPE: TRAP SEAL: ROUGH-IN: TYPE: DESCRIPTION: WCO WALL CLEANOUT, CAST IRON BODY AND ADJUSTABLE TOP ASSEMBLY WITH GASKET SEAL, AND ROUND SCORATED STAINLESS STEEL COVER. WADE 6000-153. FOR CARPETED FLOORS PROVIDE 6000-CM.	TYPE: TRAP SEAL: ROUGH-IN: TYPE: DESCRIPTION: WCO WALL CLEANOUT, CAST IRON BODY AND ADJUSTABLE TOP ASSEMBLY WITH GASKET SEAL, AND ROUND SCORATED STAINLESS STEEL COVER. WADE 6000-153. FOR CARPETED FLOORS PROVIDE 6000-CM.	TYPE: TRAP SEAL: ROUGH-IN: TYPE: DESCRIPTION: WCO WALL CLEANOUT, CAST IRON BODY AND ADJUSTABLE TOP ASSEMBLY WITH GASKET SEAL, AND ROUND SCORATED STAINLESS STEEL COVER. WADE 6000-153. FOR CARPETED FLOORS PROVIDE 6000-CM.
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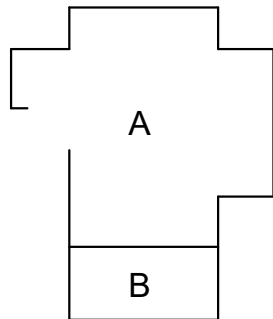


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# TOMBALL HIGH SCHOOL CTE & MISC. RENOVATIONS

TOMBALL INDEPENDENT SCHOOL DISTRICT  
30330 QUIN ROAD, TOMBALL, TX 77375

**ARCADIS**  
TEXAS ARCADIS INC.  
10205 WESTHEIMER SUITE 800  
HOUSTON, TX 77042  
tel 713.953.4897, fax 713.977.4620



11-06-23

PROJECT #: 202311  
DATE: 2023-11-03  
DRAWN: MA  
CHECKED: DS

DATE: 2023-11-03  
ISSUE: BID SET

## T0.00

TECHNOLOGY  
NOTES AND  
LEGENDS

TECHNOLOGY LEGEND				
SYMBOL	DESCRIPTION	ELEVATION	BACK BOX/RACEWAY	NOTES
# ▼	WALL MOUNTED NETWORK OUTLET DF: NUMBER OF DATA DROPS IN OUTLET AP: WIRELESS ACCESS POINT	+18" AFF, UNLESS OTHERWISE NOTED	4"X4"X2 1/8" BACK BOX WITH 1-G MUD RING, 1" C	
W ▼	COMMUNICATIONS OUTLET	FIELD COORDINATE	FIELD COORDINATE	
W ▼	WALL MOUNTED NETWORK OUTLET	+44" AFF	4"X4"X2 1/8" BACK BOX WITH 1-G MUD RING, 1" C	
B ▼	WALL MOUNTED BOX FOR FUTURE USE.	+18" AFF UNO	4"X4"X2 1/8" BACK BOX WITH 1-G MUD RING, 1" C	
D ▼	FLOOR MOUNTED NETWORK OUTLET	N/A	COORDINATE WITH ELECTRICAL CONTRACTOR	FINISHED HARDWARE PROVIDED BY DIV 27
⬆ #	CEILING MOUNTED NETWORK OUTLET AP: WIRELESS ACCESS POINT DF: NETWORK OUTLET	ABOVE CEILING	CEILING BRACKET WITH BISCUIT BLOCK	

NOTES:  
1. #G INDICATES BACK BOX SIZE.  
2. #C INDICATES CONDUIT SIZE.  
3. UNO: UNLESS NOTED OTHERWISE.  
4. CONDUIT STUB UP AND SLEEVES SHALL HAVE A SOLID UNO/IT PLASTIC PROTECTIVE BUSHING.  
5. NO CONDUITS SHALL EXCEED FOR 40% MAXIMUM FILL RATIO. CONTRACTOR TO PROVIDE ADDITIONAL CONDUITS REQUIRED.

ACCESS CONTROL LEGEND				
SYMBOL	DESCRIPTION	ELEVATION	BACK BOX/RACEWAY	NOTES
ACP	ACCESS CONTROL SYSTEM, CONTROL PANEL.	+60" AFF TO CENTER	AS REQUIRED	COORDINATE POWER. NOTE #4.
CR #	ACCESS CONTROL PROXIMITY CARD READER. "W" - INDICATES WALL MOUNTED READER "U" - INDICATES MULLION MOUNTED READER	+42" A.F.F.	1-G, 3/4" C	
CR	DOOR MOUNTED ACCESS CONTROL PROXIMITY CARD READER THAT IS INTEGRATED INTO THE DOOR HARDWARE.	+42" AFF	N/A	
DS #	2-WAY AUDIO/VIDEO INTERCOM DOOR STATION. "W" - INDICATES WALL MOUNTED READER "U" - INDICATES MULLION MOUNTED READER	+42" AFF	"W: 1-G, 3/4" C "U: 3/4" C	COORDINATE POWER. NOTE #4.
DS	DOOR MOUNTED 2-WAY AUDIO/VIDEO INTERCOM DOOR STATION	+42" AFF, FIELD COORDINATE		COORDINATE POWER. NOTE #4.
MS	2-WAY AUDIO/VIDEO INTERCOM MASTER STATION.	DESK MOUNTED UNO		COORDINATE POWER. NOTE #4.
DR	DOOR RELEASE BUTTON	COORDINATE WITH GC	1-G, 3/4" C	
REX	PIR MOTION REQUEST TO EXIT DEVICE			
DP	DOOR PROP ALARM	CEILING MOUNTED UNO	N/A	N/A
DC	DPDT MAGNETIC DOOR CONTACT/DOOR POSITION SENSOR.	FLUSH MOUNTED IN DOOR FRAME	N/A	PROVIDED BY ACS CONTRACTOR.
RFID	VEHICLE RFID TAG READER.		FIELD COORDINATE RACEWAYS AND BACK BOXES	PROVIDE NECESSARY EQUIPMENT FOR A FULLY FUNCTIONAL VEHICLE ENTRY POINT

NOTES:  
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3. UNO: UNLESS NOTED OTHERWISE.  
4. PROVIDE AND INSTALL ONE (1) CATEGORY CABLE TO CONNECT DEVICE TO NETWORK.

INTERCOM LEGEND				
SYMBOL	DESCRIPTION	ELEVATION	BACK BOX/RACEWAY	NOTES
ICS	INTERCOM COMMUNICATIONS SYSTEM HEAD END UNIT.	FLOOR MOUNTED	COORDINATE WITH EC	COORDINATE POWER WITH EC
S	CEILING MOUNTED INTERCOM SPEAKER, LAY-IN CEILING.	CEILING	CONTRACTOR PROVIDED.	
S2	CEILING MOUNTED INTERCOM SPEAKER, HARD CEILING.	CEILING	CONTRACTOR PROVIDED	
S3	WALL MOUNTED INTERIOR INTERCOM SPEAKER	REFERENCE FLOOR PLANS	CONTRACTOR PROVIDED	
S4	WALL MOUNTED EXTERIOR INTERCOM SPEAKER	+10" AFF UNO	CONTRACTOR PROVIDED	
#IP	IP BASED SPEAKER, "I" TO BE REPLACED WITH S, S2, S3, S4 INDICATING THE SPECIFIC TYPE OF SPEAKER.	REFERENCE FLOOR PLANS	CONTRACTOR PROVIDED	NOTE #5
VC	WALL MOUNTED VOLUME CONTROL	+48" AFF	4"X4"X2 1/8" BACK BOX WITH 1-G MUD RING, 1" C	
CB	INTERCOM CALL BUTTON	+48" AFF	4"X4"X2 1/8" BACK BOX WITH 1-G MUD RING, 1" C	
C	SINGLE FACE CLOCK	REFERENCE FLOOR PLANS	4"X4"X2 1/8" BACK BOX WITH 1-G MUD RING, 1" C	
C2	DOUBLE FACE CLOCK	REFERENCE FLOOR PLANS	4"X4"X2 1/8" BACK BOX WITH 1-G MUD RING, 1" C	
RPS	REMOTE PROGRAM SOURCE	DESK TOP	COORDINATE WITH EC	NOTE #5
ACS	ADMINISTRATIVE CALL STATION.	DESK TOP	N/A	NOTE #5
LD	LOCKDOWN BUTTON	+48" AFF	4"X4"X2 1/8" BACK BOX WITH 1-G MUD RING, 1" C	

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4. THE SYSTEM INTEGRATOR SHALL COORDINATE ALL BOX AND CONDUIT SIZE REQUIREMENTS PRIOR TO ROUGH-IN BY THE PROJECT'S ELECTRICAL CONTRACTOR.  
5. PROVIDE AND INSTALL ONE (1) CATEGORY CABLE TO CONNECT DEVICE TO NETWORK.

VIDEO SURVEILLANCE LEGEND				
SYMBOL	DESCRIPTION	ELEVATION	BACK BOX/RACEWAY	NOTES
4K ZC	WALL/CORNER MOUNT 4-SENSOR CAMERA	REFERENCE FLOOR PLANS	4"X4"X2 1/8" BACK BOX WITH 1-G MUD RING, 1" C	NOTE #5
4K b ZC	CEILING MOUNTED 4-SENSOR CAMERA	CEILING		NOTE #5
4K W ZC	2-SENSOR CAMERA "W" - INDICATES WALLMOUNTED CAMERA	REFERENCE FLOOR PLANS	4"X4"X2 1/8" BACK BOX WITH 1-G MUD RING, 1" C	NOTE #5
4K W	1-SENSOR CAMERA "W" - INDICATES WALLMOUNTED CAMERA	REFERENCE FLOOR PLANS	4"X4"X2 1/8" BACK BOX WITH 1-G MUD RING, 1" C	NOTE #5
VRS	VIDEO RECORDING SERVER			NOTE #5
IMU	VIDEO SURVEILLANCE MAIN UNIT	ABOVE CEILING		NOTE #5

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5. PROVIDE AND INSTALL ONE (1) CATEGORY CABLE TO CONNECT DEVICE TO NETWORK.

AUDIO/VIDEO LEGEND				
SYMBOL	DESCRIPTION	ELEVATION	BACK BOX/RACEWAY	NOTES
AV-1 ▼	WALL MOUNTED AUDIO/VIDEO INPUT OUTLET	+18" AFF UNO	4 11/16"X4 11/16"X2-1/8" BACK BOX WITH DOUBLE GANG RING, TWO(2) 1.25" C	
FSD-1 ▼	WALL MOUNTED FLAT SCREEN DISPLAY AUDIO/VIDEO OUTPUT OUTLET	REFERENCE FLOOR PLAN	4"X4"X2 1/8" BACK BOX WITH 1-G MUD RING, 1" C	NOTE #5
FSD-2 ▼	WALL MOUNTED FLAT SCREEN DISPLAY AUDIO/VIDEO OUTPUT OUTLET ASSOCIATED WITH AV-1 INPUT OUTLET	REFERENCE FLOOR PLAN	4 11/16"X4 11/16"X2-1/8" BACK BOX WITH DOUBLE GANG RING, TWO(2) 1.25" C	NOTE #5
IVD ▼	INTERACTIVE VIDEO DISPLAY ON CART	N/A	N/A	N/A
CP ▼	AV CONTROL PANEL	+48" AFF TO TOP	4"X4"X2 1/8" BACK BOX WITH 1-G MUD RING, 1" C	

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2. #C INDICATES CONDUIT SIZE.  
3. UNO: UNLESS NOTED OTHERWISE.  
4. THE SYSTEM INTEGRATOR SHALL COORDINATE ALL BOX AND CONDUIT SIZE REQUIREMENTS PRIOR TO ROUGH-IN BY THE PROJECT'S ELECTRICAL CONTRACTOR.  
5. PROVIDE AND INSTALL ONE (1) CATEGORY CABLE TO CONNECT DEVICE TO NETWORK.

INTRUSION LEGEND				
SYMBOL	DESCRIPTION	ELEVATION	BACK BOX/RACEWAY	NOTES
IDP	INTRUSION DETECTION SYSTEM CONTROL PANEL	+60" AFF	TWO(2) - 1" C TO CONTRACTOR PROVIDED BACK BOX	COORDINATE POWER WITH EC. NOTE #5
KP	INTRUSION DETECTION SYSTEM KEYPAD	+48" AFF TO TOP	4"X4"X2 1/8" BACK BOX WITH 1-G MUD RING, 1" C	
M	CEILING MOUNTED MOTION DETECTOR	CEILING		
M	WALL MOUNTED MOTION DETECTOR LR, LONG RANGE	REFERENCE FLOOR PLAN	N/A	
GB	CEILING MOUNTED GLASS BREAK DETECTOR	CEILING	N/A	
DC	DPDT MAGNETIC DOOR CONTACT/DOOR POSITION SENSOR.	FLUSH MOUNTED IN DOOR FRAME	N/A	DEVICE PROVIDED BY ACS CONTRACTOR.
SDC	SURFACE MOUNT MAGNETIC DOOR CONTACT.	SURFACE MOUNTED ON DOOR FRAME	N/A	
ODC	OVERHEAD DOOR MOUNT MAGNETIC DOOR CONTACT.	SURFACE MOUNTED ON DOOR FRAME	N/A	
DB	DURESS PANIC BUTTON	UNDER DESK UNO	N/A	

NOTES:  
1. #G INDICATES BACK BOX SIZE.  
2. #C INDICATES CONDUIT SIZE.  
3. UNO: UNLESS NOTED OTHERWISE.  
4. REFERENCE DIVISION 28 SPECIFICATION FOR ADDITIONAL INFORMATION AND REQUIREMENTS.  
5. PROVIDE AND INSTALL ONE (1) CATEGORY CABLE TO CONNECT DEVICE TO NETWORK.

FIRE ALARM	
*FIRE ALARM CONTROL PANEL SHALL BE EXISTING TO REMAIN. FIRE ALARM SYSTEM SHALL BE FULLY OPERATIONAL THROUGHOUT ALL PHASES OF CONSTRUCTION. DEMOLISH EXISTING SYSTEM ONCE NEW SYSTEM IS INSTALLED, TESTED, AND ACCEPTED BY THE AHI.	
*EXISTING FIELD DEVICE LOCATIONS SHALL BE REUSED WHENEVER POSSIBLE. INSTALL NEW FIRE ALARM SYSTEM SPEAKER AS SPECIFIED FOR VOICE EVACUATION.	

LEGEND	
SYMBOL	DESCRIPTION
FACP	FIRE ALARM CONTROL
FAA	FIRE ALARM ANNUNCIATOR PANEL

NOTES:  
1. FIRE ALARM SYSTEM IS PERFORMANCE BASED PER SPECIFICATIONS. CONTRACTOR TO REFERENCE SPECIFICATIONS FOR ADDITIONAL INFORMATION.  
2. A LICENSED FIRE ALARM PLANNING SUPERINTENDENT CERTIFIED TO A MINIMUM LEVEL 3, IN THE SUBFIELD OF FIRE ALARM SYSTEMS THROUGH THE NATIONAL INSTITUTE FOR CERTIFICATION IN ENGINEERING TECHNOLOGIES (NICET), SHALL PROVIDE PLANS AND CALCULATIONS FOR A MANUAL AND AUTOMATIC FIRE DETECTION AND ALARM SYSTEM TO COMPLY WITH THE BUILDING SPACE LAYOUT, BUILDING OCCUPANCY, CURRENT NFPA 72, LOCAL AND STATE CODE REQUIREMENTS, AND THE FIRE ALARM AND DETECTION SYSTEM SPECIFICATIONS.

SUBSCRIPTS AND ABBREVIATIONS	
TEXT	DESCRIPTION
'WP'	DEVICE SHALL BE WEATHER PROOF AND RATED FOR EXTERIOR CONDITIONS
•	FIELD COORDINATE ELEVATION.
AFF	ABOVE FINISHED FLOOR
'UC'	DEVICE IS TO BE MOUNTED ON THE UNDERSIDE OF THE ELEVATED CANOPY.

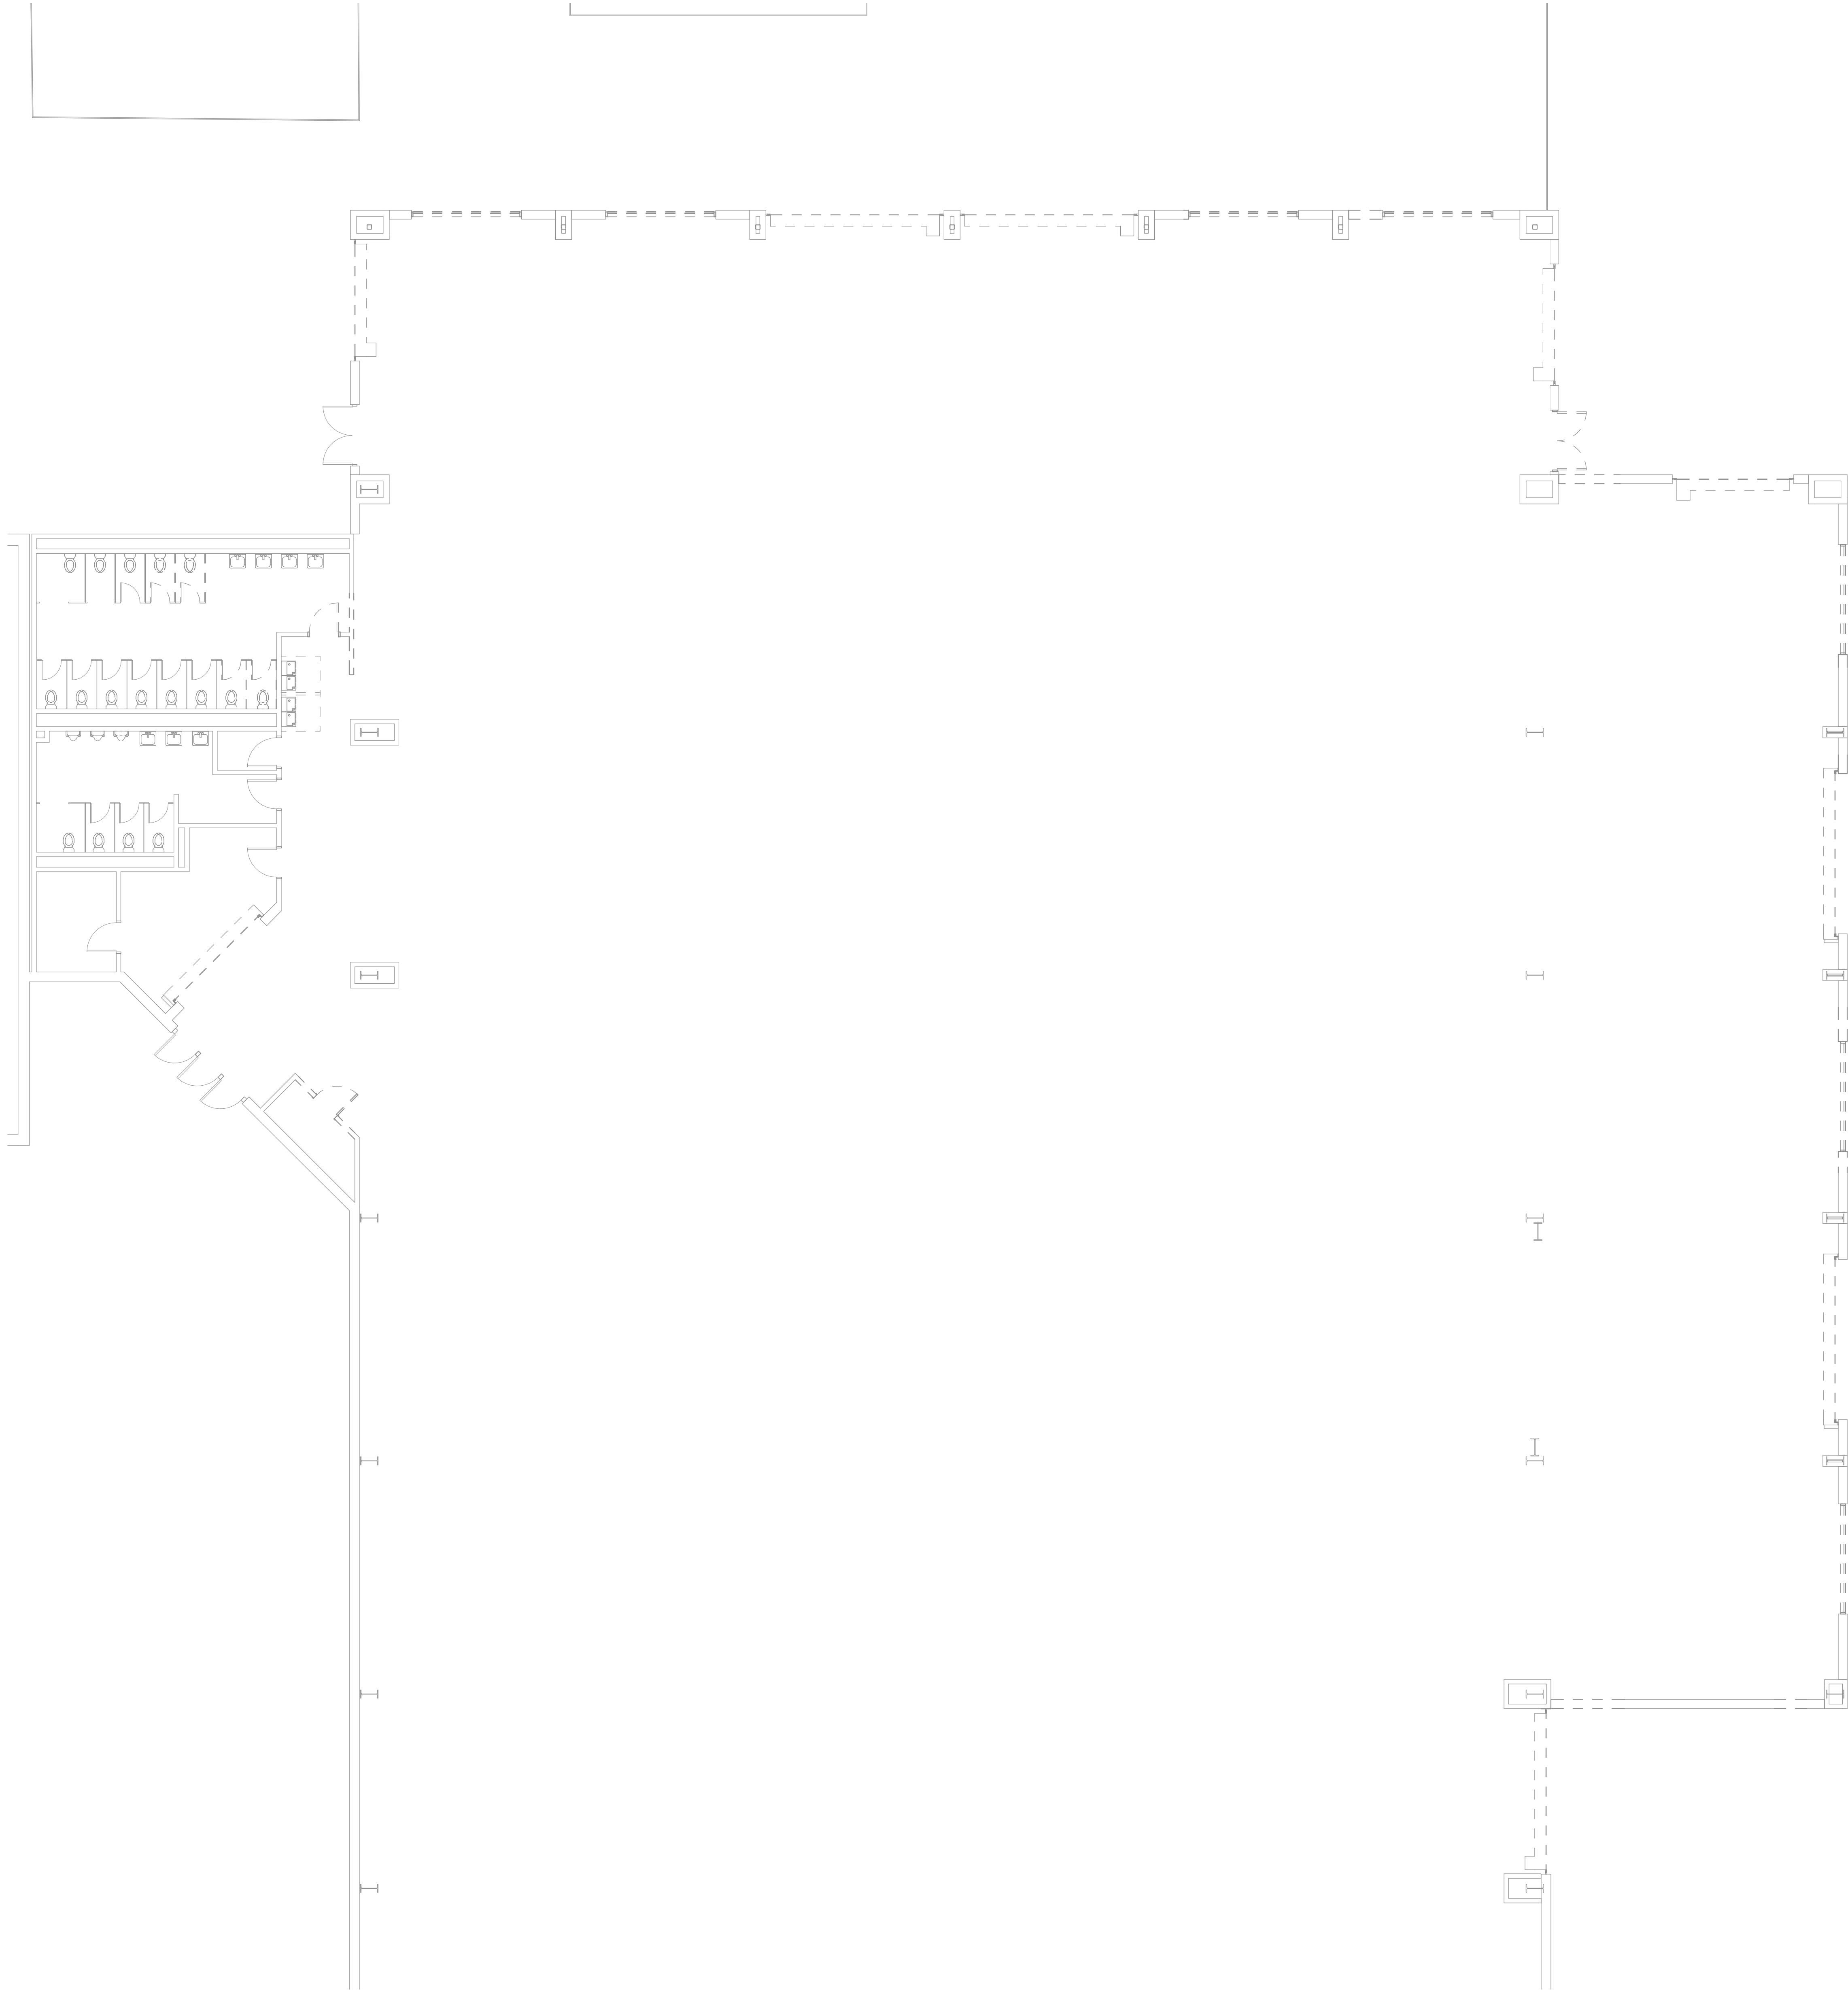
SUBSCRIPTS LEGEND - EXISTING DEVICES	
TEXT	DESCRIPTION
'E'	EXISTING TO REMAIN.
'D'	DEVICE IS EXISTING AND IS TO BE REMOVED. CONTRACTOR TO REMOVE THE DEVICE AND RETURN TO OWNER.
'RR'	REMOVE EXISTING DEVICE AND RELOCATE TO A LOCATION INDICATED ON THE DRAWINGS.

NOTES TO CONTRACTOR  
1. EVERY SYMBOL SHOWN ON LEGEND MAY NOT APPEAR ON DRAWINGS.  
2. SYSTEM INSTALLERS SHALL COORDINATE LOCATIONS AND CONNECTIONS WITH THE PROJECT'S ELECTRICAL CONTRACTOR.  
3. CONTRACTOR TO PROVIDE PROPERLY GROUNDED LIGHTING PROTECTION ON ALL CABLES ENTERING AND EXITING THE BUILDING.

RESPONSIBILITY MATRIX				
SCOPE ITEM	RESPONSIBILITY			NOTES
	OFOI	OFCI	OFCI	
COMMUNICATIONS - DIVISION 27				
CATEGORY 6/6A STRUCTURED CABLING SYSTEM		✓		
FLAT PANEL DISPLAYS				
FLAT PANEL DISPLAY MOUNTS		✓		
INTERACTIVE DISPLAYS		✓		
INTERACTIVE DISPLAY MOUNTS		✓		
BUILDING INTERCOM/PA, BELL, AND CLOCK SYSTEM		✓		
NETWORK EQUIPMENT				
--> MOD/IDF NETWORK EQUIPMENT		✓		
--> VOIP TELEPHONES		✓		
--> WIRELESS ACCESS POINTS		✓		
--> UNINTERRUPTIBLE POWER SUPPLIES (UPS)		✓		
RACEWAY, CONDUIT, BACK BOXES, SLEEVES, ETC.		✓		SEE NOTE 4.
ELECTRICAL POWER		✓		SEE NOTE 4.
LIFE SAFETY AND SECURITY - DIVISION 28				
ACCESS CONTROL SYSTEM(ACS)	OFOI	OFCI	OFCI	
INTRUSION DETECTION SYSTEM		✓		
DOOR ACCESS VIDEO INTERCOM SYSTEM		✓		
VIDEO SURVEILLANCE SYSTEM (VSS)				
--> VSS SERVERS		✓		
--> VSS CAMERAS		✓		
--> VSS PROGRAMMING		✓		
--> VSS CABLING		✓		SEE NOTE 7.
FIRE ALARM SMOKE DETECTION WITH VOICE EVACUATION		✓		
RACEWAY, CONDUIT, BACK BOXES, SLEEVES, ETC.		✓		SEE NOTE 4.
ELECTRICAL POWER		✓		SEE NOTE 4.
OFOI - OWNER FURNISHED AND OWNER INSTALLED OFCI - CONTRACTOR FURNISHED AND CONTRACTOR INSTALLED OFCI - OWNER FURNISHED AND CONTRACTOR INSTALLED				
RESPONSIBILITY MATRIX NOTES: 1. NONE IN PROJECT. 2. OWNER CONFIGURED, CONTRACTOR INSTALLED AND PATCHED. 3. OWNER CONFIGURED, CONTRACTOR INSTALLED AND PATCHED. CONTRACTOR TO PROVIDE AND INSTALL WALL MOUNT BRACKETS AND HIGH IMPACT ENCLOSURES. 4. BY DIVISION 26. 5. REFERENCE DIVISION 8 FOR DOOR HARDWARE. 6. BY DIVISION 11. 7. BY DIVISION 27. 8. UNLESS SPECIFIED OTHERWISE				







 **1** **TECHNOLOGY DEMOLITION 1ST FLOOR PLAN - AREA 'A1'**  
Scale: 1/8" = 1'-0"


TECHNOLOGY DEMO PLAN GENERAL NOTES	
A	CONTRACTOR SHALL HAVE EACH LOW VOLTAGE SYSTEM TESTED PRIOR TO THE COMMENCEMENT OF CONSTRUCTION. SYSTEMS SHALL INCLUDE BUT NOT BE LIMITED TO: 1) FIRE ALARM 2) INTERCOM 3) STRUCTURED CABLING 4) INTRUSION DETECTION 5) ACCESS CONTROL 6) AUDIO VIDEO 7) VIDEO SURVEILLANCE TESTING SHALL INCLUDE THE FUNCTIONALITY OF ALL FIELD DEVICES AND EQUIPMENT. ANY FAILURES OR ITEMS FOUND NOT TO BE FUNCTIONING TO SPECIFICATION, SHALL BE REPORTED PRIOR TO CONSTRUCTION. ANY ITEMS FOUND TO BE IMPROPERLY OR NON-FUNCTIONING UPON THE COMPLETION OF THE PROJECT, SHALL BE REPLACED AND/OR REPAIRED, BY THE CONTRACTOR, AT NO ADDITIONAL COST TO THE PROJECT OR THE OWNER.
B	CONTRACTOR SHALL REMOVE ANY DEVICES WHERE CONSTRUCTION OCCURS TO PREVENT POSSIBLE DAMAGE TO THE DEVICE. REMOVAL OF ANY DEVICES WHICH SUPPORT USER CONNECTION OR OTHER SYSTEMS, SHALL BE COORDINATED WITH THE OWNER PRIOR TO REMOVAL AND/OR TAKING OFF LINE. REMOVAL SHALL CONSIST OF BUT NOT BE LIMITED TO THE FOLLOWING DEVICES AND ASSOCIATED SUPPORT INFRASTRUCTURE: 1) FIRE ALARM DEVICES 2) INTERCOM DEVICES 3) WIRELESS ACCESS POINTS 4) TELEPHONES 5) VIDEO SURVEILLANCE CAMERAS 6) INTRUSION DETECTION DEVICES 7) ACCESS CONTROL DEVICES 8) VIDEO PROJECTION DEVICES 9) VIDEO DISPLAY DEVICES ANY DEVICES, NOT BEING REINSTALLED, SHALL BE RETURNED TO THE OWNER.
C	CONTRACTOR SHALL DOCUMENT THE LOCATION AND ANY ID TAG, MAC ADDRESS, IP ADDRESS, OR BAR CODE OF ANY EXISTING DEVICE THAT IS TO BE REMOVED FROM ITS CURRENT LOCATION. DEVICES THAT ARE TO REMAIN, SHALL BE REINSTALLED IN THE EXACT LOCATION THAT THEY RESIDE IN PRIOR TO CONSTRUCTION, UNLESS NOTED OTHERWISE.
D	ANY INDIVIDUAL THAT WILL BE REMOVING, RELOCATING, REINSTALLING, AND/OR TAMPERING WITH ANY EXISTING DEVICES, SHALL BE CERTIFIED BY THE MANUFACTURER OF THE SPECIFIC SYSTEM AND/OR LICENSED AS REQUIRED BY THE STATE TO PERFORM WORK ON THE SYSTEM. THE INDIVIDUAL SHALL BE A FULL-TIME EMPLOYEE OF THE FIRM CONTRACTED TO CONDUCT SUCH WORK ON THE PROJECT AND THAT FIRM SHALL ALSO HOLD ANY CERTIFICATIONS AND/OR LICENSES REQUIRED TO CONDUCT WORK ON THE SPECIFIC SYSTEM.
E	ANY INDIVIDUAL/FIRM THAT WILL BE REMOVING, RELOCATING, REINSTALLING, OR TAMPERING WITH IN ANY DEVICES; SHALL BE LICENSED BY THE STATE, AS APPLICABLE, AND CERTIFIED BY THE MANUFACTURER OF THE SYSTEM.
F	ALL CABLING ASSOCIATED WITH DEVICES THAT ARE TO BE DEMOLISHED, SHALL BE REMOVED FROM THE DEVICE LOCATION TO THE CABLES POINT OF ORIGIN. NO CABLE SHALL BE ABANDONED IN PLACE.
G	ALL CATEGORY CABLING RATED LOWER THAN CATEGORY 6 SHALL BE REMOVED AND REPLACED WITH CATEGORY 6 CABLING. COORDINATE WITH OWNER PRIOR TO DEMOLITION OF CABLE.
H	CONTRACTOR TO COORDINATE WITH TISD TECHNOLOGY DEPARTMENT PRIOR TO CONSTRUCTION ON WHICH DEVICES ARE TO BE REMOVED BY THE OWNER'S VENDER IN ORDER TO PREVENT VOID OF WARRANTY.
I	CONTRACTOR SHALL VERIFY EXISTING CONDITIONS IN FIELD.
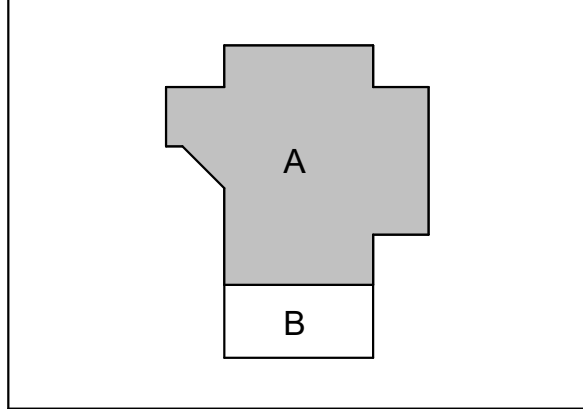
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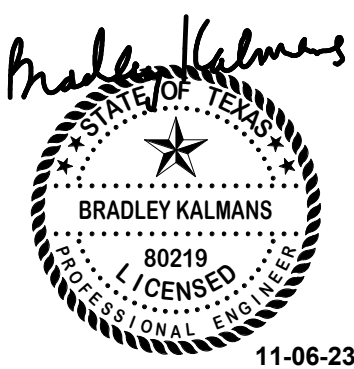
TOMBALL HIGH SCHOOL  
CTE & MISC. RENOVATIONS

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30330 QUIN ROAD, TOMBALL, TX 77375

ARCADIS

TEXAS ARCADIS INC.

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PROJECT #:	202311
DATE:	2023-11-03
DRAWN:	MA
CHECKED:	DS
DATE	ISSUE
2023-11-03	BID SET

T1.01  
TECHNOLOGY  
DEMOLITION  
AREA 'A1' 1ST  
FLOOR PLAN





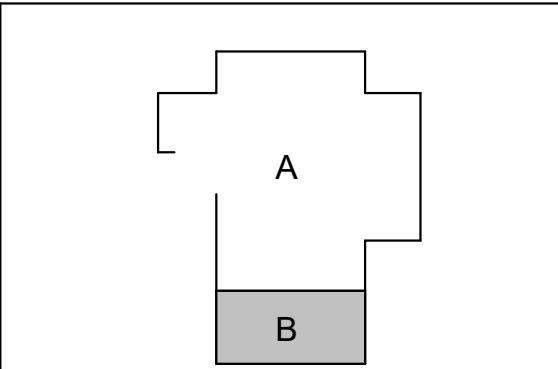
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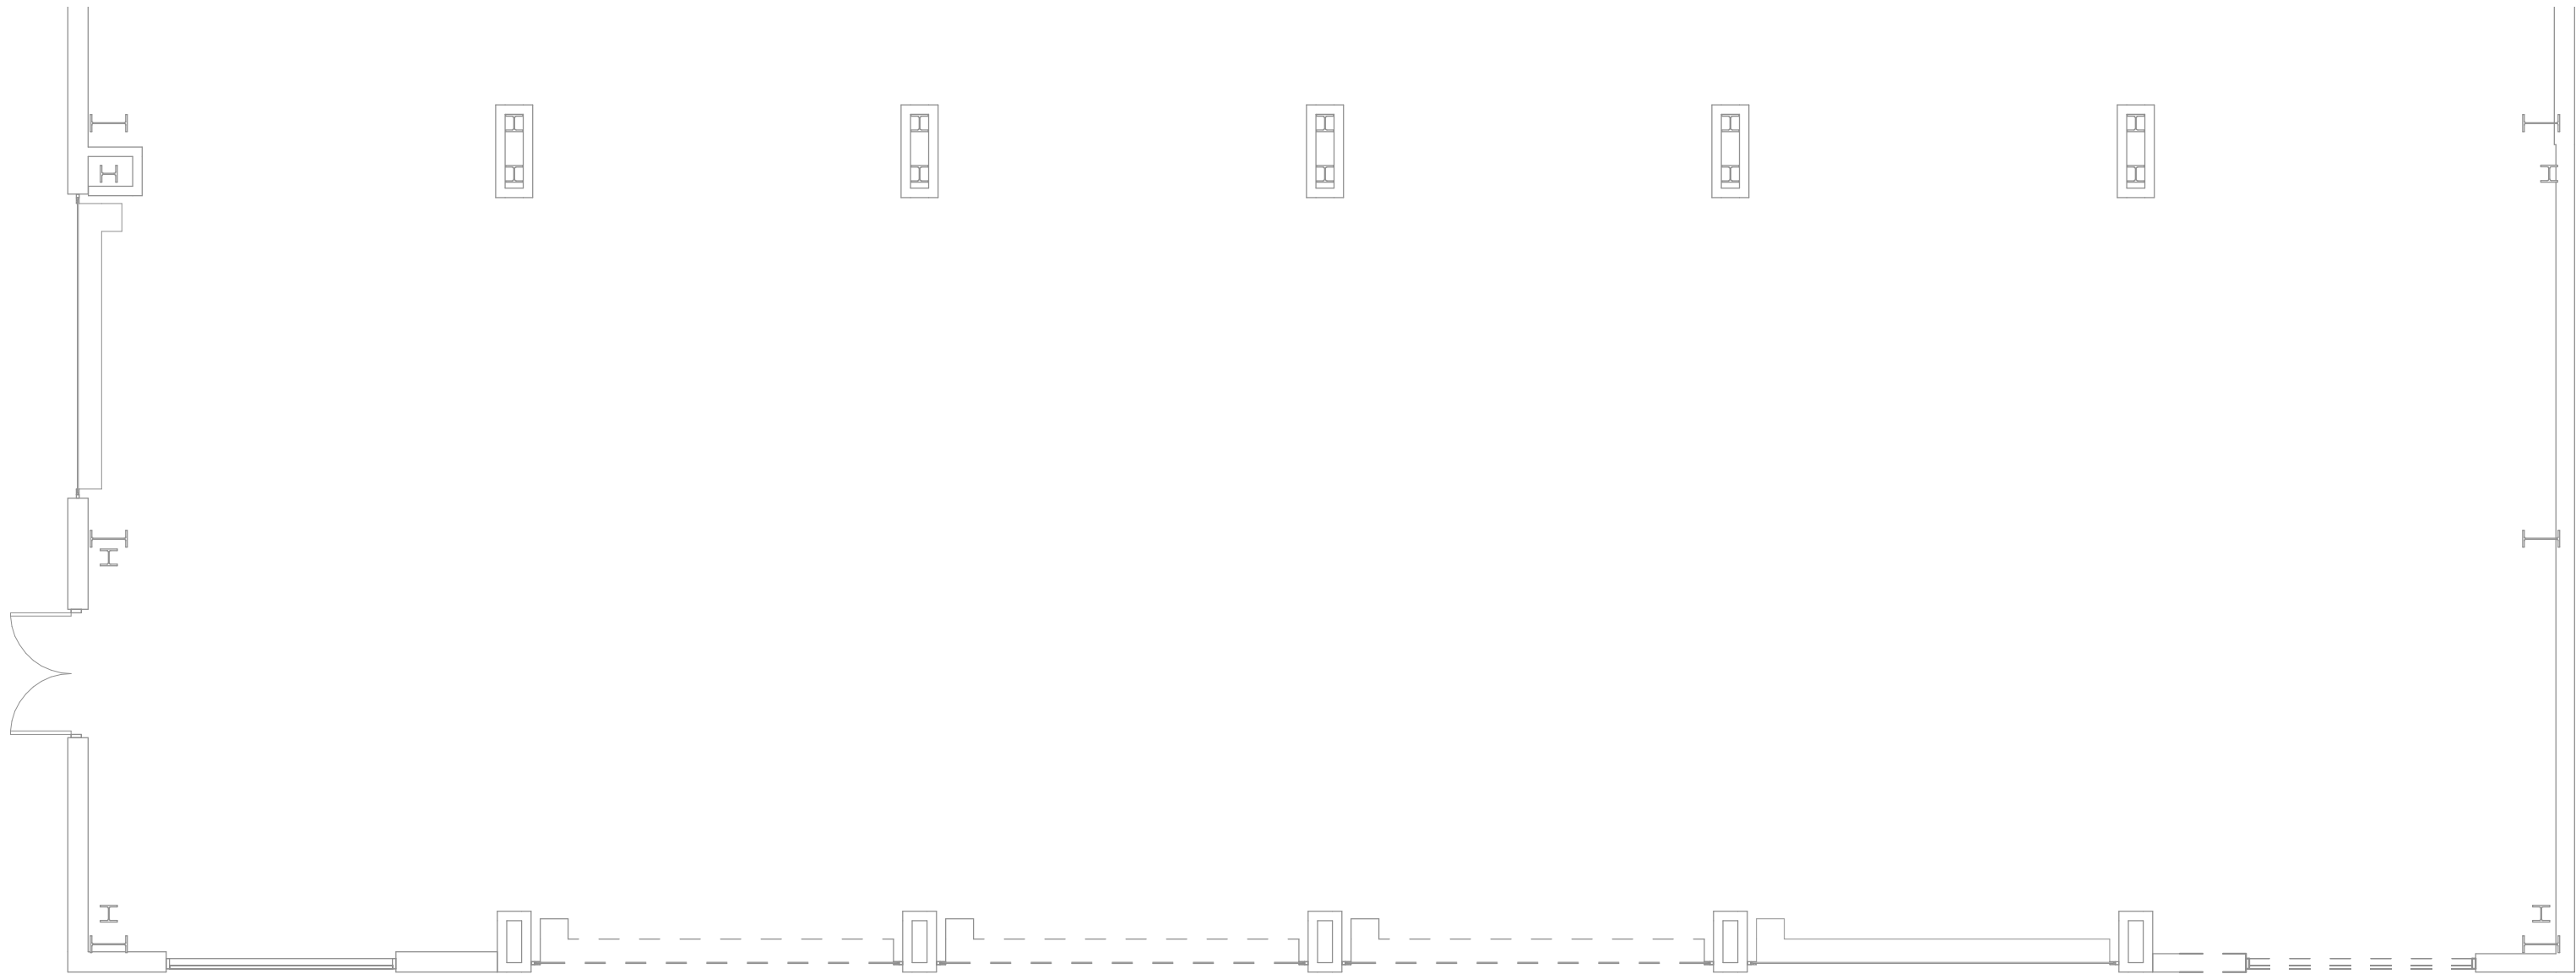
*Bradley Kalmans*

BRADLEY KALMANS  
80219  
CENSUS  
11-06-23

PROJECT #:	202311
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**T1.02**

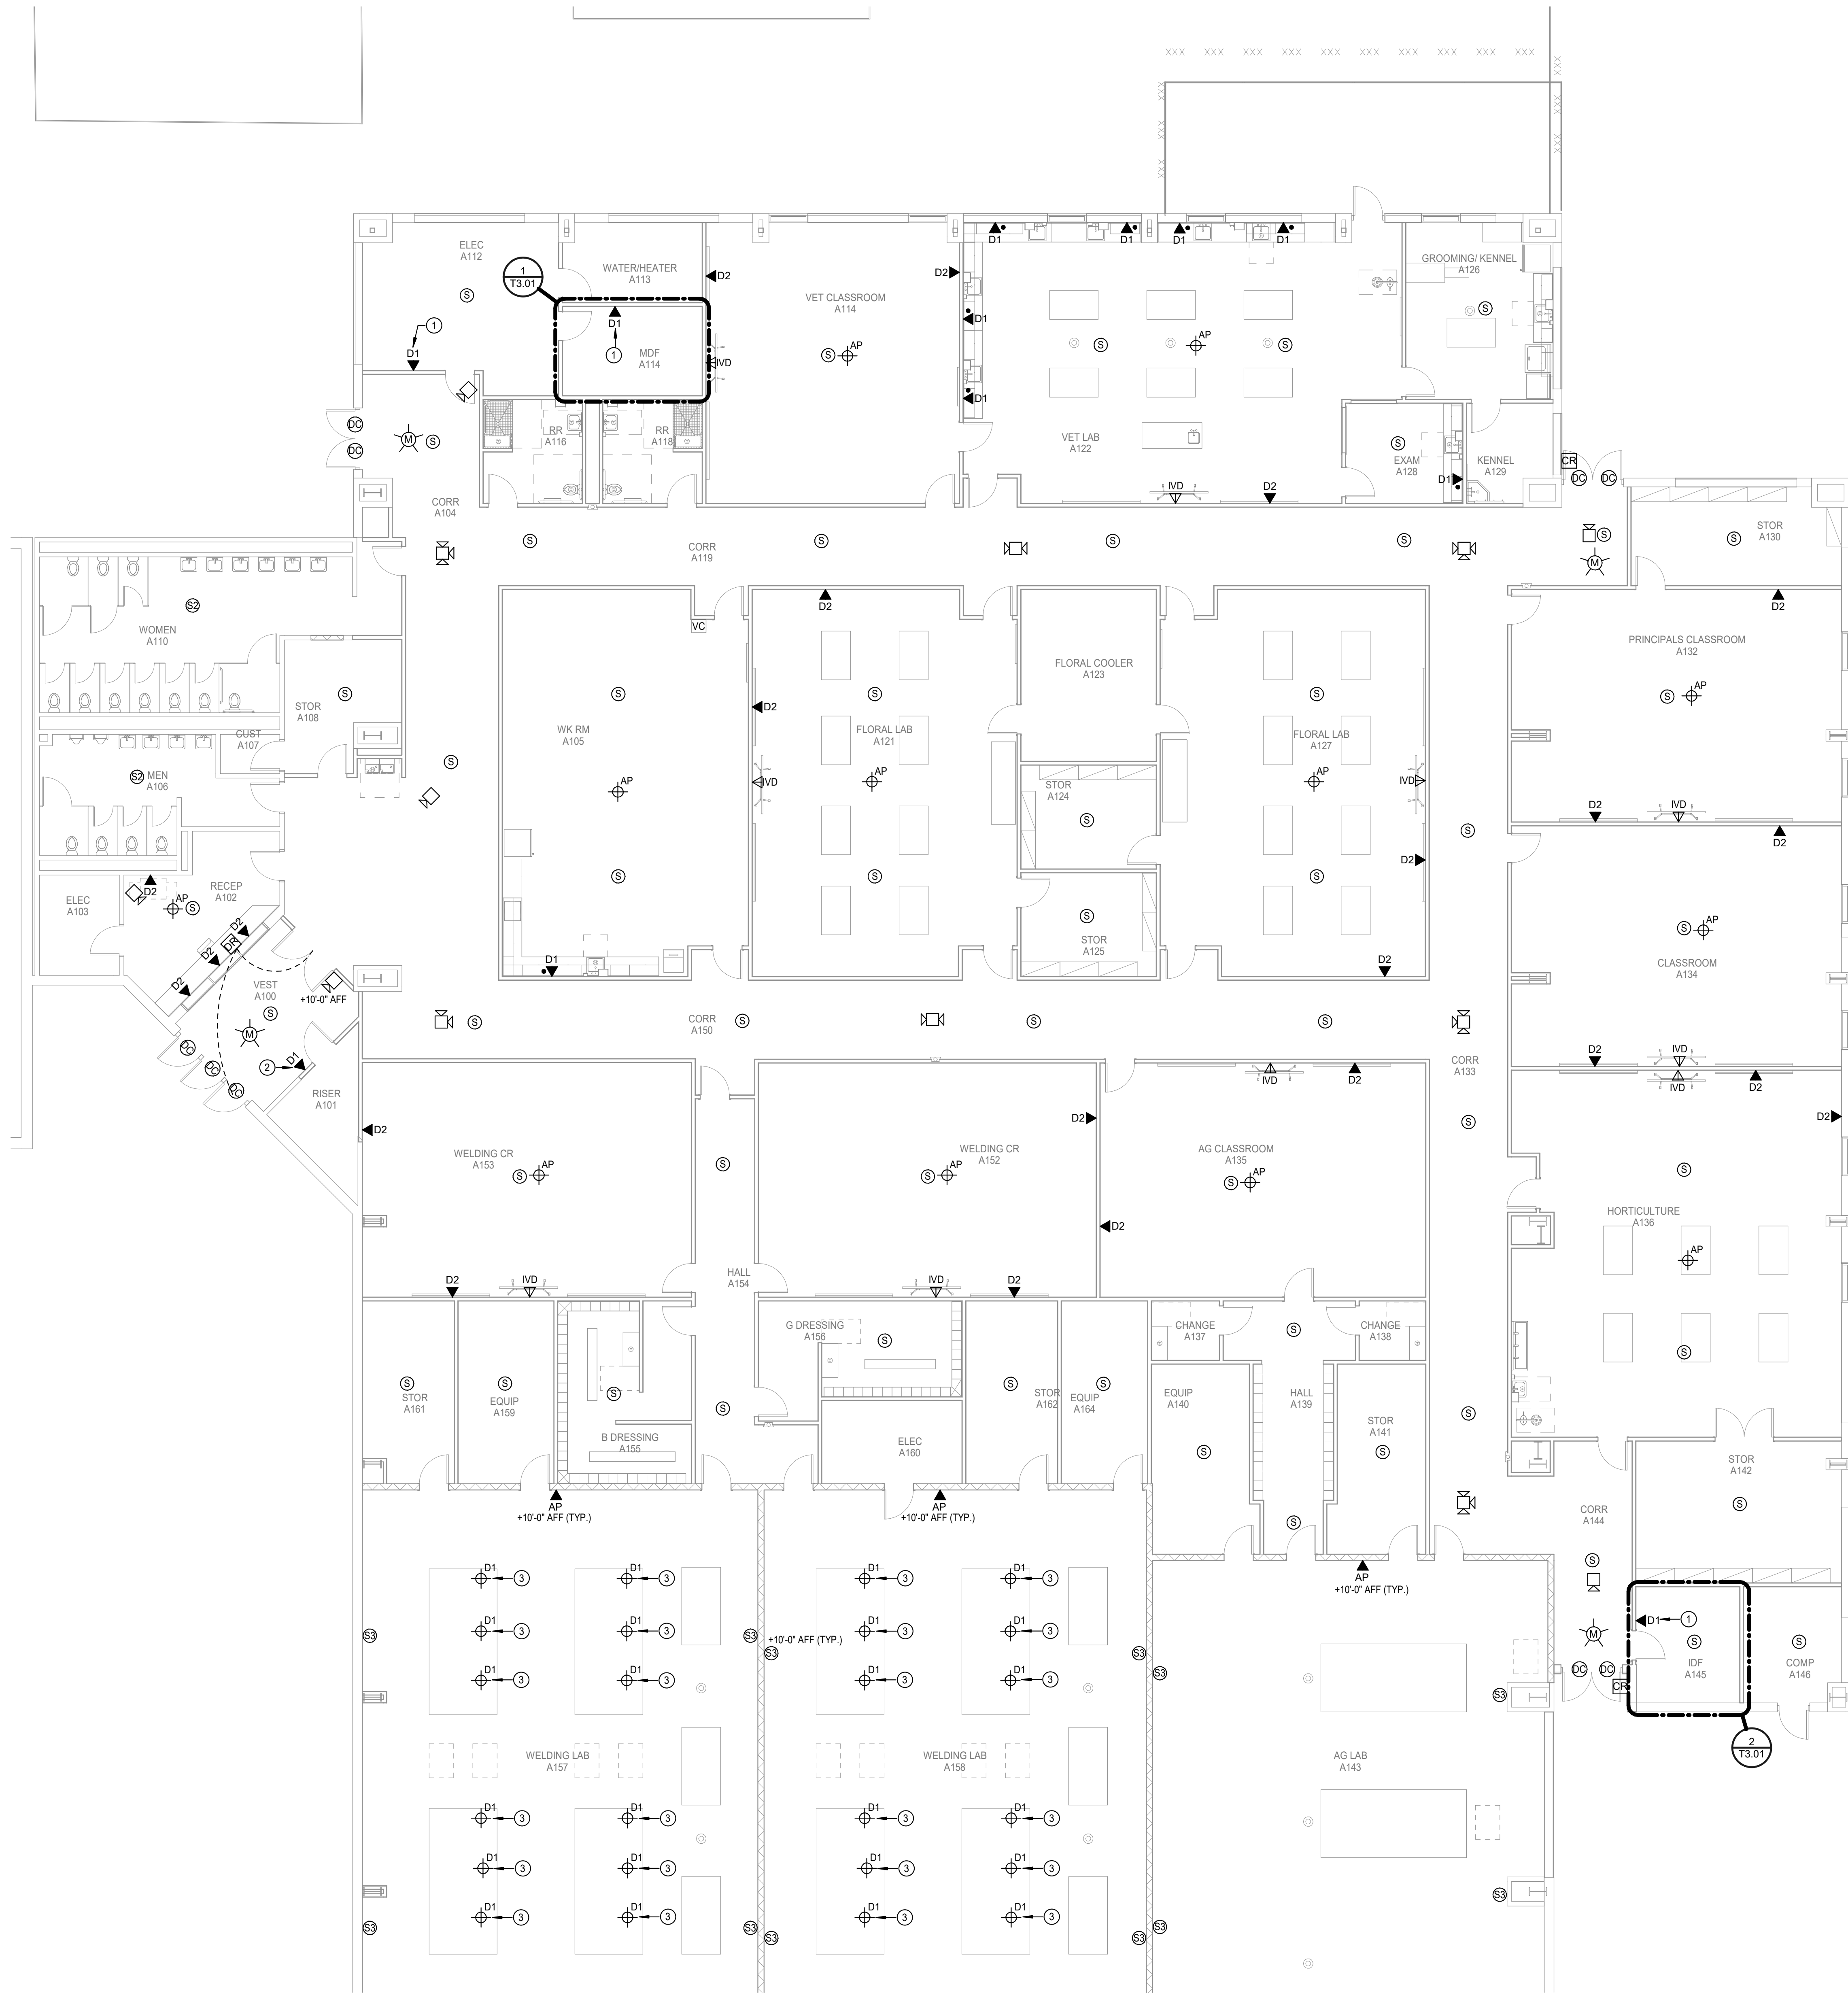
TECHNOLOGY  
DEMOLITION  
AREA 'B1' 1ST  
FLOOR PLAN



**1 TECHNOLOGY DEMOLITION 1ST FLOOR PLAN - AREA 'B1'**  
Scale: 1/8" = 1'-0"

PLAN  
NORTH





1 TECHNOLOGY 1ST FLOOR PLAN - AREA 'A1'  
Scale: 1/8" = 1'-0"

TECHNOLOGY KEYED NOTES

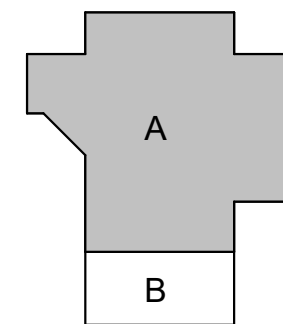
- 1 PROVIDE ONE (1) CATEGORY 6 DATA CIRCUIT TO EACH MECHANICAL ROOM FOR THE BUILDING MANAGEMENT CONTROL SYSTEM AND MDF / IDF ROOMS. COORDINATE WITH THE CONTRACTOR FOR EXACT LOCATION AND TERMINATION TYPE.
- 2 DATA DROP SHALL BE USED FOR TIMECLOCK. MOUNT AT +48" A.F.F.
- 3 PROVIDE (1) DATA DROP FOR CONNECTION OF WELDING BOOTH HUMAN-MACHINE INTERFACE (HMI). VERIFY EXACT LOCATION PRIOR TO INSTALLATION. REFER TO ELECTRICAL PLANS FOR J-BOX AND CONDUIT REQUIREMENTS.

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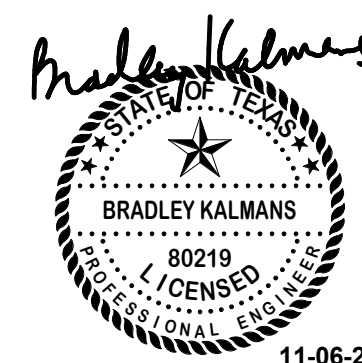


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**T2.01**

TECHNOLOGY  
AREA 'A1' 1ST  
LOOR PLAN



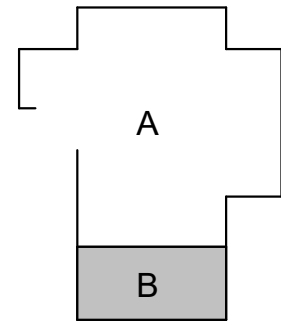


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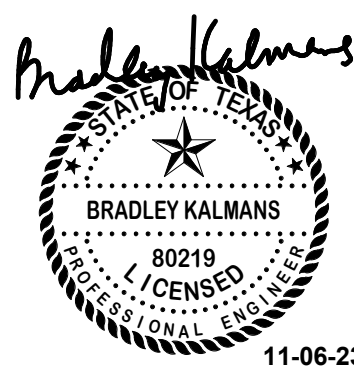


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**ARCADIS**


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**T2.02**

TECHNOLOGY  
AREA 'B1' 1ST  
LOOR PLAN



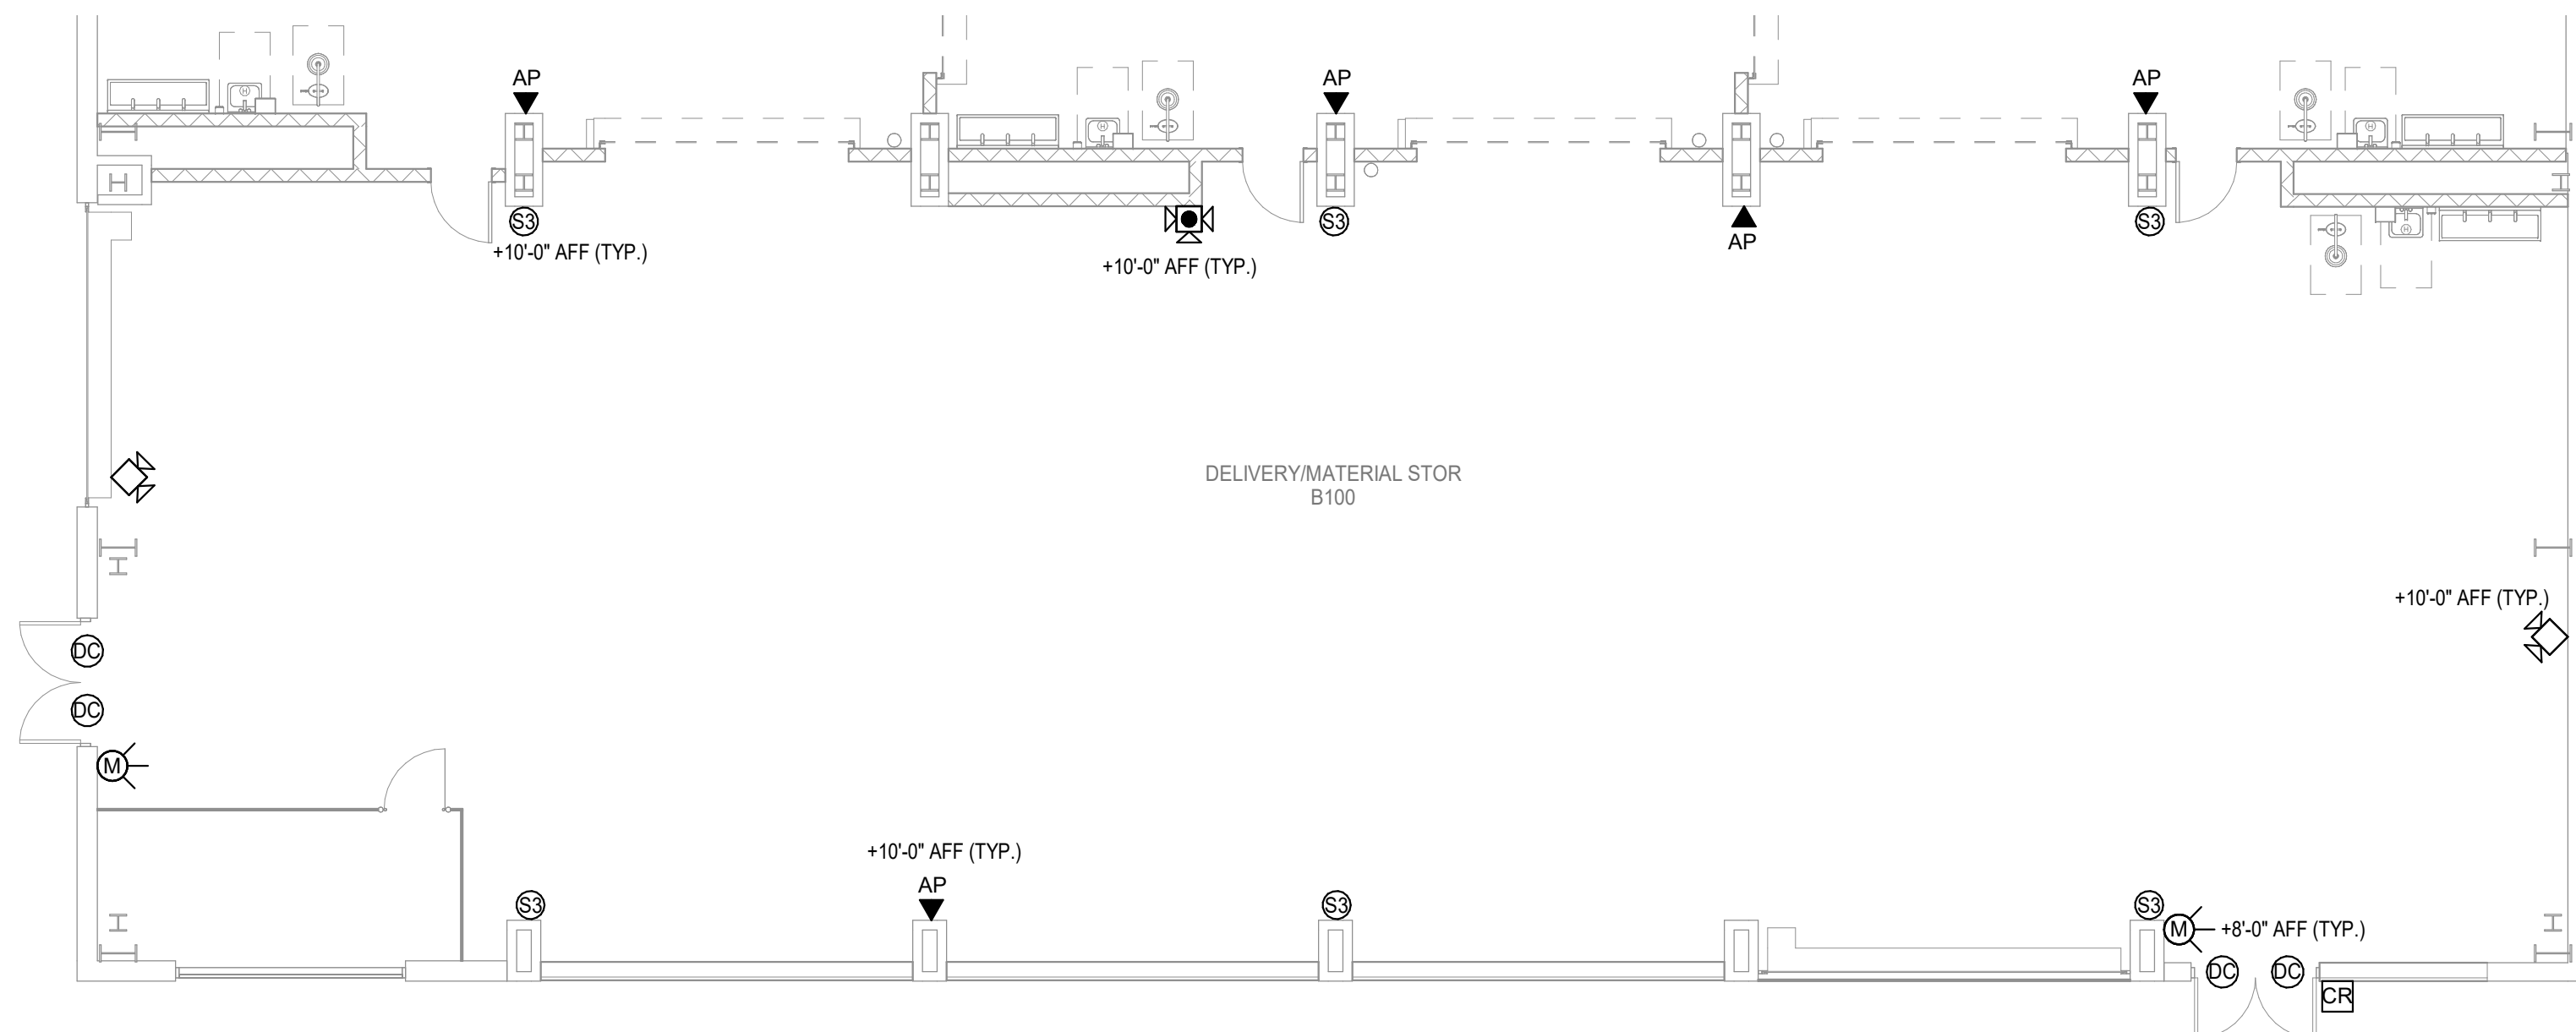**1 TECHNOLOGY 1ST FLOOR PLAN - AREA 'B1'**  
Scale: 1/8" = 1'-0"





TECHNOLOGY ENLARGED KEYED NOTES

- 1

INDICATES THE LOCATION OF A 8' TALL, 3/4" FIRE RATED PLYWOOD. CONTRACTOR TO PROVIDE AND INSTALL PLYWOOD AND ALL REQUIRED MOUNTING HARDWARE. PLYWOOD SHALL BE PAINTED WHITE WITH FIRE RATED PAINT. TYPICAL FOR ALL SHOWN ON DRAWING.
- 2

INDICATES THE LOCATION OF A NEW WALL MOUNTED TELECOMMUNICATION GROUND BUSBAR (TGGB). CABLING CONTRACTOR TO PROVIDE BUSBAR AND ALL REQUIRED MATERIAL TO MOUNT AT THE LOCATION SHOWN. TGGB TO BE MOUNTED AT +80' A.F.F.
- 3

PROVIDE AND INSTALL A 12" WIDE, UNIVERSAL LADDER TRAY AND ALL REQUIRED MOUNTING HARDWARE. LADDER TRAY SHALL BE BLACK IN COLOR. TYPICAL FOR ALL SHOWN ON ENTIRE PROJECT.
- 4

PROVIDE AND INSTALL ONE (1) 2-POST, FLOOR MOUNTED, 7' RELAY RACK (BLACK IN CONNECTED LOCATIONS OF THE RACK TO ENSURE THAT ALL PIECES OF THE RACK ARE COMPLETELY BONDED. SCRAPING PAINT FROM RACKS TO MAKE A BOND WILLNOT BE ACCEPTED. ALL RACK MOUNTED COMPONENTS SHALL BE MOUNTED WITH BONDING SCREWS AND THE CONTRACTOR SHALL PROVIDE THE OWNER WITH (50) ADDITIONAL BONDING SCREWS FOR THE INSTALLATION OF OWNER EQUIPMENT. NO DAISY CHAINING GROUNDS FROM RACK TO CABLE TRAY OR TO OTHER RACKS WILL BE ACCEPTED. ALL GROUNDS SHALL BE HOME RUN TO THE TELECOMMUNICATIONS GROUND BUS BAR (TGBB). TYPICAL FOR ALL SHOWN ON THE ENTIRE PROJECT.
- 5

PROVIDE AND INSTALL ONE (1) 7X6" FRONT AND REAR MANAGED, VERTICAL CABLE MANAGER (BLACK IN COLOR). CABLE MANAGERS SHALL BE INSTALLED ON EACH END OF THE RACK SYSTEMS AND BETWEEN EACH RACK. CABLE MANAGERS SHALL HAVE A SINGLE, SOLID, FULL HEIGHT HINGED DOOR IN THE FRONT AND WIDE SPACED CABLE RINGS WITH SPIN-OPEN LATCHES IN THE REAR. TYPICAL FOR ALL SHOWN IN THE ENTIRE PROJECT.
- 6

PROVIDE AND INSTALL RACK-TO-RUNWAY MOUNTING PLATE FOR ALL LOCATIONS WHEN ASSOCIATED WITH A 2-POST OR 4-POST BACK RACK. MOUNTING PLATE SHALL BE BLACK IN COLOR. PROVIDE (1) 6" LADDER TRAY ELEVATION KIT (BLACK IN COLOR) AT EACH RACK-TO-RUNWAY MOUNTING PLATE LOCATION. TYPICAL FOR ALL SHOWN ON THE ENTIRE PROJECT.
- 7

INDICATES THE LOCATION OF A 12" LADDER TRAY WALL ANGLE SUPPORT BRACKET, BLACK IN COLOR. CONTRACTOR TO PROVIDE AND INSTALL WALL ANGLE SUPPORT BRACKET AND ALL REQUIRED MOUNTING HARDWARE AT EACH LOCATION WHERE LADDER TRAY TERMINATES INTO A VERTICAL WALL SECTION. TYPICAL FOR ALL SHOWN.
- 8

PROVIDE AND INSTALL A LADDER JUNCTION SPLICE KIT, BLACK IN COLOR. PROVIDE ONE (1) KIT AT EACH LADDER TRAY JUNCTION SPLICE LOCATION ON THE ENTIRE PROJECT.
- 9

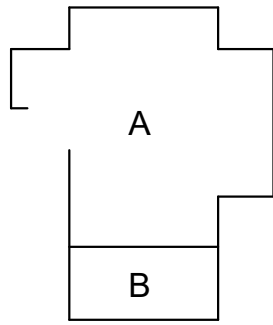
PROVIDE AND INSTALL A MINIMUM OF THREE (3) STI EZPATH SERIES 44+ THRU-WALL PENETRATION SLEEVES WITH MULTI-GANG WALLPLATE BRACKET SYSTEM AT INDICATED LOCATION. PROVIDE ADDITIONAL AS REQUIRED TO MAINTAIN A MAXIMUM OF 40% FILL RATIO, PLUS ONE (1) ADDITIONAL FOR SPARE.

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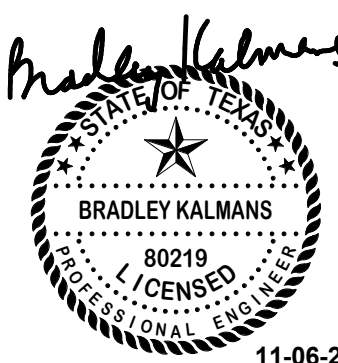
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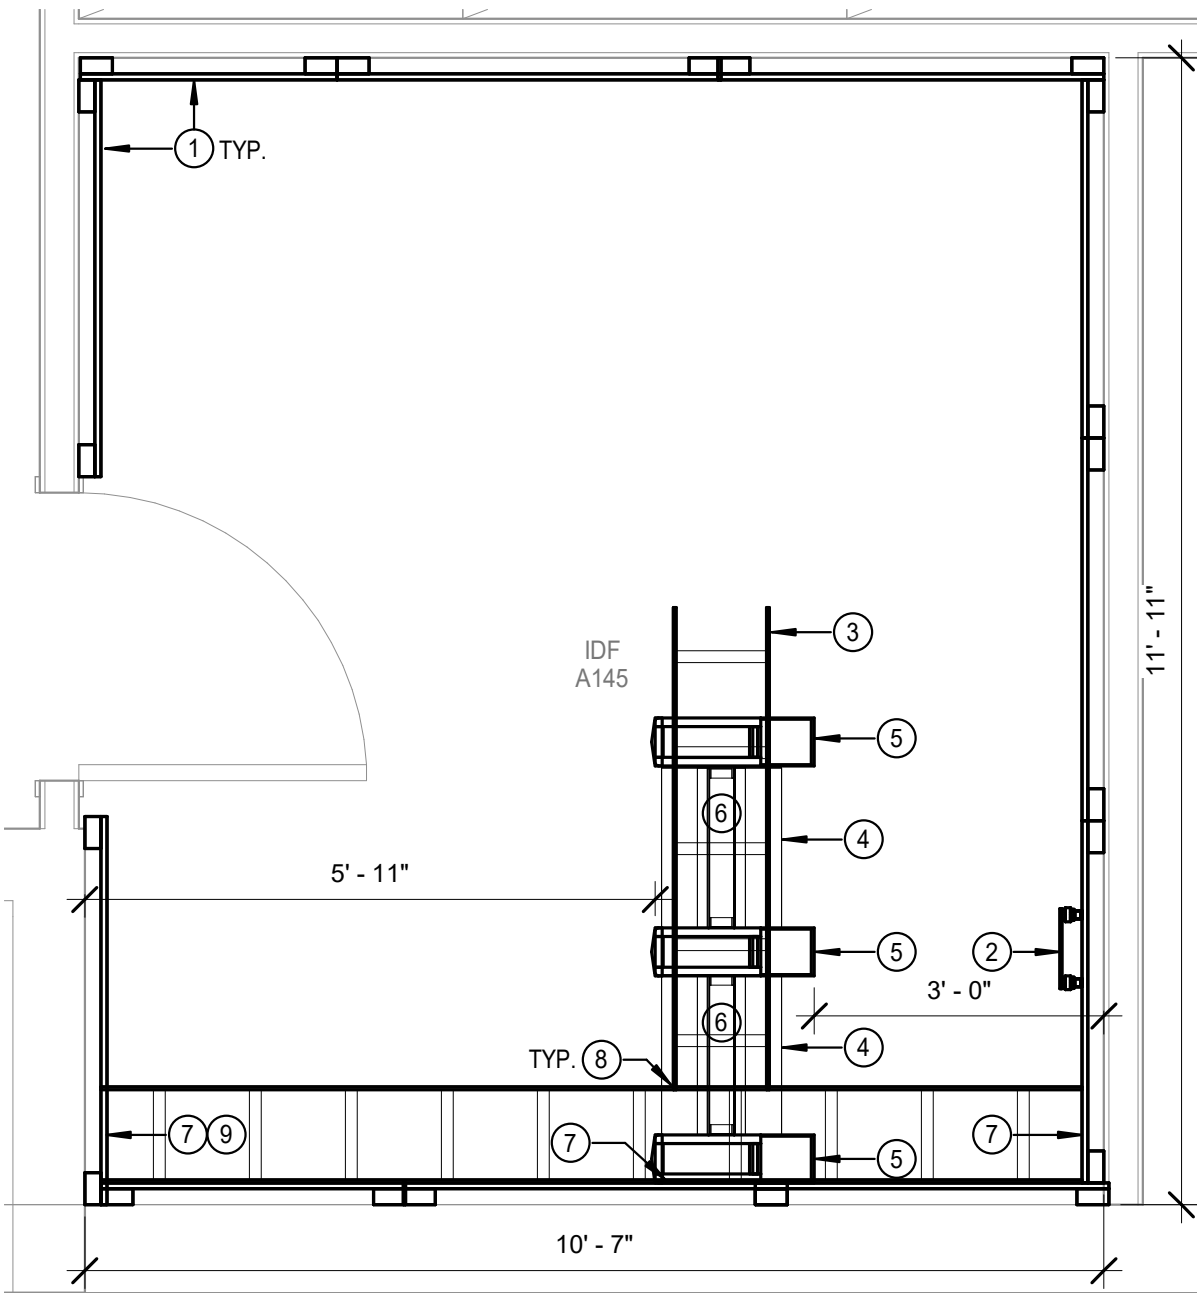


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DRAWN: MA  
CHECKED: DS

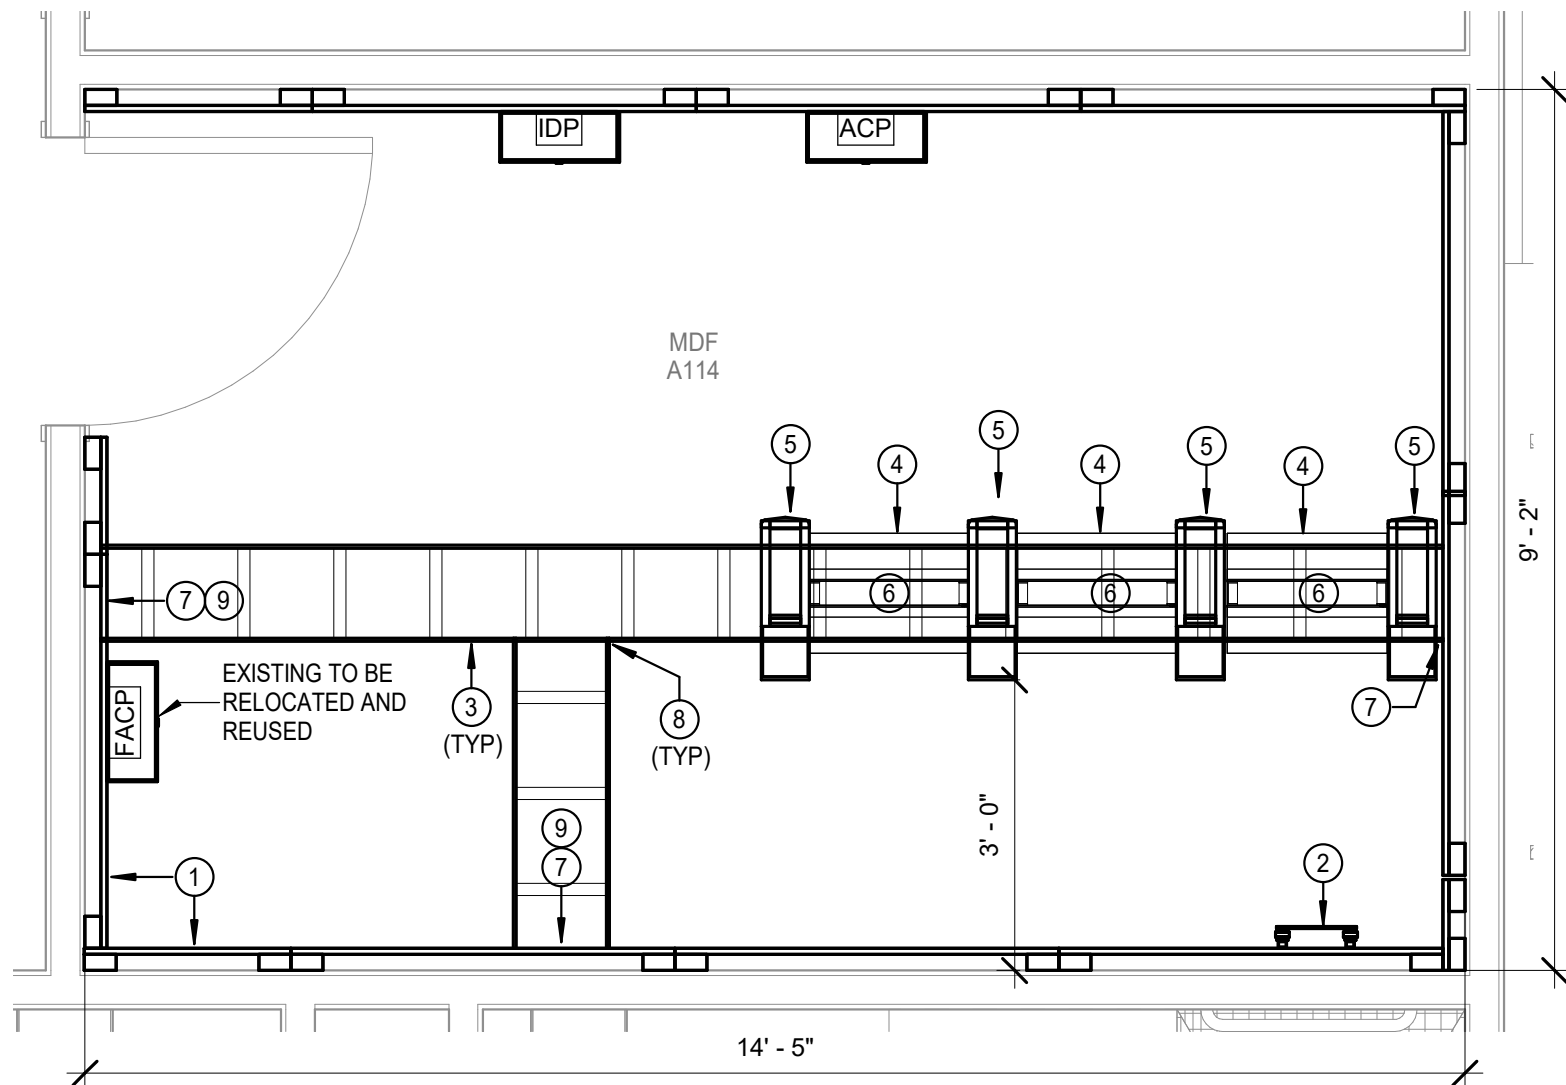
DATE: 2023-11-03  
ISSUE: BID SET

T3.01

TECHNOLOGY  
ENLARGED  
PLANS




2 TECHNOLOGY ENLARGED PLAN - IDF A145  
Scale: 1/2" = 1'-0"



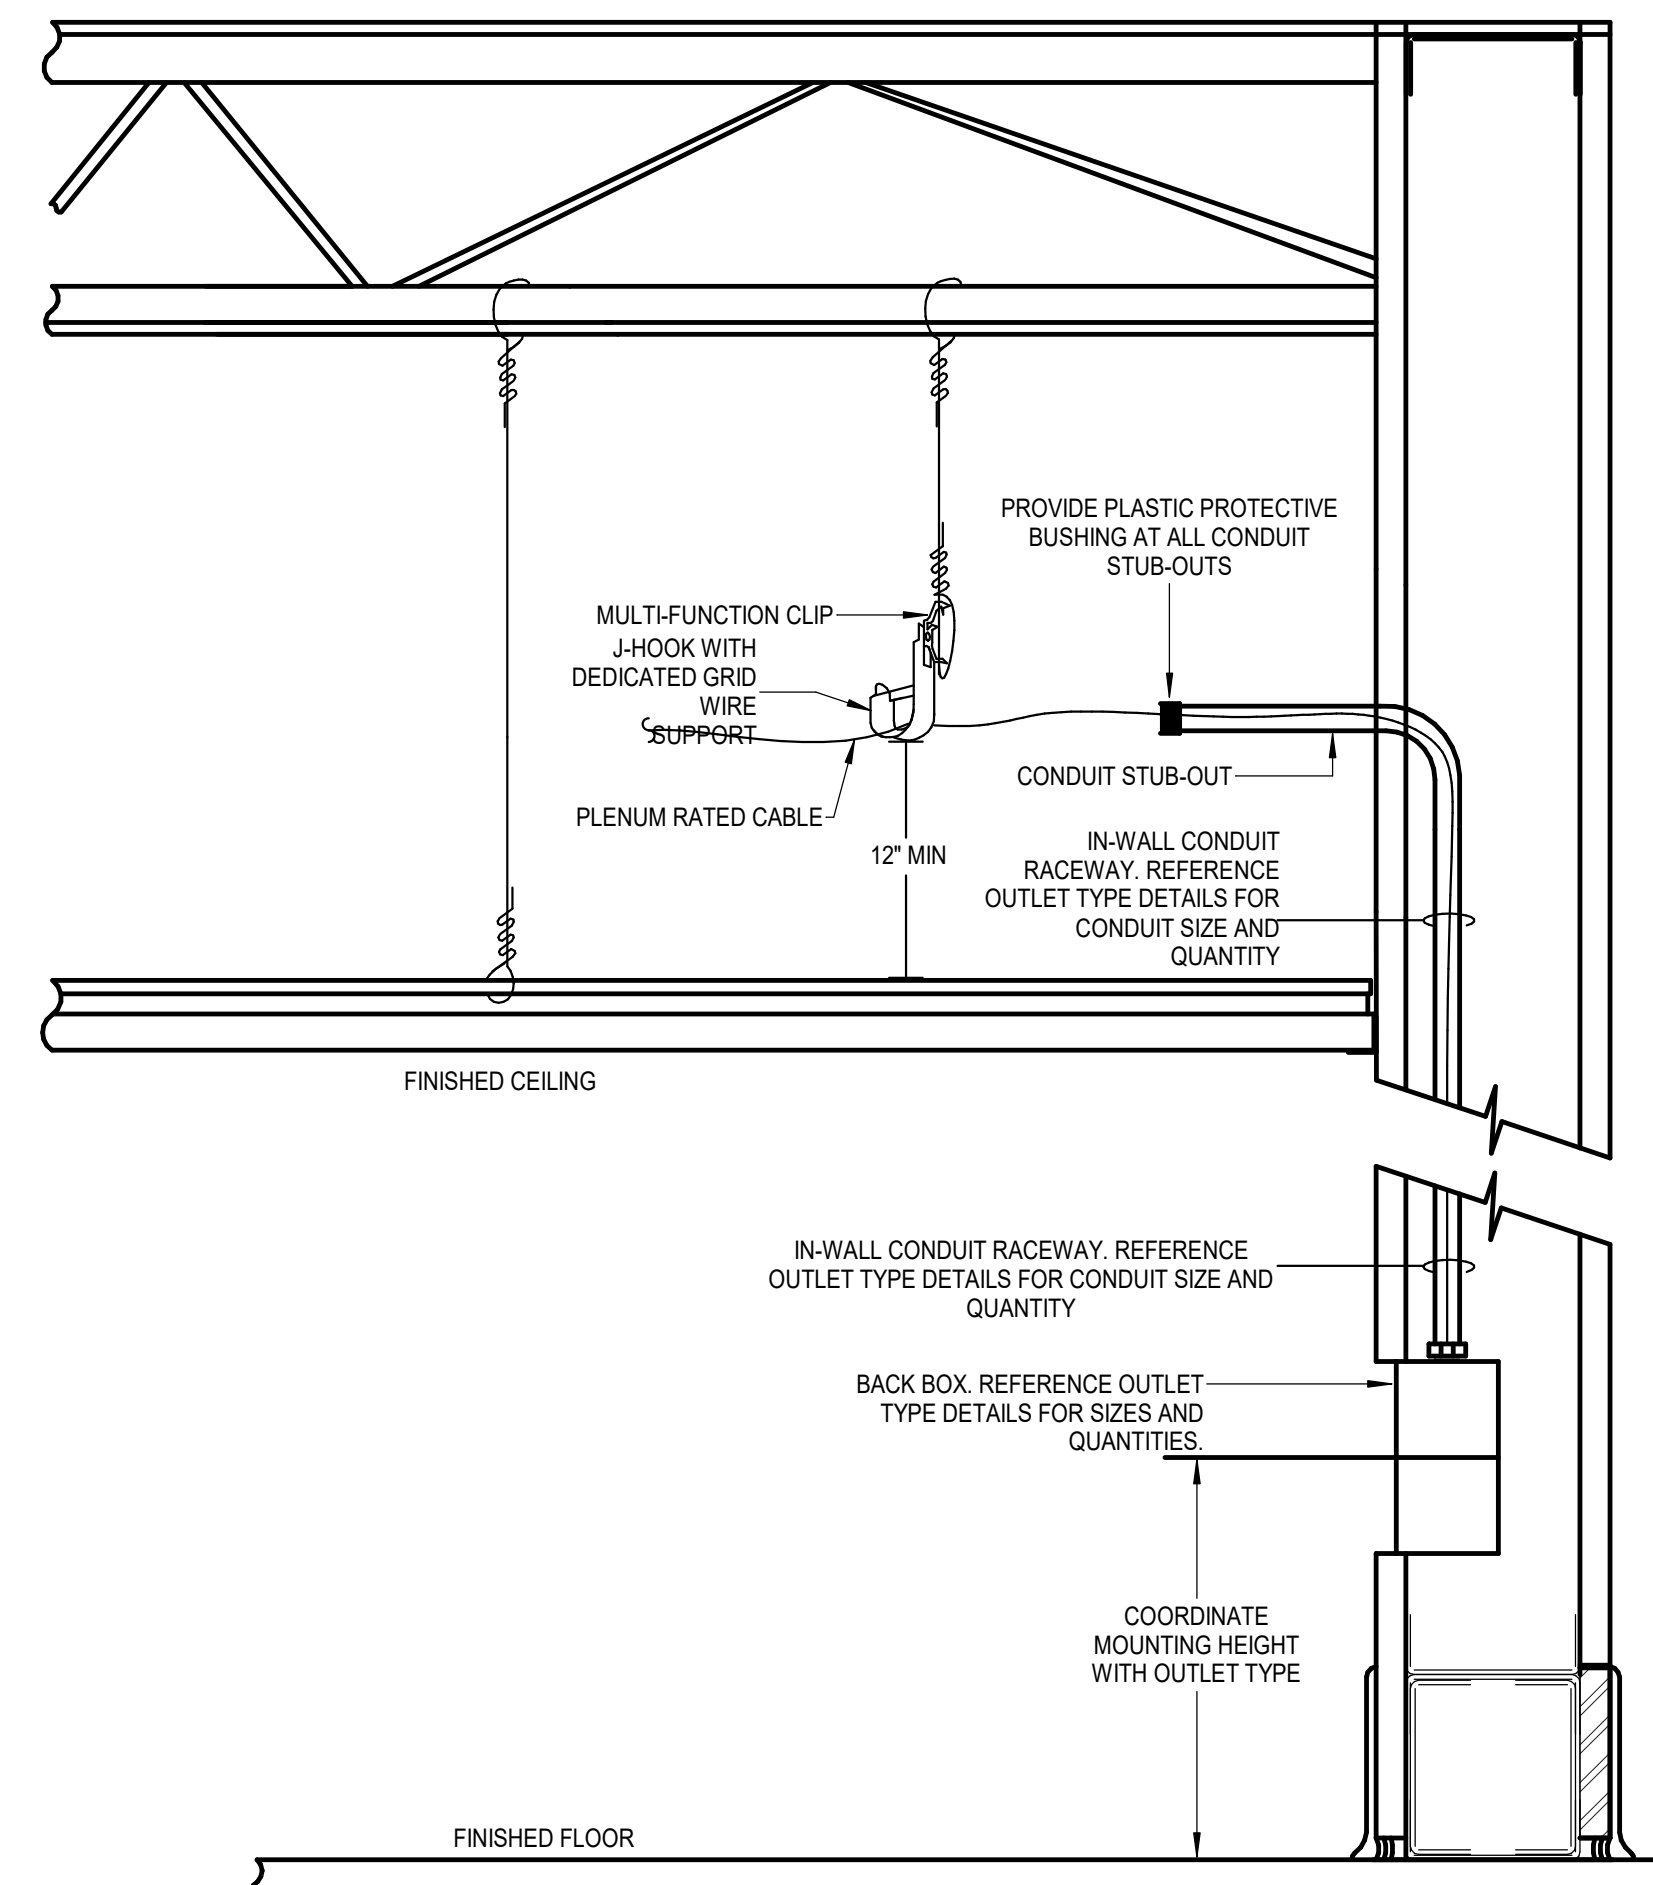
1 TECHNOLOGY ENLARGED PLANS - MDF A114  
Scale: 1/2" = 1'-0"






01	LOW VOLTAGE ELEVATION - IN-WALL RACEWAY
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NOT  
SCALE

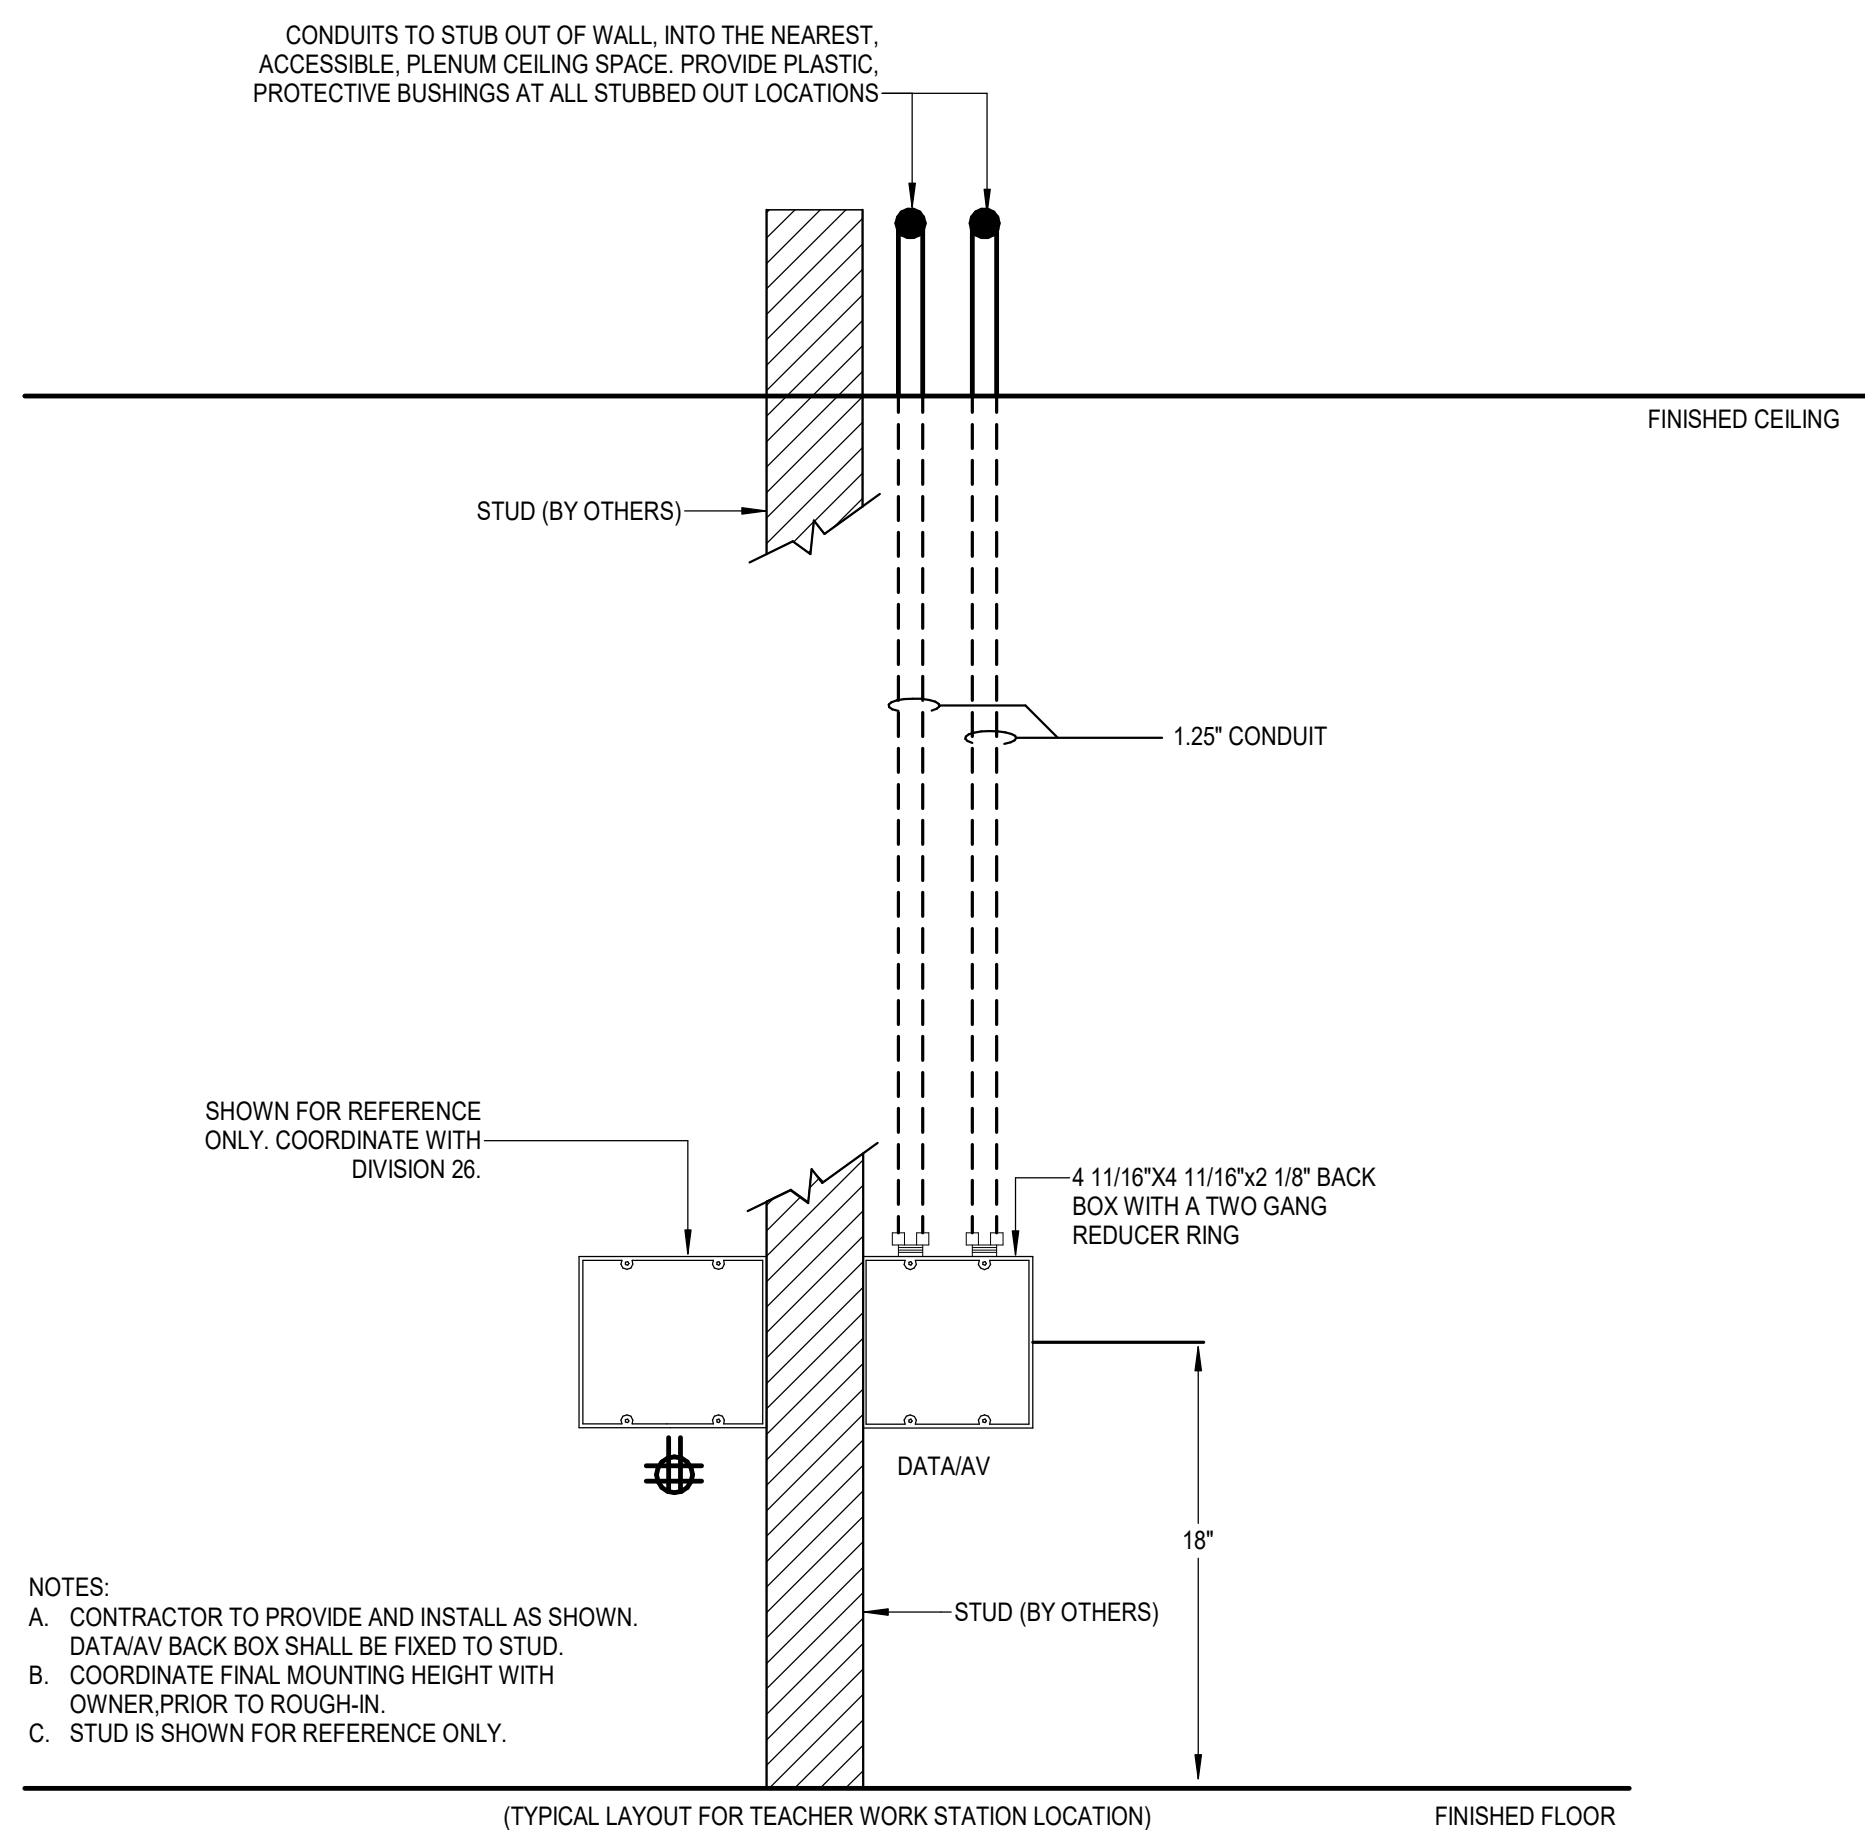


02	RACEWAY DETAIL - TYPICAL INSTRUCTORS OUTLET
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NOT TO SCALE




03	RACEWAY DETAIL - TYPICAL VOICE/DATA OUTLET
----	--

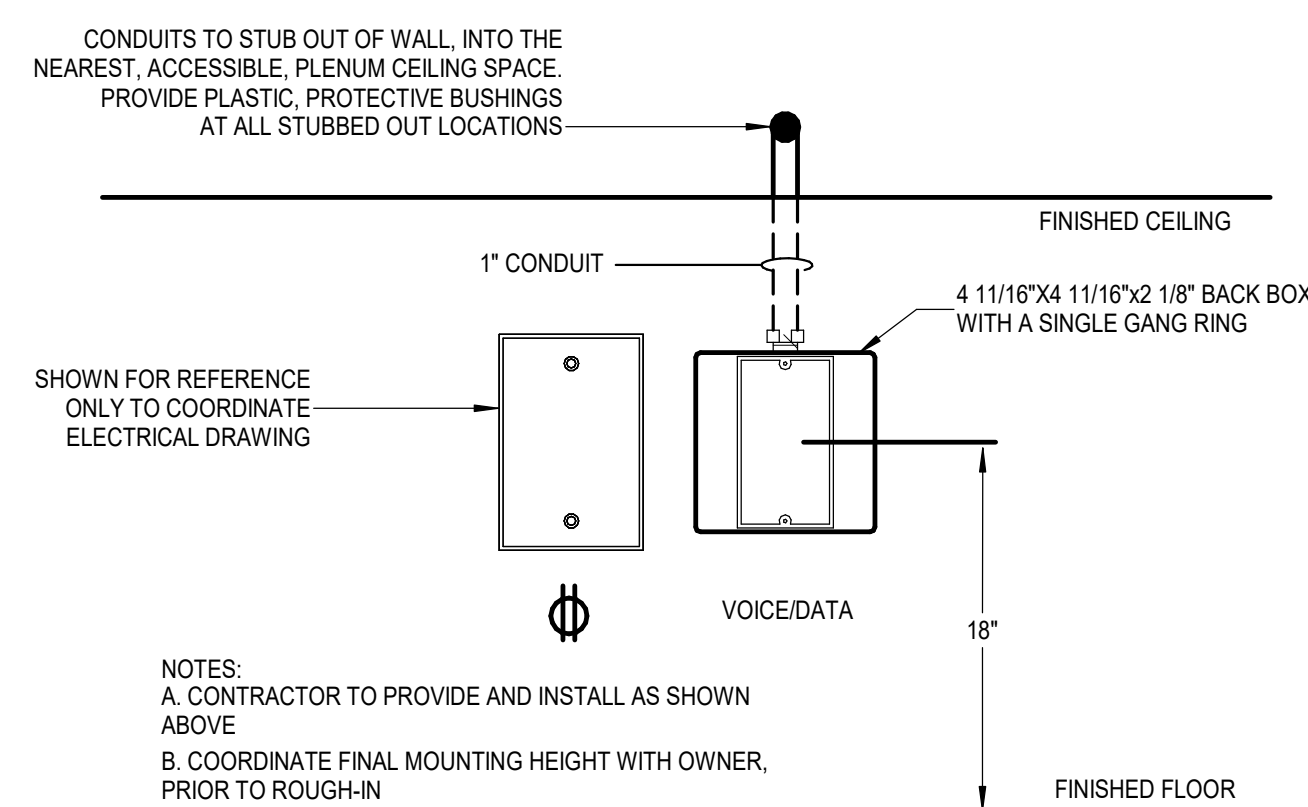NOT TO  
SCALE

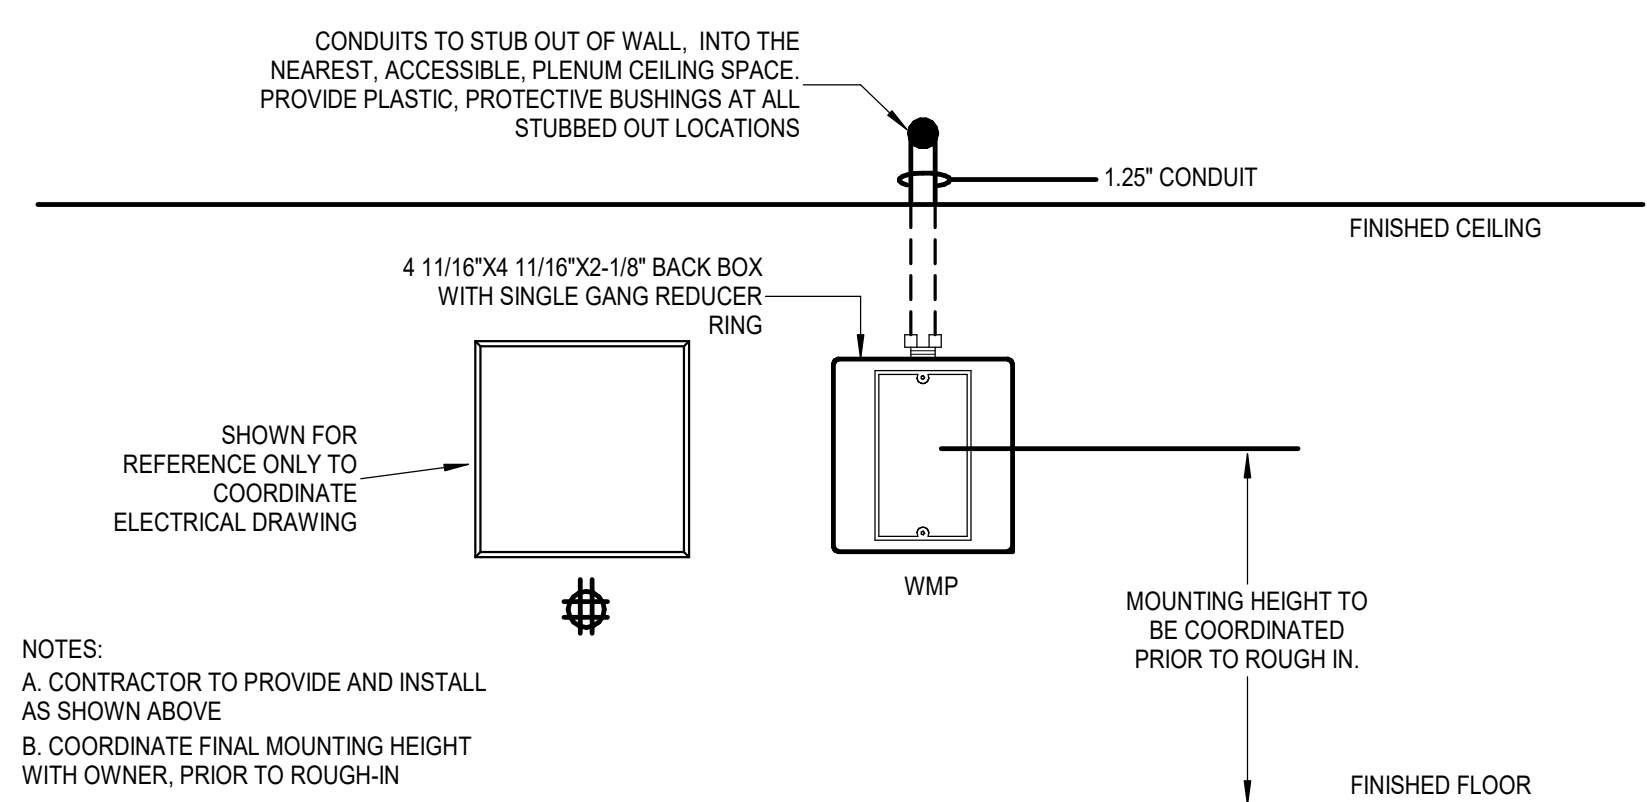


04	RACEWAY DETAIL - WALL MOUNTED PROJECTOR
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NOT TO SCALE

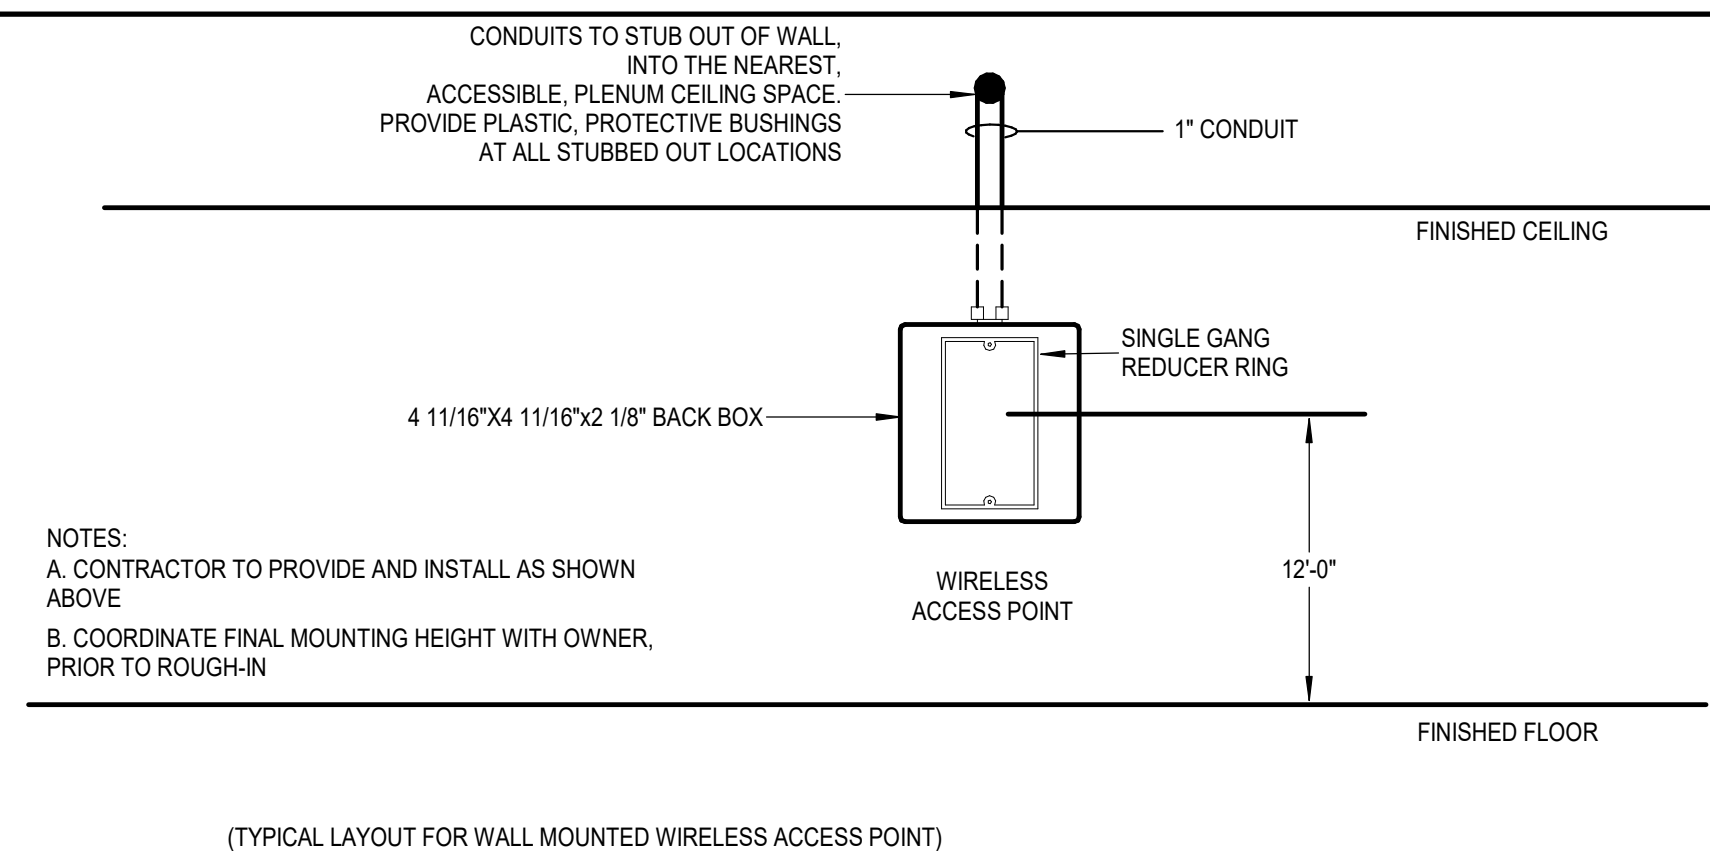


05	RACEWAY DETAIL - WALL MOUNTED WIRELESS AP
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NOT T




06	RACEWAY DETAIL - WALL MOUNTED TELEPHONE
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NOT T

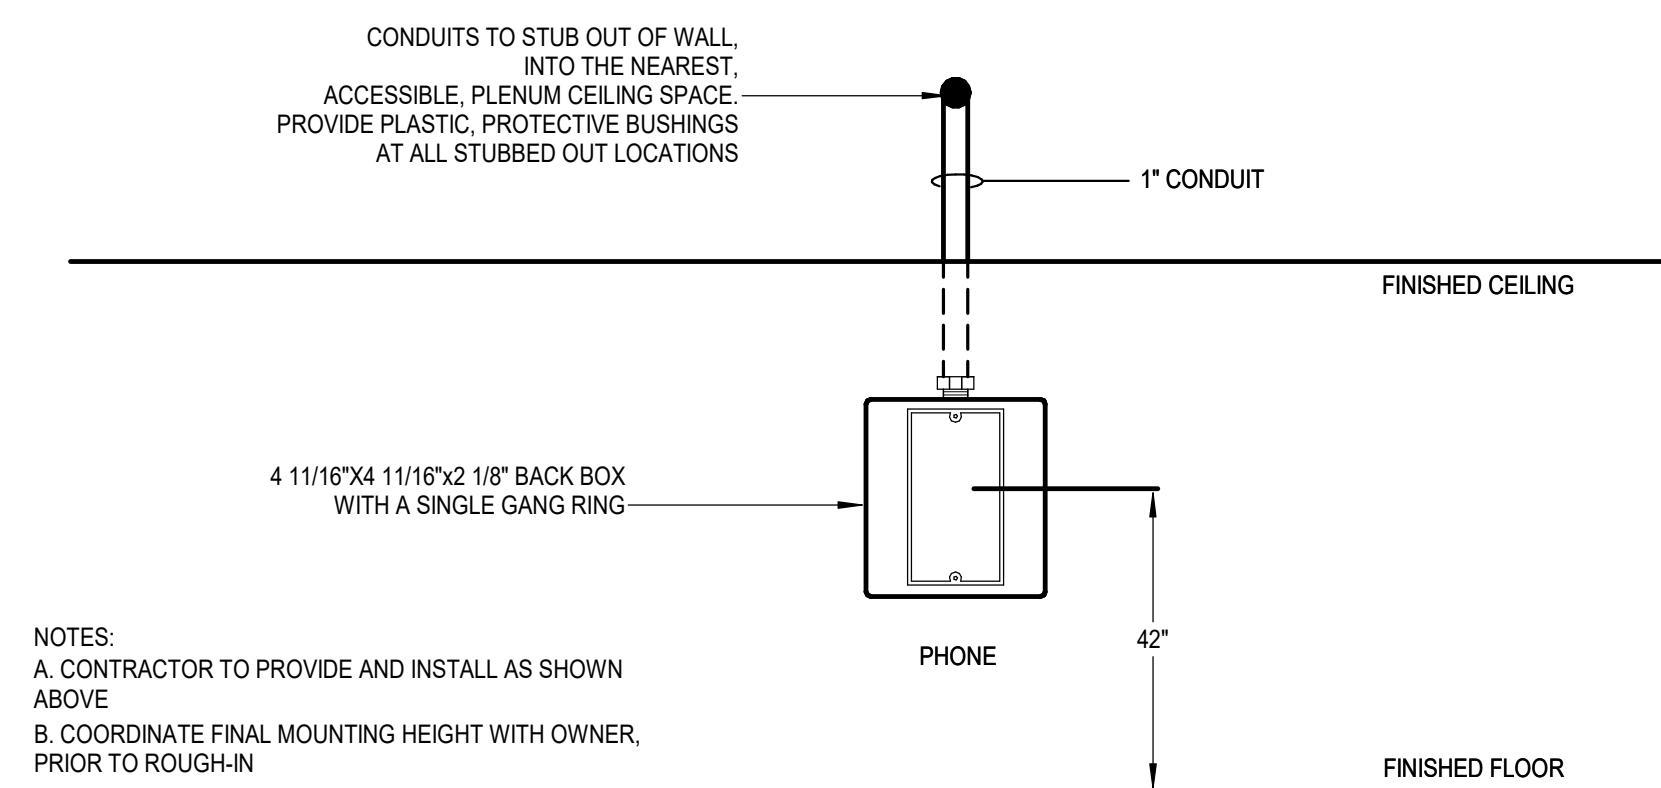


07	RACEWAY DETAIL - WALL MOUNTED DISPLAY
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NOT T

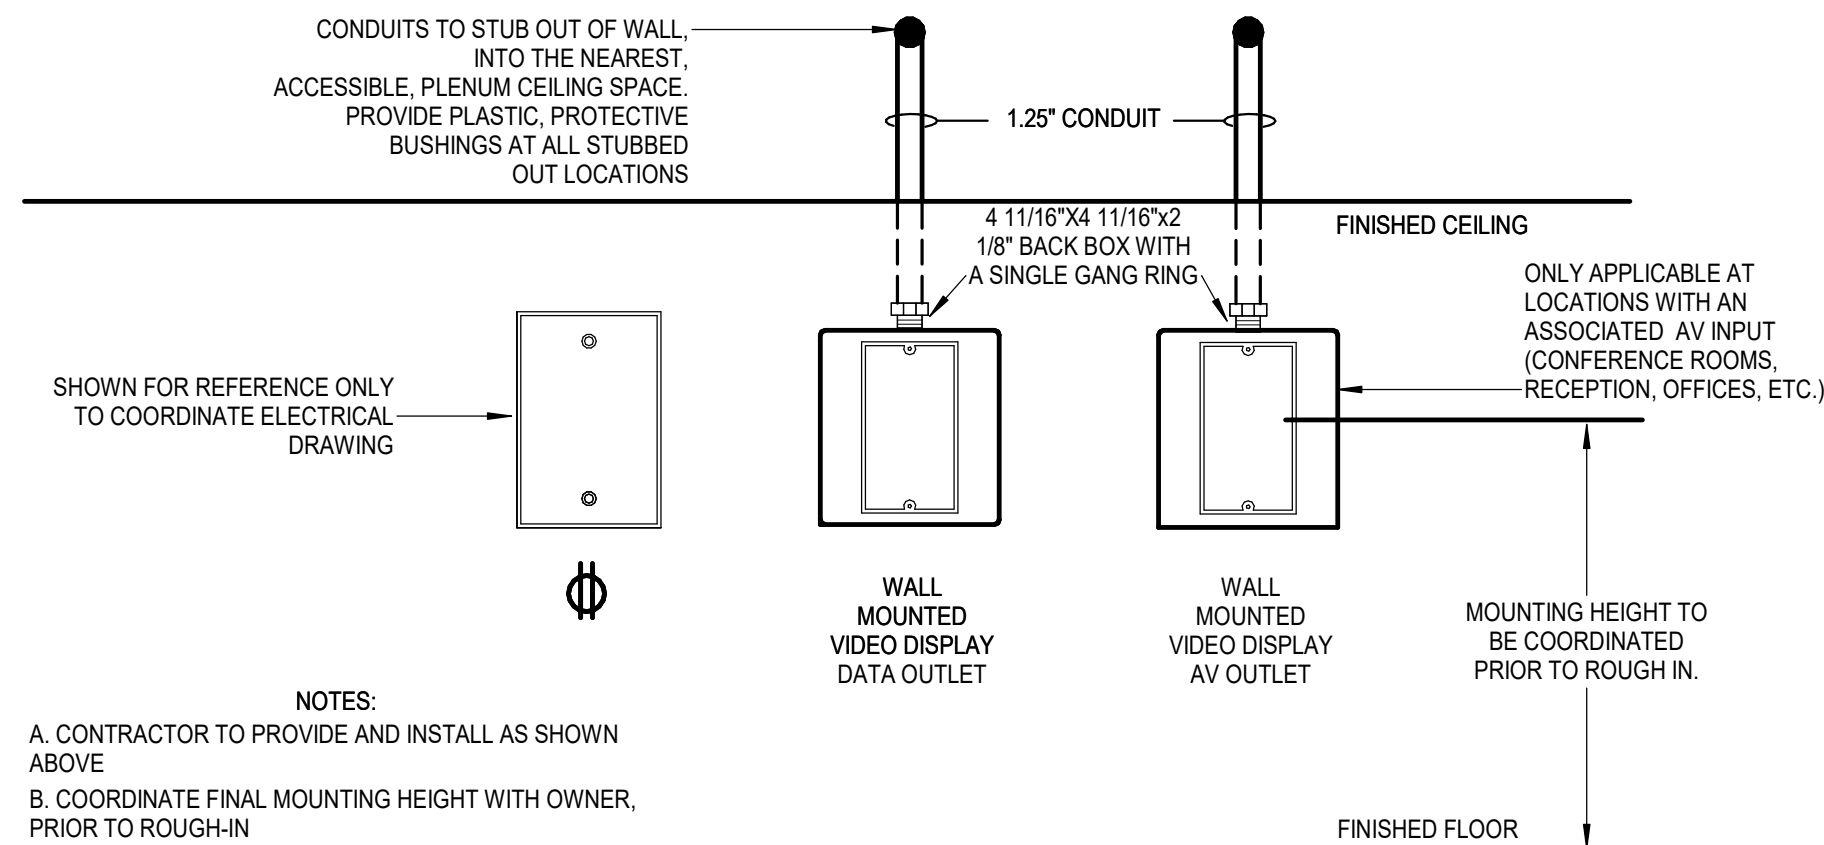


08	ABOVE CEILING STAND ALONE OUTLET
----	----------------------------------

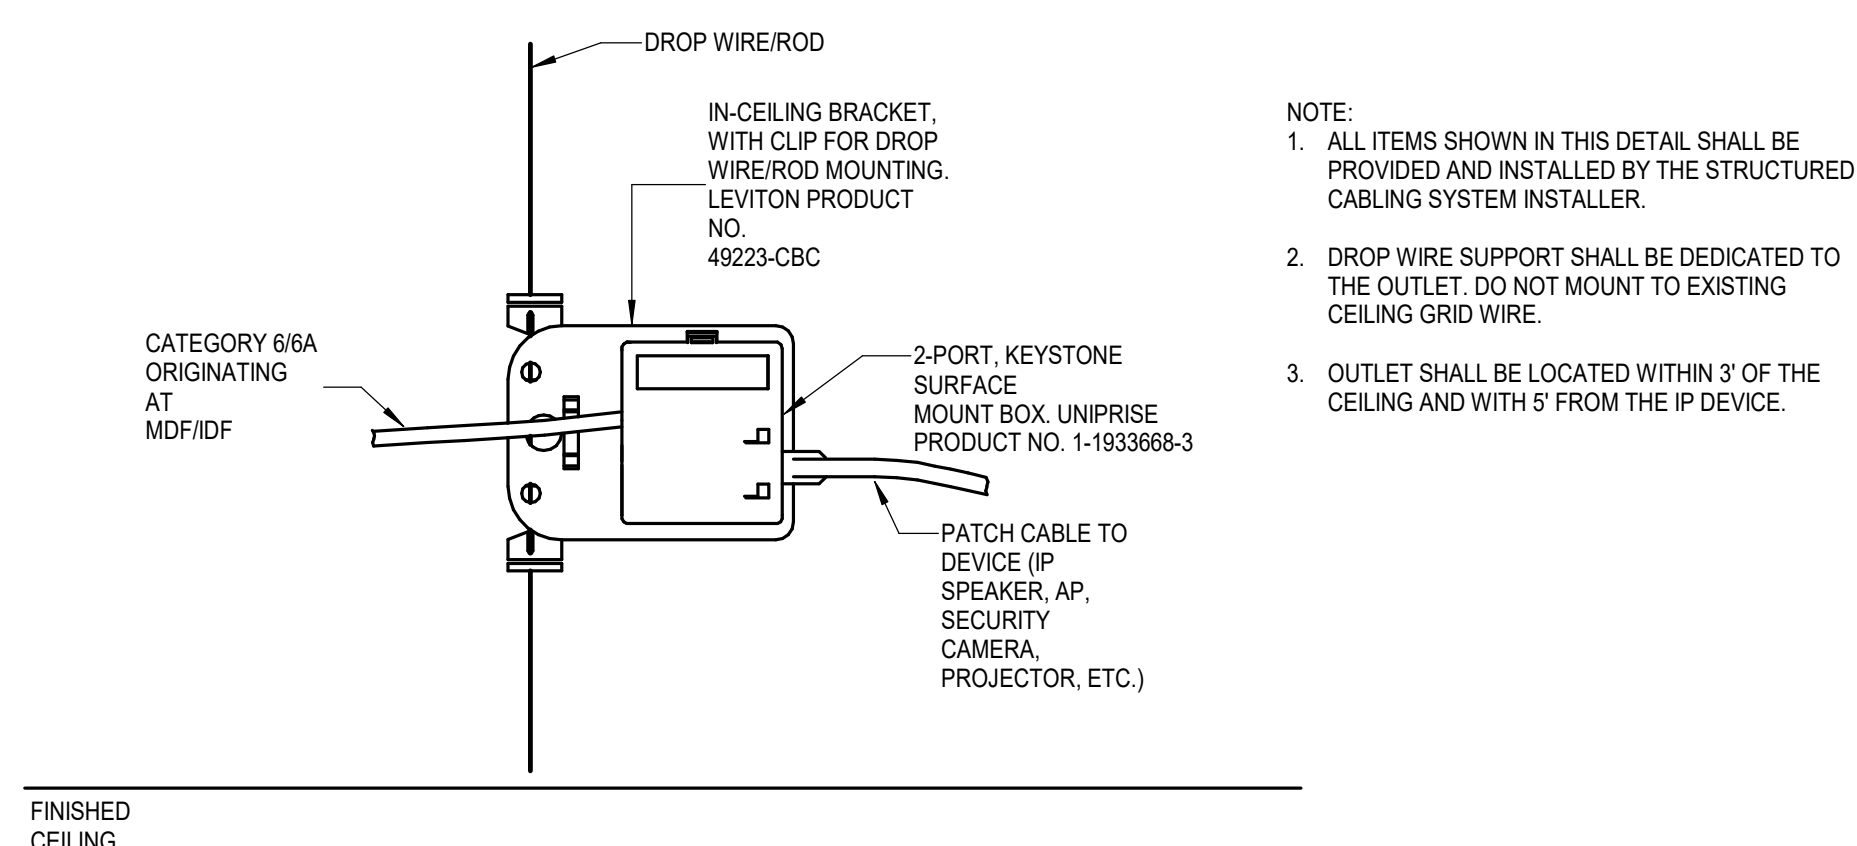NOT T

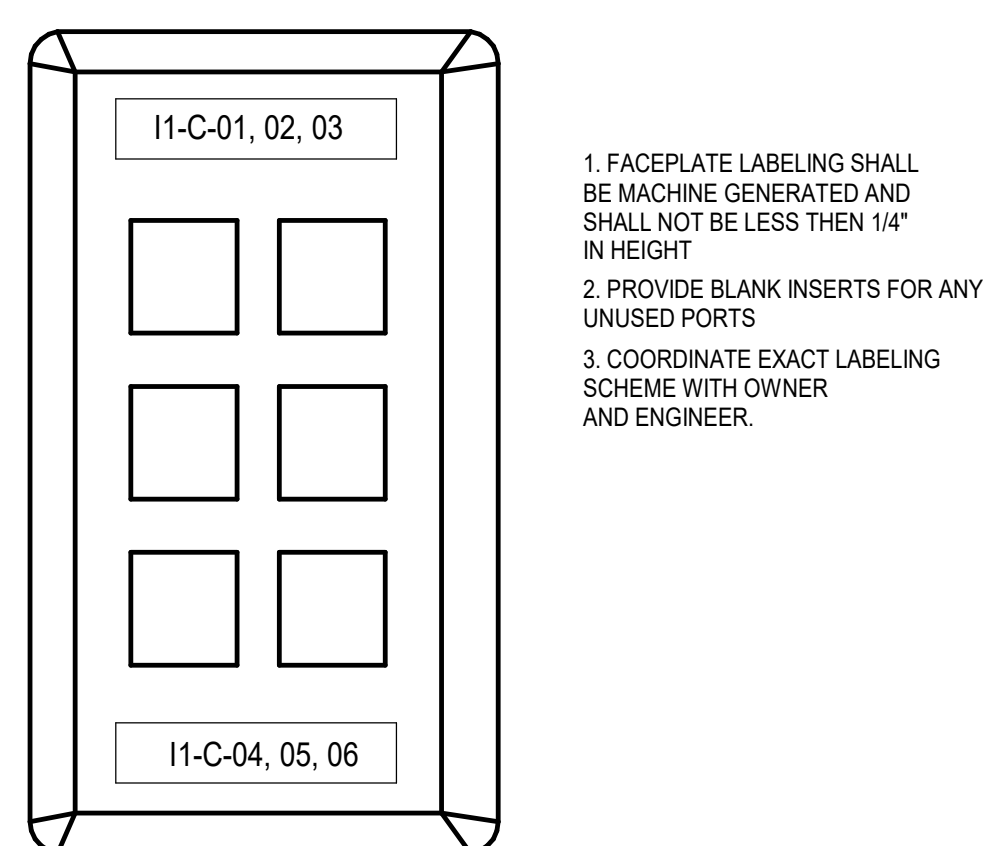

09	FACEPLATE LABEL DETAIL
----	------------------------

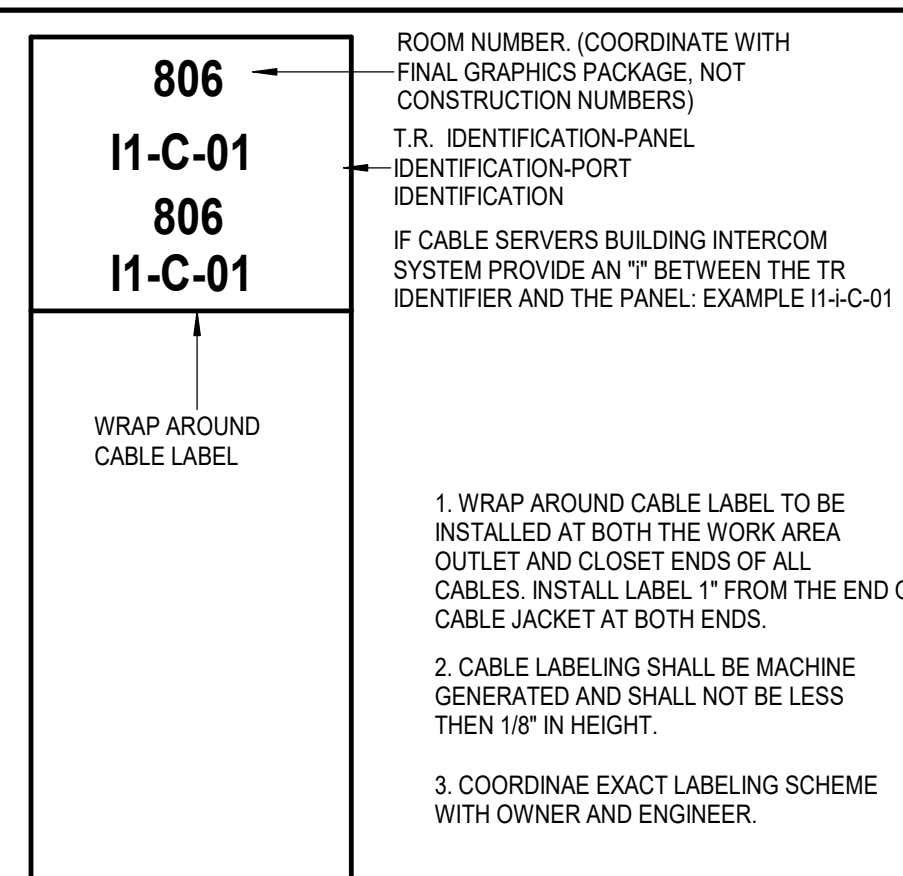NOT T



10	CABLE LABEL DETAIL
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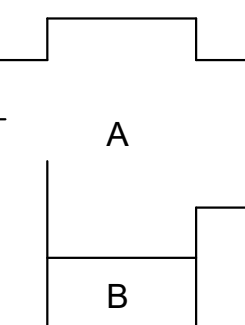
NOT T

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**TOMBALL HIGH SCHOOL  
CTE & MISC. RENOVATIONS**

TOMBALL INDEPENDENT SCHOOL DISTRICT  
30330 QUIN ROAD, TOMBALL, TX 77375



**TEXAS ARCADIS INC.**


10205 WESTHEIMER SUITE 800

HOUSTON, TX 77042

tel 713.953.4897, fax 713.977.4620



11-06-23

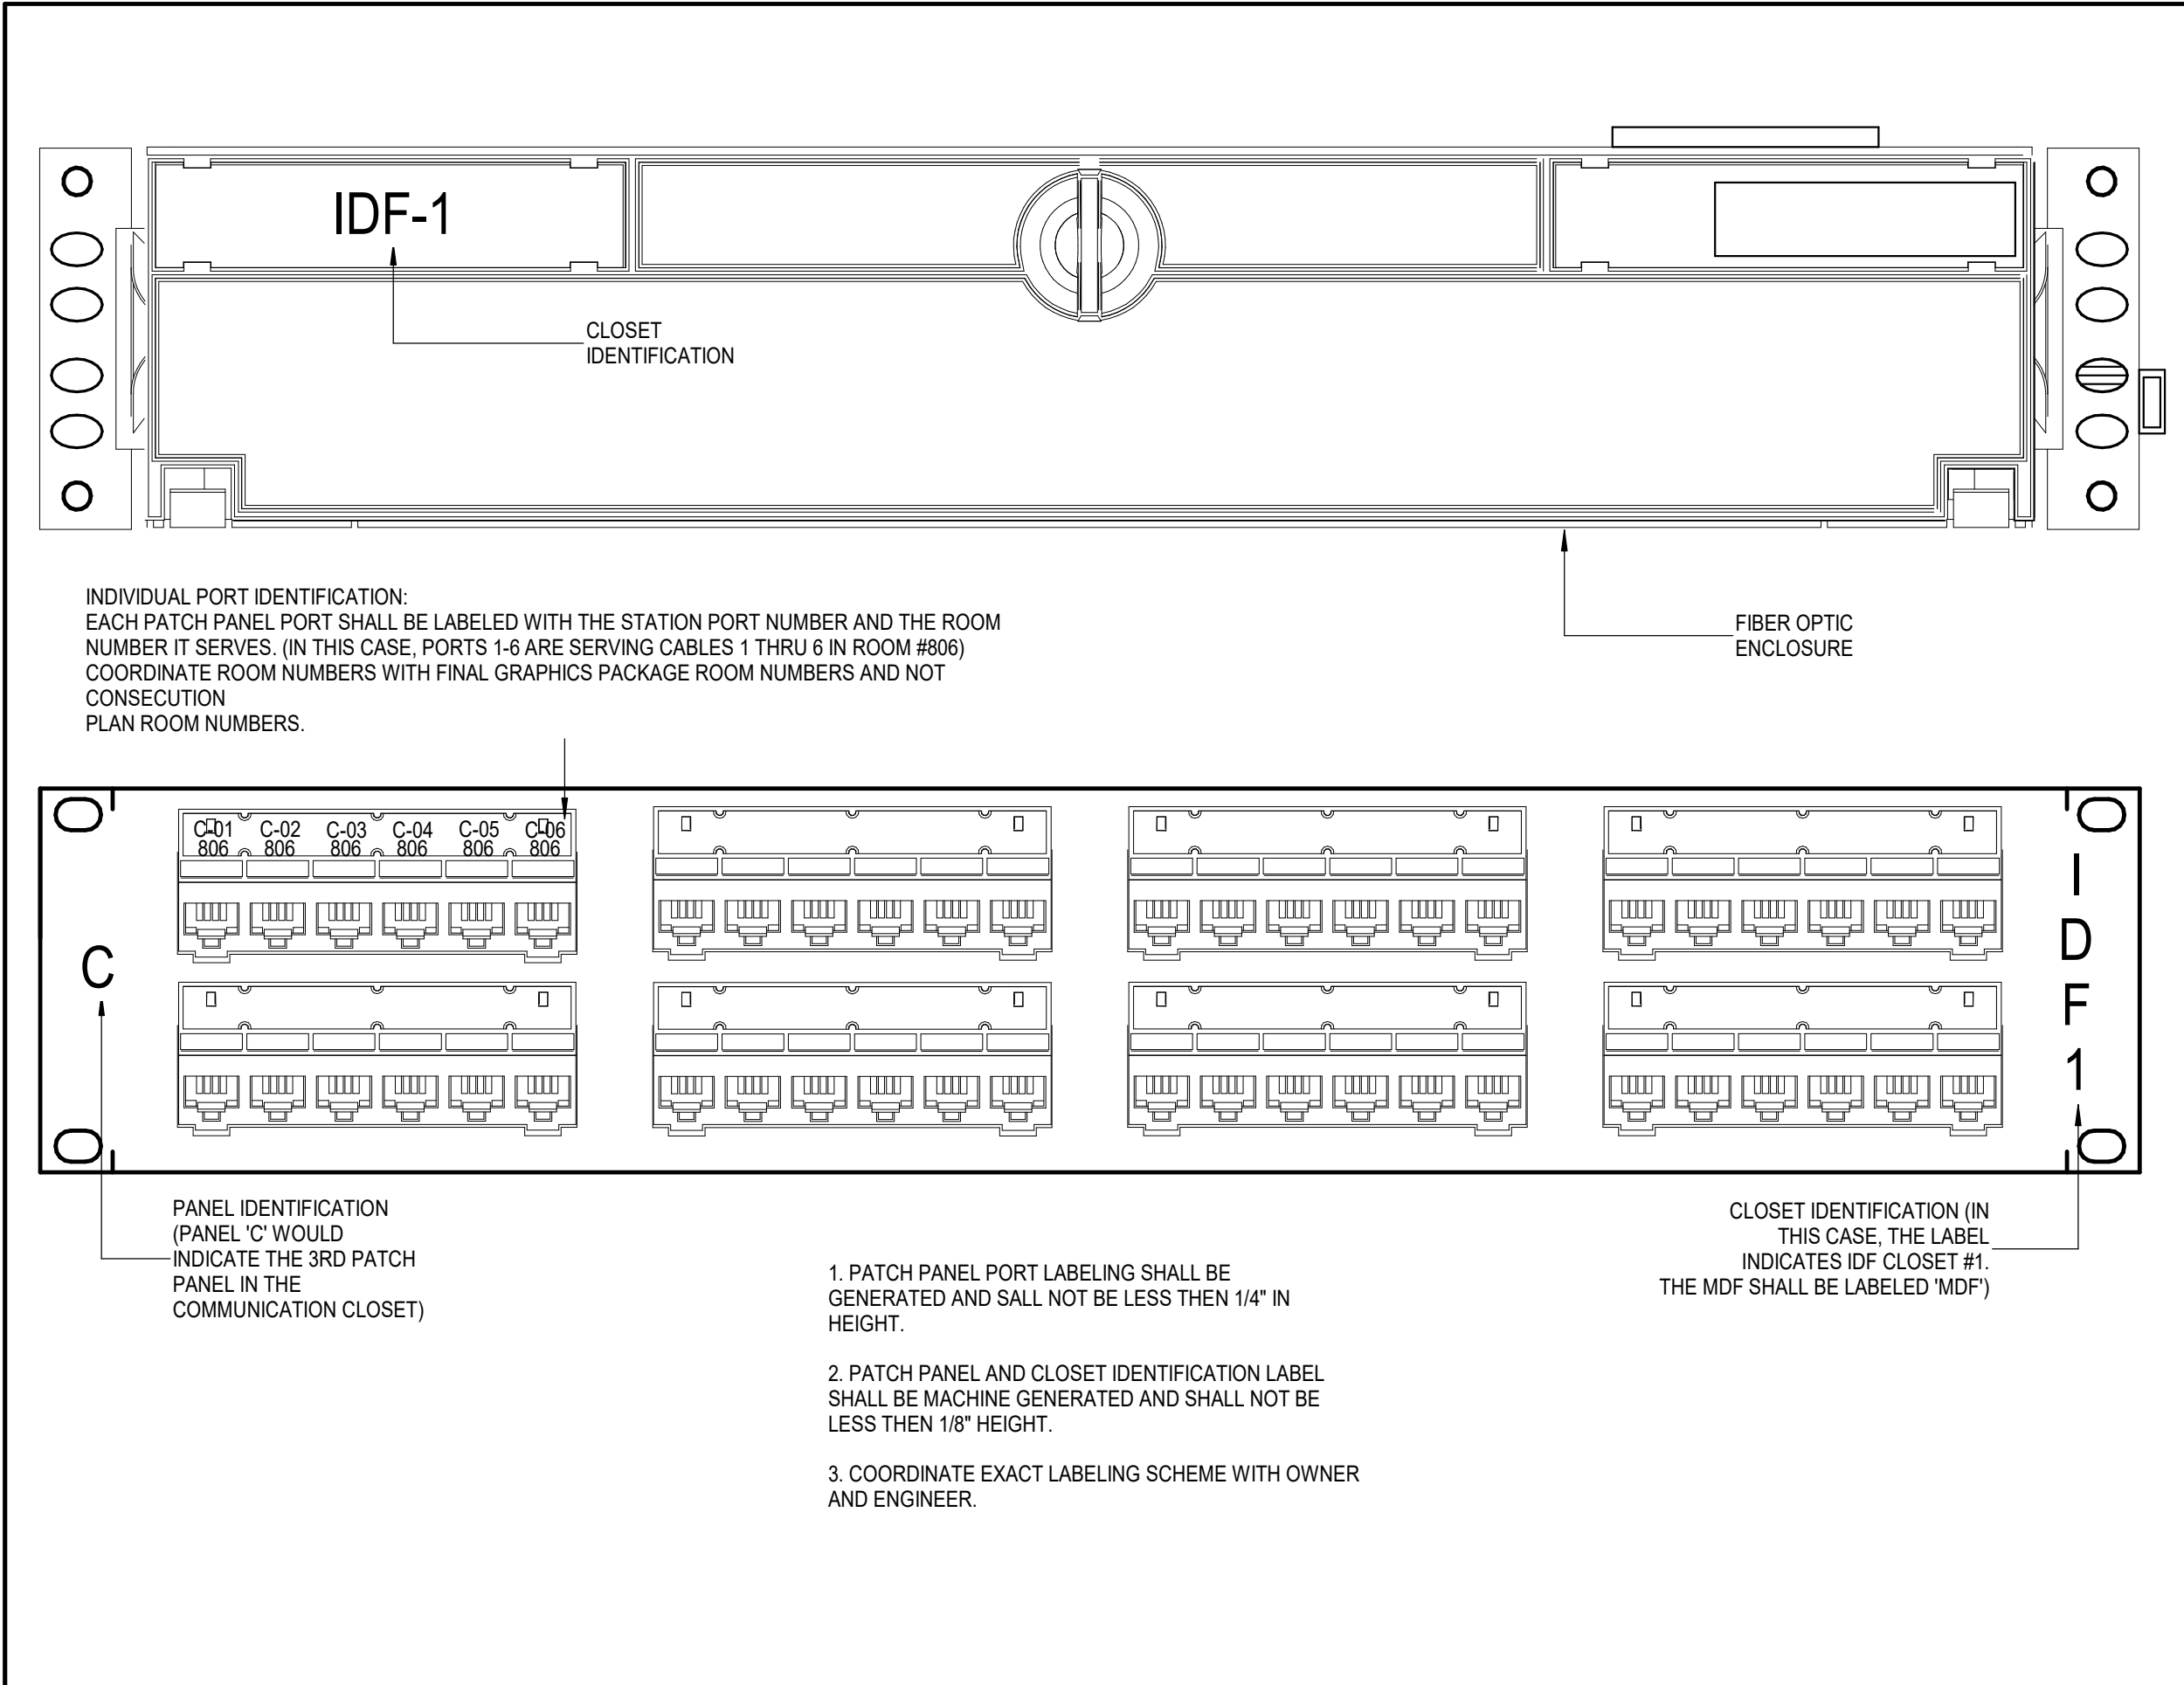
PROJECT #: 202311		
DATE: 2023-11-03		
DRAWN: MA		
CHECKED: DS		
DATE	ISSUE	
2023-11-03	BID SET	

# T4.01


## TECHNOLOGY DETAILS









01|FIBER ENCLOSURE/ COPPER PATCH PANEL LABELING DETAIL NOT TO SCALE

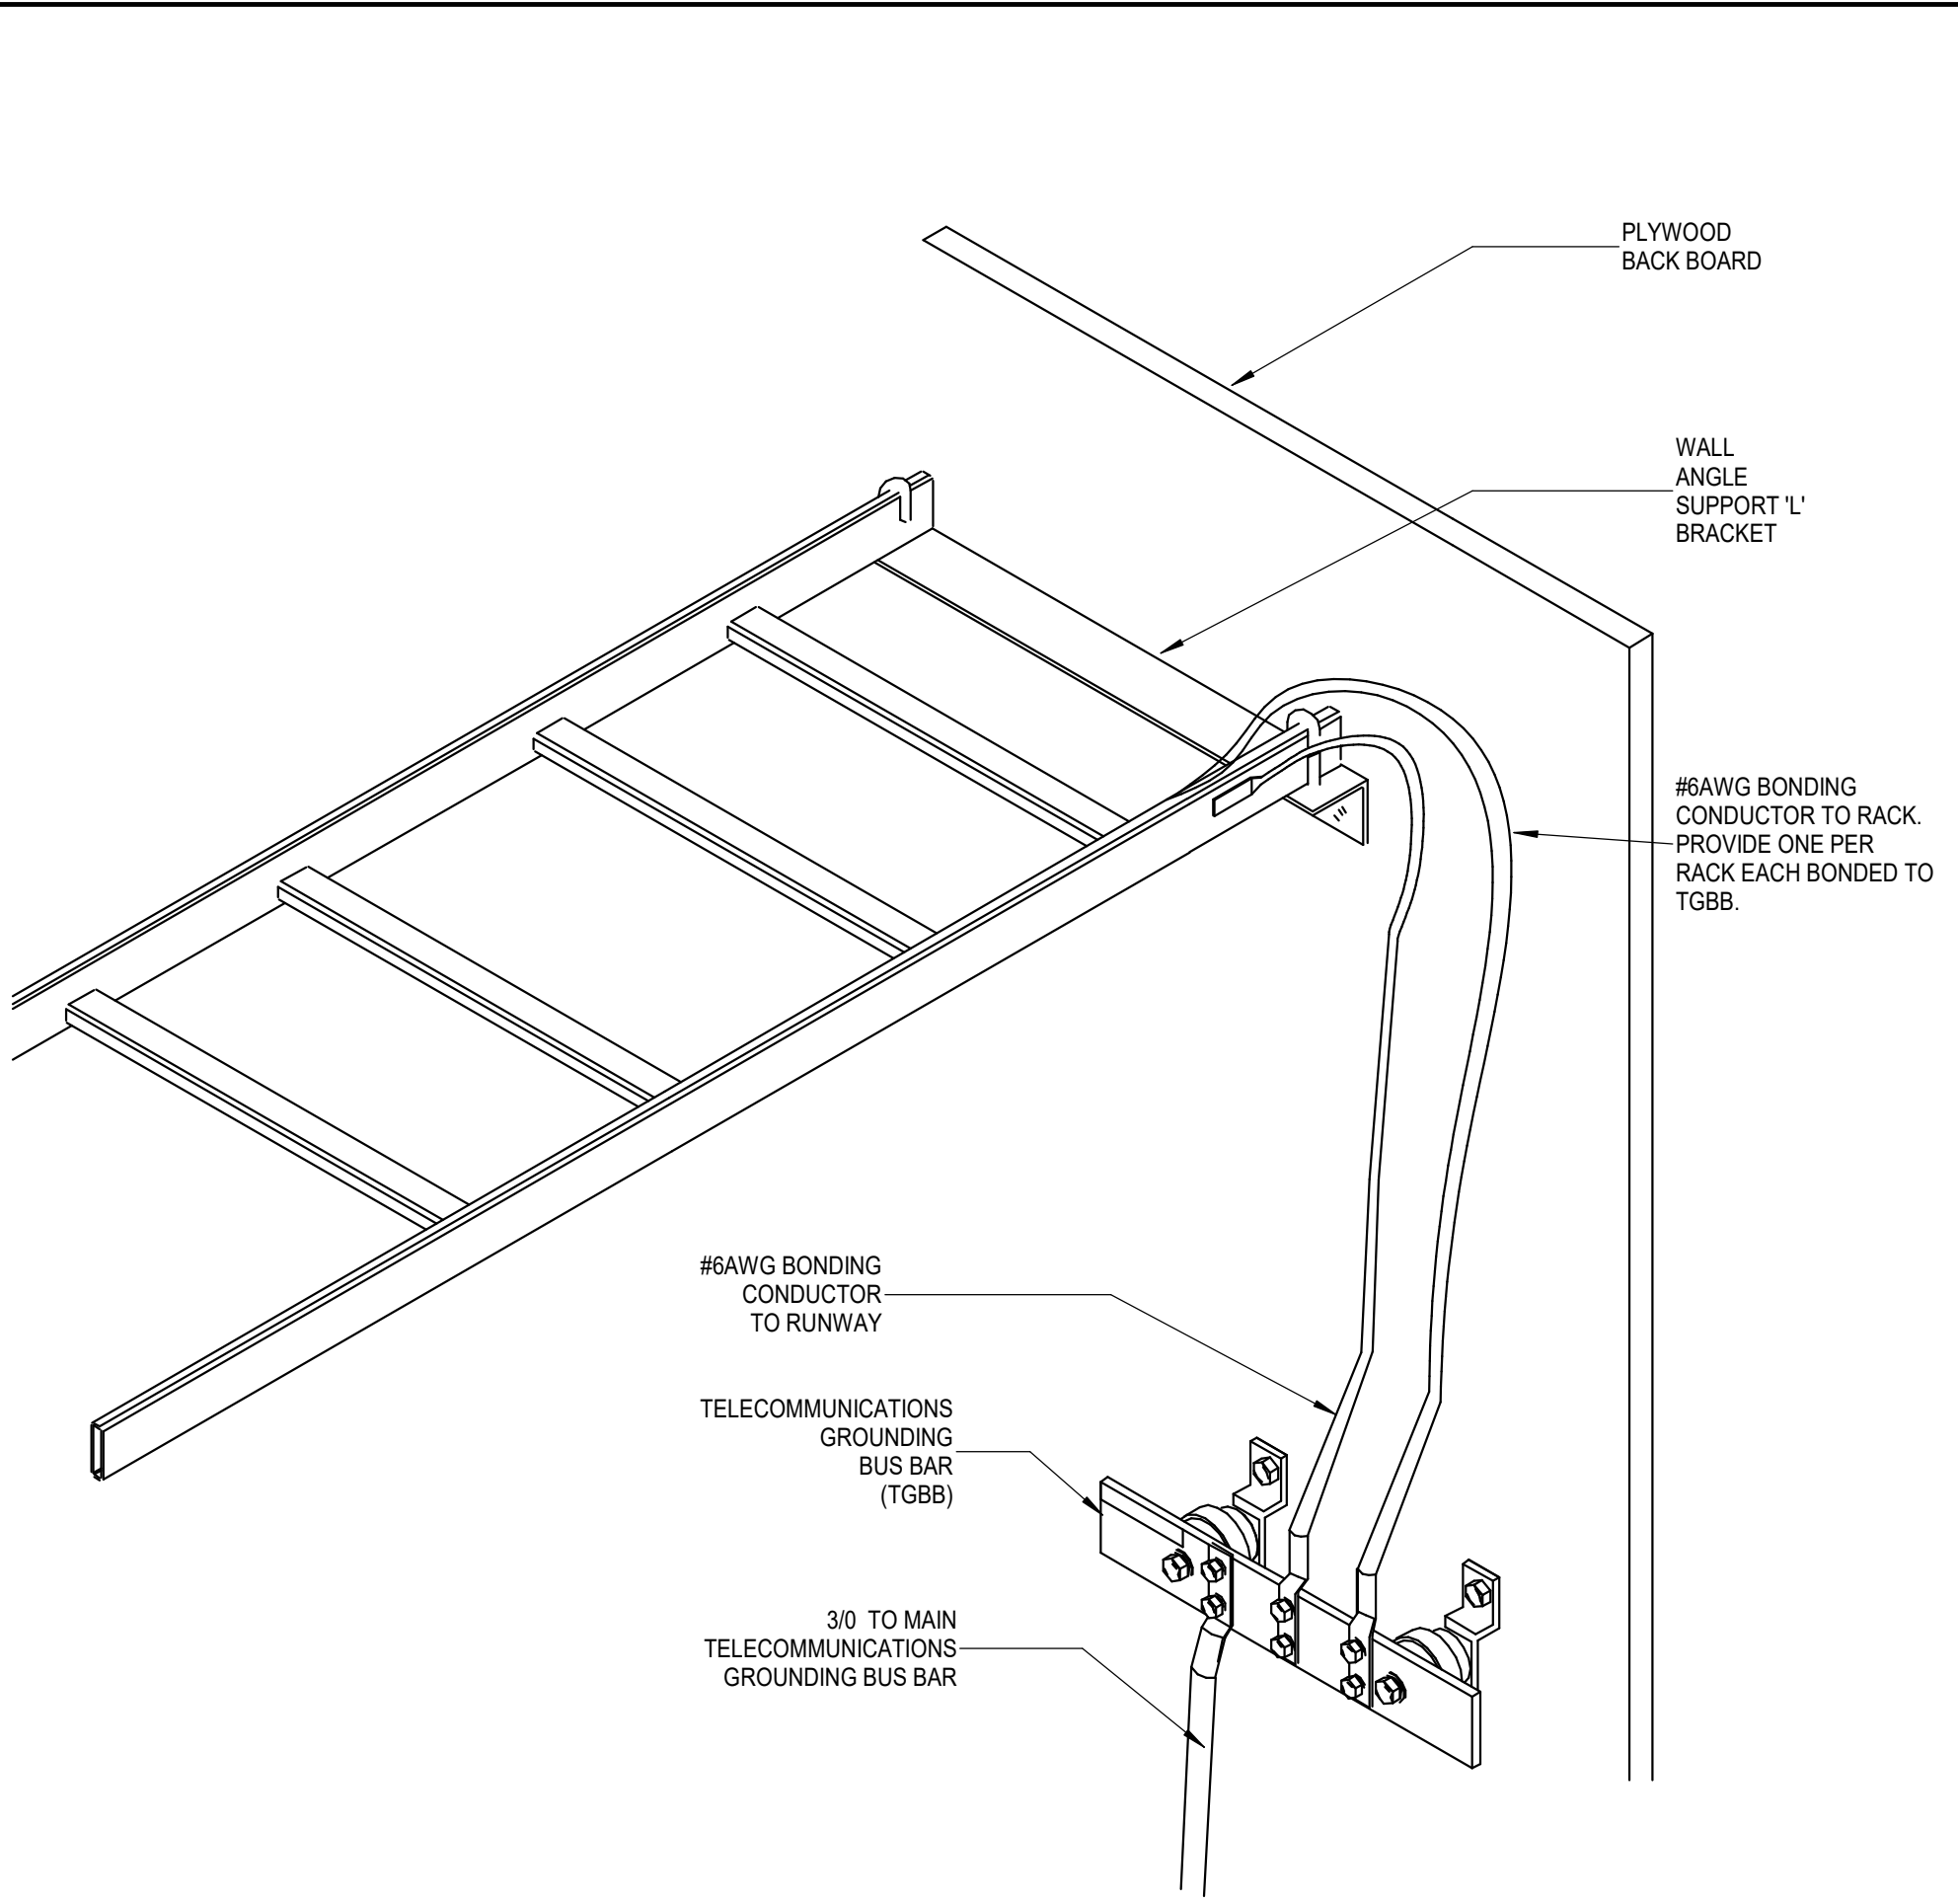


02|CABLE RUNWAY - GROUNDING AND BONDING NOT TO SCALE

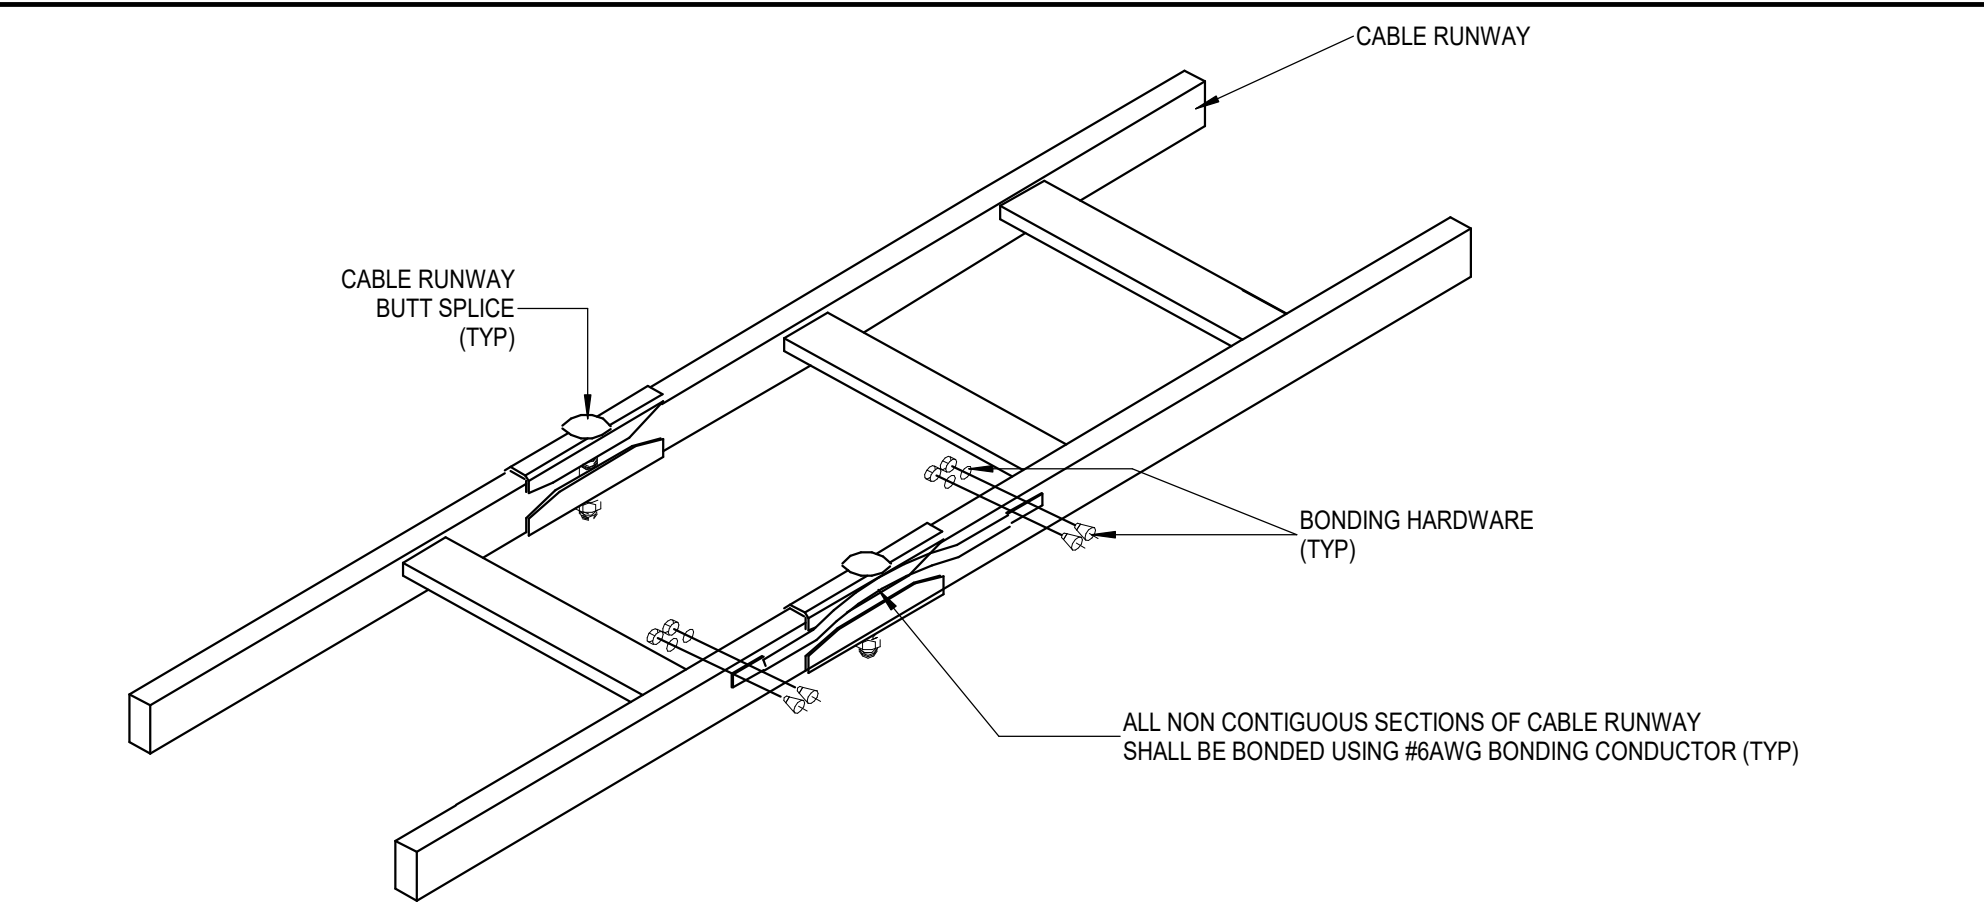


03|CABLE RUNWAY - BONDING AND BUTT SPLICE NOT TO SCALE

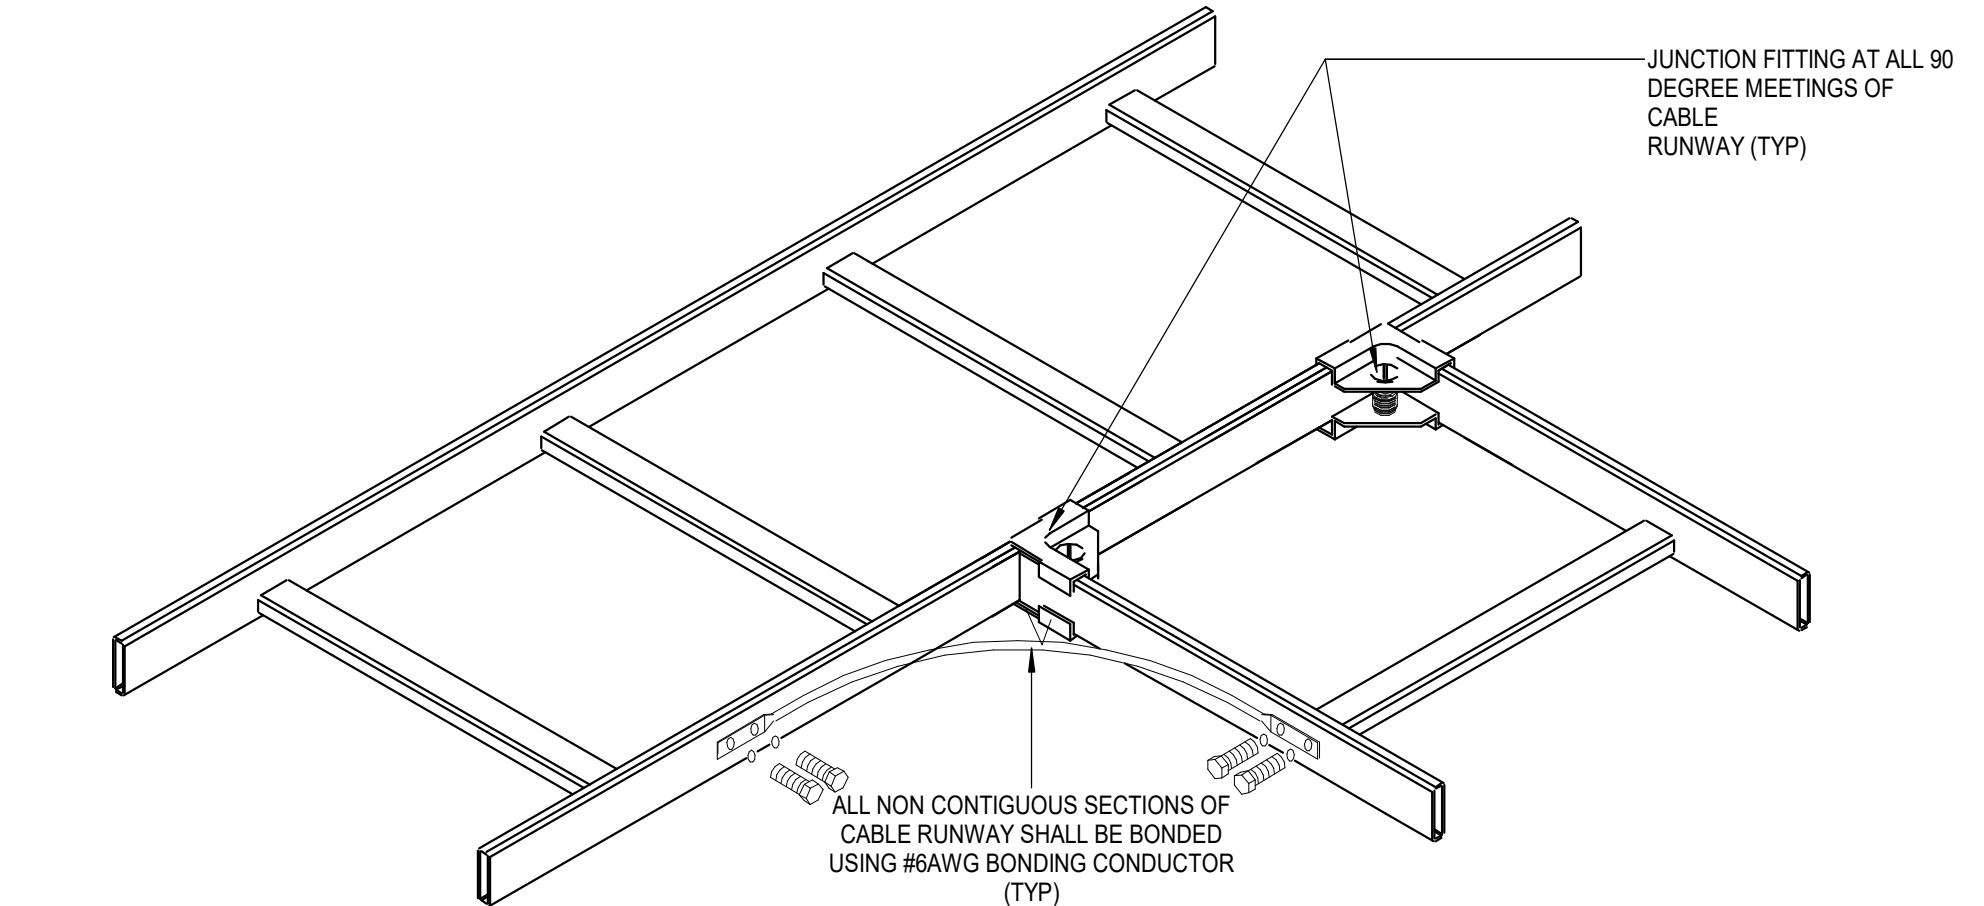

04|CABLE RUNWAY - JUNCTION AND BONDING NOT TO SCALE

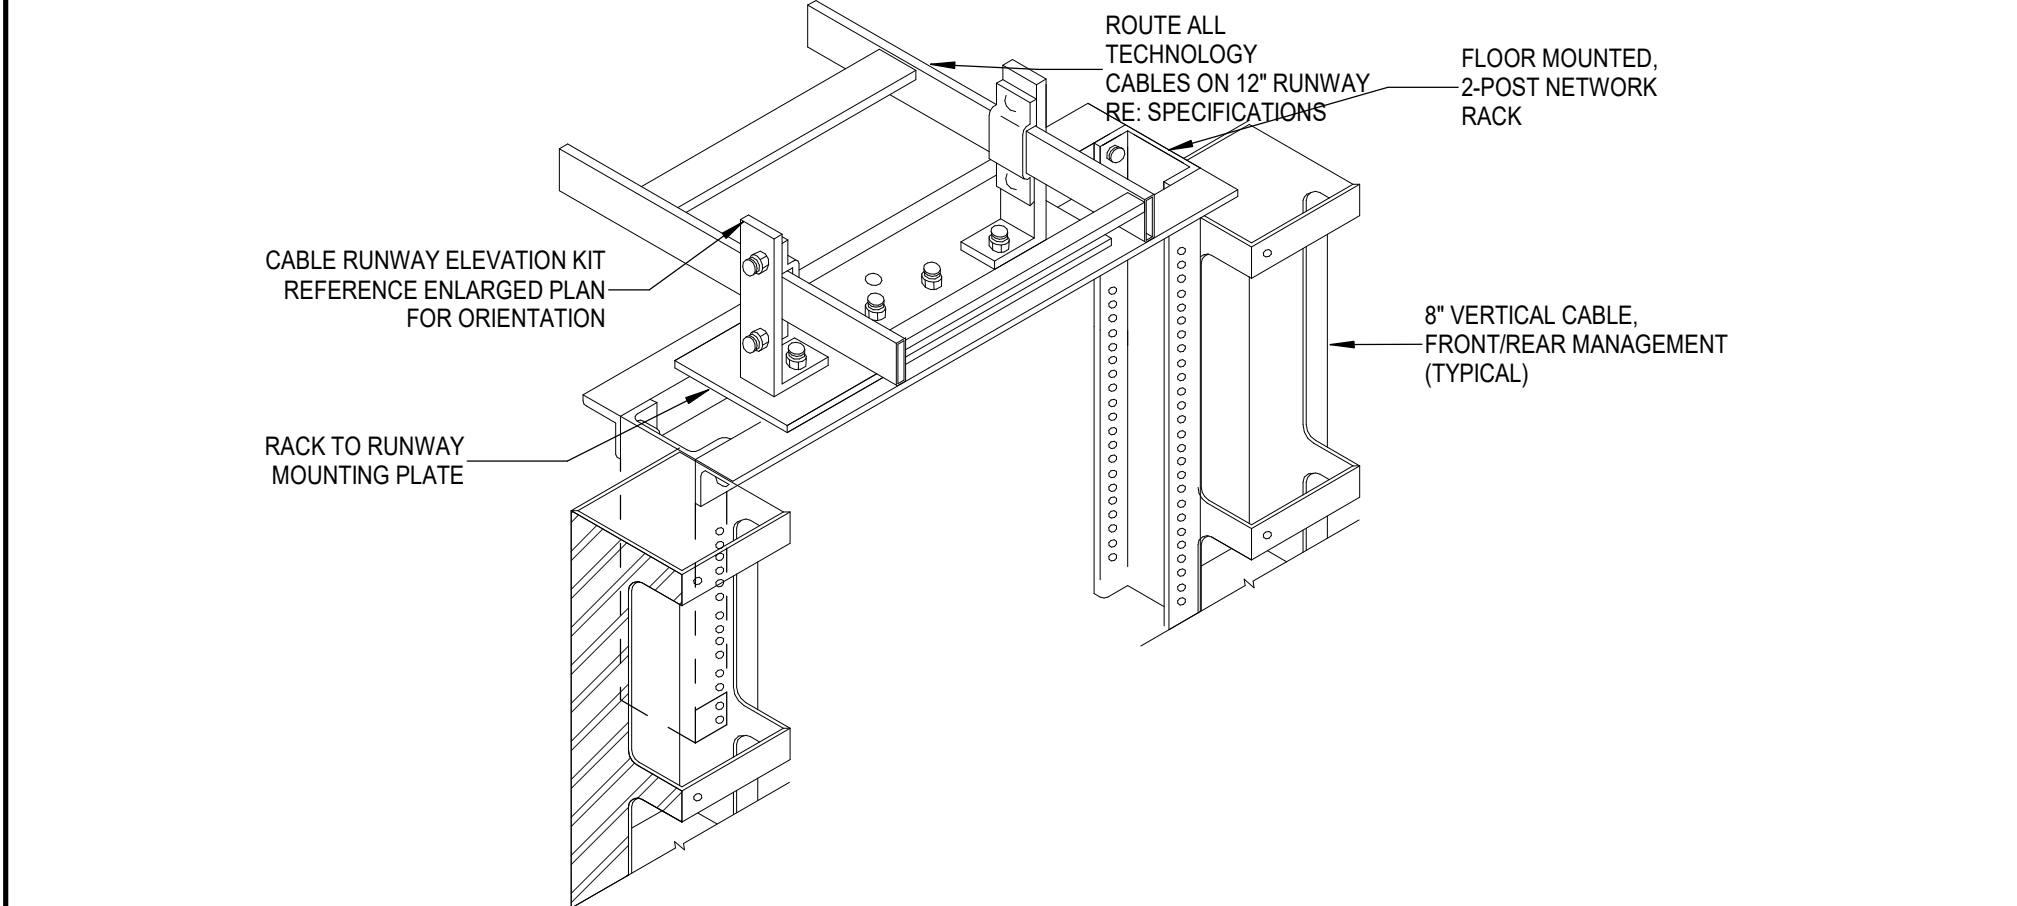

05|RACK TO RUNWAY DETAIL NOT TO SCALE

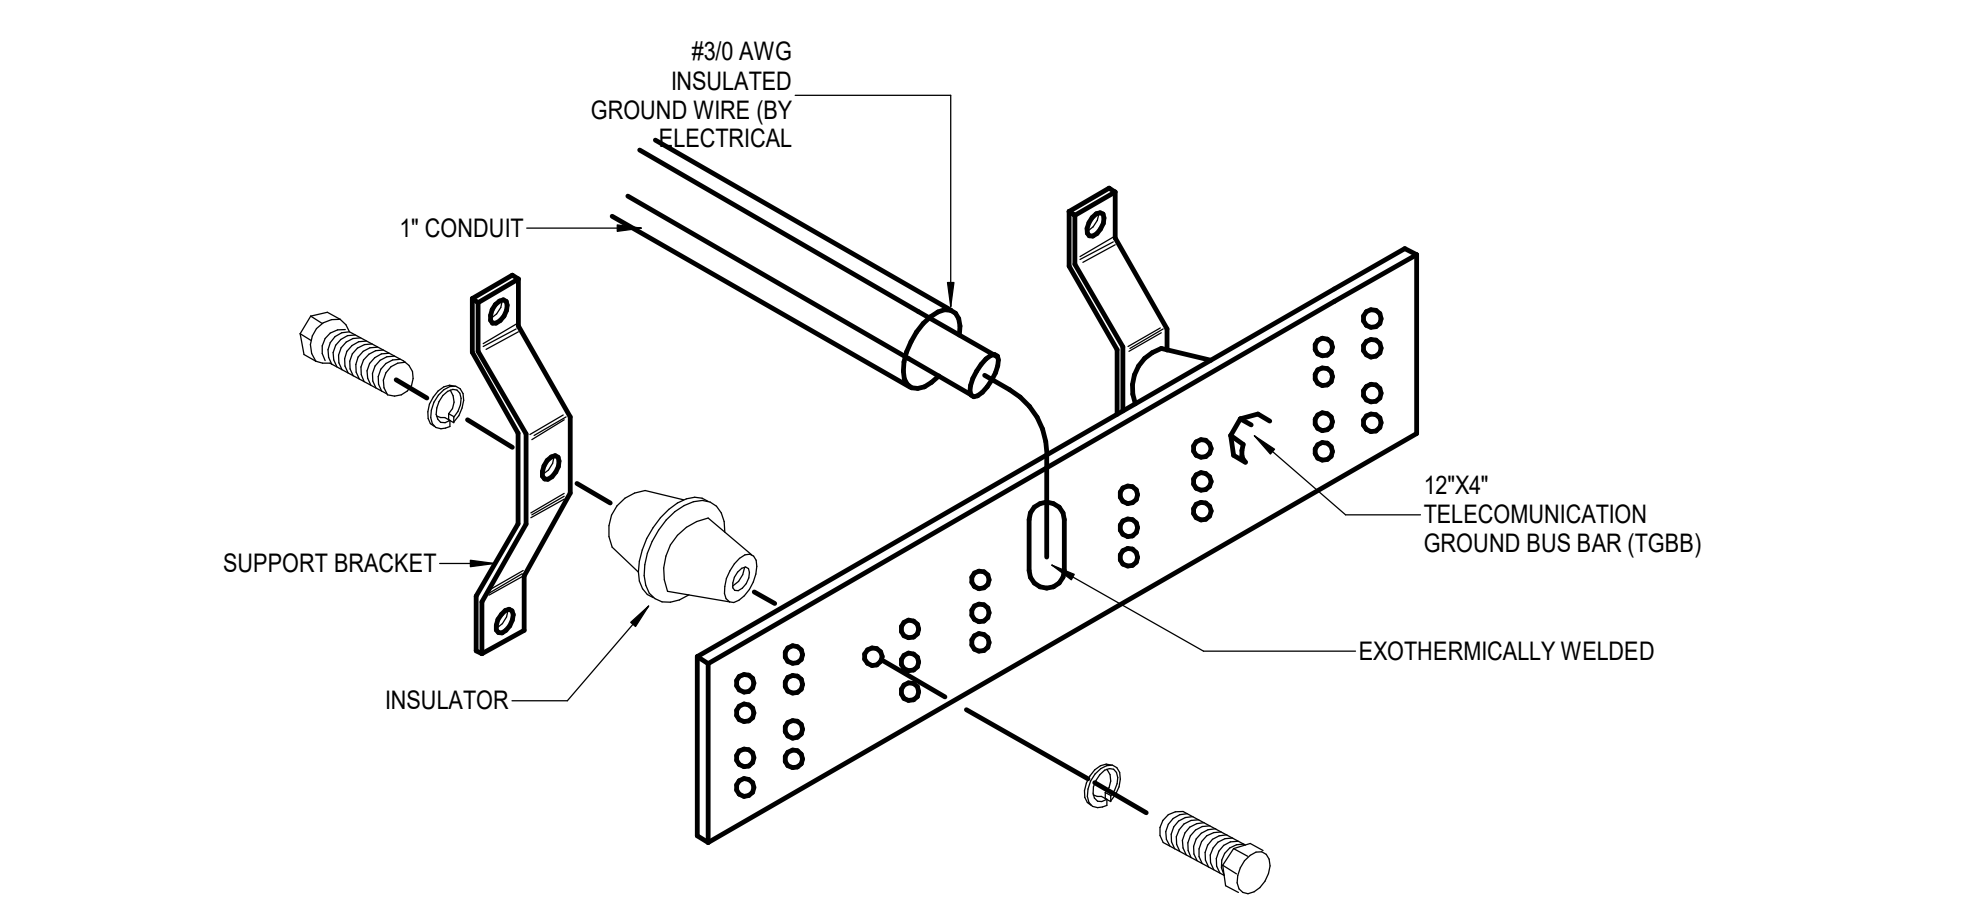


07|TELECOMMUNICATION GROUNDING BUS DETAIL NOT TO SCALE
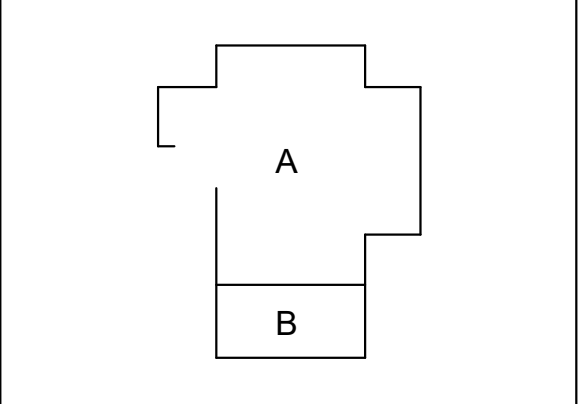
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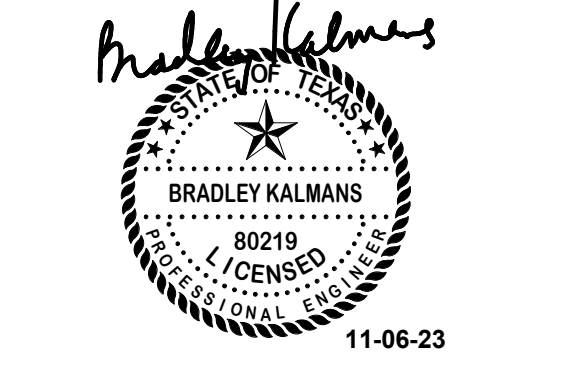


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PROJECT #: 202311  
DATE: 2023-11-03  
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CHECKED: DS


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ISSUE: BID SET

**T4.02**

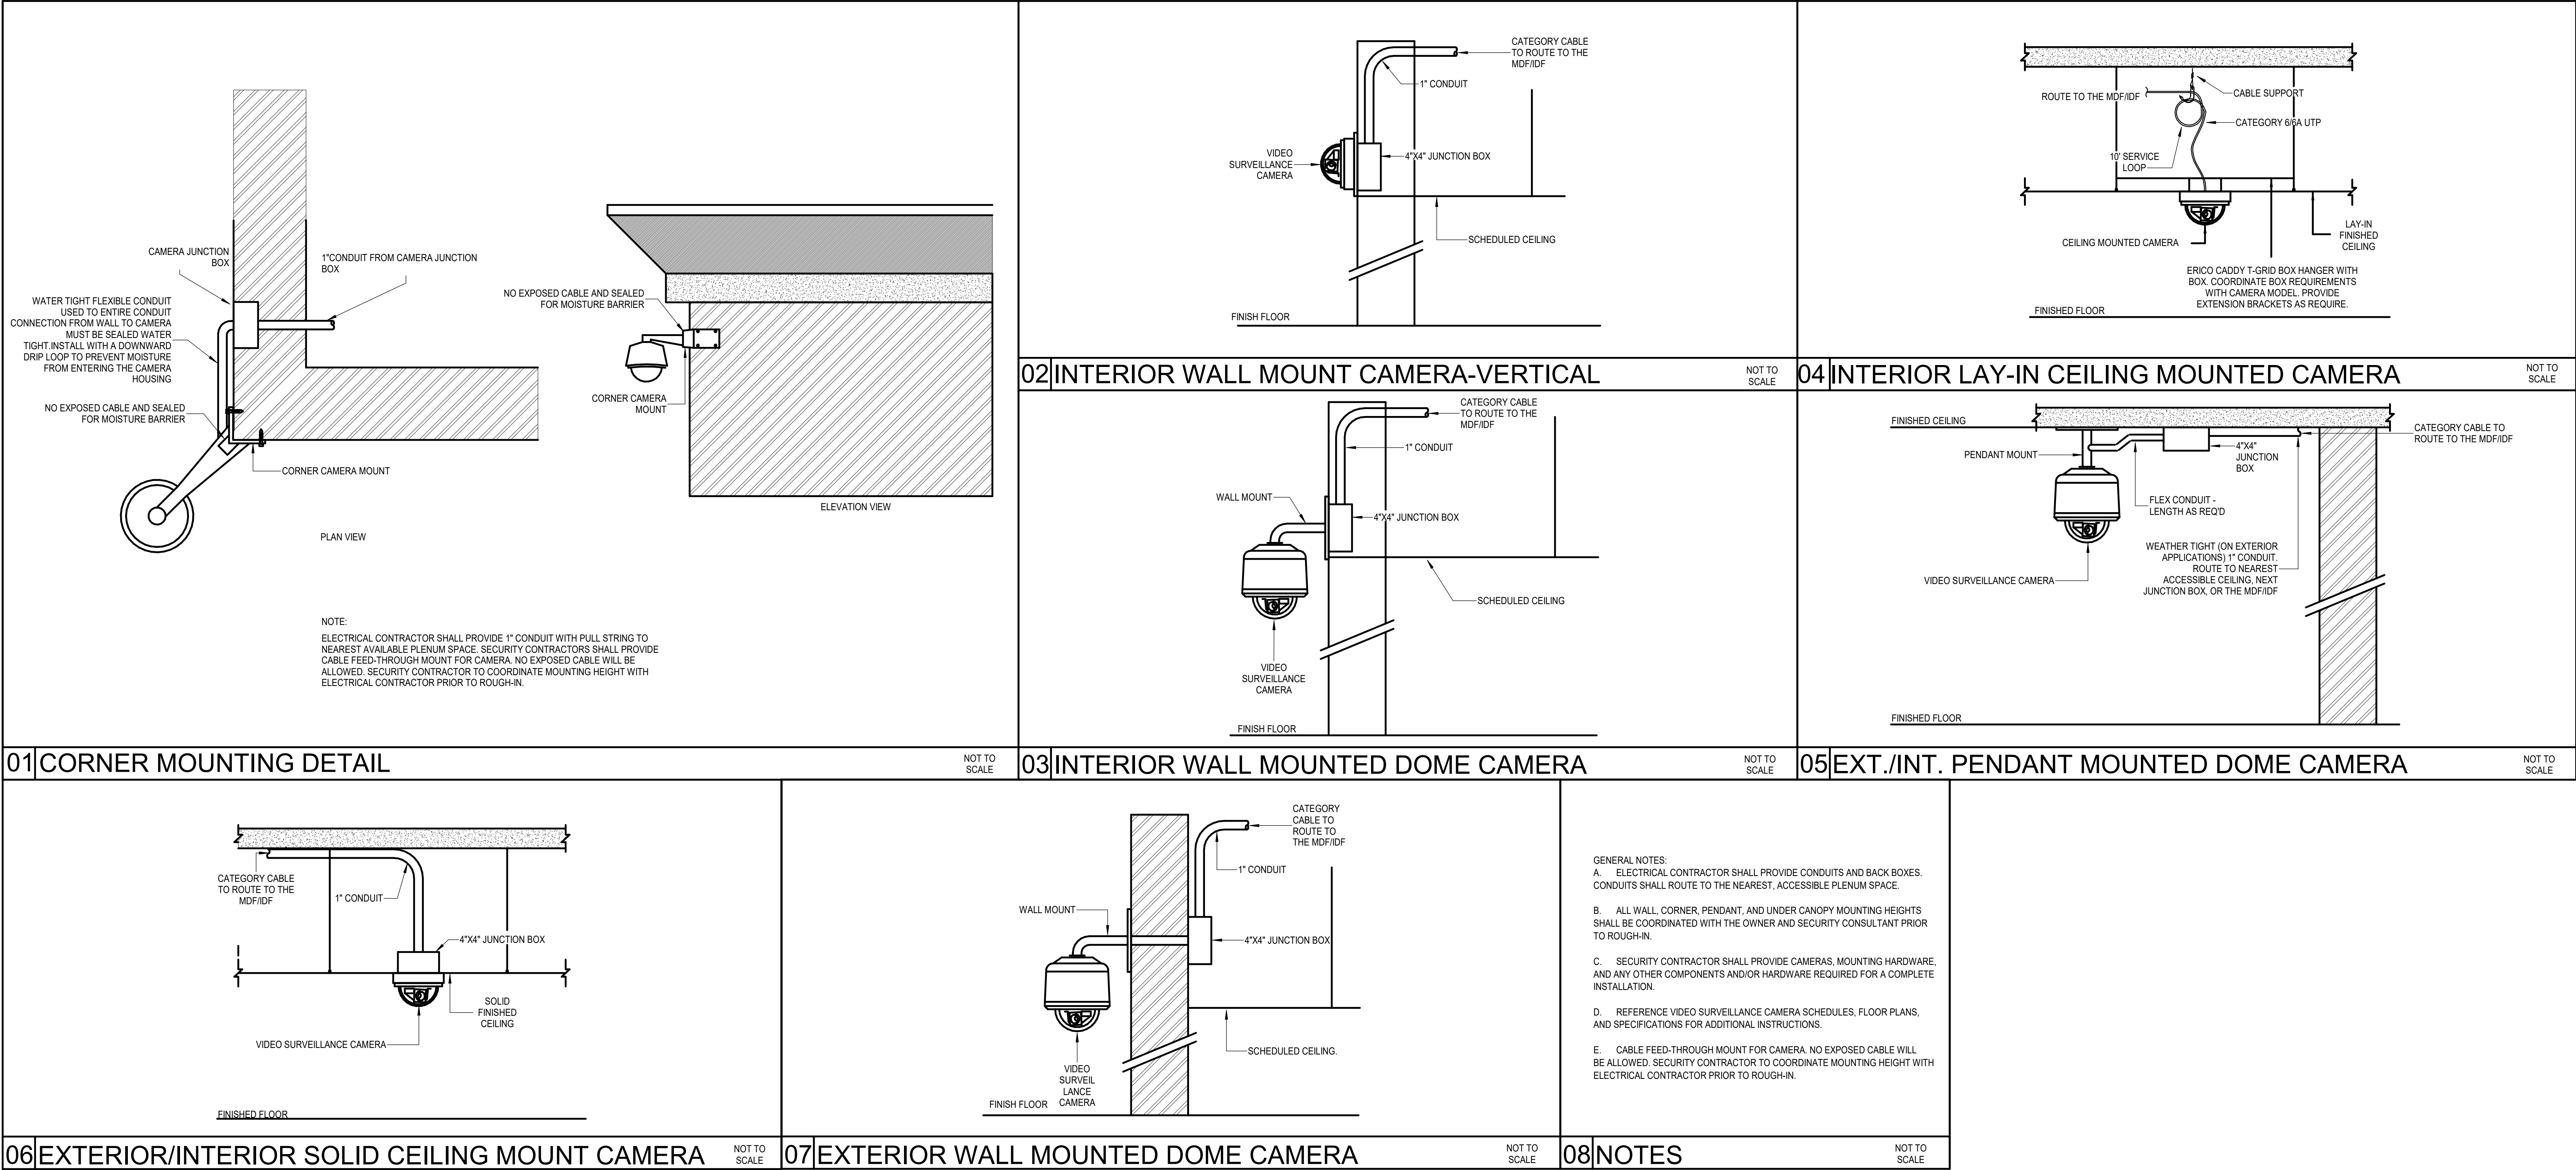TECHNOLOGY  
DETAILS





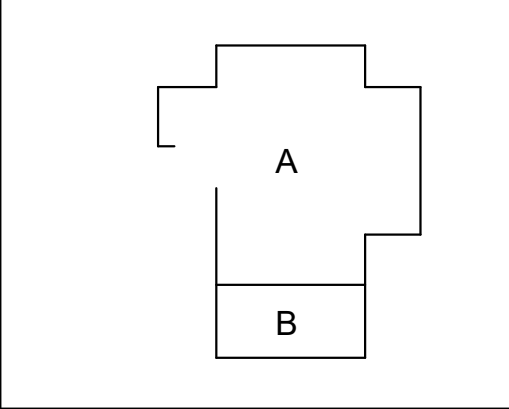


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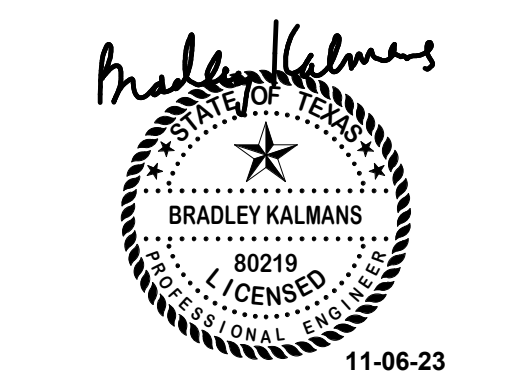


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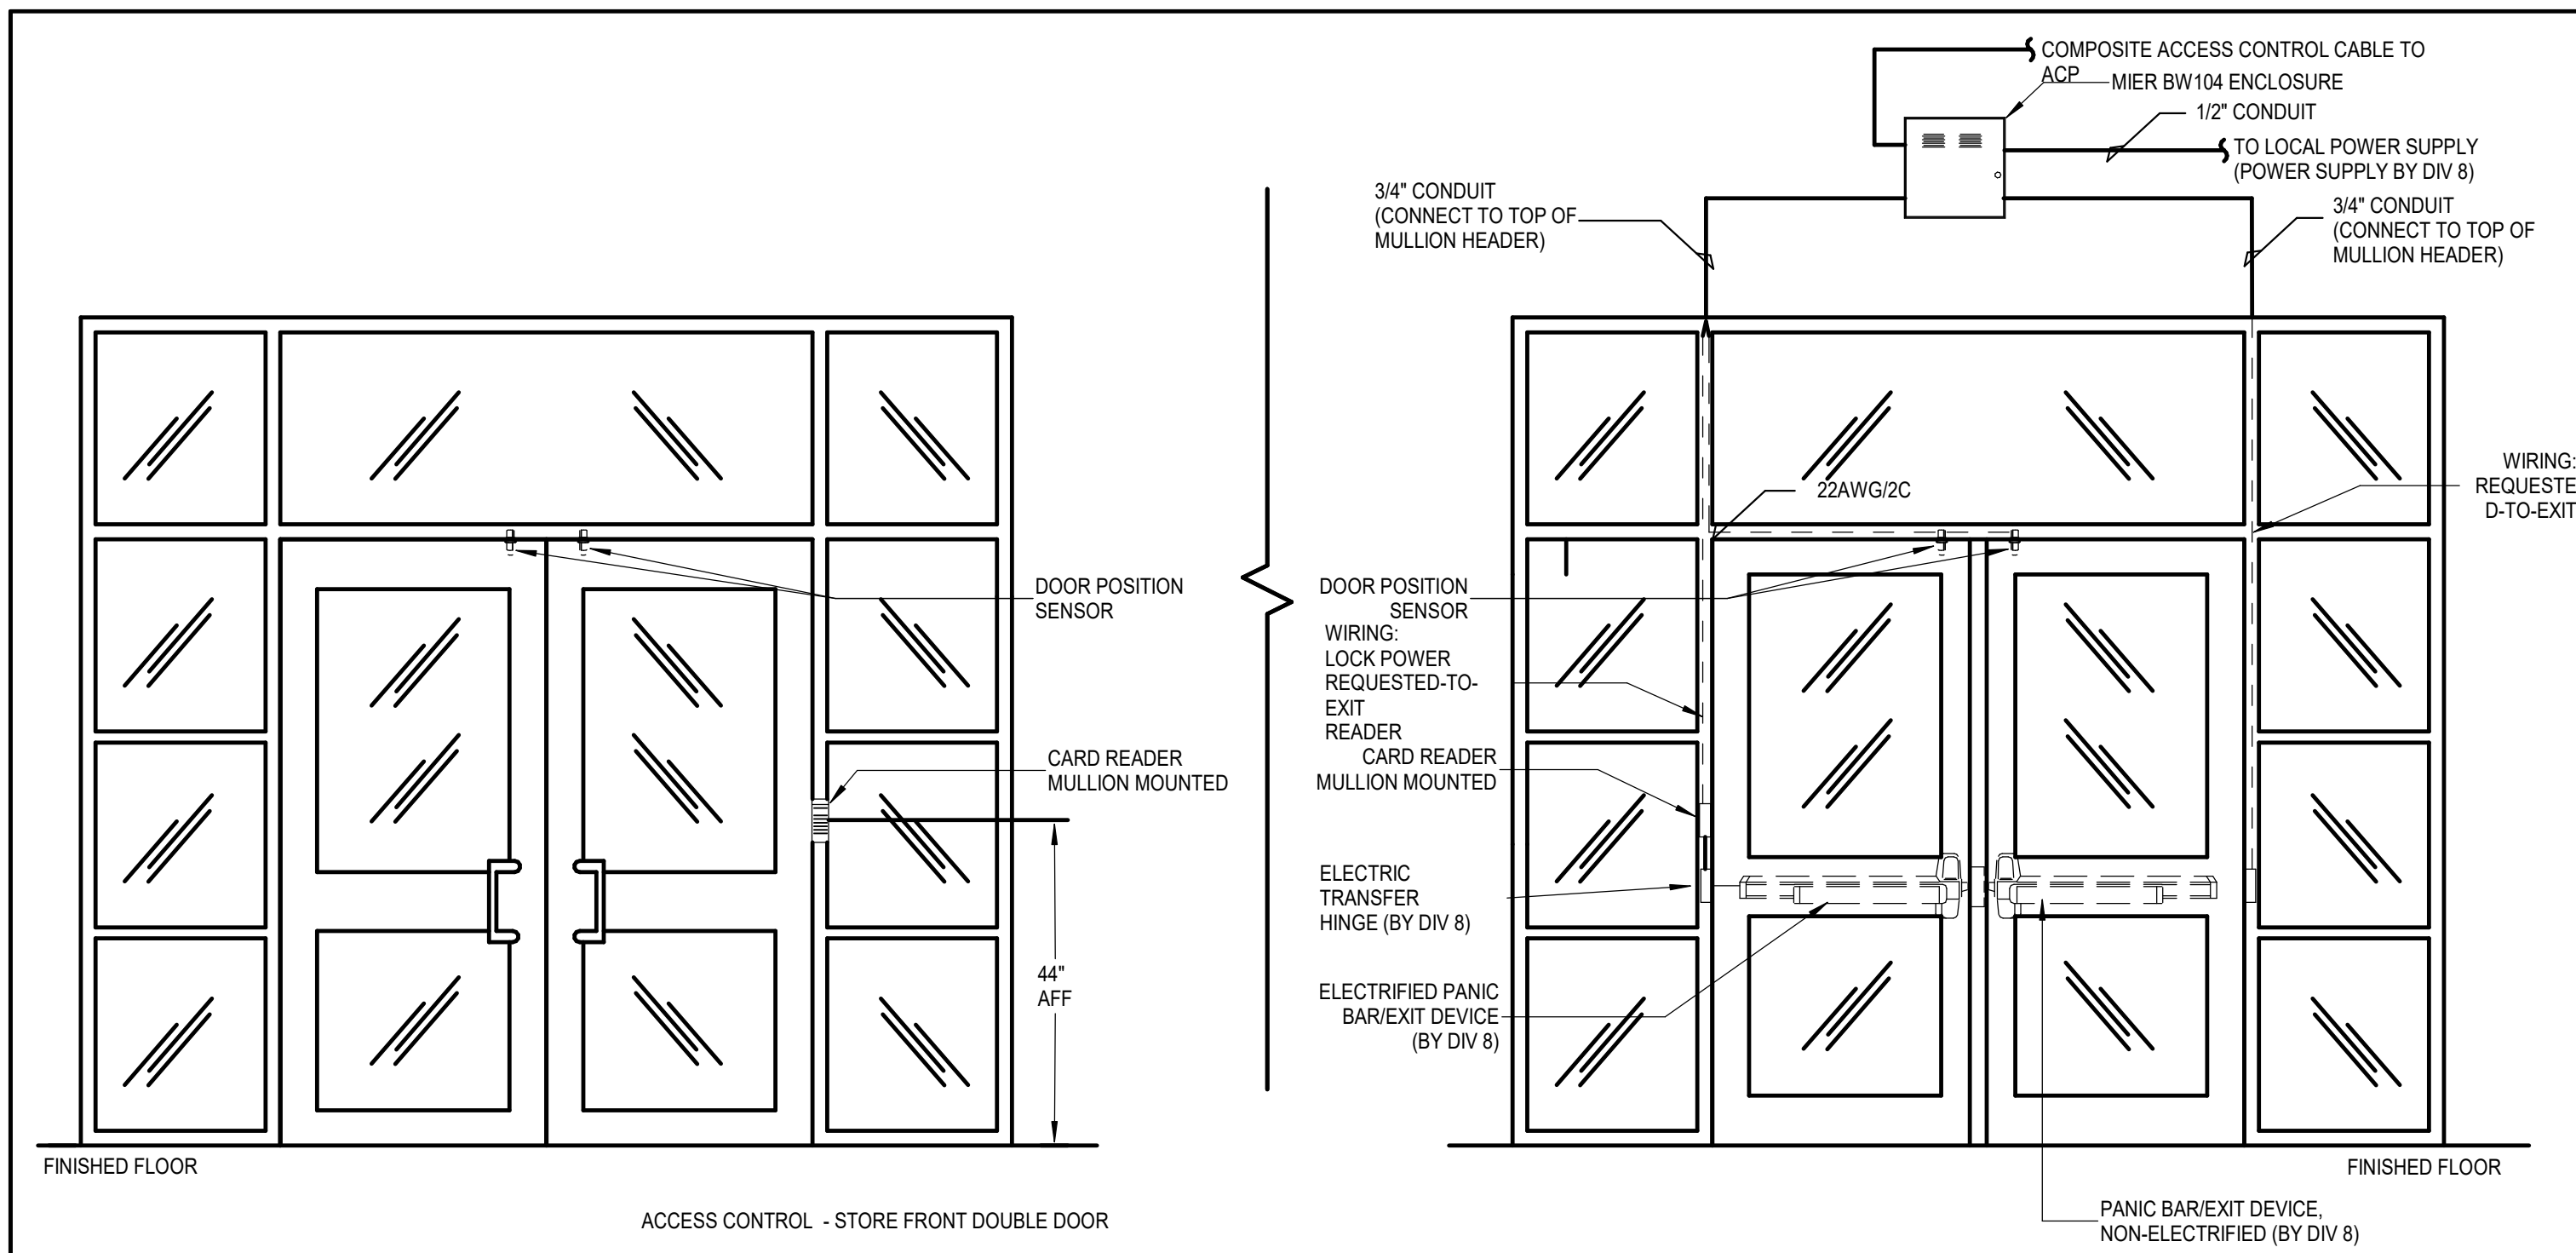
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ISSUE: BID SET

**T4.03**

TECHNOLOGY  
DETAILS

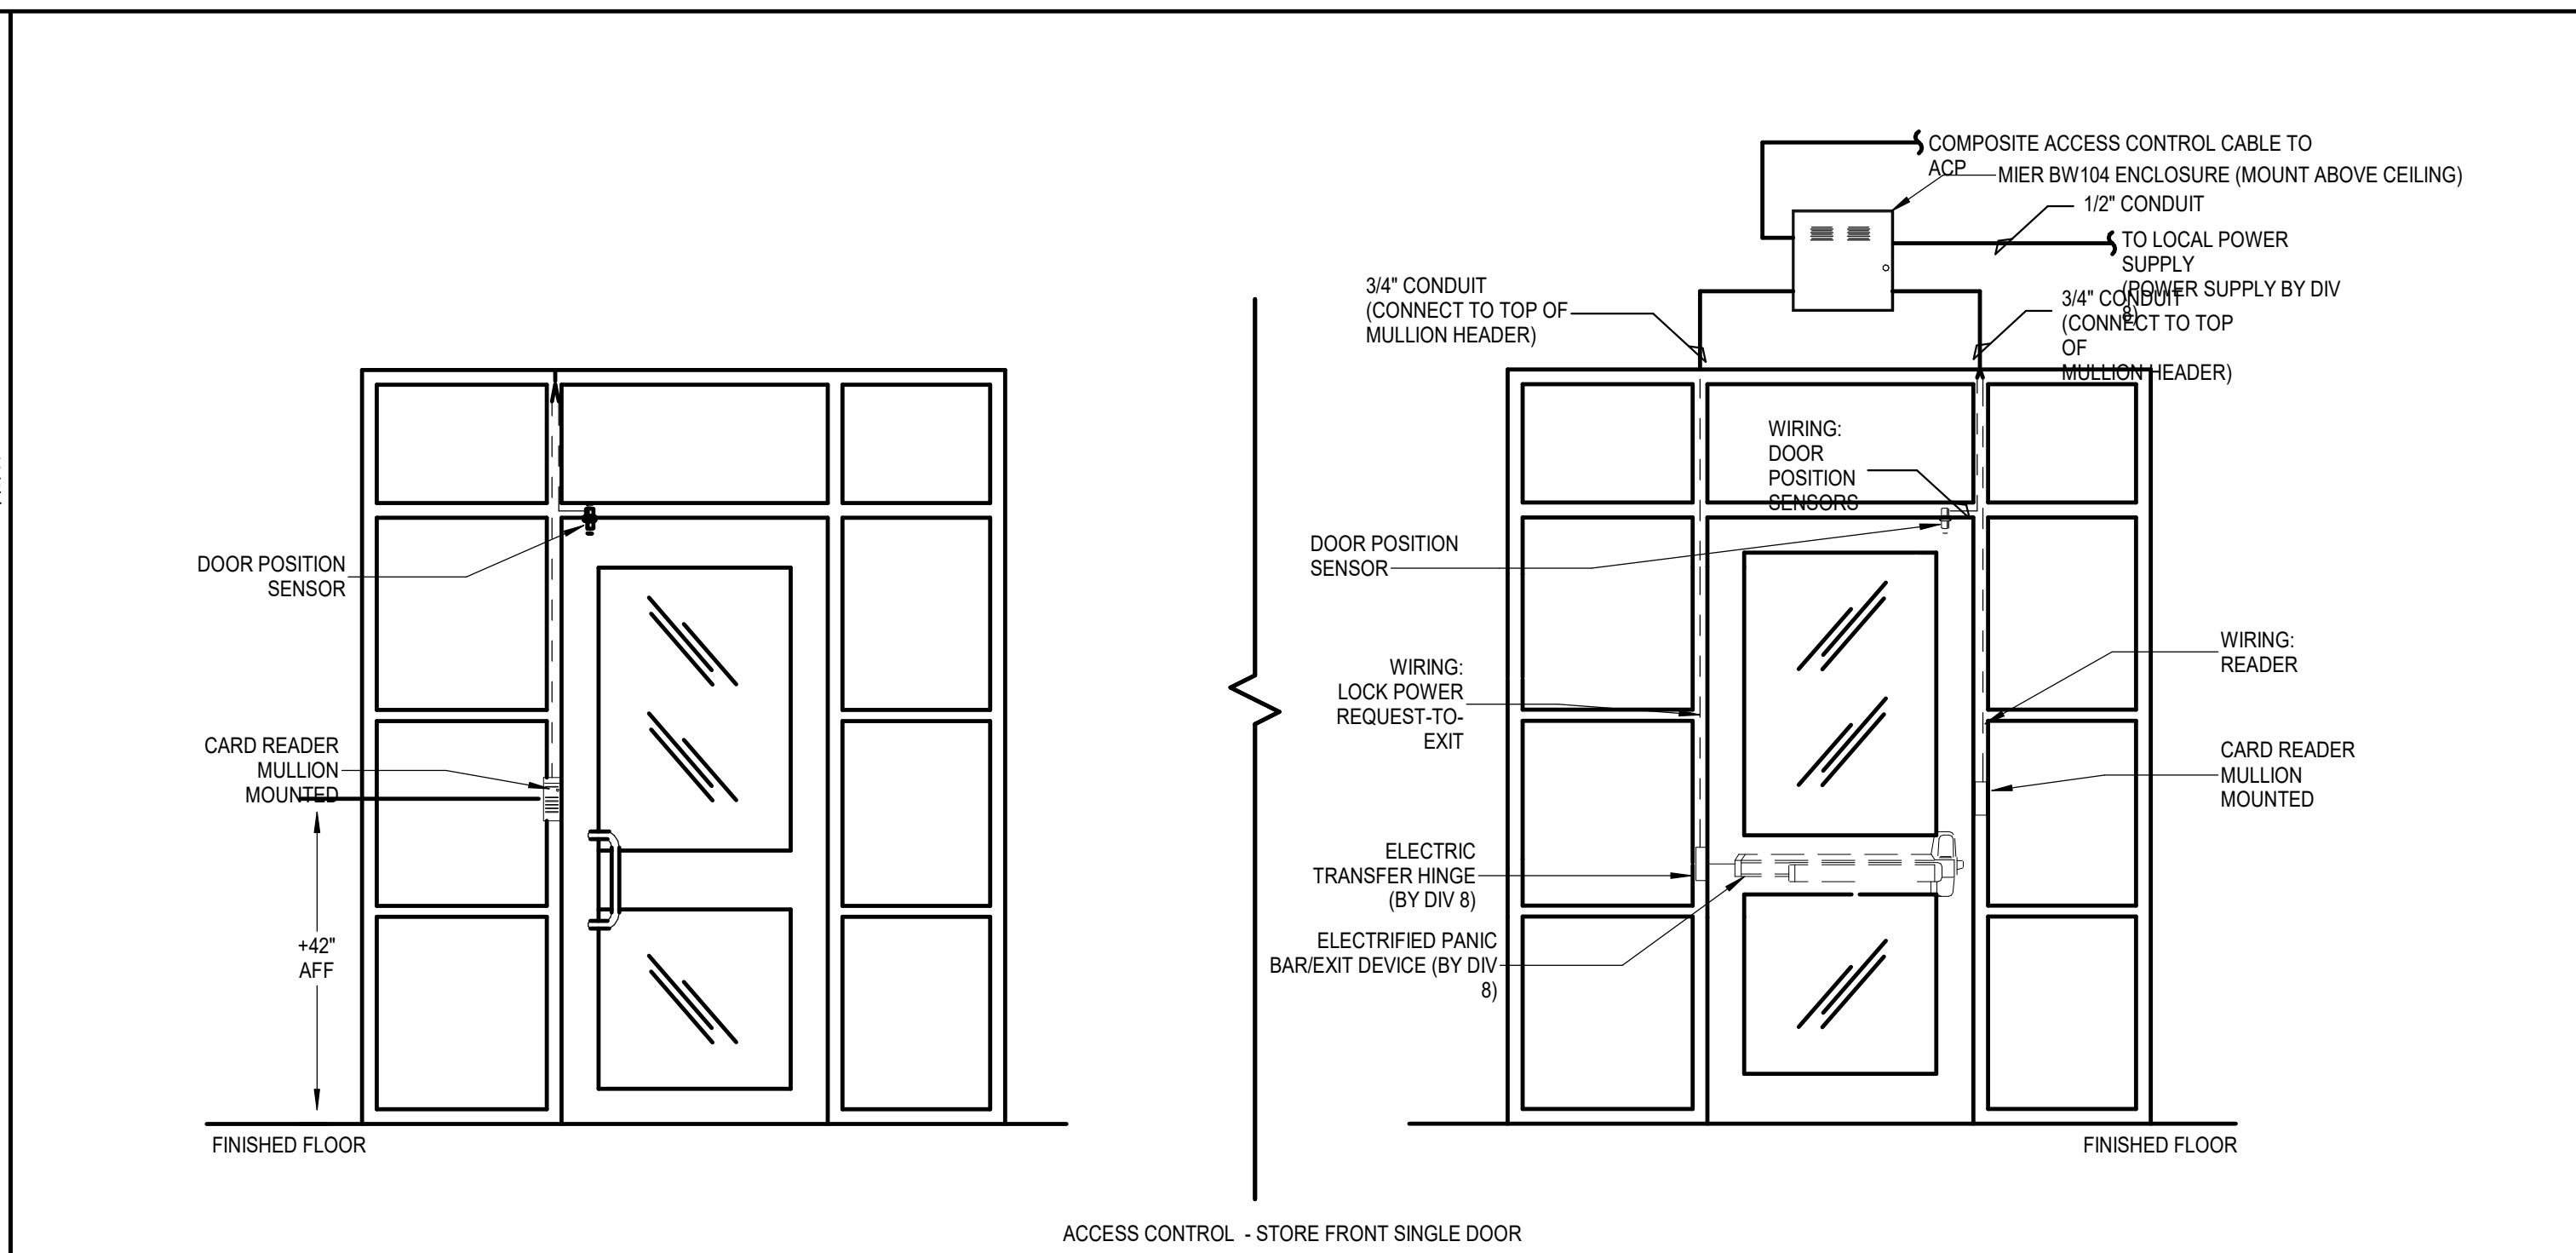







01 ACCESS CONTROL - STORE FRONT DOUBLE DOOR

NOT TO SCALE




02 ACCESS CONTROL - STORE FRONT SINGLE DOOR

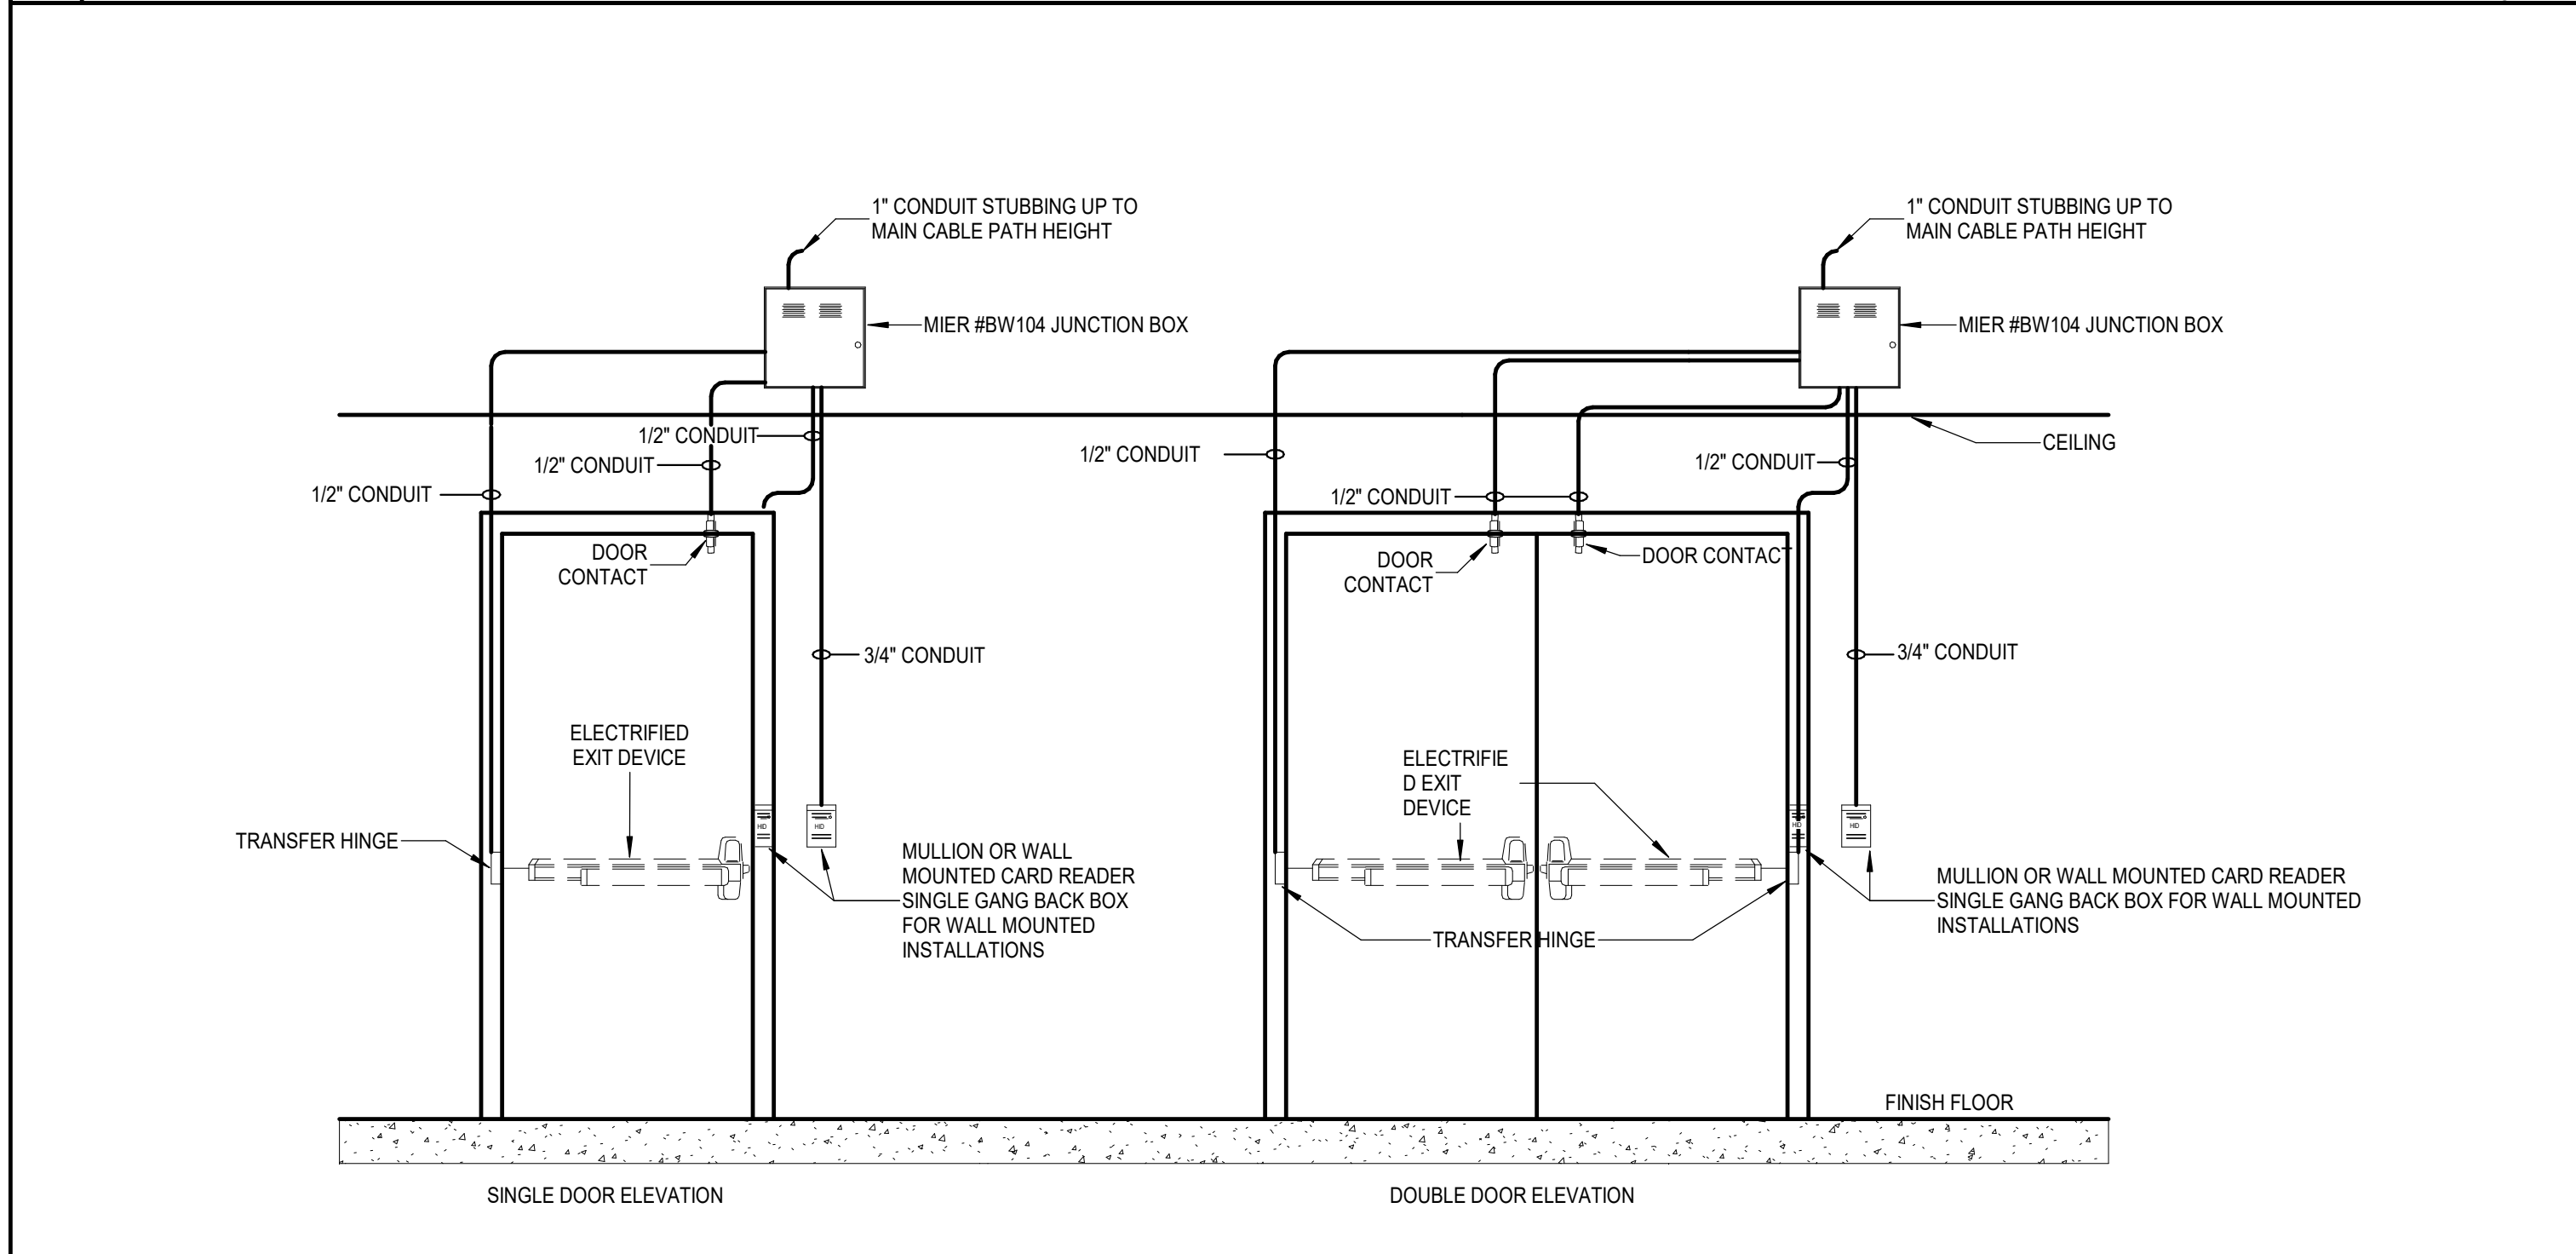NOT TO SCALE




03 ACCESS CONTROL - EXIT DEVICE DOOR ELEVATION

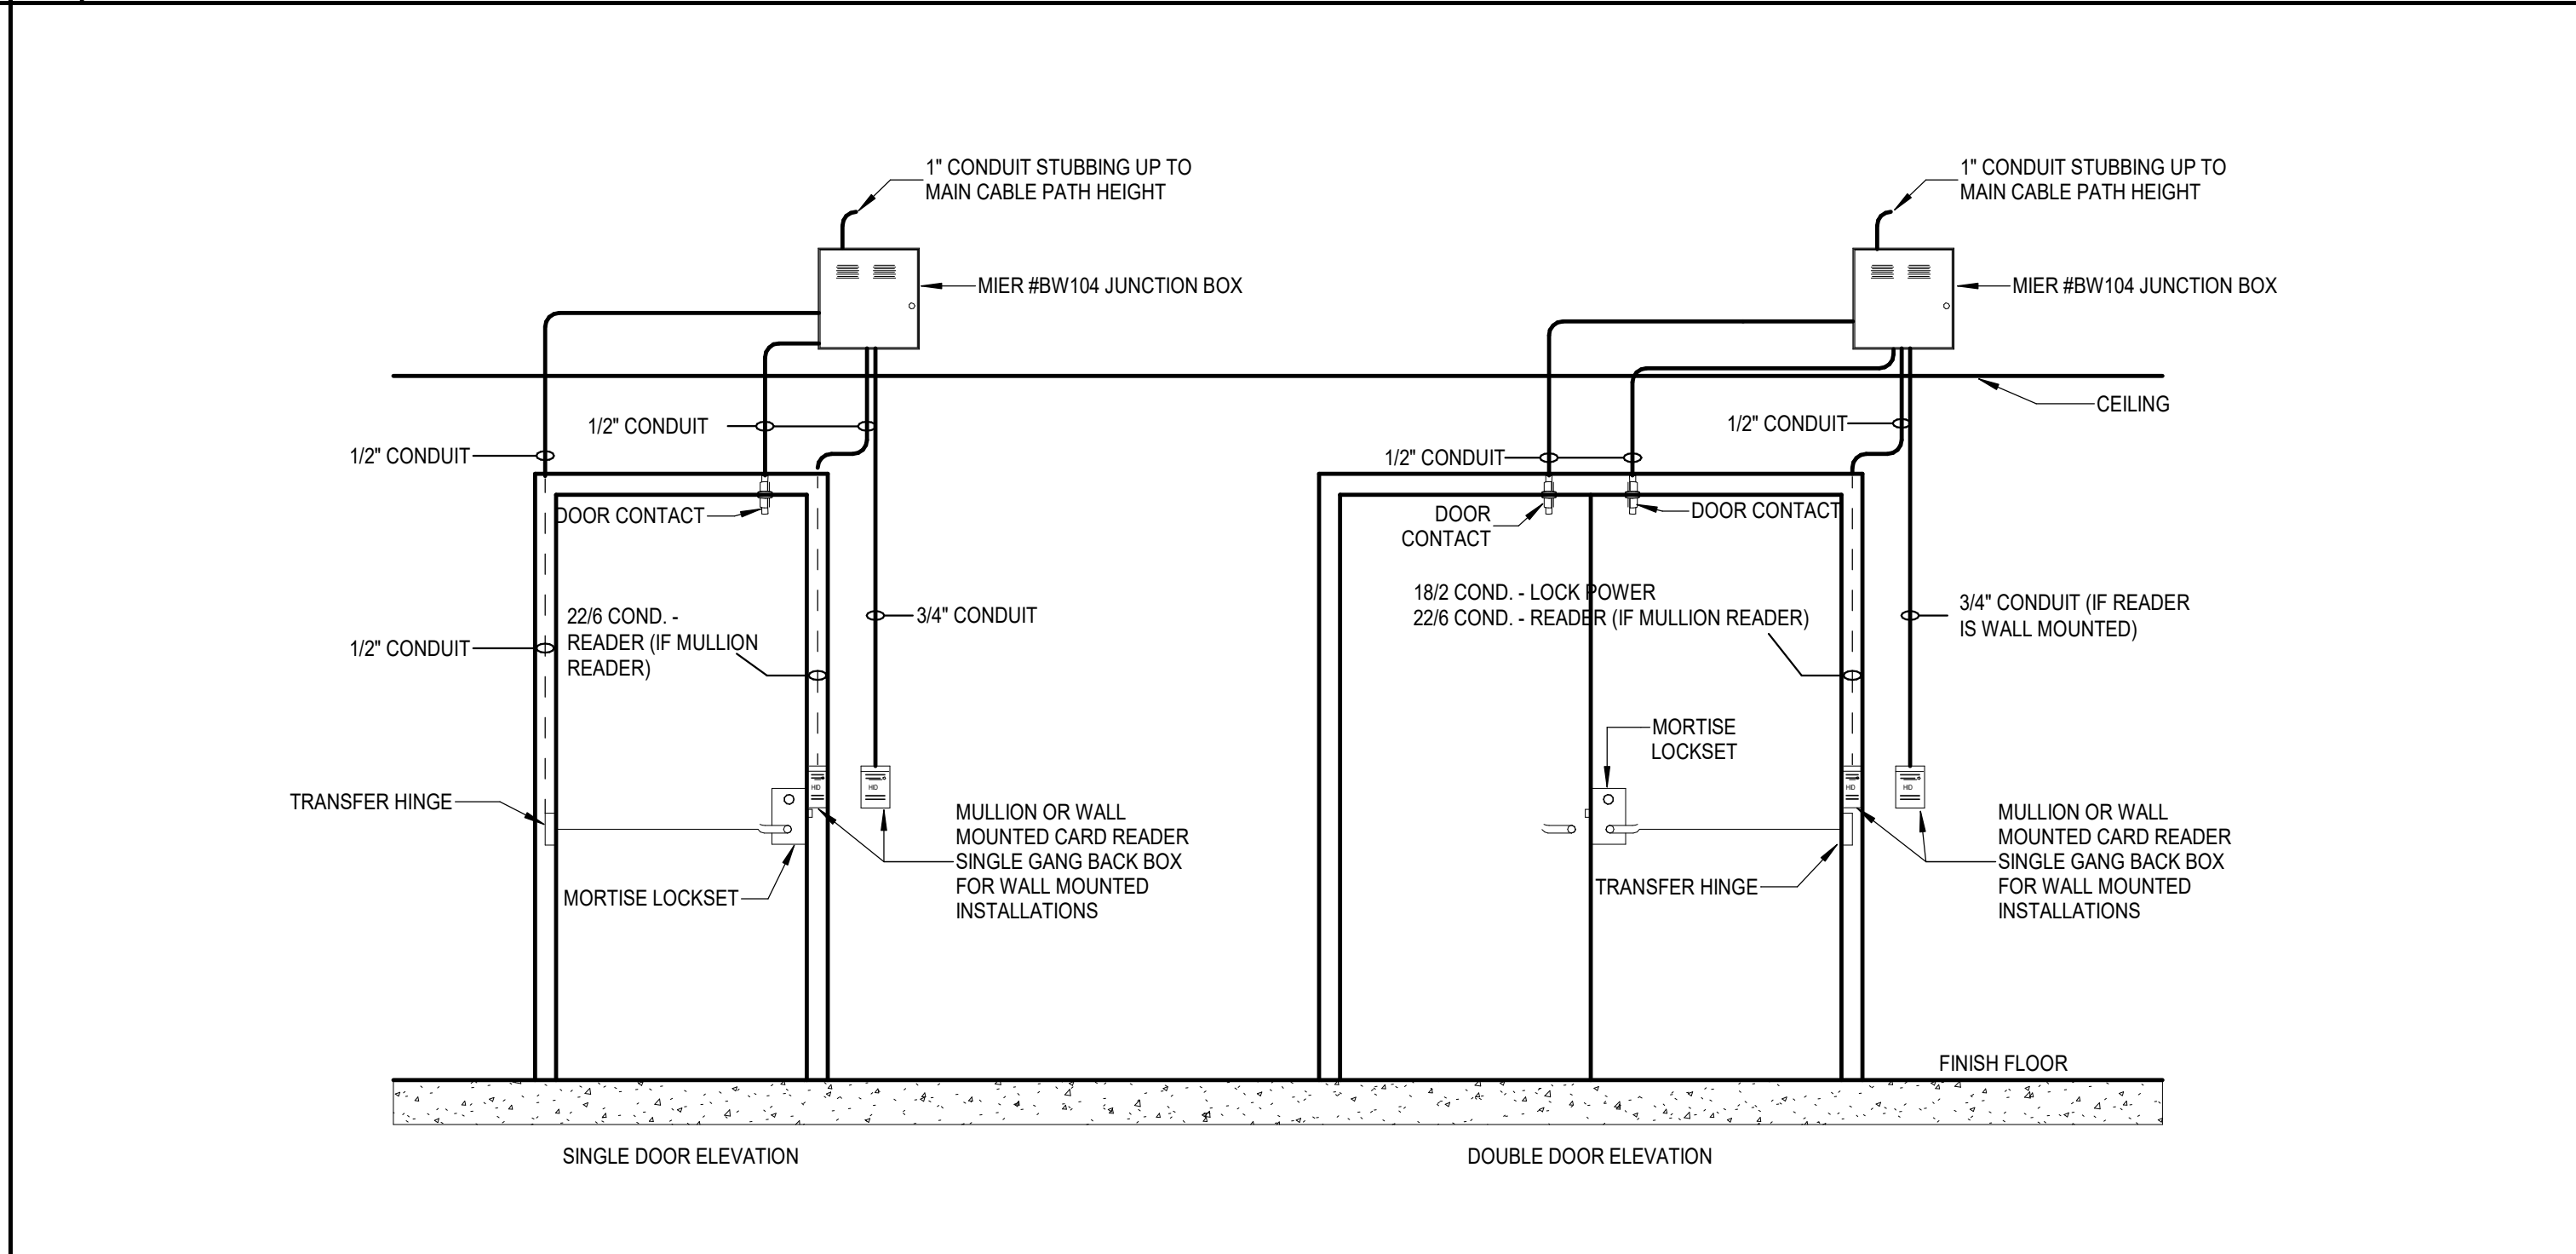NOT TO SCALE




04 ACCESS CONTROL - MORTISE LOCK DOOR ELEVATION

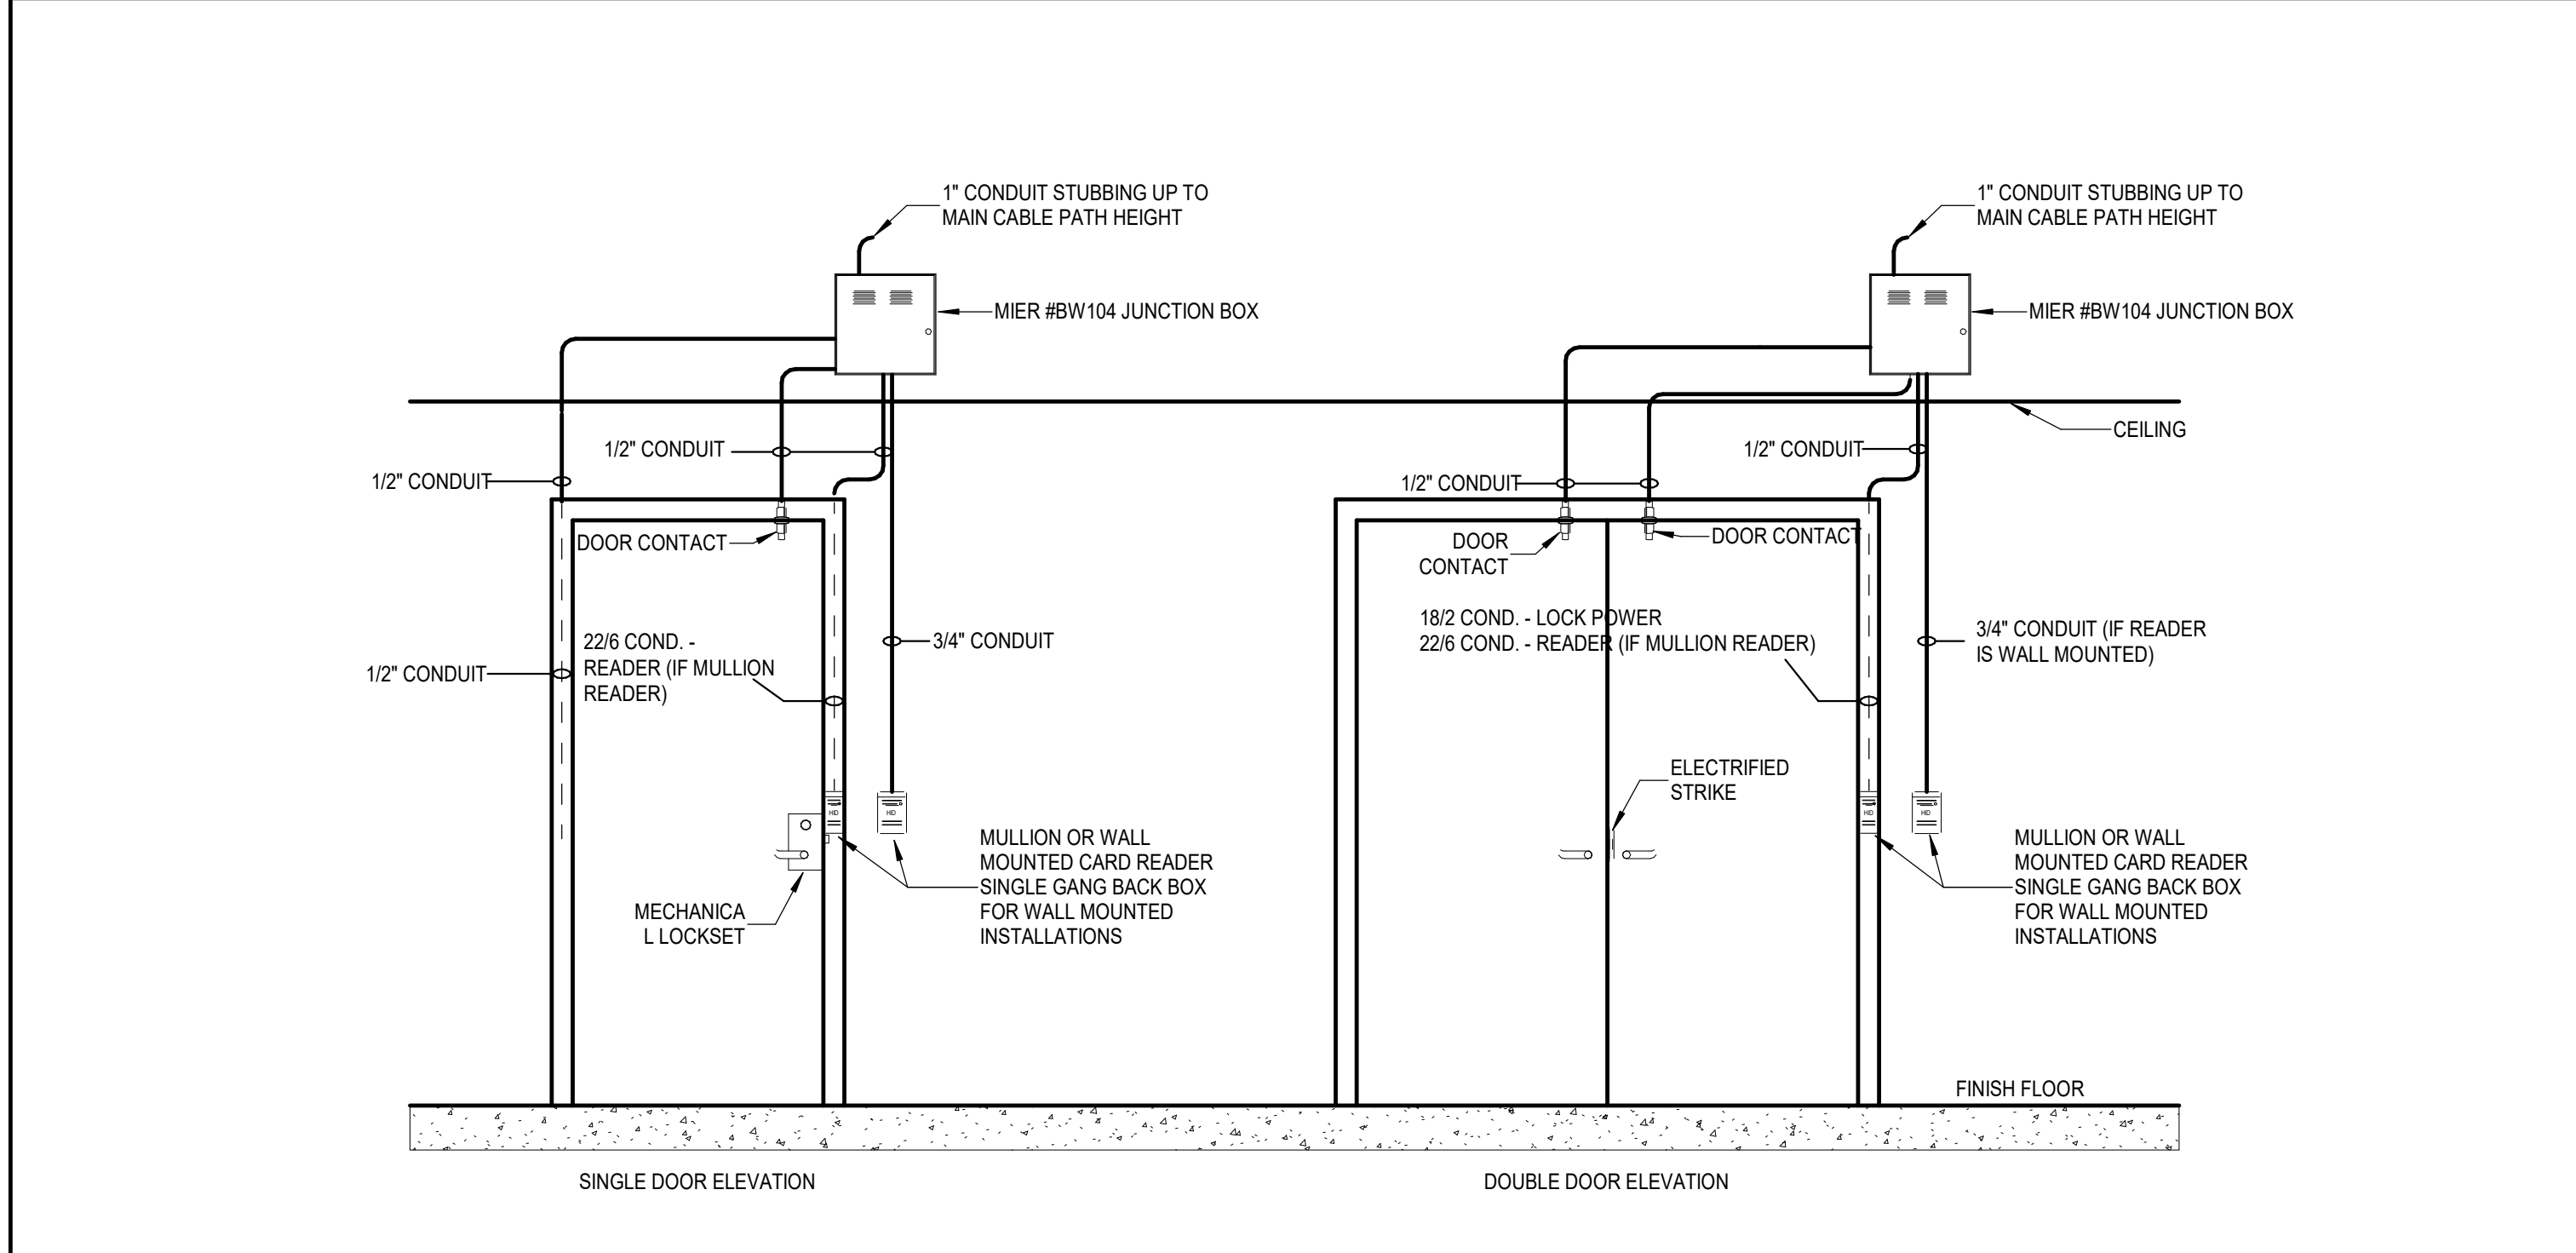NOT TO SCALE



05 ACCESS CONTROL - ELECTRIFIED STRIKE DOOR ELEVATION

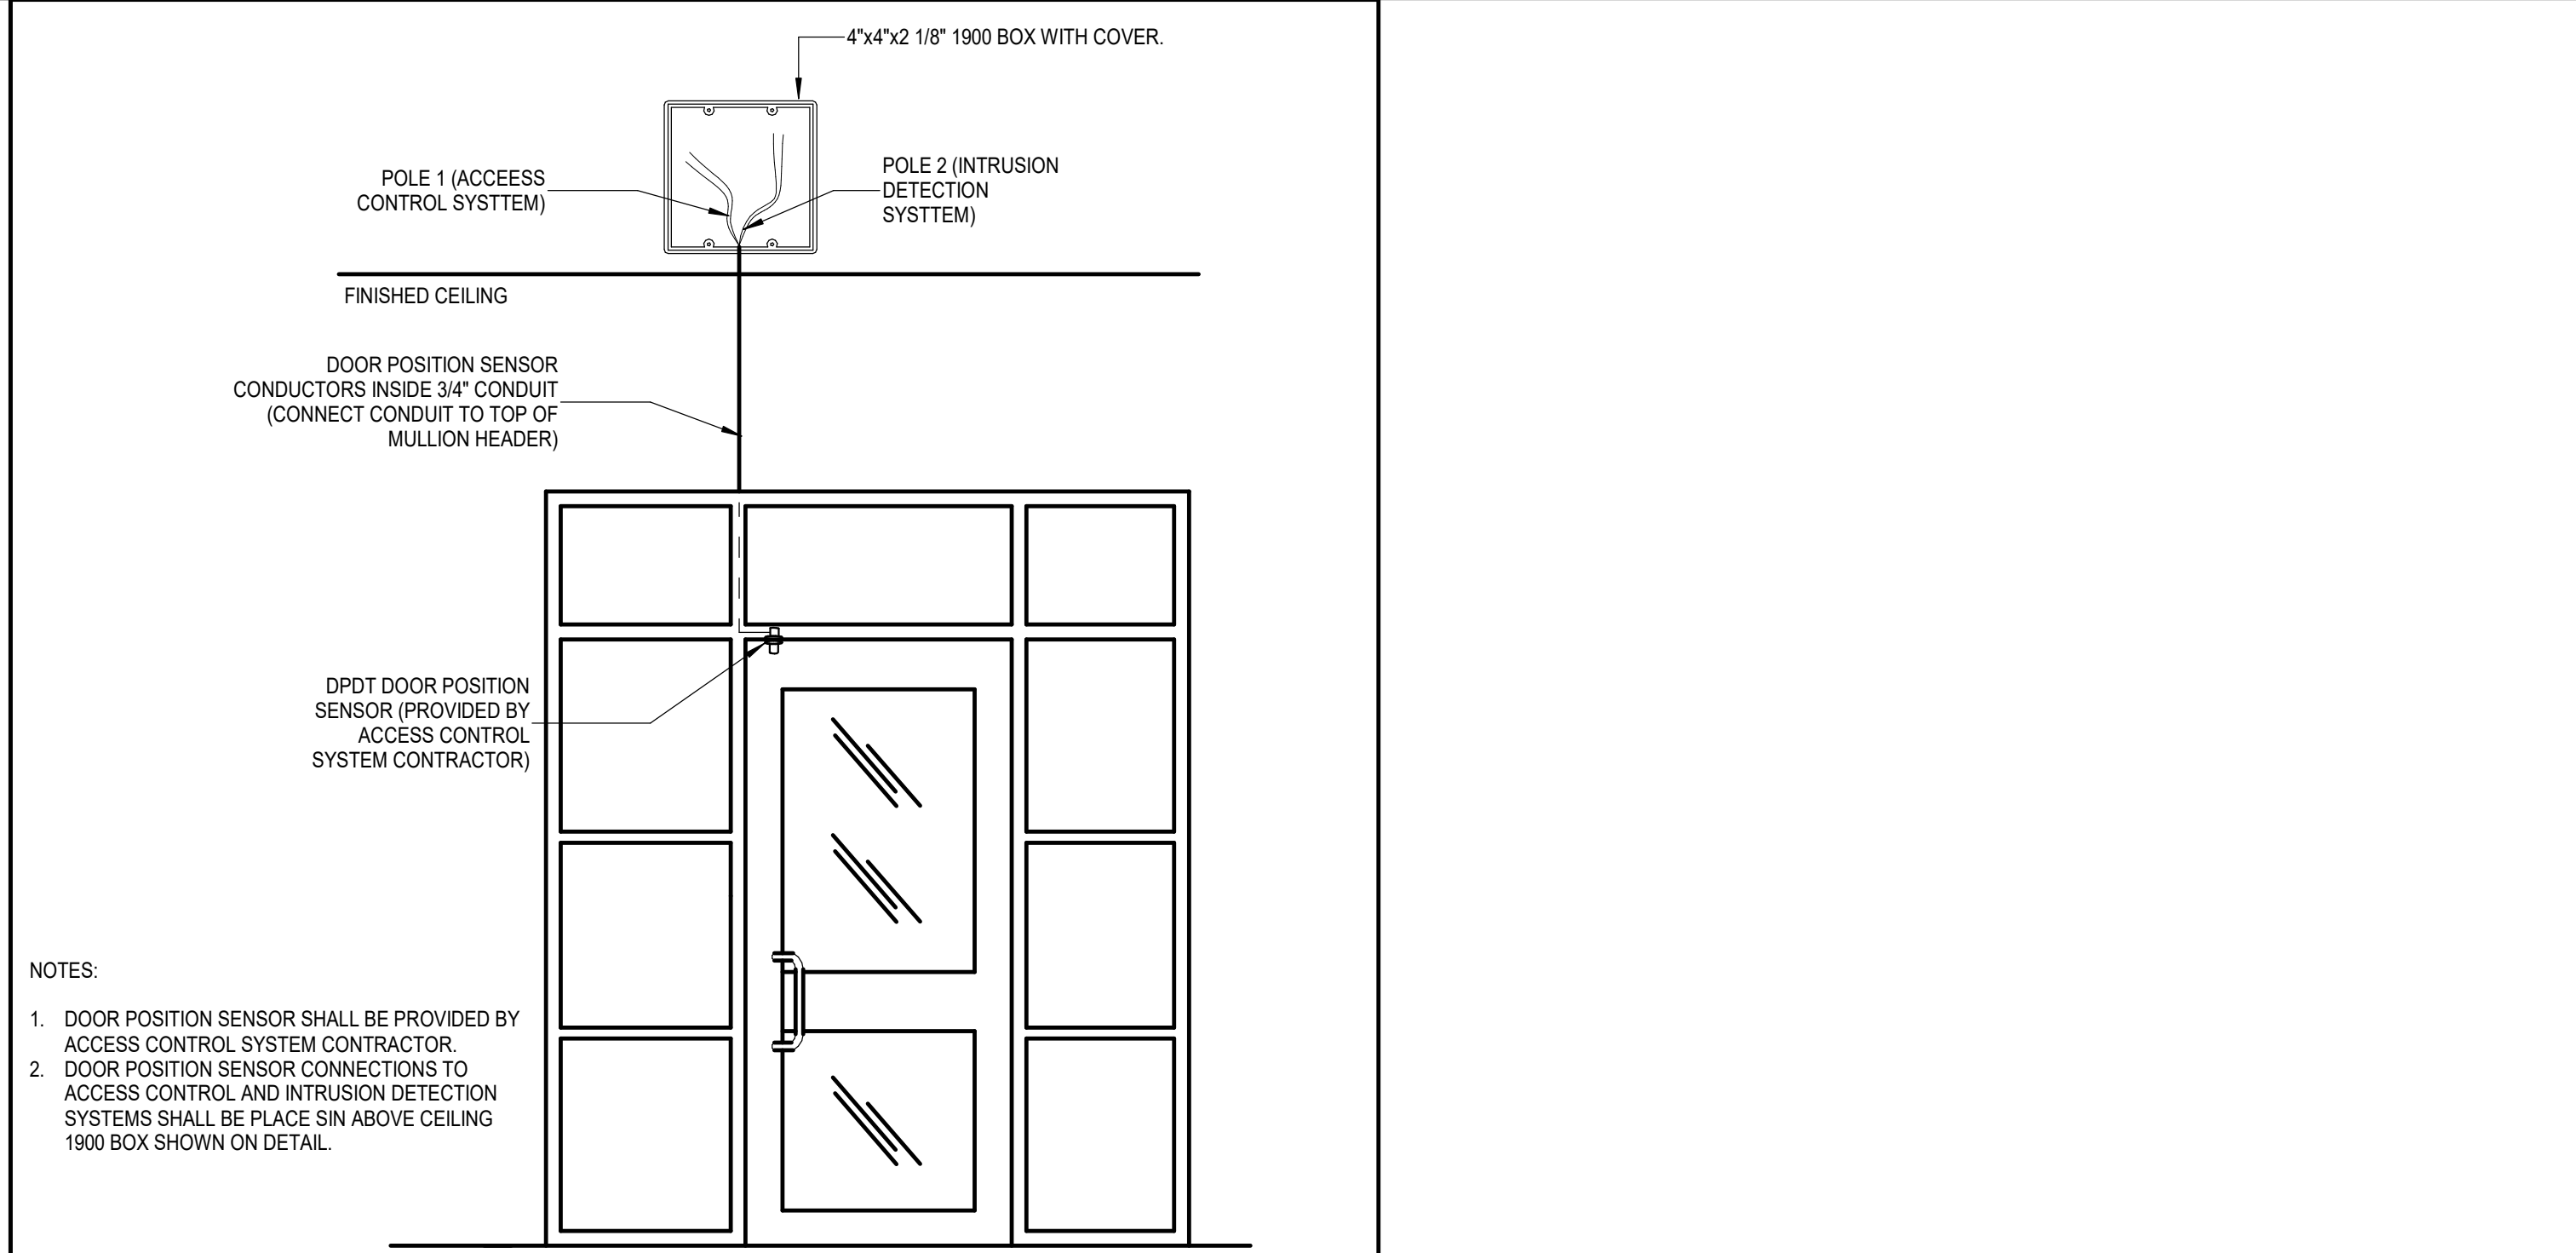NOT TO SCALE



06 DOOR POSITION SENSOR ELEVATION

NOT TO SCALE

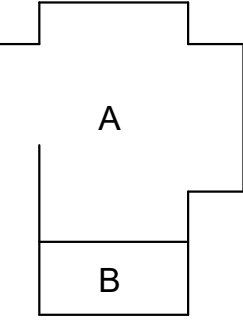
- NOTES:
1. DOOR POSITION SENSOR SHALL BE PROVIDED BY ACCESS CONTROL SYSTEM CONTRACTOR.
  2. DOOR POSITION SENSOR CONNECTIONS TO ACCESS CONTROL AND INTRUSION DETECTION SYSTEMS SHALL BE PLACED SIN ABOVE CEILING 1900 BOX SHOWN ON DETAIL.

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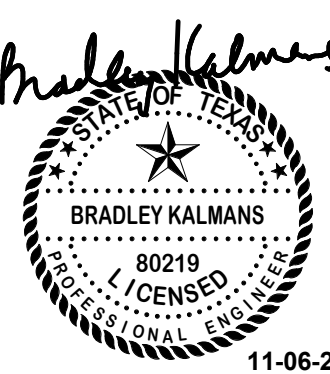
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**T4.04**  
TECHNOLOGY  
DETAILS

