Architect: **STR PARTNERS LLC** Chicago, Illinois



### **ADDENDUM NO. 1**

March 17, 2022

STR Project Number 21051.01

### Project:

**D116 RLHS Theater AV Improvements** Round Lake High School

Round Lake High School Drive Round Lake, Illinois 60073

### Owner:

Round Lake Area Schools Community Unit District 116

884 W. Nippersink Rd. Round Lake, Illinois 60073



#### **ADDENDUM NO. 01**

PROJECT: D116 RLHS Theater AV Improvements

Round Lake Area Schools Community Unit District 116

PROJECT NO: 21051.01

ISSUE DATE: March 17, 2022

Construction Drawings, Specifications and Bidding Documents for the above captioned Project, dated March 3, 2022, are revised, amended and clarified as follows. All provisions of the original Drawings and Specifications shall remain in force, except as specifically modified or changed herein, or by other Addenda.

#### A. CLARIFICATIONS:

**1. General:** Please find attached the Sign-In sheet from the Pre-Bid conference held on Wednesday, March 9, 2022 at 10:00am.


#### D. AV DRAWINGS:

- 1. Sheet AV-01, AV DEMOLITION PLAN
  - a. CLARIFY Added note.
- 2. Sheet AV-02. AV LAYOUT- AUDITORIUM MAIN LEVEL
  - a. CLARIFY Added note.
- 3. Sheet AV-03, AV LAYOUT- AUDITORIUM MEZZANINE LEVEL
  - a. CLARIFY Added note.

### H. ELECTRICAL DRAWINGS:

- 1. Sheet E1.0, LOWER LEVEL ELECTRICAL PLAN
  - a. CLARIFY Revised and added notes.
- 2. Sheet E1.1. UPPER LEVEL ELECTRICAL PLAN
  - a. CLARIFY Revised and added notes.
- 3. Sheet E1.2, UPPER LEVEL ELECTRICAL PLAN
  - a. CLARIFY Revised and added notes.

**END OF ADDENDUM #01** 

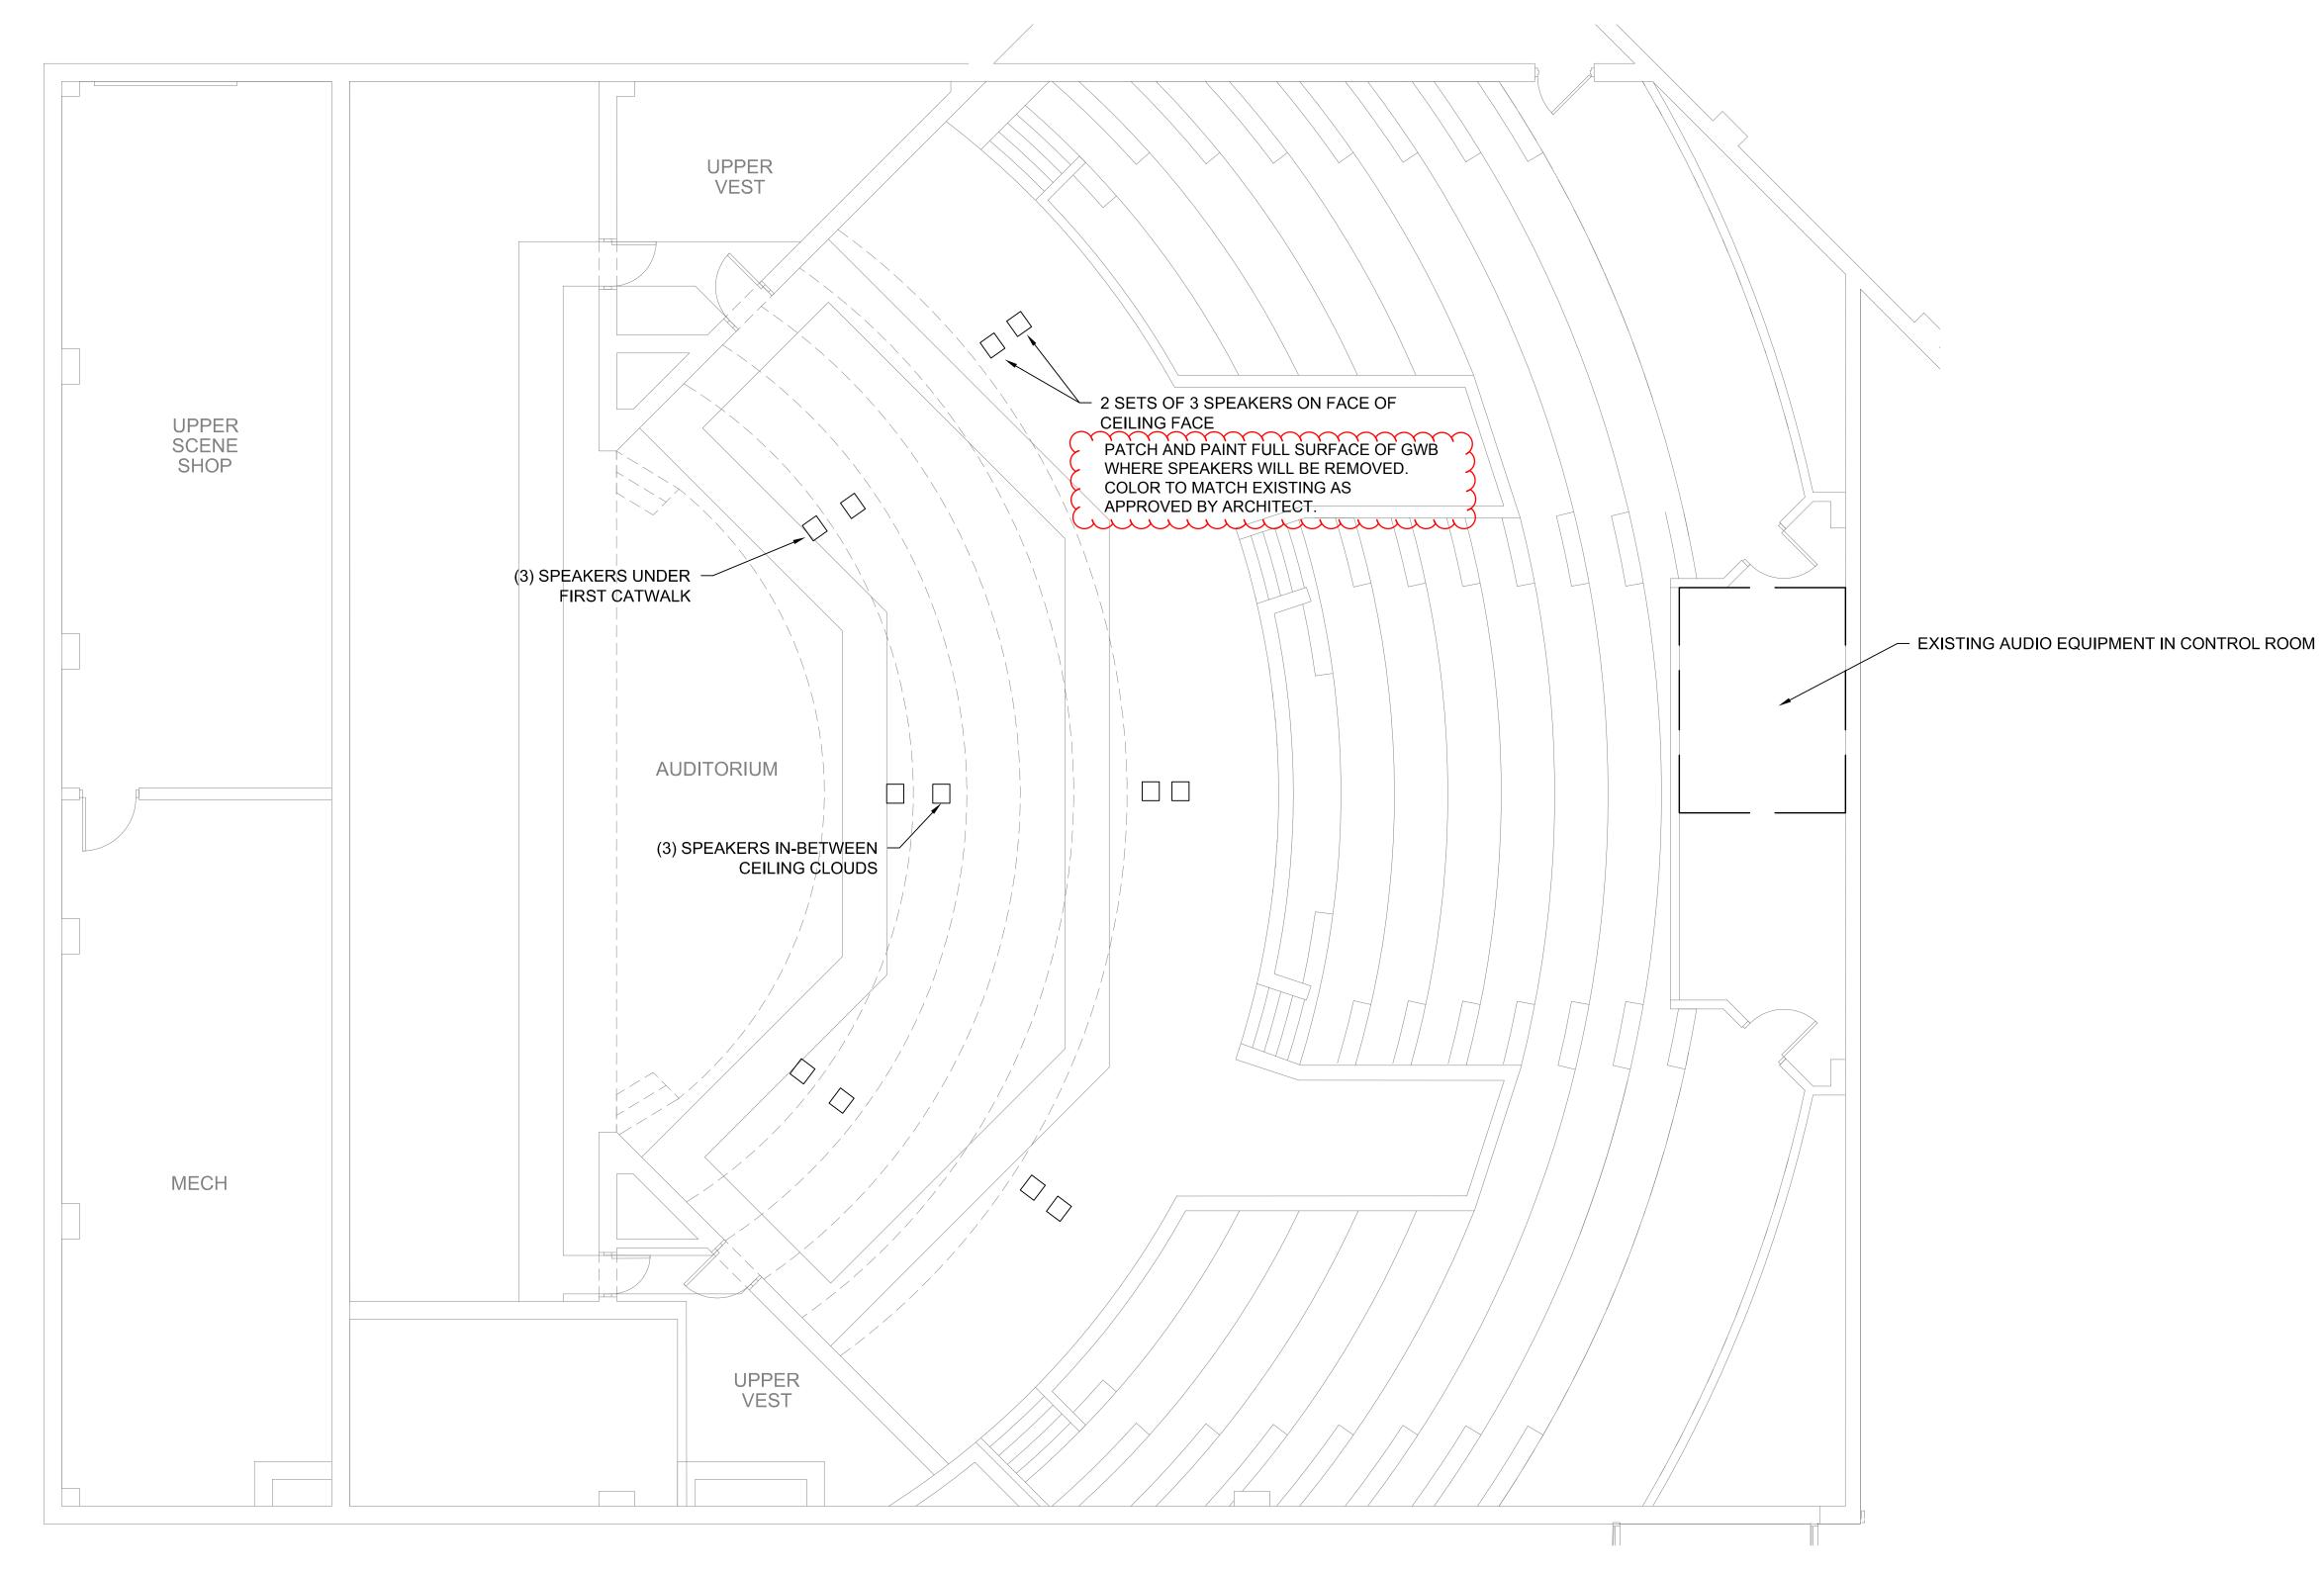



### NOTES

1 - REMOVE ALL EXISTING EQUIPMENT ON DEMOLITION PLAN AND TURN OVER TO OWNER

2 - REMOVE RIGGING HARDWARE FROM SPEAKERS AS MUCH AS PRACTICAL OR REUSE FOR NEW SPEAKERS

3 - REMOVE RIGGING HARDWARE FROM SPEAKERS

3 - REMOVE WIRE FEEDING EXISTING EQUIPMENT

### NOTE

AT AREAS WHERE EQUIPMENT, RIGGING, AND WIRING HAS BEEN REMOVED, THE EXISTING FINISH SHALL BE PATCHED, REPAIRED AND REFINISHED TO MATCH EXISTING. CONFIRM WITH ARCHITECT FINISH.

**ARCHITECTS:** 

STR Partners, LLC 350 West Ontario Street | Suite 200 Chicago, IL 60654

T: 312.464.1444 www.strpartners.com

• A/V ENGINEER:

LIPP A/V DESIGN, INC.
420 Mayfair Ln.
Buffalo Grove, IL. 60089
(847) 808-8790





Consulting in Sound & Video Systems

420 Mayfair Lane Buffalo Grove, IL 60089 Phone (847) 808-8790

MEP/FP ENGINEERING:

CS2 DESIGN GROUP, LLC
837 Oakton St
Elk Grove Village, IL 60007
(847) 981-1880

**KEY PLAN** 

### SCOPE DOCUMENT

This drawing is one drawing within a complete set of documents and shall not be considered separately from the Drawings as a whole. The Drawings indicate the general scope of the project in terms of architectural design concept, the dimensions of the building, the major architectural elements and the type of structural, mechanical, and electrical systems. As Scope Documents, the Drawings do not necessarily indicate or describe all work required for full performance and completion of the requirements of the Construction Documents. On the basis of the general scope indicated or described, the Contractor shall furnish all items required for the proper execution and completion of the Work.

Copyright Notice, Copyright © 2021 STR PARTNERS, LLC
The information in this document is the intellectual property of STR
Partners, LLC. It is intended solely for use by the "Client" during only this
specific project. Reproduction of any portion of this document for any
purpose other than for its intended use is not permitted without specific
written permission of STR Partners, LLC.

PROJ

### D116 RLHS THEATER AV SYSTEM RENOVATION ROUND LAKE HIGH SCHOOL

800 High School Drive Round Lake, IL 60073

# Round Lake Area Schools Community Unit District 116

884 Nippersink Rd.
Round Lake, IL 60073

STR PROJECT NUMBER

21051.01

DRAWING DATES

NUMBER DATE COMMENTS

•

. 02 03/17/2022 ADDENDUM NO. 1


· 3-3-2022 ISSUED FOR BID

DRAWING TITLE

**AV DEMOLITION PLAN** 

SHEET NUMBER

**AV-01** 

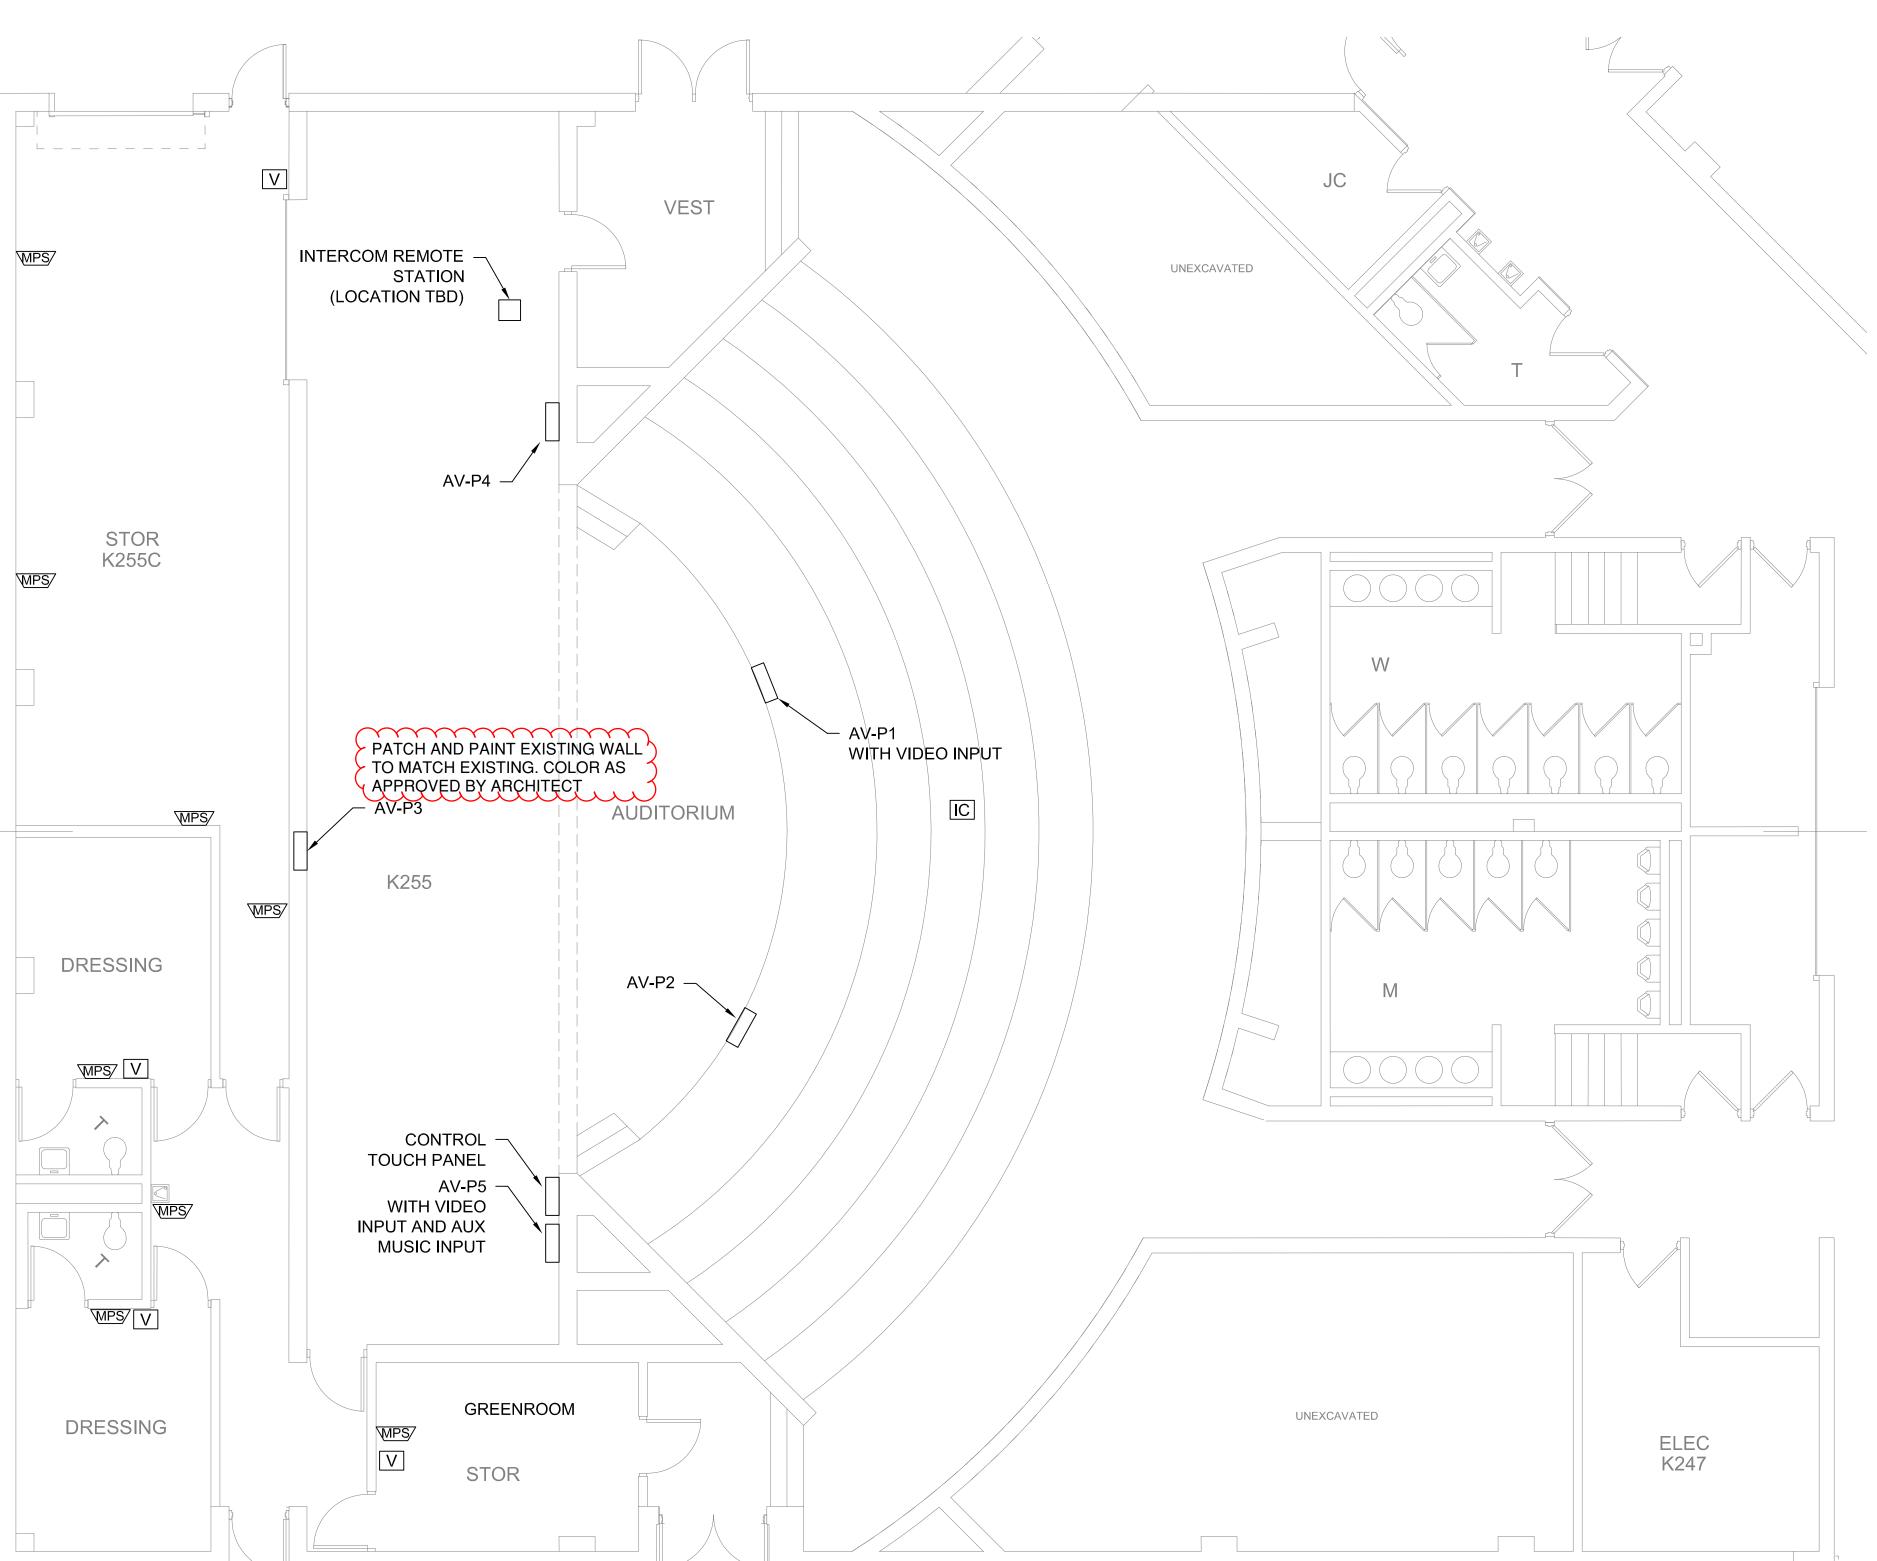

			AV	Wall	Plate	Sched	ule				
Plate	Location	Mic (XLR-F)	Efx. Spkr. (Speakon)	I-Com (XLR-M)	I-Com & Page Out (XLR-F)	Video (Decora)	Aux Audio (Decora)	AV Network/Video Mon (RJ45)	Plate Size	Adjacent AC Outlet	Adjacent Data Outlet
AV-P1	Stage Front - SL	1	1	2	-	1	-	1	(2) 3 - Gang, Deep	1	1
AV-P2	Stage Front - SR	2	1	_	_	_	-	-	3 - Gang	1	_
AV-P3	Upstage Center	3	1	2	_	_	-	1	Wall Box w/ Cover	-	_
AV-P4	Down Stage Left	2	1	2	3	-	-	2	(2) 3 - Gang	1	_
AV-P5	Down Stage Right	2	1	2	-	1	1	1	(2) 4 - Gang, Deep	1	1
AV-P6	House Mix Position	-	-	2	-	1	-	3	4 - Gang, Deep	2	1
AV-P7	Lobby Theatre Entry	2	_	_	_	-	1	_	2 - Gang	1	_
AV-P8	Lobby East Side	2	-	_	-	-	-	-	1 - Gang	-	_
AV-P9	2nd House Catwalk	-	1	_	_	_	-	_	1 - Gang	_	_
AV-P10	1st House Catwalk	1	-	_	_	-	-	-	1 - Gang	-	-
AV-P11	2nd House Catwalk	2	-	_	_	-	-	-	1 - Gang	-	_
AV-P12	Control Room	_	_	_	3	_	_	2	3 - Gang	1	_

### NOTE:

WHERE EQUIPMENT, CONTROLS, AND WIRING ARE INSTALLED THE ADJACENT FINISH SHALL BE REPAIRED, PATCHED AND FINISHED TO MATCH EXISTING.



**ARCHITECTS:** STR Partners, LLC 350 West Ontario Street | Suite 200 Chicago, IL 60654

T. 312.464.1444

A/V ENGINEER:

420 Mayfair Ln. Buffalo Grove, IL. 60089 (847) 808-8790

www.strpartners.com

LIPP A/V DESIGN, INC.

Consulting in Sound & Video Systems

420 Mayfair Lane Buffalo Grove, IL 60089 Phone (847) 808-8790

MEP/FP ENGINEERING: CS2 DESIGN GROUP, LLC 837 Oakton St Elk Grove Village, IL 60007 (847) 981-1880

**KEY PLAN** 

SCOPE DOCUMENT

This drawing is one drawing within a complete set of documents and shall not be considered separately from the Drawings as a whole. The Drawings indicate the general scope of the project in terms of architectural design concept, the dimensions of the building, the major architectural elements and the type of structural, mechanical, and electrical systems. As Scope Documents, the Drawings do not necessarily indicate or describe all work required for full performance and completion of the requirements of the Construction Documents. On the basis of the general scope indicated or described, the Contractor shall furnish all items required for the proper execution and completion of the Work.

Copyright Notice, Copyright © 2021 STR PARTNERS, LLC The information in this document is the intellectual property of STR Partners, LLC. It is intended solely for use by the "Client" during only this specific project. Reproduction of any portion of this document for any purpose other than for its intended use is not permitted without specific written permission of STR Partners, LLC.

## D116 RLHS THEATER AV SYSTEM RENOVATION **ROUND LAKE HIGH SCHOOL**

800 High School Drive Round Lake, IL 60073

Round Lake Area Schools **Community Unit District 116** 

884 Nippersink Rd. Round Lake, IL 60073

CLIENT PROJECT NUMBER

STR PROJECT NUMBER 21051.01

DRAWING DATES

NUMBER DATE COMMENTS

ADDENDUM NO. 1 · 02 03/17/2022 · 3-3-2022 ISSUED FOR BID

DRAWING TITLE

**AV LAYOUT -AUDITORIUM MAIN LEVEL** 


**AV-02** 

WPS/ MONITOR/PAGE SPEAKER V VOLUME CONTROL IC INTERCOM WALL PLATE

AV-Px AV WALL PLATE

1 LOWER LEVEL FLOOR PLAN Scale: 3/16" = 1'-0"



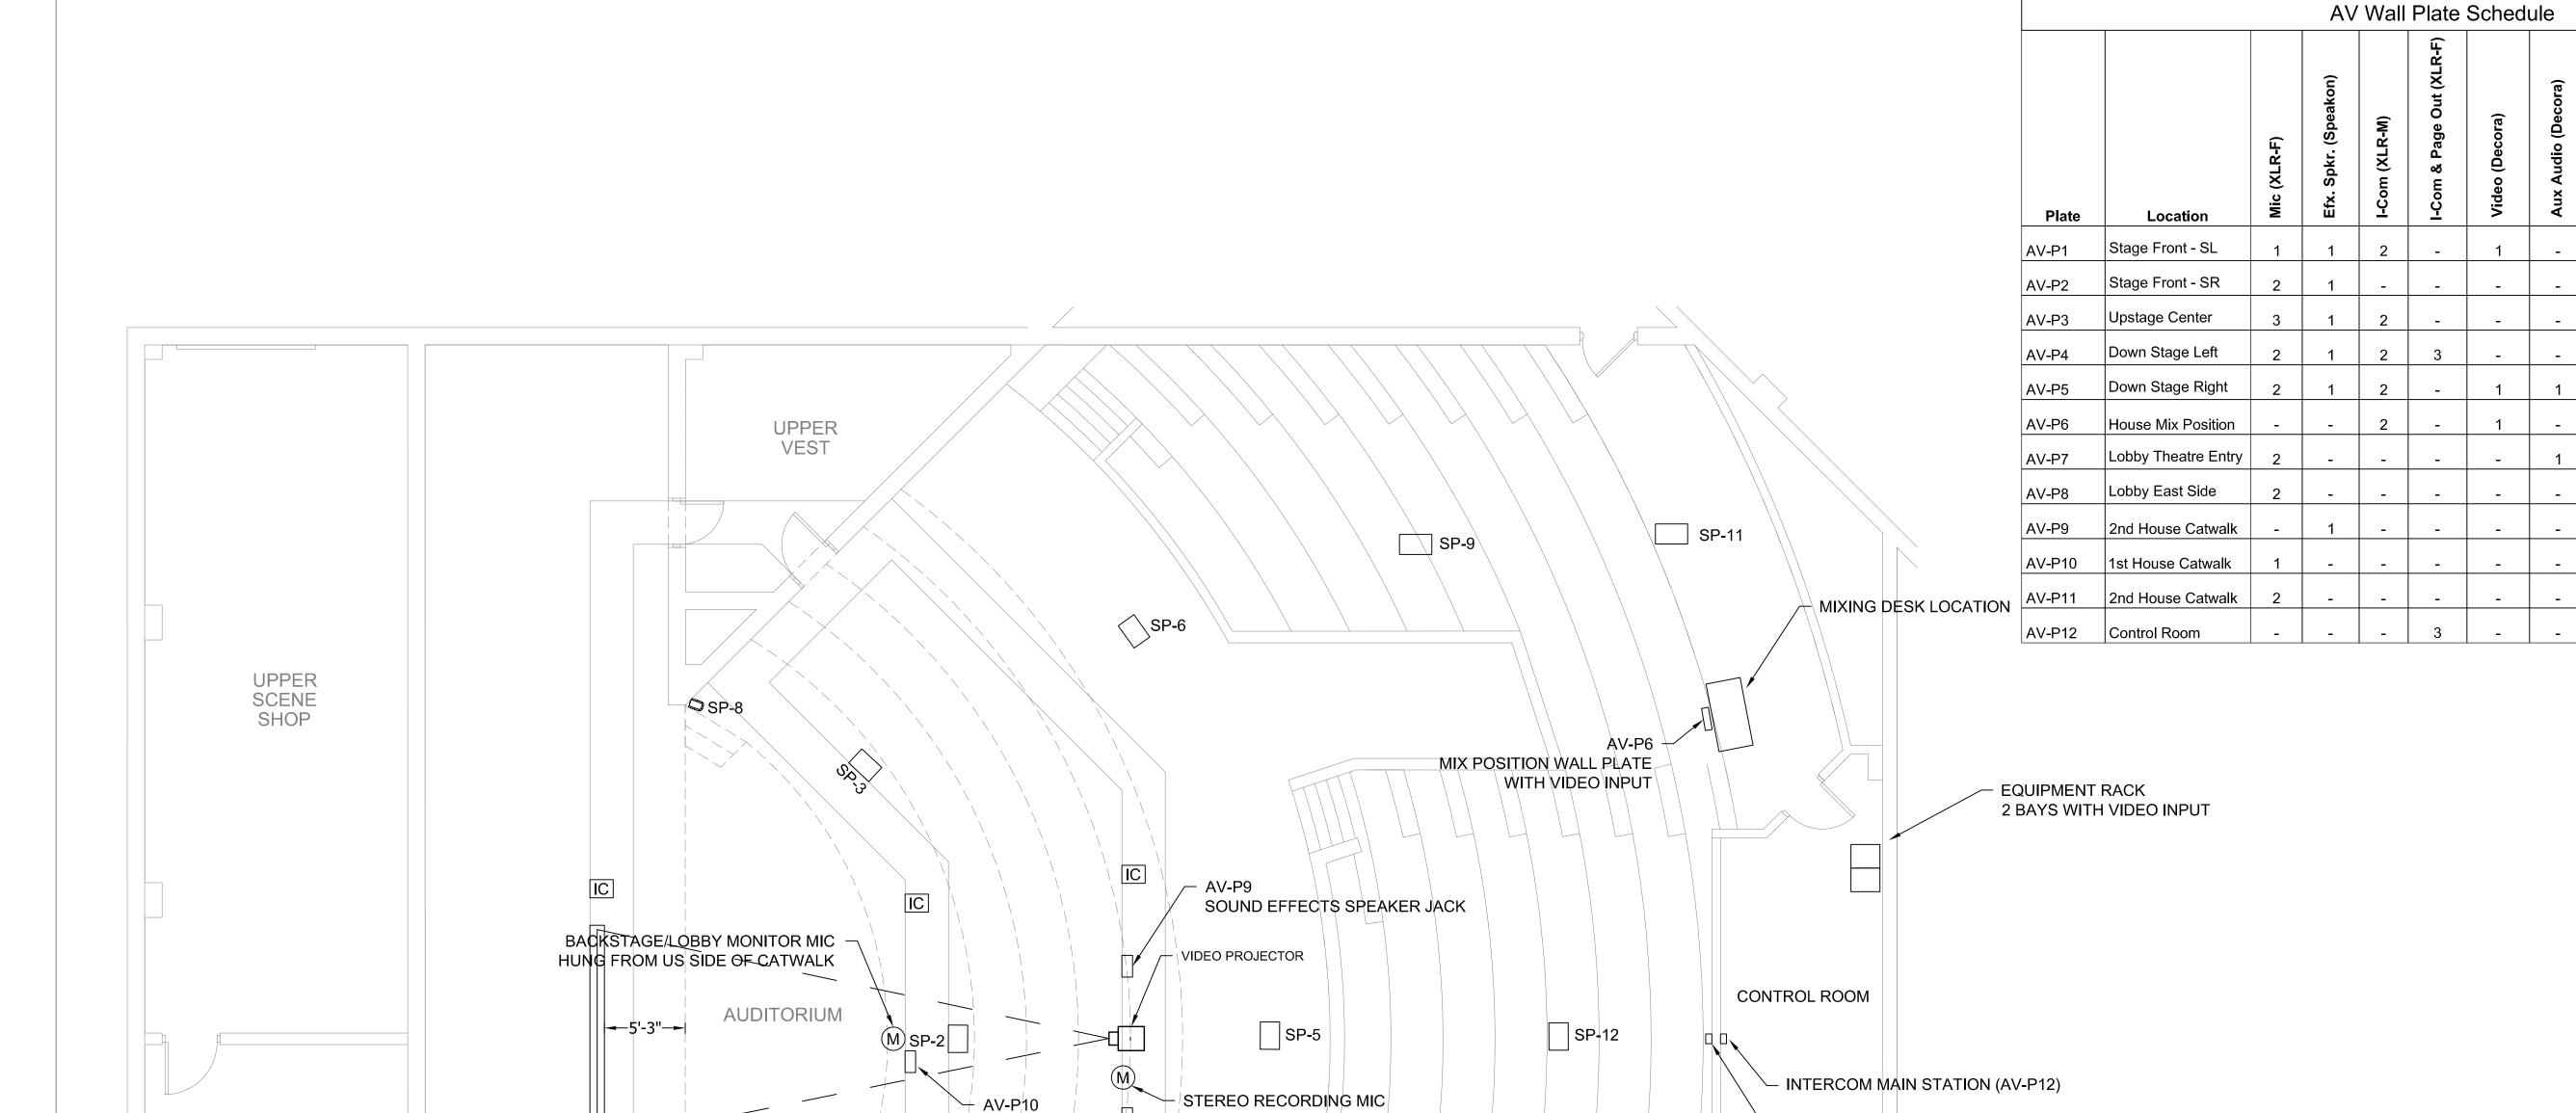

HUNG FROM US SIDE OF CATWALK

SP-1/0

	SPEAKER TYPE AND LOC	CATION					
SPKR	FUNCTION	NOTES					
SP-1	MAIN HOUSE LEFT	HUNG UNDER CATWALK #1 LEFT					
SP-2	MAIN HOUSE CENTER	HUNG UNDER CATWALK #1 CENTER					
SP-3	MAIN HOUSE RIGHT	HUNG UNDER CATWALK #1 RIGHT					
SP-4	DELAY HOUSE LEFT	ON FACE OF DS CLOUD LEFT					
SP-5	DELAY HOUSE CENTER	ON FACE OF DS CLOUD CENTER					
SP-6	DELAY HOUSE RIGHT	ON FACE OF DS CLOUD RIGHT					
SP-7	SIDE COLUMN SPKR LEFT	HUNG UNDER CATWALK #1 LEFT AT WALL					
SP-8	SIDE COLUMN SPKR RIGHT	HUNG UNDER CATWALK #1 RIGHT AT WALL					
SP-9	EFFECTS SPKR RIGHT	EXISTING SPKR, PAINT TO MATCH CEILING					
SP-10	EFFECTS SPKR LEFT	EXISTING SPKR, PAINT TO MATCH CEILING					
SP-11	EFFECTS SPKR RIGHT	EXISTING SPKR, PAINT TO MATCH CEILING					
SP-12	EFFECTS SPKR CENTER	EXISTING SPKR, PAINT TO MATCH CEILING					
SP-13	EFFECTS SPKR LEFT	EXISTING SPKR, PAINT TO MATCH CEILING					

WHERE EQUIPMENT, CONTROLS AND WIRING ARE INSTALLED THE ADJACENT FINISH SHALL BE PATCHED, REPAIRED AND FINISHED TO MATCH EXISTING. ALL PAINT COLORS AS APPROVED BY ARCHITECT

**ARCHITECTS:** 

STR Partners, LLC 350 West Ontario Street | Suite 200 Chicago, IL 60654

T: 312.464.1444 www.strpartners.com

LIPP A/V DESIGN, INC.

420 Mayfair Ln. Buffalo Grove, IL. 60089

(847) 808-8790

Plate Size

(2) 3 - Gang, Deep

Wall Box w/ Cover

(2) 4 - Gang, Deep

3 - Gang

2 (2) 3 - Gang

3 4 - Gang, Deep

\_ 2 - Gang

\_ |1 - Gang

1 - Gang

1 - Gang

1 - Gang

2 3 - Gang





Consulting in Sound & Video Systems

420 Mayfair Lane Buffalo Grove, IL 60089 Phone (847) 808-8790

CS2 DESIGN GROUP, LLC 837 Oakton St Elk Grove Village, IL 60007 (847) 981-1880

**KEY PLAN** 

### SCOPE DOCUMENT

This drawing is one drawing within a complete set of documents and shall not be considered separately from the Drawings as a whole. The Drawings indicate the general scope of the project in terms of architectural design concept, the dimensions of the building, the major architectural elements and the type of structural, mechanical, and electrical systems. As Scope Documents, the Drawings do not necessarily indicate or describe all work required for full performance and completion of the requirements of the Construction Documents. On the basis of the general scope indicated or described, the Contractor shall furnish all items required for the proper execution and completion of the Work.

Copyright Notice, Copyright © 2021 STR PARTNERS, LLC The information in this document is the intellectual property of STR Partners. LLC. It is intended solely for use by the "Client" during only this specific project. Reproduction of any portion of this document for any purpose other than for its intended use is not permitted without specific written permission of STR Partners, LLC.

## D116 RLHS THEATER AV SYSTEM RENOVATION **ROUND LAKE HIGH SCHOOL**

800 High School Drive Round Lake, IL 60073

## Round Lake Area Schools **Community Unit District 116**

884 Nippersink Rd. Round Lake, IL 60073

CLIENT PROJECT NUMBER

STR PROJECT NUMBER 21051.01

DRAWING DATES

COMMENTS NUMBER DATE

· 02 03/17/2022 ADDENDUM NO. 1

· 3-3-2022 ISSUED FOR BID DRAWING TITLE

> **AV LAYOUT -AUDITORIUM MEZZANINE LEVEL**

SHEET NUMBER

**AV-03** 

UPPER LEVEL FLOOR PLAN Scale: 3/16" = 1'-0"

SP-4

SP-7

UPPER VEST

MECH



SP-13

CAMERA &

WIRELESS MIC ANTENNA

### **ROUTING AND SEPARATION NOTE:**

A/V SYSTEM RACEWAYS SHOULD NOT BE INDISCRIMINATELY ROUTED THROUGHOUT A FACILITY. A/V CIRCUITS ARE SUSCEPTIBLE TO ELECTRICAL NOISE AND REQUIRE SPECIFIC SEPARATION TO MINIMIZE THESE INTERFERENCES. SEPARATE INNERDUCT BY AT LEAST TWELVE INCHES FOR VARIOUS A/V SIGNAL LEVELS INCLUDING MIC / LINE LEVEL. SPEAKER LEVEL, AND AC POWER. REFER TO <u>A/V-SERIES</u> DRAWINGS.

### CIRCUITTING NOTE:

THE ELECTRICAL CONTRACTOR SHALL VERIFY ALL AS REQUIRED FOR THIS PROJECT'S WORK. PROVIDE NEW CIRCUITS / CIRCUIT BREAKERS (MATCH EXISTING TYPE) WHERE REQUIRED - VERIFY SPARES AND SPACES IN RESPECTIVE EXISTING ELECTRICAL PANEL AND CIRCUIT ACCORDINGLY. VERIFY PANEL LOADING PRIOR TO ALL FINAL CONNECTIONS.

### **AUDIO-VISUAL SYSTEMS COORDINATION NOTE:**

REFER TO A/V-SERIES DRAWINGS FOR EXACT REQUIREMENTS. THIS CONTRACTOR SHALL BE RESPONSIBLE TO CONFIRM EXACT CONDUIT / RACEWAY QUANTITIES AND SIZES, BACKBOX SIZES, LOCATIONS, ETC .... CLOSELY COORDINATE WITH AUDIO-VISUAL CONSULTANT AS REQUIRED. PROVIDE AND ADJUST ALL AS REQUIRED FOR COMPLETE AND FULLY FUNCTIONAL INSTALLATION.

### LEGEND:

DUPLEX RECEPTACLE

JUNCTION BOX

CONDUIT W/ OR

MONITOR / PAGE SPEAKER

VOLUME CONTROL

INTERCOM WALL PLATE

AV-P# A/V WALL PLATE

5. FSR WALL BOX (WITH HINGED COVER) FURNISHED BY A/V CONTRACTOR BUT

6. TWO 3-GANG SURFACE MOUNTED TYPE JUNCTION BOXES WITH ADJACENT AC BOX. WITH ONE 3-COMPARTMENT VERTICAL RACEWAY (UP TO HIGH CEILING) legrand / WIREMOLD MODEL# 5500-SERIES FOR LOW-VOLTAGE AND POWER: COMPARTMENT 1: LOW-VOLTAGE COMPARTMENT 2: LOW-VOLTAGE

7. FLUSH-MOUNT TYPE JUNCTION BOXES IN BLOCK WALL. ROUTE CONDUIT TO

8. FLUSH-MOUNT TYPE JUNCTION BOXES IN STAGE FRONT. ROUTE CONDUITS

9. TWO 4-GANG SURFACE MOUNTED TYPE JUNCTION BOXES WITH ADJACENT AC AND DATA BOXES. WITH ONE 3-COMPARTMENT VERTICAL RACEWAY (UP TO HIGH CEILING) legrand / WIREMOLD MODEL# 5500-SERIES FOR LOW-VOLTAGE

1. THE MINIMUM WIRE SIZE SHALL BE #12 AWG. PROVIDE DEDICATED NEUTRALS;

3/4". 1/2" CONDUIT SHALL BE ACCEPTABLE FOR BRANCH WIRING FOR SINGLE CIRCUITS ONLY. ALL BRANCH CIRCUITS CIRCUITS SHALL TERMINATE AT 20A-1P CIRCUIT BREAKERS IN PANELBOARD INDICATED UNLESS SPECIFICALLY

3. THE CONTRACTOR SHALL UPSIZE CONDUCTORS AND CONDUITS (OVER 75'-0" IN

4. THE CONTRACTOR SHALL PROVIDE ALL PENETRATIONS, SLEEVES AND SEALANT AS REQUIRED THRU PARTITIONS TO ACCOMMODATE ANY CONDUITS / RACEWAYS, CABLING, ETC... ALL PENETRATIONS THRU RATED WALL ASSEMBLY(IES) MUST MEET THE UL RATING OF THE WALL SYSTEM(S).

5. REFER TO AV PLANS FOR ADDITIONAL INFORMATION REGARDING MOUNTING HEIGHTS AND EXACT LOCATIONS OF ALL ELECTRICAL DEVICES BEFORE

INFORMATION, VOLTAGE, AMPERAGE, CONNECTION TYPE, ETC... WITH EQUIPMENT BEING SUPPLIED PRIOR TO ROUGH-IN.

ALL WALL-MOUNTED ELECTRICAL DEVICES (RECEPTACLES, OUTLETS, LIGHT SWITCHES, ETC...) TO HAVE COLOR SELECTED BY ARCHITECT WITH STAINLESS STEEL FACEPLATE(S).

CONTRACTOR SHALL HOMERUN NEW BRANCH CIRCUITS TO AVAILABLE PANEL SPACES WITHIN THIS ROOM. FIELD VERIFY AVAILABILITY PRIOR TO ROUGH-IN

> WHERE EQUIPMENT, CONTROLS, AND WIRING ARE INSTALLED THE ADJACENT FINISH SHALL BE PATCHED, REPAIRED AND FINISHED TO MATCH EXISTING.

### **DRAWING NOTES:**

1. ONE 1-GANG DEEP JUNCTION BOX WITH ONE 3/4" CONDUIT FOR LOW-VOLTAGE.

2. ONE 1-GANG DEEP JUNCTION BOX WITH ONE 1-COMPARTMENT VERTICAL RACEWAY (UP TO HIGH CEILING) legrand / WIREMOLD MODEL# V700-SERIES FOR

3. ig( ONE 1-GANG SURFACE MOUNTED TYPE JUNCTION BOX WITH ONE 3/4" CONDUIT RACEWAY FOR LOW-VOLTAGE. ROUTE RACEWAY BEHIND SEATS AND ACROSS 102 TWO WALKWAYS TO VESTIBULE, THEN UP TO HIGH CEILING. EXPOSED PORTION CONDUIT TO BE PAINTED TO MATCH ADJACENT SURFACE, COLOR APPROVED BY ARCHITECT.

4. CUSTOM SURFACE MOUNTED TYPE JUNCTION BOX SIZED FOR 10" CONTROL SYSTEM TOUCH PANEL. CONFIRM EXACT SIZE WITH A/V CONTRACTOR. PAINT BLACK. MOUNT AT 58" A.F.F.. PROVIDE ONE 3/4" CONDUIT FOR LOW-VOLTAGE TO LOW-VOLTAGE SECTION OF ADJACENT VERTICAL RACEWAY.

INSTALLED BY THIS CONTRACTOR.

COMPARTMENT 3: POWER

EXIT INTO STOR K255C HALLWAY, THEN UP TO HIGH CEILING.

UNDER STAGE FLOOR; CLOSELY COORDINATE INSTALLATION WITH OWNER.

COMPARTMENT 1: LOW-VOLTAGE COMPARTMENT 2: LOW-VOLTAGE COMPARTMENT 3: POWER

10. TWO 3-GANG DEEP JUNCTION BOXES WITH ADJACENT AC AND DATA BOXES.

11. TWO 3-GANG DEEP JUNCTION BOXES WITH ADJACENT AC BOX.

### **GENERAL NOTES:**

NO COMMON NEUTRALS ARE PERMITTED.

2. THE MINIMUM CONDUIT SIZE FOR HOMERUNS AND BRANCH FEEDS SHALL BE INDICATED OTHERWISE.

LENGTH) TO COMPENSATE FOR VOLTAGE DROP.

THE CONTRACTOR SHALL VERIFY EXACT EQUIPMENT LOCATIONS, LOAD

8. ALL EQUIPMENT / ITEMS INDICATED ON PLANS ARE NEW UNLESS SPECIFICALLY INDICATED OTHERWISE.

# **ROUND LAKE COMMUNITY UNIT**

STR

350 West Ontario Street | Suite 200

ARCHITECTS:

STR Partners, LLC

Chicago, IL 60654

www.strpartners.com

ROOFING AND BUILDING ENVELOPE

420 Mayfair Ln

(847) 808-8790

MEP /FP ENGINEERING:

837 Oakton Street

(847) 981-1880

KEY PLAN

LIPP A/V DESIGN INC

Buffalo Grove, IL 60089

CS2 DESIGN GROUP, LLC

Elk Grove Village, IL 60007

-AREA OF

This drawing is one drawing within a complete set of documents and shall not be considered separately from the Drawings as a whole. The Drawings

indicate the general scope of the project in terms of architectural design

required for full performance and completion of the requirements of the

Construction Documents. On the basis of the general scope indicated or described, the Contractor shall furnish all items required for the proper

the type of structural, mechanical, and electrical systems. As Scope Documents, the Drawings do not necessarily indicate or describe all work

D116 RLHS THEATER AV

**SYSTEM RENOVATION** 

**ROUND LAKE HIGH SCHOOL** 

concept, the dimensions of the building, the major architectural elements and

WORK

SCOPE DOCUMENTS

execution and completion of the Work.

800 High School Drive

Round Lake, IL 60073

© 2022 STR PARTNERS, LLC

PROJECT

T: 312.464.1444

**SCHOOL DISTRICT 116** 884 W Nippersink Road

Round Lake, IL 60073 CLIENT PROJECT NUMBER

886-B-2 STR PROJECT NUMBER 21051.01

DRAWING DATES NUMBER DATE COMMENTS

 02 03/17/2022 ADDENDUM 1


• 01 03/03/2022 ISSUED FOR BID

DRAWING TITLE

# **LOWER LEVEL -ELECTRICAL PLAN**

SHEETNUMBER

E1.0

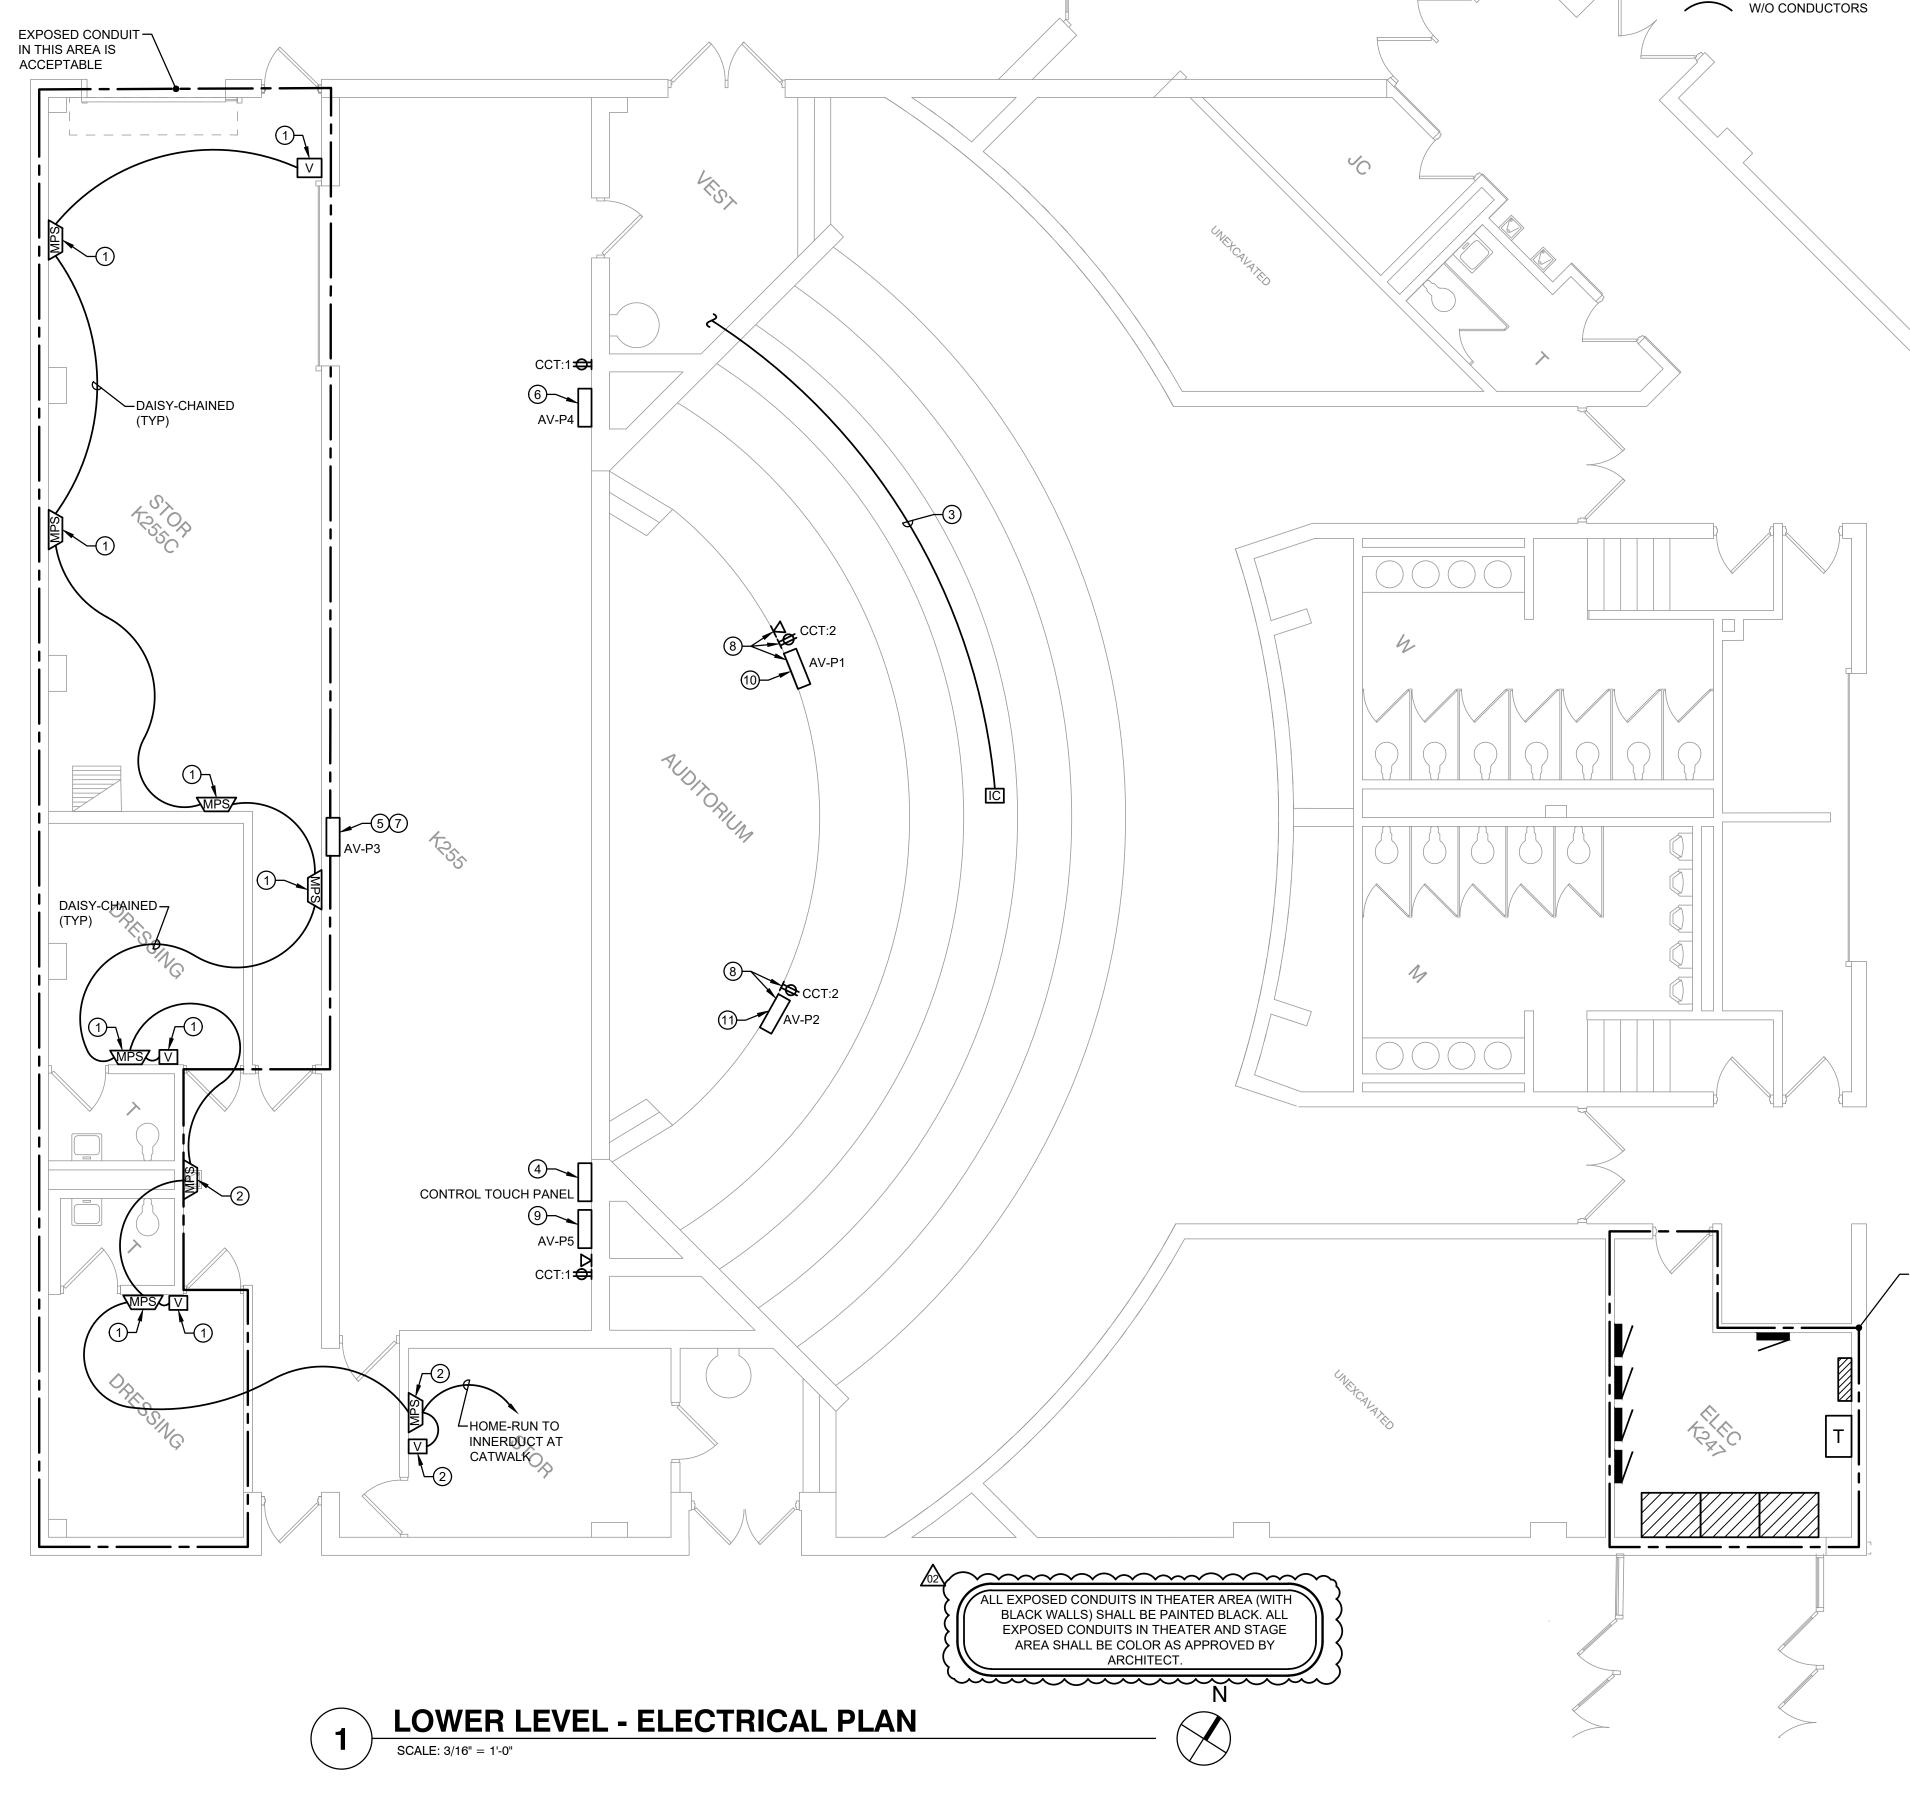

### **ROUTING AND SEPARATION NOTE:**

A/V SYSTEM RACEWAYS SHOULD NOT BE INDISCRIMINATELY ROUTED THROUGHOUT A FACILITY. A/V CIRCUITS ARE SUSCEPTIBLE TO ELECTRICAL NOISE AND REQUIRE SPECIFIC SEPARATION TO MINIMIZE THESE INTERFERENCES. SEPARATE INNERDUCT BY AT LEAST TWELVE INCHES FOR VARIOUS A/V SIGNAL LEVELS INCLUDING MIC / LINE LEVEL, SPEAKER LEVEL, AND AC POWER. REFER TO <u>A/V-SERIES</u> DRAWINGS.

AT STAGE—

CATWALK LEVEL

### CIRCUITTING NOTE:

THE ELECTRICAL CONTRACTOR SHALL VERIFY ALL AS REQUIRED FOR THIS PROJECT'S WORK. PROVIDE NEW CIRCUITS / CIRCUIT BREAKERS (MATCH EXISTING TYPE) WHERE REQUIRED - VERIFY SPARES AND SPACES IN RESPECTIVE EXISTING ELECTRICAL PANEL AND CIRCUIT ACCORDINGLY. VERIFY PANEL LOADING PRIOR TO ALL FINAL CONNECTIONS.

### **AUDIO-VISUAL SYSTEMS COORDINATION NOTE:**

REFER TO A/V-SERIES DRAWINGS FOR EXACT REQUIREMENTS. THIS CONTRACTOR SHALL BE RESPONSIBLE TO CONFIRM EXACT CONDUIT / RACEWAY QUANTITIES AND SIZES, BACKBOX SIZES, LOCATIONS, ETC .... CLOSELY COORDINATE WITH AUDIO-VISUAL CONSULTANT AS REQUIRED. PROVIDE AND ADJUST ALL AS REQUIRED FOR COMPLETE AND FULLY FUNCTIONAL INSTALLATION.

## LEGEND:

DUPLEX RECEPTACLE

JUNCTION BOX

MONITOR / PAGE SPEAKER

AV-P# A/V WALL PLATE

conduit w/ or

MIXING DESK LOCATION-

PROVIDE 3/4"---

FLEXIBLE METAL

JUNCTION BOX

CONDUIT TO RACK

MI¢ ANTENNA

PROVIDE 1/2"

FLEXIBLE METAL

JUNCTION BOX

SP-10

CONDUIT TO RACK

CAMERA & WIRELESS-

SP-13

VOLUME CONTROL

INTERCOM WALL PLATE

A/V EQUIPMENT FOR RACK, VERIFY

VERIFY

WIRING, ETC... AS REQUIRED. W/O CONDUCTORS

INSTALLATION WITH OWNER.

PROVIDE SLEEVES (QUANTITIES AS REQUIRED) TO CATWALK AREA - SEE KEY

8. UP TO HIGH CEILING, IN BAR JOIST.

9. MOUNT LOW ON SIDE OF CATWALK.

10. UTILIZE EXISTING SPEAKER CONDUIT AND ROUTE BACK TO A/V EQUIPMENT

11. TWO 2" AND TWO 1" INNERDUCTS FROM HIGH CEILING ABOVE THE 1ST CATWALK TO THE 2ND CATWALK. BLACK IN COLOR.

12. TWO 2" AND THREE 1" INNERDUCTS FROM HIGH CEILING ABOVE THE 2ND CATWALK TO THE JUNCTION BOX ABOVE A/V EQUIPMENT RACK. BLACK IN COLOR.

13. ONE 3-GANG JUNCTION BOX AT OUTLET HEIGHT WITH CONDUIT TO RACK.

EXACT LOCATION WITH A/V CONTRACTOR.

2. THE MINIMUM CONDUIT SIZE FOR HOMERUNS AND BRANCH FEEDS SHALL BE 3/4". 1/2" CONDUIT SHALL BE ACCEPTABLE FOR BRANCH WIRING FOR SINGLE CIRCUITS ONLY. ALL BRANCH CIRCUITS CIRCUITS SHALL TERMINATE AT 20A-1P CIRCUIT BREAKERS IN PANELBOARD INDICATED UNLESS SPECIFICALLY INDICATED OTHERWISE.

SEALANT AS REQUIRED THRU PARTITIONS TO ACCOMMODATE ANY CONDUITS / RACEWAYS, CABLING, ETC... ALL PENETRATIONS THRU RATED WALL ASSEMBLY(IES) MUST MEET THE UL RATING OF THE WALL SYSTEM(S). 5. REFER TO AV PLANS FOR ADDITIONAL INFORMATION REGARDING MOUNTING HEIGHTS AND EXACT LOCATIONS OF ALL ELECTRICAL DEVICES BEFORE ROUGH-IN.

6. THE CONTRACTOR SHALL VERIFY EXACT EQUIPMENT LOCATIONS, LOAD INFORMATION, VOLTAGE, AMPERAGE, CONNECTION TYPE, ETC... WITH

8. ALL EQUIPMENT / ITEMS INDICATED ON PLANS ARE NEW UNLESS

SPECIFICALLY INDICATED OTHERWISE.

\(\rac{1}{2}\sqrt{\frac{1}\sqrt{\frac{1}{2}\sqrt{\frac{1}\sqrt{\frac{1}{2}\sqrt{\frac{1}\sqrt{\fr

WHERE EQUIPMENT, CONTROLS, AND WIRING ARE

INSTALLED THE ADJACENT FINISH SHALL BE

PATCHED, REPAIRED AND FINISHED TO MATCH

EXISTING.

### **DRAWING NOTES:**

FOR LOW VOLTAGE, UP TO HIGH CEILING, IN BAR JOIST.

1. ONE 1-GANG SURFACE MOUNTED TYPE JUNCTION BOX WITH ONE 3/4" CONDUIT

2. ONE 3/4" CONDUIT STUB FOR LOW VOLTAGE INTO "DEAD SPACE", THEN UP TO

3. ONE 1-GANG DEEP JUNCTION BOX WITH ONE 3/4" CONDUIT STUB-UP FOR LOW-VOLTAGE AND ONE 1-GANG JUNCTION BOX WITH ONE 3/4" CONDUIT FOR

4. CONNECT TO NEAREST (NON-DEDICATED) LOCAL RECEPTACLE CIRCUIT WITH AVAILABLE SPARE CAPACITY - VERIFY. PROVIDE ANY CONDUIT, RACEWAYS,

5. ONE 4-GANG DEEP SURFACE MOUNTED TYPE JUNCTION BOX TO SIDE OF STEP WITH ADJACENT SURFACE MOUNTED TYPE JUNCTION BOXES FOR AC AND

6. EXACT ROUTING UNKNOWN AT TIME OF ISSUANCE; CLOSELY COORDINATE

7. LARGE (SIZED ACCORDINGLY) JUNCTION BOX IN CEILING ABOVE RACK.

14. AC OUTLET FOR SUBWOOFER. MOUNT HIGH, JUST BELOW CEILING. CONFIRM

### **GENERAL NOTES:**

1. THE MINIMUM WIRE SIZE SHALL BE #12 AWG. PROVIDE DEDICATED NEUTRALS; NO COMMON NEUTRALS ARE PERMITTED.

THE CONTRACTOR SHALL UPSIZE CONDUCTORS AND CONDUITS (OVER 75'-0" IN LENGTH) TO COMPENSATE FOR VOLTAGE DROP.

LOCATIONS 4. THE CONTRACTOR SHALL PROVIDE ALL PENETRATIONS, SLEEVES AND

EQUIPMENT BEING SUPPLIED PRIOR TO ROUGH-IN.

ALL WALL-MOUNTED ELECTRICAL DEVICES (RECEPTACLES, OUTLETS, LIGHT SWITCHES, ETC...) TO HAVE COLOR SELECTED BY ARCHITECT WITH STAINLESS STEEL FACEPLATE(S).

# STR

### ARCHITECTS:

STR Partners, LLC 350 West Ontario Street | Suite 200 Chicago, IL 60654

T: 312.464.1444

www.strpartners.com

 ROOFING AND BUILDING ENVELOPE LIPP A/V DESIGN INC 420 Mayfair Ln Buffalo Grove, IL 60089

(847) 808-8790 MEP /FP ENGINEERING: CS2 DESIGN GROUP, LLC 837 Oakton Street

Elk Grove Village, IL 60007

(847) 981-1880

KEY PLAN - AREA OF WORK

SCOPE DOCUMENTS

This drawing is one drawing within a complete set of documents and shall not be considered separately from the Drawings as a whole. The Drawings indicate the general scope of the project in terms of architectural design concept, the dimensions of the building, the major architectural elements and the type of structural, mechanical, and electrical systems. As Scope Documents, the Drawings do not necessarily indicate or describe all work required for full performance and completion of the requirements of the Construction Documents. On the basis of the general scope indicated or described, the Contractor shall furnish all items required for the proper execution and completion of the Work.

© 2022 STR PARTNERS, LLC

PROJECT

## D116 RLHS THEATER AV **SYSTEM RENOVATION**

**ROUND LAKE HIGH SCHOOL** 800 High School Drive

Round Lake, IL 60073

### **ROUND LAKE COMMUNITY UNIT SCHOOL DISTRICT 116**

884 W Nippersink Road Round Lake, IL 60073

CLIENT PROJECT NUMBER 886-B-2

STR PROJECT NUMBER 21051.01

DRAWING DATES NUMBER DATE COMMENTS

 02 03/17/2022 ADDENDUM 1 • 01 03/03/2022 ISSUED FOR BID

DRAWING TITLE

# **UPPER LEVEL -ELECTRICAL PLAN**

SHEETNUMBER

E1.1

ALL EXPOSED CONDUITS IN THIS AREA SHALL BE PAINTED BLACK. **UPPER LEVEL - ELECTRICAL PLAN** SCALE: 3/16" = 1'-0"


-EXISTING SIDE PROJECTION

SCREE TO REMAIN; NO NEW

WORK REQ'D

VIDEO PROJECTOR

SP-5

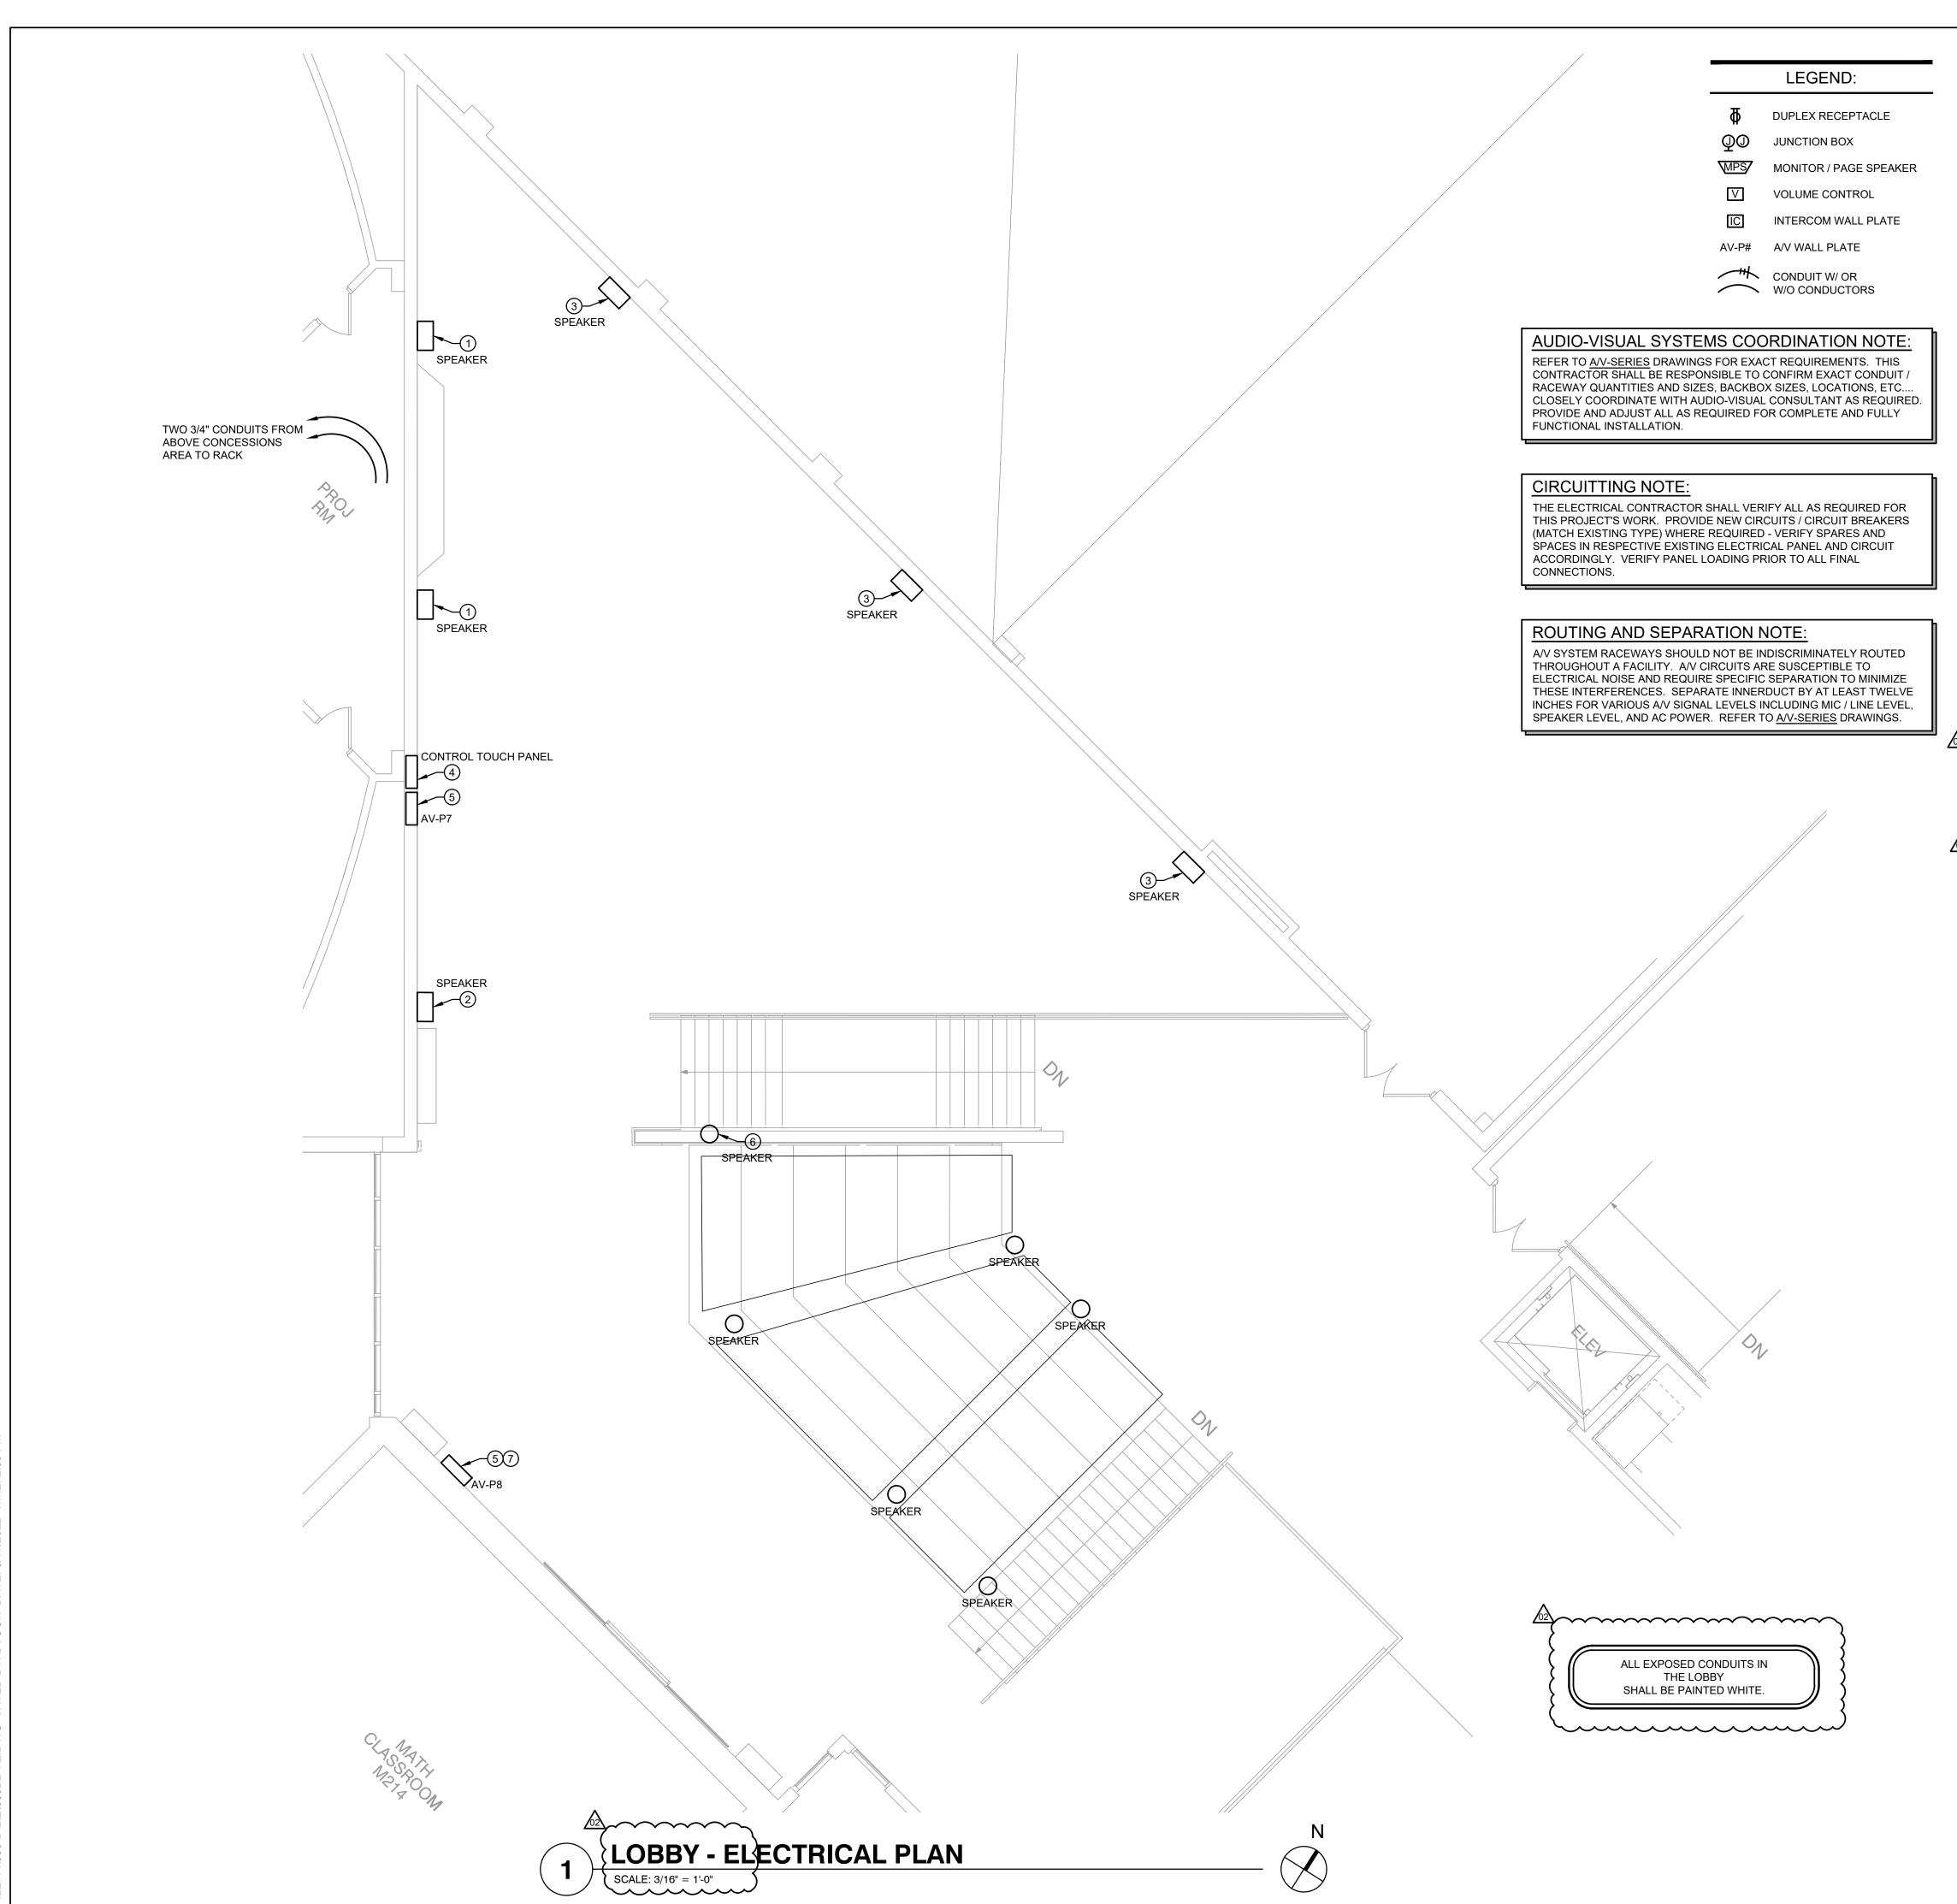

### DRAWING NOTES:

- ONE 1-COMPARTMENT VERTICAL RACEWAY (UP TO CONCESSIONS AREA CEILING) legrand / WIREMOLD MODEL# V700-SERIES FOR LOW VOLTAGE. FIELD PAINT TO WHITE.
- 2. ONE 1-GANG DEEP JUNCTION BOX WITH ONE 3/4" CONDUIT INTO ELECTRICAL ROOM; THEN UP, ACROSS, AND INTO CONCESSIONS AREA CEILING.

FROM THE TRACK TO ABOVE THE CONCESSION STAND.

- 3. RUN SPEAKER CABLING IN EXISTING WIREMOLD RACEWAY. PROVIDE CONDUIT
- 4. CUSTOM SURFACE MOUNTED TYPE JUNCTION BOX SIZED FOR 7" CONTROL SYSTEM TOUCH PANEL. CONFIRM EXACT SIZE WITH A/V CONTRACTOR. PAINT BLACK. MOUNT AT 58" A.F.F.. ROUTE CONDUIT INTO ELECTRICAL ROOM; THEN UP, ACROSS, AND INTO CONCESSIONS AREA CEILING.
- 5. ONE 1-GANG SURFACE MOUNTED TYPE JUNCTION BOX AT OUTLET HEIGHT. ROUTE CONDUIT UP WALL AND INTO CONCESSIONS AREA CEILING FOR EAST MIC PLATE AND TO TOUCH PANEL BOX FOR A/V PLATE AT THE THEATER DOOR.
- 6. FOR OPEN CEILING-MOUNTED SPEAKER (BETWEEN CEILING "CLOUDS"), PROVIDE ONE 2-GANG J-BOX MOUNTED AT CEILING SLAB OR OTHER STRUCTURE. COORDINATE EXACT REQUIREMENTS WITH A/V CONSULTANT. LOOSE WIRE RUN BY A/V CONTRACTOR. PROVIDE ONE JUNCTION BOX WITH 3/4" CONDUIT TO ABOVE CONCESSION STAND.
- 7. COORDINATE EXACT ROUTING WITH OWNER TO ABOVE CONCESSION STAND.

### **GENERAL NOTES:**

- THE MINIMUM WIRE SIZE SHALL BE #12 AWG. PROVIDE DEDICATED NEUTRALS; NO COMMON NEUTRALS ARE PERMITTED.
- 2. THE MINIMUM CONDUIT SIZE FOR HOMERUNS AND BRANCH FEEDS SHALL BE 3/4". 1/2" CONDUIT SHALL BE ACCEPTABLE FOR BRANCH WIRING FOR SINGLE CIRCUITS ONLY. ALL BRANCH CIRCUITS CIRCUITS SHALL TERMINATE AT 20A-1P CIRCUIT BREAKERS IN PANELBOARD INDICATED UNLESS SPECIFICALLY INDICATED OTHERWISE.
- 3. THE CONTRACTOR SHALL UPSIZE CONDUCTORS AND CONDUITS (OVER 75'-0" IN LENGTH) TO COMPENSATE FOR VOLTAGE DROP.
- 4. THE CONTRACTOR SHALL PROVIDE ALL PENETRATIONS, SLEEVES AND SEALANT AS REQUIRED THRU PARTITIONS TO ACCOMMODATE ANY CONDUITS / RACEWAYS, CABLING, ETC... ALL PENETRATIONS THRU RATED WALL ASSEMBLY(IES) MUST MEET THE UL RATING OF THE WALL SYSTEM(S).
- 5. REFER TO AV PLANS FOR ADDITIONAL INFORMATION REGARDING MOUNTING HEIGHTS AND EXACT LOCATIONS OF ALL ELECTRICAL DEVICES BEFORE ROUGH-IN.
- THE CONTRACTOR SHALL VERIFY EXACT EQUIPMENT LOCATIONS, LOAD INFORMATION, VOLTAGE, AMPERAGE, CONNECTION TYPE, ETC... WITH EQUIPMENT BEING SUPPLIED PRIOR TO ROUGH-IN.
- 7. ALL WALL-MOUNTED ELECTRICAL DEVICES (RECEPTACLES, OUTLETS, LIGHT SWITCHES, ETC...) TO HAVE COLOR SELECTED BY ARCHITECT WITH STAINLESS STEEL FACEPLATE(S).
- 8. ALL EQUIPMENT / ITEMS INDICATED ON PLANS ARE NEW UNLESS SPECIFICALLY INDICATED OTHERWISE.



### ARCHITECTS:

STR Partners, LLC 350 West Ontario Street | Suite 200 Chicago, IL 60654


T: 312.464.1444 www.strpartners.com

ROOFING AND BUILDING ENVELOPE:
 LIPP A/V DESIGN INC
 420 Mayfair Ln

Buffalo Grove, IL 60089 (847) 808-8790

MEP /FP ENGINEERING:

CS2 DESIGN GROUP, LLC 837 Oakton Street Elk Grove Village, IL 60007 (847) 981-1880

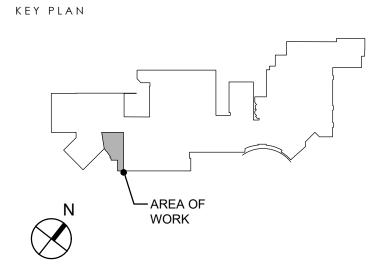

SCOPE DOCUMENTS

This drawing is one drawing within a complete set of documents and shall not be considered separately from the Drawings as a whole. The Drawings indicate the general scope of the project in terms of architectural design concept, the dimensions of the building, the major architectural elements and the type of structural, mechanical, and electrical systems. As Scope Documents, the Drawings do not necessarily indicate or describe all work required for full performance and completion of the requirements of the Construction Documents. On the basis of the general scope indicated or described, the Contractor shall furnish all items required for the proper execution and completion of the Work.

© 2022 STR PARTNERS, LLC

PROJECT

# D116 RLHS THEATER AV SYSTEM RENOVATION

ROUND LAKE HIGH SCHOOL 800 High School Drive Round Lake, IL 60073

# ROUND LAKE COMMUNITY UNIT SCHOOL DISTRICT 116

884 W Nippersink Road Round Lake, IL 60073

CLIENT PROJECT NUMBER 886-B-2

STR PROJECT NUMBER 21051.01

DRAWING DATES

NUMBER DATE COMMENTS

02 03/17/2022 ADDENDUM 1
 01 03/03/2022 ISSUED FOR BID

DRAWING TITLE

## UPPER LEVEL -ELECTRICAL PLAN

SHEET NUMBER

E1.2