



HACIENDA LA PUENTE UNIFIED SCHOOL DISTRICT PURCHASING DEPARTMENT

15959 E. GALE AVENUE • CITY OF INDUSTRY, CA 91716-0002
(626) 933-3930 • (626) 933-3939

Joel Duarte
Director Purchasing and Warehouse

September 28, 2023

HACIENDA LA PUENTE UNIFIED SCHOOL DISTRICT BID NUMBER 2023-24.03 DISTRICT OFFICE PORTABLE AND RESTROOM INSTALLATION

ADDENDUM NO. 4

This Addendum Number Four (#4) hereby makes changes to Bid #2023-24.03. Bidders shall acknowledge receipt of this Addendum in space provided on the Bid Form. Failure to acknowledge any addenda issued may subject Bidders to disqualification.


- Section 32 31 13 Chain Link Fences and Gates 1.06 B shall be revised to read:

B. Correct defective Work within a twelve-month period after Date of Substantial Completion.

- The following project sheets are incorporated herein:
 - T-2
 - AS-1
 - A-01
 - A-1
 - A-2
 - A-4
 - 2.00
 - 2.01
 - 5.00
 - 8.00
 - E-0.1
 - E-1.1
 - F0.2
 - F2.0
 - F3.0

Sincerely,

Joel Duarte
Director of Purchasing and Warehouse
Hacienda La Puente Unified School District

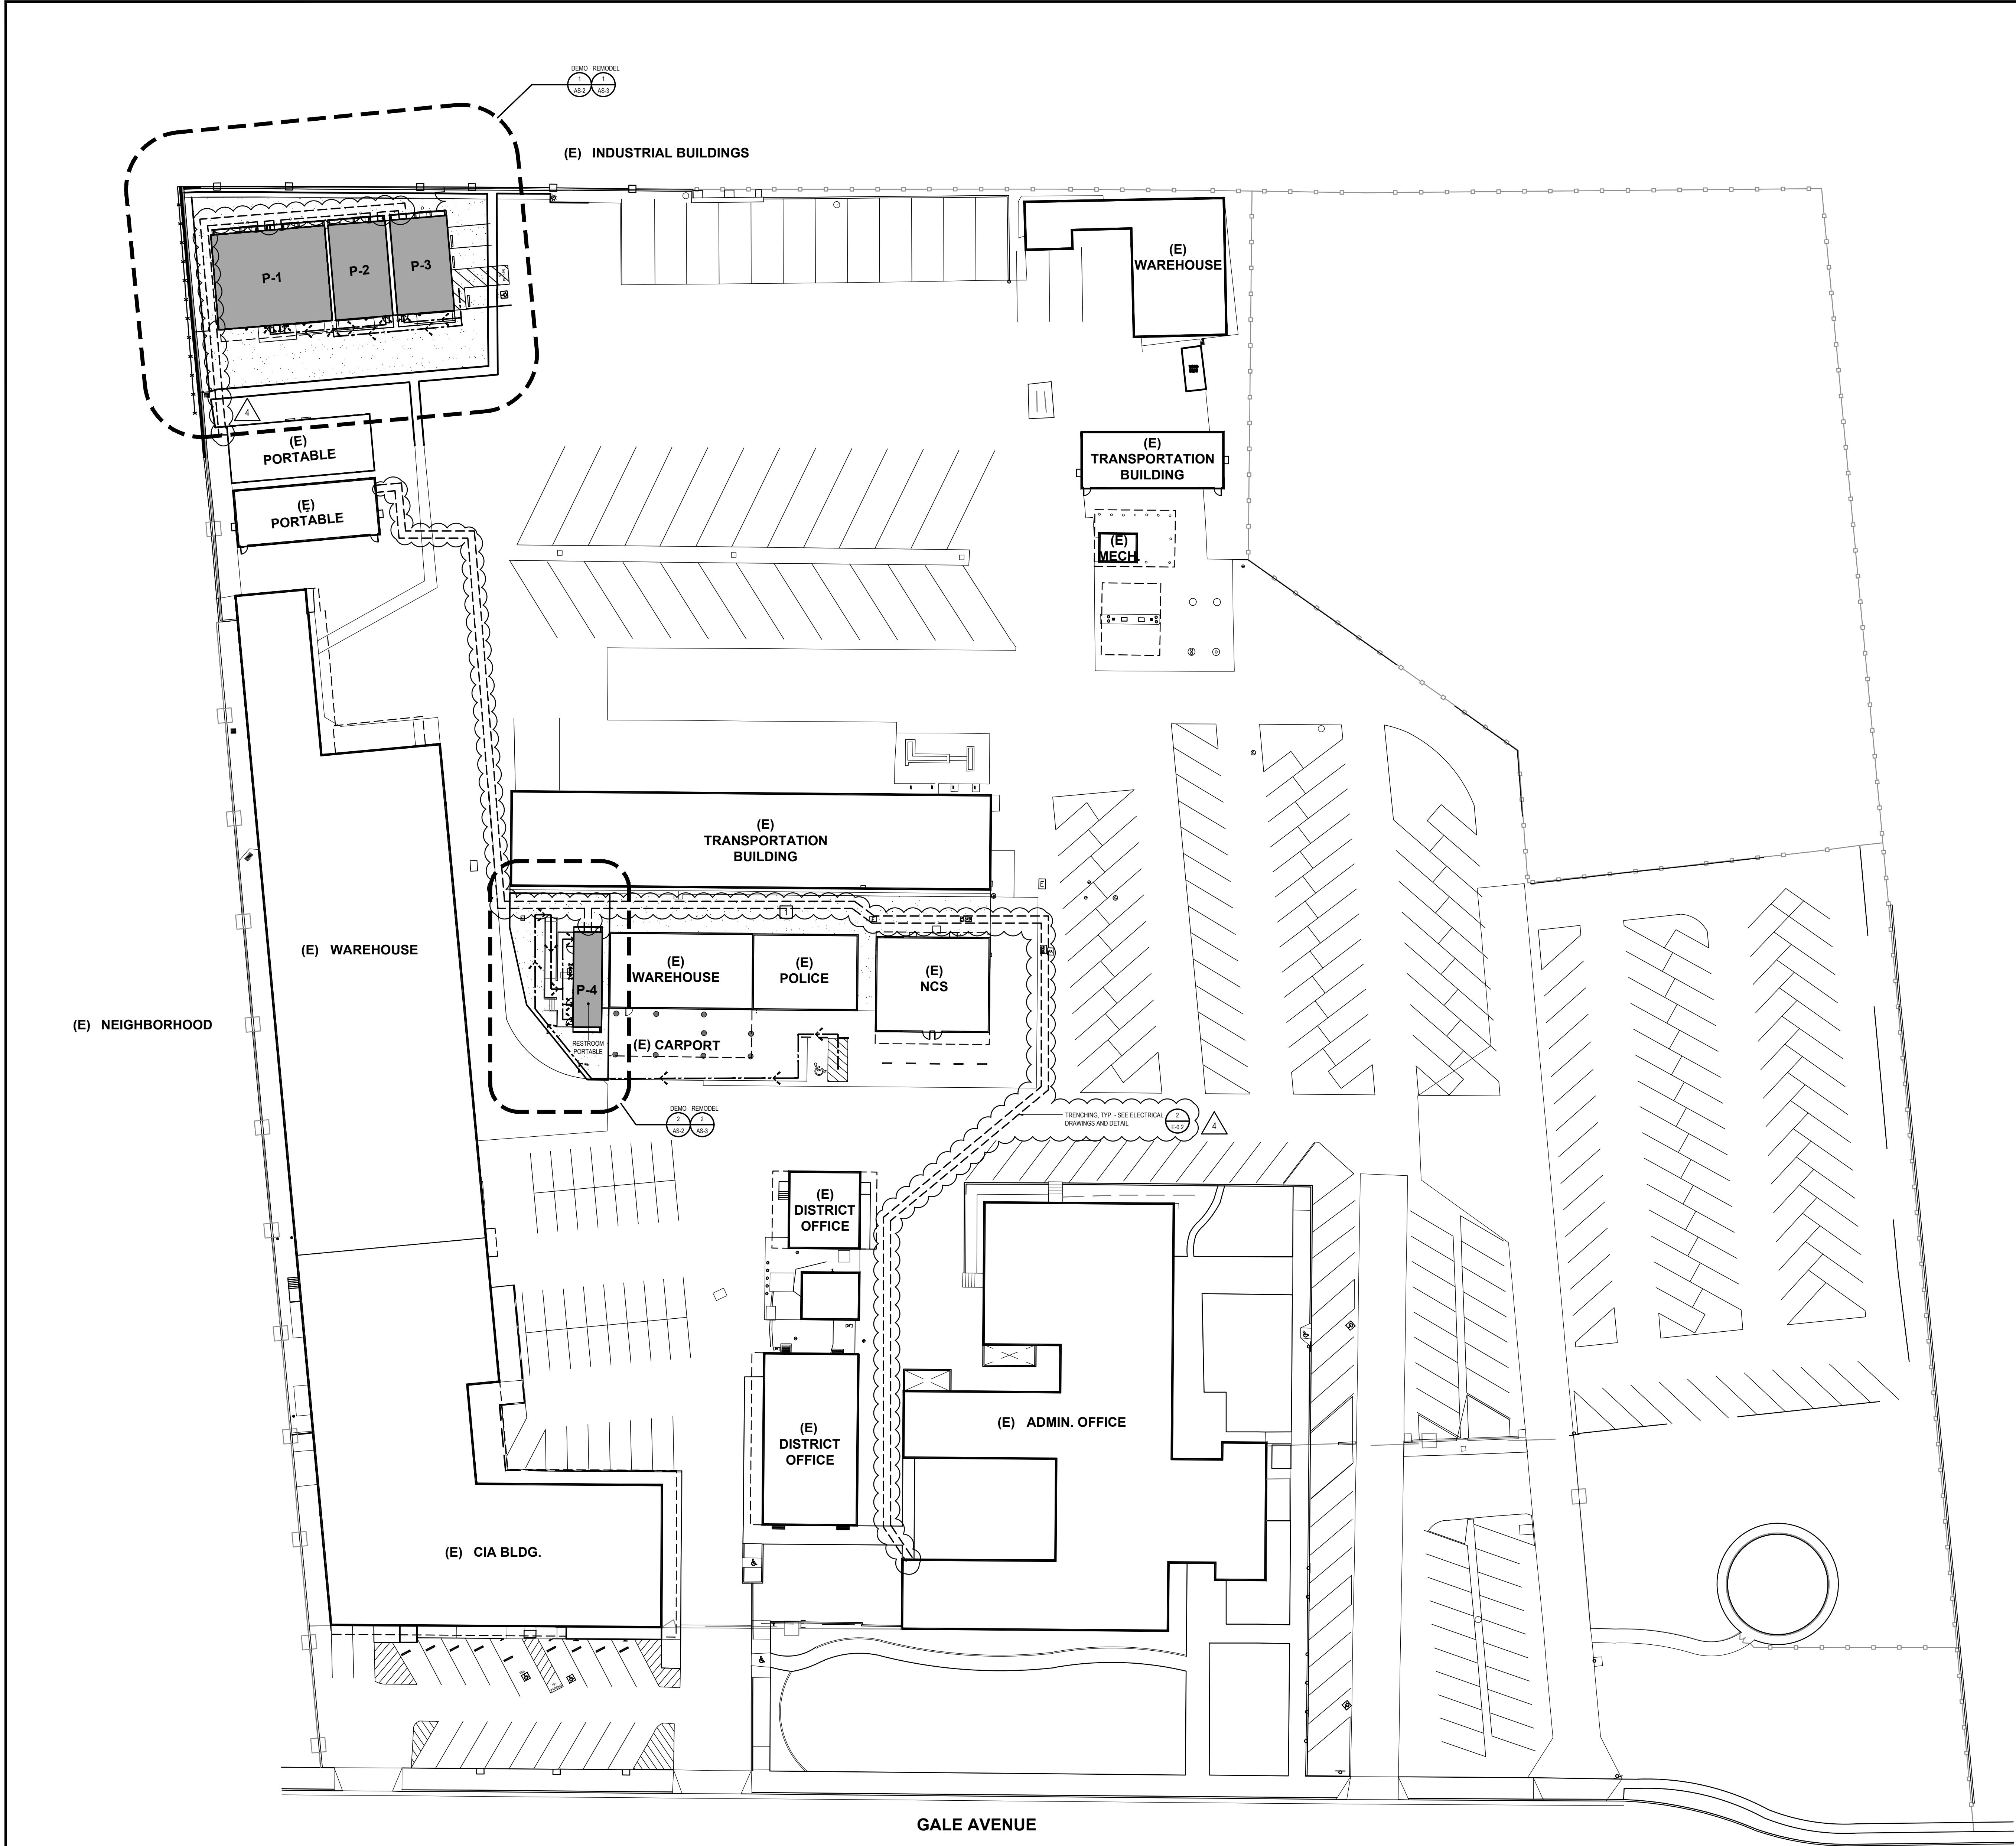

GENERAL NOTES

1. LOCATIONS OF ALL UTILITIES SHOWN ARE APPROXIMATE. CONTRACTOR SHALL EXERCISE EXTREME CAUTION IN EXCAVATING AND TRENCHING TO AVOID INTERCEPTING EXISTING PIPING OR CONDUITS. THE ARCHITECT IS NOT RESPONSIBLE FOR THE LOCATION OF UNDERGROUND UTILITIES OR STRUCTURES WHETHER OR NOT SHOWN OR DETAILED AND INSTALLED BY OTHER CONTRACTS. THE CONTRACTOR SHALL IMMEDIATELY NOTIFY THE OWNER SHOULD SUCH UNIDENTIFIED CONDITIONS BE DISCOVERED. THESE DRAWING DO NOT INCLUDE NECESSARY COMPONENTS FOR CONSTRUCTION SAFETY.
2. VERIFY ALL EXISTING AND FINISH GRADES, DIMENSIONS AND SITE CONDITIONS BEFORE COMMENCING WORK AND REPORT ANY DISCREPANCIES TO THE ARCHITECT.

KEYNOTES

- 1 REMOVE (E) GRAVEL AND PROVIDE AC PAVING - SEE CIVIL DWGS.

SITE PLAN LEGEND

DESIGN PROFESSIONAL IN GENERAL RESPONSIBLE CHARGE STATEMENT: THE POT IDENTIFIED IN THESE CONSTRUCTION DOCUMENTS IS COMPLIANT WITH THE CURRENT APPLICABLE CALIFORNIA BUILDING CODE ACCESSIBILITY PROVISIONS FOR THE PATH OF TRAVEL REQUIREMENTS FOR ALTERATIONS, ADDITIONS AND STRUCTURAL REPAIRS. AS PART OF THE DESIGN OF THIS PROJECT, THE POT WAS EXAMINED AND ANY ELEMENTS, COMPONENTS OR PORTIONS OF THE POT THAT WERE DETERMINED TO BE NONCOMPLIANT 1) HAVE BEEN IDENTIFIED AND 2) THE CORRECTIVE WORK NECESSARY TO BRING THEM INTO COMPLIANCE HAS BEEN INCLUDED WITHIN THE SCOPE OF THIS PROJECT'S WORK THROUGH DETAILS, DRAWINGS AND SPECIFICATIONS INCORPORATED INTO THESE CONSTRUCTION DOCUMENTS. ANY NONCOMPLIANT ELEMENTS, COMPONENTS OR PORTIONS OF THE POT THAT WILL NOT BE CORRECTED BY THIS PROJECT BASED ON VALUATION THRESHOLD, LIMITATIONS OR A FINDING OF UNREASONABLE HARDSHIP ARE SO INDICATED IN THESE CONSTRUCTION DOCUMENTS. ARCHITECT HAS VERIFIED P.O.T. IS BARRIER FREE.

DURING CONSTRUCTION, IF POT ITEMS WITHIN THE SCOPE OF THE PROJECT REPRESENTED AS CODE COMPLIANT ARE FOUND TO BE NONCONFORMING BEYOND REASONABLE CONSTRUCTION TOLERANCES, THEY SHALL BE BROUGHT INTO COMPLIANCE WITH THE CBC AS PART OF THIS PROJECT BY MEANS OF A CONSTRUCTION CHANGE DOCUMENT.

- PATH OF TRAVEL (P.O.T.) AS VERIFIED BY ARCHITECT IS:
- A COMMON BARRIER FREE ACCESSIBLE ROUTE AT LEAST 48" WIDE WITHOUT ANY ABRUPT VERTICAL CHANGES EXCEEDING 1/2" BEVELED AT 1:2 MAXIMUM SLOPE, EXCEPT THAT LEVEL CHANGES DO NOT EXCEED 1/4" VERTICAL.
 - THE PATH SURFACE IS SLIP RESISTANT, STABLE, FIRM AND SMOOTH.
 - PASSING SPACES AT LEAST 60"x60" ARE LOCATED NOT MORE THAN 200' APART.
 - CONTINUOUS GRADIENTS HAVE 60" LEVEL AREAS NOT MORE THAN 400' APART.
 - GROSS SLOPE DOES NOT EXCEED 2%.
 - SLOPE IN THE DIRECTION OF TRAVEL IS LESS THAN 5%, UNLESS OTHERWISE INDICATED AS A RAMP.
 - MAINTAIN POT FREE OF OVERHANGING OBSTRUCTIONS TO 80" MINIMUM. PROTRUDING OBJECTS GREATER THAN 4" PROJECTION FROM WALL OR EDGE AND 27" ABOVE FINISH GRADE.
 - ARCHITECT SHALL VERIFY THAT THERE ARE NO BARRIERS IN THE PATH OF TRAVEL.

- AREA OF WORK
- AC PAVING
- PATH OF TRAVEL

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KEYNOTES

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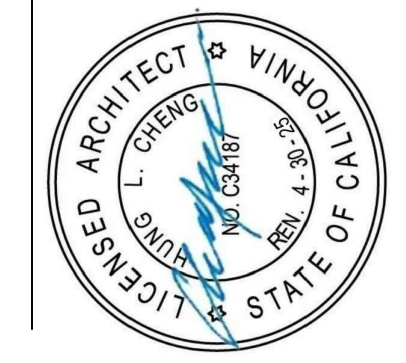
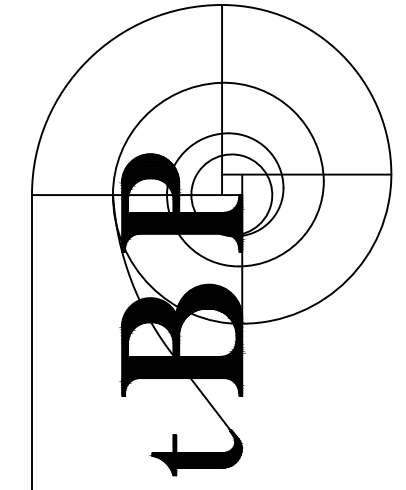
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- AREA OF WORK
- AC PAVING
- PATH OF TRAVEL



tBPArchitecture
4611 Teller Avenue
Newport Beach, CA 92660
ph: 949.873.0300

DISTRICT OFFICE PORTABLES &
RESTROOM PORTABLE
HACIENDA LA PUENTE UNIFIED SCHOOL DISTRICT
15959 GALE AVE.
CITY OF INDUSTRY, CA 91716

tBP project number : 21124.00

file name:

drawn by: checked by:

date: 7/11/2023

Rev: date: description:

9/20/2023 ADDENDUM 04


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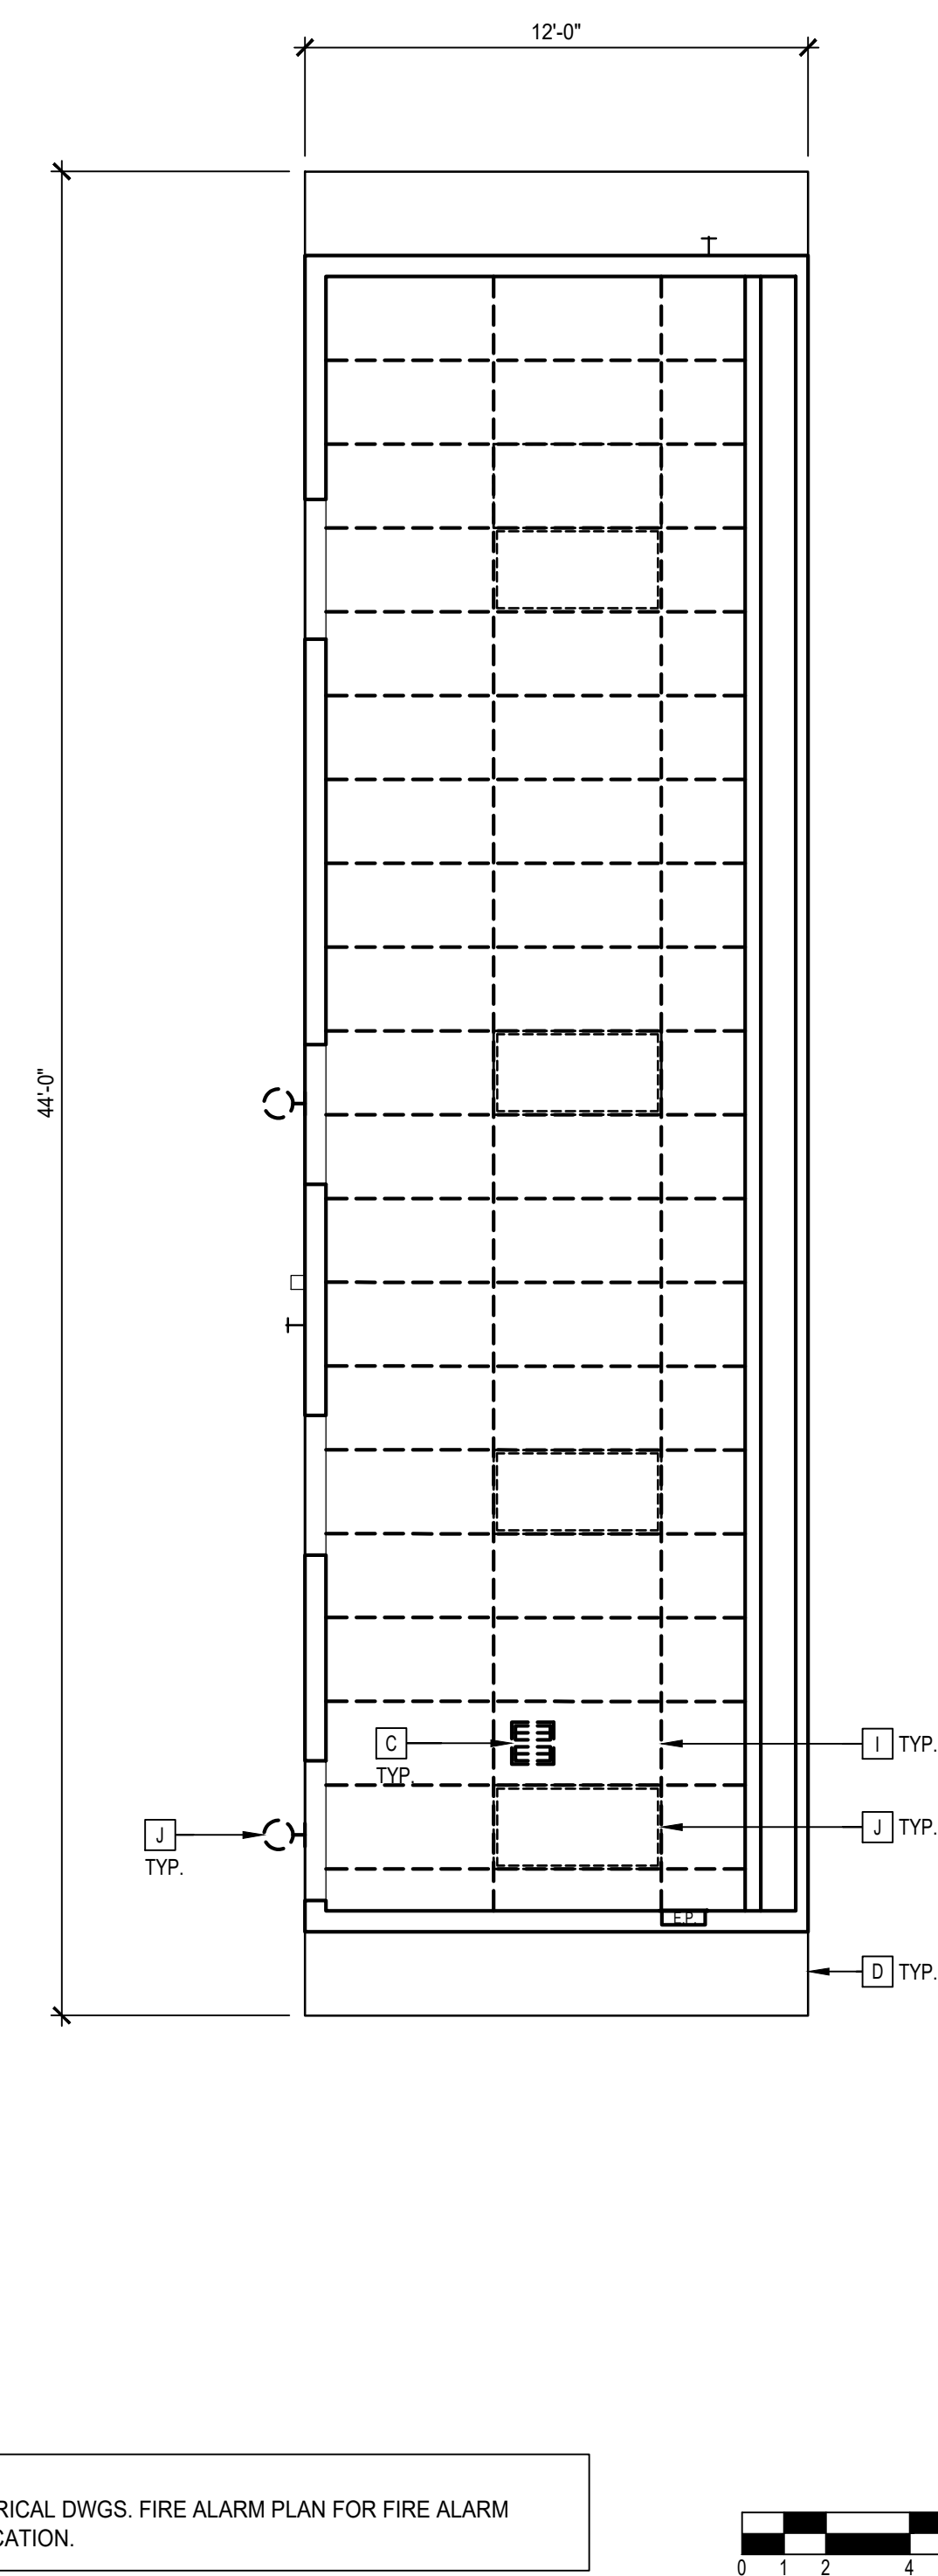
OVERALL CAMPUS
SITE PLAN

drawing no.:

AS-1
drawing of




DEMOLITON ROOF PLAN P-4
SCALE: 1/4" = 1'-0"

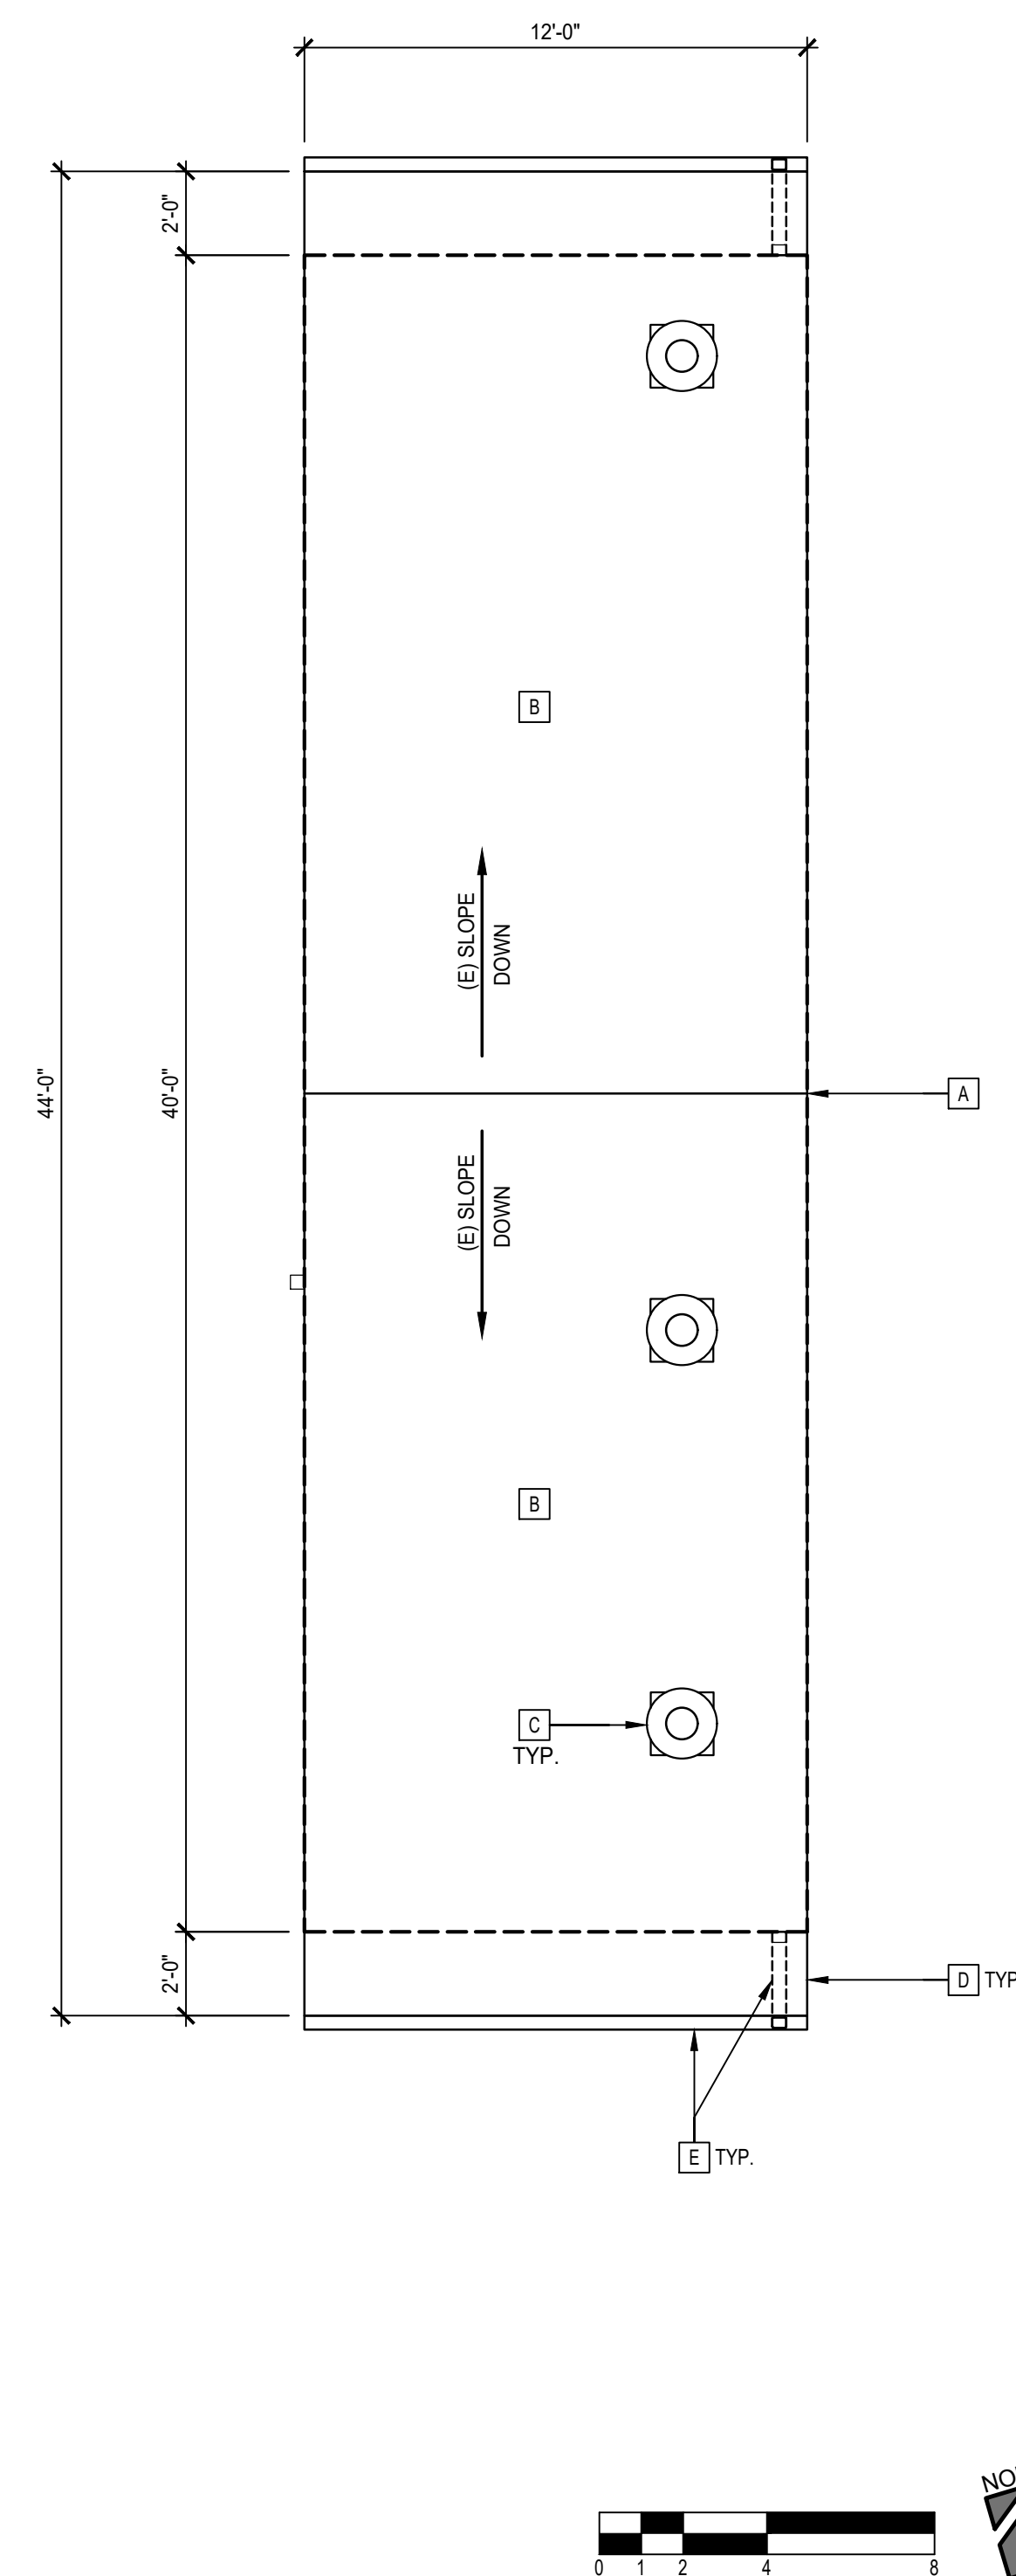









NOTE:
SEE ELECTRICAL DWGS. FIRE ALARM PLAN FOR FIRE ALARM
DEVICE LOCATION.

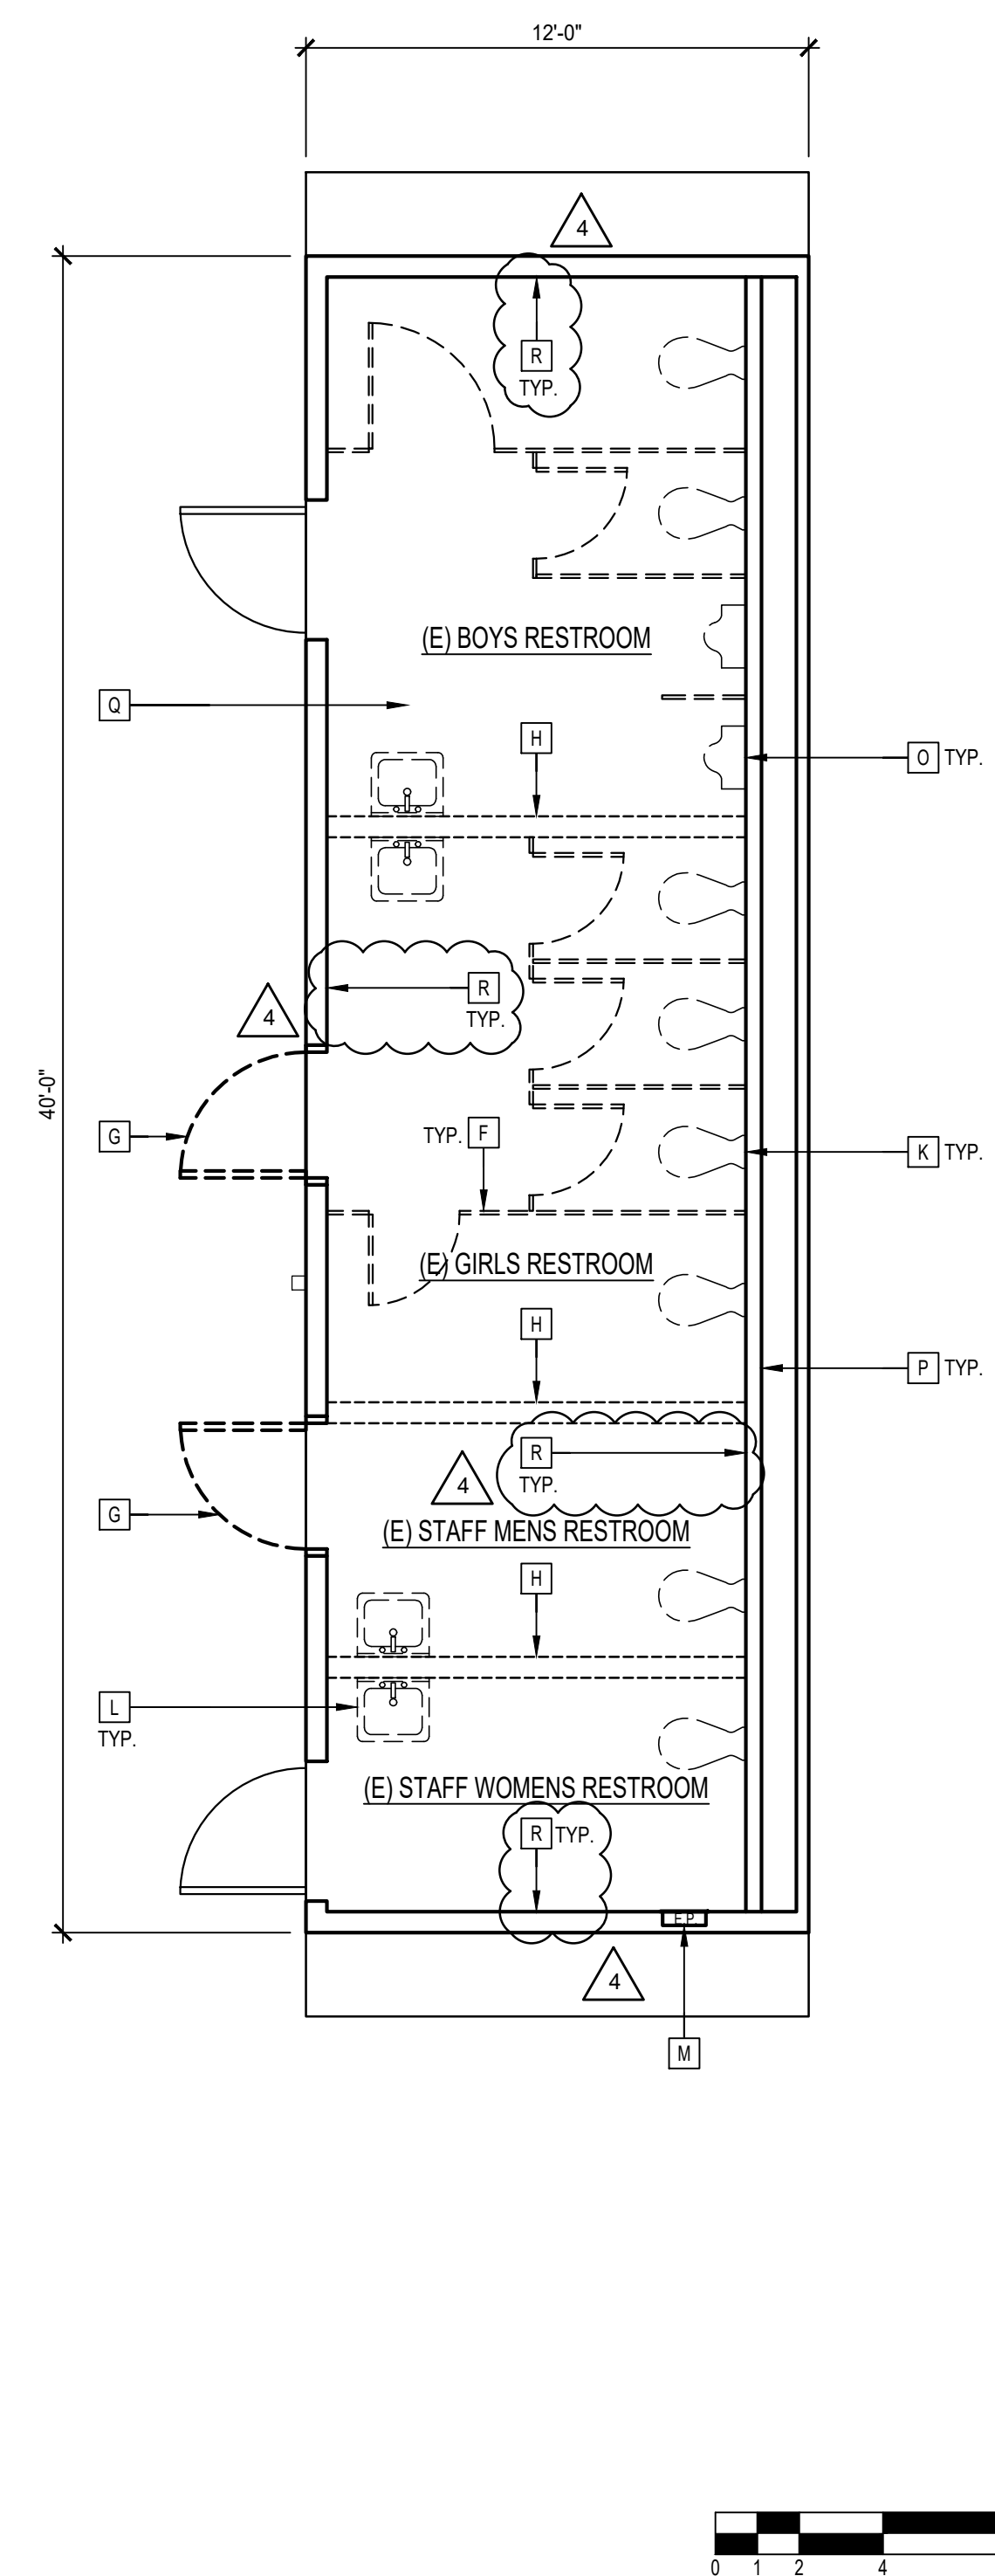DEMOLITON CEILING PLAN P-4
SCALE: 1/4" = 1'-0"




DEMOLITON FLOOR PLAN -P-4
SCALE: 1/4" = 1'-0"

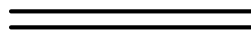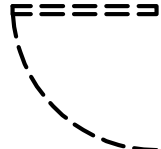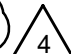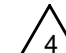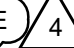LEGEND	GENERAL NOTES	DEMOLITION KEYNOTES
 EXISTING EXTERIOR PORTABLE BUILDING WALL TO REMAIN  ITEMS TO BE DEMOLISHED  EXISTING INTERIOR WALL TO REMAIN  REMOVE (E) DOOR AND FRAME	<ol style="list-style-type: none"> REMOVE (E) FLOOR FINISH MATERIAL IN ITS ENTIRETY. COORDINATE W/ DISTRICT TO REMOVE (E) LIGHT FIXTURES, MECHANICAL FIXTURES TO EITHER DISPOSE, OR TURN OVER TO DISTRICT FOR SALVAGE /REUSE. CAREFULLY REMOVE (E) MECHANICAL UNITS WHERE OCCURS. PATCH (E) GYPSUM BOARD AT INTERIOR AND INSTALL T-11 SIDING AT EXTERIOR TO MATCH (E) ADJACENT FINISH W/ FLUSH TRANSITION. REMOVE (E) GYPSUM BOARD FINISH AND (E) FLOOR SHEATHING AS REQUIRED TO INSTALL (N) ELECTRICAL, PLUMBING, AND MECHANICAL OUTLETS, DEVICES, CONTROLS, CONDUITS, AND PIPING. PATCH (E) WALL FINISHES AND (E) FLOOR SHEATHING TO MATCH ADJACENT (E) FINISH AND (E) SHEATHING W/ FLUSH TRANSITION. REFER TO DETAIL 16/4.00 FOR TYPICAL ELECTRICAL OUTLET IN PARTITION. REMOVE ALL TOILET ACCESSORIES AND PATCH AND REPAIR WALLS AS REQUIRED 	<p>A EXISTING ROOF RIDGE</p> <p>B REMOVE (E) ROOFING ON ENTIRE BUILDING. PREP FOR (N) ROOFING </p> <p>C REMOVE (E) EXHAUST FAN PATCH AND REPAIR. (E) ROOFING AS REQUIRED, TYP. CONNECT TO EXISTING DUCT WHEN AVAILABLE, V.I.F. SEE MECHANICAL DRAWINGS.</p> <p>D (E) ROOF OVERHANG</p> <p>E (E) GUTTER AND DOWNSPOUT TO REMAIN - REPAIR AS REQUIRED</p> <p>F REMOVE (E) TOILET PARTITION</p> <p>G REMOVE (E) DOOR AND FRAME</p> <p>H REMOVE (E) WALL. PATCH AND REPAIR FLOOR, WALLS, AND CEILING AS REQUIRED </p> <p>I REMOVE (E) T-BAR CEILING</p> <p>J REMOVE (E) CEILING LIGHT AND WALL MOUNTED FIXTURE </p> <p>K REMOVE (E) TOILET</p> <p>L REMOVE (E) SINK</p> <p>M REMOVE (E) EXTERIOR LIGHT</p> <p>N (E) ELECTRICAL PANEL TO REMAIN</p> <p>O REMOVE (E) URINAL</p> <p>P (E) PLUMBING CHASE TO REMAIN</p> <p>Q REMOVE (E) FLOORING</p> <p>R REMOVE (E) WALL FINISH AND GYP BD. </p>

DISTRICT OFFICE PORTABLES & RESTROOM PORTABLE

HACIENDA LA PUENTE UNIFIED SCHOOL DISTRICT
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CITY OF INDUSTRY, CA 91716



agency

architecture
planning
interiors

tBP/Architecture
4611 Teller Avenue
Newport Beach, CA 92660
ph: 949.673.0300

architect

consultant

tBP project number : 21124.00

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file name:

drawn by: _____ checked by: _____

date: 7/11/2023

Rev: date: description:

4 9/20/2023 ADDENDUM C

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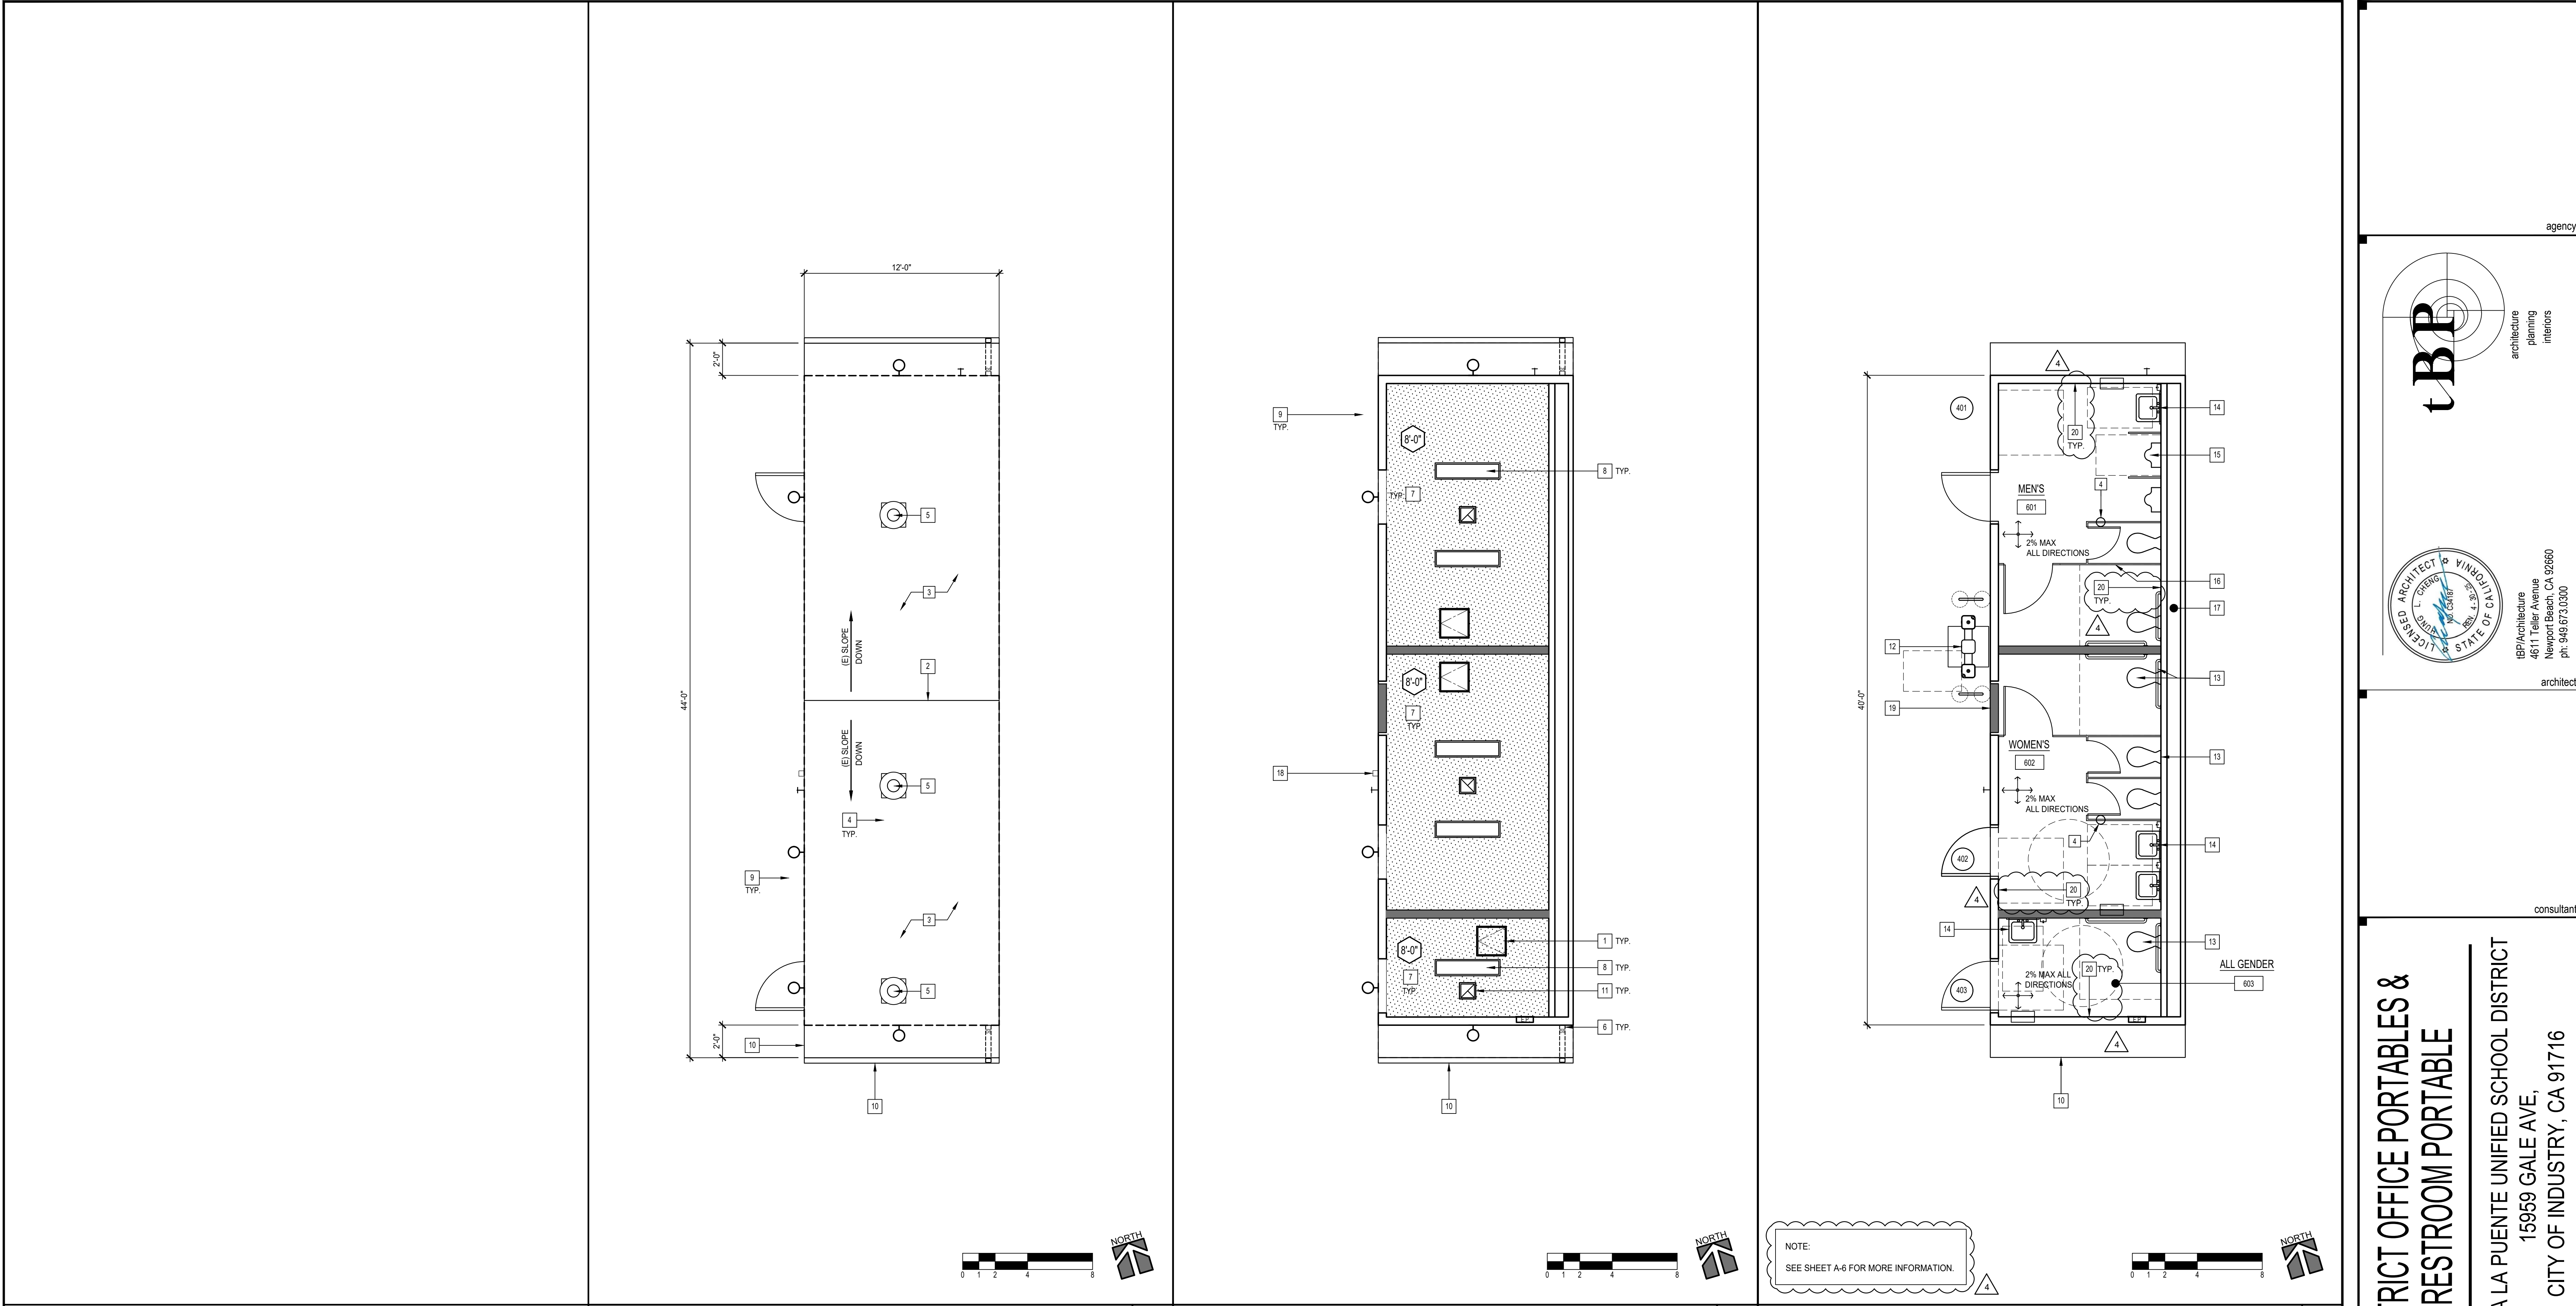
RESTROOM PORTABLE

DEMOLITION PLANS

drawing no.:

A-01

drawing of



ROOF PLAN P-4 3

REFLECTED CEILING PLAN P-4 2

FLOOR PLAN P-4 1

LEGEND		GENERAL NOTES		KEYNOTES	
<div><div><div><div></div><div>EXISTING EXTERIOR PORTABLE BUILDING WALL TO REMAIN</div></div><div><div></div><div>NEW 2x WOOD STUD WALL</div></div><div><div><div>#</div><div>DOOR TYPE - SEE DOOR SCHEDULE</div></div><div><div>⊗</div><div>EXIT SIGN - SEE ELECTRICAL DRAWINGS</div></div><div><div>----</div><div>ITEMS TO BE REMOVED</div></div><div><div><div>0' CLG</div><div>CEILING HEIGHT ABOVE FINISHED FLOOR (EL.=0'-0")/ITEMS TO BE REMOVED (HEIGHT AS NOTED ON PLANS)</div></div><div><div></div><div>WOOD FRAMED GYP. BD. CEILING</div></div><div><div></div><div>1' x 4' FLUORESCENT FIXTURE</div></div><div><div></div><div>CEILING ACCESS HATCH</div></div><div><div></div><div>CEILING REGISTER</div></div></div></div></div></div>		<div>1. GENERAL CONTRACTOR SHALL FIELD VERIFY EXISTING CONDITIONS AND INFORM THE ARCHITECT OF ANY DISCREPANCIES</div> <div>2. REFER TO SHEET T-2 FOR ADDITIONAL GENERAL NOTES, ABBREVIATIONS AND DRAFTING SYMBOLS</div> <div>3. REMOVE (E) FLOOR AND WALL FINISH MATERIAL, INTERIOR PARTITION(S), AND CEILING IN ITS ENTIRETY. SALVAGE (E) THERMAL BATT INSULATION IN EXTERIOR WALLS, FLOOR, AND ROOF FOR RE-USE, V.I.F....</div> <div>4. PREPARE (E) FLOOR SUBSTRATE PER MANUFACTURER'S RECOMMENDATIONS TO RECEIVE TILE FINISHES.</div> <div>5. COORDINATE W/ DISTRICT TO REMOVE (E) LIGHT FIXTURES, MECHANICAL FIXTURES, PLUMBING FIXTURES, AND ACCESSORIES TO EITHER DISPOSE, OR TURN OVER TO DISTRICT FOR SALVAGE / RE-USE.</div> <div>6. CAREFULLY REMOVE (E) MECHANICAL UNITS WHERE OCCURS. PATCH (E) T1-11 SIDING AT EXTERIOR TO MATCH (E) ADJACENT FINISH W/ FLUSH TRANSITION.</div> <div>7. REMOVE (E) EXTERIOR T1-11 SIDING AND (E) FLOOR SHEATHING AS REQUIRED TO INSTALL ELECTRICAL, PLUMBING, AND MECHANICAL OUTLETS, DEVICES, CONTROLS, CONDUITS, AND PIPING. PATCH (E) EXTERIOR WALL FINISHES AND (E) FLOOR SHEATHING TO MATCH ADJACENT (E) FINISH AND SHEATHING W/ FLUSH TRANSITION.</div> <div>8. REFER TO DETAIL 16/4.00 FOR TYPICAL ELECTRICAL OUTLET IN PARTITION.</div> <div>9. DIMENSIONS ARE TO CENTER LINE OF STUD (U.N.O.)</div> <div>10. INTERIOR PARTITIONS:<ul style="list-style-type: none">INTERIOR PARTITIONS SHALL BE 2X4 STUDS AT 16" O.C. WITH 5/8" TYPE 'X' GYPSUM BOARD EACH SIDE INSTALLED TO STRUCTURE ABOVE. (UNLESS NOTED OTHERWISE)PROVIDE ACOUSTIC BATT INSULATION AT ALL INTERIOR WALLS TO UNDERSIDE OF ROOF, TYP.(E) THERMAL BATT INSULATION TO REMAIN. REPLACE DAMAGED OR MISSING INSULATION TO MATCH (E), V.I.F.</div> <div>11. PATCH ALL (E) DAMAGED AND MISSING EXTERIOR T1-11 SIDING AND TRIM WHERE OCCURS, V.I.F. W/ T1-11 SIDING AND TRIM TO MATCH (E), PAINT TO MATCH ADJACENT (E) PORTABLE.</div> <div>12. AT T1-11 SIDING AND TRIM AREAS REQUIRED TO BE REMOVED FOR SCOPE OF PROJECT, PROVIDE T1-11 SIDING AND TRIM TO MATCH (E) FINISH AND COLORS. ALIGN T1-11 SIDING AND TRIM AT TOP AND BOTTOM W/ ADJACENT (E) SIDING AND TRIM, TYP.</div> <div>13. REPLACE DAMAGED OR MISSING EXPOSED FLASHING AT EXTERIOR PERIMETER WALL BASE OF PORTABLES. PAINT TO MATCH (E).</div> <div>14. PAINT PORTABLE BUILDING EXTERIOR T1-11 SIDING, TRIM, FASCIA, WINDOW FRAMES, DOORS, AND DOOR FRAMES TO MATCH ADJACENT (E) PORTABLE.</div> <div>15. MECHANICAL REGISTERS, GRILLES, EXTERIOR LOUVERS, AND ELECTRICAL FIXTURES ARE SHOWN FOR LOCATION PURPOSES ONLY. VERIFY QUANTITY AND SIZES WITH MECHANICAL AND ELECTRICAL DRAWINGS. VERIFY LOCATIONS OF CEILING ACCESS PANELS.</div> <div>16. 16" x 16" ACCESS PANELS REQUIRED PER MECHANICAL AND ELECTRICAL DRAWINGS, AND CBC 1209.3</div> <div>17. SEE DETAIL SHEETS 5.00 FOR DETAILS OF CEILING SYSTEMS, SOFFITS AND NOTES</div>		<div><div><div>1</div><div>20'x20' CEILING ACCESS HATCH, PAINTED TO MATCH ADJACENT FINISHES, TYP. - SEE DETAIL</div><div>20</div><div>5.00</div></div><div><div>2</div><div>EXISTING ROOF RIDGE</div><div></div><div></div></div><div><div>3</div><div>RE-ROOF THE ENTIRE BUILDING - SEE SPECS SECTIONS 07 01 50.19 AND 07 52 00</div><div></div><div>4</div></div><div><div>4</div><div>FLOOR DRAIN - SEE PLUMBING DWGS.</div><div></div><div></div></div><div><div>5</div><div>EXHAUST FAN. PATCH AND REPAIR (E) ROOFING AS REQUIRED, TYP. CONNECT TO EXISTING DUCT WHEN AVAILABLE, V.I.F. SEE STRUCTURAL AND MECHANICAL DWGS</div><div></div><div></div></div><div><div>6</div><div>(E) GUTTER AND DOWNSPOUT PROTECT IN PLACE AND PAINT</div><div></div><div></div></div><div><div>7</div><div>WOOD FRAMED GYP. BD. CEILING - SEE</div><div>19</div><div>5.00</div></div><div><div>8</div><div>INTERIOR LIGHT FIXTURE - SEE ELECTRICAL DWGS.</div><div></div><div></div></div><div><div>9</div><div>EXTERIOR LIGHT FIXTURES, CENTERED ON DOOR AT 9'-6" AFF. TO CENTERLINE OF LIGHT FIXTURE - SEE ELECTRICAL DWGS.</div><div></div><div></div></div><div><div>10</div><div>(E) ROOF OVERHANG</div><div></div><div></div></div><div><div>11</div><div>CEILING REGISTER - SEE MECH. DWGS.</div><div></div><div></div></div><div><div>12</div><div>DRINKING FOUNTAIN - SEE DETAIL</div><div>4</div><div>2.00</div><div>AND PLUMBING DWGS.</div></div><div><div>13</div><div>WALL TOILET - SEE PLUMBING DWGS.</div><div></div><div></div></div><div><div>14</div><div>(E) WALL HUNG LAVATORY - SEE PLUMBING DWGS</div><div></div><div></div></div><div><div>15</div><div>URINAL - SEE PLUMBING DWGS.</div><div></div><div></div></div><div><div>16</div><div>TOILET PARTITION - SEE SPECS.</div><div></div><div></div></div><div><div>17</div><div>(E) PLUMBING CHASE TO REMAIN</div><div></div><div></div></div><div><div>18</div><div>FIRE HORN - SEE ELEC. DWGS.</div><div></div><div></div></div><div><div>19</div><div>INFILL (E) DOOR OPENING - PAINT TO MATCH (E)</div><div></div><div></div></div></div>	

agency

architecture

planning

interiors

architecture

planning

interiors

architect

consultant

OWNER

tBP project number : 21124.00

file name:

drawn by:

checked by:

date:

7/11/2023

Rev.

date:

description:

9/20/2023

ADDENDUM 04

drawing title:

RESTROOM PORTABLE REMODEL PLANS

drawing no.:

A-1

drawing of


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DEMO FLOOR PLAN P-1
SCALE: 1/4" = 1'-0"

2

DEMO KEYNOTES

- [A] (E) DOOR TO REMAIN PROTECT IN PLACE - PAINT
- [B] (E) PORTABLE BUILDING WINDOW - PROTECT IN PLACE
- [C] (E) ROOF OVERHANG
- [D] REMOVE (E) EXTERIOR LIGHTS
- [E] (E) ELECTRICAL PANEL TO REMAIN
- [F] DEMO (E) CASEWORK (CAP UTILITIES) PATCH AND REPAIR WALL AS REQUIRED
- [G] (E) GRILL TO REMAIN
- [H] REMOVE (E) VCT FLOORING AND BASE
- [I] (E) SPEAKER TO REMAIN
- [J] (E) PHONE TO REMAIN
- [K] REMOVE (E) WALL MOUNT. HVAC UNIT

LEGEND

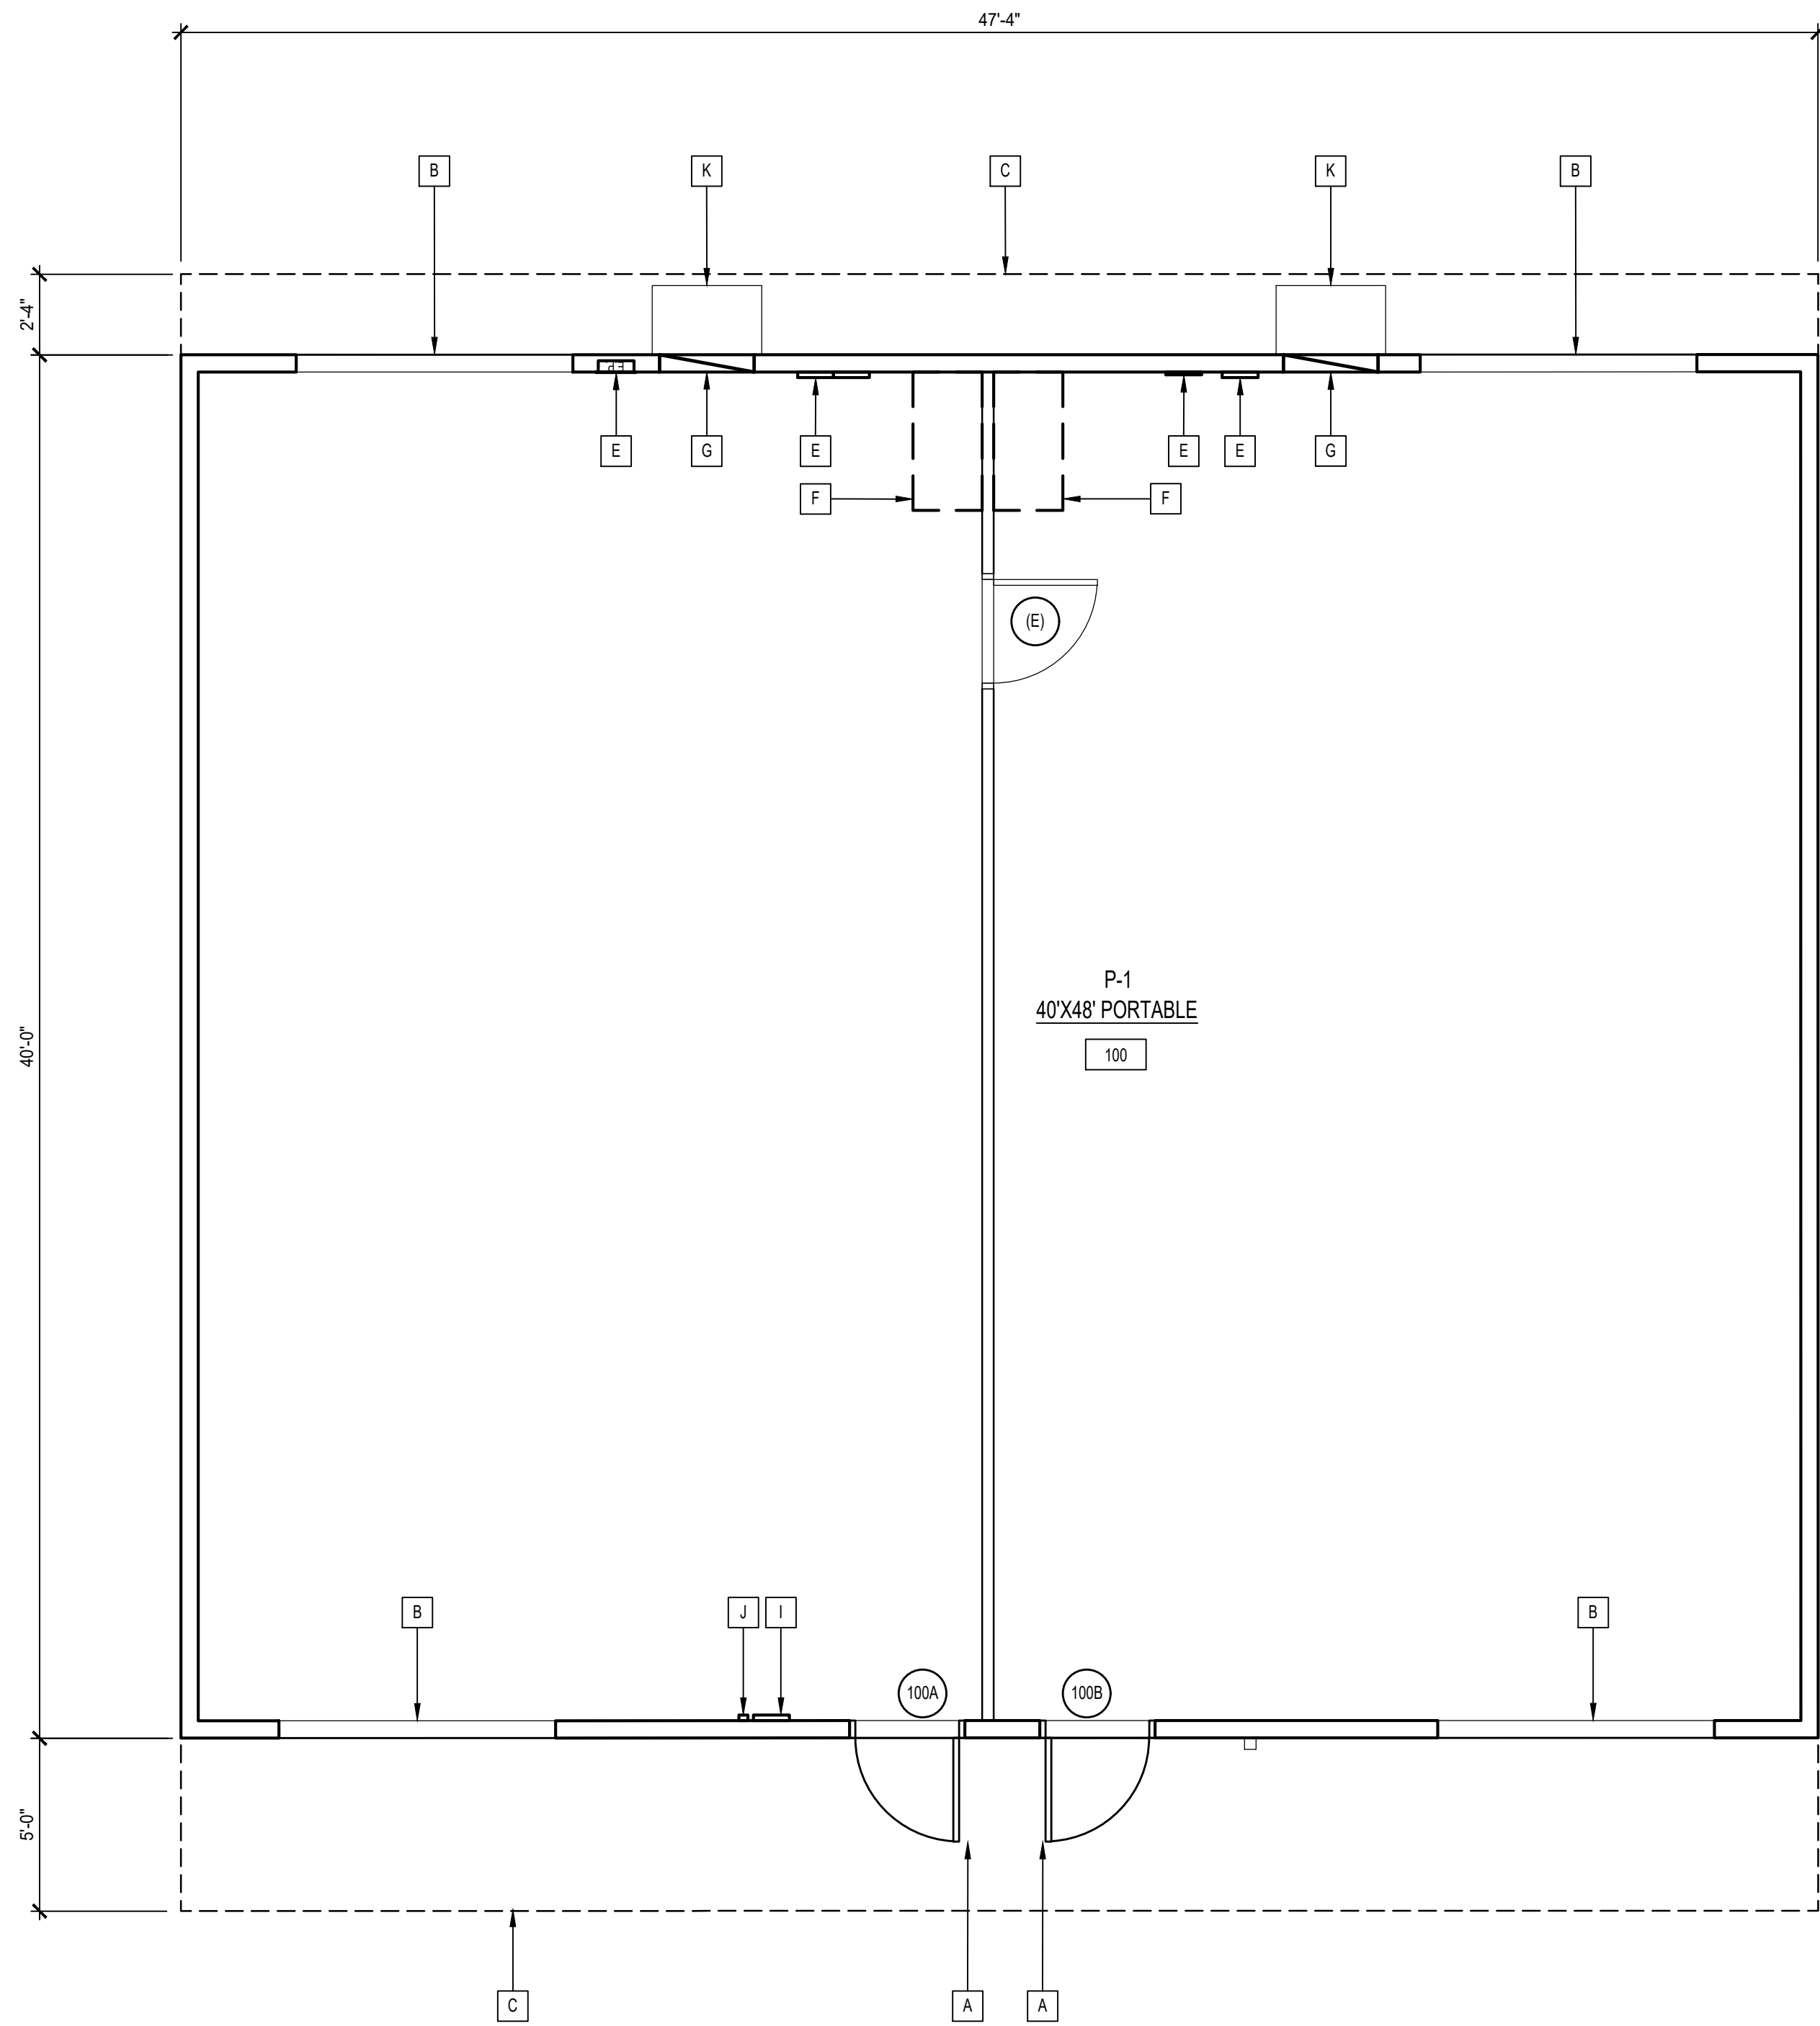- EXISTING EXTERIOR PORTABLE BUILDING WALL TO REMAIN
- NEW 2x WOOD STUD WALL
- DOOR TYPE - SEE DOOR SCHEDULE
- ITEMS TO BE REMOVED

GENERAL NOTES

- GENERAL CONTRACTOR SHALL FIELD VERIFY EXISTING CONDITIONS AND INFORM THE ARCHITECT OF ANY DISCREPANCIES
- REFER TO SHEET T-2 FOR ADDITIONAL GENERAL NOTES, ABBREVIATIONS AND DRAFTING SYMBOLS
- DIMENSIONS ARE TO CENTER LINE OF STUD (U.N.O.)
- INTERIOR PARTITIONS:
 - INTERIOR PARTITIONS SHALL BE 2X4 STUDS AT 16" O.C. WITH 5/8" TYPE 'X' GYPSUM BOARD EACH SIDE INSTALLED TO STRUCTURE ABOVE. (UNLESS NOTED OTHERWISE)
 - PROVIDE ACOUSTIC BATT INSULATION AT ALL INTERIOR WALLS TO UNDERSIDE OF ROOF, TYP.
 - (E) ACOUSTIC BATT INSULATION TO REMAIN. REPLACE DAMAGED OR MISSING INSULATION TO MATCH (E), V.I.F.
- PATCH ALL (E) DAMAGED AND MISSING EXTERIOR T1-11 SIDING AND TRIM WHERE OCCURS, V.I.F. W/ T1-11 SIDING AND TRIM TO MATCH (E), FINISH AND COLORS. ALIGN T1-11 SIDING AND TRIM AT TOP AND BOTTOM W/ ADJACENT (E) SIDING AND TRIM, TYP.
- REPLACE DAMAGED OR MISSING EXPOSED FLASHING AT EXTERIOR PERIMETER WALL BASE OF PORTABLES. PAINT TO MATCH (E).
- PAINT PORTABLE BUILDING EXTERIOR T1-11 SIDING, TRIM, FASCIA, WINDOW FRAMES, DOORS, AND DOOR FRAMES TO MATCH ADJACENT (E) PORTABLE.

REMODEL FLOOR PLAN P-1
SCALE: 1/4" = 1'-0"

1

REMODEL KEYNOTES

- [1] ROOM SIGN - SEE DETAIL
- [2] TACTILE EXIT SIGN - SEE DETAIL
- [3] NOT USED
- [4] ROOF OVERHANG
- [5] GAUDDRAIL FOR HVAC UNIT - SEE DETAIL
- [6] WALL MOUNTED HVAC UNIT - SEE MECH. DWGS.
- [7] WALK - OFF MAT
- [8] PORTABLE BUILDING WINDOW - PROTECT IN PLACE
- [9] RAMP - SEE DETAIL
- [10] HANDRAIL - SEE DETAIL
- [11] VERTICAL WINDOW BINDS - SEE FINISH SCHEDULE
- [12] DRY WELL - SEE DETAIL
- [13] REPLACE (E) CARPET WITH NEW FLOOR FINISH - SEE FINISH SCHEDULE
- [14] DOWNSPOUT - SIZE TO MATCH (E)

DISTRICT OFFICE PORTABLES &
RESTROOM PORTABLE

HACIENDA LA PUENTE UNIFIED SCHOOL DISTRICT
15959 GALE AVE.
CITY OF INDUSTRY, CA 91716

OWNER

tBP project number : 21124.00

file name:

drawn by:

checked by:

date: 7/11/2023

Rev: date: description:

9/20/2023 ADDENDUM 04

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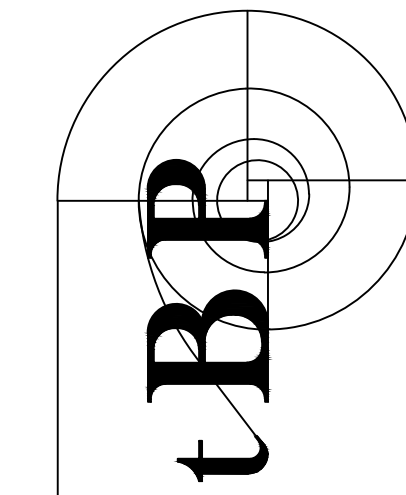
drawing title:

48X40 PORTABLE
FLOOR PLANS


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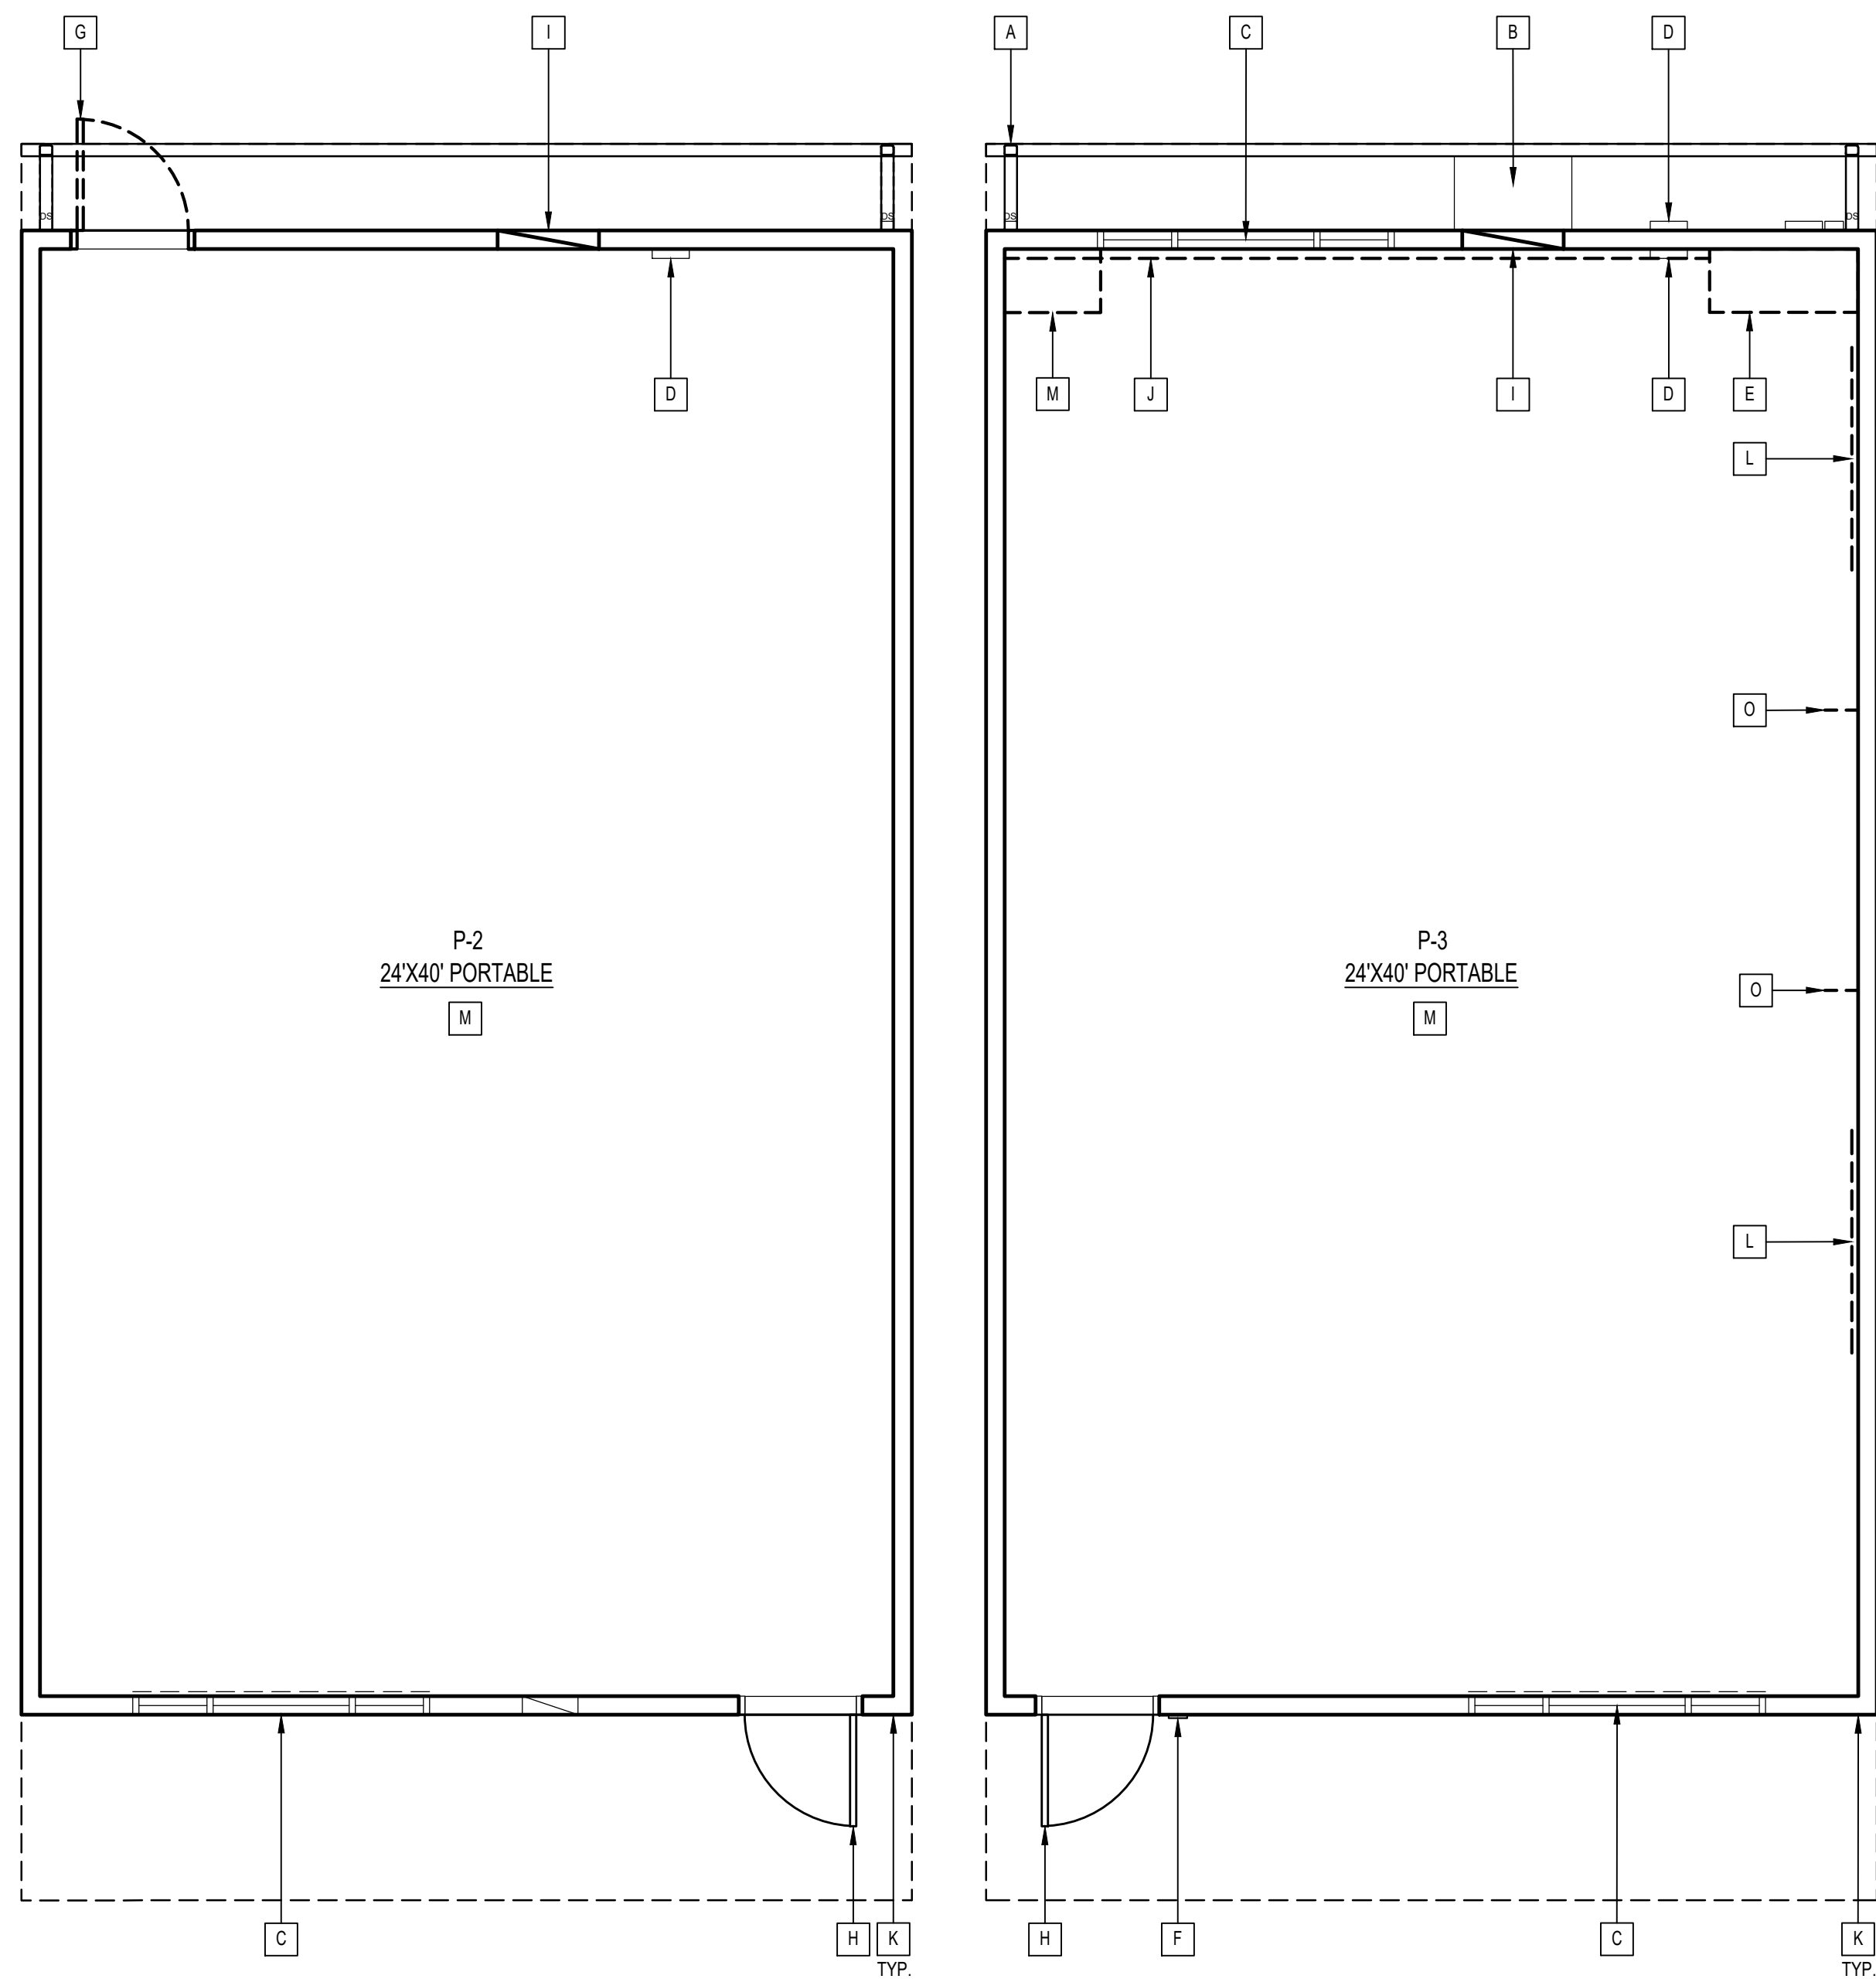
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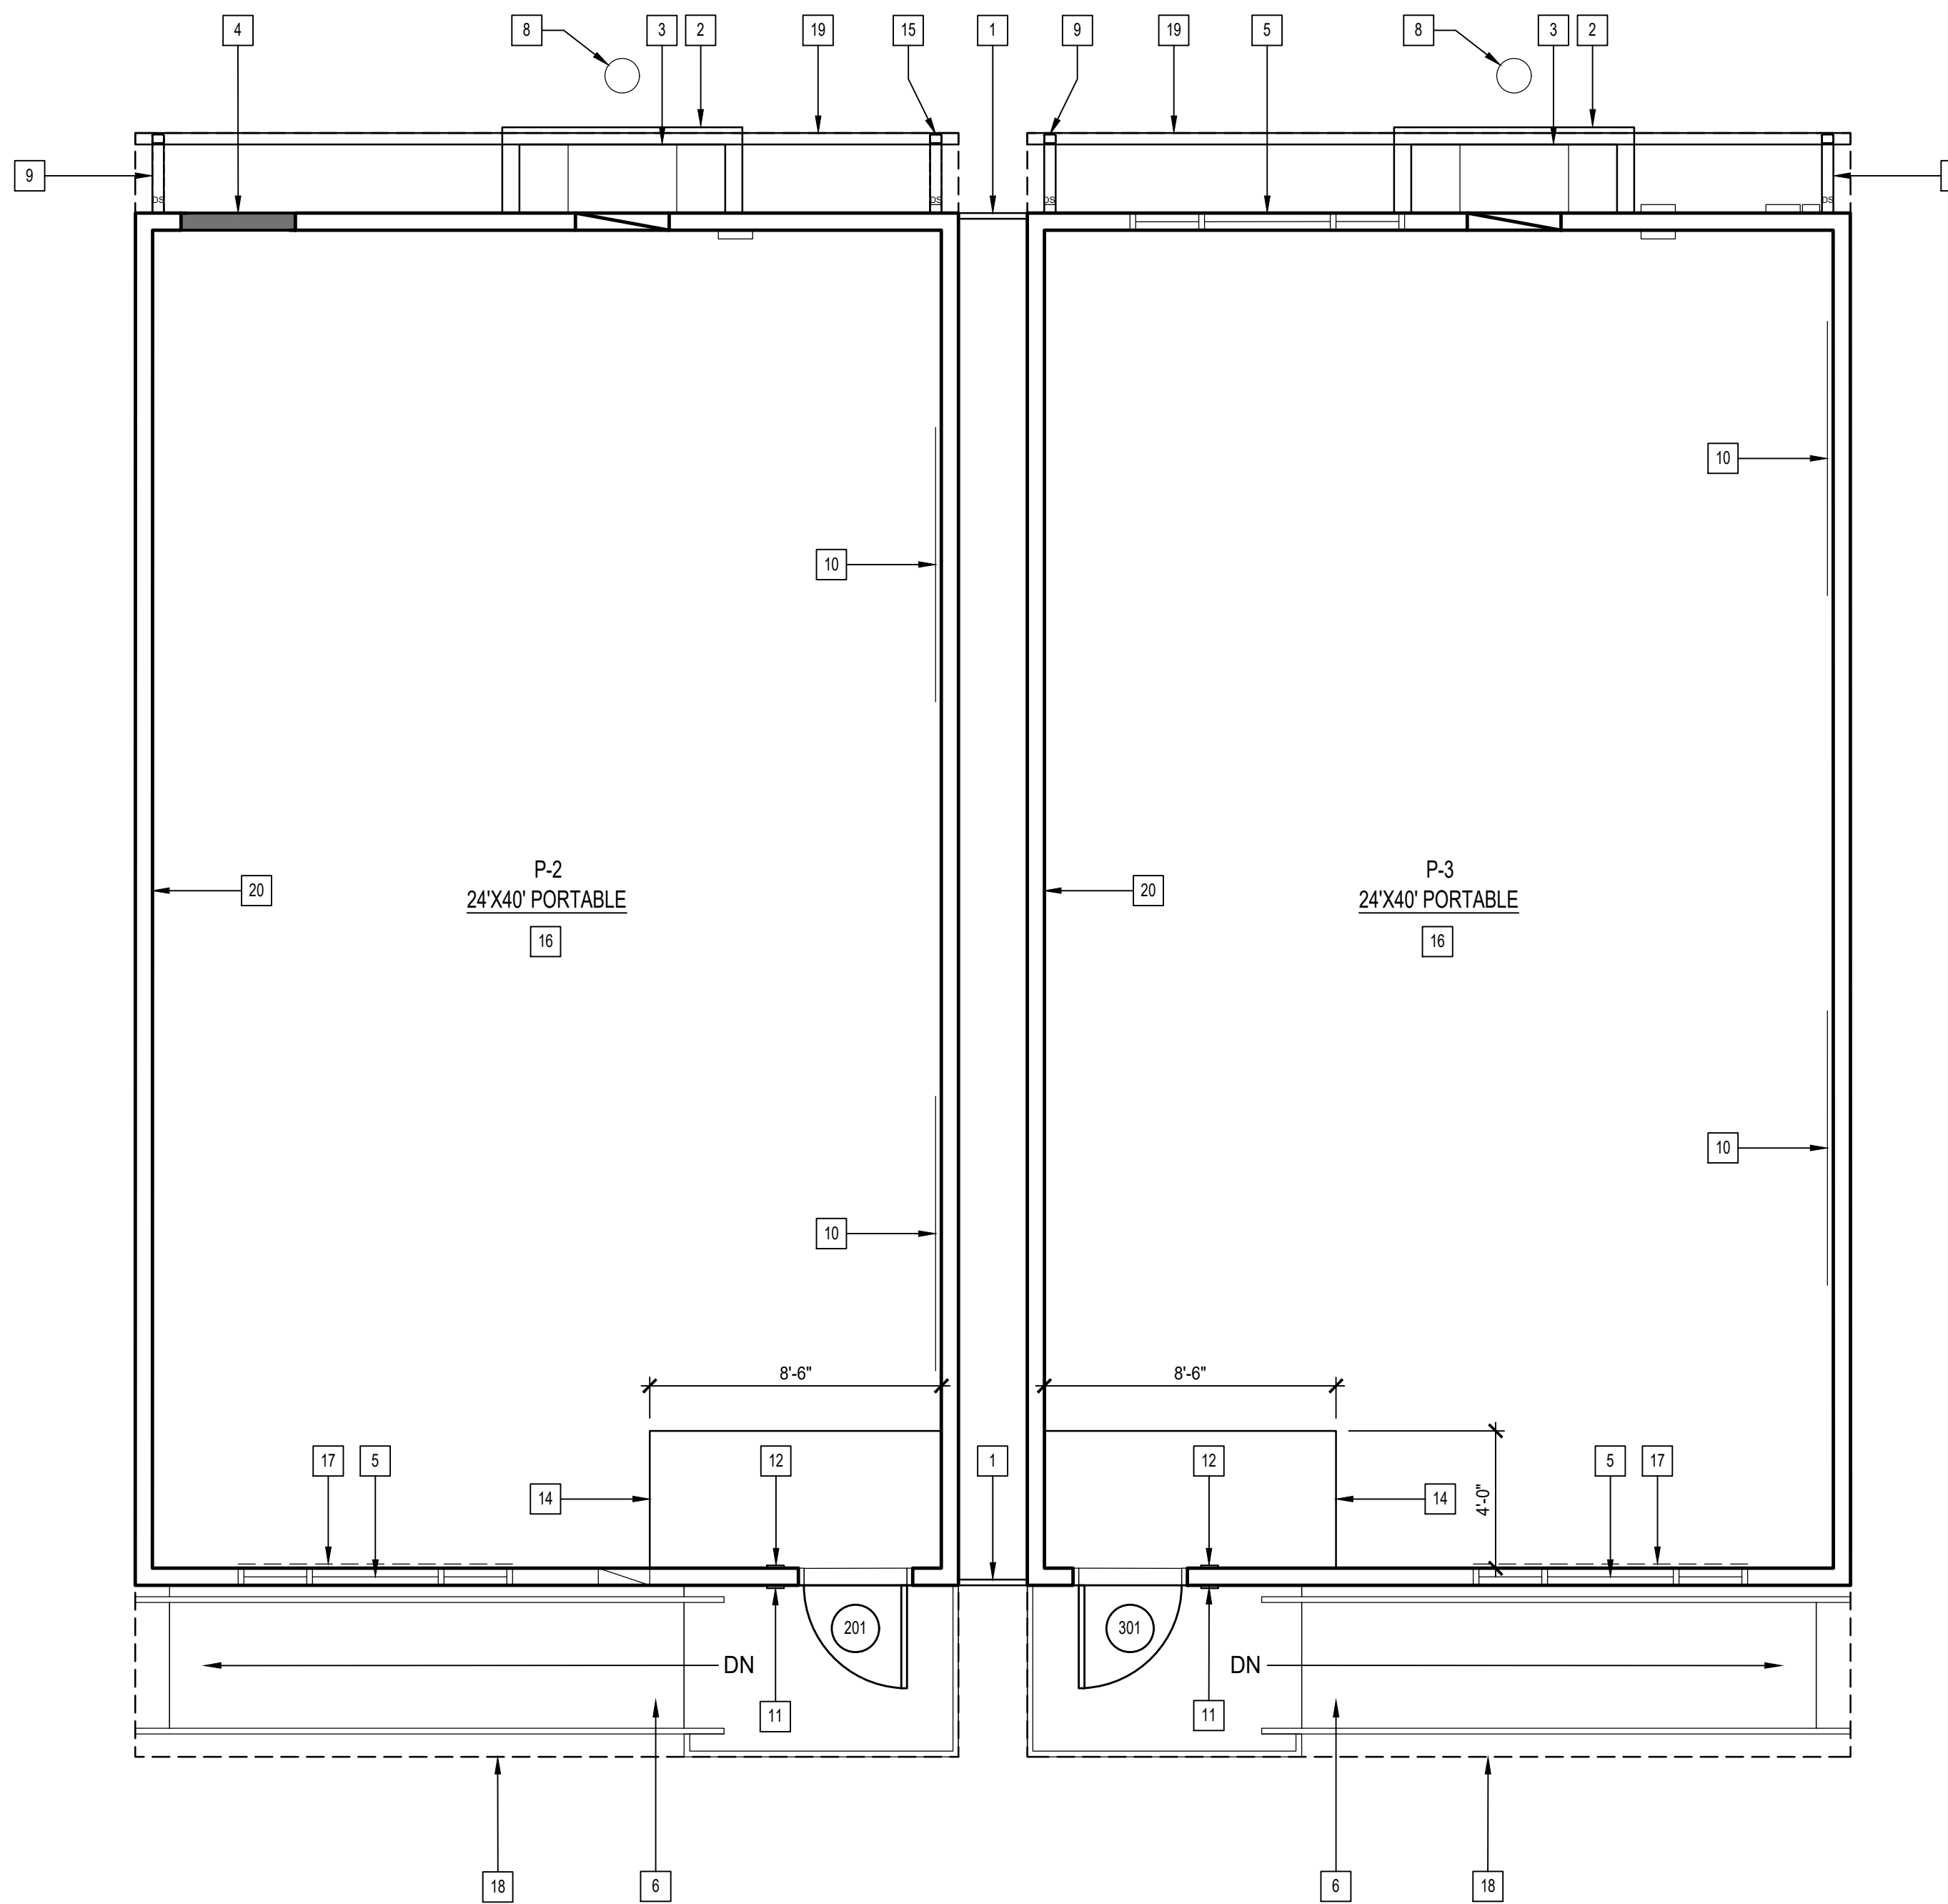
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DEMO FLOOR PLAN

SCALE: 1/4" = 1'-0"

2



NOTE:

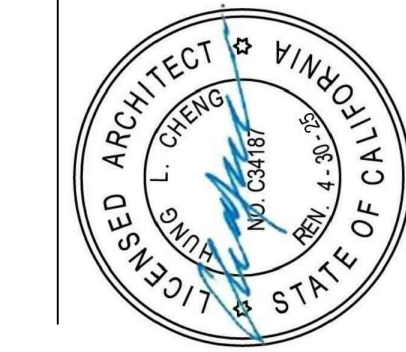
RE-ROOF THE ENTIRE BUILDING PER SPECIFICATION
SECTION 07 01 50.19 AND SECTION 07 52 00.

REMODEL FLOOR PLAN

SCALE: 1/4" = 1'-0"

1


DISTRICT STANDARD EXTERIOR FINISHES

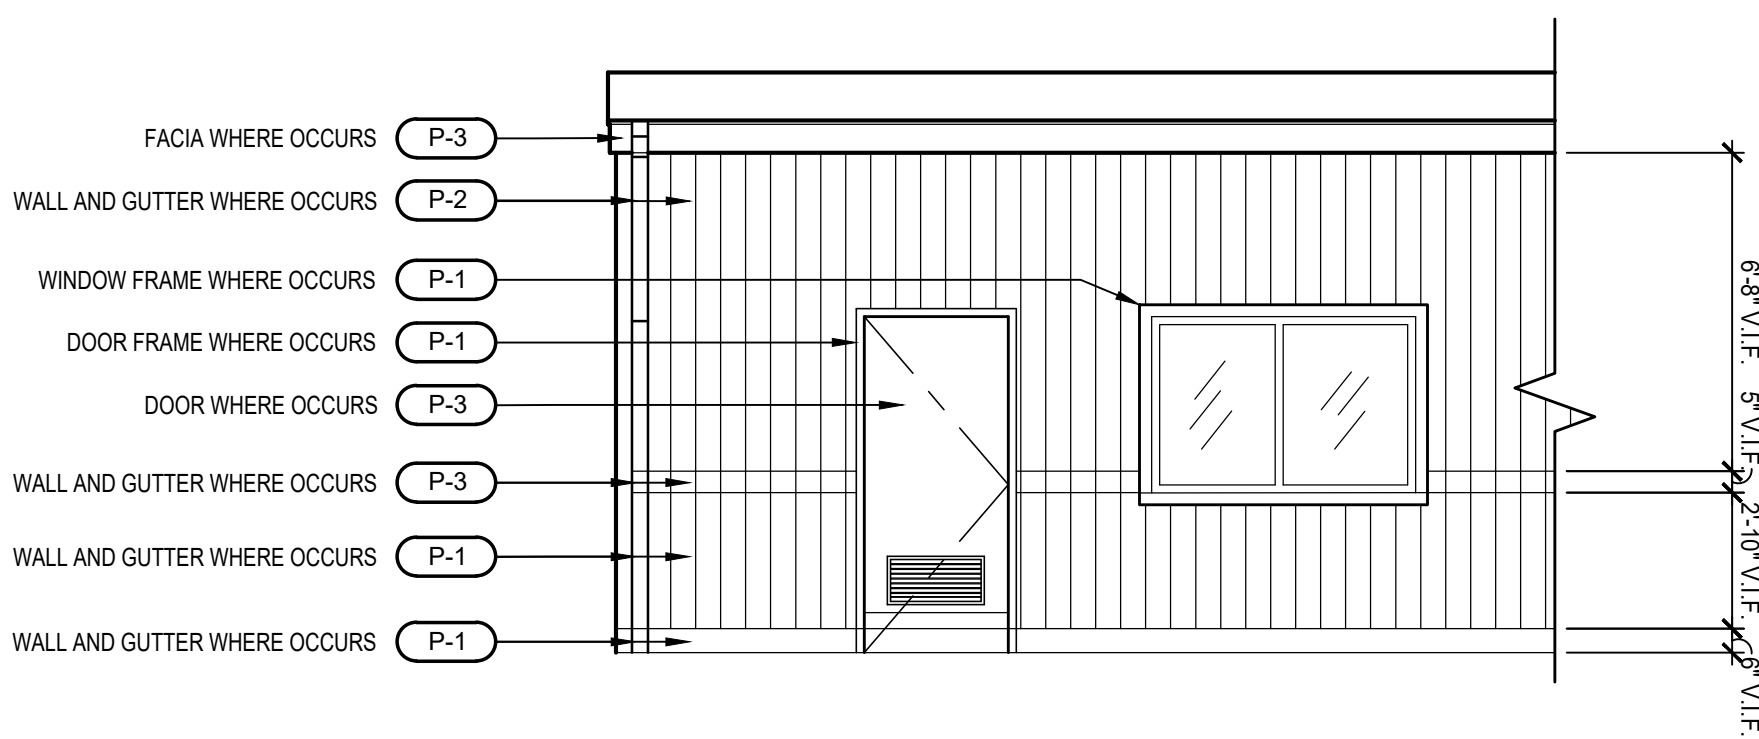

DEMO KEYNOTES

- (E) GUTTER AND DOWNSPOUT TO REMAIN
- REMOVE (E) WALL MOUNTED HVAC UNIT
- (E) PORTABLE BUILDING WINDOW
- (E) ELECTRICAL PANEL TO REMAIN
- REMOVE (E) CASEWORK (CAP UTILITIES) PATCH AND REPAIR WALL AS REQUIRED
- REMOVE ROOM SIGNAGE
- (E) DOOR AND FRAME TO BE REMOVED
- (E) DOOR TO REMAIN PROTECT IN PLACE
- (E) GRILL TO REMAIN
- (E) RACEWAY ALONG WALL TO BE REMOVED
- (E) DAMAGED TRIM - REPAIR AS REQUIRED
- (E) WHITEBOARD TO BE REMOVED
- REMOVE (E) VTC-FLOORING AND BASE
- (E) IDF CABINET TO REMAIN
- REMOVE (E) WALL BRACKETS - PATCH AND REPAIR AS REQUIRED

LEGEND

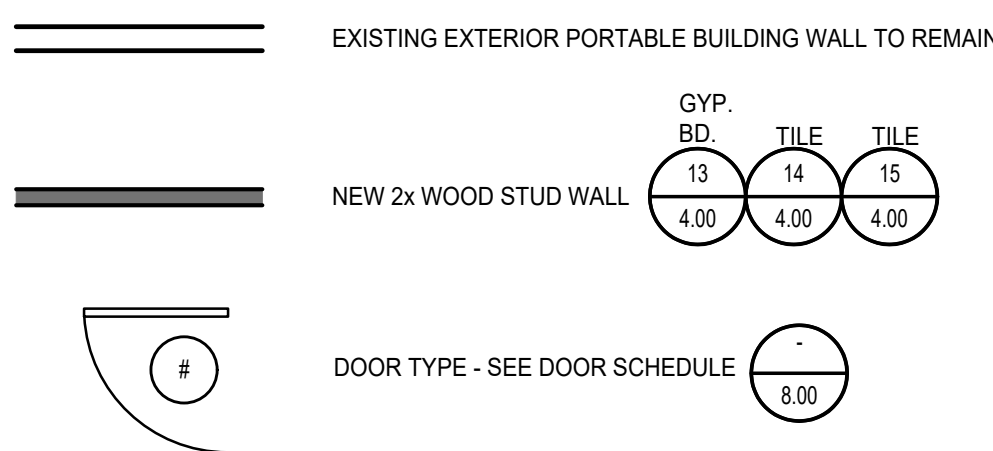

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 - PROVIDE ACOUSTIC BATT INSULATION AT ALL INTERIOR WALLS TO UNDERSIDE OF ROOF, TYP.
 - (E) ACOUSTIC BATT INSULATION TO REMAIN. REPLACE DAMAGED OR MISSING INSULATION TO MATCH (E), V.I.F.
- PATCH ALL (E) DAMAGED, HOLES AND MISSING EXTERIOR T1-11 SIDING AND TRIM WHERE OCCURS. V.I.F. W/ T1-11 SIDING AND TRIM TO MATCH (E). PAINT TO MATCH ADJACENT (E) PORTABLE.
- AT T1-11 SIDING AND TRIM AREAS REQUIRED TO BE REMOVED FOR SCOPE OF PROJECT, PROVIDE T1-11 SIDING AND TRIM TO MATCH (E) FINISH AND COLORS. ALIGN T1-11 SIDING AND TRIM AT TOP AND BOTTOM W/ ADJACENT (E) SIDING AND TRIM, TYP.
- REPLACE DAMAGED OR MISSING EXPOSED FLASHING AT EXTERIOR PERIMETER WALL BASE OF PORTABLES. PAINT TO MATCH (E).
- PAINT PORTABLE BUILDING EXTERIOR T1-11 SIDING, TRIM, FASCIA, WINDOW FRAMES, DOORS, AND DOOR FRAMES TO MATCH ADJACENT (E) PORTABLE.

REMODEL KEYNOTES

- CLOSURE PANEL - SEE DETAIL
- GAURDRAIL FOR HVAC UNIT - SEE DETAIL
- WALL MOUNTED HVAC UNIT - SEE MECH. DWGS.
- INFILL (E) DOOR OPENING
- PORTABLE BUILDING WINDOW - PROTECT IN PLACE
- RAMP - SEE DETAIL
- HANDRAIL - SEE DETAIL
- DRY WELL - SEE DETAIL
- DOWNSPOUT - TO MATCH (E) SIZE
- 4'-x 8' WHITE BOARD
- ROOM SIGN - SEE DETAIL
- TACTILE EXIT SIGN - SEE DETAIL
- NOT USED
- WALK - OFF MAT
- DOWNSPOUT TO REMAIN - PAINT
- CARPET - SEE FINISH SCHEDULE
- VERTICAL WINDOW BLINDS
- (E) ROOF OVERHANG - PATCH AND REPAIR FLASHING AND PAINT
- (E) ROOF DRAIN - PATCH AND REPAIR GUTTER AND PAINT
- (E) INTERIOR WALLS TO BE PAINTED - PATCH AND REPAIR AS REQUIRED - SEE FINISH SCHEDULE

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CITY OF INDUSTRY, CA 91716

OWNER

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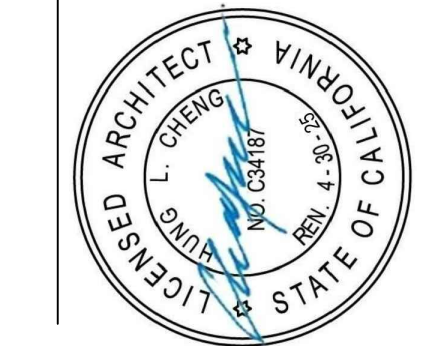
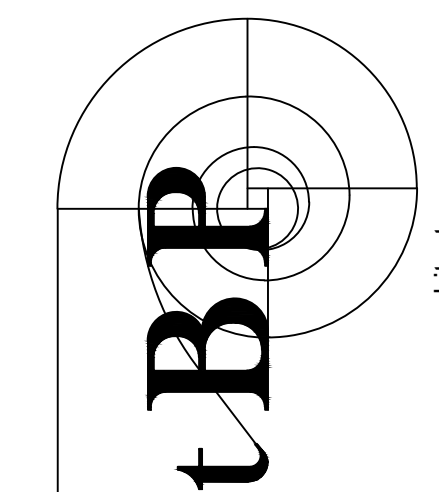
24X40 PORTABLE
FLOOR PLANS

drawing no.:

A-4

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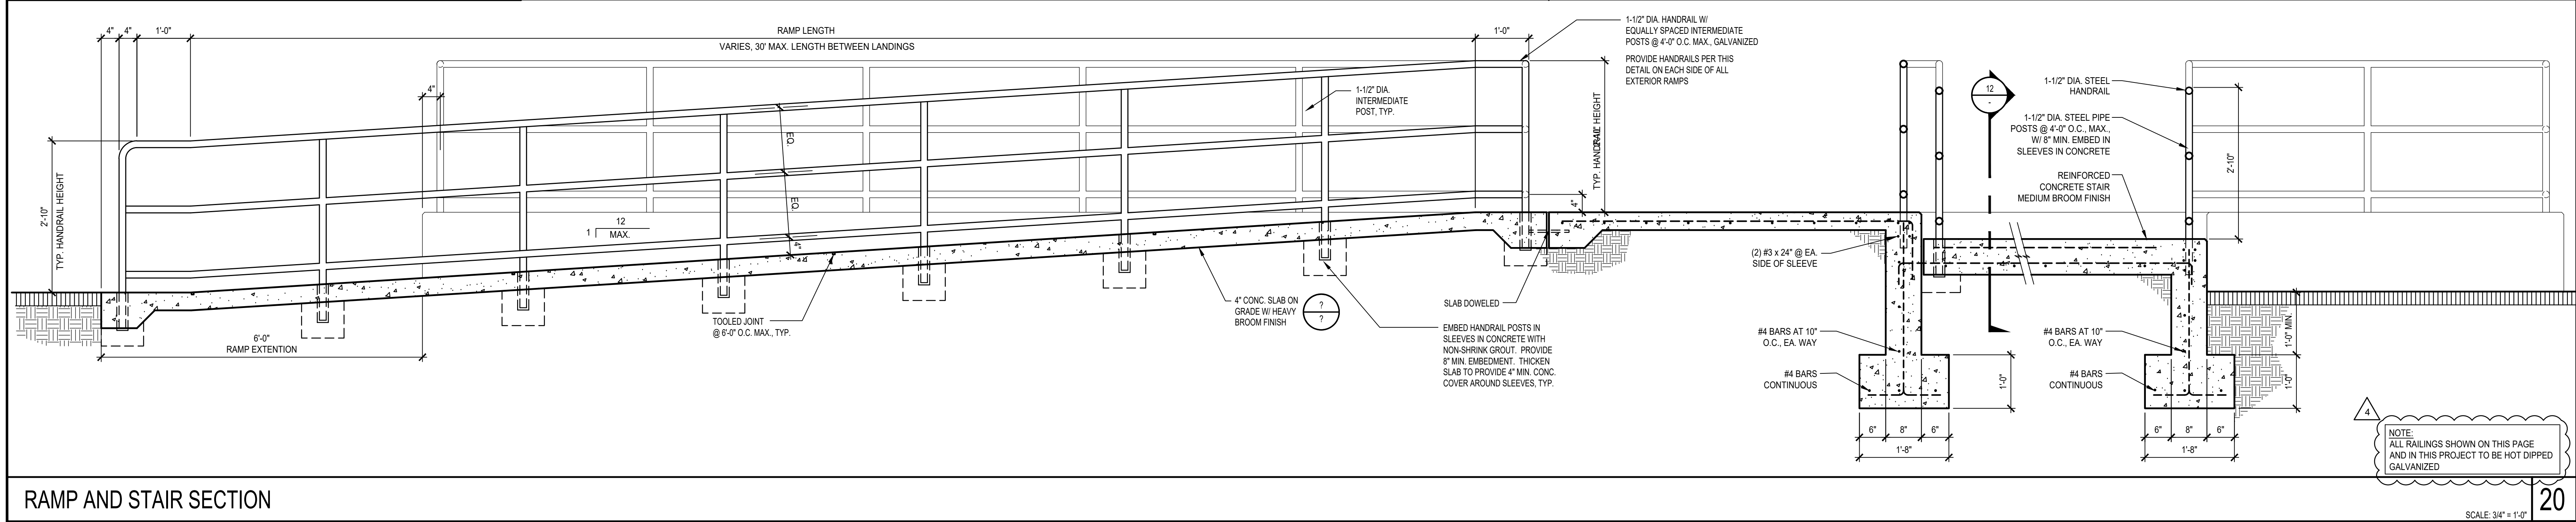
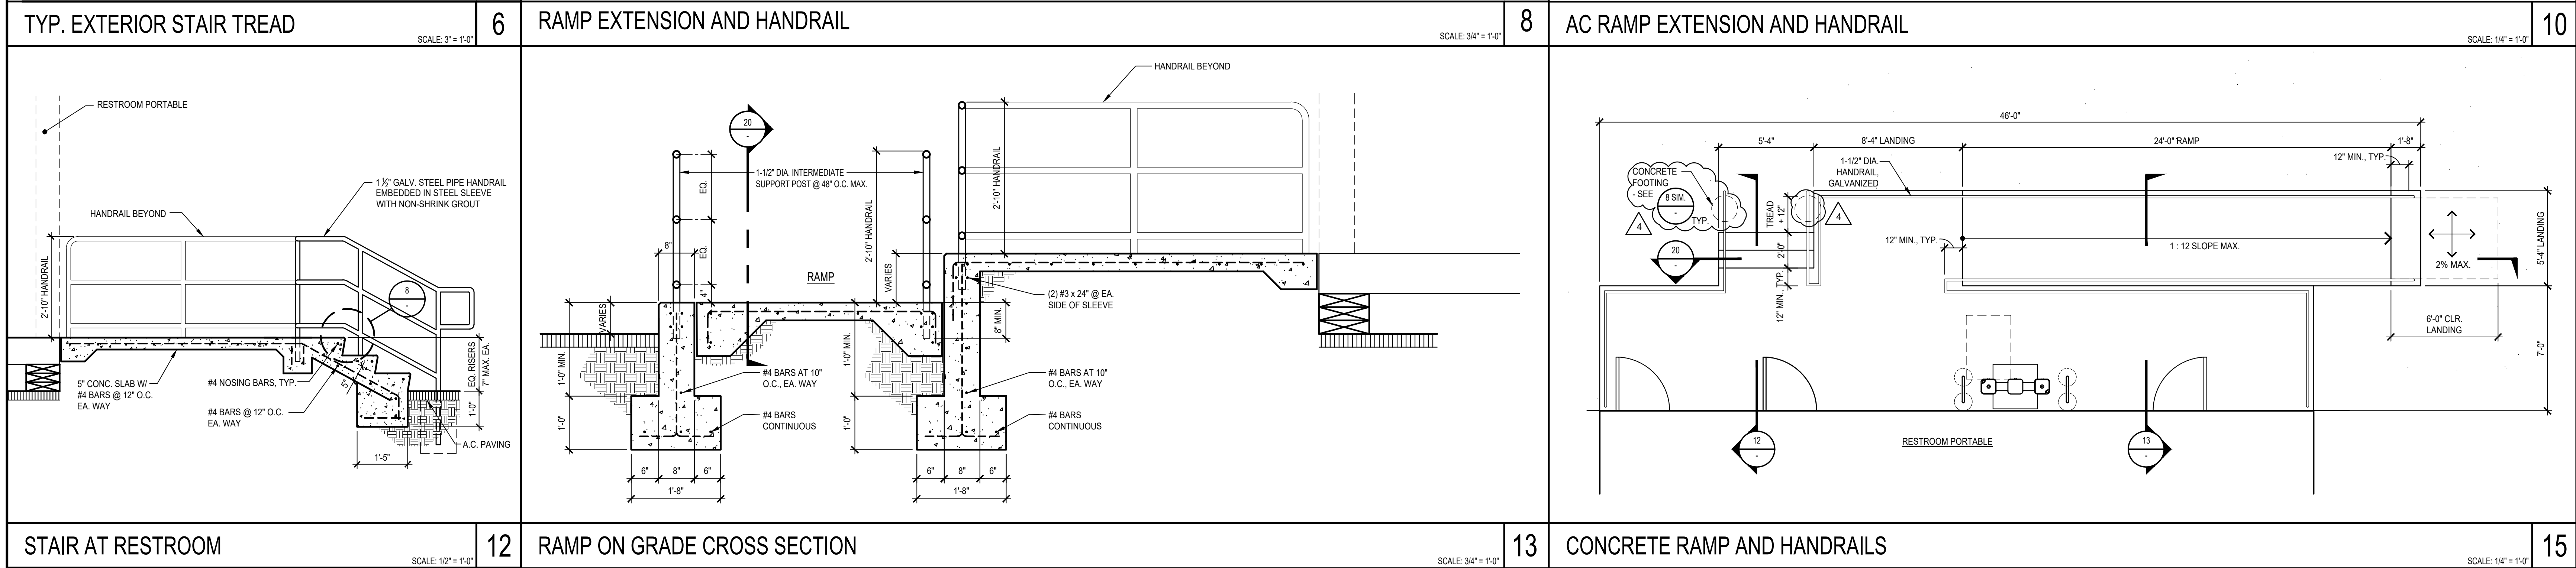
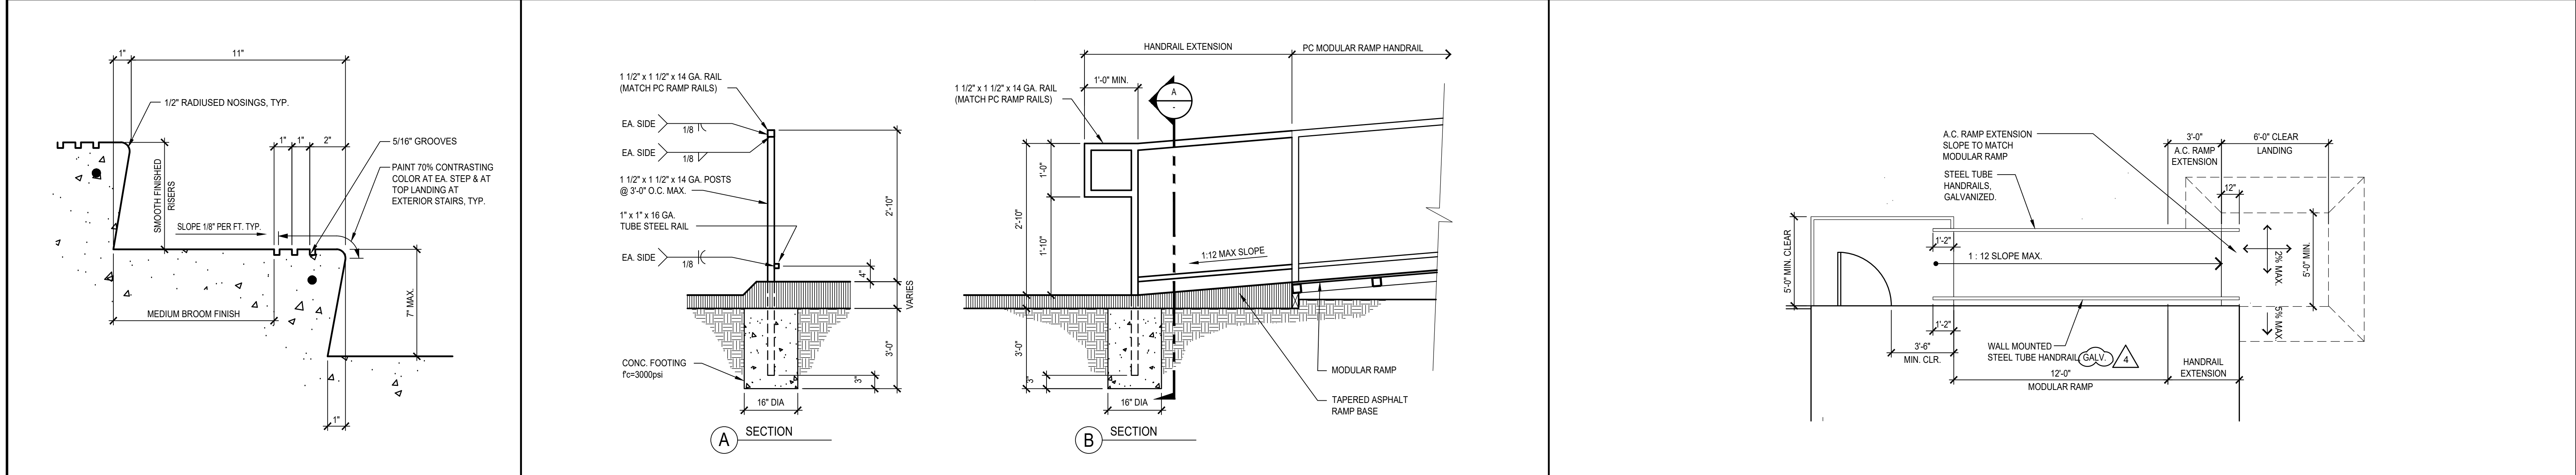
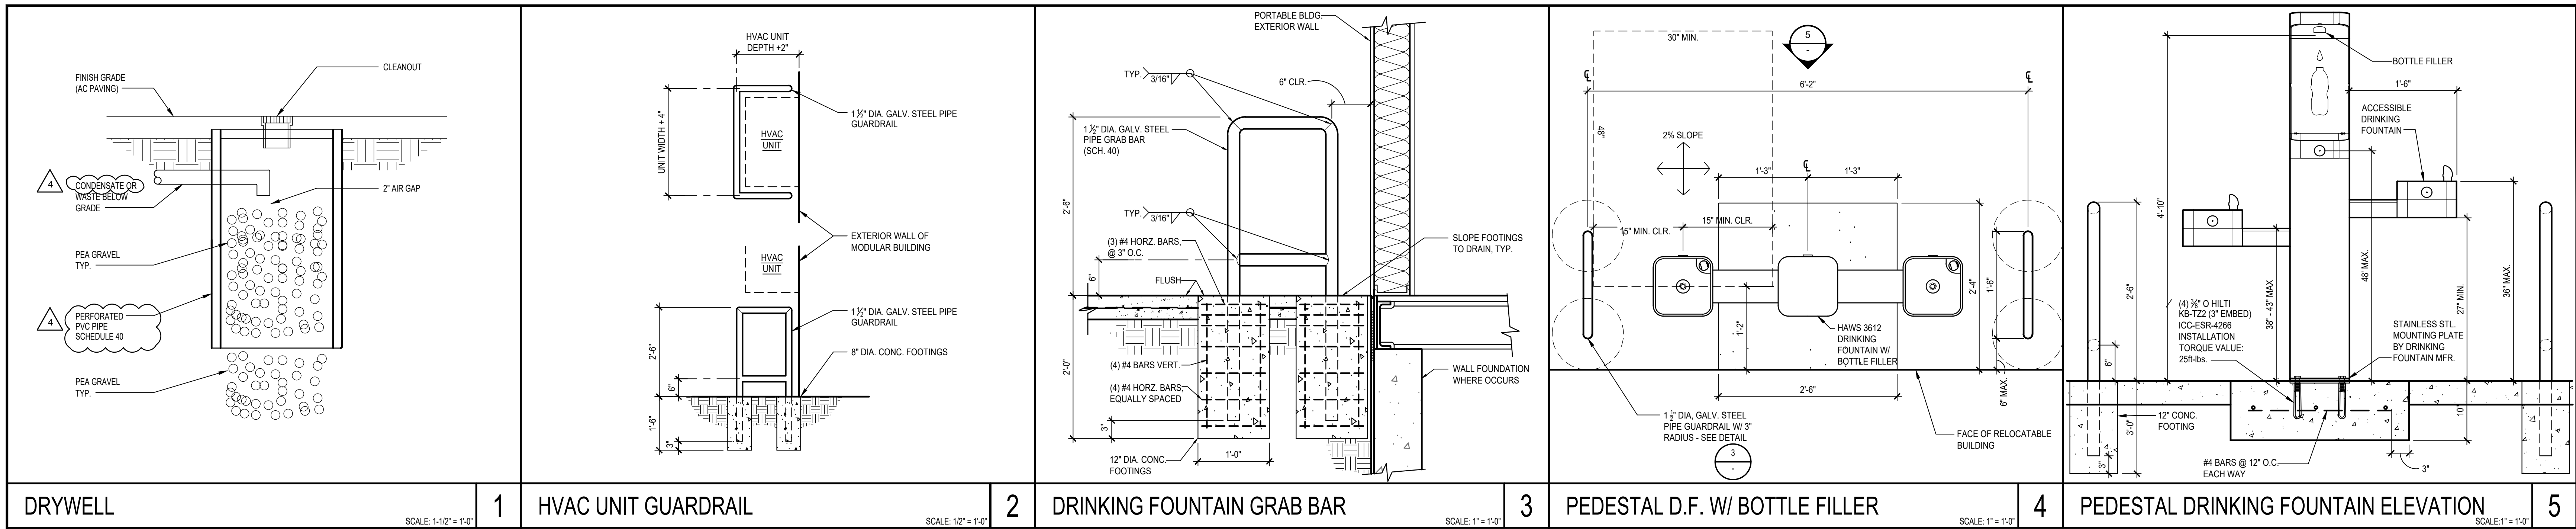
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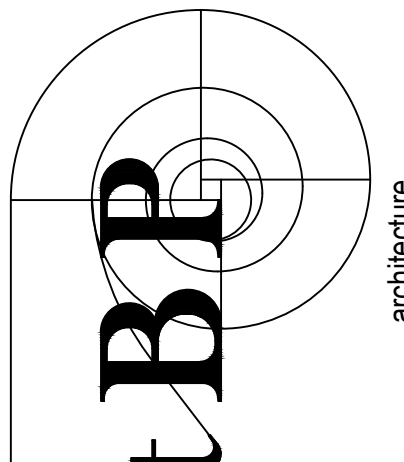
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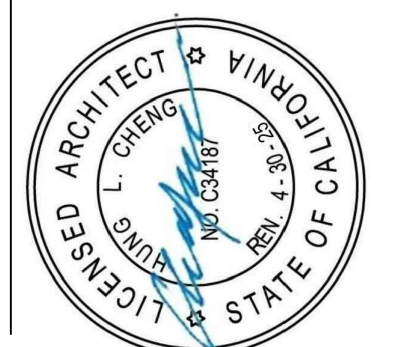
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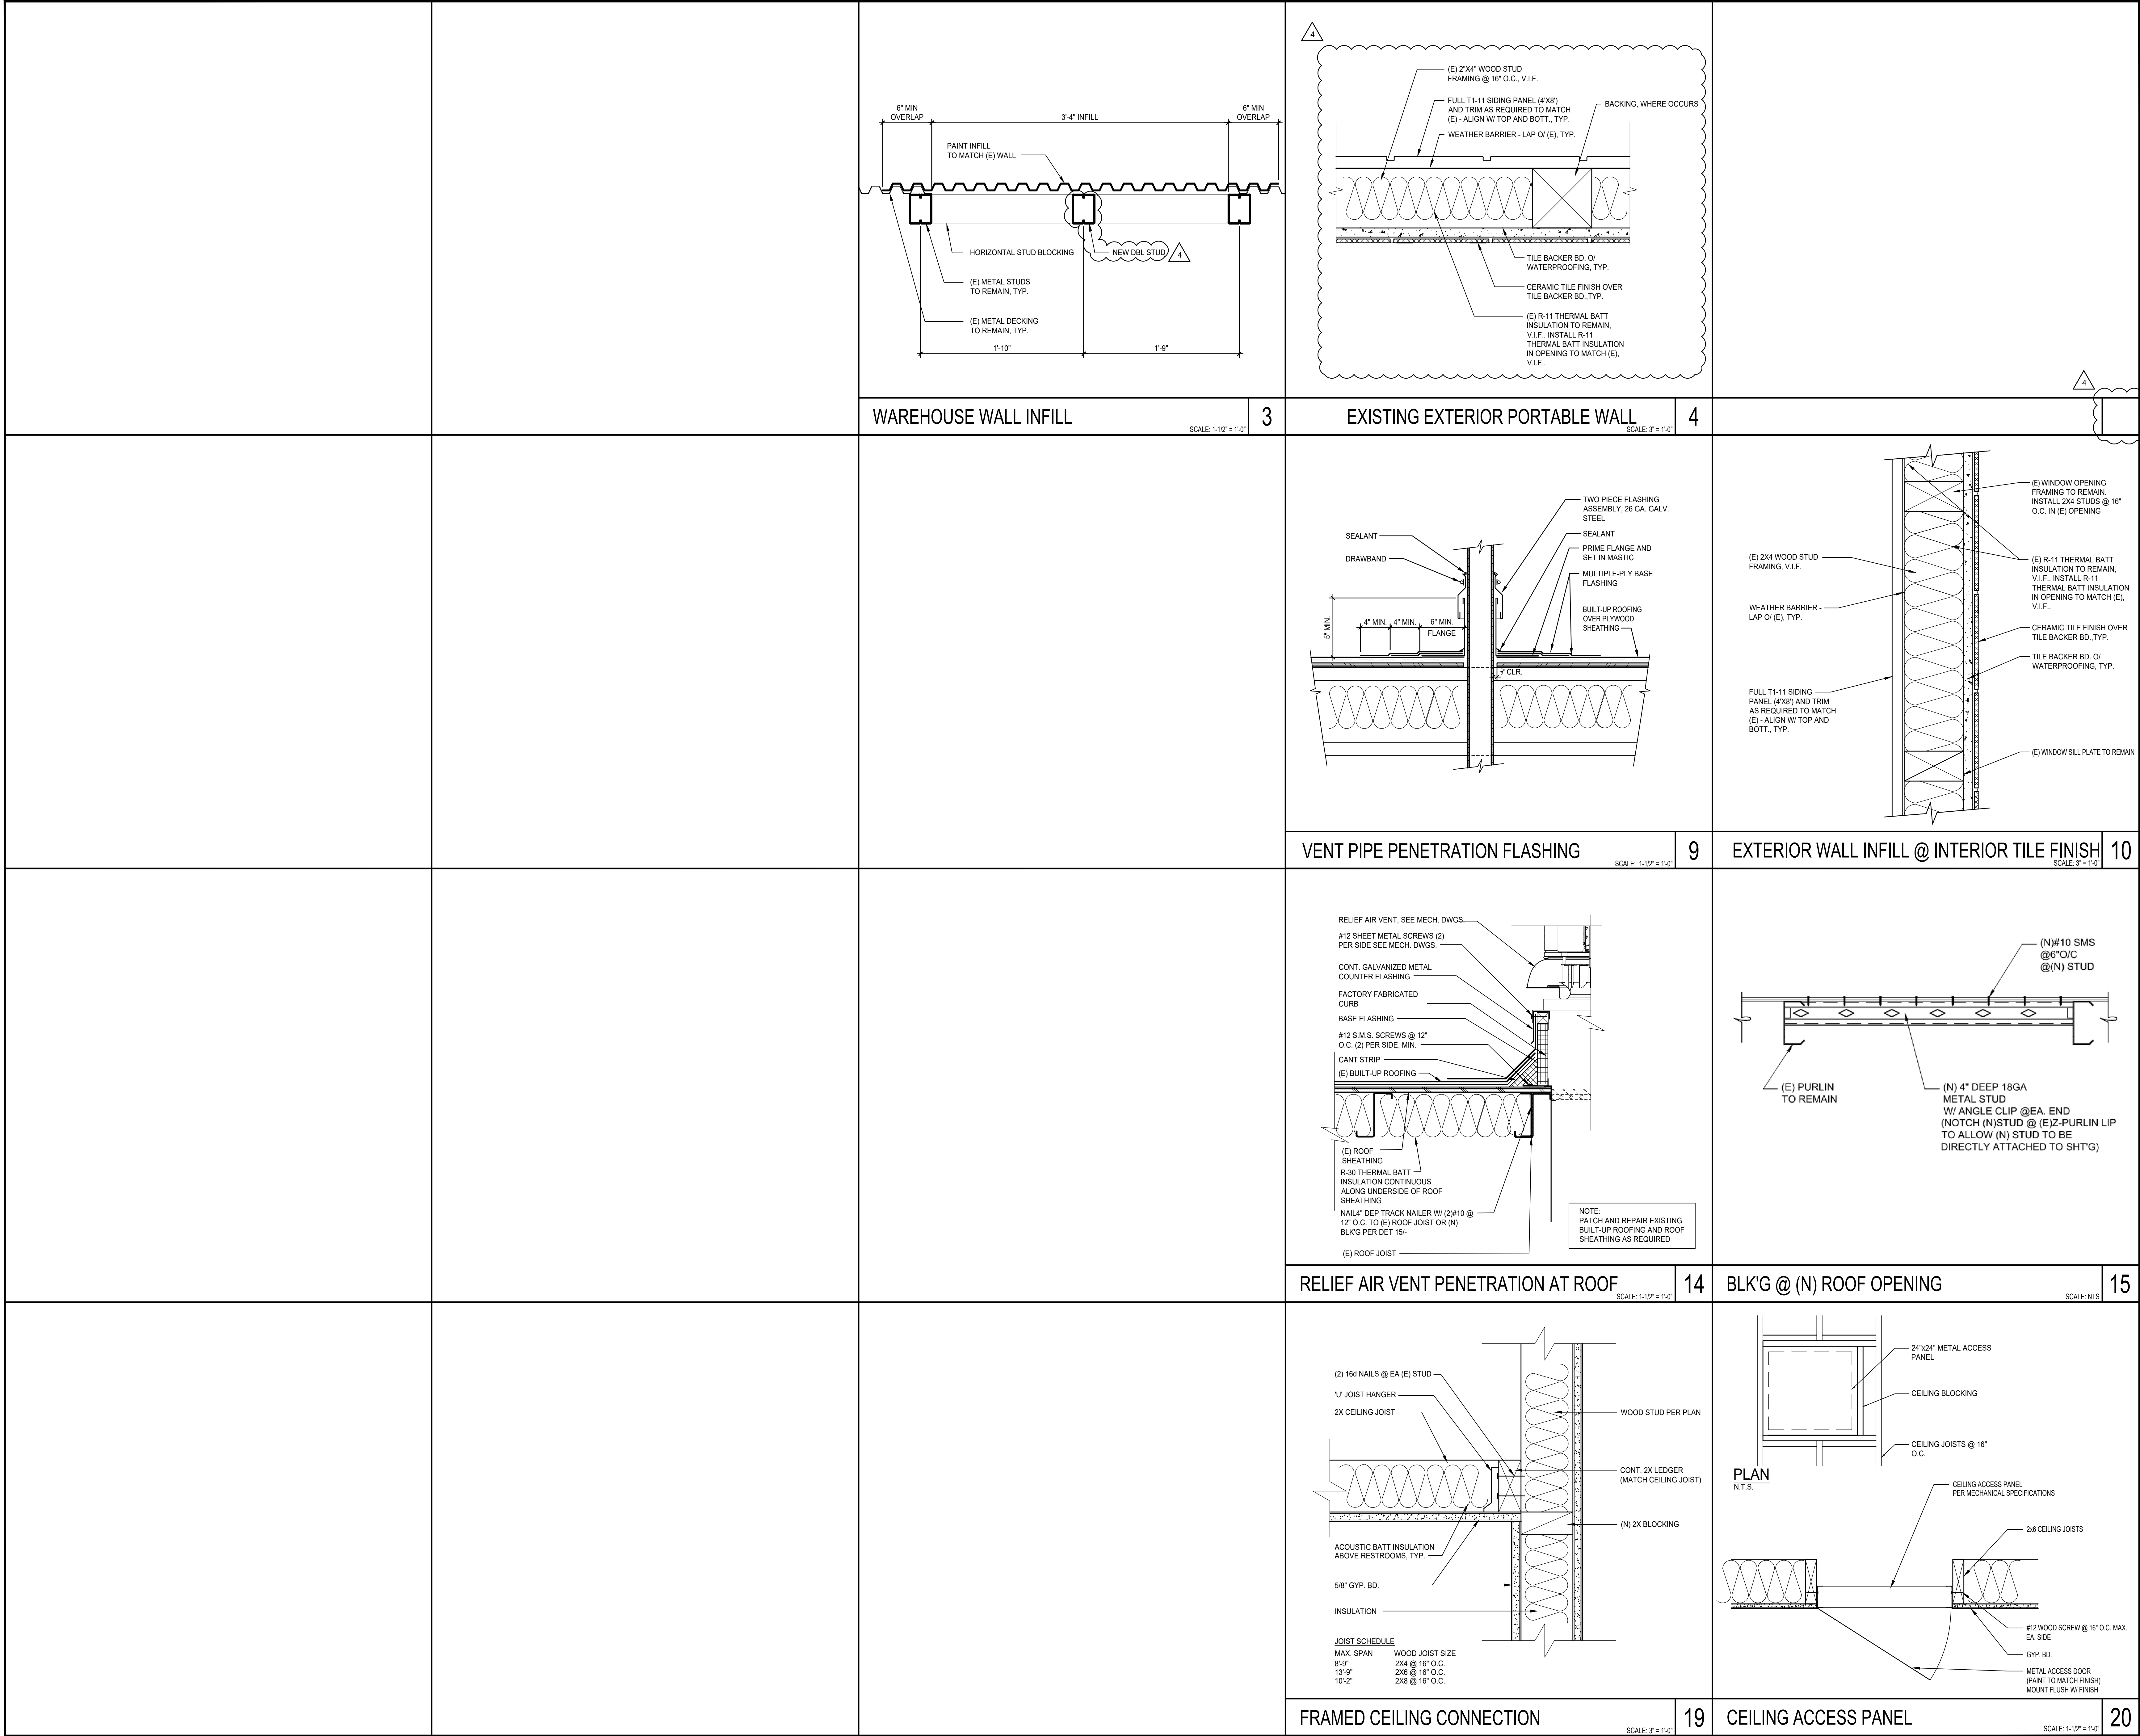
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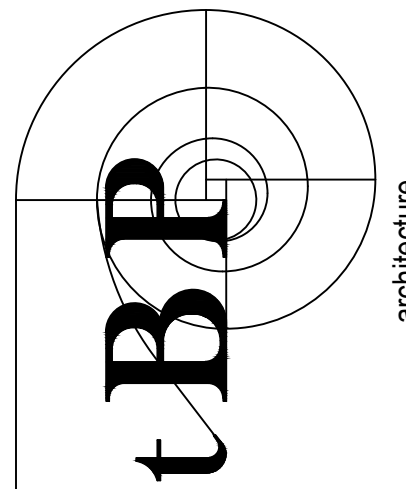
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SITE DETAILS AND
ENLARGED SITE PLANS

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
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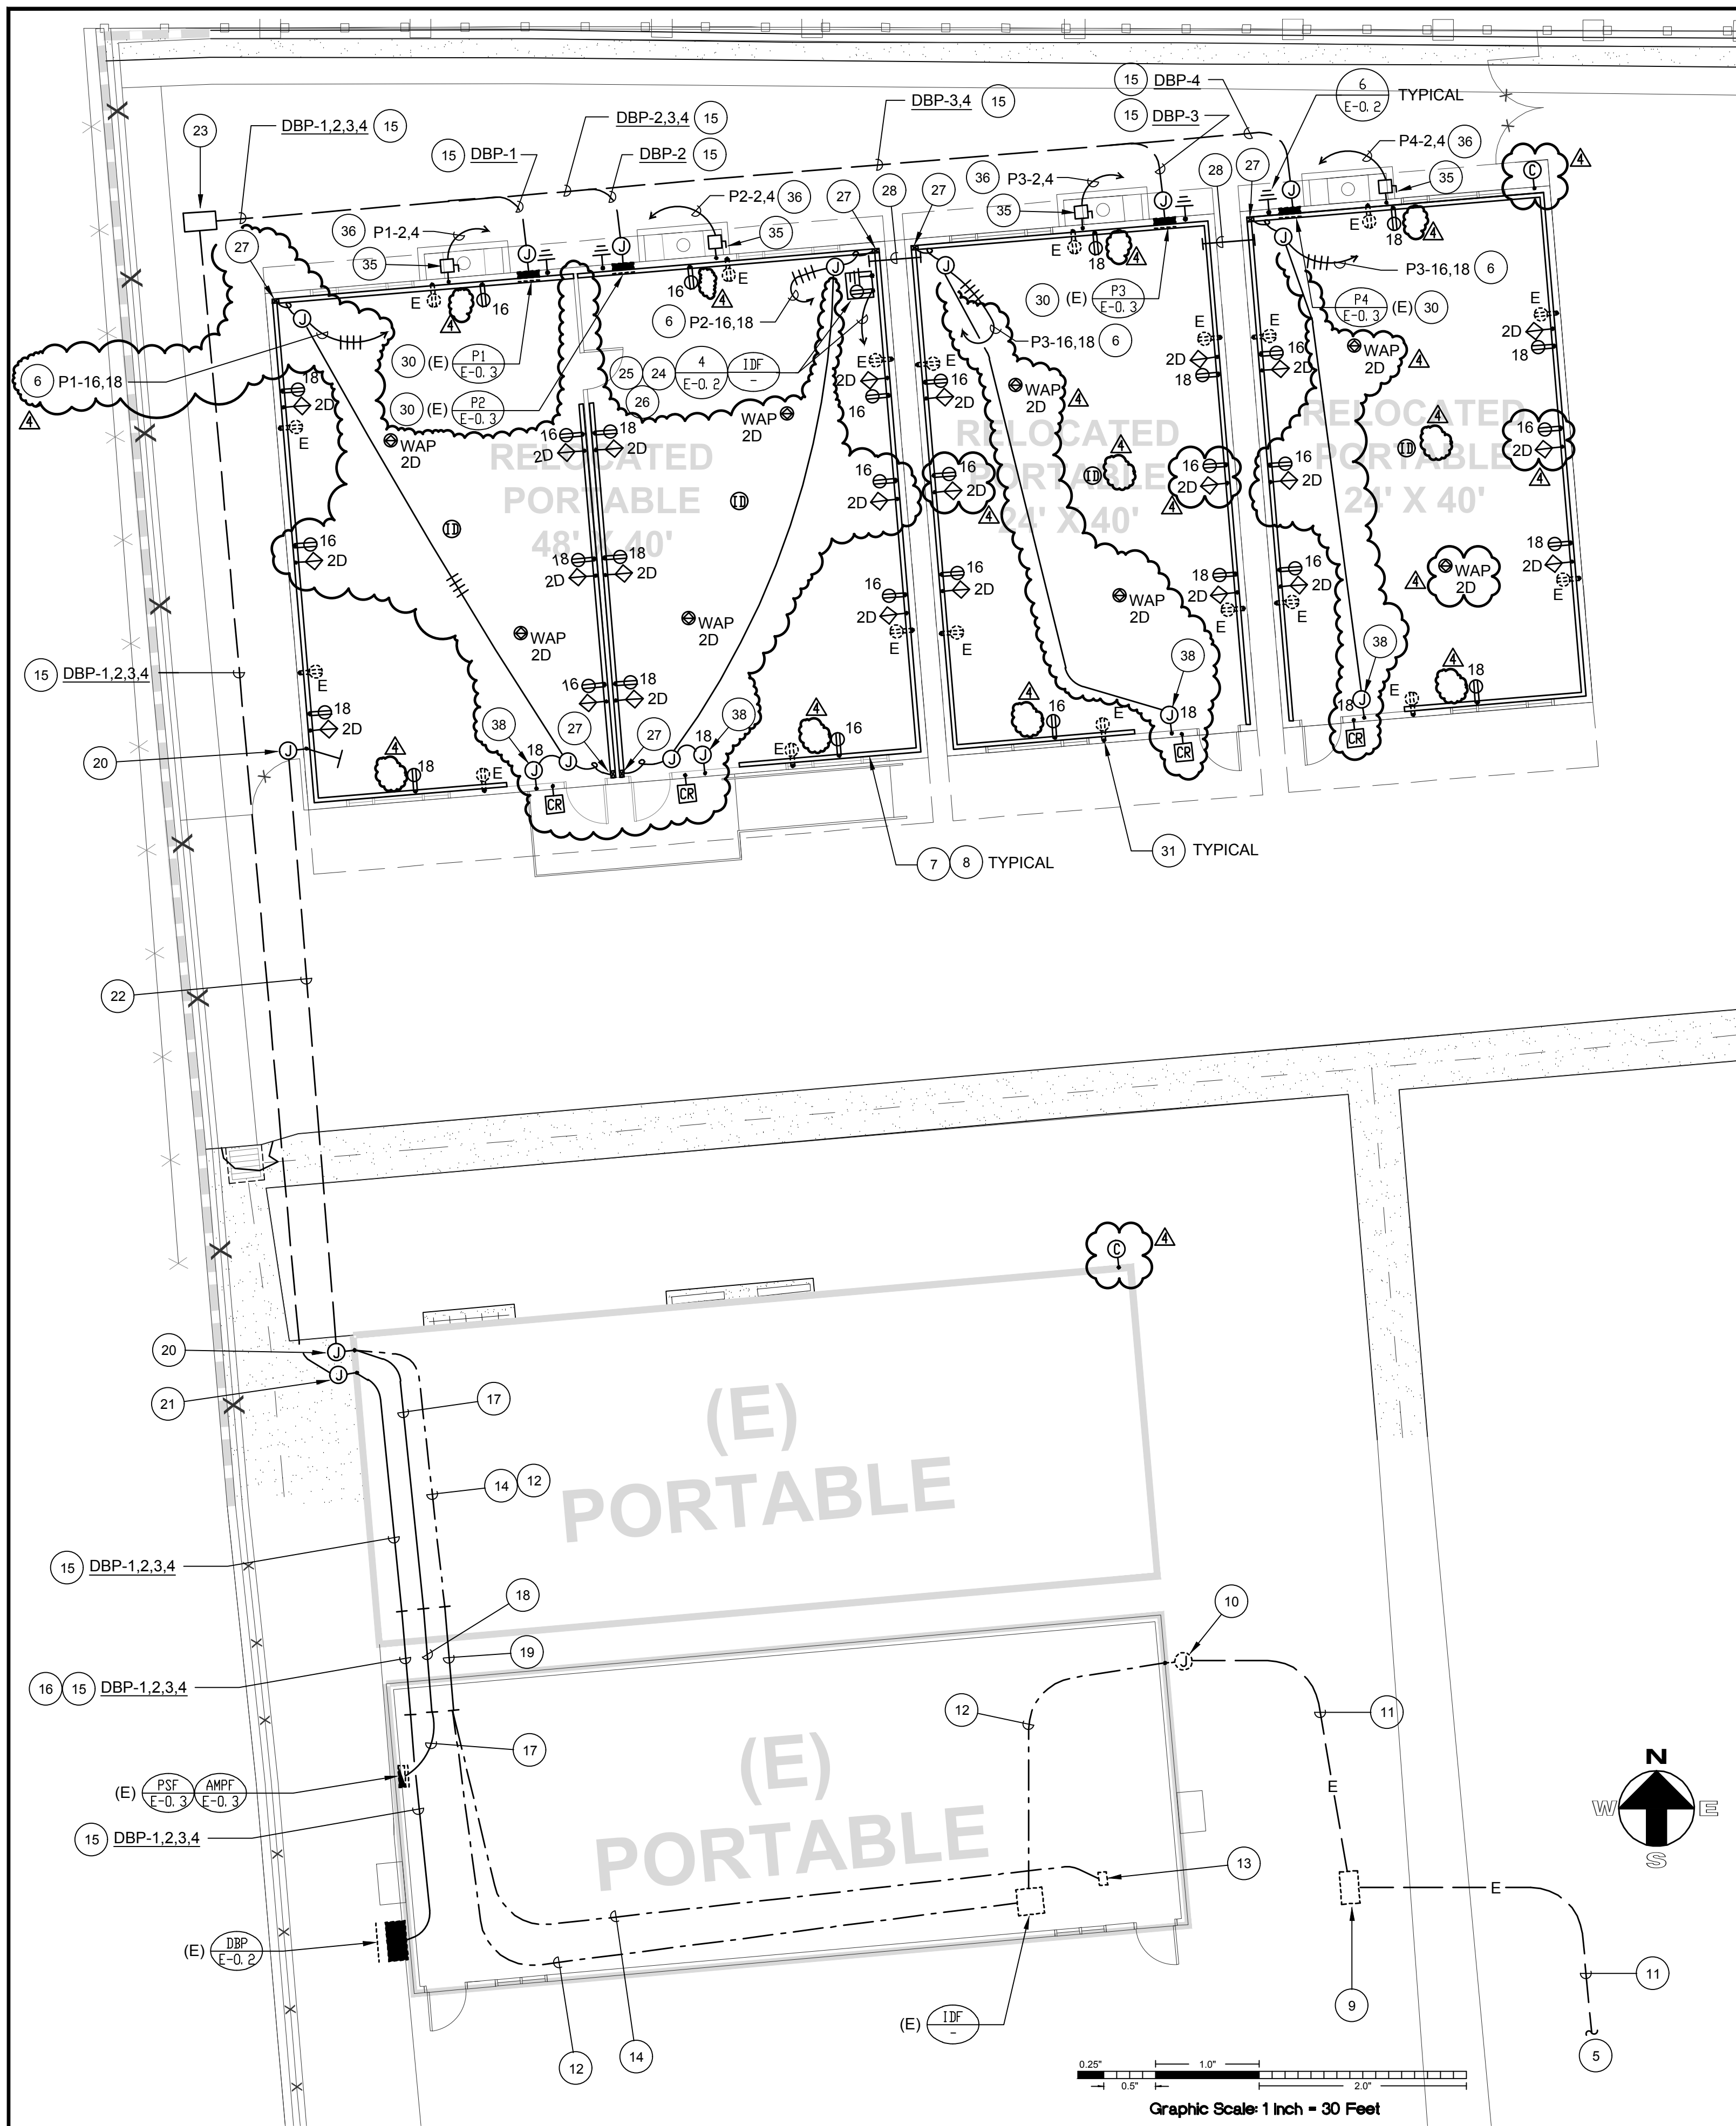
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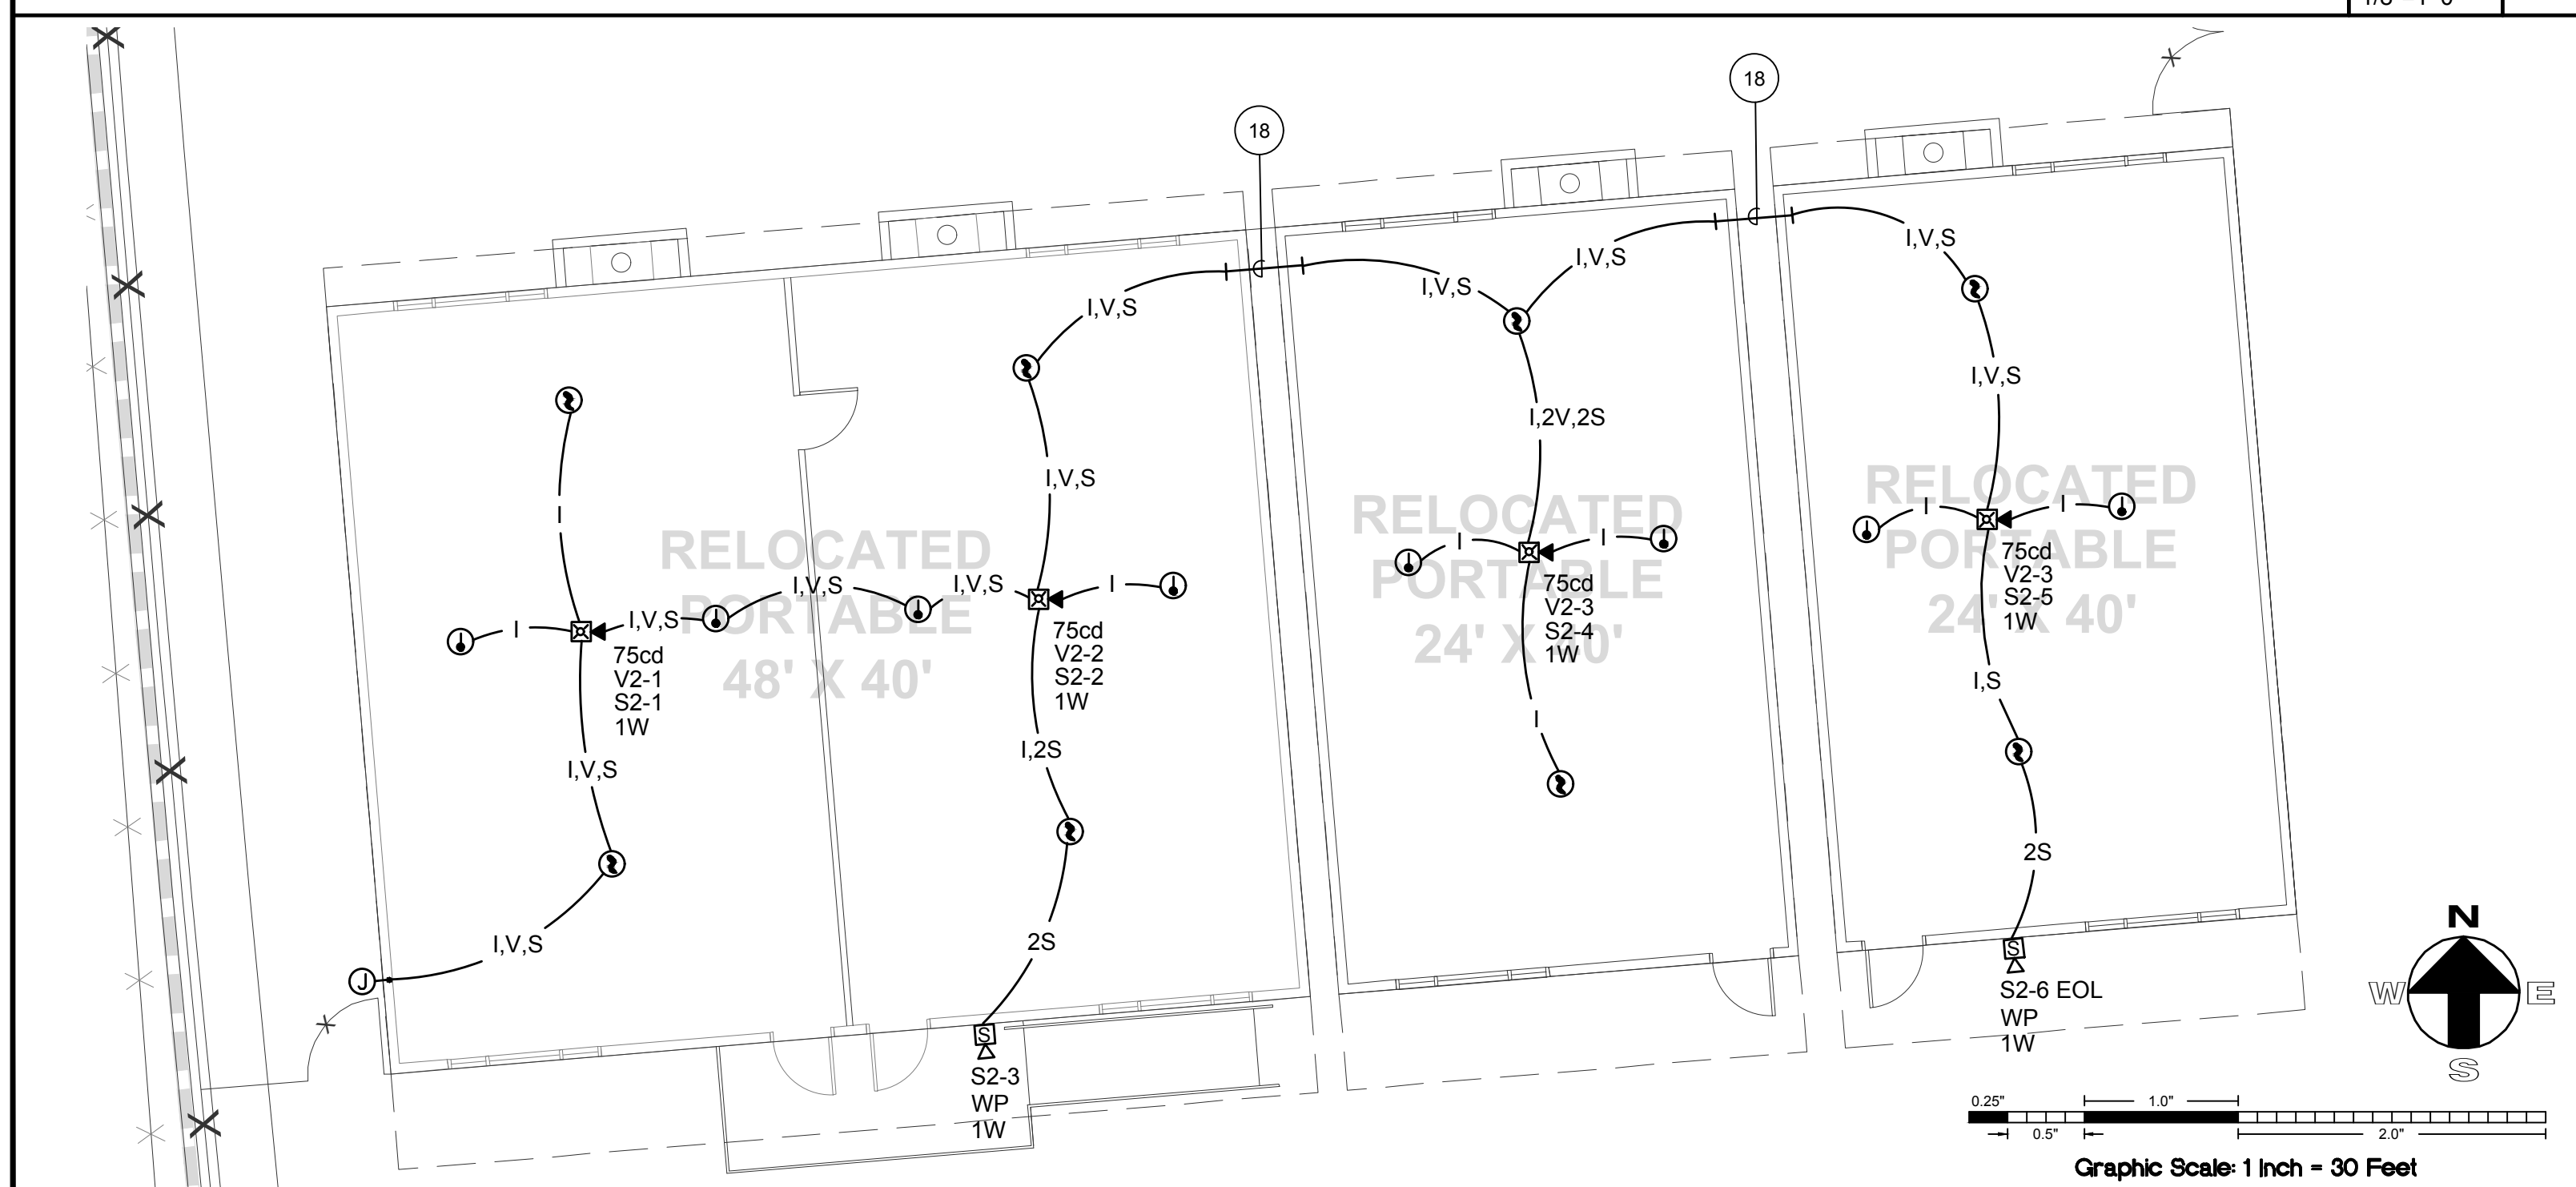
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CEILING AND ROOF DETAILS

drawing no.: 5.00
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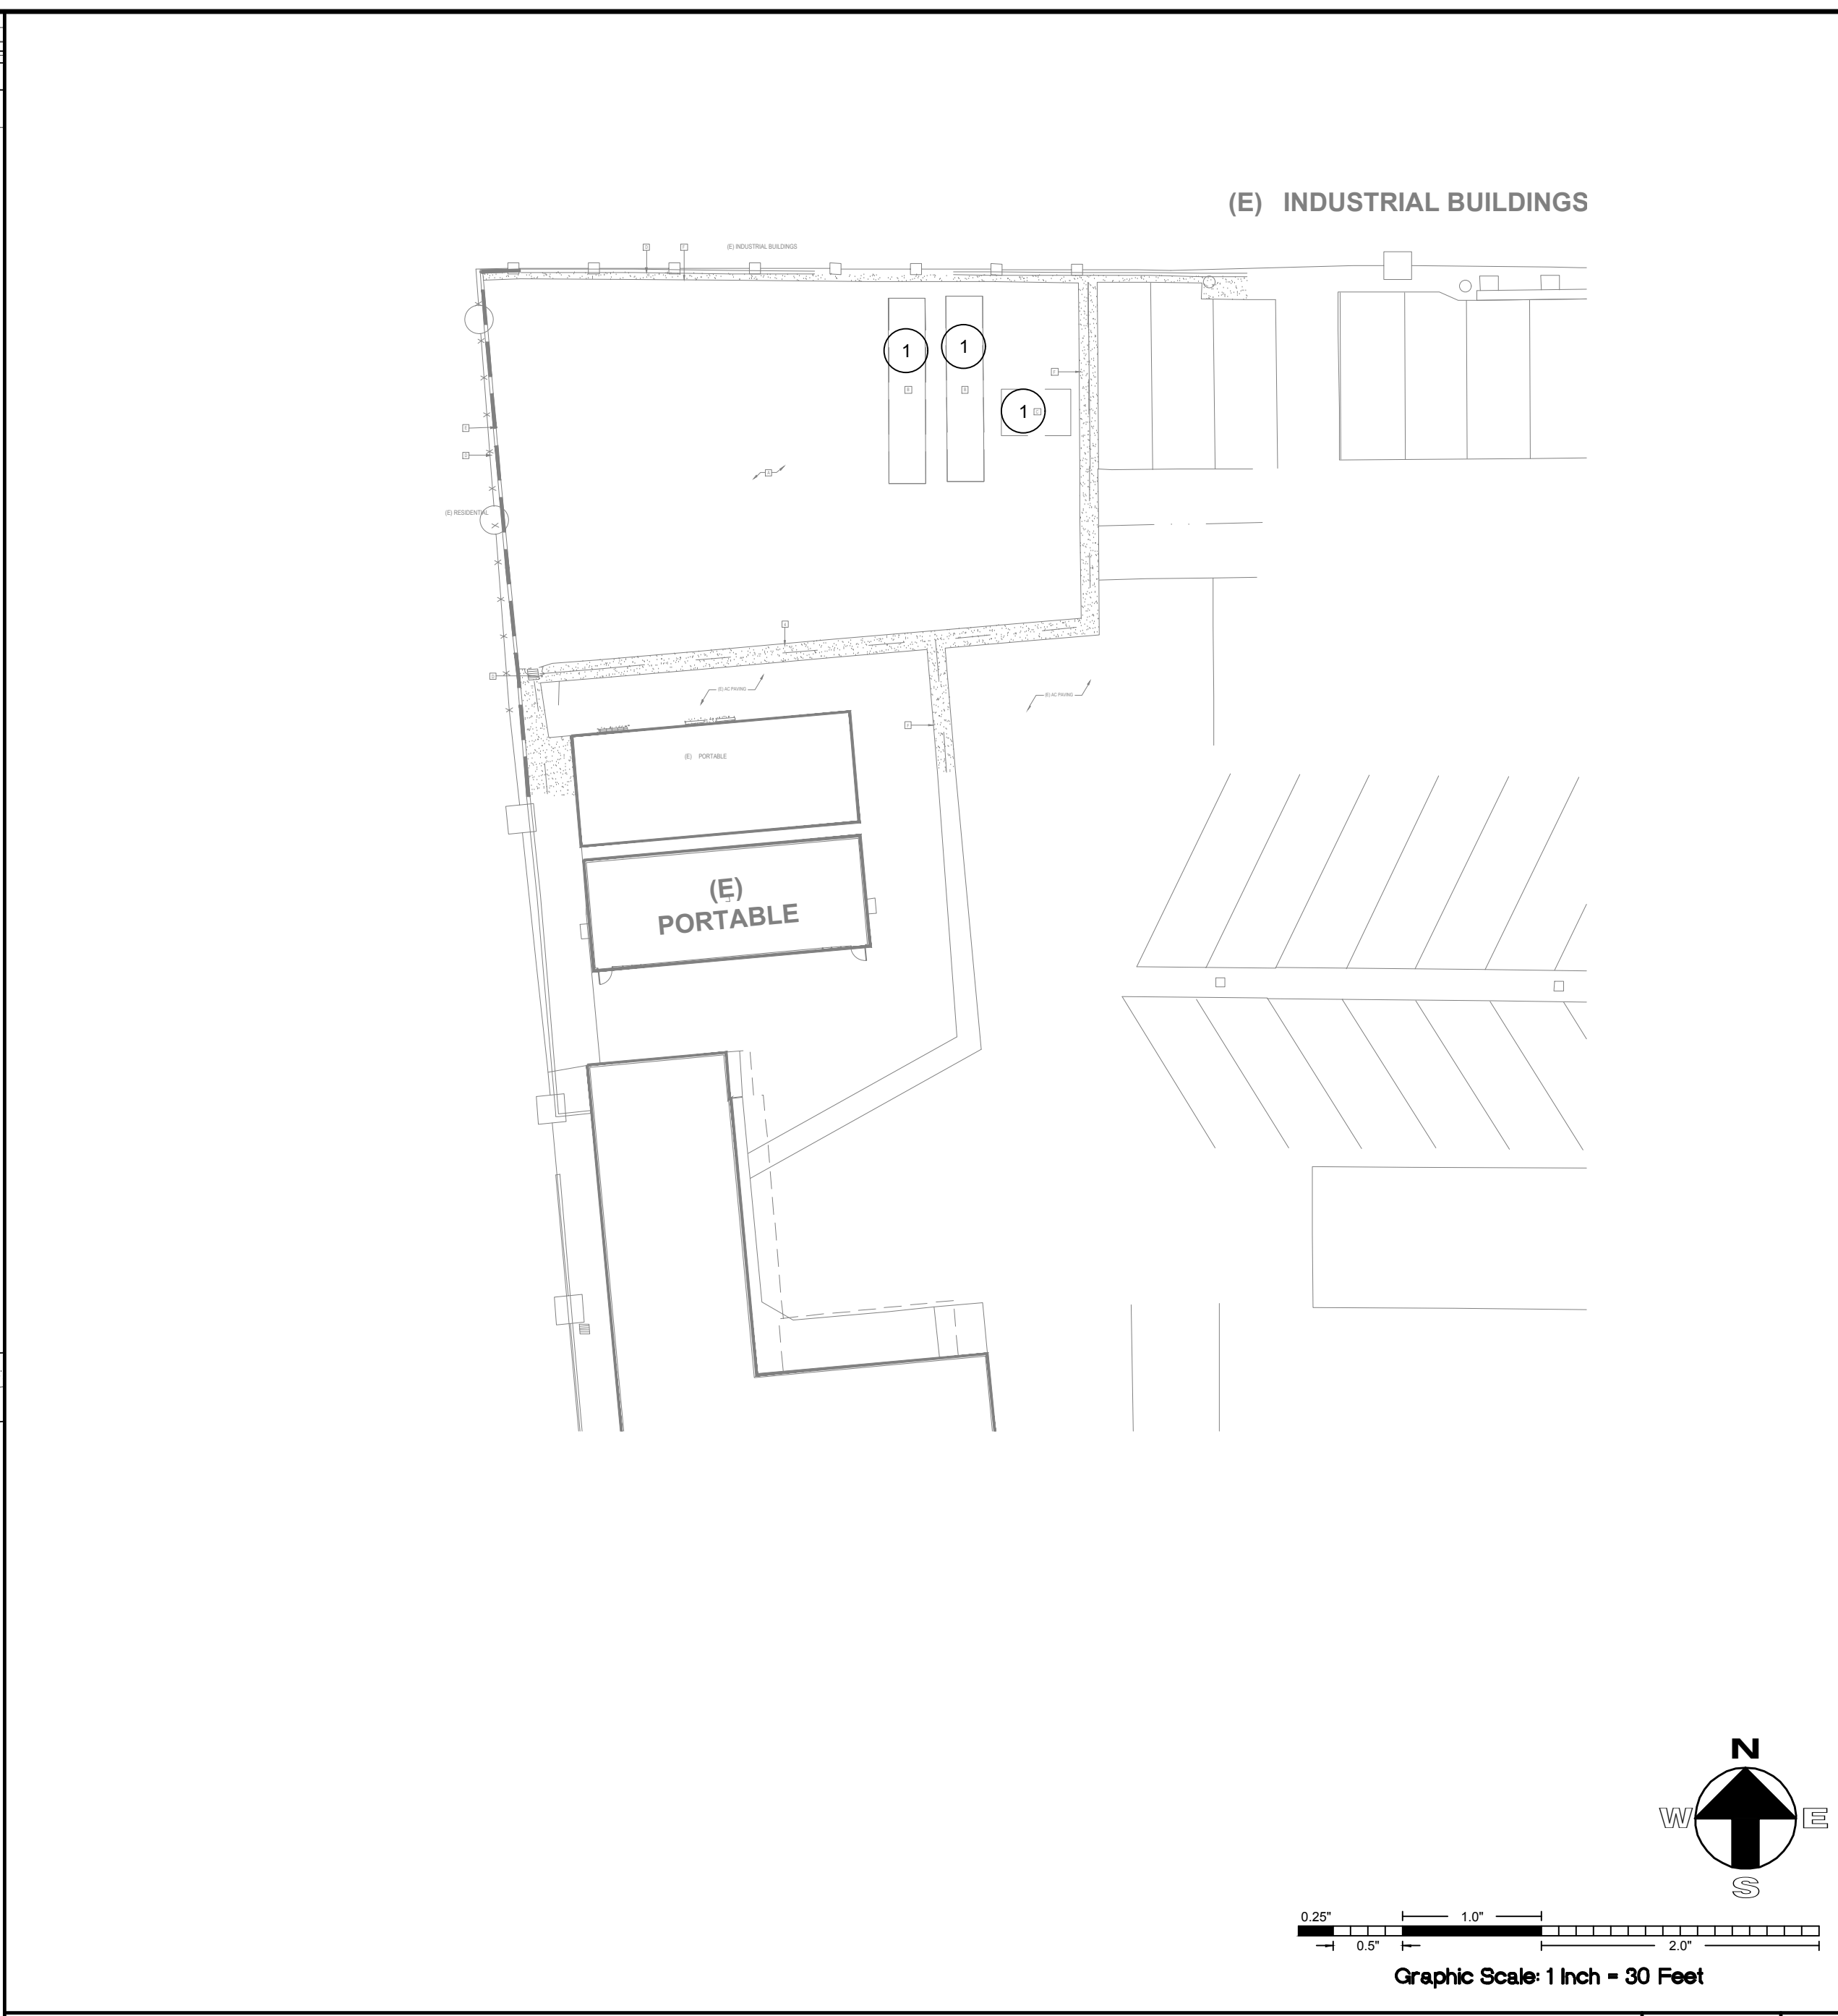
ELECTRICAL PLAN - RELOCATABLE CLASSROOM BUILDING

SCALE: 1/8"=1'-0" 2




FIRE ALARM PLAN - RELOCATABLE CLASSROOM BUILDING

SCALE: 1/8"=1'-0" 3




DEMOLITION SITE ELECTRICAL PLAN

SCALE: 1"=30'-0" 1

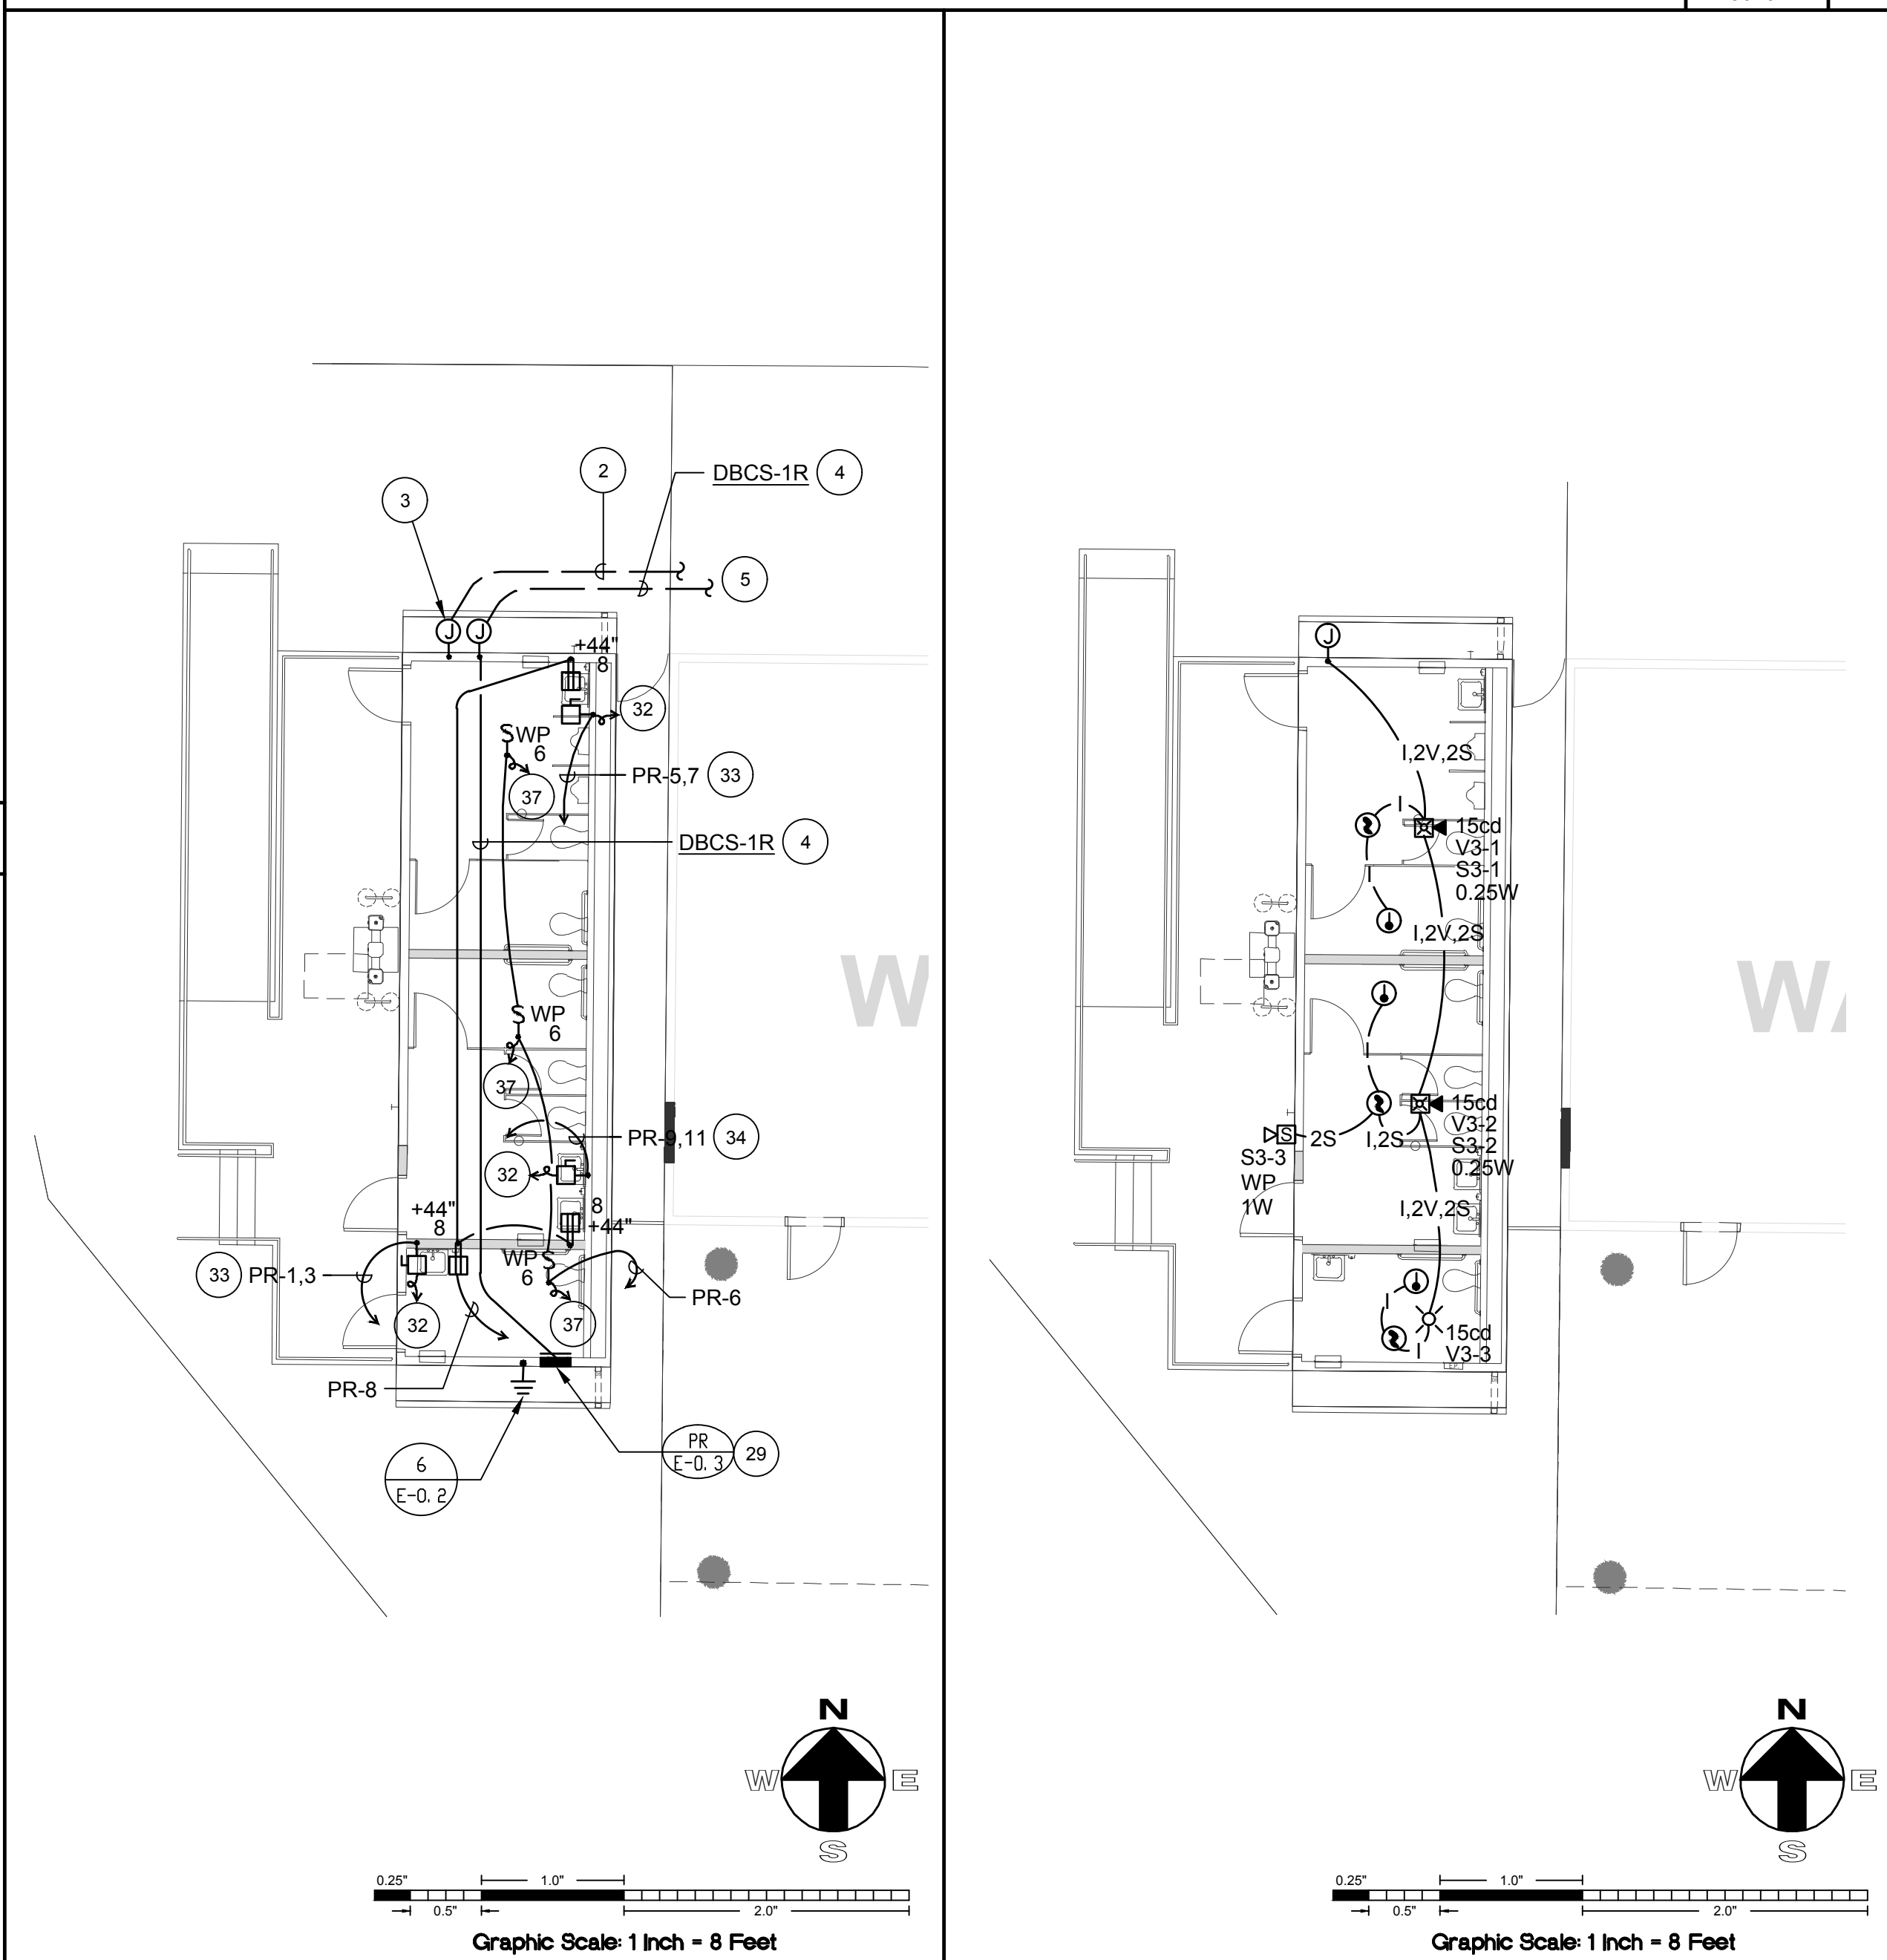

ELECTRICAL PLAN - RESTROOM

SCALE: 1/8"=1'-0" 4

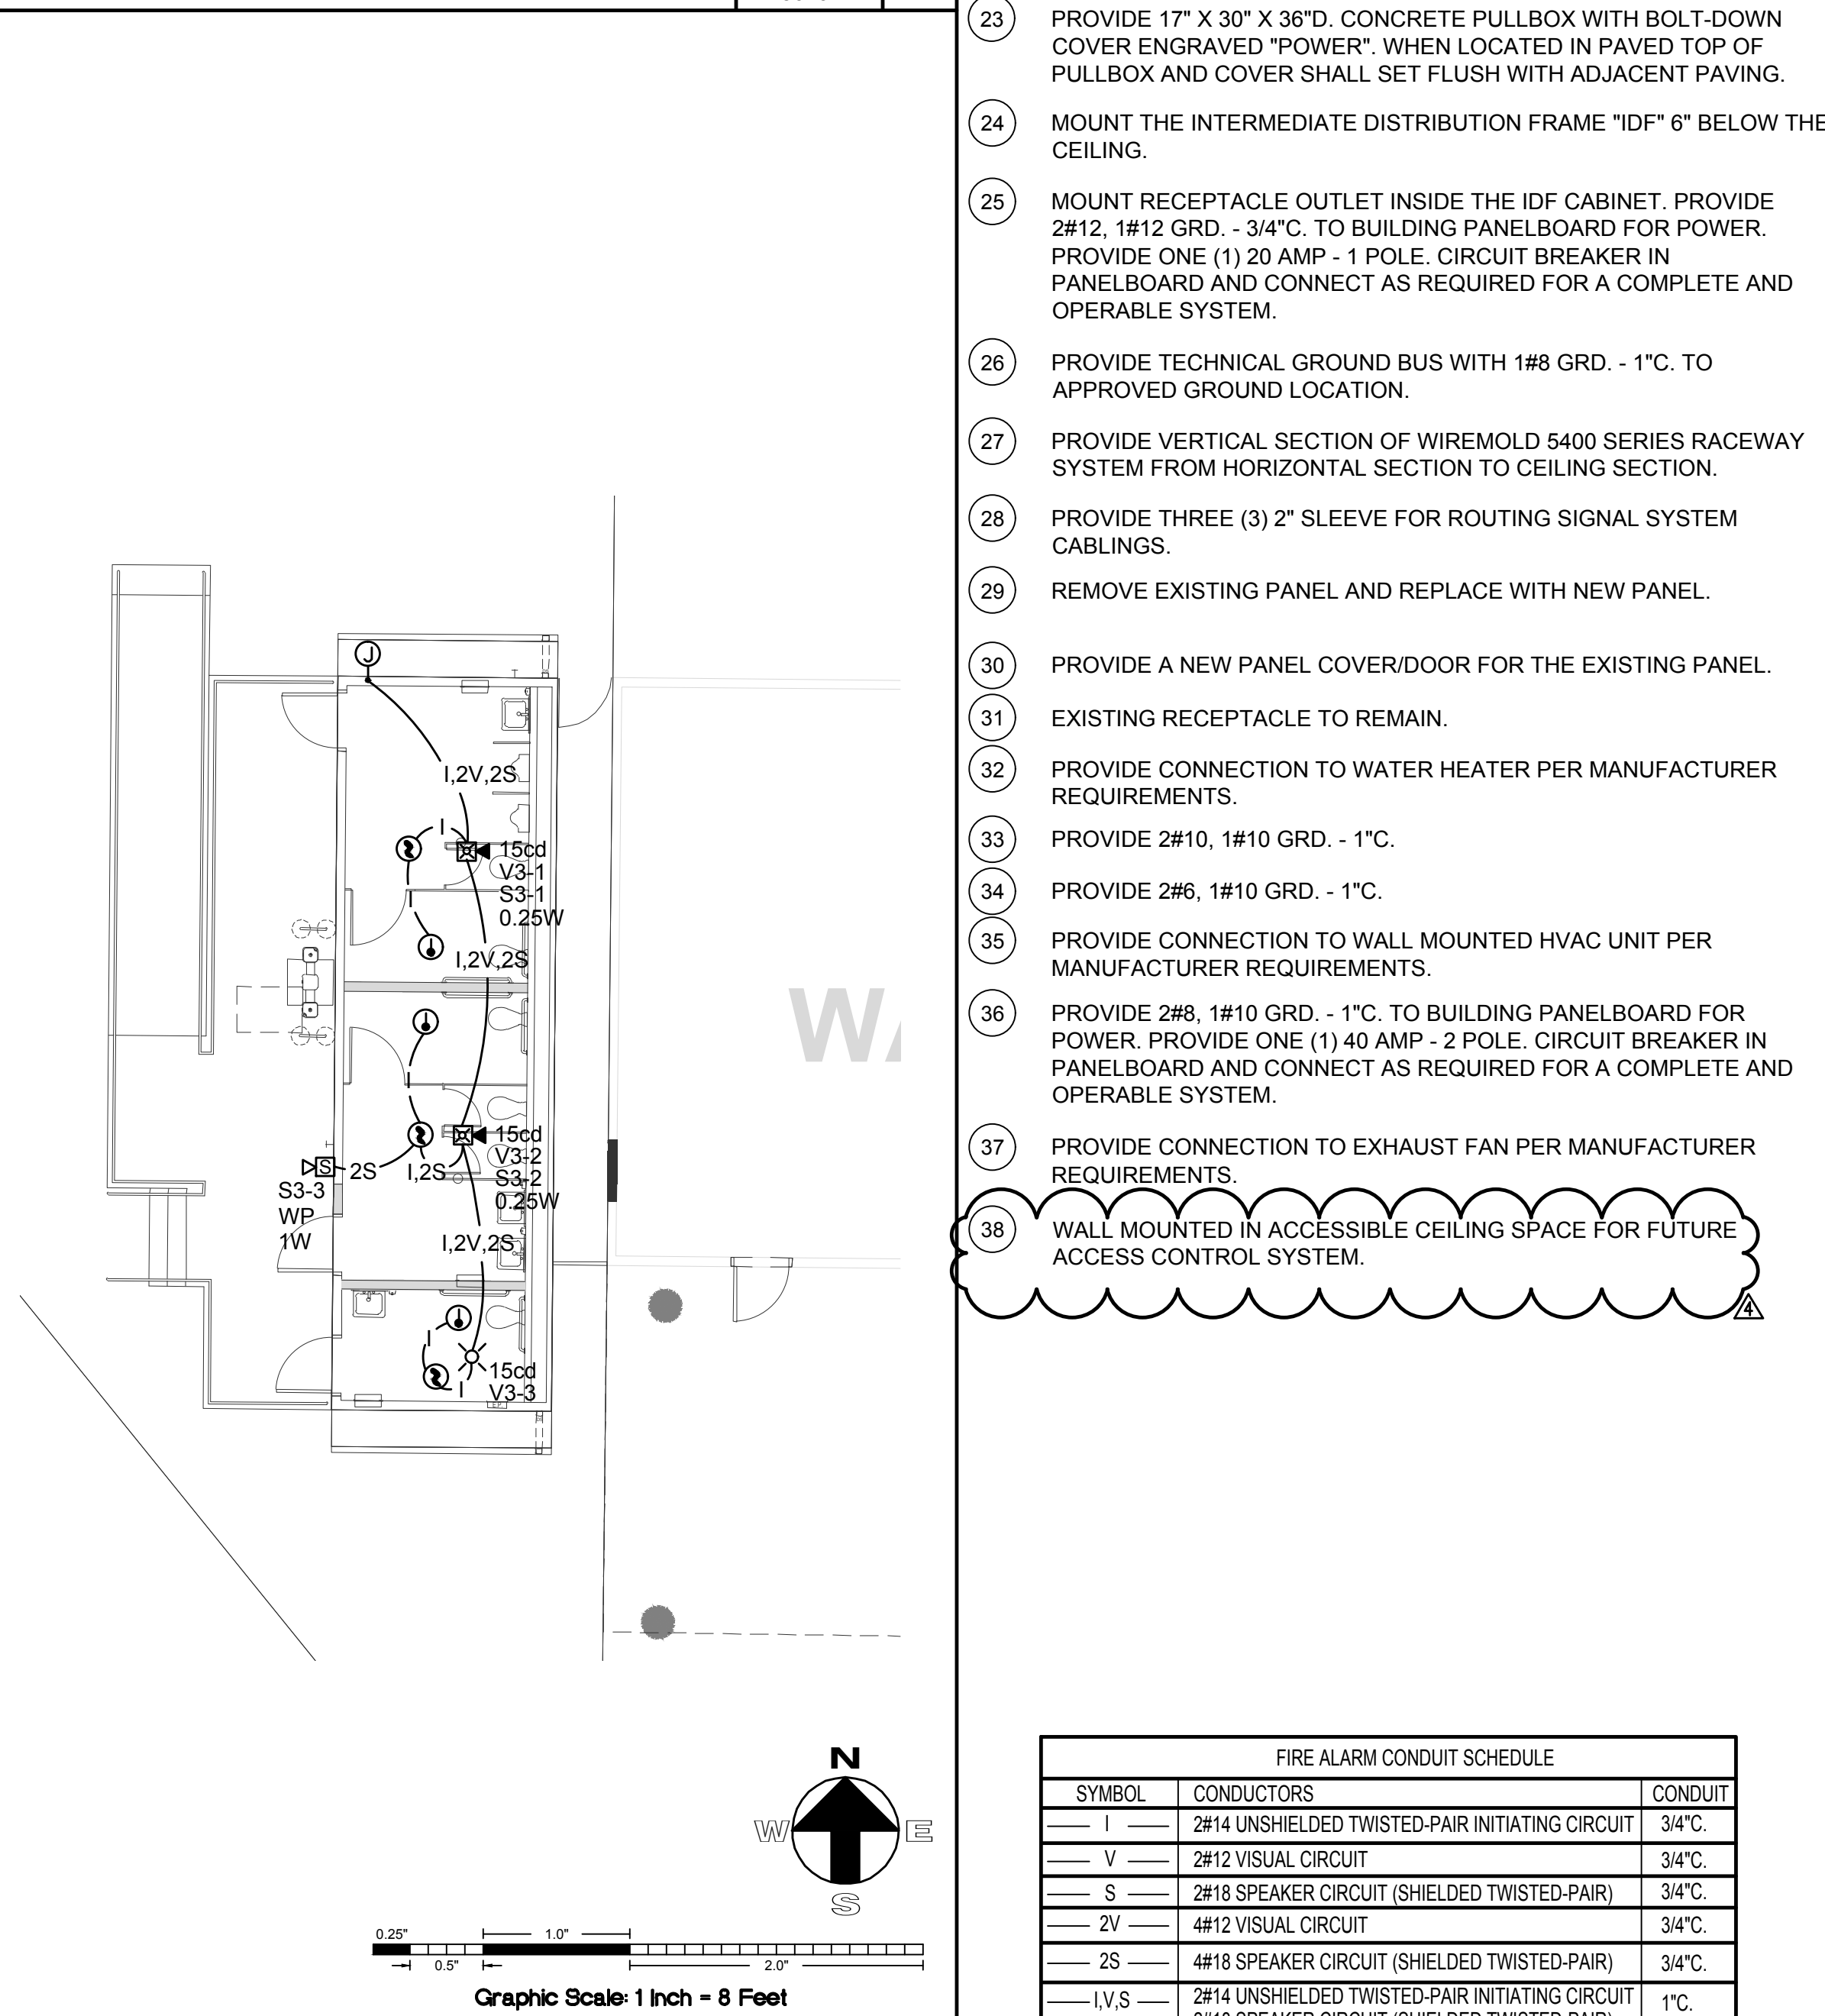

FIRE ALARM PLAN - RESTROOM

SCALE: 1/8"=1'-0" 5


PLAN NOTES

- DISCONNECT AND REMOVE ALL EXISTING ELECTRICAL AND TELECOMMUNICATION SYSTEMS FROM BUILDING TO BE DEMOLISHED. ALL ELECTRICAL EQUIPMENT, ETC. DEEMED SALVAGEABLE BY THE DISTRICT SHALL BE RETURNED TO THE DISTRICT AND DEPOSITED AT THE LOCATION AS DIRECTED BY THE DISTRICT.
- PROVIDE THE FOLLOWING SIGNAL SYSTEM CONDUITS WITH SPECIFIED SYSTEM CONDUCTORS:
1 1/2" (FIRE ALARM)
1 1/2" (SPARE)
- PROVIDE 8" X 8" X 6"D. WEATHERPROOF PULLBOX FOR FIRE ALARM. MOUNT PULLBOXES TO EXTERIOR WALL OF BUILDING. PROVIDE ENGRAVED PLATE FOR PULLBOX INDICATING SYSTEM.
- REFER TO SINGLE LINE DIAGRAM ON SHEET E-0.2 FOR FEEDER SIZE.
- REFER TO SITE ELECTRICAL PLAN DETAIL #1/E-1.0 FOR CONTINUATION.
- PROVIDE #12, #12 GRD. - 1" TO BUILDING PANELBOARD. PROVIDE TWO (2) 20A 1 POLE CIRCUIT BREAKERS IN AVAILABLE SPACE AND CONNECT AS REQUIRED.
- PROVIDE HORIZONTAL SECTION OF WIREMOLD 5400 SERIES RACEWAY SYSTEM SURFACE MOUNTED AT +24" AFF.
- PROVIDE WIREMOLD 5400 SERIES RACEWAY SYSTEM AS SHOWN COMPLETE WITH ALL NECESSARY ACCESSORIES SUCH AS END FITTINGS, ELBOWS, COUPLINGS, DEVICES PLATES, OUTLETS, ETC.
- EXISTING SIGNAL PULLBOX TO REMAIN.
- EXISTING WALL MOUNTED SIGNAL PULLBOX TO REMAIN.
- PROVIDE 12 STRAND SINGLE MODE AND 12 STRAND MULTI-MODE FIBER OPTIC CABLE THROUGH THE EXISTING COMPUTER/DATA NETWORK CONDUIT SYSTEM.
- PROVIDE 12 STRAND SINGLE MODE AND 12 STRAND MULTI-MODE FIBER OPTIC CABLE. SUSPEND CABLES ABOVE ACCESSIBLE CEILING SPACE.
- EXISTING INTRUSION DETECTION KEYPAD TO REMAIN. INTERCEPT EXISTING INTRUSION DETECTION CABLING IN EXISTING J-BOX AND EXTEND WITH NEW CABLING AS INDICATED.
- PROVIDE NEW INTRUSION DETECTION CABLING PER MANUFACTURER REQUIREMENT. SUSPEND CABLES ABOVE ACCESSIBLE CEILING SPACE.
- REFER TO SINGLE LINE DIAGRAM DETAIL #1/E-0.2 FOR FEEDER SIZE.
- PROVIDE FOUR (4) 2" SLEEVES FOR ROUTING POWER SYSTEM CONDUCTORS.
- PROVIDE 2#16 TSP, 2#12 NOTIFICATION, 2#16TP - 1" C.
- PROVIDE 1" SLEEVE FOR ROUTING FIRE ALARM SYSTEM CABLINGS.
- PROVIDE 2" SLEEVE FOR ROUTING DATA FIBER OPTIC AND 1" SLEEVE FOR ROUTING INTRUSION DETECTION SYSTEM CABLINGS.
- PROVIDE THREE (3) 8" X 8" X 6"D. WEATHERPROOF PULLBOXES FOR DATA, INTRUSION DETECTION AND FIRE ALARM. MOUNT PULLBOXES TO EXTERIOR WALL OF BUILDING. PROVIDE ENGRAVED PLATE FOR EACH PULLBOX INDICATING SYSTEM.
- PROVIDE 18" X 18" X 6"D. WEATHERPROOF PULLBOXES FOR POWER. MOUNT PULLBOX TO EXTERIOR WALL OF BUILDING. PROVIDE ENGRAVED PLATE FOR EACH PULLBOX INDICATING SYSTEM.
- PROVIDE THE FOLLOWING SIGNAL SYSTEM CONDUITS WITH SPECIFIED SYSTEM CONDUCTORS:
1" (FIRE ALARM)
1" (INTRUSION DETECTION)
2" (DATA - 12 STRAND SM AND 12 STRAND MM FIBER OPTIC)


- PROVIDE 17" X 30" X 36"D. CONCRETE PULLBOX WITH BOLT-DOWN COVER ENGRAVED "POWER". WHEN LOCATED IN PAVED TOP OF PULLBOX AND COVER SHALL SET FLUSH WITH ADJACENT PAVING.
- MOUNT THE INTERMEDIATE DISTRIBUTION FRAME "IDF" 6" BELOW THE CEILING.
- MOUNT RECEPTACLE OUTLET INSIDE THE IDF CABINET. PROVIDE #12, #12 GRD. - 3/4" TO BUILDING PANELBOARD FOR POWER. PROVIDE ONE (1) 20 AMP - 1 POLE. CIRCUIT BREAKER IN PANELBOARD AND CONNECT AS REQUIRED FOR A COMPLETE AND OPERABLE SYSTEM.
- PROVIDE TECHNICAL GROUND BUS WITH #6 GRD. - 1" C. TO APPROVED GROUND LOCATION.
- PROVIDE VERTICAL SECTION OF WIREMOLD 5400 SERIES RACEWAY SYSTEM FROM HORIZONTAL SECTION TO CEILING SECTION.
- PROVIDE THREE (3) 2" SLEEVE FOR ROUTING SIGNAL SYSTEM CABLINGS.
- REMOVE EXISTING PANEL AND REPLACE WITH NEW PANEL.
- PROVIDE A NEW PANEL COVER/DOOR FOR THE EXISTING PANEL.
- EXISTING RECEPTACLE TO REMAIN.
- PROVIDE CONNECTION TO WATER HEATER PER MANUFACTURER REQUIREMENTS.
- PROVIDE 2#10, #10 GRD. - 1" C.
- PROVIDE 2#6, #10 GRD. - 1" C.
- PROVIDE CONNECTION TO WALL MOUNTED HVAC UNIT PER MANUFACTURER REQUIREMENTS.
- PROVIDE 2#8, #10 GRD. - 1" C. TO BUILDING PANELBOARD FOR POWER. PROVIDE ONE (1) 40 AMP - 2 POLE. CIRCUIT BREAKER IN PANELBOARD AND CONNECT AS REQUIRED FOR A COMPLETE AND OPERABLE SYSTEM.
- PROVIDE CONNECTION TO EXHAUST FAN PER MANUFACTURER REQUIREMENTS.
- WALL MOUNTED IN ACCESSIBLE CEILING SPACE FOR FUTURE ACCESS CONTROL SYSTEM.

FIRE ALARM CONDUIT SCHEDULE		
SYMBOL	CONDUCTORS	CONDUIT
I	2#14 UNSHIELDED TWISTED-PAIR INITIATING CIRCUIT	3/4"
V	2#12 VISUAL CIRCUIT	3/4"
S	2#18 SPEAKER CIRCUIT (SHIELDED TWISTED-PAIR)	3/4"
2V	4#12 VISUAL CIRCUIT	3/4"
2S	4#18 SPEAKER CIRCUIT (SHIELDED TWISTED-PAIR)	3/4"
I,V,S	2#14 UNSHIELDED TWISTED-PAIR INITIATING CIRCUIT 2#18 SPEAKER CIRCUIT (SHIELDED TWISTED-PAIR) 4#12 VISUAL CIRCUIT	1"

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DISTRICT OFFICE PORTABLES & RESTROOM PORTABLE
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date:
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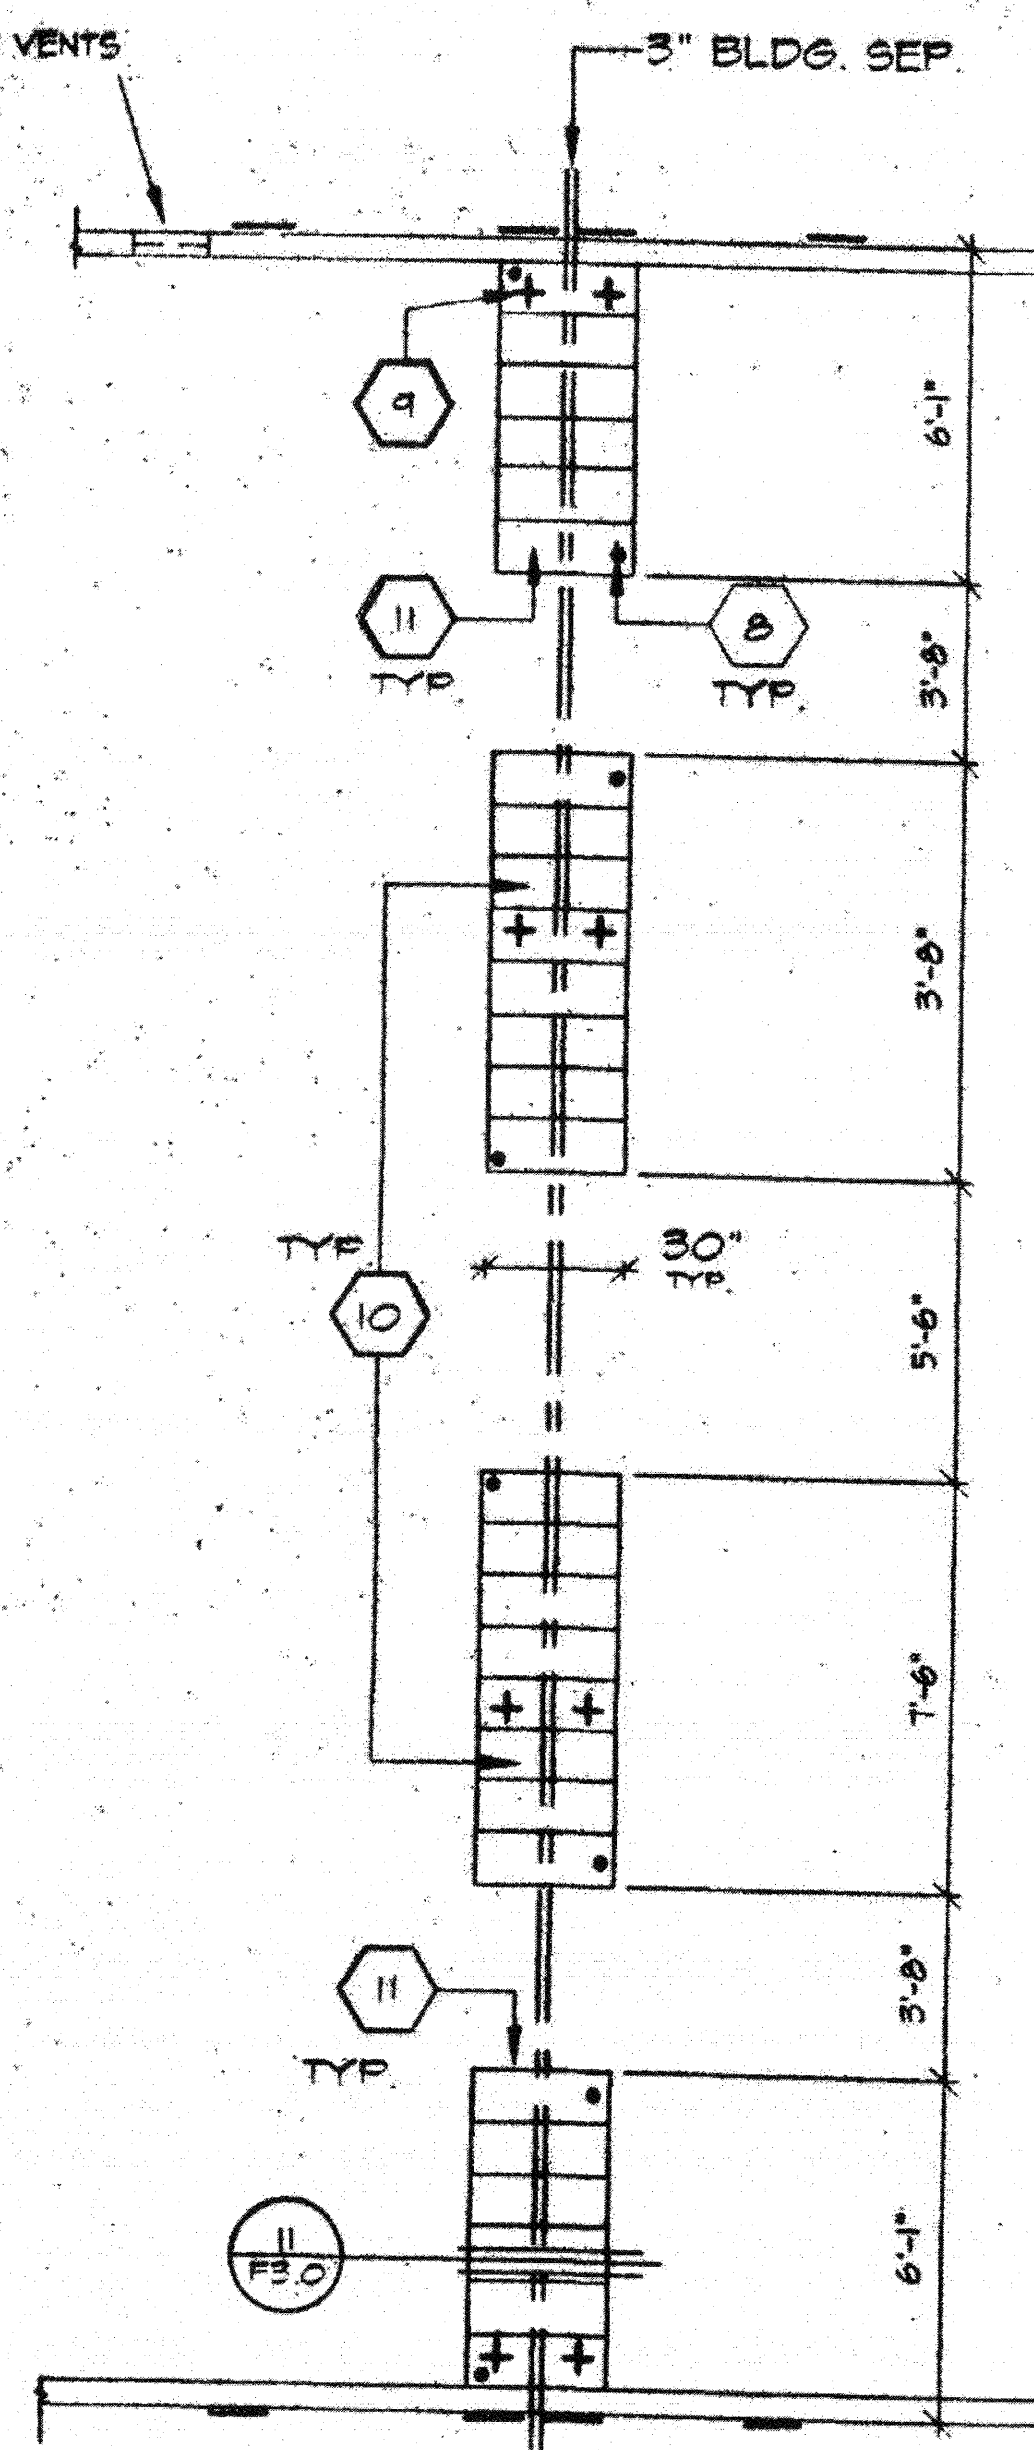
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DEMOLITION BUILDINGS AND ELECTRICAL PLANS
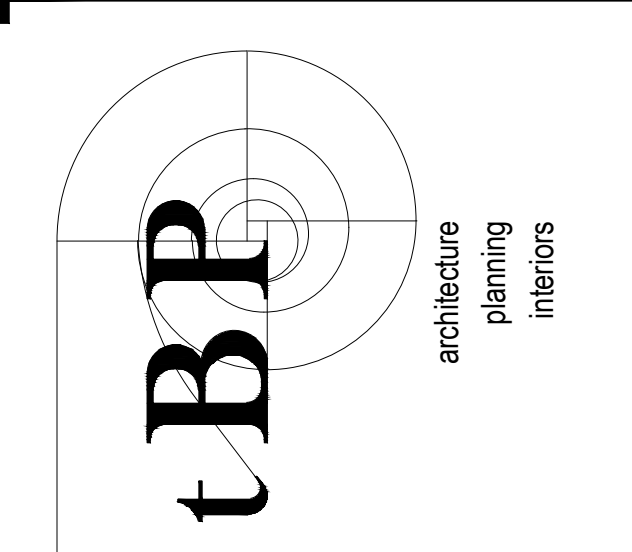
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E-1.1

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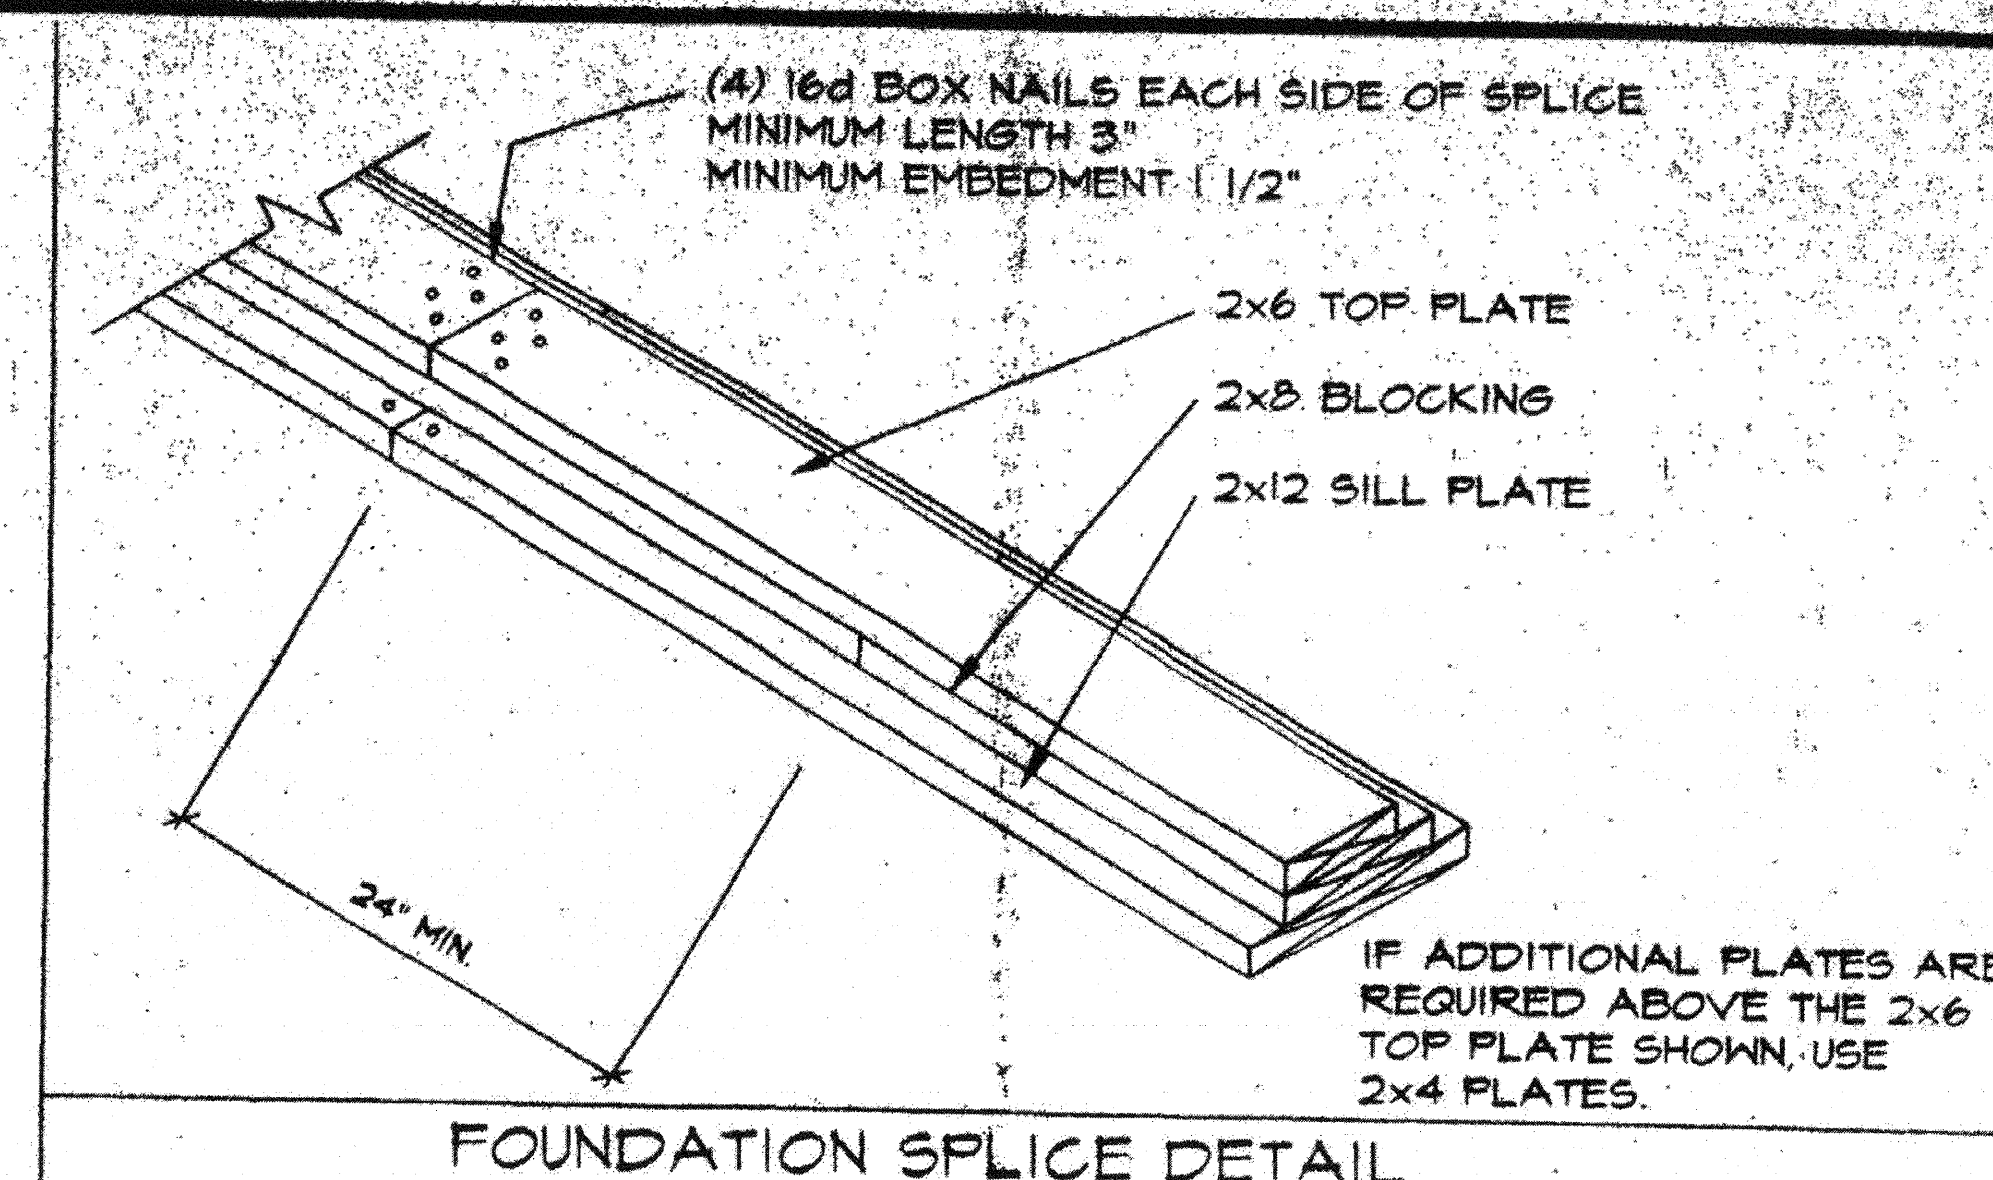
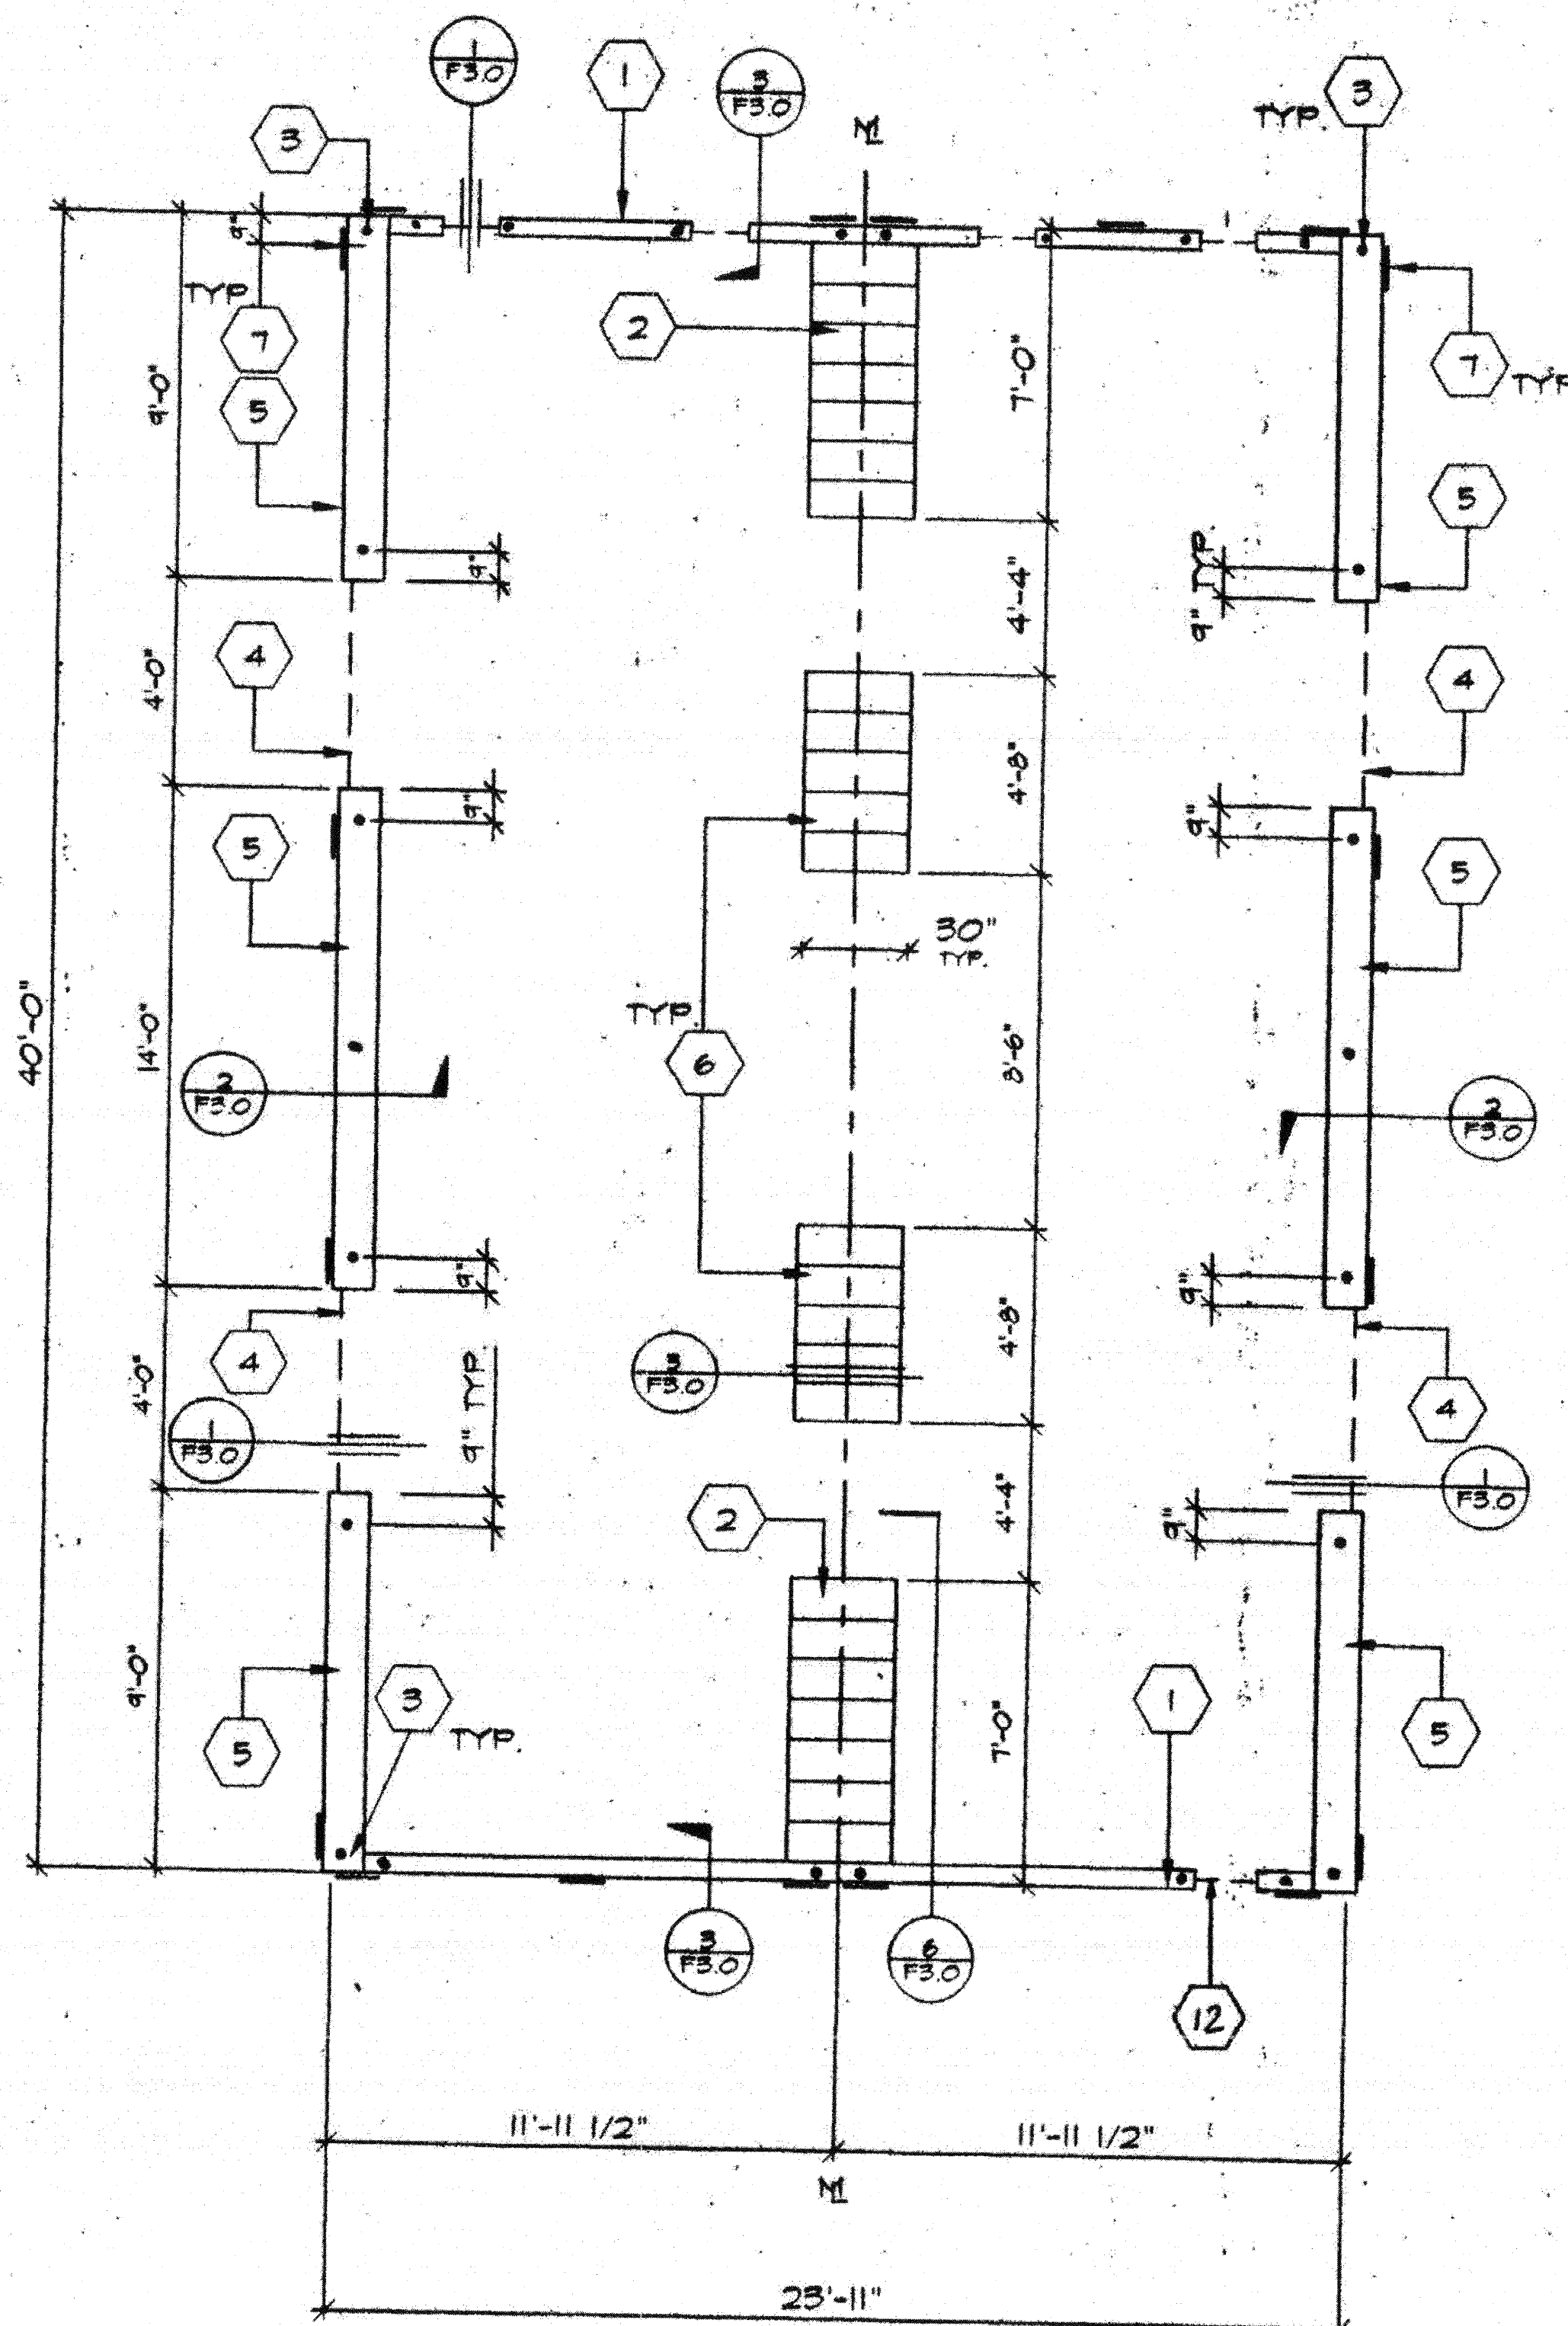
3" X 16" END WALL VENTS
AS REQUIRED FOR ADJACENT
BUILDING APPLICATIONS
MIN. 18" FROM BLDG. CORNERS
MIN. 18" FROM MODLINES
MIN. 12" BLOCKING BETWEEN VENTS

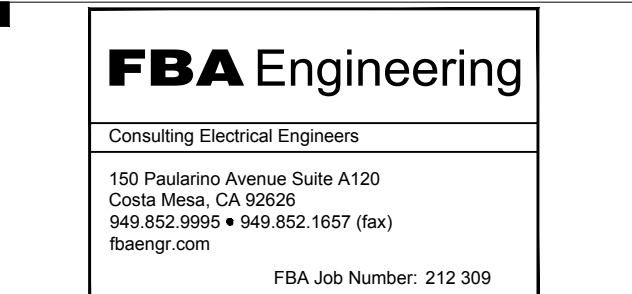

PAD FTGS AT ADJ. BLDG.

"MACHINE APPLIED 16d FASTENERS SHALL HAVE AN EMBEDMENT OF NOT LESS THAN 1 1/2" INTO SECOND MEMBER, AND SHALL BE NOT LESS THAN 3" IN OVERALL LENGTH"

THE ABOVE NAILS SHALL ALSO BE ACCEPTABLE FOR HAND NAILING, PROVIDED THE REQUIRED EMBEDMENT IS MAINTAINED.



KEY NOTES

- 1 2"x6" SILL PLATE (ENDWALL)
- 2 7 - 2"x12"x30" LONG SILL PADS
- 3 PIPE TO GRADE (TYP.)
- 4 3" HIGH BY 4'-0" LONG VENT - SIDEWALL
3" HIGH BY 2'-0" LONG VENT - ENDWALL
- 5 2"x12 SILL PLATE (SIDE WALL)
- 6 5-2"x12"x30" LONG SILL PADS
- 7 6"x12"x10 GA. PLATES
- 8 1" Ø PIPE EA. END
EA. PAD AT ADJ. BLDG. LINE
- 9 5/8" Ø X4" LAG
(4-PER BLDG. MIN.)
- 10 8 - 2"x12"x30" LONG SILL PADS
- 11 6 - 2"x12"x30" LONG SILL PADS
- 12 THIS VENT TO BE LOCATED UNDER LANDIN.
PROVIDE EQUAL AREA SCREENED VENT TO LANDINGSKIRT.

NOTES

1. SILL RESTRAINT: ON A.C. PAVING AND ON SOIL 1" O.D. GALVANIZED PIPE AT 10'-0" 12" PENETRATION BELOW SURFACE. VERTICALLY, DRILL SILL 1-1/4" MAX. PIPE MAY BE DRIVEN MAX. OF 45° ANGLE TO VERTICAL (18-1/2" LONG PIPE REQUIRED FOR PENETRATION AT 45° ANGLE)
2. ON CONCRETE PAVING HILT DS 82-PIO THRU SILL PLATE.
END WALLS: 8" O.C.
SIDE WALLS: 22" O.C.
3. WHERE SHIM STOCK IS REQUIRED FOR LEVELING USE 1/4", 1/2", OR 3/4" THICK PLYWOOD SAME WIDTH AS BLOCK, P.T.
4. VERIFY DRAINAGE, TO PREVENT WATER FROM PONDING BENEATH THE STRUCTURE, WITH DISTRICT ARCHITECT SITE PLANS
5. ALL FOUNDATION MATERIAL SHALL BE HEM FIR
GROUND CONTACT: LF-22 (CCA 40)
ABOVE GROUND: LF-2 (CCA 25)
6. FOUNDATION DESIGNED FOR 1000 PS SOIL BEARING PRESSURE
PER ORS IR 23-6.

VENT CALCS.




BLDG SIZE 24' X 40' = 960 sq
VENTILATION REQ'D 960 ÷ 150 = 6.4 sq
3" X 4'-0" VENT = 1.0 sq
4 VENTS X 1.0 sq = 4 sq VENTING PROVIDED
3" X 2'-0" VENT = 0.5 sq
5 VENTS X 0.5 sq = 2.5 sq VENTING PROVIDED
6.5 sq > 6.4 sq

FOUNDATION (WOOD SILL)

24 x 40 - 50 + 20 PSF LL

SCALE 1/4"=1'-0"

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Δ					
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Δ					
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APPL 65 111
DATE 10/1/90
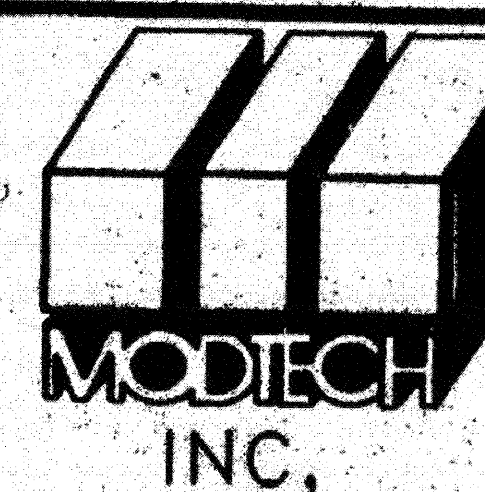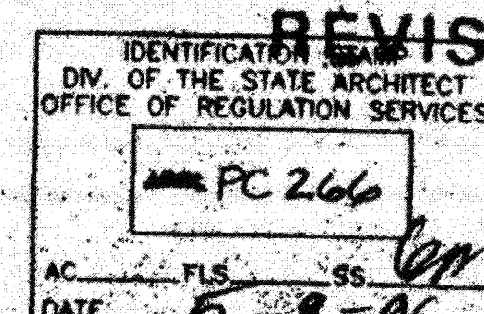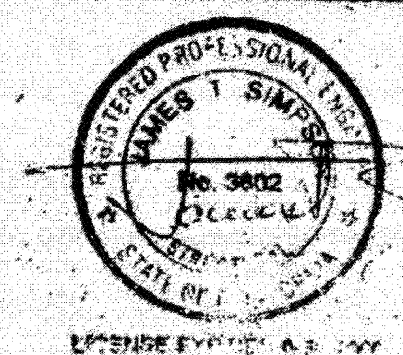
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DIV. OF THE STATE ARCHITECT


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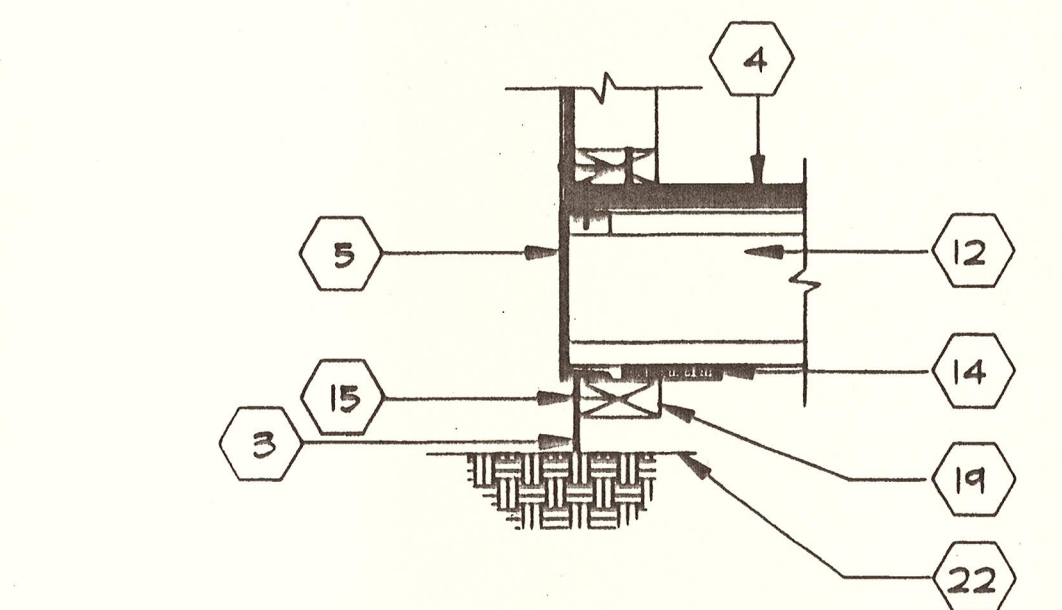
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DATE 8/96

FOUNDATION PLAN


F0.2




1 PERIMETER FD. SIDE WALL
SCALE 1/2"=1'

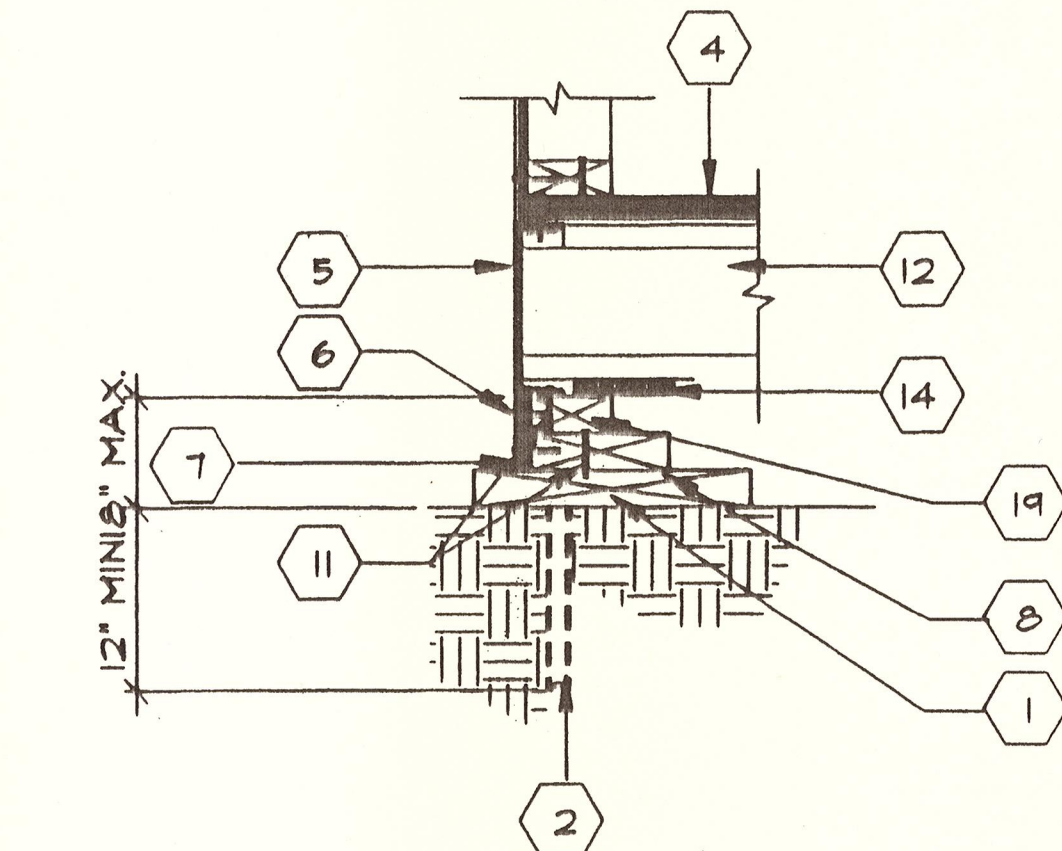


2 FOUNDATION VENT
SCALE 1/2"=1'

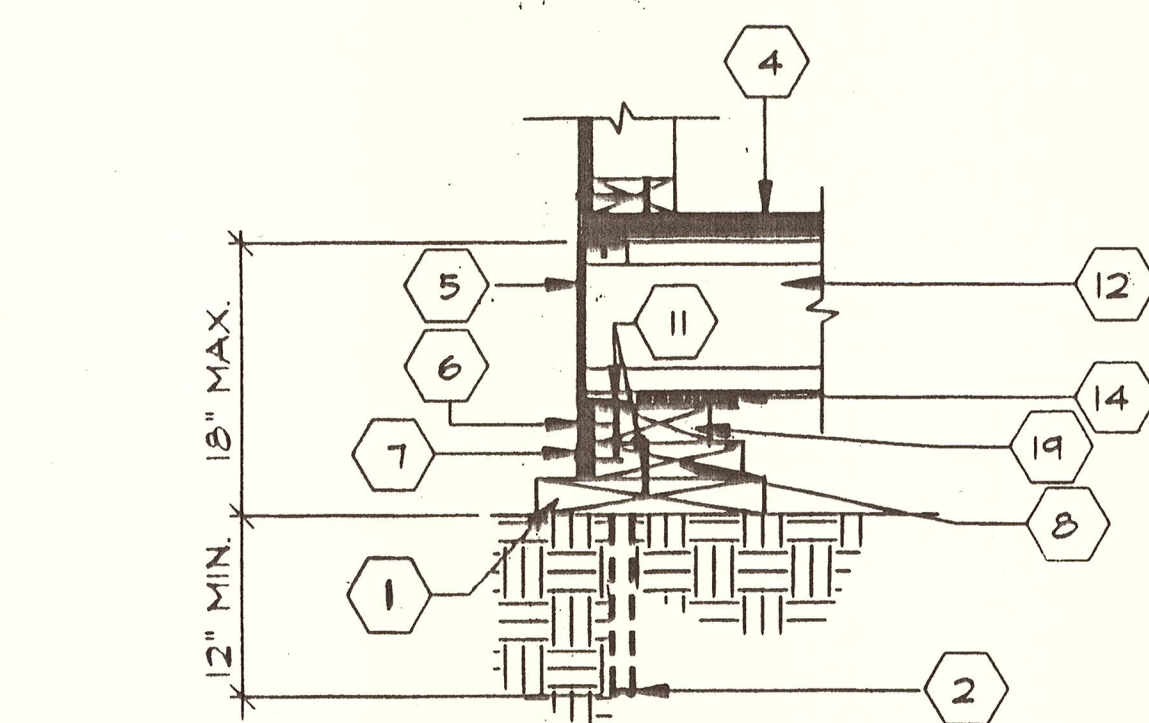

3 PERIMETER FD. END WALL
SCALE 1/2"=1'

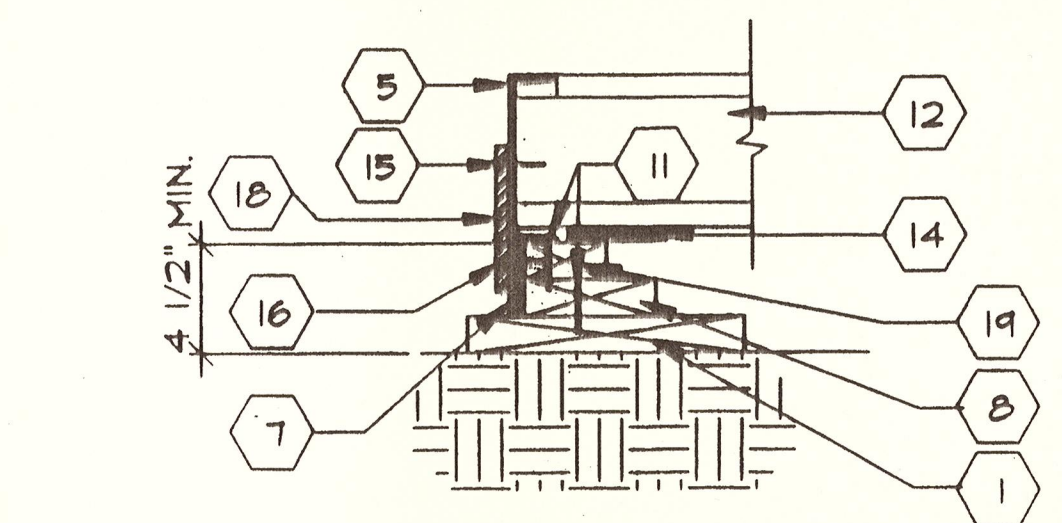


4 TYPICAL HOLD-DOWN
SCALE 1/2"=1'

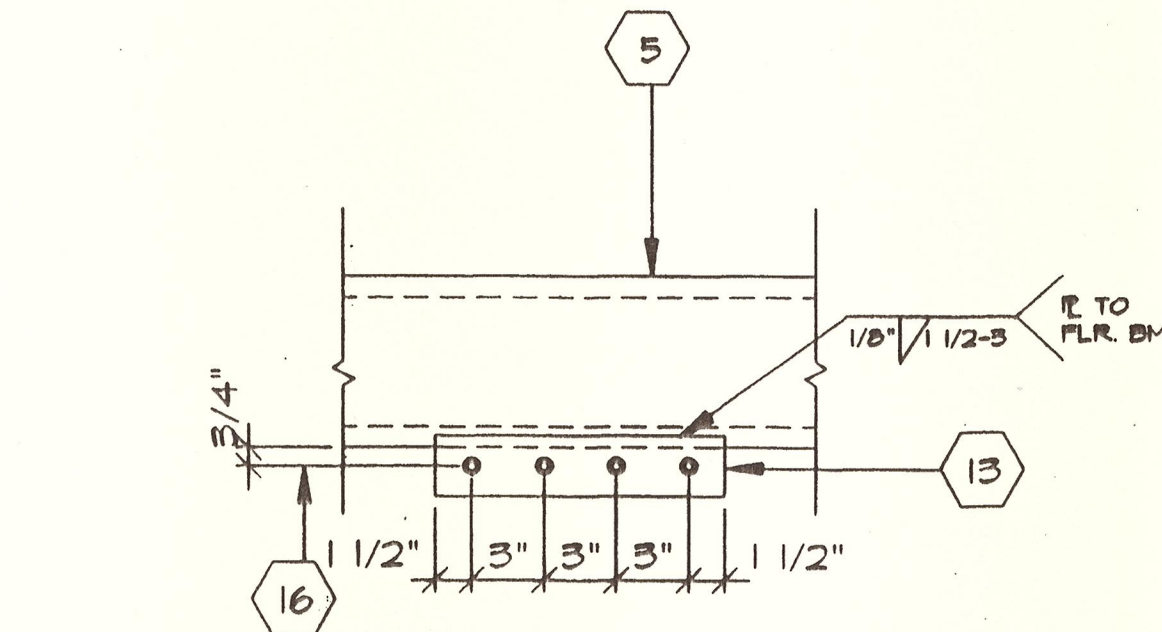


5 ALTERNATE HOLD-DOWN
SCALE 1/2"=1'


NOTE:
SIDE WALL SHOWN

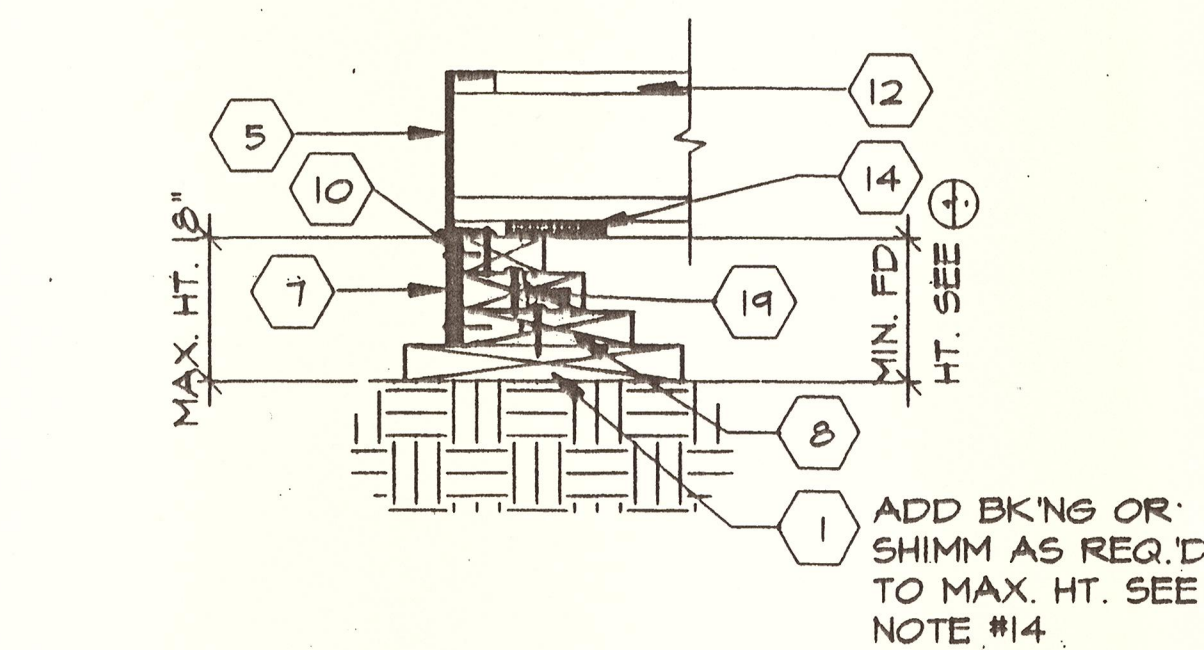

6 FOUNDATION MAX. HEIGHT
SCALE 1/2"=1'

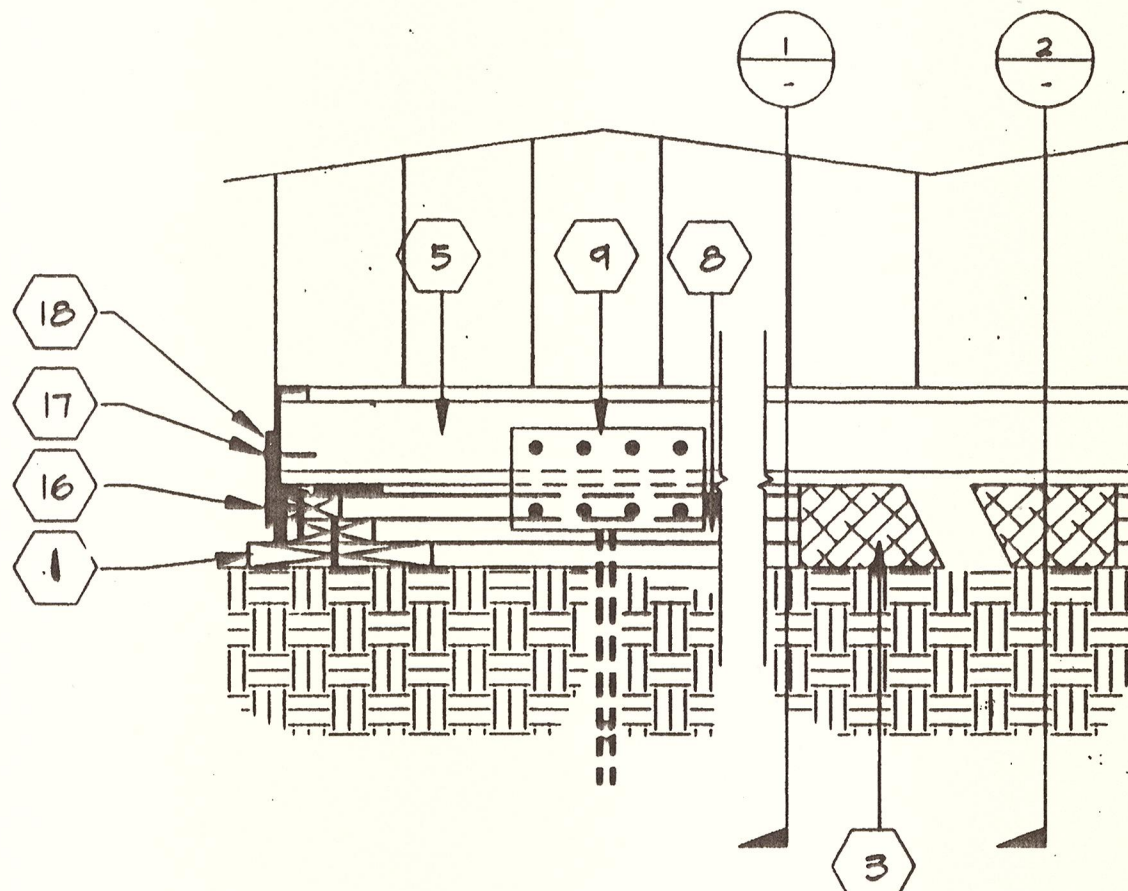

7 DETAIL @ FOUNDATION CORNER
SCALE 1/2"=1'

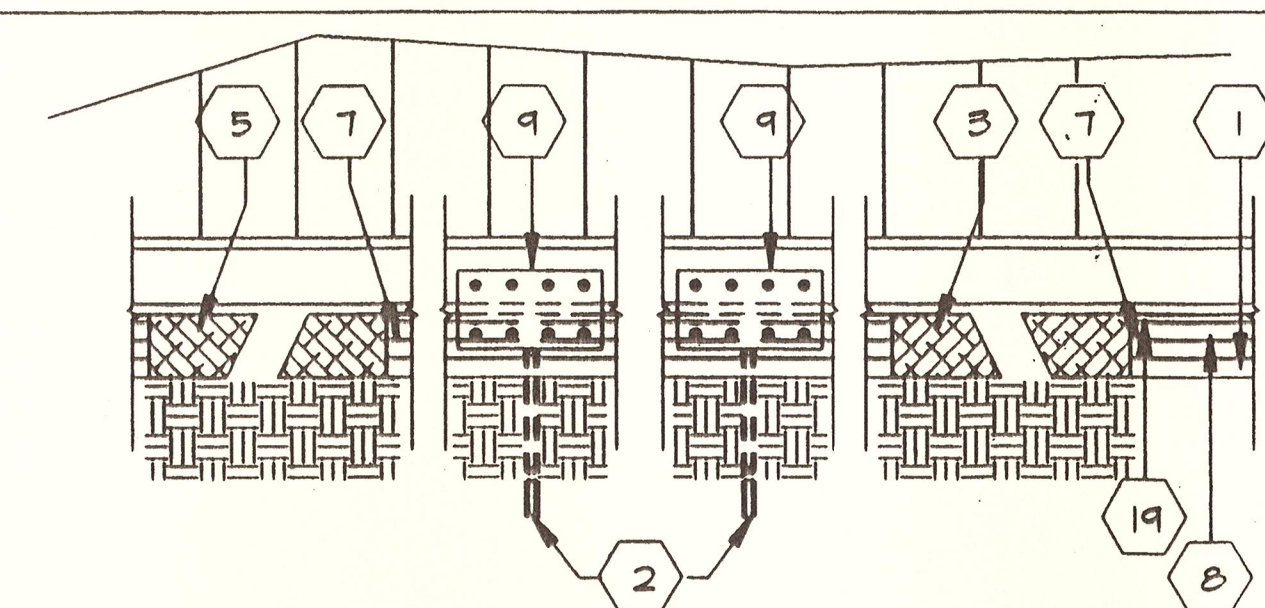


8 FOUNDATION ELEVATION @ SIDEWALL
SCALE 1/2"=1'

VENTING REQUIREMENTS		
SIZE OF BUILDING	12' X 40'	
TOTAL SQ. FT. OF BLD'G(S)	480	
NO. OF BUILDINGS	1	
U.B.C. SECT. 2516 (C) (6)	480/	
DIVIDE TOY. SQ.FT./150	150	
REQ'D VENTING SQ.FT.	32	


TYPE "C" (SIDEWALLS) 3" X 60" 180 SQ. IN / 144 = 125 SQ.FT.

SIZE OF BUILDINGS	12' X 40'
REQ'D VENTING SQ.FT.	32
VENTING PROVIDED	(4) "C"
1.25 SQ. FT. X 4 VENTS	5 SQ. FT.
OK	5 > 3.2

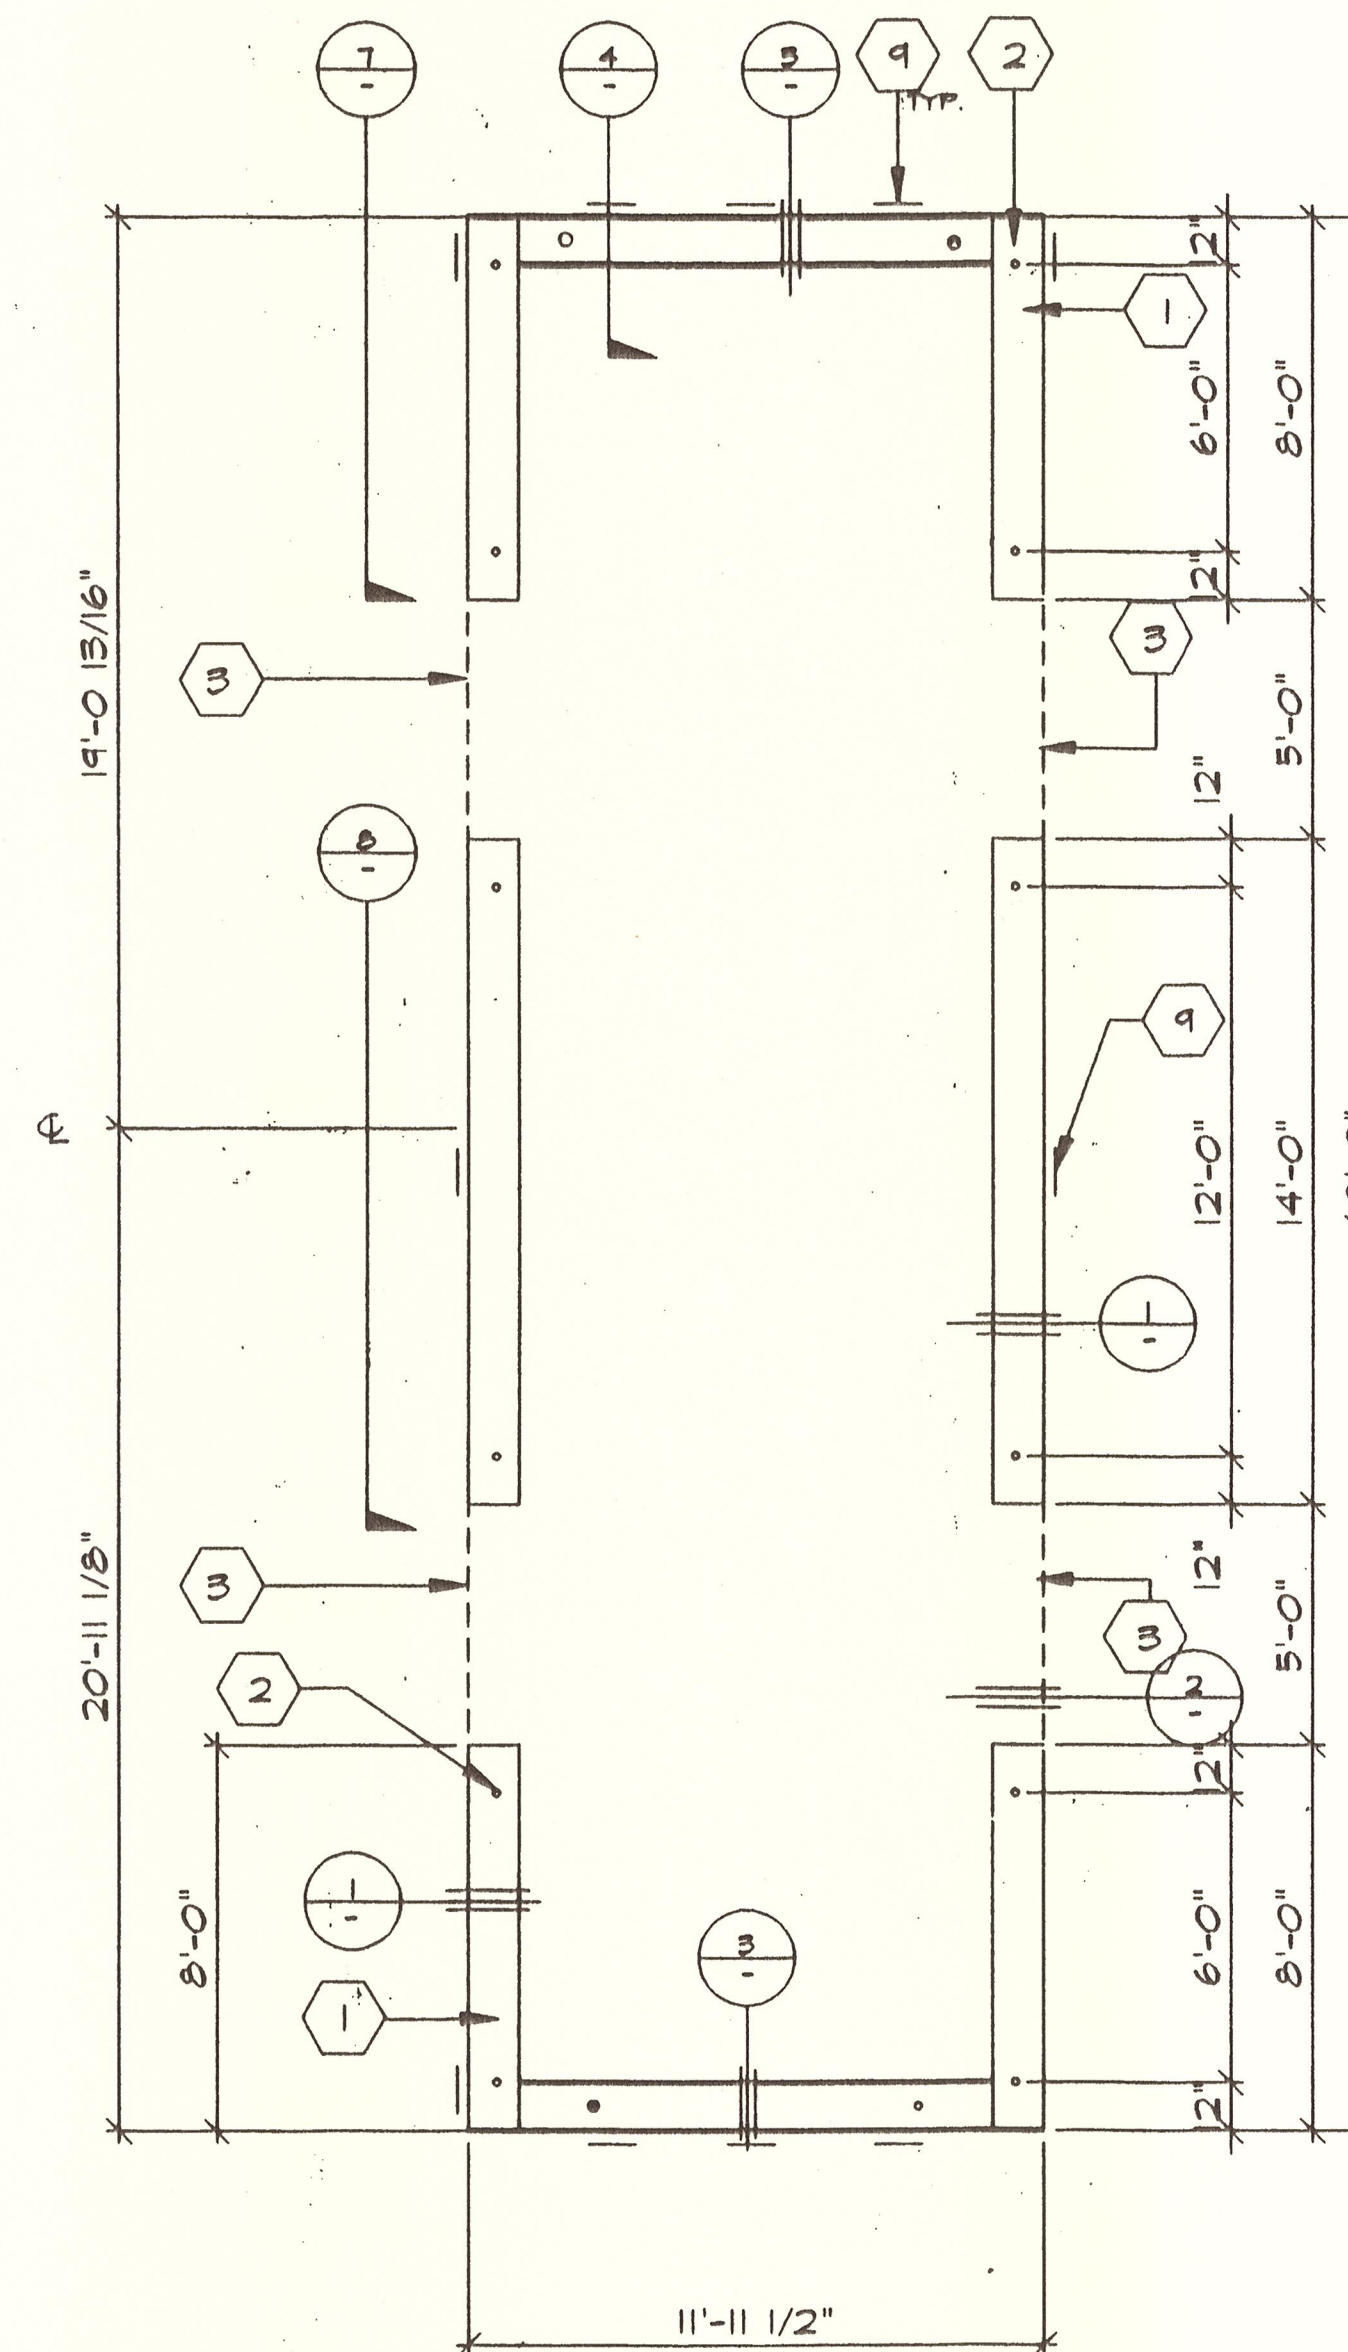

FOUNDATION (WOOD SILL)

SCALE 1/4"=1'-0"

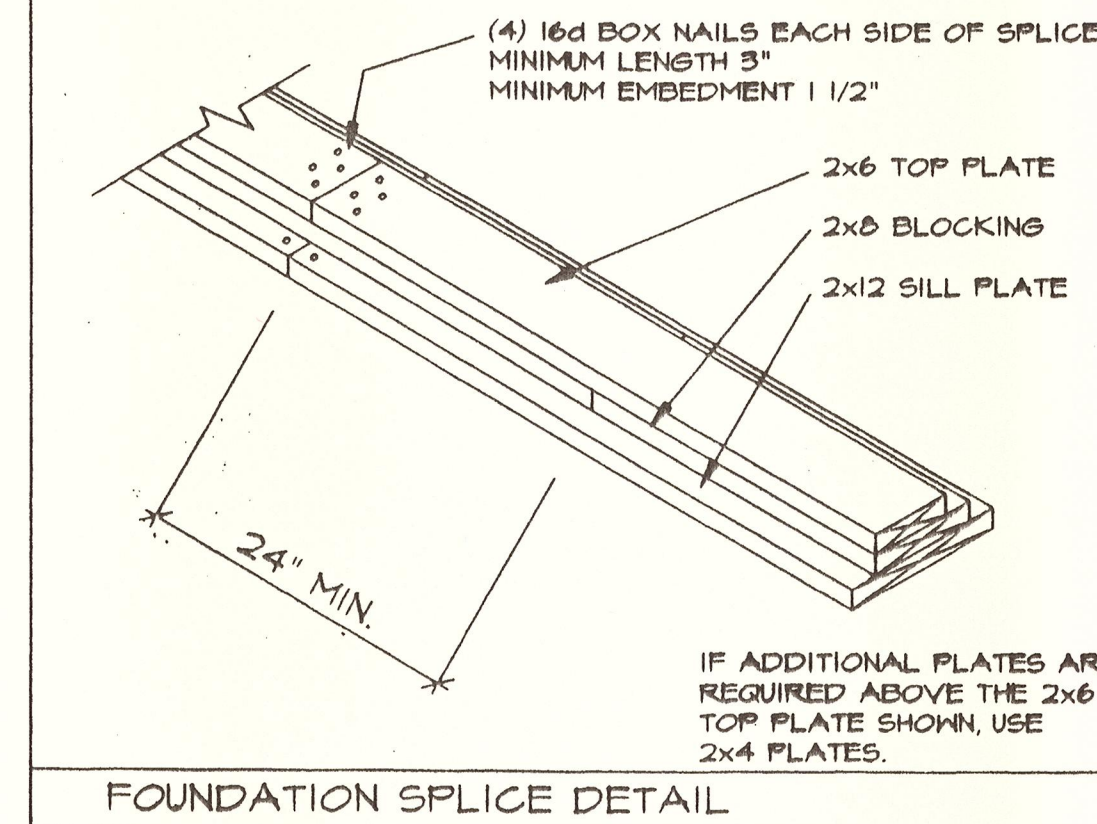

"MACHINE APPLIED 16d FASTENERS SHALL HAVE AN EMBEDMENT OF NOT LESS THAN 1 1/2" INTO SECOND MEMBER, AND SHALL BE NOT LESS THAN 3" IN OVERALL LENGTH"

THE ABOVE NAILS SHALL ALSO BE ACCEPTABLE FOR HAND NAILING, PROVIDED THE REQUIRED EMBEDMENT IS MAINTAINED.

NOTE:
TOP PLATE TO BE CONTINUOUS

KEY NOTES

- 2"x12" SILL PLATE (SEE FOUND.)
- SILL RESTRAINT 1" Ø PIPE (SEE FOUNDATION PLAN FOR LOCATION)
- VENT MIN. 3"x5'-0" TYPICAL EXPANDED METAL MESH PRIME PAINTED
- PLYWOOD FLOOR SHEETING
- FLOOR FRAMING BEAM
- EN (EDGE NAIL SEE NOTE #7)
- EN ATTACH 5/8" EXT. PLYWD W/10 STSMS OR AREOSMITH 6" Ø SIDEWALL 4" Ø ENDWALL TO STEEL CHANNEL AND 10d BOX Ø 6" O.C. & 4" O.C. TO WD. PLATE. AT VENT ATTACH SKIRTF Ø12" O.C. TOP AND BOTTOM
- 2 X 8 PLATE
- 6"x12"x10GA. PLATE W/4 - #10 STSMS TO FLOOR & 4 -1/4"x3" LAG TO FOUNDATION TOP PLATE TYPICAL 12 PLACES
- 2 X 4 BLOCKING
- 16d BOX Ø 9" O.C. AT SIDEWALLS AND 6" O.C. AT ENDWALLS
- FLOOR JOIST
- 2 1/2"x12"x10GA. PLATE
- 5/8" SHIM CONT.
- 10d ELECTROGAL BOX NAIL Ø MAX. 4" O.C.
- 1/4" ØX3" LAB BOLT TYP. 4 PER PLATE
- #10X3/4" STS TYP. 4 PER PLATE
- 6"x12"x10GA. PLATE
- 2X6 TOP PLATE W/16d FACE NAIL NAIL TO BK'NG Ø MAX. 12" O.C.
- 2 X 6 SILL PLATE
- 2-16d BOX NAILS PLATE TO PLATE Ø 6" O.C. TYP. AT INTERIOR WALL
- FINISH GRADE

GENERAL NOTES

- SOIL RESTRAINT: ON A.C. PAVING AND ON SOIL 1" O.D. GALVANIZED PIPE AT 10'-0" 12" PENETRATION BELOW SURFACE VERTICALLY. DRILL SILL 1-1/4" MAX. PIPE MAY BE DRIVEN MAX. OF 45° ANGLE TO VERTICAL. (18-1/2" LONG PIPE REQUIRED FOR PENETRATION AT 45° ANGLE.)
- ON CONCRETE PAVING HILTI DS B2-PIO THRU SILL PLATE:
END WALLS: 7" O.C.
SIDE WALLS: 19" O.C.
INTERIOR WALL 3 1/2" O.C.
- WHERE SHIM STOCK IS REQUIRED FOR LEVELING USE 1/4", 1/2", OR 3/4" THICK PLYWOOD SAME WIDTH AS BLOCK. P.T.
- VERIFY DRAINAGE TO PREVENT WATER FROM PONDING BENEATH THE STRUCTURE. WITH DISTRICT ARCHITECT SITE PLANS
- ALL FOUNDATION MATERIAL SHALL BE PRESSURE TREATED D.F.
GROUND CONTACT: LP-22 (CCA .40)
ABOVE GROUND: LP-22 (CCA .25)

ARCHITECT

ELECTRICAL




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MECHANICAL

FIRE MARSHAL

ACCESS COMPLIANCE

STRUCTURAL SAFETY

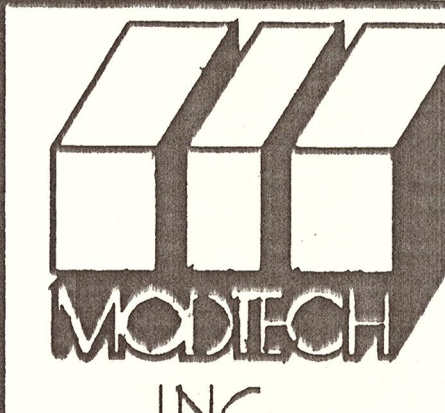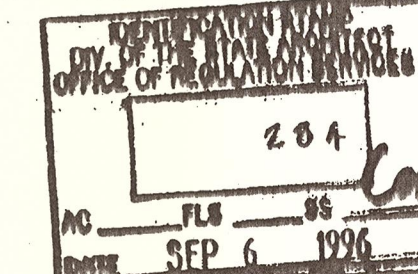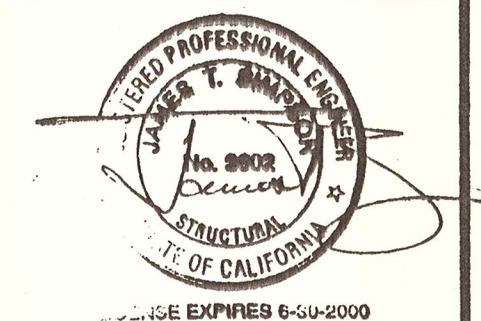


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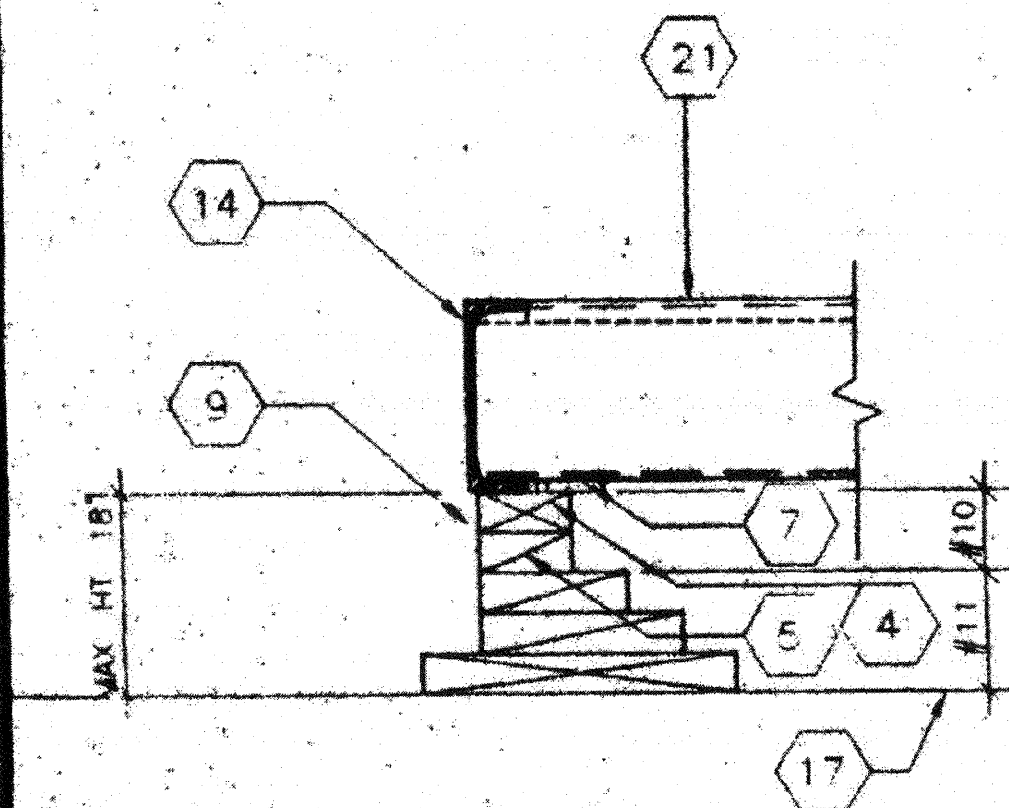
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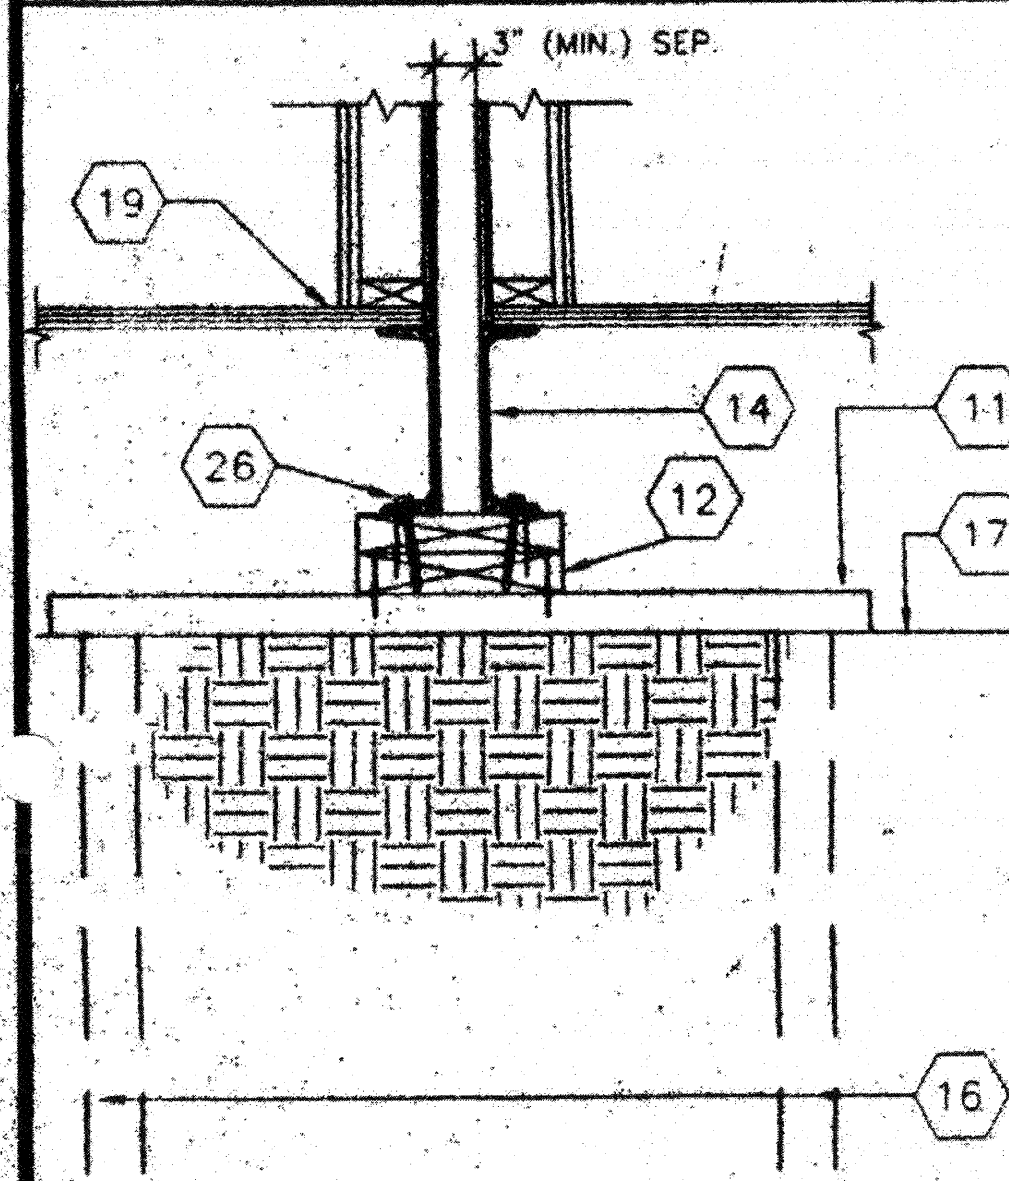
FOUNDATION (WOOD) F2.0




9 SCALE: 1 1/2"=1'-0"
ALTERNATE HOLD DOWN

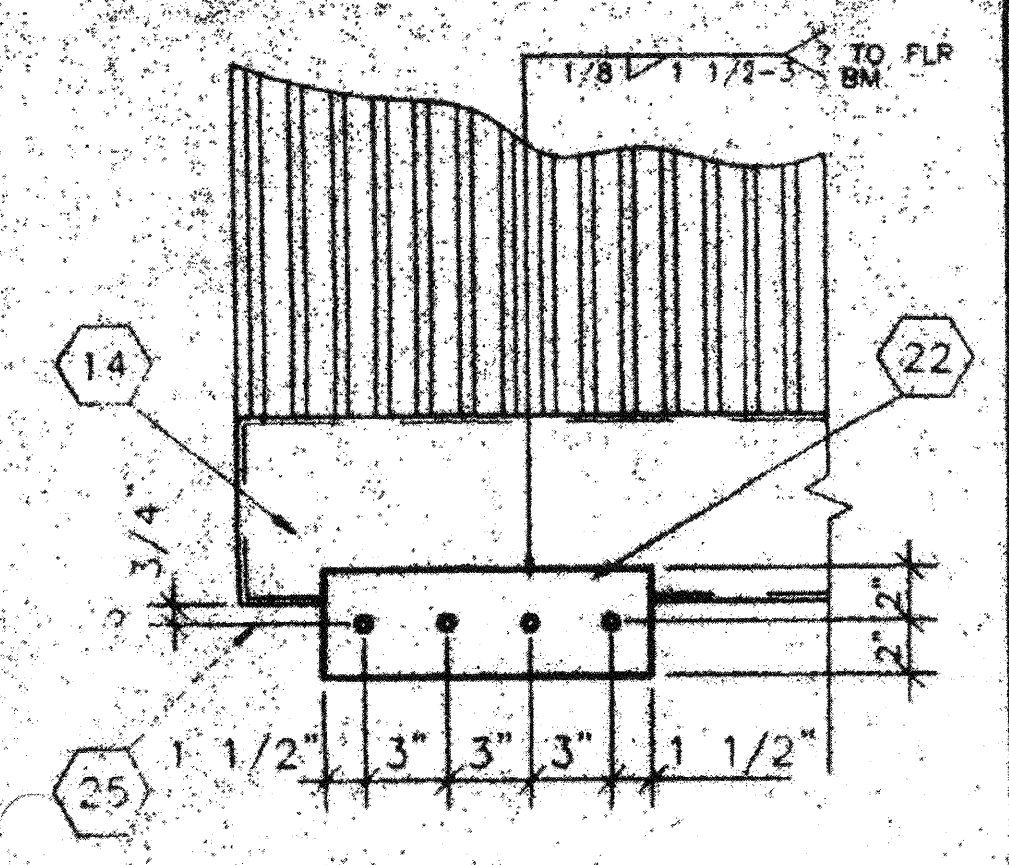


10 SCALE: 1 1/2"=1'-0"
ADD BLK'S/SHIMS TO LEVEL FOUND.




11 SCALE: 1 1/2"=1'-0"
FOUND. AT ADJ. BLDG.

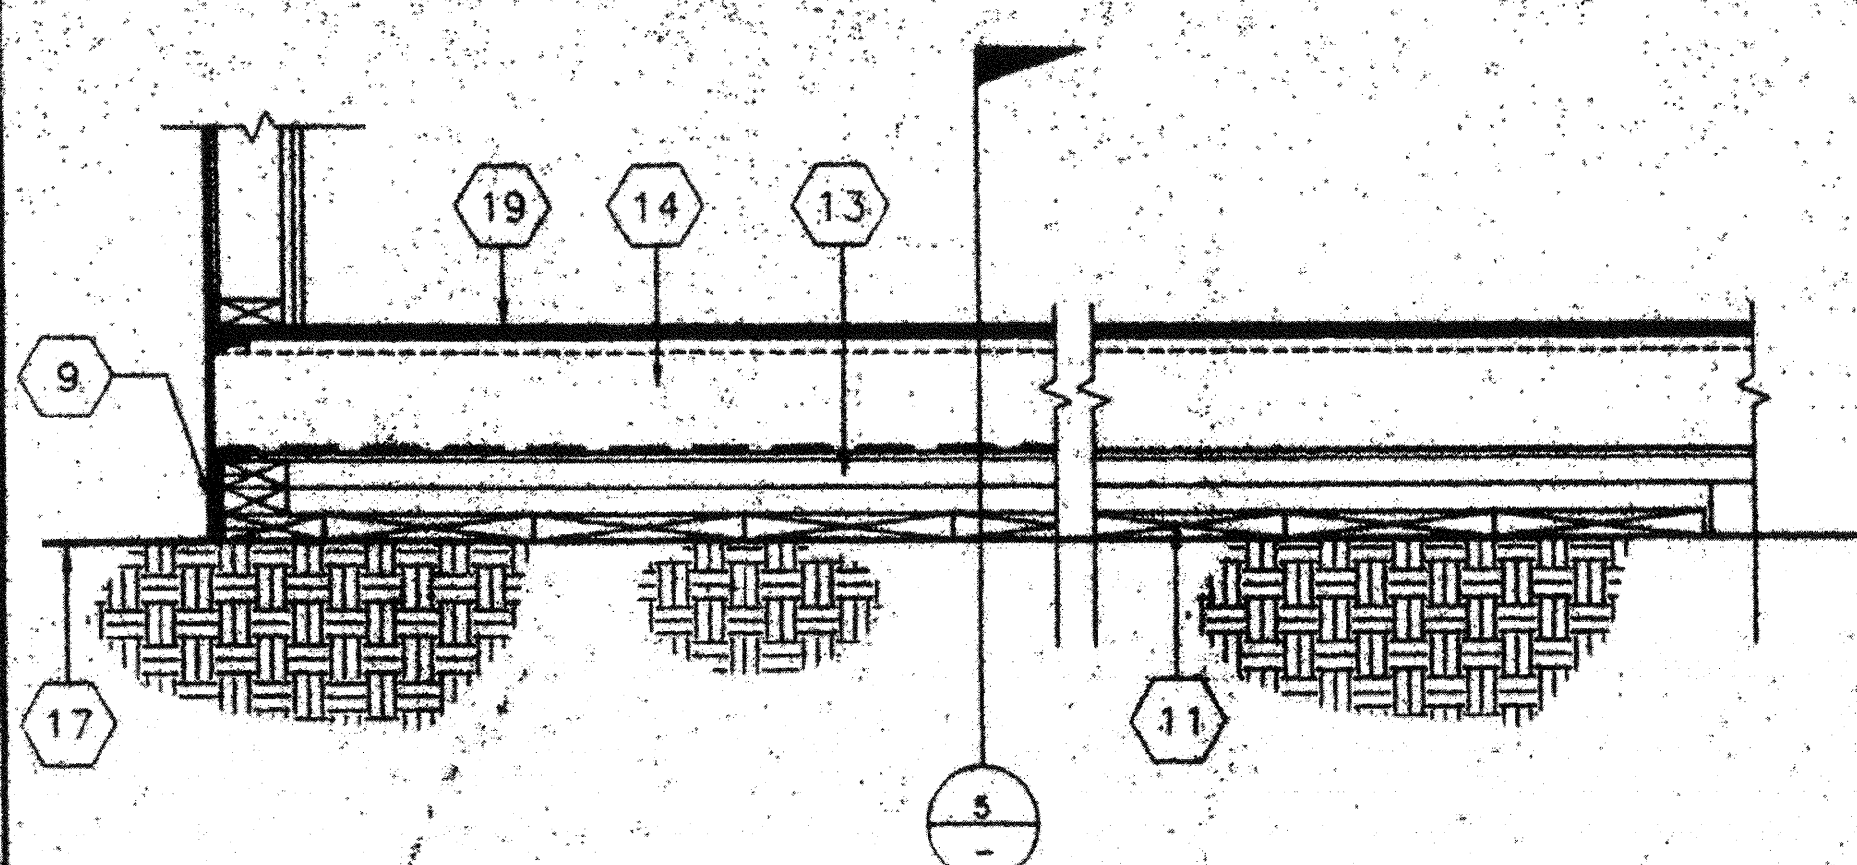


6 SCALE: 1 1/2"=1'-0"
MODLINE PAD @ END WALL

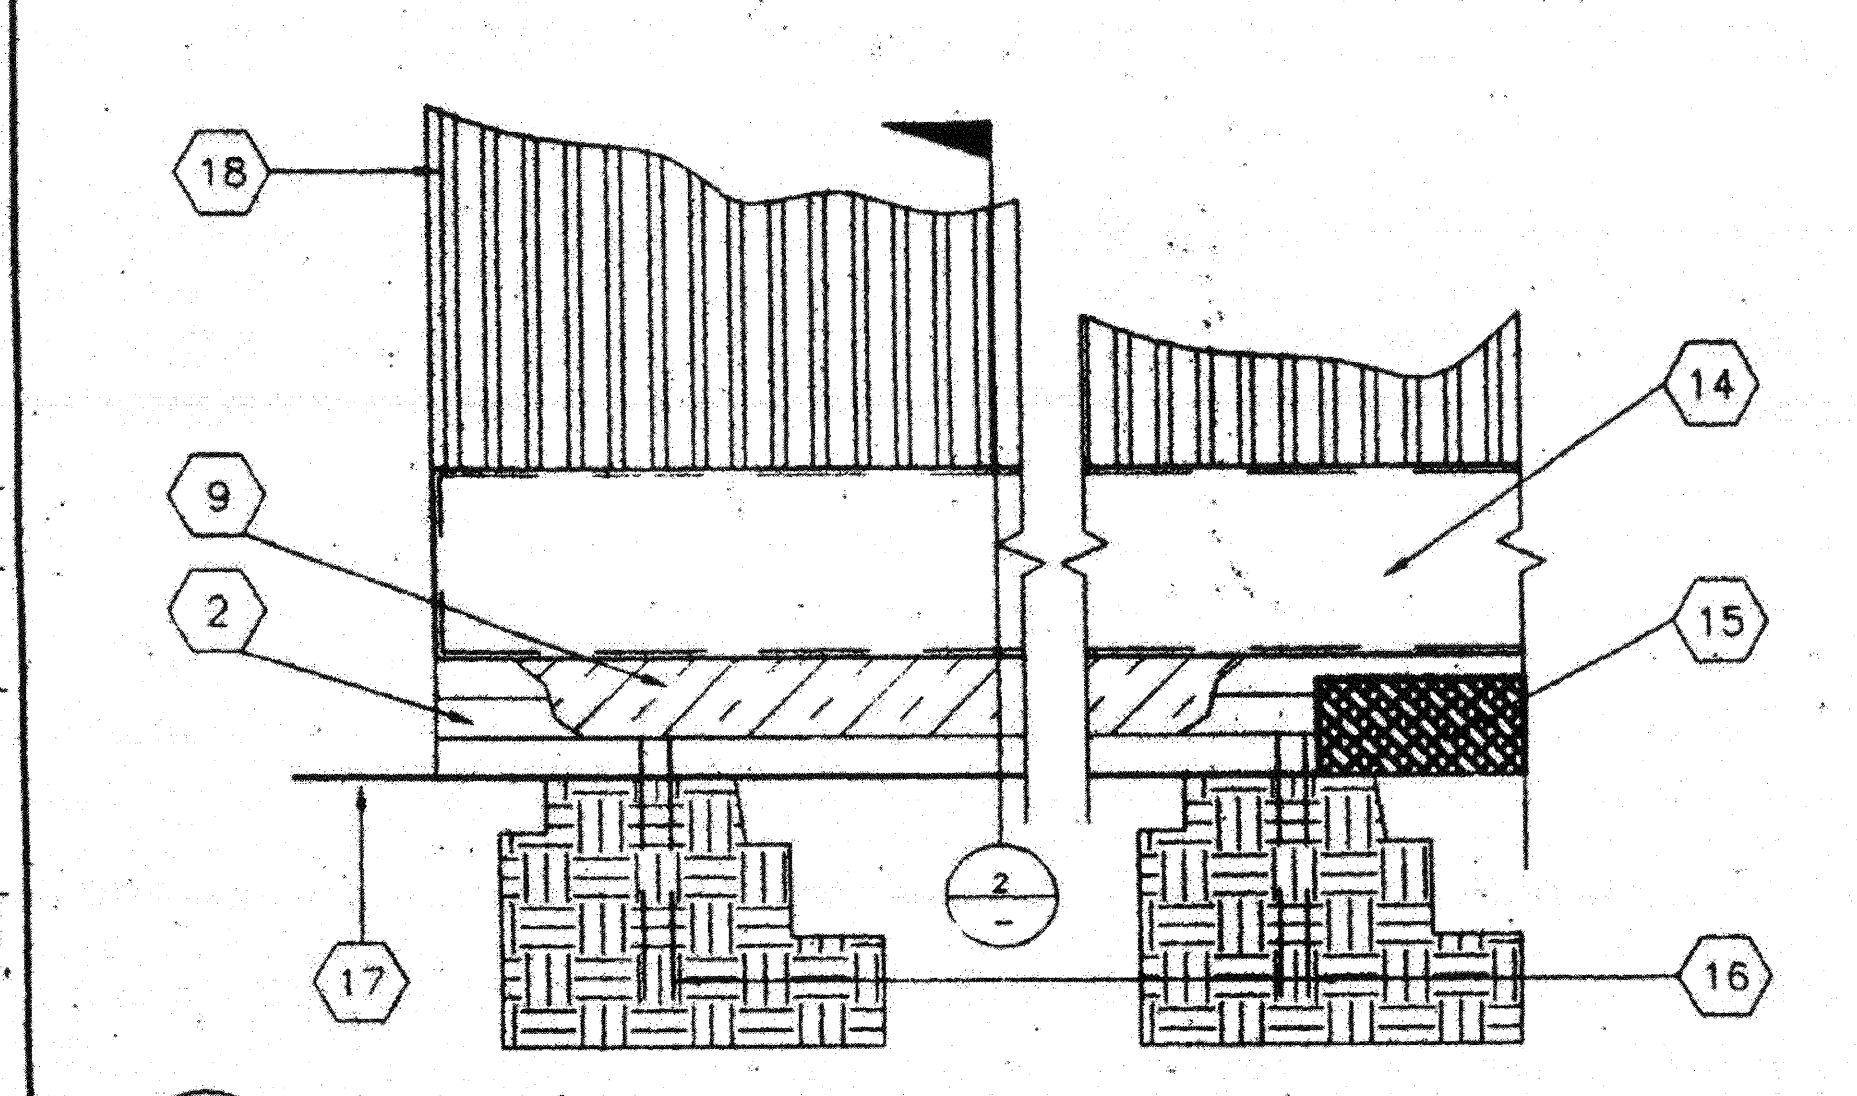


7 SCALE: 1 1/2"=1'-0"
FOUNDATION ELEVATION @ SIDE WALL

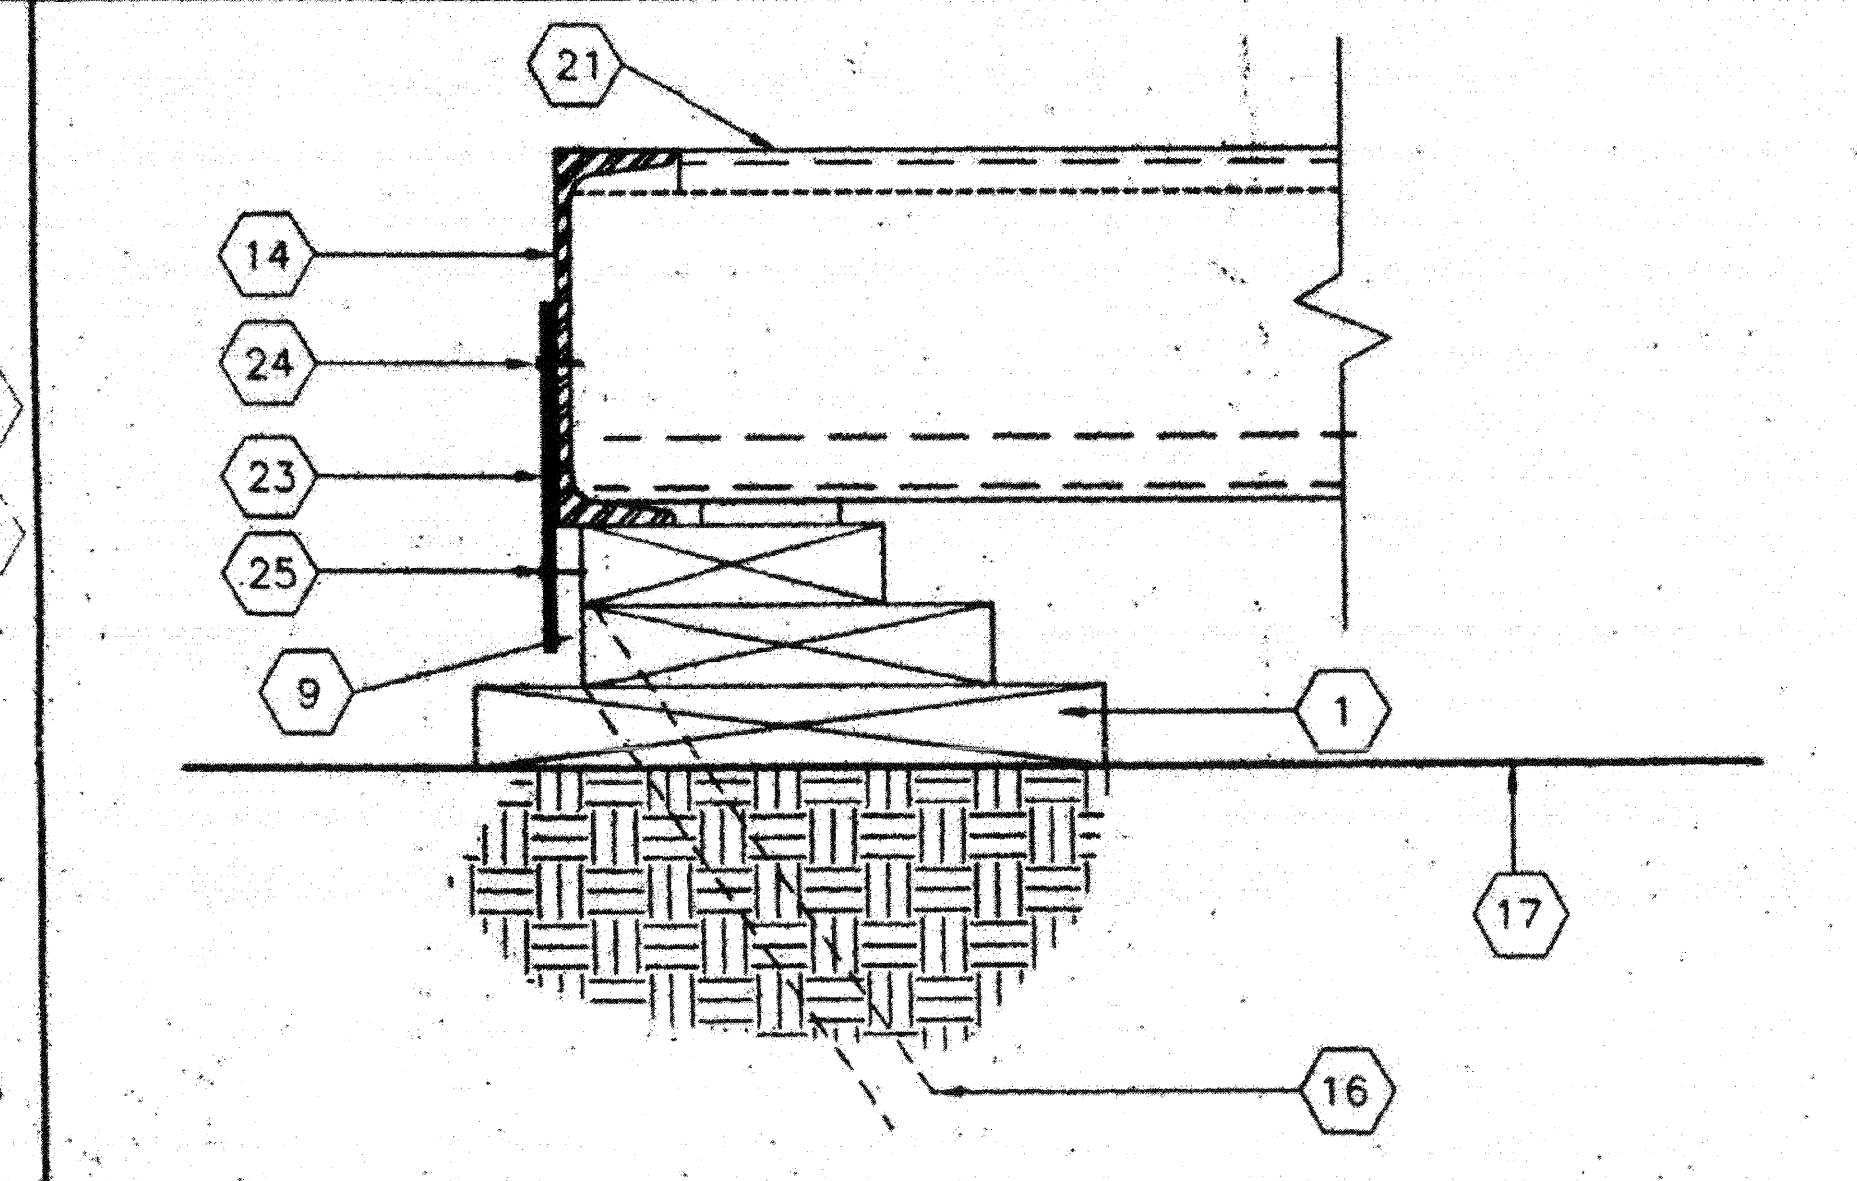


8 SCALE: 3"=1'-0"
TYPICAL TIE PLATE

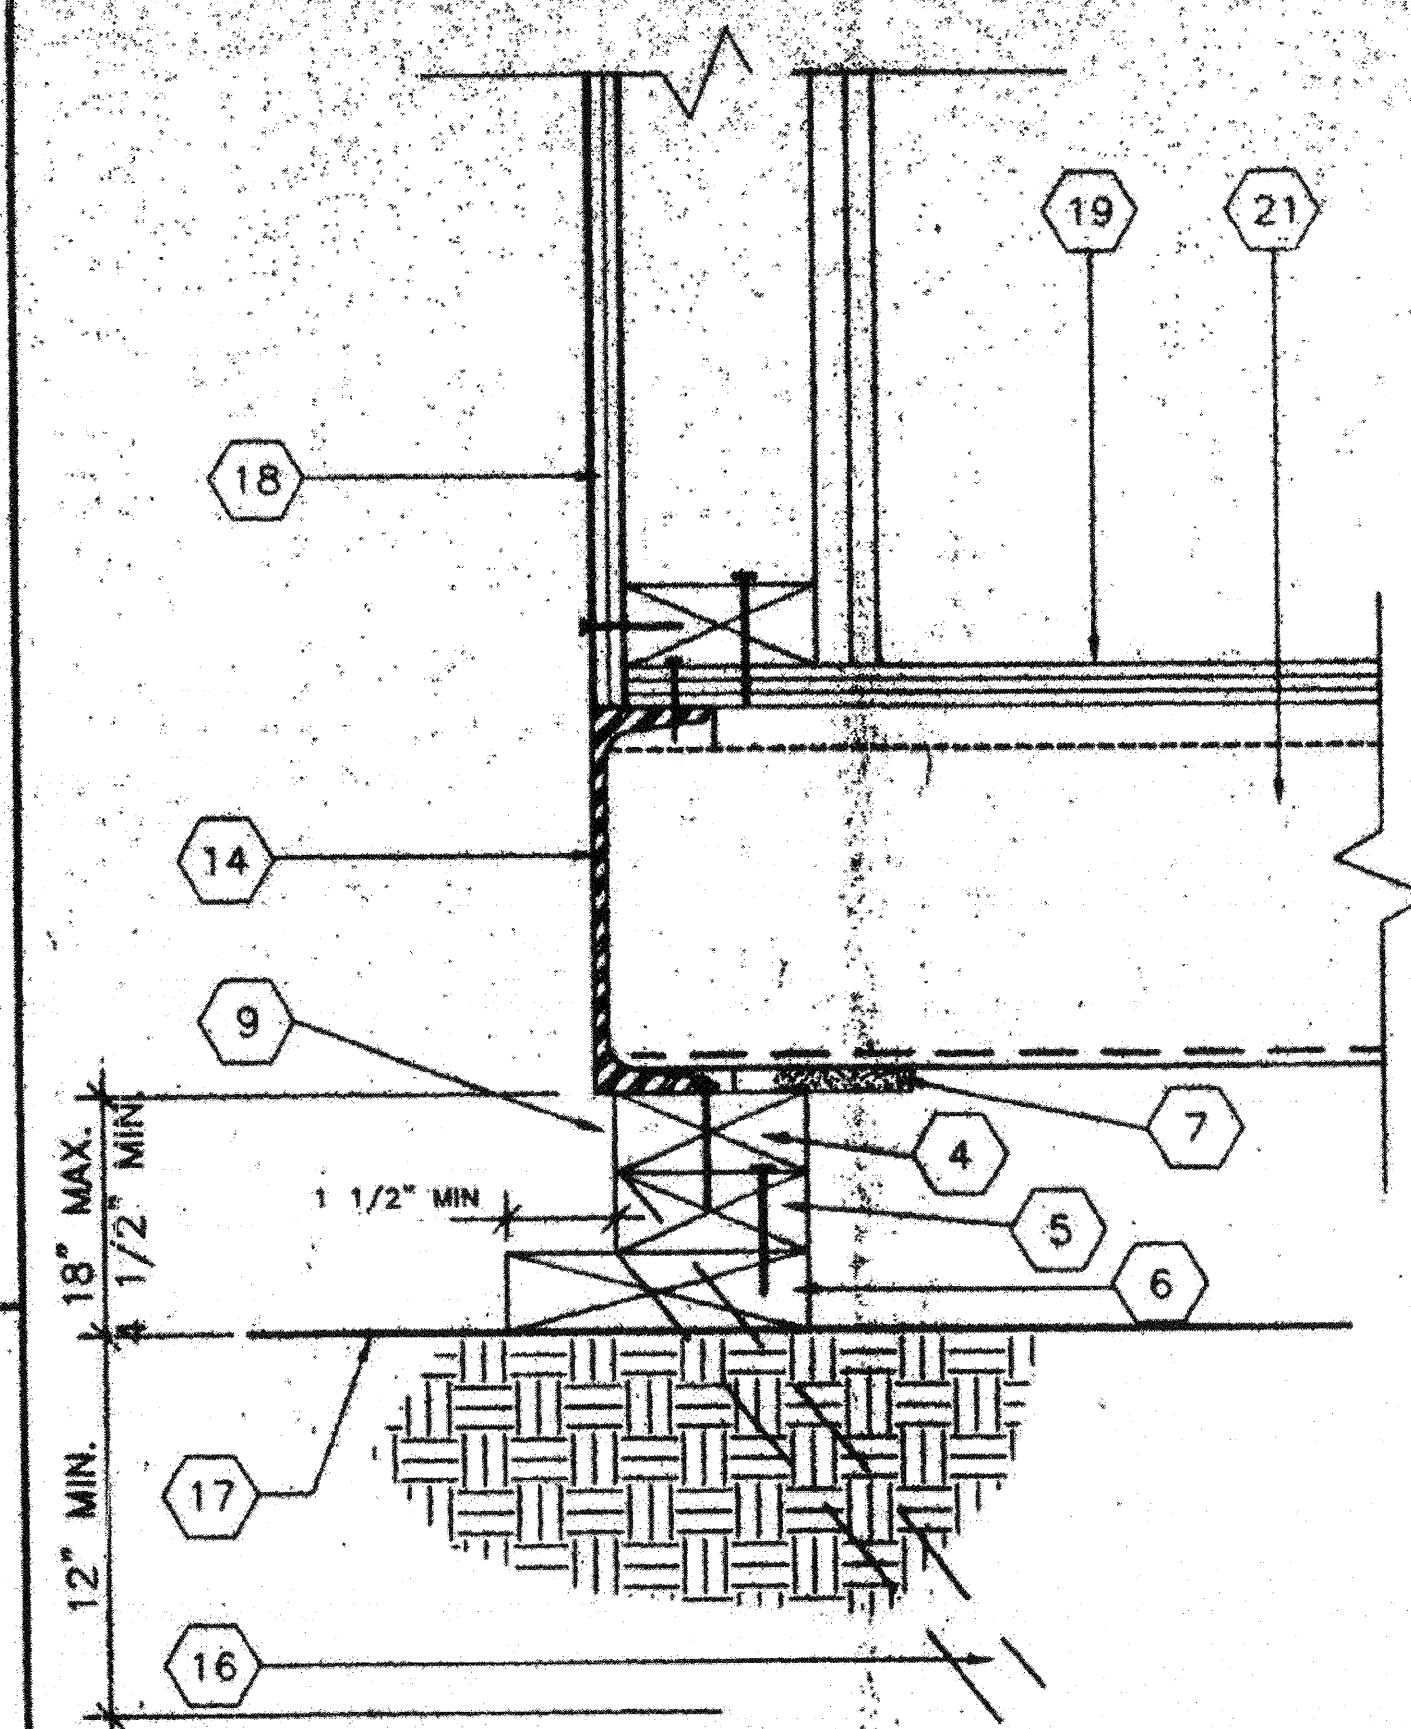



3 SCALE: 3"=1'-0"
FOUNDATION @ END WALL

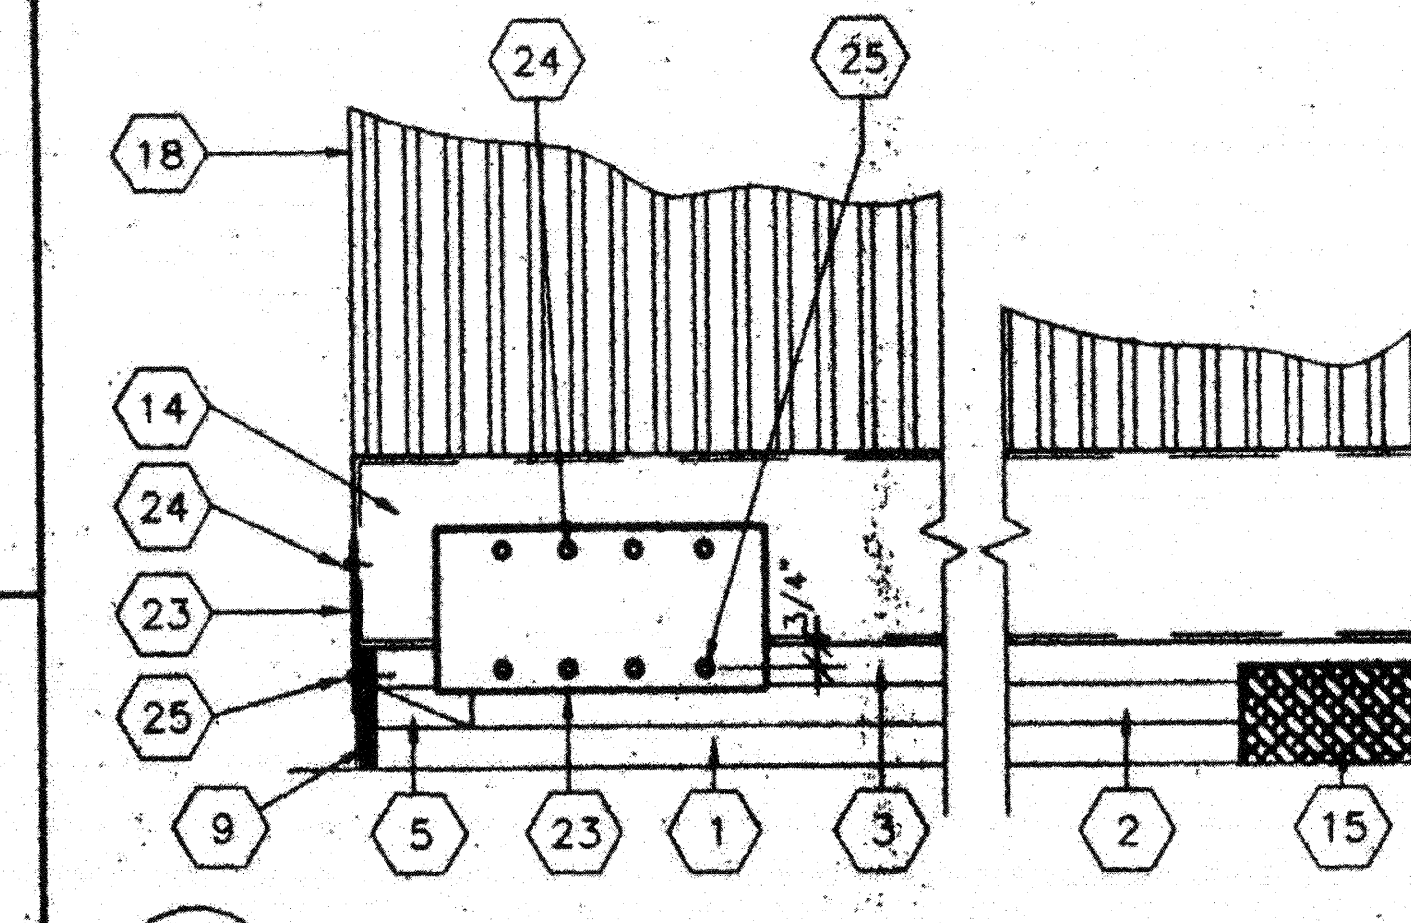


4 SCALE: 1 1/2"=1'-0"
DETAIL @ FOUNDATION CORNER

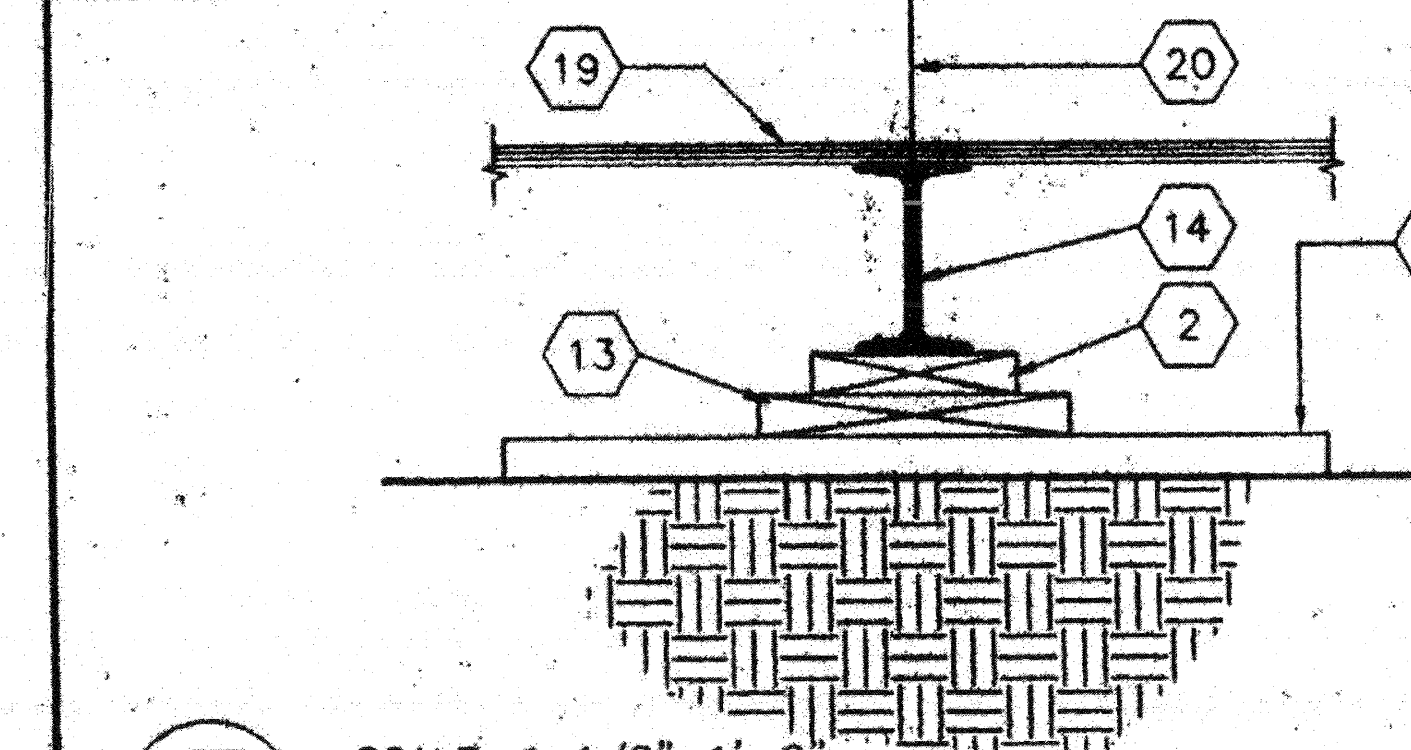

5 SCALE: 1 1/2"=1'-0"
FOUNDATION PAD @ MODLINE

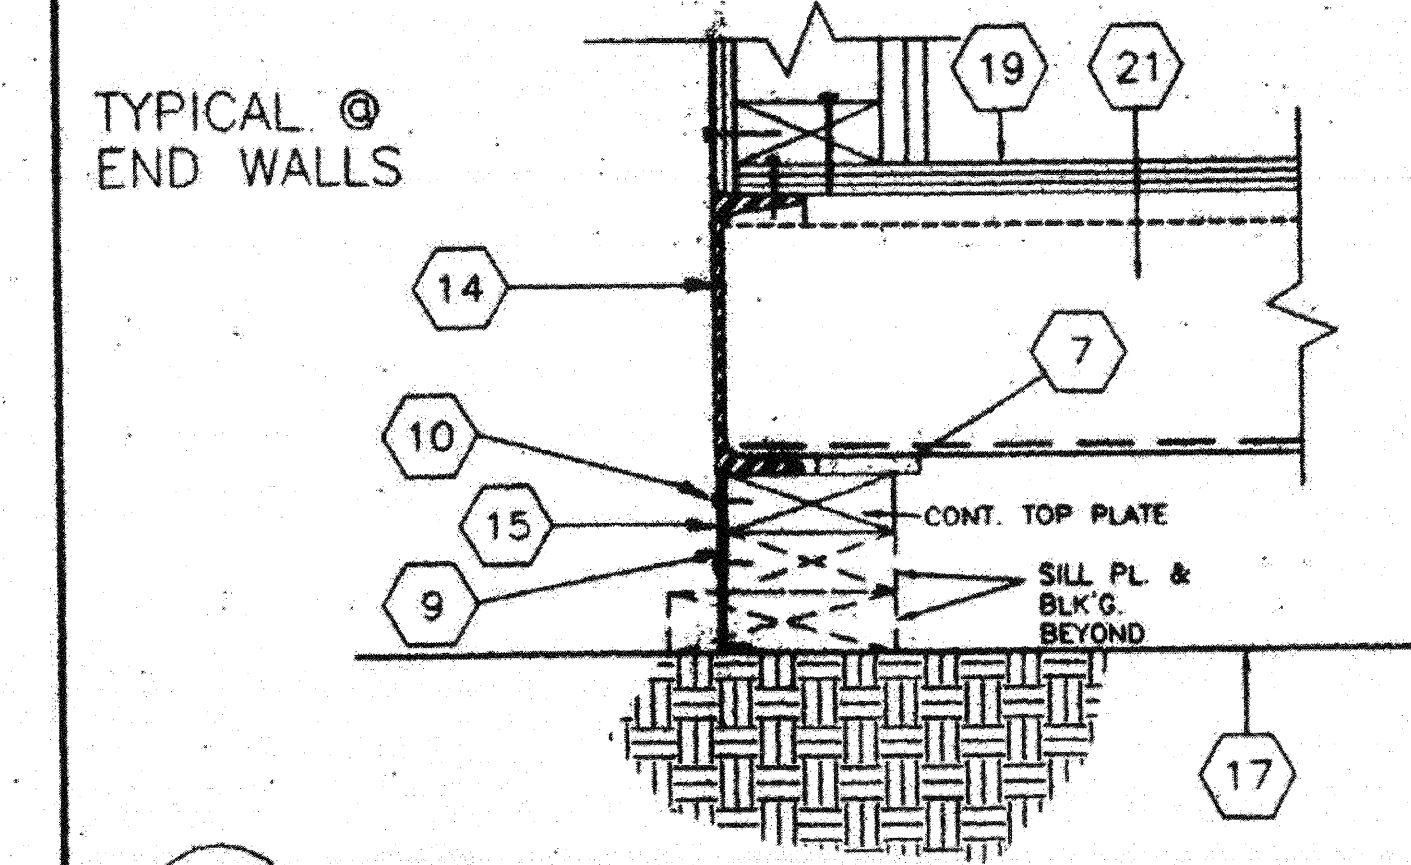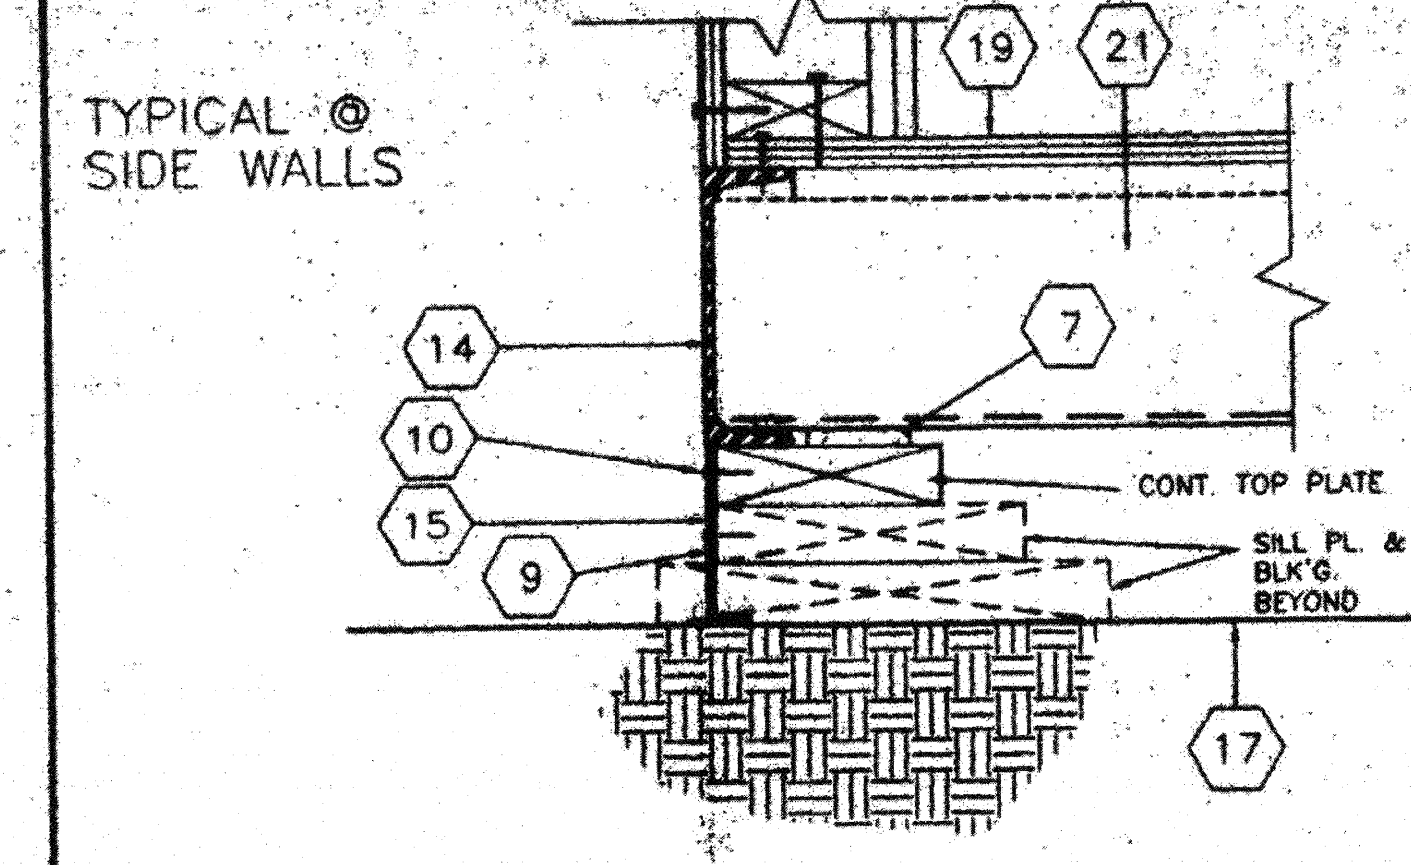

1 SCALE: NTS
FOUNDATION VENT

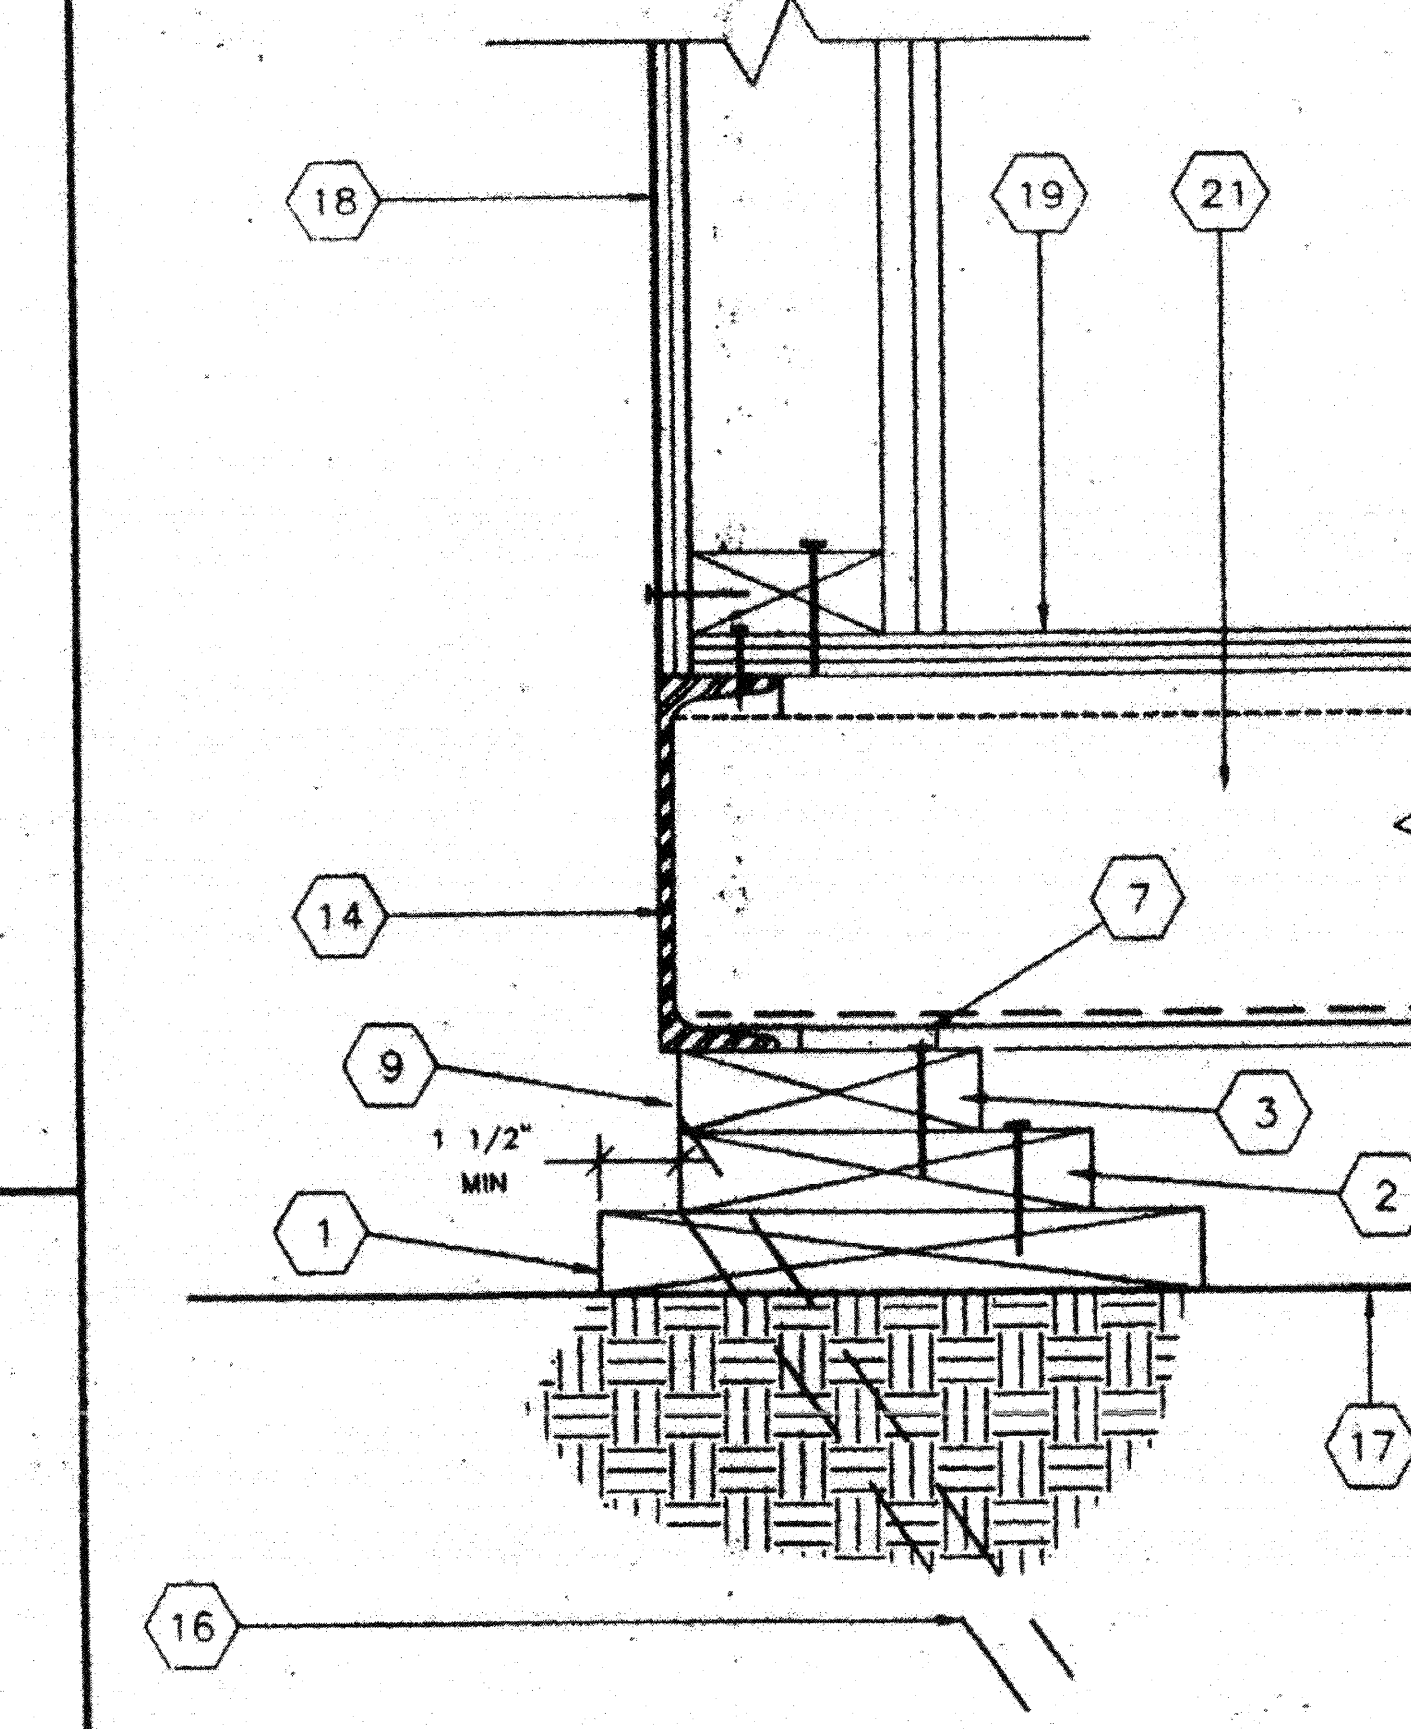

2 SCALE: 3"=1'-0"
FOUNDATION @ SIDE WALL

KEY NOTES

- 1 2X12 SILL PLATE SEE FOUND. PLAN FOR LENGTH
- 2 2X8 BLOCKING W/16d @MAX 5" O.C. TO SILL PLATE
- 3 2X6 TOP PLATE W/16d @MAX 5" O.C. TO BLOCKING
- 4 2X4 TOP PLATE W/16d @ MAX 5" O.C. TO BLOCKING
- 5 2X4 BLOCKING W/16d MAX. 5" O.C. TO SILL PLATE
- 6 2X6 SILL PLATE SEE FOUND. PLAN FOR LENGTH
- 7 5/8"x2 1/2" SHIM (WHEN REQ.)
- 8 INSERT REQ'D 2X4 BLK'NG OR PLYWD SHIM W/16d @ 12" O.C. FACE NAIL
- 9 OPTIONAL - MIN. 3/8" PLYWOOD SHIRTING W/ 10d @ MIN. 4" O.C. @ ENDWALLS & 8" O.C. @ SIDEWALLS E.N. & TYP. 12" O.C. FN. PLATE TO PLATE, NAILING FOR THE FOUNDATION MEMBERS CAN BE DECREASED TO 12" O.C. AND FOUNDATION BLOCKING SHALL BE RECESSED SUCH THAT THE SHIRTING SHALL BE INSTALLED FLUSH WITH THE PERIMETER FLOOR CHANNEL
- 10 10d GALV. NAIL @ MAX. 4" O.C.
- 11 2X12X2'-6" SILL PLATE SEE FOUND. PLAN FOR QUANTITY REQ'D
- 12 2 X 10 PLATES W/ 2-16D BOX @ 6" O.C.
- 13 2X10 BLK'NG FACE OR TOE NAIL 16d @ MAX 12" O.C. ADD BLKS. OR SHIMS AS REQ'D
- 14 FLOOR FRAME BEAM SEE. STRUCTURAL
- 15 TYPICAL FOUNDATION VENT (SEE FOUNDATION PLAN FOR SIZES AND LOCATIONS)
- 16 SILL RESTRAINT 1" @ PIPE SEE FOUND. FOR LOCATION
- 17 FINISH GRADE
- 18 EXTERIOR FINISH
- 19 PLYWOOD SUBFLOOR
- 20 MOD-LINE
- 21 FLOOR-JOIST
- 22 4"x12"x10 GA. PLATE
- 23 6"x12"x10 GA. PLATE
- 24 1/4" @ S.T.S. TYP. 4-PLACES
- 25 1/4" @ X3" LG. LAG SCREW TYP. 4-PLACES
- 26 5/8" @X4" LAGS (FOR LOCATION SEE PLAN)

FOUNDATION LUMBER TO BE PRE-CUT AT FACTORY. LUMBER GRADES & PRESSURE TREATING TO BE VERIFIED BY IN-PLANT INSPECTOR.

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AC FLS SS
Date MAY 10 2017
AUG 28 2017

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FOUNDATION DETAILS F3.0