2018 HVAC - Davis

PUBLIC MEETING ARA ZARECZNY – DIRECTOR OF FACILITIES

2018 HVAC Upgrades

Project Description:

Heating, Ventilation and Air Conditioning (HVAC) projects include the complete replacement of systems at various schools.


Anticipated Heating, Ventilation and Air Conditioning (HVAC) Installation Plan

Below is the Newport-Mesa Unified School District's anticipated phased-in plan for installing Heating, Ventilation and Air Conditioning (HVAC) in all schools and district facilities. Please note that the following schedule is tentative and subject to change due to varying unforeseen factors.

SCHOOL	HVAC	NOTES
California	Yes	Completed Summer, 2015
TeWinkle	Yes	Completed Summer, 2015
Killybrooke	Yes	Completed Summer, 2015
ECHS	Yes	Completed as part of modernization in 2016
Paularino	Yes	Summer Completed Summer, 2016
Sonora	Yes	Completed Summer, 2016
Adams	Yes	Completed Summer, 2016
Victoria	Yes	Had HVAC prior to projects
Rea	Yes	Had HVAC prior to projects
Eastbluff	Yes	Had HVAC prior to projects
Andersen	Yes	Had HVAC prior to projects
Lincoln	Yes	Had HVAC prior to projects
Newport Coast	Yes	Had HVAC prior to projects
Estancia	Yes	Had HVAC prior to projects
Corona del Mar	Yes	Had HVAC prior to projects
HS/MS		
Davis Magnet	Anticipated Completion 2018	In design
College Park	Anticipated Completion 2018	In design
Wilson	Anticipated Completion 2018	In design
Pomona	Anticipated Completion 2018	In design
Kaiser	Anticipated Completion 2018	In design
Woodland	Anticipated Completion 2018	In design
Whittier	Anticipated Completion 2019	
Mariners	Anticipated Completion 2019	
Newport Heights	Anticipated Completion 2019	
Ensign	Anticipated Completion 2019	
Newport El	Anticipated Completion 2019	
Harbor View	Anticipated Completion 2019	
Back Bay	Anticipated Completion 2019	
Costa Mesa HS/MS	Anticipated Completion 2020	Partial HVAC; full HVAC anticipated 2020
Newport Harbor	Anticipated Completion 2021	Partial HVAC; full HVAC anticipated 2021





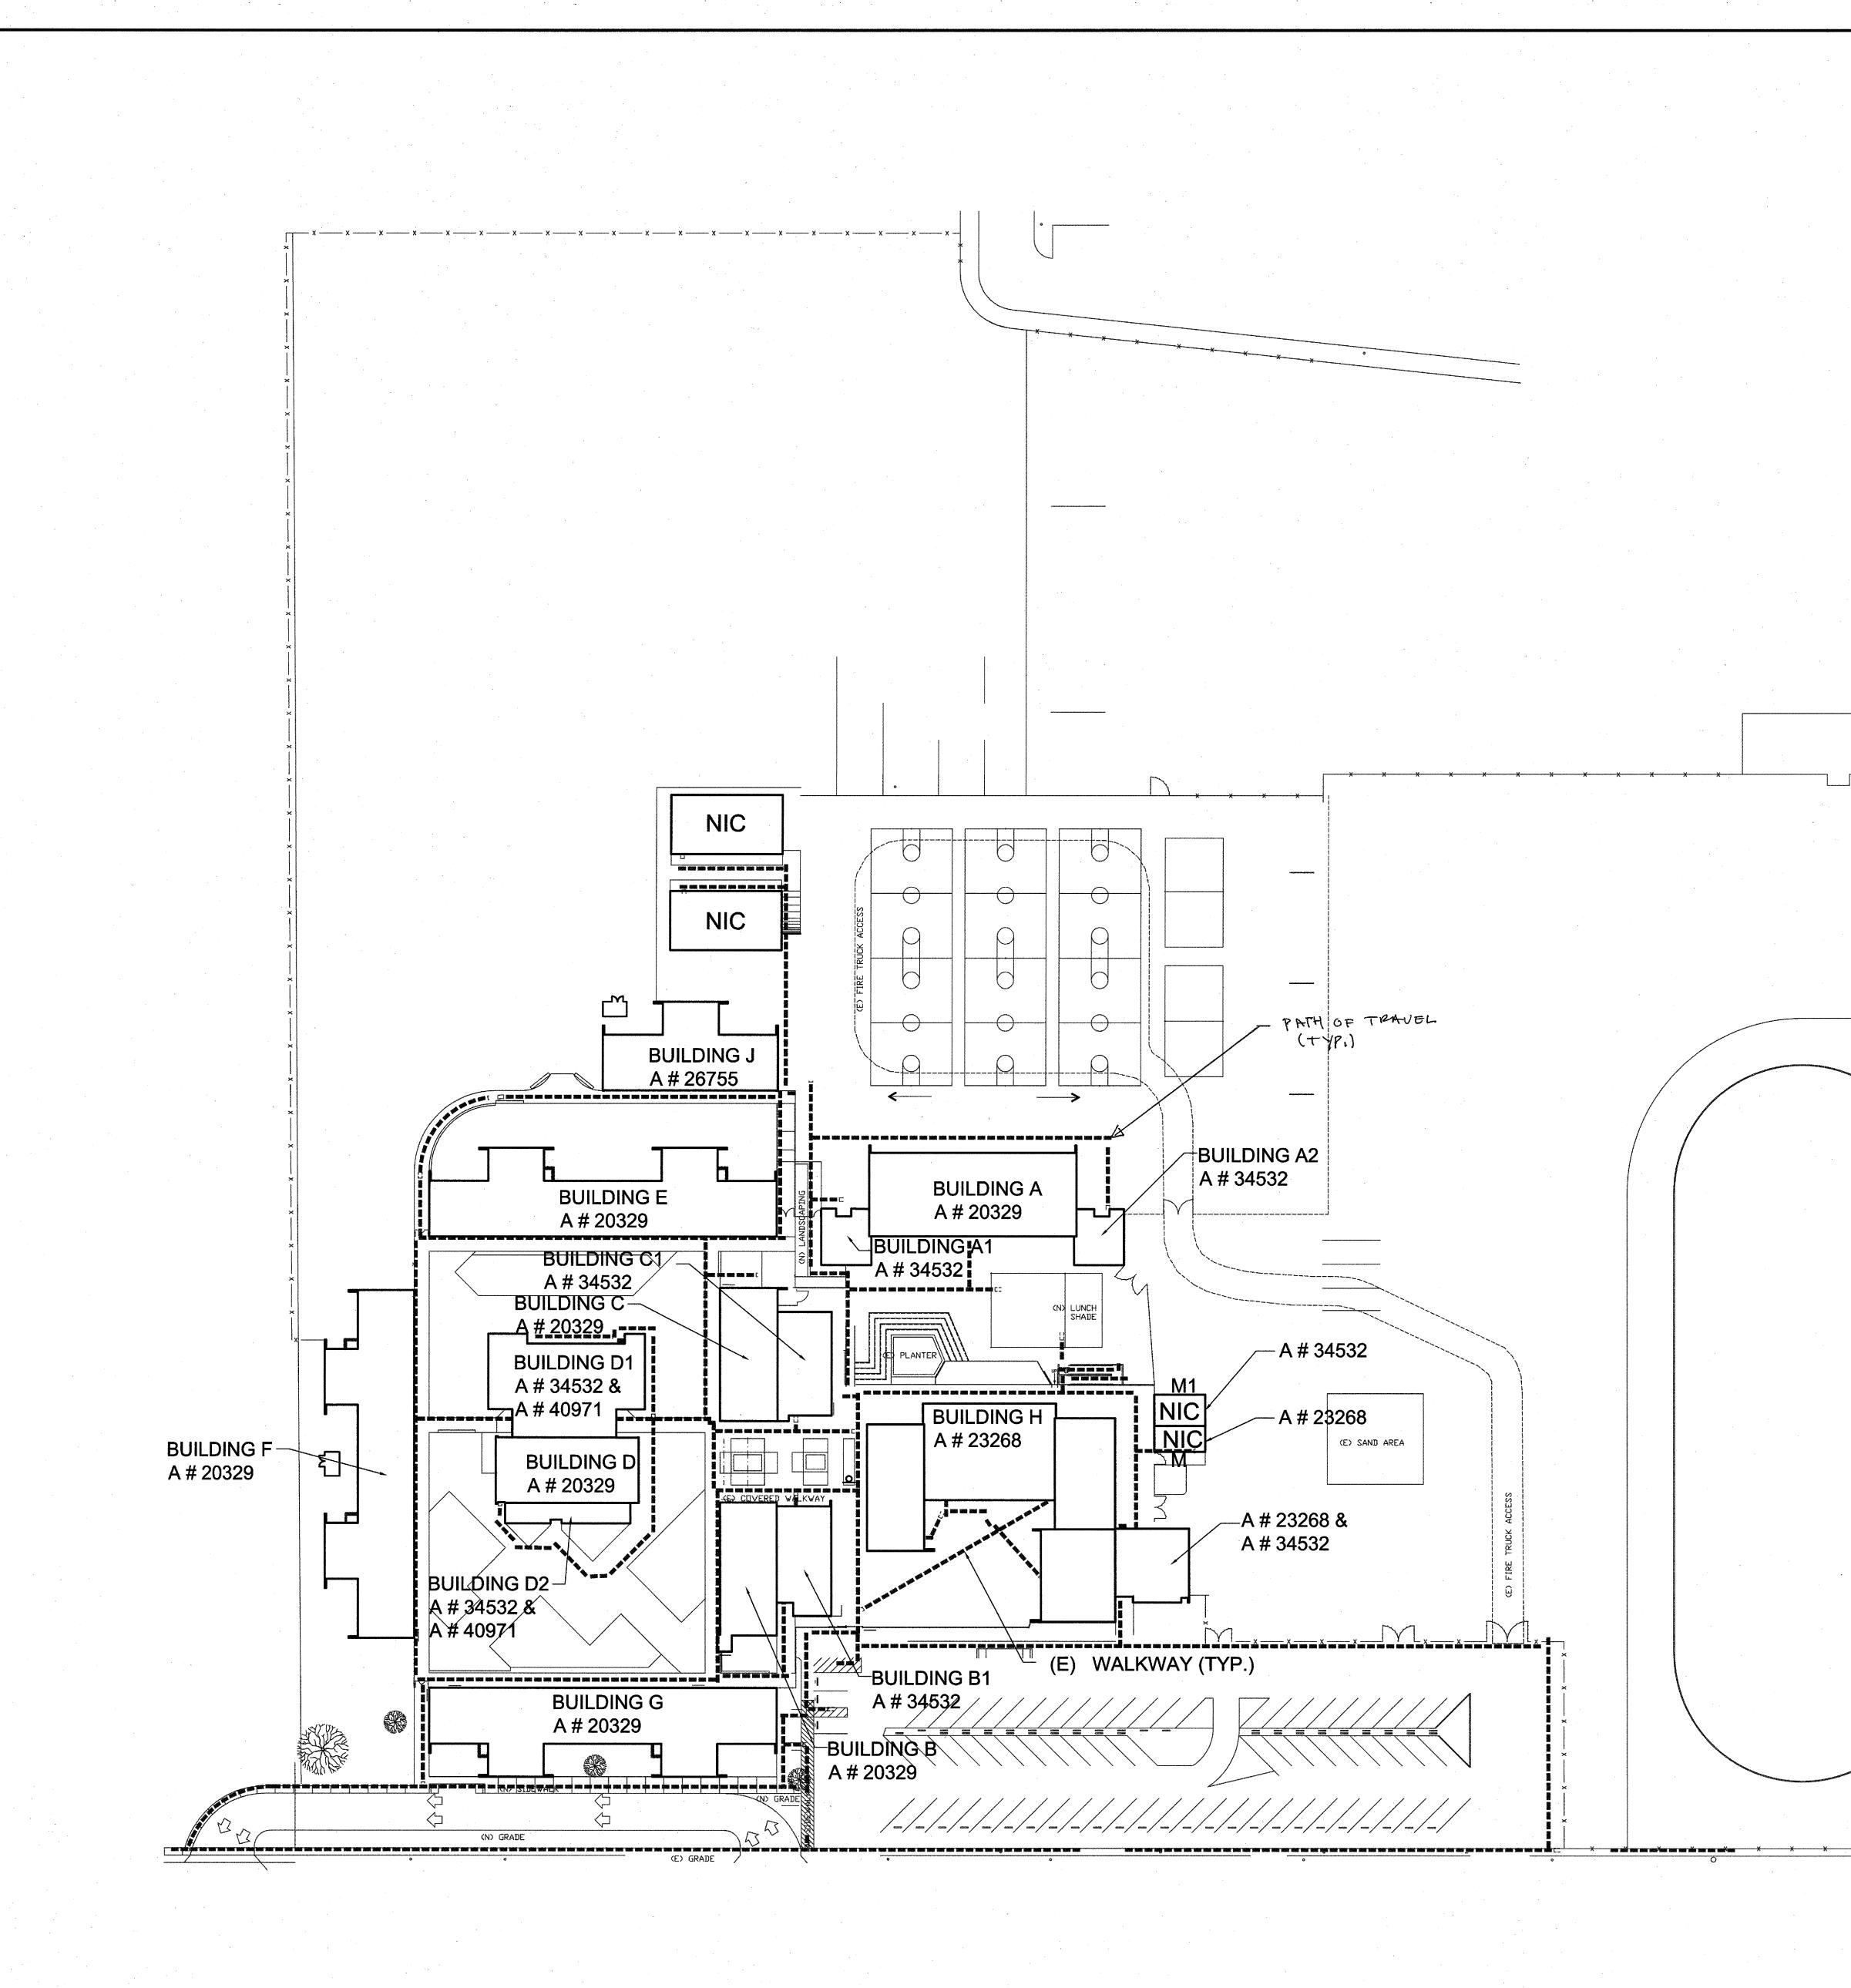


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		SCOPE OF WORK
		(1) BUILDING A. CLASSROOM: REPLACE (E) ROOFTOP PACKAGED UNIT WITH (N)
	·	SPLIT HEAT PUMP/FAN COIL. THE BUILDING HAS (6) CLASSROOMS, EACH
		WITH AN (E) ROOFTOP PACKAGED UNIT ON THE ROOF. EXISTING
		DUCTWORK AND AIR DISTRIBUTION TO REMAIN. EACH CLASSROOM WILL BE
		SERVED BY (N) SPLIT FAN COIL UNIT. REFER TO MD-1 FOR DEMOLITION

- (2) BUILDING B. CLASSROOM: REPLACE (E) ROOFTOP PACKAGED UNIT WITH (N) SPLIT HEAT PUMP. THE BUILDING HAS (2) CLASSROOMS, EACH WITH AN (E) ROOFTOP PACKAGED UNIT ON THE ROOF. EXISTING DUCTWORK AND AIR DISTRIBUTION TO REMAIN BELOW ROOF AND EXPOSED DUCTWORK ON ROOF TO BE REMOVED AND REPLACED WITH NEW DUCTWORK. EACH CLASSROOM WILL BE SERVED BY (N) SPLIT FAN COIL UNIT. REFER TO MD-2 FOR DEMOLITION WORK IN THIS BUILDING. REFER TO M-2 FOR NEW WORK IN THIS BUILDING.
- 3 BUILDING C. CLASSROOM: REPLACE (E) ROOFTOP PACKAGED UNIT WITH (N) SPLIT HEAT PUMP, HEAT PUMP LOCATED ON ROOF OF BUILDING D. THE BUILDING HAS (2) CLASSROOMS. ONE WITH AN (E) ROOFTOP PACKAGED UNIT ON THE ROOF AND OTHER HAS (E) FURNACE UNIT. EXISTING DUCTWORK AND AIR DISTRIBUTION TO REMAIN BELOW ROOF AND EXPOSED DUCTWORK ON ROOF TO BE REMOVED AND REPLACED WITH NEW DUCTWORK. EACH CLASSROOM WILL BE SERVED BY (N) SPLIT FAN COIL UNIT. REFER TO MD-3 FOR DEMOLITION WORK IN THIS BUILDING. REFER TO M-3 FOR NEW WORK IN THIS BUILDING.
- (4) BUILDING D. LIBRARY AND ADMINISTRATION: REPLACE (E) ROOFTOP PACKAGED UNIT WITH TWO (N) VRF SYSTEMS, AND INDOOR FAN COILS. EXISTING DUCTWORK AND AIR DISTRIBUTION TO BE REMOVED. REFER TO MD-4 FOR DEMOLITION WORK IN THIS BUILDING. REFER TO M-4 FOR NEW WORK IN THIS BUILDING.
- 5) <u>BLDG E. CLASSROOMS</u>: REPLACE FOUR (4) EXISTING FAUs AND (E) ROOFTOP PACKAGED UNIT WITH (N) SPLIT HEAT PUMP/FAN COIL UNITS. THE BUILDING HAS (6) CLASSROOMS, FOUR CLASSROOMS WITH AN EXISTING FURNACE EACH IN A MECHANICAL CLOSET WITHIN THE CLASSROOM AND TWO (2) CLASSROOMS WITH ROOFTOP PACKAGED UNIT. THE SCOPE IN THE MECHANICAL CLOSET INCLUDES FURNACE REMOVAL AND WALL PATCH AND INSTALLING NEW FAN COIL UNITS AND CONNECTING EXISTING DUCTWORK UTILITIES TO NEW FAN COILS. EXISTING DUCTWORK TO BE MODIFIED TO USE WITH NEW AC UNITS. EACH CLASSROOM WILL BE SERVED BY (N) SPLIT FAN COIL UNIT. REFER TO MD-5 FOR DEMOLITION WORK IN THIS BUILDING. REFER TO M-5 FOR NEW WORK IN THIS BUILDING.
- (6) BLDG F. CLASSROOMS; REPLACE EXISTING FAUS IN CLASSROOMS WITH (N) SPLIT HEAT PUMP/FAN COIL UNITS. THE BUILDING HAS (6) CLASSROOMS, EACH WITH AN EXISTING FURNACE IN A MECHANICAL CLOSET WITHIN THE CLASSROOM. THE SCOPE IN THE MECHANICAL CLOSET INCLUDES FURNACE REMOVAL AND WALL PATCH AND INSTALLING NEW FAN COIL UNITS AND CONNECTING EXISTING DUCTWORK UTILITIES TO NEW FAN COILS. EXISTING DUCTWORK TO BE MODIFIED TO USE WITH NEW AC UNITS. EACH CLASSROOM WILL BE SERVED BY (N) SPLIT FAN COIL UNIT. REFER TO MD-6 FOR DEMOLITION WORK IN THIS BUILDING. REFER TO M-6 FOR NEW WORK IN THIS BUILDING.
- 7) BUILDING G. CLASSROOM; REPLACE SIX (6) EXISTING PACKAGED UNITS WITH (N) SPLIT HEAT PUMP/FAN COIL UNITS. THE BUILDING HAS SIX (6) CLASSROOMS. EACH WITH AN (E) ROOFTOP PACKAGED UNIT ON THE ROOF. EXISTING DUCTWORK AND AIR DISTRIBUTION TO REMAIN IN CLASSROOM. EACH CLASSROOM WILL BE SERVED BY (N) SPLIT FAN COIL WHICH WILL BE INSIDE EXISTING MECHANICAL ROOM. REFER TO MD-7 FOR DEMOLITION WORJ IN THIS BUILDING. REFER TO M-7 FOR NEW WORK IN THIS BUILDING.
- 8) BUILDING H. ADMINISTRATION. OFFICE AND MUSIC ROOM: ADMIN, MPR, KITCHEN AND BAND ROOM / 8 TON VRF FOR ADMIN AREA AND CLASSROOM AND 14 TON VRF FOR BAND ROOM AND CLASSROOM. 2.5 TON SPLIT SYSTEM FOR IDF ROOM. INDOOR FAN COILS ARE INSIDE ADMIN AREA CLASSROOM, BAND ROOM, IDF ROOM.8 TON VRF AND 4.5 TON SHP SYSTEM UNITS ARE LOCATED ON ROOF AT BUILDING D. 14 TON VRF OUTDOOR UNIT ON GROUND.

REFER TO MD-8 FOR DEMOLITION WORK IN THIS BUILDING. REFER TO M-8 FOR NEW WORK IN THIS BUILDING. MPR AND KITCHEN ARE NOT IN SCOPE OF WORK.

BUILDING J. CLASSROOM: REPLACE EXISTING FAUS IN CLASSROOMS WITH (N) SPLIT HEAT PUMP/FAN COIL UNITS. THE BUILDING HAS (3) CLASSROOMS, EACH WITH AN EXISTING FURNACE IN A MECHANICAL CLOSET CLASSROOMS, EACH WITH AN EXISTING FURNACE IN A MECHANICAL CLOSET WITHIN THE CLASSROOM. THE SCOPE IN THE MECHANICAL CLOSET INCLUDES FURNACE REMOVAL AND WALL PATCH AND INSTALLING NEW FAN COIL UNITS AND CONNECTING EXISTING DUCTWORK UTILITIES TO NEW FAN COILS. EXISTING DUCTWORK TO BE MODIFIED TO USE WITH NEW AC UNITS. EACH CLASSROOM WILL BE SERVED BY (N) SPLIT FAN COIL UNIT. REFER TO MD-9 FOR DEMOLITION WORK IN THIS BUILDING. REFER TO M-9 FOR NEW WORK IN THIS BUILDING.


(10) PORTABLE BUILDINGS: NOT IN SCOPE OF WORK.

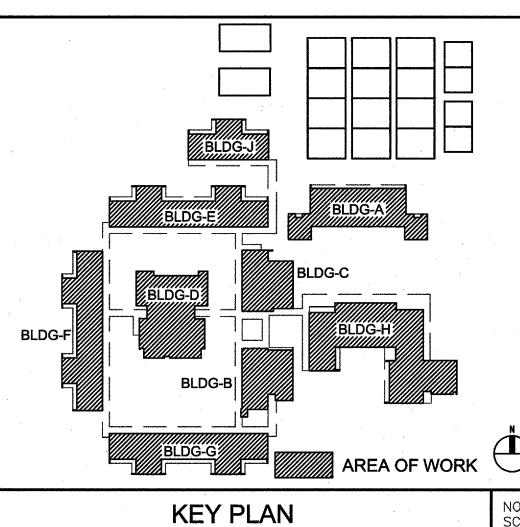


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1" = 40'-0" **1**

Consulting Engineers 5200 E. La Palma Ave WORK IN THIS BUILDING. REFER TO M-1 FOR NEW WORK IN THIS BUILDING. Anaheim, CA 92807 Telephone (714) 693-2277 STAMP A R No. M29253 Exp. 6/30/19 PROJECT NAME: DRIVE 92626 Ζ NON NON 1AG 00 GT. SA. ΣĬ MES MES \odot S € Ω AR 0 0 1050 COS No. Rev. Date Description 2017-09-26 1ST DSA SUBMITTAL 2018-01-16 DSA BACKCHECK JOB NO: 570036 DATE: 2018-01-16 DRAWN: CHECK: ARCHITECT: ENGINEER: OED CONSULTANT STATE **IDENTIFICATION STAMP** DIV. OF THE STATE ARCHITECT SITE PLAN SHEET NO **T-2** NOT T SCALE

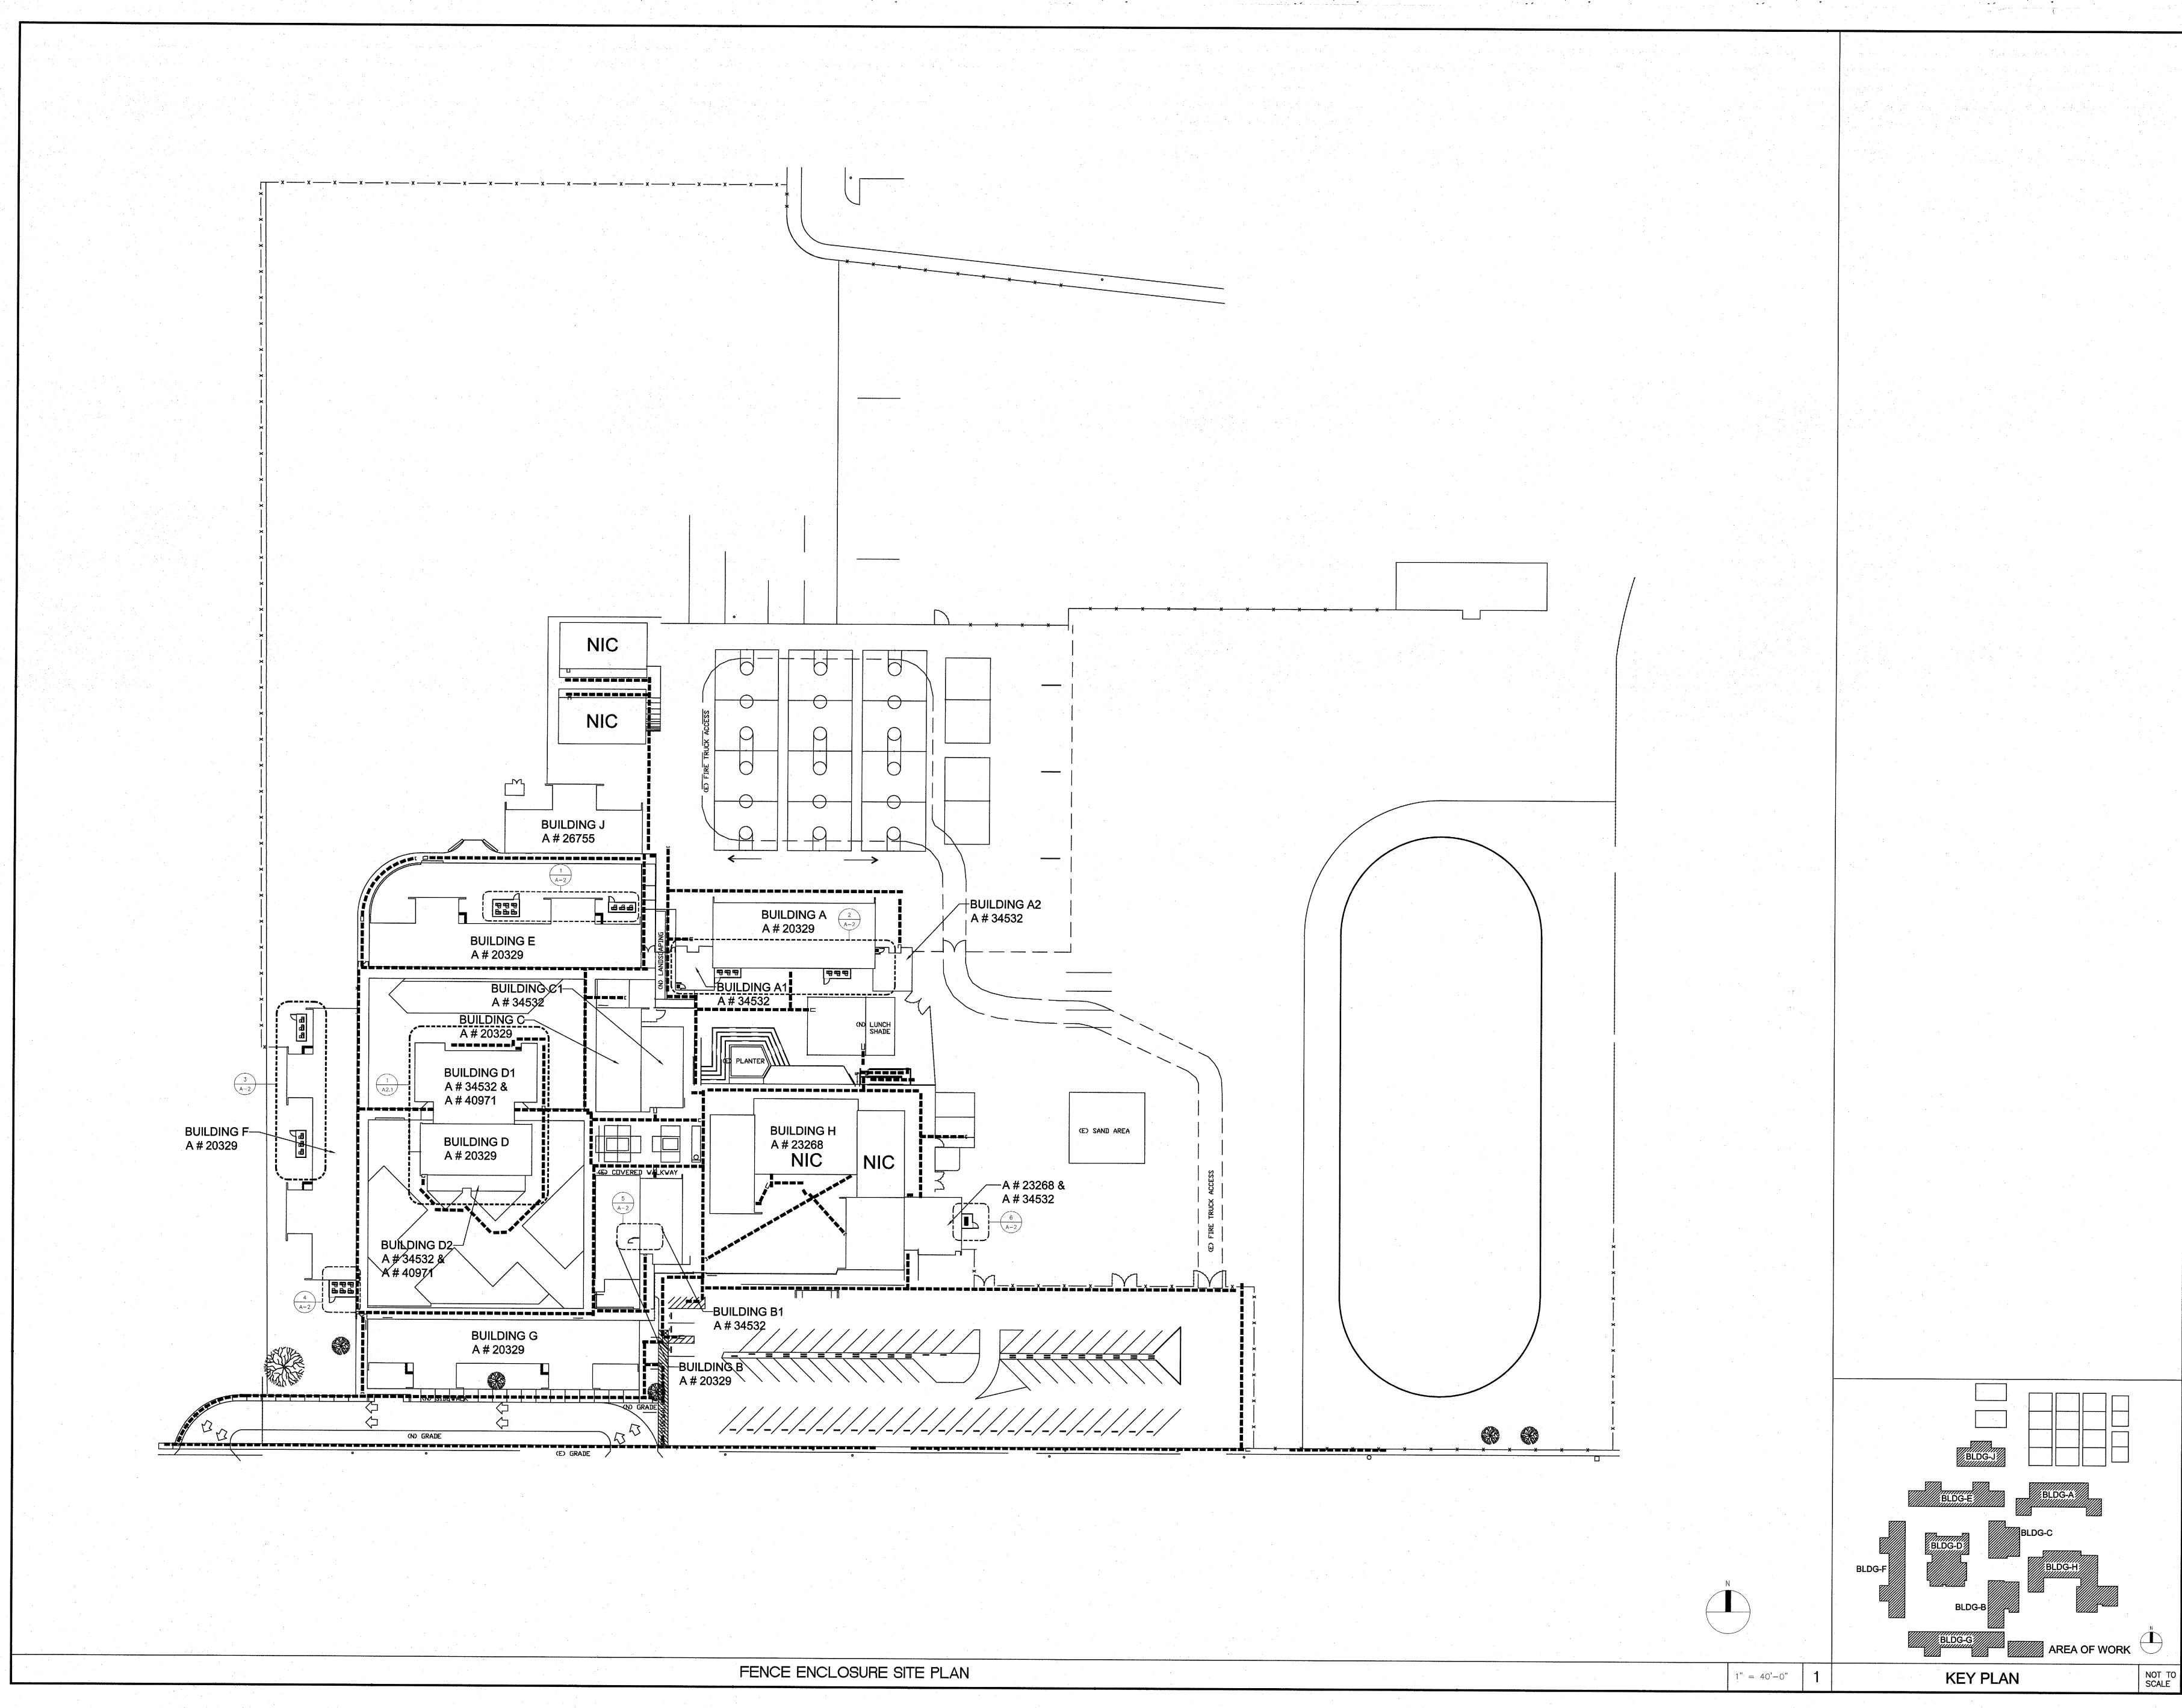

nsulting Engine 5200 E. La Palma Ave Anaheim, CA 92807 Telephone (714) (714) 693-2277 STAMP PROJECT NAME ARLINGTON DRIVE FA MESA, CA 92626 AVIS MAGNET SCHOOL 1050 COS⁻ D No. Rev. Date Description 2017-09-26 1ST DSA SUBMITTAI 2018-01-16 DSA BACKCHECK JOB NO: 570036 DATE: 2018-01-16 DRAWN: MR -----CHECK: ·-----ARCHITECT: SWA ENGINEER: OED CONSULTANT STAME NIALL F SAUNDERS C-26955 STATE: IDENTIFICATION STAMP DIV. OF THE STATE ARCHITECT APP # 4-116609 DATE_ SHEET DESCRIPTION: FENCE ENCLOSURE SITE PLAN SHEET NO: A-1 NOT TO SCALE

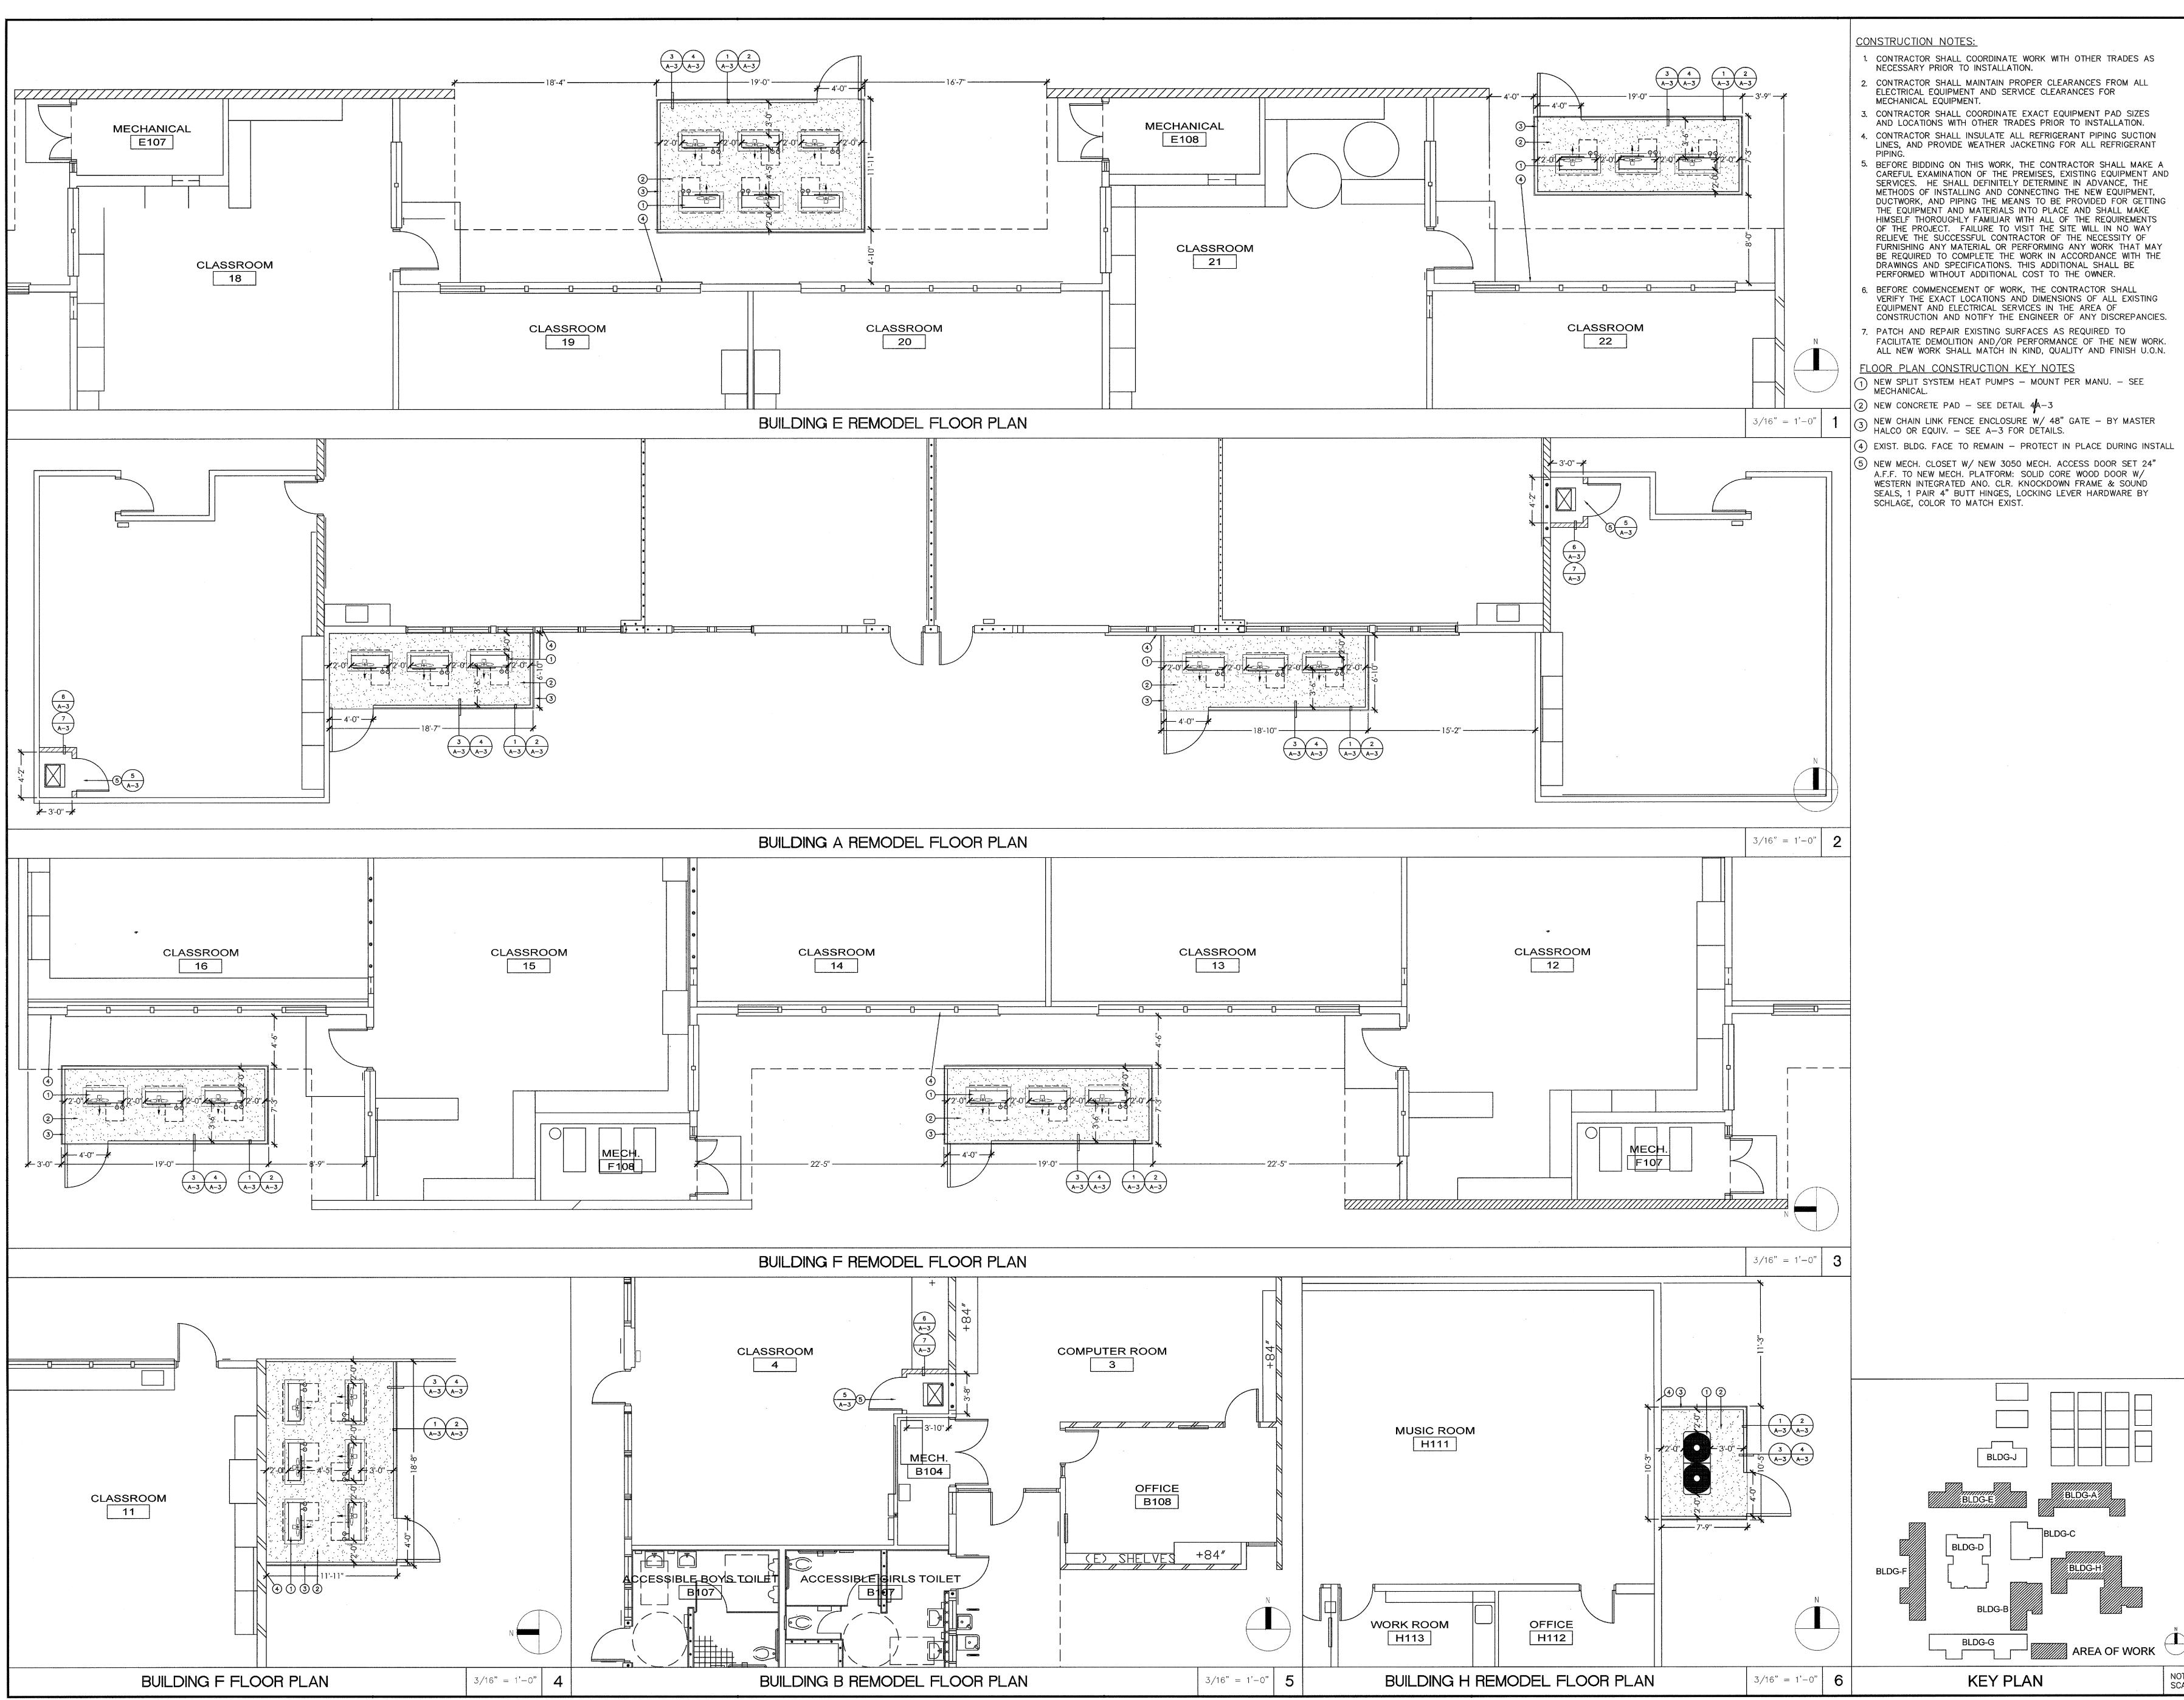

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- 3. CONTRACTOR SHALL COORDINATE EXACT EQUIPMENT PAD SIZES
- 4. CONTRACTOR SHALL INSULATE ALL REFRIGERANT PIPING SUCTION LINES, AND PROVIDE WEATHER JACKETING FOR ALL REFRIGERANT

