LEVEL 1 ALTERATION:

MILLBURY HIGH SCHOOL FOODS PROGRAM ROOM

(T) 508.755.0533

OWNER

TOWN OF MILLBURY
SCHOOL DEPARTMENT
12 MARTIN STREET
MILLBURY, MA 01527

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WORCESTER, MA 01608
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MECHANICAL ENGINEER

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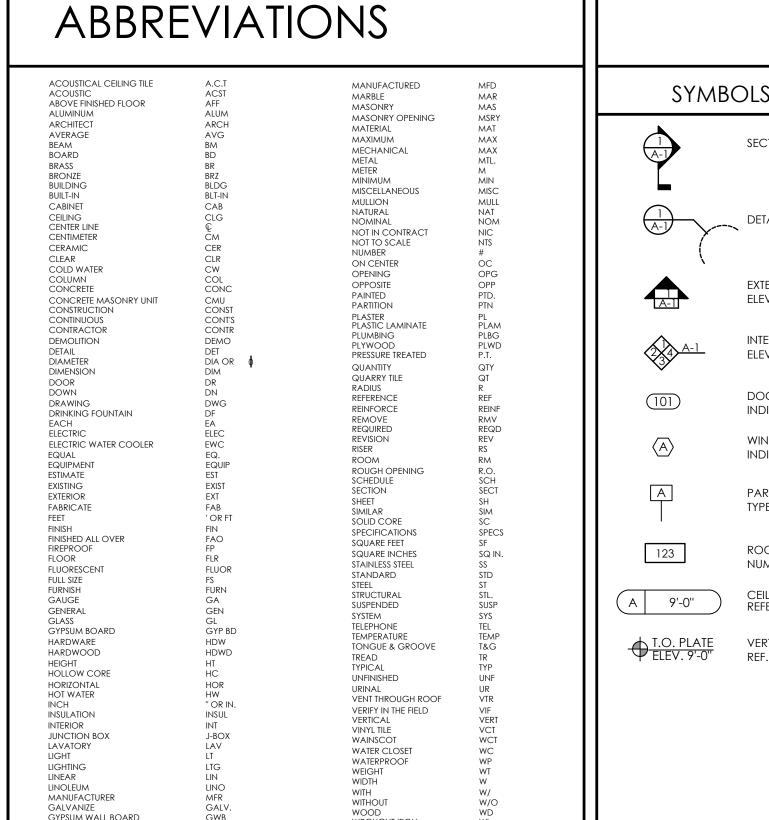
ELECTRICAL ENGINEER
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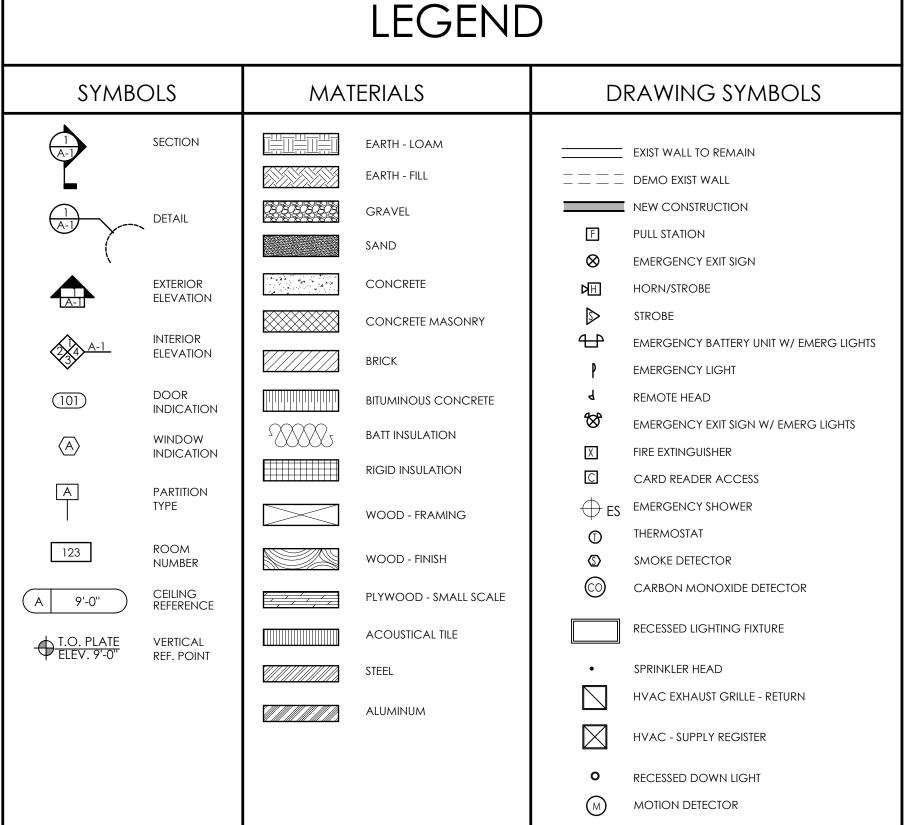
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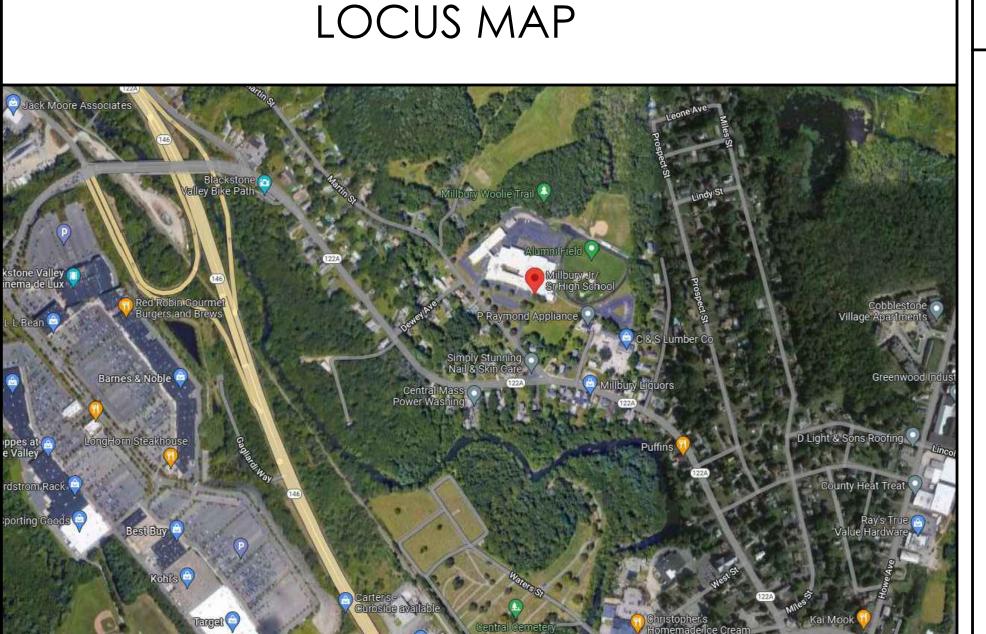
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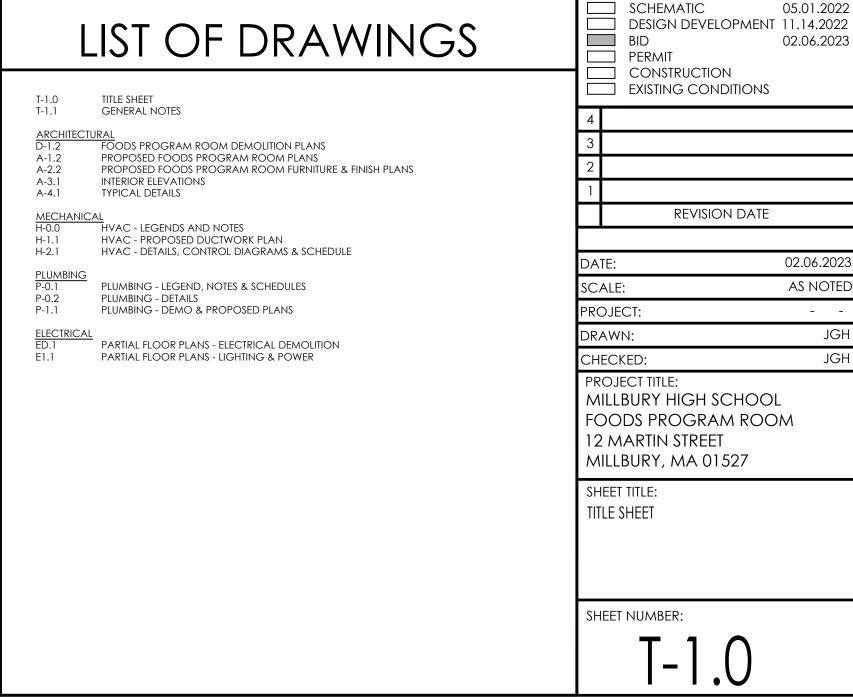
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GENERAL INFORMATION.









GENERAL DEMOLITION NOTES

A. CONTRACTOR SHALL VISUALLY INSPECT THE SITE TO DETERMINE THE CONDITION OF EXISTING CONSTRUCTION AND FAMILIARIZE HIMSELF/HERSELF WITH THE PROPOSED WORK.

- ALL WORK SHALL COMPLY WITH MUNICIPAL, STATE AND FEDERAL RULES AND REGULATIONS, LAWS AND ORDINANCES OF ALL THE AUTHORITIES HAVING JURISDICTION.
- 2. DISCONNECTION OF UTILITIES REQUIRED BY THE WORK SHALL BE PERFORMED BY QUALIFIED
- 3. ALL WORK IS TO COMPLY WITH APPLICABLE PROVISIONS OF ANSI CODE FOR BUILDING CONSTRUCTION; ANS 110.6, SAFETY OF DEMOLITION.
- 4. UTILITY LINES TO BE ABANDONED SHALL BE DISCONNECTED. REMOVE AS REQUIRED, AND/OR CAPPED OFF IN ACCORDANCE WITH APPLICABLE CODE AND REGULATIONS.
- 5. REMOVE ALL AREAS SHOWN DASHED (TYPICAL) ON DEMOLITION PLANS.
- CONTRACTOR TO PROTECT ALL EXISTING AREAS BEYOND LIMIT OF WORK OR ITEMS THAT ARE TO REMAIN, AS REQUIRED.
- COORDINATE DEMOLITION WORK WITH PROPOSED NEW WORK SHOWN ON PROJECT DRAWINGS.
- 8. THE GENERAL CONTRACTOR SHALL NOT INTERFERE WITH NORMAL ACTIVITY IN OR ADJACENT TO THE BUILDING, AND IS SHALL TAKE ALL NECESSARY SAFETY PRECAUTIONS TO PREVENT EXCESSIVE DUST, AND NOISE. ACCESS AND EGRESS TO AND FROM THE EXISTING BUILDING AS WELL AS FIRE PROTECTION IS TO BE MAINTAINED AT ALL TIMES THROUGHOUT THE ENTIRE CONSTRUCTION PROCESS.
- PROVIDE ALL TEMPORARY SHORING BRACING, FRAMING, AND PROTECTION OF EXISTING WORK TO REMAIN BEFORE PROCEEDING WITH DEMOLITION AND DURING ALTERATION WORK.
- 10. PERFORM DEMOLITION WORK AS REQUIRED TO ACCOMMODATE NEW CONSTRUCTION. CONTRACTOR SHALL VERIFY THAT ALL REMOVED COMPONENTS ARE NOT STRUCTURAL, NOTIFY ARCHITECT BEFORE REMOVING ANY STRUCTURAL MEMBERS. NOTIFY ARCHITECT IN CASE OF DISCREPANCY BEFORE PROCEEDING WITH WORK.
- 11. IF DURING DEMOLITION CONDITIONS ARE REVEALED THAT MAY JEOPARDIZE THE INTEGRITY OF THE STRUCTURE OR PRECLUDE THE DESIGN INTENT, THE GENERAL CONTRACTOR SHALL NOTIFY THE ARCHITECT IMMEDIATELY.
- 12. DEMOLITION PLANS ASSUME THAT PORTIONS OF EXISTING WIRING, PLUMBING, EQUIPMENT, DUCTWORK, ETC., IN AREAS OF NEW WORK WILL BE REQUIRED TO BE REMOVED/RELOCATED TO MEET THE REQUIRED DESIGN PARAMETERS OF THE NEW WORK. PRIOR TO COMMENCING DEMOLITION/RELOCATION, CONTRACTOR SHALL VERIFY SPECIFIC CONDITIONS IN THE FIELD AND COORDINATE WITH GC AND ARCHITECT. (SEE M.E.P. DEMOLITION NOTES.)
- 13. BEFORE DISPOSING OF ANY REMOVED ITEMS, CONSULT WITH OWNER AND VERIFY POSSIBLE RE-USE, SALVAGE, OR DISPOSAL OF ANY EXISTING ITEMS AND EQUIPMENT, INCLUDING BUT NOT LIMITED TO, PLUMBING, FIXTURES, EQUIPMENT, LIGHT FIXTURES AND DOORS, ETC.

B. CUTTING AND PATCHING

- 14. GENERAL CONTRACTOR IS RESPONSIBLE FOR COORDINATION OF ALL SUBCONTRACTORS, DEMOLITION CUTTING AND PATCHING
- 15. ALL PARTITIONS, FLOORS, CEILINGS OR ITEMS TO BE REMOVED SHALL BE CLEANLY CUT BACK TO THE LIMITS SHOWN ON THE PLANS, SECTIONS, AND DETAILS OR AS DIRECTED BY THE ARCHITECT.
- 16. ALL EXISTING FLOORS, WALLS, AND CEILINGS AFFECTED BY NEW WALL LOCATIONS ARE TO BE PATCHED AND REPAIRED AS NECESSARY TO PROVIDE A SMOOTH UN-NOTICEABLE TRANSITION OF NEW AND EXISTING MATERIALS AND SURFACES.
- 17. PROVIDE CUTTING AND PATCHING AS REQUIRED FOR ALL DEMOLITION AND ALTERATION WORK. CUTTING AND PATCHING INCLUDE CUTTING INTO OR THROUGH TO PROVIDE FOR THE INSTALLATION OR PERFORMANCE OF OTHER WORK, AND THE SUBSEQUENT FITTING AND PATCHING REQUIRED TO RESTORE THE CUT SURFACES TO THEIR ORIGINAL CONDITION
- 18. REMOVE EXISTING INTERIOR FINISHES AND MATERIALS AS REQUIRED TO ACCOMMODATE NEW WORK. ALL ITEMS ARE TO BE REMOVED IN A MANNER SO AS TO NOT DAMAGE THE EXISTING MATERIALS OR FINISHES THAT ARE TO REMAIN OR BE REINSTALLED.
- 19. PERFORM DEMOLITION WORK CAREFULLY. REMOVE MASONRY, STEEL, CONCRETE, WALLS AND OTHER STRUCTURAL ELEMENTS IN SMALL SECTIONS. REMOVE THESE MATERIALS TO A CLEANLY CUT, STRAIGHT LINE, ACCURATELY ESTABLISHED.
- 20. REMOVE FROM THE SITE AND DISPOSE OF LEGALLY, ALL EXISTING MATERIALS, DEMOLITION DEBRIS, TRASH, RUBBISH AND ITEMS THAT WILL NOT BE USED IN THE NEW WORK OR WILL NOT BE REUSED BY THE OWNER. STORAGE OF DEBRIS WILL NOT BE PERMITTED. ALL DEBRIS TO BE REMOVED AND DISPOSED OF IN ACCORDANCE WITH STATE AND LOCAL REGULATIONS.
- 21. COORDINATE REMOVAL OF ANY RATED ASSEMBLIES WITH LOCAL OFFICIALS BEFORE COMMENCING

C. M.E.P. DEMOLITION NOTES

- 22. SEE ELECTRICAL, HVAC, PLUMBING AND FIRE PROTECTION DRAWINGS FOR LOCATION OF NEW UTILITIES AND DEMOLITION OF EXISTING WORK NOT SHOWN ON THESE PLANS. GC TO COORDINATE ALL WORK WITH SUBCONTRACTORS.
- 23. WHERE EXISTING ELECTRICAL DEVICES OCCUR IN PARTITIONS INDICATED TO BE REMOVED, THE WIRING SHALL BE REMOVED, ALL ELECTRICAL LINES BEING DISCONNECTED SHALL BE ADEQUATELY TRACED AND RECONNECTED AS REQUIRED TO ENSURE PROPER FUNCTION FOR THE ADJACENT AREAS AND TO ENSURE PROPER FUNCTION OF THE EXISTING BUILDING EQUIPMENT OR SYSTEM TO REMAIN. ELECTRICAL CONTRACTOR TO VERIFY ALL ELECTRICAL SYSTEMS PRIOR TO THE COMMENCEMENT OF WORK.
- WHERE EXISTING PLUMBING LINES ARE TO BE REWORKED OR REMOVED, ALL PLUMBING LINES BEING DISCONNECTED SHALL BE ADEQUATELY TRACED AND RECONNECTED AS REQUIRED TO ENSURE PROPER FUNCTION FOR THE ADJACENT AREAS AND TO ENSURE PROPER FUNCTION OF THE EXISTING BUILDING EQUIPMENT TO REMAIN IN PLACE.
- 25. WHERE EXISTING HVAC LINES, DUCTWORK, ETC. ARE TO BE REWORKED, ALL LINES AND EQUIPMENT BEING DISCONNECTED SHOULD BE ADEQUATELY TRACED AND RECONNECTED AS REQUIRED TO ENSURE PROPER FUNCTION FOR THE ADJACENT AREAS AND TO ENSURE PROPER FUNCTION TO THE EXISTING BUILDING EQUIPMENT OR SYSTEMS TO REMAIN.
- 26. COORDINATE WITH MECHANICAL AND ELECTRICAL DRAWINGS FOR LOCATIONS OF ALL NEW PENETRATIONS THRU ROOF, FLOORS, WALLS, AND CEILINGS.

D. CLEANING


27. CONTRACTOR IS FULLY RESPONSIBLE FOR THE CLEANING AND PREPARING OF ALL FLOOR, WALL AND CEILING SURFACES FOR THE INSTALLATION OF NEW MATERIALS AS SCHEDULED, UTILITIES, HVAC AND ELECT. SYSTEMS EQUIPMENT, ETC. AFTER DEMO CLEAN-UP.

OTHER: REMINDERS/SPECIFIC TO INDIVIDUAL PROJECTS

- 28. EXISTING LARGE FLOOR OPENINGS TO BE FILLED ARE INDICATED, SMALLER PIPE HOLES, ETC. TO BE FILLED ARE NOT INDICATED ON THE DRAWINGS. REFER TO DETAILS FOR REQUIREMENTS FOR FILLING
- 29. ALL EXISTING COLUMNS TO REMAIN UNLESS NOTED.
- 30. ALL EXPOSED UNUSED PIPING AND CONDUITS SHALL BE REMOVED BY THE GENERAL CONTRACTOR. SEE SPECIFICATIONS FOR CAPPING.

GENERAL CONSTRUCTION NOTES

- 1. ALL WORK IS TO BE PERFORMED IN PROFESSIONAL AND WORKMANLIKE MANNER, IN ACCORDANCE WITH ALL APPLICABLE FEDERAL & STATE CODES, INCLUDING THE INTERNATIONAL BUILDING CODE (IBC). THESE INCLUDE, BUT ARE NOT LIMITED TO, THE INTERNATIONAL EXISTING BUILDING CODE (IEBC), MASS STATE BUILDING CODE, THE AMERICAN NATIONAL STANDARD (ANSI), THE INTERNATIONAL ENERGY CONSERVATION CODE (IECC), THE NATIONAL ELECTRIC CODE (NEC), THE INTERNATIONAL PLUMBING CODE (IPC), THE INTERNATIONAL MECHANICAL CODE (IMC), AND THE NATIONAL FIRE PROTECTION STANDARDS, AS WELL AS ALL LOCAL REGULATIONS GOVERING THE PROJECT.
- 2. CONTRACTOR TO VISIT SITE AND TO VERIFY ALL DIMENSIONS AND CONDITIONS IN THE FIELD, AND REPORT ALL DISCREPANCIES TO ARCHITECT, PRIOR TO PROCEEDING WITH WORK.
- 3. ALL MATERIALS USED ON THIS PROJECT SHALL BE IN COMPLIANCE WITH THE APPLICABLE INTERNATIONAL BUILDING CODE.
- 4. THE CONTRACTOR SHALL MAINTAIN COMPLETE AND UP-TO-DATE DRAWINGS AT THE JOB SITE, AND SHALL SUBMIT ACCURATE AS-BUILT DRAWINGS TO ARCHITECT AND OWNER AT END OF PROJECT.
- 5. THE INTENTION OF THE CONTRACT DOCUMENTS IS TO INCLUDE ALL LABOR, MATERIALS, EQUIPMENT AND OTHER ITEMS NECESSARY FOR THE PROPER EXECUTION AND COMPLETION OF THE WORK.
- 6. BY EXECUTING THE CONTRACT, THE CONTRACTOR REPRESENTS THAT THEY HAVE VISITED THE SITE AND HAVE FAMILIARIZED THEM SELF WITH THE CONDITIONS UNDER WHICH THE WORK IS TO BE PERFORMED.
- 7. THE ARCHITECT WILL HAVE AUTHORITY TO REJECT WORK WHICH DOES NOT CONFORM TO THE CONTRACT DOCUMENTS.
- 8. THE CONTRACTOR SHALL SUPERVISE AND DIRECT THE WORK, USING THEIR BEST SKILLS AND ATTENTION. THE CONTRACTOR SHALL BE SOLELY RESPONSIBLE FOR ALL CONSTRUCTION MEANS, METHODS, TECHNIQUES, SEQUENCES, PROCEDURES, & SHORING, AND FOR COORDINATING THE WORK OF ALL SUB-CONTRACTORS.
- 9. EACH CONTRACTOR SHALL PERFORM ALL REQUIRED CUTTING AND PATCHING FOR THEIR OWN TRADE, UNLESS OTHERWISE NOTED.
- 10. DRAWINGS SHALL NOT BE SCALED TO OBTAIN DIMENSIONS.
- 11. CONTRACTOR SHALL PROPERLY PROTECT AND MAKE SAFE WORK PREMISES.
- 12. THE CONTRACTOR SHALL KEEP THE WORKSITE CLEAN AND TIDY, AND AT ALL TIMES SHALL KEEP THE PREMISES FREE FROM ACCUMULATION OF WASTE MATERIALS OR TRASH CAUSED BY THEIR OPERATIONS.
- 13. ALL EXITS SHALL BE KEPT READILY ACCESSIBLE AND UNOBSTRUCTED AT ALL TIMES AND SHALL MAINTAIN REQUIRED EMERGENCY EGRESS DURING CONSTRUCTION.
- 14. THE CONTRACTOR SHALL INDEMNIFY AND HOLD HARMLESS THE OWNER AND THE ARCHITECT, AND THEIR AGENTS AND EMPLOYEES, FROM AND AGAINST ANY CLAIMS, DAMAGES, LOSSES AND EXPENSES INCLUDING ATTORNEY'S FEES ARISING OUT OF OR RESULTING FROM THE PERFORMANCES OF THE WORK.
- 15. THE CONTRACTOR SHALL PAY ALL FEES AND SECURE PERMITS FROM ALL AGENCIES HAVING JURISDICTION AND AT COMPLETION SHALL SEE THAT THE PROJECT IS SIGNED OFF BY THE APPROPRIATE
- 16. WEATHER PROTECTION: THE CONTRACTOR SHALL AT ALL TIMES PROVIDE PROTECTION AGAINST THE RAIN, WIND, STORM, FROST, OR HEAT SO AS TO MAINTAIN ALL WORK MATERIALS, APPARATUS, AND FIXTURES FROM INJURY OR DAMAGE.
- 17. THE CONTRACTOR SHALL PROTECT ALL AREAS OUTSIDE THE CONTRACT LIMITS AND RESTORE ALL SUCH PROPERTY TO ITS CONDITION PRIOR TO THE START OF THE WORK.
- 18. DAMAGE: ALL WORK DAMAGED BY FAILURE TO PROVIDE PROTECTION SHALL BE REMOVED AND REPLACED WITH NEW WORK AT THE CONTRACTORS EXPENSE. THE CONTRACTOR SHALL UNCONDITIONALLY GUARANTEE ALL MATERIALS AND WORKMANSHIP UNTIL THE DATE OF OWNER'S ACCEPTANCE AND SHALL REPLACE ANY DEFECTIVE WORK WITHIN THAT PERIOD WITHOUT EXPENSES TO THE OWNER AND PAY FOR ALL DAMAGES TO OTHER PARTS OF THE BUILDING CAUSED BY REPAIR OF THEIR WORK.
- 19. ALL FINISHES SHALL COMPLY WITH THE LIMITS FOR FIRE RESISTANCE/FLAMMABILITY AS SPECIFIED IN THE APPLICABLE INTERNATIONAL BUILDING CODE.
- 20. ALL DEMOLITION AND RELOCATING OF EXISTING MEP SYSTEMS EFFECTING NEW PLUMBING, HVAC, AND ELECTRICAL SYSTEMS SHALL BE COORDINATED WITH RESPECTIVE SUBCONTRACTORS. RELOCATE/REWORK ALL ACTIVE MECHANICAL AND ELECTRICAL LINES WHERE REQUIRED DUE TO REMOVALS AND NEW LAYOUT. MODIFICATIONS FROM THE DRAWINGS SHALL BE BROUGHT TO THE ATTENTION OF THE ARCHITECT BEFORE COMMENCING WORK.
- 21. CONTRACTORS SHALL COORDINATE WITH PROPERTY MANAGER AS REQUIRED WHEN ITEMS OF NEW PLUMBING WORK REQUIRE ACCESS TO ADJACENT COMMON AREAS, AND TENANT SPACES OUTSIDE AREA OF WORK REPLACE AND RESTORE FINISHES TO MATCH AFTER COMPLETION OF WORK.
- 22. PROVIDE ALL BLOCKING REQUIRED TO INSTALL MILLWORK, EQUIPMENT, CASEWORK, GRAB BARS, RAILINGS, ETC. TYPE AND LOCATION SHALL BE SUBJECT TO REVIEW BY ARCHITECT.
- 23. FOAM IN PLACE INSULATION FOR SMALL GAPS AND VOIDS.
- 24. CAULK ALL JOINTS OF DISSIMILAR MATERIALS.
- 25. PLAN DIMENSIONS ARE TO FACE OF PARTITION AT INTERIOR AND FACE OF FOUNDATION AT EXTERIOR, UNLESS OTHERWISE NOTED.
- 26. REFER TO OWNERS ENVIRONMENTAL REPORT REGARDING CONTAMINANTS AND ASBESTOS ON THE PROJECT SITE/BUILDING.

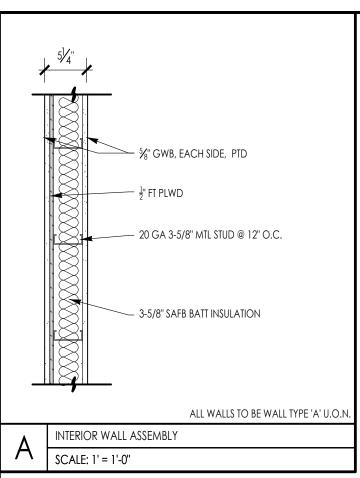

ARCHITECT: **DIXON SALO ARCHITECTS** INCORPORATED®ĂĔ ARCHITECT'S STAMP: ENGINEER: ENGINEER'S STAMP: GENERAL INFORMATION: SCHEMATIC 05.01.2022 DESIGN DEVELOPMENT 11.14.2022 BID 02.06.2023 PERMIT CONSTRUCTION EXISTING CONDITIONS

REVISION DATE


02.06.2023 AS NOTED PROJECT: JGH DRAWN: CHECKED: JGH


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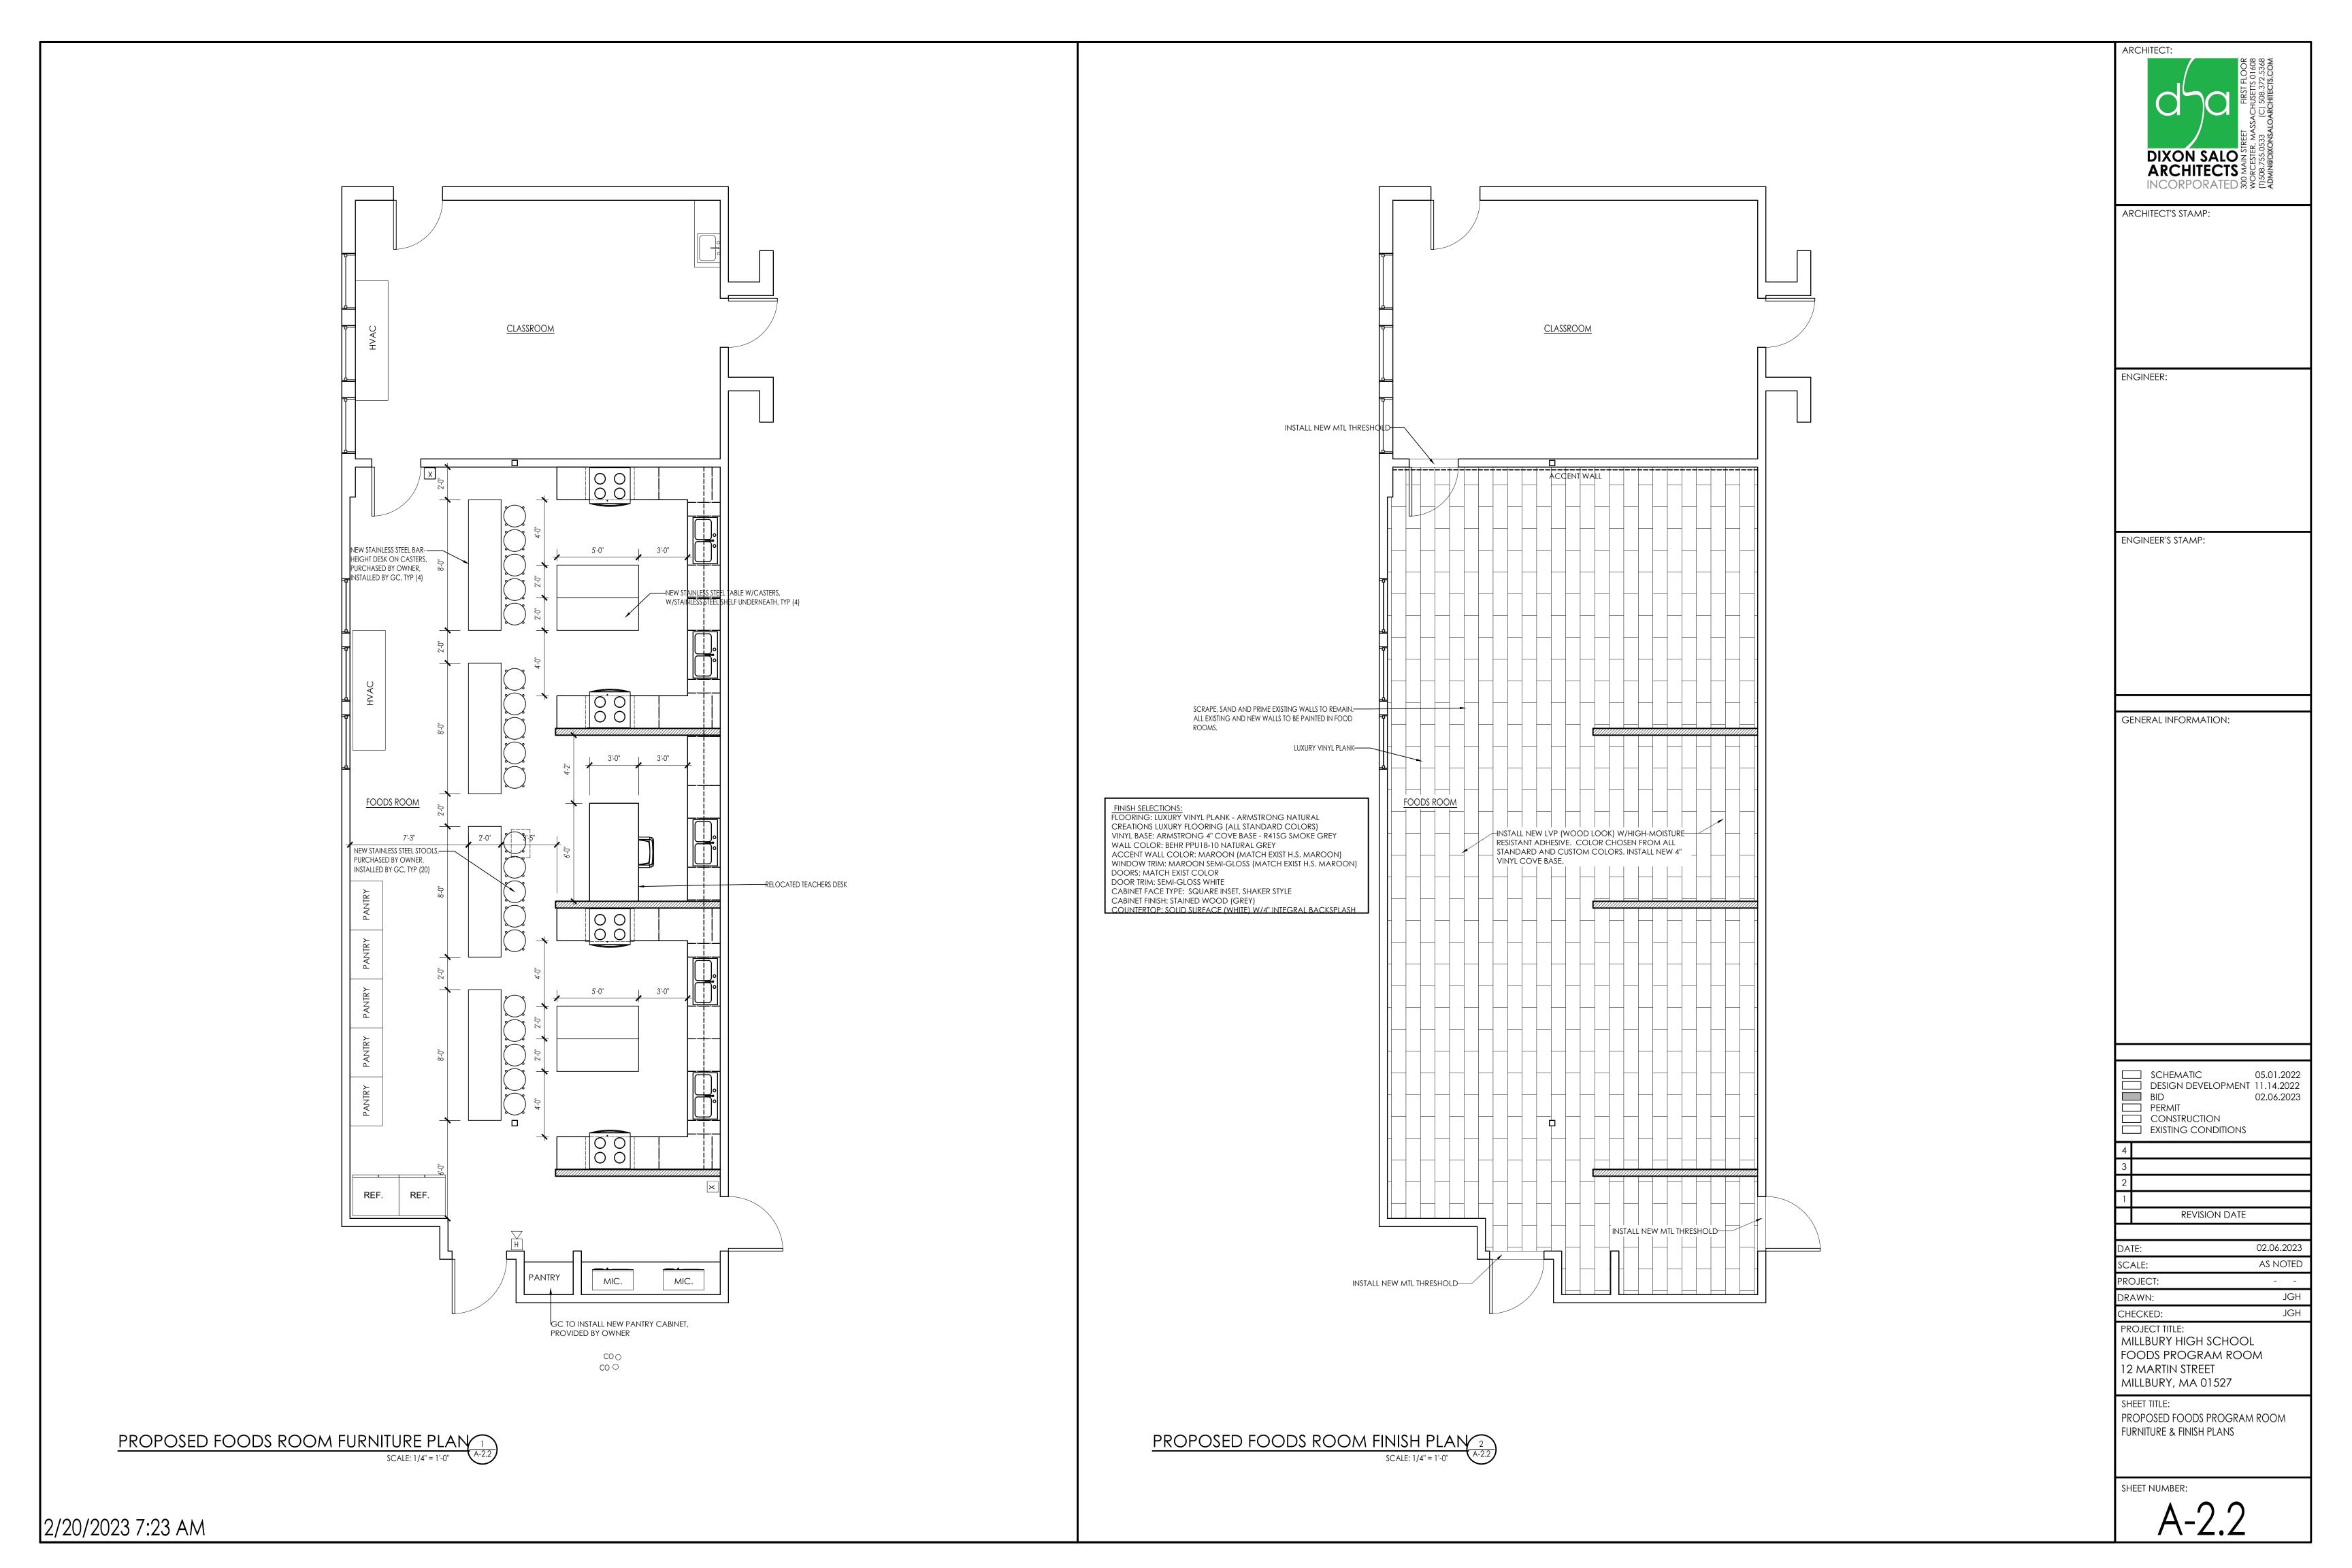
SHEET TITLE: GENERAL NOTES


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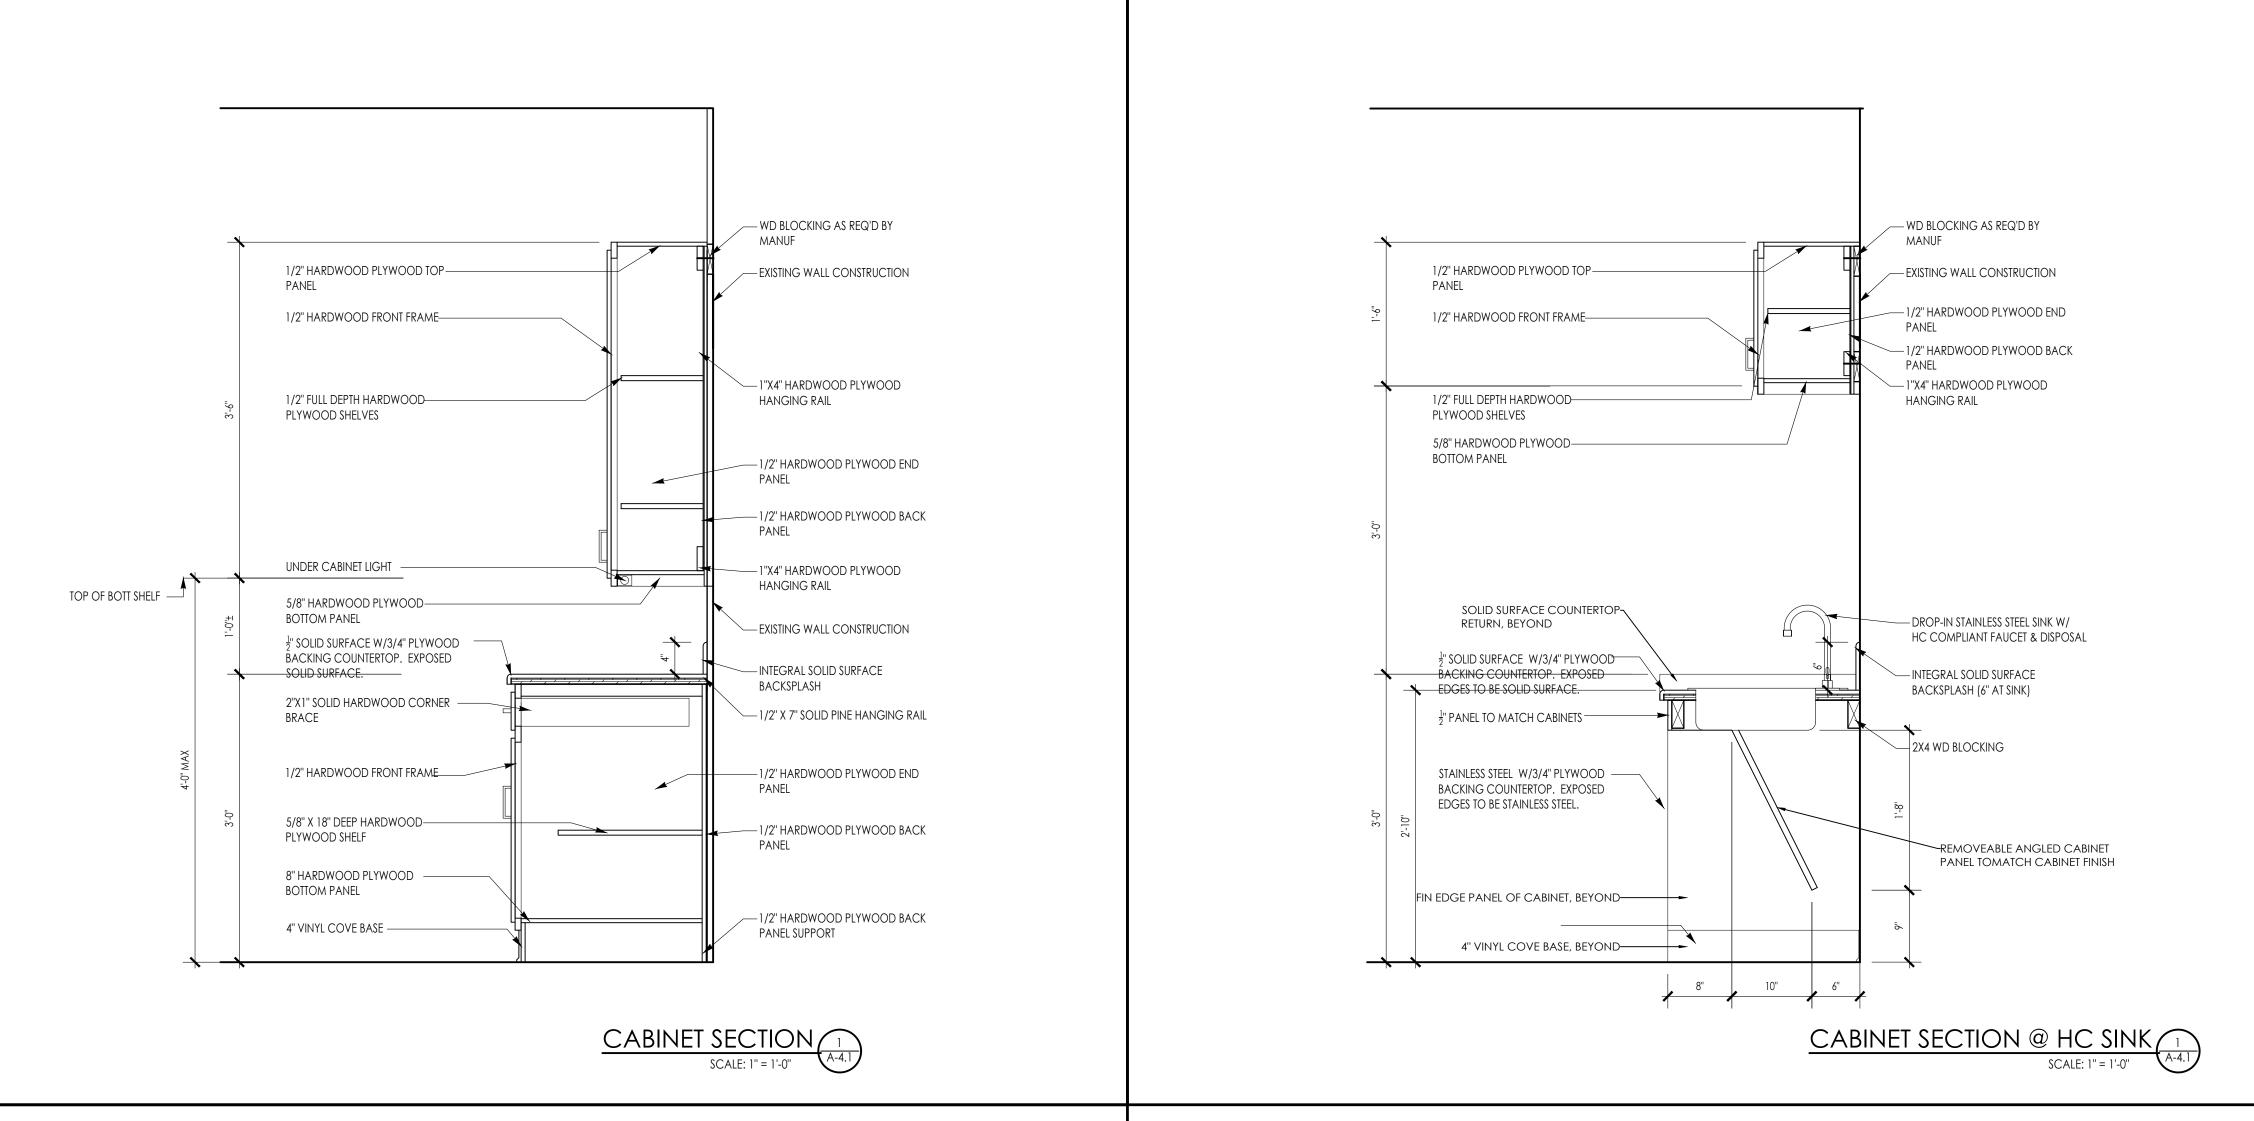
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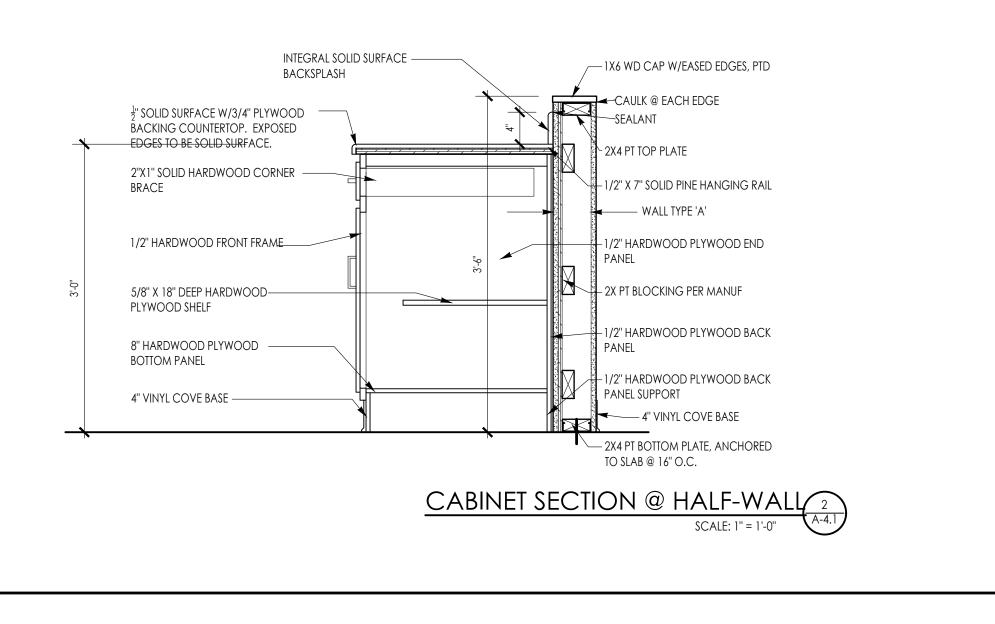







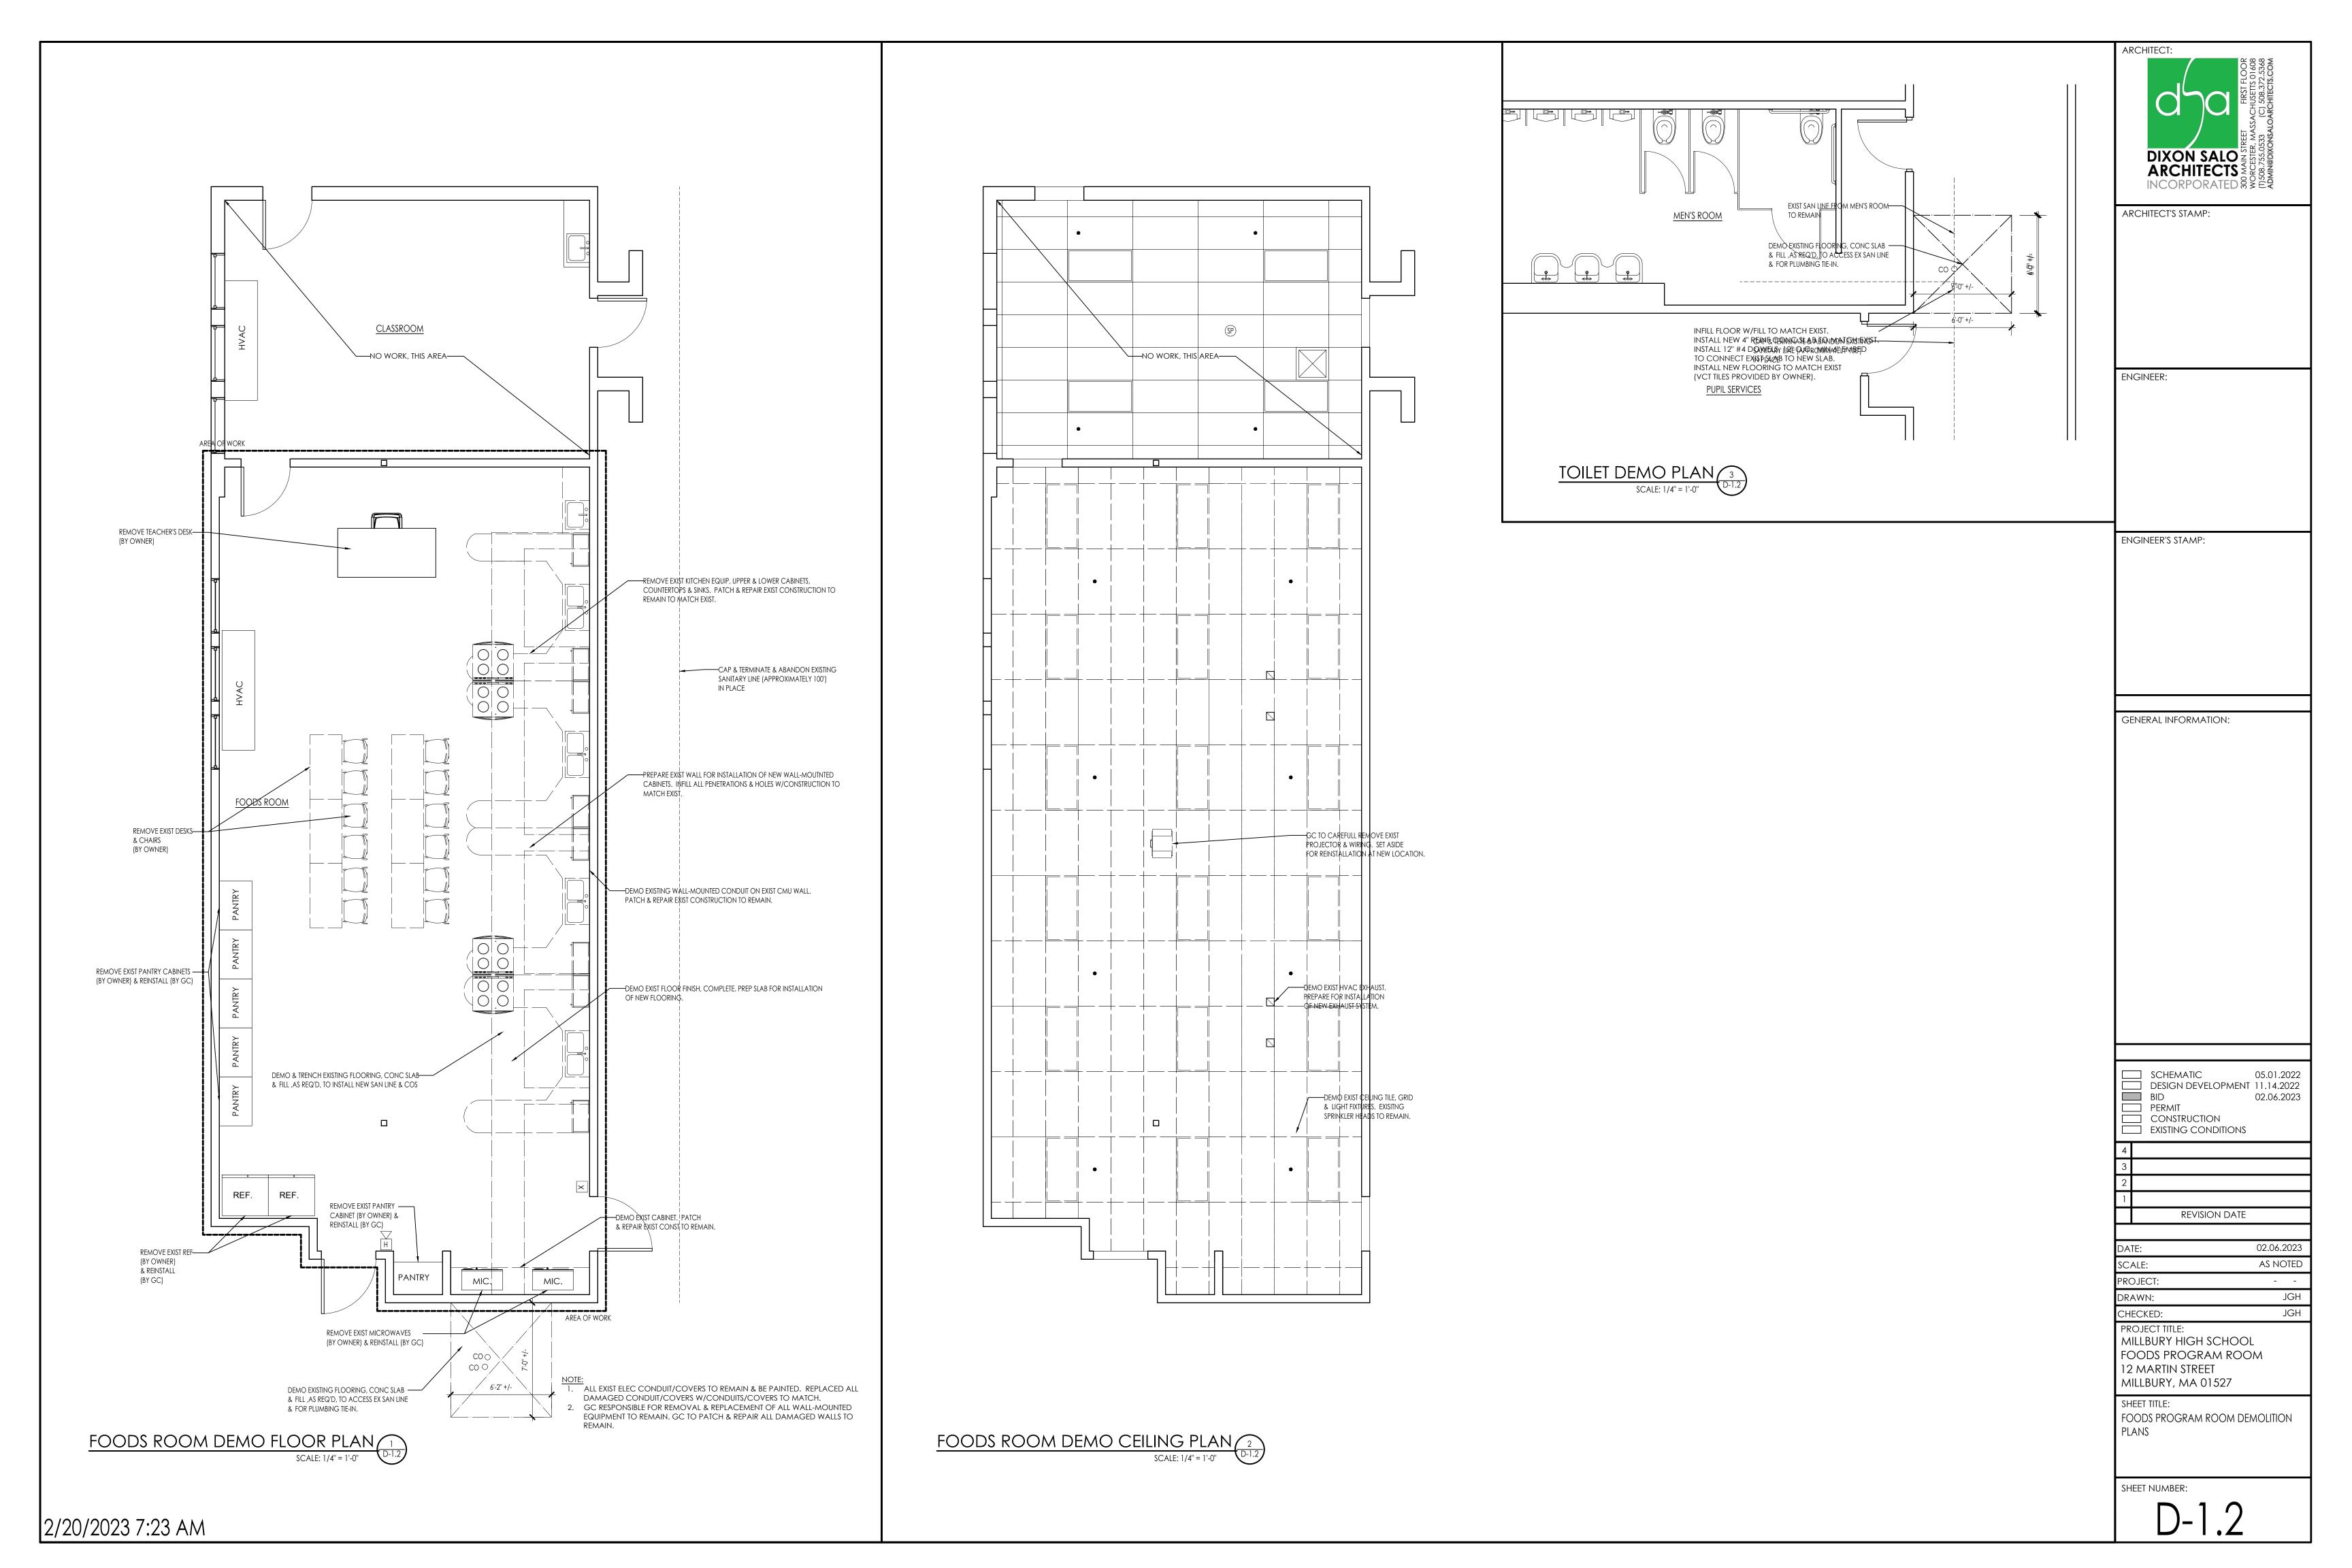

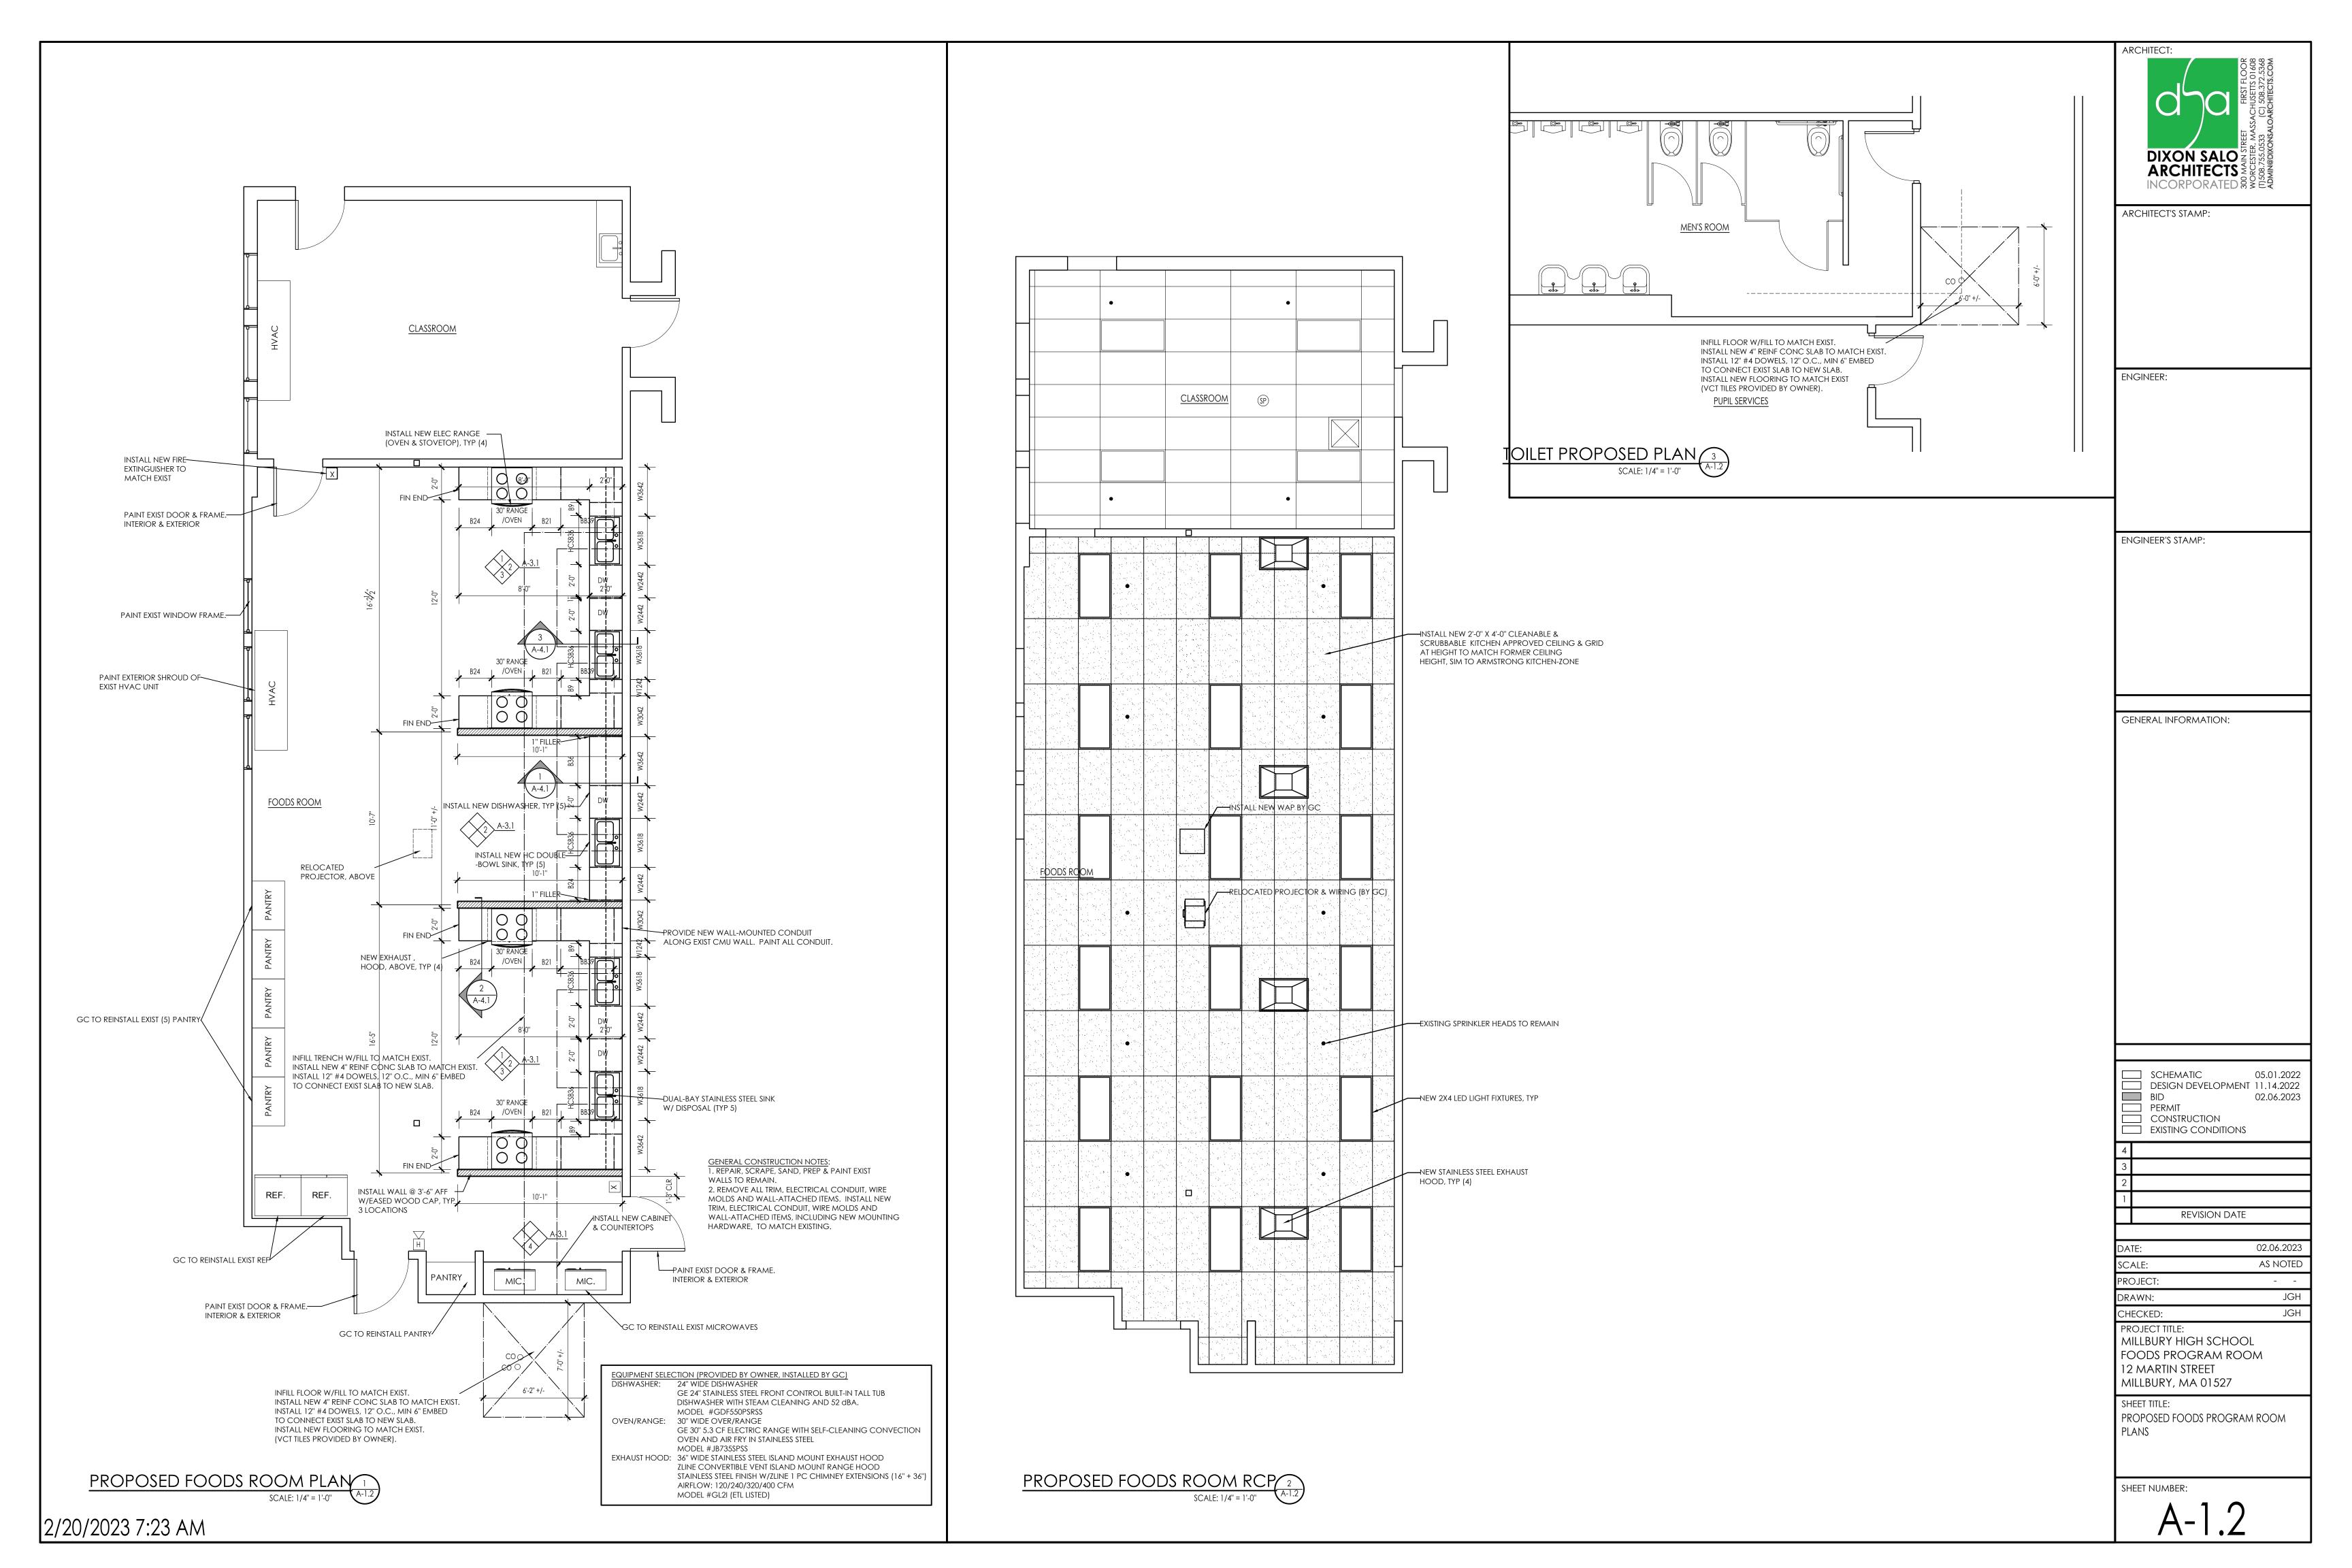

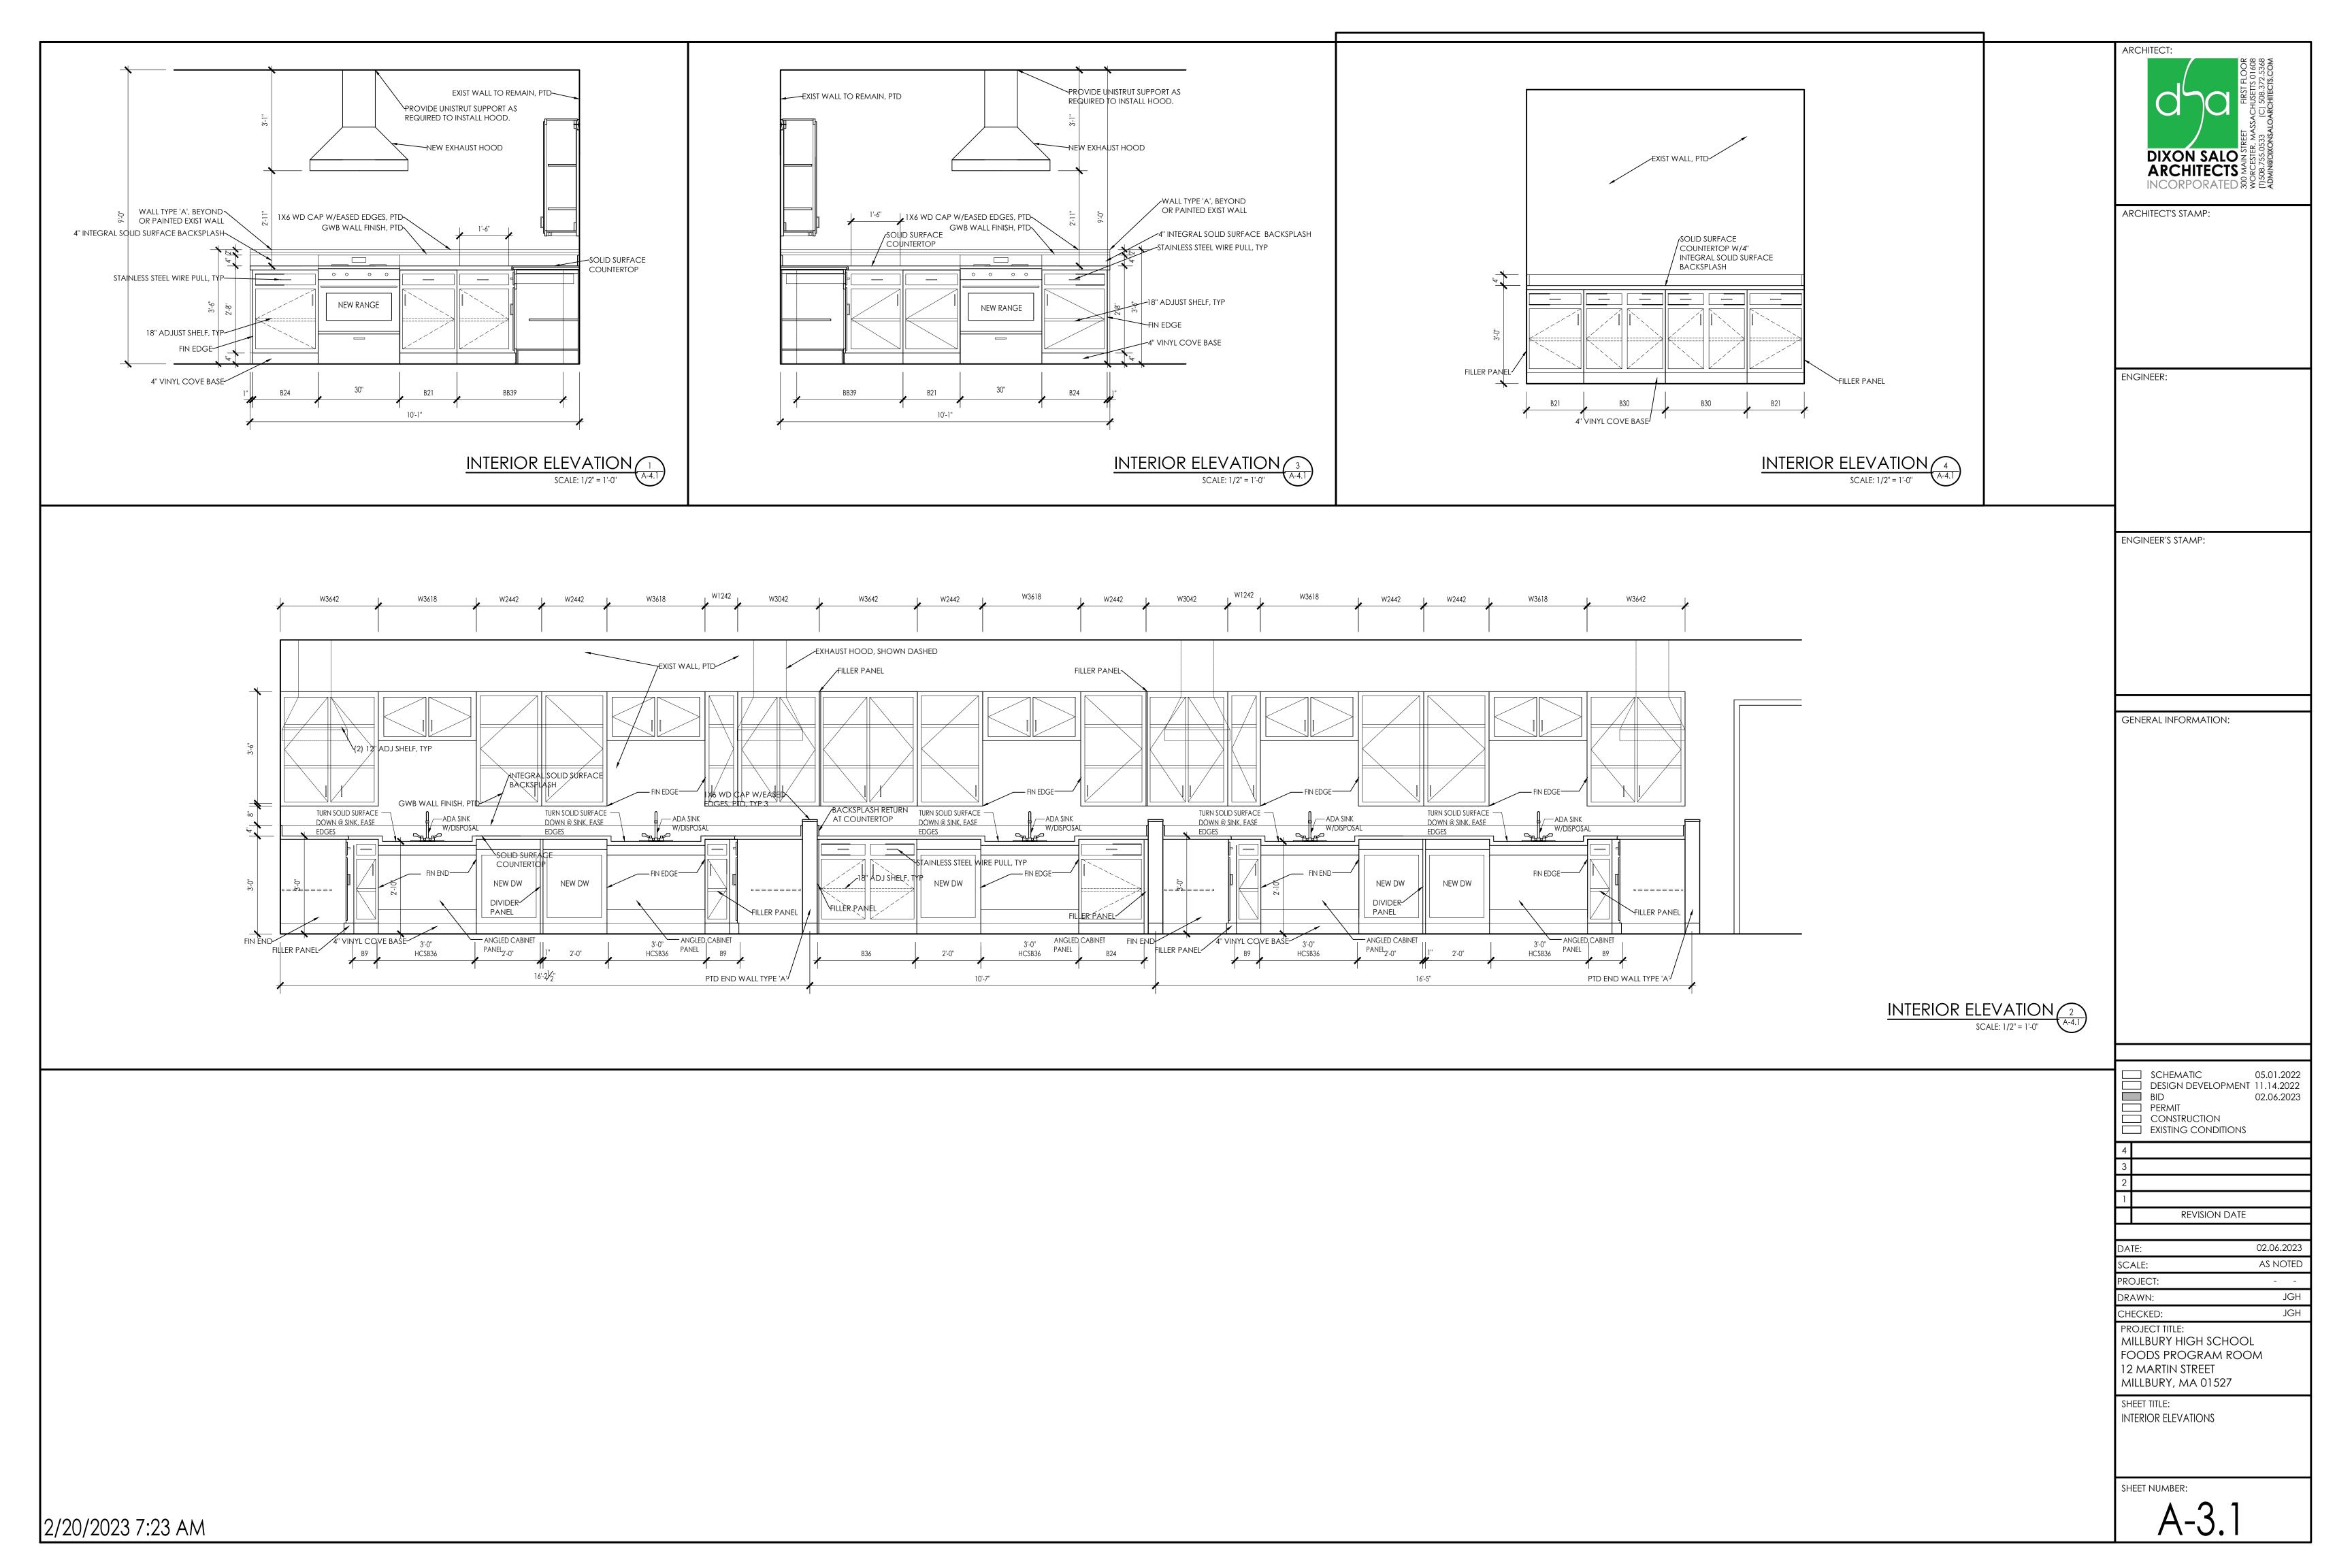

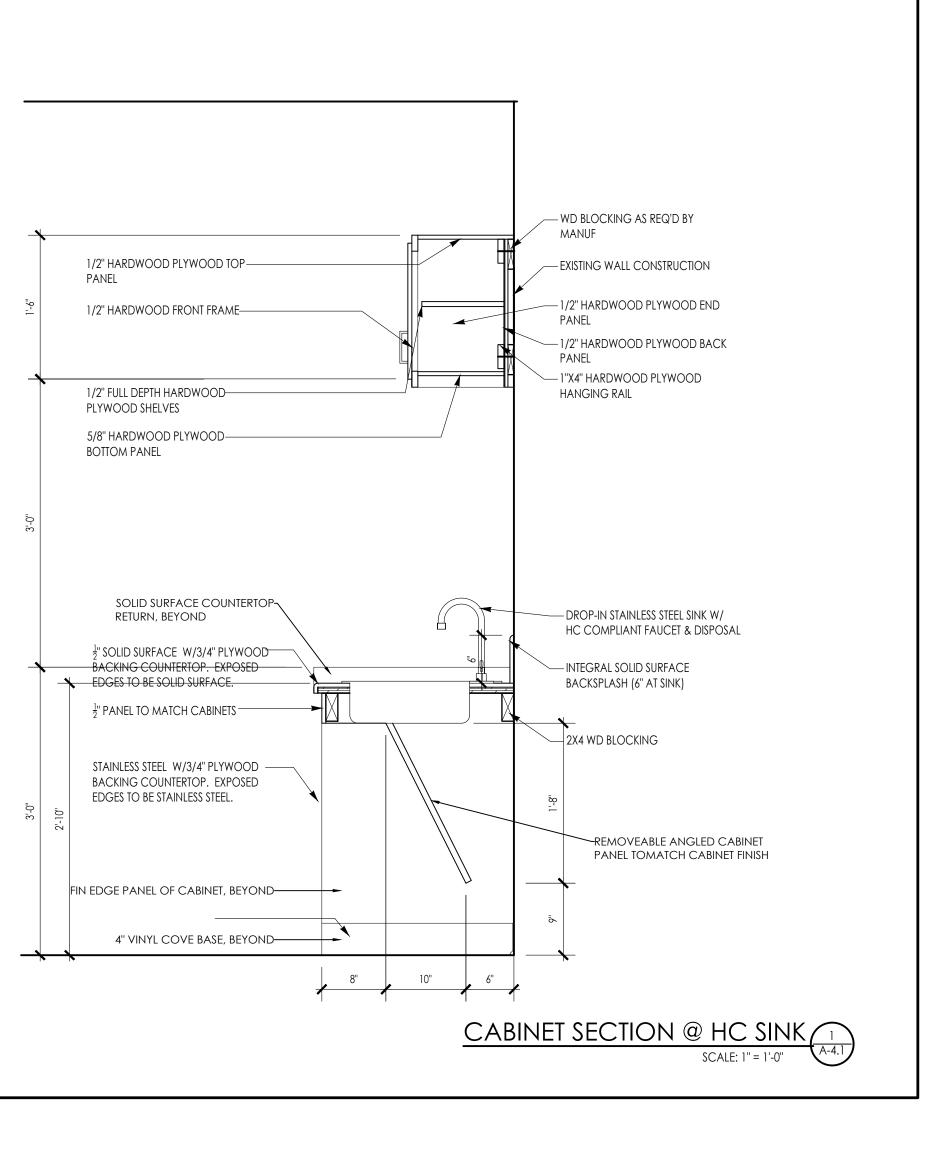

ARCHITECT: **DIXON SALO ARCHITECTS** INCORPORATED 8 5 € \$ ARCHITECT'S STAMP:

ENGINEER:

ENGINEER'S STAMP:

GENERAL INFORMATION:

SCHEMATIC DESIGN DEVELOPMENT BID	05.01.2022 11.14.2022 02.06.2023
PERMIT	02.00.2023
CONSTRUCTION EXISTING CONDITIONS	
EXISTING CONDITIONS	

02.06.2023 AS NOTED PROJECT: DRAWN: JGH

JGH


REVISION DATE

CHECKED: PROJECT TITLE: MILLBURY HIGH SCHOOL FOODS PROGRAM ROOM

MILLBURY, MA 01527 SHEET TITLE: TYPICAL DETAILS

12 MARTIN STREET

SHEET NUMBER:

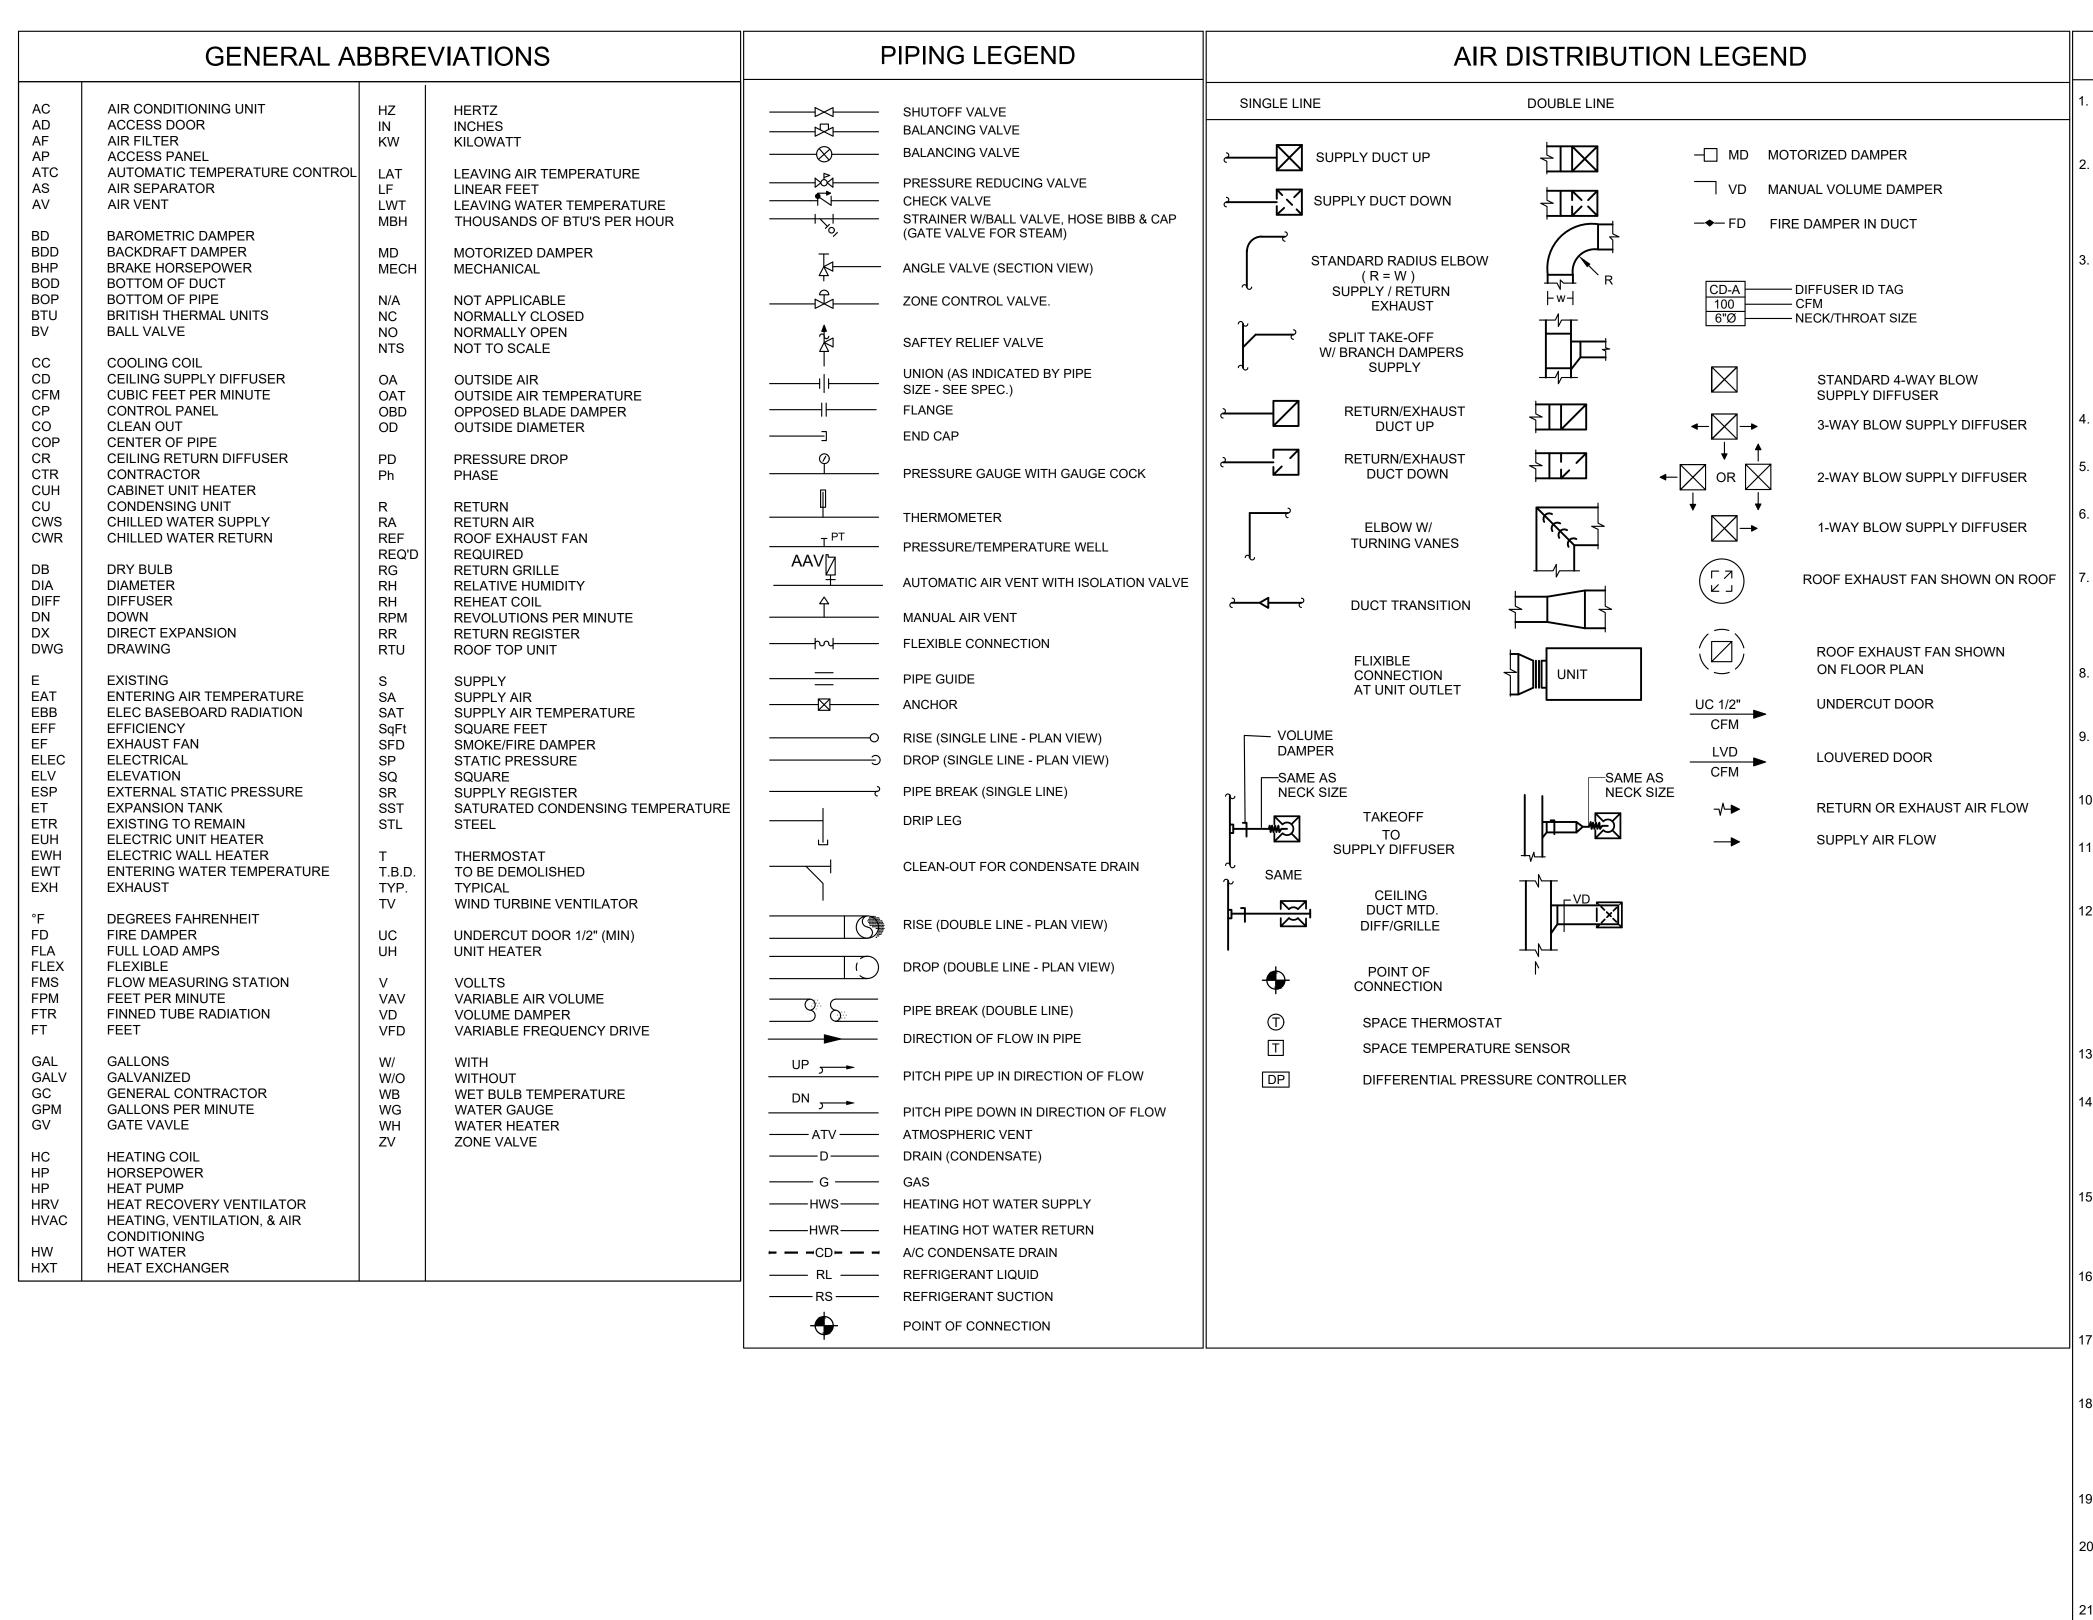

HVAC GENERAL NOTES

- GENERAL NOTES, SYMBOLS AND DETAILS ARE APPLICABLE TO ALL DRAWINGS WITHIN DIVISION 23. NOTES BELOW ARE NOT INTENDED TO REPLACE SPECIFICATIONS. SEE SPECIFICATIONS IN ADDITION TO GENERAL NOTES. NOT ALL SYMBOLS SHOWN ARE NECESSARILY APPLICABLE TO THIS PROJECT.
- 2. SCOPE OF WORK SHALL INCLUDE ALL LABOR, MATERIALS, TOOLS, EQUIPMENT, TRANSPORTATION, HOISTING, RIGGING, INSURANCE, REQUIRED PERMITS AND INSPECTIONS, ETC. REQUIRED TO PERFORM THE WORK AS INDICATED ON THE DRAWINGS AND SPECIFICATIONS FOR A COMPLETE INSTALLATION. ALL SHALL BE DONE BY LICENSED WORKMEN IN ACCORDANCE WITH NATIONAL, STATE, AND LOCAL CODES AND ORDINANCES HAVING JURISDICTION.
- 3. THE DRAWINGS SHOW THE LAYOUT OF THE MECHANICAL SYSTEMS AND INDICATE THE APPROXIMATE LOCATIONS OF DUCTWORK, PIPING, BRANCHES AND ELBOWS, AND EQUIPMENT. THE DRAWINGS ARE DIAGRAMMATIC AND ARE BASED ON VISIBLE OBSERVABLE CONDITIONS. CAREFULLY REVIEW AND STUDY DRAWINGS. IF ANY DISCREPANCIES EXIST, NOTIFY THE ARCHITECT AND ENGINEER BEFORE ADVANCING TO SUCH A POINT THAT ADDITIONAL COSTS WILL BE INCURRED. THE EXACT LOCATION OF ALL COMPONENTS ARE TO BE DETERMINED IN THE FIELD BY THE ACTUAL BUILDING CONDITIONS. EQUIPMENT, DUCTS, PIPES, AND MECHANICAL COMPONENTS INTERFERING WITH OTHER INSTALLATION OR EXISTING BUILDING CONSTRUCTION, STRUCTURE, OR COMPONENTS SHALL BE RELOCATED AS REQUIRED AT NO ADDITIONAL COST TO THE OWNER.
- 4. PRODUCTS REQUIRED BY CONSTRUCTION BUT NOT SPECIFICALLY DESCRIBED HEREIN SHALL BE AS SELECTED BY THE CONTRACTOR SUBJECT TO THE APPROVAL OF THE ARCHITECT AND ENGINEER.
- 6. CONTRACTOR SHALL VISIT THE SITE AND BECOME INFORMED AS TO THE NATURE AND SCOPE OF WORK REQUIRED BY CONTRACT DOCUMENTS PRIOR TO BIDDING PROJECT.
- PROVIDE ALL REQUIRED MATERIALS, LABOR, EQUIPMENT, AND SERVICES NECESSARY FOR THE INSTALLATION OF THE WORK AS SHOWN ON THESE DRAWINGS OR SPECIFIED BY THE BASE BUILDING DRAWING AND SPECIFICATIONS.
- 7. REFER TO AND CAREFULLY CHECK ARCHITECTURAL, ELECTRICAL, PLUMBING, AND FIRE PROTECTION DRAWINGS AND DETAILS, NOTES, LOCATIONS WHERE WALLS, PARTITIONS, CEILINGS, AND OTHER SURFACES ARE FURRED, LOCATIONS OF SHAFTS, SOFFITS, AND CONFLICTS WITH WORK OF OTHER TRADES, AND ARRANGE WORK ACCORDINGLY. FURNISH ALL OFFSETS, DAMPERS, CONNECTORS, ETC., REQUIRED TO MEET SUCH CONDITIONS.
- 8. CONTRACTOR SHALL CONFIRM DUCTWORK, PIPING, EQUIPMENT, AND MECHANICAL COMPONENT LOCATIONS, ELEVATIONS AND SIZES BEFORE ANY WORK IS STARTED. IF ANY DISCREPANCIES ARE FOUND, NOTIFY ENGINEER BEFORE PROCEEDING WITH WORK.
- BEFORE SELECTING MATERIAL AND EQUIPMENT, AND PROCESSING THE WORK, INSPECT AREAS WHERE MATERIAL AND EQUIPMENT ARE TO BE INSTALLED TO INSURE SUITABILITY AND CHECK NEEDED SPACE FOR PLACEMENT AND CLEARANCES.
- 0. FOLLOW MANUFACTURER'S RECOMMENDATIONS AND REQUIREMENTS FOR INSTALLATION OF THE
- 11. IF MANUFACTURER OF SELECTED EQUIPMENT REQUIRES LARGER CAPACITY, CIRCUITRY, AND/OR EQUIPMENT THE CONTRACTOR SHALL PROVIDE SUCH CAPACITY AND/OR EQUIPMENT UNDER THIS CONTRACT AT NO COST TO THE OWNER.
- 12. WHERE THE CONTRACTOR PROPOSES TO USE AN ITEM OF EQUIPMENT OTHER THAN THAT SPECIFIED OR DETAILED ON THE DRAWINGS WHICH REQUIRES ANY REDESIGN OF THE STRUCTURE, PARTITIONS, FOUNDATIONS, PIPING, WIRING OR ANY OTHER PART OF THE MECHANICAL, PLUMBING, ELECTRICAL, OR ARCHITECTURAL LAYOUT, ALL SUCH REDESIGN AND ALL NEW DRAWINGS AND DETAILING REQUIRED THEREFORE, SHALL BE PREPARED AT THE CONTRACTOR'S EXPENSE AND ARE SUBJECT TO THE REVIEW AND APPROVAL OF THE OWNER OR HIS AUTHORIZED REPRESENTATIVE. OWNER RESERVES THE RIGHT TO HAVE THE ARCHITECT OR ENGINEER OF HIS CHOICE PREPARE ANY REDESIGN WORK.
- 13. CONTRACTOR SHALL COORDINATE ELECTRICAL REQUIREMENTS OF MECHANICAL EQUIPMENT WITH DIVISION 26
- 14. ALL WORK IN INTERIOR FINISHED SPACES EXCEPT INDICATED IS TO BE CONCEALED. PROVIDE ALL NECESSARY CUTTING, PATCHING, REPAINTING AND/OR REPLACEMENT OF FINISHES AS REQUIRED TO PERFORM WORK, COORDINATE WITH OTHER DIVISIONS. ALL EXPOSED COMPONENTS INCLUDING: DUCT, PIPE, EQUIPMENT, AND CONTROLS SHALL BE FULLY COORDINATED WITH ARCHITECTURAL ELEMENTS.
- 15. BEFORE CUTTING AND DRILLING INTO BUILDING ELEMENTS, INSPECT AND LAYOUT WORK TO AVOID DAMAGING STRUCTURAL ELEMENTS AND BUILDING UTILITIES. NOTIFY THE ARCHITECT AND ENGINEER WHERE EXISTING COMPONENTS AND OR BUILDING UTILITIES OBSTRUCT THE PROPOSED WORK.
- S. SUPPORT ALL EQUIPMENT, PIPING, DUCTWORK, AND OTHER REQUIRED MECHANICAL COMPONENTS FROM BUILDING STRUCTURE TO PROVIDE A VIBRATION FREE INSTALLATION. NOTIFY ARCHITECT AND STRUCTURAL ENGINEER OF ALL WEIGHTS AND METHODS OF SUPPORT.
- 17. ALL PENETRATIONS THRU WALLS, ROOF, AND FLOORS AND ASSOCIATED CUTTING, PATCHING, WATERPROOFING, AND FLASHING SHALL BE COORDINATED WITH THE WORK OF OTHER SECTIONS BEFORE SITE WORK EXECUTION AND WITH THE ARCHITECT AND STRUCTURAL ENGINEER.
- 18. ALL DUCT PASSING THROUGH FIRE, SMOKE RATED OR SMOKE/FIRE RATED BARRIERS (WALLS, FLOOR) SHALL BE PROVIDED WITH FIRE, SMOKE OR SMOKE/FIRE DAMPERS. LOCATIONS OR RATED WALLS SEE ARCHITECTURAL DRAWINGS. CONTRACTOR SHALL VERIFY QUANTITY OF ALL DAMPERS IN ACCORDANCE WITH FINAL CONTRACT DOCUMENTS. ALL REQUIRED SMOKE DETECTORS PROVIDED BY DIV 23 SHALL BE CONNECTED TO FIRE ALARM SYSTEM.
- 9. REFER TO SPECIFICATION SECTION 078413 "THROUGH PENETRATION FIRESTOP SYSTEMS" FOR ALL MATERIALS AND METHODS FOR PENETRATION THROUGH FIRE AND SMOKE RATED ASSEMBLIES.
- 20. COORDINATE DIFFUSERS LOCATIONS AND DUCT WITH LIGHTING FIXTURES AND SPRINKLER HEADS. SEE ARCHITECTURAL DRAWINGS FOR EXACT LOCATIONS AND DETAILS OF PARTITIONS, SUSPENDED CEILINGS, AND SOFFITS.
- 21. PROVIDE FLEXIBLE JOINTS ON ALL PIPING AND DUCTWORK WHERE PENETRATING ALL BUILDING EXPANSION JOINTS.
- 22. PROVIDE FLEXIBLE CONNECTIONS BETWEEN MECHANICAL EQUIPMENT AND DUCTWORK AND PIPING.
- 23. PROVIDE VOLUME DAMPERS ON ALL BRANCHES OF DUCTWORK (SUPPLY, RETURN, EXHAUST).
- 24. PROVIDE ACCESS PANELS TO CLEAN COILS, SERVICE DAMPERS, HEATERS, VALVES, AND ALL OTHER MECHANICAL EQUIPMENT. COORDINATE LOCATIONS WITH THE ARCHITECT.
- 25. PROVIDE DUCT ACCESS DOORS AT MOTORIZED DAMPERS, FIRE/SMOKE DAMPERS, COILS, DUCT MOUNTED DEVICES IRRESPECTIVE OF WHETHER ACCESS DOOR IS INDICATED ON THE PLANS.
- 26. CONTRACTOR SHALL SELECT AND PROVIDE EXPANSION JOINTS OR EXPANSION LOOPS AND ANCHORS AS REQUIRED TO PREVENT TEMPERATURE EXPANSION STRESSES OF HYDRONIC PIPES BASED ON ACTUAL INSTALLATION/CONDITIONS.
- 27. LOCATE ROOF MOUNTED HVAC EQUIPMENT MORE 10 FEET FROM ROOF EDGE. PROVIDE HANDRAILS IF EQUIPMENT ON THE ROOF LOCATED LESS 10 FEET FROM ROOF EDGE (SEE ARCHITECTURAL DRAWINGS)
- 28. CONTROL CONTRACTOR TO PROVIDE ALL CONTROL DEVICES, EQUIPMENT, ACCESSORIES, OTHER APPARATUSES, CONTROL VALVES AND DAMPERS, ACTUATORS, SENSORS, ETC. AND ALL CONTROL WIRING AND LOW VOLTAGE POWER WIRING RELATED TO CENTRAL DDC CONTROL SYSTEM.



ARCHITECT'S STAMP:

ENGINEER:



ENGINEER'S STAMP:

GENERAL INFORMATION:

	SCHEMATIC DESIGN DEVELOPMENT BID PERMIT CONSTRUCTION EXISTING CONDITIONS	01.31.2023
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	REVISION DATE	·

01.31.2023

SCALE: AS NOTED
PROJECT: - DRAWN: SRK
CHECKED: AG
PROJECT TITLE:
MILLBURY HIGH SCHOOL
FOODS PROGRAM ROOM
12 MARTIN STREET
MILLBURY, MA 01527

SHEET TITLE:

HVAC - LEGEND AND NOTES

SHEET NUMBER:

H-0.0


CLASSROOM NO WORK, THI\$ AREA EXISTING TO REMAIN UNIT VENTILATOR FOODS ROOM

FOODS ROOM HVAC DEMO FLOOR PLAN

SCALE 1/4" = 1'-0"


DEMO PLAN KEYNOTES:

- REMOVE AND PROPERLY DISPOSE OF EXISTING EXHAUST
- REMOVE AND PROPERLY DISPOSE OF EXISTING DUCTWORK, HANGERS, AND ASSOCIATED APPURTENANCES.
- 3. END OF DUCTWORK DEMOLITION. EXISTING DUCTWORK BEYOND THIS POINT SHALL BE EXISTING TO REMAIN.
- (4.) EXISTING 16x10 DUCT UP TO EXISTING EXHAUST FAN ON ROOF. EXISTING 120V EXHAUST FAN AND ASSOCIATED ROOF CURB TO BE REMOVED AND PROPERLY DISPOSED OF.
- EXISTING 8x8 DUCT UP TO EXISTING EXHAUST FAN ON ROOF. EXISTING 120V EXHAUST FAN AND ASSOCIATED ROOF CURB TO BE REMOVED AND PROPERLY DISPOSED OF.

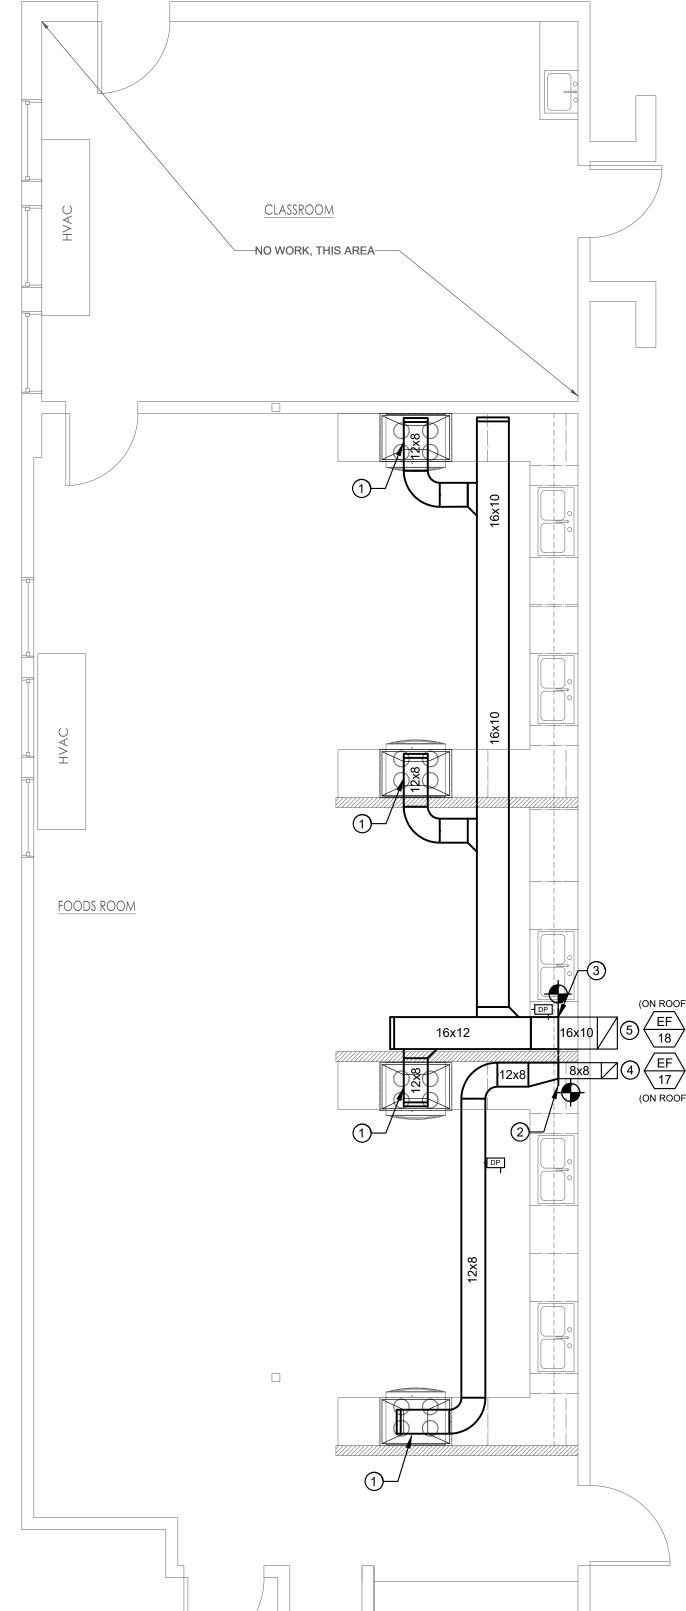

PLAN KEYNOTES:

- 1) PROVIDE DUCT CONNECTION TO NEW STAINLESS STEEL EXHAUST HOOD (BY OTHERS).
- PROVIDE NEW DUCT TRANSITION AND CONNECT TO EXISTING
- PROVIDE NEW DUCT TRANSITION AND CONNECT TO EXISTING 16x10 DUCT.
- 4. EXISTING 8x8 DUCT UP TO NEW ROOF MOUNTED EXHAUST FAN EF-17 (CONFIRM FINAL EQUIPMENT TAG NUMBER WITH
- (5) EXISTING 16x10 DUCT UP TO NEW ROOF MOUNTED EXHAUST FAN EF-18 (CONFIRM FINAL EQUIPMENT TAG NUMBER WITH

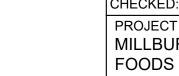

SCALE:

PROJECT:

CHECKED: PROJECT TITLE:
MILLBURY HIGH SCHOOL
FOODS PROGRAM ROOM 12 MARTIN STREET MILLBURY, MA 01527

SCHEMATIC
DESIGN DEVELOPMENT
BID
PERMIT
CONSTRUCTION
EXISTING CONDITIONS

SHEET TITLE:

ARCHITECT:

DIXON SALO EX ARCHITECTS

ARCHITECT'S STAMP:

ENGINEER:

ENGINEER'S STAMP:

GENERAL INFORMATION:

INCORPORATED & SER

44 Central Street. Unit # 4

Berlin, MA. 01503 Telephone - (508) 869-0403 Fax - (508) 869-2891 www.akalengineering.com

HVAC - PROPOSED DUCTWORK PLAN

REVISION DATE


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AS NOTED

- -SRK


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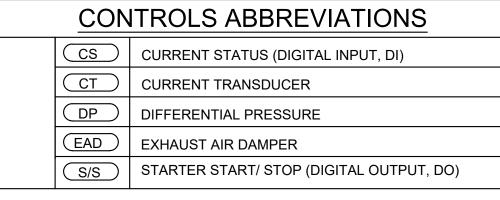
H-1.1





SCALE 1/4" = 1'-0"

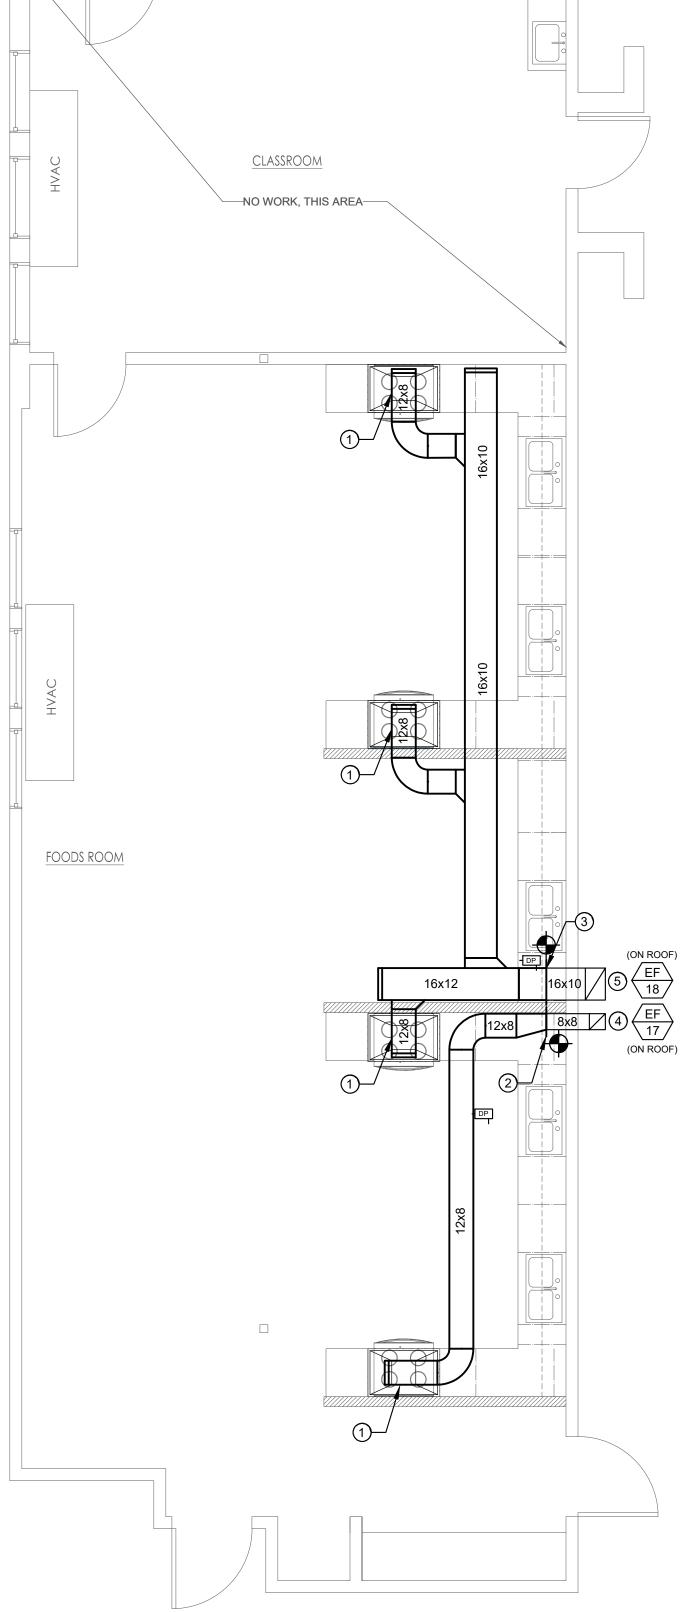PROPOSED FOODS ROOM HVAC PLAN



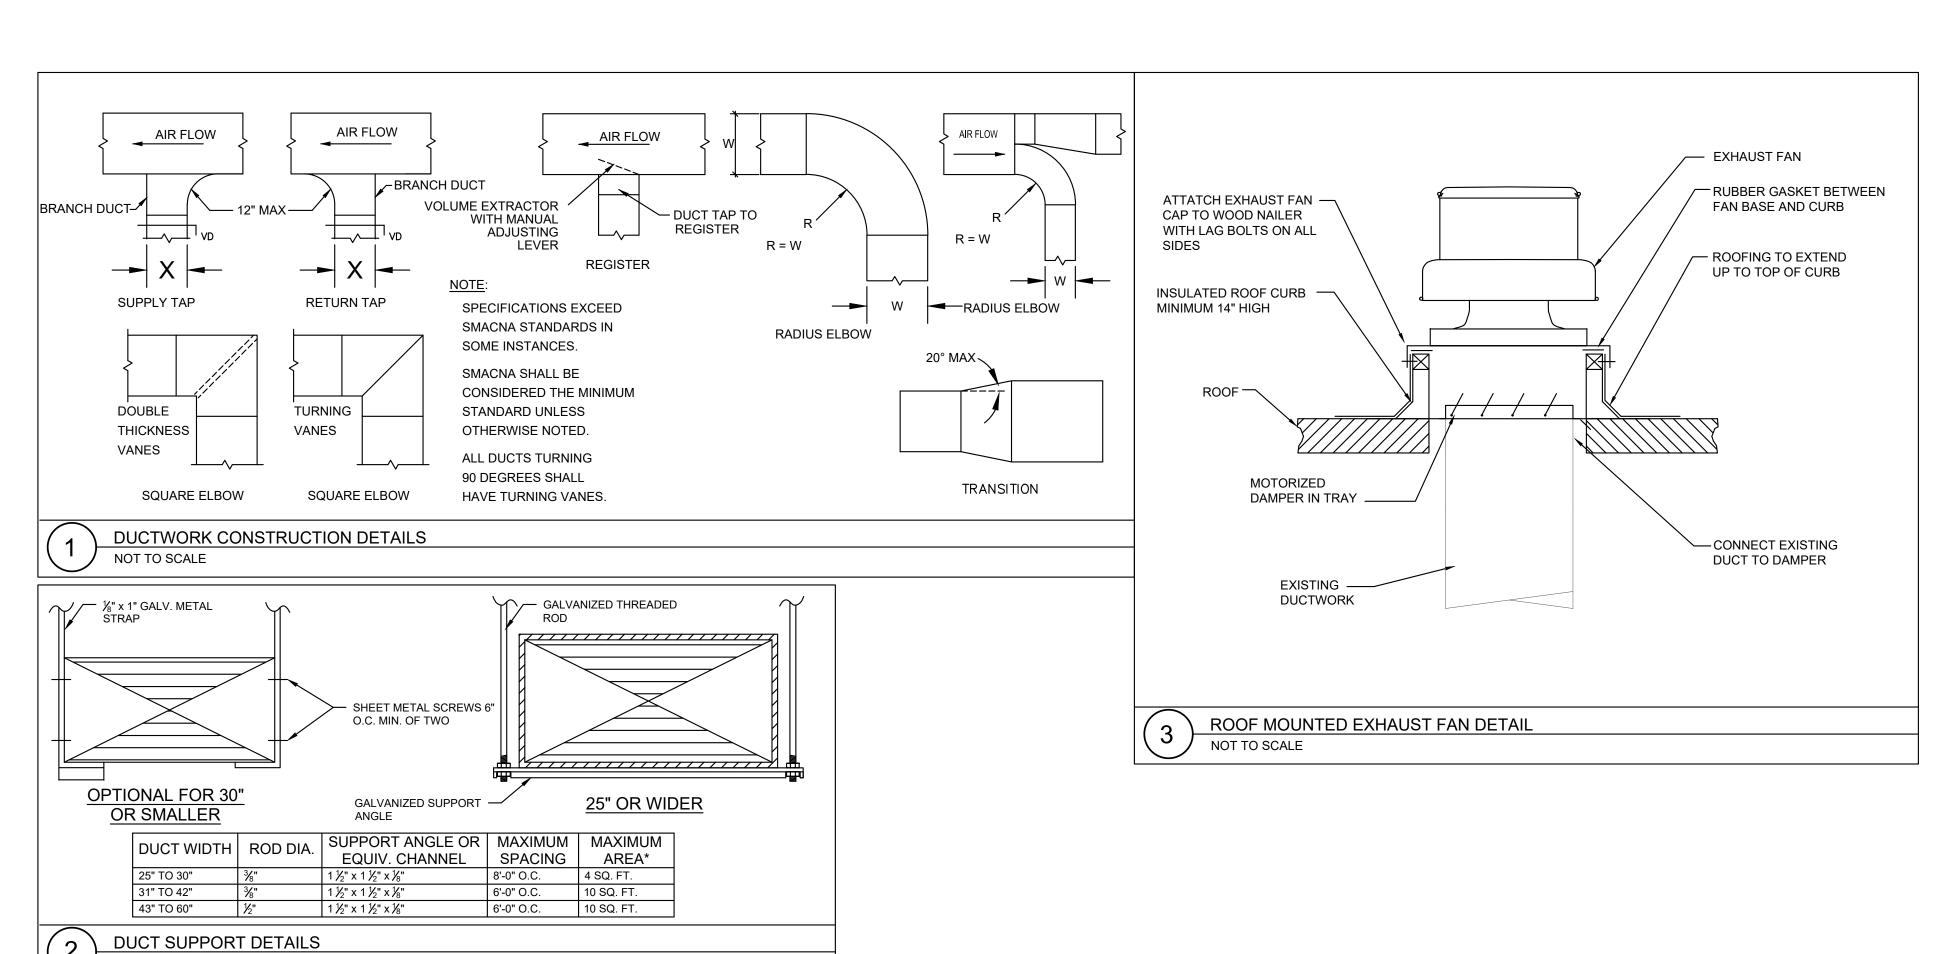

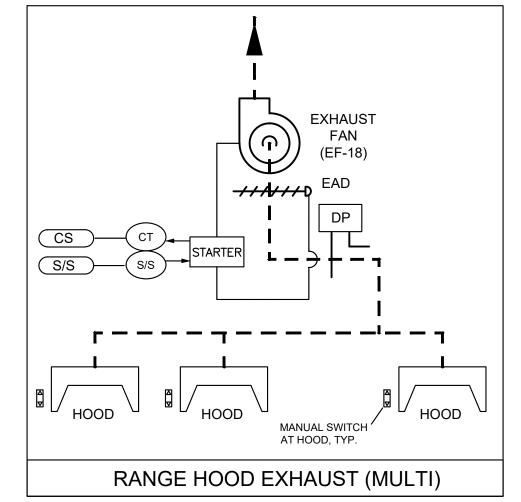

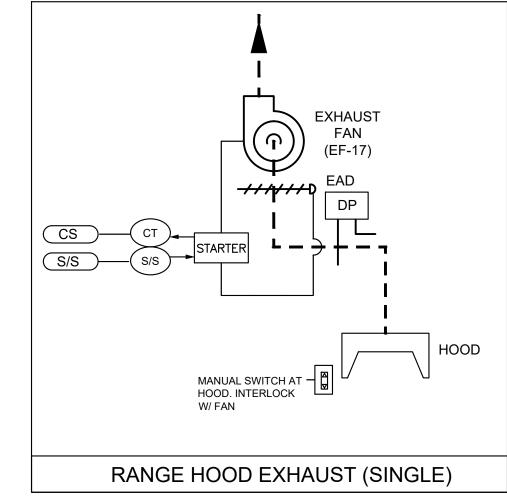





ARCHITECT'S STAMP: ENGINEER: 44 Central Street. Unit # 4 Berlin, MA. 01503 Telephone - (508) 869-0403

Fax - (508) 869-2891

ENGINEER'S STAMP:

www.akalengineering.com

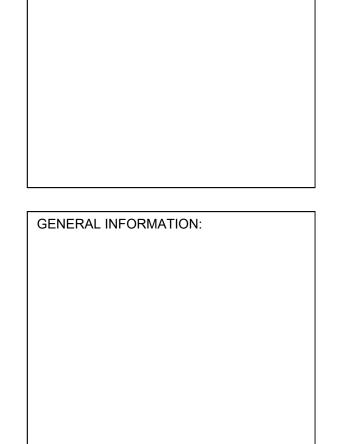

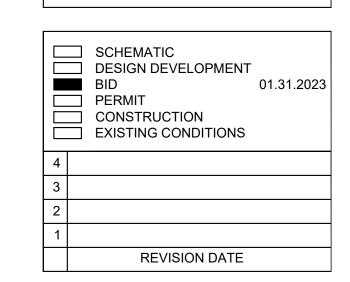

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HVAC - DETAILS, CONTROL DIAGRAMS & SCHEDULES

SHEET NUMBER:

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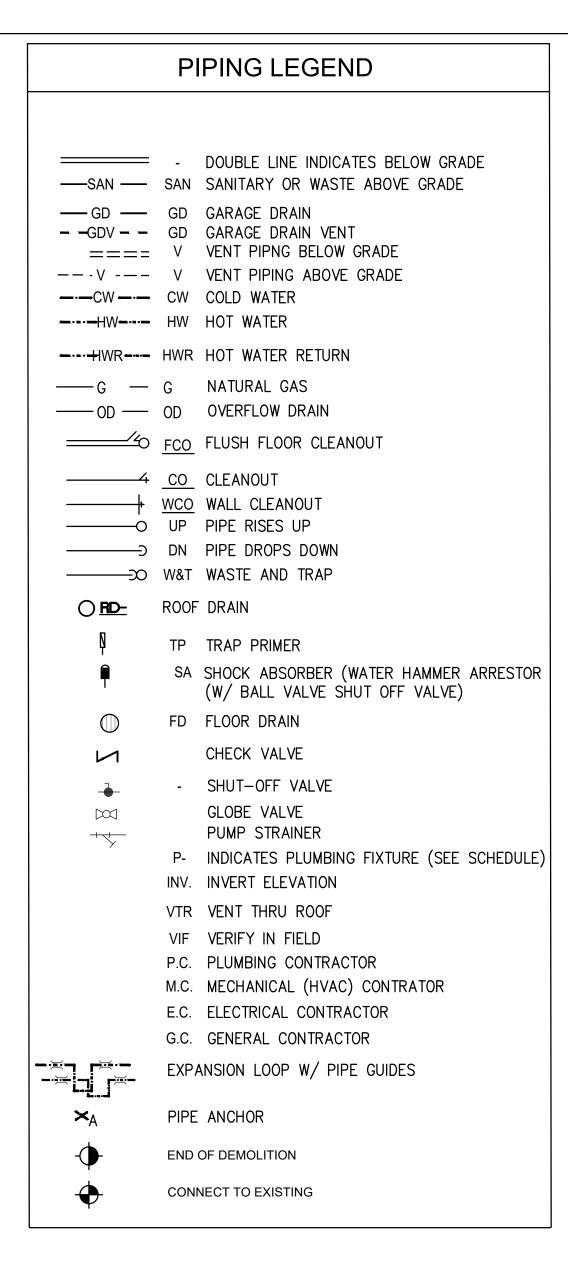
EXHAUST FAN SCHEDULE

NOT TO SCALE

TAG	CFM	S.P. (IN. WC)	MOTOR POWER	V/PH/HZ	MANUFACTURER	MODEL	REMARKS
EF-17	400	0.3	30 W	115/1/60	GREENHECK	G-090-VG	1,2,3,4
EF-18	1200	0.625	1/4 HP	115/1/60	GREENHECK	G-130-VG	1,2,3,4

- 1. PROVIDE 14 INCH HIGH INSULATED ROOF CURB.
- 2. PROVIDE MOTORIZED DAMPER TO POWER OPEN WHEN FAN OPERATES.
- 3. COORDINATE WITH ELECTRICAL FOR FAN DISCONNECT SWITCH.
- 4. PROVIDE CONSTANT PRESSURE CONTROLLER WITH TRANSDUCER EQUAL TO GREENHECK VARI-GREEN CONSTANT PRESSURE CONTROL.

GENERAL ABBREVIATIONS AIR CONDITIONING UNIT HW **HOT WATER** AD ACCESS DOOR HWH HOT WATER HEATER ΑF AIR FILTER ΗZ HERTZ **ACCESS PANEL** INCHES ATC AUTOMATIC TEMPERATURE CONTROL KW KILOWATT ΑV AIR VENT LAT LEAVING AIR TEMPERATURE BD BAROMETRIC DAMPER LINEAR FEET BDD BACKDRAFT DAMPER LWT LEAVING WATER TEMPERATURE THOUSANDS OF BTU'S PER HOUR BHP **BRAKE HORSEPOWER** MBH BOP BOTTOM OF PIPE MD MOTORIZED DAMPER BTU **BRITISH THERMAL UNITS** MECH MECHANICAL BV BALL VALVE N/A NOT APPLICABLE CC NC COOLING COIL NORMALLY CLOSED CFM NO CUBIC FEET PER MINUTE NORMALLY OPEN CFH CUBIC FEET PER HOUR NTS NOT TO SCALE CP CONTROL PANEL OA OAT OUTSIDE AIR CO CLEAN OUT **OUTSIDE AIR TEMPERATURE** OBD OD COP **CENTER OF PIPE** OPPOSED BLADE DAMPER CTE CONNECT TO EXISTING OUTSIDE DIAMETER Ph R CUH CABINET UNIT HEATER PHASE CU CONDENSING UNIT RETURN CW RA COLD WATER RETURN AIR REF DRAIN ROOF EXHAUST FAN DRY BULB REQ'D DB REQUIRED DIA DIAMETER RD ROOF DRAIN RG DIFF **DIFFUSER** RETURN GRILLE DN DOWN RH RELATIVE HUMIDITY DWG DRAWING RPM REVOLUTIONS PER MINUTE **EXISTING** RTU **ROOF TOP UNIT** EAT ENTERING AIR TEMPERATURE SANITARY EFF **EFFICIENCY** SA SUPPLY AIR SAT EF **EXHAUST FAN** SUPPLY AIR TEMPERATURE **ELEC ELECTRICAL** SqFt SFD SQUARE FEET ELV **ELEVATION** SMOKE/FIRE DAMPER ESP **EXTERNAL STATIC PRESSURE** SP STATIC PRESSURE **ELECTRIC UNIT HEATER** EUH SQ SQUARE EWH **ELECTRIC WALL HEATER** SR SUPPLY REGISTER **EWT** ENTERING WATER TEMPERATURE STORM EXH EXHAUST STL STEEL DEGREES FAHRENHEIT **THERMOSTAT** FCO FLOOR CLEAN OUT T.B.D. TO BE DEMOLISHED FD FIRE DRAIN TYP. TYPICAL FLA **FULL LOAD AMPS** TV WIND TURBINE VENTILATOR **FLEX FLEXIBLE** UC UNDERCUT DOOR 3/4" (MIN) **FMS** FLOW MEASURING STATION UH UNIT HEATER FPM FEET PER MINUTE VENT **FPHB** FREEZE PROOF HOSE BIBB VAV VARIABLE AIR VOLUME FTR FINNED TUBE RADIATION VΒ VACUUM BREAKER FT FEET VTR VENT THRU ROOF GAL GALLONS WASTE W GC GENERAL CONTRACTOR W/ WITH GPM GALLONS PER MINUTE WCO WALL CLEANOUT GV GATE VAVLE W/O WITHOUT HOSE BIBB WB WET BULB TEMPERATURE **HEATING COIL** WG WATER GAUGE **HORSEPOWER** WH WATER HEATER **HEAT PUMP** WHA WATER HAMMER ARRESTOR HVAC HEATING, VENTILATION, & AIR CONDITIONING



GENERAL PLUMBING NOTES AL NOTES, SYMBOLS AND DETAILS ARE APPLICABLE TO ALL DRAWINGS WITHIN DIVISION 22. 15. 15.

GENERAL NOTES, SYMBOLS AND DETAILS ARE APPLICABLE TO ALL DRAWINGS WITHIN DIVISION 22. NOTES BELOW ARE NOT INTENDED TO REPLACE SPECIFICATIONS. SEE SPECIFICATIONS IN ADDITION TO GENERAL NOTES. NOT ALL SYMBOLS SHOWN ARE NECESSARILY APPLICABLE TO THIS PROJECT.

- 2. SCOPE OF WORK SHALL INCLUDE ALL LABOR, MATERIALS, TOOLS, EQUIPMENT, TRANSPORTATION, HOISTING, RIGGING, INSURANCE, REQUIRED PERMITS AND INSPECTIONS, ETC. REQUIRED TO PERFORM THE WORK AS INDICATED ON THE DRAWINGS AND SPECIFICATIONS FOR A COMPLETE INSTALLATION. ALL SHALL BE DONE BY LICENSED WORKMEN IN ACCORDANCE WITH NATIONAL, STATE, AND LOCAL CODES AND ORDINANCES HAVING JURISDICTION.
- 3. THE DRAWINGS SHOW THE LAYOUT OF THE PLUMBING SYSTEMS AND INDICATE THE APPROXIMATE LOCATIONS OF FIXTURES, PIPING, BRANCHES AND ELBOWS, SPECIALTIES, AND EQUIPMENT. THE DRAWINGS ARE DIAGRAMMATIC AND ARE BASED ON VISIBLE OBSERVABLE CONDITIONS. CAREFULLY REVIEW AND STUDY DRAWINGS. IF ANY DISCREPANCIES EXIST, NOTIFY THE ARCHITECT AND ENGINEER BEFORE ADVANCING TO SUCH A POINT THAT ADDITIONAL COSTS WILL BE INCURRED. THE EXACT LOCATION OF ALL COMPONENTS ARE TO BE DETERMINED IN THE FIELD BY THE ACTUAL BUILDING CONDITIONS. FIXTURES, PIPING, SPECIALTIES, EQUIPMENT, AND PLUMBING COMPONENTS INTERFERING WITH OTHER INSTALLATION OR EXISTING BUILDING CONSTRUCTION, STRUCTURE, OR COMPONENTS, SHALL BE RELOCATED AS REQUIRED AT NO ADDITIONAL COST TO THE OWNER.
- . ALL PLUMBING WORK SHALL BE IN ACCORDANCE WITH THE MASSACHUSETTS PLUMBING CODE, MASSACHUSETTS PLUMBING BOARD, AND ALL APPLICABLE LOCAL CODES AND REGULATIONS.
- ALL PLUMBING PRODUCTS INSTALLED SHALL BE APPROVED AND RECOGNIZED BY THE MASSACHUSETTS PLUMBING BOARD AND THE APPROVED PLUMBING PRODUCTS DIRECTORY.
- 6. PRODUCTS REQUIRED BY CONSTRUCTION BUT NOT SPECIFICALLY DESCRIBED HEREIN SHALL BE AS SELECTED BY THE CONTRACTOR SUBJECT TO THE APPROVAL OF THE ARCHITECT AND ENGINEER.
- 7. PRODUCT INSTALLATION SHALL ADHERE TO MANUFACTURER'S RECOMMENDATIONS AND REQUIREMENTS FOR THE INSTALLATION PROVIDED.
- 8. PROVIDE ALL REQUIRED MATERIALS, LABOR, EQUIPMENT, AND SERVICES NECESSARY FOR THE INSTALLATION OF THE WORK AS SHOWN ON THESE DRAWINGS OR SPECIFIED BY THE BASE BUILDING DRAWING AND SPECIFICATIONS.
- 9. CONTRACTOR SHALL VISIT THE SITE AND BECOME INFORMED AS TO THE NATURE AND SCOPE OF WORK REQUIRED BY CONTRACT DOCUMENTS PRIOR TO BIDDING PROJECT.
- 10. BEFORE SELECTING MATERIAL AND EQUIPMENT, AND PROCESSING THE WORK, INSPECT AREAS WHERE MATERIAL AND EQUIPMENT ARE TO BE INSTALLED TO INSURE SUITABILITY AND CHECK NEEDED SPACE FOR PLACEMENT AND CLEARANCES.
- 11. NEITHER ACCURACY NOR COMPLETION OF UTILITY LOCATIONS SHOWN ON DRAWINGS IS GUARANTEED. DETERMINE EXACT LOCATIONS OF UTILITIES IN FIELD, WHETHER SHOWN ON DRAWINGS OR NOT. EXERCISE CAUTION AND IDENTIFY LOCATIONS OF UNMARKED UTILITY LINES AS NECESSARY TO PERFORM THE WORK OF THIS SECTION.
- 12. REFER TO AND CAREFULLY CHECK ARCHITECTURAL, MECHANICAL, ELECTRICAL, AND FIRE PROTECTION DRAWINGS AND DETAILS, NOTES, LOCATIONS WHERE WALLS, PARTITIONS, CEILINGS, AND OTHER SURFACES ARE FURRED, LOCATIONS OF SHAFTS, SOFFITS, AND CONFLICTS WITH WORK OF OTHER TRADES, AND ARRANGE WORK ACCORDINGLY. FURNISH ALL OFFSETS, TRANSITIONS, CONNECTORS, ETC., REQUIRED TO MEET SUCH CONDITIONS.
- 13. CONTRACTOR SHALL CONFIRM PIPING, EQUIPMENT, FIXTURES, SPECIALTIES, AND PLUMBING COMPONENT LOCATIONS, ELEVATIONS AND SIZES BEFORE ANY WORK IS STARTED. IF ANY DISCREPANCIES OR INTERFERENCES ARE FOUND, NOTIFY ENGINEER BEFORE PROCEEDING WITH WORK.
- 14. IF MANUFACTURER OF SELECTED EQUIPMENT REQUIRES LARGER CAPACITY, CIRCUITRY, AND/OR EQUIPMENT THE CONTRACTOR SHALL PROVIDE SUCH CAPACITY AND/OR EQUIPMENT UNDER THIS CONTRACT AT NO COST TO THE OWNER.

GENERAL PLUMBING NOTES (CONTINUED)

- 15. WHERE THE CONTRACTOR PROPOSES TO USE AN ITEM OF EQUIPMENT OTHER THAN THAT SPECIFIED OR DETAILED ON THE DRAWINGS WHICH REQUIRES ANY REDESIGN OF THE STRUCTURE, PARTITIONS, FOUNDATIONS, PIPING, WIRING OR ANY OTHER PART OF THE PLUMBING, MECHANICAL, ELECTRICAL, OR ARCHITECTURAL LAYOUT, ALL SUCH REDESIGN AND ALL NEW DRAWINGS AND DETAILING REQUIRED THEREFORE, SHALL BE PREPARED AT THE CONTRACTOR'S EXPENSE AND ARE SUBJECT TO THE REVIEW AND APPROVAL OF THE OWNER OR HIS AUTHORIZED REPRESENTATIVE. OWNER RESERVES THE RIGHT TO HAVE THE ARCHITECT OR ENGINEER OF HIS CHOICE PREPARE ANY REDESIGN WORK.
- 16. CONTRACTOR SHALL COORDINATE ELECTRICAL REQUIREMENTS OF PLUMBING EQUIPMENT WITH DIVISION 26.
- 17. ALL WORK IN INTERIOR FINISHED SPACES EXCEPT INDICATED IS TO BE CONCEALED. PROVIDE ALL NECESSARY CUTTING, PATCHING, REPAINTING AND/OR REPLACEMENT OF FINISHES AS REQUIRED TO PERFORM WORK, COORDINATE WITH OTHER DIVISIONS. ALL EXPOSED COMPONENTS INCLUDING: FIXTURES, PIPE, EQUIPMENT, VALVES, PANELS, AND CONTROLS SHALL BE FULLY COORDINATED WITH ARCHITECTURAL ELEMENTS.
- 18. BEFORE CUTTING AND DRILLING INTO BUILDING ELEMENTS, INSPECT AND LAYOUT WORK TO AVOID DAMAGING STRUCTURAL ELEMENTS AND BUILDING UTILITIES. NOTIFY THE ARCHITECT AND ENGINEER WHERE EXISTING COMPONENTS AND OR BUILDING UTILITIES OBSTRUCT THE PROPOSED WORK.
- 9. SUPPORT ALL EQUIPMENT, PIPING, AND OTHER REQUIRED PLUMBING COMPONENTS FROM BUILDING STRUCTURE TO PROVIDE A VIBRATION FREE INSTALLATION. NOTIFY ARCHITECT AND STRUCTURAL ENGINEER OF ALL WEIGHTS AND METHODS OF SUPPORT.
- 20. ALL PENETRATIONS THRU WALLS, ROOF, AND FLOORS AND ASSOCIATED CUTTING, PATCHING, WATERPROOFING, AND FLASHING SHALL BE COORDINATED WITH THE WORK OF OTHER SECTIONS BEFORE SITE WORK EXECUTION AND WITH THE ARCHITECT AND STRUCTURAL ENGINEER.
- 21. ALL SLEEVES THROUGH CONCRETE FLOORS AND ALL CORE DRILLING OF CONCRETE FLOORS AND WALLS SHALL BE THE RESPONSIBILITY OF THIS CONTRACTOR.
- ALL PIPING PENETRATING CEILING AND WALLS SHALL BE INSTALLED WITH CHROME PLATED ESCUTCHEONS AT THE PENETRATION. ALL PIPING PENETRATING EXTERIOR WALLS AND ROOFS SHALL BE FLASHED IN AN APPROVED MANNER AND SHALL BE SEALED WEATHER-TIGHT. PIPING PENETRATING FIRE RATED PARTITIONS SHALL BE PROTECTED AS REQUIRED BY CODE.
- PROVIDE FLEXIBLE JOINTS ON ALL PIPING WHERE PENETRATION ALL BUILDING EXPANSION JOINTS.
- 24. PROVIDE SHUTOFF VALVES ON ALL BRANCH PIPING AND ON ALL SUPPLIES TO INDIVIDUAL FIXTURES AND EQUIPMENT. PROVIDE BALL VALVES ON ALL WATER MAIN BRANCHES IN CORRIDORS AND WHERE INDICATED ON DRAWINGS.
- 25. PROVIDE ACCESS PANELS FOR CONCEALED PLUMBING COMPONENTS AND EQUIPMENT REQUIRING ACCESS FOR OPERATION, SERVICE, INSPECTION, AND MAINTENANCE. COORDINATE LOCATIONS WITH THE ARCHITECT.
- 26. TOP OF ALL FLOOR DRAINS SHALL BE SET FLUSH WITH FINISHED FLOORING UNLESS OTHERWISE
- 27. INSULATE PIPING AS SPECIFIED. PERFORM REQUIRED TESTS BEFORE INSULATING.
- _____
- 3. TEST AND STERILIZATION:
 ENTIRE SANITARY, WASTE, VENT, STORM, AND GAS PIPING SYSTEMS SHALL BE TESTED, FLUSHED,
 AND/OR STERILIZED BY THE PLUMBING CONTRACTOR IN THE PRESENCE OF THE GC. AND LOCAL
 AUTHORITIES (PLUMBING INSPECTOR AND GAS FITTING INSPECTOR IF SEPARATE FROM THE
 PLUMBING INSPECTOR).

PLUMBING FIXTURES & CONNECTION SCHEDULE

TAG	DESCRIPTION	SOIL/ WASTE	VENT	COLD WATER	HOT WATER	REMARKS
P-1	KITCHEN SINK	2"	1-1/2"	1/2"	1/2"	1

1. PROVIDE PLUMBING EQUIPMENT AS APPROVED BY ARCHITECT OR OWNER. ALL FIXTURES TO BE APPROVED BY THE MASS PLUMBING BOARD.



ARCHITECT'S STAMP:

ENGINEER:



ENGINEER'S STAMP:

GENERAL INFORMATION:

SCHEMATIC
DESIGN DEVELOPMENT
BID 01.31.2023
PERMIT
CONSTRUCTION
EXISTING CONDITIONS

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REVISION DATE

DATE: 01.31.2023

SCALE: AS NOTED

PROJECT: -
DRAWN: SRK

CHECKED: AG

PROJECT TITLE:

MILLBURY HIGH SCHOOL

FOODS PROGRAM ROOM


FOODS PROGRAM RO 12 MARTIN STREET MILLBURY, MA 01527


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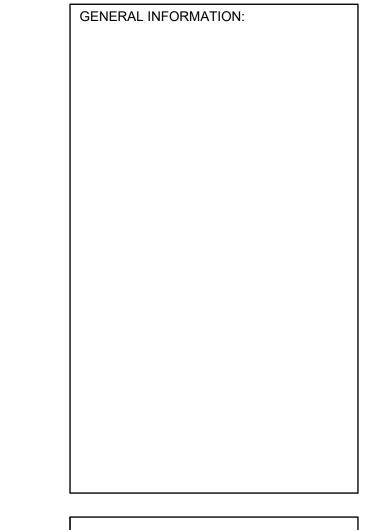
PLUMBING-LEGEND, NOTES & SCHEDULES

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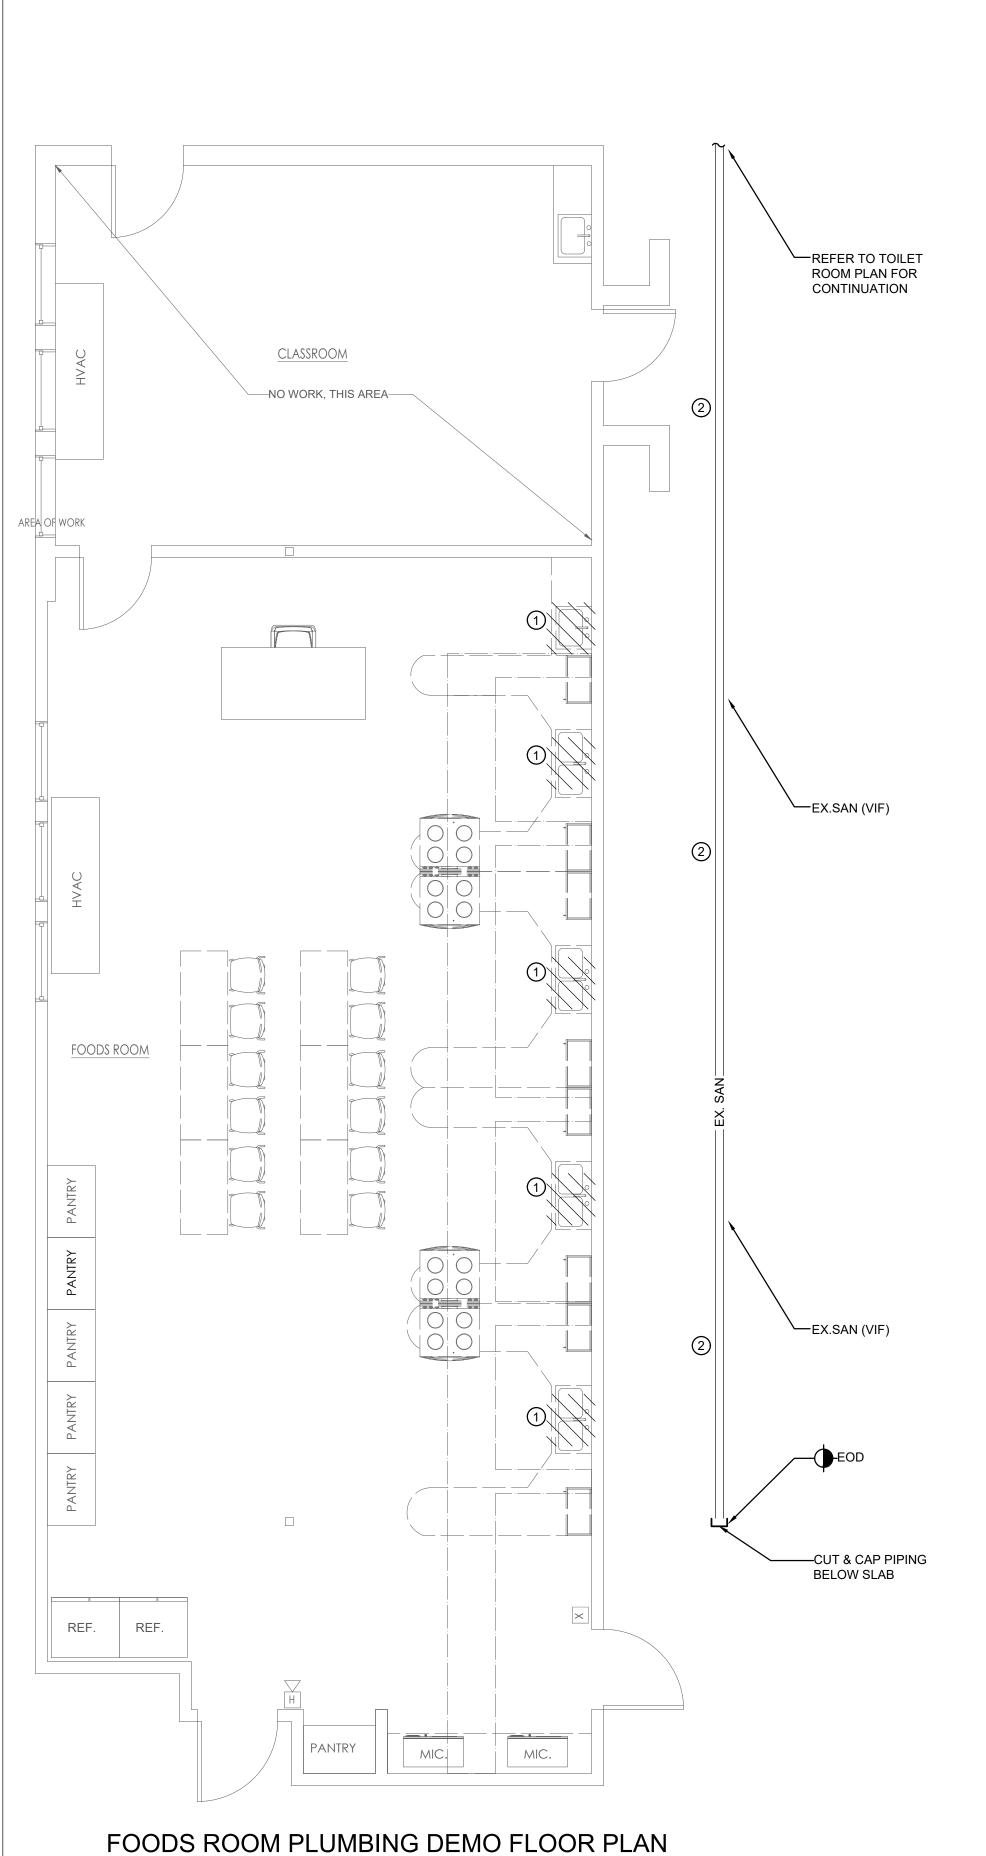
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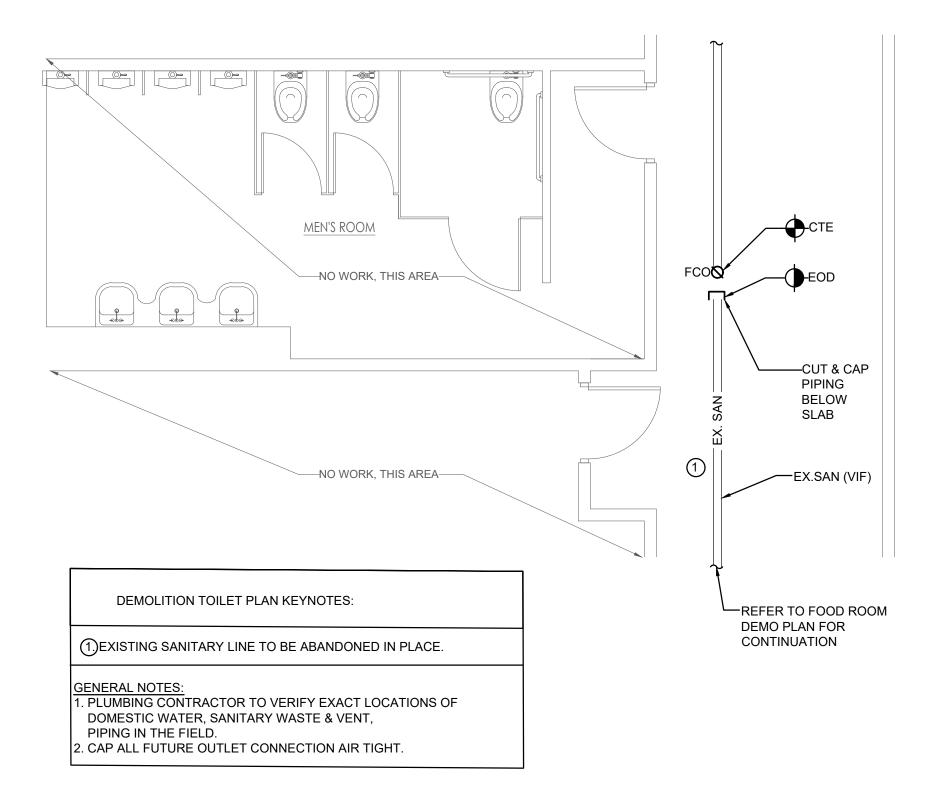
PLUMBING-DETAILS

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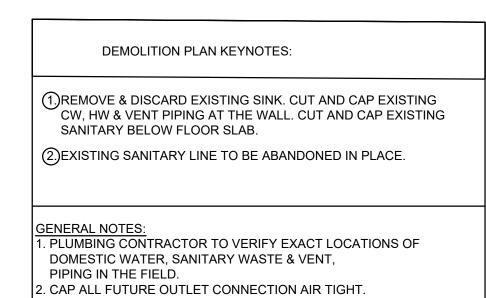
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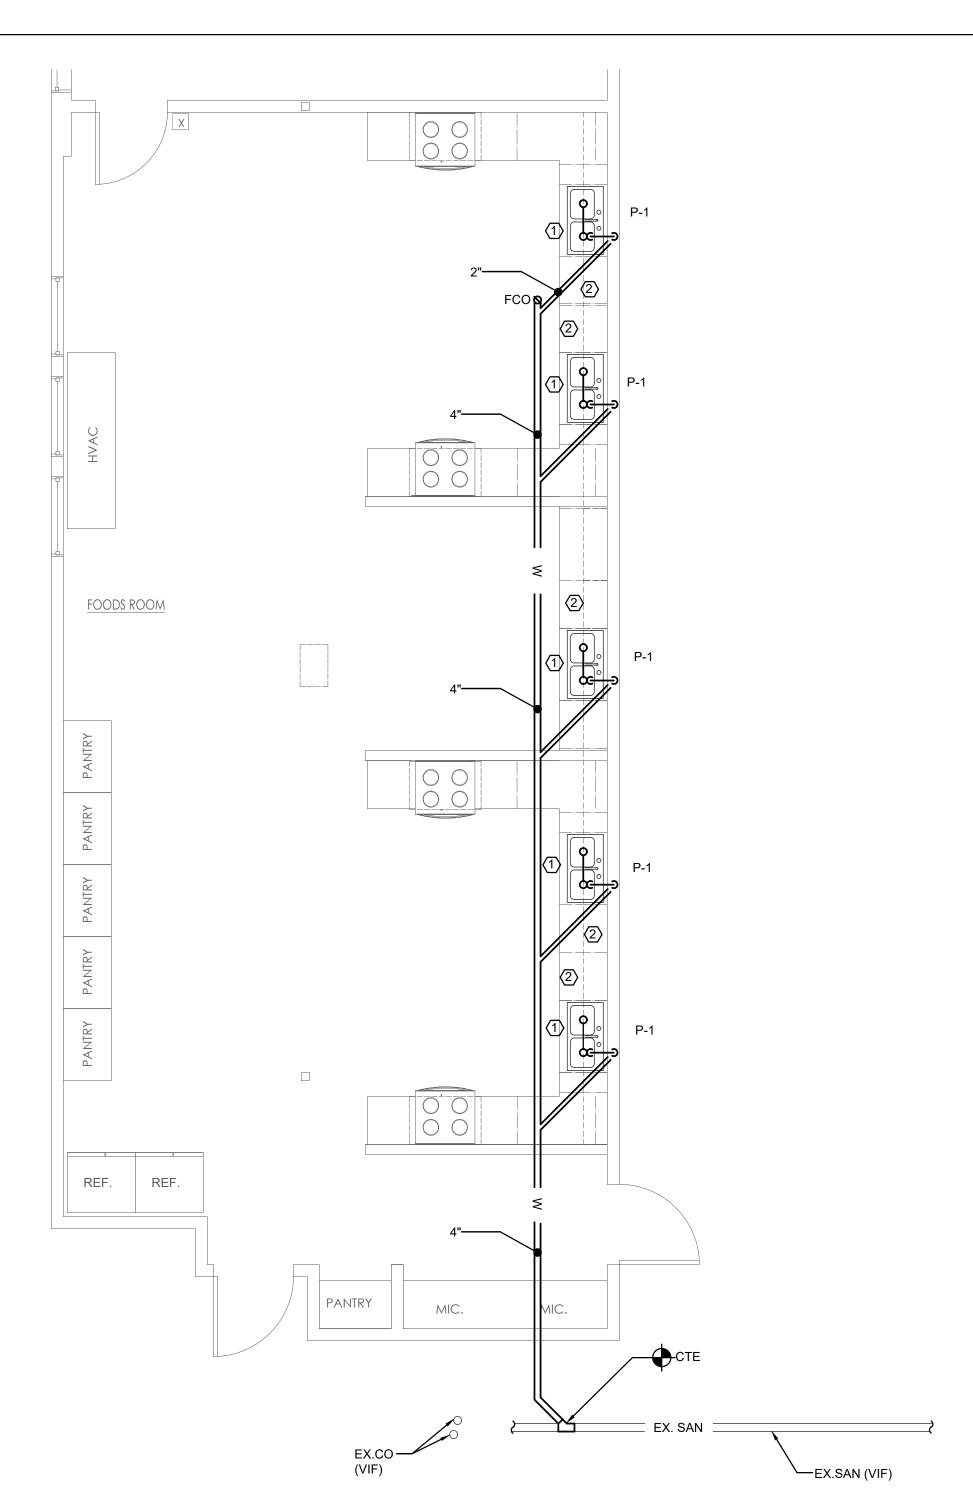


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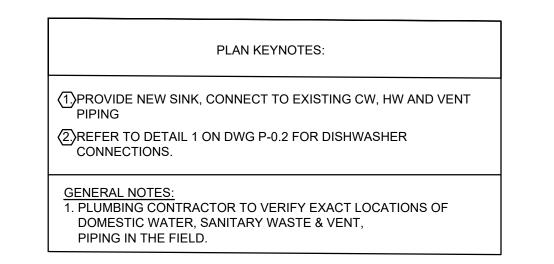


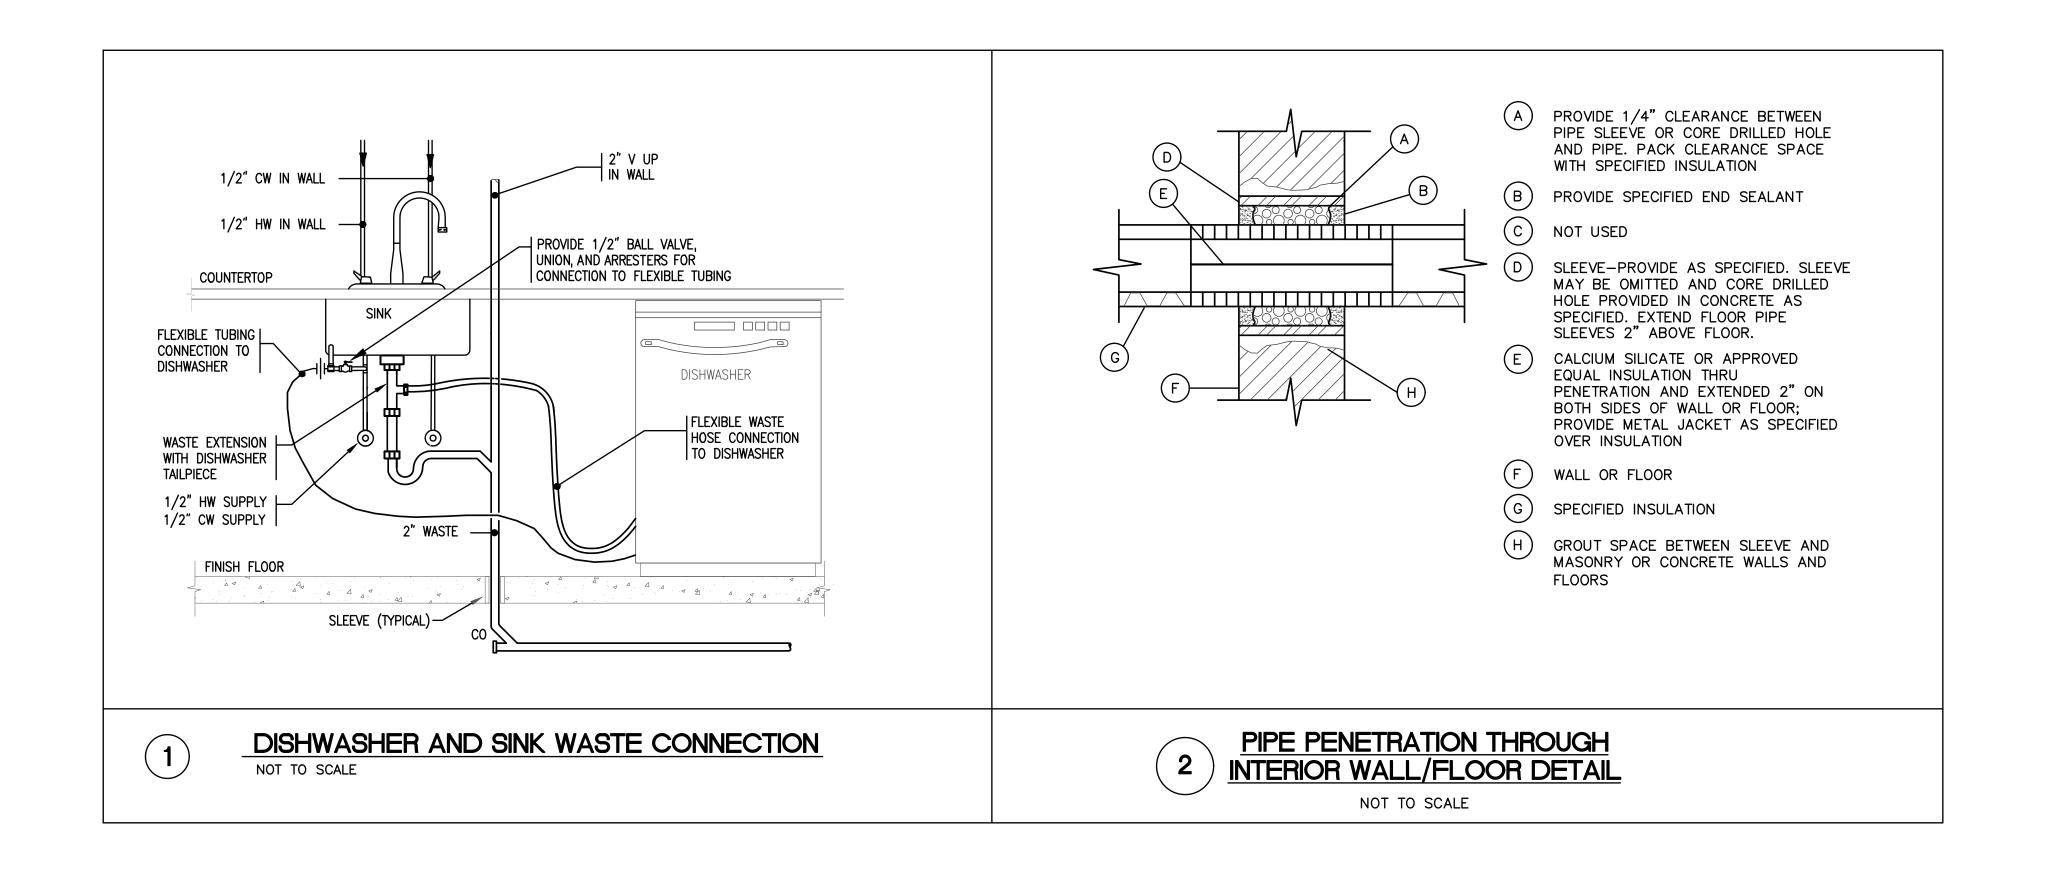
TOILET ROOM PLUMBING DEMO FLOOR PLAN SCALE 1/4" = 1'-0"

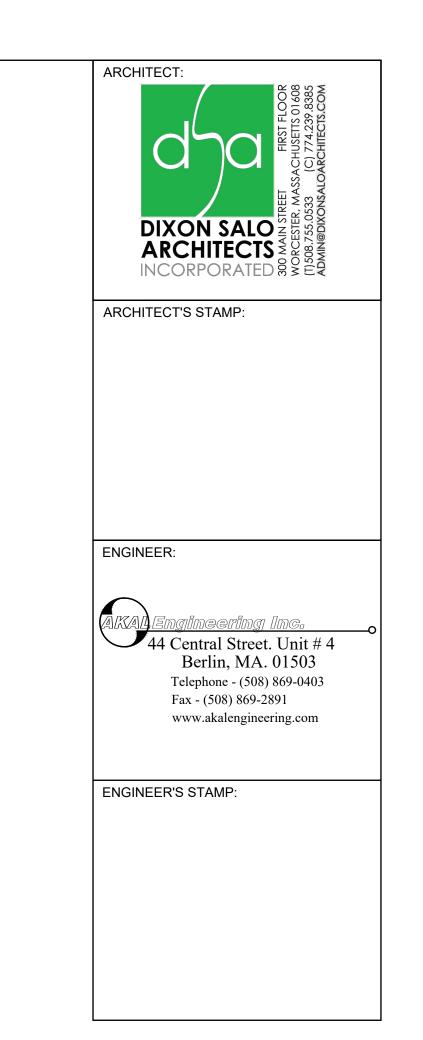




PROPOSED FOODS ROOM PLUMBING PLAN
SCALE 1/4" = 1'-0"



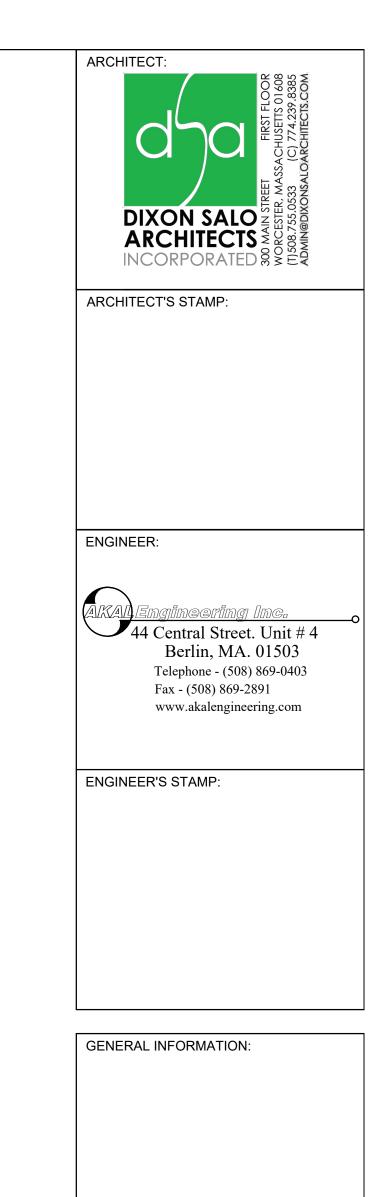

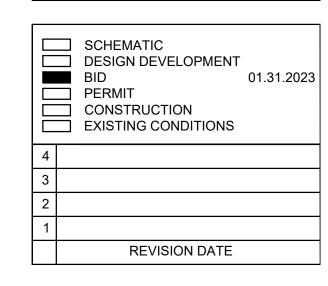


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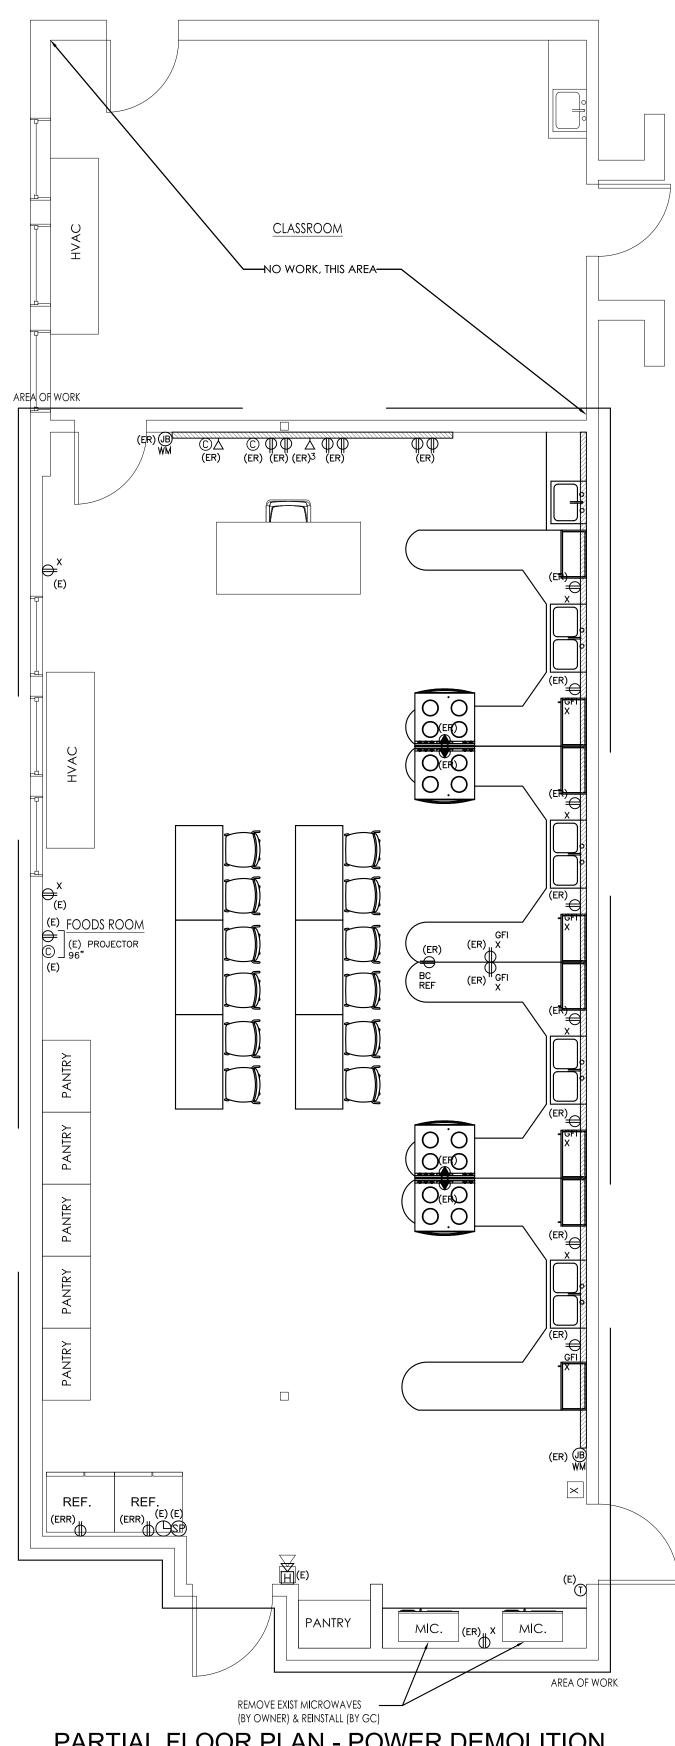
PLUMBING- DEMO & PROPOSED PLANS

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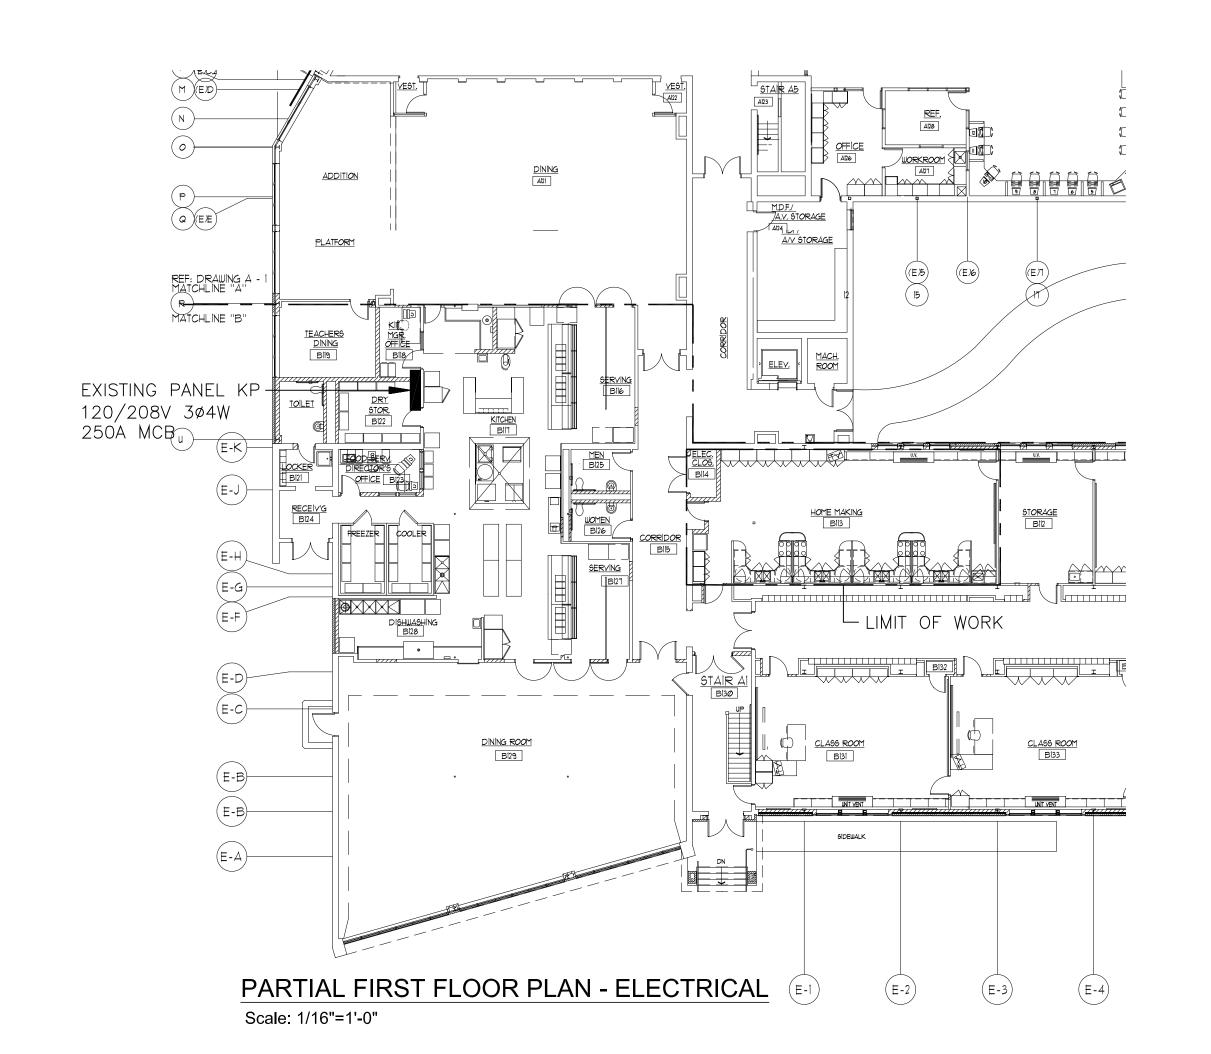
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PARTIAL FLOOR PLAN - LIGHTING DEMOLITION Scale: 1/4"=1'-0"



PARTIAL FLOOR PLAN - POWER DEMOLITION Scale: 1/4"=1'-0"

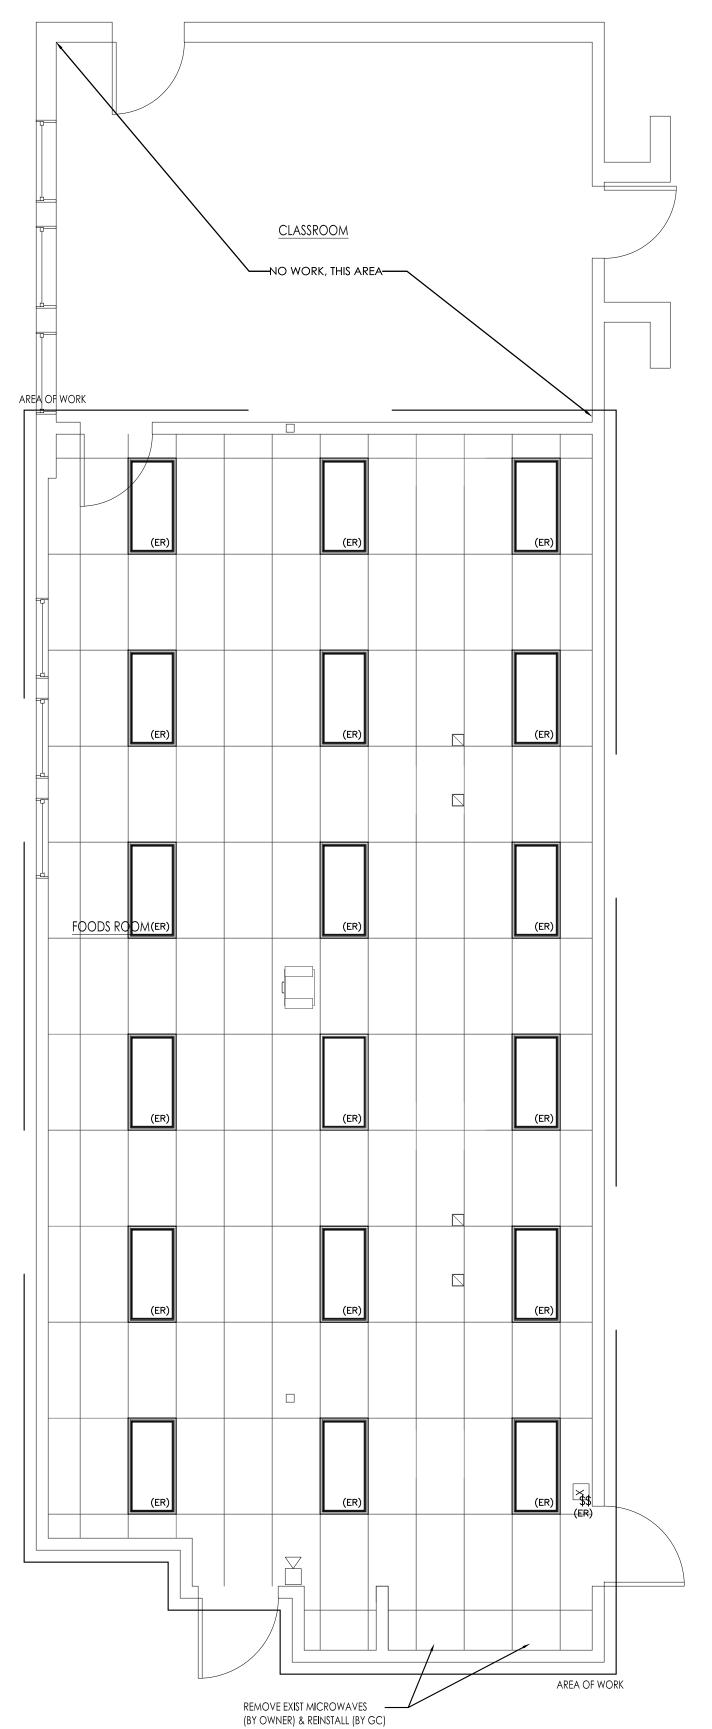

DEMOLITION NOTES:

NOTE 1:
THE EQUIPMENT SHOWN IS TO BE USED FOR DIAGRAMMATIC PURPOSES ONLY. IT SHALL BE THE RESPONSIBILITY OF THIS CONTRACTOR TO REVIEW THE SITE AND TO COORDINATE WITH THE GENERAL CONTRACTOR TO DETERMINE THE AMOUNT AND PHASING OF DEMOLITION WORK REQUIRED.

<u>NOTE 2:</u> THIS CONTRACTOR SHALL BE RESPONSIBLE TO ENSURE THAT ELECTRICAL EQUIPMENT BEING REMOVED BY THE GENERAL/DEMOLITION CONTRACTOR IS TAGGED AND MADE ELECTRICALLY SAFE. CUT ALL CABLES FROM THE PANEL AND AT THE EQUIPMENT TO ENSURE SAFE REMOVAL.

IN THE EVENT THAT A DEVICE BEING REMOVED CAUSES ANOTHER DEVICE REMAINING NOT TO OPERATE, IT SHALL BE THIS CONTRACTORS RESPONSIBILITY TO RECONNECT THE EQUIPMENT REMAINING BACK TO ITS SOURCE.

<u>NOTE 4:</u>

EXISTING TO REMAIN

EXISTING TO BE REMOVED BACK TO ITS SOURCE EXISTING TO BE REMOVED AND REPLACED

WITH NEW



ARCHITECT'S STAMP:

ENGINEER:

ENGINEER'S STAMP:

GENERAL INFORMATION:

SHEPHERD ENGINEERING, INC. ELECTRICAL CONSULTANTS 1308 GRAFTON STREET WORCESTER, MASSACHUSETTS 01604 PHONE: (508) 757-7793 * FAX: (508) 753-2309 REFERENCE NO.: 23007


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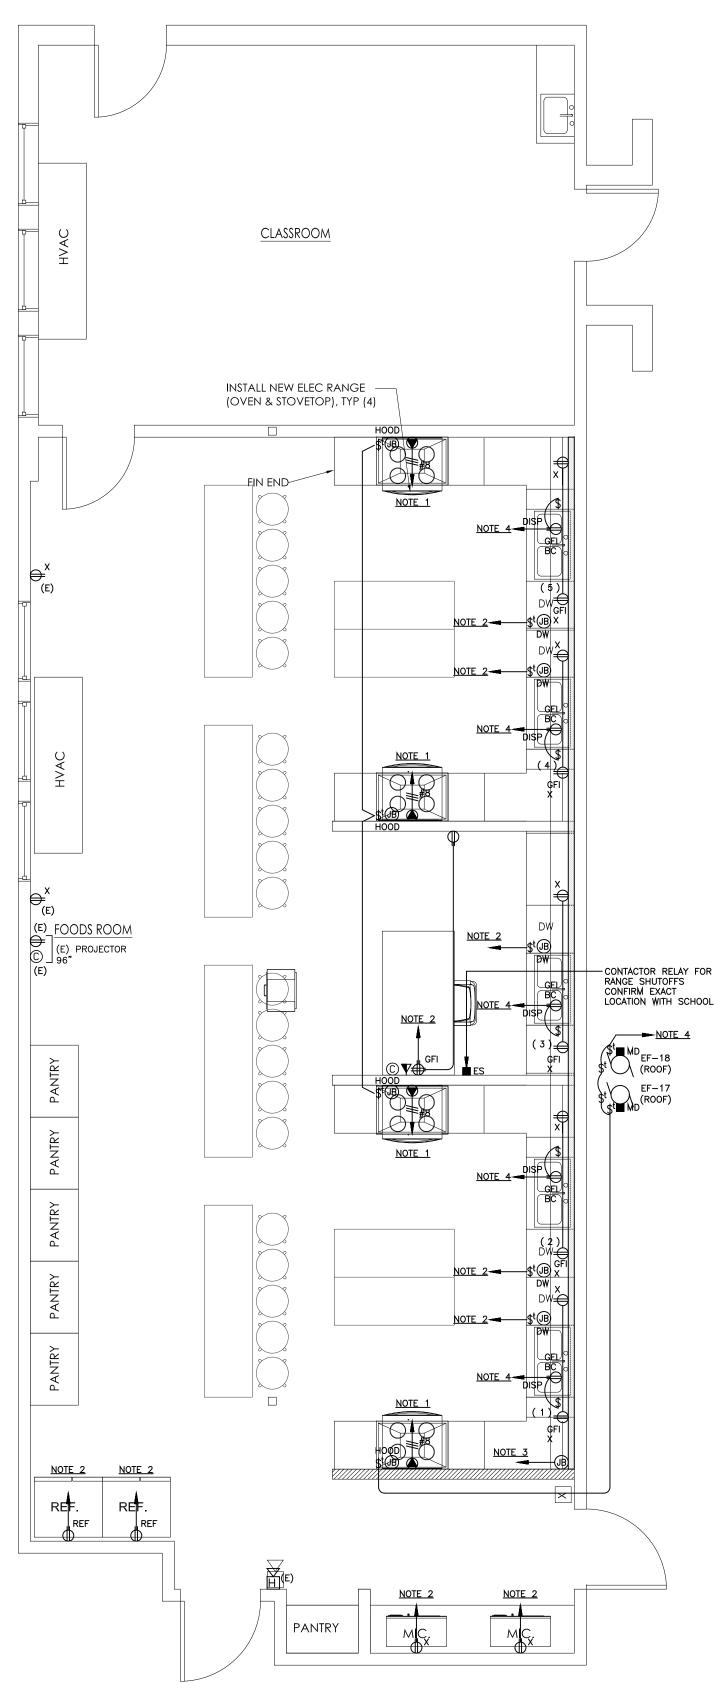
SHEET TITLE: PARTIAL FLOOR PLANS -ELECTRICAL DEMOLITION


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PARTIAL FLOOR PLAN - LIGHTING Scale: 1/4"=1'-0"

NOTE:
EXIT SIGNS AND EMERGENCY BATTERY UNITS ARE TO BE CONNECTED TO THE LINE SIDE OF THE LOCAL LIGHTING CIRCUIT.



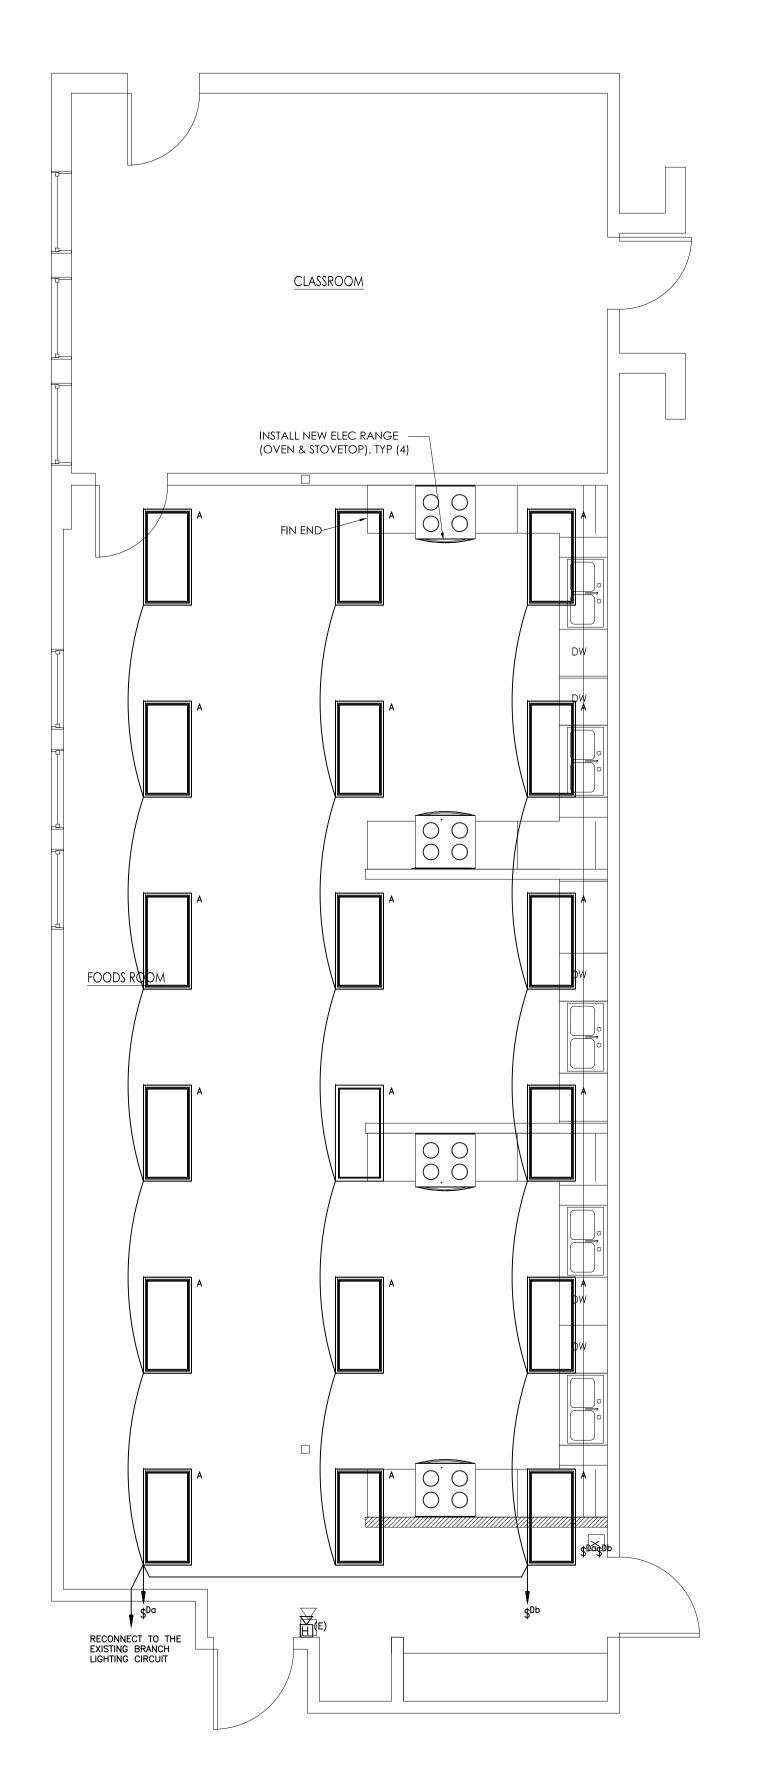

		4 (2) RANGE	8 (4	-) RANGE		EC ELECTRICAL CONTRACTOR
			LIGHTING	FIXTUR	E SCHEDUI	LE	
T/DE	MANUELOTUDED			LAMPING			DEMARKS
TYPE MANUFACTURER	CATALOGUE #	TYPE	WATTAGE	QUANTITY	MOUNTING	REMARKS	

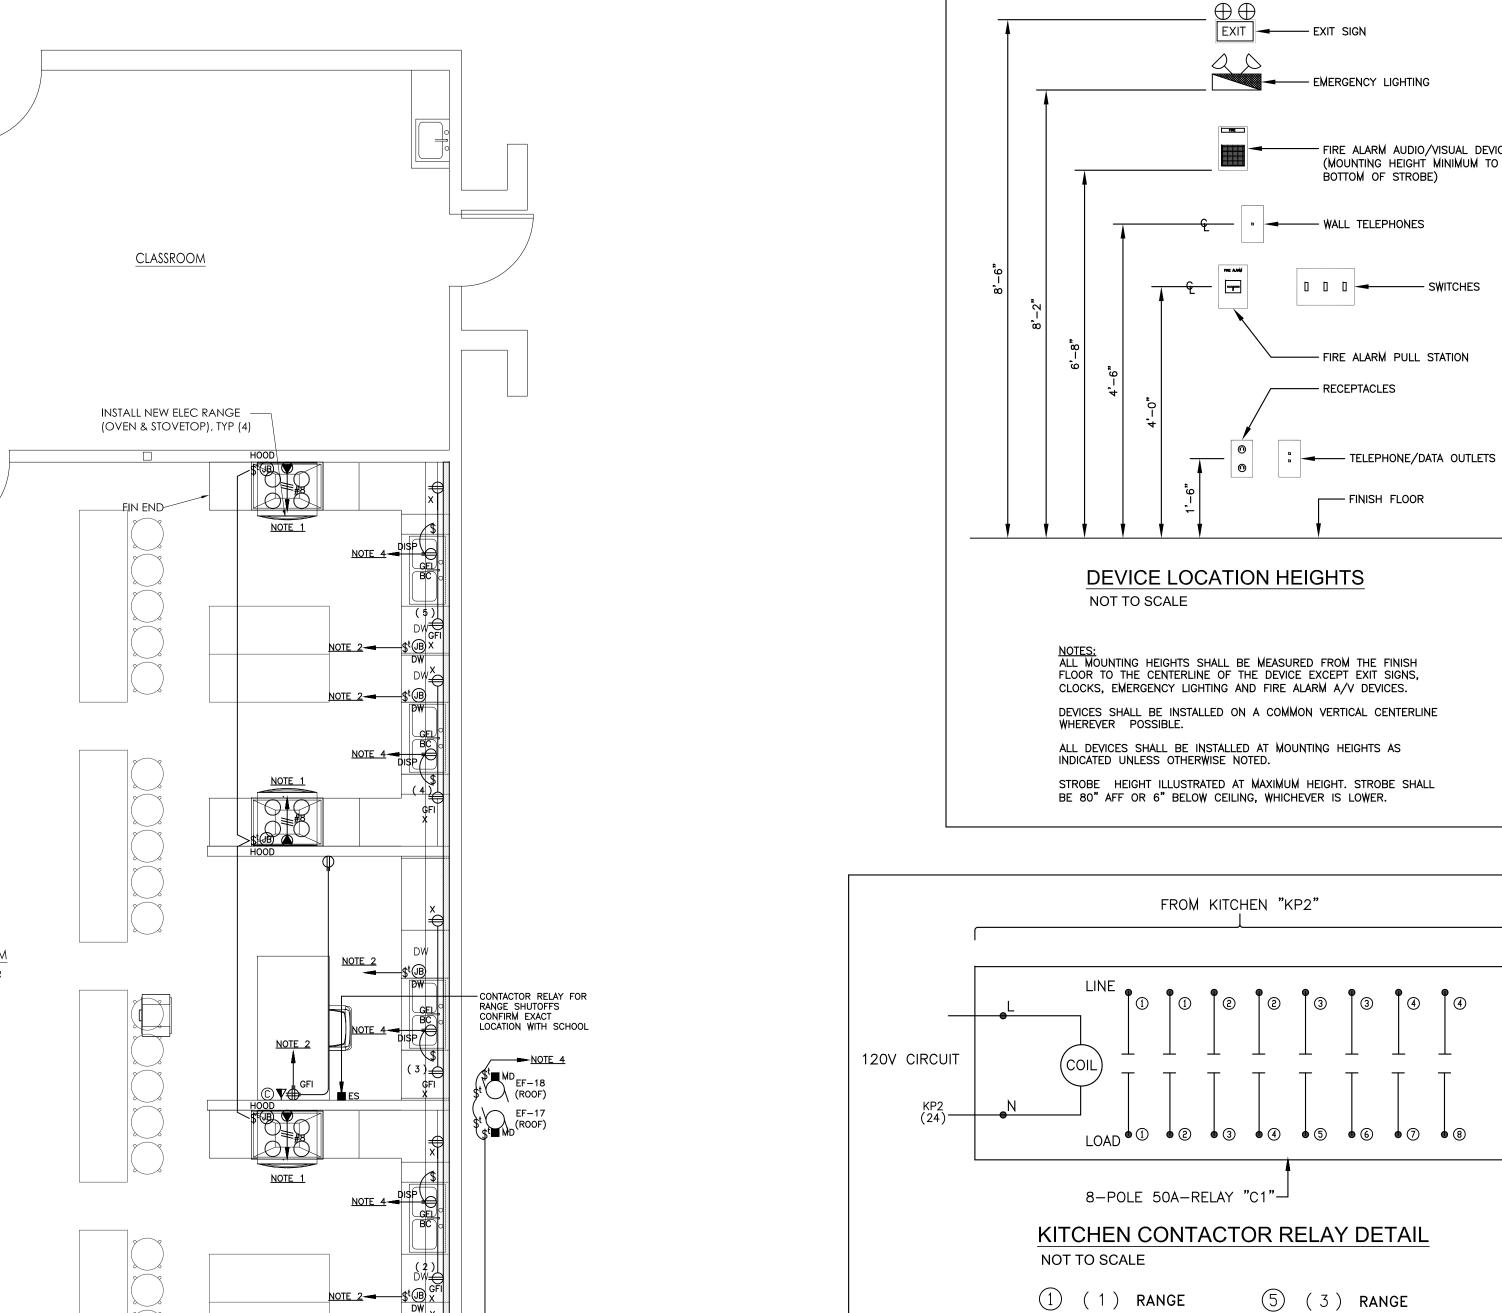6 (3) RANGE

7 (4) RANGE

② (1) RANGE

③ (2) RANGE

FOR FIXTURES WITH 0-10VOLT DIMMING, INSTALL A VIOLET AND GRAY CONTROL CABLE FROM EACH LIGHT FIXTURE TO THE DIMMING CONTROL SWITCH FOR THE 0-10V DIMMING CONTROL.

PARTIAL FLOOR PLAN - POWER Scale: 1/4"=1'-0"

THE E.C. SHALL DISCONNECT, REMOVE, AND REPLACE WITH NEW THE EXISTING 50A-2P CIRCUIT BREAKER IN PANEL KP FOR THE RANGE. THE E.C. SHALL FURNISH AND INSTALL A NEW 50A-2P GFCI CIRCUIT BREAKER.

NOTE 2: THE E.C. SHALL DISCONNECT, REMOVE, AND REPLACE WITH NEW AN EXISTING SPARE 20A-1P CIRCUIT BREAKER IN PANEL KP. THE E.C. SHALL FURNISH AND INSTALL A NEW 20A-1P GFCI CIRCUIT BREAKER.

NOTE 3: THE E.C. SHALL CONNECT THE NEW 5-CIRCUIT WIREMOLD TO PANEL KP.

NOTE 4: THE E.C. SHALL CONNECT TO AN EXISTING SPARE 20A-1P CIRCUIT BREAKER IN PANEL KP.

NOTE 5: COORDINATE WITH HVAC INSTALLER FOR ALL HOOD CONTROLS, RELAYS, AND INTERLOCKS. ALL HOOD CONTROLS, RELAYS, AND INTERLOCKS TO BE INSTALLED BY HVAC INSTALLER.

LIGHTING LEGEND

ARCHITECT:

DIXON SALO **ARCHITECTS**

ARCHITECT'S STAMP:

ENGINEER:

ENGINEER'S STAMP:

REFERENCE NO.: 23007

GENERAL INFORMATION:

SHEPHERD ENGINEERING, INC.

ELECTRICAL CONSULTANTS

1308 GRAFTON STREET

PHONE: (508) 757-7793 * FAX: (508) 753-2309

WORCESTER, MASSACHUSETTS 01604

INCORPORATED®ĂĚ₽

2X4 LIGHT FIXTURE SINGLE POLE SWITCH

DIMMER SWITCH (0-10V RATED)

- FIRE ALARM AUDIO/VISUAL DEVICES (MOUNTING HEIGHT MINIMUM TO

BOTTOM OF STROBE)

— FIRE ALARM PULL STATION

- RECEPTACLES

THERMAL SWITCH

WALL-MOUNTED MOTION SENSOR

CEILING-MOUNTED MOTION SENSOR

POWER LEGEND

DUPLEX RECEPTACLE

DOUBLE DUPLEX RECEPTACLE

GFI RECEPTACLE

50A-2P RANGE OUTLET

DISCONNECT SWITCH

JUNCTION BOX

TRANSFORMER

TEL/DATA OUTLET

PROJECTOR CABLE OUTLET

HOMERUN TO PANEL

FIRE ALARM LEGEND

HORN/STROBE

ABBREVIATIONS

WEATHER PROOF

GROUND FAULT INTERRUPTER

AFF ABOVE FINISHED FLOOR

AMPERE

CONDUIT

CIRCUIT BREAKER

FIRE ALARM

ROOFTOP UNIT

ELECTRIC METALLIC TUBING

RIGID METALLIC CONDUIT

EXHAUST FAN

SCHEMATIC 05.01.2022
DESIGN DEVELOPMENT 11.14.2022 BID
PERMIT
CONSTRUCTION
EXISTING CONDITIONS **REVISION DATE**

> 11.14.2022 SCALE: 1/4"=1'-0" PROJECT: - -DRAWN: CHECKED: PROJECT TITLE: MILLBURY HIGH SCHOOL FOODS PROGRAM ROOM 12 MARTIN STREET MILLBURY, MA 01527

SHEET TITLE: PARTIAL FLOOR PLANS -LIGHTING AND POWER

SHEET NUMBER: