TOWN OF VERNON, CONNECTICUT


EXIT 66 GRAVITY SEWER EXTENSION PROJECT

ISSUED FOR BIDDING MARCH, 2023

	LIST OF DRAWINGS			
SHEET NO.	DRAWING NO.	DRAWING TITLE		
		GENERAL		
1	G-001	COVER SHEET		
CIVIL	-			
2	C-101	SANITARY SEWER PLAN AND PROFILE - 1		
3	C-102	SANITARY SEWER PLAN AND PROFILE - 2		
4	C-103	SANITARY SEWER PLAN AND PROFILE - 3		
5	C-201	GENERAL NOTES & DETAILS - 1		
6	C-202	DETAILS - 2		
7	C-203	CTDOT PAVEMENT REPAIR DETAILS		
8	C-204	C.C.M. PIPE INSTALLATION DETAILS		
9	TTC-001	TEMPORARY TRAFFIC CONTROL PLAN 1		
10	TTC-002	TEMPORARY TRAFFIC CONTROL PLAN 2		
11	TTC-003	TEMPORARY TRAFFIC CONTROL PLAN 3		
12	TTC-004	TEMPORARY TRAFFIC CONTROL PLAN 4		
13	TTC-005	TEMPORARY TRAFFIC CONTROL PLAN 5		
14	TTC-006	TEMPORARY TRAFFIC CONTROL PLAN 6		
15	TTC-007	TEMPORARY TRAFFIC CONTROL PLAN 7		
16	TTC-008	TEMPORARY TRAFFIC CONTROL PLAN 8		
17	TTC-009	TEMPORARY TRAFFIC CONTROL DETAILS 1		
18	TTC-010	TEMPORARY TRAFFIC CONTROL DETAILS 2		

FORM 818 NOTES


- 1. CONSTRUCTION SPECIFICATIONS FOR WORK WITHIN THE STATE RIGHT-OF-WAY SHALL BE THE STATE OF CONNECTICUT DEPARTMENT OF TRANSPORTATION STANDARD SPECIFICATIONS FOR ROADS, BRIDGES AND INCIDENTAL CONSTRUCTION, FORM 818, DATED 2020; SUPPLEMENTAL SPECIFICATIONS, DATED JULY 2022 AND ALL SUPPLEMENTS THERETO; AND SPECIAL PROVISIONS.
- 2. REMOVAL OF PAVEMENT MARKINGS ALONG STATE ROADWAYS SHALL BE COMPLETED BY A NON-DESTRUCTIVE METHOD IN COMPLIANCE WITH THE STATE OF CONNECTICUT DEPARTMENT OF TRANSPORTATION STANDARD SPECIFICATIONS FOR ROADS, BRIDGES, AND INCIDENTAL CONSTRUCTION FORM 818, SECTION 12.11.
- 3. NEW PAVEMENT MARKINGS SHALL BE PAINTED WITH EPOXY RESIN PAINT IN COMPLIANCE WITH THE STATE OF CONNECTICUT DEPARTMENT OF TRANSPORTATION STANDARD SPECIFICATIONS FOR ROADS, BRIDGES, AND INCIDENTAL CONSTRUCTION FORM 818, SECTION 12.10.
- 4. NEW SIGN MATERIAL AND SHEETING SHALL BE MADE OF REFLECTIVE MATERIAL IN COMPLIANCE WITH THE STATE OF CONNECTICUT DEPARTMENT OF TRANSPORTATION STANDARD SPECIFICATIONS FOR ROADS, BRIDGES, AND INCIDENTAL CONSTRUCTION FORM 817, SECTION 12.08. TYPE 1 REFLECTIVE SHEETING SHALL BE USED FOR SIGNS WITH WHITE BACKGROUND, TYPE 3 REFLECTIVE SHEETING SHALL BE USED FOR SIGNS WITH COLORED BACKGROUND EXCEPT FOR SIGNS WITH RED BACKGROUND THAT SHALL BE TYPE 8 OR 9 REFLECTIVE SHEETING.
- 5. ALL SIGNS AND PAVEMENT MARKINGS INSTALLED ALONG THE STATE ROAD MUST CONFORM TO THE "MANUAL ON UNIFORM TRAFFIC CONTROL DEVICES," LATEST STATE OF CONNECTICUT CATALOGUE OF SIGNS AND STANDARDS, AS REVISED.
- 6. ANY DAMAGE TO EXISTING CURB, SIDEWALK, OR ANY OTHER HIGHWAY APPURTENANCES DURING THE DEVELOPMENT OF THE PERMITTED SITE WILL BE REPLACED BY THE CONTRACTOR AS DIRECTED BY THE DISTRICT 3 PERMIT SECTION AT NO COST TO THE STATE.
- 7. ALL WORK WITHIN THE STATE RIGHT-OF-WAY WILL COMPLY STATE OF CONNECTICUT DEPARTMENT OF TRANSPORTATION STANDARD SPECIFICATIONS FOR ROADS, BRIDGES AND INCIDENTAL CONSTRUCTION, FORM 818 WITH THE LATEST SPECIAL PROVISIONS AND STANDARD STATE STANDARD DETAILS

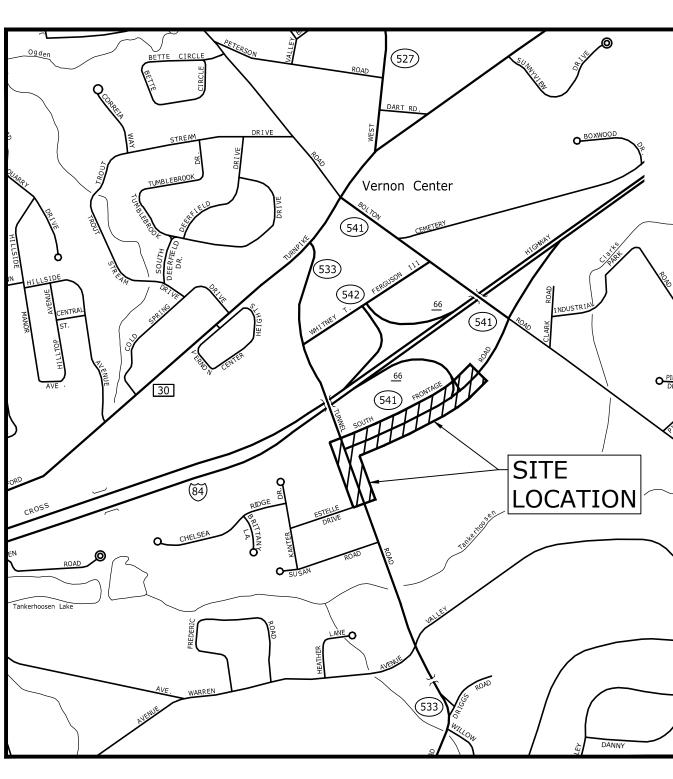


LOCATION MAP
SCALE: 1" = 1000'

PREPARED BY:

1000 Bridgeport Avenue Suite 320 Shelton, CT 06484 (203) 712-1100

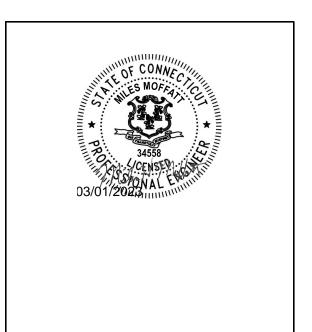

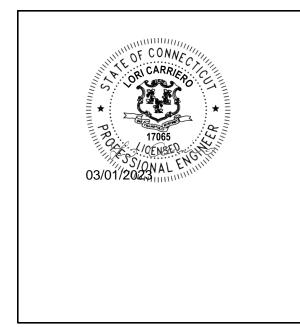


PREPARED FOR:


TOWN OF VERNON, CONNECTICUT


NOTE:


"PER SECTION 6.2 OF THE DEPARTMENT'S UTILITY ACCOMMODATION MANUAL (UAM), A MINIMUM VERTICAL CLEARANCE OF 12" SHALL BE MAINTAINED BETWEEN FACILITIES. CATCH BASINS AND DRAINAGE PIPE FILLED WITH SEDIMENT DURING CONSTRUCTION ACTIVITIES MUST BE, CLEANED AND FLUSHED AT CONTRACTOR'S EXPENSE. ANY DRAINAGE PIPES DAMAGED DURING CONSTRUCTION MUST BE REPAIRED USING THE "CLASS "F" CONCRETE PIPE CONNECTION" DETAIL FOUND ON THE DEPARTMENT'S STANDARD SHEET HW-651-01 AS DIRECTED AND APPROVED BY THE PERMIT INSPECTOR. REPAIR MUST BE PERFORMED UTILIZING SOLID SECTION OF EXISTING PIPE. WHERE THIS CANNOT BE ACHIEVED, FULL PIPE REPLACEMENT


COMPLETE SET 18 SHEETS

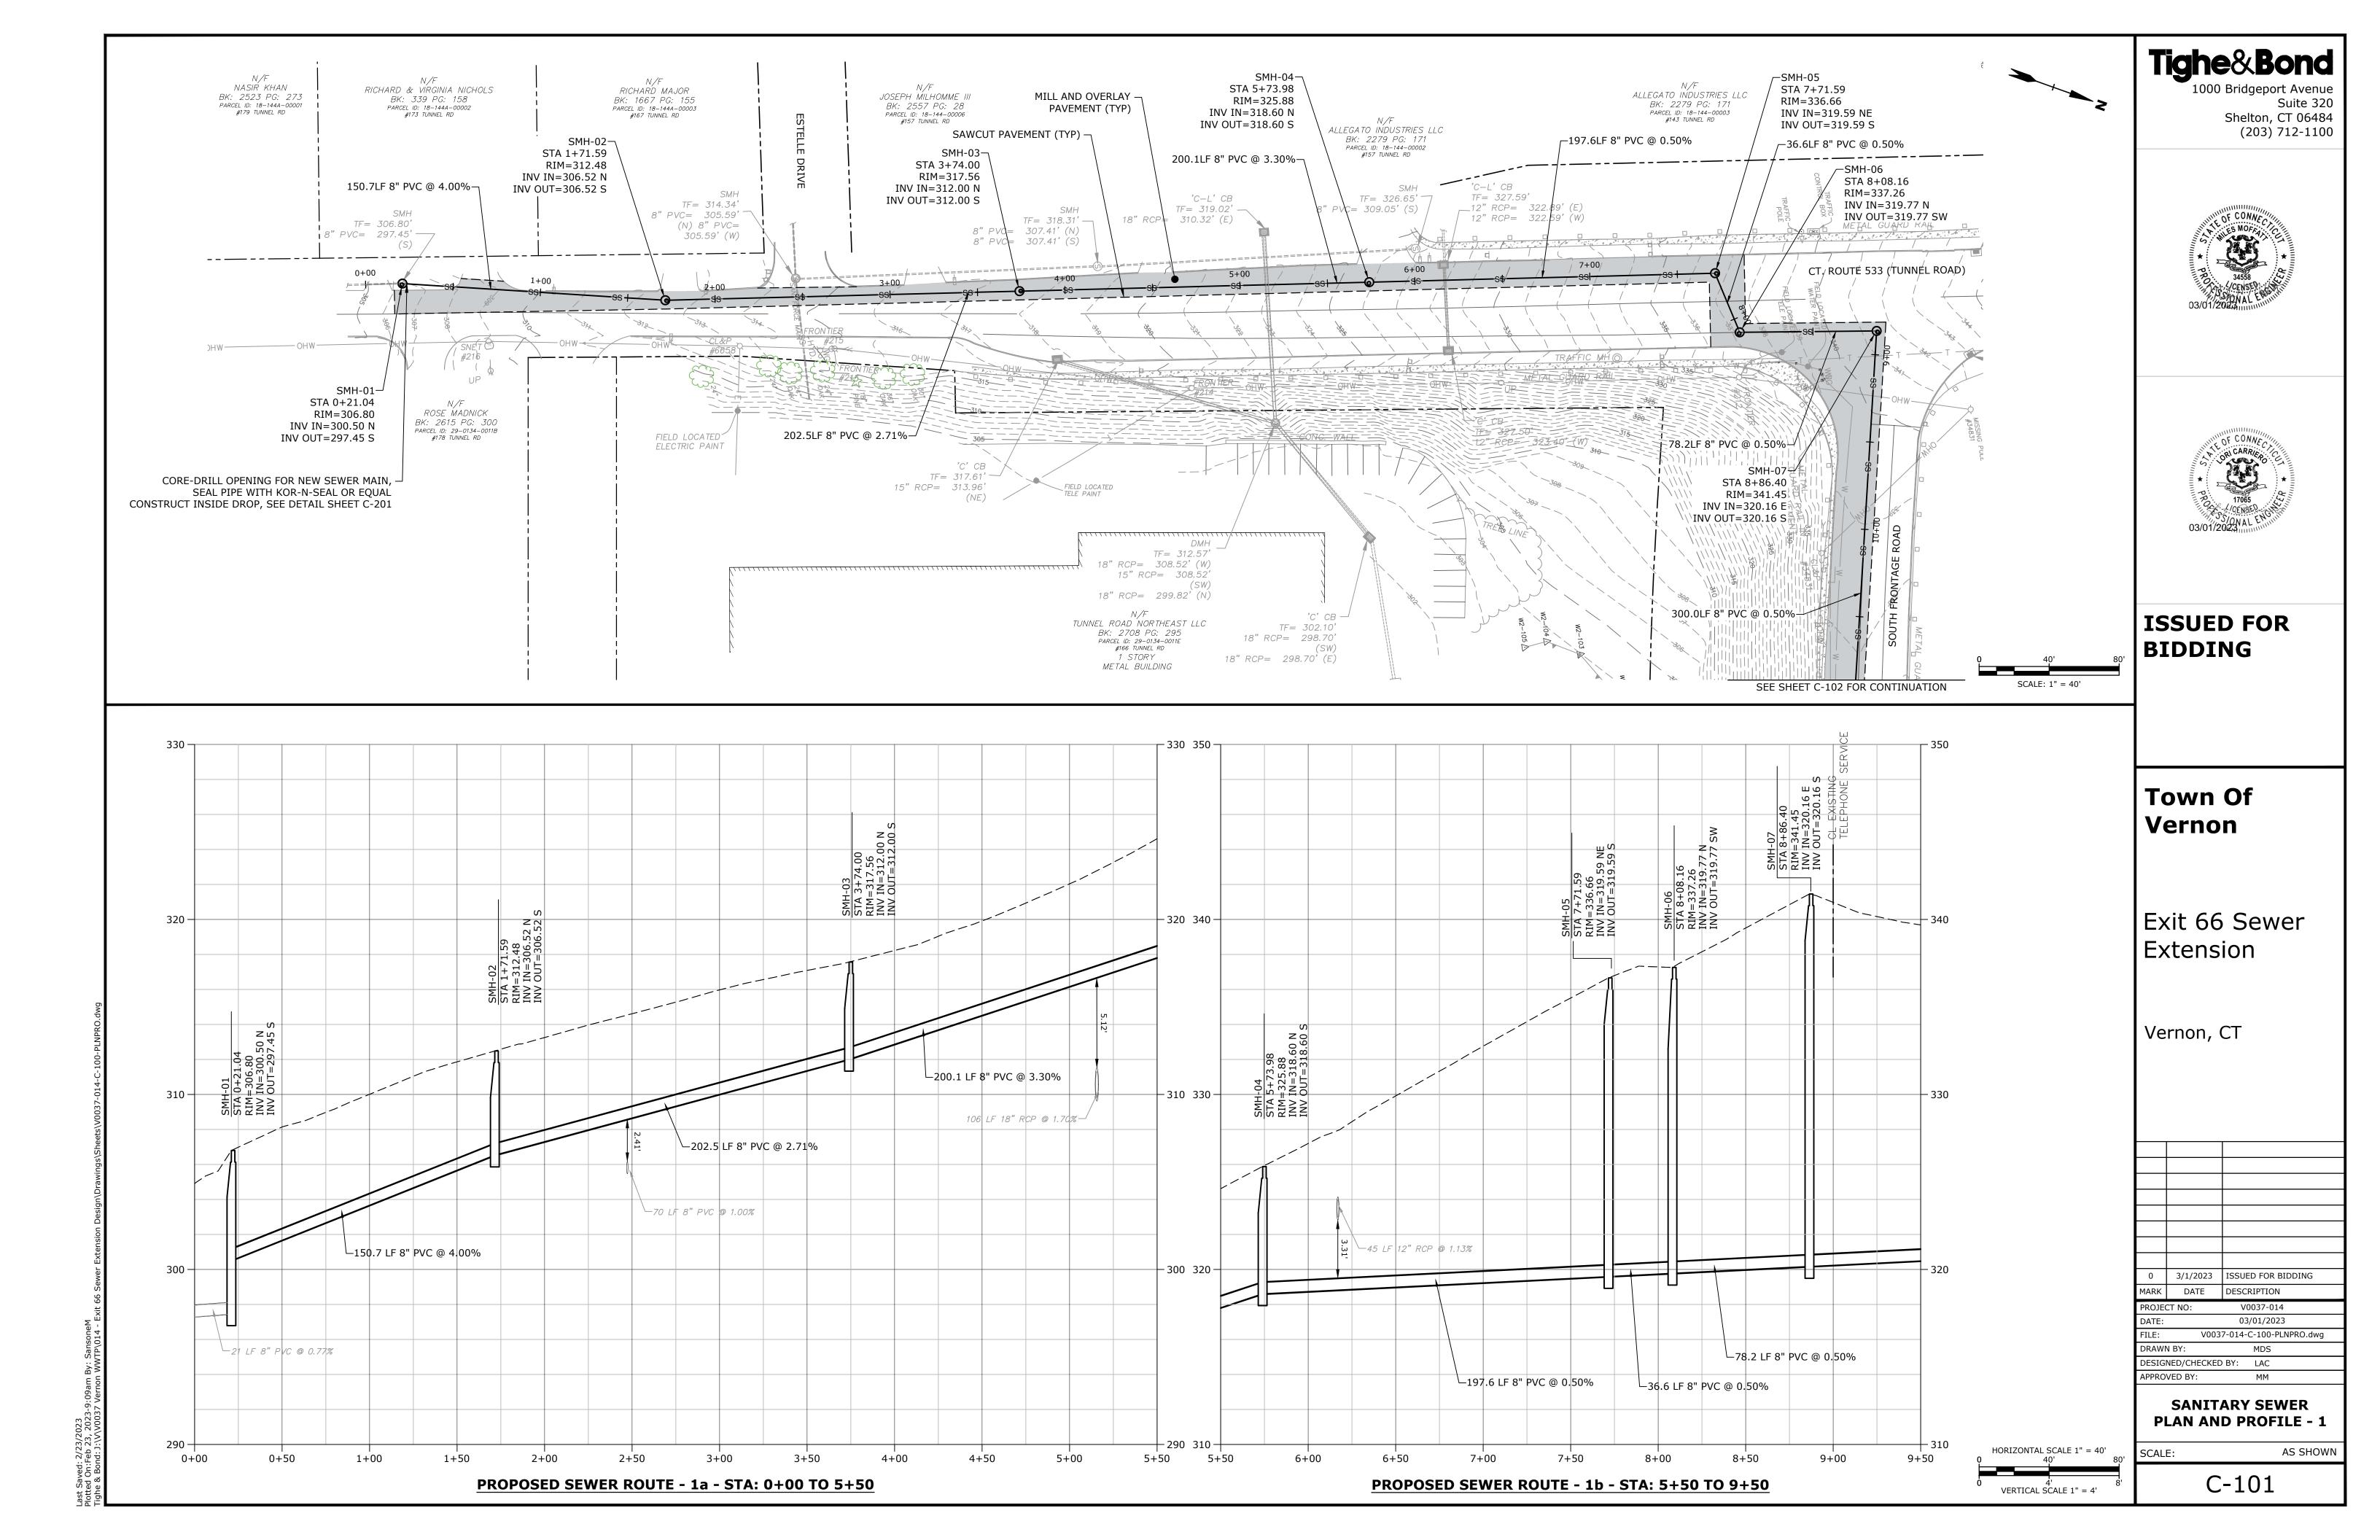

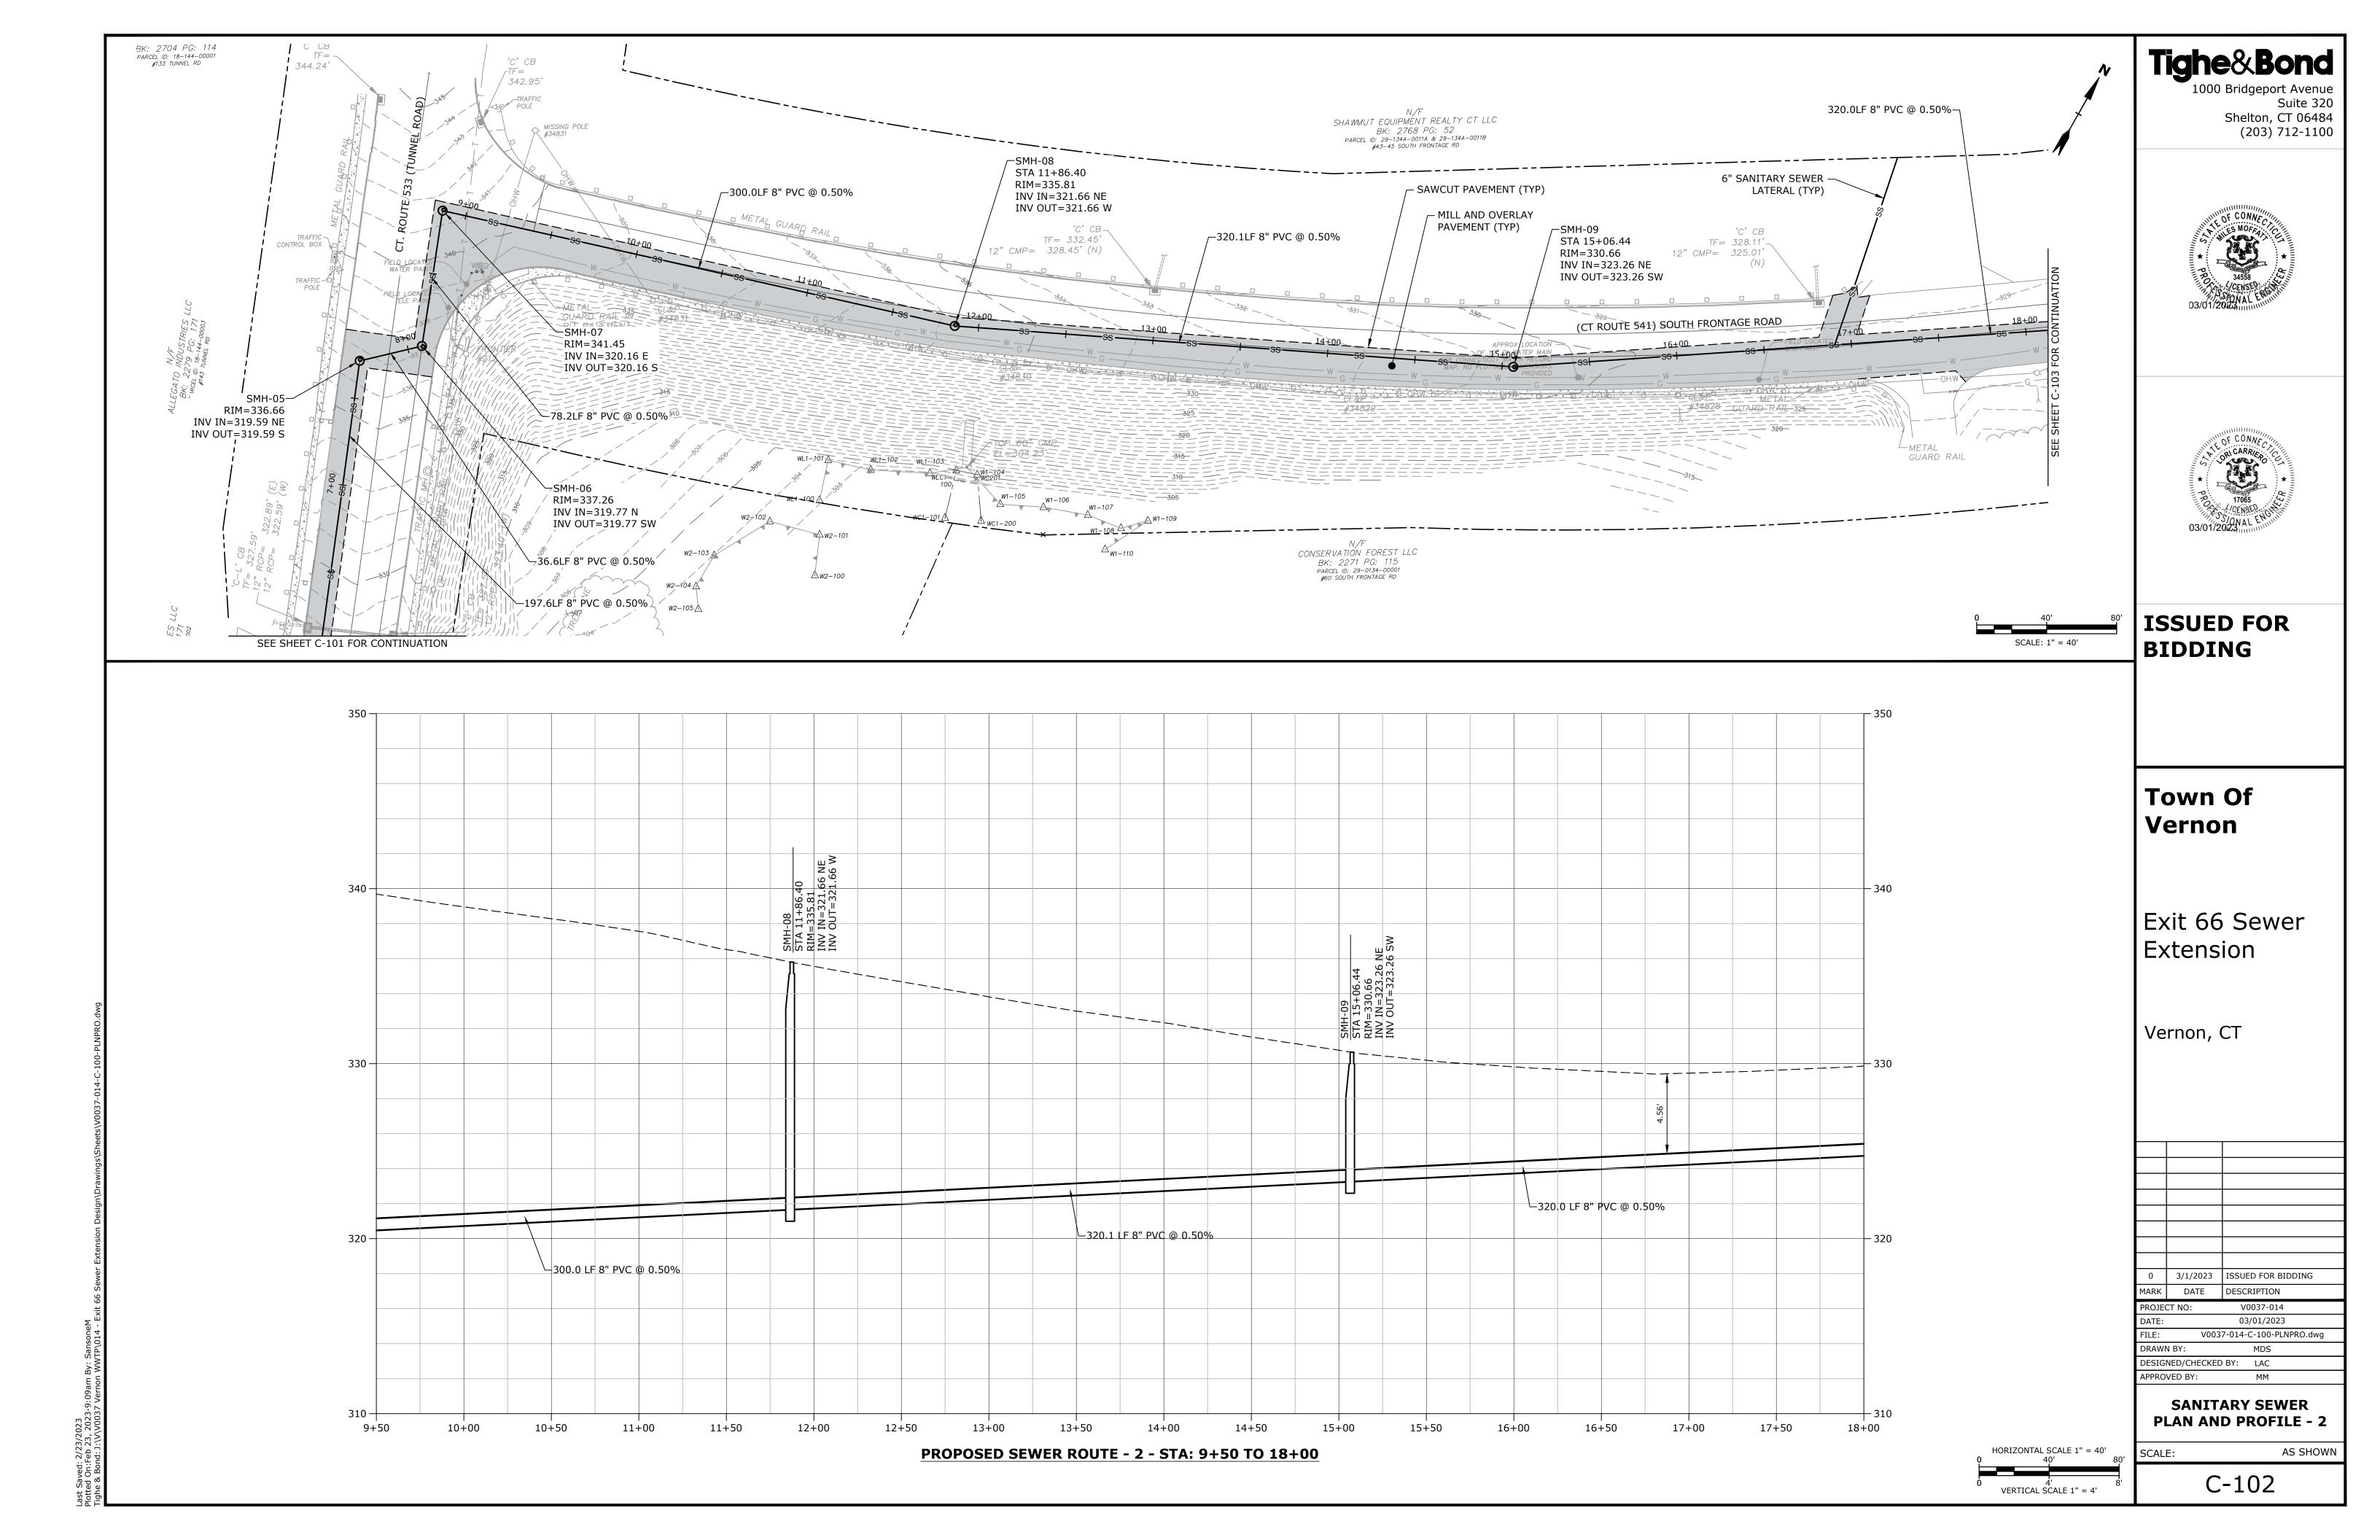

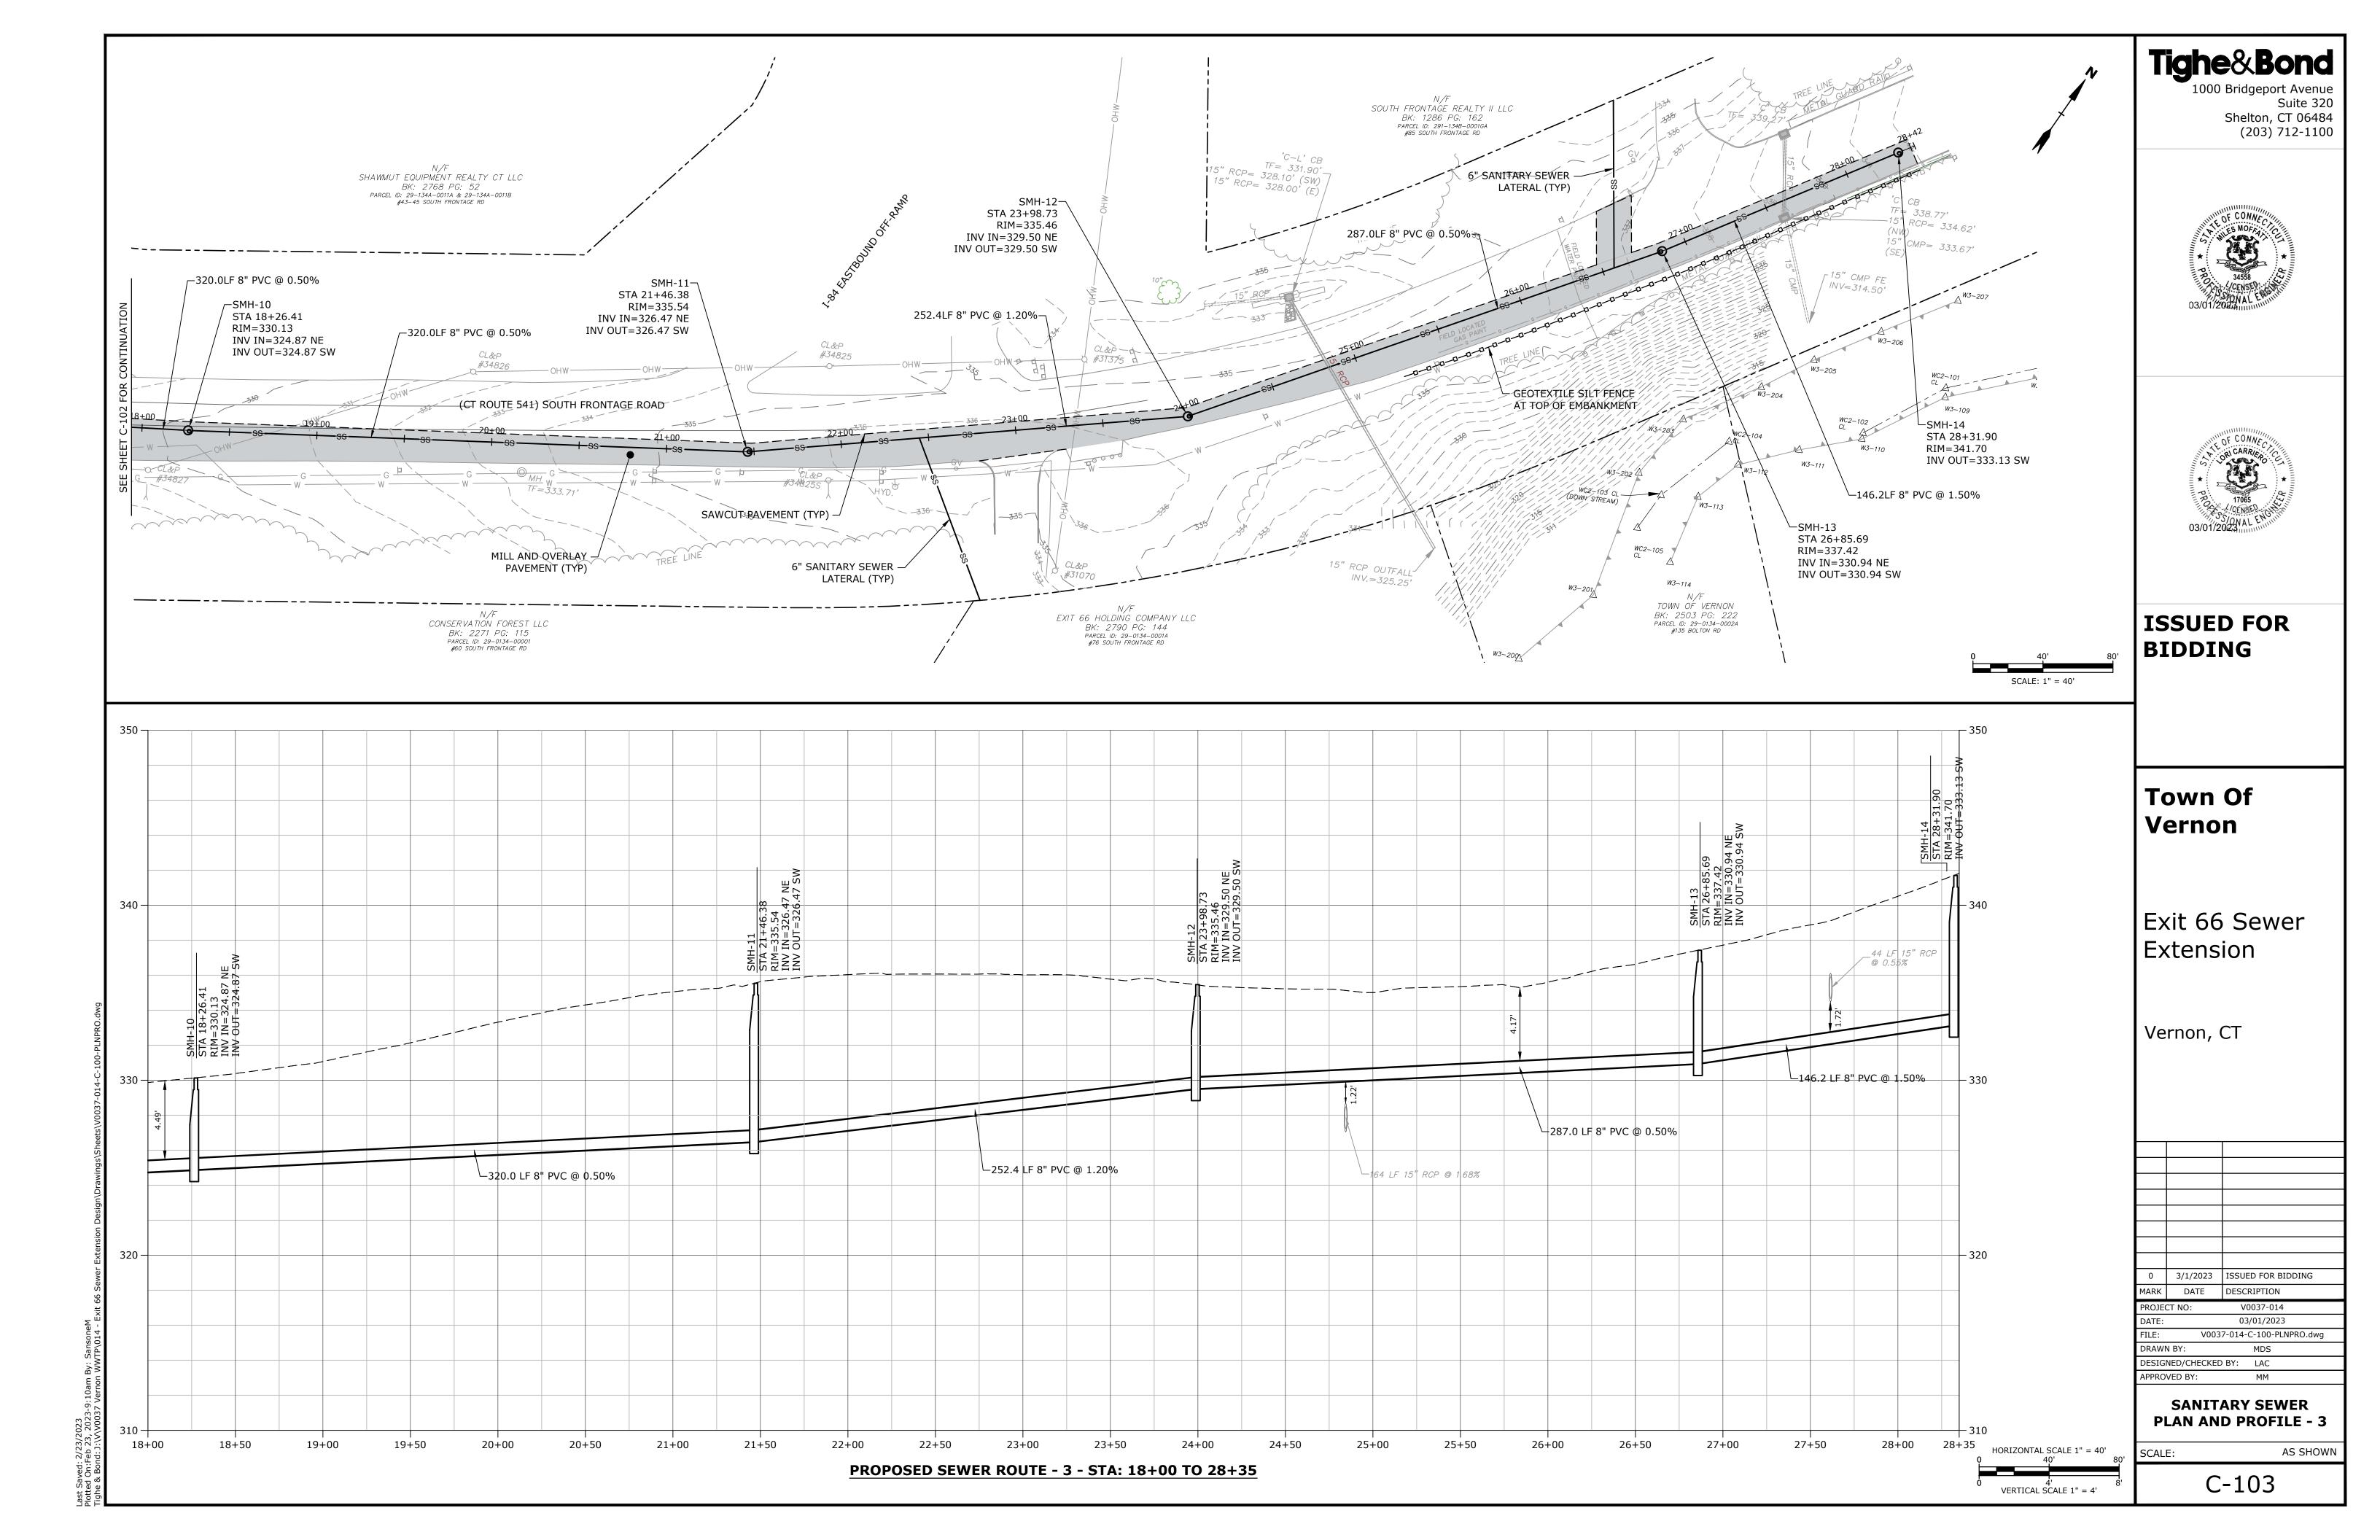

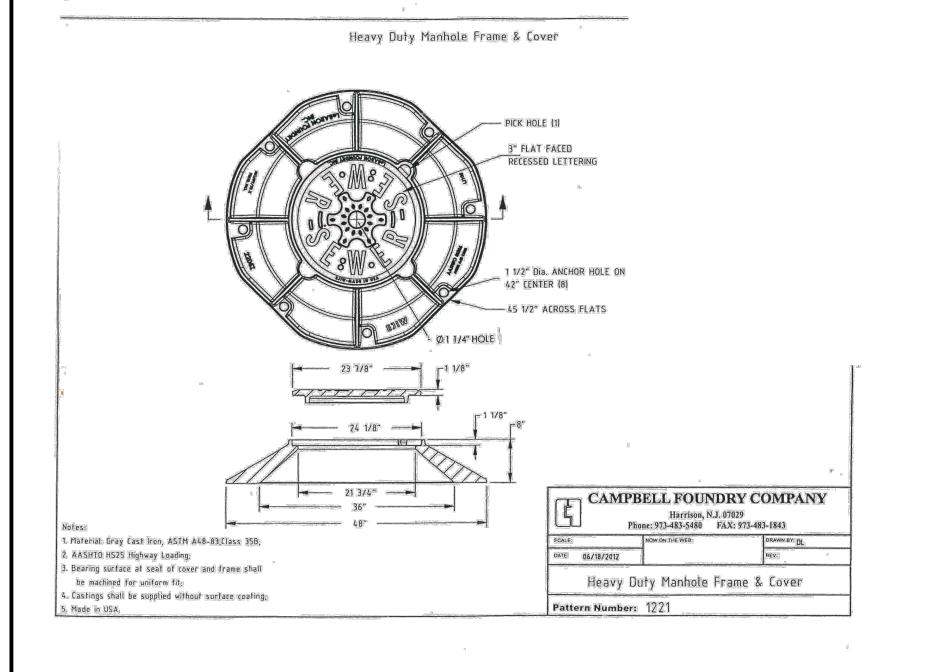

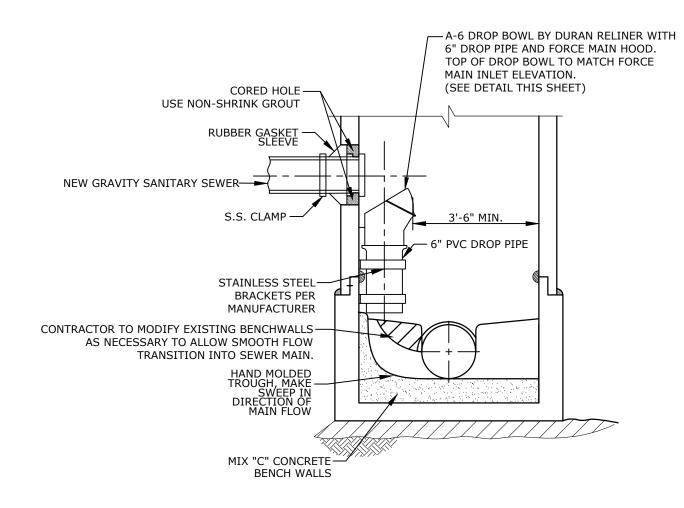

GRAVITY SEWER CONNECTION DETAIL NO SCALE

DOWN PIPE DIAMETER DROP BOWL TOP VIEW NO SCALE DROP BOWL MOUNTS TO WALL WITH RELINER STAINLESS STEEL ANCHOR BOLT ASSEMBLIES HOOD BOUL WITH INCLUDED STAINLESS STEEL BOLTS

FORCE LINE HOOD NO SCALE

NOTES:

1. A6FDB FLAT WALL.

SANITARY MANHOLE INSIDE DROP BOWL DETAIL


NO SCALE

GENERAL NOTES


- BASE MAP BASED UPON SURVEY PROVIDED BY MARTIN SURVEYING ASSOCIATES, LLC OF BERLIN, CT. THE SURVEY IS BASED UPON NAD 1983 HORIZONTAL DATUM AND NAVD 1988 VERTICAL DATUM.
- 2. CONTRACT LIMITS ARE DEFINED AS THE EXISTING RIGHT OF WAY FOR ALL ROADS.
- 3. CONTRACTOR SHALL NOTIFY "CALL BEFORE YOU DIG" AT 1-800-922-4455 AT LEAST 72 HOURS PRIOR TO PERFORMING ANY WORK ON THE SITE.
- 4. ALL CONSTRUCTION MATERIALS AND METHODS IN THE STATE ROW SHALL CONFORM TO THE CT DEPARTMENT OF TRANSPORTATION'S SPECIFICATION FORM 818. ALL PAVEMENT RESTORATION METHODS WILL BE DISCUSSED WITH THE PERMIT INSPECTOR PRIOR TO RESTORATION.
- 5. CONTRACTOR SHALL DIG TEST PITS IF NECESSARY TO CONFIRM THE ELEVATION AND LOCATION OF EXISTING UTILITIES THAT MAY CONFLICT WITH THE INSTALLATION OF THE NEW SEWER MAIN.
- 6. CONTRACTOR SHALL SUPPORT AND PROTECT EXISTING UTILITIES WHERE NECESSARY IN ACCORDANCE WITH THE REQUIREMENTS OF THE UTILITY OWNER. NOT ALL OVERHEAD WIRES AND POWER LINES ARE SHOWN ON THE DRAWINGS. WHERE CONTRACTOR'S WORK IS WITHIN 5' OF AN EXISTING UTILITY POLE, CONTRACTOR MUST COORDINATE SUPPORTING THE POLES WITH THE APPROPRIATE UTILITY OWNER.
- 7. ALL PAVEMENT INSTALLED SHALL MATCH THE ELEVATION OF THE ADJACENT ROAD SURFACE, AND EXISTING DRAINAGE PATTERNS SHALL BE MAINTAINED THROUGHOUT CONSTRUCTION.
- 8. CONTRACTOR SHALL MAKE HIS OWN ARRANGEMENTS FOR STOCKPILE AREAS. NO MATERIALS OR EQUIPMENT SHALL BE STORED OUTSIDE OF THE CONTRACT LIMITS.
- 9. NOT ALL EXISTING ITEMS (INCLUDING TREES, PLANTERS, SHRUBS, FENCES, ETC.) ARE SHOWN ON THE DRAWINGS. HOWEVER, ALL EXISTING ITEMS DAMAGED BY THE CONTRACTOR SHALL BE RESTORED TO THEIR EXISTING CONDITION OR BETTER IN ACCORDANCE WITH THE CONTRACT DOCUMENTS.
- 10. CONTRACTOR SHALL BE RESPONSIBLE FOR MEETING ALL APPLICABLE SAFETY REGULATIONS IN THE PROJECT AREA.
- 11. ALL PIPE FOUNDATIONS SHALL BE AS SHOWN ON THE DETAIL FOR A TYPICAL CROSS SECTION UNLESS DIRECTED OTHERWISE BY THE OWNER.


MANHOLE FRAME AND COVER


NO SCALE

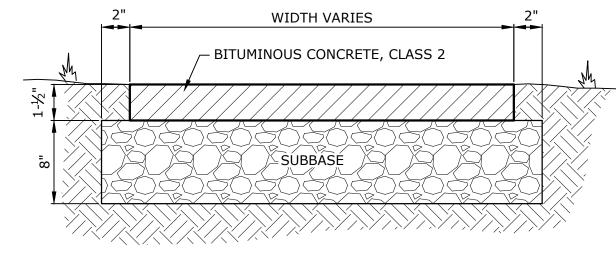

BITUMINOUS CONCRETE DRIVEWAY PAVEMENT REPAIR NO SCALE

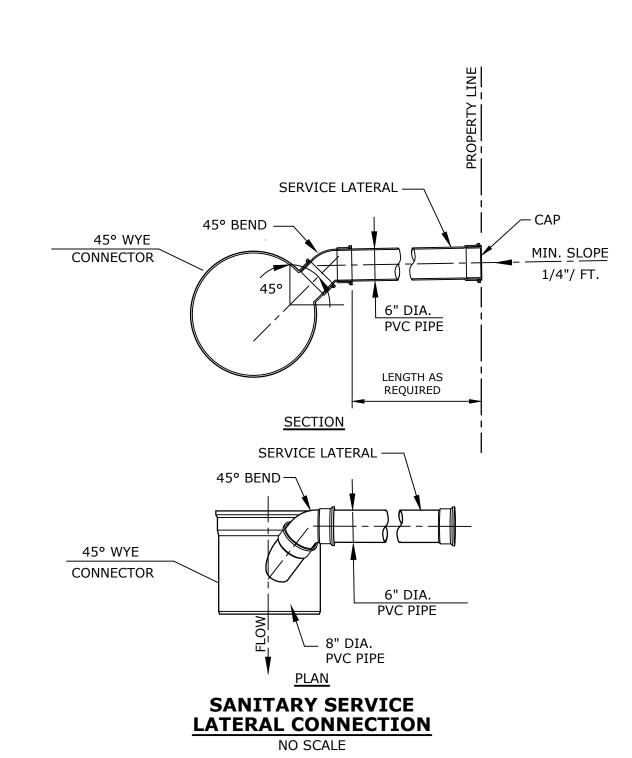

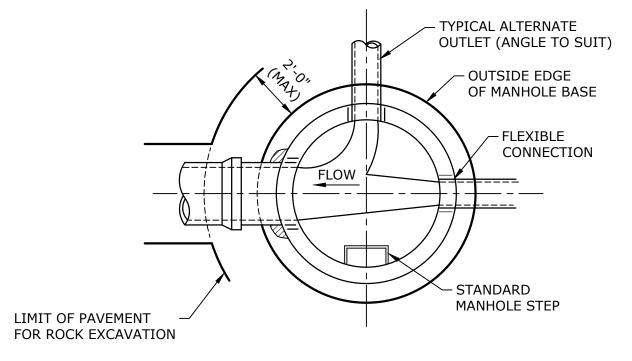

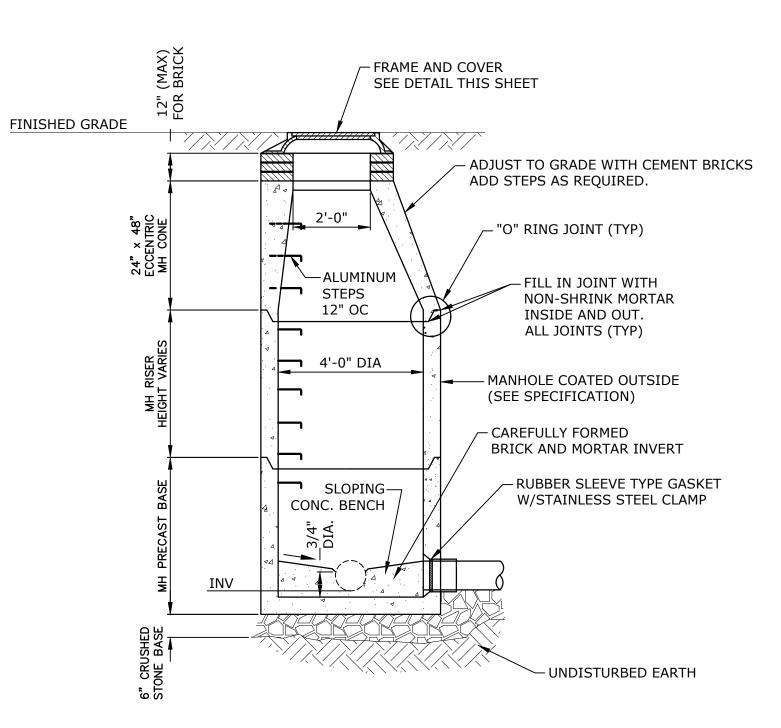

STANDARD SANITARY SEWER MANHOLE

NO SCALE

Tighe&Bond

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0	3/1/2023	ISSUED FOR BIDDING
MARK	DATE	DESCRIPTION
PROJE	CT NO:	V0037-014
DATE:		03/01/2023
FILE:	V003	7-014-C-100-PLNPRO.dwg

GENERAL NOTES &

DESIGNED/CHECKED BY: LAC

MDS

DRAWN BY:


SCALE: AS SHOWN

C-201

DETAILS - 1

SILTSACK MANUFACTURED BY: ACF ENFIRONMENTAL 2831 CARDWELL ROAD RICHMOND, VIRGINIA 23237

SILTSACK[®] NO SCALE

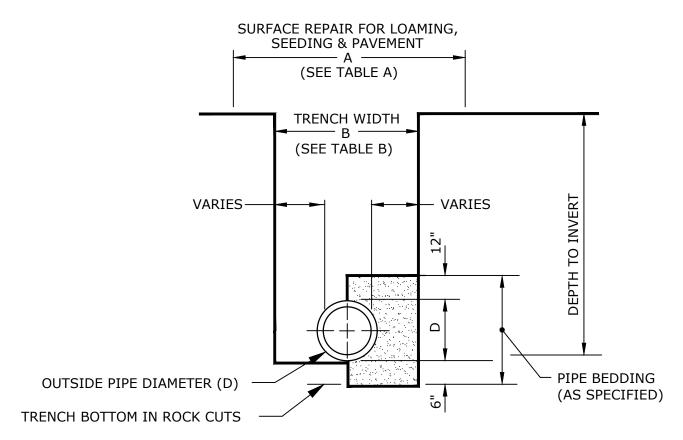


TYPICAL TRENCH SECTION

TABLE A - MAXIMUM SURFACE REPAIR PAY WIDTHS (SEE NOTE 1)				
OUTSIDE PIPE DIAMETER 0 - 24"		OUTSIDE PIPE DIAMETER GREATER THAN 24"		
TEMPORARY REPAIR (3)	PERMANENT RAPAIR (4)	TEMPORARY REPAIR (3)	PERMANENT REPAIR (4)	
6'-6" MAX.	8'-6" MAX.	D + 4'-0" MAX.	D + 6'-0" MAX.	
TABLE B - MA	XIMUM TRENCH EX	CAVATION PAY WIDT	HS (SEE NOTE 1)	
OUTSIDE PIPE DIAMETER 0 - 24"		OUTSIDE PIPE DIAMETER GREATER THAN 24"		
5'-0"		D +	3'-0"	


- 1. THE PAYLINE DIMENSIONS SHOWN REPRESENT THE MAXIMUM PAYLINE LIMITS TO BE PAID. WHEN THE ACTUAL SURFACE REPAIR OR TRENCH WIDTH IS LESS, THE ACTUAL WIDTH SHALL BE PAID FOR AT THE APPLICABLE UNIT PRICE.
- 2. TRENCH SURFACE REPAIR WIDTH FOR STREETS WHICH INCLUDE FULL WIDTH OVERLAY OR GRAVEL SURFACE SHALL BE 6'-6" MAX, FOR PIPES 0"-24".
- 3. INCLUDES TEMPORARY PAVEMENT PATCHES FOR SIDEWALKS AND DRIVEWAYS.
- 4. INCLUDES PERMANENT REPAIRS FOR DRIVEWAYS, SIDEWALKS, LAWN AREAS (LOAM & SEED), BERMS, ROADWAYS AND CURBS.

TRENCH EXCAVATION AND SURFACE REPAIR PAYLINES (EXCLUDING STREET TRENCH PATCH AND FULL WIDTH OVERLAY)

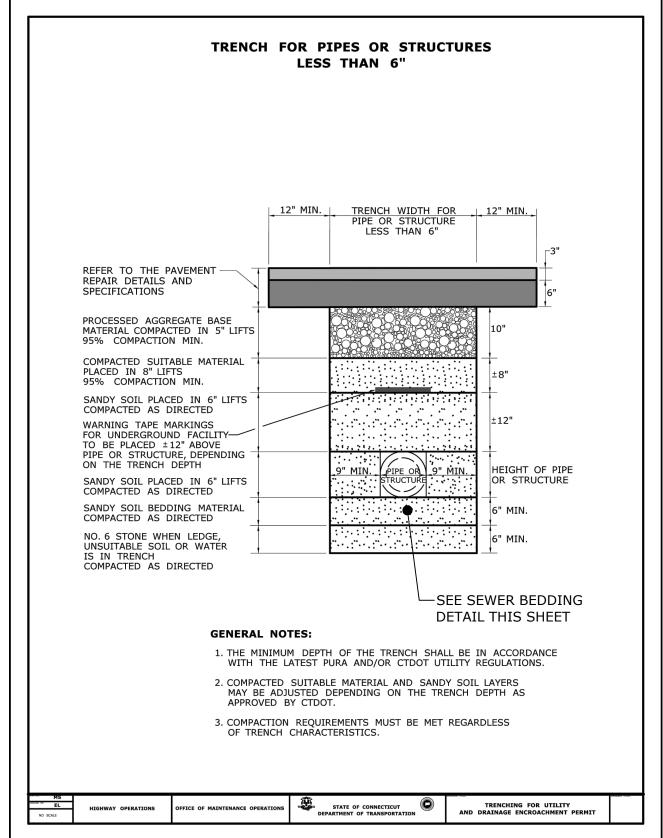


SANITARY SEWER TRENCH < 6"

NO SCALE

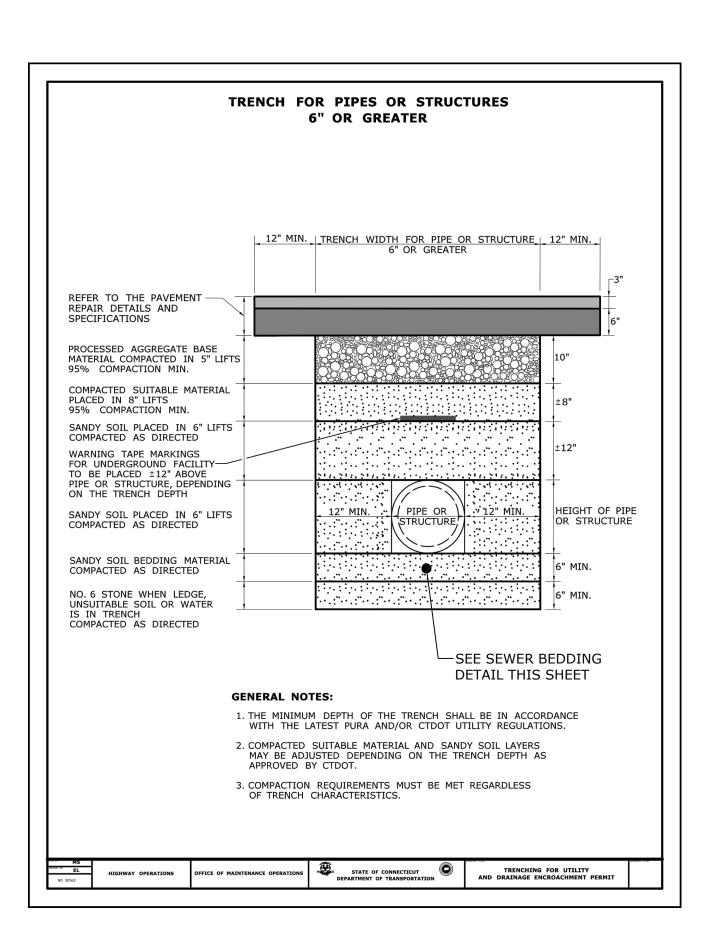

SANITARY SEWER TRENCH >6"

NO SCALE

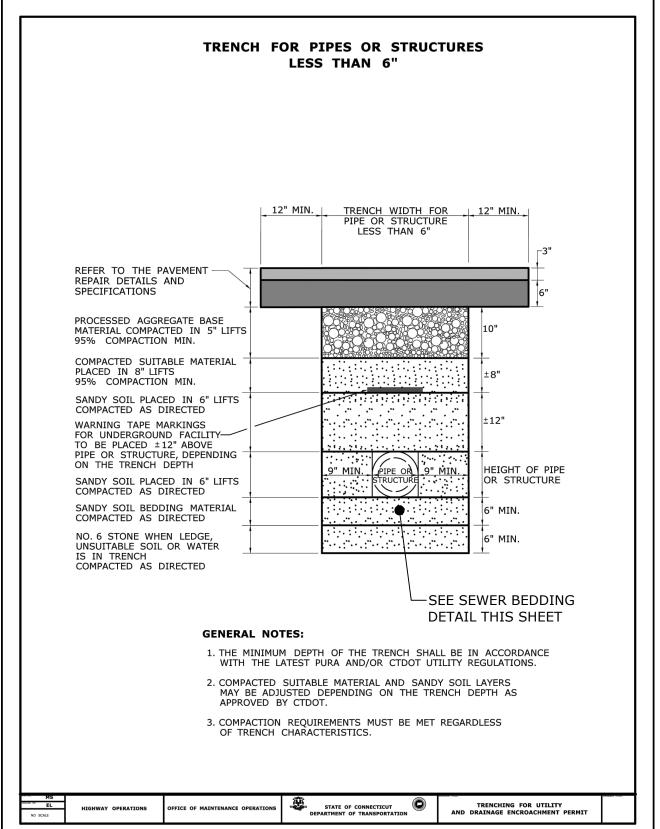

TRENCH, WIDTH -OF BALE


STAKE –


– HAYBALE

BINDING WIRE OR TWINE

1. EXCAVATE A TRENCH 4" DEEP AND THE WIDTH OF THE HAYBALE

PLACE AND STAKE HAYBALES TWO STAKES PER BALE

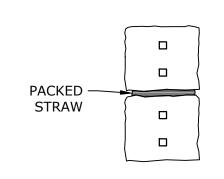

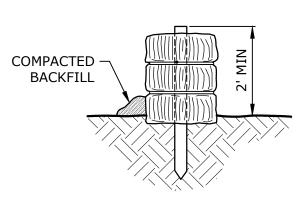


3. WEDGE LOOSE STRAW BETWEEN BALES TO CREATE A CONTINUOUS BARRIER

4. BACKFILL AND COMPACT EXCAVATED SOIL ON THE UPHILL SIDE OF THE BARRIER TO PREVENT PIPING

PLACEMENT AND CONSTRUCTION **OF HAYBALE BARRIER**

NO SCALE

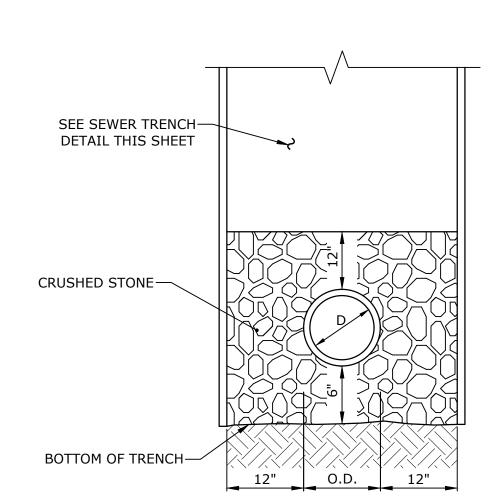

SANITARY SEWER BEDDING DETAIL NO SCALE

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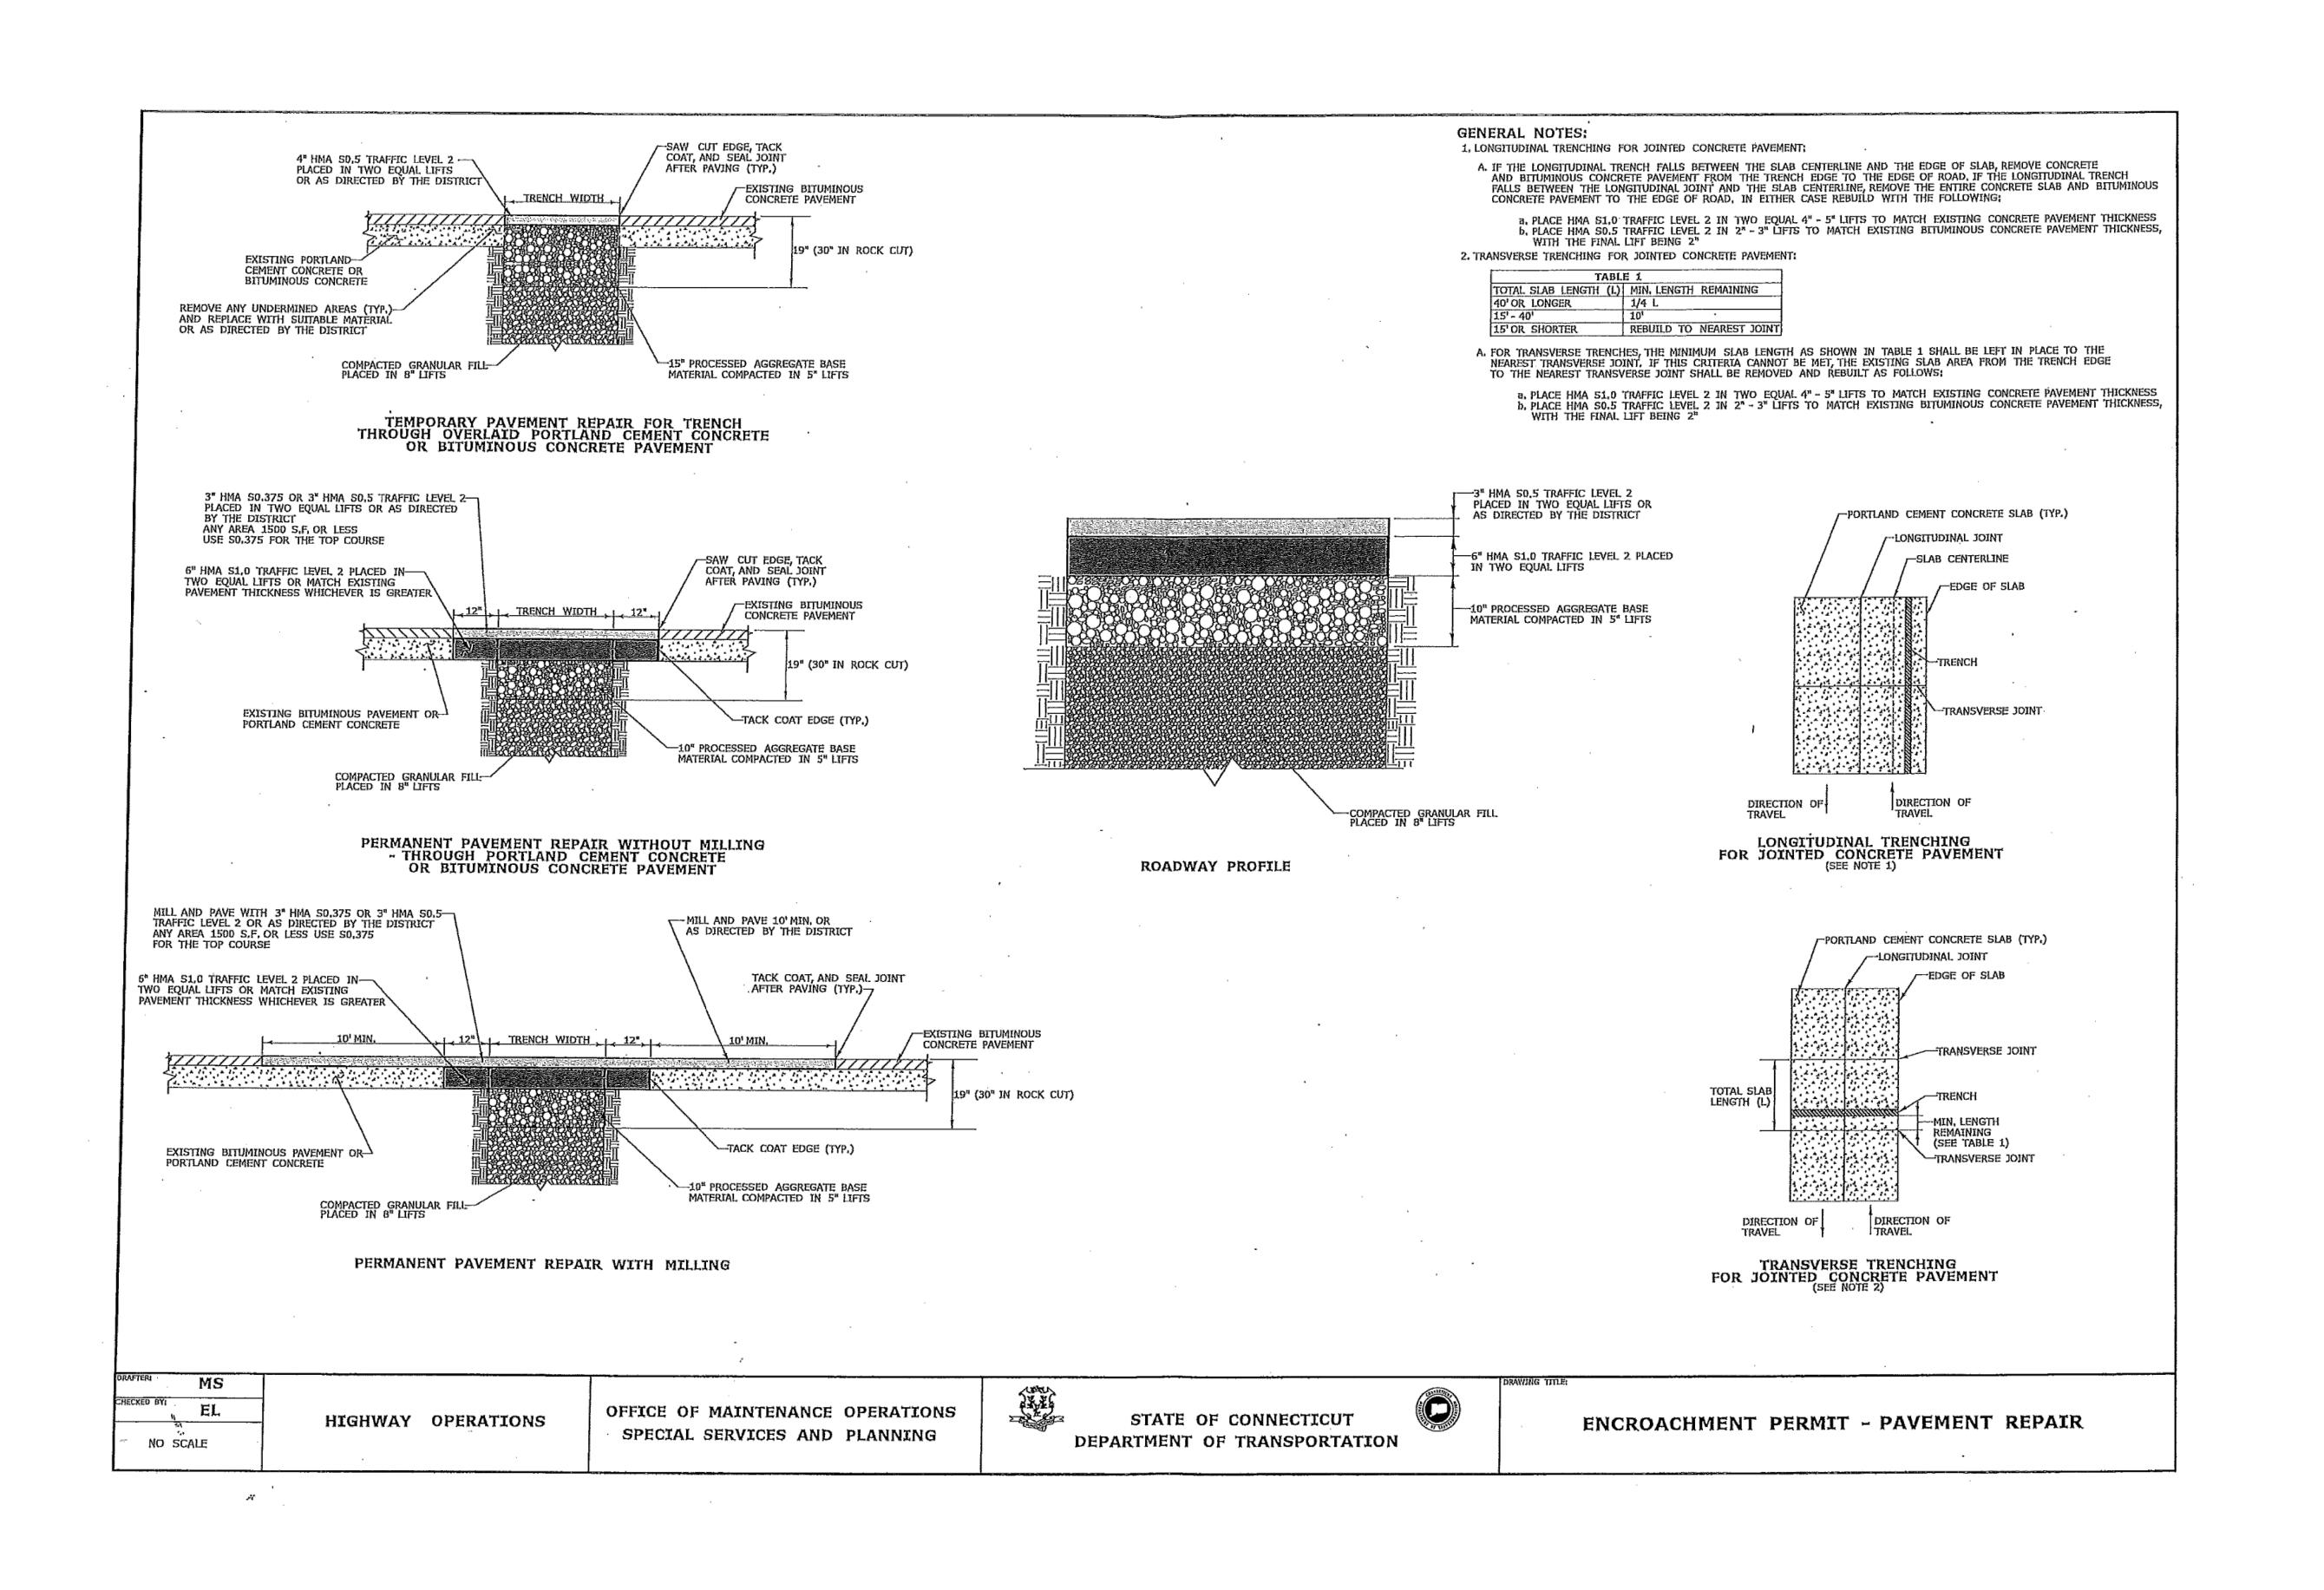
DETAILS - 2

DESIGNED/CHECKED BY: LAC

APPROVED BY:

AS SHOWN SCALE:

C-202



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Town Of Vernon

Exit 66 Sewer Extension

Vernon, CT


0	3/1/2023	ISSUED FOR BIDDING	
MARK	DATE	DESCRIPTION	
PROJECT NO: V0037-01		V0037-014	
DATE:	DATE: 03/01/2023		
FILE:	V003	V0037-014-C-100-PLNPRO.dwg	
DRAWI	N BY:	MDS	

CT DOT **PAVEMENT REPAIR DETAILS**

AS SHOWN

DESIGNED/CHECKED BY: LAC

C-203

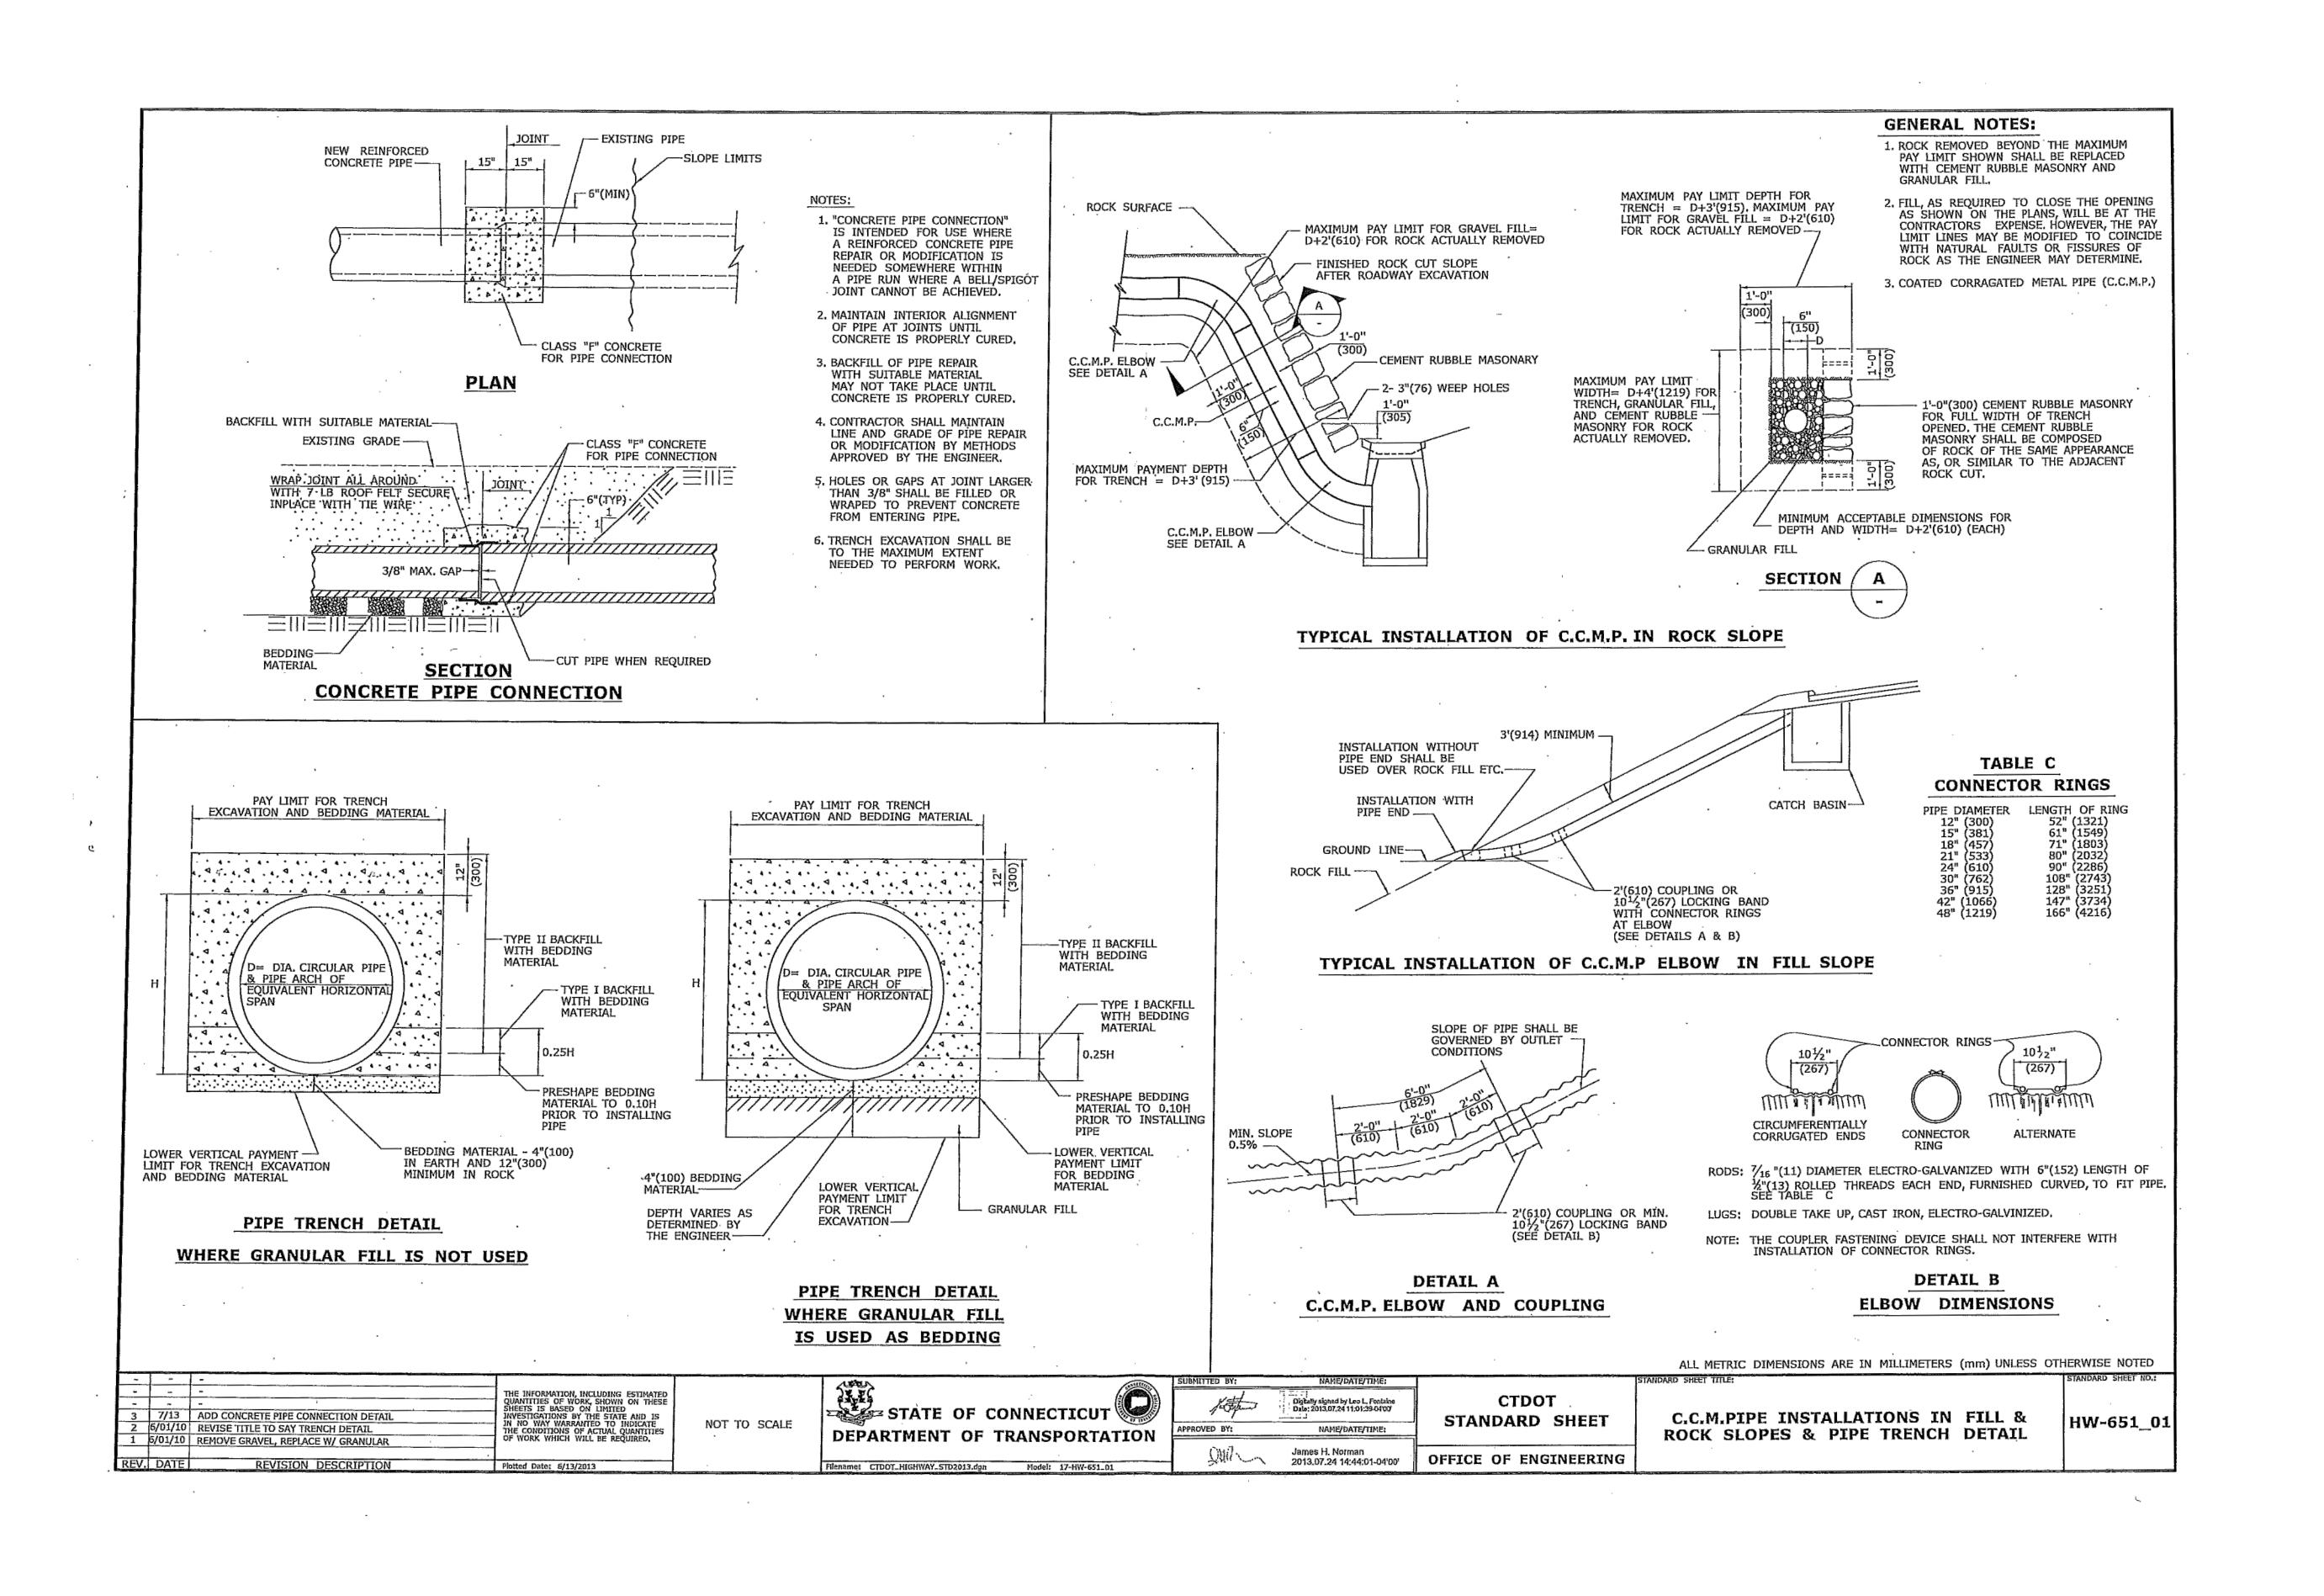

Tighe&Bond
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Suite 320

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Town Of Vernon

Exit 66 Sewer Extension

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1ARK	DATE	DESCRIPTION	
ROJECT NO:		V0037-014	
DATE:		03/01/2023	
ILE:	: V0037-014-C-100-PLNPRO.dwg		

DRAWN BY: MDS

DESIGNED/CHECKED BY: LAC

APPROVED BY: MM


C.C.M. PIPE

INSTALLATION DETAILS

AS SHOWN

C 20

C-204

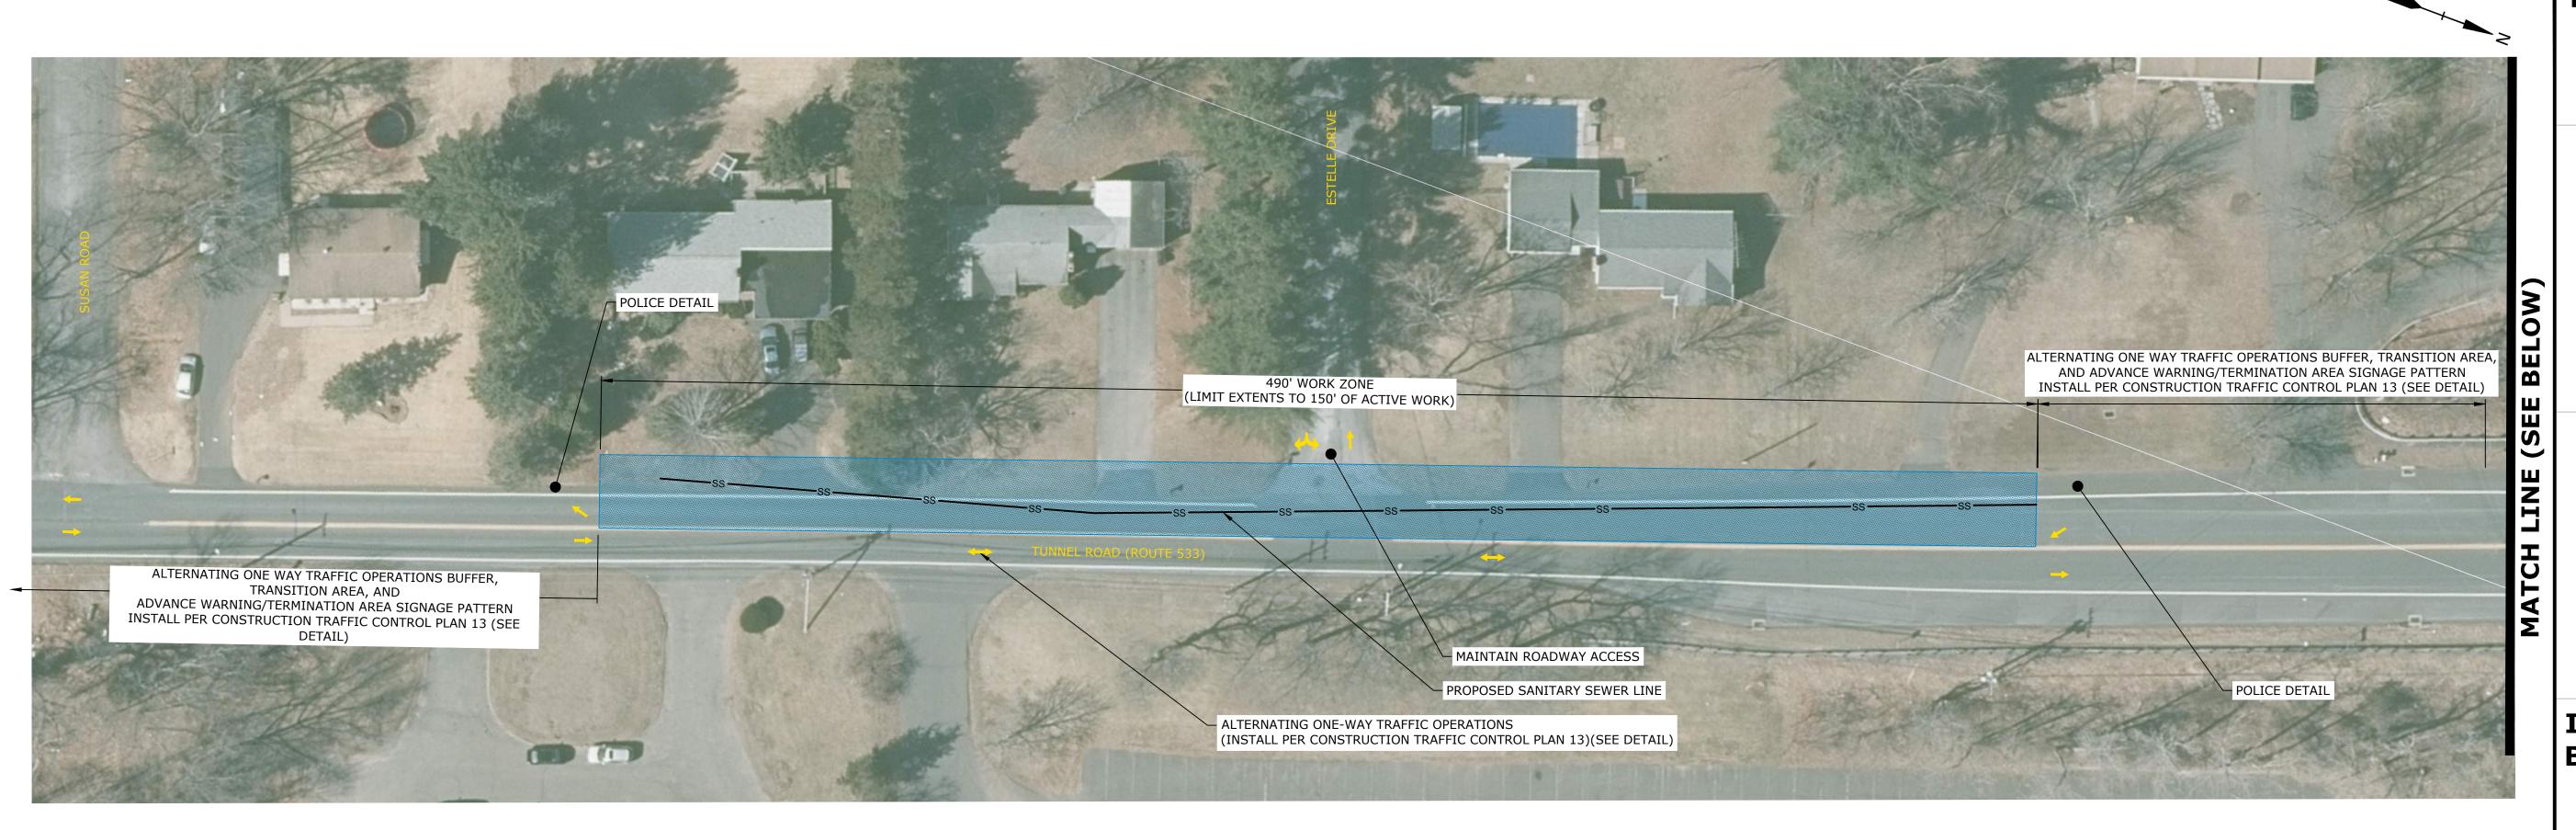



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Town Of Vernon

Exit 66 Sewer Extension

Vernon, CT

0	3/1/2023	ISSUED FOR BIDDING		
MARK	DATE	DESCRIPTION		
PROJEC	PROJECT NO: V0037-014			
DATE:	E: 03/01/2023			
FILE:	FILE: V0037-014-TTC.dwg			
DRAWN BY:		KAH, MDS		
DESIG	DESIGNED/CHECKED BY: TJW			
APPRO	APPROVED BY: COG			

TEMPORARY TRAFFIC CONTROL PLAN 1

TEMPORARY TRAFFIC CONTROL LEGEND

ACTIVE WORK ZONE

TRAFFIC FLOW ARROW

CONSTRUCTION SIGN

TTC-001




MAINTAIN ALL DRIVEWAY ACCESS AND ROADWAY ACCESS DURING ACTIVE WORK.

EXIT 66 SEWER EXTENSION TEMPORARY TRAFFIC CONTROL PLAN - PHASE 1 (MON-FRI, 9AM - 4PM)



EXIT 66 SEWER EXTENSION TEMPORARY TRAFFIC CONTROL PLAN - PHASE 2 (MON-FRI, 9AM - 4PM)

TEMPORARY TRAFFIC CONTROL LEGEND

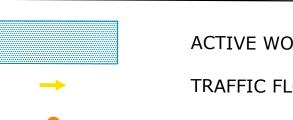

ACTIVE WORK ZONE TRAFFIC FLOW ARROW

CONSTRUCTION SIGN

DESIGNED/CHECKED BY:

DRAWN BY:

APPROVED BY:

MARK DATE DESCRIPTION

TTC-002

TEMPORARY TRAFFIC CONTROL PLAN 2

03/01/2023 V0037-014-TTC.dwg

KAH, MDS

TJW

SCALE: 1" = 30'

1000 Bridgeport Avenue Suite 320 Shelton, CT 06484 (203) 712-1100

MAINTAIN ALL DRIVEWAY ACCESS AND ROADWAY ACCESS DURING ACTIVE WORK.



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PROJECT NO:		V0037-014
DATE:		03/01/2023
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TEMPORARY TRAFFIC CONTROL PLAN 3

KAH, MDS

TJW

TRAFFIC FLOW ARROW





0	3/1/2023	ISSUED FOR BIDDING	1
MARK	DATE	DESCRIPTION	
PROJECT NO:		V0037-014	
DATE:		03/01/2023	
FILE:		V0037-014-TTC.dwg	
DRAWN BY:		KAH, MDS	



ACTIVE WORK ZONE

TRAFFIC FLOW ARROW

42" TRAFFIC CONE

CONSTRUCTION SIGN

TTC-006

TEMPORARY TRAFFIC

CONTROL PLAN 6

DRAWN BY:

APPROVED BY:

DESIGNED/CHECKED BY:

03/01/2023 V0037-014-TTC.dwg

KAH, MDS


TJW


1000 Bridgeport Avenue Suite 320 Shelton, CT 06484 (203) 712-1100

SCALE: 1" = 30'

EXIT 66 SEWER EXTENSION TEMPORARY TRAFFIC CONTROL PLAN - PHASE 6 (MON-FRI, 9AM - 4PM)

MAINTAIN ALL DRIVEWAY ACCESS AND ROADWAY ACCESS DURING ACTIVE WORK.

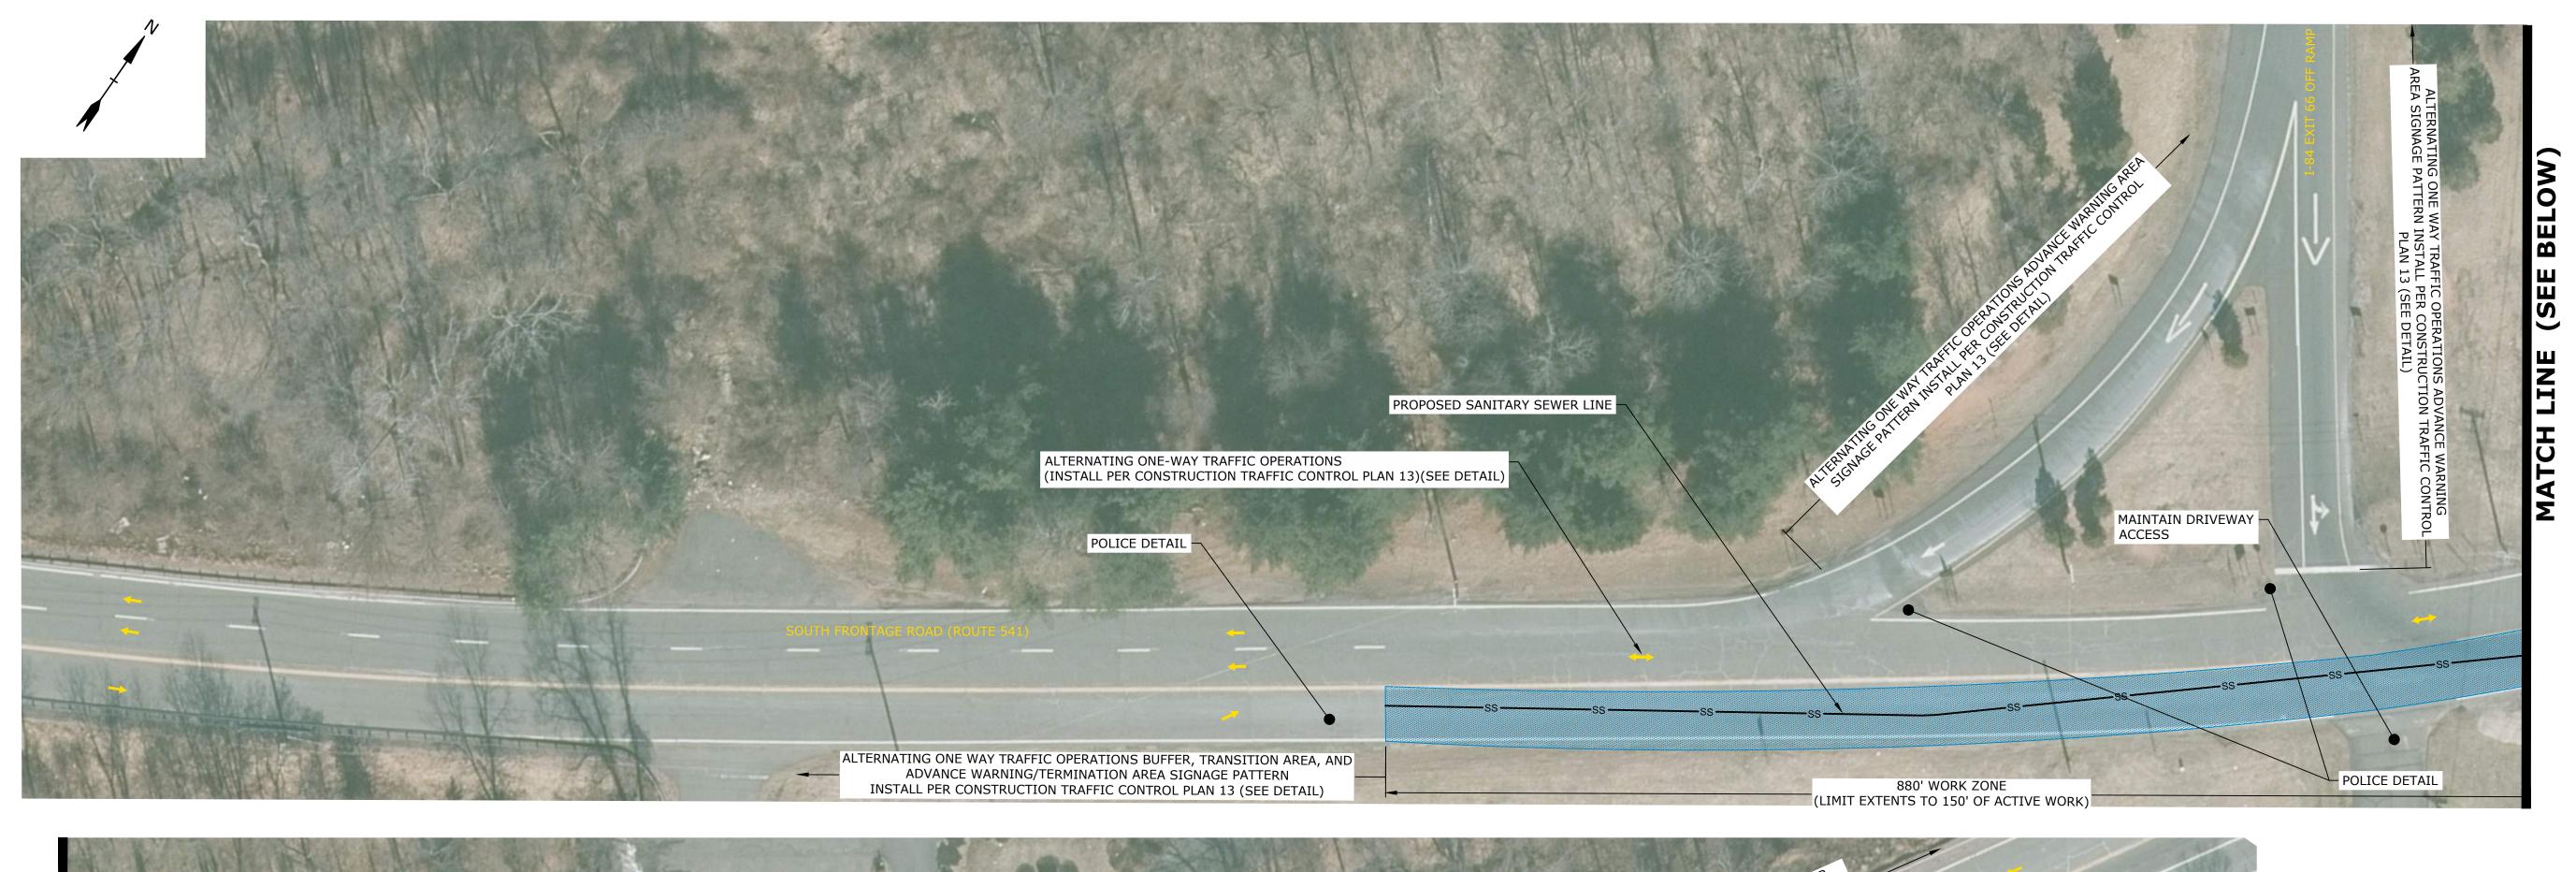

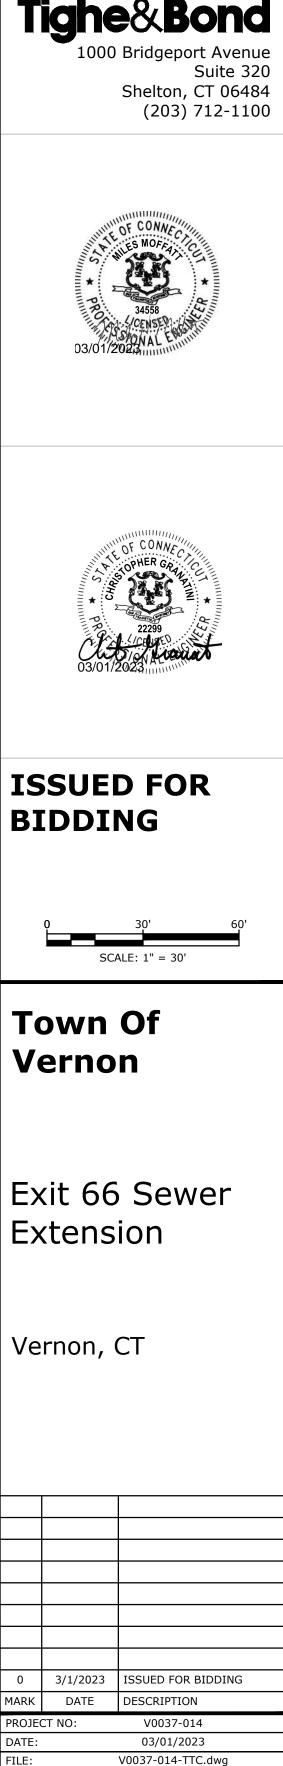



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DATE:		03/01/2023		
FILE:	FILE: V0037-014-TTC.dwg			
DRAWI	DRAWN BY: KAH, MDS			
DESIGNED/CHECKED BY: TJW				


TEMPORARY TRAFFIC CONTROL PLAN 7

APPROVED BY:





TEMPORARY TRAFFIC CONTROL LEGEND

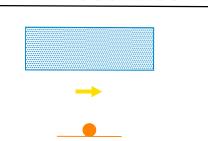

ACTIVE WORK ZONE TRAFFIC FLOW ARROW

CONSTRUCTION SIGN

MAINTAIN ALL DRIVEWAY ACCESS AND ROADWAY ACCESS DURING ACTIVE WORK.

EXIT 66 SEWER EXTENSION TEMPORARY TRAFFIC CONTROL PLAN - PHASE 8 (MON-FRI, 9AM - 4PM)

Exit 66 Sewer

SCALE: 1" = 30'

Vernon, CT

0 3/1/2023 ISSUED FOR BIDDING MARK DATE DESCRIPTION


03/01/2023 V0037-014-TTC.dwg DRAWN BY: KAH, MDS

DESIGNED/CHECKED BY:

APPROVED BY:

TEMPORARY TRAFFIC CONTROL PLAN 8

TJW

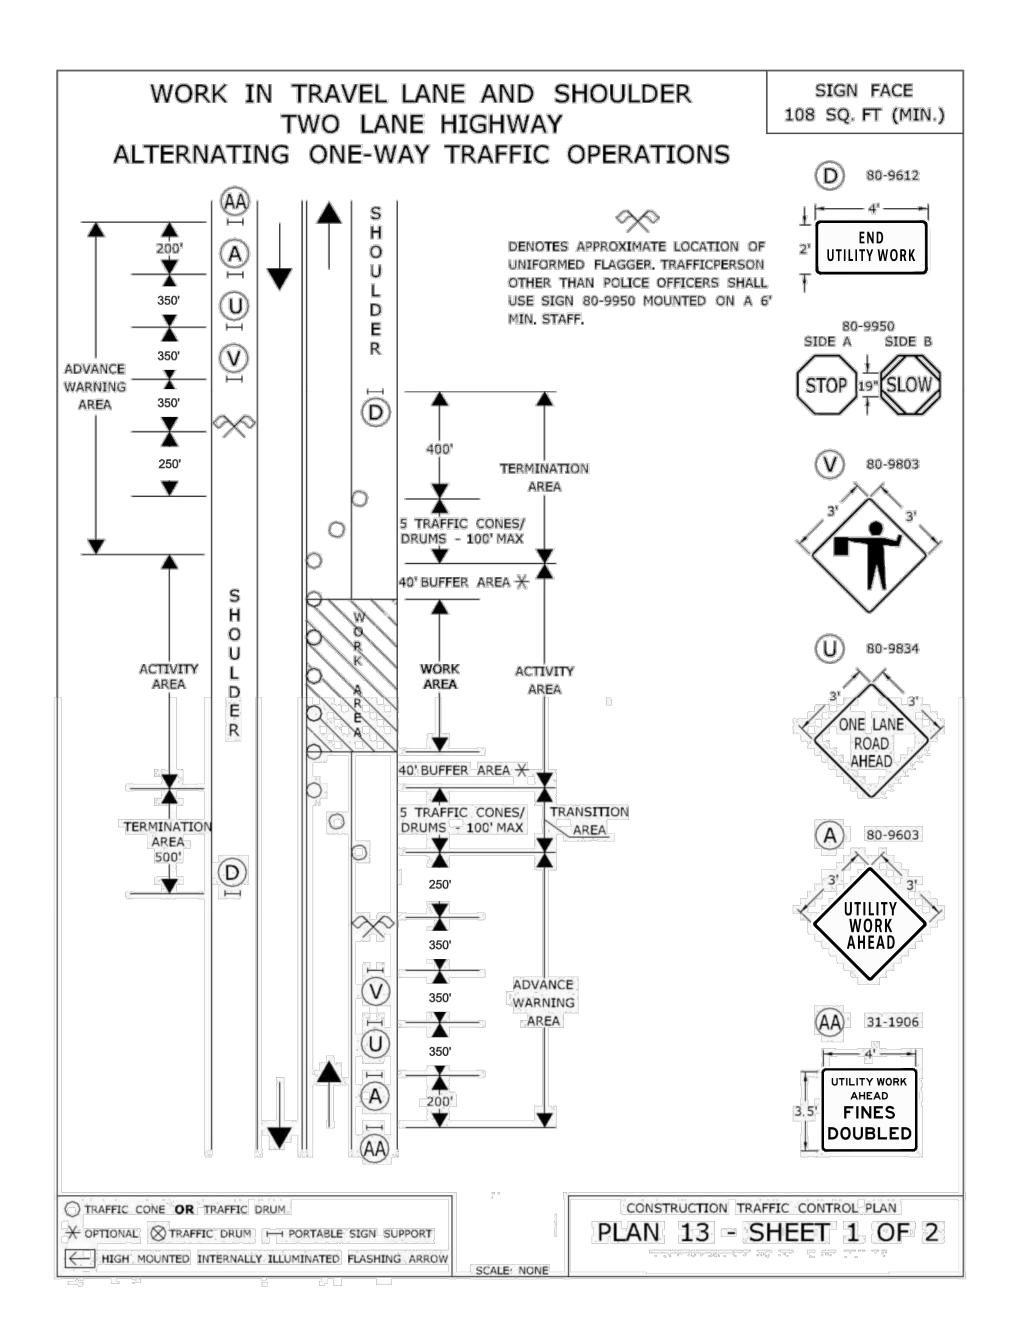

WORK IN TRAVEL LANE AND SHOULDER TWO LANE HIGHWAY ALTERNATING ONE-WAY TRAFFIC OPERATIONS

SIGN FACE 108 SQ. FT (MIN.)

HAND SIGNAL METHODS TO BE USED BY UNIFORMED FLAGGERS

THE FOLLOWING METHODS FROM SECTION 6E.07, FLAGGER PROCEDURES, IN THE "MANUAL ON UNIFORM TRAFFIC CONTROL DEVICES," SHALL BE USED BY UNIFORMED FLAGGERS WHEN DIRECTING TRAFFIC THROUGH A WORK AREA. THE STOP/SLOW SIGN PADDLE (SIGN NO. 80-9950) SHOWN ON THE TRAFFIC STANDARD SHEET TR-1220 01 ENTITLED, "SIGNS FOR CONSTRUCTION AND PERMIT OPERATIONS" SHALL BE USED.

A. TO STOP TRAFFIC

TO STOP ROAD USERS, THE FLAGGER SHALL FACE ROAD USERS AND AIM THE STOP PADDLE FACE TOWARD ROAD USERS IN A STATIONARY POSITION WITH THE ARM EXTENDED HORIZONTALLY AWAY FROM THE BODY. THE FREE ARM SHALL BE HELD WITH THE PALM OF THE HAND ABOVE SHOULDER LEVEL TOWARD APPROACHING TRAFFIC.



TO DIRECT STOPPED ROAD USERS TO PROCEED, THE FLAGGER SHALL FACE ROAD USERS WITH THE SLOW PADDLE FACE AIMED TOWARD ROAD USERS IN A STATIONARY POSITION WITH THE ARM EXTENDED HORIZONTALLY AWAY FROM THE BODY. THE FLAGGER SHALL MOTION WITH THE FREE HAND FOR ROAD USERS TO PROCEED.

C. TO ALERT OR SLOW TRAFFIC



TO ALERT OR SLOW TRAFFIC, THE FLAGGER SHALL FACE ROAD USERS WITH THE SLOW PADDLE FACE AIMED TOWARD ROAD USERS IN A STATIONARY POSITION WITH THE ARM EXTENDED HORIZONTALLY AWAY FROM THE BODY. TO FURTHER ALERT OR SLOW TRAFFIC, THE FLAGGER HOLDING THE SLOW PADDLE FACE TOWARD ROAD USERS MAY MOTION UP AND DOWN WITH THE FREE HAND, PALM DOWN.

TRAFFIC CONE OR TRAFFIC DRUM

* OPTIONAL * TRAFFIC DRUM - PORTABLE SIGN SUPPORT HIGH MOUNTED INTERNALLY ILLUMINATED FLASHING ARROW

SCALE: NONE

CONSTRUCTION TRAFFIC CONTROL PLAN PLAN 13 - SHEET 2 OF 2

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Exit 66 Sewer Extension

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PROJE	CT NO:	V0037-014
DATE:		03/01/2023


DESIGNED/CHECKED BY: TJW APPROVED BY: TEMPORARY TRAFFIC

V0037-014-TTC.dwg

KAH, MDS

CONTROL DETAILS 1

DRAWN BY:

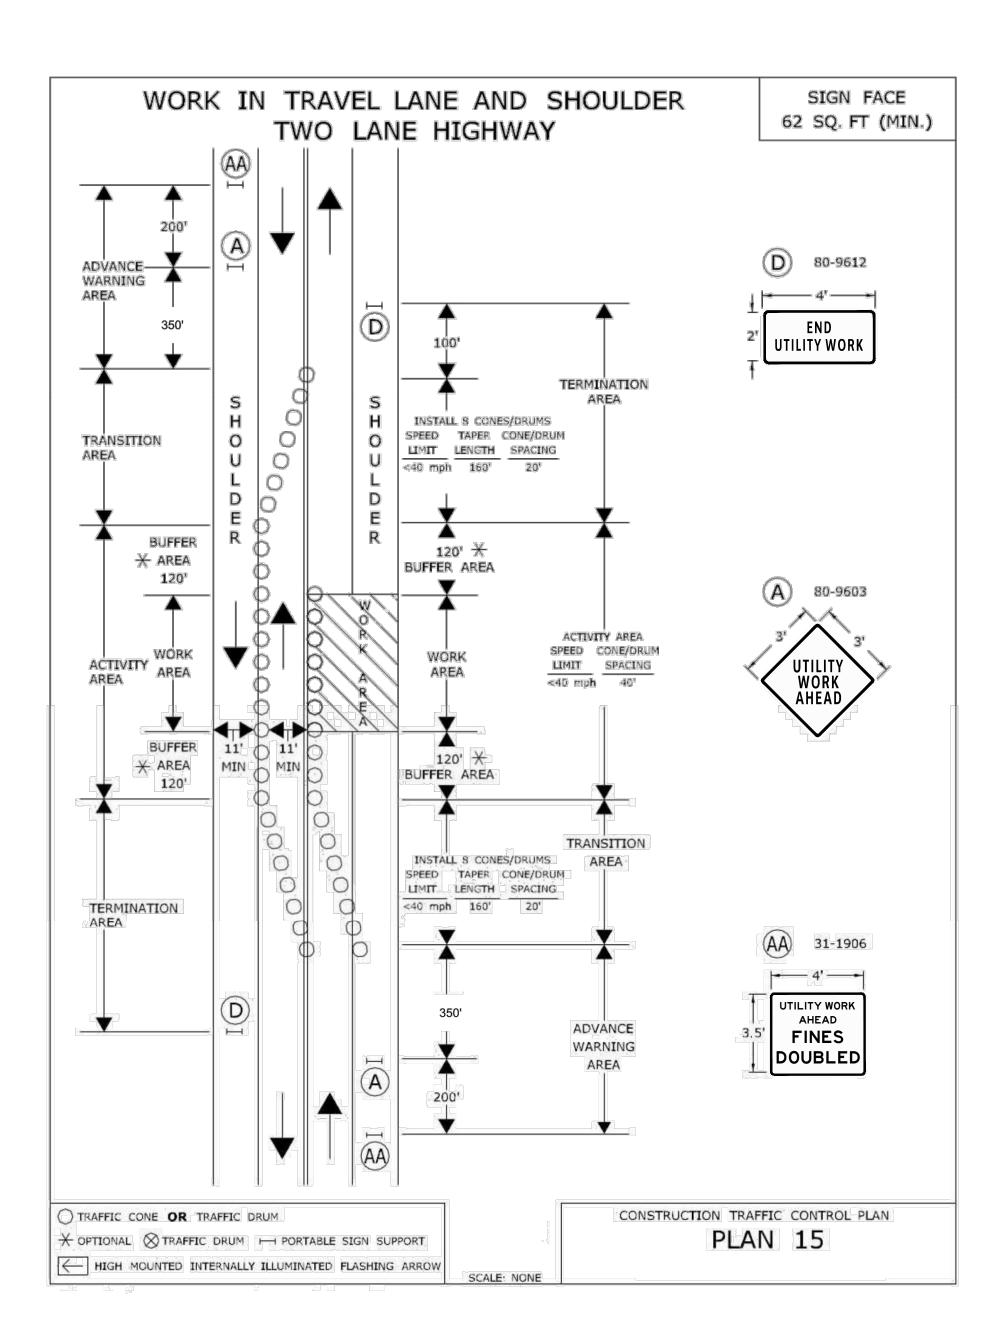

OVERALL TRAFFIC MANAGEMENT NOTES

- 1. MAINTAIN AND PROTECT PEDESTRIAN TRAFFIC THROUGH THE WORK AREA. MAINTAIN PEDESTRIAN ROUTES, CROSSWALKS, AND CROSSINGS AS SHOWN.
- 2. CONSTRUCTION SIGN SHEETING SHALL BE FLUORESCENT ORANGE WITH BLACK LETTERING AND SYMBOLS, UNLESS OTHERWISE NOTED ON THE DRAWINGS.
- 3. SIGN SHEETING MATERIAL SHALL MEET THE MINIMUM RETROREFLECTIVITY REQUIREMENTS AS DEFINED IN PART 2 OF THE 2009 MANUAL ON UNIFORM TRAFFIC CONTROL DEVICES. REPLACE SIGNS AS DIRECTED TO MAINTAIN MINIMUM REQUIREMENTS.
- 4. CONSTRUCTION SIGNS MUST BE PLACED ON POSTS IN GRASSY AREAS OR ON PORTABLE SIGN SUPPORTS (SEE CTDOT TRAFFIC STANDARD SHEET TR-1220_02)
- 5. COORDINATE THE LOCATION OF CONSTRUCTION SIGNS WITH OTHER ACTIVE CONSTRUCTION ACTIVITY. DO NOT INSTALL DUPLICATE SIGNS WHERE EXISTING CONSTRUCTION SIGNS CURRENTLY EXIST.
- 6. CONSTRUCTION SIGN DIMENSIONS SHALL BE IN ACCORDANCE WITH CTDOT TRAFFIC STANDARD SHEET TR-1220_01.
- 7. ALL SIGNS AND TRAFFIC CONTROL DEVICES SHALL CONFORM TO THE LATEST EDITION OF THE MANUAL ON UNIFORM TRAFFIC CONTROL DEVICES.
- 8. NO SIGNS OR PERMANENT PAVEMENT MARKINGS SHALL BE REMOVED.
- 9. MAINTAIN SIGNAGE APPROPRIATE FOR THE CURRENT TRAFFIC PATTERN AT ALL TIMES. SIGNS IN CONFLICT WITH THE EXISTING TRAFFIC PATTERN SHALL BE COVERED OR REMOVED. NO SIGNAGE SHALL BE PLACED THAT OBSTRUCTS EXISTING SIGNAGE, EXCEPT WHERE THE NEW SIGN INFORMATION SUPERSEDES THE EXISTING SIGNAGE AND IS REQUIRED TO ACCOMMODATE CONSTRUCTION ACTIVITIES.
- 10. ALL "UTILITY WORK AHEAD" SIGNS SHALL BE DISPLAYED AT ALL TIMES THROUGHOUT THE DURATION OF CONSTRUCTION.
- 11. TRAFFIC FLOW ARROWS SHOWN ON THE PLAN ARE ONLY INTENDED TO INDICATE LOCATIONS OF TRAVEL LANES AND ARE NOT TO BE INSTALLED AS PAVEMENT MARKINGS.
- 12. COORDINATE THE WORK WITH ADJACENT PROPERTY OWNERS. MAINTAIN ACCESS TO DRIVEWAYS AT ALL TIMES UNLESS OTHER ACCOMMODATIONS ARE MADE WITH PROPERTY OWNERS IN ADVANCE OF THE WORK.



(203) 712-1100





ISSUED FOR BIDDING

Town Of Vernon

Exit 66 Sewer Extension

Vernon, CT

0	3/1/2023	ISSUED FOR BIDDING
MARK	DATE	DESCRIPTION
PROJE	CT NO:	V0037-014
DATE:	:: 03/01/2023	
FILE:		V0037-014-TTC.dwg

TEMPORARY TRAFFIC CONTROL DETAILS 2

KAH, MDS

TJW

AS SHOWN

SCALE:

DESIGNED/CHECKED BY:

DRAWN BY: