


CONSTRUCTION PLANS

TSD 2023 SITE IMPROVEMENTS

PAVING PROJECTS

TROY, OAKLAND COUNTY, MICHIGAN

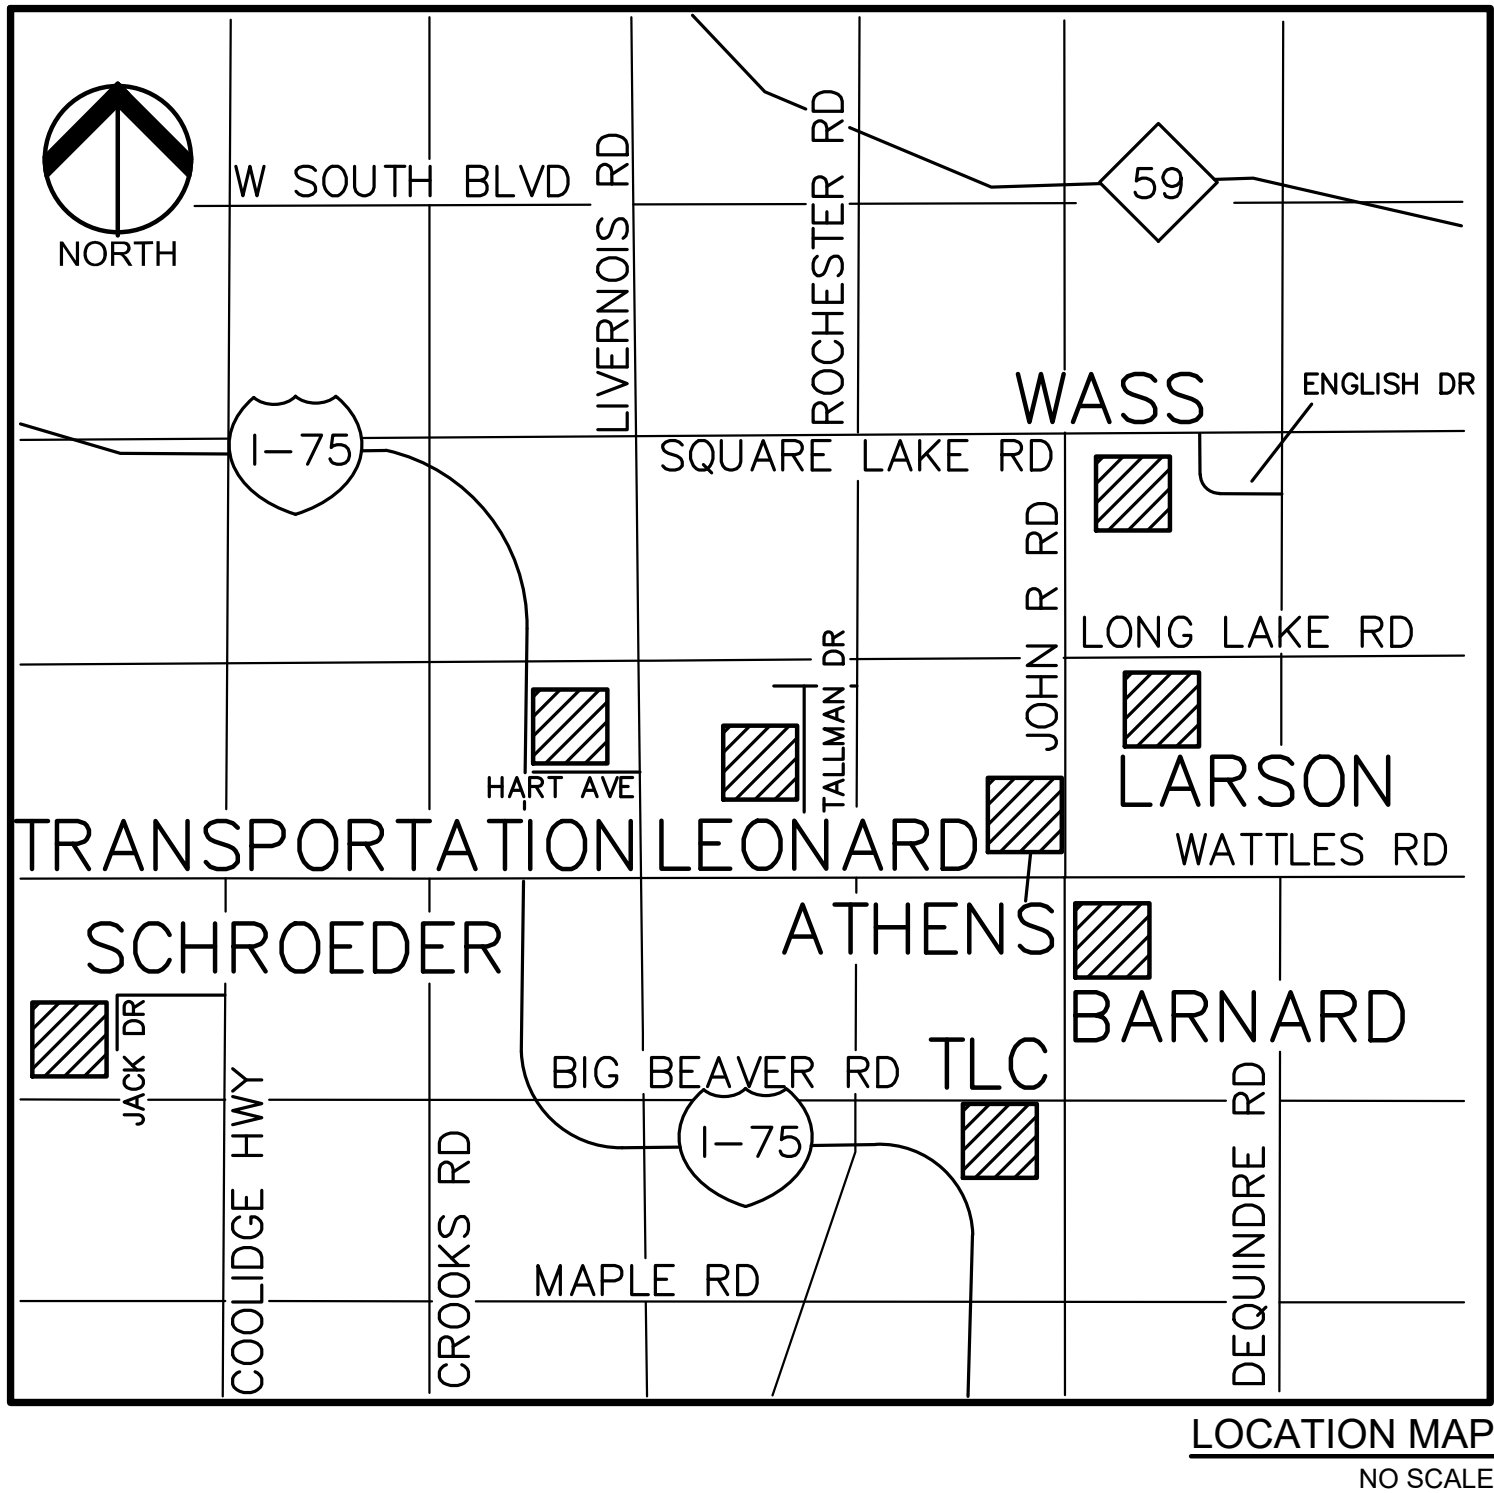


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DESIGN TEAM

OWNER	CIVIL ENGINEER
TROY SCHOOL DISTRICT 1140 RANKIN DRIVE TROY, MI 48063 CONTACT: ROB CARSON PHONE: 248.823.4067 EMAIL: RCARSON@TROY.K12.MI.US	PEA GROUP 1849 POND RUN AUBURN HILLS, MI 48326 CONTACT: ROBERT ROCHON, P.E. PHONE: (248) 689-9090 EXT. 1161 FAX: (248) 689-1044 EMAIL: RROCHON@PEAGROUP.COM



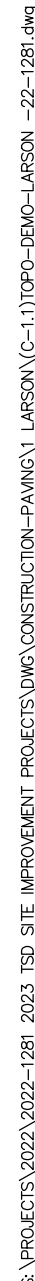

BENCHMARKS
(GPS DERIVED – NAVD83)

BM #3300 (NOT SHOWN).
ARROW ON A HYDRANT LOCATED APPROX. 60±' NORTHWEST FROM THE NORTHWEST SCHOOL BUILDING CORNER AND APPROX. 15±' WEST OF THE CURB.
ELEV. = 656.17

BM #350 (NOT SHOWN).
FOUND CHISELED "+4" ON TOP EAST SIDE OF A CONCRETE LIGHT POLE BASE LOCATED APPROX. 70±' NORTH EAST OF THE SOUTHEAST SCHOOL BUILDING CORNER.
ELEV. = 655.24

LEGAL DESCRIPTION
(Per City of Troy on-line Assessment)

PARCEL ID 20-13-100-033
Land in the City of Troy, Oakland County, Michigan, described as follows:

Town 2 North, Range 11 East, Section 13, Part of the Northwest 1/4, Beginning at a point distant EAST 660 feet and S00°50'00" W 778.55 feet from the Northwest section corner; thence S00°50'00" W 2028.05 feet; thence N89°05'00"E, 540.10 feet; thence N00°50'00"E, 2010.83 feet to the Northwest corner; 540 feet to the Point of Beginning. Also the East 108 feet of the West 1308 feet of the Northwest 1/4.

GENERAL DEMOLITION NOTES:

THESE NOTES APPLY TO ALL CONSTRUCTION ACTIVITIES ON THIS PROJECT:

1. ALL MATERIAL TO BE REMOVED, WHETHER SPECIFICALLY NOTED IN THE PLANS OR NOT, SHALL BE REMOVED FROM THE SITE BY THE CONTRACTOR AND DISPOSED OF OFF-SITE IN A LEGAL MANNER. NO ON-SITE BURY OR BURN PITS SHALL BE ALLOWED.
2. ALL DEMOLITION WORK SHALL CONFORM TO ALL LOCAL CODES AND ORDINANCES.
3. STAGING/PHASING OF DEMOLITION AND CONSTRUCTION IS TO BE COORDINATED WITH THE OWNER AND THE CONTRACTOR PRIOR TO CONSTRUCTION.
4. SPECIFIC DEMOLITION ITEMS HAVE BEEN INDICATED ON THE PLANS AS A GUIDE TO THE GENERAL SCOPE OF THE WORK. IT IS THE INTENT THAT THESE ITEMS SHALL BE COMPLETELY REMOVED BY THE CONTRACTOR ABOVE AND BELOW GROUND, UNLESS SPECIFICALLY NOTED OTHERWISE, THAT DEMOLITION WILL INCLUDE BUT WILL NOT NECESSARILY BE LIMITED TO THESE ITEMS. CONTRACTOR SHALL VISIT SITE TO VERIFY EXISTING CONDITIONS AND EXTENTS OF THE DEMOLITION THAT WILL BE REQUIRED PRIOR TO SUBMITTING A BID.
5. REMOVE ALL STRUCTURES DESIGNATED FOR REMOVAL ACCORDING TO THE DEMOLITION PLAN. THIS INCLUDES FOUNDATIONS, FOOTINGS, CONCRETE, ASPHALT, TREES, ETC.
6. THE CONTRACTOR SHALL, AS A MINIMUM, PROVIDE TREE PROTECTION FENCING AROUND EXISTING TREES TO BE SAVED THAT ARE WITHIN 15 FEET OF CONSTRUCTION ACTIVITIES AND AS INDICATED IN THE PLANS OR PER LOCAL AGENCY REQUIREMENTS.
7. THE CONTRACTOR SHALL BE RESPONSIBLE FOR CLEAN UP, NOISE, DUST CONTROL, STREET SWEEPING AND HOURS OF OPERATION IN ACCORDANCE WITH THE LOCAL CODES.
8. THE CONTRACTOR SHALL PROVIDE ALL NECESSARY BARRICADES, SIGNAGE, MARKINGS, LIGHTS AND OTHER TRAFFIC CONTROL DEVICES TO MAINTAIN OR TO FACILITATE CONSTRUCTION. SIGNS SHALL BE PROTECTED OR STOCKPILED FOR REUSE AS SPECIFIED IN THE PLANS OR AS REQUIRED BY THE AGENCY OF JURISDICTION. THE CONTRACTOR SHALL REPLACE ANY DAMAGED SIGNS AND SUPPORTS AT NO ADDITIONAL COST TO THE OWNER.
9. THE CONTRACTOR SHALL NOTIFY THE APPROPRIATE 811/ONE CALL UTILITY MAINTENANCE CENTER, PRIVATE UTILITY LOCATOR, THE CITY ENGINEER AND/OR THE AUTHORITY HAVING JURISDICTION 3 BUSINESS DAYS PRIOR TO THE BEGINNING OF CONSTRUCTION.
11. CONTRACTOR TO REMOVE TOPSOIL, GRASS, SUBGRADE AND EXISTING SIDEWALK, AS NECESSARY FOR PROPER SIDEWALK ALIGNMENT TO PROVIDE A STRAIGHT SIDEWALK RUNNING THROUGH APPROACH.

REFERENCE DRAWINGS:	
CABLE	HAVE NOT RECEIVED AS OF 11/27/2022
FIBER OPTIC	HAVE NOT RECEIVED AS OF 11/27/2022
WATER MAIN	HAVE NOT RECEIVED AS OF 11/27/2022
SANITARY SEWER	HAVE NOT RECEIVED AS OF 11/27/2022
STORM SEWER	HAVE NOT RECEIVED AS OF 11/27/2022
ELECTRIC	HAVE NOT RECEIVED AS OF 11/27/2022

NOTES:

1. CONTRACTOR TO VERIFY ALL QUANTITIES SHOWN ON THE PLANS. ANY DEVIATIONS TO THE PLAN QUANTITIES SHALL BE BROUGHT TO THE ATTENTION OF THE SCHOOL DISTRICT AND PEA GROUP, IN WRITING PER THE BID PACKAGE, FOR VERIFICATION PRIOR TO BIDDING.


DEMOLITION QUANTITIES:	
REMOVE ASPHALT CURB:	2714 LF
REMOVE ASPHALT AND BASE:	25,929 SF
REMOVE CONCRETE:	2,834 SF
SAWCUT PAVEMENT:	629 LF
REMOVE SIGN AND POST:	8 EA
REMOVE TREE	6 EA
TOPSOIL, GRASS, SOIL REMOVAL	52 SF



PROJECT TITLE
**LARSON MIDDLE
SCHOOL**
2222 LONG LAKE ROAD, TROY, MI

REVISIONS	
ORIGINAL ISSUE DATE: JANUARY 4, 2023	
DRAWING TITLE	
TOPOGRAPHIC SURVEY AND DEMOLITION PLAN	
PEA JOB NO.	2022-1281
P.M.	RR
DN.	JJP
DES.	RR
DRAWING NUMBER:	

C-1.1

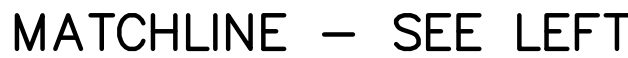

MATCHLINE - SEE RIGHT


SIGN LEGEND:

'NO PARKING FIRE LANE' SIGN	1
'STOP' SIGN	2
'HANDHELD DEVICES PROHIBITED' SIGN	3

REFER TO DETAIL SHEET FOR SIGN DETAILS

1. TO MINIMIZE SUBGRADE INSTABILITY AND UNDERCUTS, THE SUBGRADE SHALL NOT BE LEFT EXPOSED TO PRECIPITATION AND CONSTRUCTION OPERATIONS AND SHOULD BE PERFORMED DURING THE SUMMER MONTHS TO ENSURE DRY, WARM, WEATHER. ADDITIONALLY, THE SUBGRADE MAY BECOME UNSTABLE UNDER REPEATED LOADING OF CONSTRUCTION TRAFFIC; THEREFORE, CONSTRUCTION EQUIPMENT SHOULD BE LIMITED ON THE EXPOSED SUBGRADE.

2. UNDERCUT EXCAVATIONS SHALL BE BACKFILLED WITH MDOT 21A DENSE GRADED AGGREGATE PLACED IN AN ENGINEERED MANNER. LIFT SHALL BE 12" MAX. EXCESS SPILLAGE USE OF TRI-AXIAL GEOTEXT W/ 100 G/SM² TO REDUCE UNDERCUT DEPTH, AS APPROVED BY THE DISTRICT AT THE UNIT PRICE PROVIDED WITH THE CONTRACTORS BID.
3. THE QUANTITY FOR EACH SITE SHALL UNDER DRAIN TILE (4") FOR EACH SITE SHALL BE INCLUDED IN THE BASE BID. THIS ITEM IS CONSIDERED AN ALLOWANCE AND FINAL PAYMENT WILL BE BASED ON THE ACTUAL FOOTAGE OF COMPACTED IN PLACE SAND FOR THE UNIT PRICE PROVIDED IN THE BID PACKAGE.
4. ALL ENGINEERED FILL SHALL BE COMPACTED TO A DENSITY OF AT LEAST 95 PERCENT OF THE MAXIMUM DENSITY DETERMINED BY THE MODIFIED PROCTOR (ASTM D1557) METHOD OF TESTING. ALL ENGINEERED FILL SHALL BE COMPACTED TO 95% AND COMPACTED AT APPROXIMATELY THE OPTIMUM MOISTURE CONTENT. FROZEN MATERIAL SHALL NOT BE USED AS FILL, NOR SHOULD FILL BE PLACED ON A FROZEN SUBGRADE.
5. SUBGRADE UNDERCUTS SHALL BE EVALUATED BY A QUALIFIED ENGINEERING TECHNICIAN TO DETERMINE IF A STABILIZATION AND NECESSARY DRAIN TILE SHALL BE PLACED WITHIN ANY UNDERCUT AREA AND CONNECTED TO THE CLOSEST CATCH BASIN. STABILIZATION SHALL BE OBTAINED WITHIN THE GRANULAR SOILS IN UNDERCUTS AND CREATING "BATHTUBS" IN THE COHESIVE SOILS.

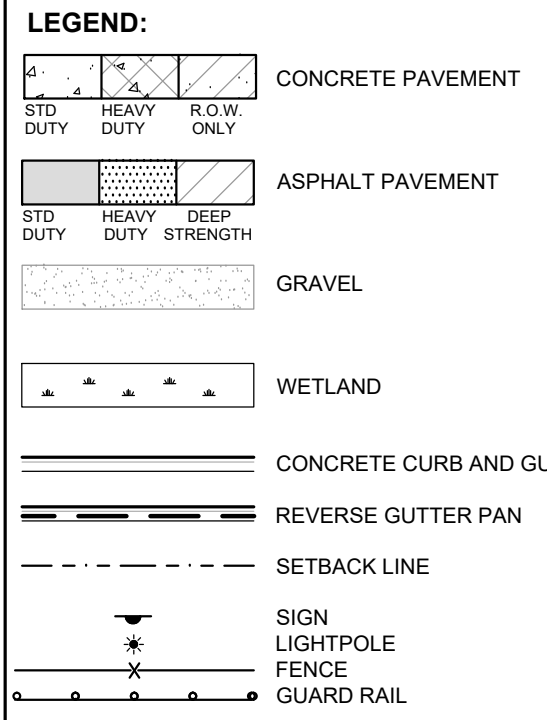

1. CONTRACTOR TO VERIFY ALL QUANTITIES SHOWN ON THE PLANS. ANY DEVIATIONS TO THE QUANTITIES SHOWN SHALL BE BROUGHT TO THE ATTENTION OF THE SCHOOL DISTRICT AND PEA GROUP, IN WRITING PER THE CONTRACT PACKAGE, FOR VERIFICATION PRIOR TO BIDDING.
2. ALL DIMENSIONS SHOWN ARE TO BACK OF CURB, FACE OF SIDEWALK, CENTER OF MANHOLE/CATCH BASIN UNLESS OTHERWISE NOTED.
3. DOWEL INTO EXISTING CURB AND GUTTER 9" WITH EPOXY COATED #4 BAR CONTINUOUS BETWEEN EXISTING AND PROPOSED CURBING.
4. THE SIDEWALK THRU THE DRIVE APPROACH SHALL BE REMOVED, STRAIGHTENED, AND RECONSTRUCTED BY THE CONTRACTOR TO MATCH EXISTING ALIGNMENT OF 8' WALK ON EITHER SIDE OF APPROACH. THE NEW SIDEWALK SHALL BE CONCRETE WITH 2" REINFORCING BARS OR CURVES THAT EXTEND THROUGH DRIVE APPROACH.
5. CONTRACTOR TO FIELD VERIFY ALL UNDERGROUND UTILITIES PRIOR TO CONSTRUCTION INCLUDING BUT NOT LIMITED TO: SITE LIGHTING, FIBER LINES, ETC.
6. REFER TO NOTES AND DETAIL SHEET FOR ON SITE PAVING DETAILS.
7. CONTRACTOR TO REMOVE AND REPLACE SIGNS AND POSTS PER DETAILS ON SHEET C-4.0. ALL SIGNS AND ANY POSTS IN GOOD CONDITION SHALL BE RETURNED TO THE OWNER. ALL POSTED DAMAGED OR IN OTHERWISE POOR CONDITION, SHALL BE DISPOSED OF AT NO ADDITIONAL COST TO THE OWNER.



CAUTION!!
THE LOCATIONS AND ELEVATIONS OF EXISTING UNDERGROUND UTILITIES AS SHOWN ON THIS DRAWING ARE ONLY APPROXIMATE. NO GUARANTEE IS EITHER EXPRESSED OR IMPLIED AS TO THE COMPLETENESS OR ACCURACY THEREOF. THE CONTRACTOR SHALL BE EXCLUSIVELY RESPONSIBLE FOR DETERMINING THE EXACT UTILITY LOCATIONS AND ELEVATIONS PRIOR TO THE START OF CONSTRUCTION.

CLIENT
TROY SCHOOLS
1140 RANKIN DRIVE
TROY, MI 48063

PROJECT TITLE

**LARSON MIDDLE
SCHOOL**

2222 LONG LAKE ROAD, TROY, MI

REVISIONS

ORIGINAL ISSUE DATE:
JANUARY 4, 2023

DRAWING TITLE

PAVING AND DIMENSION PLAN

PEA JOB NO. 2022-1281

P.M. RF

DN. JJP

DES. RF

DRAWING NUMBER

C-2.1

\\projects\2022\2022-1281 2023 TSD SITE IMPROVEMENT PROJECTS\DWG\CONSTRUCTION-PAVING\1 LARSON\1(C-2.1)ENGR-LARSON-22-1281.dwg

FLOODPLAIN NOTE:
BY GRAPHICAL PLOTTING, SITE IS WITHIN ZONE 'X', AN AREA DETERMINED TO BE OUTSIDE OF THE 0.2% ANNUAL CHANCE FLOODPLAIN, PER FLOOD INSURANCE RATE MAP NUMBER 26125C0553G, DATED JANUARY 16, 2009.



0 10 20 40
SCALE: 1" = 20'



CAUTION!!
THE LOCATIONS AND ELEVATIONS OF EXISTING UNDERGROUND UTILITIES AS SHOWN ON THIS DRAWING ARE ONLY APPROXIMATE. NO GUARANTEE IS EITHER EXPRESSED OR IMPLIED AS TO THE COMPLETENESS OR ACCURACY THEREOF. THE CONTRACTOR SHALL BE RESPONSIBLE FOR DETERMINING THE EXACT UTILITY LOCATIONS AND ELEVATIONS PRIOR TO THE START OF CONSTRUCTION.

CLIENT

TROY SCHOOLS
1140 RANKIN DRIVE
TROY, MI 48063

PROJECT TITLE

LARSON MIDDLE SCHOOL
3222 LONG LAKE ROAD, TROY, MI

REVISIONS

ORIGINAL ISSUE DATE:
JANUARY 4, 2023

DRAWING TITLE

**GRADING AND
SESC PLAN**

PEA JOB NO. 2022-1281

P.M. RR

DN. JJP

DES. RR

DRAWING NUMBER:

C-3.1

EARTHWORK BALANCING NOTE:

THE CONTRACTOR SHALL BE RESPONSIBLE FOR IMPORTING OR EXPORTING ALL MATERIALS AS REQUIRED TO PROPERLY GRADE THIS PROJECT TO THE FINISHED ELEVATIONS SHOWN ON THE APPROVED PLANS. THE CONTRACTOR SHALL MAKE THEIR OWN DETERMINATION OF CUT AND FILL QUANTITIES AND ALLOW FOR REMOVAL OF EXCESS OR IMPORTATION OF ADDITIONAL MATERIAL AT NO ADDITIONAL COST TO THE OWNER.

**SOIL EROSION AND SEDIMENTATION CONTROL
SEQUENCE OF CONSTRUCTION**

1. SEE OAKLAND COUNTY W.R.C. SOIL EROSION AND SEDIMENTATION CONTROL DETAILS SHEET FOR ALL SOIL EROSION CONTROL RELATED DETAILS.
2. PLACE SILT FENCE & INSTALL INLET FILTERS ON EXISTING STORM SEWER STRUCTURES, ACCORDING TO PLANS.
3. INSTALL TEMPORARY CRUSHED CONCRETE ACCESS DRIVE AT ALL CONSTRUCTION ENTRANCES. (80'x24'x8" W/MINIMUM OF 1"-3" CRUSHED CONCRETE - NO FINES).
4. REMOVE CURB, PAVEMENT, TREES, ETC. AS DIRECTED ON THE DEMOLITION PLAN.
5. STRIP AND STOCKPILE TOPSOIL FOR RESTORATION REQUIREMENTS.
6. DISPOSE OF ALL EXCESS, UNSUITABLE MATERIALS OFF SITE IN A LEGAL MANNER. NO BURN OR BURY PITS ALLOWED.
7. UNSUITABLE MATERIALS CONSIST OF, BUT ARE NOT NECESSARILY LIMITED TO THE FOLLOWING: CONCRETE, ASPHALT, TREES, BRUSH, STUMPS, ROOTS, OR OTHER MISCELLANEOUS DEBRIS OR TRASH.
8. MASS GRADE THE SITE IN ACCORDANCE WITH THE PLANS.
9. INSTALL HYDROSEED AS SHOWN ON THE PLAN WITHIN 5 DAYS OF COMPLETION OF MASS GRADING OR WHENEVER DISTURBED AREAS WILL REMAIN UNCHANGED FOR 30 DAYS OR GREATER. MINIMUM 3"-4" TOPSOIL WILL BE USED WHERE VEGETATION IS REQUIRED.
10. COMPLETE ROUGH GRADING OF SITE. PLACE INLET FILTERS AT ALL INLETS AND CATCH BASINS, AS SHOWN.
11. FINISH GRADE AND PAVE SITE AS PROPOSED TO DRAIN TO STORM SEWER SYSTEM. REPAIR INLET FILTERS AS REQUIRED.
12. APPLY TOPSOIL, HYDROSEED TO ALL DISTURBED AREAS UPON COMPLETION OF GRADING. THE CONTRACTOR SHALL STAGE CONSTRUCTION ACTIVITIES IN ORDER TO MINIMIZE THE EXPOSURE OF UNSTABILIZED AREAS.
13. CLEAN PAVEMENT AND STORM SEWERS. REMOVE SILT FENCE AND TREE PROTECTION FENCE, AND INLET FILTERS ONCE VEGETATION HAS BEEN ESTABLISHED.
14. ALL DIRT AND MUD TRACKED ONTO PUBLIC ROADS SHALL BE REMOVED DAILY.
15. STREET CATCH BASINS TO BE PERIODICALLY CLEANED AND FILTER CLOTH CHANGED AND MAINTAINED.

EROSION CONTROL QUANTITIES:

R.Y.C.B. INLET FILTER	2 EA.
LOW POINT INLET FILTER	6 EA.
LAWN RESTORATION	1881 SY

NOTE:

1. PER THE 'SOIL EROSION AND SEDIMENTATION CONTROL SEQUENCE OF CONSTRUCTION' NOTES THE SUCCESSFUL BIDDER TO THE CLEAN THE STORM SEWER, THIS CLEANING SHALL INCLUDE CLEANING OUT THE STRUCTURES AND ENTIRE SEWER RUNS BETWEEN STRUCTURES USING HYDRAULICALLY PROPELLED, HIGH-VELOCITY JET, OR MECHANICALLY POWERED EQUIPMENT. SELECTION OF THE EQUIPMENT USED SHALL BE BASED ON THE CONDITIONS OF LINES AT THE TIME THE WORK COMMENCES. THE EQUIPMENT AND METHODS SELECTED SHALL BE SATISFACTORY TO THE SCHOOL DISTRICT'S REPRESENTATIVE. THE EQUIPMENT SHALL BE CAPABLE OF REMOVING DIRT, GREASE, ROCKS, SAND, AND OTHER MATERIALS AND OBSTRUCTIONS FROM THE SEWER LINES AND MANHOLES. IF CLEANING OF AN ENTIRE SECTION CANNOT BE SUCCESSFULLY PERFORMED FROM ONE MANHOLE, THE EQUIPMENT SHALL BE SET UP ON THE OTHER MANHOLE AND CLEANING AGAIN ATTEMPTED. IF, AGAIN, SUCCESSFUL CLEANING CANNOT BE PERFORMED OR THE EQUIPMENT FAILS TO TRAVERSE THE ENTIRE MANHOLE SECTION, IT WILL BE ASSUMED THAT A MAJOR BLOCKAGE EXISTS AND THE CLEANING EFFORT SHALL BE ABANDONED.
2. PER THE PROJECT SPECIFICATIONS: PRIOR TO THE PLACEMENT OF TOPSOIL THE SUCCESSFUL BIDDER TO SCHEDULE AN INSPECTION BY THE SCHOOL DISTRICT OR PEA GROUP TO CONFIRM THAT THE GRADE IS AT THE PROPER ELEVATION WHERE THE MINIMUM DEPTH OF TOPSOIL CAN BE PLACED THROUGHOUT THE AREA.
3. CONTRACTOR TO FIELD VERIFY ALL UNDERGROUND UTILITIES PRIOR TO CONSTRUCTION INCLUDING BUT NOT LIMITED TO: SITE LIGHTING, FIBER LINES, ETC.

SOIL EROSION MAINTENANCE SCHEDULE AND NOTES:

1. THE SOIL EROSION CONTROLS WILL BE MAINTAINED WEEKLY AND AFTER EVERY STORM EVENT BY:

ROB CARSON
TROY SCHOOL DISTRICT
1140 RANKIN
TROY, OAKLAND COUNTY, MICHIGAN
248-823-4067
2. IF ANY DAMAGE HAS OCCURRED AS A RESULT OF STORM WATER DISCHARGE FROM THE SITE, THE FOLLOWING STEPS SHALL BE IMPLEMENTED.
3. ANY DEBRIS OR DIRT ON ANY PAVED AREA RESULTING FROM CONSTRUCTION TRAFFIC SHALL BE CLEANED IN A PROMPT MANNER BY THE CONTRACTOR. THE CONSTRUCTION DRIVE SHALL BE CLEANED AT THE END OF EACH DAY.
4. ALL DIRT AND MUD TRACKED ONTO PAVED AREAS SHALL BE REMOVED BY THE CONTRACTOR DAILY BY SCRAPING. STREET SWEEPING IS REQUIRED WEEKLY.
5. SILT FENCE MAINTENANCE SHALL INCLUDE THE REMOVAL OF ANY BUILT UP SEDIMENT WHEN THE SEDIMENT HEIGHT ACCUMULATES TO 1/3 TO 1/2 OF THE HEIGHT OF THE FENCE. THE CONTRACTOR IS RESPONSIBLE TO REMOVE, REPLACE, RETRENCH OR REBACKFILL THE SILTATION FENCE SHOULD IT FALL OR BE DAMAGED DURING CONSTRUCTION.
6. INLET FILTER MAINTENANCE SHALL INCLUDE THE REMOVAL OF ANY ACCUMULATED SILT OR OTHER DEBRIS. THE REMOVAL OF SILT SHOULD BE WITH THE USE OF A STIFF BRISTLE BROOM OR SQUARE POINT SHOVEL. IF INLET FILTERS CAN NOT BE CLEANED OR ARE DAMAGED, THEN THE FABRIC MUST BE REPLACED.
7. CONTRACTOR TO PROVIDE WATER TRUCK TO WATER DOWN THE SITE ON A DAILY BASIS AS REQUIRED TO MAINTAIN DUST CONTROL.
8. IF HIGH GROUNDWATER IS ANTICIPATED OR ENCOUNTERED DURING CONSTRUCTION A DEWATERING PLAN MUST BE SUBMITTED TO THE CITY ENGINEERING DIVISION FOR REVIEW.

SEQUENCE OF CONSTRUCTION:

START DAY	END DAY	DESCRIPTION
1	2	INSTALL TEMPORARY SOIL EROSION CONTROL MEASURES, SILT FENCES, INLET PROTECTION, ETC. AS NECESSARY.
1	90	MAINTAIN A 25' BUFFER OF VEGETATION AROUND PERIMETER OF SITE WHERE POSSIBLE.
1	5	STRIP AND STOCKPILE TOPSOIL AS REQUIRED RESTORATION. ALL STOCKPILES MUST BE GRADED AND SEEDED.
5	15	REMOVE ALL PAVEMENT, CURB, UTILITIES, ETC. AS REQUIRED TO INSTALL THE PROPOSED WORK AS SHOWN ON THE TOPOGRAPHIC SURVEY AND DEMOLITION PLAN.
10	15	DISPOSE OF ALL EXCESS/UNSUITABLE MATERIALS OFF SITE IN A LEGAL MANNER. NO ON-SITE BURN OR BURY PITS ALLOWED.
30	40	ROUGH GRADE SITE. SEED AND MULCH BLANKETS MUST BE INSTALLED AS SHOWN WITHIN 5 DAYS OF FINAL GRADE. REPAIR AND/OR RE-INSTALL ANY TEMPORARY SOIL EROSION CONTROL MEASURES THAT WERE DAMAGED DURING GRADING OPERATIONS.
15	90	TEMPORARY SEEDING MUST BE PROVIDED IN AREAS NOT TO BE WORKED ON FOR 15 DAYS OR LONGER.
40	50	FINE GRADE SITE AND PREPARE FOR SITE PAVING OPERATIONS.
50	80	INSTALL ALL PAVEMENT, SIDEWALKS, CURBING AS PROPOSED. IF PERMANENT LANDSCAPING IS NOT TO BE INSTALLED SOON AFTER PAVING IS COMPLETE, ALL AREAS WITHIN 20 FEET OF BACK OF CURB MUST BE TEMPORARILY SEEDED. REPAIR INLET PROTECTION, SILT FENCE AND ANY OTHER DAMAGED SOIL EROSION CONTROL MEASURES AS NECESSARY.
80	89	FINAL GRADE, REDISTRIBUTE STOCKPILED TOPSOIL, ESTABLISH VEGETATION AND INSTALL ALL PERMANENT LANDSCAPING IN ALL DISTURBED AREAS NOT BUILT.
88	90	CLEAN PAVEMENT AND REMOVE ALL TEMPORARY SOIL EROSION CONTROL MEASURES. RE-ESTABLISH VEGETATION AS REQUIRED.
90	90	REMOVE SEDIMENTATION CONTROLS ONCE ENTIRE SITE HAS BEEN PERMANENTLY STABILIZED.

MATCHLINE - SEE LEFT

MATCHLINE - SEE RIGHT

R.Y.C.B. INLET FILTER (SI-3), TYP. FOR USE AT INLETS IN GRASS AREAS ONLY. REFER TO TROY STANDARD DETAILS ON SHEET D.

SILT SACKS AT ALL CATCH BASINS, TYP.

GRADE AROUND EXISTING LIGHTPOLES DURING PROPOSED SWALE CONSTRUCTION, TYP.

NOTE: ALL DISTURBED AREAS WILL BE RESTORED WITH 3" TOPSOIL AND HYDROSEED, TYP.

NOTE: SCRAPE AND SWEEP DAILY ALL DIRT AND MUD TRACKED ON TO ALL EXISTING PAVED AREAS ADJACENT TO THE PROPOSED EARTH DISRUPTION.

NOTE: ALL DISTURBED AREAS WILL BE RESTORED WITH 3" TOPSOIL AND HYDROSEED, TYP.

NOTE: SCRAPE AND SWEEP DAILY ALL DIRT AND MUD TRACKED ON TO ALL EXISTING PAVED AREAS ADJACENT TO THE PROPOSED EARTH DISRUPTION.

FLOODPLAIN NOTE:
BY GRAPHICAL PLOTTING, SITE IS WITHIN ZONE 'X', AN AREA DETERMINED TO BE OUTSIDE OF THE 0.2% ANNUAL CHANCE FLOODPLAIN, PER FLOOD INSURANCE RATE MAP NUMBER 26125C01553G, DATED JANUARY 16, 2009.

S:\PROJECTS\2022\2022-1281\2023\TSD SITE IMPROVEMENT PROJECTS\INFO\CONSTRUCTION\DRAWING\1 LARSON\C-3.1\GRADE-SESC-LARSON-22-1281.dwg



0 10 20 40
SCALE: 1" = 20'



CAUTION!!
THE LOCATIONS AND ELEVATIONS OF EXISTING UNDERGROUND UTILITIES AS SHOWN ON THIS DRAWING ARE ONLY APPROXIMATE. NO GUARANTEE IS EITHER EXPRESSED OR IMPLIED AS TO THE COMPLETENESS OR ACCURACY THEREOF. THE CONTRACTOR SHALL BE EXCLUSIVELY RESPONSIBLE FOR DETERMINING THE EXACT UTILITY LOCATIONS AND ELEVATIONS PRIOR TO THE START OF CONSTRUCTION.

CLIENT
TROY SCHOOLS
1140 RANKIN DRIVE
TROY, MI 48065

PROJECT TITLE
SCHROEDER ELEMENTARY SCHOOL
3514 JACK DRIVE,
TROY, MI

REVISIONS	

ORIGINAL ISSUE DATE:
JANUARY 4, 2023

DRAWING TITLE
TOPOGRAPHIC SURVEY AND DEMOLITION PLAN

PEA JOB NO. 2022-1281


P.M. RR

DN. JJP

DES. RR

DRAWING NUMBER:

C-1.2

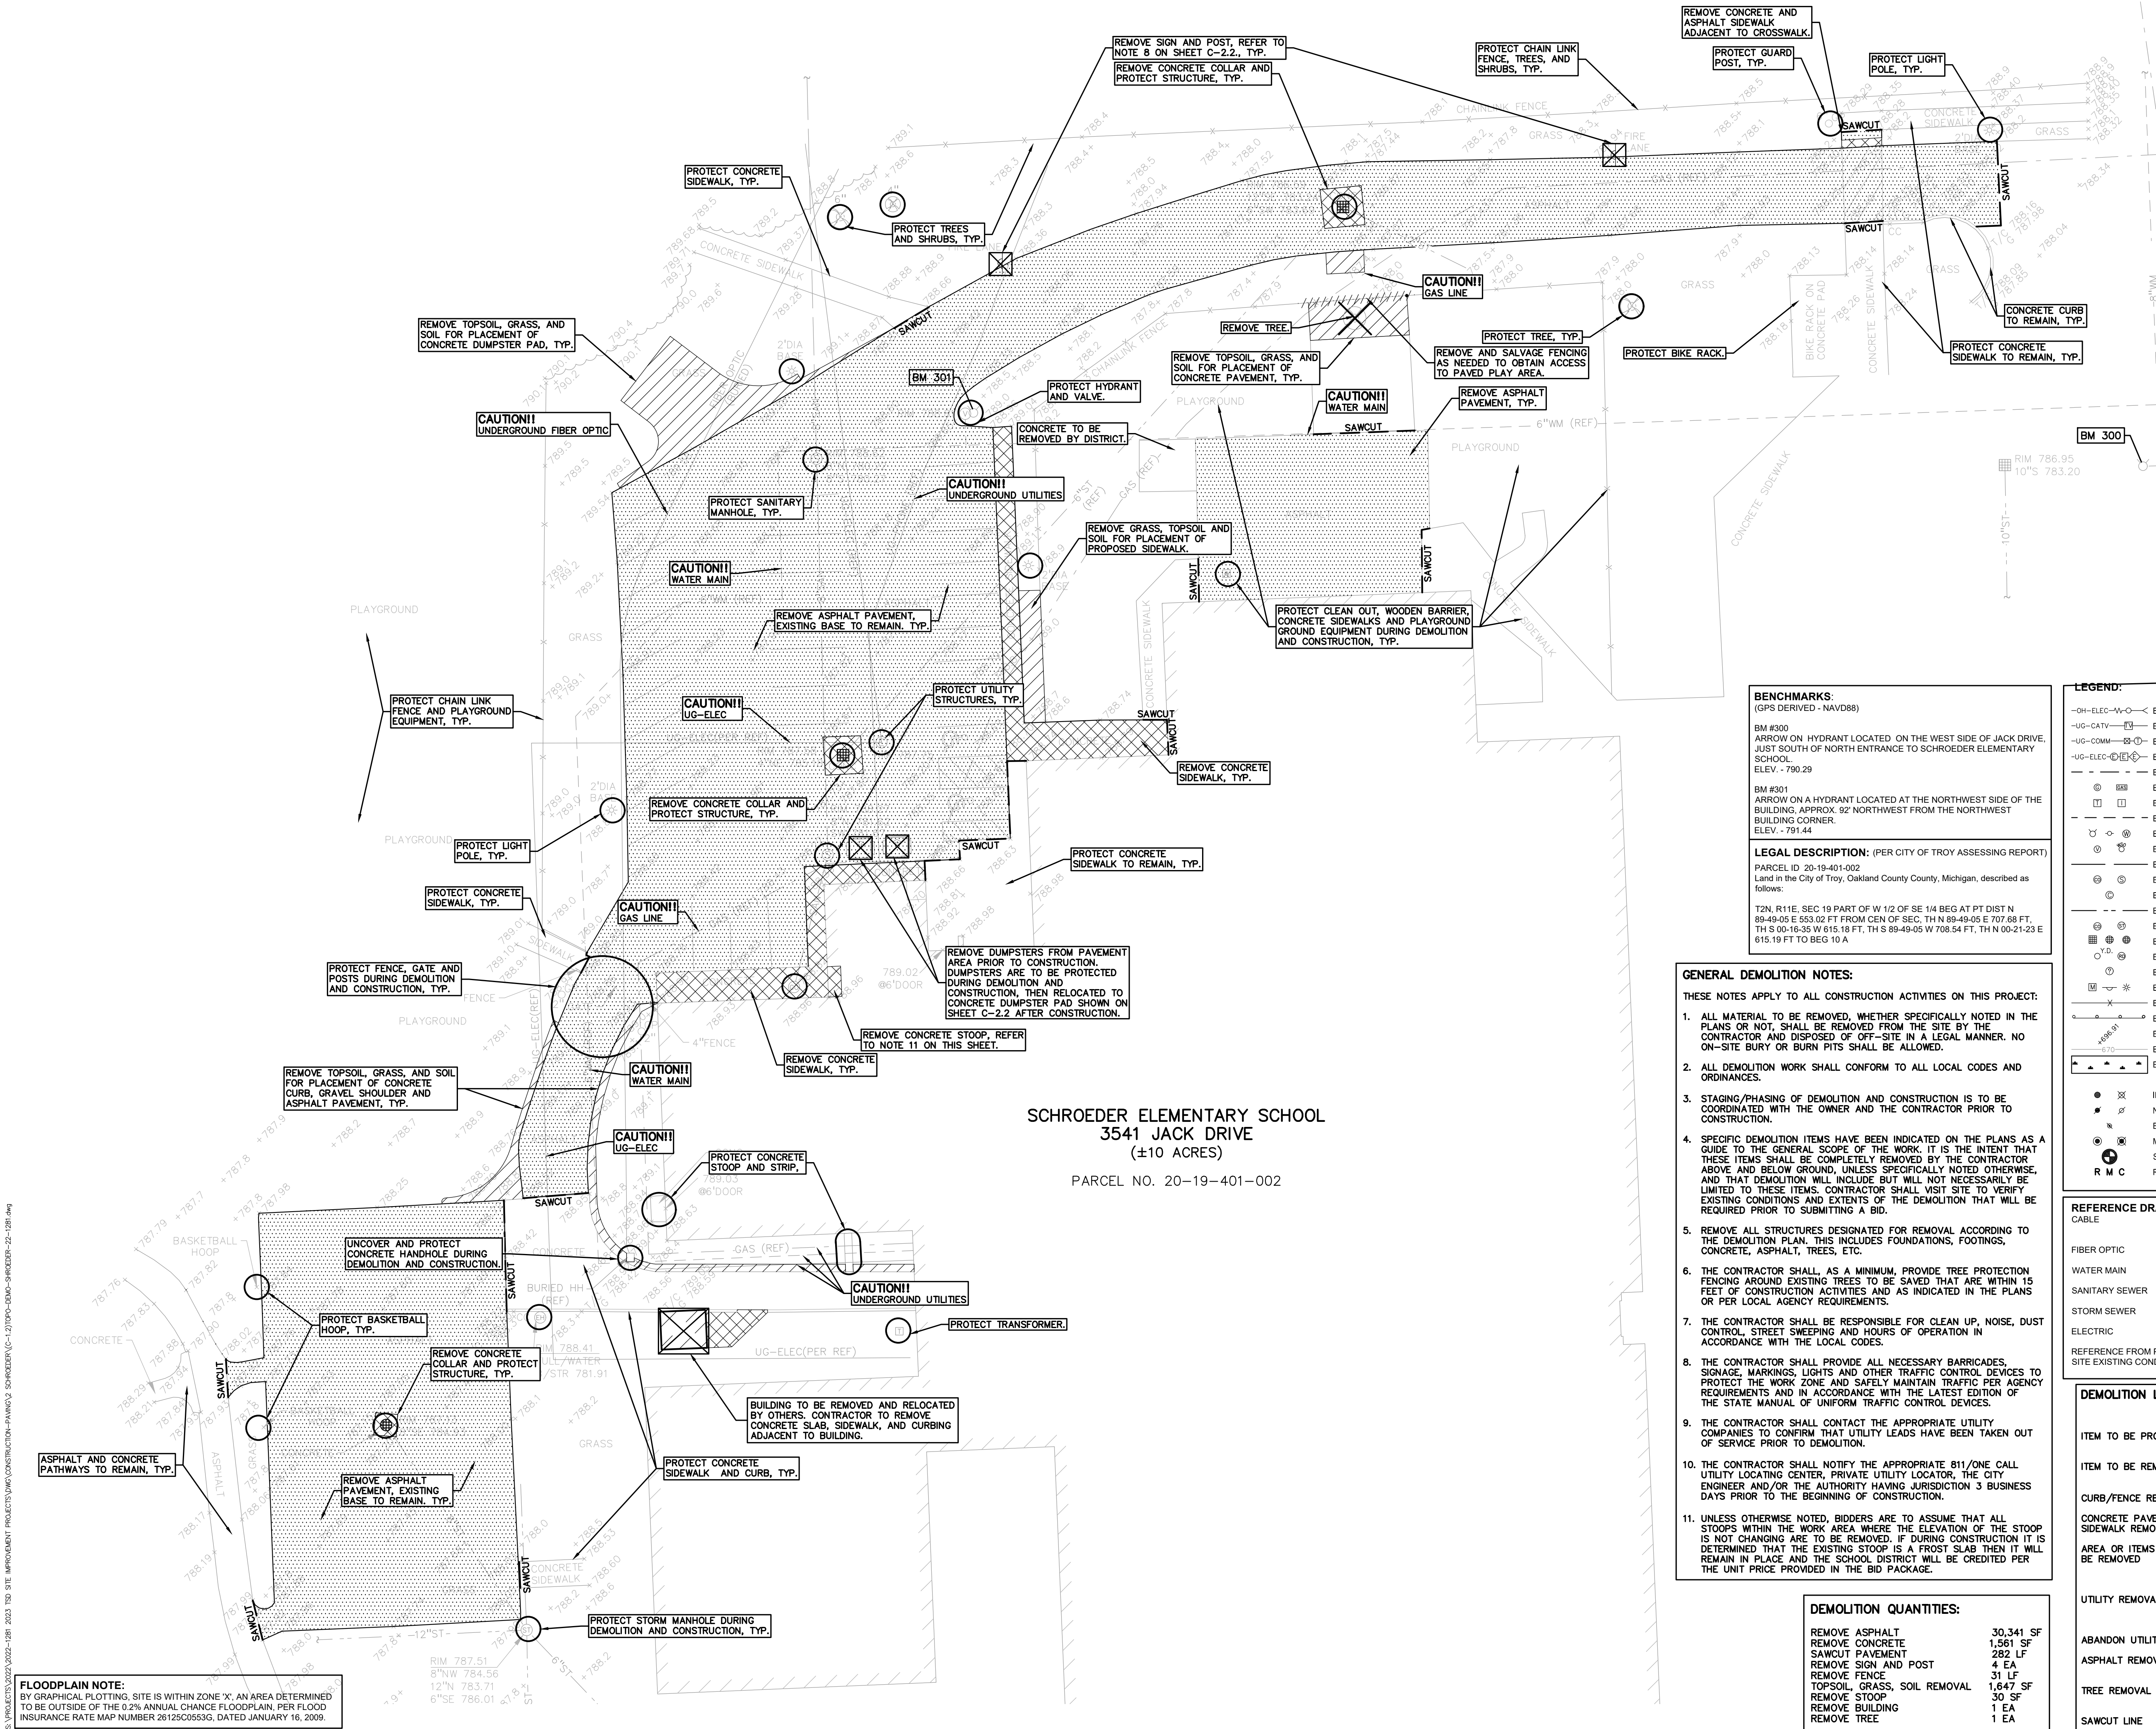

BENCHMARKS:
(GPS DERIVED - NAVD88)
BM #300
ARROW ON HYDRANT LOCATED ON THE WEST SIDE OF JACK DRIVE, JUST SOUTH OF NORTH ENTRANCE TO SCHROEDER ELEMENTARY SCHOOL. ELEV. - 790.29
BM #301
ARROW ON A HYDRANT LOCATED AT THE NORTHWEST SIDE OF THE BUILDING, APPROX. 32' NORTHWEST FROM THE NORTHWEST BUILDING CORNER. ELEV. - 791.44
LEGAL DESCRIPTION: (PER CITY OF TROY ASSESSING REPORT)
PARCEL ID: 20-19-401-002
Land in the City of Troy, Oakland County County, Michigan, described as follows:
T2N, R11E, SEC 19 PART OF W 1/2 OF SE 1/4 BEG AT PT DIST N 89-49-05 E 553.02 FT FROM CEN OF SEC, TH N 89-49-05 E 707.68 FT, TH S 00-16-35 W 615.18 FT, TH S 89-49-05 W 708.54 FT, TH N 00-21-23 E 615.19 FT TO BEG 10 A

- GENERAL DEMOLITION NOTES:**
THESE NOTES APPLY TO ALL CONSTRUCTION ACTIVITIES ON THIS PROJECT:
- ALL MATERIAL TO BE REMOVED, WHETHER SPECIFICALLY NOTED IN THE PLANS OR NOT, SHALL BE REMOVED FROM THE SITE BY THE CONTRACTOR AND DISPOSED OF OFF-SITE IN A LEGAL MANNER. NO ON-SITE BURY OR BURN PITS SHALL BE ALLOWED.
 - ALL DEMOLITION WORK SHALL CONFORM TO ALL LOCAL CODES AND ORDINANCES.
 - STAGING/PHASING OF DEMOLITION AND CONSTRUCTION IS TO BE COORDINATED WITH THE OWNER AND THE CONTRACTOR PRIOR TO CONSTRUCTION.
 - SPECIFIC DEMOLITION ITEMS HAVE BEEN INDICATED ON THE PLANS AS A GUIDE TO THE GENERAL SCOPE OF THE WORK. IT IS THE INTENT THAT THESE ITEMS SHALL BE COMPLETELY REMOVED BY THE CONTRACTOR ABOVE AND BELOW GROUND, UNLESS SPECIFICALLY NOTED OTHERWISE, AND THAT DEMOLITION WILL INCLUDE BUT WILL NOT NECESSARILY BE LIMITED TO THESE ITEMS. CONTRACTOR SHALL VISIT SITE TO VERIFY EXISTING CONDITIONS AND EXTENTS OF THE DEMOLITION THAT WILL BE REQUIRED PRIOR TO SUBMITTING A BID.
 - REMOVE ALL STRUCTURES DESIGNATED FOR REMOVAL ACCORDING TO THE DEMOLITION PLAN. THIS INCLUDES FOUNDATIONS, FOOTINGS, CONCRETE, ASPHALT, TREES, ETC.
 - THE CONTRACTOR SHALL, AS A MINIMUM, PROVIDE TREE PROTECTION FENCING AROUND EXISTING TREES TO BE SAVED THAT ARE WITHIN 15 FEET OF CONSTRUCTION ACTIVITIES AND AS INDICATED IN THE PLANS OR PER LOCAL AGENCY REQUIREMENTS.
 - THE CONTRACTOR SHALL BE RESPONSIBLE FOR CLEAN UP, NOISE, DUST CONTROL, STREET SWEEPING AND HOURS OF OPERATION IN ACCORDANCE WITH THE LOCAL CODES.
 - THE CONTRACTOR SHALL PROVIDE ALL NECESSARY BARRICADES, SIGNAGE, MARKINGS, LIGHTS AND OTHER TRAFFIC CONTROL DEVICES TO PROTECT THE WORK ZONE AND SAFELY MAINTAIN TRAFFIC PER AGENCY REQUIREMENTS AND IN ACCORDANCE WITH THE LATEST EDITION OF THE STATE MANUAL OF UNIFORM TRAFFIC CONTROL DEVICES.
 - THE CONTRACTOR SHALL CONTACT THE APPROPRIATE UTILITY COMPANIES TO CONFIRM THAT UTILITY LEADS HAVE BEEN TAKEN OUT OF SERVICE PRIOR TO DEMOLITION.
 - THE CONTRACTOR SHALL NOTIFY THE APPROPRIATE 811/ONE CALL UTILITY LOCATING CENTER, PRIVATE UTILITY LOCATOR, THE CITY ENGINEER AND/OR THE AUTHORITY HAVING JURISDICTION 3 BUSINESS DAYS PRIOR TO THE BEGINNING OF CONSTRUCTION.
 - UNLESS OTHERWISE NOTED, BIDDERS ARE TO ASSUME THAT ALL STOOPS WITHIN THE WORK AREA WHERE THE ELEVATION OF THE STOOP IS NOT CHANGING ARE TO BE REMOVED. IF DURING CONSTRUCTION IT IS DETERMINED THAT THE EXISTING STOOP IS A FROST SLAB THEN IT WILL REMAIN IN PLACE AND THE SCHOOL DISTRICT WILL BE CREDITED PER THE UNIT PRICE PROVIDED IN THE BID PACKAGE.


DEMOLITION QUANTITIES:	
REMOVE ASPHALT	30,341 SF
REMOVE CONCRETE	1,561 SF
SAWCUT PAVEMENT	282 LF
REMOVE SIGN AND POST	4 EA
REMOVE FENCE	31 LF
TOPSOIL, GRASS, SOIL REMOVAL	1,647 SF
REMOVE STOOP	30 SF
REMOVE BUILDING	1 EA
REMOVE TREE	1 EA

LEGEND:	
-OH-ELEC-W-O-	EX. OH. ELEC. POLE & GUY WIRE
-UG-CATV-	EX. U.G. CABLE TV & PEDESTAL
-UG-COMM-	EX. U.G. COMMUNICATION LINE, PEDESTAL & MANHOLE
-UG-ELEC-	EX. U.G. ELEC. MANHOLE, METER & HANDHOLE
- - - - -	EX. GAS LINE
⊗	EX. GAS VALVE & GAS LINE MARKER
⊠	EX. TRANSFORMER & IRRIGATION VALVE
- - - - -	EX. WATER MAIN
⊕	EX. HYDRANT, GATE VALVE & POST INDICATOR VALVE
⊗	EX. WATER VALVE BOX & SHUTOFF
⊗	EX. SANITARY SEWER
⊗	EX. SANITARY CLEANOUT & MANHOLE
⊗	EX. COMBINED SEWER MANHOLE
- - - - -	EX. STORM SEWER
⊗	EX. CLEANOUT & MANHOLE
⊗	EX. SQUARE, ROUND, & BEEHIVE CATCH BASIN
⊗	EX. YARD DRAIN & ROOF DRAIN
⊗	EX. UNIDENTIFIED STRUCTURE
⊗	EX. MAILBOX, SIGN & LIGHTPOLE
⊗	EX. FENCE
⊗	EX. GUARD RAIL
⊗	EX. SPOT ELEVATION
⊗	EX. CONTOUR
⊗	EX. WETLAND
⊗	IRON FOUND / SET
⊗	NAIL FOUND / NAIL & CAP SET
⊗	BRASS PLUG SET
⊗	MONUMENT FOUND / SET
⊗	SECTION CORNER FOUND
⊗	RECORDED / MEASURED / CALCULATED

REFERENCE DRAWINGS:	
CABLE	AT&T MAP A1, DATED 10/28/2022 WOW EMAIL DATED 10/27/2022
FIBER OPTIC	MAP, FIBER LINK EMAIL DATED 3/8/2010
WATER MAIN	CITY OF TROY GIS MAP DATED 10/26/2022
SANITARY SEWER	CITY OF TROY GIS MAP DATED 10/26/2022
STORM SEWER	CITY OF TROY GIS MAP DATED 10/26/2022
ELECTRIC	HAVE NOT RECEIVED AS OF 11/09/2022
REFERENCE FROM PEA JOB NO. 2012-144: SITE EXISTING CONDITIONS	

DEMOLITION LEGEND:	
ITEM TO BE PROTECTED	⊗
ITEM TO BE REMOVED	⊗
CURB/FENCE REMOVAL	//////
CONCRETE PAVEMENT AND SIDEWALK REMOVAL	XXXXXX
AREA OR ITEMS TO BE REMOVED	XXXXXX
UTILITY REMOVAL	XXXXXX
ABANDON UTILITY
ASPHALT REMOVAL	XXXXXX
TREE REMOVAL	⊗
SAWCUT LINE	----

S:\PROJECTS\2022\2022-1281-2023 SITE IMPROVEMENT PROJECTS\DMO\CONSTRUCTION-PAVING\2 SCHROEDER\22-1281.dwg
FLOODPLAIN NOTE:
BY GRAPHICAL PLOTTING, SITE IS WITHIN ZONE 'X', AN AREA DETERMINED TO BE OUTSIDE OF THE 0.2% ANNUAL CHANCE FLOODPLAIN, PER FLOOD INSURANCE RATE MAP NUMBER 26125C0553G, DATED JANUARY 16, 2009.

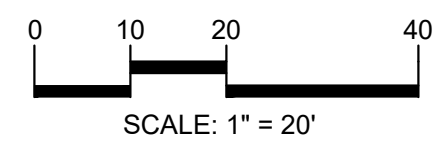

CAUTION!!
THE LOCATIONS AND ELEVATIONS OF EXISTING UNDERGROUND UTILITIES AS SHOWN ON THIS DRAWING ARE ONLY APPROXIMATE. NO GUARANTEE OR OTHER EXPRESSED OR IMPLIED AS TO THE COMPLETENESS OR ACCURACY THEREOF. THE CONTRACTOR SHALL BE EXCLUSIVELY RESPONSIBLE FOR DETERMINING THE EXACT UTILITY LOCATIONS AND ELEVATIONS PRIOR TO THE START OF CONSTRUCTION.

CLIENT
TROY SCHOOLS
1140 RANKIN DRIVE
TROY, MI 48063

PROJECT TITLE
SCHROEDER ELEMENTARY SCHOOL
3541 JACK DRIVE
TROY, MI

REVISIONS

ORIGINAL ISSUE DATE:
JANUARY 4, 2023

DRAWING TITLE
**PAVING AND
DIMENSION
PLAN**

PEA JOB NO. 2022-1281
P.M. RR

DN. JJP
DES. RR

DRAWING NUMBER:

C-2.2

LEGEND:

CONCRETE PAVEMENT	CONCRETE CURB AND GUTTER
ASPHALT PAVEMENT	REVERSE GUTTER PAN
GRAVEL	SETBACK LINE
WETLAND	SIGN
	LIGHTPOLE
	FENCE
	GUARD RAIL

SIGN LEGEND:

'BARRIER FREE PARKING' SIGN	1
'VAN ACCESSIBLE' SIGN	2
'NO-PARKING FIRE LANE' SIGN	3

REFER TO DETAIL SHEET FOR SIGN DETAILS

SIDEWALK RAMP LEGEND:

SIDEWALK RAMP 'TYPE X' X

REFER TO LATEST MDOT R-28 STANDARD RAMP AND DETECTABLE WARNING DETAILS

- NOTES:**
- CONTRACTOR TO VERIFY ALL QUANTITIES SHOWN ON THE PLANS. ANY DEVIATIONS TO THE PLAN QUANTITIES SHALL BE BROUGHT TO THE ATTENTION OF THE SCHOOL DISTRICT AND PEA GROUP, IN WRITING PER THE BID PACKAGE, FOR VERIFICATION PRIOR TO BIDDING.
 - ALL DIMENSIONS SHOWN ARE TO BACK OF CURB, FACE OF SIDEWALK, CENTER OF MANHOLE/CATCH BASIN UNLESS OTHERWISE NOTED.
 - DOWEL INTO EXISTING CURB AND GUTTER 9" WITH EPOXY COATED #4 BAR CONTINUOUS BETWEEN EXISTING AND PROPOSED CURBING.
 - CONTRACTOR TO REPLACE PLAYSCAPE AREA STRIPING IN KIND IN REGARDS TO LAYOUT, WIDTH, COLOR (TYP.) (2 COATS).
 - REFER TO NOTES AND DETAIL SHEET FOR ON SITE PAVING DETAILS.
 - THE QUANTITY FOR 'SUBGRADE UNDERCUT' FOR EACH SITE SHALL BE INCLUDED IN THE BASE BID. THIS ITEM IS CONSIDERED AN ALLOWANCE AND FINAL PAYMENT WILL BE BASED ON THE ACTUAL VOLUME OF COMPACTED IN PLACE STONE PER THE UNIT PRICE PROVIDED IN THE BID PACKAGE.
 - CONTRACTOR TO FIELD VERIFY ALL UNDERGROUND UTILITIES PRIOR TO CONSTRUCTION INCLUDING BUT NOT LIMITED TO: SITE LIGHTING, FIBER LINES, ETC.
 - CONTRACTOR TO REMOVE AND REPLACE SIGNS AND POSTS PER DETAIL ON SHEET C-4.0. ALL SIGNS AND ANY POSTS IN GOOD CONDITION SHALL BE RETURNED TO THE OWNER. ALL POSTS DAMAGED OR OTHERWISE NOT IN A USABLE CONDITION SHALL BE DISPOSED OF AT NO ADDITIONAL COST TO THE OWNER.
 - FOR THE THREE (3) CATCH BASINS AND TWO (2) MANHOLES, LOCATED IN THE WORK AREA, BIDDERS ARE TO INCLUDE RECONSTRUCTION OF THESE STRUCTURES (GREATER THAN 12-INCHES IN DEPTH FROM THE RIM ELEVATION OF REPAIR WORK) IN THE BASE BID. THE SUCCESSFUL BIDDER WILL BE PAID FOR REPAIRING EACH STRUCTURE BASED ON THE ACTUAL DEPTH OF REPAIR WITH EITHER STRUCTURAL ADJUSTMENT (WITHIN TOP 12-INCHES OF RIM ELEVATION) OR STRUCTURAL RECONSTRUCTION (GREATER THAN 12-INCHES IN DEPTH) PER THE UNIT PRICES PROVIDED IN THE BID PACKAGE AND THE SCOPE OF WORK DETERMINED AND APPROVED PRIOR TO THE WORK COMMENCING. REPLASTERING OF THE ENTIRE STRUCTURE SHALL BE INCLUDED IN THE UNIT PRICE FOR BOTH STRUCTURAL ADJUSTMENT AND STRUCTURAL RECONSTRUCTION.
 - ALL PROPOSED ADA RAMPS SHALL HAVE TRUNCATED DOMES, PLASTIC OR METAL STYLE DOMES ARE BOTH ACCEPTABLE.
 - A THICKENED EDGE OF ASPHALT PER THE DETAIL ON SHEET C-4.1 OF THE PLANS SHALL BE LOCATED WHERE CALLED FOR IN THE PLAN. BIDDERS SHALL INCREASE THE QUANTITIES FOR THIS ITEM ACCORDINGLY IN THE BASE BID.

PAVING QUANTITIES:	
18" CONCRETE CURB AND GUTTER	64 LF
4" CONCRETE SIDEWALK	1,880 SF
CONCRETE FROST SLAB AT BUILDING ENTRANCE	40 SF
3" PLAY AREA ASPHALT	2,566 SF
6" 21AA AGGREGATE	2,566 SF
4.5" ASPHALT PAVEMENT	27,978 SF
AGGREGATE BASE PREPARATION	27,978 SF
GRAVEL SHOULDER	297 SF
BUTT JOINT	29 LF
6" CONCRETE PAVEMENT	284 SF
HEAVY DUTY CONCRETE DUMPSTER PAD	656 SF
GUARD POSTS	8 EA
CONCRETE COLLAR	3 EA
SIGN AND POST	4 EA
SUBGRADE UNDERCUT ALLOWANCE	375 CYD
SUBGRADE UNDERCUT DRAIN TILE (4") ALLOWANCE	600 LF
ENGINEERING QUANTITIES:	
ADJUST/RECONSTRUCT STORM STRUCTURE	4 EA
4" HDPE PERF. UNDERDRAIN	489 LF
8" SDR 26	15 LF

HEAVY DUTY ASPHALT ON EXISTING AGGREGATE BASE REMAINING IN PLACE DETAIL

NOT TO SCALE

ASPHALT MATERIAL NOTES:
HOT-MIX ASPHALT MIXTURES UTILIZING RECYCLED ASPHALT PAVEMENT (RAP) MUST MEET MDOT SPECIAL PROVISION 1225P(0)(3). THE BINDER GRADE FOR THIS WORK IS PG64-22. IF ASPHALT MIXES CONTAINING RAP ARE TO BE SUPPLIED FOR THIS PROJECT, THE ASPHALT BINDER MUST BE REVISED PER MDOT TIER 1 OR TIER 2 REQUIREMENTS (RAP CONTENT UP TO 17% MAXIMUM). TIER 3 MIXES ARE NOT ACCEPTABLE ON THIS PROJECT. AN ASPHALT MIX DESIGN FOR ALL SPECIFIED MIXES SHOULD BE FORWARDED TO PEA INC. FOR REVIEW PRIOR TO CONSTRUCTION.

- PAVEMENT PREPARATION NOTES:**
- PAVEMENT PREPARATION SHALL FOLLOW THE PROCESS SUMMARIZED BELOW:
 - REMOVE AND STOCKPILE THE EXISTING AGGREGATE BASE FOR RE-USE IN THE PAVEMENT OPERATION. EXCAVATE THE EXISTING BASE UP TO 2-INCHES ABOVE THE SUBGRADE TO REDUCE THE CHANCE FOR CONTAMINATION. ALL AGGREGATE 2 INCHES AND LESS ABOVE THE SUBGRADE IS TO BE REMOVED AND HAULED OFF WITH NEW AGGREGATE BEING PLACED BACK TO THE EXISTING ELEVATION AS PART OF THE SUBGRADE UNDERCUTTING PAY ITEM.
 - PROOFROLL EXISTING BASE AND SUBGRADE PER PLANS, SPECS, AND GEOTECH REPORT.
 - DETERMINE AREAS THAT FAIL THE PROOFROLL. SUBGRADE UNDERCUTS SHALL BE EVALUATED BY A QUALIFIED ENGINEERING TECHNICIAN TO DETERMINE IF SUBGRADE STABILIZATION IS NECESSARY. DRAIN TILE SHALL BE PLACED WITHIN ANY UNDERCUT AND CONNECTED TO THE CLOSEST CATCH BASIN TO PREVENT GROUNDWATER FROM POOLING WITHIN THE GRANULAR SOILS IN UNDERCUTS AND CREATING "BATHTUBS" IN THE COHESIVE SOILS.
 - TO MINIMIZE SUBGRADE INSTABILITY AND UNDERCUTS, THE SUBGRADE SHALL NOT BE LEFT EXPOSED TO PRECIPITATION AND CONSTRUCTION OPERATIONS AND SHOULD BE PERFORMED DURING THE SUMMER MONTHS TO ENSURE DRY, WARM, WEATHER. ADDITIONALLY, THE SUBGRADE MAY BECOME UNSTABLE UNDER REPEATED LOADING OF CONSTRUCTION TRAFFIC; THEREFORE, CONSTRUCTION EQUIPMENT SHOULD BE LIMITED ON THE EXPOSED SUBGRADE.
 - BACKFILL THE INITIAL PORTION OF THE UNDERCUT WITH THE SALVAGED AGGREGATE BASE AND THEN COMPLETE THE BACKFILL PROCESS WITH IMPORTED MDOT 21AA CRUSHED Limestone AGGREGATE PER THE PLANS, SPECS AND GEOTECH REPORT.
 - ALL ENGINEERED FILL SHALL BE COMPACTED TO A DENSITY OF AT LEAST 95 PERCENT OF THE MAXIMUM DENSITY DETERMINED BY THE MODIFIED PROCTOR (ASTM D1557) METHOD OF TESTING. ALL ENGINEERED FILL MATERIAL SHALL BE PLACED AND COMPACTED AT APPROXIMATELY THE OPTIMUM MOISTURE CONTENT. FROZEN MATERIAL SHALL NOT BE USED AS FILL, NOR SHOULD FILL BE PLACED ON A FROZEN SUBGRADE.
 - SUBGRADE UNDERCUT DRAIN TILE SHALL BE EVALUATED BY A QUALIFIED ENGINEERING TECHNICIAN TO DETERMINE IF SUBGRADE STABILIZATION IS NECESSARY. DRAIN TILE SHALL BE PLACED WITHIN ANY UNDERCUT AREA AND CONNECTED TO THE CLOSEST CATCH BASIN TO PREVENT GROUNDWATER FROM POOLING WITHIN THE GRANULAR SOILS IN UNDERCUTS AND CREATING "BATHTUBS" IN THE COHESIVE SOILS.
 - THE QUANTITY FOR 'SUBGRADE UNDERCUT DRAIN TILE (4")' FOR EACH SITE SHALL BE INCLUDED IN THE BASE BID. THIS ITEM IS CONSIDERED AN ALLOWANCE AND FINAL PAYMENT WILL BE BASED ON THE ACTUAL FOOTAGE OF COMPACTED IN PLACE STONE PER THE UNIT PRICE PROVIDED IN THE BID PACKAGE.

SCHROEDER ELEMENTARY SCHOOL
3541 JACK DRIVE
(±10 ACRES)

PARCEL NO. 20-19-401-002

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S:\PROJECTS\2022\2022-1281 2023 SITE IMPROVEMENT PROJECTS\CONSTRUCTION\PAVING\2 SCHROEDER-C-2.2\DWG-SCHROEDER-C-2.2.dwg

FLOODPLAIN NOTE:
BY GRAPHICAL PLOTTING, SITE IS WITHIN ZONE 'X'. AN AREA DETERMINED TO BE OUTSIDE OF THE 0.2% ANNUAL CHANCE FLOODPLAIN PER FLOOD INSURANCE RATE MAP NUMBER 26125C0553G, DATED JANUARY 16, 2009.

1. PER THE SOIL EROSION AND SEDIMENTATION CONTROL SEQUENCE OF CONSTRUCTION NOTES THE SUCCESSFUL BIDDER TO CLEAN THE STORM SEWER, THIS CLEANING SHALL INCLUDE CLEANING OUT THE MANHOLES AND THE SEWER LINES. THE CLEANING SHALL BE HYDRAULICALLY PROPELLED, HIGH-VELOCITY JET, OR MECHANICALLY POWERED EQUIPMENT. SELECTION OF THE EQUIPMENT USED SHALL BE BASED ON THE CONDITIONS OF LINES AT THE TIME THE WORK COMMENCES. THE BIDDER SHALL BE RESPONSIBLE FOR IDENTIFYING A SATISFACTORY TO THE SCHOOL DISTRICT'S REPRESENTATIVE. THE EQUIPMENT SHALL BE CAPABLE OF REMOVING DIRT, GREASE, ROCKS, SAND, AND OTHER MATERIALS AND OBSTRUCTIONS FROM THE SEWER LINES. THE MANHOLES SHALL BE CLEANED BY THE SAME METHOD. IF BE SUCCESSFULLY PERFORMED FROM ONE MANHOLE, THE EQUIPMENT SHALL BE SET UP ON THE OTHER MANHOLE AND CLEANING AGAIN ATTEMPTED. IF, AGAIN, SUCCESSFUL CLEANING CANNOT BE PERFORMED, THE EQUIPMENT SHALL BE SET UP AT THE NEXT MANHOLE. IN THIS SECTION, IT WILL BE ASSUMED THAT A MAJOR BLOCKAGE EXISTS AND THE CLEANING EFFORT SHALL BE ABANDONED.

2. PER THE PROJECT SPECIFICATIONS; PRIOR TO THE PLACEMENT OF TOPSOIL THE SUCCESSFUL BIDDER TO SCHEDULE AN INSPECTION BY THE SCHOOL DISTRICT OR FEA GROUP TO CONFIRM THAT THE GRADE IS AT THE PROPER ELEVATION WHERE THE MINIMUM DEPTH OF TOPSOIL CAN BE PLACED THROUGHOUT THE AREA.
3. CONTRACTOR TO FIELD VERIFY ALL UNDERGROUND UTILITIES PRIOR TO CONSTRUCTION INCLUDING BUT NOT LIMITED TO: SITE LIGHTING, FIBER LINES, ETC.

THE CONTRACTOR SHALL BE RESPONSIBLE FOR IMPORTING OR EXPORTING ALL MATERIALS AS REQUIRED TO PROPERLY GRADE THIS PROJECT TO THE FINISHED ELEVATIONS SHOWN ON THE APPROVED PLANS. THE CONTRACTOR SHALL MAKE THEIR OWN DETERMINATION OF CUT AND FILL QUANTITIES AND ALLOW FOR REMOVAL OF EXCESS OR IMPORTATION OF ADDITIONAL MATERIAL AT NO ADDITIONAL COST TO THE OWNER.

NOTE:
SCRAPE AND SWEEP DAILY ALL DIRT
AND MUD TRACKED ON TO ALL
EXISTING PAVED AREAS ADJACENT TO
THE PROPOSED EARTH DISRUPTION.

EXISTING SPOT ELEVATION

PROPOSED SPOT ELEVATION:
TYPICALLY TOP OF PAVEMENT
IN PAVED AREAS, GUTTER GRADE
IN CURB LINES.

670' EXISTING CONTOUR


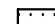

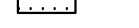

922' PROPOSED CONTOUR

PROPOSED REVERSE GUTTER PAN

PROPOSED RIDGE LINE

PROPOSED SWALE/DITCH

T/C = TOP OF CURB	G = GUTTER GRADE
T/P = TOP OF PAVEMENT	F.G. = FINISH GRADE
T/S = TOP OF SIDEWALK	RIM = RIM ELEVATION
T/W = TOP OF WALL	B/W = BOTTOM OF WALL

 (SI-2A) LOW POINT INLET FILTER
 (SI-3) RYCB FILTER
 (SP-2) SILT FENCE
 (SP-9) TEMPORARY STONE ACCESS DRIVE
 LAWN RESTORATION

1. THE SOIL EROSION CONTROLS WILL BE MAINTAINED WEEKLY AND AFTER EVERY STORM EVENT BY:

ROY CARSON
TROY SCHOOL DISTRICT
140 RANKIN
TROY, OAKLAND COUNTY, MICHIGAN
248--823--4067
2. IF ANY DAMAGE HAS OCCURRED AS A RESULT OF STORM WATER DISCHARGE FROM THE SITE, THE FOLLOWING STEPS SHALL BE IMPLEMENTED
3. ANY DEBRIS OR DIRT ON ANY PAVED AREA RESULTING FROM CONSTRUCTION TRAFFIC SHALL BE CLEANED IN A PROMPT MANNER BY THE CONTRACTOR. THE CONSTRUCTION DRIVE SHALL BE CLEANED AT THE END OF EACH DAY.
4. ALL DIRT AND MUD TRACKED ONTO PAVED AREAS SHALL BE REMOVED BY THE CONTRACTOR DAILY BY SCRAPING. STREET SWEEPING IS REQUIRED WEEKLY.
5. SILT FENCE MAINTENANCE PLAN INCLUDE THE REMOVAL OF ANY BUILT UP SEDIMENT WHEN THE SEDIMENT HEIGHT ACCUMULATES TO 1/3 TO 1/2 OF THE HEIGHT OF THE FENCE. THE CONTRACTOR IS RESPONSIBLE TO REMOVE, REPLACE, RETRENCH OR REBACKFILL THE SILTATION FENCE SHOULD IT FALL OR BE DAMAGED DURING CONSTRUCTION.
6. INLET FILTER MAINTENANCE SHALL INCLUDE THE REMOVAL OF ANY ACCUMULATED SILT OR OTHER DEBRIS. THE REMOVAL OF SILT SHOULD BE WITH THE USE OF A STIFF BRISTLE BROOM OR SQUARE POINT SHOVEL. IF INLET FILTERS CANNOT BE CLEANED OR ARE DAMAGED, THEN THE FABRIC MUST BE REPLACED.
7. CONTRACTOR TO PROVIDE WATER TRUCK TO WATER DOWN THE SITE ON A DAILY BASIS AS REQUIRED TO MAINTAIN DUST CONTROL
8. IF HIGH GROUNDWATER IS ANTICIPATED OR ENCOUNTERED DURING CONSTRUCTION A DEWATERING PLAN MUST BE SUBMITTED TO THE CITY ENGINEERING DIVISION FOR REVIEW.

TREE PROTECTION FENCING	75 LF
SILT FENCE	818 LF.
LOW POINT INLET FILTER	4 EA.
LAWN RESTORATION	489 SY

1. SEE OAKLAND COUNTY W.R.C. SOIL EROSION AND SEDIMENTATION CONTROL DETAILS SHEET FOR ALL SOIL EROSION CONTROL RELATED DETAILS.
2. PLACE SILT FENCE & INSTALL INLET FILTERS ON EXISTING STORM SEWER STRUCTURES, ACCORDING TO PLANS.
3. INSTALL TEMPORARY CRUSHED CONCRETE ACCESS DRIVE AT ALL CONSTRUCTION ENTRANCES. (80"x24"x8" W/MINIMUM OF 1"-3" CRUSHED CONCRETE - NO FINES).
4. REMOVE CURB, PAVEMENT, TREES, ETC. AS DIRECTED ON THE DEMOLITION PLAN.
5. STRIP AND STOCKPILE TOPSOIL FOR RESTORATION REQUIREMENTS.
6. DISPOSE OF ALL EXCESS, UNSUITABLE MATERIALS OFF SITE IN A LEGAL MANNER. NO BURN OR BURY PITS ALLOWED.
7. UNSUITABLE MATERIALS CONSIST OF, BUT ARE NOT NECESSARILY LIMITED TO THE FOLLOWING: CONCRETE, ASPHALT, TREES, BRUSH, STUMPS, ROOTS, OR OTHER MISCELLANEOUS DEBRIS OR TRASH.
8. MASS GRADE THE SITE IN ACCORDANCE WITH THE PLANS.
9. INSTALL HYDROSEED AS SHOWN ON THE PLAN WITHIN 5 DAYS OF COMPLETION OF MASS GRADING OR WHENEVER DISTURBED AREAS WILL REMAIN UNCHANGED FOR 30 DAYS OR GREATER. MINIMUM 3"-4" TOPSOIL WILL BE USED WHERE VEGETATION IS REQUIRED.
10. COMPLETE ROUGH GRADING OF SITE. PLACE INLET FILTERS AT ALL INLETS AND CATCH BASINS, AS SHOWN.
11. FINISH GRADE AND PAVE SITE AS PROPOSED TO DRAIN TO STORM SEWER SYSTEM. REPAIR INLET FILTERS AS REQUIRED.
12. APPLY TOPSOIL, HYDROSEED TO ALL DISTURBED AREAS UPON COMPLETION OF GRADING. THE CONTRACTOR SHALL STAGE CONSTRUCTION ACTIVITIES IN ORDER TO MINIMIZE THE EXPOSURE OF UNSTABILIZED AREAS.
13. CLEAN PAVEMENT AND STORM SEWERS. REMOVE SILT FENCE AND TREE PROTECTION FENCE, AND INLET FILTERS ONCE VEGETATION HAS BEEN ESTABLISHED.
14. ALL DIRT AND MUD TRACKED ONTO PUBLIC ROADS SHALL BE REMOVED DAILY.
15. STREET CATCH BASINS TO BE PERIODICALLY CLEANED AND FILTER CLOTH CHANGED AND MAINTAINED.

START DAY	END DAY	
1	2	INSTALL TEMPORARY SOIL EROSION CONTROL MEASURES, SILT FENCES, INLET PROTECTION, ETC. AS NECESSARY.
1	90	MAINTAIN A 25' BUFFER OF VEGETATION AROUND PERIMETER OF SITE WHERE POSSIBLE.
1	5	STRIP AND STOCKPILE TOPSOIL AS REQUIRED RESTORATION. ALL STOCKPILES MUST BE GRADED AND SEEDDED.
5	15	REMOVE ALL PAVEMENT, CURB, UTILITIES, ETC. AS REQUIRED TO INSTALL THE PROPOSED WORK AS SHOWN ON THE TOPOGRAPHIC SURVEY AND DEMOLITION PLAN.
10	15	DISPOSE OF ALL EXCESS/UNSUITABLE MATERIALS OFF SITE IN A LEGAL MANNER. NO ON-SITE BURN OR BURY PITS ALLOWED.
30	90	ROUGH GRADE SITE. SEED AND MULCH BLANKETS MUST BE INSTALLED AS SHOWN WITHIN 5 DAYS OF FINAL GRADE. REPAIR AND/OR RE-INSTALL ANY TEMPORARY SOIL EROSION CONTROL MEASURES THAT WERE DAMAGED DURING GRADING OPERATIONS.
15	90	TEMPORARY SEEDING MUST BE PROVIDED IN AREAS NOT TO BE WORKED ON FOR 15 DAYS OR LONGER.
40	50	FINE GRADE SITE AND PREPARE FOR SITE PAVING OPERATIONS.
80	180	INSTALL ALL PAVEMENT, SIDEWALKS, CURBING AS PROPOSED. IF PERMANENT LANDSCAPING IS NOT TO BE INSTALLED SOON AFTER PAVING IS COMPLETE, ALL AREAS WITHIN 20 FEET OF BACK OF CURB MUST BE TEMPORARILY SEEDDED. REPAIR INLET PROTECTION, SILT FENCE AND ANY OTHER DAMAGED SOIL EROSION CONTROL MEASURES AS NECESSARY.
80	89	FINAL GRADE, REDISTRIBUTE STOCKPILED TOPSOIL, ESTABLISH VEGETATION AND INSTALL ALL PERMANENT LANDSCAPING IN ALL DISTURBED AREAS NOT BUILT.
88	90	CLEAN PAVEMENT AND REMOVE ALL TEMPORARY SOIL EROSION CONTROL MEASURES. RE-ESTABLISH VEGETATION AS REQUIRED.
90	90	REMOVE SEDIMENTATION CONTROLS ONCE ENTIRE SITE HAS BEEN PERMANENTLY STABILIZED.

FLOODPLAIN NOTE:
BY GRAPHICAL PLOTTING, SITE IS WITHIN ZONE 'X', AN AREA DETERMINED
TO BE OUTSIDE OF THE 0.2% ANNUAL CHANCE FLOODPLAIN, PER FLOOD
INSURANCE RATE MAP NUMBER 26125C0553G, DATED JANUARY 16, 2009.



0 10 20 40

SCALE: 1" = 20'



CAUTION!!
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CLIENT
TROY SCHOOLS
1140 RANKIN DRIVE
TROY, MI 48063

PROJECT TITLE
**SCHROEDER
ELEMENTARY
SCHOOL**
3514 JACK DRIVE,
TROY, MI

REVISIONS

ORIGINAL ISSUE DATE:
JANUARY 4, 2023

DRAWING TITLE

**GRADING AND
SESC PLAN**

PEA JOB NO 2022-1281


P.M.	RR
DN.	JJP
DES.	RR

DRAWING NUMBER:

C-3.2

S:\PROJECTS\2022\2022-1281 - 2023 - SITE IMPROVEMENT PROJECTS\DWG\CONSTRUCTION-FINALS\1. LEONARD-1.DWG (C-1.3)DWG-C-1.3.DWG-2022-1281.dwg

FLOODPLAIN NOTE:
BY GRAPHICAL PLOTTING, SITE IS WITHIN ZONE "X". AN AREA DETERMINED TO BE OUTSIDE OF THE 0.2% ANNUAL CHANCE FLOODPLAIN, PER FLOOD INSURANCE RATE MAP NUMBER 26125C0553G, DATED JANUARY 16, 2009.

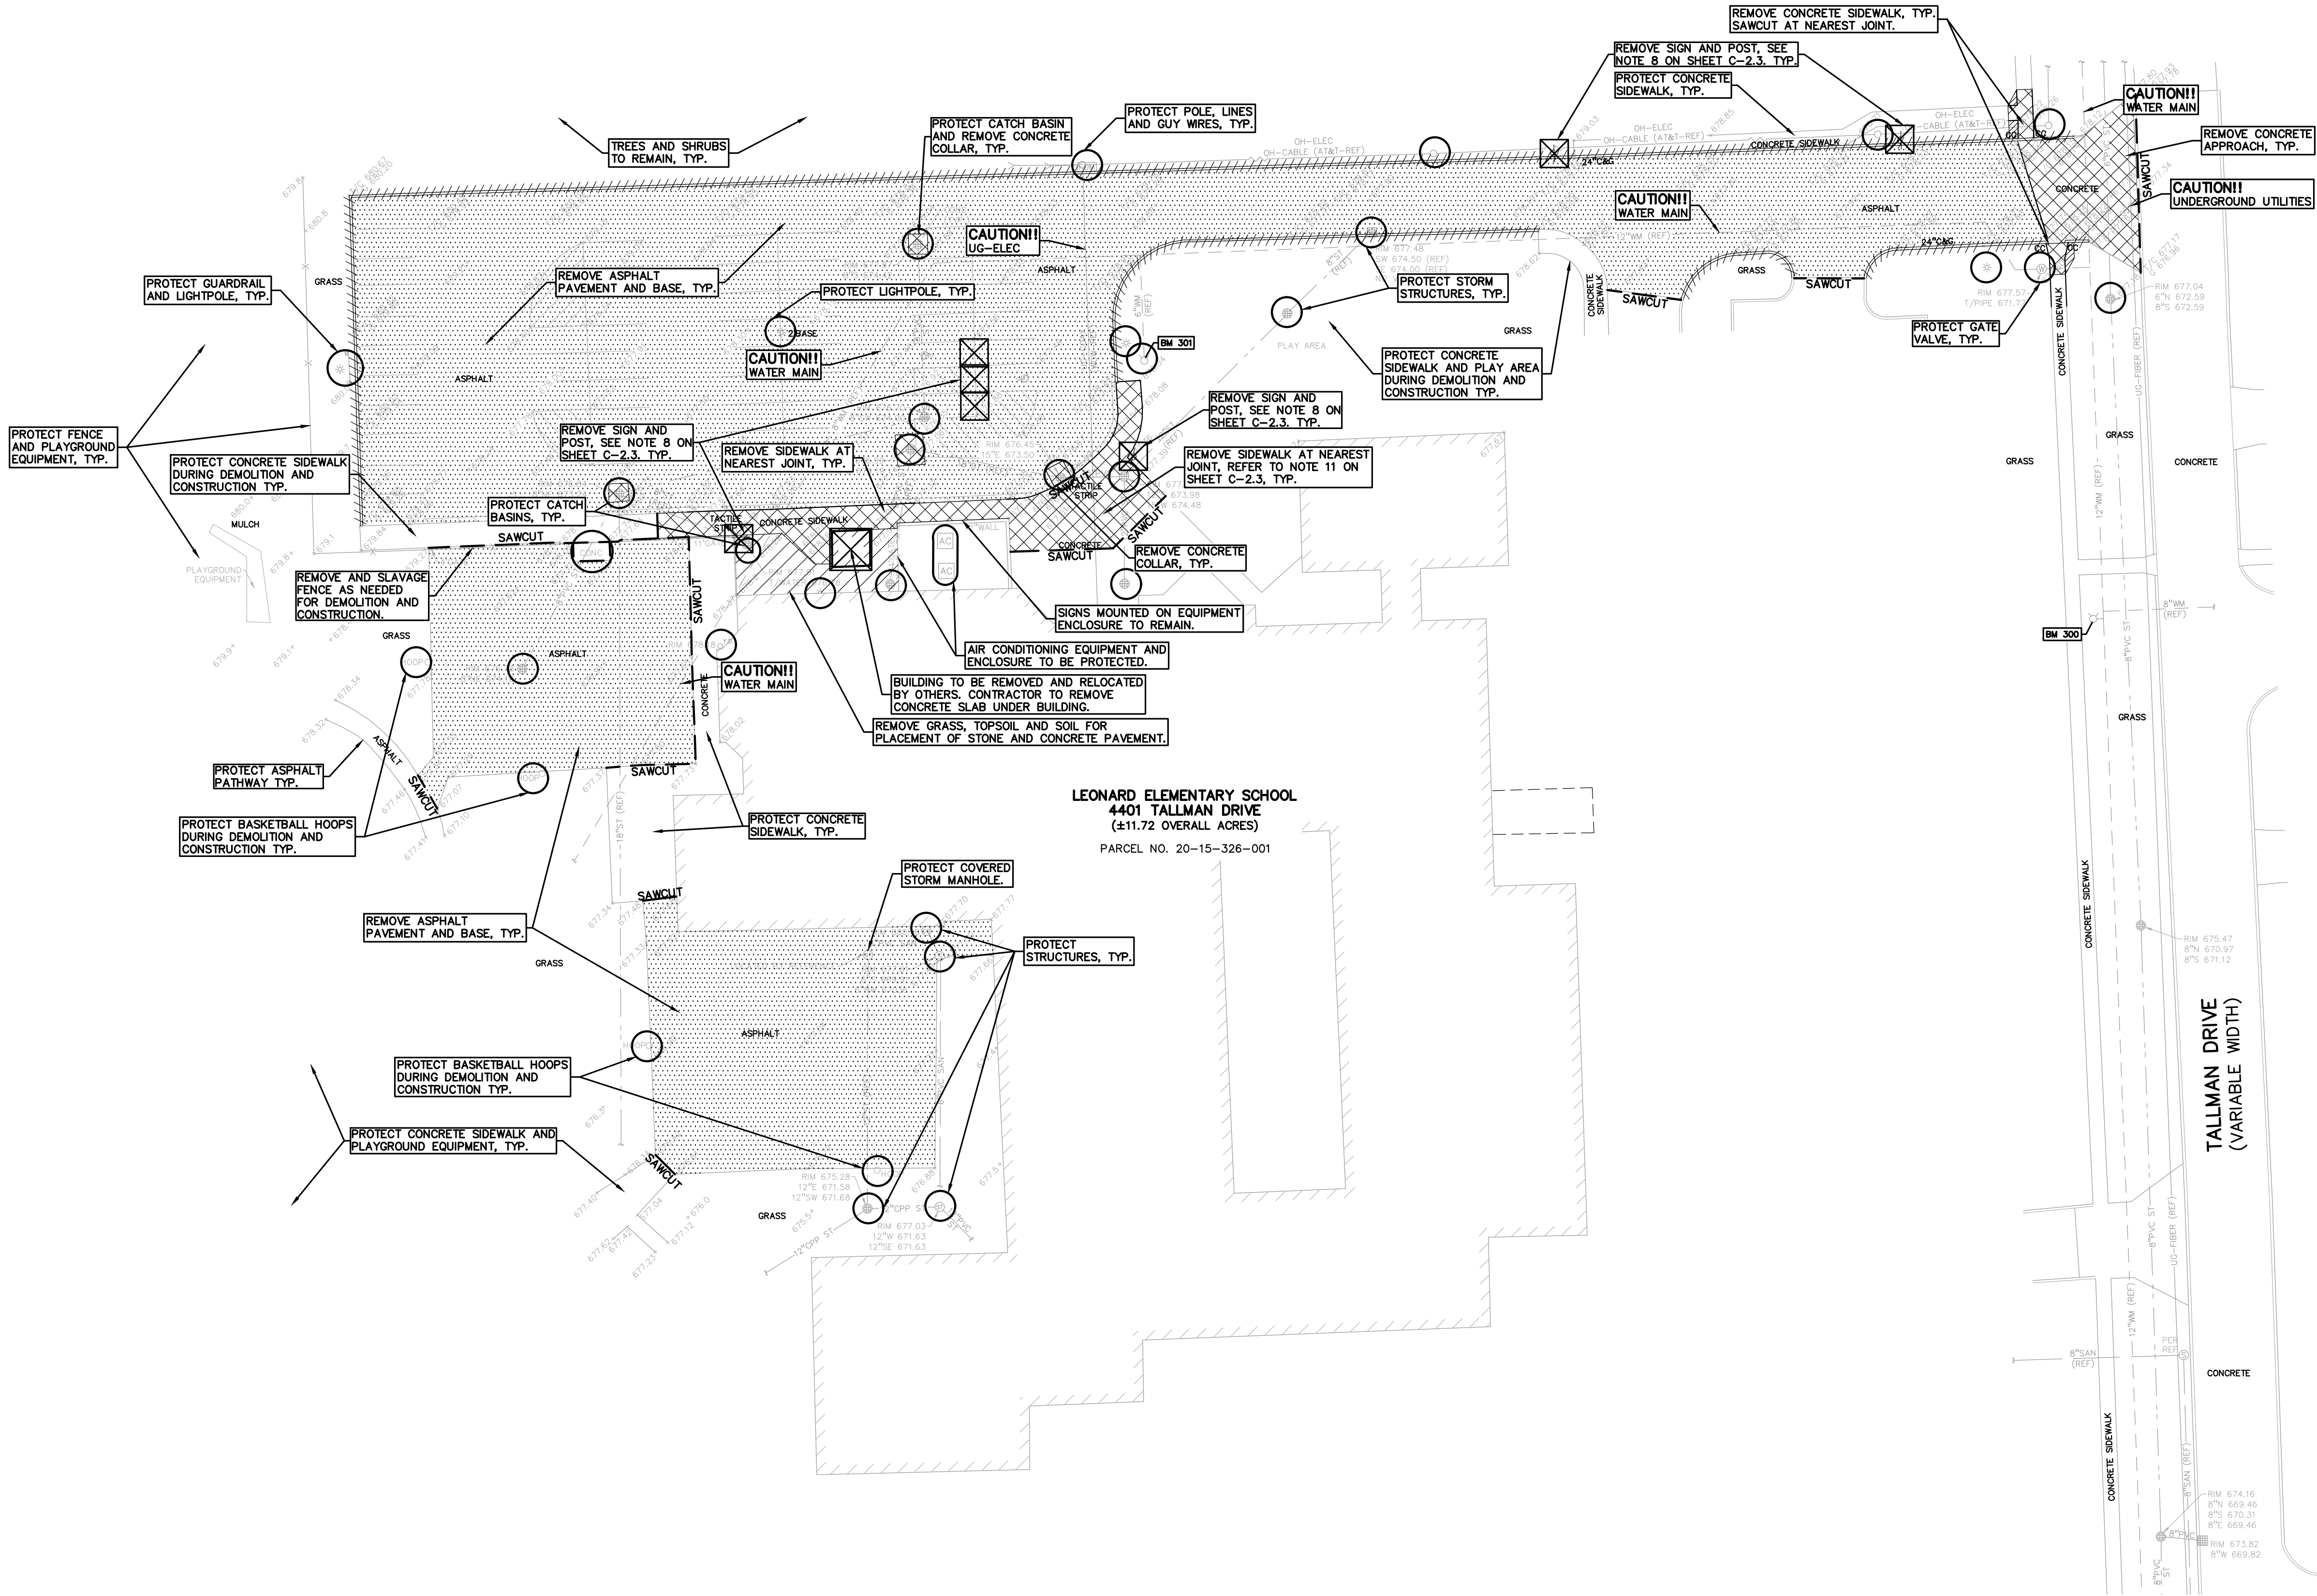

BENCHMARKS:
(GPS DERIVED - NAVD83)

BM #300
ARROW ON FLANGE OF A HYDRANT LOCATED ON THE WEST SIDE OF TALLMAN DRIVE, ACROSS FROM NORTH SIDE OF THURBER DRIVE.
ELEV. - 677.86

BM #301
ARROW ON A HYDRANT LOCATED ON THE EAST SIDE OF THE BACK NORTH PARKING LOT, APPROX. 56' NORTHEAST FROM THE NORTHWEST BUILDING CORNER.
ELEV. - 680.91

LEGAL DESCRIPTION:
PARCEL ID 20-15-326-001
Land in the City of Troy, Oakland County County, Michigan, described as follows:
T2N, R11E, SEC 15 E 60 FT OF S 448.03 FT OF NW 1/4, ALSO PART OF SW 1/4 BEG AT CEN OF SEC. TH S 00-42-10 W 400 FT, TH N 89-27-25 W 1261.80 FT, TH NELY ALG CEN LINE OF STURGIS DRAIN 411 FT MORE OR LESS TO E & W 1/4 LINE, TH S 89-27-25 E 1189.90 FT TO BEG EXC PART OF NW 1/4, ALSO PART OF NE 1/4 OF SW 1/4 BEG AT CEN OF SEC. TH N 00-32-35 E 448.03 FT, TH N 89-27-25 W 60 FT, TH S 00-32-35 W 448.03 FT, TH S 00-42-10 W 400 FT, TH S 89-27-25 E 60 FT, TH N 00-42-10 W ALG N & S 1/4 LINE TO BEG 11.72 A

NOTES:

1. CONTRACTOR TO VERIFY ALL QUANTITIES SHOWN ON THE PLANS. ANY DEVIATIONS TO THE PLAN QUANTITIES SHALL BE BROUGHT TO THE ATTENTION OF THE SCHOOL DISTRICT AND PEA GROUP, IN WRITING PER THE BID PACKAGE, FOR VERIFICATION PRIOR TO BIDDING.

DEMOLITION QUANTITIES:

REMOVE ASPHALT AND BASE	34,251 SF
REMOVE CONCRETE	13,086 SF
SAWCUT PAVEMENT	450 LF
REMOVE SIGN AND POST	7 EA
TOPSOIL, GRASS, SOIL REMOVAL	792 SF
REMOVE BUILDING	1 EA

REFERENCE DRAWINGS:

CABLE AT&T MAP A1, DATED 10/28/2022
WOW EMAIL DATED 10/27/2022

FIBER OPTIC MAP, FIBER LINK EMAIL DATED 10/26/2022

WATER MAIN CITY OF TROY GIS MAP DATED 10/26/2022

SANITARY SEWER CITY OF TROY GIS MAP DATED 10/26/2022

STORM SEWER CITY OF TROY GIS MAP DATED 10/26/2022

ELECTRIC HAVE NOT RECEIVED AS OF 11/09/2022

REFERENCE FROM PEA JOB NO. 2012-144:
SITE EXISTING CONDITIONS, KINGSCOTT JOB NO. 2643-09, SHEET NO. C1.00, BID ISSUE DATE 10/28/2005

LEGEND:

OH-ELEC-W-O- EX. OH. ELEC. POLE & GUY WIRE
UG-CATV- EX. U.G. CABLE TV & PEDESTAL
UG-COMM- EX. U.G. COMMUNICATION LINE, PEDESTAL & MANHOLE
UG-ELEC- EX. U.G. ELEC. MANHOLE, METER & HANDHOLE
EX. GAS LINE
EX. GAS VALVE & GAS LINE MARKER
EX. TRANSFORMER & IRRIGATION VALVE
EX. WATER MAIN
EX. HYDRANT, GATE VALVE & POST INDICATOR VALVE
EX. WATER VALVE BOX & SHUTOFF
EX. SANITARY SEWER
EX. SANITARY CLEANOUT & MANHOLE
EX. COMBINED SEWER MANHOLE
EX. STORM SEWER
EX. CLEANOUT & MANHOLE
EX. SQUARE, ROUND, & BEEHIVE CATCH BASIN
EX. YARD DRAIN & ROOF DRAIN
EX. UNIDENTIFIED STRUCTURE
EX. MAILBOX, SIGN & LIGHTPOLE
EX. FENCE
EX. GUARD RAIL
EX. SPOT ELEVATION
EX. CONTOUR
EX. WETLAND
IRON FOUND / SET
NAIL FOUND / NAIL & CAP SET
BRASS PLUG SET
MONUMENT FOUND / SET
SECTION CORNER FOUND
RECORDED / MEASURED / CALCULATED

DEMOLITION LEGEND:

ITEM TO BE PROTECTED
ITEM TO BE REMOVED
CURB/FENCE REMOVAL
CONCRETE PAVEMENT AND SIDEWALK REMOVAL
AREA OR ITEMS TO BE REMOVED
UTILITY REMOVAL
ABANDON UTILITY
ASPHALT REMOVAL
TREE REMOVAL
SAWCUT LINE

GENERAL DEMOLITION NOTES:

THESE NOTES APPLY TO ALL CONSTRUCTION ACTIVITIES ON THIS PROJECT:

- ALL MATERIAL TO BE REMOVED, WHETHER SPECIFICALLY NOTED IN THE PLANS OR NOT, SHALL BE REMOVED FROM THE SITE BY THE CONTRACTOR AND DISPOSED OF OFF-SITE IN A LEGAL MANNER. NO ON-SITE BURY OR BURN PITS SHALL BE ALLOWED.
- ALL DEMOLITION WORK SHALL CONFORM TO ALL LOCAL CODES AND ORDINANCES.
- STAGING/PHASING OF DEMOLITION AND CONSTRUCTION IS TO BE COORDINATED WITH THE OWNER AND THE CONTRACTOR PRIOR TO CONSTRUCTION.
- SPECIFIC DEMOLITION ITEMS HAVE BEEN INDICATED ON THE PLANS AS A GUIDE TO THE GENERAL SCOPE OF THE WORK. IT IS THE INTENT THAT THESE ITEMS SHALL BE COMPLETELY REMOVED BY THE CONTRACTOR ABOVE AND BELOW GROUND, UNLESS SPECIFICALLY NOTED OTHERWISE, AND THAT DEMOLITION WILL INCLUDE BUT WILL NOT NECESSARILY BE LIMITED TO THESE ITEMS. CONTRACTOR SHALL VISIT SITE TO VERIFY EXISTING CONDITIONS AND EXTENTS OF THE DEMOLITION THAT WILL BE REQUIRED PRIOR TO SUBMITTING A BID.
- REMOVE ALL STRUCTURES DESIGNATED FOR REMOVAL ACCORDING TO THE DEMOLITION PLAN. THIS INCLUDES FOUNDATIONS, FOOTINGS, CONCRETE, ASPHALT, TREES, ETC.
- THE CONTRACTOR SHALL, AS A MINIMUM, PROVIDE TREE PROTECTION FENCING AROUND EXISTING TREES TO BE SAVED THAT ARE WITHIN 15 FEET OF CONSTRUCTION ACTIVITIES AND AS INDICATED IN THE PLANS OR PER LOCAL AGENCY REQUIREMENTS.
- THE CONTRACTOR SHALL BE RESPONSIBLE FOR CLEAN UP, NOISE, DUST CONTROL, STREET SWEEPING AND HOURS OF OPERATION IN ACCORDANCE WITH THE LOCAL CODES.
- THE CONTRACTOR SHALL PROVIDE ALL NECESSARY BARRICADES, SIGNAGE, MARKINGS, LIGHTS AND OTHER TRAFFIC CONTROL DEVICES TO PROTECT THE WORK ZONE AND SAFELY MAINTAIN TRAFFIC PER AGENCY REQUIREMENTS AND IN ACCORDANCE WITH THE LATEST EDITION OF THE STATE MANUAL OF UNIFORM TRAFFIC CONTROL DEVICES.
- THE CONTRACTOR SHALL CONTACT THE APPROPRIATE UTILITY COMPANIES TO CONFIRM THAT UTILITY LEADS HAVE BEEN TAKEN OUT OF SERVICE PRIOR TO DEMOLITION.
- THE CONTRACTOR SHALL NOTIFY THE APPROPRIATE 811/ONE CALL UTILITY LOCATING CENTER, PRIVATE UTILITY LOCATOR, THE CITY ENGINEER AND/OR THE AUTHORITY HAVING JURISDICTION 3 BUSINESS DAYS PRIOR TO THE BEGINNING OF CONSTRUCTION.

PEA GROUP
t: 844.813.2949
www.peagroup.com

PROFESSIONAL ENGINEER
License No. 62010-6143
PEA GROUP, INC.

NORTH

0 15 30 60
SCALE: 1" = 30'

811 Know what's below. Call before you dig.

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CLIENT
TROY SCHOOLS
1140 RANKIN DRIVE
TROY, MI 48065

PROJECT TITLE
LEONARD ELEMENTARY SCHOOL
4401 TALLMAN DRIVE
TROY, MI

REVISIONS

ORIGINAL ISSUE DATE:
JANUARY 4, 2023

DRAWING TITLE
TOPOGRAPHIC SURVEY AND DEMOLITION PLAN

PEA JOB NO. 2022-1281


P.M.	RR
DN.	JJP
DES.	RR

DRAWING NUMBER:

C-1.3

PAVEMENT PREPARATION NOTES:

1. PAVEMENT PREPARATION SHALL FOLLOW THE PROCESS SUMMERIZED BELOW.
- 1.1. REMOVE AND STOCKPILE THE EXISTING AGGREGATE BASE FOR RE-USE IN THE PAVEMENT OPERATION. EXCAVATE THE EXISTING BASE UP TO 2-INCHES ABOVE THE SUBGRADE TO REDUCE THE CHANCE FOR CONTAMINATION. ALL AGGREGATE 2 INCHES AND LESS ABOVE THE SUBGRADE IS TO BE REMOVED AND HAULED OFF WITH NEW AGGREGATE BEING PLACED BACK TO THE EXISTING ELEVATION AS PART OF THE SUBGRADE UNDERCUTTING PAY ITEM.
- 1.2. PROOFROLL EXISTING BASE AND SUBGRADE PER PLANS, SPECS, AND GEOTECH REPORT.
- 1.3. DETERMINE AREAS THAT FAIL THE PROOFROLL. SUBGRADE UNDERCUTS SHALL BE EVALUATED BY A QUALIFIED ENGINEERING TECHNICIAN TO DETERMINE IF SUBGRADE STABILIZATION IS NECESSARY. DRAIN TILE SHALL BE PLACED WITHIN ANY UNDERCUT AREA AND CONNECTED TO THE CLOSEST CATCH BASIN TO PREVENT GROUNDWATER FROM POOLING WITHIN THE GRANULAR SOILS IN UNDERCUTS AND CREATING "BATHTUBS" IN THE COHESIVE SOILS.
- 1.4. TO MINIMIZE SUBGRADE INSTABILITY AND UNDERCUTS, THE SUBGRADE SHALL NOT BE LEFT EXPOSED TO PRECIPITATION AND CONSTRUCTION OPERATIONS AND SHOULD BE PERFORMED DURING THE SUMMER MONTHS TO ENSURE DRY, WARM, WEATHER. ADDITIONALLY, THE SUBGRADE MAY BECOME UNSTABLE UNDER REPEATED LOADING OF CONSTRUCTION TRAFFIC; THEREFORE, CONSTRUCTION EQUIPMENT SHOULD BE LIMITED ON THE EXPOSED SUBGRADE. BACKFILL THE INITIAL PORTION OF THE UNDERCUT WITH THE SALVAGED AGGREGATE BASE AND THEN COMPLETE THE BACKFILL PROCESS WITH IMPORTED MDOT 21AA CRUSHED LIMESTONE AGGREGATE PER THE PLANS, SPECS AND GEOTECH REPORT.
- 1.5. SUBGRADE UNDERCUT DRAIN TILE SHALL BE EVALUATED BY A QUALIFIED ENGINEERING TECHNICIAN TO DETERMINE IF SUBGRADE STABILIZATION IS NECESSARY. DRAIN TILE SHALL BE PLACED WITHIN ANY UNDERCUT AREA AND CONNECTED TO THE CLOSEST CATCH BASIN TO PREVENT GROUNDWATER FROM POOLING WITHIN THE GRANULAR SOILS IN UNDERCUTS AND CREATING "BATHTUBS" IN THE COHESIVE SOILS.
2. ALL ENGINEERED FILL SHALL BE COMPACTED TO A DENSITY OF AT LEAST 95 PERCENT OF THE MAXIMUM DENSITY DETERMINED BY THE MODIFIED PROCTOR (ASTM D1557) METHOD OF TESTING. ALL ENGINEERED FILL MATERIAL SHALL BE PLACED AND COMPACTED AT APPROXIMATELY THE OPTIMUM MOISTURE CONTENT. FROZEN MATERIAL SHALL NOT BE USED AS FILL, NOR SHOULD FILL BE PLACED ON A FROZEN SUBGRADE.
3. SUBGRADE UNDERCUT DRAIN TILE SHALL BE EVALUATED BY A QUALIFIED ENGINEERING TECHNICIAN TO DETERMINE IF SUBGRADE STABILIZATION IS NECESSARY. DRAIN TILE SHALL BE PLACED WITHIN ANY UNDERCUT AREA AND CONNECTED TO THE CLOSEST CATCH BASIN TO PREVENT GROUNDWATER FROM POOLING WITHIN THE GRANULAR SOILS IN UNDERCUTS AND CREATING "BATHTUBS" IN THE COHESIVE SOILS.
4. THE QUANTITY FOR SUBGRADE UNDERCUT DRAIN TILE (4") FOR EACH SITE SHALL BE INCLUDED IN THE BASE BID. THIS ITEM IS CONSIDERED AN ALLOWANCE AND FINAL PAYMENT WILL BE BASED ON THE ACTUAL FOOTAGE OF COMPACTED IN PLACE STONE PER THE UNIT PRICE PROVIDED IN THE BID PACKAGE.

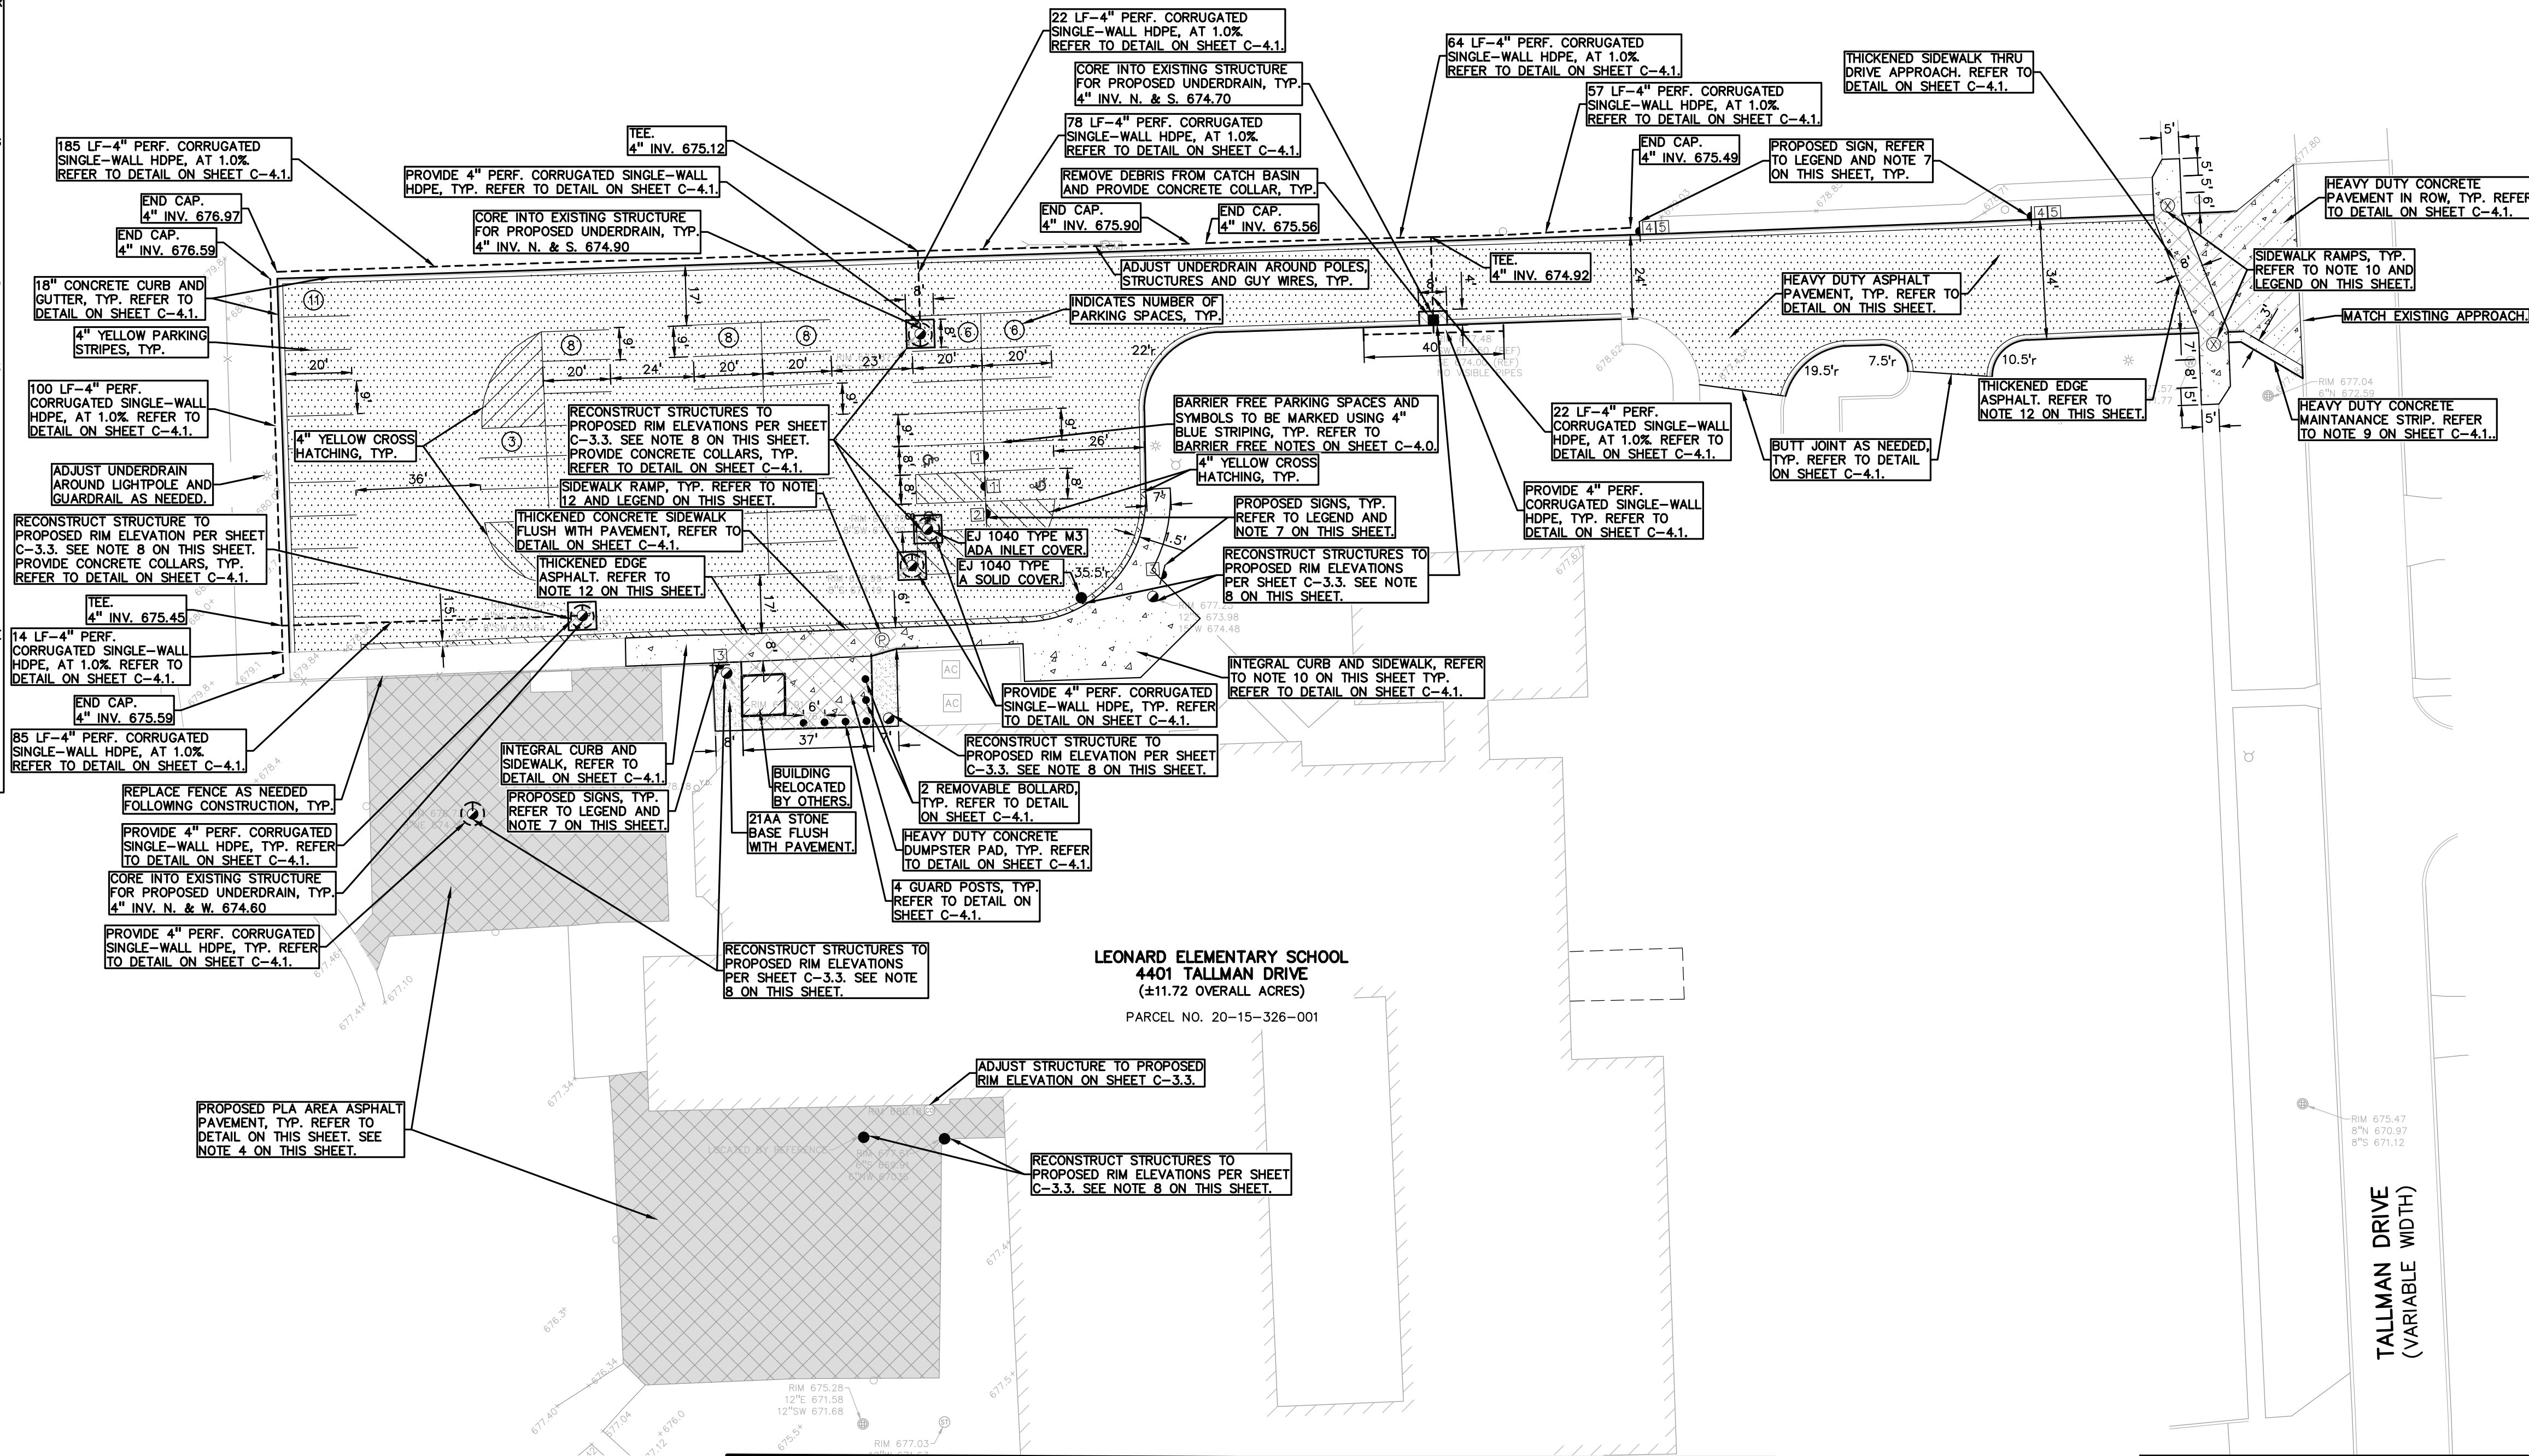

CONCRETE PAVEMENT

ASPHALT PAVEMENT

GRAVEL

WETLAND

CONCRETE CURB AND GUTTER

REVERSE GUTTER PAN

SETBACK LINE

SIGN

LIGHTPOLE

FENCE

GUARD RAIL

SIGN LEGEND:

1. BARRIER FREE PARKING' SIGN

2. 'VAN ACCESSIBLE' SIGN

3. 'BUS DROP OFF-NO PARKING' SIGN

4. 'YIELD' SIGN

5. 'NO PARKING STOPPING OR STANDING' SIGN

REFER TO DETAIL SHEET FOR SIGN DETAILS

SIDEWALK RAMP LEGEND:


1. SIDEWALK RAMP 'TYPE P'

2. SIDEWALK RAMP 'TYPE X'


REFER TO LATEST MDOT R-28 STANDARD RAMP AND DETECTABLE WARNING DETAILS

- NOTES:**
1. CONTRACTOR TO VERIFY ALL QUANTITIES SHOWN ON THE PLANS. ANY DEVIATIONS TO THE PLAN QUANTITIES SHALL BE BROUGHT TO THE ATTENTION OF THE SCHOOL DISTRICT AND PEA GROUP, IN WRITING PER THE BID PACKAGE, FOR VERIFICATION PRIOR TO BIDDING.
2. ALL DIMENSIONS SHOWN ARE TO BACK OF CURB, FACE OF SIDEWALK, CENTER OF MANHOLE/CATCH BASIN UNLESS OTHERWISE NOTED.
3. DOWEL INTO EXISTING CURB AND GUTTER 9" WITH EPOXY COATED #4 BAR CONTINUOUS BETWEEN EXISTING AND PROPOSED CURBING.
4. CONTRACTOR TO REPLACE PLAYSCAPE AREA STRIPING IN KIND IN REGARDS TO LAYOUT, WIDTH, COLOR (TYP.) (2 COATS).
5. REFER TO NOTES AND DETAIL SHEET FOR ON SITE PAVING DETAILS.
6. CONTRACTOR TO FIELD VERIFY ALL UNDERGROUND UTILITIES PRIOR TO CONSTRUCTION INCLUDING BUT NOT LIMITED TO: SITE LIGHTING, FIBER LINES, ETC.
7. CONTRACTOR TO REMOVE AND REPLACE SIGNS AND POSTS PER DETAIL ON SHEET C-4.0. ALL SIGNS AND ANY POSTS IN GOOD CONDITION SHALL BE RETURNED TO THE OWNER. ALL POSTS DAMAGED OR OTHERWISE NOT IN A USABLE CONDITION SHALL BE DISPOSED OF AT NO ADDITIONAL COST TO THE OWNER.
8. FOR THE EIGHT (8) CATCH BASINS, ONE (1) STORM MANHOLE AND ONE (1) SANITARY MANHOLE LOCATED IN THE WORK AREA, BIDDERS ARE TO INCLUDE RECONSTRUCTION OF THESE STRUCTURES (GREATER THAN 12-INCHES IN DEPTH FROM THE RIM ELEVATION OF REPAIR WORK) IN THE BASE BID. THE SUCCESSFUL BIDDER WILL BE PAID FOR REPAIRING EACH STRUCTURE BASED ON THE ACTUAL DEPTH OF REPAIR WITH EITHER STRUCTURAL ADJUSTMENT (WITHIN TOP 12-INCHES OF RIM ELEVATION) OR STRUCTURAL RECONSTRUCTION (GREATER THAN 12-INCHES IN DEPTH) PER THE UNIT PRICES PROVIDED IN THE BID PACKAGE AND THE SCOPE OF WORK DETERMINED AND APPROVED PRIOR TO THE WORK COMMENCING. REPLASTERING OF THE ENTIRE STRUCTURE SHALL BE INCLUDED IN THE UNIT PRICE FOR BOTH STRUCTURAL ADJUSTMENT AND STRUCTURAL RECONSTRUCTION.
9. FOR 3' MAINTENANCE STRIP: 3" HOOK BOLTS TO BE INSTALLED INTO DRIVE AT 40" OFFCENTER. AN EXPANSION JOINT SHALL BE USED WHEN STRIP ABUTS CURBING.
10. CONTRACTOR TO REMOVE SIDEWALK AS NECESSARY AT BUILDING ENTRANCE TO PROVIDE PROPER DRAINAGE AWAY FROM BUILDING. SIDEWALK TO BE FLUSH WITH ASPHALT AS SHOWN ON SHEET C-3.3. SIDEWALK SHALL BE RECONSTRUCTED TO PROVIDE A CONTINUAL CURVE.
11. ALL PROPOSED ADA RAMPS SHALL HAVE TRUNCATED DOMES. PLASTIC OR METAL STYLE DOMES ARE BOTH ACCEPTABLE.
12. A THICKENED EDGE OF ASPHALT PER THE DETAIL ON SHEET C-4.1. OF THE PLANS SHALL BE LOCATED WHERE CALLED FOR IN THE PLAN. BIDDERS SHALL INCREASE THE QUANTITIES FOR THIS ITEM ACCORDINGLY IN THE BASE BID.

PAVING QUANTITIES:	
18" CONCRETE CURB AND GUTTER	955 LF
4" CONCRETE SIDEWALK	1,867 SF
THICKENED SIDEWALK AT APPROACH	180 SF
4" ASPHALT PLAY AREA	13,659 SF
5" ASPHALT PAVEMENT	33,708 SF
AGGREGATE BASE PREPARATION	47,367 SF
GRAVEL	305 SF
BUTT JOINT	79 LF
HEAVY DUTY CONCRETE PAVEMENT	573 SF
HEAVY DUTY CONCRETE DUMPSTER PAD	741 SF
ASPHALT AS SHOWN ON SHEET C-3.3	4 EA
REMOVEABLE GUARD POSTS	2 EA
CONCRETE COLLAR	5 EA
SIGN AND POST	7 EA
SUBGRADE UNDERCUT ALLOWANCE	
SUBGRADE UNDERCUT	450 CYD
DRAIN TILE (4") ALLOWANCE	400 LF
ENGINEERING QUANTITIES:	
ADJUST/RECONSTRUCT STORM STRUCTURE	11 EA
4" HDPE PERF. UNDERDRAIN	624 LF

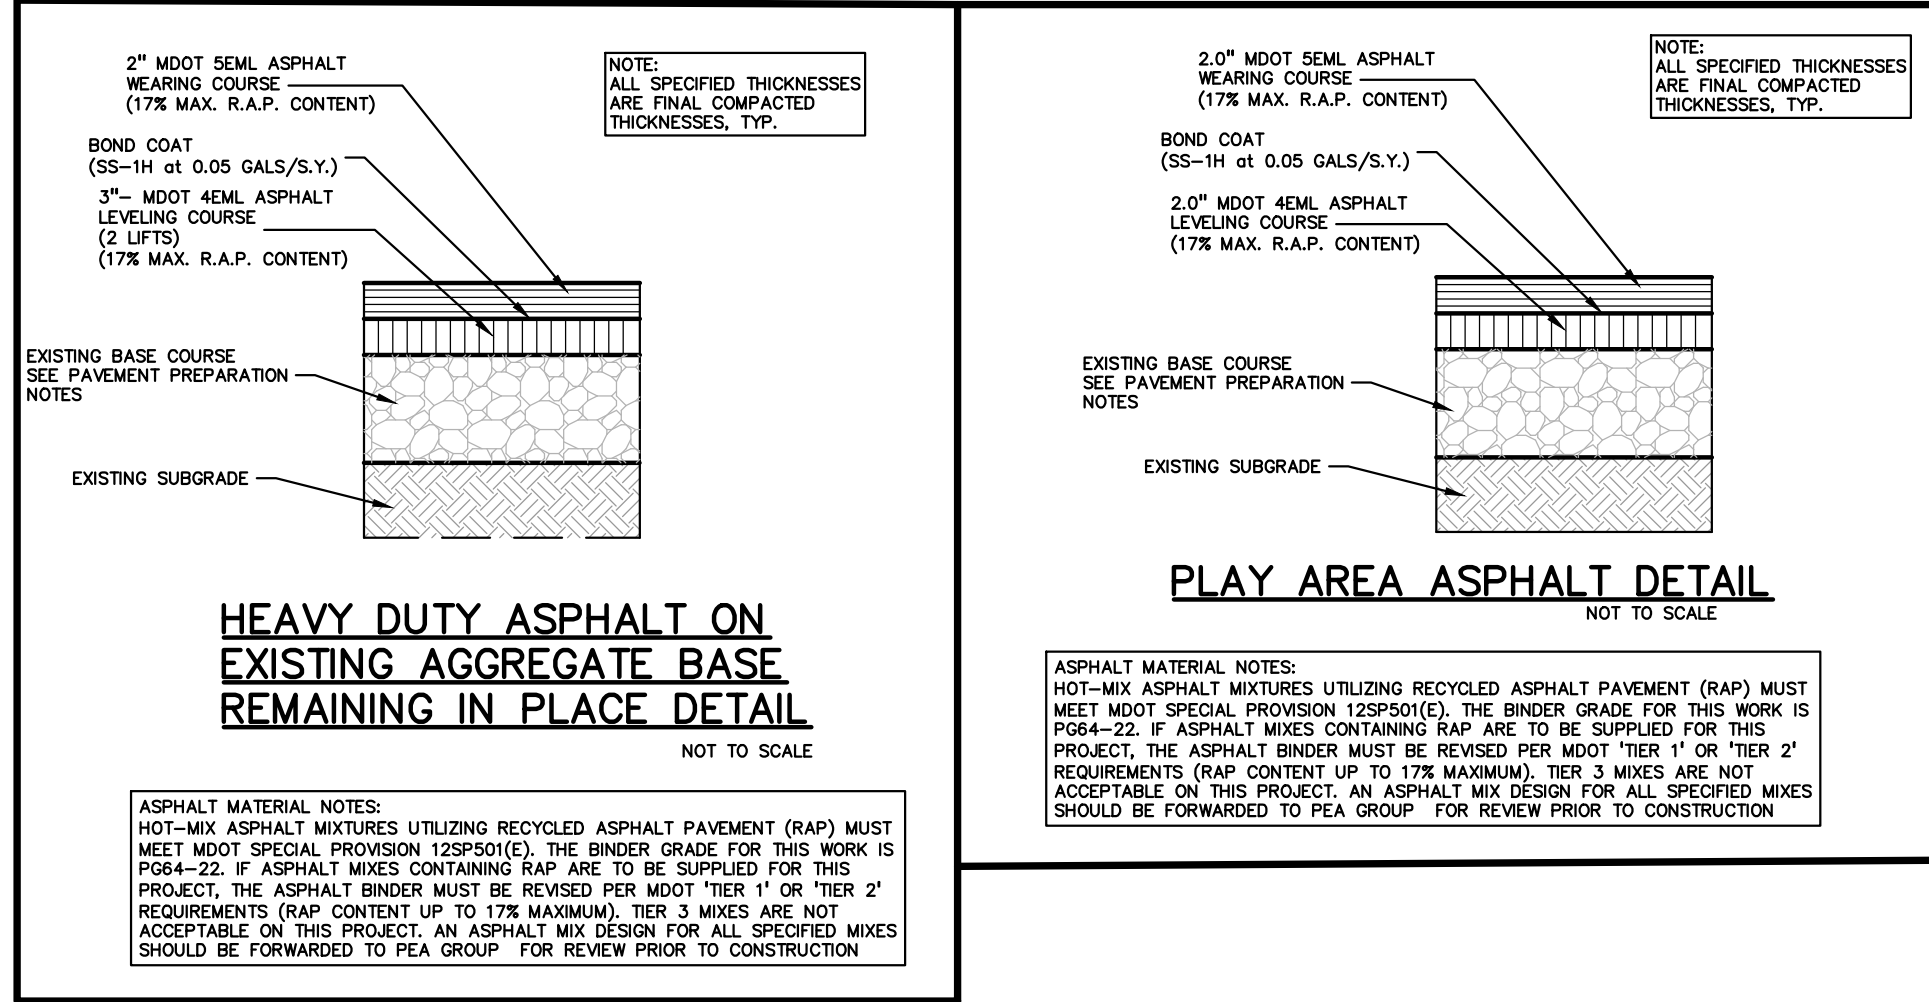

FLOODPLAIN NOTE:
BY GRAPHICAL PLOTTING, SITE IS WITHIN ZONE 'X'. AN AREA DETERMINED TO BE OUTSIDE OF THE 0.2% ANNUAL CHANCE FLOODPLAIN, PER FLOOD INSURANCE RATE MAP NUMBER 26125C0553G, DATED JANUARY 16, 2009.

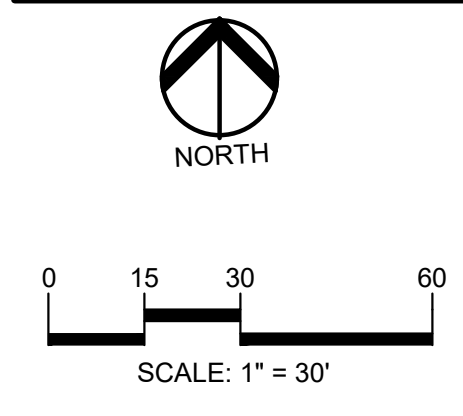

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CLIENT
TROY SCHOOLS
1140 RANKIN DRIVE
TROY, MI 48063

PROJECT TITLE
LEONARD ELEMENTARY SCHOOL
4401 TALLMAN DRIVE
TROY, MI

REVISIONS

ORIGINAL ISSUE DATE:
JANUARY 4, 2023

DRAWING TITLE
PAVING AND DIMENSION PLAN

PEA JOB NO.	2022-1281
P.M.	RR
DN.	JJP
DES.	RR
DRAWING NUMBER:	

C-2.3



0 10 20 40
SCALE: 1" = 20'



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CLIENT
TROY SCHOOLS
1140 RANKIN DRIVE
TROY, MI 48063

PROJECT TITLE
LEONARD ELEMENTARY SCHOOL
4401 TALLMAN DRIVE
TROY, MI

REVISIONS	

ORIGINAL ISSUE DATE:
JANUARY 4, 2023

DRAWING TITLE
**GRADING AND
SESC PLAN**

PEA JOB NO. 2022-1281


P.M. RR

DN. JJP

DES. RR

DRAWING NUMBER:

C-3.3

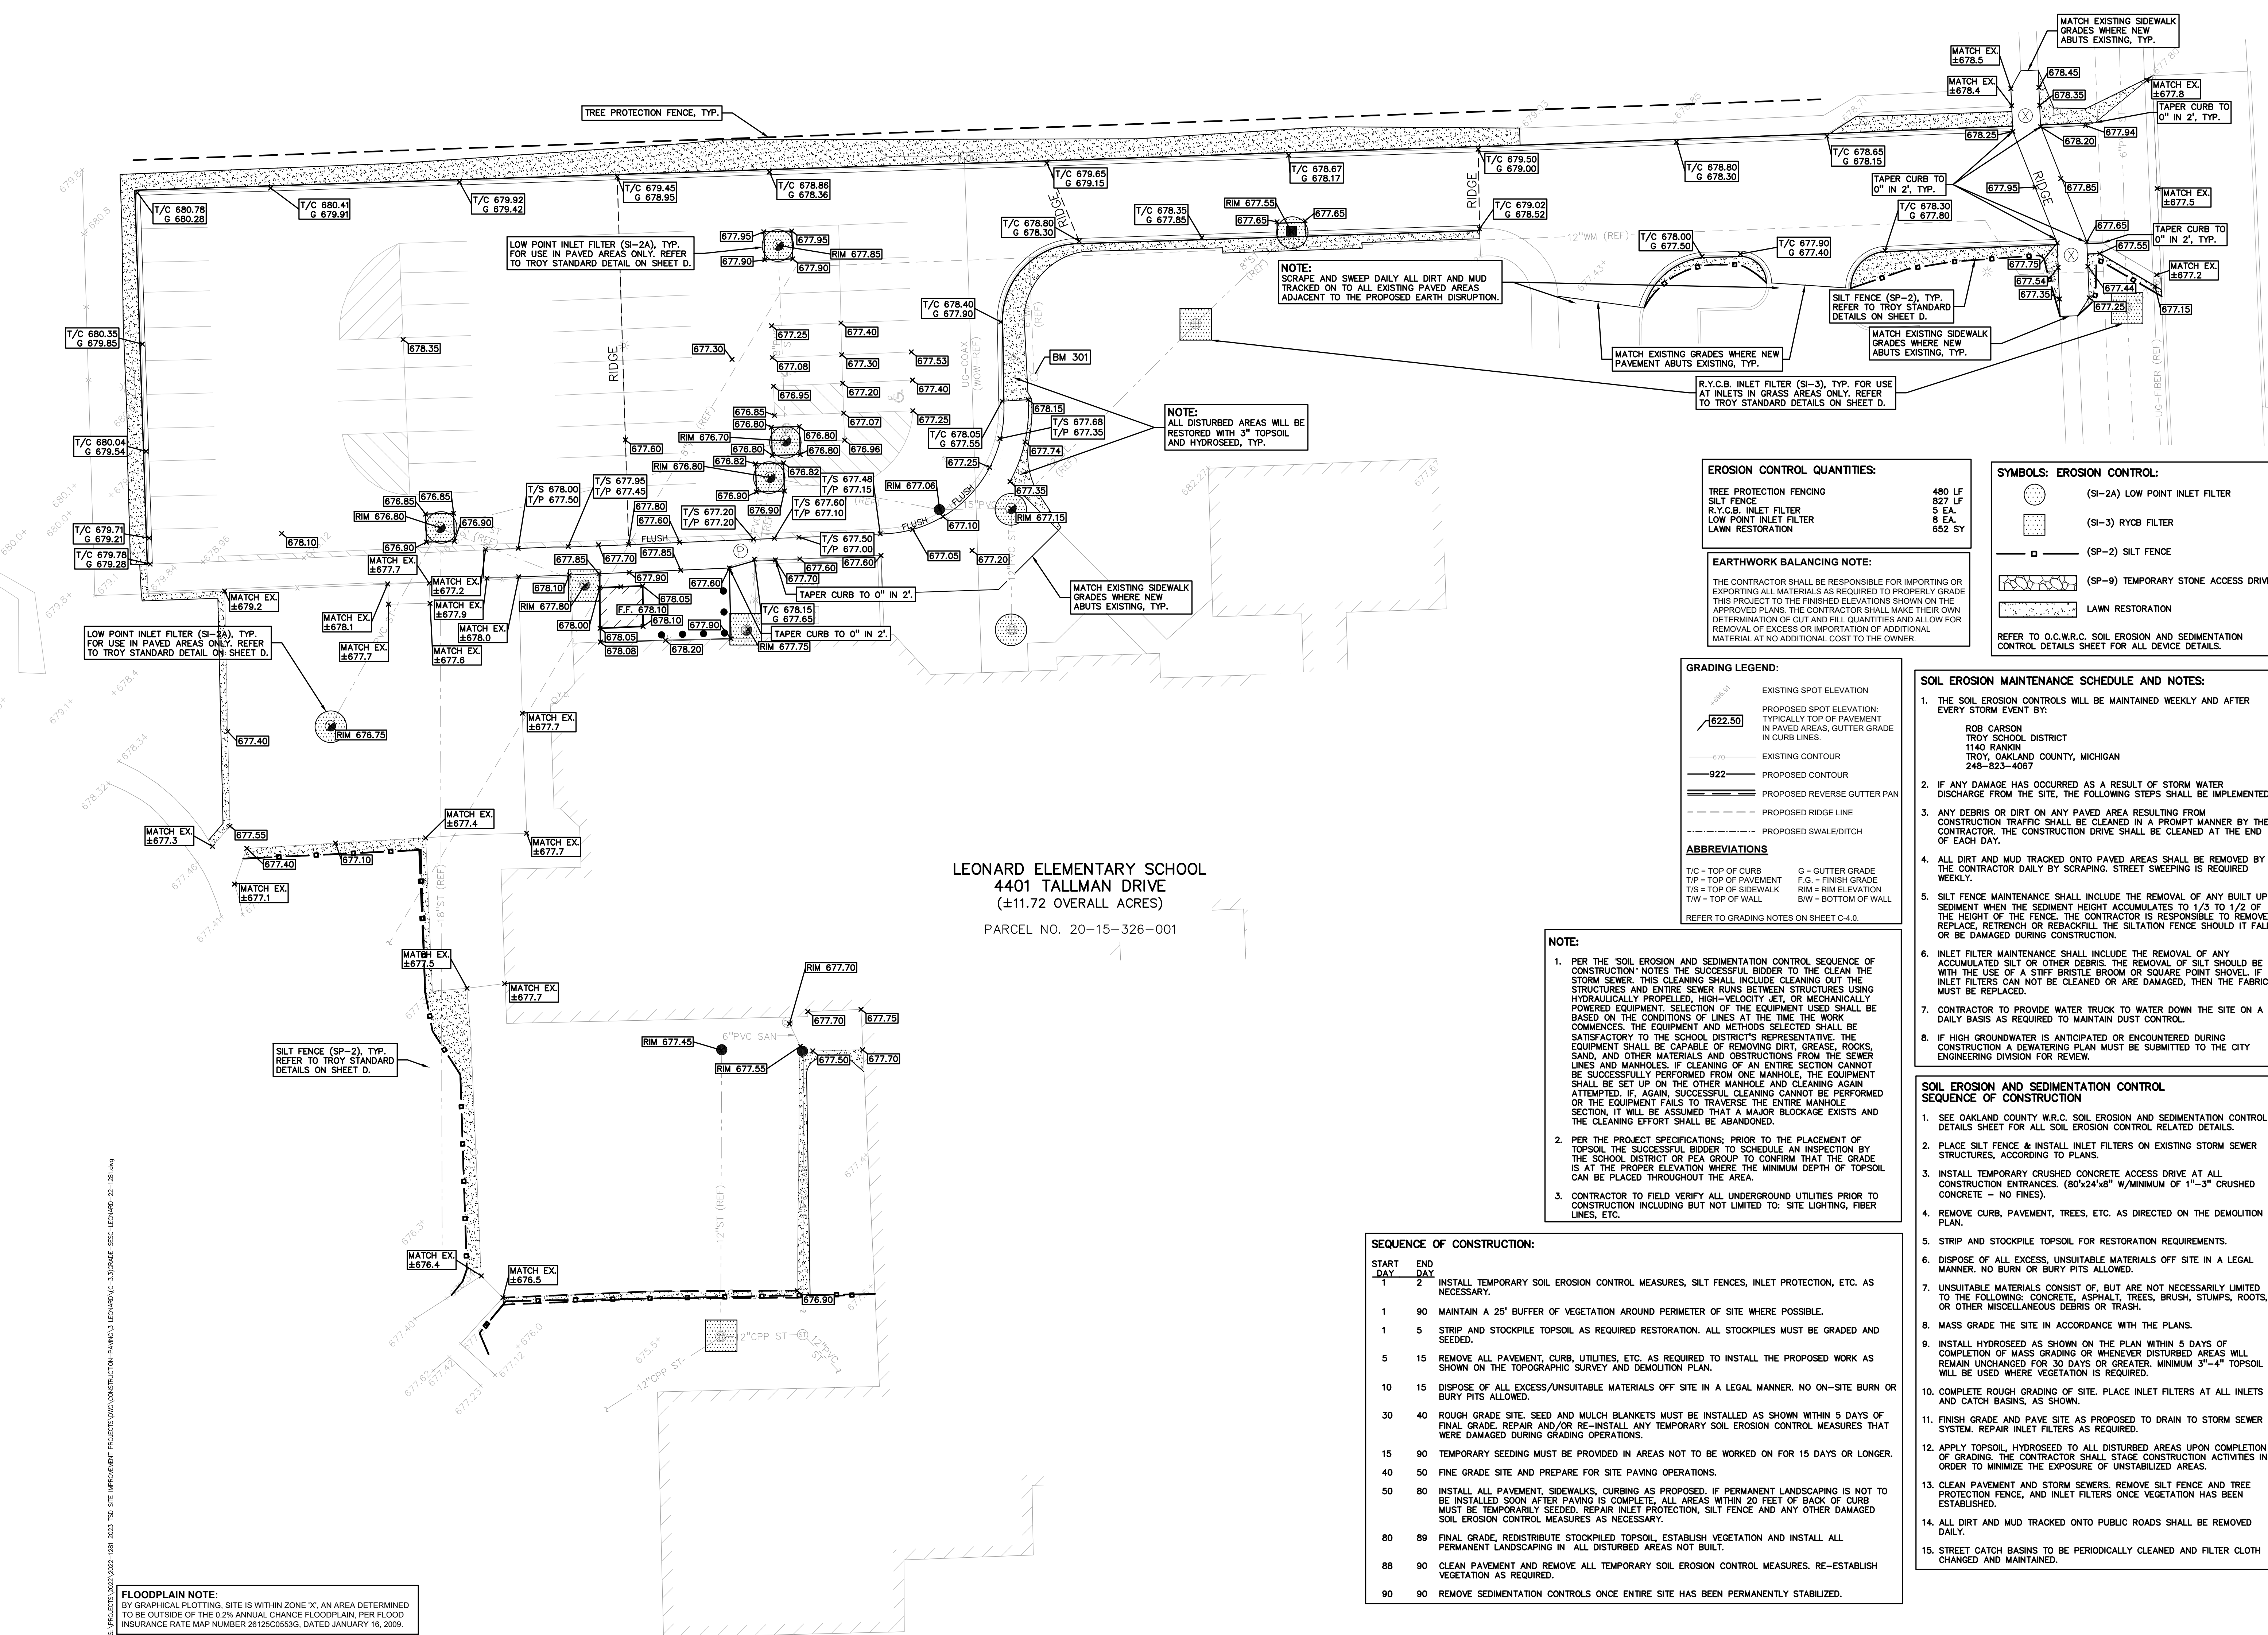



NORTH



CAUTION!!!

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CLIENT

1140 RANKIN DRIVE
TROY, MI 48063

PROJECT TITLE

2340 WILLARD DRIVE, TROY, MI 48064

REVISIONS

ORIGINAL ISSUE DATE:
JANUARY 4, 2023

DRAWING TITLE

PAVING AND DIMENSION PLAN

PEA JOB NO. 2022-1281

P.M. RF

DN. JJP

DES.	RF
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






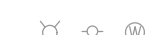















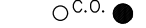



DRAWING NUMBER

C-2.4

SUBGRADE UNDERCUTTING NOTES:

1. TO MINIMIZE SUBGRADE INSTABILITY AND UNDERCUTS, THE SUBGRADE SHALL NOT BE LEFT EXPOSED TO PRECIPITATION AND CONSTRUCTION EQUIPMENT SHOULD BE PERFORMED DURING THE SUMMER MONTHS TO ENSURE DRY, WARM, WEATHER. ADDITIONALLY, THE SUBGRADE MAY BE STABILIZED WITH A COURSE OF LAYERS OF CONSTRUCTION TRAFFIC. THEREFORE, CONSTRUCTION EQUIPMENT SHOULD BE LIMITED ON THE EXPOSED SUBGRADE.
2. UNDERCUT EXCAVATIONS SHALL BE BACKFILLED WITH MDOT 21A DENSE GRADED AGGREGATE PLACED IN AN ENGINEERED MANNER. LIFT THICKNESS SHALL NOT EXCEED 10" AND THE USE OF TRI-AXIAL GEOTRID MAY BE USED TO REDUCE UNDERCUT DEPTHS, AS APPROVED BY THE DISTRICT ENGINEER. THE UNIT PRICE PROVIDED WITH THE CONTRACTORS BID.
3. THE QUANTITY FOR SUBGRADE UNDERCUT DRAIN TIE (A) FOR EACH SITE SHALL BE INCLUDED IN THE BASE BID. THIS ITEM IS CONSIDERED AN ALLOWANCE AND FINAL PAYMENT WILL BE BASED ON THE ACTUAL FOOTAGE OF COMPACTED IN PLACE STONE FOR THE UNIT PRICE PROVIDED IN THE BID PACKAGE.
4. ALL ENGINEERED FILL SHALL BE COMPACTED TO A DENSITY OF AT LEAST 95 PERCENT OF THE MAXIMUM DENSITY DETERMINED BY THE MODIFIED PROCTOR (ASTM D1557) METHOD OF TESTING. ALL ENGINEERED FILL SHALL BE PLACED IN LIFTS AND COMPAKED AT APPROXIMATELY THE OPTIMUM MOISTURE CONTENT. FROZEN MATERIAL SHALL NOT BE USED AS FILL, NOR SHOULD FILL BE PLACED ON A FROZEN SUBGRADE.
5. SUBGRADE UNDERCUTS SHALL BE EVALUATED BY A QUALIFIED ENGINEERING TECHNICIAN TO DETERMINE IF PREVENTIVE STABILIZATION IS NECESSARY. DRAIN TIE SHALL BE PLACED WITHIN ANY UNDERCUT AREA AND CONNECTED TO THE CLOSEST CATCH BASIN TO PREVENT FLOODING FROM FLOWING WITHIN THE GRANULAR LAYERS OF UNDERCUTS, AND CREATING "BATHTUBS" IN THE COHESIVE SOILS.

UTILITY LEGEND:

	EX. OH. ELEC. POLE & GUY WIRE
	EX. U.G. CABLE TV & PEDESTAL
	EX. U.G. COMMUNICATION LINE, PEDESTAL & MANHOLE
	EX. U.G. ELEC. MANHOLE, METER & HANDHOLE
	EX. GAS LINE
	EX. GAS VALVE & GAS LINE MARKER
	EX. TRANSFORMER & IRRIGATION VALVE
	EX. WATER MAIN
	EX. HYDRANT, GATE VALVE & POST INDICATOR VALVE
	EX. WATER VALVE BOX & SHUTOFF
	EX. SANITARY SEWER
	EX. SANITARY SEWER & MANHOLE
	EX. COMBINED SEWER & MANHOLE
	EX. STORM SEWER
	EX. CLEANOUT & MANHOLE
	EX. SQUARE, ROUND, & BEEHIVE CATCH BASIN
	EX. YARD DRAIN & ROOF DRAIN
	EX. UNIDENTIFIED STRUCTURE
	PROPOSED WATER MAIN
	PROPOSED HYDRANT AND GATE VALVE
	PROPOSED TAPPING SLEEVE, VALVE & WELL
	PROPOSED POST INDICATOR VALVE
	PROPOSED SANITARY SEWER
	PROPOSED SANITARY CLEANOUT & MANHOLE
	PROPOSED STORM SEWER
	PROPOSED STORM SEWER CLEANOUT & MANHOLE
	PROPOSED CATCH BASIN, INLET & YARD DRAIN

The diagram illustrates various road markings and their corresponding labels:

- CONCRETE PAVEMENT**:
 - STD DUTY: A series of parallel diagonal lines.
 - HEAVY DUTY: A series of parallel diagonal lines with a central dashed line.
 - R.O.W. ONLY: A series of parallel diagonal lines with a central dashed line and a solid line on the outer edge.
- ASPHALT PAVEMENT**:
 - STD DUTY: A series of parallel diagonal lines.
 - PLAY SCAPE: A series of parallel diagonal lines with a central dashed line and a solid line on the outer edge.
 - HEAVY DUTY: A series of parallel diagonal lines with a central dashed line and a solid line on the outer edge.
- GRAVEL**: A series of parallel diagonal lines with a central dashed line and a solid line on the outer edge.
- WETLAND**: A series of parallel diagonal lines with a central dashed line and a solid line on the outer edge.
- CONCRETE CURB AND GUTTER**: A series of parallel diagonal lines with a central dashed line and a solid line on the outer edge.
- REVERSE GUTTER PAN**: A series of parallel diagonal lines with a central dashed line and a solid line on the outer edge.
- SETBACK LINE**: A series of parallel diagonal lines with a central dashed line and a solid line on the outer edge.
- SIGN LIGHTPOLE**: A series of parallel diagonal lines with a central dashed line and a solid line on the outer edge.
- FENCE**: A series of parallel diagonal lines with a central dashed line and a solid line on the outer edge.
- GUARD RAIL**: A series of parallel diagonal lines with a central dashed line and a solid line on the outer edge.

NOTES:

1. CONTRACTOR TO VERIFY ALL QUANTITIES SHOWN ON THE PLANS. ANY DEVIATIONS TO THE PLAN QUANTITIES SHALL BE SUBMITTED TO THE BOARD OF THE SCHOOL DISTRICT AND PEA GROUP, IN WRITING PER THE BID PACKAGE, FOR VERIFICATION PRIOR TO BIDDING.
2. CONTRACTOR TO REPLACE PLAYSCAPE AREA STRIPING IN KIND IN REGARDS TO LAYOUT, WIDTH, COLOR (TYP.) (2 COATS).
3. THE QUANTITY FOR SUBGRADE UNDERCUT FOR EACH SITE SHALL BE INCLUDED IN THE BASE BID. THIS QUANTITY SHALL BE ALLOWANCE AND FINAL PAYMENT WILL BE BASED ON THE ACTUAL VOLUME OF COMPACTED IN PLACE STONE PER THE UNIT PRICE PROVIDED IN THE BID PACKAGE.
4. CONTRACTOR TO FIELD VERIFY ALL UNDERGROUND UTILITIES PRIOR TO CONSTRUCTION INCLUDING, BUT NOT LIMITED TO: SITE LIGHTING, FIBER LINES, ETC

PAVING QUANTITIES:

3" ASPHALT PLAY AREA	12,686 SF
6" 21AA AGGREGATE	12,686 SF
SUBGRADE UNDERCUT ALLOWANCE	75 CYD
SUBGRADE UNDERCUT	
DRAIN TILE (4") ALLOWANCE	300 LF
ENGINEERING QUANTITIES:	
4' CATCH BASIN	2 EA
8" PVC SDR 26	40 LF

FLOODPLAIN NOTE:
BY GRAPHICAL PLOTTING, SITE IS WITHIN ZONE 'X', AN AREA DETERMINED TO BE OUTSIDE OF THE 0.2% ANNUAL CHANCE FLOODPLAIN, PER FLOOD INSURANCE RATE MAP NUMBER 26125C0553G, DATED JANUARY 16, 2009.

EARTHWORK BALANCING NOTE:

THE CONTRACTOR SHALL BE RESPONSIBLE FOR IMPORTING OR EXPORTING ALL MATERIALS AS REQUIRED TO PROPERLY GRADE THIS PROJECT TO THE FINISHED ELEVATIONS SHOWN ON THE APPROVED PLANS. THE CONTRACTOR SHALL MAKE THEIR OWN DETERMINATION OF CUT AND FILL QUANTITIES AND ALLOW FOR REMOVAL OF EXCESS OR IMPORTATION OF ADDITIONAL MATERIAL AT NO ADDITIONAL COST TO THE OWNER.

SOIL EROSION AND SEDIMENTATION CONTROL SEQUENCE OF CONSTRUCTION


1. SEE OAKLAND COUNTY W.R.C. SOIL EROSION AND SEDIMENTATION CONTROL DETAILS SHEET FOR ALL SOIL EROSION CONTROL RELATED DETAILS.
2. PLACE SILT FENCE & INSTALL INLET FILTERS ON EXISTING STORM SEWER STRUCTURES, ACCORDING TO PLANS.
3. INSTALL TEMPORARY CRUSHED CONCRETE ACCESS DRIVE AT ALL CONSTRUCTION ENTRANCES. (80'x24'x8" W/MINIMUM OF 1"-3" CRUSHED CONCRETE - NO FINES).
4. REMOVE CURB, PAVEMENT, TREES, ETC. AS DIRECTED ON THE DEMOLITION PLAN.
5. STRIP AND STOCKPILE TOPSOIL FOR RESTORATION REQUIREMENTS.
6. DISPOSE OF ALL EXCESS, UNSUITABLE MATERIALS OFF SITE IN A LEGAL MANNER. NO BURN OR BURY PITS ALLOWED.
7. UNSUITABLE MATERIALS CONSIST OF, BUT ARE NOT NECESSARILY LIMITED TO THE FOLLOWING: CONCRETE, ASPHALT, TREES, BRUSH, STUMPS, ROOTS, OR OTHER MISCELLANEOUS DEBRIS OR TRASH.
8. MASS GRADE THE SITE IN ACCORDANCE WITH THE PLANS.
9. INSTALL HYDROSEED AS SHOWN ON THE PLAN WITHIN 5 DAYS OF COMPLETION OF MASS GRADING OR WHENEVER DISTURBED AREAS WILL REMAIN UNCHANGED FOR 30 DAYS OR GREATER. MINIMUM 3"-4" TOPSOIL WILL BE USED WHERE VEGETATION IS REQUIRED.
10. COMPLETE ROUGH GRADING OF SITE. PLACE INLET FILTERS AT ALL INLETS AND CATCH BASINS, AS SHOWN.
11. FINISH GRADE AND PAVE SITE AS PROPOSED TO DRAIN TO STORM SEWER SYSTEM. REPAIR INLET FILTERS AS REQUIRED.
12. APPLY TOPSOIL, HYDROSEED TO ALL DISTURBED AREAS UPON COMPLETION OF GRADING. THE CONTRACTOR SHALL STAGE CONSTRUCTION ACTIVITIES IN ORDER TO MINIMIZE THE EXPOSURE OF UNSTABILIZED AREAS.
13. CLEAN PAVEMENT AND STORM SEWERS. REMOVE SILT FENCE AND TREE PROTECTION FENCE, AND INLET FILTERS ONCE VEGETATION HAS BEEN ESTABLISHED.
14. ALL DIRT AND MUD TRACKED ONTO PUBLIC ROADS SHALL BE REMOVED DAILY.
15. STREET CATCH BASINS TO BE PERIODICALLY CLEANED AND FILTER CLOTH CHANGED AND MAINTAINED.

SOIL EROSION MAINTENANCE SCHEDULE AND NOTES:

1. THE SOIL EROSION CONTROLS WILL BE MAINTAINED WEEKLY AND AFTER EVERY STORM EVENT BY:
ROB CARSON
TROY SCHOOL DISTRICT
1140 RANKIN
TROY, OAKLAND COUNTY, MICHIGAN
248-823-4067
2. IF ANY DAMAGE HAS OCCURRED AS A RESULT OF STORM WATER DISCHARGE FROM THE SITE, THE FOLLOWING STEPS SHALL BE IMPLEMENTED.
3. ANY DEBRIS OR DIRT ON ANY PAVED AREA RESULTING FROM CONSTRUCTION TRAFFIC SHALL BE CLEANED IN A PROMPT MANNER BY THE CONTRACTOR. THE CONSTRUCTION DRIVE SHALL BE CLEANED AT THE END OF EACH DAY.
4. ALL DIRT AND MUD TRACKED ONTO PAVED AREAS SHALL BE REMOVED BY THE CONTRACTOR DAILY BY SCRAPING. STREET SWEEPING IS REQUIRED WEEKLY.
5. SILT FENCE MAINTENANCE SHALL INCLUDE THE REMOVAL OF ANY BUILT UP SEDIMENT WHEN THE SEDIMENT HEIGHT ACCUMULATES TO 1/3 TO 1/2 OF THE HEIGHT OF THE FENCE. THE CONTRACTOR IS RESPONSIBLE TO REMOVE, REPLACE, RETRENCH OR REBACKFILL THE SILTATION FENCE SHOULD IT FALL OR BE DAMAGED DURING CONSTRUCTION.
6. INLET FILTER MAINTENANCE SHALL INCLUDE THE REMOVAL OF ANY ACCUMULATED SILT OR OTHER DEBRIS. THE REMOVAL OF SILT SHOULD BE WITH THE USE OF A STIFF BRISTLE BROOM OR SQUARE POINT SHOVEL. IF INLET FILTERS CAN NOT BE CLEANED OR ARE DAMAGED, THEN THE FABRIC MUST BE REPLACED.
7. CONTRACTOR TO PROVIDE WATER TRUCK TO WATER DOWN THE SITE ON A DAILY BASIS AS REQUIRED TO MAINTAIN DUST CONTROL.
8. IF HIGH GROUNDWATER IS ANTICIPATED OR ENCOUNTERED DURING CONSTRUCTION A DEWATERING PLAN MUST BE SUBMITTED TO THE CITY ENGINEERING DIVISION FOR REVIEW.

FLOODPLAIN NOTE:

BY GRAPHICAL PLOTTING, SITE IS WITHIN ZONE "X". AN AREA DETERMINED TO BE OUTSIDE OF THE 0.2% ANNUAL CHANCE FLOODPLAIN, PER FLOOD INSURANCE RATE MAP NUMBER 26125C01553G, DATED JANUARY 16, 2009.

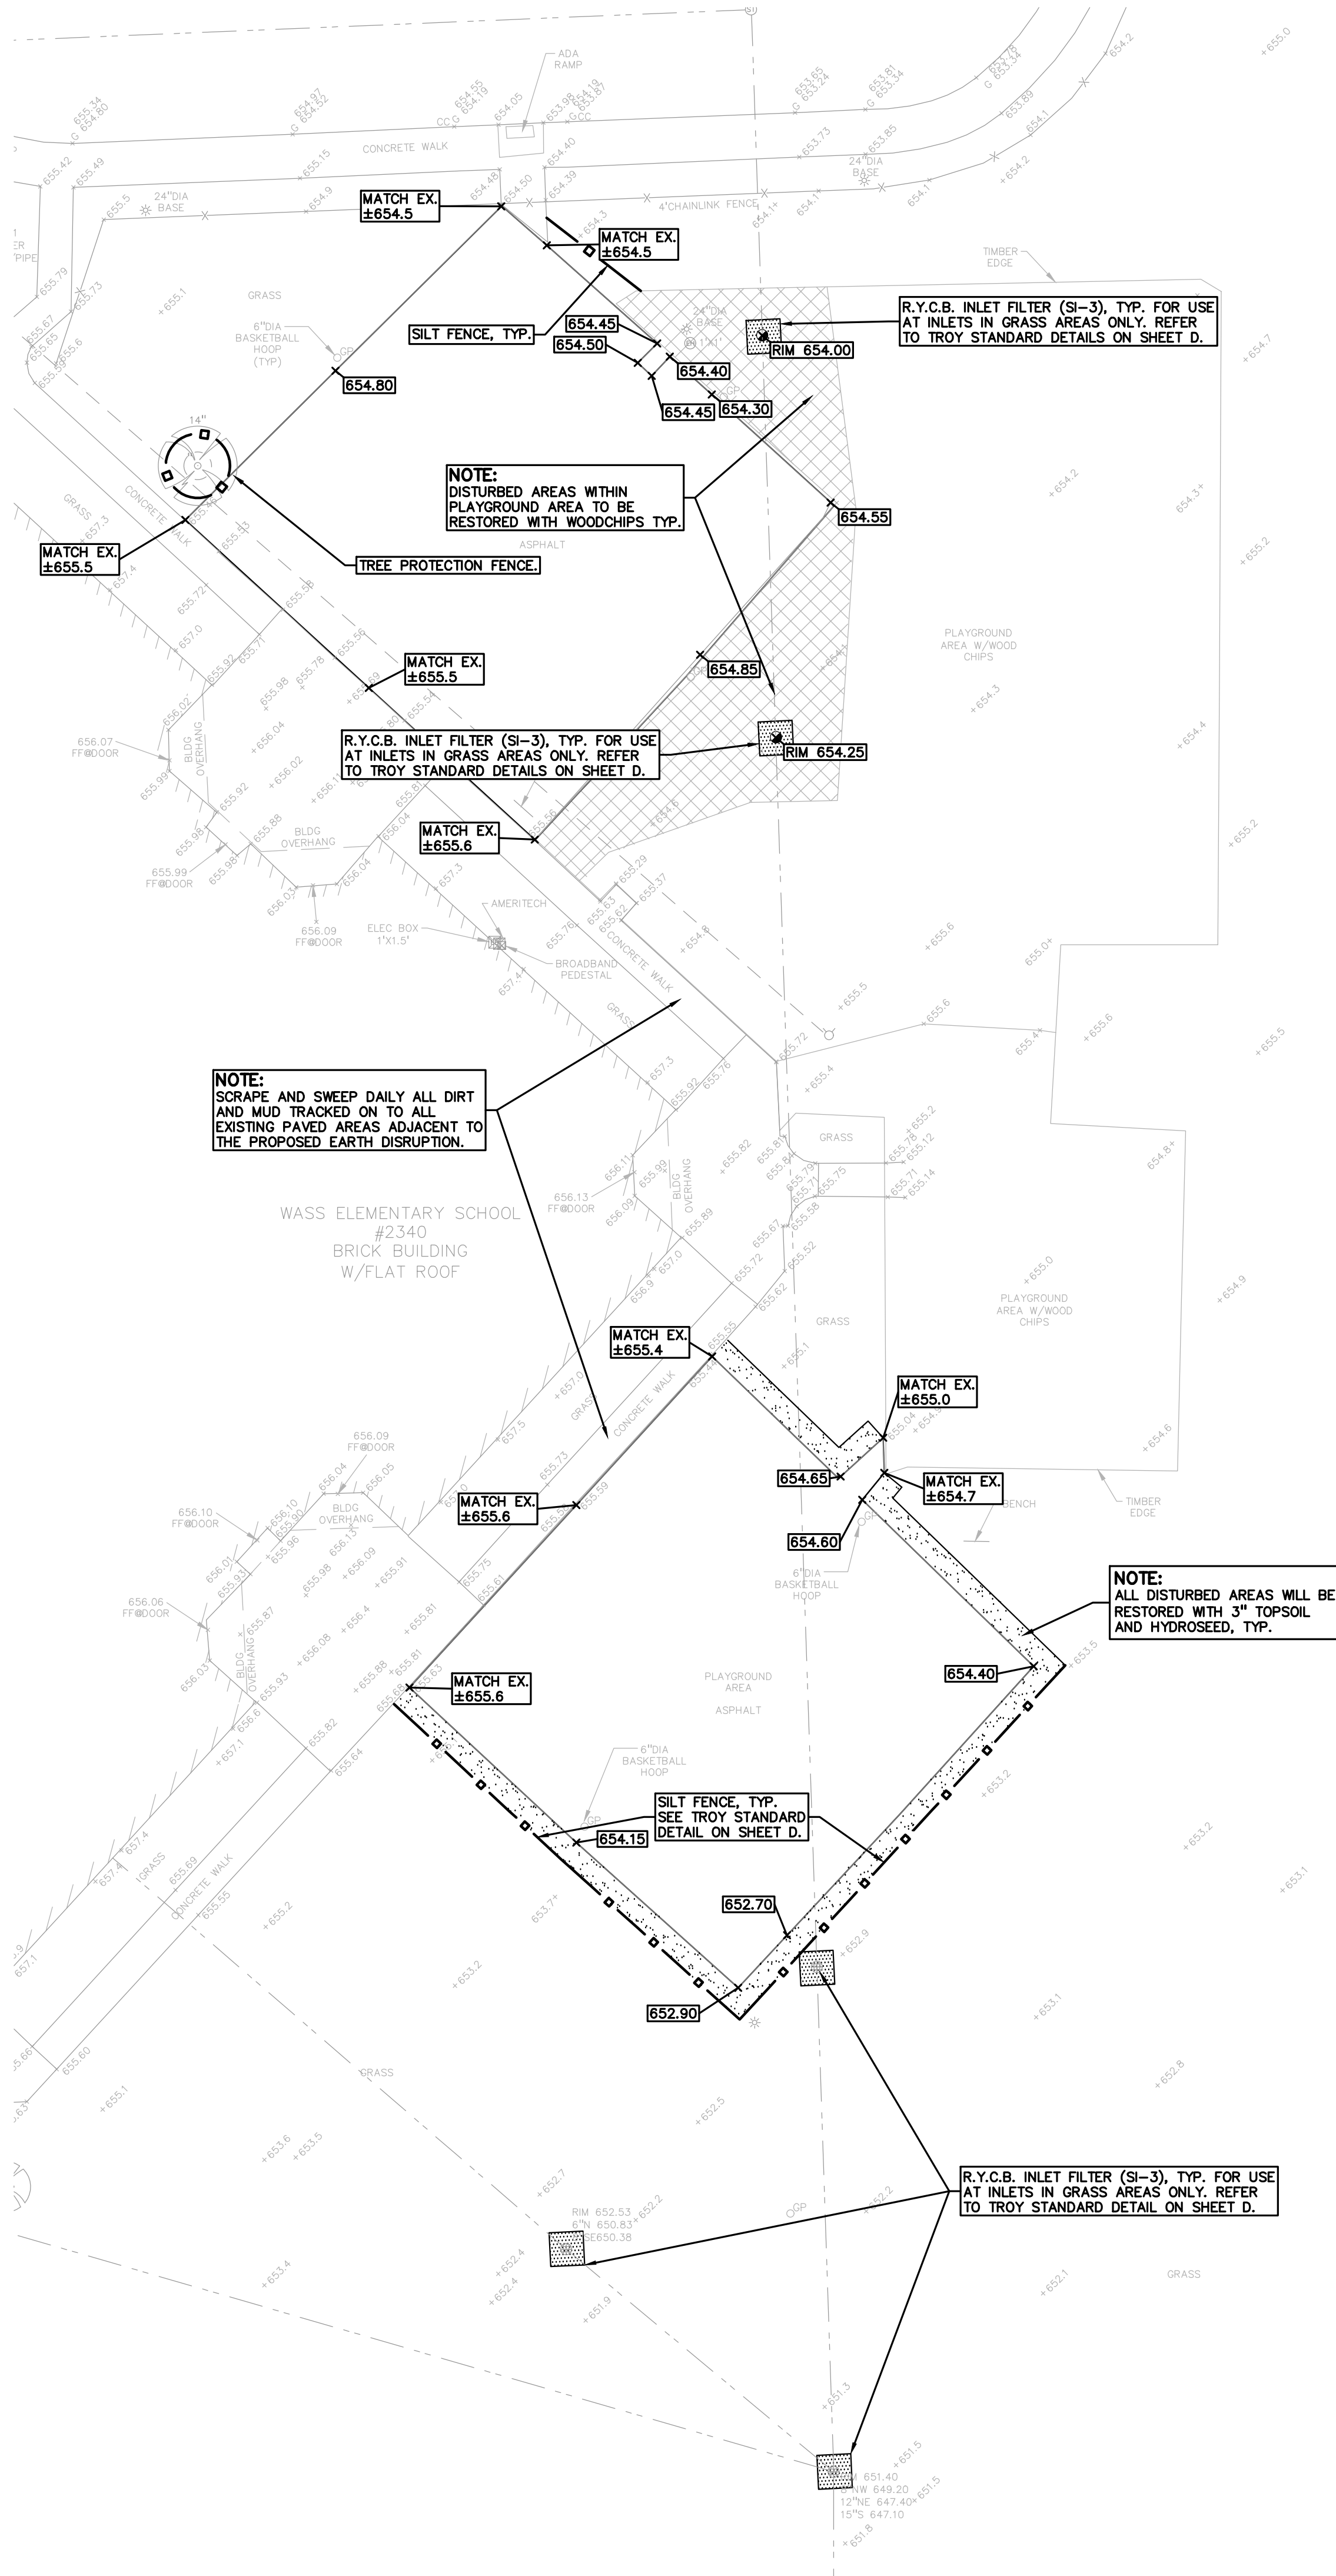

SYMBOLS: EROSION CONTROL:

- (SI-2A) LOW POINT INLET FILTER
- (SI-3) RYCB FILTER
- (SP-2) SILT FENCE
- AREA OF REGRADING
- LAWN RESTORATION

REFER TO O.C.W.R.C. SOIL EROSION AND SEDIMENTATION CONTROL DETAILS SHEET FOR ALL DEVICE DETAILS.

GRADING LEGEND:

- EXISTING SPOT ELEVATION
- PROPOSED SPOT ELEVATION: TYPICALLY TOP OF PAVEMENT IN PAVED AREAS, GUTTER GRADE IN CURB LINES.
- EXISTING CONTOUR
- PROPOSED CONTOUR
- PROPOSED REVERSE GUTTER PAN
- PROPOSED RIDGE LINE
- PROPOSED SWALE/DITCH

ABBREVIATIONS

- T/C = TOP OF CURB
- T/P = TOP OF PAVEMENT
- T/S = TOP OF SIDEWALK
- T/W = TOP OF WALL
- G = GUTTER GRADE
- F.G. = FINISH GRADE
- RIM = RIM ELEVATION
- BW = BOTTOM OF WALL

REFER TO GRADING NOTES ON SHEET C-4.0.

EROSION CONTROL QUANTITIES:

TREE PROTECTION FENCING	71 LF
SILT FENCE	184 LF.
R.Y.C.B. INLET FILTER	6 EA.
WOODCHIP RESTORATION	828 SF
PLAYGROUND REGRADING	4,659 SF
LAWN RESTORATION	110 SY

NOTE:

CONTRACTOR TO FIELD VERIFY ALL UNDERGROUND UTILITIES PRIOR TO CONSTRUCTION INCLUDING BUT NOT LIMITED TO: SITE LIGHTING, FIBER LINES, ETC

PEA GROUP

t: 844.813.2949
www.peagroup.com



0 10 20 40
SCALE: 1" = 20'



CAUTION!!

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CLIENT

TROY SCHOOLS
1140 RANKIN DRIVE
TROY, MI 48063

PROJECT TITLE

WASS
ELEMENTARY
SCHOOL
2340 WILLARD DRIVE, TROY, MI

REVISIONS

ORIGINAL ISSUE DATE:
JANUARY 4, 2023

DRAWING TITLE
GRADING AND
SESC PLAN

PEA JOB NO. 2022-1281

P.M. RR

DN. JJP

DES. RR


DRAWING NUMBER:

C-3.4

QUANTITIES:	
SLURRY SEAL	37888 SF
HOT RUBBER JOINT SEALANT	3000 LF
LOW POINT INLET FILTER	2 EA

PEA
GROUP

t: 844.813.2949
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CLIENT

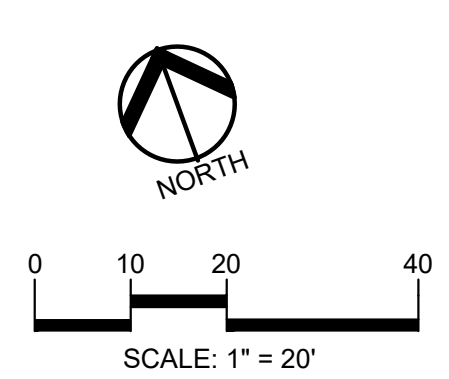TROY SCHOOLS
1140 RANKIN DRIVE
TROY, MI 48063

PROJECT TITLE

TROY LEARNING CENTER
1522 BIG BEAVER ROAD, TROY, MI

REVISIONS


ORIGINAL ISSUE DATE:
JANUARY 4, 2023

DRAWING TITLE

ENGINEERING PLAN


PEA JOB NO.	2022-1281
P.M.	RR
DN.	JJP
DES.	RR
DRAWING NUMBER:	

C-2.5

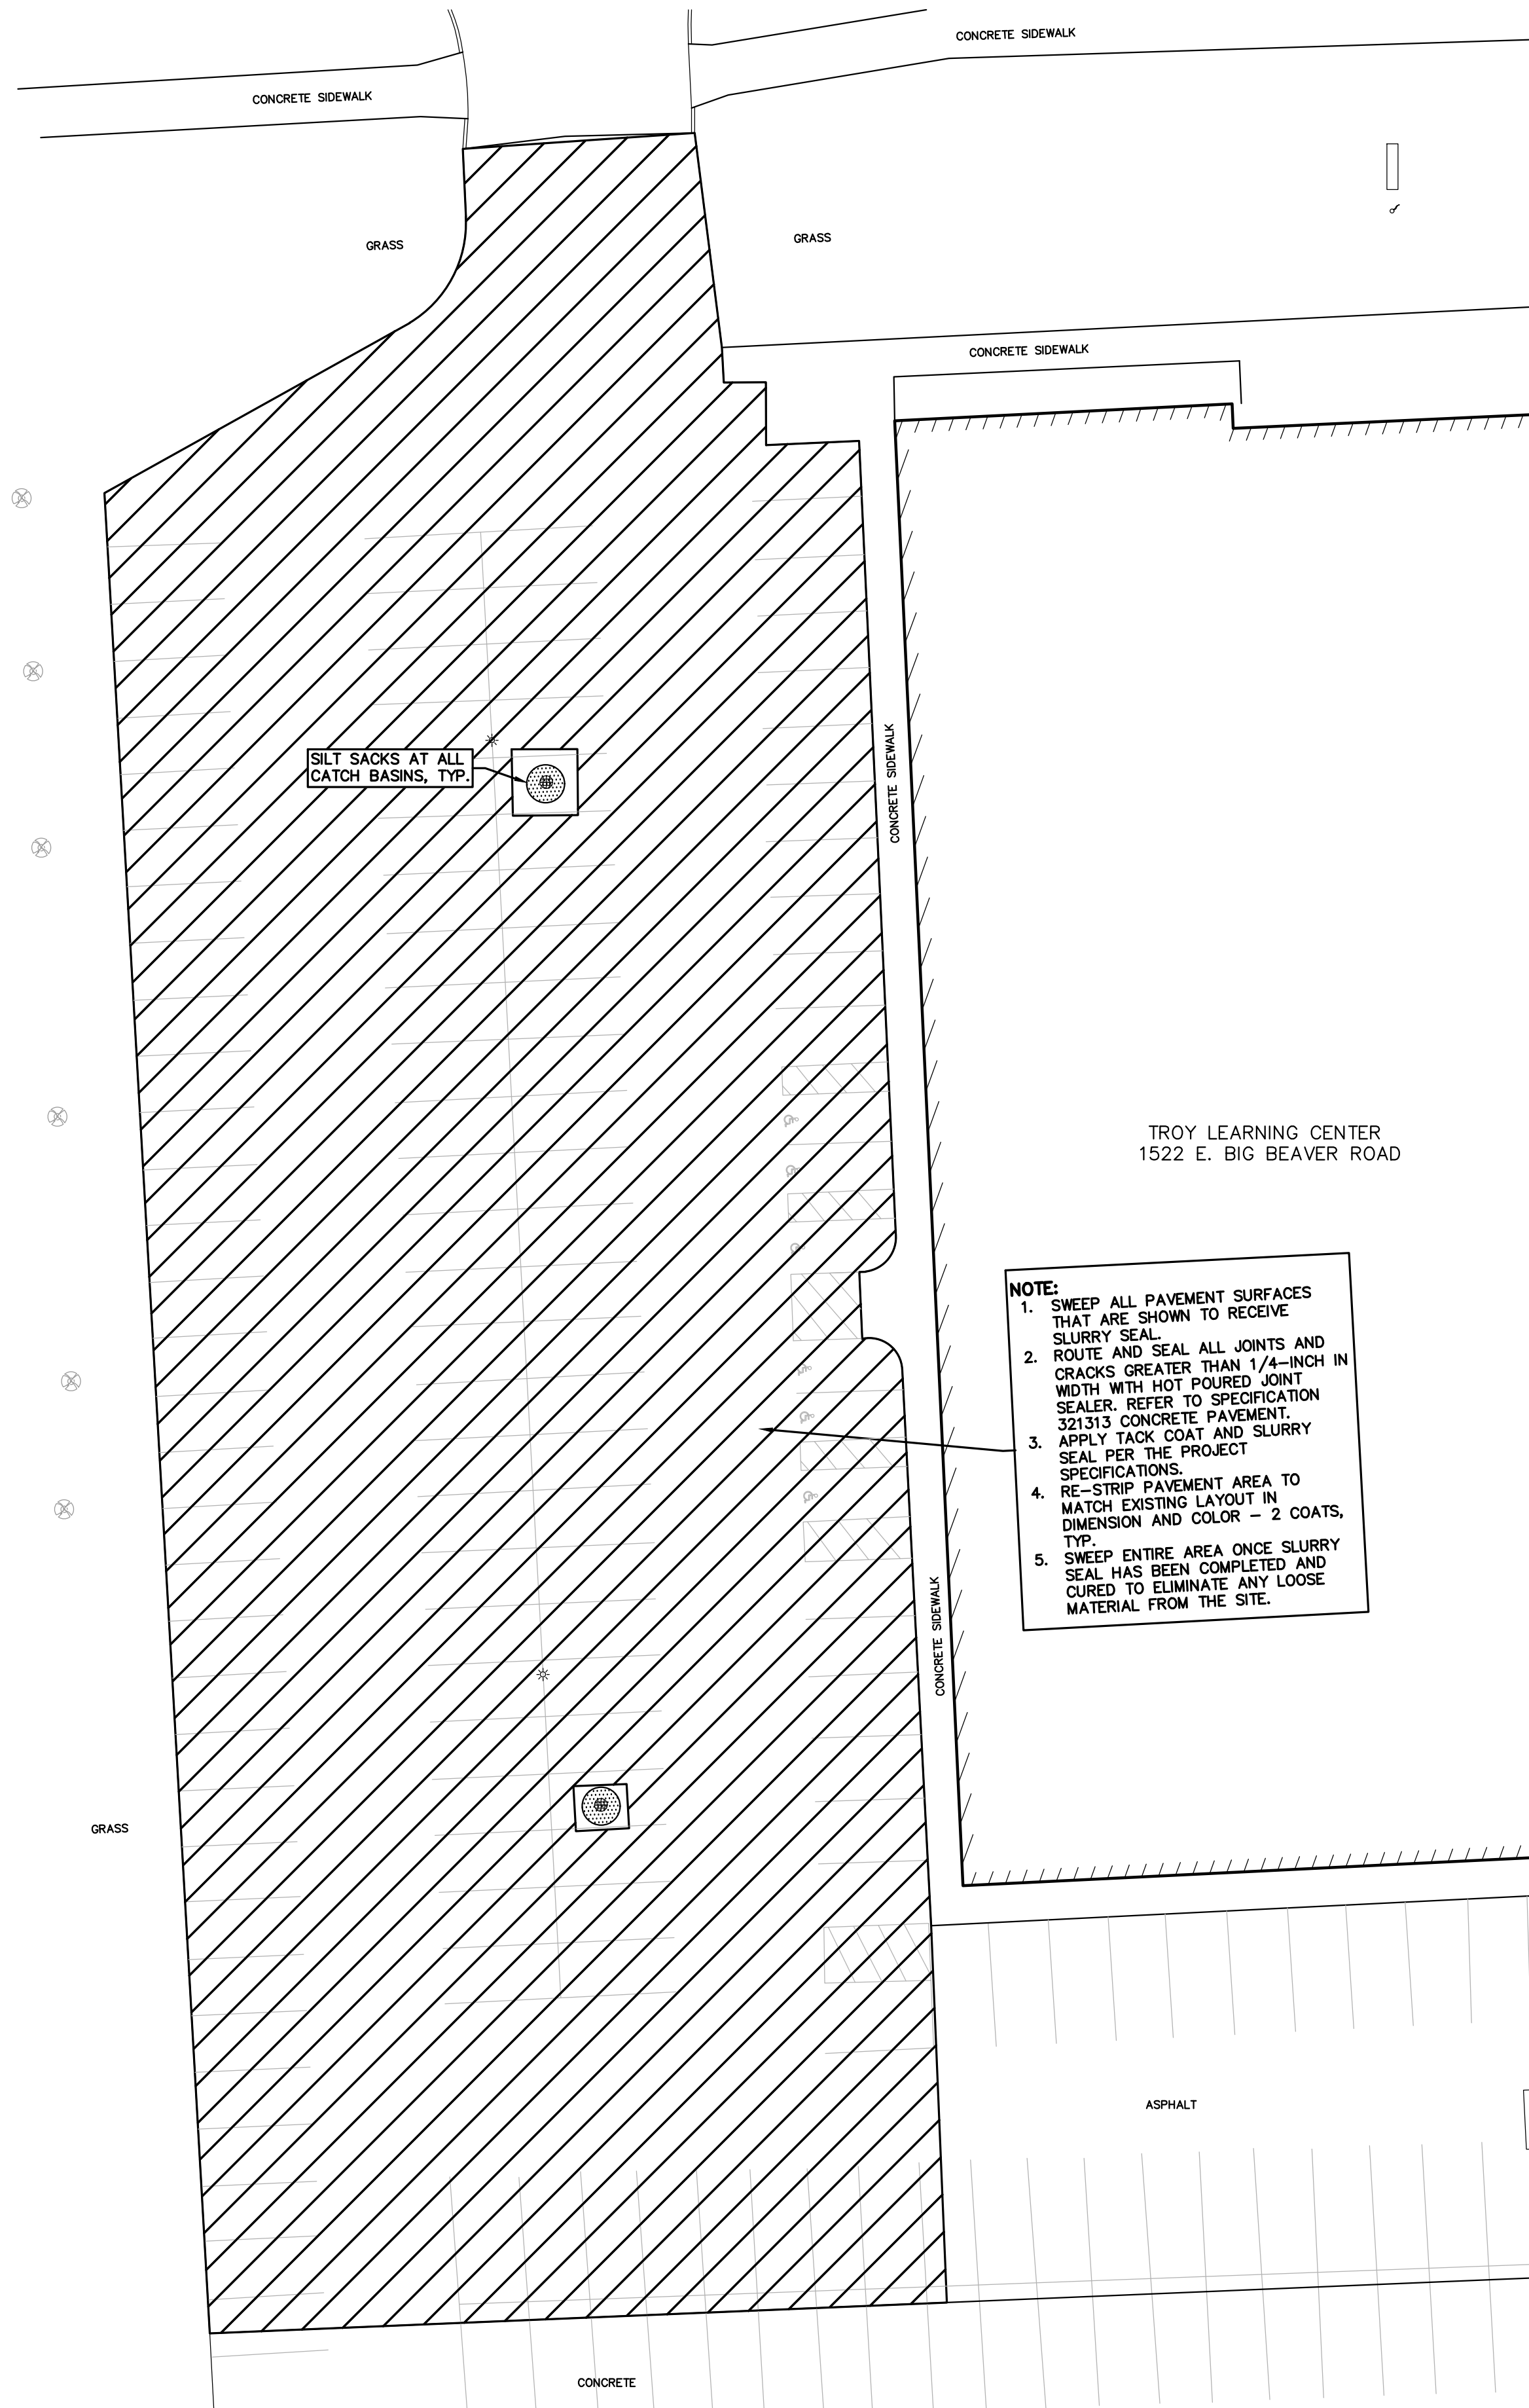

FLOODPLAIN NOTE:
BY GRAPHICAL PLOTTING, SITE IS WITHIN ZONE 'X', AN AREA DETERMINED TO BE OUTSIDE OF THE 0.2% ANNUAL CHANCE FLOODPLAIN, PER FLOOD INSURANCE RATE MAP NUMBER 26125C0553G, DATED JANUARY 16, 2009.

FLOODPLAIN NOTE:
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REFERENCE DRAWINGS
TROY TRANSPORTATION BUILDING, SITE SURVEY INFORMATION, KINGSCOTT JOB NO. 2649-14, SHEET C4.0, BID DATE 03-23-07
TROY TRANSPORTATION BUILDING, PROPOSED SITE LAYOUT, KINGSCOTT JOB NO. 2649-14, SHEET C4.0, BID DATE 03-23-07
TROY TRANSPORTATION BUILDING, SITE ALTERNATIVES, KINGSCOTT JOB NO. 2649-14, SHEET C4.1, BID DATE 03-23-07

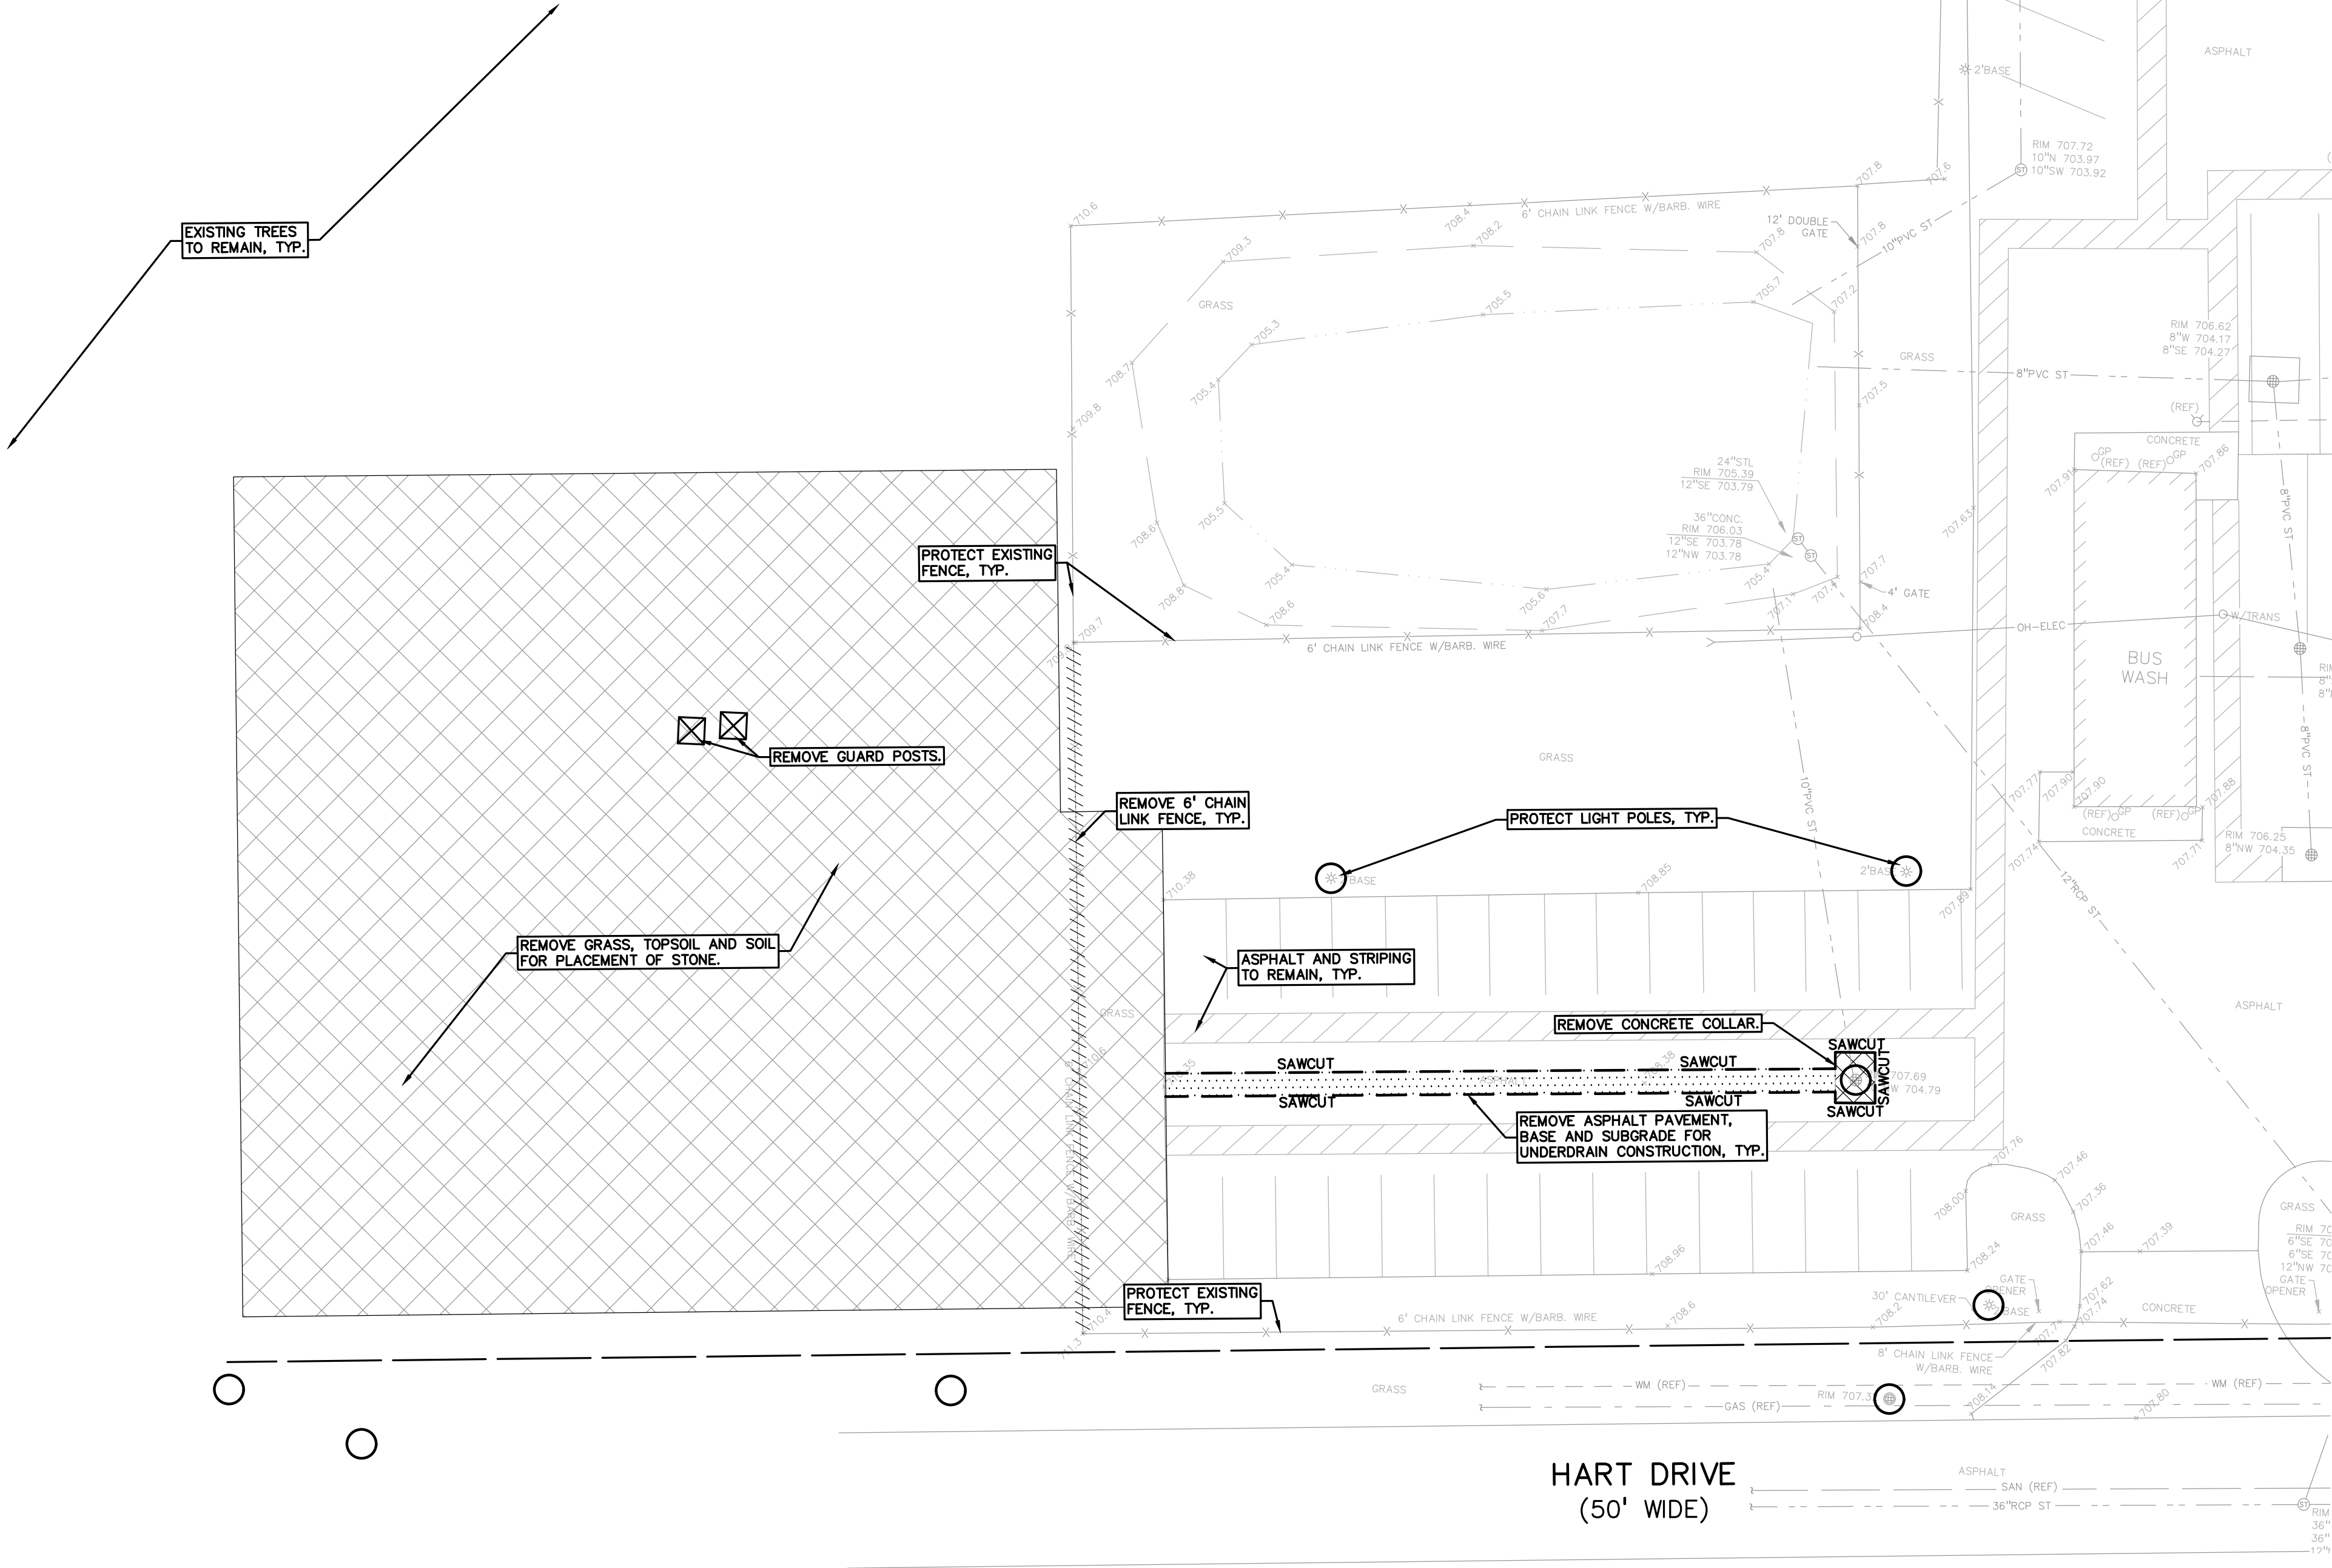LEGAL DESCRIPTION
(Access Oakland)
PARCEL ID 20-16-200-034
Land in the City of Troy, Oakland County, Michigan, described as follows:
T2N, R11E, SEC 16 MCCORMICK & LAWRENCE LITTLE FARMS SUB LOTS 3 & 4, ALSO PART OF NE 1/4 BEG AT PT DIST S 89-19-00 W 581.09 FT FROM E 1/4 COR, TH N 150 FT, TH W 439.11 FT, TH S 150 FT, TH E 439.11 FT TO BEG 9-3-09 FR 016, 426-002 & 003
PARCEL ID 20-16-426-001
Land in the City of Troy, Oakland County, Michigan, described as follows:
T2N, R11E, SEC 15 & 16 MC CORMICK & LAWRENCE LITTLE FARMS SUB LOTS 1 & 2

DEMOLITION QUANTITIES:

REMOVE ASPHALT	460 SF
REMOVE CONCRETE	60 SF
SAWCUT PAVEMENT	276 LF
REMOVE GRASS AND TOPSOIL	21,880 SF
REMOVE FENCE	119 LF
REMOVE GUARD POST	2 EA

LEGEND:

OH-ELEC-W-O- EX. OH. ELEC. POLE & GUY WIRE
UG-CATV- EX. U.G. CABLE TV & PEDESTAL
UG-COMM- EX. U.G. COMMUNICATION LINE, PEDESTAL & MANHOLE
UG-ELEC-C-EX- EX. U.G. ELEC. MANHOLE, METER & HANDHOLE

EX. GAS LINE
EX. GAS VALVE & GAS LINE MARKER
EX. TRANSFORMER & IRRIGATION VALVE
EX. WATER MAIN
EX. HYDRANT, GATE VALVE & POST INDICATOR VALVE
EX. WATER VALVE BOX & SHUTOFF
EX. SANITARY SEWER
EX. SANITARY CLEANOUT & MANHOLE
EX. COMBINED SEWER MANHOLE
EX. STORM SEWER
EX. CLEANOUT & MANHOLE
EX. SQUARE, ROUND, & BEEHIVE CATCH BASIN
EX. YARD DRAIN & ROOF DRAIN
EX. UNIDENTIFIED STRUCTURE
EX. MAILBOX, SIGN & LIGHTPOLE
EX. FENCE
EX. GUARD RAIL
EX. SPOT ELEVATION
EX. CONTOUR
EX. WETLAND

IRON FOUND / SET
NAIL FOUND / NAIL & CAP SET
BRASS PLUG SET
MONUMENT FOUND / SET
SECTION CORNER FOUND
RECORDED / MEASURED / CALCULATED

DEMOLITION LEGEND:

ITEM TO BE PROTECTED
ITEM TO BE REMOVED
CURB/FENCE REMOVAL
CONCRETE PAVEMENT AND SIDEWALK REMOVAL
AREA OR ITEMS TO BE REMOVED
UTILITY REMOVAL
ABANDON UTILITY
ASPHALT REMOVAL
TREE REMOVAL
SAWCUT LINE

GENERAL DEMOLITION NOTES:
THESE NOTES APPLY TO ALL CONSTRUCTION ACTIVITIES ON THIS PROJECT:

- ALL MATERIAL TO BE REMOVED, WHETHER SPECIFICALLY NOTED IN THE PLANS OR NOT, SHALL BE REMOVED FROM THE SITE BY THE CONTRACTOR AND DISPOSED OF OFF-SITE IN A LEGAL MANNER. NO ON-SITE BURY OR BURN PITS SHALL BE ALLOWED.
- ALL DEMOLITION WORK SHALL CONFORM TO ALL LOCAL CODES AND ORDINANCES.
- STAGING/PHASING OF DEMOLITION AND CONSTRUCTION IS TO BE COORDINATED WITH THE OWNER AND THE CONTRACTOR PRIOR TO CONSTRUCTION.
- SPECIFIC DEMOLITION ITEMS HAVE BEEN INDICATED ON THE PLANS AS A GUIDE TO THE GENERAL SCOPE OF THE WORK. IT IS THE INTENT THAT THESE ITEMS SHALL BE COMPLETELY REMOVED BY THE CONTRACTOR ABOVE AND BELOW GROUND, UNLESS SPECIFICALLY NOTED OTHERWISE, AND THAT DEMOLITION WILL INCLUDE, BUT WILL NOT NECESSARILY BE LIMITED TO THESE ITEMS. CONTRACTOR SHALL VISIT SITE TO VERIFY EXISTING CONDITIONS AND EXTENTS OF THE DEMOLITION THAT WILL BE REQUIRED PRIOR TO SUBMITTING A BID.
- REMOVE ALL STRUCTURES DESIGNATED FOR REMOVAL ACCORDING TO THE DEMOLITION PLAN. THIS INCLUDES FOUNDATIONS, CONCRETE, ASPHALT, TREES, ETC.
- THE CONTRACTOR SHALL, AS A MINIMUM, PROVIDE TREE PROTECTION FENCING AROUND EXISTING TREES TO BE SAVED THAT ARE WITHIN 15 FEET OF CONSTRUCTION ACTIVITIES AND AS INDICATED IN THE PLANS OR PER LOCAL AGENCY REQUIREMENTS.
- THE CONTRACTOR SHALL BE RESPONSIBLE FOR CLEAN UP, NOISE, DUST CONTROL, STREET SWEEPING AND HOURS OF OPERATION IN ACCORDANCE WITH THE LOCAL CODES.
- THE CONTRACTOR SHALL PROVIDE ALL NECESSARY BARRICADES, SIGNAGE, MARKINGS, LIGHTS AND OTHER TRAFFIC CONTROL DEVICES TO PROTECT THE WORK ZONE AND SAFELY MAINTAIN TRAFFIC PER AGENCY REQUIREMENTS AND IN ACCORDANCE WITH THE LATEST EDITION OF THE STATE MANUAL OF UNIFORM TRAFFIC CONTROL DEVICES.
- THE CONTRACTOR SHALL CONTACT THE APPROPRIATE UTILITY COMPANIES TO CONFIRM THAT UTILITY LEADS HAVE BEEN TAKEN OUT OF SERVICE PRIOR TO DEMOLITION.
- THE CONTRACTOR SHALL NOTIFY THE APPROPRIATE 811/ONE CALL UTILITY LOCATING CENTER, PRIVATE UTILITY LOCATOR, THE CITY ENGINEER AND/OR THE AUTHORITY HAVING JURISDICTION 3 BUSINESS DAYS PRIOR TO THE BEGINNING OF CONSTRUCTION.

NOTES:

- CONTRACTOR TO VERIFY ALL QUANTITIES SHOWN ON THE PLANS. ANY DEVIATIONS TO THE PLAN QUANTITIES SHALL BE BROUGHT TO THE ATTENTION OF THE SCHOOL DISTRICT AND PEA GROUP, IN WRITING PER THE BID PACKAGE, FOR VERIFICATION PRIOR TO BIDDING.

PEA GROUP
t: 844.813.2949
www.peagroup.com

811 Know what's below. Call before you dig.

CAUTION!!
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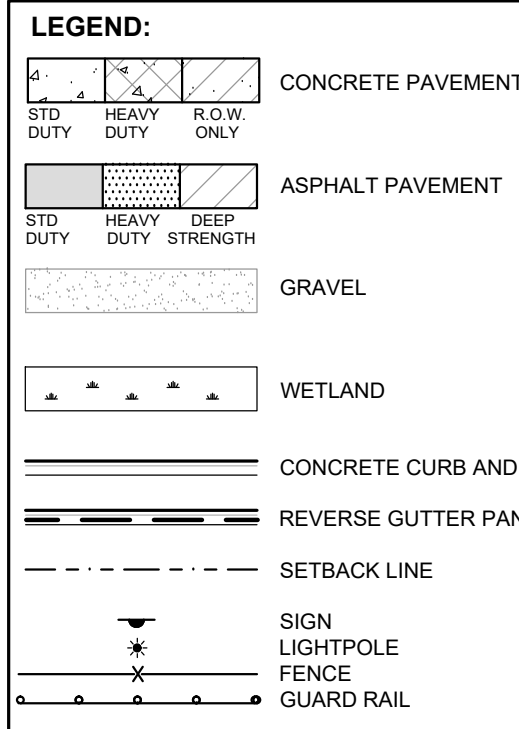
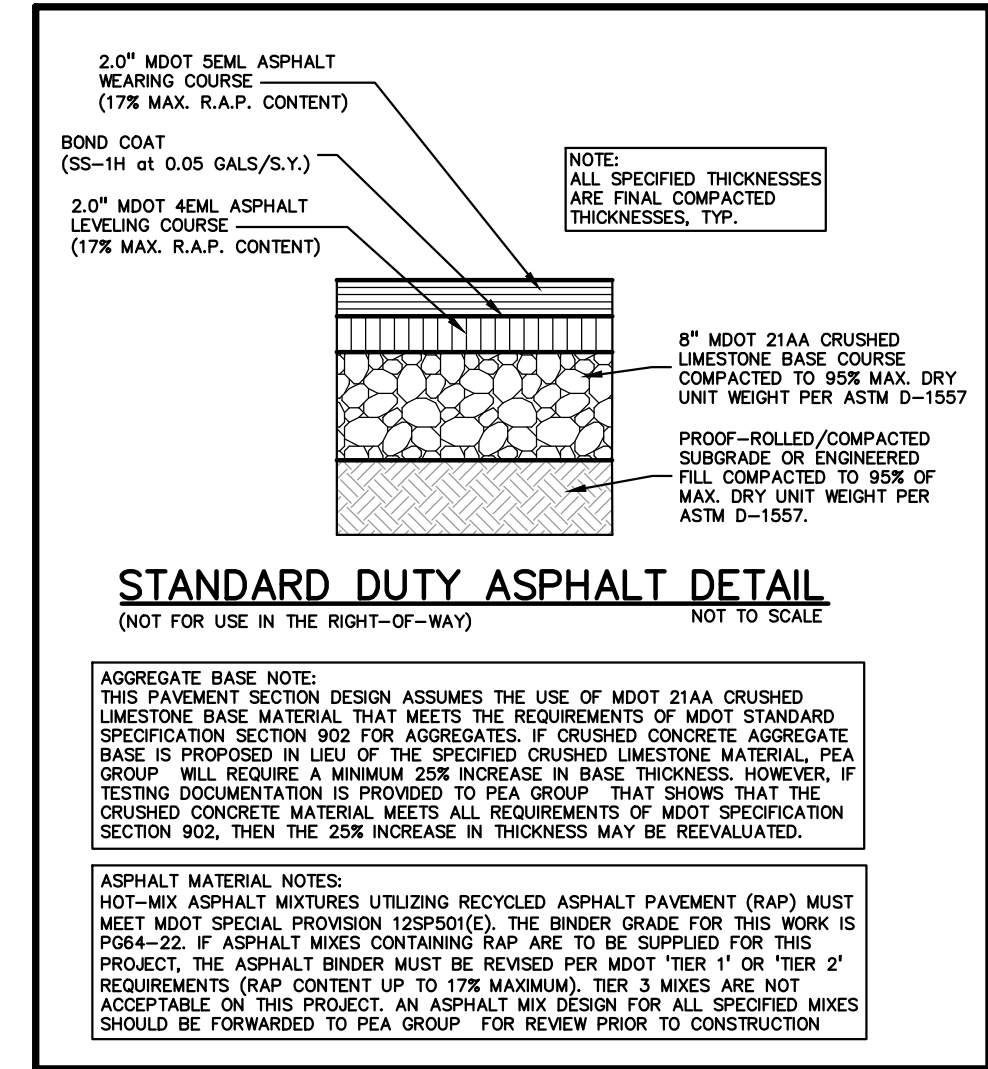
CLIENT
TROY SCHOOLS
1140 RANKIN DRIVE
TROY, MI 48063

PROJECT TITLE
TRANSPORTATION CENTER
120 HART AVE, TROY, MI

REVISIONS

ORIGINAL ISSUE DATE:	JANUARY 4, 2023
DRAWING TITLE	TOPOGRAPHIC SURVEY AND DEMOLITION PLAN

PEA JOB NO.	2022-1281
P.M.	RR
DN.	JJP
DES.	RR
DRAWING NUMBER:	C-1.6




NOTES:

- CONTRACTOR TO VERIFY ALL QUANTITIES SHOWN ON THE PLANS. ANY DEVIATIONS TO THE PLAN QUANTITIES SHALL BE BROUGHT TO THE ATTENTION OF THE SCHOOL DISTRICT AND PEA GROUP, IN WRITING PER THE BID PACKAGE, FOR VERIFICATION PRIOR TO BIDDING.
- CONTRACTOR TO FIELD VERIFY ALL UNDERGROUND UTILITIES PRIOR TO CONSTRUCTION INCLUDING BUT NOT LIMITED TO: SITE LIGHTING, FIBER LINES, ETC.
- FOR THE ONE (1) CATCH BASIN LOCATED IN THE WORK AREA, BIDDERS ARE TO INCLUDE RECONSTRUCTION OF THESE STRUCTURES (GREATER THAN 12-INCHES IN DEPTH FROM THE RIM ELEVATION OF REPAIR WORK) IN THE BASE BID. THE SUCCESSFUL BIDDER WILL BE PAID FOR REPAIRING EACH STRUCTURE BASED ON THE ACTUAL DEPTH OF REPAIR WITH EITHER STRUCTURAL ADJUSTMENT (WITHIN TOP 12-INCHES OF RIM ELEVATION) OR STRUCTURAL RECONSTRUCTION (GREATER THAN 12-INCHES IN DEPTH) PER THE UNIT PRICES PROVIDED IN THE BID PACKAGE AND THE SCOPE OF WORK DETERMINED AND APPROVED PRIOR TO THE WORK COMMENCING. REPLASTERING OF THE ENTIRE STRUCTURE SHALL BE INCLUDED IN THE UNIT PRICE FOR BOTH STRUCTURAL ADJUSTMENT AND STRUCTURAL RECONSTRUCTION.

PAVING QUANTITIES:	
4" ASPHALT PAVEMENT	692 SF
8" 21AA AGGREGATE	692 SF
GRAVEL	13,954 SF
BUTT JOINT	230 LF
CONCRETE COLLAR	1 EA.
SUBGRADE UNDERCUT ALLOWANCE	
115 CYD	
ENGINEERING QUANTITIES:	
RECONSTRUCT STORM STRUCTURE	1 EA
4" HDPE PERF. UNDERDRAIN	392 LF
6" HDPE PERF. UNDERDRAIN	205 LF

SUBGRADE UNDERCUTTING NOTES:


- TO MINIMIZE SUBGRADE INSTABILITY AND UNDERCUTS, THE SUBGRADE SHALL NOT BE LEFT EXPOSED TO PRECIPITATION AND CONSTRUCTION OPERATIONS AND SHOULD BE PERFORMED DURING THE SUMMER MONTHS TO ENSURE DRY, WARM WEATHER. ADDITIONALLY, THE SUBGRADE MAY BECOME UNSTABLE UNDER REPEATED LOADING OF CONSTRUCTION TRAFFIC, THEREFORE, CONSTRUCTION EQUIPMENT SHOULD BE LIMITED ON THE EXPOSED SUBGRADE.
- UNDERCUT EXCAVATIONS SHALL BE BACKFILLED WITH MDOT 21AA DENSE GRADED AGGREGATE PLACED IN AN ENGINEERED MANNER. LIFT THICKNESS SHALL NOT EXCEED 9 INCHES. THE USE OF TRI-AXIAL GEOGRID MAY BE USED TO REDUCE UNDERCUT DEPTHS, AS APPROVED BY THE DISTRICT AND PER THE UNIT PRICE PROVIDED WITH THE CONTRACTORS BID.
- THE QUANTITY FOR "SUBGRADE UNDERCUT" FOR EACH SITE SHALL BE INCLUDED IN THE BASE BID. THIS ITEM IS CONSIDERED AN ALLOWANCE AND FINAL PAYMENT WILL BE BASED ON THE ACTUAL FOOTAGE OF COMPACTED IN PLACE STONE PER THE UNIT PRICE PROVIDED IN THE BID PACKAGE.
- ALL ENGINEERED FILL SHALL BE COMPACTED TO A DENSITY OF AT LEAST 95 PERCENT OF THE MAXIMUM DENSITY DETERMINED BY THE MODIFIED PROCTOR (ASTM D1557) METHOD OF TESTING. ALL ENGINEERED FILL MATERIAL SHALL BE PLACED AND COMPACTED AT APPROXIMATELY THE OPTIMUM MOISTURE CONTENT. FROZEN MATERIAL SHALL NOT BE USED AS FILL, NOR SHOULD FILL BE PLACED ON A FROZEN SUBGRADE.
- SUBGRADE UNDERCUTS SHALL BE EVALUATED BY A QUALIFIED ENGINEERING TECHNICIAN TO DETERMINE IF SUBGRADE STABILIZATION IS NECESSARY.

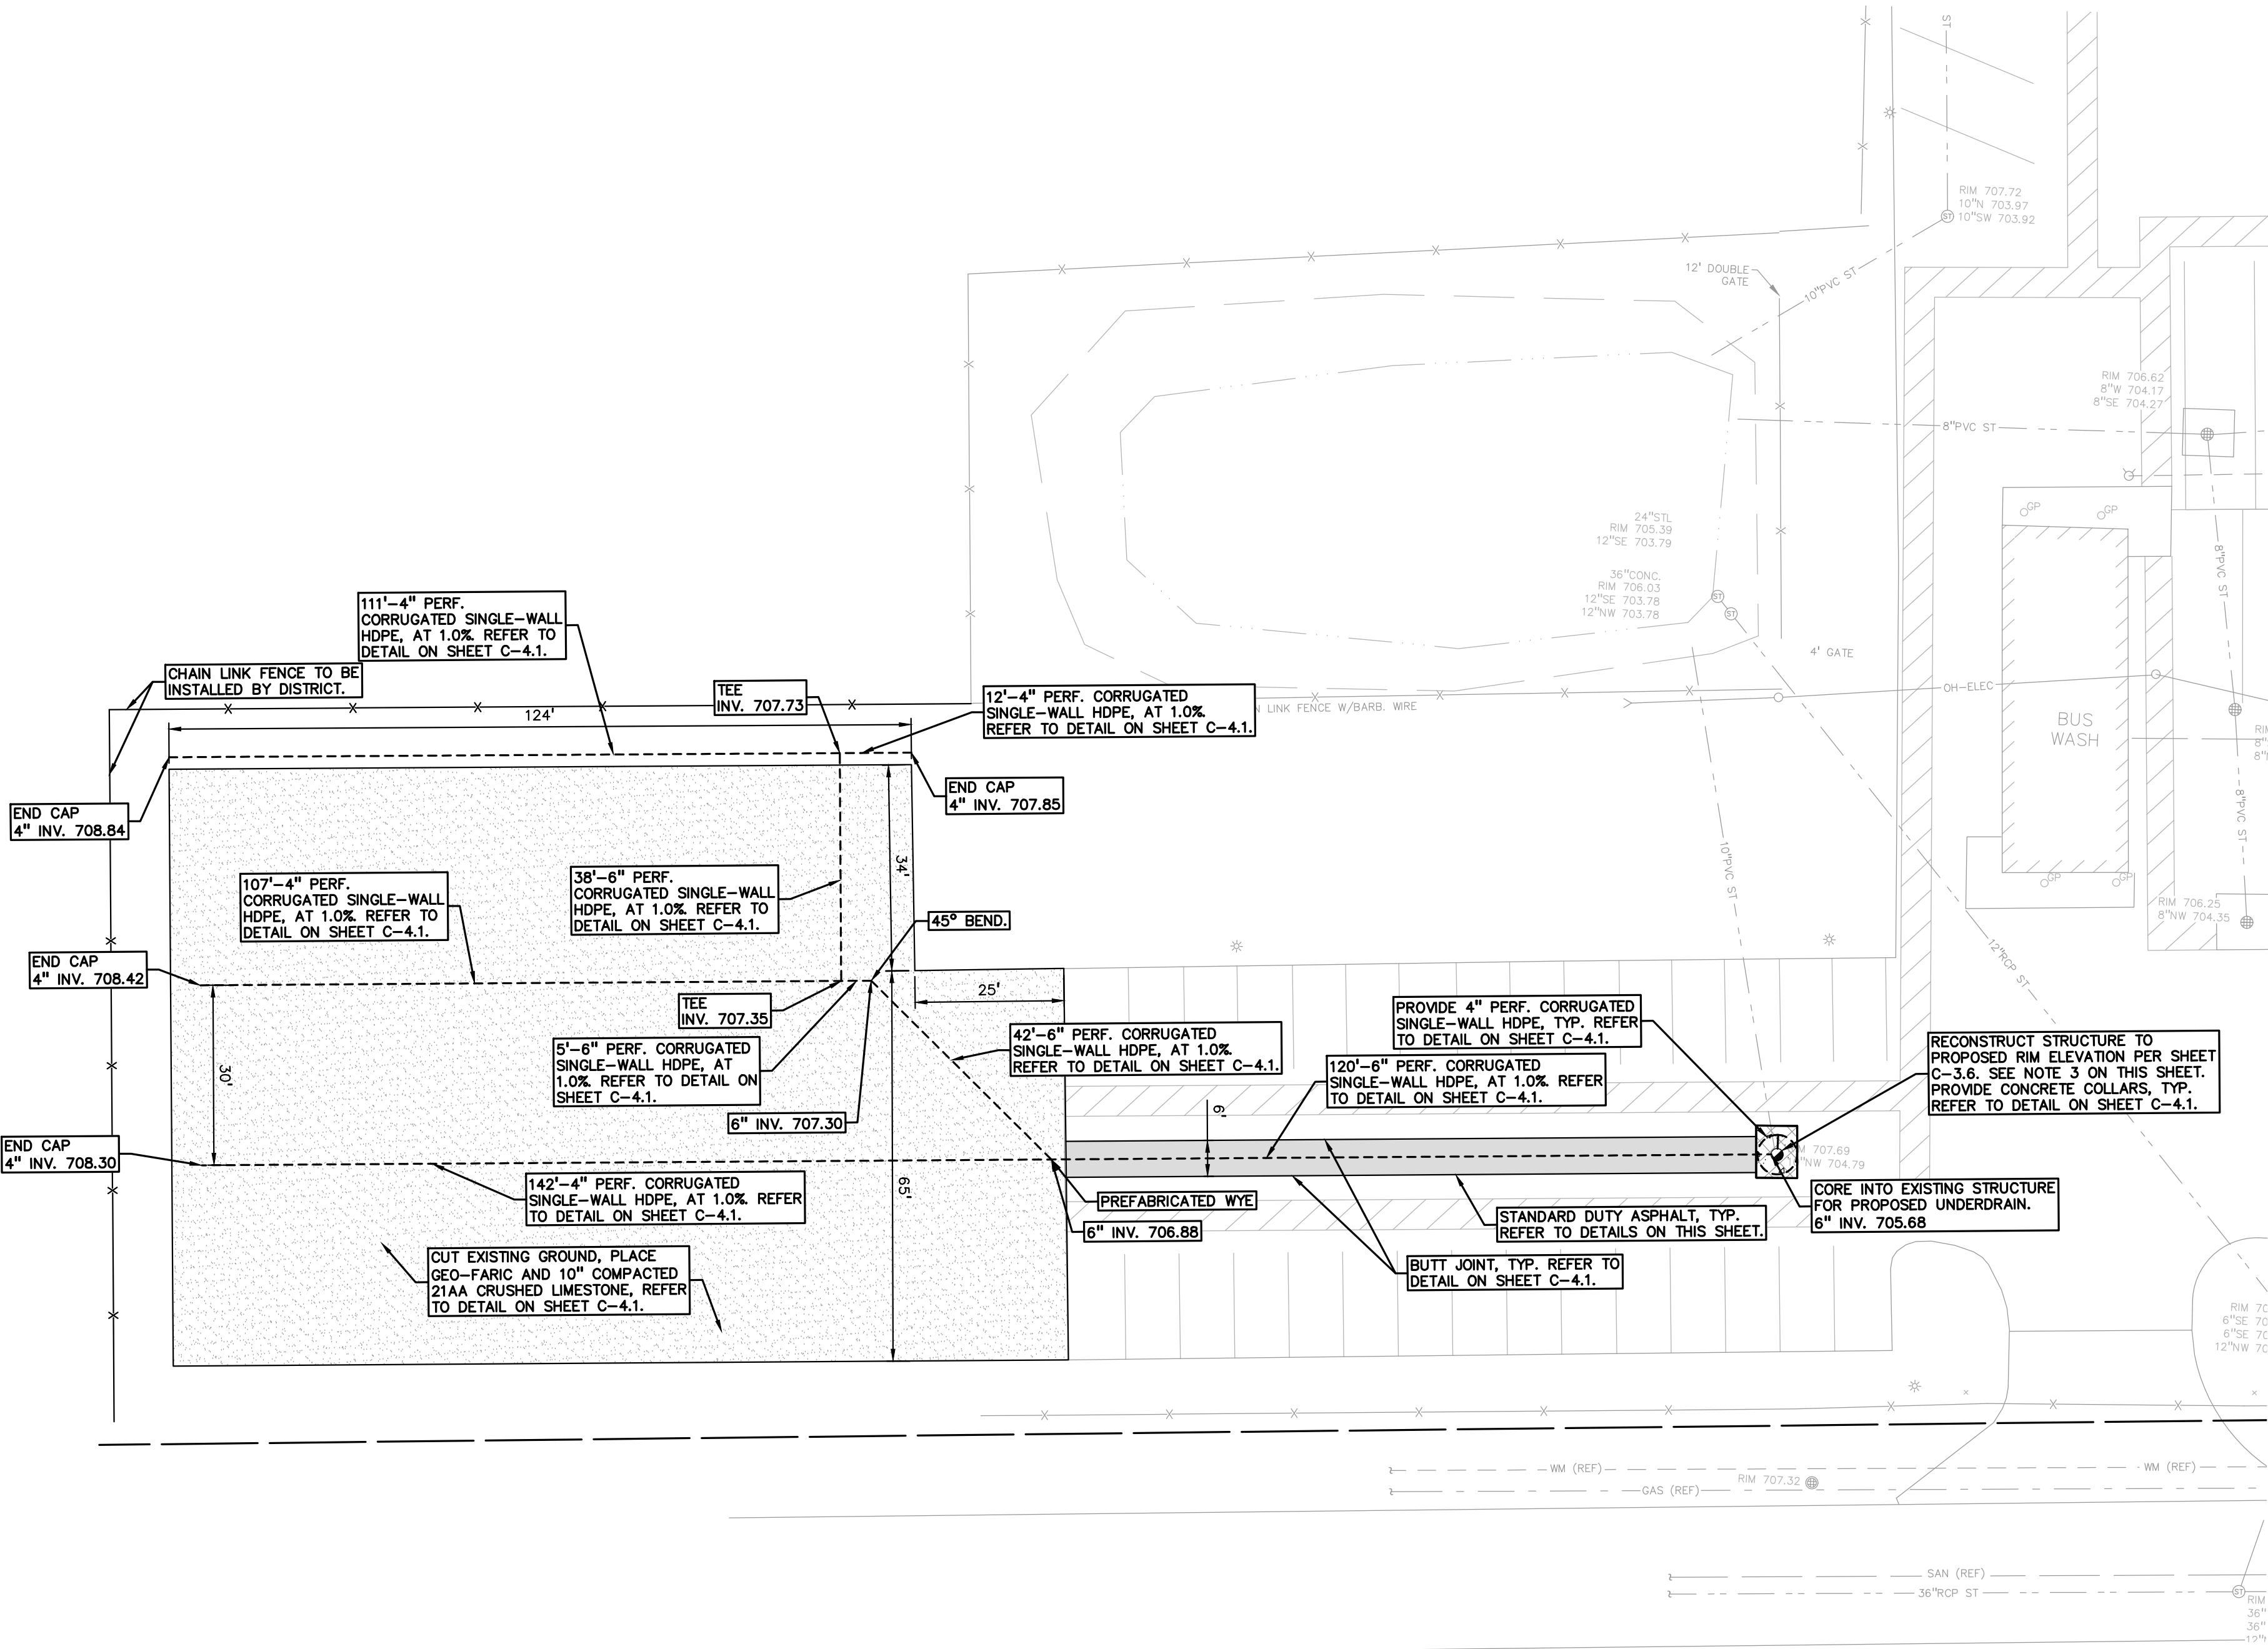

S:\PROJECTS\2022\2022-1281 2022-1281 SITE IMPROVEMENT PROJECTS\CONSTRUCTION-PAVING\TRANSPORTATION CENTER\C-2.6\END-TRANS CENTER-22-1281.dwg 2023 750 SITE IMPROVEMENT PROJECTS\CONSTRUCTION-PAVING\TRANSPORTATION CENTER\C-2.6\END-TRANS CENTER-22-1281.dwg

FLOODPLAIN NOTE:
BY GRAPHICAL PLOTTING, SITE IS WITHIN ZONE 'X'. AN AREA DETERMINED TO BE OUTSIDE OF THE 0.2% ANNUAL CHANCE FLOODPLAIN, PER FLOOD INSURANCE RATE MAP NUMBER 26125C0553G, DATED JANUARY 16, 2009.

PEA GROUP
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CAUTION!!
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CLIENT
TROY SCHOOLS
1140 RANKIN DRIVE
TROY, MI 48063

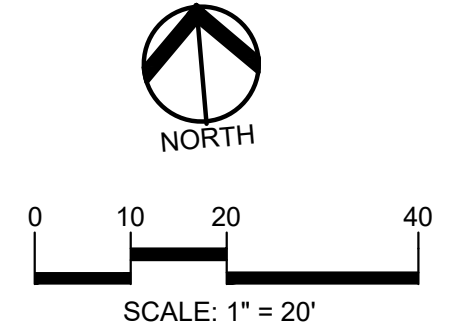PROJECT TITLE
TRANSPORTATION CENTER
120 HART AVE, TROY, MI

REVISIONS

ORIGINAL ISSUE DATE:
JANUARY 4, 2023

DRAWING TITLE
PAVING AND DIMENSION PLAN

PEA JOB NO.	2022-1281
P.M.	RR
DN.	JJP
DES.	RR
DRAWING NUMBER:	

C-2.6

EROSION CONTROL QUANTITIES:		
SILT FENCE	775 LF.	
LOW POINT INLET FILTER	1 EA.	
R.Y.C.B. FILTER	1 EA.	
LAWN RESTORATION	565 SY	

SOIL EROSION AND SEDIMENTATION CONTROL
SEQUENCE OF CONSTRUCTION

- SEE OAKLAND COUNTY W.R.C. SOIL EROSION AND SEDIMENTATION CONTROL DETAILS SHEET FOR ALL SOIL EROSION CONTROL RELATED DETAILS.
- PLACE SILT FENCE & INSTALL INLET FILTERS ON EXISTING STORM SEWER STRUCTURES, ACCORDING TO PLANS.
- INSTALL TEMPORARY CRUSHED CONCRETE ACCESS DRIVE AT ALL CONSTRUCTION ENTRANCES. (80'x24'x8" W/MINIMUM OF 1"-3" CRUSHED CONCRETE - NO FINES).
- REMOVE CURB, PAVEMENT, TREES, ETC. AS DIRECTED ON THE DEMOLITION PLAN.
- STRIP AND STOCKPILE TOPSOIL FOR RESTORATION REQUIREMENTS.
- DISPOSE OF ALL EXCESS, UNSUITABLE MATERIALS OFF SITE IN A LEGAL MANNER. NO BURN OR BURY PITS ALLOWED.
- UNSUITABLE MATERIALS CONSIST OF, BUT ARE NOT NECESSARILY LIMITED TO THE FOLLOWING: CONCRETE, ASPHALT, TREES, BRUSH, STUMPS, ROOTS, OR OTHER MISCELLANEOUS DEBRIS OR TRASH.
- MASS GRADE THE SITE IN ACCORDANCE WITH THE PLANS.
- INSTALL HYDROSEED AS SHOWN ON THE PLAN WITHIN 5 DAYS OF COMPLETION OF MASS GRADING OR WHENEVER DISTURBED AREAS WILL REMAIN UNCHANGED FOR 30 DAYS OR GREATER. MINIMUM 3"-4" TOPSOIL WILL BE USED WHERE VEGETATION IS REQUIRED.
- COMPLETE ROUGH GRADING OF SITE. PLACE INLET FILTERS AT ALL INLETS AND CATCH BASINS, AS SHOWN.
- FINISH GRADE AND PAVE SITE AS PROPOSED TO DRAIN TO STORM SEWER SYSTEM. REPAIR INLET FILTERS AS REQUIRED.
- APPLY TOPSOIL, HYDROSEED TO ALL DISTURBED AREAS UPON COMPLETION OF GRADING. THE CONTRACTOR SHALL STAGE CONSTRUCTION ACTIVITIES IN ORDER TO MINIMIZE THE EXPOSURE OF UNSTABILIZED AREAS.
- CLEAN PAVEMENT AND STORM SEWERS. REMOVE SILT FENCE AND TREE PROTECTION FENCE, AND INLET FILTERS ONCE VEGETATION HAS BEEN ESTABLISHED.
- ALL DIRT AND MUD TRACKED ONTO PUBLIC ROADS SHALL BE REMOVED DAILY.
- STREET CATCH BASINS TO BE PERIODICALLY CLEANED AND FILTER CLOTH CHANGED AND MAINTAINED.

SOIL EROSION MAINTENANCE SCHEDULE AND NOTES:

- THE SOIL EROSION CONTROLS WILL BE MAINTAINED WEEKLY AND AFTER EVERY STORM EVENT BY:

ROB CARSON
TROY SCHOOL DISTRICT
1140 RANKIN
TROY, OAKLAND COUNTY, MICHIGAN
248-823-4067
- IF ANY DAMAGE HAS OCCURRED AS A RESULT OF STORM WATER DISCHARGE FROM THE SITE, THE FOLLOWING STEPS SHALL BE IMPLEMENTED.
- ANY DEBRIS OR DIRT ON ANY PAVED AREA RESULTING FROM CONSTRUCTION TRAFFIC SHALL BE CLEANED IN A PROMPT MANNER BY THE CONTRACTOR. THE CONSTRUCTION DRIVE SHALL BE CLEANED AT THE END OF EACH DAY.
- ALL DIRT AND MUD TRACKED ONTO PAVED AREAS SHALL BE REMOVED BY THE CONTRACTOR DAILY BY SCRAPING. STREET SWEEPING IS REQUIRED WEEKLY.
- SILT FENCE MAINTENANCE SHALL INCLUDE THE REMOVAL OF ANY BUILT UP SEDIMENT WHEN THE SEDIMENT HEIGHT ACCUMULATES TO 1/3 TO 1/2 OF THE HEIGHT OF THE FENCE. THE CONTRACTOR IS RESPONSIBLE TO REMOVE, REPLACE, RETRAIL, OR REBACKFILL THE SILTATION FENCE SHOULD IT FALL OR BE DAMAGED DURING CONSTRUCTION.
- INLET FILTER MAINTENANCE SHALL INCLUDE THE REMOVAL OF ANY ACCUMULATED DIRT OR OTHER DEBRIS. THE REMOVAL OF SILT SHOULD BE WITH THE USE OF A STIFF BRISTLE BROOM OR SQUARE POINT SHOVEL. IF INLET FILTERS CAN NOT BE CLEANED OR ARE DAMAGED, THEN THE FABRIC MUST BE REPLACED.
- CONTRACTOR TO PROVIDE WATER TRUCK TO WATER DOWN THE SITE ON A DAILY BASIS AS REQUIRED TO MAINTAIN DUST CONTROL.
- IF HIGH GROUNDWATER IS ANTICIPATED OR ENCOUNTERED DURING CONSTRUCTION A DEWATERING PLAN MUST BE SUBMITTED TO THE CITY ENGINEERING DIVISION FOR REVIEW.

SEQUENCE OF CONSTRUCTION:

START DAY	END DAY	
1	2	INSTALL TEMPORARY SOIL EROSION CONTROL MEASURES, SILT FENCES, INLET PROTECTION, ETC. AS NECESSARY.
1	90	MAINTAIN A 25' BUFFER OF VEGETATION AROUND PERIMETER OF SITE WHERE POSSIBLE.
1	5	STRIP AND STOCKPILE TOPSOIL AS REQUIRED RESTORATION. ALL STOCKPILES MUST BE GRADED AND SEEDED.
1	15	REMOVE ALL PAVEMENT, CURB, UTILITIES, ETC. AS REQUIRED TO INSTALL THE PROPOSED WORK AS SHOWN ON THE TOPOGRAPHIC SURVEY AND DEMOLITION PLAN.
10	15	DISPOSE OF ALL EXCESS/UNSUITABLE MATERIALS OFF SITE IN A LEGAL MANNER. NO ON-SITE BURN OR BURY PITS ALLOWED.
30	40	ROUGH GRADE SITE. SEED AND MULCH BLANKETS MUST BE INSTALLED AS SHOWN WITHIN 5 DAYS OF FINAL GRADE. REPAIR AND/OR RE-INSTALL ANY TEMPORARY SOIL EROSION CONTROL MEASURES THAT WERE DAMAGED DURING GRADING OPERATIONS.
15	90	TEMPORARY SEEDING MUST BE PROVIDED IN AREAS NOT TO BE WORKED ON FOR 15 DAYS OR LONGER.
40	50	FINE GRADE SITE AND PREPARE FOR SITE PAVING OPERATIONS.
50	80	INSTALL ALL PAVEMENT, SIDEWALKS, CURBING AS PROPOSED. IF PERMANENT LANDSCAPING IS NOT TO BE INSTALLED SOON AFTER PAVING IS COMPLETE, ALL AREAS WITHIN 20 FEET OF BACK OF CURB MUST BE TEMPORARILY SEEDED. REPAIR INLET PROTECTION, SILT FENCE AND ANY OTHER DAMAGED SOIL EROSION CONTROL MEASURES AS NECESSARY.
80	89	FINAL GRADE, REDISTRIBUTE STOCKPILED TOPSOIL, ESTABLISH VEGETATION AND INSTALL ALL PERMANENT LANDSCAPING IN ALL DISTURBED AREAS NOT BUILT.
88	90	CLEAN PAVEMENT AND REMOVE ALL TEMPORARY SOIL EROSION CONTROL MEASURES. RE-ESTABLISH VEGETATION AS REQUIRED.
90	90	REMOVE SEDIMENTATION CONTROLS ONCE ENTIRE SITE HAS BEEN PERMANENTLY STABILIZED.

FLOODPLAIN NOTE:
BY GRAPHICAL PLOTTING, SITE IS WITHIN ZONE "X". AN AREA DETERMINED TO BE OUTSIDE OF THE 0.2% ANNUAL CHANCE FLOODPLAIN, PER FLOOD INSURANCE RATE MAP NUMBER 26125C01553G, DATED JANUARY 16, 2009.

SYMBOLS: EROSION CONTROL:

- (SP-2) SILT FENCE
- (SI-2A) LOW POINT INLET FILTER
- (SI-3) RYCB INLET FILTER
- (E-9) EROSION CONTROL BLANKET
- LAWN RESTORATION

REFER TO O.C.W.R.C. SOIL EROSION AND SEDIMENTATION CONTROL DETAILS SHEET FOR ALL DEVICE DETAILS.

GRADING LEGEND:

- EXISTING SPOT ELEVATION
- PROPOSED SPOT ELEVATION: TYPICALLY TOP OF PAVEMENT IN PAVED AREAS, GUTTER GRADE IN CURB LINES.
- EXISTING CONTOUR
- PROPOSED CONTOUR
- PROPOSED REVERSE GUTTER PAN
- PROPOSED RIDGE LINE
- PROPOSED SWALE/DITCH

ABBREVIATIONS


T/C = TOP OF CURB
T/P = TOP OF PAVEMENT
T/S = TOP OF SIDEWALK
T/W = TOP OF WALL
G = GUTTER GRADE
F.G. = FINISH GRADE
RIM = RIM ELEVATION
BW = BOTTOM OF WALL
REFER TO GRADING NOTES ON SHEET C-4.0.

EARTHWORK BALANCING NOTE:

THE CONTRACTOR SHALL BE RESPONSIBLE FOR IMPORTING OR EXPORTING ALL MATERIALS AS REQUIRED TO PROPERLY GRADE THIS PROJECT TO THE FINISHED ELEVATIONS SHOWN ON THE APPROVED PLANS. THE CONTRACTOR SHALL MAKE THEIR OWN DETERMINATION OF CUT AND FILL QUANTITIES AND ALLOW FOR REMOVAL OF EXCESS OR IMPORTATION OF ADDITIONAL MATERIAL AT NO ADDITIONAL COST TO THE OWNER.

NOTE:

- PER THE 'SOIL EROSION AND SEDIMENTATION CONTROL SEQUENCE OF CONSTRUCTION' NOTES THE SUCCESSFUL BIDDER TO THE CLEAN THE STORM SEWER. THIS CLEANING SHALL INCLUDE CLEANING OUT THE STRUCTURES AND ENTIRE SEWER RUNS BETWEEN STRUCTURES USING HYDRAULICALLY PROPELLED, HIGH-VELOCITY JET, OR MECHANICALLY POWERED EQUIPMENT. SELECTION OF THE EQUIPMENT USED SHALL BE BASED ON THE CONDITIONS OF LINES AT THE TIME THE WORK COMMENCES. THE EQUIPMENT AND METHODS SELECTED SHALL BE SATISFACTORY TO THE SCHOOL DISTRICT'S REPRESENTATIVE. THE EQUIPMENT SHALL BE CAPABLE OF REMOVING DIRT, GREASE, ROCKS, SAND, AND OTHER MATERIALS AND OBSTRUCTIONS FROM THE SEWER LINES AND MANHOLES. IF CLEANING OF AN ENTIRE SECTION CANNOT BE SUCCESSFULLY PERFORMED FROM ONE MANHOLE, THE EQUIPMENT SHALL BE SET UP ON THE OTHER MANHOLE AND CLEANING AGAIN ATTEMPTED. IF, AGAIN, SUCCESSFUL CLEANING CANNOT BE PERFORMED OR THE EQUIPMENT FAILS TO TRAVERSE THE ENTIRE MANHOLE SECTION, IT WILL BE ASSUMED THAT A MAJOR BLOCKAGE EXISTS AND THE CLEANING EFFORT SHALL BE ABANDONED.
- PER THE PROJECT SPECIFICATIONS; PRIOR TO THE PLACEMENT OF TOPSOIL THE SUCCESSFUL BIDDER TO SCHEDULE AN INSPECTION BY THE SCHOOL DISTRICT OR PEA GROUP TO CONFIRM THAT THE GRADE IS AT THE PROPER ELEVATION WHERE THE MINIMUM DEPTH OF TOPSOIL CAN BE PLACED THROUGHOUT THE AREA.
- CONTRACTOR TO FIELD VERIFY ALL UNDERGROUND UTILITIES PRIOR TO CONSTRUCTION INCLUDING BUT NOT LIMITED TO: SITE LIGHTING, FIBER LINES, ETC.

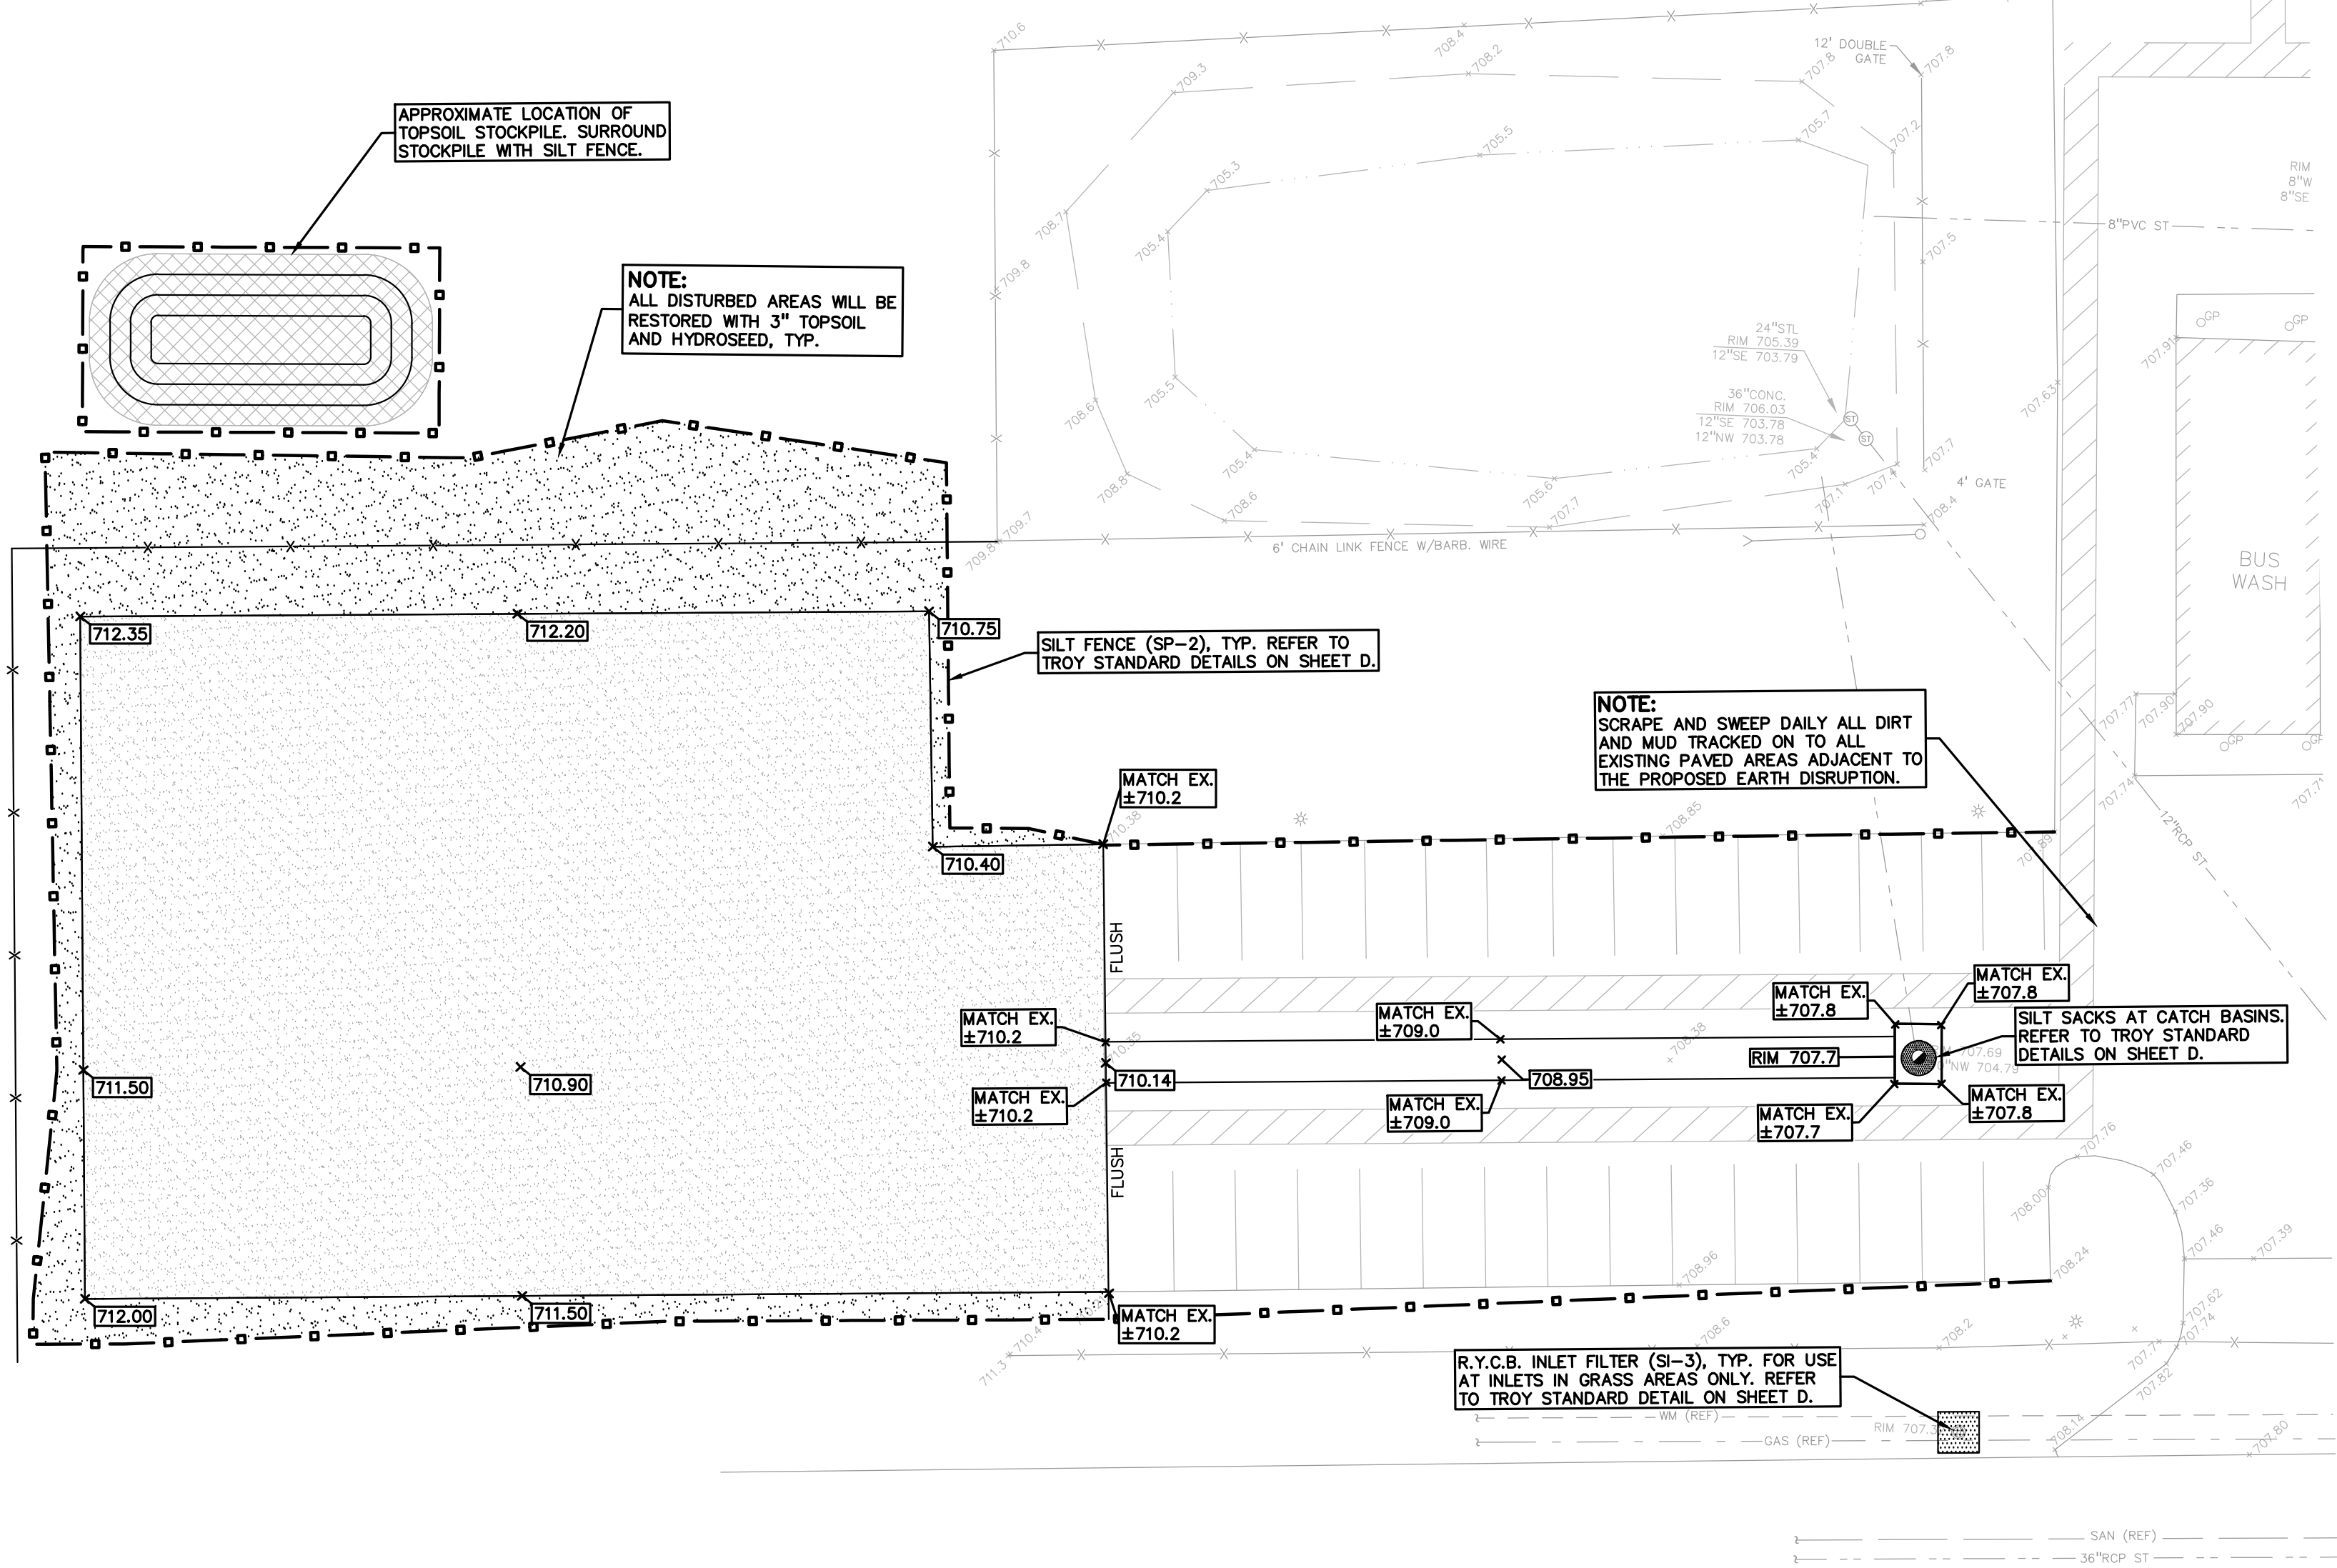

PEA GROUP

t: 844.813.2949
www.peagroup.com



0 10 20 40
SCALE: 1" = 20'



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CLIENT

TROY SCHOOLS
1140 RANKIN DRIVE
TROY, MI 48063

PROJECT TITLE

TRANSPORTATION CENTER
120 HART AVE., TROY, MI

REVISIONS

ORIGINAL ISSUE DATE:
JANUARY 4, 2023


DRAWING TITLE
**GRADING AND
SESC PLAN**

PEA JOB NO.	2022-1281
P.M.	RR
DN.	JJP
DES.	RR
DRAWING NUMBER:	

C-3.6

- GENERAL DEMOLITION NOTES:**
- THESE NOTES APPLY TO ALL CONSTRUCTION ACTIVITIES ON THIS PROJECT:
- ALL MATERIAL TO BE REMOVED, WHETHER SPECIFICALLY NOTED IN THE PLANS OR NOT, SHALL BE REMOVED FROM THE SITE BY THE CONTRACTOR AND DISPOSED OF OFF-SITE IN A LEGAL MANNER. NO ON-SITE BURY OR BURN PITS SHALL BE ALLOWED.
 - ALL DEMOLITION WORK SHALL CONFORM TO ALL LOCAL CODES AND ORDINANCES.
 - STAGING/PHASING OF DEMOLITION AND CONSTRUCTION IS TO BE COORDINATED WITH THE OWNER AND THE CONTRACTOR PRIOR TO CONSTRUCTION.
 - SPECIFIC DEMOLITION ITEMS HAVE BEEN INDICATED ON THE PLANS AS A GUIDE TO THE GENERAL SCOPE OF THE WORK. IT IS THE INTENT THAT THESE ITEMS SHALL BE COMPLETELY REMOVED BY THE CONTRACTOR ABOVE AND BELOW GROUND, UNLESS SPECIFICALLY NOTED OTHERWISE, AND THAT DEMOLITION WILL INCLUDE BUT WILL NOT NECESSARILY BE LIMITED TO THESE ITEMS. CONTRACTOR SHALL VISIT SITE TO VERIFY EXISTING CONDITIONS AND EXTENTS OF THE DEMOLITION THAT WILL BE REQUIRED PRIOR TO SUBMITTING A BID.
 - REMOVE ALL STRUCTURES DESIGNATED FOR REMOVAL ACCORDING TO THE DEMOLITION PLAN. THIS INCLUDES FOUNDATIONS, FOOTINGS, CONCRETE, ASPHALT, TREES, ETC.
 - THE CONTRACTOR SHALL, AS A MINIMUM, PROVIDE TREE PROTECTION FENCING AROUND EXISTING TREES TO BE SAVED THAT ARE WITHIN 15 FEET OF CONSTRUCTION ACTIVITIES AND AS INDICATED IN THE PLANS OR PER LOCAL AGENCY REQUIREMENTS.
 - THE CONTRACTOR SHALL BE RESPONSIBLE FOR CLEAN UP, NOISE, DUST CONTROL, STREET SWEEPING AND HOURS OF OPERATION IN ACCORDANCE WITH THE LOCAL CODES.
 - THE CONTRACTOR SHALL PROVIDE ALL NECESSARY BARRICADES, SIGNAGE, MARKINGS, LIGHTS AND OTHER TRAFFIC CONTROL DEVICES TO PROTECT THE WORK ZONE AND SAFELY MAINTAIN TRAFFIC PER AGENCY REQUIREMENTS AND IN ACCORDANCE WITH THE LATEST EDITION OF THE STATE MANUAL OF UNIFORM TRAFFIC CONTROL DEVICES.
 - THE CONTRACTOR SHALL CONTACT THE APPROPRIATE UTILITY COMPANIES TO CONFIRM THAT UTILITY LEADS HAVE BEEN TAKEN OUT OF SERVICE PRIOR TO DEMOLITION.
 - THE CONTRACTOR SHALL NOTIFY THE APPROPRIATE 811/ONE CALL UTILITY LOCATING CENTER, PRIVATE UTILITY LOCATOR, THE CITY ENGINEER AND/OR THE AUTHORITY HAVING JURISDICTION 3 BUSINESS DAYS PRIOR TO THE BEGINNING OF CONSTRUCTION.

FLOODPLAIN NOTE:
BY GRAPHICAL PLOTTING, SITE IS WITHIN ZONE 'X'. AN AREA DETERMINED TO BE OUTSIDE OF THE 0.2% ANNUAL CHANCE FLOODPLAIN, PER FLOOD INSURANCE RATE MAP NUMBER 26125C0553G, DATED JANUARY 16, 2009.

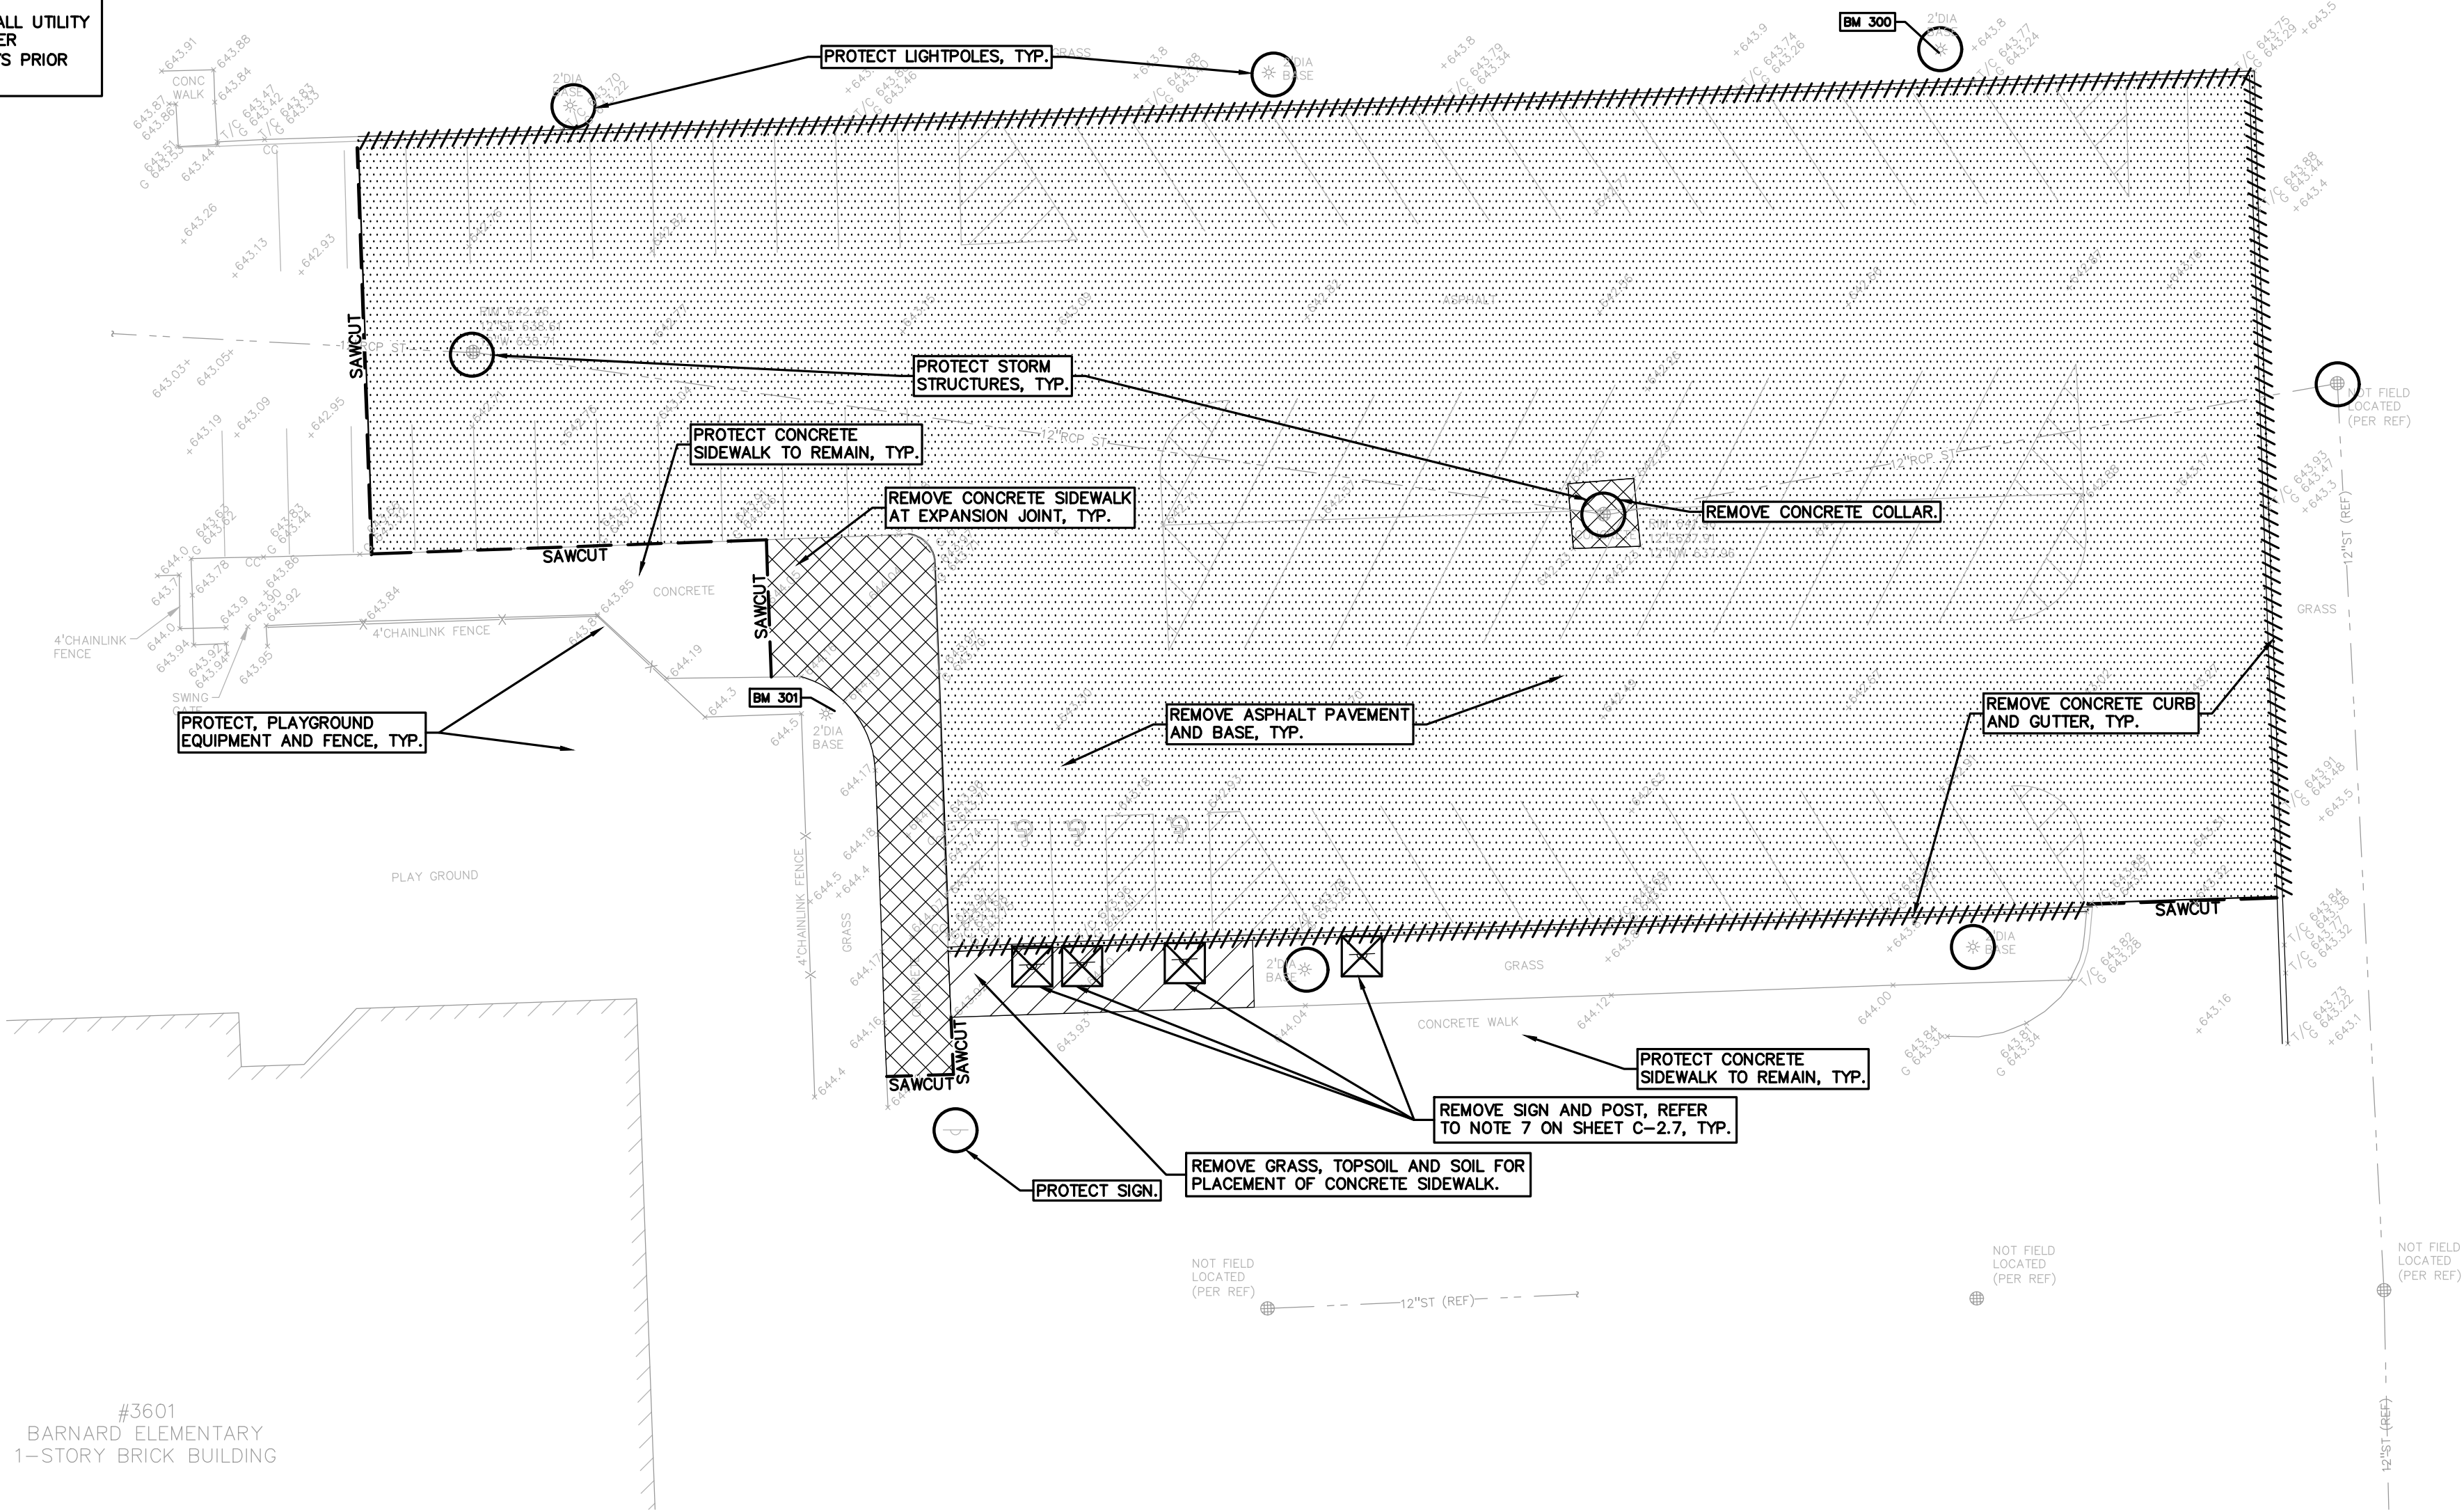

LEGEND:

-OH-ELEC-W-O-	EX. OH. ELEC. POLE & GUY WIRE
-UG-CATV-	EX. U.G. CABLE TV & PEDESTAL
-UG-COMM-	EX. U.G. COMMUNICATION LINE, PEDESTAL & MANHOLE
-UG-ELEC-	EX. U.G. ELEC. MANHOLE, METER & HANDHOLE
- - - - -	EX. GAS LINE
⊙	EX. GAS VALVE & GAS LINE MARKER
⊠	EX. TRANSFORMER & IRRIGATION VALVE
- - - - -	EX. WATER MAIN
⊕	EX. HYDRANT, GATE VALVE & POST INDICATOR VALVE
⊙	EX. WATER VALVE BOX & SHUTOFF
⊕	EX. SANITARY SEWER
⊕	EX. SANITARY CLEANOUT & MANHOLE
⊕	EX. COMBINED SEWER MANHOLE
- - - - -	EX. STORM SEWER
⊕	EX. CLEANOUT & MANHOLE
⊕	EX. SQUARE, ROUND, & BEEHIVE CATCH BASIN
⊕	EX. YARD DRAIN & ROOF DRAIN
⊕	EX. UNIDENTIFIED STRUCTURE
⊕	EX. MAILBOX, SIGN & LIGHTPOLE
- - - - -	EX. FENCE
- - - - -	EX. GUARD RAIL
- - - - -	EX. SPOT ELEVATION
- - - - -	EX. CONTOUR
- - - - -	EX. WETLAND
⊙	IRON FOUND / SET
⊕	NAIL FOUND / NAIL & CAP SET
⊕	BRASS PLUG SET
⊕	MONUMENT FOUND / SET
⊕	SECTION CORNER FOUND
R M C	RECORDED / MEASURED / CALCULATED

REFERENCE DRAWINGS:

CABLE	HAVE NOT RECEIVED AS OF 11/27/2022
FIBER OPTIC	HAVE NOT RECEIVED AS OF 11/27/2022
WATER MAIN	HAVE NOT RECEIVED AS OF 11/27/2022
SANITARY SEWER	HAVE NOT RECEIVED AS OF 11/27/2022
STORM SEWER	HAVE NOT RECEIVED AS OF 11/27/2022
ELECTRIC	HAVE NOT RECEIVED AS OF 11/27/2022

REFERENCE FROM PEA JOB NO. 2012-144:
SITE EXISTING CONDITIONS

DEMOLITION LEGEND:

ITEM TO BE PROTECTED	⊕
ITEM TO BE REMOVED	⊗
CURB/FENCE REMOVAL	////
CONCRETE PAVEMENT AND SIDEWALK REMOVAL	XXXX
AREA OR ITEMS TO BE REMOVED	XXXX
UTILITY REMOVAL	XXXX
ABANDON UTILITY
ASPHALT REMOVAL	XXXX
TREE REMOVAL	⊗
SAWCUT LINE	- - - - -

BENCHMARKS:
(GPS DERIVED - NAVD88)

BM #300
SCRIBED "+" ON SOUTH SIDE OF LIGHT POLE BASE, 5' NORTH OF BACK OF CURB, 140' WEST OF NORTHEAST CORNER OF PARKING LOT.
ELEV. - 644.27

BM #301
SCRIBED "+" ON NORTHEAST SIDE OF LIGHT POLE BASE, 15' WEST OF BACK OF WALK, ± 80' NORTHEAST OF NORTHEAST CORNER OF BUILDING.
ELEV. - 644.97

LEGAL DESCRIPTION:
PARCEL ID 20-24-100-043
Land in the City of Troy, Oakland County, Michigan, described as follows:
T2N, R11E, SEC 24 PART OF SW 1/4 OF NW 1/4 BEG AT PT DIST S 1486.87 FT & S 89-16-00 E 316.80 FT FROM NW SEC COR, TH S 89-18-00 E 980.63 FT, TH S 00-33-00 W 662.70 FT, TH N 89-13-00 W 984.28 FT, TH N 661.88 FT TO BEG. 15.01 A 11/07/02 FR -022 & -028

DEMOLITION QUANTITIES:

REMOVE ASPHALT AND BASE	29,202 SF
REMOVE CONCRETE CURB	595 LF
REMOVE CONCRETE	1,252 SF
SAWCUT PAVEMENT	213 LF
REMOVE SIGN AND POST	4 EA
REMOVE TOPSOIL, GRASS, SOIL	452 SF

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0 10 20 40
SCALE: 1" = 20'



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CLIENT
TROY SCHOOLS
1140 RANKIN DRIVE
TROY, MI 48063

PROJECT TITLE
BARNARD ELEMENTARY SCHOOL
3601 FORGE RD.
TROY, MI

REVISIONS

ORIGINAL ISSUE DATE:
JANUARY 4, 2023

DRAWING TITLE
TOPOGRAPHIC SURVEY AND DEMOLITION PLAN

PEA JOB NO. 2022-1281

P.M. RR

DN. JJP

DES. RR

DRAWING NUMBER:

C-1.7


1. TO MINIMIZE SUBGRADE INSTABILITY AND UNDERCUTS, THE SUBGRADE SHALL NOT BE LEFT EXPOSED TO PRECIPITATION AND CONSTRUCTION OPERATIONS AND SHOULD BE PERFORMED DURING THE SUMMER MONTHS TO ENSURE DRY, WARM, WEATHER. ADDITIONALLY, THE SUBGRADE MAY BECOME UNSTABLE UNDER REPEATED LOADING OF CONSTRUCTION TRAFFIC; THEREFORE, CONSTRUCTION EQUIPMENT SHOULD BE LIMITED ON THE EXPOSED SUBGRADE.

2. UNDERCUT EXCAVATIONS SHALL BE BACKFILLED WITH MDOT 21AA DENSE GRADED AGGREGATE PLACED IN AN ENGINEERED MANNER. LIFT THICKNESS SHALL NOT EXCEED 9 INCHES. THE USE OF TRI-AXIAL GEGRID MAY BE USED TO REDUCE UNDERCUT DEPTHS, AS APPROVED BY THE DISTRICT AND PER THE UNIT PRICE PROVIDED WITH THE CONTRACTORS BID.

3. THE QUANTITY FOR "SUBGRADE UNDERCUT DRAIN TILE (4")" FOR EACH SITE SHALL BE INCLUDED IN THE BASE BID. THIS ITEM IS CONSIDERED AN ALLOWANCE AND FINAL PAYMENT WILL BE BASED ON THE ACTUAL FOOTAGE OF COMPACTED IN PLACE STONE PER THE UNIT PRICE PROVIDED IN THE BID PACKAGE.

4. ALL ENGINEERED FILL SHALL BE COMPACTED TO A DENSITY OF AT LEAST 95 PERCENT OF THE MAXIMUM DENSITY DETERMINED BY THE MODIFIED PROCTOR (ASTM D1557) METHOD OF TESTING. ALL ENGINEERED FILL MATERIAL SHALL BE PLACED AND COMPACTED AT APPROXIMATELY THE OPTIMUM MOISTURE CONTENT. FROZEN MATERIAL SHALL NOT BE USED AS FILL, NOR SHOULD FILL BE PLACED ON A FROZEN SUBGRADE.


5. SUBGRADE UNDERCUTS SHALL BE EVALUATED BY A QUALIFIED ENGINEERING TECHNICIAN TO DETERMINE IF SUBGRADE STABILIZATION IS NECESSARY. DRAIN TILE SHALL BE PLACED WITHIN ANY UNDERCUT AREA AND CONNECTED TO THE CLOSEST CATCH BASIN TO PREVENT GROUNDWATER FROM POOLING WITHIN THE GRANULAR SOILS IN UNDERCUTS AND CREATING "BATHTUBS" IN THE COHESIVE SOILS.

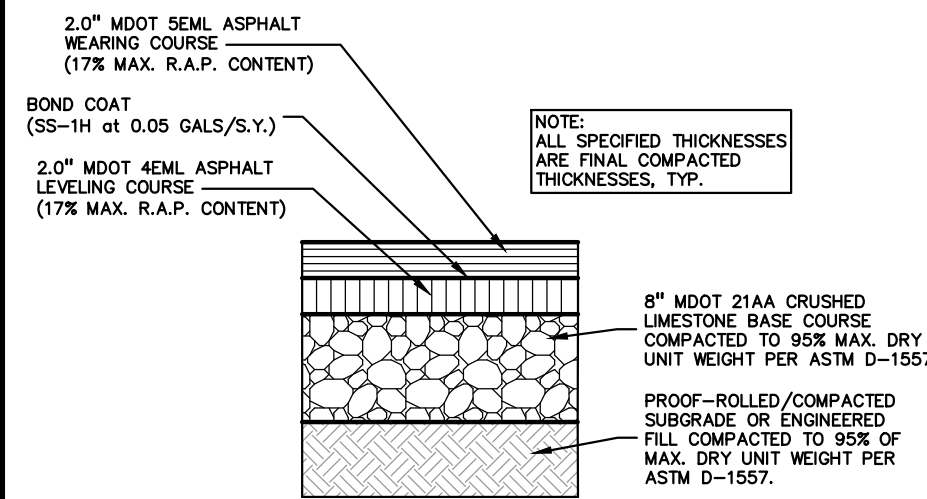

STANDARD DUTY ASPHALT DETAIL

AGGREGATE BASE NOTE:
THIS PAVEMENT SECTION DESIGN ASSUMES THE USE OF MDOT 21AA CRUSHED LIMESTONE BASE MATERIAL THAT MEETS THE REQUIREMENTS OF MDOT STANDARD SPECIFICATION SECTION 902 FOR AGGREGATES. IF CRUSHED CONCRETE AGGREGATE IS USED INSTEAD OF ALL OF THE SPECIFIED CRUSHED LIMESTONE MATERIAL, PEAK GROUP WILL REQUIRE A MINIMUM 25% INCREASE IN BASE THICKNESS. HOWEVER, IF TESTING DOCUMENTATION IS PROVIDED TO PEA GROUP THAT SHOWS THAT THE CRUSHED CONCRETE MATERIAL MEETS ALL REQUIREMENTS OF MDOT SPECIFICATION SECTION 902, THEN THE 25% INCREASE IN THICKNESS MAY BE REEVALUATED.


ASPHALT MATERIAL NOTES:
HOT-MIX ASPHALT MIXTURES UTILIZING RECYCLED ASPHALT PAVEMENT (RAP) MUST
MEET MDOT SPECIAL PROVISION 12D5P01(E). THE BINDER GRADE FOR THIS WORK IS
PG64-22. IF ASPHALT MIXES CONTAINING RAP ARE TO BE SUPPLIED FOR THIS
PROJECT, THE ASPHALT BINDER MUST BE REVISED PER MDOT 'TIER 1' OR 'TIER 2'
REQUIREMENTS (RAP CONTENT UP TO 17% MAXIMUM). TIER 3 MIXES ARE NOT
ACCEPTABLE ON THIS PROJECT. AN ASPHALT MIX DESIGN FOR ALL SPECIFIED MIXES
SHOULD BE FORWARDED TO PEA GROUP FOR REVIEW PRIOR TO CONSTRUCTION

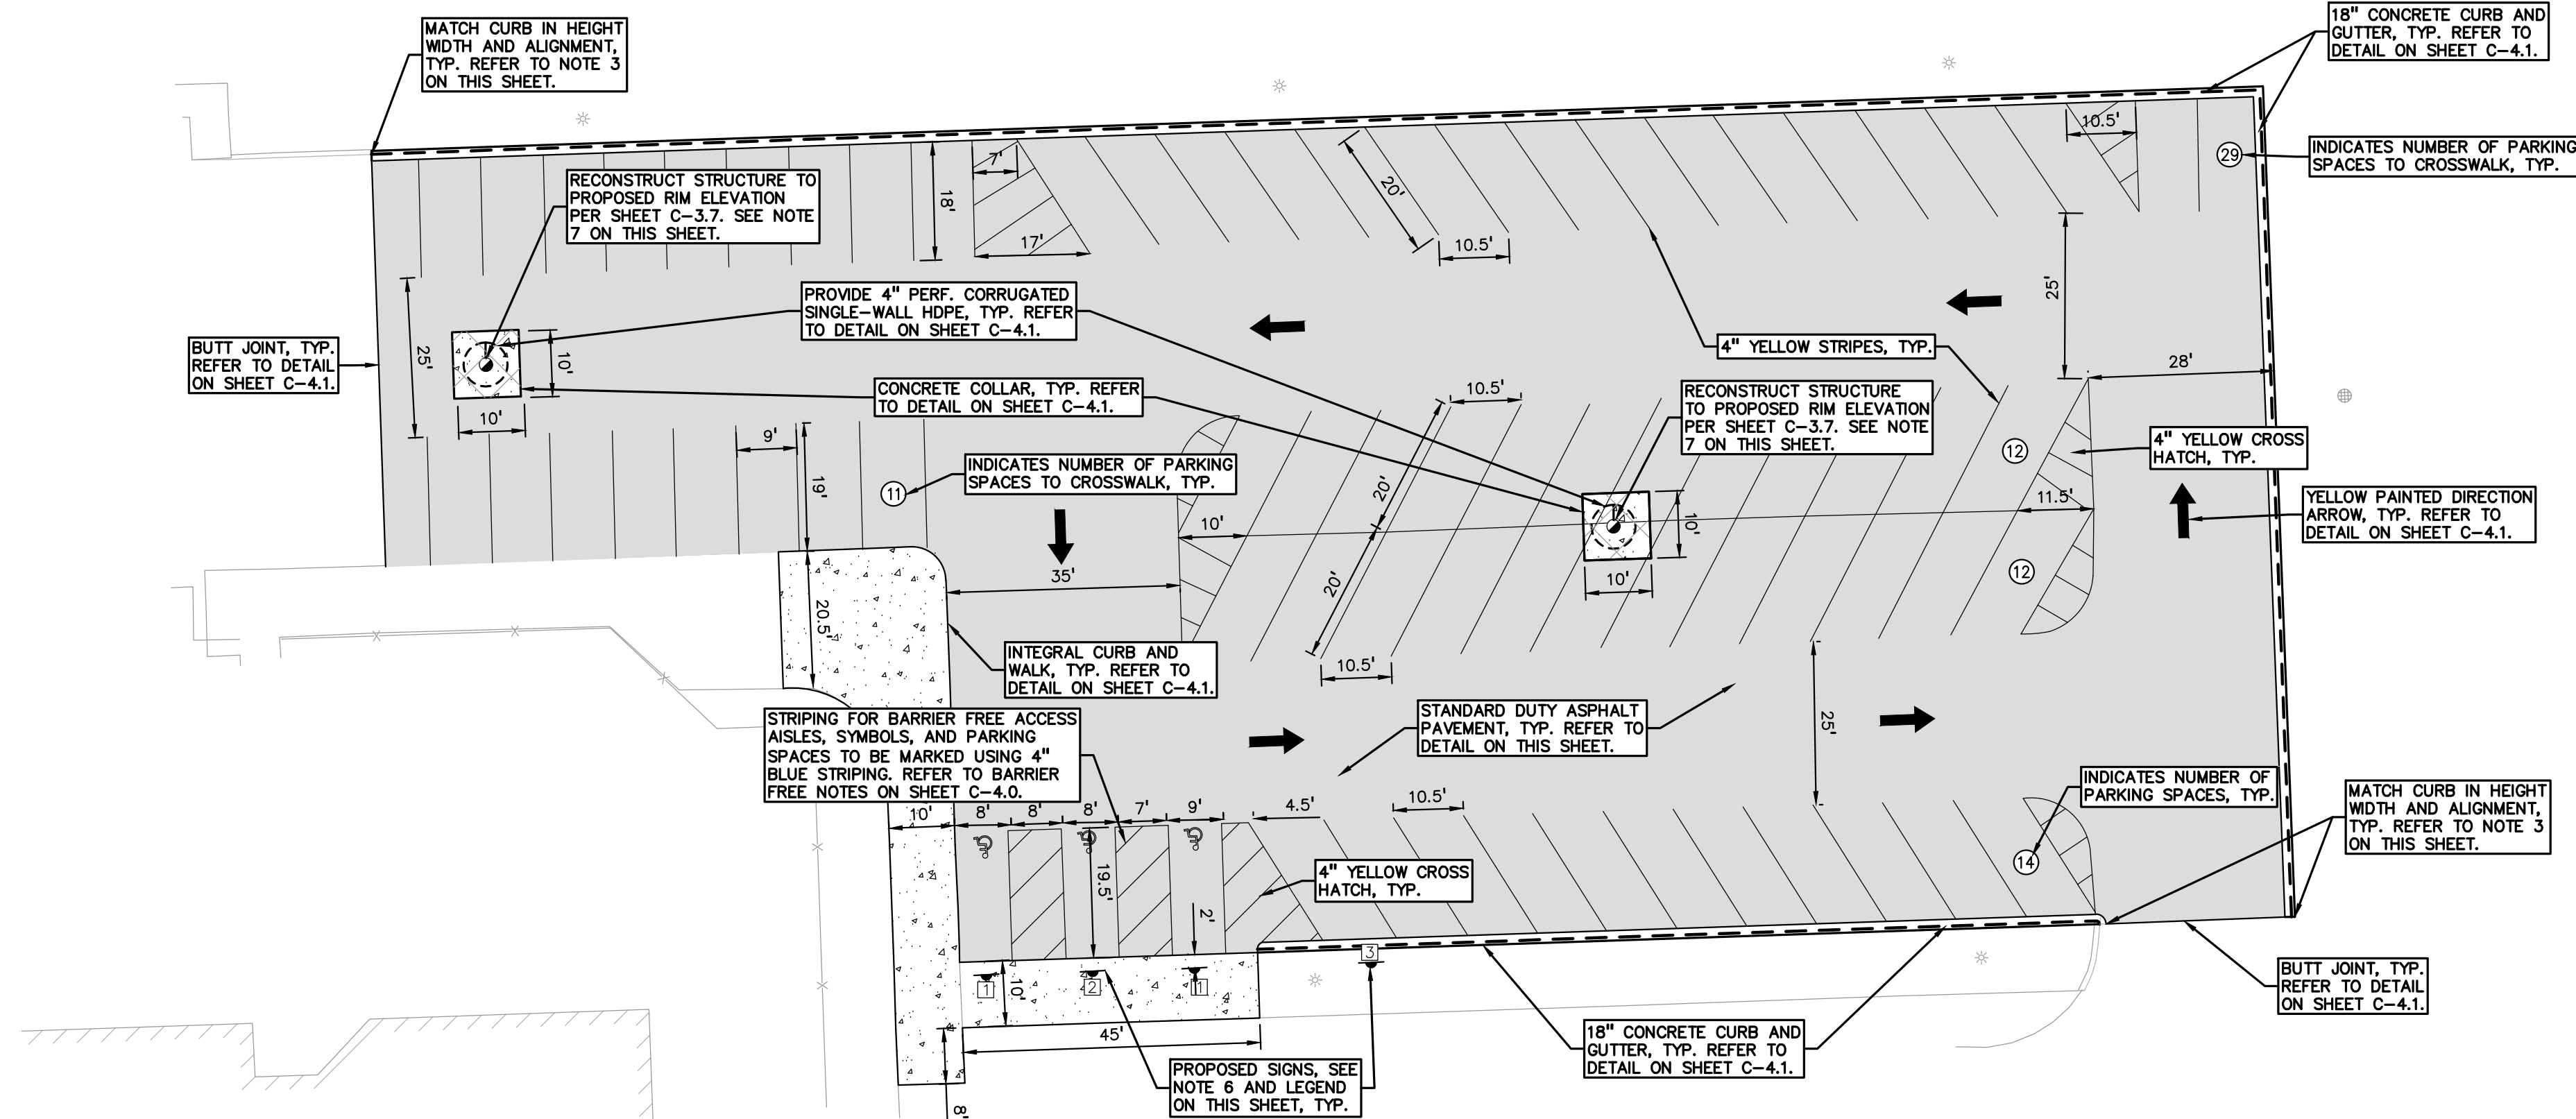

FLOODPLAIN NOTE:

BY GRAPHICAL PLOTTING, SITE IS WITHIN ZONE 'X', AN AREA DETERMINED TO BE OUTSIDE OF THE 0.2% ANNUAL CHANCE FLOODPLAIN, PER FLOOD INSURANCE RATE MAP NUMBER 26125C0553G, DATED JANUARY 16, 2009.

LEGEND:

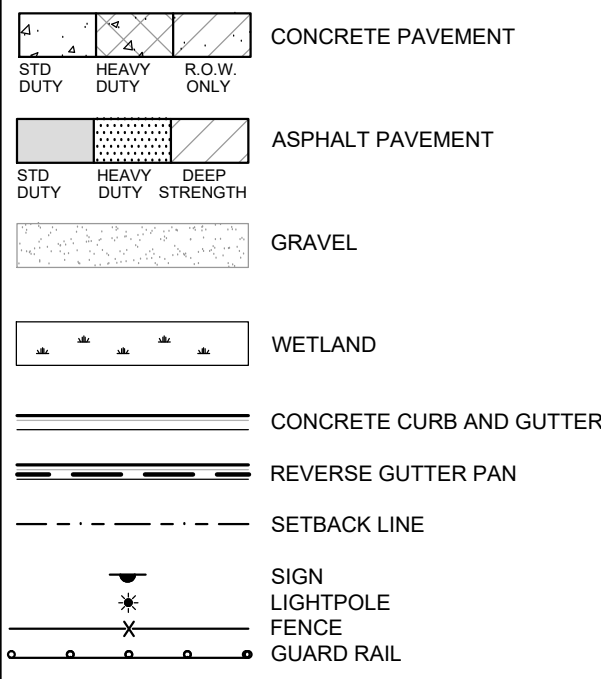

NOTES:

1. CONTRACTOR TO VERIFY ALL QUANTITIES SHOWN ON THE PLANS. ANY DEVIATIONS TO THE PLAN QUANTITIES SHALL BE BROUGHT TO THE ATTENTION OF THE SCHOOL DISTRICT AND PEA GROUP, IN WRITING PER THE BID PACKAGE, FOR VERIFICATION PRIOR TO BIDDING.
2. ALL DIMENSIONS SHOWN ARE TO BACK OF CURB, FACE OF SIDEWALK, CENTER OF MANHOLE/CATCH BASIN UNLESS OTHERWISE NOTED.
3. DOWEL INTO EXISTING CURB AND GUTTER WITH 2" EPOXY. PROVIDE #4 BARS CONTINUOUSLY BETWEEN EXISTING AND PROPOSED CURBING.
4. REFER TO NOTES AND DETAILS SHEET FOR PAVING DETAILS.
5. CONTRACTOR TO FIELD VERIFY ALL UNDERGROUND UTILITIES PRIOR TO CONSTRUCTION INCLUDING BUT NOT LIMITED TO: SITE LIGHTING, FIBER LINES, ETC.
6. CONTRACTOR TO REMOVE AND REPLACE SIGNS AND POSTS PER DETAILS ON SHEET 10. ALL SIGNS AND ANY POSTS IN GOOD CONDITION SHALL BE RETURNED TO THE OWNER. ALL POSTS DAMAGED OR OTHERWISE, NOT IN USE DUE TO CONDITION SHALL BE DISPOSED OF AT NO ADDITIONAL COST TO THE OWNER.
7. FOR THE TWO (2) CATCH BASINS, LOCATED IN THE WORK AREA; BIDDERS ARE TO INCLUDE RECONSTRUCTION OF THESE STRUCTURES (GREATER THAN 12-INCHES IN DEPTH FROM THE RIM ELEVATION OF REPAIR WORK) IN THE BASE BID. THE SUCCESSFUL BIDDER WILL BE PAID FOR REPAIRING EACH STRUCTURE BASED ON THE ACTUAL DEPTH OF REPAIR WITH EITHER STRUCTURAL ADJUSTMENT (WITHIN TOP 12-INCHES OF RIM ELEVATION) OR STRUCTURAL RECONSTRUCTION (FOR GREATER THAN 12-INCHES IN DEPTH) PER THE UNIT PRICES PROVIDED IN THE BID PACKAGE AND THE SCOPE OF WORK DETERMINED AND AGREED PRIOR TO THE WORK COMMENCING. REPLASTERING OF THE ENTIRE STRUCTURE SHALL BE INCLUDED IN THE UNIT PRICE FOR BOTH STRUCTURAL ADJUSTMENT AND FOR STRUCTURAL RECONSTRUCTION.

PAVING QUANTITIES:

18" CONCRETE CURB AND GUTTER	538 LF
4" CONCRETE SIDEWALK	1,499 SF
4" ASPHALT PAVEMENT	29,204 SF
8" 21AA AGGREGATE	29,204 SF
BUTT JOINT	88 LF
CONCRETE COLLAR	2 EA.
SIGN AND POST	4 EA.

SUBGRADE UNDERCUT ALLOWANCE

SUBGRADE UNDERCUT	
DRAIN TILE (4") ALLOWANCE	500 LF
ENGINEERING QUANTITIES:	
ADJUST/RECONSTRUCT STORM STRUCTURE	2 EA
4" HDPE PERF. UNDERDRAIN	46 LF

SIGN LEGEND:

'BARRIER FREE PARKING' SIGN	1
'VAN ACCESSIBLE' SIGN	2
'RESERVED PARKING' SIGN	3

REFER TO DETAIL SHEET FOR SIGN DETAILS



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CAUTION!!
THE LOCATIONS AND ELEVATIONS OF EXISTING UNDERGROUND UTILITIES AS SHOWN ON THIS DRAWING ARE ONLY APPROXIMATE. NO GUARANTEE IS EITHER EXPRESSED OR IMPLIED AS TO THE COMPLETENESS OR ACCURACY THEREOF. THE CONTRACTOR SHALL BE EXCLUSIVELY RESPONSIBLE FOR DETERMINING THE EXACT UTILITY LOCATIONS AND ELEVATIONS PRIOR TO THE START OF CONSTRUCTION.

CLIENT

TROY SCHOOLS

1140 RANKIN DRIVE
TROY, MI 48083

PROJECT TITLE

**BARNARD
ELEMENTARY
SCHOOL**

3601 FORGE RD
TROY,MI

REVISIONS

ORIGINAL ISSUE DATE:
JANUARY 4, 2023

DRAWING TITLE

DRAWING TITLE

PAVING AND DIMENSION PLAN

PEA JOB NO. 2022-1281

P.M.	RF
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DN	.JIE
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DES.	RF
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DRAWING NUMBER

C-2.7

SEQUENCE OF CONSTRUCTION:

START DAY	END DAY	
1	2	INSTALL TEMPORARY SOIL EROSION CONTROL MEASURES, SILT FENCES, INLET PROTECTION, ETC. AS NECESSARY.
1	90	MAINTAIN A 25' BUFFER OF VEGETATION AROUND PERIMETER OF SITE WHERE POSSIBLE.
1	5	STRIP AND STOCKPILE TOPSOIL AS REQUIRED RESTORATION. ALL STOCKPILES MUST BE GRADED AND SEEDED.
5	15	REMOVE ALL PAVEMENT, CURB, UTILITIES, ETC. AS REQUIRED TO INSTALL THE PROPOSED WORK AS SHOWN ON THE TOPOGRAPHIC SURVEY AND DEMOLITION PLAN.
10	15	DISPOSE OF ALL EXCESS/UNSUITABLE MATERIALS OFF SITE IN A LEGAL MANNER. NO ON-SITE BURN OR BURY PITS ALLOWED.
30	40	ROUGH GRADE SITE. SEED AND MULCH BLANKETS MUST BE INSTALLED AS SHOWN WITHIN 5 DAYS OF FINAL GRADE. REPAIR AND/OR RE-INSTALL ANY TEMPORARY SOIL EROSION CONTROL MEASURES THAT WERE DAMAGED DURING GRADING OPERATIONS.
15	90	TEMPORARY SEEDING MUST BE PROVIDED IN AREAS NOT TO BE WORKED ON FOR 15 DAYS OR LONGER.
40	50	FINE GRADE SITE AND PREPARE FOR SITE PAVING OPERATIONS.
50	80	INSTALL ALL PAVEMENT, SIDEWALKS, CURBING AS PROPOSED. IF PERMANENT LANDSCAPING IS NOT TO BE INSTALLED SOON AFTER PAVING IS COMPLETE, ALL AREAS WITHIN 20 FEET OF BACK OF CURB MUST BE TEMPORARILY SEEDED. REPAIR INLET PROTECTION, SILT FENCE AND ANY OTHER DAMAGED SOIL EROSION CONTROL MEASURES AS NECESSARY.
80	89	FINAL GRADE, REDISTRIBUTE STOCKPILED TOPSOIL, ESTABLISH VEGETATION AND INSTALL ALL PERMANENT LANDSCAPING IN ALL DISTURBED AREAS NOT BUILT.
88	90	CLEAN PAVEMENT AND REMOVE ALL TEMPORARY SOIL EROSION CONTROL MEASURES. RE-ESTABLISH VEGETATION AS REQUIRED.
90	90	REMOVE SEDIMENTATION CONTROLS ONCE ENTIRE SITE HAS BEEN PERMANENTLY STABILIZED.

NOTE:

- PER THE 'SOIL EROSION AND SEDIMENTATION CONTROL SEQUENCE OF CONSTRUCTION' NOTES THE SUCCESSFUL BIDDER TO THE CLEAN THE STORM SEWER. THIS CLEANING SHALL INCLUDE CLEANING OUT THE STRUCTURES AND ENTIRE SEWER RUNS BETWEEN STRUCTURES USING HYDRAULICALLY PROPELLED, HIGH-VELOCITY JET, OR MECHANICALLY POWERED EQUIPMENT. SELECTION OF THE EQUIPMENT USED SHALL BE BASED ON THE CONDITIONS OF LINES AT THE TIME THE WORK COMMENCES. THE EQUIPMENT AND METHODS SELECTED SHALL BE SATISFACTORY TO THE SCHOOL DISTRICT'S REPRESENTATIVE. THE EQUIPMENT SHALL BE CAPABLE OF REMOVING DIRT, GREASE, ROCKS, SAND, AND OTHER MATERIALS AND OBSTRUCTIONS FROM THE SEWER LINES AND MANHOLES. IF CLEANING OF AN ENTIRE SECTION CANNOT BE SUCCESSFULLY PERFORMED FROM ONE MANHOLE, THE EQUIPMENT SHALL BE SET UP ON THE OTHER MANHOLE AND CLEANING AGAIN ATTEMPTED. IF, AGAIN, SUCCESSFUL CLEANING CANNOT BE PERFORMED OR THE EQUIPMENT FAILS TO TRAVERSE THE ENTIRE MANHOLE SECTION, IT WILL BE ASSUMED THAT A MAJOR BLOCKAGE EXISTS AND THE CLEANING EFFORT SHALL BE ABANDONED.
- PER THE PROJECT SPECIFICATIONS; PRIOR TO THE PLACEMENT OF TOPSOIL, THE SUCCESSFUL BIDDER TO SCHEDULE AN INSPECTION BY THE SCHOOL DISTRICT OR PEA GROUP TO CONFIRM THAT THE GRADE IS AT THE PROPER ELEVATION WHERE THE MINIMUM DEPTH OF TOPSOIL CAN BE PLACED THROUGHOUT THE AREA.
- CONTRACTOR TO FIELD VERIFY ALL UNDERGROUND UTILITIES PRIOR TO CONSTRUCTION INCLUDING BUT NOT LIMITED TO: SITE LIGHTING, FIBER LINES, ETC.

EARTHWORK BALANCING NOTE:

THE CONTRACTOR SHALL BE RESPONSIBLE FOR IMPORTING OR EXPORTING ALL MATERIALS AS REQUIRED TO PROPERLY GRADE THIS PROJECT TO THE FINISHED ELEVATIONS SHOWN ON THE APPROVED PLANS. THE CONTRACTOR SHALL MAKE THEIR OWN DETERMINATION OF CUT AND FILL QUANTITIES AND ALLOW FOR REMOVAL OF EXCESS OR IMPORTATION OF ADDITIONAL MATERIAL AT NO ADDITIONAL COST TO THE OWNER.

EROSION CONTROL QUANTITIES:

SILT FENCE	410 LF
R.Y.C.B. INLET FILTER	1 EA
LOW POINT INLET FILTER	5 EA
LAWN RESTORATION AREA	170 SY

GRADING LEGEND:

- EXISTING SPOT ELEVATION
PROPOSED SPOT ELEVATION: TYPICALLY TOP OF PAVEMENT IN PAVED AREAS, GUTTER GRADE IN CURB LINES.
EXISTING CONTOUR
PROPOSED CONTOUR
PROPOSED REVERSE GUTTER PAN
PROPOSED RIDGE LINE
PROPOSED SWALE/DITCH

ABBREVIATIONS

T/C = TOP OF CURB
T/P = TOP OF PAVEMENT
T/S = TOP OF SIDEWALK
T/W = TOP OF WALL
G = GUTTER GRADE
F.G. = FINISH GRADE
RIM = RIM ELEVATION
B/W = BOTTOM OF WALL

REFER TO GRADING NOTES ON SHEET C-4.0.

SYMBOLS: EROSION CONTROL:

- (SP-2) SILT FENCE
(SI-2A) LOW POINT INLET FILTER
(SI-3) RYCB INLET FILTER
(E-9) EROSION CONTROL BLANKET
LAWN RESTORATION
REFER TO O.C.W.R.C. SOIL EROSION AND SEDIMENTATION CONTROL DETAILS SHEET FOR ALL DEVICE DETAILS.

PEA GROUP
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0 10 20 40
SCALE: 1" = 20'



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CLIENT
TROY SCHOOLS
1140 RANKIN DRIVE
TROY, MI 48063

PROJECT TITLE
BARNARD ELEMENTARY SCHOOL
3601 FORGE RD.
TROY, MI


REVISIONS

ORIGINAL ISSUE DATE:
JANUARY 4, 2023

DRAWING TITLE
**GRADING AND
SESC PLAN**

PEA JOB NO.	2022-1281
P.M.	RR
DN.	JJP
DES.	RR
DRAWING NUMBER:	

C-3.7

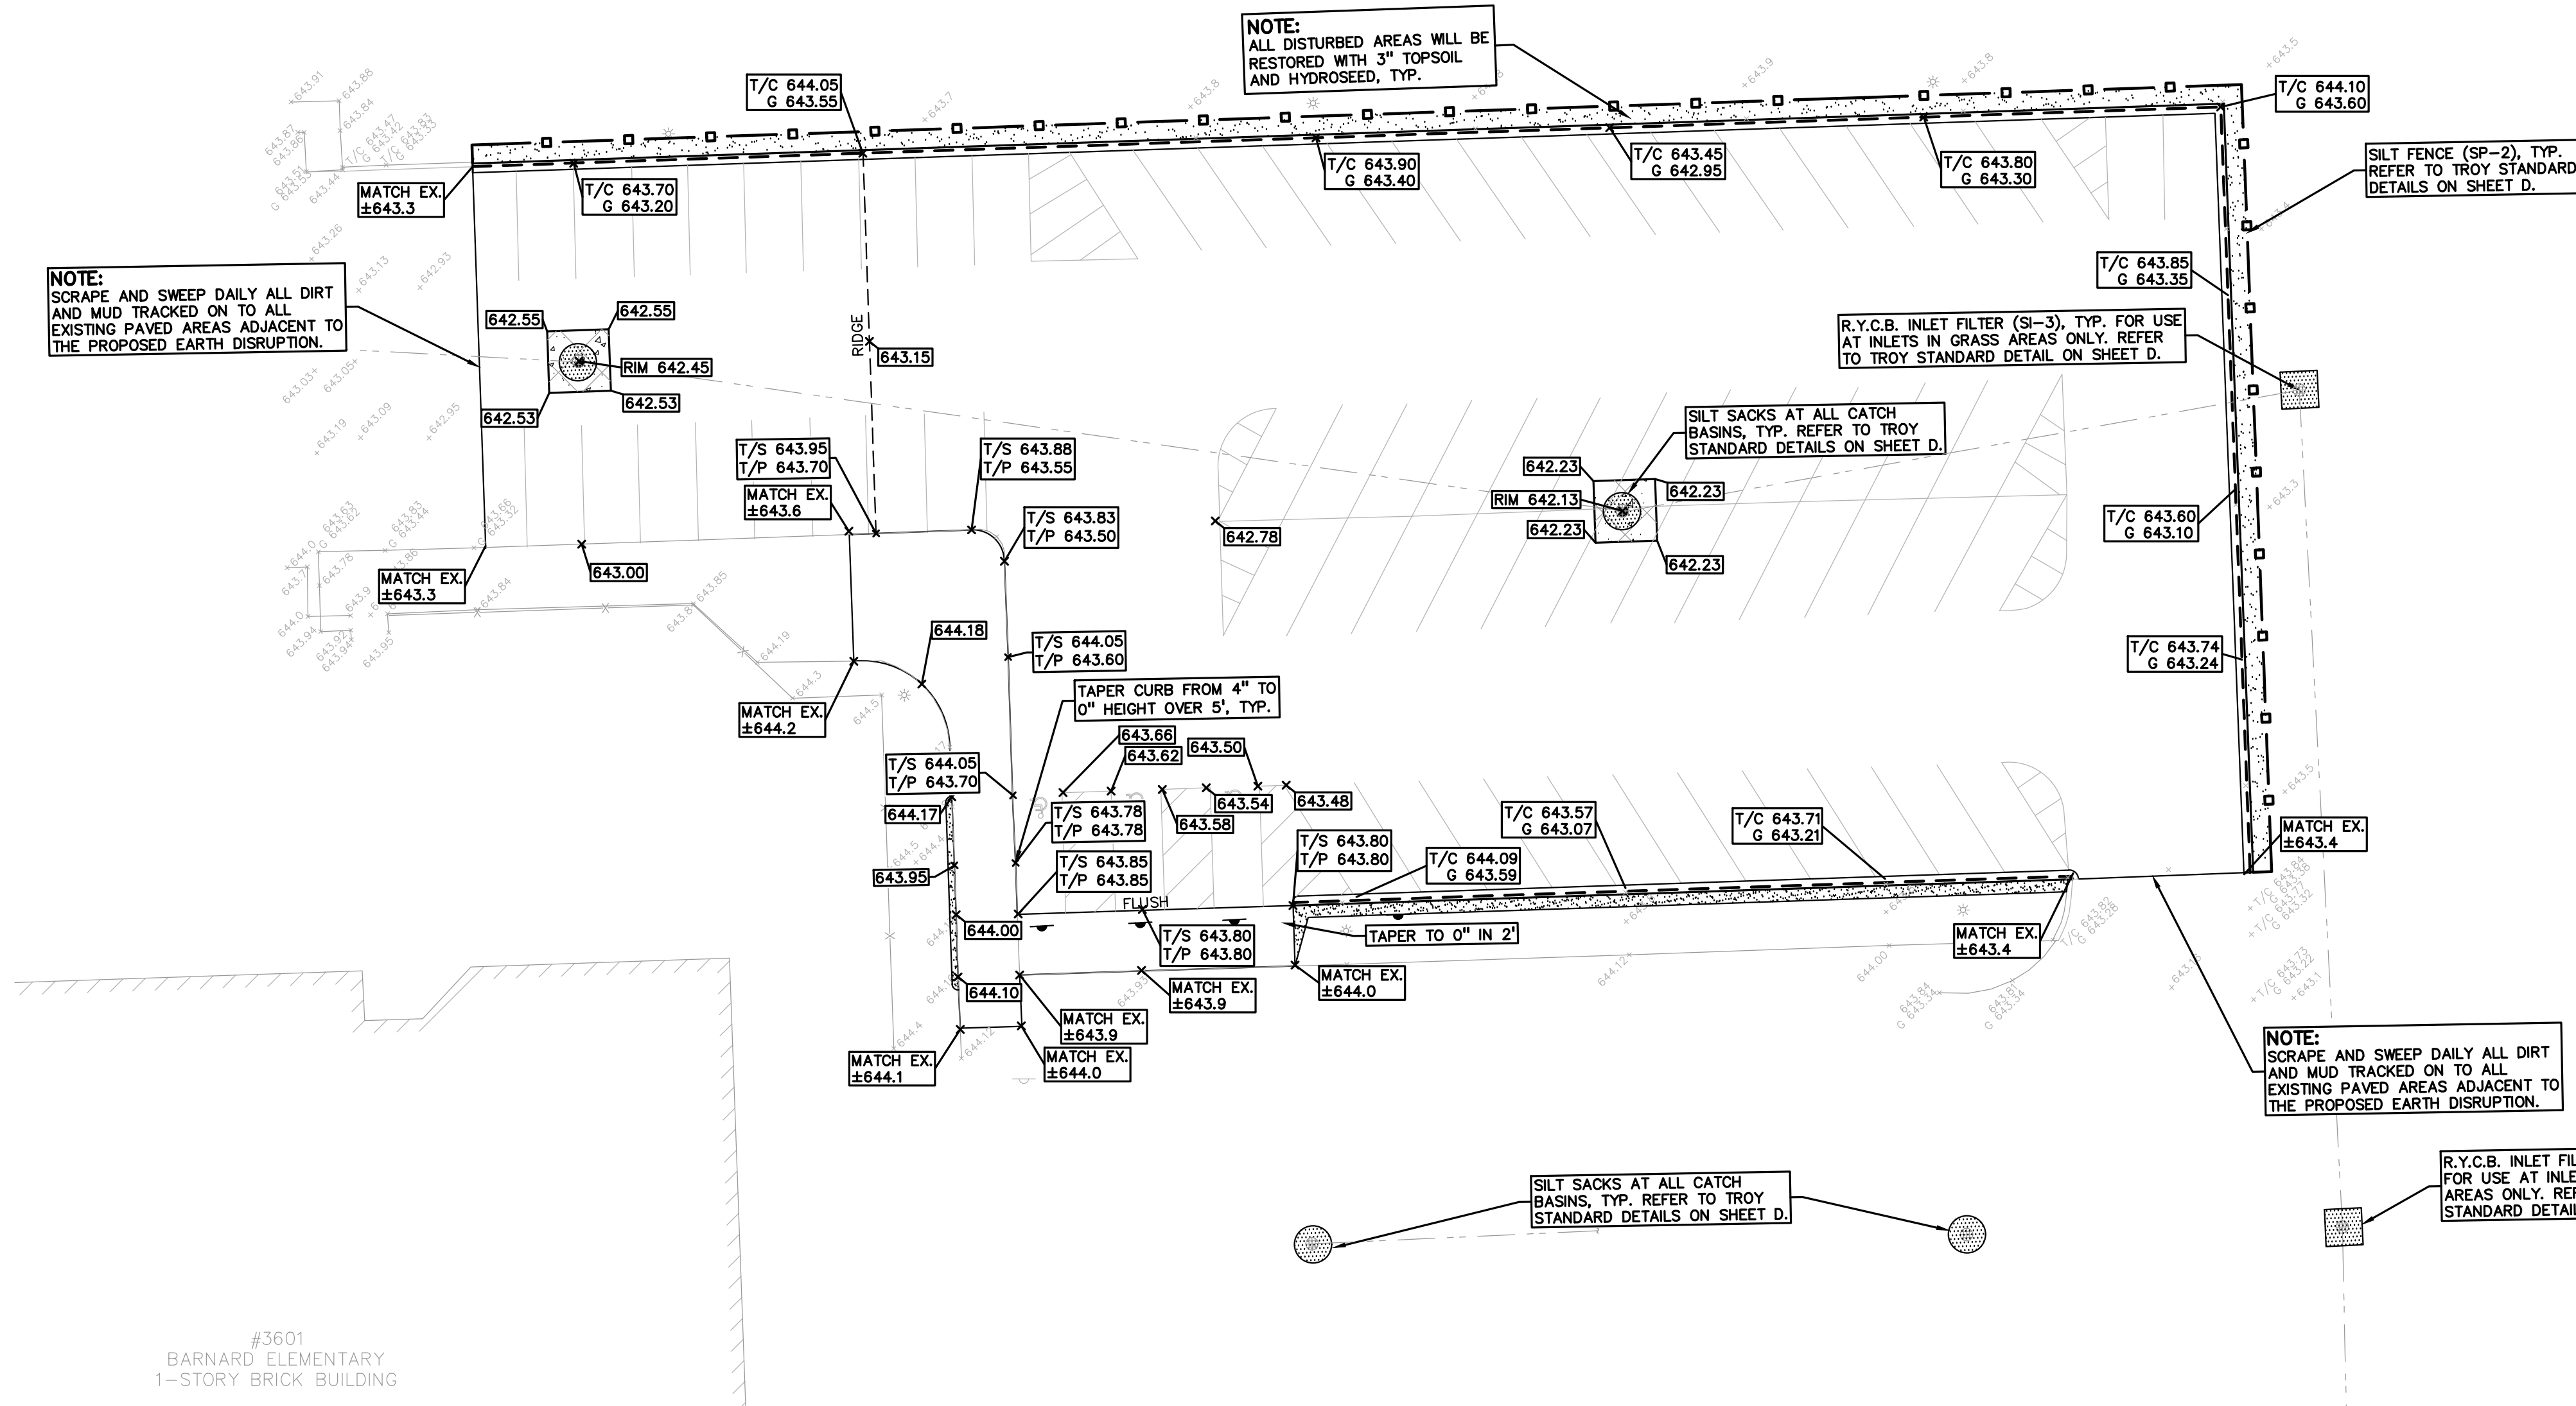

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#3601
BARNARD ELEMENTARY
1-STORY BRICK BUILDING
FLOODPLAIN NOTE:
BY GRAPHICAL PLOTTING, SITE IS WITHIN ZONE 'X'; AN AREA DETERMINED TO BE OUTSIDE OF THE 0.2% ANNUAL CHANCE FLOODPLAIN, PER FLOOD INSURANCE RATE MAP NUMBER 26125C01553G, DATED JANUARY 16, 2009.

QUANTITIES:	
SLURRY SEAL	33943 SF
HOT RUBBER JOINT SEALANT	3300 LF
LOW POINT INLET FILTER	1 EA

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0102040

SCALE: 1" = 20'

811

Know what's below.
Call before you dig.

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CLIENT
TROY SCHOOLS
1140 RANKIN DRIVE
TROY, MI 48063

PROJECT TITLE
ATHENS HIGH SCHOOL
4333 JOHN R. ROAD, TROY, MI


REVISIONS

ORIGINAL ISSUE DATE:
JANUARY 4, 2023

DRAWING TITLE
ENGINEERING PLAN

PEA JOB NO.	2022-1281
P.M.	RR
DN.	JJP
DES.	RR

DRAWING NUMBER:
C-2.8






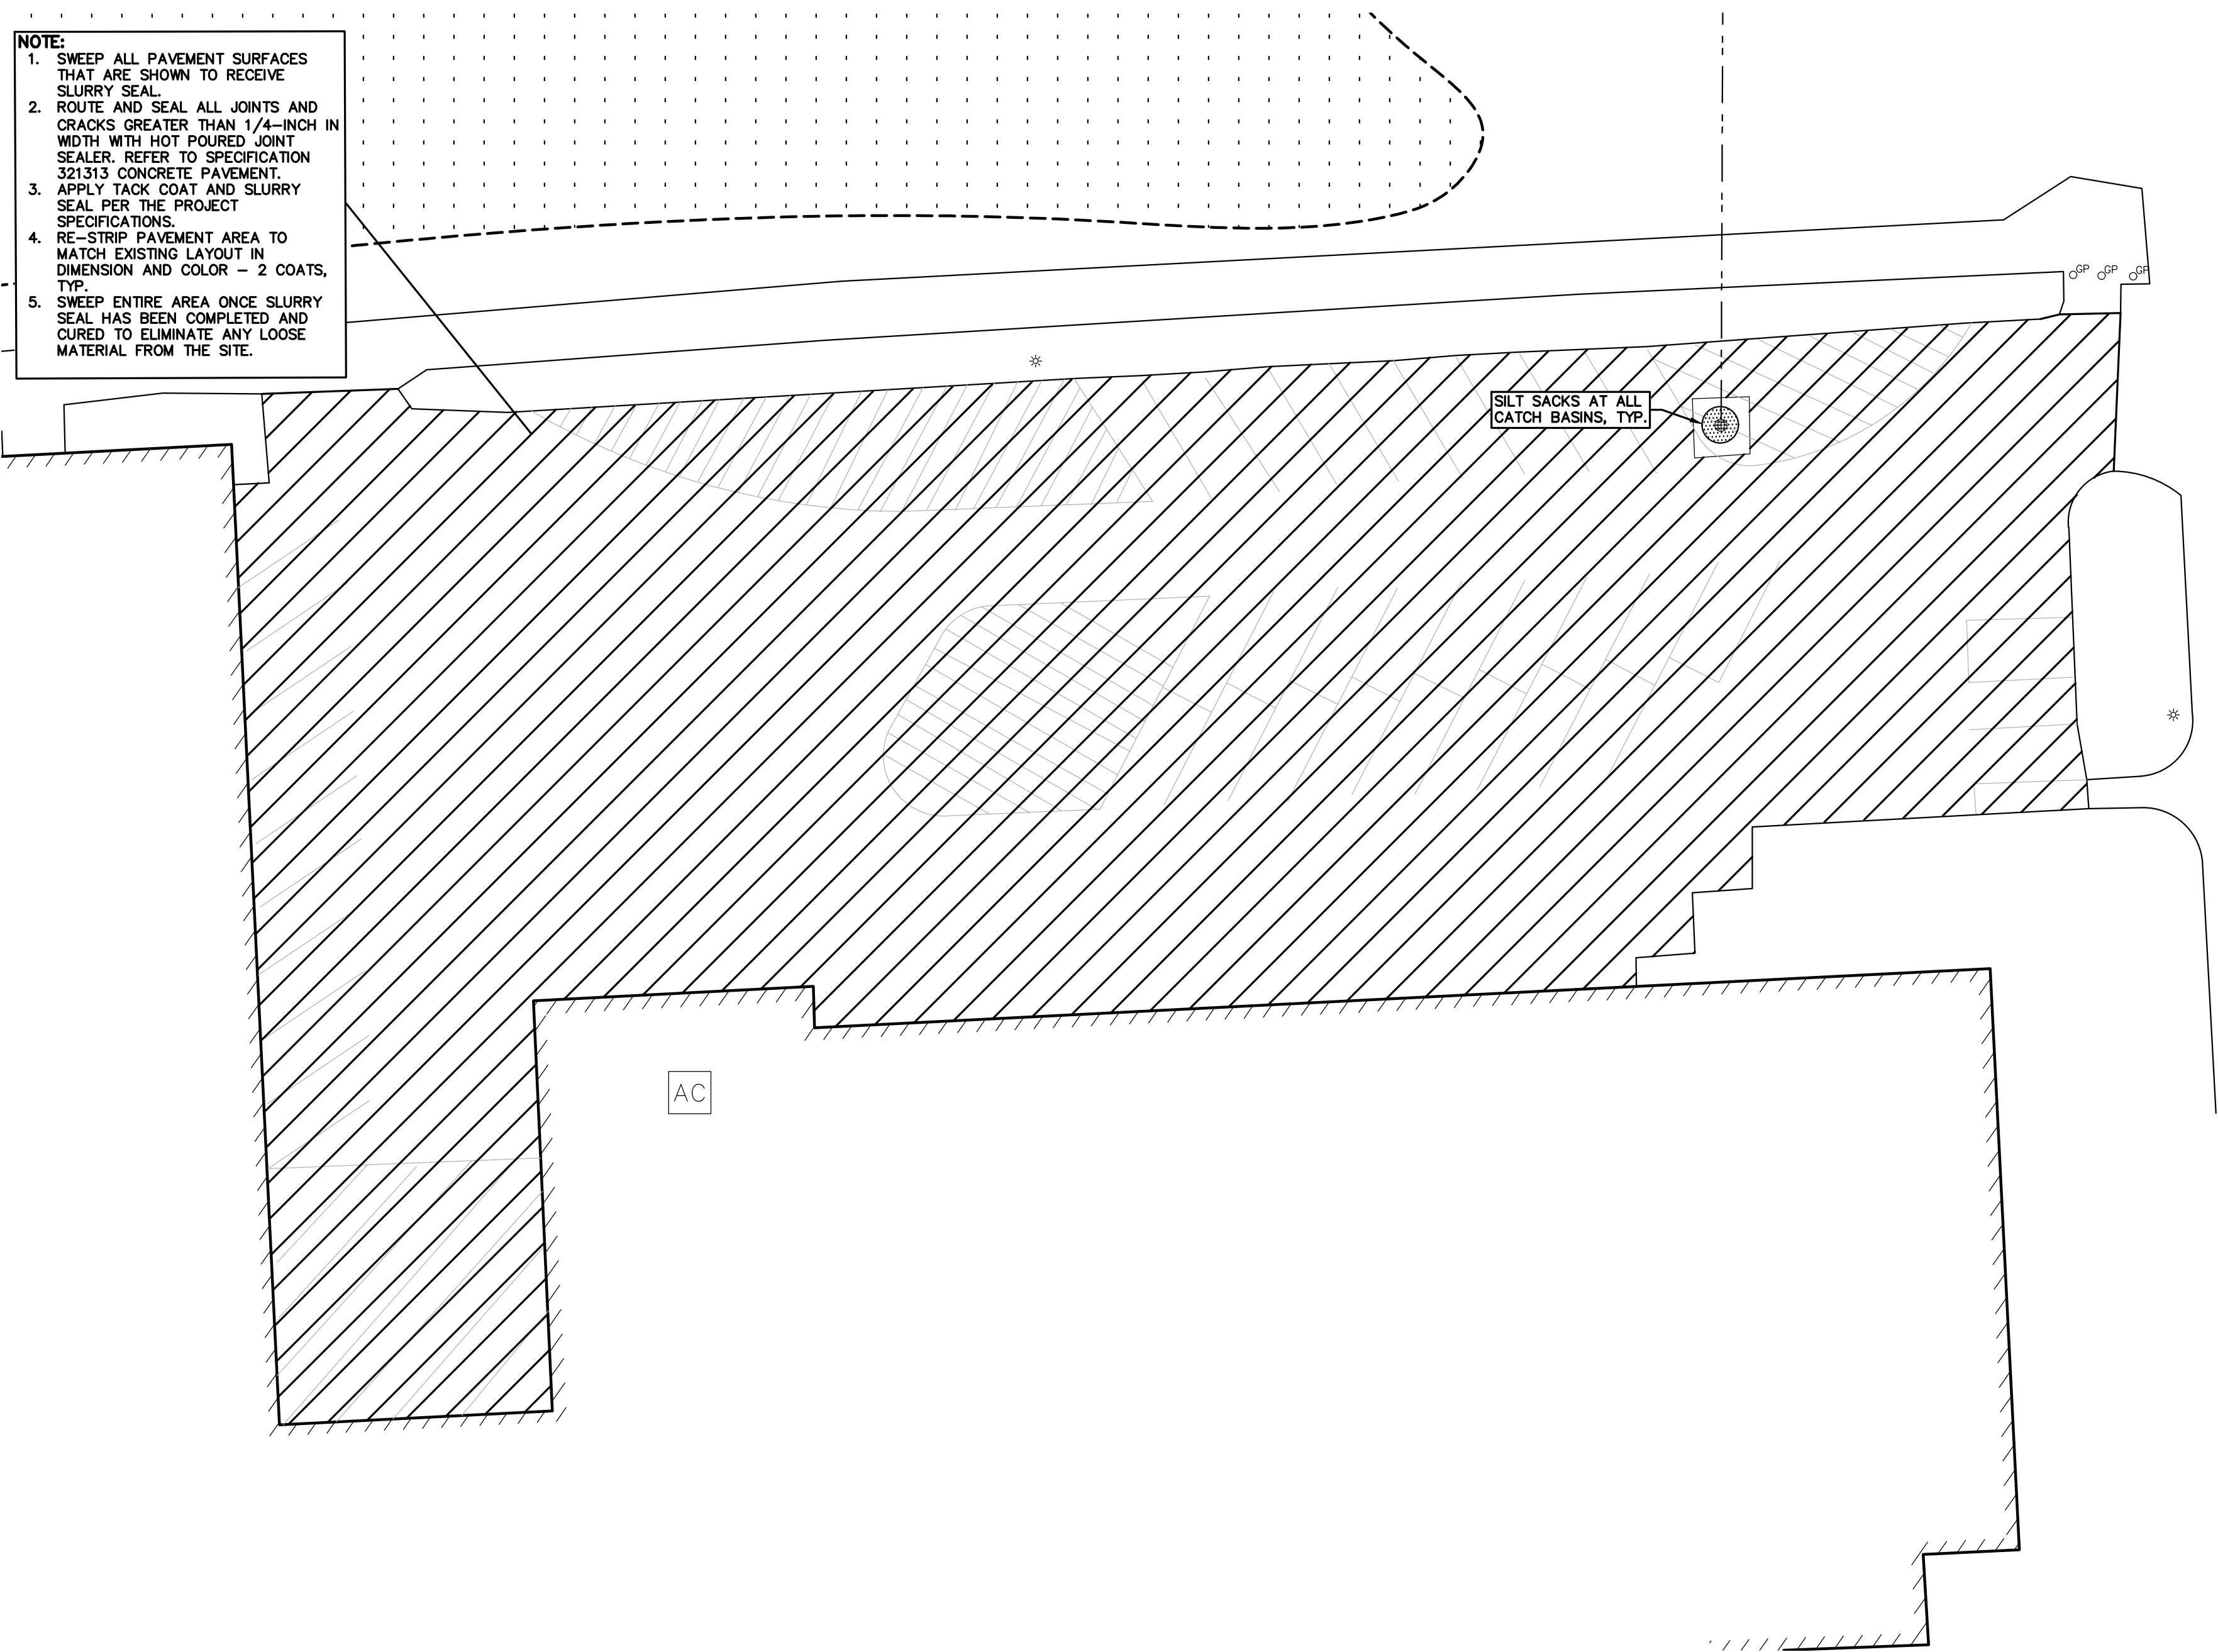


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FLOODPLAIN NOTE:
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— FULL CURB HEIGHT (18")



REVISIONS

DRAWING TITLE

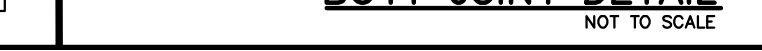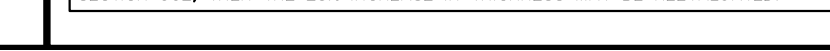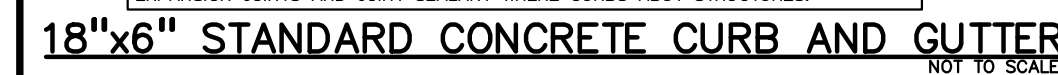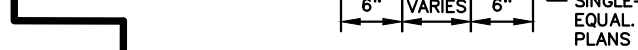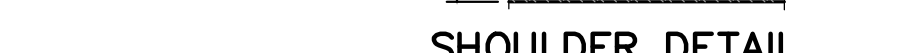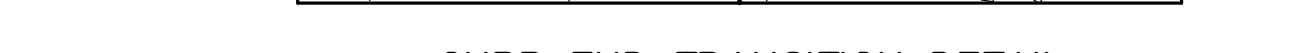REFERENCES

M. F.

ES. F

C 4 1

C-4.1

