

ROOFING REPLACEMENT BEAVERTON SCHOOL DISTRICT NANCY RYLES ELEMENTARY SCHOOL

10250 SW CORMORANT DR., BEAVERTON, OR 97007

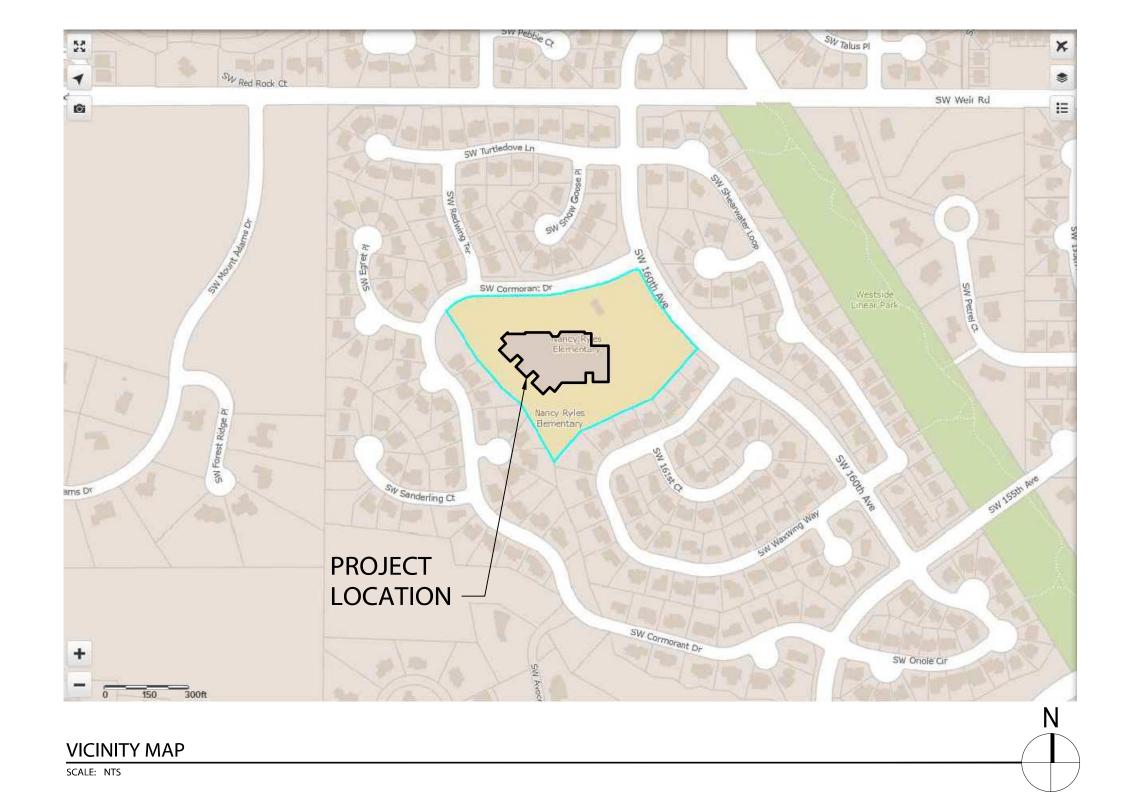

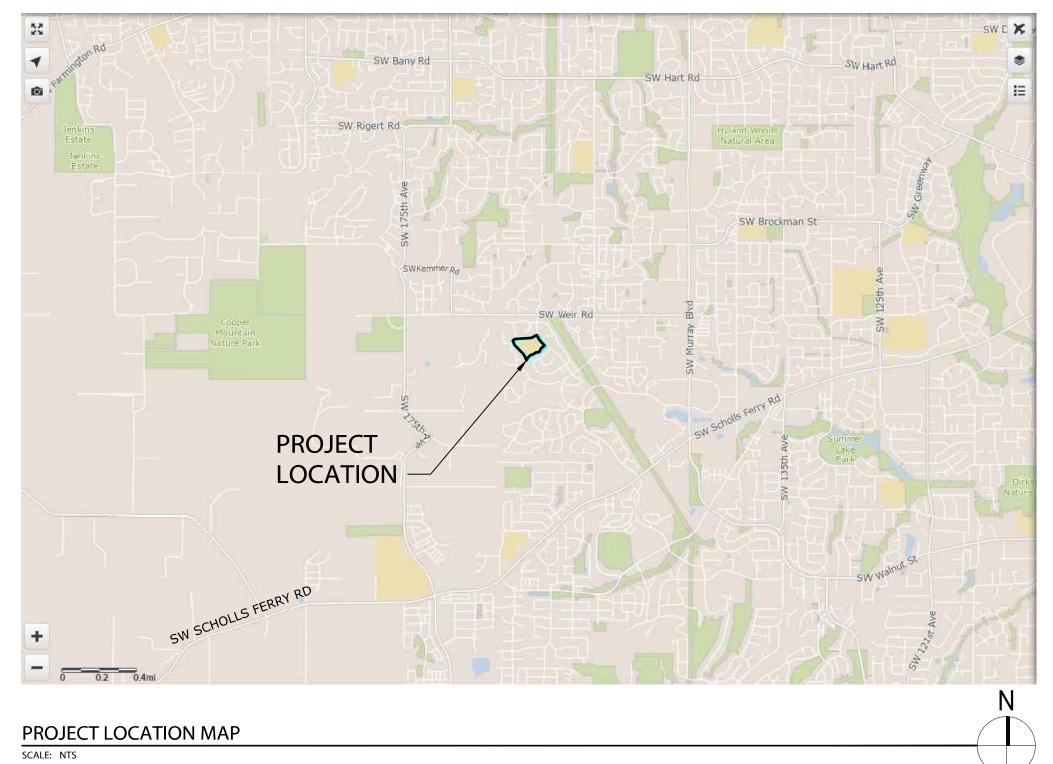



PROJECT DESCRIPTION

ARCHITECTURAL SERVICES ASSOCIATED WITH GENERAL BUILDING CONSTRUCTION PROJECTS; RENOVATIONS AND REPAIRS AS ASSIGNED BY THE BEAVERTON SCHOOL DISTRICT IN RESPONSE TO THE VOTER APPROVED BOND MEASURE.

THE PROJECT CONSISTS OF THE ALTERATION OF A PORTION OF AN EXISTING BEAVERTON SCHOOL DISTRICT NANCY RYLES ELEMENTARY SCHOOL. THE WORK WILL INCLUDE THE FOLLOWING: REMOVE AND REPLACE THE EXISTING LOW-SLOPE BUILT UP ROOF ASSEMBLY PE ROOFING ASSESSMENT RECOMMENDATIONS WITH NEW BUILT UP ROOF ASSEMBLY. TO INCLUDE CLEANING OF ROOF AND OVERFLOW DRAIN BODIES, AS WELL AS CLEANING AND RESETTING OF ROOF DRAIN DOMES ASSEMBLIES. CLEAN THE EXISTING STEEP-SLOPE ASPHAL COMPOSITION SHINGLE ROOF PER ROOFING ASSESSMENT RECOMMENDATIONS. WORK INCLUDES NEW ASSOCIATED FLASHINGS, SCUPPERS, GUTTERS, DOWNSPOUTS, SPLASH BLOCKS, FASCIA'S, COPINGS, CURBS AND COUNTER-FLASHING FOR MECHANICAL EQUIPMEN ROOF TOP SUPPORTS (CONDUIT, PIPES), NEW ROOF ACCESS LADDERS, AND ROOF HATCH GUARDRAILS. CONTRACTOR TO REPLACE EXISTING ROOF SYSTEMS DAMAGED FROM WATEF INTRUSION AS REQUIRED FOR NEW SCOPE OF WORK INCLUDING, BUT NOT LIMITED, TO SHEATHING, INSULATION, CURBS, BLOCKING, ROOF FLASHING, ETC. ADDITIONALLY, THERE WILL BE NEW WALL AND FASCIA PANEL CLADDING.

PROJECT INFORMATION

| ADDRESS: | 10250 SW CORMORANT DR. BEAVERTON, OR 97007 |
|-------------------------------|---|
| PROPERTY ID: | W268581 |
| STATE ID: | 1S132BB - 05400 |
| COUNTY: | WASHINGTON |
| JURISDICTION: | CITY OF BEAVERTON |
| FIRE DISTRICT: | TUALATIN VALLEY FIRE & RESCUE |
| DESCRIPTION OF USE: | ELEMENTARY SCHOOL |
| OCCUPANCY CLASSIFICATION: | EDUCATION (E) |
| AREA (APPROX.): | PROPERTY: 7.02 ACRES (PORTLAND MAPS) BUILDING: 86,440 S.F. |
| YEAR BUILT: | 1992, 1997 |
| CONSTRUCTION TYPE: | VA & VB |
| ROOF COVERING CLASSIFICATION: | B(VA) & C(VB) |
| | |

PROJECT TEAM

| OWNER: | BEAVERTON SCHOOL DISTRICT 48 |
|----------------------|----------------------------------|
| | 16550 SW MERLO ROAD |
| | BEAVERTON, OR 97003 |
| | PHONE: (503) 356-4500 |
| PROJECT MANAGER: | BEAVERTON SCHOOL DISTRICT 48 |
| | FACILITIES DEVELOPMENT |
| | 16550 SW MERLO ROAD |
| | BEAVERTON, OR 97003 |
| | PHONE: (503) 356-4500 |
| | CONTACT: CHRISTOPHER HANSEN |
| ARCHITECT: | AXIS DESIGN GROUP |
| | ARCHITECTURE & ENGINEERING, INC. |
| | 11104 S.E. STARK STREET |
| | PORTLAND, OR 97216 |
| | PHONE: (503) 284-0988 |
| | CONTACT: STEVEN EGGLESTON |
| ROOFING CONSULTANT: | CERTA BUILDING SOLUTIONS, INC. |
| | 1510 SE 44TH AVE, STE 102 |
| | PORTLAND, OR 97215 |
| | PHONE: (206) 941-6953 |
| | CONTACT: DAN RUNDLE |
| STRUCTURAL ENGINEER: | KPFF CONSULTING ENGINEERS |
| | 111 SW FIFTH AVE, STE 2500 |
| | PORTLAND, OR 97204 |
| | PHONE: (503)227-3251 |
| | CONTACT: JERRY ABDIE |
| | |

APPLICABLE CODES

WORK TO COMPLY WITH CURRENT FEDERAL, STATE, COUNTY, CITY BUILDING & ADA CODES & REGULATIONS.

OREGON BUILDING CODES:

- 2019 OREGON STRUCTURAL SPECIALTY CODE (OSSC)
- 2. 2021 OREGON ENERGY EFFICIENCY SPECIALTY CODE (OEESC) 2019 OREGON FIRE CODE (OFC)
- 4. 2019 OREGON MECHANICAL SPECIALTY CODE (OMSC)
- 5. 2021 OREGON PLUMBING SPECIALTY CODE (OPSC)
- 6. 2021 OREGON ELECTRICAL SPECIALTY CODE (OESC)


SEPARATE PERMITS (DESIGN BUILD) ITEMS FOR SEPARATE PERMITS PROCEDURE, SEE NO. 20 UNDER GENERAL NOTES ON SHEET G-001.


1. NO SEPARATE PERMITS IDENTIFIED.

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| SHEET | INDEX | 100% SD | 100% DD |
| SHEET NO. | SHEET TITLE | | |
| GENERAL | | | |
| G-000 | SHEET INDEX, PROJECT DESCRIPTION AND PROJECT INFO. | Х | Х |
| G-001 | GENERAL NOTES | | Х |
| ARCHITECTU | RAL ABBREVIATIONS, SYMBOLS & MAT HATCHES | | |
| A-011 A-161 | ROOF PLAN | Х | X X |
| A-161.1 | ROOF PLAN ROOF PLAN - ASSEMBLY AREAS | ^ | ^ |
| A-221 | EXTERIOR ELEVATIONS | | X |
| A-321 | PARTIAL WALL SECTIONS | | х |
| A-511 | GENERAL ROOF ASSEMBLIES AND TYPICAL ROOF DETAILS | | х |
| A-512 | TYPICAL ROOF DETAILS | | x |
| A-513 | ROOF DETAILS | | х |
| A-515 | ENLARGED PLAN AND DETAILS | | |
| LEGEND: x = ISSUED AS P | ART OF SET | | |

♦ = NOT PART OF ISSUED SET

* = ISSUED FOR INFORMATION ONLY

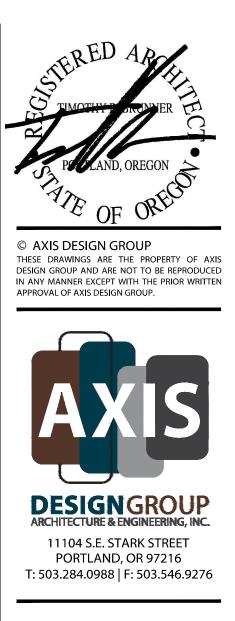

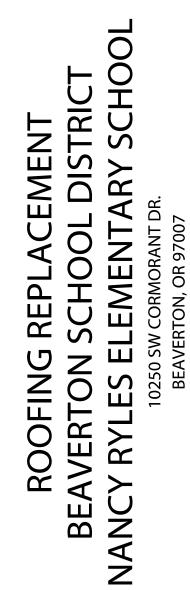



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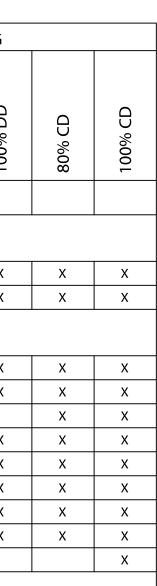
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SHEET TITLE

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SHEET INDEX, PROJECT DESCRIPTION AND PROJECT INFORMATION

G-000



GENERAL NOTES

1. GENERAL

- A. DRAWINGS INDICATE THE GENERAL SCOPE OF THE PROJECT IN TERMS OF ARCHITECTURAL DESIGN CONCEPT, DIMENSIONS, AND MAJOR ELEMENTS OF STRUCTURAL SYSTEMS. AS SUCH, THE DRAWINGS DO NOT NECESSARILY INDICATE OR DESCRIBE ALL WORK REQUIRED FOR FULL PERFORMANCE AND COMPLETION OF THE REQUIREMENTS OF THE CONTRACT DOCUMENTS. ON THE BASIS OF GENERAL SCOPE INDICATED OR DESCRIBED, THE CONTRACTOR SHALL FURNISH ALL ITEMS REQUIRED FOR THE PROPER EXECUTION AND COMPLETION OF THE WORK.
- B. IN PERFORMING PROFESSIONAL SERVICES FOR THIS PROJECT, AXIS DESIGN GROUP ARCHITECTURE AND ENGINEERING INC. NEITHER ISSUES, EXPRESSES, OR IMPLIES ANY WARRANTIES OR CERTIFICATIONS EXCEPT AS REQUIRED FOR BY GOVERNING JURISDICTIONS.
- C. ALL WORK TO CONFORM WITH CONTRACT DOCUMENTS. NO CHANGES SHALL BE MADE WITHOUT REVIEW BY THE ARCHITECT. WHEN MORE INFORMATION OR AN INTERPRETATION OF THE CONTRACT DOCUMENTS IS NEEDED, THE CONTRACTOR WILL REFER THE MATTER TO THE ARCHITECT WHO WILL FURNISH INFORMATION OR INTERPRETATION IN THE FORM OF SUPPLEMENTAL INFORMATION OR OTHER WRITTEN FORM OR DRAWING.
- D. THE CONTRACTOR SHALL COORDINATE ALL TRADES RELATED TO HIS OR HER WORK. E. INFORMATION RELATING TO THE EXISTING BUILDING IS BASED ON LIMITED EXISTING BUILDING DOCUMENTS AND LIMITED FIELD MEASUREMENTS. ACTUAL CONDITIONS MAY VARY. CONTRACTOR TO VERIFY ALL DIMENSIONS IN THE FIELD.
- F. SYSTEMS AND CONDITIONS HIDDEN FROM VIEW ARE BASED ON OWNER PROVIDED AS BUILT DOCUMENTS, HAVE NOT BEEN VERIFIED BY THE ARCHITECT, AND ARE PROVIDED FOR REFERENCE PURPOSES ONLY. ALL SYSTEMS AND CONDITIONS TO BE VERIFIED BY THE GENERAL CONTRACTOR.
- G. ALL WORK SHALL BE PREFORMED WITH PROCEDURES SET FORTH BY PRODUCT MANUFACTURERS STANDARD SPECIFICATIONS OR STANDARD PRACTICE PROCEDURES PUBLISHED BY TRADE ASSOCIATIONS. WHEN SEPARATELY BOUND SPECIFICATIONS ACCOMPANY THESE DRAWINGS THEY SHALL BE CONSIDERED PART OF THESE CONSTRUCTION DOCUMENTS.
- H. LARGE SCALE PLANS OR DETAILS TAKE PRECEDENCE OVER SMALL SCALE PLANS OR DETAILS. I. IF AN ITEM IS INDICATED ON THE DRAWINGS AS (NIC) IT IS "NOT IN THE CONTRACT". SUBSEQUENT DRAWINGS AND SPECIFICATIONS WILL BE SUBMITTED BY OTHERS FOR SEPARATE APPROVAL AND PERMITS.
- J. ANY DETAIL THAT APPLIES TO A SPECIFIC SITUATION SHALL APPLY TO ALL SIMILAR SITUATIONS UNLESS OTHERWISE NOTED.
- K. "TYP" OR "TYPICAL" AS USED IN THESE DOCUMENTS, SHALL MEAN THAT THE CONDITION IS THE SAME THROUGHOUT, UNLESS OTHERWISE NOTED.
- L. ANY SUBCONTRACTOR DESIGNED ITEMS TO BE SUBMITTED TO AND APPROVED BY THE OWNER AND ARCHITECT PRIOR TO CONSTRUCTION.
- M. SPOT ELEVATIONS ARE FROM FLOOR TO FINISH CEILING AND ARE ROUNDED TO NEAREST INCH (TYP).
- N. CONTRACTOR IS RESPONSIBLE FOR ALL MEANS AND METHODS OF CONSTRUCTION AND SHALL COORDINATE ALL CONSTRUCTION EFFORTS WITH OWNER'S REQUIREMENTS.
- O. CONTRACTOR SHALL PROVIDE FOR DUST CONTROL THROUGHOUT. PROVIDE TEMPORARY MEASURES TO VENTILATE ARES DURING ALL PHASES OF DEMOLITION AND CONSTRUCTION TO ERADICATE BUILDUP OF FUMES FROM FINISH MATERIALS AND CONSTRUCTION ACTIVITIES. CONTRACTOR TO MAINTAIN SIX (6) AIR EXCHANGES PER HOUR UNLESS MORE STRINGENT OSHA, STATE OR LOCAL STANDARDS ARE TO BE ADHERED TO.
- P. CONTRACTOR TO NOTIFY THE OWNER UPON DISCOVERY OF ASBESTOS OR ANY OTHER HAZARDOUS MATERIAL DURING THE COURSE OF WORK. ALL WORK SHALL STOP IMMEDIATELY IN AFFECTED AREA UNTIL THE CONDITION IS CORRECTED.
- Q. PROVIDE BLOCKING SECURED TO WALL FRAMING FOR ALL CASEWORK, RESTROOM ACCESSORIES, HANDRAIL BRACKETS AND ANY OTHER WALL-MOUNTED ACCESSORIES REQUIRING SUPPORT.

2. CODES

- A. ALL WORK TO COMPLY WITH THE LATEST EDITION OF ALL APPLICABLE CODES AS ADOPTED BY LOCAL AUTHORITIES HAVING JURISDICTION FOR THIS PROJECT ARE AS FOLLOWS: 1. 2019 OREGON STRUCTURAL SPECIALTY CODE (OSSC)
- 2. 2021 OREGON ENERGY EFFICIENCY SPECIALTY CODE (OEESC) 3. 2019 OREGON FIRE CODE (OFC)
- 4. ICC A117.1-2009 ACCESSIBLE AND USABLE BUILDINGS AND FACILITIES 5. NATIONAL FIRE PROTECTION ASSOCIATION (NFPA)
- 6. 2019 OREGON MECHANICAL SPECIALTY CODE (OMSC) 7. 2021 OREGON PLUMBING SPECIALTY CODE (OPSC)
- 8. 2021 OREGON ELECTRICAL SPECIALTY CODE (OESC)

3. PERMITS

- A. OTHER THAN THE BUILDING PERMIT, THE GENERAL CONTRACTOR SHALL SECURE AND PAY FOR ALL PERMITS, FEES, LICENSES, AND INSPECTIONS REQUIRED FOR THE COMPLETION OF THE WORK.
- 4. COORDINATION AND VERIFICATION
- A. ALL FIELD DIMENSIONS TAKE PRECEDENCE OVER DIMENSIONS ON DRAWINGS.
- B. THE DRAWINGS ARE DIVIDED INTO SEPARATE SHEETS FOR GENERAL CONVENIENCE ONLY. SHEET DESIGNATION OR NUMBERS ARE TO BE CONSIDERED SD LIMITATIONS OF AREAS OF WORK, RESPONSIBILITY OR TRADES. COORDINATE THE WORK SHOWN IN THE DRAWINGS AND IN THE PROJECT MANUAL IN ORDER TO COMPLETE THE PROJECT AS DESIGNED.
- C. LOCATIONS AND SIZES OF EQUIPMENT ARE BASED ON AVAILABLE INFORMATION. PROVIDE AND COORDINATE THE EXACT DIMENSIONS, SIZES AND POSITIONS OF ALL EQUIPMENT, PADS, BASES, MOUNTINGS, ATTACHMENTS AND CONDUIT RELATING TO THE WORK.
- D. PROVIDE AND COORDINATE THE EXACT DIMENSIONS, SIZES AND POSITIONS OF OPENINGS IN SLABS AND WALLS NECESSARY FOR THE INSTALLATION OF THE WORK.
- E. POSITION ALL VALVES CONTROLS AND TERMINATIONS TO BE POSITIONED FOR SAFE, DIRECT AND EASY ACCESS. ALL PIPING AND DUCTWORK TO BE INSTALLED FOR CONVENIENT FUTURE ADDITIONS AND MODIFICATIONS. ITEMS TO BE LABELED PER OWNER REQUIREMENTS.
- F. QUANTITIES LISTED ON THE DRAWINGS ARE APPROXIMATE. CONTRACTOR TO VERIFY QUANTITIES AND INCLUDE ACCURATE QUANTITIES AS PART OF THE WORK.
- G. SPECIFIC NOTES OR KEYNOTES ON DETAILS APPLY TO SIMILAR CONDITIONS ON OTHER DETAILS ON ALL DRAWINGS UNLESS SPECIFICALLY NOTED OTHERWISE.
- H. CONTRACTOR TO REVIEW ADDITIONAL GENERAL REQUIREMENTS IN SPECIFICATION. I. CONTRACTOR TO COORDINATE SCHEDULING OF ALL TENANT RELATED WORK OCCURRING IN
- ADJACENT SUITES WITH OWNERS REPRESENTATIVE, SECURITY OFFICE, AND ADJACENT TENANTS WELL IN ADVANCE OF ACTUAL WORK. J. CONTRACTOR TO COORDINATE WITH THE TENANT AND/OR VENDOR WHEN INSTALLING ITEMS
- SUPPLIED BY THAN THE CONTRACTOR.
- K. CONTRACTOR SHALL COORDINATE ALL WORK WITH OWNER AS REOUIRED TO IMPLEMENT SCOPE OF WORK, INCLUDING ANY OWNER PROVIDED CONTRACTORS.
- 5. UTILITIES AND DEMOLITION
- A. THE CONTRACTOR IS RESPONSIBLE FOR THE LOCATION AND PROTECTION OF ALL EXISTING UTILITY LINES INCLUDING ELECTRICAL, SEWER, WATER, GAS, TELEPHONE, ETC. IN ADDITION THE CONTRACTOR SHALL CAUTION ALL SUBCONTRACTORS THAT THE SITE CONTAINS UNDERGROUND UTILITY LINES. THE DRAWINGS SHOW DIAGRAMMATICALLY THE APPROXIMATE LOCATION OF UNDERGROUND UTILITIES WHERE INFORMATION IS AVAILABLE, BUT THE DRAWINGS ARE NOT EXACT AS TO THE QUANTITY, EXTENT OR LOCATION.
- B. THE CONTRACTOR IS REQUIRED TO EXERCISE EXTREME CAUTION DURING ALL PHASES OF THE WORK TO LOCATE, IDENTIFY AND PROTECT EXISTING UTILITIES TO BE MODIFIED OR TO REMAIN. THE CONTRACTOR SHALL RECORD LOCATION OF, DISCONNECT, AND CAP AS NECESSARY, AND REPAIR DAMAGE TO EXISTING UTILITIES WHICH ARE ENCOUNTERED AS A RESULT OF WORK UNDER THIS CONTRACT.
- C. IF REQUIRED BY THE PROJECT, THE CONTRACTOR IS REQUIRED TO PROVIDE OUTSIDE GAS SHUT-OFF VALVE CONSPICUOUSLY MARKED PER OWNER REQUIREMENTS.
- D. CONTRACTOR TO COORDINATE ALL NEW SERVICE REQUIREMENTS WITH LOCAL UTILITY AGENCIES AND OWNER.
- E. THE CONTRACTOR TO ARRANGE AND PAY FOR TEMPORARY POWER, UTILITIES EXCEPT AS PREARRANGED WITH OWNER.
- F. IN PERFORMING PROFESSIONAL SERVICES FOR THIS PROJECT, CONTRACTOR SHALL PROVIDE SHORING, BRACING, SUPPORT, AND PROTECTION AS REQUIRED TO MAINTAIN STRUCTURAL INTEGRITY OF THE PROJECT, ADJACENT PROPERTIES, AND PUBLIC SAFETY.

6. GENERAL DEMOLITION

- A. DEMOLISH AS REQUIRED TO ACCOMPLISH WORK INDICATED IN THESE DOCUMENTS. ALL REQUIRED DEMOLITION WORK SHALL BE INCLUDED IN THE BASE BID PACKAGE SUBMITTED BY THE CONTRACTOR.
- B. THE CONTRACTOR MUST TAKE ALL NECESSARY PRECAUTIONS TO ENSURE THE SAFETY OF THE PUBLIC AND/OR WORKMEN ON THE SITE TO PREVENT ACCIDENTS OR INJURY TO ANY PERSON ON, ABOUT OR ADJACENT TO THE PREMISES. THE CONTRACTOR SHALL COMPLY WITH ALL LAWS, ORDINANCES, CODES AND REGULATIONS PERTAINING TO SAFETY AND THE PREVENTION OF ACCIDENTS.
- C. THE CONTRACTOR MUST MAINTAIN ADEQUATE SUPPORT, INSULATION, WATERPROOFING, EMERGENCY LIGHTING, SECURITY, ALARMS, ETC. FOR ALL OR PART OF ITEMS WHICH ARE TO RFMAIN.
- D. INFORMATION RELATING TO THE EXISTING BUILDING IS BASED ON FIELD MEASUREMENTS. ACTUAL CONDITIONS MAY VARY AND SHALL BE FIELD VERIFIED BY THE CONTRACTOR.
- E. VERIFY LIMITS OF DEMOLITION REQUIRED TO COMPLETE WORK PRIOR TO COMMENCEMENT. GRAPHIC REPRESENTATION OF AFFECTED AREAS ON DRAWINGS MAY BE SMALLER OR LARGER THAN INDICATED.
- F. IN THE EVENT OF DAMAGE TO EXISTING CONSTRUCTION, CONTRACTOR SHALL REPAIR AND RESTORE THE DAMAGE TO ITS ORIGINAL CONDITION AT NO ADDITIONAL COST TO THE OWNER. G. ONLY MAJOR ITEMS OF DEMOLITION ARE SHOWN. REMOVE MISCELLANEOUS MINOR ITEMS AS
- H. THE DEMOLITION NOTES IN THE DRAWINGS REQUIRE THE REMOVAL OF A BUILDING ELEMENT OR SYSTEM OR A COMPLETE COMPONENT COMPRISED OF MULTIPLE ELEMENTS. THE CONTRACTOR SHALL DISASSEMBLE AND REMOVE FORM THE SITE EACH ITEM IN ITS ENTIRETY AS REQUIRED TO ACCOMMODATE THE INSTALLATION OF THE NEW WORK TO FOLLOW.

APPROPRIATE FOR PROPER COMPLETION OF THE WORK.

- I. REMOVE ALL MISCELLANEOUS TRIM, CASEWORK, EQUIPMENT, CONDUIT, BASES, AND OTHER SURFACE MOUNTED ITEMS WHETHER SHOWN OR NOT ON PARTITIONS TO BE DEMOLISHED.
- J. REMOVE ALL MISCELLANEOUS PIPE AND DUCT SUPPORTS, PARTITION TRACKS AND CLIPS NO LONGER FUNCTIONAL IN EXISTING CEILING CAVITIES OF ROOMS TO BE DEMOLISHED.
- K. CUT AND PATCH WALL, CEILING AND FLOOR ASSEMBLIES AND REPAIR FINISHES AS NECESSARY AT MECH., PLUM., AND ELECT. DEMOLITION LOCATIONS; SEE MECH., PLUMB., AND ELECT. DEMOLITION PLANS FOR ADDITIONAL INFORMATION.
- L. THE CONTRACTOR SHALL PATCH AND REPAIR ELEMENTS WHERE ITEMS WERE REMOVED AND IN AREAS DAMAGED DURING DEMOLITION. M. THE CONTRACTOR SHALL CLEAN, PLUG, PATCH AND REPAIR ALL MATERIALS AND SURFACES
- AND PREPARE THEM FOR NEW WORK. N. THE ARCHITECT SHALL NOT BE RESPONSIBLE FOR LOCATING, IDENTIFYING, OR SPECIFYING
- MEANS OF REMOVAL OF ANY HAZARDOUS MATERIALS. HAZARDOUS MATERIAL TESTING BY OWNER CONTRACTED CONSULTANT.

7. DISCREPANCIES

- A. VERIFY ALL DIMENSIONS, ELEVATIONS, AND ALL EXISTING CONDITIONS AT THE SITE BEFORE COMMENCING WORK AND REPORT ANY DISCREPANCIES TO THE ARCHITECT AND THE OWNER.
- B. IF ANY ERRORS, INCONSISTENCIES, OR OMISSIONS IN THE CONTRACT DOCUMENTS ARE RECOGNIZED BY THE CONTRACTOR OR ANY MEMBER OF HIS ORGANIZATION, THE CONTRACTOR IS REQUIRED TO NOTIFY THE ARCHITECT IN WRITING OF SUCH ERROR, INCONSISTENCY OR OMISSION BEFORE PROCEEDING WITH THE WORK.
- C. SHOULD THE SPECIFICATIONS FAIL TO DESCRIBE THE MATERIAL OR KIND OF GOODS TO BE USED, SUBMIT AN INQUIRY OF THE ARCHITECT FOR CLARIFICATION.
- D. ALL WORK TO CONFORM TO THE CONTRACT DOCUMENTS. NO SUBSTITUTIONS PERMITTED WITHOUT REVIEW AND APPROVAL BY THE ARCHITECT AND OWNER.
- E. IN THE EVENT OF A CONFLICT BETWEEN DRAWINGS AND THE PROJECT MANUAL, THE CONTRACTOR IS TO PRICE THE MORE EXPENSIVE, OR MORE ELABORATE METHOD, MATERIALS, AND EQUIPMENT DESCRIBED OR SHOWN, SHOULD THE OWNER, AT THE OWNER'S DISCRETION, APPROVE TO UTILIZE THE LESS EXPENSIVE, OR LESS ELABORATE METHOD, MATERIALS, OR EQUIPMENT, AN APPROPRIATE CREDIT NEGOTIATED BETWEEN THE CONTRACTOR AND OWNER SHALL BE DUE TO THE OWNER.
- F. THE CONTRACTOR SHALL CAREFULLY STUDY AND COMPARE THE INDIVIDUAL CONTRACT DOCUMENTS AND REPORT AT ONCE IN WRITING TO THE ARCHITECT ANY DEFICIENCIES PRIOR TO BIDDING. THE CONTRACTOR SHALL REQUIRE EACH SUBCONTRACTOR TO LIKEWISE STUDY THE DOCUMENTS AND IMMEDIATELY REPORT ANY DEFICIENCIES.

8. MODIFICATIONS

A. MODIFICATIONS TO DETAILS MAY BE REQUIRED TO SUIT THE JOB DIMENSIONS OR CONDITIONS AND WILL BE MADE PART OF THE WORK.

9. ACCESS PANELS

A. AT ALL WALL AND CEILING LOCATIONS PROVIDE ACCESS PANELS FOR ELECTRICAL, PLUMBING AND AIR CONDITIONING CONTROLS, VALVES, DAMPERS, COUNTER FIRE SHUTTERS OR OTHER DEVICESAS REQUIRED BY THE WORK AND APPLICABLE EVEN IF ACCESS PANEL IS NOT SHOWN ON CONTRACT DOCUMENTS. AT NON-ACCESSIBLE CEILINGS, ACCESS PANELS SHALL BE 24"x24" FLUSH MOUNTED AND FIT WITHIN THE CEILING PATTERN. SUBMIT SHOP DRAWINGS INDICATING THE EXACT LOCATIONS OF ALL ACCESS PANELS. NO INSTALLATION OF ACCESS PANELS TO BE MADE UNTIL THE ARCHITECT HAS APPROVED THE LOCATIONS. ACCESS PANELS TO BE LABELED AS REQUIRED BY OWNER.

10. EXITS

- A. EVERY EXIT DOOR TO BE OPENABLE FROM THE INSIDE WITHOUT THE USE OF A KEY OR ANY SPECIAL KNOWLEDGE OR EFFORT.
- 11. PENETRATION OF RATED ASSEMBLIES
- A. MECHANICAL DUCTS, ETC. PENETRATING FIRE-RATED CEILINGS AND FIRE WALLS TO BE CORRESPONDINGLY RATED OR DAMPERED. CABINETS, ELECTRICAL PANELS, LIGHTS, ETC. RECESSED INTO FIRE-RATED WALLS OR CEILINGS TO BE BACKED WITH CORRESPONDING FIRE-RESISTIVE CONSTRUCTION AS REQUIRED TO MAINTAIN THE INTEGRITY OF THE FIRE PROTECTION.
- B. FIRE RESISTIVE ASSEMBLIES FOR PROTECTION OF OPENINGS TO COMPLY WITH THE REQUIREMENTS OF THE AUTHORITY HAVING JURISDICTION.
- C. PENETRATION OF FIRE-RATED ASSEMBLIES WHICH REQUIRE OPENING PROTECTION TO BE FIRE STOPPED. FIRE RATING FOR FIRE STOP SYSTEMS TO BE EQUAL TO THE ASSEMBLY PENETRATED.

12. DISSIMILAR METALS

A. ALL DISSIMILAR METALS TO BE EFFECTIVELY ISOLATED FROM EACH OTHER WITH NEOPRENE ISOLATOR OR SIMILAR MATERIAL TO PREVENT MOLECULAR BREAKDOWN.

13. ELECTRICAL BACKBOARDS

A. REFER TO ELECTRICAL, TELEPHONE/DATA AND SECURITY ELECTRONICS DRAWINGS FOR LOCATION OF AND SPECIFICATIONS FOR THE INSTALLATION OF FIRE RETARDANT TREATED PLYWOOD BACKBOARDS REQUIRED IN ELECTRICAL AND COMMUNICATION ROOMS. THESE REQUIRED PLYWOOD BACKBOARDS HAVE NOT BEEN SHOWN ON THE ARCHITECTURAL DRAWINGS, BUT MUST BE FURNISHED AND INSTALLED AS A PART OF THE OVERALL CONTRACT. BACKBOARDS TO BE PAINTED TO MATCH THE SURFACE UPON WHICH THEY ARE MOUNTED. ALL REQUIRED BLOCKING IN WALLS TO ACCEPT PLYWOOD SHOULD BE VERIFIED AND APPROVED WITH THE ELECTRICAL TEAM REPRESENTATIVE. COORDINATE LOCATIONS WITH OWNER PRIOR TO INSTALLATION.

14. SIGNAGE

A. FURNISH AND INSTALL SUPPORTS AND OTHER NECESSARY FINISH MATERIALS FOR A COMPLETE CODE REQUIRED SIGNAGE INSTALLATION. REMOVE AND REINSTALL EXISTING SIGNAGE.

15. COORDINATION OF DEVICES

A. EXACT LOCATIONS AND HEIGHTS OF ELECTRICAL, LOW VOLTAGE, MECHANICAL AND PLUMBING DEVICES, INCLUDING BUT NOT LIMITED TO SMOKE DETECTORS, PULL STATIONS, SWITCHES, OUTLETS, PHONE JACKS, AND THERMOSTATS, TO BE COORDINATED BY THE CONTRACTOR FOR ALIGNMENT, COORDINATION WITH EACH OTHER AND OTHER BUILDING FEATURES PRIOR TO INSTALLATION AS APPROVED BY ARCHITECT AND OWNER.

16. FIRE ALARM COORDINATION

- A. FIRE DETECTION ENGINEERING SERVICES, DOCUMENTS, AND PERMIT ACQUISITION TO BE PROVIDED ON A DESIGN-BUILD BASIS WITH THE SELECTED FIRE SYSTEM SUBCONTRACTOR PROVIDING THE REQUIRED DESIGN WORK WORK AND INSTALLATION BASED ON DIAGRAMS AND PERFORMANCE SPECIFICATIONS PROVIDED BY OWNER AND AND EXISTING CONDITIONS.
- B. CONTRACTOR TO VERIFY ALL UTILITIES AND COORDINATE EQUIPMENT AND UTILITY REQUIREMENTS AND LOCATIONS WITH FIRE SYSTEM ENGINEER PRIOR TO PROCEEDING AND REVIEW WITH ARCHITECT PRIOR TO FINAL ROUGH-IN.

17. ELECTRICAL COORDINATION

- A. ELECTRICAL CONTRACTOR TO EXAMINE EXISTING CONDITIONS, VERIFY ALL UTILITIES, AND COORDINATE POWER REQUIREMENTS WITH BUILDING OWNER'S REPRESENTATIVE PRIOR TO PROCEEDING. REVIEW AND VERIFY LIGHTING, CONTROLS, OUTLETS, AND OWNER EQUIPMENT POWER LOCATIONS WITH THE ARCHITECT PRIOR TO APPROVAL AND FINAL ROUGH-IN.
- B. ALL LIGHT FIXTURES SHALL MEET CURRENT CODES AND BE PRE-APPROVED BY THE ARCHITECT AND OWNER.
- C. PROPOSALS AND DOCUMENTS PERTAINING TO THIS WORK TO BE PROVIDED TO THE ARCHITECT FOR REVIEW PRIOR TO PROCEEDING. ALL ELECTRICAL AND FIRE ALARM FIXTURES, COMPONENTS, AND ANY OTHER EXPOSED EQUIPMENT, ALONG WITH THEIR LOCATIONS TO BE SUBMITTED FOR REVIEW.
- D. ELECTRICAL AND COMMUNICATIONS SYSTEM RECEPTACLES TO BE MOUNTED AT 15" A.F.F. UNLESS OTHERWISE NOTED.
- E. ELECTRICAL OUTLETS AT OPPOSITE SIDES OF FIRE RATED AND/OR ACOUSTICALLY RATED WALLS ARE TO BE SEPARATED BY A MINIMUM OF 24" MINIMUM HORIZONTAL SPACING AND SEPARATE STUD SPACES OR AS INDICATED IN THE DRAWINGS.

18. MECHANICAL COORDINATION

A. CONTRACTOR TO VERIFY ALL UTILITIES AND COORDINATE EQUIPMENT POWER REQUIREMENTS AND LOCATIONS WITH MECHANICAL SPECIFICATIONS AND MECHANICAL ENGINEER PRIOR TO PROCEEDING AND REVIEW WITH ARCHITECT PRIOR TO FINAL ROUGH-IN.

19. PROJECT CLOSEOUT

- A. CONTRACTOR TO WARRANTEE ALL PARTS, LABOR, EQUIPMENT, AND MATERIAL PROVIDED UNDER THIS CONTRACT, UNLESS OTHERWISE NOTED, FOR A PERIOD OF (1) YEAR, UPON COMPLETION OF CONTRACT.
- B. WHEN REQUESTING THE ARCHITECT'S INSPECTION FOR SUBSTANTIAL COMPLETION: 1. KNOWN EXEMPTIONS MUST BE LISTED IN THE REQUEST. 2. ALL WARRANTIES AND CERTIFICATES MUST BE SUBMITTED TO THE ARCHITECT. 3. THE CONTRACTOR'S PUNCH LIST MUST BE SUBMITTED WITH THE REQUEST.
- C. THE ARCHITECT WILL VERIFY THE CONTRACTOR'S PUNCH LIST AND INDICATE ADDITIONAL PUNCH LIST ITEMS AS NEEDED. RESULTS OF THE ARCHITECT COMPLETED INSPECTION WIL FORM THE "PUNCH LIST" FOR FINAL ACCEPTANCE. ONE RE-INSPECTION WILL BE PERFORMED BY THE ARCHITECT TO ESTABLISH CERTIFICATION OF FINAL ACCEPTANCE; FURTHER RE-INSPECTIONS BY THE ARCHITECT TO BE AT THE CONTRACTOR'S EXPENSE.
- D. ALL MAINTENANCE AND OPERATIONS MANUALS FOR ALL EQUIPMENT AND MATERIALS PROVIDED TO BE ORGANIZED AND PREPARED AS INDICATED IN THE PROJECT MANUAL.

20. SEPARATE PERMIT (DESIGN BUILD) ITEMS

- A. THIS PROJECT WILL HAVE THE FOLLOWING SEPARATE PERMIT ITEMS WHICH MAY UTILIZE A DESIGN/BUILD APPROACH. THE INFORMATION CONTAINED IN THESE DOCUMENTS ARE PRELIMINARY, PROVIDING A BASIS FOR BIDDING AND PLANNING. ACTUAL ENGINEERING AND INSTALLATION DRAWINGS ARE TO BE PROVIDED UNDER A SEPARATE PERMIT AND REQUIRE THE WILL APPROVAL OF BOTH THE THE ARCHITECT/ THE ENGINEERS AND THE AUTHORITY HAVING JURISDICTION.
- SEE G-000 FOR LIST OF SEPARATE PERMIT ITEMS.
- B. THE PROCEDURE FOR "SEPARATE PERMIT APPROVAL DOCUMENTS" TO BE AS FOLLOWS: 1. THE DESIGN/BUILD CONTRACTOR TO PROVIDE (4) SETS OF (PDF) SUBMITTAL DOCUMENTS TO THE ARCHITECT FOR INITIAL REVIEW AND COORDINATION WITH THE DESIGN INTENT OF THE PROJECT.
- 2. IF THE SUBMITTAL DOCUMENTS ARE FOUND TO BE ACCEPTABLE THE ARCHITECT WILL ADD A NOTATION INDICATING THAT THE SUBMITTAL DOCUMENTS HAVE BEEN REVIEWED AND FOUND IN GENERAL CONFORMANCE WITH THE DESIGN OF THE BUILDING.
- 3. FOLLOWING THE ARCHITECT'S APPROVAL, THE DESIGN/BUILD CONTRACTOR IS RESPONSIBLE FOR SUBMITTING, TRACKING, AND OBTAINING APPROVAL FROM THE AUTHORITY HAVING JURISDICTION.
- 4. UPON APPROVAL BY THE AUTHORITY HAVING JURISDICTION, THE DESIGN/BUILD CONTRACTOR IS REQUIRED TO PROVIDE A COPY OF THE DRAWINGS TO THE ARCHITECT AND OWNER FOR REFERENCE.



ARCHITECTURE & ENGINEERING, IN

11104 S.E. STARK STREET

PORTLAND, OR 97216

T: 503.284.0988 | F: 503.546.9276

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DRAWN BY: SEE CHECKED BY: SEE JOB NO: 22-002 BSD NRES DATE: 07/08/2022

ISSUED FOR: BID | PERMIT SHEET TITLE

G-00'

GENERAL NOTES

| SYMBOLS: | |
|------------------------------|----------|
| # | BUILDIN |
| 1 A1.0 | BUILDIN |
| TITLE SCALE: X/X.X | DRAWIN |
| | DETAIL I |
| 1 A1.0 | EXTERIC |
| $D \xrightarrow{A}_{A1.0} B$ | INTERIO |
| MATCH LINE SEE Ax.x | МАТСН |
| N | NORTH |
| | REVISIO |
| 1 A1.0 | WALL SE |

| | | | ABBREVIAT | TIONS: | | | |
|-----------------------------------|--|---------------------------------|--|--|---|-------------------------------------|--|
| BUILDING GRID IDENTIFICATION | 0'-0" | CEILING HEIGHT TAG (AFF) | ACOUS ACO ACT ACO AD ARE AFF ABO | OUSTICAL CEILING TILE EA DRAIN | GA GAUGE GALV GALVANIZED GB GRAB BAR GL GLASS/GLAZING | | |
| BUILDING SECTION IDENTIFICATION | | DATUM TAG | ALT ALTI ALUM ALU ANOD ANC ARCH ARC | TERNATE JMINUM ODIZED | GWB GYPSUM WALL BOARD HB HOSE BIB HC HOLLOW CORE HDWR HARDWARE | RFG RB RD RD/OD REF | REFRIGERATOR RUBBER BASE ROOF DRAIN ROOF DRAIN/OVERFLOW DRAIN REFERENCE |
| DRAWING IDENTIFICATION | (101A) | DOOR NUMBER | BD BOA BETW BETV BLD'G BUIL BLK'G BLO BO BOT | WEEN LDING DCKING | HM HOLLOW METAL HORIZ HORIZONTAL HSS HOLLOW STRUCTURAL STEEL TUBE HT HEIGHT ID INSIDE DIAMETER | REQ'D RESIL RM | RESILIENT ROOM ROUGH OPENING |
| DETAIL IDENTIFICATION | $\begin{pmatrix} 1 \\ A \end{pmatrix}$ | EXTERIOR FINISH MATERIAL/COLORS | BOT/BTM BOT CFCI CON CON | ITOM NTRACTOR FURNISHED NTRACTOR INSTALLED | INSUL INSULATION INT INTERIOR JAN JANITOR | RW | RESINOUS WALL SELF-ADHERED MEMBRANE SEALED CONCRETE |
| EXTERIOR ELEVATION IDENTIFICATION | A | EXTERIOR WALL TYPE | CIP CAS CJ CON | AT HOOK NTINUOUS INSULATION ST IN PLACE CONCRETE NTROL JOINT | JT JOINT KD KNOCK DOWN FRAME L LINOLEUM LAM LAMINATES | SCHED SCS SD SECT | SHOWER COMPARTMENT SEAT SOAP DISPENSER SECTION |
| INTERIOR ELEVATION IDENTIFICATION | XX-1 | FURNITURE TAG | CONC CON | LING EAR NCRETE MASONRY UNIT NCRETE | LAV LAVATORY LT LIGHT M MIRROR | | SHEATHING SIMILAR STAIN SANITARY NAPKIN DISPENSER |
| MATCH LINE IDENTIFICATION | X-X | INTERIOR FINISH MATERIAL | COL COL CONT CON CPT CAR CT CER/ D DRY | NTINUOUS RPET RAMIC TILE | MANUF MANUFACTURER MAX MAXIMUM MB MARKER BOARD MCM METAL COMPOSITE MATERIAL MCP METAL CEILING PANEL MDO MEDIUM DENSITY OVERLAY | SR SQ SS SST | SANITARY NAPKIN RECEPTACLE SHOWER ROD SQUARE SOLID SURFACING MATERIAL STAINLESS STEEL STRUCTURAL SILICONE GLAZING |
| NORTH ARROW | A | KEY NOTES | DEL DRT DBL DOL DBRON DAR DEMO DEM DET DET DF DRIN | UBLE RK BRONZE MOLISHED FAIL | ME MATCH EXISTING MFR MANUFACTURE MIN MINIMUM, MINUTE MISC MISCELLANEOUS MO MASONRY OPENING | SSG | STANDARD STONE STEEL STORAGE |
| REVISION IDENTIFICATION | ROOM NAME | ROOM NAME AND NUMBER | DIA DIAM DIM DIAM DIM PT DIM DIST DIST DN DOV | 1ENSION 1ENSION POINT TANCE WN | MP METAL PANEL MR MOP RACK MRP METAL ROOF PANEL MTD MOUNTED MTL METAL | SYM | SHEET VINYL SHEET VINYL BASE SYMMETRICAL |
| WALL SECTION IDENTIFICATION | Â | WINDOW TYPE | DO DOC DS DOV DWG DRA (E) EXIS | WNSPOUT AWING(S) ST EXISTING | MUL MULLION MWP METAL WALL PANEL NTS NOT TO SCALE (N) NEW | TBF...... T/G...... THK | TACK BOARD TACK BOARD FABRIC TOUNGE AND GROOVE THICK |
| | # | EQUIPMENT NUMBER | EA EACI EJ EXP/ ELECT ELEC EL/ELEV ELEV EP EPO | PANSION JOINT CTRICAL VATION | NIC NOT IN CONTRACT NO./# NUMBER OA OVERALL OC ON CENTER | тос | TOP OF TOP OF BEAM/BRICK/BLOCK |
| | | | EQ EQU EQUIP EQU ES EAC EX EXIT EXIST EXIS EXP EXTE | JIPMENT CH SIDE T STING PANSION | OD OUTSIDE DIAMETER OFCI OWNER FURNISHED CONTRACTOR INSTALLED OFOI OWNER FURNISHED OWNER INSTALLED OPNG OPENING OPP OPPOSITE HAND | TOW TPD TR TS | TOILET SEAT COVER DISPENSER |
| ACOUSTICAL CEILING TILE | | GROUT | (F) FUT(FAA FIRE | URE E ALARM ANNUNCIATOR E ALARM CONTROL PANEL | P PAINTED PAF POWER ACTUATED FASTENER PL/PLAM PLASTIC LAMINATE PLAS PLASTIC | | UNLESS OTHERWISE NOTED |
| BATT INSULATION | | GYPSUM BOARD IN SECTION | FD FLOO FE FIRE | OOR DRAIN E EXTINGUISHER E EXTINGUISHER CABINET ISHED FLOOR ISH | PNLPANELPRPAIRPSPROJECTOR SCREENPTPRESSURE TREATEDPTDPAPER TOWEL DISPENSERPTDRPAPER TOWEL DISPENSER | VCT VER VERT VIF | VINYL COMPOSITE TILE VERIFY |
| CONCRETE IN SECTION | | INTERMITTENT BLOCKING | FLR FLOO FOB FACI FOC FACI FOF FACI FOS FACI | OOR EE OF BRICK/BLOCK EE OF CONCRETE EE OF FINISH EE OF STUDS OR STEEL | & RECEPTACLE PLYWD PLYWOOD QT QUARRY TILE | WC | WITHOUT WEATHER BARRIER WINDOW COVERING WOOD |
| CONTINUOUS LUMBER | | MASONRY IN SECTION | FRT FIRE FT FOO FTG FOO FURR FURI FV FIELI | DTING RRING | | WM WP WPRF WSV | WALL GUARD WALK-OFF MAT WORK POINT WATERPROOF WELDED SHEET VINYL WELDED SHEET VINYL BASE |

MATERIAL HATCHES:

| | ACOUSTICAL CEILING TILE | |
|-------|-------------------------|--|
| | BATT INSULATION | |
| р | CONCRETE IN SECTION | |
| | CONTINUOUS LUMBER | |
| | EARTH | |
| | FINSHED LUMBER | |
| | GRAVEL | |

METAL IN SECTION

PLYWOOD IN SECTION

RIGID INSULATION IN SECTION

WM. WALK-OFF MAT WP. WORK POINT WPRF. WATERPROOF WSV WELDED SHEET VINYL WSVB. WELDED SHEET VINYL BASE WWF WELDED WIRE FABRIC



 \frown SC ROOFING REPLACEMEN BEAVERTON SCHOOL DISTF NANCY RYLES ELEMENTARY SC 10250 SW CORMORANT DR. BEAVERTON, OR 97007




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SHEET TITLE ABBREVIATIONS, SYMBOLS & MATERIAL HATCHES





ROOF PLAN SHEET NOTES

- 1. ROOF PLAN FOR GENERAL PURPOSE ONLY. 2. INFORMATION RELATING TO THE EXISTING BUILDING IS BASE ON CASUAL OBSERVATION ACTUAL CONDITIONS VERY AND SHELL BE FIELD VERIFIED BY THE CONTRACTOR.
- 3. GRAPHIC PRESENTATION OF THE AFFECTED AREAS ON DRAWINGS MAY BE SMALLER OR LARGER THAN INDICATED.
- 4. ONLY MAJOR ELEMENTS ARE SHOWN.
- RESPONSIBLE FOR VERIFICATION OF AREAS FOR BIDDING AND CONSTRUCTION PURPOSES. 6. MINIMUM ROOF COVERING CLASSIFICATION FOR TYPES OF CONSTRUCTION
- IS BASED ON TABLE 1501.1 IN CHAPTER 15 ROOF ASSEMBLIES FOR SPECIFIED ROOFTOP STRUCTURES. ROOFING REPLACEMENT ASSEMBLIES ARE CLASS A. 7. CONTRACTOR RESPONSIBLE FOR THE DISCONNECTION AND RECONNECTION OF ALL UTILITY CONNECTIONS AS REQ'D TO COMPLETE
- WORK. THIS INCLUDES ANY WORK REQ'D TO EXTEND PIPES, WIRES, ETC. TO MEET MIN. CLEARANCES. 8. THE VENT AND PIPE SIZES NOTED ON THE DRAWINGS ARE APPROXIMATE AND MUST BE VERIFIED BY THE CONTRACTOR PRIOR TO ANY WORK.
- 9. ROOF CANNOT BE LEFT UNPROTECTED FROM THE ELEMENTS FOR A WEEKEND OR HOLIDAY PERIOD. CONTRACTOR MAY LEAVE ROOF UNPROTECTED OVERNIGHT AND ASSUMES ALL RISK FOR ANY DAMAGE
- 10. CONTRACTOR TO PROVIDE SITE CLEANUP AT THE END OF EACH WORK DAY. CLEANUP SHALL INCLUDE A MAGNET/METAL DETECTOR FOR ALL HARD SURFACES WITHIN 15 FEET OF BUILDING AND ALL LANDSCAPED AREAS.
- 11. REMOVE EXISTING ROOFING DOWN TO EXISTING SHEATHING UNLESS OTHERWISE NOTED IN ASSEMBLY A. REMOVE AND DISPOSE OF ROOFING AS REQ'D. BY GOVERNING AUTHORITIES. 12. REPLACE EXISTING ROOF SYSTEM DAMAGED FROM WATER INTRUSION AS
- REQ'D FOR NEW SCOPE OF WORK INCLUDING, BUT NOT LIMITED TO, SHEATHING, CURBS, BLOCKING, FLASHING, ETC.
- 13. FOR ADDITIONAL GENERAL DEMOLITION INFORMATION SEE NO. 6 UNDER GENERAL NOTES ON SHEET G-001.
- 14. CONTACT DISTRICT MAINTENANCE BEFORE REMOVING OR RELOCATING ANY ELECTRICAL CONDUIT OR CABLE FROM THE ROOF.

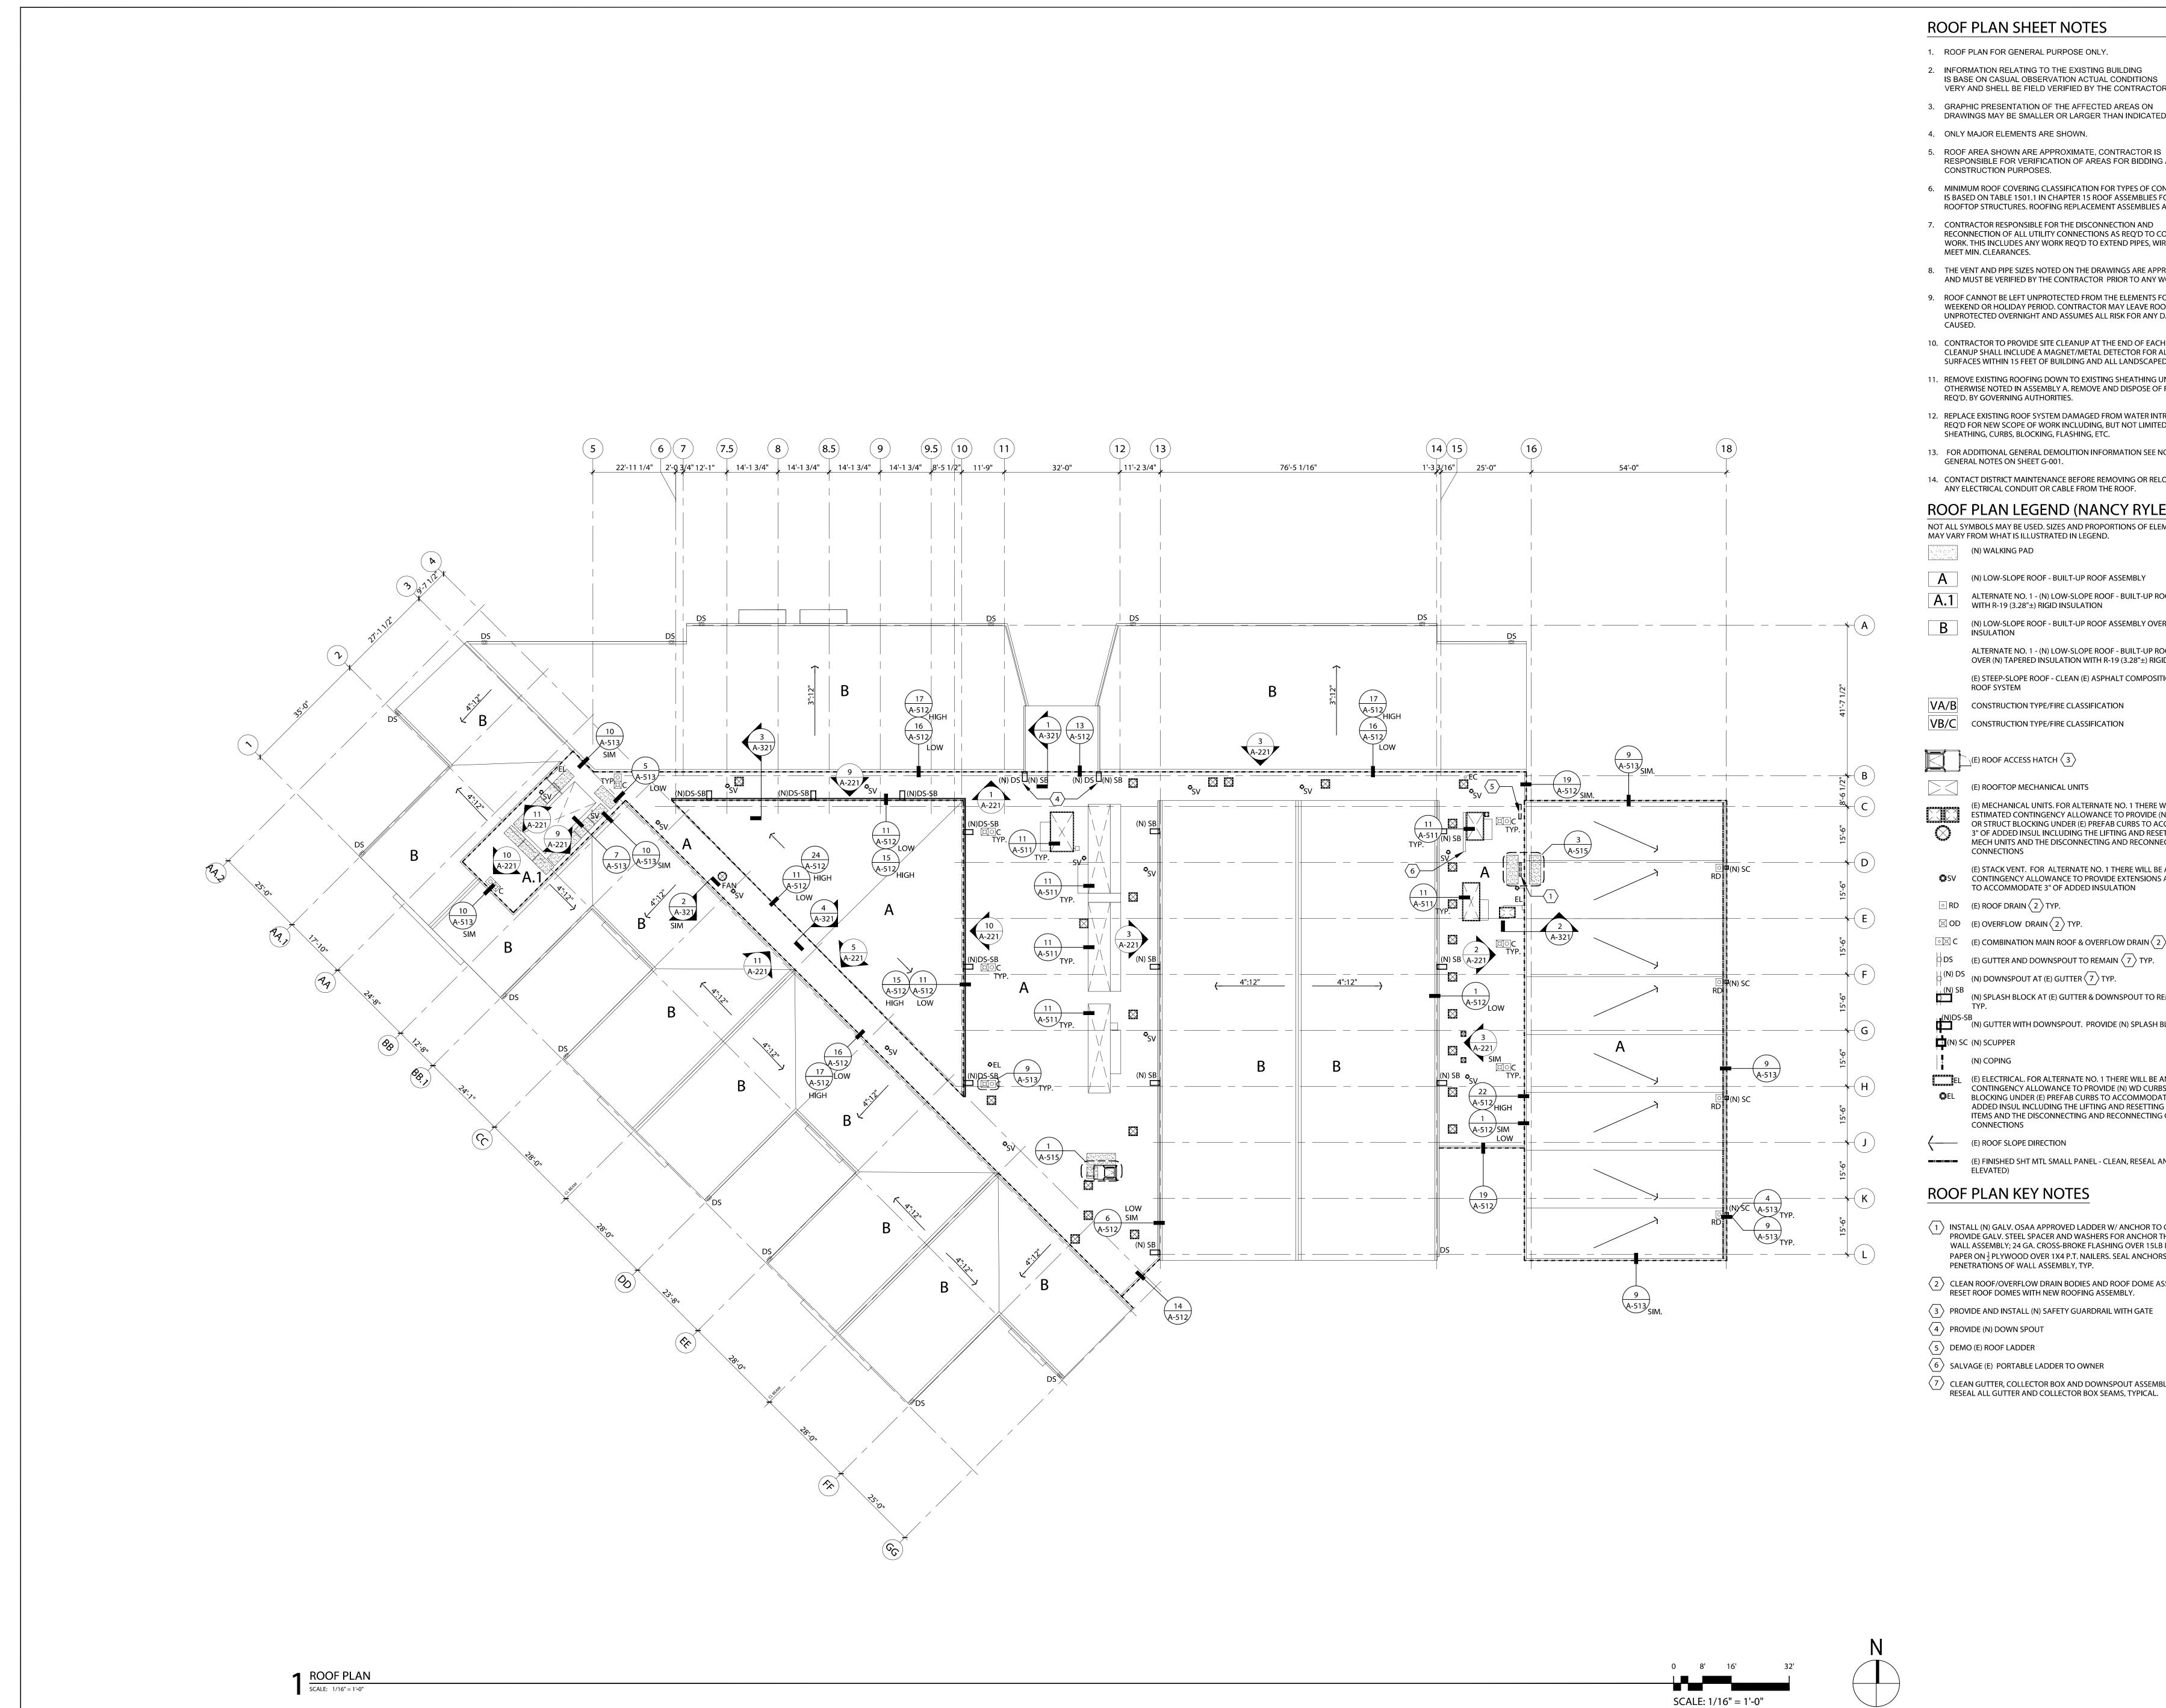ROOF PLAN LEGEND (NANCY RYLES ES) NOT ALL SYMBOLS MAY BE USED. SIZES AND PROPORTIONS OF ELEMENTS MAY VARY FROM WHAT IS ILLUSTRATED IN LEGEND. (N) WALKING PAD

| 7 | |
|---|--|
| Α | (N) LOW-SLOPE ROOF - BUILT-UP ROOF ASSEMB |
| A.1 | ALTERNATE NO. 1 - (N) LOW-SLOPE ROOF - BUIL WITH R-19 (3.28"±) RIGID INSULATION |
| В | (N) LOW-SLOPE ROOF - BUILT-UP ROOF ASSEMB |
| | ALTERNATE NO. 1 - (N) LOW-SLOPE ROOF - BUIL OVER (N) TAPERED INSULATION WITH R-19 (3.28 |
| | (E) STEEP-SLOPE ROOF - CLEAN (E) ASPHALT CO ROOF SYSTEM |
| VA/B | CONSTRUCTION TYPE/FIRE CLASSIFICATION |
| VB/C | CONSTRUCTION TYPE/FIRE CLASSIFICATION |
| | _(E) ROOF ACCESS HATCH $\langle 3 \rangle$ |
| | (E) ROOFTOP MECHANICAL UNITS |
| \bigotimes | (E) MECHANICAL UNITS. FOR ALTERNATE NO. 1 ESTIMATED CONTINGENCY ALLOWANCE TO PRO OR STRUCT BLOCKING UNDER (E) PREFAB CURB: 3" OF ADDED INSUL INCLUDING THE LIFTING AN MECH UNITS AND THE DISCONNECTING AND RE CONNECTIONS |
| SV | (E) STACK VENT. FOR ALTERNATE NO. 1 THERE CONTINGENCY ALLOWANCE TO PROVIDE EXTEN TO ACCOMMODATE 3" OF ADDED INSULATION |
| ○ RD | (E) ROOF DRAIN $\langle 2 \rangle$ TYP. |
| 🖾 OD | (E) OVERFLOW DRAIN $\langle 2 \rangle$ TYP. |
| • 🛛 C | (E) COMBINATION MAIN ROOF & OVERFLOW DR |
| ϕ ds | (E) GUTTER AND DOWNSPOUT TO REMAIN $\langle 7 \rangle$ |
| $\left \begin{array}{c} \left \right\rangle \right\rangle$ (N) DS | (N) DOWNSPOUT AT (E) GUTTER $\langle 7 \rangle$ TYP. |
| (N) SB | (N) SPLASH BLOCK AT (E) GUTTER & DOWNSPOU TYP. |
| (N)DS-S | B (N) GUTTER WITH DOWNSPOUT. PROVIDE (N) SI |
| (N) SC | (N) SCUPPER |
| l ÷ | (N) COPING |
| CEL | (E) ELECTRICAL. FOR ALTERNATE NO. 1 THERE W CONTINGENCY ALLOWANCE TO PROVIDE (N) W BLOCKING UNDER (E) PREFAB CURBS TO ACCOM ADDED INSUL INCLUDING THE LIFTING AND RES ITEMS AND THE DISCONNECTING AND RECONN CONNECTIONS |
| 〈 | (E) ROOF SLOPE DIRECTION |
| | (E) FINISHED SHT MTL SMALL PANEL - CLEAN, RE ELEVATED) |
| ROOF | PLAN KEY NOTES |
| | |

| | INSTALL (N) GALV. OSAA APPROVED LADDER W/ ANC PROVIDE GALV. STEEL SPACER AND WASHERS FOR AN WALL ASSEMBLY; 24 GA. CROSS-BROKE FLASHING OV PAPER ON $\frac{1}{2}$ PLYWOOD OVER 1X4 P.T. NAILERS. SEAL A PENETRATIONS OF WALL ASSEMBLY, TYP. |
|---------------------|--|
| $\langle 2 \rangle$ | CLEAN ROOF/OVERFLOW DRAIN BODIES AND ROOF DRESET ROOF DOMES WITH NEW ROOFING ASSEMBLY. |
| $\langle 3 \rangle$ | PROVIDE AND INSTALL (N) SAFETY GUARDRAIL WITH |
| $\langle 4 \rangle$ | PROVIDE (N) DOWN SPOUT |
| $\langle 5 \rangle$ | DEMO (E) ROOF LADDER |
| 6 | SALVAGE (E) PORTABLE LADDER TO OWNER |
| $\langle 7 \rangle$ | CLEAN GUTTER, COLLECTOR BOX AND DOWNSPOUT |

MBLY JILT-UP ROOF ASSEMBLY

MBLY OVER (N) TAPERED

ILT-UP ROOF ASSEMBLY .28"±) RIGID INSULATION COMPOSITION SHINGLE

THERE WILL BE AN ROVIDE (N) WD CURBS **RBS TO ACCOMMODATE** AND RESETTING OF **RECONNECTING OF MEP**

E WILL BE AN ESTIMATED TENSIONS AND FLASHING

 $DRAIN \langle 2 \rangle TYP.$ TYP.

POUT TO REMAIN $\langle 7 \rangle$

SPLASH BLOCK

WILL BE AN ESTIMATED WD CURBS OR STRUCT OMMODATE 3" OF RESETTING OF ELECT NNECTING OF ELECT


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ICHOR TO CMU. ANCHOR THROUGH (E) OVER 15LB BLDG ANCHORS AT

DOME ASSEMBLIES.

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TASSEMBLIES.



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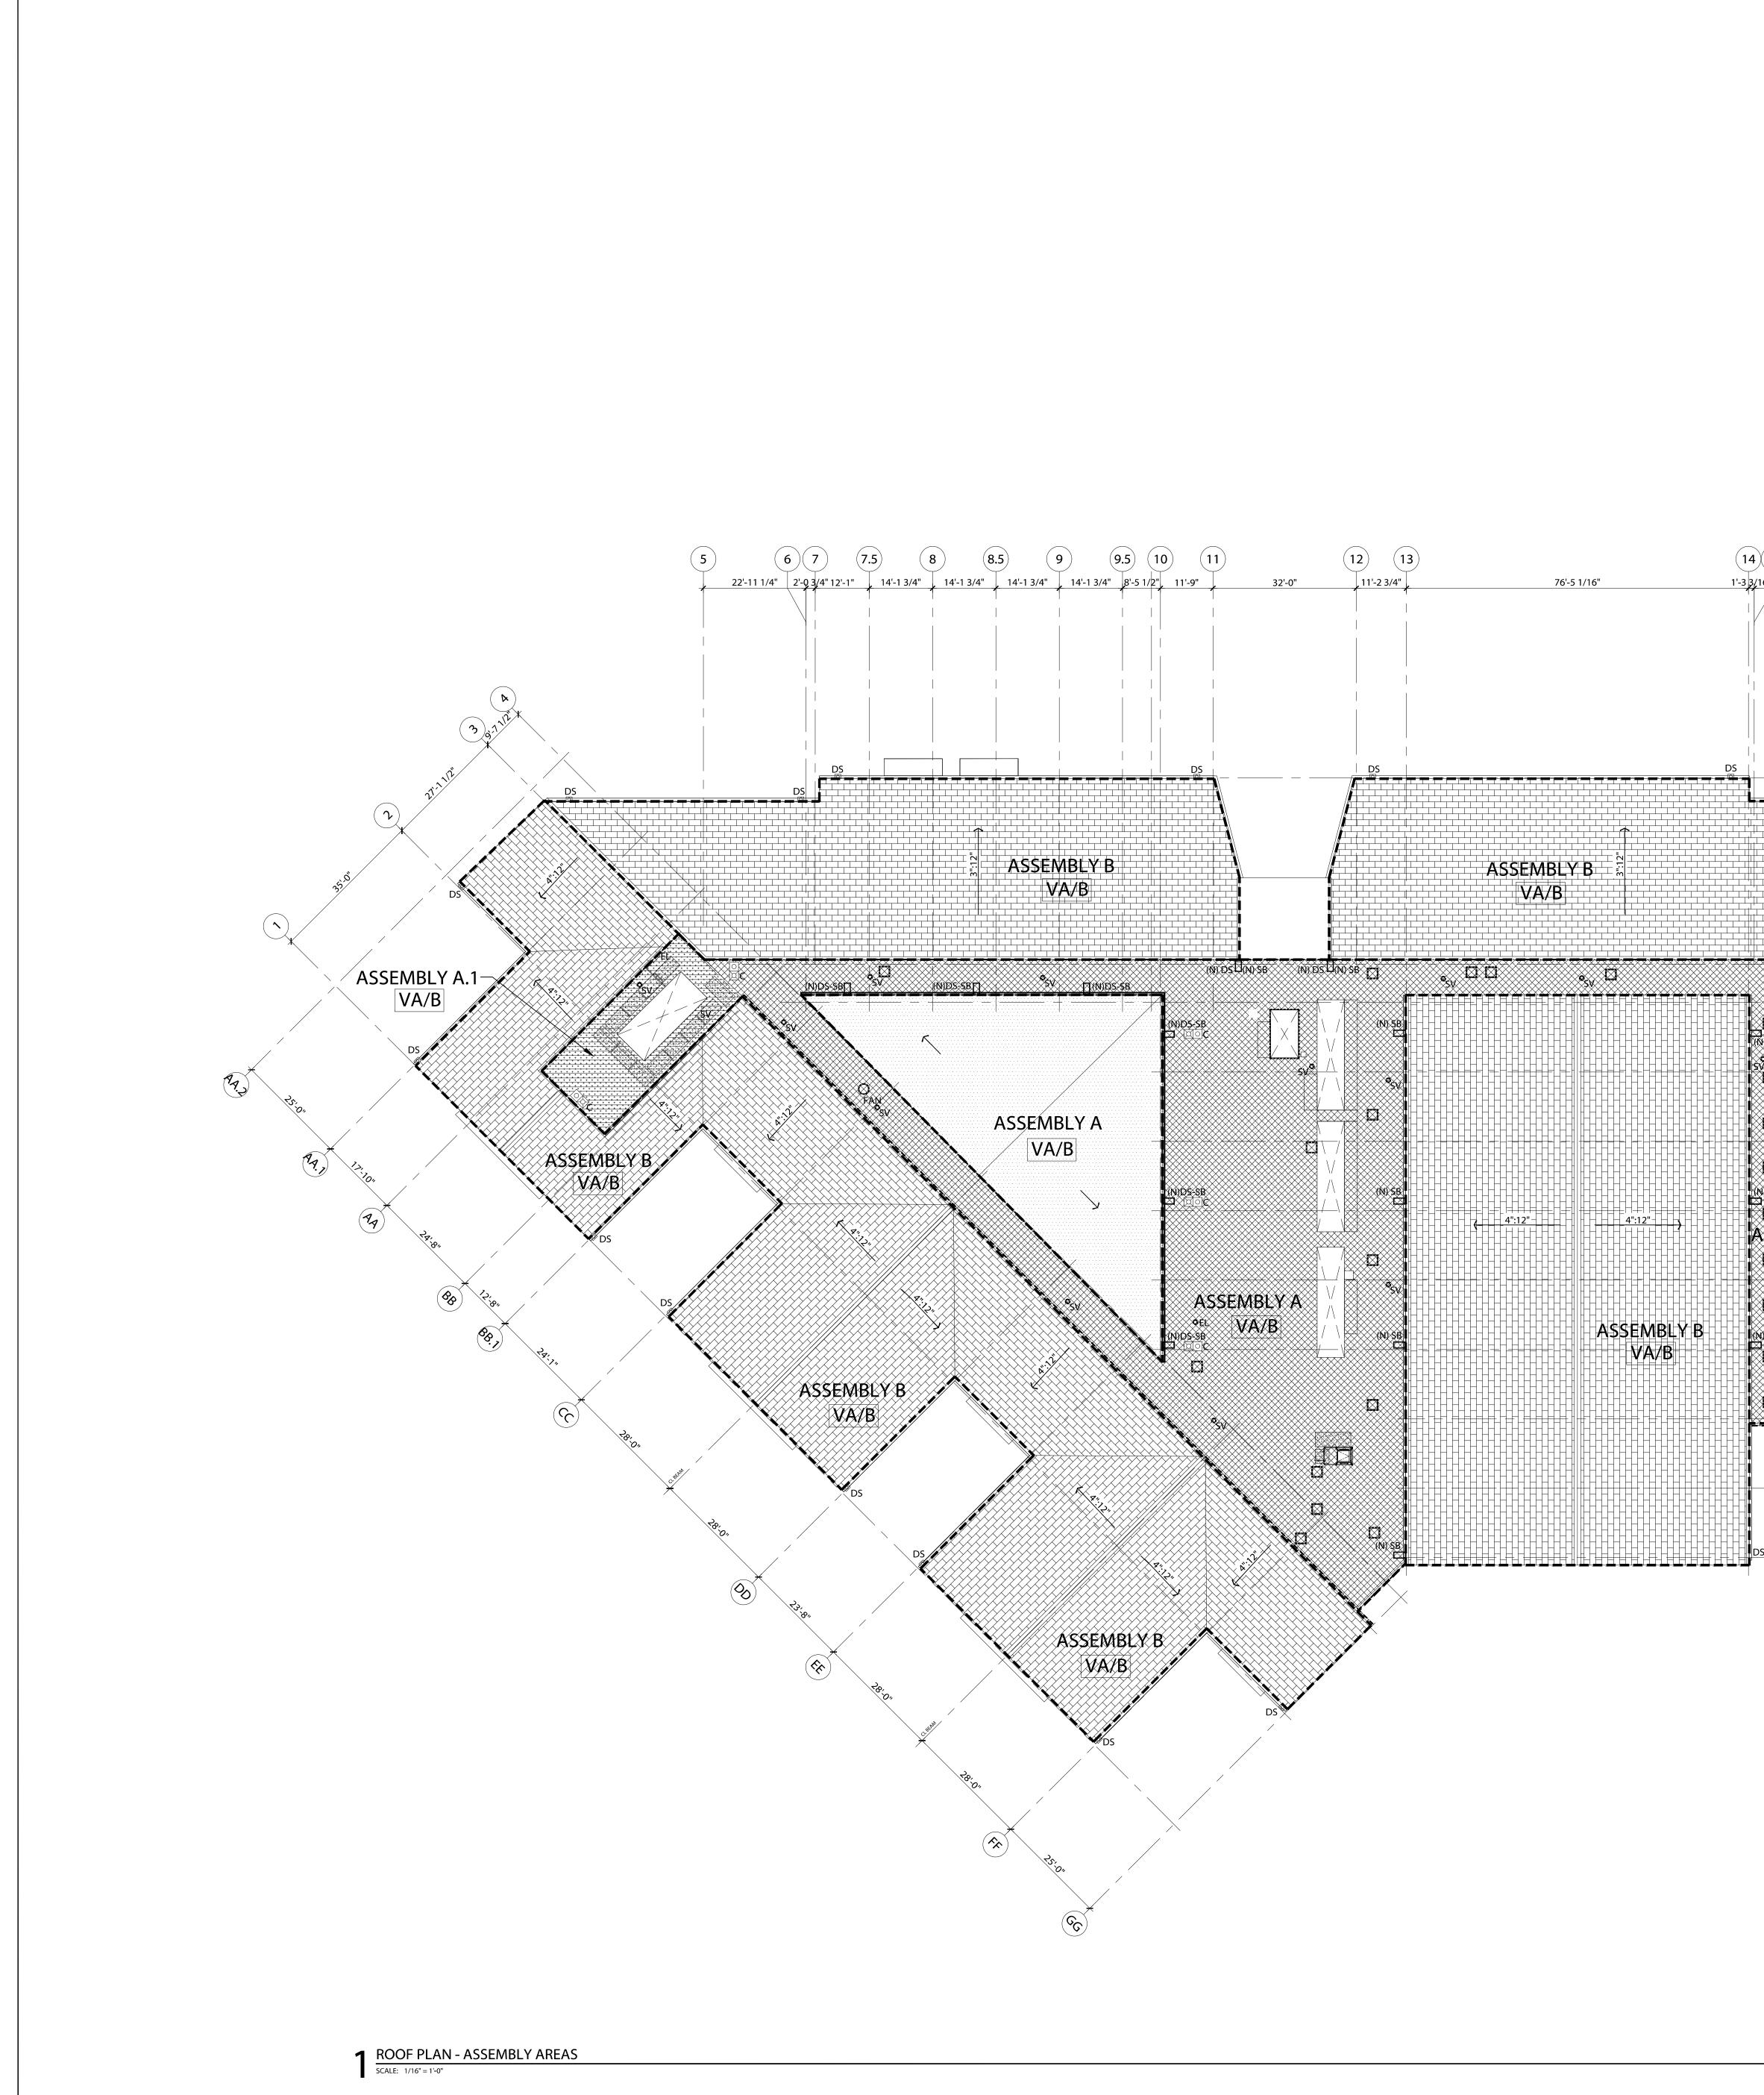
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DATE: 07/08/2022 ISSUED FOR: BID | PERMIT

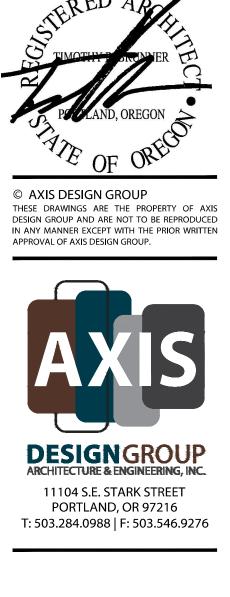SHEET TITLE ROOF PLAN





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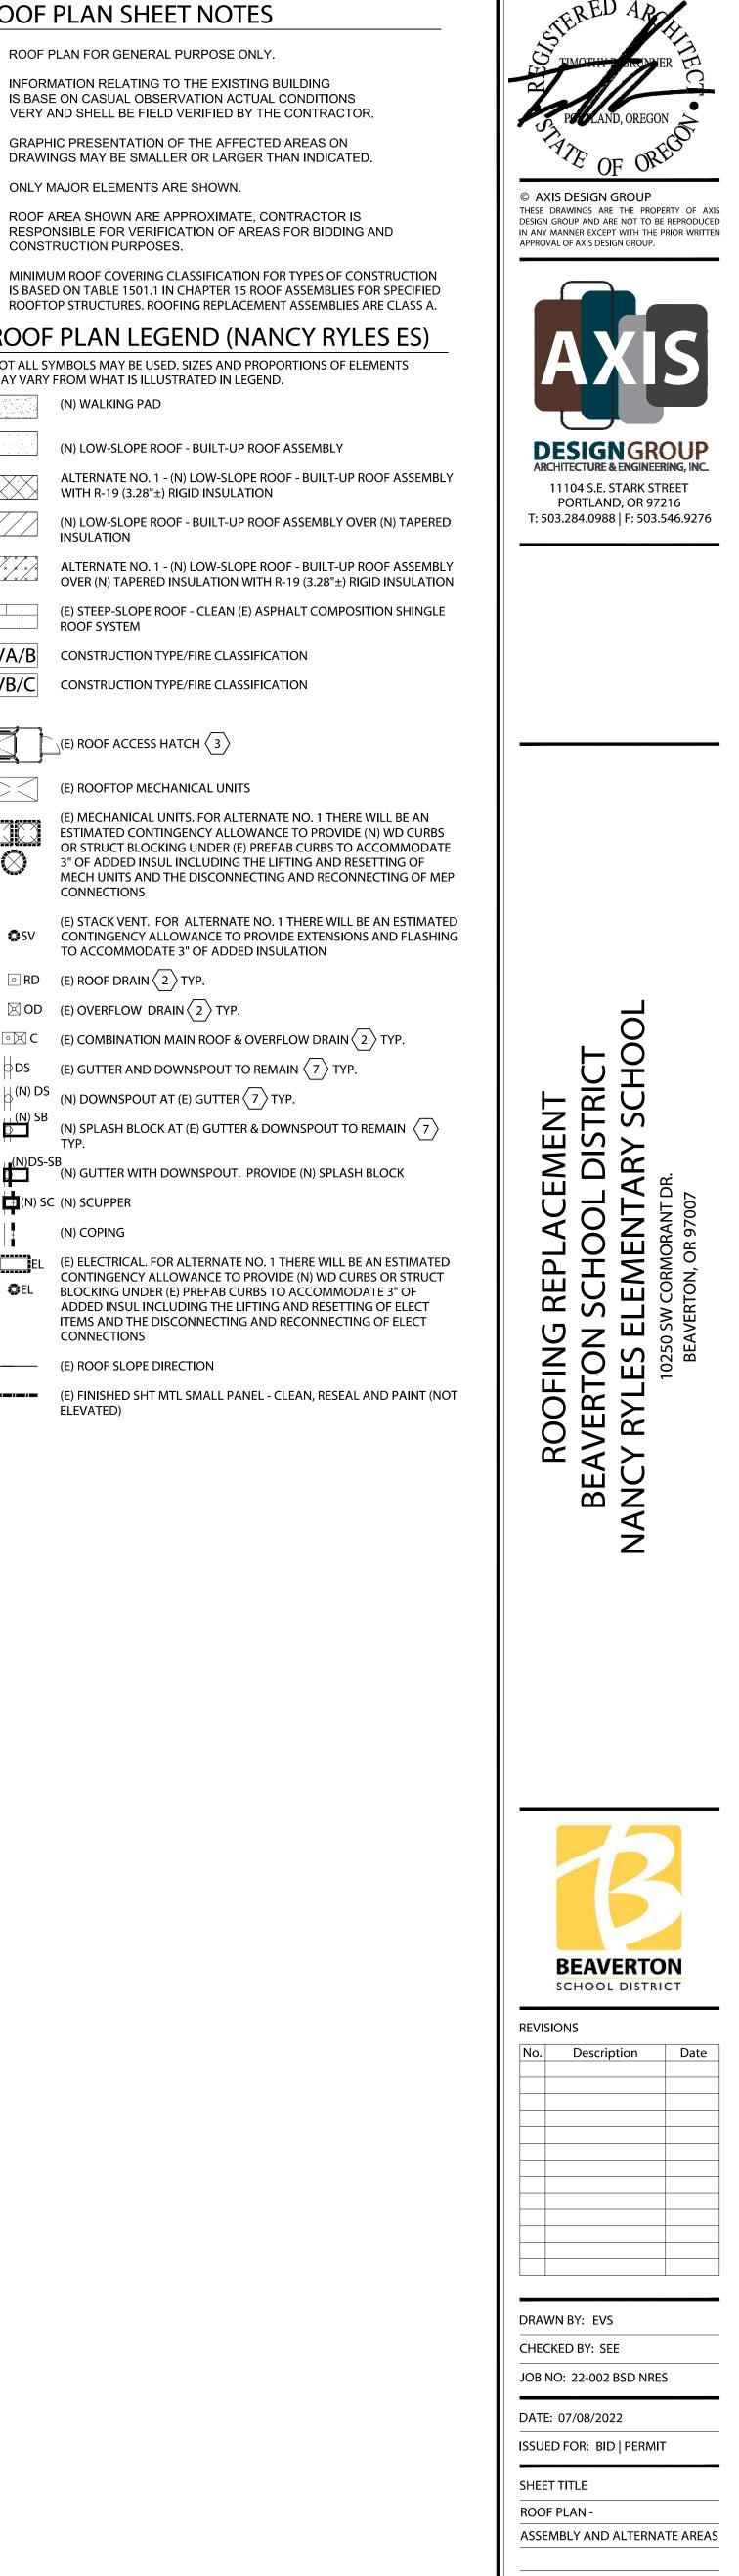
ROOF PLAN SHEET NOTES

- 1. ROOF PLAN FOR GENERAL PURPOSE ONLY. 2. INFORMATION RELATING TO THE EXISTING BUILDING IS BASE ON CASUAL OBSERVATION ACTUAL CONDITIONS
- 3. GRAPHIC PRESENTATION OF THE AFFECTED AREAS ON DRAWINGS MAY BE SMALLER OR LARGER THAN INDICATED.
- 4. ONLY MAJOR ELEMENTS ARE SHOWN.
- 5. ROOF AREA SHOWN ARE APPROXIMATE, CONTRACTOR IS RESPONSIBLE FOR VERIFICATION OF AREAS FOR BIDDING AND CONSTRUCTION PURPOSES.
- 6. MINIMUM ROOF COVERING CLASSIFICATION FOR TYPES OF CONSTRUCTION IS BASED ON TABLE 1501.1 IN CHAPTER 15 ROOF ASSEMBLIES FOR SPECIFIED ROOFTOP STRUCTURES. ROOFING REPLACEMENT ASSEMBLIES ARE CLASS A.


ROOF PLAN LEGEND (NANCY RYLES ES) NOT ALL SYMBOLS MAY BE USED. SIZES AND PROPORTIONS OF ELEMENTS MAY VARY FROM WHAT IS ILLUSTRATED IN LEGEND. (N) WALKING PAD

| | (II) WALKING FAD |
|-------------|--|
| | (N) LOW-SLOPE ROOF - BUILT-UP ROOF ASSEME |
| | ALTERNATE NO. 1 - (N) LOW-SLOPE ROOF - BUIL WITH R-19 (3.28"±) RIGID INSULATION |
| | (N) LOW-SLOPE ROOF - BUILT-UP ROOF ASSEME |
| | ALTERNATE NO. 1 - (N) LOW-SLOPE ROOF - BUIL OVER (N) TAPERED INSULATION WITH R-19 (3.2) |
| | (E) STEEP-SLOPE ROOF - CLEAN (E) ASPHALT CC ROOF SYSTEM |
| VA/B | CONSTRUCTION TYPE/FIRE CLASSIFICATION |
| VB/C | CONSTRUCTION TYPE/FIRE CLASSIFICATION |
| | (E) ROOF ACCESS HATCH $\langle 3 \rangle$ |
| | (E) ROOFTOP MECHANICAL UNITS |
| Ø | (E) MECHANICAL UNITS. FOR ALTERNATE NO. 1 ESTIMATED CONTINGENCY ALLOWANCE TO PR OR STRUCT BLOCKING UNDER (E) PREFAB CURE 3" OF ADDED INSUL INCLUDING THE LIFTING A MECH UNITS AND THE DISCONNECTING AND R CONNECTIONS |
| © SV | (E) STACK VENT. FOR ALTERNATE NO. 1 THERE CONTINGENCY ALLOWANCE TO PROVIDE EXTE TO ACCOMMODATE 3" OF ADDED INSULATION |
| ○ RD | (E) ROOF DRAIN $\langle 2 \rangle$ TYP. |
| 🖂 OD | (E) OVERFLOW DRAIN $\langle 2 \rangle$ TYP. |
| • 🔀 C | (E) COMBINATION MAIN ROOF & OVERFLOW DF |
| DS | (E) GUTTER AND DOWNSPOUT TO REMAIN 7 |
| | (N) DOWNSPOUT AT (E) GUTTER $\langle 7 \rangle$ TYP. |
| (N) SB | (N) SPLASH BLOCK AT (E) GUTTER & DOWNSPO TYP. |
| (N)DS-SI | B (N) GUTTER WITH DOWNSPOUT. PROVIDE (N) S |
| (N) SC | (N) SCUPPER |
| | (N) COPING |
| EL | (E) ELECTRICAL. FOR ALTERNATE NO. 1 THERE W CONTINGENCY ALLOWANCE TO PROVIDE (N) W BLOCKING UNDER (E) PREFAB CURBS TO ACCOU ADDED INSUL INCLUDING THE LIFTING AND RE ITEMS AND THE DISCONNECTING AND RECONN CONNECTIONS |
| <u> </u> | (E) ROOF SLOPE DIRECTION |
| | |

(E) FINISHED SHT MTL SMALL PANEL - CLEAN, RESEAL AND PAINT (NOT ELEVATED)





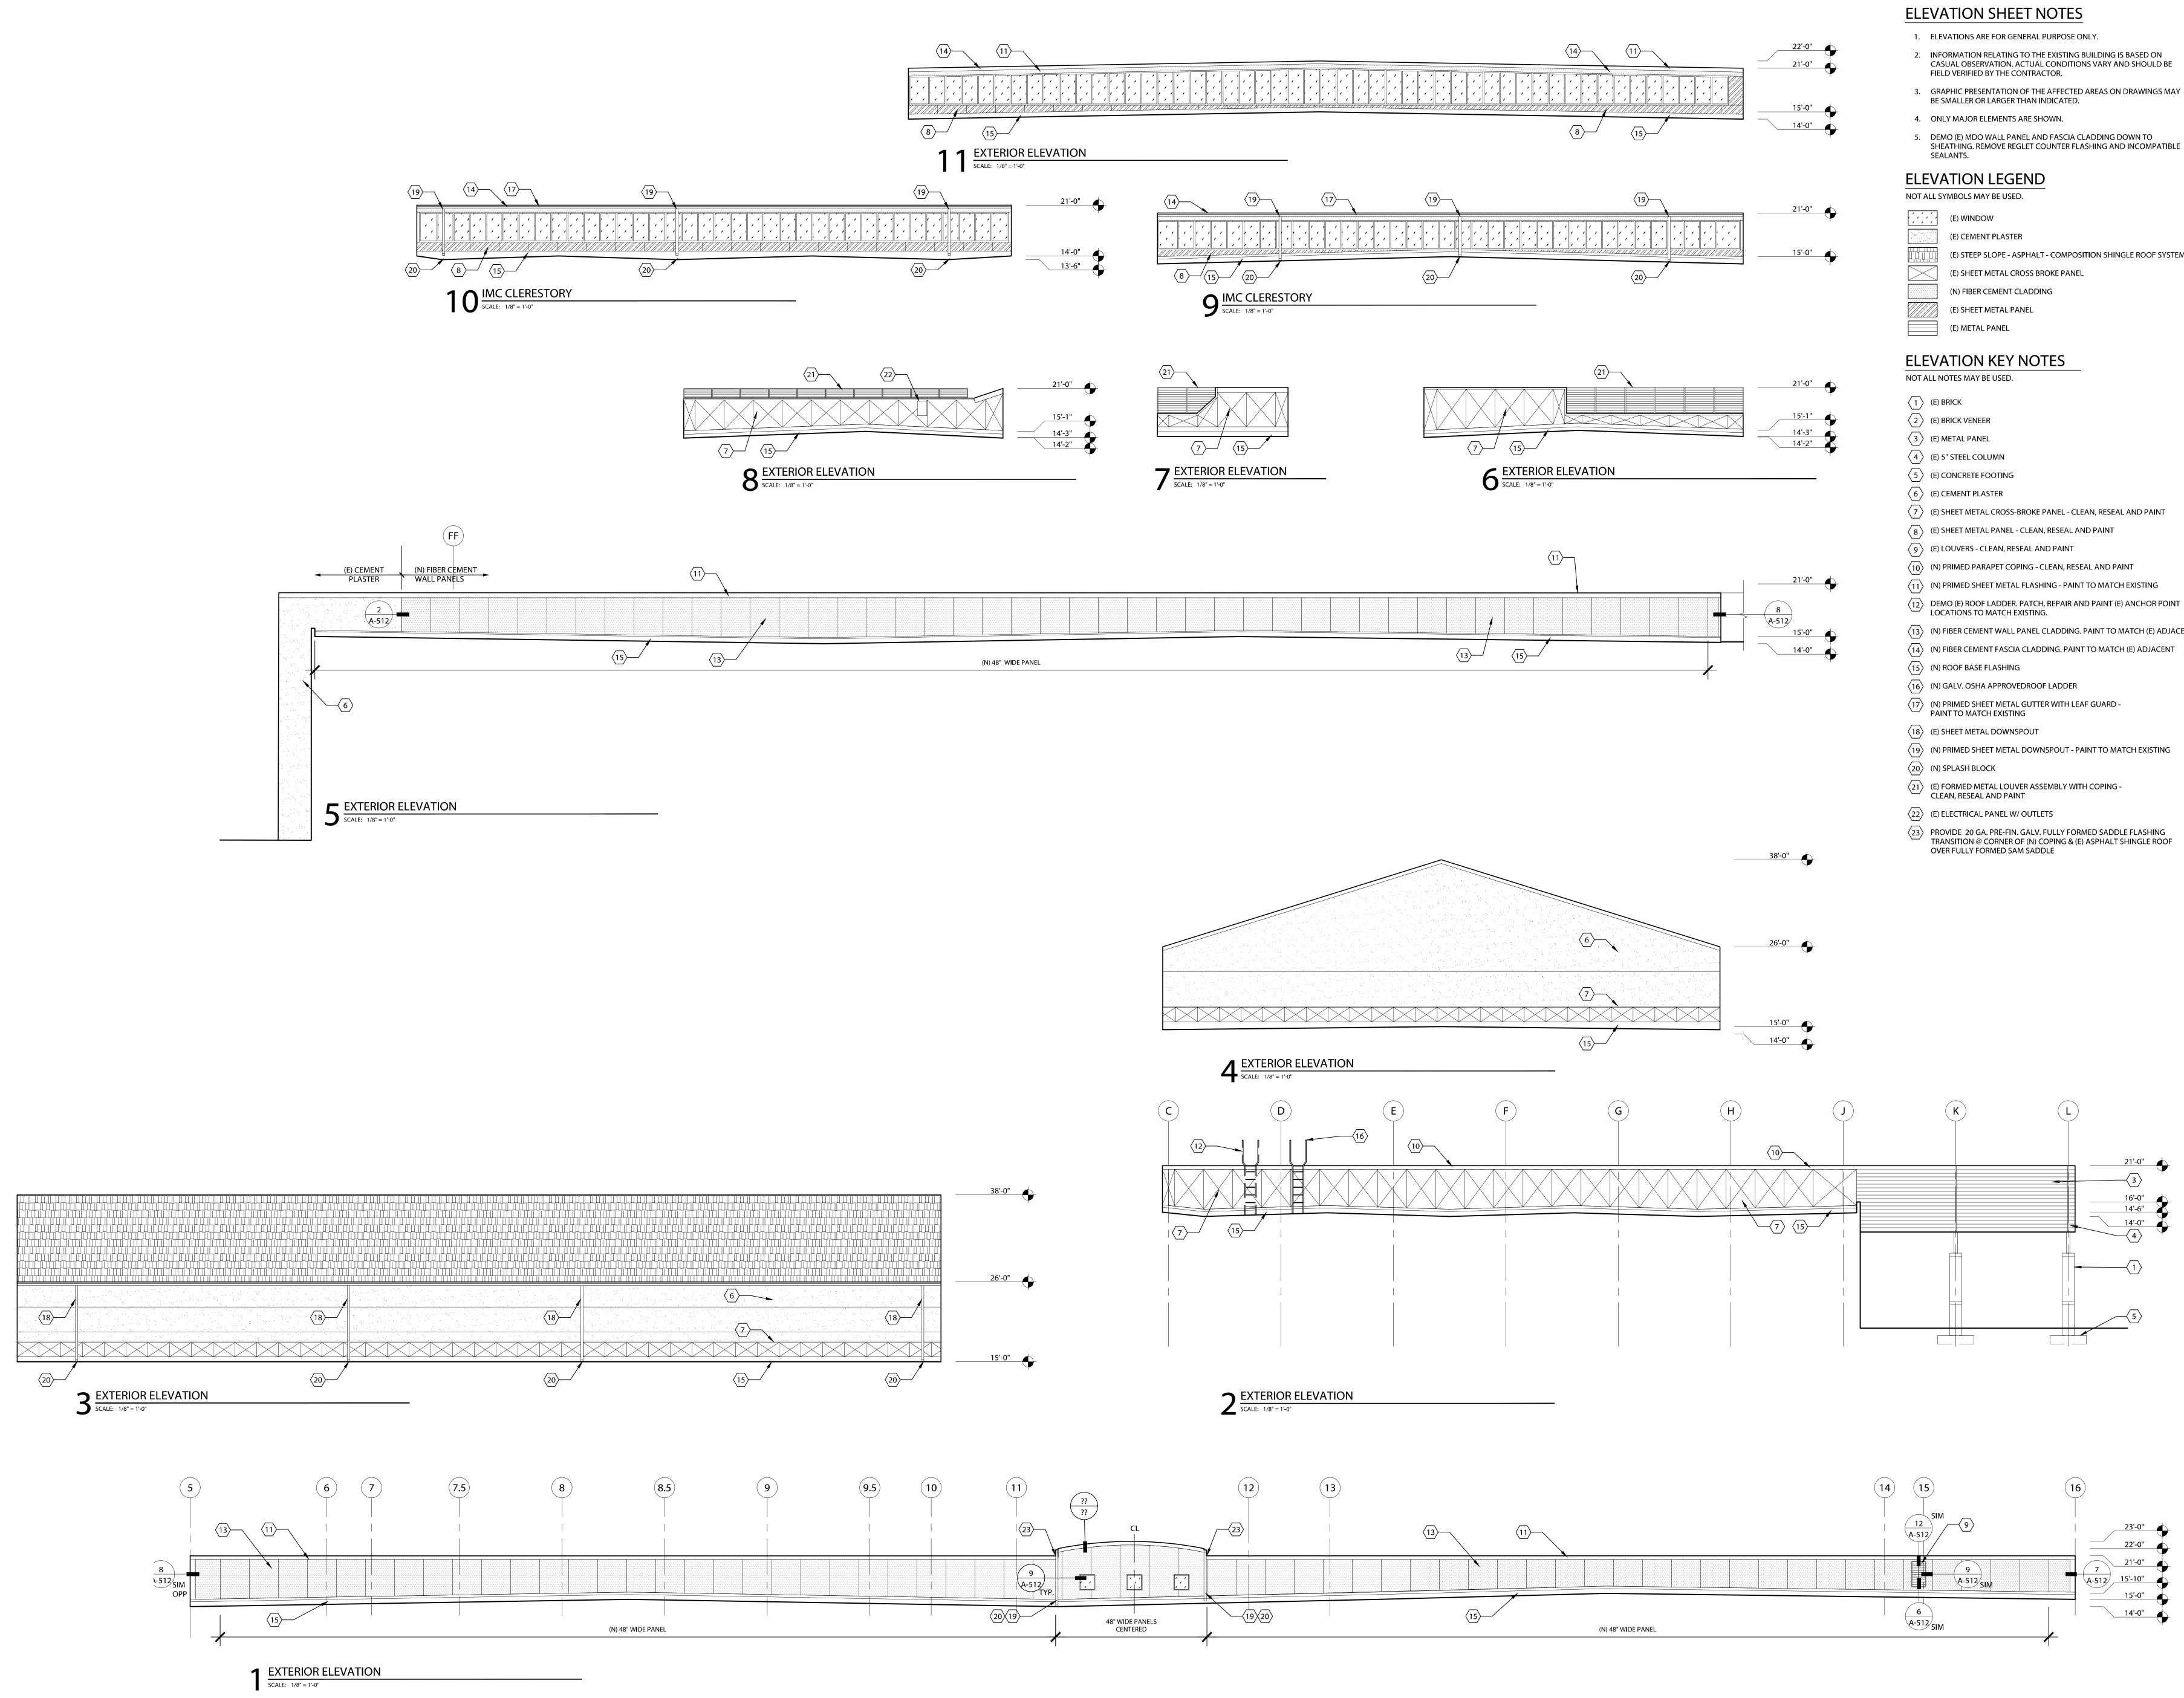

| · · · · · | (E) WINDOW |
|-----------|--|
| | (E) CEMENT PLASTER |
| | (E) STEEP SLOPE - ASPHALT - COMPOSITIO |
| | (E) SHEET METAL CROSS BROKE PANEL |
| | (N) FIBER CEMENT CLADDING |
| | (E) SHEET METAL PANEL |
| | (E) METAL PANEL |

| $\langle 1 \rangle$ | (E) BRICK |
|----------------------|---|
| $\langle 2 \rangle$ | (E) BRICK VENEER |
| $\langle 3 \rangle$ | (E) METAL PANEL |
| $\langle 4 \rangle$ | (E) 5" STEEL COLUMN |
| $\langle 5 \rangle$ | (E) CONCRETE FOOTING |
| $\langle 6 \rangle$ | (E) CEMENT PLASTER |
| $\langle 7 \rangle$ | (E) SHEET METAL CROSS-BROKE PANEL - CLEAN, |
| 8 | (E) SHEET METAL PANEL - CLEAN, RESEAL AND P |
| $\langle 9 \rangle$ | (E) LOUVERS - CLEAN, RESEAL AND PAINT |
| $\langle 10 \rangle$ | (N) PRIMED PARAPET COPING - CLEAN, RESEAL A |
| $\langle 11 \rangle$ | (N) PRIMED SHEET METAL FLASHING - PAINT TO |
| (12) | DEMO (E) ROOF LADDER. PATCH, REPAIR AND PALOCATIONS TO MATCH EXISTING. |
| (13) | (N) FIBER CEMENT WALL PANEL CLADDING. PAIN |
| (14) | (N) FIBER CEMENT FASCIA CLADDING. PAINT TO |
| (15) | (N) ROOF BASE FLASHING |
| (16) | (N) GALV. OSHA APPROVEDROOF LADDER |
| (17) | (N) PRIMED SHEET METAL GUTTER WITH LEAF GU PAINT TO MATCH EXISTING |
| $\langle 18 \rangle$ | (E) SHEET METAL DOWNSPOUT |
| (19) | (N) PRIMED SHEET METAL DOWNSPOUT - PAINT |
| 20 | (N) SPLASH BLOCK |
| 21 | (E) FORMED METAL LOUVER ASSEMBLY WITH CO CLEAN, RESEAL AND PAINT |
| 22 | (E) ELECTRICAL PANEL W/ OUTLETS |
| 23 | PROVIDE 20 GA. PRE-FIN. GALV. FULLY FORMED TRANSITION @ CORNER OF (N) COPING & (E) ASF |

TION SHINGLE ROOF SYSTEM


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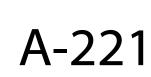



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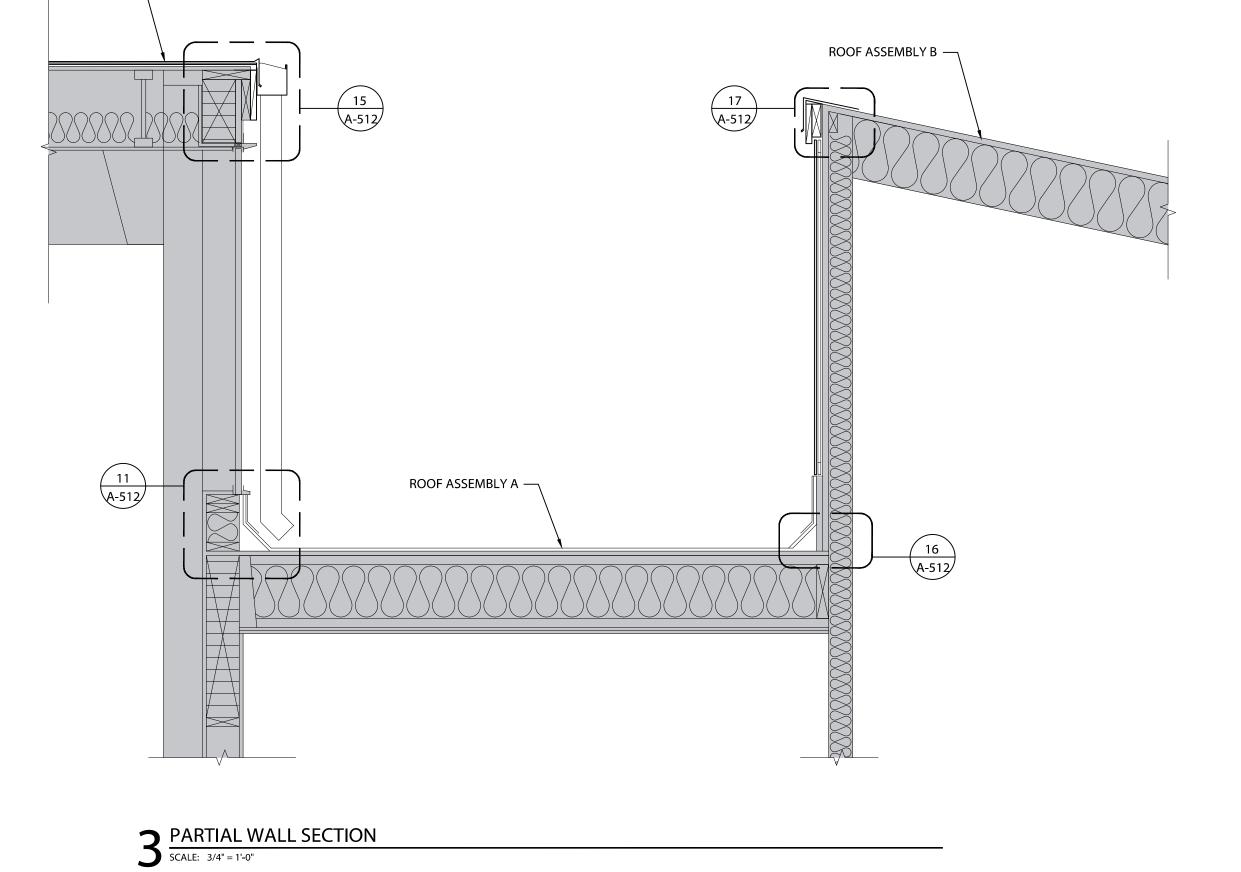
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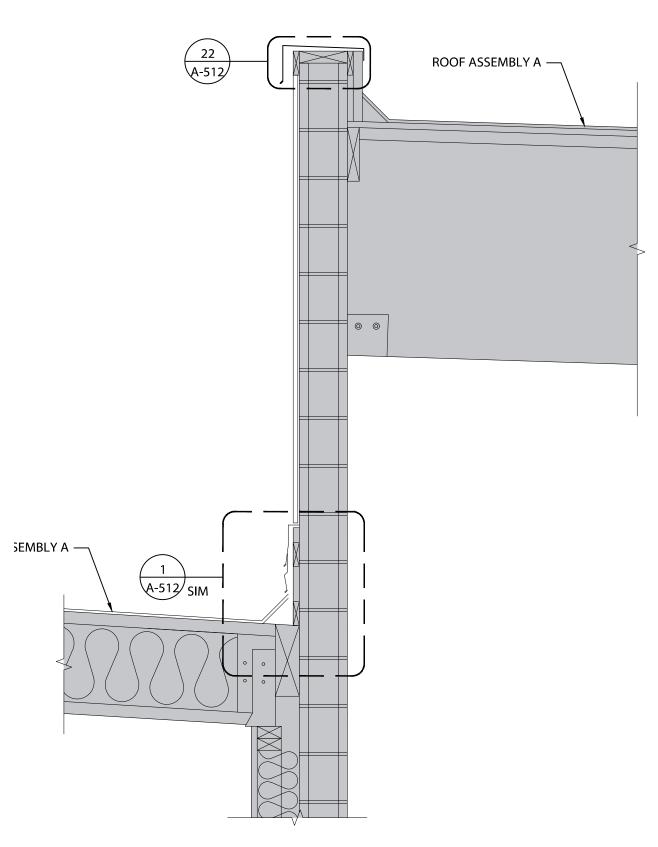
SHEET TITLE EXTERIOR ELEVATIONS








ROOF ASSEMBLY A —

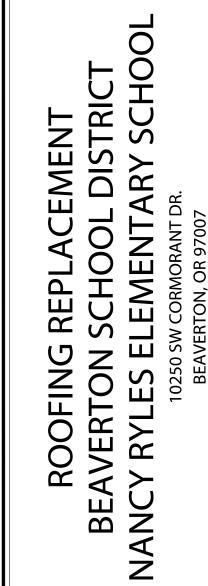


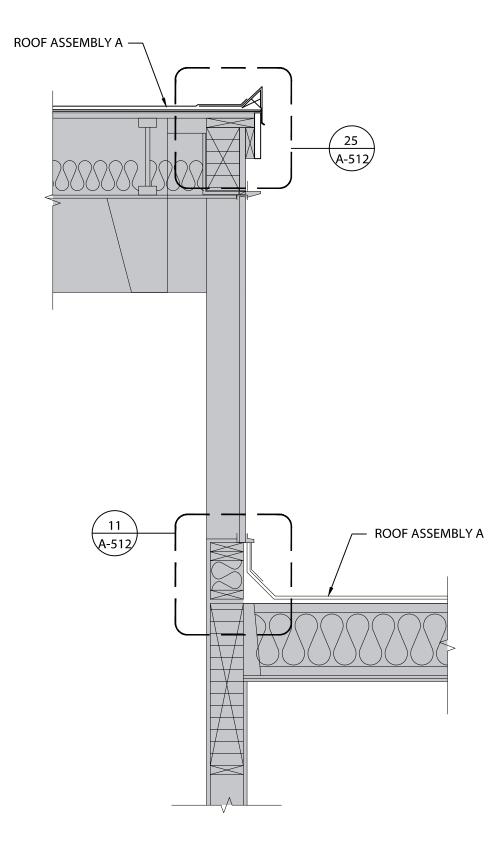


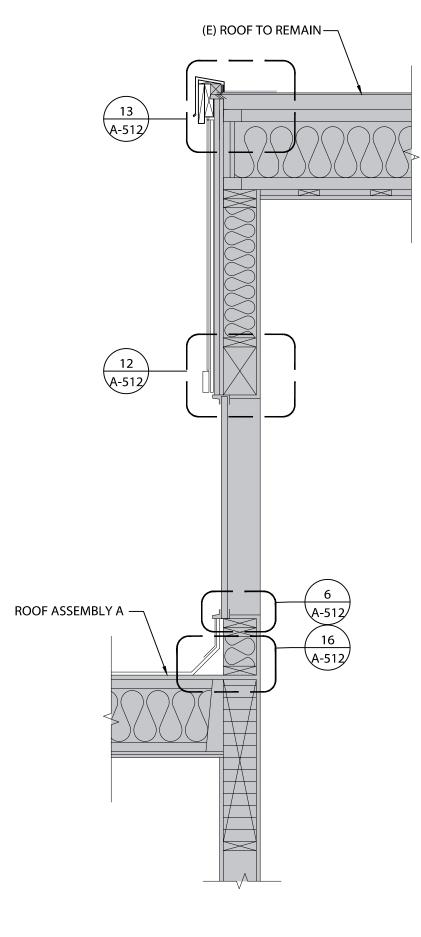

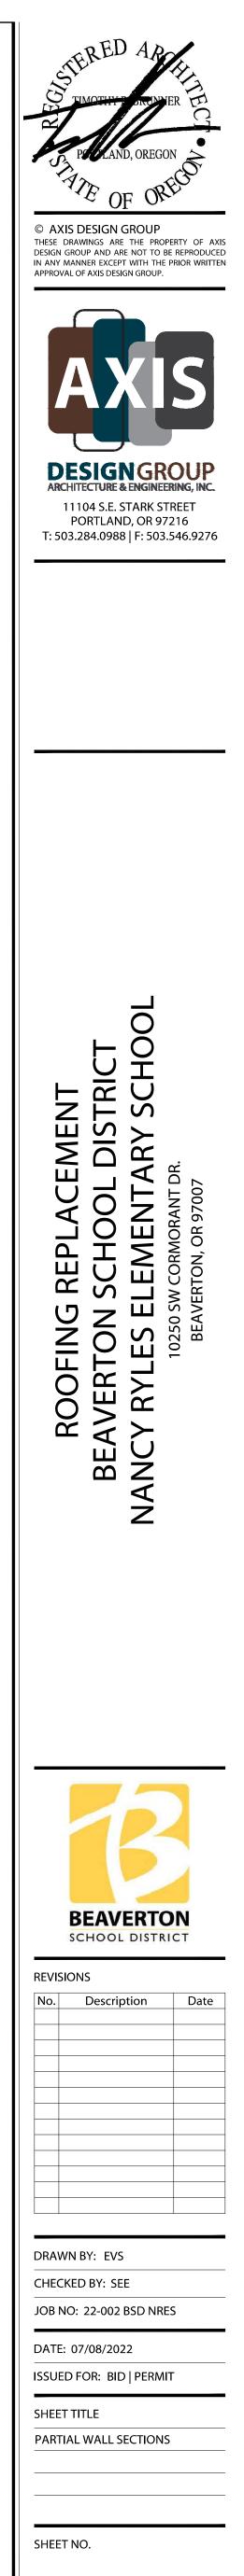

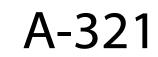

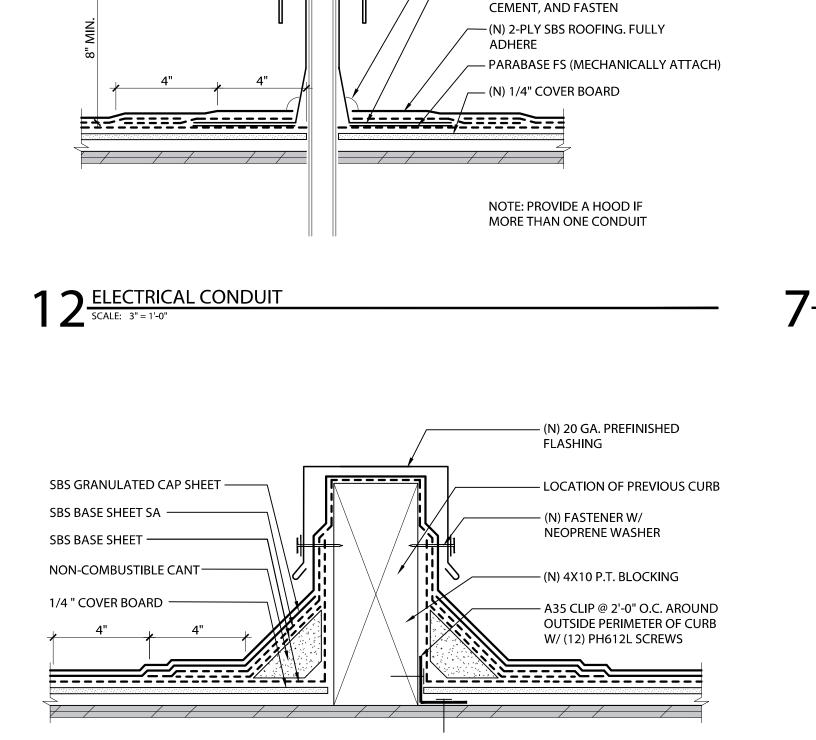

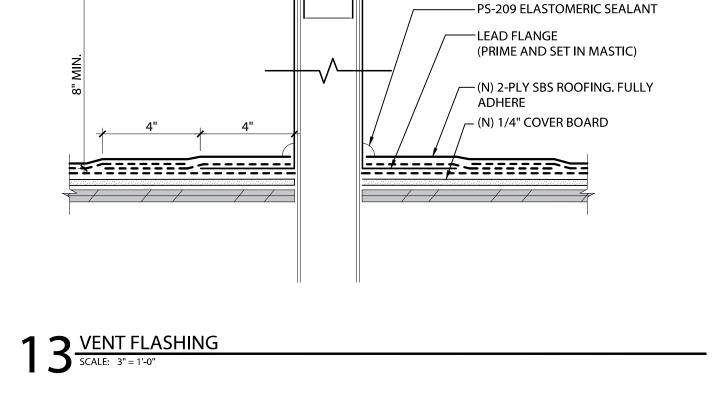

– (N) CAP

— (E) CONDUIT

— (N) SEALANT

— (N) WEATHER SHIELD

- PS-209 ELASTOMERIC SEALANT


— (N) TWO PIECE 24 GA GALVANIZED


CONDUIT FLASHING WITH (N) DRAW


BAND. PRIME, SET IN PA-1021 PLASTIC

SET IN SEALANT



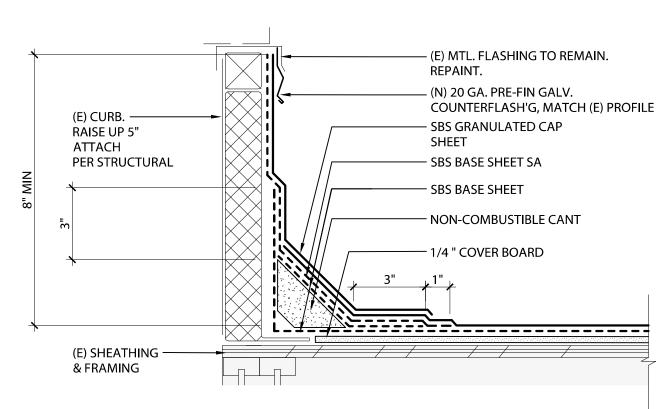

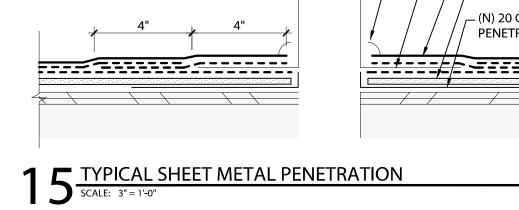


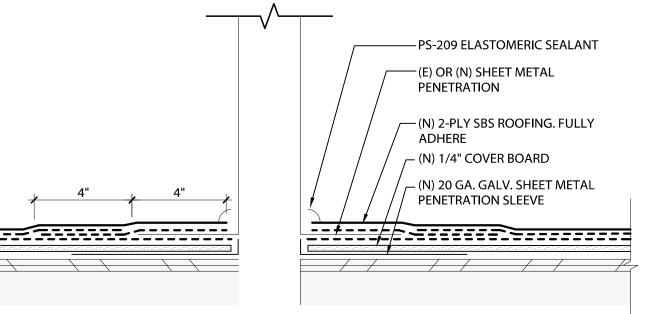



ROOFING DETAIL SHEET NOTES

- 1. INFORMATION RELATING TO THE EXISTING BUILDING IS BASED ON CASUAL OBSERVATION ACTUAL CONDITIONS VERY AND SHELL BE FIELD VERIFIED BY THE CONTRACTOR.
- 2. GRAPHIC PRESENTATION OF THE AFFECTED AREAS ON DRAWINGS MAY BE SMALLER OR LARGER THAN INDICATED.
- 3. ONLY MAJOR ELEMENTS ARE SHOWN.
- 4. CONTRACTOR RESPONSIBLE FOR THE DISCONNECTION AND RECONNECTION OF ALL UTILITY CONNECTIONS AS REQ'D TO COMPLETE WORK. THIS INCLUDES ANY WORK REQ'D TO EXTEND PIPES, WIRES, ETC. TO MEET MIN. CLEARANCES.
- 5. ROOF CANNOT BE LEFT UNPROTECTED FROM THE ELEMENTS FOR A WEEKEND OR HOLIDAY PERIOD. CONTRACTOR MAY LEAVE ROOF UNPROTECTED OVERNIGHT AND ASSUMES ALL RISK FOR ANY DAMAGE CAUSED.
- 6. CONTRACTOR TO PROVIDE SITE CLEANUP AT THE END OF EACH WORK DAY. CLEANUP SHALL INCLUDE A MAGNET/METAL DETECTOR FOR ALL HARD SURFACES WITHIN 15 FEET OF BUILDING AND ALL LANDSCAPED AREAS.
- 7. REMOVE EXISTING ROOFING DOWN TO EXISTING SHEATHING. REMOVE AND DISPOSE OF ROOFING AS REQ'D. BY GOVERNING AUTHORITIES.
- 8. REPLACE EXISTING ROOF SYSTEM DAMAGED FROM WATER INTRUSION AS REQ'D FOR NEW SCOPE OF WORK INCLUDING, BUT NOT LIMITED TO, SHEATHING, CURBS, BLOCKING, FLASHING, ETC.
- 9. FOR ADDITIONAL GENERAL DEMOLITION INFORMATION SEE NO. 6 UNDER GENERAL NOTES ON SHEET G-001.
- 10. NEW SHEET METAL PROFILES (COPINGS, EDGE METAL, ETC.) SHALL CLOSELY MATCH EXISTING TO BE REPLACED. CONTRACTOR TO FIELD-MEASURE EXISTING FABRICATION PRIOR TO DISPOSAL.
- 11. TYPICAL ROOF DETAIL SHEET NOTES APPLY TO ALL ROOFING DETAIL SHEETS.

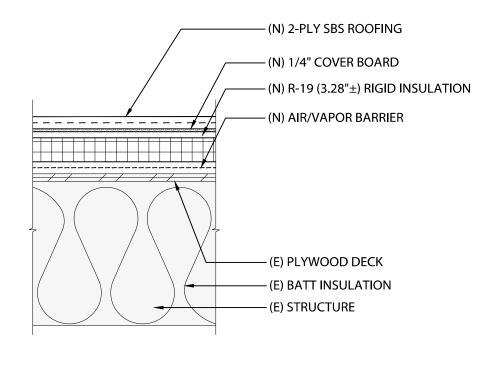


NOTE: THERE WILL BE AN ESTIMATED CONTINGENCY ALLOWANCE FOR ADDITIONAL MEP WORK ASSOCIATED WITH ALTERNATE NO. 1

ROOF ASSEMBLY A- LOW SLOPE - ALTERNATE NO. 1


(E) ASPHALT SHINGLE ROOF TO REMAIN

a. BLOW OR SWEEP AWAY LOOSE DEBRIS FROM THE SURFACE OF THE ROOF. DO NOT ALLOW DEBRIS b. TO COLLECT IN GUTTERS. 50:50 RATIO OF CHLORINE BLEACH AND WATER. APPLY WITH A SPRAYER AND ALLOW FULL d. SATURATION (MIN. 15 MINUTES) SCRUB ROOF WITH A SOFT BRISTLE BRUSH, RINSING AWAY MOSS AND ALGAE WITH A GARDEN HOSE (NOT A POWER WASHER). CLEAN GUTTERS OF DEBRIS AS A RESULT OF MOSS REMOVAL.

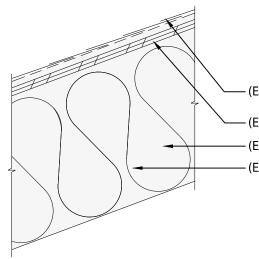


(E) ASPHALT SHINGLE ROOF (E) PLYWOOD DECK (E) BATT INSULATION (E) STRUCTURE


3 ROOF ASSEMBLY B - STEEP SLOPE SCALE: 1 1/2" = 1'-0"

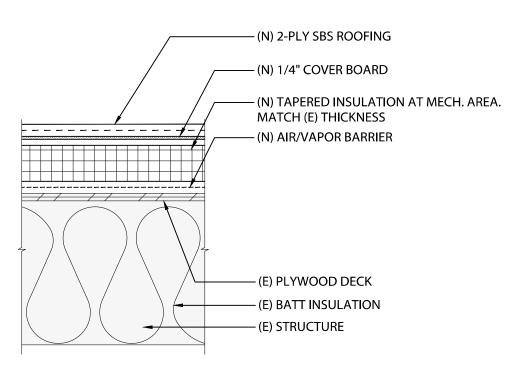

2 ROOF ASSEMBLY A.1 - LOW SLOPE SCALE: 1 1/2" = 1'-0"

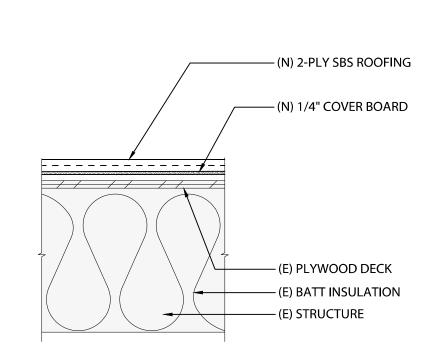


1 ROOF ASSEMBLY A - LOW SLOPE SCALE: 1 1/2" = 1'-0"

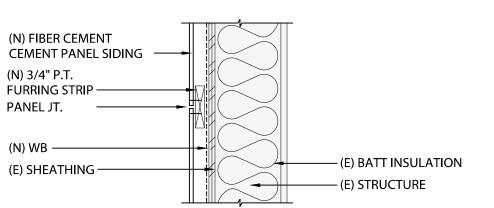


 WALL ASSEMBLY C

 SCALE:
 1 1/2" = 1'-0"

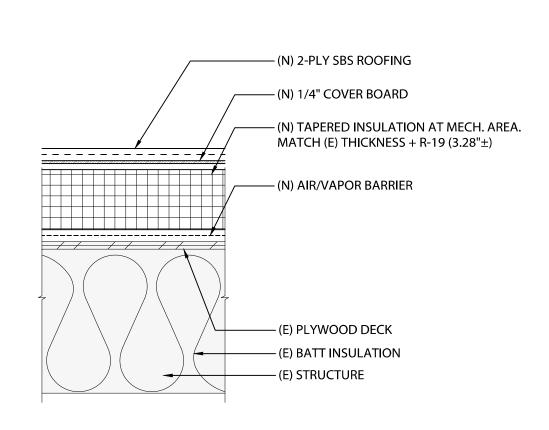

NOTE: THERE WILL BE AN ESTIMATED CONTINGENCY ALLOWANCE FOR ADDITIONAL MEP WORK ASSOCIATED WITH ALTERNATE NO. 1

ROOF ASSEMBLY A.1 LOW SLOPE - ALTERNATE NO. 1

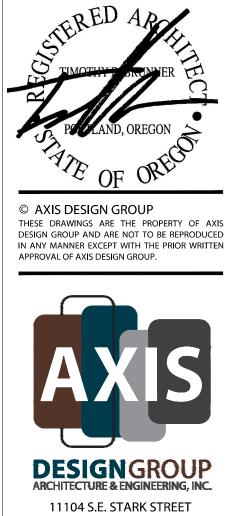

PORTLAND, OR 97216 T: 503.284.0988 | F: 503.546.9276

<u>പ</u> ഗ REPLACEMEN School DIST ELEMENTARY 5 ROOFING AVERTON BEAVE




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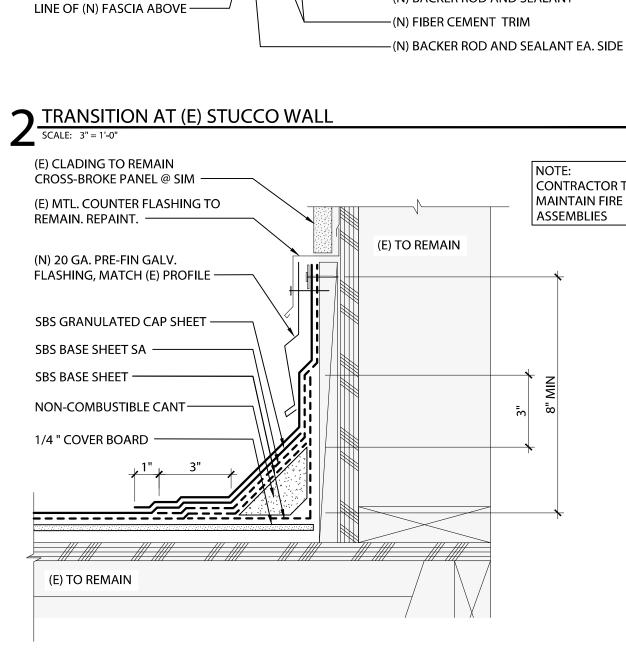
DATE: 07/08/2022 ISSUED FOR: BID | PERMIT

SHEET TITLE GENERAL ROOF ASSEMBLIES AND TYPICAL ROOF DETAILS

A-511





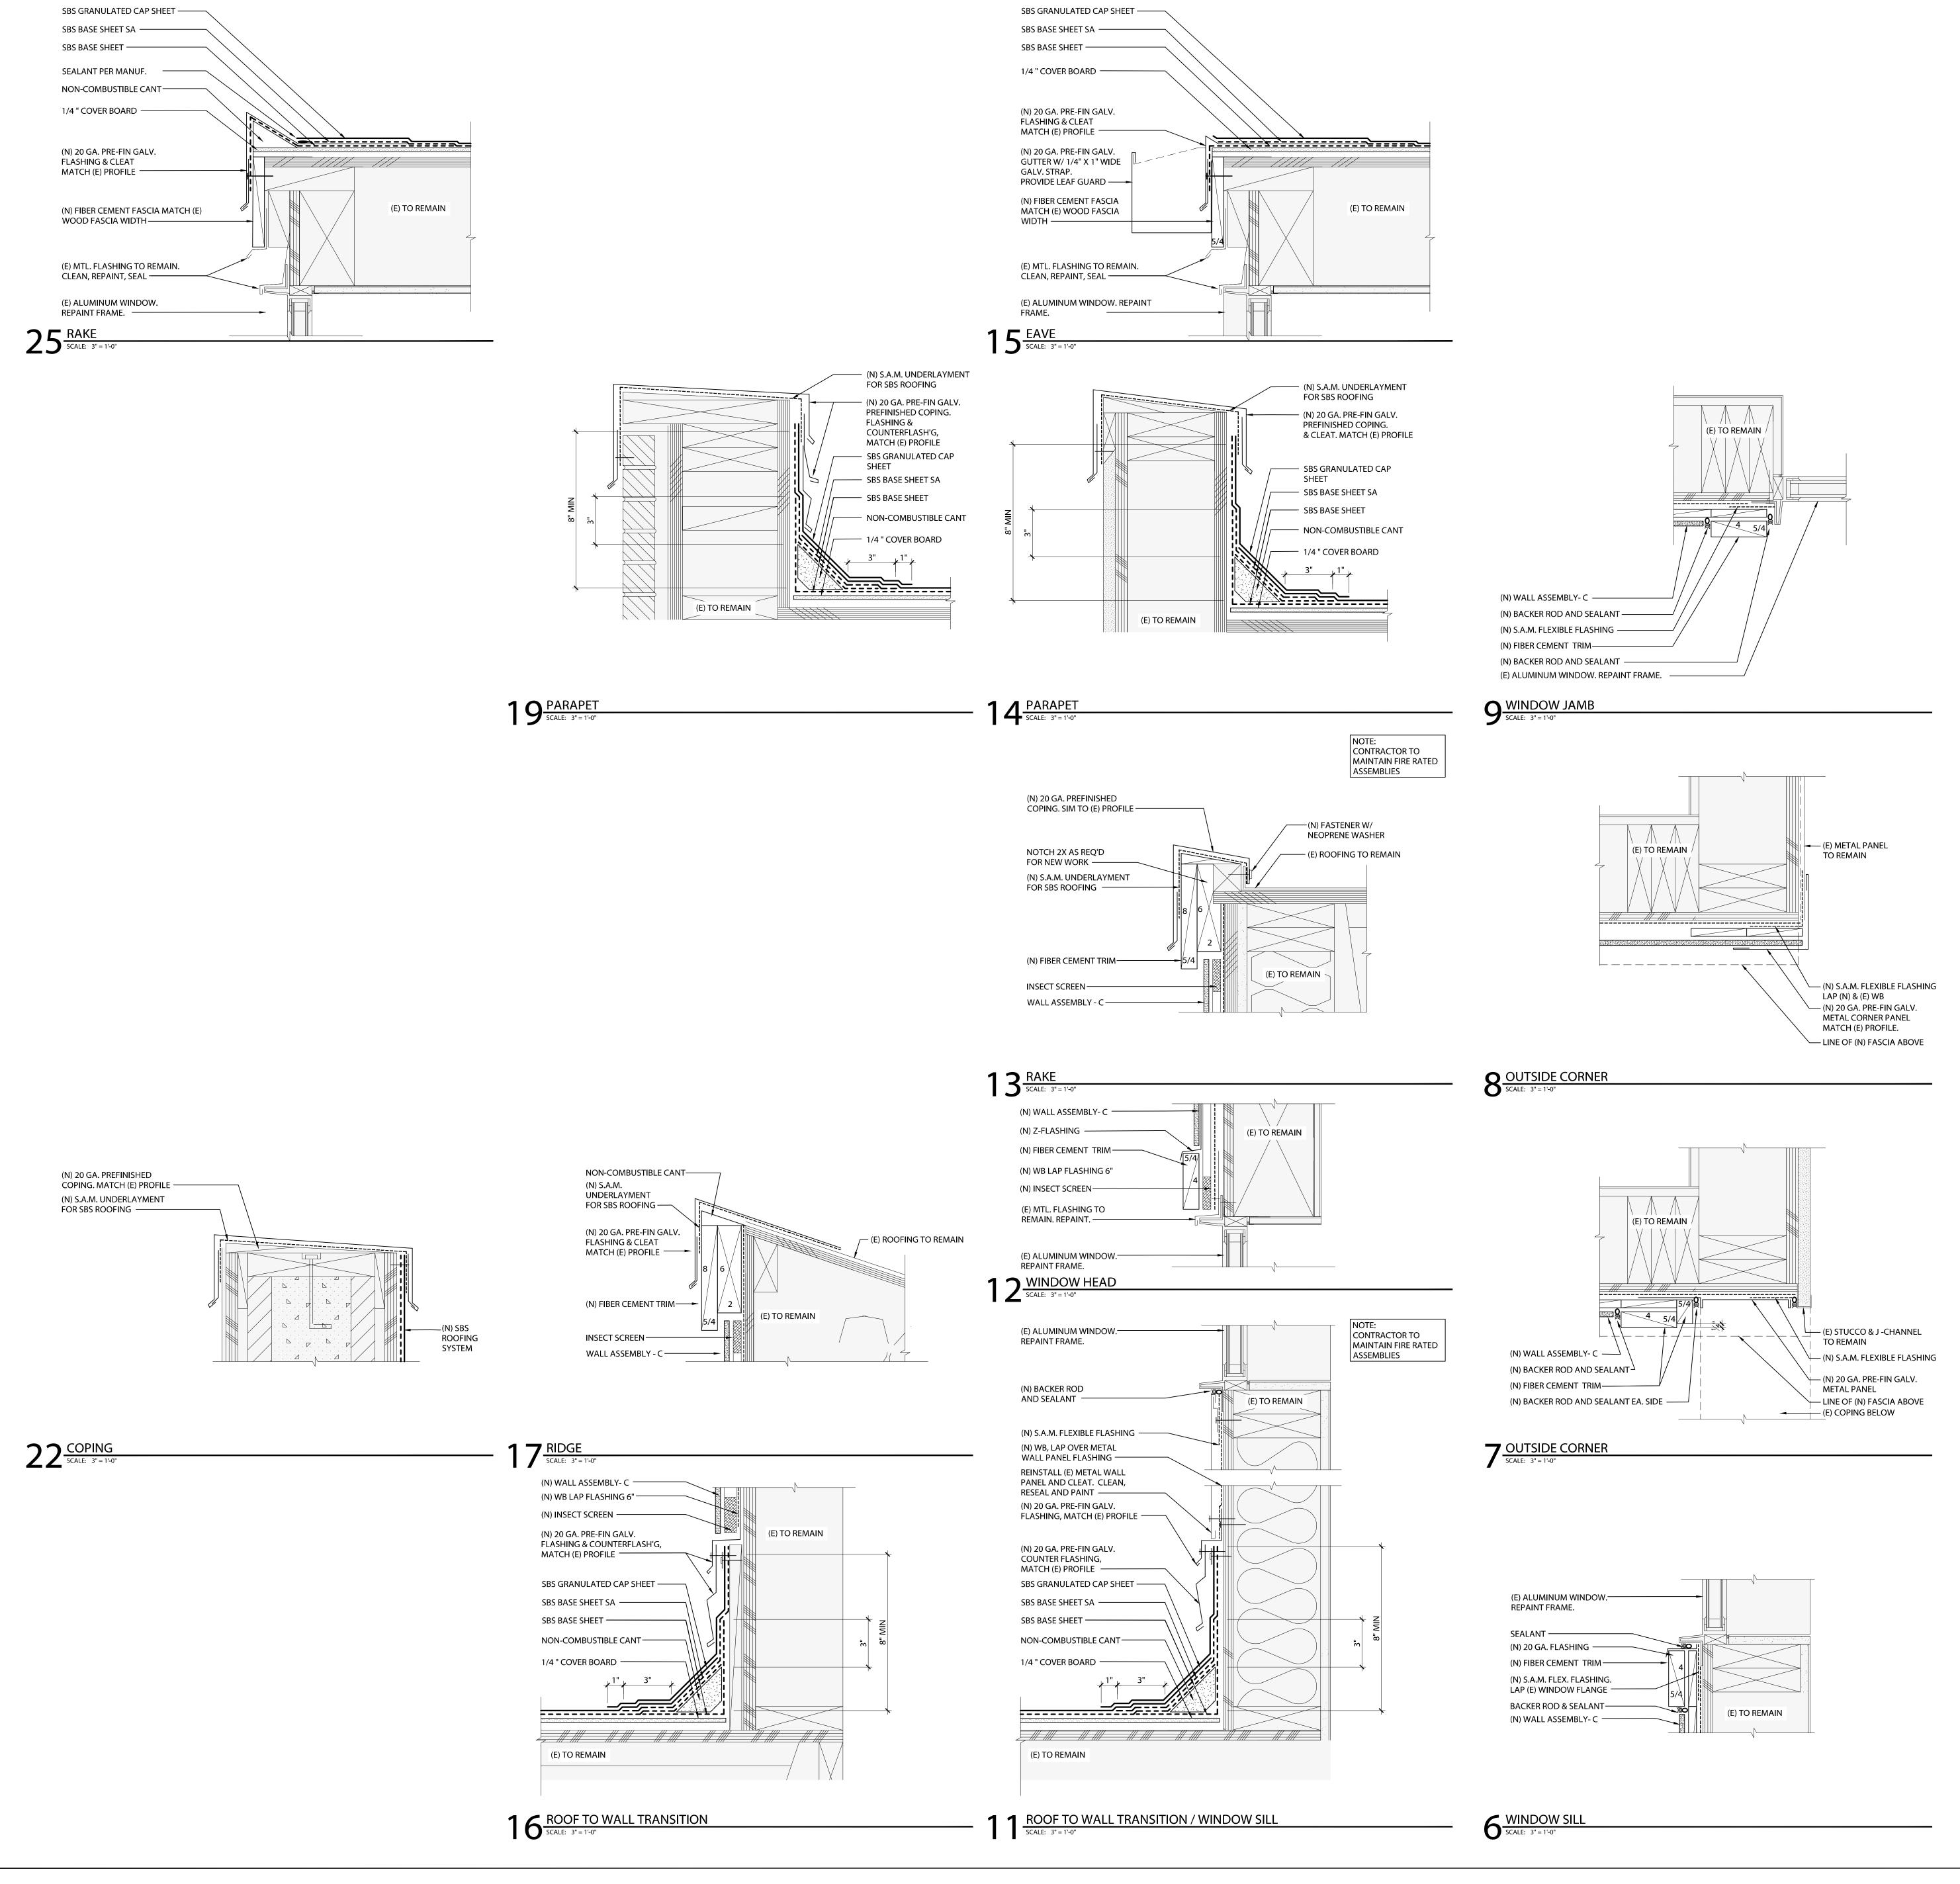



ROOF TO WALL TRANSITION SCALE: 3" = 1'-0"

(E) STUCCO & J -CHANNEL

(N) S.A.M. FLEXIBLE FLASHING –

TO REMAIN

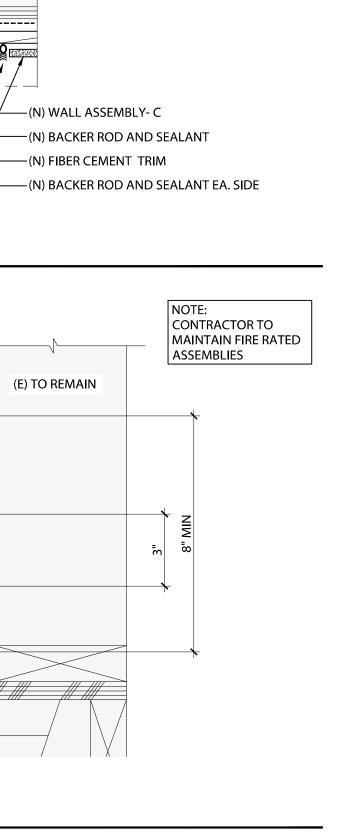

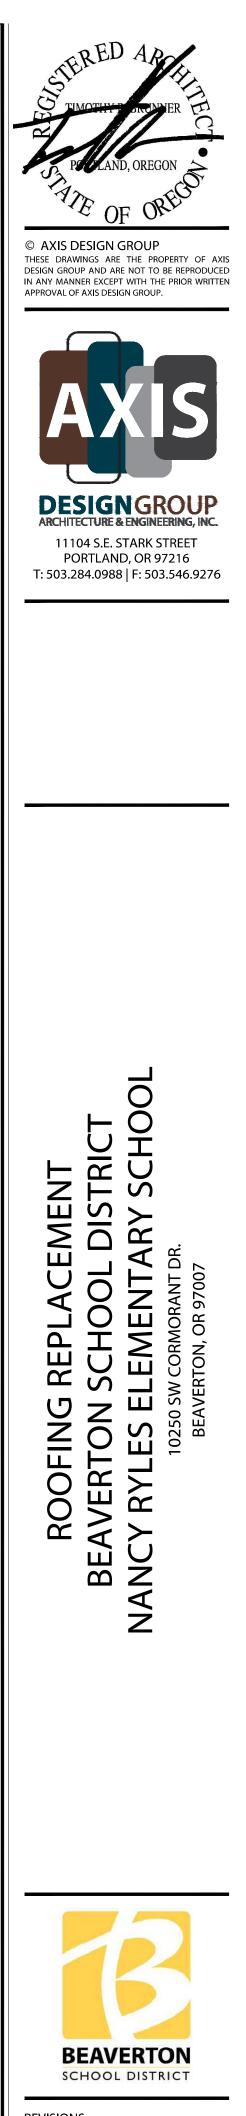


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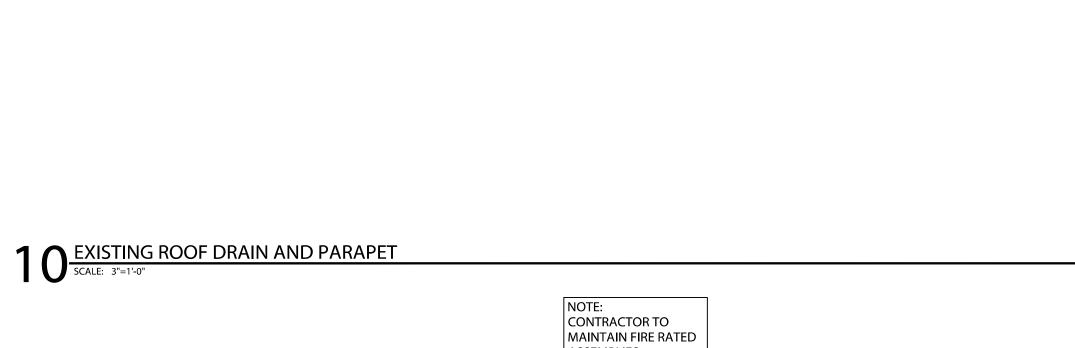
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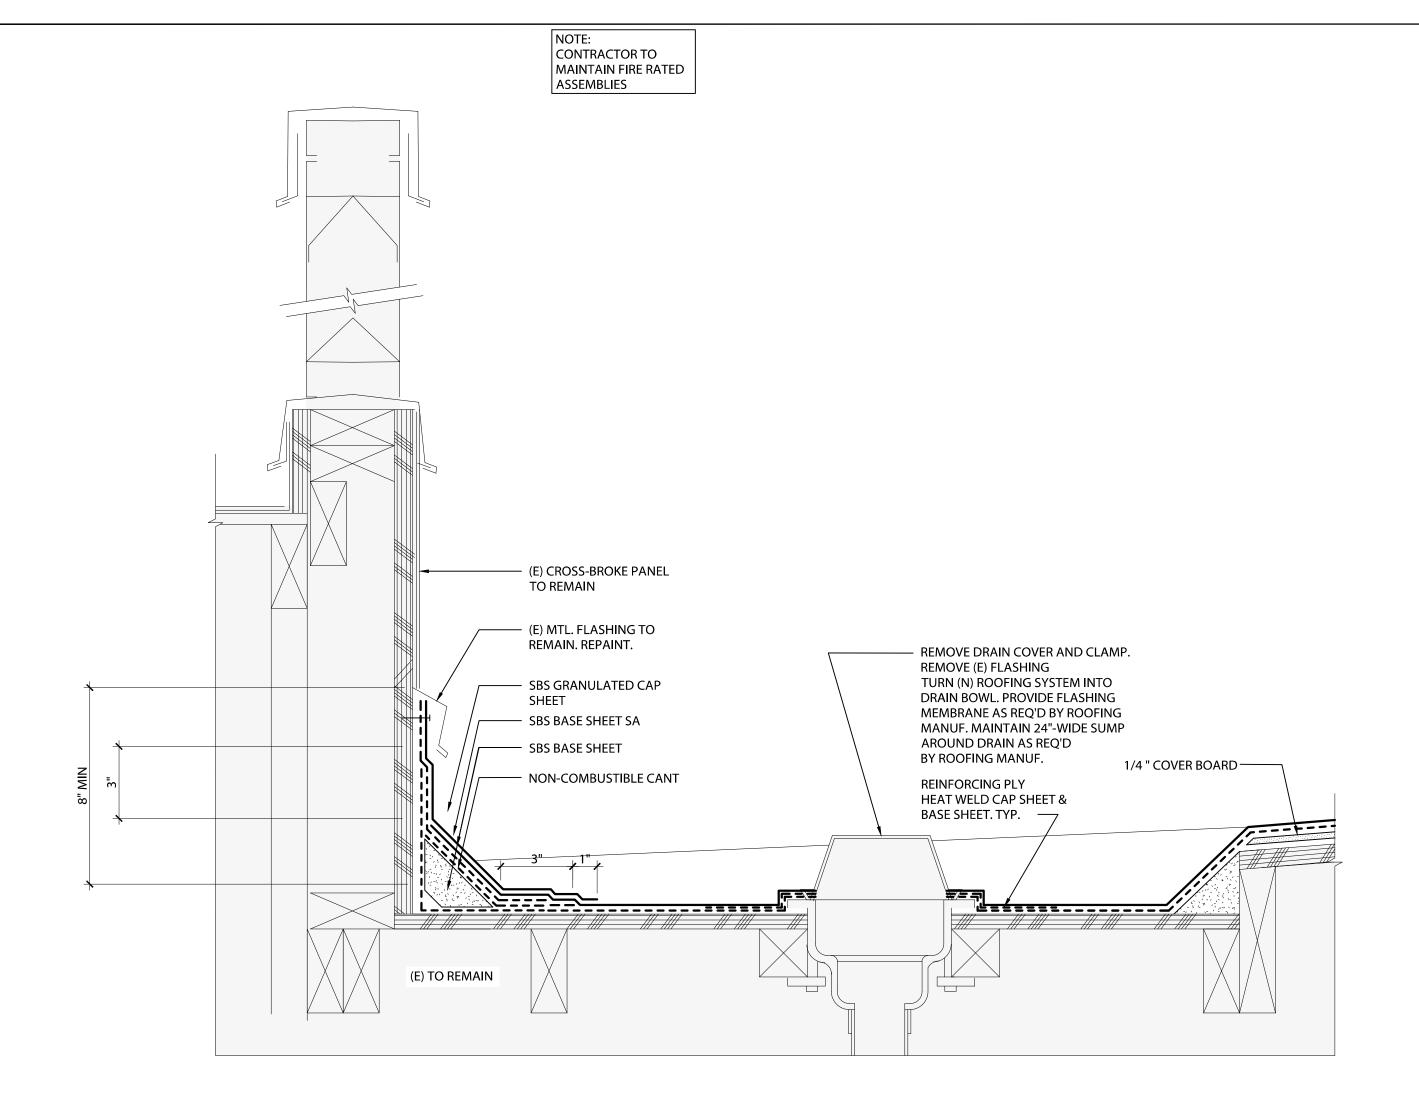
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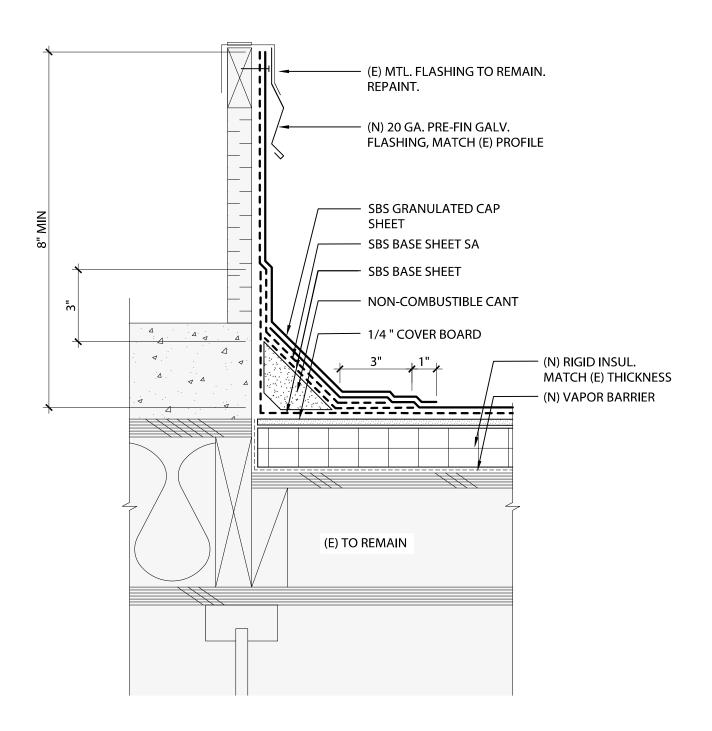
TYPICAL ROOF DETAILS











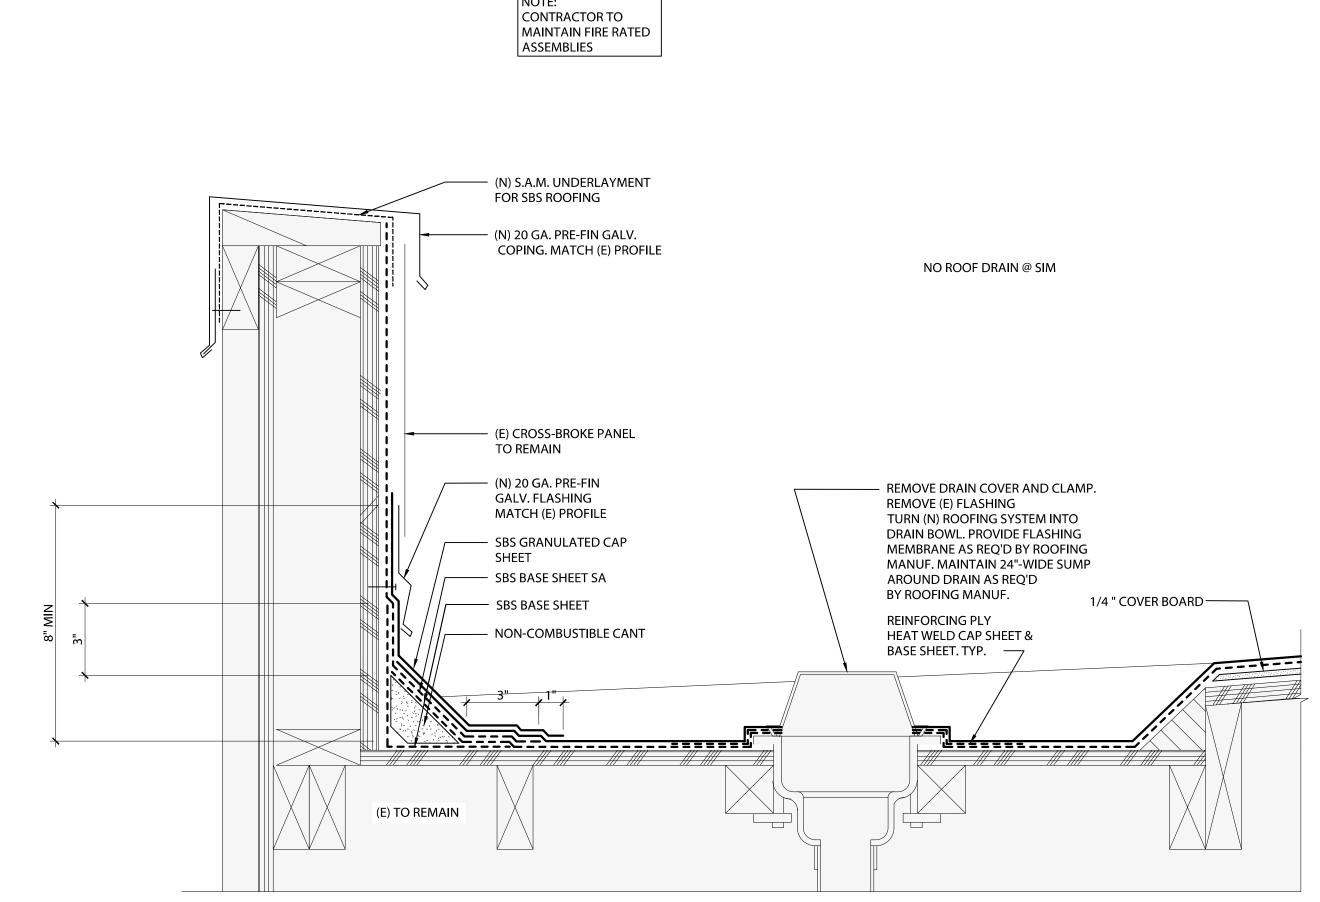




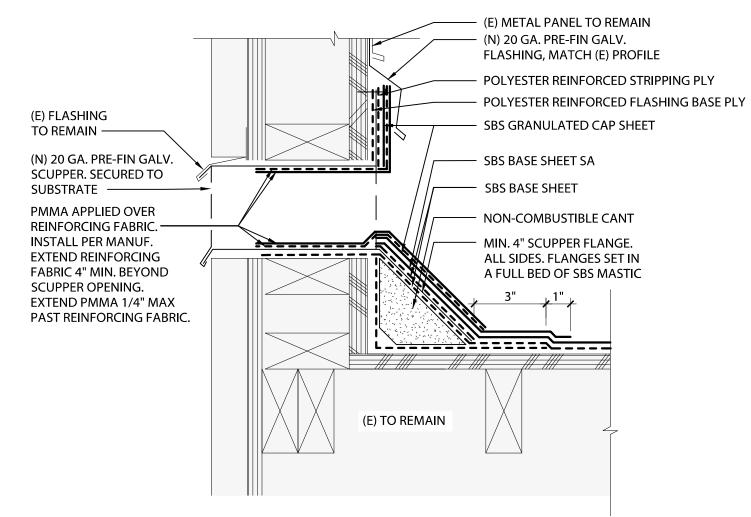

5 EXISTING ROOF SCALE: none

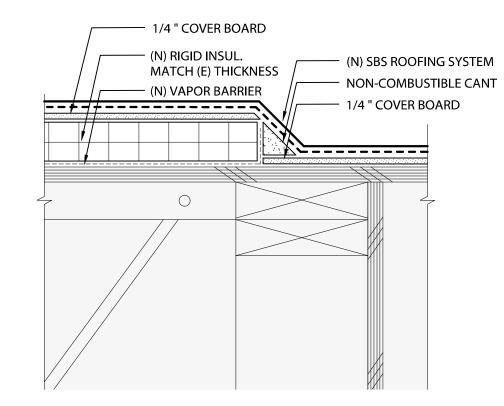



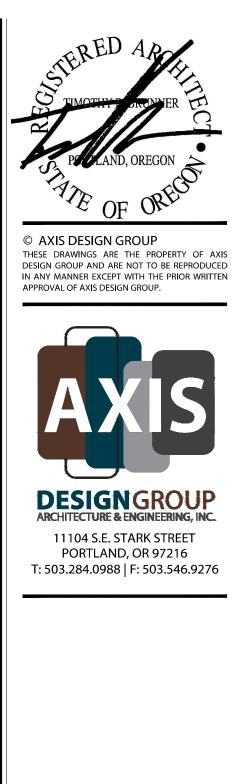

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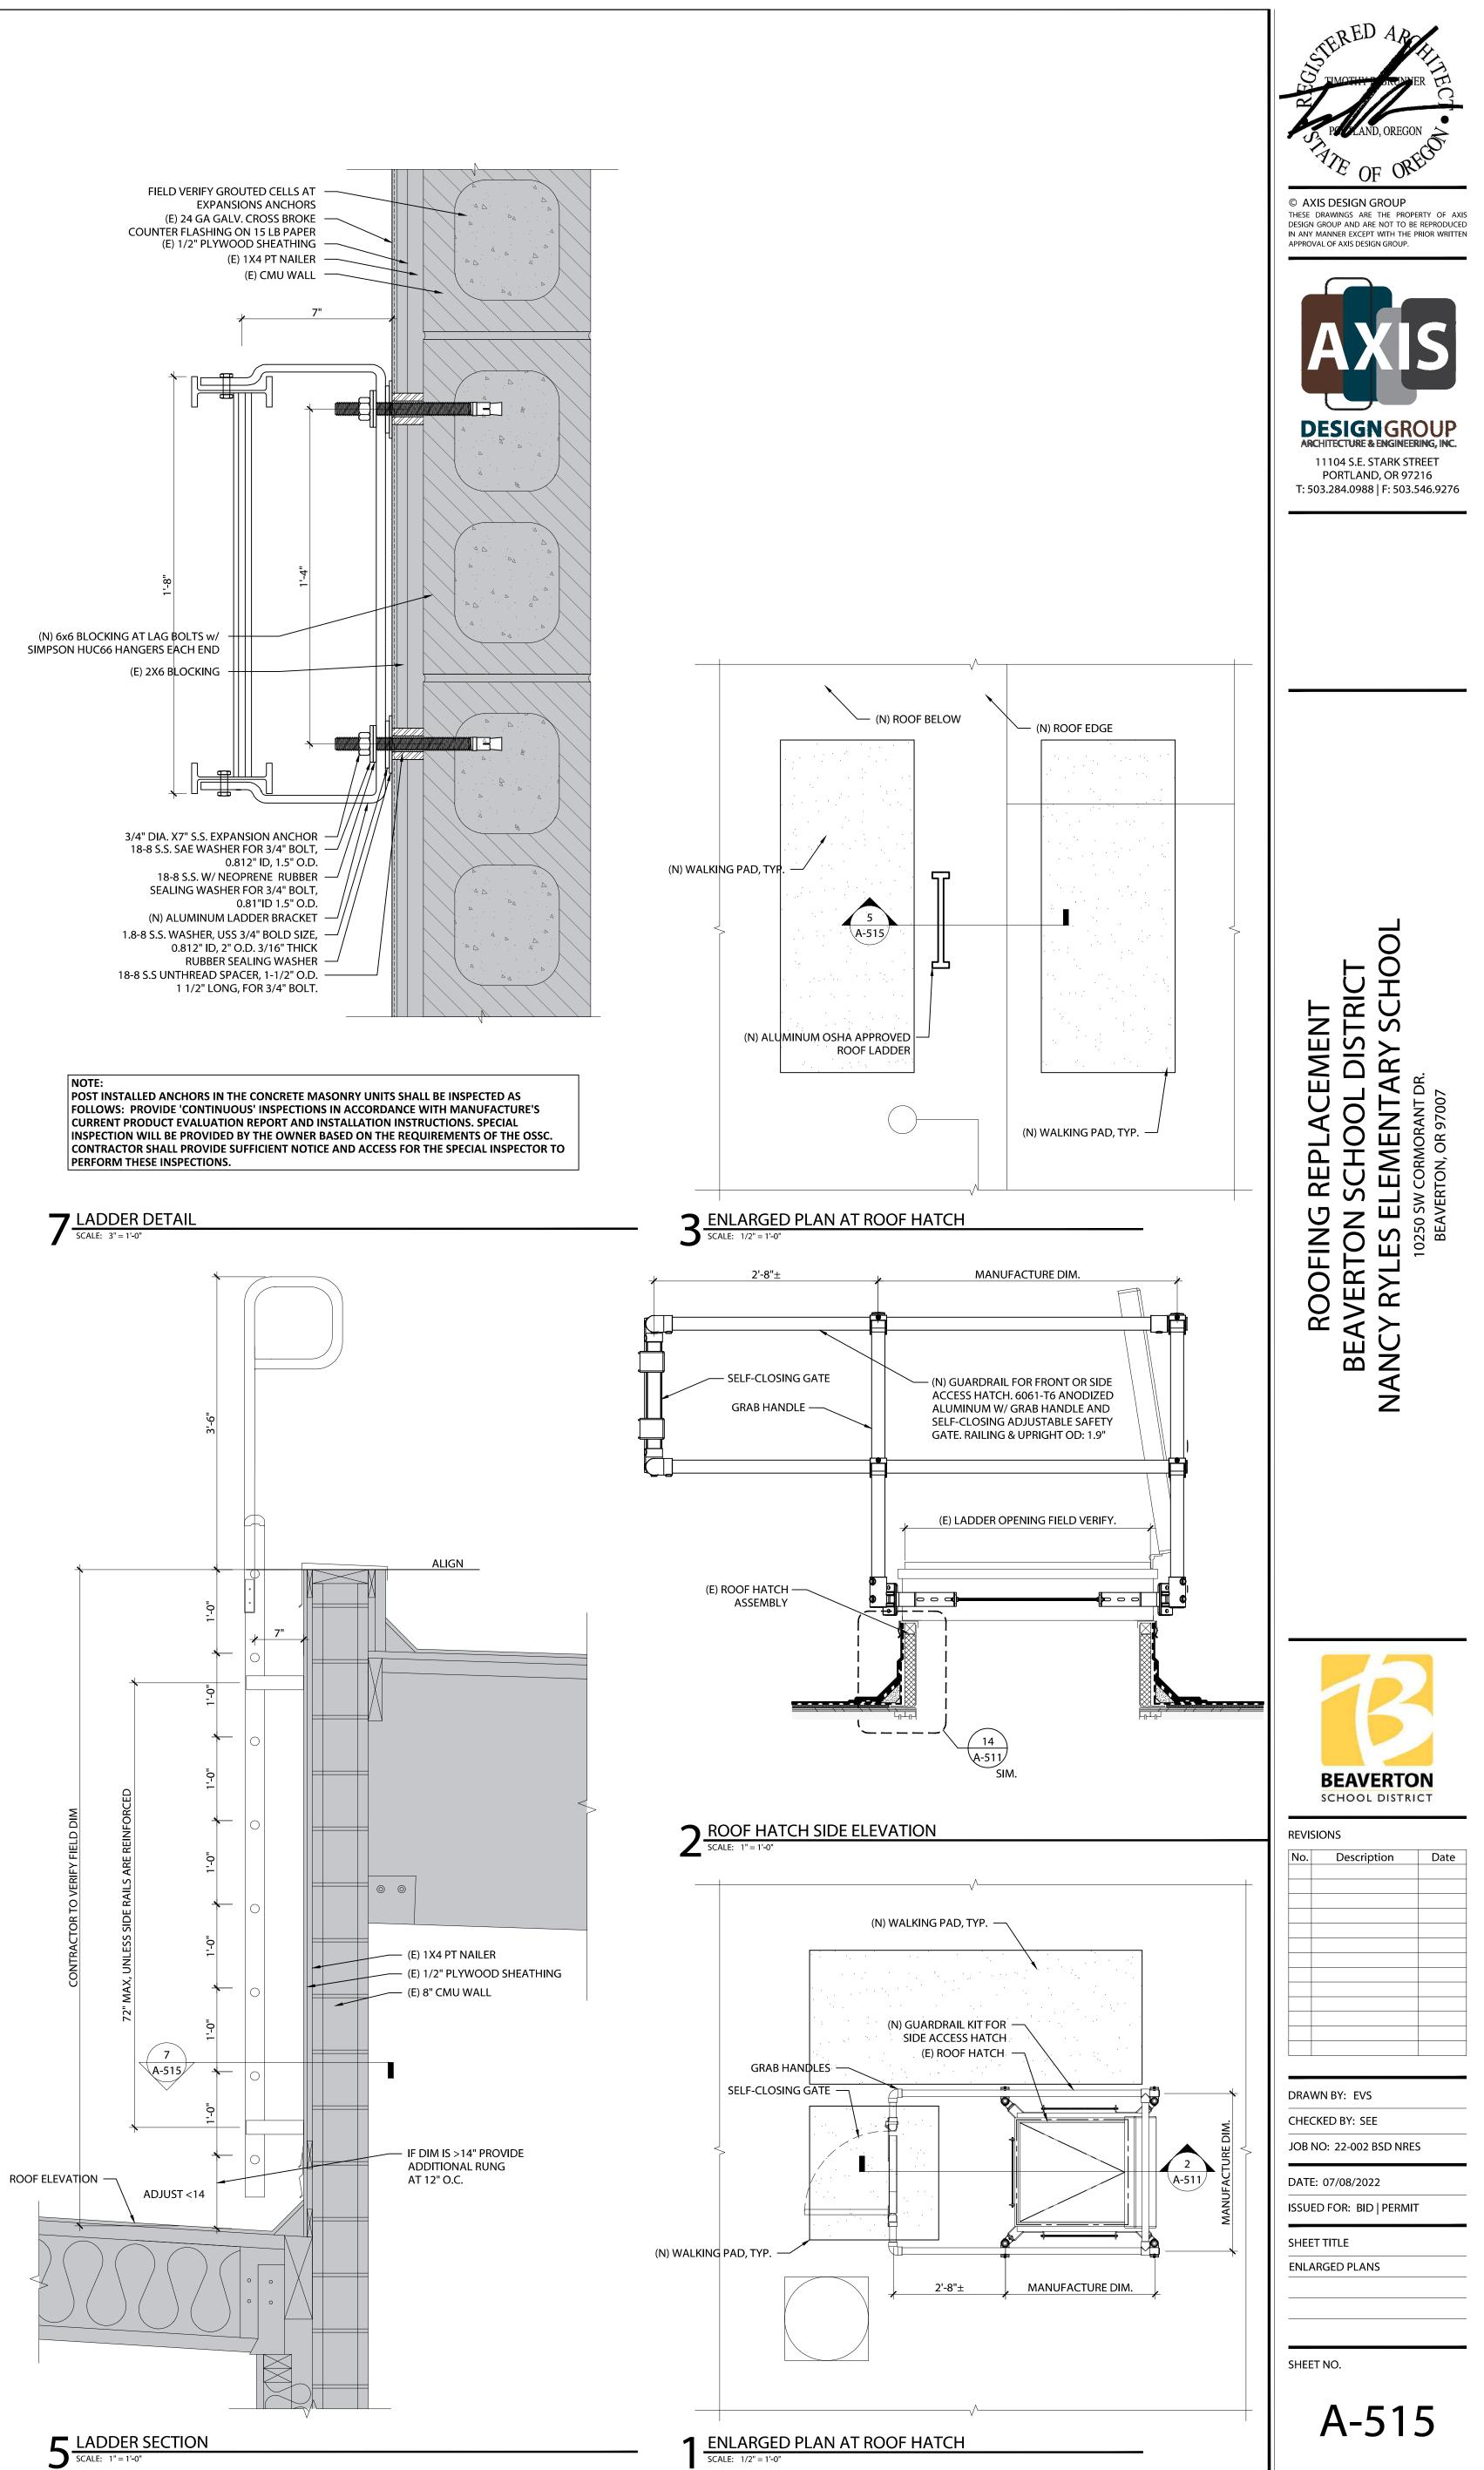
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DATE: 07/08/2022 ISSUED FOR: BID | PERMIT

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SHEET TITLE

ROOF DETAILS



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ARCHITECTURALDESIGN INTERIORDESIGN MASTERPLANNING LANDUSEPLANNING

PLAN CHECK COMMENT REVISIONS NO. 1 – Nancy Ryles Elementary

| Date: | September 9, 2022 |
|----------------------|--|
| To: | Beaverton School District #48J |
| | 16550 SW Merlo Road |
| | Beaverton, OR 97003 |
| Attn: | Christopher Hansen–Project Manager |
| From: | Steven Eggleston |
| Project: | 2022 Roof projects Architectural / Engineering Consultant Services: Findley Elementary (FIES) McKinley Elementary (MKES) Nancy Ryles (NRES) – Seismic Upgrade |
| Project location(s): | |
| Project location(s): | Nancy Ryles Elementary (NRES); Beaverton, Oregon |

The Plan Check Comment Revisions forms a part of the Contract Documents and modifies the original documents for the Roofing Replacement Beaverton School District Nancy Ryles Elementary School – Bid/Permit Documents, dated 7/8/22 as noted below.

It is essential that prospective bidders note the contents of the Plan Check Comment Revisions and that the Beaverton School District and AXIS Design Group be made aware that the document has been received. Therefore, acknowledge receipt by inserting the number of this document in the space provided on in the Acknowledgement of the bid form.

CHANGES TO GENERAL INFORMATION

| P1.0 | REFER TO: | Bid Date/Time or Other General Info |
|------|-----------------|-------------------------------------|
| | ADD: | Instructions |
| | CHANGE/DELETE: | Instructions |
| | CLARIFICATIONS: | Instructions |
| | | |

CHANGES TO PROCUREMENT AND CONTRACTING REQUIREMENTS PROJECT MANUAL

| P1.1 | REFER TO: | Section #; Name – Description | |
|------|------------------|--------------------------------|--|
| | CHANGE/DELETE: | 01 40 00; Quality Requirements | |
| | | | |

 P1.2
 REFER TO: CHANGE/DELETE:
 Section #; Name – Description

 07 72 00; Roof Accessories

CHANGES TO DISCIPLINE DRAWINGS

| P1.3 | REFER TO: | Sheet #; Name – Description | |
|---|-----------|---|--|
| CLARIFICATIONS: Sheet G-000; Sheet Index, Pro | | Sheet G-000; Sheet Index, Project Description And Project Information | |
| | | Clarification to Separate Permits (Design Build) Items | |

| P1.4 | REFER TO: CLARIFICATIONS: | Sheet #; Name - Description Sheet A-511; General Roof Assemblies and Typical Roof Details Clarification Note to Detail 14 Typical Raised Curb. | | |
|-------------------|---------------------------------|--|--|--|
| | CLARIFICATIONS: | Sheet A-515; Enlarged Plans and Details Clarification to Detail 2 Roof Hatch Side Elevation. Clarification to Detail 7 Ladder Detail. | | |
| SUBSTITUTIONS | | | | |
| ltem #1 | REQUEST: No 1 DETERMINATION: | Section #; Name - Description Section # ; Name - Description Rejected/Approved: See attached Submittal Review | | |
| QUESTION/RESPONSE | | | | |
| ltem #1 | QUESTION: RESPONSE: | RFI #0.0; Name - Description See attached RFI. | | |

ATTACHMENTS:

| REFERENCE NO. | DATED | DESCRIPTION |
|---------------|-------------------|--|
| P1.1 | September 2, 2022 | 01 40 00; Quality Requirements |
| | | |
| P1.2 | September 2, 2022 | 07 72 00; Roof Accessories |
| | | |
| P1.3 | September 2, 2022 | Sheet G-000; Sheet Index, Project Description And Project Information |
| | | |
| P1.4 | September 2, 2022 | Sheet A-511; General Roof Assemblies and Typical Roof Details |
| | | Sheet A-515; Enlarged Plans and Details |

DISTRIBUTION:

| то | COMPANY | EMAIL | |
|--------------------|---------------------------|--|--|
| Christopher Hansen | Beaverton School District | christopher_hansen@beaverton.k12.or.us | |
| Design Team | Varies | Varies | |