



NEW ROOFING

AMADOR VALLEY HIGH SCHOOL

1155 SANTA RITA RD, PLEASANTON, CA 94566
PLEASANTON UNION SCHOOL DISTRICT

DSA FILE NUMBER XX-XX
DSA APPLICATION NUMBER 01-
OPSC TRACKING NUMBER XXXXX-XX

GENERAL NOTES

PRE-BID SITE VISIT
CONTRACTOR SHALL VISIT THE PROJECT AREA IN ORDER TO BECOME FAMILIAR WITH EXISTING CONDITIONS AND THE REQUIREMENTS OF THE PROJECT. THE CONTRACTOR MAY CONTACT THE ARCHITECT DURING THE BIDDING PHASE REGARDING CLARIFICATIONS AND PROJECT REQUIREMENTS.

SAFETY
IN ACCORDANCE WITH GENERALLY ACCEPTED CONSTRUCTION PRACTICES, THE CONTRACTOR WILL BE SOLELY AND COMPLETELY RESPONSIBLE FOR CONDITIONS OF THE JOB SITE INCLUDING SAFETY OF ALL PERSONS AND PROPERTY DURING PERFORMANCE OF THE WORK. THIS REQUIREMENT WILL APPLY CONTINUOUSLY AND NOT BE LIMITED TO NORMAL WORKING HOURS.

DAMAGE TO STRUCTURE OR SYSTEMS TO REMAIN
CONTRACTOR SHALL REIMBURSE THE OWNER FOR REPAIR AND REPLACEMENT, INCLUDING ARCHITECT'S FEES, FOR ANY DAMAGE CAUSED TO STRUCTURES, LANDSCAPE, SITE WORK, OR EXISTING SYSTEMS TO REMAIN, AS THE RESULT OF CONSTRUCTION OPERATIONS.

EXISTING CONDITIONS
ALL EXISTING CONDITIONS ARE SHOWN BASED ON THE BEST INFORMATION AVAILABLE AT THE TIME, BUT WITHOUT GUARANTEE OF ACCURACY. THE CONTRACTOR SHALL FIELD VERIFY ALL EXISTING CONDITIONS, DIMENSIONS, AND BUILDING DATA AT THE JOB SITE. ANY DISCREPANCIES REQUIRING MODIFICATION TO THE CONSTRUCTION DOCUMENTS SHALL BE REPORTED TO THE ARCHITECT IMMEDIATELY. NO MODIFICATIONS SHALL BE MADE BY THE CONTRACTOR WITHOUT PRIOR APPROVAL FROM THE ARCHITECT.

CONTRACTOR'S EQUIPMENT
COORDINATE WITH OWNER'S REPRESENTATIVE FOR APPROVED LOCATION OF JOB SITE ACCESS, PARKING, AND LOCATION OF CONTRACTOR'S EQUIPMENT AND MATERIAL STORAGE AREA. SEE SITE PLAN FOR ADDITIONAL NOTES.

UTILITY SHUT-DOWNS AND CONNECTIONS
ALL REQUIRED UTILITY SHUT DOWNS SHALL HAVE PRIOR APPROVAL FROM THE OWNER'S REPRESENTATIVE. REQUEST SHALL BE SUBMITTED WITH ADEQUATE ADVANCE NOTICE PER PROJECT REQUIREMENTS.

ASBESTOS AND ASBESTOS PRODUCTS
THE OWNER/OPERATOR AND CONTRACTOR SHALL BE AWARE THAT BUILDINGS CONSTRUCTED PRIOR TO 1978 (OR THEREABOUT) POSSIBILITY CONTAIN ASBESTOS IN SOME EXISTING CONSTRUCTION MATERIALS, AND WILL LIKELY BE ENCOUNTERED DURING ALTERATIONS OR REMODELING.

UNDER CALIFORNIA TITLE 8, THE OWNER AND CONTRACTOR BOTH HAVE RESPONSIBILITIES TO DETERMINE THE EXISTENCE OF ASBESTOS CONTAINING MATERIALS IN AREAS TO BE ALTERED OR REMODELED PRIOR TO COMMENCEMENT OF WORK AND TO TAKE APPROPRIATE MEASURES TO PROTECT PERSONNEL. CAL-OSHA HAS JURISDICTION OVER ASBESTOS RELATED WORK. ASBESTOS RELATED WORK SHALL BE DONE IN ACCORDANCE WITH CALIFORNIA GENERAL INDUSTRIAL SAFETY ORDERS, TITLE 8, SECTION 341.6 THROUGH 341.14. ASBESTOS IN THE WORK ENVIRONMENT IS REGULATED BY TITLE 8, SECTION 5208.

THE BAY AREA AIR QUALITY MANAGEMENT DISTRICT AND DISTRICT REGULATION 11-2-401.3 REQUIRES EVERY RENOVATION INVOLVING THE REMOVAL OF 100 SQ. FT., LN.FT. OR GREATER OF REGULATED ASBESTOS CONTAINING MATERIAL, AND FOR EVERY DEMOLITION (EVEN WHEN NO ASBESTOS IS PRESENT), A NOTIFICATION MUST BE SENT TO THE BAAQMD AT LEAST 10 WORKING DAYS PRIOR TO COMMENCEMENT OF DEMOLITION / RENOVATION.

ALL BUILDING MATERIALS MUST BE ASBESTOS FREE.

THESE DOCUMENTS DO NOT ADDRESS CONTAINMENT FOR EXISTING AREAS OF ASBESTOS WHICH MAY BE DISCOVERED DURING CONSTRUCTION. THE OWNER'S ABSENT SUBCONTRACTOR IS SOLELY RESPONSIBLE FOR THE DETECTION, REMOVAL, AND THE DISPOSAL OF ANY EXISTING ASBESTOS MATERIAL, ARCHITECTURAL AND ENGINEERING DESIGN EFFORT TO OBTAIN NECESSARY STATE APPROVALS, AS WELL AS THE COST OF ANY REPAIRS, FOR DAMAGE CAUSED OR REPLACEMENT OF EXISTING SYSTEMS TO REMAIN, DUE TO WORK PERFORMED BY THE CONTRACTOR OR SUBCONTRACTOR. SUBCONTRACTOR SHALL BE THE RESPONSIBILITY OF SAID SUBCONTRACTOR.

CONSTRUCTION SCHEDULING
CONTRACTOR SHALL COORDINATE ALL CONSTRUCTION OPERATIONS WITH OWNER'S REPRESENTATIVE PRIOR TO SCHEDULING AND START OF THE WORK. CONTRACTOR SHALL PROVIDE PROTECTION TO ALL EXISTING SPACES AND SYSTEMS WHICH ARE IN USE, ADJOINING THE PROJECT, AND NOT PART OF THE PROJECT.

INTERIOR FINISHES
INTERIOR FINISHES AND ALL WALL COVERING MATERIAL SHALL CONFORM TO CCR TITLE 24, PART 2, CHAPTER 6.

PIPES, DUCTS AND CONDUIT - SUPPORT AND BRACING

PIPES, DUCTS, AND CONDUITS SHALL BE SUPPORTED AND BRACED PER THE SMACNA "GUIDELINES FOR SEISMIC RESTRAINTS OF MECHANICAL SYSTEMS AND PLUMBING PIPING SYSTEMS", 09M 0002-13 SEISMIC BRACING AND SUPPORT SYSTEMS.

DRILLED-IN EXPANSION ANCHORS

WHEN INSTALLING DRILLED-IN ANCHORS AND/OR POWDER DRIVEN PINS IN EXISTING NON-PRESTRESSED REINFORCED CONCRETE, USE CARE AND CAUTION TO AVOID CUTTING OR DAMAGING THE EXISTING REINFORCING BARS. WHEN INSTALLING THEM INTO EXISTING PRESTRESSED CONCRETE (PRE- OR POST-TENSIONED), LOCATE THE PRESTRESSED TENDONS BY USING A NON-DESTRUCTIVE METHOD PRIOR TO INSTALLATION. EXERCISE EXTREME CARE AND CAUTION TO AVOID CUTTING OR DAMAGING THE TENDONS DURING INSTALLATION. MAINTAIN A MINIMUM CLEARANCE OF ONE INCH BETWEEN THE REINFORCEMENT AND THE DRILLED-IN ANCHOR AND/OR PIN.

TITLE 24 COMPLIANCE

THE INTENT OF THESE DRAWINGS AND SPECIFICATIONS IS THAT THE WORK OF THE ALTERATION, REHABILITATION OR RECONSTRUCTION IS TO BE IN ACCORDANCE WITH TITLE 24, CALIFORNIA CODE OF REGULATIONS (2019 CBC), SHOULD ANY EXISTING CONDITIONS SUCH AS DETEIORATION OR NON-COMPLYING CONSTRUCTION BE DISCOVERED NOT COVERED BY THE CONTRACT DOCUMENTS WHEREIN THE FINISHED WORK WILL NOT COMPLY WITH TITLE 24, CCR, A CONSTRUCTION CHANGE DOCUMENT OR A SEPARATE SET OF PLANS AND SPECIFICATIONS, DETAILING AND SPECIFYING THE REQUIRED WORK, SHALL BE SUBMITTED TO AND APPROVED BY THE DSA BEFORE PROCEEDING WITH THE WORK.

ABBREVIATIONS

(REFER TO CONSULTANT DRAWINGS FOR ADDITIONAL ABBREVIATIONS)

A.F.F.	ABOVE FINISHED FLOOR	LAM.	LAMINATE
A.P.	ACCESS PANEL	LAV.	LAVATORY
ADJ.	ADJUSTABLE	M.B.	MACHINE BOLT
ALUM.	ALUMINUM	M.S.	MACHINE SCREW
AB.	ANCHOR BOLT	MFG.	MANUFACTURER
APPROX.	APPROXIMATELY	M.B.	MARKER BOARD
ARCH.	ARCHITECT	MATL.	MATERIAL
AC	ASPHALTIC CONCRETE	MAX.	MAXIMUM
B	BENCH MARK	MECH.	MECHANICAL
BLKG.	BLOCKING	MIN.	MINIMUM
BD.	BOARD	MISC.	MISCELLANEOUS
B.W.	BOTH WAYS	MTD.	MOUNTED
BOT.	BOTTOM	(N)	NEW
B.LDG.	BUILDING	NOM.	NOMINAL
B.U.R.	BUILT-UP ROOFING	N.I.C.	NOT IN CONTRACT
C.B.	CATCH BASIN	N.T.S.	NOT TO SCALE
CLG.	CEILING	NO. or #	NUMBER
CEM.	CEMENT	OCC.	OCCUPANT(CY)
C.C or O.C.	CENTER TO CENTER	O.C.	ON CENTER
	CERAMIC TILE	OPNG.	OPENING
CER. TILE	CLEANOUT	OPP.	OPPOSITE
C.O.	CLEANOUT TO GRADE	O.H.	OPPOSITE HAND
C.O.T.G.	CLEAR	O.F.O.S.	OUTSIDE FACE OF STUD
CLR.	CLEAR ALL HEART	O.H.W.S.	OVAL HEAD WOOD SCREW
C.A.H.R.	REDWOOD	O.D.	OVERFLOW DRAIN and/or OUTSIDE DIAMETER
	COLD WATER	O.F.C.I.	OWNER FURNISHED AND CONTRACTOR INSTALLED
C.W.	COMMON	PR.	PARTITION
COL.	CONCRETE	PL	PLATE
CONC.	CONSTRUCTION	P	PENNY (NAILS)
CONST.	CONSTRUCTION HEART	PLAS.	PLASTER
C.H.	CONSTRUCTION JOINT	PLYWD.	PLYWOOD
CONT.	CONTINUOUS	P.V.C.	POLY VINYL CHLORIDE
CONTR.	COUNTER	P.T.	PRESSURE TREATED
CTSK.	COUNTER SUNK	P.L.	PROPERTY LINE
DET.	DETAIL	R. or RAD.	RADIUS
DIA. or Ø	DIAMETER	R.W.L.	RAIN WATER LEADER
DIM.	DIMENSION	RWD./R.W.	REDWOOD
D.A.	DISABLED ACCESS	REINF.	REINFORCING
DR.	DOOR	RECD.	REQUIRED
D.S.	DOWNSPOUT	R.A.G.	RETURN AIR GRILLE
DWG.	DRAWING	R.E.	RM ELEVATION
D.F.	DRINKING FOUNTAIN and/or DOUBLE GLASS FIR	R.D.	ROOF DRAIN
EA.	EACH	RM.	ROOM
E.W.	EACH WAY	R.O.	ROUGH OPENING
ELEC.	ELECTRIC OR ELECTRICAL	RND.	ROUND
EL. or ELEV.	ELEVATION	R.H.M.S.	ROUND HEAD METAL SCREW
ENCL.	ENCLOSURE and/or ENCLOSURE	R.H.W.S.	ROUND HEAD WOOD SCREW
EQ.	EQUAL	SSD.	SEE STRUCTURAL DRAWINGS
EQUIP.	EQUIPMENT	S.T.S.M.S.	SELF TAPPING SHEET METAL SCREW
(E)	EXISTING	SHEATH.	SHEATHING
EX.	EXPANSION	S.M.	SHEET METAL
E.J.	EXPANSION JOINT	S.M.S.	SHEET METAL SCREW
EXP.	EXPOSED	S.O.V.	SHUT OFF VALVE
EXT.	EXTERIOR	SIM.	SIMILAR
F.O.C.	FACE OF CONCRETE	S.C.	SOLID CORE
F.O.M.	FACE OF MASONRY	SPEC.	SPECIFICATION
F.O.S.	FACE OF STUD	SQ.	SQUARE
F.O.F.	FACE OF FINISH	S.F.	SQUARE FEET
FIN.	FINISH	STAG.	STAGGERED
F.F.	FINISHED FLOOR	STD.	STANDARD
F.S.	FINISH SLAB	S.S.	STAINLESS STEEL
F.E.	FIRE EXTINGUISHER	STL.	STEEL
F.E.C.	FIRE EXTINGUISHER CABINET	STOR.	STORAGE
F.H.	FIRE HYDRANT	STRUCT.	STRUCTURAL
F.H.M.S.	FLAT HEAD METAL SCREW	S.A.G.	SUPPLY AIR GRILLE
F.H.W.S.	FLAT HEAD WOOD SCREW	THRES.	THRESHOLD
FL. or FLR.	FLOOR	T&G.	TONGUE & GROOVE
F.D.	FLOOR DRAIN	T.J.	TOOLED JOINT
FTG.	FOOTING	T.O.B.	TOP OF BEAM
FND.	FOUNDATION	T.O.C.	TOP OF CURB OR CONCRETE
GALV.	GALVANIZED	T.O.S.	TOP OF STEEL OR SHEATHING
G.I.	GALVANIZED IRON	T.O.W.	TOP OF WALK
GA.	GAUGE	TYP.	TYPICAL
GL.	GLASS	U.O.N.	UNLESS OTHERWISE NOTED
GLU-LAM	GLUE-LAMINATED	U.O.S.	UNLESS OTHERWISE SHOWN
GRD.	GRADE	V.T.R.	VENT THROUGH ROOF
GYP. BD.	GYPSUM BOARD	VERT.	VERTICAL
HDW.	HARDWARE	V.G.	VERTICAL GRAIN
HT.	HEIGHT	V.E.F.	VERIFY IN FIELD
H.C.	HOLLOW CORE	V.C.T.	VINYL COMPOSITION TILE
H.M.	HOLLOW METAL	V.W.C.	VINYL WALL COVERING
HORIZ.	HORIZONTAL	V.O.I.P.	VOICE OVER INTERNET PROTOCOL
H.B.	HORSE BIRD	W.C.	WATER CLOSET
I.D.	INSIDE DIAMETER	W.H.	WATER HEATER
INSUL.	INSULATION	WP.	WATERPROOF
INT.	INTERIOR	WR.	WATER RESISTANT
INV.	INVERT	W.W.M.	WELDED WIRE MESH
JT.	JOINT	W.D.	WINDOW DIMENSION
J.H.	JOIST HANGER	W	WITH
K.D.	KILN DRIED	WD.	WITHOUT
		WD.	WOOD



BUILDING CODES AND STANDARDS:

2019	CALIFORNIA ADMINISTRATIVE CODE, PART 1, TITLE 24, C.C.R.	
2019	CALIFORNIA BUILDING CODE (CBC), PART 2, TITLE 24, C.C.R.	
	(2018 INTERNATIONAL BUILDING CODE, VOLUMES 1 AND 2, WITH 2019 CALIFORNIA AMENDMENTS.)	
2019	CALIFORNIA ELECTRIC CODE (CEC), PART 3, TITLE 24, C.C.R.	
2019	(2018 NATIONAL ELECTRIC CODE WITH 2019 CALIFORNIA AMENDMENTS.)	
2019	CALIFORNIA MECHANICAL CODE (CMC), PART 4, TITLE 24, C.C.R.	
2019	(2018 UNIFORM MECHANICAL CODE WITH 2019 CALIFORNIA AMENDMENTS.)	
2019	CALIFORNIA PLUMBING CODE (CPC), PART 5, TITLE 24, C.C.R.	
2019	(2018 UNIFORM PLUMBING CODE WITH 2019 CALIFORNIA AMENDMENTS.)	
2019	CALIFORNIA ENERGY CODE (CENC), PART 6, TITLE 24, C.C.R.	
2019	CALIFORNIA FIRE CODE (CFC), PART 9, TITLE 24, C.C.R.	
2019	(2018 INTERNATIONAL FIRE CODE WITH 2019 CALIFORNIA AMENDMENTS.)	
2019	CALIFORNIA GREEN BUILDING STANDARDS CODE, PART 11, TITLE 24, C.C.R.	
2019	CALIFORNIA REFERENCED STANDARDS, PART 12, TITLE 24, C.C.R.	
2019	ASME A17.1 (W1417-1) (CSA B44-08 ADDENDA) SAFETY CODE FOR ELEVATORS AND ESCALATORS	
2010	ADA STANDARDS FOR ACCESSIBLE DESIGN (28 CFR PART 35 FOR TITLE II ENTITIES)	
CCR TITLE-19, PUBLIC SAFETY, STATE FIRE MARSHAL REGULATIONS.		
NFPA 13	INSTALLATION OF SPRINKLER SYSTEMS (CA AMENDED)	2016 EDITION
NFPA 14	INSTALLATION OF STANDPIPE & HOSE SYSTEMS (CA AMENDED)	2016 EDITION
NFPA 17	DRY CHEMICAL EXTINGUISHING SYSTEMS	2017 EDITION
NFPA 17A	WET CHEMICAL EXTINGUISHING SYSTEM	2017 EDITION
NFPA 20	STATIONARY FIRE PUMPS TO FIRE PROTECTION	2016 EDITION
NFPA 22	WATER TANKS FOR PRIVATE FIRE PROTECTION	2013 EDITION
NFPA 24	PRIVATE FIRE SERVICE MAINS (CA AMENDED)	2016 EDITION
NFPA 25	INSPECTION, TESTING AND MAINTENANCE OF WATER BASED FIRE PROTECTION SYSTEMS	2013 CALIFORNIA EDITION
NFPA 72	NATIONAL FIRE ALARM CODE (CA AMENDED)	2016 EDITION
NFPA 80	FIRE DOORS AND OTHER OPENING PROTECTIVES	2016 EDITION
NFPA 92	STANDARD FOR SMOKE CONTROL SYSTEMS	2015 EDITION
NFPA 110	EMERGENCY AND STANDBY POWER SYSTEMS	2016 EDITION
NFPA 170	STANDARD FOR FIRE SAFETY AND EMERGENCY SYMBOLS	2018 EDITION
NFPA 253	CRITICAL RADIANT FLUX OF FLOOR COVERING SYSTEMS	2015 EDITION
NFPA 2001	CLEAN AGENT FIRE EXTINGUISHING SYSTEMS	2015 EDITION
ICC 300	STANDARDS FOR BLEACHERS, FOLDING AND TELESCOPIC SEATING, AND GRANDSTANDS	2017 EDITION
SFM 12-10-1	POWER OPERATED EXIT DOORS	
SFM 12-10-2	SINGLE POINT LATCHING OR LOCKING DEVICES	
SFM 12-10-3	EMERGENCY EXIT & PANIC HARDWARE	
UL 38	MANUAL OPERATING SIGNAL BOXES	1999/2005 EDITION
UL 288	SMOKE DETECTORS FOR FIRE PROTECTIVE SIGNALING SYSTEMS	2009 EDITION
UL 268A	SMOKE DETECTORS DUCT APPLICATIONS	1998/2003 EDITION
UL 300	FIRE TESTING OF FIRE EXTINGUISHING SYSTEMS FOR PROTECTION OF COMMERCIAL COOKING EQUIPMENT	2005 (R2010)
UL 305	PANIC HARDWARE	2012 EDITION
UL 464	AUDIBLE SIGNALING DEVICES FOR FIRE ALARM AND SIGNALING SYSTEMS, AND ACCESSORIES	2003 EDITION
UL 521	HEAT DETECTORS FOR FIRE PROTECTIVE SIGNALING SYSTEMS	1999 EDITION
UL 864	CONTROL UNITS FOR FIRE PROTECTIVE SIGNALING SYSTEMS	2003 EDITION
UL 1971	(W) REVISIONS THROUGH DEC. 2014) SIGNALING DEVICES FOR THE HEARING IMPAIRED	2002 EDITION
COMPLIANCE WITH CFC CHAPTER 33, FIRE SAFETY DURING CONSTRUCTION AND DEMOLITION AND CBC CHAPTER 33, SAFETY DURING CONSTRUCTION WILL BE ENFORCED.		

SYMBOLS LEGEND

	SECTION / EXTERIOR ELEVATION
	DETAIL
	INTERIOR ELEVATION
	CLASSROOM
	SPECIFIC NOTE
	DOOR DESIGNATION
	WINDOW DESIGNATION
	ADDENDUM REVISION
	CCD REVISION
	FINISH NUMBER
	EQUIPMENT LETTER
	CEILING HEIGHT
	WALL TYPE
	MATCH LINE
	ELEV. HEIGHT
	CENTER OF
	FACE OF

PROJECT SUMMARY

THE DEMOLITION OF EXISTING ROOFING AND THE INSTALLATION OF NEW BUILD UP ROOFING ON BUILDING P.

THERE ARE NO DEFERRED SUBMITTALS FOR THIS PROJECT.

DESIGN TEAM


ARCHITECT
SUGIMURA FINNEY ARCHITECTS
2155 SOUTH BASCOM AVENUE SUITE 200
CAMPBELL, CALIFORNIA 95008
(408) 879-0600
(408) 377-6066 FAX
ATTN: MARK FINNEY MARK@SUGIMURA.COM

DRAWING INDEX

T1	TITLE SHEET
A0.2	SITE PLAN
A4.1	DEMOLITION ROOF PLAN
A4.2	NEW ROOF PLAN
A9.1	TYPICAL DETAILS

SHEET TOTAL = 5

VICINITY MAP

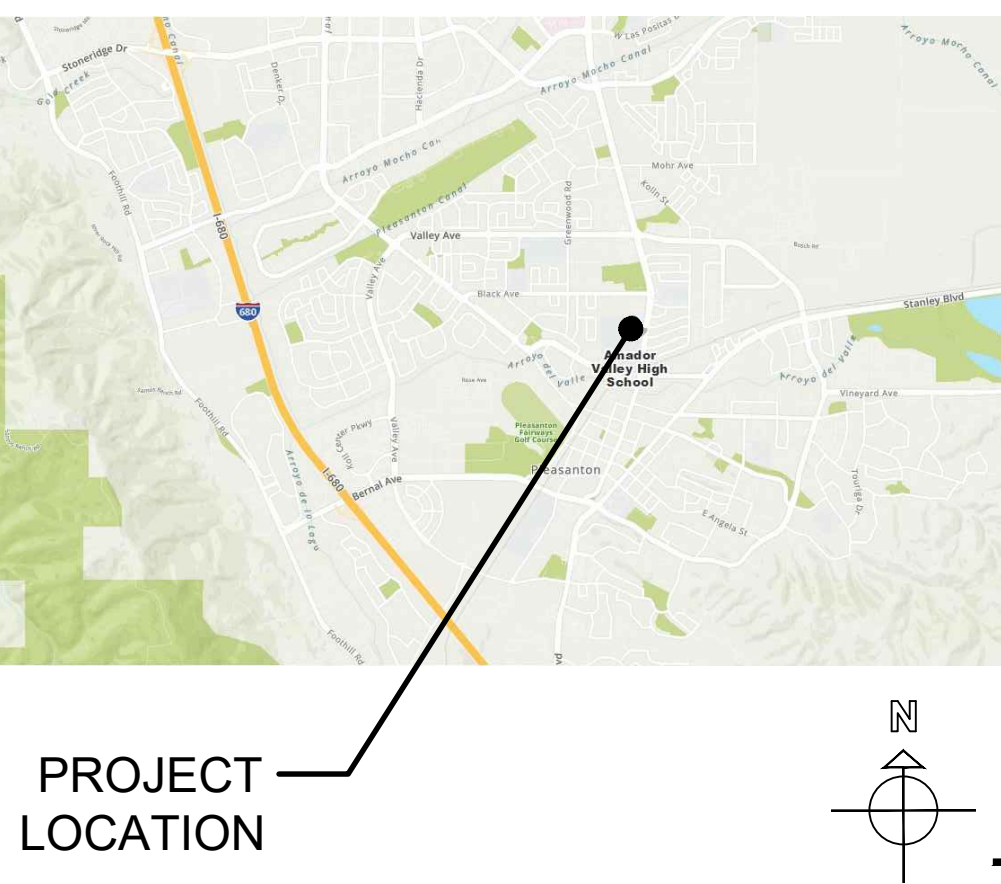

TITLE SHEET



REVISIONS	NO.	ITEM	DATE

DRAWN BY:	KNU
CHECKED BY:	MB
SFA JOB NO:	DATE:
21072	11/12/2021

T1

1 SITE PLAN

1" = 60'-0"

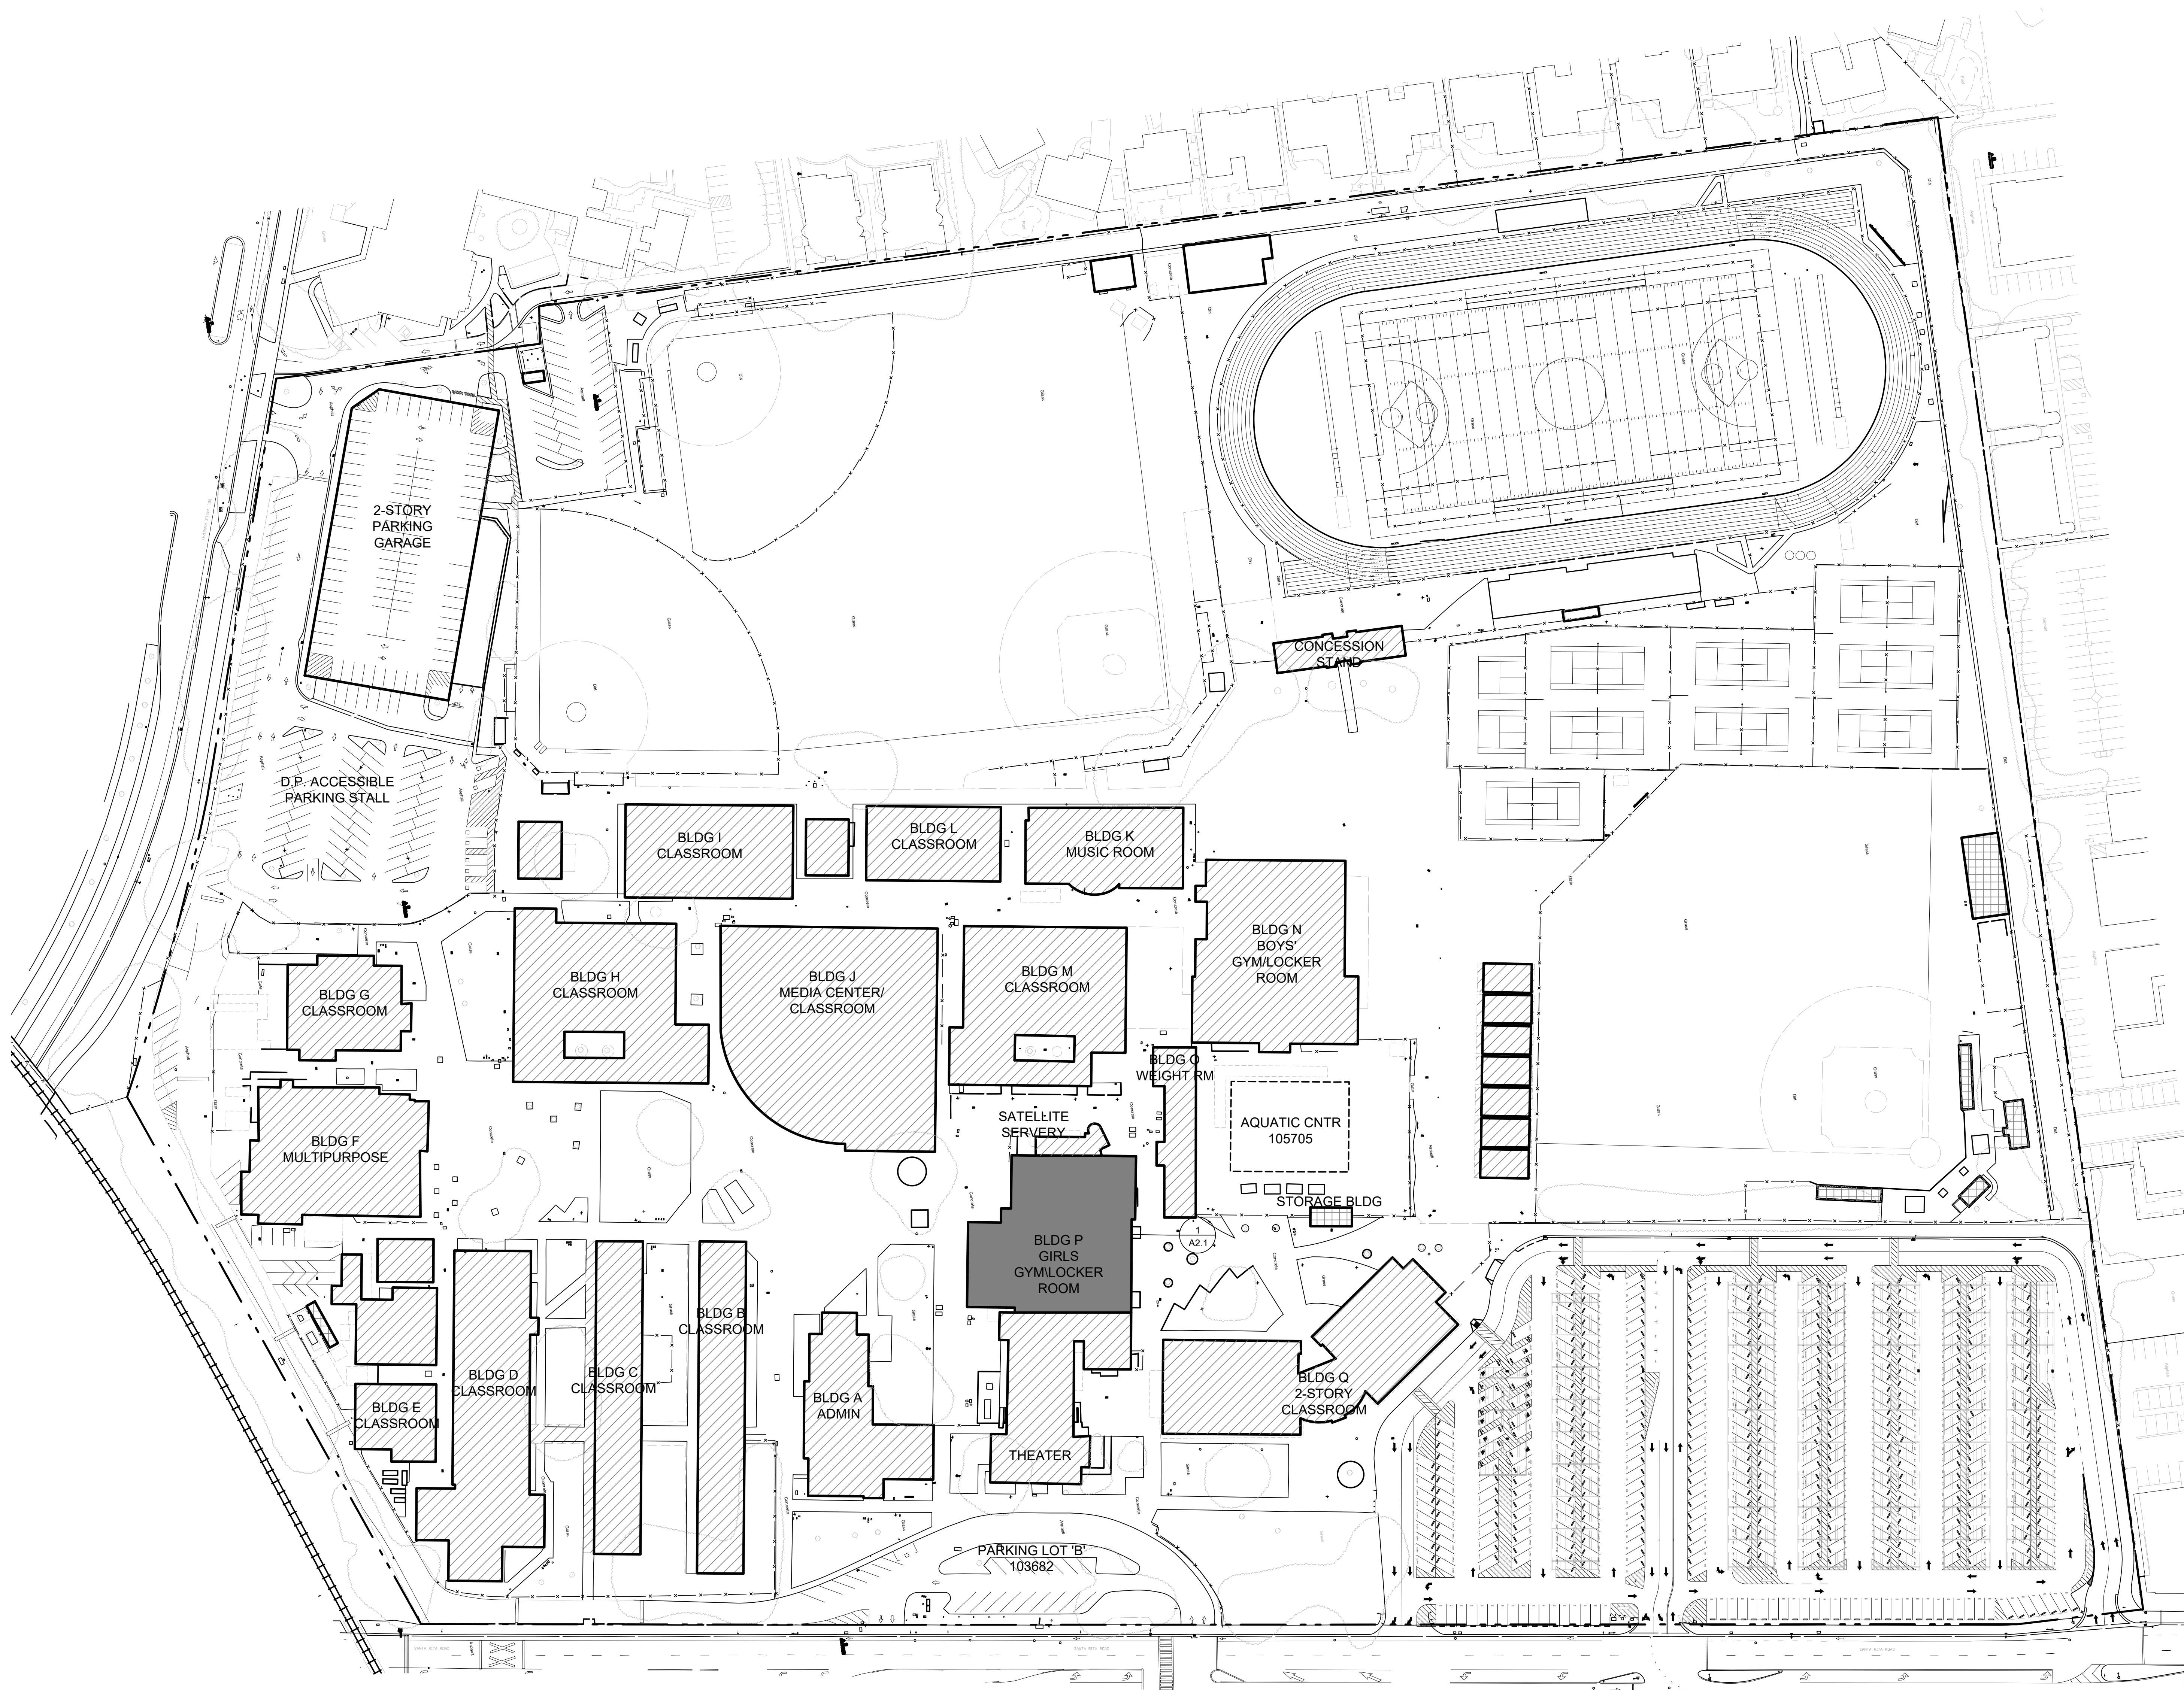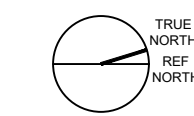


GRAPHIC KEY

- EXISTING PROPERTY LINE
- - - ROOF OVERHANG
- - - CHAINLINK FENCE

- NEW BUILDING
- EXISTING BUILDING

- (E) DRY STAND PIPE
- DRINKING FOUNTAIN
- (E) FIRE HYDRANT
- (E) SIGN

(DSA STAMP AREA)

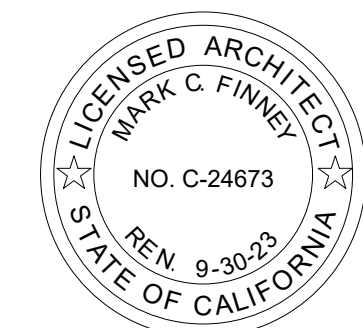

SITE PLAN


REVISIONS NO.	ITEM	DATE
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DRAWN BY: KNU
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NEW ROOFING
AMADOR VALLEY HIGH SCHOOL
4375 FOOTHILL ROAD, PLEASANTON, CA 94588
PLEASANTON UNION SCHOOL DISTRICT


A0.2

6



1 DEMOLITION ROOF PLAN

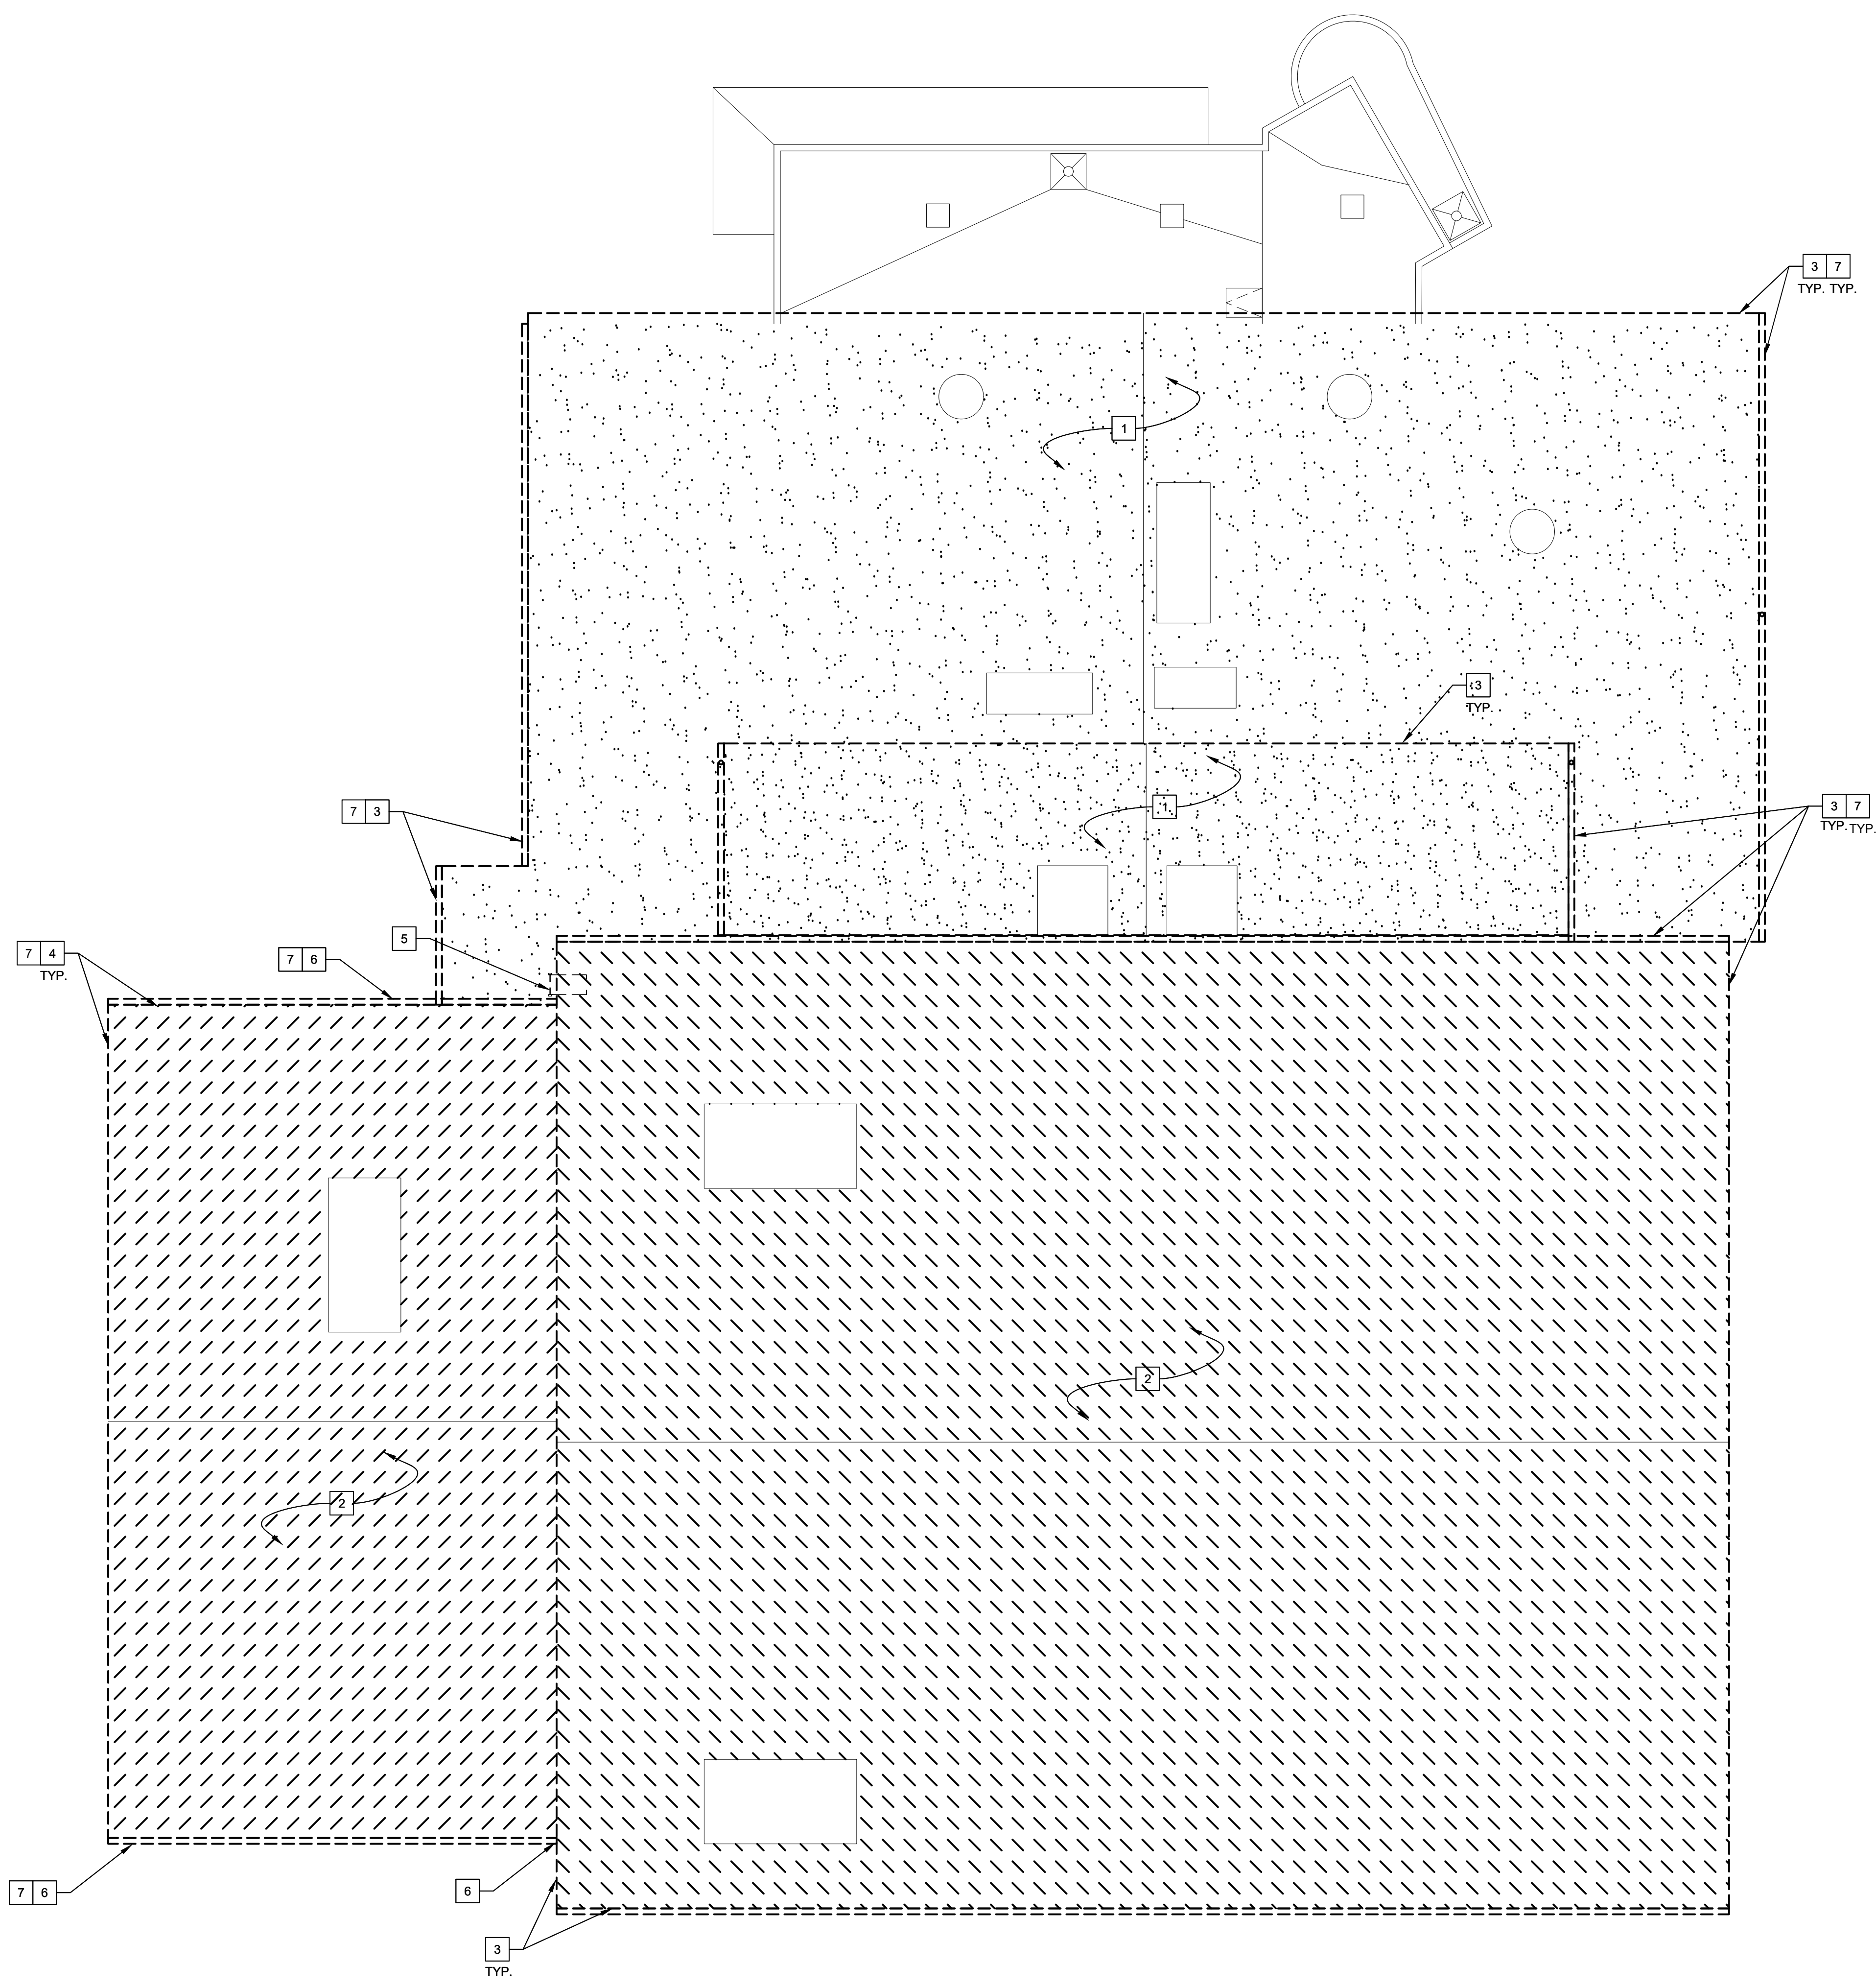1/8" = 1'-0"

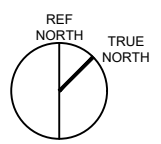

GENERAL NOTES

- NOT ALL ROOF APPURTENANCES ARE SHOWN ON DRAWINGS. CONTRACTOR TO FIELD VERIFY QUANTITIES AND LOCATIONS OF ALL DEVICES AND EQUIPMENT. REFER TO MECHANICAL AND ELECTRICAL DRAWINGS FOR ADDITIONAL SCOPE OF WORK.
- CONTRACTOR TO REMOVE ALL EXISTING MECHANICAL UNITS, DUCTWORK AND ALL OTHER ROOF TOP APPURTENANCES AS INDICATED ON MECHANICAL DRAWINGS.
- CONTRACTOR TO REINSTALL AND RECONNECT ALL DEVICES THAT ARE TO REMAIN AND RETURN THEM TO WORKING ORDER. CONTRACTOR TO NOTIFY DISTRICT AND ARCHITECT OF ANY DEVICES NOT FUNCTIONING PRIOR TO REMOVAL.
- ALL EXISTING ROOF SYSTEMS, TAPERED INSULATION, FLASHING, ETC. ARE TO BE REMOVED AND PREPARED FOR INSTALLATION OF NEW ROOFING AND FLASHING SYSTEMS.
- PATCH AND REPAIR BUILT-UP ROOFING WHERE REQUIRED IN ADJACENT AREAS AS A RESULT OF NEW WORK.
- COORDINATE SLEEPER LOCATIONS WITH MECHANICAL, PLUMBING, AND/OR ELECTRICAL AS REQUIRED. SEE DETAILS 5 AND 6/A9.1.
- FOR PIPES OR CONDUITS THROUGH ROOF, SEE DETAIL 4/A9.1.
- CONTRACTOR TO ASSUME 10% OF EXISTING ROOF DECKING, FASCIA AND RIM JOIST IS DAMAGED AND WILL NEED REPLACEMENT. REPLACEMENT IS TO BE IN KIND, IN LOCATION.


DEMOLITION ROOF PLAN NOTES

- REMOVE (E) FLAT TAR AND GRAVEL ROOF SYSTEM TO EXPOSED DECKING.
- REMOVE (E) B.U.R. SYSTEM TO EXPOSED DECKING. CONTRACTOR RESPONSIBLE FOR COVERING GYM FLOOR DURING DEMOLITION TO PROTECT FROM DEBRIS AND PREVENT ANY DAMAGE TO GYM FLOOR.
- REMOVE (E) WOOD FASCIA, GUTTER AND METAL EDGE COPING. EXISTING ROOF AND SUPPORT TO BE CUT BACK FOR NEW OUTSIDE MOUNT GUTTER, SEE DETAILS 10 & 11/A9.1 @ LOCKER ROOM BUILDING.
- REMOVE (E) WOOD FASCIA, GUTTER AND METAL EDGE COPING. EXISTING ROOF AND SUPPORT TO BE CUT BACK FOR NEW OUTSIDE MOUNT GUTTER, SEE DETAIL 8 & 9/A9.1 @ EXERCISE ROOM BUILDING.
- REMOVE (E) ROOF LADDER.
- DAMAGED CEMENT PLASTER, REMOVE LOOSE DEBRIS OF DAMAGED CEMENT PLASTER AND PREP FOR NEW CEMENT PLASTER REPAIR/PATCH UNDER EAVES OF OVERHANGS AROUND GYM AND LOCKER PORTION OF BUILDING.
- REMOVE AREAS OF DAMAGED SOFFIT UNDER OVERHANG, PREP FOR NEW.

GRAPHIC KEY

- EXISTING TO BE DEMOLISHED
- [Hatched Box] EXISTING ROOFING TO BE REMOVED
- [Stippled Box] EXISTING GRAVEL ROOFING TO BE REMOVED

BUILDING KEY

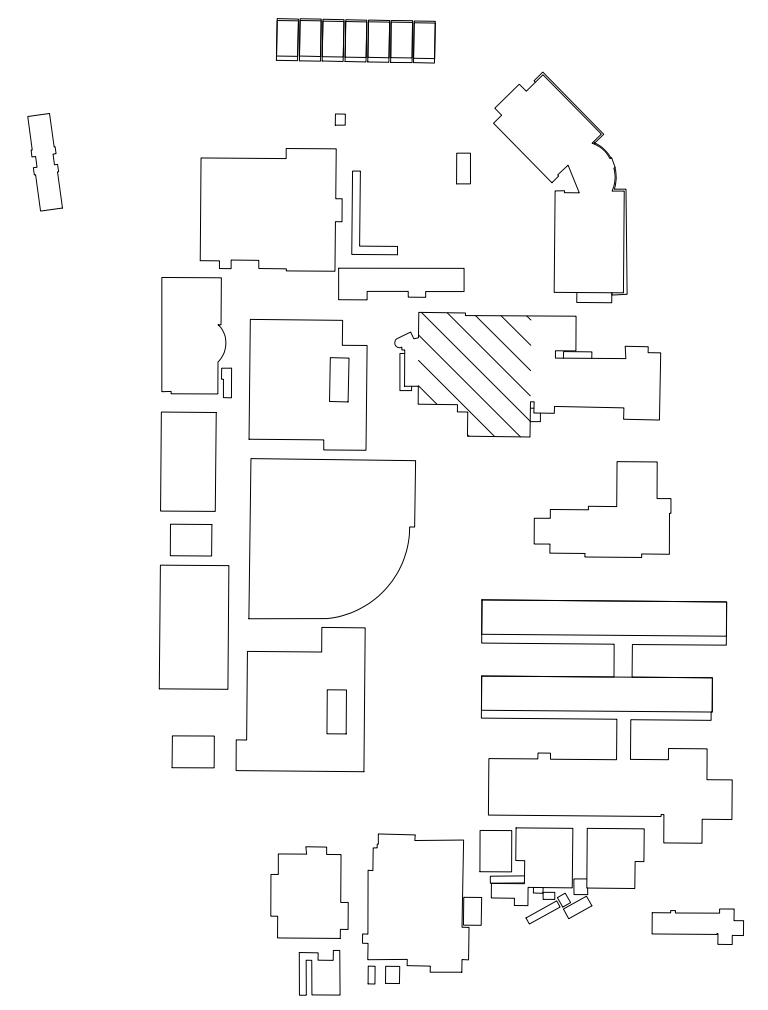

DEMOLITION ROOF PLAN

NEW ROOFING
AMADOR VALLEY HIGH SCHOOL
4375 FOOTHILL ROAD, PLEASANTON, CA 94588
PLEASANTON UNION SCHOOL DISTRICT

REVISIONS		
NO.	ITEM	DATE

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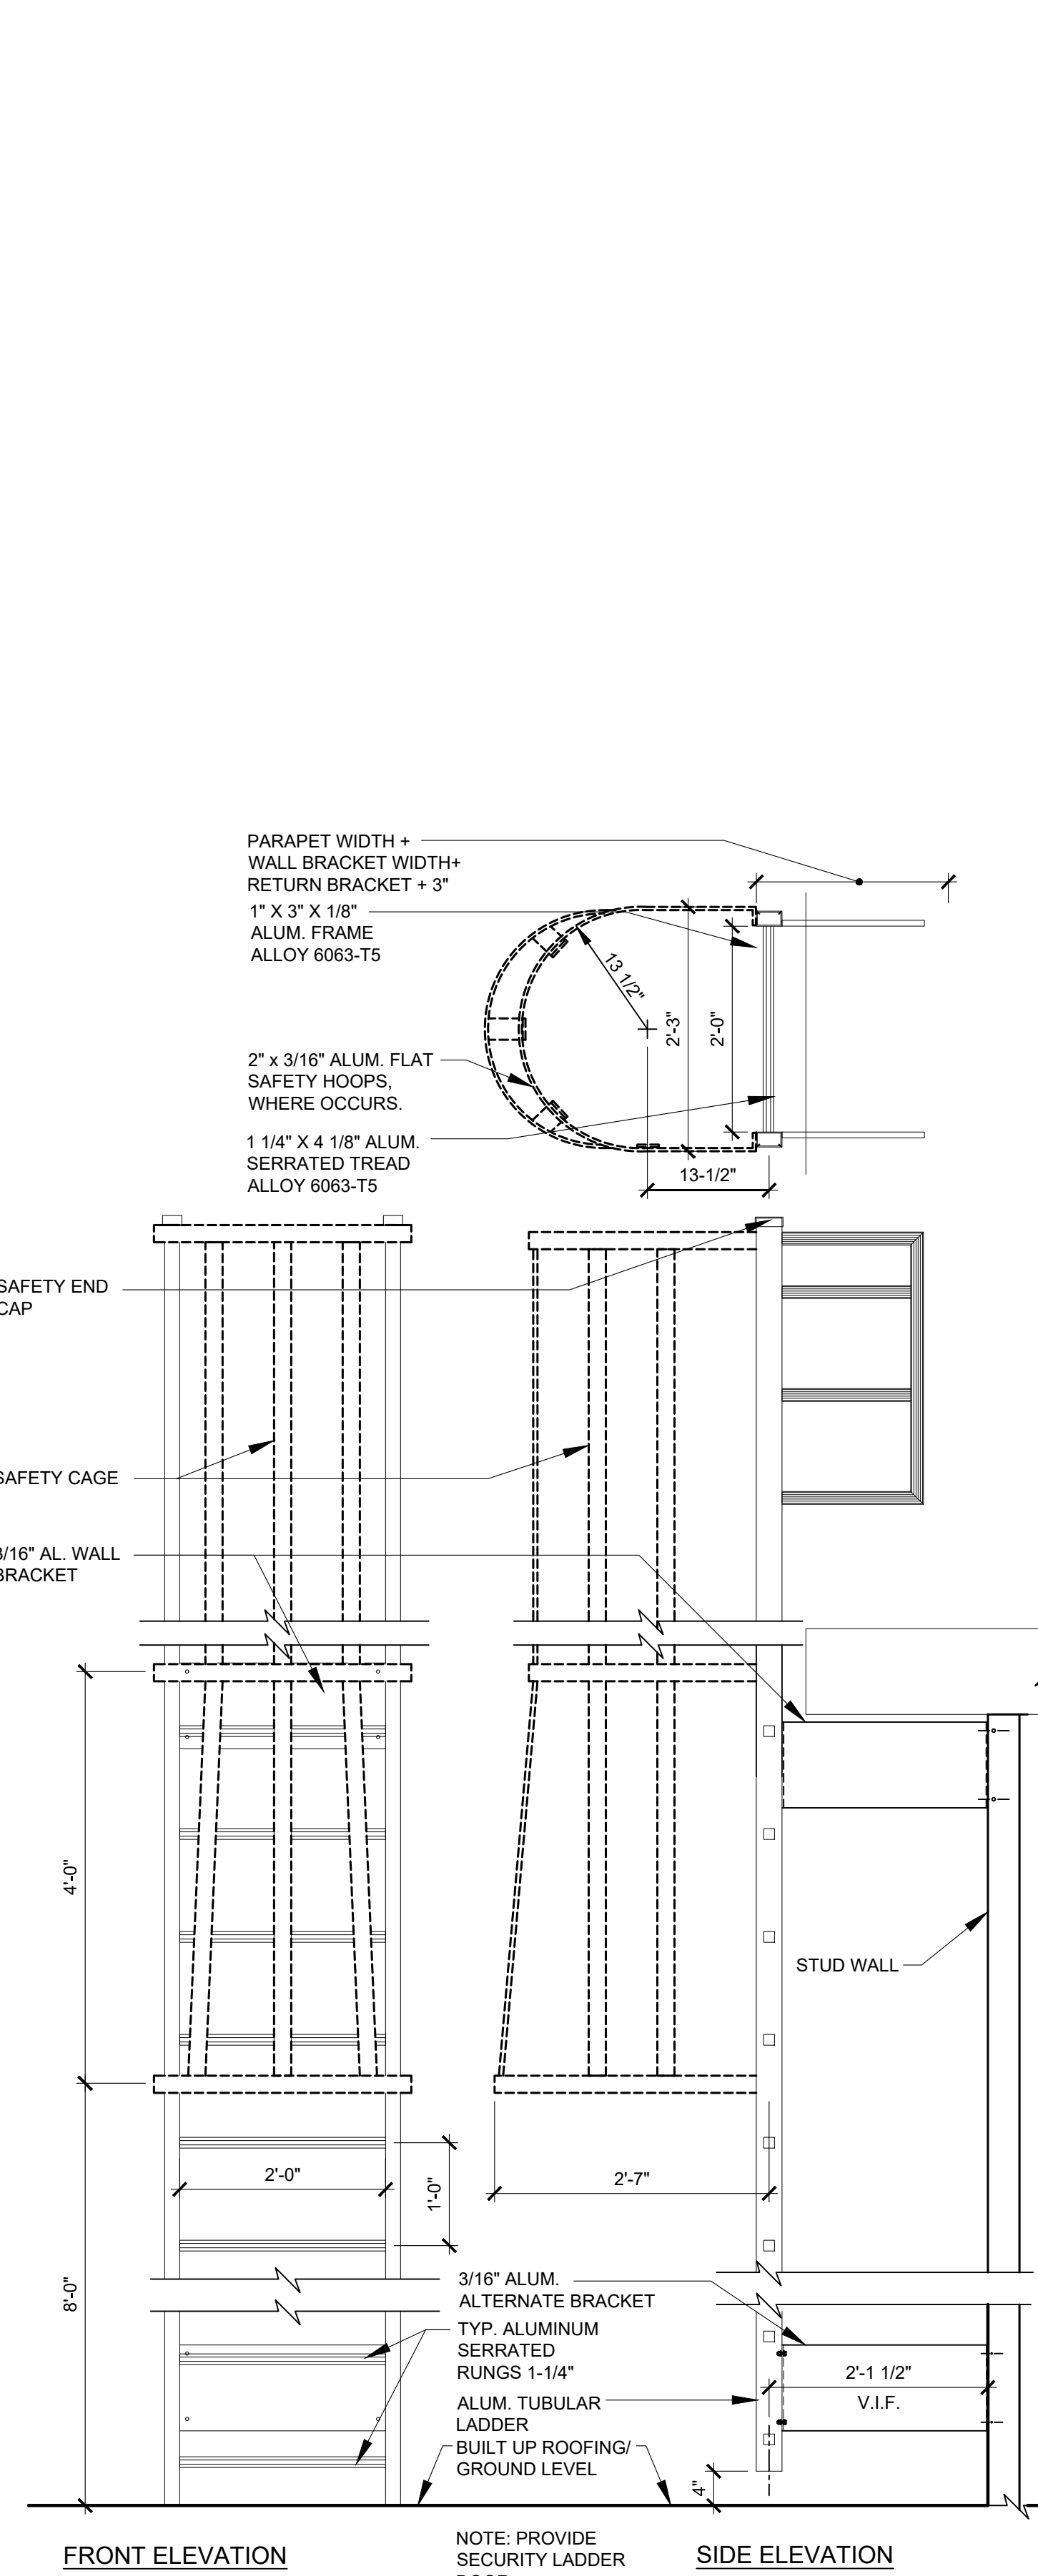
A4.1

(DSA STAMP AREA)







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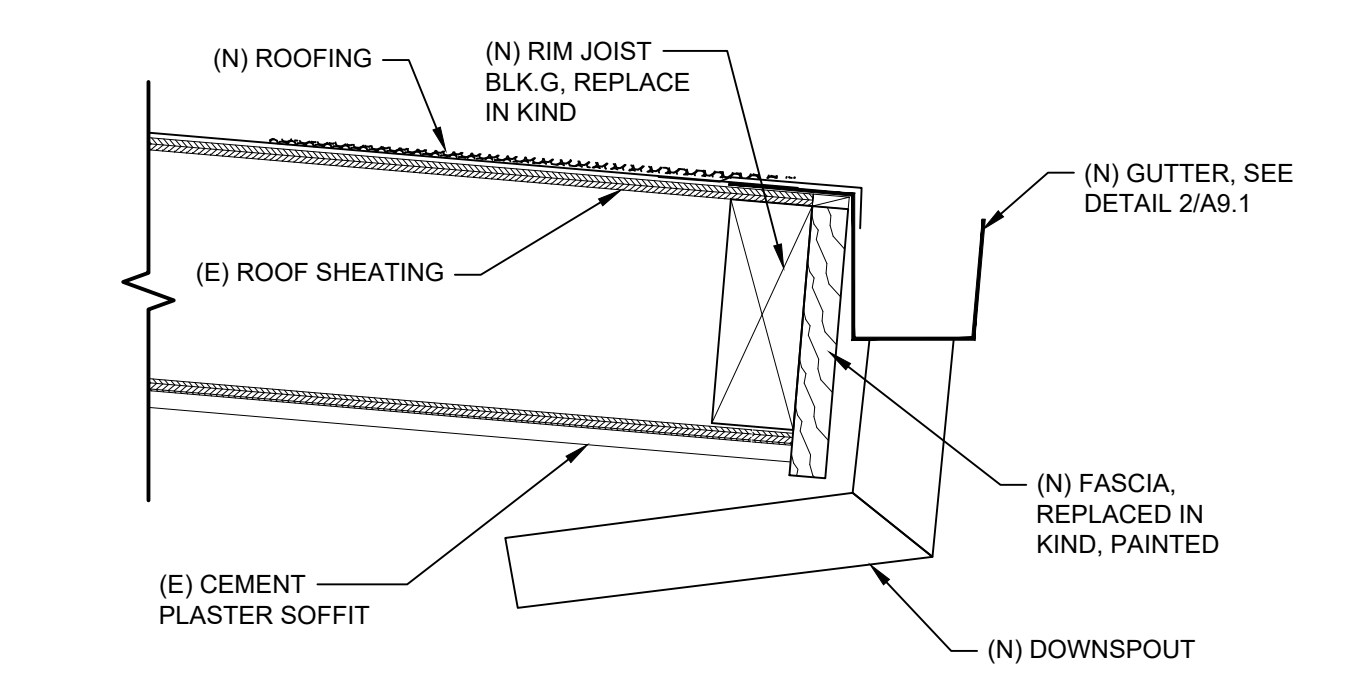
14 ROOF ACCESS LADDER
3/4"=1'-0"




13 RAKE
@ LOCKER ROOM
1-1/2"=1'-0"

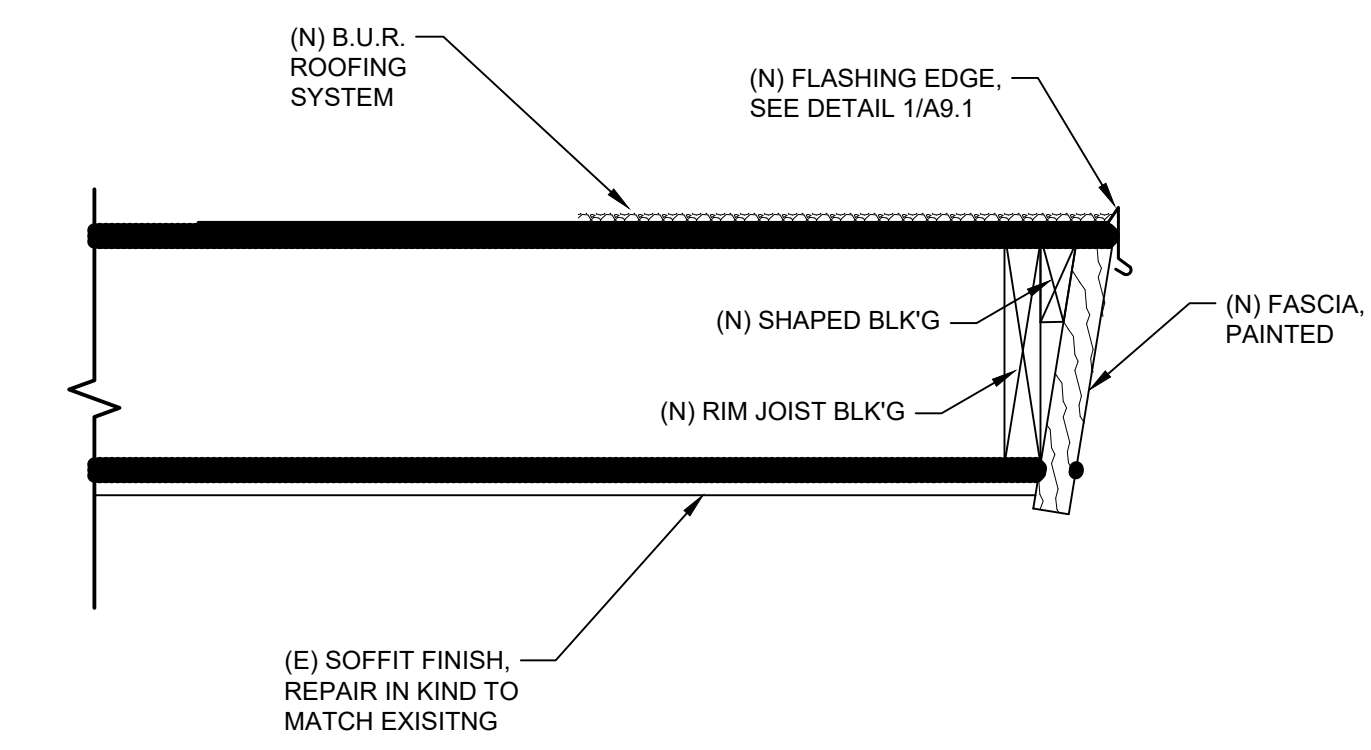


12 RAKE
@ EXERCISE ROOM
1-1/2"=1'-0"

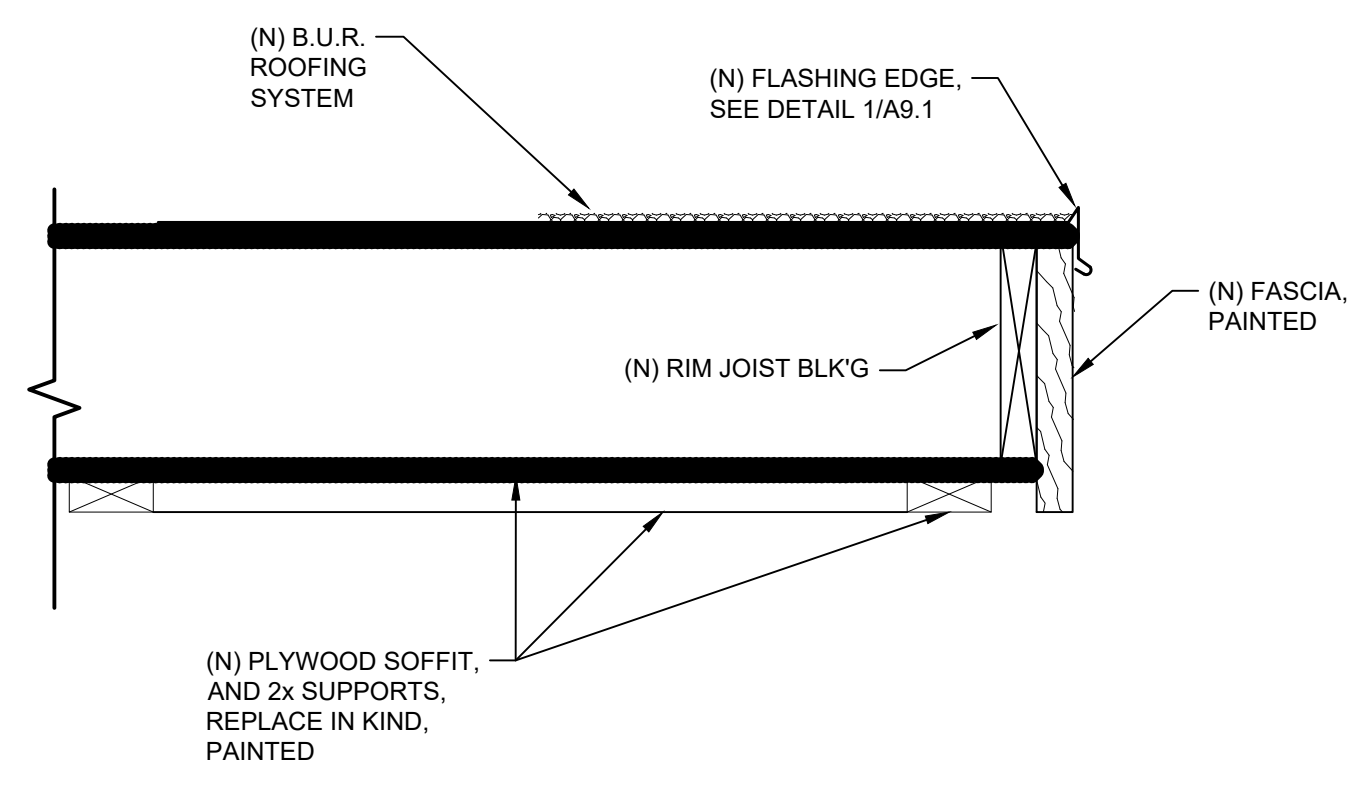


11 EAVE/GUTTER RE-CONSTRUCTION
@ LOCKER ROOM
1-1/2"=1'-0"

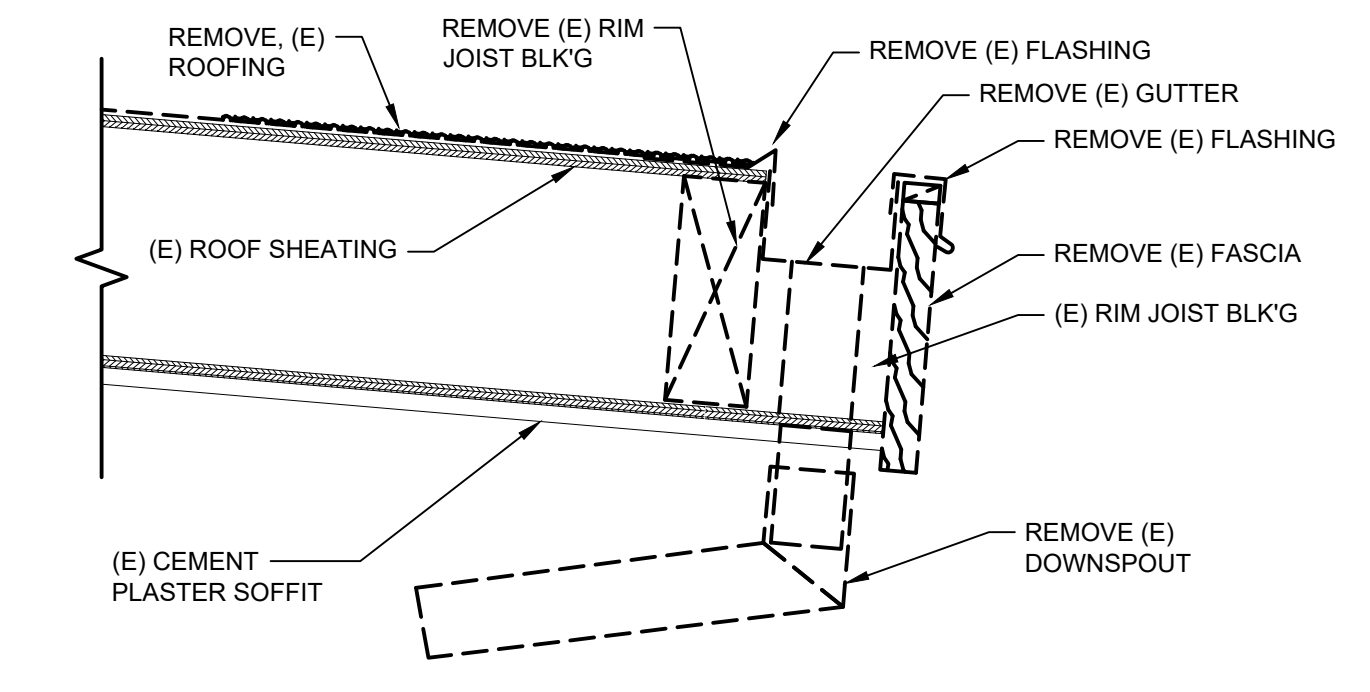


10 EAVE/GUTTER DEMOLITION
@ LOCKER ROOM
1-1/2"=1'-0"

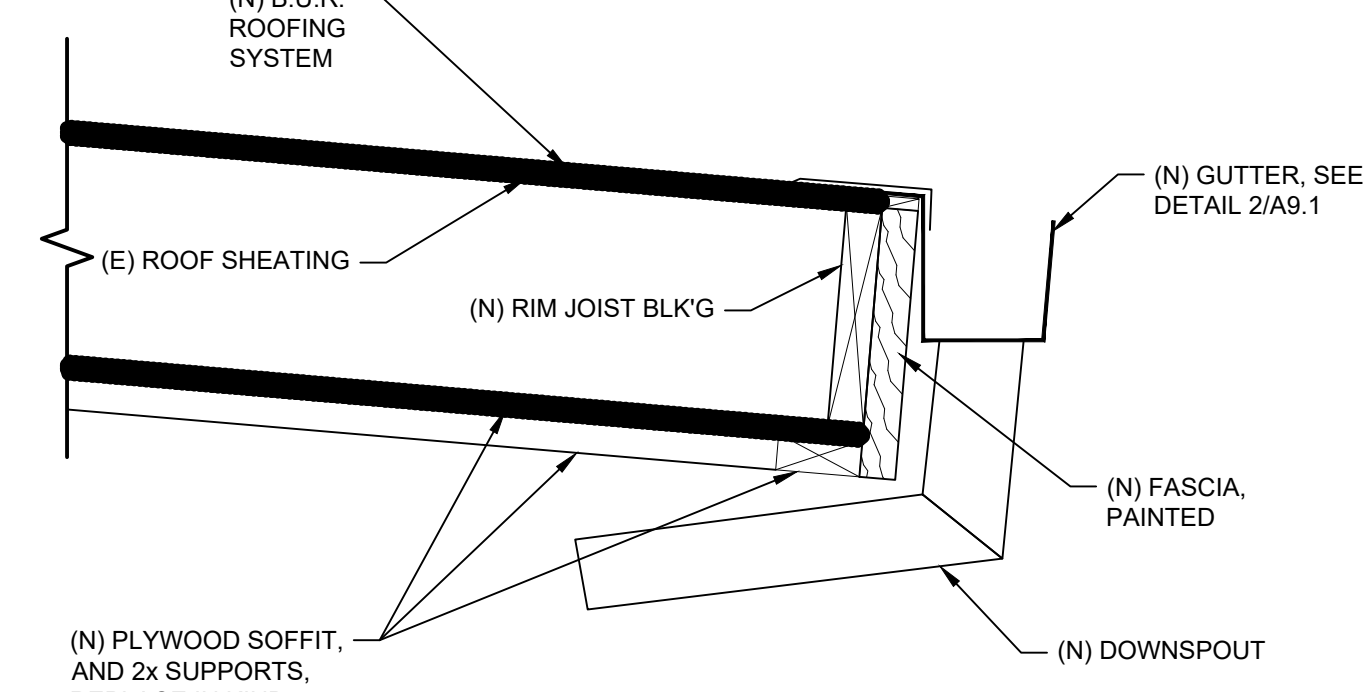


9 EAVE/GUTTER RE-CONSTRUCTION
@ EXERCISE ROOM
1-1/2"=1'-0"

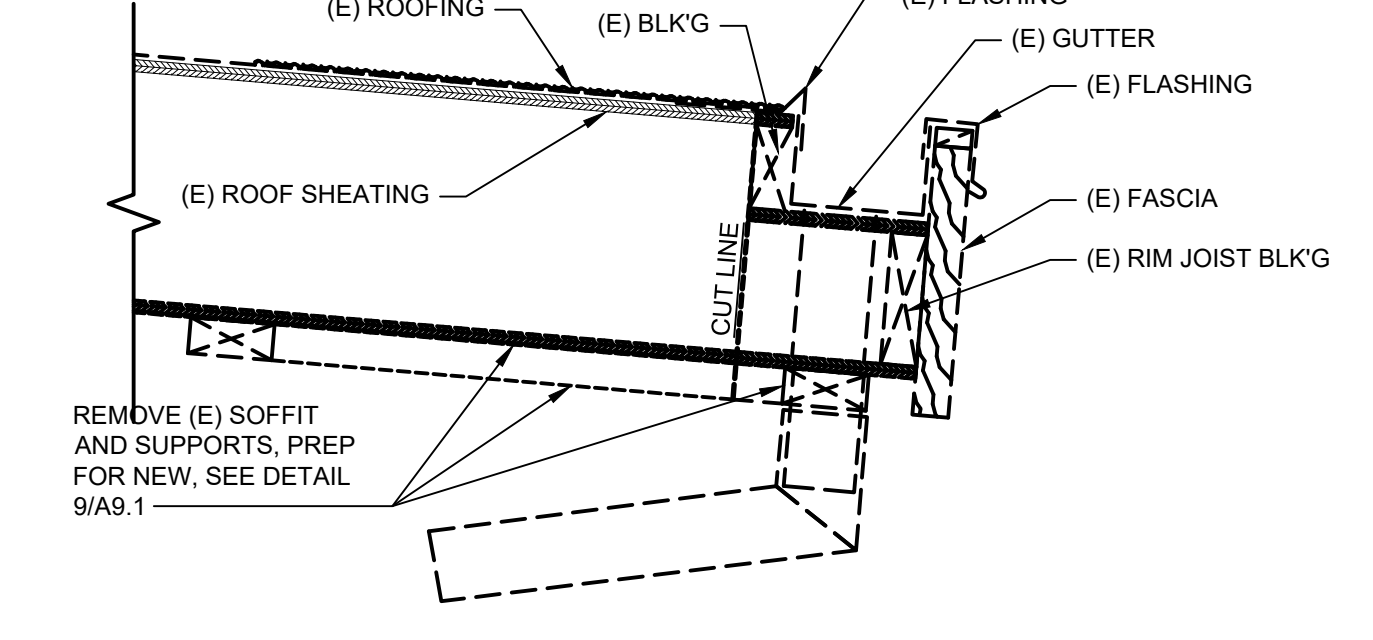


8 EAVE/GUTTER DEMOLITION
@ EXERCISE ROOM
1-1/2"=1'-0"

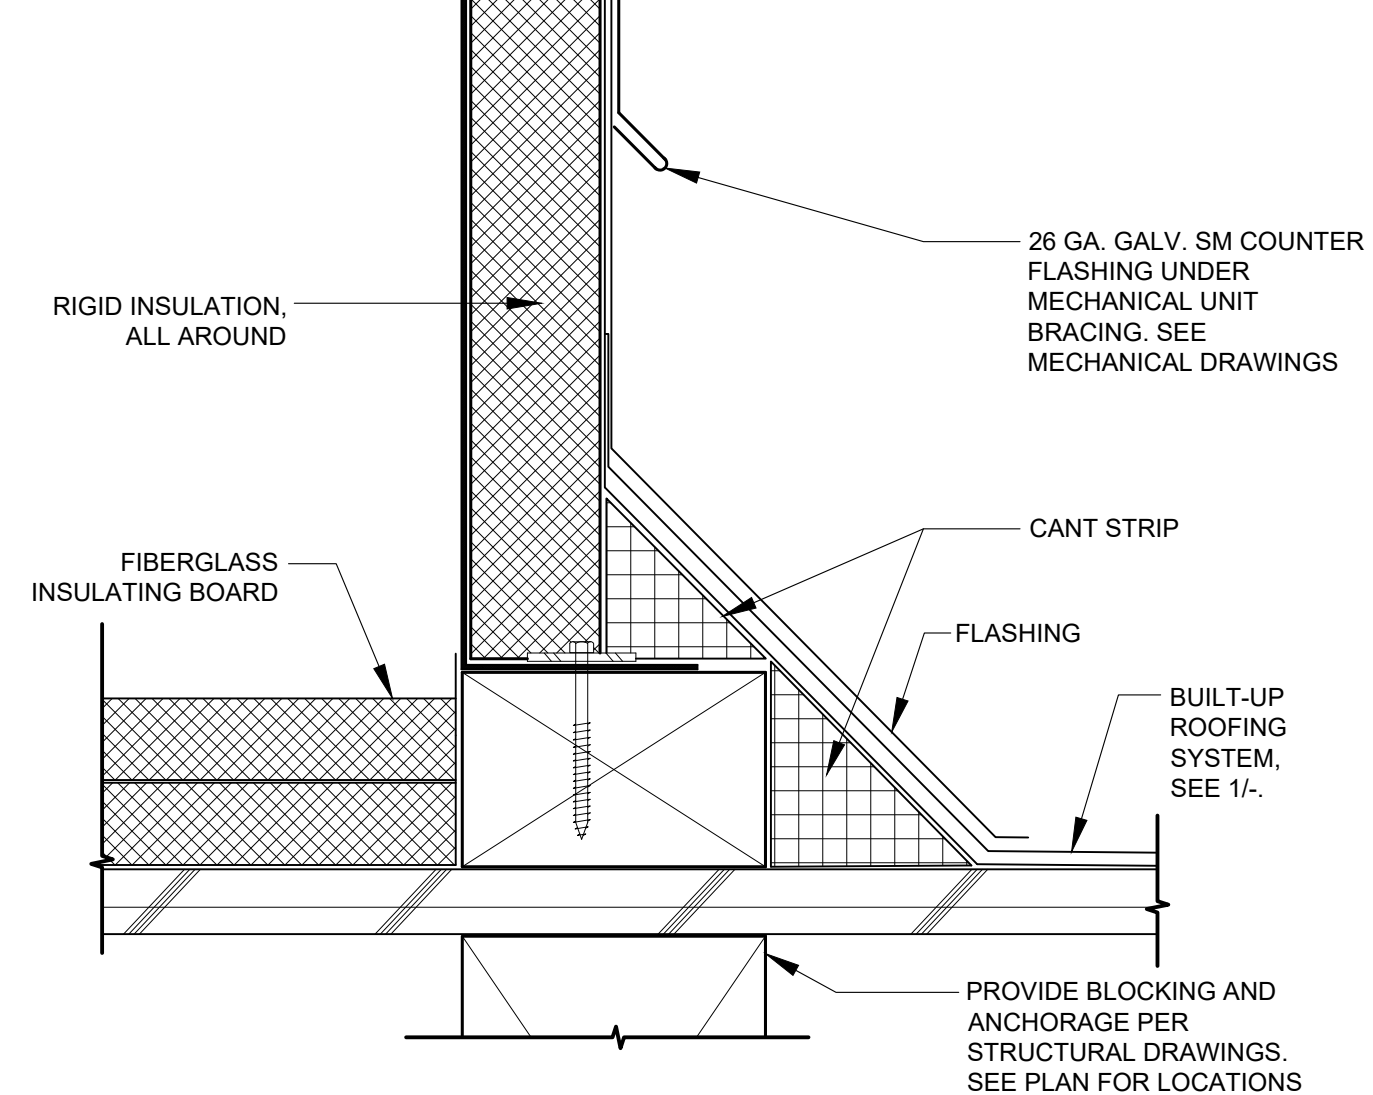


7 FLASHING @ MECH. UNIT CURB
N.T.S.

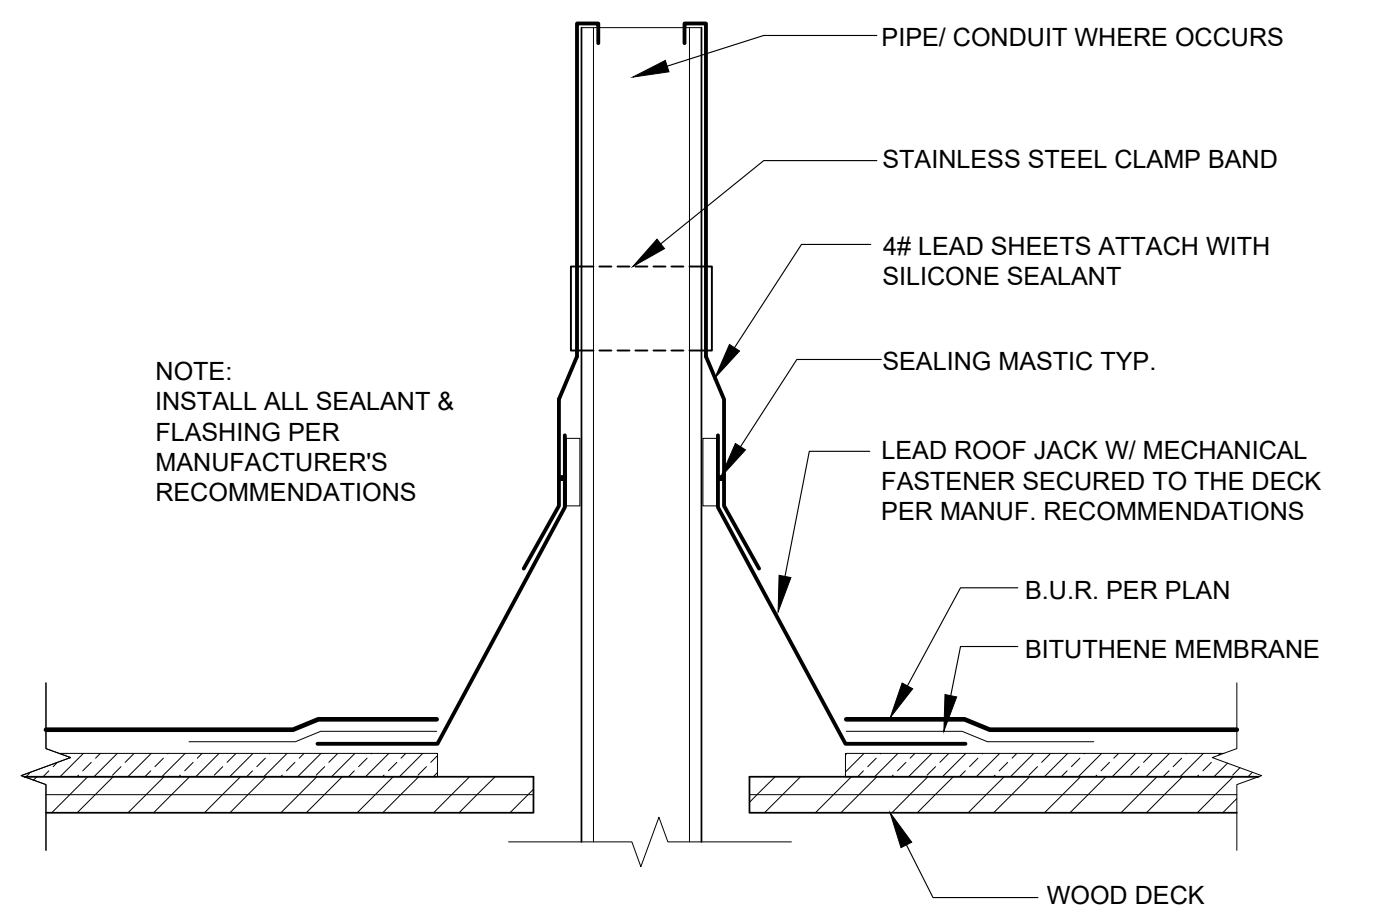


6 PIPE/CONDUIT FLASHING
3"=1'-0"

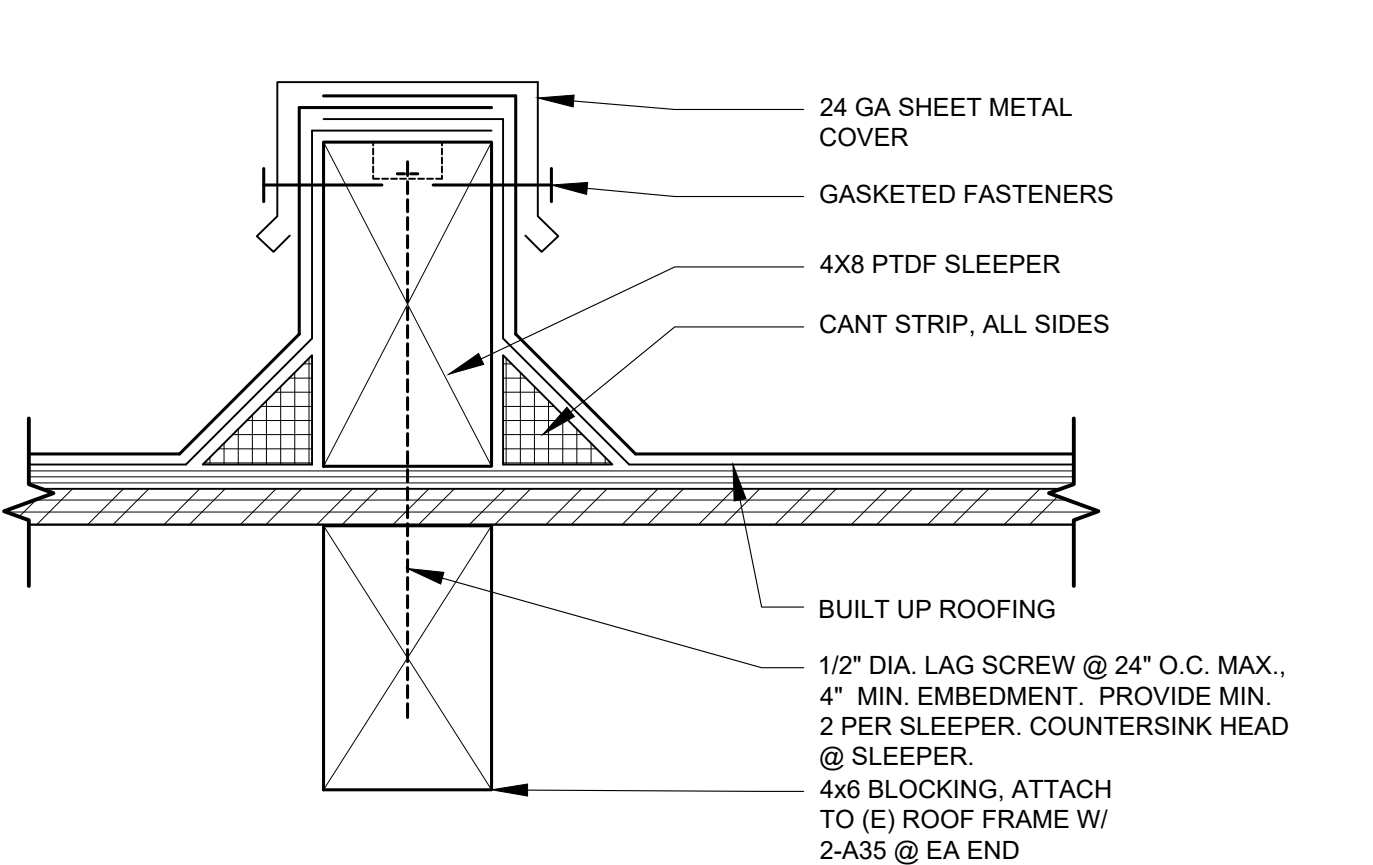


5 EQUIPMENT/ PIPE SLEEPER
3"=1'-0"

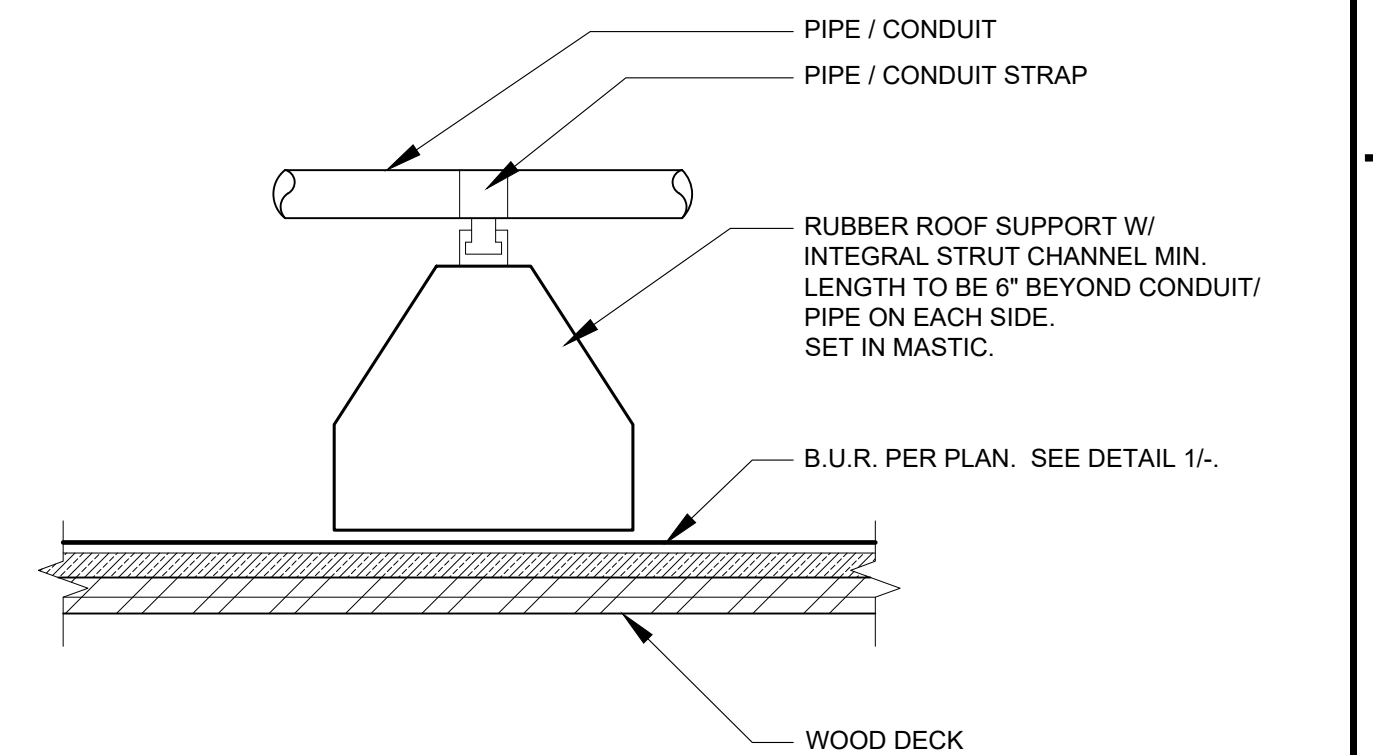


4 FLOATING SLEEPER
3"=1'-0"

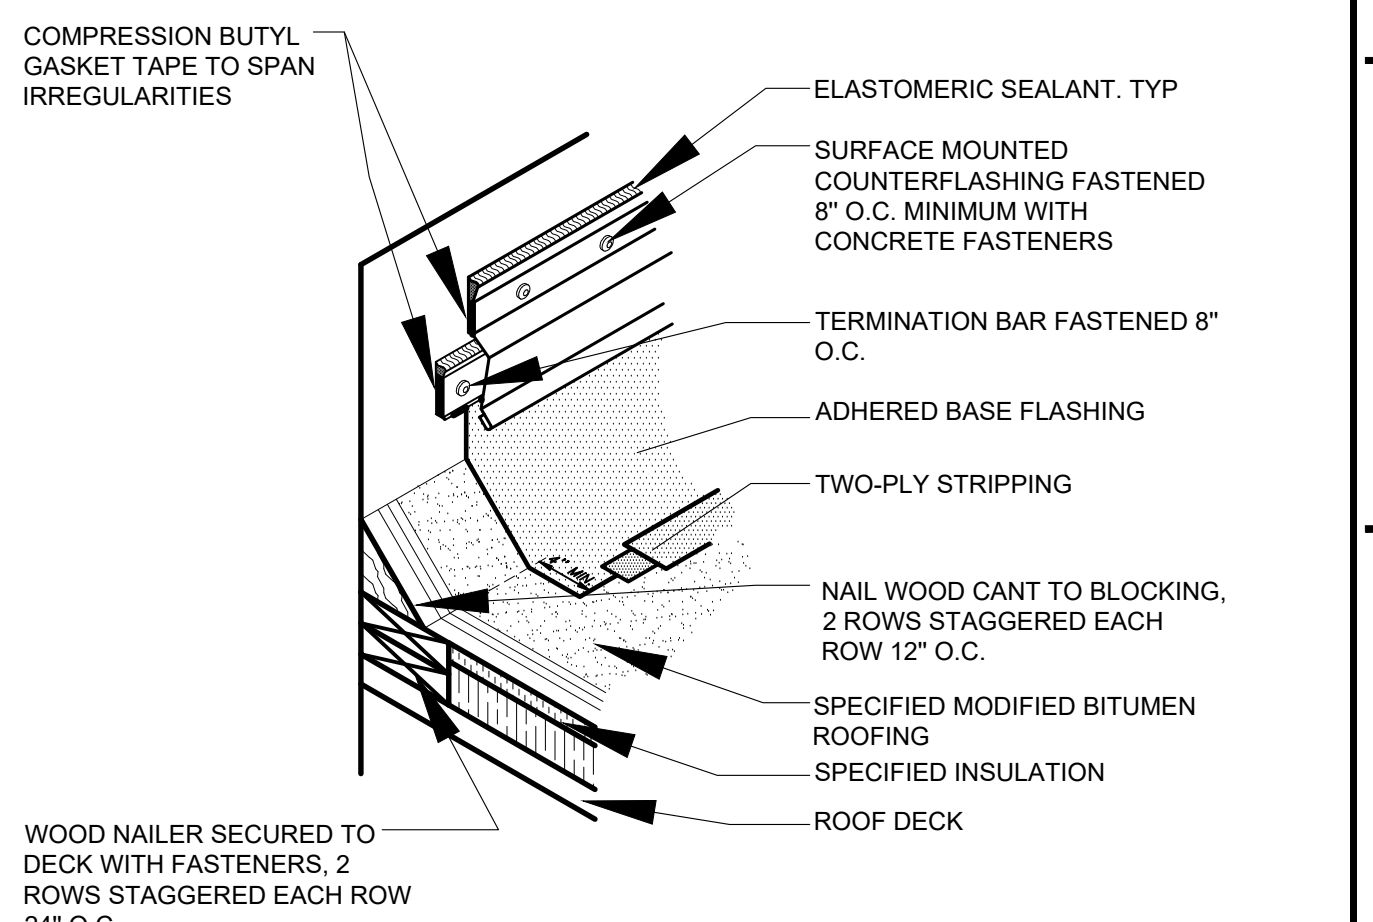

3 WALL FLASHING FOR PARAPETS
TREMCO DWG NO. 06
NTS

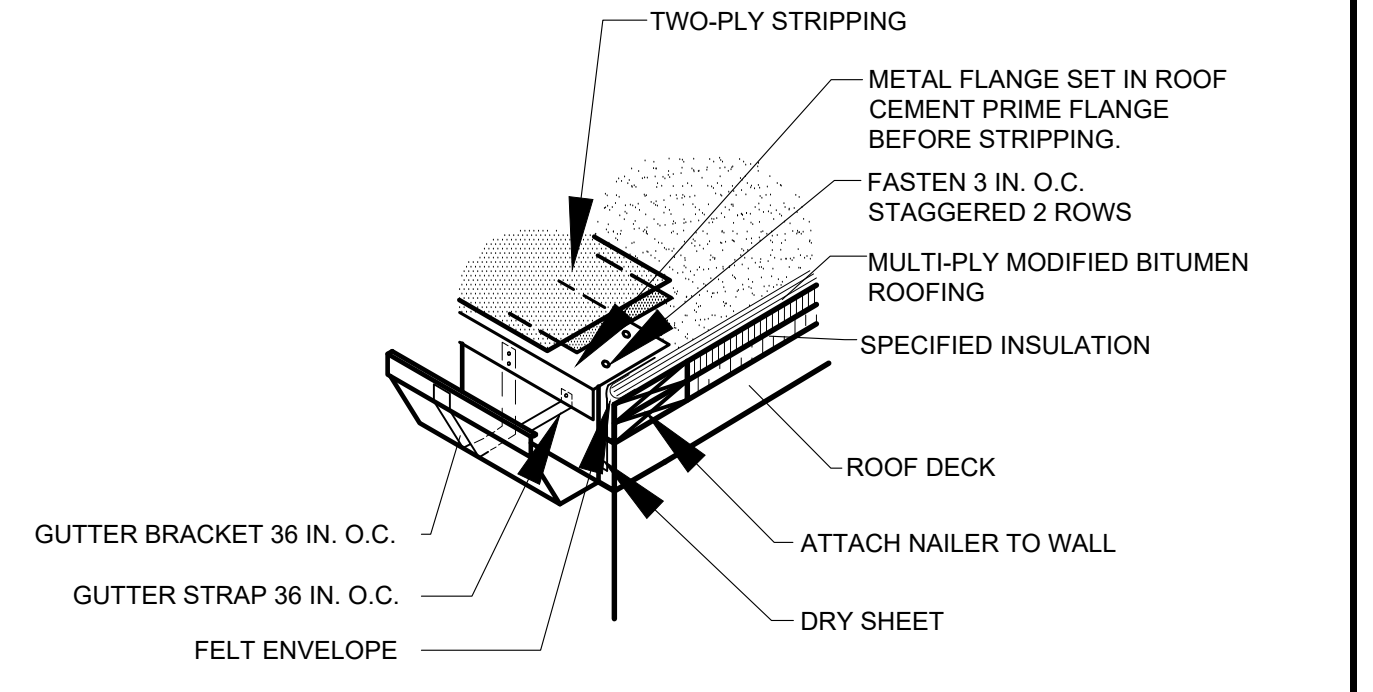

2 ROOF EDGE WITH GUTTER
TREMCO DWG NO. 09
NTS

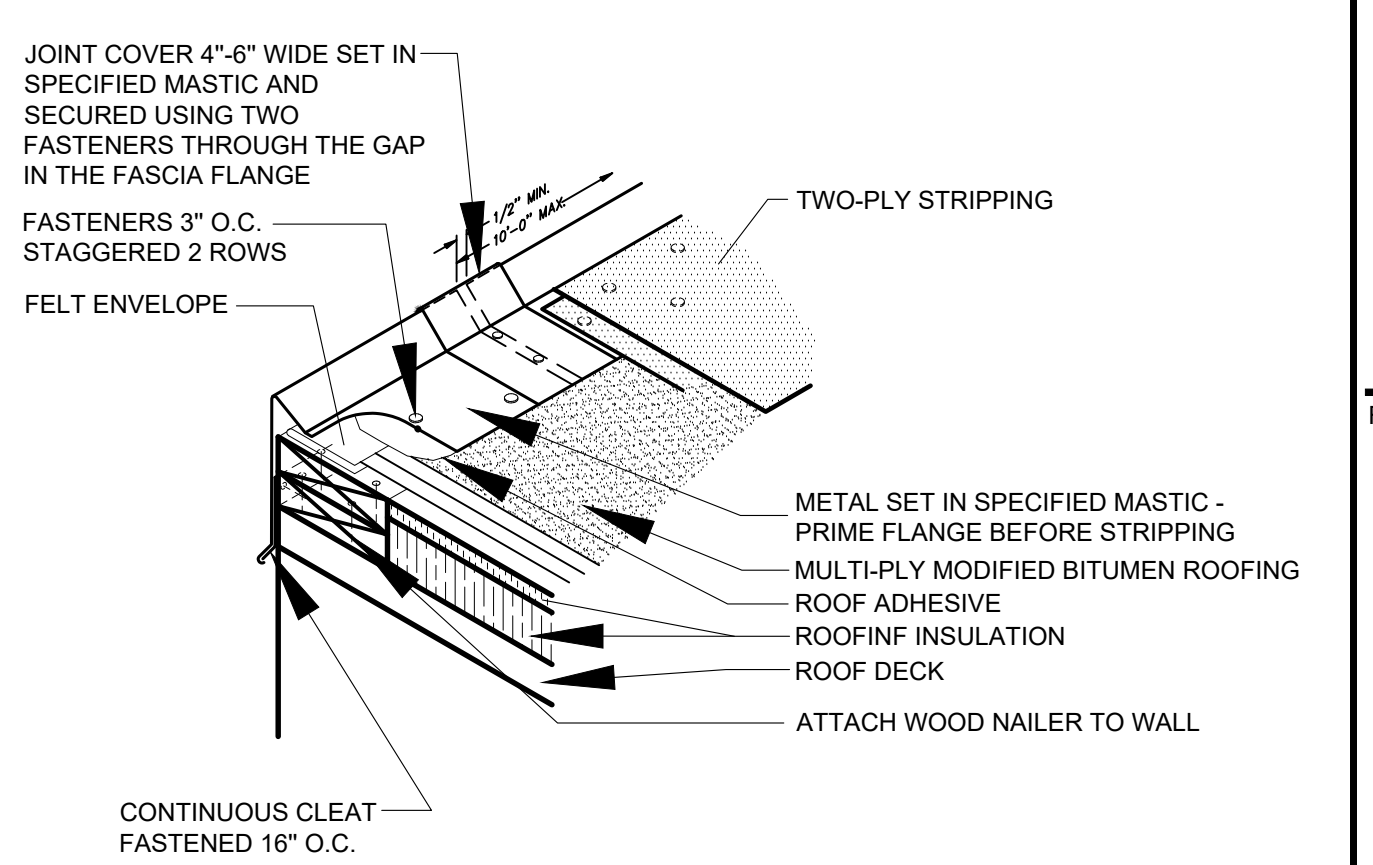

1 LIGHT METAL ROOF EDGE
TREMCO DWG NO. 01
NTS