SAN MATEO FOSTER CITY SCHOOL DISTRICT FACILITIES DEVELOPMENT

1410 South Amphlett Blvd., San Mateo, CA 94402 Office (650) 312-7690 FAX (650) 312-7696

GEORGE HALL MPR AND SUPPORT ROOMS PROJECT #19-143

ADDENDUM NO. 3

Date: November 24, 2021

Project: #19-143 George Hall MPR and Support Rooms Project

DSA #: 01-119574 41-26

Owner: San Mateo Foster City School District

1170 Chess Drive Foster City, CA 94404

Notice is hereby given to all prospective bidders that plans and specifications on the subject project are modified as hereinafter set forth. This addendum shall be attached to and form a part of the plans and specifications. All bidders must acknowledge receipt of this addendum on the Bid Form. In case of difference with previous addenda or communications, this addendum takes precedence.

It is the responsibility of all bidders to notify all subcontractors from whom they request bids and from whom they accept bids of all changes contained in this addendum.

3.1 Notice to Bidders

1. A new Bid Form.

3.2 RFIs – Questions and Answers

1. Question: Is this project Base Bid plus Alternate?

Answer: No, it will be Base Bid plus AV Allowance only.

2. **Q:** Please provide pre-qualified MEP's?

A: MEP's do not need to be pre-qualified. This project MEP's are under a million dollars.

3. **Q:** Is this a PLA project?

A: This is NOT a PLA project.



4. **Q:** PRE-BID RFI 11 – Turf pad thickness?

A: See attached PRE-BID RFI 11 response and detail 6/L4.2 re-issued.

5. **Q:** PRE-BID RFI 16 – Sun shade devices 08 41 13 - 2.05?

A: See attached PRE-BID RFI 16 response.

6. **Q:** PRE-BID RFI 17-21 – AV, ALS questions

A: See attached PRE-BID RFI 17-21 responses.

7. **Q:** Substitution Request 1 - 07 26 13 Weather Barrier (Delta-Fassade SA).

A: Rejected – pending additional info given.

8. **Q:** Substitution Request 2 – 07 26 13 Weather Barrier (Air-Shield SMP by W.R. Meadows).

A: Rejected

9. **Q:** Substitution Request 3 – 03 30 00 Waterproofing Admix (MasterLife 300C & 300D from Master Builders Solutions).

A: Approved

10. **Q:** Substitution Request 4 – 09 67 23 Resinous Flooring (Florock,)

A: Rejected – pending additional info given.

11. Q: Substitution Request 5 – 09 67 23 MCM panels (Alpolic MCM).

A: Not applicable.

3.3 SPECIFICATIONS

1. SPECIFICATION SECTION 10 14 54 - EXTERIOR SIGNS

A. Delete the following paragraph 2.01 Exterior Signs – Individual Cast Letters

2. SPECIFICATION SECTION 10 14 19 - DIMENTIONAL LETTERS

A. The following specification section is hereby issued. See attached.

3.4 DRAWINGS

1. SHEET 'A10.91 SIGNAGE DETAILS

The following drawing is hereby reissued with these changes:

A. Detail 12 - BUILDING SIGN - Add notes to define dimensional letter

2. SHEET 'LD0.0 IRRIGATION DEMOLITION'

The following drawing is hereby reissued with these changes:

A. Demolition Site Plan - Remove (3) existing trees



3. SHEET 'L1.1 TREE PLANTING PLAN'

The following drawing is hereby reissued with these changes:

A. Planting Site Plan - Plant (3) trees

4. SHEET 'L2.1 SHRUB PLANTING PLAN'

The following drawing is hereby reissued with these changes:

A. Landscape Legend – Revise Lawn (Artificial) notes

5. SHEET 'L3.1 LANDSCAPE IRRIGATION PLAN'

The following drawing is hereby reissued with these changes:

A. Irrigation Site Plan - Repair existing irrigation

6. SHEET 'L4.21 LANDSCAPE CONSTRUCTION AND PLANTING DETAILS'

The following drawing is hereby reissued with these changes:

A. Detail 6 Artificial Turf Detail – Revise notes to clarify and specify Turf components

Reminder Bid Date December 2, 2021 at 2:00pm. At the District Office 1170 Chess Dr. Foster City, CA 94404.

Attachments:

Attachment A - New Bid Form

Attachment B – RFI 11, RFI 16, RFI 17, RFI 18, RFI 19, RFI 20, RFI 21 Response

Attachment C – Re-issued drawings L0.0, L1.1, L2.1, L3.1, L4.2, A10.91

Attachment D - Spec Section 10 41 19 Dimensional Letters

End of Addendum





SAN MATEO FOSTER CITY SCHOOL DISTRICT 1170 CHESS DR., FOSTER CITY, CA 94404

DSA #01-119574 FILE #41-26

PRE-BID RFI 11

SITE: GEORGE HALL ELEMENTARY SCHOOL,

130 SAN MIGUEL WAY, SAN MATEO, CA94403

PROJECT: MULTIPURPOSE BUILDING AND SITE WORK

Gary Chen Senior Project Manager

3486 Investment Blvd, Suite B, Hayward, CA 94545 P 650.508.1700 C 650.863.9240 F 650.508.1708 Bid Fax 650.508.1705 E gchen@rodanbuilders.com rodanbuilders.com

HAYWARD + CONCORD

QUESTION : submitted
Can you confirm the thickness of pad below the artificial turf?

Pad thickness to be 3/4" inch with Field Turf Nutmeg Lush 1 5/8" turf with Anti-microbial silica sand fill.

Peter Larimer MTWgroup 11/23/21



SAN MATEO FOSTER CITY SCHOOL DISTRICT 1170 CHESS DR., FOSTER CITY, CA 94404

DSA #01-119574 FILE #41-26

PRE-BID RFI 16

SITE: GEORGE HALL ELEMENTARY SCHOOL,

130 SAN MIGUEL WAY, SAN MATEO, CA94403

PROJECT: MULTIPURPOSE BUILDING AND SITE WORK

Rob Ritter Project Manager/Estimator

5353 Napa Vallejo Highway American Canyon, CA 94503 (707) 257-7111 (Office) (707) 327-4348 (Direct Line) (707) 732-1801 (Mobile) (707) 647-7111 (Fax) Email: rritter@rsglazing.com



QUESTION:

The storefront specs 2.05 Shading Devices mentions Kawneer interior light shelf as shading device but drawings all show interior roller shades. Do you know if these Kawneer light shelves are to be used at all in project?

RESPONSE:

This project has no interior light shelves. Specification section 08 41 13 - 2.05 Shading devices, shall be deleted. submitted 11.22.21



REQUEST FOR INFORMATION

Request for Information Submitted To:

Judy Krall Date: November 23, 2021

HMC ArchitectsRFI No.: 01
333 W. San Carlos Street, Studio 750
CCT Job Quote No.: Q21221

San Jose, CA 95110
408-977-9160
judy.krall@hmcarchitects.com
Submitted By: Nathan Hocking
(408) 454-7221
Email: nathan@cctcom.net

Project:

George Hall Elementary School Multipurpose Building and Site Work 130 San Miguel Way San Mateo, CA 94403

ITEM	DESCRIPTION
Question No. 01 PRE-BID RFI 17	Reference: Drawing Sheet T2.10 – Key Note 4, 8, 9, Symbols PR, S, AV and AV cabinet. Question: Who is responsible for providing the AV devices and cabling shown/referenced on the drawing sheet? If the contractor is responsible, will a scope of work, spec and system diagrams be provided?
RFI Response	AV CABLING & DEVICES WILL BE PART OF ALLOWANCE. SCOPE WILL BE CLARIFIED AT A LATER DATE.
Question No. 02	Reference: Spec Section 275100 ALL-IN-ONE CLASSROOM AUDIO SYSTEM, Drawing Sheet T2.10
PRE-BID RFI 18	Question: I am not able to locate the Classroom audio systems on the drawings. Which rooms should receive the Classroom audio system?
RFI Response	THIS SCOPE IS NOT PART OF PROJECT, DELETE SPECIFICATION SECTION 275100
Question No. 83	Reference: Drawing Sheet T2.10 – Assistive Listening Device Schedule - Classroom
PRE-BID RFI 19	Question: Is the Listen Technologies LKS-8-A1 an acceptable product for the Classroom ALS portable system?
RFI Response	TBD
Question No. 84	Reference: Drawing Sheet T2.10 – Assistive Listening Device Schedule



Cal Coast Telecom

PRE-BID RFI 20	Question: The Schedule states "Each Room that requires an ALS system shall have a Listen RF transmitter (LT-800-072 or equal) and a microphone. Does the Listen Technologies LKS-8-A1 portable system satisfy this requirement for the Classroom system or is it needed in addition to the transmitter and microphone?
RFI Response	NO ALS SYSTEM IN ROOMS 17, 18, 19, 20 OR ANY OTHER. ELIMINATE THIS SCOPE.
Question No. 05	Reference: Drawing Sheet T2.10 – Assistive Listening Device Schedule
PRE-BID RFI 21	Question: The Schedule states "Each Room that requires an ALS system shall have a Listen RF transmitter (LT-800-072 or equal) and a microphone. Does the Listen Technologies LCS-120-01 Wi-Fi/RF Base System satisfy this requirement for the Multipurpose room system or is it needed in addition to the transmitter and microphone?
RFI Response	ALS SYSTEM IS ONLY REQUIRED IN ONE ROOM : MULTIPURPOSE ROOM A01 .

SECTION 10 14 19

DIMENSIONAL LETTERS

PART 1 - GENERAL

1.01 SECTION INCLUDES

A. Cut exterior dimensional letters of metal composition.

1.02 SUBMITTALS

- A. Product Data: Submit product data for specified products. Include material details for each sign specified.
- B. Shop Drawings: Submit shop drawings showing layout, profiles, and product components, including dimensions, anchorage, and accessories.
- C. Samples: Submit supplier's standard color chart for selection purposes and selected colors for verification purposes.
- D. Installation: Submit supplier's installation instructions.
- E. Closeout Submittals per Division 01.
- F. Submit operation and maintenance data for installed products, including precautions against harmful cleaning materials and methods.
- G. Submit warranty documents specified herein.

1.03 QUALITY ASSURANCE

- A. Supplier: Obtain all products in this section from a single supplier.
- B. Installer: Installation shall be performed by installer specialized and experienced in work similar to that required for this project.

1.04 DELIVERY, STORAGE, AND HANDLING

- A. Comply with requirements of Division 01.
 - 1. Comply with manufacturer's ordering instructions and lead time requirements to avoid construction delays.
 - 2. Deliver products in manufacturer's original, unopened, undamaged containers with identification labels intact.
 - 3. Store products protected from weather, temperature, and other harmful conditions as recommended by supplier.
 - 4. Handle products in accordance with manufacturer's instructions.

HMC Architects

1.05 WARRANTY

- A. Project Warranty: Comply with requirements of Division 01.
- B. Manufacturer's Warranty: Submit manufacturer's standard warranty document executed by authorized company official.
 - 1. Warranty Period: One year from product ship date. Warranty specifically excludes letter mounting substrate.

PART 2 - PRODUCTS

2.01 SIGNAGE SYSTEMS

- A. Acceptable Manufacturers
 - 1. ASI-Modulex, Dallas, TX.
 - 2. A.R.K. Ramos, Oklahoma City, OK.
 - 3. Gemini Incorporated, Cannon Falls, MN.
- B. Or equal as approved in accordance with Division 01, General Requirements for substitutions.

2.02 CUT METAL LETTERS - DIMENSIONAL LETTERS

- A. Graphic Material: ASI LPS (Cut Metal Letters) Series or equal.
 - 1. Material: Aluminum.
- B. Fabricated Letter:
 - 1. Letterstyle: As indicated on drawings.
 - 2. Height: 15-inches, unless noted otherwise.
 - 3. Depth: 2-inches.
 - 4. Thickness: As indicated on Drawings.
 - 5. Finish: Baked Enamel, both sides.
 - 6. Color: As selected by Architect.
- C. Mounting Method: F-3 Mounting, aluminum clips with threaded insert for stud mount. No visible fasteners.

2.03 FABRICATION - GENERAL

- A. General: Comply with requirements indicated for materials, thicknesses, finishes, colors, designs, shapes, sizes, and details of construction.
- B. Conceal fasteners if possible; otherwise, locate fasteners where they will be inconspicuous.
- C. Create signage to required sizes and layout. Comply with requirements indicated for design, dimensions, finish, color, and details of construction.

HMC Architects

PART 3 - EXECUTION

3.01 EXAMINATION

- A. Site Verification of Conditions: Verify installation conditions previously established under other sections are acceptable for product installation in accordance with manufacturer's instructions.
- B. Scheduling of installation by Owner or its representative implies that substrate and conditions are prepared and ready for product installation. Proceeding with installation implies installer's acceptance of substrate and conditions.


3.02 INSTALLATION

- A. Install letters in accordance with manufacturer's written installation instructions.
- B. Install letters in locations indicated using mounting methods specified and free from distortion, warp, or defect adversely affecting appearance.
- C. Install letters level, plumb, and at heights indicated per mounting specified.
- D. Install signs within the following tolerances and in accordance with manufacturer's recommendations.
- E. Exterior Signs: Within 1 inch vertically and horizontally of intended location.

3.03 CLEANING, PROTECTION, AND REPAIR

- A. Repair scratches and other damage which might have occurred during installation. Replace components where repairs were made but are still visible to the unaided eye from a distance of 10 feet.
- B. Remove temporary coverings and protection to adjacent work areas. Clean installed products in accordance with manufacturer's instructions prior to Owner's acceptance. Remove construction debris from project in accordance with provisions in Division 01.

END OF SECTION

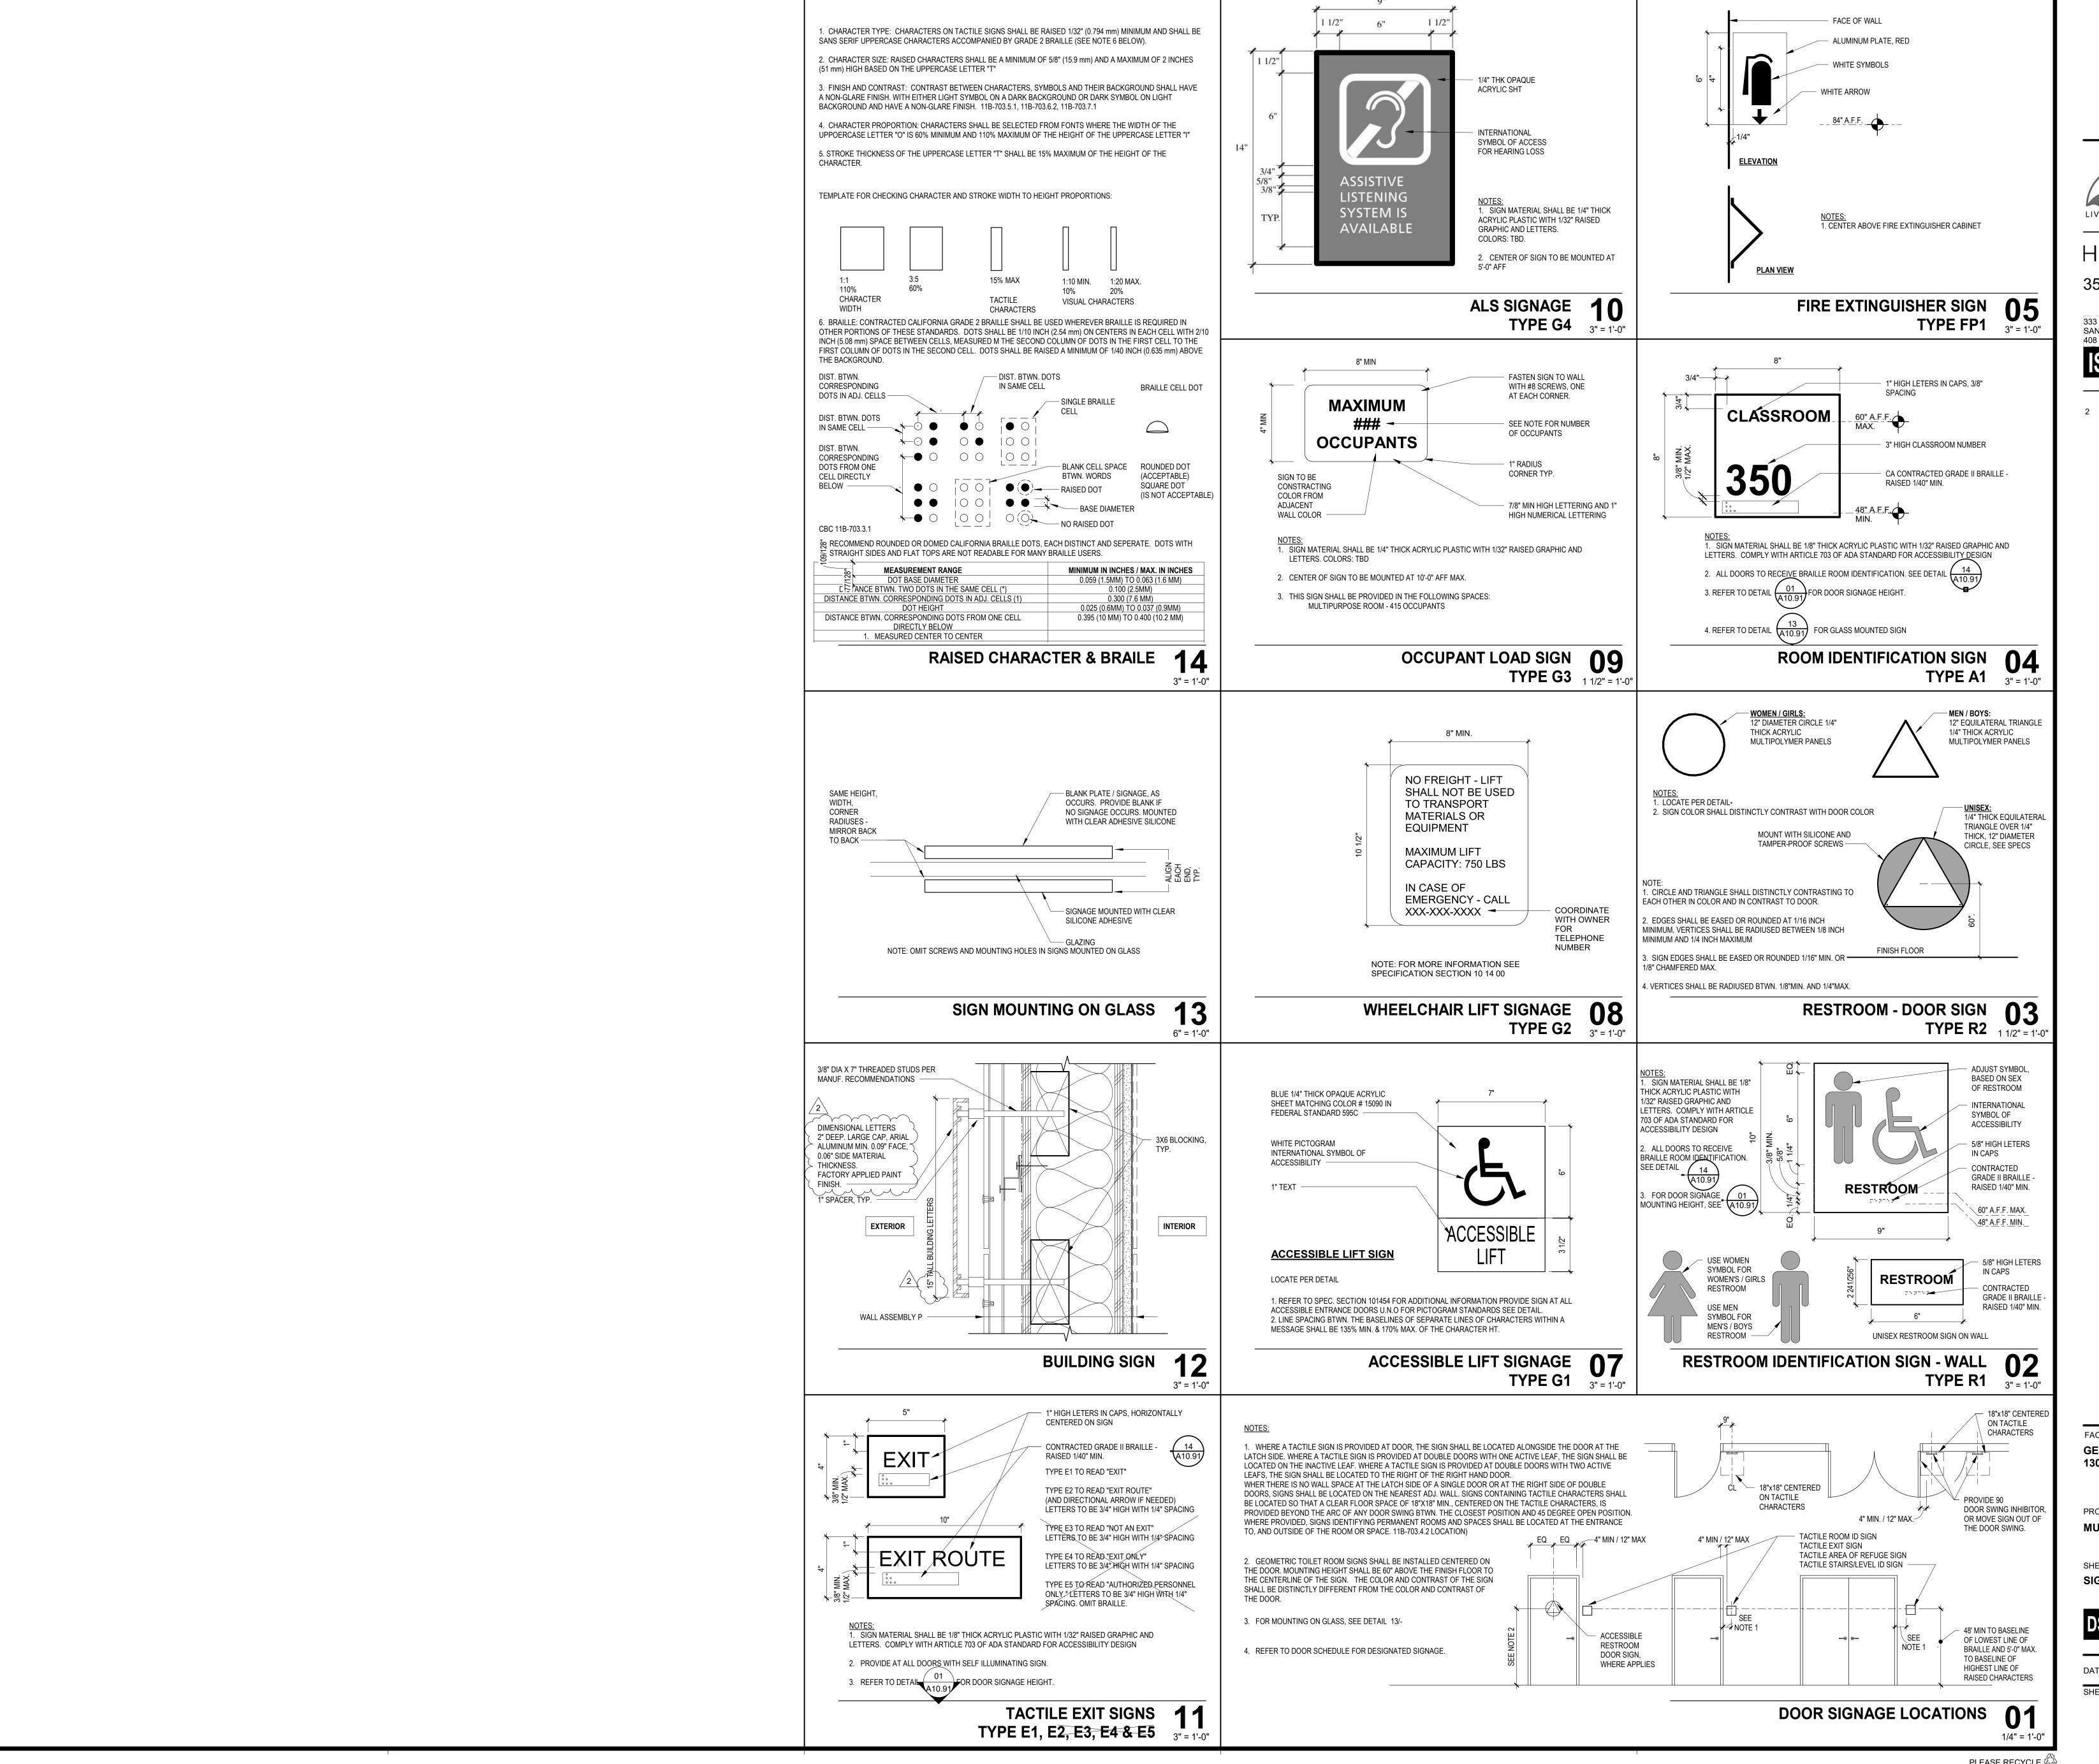

AGENCY APPROVAL: DSA # 01-119574 FILE # 41-26

SAN MATEO-FOSTER CITY SCHOOL DISTRICT 1170 CHESS DR., FOSTER CITY, CA 94404 LIVE·LEAD·LEARN

HMC Architects 3542004-000

333 W. SAN CARLOS STREET, #750 SAN JOSE, CA 95110

408 977 9160 / www.hmcarchitects.com DESCRIPTION

DATE

11.24.2021

2 PRE-BID ADDENDUM 03

GEORGE HALL ELEMENTARY SCHOOL 130 SAN MIGUEL WAY, SAN MATEO, CA 94403


PROJECT: MULTIPURPOSE BUILDING AND SITE WORK

SHEET NAME: **SIGNAGE DETAILS**

DSA BACKCHECK

DATE: 10.04.2021 PROJ NO: **3542-004**

PLEASE RECYCLE 🖧

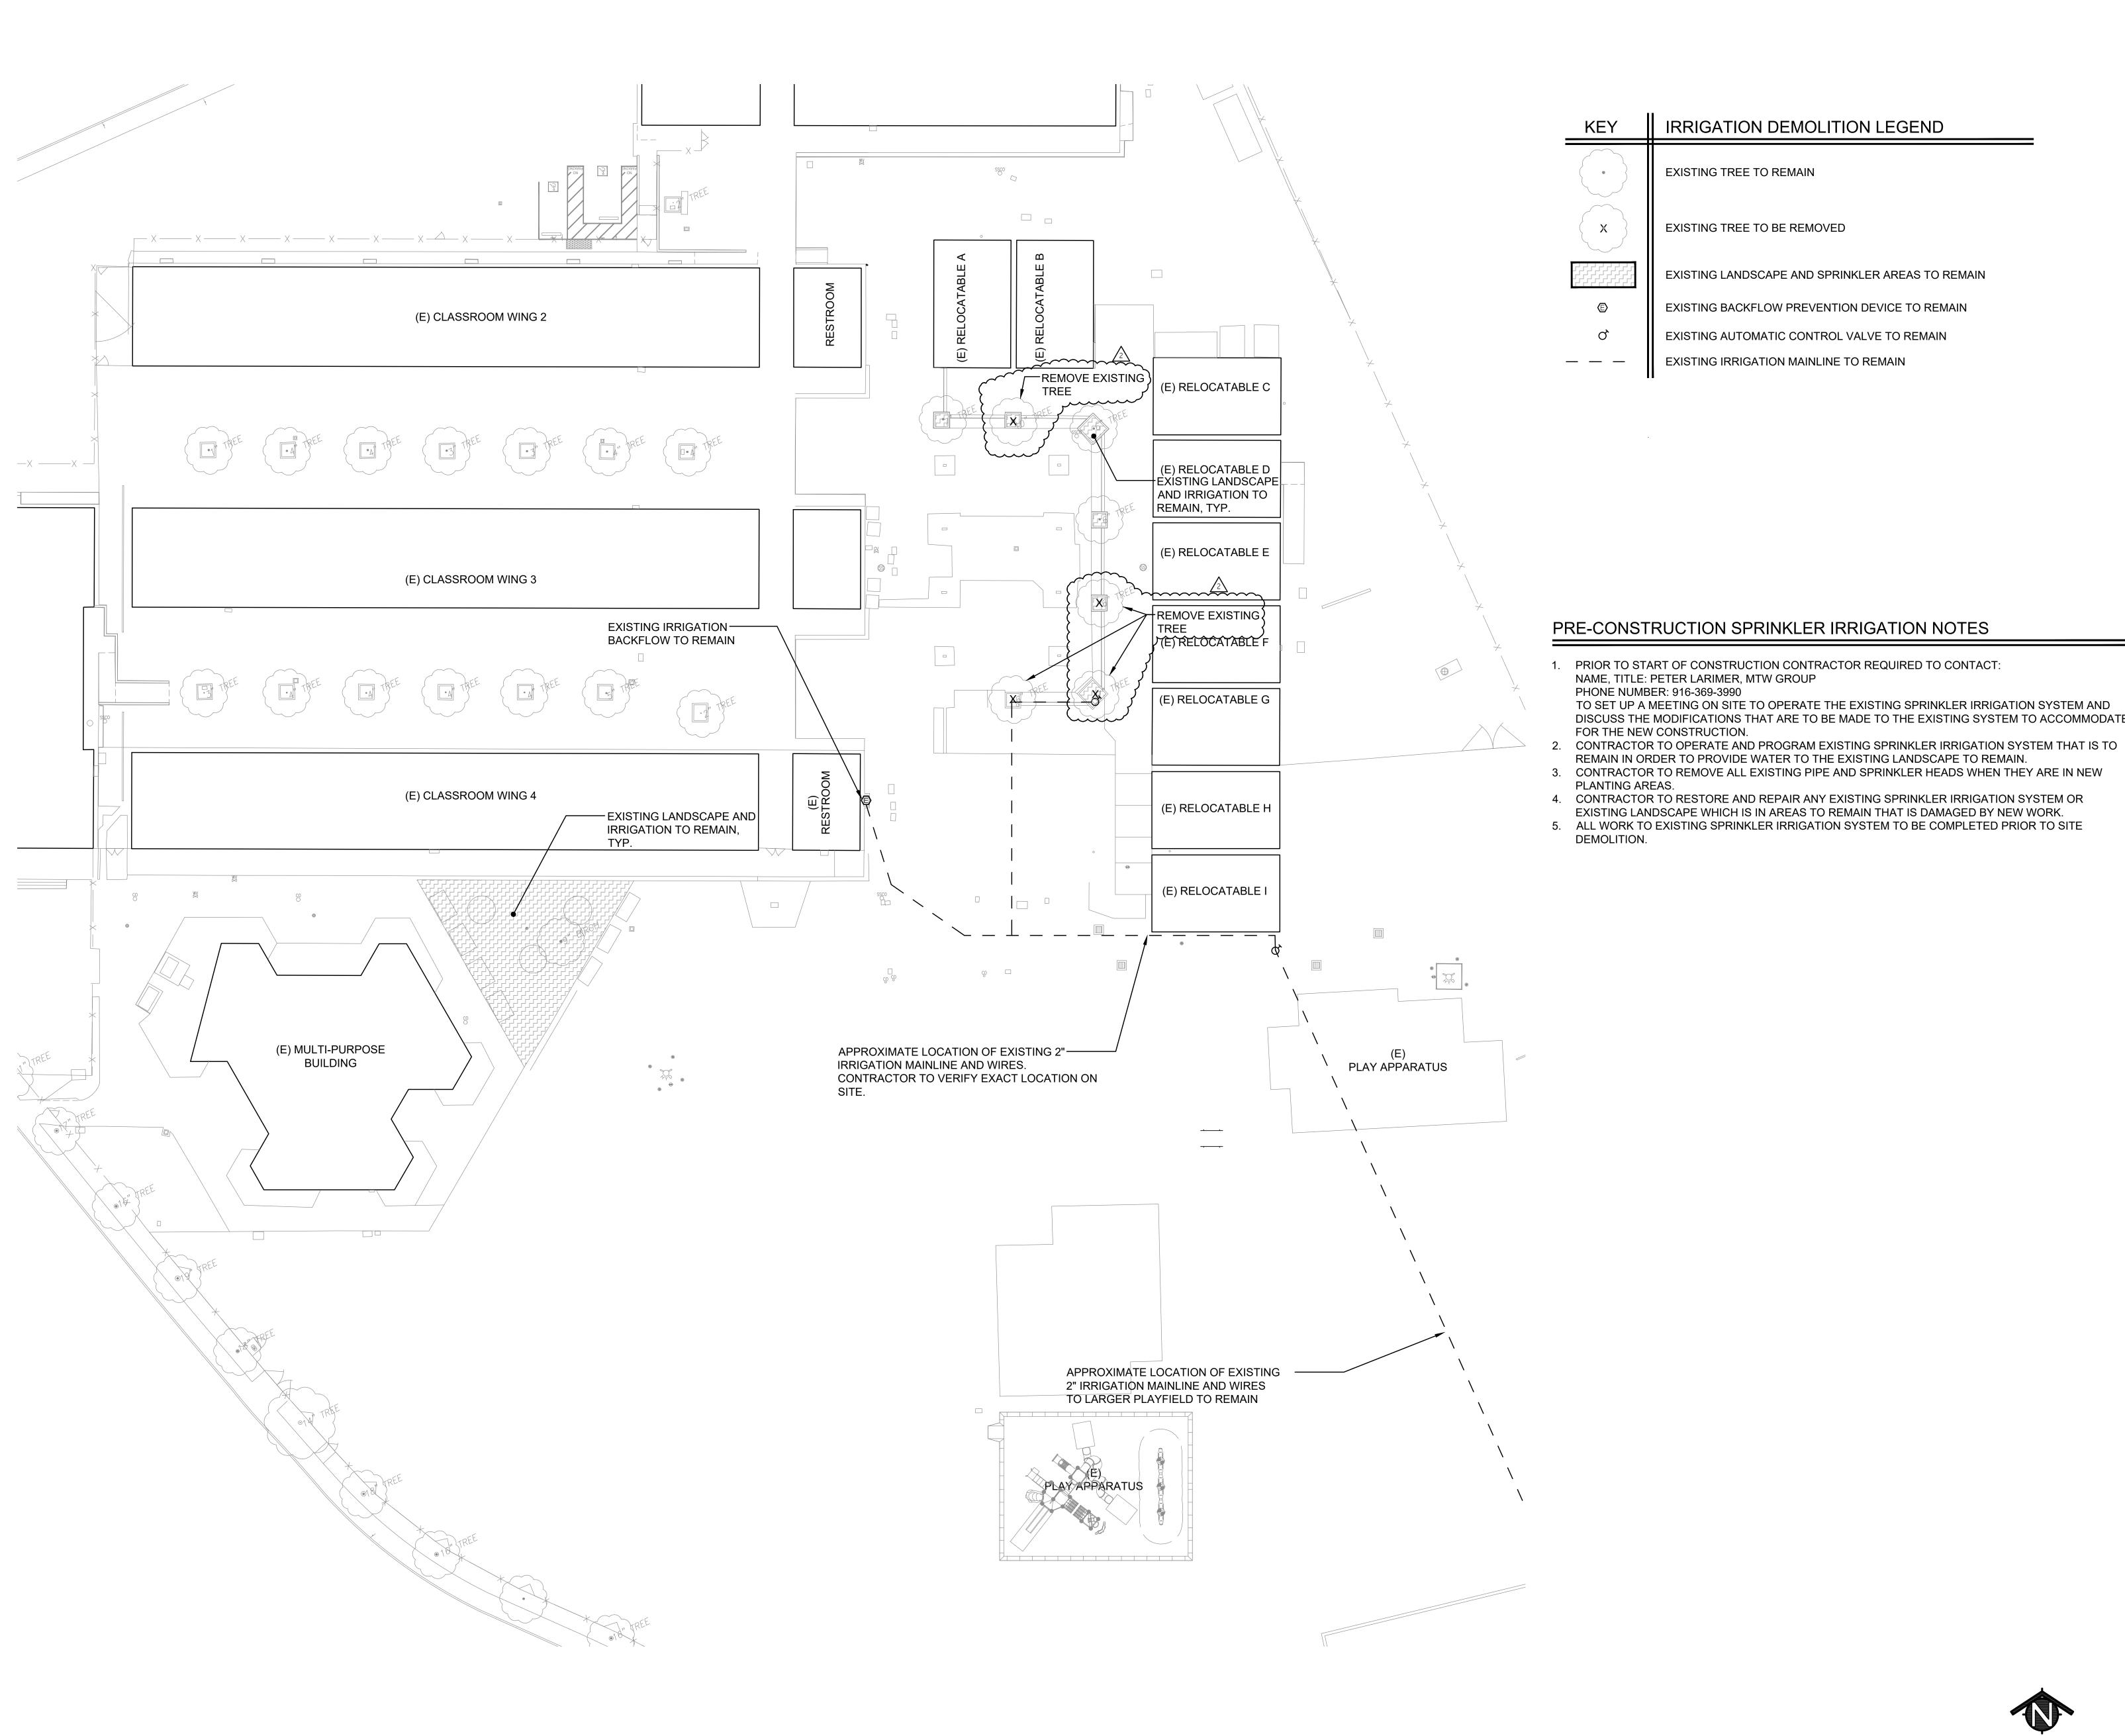

EXISTING TREE TO BE REMOVED

EXISTING LANDSCAPE AND SPRINKLER AREAS TO REMAIN

EXISTING BACKFLOW PREVENTION DEVICE TO REMAIN

EXISTING IRRIGATION MAINLINE TO REMAIN

PRE-CONSTRUCTION SPRINKLER IRRIGATION NOTES

PRIOR TO START OF CONSTRUCTION CONTRACTOR REQUIRED TO CONTACT: NAME, TITLE: PETER LARIMER, MTW GROUP

TO SET UP A MEETING ON SITE TO OPERATE THE EXISTING SPRINKLER IRRIGATION SYSTEM AND DISCUSS THE MODIFICATIONS THAT ARE TO BE MADE TO THE EXISTING SYSTEM TO ACCOMMODATE

REMAIN IN ORDER TO PROVIDE WATER TO THE EXISTING LANDSCAPE TO REMAIN. 3. CONTRACTOR TO REMOVE ALL EXISTING PIPE AND SPRINKLER HEADS WHEN THEY ARE IN NEW

4. CONTRACTOR TO RESTORE AND REPAIR ANY EXISTING SPRINKLER IRRIGATION SYSTEM OR

EXISTING LANDSCAPE WHICH IS IN AREAS TO REMAIN THAT IS DAMAGED BY NEW WORK.

5. ALL WORK TO EXISTING SPRINKLER IRRIGATION SYSTEM TO BE COMPLETED PRIOR TO SITE

AND PLANNING 2707 K Street, Suite 201 Sacramento, CA 95816 916 369-3990

AGENCY APPROVAL: DSA #01-119574

FILE #41-26



SAN MATEO FOSTER CITY SCHOOL DISTRICT 1170 CHESS DR., FOSTER CITY, CA 94404

HMC Architects


3542004-000

408 977 9160 / www.hmcarchitects.com

SAN JOSE, CA 95110

333 WEST SAN CARLOS STREET, STUDIO 750

	SSUE	
	DESCRIPTION	DATE
2	ADDENDUM #3	11.24.2021

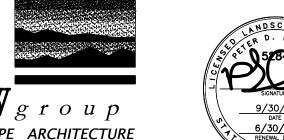

LANDSCAPE ARCHITECTURE



GEORGE HALL ELEMENTARY SCHOOL 130 SAN MIGUEL WAY, SAN MATEO, CA 94403

MULTIPURPOSE BUILDING AND SITE WORK


IRRIGATION DEMOLITION PLAN

DSA BACKCHECK

PROJ NO: **3542-004**

SCALE: 1"= 20'-0"

NOTE: SEE SHEET L5.1 FOR SHADING CALCULATIONS.

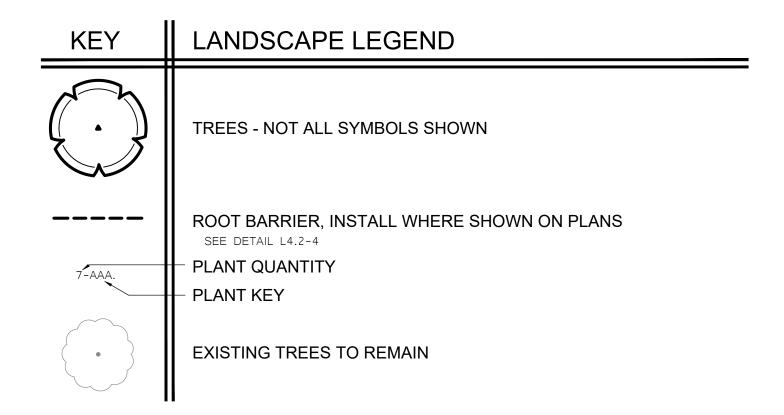

PLANT MATERIAL LIST

SIZE	QUANTITY	KEY	BOTANICAL NAME COMMON NAME	
			TREES:	
24" BOX 24" BOX 24" BOX	4 5 3	ACE.B. ACE.C. BRA.	ACER BUEGERIANUM TRIDENT MAPLE ACER CIRCINATUM VINE MAPLE BRACHYCHITON ACERIFOLIUS FLAME TREE	
24" BOX 24" BOX	1 4	GIN. LAU.	GINKGO BILOBA 'SARTOGA' MAINDENHAIR TREE LAURUS NOBILIS SWEET BAY	

GENERAL LANDSCAPE REQUIREMENTS/NOTES

- 1. NO PLANTING SHALL BE STARTED UNTIL SPRINKLER IRRIGATION SYSTEM HAS BEEN TESTED BY CONTRACTOR IN PRESENCE OF OWNER'S REPRESENTATIVE AND NOTED DEFICIENCIES CORRECTED.
- 2. NO PLANTING SHALL BE STARTED UNTIL SOIL PREPARATION AND FINISH GRADING OPERATIONS HAVE BEEN COMPLETED AND APPROVED BY THE OWNER'S REPRESENTATIVE.
- 3. QUANTITIES SHOWN ON PLANT MATERIAL LIST ARE APPROXIMATE. PROVIDE QUANTITIES INDICATED ON LANDSCAPE PLAN.
- 4. PLANT MATERIAL IS SUBJECT TO APPROVAL OF OWNER'S REPRESENTATIVE.
- 5. SEE SHEET L4.2 FOR PLANTING INSTALLATION DETAILS.

ENVIRONMENTAL REQUIREMENTS:

GENERAL: PROCEED WITH WORK IN ORDERLY AND TIMELY MANNER TO COMPLETE INSTALLATION OF LANDSCAPING WITHIN CONTRACT LIMITS.

PROTECTION:

EXISTING CONSTRUCTION: EXECUTE WORK IN AN ORDERLY AND CAREFUL MANNER TO PROTECT NEW CONCRETE WALKS, WORK OF OTHER TRADES, AND OTHER IMPROVEMENTS.

EXISTING UTILITIES: DETERMINE LOCATION OF UNDERGROUND UTILITIES AND PERFORM WORK IN A MANNER WHICH WILL AVOID POSSIBLE DAMAGE. HAND EXCAVATE, AS REQUIRED, TO MINIMIZE POSSIBILITY OF DAMAGE TO UNDERGROUND UTILITIES. MAINTAIN GRADE STAKES SET BY OTHERS UNTIL REMOVAL IS MUTUALLY AGREED UPON BY ALL PARTIES CONCERNED. BE RESPONSIBLE FOR PROTECTION OF EXISTING UTILITIES WITHIN CONSTRUCTION AREA; REPAIR DAMAGE TO UTILITIES THAT OCCUR AS A RESULT OF OPERATIONS OF THIS WORK.

LANDSCAPING: PROTECT LANDSCAPE WORK AND MATERIALS FROM DAMAGE DUE TO LANDSCAPE OPERATIONS, OPERATIONS BY OTHER CONTRACTORS AND TRADES AND TRESPASSERS. MAINTAIN PROTECTION DURING INSTALLATION AND MAINTENANCE PERIODS. TREAT, REPAIR OR REPLACE DAMAGED LANDSCAPE WORK AS DIRECTED AT NO ADDITIONAL COST TO CONTRACT.

ADVERSE CONDITIONS: WHEN CONDITIONS DETRIMENTAL TO SOD OR PLANT GROWTH ARE ENCOUNTERED, SUCH AS RUBBLE FILL, ADVERSE DRAINAGE CONDITIONS, OR OBSTRUCTIONS, NOTIFY OWNER'S REPRESENTATIVE BEFORE STARTING WORK.

PLANTING AND TURF INSTALLATION SEASONS AND CONDITIONS

NO WORK SHALL BE DONE WHEN GROUND IS FROZEN, SNOW COVERED, TOO WET OR IN AN OTHERWISE UNSUITABLE CONDITION FOR AMENDING SOIL, FINISH GRADING OR PLANTING.

SOIL TESTING/SOIL IMPROVEMENT:

SEE SPECIFICATIONS 32 90 00, SECTION 3.02 SOIL TESTING AND SECTION 3.03 PREPARATION.

SOIL PERCOLATION

EXCAVATE 10 PLANTING PITS IN RANDOM AREAS OF SITE. FILL EXCAVATED PLANTING PITS WITH WATER TO 1/2 DEPTH OF PIT. PITS SHOULD DRAIN WITHIN 4 HOURS. IF PLANTING PITS DO NOT DRAIN, NOTIFY INSPECTOR IMMEDIATELY. PLANTING SHALL NOT BE STARTED UNTIL OWNER'S REPRESENTATIVE HAS RESOLVED A METHOD TO REMEDY DRAINAGE ISSUE.

PLANT MATERIAL STANDARDS

PLANTS SHALL BE IN ACCORDANCE WITH AMERICAN NATIONAL STANDARDS INSTITUTE (ANSI) ANSI Z60.1-AMERICAN STANDARD FOR NURSERY STOCK, EXCEPT AS OTHERWISE STATED IN SPECIFICATIONS OR SHOWN ON DRAWINGS. WHERE DRAWINGS OR SPECIFICATIONS ARE IN CONFLICT WITH ANSI Z60.1, DRAWINGS AND SPECIFICATIONS SHALL PREVAIL. PRUNE, THIN OUT AND SHAPE TREES IN ACCORDANCE WITH ANSI STANDARD HORTICULTURAL PRACTICE. PRUNE TREES TO RETAIN REQUIRED HEIGHT AND SPREAD. UNLESS OTHERWISE DIRECTED BY LANDSCAPE ARCHITECT, DO NOT CUT TREE LEADERS, AND REMOVE ONLY INJURED OR DEAD BRANCHES FROM FLOWERING TREES.

EXISTING LANDSCAPE AND SPRINKLER IRRIGATION SYSTEM

WORK LIMITS OF THIS PROJECT EXTEND INTO AREAS THAT WERE PREVIOUSLY DEVELOPED UNDER OTHER CONTRACTS. PRIOR TO START OF WORK, CONTRACTOR SHALL MEET WITH OWNER'S REPRESENTATIVE TO LOCATE ALL CONNECTIONS CALLED FOR ON DRAWINGS. WORK LIMITS/FENCING SHALL BE LAID OUT BY CONTRACTOR AND VERIFIED BY OWNER'S REPRESENTATIVE. FENCE TO BE INSTALLED AND IRRIGATION SYSTEM SHALL BE TESTED WITH CONTRACTOR, INSPECTOR, AND OWNER'S REPRESENTATIVE PRESENT. DEFICIENCIES SHALL BE NOTED AT THIS TIME AND ARE THE RESPONSIBILITY OF OWNER. AT COMPLETION OF WORK, SYSTEM WILL AGAIN BE TESTED, DEFICIENCIES NOTED AT THIS TIME THAT WERE NOT NOTED PREVIOUSLY WILL BE RESPONSIBILITY OF CONTRACTOR. EXISTING LANDSCAPE THAT HAS BEEN DAMAGED DUE TO CONSTRUCTION SHALL BE RESTORED TO ORIGINAL CONDITION BY CONTRACTOR AT NO ADDITIONAL COST TO OWNER. PRIOR TO MAKING ANY CONNECTION TO MAIN LINE, CONTRACTOR SHALL NOTIFY OWNER 1 WEEK IN ADVANCE SO ADJUSTMENTS TO EXISTING WATERING PROGRAMS CAN BE MADE.

AGENCY APPROVAL: DSA #01-119574 FILE #41-26



SAN MATEO FOSTER CITY SCHOOL DISTRICT 1170 CHESS DR., FOSTER CITY, CA 94404

HMC Architects


3542004-000

SAN JOSE, CA 95110


333 WEST SAN CARLOS STREET, STUDIO 750

408 977 9160 / www.hmcarchitects.com

	ISSUE	
	DESCRIPTION	DATE
2	ADDENDUM #3	11.24.2021

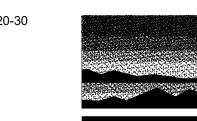

LANDSCAPE ARCHITECTURE AND PLANNING 2707 K Street, Suite 201 Sacramento, CA 95816 916 369-3990

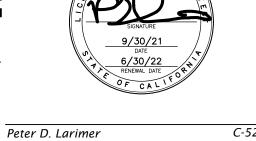


GEORGE HALL ELEMENTARY SCHOOL 130 SAN MIGUEL WAY, SAN MATEO, CA 94403


MULTIPURPOSE BUILDING AND SITE WORK


SHEET NAME: TREE PLANTING PLAN

DSA BACKCHECK

PROJ NO: **3542-004**

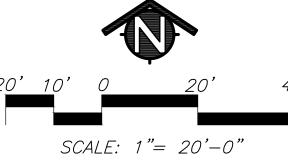

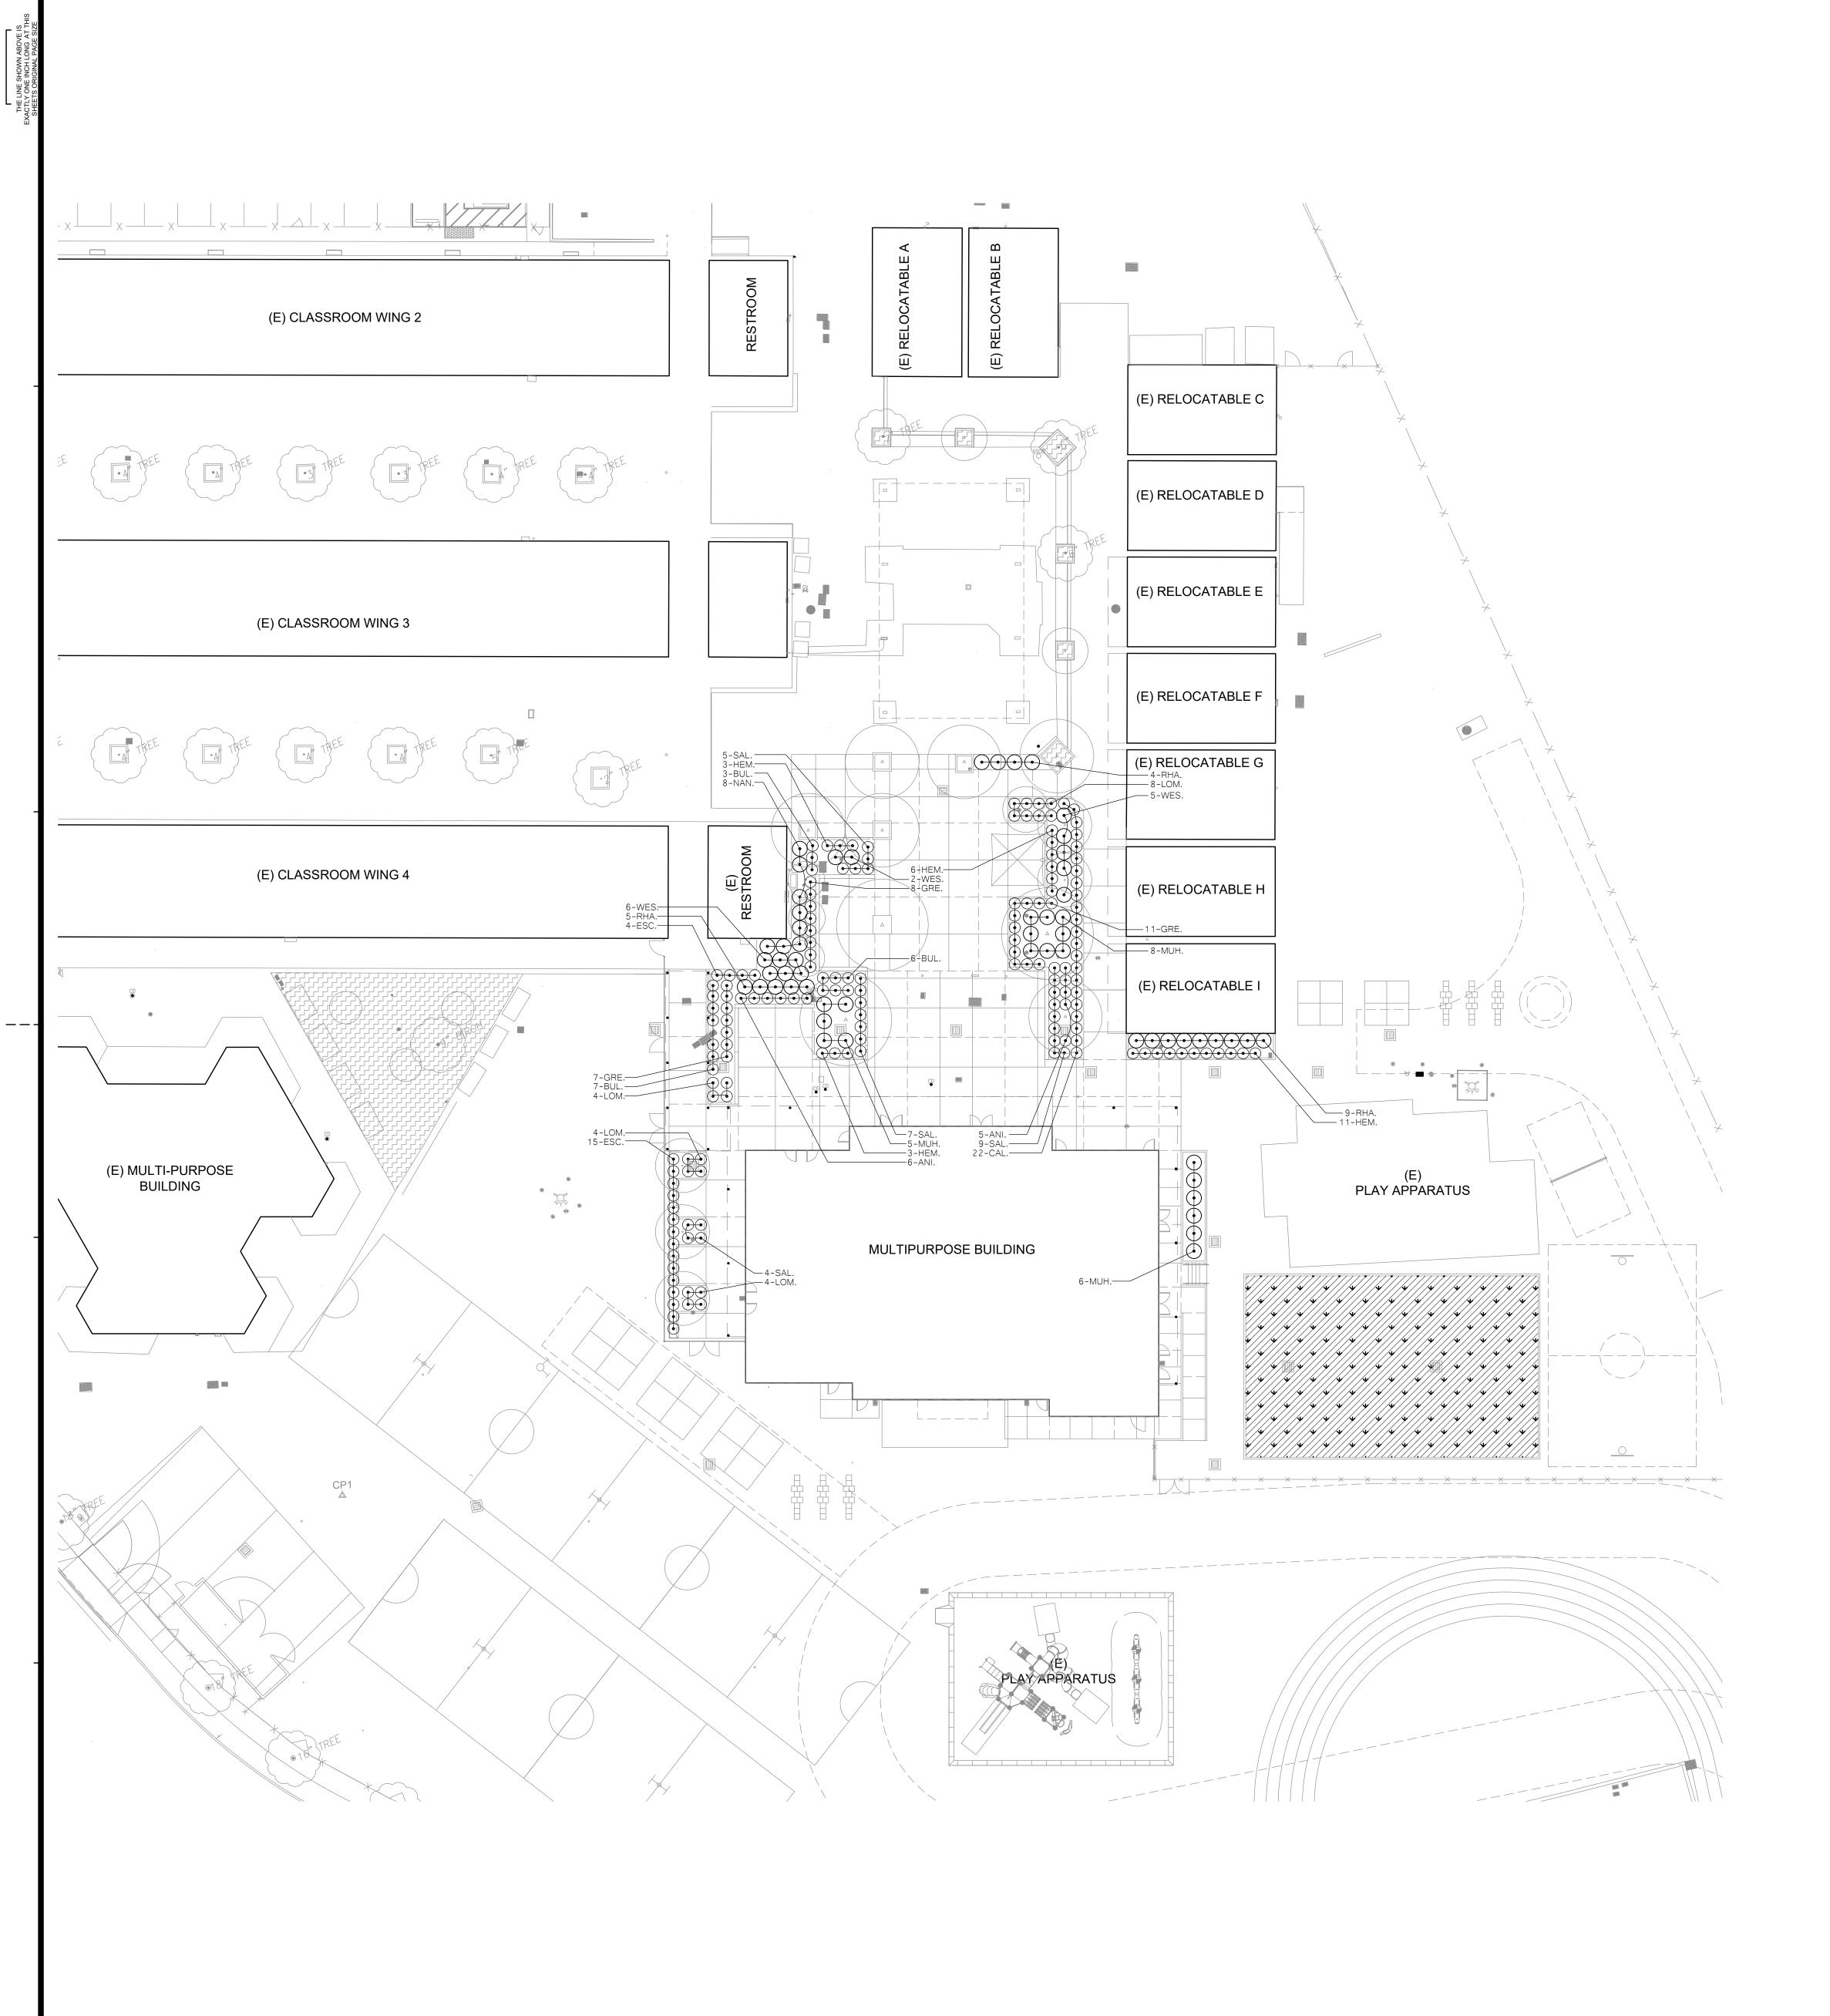

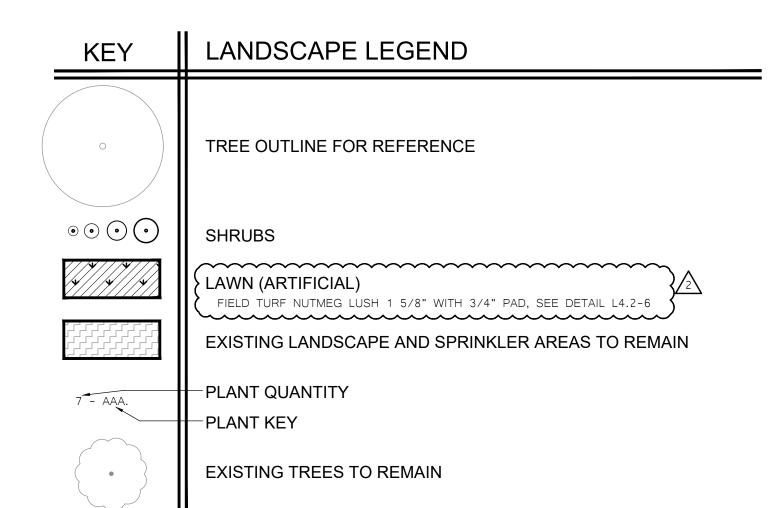

PROPOSED PLANT MATERIAL LIST

WATER USE	SIZE	QUANTITY	KEY BOTANICAL NAME COMMON NAME	
				SHRUBS:
LOW LOW	5 G.C. 5 G.C.	11 16	ANI. BUL.	ANIGOZANTHOS 'BIG RED' HYBRID KANGROO PAW BULBINE FRUCTESCENS ORANGE ORANGE BULBINE
LOW	5 G.C.	22	CAL.	CALLISTEMON VIMINALIS 'LITTLE JOHN' DWARF BOTTLE BRUSH
LOW	5 G.C.	19	ESC.	ESCALLONIA RUBRA 'NEWPORT DWARF' DWARF ESCALLONIA
LOW LOW	5 G.C. 5 G.C.	23 26	HEM. GRE.	HEMEROCALLIS SPP ORANGE EVERGREEN DAYLILY GREVILLEA LANIGERA 'MT. TAMBORITHA' WOOLY GREVILLEA
LOW	5 G.C.	20	LOM.	LOMANDRA LONGIFOLIA 'ROMA13' PLATINUM BEAUTY LOMANDRA
LOW	5 G.C.	19	MUH.	MUHLENBERGIA RIGENS DEER GRASS
LOW	5 G.C.	8	NAN.	NANDINA DOMESTICA HEAVENLY BAMBOO
LOW	5 G.C.	18	RHA.	RHAPHIOLEPIS UMBELLATA 'MINOR' YEDDO HAWTHORN
LOW	5 G.C.	25	SAL.	SALVIA CHAMAEDRYOIDES GERMANDER SAGE
LOW	5 G.C.	13	WES.	WESTRINGIA 'MORNING LIGHT' VARIEGATED AUSTRALIAN ROSEMARY

SUNSET ZONE 17

GENERAL LANDSCAPE REQUIREMENTS/NOTES

- 1. NO PLANTING SHALL BE STARTED UNTIL SPRINKLER IRRIGATION SYSTEM HAS BEEN TESTED BY CONTRACTOR IN PRESENCE OF OWNER'S REPRESENTATIVE AND NOTED DEFICIENCIES CORRECTED.
- 2. NO PLANTING SHALL BE STARTED UNTIL SOIL PREPARATION AND FINISH GRADING OPERATIONS HAVE BEEN COMPLETED AND APPROVED BY THE OWNER'S REPRESENTATIVE.
- 3. QUANTITIES SHOWN ON PLANT MATERIAL LIST ARE APPROXIMATE. PROVIDE QUANTITIES INDICATED ON LANDSCAPE PLAN.
- 4. PLANT MATERIAL IS SUBJECT TO APPROVAL OF OWNER'S REPRESENTATIVE.
- 5. SEE SHEET L4.2 FOR PLANTING INSTALLATION DETAILS.

ENVIRONMENTAL REQUIREMENTS:

GENERAL: PROCEED WITH WORK IN ORDERLY AND TIMELY MANNER TO COMPLETE INSTALLATION OF LANDSCAPING WITHIN CONTRACT LIMITS.

PROTECTION:

EXISTING CONSTRUCTION: EXECUTE WORK IN AN ORDERLY AND CAREFUL MANNER TO PROTECT NEW CONCRETE WALKS, WORK OF OTHER TRADES, AND OTHER IMPROVEMENTS.

EXISTING UTILITIES: DETERMINE LOCATION OF UNDERGROUND UTILITIES AND PERFORM WORK IN A MANNER WHICH WILL AVOID POSSIBLE DAMAGE. HAND EXCAVATE, AS REQUIRED, TO MINIMIZE POSSIBILITY OF DAMAGE TO UNDERGROUND UTILITIES. MAINTAIN GRADE STAKES SET BY OTHERS UNTIL REMOVAL IS MUTUALLY AGREED UPON BY ALL PARTIES CONCERNED. BE RESPONSIBLE FOR PROTECTION OF EXISTING UTILITIES WITHIN CONSTRUCTION AREA; REPAIR DAMAGE TO UTILITIES THAT OCCUR AS A RESULT OF OPERATIONS OF THIS WORK.

LANDSCAPING: PROTECT LANDSCAPE WORK AND MATERIALS FROM DAMAGE DUE TO LANDSCAPE OPERATIONS, OPERATIONS BY OTHER CONTRACTORS AND TRADES AND TRESPASSERS. MAINTAIN PROTECTION DURING INSTALLATION AND MAINTENANCE PERIODS. TREAT, REPAIR OR REPLACE DAMAGED LANDSCAPE WORK AS DIRECTED AT NO ADDITIONAL COST TO CONTRACT.

ADVERSE CONDITIONS: WHEN CONDITIONS DETRIMENTAL TO SOD OR PLANT GROWTH ARE ENCOUNTERED, SUCH AS RUBBLE FILL, ADVERSE DRAINAGE CONDITIONS, OR OBSTRUCTIONS, NOTIFY OWNER'S REPRESENTATIVE BEFORE STARTING WORK.

PLANTING AND TURF INSTALLATION SEASONS AND CONDITIONS

NO WORK SHALL BE DONE WHEN GROUND IS FROZEN, SNOW COVERED, TOO WET OR IN AN OTHERWISE UNSUITABLE CONDITION FOR AMENDING SOIL, FINISH GRADING OR PLANTING.

SOIL TESTING/SOIL IMPROVEMENT:

SOIL TESTING/SOIL IMPROVEMENT:

SEE SPECIFICATIONS 32 90 00, SECTION 3.02 SOIL TESTING AND SECTION 3.03 PREPARATION.

SOIL PERCOLATION

EXCAVATE 10 PLANTING PITS IN RANDOM AREAS OF SITE. FILL EXCAVATED PLANTING PITS WITH WATER TO 1/2 DEPTH OF PIT. PITS SHOULD DRAIN WITHIN 4 HOURS. IF PLANTING PITS DO NOT DRAIN, NOTIFY INSPECTOR IMMEDIATELY. PLANTING SHALL NOT BE STARTED UNTIL OWNER'S REPRESENTATIVE HAS RESOLVED A METHOD TO REMEDY DRAINAGE ISSUE.

PLANT MATERIAL STANDARDS

PLANTS SHALL BE IN ACCORDANCE WITH AMERICAN NATIONAL STANDARDS INSTITUTE (ANSI) ANSI Z60.1-AMERICAN STANDARD FOR NURSERY STOCK, EXCEPT AS OTHERWISE STATED IN SPECIFICATIONS OR SHOWN ON DRAWINGS. WHERE DRAWINGS OR SPECIFICATIONS ARE IN CONFLICT WITH ANSI Z60.1, DRAWINGS AND SPECIFICATIONS SHALL PREVAIL. PRUNE, THIN OUT AND SHAPE TREES IN ACCORDANCE WITH ANSI STANDARD HORTICULTURAL PRACTICE. PRUNE TREES TO RETAIN REQUIRED HEIGHT AND SPREAD. UNLESS OTHERWISE DIRECTED BY LANDSCAPE ARCHITECT, DO NOT CUT TREE LEADERS, AND REMOVE ONLY INJURED OR DEAD BRANCHES FROM FLOWERING TREES.

EXISTING LANDSCAPE AND SPRINKLER IRRIGATION SYSTEM

WORK LIMITS OF THIS PROJECT EXTEND INTO AREAS THAT WERE PREVIOUSLY DEVELOPED UNDER OTHER CONTRACTS. PRIOR TO START OF WORK, CONTRACTOR SHALL MEET WITH OWNER'S REPRESENTATIVE TO LOCATE ALL CONNECTIONS CALLED FOR ON DRAWINGS. WORK LIMITS/FENCING SHALL BE LAID OUT BY CONTRACTOR AND VERIFIED BY OWNER'S REPRESENTATIVE. FENCE TO BE INSTALLED AND IRRIGATION SYSTEM SHALL BE TESTED WITH CONTRACTOR, INSPECTOR, AND OWNER'S REPRESENTATIVE PRESENT. DEFICIENCIES SHALL BE NOTED AT THIS TIME AND ARE THE RESPONSIBILITY OF OWNER. AT COMPLETION OF WORK, SYSTEM WILL AGAIN BE TESTED, DEFICIENCIES NOTED AT THIS TIME THAT WERE NOT NOTED PREVIOUSLY WILL BE RESPONSIBILITY OF CONTRACTOR. EXISTING LANDSCAPE THAT HAS BEEN DAMAGED DUE TO CONSTRUCTION SHALL BE RESTORED TO ORIGINAL CONDITION BY CONTRACTOR AT NO ADDITIONAL COST TO OWNER. PRIOR TO MAKING ANY CONNECTION TO MAIN LINE, CONTRACTOR SHALL NOTIFY OWNER 1 WEEK IN ADVANCE SO ADJUSTMENTS TO EXISTING WATERING PROGRAMS CAN BE MADE.

AGENCY APPROVAL: DSA #01-119574 FILE #41-26



SAN MATEO FOSTER CITY SCHOOL DISTRICT 1170 CHESS DR., FOSTER CITY, CA 94404

HMC Architects


3542004-000

SAN JOSE, CA 95110


333 WEST SAN CARLOS STREET, STUDIO 750

408 977 9160 / www.hmcarchitects.com

	ISSUE	
	DESCRIPTION	DATE
2	ADDENDUM #3	11.24.2021

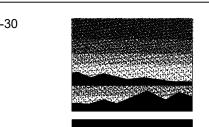

MTW g f O U p
LANDSCAPE ARCHITECTURE
AND PLANNING
2707 K Street, Suite 201
Sacramento, CA 95816
916 369-3990

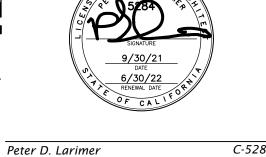

FACILITY:

GEORGE HALL ELEMENTARY SCHOOL 130 SAN MIGUEL WAY, SAN MATEO, CA 94403

PROJECT:

MULTIPURPOSE BUILDING AND SITE WORK


SHEET NAME: SHRUB PLANTING PLAN


DSA BACKCHECK

DATE: **10.04.2021**

SCALE: 1"= 20'-0"

PROJ NO: **3542-004**

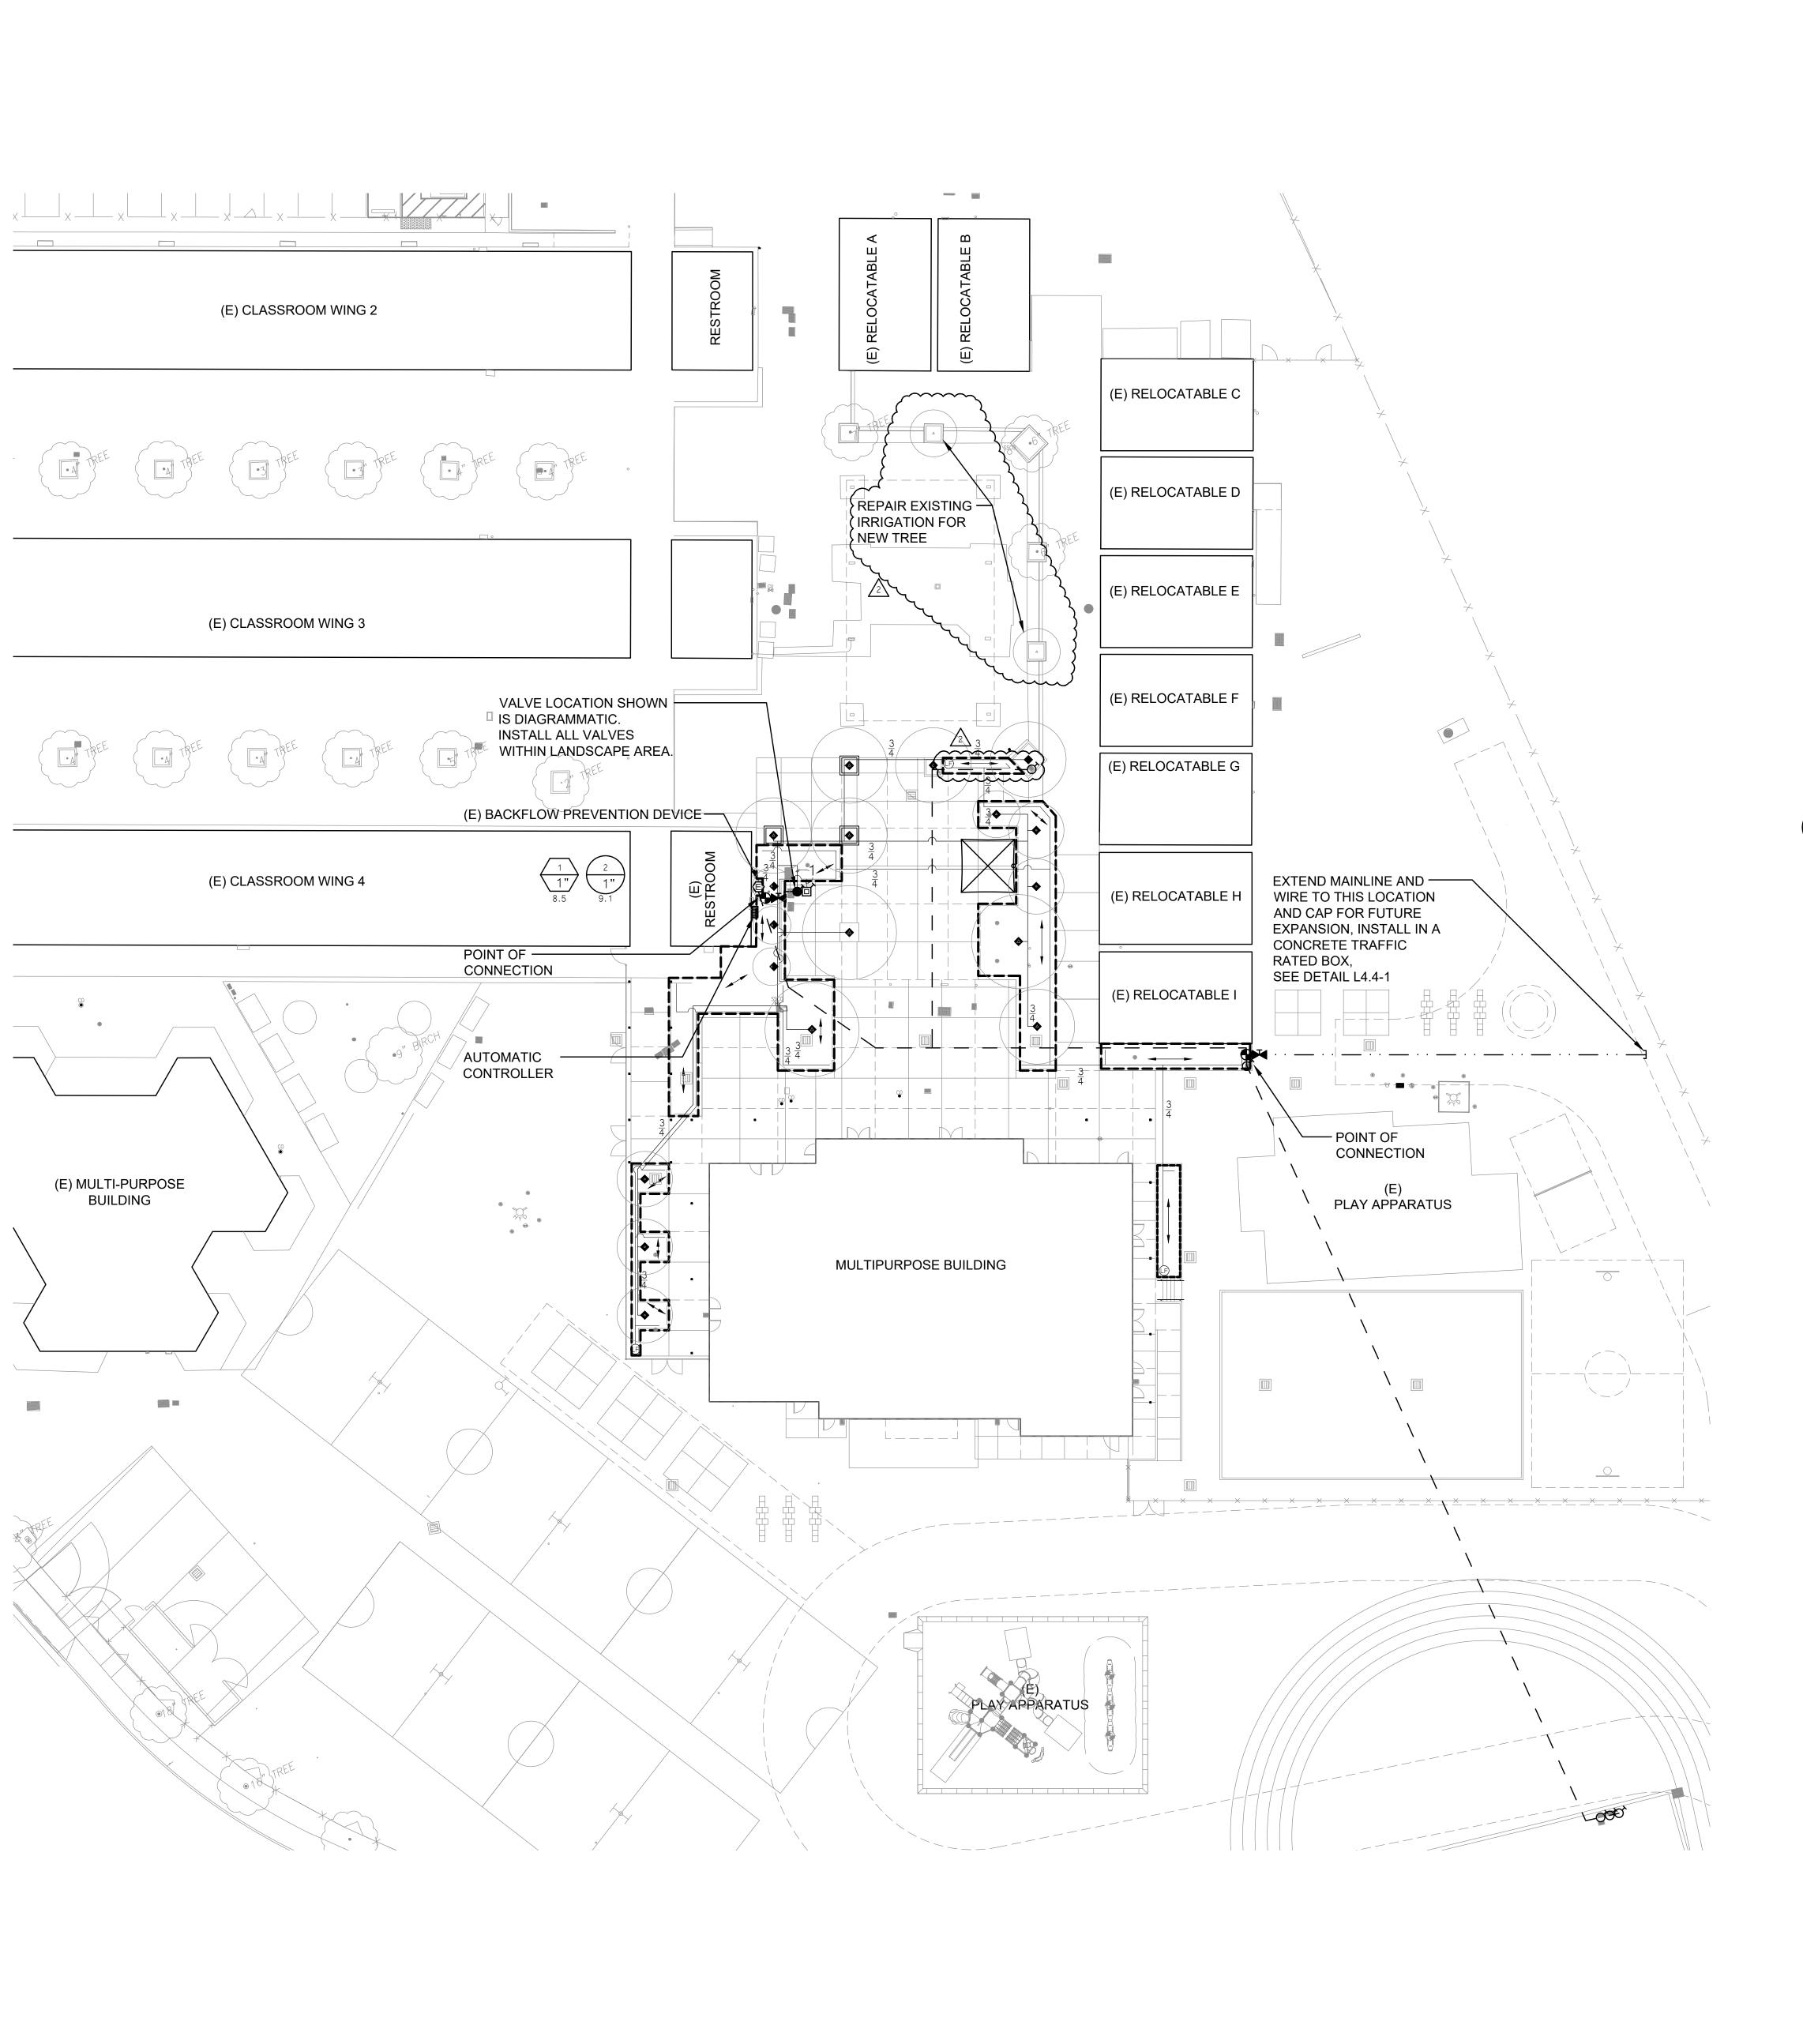

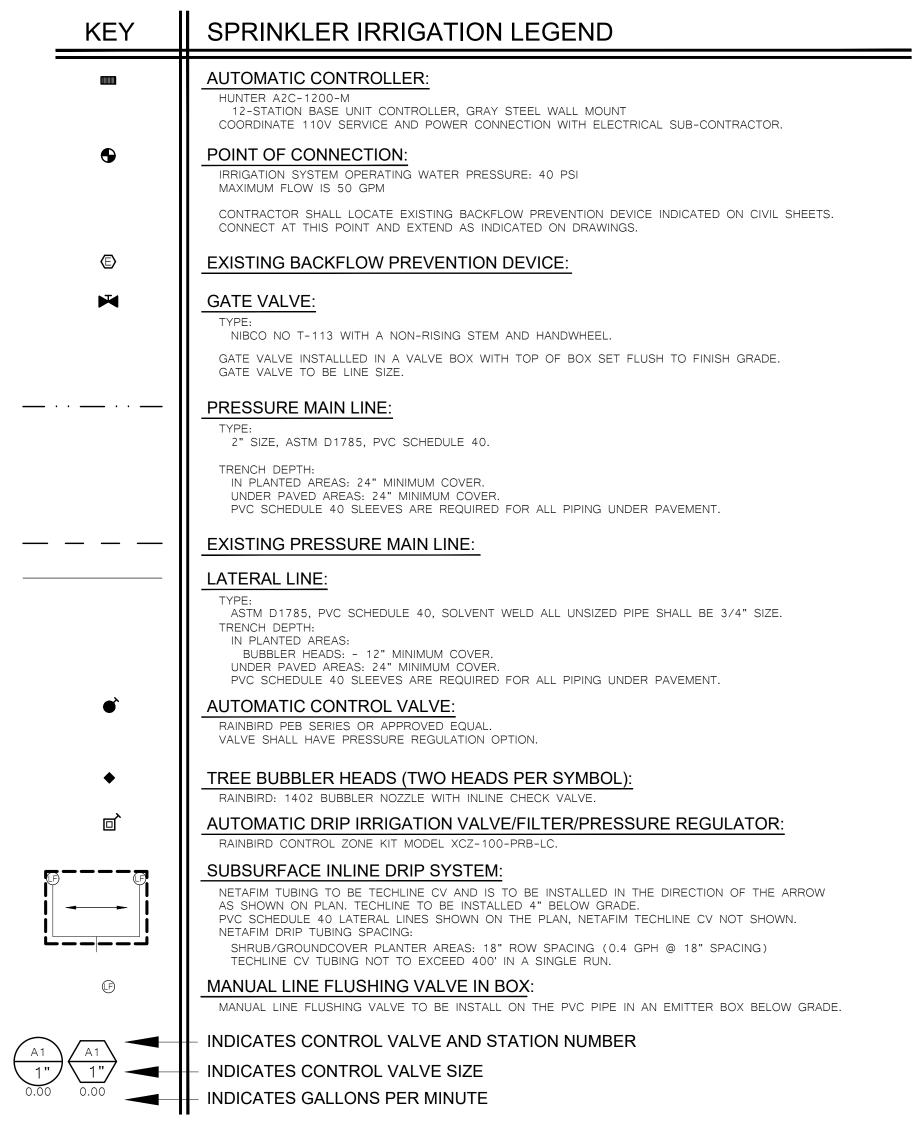

SPRINKLER IRRIGATION NOTES

- I. COMPOSITE BASE SHEET: PROPOSED IMPROVEMENTS SHOWN ON DRAWINGS ARE SUPERIMPOSED ON A COMPOSITE BASE SHEET. THE COMPOSITE BASE SHEET IS A COMPILATION OF ARCHITECTURAL, ENGINEERING, AND OTHER DATA THAT IS PROVIDED. THE LANDSCAPE ARCHITECT SHALL NOT BE HELD LIABLE FOR CHANGES, INACCURACIES, OMISSIONS, OR ERRORS PERTAINING TO THE COMPOSITE BASE SHEET. CONTRACTOR SHALL BE RESPONSIBLE FOR REVIEWING THESE DOCUMENTS. ANY DISCREPANCIES NEED TO BE BROUGHT TO THE ATTENTION OF THE DESIGN TEAM AND RESOLVED PRIOR TO CONTINUATION OF WORK.
- 2. DESIGN PRESSURE SHOWN ON PLANS HAS BEEN FURNISHED BY WATER COMPANY OR WATER DISTRICT SERVING SITE. VERIFY PRESSURE ON-SITE PRIOR TO THE INSTALLATION OF ANY SPRINKLER IRRIGATION EQUIPMENT. IF THERE IS A DISCREPANCY, NOTIFY OWNER'S REPRESENTATIVE IMMEDIATELY IN WRITING SO ADJUSTMENTS CAN BE MADE BY LANDSCAPE ARCHITECT. FAILURE TO REPORT
- DISCREPANCIES AND CONTINUANCE OF WORK WILL RESULT IN ALL RE-DESIGN COSTS BEING CHARGED TO CONTRACTOR. 3. DETERMINE LOCATION OF UNDERGROUND UTILITIES. DAMAGE CAUSED BY INSTALLATION OF THIS WORK SHALL BE REPAIRED TO
- SATISFACTION OF GOVERNING AGENCY OR OWNER AT NO ADDITIONAL COST TO THE CONTRACT. 4. SPRINKLER OVER SPRAY SHALL NOT BE ALLOWED ON PUBLIC SIDEWALKS, BUILDING WALLS OR FENCES. MINIMUM OVERSPRAY MAY OCCUR IN PARKING AREAS. USE ADJUSTABLE NOZZLES WHENEVER POSSIBLE TO CONTROL SPRINKLER OVERSPRAY.
- 5. ALL LOCAL CODES AND ORDINANCES SHALL BE COMPLIED WITH. IF THERE IS A CONFLICT, NOTIFY OWNER'S REPRESENTATIVE
- A. PRESSURE TEST ALL UNDERGROUND PIPING AS FOLLOWS:
- SYSTEMS WITH BOOSTER PUMP: MAIN LINE - AT 100 PSI FOR 4 HOURS.
- LATERAL LINES AT 100 PSI FOR 2 HOURS. SYSTEMS WITH OUT BOOSTER PUMP:
- MAIN LINE AT STATIC PSI FOR 4 HOURS. LATERAL LINES - AT STATIC PSI FOR 2 HOURS.
- B. COVERAGE TEST: NOTE: PRIOR TO REQUESTING COVERAGE TEST, INSURE ALL HEADS ARE SET PLUMB, NOZZLES ARE ADJUSTED PROPERLY AND SYSTEM HAS BEEN CHECKED FOR AUTOMATION. REQUEST OWNER'S REPRESENTATIVES PRESENCE ON-SITE WHEN SPRINKLER SYSTEM IS COMPLETELY INSTALLED AND FULLY AUTOMATIC. PROVIDE ADEQUATE PERSONNEL AT THIS MEETING TO ADJUST AND FINE TUNE SYSTEM TO SATISFACTION OF OWNER'S REPRESENTATIVE.
- 7. LAYOUT ALL WORK PRIOR TO TRENCHING OPERATIONS TO DETERMINE IF MINOR MODIFICATIONS OR ADJUSTMENTS WILL BE REQUIRED.
- 8. INSTALL ALL SPRINKLER HEADS PERPENDICULAR TO SLOPES OR GRADE. 9. CONTROL WIRE SHALL BE UF-14, COLOR FOR LEAD AND WHITE FOR COMMON. SPLICES SHALL BE PERMITTED AT VALVE BOX LOCATIONS
- 10. PROVIDE AND INSTALL AUTOMATIC CONTROLLER AND UF-14 CONTROL WIRE. ELECTRICAL SUBCONTRACTOR SHALL PROVIDE 110V
- SERVICE AND SERVICE HOOKUP FROM POWER SOURCE TO AUTOMATIC CONTROLLER. 11. COORDINATE ALL WORK WITH OTHER TRADES SO PROGRESS OF WORK IS NOT INTERRUPTED AND CAN BE COMPLETED IN A TIMELY
- 12. NO PLANTING SHALL BE STARTED UNTIL ALL SPRINKLER WORK HAS BEEN TESTED AND APPROVED IN PRESENCE OF OWNER'S
- 13. FOR SPRINKLER IRRIGATION INSTALLATION DETAILS, SEE SHEET NO. L4.3-L4.4.

AGENCY APPROVAL: DSA #01-119574

FILE #41-26



SAN MATEO FOSTER CITY SCHOOL DISTRICT 1170 CHESS DR., FOSTER CITY, CA 94404

HMC Architects


3542004-000

408 977 9160 / www.hmcarchitects.com


SAN JOSE, CA 95110

333 WEST SAN CARLOS STREET, STUDIO 750

	SSUE	
	DESCRIPTION	DATE
2	ADDENDUM #3	11.24.2021

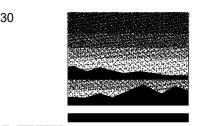

LANDSCAPE ARCHITECTURE AND PLANNING 2707 K Street, Suite 201 Sacramento, CA 95816 916 369-3990

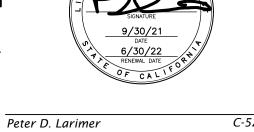

GEORGE HALL ELEMENTARY SCHOOL 130 SAN MIGUEL WAY, SAN MATEO, CA 94403


MULTIPURPOSE BUILDING AND SITE WORK


LANDSCAPE IRRIGATION PLAN

DSA BACKCHECK

PROJ NO: **3542-004**

SCALE: 1"= 20'-0"

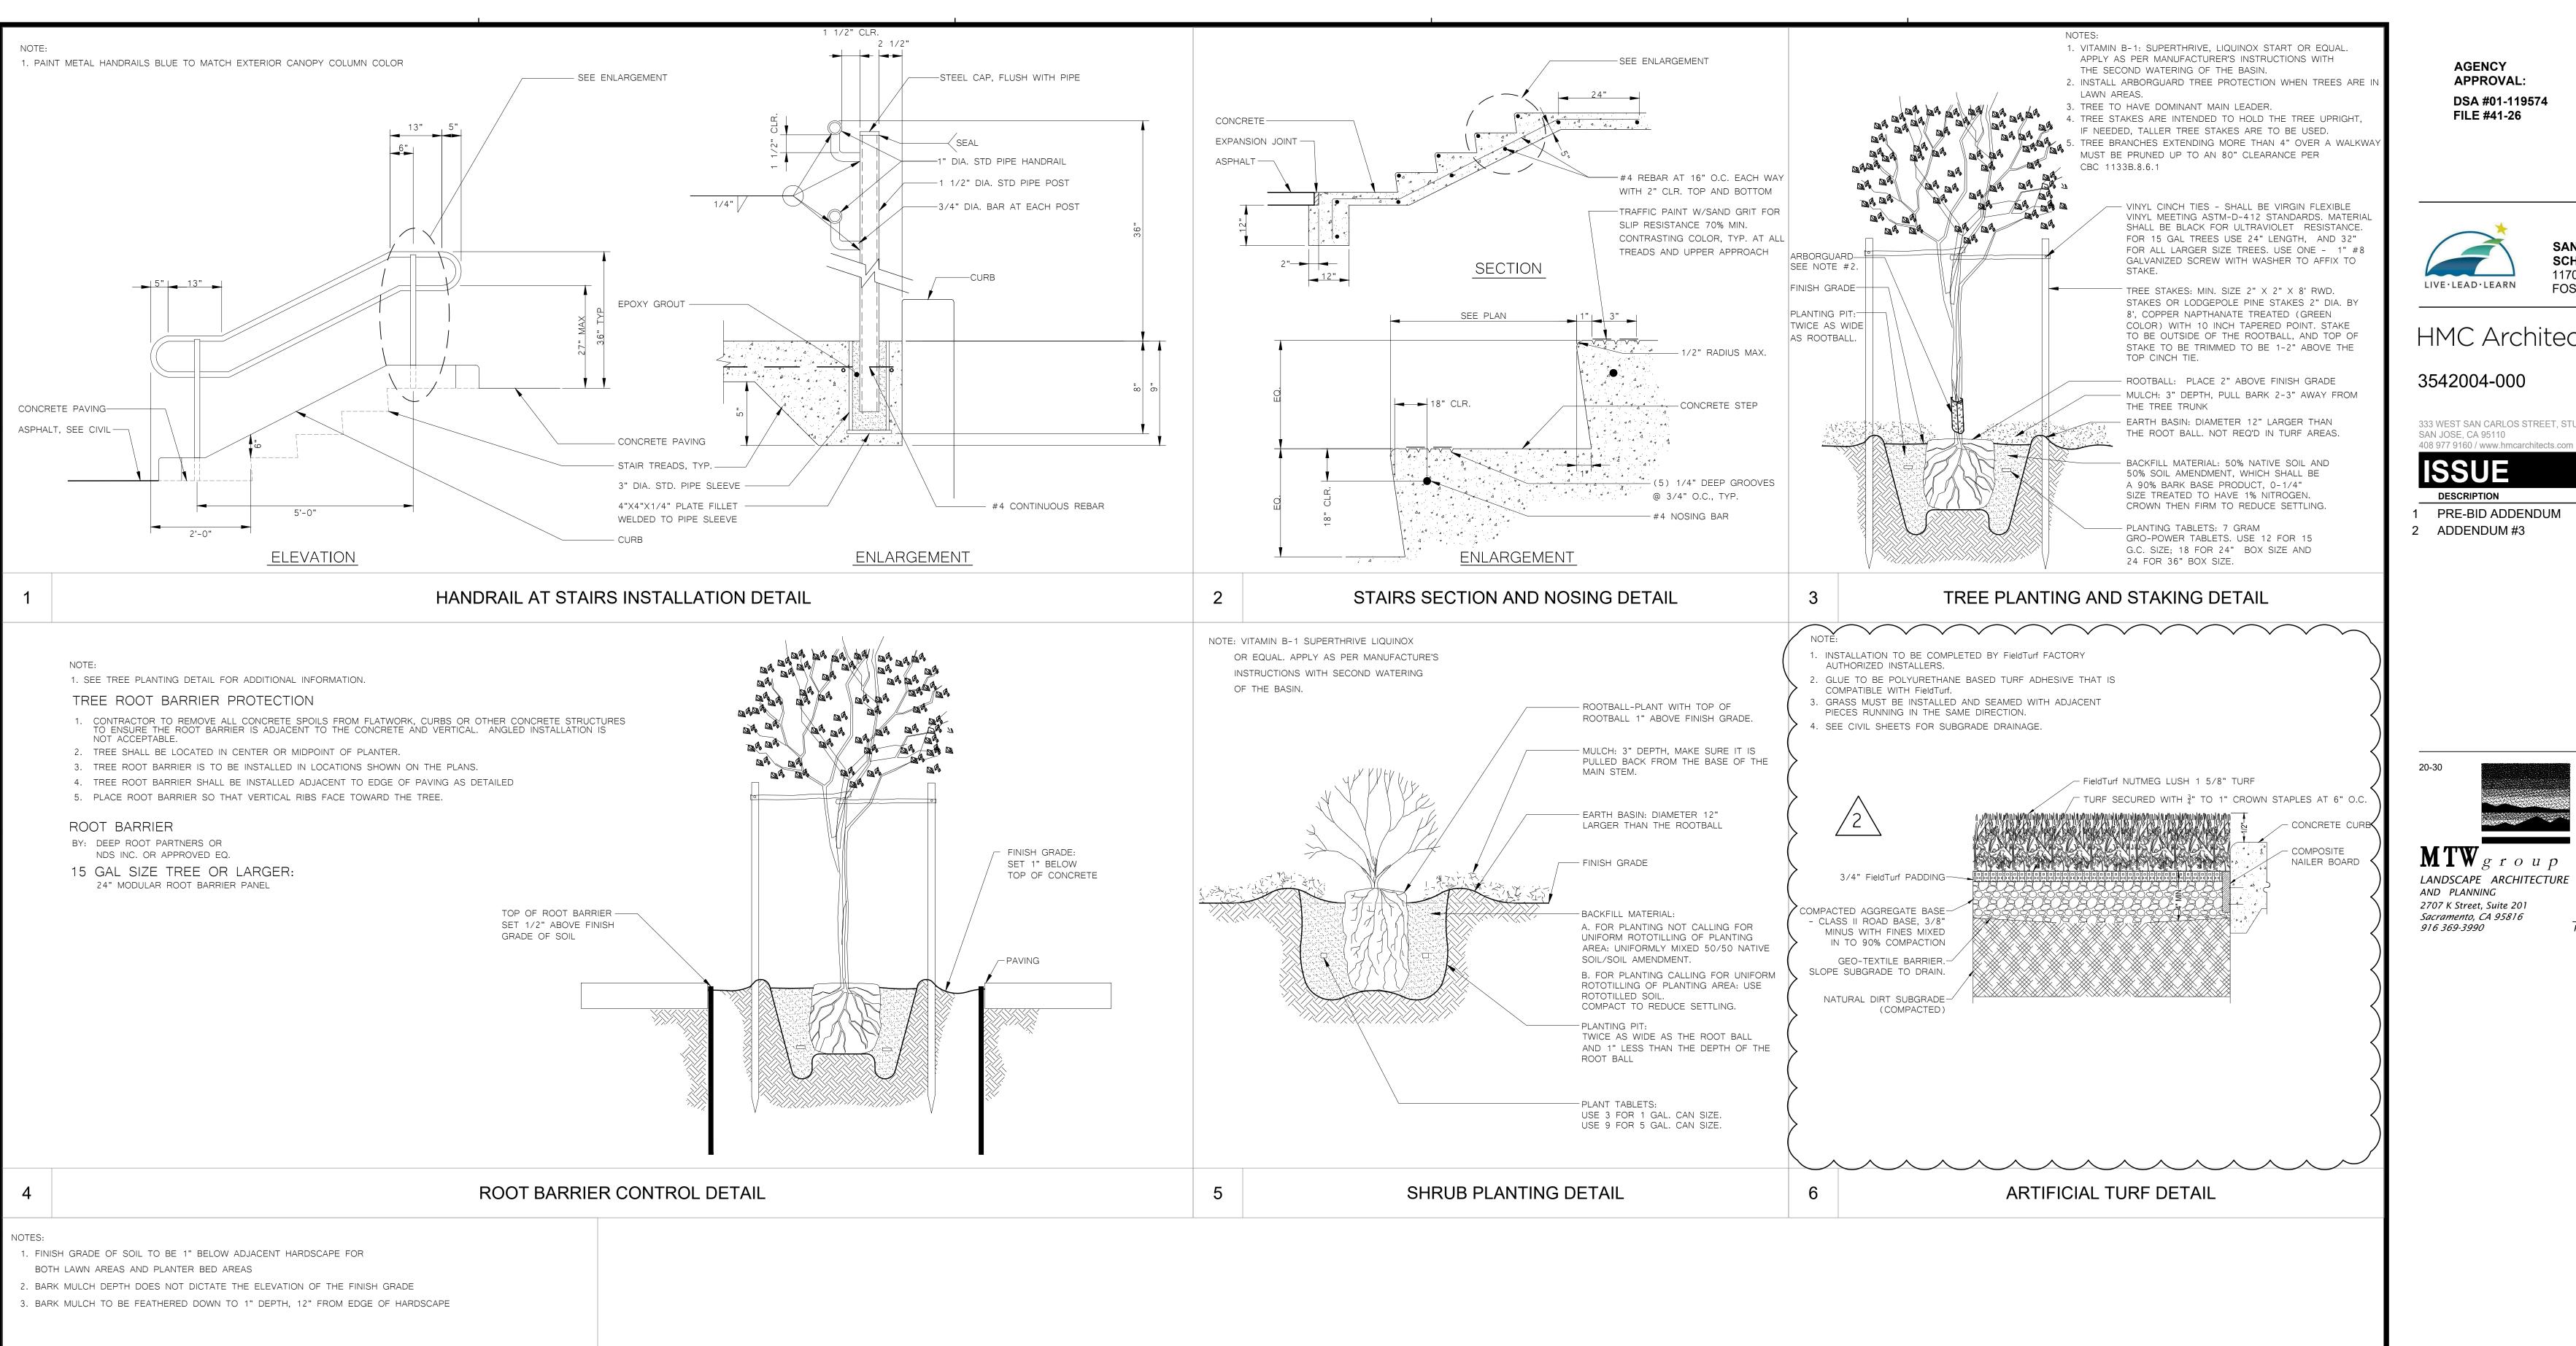

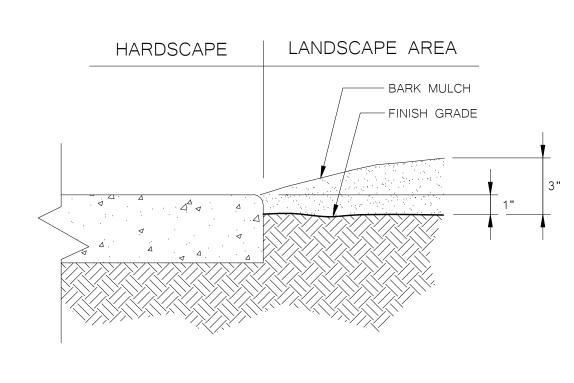

LANDSCAPE GRADE ADJACENT TO HARDSCAPE DETAIL

AGENCY APPROVAL: DSA #01-119574




SAN MATEO FOSTER CITY SCHOOL DISTRICT 1170 CHESS DR., FOSTER CITY, CA 94404


3542004-000

333 WEST SAN CARLOS STREET, STUDIO 750

	ISSUE	
	DESCRIPTION	DATE
1	PRE-BID ADDENDUM	11.05.2021
2	ADDENDUM #3	11.24.2021

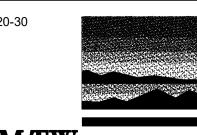

LANDSCAPE ARCHITECTURE AND PLANNING 2707 K Street, Suite 201 Sacramento, CA 95816

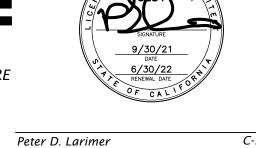

GEORGE HALL ELEMENTARY SCHOOL

130 SAN MIGUEL WAY, SAN MATEO, CA 94403

MULTIPURPOSE BUILDING AND SITE WORK

LANDSCAPE CONSTRUCTION AND PLANTING DETAILS

DSA BACKCHECK

DATE: **10.04.2021**

PROJ NO: **3542-004**