SECURITY UPGRADES CLASSROOM WALLS

BID PACKAGE

BETHANY ELEMENTARY SCHOOL OAK HILLS ELEMENTARY SCHOOL

MARCH 29, 2021

CONTACT INFORMATION

OWNER: BEAVERTON SCHOOL DISTRICT 16550 SW MERLO RD BEAVERTON, OR 97003

CLIENT CONTACT: MEGAN FINCH, PROJECT MANAGER 16550 SW MERLO RD BEAVERTON, OR 97003

Megan_Finch@beaverton.k12.or.us

ARCHITECT: CONVERGENCE ARCHITECTURE BARB ANDERSON 503-208-1028 X-104

BANDERSON@CONVERGENCEARCH.COM

LANDIS CONSULTING ELECTRICAL: MICHAEL HENNING

MICHAEL_HENNING@LANDISCONSULTING.COM


TO BE DETERMINED CONTRACTOR:

PROJECT DESCRIPTION

ADDING SECURE WALLS AND DOORS TO EACH OF THE CLASSROOM SPACES IDENTIFIED IN PROJECT SCOPE. MAINTAIN OR IMPROVE PATHS OF EGRESS AS REQUIRED BY CODE.

GENERAL NOTES

- THE INTENT OF THE CONTRACT DOCUMENTS IS THAT THE WORK SHALL CONFORM TO THE APPLICABLE CODES, REGULATIONS, AND ORDINANCES HAVING JURISDICTION. IF THE CONTRACTOR BELIEVES THAT ANY EXISTING CONDITIONS OR CONDITIONS CREATED BY THE PERFORMANCE OF THE WORK IS NON-COMPLIANT WITH THE LAW, THE CONTRACTOR SHALL NOTIFY THE ARCHITECT IMMEDIATELY.
- CONTRACTOR TO VERIFY THAT THE DRAWINGS ARE ACCURATE WITH RESPECT TO THE EXISTING CONDITIONS BEFORE PROCEEDING WITH THE WORK. IN THE EVENT THAT THE DOCUMENTS CONFLICT WITH THE EXISTING CONDITIONS, NOTIFY THE ARCHITECT PRIOR TO PROCEEDING WITH THE WORK OR REALTED
- CONTRACTOR SHALL KEEP THE SITE FREE OF GARBAGE AND DEBRIS.
- ALL ITEMS ARE TO BE INSTALLED IN STRICT ACCORDANCE WITH THE MANUFACTURER'S INSTRUCTIONS. MATERIALS THAT DO NOT INCLUDE SPECIAL INSTULATION INSTRUCTIONS ARE TO BE INSTALLED USING THE MOST APPROPRIATE INDUSTRY STANDARD FOR THE INTENDED RESULT OF THE
- MECHANICAL AND PLUMBING MODIFICATIONS FOR WORK SHOWN TO BE

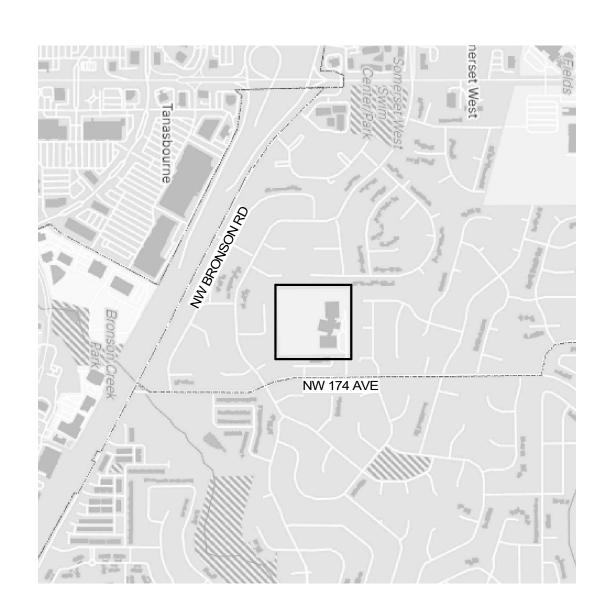

ABBREVIATIONS

DOWN

EXISTING

FIRE ALARM

GYPSUM BOARD

EWC

FΒ

FEC

FLR

FOC

FIN FLR

G,GND

GALV

GB

(E), EXIST

ABV ACT AFF JUNCTION BOX MAG MAGNETIC ACOUSTIC CEILING TILE MAX ABOVE FINISHED FLOOR MAXIMUM MH MANHOLE ABOVE GRADE MINIMUM AHJ AUTHORITY HAVING JURISDICTION MTD MOUNTED ALTERNATE MTL METAL AUDIO/VISUAL DRINKING FOUNTAIN NIC NOT IN CONTRACT OPERATER/OPERABLE CIRCUIT BREAKER **OPER** OFCI OWNER FURNISHED CONTRACTER CKT CIRCUIT INSTALLED CLG CEILING CLR OFOI OWNER FURNISHED OWNER INSTALLED CLEAR CM CEILING MOUNTED PULLBOX **PLYWD** PLYWOOD COMM COMMUNICATIONS P LAM PLASTIC LAMINATE CTRL CONTROL PNL PANEL, PANELBOARD CU POS POSITION/POINT OF SALE PR DATA PRESSURE TREATED DED DEDICATED RCP REFLECTED CEILING PLAN DEV DEVICE DIST DISTANCE

RECEPT RECEPTACLE REF REFERENCE **ELECTRIC WATER COOLER** SQUARE FEET, SQUARE FOOT SLV SLEEVE

WIRELESS ACCESS POINT

WEATHERPROOF

TRANSFORMER

WOOD

SPECS SPECIFICATIONS FLOOR BOX SWITCH FIRE EXTINGUISHER FIRE EXTINGUISHER CABINET **TELECOM** TELECOMMUNICATIONS FINISH FLOOR TELEVISION TYP FACE OF COLUMN TYPICAL

UNDER FLOOR GROUND UG UNDER GROUND GAUGE UON UNLESS OTHERWISE NOTED **GALVANIZED VOLT OR VOICE** GRAB BAR VIF VERIFY IN FIELD **GROUND FAULT CIRCUIT** GFI,GFCI INTERRRUPTER


WD

XFMR

	SHEET INDEX-B
Sheet Number	Sheet Name
٨.0	COVER SHEET
\.1	COVER SHEET
3.A0	CODE, GENERAL NOTES, SITE PLAN, OVERALL PLAN
3.A1	ACCESSIBILITY IMPROVEMENTS
3.A2	FLOOR PLAN
3.A3	REFLECTED CEILING PLAN, SCHEDULES
۸.8	GENERAL DETAILS

ELECTRICAL DEMOLITION PLANS

ELECTRICAL PLANS

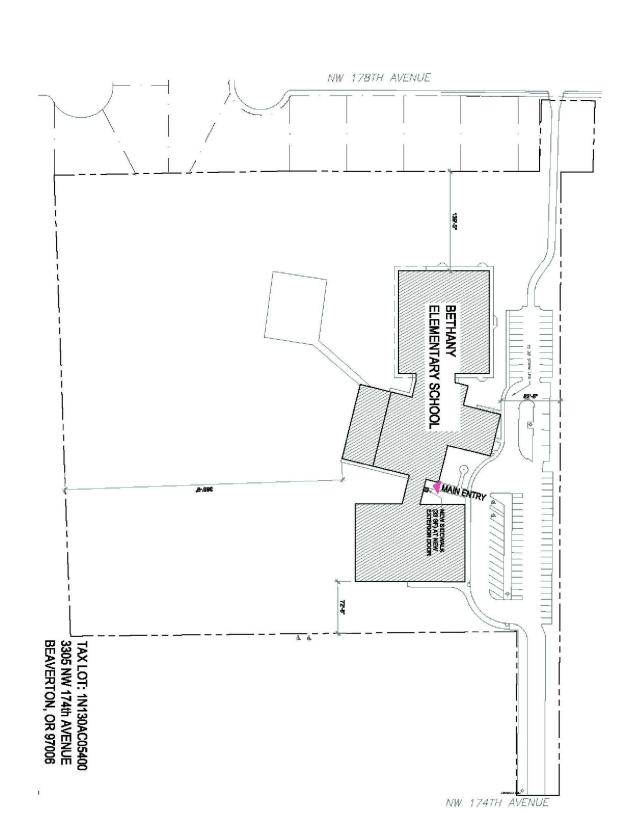

PROJECT DATA AND CODE ANALYSIS

PROPERTY ID#: R613483 TAXLOT ID#: 1N130AC05400

RELEVANT CODES: 2019 OREGON STRUCTURAL SPECIALTY CODE (OSSC)

YEAR OF ORIGINAL CONSTRUCTION: 1970

OVERALL BUILDING AREA:

AREA A: AREA B:

ACTUAL AREA: 16,734 SF (EXISTING NO CHANGE) ACTUAL AREA: 17,542 SF (EXISTING NO CHANGE)

ACTUAL AREA: 6,916 SF (EXISTING NO CHANGE) ACTUAL AREA: 8,852 SF (EXISTING NO CHANGE)

CHAPTER 3 - OCCUPANCY CLASSIFICATION AND USE

CLASSIFICATION: GROUP E, EDUCATIONAL; GROUP A-3, ASSEMBLY (GYMNASIUM, CAFETERIA) (EXISTING, NO CHANGE BY THIS WORK)

USE: ELEMENTARY SCHOOL (EXISTING, NO CHANGE)

CHAPTER 6 - TYPES OF CONSTRUCTION

TYPE VB, ANY MATERIALS PERMITTED BY OSSC (EXISTING, NO CHANGE)

NON-FIRE SPRINKLERED IN AREAS OF WORK.

EXISTING FIRE RESISTANCE RATING OF BUILDING ELEMENTS AS INDICATED ON OVERALL FLOOR PLAN. BUILDING SEPERATED INTO (4) FIRE SEPARATED AREAS. EXISTING TO REMAIN AS-IS.

NOTE: FACILITY HAS EXISTING FULL FIRE ALARM INCLUDING HORN, STROBES, SMOKE DETECTORS, AND MANUAL PULLS TO REMAIN

AREA OF WORK

CHAPTER 10 - MEANS OF EGRESS

OCCUPANCY LOADS ALLOWABLE

- CLASS ROOM: 20 SF/OCC LIBRARY: 50 SF/OCC
- ACCESSORY ROOMS: 100 SF/OCC
- STORAGE: 100 SF/OCC OFFICE: 150 SF/OCC

MAXIMUM TRAVEL DISTANCE COMMON (SINGLE) PATH OF EGRESS TO EXIT OR POINT OF TWO DIRECTIONS TO EXIT: 75 FEET

TOTAL EGRESS PATH TO EXIT: 200 FEET

- TWO REQUIRED MINIMUM UNLESS EXCEPTIONS MET SEPARATED BY MINIMUM 1/2 THE DIAGONAL DISTANCE OF THE SPACE SERVED
- HALL WIDTH MINIMUM 44 INCHES WIDE DOORS MINIMUM 36 INCHES WIDE TO MEET ANSI A117.1

SPACES WITH ONE EXIT


- ALLOWABLE IF COMMON PATH IS NOT EXCEEDED
- ALLOWABLE IF ONE EXIT IS TO EXTERIOR MAXIMUM 49 OCCUPANTS


DEAD END CORRIDORS LIMITED TO 20 FEET MAXIMUM

NO EXIT PATH TO THROUGH INTERVENING ROOMS ALLOWED

CHAPTER 11 - ACCESSIBILITY

ALL CONSTRUCTION AND ITEMS NOTED TO BE IMPROVED HEREIN TO COMPLY WITH INTERNATIONAL CODE COUNCIL (ICC) A117.1-2009

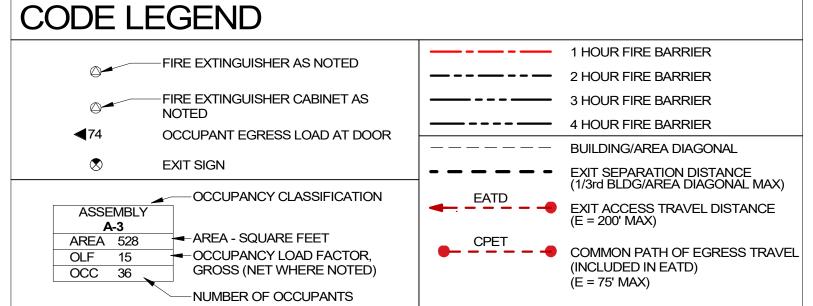

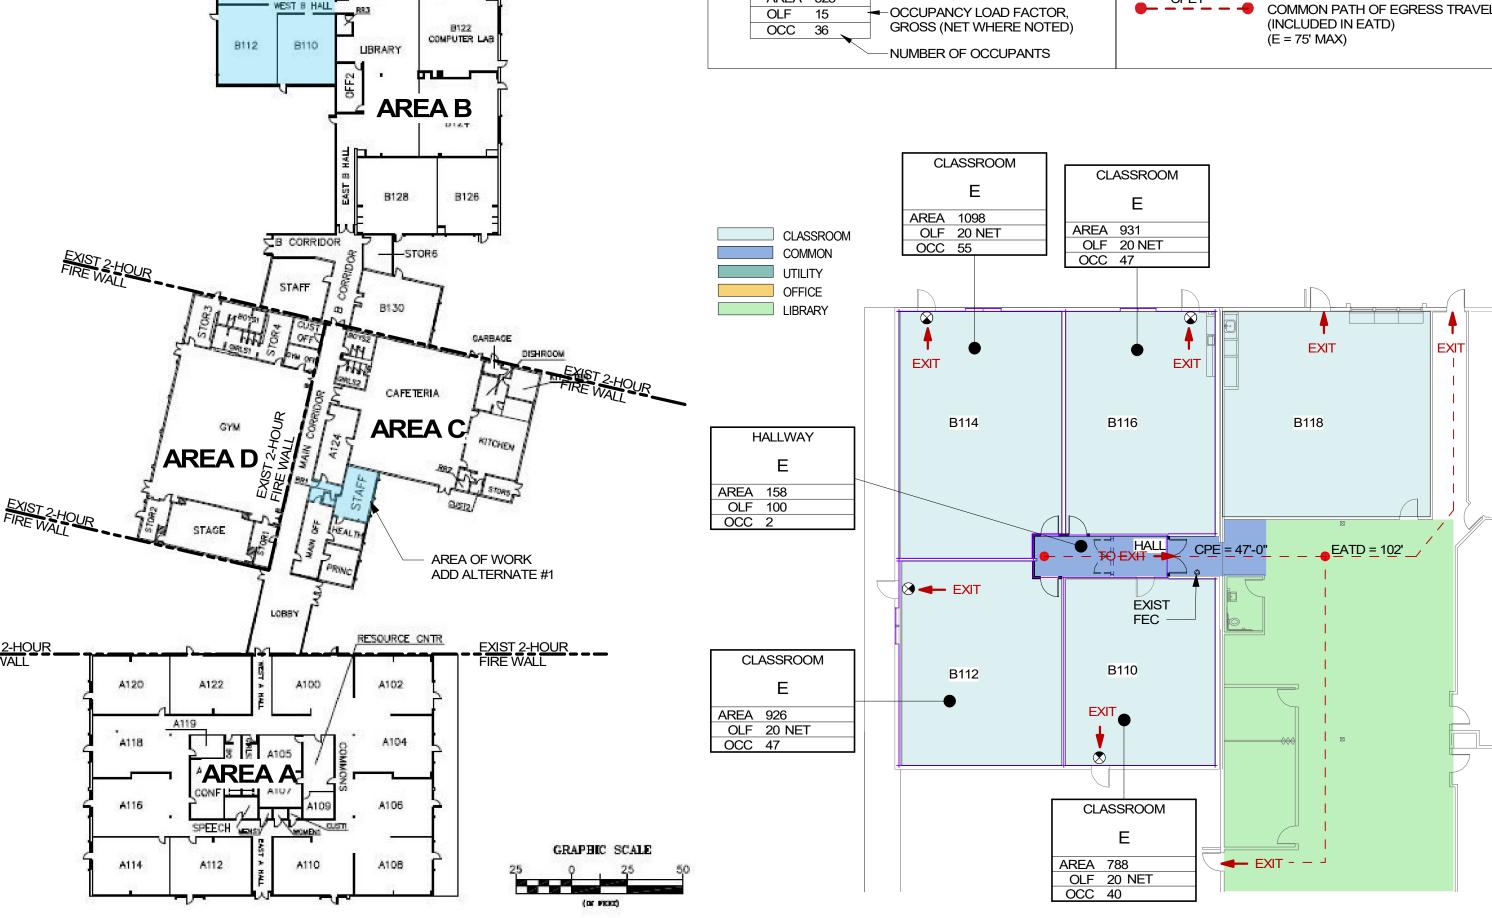

1 VICINITY PLAN NTS - FOR REFERENCE ONLY



2 SITE PLAN

NTS - FOR REFERENCE ONLY



3 OVERALL FLOOR PLAN NTS - FOR REFERENCE ONLY



LIFE SAFETY PLAN




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Revisions:

Checked by:

CODE, **GENERAL**

NOTES, SITE PLAN, **OVERALL** PLAN

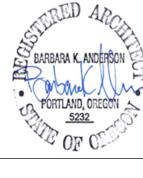B.A0

CHARACTER

CHARACTER

TYPICAL MOUNTING HEIGHTS

NW 178TH AVENUE PRIMARY ACCESSIBLE ROUTE - EXISTING

SITE ACCESSIBLE ROUTE AND IMPROVEMENTS PLAN

NTS - FOR REFERENCE ONLY

NW 174TH AVENUE

ELECTRICAL OUTLET

18" VERTICAL GRAB BAR

IMPROVEMENT NARRATIVE

PER OSSC SECTION 3403.4, ALTERATIONS FOR AN EXISTING FACILITY TO COMPLY WITHE THE APPLICABLE PROVISION IN CH. 11 OF THE BUILDING CODE. THE ACCESSIBLE ROUTE TO THE PRIMARY FUNCTION SHALL BE ACCESSIBLE TO THE MAXIMUM EXTENT FEASIBLE, COSTS NOT EXCEEDING 25% OF THE ALTERATION COSTS.


BASED ON FIELD OBSERVATIONS THE FOLLOWING ITEMS CAN BE ADDRESSED BASED ON THE CRITERIA NOTED ABOVE. ITEMS NOTED **OFOI** ARE PROPOSED TO BE SELF-PERFORMED BY BEAVERTON SCHOOL DISTRICT.


ADD 18" VERTICAL GRAB BAR AT SINGLE USER RESTROOM.

 OFOI - ADD AT ACCESSIBLE PARKING ACCESS AISLE "NO PARKING" SIGN AND STRIPING PER ODOT STANDARDS.

KEY NOTE LEGEND


- 1. INSTALL 18" VERTICAL GRAB BAR IN ACCESSIBLE SINGLE USER RESTROOM
- 2. PARKING STRIPING AND 'NO PARKING' SIGN TO MEET ODOT STANDARDS IN (2) PLACES PER NOTED FIGURE 2
- USE STANDARD ODOT APPROVED COLORS FOR PARKING LOT STRIPING
 ADA UPGRADES TO MEET ODOT AUGUST 2018 STANDARDS FOR ACCESSIBLE PARKING PLACES

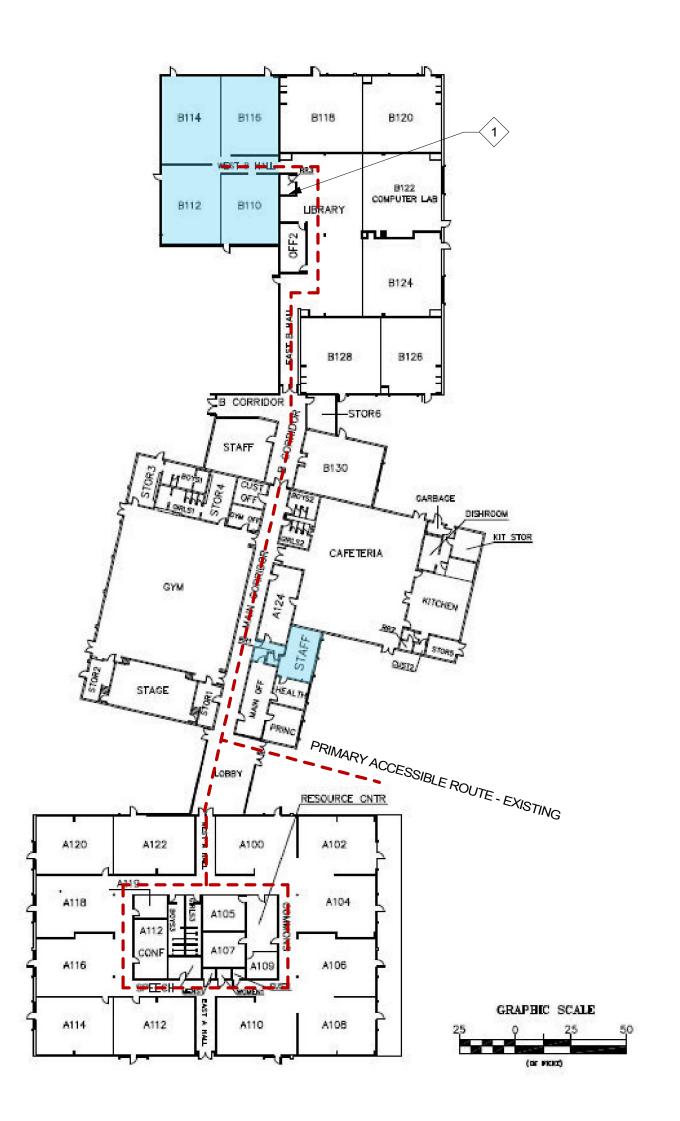

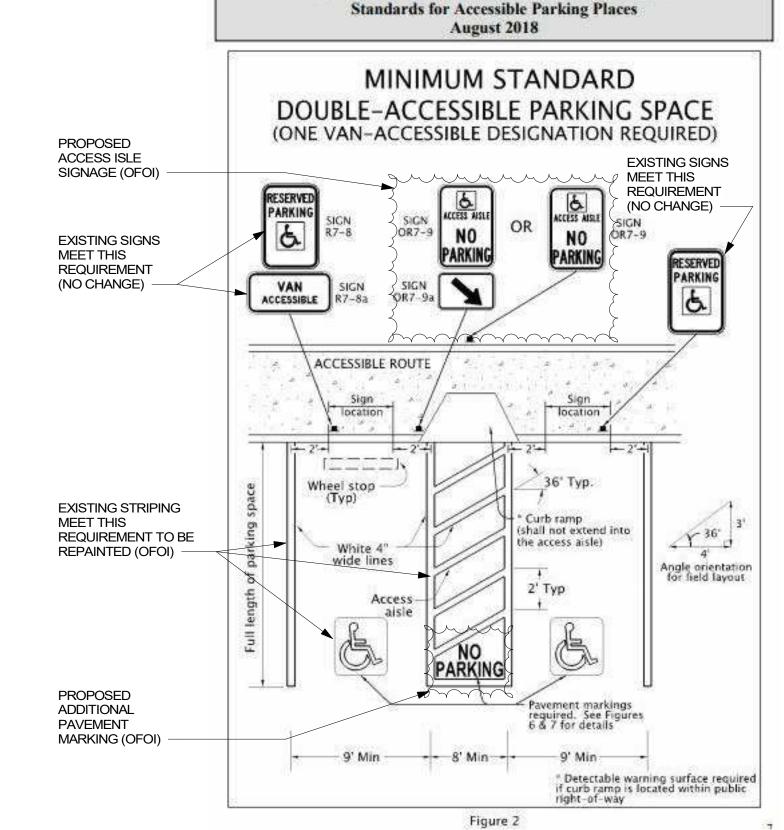

OREGON TRANSPORTATION COMMISSION



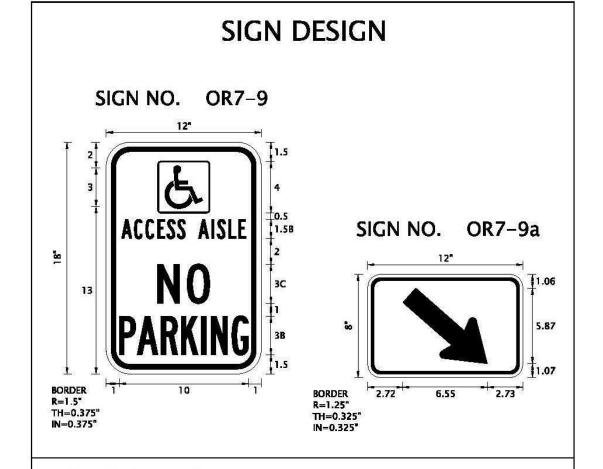

Sign Background: White, Retroreflective sheeting

Sign Legend: Red, Retroreflective sheeting

Sign Symbol: White on Blue, Retroreflective sheeting

possible outside of accessible route.

Sign OR7-9a: Use when back of walk directly behind access aisle is not available for sign placement and sign must be placed to one slde of pedestrlan access ramp.

The No Parking in Access Aisle sign is used to designate an access aisle reserved for persons use parking with DMV permit. Install sign in locations where "No Parking" pavement marking may not be visible regularly from snow or sand. Place sign to have direct view from end of access aisle when

Figure 11

CONVE 7302 N Richmond Av ph. 503.308.1028 info@conver

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ATY UPGRADE,
AY ELEMENTARY SCHOOL
305 NW 174TH AVE,
AVERTON, OR 97006

Date: 3/29/2021
Project #: 4008
Drawn by: GS

Revisions:

Checked by:

ACCESSIBILITY IMPROVEMENTS

B.A1



Date:

Project #:

Drawn by:

Revisions:

Checked by:

3/29/2021

B.A1 MOUNTING HEIGHTS EXISTING CASEWORK TO REMAIN

EXISTING ELECTRICAL PANELS. VERIFY DOOR CLEARANCE PRIOR TO WORK

MATCH THICKNESS (6"±) EXISTING WALL ABOVE TO REMAIN EXISTING CORNER GUARD TO BE REMOVED

NEW CORNER GUARD

SECTION 09 72 00 WALL COVERINGS FIRE EXTINGUISHER / FE CABINET 18" VERTICAL GRAB BAR. SEE TYPICAL MOUNTING

ELECTRICAL LEGEND


POWER SWITCH FIRE ALARM **EXISTING**

PLAN CODE NOTES




ADA 5'-0" MINIMUM TURN RADIUS


EXIT DOOR TO EXIT DISCHARGE

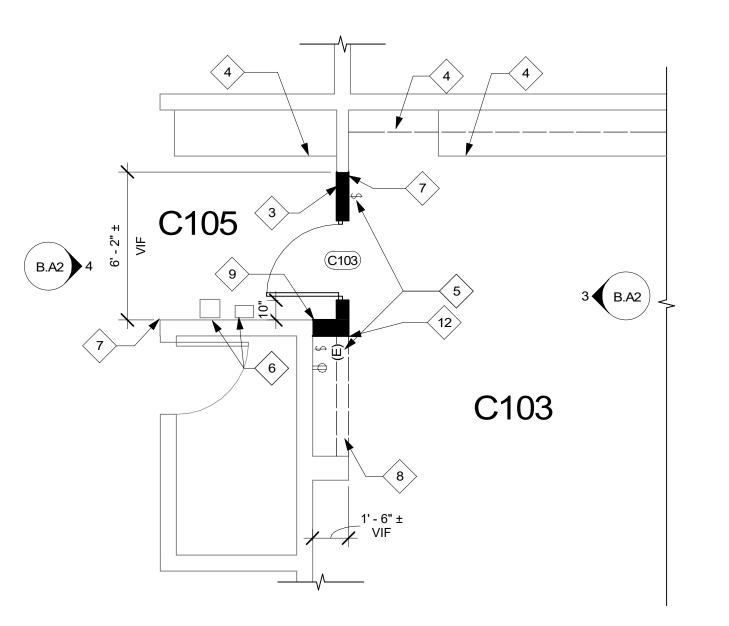

2 FLOOR PLAN ADD ALTERNATE #1 1/4" = 1'-0"

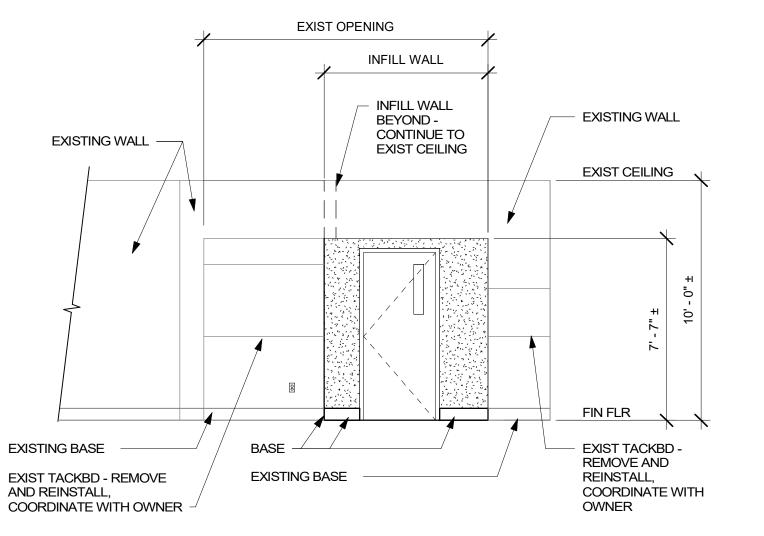

INTERIOR ELEVATION ADD ALTERNATE #1

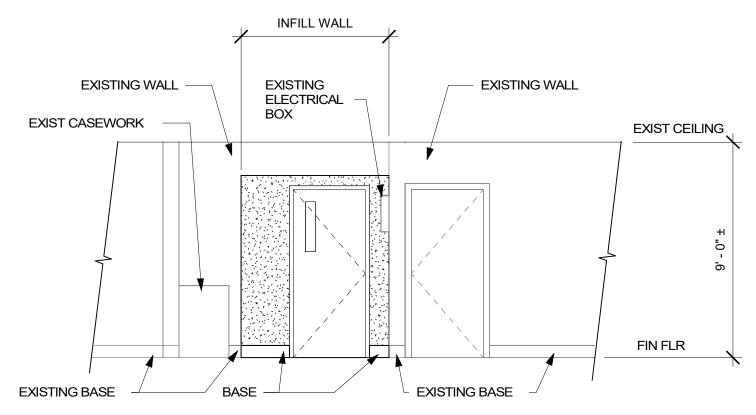

INTERIOR ELEVATION ADD ALTERNATE #1



PAINT TO BE AS FOLLOWS: NEW CLASSROOM WALLS, P-1. NEW DOOR FRAMES, P-2. NEW DOORS, P-3. NEW STAFF ROOM WALLS, P-4. SEE SPEC SECTION 09 91 00 PAINTING

NO EXISTING SURFACES TO BE PAINTED, UNLESS

OTHERWISE NOTED NEW 3-WAY LIGHT SWITCHES TO BE PLACED IN CLASSROOMS, NEAR NEW DOORS. PER

ELECTRICAL B.E2 MATCH EXISTING CONDITIONS: LIGHTING (SEE ELECTRICAL B.E2) AND ACT

THIS DRAWING RÉFERENCES EXISTING CONDITIONS, VERIFY ALL IN FIELD. DIMENSIONS ARE TO FACE OF WALL UNLESS

OTHERWISE NOTED. DIMENSIONS CONTAINING CLR MIN ARE THE MINIMUM DISTANCE OF CLEARANCE REQUIRED BY

CODE. ADVISE ARCHITECT OF ANY DISCREPANCIES PRIOR TO CONSTRUCTION. ALL DOOR OPENINGS PERPENDICULAR TO A WALL

ARE 6" TO THE WALL UNLESS OTHERWISE NOTED. TEMPORARY PROTECTION MUST BE COMPLETED PRIOR TO THE START OF INTERIOR

CONSTRUCTION. DO NOT REMOVE TEMPORARY PROTECTION UNTIL INTERIOR CONSTRUCTION IS COMPLETED. IN ALL WORK AREAS FLOORING, CEILING TILES,

AND FINISHES TO REMAIN IN PLACE SHALL BE PRESERVED AND PROTECTED BY CONTRACTOR. CONTRACTOR IS RESPONSIBLE FOR ANY DAMAGE CAUSED BY WORK AND SHALL REPAIR TO

ORIGINAL CONDITION AT NO COST TO OWNER. ALL NEW DOORS ARE TO BE 3'-0" WIDE MINIMUM REMOVE SIGNAGE FOR: B114. ALL NEW SIGNAGE

FE/FEC(S) SHALL NOT BE LOCATED INSIDE

CLASSROOMS AS THEY CAN BE LOCKED (TYP) PROVIDE WOOD BLOCKING AT ALL DOOR STOP AND SIGNAGE LOCATIONS

WALL LEGEND

EXISTING WALL

NEW WALL - SEE DETAIL 1/A.8

DEMO WALL

KEY NOTE LEGEND

POCKET TRIM. SEE DETAIL 3/A.8 PATCH CARPET AT REMOVED PARTITION, OFCI NEW OFOI CLASSROOM SIGNAGE, INSTALLED PER

RELOCATE SWITCH PER ELECTRICAL B.E2

NEW WALL FACE TO ALIGN WITH EXISTING WALL

RELOCATED 72" WIDE HM DOUBLE DOORS AND FRAMES (NON FIRE-RATED) NEW MAGNETIC HOLD OPENS FOR EACH LEAF TIED TO FIRE ALARM PANEL PANIC HARDWARE ONLY (NON LOCKDOWN) DEMO WALL, REPAIR FLOOR AND CEILING

PATCH AND REPAIR WALL COVERING .SEE SPEC


HEIGHTS B.A1

FIRE EXTINGUISHER



B.A2

FLOOR PLAN

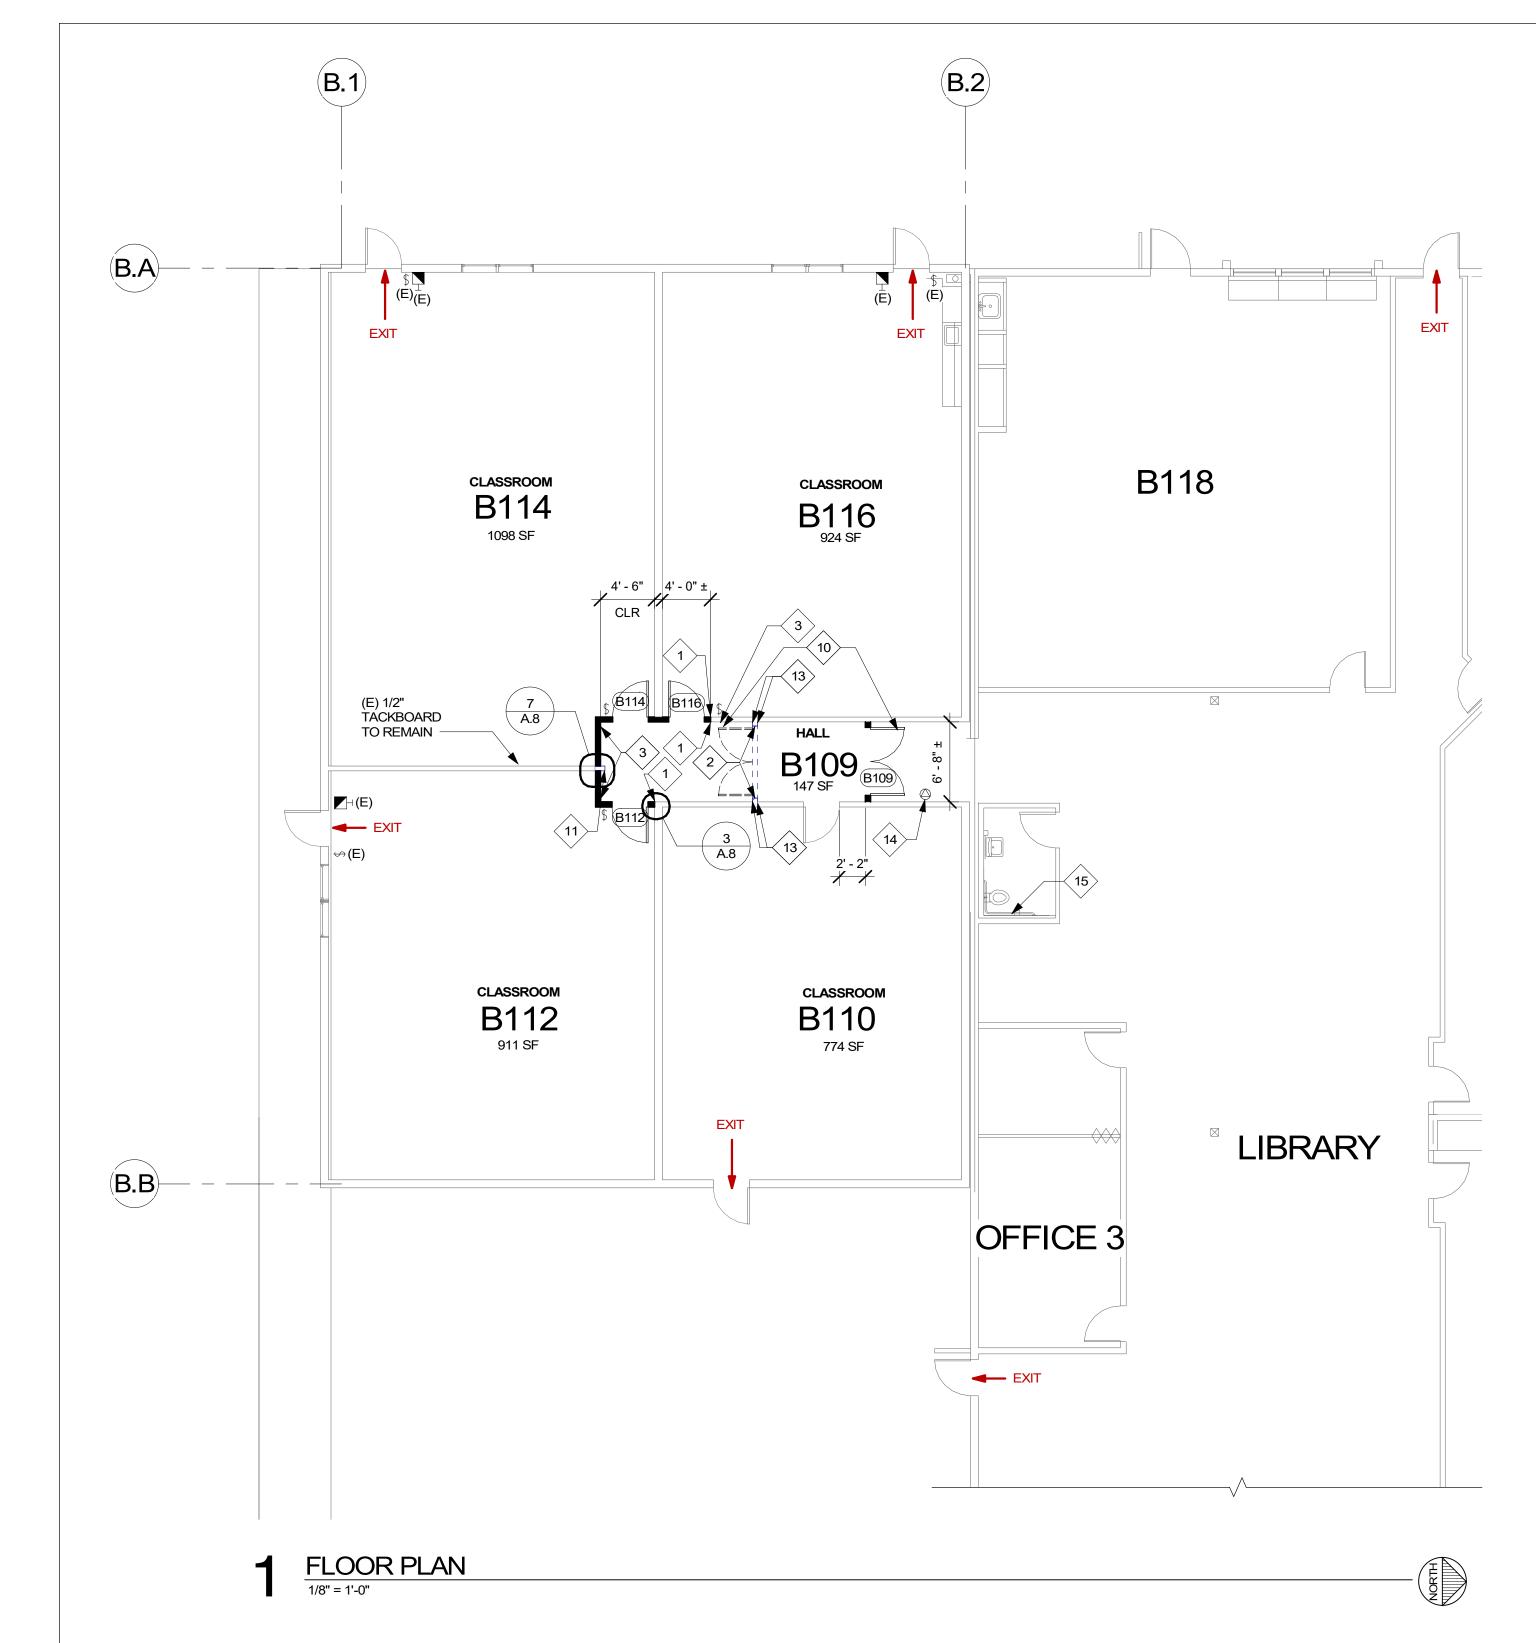

1	REFLECTED CEILING PLAN
	1/8" = 1'-0"

ROOM FINISH SCHEDULE-B						
NUMBER	NAME	FLOOR FINISH	NEW WALL FINISH	BASE FINISH	CEILING FINISH	
B109	HALL	EXISTING BROADLOOM CARPET (1)	P-1	COVE BASE	EXISTING (2)	
B110	CLASSROOM	EXISTING BROADLOOM CARPET (1)	P-1	COVE BASE	EXISTING (2)	
B112	CLASSROOM	EXISTING BROADLOOM CARPET (1)	P-1	COVE BASE	EXISTING (2)	
B114	CLASSROOM	EXISTING BROADLOOM CARPET (1)	P-1	COVE BASE	EXISTING (2)	
B116	CLASSROOM	EXISTING BROADLOOM CARPET (1)	P-1	COVE BASE	EXISTING (2)	


- EXISTING CARPET AND VCT FLOOR TO REMAIN, SEE FLOOR PLAN FOR SPECIFIC REPAIRS EXISTING ACT CEILING TO REMAIN, SEE REFLECTED CEILING PLAN FOR
- SPECIFIC REPAIRS
 SEE SPECIFICATIONS FOR PAINT TYPE AND COLOR SELECTION

0.	CEE OF EON TO THE FORT THE PART OCCUPATION
4.	NEW WALLS TO BE PAINTED P-1. PAINTED AREAS WILL GO TO EITHER AN
	EXISTING WALL (CORNER) OR TO THE EDGE OF POCKET TRIM.

													DETAILS
		DOOR							FRA	FRAME			
		NEW /			SIZE								
NO	HW	EXISTING	INT / EXT	W	Н	Т	TYPE	MATL	FINISH	GLASS	MATL	FINISH	DETAIL
B109	H-2	EXISTING	INTERIOR	PR 3' - 0"	6' - 8"	1 3/4"	В	SOLID CORE WOOD	P-3	NONE	НМ	P-2	5/A.8
B112	H-1	NEW	INTERIOR	3' - 0"	7' - 0"	1 3/4"	A	SOLID CORE WOOD	P-3	CLEAR TEMPERED SAFETY GLASS	НМ	P-2	5/A.8
B114	H-1	NEW	INTERIOR	3' - 0"	7' - 0"	1 3/4"	A	SOLID CORE WOOD	P-3	CLEAR TEMPERED SAFETY GLASS	HM	P-2	5/A.8
B116	H-1	NEW	INTERIOR	3' - 0"	7' - 0"	1 3/4"	А	SOLID CORE WOOD	P-3	CLEAR TEMPERED SAFETY GLASS	НМ	P-2	5/A.8
C103	H-5	NEW	INTERIOR	3' - 0"	7' - 0"	1 3/4"	А	SOLID CORE WOOD	P-3	CLEAR TEMPERED SAFETY GLASS	НМ	P-2	5/A.8

Grand total: 5

HM - HOLLOW METAL PR - EACH INDIVIDUAL LEAF OF A PAIR

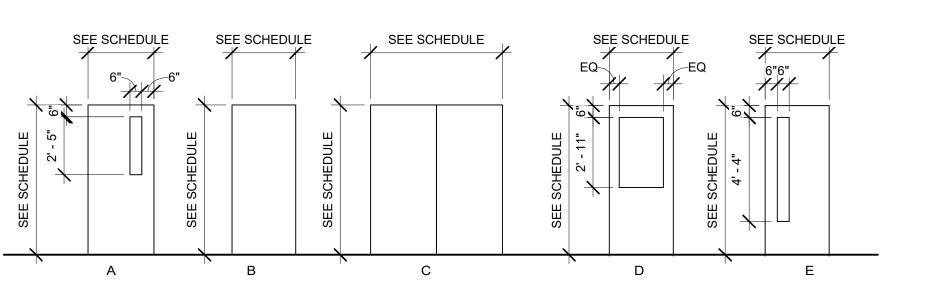

DOOR TYPES

SEE DOOR SCHEDULE FOR FINISH AND SIZE DETAILS

MATCH PROFILE AND FINISH OF NEW DOORS TO EXISTING CLASSROOM DOORS IN PROJECT AREA. CONTRACTOR TO VERIFY LITE SIZE AND
CONFIGURATION TO MATCH ON-SITE CONDITIONS

KEY NOTE LEGEND

- EXISTING LIGHT TO BE REMOVED AND SALVAGED: SEE ELECTRICAL NEW ACT TILE WHERE LIGHTING IS REMOVED DEMO WALL, REPAIR CEILING

RCP LEGEND

ACT CEILING: EXISTING

2X4 OVERHEAD LIGHT

DIFFUSER



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Date: 3/29/2021 Project #: Drawn by:

Checked by: CGK

Revisions:

REFLECTED CEILING PLAN, SCHEDULES

B.A3

EXISTING ACT CEILING

SLIP TRACK

CASING BEAD

PER DETAIL 2/-


CLASSROOM

Revisions:

DETAILS


ACOUSTIC INSULATION -5/8" GYPSUM WALLBOARD 3 1/2" LIGHT GAUGE STEEL FRAMING AT 16" O.C., TYP NOTE: EQ STUDS NOT ACCEPTABLE

TYPICAL WALL ASSEMBLY

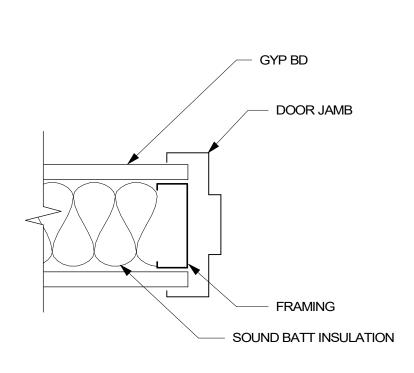


DOOR JAMB, TYP


SIM AT DOOR HEAD, TYP

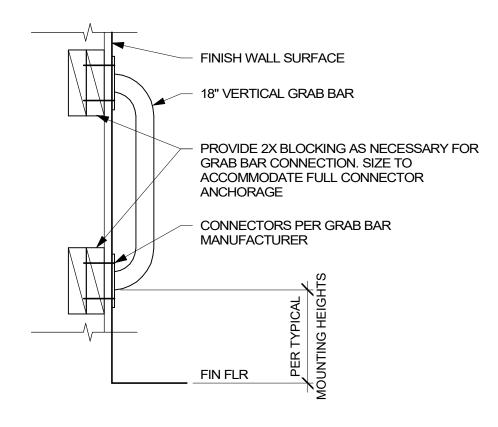


VERTICAL GRAB BAR DETAIL

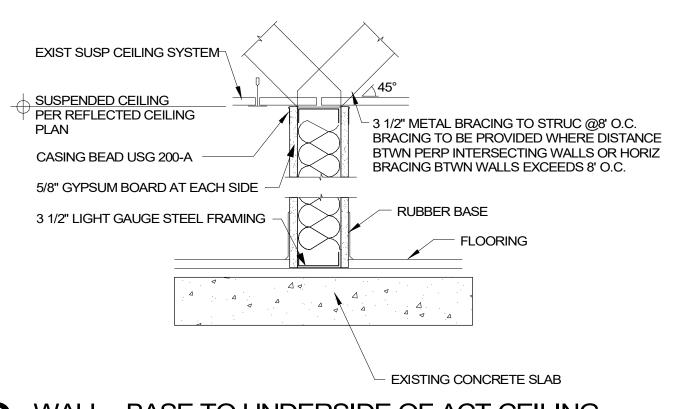


WALL - BASE TO UNDERSIDE OF ACT CEILING

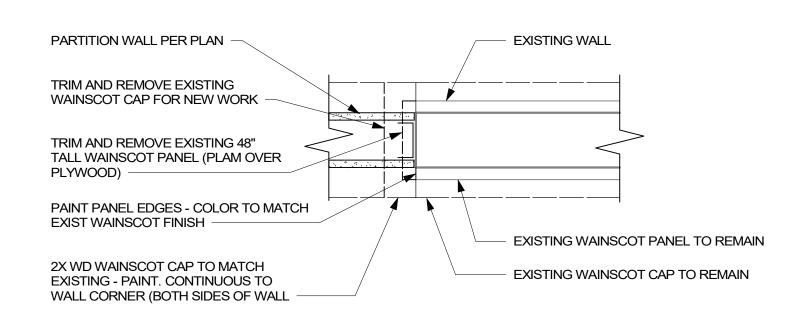


6A WAINSCOT MODIFICATION DETAIL @ END WALL

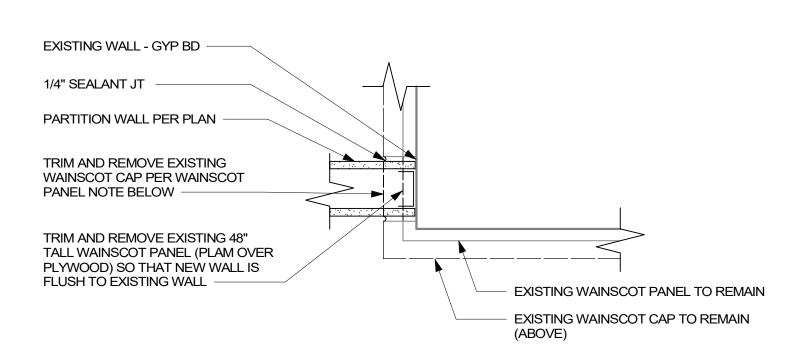


6BWAINSCOT MODIFICATION DETAIL@ CORNER

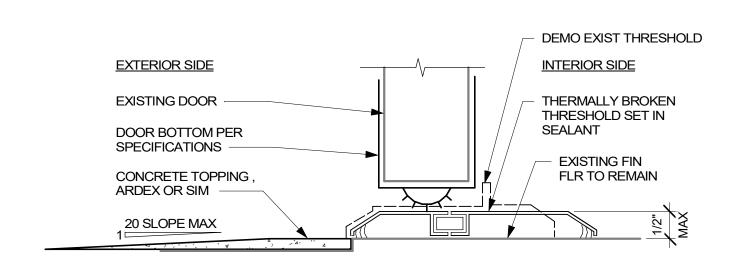


1 O DOOR BOTTOM AND THRESHOLD
6" = 1'-0"

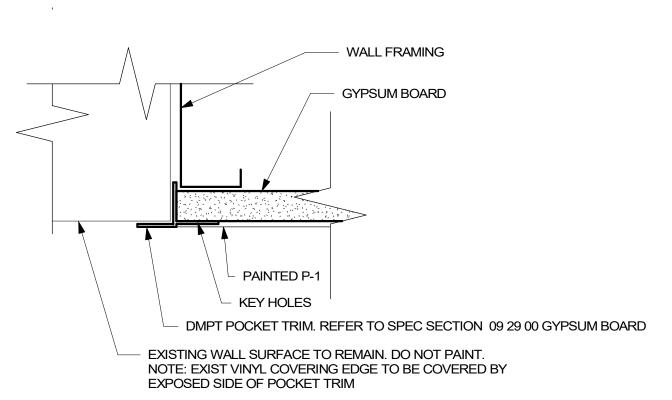

POCKET TRIM DETAIL

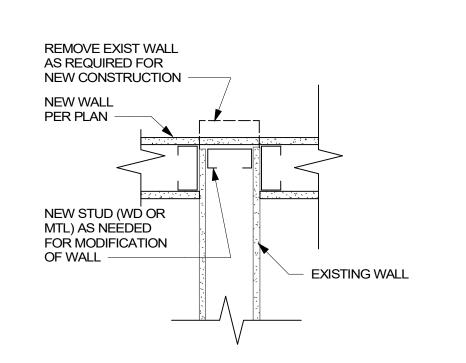

GYP COVERING WALL STUB
1 1/2" = 1'-0"

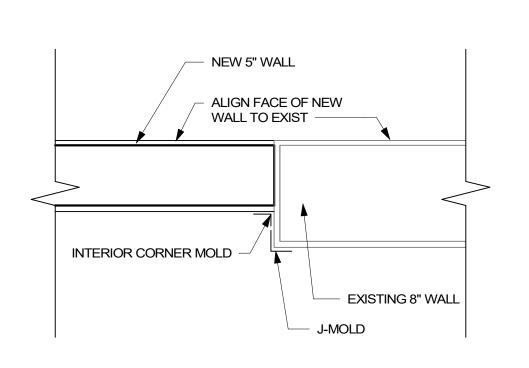

NEW WALL TO EXISTING PARTITION TRACK

8" WALL TO 5" WALL TRIM TRANSITION

EXIST STRUCTURE

FINSH TO REMAIN

PARTITION TRACK

EXIST ACT CEIL AT SIM CONDITION —

COMMON AREA (CLASSROOM AS SIM)

PARTITION WALL - ALIGN W/ FACE OF EXIST GYP

BD FINISH ABOVE

ABANDONED IN PLACE

EXIST GYP BD

DETAILS PER SCHOOL

SOME DETAILS APPLY TO SPECIFIC SCHOOLS. SEE LIST BELOW **BETHANY** 2/A.8 3/A.8 7/A.8 9/A.8 MONTCLAIR 1/A.8 2/A.8 3/A.8 5/A.8 7/A.8 OAK HILLS 1/A.8 2/A.8 3/A.8 5/A.8 6A/A.8 8/A.8 WEST TUALATIN VIEW 2/A.8 3/A.8 4/A.8 5/A.8 6B/A.8 10/A.8 - SEE DOOR SCHEDULES

Revisions:

Annotation INDICATES NEW EQUIPMENT. INDICATES EXISTING EQUIPMENT TO REMAIN. INDICATES EXISTING EQUIPMENT TO BE DEMOLISHED. INDICATES EXISTING EQUIPMENT OR DEVICE TO BE REMOVED AND

CONDUIT & CONDUCTOR CALLOUT. REFER TO CONDUIT & CONDUCTOR SCHEDULE. KEYED NOTE CALLOUT. REFER TO CORRESPONDING SHEET

KEYED NOTE CALLOUT. REFER TO CORRESPONDING SHEET KEYED NOTE CALLOUT. REFER TO CORRESPONDING SHEET

MECHANICAL EQUIPMENT CALLOUT. REFER TO MECHANICAL EQUIPMENT CONNECTION SCHEDULE. DETAIL CALLOUT. REFER TO DETAIL AND SHEET AS INDICATED ON

FIXTURE MOUNTING CALLOUT. HEIGHT ABOVE FINISHED FLOOR

EQUIPMENT CALLOUT. REFER TO NEMA CONNECTION SCHEDULE. SECTION CALLOUT. REFER TO DETAIL AND SHEET AS INDICATED ON CALLOUT. CALLOUT.

> ELEVATION CALLOUT. REFER TO DETAIL AND SHEET AS INDICATED ON CALLOUT.

CONDUIT AND/OR CONDUCTORS INSTALLED ABOVE GRADE,

Raceways

XX

X

EX.XX

XXXXX

XX'-XX"

(EX.XX)

CONCEALED IN WALL OR CEILING SPACE.
CONDUIT AND/OR CONDUCTORS INSTALLED BELOW GRADE, BELOW SLAB.
CONDUIT TURNED DOWN.
CONDUIT TURNED UP.
CONDUIT STUBBED AND CAPPED.
CONDUIT DIRECT CONNECTION TO EQUIPMENT.
FLEXIBLE CONNECTION TO EQUIPMENT.
CONDUIT / WIRING CONTINUATION.
HOMERUN TO PANELBOARD.
CABLE TRAY. SIZE AND TYPE AS INDICATED ON DRAWINGS.

Switches

OWILLIE	55
_	
\$	SINGLE POLE SWITCH - MOUNTED AT 42" AFF, UON.
+	LOW VOLTAGE 0-10 VOLT DIMMING SWITCH - MOUNTED AT 42" AFF, UON.
	OCCUPANCY SENSOR - CEILING OR WALL MOUNTED.
PP	OCCUPANCY SENSOR POWER PACK.
PC PC	PHOTOCELL - CEILING OR WALL MOUNTED.
\dashv	ADA DOOR PUSHPLATE.
	EMERGENCY STOP SWITCH, MUSHROOM HEAD.
•	PUSHBUTTON, SINGLE OR DOUBLE.

Power Distribution

Φ	DUPLEX RECEPTACLE, MOUNTED AT 18" AFF, UON.
Ф	SIMPLEX RECEPTACLE, MOUNTED AT 18" AFF, UON.
\Pi	QUADPLEX RECEPTACLE, MOUNTED AT 18" AFF, UON.
\Diamond	GFCI DUPLEX RECEPTACLE, MOUNTED AT 18" AFF, UON.
*	GFCI QUADPLEX RECEPTACLE, MOUNTED AT 18" AFF, UON.
\Box	TAMPERPROOF DUPLEX RECEPTACLE, MOUNTED AT 18" AFF, UON.
#	TAMPERPROOF QUADPLEX RECEPTACLE, MOUNTED AT 18" AFF, UOI
\Diamond	NEMA SPECIAL RECEPTACLE, MOUNTED AT 18" AFF, UON. NEMA CONFIGURATION AS INDICATED.
igoplus	SIDE HATCHED RECEPTACLE, TO BE WIRED TO SWITCHED CIRCUIT.
	CENTER HATCHED RECEPTACLE TO BE WIRED TO EMERGENCY CIRCUIT.
\Box	RECEPTACLE MOUNTED ON CEILING.
Φ	RECEPTACLE MOUNTED IN-COUNTER.
	DISCONNECT SWITCH.
	FUSED DISCONNECT SWITCH.
	ENCLOSED CIRCUIT BREAKER.
	COMBINATION STARTER.
	FLOORBOX COMBINATION POWER & DATA.
	FLOORBOX POWER.
	POKETHRU COMBINATION POWER & DATA.
	POKETHRU POWER.
	POWER POLE.
	PANELBOARD SURFACE MOUNT.
	PANELBOARD FLUSH MOUNT.

Low Voltage

\triangleleft	ETHERNET OUTLET MOUNTED AT 18" AFF, UON.
\triangleleft	COAXIAL OUTLET MOUNTED AT 18" AFF, UON.
\triangleleft	PHONE OUTLET MOUNTED AT 18" AFF, UON.
\triangle	LOW VOLTAGE OUTLET CEILING MOUNTED.
(·))))	WIRELESS ACCESS POINT CEILING MOUNTED.
H-0))))	WIRELESS ACCESS POINT WALL MOUNTED.
\bigcap	DIGITAL CLOCK.
	FLOORBOX DATA.
	POKETHRU DATA.
	IT RACK.
A	VERTICAL WIRE MANAGEMENT.

MAIN DISTRIBUTION PANEL

UTILITY TRANSFORMER.

UTILITY CT METER.

Lighting

	,
	TROFFER LUMINAIRE, SURFACE, RECESS, OR PENDANT MOUNTED AS INDICATED ON THE DRAWINGS.
	DOWNLIGHT LUMINAIRE, SURFACE, RECESS, OR PENDANT MOUNTED AS INDICATED ON THE DRAWINGS.
-	UNDERCABINET LUMINAIRE.
	EMERGENCY BATTERY PACK LUMINAIRE, WALL OR CEILING MOUNTED.
0 0	LINEAR PENDANT MOUNTED LUMINAIRE.
	LINEAR WALL MOUNTED LUMINAIRE.
÷ \	BOLLARD LUMINAIRE.
	SITE LUMINAIRE POLE MOUNTED. NUMBER OF HEADS AS SHOWN.
	TRACK LUMINAIRE.
OI	SPOT LUMINAIRE.
9	WALL MOUNTED LUMINAIRE.
	RING PENDANT LUMINAIRE.
\bigcirc	WALL WASH LUMINAIRE POINTED IN DIRECTION AS SHOWN.
$\stackrel{\longrightarrow}{\boxtimes}$	EXIT SIGN, WALL OR CEILING MOUNTED, SINGLE FACE WITH DIRECTIONAL CHEVRONS AS INDICATED ON DRAWINGS.
	EXIT SIGN, WALL OR CEILING MOUNTED, DOUBLE FACE WITH DIRECTIONAL CHEVRONS AS INDICATED ON DRAWINGS.
	HALF HATCHED LUMINAIRE TO BE WIRED TO EMERGENCY CIRCUIT
	FULL HATCHED LUMINAIRE TO BE WIRED TO NIGHTLIGHT CIRCUIT.
Audio/\	/isual
\Diamond	AV OUTLET - WALL MOUNTED AT 18" AFF, UON. SEE AUDIO VISUAL DETAILS FOR CONFIGURATIONS.

S	AUDIO SPEAKER - WALL MOUNTED AT 96" AFF, UON.
S	AUDIO SPEAKER - CEILING MOUNTED.
P	PAGING SPEAKER - WALL MOUNTED AT 96" AFF, UON.
P	PAGING SPEAKER - CEILING MOUNTED.
	PAGING HORN - WALL MOUNTED AT 96" AFF, UON.
	INTERCOM SPEAKER - WALL MOUNTED AT 96" AFF, UON.
	INTERCOM SPEAKER - CEILING MOUNTED.
1	INTERCOM CALL BUTTON - MOUNTED AT 42", UON.
AE	ADMINISTRATION CONSOLE. PROVIDE ONE (1) CAT6 CABLE.
$\boxed{\circ}$	AV PROJECTOR - CEILING MOUNTED.
AE	AUDIO ENHANCEMENT DEVICE.

AUDIO VIDEO OUTLET - CEILING MOUNTED.

Miscellaneous

IVIISCEII	Miscellaneous					
(J) [J]	JUNCTION BOX (ROUND, SQUARE).					
_	SONOTION BOX (NOOND, OQUANE).					
T	THERMOSTAT.					
R	RELAY.					
Š	CORD REEL.					
	MOTOR / EXHAUST FAN.					
	CEILING FAN.					
	UTILITY POLE.					
\cap	WEATHERHEAD.					
\otimes	GROUND ROD.					
\bigotimes	GROUND ROD WITH TEST WELL.					
V///////	SURFACE RACEWAY / WIREMOLD.					
	FIRE RATED BACKBOARD.					

GROUND BUS BAR.


Fire Alarm

H(0)) 15	FIRE ALARM AUDIO/VISUAL - WALL MOUNTED. CANDELA RATING AS SHOWN ON DRAWING.
H O 15	FIRE ALARM VISUAL - WALL MOUNTED. CANDELA RATING AS SHOWN ON DRAWING.
(a) (b)) 15	FIRE ALARM AUDIO/VISUAL - CEILING MOUNTED. CANDELA RATING AS SHOWN ON DRAWING.
15	FIRE ALARM VISUAL - CEILING MOUNTED. CANDELA RATING AS SHOWN ON DRAWING.
FB	FIRE ALARM BELL.
©	FIRE ALARM SMOKE DETECTOR - CEILING MOUNTED.
	FIRE ALARM SMOKE DETECTOR - WALL MOUNTED.
(H)	FIRE ALARM HEAT DETECTOR - CEILING MOUNTED.
	FIRE ALARM HEAT DETECTOR - WALL MOUNTED.
	FIRE ALARM DUCT SMOKE DETECTOR.
TS	FIRE ALARM DUCT SMOKE DETECTOR WITH REMOTE TEST STATION.
F	FIRE ALARM MANUAL PULL STATION - WALL MOUNTED.
TS	FIRE ALARM MANUAL TAMPER SWITCH.
FS	FIRE ALARM MANUAL FLOW SWITCH.
PS	FIRE ALARM MANUAL PRESSURE SWITCH.
ММ	FIRE ALARM MONITOR MODULE.
RI	FIRE ALARM RELAY INPUT.
RO	FIRE ALARM RELAY OUTPUT.
PIV	FIRE ALARM POST INDICATOR VALVE.
SA	FIRE ALARM SURGE ARRESTOR.
IM	FIRE ALARM ISOLATION MODULE.
FAA	FIRE ALARM ANNUNCIATOR.
	FIRE ALARM MAGNETIC DOOR HOLD.
Access	Control & Security

Access Control & Security

	DOOR FRAME TO ACCESSIBLE CEILING OR SECURITY JUNCTION BOX AS SHOWN ON THE DRAWINGS.
	ACCESS CONTROL - CARD READER. PROVIDE 3/4" CONDUIT FROM DOOR FRAME TO ACCESSIBLE CEILING OR SECURITY JUNCTION BOX AS SHOWN ON THE DRAWINGS.
	ACCESS CONTROL - ELECTRIC STRIKE. PROVIDE 3/4" CONDUIT FROM DOOR FRAME TO ACCESSIBLE CEILING OR SECURITY JUNCTION BOX AS SHOWN ON THE DRAWINGS.
	ACCESS CONTROL - KEY PAD. PROVIDE 3/4" CONDUIT FROM DOOR FRAME TO ACCESSIBLE CEILING OR SECURITY JUNCTION BOX AS SHOWN ON THE DRAWINGS.
	ACCESS CONTROL - MAGNETIC LOCK. PROVIDE 3/4" CONDUIT FROM DOOR FRAME TO ACCESSIBLE CEILING OR SECURITY JUNCTION BOX AS SHOWN ON THE DRAWINGS.
	ACCESS CONTROL - REQUEST TO EXIT. PROVIDE 3/4" CONDUIT FROM DOOR FRAME TO ACCESSIBLE CEILING OR SECURITY JUNCTION BOX AS SHOWN ON THE DRAWINGS.
	ACCESS CONTROL - ELECTRIFIED PANIC BAR. PROVIDE 3/4" CONDUIT FROM DOOR FRAME TO ACCESSIBLE CEILING OR SECURITY JUNCTION BOX AS SHOWN ON THE DRAWINGS.
	ACCESS CONTROL - SECURITY JUNCTION BOX. SIZED AS RECOMMENDED BY SECURITY SYSTEM MANUFACTURER.
	ACCESS CONTROL - CAMERA / INTERCOM.
	ACCESS CONTROL - PANIC BUTTON.
Ŋ	SECURITY CAMERA - CEILING MOUNTED. PROVIDE ONE (1) CAT6.
Ú	SECURITY CAMERA - WALL MOUNTED. PROVIDE ONE (1) CAT6.
	INTRUSION SENSOR - CEILING MOUNTED.
	INTRUSION SENSOR - WALL MOUNTED.
	INTRUSION KEYPAD.

ACCESS CONTROL - DOOR CONTACT. PROVIDE 3/4" CONDUIT FROM

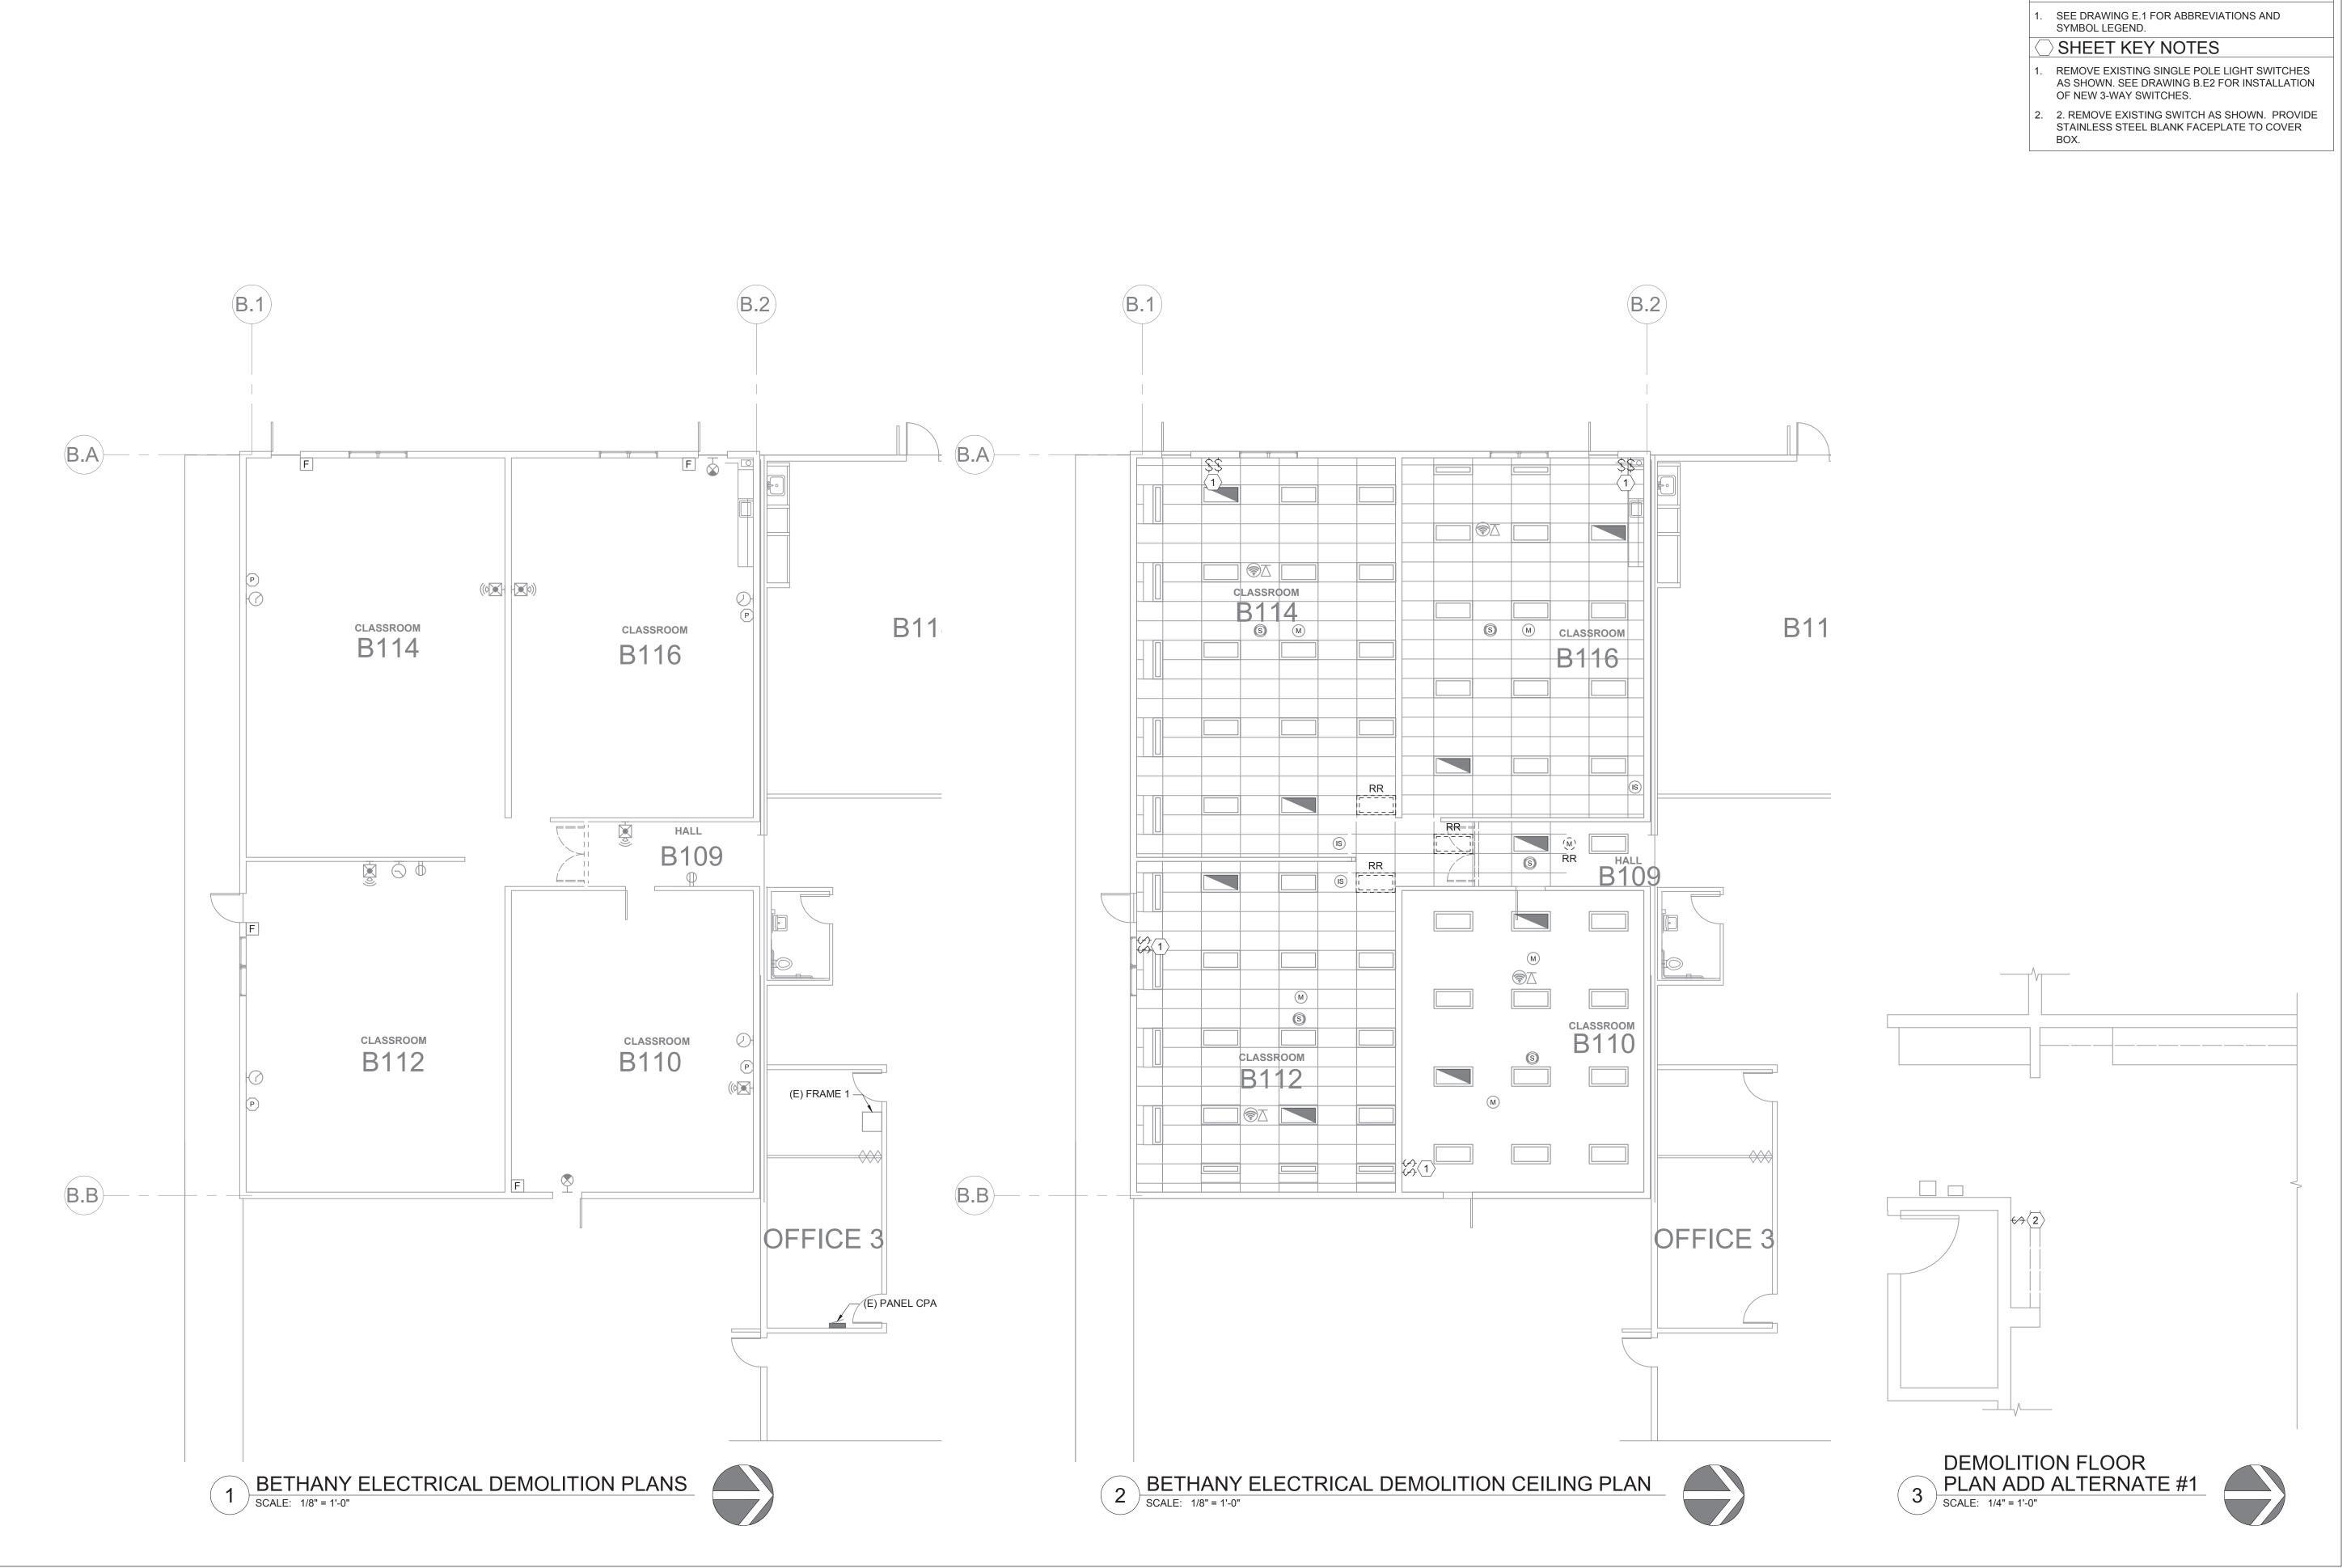

GENERAL SHEET NOTES

CONVERGENCE

ARCHITECTURE

7302 N Richmond Ave, Portland, OR 97203
ph. 503.308.1028 fax 503.308.6272
info@convergencearch.com
www.convergencearch.com

Landis Consulting
ENGINEERING SERVICES
Salem | Lake Oswego
503-584-1576
www.landisconsulting.com

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Digital Signature

OREGON

OREGON

OREGON

EXPIRES: 12-31-2022

FHANY ELEMENTARY SCHOOL 9150 SW DOWNING RD, BEAVERTON, OR 97008

Date: 03/25/202
Project #: 4008
Drawn by: SR

Revisions:

Checked by:

BETHANY ELECTRICAL DEMOLITION PLANS

B.ED2



GENERAL SHEET NOTES

SEE DRAWING E.1 FOR ABBREVIATIONS AND SYMBOL LEGEND.

SHEET KEY NOTES

- CONTRACTOR SHALL INTERCEPT AND EXTEND EXISTING CIRCUITING TO NEW RECEPTACLE.
- PROVIDE NEW 3-WAY SWITCHES AND INSTALL IN EXISTING WALL BOX. RE-WIRE EXISTING LIGHTING FIXTURES IN ROOM FOR 3-WAY SWITCHING FUNCTION. MAINTAIN EXISTING SWITCHING SCHEME.
- INSTALL NEW 3-WAY SWITCHES.
- INSTALL NEW 3-WAY SWITCHES IN EXISTING WALL. CONTRACTOR SHALL PATCH AND PAINT TO MATCH EXISTING WALL CONDITIONS.
- INSTALL NEW FIRE ALARM HORN/STROBE IN EXISTING WALL. COORDINATE EXACT CONNECTION REQUIREMENTS WITH SIMPLEX.
- PROVIDE NEW MAGNETIC HOLD OPEN AS SHOWN. COORDINATE EXACT CONNECTION REQUIREMENTS

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Landis Consulting
ENGINEERING SERVICES
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Digital Signature EXPIRES: 12-31-2022

Date: Project #:

Revisions:

Checked by:

BETHANY ELECTRICAL **PLANS**

B.E2

CONTACT INFORMATION

OWNER: BEAVERTON SCHOOL DISTRICT 16550 SW MERLO RD BEAVERTON, OR 97003

CLIENT CONTACT: MEGAN FINCH, PROJECT MANAGER 16550 SW MERLO RD BEAVERTON, OR 97003

Megan_Finch@beaverton.k12.or.us

ARCHITECT: CONVERGENCE ARCHITECTURE BARB ANDERSON

503-208-1028 X-104 BANDERSON@CONVERGENCEARCH.COM

LANDIS CONSULTING ELECTRICAL: MICHAEL HENNING

MICHAEL_HENNING@LANDISCONSULTING.COM

TO BE DETERMINED CONTRACTOR:

PROJECT DESCRIPTION

ADDING SECURE WALLS AND DOORS TO EACH OF THE CLASSROOM SPACES IDENTIFIED IN PROJECT SCOPE. MAINTAIN OR IMPROVE PATHS OF EGRESS AS

GENERAL NOTES

- THE INTENT OF THE CONTRACT DOCUMENTS IS THAT THE WORK SHALL CONFORM TO THE APPLICABLE CODES, REGULATIONS, AND ORDINANCES HAVING JURISDICTION. IF THE CONTRACTOR BELIEVES THAT ANY EXISTING CONDITIONS OR CONDITIONS CREATED BY THE PERFORMANCE OF THE WORK IS NON-COMPLIANT WITH THE LAW, THE CONTRACTOR SHALL NOTIFY THE ARCHITECT IMMEDIATELY.
- CONTRACTOR TO VERIFY THAT THE DRAWINGS ARE ACCURATE WITH RESPECT TO THE EXISTING CONDITIONS BEFORE PROCEEDING WITH THE WORK. IN THE EVENT THAT THE DOCUMENTS CONFLICT WITH THE EXISTING CONDITIONS, NOTIFY THE ARCHITECT PRIOR TO PROCEEDING WITH THE WORK OR REALTED WORK IN QUESTION.
- CONTRACTOR SHALL KEEP THE SITE FREE OF GARBAGE AND DEBRIS.
- ALL ITEMS ARE TO BE INSTALLED IN STRICT ACCORDANCE WITH THE MANUFACTURER'S INSTRUCTIONS. MATERIALS THAT DO NOT INCLUDE SPECIAL INSTULATION INSTRUCTIONS ARE TO BE INSTALLED USING THE MOST APPROPRIATE INDUSTRY STANDARD FOR THE INTENDED RESULT OF THE
- MECHANICAL AND PLUMBING MODIFICATIONS FOR WORK SHOWN TO BE DESIGN/BUILD.

ABBREVIATIONS

ABV ACT

J-BOX ACOUSTIC CEILING TILE MAG MAX ABOVE FINISHED FLOOR ABOVE GRADE **AUTHORITY HAVING JURISDICTION** MIN MTD ALTERNATE MTL AUDIO/VISUAL **DRINKING FOUNTAIN** CIRCUIT BREAKER **OPER**

SHEET INDEX-OH

ACCESSIBILITY IMPROVEMENTS

FLOOR PLAN, REFLECTED CEILING PLAN,

COVER SHEET

COVER SHEET

Sheet Name

CODE, GENERAL NOTES, SITE PLAN, OVERALL PLAN

CIRCUIT CLG CEILING CLR CLEAR CM **CEILING MOUNTED** COMM COMMUNICATIONS CTRL CONTROL

COPPER DEDICATED DED DEV DEVICE DIST DISTANCE DN DOWN **EWC**

ELECTRIC WATER COOLER (E), EXIS **EXISTING** FIRE ALARM FLOOR BOX FIRE EXTINGUISHER FIRE EXTINGUISHER CABINET FEC

FIN FLR FINISH FLOOR FLR FLOOR FOC **FACE OF COLUMN** G,GND GROUND GA GAUGE

GALVANIZED **GALV GRAB BAR** GB **GROUND FAULT CIRCUIT** GFI,GFCI **INTERRRUPTER** GYPSUM BOARD

Sheet Number

OH.A2

JUNCTION BOX MAGNETIC MAXIMUM MANHOLE

MINIMUM MOUNTED METAL

NOT IN CONTRACT OPERATER/OPERABLE OFCI OWNER FURNISHED CONTRACTER INSTALLED OWNER FURNISHED OWNER INSTALLED

OFOI PULLBOX PB PLYWD PLYWOOD P LAM PLASTIC LAMINATE PNL PANEL, PANELBOARD POS POSITION/POINT OF SALE PR PRESSURE TREATED RCP REFLECTED CEILING PLAN RECEPTACLE RECEPT REF

REFERENCE SQUARE FEET, SQUARE FOOT SLEEVE **SPECS** SPECIFICATIONS

SWITCH TELECOM TELECOMMUNICATIONS **TELEVISION** TYP TYPICAL

UNDER FLOOR UNDER GROUND UG UON UNLESS OTHERWISE NOTED VOLT OR VOICE **VERIFY IN FIELD**

SLV

WIRELESS ACCESS POINT WAP WD WOOD **WEATHERPROOF TRANSFORMER**

PROJECT DATA AND CODE ANALYSIS

PROPERTY ID#: R605624 TAXLOT ID#: 1N129CA09100

RELEVANT CODES: 2019 OREGON STRUCTURAL SPECIALTY CODE (OSSC)

YEAR OF ORIGINAL CONSTRUCTION: 1955 WITH MULTIPLE ADDITIONS, 1992 AREA OF WORK

OVERALL BUILDING AREA:

AREA OF WORK: ACTUAL AREA: 48,144 SF (EXISTING NO CHANGE) ACTUAL AREA: 3,500 SF (EXISTING NO CHANGE)

CHAPTER 3 - OCCUPANCY CLASSIFICATION AND USE

CLASSIFICATION: GROUP E, EDUCATIONAL; GROUP A-3, ASSEMBLY (GYMNASIUM, CAFETERIA) (EXISTING, NO CHANGE BY THIS WORK)

USE: ELEMENTARY SCHOOL (EXISTING, NO CHANGE)

CHAPTER 6 - TYPES OF CONSTRUCTION

TYPE VB, ANY MATERIALS PERMITTED BY OSSC (EXISTING, NO CHANGE)

NON-FIRE SPRINKLERED IN AREAS OF WORK.(EXISTING, NO CHANGE)

NOTE: FACILITY HAS EXISTING FULL FIRE ALARM INCLUDING HORN, STROBES, SMOKE DETECTORS, AND MANUAL PULLS TO REMAIN

CHAPTER 10 - MEANS OF EGRESS

OCCUPANCY LOADS ALLOWABLE

CLASS ROOM: 20 SF/OCC

LIBRARY: 50 SF/OCC ACCESSORY ROOMS: 100 SF/OCC

STORAGE: 100 SF/OCC OFFICE: 150 SF/OCC

MAXIMUM TRAVEL DISTANCE

COMMON (SINGLE) PATH OF EGRESS TO EXIT OR POINT OF TWO DIRECTIONS TO EXIT: 75 FEET TOTAL EGRESS PATH TO EXIT: 200 FEET

EXITS

TWO REQUIRED MINIMUM UNLESS EXCEPTIONS MET

SEPARATED BY MINIMUM 1/2 THE DIAGONAL DISTANCE OF THE SPACE SERVED

HALL WIDTH MINIMUM 44 INCHES WIDE DOORS MINIMUM 36 INCHES WIDE TO MEET ANSI A117.1

SPACES WITH ONE EXIT

CODE LEGEND

B118

ALLOWABLE IF COMMON PATH IS NOT EXCEEDED

ALLOWABLE IF ONE EXIT IS TO EXTERIOR MAXIMUM 49 OCCUPANTS

DEAD END CORRIDORS LIMITED TO 20 FEET MAXIMUM

NO EXIT PATH TO THROUGH INTERVENING ROOMS ALLOWED

FIRE EXTINGUISHER AS NOTED

FIRE EXTINGUISHER CABINET AS

CHAPTER 11 - ACCESSIBILITY ALL CONSTRUCTION AND ITEMS NOTED TO BE IMPROVED HEREIN TO COMPLY WITH INTERNATIONAL CODE COUNCIL (ICC) A117.1-2009

LIFE SAFETY PLAN

1 HOUR FIRE BARRIER

— – – — 2 HOUR FIRE BARRIER

3 HOUR FIRE BARRIER

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ENC

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L DISTRICT **GRAD**

Checked by: Revisions:


CODE, **GENERAL** NOTES, SITE PLAN,


OH.A0

(AGETY)

OVERALL

PLAN

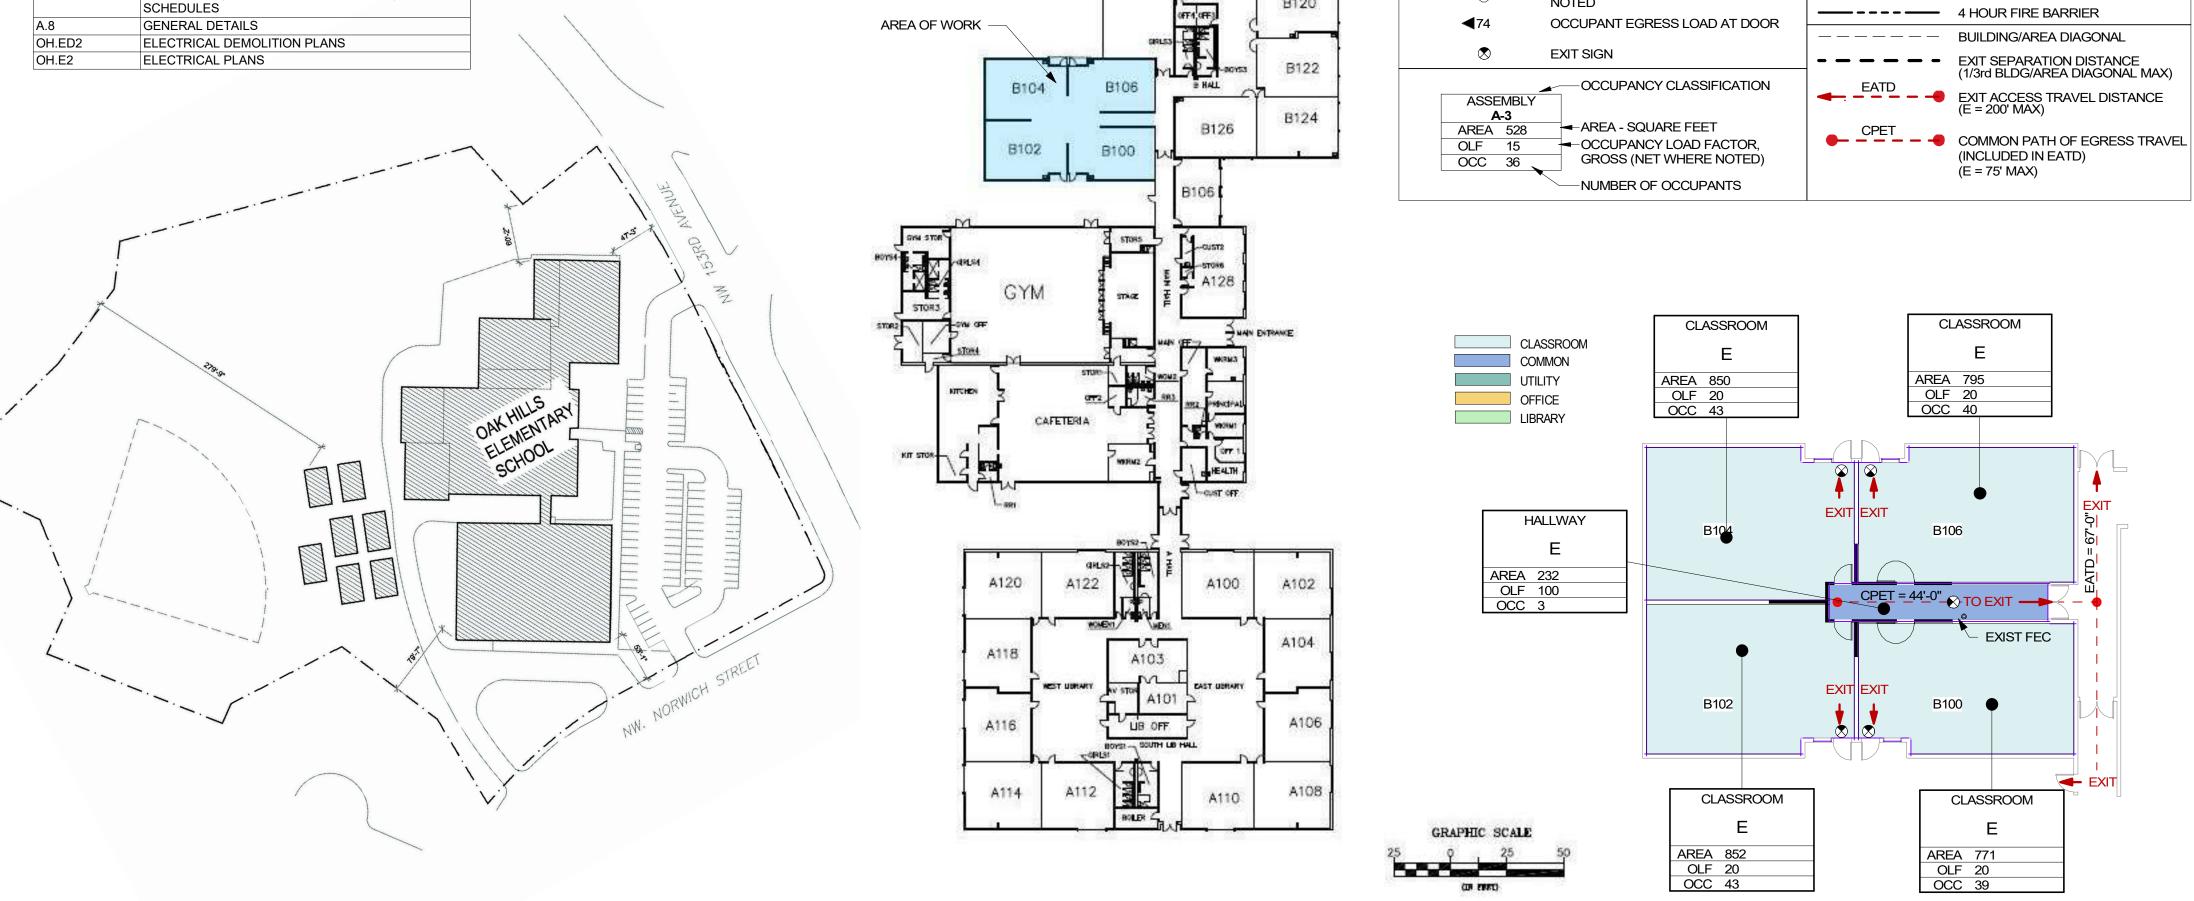

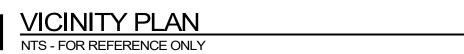



OREGON TRANSPORTATION COMMISSION

Standards for Accessible Parking Places

August 2018

MINIMUM STANDARD

DOUBLE-ACCESSIBLE PARKING SPACE

(ONE VAN-ACCESSIBLE DESIGNATION REQUIRED)

NO

MEET THIS

NO

required. See Figures 6 & 7 for details

Figure 2

OREGON TRANSPORTATION COMMISSION **Standards for Accessible Parking Places**

August 2018

SIGN DESIGN

Detectable warning surface required if curb ramp is located within public right-of-way

SIGN NO. OR7-9a

REQUIREMENT

(NO CHANGE)

RESERVED PARKING

Angle orientation for field layout

PROPOSED

ACCESS ISLE

SIGNAGE (OFOI)

EXISTING SIGNS

REQUIREMENT

(NO CHANGE)

EXISTING STRIPING

REPAINTED (OFOI)

REQUIREMENT TO BE

MEET THIS

PROPOSED ADDITIONAL

PAVEMENT MARKING (OFOI)

MEET THIS

PARKIN

VAN ACCESSIBLE

ACCESSIBLE ROUTE

Wheel stop -


White 4"

wide lines


SIGN NO. OR7-9

BORDER R=1.5" TH=0.375" IN=0.375"

OH.A1

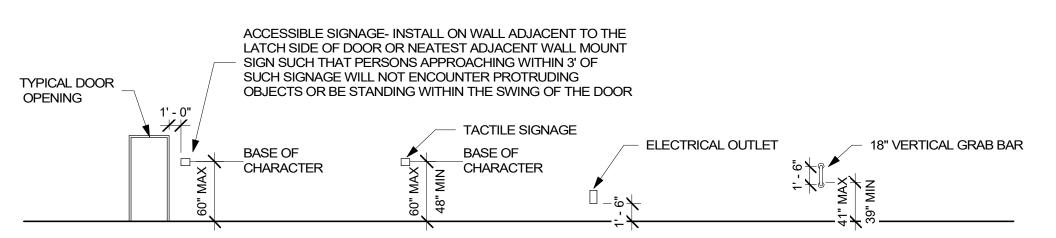

TYPICAL MOUNTING HEIGHTS

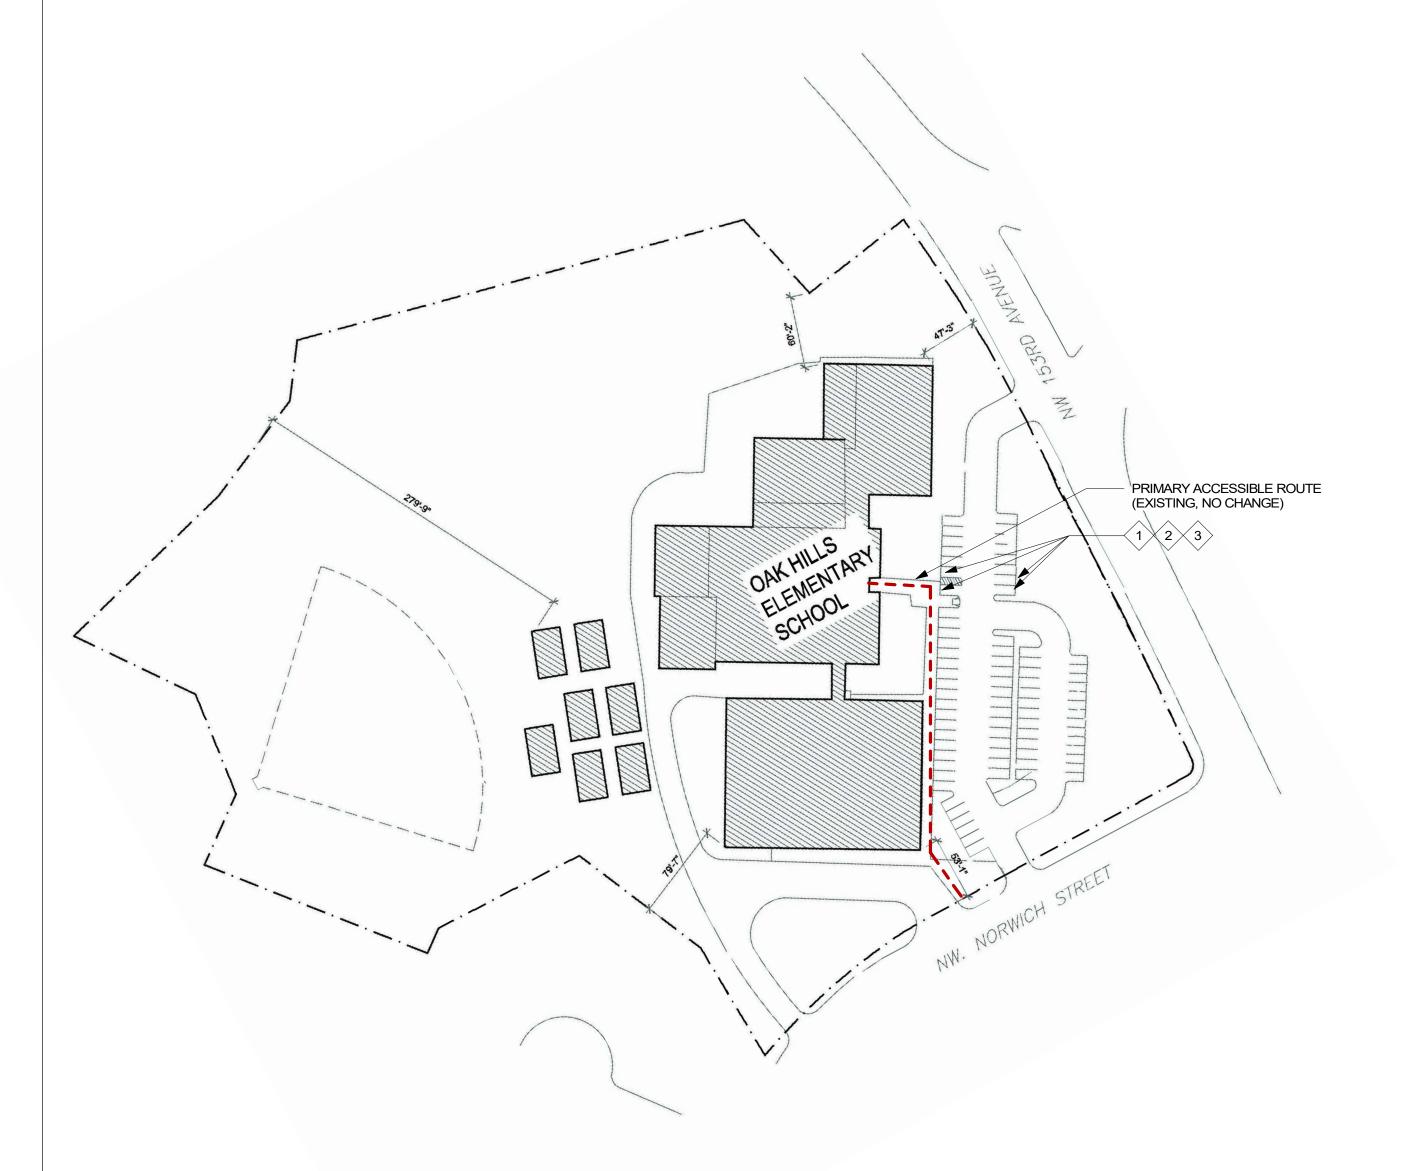

NTS - FOR REFERENCE ONLY

IMPROVEMENT NARRATIVE


PER OSSC SECTION 3403.4, ALTERATIONS FOR AN EXISTING FACILITY TO COMPLY WITHE THE APPLICABLE PROVISION IN CH. 11 OF THE BUILDING CODE. THE ACCESSIBLE ROUTE TO THE PRIMARY FUNCTION SHALL BE ACCESSIBLE TO THE MAXIMUM EXTENT FEASIBLE, COSTS NOT EXCEEDING 25% OF THE ALTERATION COSTS.

BASED ON FIELD OBSERVATIONS THE FOLLOWING ITEMS CAN BE ADDRESSED BASED ON THE CRITERIA NOTED ABOVE. ITEMS NOTED **OFOI** ARE PROPOSED TO BE SELF-PERFORMED BY BEAVERTON SCHOOL DISTRICT.

- OFOI ADD AT ACCESSIBLE PARKING ACCESS AISLE "NO PARKING" SIGN AND STRIPING PER
- REPLACE EXISTING 1"+ TALL THRESHOLDS FOR ROOMS B100, B102, B104, B106 WITH ACCESSIBLE COMPLIANT THRESHOLDS OF 1/2" TALL MAXIMIM, AND TRANSITION EXTERIOR EXISTING CONCRETE PAD AS REQUIRED TO MEET 1/2".

KEY NOTE LEGEND

- PARKING STRIPING AND 'NO PARKING' SIGN TO MEET ODOT STANDARDS IN (4) PLACES PER
- NOTED FIGURE 2
- USE STANDARD ODOT APPROVED COLORS FOR PARKING LOT UPGRADE ADA UPGRADES TO MEET ODOT AUGUST 2018 STANDARDS FOR ACCESSIBLE PARKING PLACES
- REPLACE THRESHOLDS WITH 1/2" MAX. SADDLE THRESHOLD AND BUILD UP EXISTING EXTERIOR CONCRETE PAD AS NECESSARY TO MEET RISE AND SLOPE REQUIREMENTS

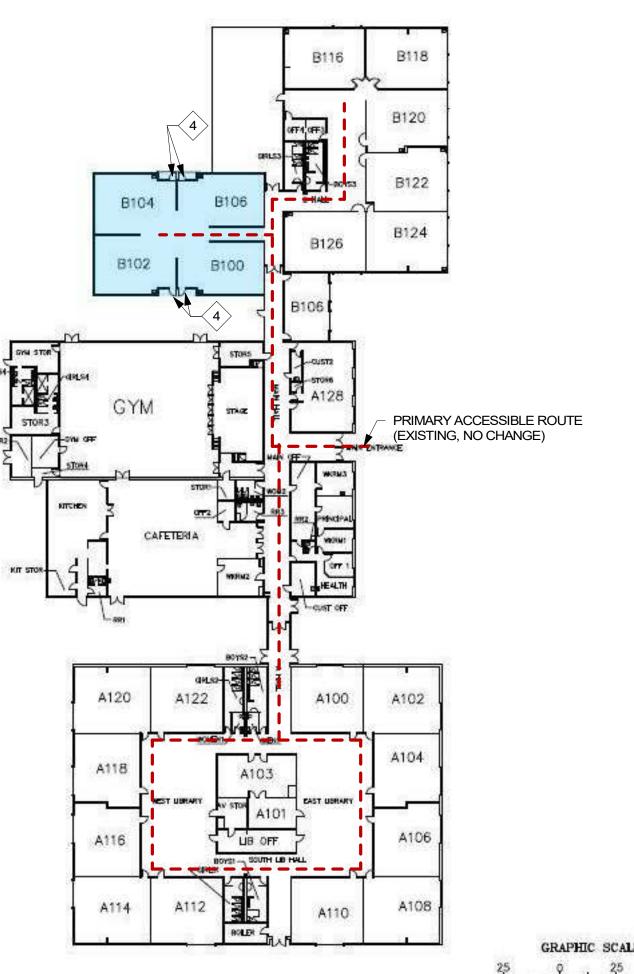

GRAPHIC SCALE

 BUILDING ACCESSIBLE ROUTE AND IMPROVELENTS PLAN NTS - FOR REFERENCE ONLY

Figure 11

Sign Background: White, Retroreflective sheeting

Sign Symbol: White on Blue, Retroreflective sheeting

Sign OR7-9a: Use when back of walk directly behind access aisle is not available for sign placement and sign must be placed to one slde of pedestrlan access ramp.

The No Parking in Access Aisle sign is used to designate an access aisle

reserved for persons use parking with DMV permit. Install sign in locations where "No Parking" pavement marking may not be visible regularly from snow or sand. Place sign to have direct view from end of access aisle when

Sign Legend: Red, Retroreflective sheeting

possible outside of accessible route.

GENERAL NOTES

SECTION 09 91 00 PAINTING

ELECTRICAL OH.E2) AND ACT

OTHERWISE NOTED

ELECTRICAL OH.E2

OTHERWISE NOTED.

CONSTRUCTION.

PAINT TO BE AS FOLLOWS: NEW WALLS, P-1. NEW

DOOR FRAMES, P-2. NEW DOORS, P-3. SEE SPEC

NO EXISTING SURFACES TO BE PAINTED, UNLESS

NEW 3-WAY LIGHT SWITCHES TO BE PLACED IN

MATCH EXISTING CONDITIONS: LIGHTING (SEE

DIMENSIONS ARE TO FACE OF WALL UNLESS

DIMENSIONS CONTAINING CLR MIN ARE THE

DISCREPANCIES PRIOR TO CONSTRUCTION.

MINIMUM DISTANCE OF CLEARANCE REQUIRED BY

ALL DOOR OPENINGS PERPENDICULAR TO A WALL

TEMPORARY PROTECTION MUST BE COMPLETED

DO NOT REMOVE TEMPORARY PROTECTION UNTIL

IN ALL WORK AREAS FLOORING, CEILING TILES,

AND FINISHES TO REMAIN IN PLACE SHALL BE

PRESERVED AND PROTECTED BY CONTRACTOR.

CONTRACTOR IS RESPONSIBLE FOR ANY DAMAGE

ORIGINAL CONDITION AT NO COST TO OWNER.

ALL NEW DOORS ARE TO BE 3'-0" WIDE MINIMUM.

ALL NEW WALLS REQUIRE CORNER GUARDS, AS

INTERIOR CONSTRUCTION IS COMPLETED.

CAUSED BY WORK AND SHALL REPAIR TO

ARE 6" TO THE WALL UNLESS OTHERWISE NOTED.

CLASSROOMS, NEAR NEW DOORS. PER

THIS DRAWING REFERENCES EXISTING

CONDITIONS, VERIFY ALL IN FIELD.

CODE. ADVISE ARCHITECT OF ANY

PRIOR TO THE START OF INTERIOR



EXISTING WALL

NEW WALL - SEE DETAIL 1/A.8

KEY NOTE LEGEND

- POCKET TRIM. SEE DETAIL 3/A.8 EXISTING POWER DROPS TO BE ROUTED ABOVE CEILING TILES TO BECOME NEW OUTLETS IN NEAREST NEW WALL(S). REPLACE ACT ABOVE ROUTED POWER DROP
- NEW OFOI CLASSROOM SIGNAGE, INSTALLED PER OH.A1 MOUNTING HEIGHTS
- EXISTING HM DOUBLE DOORS TO REMAIN, EXISTING
- MAGNETIC HOLD OPEN HARDWARE TO REMAIN EXISTING PARTITION'S FINISH IS PAINTED GWB AND PLAM WAINSCOT WITH A WOOD TOP CAP. NEW WALL TO TIE IN TO EXISTING GYP. MODIFY WOOD TOP CAP AND PLAM WAINSCOt.
- EXISTING FIRE EXTINGUISHER / FE CABINET

ELECTRICAL LEGEND

DUPLEX OUTLET	
POWER SWITCH	\$
POWER DROP	
FLOOR DUPLEX OUTLET	Φ
THERMOSTAT	(T)
FIRE ALARM	4
EXISTING	(E

FIRE EXTINGUISHER

PLAN CODE NOTES



ADA 5'-0" MINIMUM TURN RADIUS



EXIT DOOR TO EXIT DISCHARGE

CEILING FINISH P-1, P-4 AT COVE BASE EXISTING (2) NEW WALL EXIST WALL P-1, P-4 AT COVE BASE EXISTING (2) NEW 2"X REQ'D WOOD WAINSCOT CAP - PAINT, **EXIST WAINSCOT CAP** CONTINUOUS TO WALL CORNER P-1, P-4 AT COVE BASE EXISTING (2) PAINTED GWB TO MATCH EXIST A.8 WAINSCOT P-4, CONTINUOUS P-1, P-4 AT COVE BASE EXISTING (2) TO WALL CORNER EXIST WAINSCOT (PLAM OVER PLYWD) -FINISH FLOOR COVE BASE EXISTING (2) EXIST BASE

NEW TO EXIST WALL ELEVATION

CLEAR

TEMPERED

SAFETY GLASS

CLEAR

TEMPERED

SAFETY GLASS

CLEAR

TEMPERED

SAFETY GLASS

CLEAR

TEMPERED

CLEAR

TEMPERED

SAFETY GLASS

CLEAR

TEMPERED

SAFETY GLASS

CLEAR

TEMPERED

SAFETY GLASS

CLEAR

TEMPERED

SAFETY GLASS

SAFETY GLASS

FRAME

HM

FINISH

P-2

P-2

P-2

P-2

DETAILS

DETAIL

5/A.8

10/A.8

5/A.8

10/A.8

5/A.8

10/A.8

10/A.8

5/A.8

EXISTING CARPET AND VCT FLOOR TO REMAIN, SEE FLOOR PLAN FOR

ROOM FINISH SCHEDULE-OH

FLOOR FINISH

BROADLOOM

BROADLOOM

BROADLOOM

BROADLOOM

BROADLOOM

CARPET (1)

EXISTING

EXISTING

CARPET + VCT (1)

CARPET + VCT (1)

CARPET + VCT (1)

CARPET + VCT (1)

CLASSROOM EXISTING

CLASSROOM EXISTING

CLASSROOM EXISTING

CLASSROOM

NUMBER

B102

BASE FINISH

DOOR SCHEDULE - OH 1

Н

3' - 0" | 7' - 0" | 1 3/4"

3' - 0" | 7' - 0" | 1 3/4"

3' - 0" | 7' - 0" | 1 3/4"

3' - 0" 7' - 0" 1 3/4"

3' - 0" 7' - 0" 1 3/4"

3' - 0" | 7' - 0" | 1 3/4"

3' - 0" | 7' - 0" | 1 3/4"

3' - 0" 7' - 0" 1 3/4"

DOOR

SOLID CORE

SOLID CORE

SOLID CORE

SOLID CORE

WOOD

WOOD

SOLID CORE

SOLID CORE

WOOD

SOLID CORE

WOOD

TYPE

Α

FINISH

WAINSCOT

WAINSCOT

WAINSCOT

WAINSCOT

P-1

EXISTING ACT CEILING TO REMAIN, SEE REFLECTED CEILING PLAN FOR SPECIFIC REPAIRS

SEE SPECIFICATIONS FOR PAINT TYPE AND COLOR SELECTION EW WALLS TO BE PAINTED P-1. PAINTED AREAS WILL GO TO EITHER AN (ISTING WALL (CORNER) OR TO THE EDGE OF POCKET TRIM.

INT / EXT | SWING

180

INTERIOR

EXTERIOR

INTERIOR

EXTERIOR

INTERIOR

EXTERIOR

INTERIOR

EXTERIOR

	4.		/ALLS TO BE PA
	NO	HW	NEW / EXISTING
	B100	H-1	NEW
	БТОО	П-1	INEVV
	B101	H-4	EXISTING
	B102	H-1	NEW
	B103	H-4	EXISTING
<u> </u>	B104	H-1	NEW
H	B105	H-4	EXISTING

ÓH.2

EXIT

OH.2

CLASSROOM

B106

787 SF

20' - 5" ±

20' - 3" ±

B100

TO EXIT -

OPP


OH.A2

B107 H-4 EXISTING

B106 H-1 NEW

HM - HOLLOW METAL

Grand total: 8

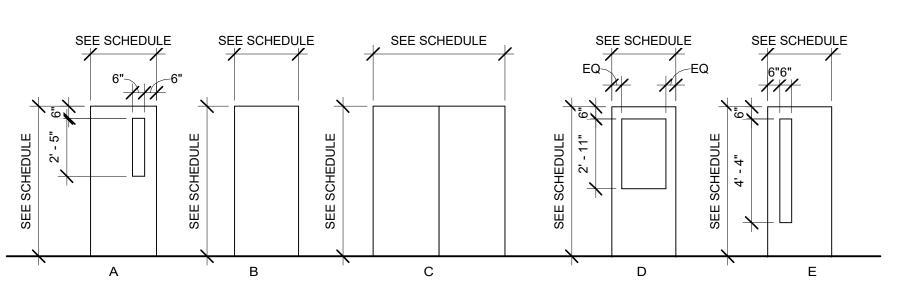

DOOR TYPES

DIFFUSER

SEE DOOR SCHEDULE FOR FINISH AND SIZE DETAILS MATCH PROFILE AND FINISH OF NEW DOORS TO EXISTING CLASSROOM DOORS IN PROJECT AREA. CONTRACTOR TO VERIFY LITE SIZE AND CONFIGURATION TO MATCH ON-SITE CONDITIONS

RCP LEGEND

ACT CEILING: EXISTING 2X4 OVERHEAD LIGHT

RCP KEY NOTE LEGEND

NEW ACT TILE WHERE LIGHTING IS REMOVED

EXISTING LIGHT TO BE REMOVED AND SALVAGED: SEE ELECTRICAL REPLACE ACT TILE

OCCUPANCY SENSOR

REFLECTED CEILING PLAN 1/8" = 1'-0"

OH.1

CLASSROOM

B104

847 SF

CLASSROOM

B102

830 SF

(B105)

SIM OPP 3

EXIT (F) (E) EXIT

(E)— (E)

(E)= (E)

(E) (E)

EXIT

EXIT

B103

214 SF

OH.A

OH.B

FLOOR PLAN

OH.1

1/8" = 1'-0"

OH.A

ÓH.B



Date: 3/29/2021 Project #: Drawn by: Checked by:

Revisions:

FLOOR PLAN, REFLECTED **CEILING** PLAN,

SCHEDULES

OH.A2


EXISTING ACT CEILING

SLIP TRACK

CASING BEAD

PER DETAIL 2/-

CLASSROOM

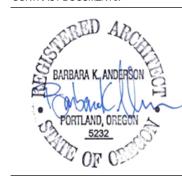


Date: 3/29/2021 Project #: Drawn by: Checked by:

Revisions:

GENERAL DETAILS


ACOUSTIC INSULATION -5/8" GYPSUM WALLBOARD 3 1/2" LIGHT GAUGE STEEL FRAMING AT 16" O.C., TYP NOTE: EQ STUDS NOT ACCEPTABLE

TYPICAL WALL ASSEMBLY

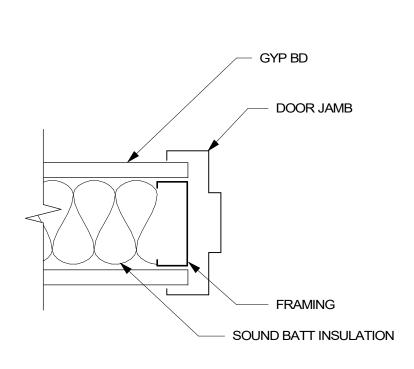


DOOR JAMB, TYP


SIM AT DOOR HEAD, TYP

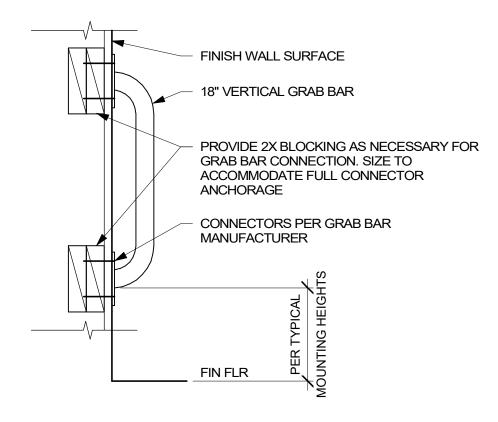


VERTICAL GRAB BAR DETAIL

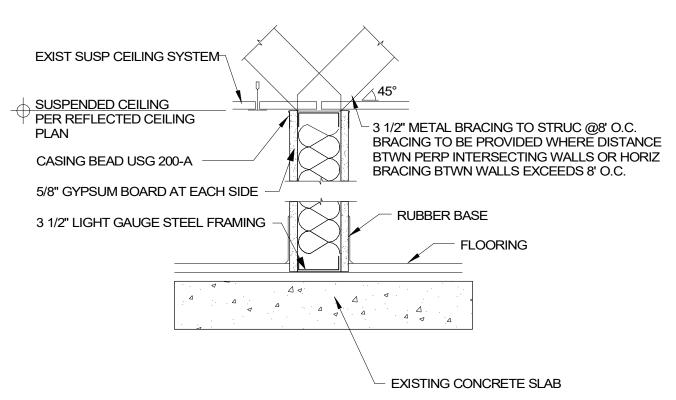


WALL - BASE TO UNDERSIDE OF ACT CEILING

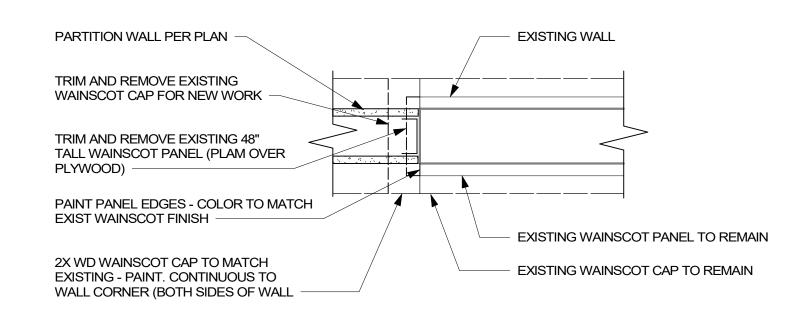


6A WAINSCOT MODIFICATION DETAIL @ END WALL

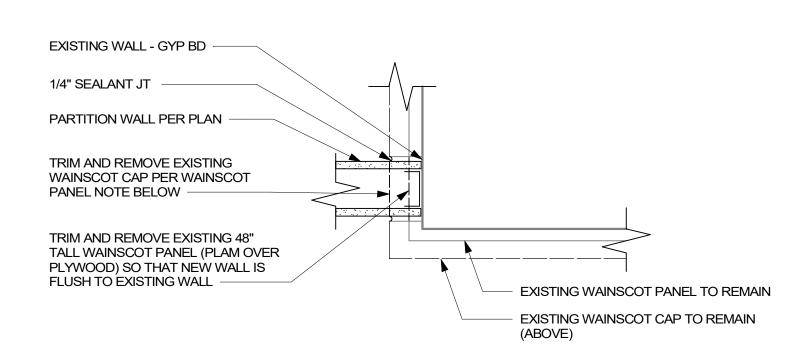


6BWAINSCOT MODIFICATION DETAIL@ CORNER

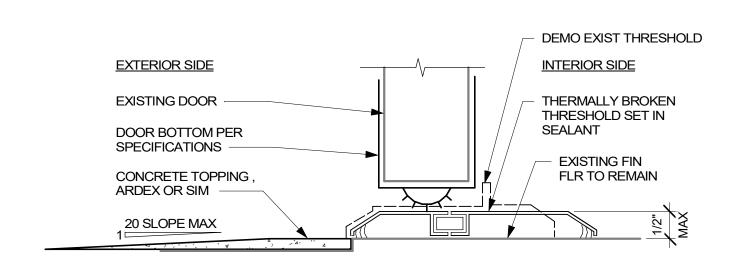


1 O DOOR BOTTOM AND THRESHOLD
6" = 1'-0"

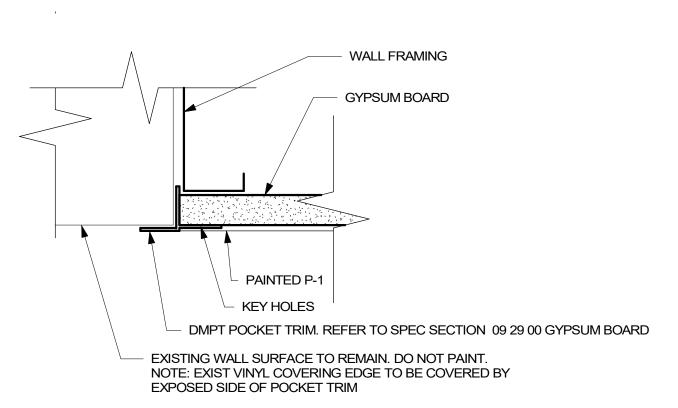

POCKET TRIM DETAIL

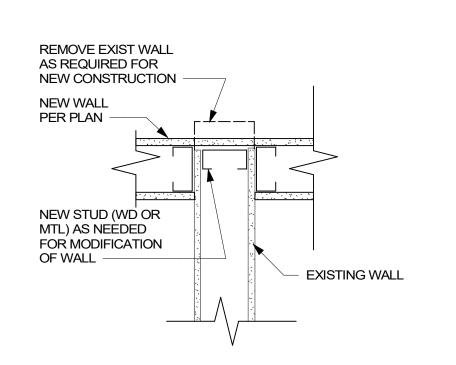

GYP COVERING WALL STUB
1 1/2" = 1'-0"

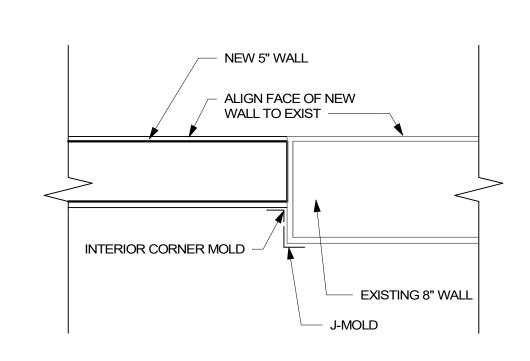

NEW WALL TO EXISTING PARTITION TRACK

8" WALL TO 5" WALL TRIM TRANSITION

EXIST STRUCTURE

FINSH TO REMAIN

PARTITION TRACK

EXIST ACT CEIL AT SIM CONDITION —

COMMON AREA (CLASSROOM AS SIM)

PARTITION WALL - ALIGN W/ FACE OF EXIST GYP

BD FINISH ABOVE

ABANDONED IN PLACE

EXIST GYP BD

DETAILS PER SCHOOL

SOME DETAILS APPLY TO SPECIFIC SCHOOLS. SEE LIST BELOW **BETHANY** 2/A.8 3/A.8 7/A.8 9/A.8 MONTCLAIR 1/A.8 2/A.8 3/A.8 5/A.8 7/A.8 OAK HILLS 1/A.8 2/A.8 3/A.8

5/A.8 6A/A.8 8/A.8 WEST TUALATIN VIEW

2/A.8 3/A.8 4/A.8 5/A.8 6B/A.8

10/A.8 - SEE DOOR SCHEDULES

Revisions:

Annotation INDICATES NEW EQUIPMENT. INDICATES EXISTING EQUIPMENT TO REMAIN. INDICATES EXISTING EQUIPMENT TO BE DEMOLISHED. INDICATES EXISTING EQUIPMENT OR DEVICE TO BE REMOVED AND

CONDUIT & CONDUCTOR CALLOUT. REFER TO CONDUIT & CONDUCTOR SCHEDULE. KEYED NOTE CALLOUT. REFER TO CORRESPONDING SHEET

KEYED NOTE CALLOUT. REFER TO CORRESPONDING SHEET KEYED NOTE CALLOUT. REFER TO CORRESPONDING SHEET

MECHANICAL EQUIPMENT CALLOUT. REFER TO MECHANICAL EQUIPMENT CONNECTION SCHEDULE. DETAIL CALLOUT. REFER TO DETAIL AND SHEET AS INDICATED ON

FIXTURE MOUNTING CALLOUT. HEIGHT ABOVE FINISHED FLOOR

EQUIPMENT CALLOUT. REFER TO NEMA CONNECTION SCHEDULE. SECTION CALLOUT. REFER TO DETAIL AND SHEET AS INDICATED ON CALLOUT. CALLOUT.

> ELEVATION CALLOUT. REFER TO DETAIL AND SHEET AS INDICATED ON CALLOUT.

CONDUIT AND/OR CONDUCTORS INSTALLED ABOVE GRADE,

Raceways

XX

X

EX.XX

XXXXX

XX'-XX"

(EX.XX)

CONCEALED IN WALL OR CEILING SPACE.
CONDUIT AND/OR CONDUCTORS INSTALLED BELOW GRADE, BELOW SLAB.
CONDUIT TURNED DOWN.
CONDUIT TURNED UP.
CONDUIT STUBBED AND CAPPED.
CONDUIT DIRECT CONNECTION TO EQUIPMENT.
FLEXIBLE CONNECTION TO EQUIPMENT.
CONDUIT / WIRING CONTINUATION.
HOMERUN TO PANELBOARD.
CABLE TRAY. SIZE AND TYPE AS INDICATED ON DRAWINGS.

Switches

SWILCHES		
_		
\$	SINGLE POLE SWITCH - MOUNTED AT 42" AFF, UON.	
+	LOW VOLTAGE 0-10 VOLT DIMMING SWITCH - MOUNTED AT 42" AFF, UON.	
	OCCUPANCY SENSOR - CEILING OR WALL MOUNTED.	
PP	OCCUPANCY SENSOR POWER PACK.	
PC PC	PHOTOCELL - CEILING OR WALL MOUNTED.	
\dashv	ADA DOOR PUSHPLATE.	
	EMERGENCY STOP SWITCH, MUSHROOM HEAD.	
•	PUSHBUTTON, SINGLE OR DOUBLE.	

Power Distribution

Φ	DUPLEX RECEPTACLE, MOUNTED AT 18" AFF, UON.
Ф	SIMPLEX RECEPTACLE, MOUNTED AT 18" AFF, UON.
\Pi	QUADPLEX RECEPTACLE, MOUNTED AT 18" AFF, UON.
\Diamond	GFCI DUPLEX RECEPTACLE, MOUNTED AT 18" AFF, UON.
*	GFCI QUADPLEX RECEPTACLE, MOUNTED AT 18" AFF, UON.
\Box	TAMPERPROOF DUPLEX RECEPTACLE, MOUNTED AT 18" AFF, UON.
#	TAMPERPROOF QUADPLEX RECEPTACLE, MOUNTED AT 18" AFF, UOI
\Diamond	NEMA SPECIAL RECEPTACLE, MOUNTED AT 18" AFF, UON. NEMA CONFIGURATION AS INDICATED.
igoplus	SIDE HATCHED RECEPTACLE, TO BE WIRED TO SWITCHED CIRCUIT.
	CENTER HATCHED RECEPTACLE TO BE WIRED TO EMERGENCY CIRCUIT.
\Box	RECEPTACLE MOUNTED ON CEILING.
Φ	RECEPTACLE MOUNTED IN-COUNTER.
	DISCONNECT SWITCH.
	FUSED DISCONNECT SWITCH.
	ENCLOSED CIRCUIT BREAKER.
	COMBINATION STARTER.
	FLOORBOX COMBINATION POWER & DATA.
	FLOORBOX POWER.
	POKETHRU COMBINATION POWER & DATA.
	POKETHRU POWER.
	POWER POLE.
	PANELBOARD SURFACE MOUNT.
	PANELBOARD FLUSH MOUNT.

Low Voltage

\triangleleft	ETHERNET OUTLET MOUNTED AT 18" AFF, UON.
\triangleleft	COAXIAL OUTLET MOUNTED AT 18" AFF, UON.
\triangleleft	PHONE OUTLET MOUNTED AT 18" AFF, UON.
\triangle	LOW VOLTAGE OUTLET CEILING MOUNTED.
(·))))	WIRELESS ACCESS POINT CEILING MOUNTED.
H-0))))	WIRELESS ACCESS POINT WALL MOUNTED.
\bigcap	DIGITAL CLOCK.
	FLOORBOX DATA.
	POKETHRU DATA.
	IT RACK.
A	VERTICAL WIRE MANAGEMENT.

MAIN DISTRIBUTION PANEL

UTILITY TRANSFORMER.

UTILITY CT METER.

Lighting

	,	
	TROFFER LUMINAIRE, SURFACE, RECESS, OR PENDANT MOUNTED AS INDICATED ON THE DRAWINGS.	
	DOWNLIGHT LUMINAIRE, SURFACE, RECESS, OR PENDANT MOUNTED AS INDICATED ON THE DRAWINGS.	
-	UNDERCABINET LUMINAIRE.	
	EMERGENCY BATTERY PACK LUMINAIRE, WALL OR CEILING MOUNTED.	
0 0	LINEAR PENDANT MOUNTED LUMINAIRE.	
	LINEAR WALL MOUNTED LUMINAIRE.	
÷ \	BOLLARD LUMINAIRE.	
	SITE LUMINAIRE POLE MOUNTED. NUMBER OF HEADS AS SHOWN.	
	TRACK LUMINAIRE.	
OI	SPOT LUMINAIRE.	
9	WALL MOUNTED LUMINAIRE.	
	RING PENDANT LUMINAIRE.	
\bigcirc	WALL WASH LUMINAIRE POINTED IN DIRECTION AS SHOWN.	
$\stackrel{\longrightarrow}{\boxtimes}$	EXIT SIGN, WALL OR CEILING MOUNTED, SINGLE FACE WITH DIRECTIONAL CHEVRONS AS INDICATED ON DRAWINGS.	
	EXIT SIGN, WALL OR CEILING MOUNTED, DOUBLE FACE WITH DIRECTIONAL CHEVRONS AS INDICATED ON DRAWINGS.	
	HALF HATCHED LUMINAIRE TO BE WIRED TO EMERGENCY CIRCUIT	
	FULL HATCHED LUMINAIRE TO BE WIRED TO NIGHTLIGHT CIRCUIT.	
Audio/Visual		
\Diamond	AV OUTLET - WALL MOUNTED AT 18" AFF, UON. SEE AUDIO VISUAL DETAILS FOR CONFIGURATIONS.	

S	AUDIO SPEAKER - WALL MOUNTED AT 96" AFF, UON.
S	AUDIO SPEAKER - CEILING MOUNTED.
P	PAGING SPEAKER - WALL MOUNTED AT 96" AFF, UON.
P	PAGING SPEAKER - CEILING MOUNTED.
	PAGING HORN - WALL MOUNTED AT 96" AFF, UON.
	INTERCOM SPEAKER - WALL MOUNTED AT 96" AFF, UON.
	INTERCOM SPEAKER - CEILING MOUNTED.
1	INTERCOM CALL BUTTON - MOUNTED AT 42", UON.
AE	ADMINISTRATION CONSOLE. PROVIDE ONE (1) CAT6 CABLE.
$\boxed{\circ}$	AV PROJECTOR - CEILING MOUNTED.
AE	AUDIO ENHANCEMENT DEVICE.

AUDIO VIDEO OUTLET - CEILING MOUNTED.

Miscellaneous

Miscellaneous		
(J) [J]	JUNCTION BOX (ROUND, SQUARE).	
_	SONOTION BOX (NOOND, OQUANE).	
T	THERMOSTAT.	
R	RELAY.	
Ą	CORD REEL.	
	MOTOR / EXHAUST FAN.	
	CEILING FAN.	
	UTILITY POLE.	
\cap	WEATHERHEAD.	
\otimes	GROUND ROD.	
\bigotimes	GROUND ROD WITH TEST WELL.	
V///////	SURFACE RACEWAY / WIREMOLD.	
	FIRE RATED BACKBOARD.	

GROUND BUS BAR.

Fire Alarm

H(0)) 15	FIRE ALARM AUDIO/VISUAL - WALL MOUNTED. CANDELA RATING AS SHOWN ON DRAWING.
H O 15	FIRE ALARM VISUAL - WALL MOUNTED. CANDELA RATING AS SHOWN ON DRAWING.
(a) (b)) 15	FIRE ALARM AUDIO/VISUAL - CEILING MOUNTED. CANDELA RATING AS SHOWN ON DRAWING.
15	FIRE ALARM VISUAL - CEILING MOUNTED. CANDELA RATING AS SHOWN ON DRAWING.
FB	FIRE ALARM BELL.
©	FIRE ALARM SMOKE DETECTOR - CEILING MOUNTED.
	FIRE ALARM SMOKE DETECTOR - WALL MOUNTED.
(H)	FIRE ALARM HEAT DETECTOR - CEILING MOUNTED.
	FIRE ALARM HEAT DETECTOR - WALL MOUNTED.
	FIRE ALARM DUCT SMOKE DETECTOR.
TS	FIRE ALARM DUCT SMOKE DETECTOR WITH REMOTE TEST STATION.
F	FIRE ALARM MANUAL PULL STATION - WALL MOUNTED.
TS	FIRE ALARM MANUAL TAMPER SWITCH.
FS	FIRE ALARM MANUAL FLOW SWITCH.
PS	FIRE ALARM MANUAL PRESSURE SWITCH.
ММ	FIRE ALARM MONITOR MODULE.
RI	FIRE ALARM RELAY INPUT.
RO	FIRE ALARM RELAY OUTPUT.
PIV	FIRE ALARM POST INDICATOR VALVE.
SA	FIRE ALARM SURGE ARRESTOR.
IM	FIRE ALARM ISOLATION MODULE.
FAA	FIRE ALARM ANNUNCIATOR.
	FIRE ALARM MAGNETIC DOOR HOLD.
Access	Control & Security

Access Control & Security

	DOOR FRAME TO ACCESSIBLE CEILING OR SECURITY JUNCTION BOX AS SHOWN ON THE DRAWINGS.
	ACCESS CONTROL - CARD READER. PROVIDE 3/4" CONDUIT FROM DOOR FRAME TO ACCESSIBLE CEILING OR SECURITY JUNCTION BOX AS SHOWN ON THE DRAWINGS.
	ACCESS CONTROL - ELECTRIC STRIKE. PROVIDE 3/4" CONDUIT FROM DOOR FRAME TO ACCESSIBLE CEILING OR SECURITY JUNCTION BOX AS SHOWN ON THE DRAWINGS.
	ACCESS CONTROL - KEY PAD. PROVIDE 3/4" CONDUIT FROM DOOR FRAME TO ACCESSIBLE CEILING OR SECURITY JUNCTION BOX AS SHOWN ON THE DRAWINGS.
	ACCESS CONTROL - MAGNETIC LOCK. PROVIDE 3/4" CONDUIT FROM DOOR FRAME TO ACCESSIBLE CEILING OR SECURITY JUNCTION BOX AS SHOWN ON THE DRAWINGS.
	ACCESS CONTROL - REQUEST TO EXIT. PROVIDE 3/4" CONDUIT FROM DOOR FRAME TO ACCESSIBLE CEILING OR SECURITY JUNCTION BOX AS SHOWN ON THE DRAWINGS.
	ACCESS CONTROL - ELECTRIFIED PANIC BAR. PROVIDE 3/4" CONDUIT FROM DOOR FRAME TO ACCESSIBLE CEILING OR SECURITY JUNCTION BOX AS SHOWN ON THE DRAWINGS.
	ACCESS CONTROL - SECURITY JUNCTION BOX. SIZED AS RECOMMENDED BY SECURITY SYSTEM MANUFACTURER.
	ACCESS CONTROL - CAMERA / INTERCOM.
	ACCESS CONTROL - PANIC BUTTON.
Ŋ	SECURITY CAMERA - CEILING MOUNTED. PROVIDE ONE (1) CAT6.
Ú	SECURITY CAMERA - WALL MOUNTED. PROVIDE ONE (1) CAT6.
	INTRUSION SENSOR - CEILING MOUNTED.
	INTRUSION SENSOR - WALL MOUNTED.
	INTRUSION KEYPAD.

ACCESS CONTROL - DOOR CONTACT. PROVIDE 3/4" CONDUIT FROM



SEE DRAWING E.1 FOR ABBREVIATIONS AND SYMBOL LEGEND.

SHEET KEY NOTES

- CONTRACTOR SHALL DEMOLISH EXISTING
 POWER/DATA POLE. EXISTING HORIZONTAL CABLES
 FOR POWER AND DATA SHALL BE REUSED IN NEW
 WALL. SEE OH.E2.
- 2. REMOVE EXISTING CORRIDOR LIGHT SWITCH. SEE OH.E2 FOR NEW LIGHT SWITCH LOCATION.



Landis Consulting
ENGINEERING SERVICES
Salem | Lake Oswego
503-584-1576
www.landisconsulting.com

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EXPIRES: 12-31-202

SCHOOL (1)

900

900

CURITY UPGRAI

CURITY UPGRAI

OAK HILLS ELEMENTARY SCHO
2625 NW 153RD AVE,
BEAVERTON, OR 97006


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Project #: 4008


Checked by:

OAK HILL ELECTRICAL DEMOLITION

PLANS


OH.ED2

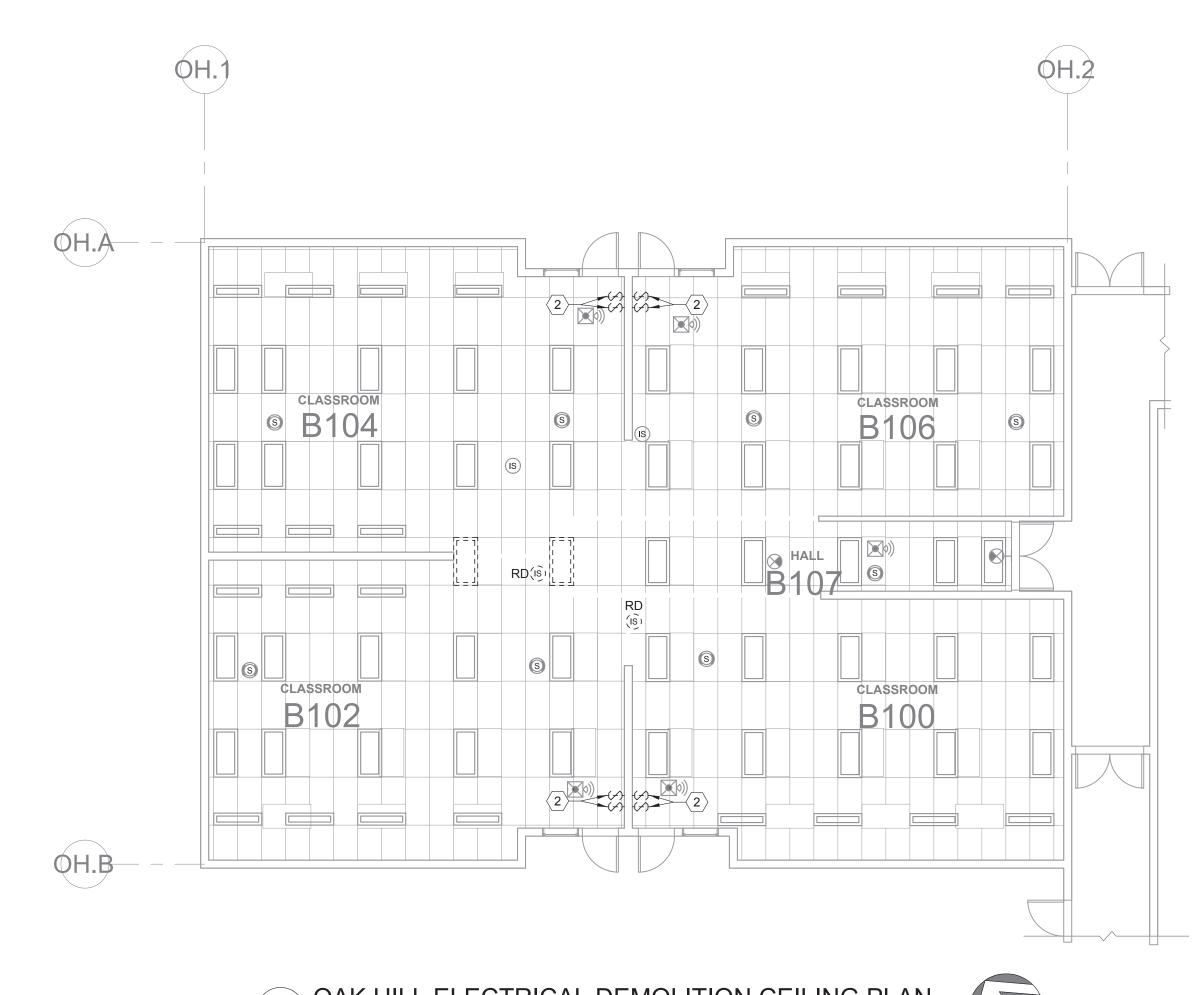


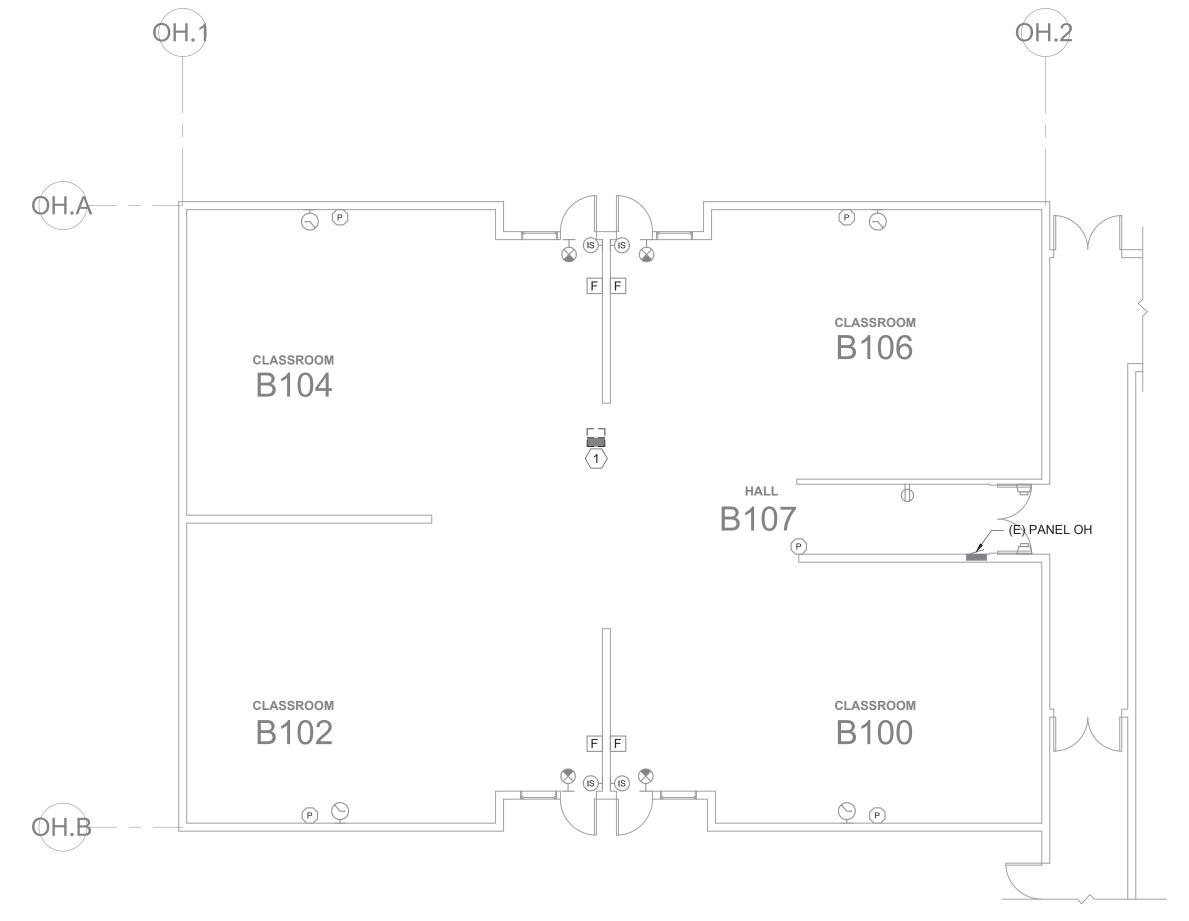






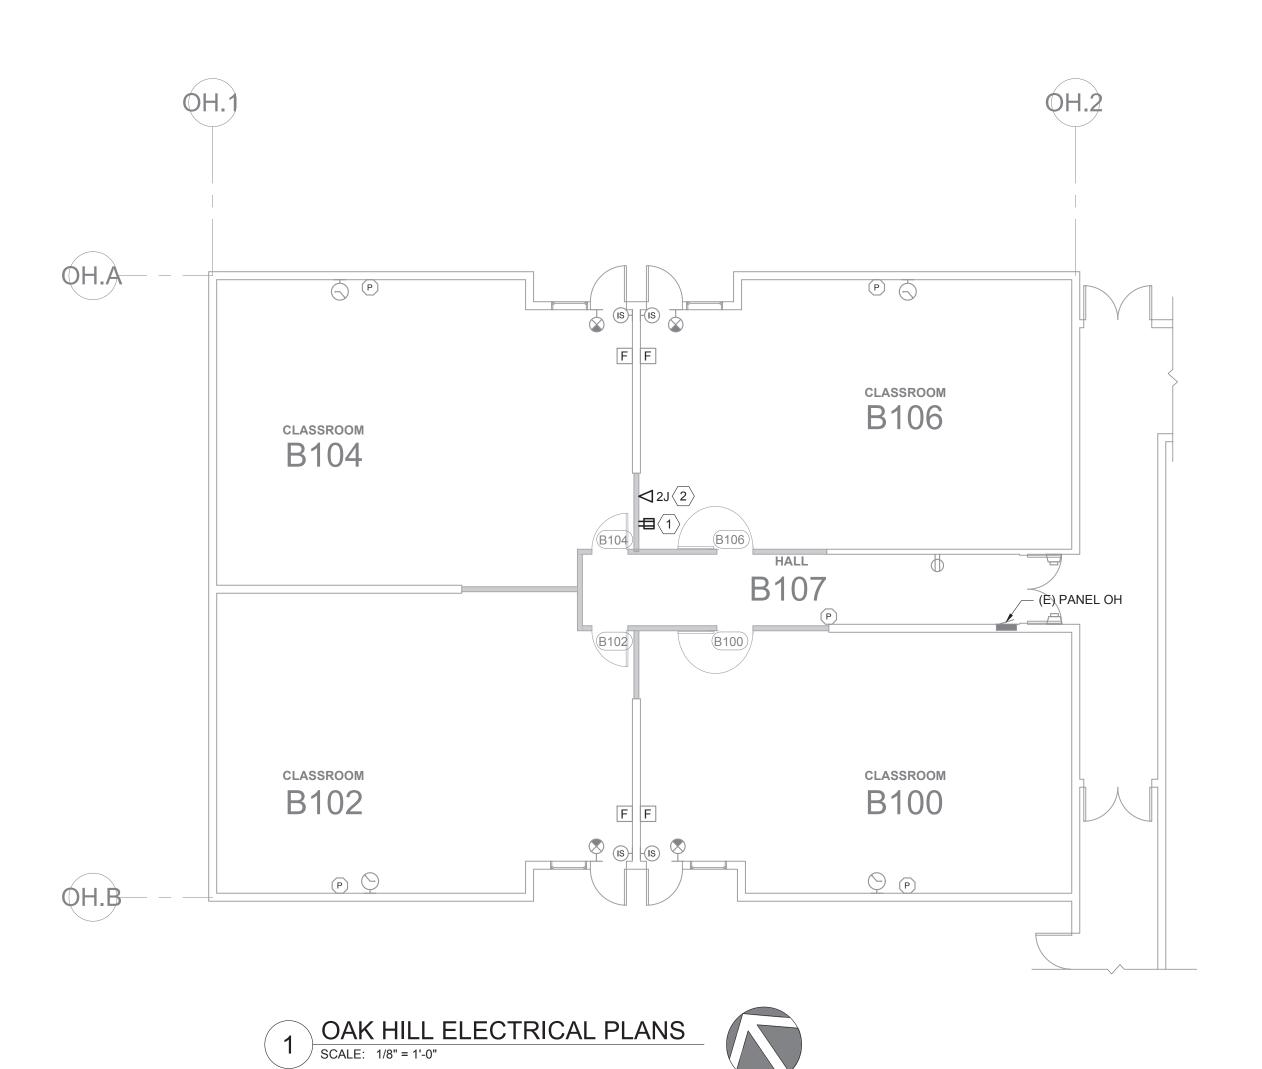

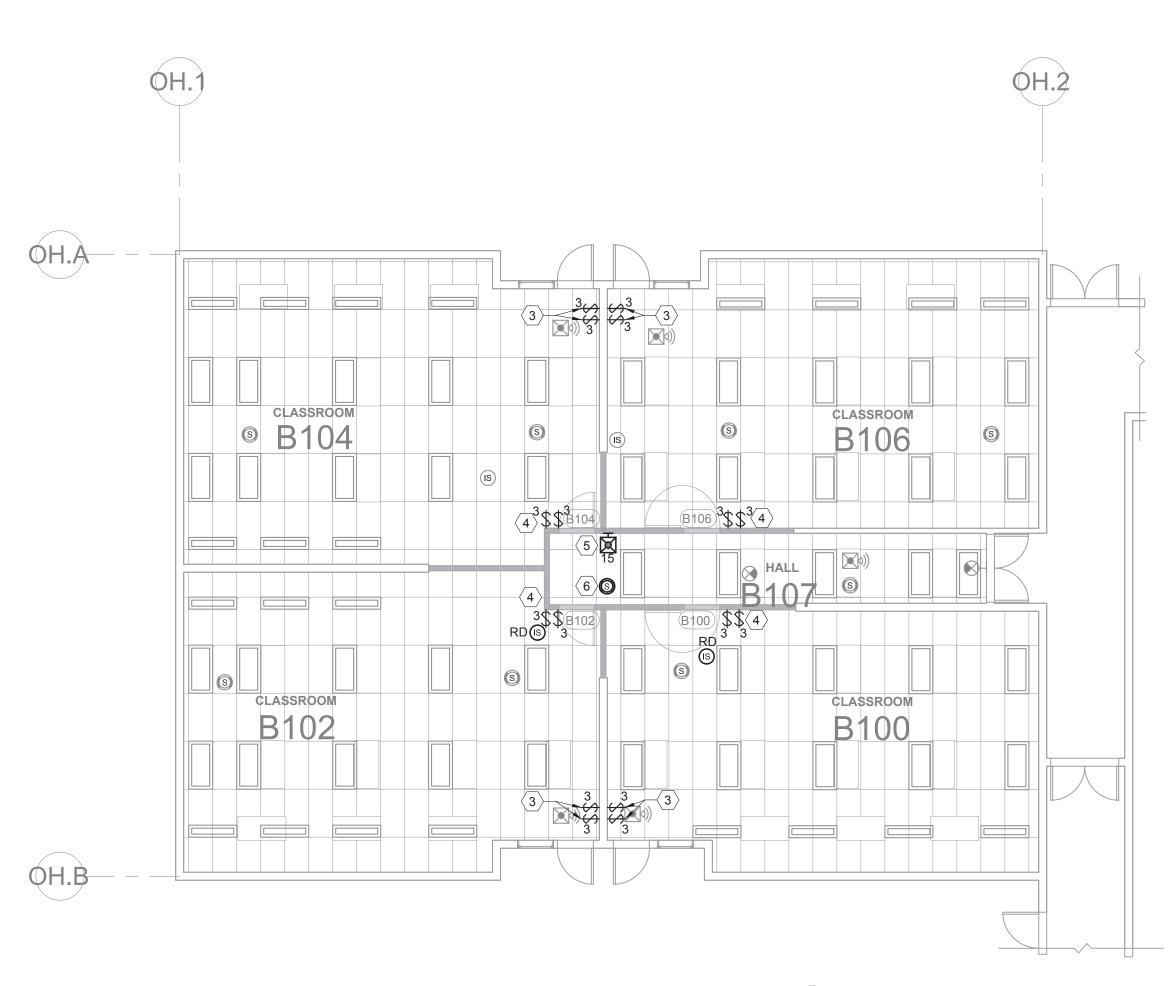

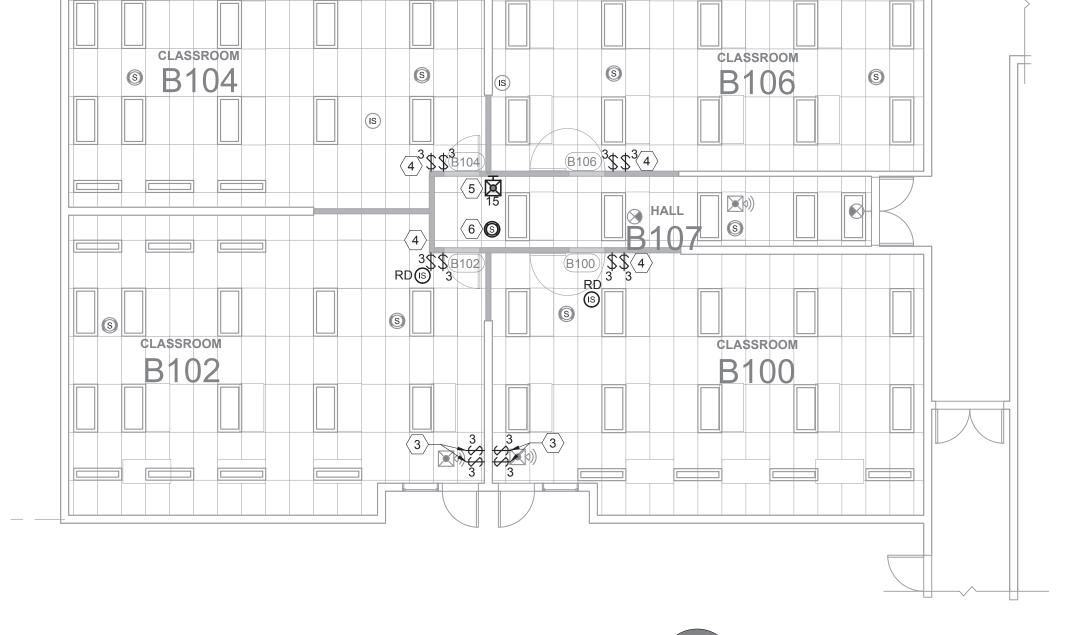

OAK HILL ELECTRICAL CEILING PLAN

SCALE: 1/8" = 1'-0"

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EXPIRES: 12-31-2022

BEAVERTON SCHED

Date: Checked by:

Revisions:

OAK HILL ELECTRICAL **PLANS**

OH.E2