Rock Creek Elementary School Freezer Replacement

4125 NW 185th Ave Portland, OR 97229

AHJ: WASHINGTON COUNTY TAX LOT #: 1N224DD00100

Finish Tags

AND

ANOD ANODIZED

BLDG BUILDING

BTWN BETWEEN

CB CATCH BASIN

CL CENTERLINE

CONT CONTINUOUS

CORR CORRIDOR CR CLASSROOM

CSMT CASEMENT

DBL DOUBLE

DIAG DIAGONAL

DIM DIMENSION

DISP DISPENSER

CT CERAMIC TILE

DRINKING FOUNTAIN

CLG CEILING


BENCH MARK

ANNOTATION SYMBOLS:


Room Tags

Equipment Tag

XX 20R @ 1' - 0"

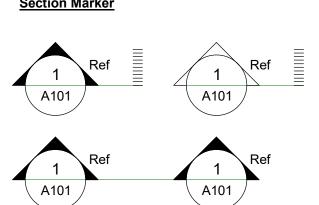


Elevation Marker

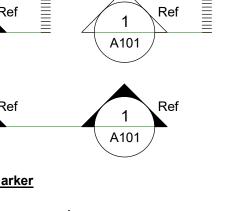

<u>Titlemark</u> ↑ View Name A101 / Scale: 1/8" = 1'-0" Revision Tags

VICINITY MAP:

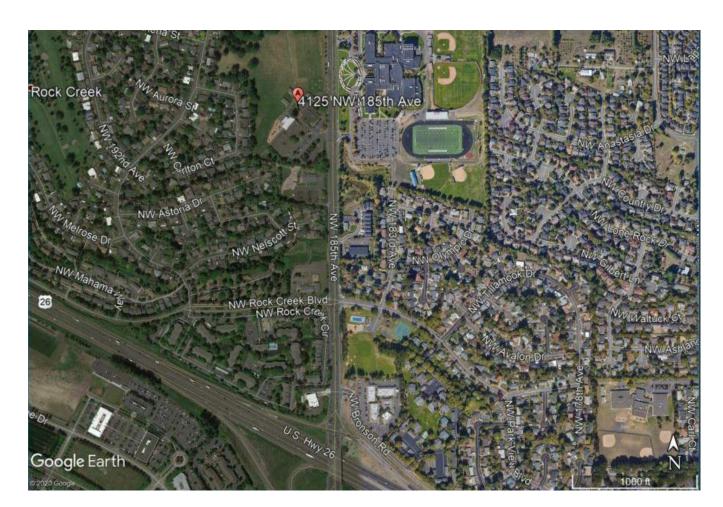

DAMPROOFING ACT ACOUSTICAL CEILING TILE DOWNSPOUT AESS ARCHITECTURAL EXPOSED STRUCTURAL STEEL DRAWING **EXISTING** ABOVE FINISH FLOOR ALS AREA LIGHT STANDARD EA EACH EXHAUST FAN **EXPANSION JOINT** ELEVATION ELEC ELECTRICAL ENGR ENGINEER EDGE OF SLAB EQ EQUAL EQUIP EQUIPMENT **EACH WAY** CCTV CLOSED CIRCUIT TELEVISION EXPANSION EXTERIOR CAST IN PLACE CONCRETE FIRE ALARM FLOOR DRAIN FOUNDATION FIRE EXTINGUISHER FIRE EXTINGUISHER CABINET CMU CONCRETE MASONRY UNIT FINISH FLOOR FLOOR CSJ CONSTRUCTION JOINT FACE OF

FIRE EXTINGUISHER CABINET WITH BLANKET FACE OF CONCRETE FACE OF FINISH FACE OF MASONRY FOS FACE OF STUD FIRE RETARDANT TREATED FTG FOOTING FURR FURRING GA GAUGE

GALVANIZED GRAB BAR GYPSUM VENEER PLASTER GYPSUM WALL BOARD HANDICAP **HOLLOW METAL** HIGH PERFORMANCE COATING HEATING, VENTILATION, AND AIR CONDITIONING INSULATION JOIST JOINT LENGTH LAVATORY LAG BOLT LANDSCAPING LOUVER MATERIAL MARKERBOARD MEZZANINE MANUFACTURER

NOT IN CONTRACT NOT TO SCALE ON CENTER OUTSIDE DIAMETER OVERFLOW DRAIN OWNER FURNISHED CONTRACTOR INSTALLED OFOI OWNER FURNISHED OWNER INSTALLED OPNG OPENING OPPOSITE OUTSIDE PROPERTY LINE PLAS PLASTER PLYWD PLYWOOD PSF PER SQUARE FOOT PRESSURE TREATED PVMT PAVEMENT REFLECTED CEILING PLAN **ROOF DRAIN** REFERENCE REFR REFRIGERATOR REQ'D REQUIRED REV REVISE OR REVISION ROUGH OPENING SAHTS SELF-ADHERED HIGH TEMPERATURE SHEET SELF-ADHERED MEMBRANE SOLID CORE SECT SECTION SQUARE FOOT SHEET SHTG SHEATHING SHWR SHOWER SIM SIMILAR

SEISMIC JOINT SHEET METAL STAINLESS STEEL STANDARD STL STEEL STOR STORAGE STRUCT STRUCTURAL TEMPERED GLAZING T&G TONGUE AND GROOVE TO MATCH TOP OF CURB TELEPHONE THICK TOOL JOINT TOP OF TOP OF DECK TOP OF STRUCTURE TOILET PAPER TUBE STEEL UNFIN UNFINISHED UNLESS NOTED OTHERWISE VAPOR BARRIER VESTIBULE WITH WITHOUT WATER CLOSET WD WOOD WIDE FLANGE WATER HEATER WATERPROOFING WRB WATER-RESISTIVE BARRIER SHEET INDEX G0000 **COVER PAGE** SITE PLAN & CODE REVIEW DEMOLITION FLOOR PLANS AND SECTIONS SYMBOLS, NOTES, & INDEX **EQUIPMENT FLOOR PLAN & SCHEDULE** REFRIGERATION & BUILDING WORKS PLANS / CONSTRUCTION DETAILS SYMBOL LIST AND GENERAL NOTES - PLUMBING E0000 SYMBOL LIST AND GENERAL NOTES - ELECTRICAL FLOOR PLAN - ELECTRICAL

DEFERRED SUBMITTALS:

SUSPENDED ACOUSTIC CEILINGS

WEST LINN-WILSONVILLE 22210 SW Stafford Road Tualatin, OR 97062 NAME: Remo Douglas EMAIL: DouglasR@wlwv.k12.or.us PHONE: (503) 673-7988

ARCHITECTURE IBI IBI GROUP

907 SW Harvey Milk Street Portland, Oregon 97205 NAME: Jim Fitzpatrick EMAIL: jim.fitzpatrick@ibigroup.com PHONE: (503) 226-6950

ELECTRICAL

INTERFACE ENGINEERING, INC. 100 SW MAIN STREET, SUITE Portland, Oregon 97204 NAME: Mark O'Leary PE PHONE: (503) 382 - 2635

INTERFACE ENGINEERING, INC. 100 SW MAIN STREET, SUITE Portland, Oregon 97204 NAME: Mark O'Leary PE PHONE: (503) 382 - 2635

Plumbing

webb. WEBB FOODSERVICE DESIGN 3700 SE Lafayette Ct. Portland, Oregon 97202 NAME: PHONE: (503) 236 - 8566

FOOD SERVICE

MISCELLANEOUS

MOUNTED

NEW

NA NOT APPLICABLE

907 SW Harvey Milk Street Portland, OR 97205, USA tel 503 226 6950 fax 503 273 9192 PROJECT NO:

SHEET NUMBER


PRIME CONSULTANT

Beaverton School District

16550 SW Merlo Rd. Beaverton OR 97003

eezer | 25 NW ortland

A BID DOCUMENTS

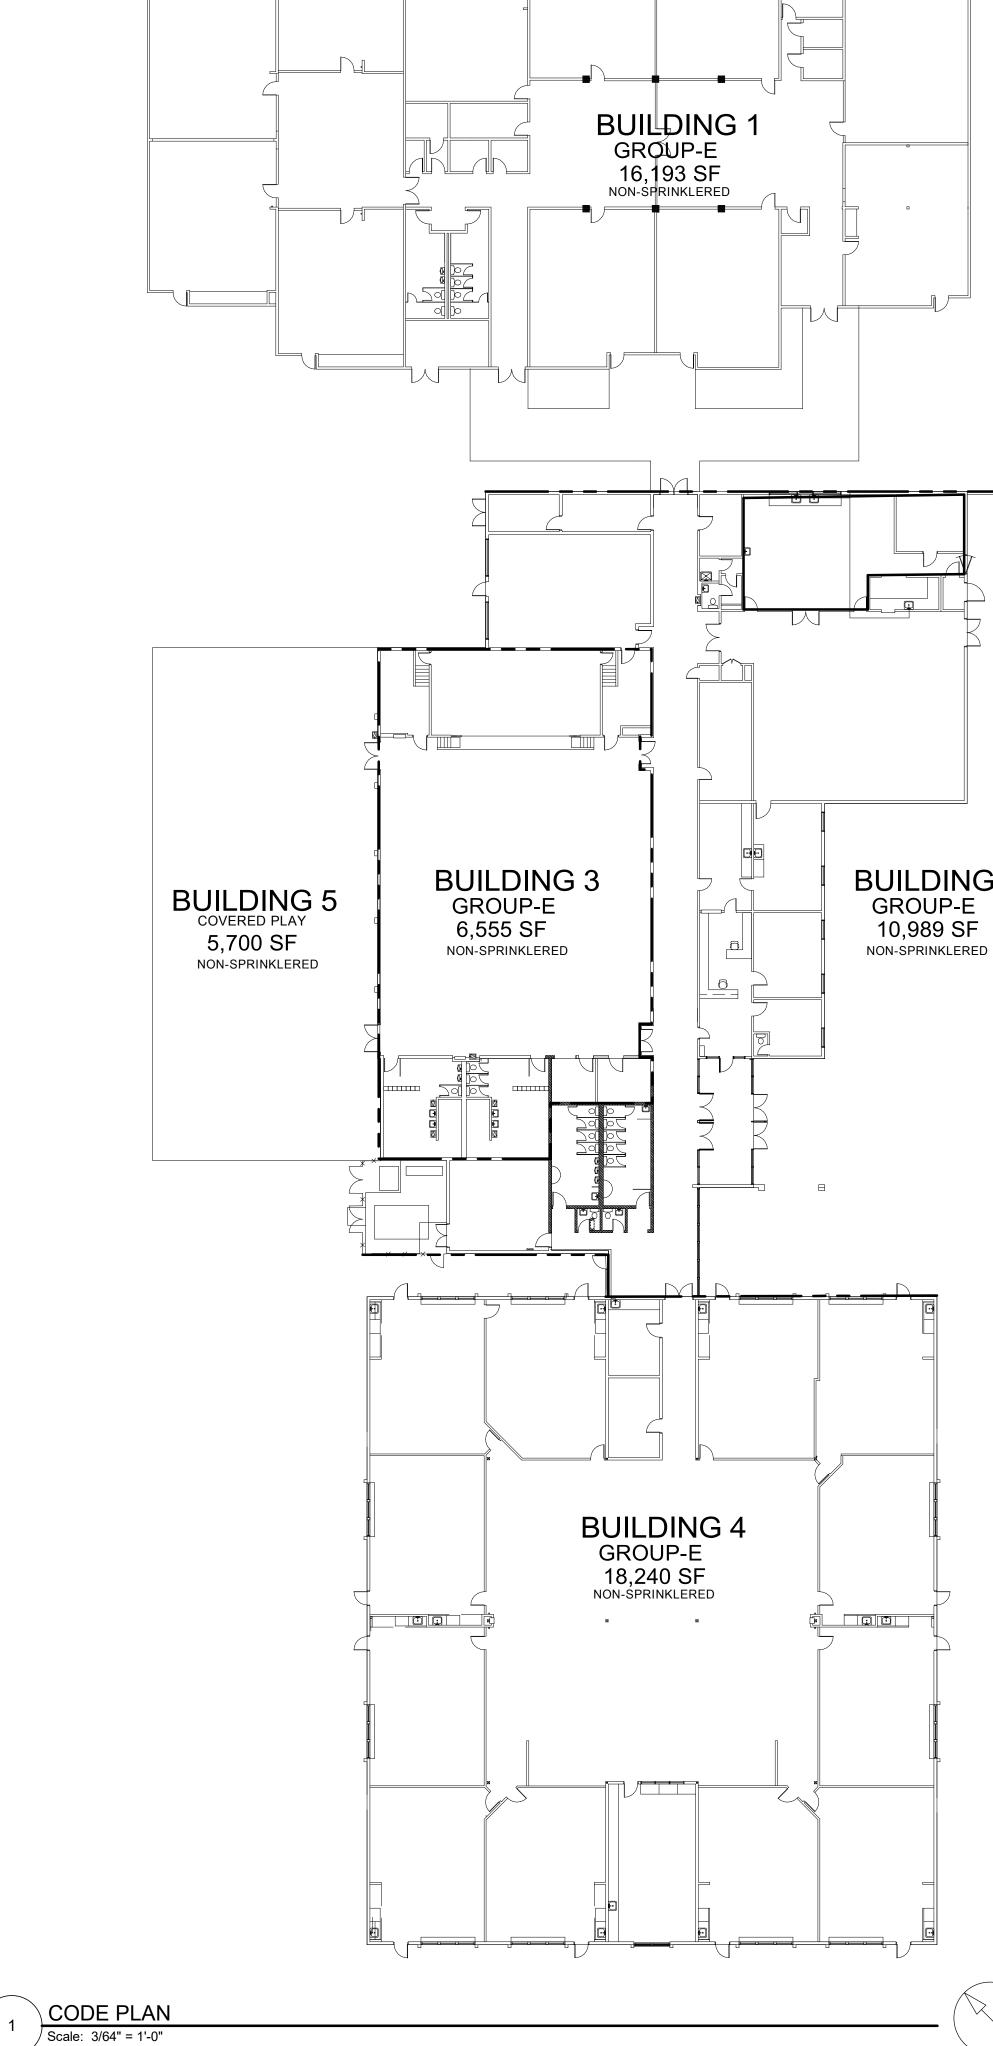

ACTUAL NUMBER OF STORIES: 1 STORY DESCRIPTION ALLOWABLE AREA: 9,500 SF PER TABLE 506.2 A BID DOCUMENTS AREA MODIFICATION: (PER SECTION 506) $A = A + [NS \times I_f] = 9,500 + [9,500 \times 0.75] = 16,625$ $| I_f = \left[\frac{F}{P} - 0.25 \right] \frac{W}{30} = |$ A = 9,500 + 7,125 = 16,625 SF TOTAL ALLOWABLE AREA PER FLOOR: 16,625 SF <u>TOTAL ACTUAL AREA:</u> 16,193 SF < 16,625 SF = OK (ACTUAL IS LESS THAN ALLOWABLE. THEREFORE, BUILDING '1' AREA IS OK) BUILDING 2 - CLASSROOMS, CAFETERIA, & OFFICES BUILDING '2' IS SINGLE STORY COMBUSTIBLE CONSTRUCTION WITH PARTIAL OPEN FRONTAGE. IT DOES NOT HAVE AN AUTOMATIC SPRINKLER SYSTEM <u>USE & OCCUPANCY:</u> EDUCATIONAL GROUP E CONSISTING OF CLASSROOMS, A CAFETERIA, AND OFFICES CONSTRUCTION TYPE: TYPE V-B PER TABLE 601 ALLOWABLE HEIGHT: 40' (PER TABLE 504.3) ALLOWABLE NUMBER OF STORIES: 1 STORY (PER TABLE 504.4) CONSULTANTS ACTUAL NUMBER OF STORIES: 1 STORY ALLOWABLE AREA: 9,500 SF PER TABLE 506.2 AREA MODIFICATION: (PER SECTION 506) A = 9,500 + 1,235 = 10,735 SF TOTAL ALLOWABLE AREA PER FLOOR: 10,735 SF TOTAL ACTUAL AREA: 10,989 SF > 10,735 SF (ACTUAL IS MORE THAN ALLOWABLE. HOWEVER, THE EXISTING BUILDING SQUARE FOOTAGE IS NOT BEING INCREASED AS PART OF THIS PROJECT.) **BUILDING 3 - GYMNASIUM** SUMMARY:
BUILDING '3' IS SINGLE STORY COMBUSTIBLE CONSTRUCTION WITH PARTIAL OPEN FRONTAGE. IT DOES NOT HAVE AN AUTOMATIC SPRINKLER SYSTEM <u>USE & OCCUPANCY:</u> EDUCATIONAL GROUP E CONSISTING OF GYMNASIUM AND RELATED SUPPORT SPACES CONSTRUCTION TYPE: TYPE V-B PER TABLE 601 ALLOWABLE HEIGHT: 40' (PER TABLE 504.3) ALLOWABLE NUMBER OF STORIES: 1 STORY (PER TABLE 504.4) **BUILDING 2** ACTUAL NUMBER OF STORIES: 1 STORY ALLOWABLE AREA: 9,500 SF PER TABLE 506.2 NON-SPRINKLERED TOTAL ACTUAL AREA: 6,555 SF < 9,500 SF = OK (ACTUAL IS LESS THAN ALLOWABLE. THEREFORE, BUILDING '3' AREA IS OK) BUILDING 4 - CLASSROOMS AND MEDIA CENTER SUMMARY:
BUILDING '4' IS SINGLE STORY COMBUSTIBLE CONSTRUCTION WITH PARTIAL OPEN FRONTAGE. IT DOES NOT HAVE AN AUTOMATIC SPRINKLER SYSTEM <u>USE & OCCUPANCY:</u> EDUCATIONAL GROUP E CONSISTING OF CLASSROOMS, A CAFETERIA, AND OFFICES CONSTRUCTION TYPE: TYPE V-B PER TABLE 601 ALLOWABLE HEIGHT: 40' (PER TABLE 504.3) ALLOWABLE NUMBER OF STORIES: 1 STORY (PER TABLE 504.4) ACTUAL NUMBER OF STORIES: 1 STORY ALLOWABLE AREA: 9,500 SF PER TABLE 506.2 AREA MODIFICATION: (PER SECTION 506) $A_{\overline{a}} A_{\overline{b}} \left[NS \times I_{f} \right] = 9,500 + \left[9,500 \times 0.61 \right] = 14,345$ A = 9,500 + 5,795 = 15,295 SF TOTAL ALLOWABLE AREA PER FLOOR: 15,295 SF TOTAL ACTUAL AREA: 18,240 SF > 15,295 SF (ACTUAL IS MORE THAN ALLOWABLE. HOWEVER, THE EXISTING BUILDING SQUARE FOOTAGE IS NOT BEING INCREASED AS PART OF THIS PROJECT.) BUILDING 5 - COVERED PLAY SUMMARY: BUILDING '3' IS SINGLE STORY COMBUSTIBLE CONSTRUCTION WITH PARTIAL OPEN FRONTAGE. IT DOES NOT HAVE AN AUTOMATIC SPRINKLER SYSTEM <u>USE & OCCUPANCY:</u> EDUCATIONAL GROUP E IBI GROUP
907 SW Harvey Milk Street
Portland, OR 97205, USA
tel 503 226 6950 fax 503 273 9192
ibigroup-edpnw.com CONSISTING OF GYMNASIUM AND RELATED SUPPORT SPACES CONSTRUCTION TYPE: TYPE V-B PER TABLE 601 ALLOWABLE HEIGHT: 40' (PER TABLE 504.3) ALLOWABLE NUMBER OF STORIES: 1 STORY (PER TABLE 504.4) Rock Creek Elementary School Freezer Replacement 4125 NW 185th Ave Portland, OR 97229 ACTUAL NUMBER OF STORIES: ALLOWABLE AREA: 9,500 SF PER TABLE 506.2 TOTAL ACTUAL AREA: 5,700 SF < 9,500 SF = OK (ACTUAL IS LESS THAN ALLOWABLE. THEREFORE, BUILDING '5' AREA IS OK) PROJECT NO: 126730 DRAWN BY: CHECKED BY: Checker APPROVED BY: PROJECT MGR:

CODE REVIEW NOTES:

TILE AND GRID IN THE KITCHEN.

LEGEND:

1. THIS CODE REVIEW IS BASED ON THE 2019 O.S.S.C.

2. THE SCOPE OF WORK FOR THIS PROJECT INCLUDES THE REMOVAL

3. THE ESTIMATED VALUE OF WORK FOR THIS PROJECT IS \$151,531

AND REPLACEMENT OF AN EXISTING FREEZER/COOLER UNIT IN THE

KITCHEN. THERE IS ALSO AN ALTERNATE FOR REPLACING THE CEILING

AT BUILDING EXTERIOR

AREA OF SCOPE OF WORK

TWO HOUR FIRE WALL ASSEMBLY - 90 MINUTE

RATED OPENINGS - ASSUMED PROPERTY LINE

ALLOWABLE AREA ANALYSIS:

CONSISTING OF CLASSROOMS AND A LIBRARY

BUILDING '1' IS SINGLE STORY COMBUSTIBLE CONSTRUCTION WITH PARTIAL

OPEN FRONTAGE. IT DOES NOT HAVE AN AUTOMATIC SPRINKLER SYSTEM

BUILDING 1 - CLASSROOMS

<u>USE & OCCUPANCY:</u> EDUCATIONAL GROUP E

CONSTRUCTION TYPE: TYPE V-B PER TABLE 601

ALLOWABLE NUMBER OF STORIES: 1 STORY (PER TABLE 504.4)

ALLOWABLE HEIGHT:

40' (PER TABLE 504.3)


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11/20/2020




SITE PLAN


Scale: 1" = 60'-0"

G1101

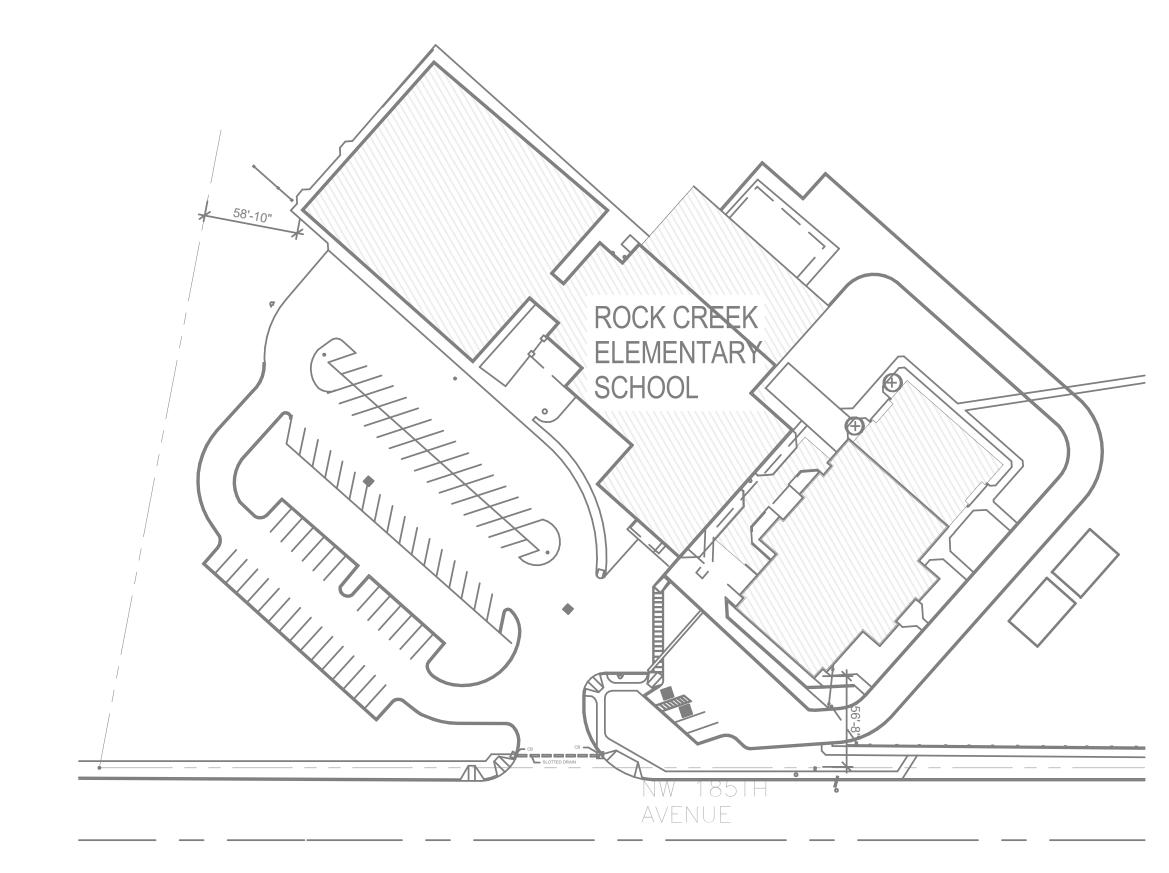Designer SHEET TITLE

SITE PLAN & CODE REVIEW

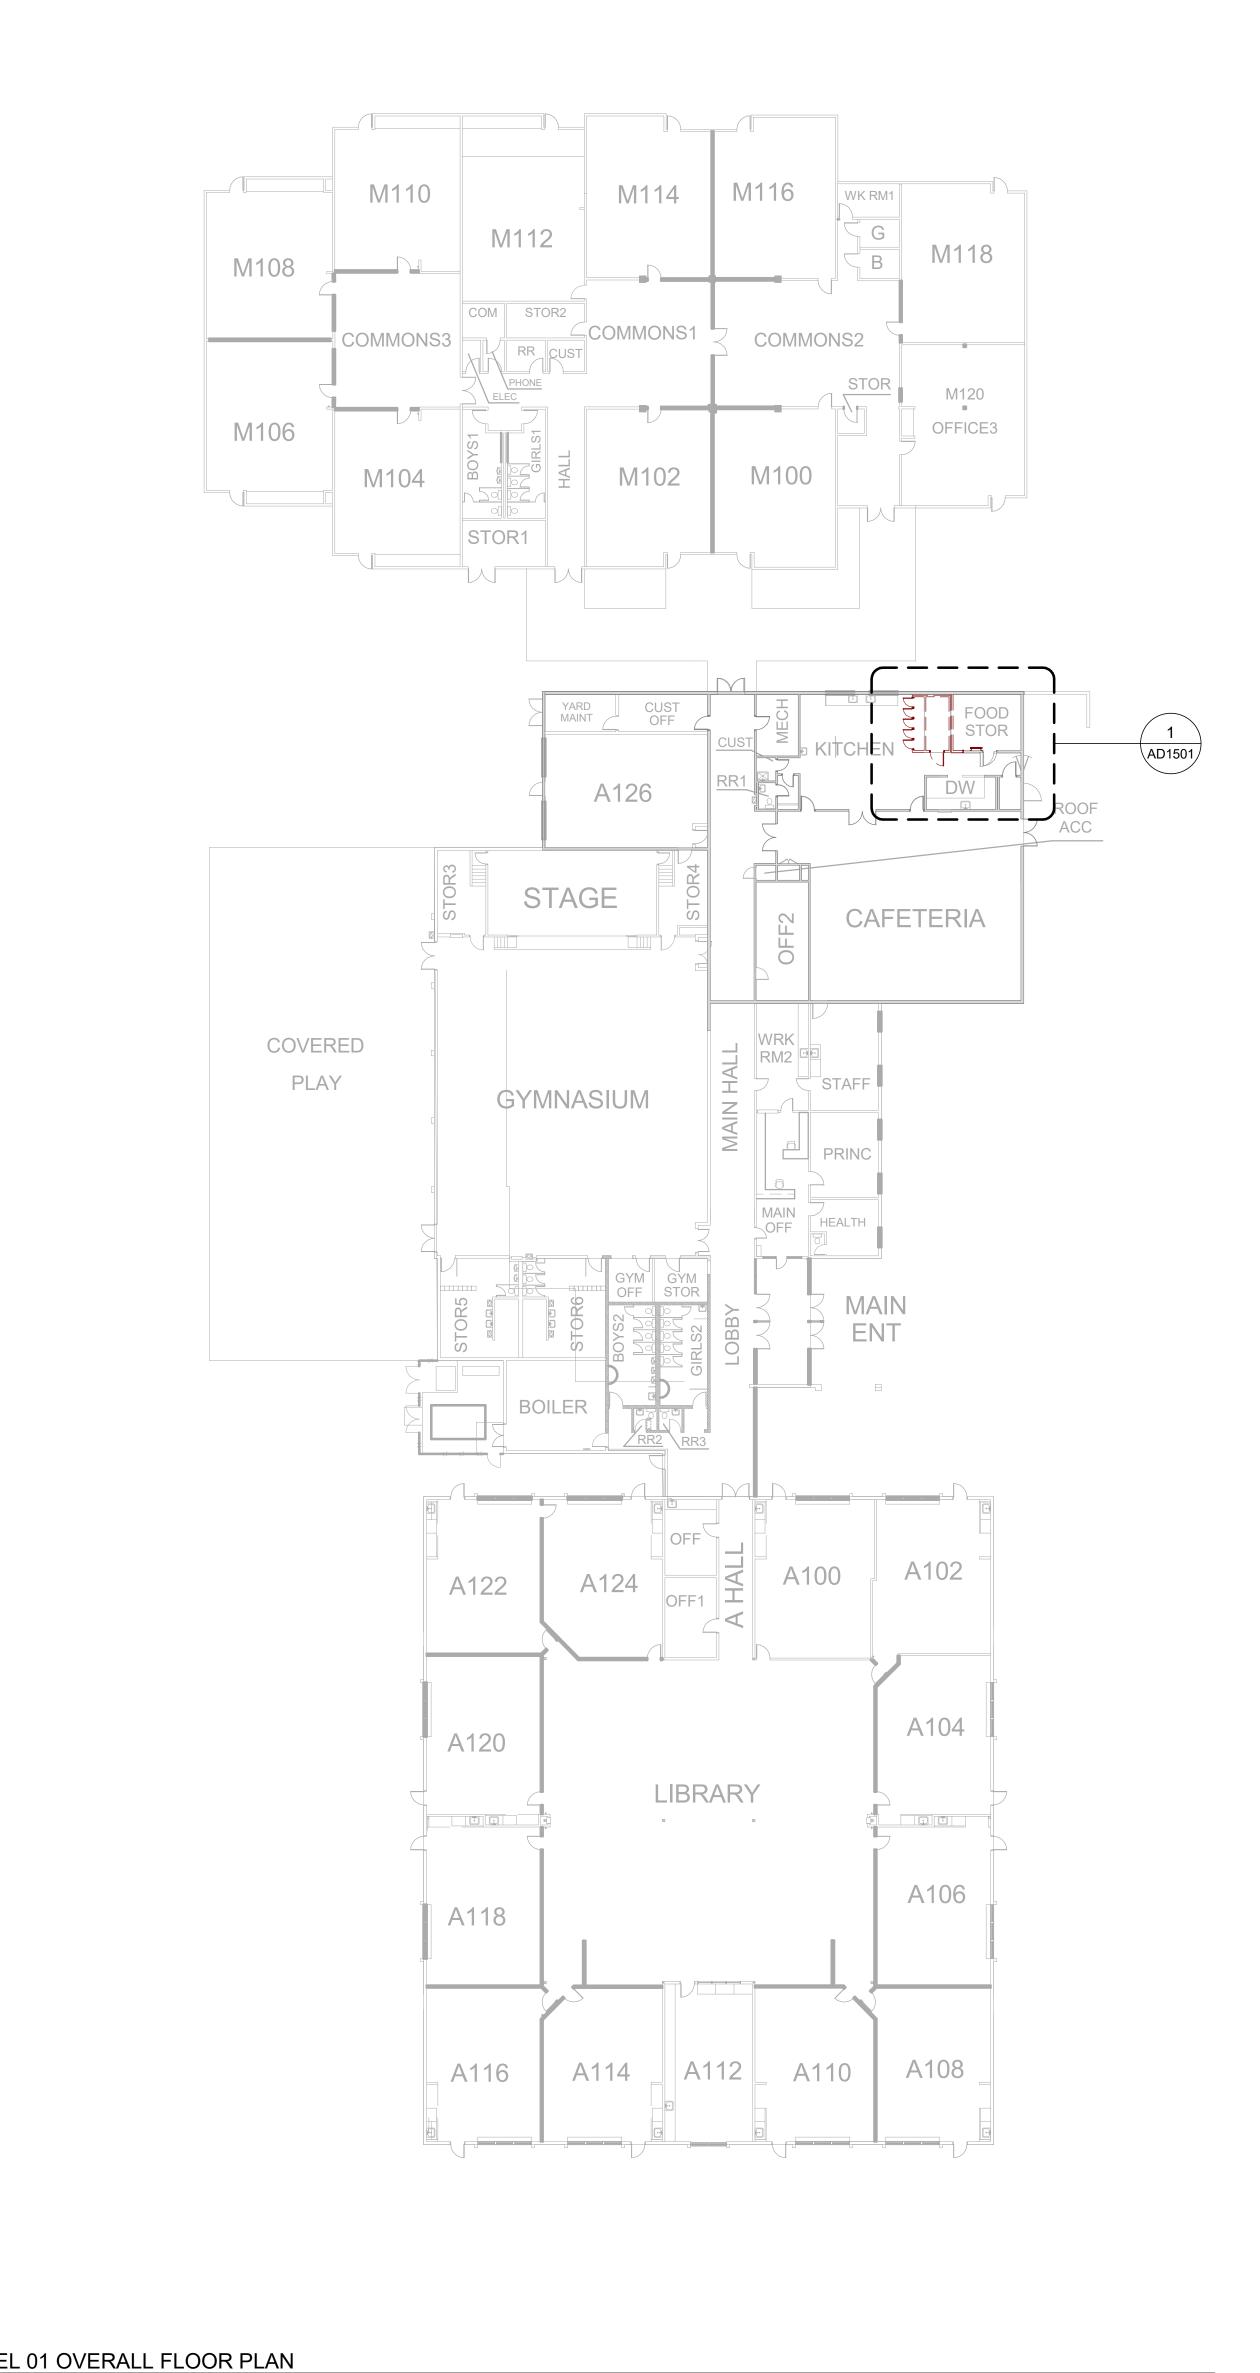

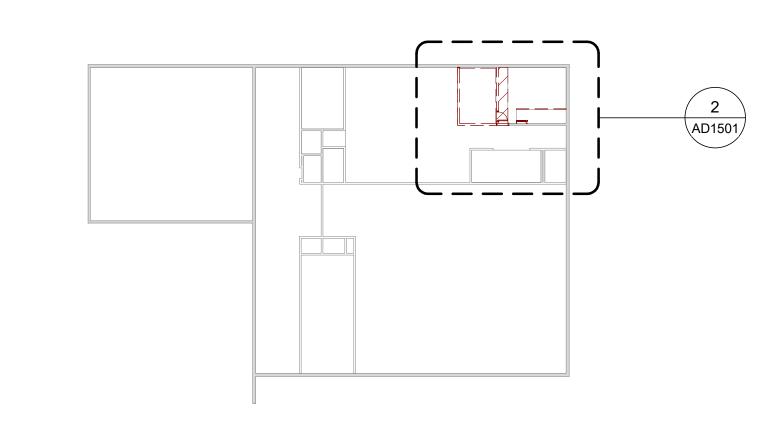

LEVEL 02 MEZZANINE FLOOR PLAN

LEVEL 01 OVERALL FLOOR PLAN

Scale: 3/64" = 1'-0"

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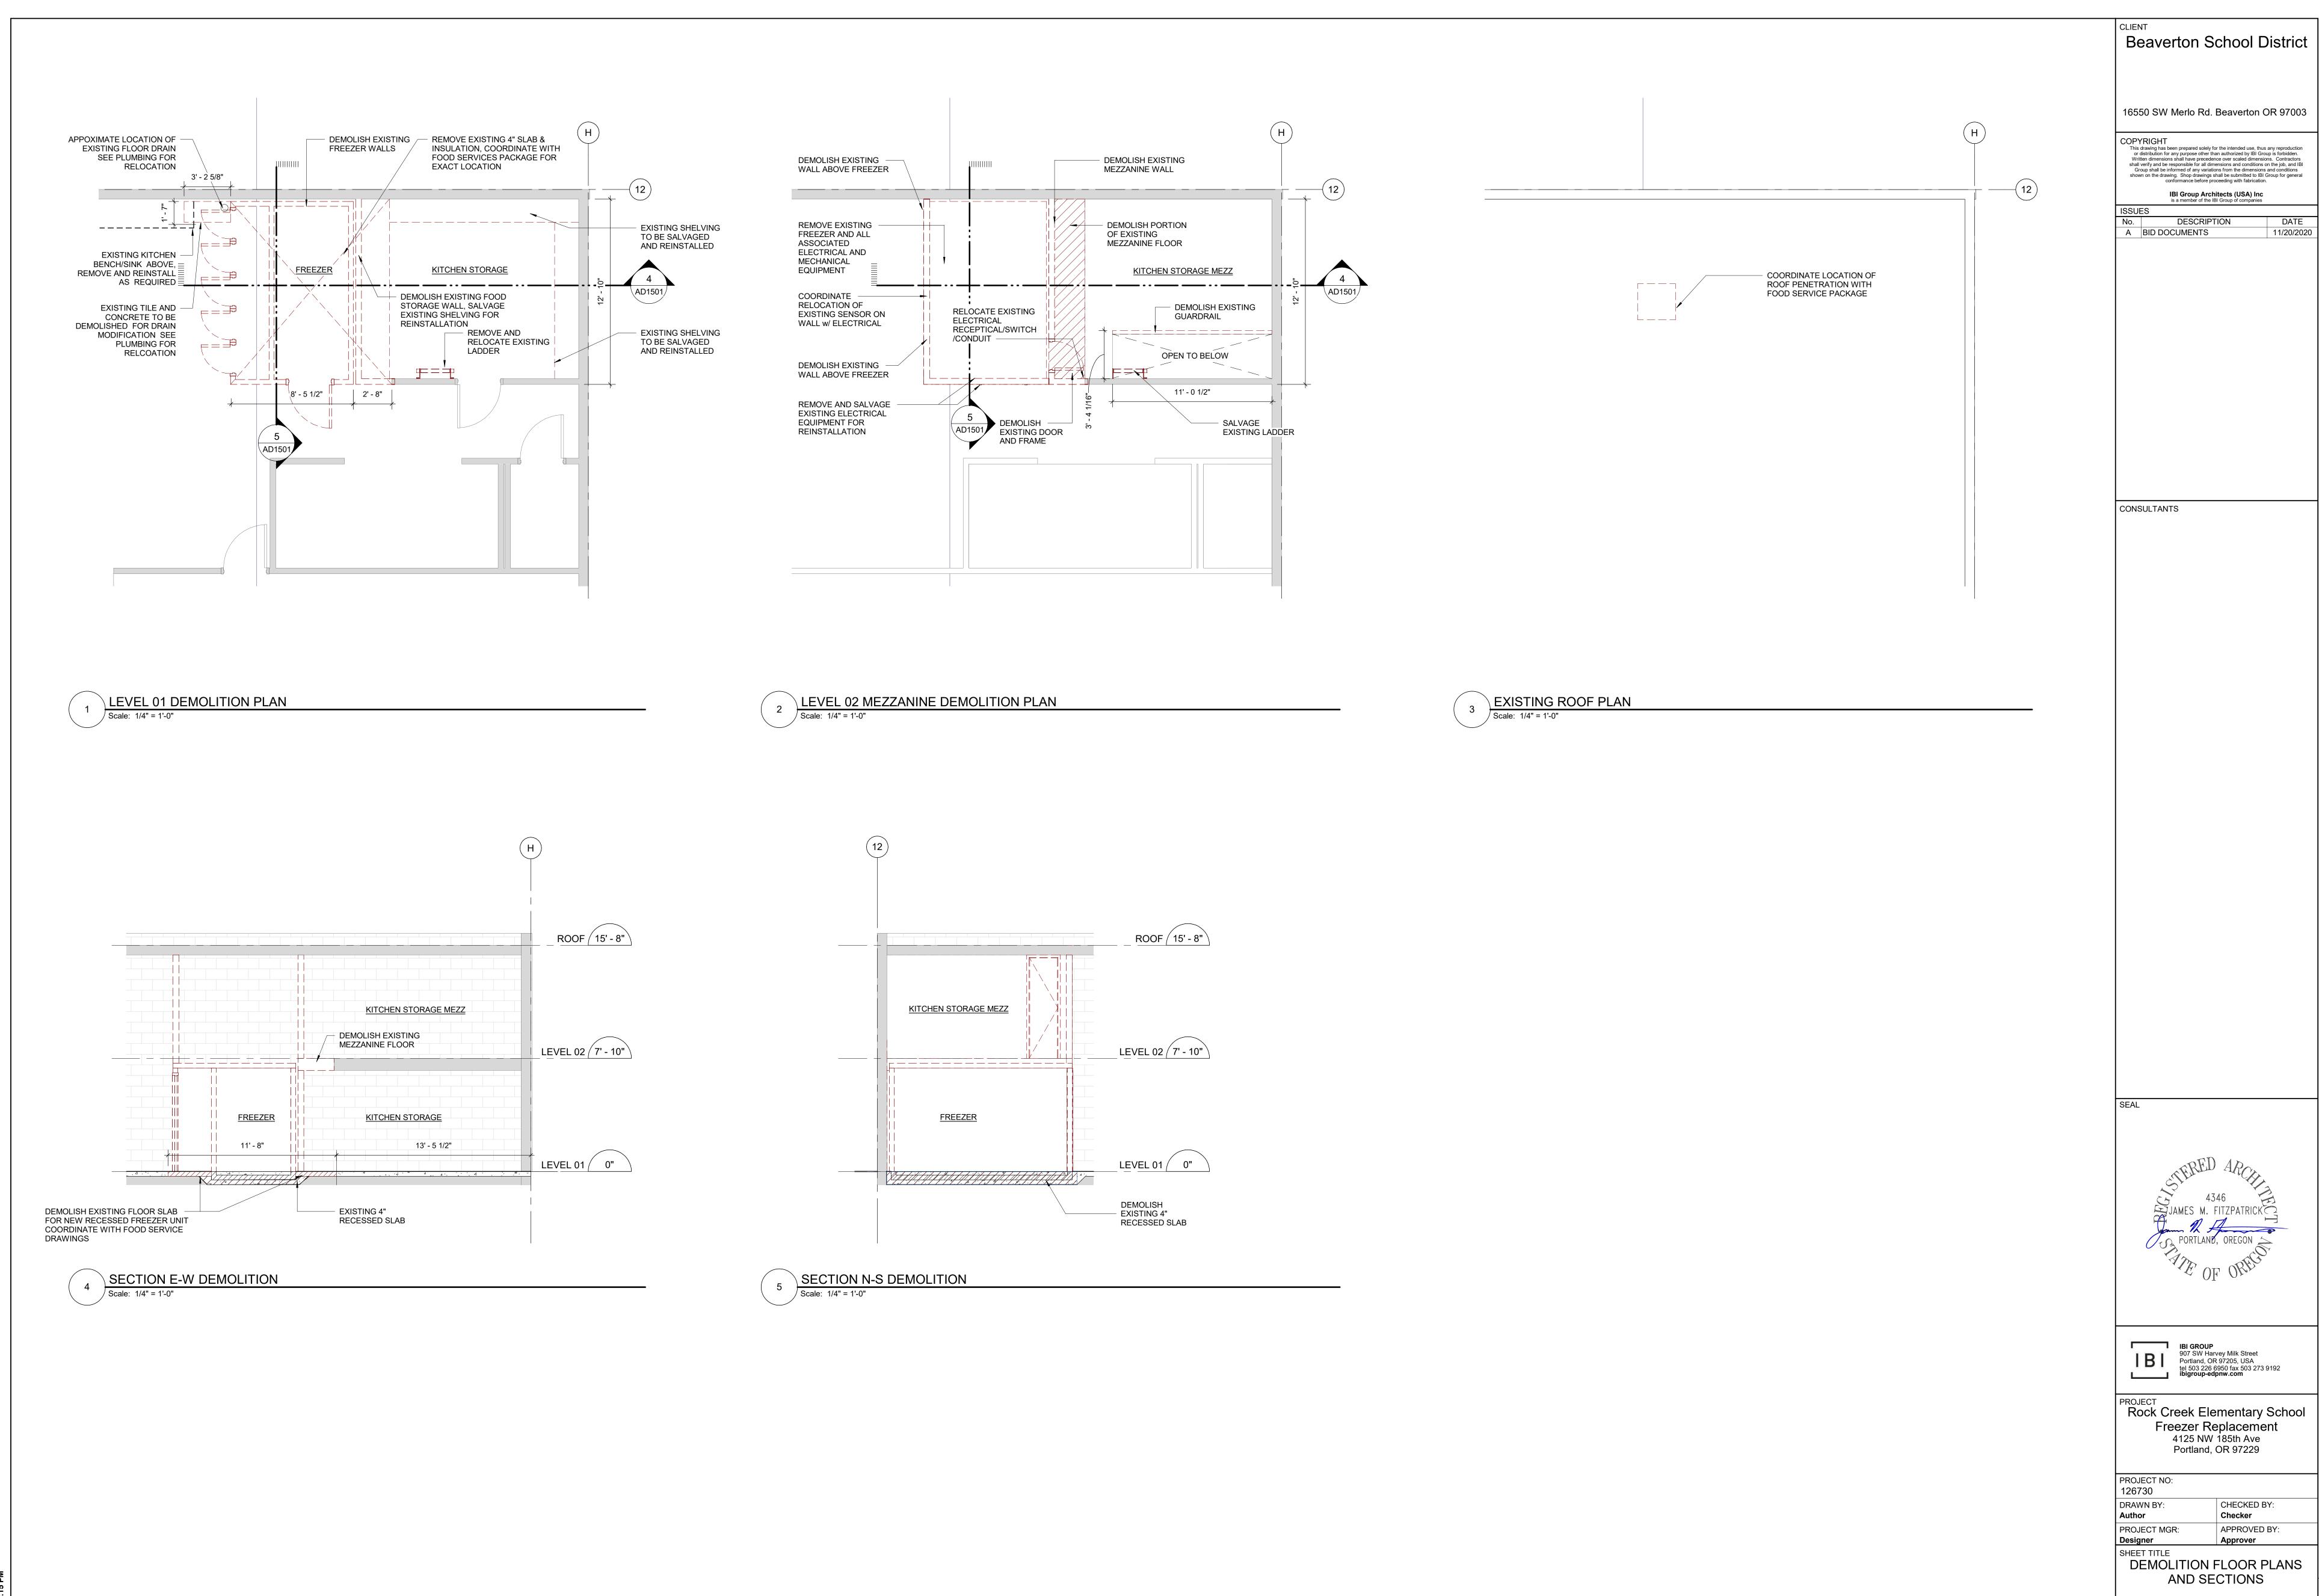
PROJECT
Rock Creek Elementary School
Freezer Replacement
4125 NW 185th Ave
Portland, OR 97229

PROJECT NO: 126730 DRAWN BY:
Author
PROJECT MGR: CHECKED BY: Checker APPROVED BY:

SHEET TITLE
OVERALL FLOOR PLAN


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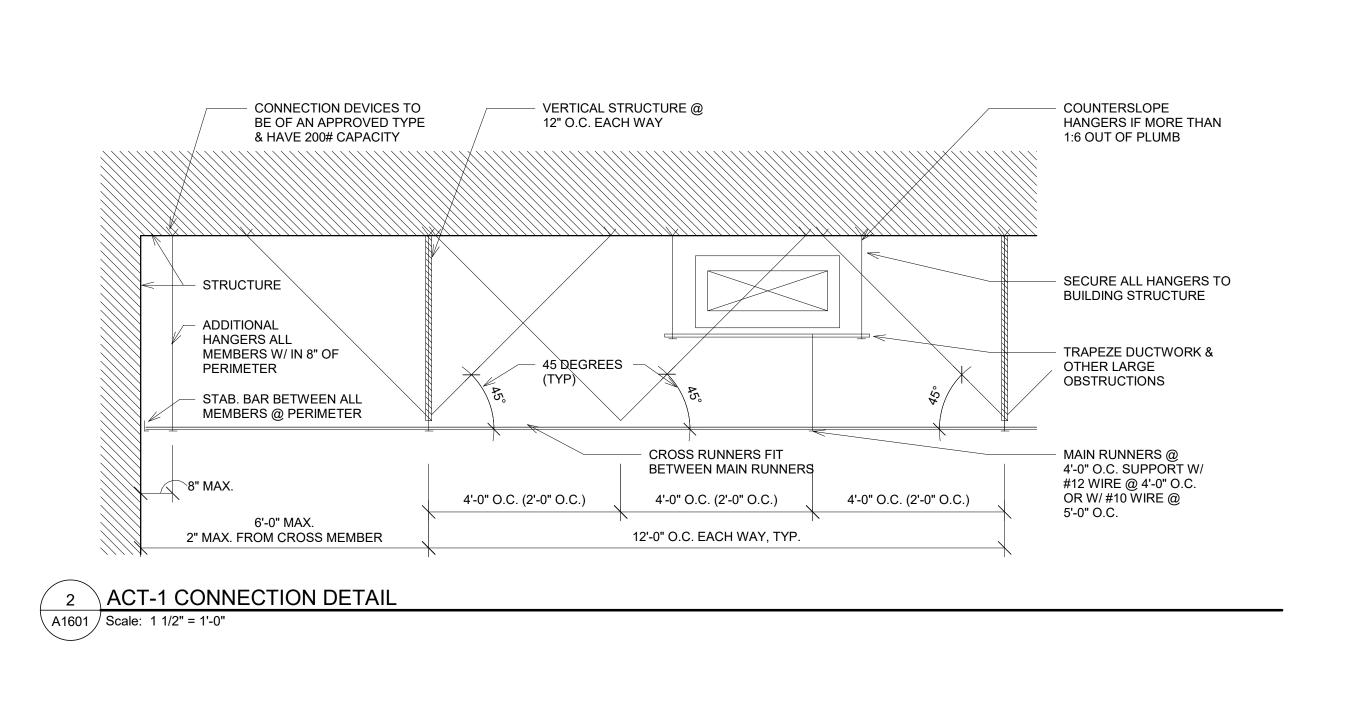
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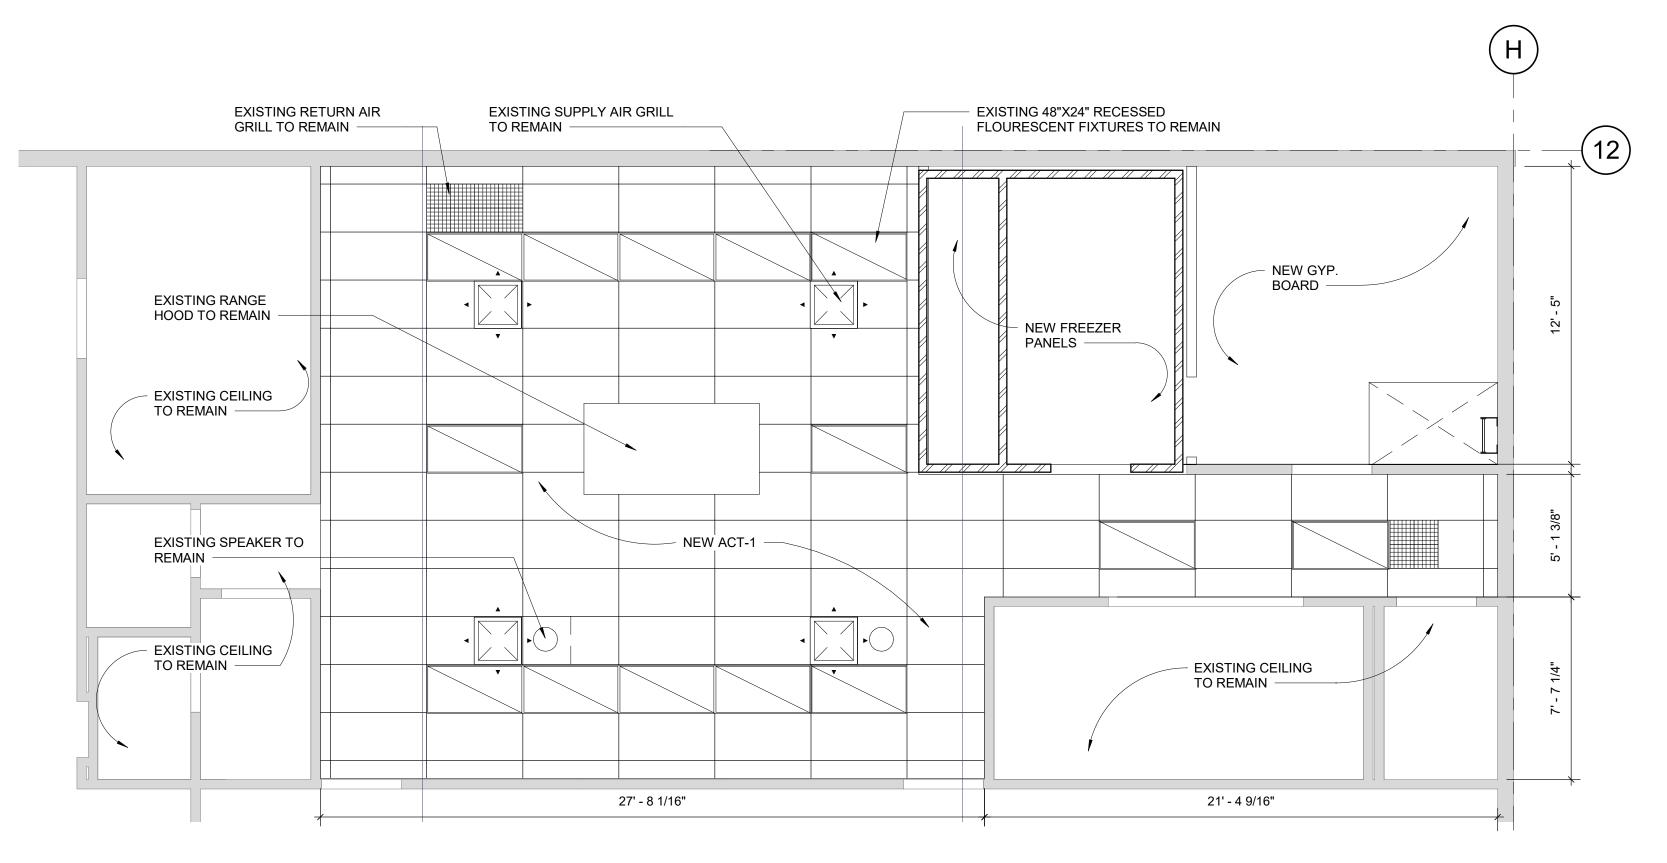


AD1501

11/20/2020





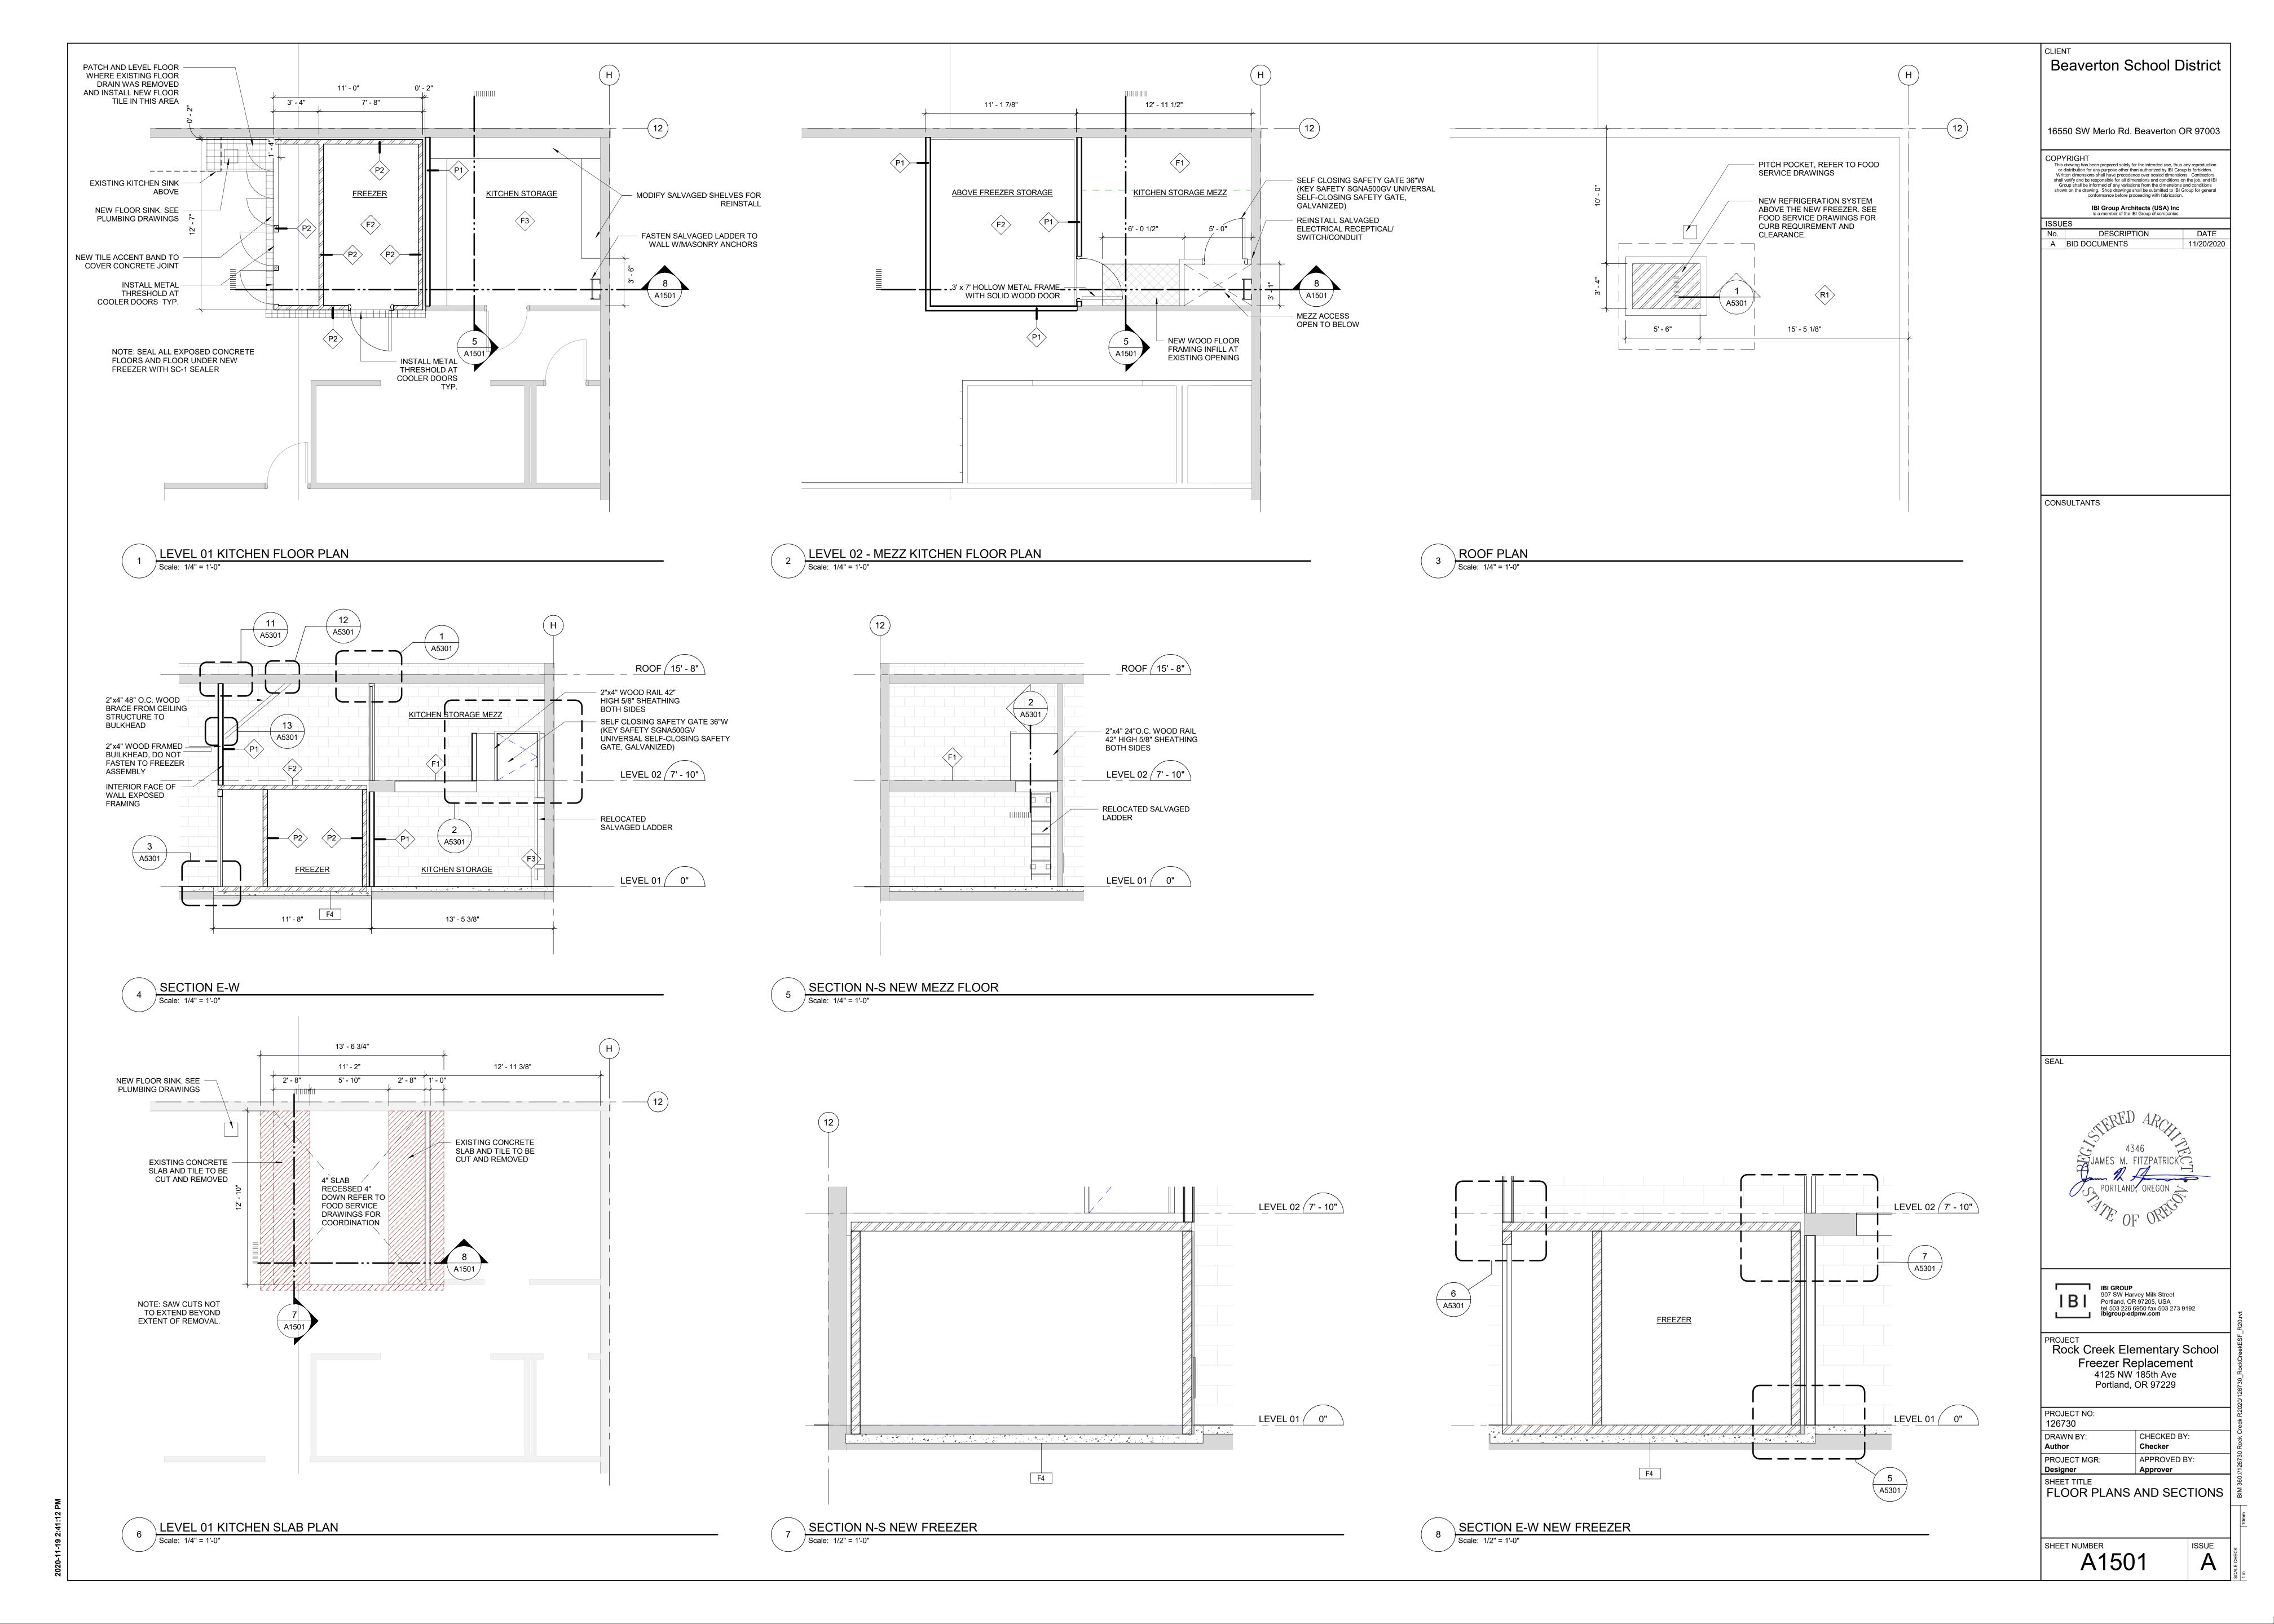

ALTERNATE #1: REMOVE AND REPLACE EXISTING SUSPENDED CEILING TILE AND GRID AND REPLACE WITH NEW

KITCHEN AREA RCP

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PROJECT
Rock Creek Elementary School
Freezer Replacement
4125 NW 185th Ave
Portland, OR 97229


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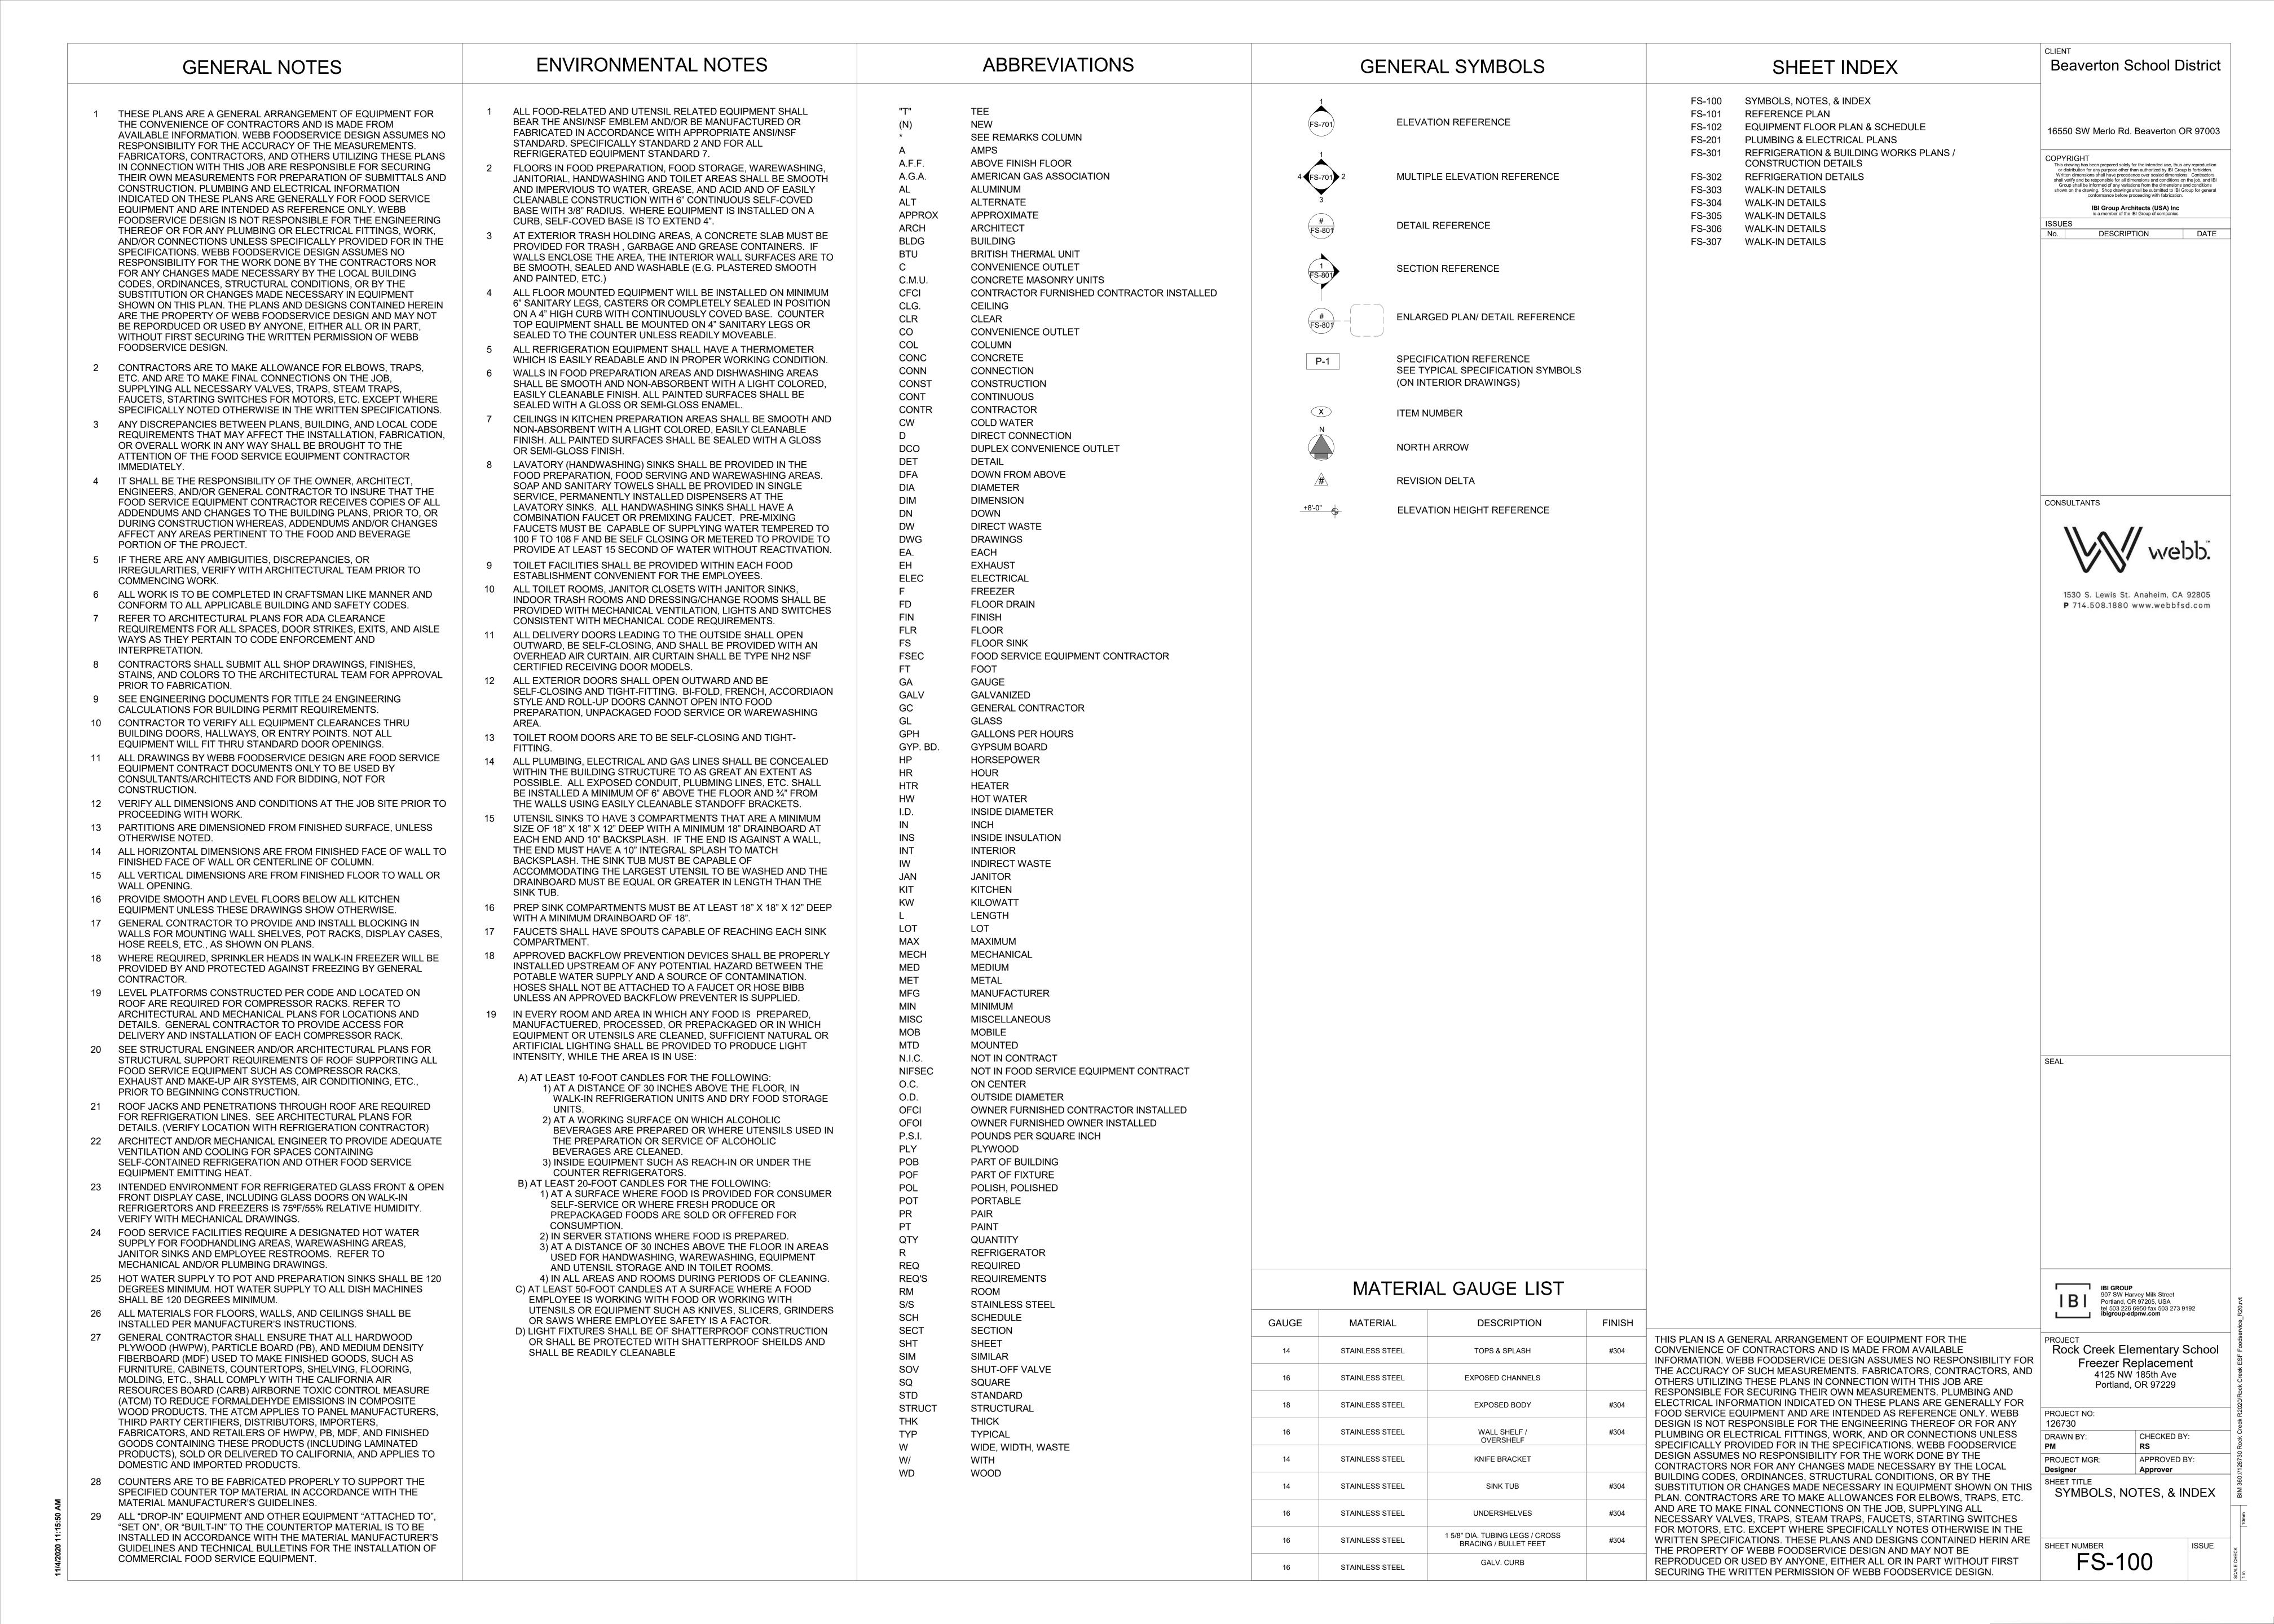
Designer


CHECKED BY: Checker APPROVED BY:

SHEET TITLE
REFLECTED CEILING PLAN

SHEET NUMBER A1601



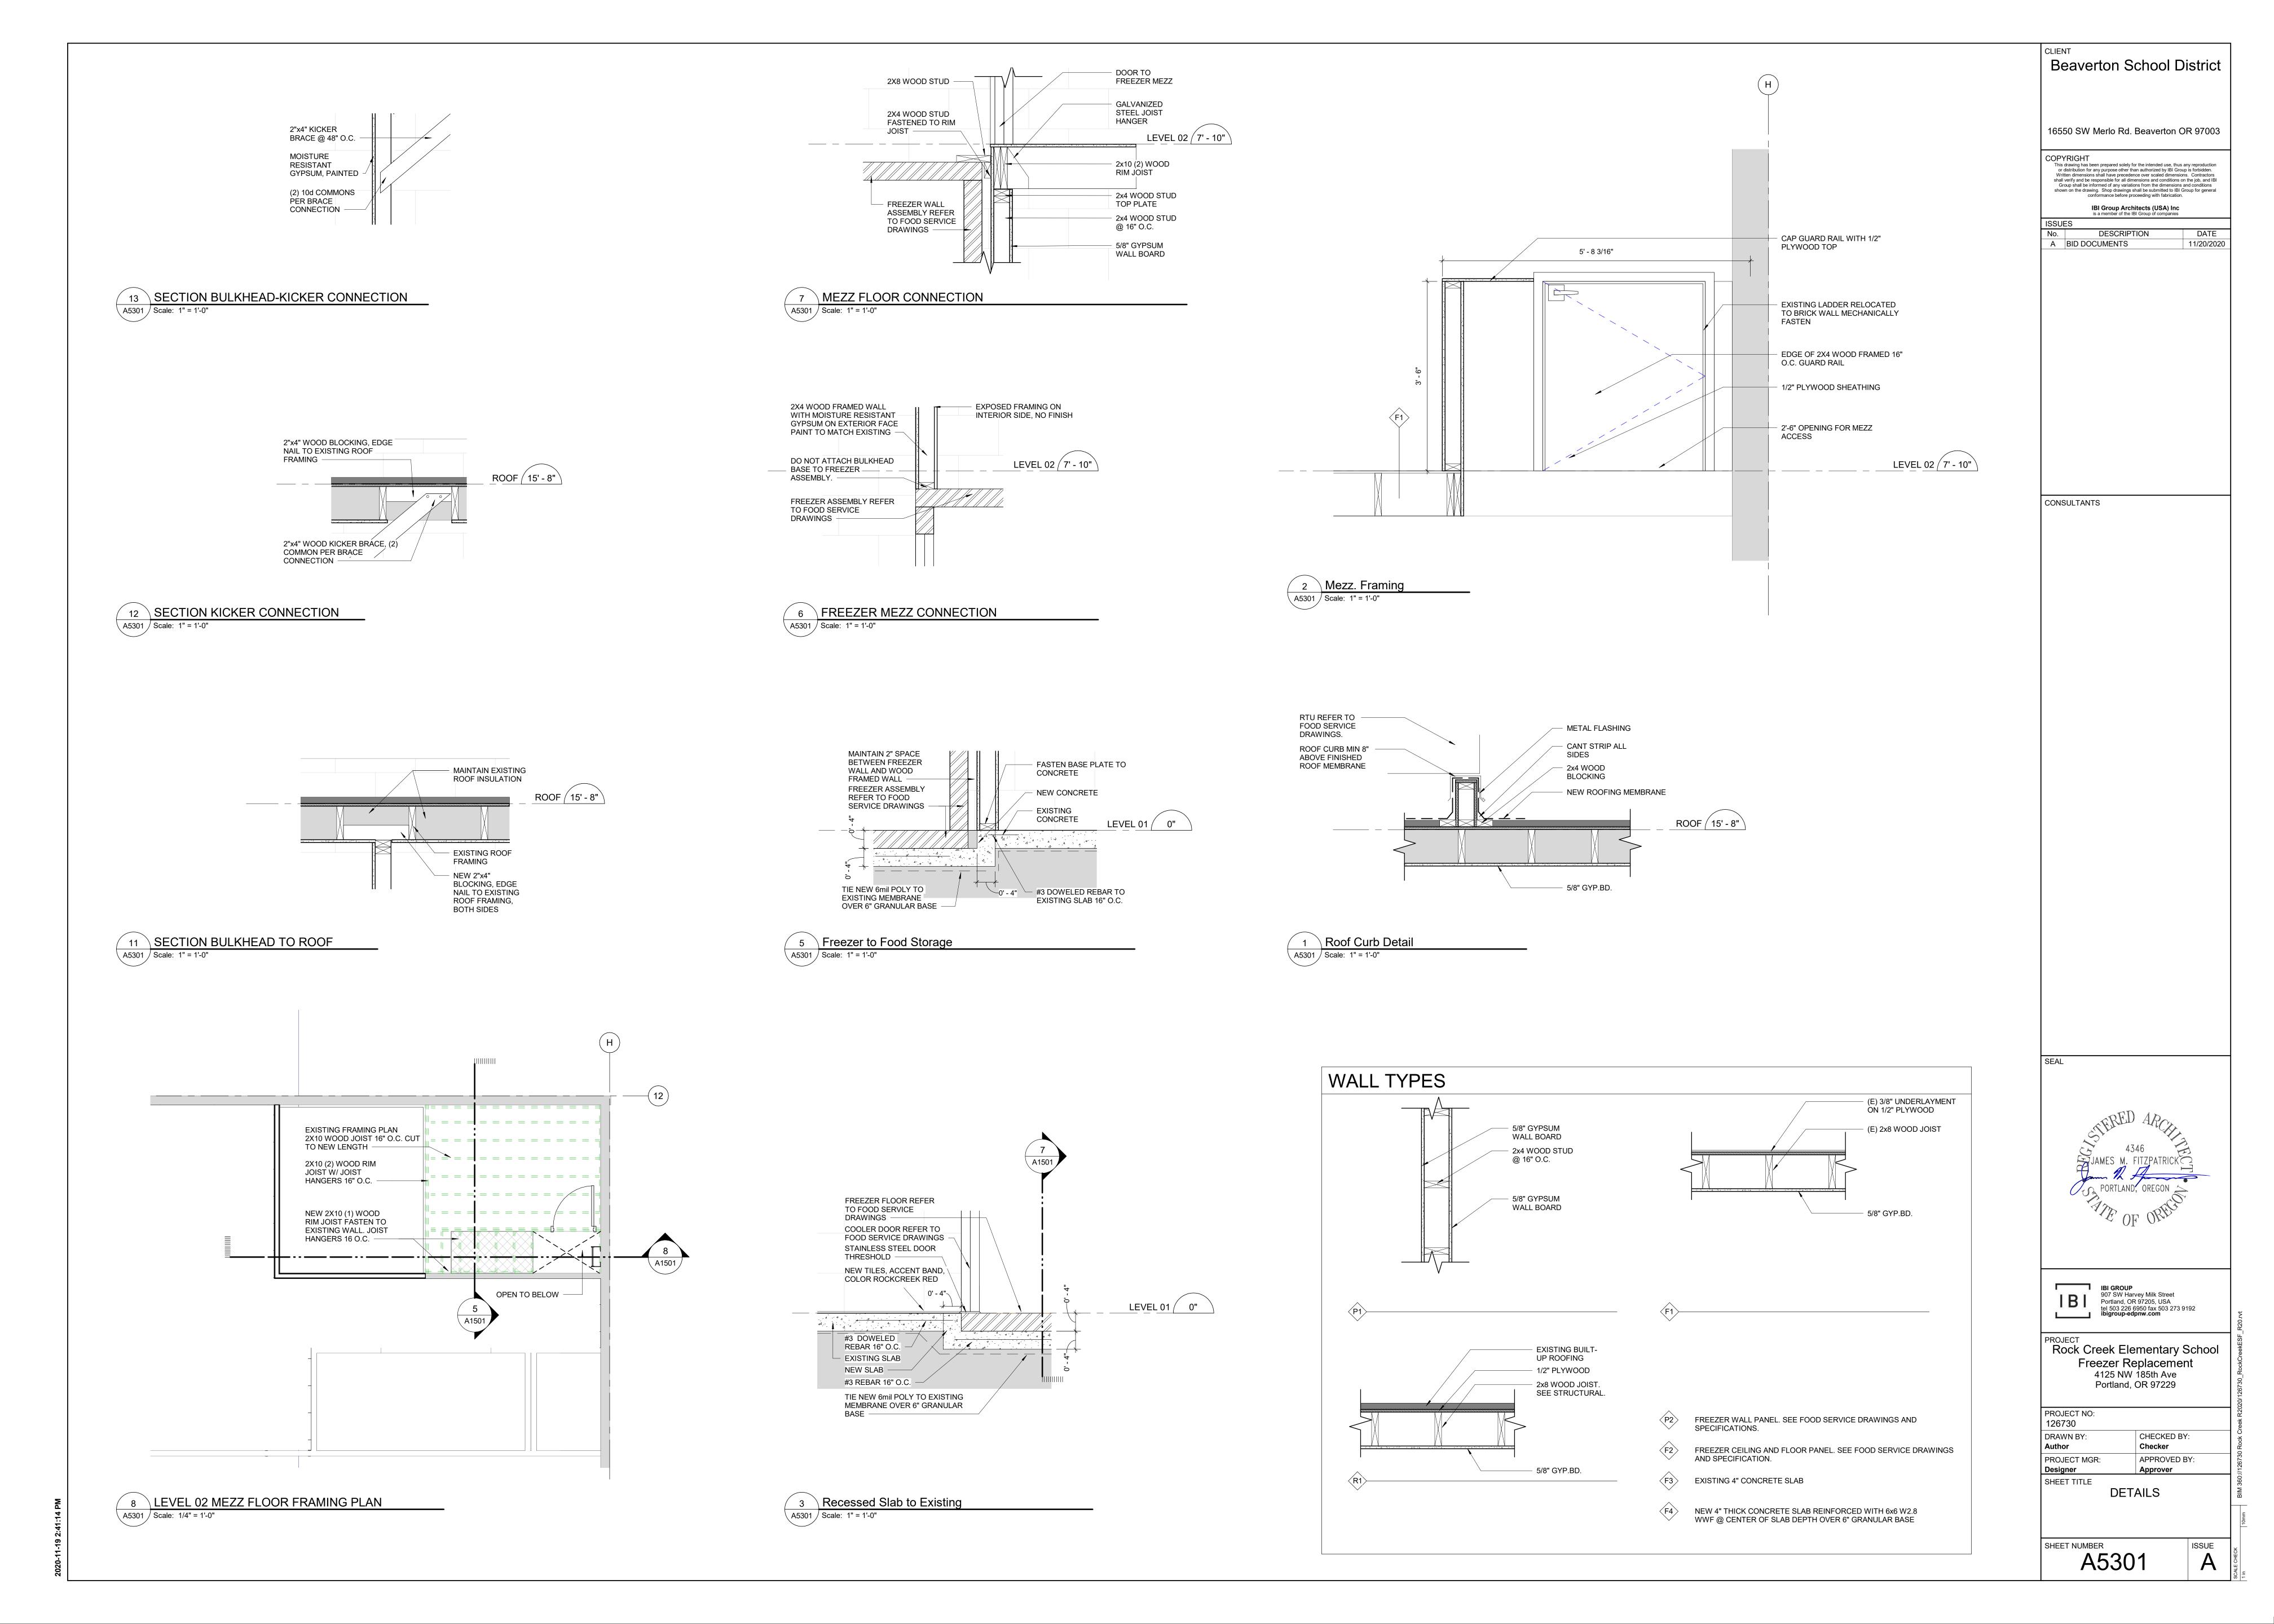

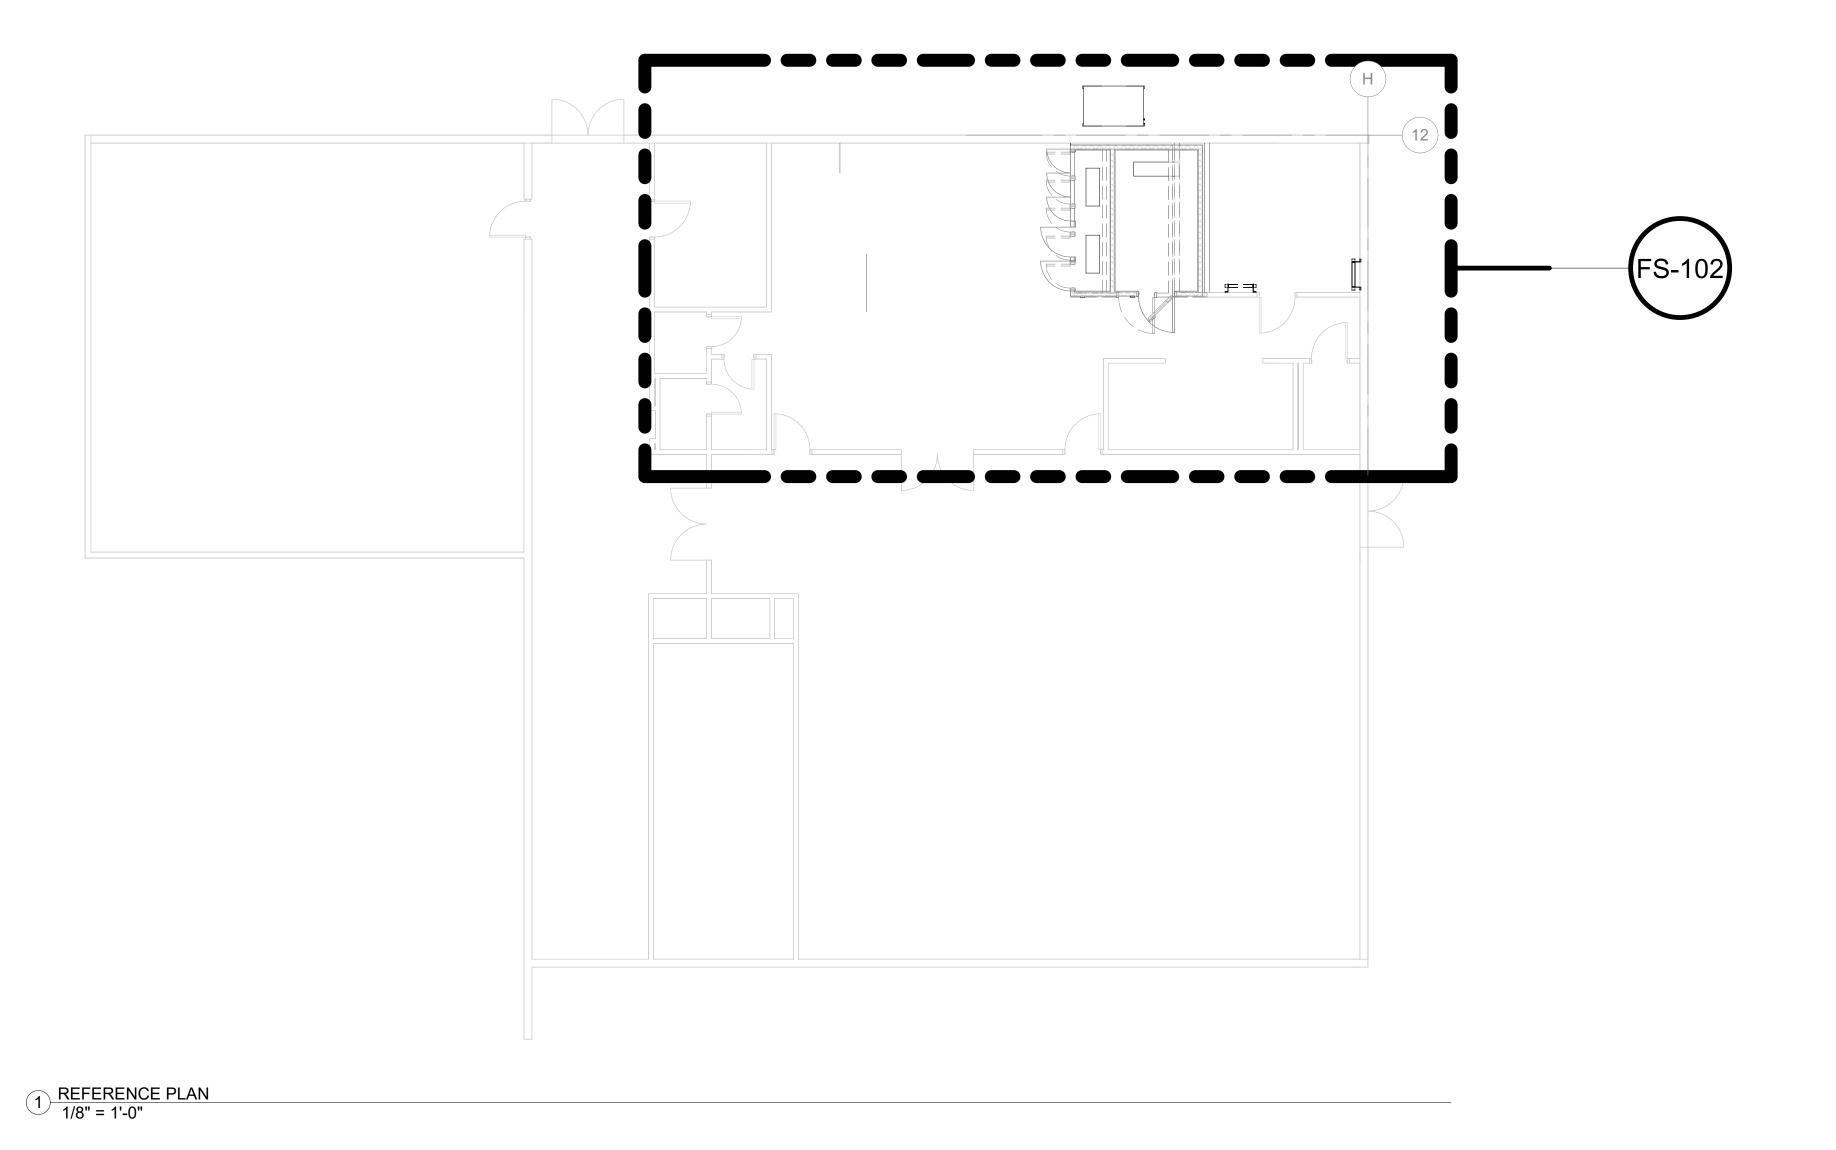

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PROJECT
Rock Creek Elementary School
Freezer Replacement
4125 NW 185th Ave
Portland, OR 97229


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CHECKED BY: PROJECT MGR: APPROVED BY:

SHEET TITLE
REFERENCE PLAN

ISSUE

FS-101

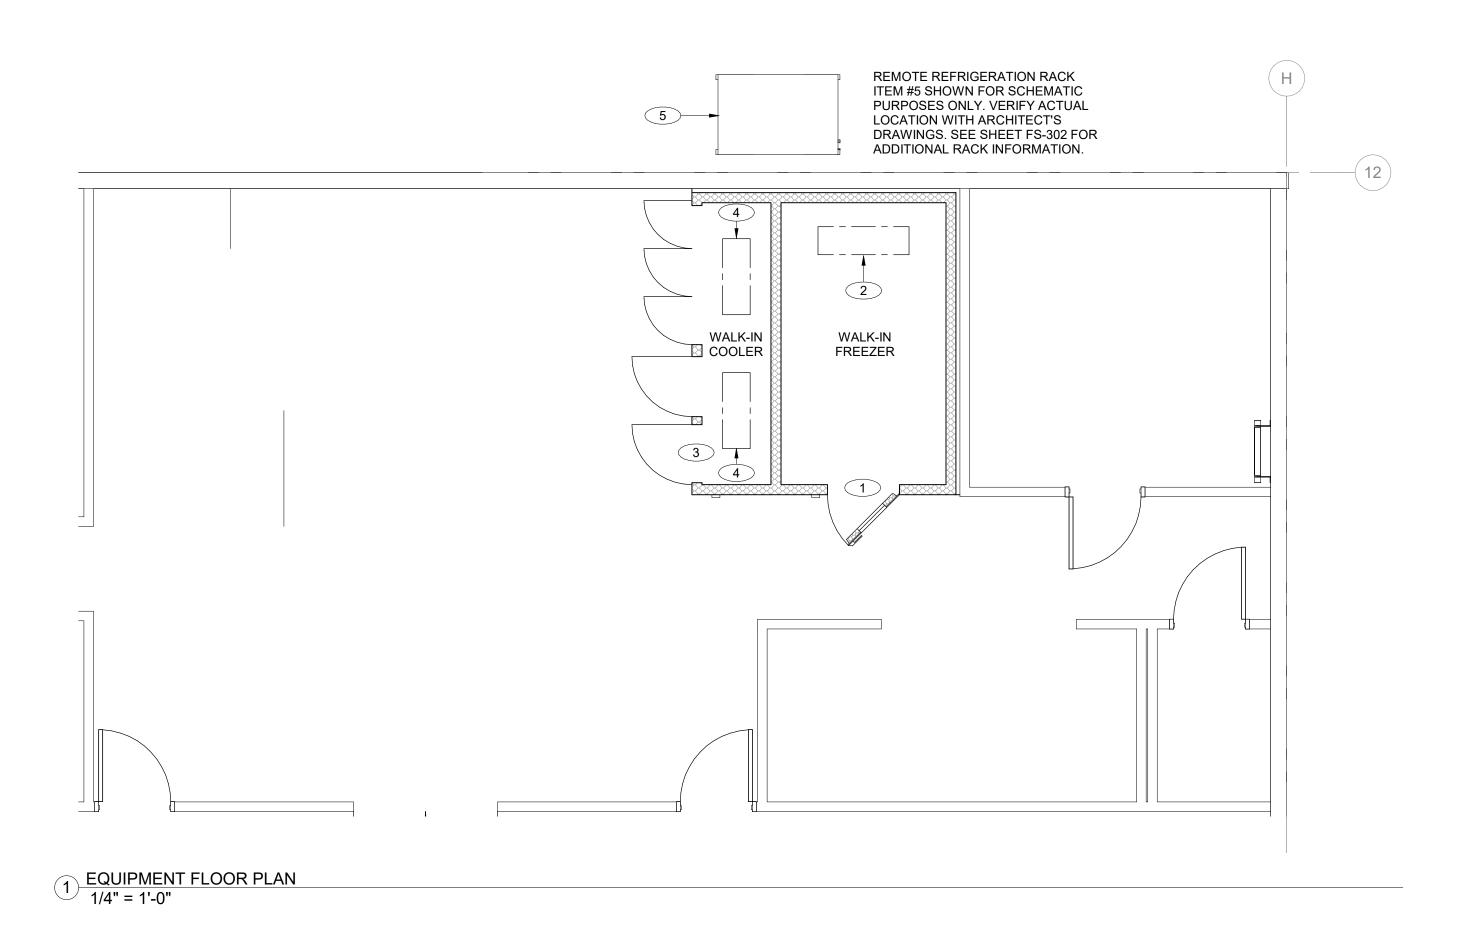

EQUIPMENT SCHEDULE				PLUMBING														
TEM# QTY	DESCRIPTION	MANUFACTURER	MODEL#	CW	HW	DW	IW	GAS	MBTU/ HR	PLUMBING REMARKS	VOLTS	K.W.	AMPS I	H.P. PH	HASE COI		GENERAL REMARKS	
1 1	WALK-IN FREEZER (REMOTE)	IMPERIAL BROWN	CUSTOM								120		10.0		1 [WIRE THRU LIGHTS, SWITCH AND DRAIN LINE HEATERS		
	EVAPORATOR COIL (FREEZER)	RDT	BEL0080				FS				*		*		* *	*SEE SHEET FS-302 FOR ELECTRICAL REQUIREMENTS.	SEE SHEET FS-302 FOR ADDITIONA INFO.	
3 1	WALK-IN REFRIGERATOR (REMOTE)	IMPERIAL BROWN	PART OF ITEM #1								120		10.0		1 [WIRE THRU LIGHTS AND SWITCH		
4 2	EVAPORATOR COIL (COOLER)	RDT	C43				FS				*		*		* *	*SEE SHEET FS-302 FOR ELECTRICAL REQUIREMENTS.	SEE SHEET FS-302 FOR ADDITIONA INFO.	
	REMOTE REFRIGERATION RACK AND SYSTEM	RDT	ZS1-02Z-CT3-AST							PPROXIMATE WEIGHT: 400 LBS. SEE RCH. DRAWINGS FOR LOCATION	208-230		27.2		3 С	*SEE SHEET FS-302 FOR ELECTRICAL INFORMATION	-	

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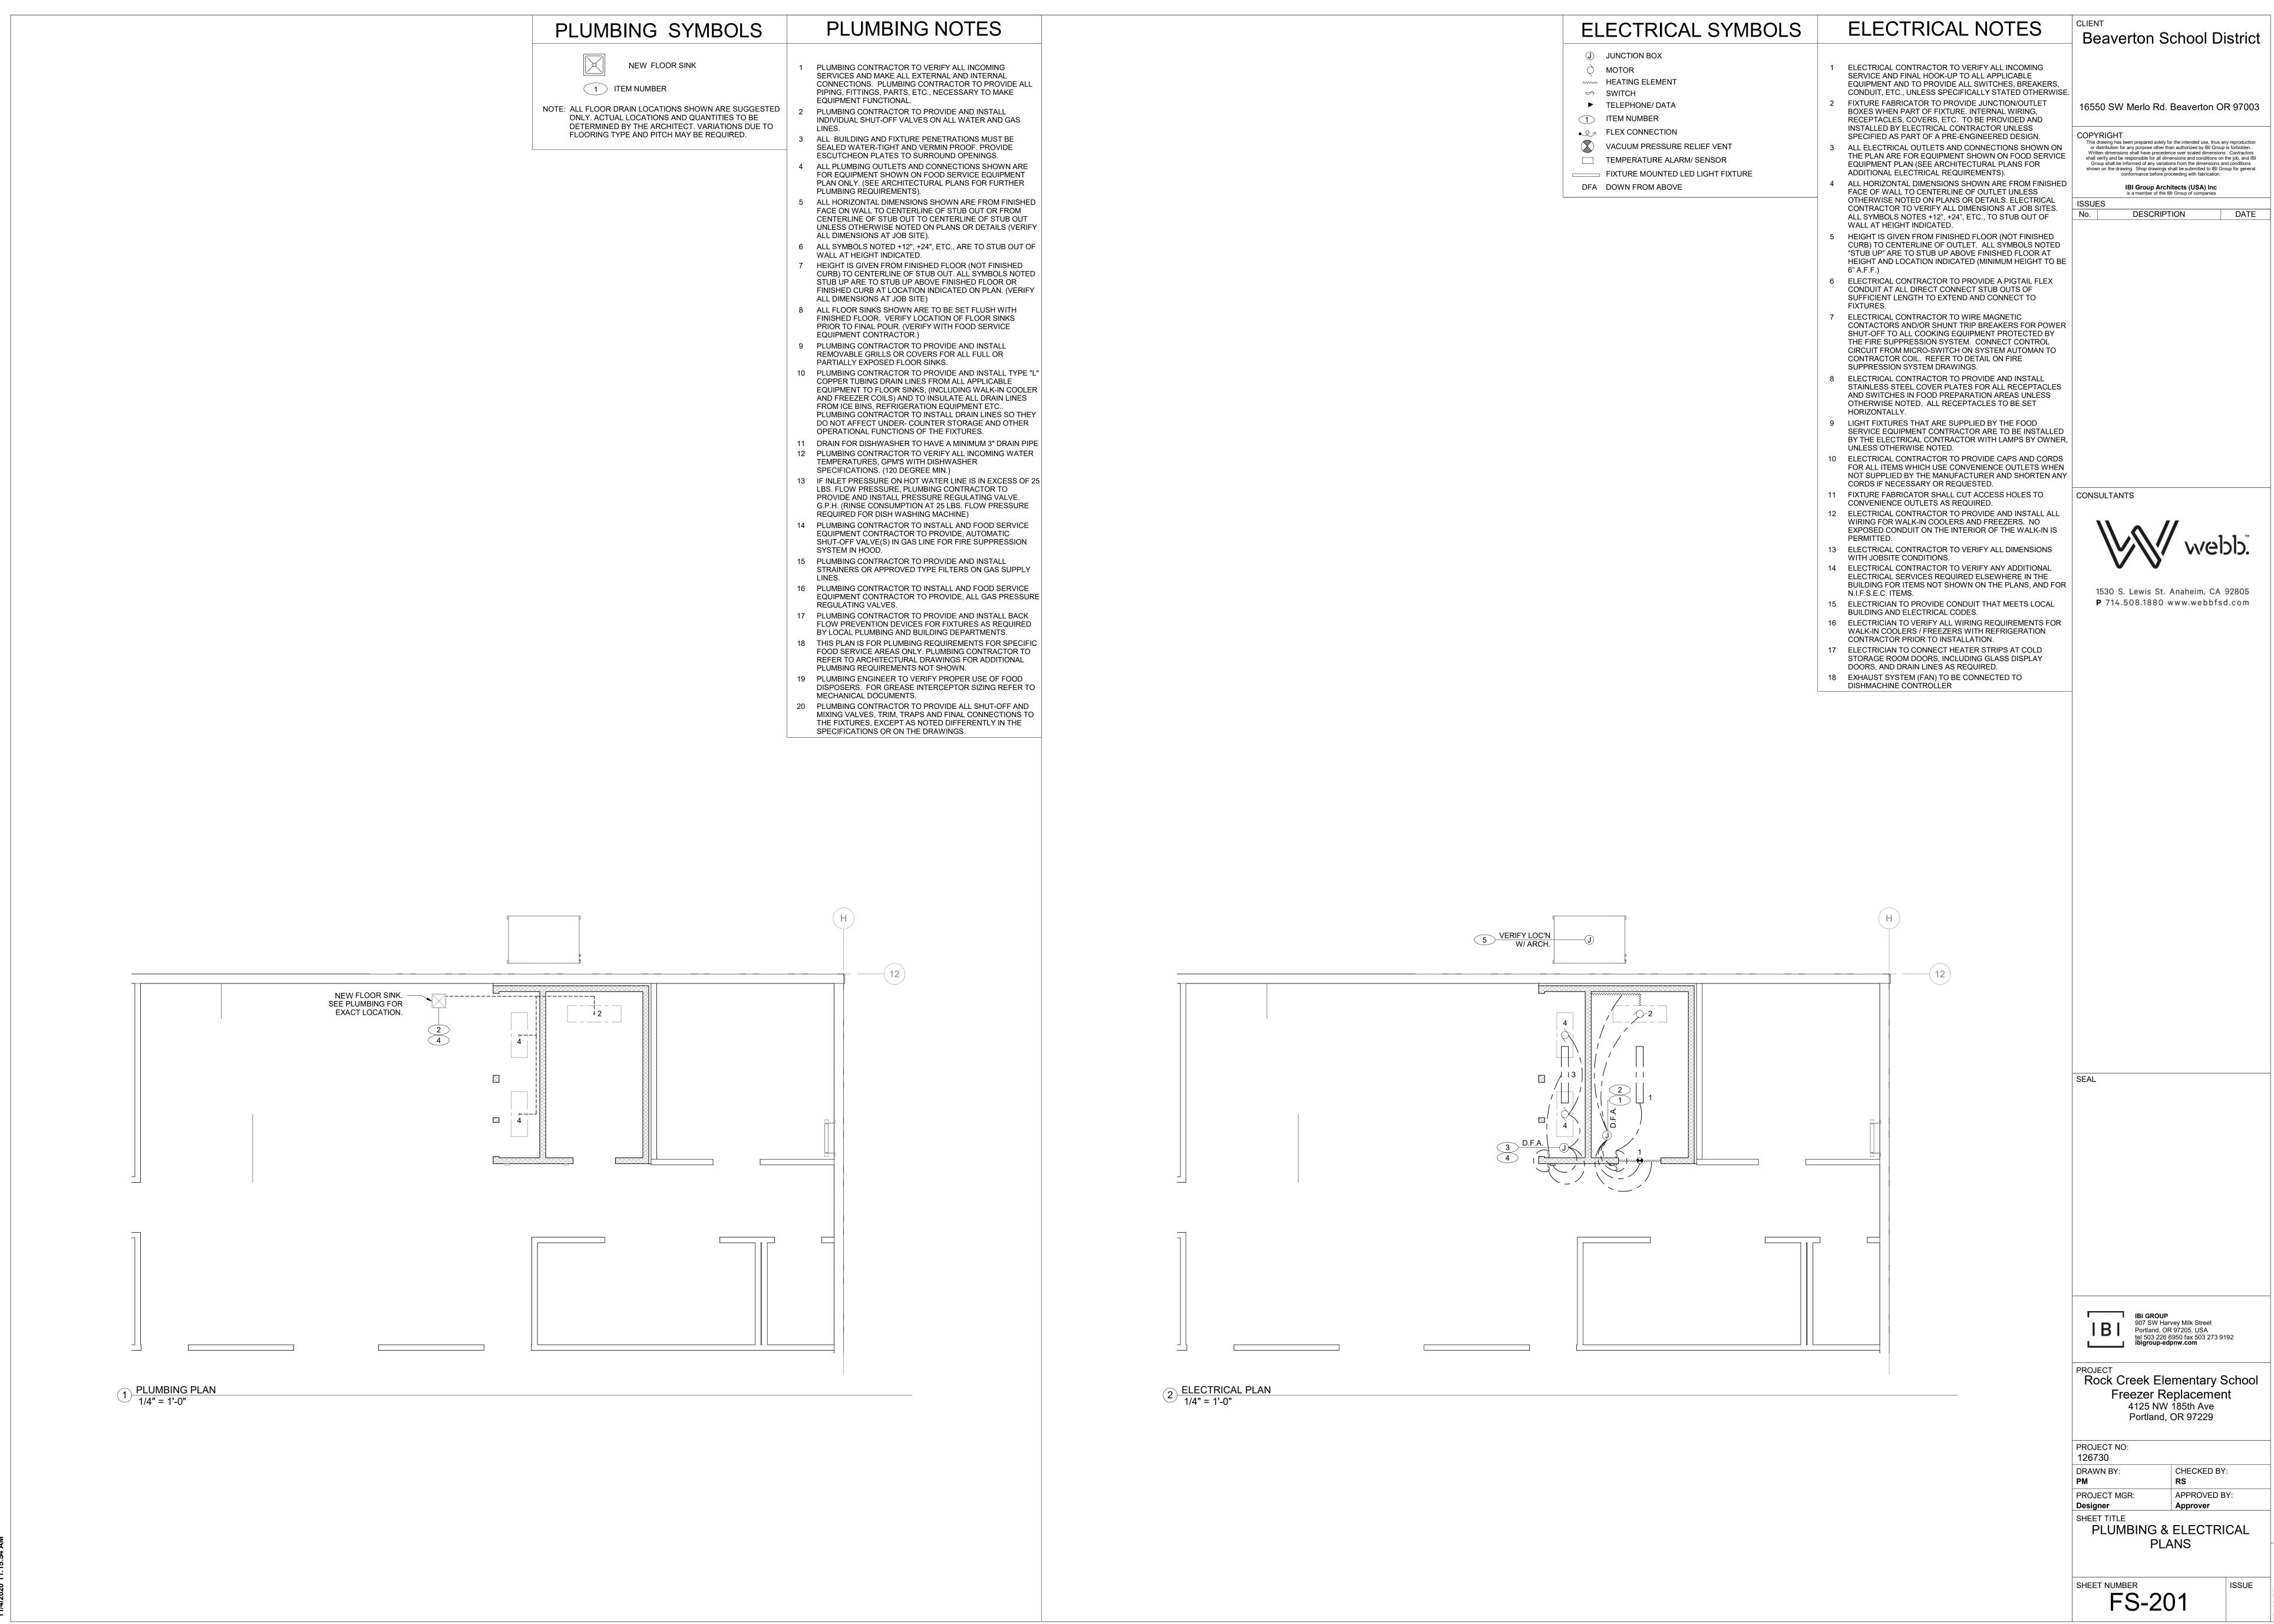
PROJECT
Rock Creek Elementary School
Freezer Replacement
4125 NW 185th Ave
Portland, OR 97229


PROJECT NO: 126730 DRAWN BY:

CHECKED BY: PROJECT MGR: APPROVED BY:

SHEET TITLE
EQUIPMENT FLOOR PLAN &
SCHEDULE

FS-102



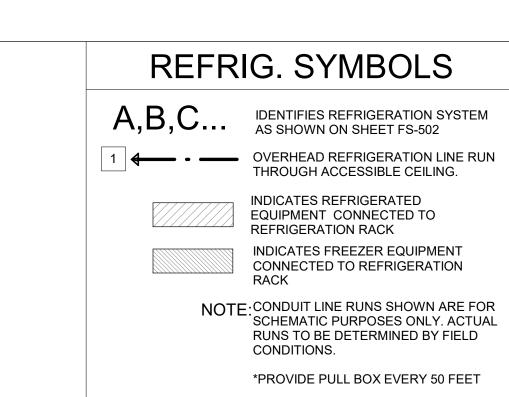

REFRIGERATION NOTES

REFRIGERATION CONTRACTOR SHALL INSULATE ALL REFRIGERATION LINES WHERE REQUIRED BY CODE. REFRIGERATION CONTRACTOR SHALL VERIFY LOCATION OF ALL REMOTE REFRGERATION SYSTEM COMPONENTS, INCLUDING EVAPORATOR COILS, REFRIGERATION RACK, COMPRESSORS, CONDENSORS, ETC. REFRIGERATION CONTRACTOR SHALL VERIFY LOCATION OF

PITCH POCKET FOR REFRIGERATION LINE PENETRATION THRU ROOF WITH GENERAL CONTRACTOR. GENERAL CONTRACTOR TO INSTALL PITCH POCKETS, CURB, CAP AND 4 GENERAL CONTRACTOR TO PROVIDE A WATERPROOF SEAL

OF ALL PENETRATIONS THROUGH THE ROOF AFTER REFRIGERATION LINES HAVE BEEN RUN. 5 REFRIGERATION CONTRACTOR TO SEAL ENDS OF CONDUIT

AFTER ALL REFRIGERATION LINES HAVE BEEN RUN. 6 CLEARANCE IS REQUIRED AROUND THE PERMITER OF ROOF MOUNTED REFRIGERATION EQUIPMENT FOR SYSTEM MAINTENANCE. REFER TO MANUFACTURER'S MINIMUM SPACE REQUIREMENTS.

PROPER VENTILATION IS REQUIRED FOR REFRIGERATION EQUIPMENT/RACK. SEE REFRIGERATION SYSTEM DRAWINGS FOR REQUIREMENTS AND MANUFACTURERS DATA OR

INSTALLATION REQUIREMENTS 8 REFRIGERATION RACK SYSTEM MANUFACTURER TO PROVIDE AND INSTALL ALL REQUIRED ELECTRICAL COMPONENTS (FUSED DISCONNECT, TIME CLOCKS, MAGNETIC STARTERS, DRAIN LINE HEATERS, ETC.) AND FACTORY WIRED (CONDUIT AND CABLE) FOR ALL CONTROLS WITHIN THE REFRIGERATION SYSTEM (PER DIVISION 16) TO A SINGLE POINT OF SERVICE FOR POWER CONNECTIONS. REFRIGERATION RACK SHALL BE UL LISTED. ELECTRICAL CONTRACTOR TO PROVIDE ALL CONDUIT AND WIRING BETWEEN REFRIGERATION RACK AND REMOTELY LOCATED SYSTEM COMPONENTS.

9 ALL SYSTEMS AND COMPONENTS SHALL BE LABELED. PROVIDE A COPY OF THE REFRIGERATION PLAN IN AN EASILY ACCESSIBLE WEATHER PROTECTED AREA. 10 ICE MACHINE REMOTE CONDENSER CONDUIT RUNS SHALL NOT EXCEED 20 FEET VERTICALLY AND 40 FEET

HORIZONTALLY.

4" DEPRESSION 11'-2"

2 BUILDING WORKS PLAN 1/4" = 1'-0"

BUILDING WORKS NOTES Beaverton School District

2 WALL BACKING LENGTHS SHOWN ON BUILDING WORKS

GENERAL CONTRACTOR UNLESS OTHERWISE NOTED.

INDICATES FREEZER DEPRESSION

FLOOR DEPRESSION

PLAN REQUIREMENTS ARE THE MINIMUM. ALWAYS EXTEND

1 ALL WALL BACKING TO BE 16 GAUGE GALVANIZED METAL SECURELY ATTACHED TO STUD/WALL FRAMING.

CONSULTANTS

WALL BACKING TO NEXT STUD OVER IN EACH DIRECTION. 16550 SW Merlo Rd. Beaverton OR 97003 3 ALL WORK SHOWN ON BUILDING WORKS PLAN TO BE BY BLDG. WORKS LEGEND

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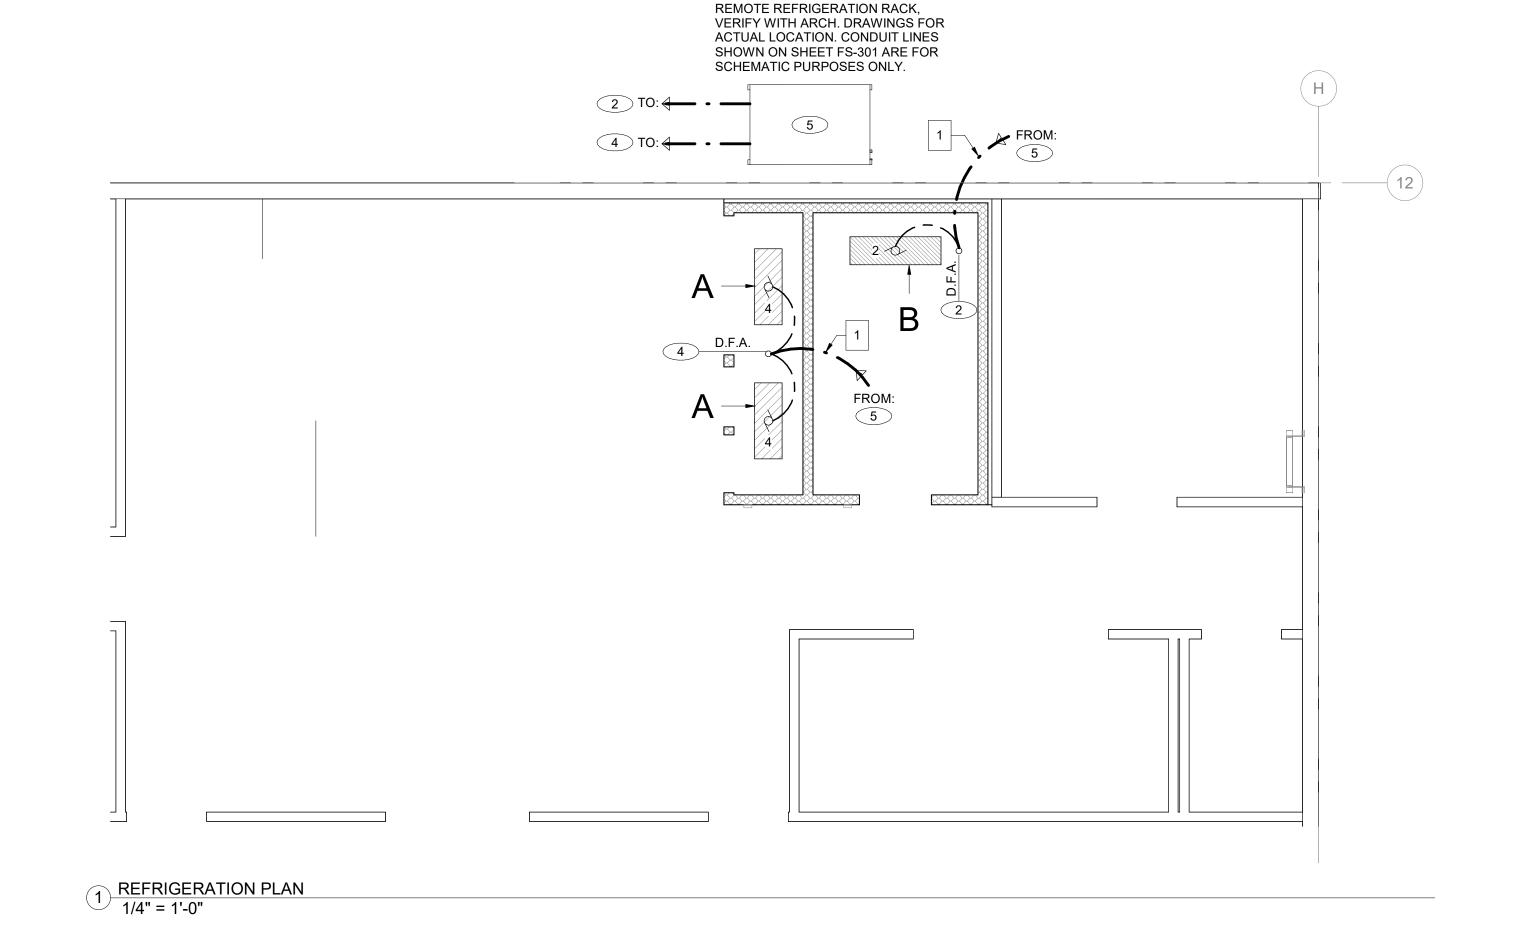
Rock Creek Elementary School Freezer Replacement 4125 NW 185th Ave Portland, OR 97229


PROJECT NO: 126730 DRAWN BY: CHECKED BY: PROJECT MGR: APPROVED BY:

SHEET TITLE

REFRIGERATION & BUILDING WORKS PLANS / CONSTRUCTION DETAILS

SHEET NUMBER FS-301



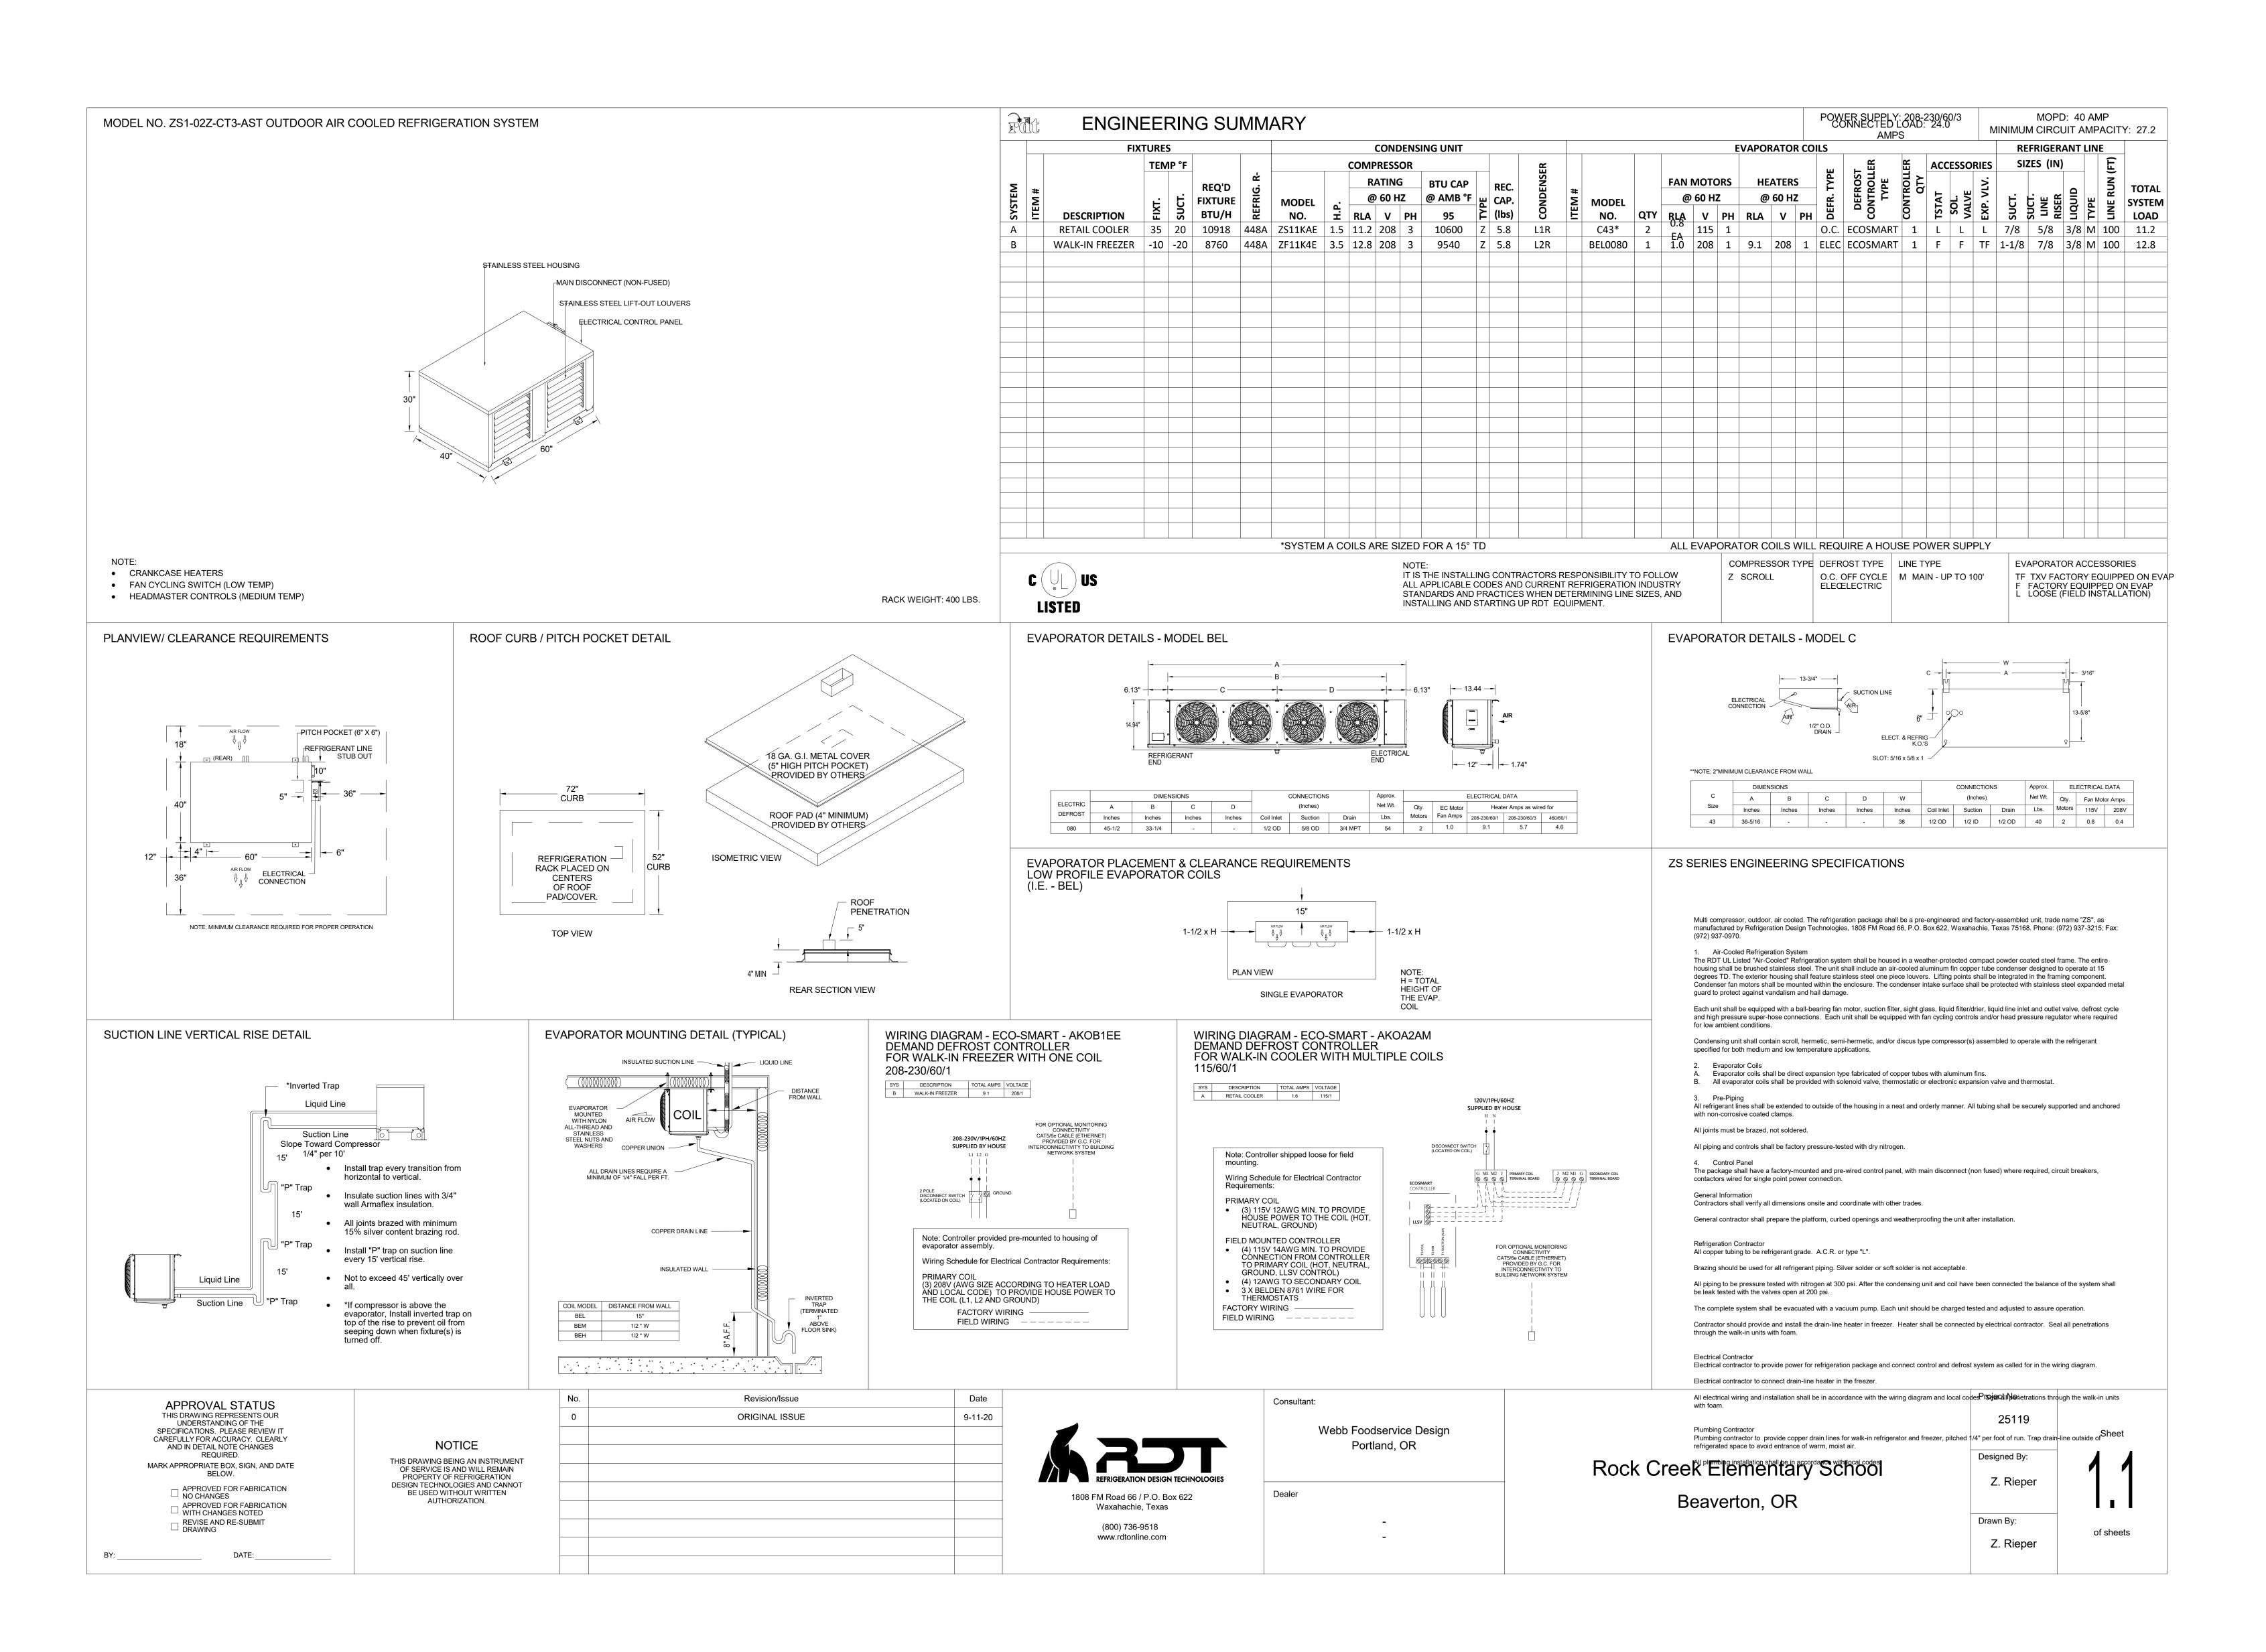

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Witten dimensions shall have precedence over scaled dimensions. Contractors


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written dimensions shall nave precedence over scaled dimensions. Contractors shall verify and be responsible for all dimensions and conditions on the job, and IBI Group shall be informed of any variations from the dimensions and conditions shown on the drawing. Shop drawings shall be submitted to IBI Group for general conformance before proceeding with fabrication.

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No. DESCRIPTION DATE

THIS SHOP DRAWING ON THIS SHEET IS FOR REFERENCE ONLY. CONTRACTOR TO PROVIDE FINAL MANUFACTURER SHOP DRAWINGS



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Rock Creek Elementary School
Freezer Replacement
4125 NW 185th Ave
Portland, OR 97229

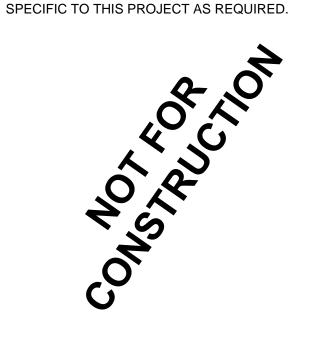PROJECT NO:
126730

DRAWN BY: CHECKED BY:
PM RS

PROJECT MGR: APPROVED BY:

Designer

SHEET TITLE
REFRIGERATION DETAILS

NUMBER ISSUE

SPECIFICATIONS Indoor combo (with floors) Vinyl foam NSF gasket (1/16" joint thickness), Cam-lock layout #4 SPECIAL INSTRUCTIONS Standard crating WALL PANELS Construction: 4" high density urethane Exterior Finish: 20 ga. smooth galv. / 20 ga. stainless steel 304 #4 Interior Finish: .040 stucco aluminum / 20 ga. stainless steel 304 #4 Ceiling connections: Camlock Floor connections: Camlock **CEILING PANELS** Construction: 4" high density urethane Exterior Finish: Metal Interior Finish: .040 stucco white aluminum Ceiling Caps: Factory mounted Live Load: 10 psf FLOOR PANELS Model: Hand-Truck Floor panels model #HTFN (NSF) Construction: 3 1/2" high density urethane w/ .100 diamond tread aluminum @ interior over 1/2 " Thermo-Lite w/ Metal @ exterior [A]: 36" x 80" flush model G3 self-closing freezer door *** NO WOOD BACKING *** *** ELECTRICAL COMPONENTS PRE-WIRED *** *** LEAF WILL NOT BE RAISED UNLESS SPECIFIED OTHERWISE *** Brand: Imperial Brown Frame: 4" high density urethane, 3-sided w/ 20 ga. stainless steel 304 #4 @ ext. w/ .040 stucco aluminum @ int. w/ 24 ga. stainless steel 430 (magnetic) liners w/ 4-sided heat cable in frame [FL-4-112W] (25'-9" x 5 ohms/ft (129 total) @ 4.4 W/ft + Pepi - 120V, 1A) Leaf: 4" thick, 3-side lap, standard height w/ 20 ga. stainless steel 304 #4 both sides w/ Magnetic gasket (3) Kason #1245 reversible cam-rise hinge (1) Kason #27C cylinder locking deadbolt handle (1) Kason #27C 1/4 turn knob inside release (1) Kason 'PUSH' pad (1) Dorma #8616 FHP 689 door closer (1) Modularm 75LC multi-monitor temperature alarm w/IP-1 illum. push button and flush door ajar sensor (2) Terminal J-Box @ int. (1) Evaporator cut-off switch (1) 14" x 24" heated view window (84W, 120V, 0.9A) (1) 12 ga. stainless steel threshold 36" high AFF 14 ga. smooth stainless steel 304 #4 kickplates (leaf, ext. & int.) (1) Kason #944 deadbolt w/ re-keyable core upgrade [B]: (1) 30" x 81" CDS entrance all glass cooler door (smooth silver frame) w/ (1) Full length handle [C]: (1) 30" x 81" CDS entrance all glass cooler door (smooth silver frame) w/ (1) Full length handle [D]: (3) 24" x 75" CDS Advantage FS Series cooler glass door w/ 2-pane low E gas filled glass, light switch & controller(s) (smooth silver frame) w/ LED lights w/ (3) Full length handle w/ (1) Energy controller for up to (15) doors w/ (1) Dimming motion sensor NSF LABEL N.S.F. LISTED (STD #7) COMPONENT N.S.F. GASKET @ ALL PANEL JOINTS THE MINIMUM BTU'S SHOWN ARE BASED ON NSF STANDARD #7, SECTION 5, PARAGRAPH 5.36.7, REQUIREMENTS (REF. TABLE 1). THESE NUMBERS ARE NOT INTENDED TO BE USED FOR SIZING OF REFRIGERATION UNITS FOR THIS WALK-IN. IMPERIAL BROWN RECOMMENDS CONSULTING WITH A QUALIFIED ENGINEER OR CONTRACTOR

(1) ea. 4' LED light fixture w/ (2) LED lamps for cooler or freezer application (Keil -36W, 120V, 0.3A) -(Fixture ships loose for field installation.) (2) ea. Kason #1803 vapor proof light fixture & E26 LED lamp (11W, 120V, 0.13A) - Cooler (E26 LED lamp included.) (1) ea. Low temp Curtron strip curtain for 36" x 80" net opening - w/ 8" strips @ 50.00% overlap (1) ea. (2" x 4") x 96" x 20 ga. stainless steel 304 #4 outside corner vertical closure (1) ea. (2" x 4") x 48" x 20 ga. stainless steel 304 #4 outside corner vertical closure (1) ea. 6" x 96" x 20 ga. stainless steel 304 #4 flat vertical closure (1) ea. 6" x 48" x 20 ga. stainless steel 304 #4 flat vertical closure (1) set 20 ga. stainless steel 304 #4 removable ceiling closure - Please Verify Closure Dimensions and Requirements Estimated Cavity Size = 1' - 6" (18") high x 23' - 7" (283") long (7) ea. (2" x 2") x 96" x 18 ga. stainless steel 304 #4 (w/ Simpson Titen screws) Interior seismic tie-down @ floor level (10) ea. (2" x 2") x 96" x .040 stucco white aluminum Interior seismic tie-down @ ceiling level Meets 2009 Federal Energy Independence and Security Act Requirements. STANDARD NOTES To prevent condensation, a minimum 2" from the walk-in exterior surface is required. High humidity conditions may require force ventilation in addition to clearance. Installation site floor must be true and level within 3/16" per 10' or additional costs may be incurred. Imperial Brown's sliding and vertical lift doors shall not be considered means of egress. Check code egress requirements for your application. RECESSED PIT Recess plan is provided to set min. size to allow panel installation. Recess depth, concrete floor above and below insulation, design, reinforcement, thickness & construction of concrete should be designed by a Qualified Professional Engineer familiar with cold storage design, the site conditions and end users application. See project contract documents. All concrete and excavation work & design is by others. Field electrician to verify maximum acceptable load for light switches. If load is too high, then relay type controls should After wiring devices, ALL conduits must be sealed to stop moisture transfer through electrical raceways. Failure to seal device per NEC codes WILL VOID WARRANTY. **ENGINEERING** Foundation, special inspection, footings, anchor bolt embedment, edge distances and all reinforcing are to be designed by a qualified professional engineer based on concrete strength and specific soil condition at the building site.

Foundation and freezer pit to be designed for loads designated on plan and/or in engineering calculations.

Components of all doors, windows, and openings to be designed for loads induced by wind, design by others.

If walk-in ceiling is suspended, existing roof structure to be designed by others for loads induced from new walk-ins where

Special Inspection is required per IBC 1704 and 1707 for post installed anchor bolts (for California, follow CBC 1704 and

REVISIONS

All loads are service loads.

All foundation dimensions to be field verified.

Walk-in is designed for code applied loads.

Design does not include static pressure review.

shown on plans and/or in engineering calculations.

All mechanical unit anchorage and support to be designed by others.

All connectors or elements in contact with aluminum to be stainless steel (STL/STL).

- PRELIMINARY DRAWING -Customer Note: This is a preliminary drawing only. Approving this drawing only indicates that you agree with overall dimensions and door and opening locations. Panel sizes and layout is subject to change. If "Nominal Size" has been quoted, then actual dimensions may end up a bit smaller than drawn herein. Actual dimensions will be shown on subsequent non-preliminary drawings. Should discrepencies be found between drawing and sales order, customer may be asked to approve standard Submittal drawings. The customer or their representative in signing these drawings is taking responsibility for overall size and fit around building walls, columns and ceiling restrictions, door locations, openings for equipment supplied by others, specifications and accessories listed.

☐ APPROVED FOR FABRICATION WITH NO CHANGES □ APPROVED FOR FABRICATION WITH CHANGES ☐ REVISE AND RESUBMIT

REV# DATE DO NOT SCALE THIS DRAWING SCALE: 3/16" = 1'-0" DATE DRAWN: 8/20/2020

9/17/2020 DATE PRINTED: BY: KWL CHK'D BY: DRW#: 20-IB-47156-01

BOX: 1 OF 1 SHEET 1 OF 5

CONSULTANTS 1530 S. Lewis St. Anaheim, CA 92805 P 714.508.1880 www.webbfsd.com

Beaverton School District

16550 SW Merlo Rd. Beaverton OR 97003

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DESCRIPTION

FINAL MANUFACTURER SHOP DRAWINGS

SPECIFIC TO THIS PROJECT AS REQUIRED.

THIS SHOP DRAWING ON THIS SHEET IS FOR REFERENCE ONLY. CONTRACTOR TO PROVIDE


Portland, OR 97205, USA tel 503 226 6950 fax 503 273 9192 ibigroup-edpnw.com

Rock Creek Elementary School Freezer Replacement 4125 NW 185th Ave Portland, OR 97229

PROJECT NO: 126730 DRAWN BY: CHECKED BY: PROJECT MGR: APPROVED BY:

WALK-IN DETAILS

FS-303

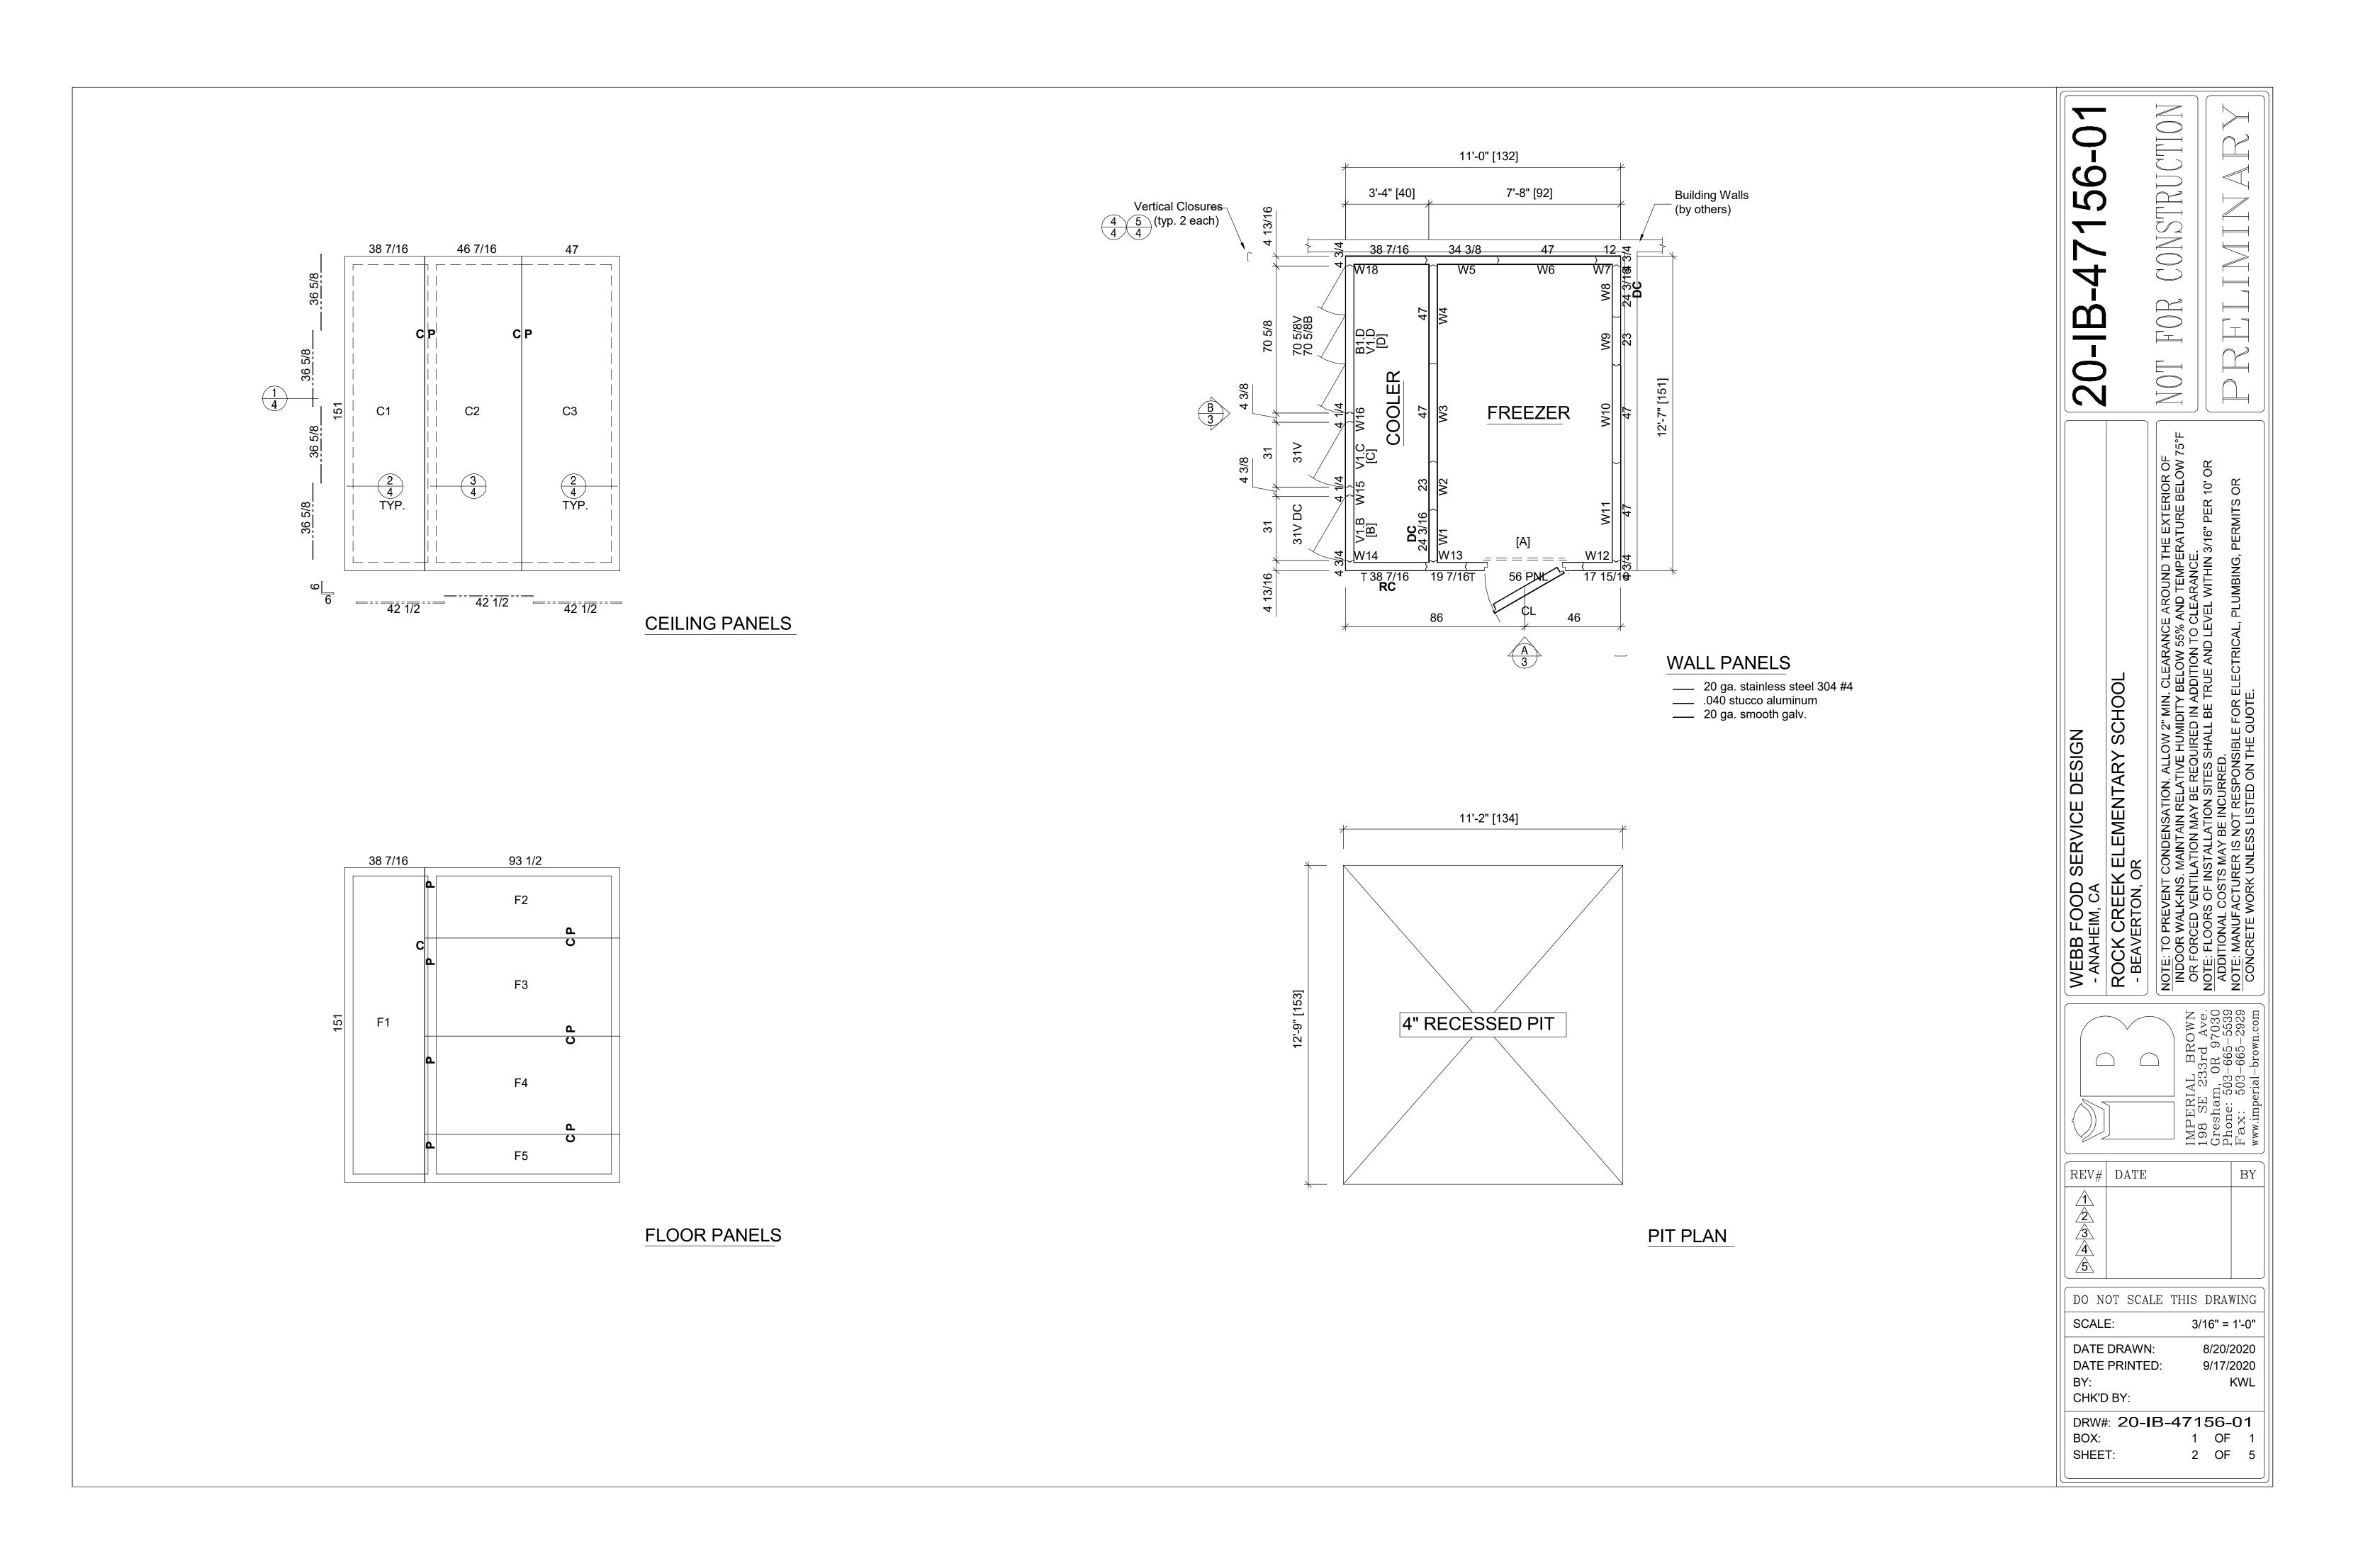

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PROJECT
Rock Creek Elementary School
Freezer Replacement
4125 NW 185th Ave
Portland, OR 97229


PROJECT NO: 126730


DRAWN BY: CHECKED BY: PROJECT MGR: APPROVED BY:


SHEET TITLE
WALK-IN DETAILS


ISSUE


FS-304

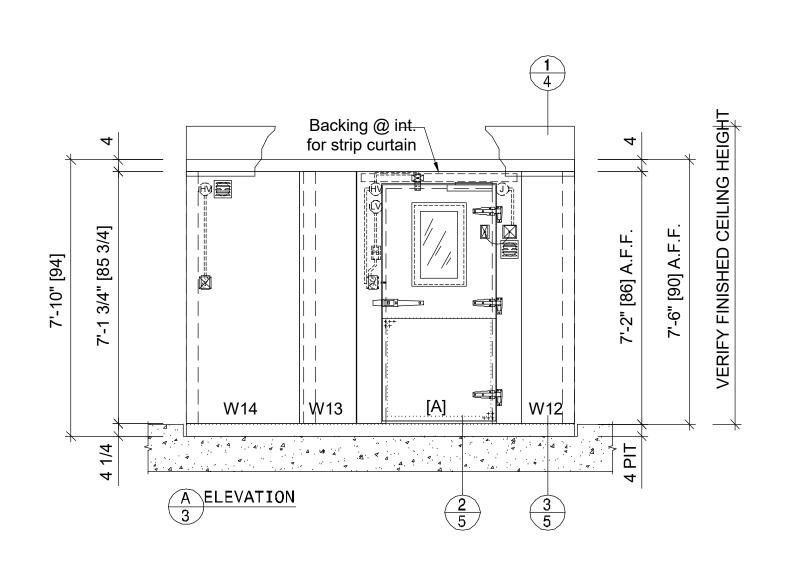

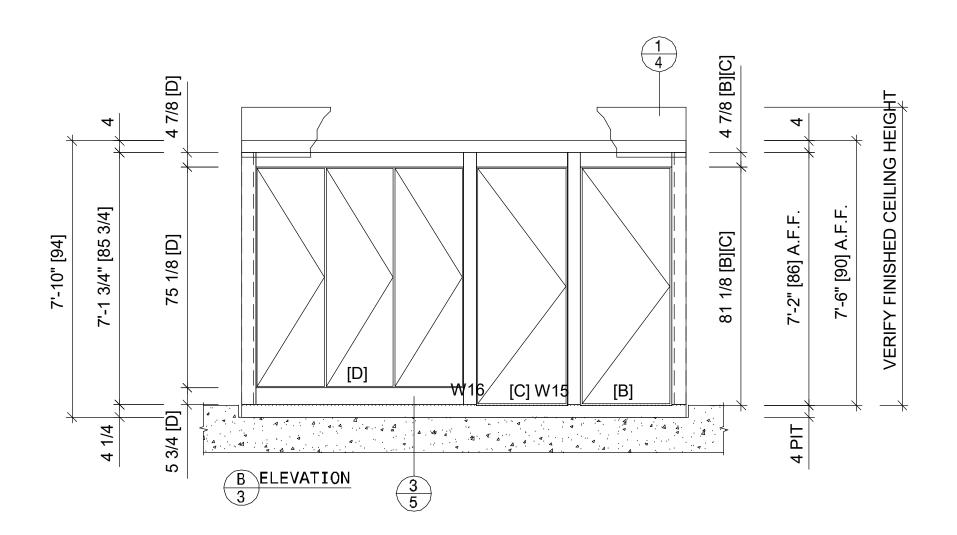

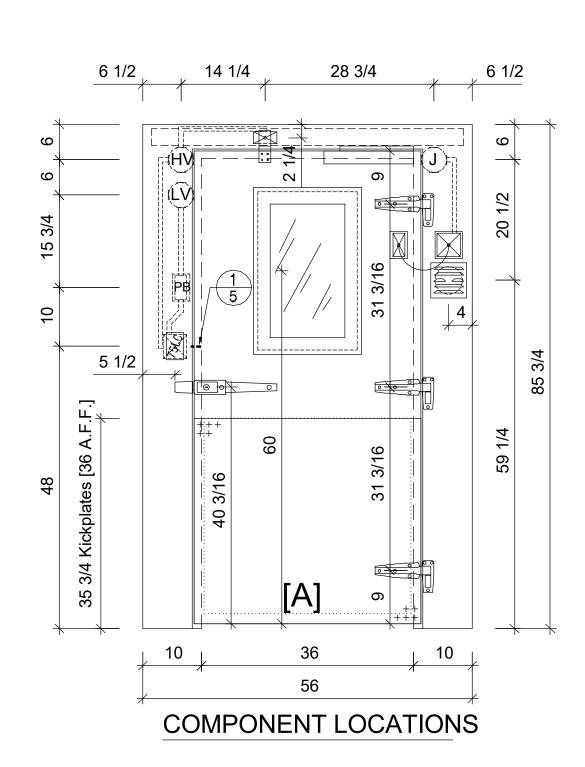

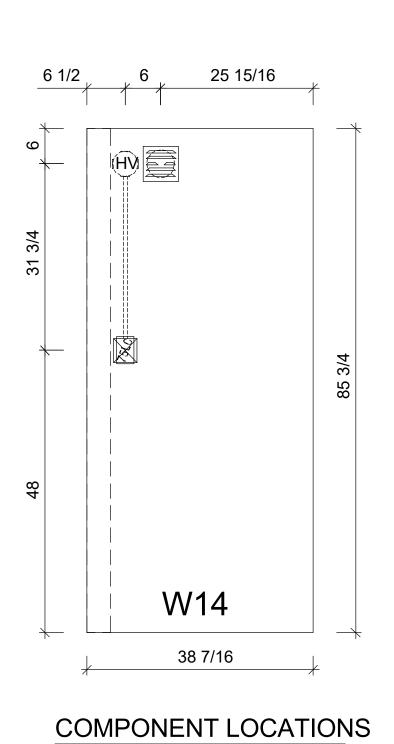

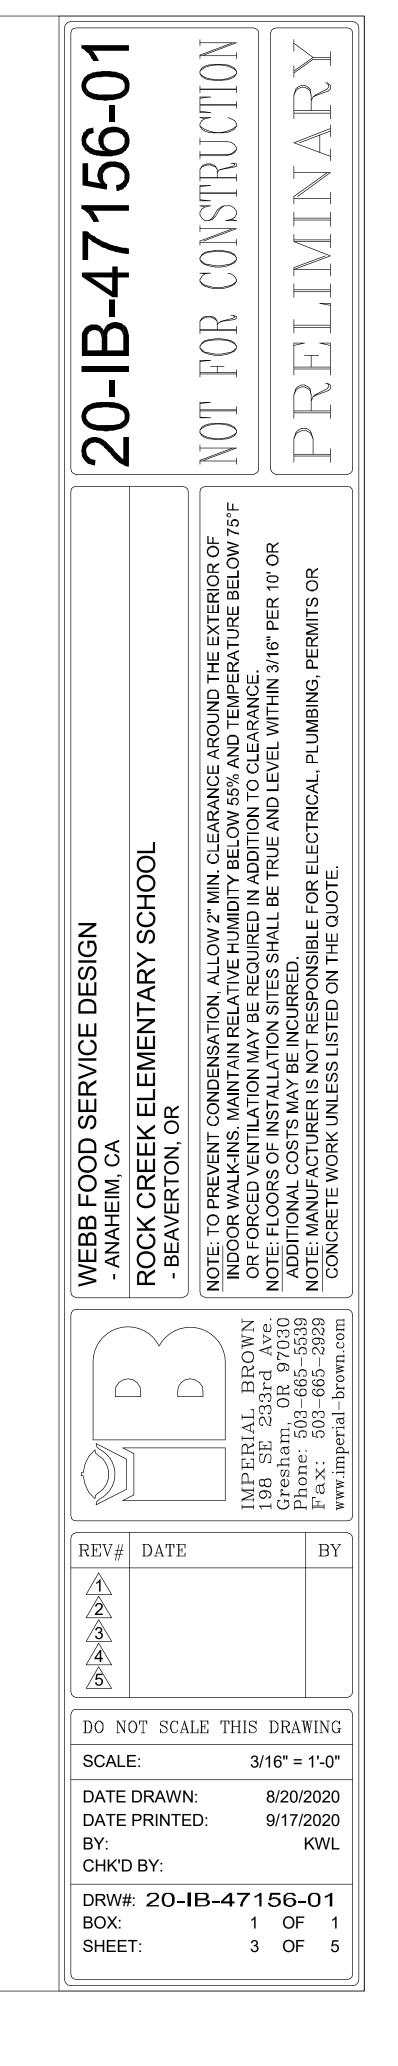

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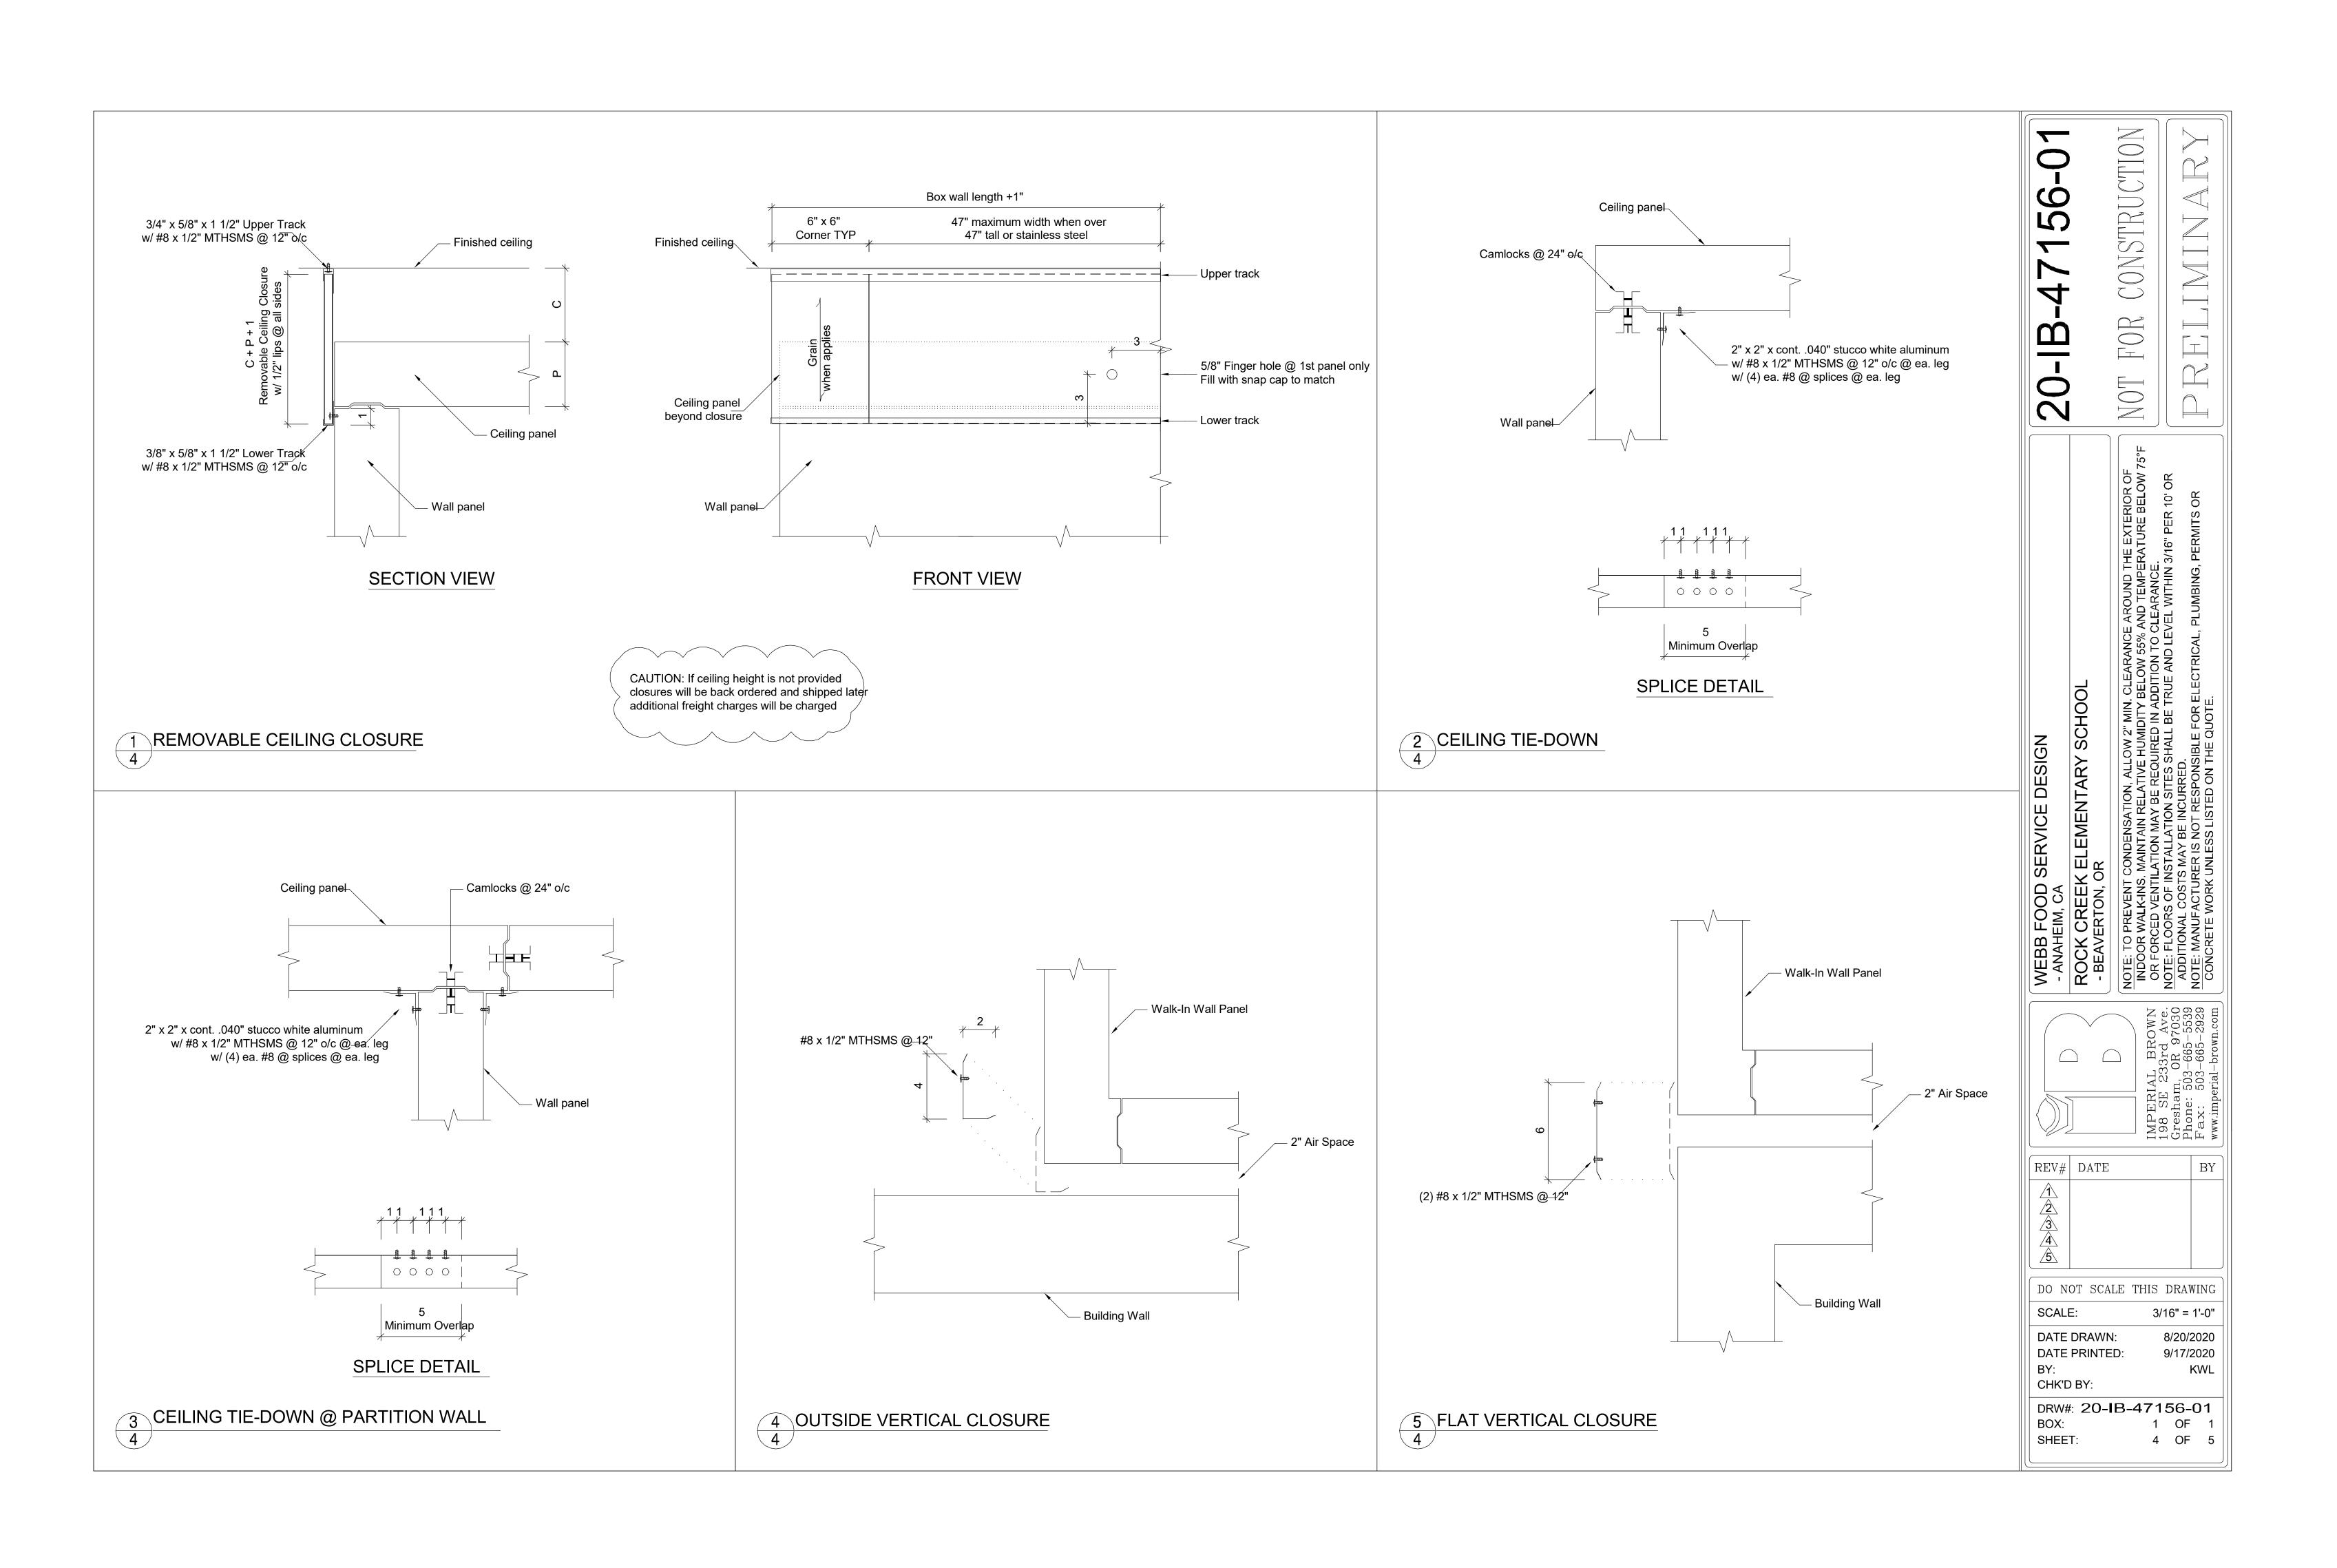
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PROJECT
Rock Creek Elementary School
Freezer Replacement
4125 NW 185th Ave
Portland, OR 97229

PROJECT NO: 126730 DRAWN BY: CHECKED BY: PROJECT MGR: APPROVED BY:

SHEET TITLE
WALK-IN DETAILS

ISSUE FS-305



Deaverton School District

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tel 503 226 6950 fax 503 273 9192
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PROJECT
Rock Creek Elementary School
Freezer Replacement
4125 NW 185th Ave
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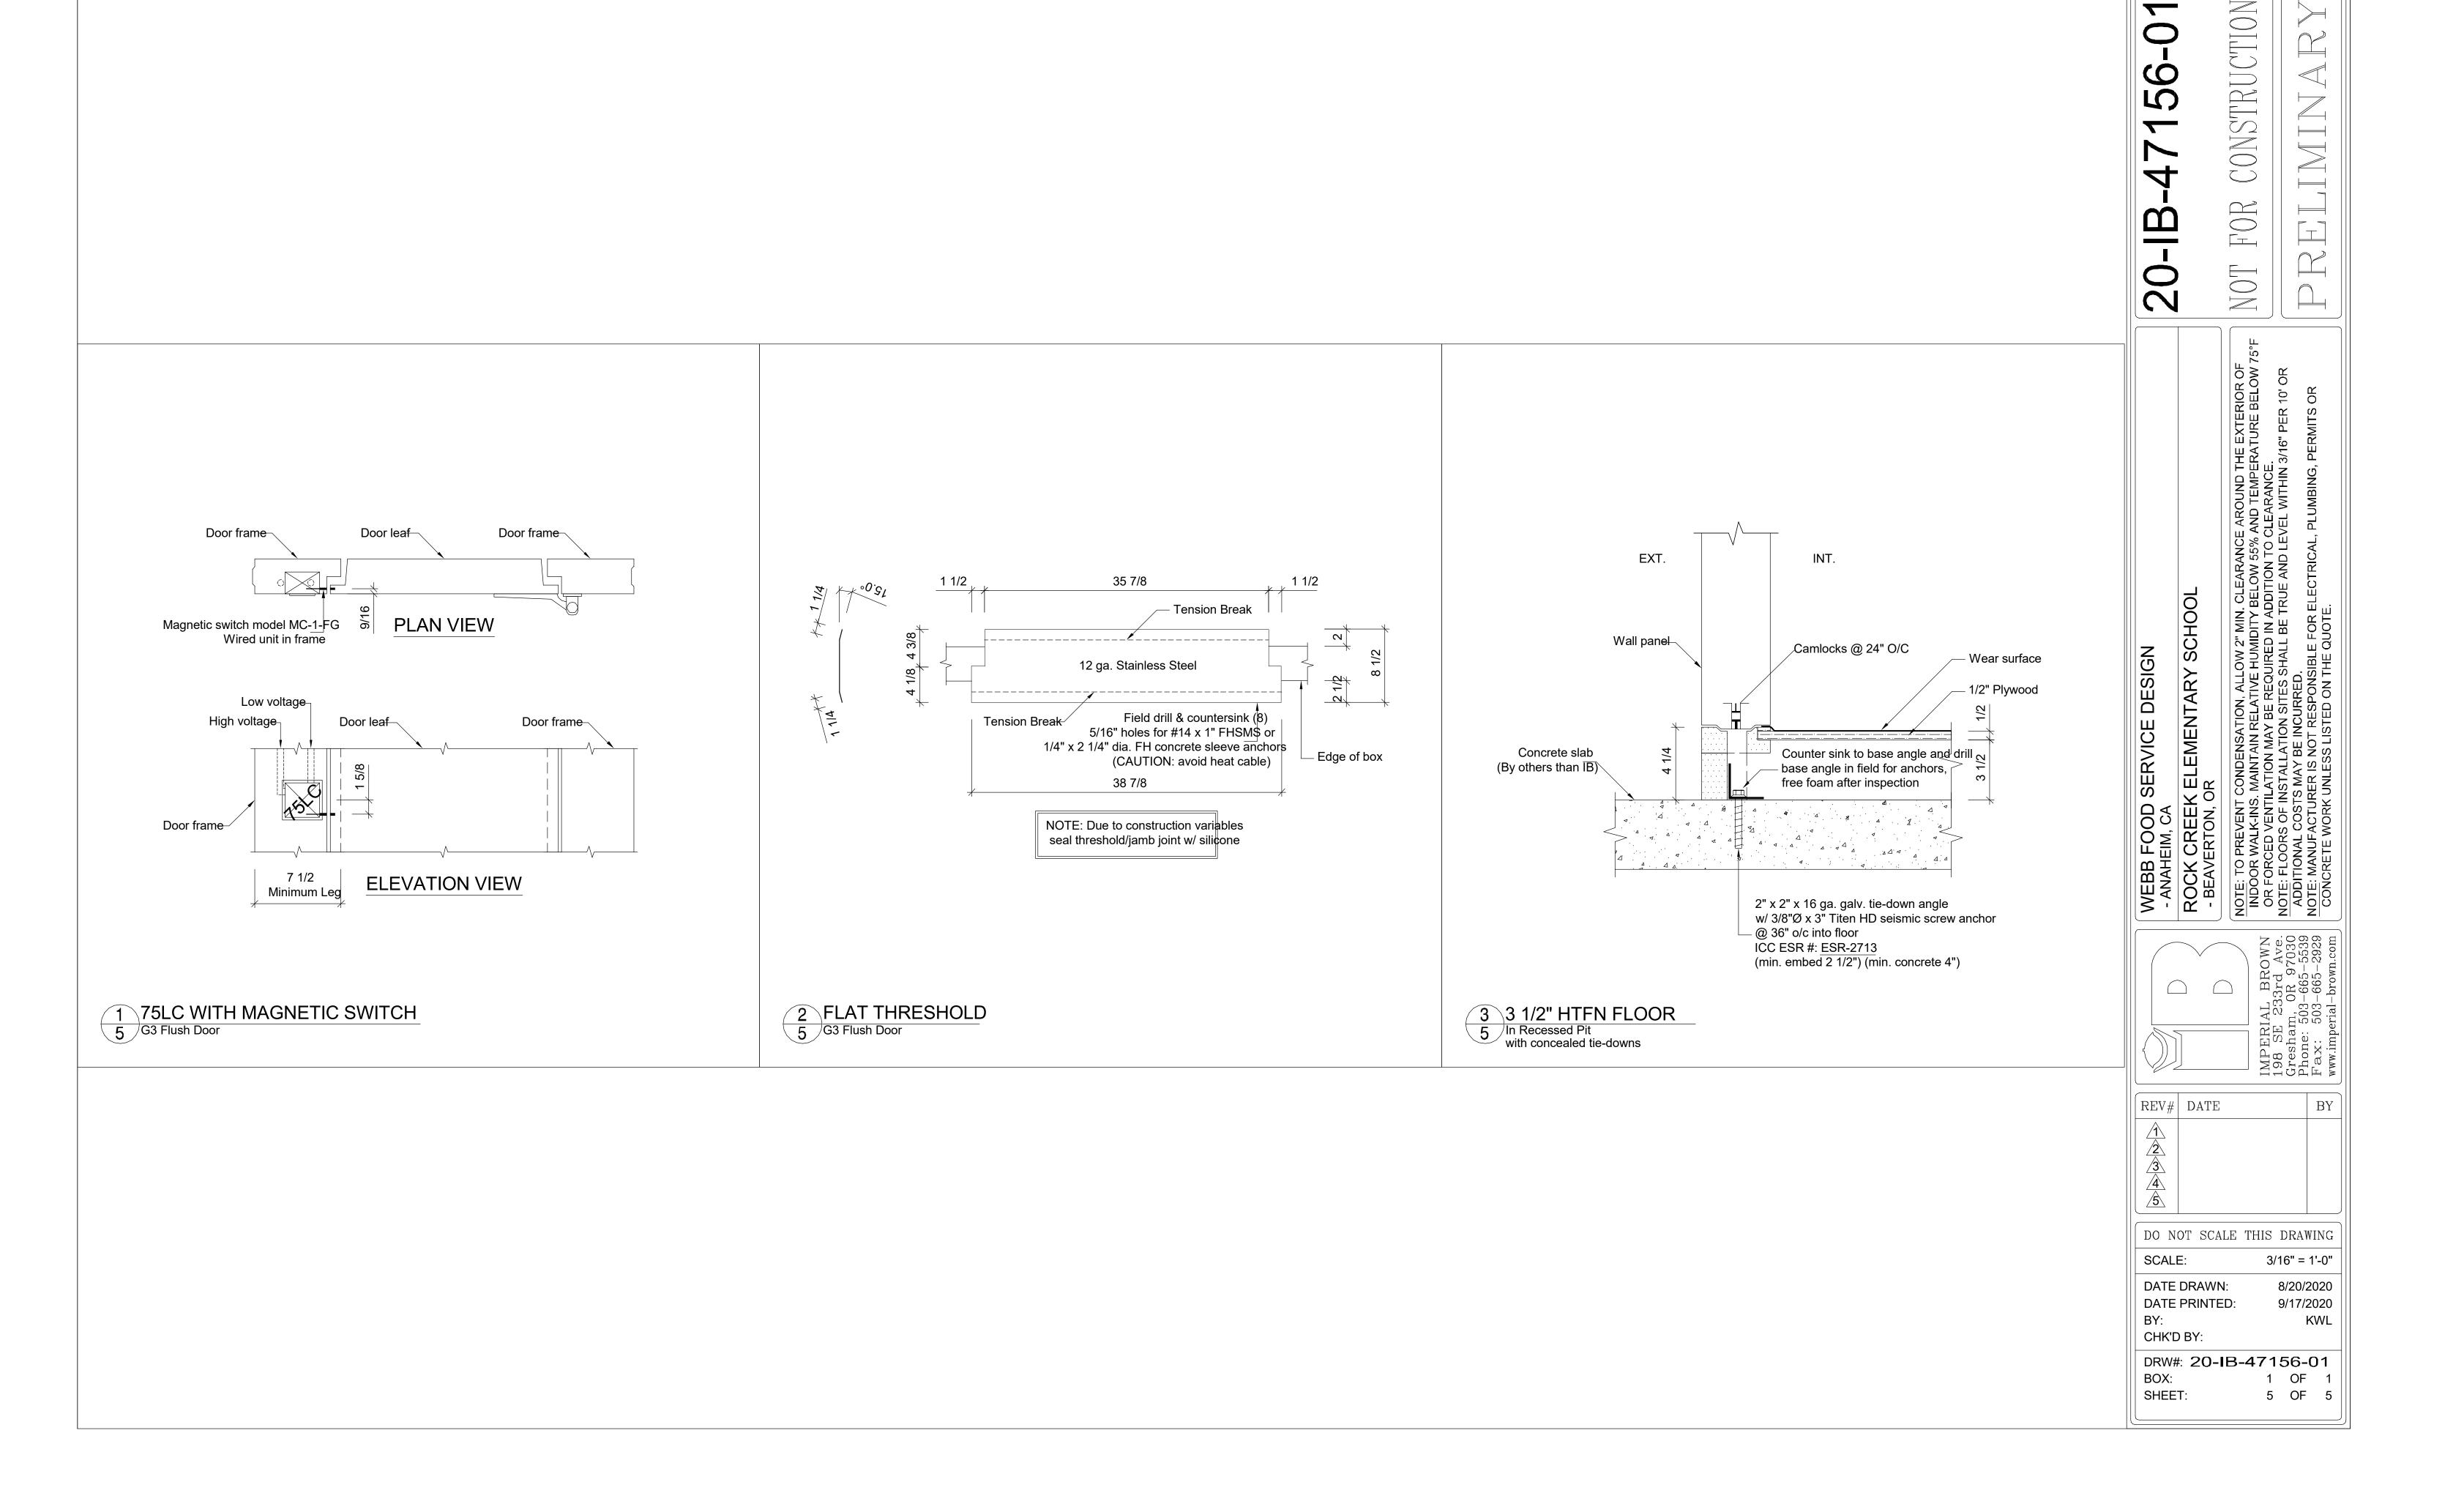
PROJECT NO: 126730

DRAWN BY: CHECKED BY: PM RS

PROJECT MGR: APPROVED BY:

SHEET TITLE
WALK-IN DETAILS

FS-306



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Portland, OR 97229

PROJECT NO: 126730

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SHEET TITLE
WALK-IN DETAILS

FS-307

————— HOT WATER PIPING

----- SANITARY VENT PIPING

TP—TP—TRAP PRIMER PIPING

─────── SHUTOFF VALVE, GENERAL

SANITARY WASTE OR SOIL PIPING ABOVE GRADE OR FINISHED

SANITARY WASTE OR SOIL PIPING BELOW GRADE OR FINISHED FLOOR

GENERAL	PLUMBING NOTES
OLITEIAL	I EUNDING NO LO


A. FIELD COORDINATE EXACT ROUTING OF KITCHEN EQUIPMENT CONDENSATE DRAINS.

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Beaverton School District

PLUMBING FIXTURE SCHEDULE										
					BASIS OF DESIGN	CONNECTION				
SYMBOL FIXTURI	E TYPE	DESCRIPTION	MFR	MODEL	ACCESSORIES	W	V	CW	HW	NOTES
FS-1 FLOOR		C FLANGED RECEPTOR, SEEPAGE HOLES, ACID RESISTANT, IME BOTTOM STRAINER 305-12 ARCIG GRATE, 6-INCH DEEP	JR SMITH	305-14		3"	1-1/2"	PRIMER CONN.		



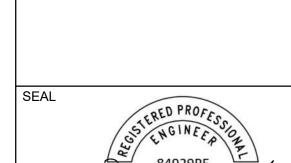

EXPIRES: 12/31/22

100 SW Main Street, Suite 1600 Portland, OR 97204 TEL 503.382.2266 www.interfaceengineering.com

IBI GROUP
907 SW Harvey Milk Street
Portland, OR 97205, USA
tel 503 226 6950 fax 503 273 9192
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PROJECT

Rock Creek ESF 4125 NW 185th Ave Portland, OR 97229

PROJECT NO: 126730 DRAWN BY: CHECKED BY:

APPROVED BY: PROJECT MGR:


SYMBOL LIST AND GENERAL **NOTES - PLUMBING**

SHEET NUMBER P0000

ISSUE


P0000 SYMBOL LIST AND GENERAL NOTES - PLUMBING


P1101 FLOOR PLANS - PLUMBING

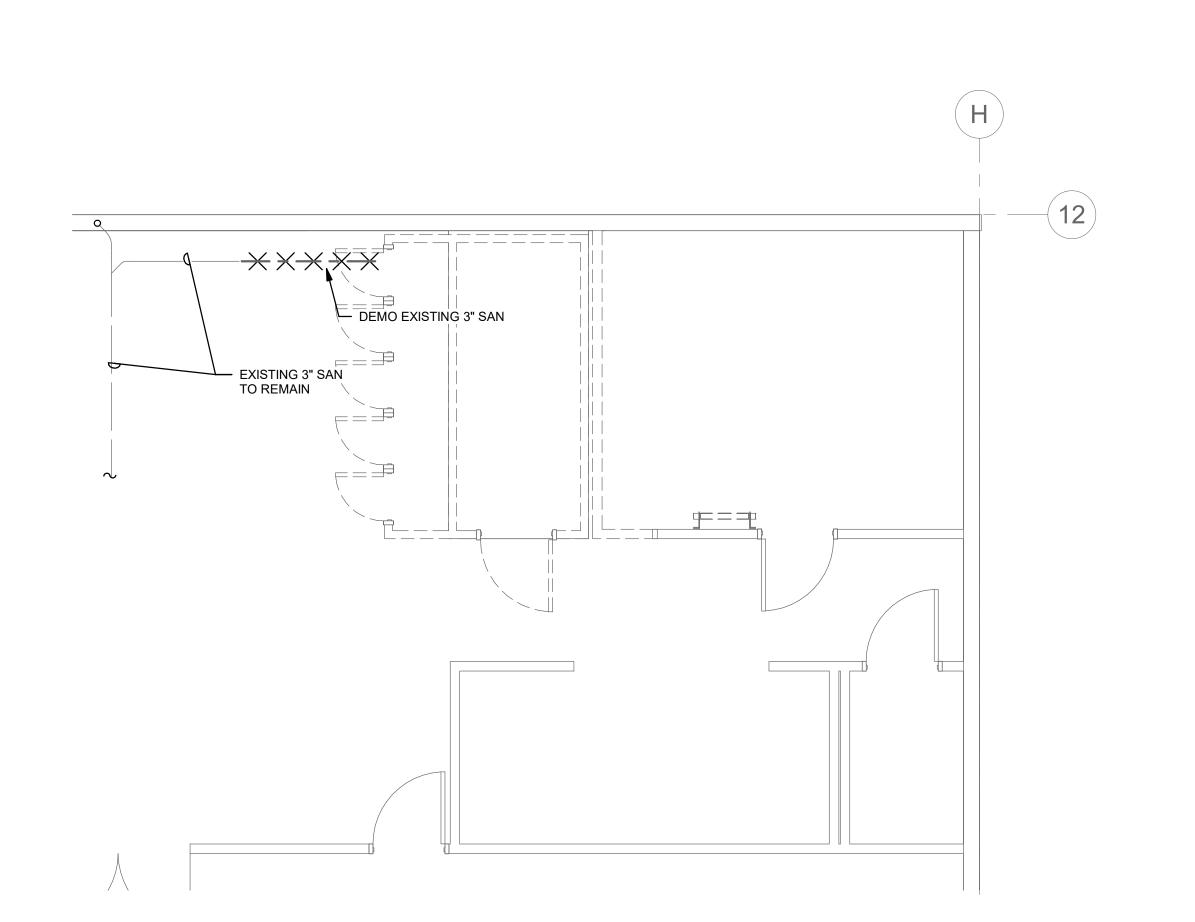


UNDERGROUND DEMO PLAN - PLUMBING

0' 2' 4' 8' 1/4" = 1'-0"

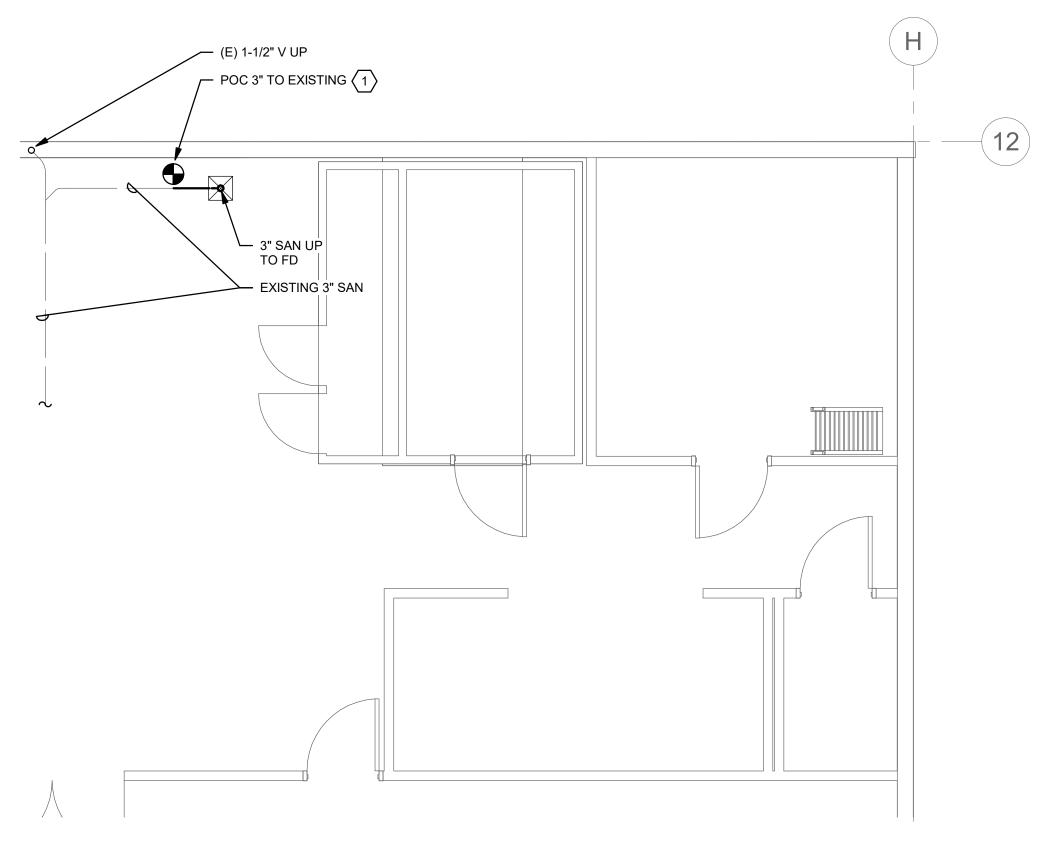

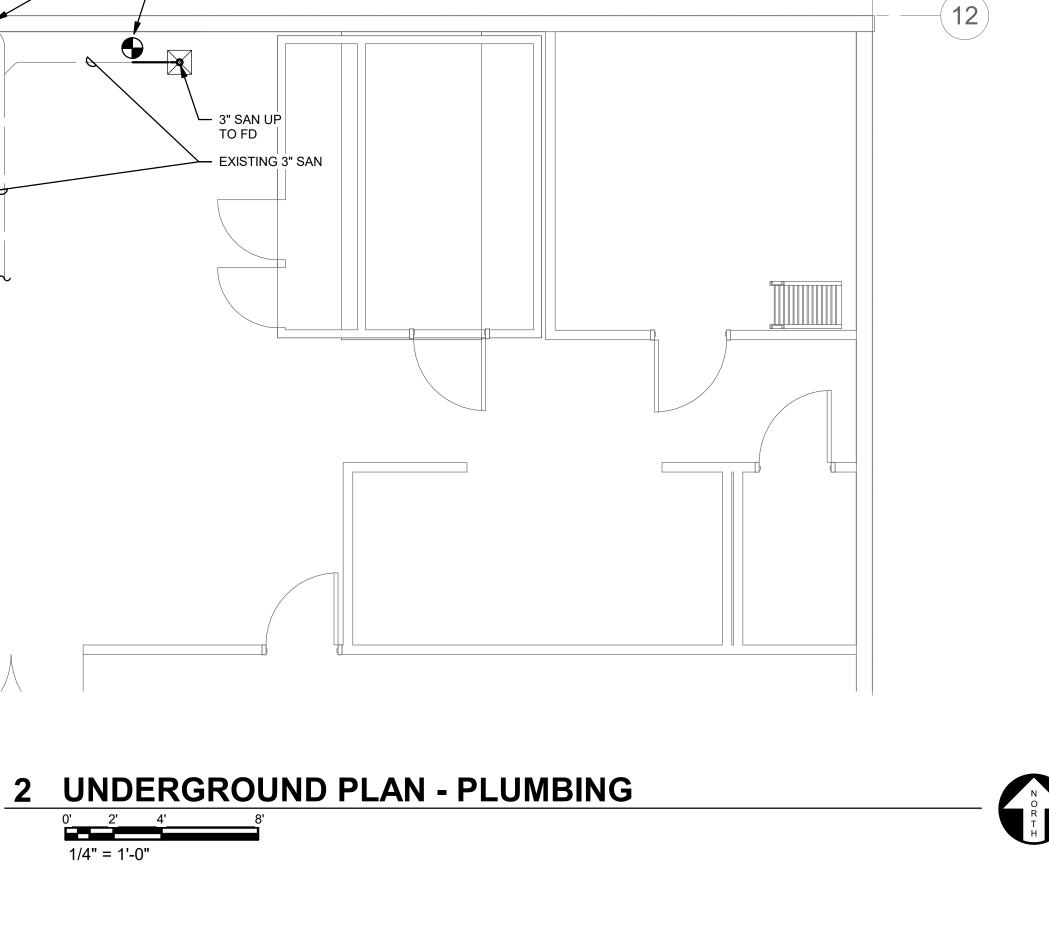


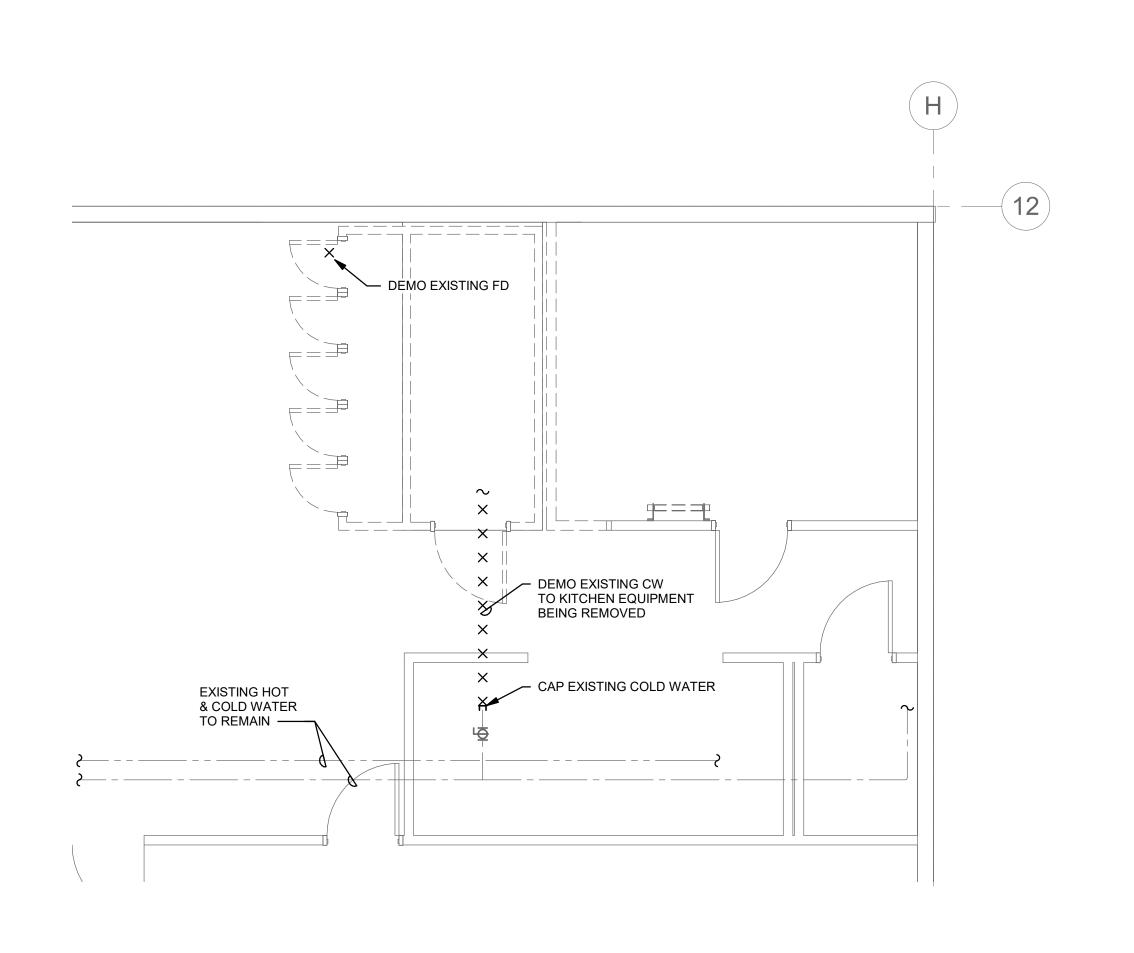



3 LEVEL 01 DEMO FLOOR PLAN - PLUMBING

0' 2' 4' 8'

1/4" = 1'-0"

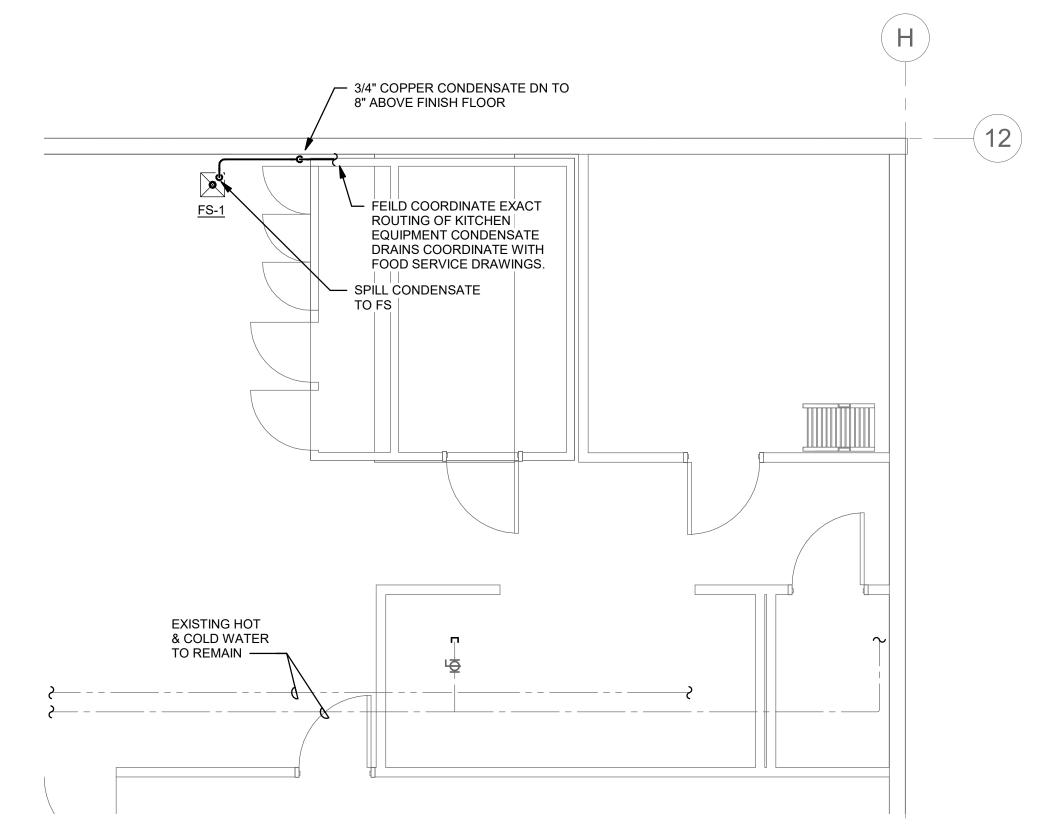

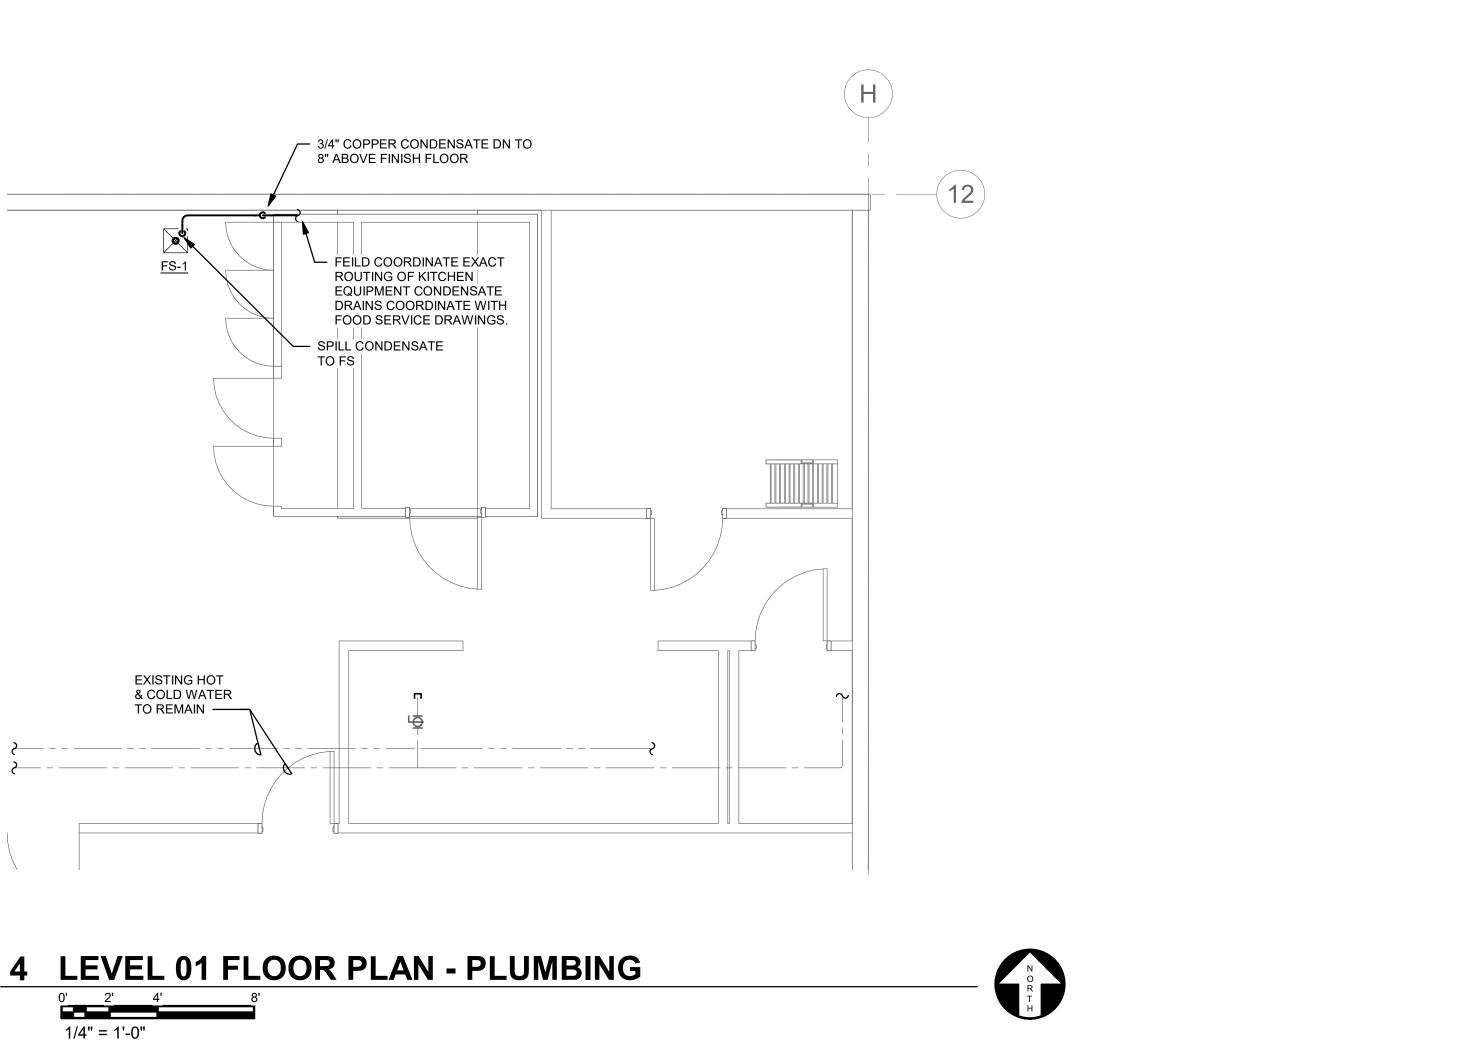

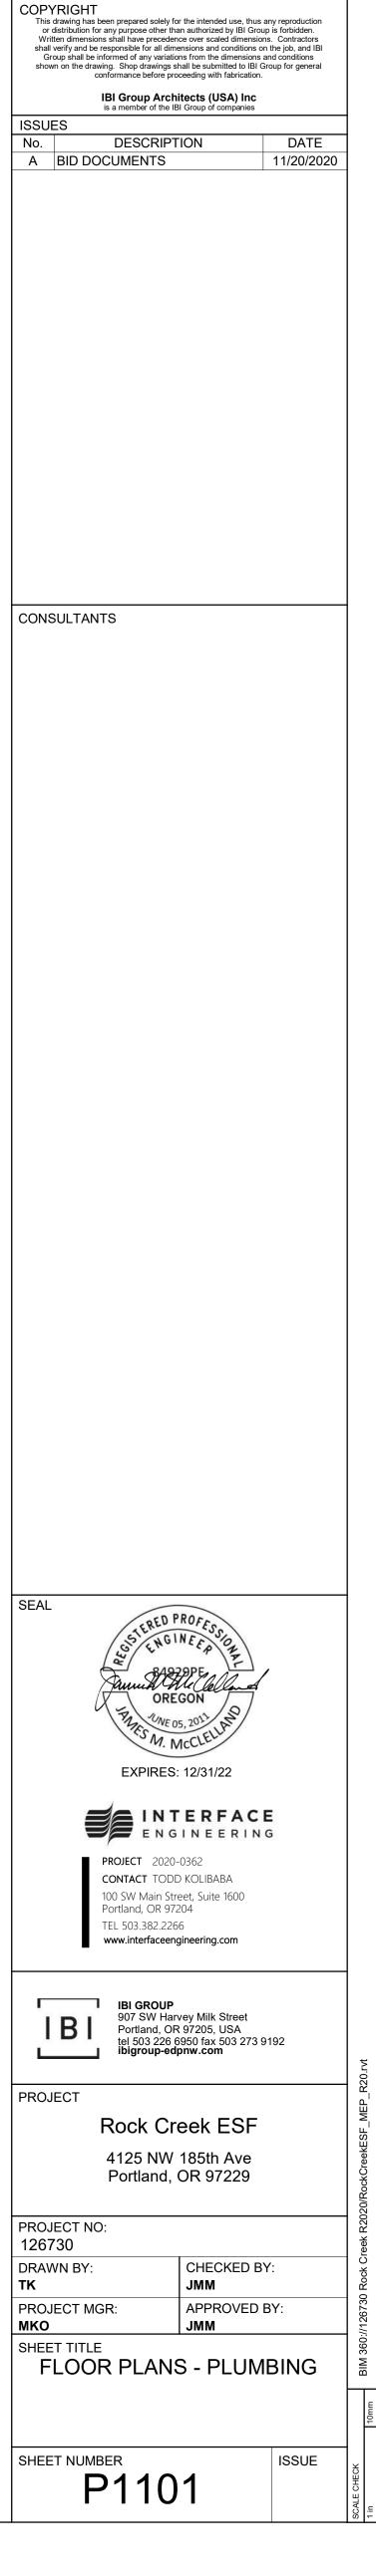

Beaverton School District

16550 SW Merlo Rd. Beaverton OR 97003

○ SHEET KEYNOTES

1 CONTRACTOR TO FIELD VERIFY EXISTING SANITARY I.E.

ELECTRICAL SYMBOL LIST

NOTE: This is a standard symbol list and not all items listed may be used. <u>Abbreviations</u> AFC ABOVE FINISHED CEILING AFF ABOVE FINISHED FLOOR AMERICAN NATIONAL STANDARDS INSTITUTE AWG AMERICAN WIRE GAUGE AMPERES, AMBER **AUTHORITY HAVING JURISDICTION** AIC AVAILABLE INTERRUPTING CAPACITY CA CABLE CAT CATEGORY CLG CEILING CONDUIT, CLOSE, CONTROL COORD COORDINATE CU COPPER DEMOLISH DTL DETAIL DIA DIAMETER DIM DIMENSION DIV DIVISION DN DOWN DWG DRAWING EA EACH ELECTRICAL METALLIC TUBING **ELEVATION EMERGENCY** EXHAUST FAN (E) EXISTING FA FIRE ALARM FLEXIBLE METAL CONDUIT FT FOOT, FEET FBO FURNISHED BY OTHERS G, GND GROUND GFCI GROUND FAULT CIRCUIT INTERRUPTER GFI GROUND FAULT INTERRUPTER HT HEIGHT IDENTIFICATION INCH, INCHES INSTITUTE OF ELECTRICAL AND ELECTRONICS ENGINEERS IEEE KVA KILOVOLT AMPERES KW KILOWATT LED LIGHT EMITTING DIODE LFMC LIQUIDTIGHT FLEXIBLE METAL CONDUIT LV LOW VOLTAGE MOCP MAXIMUM OVERCURRENT PROTECTION MIN MINIMUM MCA MINIMUM CIRCUIT AMPS MISC MISCELLANEOUS MT, MTD MOUNT, MOUNTED

NATIONAL ELECTRIC CODE

NEUTRAL NOT APPLICABLE

ON CENTER

PHASE

POWER QUANTITY

RELOCATE

REQUIRED

STANDARD

TO BE DETERMINED

VOLTS, VOLTAGE

WEATHERPROOF

ROOM

SHEET

WITH

TYP TYPICAL

W/O WITHOUT

NOT IN CONTRACT NOT TO SCALE

NATIONAL ELECTRIC SAFETY CODE

OFCI OWNER FURNISHED, CONTRACTOR INSTALLED

REQUEST FOR INFORMATION

UNDERWRITERS LABORATORIES UNLESS OTHERWISE NOTED

NATIONAL ELECTRICAL MANUFACTURERS ASSOCIATION

NESC

NEMA

N.I.C.

OC

PH

PWR

RFI

RM

SHT

STD

WP

W/

REQD

Connections / Equipment Switches and Receptacles HEAVY DUTY FUSED DISCONNECT SWITCH

MOTOR CONNECTION

NON-FUSED DISCONNECT SWITCH

CEILING MOUNTED JUNCTION BOX

FLOOR MOUNTED JUNCTION BOX

WALL-MOUNTED JUNCTION BOX

EQUIPMENT IDENTIFICATION

WALL MOUNTED LUMINAIRE

YELLOW STRIPE) CONDUCTOR.

CONDUIT ELLED DOWN

— O CONDUIT ELLED UP

FLEXIBLE CONDUIT

CONDUIT/WIRING CONTINUATION

FLUSH WALL MOUNTED BRANCH PANEL

BRANCH CIRCUIT WIRING. ARROW INDICATES HOME RUN TO PANEL WITH CIRCUITS AS NOTED. WIRE SIZE IS #12 AWG MINIMUM

CONDUCTORS. LONG TICK MARKS INDICATE NEUTRAL

CONDUCTORS. A SINGLE CURVED TICK MARK INDICATES

UNLESS NOTED OTHERWISE. SHORT TICK MARKS INDICATE PHASE

INSULATED GREEN GROUND CONDUCTOR. SECOND CURVED TICK

MARK INDICATES "ISOLATED GROUND" (GREEN INSULATION WITH

KEYED NOTE

LOCATION

Lighting

<u>Miscellaneous</u>

B-27,29,31.

Raceways Page 1985

—X—X— DEMOLISH

----- NEW WORK

----- EXISTING WORK

DUPLEX RECEPTACLE (MULTIPLE LETTERS INDICATE MULTIPLE A = ABOVE COUNTER C = FLUSH CEILING MOUNTED

G = GROUND FAULT CIRCUIT INTERRUPTER W = WEATHERPROOF CONTINUOUS USE COVER, GFCI PROTECTED, WITH WEATHER-RESISTANT RECEPTACLE SINGLE POLE SWITCH L = LIGHTED HANDLE M = MANUAL MOTOR STARTER WITH THERMAL OVERLOAD W = WEATHERPROOF SWITCH

GENERAL ELECTRICAL NOTES

- A. IT IS THE INTENT OF THESE DOCUMENTS TO PROVIDE FOR ALL NECESSARY ADJUSTMENTS TO THE ELECTRICAL SYSTEM TO MEET CODE AND TO ACCOMMODATE THE INSTALLATION OF NEW WORK.
- B. PROTECT EXISTING UTILITIES THAT PASS THRU AND EXTEND BEYOND THE LIMITS OF CONSTRUCTION. PROVIDE NEW RACEWAY, CONDUCTORS,
- C. EXISTING UTILITIES ARE TO REMAIN OPERATIONAL DURING CONTRUCTION. COORDINATE REQUIRED SHUTDOWN(S) WITH OWNER PRIOR TO ANY INTERRUPTIONS.

SUPPORTS, BRACING ETC. AS REQUIRED TO MAINTAIN SERVICES.

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DESCRIPTION 11/20/2020 A BID DOCUMENTS

CONSULTANTS

KITCHEN EQUIPMENT CONNECTION SCHEDULE PHASE LOAD CONDUIT CIRCUIT NOTES DESCRIPTION C-COMP RETAIL COOLER - CU 208/3 11.2 A 203 K-7. RETAIL COOLER - EVAP | 120/1 | 1.6 A | 202 WALK-IN FREEZER - CU 208/3 12.8 A K-5. F-EVAP WALK-IN FREEZER - EVAP 208/1 10.1 A 202 LP-C-28,30.

GENERAL KITCHEN EQUIPMENT CONNECTION SCHEDULE NOTES

REFER TO KITCHEN CONSULTANT DRAWINGS FOR EXACT LOCATIONS AND CONNECTION TYPES. COORDINATE CONNECTION WITH SUPPLIED EQUIPMENT AND VENDOR DRAWINGS.

SHEET INDEX

E1101 FLOOR PLANS - ELECTRICAL

E0000 SYMBOL LIST AND GENERAL NOTES - ELECTRICAL

KITCHEN EQUIPMENT CONNECTION SCHEDULE NOTES

REUSE EXISTING 20A/3P BREAKER.

REUSE EXISTING 20A/1P BREAKER.

REPLACE EXISTING 20A/1P SPARE BREAKER AND SPACE WITH (1) NEW 20A/2P BREAKER. MATCH EXISTING MANUFACTURER AND AIC RATING.

WIRE / CONDUIT SCHEDULE

202 2 #12 CU, 1 #12 CU GND., IN 3/4" C. 203 3 #12 CU, 1 #12 CU GND., IN 3/4" C.

INTERFACE ENGINEERING **PROJECT** 2020-0362 CONTACT HUONG NGUYEN 100 SW Main Street, Suite 1600 Portland, OR 97204 TEL 503.382.2266 www.interfaceengineering.com

EXPIRES: 12/31/20



PROJECT

Rock Creek ESF 4125 NW 185th Ave Portland, OR 97229


CHECKED BY: APPROVED BY:


SYMBOL LIST AND GENERAL

PROJECT NO: 126730 DRAWN BY: PROJECT MGR:

NOTES - ELECTRICAL


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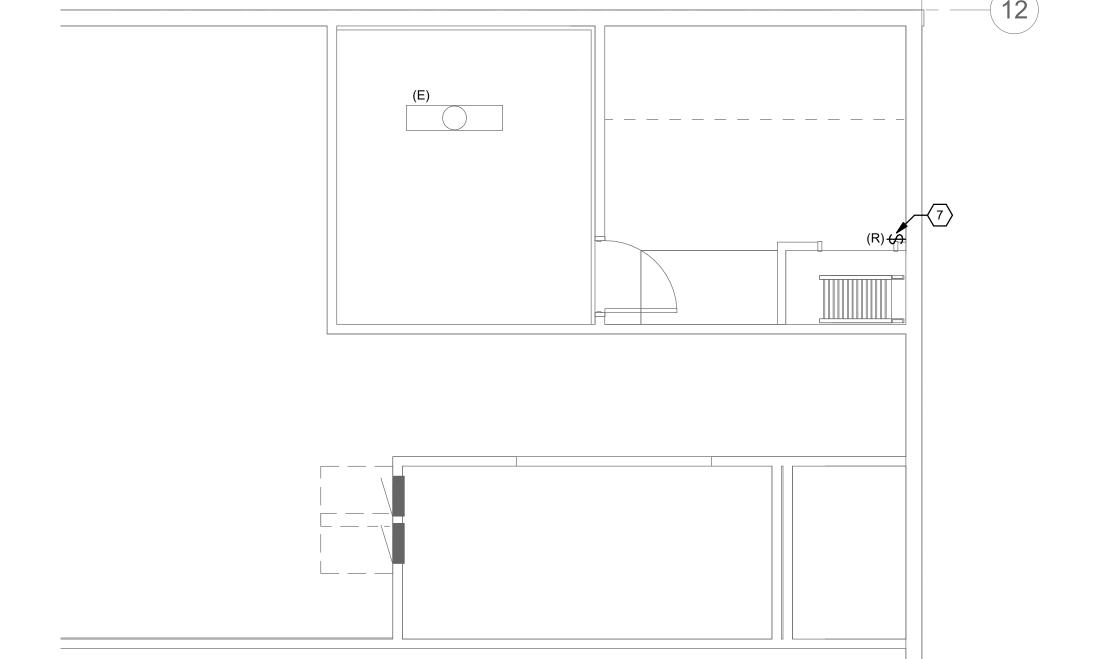


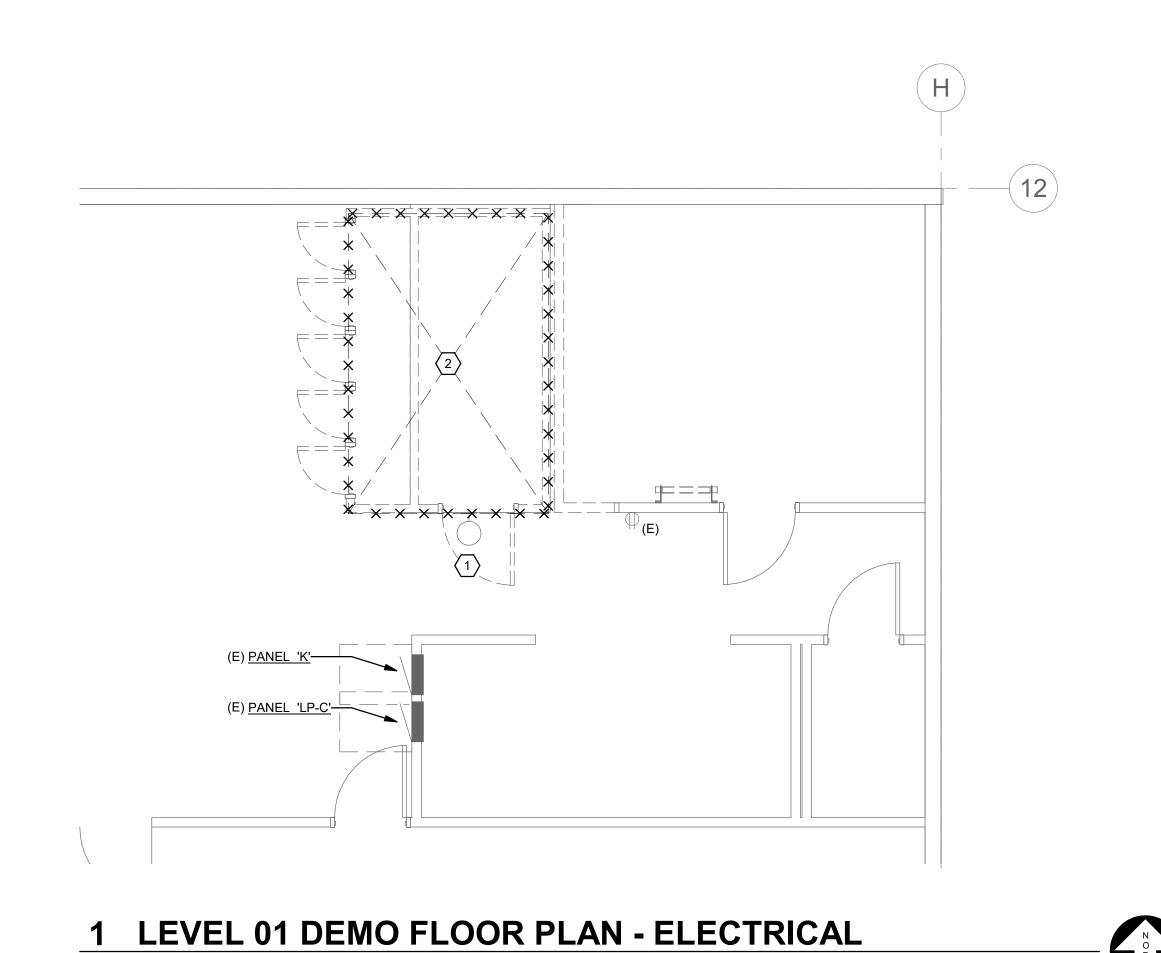

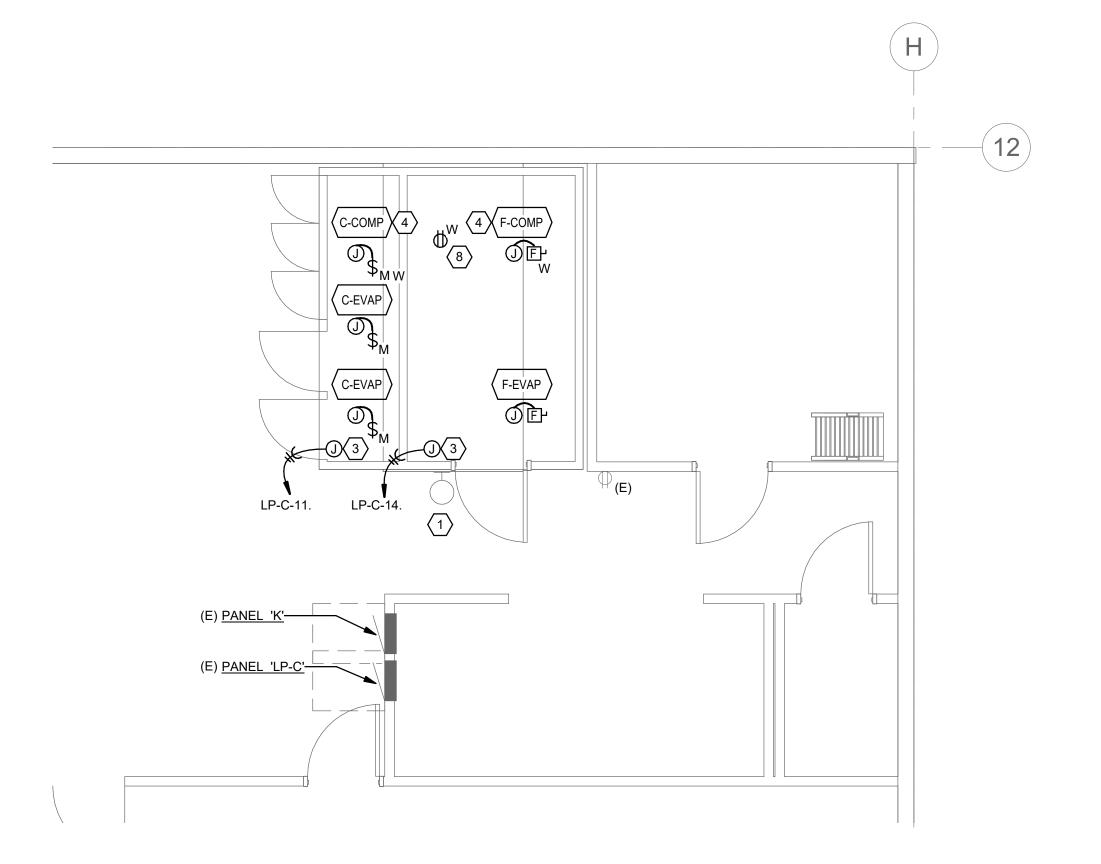

3 LEVEL 02 MEZZANINE DEMO FLOOR PLAN - ELECTRICAL

0' 2' 4' 8'

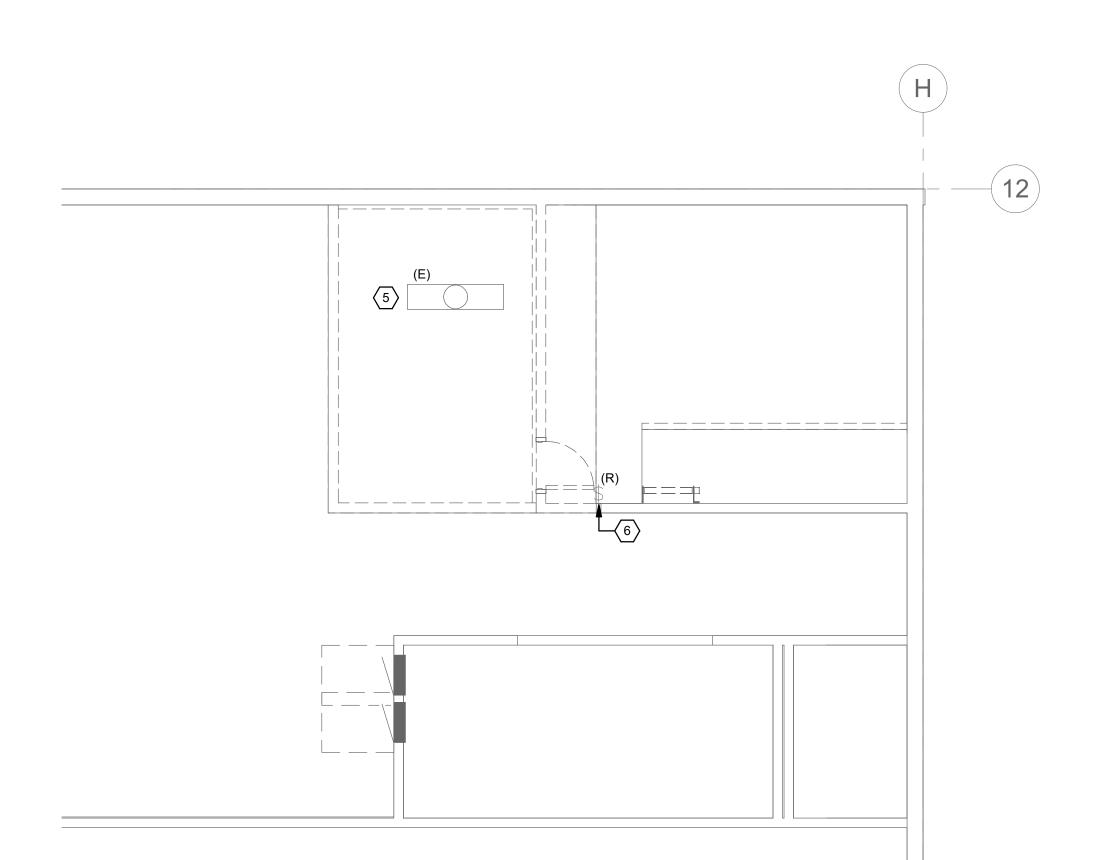

4 LEVEL 02 MEZZANINE FLOOR PLAN - ELECTRICAL 0' 2' 4' 8'



○ SHEET KEYNOTES

1 SALVAGE EXISTING WALL MOUNTED LUMINAIRE FOR REINSTALLATION ON NEW WALL.

- 2 DEMOLISH EXISTING POWER, ASSOCIATED WIRING AND CONDUIT TO COOLER AND FREEZER BACK TO SOURCE PANEL.
- 3 PROVIDE CONNECTIONS TO MISCELLANEOUS ITEMS (LIGHTS, HEAT TRACE, DOOR SWITCHES, CONDENSATE DRAIN HEATERS, BLOW FANS, ETC) WITHIN WALK-COOLER AND FREEZER.
- 4 ROOF MOUNTED. COORDINATE LOCATION WITH KITCHEN CONSULTANT PRIOR TO ROUGH-IN.
- 5 EXISTING LUMINAIRE TO REMAIN.
- 6 SALVAGE EXISTING LIGHT SWITCH FOR REINSTALLATION IN NEW LOCATION.
- 7 INTERCEPT AND EXTEND CONDUIT AND WIRING FROM EXISTING LOCATION TO NEW LOCATION OF RELOCATED LIGHT SWITCH.
- 8 CONNECT ROOF RECEPTACLE TO NEAREST 20A/1P GENERAL PURPOSE RECEPTACLE CIRCUIT.

16550 SW Merlo Rd. Beaverton OR 97003

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DESCRIPTION A BID DOCUMENTS 11/20/2020

Beaverton School District

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PROJECT NO: 126730 DRAWN BY: PROJECT MGR:

CHECKED BY: MKO APPROVED BY:

ISSUE

FLOOR PLANS - ELECTRICAL

E1101