

WAYNE REGIONAL EDUCATIONAL SERVICE AGENCIES **BID PACKAGE T1 - ACCESS CONTROL** SEPTEMBER 4, 2020

GENERAL SECURITY NOTES

- PROXIMITY CARD READERS SHALL BE INSTALLED AS PART OF THIS PROJECT. LOCATIONS OF DEVICES AS SHOWN ON DRAWINGS IS APPROXIMATE. COORDINATE FINAL LOCATION ON-SITE WITH BARTON MALOW AND THE OWNER. UNITS SHALL BE VANDAL RESISTANT AND INSTALLED USING TAMPER PROOF SCREWS.
- 2. EXISTING WIRING AND ELECTRIFIED HARDWARE CAN BE REUSED AS SPECIFIED ON THE DOOR HARDWARE SCHEDULE. PRIOR TO INSTALLATION, ALL EXISTING EQUIPMENT WILL BE FIELD VERIFIED FOR USE. WIRE THAT IS DETERMINED AS NON-FUNCTIONAL WILL BE REPLACED THROUGH SIGNED CHANGED ORDER. CHANGE ORDER DOES NOT GIVE AUTHORITY TO PROCEED. CHANGE ORDERS MUST BE SIGNED BY THE OWNER.
- CONTRACTOR SHALL COORDINATE TELECOMMUNICATION ROOM LAYOUTS FOR ACCESS 3. CONTROL SYSTEM WORK WITH BARTON MALOW AND OWNER.


GENERAL TECHNOLOGY NOTES:


- 1. THESE DRAWINGS ARE DIAGRAMMATIC AND INDICATE THE GENERAL EXTENT OF THE WORK. CONTRACTORS SHALL PROVIDE ALL INCIDENTAL MATERIALS AND LABOR FOR A COMPLETE AND FULLY FUNCTIONAL SYSTEM.
- 2. FIELD VERIFY LOCATIONS, CONDITIONS AND LENGTHS PRIOR TO INSTALLATION.
- WHERE ADEQUATE PATHWAYS ARE NOT PROVIDED. EACH CONTRACTOR IS REQUIRED TO PROVIDE THEIR OWN PENETRATIONS, SLEEVES, AND CORES WITH FIRESTOPPING. SLEEVES AND CORES SHALL BE USED THROUGH ALL WALLS AND FLOORS AND SHALL HAVE NYLON BUSHINGS.
- 4. EACH CONTRACTOR SHALL PROVIDE FIRESTOPPING ON CONDUITS PASSING THROUGH WALLS AND FLOORS. CONTRACTOR SHALL INSTALL FIRESTOPPING ON ANY CONDUITS WHERE CABLES ARE REMOVED OR DISTURBED DURING DEMOLITION
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- 9. WHERE EXISTING DUAL-CHANNEL RACEWAY IS SHOWN. CONTRACTOR SHOULD NOT ASSUME THAT POWER AND LOW VOLTAGE SIDES ARE SHOWN ACCURATELY. CONTRACTOR MAY BE REQUIRED TO PROVIDE AND INSTALL INTERNAL CROSSOVER TO ROUTE LOW VOLTAGE CABLING ACROSS POWER CABLING.
- 10. ALARM PANEL LOCATIONS ARE TO BE REPLACED WITH CARD READERS WITH KEYPADS. THESE NOTED LOCATION WILL ALLOW THE OWNER TO ARM AND DISARM DOORS AND MOTION SENSOR AS NEEDED.



TECHNOLOGY DESIGNER BARTON MALOW 26500 AMERICAN DRIVE SOUTHFIELD, MI 48034 248.436.5000

TITLE SHEET & NOTES WAYNE RESA - FIRST FLOOR COMPOSITE - SECURITY PLAN WAYNE RESA - SECOND FLOOR COMPOSITE - SECURITY PLAN WAYNE RESA - THIRD FLOOR COMPOSITE - SECURITY PLAN WAYNE RESA - FIRST FLOOR - UNIT A - SECURITY PLAN WAYNE RESA - FIRST FLOOR - UNIT B - SECURITY PLAN WAYNE RESA - FIRST FLOOR - UNIT C - SECURITY PLAN WAYNE RESA - SECOND FLOOR - UNIT A - SECURITY PLAN WAYNE RESA - SECOND FLOOR - UNIT B - SECURITY PLAN WAYNE RESA - SECOND FLOOR - UNIT C - SECURITY PLAN WAYNE RESA - THIRD FLOOR - UNIT A - SECURITY PLAN WAYNE RESA - THIRD FLOOR - UNIT B - SECURITY PLAN WAYNE RESA - THIRD FLOOR - UNIT C - SECURITY PLAN ANNEX - FIRST FLOOR COMPOSITE - SECURITY PLAN ANNEX - SECOND FLOOR COMPOSITE - SECURITY PLAN BURGER BAYLOR CAMPUS - FIRST FLOOR COMPOSITE - SECURITY PLAN WAYNE RESA BURGER BAYLOR CAMPUS - FIRST FLOOR - SECURITY PLAN

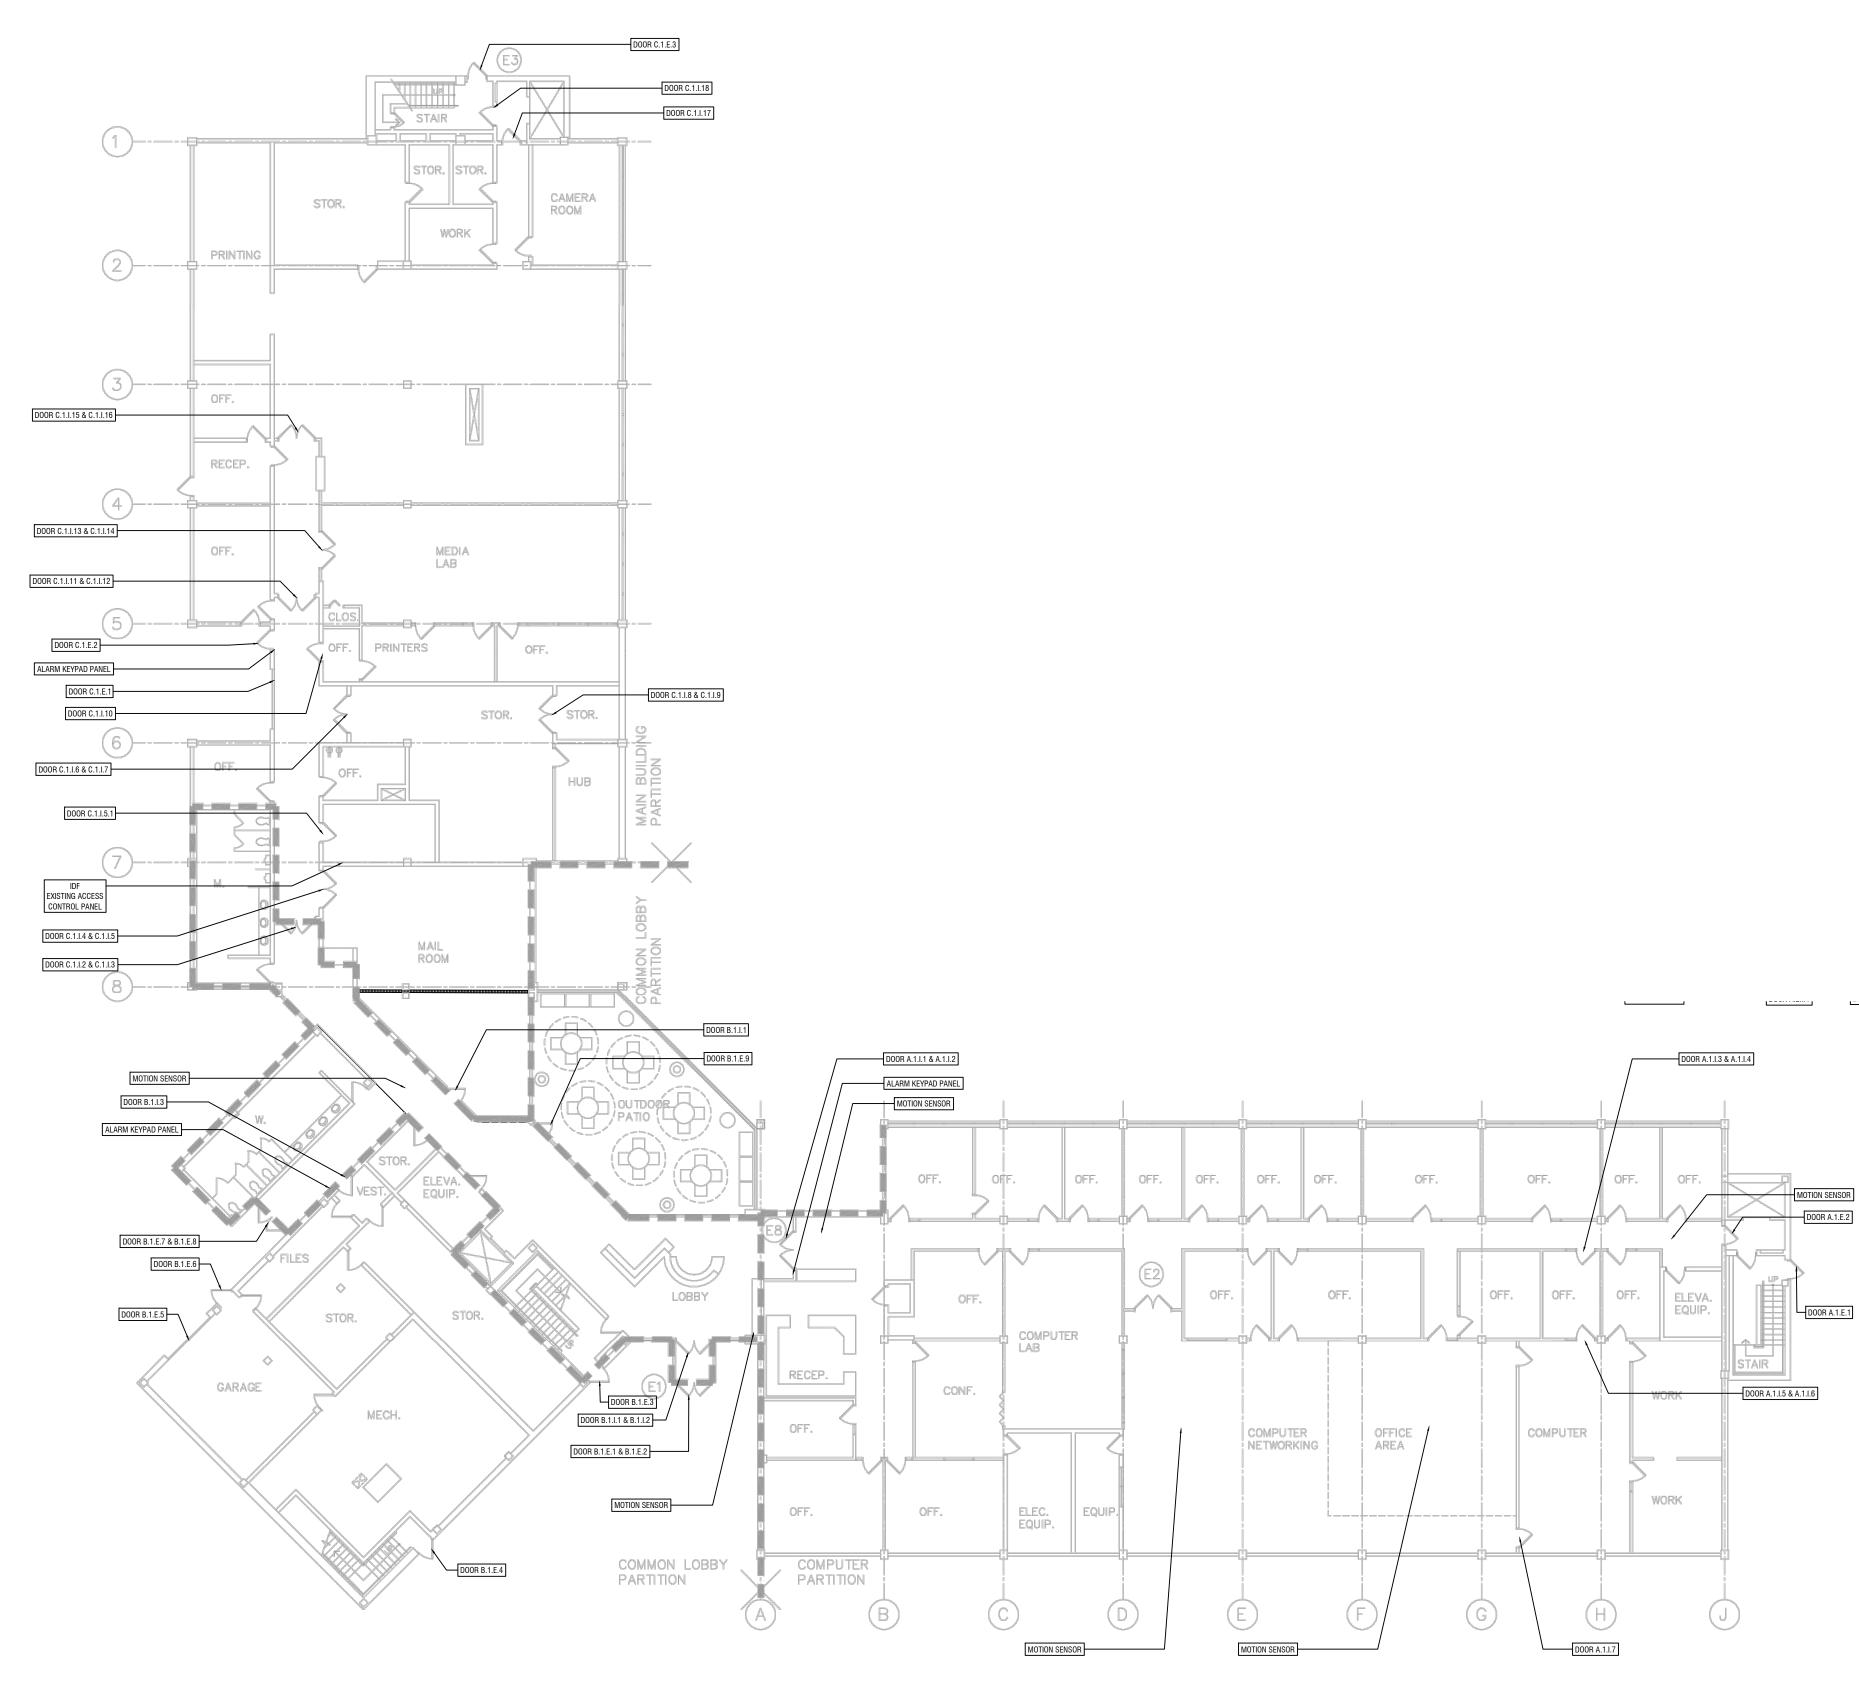

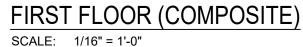

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Barton Malow 26500 American Drive Southfield, MI 48034

tel 248.436.5000 fax 248.436.5001 www.bartonmalow.com

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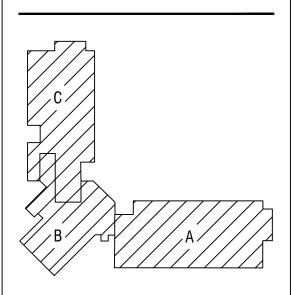
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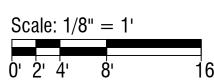
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Drawn By CM

Project Manager


PT Project Director






First Floor - Composite Security Plan Wayne RESA

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PROJECT NO.	
	T101
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SECOND FLOOR (COMPOSITE) SCALE: 1/16" = 1'-0"

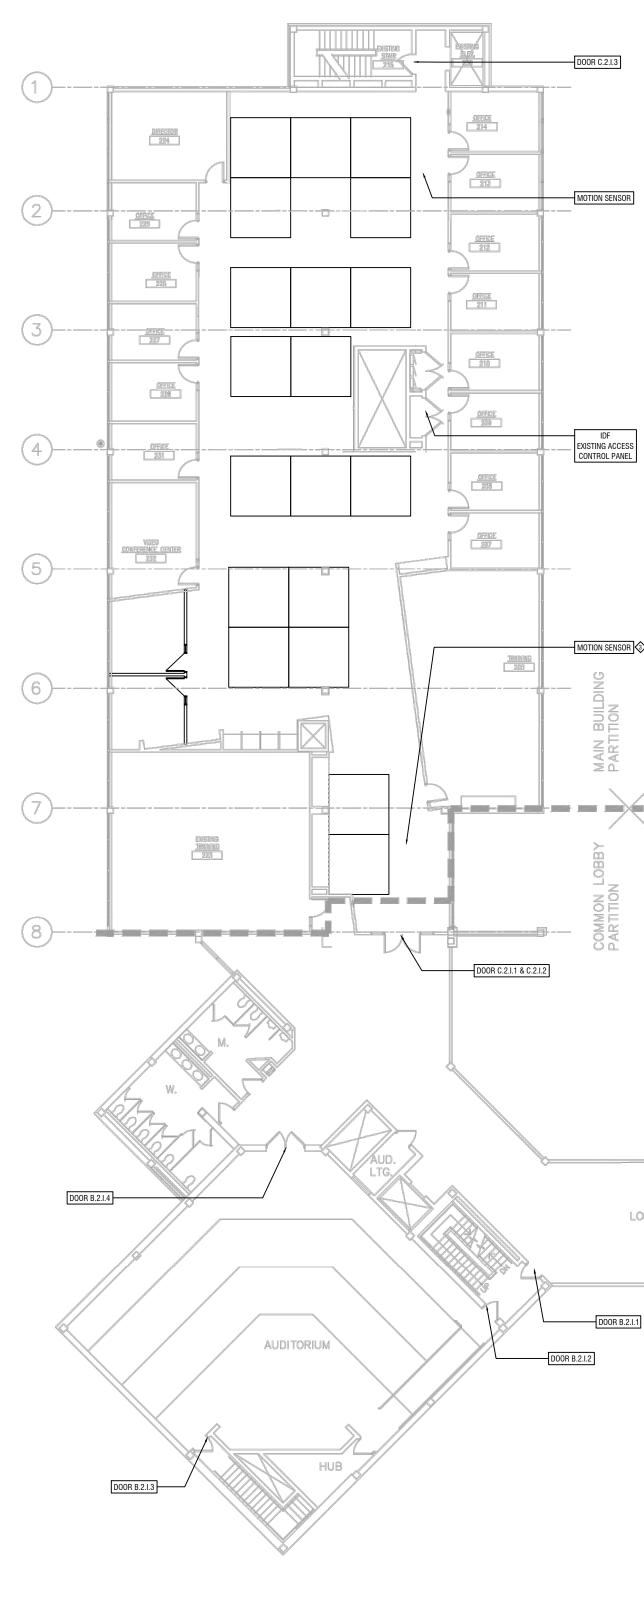

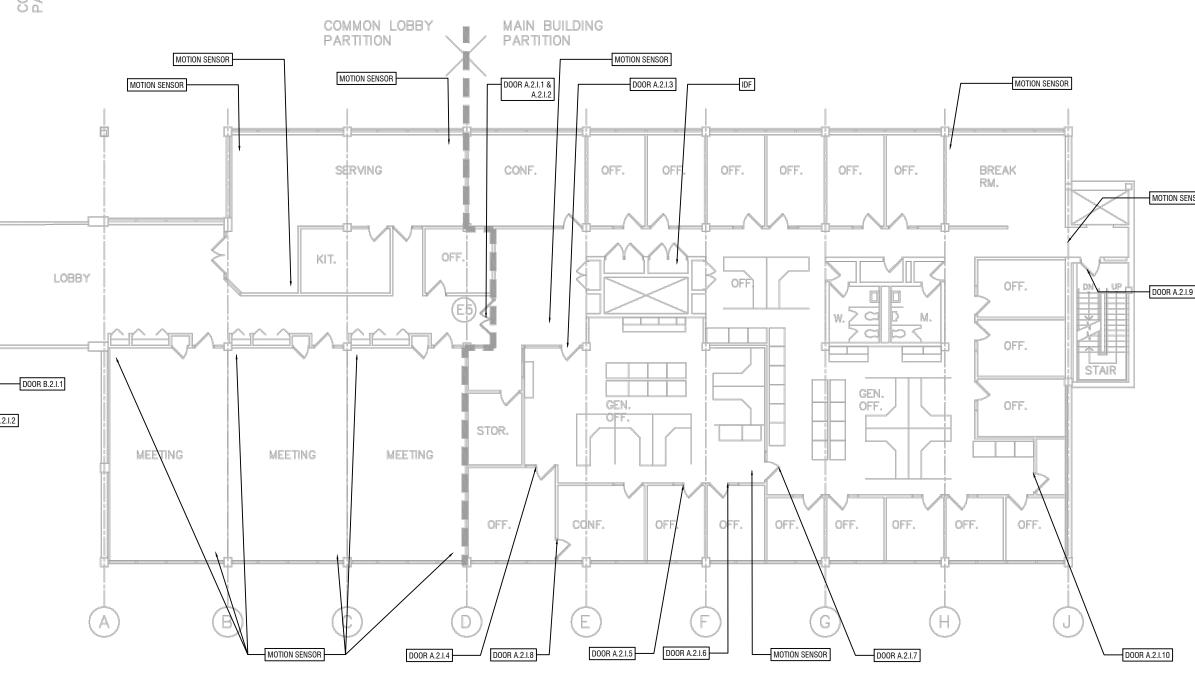

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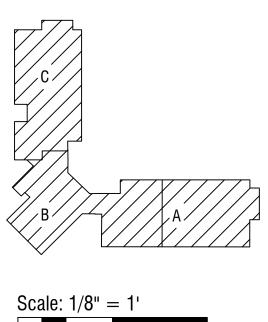
9/4/20 Date

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Drawn By СМ

Project Manager

PT Project Director





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Second Floor - Comp. Security Plan Wayne RESA

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PROJECT NO.	
	T202

THIRD FLOOR (COMPOSITE) SCALE: 1/16" = 1'-0"



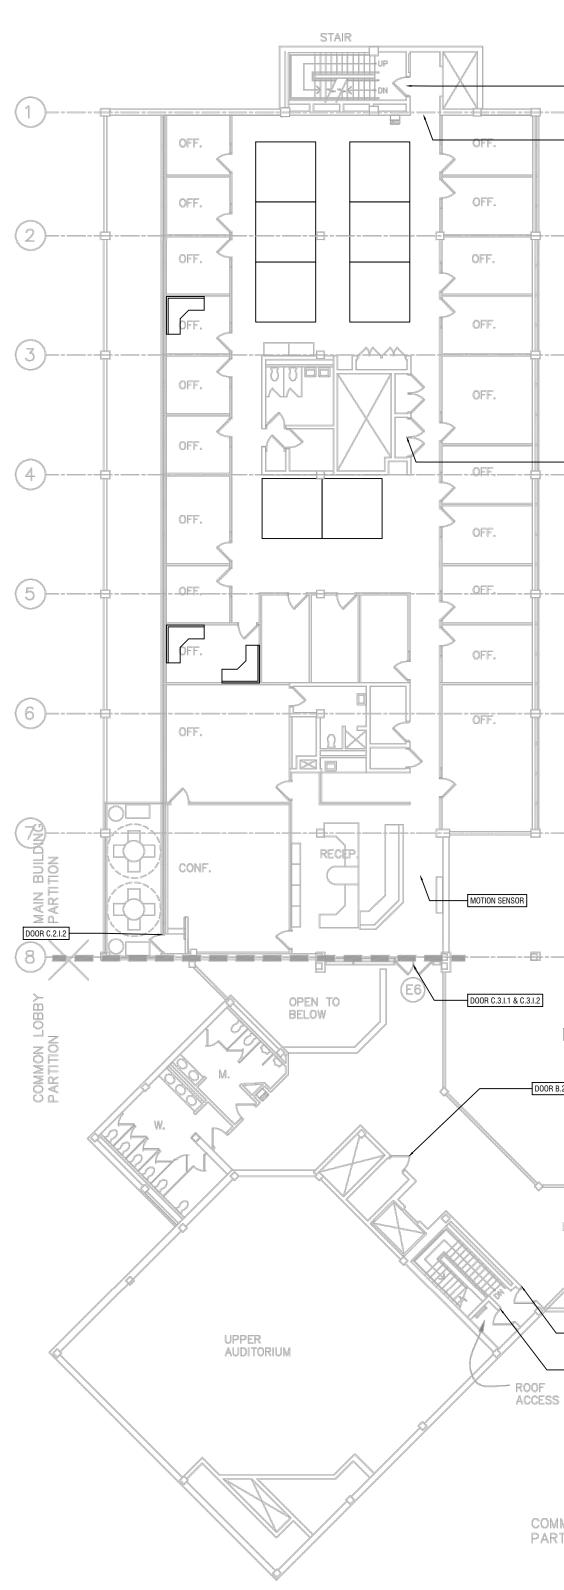

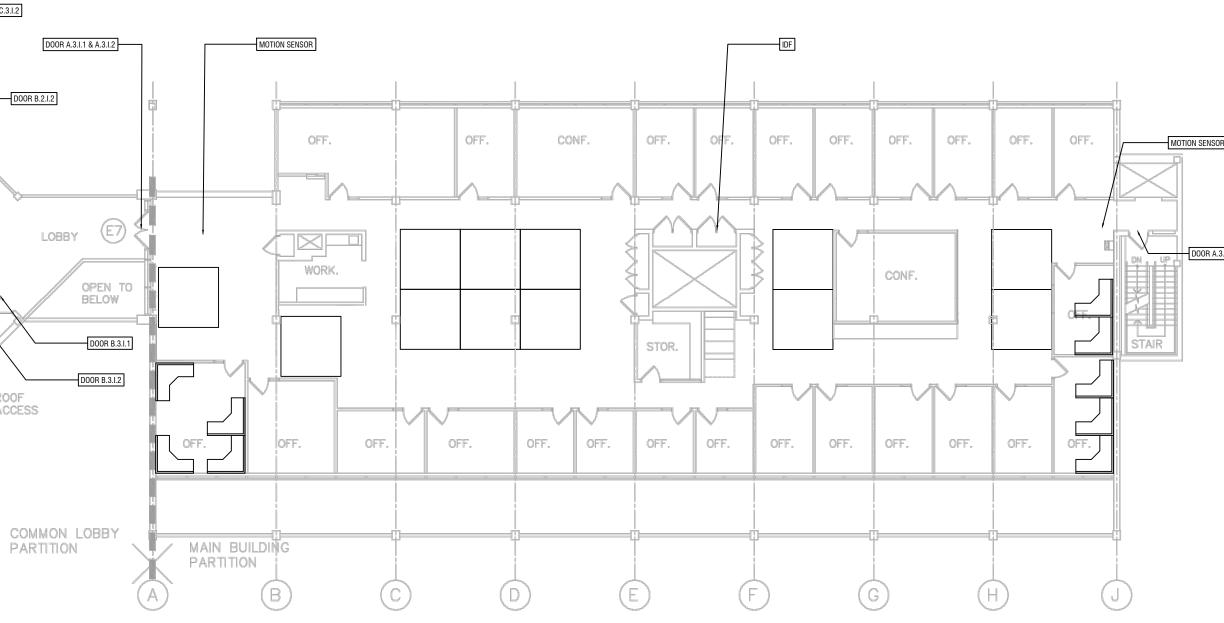IDF Existing Access Control Panel

D00R C.3.I.3 MOTION SENSOR

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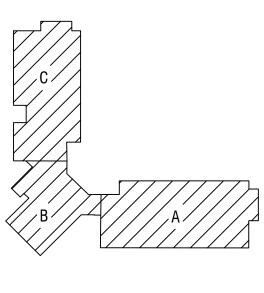
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Drawn By СМ

Project Manager

ΡT Project Director




Scale: 1/8" = 1'				
ט'	2' ·	4' 8	3'	16

Third Floor - Composite Security Plan Wayne RESA

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PROJECT NO.	
	T303

FIRST FLOOR (A WING) SCALE: 1/8" = 1'-0"



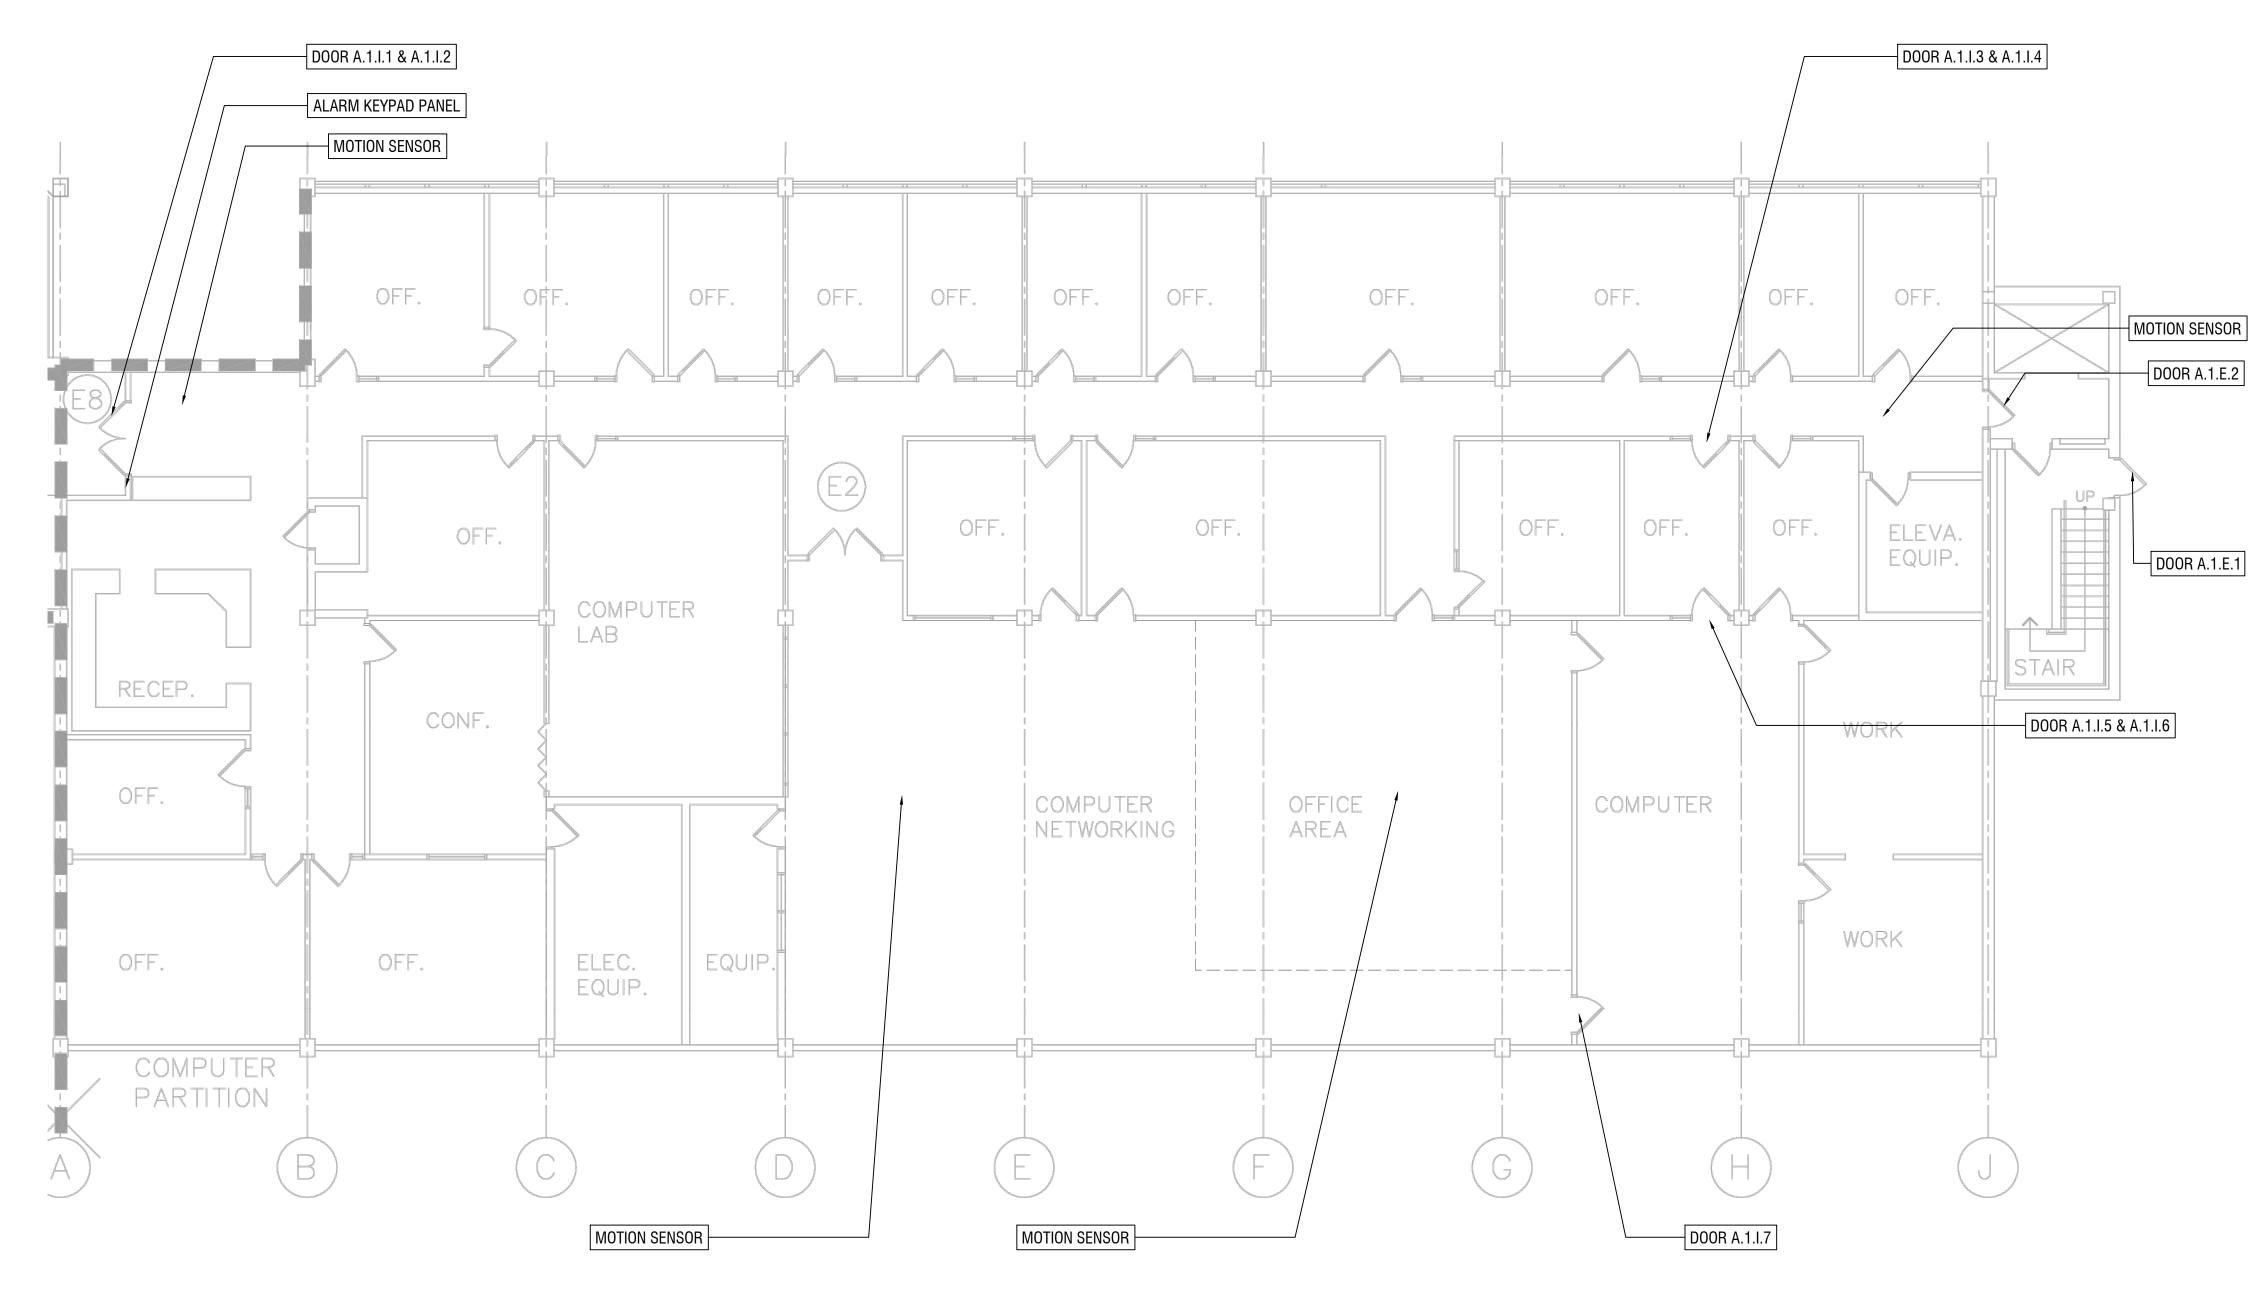

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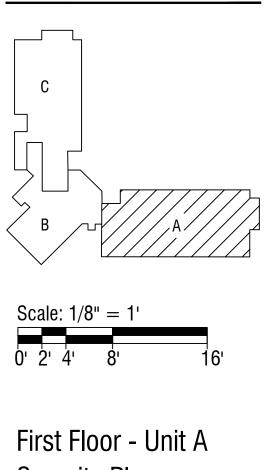
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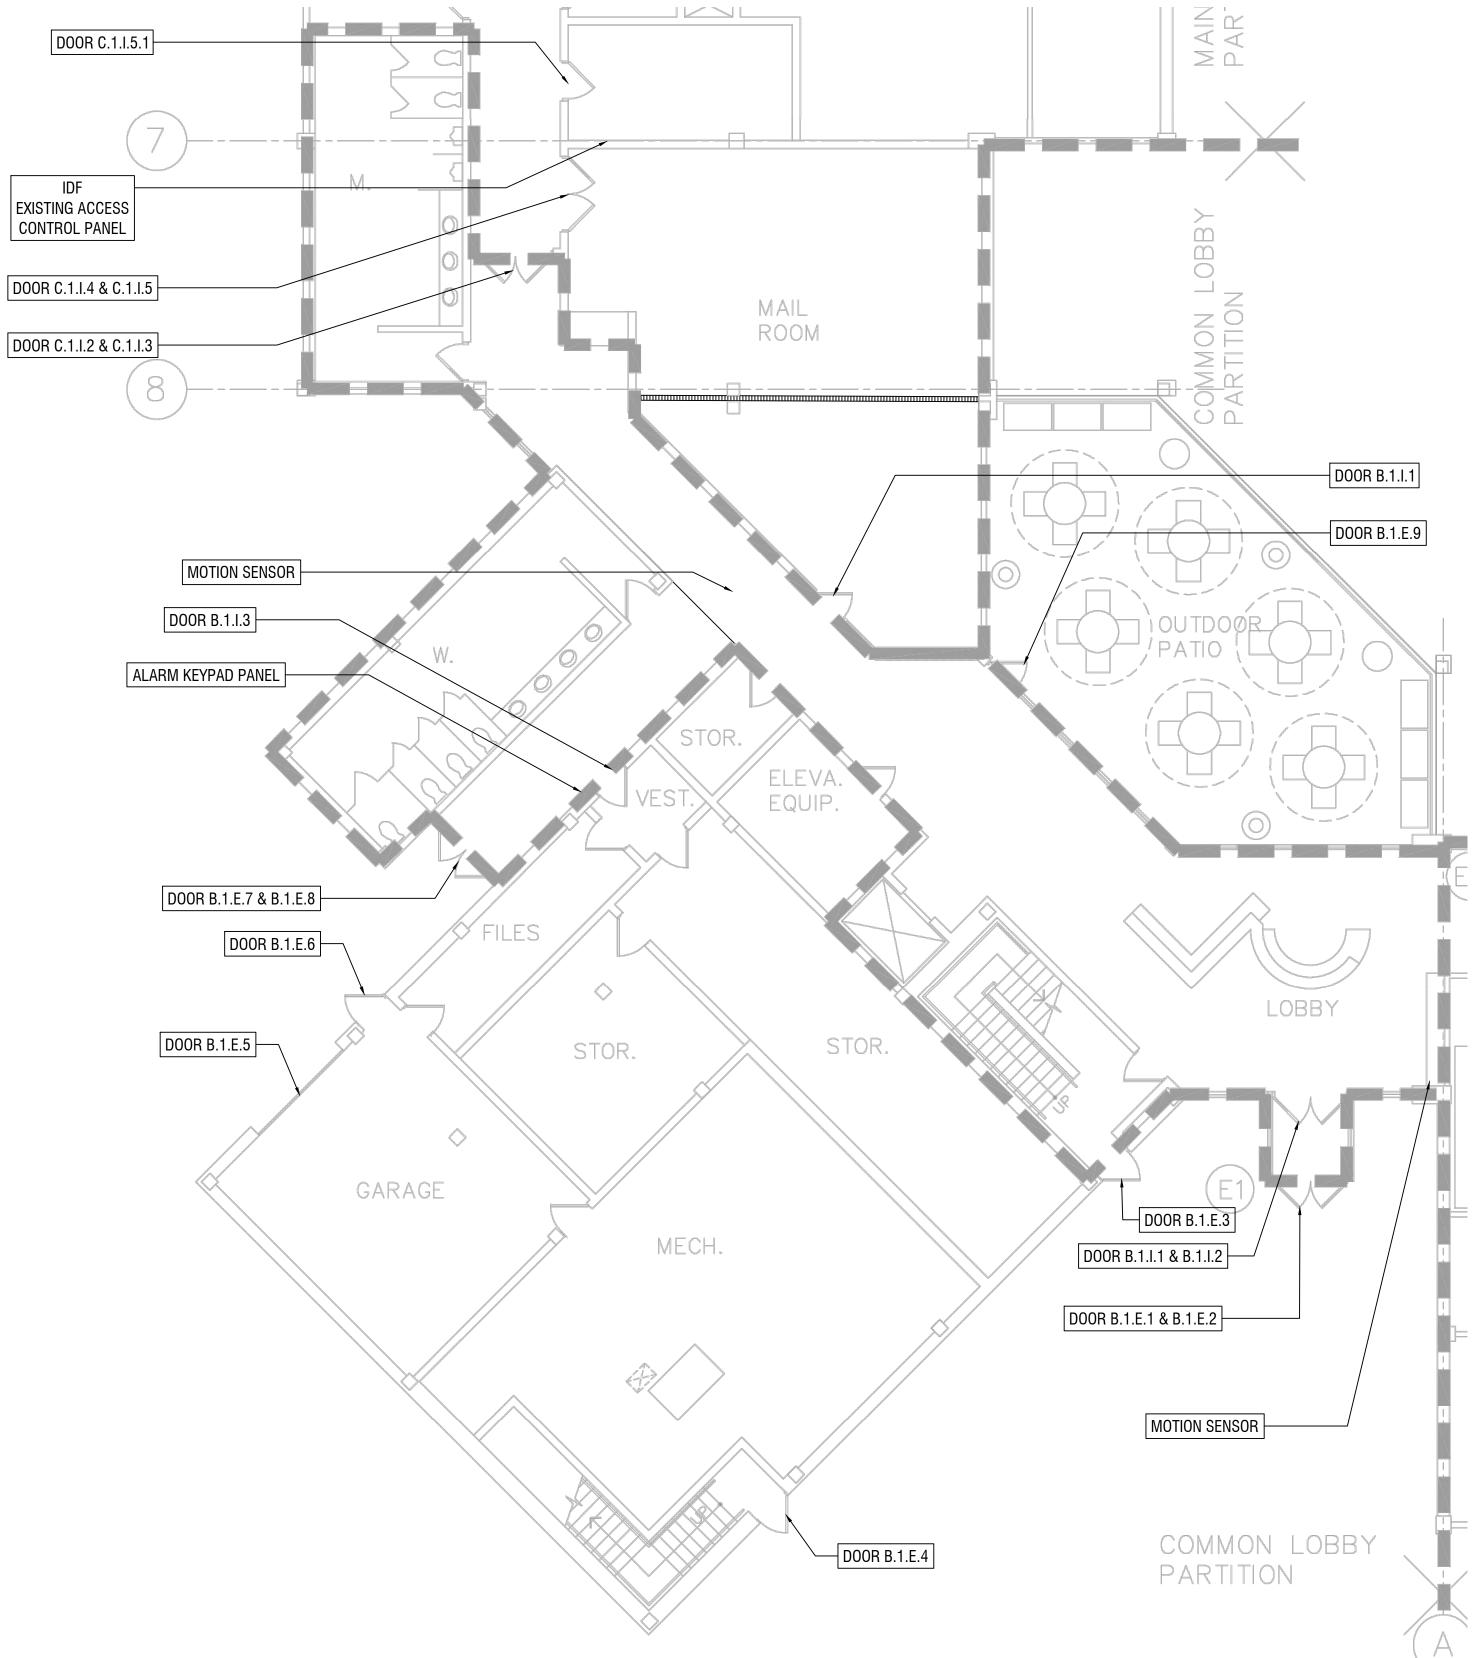
Project Manager


ΡT Project Director



Security Plan Wayne RESA

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PROJECT NO.	
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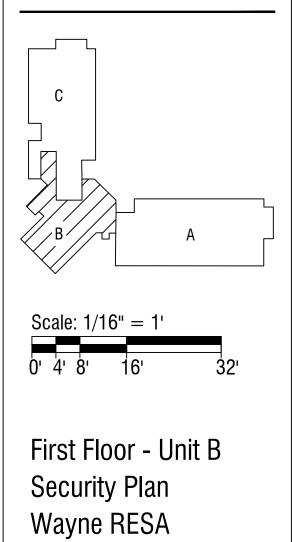
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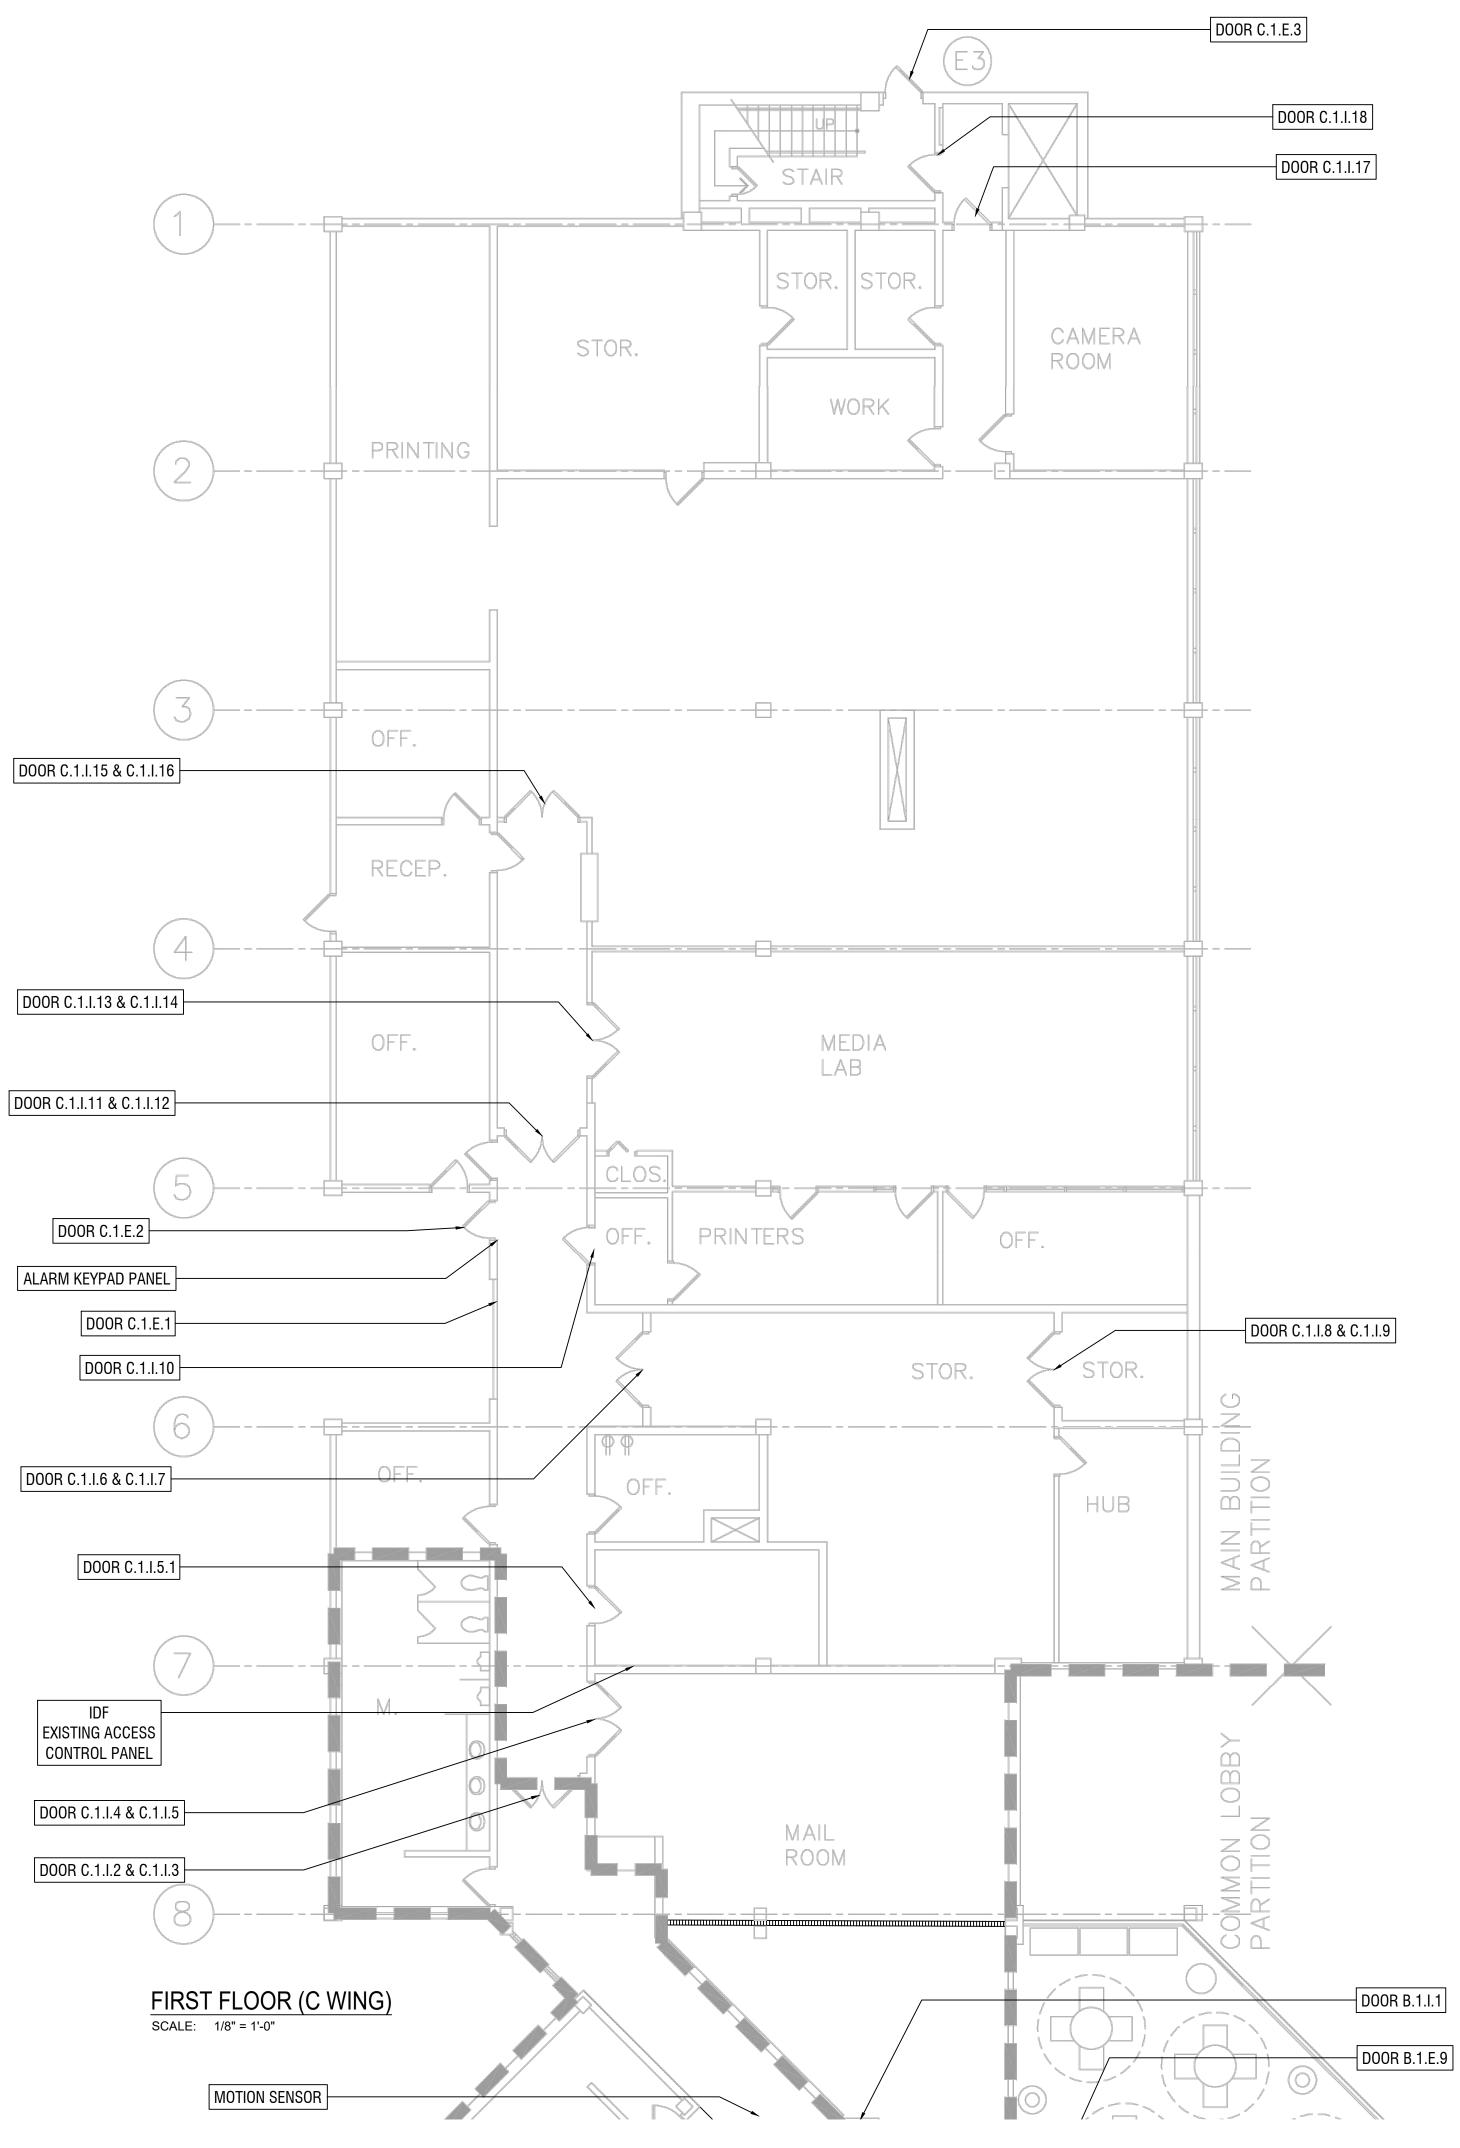
Drawn By СМ

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000000 PROJECT NO. T101B

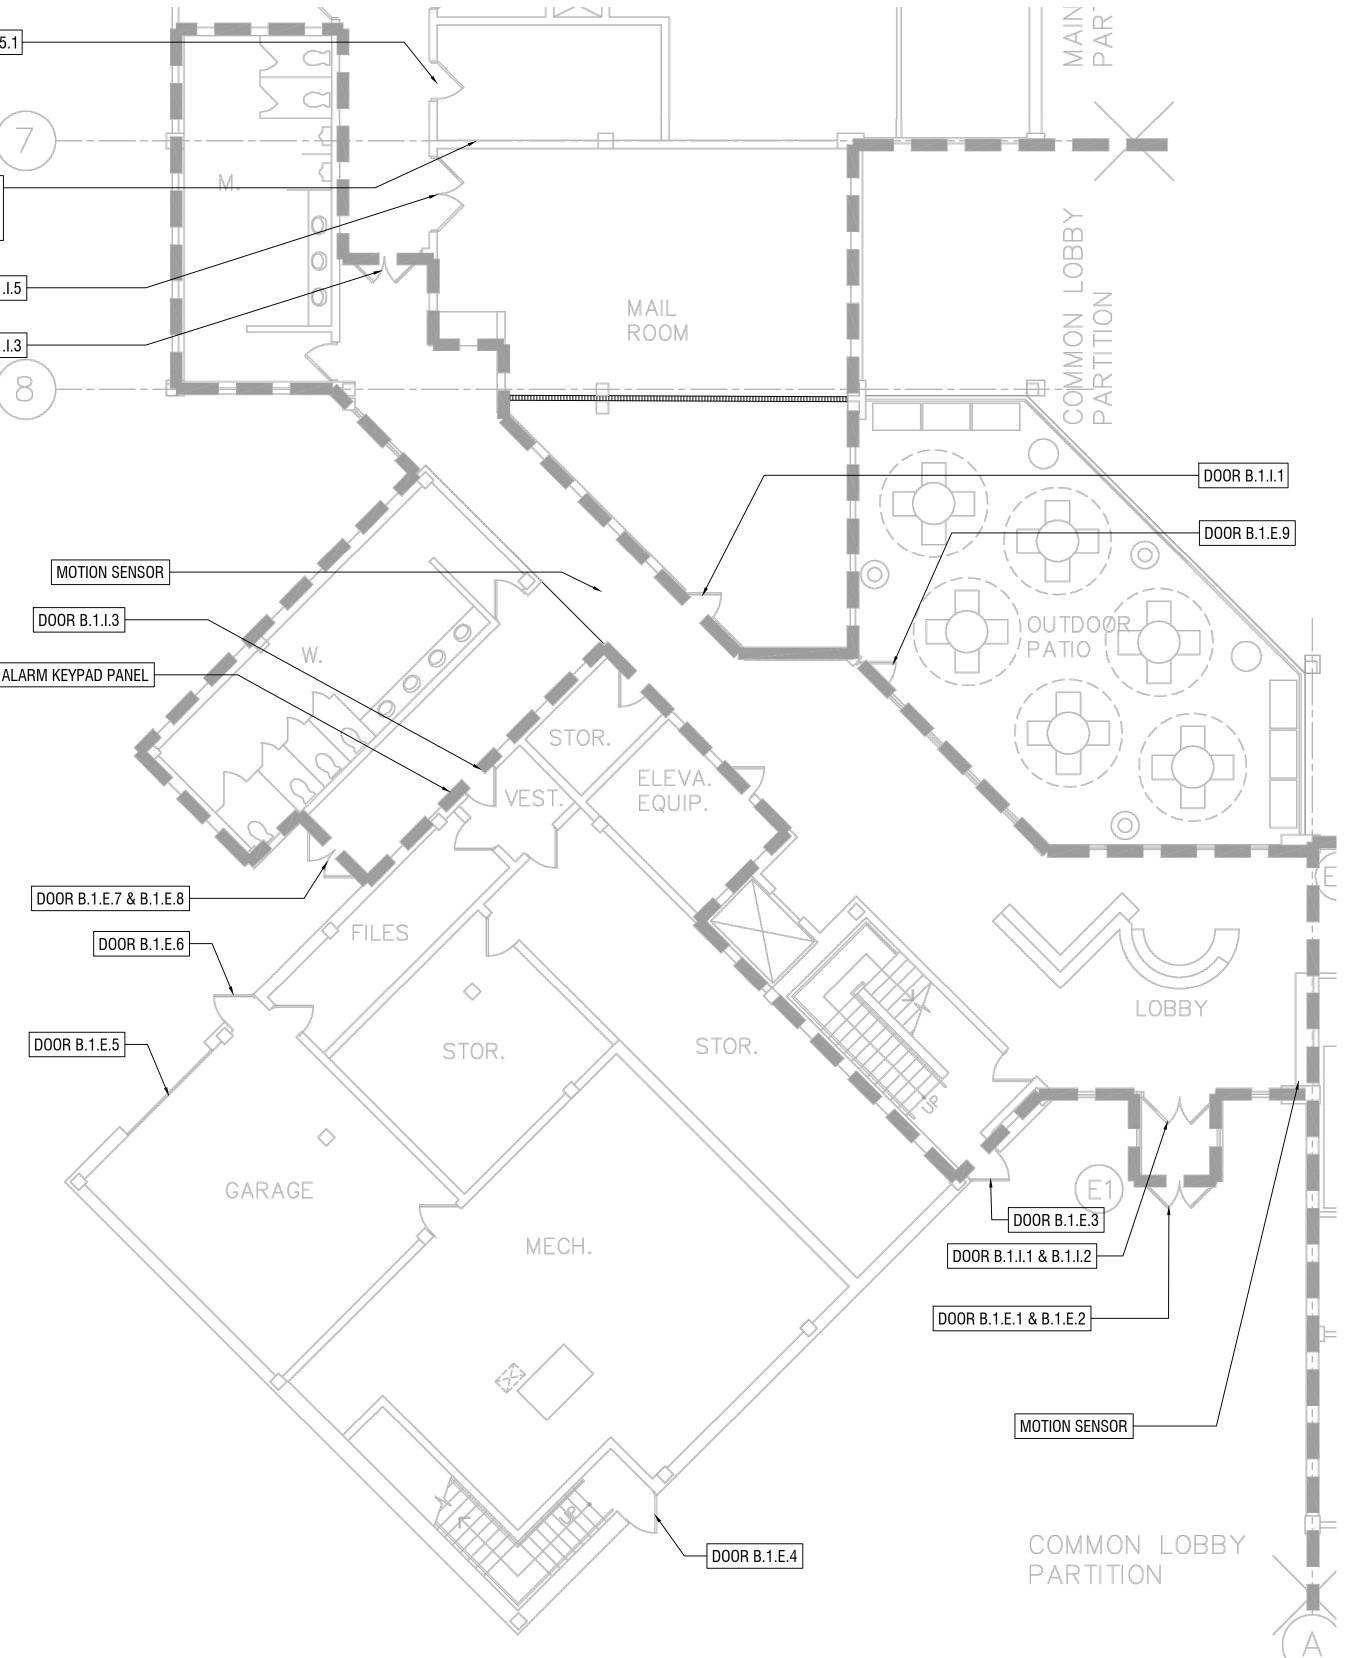

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GENERAL SECURITY NOTES:

- 1. PROXIMITY CARD READERS SHALL BE INSTALLED AS PART OF THIS PROJECT. LOCATIONS OF DEVICES AS SHOWN ON DRAWINGS IS APPROXIMATE. COORDINATE FINAL LOCATION ON-SITE WITH BARTON MALOW AND THE OWNER. UNITS SHALL BE VANDAL RESISTANT AND INSTALLED USING TAMPER PROOF SCREWS.
- 2. EXISTING WIRING AND ELECTRIFIED HARDWARE CAN BE REUSED AS SPECIFIED ON THE DOOR HARDWARE SCHEDULE. PRIOR TO INSTALLATION, ALL EXISTING EQUIPMENT WILL BE FIELD VERIFIED FOR USE. WIRE THAT IS DETERMINED AS NON-FUNCTIONAL WILL BE REPLACED THROUGH SIGNED CHANGED ORDER. CHANGE ORDER DOES NOT GIVE AUTHORITY TO PROCEED. CHANGE ORDERS MUST BE SIGNED BY THE OWNER.
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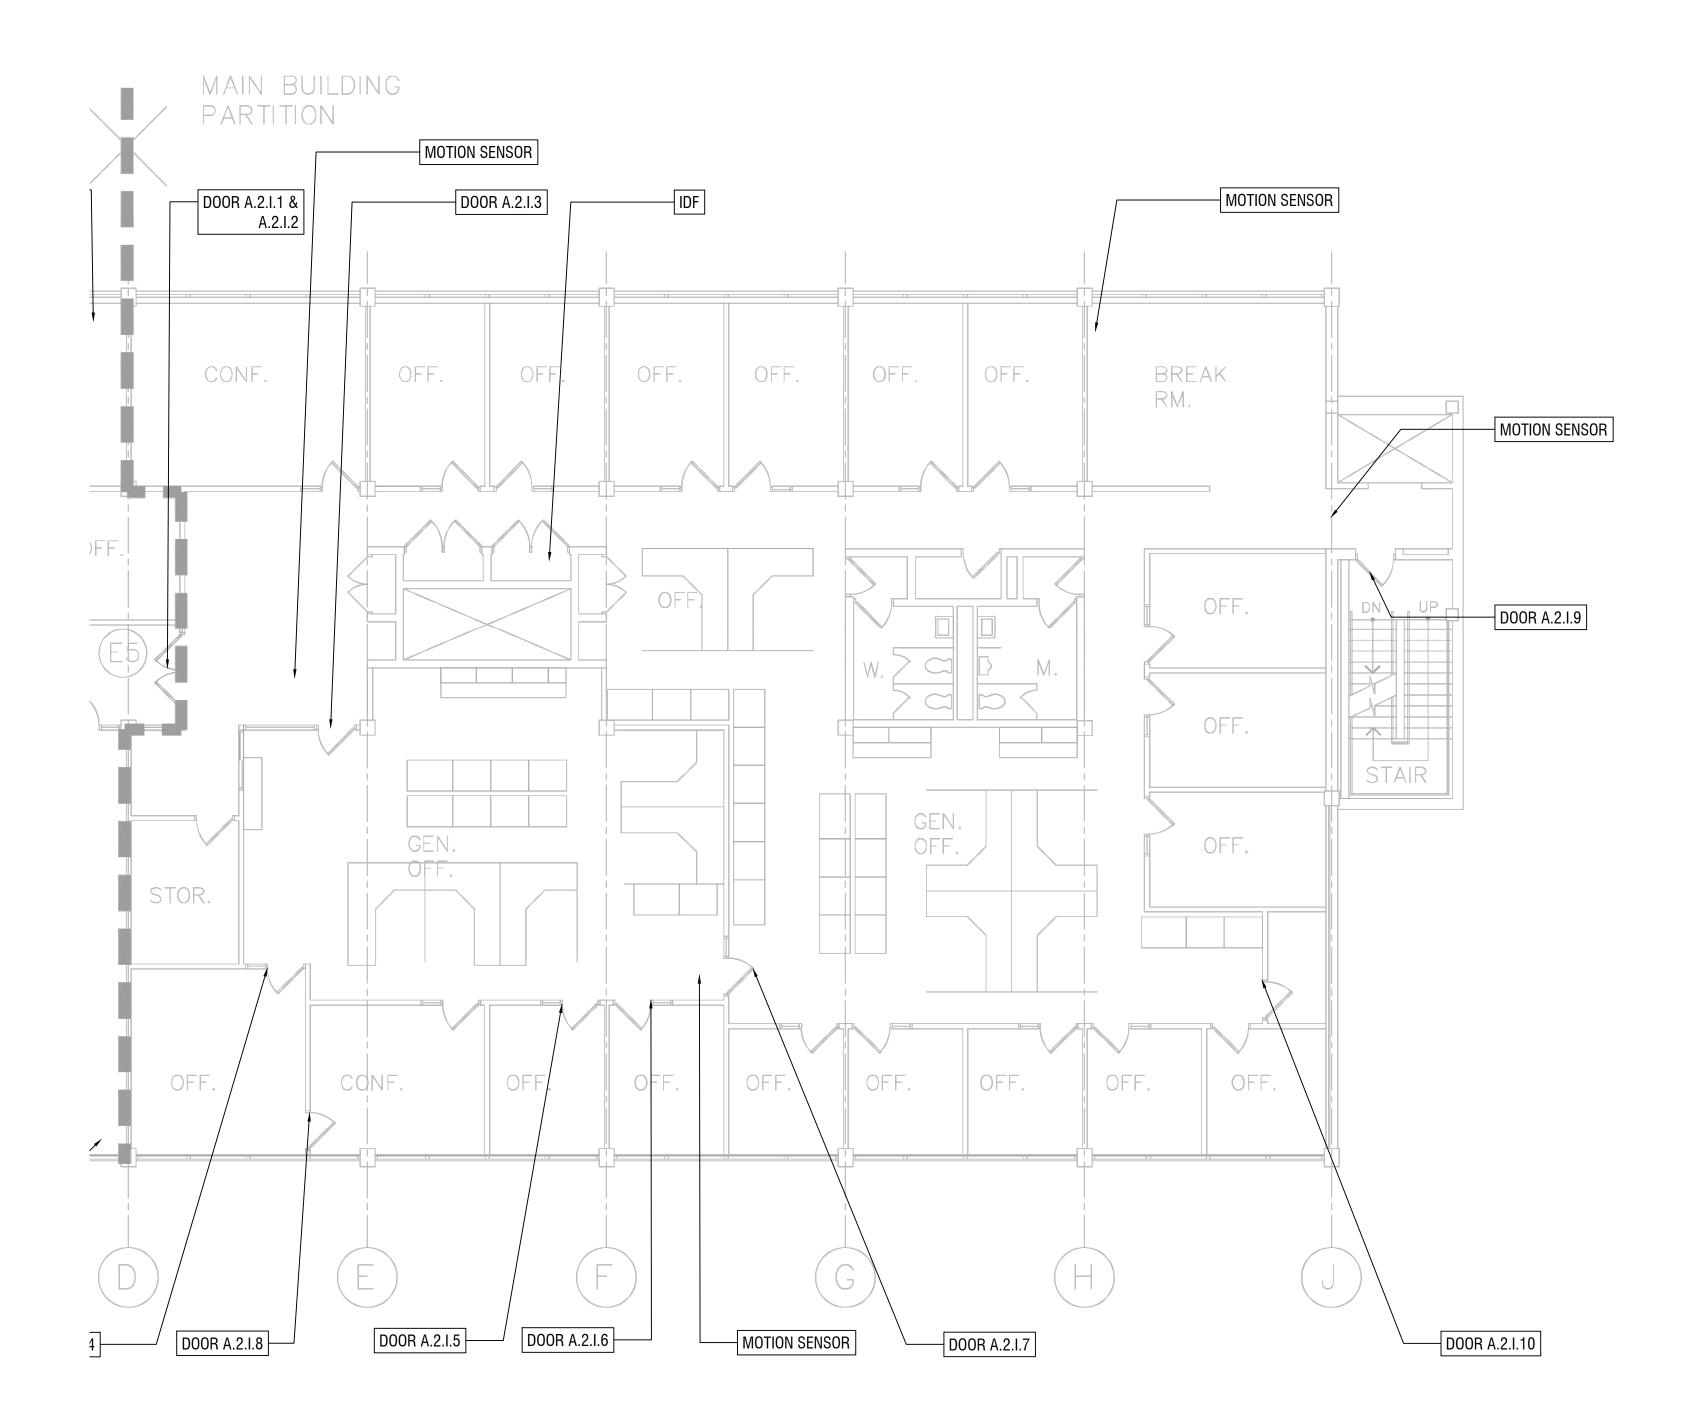
Drawn By

СМ Project Manager

PT Project Director

Scale: 1/8" = 1' 0' 2' 4' 8' First Floor - Unit C Security Plan Wayne RESA

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SECOND FLOOR WEST (A WING) SCALE: 1/8" = 1'-0" GENERAL TECHNOLOGY NOTES:

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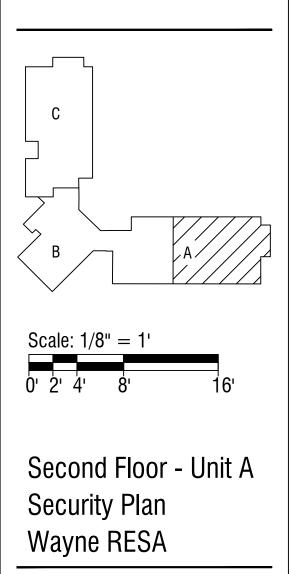
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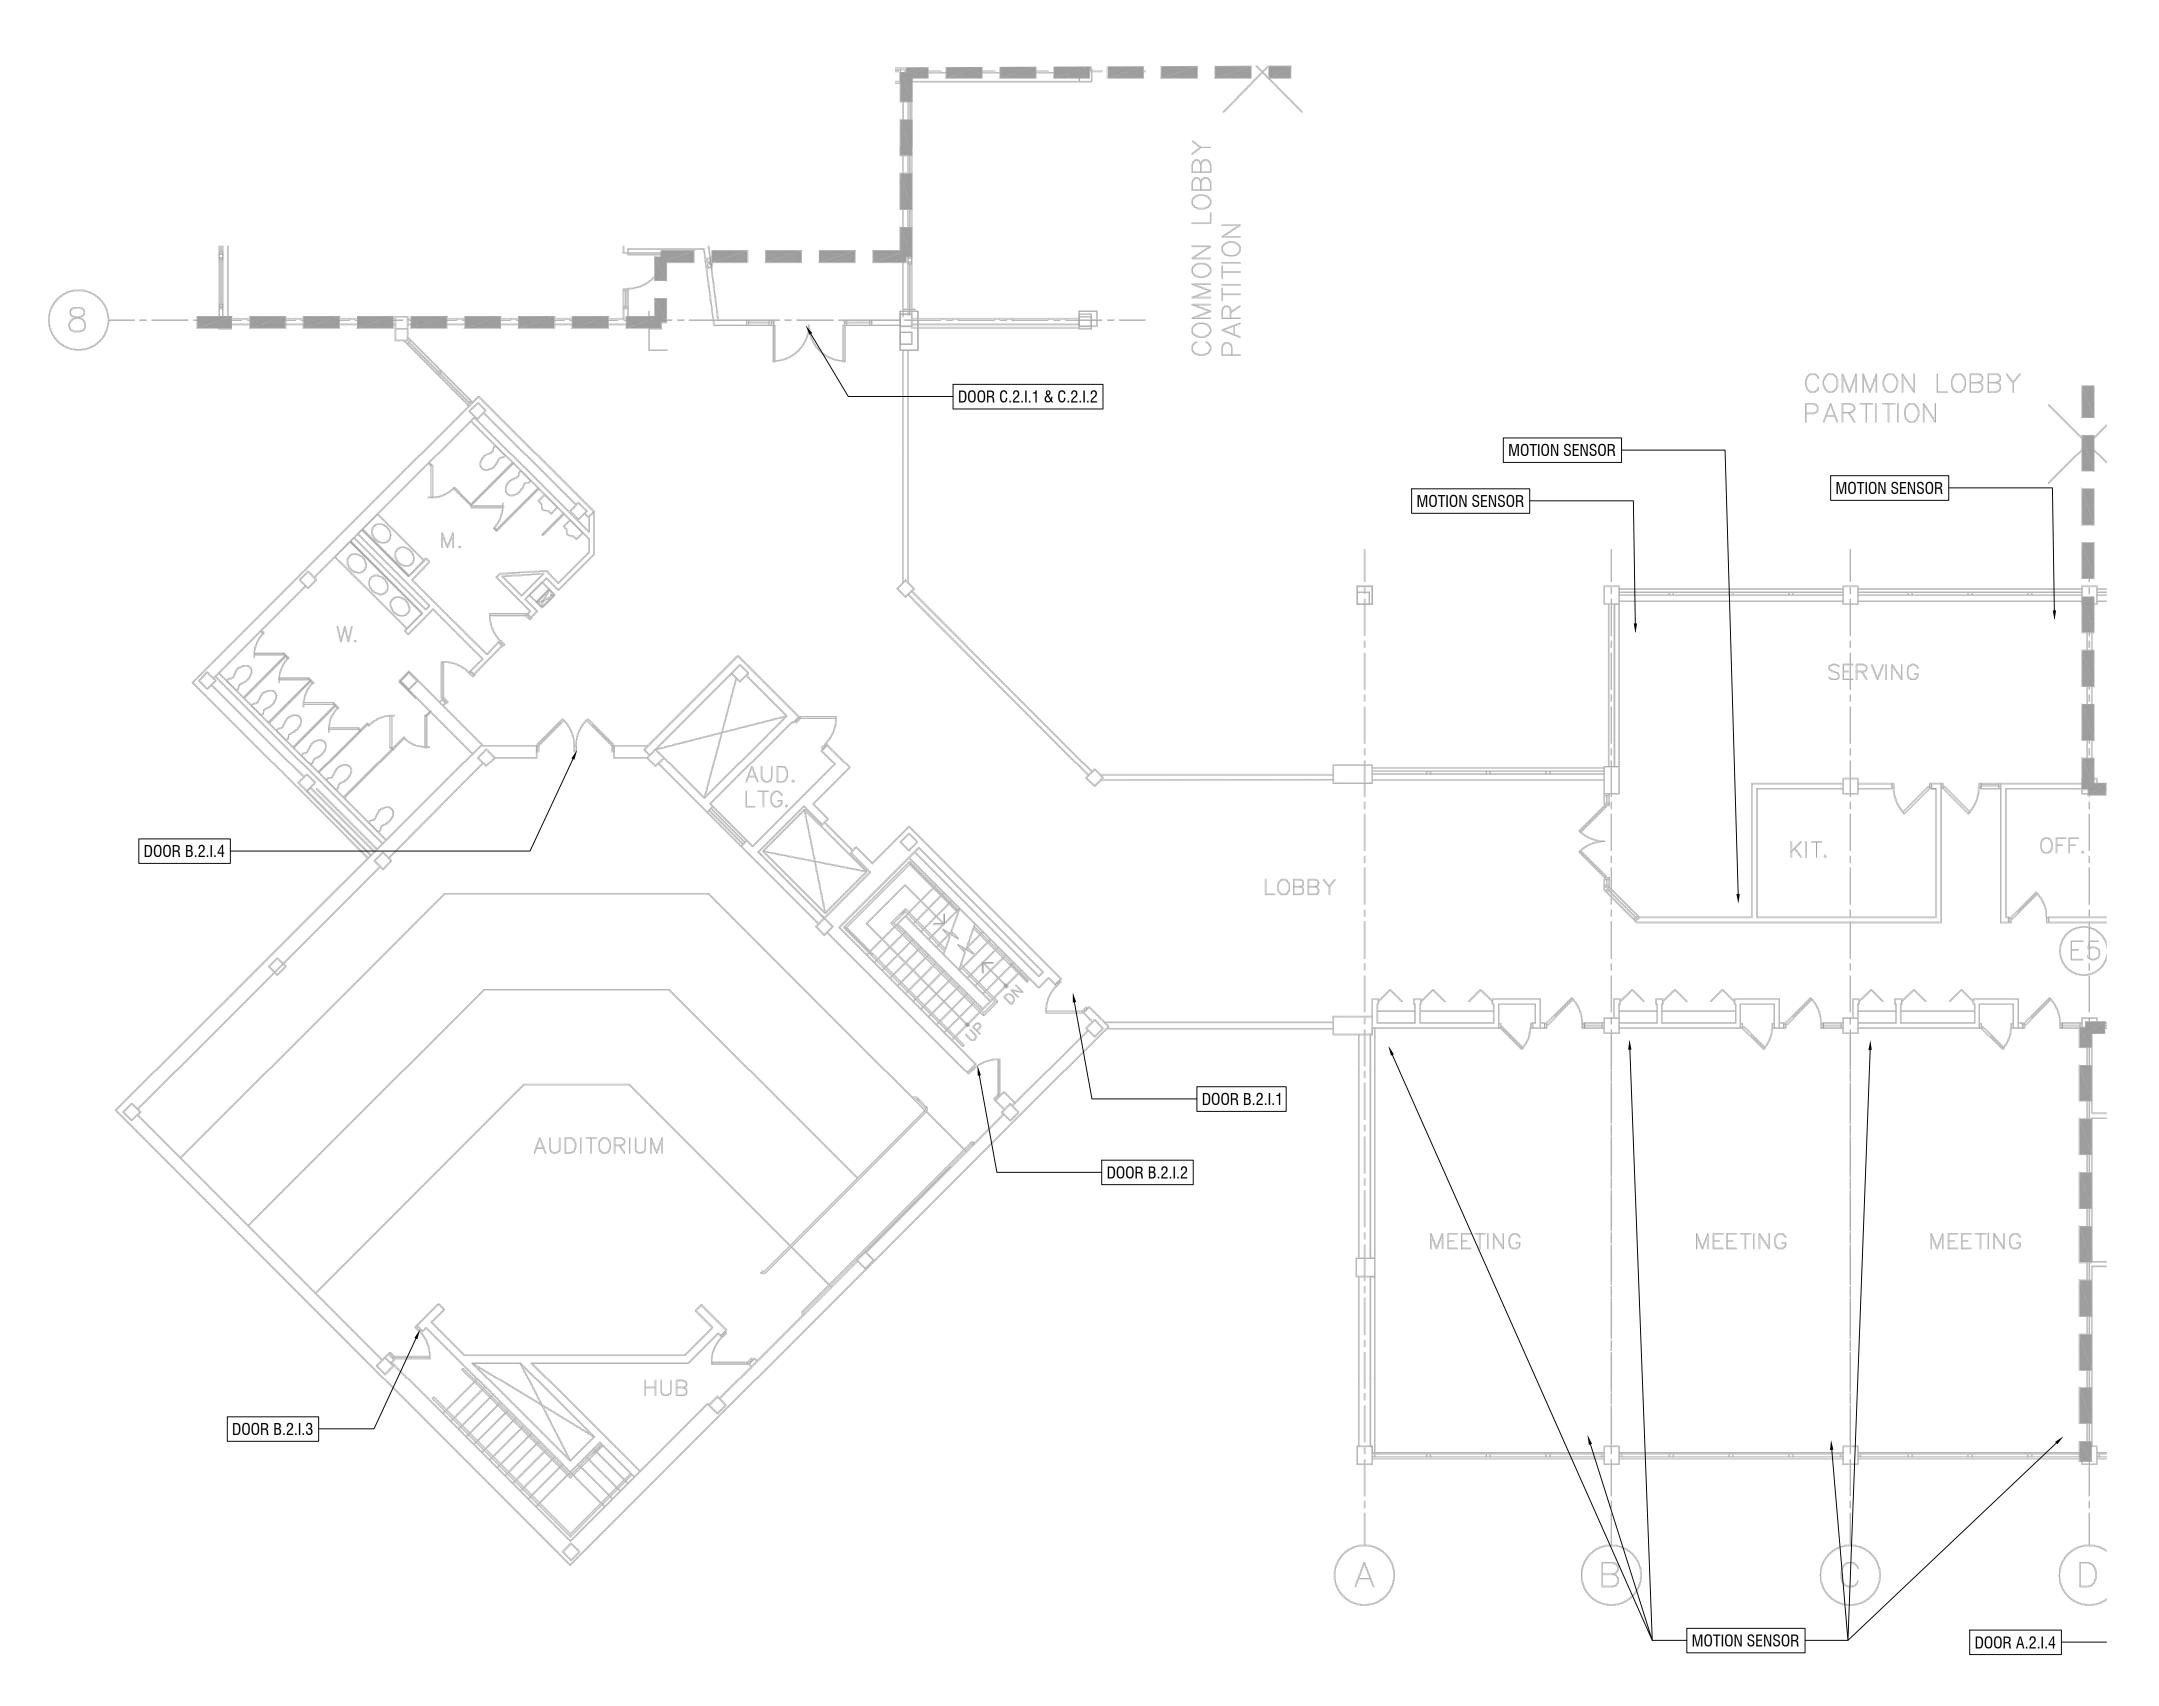
Drawn By

CM Project Manager

PT Project Director



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SECOND FLOOR WEST (B WING) SCALE: 1/8" = 1'-0"

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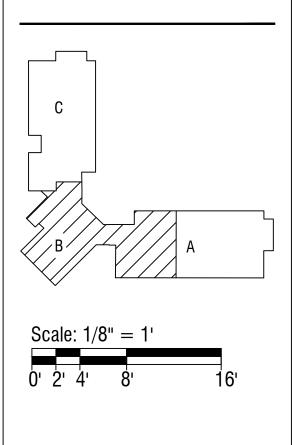
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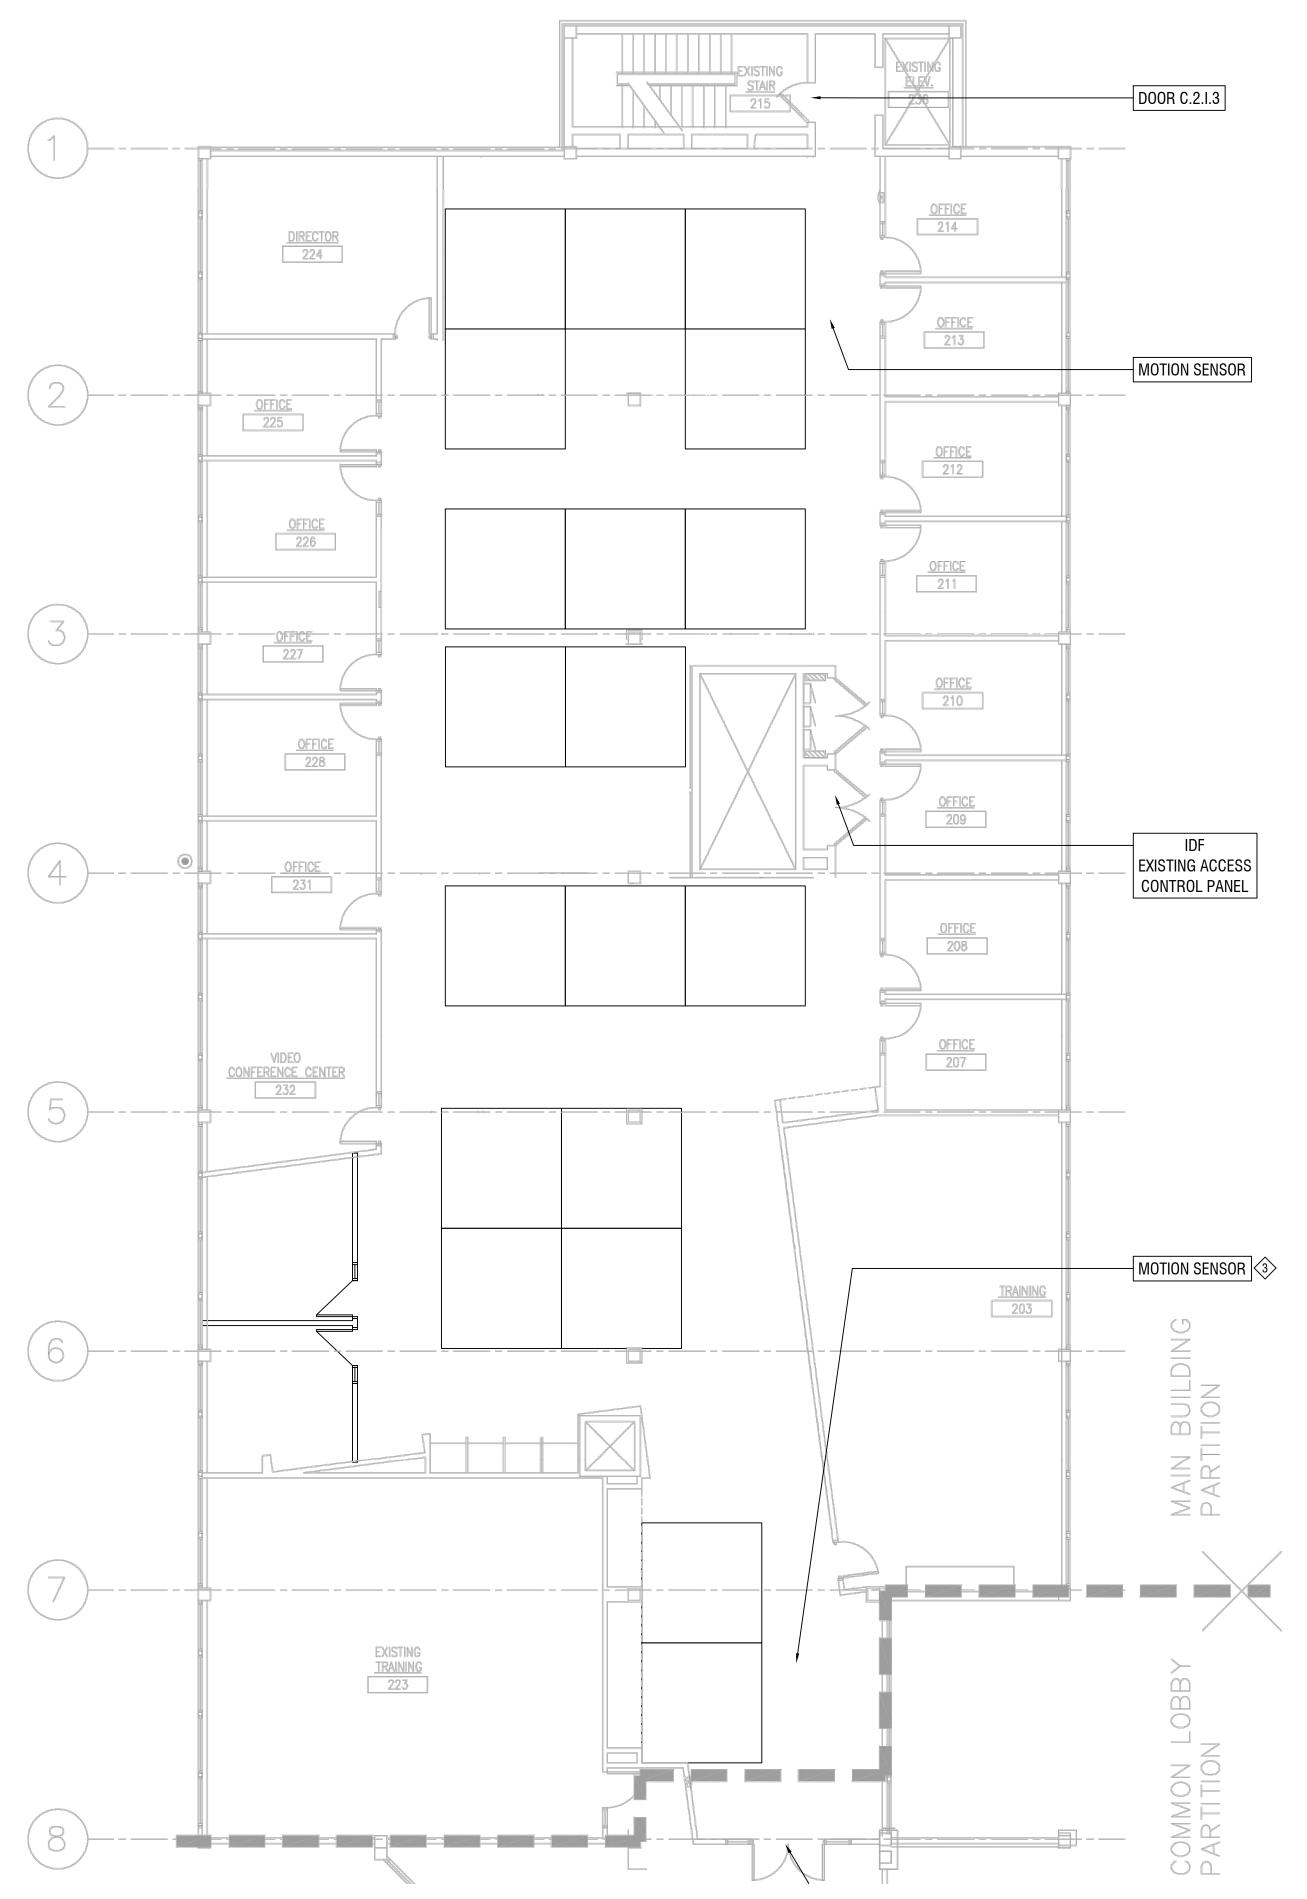
Project Manager

PT Project Director



Second Floor - Unit B Security Plan Wayne RESA

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PROJECT NO.	
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SECOND FLOOR WEST (C WING) SCALE: 1/8" = 1'-0"

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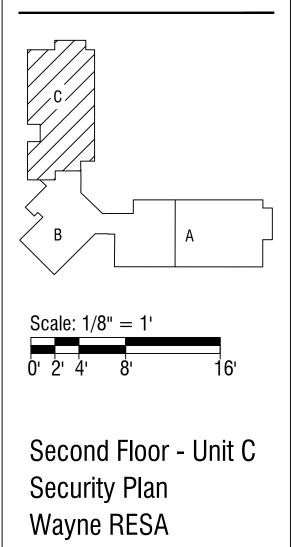
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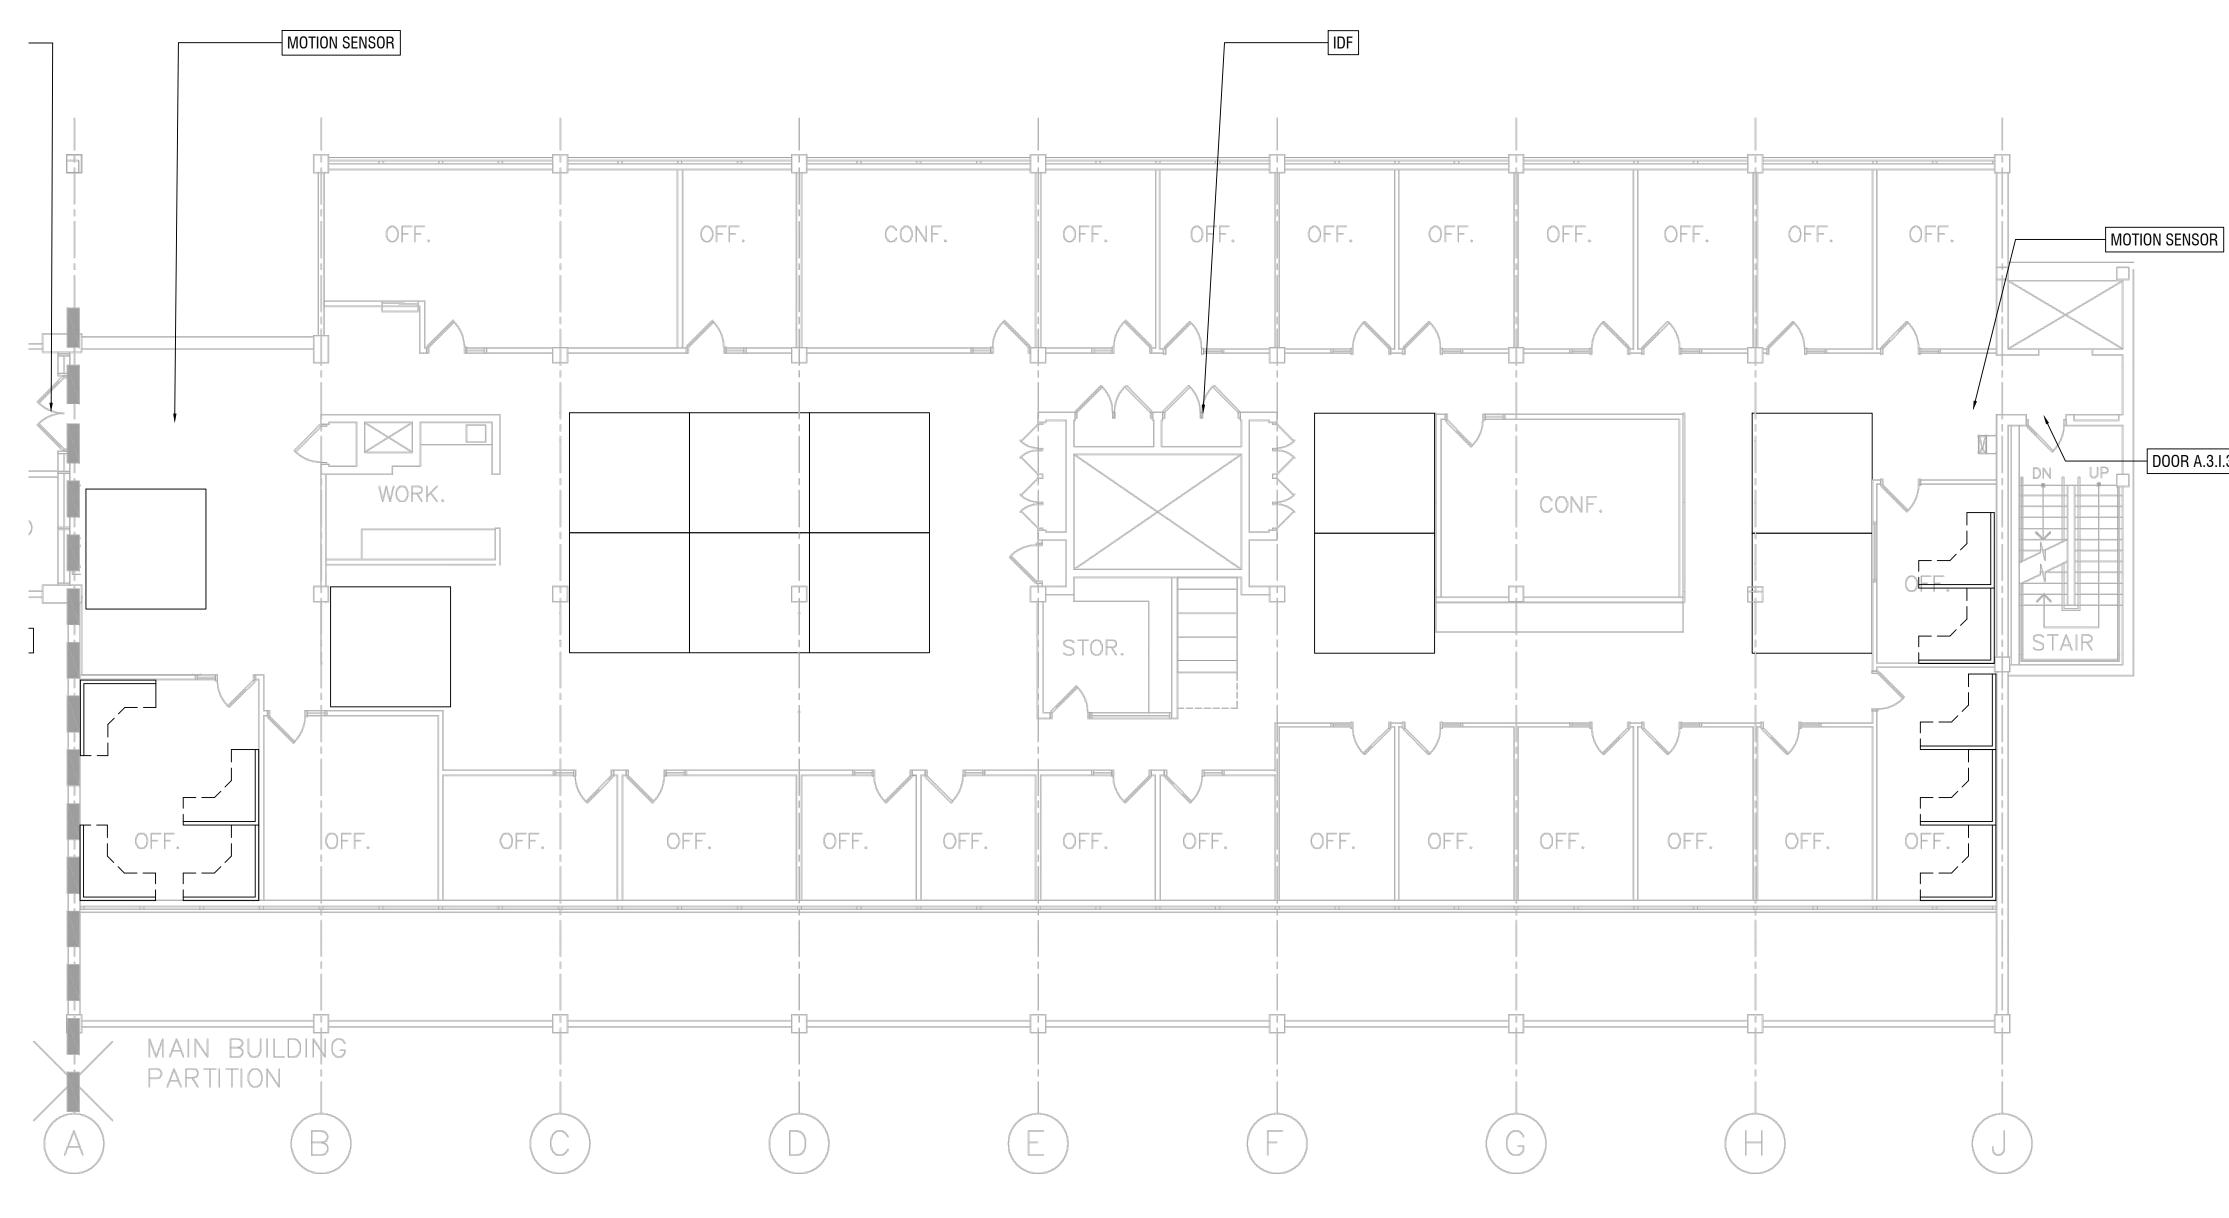
Drawn By CM

Project Manager

PT Project Director



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PROJECT NO.	
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THIRD FLOOR EAST (A WING) SCALE: 1/8" = 1'-0"

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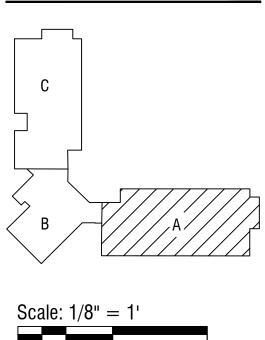
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Drawn By

Project Manager


PT Project Director



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Third Floor - Unit A Security Plan Wayne RESA

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PROJECT NO.	
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THIRD FLOOR WEST (B WING) SCALE: 1/8" = 1'-0"

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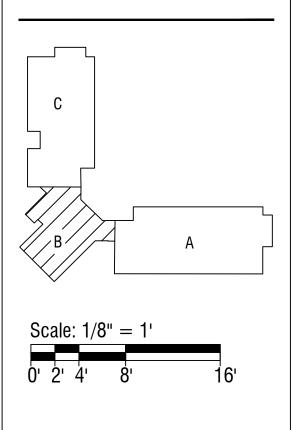
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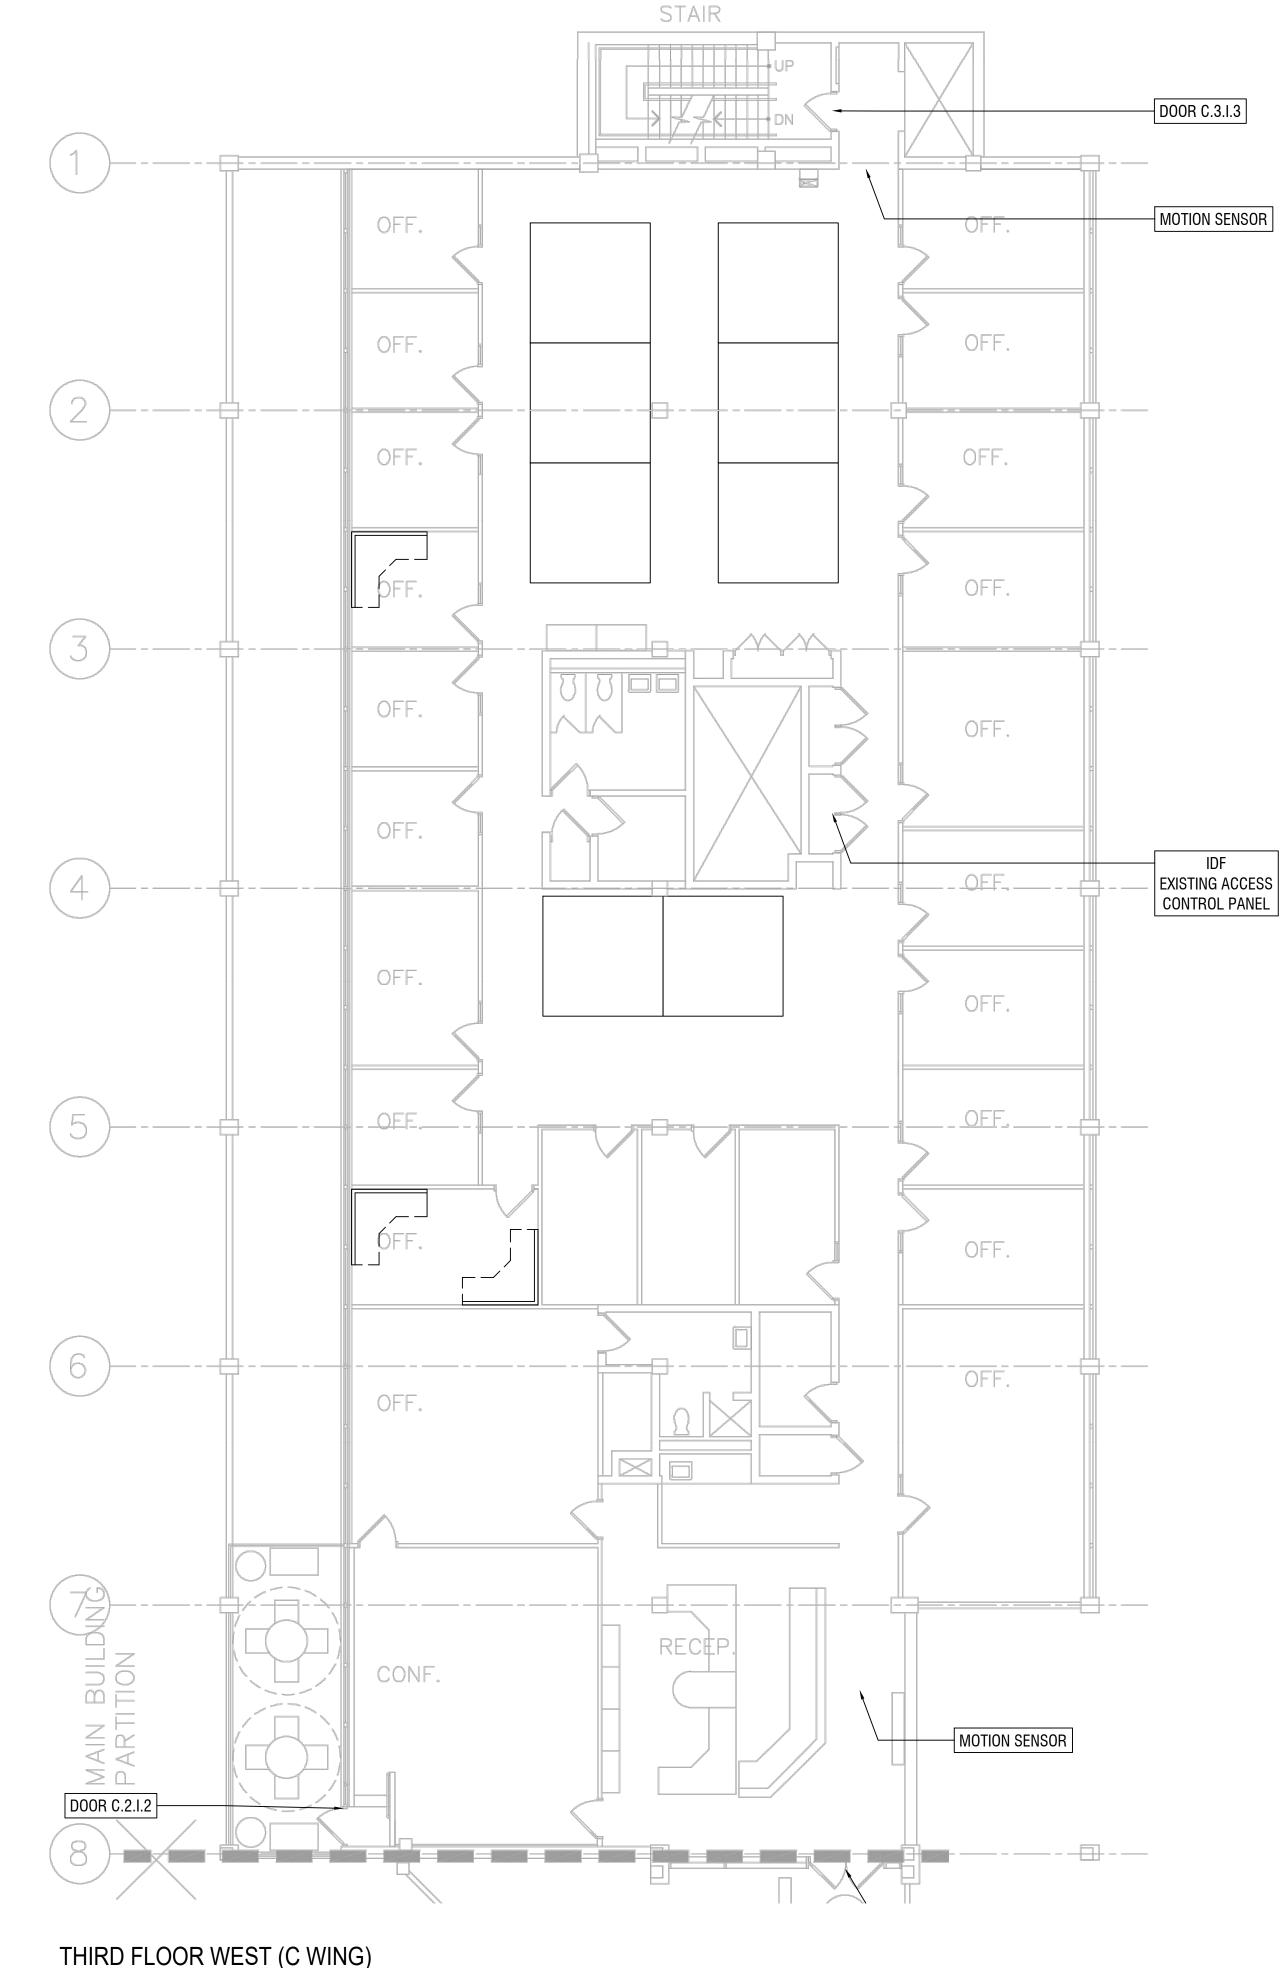
Project Manager

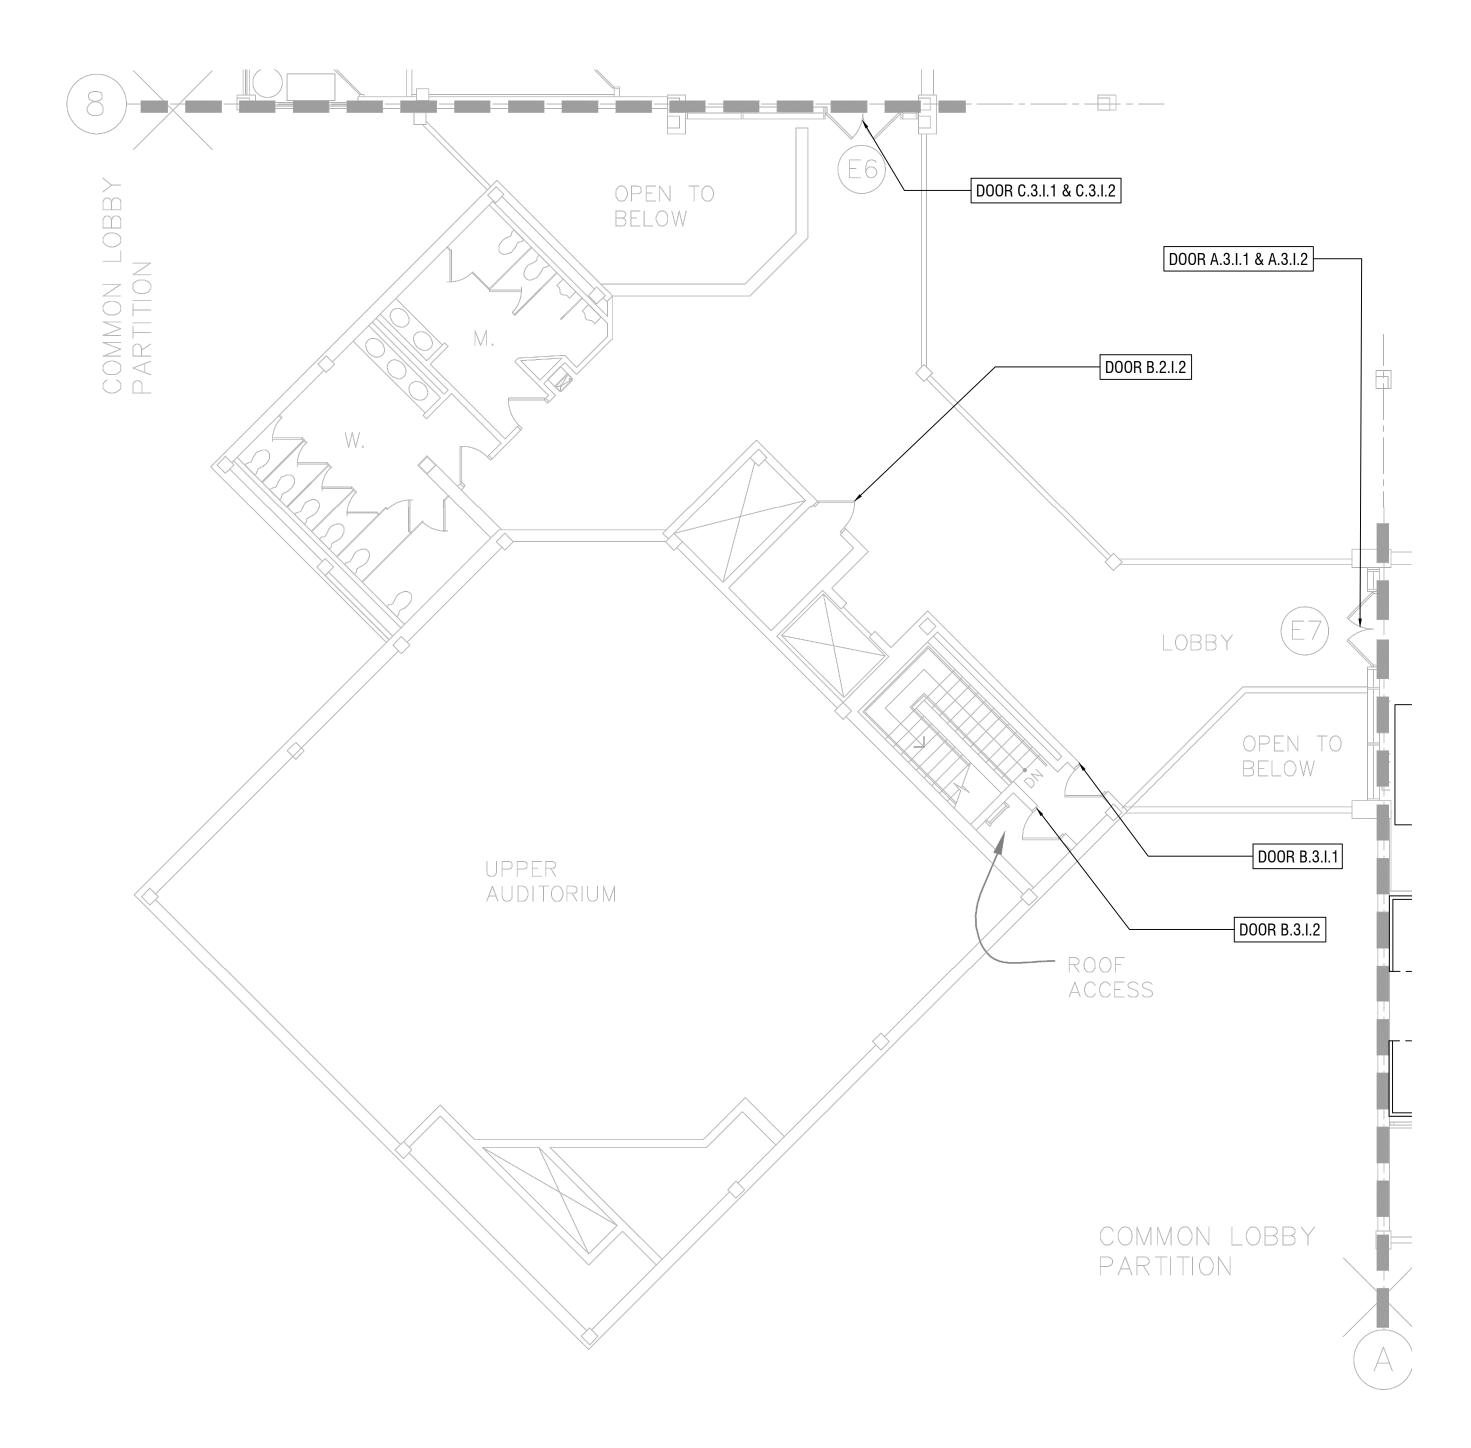ΡT Project Director



Third Floor - Unit B Security Plan Wayne RESA

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SCALE: 1/8" = 1'-0"

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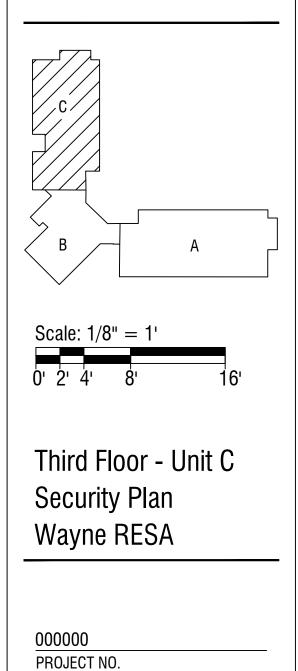
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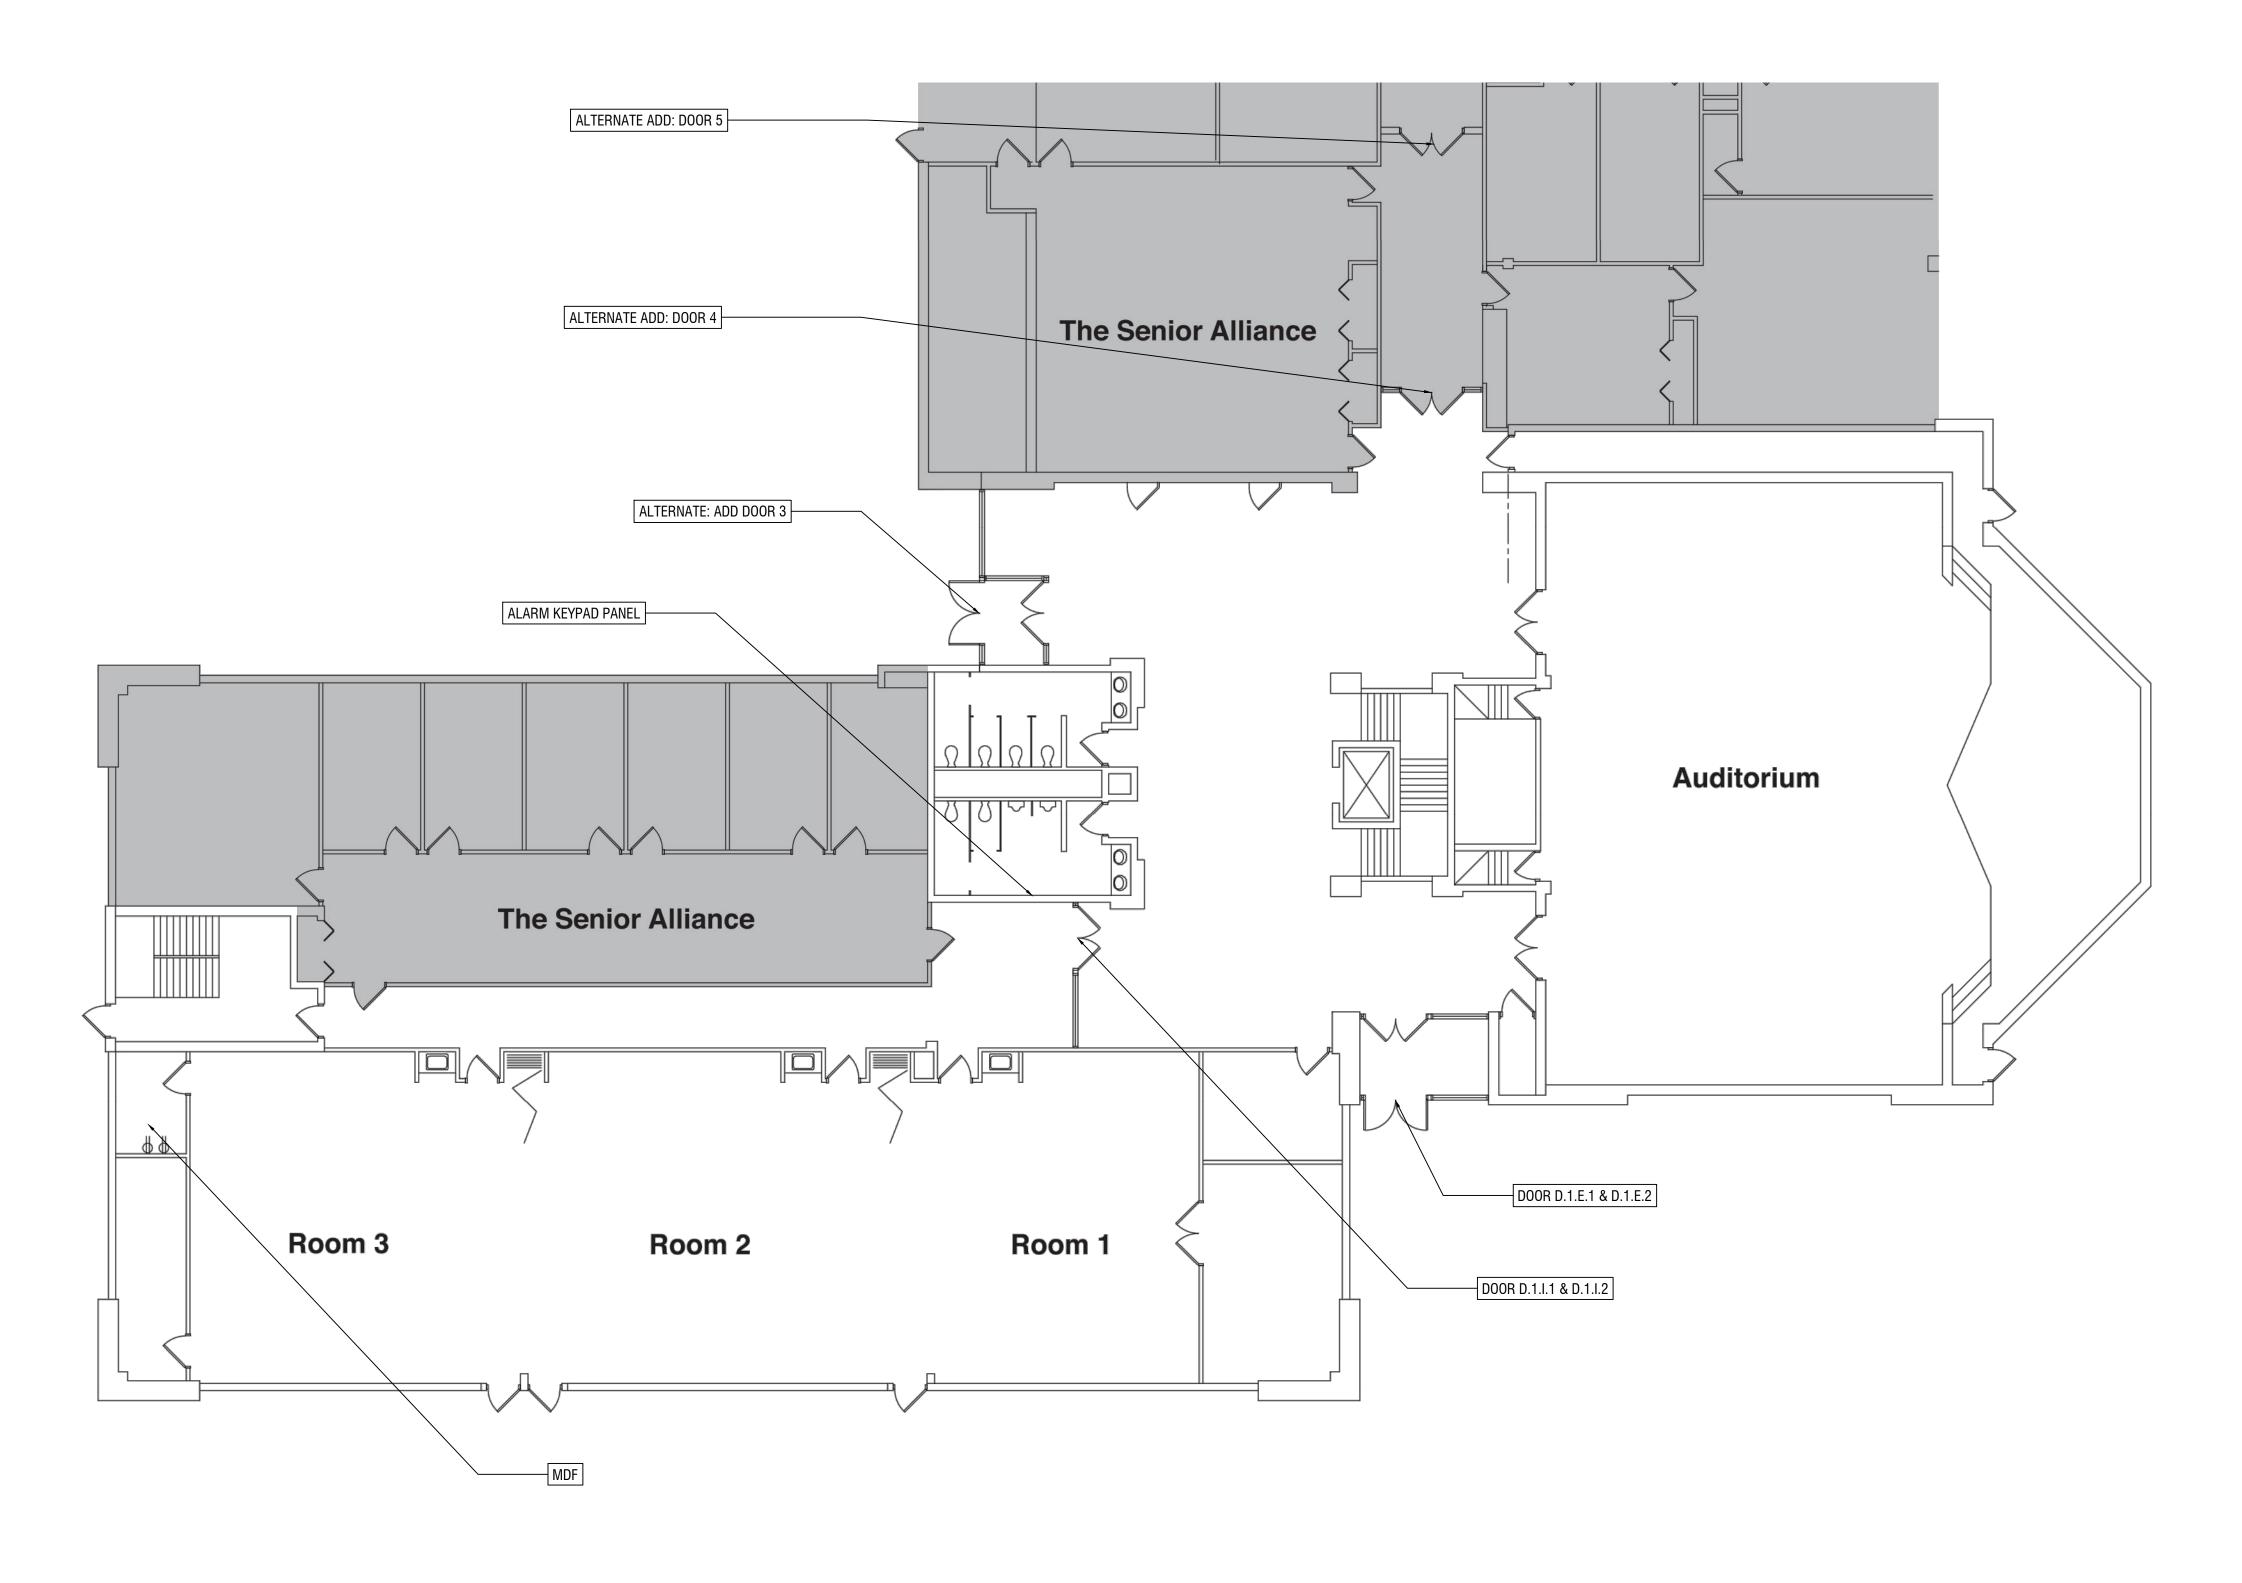
Drawn By СМ

Project Manager

ΡT Project Director



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FIRST FLOOR (COMPOSITE) SCALE: 1/16" = 1'-0"

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- 9. WHERE EXISTING DUAL-CHANNEL RACEWAY IS SHOWN, CONTRACTOR SHOULD NOT ASSUME THAT POWER AND LOW VOLTAGE SIDES ARE SHOWN ACCURATELY. CONTRACTOR MAY BE REQUIRED TO PROVIDE AND INSTALL INTERNAL CROSSOVER TO ROUTE LOW VOLTAGE CABLING ACROSS POWER CABLING.
- 10. ALARM PANEL LOCATIONS ARE TO BE REPLACED WITH CARD READERS WITH KEYPADS THESE NOTED LOCATION WILL ALLOW THE OWNER TO ARM AND DISARM DOORS AND MOTION SENSOR AS NEEDED.

GENERAL SECURITY NOTES:

- 1. PROXIMITY CARD READERS SHALL BE INSTALLED AS PART OF THIS PROJECT. LOCATIONS OF DEVICES AS SHOWN ON DRAWINGS IS APPROXIMATE. COORDINATE FINAL LOCATION ON-SITE WITH BARTON MALOW AND THE OWNER. UNITS SHALL BE VANDAL RESISTANT AND INSTALLED USING TAMPER PROOF SCREWS.
- 2. EXISTING WIRING AND ELECTRIFIED HARDWARE CAN BE REUSED AS SPECIFIED ON THE DOOR HARDWARE SCHEDULE. PRIOR TO INSTALLATION, ALL EXISTING EQUIPMENT WILL BE FIELD VERIFIED FOR USE. WIRE THAT IS DETERMINED AS NON-FUNCTIONAL WILL BE REPLACED THROUGH SIGNED CHANGED ORDER. CHANGE ORDER DOES NOT GIVE AUTHORITY TO PROCEED. CHANGE ORDERS MUST BE SIGNED BY THE OWNER.
- 3. CONTRACTOR SHALL COORDINATE TELECOMMUNICATION ROOM LAYOUTS FOR ACCESS CONTROL SYSTEM WORK WITH BARTON MALOW AND OWNER.

ALTERNATE ADD: MOTION SENSOR QUANTITIES NOT SHOW ON PRINT: 4

ALTERNATE ADD: DOOR 6 - NOT SHOWN ON PRINT

- PROVIDE AND INSTALL ELECTRIC STRIKE
- PROVIDE AND INSTALL CARD READER
- PROVIDE AND INSTALL DOOR CONTACT PROVIDE AND INSTALL MOTION REQUEST TO EXIT DEVICE
- ALTERNATE ADD: DOOR 7 NOT SHOWN ON PRINT
- PROVIDE AND INSTALL ELECTRIC STRIKE
- PROVIDE AND INSTALL CARD READER
- PROVIDE AND INSTALL DOOR CONTACT PROVIDE AND INSTALL MOTION REQUEST TO EXIT DEVICE

ALTERNATE ADD: DOOR 8 - NOT SHOWN ON PRINT

PROVIDE AND INSTALL OVERHEAD DOOR CONTACT



Barton Malow 26500 American Drive Southfield, MI 48034

tel 248.436.5000 fax 248.436.5001 www.bartonmalow.com

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JB

Drawn By СМ

Project Manager


PT Project Director

Scale: None

First Floor - Composite Security Plan Wayne RESA Annex

000000 PROJECT NO.



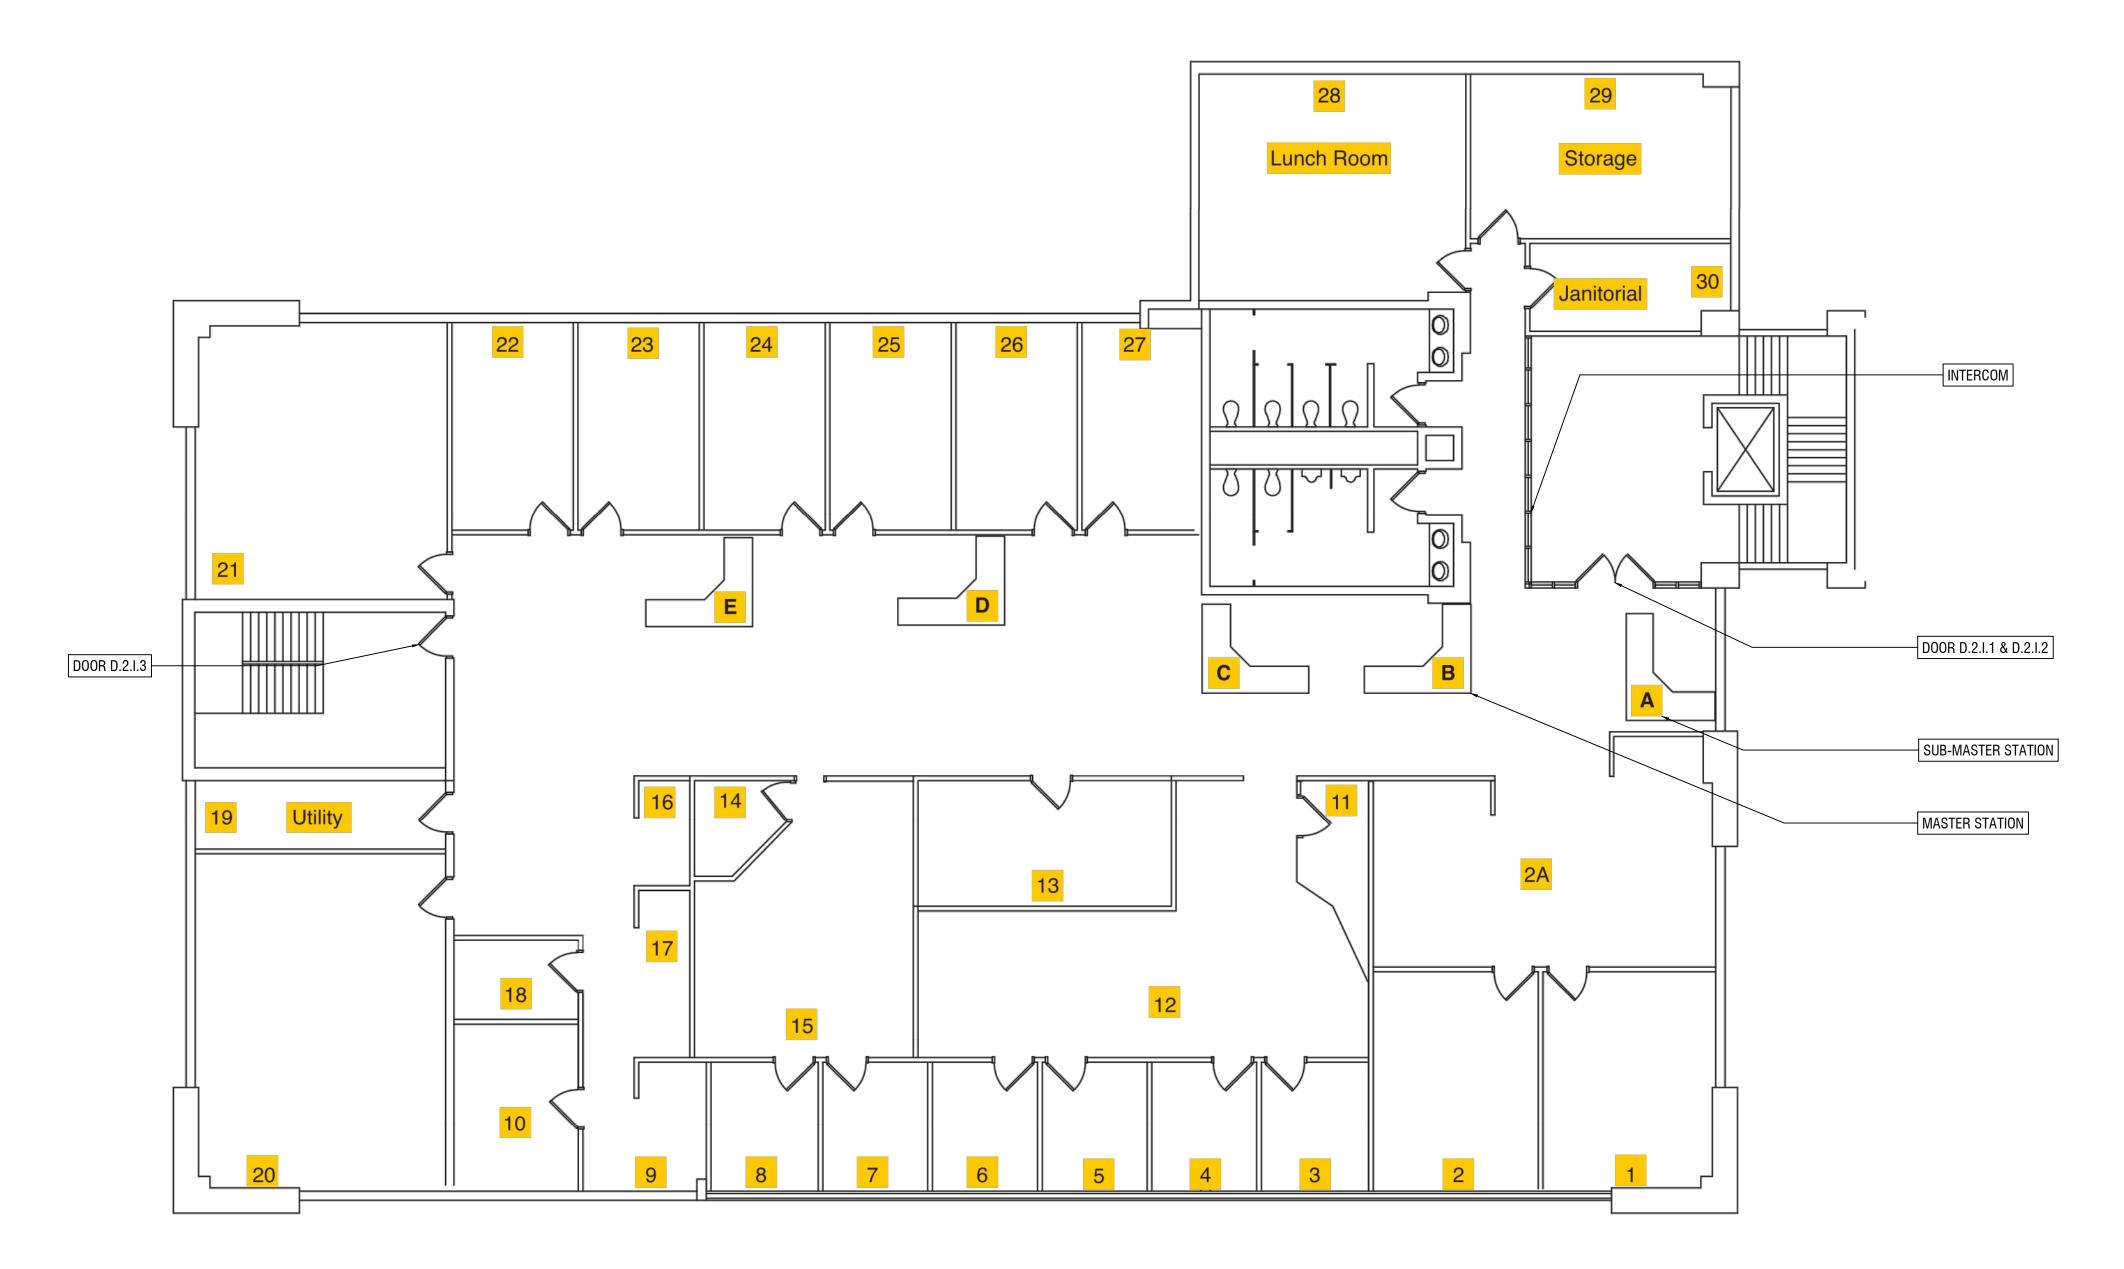

SECOND FLOOR (COMPOSITE) SCALE: 1/16" = 1'-0"

GENERAL TECHNOLOGY NOTES:

- 1. THESE DRAWINGS ARE DIAGRAMMATIC AND INDICATE THE GENERAL EXTENT OF THE WORK. CONTRACTORS SHALL PROVIDE ALL INCIDENTAL MATERIALS AND LABOR FOR A COMPLETE AND FULLY FUNCTIONAL SYSTEM.
- 2. FIELD VERIFY LOCATIONS, CONDITIONS AND LENGTHS PRIOR TO INSTALLATION.
- 3. WHERE ADEQUATE PATHWAYS ARE NOT PROVIDED, EACH CONTRACTOR IS REQUIRED TO PROVIDE THEIR OWN PENETRATIONS, SLEEVES, AND CORES WITH FIRESTOPPING. SLEEVES AND CORES SHALL BE USED THROUGH ALL WALLS AND FLOORS AND SHALL HAVE NYLON BUSHINGS.
- 4. EACH CONTRACTOR SHALL PROVIDE FIRESTOPPING ON CONDUITS PASSING THROUGH WALLS AND FLOORS. CONTRACTOR SHALL INSTALL FIRESTOPPING ON ANY CONDUITS WHERE CABLES ARE REMOVED OR DISTURBED DURING DEMOLITION
- 5. EACH CONTRACTOR SHALL COORDINATE TELECOMMUNICATION ROOM LAYOUTS WITH BARTON MALOW AND ALL IMPACTED CONTRACTORS PRIOR TO INSTALLATION.
- 6. EACH CONTRACTOR SHALL COORDINATE ALL EQUIPMENT LOCATIONS AND ROUGH-IN REQUIREMENTS WITH BARTON MALOW AND ALL IMPACTED CONTRACTORS PRIOR TO INSTALLATIONS.
- 7. EACH CONTRACTOR SHALL PROVIDE FACEPLATES AND INSERTS FOR THEIR DEVICES.
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- 10. ALARM PANEL LOCATIONS ARE TO BE REPLACED WITH CARD READERS WITH KEYPADS. THESE NOTED LOCATION WILL ALLOW THE OWNER TO ARM AND DISARM DOORS AND MOTION SENSOR AS NEEDED.

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tel 248.436.5000 fax 248.436.5001 www.bartonmalow.com

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Project Manager


ΡT Project Director

Scale: None

Second Floor - Comp. Security Plan Wayne RESA Annex

000000 PROJECT NO.



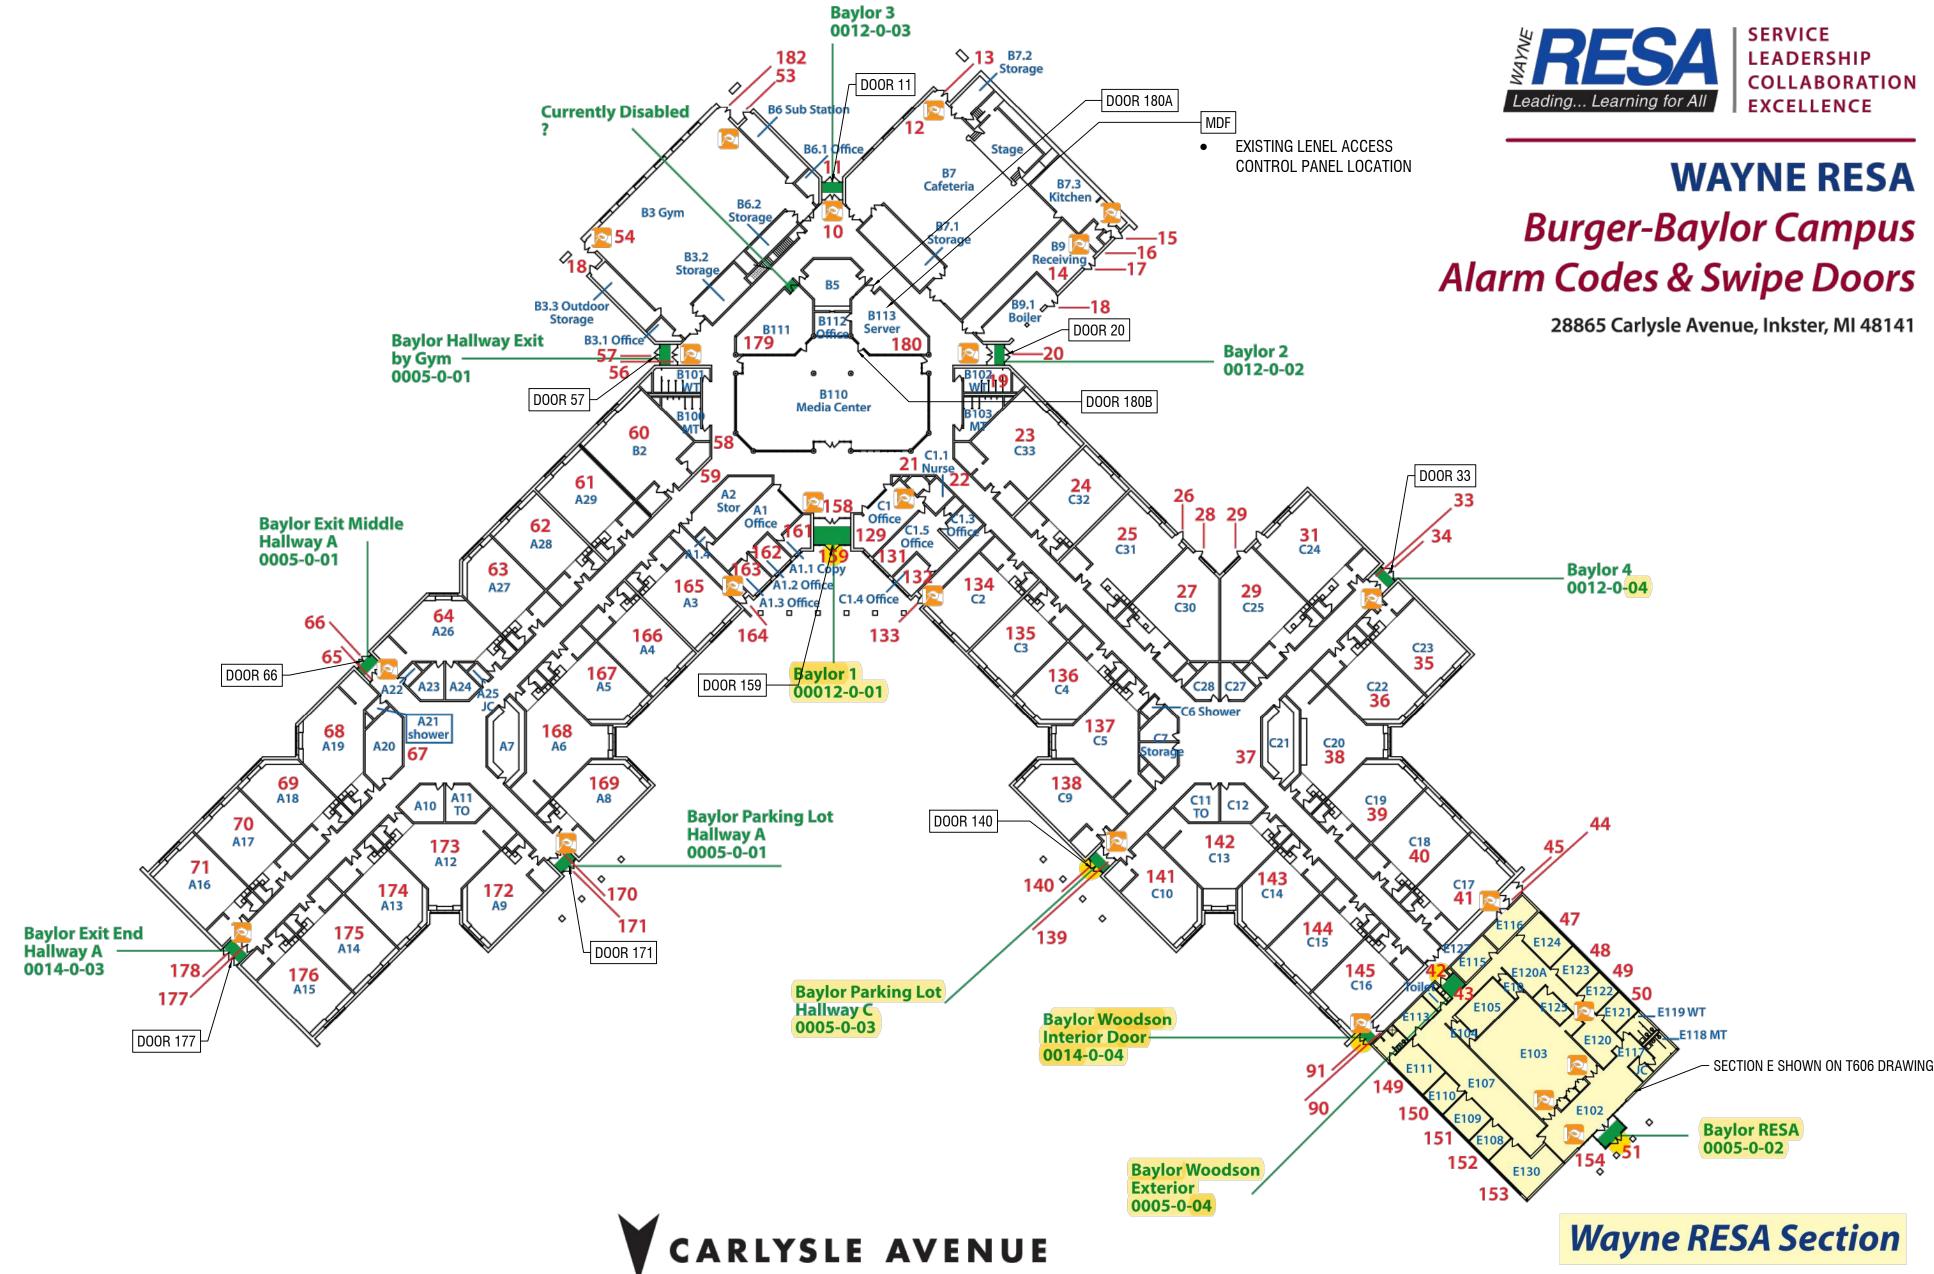

FIRST FLOOR (COMPOSITE) SCALE: 1/16" = 1'-0"

GENERAL TECHNOLOGY NOTES:

- 1. THESE DRAWINGS ARE DIAGRAMMATIC AND INDICATE THE GENERAL EXTENT OF THE WORK. CONTRACTORS SHALL PROVIDE ALL INCIDENTAL MATERIALS AND LABOR FOR A COMPLETE AND FULLY FUNCTIONAL SYSTEM.
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- 4. EACH CONTRACTOR SHALL PROVIDE FIRESTOPPING ON CONDUITS PASSING THROUGH WALLS AND FLOORS. CONTRACTOR SHALL INSTALL FIRESTOPPING ON ANY CONDUITS WHERE CABLES ARE REMOVED OR DISTURBED DURING DEMOLITION
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- 6. EACH CONTRACTOR SHALL COORDINATE ALL EQUIPMENT LOCATIONS AND ROUGH-IN REQUIREMENTS WITH BARTON MALOW AND ALL IMPACTED CONTRACTORS PRIOR TO INSTALLATIONS.
- 7. EACH CONTRACTOR SHALL PROVIDE FACEPLATES AND INSERTS FOR THEIR DEVICES.
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- WHERE EXISTING DUAL-CHANNEL RACEWAY IS SHOWN, CONTRACTOR SHOULD NOT ASSUME THAT POWER AND LOW VOLTAGE SIDES ARE SHOWN ACCURATELY. CONTRACTOR MAY BE REQUIRED TO PROVIDE AND INSTALL INTERNAL CROSSOVER TO ROUTE LOW VOLTAGE CABLING ACROSS POWER CABLING.

GENERAL SECURITY NOTES:

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- EXISTING WIRING AND ELECTRIFIED HARDWARE CAN BE REUSED AS SPECIFIED ON THE DOOR HARDWARE SCHEDULE. PRIOR TO INSTALLATION, ALL EXISTING EQUIPMENT WILL BE FIELD VERIFIED FOR USE. WIRE THAT IS DETERMINED AS NON-FUNCTIONAL WILL BE REPLACED THROUGH SIGNED CHANGED ORDER. CHANGE ORDER DOES NOT GIVE AUTHORITY TO PROCEED. CHANGE ORDERS MUST BE SIGNED BY THE OWNER.
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Project Manager


PT Project Director

Scale: None

First Floor - Composite Security Plan Burger Baylor Campus

000000 PROJECT NO.



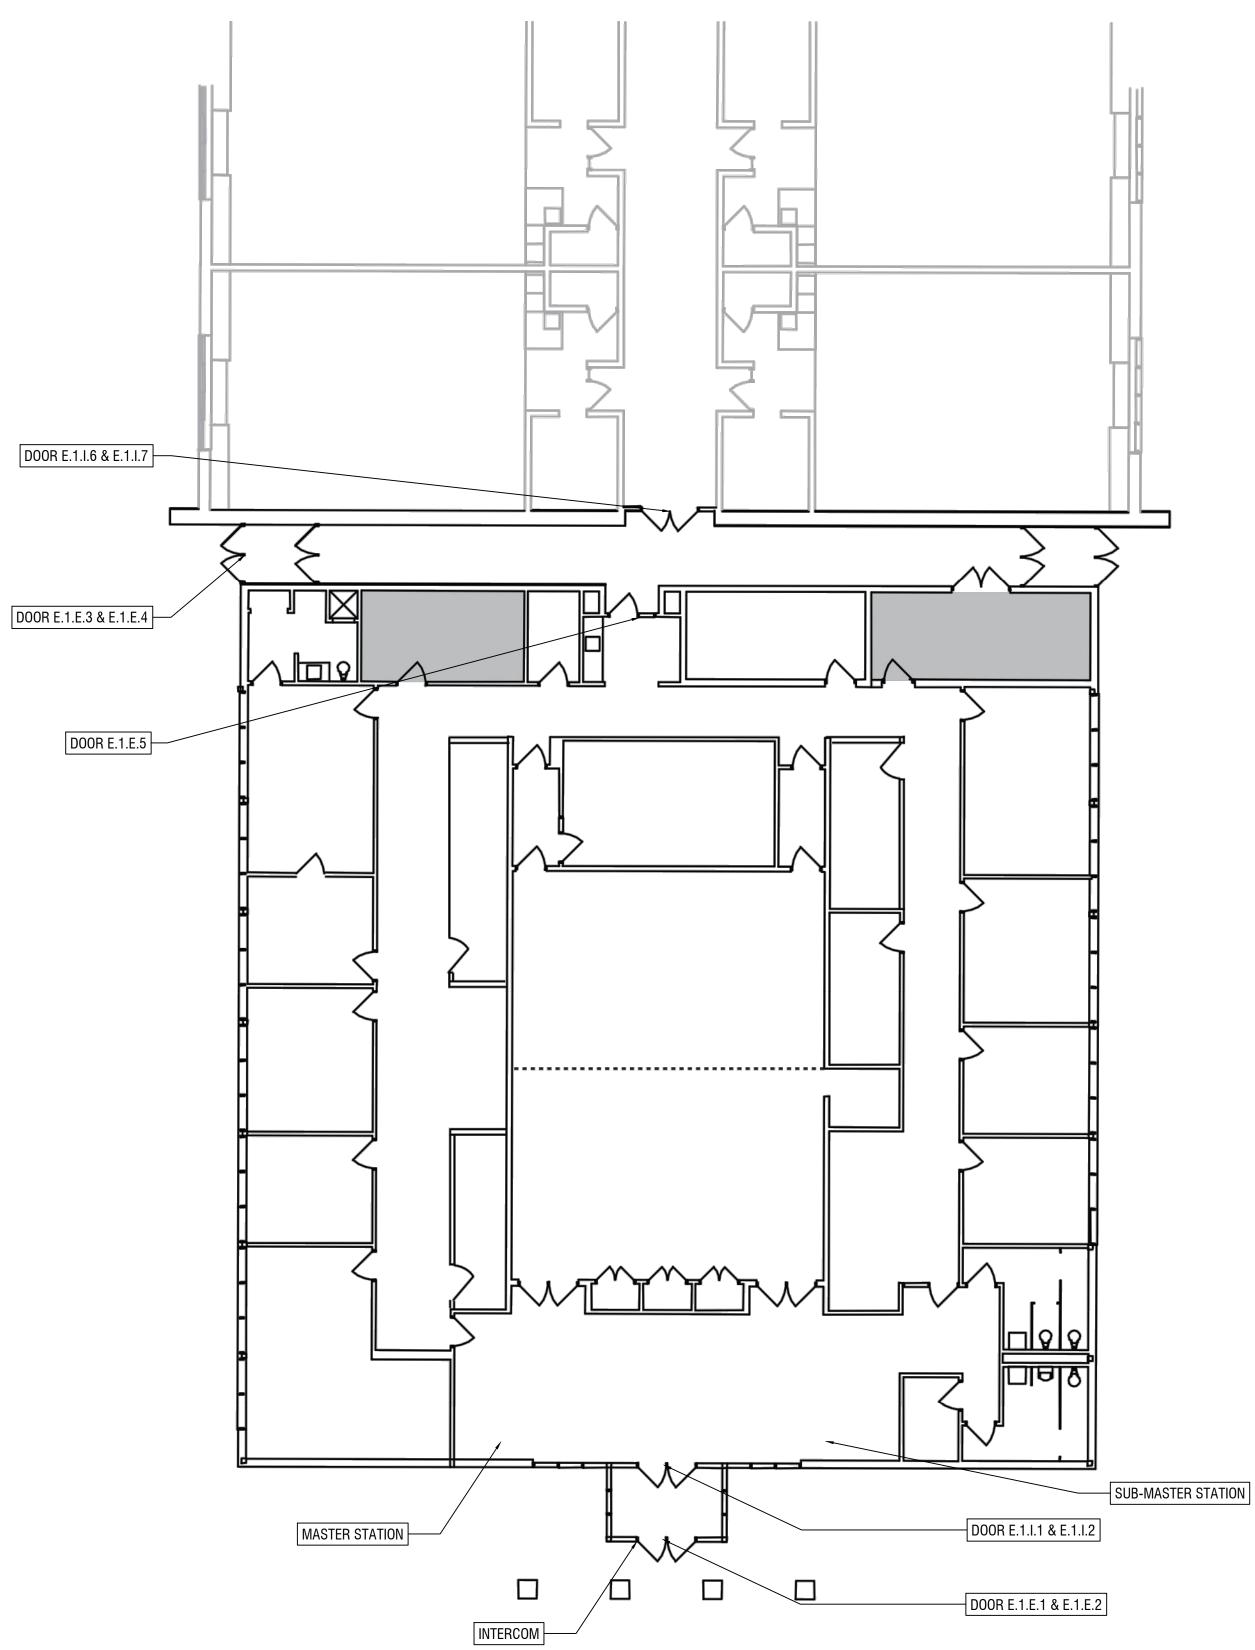

SECOND FLOOR (COMPOSITE) SCALE: 1/16" = 1'-0"

GENERAL TECHNOLOGY NOTES:

- 1. THESE DRAWINGS ARE DIAGRAMMATIC AND INDICATE THE GENERAL EXTENT OF THE WORK. CONTRACTORS SHALL PROVIDE ALL INCIDENTAL MATERIALS AND LABOR FOR A COMPLETE AND FULLY FUNCTIONAL SYSTEM.
- 2. FIELD VERIFY LOCATIONS, CONDITIONS AND LENGTHS PRIOR TO INSTALLATION.
- 3. WHERE ADEQUATE PATHWAYS ARE NOT PROVIDED, EACH CONTRACTOR IS REQUIRED TO PROVIDE THEIR OWN PENETRATIONS, SLEEVES, AND CORES WITH FIRESTOPPING. SLEEVES AND CORES SHALL BE USED THROUGH ALL WALLS AND FLOORS AND SHALL HAVE NYLON BUSHINGS.
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- 10. ALARM PANEL LOCATIONS ARE TO BE REPLACED WITH CARD READERS WITH KEYPADS. THESE NOTED LOCATION WILL ALLOW THE OWNER TO ARM AND DISARM DOORS AND MOTION SENSOR AS NEEDED.
- 11. MOTION SENSOR ARE TO REMAIN AND CONTRACTOR WILL INTEGRATE INTO THE NEW ACCESS CONTROL SYSTEM.

GENERAL SECURITY NOTES:

- 1. PROXIMITY CARD READERS SHALL BE INSTALLED AS PART OF THIS PROJECT. LOCATIONS OF DEVICES AS SHOWN ON DRAWINGS IS APPROXIMATE. COORDINATE FINAL LOCATION ON-SITE WITH BARTON MALOW AND THE OWNER. UNITS SHALL BE VANDAL RESISTANT AND INSTALLED USING TAMPER PROOF SCREWS.
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Drawn By

Project Manager

ΡT Project Director

Scale: None

Second Floor - Comp. Security Plan Wayne RESA BBC

000000 PROJECT NO.

