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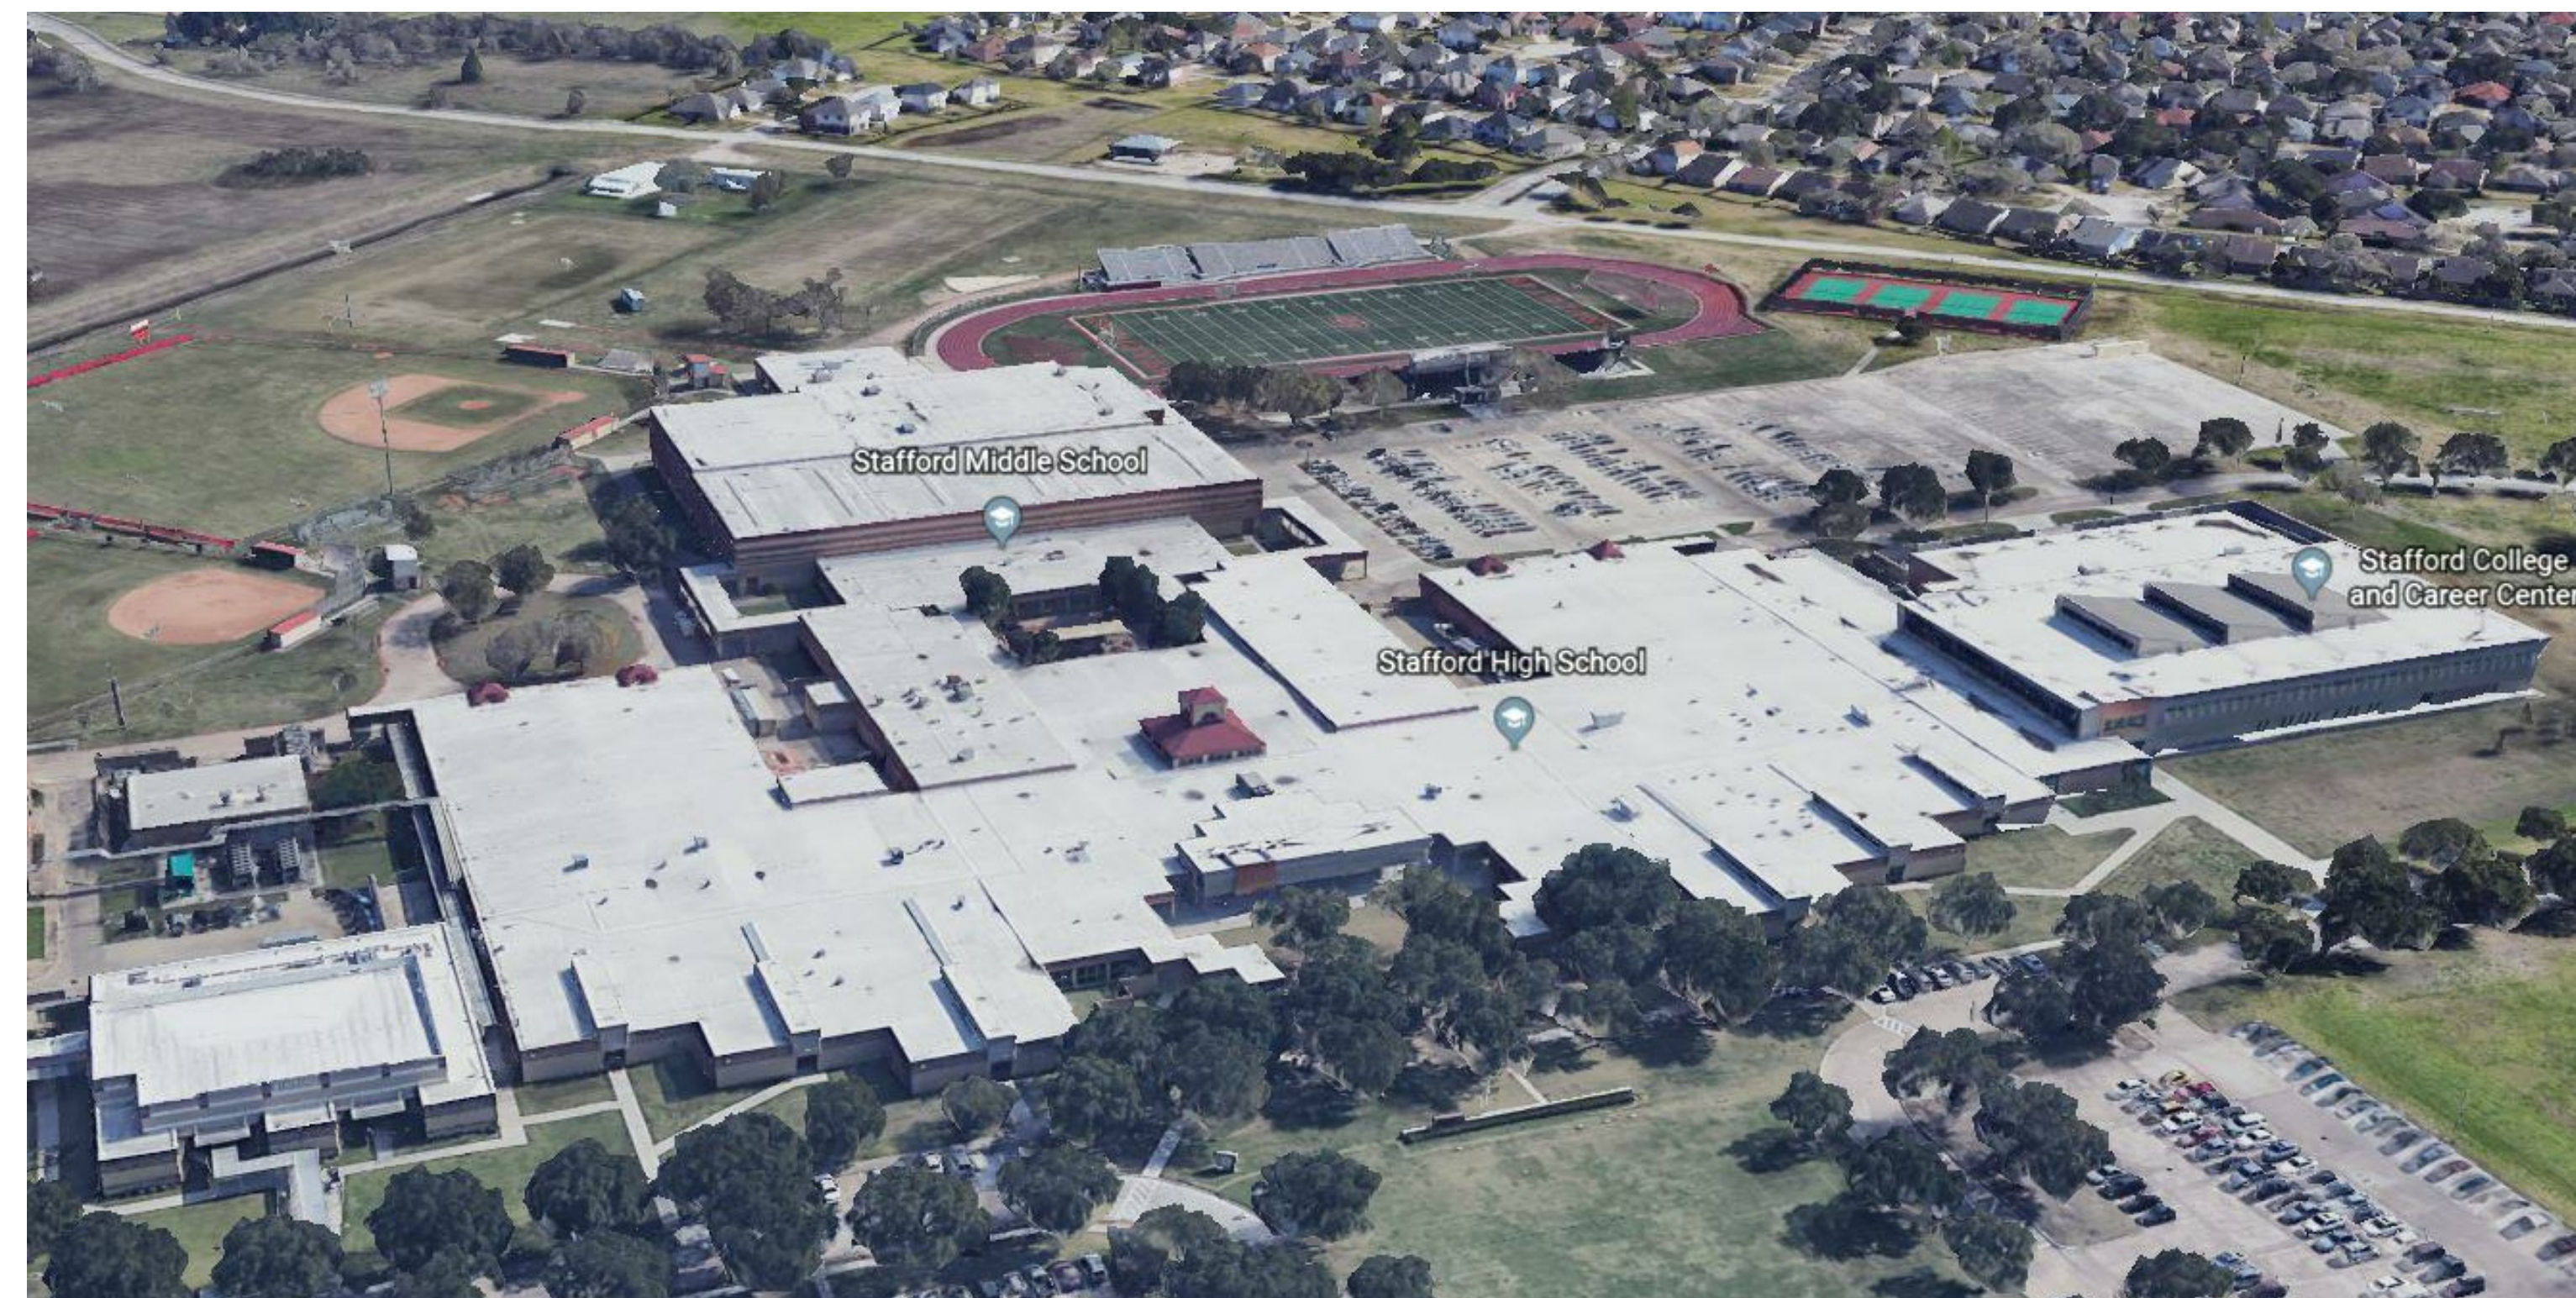


Stafford Municipal School District

1625 Staffordshire Road
 Stafford, TX 77477



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PROJECTS:

(HS) - HIGH SCHOOL RENOVATIONS

(MS) - MAGNET SCHOOL BUILT-OUT

STAFFORD HIGH SCHOOL & MAGNET SCHOOL RENOVATIONS

STAFFORD MUNICIPAL SCHOOL DISTRICT

M.E.P. Engineers

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BID, PERMIT, & CONSTRUCTION 03/13/2020



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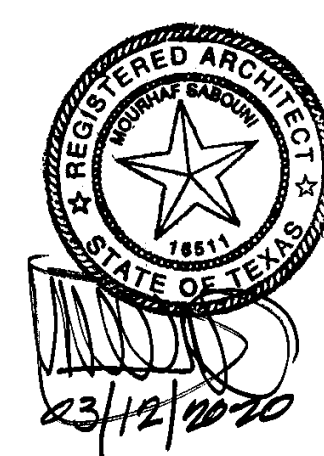


CONSULTANTS:

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PROFESSIONAL SEAL:





A PROJECT FOR:

STAFFORD
HIGH SCHOOL
& MAGNET
SCHOOL
RENOVATIONS

1625 STAFFORDSHIRE
ROAD,
STAFFORD, TX 77477

#	Date	ISSUED FOR
	03/13/2020	ISSUE FOR BID, PERMIT, & CONSTRUCTION

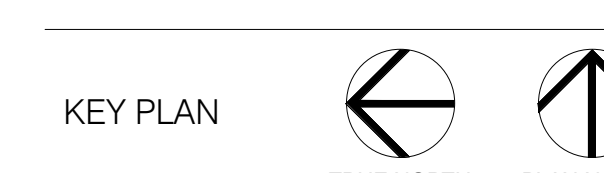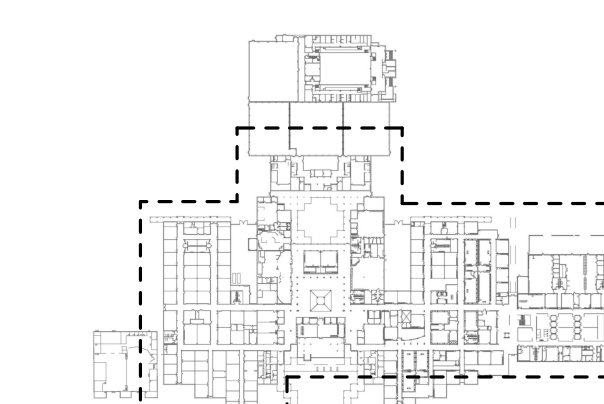

Project Number	19006-A
Drawn By	LT
Checked By	AW
Approved By	MS
Drawing Title	
CODE ANALYSIS INFORMATION	
Drawing Number	A0.20




27 CODE REVIEW PLAN
Scale: 1" = 30'-0"

02 CODE ANALYSIS KEY
Scale: NTS

- AREA NOT IN SCOPE
- NO SPRINKLERS
- EXISTING SPRINKLERS
- SPRINKLERS EXTENDED TO SPACE.

1. THIS WORK IS TO BE PERMITTED UNDER THE REQUIREMENTS OF THE 2015 INTERNATIONAL EXISTING BUILDING CODE, AS ENFORCED IN THE CITY OF STAFFORD, TX.
2. REFER TO 12/00.00 FOR CODE ANALYSIS NARRATIVE.
3. SAFE AND UNRESTRICTED ACCESS AND EGRESS ROUTES WILL BE MAINTAINED FOR OCCUPIED AREAS ADJACENT TO WORK AREA IN ACCORDANCE WITH APPLICABLE CODES.
4. ALL NEW WORK IN THIS PROJECT IS TO BE ACCESSIBLE IN ACCORDANCE WITH THE MOST RECENT EDITION OF THE TEXAS ACCESSIBILITY STANDARDS. REFER TO ACCESSIBILITY REQUIREMENTS ON SHEETS A0.00 AND A0.30 FOR MORE INFORMATION.
5. EGRESS ROUTES ARE AFFECTED PER THE DRAWINGS ON THIS SHEET.
6. NOTE: THE CAFETERIA IS NOT IN SCOPE, HOWEVER, ONE EXIT DOOR IS TO BE CONVERTED TO A CONNECTOR ACCESS DOOR BACK TO THE RENOVATED SPACE. ANALYSIS OF THE CAFETERIA IS INDICATED HERE:
 - A. PER PLAN DIAGRAM 11/A0.20, THE CAFETERIA HAS 3 NUMBER OF EXITS WITH A CAPACITY OF 2,160.
 - B. THE CAFETERIA HAS A CALCULATED OCCUPANT LOAD OF 519; THIS REQUIRING 3 EXITS.
 - C. PER THIS CALCULATION AND IN ACCORDANCE WITH 2015 IBC CHAPTER 10, THE ELIMINATION OF THE EGRESS DOORS INDICATED IN PLAN IS ACCEPTABLE.
7. REFER TO FIRE PROTECTION SHEET FP1.01 FOR MORE INFORMATION ON SPRINKLER SYSTEM.
8. NET CHANGE IN OCCUPANT LOAD IS -117 (OCCUPANT LOAD OF BUILDING IS REDUCED BY 117 OCCUPANTS). OCCUPANT LOAD IN THE HIGH SCHOOL IS REDUCED BY 22 OCCUPANTS; AND THE REMAINDER OF THE REDUCTION IS IN THE MAGNET SCHOOL.

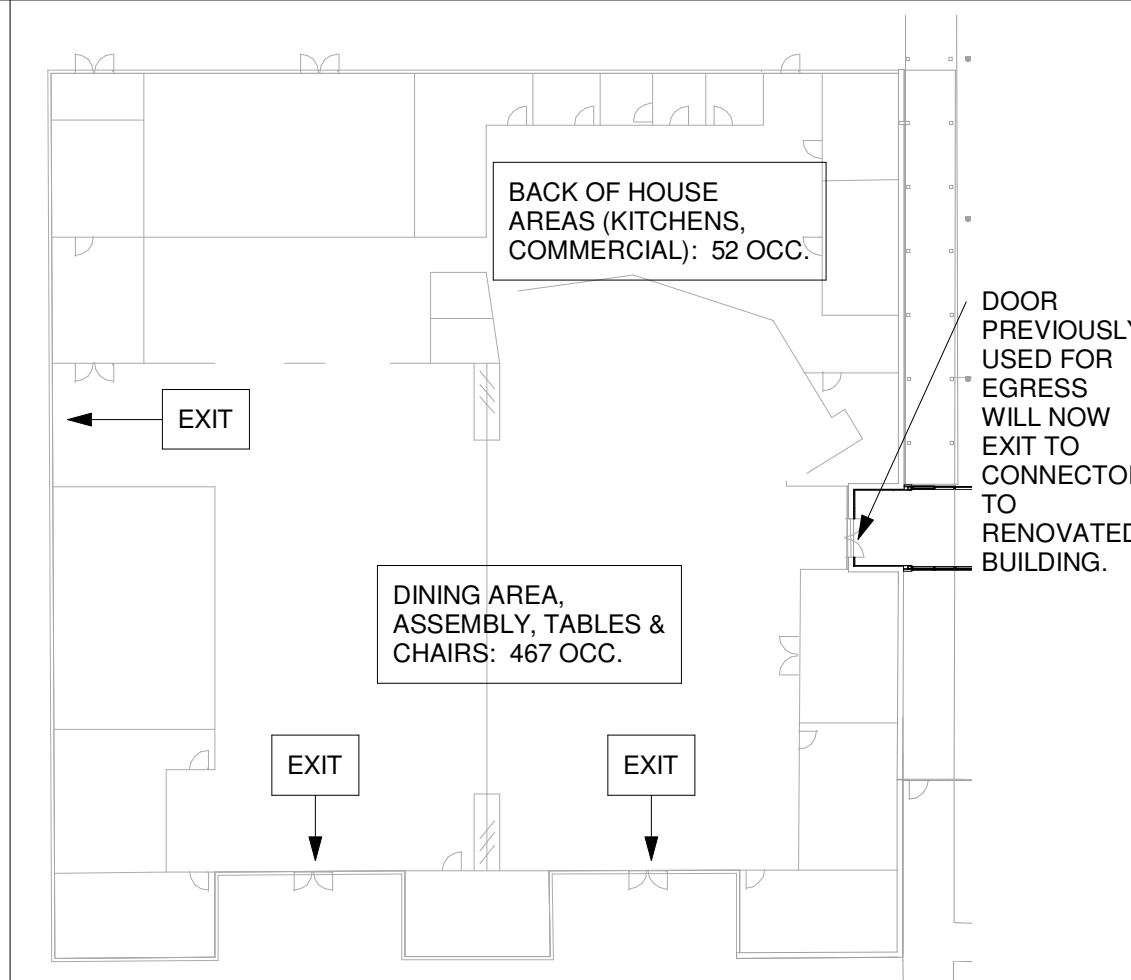

11 CAFETERIA ANALYSIS DIAGRAM
Scale: 1" = 30'-0"

- CD001 SEE NOTES AT 11/A0.20 FOR CAFETERIA EGRESS.
- CD002 LEARNING STAIR IS ADJUSTED TO ASSEMBLY OCCUPANT LOAD WITH CIRCULATION SPACE UNOCCUPIED. OCCUPANT LOAD ADJUSTMENT: +18 OCC.
- CD003 SCIENCE LABS CONVERTED TO CTE LABS; NO CHANGE IN OCCUPANT LOAD.
- CD004 CLASSROOMS CONVERTED TO CTE LABS. OCCUPANT LOAD ADJUSTMENT: -96 OCC.
- CD005 CLASSROOM CONVERTED TO CTE LAB. OCCUPANT LOAD ADJUSTMENT: -22 OCC.
- CD007 CLASSROOMS CONVERTED TO MULTIPURPOSE SPACE, COUNTED AS LAB SPACE FOR OCCUPANT LOAD. OCCUPANT LOAD ADJUSTMENT: +39 OCC.
- CD008 NEW STUDY ROOMS, ADDITIONAL OCCUPANT LOAD ASSUMING CLASSROOM OCCUPANCY (FORMERLY UNOCCUPIED EXTERIOR SPACE): +39 OCC.
- CD009 NEW RESTROOMS CONSTRUCTED IN LIBRARY SPACE.
- CD010 RESTROOMS RENOVATED TO MEET CURRENT ACCESSIBILITY REQUIREMENTS. RE: DWG/WD
- CD011 RENOVATED LIFE SKILLS ROOM; NO CHANGE TO OCCUPANT LOAD.
- CD012 NEW RESTROOMS) CONSTRUCTED IN CIRCULATION SPACE.
- CD013 WORK IN BLACK BOX THEATER IS LIMITED TO AUDIO-VISUAL & ELECTRICAL UPGRADES.
- CD014 WORK IN THIS AREA HAS NO EFFECT ON OCCUPANT LOAD.
- CD015 NEW DOORS SHALL BE EQUIPPED WITH PANIC DEVICES TO ALLOW FOR FREE EGRESS.
- CD016 WORK IN SHOPS IS LIMITED TO NEW EXHAUST SYSTEM & ASSOCIATED MEP WORK.

06 KEYNOTES - CODE ANALYSIS
Scale: NTS

01 GENERAL NOTES - CODE ANALYSIS
Scale: NTS

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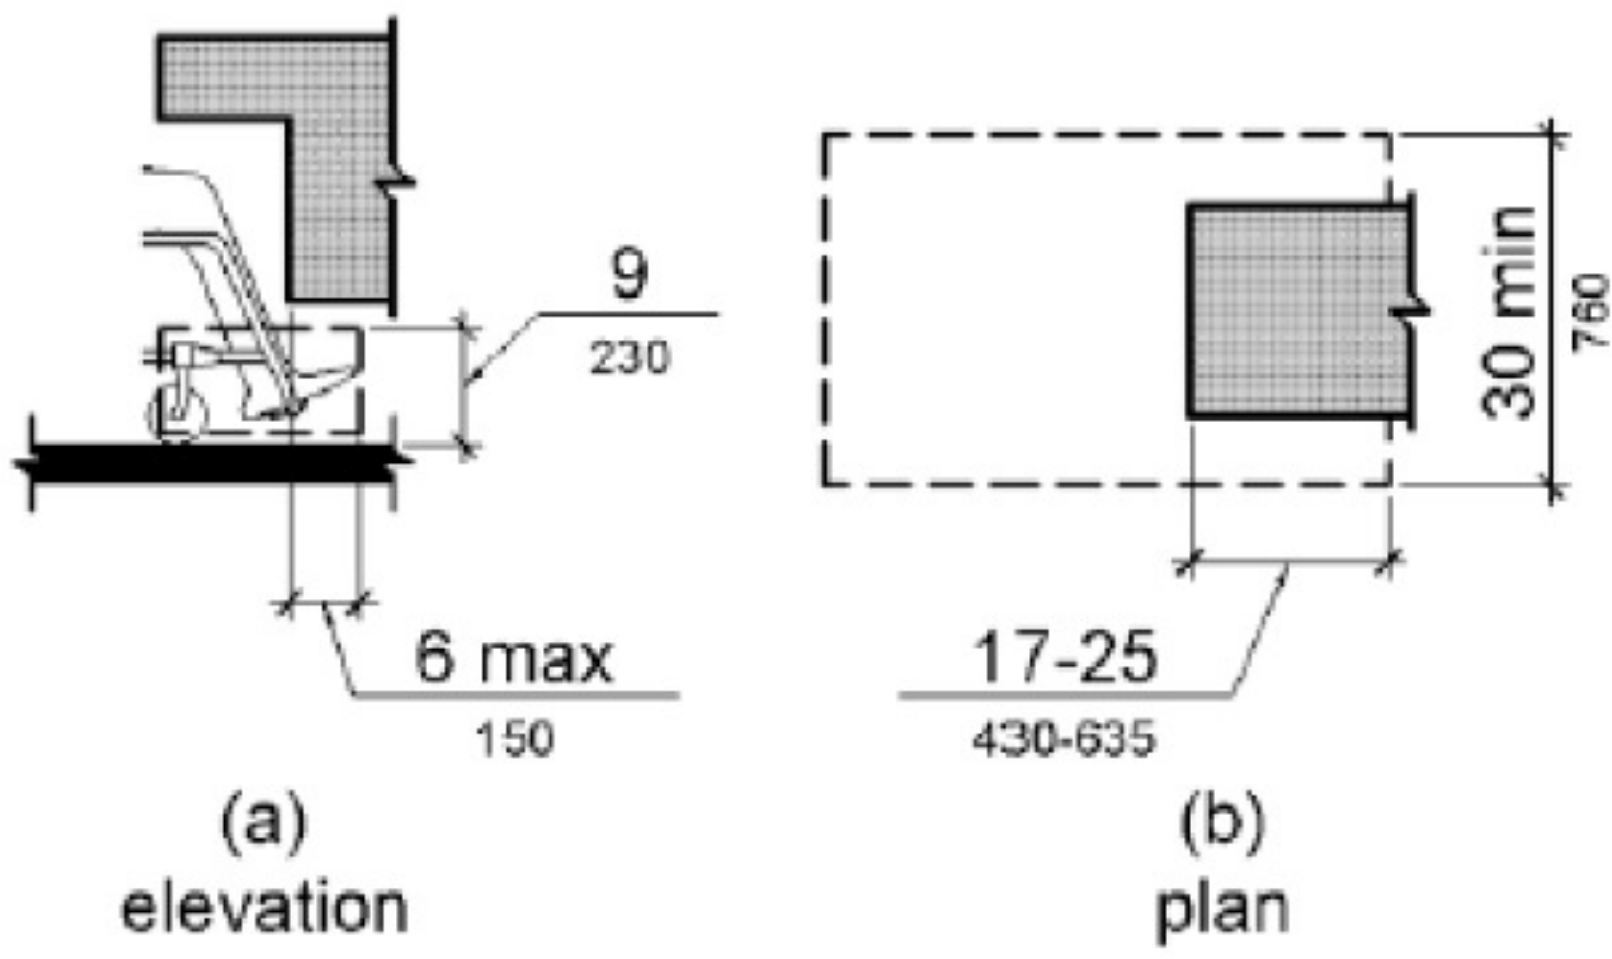


Figure 306.2 Toe Clearance

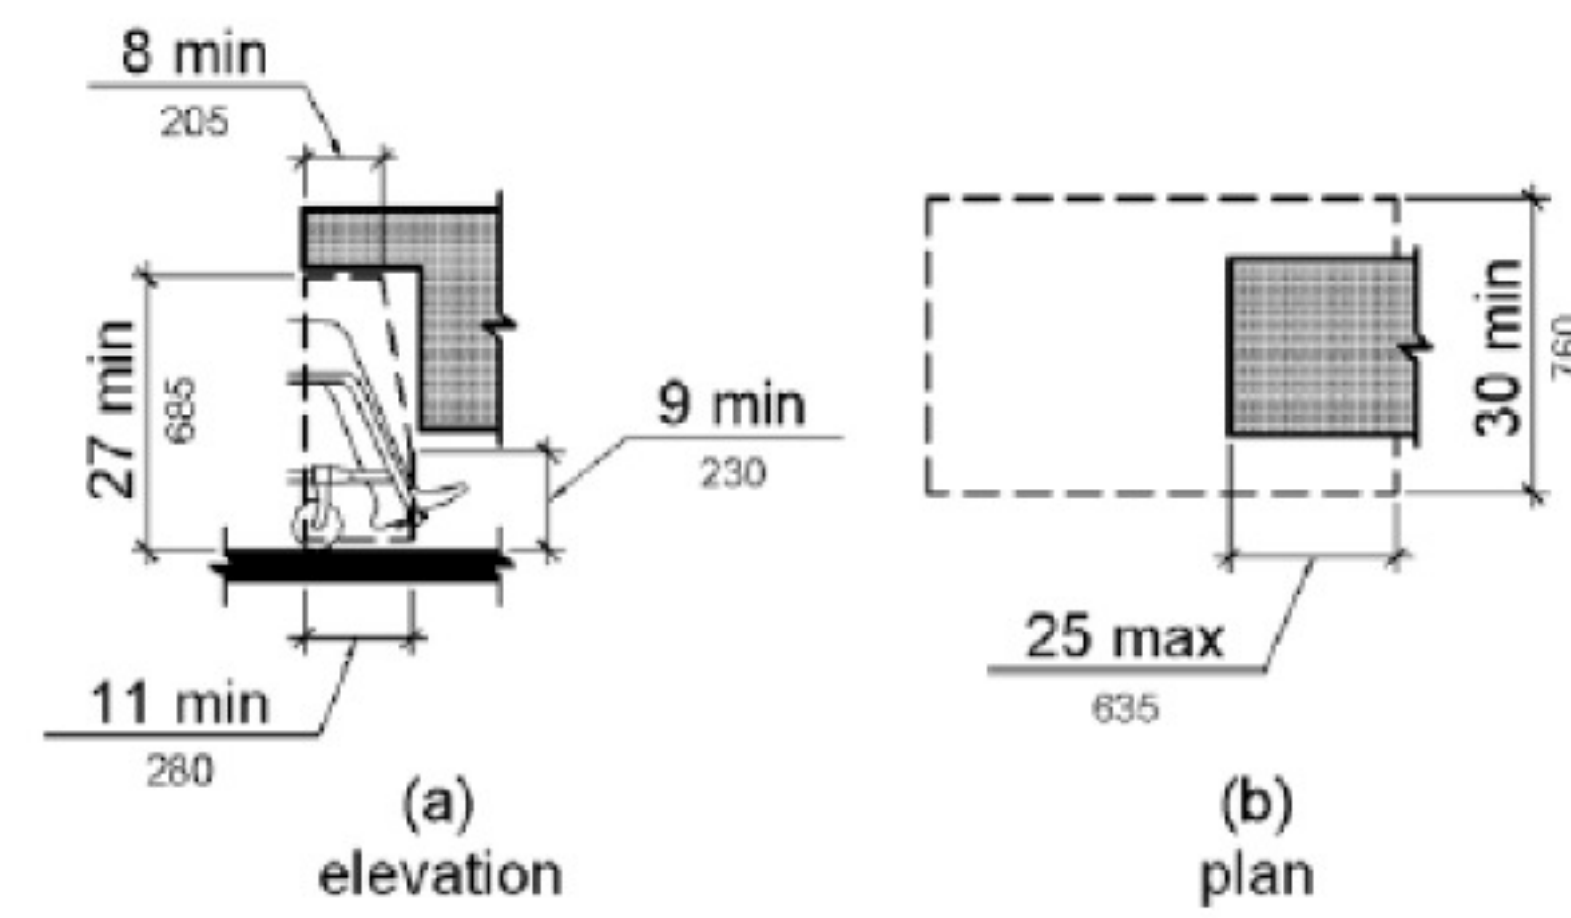


Figure 306.3 Knee Clearance

Advisory 308.1 General. The following table provides guidance on reach ranges for children according to age where building elements such as coat hooks, lockers, or operable parts are designed for use primarily by children. These dimensions apply to either forward or side reaches. Accessible elements and operable parts designed for adult use or children over age 12 can be located outside these ranges but must be within the adult reach ranges required by 308.

Children's Reach Ranges			
Forward or Side Reach	Ages 3 and 4	Ages 5 through 8	Ages 9 through 12
High (maximum)	36 in (915 mm)	40 in (1015 mm)	44 in (1120 mm)
Low (minimum)	20 in (510 mm)	18 in (455 mm)	16 in (405 mm)



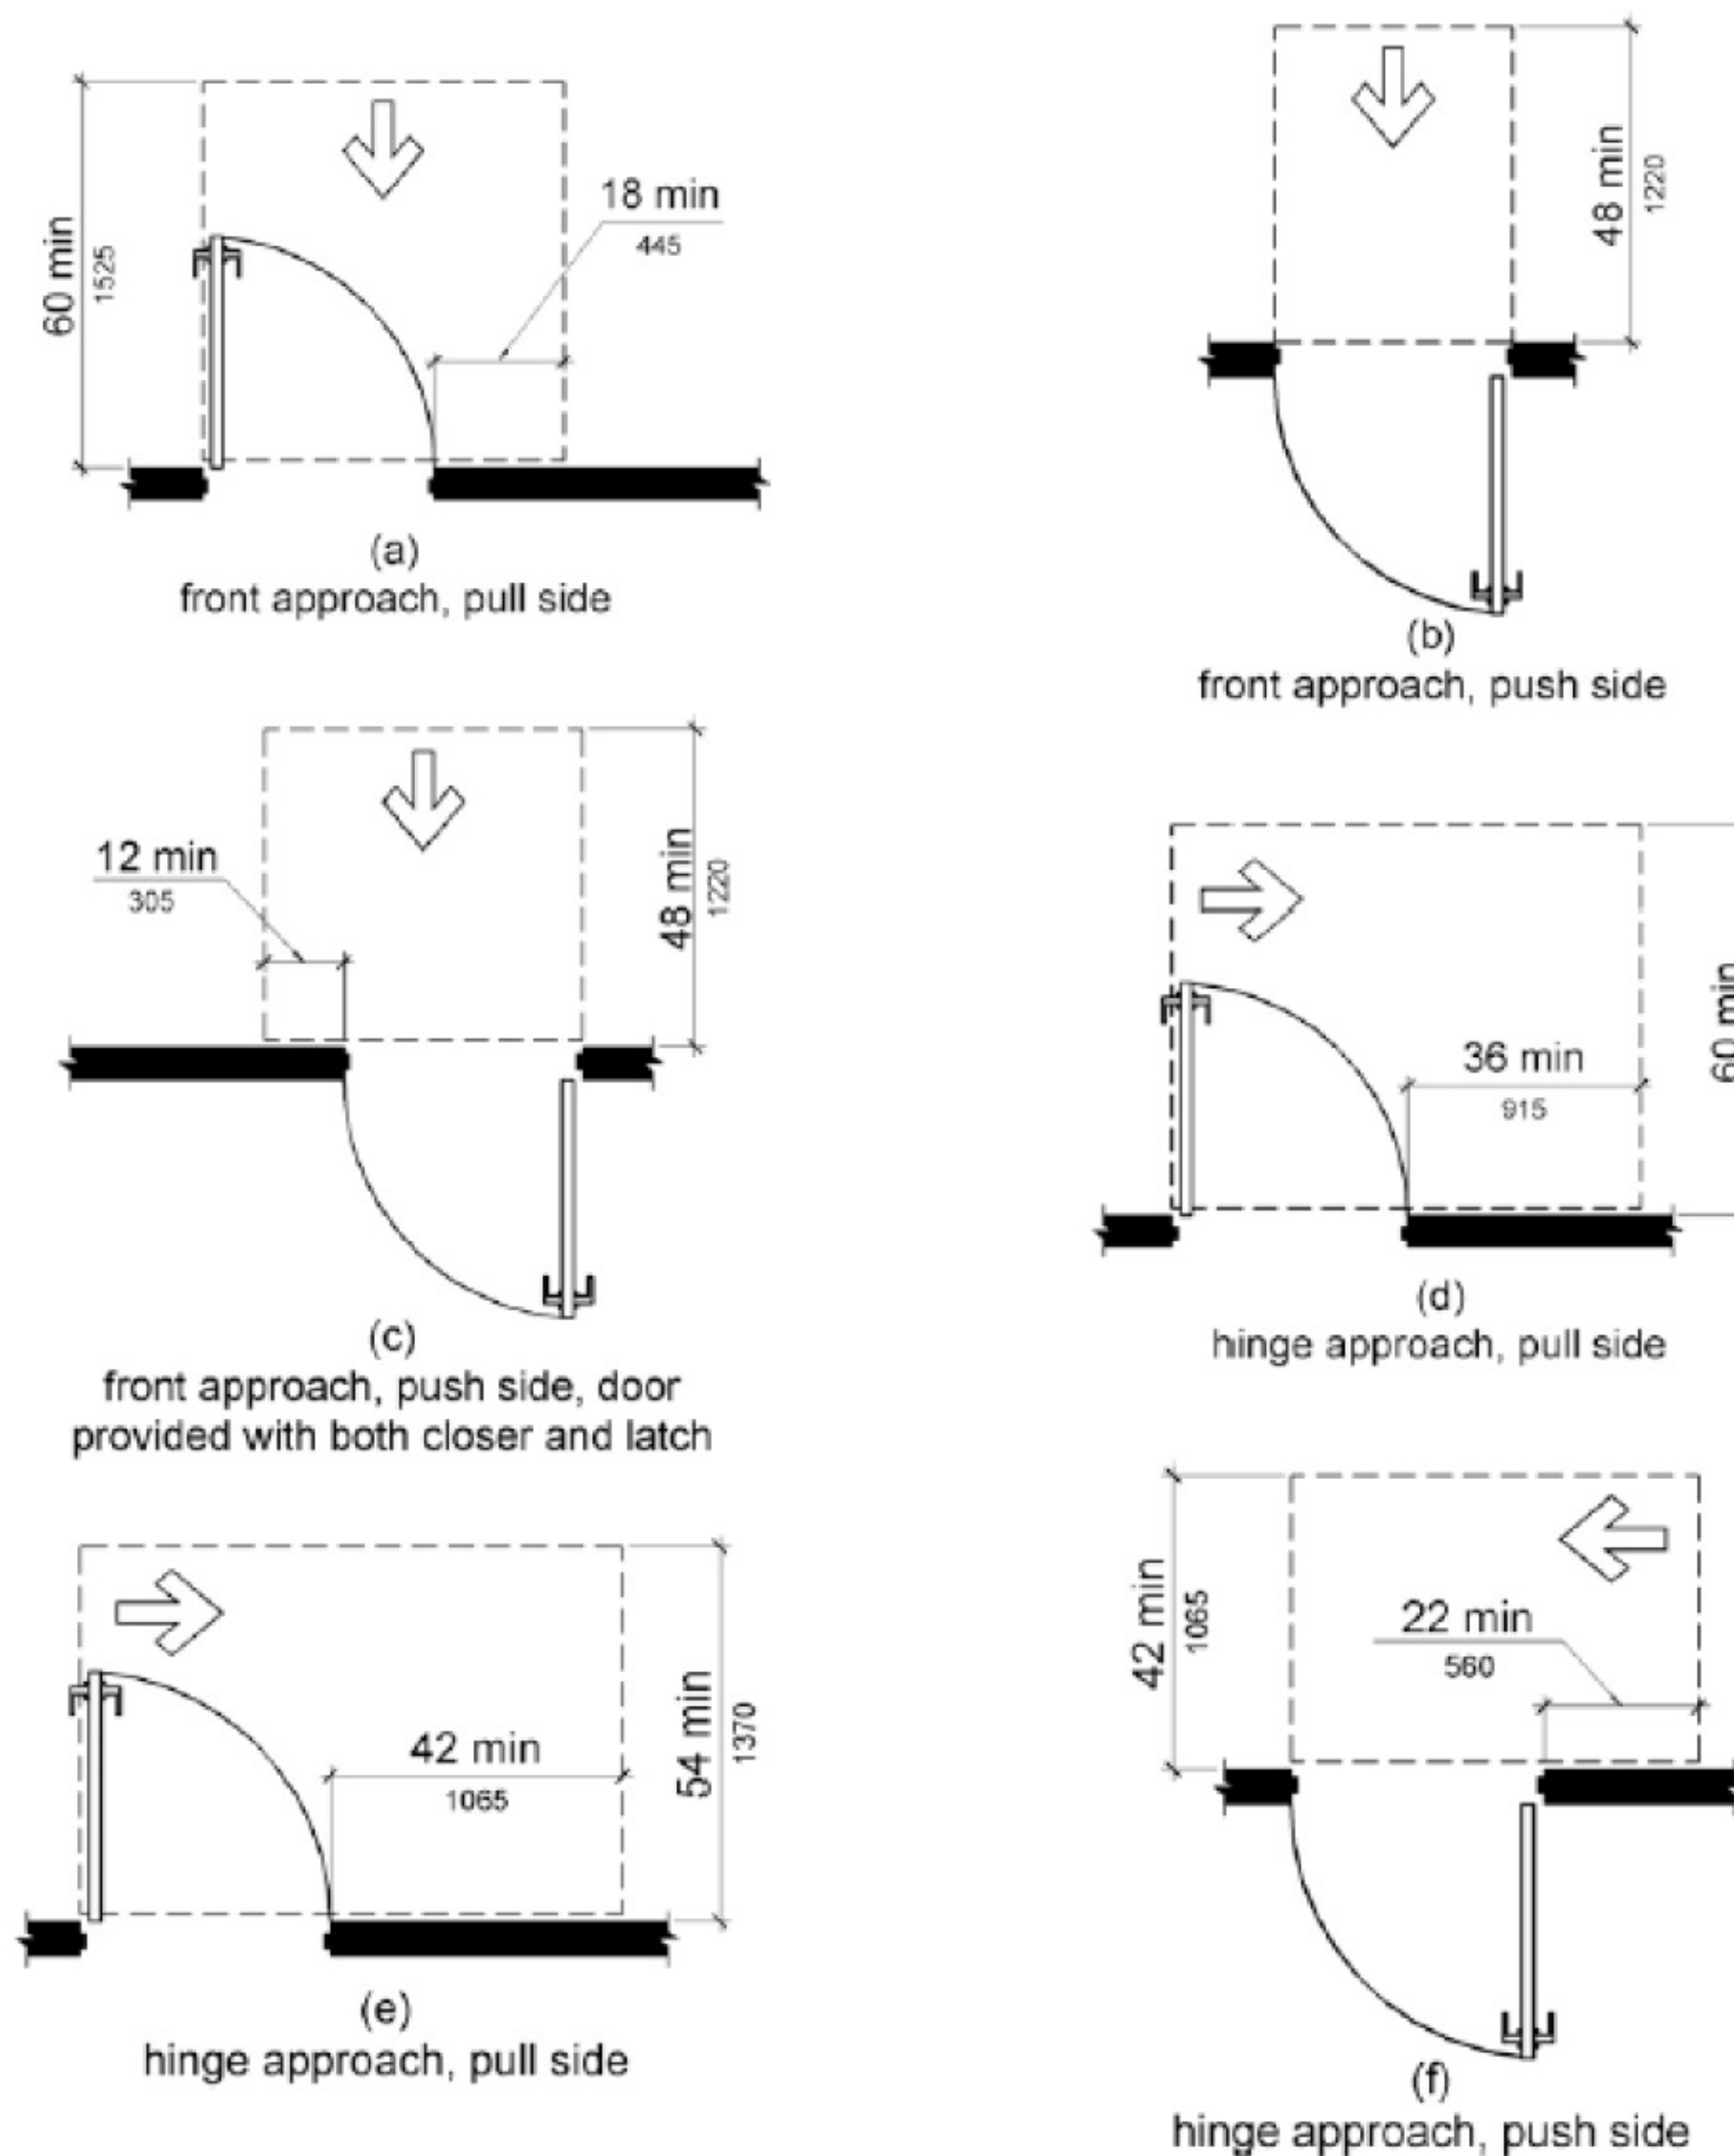


Figure 404.2.4.1 Maneuvering Clearances at Manual Swinging Doors and Gates

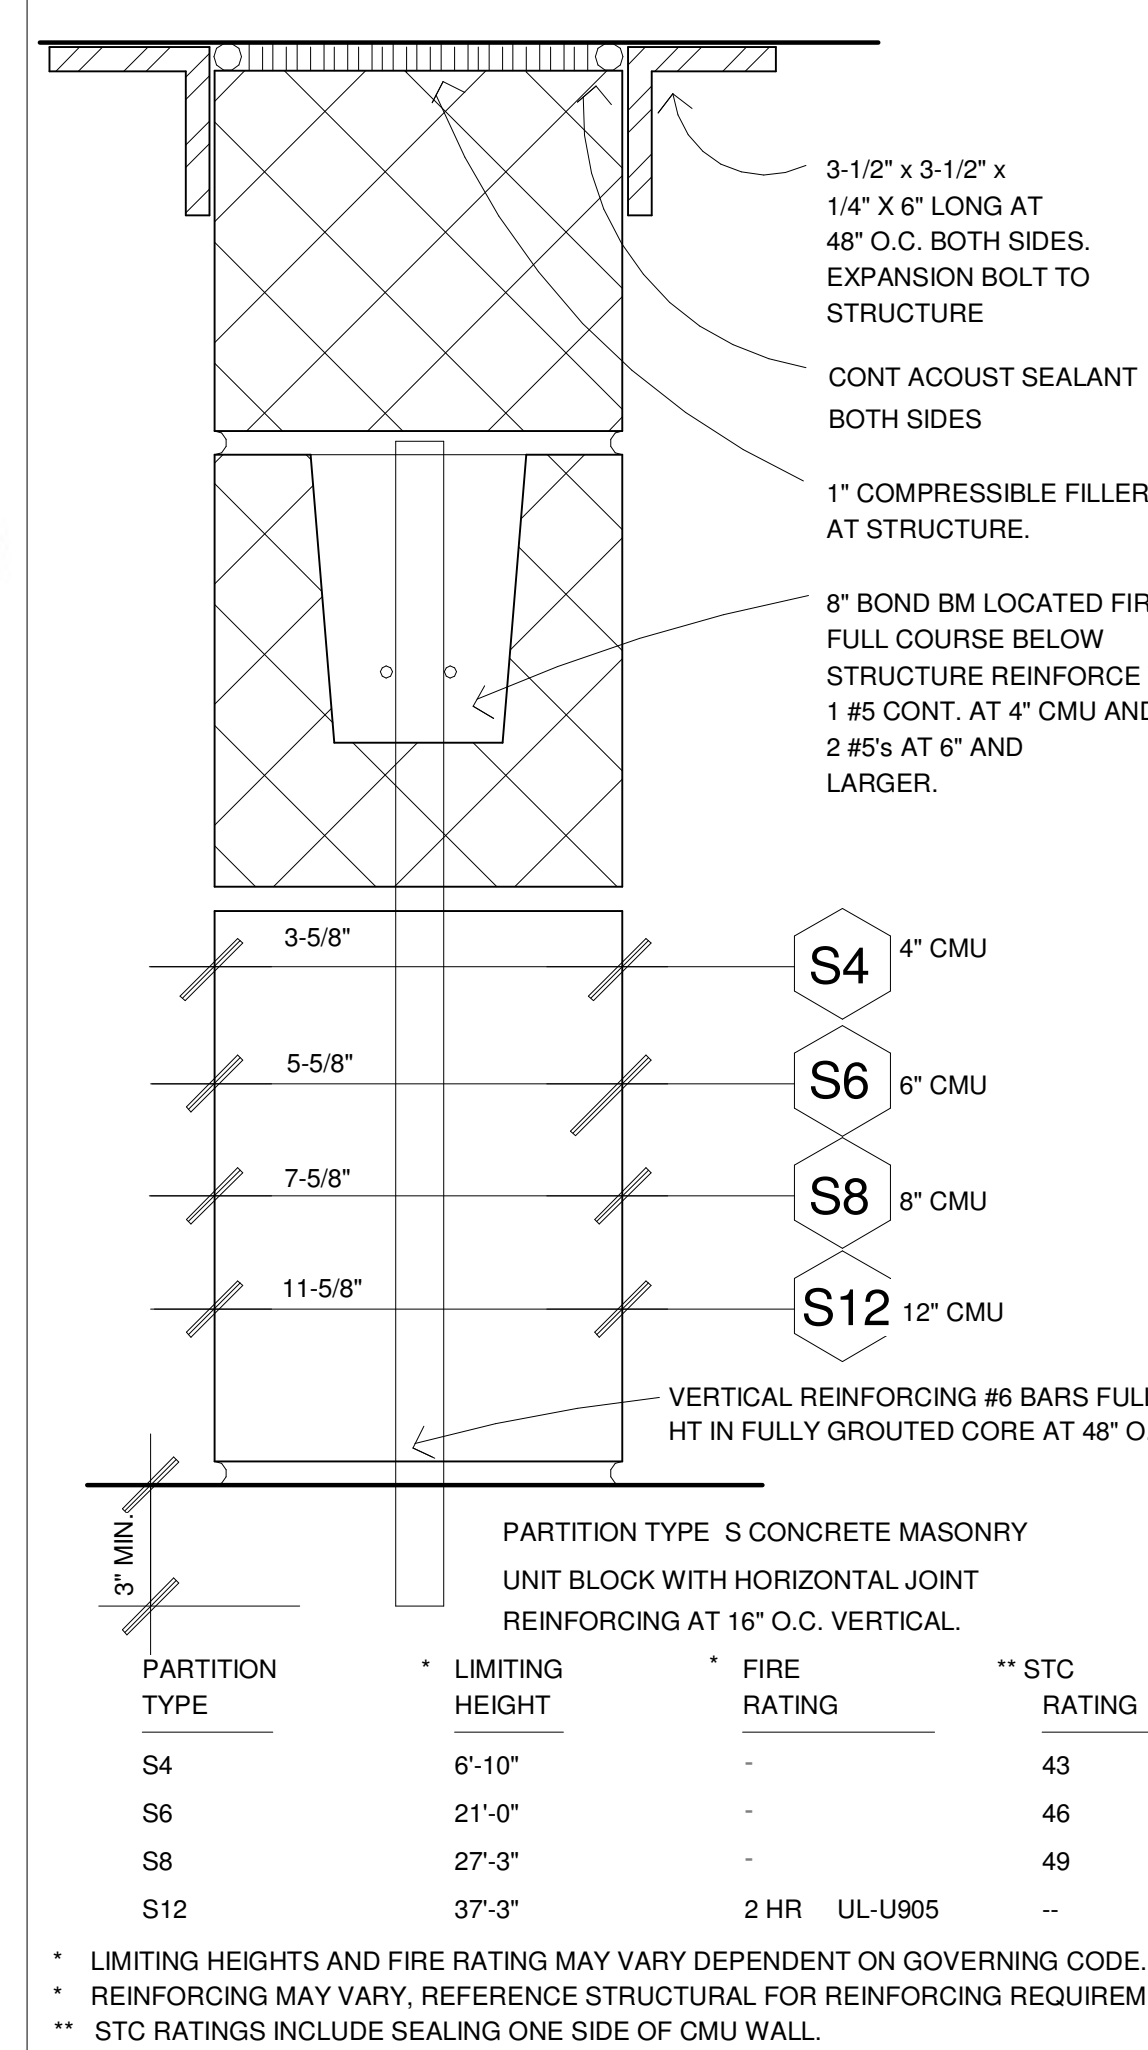

15 PARTITION TYPE S

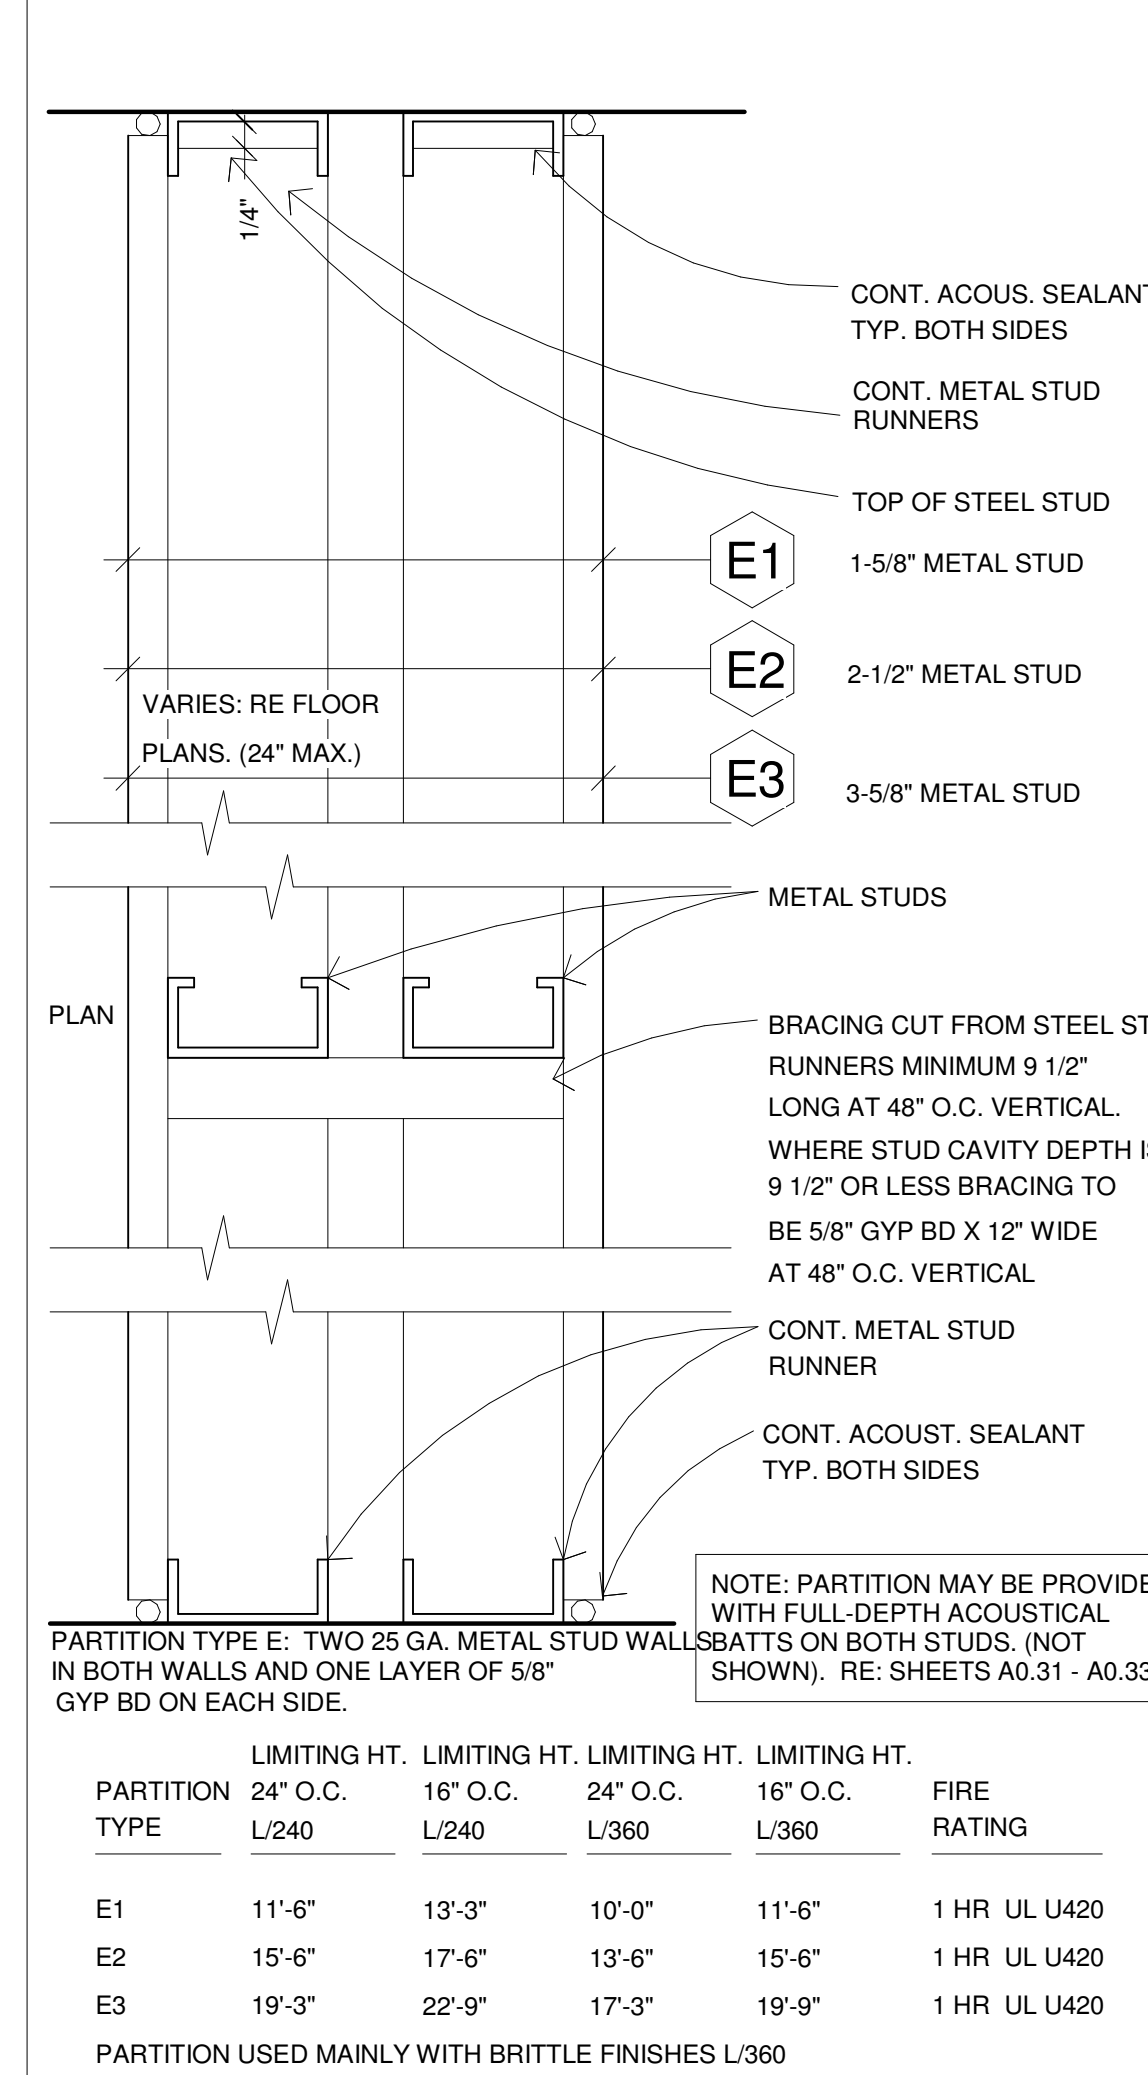



10 PARTITION TYPE D

PARTITION TYPE	LIMITING HT. 24" O.C.	LIMITING HT. 16" O.C.	FIRE RATING	STC RATING
C1	7'-3"	8'-3"	1 HR UL U419	-
C2	9'-9"	11'-0"	2 HR UL U411	STC 51
C3	12'-9"	14'-6"	2 HR UL U411	STC 56
C4	13'-9"	15'-9"	2 HR UL U411	STC 56+
C6	15'-0"	20'-0"	2 HR UL U411	STC 56+

14 PARTITION TYPE E

PARTITION TYPE	LIMITING HT. 24" O.C.	LIMITING HT. 16" O.C.	LIMITING HT. 24" O.C.	LIMITING HT. 16" O.C.	FIRE RATING
E1	11'-6"	13'-3"	10'-0"	11'-6"	1 HR UL U420
E2	15'-6"	17'-6"	13'-6"	15'-6"	1 HR UL U420
E3	19'-3"	22'-9"	17'-3"	19'-9"	1 HR UL U420

09 PARTITION TYPE C

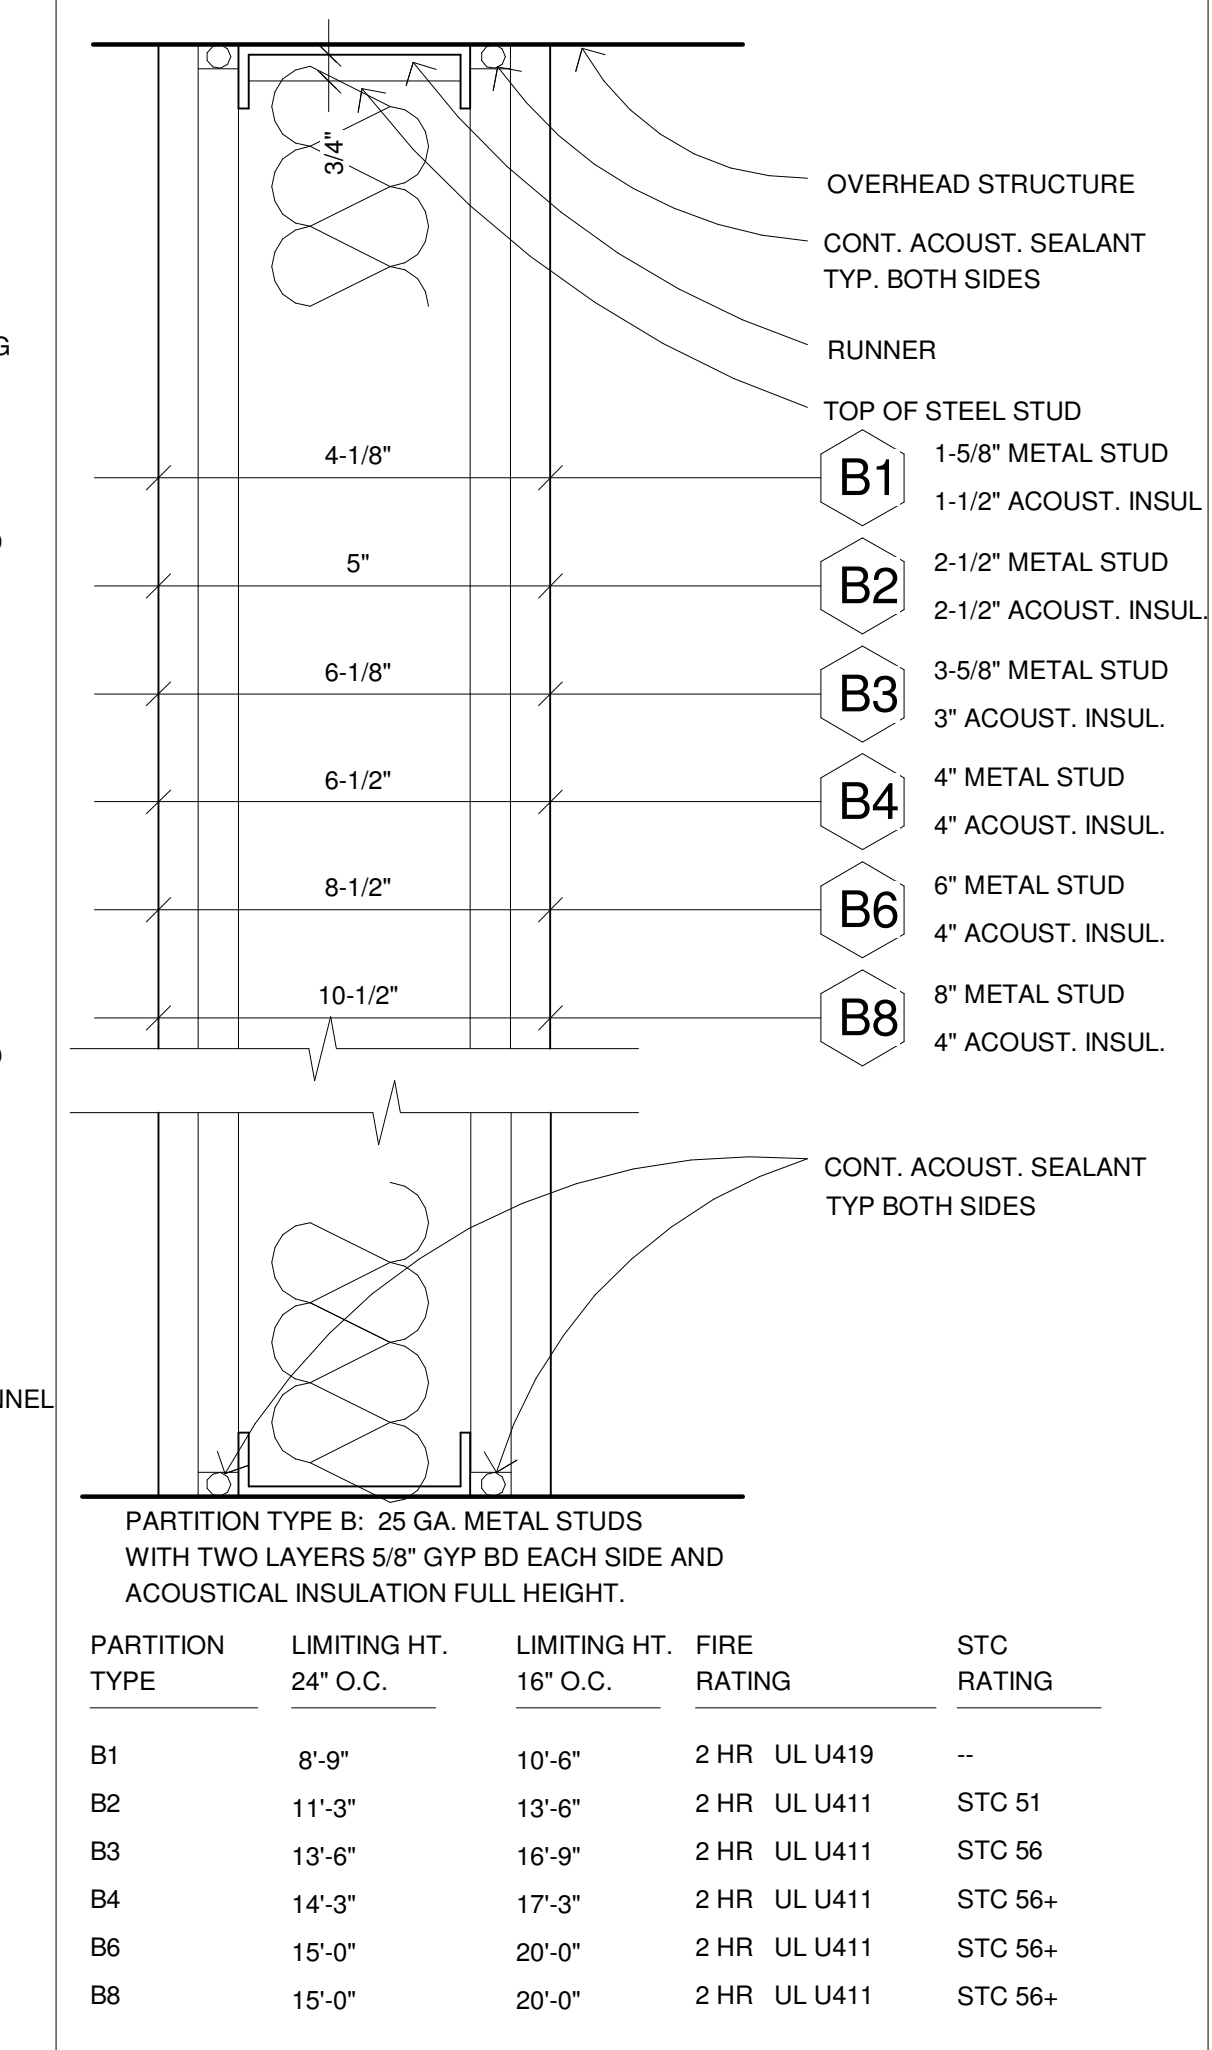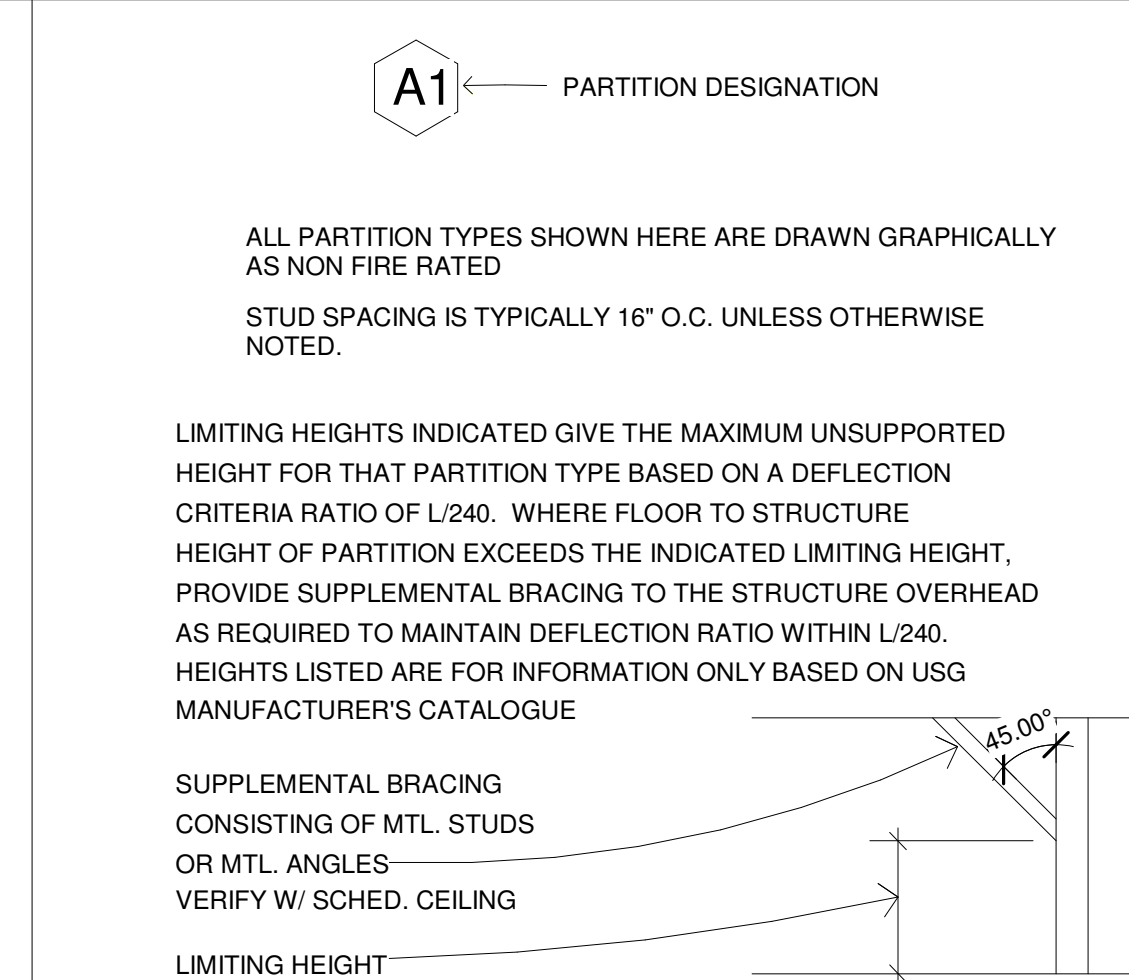

05 PARTITION TYPE B

PARTITION TYPE	LIMITING HT. 24" O.C.	LIMITING HT. 16" O.C.	FIRE RATING	STC RATING	W/SOUND BATT INSULATION **
A1	8'-3"	9'-6"	-	38	38
A2	10'-9"	12'-6"	1 HR UL U419	38+	47
A3	13'-6"	16'-0"	1 HR UL U465	40	48+
A4	14'-3"	17'-3"	1 HR UL U465	40+	48+
A6	15'-0"	20'-0"	1 HR UL U465	40+	48+

04 PARTITION TYPE A

FOR PARTITIONS WITH "BRITTLE" FINISHES SUCH AS PLASTER AND CERAMIC TILE, DESIGN PARTITION SYSTEM TO MAINTAIN DEFLECTION RATIO WITHIN L360. SUSPENDED CEILINGS SHALL NOT BE CONSIDERED AS BRACING.

WHERE GYPSUM WALLBOARD IS THE SUBSTRATE FOR APPLICATION OF CERAMIC TILE, PROVIDE "WATER-RESISTANT" BOARD, WHERE FIRE RESISTIVE CONSTRUCTION IS INDICATED, PROVIDE FIRE RESISTIVE W/R BOARD.

STC RATINGS SHOWN FOR SOUND WALLS ARE BASED ON LABORATORY TESTED ASSEMBLIES AND DO NOT NECESSARILY INDICATE THE ACTUAL STC RATING OF THE COMPLETED WORK. PROVIDE MTL DECK FILLERS WHERE FULL HEIGHT PARTITIONS ARE PERPENDICULAR TO SPAN OF DECK. DECK FILLERS ARE TO BE COMPATIBLE WITH ALL FIRE RATED ASSEMBLIES AND ARE TO BE APPROVED BY ALL GOVERNING AGENCIES.

REFER TO FINISH SCHEDULE AND INTERIOR ELEVATIONS FOR APPLIED FINISHES TO PARTITIONS


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PROFESSIONAL SEAL:

A PROJECT FOR:
STAFFORD HIGH SCHOOL & MAGNET SCHOOL RENOVATIONS
 1625 STAFFORDSHIRE ROAD, STAFFORD, TX 77477

#	Date	ISSUED FOR
	03/13/2020	ISSUE FOR BID, PERMIT, & CONSTRUCTION



KEY PLAN

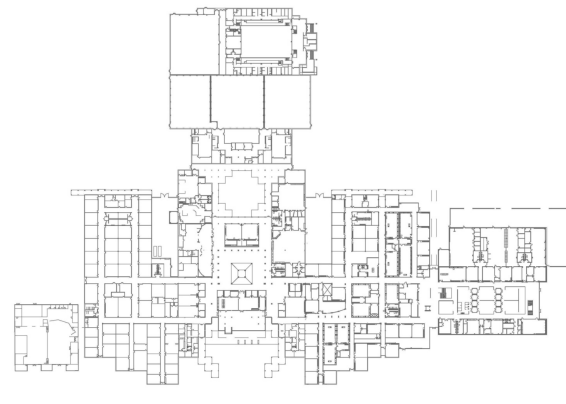Project Number	19006-A
Drawn By	LT
Checked By	AW
Approved By	MS

Drawing Title
PARTITION TYPES & ACCESSIBILITY REQUIREMENTS

Drawing Number
A0.30



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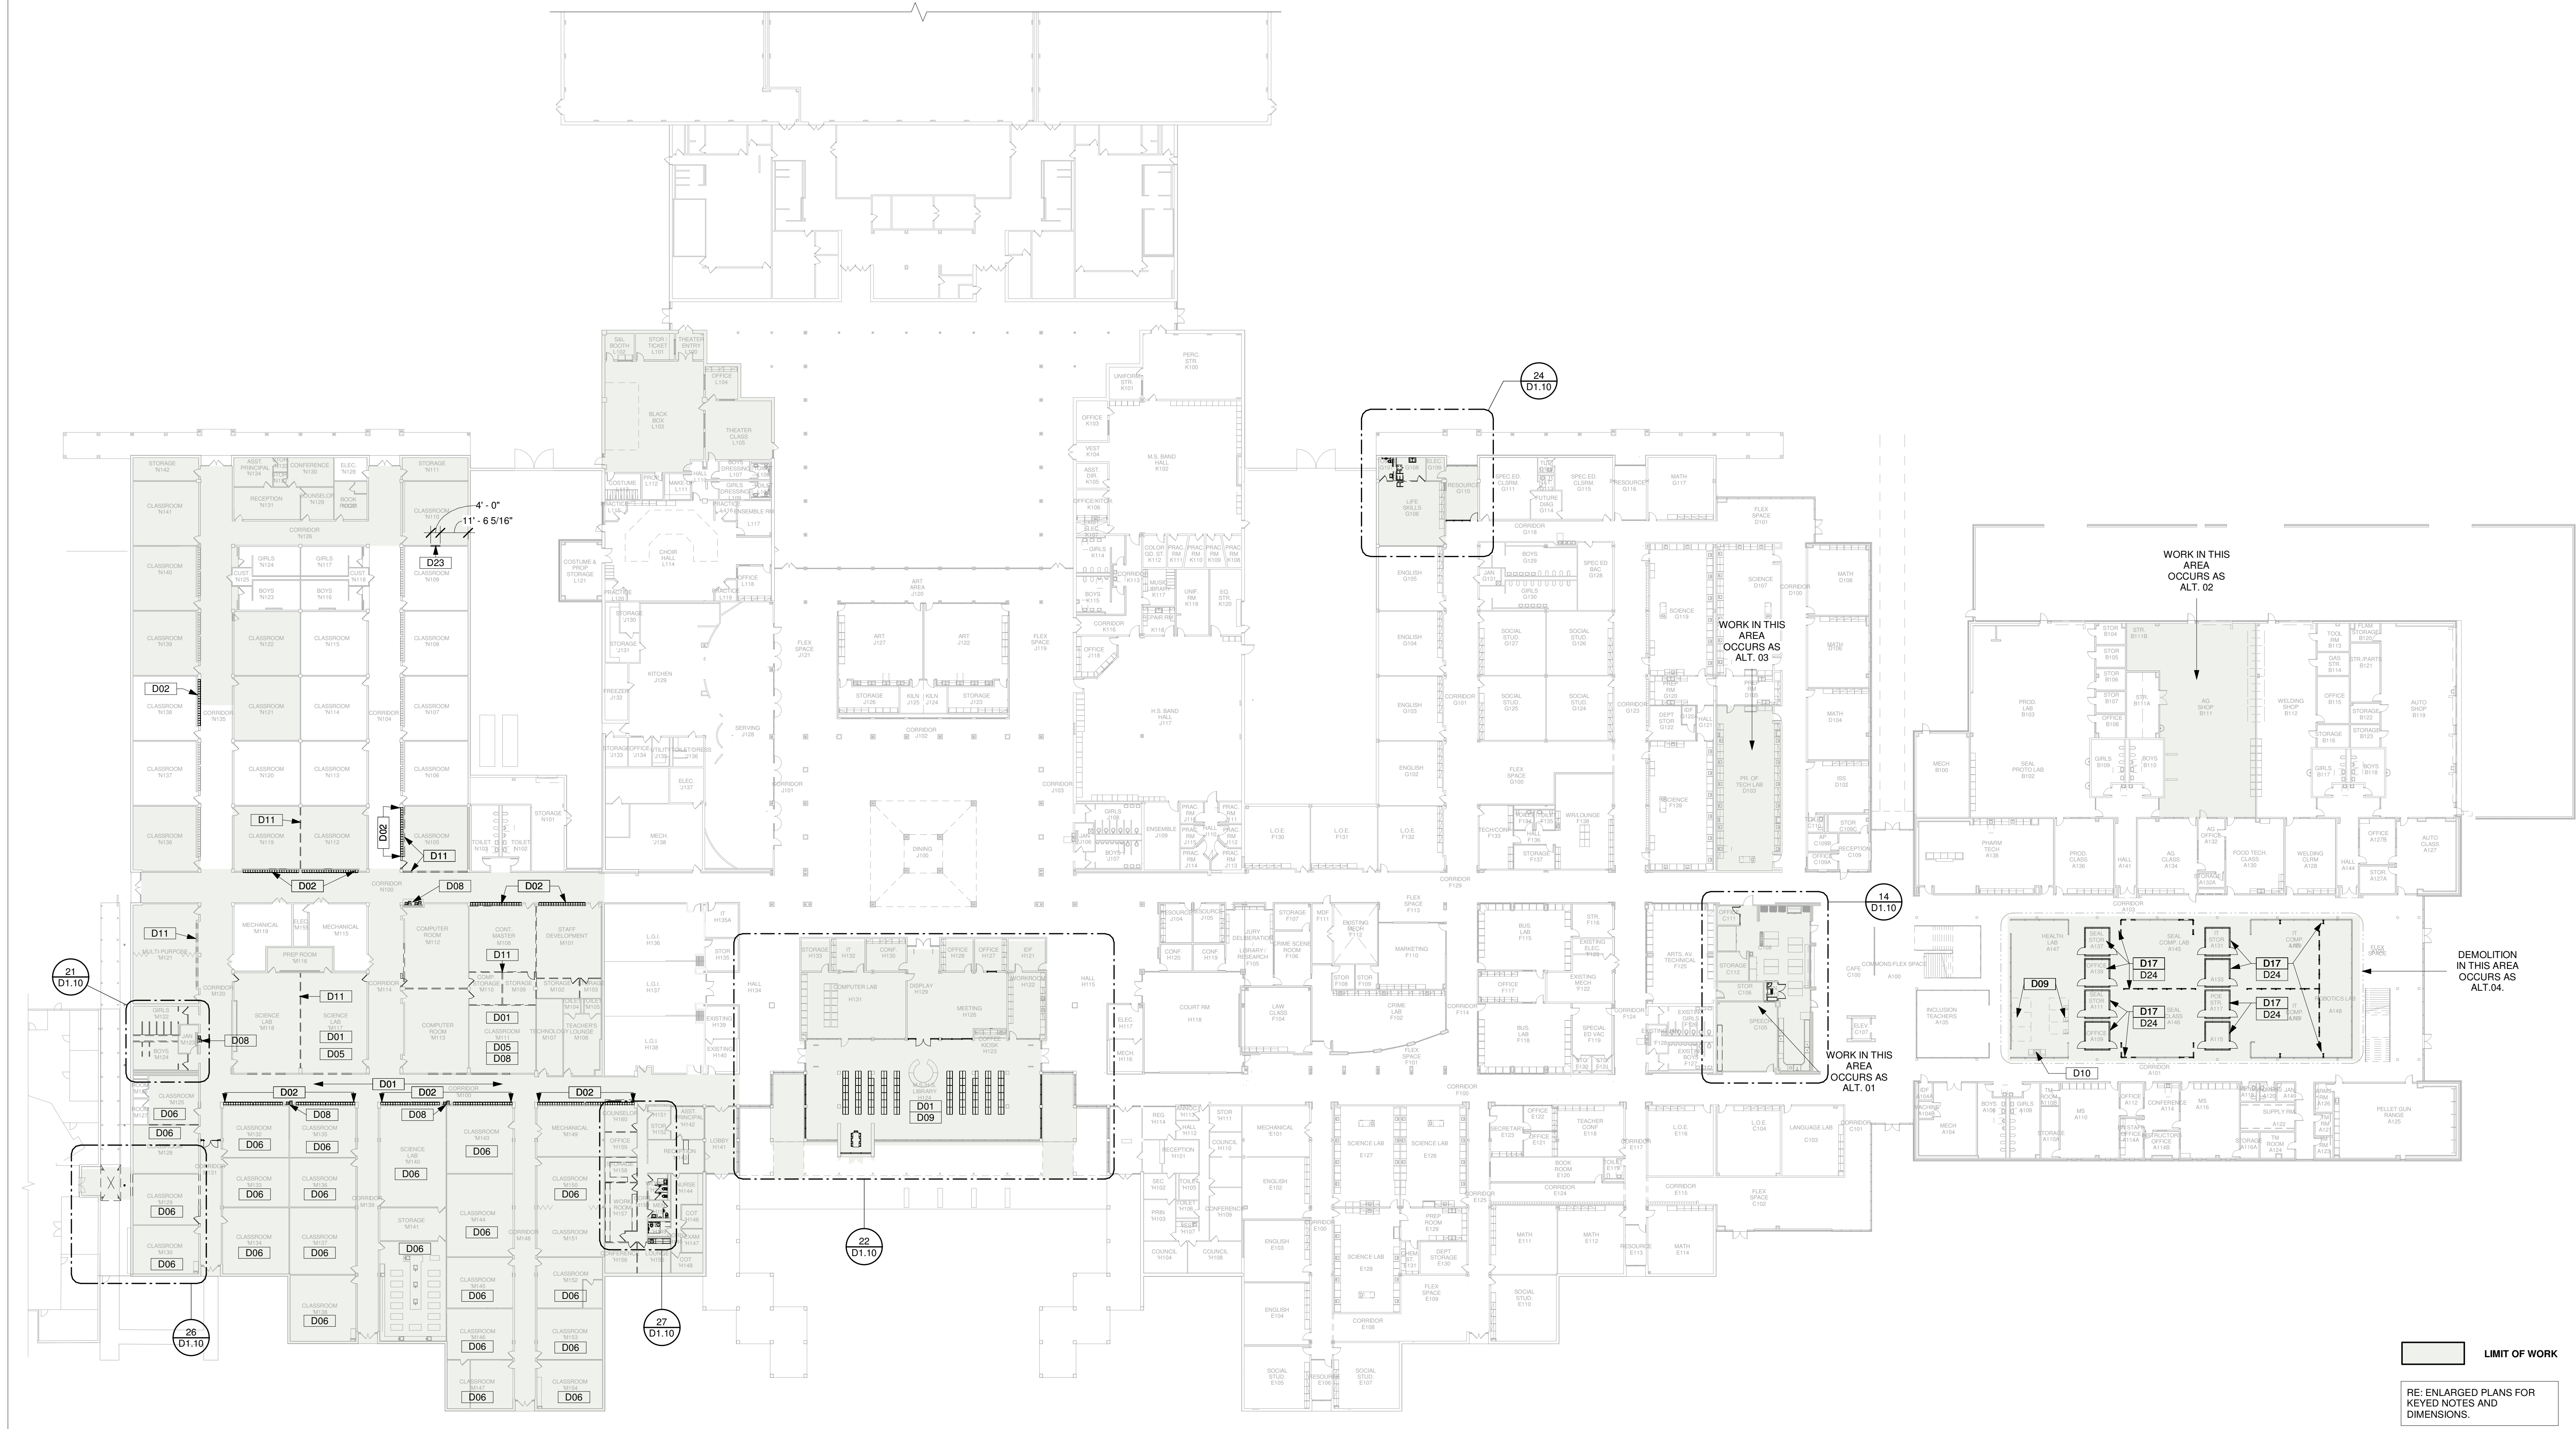
PROFESSIONAL SEAL:



STAFFORD HIGH SCHOOL & MAGNET SCHOOL RENOVATIONS


1625 STAFFORDSHIRE ROAD, STAFFORD, TX 77477

#	Date	ISSUED FOR
	03/13/2020	ISSUE FOR BID, PERMIT, & CONSTRUCTION



27 OVERALL DEMOLITION PLAN

Scale: 1" = 30'-0"

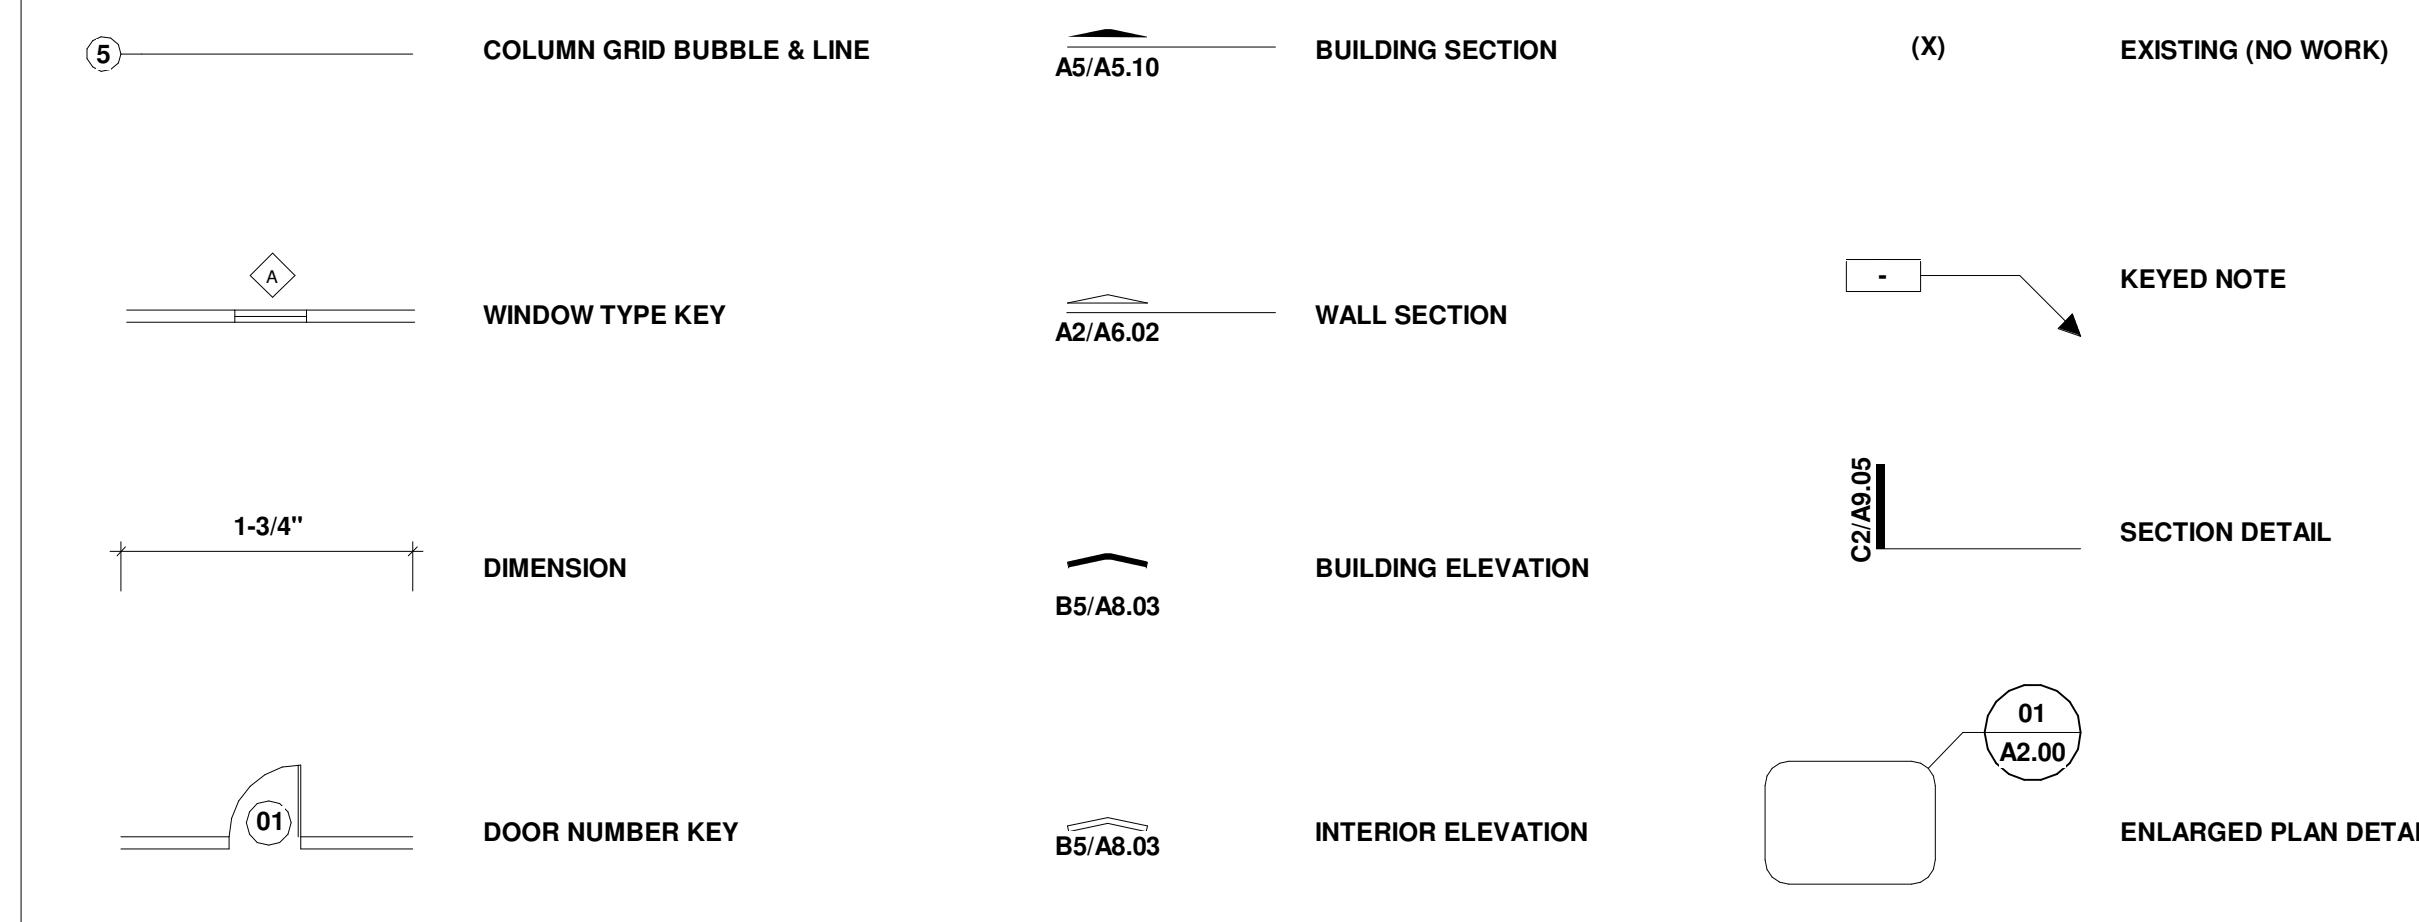

26 LEGEND

Scale: NTS

Dimension & Alignment Support Notes:
ALIGN 1: Align face of new construction w/face of existing.
ALIGN 2: Align centerline of new construction w/centerline of existing.
ALIGN 3: Align gridline/line grid w/centerline of existing.
LEVEL 1: Ensure top of new construction is level w/existing surface.
LEVEL 2: Level floor & surface to receive new construction.
LEVEL 3: Ensure the top of grade is level w/surrounding ground.

Construction & Condition Support Notes:
HANDLE 1: Handle item w/care, and store for owner review.
HANDLE 2: Handle remaining building, pavement, fence, or item w/care.
HANDLE 3: Handle re-located items with care. DISCONNECT 1, FIXW.
FIX: Fix floor/wall/ceiling item where construction was removed and prepare the area to receive new construction. Ensure the top of grade is level w/surrounding ground & maintain positive slope towards drain, gutter, and storm system away from building.
FIXW: Fix floor/wall/ceiling item where construction was removed and prepare the area to an acceptable condition. Ensure the top of grade is level w/surrounding ground & maintain positive slope towards drain, gutter, and storm system away from building.
PROTECT: Protect remaining items to be retained, and ensure structural integrity while meeting local codes. Handle remaining buildings, pavement, fences, and other items w/care during the Demolition and Construction phases.
DISCONNECT: Disconnect and conceal all pipes, electrical cables, data cables, and conduits where construction is removed.
ENGINEER 1: Professional engineering supervision is required for this work.
SHOP: Provide shop drawings for this work.
REFERENCE: Refer to plans # for the existing condition at this location.
SLOPE 1: Maintain positive slope towards drains, gutters, and storm systems and away from the building.
PROTECT 1: Protect items to remain, including any buildings, furniture, sidewalks, roofs, utilities, and other items during the Demolition and Construction phases.
EGRESS: Maintain safe and unrestricted egress routes from areas adjacent to the Demolition site. Comply with all Applicable Codes.
TREE: Refer to Landscape Drawings & Specs for removing trees.
UTILITIES: Ensure all routes and utilities required for school operation are protected. Ensure school operation will not be interrupted.
UNSURE: Ensure all slopes to drain as intended, and that downspouts indicated to remain are protected to maintain normal flow at all times during demolition and construction. Protect items to remain including any buildings, furniture, sidewalks, roofs, utilities, and other items during demolition and construction. Ensure system is safe/right. Provide additional flashing & sealants as needed.
ENSURE: Ensure the slope of the new roof matches the slope and slope direction of the existing roof.
PHASE 1: Work within this area may occur in phase ONE.
PHASE 2: Work within this area may occur in phase TWO.

11 SUPPORT NOTES

Scale: NTS

- D001 REMOVE CEILING TILE, LIGHT FIXTURES FROM THIS SPACE. PREPARE AREA TO RECEIVE NEW CONSTRUCTION. ADJUST CEILING EQUIPMENT AND PLENUM. RE: NEW CONSTRUCTION PLAN & SPECS. (FIXW; HANDLE 2)
- D002 REMOVE METAL LOCKERS & FIX WALLS/FLOOR/CEILING TO RECEIVE NEW CONSTRUCTION PLAN & SPECS (FIXW; HANDLE 1).
- D005 REMOVE EXISTING FLOORING AND PREPARE THE AREA TO RECEIVE THE NEW CONSTRUCTION PLAN & SPECS (FIXW; HANDLE 2)
- D006 REMOVE EXISTING CEILING PROJECTOR, POWER / DATA / AV CABLING TO BE RE-ROUTED AND RE-TERMINATED AT NEW WALL-MOUNTED SMART-PROJECTOR LOCATION. RE: NEW CONSTRUCTION PLAN, MEP DRAWINGS, AND SPECS. (FIXW; HANDLE 2)
- D008 REMOVE PLUMBING FIXTURES/PREPARE AREA TO RECEIVE NEW CONSTRUCTION. (FIXW; HANDLE 2, DISCONNECT 1)
- D009 REMOVE ALL FURNITURE, FURNITURE SYSTEMS, SHELVES & MILLWORK IN THIS AREA, REPAIR WALL AS NEEDED. (HANDLE 1; FIXW)
- D010 REMOVE EXISTING MILLWORK AS INDICATED. (FIXW; PROTECT 1)
- D011 REMOVE INTERIOR PARTITIONS AND DOORS AS INDICATED AT THIS LOCATION TO ALLOW FOR NEW CONSTRUCTION. RE: NEW CONSTRUCTION PLANS & SPECS. (FIXW; PROTECT 1)
- D012 REMOVE PORTIONS OF EXISTING STOREFRONT AS INDICATED IN NEW CONSTRUCTION DETAILS AND PREPARE AREA TO RECEIVE NEW CONSTRUCTION. CONTRACTOR IS RESPONSIBLE FOR SEQUENCING THE WORK OF THIS ITEM TO KEEP THE BUILDING WEATHERTIGHT UNTIL THE COMPLETION OF THIS TASK.
- D017 REMOVE EXISTING MOVABLE PARTITIONS AS INDICATED. RE: CONSTRUCTION PLANS FOR MOVABLE PARTITION SECTIONS TO BE REINSTALLED. (HANDLE 1; FIXW)
- D023 REMOVE INDICATED PORTION OF WALL CREATING AN OPENING BETWEEN THE TWO ROOMS, HEIGHT SIMILAR TO DOORS @ SAME ROOM (HANDLE 2; FIXW; PROTECT 1)
- D024 CAP ELECTRICAL CONNECTIONS BELOW RAISED FLOOR. REPLACE FLOORING AND REPAIR / REPLACE CARPET. (FIXW)


06 KEYNOTES

Scale: NTS

1. HANDLE THE BUILDING WITH CARE. NO WORK SHOULD HAVE ANY AFFECT ON THE STRUCTURAL INTEGRITY OF THE BUILDING OR DISTURB ANY SYSTEM THAT SHOULD REMAIN OR REQUIRED FOR OPERATION. REPORT TO THE ARCHITECT ANY INDICATION OF DAMAGE OR POSSIBLE DISRUPTION OF OPERATION.
2. DURING DEMOLITION PROTECT ITEMS TO REMAIN INCLUDING STRUCTURE SYSTEM, ARCHITECTURE, MEP/IT SYS, FURNITURE, FIRE ALARM, SECURITY DEVICES, ROOF, SIDEWALKS, UTILITIES, ETC.
3. ENSURE THERE IS NO INTERRUPTION TO SCHOOL OPERATIONS DURING THE DEMOLITION PHASE.
4. ALL ALARM & SECURITY DEVICES TO REMAIN IN OPERATION DURING DEMOLITION.
5. ALL UTILITIES & POWER TO REMAIN DURING DEMOLITION PHASE.
6. ALL SECURITY CAMERAS, ALARM DEVICES, HVAC THERMOSTATS, OR LIGHT SWITCHES THAT CONFLICT WITH NEW CONSTRUCTION TO BE RELOCATED AND/OR ADJUSTED TO REMAIN FULLY FUNCTIONAL AS INTENDED. REFER TO ARCHITECT FOR DIRECTION.
7. MAINTAIN SAFE & UNRESTRICTED EGRESS ROUTE FOR THE DURATION OF THE DEMOLITION. COMPLY WITH ALL APPLICABLE CODES.
8. REPORT TO ARCHITECT ANY UN-SEEN DISCOVERED CONDITIONS THAT MAY HAVE STRUCTURAL, MEP, OR ARCHITECTURAL COMPLICATIONS AFFECTING THE PROJECT SCHEDULE/CONSTRUCTION COST/OPERATION.
9. REMOVE ABUNDANT CABLE, SYSTEMS, LIGHT FIXTURE, (FIXW)
10. SAW-CUT & REMOVE EXISTING SIDEWALK/PAVEMENT AS INDICATED TO ALLOW FOR NEW CONSTRUCTION. RE: NEW CONSTRUCTION PLAN, (SITE 1; HANDLE 2; PROTECT 1; OPERATE).

01 GENERAL NOTES - DEMOLITION

Scale: NTS


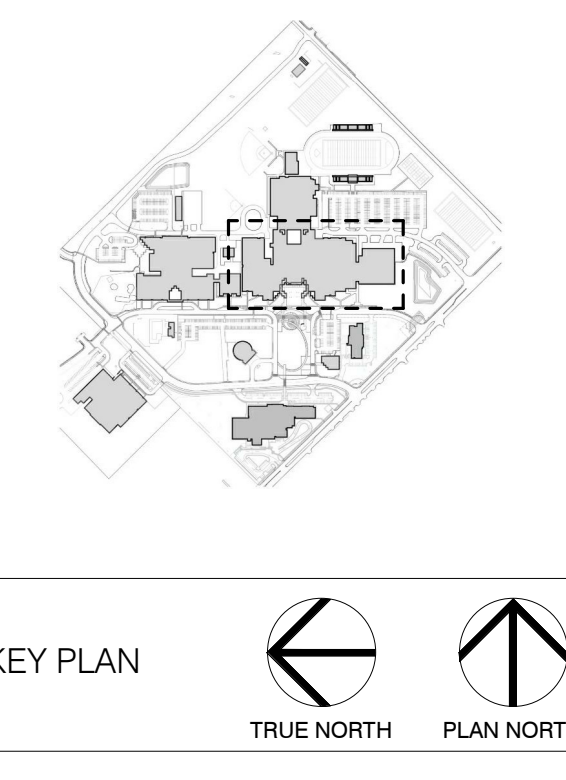


KEY PLAN
TRUE NORTH
PLAN NORTH

Project Number	19006-A
Drawn By	LT
Checked By	AW
Approved By	MS
Drawing Title	OVERALL DEMOLITION PLAN

Drawing Number **D1.00**

#	Date	ISSUE FOR
03/13/2020	03/13/2020	ISSUE FOR BID, PERMIT, & CONSTRUCTION

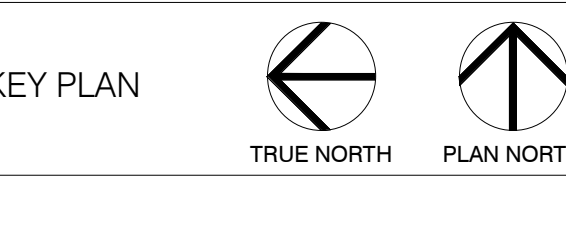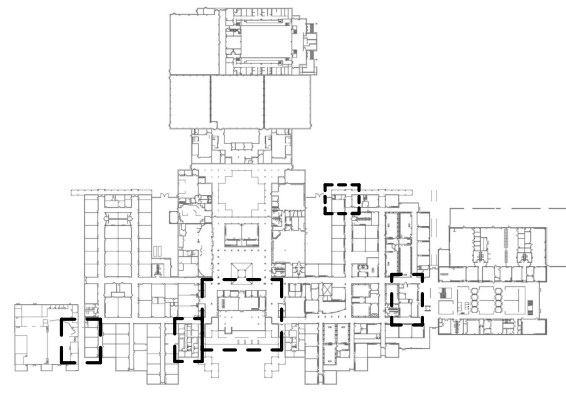

Project Number	19006-A
Drawn By	LT
Checked By	AW
Approved By	MS
Drawing Title	ENLARGED DEMOLITION PLANS

Drawing Number	D1.10
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Dimension & Alignment Support Notes:
ALIGN 1: Align face of new construction w/face of existing.
ALIGN 2: Align centerline of new construction w/centerline of existing.
ALIGN 3: Align grid/section grid w/existing grid.
LEVEL 1: Ensure top of new construction is level w/existing surface.
LEVEL 2: Level floor & surface to receive new construction.
LEVEL 3: Ensure the top of grade is level w/ground.
Construction & Condition Support Notes:
HANDLE 1: Handle item with care, and store for owner review.
HANDLE 2: Handle remaining building, pavement, fence, or item with care.
HANDLE 3: Handle re-located items with care. DISCONNECT 1, FIXW.
FIXW: Fix floor/walling/items where construction was removed and prepare the area to receive new construction. Ensure the top of grade is level w/ground & maintain positive slope towards drain, gutter, and storm system away from building.
FIXW 2: Fix floor/walling/items where construction was removed and prepare the area to receive new construction. Ensure the top of grade is level w/ground & maintain positive slope towards drain, gutter, and storm system away from building.
FIXW 3: Fix floor/walling/items where construction was removed and prepare the area to receive new construction. Ensure the top of grade is level w/ground & maintain positive slope towards drain, gutter, and storm system away from building.
PROTECT 1: Prepare the site where construction was removed, and prepare the ground to an acceptable condition. Inform Architect prior to the start of this work.
CONNECT 1: Connect new construction to existing, ensure continuity and structural integrity. Ensure the top of new construction is level w/ground.
CONNECT 2: Connect remaining item to the new structure, and ensure structural integrity while meeting local codes. Handle remaining buildings, pavement, fences, and other items with care.
DISCONNECT 1: Disconnect and conceal all pipes, electrical cables, data cables, and consult where construction is removed.
ENGINEER 1: Professional engineering supervision is required for this work.
SHOP 1: Provide shop drawings for this work.
REFERENCE: Refer to photos if the existing condition at this location.
SLOPE 1: Maintain positive slope towards drains, gutters, and storm systems and away from the building during the Demolition and Construction phases.
PROTECT 1: Protect items to remain, including any buildings, furniture, sidewalks, roofs, utilities, and other items during the Demolition and Construction phases.
EGRESS: Maintain safe and unobstructed egress routes from areas adjacent to the Demolition site. Comply with all Applicable Codes.
TREES: Refer to Landscape Drawings & Specs for removing trees.
OPERATE: Ensure all routes and utilities required for school operation are protected. Ensure school operation will not be interrupted.
ENSURE: Ensure all slopes to drain as intended, and that downspouts indicated to remain are protected to maintain normal flow at all times during demolition and construction. Protect items to remain including any buildings, furniture, sidewalks, roofs, utilities, and other items during demolition and construction. Ensure system is water tight. Provide additional lighting & signage as needed.
INSURE: Ensure the slope of the new roof matches the slope and slope direction of the existing roof.
WORK: Work within this area may occur in phase ONE.
PHASE 2: Work within this area may occur in phase TWO.

05 SUPPORT NOTES
 Scale: NTS


- D01 REMOVE CEILING TILE, LIGHT FIXTURES FROM THIS SPACE. PREPARE AREA TO RECEIVE NEW CONSTRUCTION. ADJUST CEILING EQUIPMENT AND PLENUM. RE: NEW CONSTRUCTION PLAN & SPECS. (FIXW, HANDLE 2).
- D03 REMOVE PLASTER CEILING & LIGHT FIXTURES AT THIS AREA. PREPARE AREA TO RECEIVE NEW CONSTRUCTION. RE: NEW CONSTRUCTION PLANS & SPECS. (FIXW, HANDLE 1, DISCONNECT 1).
- D04 REMOVE MILLWORK & KITCHEN FIXTURES AS INDICATED IN THIS ROOM. (HANDLE 1, HANDLE 2, DISCONNECT 1).
- D05 REMOVE EXISTING FLOORING AND PREPARE THE AREA TO RECEIVE THE NEW CONSTRUCTION. RE: CONSTRUCTION PLAN & SPECS. (FIXW, HANDLE 2).
- D06 REMOVE EXISTING CEILING PROJECTOR, POWER / DATA / AV CABLING TO BE RE-ROUTED AND RE-TERMINATED AT NEW WALL-MOUNTED SMART-PROJECTOR LOCATION. RE: NEW CONSTRUCTION PLAN, MEP DRAWINGS, AND SPECS. (FIXW, HANDLE 2).
- D07 SAW-CUT & REMOVE EXISTING BRICK VENEER & CONSTRUCTION TO ALLOW FOR NEW CONSTRUCTION. RE: 25/A2.20 (HANDLE 2, FIXW).
- D08 REMOVE PLUMBING FIXTURES PREPARE AREA TO RECEIVE NEW CONSTRUCTION. (FIXW, HANDLE 2, DISCONNECT 1).
- D09 REMOVE ALL FURNITURE, FURNITURE SYSTEMS, SHELVES & MILLWORK IN THIS AREA, REPAIR WALL AS NEEDED. (HANDLE 1, FIXW).
- D11 REMOVE INTERIOR PARTITIONS AND DOORS AS INDICATED AT THIS LOCATION TO ALLOW FOR NEW CONSTRUCTION. RE: NEW CONSTRUCTION PLANS & SPECS. (FIXW, PROTECT 1).
- D12 REMOVE PORTIONS OF EXISTING STOREFRONT AS INDICATED IN NEW CONSTRUCTION DETAILS AND PREPARE AREA TO RECEIVE NEW CONSTRUCTION. CONTRACTOR IS RESPONSIBLE FOR SEQUENCING THE WORK OF THIS ITEM TO KEEP THE BUILDING WEATHERTIGHT UNTIL THE COMPLETION OF THIS TASK.
- D13 REMOVE EXISTING TOILET PARTITIONS AND ACCESSORIES. (HANDLE 2, FIXW).
- D14 REMOVE PORTION OF EXISTING CANOPY. (HANDLE 1, FIXW).
- D15 REMOVE AND RELOCATE EQUIPMENT AS INDICATED. (HANDLE 1, FIXW).
- D16 SAW CUT AND REMOVE EXISTING SIDEWALK AT THIS AREA. PREPARE AREA TO RECEIVE NEW CONSTRUCTION (PROTECT 1, ENGINEER 1).
- D18 REMOVE EXISTING WINDOW AND PREPARE AREA TO RECEIVE NEW CONSTRUCTION. (HANDLE 1, FIXW).
- D19 REMOVE AND RELOCATE PROJECTOR AND PROJECTOR SCREEN AS INDICATED IN THE NEW RCP (DISCONNECT, CONNECT 1, FIXW, HANDLE 3).
- D20 REMOVE EXISTING WALL FINISHES AND PREPARE AREA TO RECEIVE NEW CONSTRUCTION RE: CONSTRUCTION PLAN & SPECS. (EXW).
- D21 REMOVE EXISTING AREA DRAIN (DISCONNECT 1, FIXW).
- X01 EXISTING UTILITIES, (PROTECT 1)
- X02 EXISTING EQUIPMENT (PROTECT 1)
- X03 EXISTING SHUTOFFS / ELECTRICAL PANELS. FIELD VERIFY. RE: MEP DRAWINGS. (PROTECT 1)
- X04 EXISTING MILLWORK (PROTECT 1)
- X05 EXISTING FURNITURE TO BE REMOVED AND RELOCATED IN THIS SPACE AS INDICATED ON THE NEW CONSTRUCTION PLAN. (PROTECT 1)

(X) NO WORK IN THIS AREA


02 DEMOLITION KEYNOTES
 Scale: NTS

1. HANDLE THE BUILDING WITH CARE. NO WORK SHOULD HAVE ANY AFFECT ON THE STRUCTURAL INTEGRITY OF THE BUILDING OR DISTURB ANY SYSTEM THAT SHOULD REMAIN OR BE REQUIRED FOR OPERATION. REPORT TO THE ARCHITECT ANY INDICATION OF DAMAGE OR POSSIBLE DISRUPTION OF OPERATION.
2. DURING DEMOLITION PROTECT ITEMS TO REMAIN INCLUDING STRUCTURE SYSTEM, ARCHITECTURE, MEP/IT SYS, FURNITURE, FIRE ALARM, SECURITY DEVICES, ROOF, SIDEWALKS, UTILITIES, ETC.
3. ENSURE THERE IS NO INTERRUPTION TO SCHOOL OPERATIONS DURING THE DEMOLITION PHASE.
4. ALL ALARM & SECURITY DEVICES TO REMAIN IN OPERATION DURING DEMOLITION.
5. ALL UTILITIES & POWER TO REMAIN DURING DEMOLITION PHASE.
6. ALL SECURITY CAMERAS, ALARM DEVICES, HVAC THERMOSTATS, OR LIGHT SWITCHES THAT CONFLICT WITH NEW CONSTRUCTION TO BE RE-COATED AND/OR ADJUSTED TO REMAIN FULLY FUNCTIONAL AS INTENDED. REFER TO ARCHITECT FOR DIRECTION.
7. MAINTAIN SAFE & UNRESTRICTED EGRESS ROUTE FOR THE DURATION OF THE DEMOLITION. COMPLY WITH ALL APPLICABLE CODES.
8. REPORT TO ARCHITECT ANY UN-SEEN DISCOVERED CONDITIONS THAT MAY HAVE STRUCTURAL, MEP, OR ARCHITECTURAL COMPLICATIONS AFFECTING THE PROJECT SCHEDULE/CONSTRUCTION/COST/OPERATION.
9. REMOVE ABUNDANT CABLE, SYSTEMS, LIGHT FIXTURE, (FIXW)
10. SAW-CUT & REMOVE EXISTING SIDEWALK/ PAVEMENT AS INDICATED TO ALLOW FOR NEW CONSTRUCTION. RE: NEW CONSTRUCTION PLAN. (SITE1, HANDLE2, PROTECT1, OPERATE).


01 GENERAL NOTES - DEMOLITION
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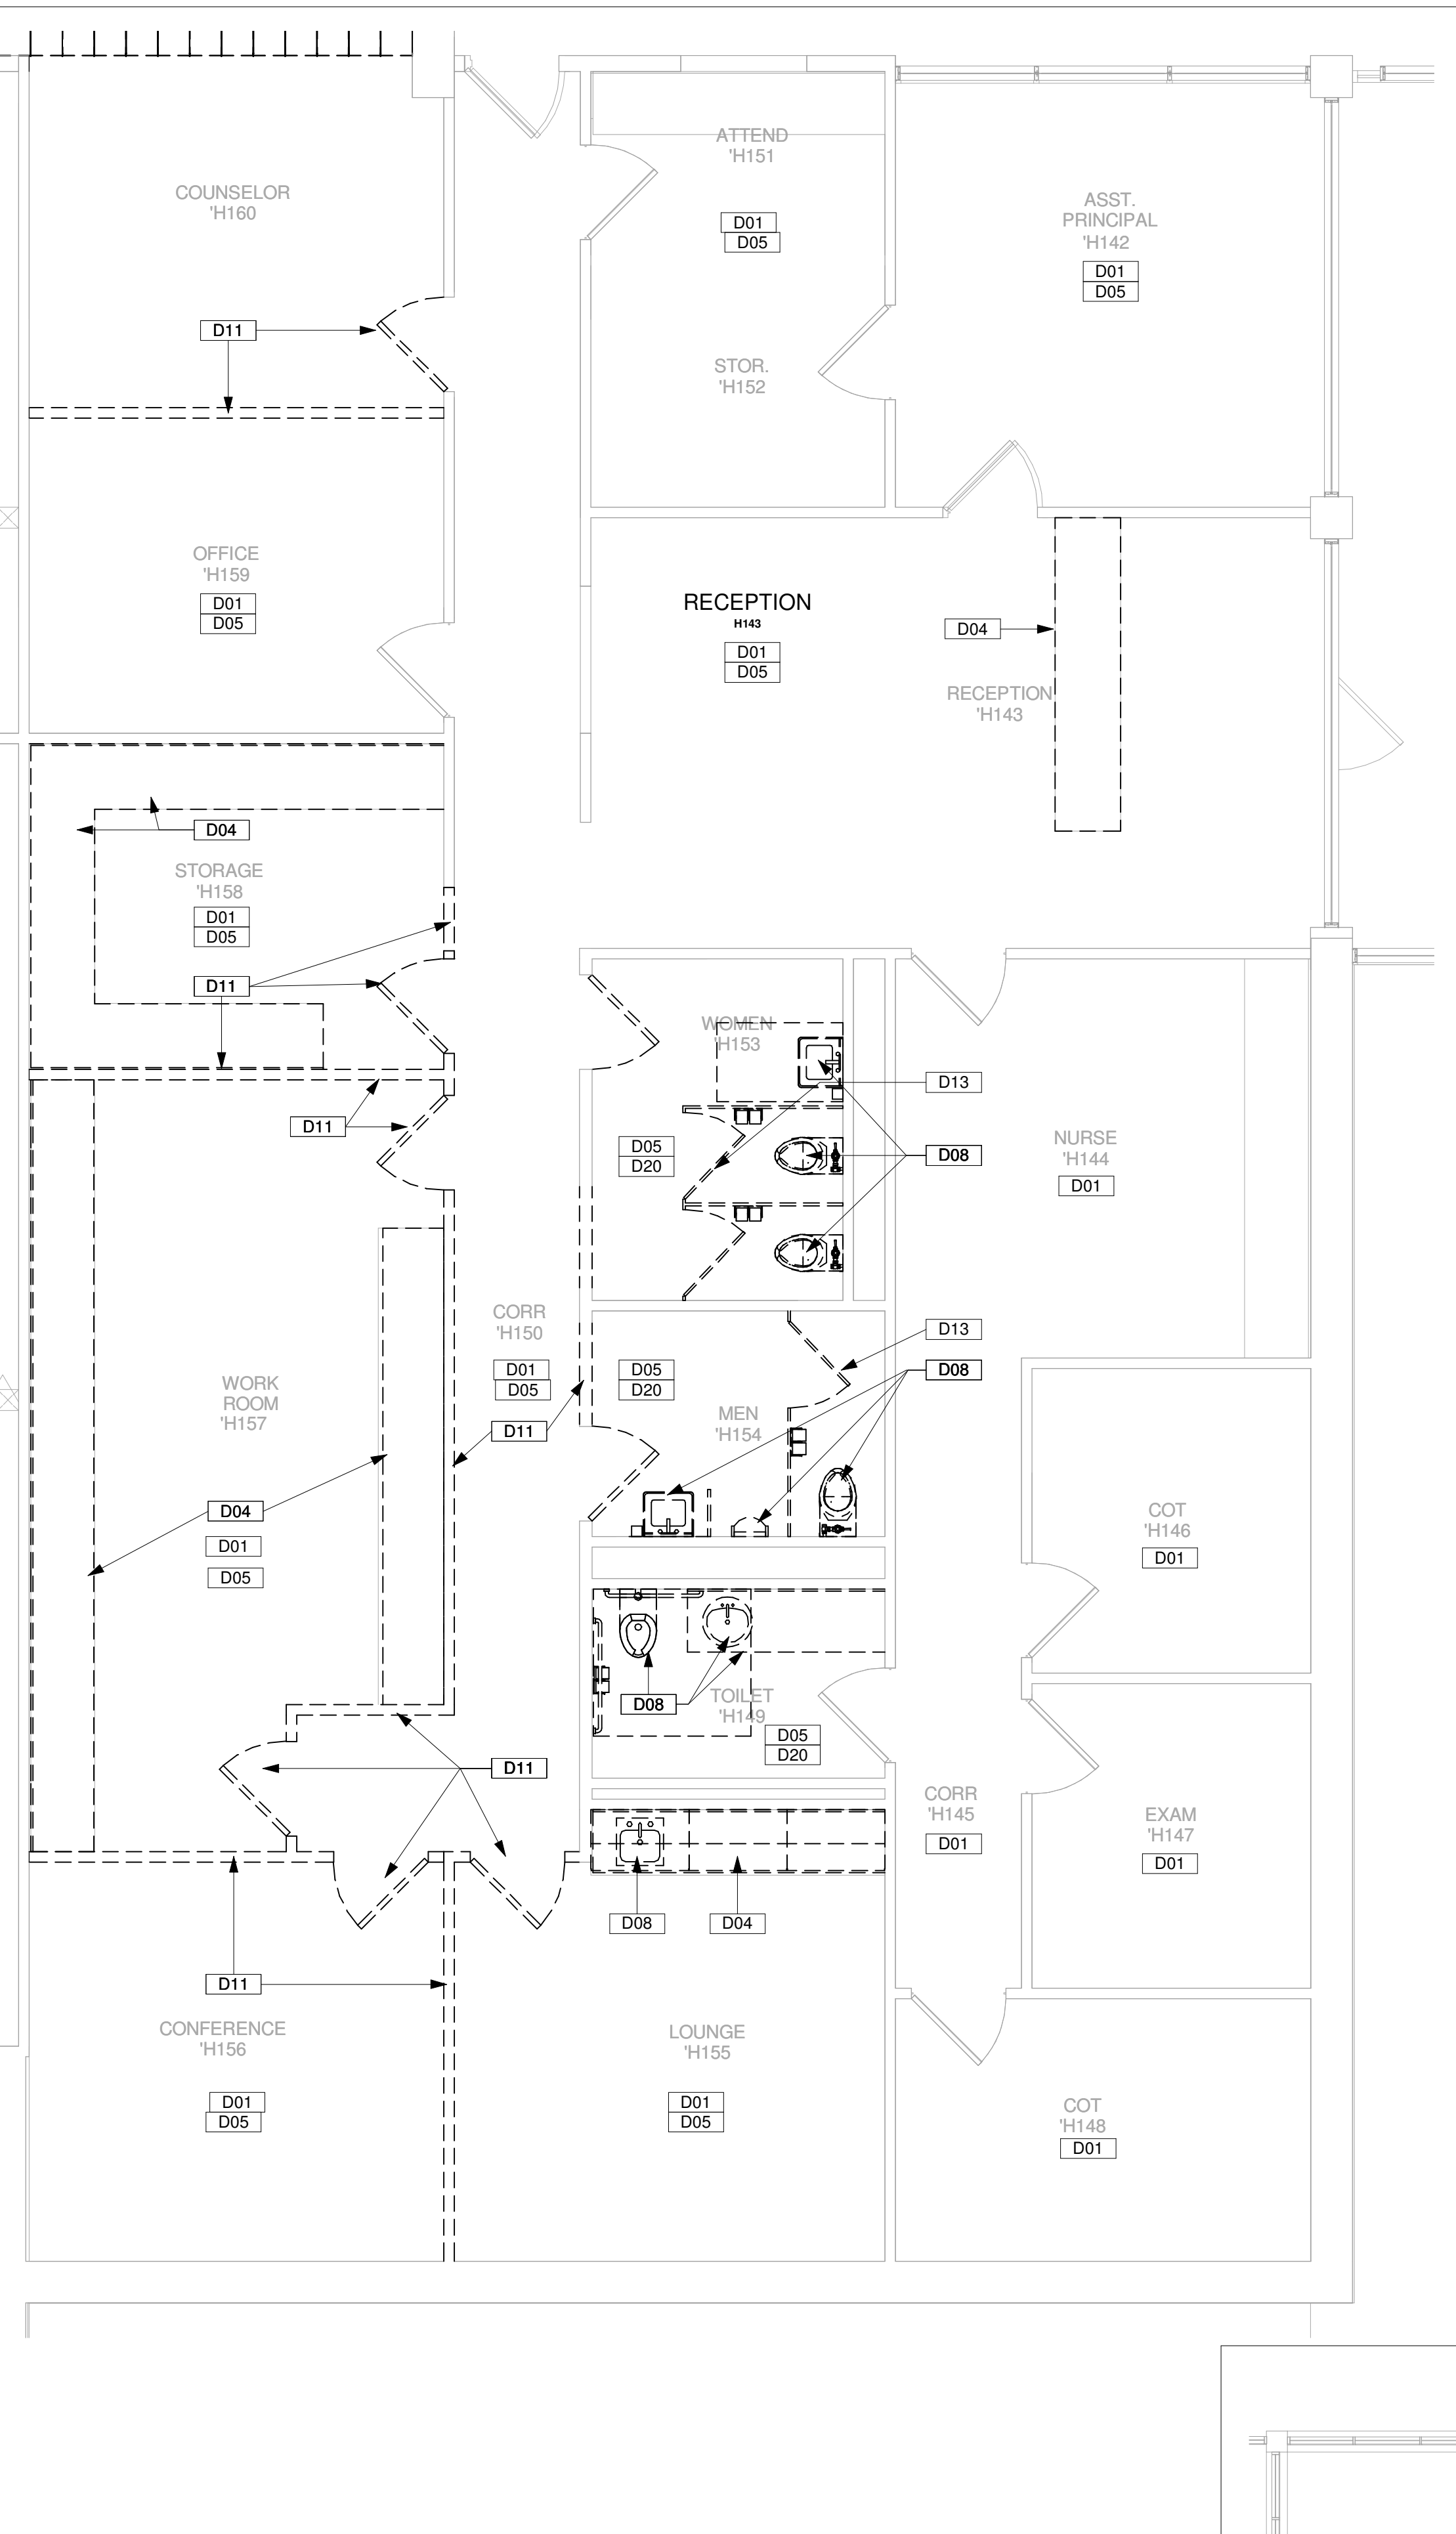
14 ENLARGED DEMOLITION PLAN - KITCHEN
 Scale: 1/8" = 1'-0"

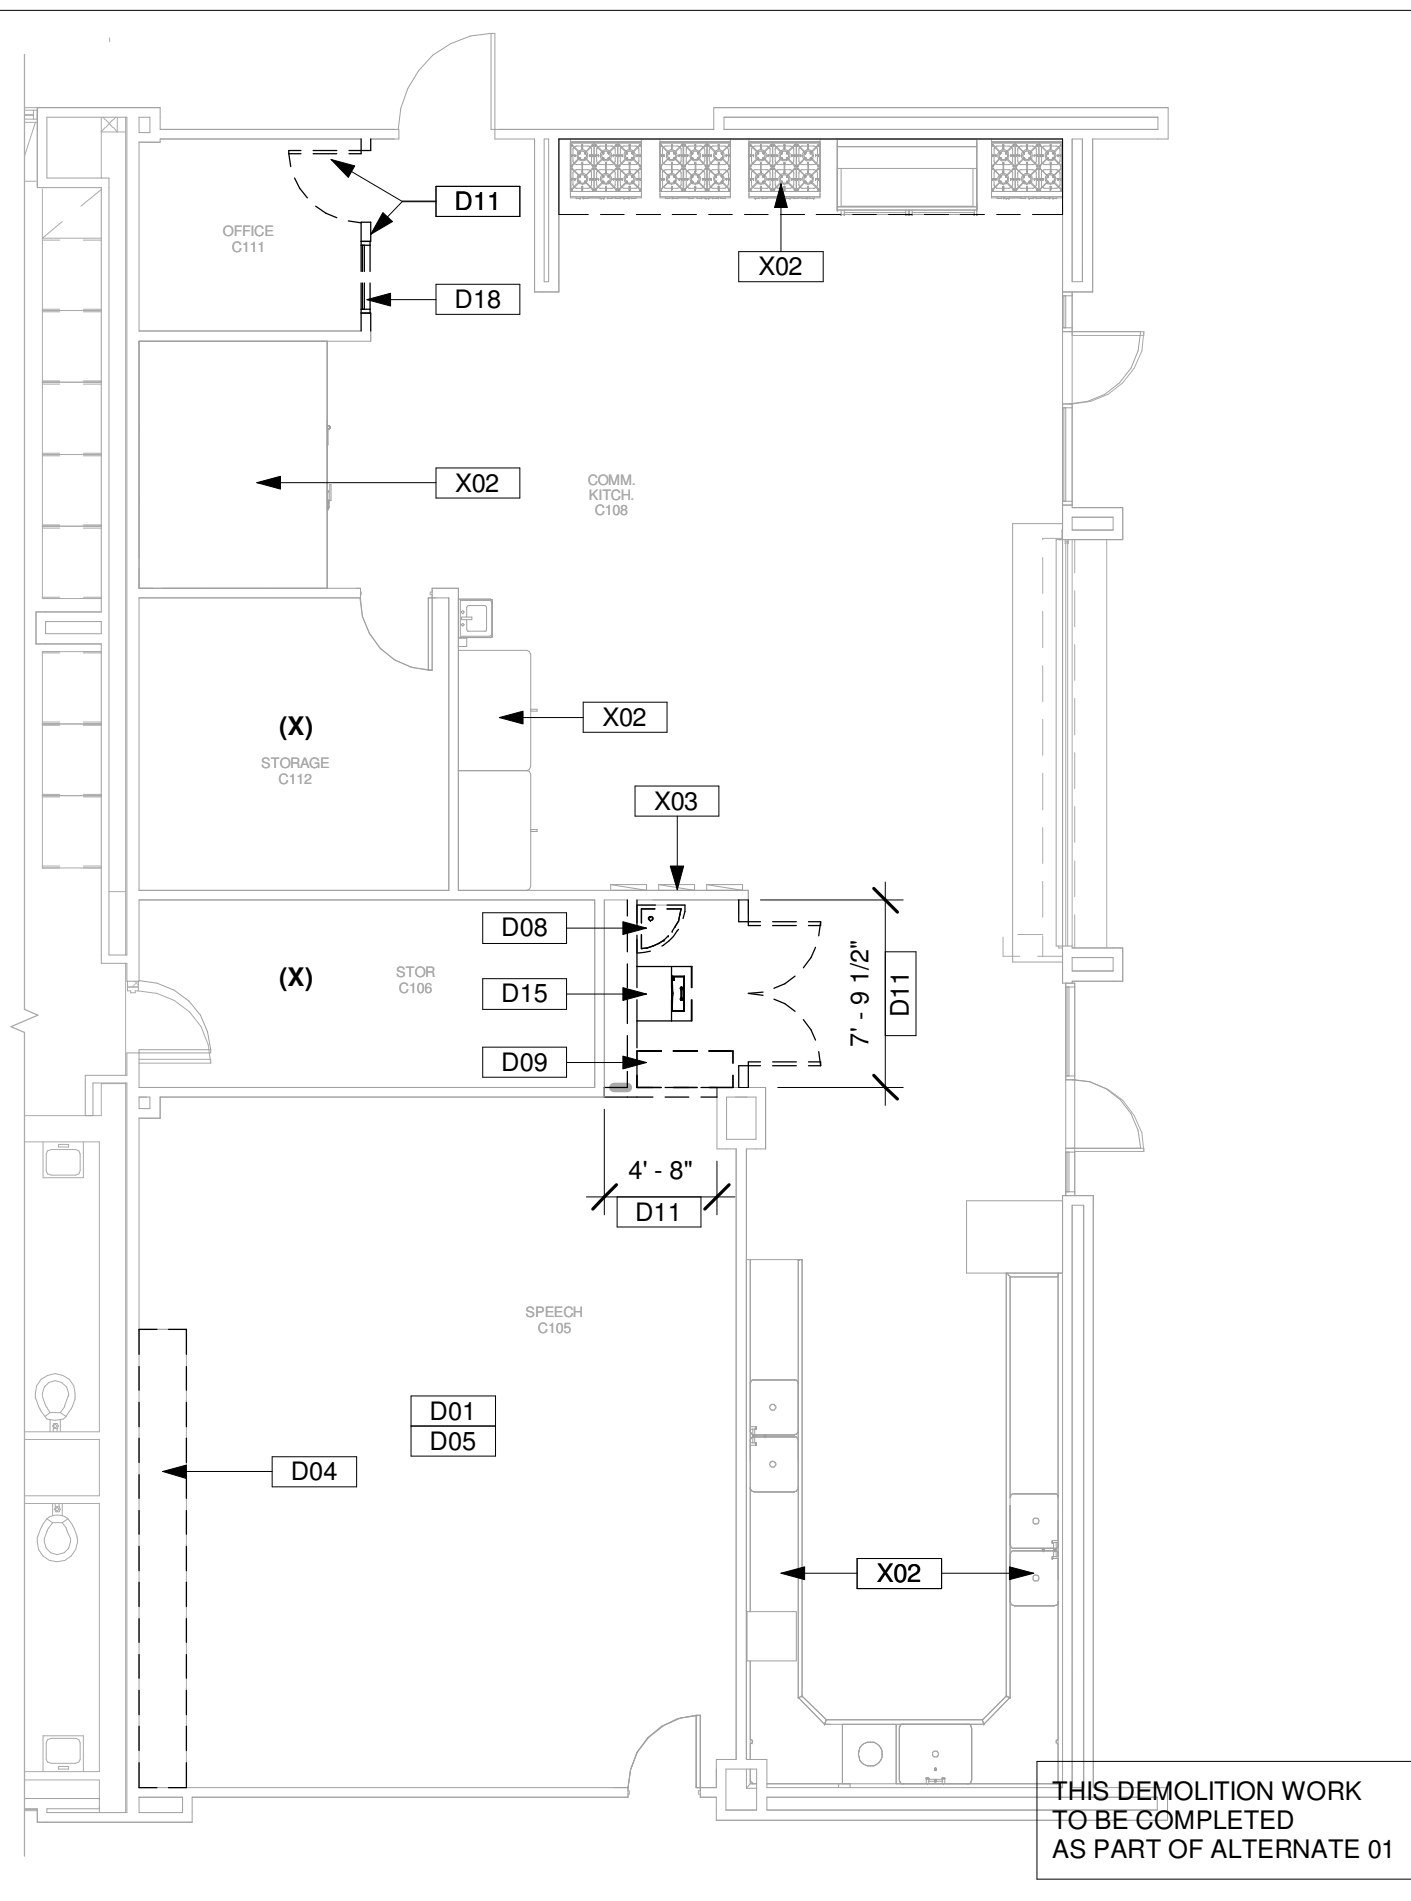


24 ENLARGED DEMOLITION PLAN - LIFE SKILLS
 Scale: 1/8" = 1'-0"

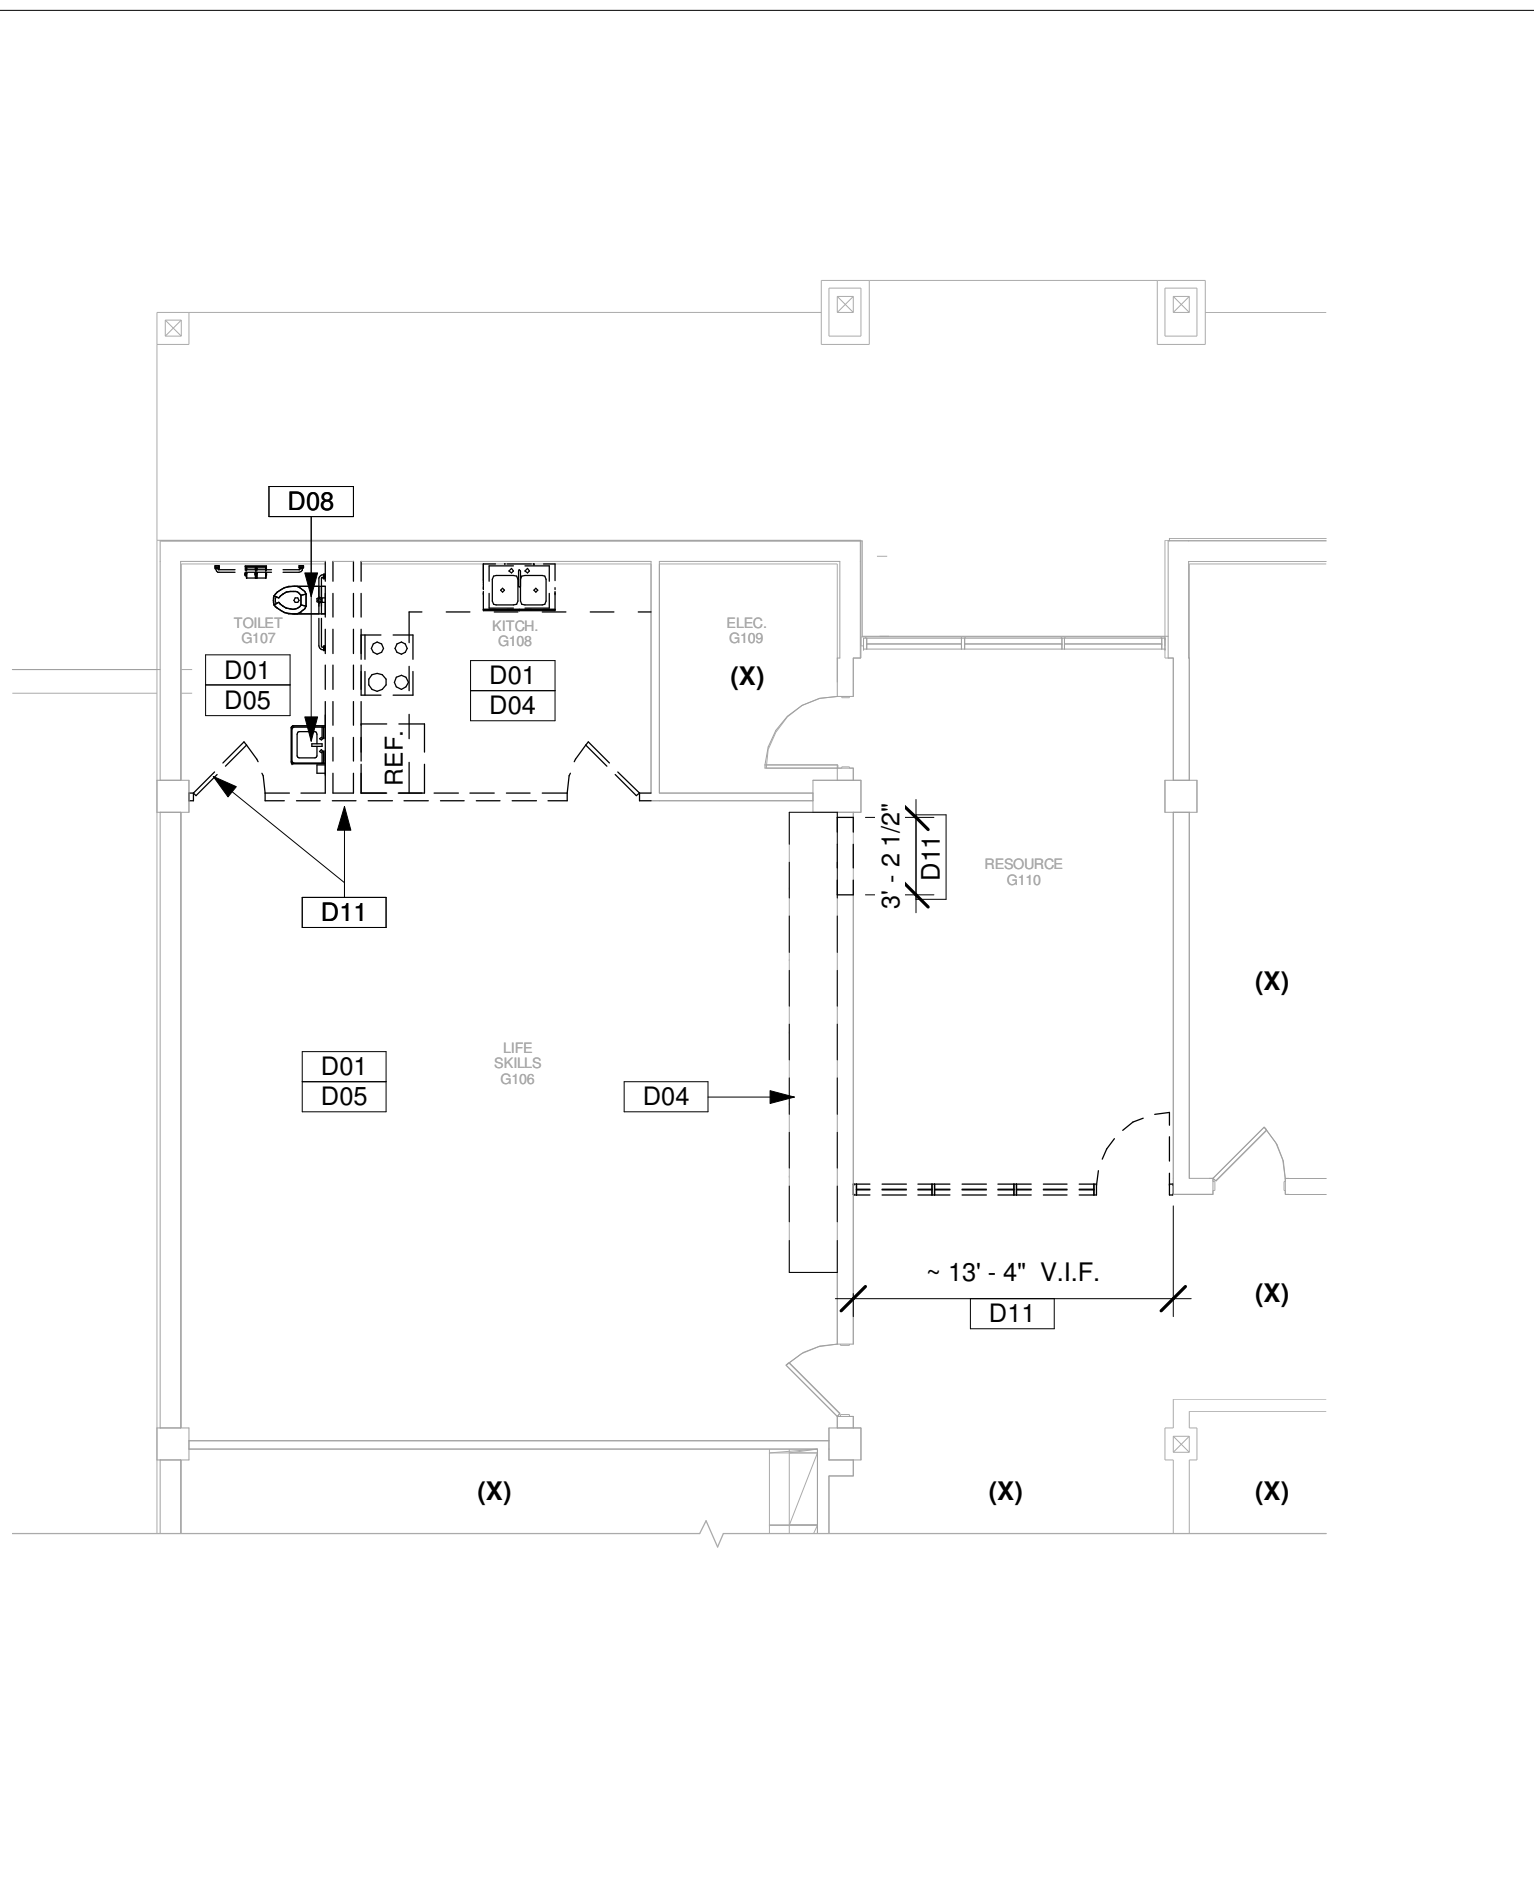


22 ENLARGED DEMOLITION PLAN - LIBRARY / CANOPY
 Scale: 1/8" = 1'-0"

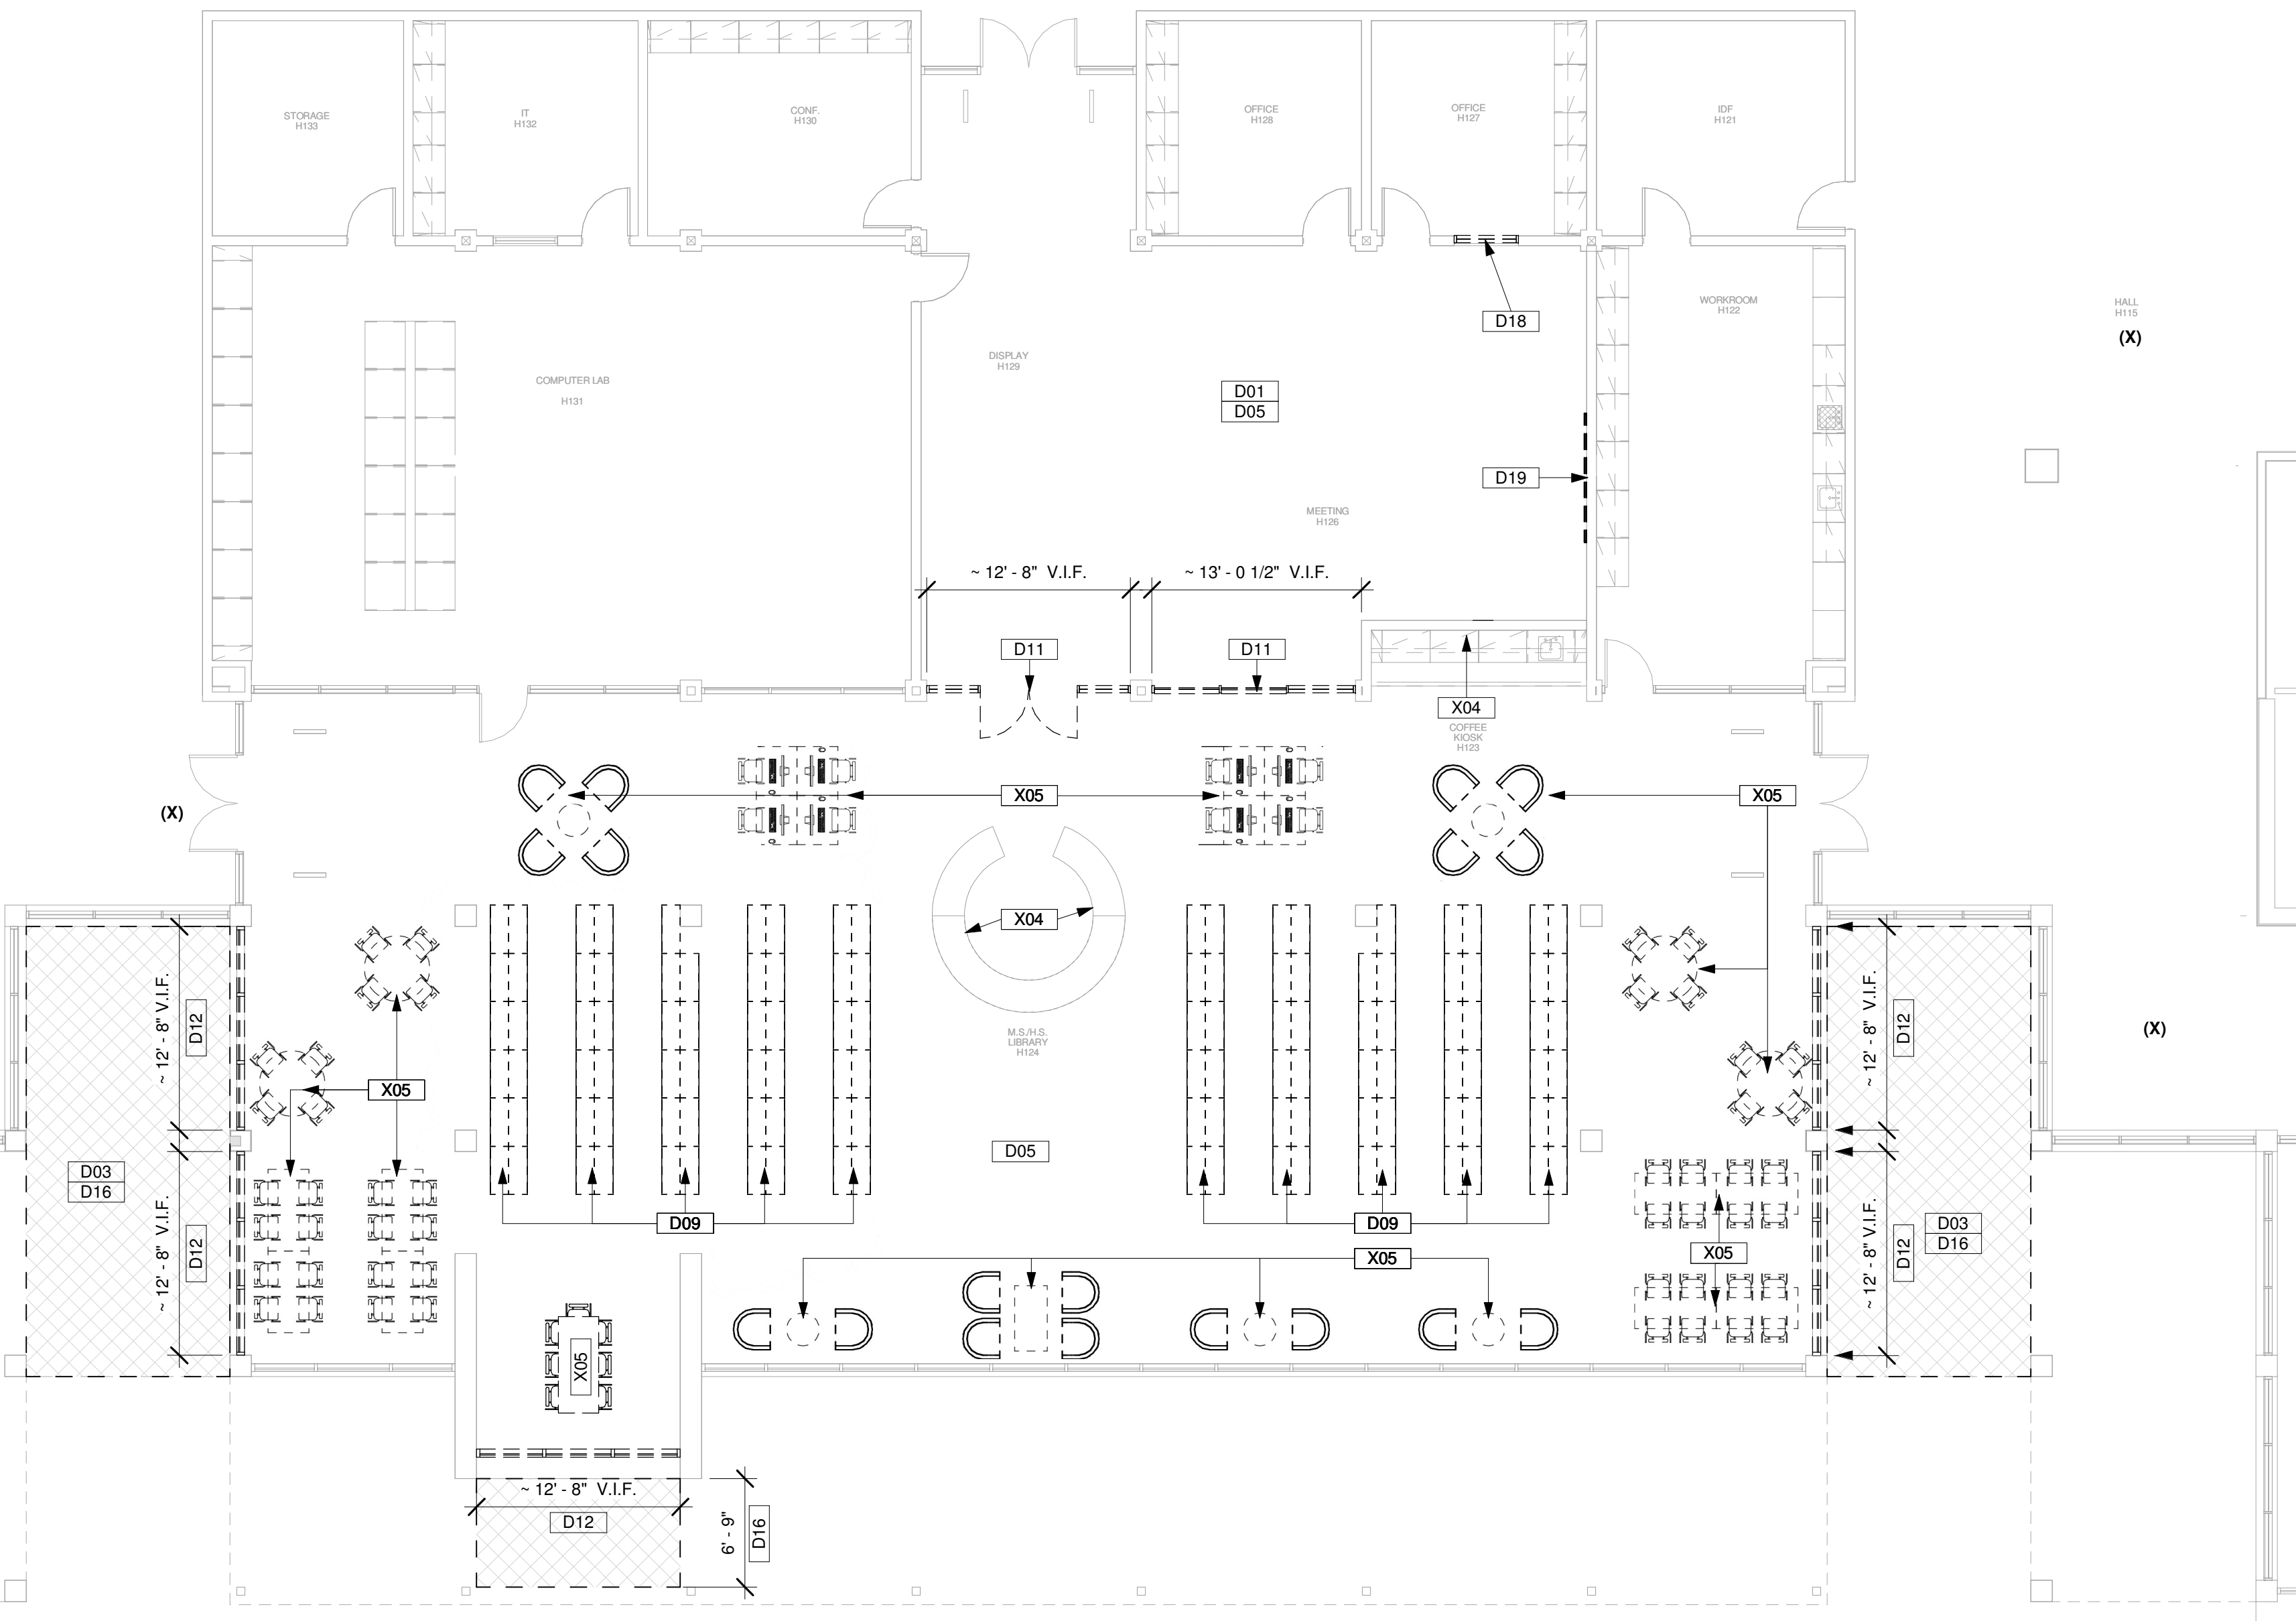


27 ENLARGED DEMOLITION PLAN - ADMIN
 Scale: 1/4" = 1'-0"

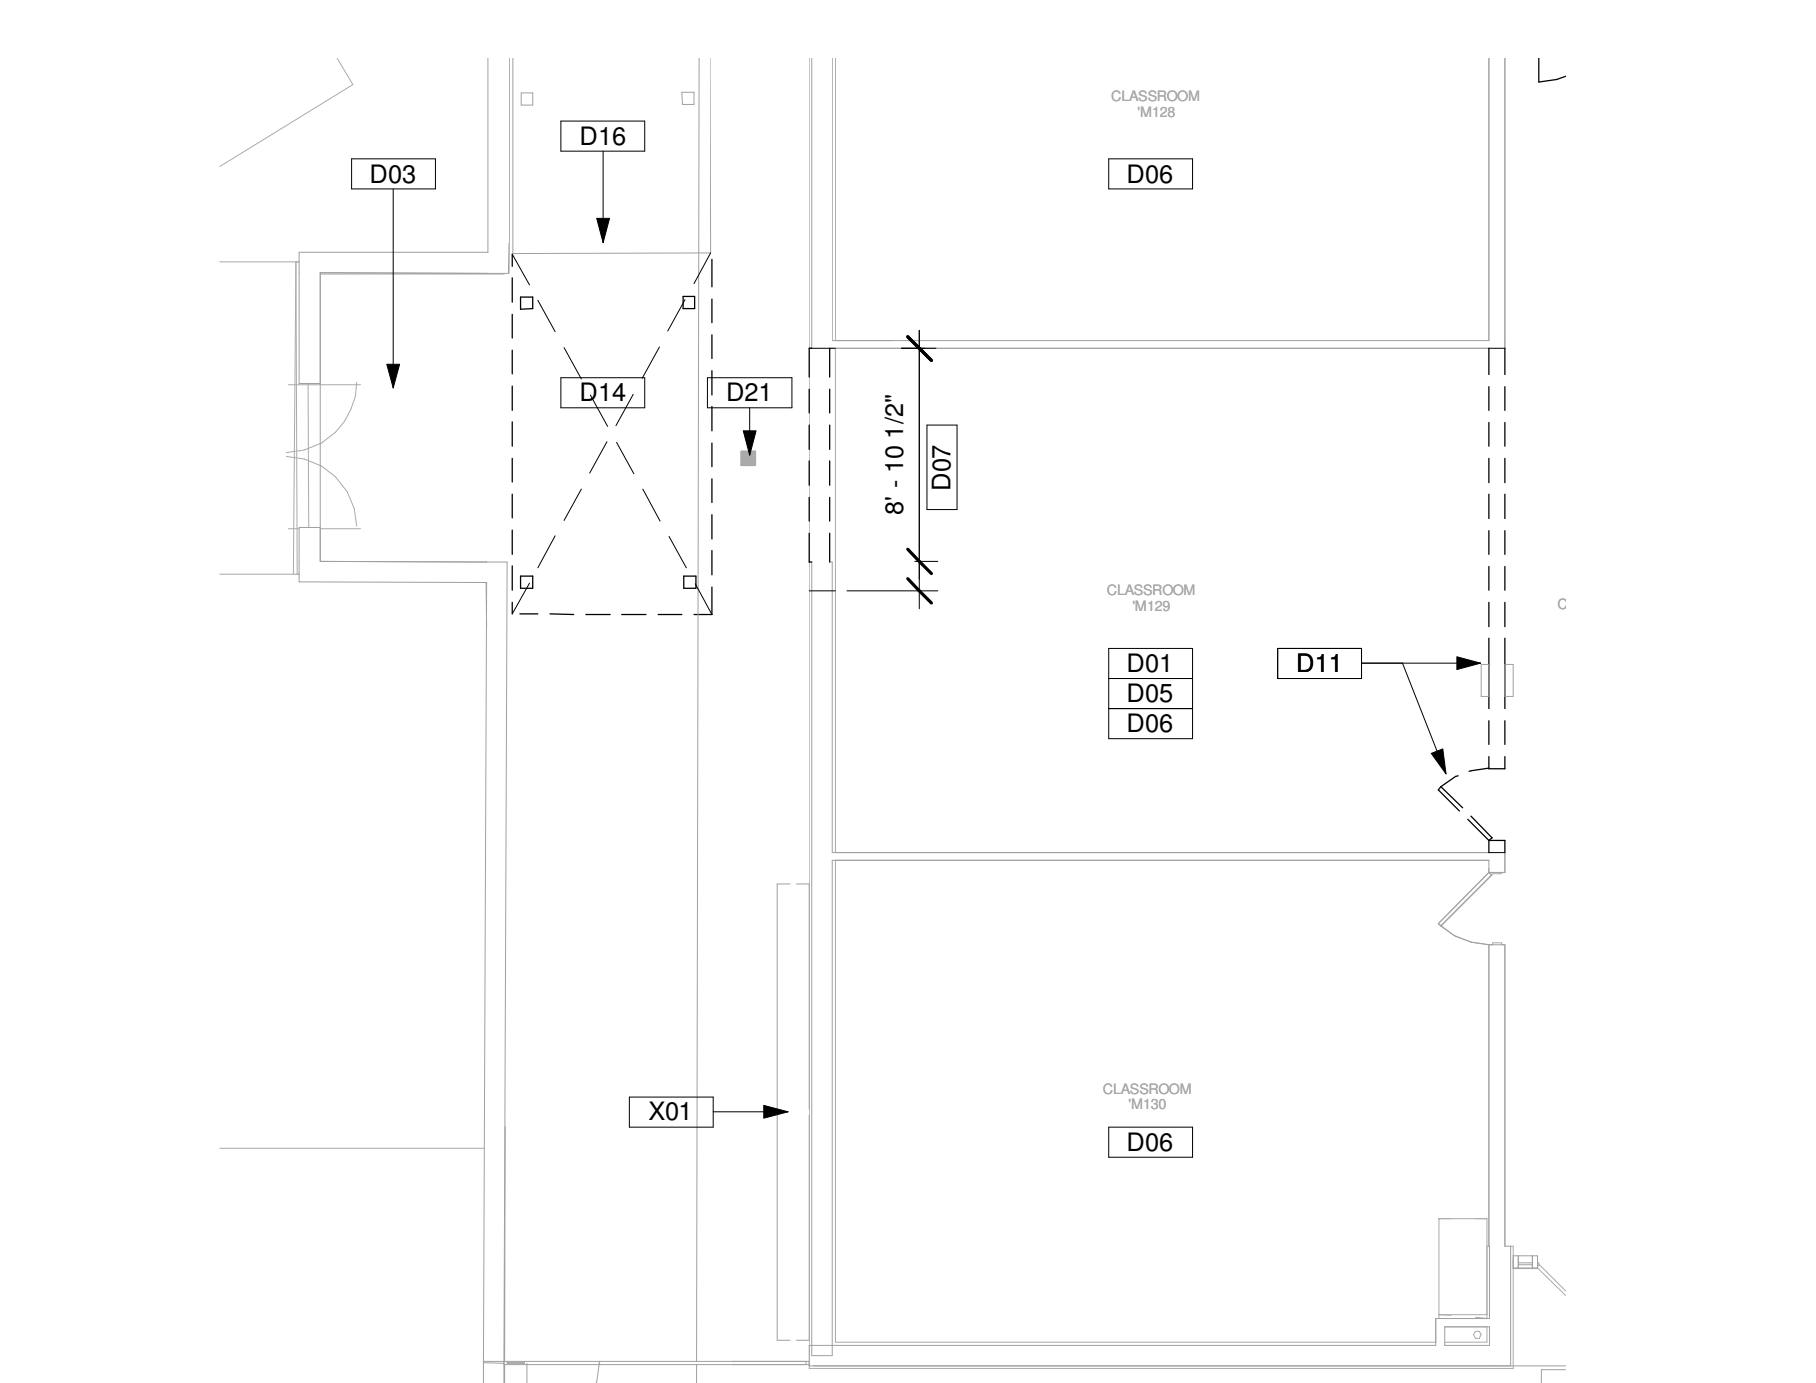

26 ENLARGED DEMOLITION PLAN - CONNECTOR
 Scale: 1/8" = 1'-0"

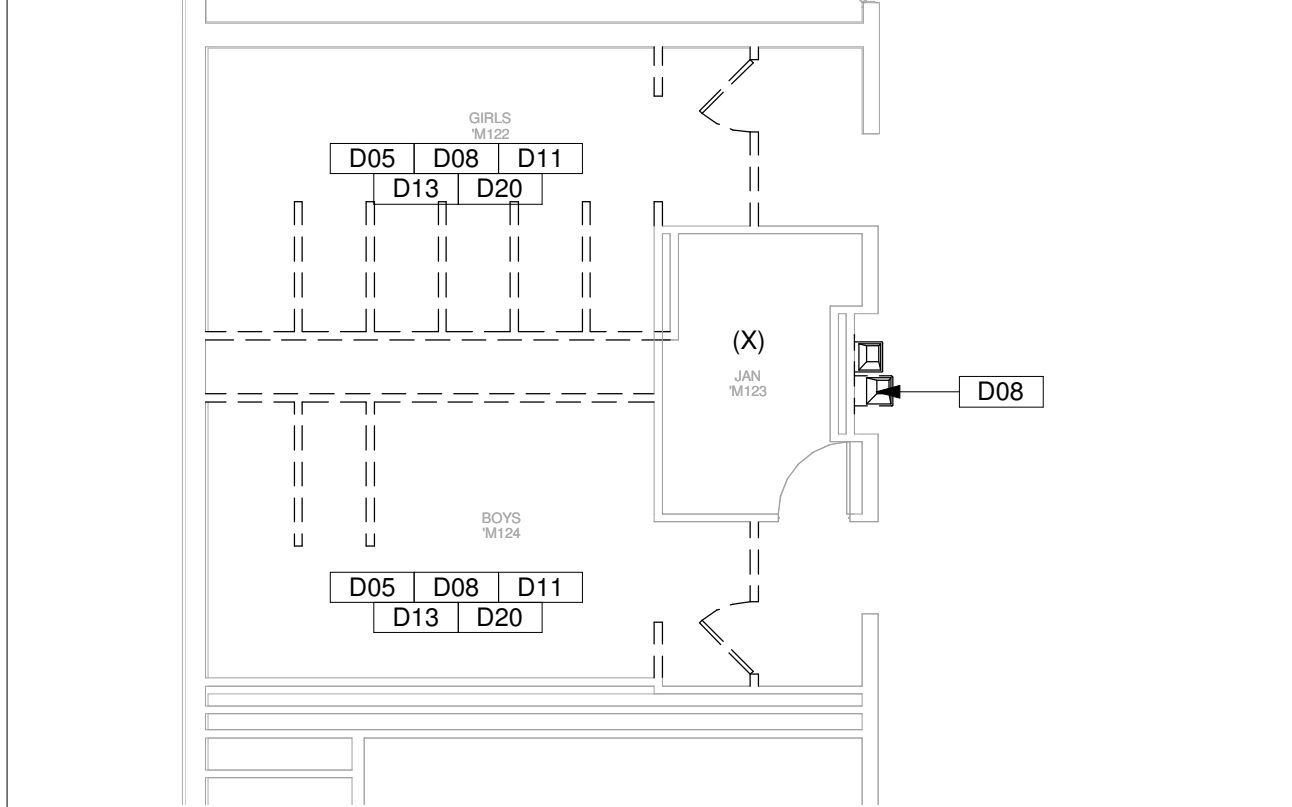

21 ENLARGED DEMOLITION PLAN - RR @ MAGNET
 Scale: 1/8" = 1'-0"

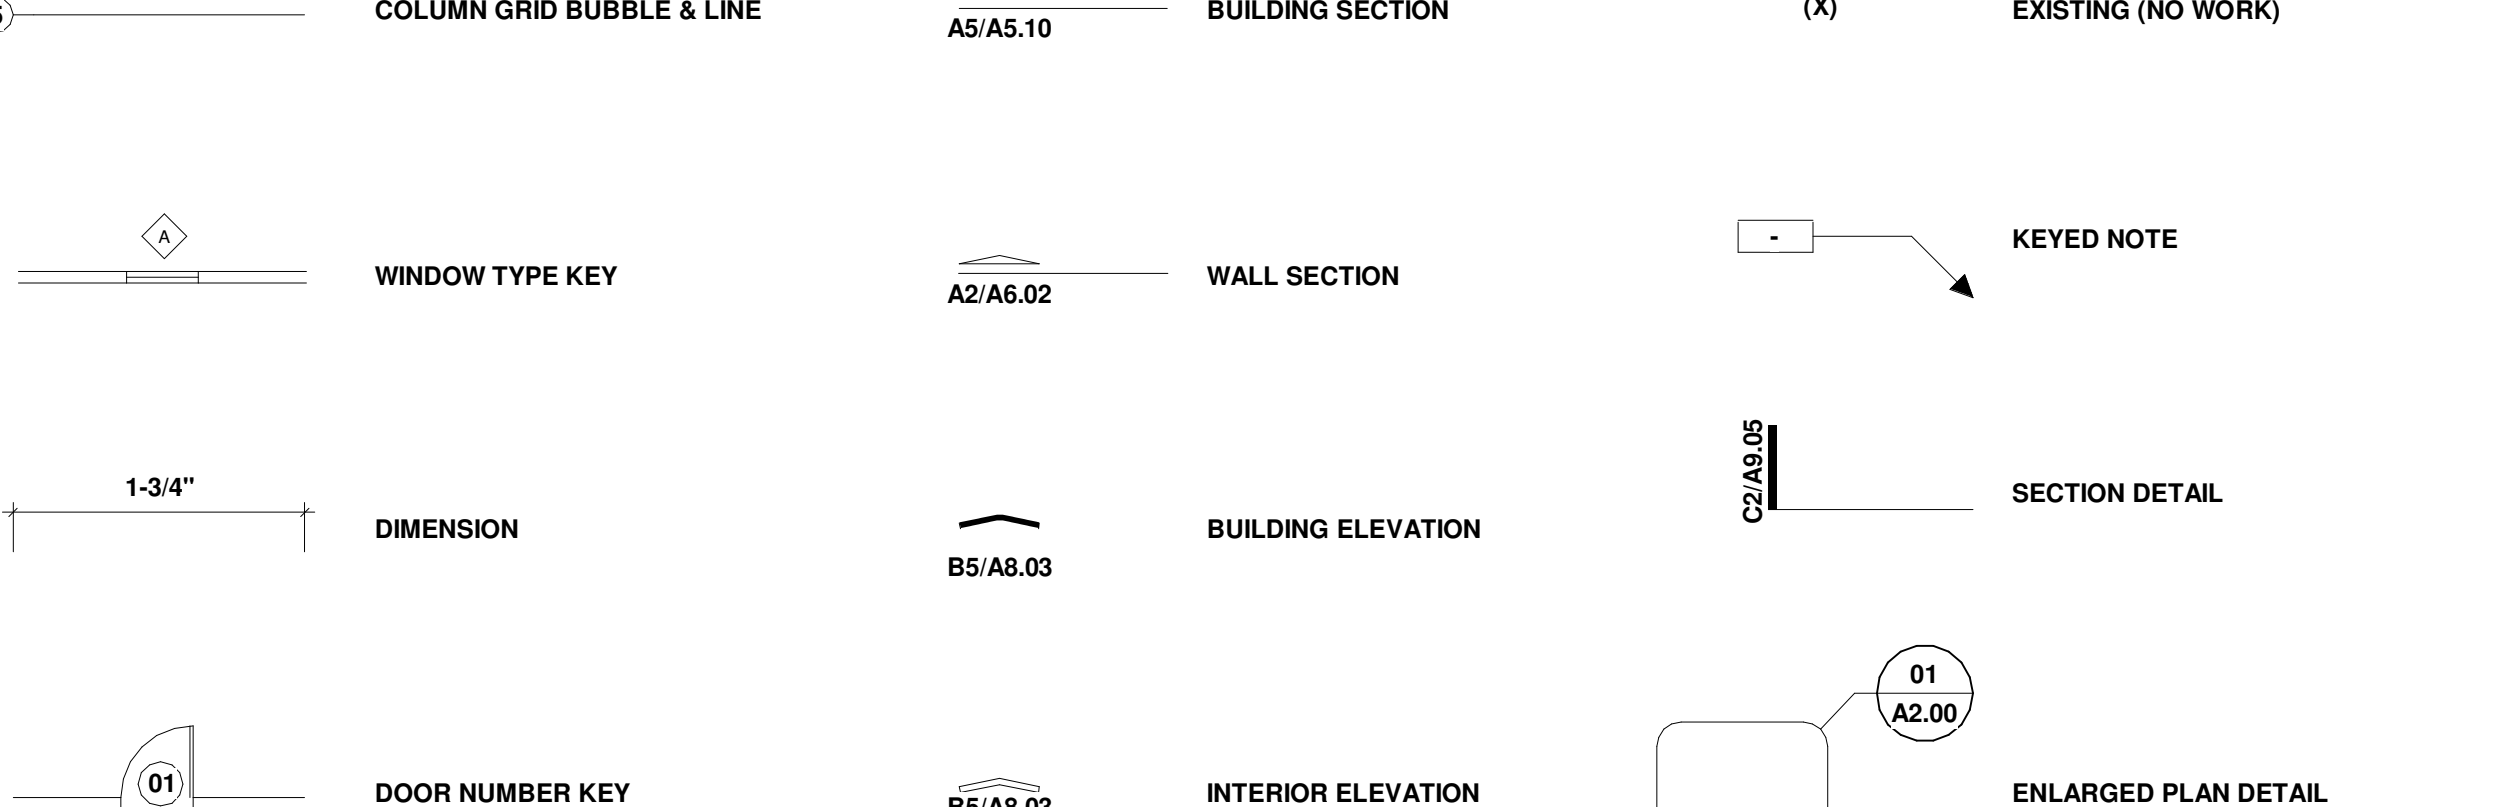



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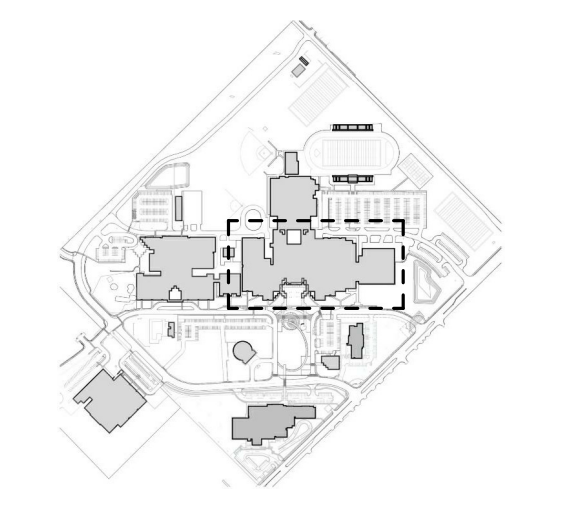
CONSULTANTS:
MEP ENGINEERS
INFRASTRUCTURE ASSOCIATES
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STRUCTURAL ENGINEERS
DALLY ASSOCIATES
713-337-8881

PROFESSIONAL SEAL:



A PROJECT FOR:
**STAFFORD
HIGH SCHOOL
& MAGNET
SCHOOL
RENOVATIONS**
1625 STAFFORDSHIRE
ROAD,
STAFFORD, TX 77477

#	Date	ISSUED FOR
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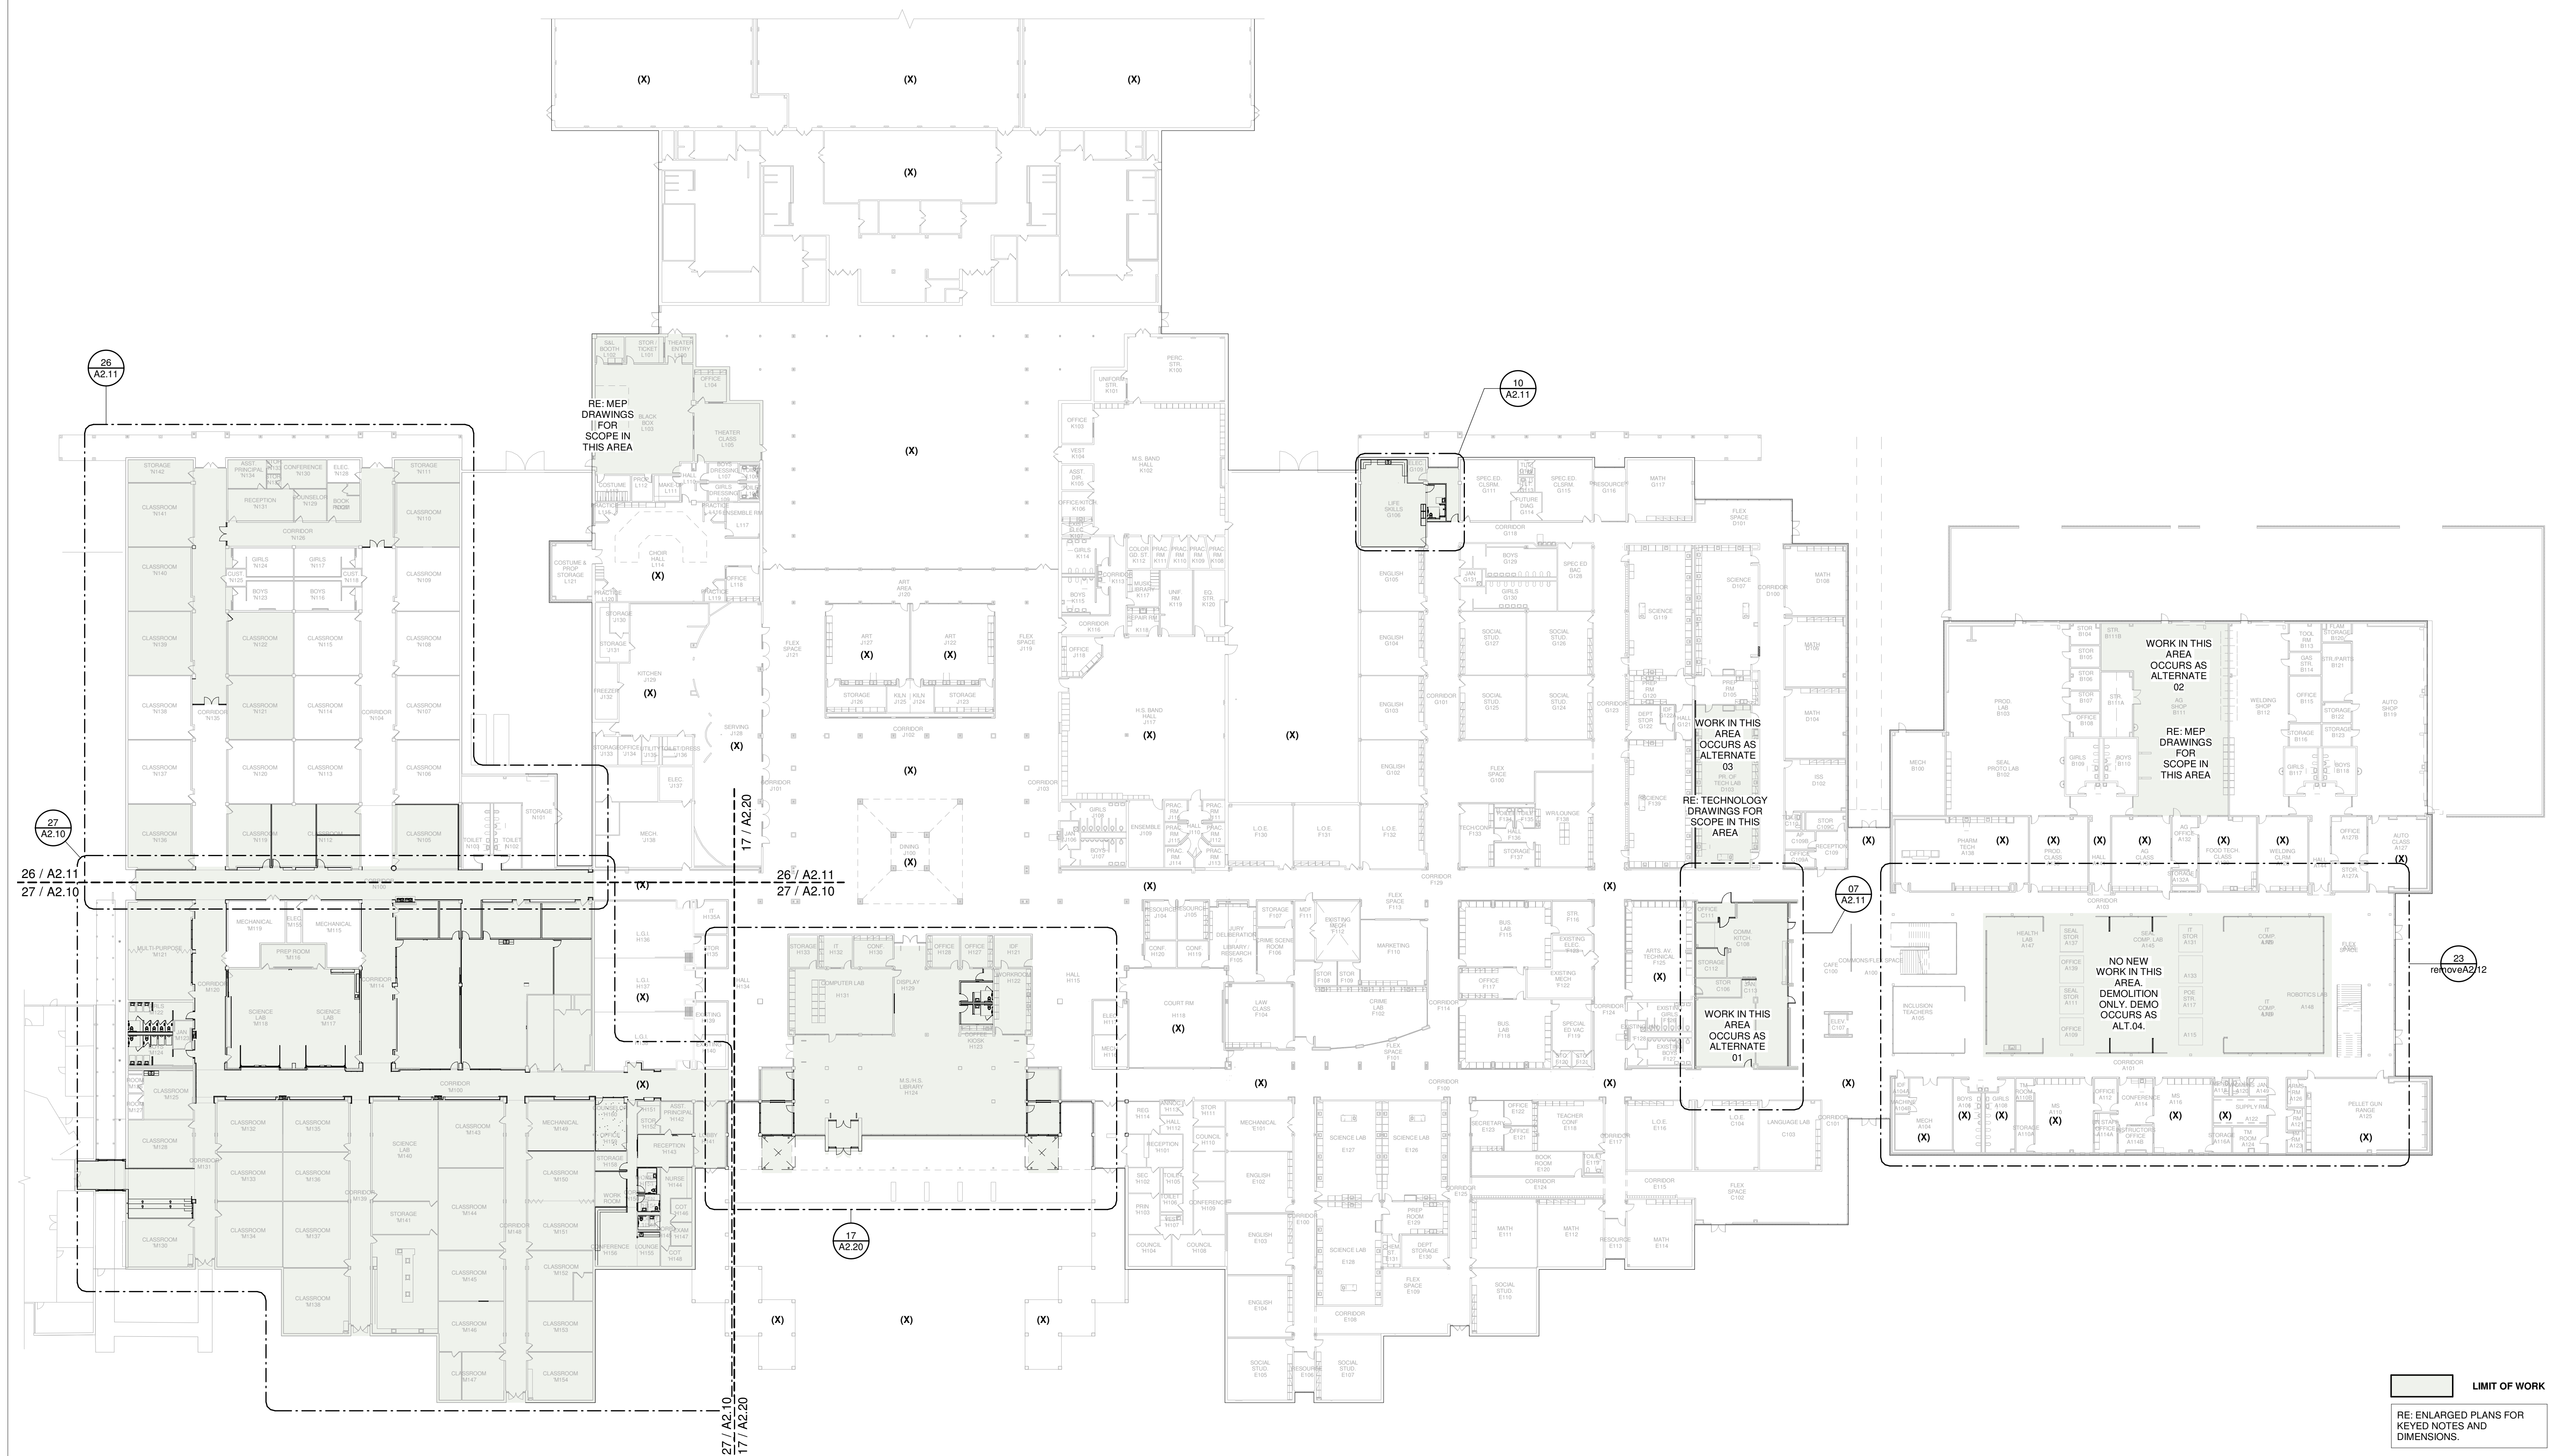


KEY PLAN
TRUE NORTH
PLAN NORTH


Project Number	19006-A
Drawn By	LT
Checked By	AW
Approved By	MS
Drawing Title	

**OVERALL
CONSTRUCTION PLAN**

Drawing Number **A2.00**




27 OVERALL FLOOR PLAN
Scale: 1" = 30'-0"

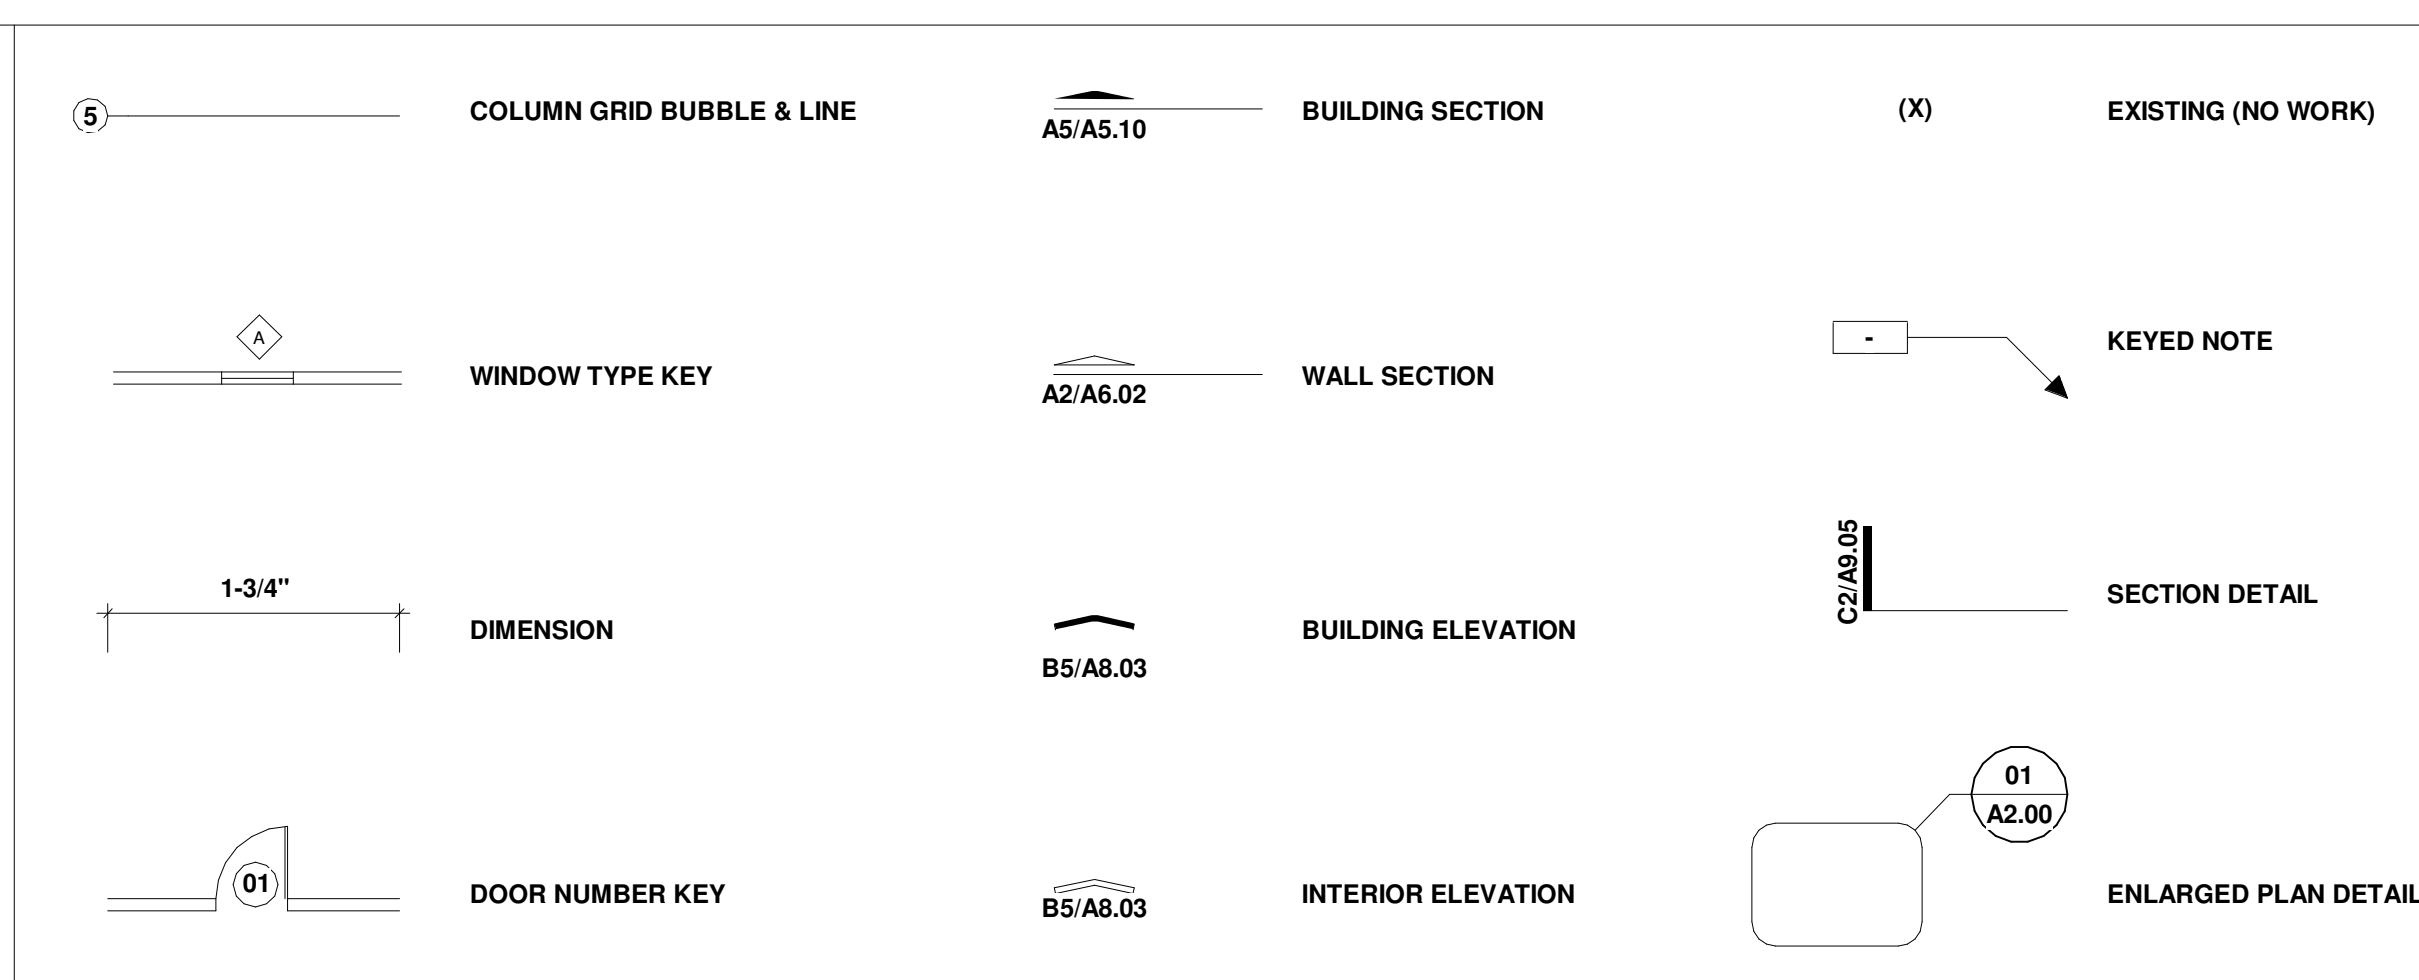

16 LEGEND
Scale: NTS

- HANDLE STRUCTURE OF EXISTING BUILDING WITH CARE. NO WORK SHOULD HAVE ANY AFFECT ON THE STRUCTURAL INTEGRITY OF THE BUILDING. REPORT TO THE ARCHITECT ANY INDICATIONS OF STRUCTURAL DAMAGE.
- PROTECT THROUGHOUT DEMOLITION AND CONSTRUCTION ALL ITEMS INDICATED TO REMAIN INCLUDING BUT NOT LIMITED TO: BUILDINGS AND OTHER STRUCTURES, FLOORING, WALLS, CEILINGS, FINISHES, MECP, SECURITY SYSTEMS, UTILITIES, MILLWORK, ETC.
- FIELD VERIFY ALL CONDITIONS PRIOR TO CONSTRUCTION, PARTICULARLY IN AREAS OF WORK.
- REPORT TO THE ARCHITECT ANY UNFORESEEN CONDITIONS OR AS-BUILT CONDITIONS NOT REFLECTED IN THE DRAWINGS, THAT COULD AFFECT THE WORK.
- MAINTAIN SAFE AND UNRESTRICTED ACCESS AND EGRESS ROUTES FOR OCCUPIED AREAS ADJACENT TO WORK AREA. IN ACCORDANCE WITH APPLICABLE CODES.
- ALL DIMENSIONS TO WALLS ARE TO FINISH FACE OF WALL UNLESS INDICATED OTHERWISE. (SIDE INDICATED GRAPHICALLY IN THE DRAWINGS).
- PROVIDE NECESSARY BLOCCING AT WALLS FOR ALL PLUMBING FIXTURES, EQUIPMENT, MILLWORK, AND ACCESSORIES.
- PLANS INDICATE HORIZONTAL DIMENSIONS ONLY. REFER TO ELEVATIONS & SECTIONS FOR VERTICAL DIMENSIONS.
- PROVIDE PARTITION CURBS FOR MECH/ELEC. ROOMS PERIMETER, TYP. UNLESS OTHERWISE NOTED.
- UNLESS INDICATED OTHERWISE, ALL NEW WORK IN THIS PROJECT IS TO BE ACCESSIBLE IN ACCORDANCE WITH THE MOST RECENT EDITION OF THE TEXAS ACCESSIBILITY STANDARDS. REFER TO ACCESSIBILITY REQUIREMENTS ON SHEETS A0.00 AND A0.30 FOR MORE INFORMATION.
- REFER TO DOOR AND WINDOW DETAILS FOR DIMENSIONS AT OPENINGS.
- REFER TO DEMOLITION DRAWINGS FOR DEMOLITION INFORMATION.
- REFER TO CODE ANALYSIS INFORMATION SHEET A0.20 FOR EXTENT OF EXTENDED FIRE-SPRINKLER SYSTEM.

01 GENERAL NOTES - CONSTRUCTION
Scale: NTS

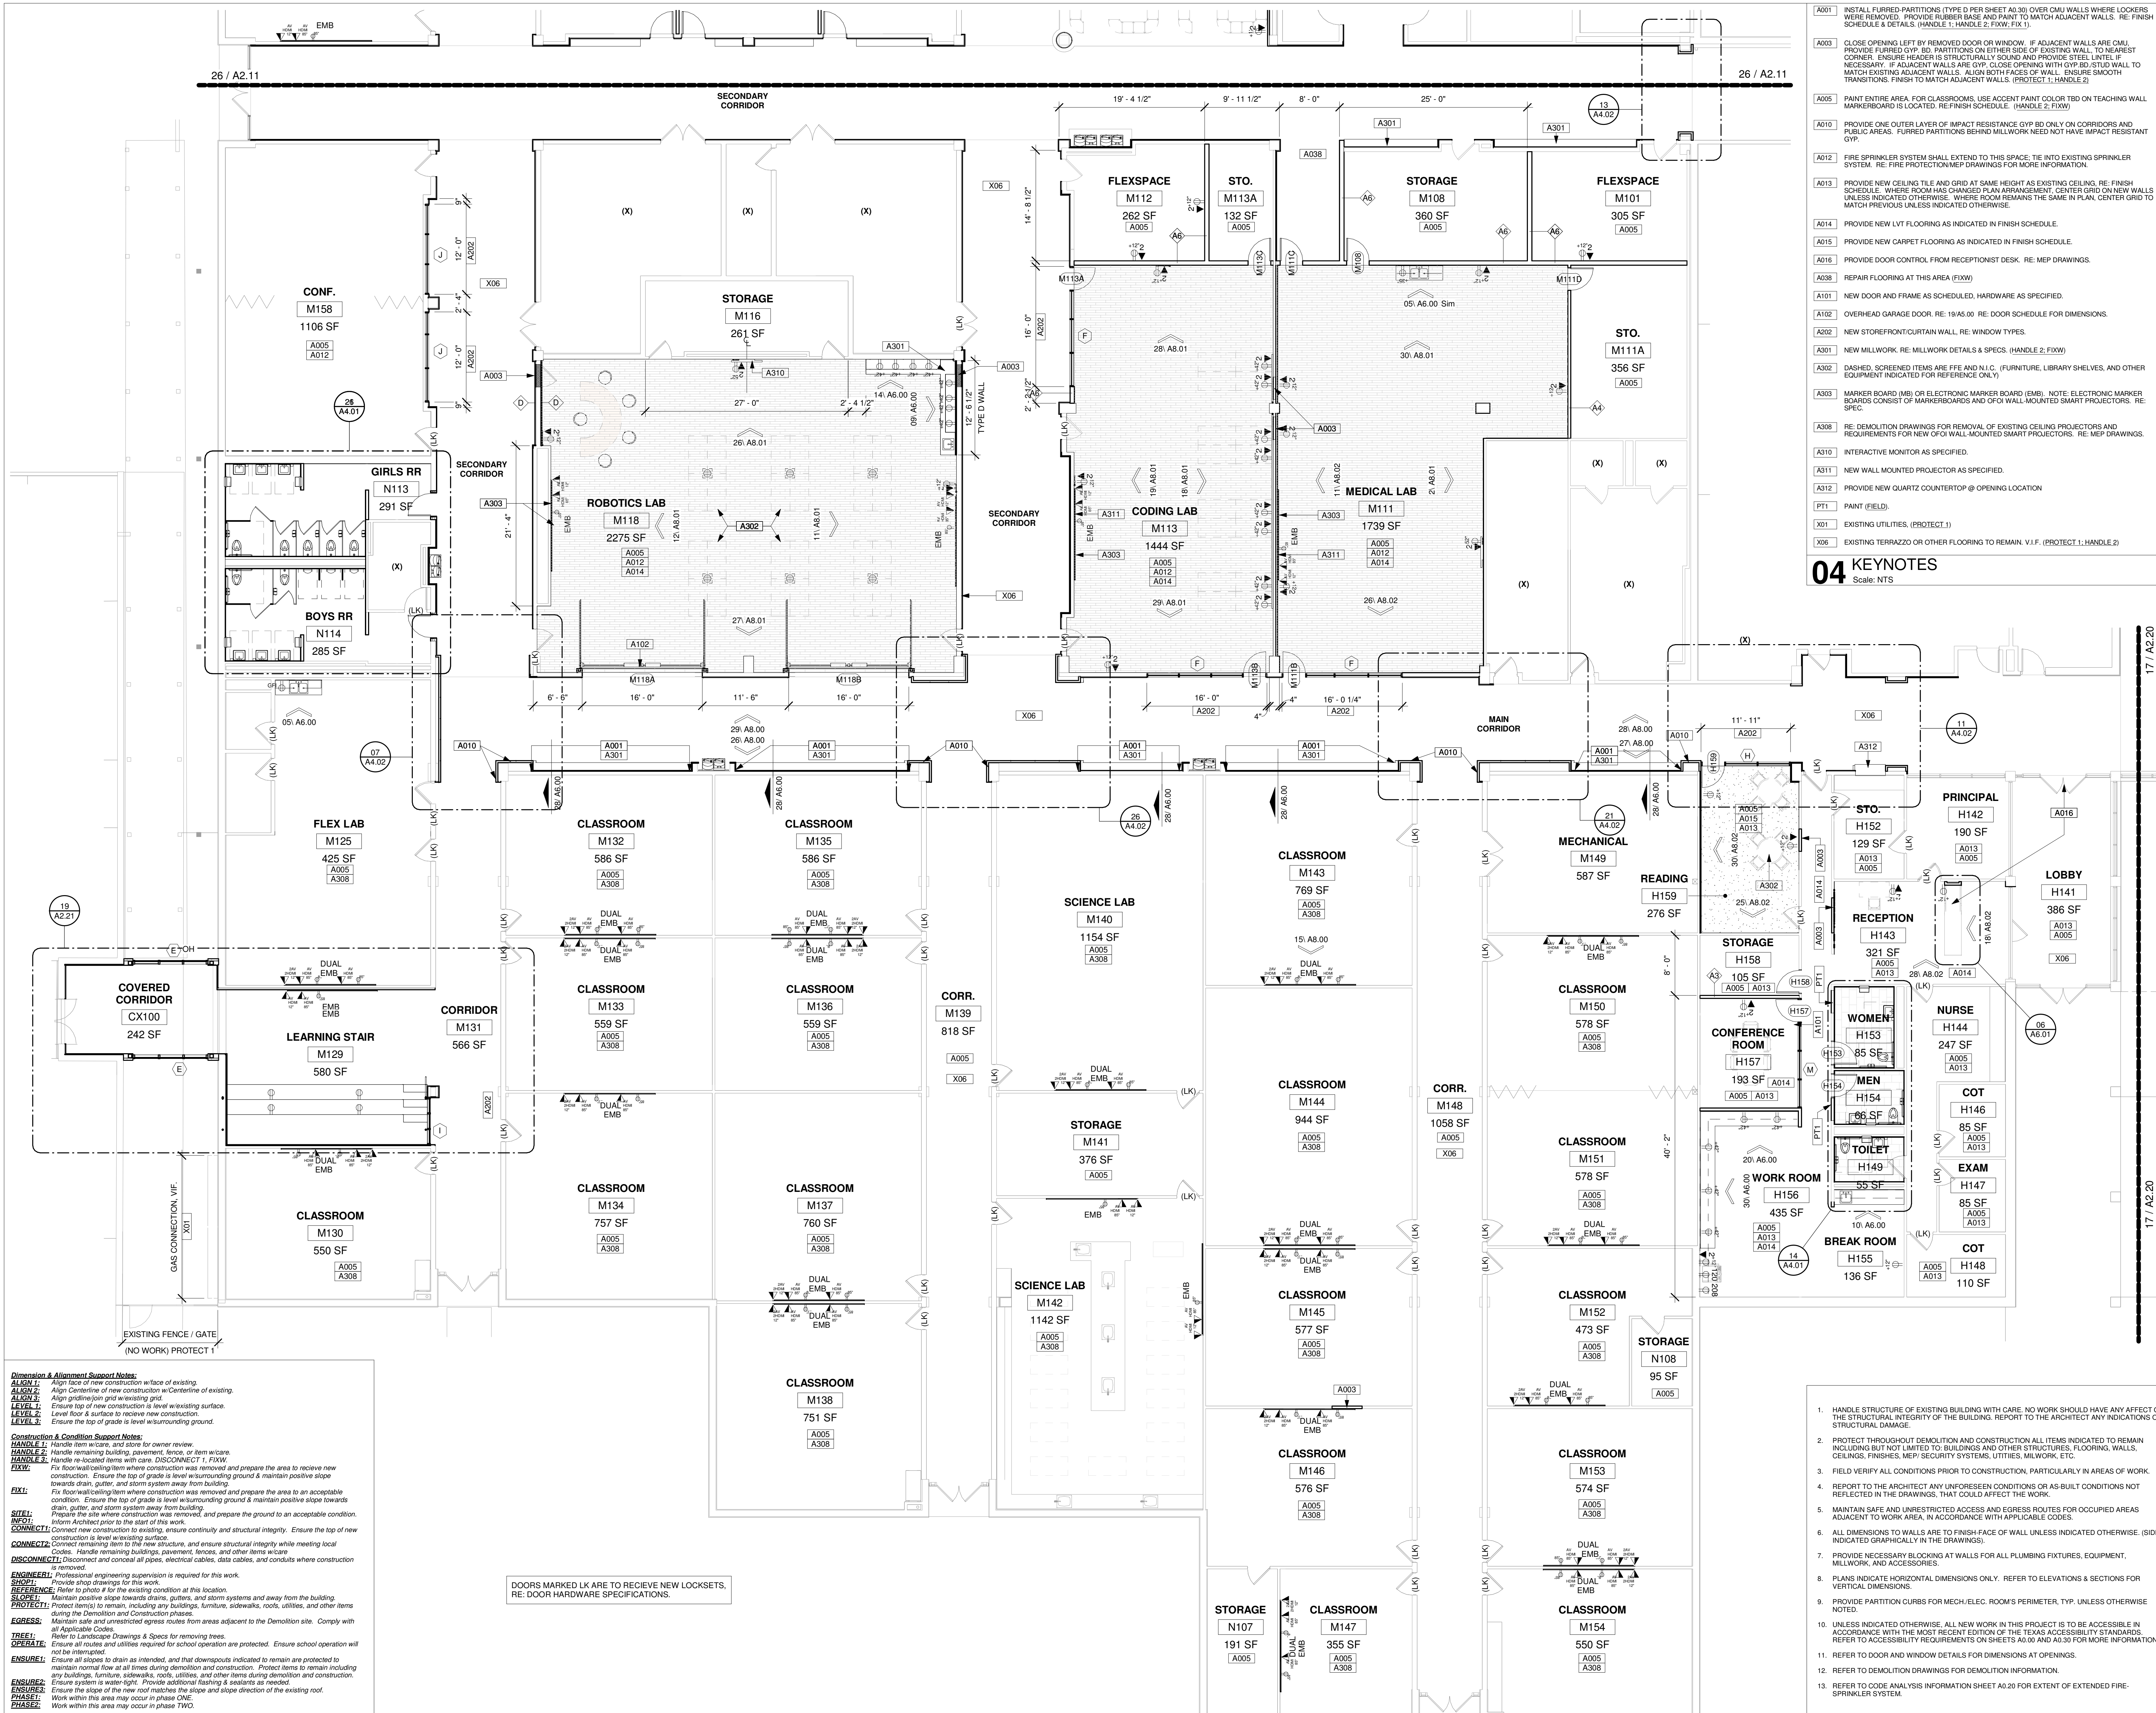

- Dimension & Alignment Support Notes:**
- ALIGN 1:** Align face of new construction with face of existing.
 - ALIGN 2:** Align centerline of new construction with centerline of existing.
 - ALIGN 3:** Align gridlines with existing grid.
 - LEVEL 1:** Ensure top of new construction is level w/existing surface.
 - LEVEL 2:** Level floor & surface to receive new construction.
 - LEVEL 3:** Ensure the top of grade is level w/surrounding ground.
- Construction & Condition Support Notes:**
- HANDLE 1:** Handle item in place, and drive for owner review.
 - HANDLE 2:** Handle remaining building, pavement, fence, or item in place.
 - HANDLE 3:** Handle re-located items with care. DISCONNECT 1, F&W.
 - FIX:** Fix floor/wall/ceiling item where construction was removed and prepare the area to receive new construction. Ensure the top of grade is level w/surrounding ground & maintain positive slope towards drain, gutter, and storm system away from building.
 - FIX1:** Fix floor/wall/ceiling item where construction was removed and prepare the area to an acceptable condition. Ensure the top of grade is level w/surrounding ground & maintain positive slope towards drain, gutter, and storm system away from building.
 - SITE:** Prepare the site where construction was removed, and prepare the ground to an acceptable condition.
 - INFORM:** Inform Architect prior to the start of this work.
 - CONNECT:** Connect new construction to existing, ensure continuity and structural integrity. Ensure the top of new construction is level w/existing surface.
 - CONNECT1:** Connect remaining item to the new structure, and ensure structural integrity while meeting local Codes. Handle remaining buildings, pavement, fences, and other items in place.
 - DISCONNECT:** Disconnect and conceal all pipes, electrical cables, data cables, and conduits where construction is removed.
 - ENGINEER:** Professional engineering supervision is required for this work.
 - SHOP:** Provide shop drawings for this work.
 - REFERENCE:** Refer to photo # for the existing condition at the location.
 - SLOPE:** Maintain positive slope towards drains, gutters, and storm systems and away from the building.
 - PROTECT:** Protect item(s) to remain, including any buildings, furniture, sidewalks, roofs, utilities, and other items during the Demolition and Construction phases.
 - REMOVE:** Maintain safe and unrestricted access routes from areas adjacent to the Demolition site. Comply with all applicable Codes.
 - TREE:** Refer to Landscape Drawings & Specs for removing trees.
 - OPERATE:** Ensure all routes and utilities required for school operation are protected. Ensure school operation will not be interrupted.
 - REMOVE1:** Ensure all slopes to drain as intended, and that downspouts indicated to remain are protected to maintain runoff at all times during demolition and construction. Protect items to remain including any buildings, furniture, sidewalks, roofs, utilities, and other items during demolition and construction.
 - REMOVE2:** Ensure system is water tight. Provide additional flashing & sealants as needed.
 - REMOVE3:** Ensure the slope of the new roof matches the slope and slope direction of the existing roof.
 - PHASE:** Work within this area may occur in phase ONE.
 - PHASE2:** Work within this area may occur in phase TWO.

DOORS MARKED LK ARE TO RECEIVE NEW LOCKSETS, RE: DOOR HARDWARE SPECIFICATIONS.

26 SUPPORT NOTES

27 CONSTRUCTION PLAN - MAGNET SCHOOL - SOUTH

- A001:** INSTALL FURRED PARTITIONS (TYPE D PER SHEET A030) OVER CMU WALLS WHERE LOCKERS WERE REMOVED. PROVIDE RUBBER BASE AND PAINT TO MATCH ADJACENT WALLS. RE: FINISH SCHEDULE & DETAILS. HANDLE 1, HANDLE 2, F&W, FIX 1.
- A003:** CLOSE OPENING LEFT BY REMOVED DOOR OR WINDOW. IF ADJACENT WALLS ARE CMU, PROVIDE FURRED GYP. BD. PARTITIONS ON EITHER SIDE OF EXISTING WALL. TO NEAREST CORNER. ENSURE HEADER IS STRUCTURALLY SOUND AND PROVIDE STEEL LINTELL UP NECESSARY. IF ADJACENT WALLS ARE GYP. CLOSE OPENING WITH STUD WALL TO MATCH EXISTING ADJACENT WALLS. ALIGN BOTH FACES OF WALL. ENSURE SMOOTH TRANSITIONS. FINISH TO MATCH ADJACENT WALLS. PROTECT 1, HANDLE 2.
- A005:** PAINT ENTIRE AREA, FOR CLASSROOMS, USE ACCENT PAINT COLOR TBD ON TEACHING WALL MARKERBOARD IS LOCATED. REFINISH SCHEDULE FOR MORE INFORMATION.
- A010:** PROVIDE ONE OUTER LAYER OF IMPACT RESISTANT GYP. BD ONLY ON CORRIDORS AND PUBLIC AREAS. FURRED PARTITIONS BEHIND MILLWORK NEED NOT HAVE IMPACT RESISTANT GYP.
- A012:** FIRE SPRINKLER SYSTEM SHALL EXTEND TO THIS SPACE. TIE INTO EXISTING SPRINKLER SYSTEM. RE: FIRE PROTECTION MEP DRAWINGS FOR MORE INFORMATION.
- A013:** PROVIDE NEW CEILING TILE AND GRID AT SAME HEIGHT AS EXISTING CEILING. RE: FINISH SCHEDULE. WHERE ROOM HAS CHANGED PLAN ARRANGEMENT, CENTER GRID ON NEW WALLS UNLESS INDICATED OTHERWISE. WHERE ROOM REMAINS THE SAME IN PLAN, CENTER GRID TO MATCH PREVIOUS UNLESS INDICATED OTHERWISE.
- A014:** PROVIDE NEW LVT FLOORING AS INDICATED IN FINISH SCHEDULE.
- A015:** PROVIDE NEW CARPET FLOORING AS INDICATED IN FINISH SCHEDULE.
- A016:** PROVIDE DOOR CONTROL FROM RECEPTIONIST DESK. RE: MEP DRAWINGS.
- A038:** REPAIR FLOORING AT THIS AREA (F&W)
- A101:** NEW DOOR AND FRAME AS SCHEDULED. HARDWARE AS SPECIFIED.
- A102:** OVERHEAD GARAGE DOOR. RE: 19/A5.00 RE: DOOR SCHEDULE FOR DIMENSIONS.
- A202:** NEW STOREFRONT/CURTAIN WALL. RE: WINDOW TYPES.
- A301:** NEW MILLWORK. RE: MILLWORK DETAILS & SPECS (HANDLE 2, F&W)
- A302:** DASHED, SCREENED ITEMS ARE FFE AND N.I.C. (FURNITURE, LIBRARY SHELVES, AND OTHER EQUIPMENT INDICATED FOR REFERENCE ONLY)
- A303:** MARKER BOARD (MB) OR ELECTRONIC MARKER BOARD (EMB). NOTE: ELECTRONIC MARKER BOARDS CONSIST OF MARKERBOARDS AND OF WALL-MOUNTED SMART PROJECTORS. RE: SPEC.
- A308:** RE: DEMOLITION DRAWINGS FOR REMOVAL OF EXISTING CEILING PROJECTORS AND REQUIREMENTS FOR NEW GYP WALL MOUNTED SMART PROJECTORS. RE: MEP DRAWINGS.
- A310:** INTERACTIVE MONITOR AS SPECIFIED.
- A311:** NEW WALL MOUNTED PROJECTOR AS SPECIFIED.
- A312:** PROVIDE NEW QUARTZ COUNTERTOP @ OPENING LOCATION
- PT 1:** PAINT (FIELD)
- X01:** EXISTING UTILITIES. (PROTECT 1)
- X06:** EXISTING TERRAZZO OR OTHER FLOORING TO REMAIN. V.I.F. (PROTECT 1, HANDLE 2)

04 KEYNOTES

Scale: NTS

- HANDLE STRUCTURE OF EXISTING BUILDING WITH CARE. NO WORK SHOULD HAVE ANY EFFECT ON THE STRUCTURAL INTEGRITY OF THE BUILDING. REPORT TO THE ARCHITECT ANY INDICATIONS OF STRUCTURAL DAMAGE.
- PROTECT THROUGHOUT DEMOLITION AND CONSTRUCTION ALL ITEMS INDICATED TO REMAIN INCLUDING BUT NOT LIMITED TO: BUILDINGS AND OTHER STRUCTURES, FLOORING, WALLS, CEILINGS, FINISHES, MEP SECURITY SYSTEMS, UTILITIES, MILLWORK, ETC.
- FIELD VERIFY ALL CONDITIONS PRIOR TO CONSTRUCTION, PARTICULARLY IN AREAS OF WORK.
- REPORT TO THE ARCHITECT ANY UNFORESEEN CONDITIONS OR AS-BUILT CONDITIONS NOT REFLECTED IN THE DRAWINGS, THAT COULD AFFECT THE WORK.
- MAINTAIN SAFE AND UNRESTRICTED ACCESS AND EGRESS ROUTES FOR OCCUPIED AREAS ADJACENT TO WORK AREA, IN ACCORDANCE WITH APPLICABLE CODES.
- ALL DIMENSIONS TO WALLS ARE TO FINISH-FACE OF WALL UNLESS INDICATED OTHERWISE. (SIDE INDICATED SPECIFICALLY IN THE DRAWINGS).
- PROVIDE NECESSARY BLOCKING AT WALLS FOR ALL PLUMBING FIXTURES, EQUIPMENT, MILLWORK, AND ACCESSORIES.
- PLANS INDICATE HORIZONTAL DIMENSIONS ONLY. REFER TO ELEVATIONS & SECTIONS FOR VERTICAL DIMENSIONS.
- PROVIDE PARTITION CURBS FOR MECH./ELEC. ROOM'S PERIMETER, TYP. UNLESS OTHERWISE NOTED.
- UNLESS INDICATED OTHERWISE, ALL NEW WORK IN THIS PROJECT IS TO BE ACCESSIBLE IN ACCORDANCE WITH THE MOST RECENT EDITION OF THE TEXAS ACCESSIBILITY STANDARDS. REFER TO DEMOLITION DRAWINGS FOR DEMOLITION INFORMATION.
- REFER TO DOOR AND WINDOW DETAILS FOR DIMENSIONS AT OPENINGS.
- REFER TO DEMOLITION DRAWINGS FOR DEMOLITION INFORMATION.
- REFER TO CODE ANALYSIS INFORMATION SHEET A020 FOR EXTENT OF EXTENDED FIRE-SPRINKLER SYSTEM.

01 GENERAL NOTES - CONSTRUCTION

Scale: NTS

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PROFESSIONAL SEAL:

23/12/2020

A PROJECT FOR:

STAFFORD HIGH SCHOOL & MAGNET SCHOOL RENOVATIONS


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#	Date	ISSUED FOR
	03/13/2020	ISSUE FOR BID, PERMIT, & CONSTRUCTION


KEY PLAN

TRUE NORTH PLAN NORTH


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Drawn By	LT
Checked By	AW
Approved By	MS
Drawing Title	PLAN AT MAGNET SCHOOL - SOUTH
Drawing Number	A2.10

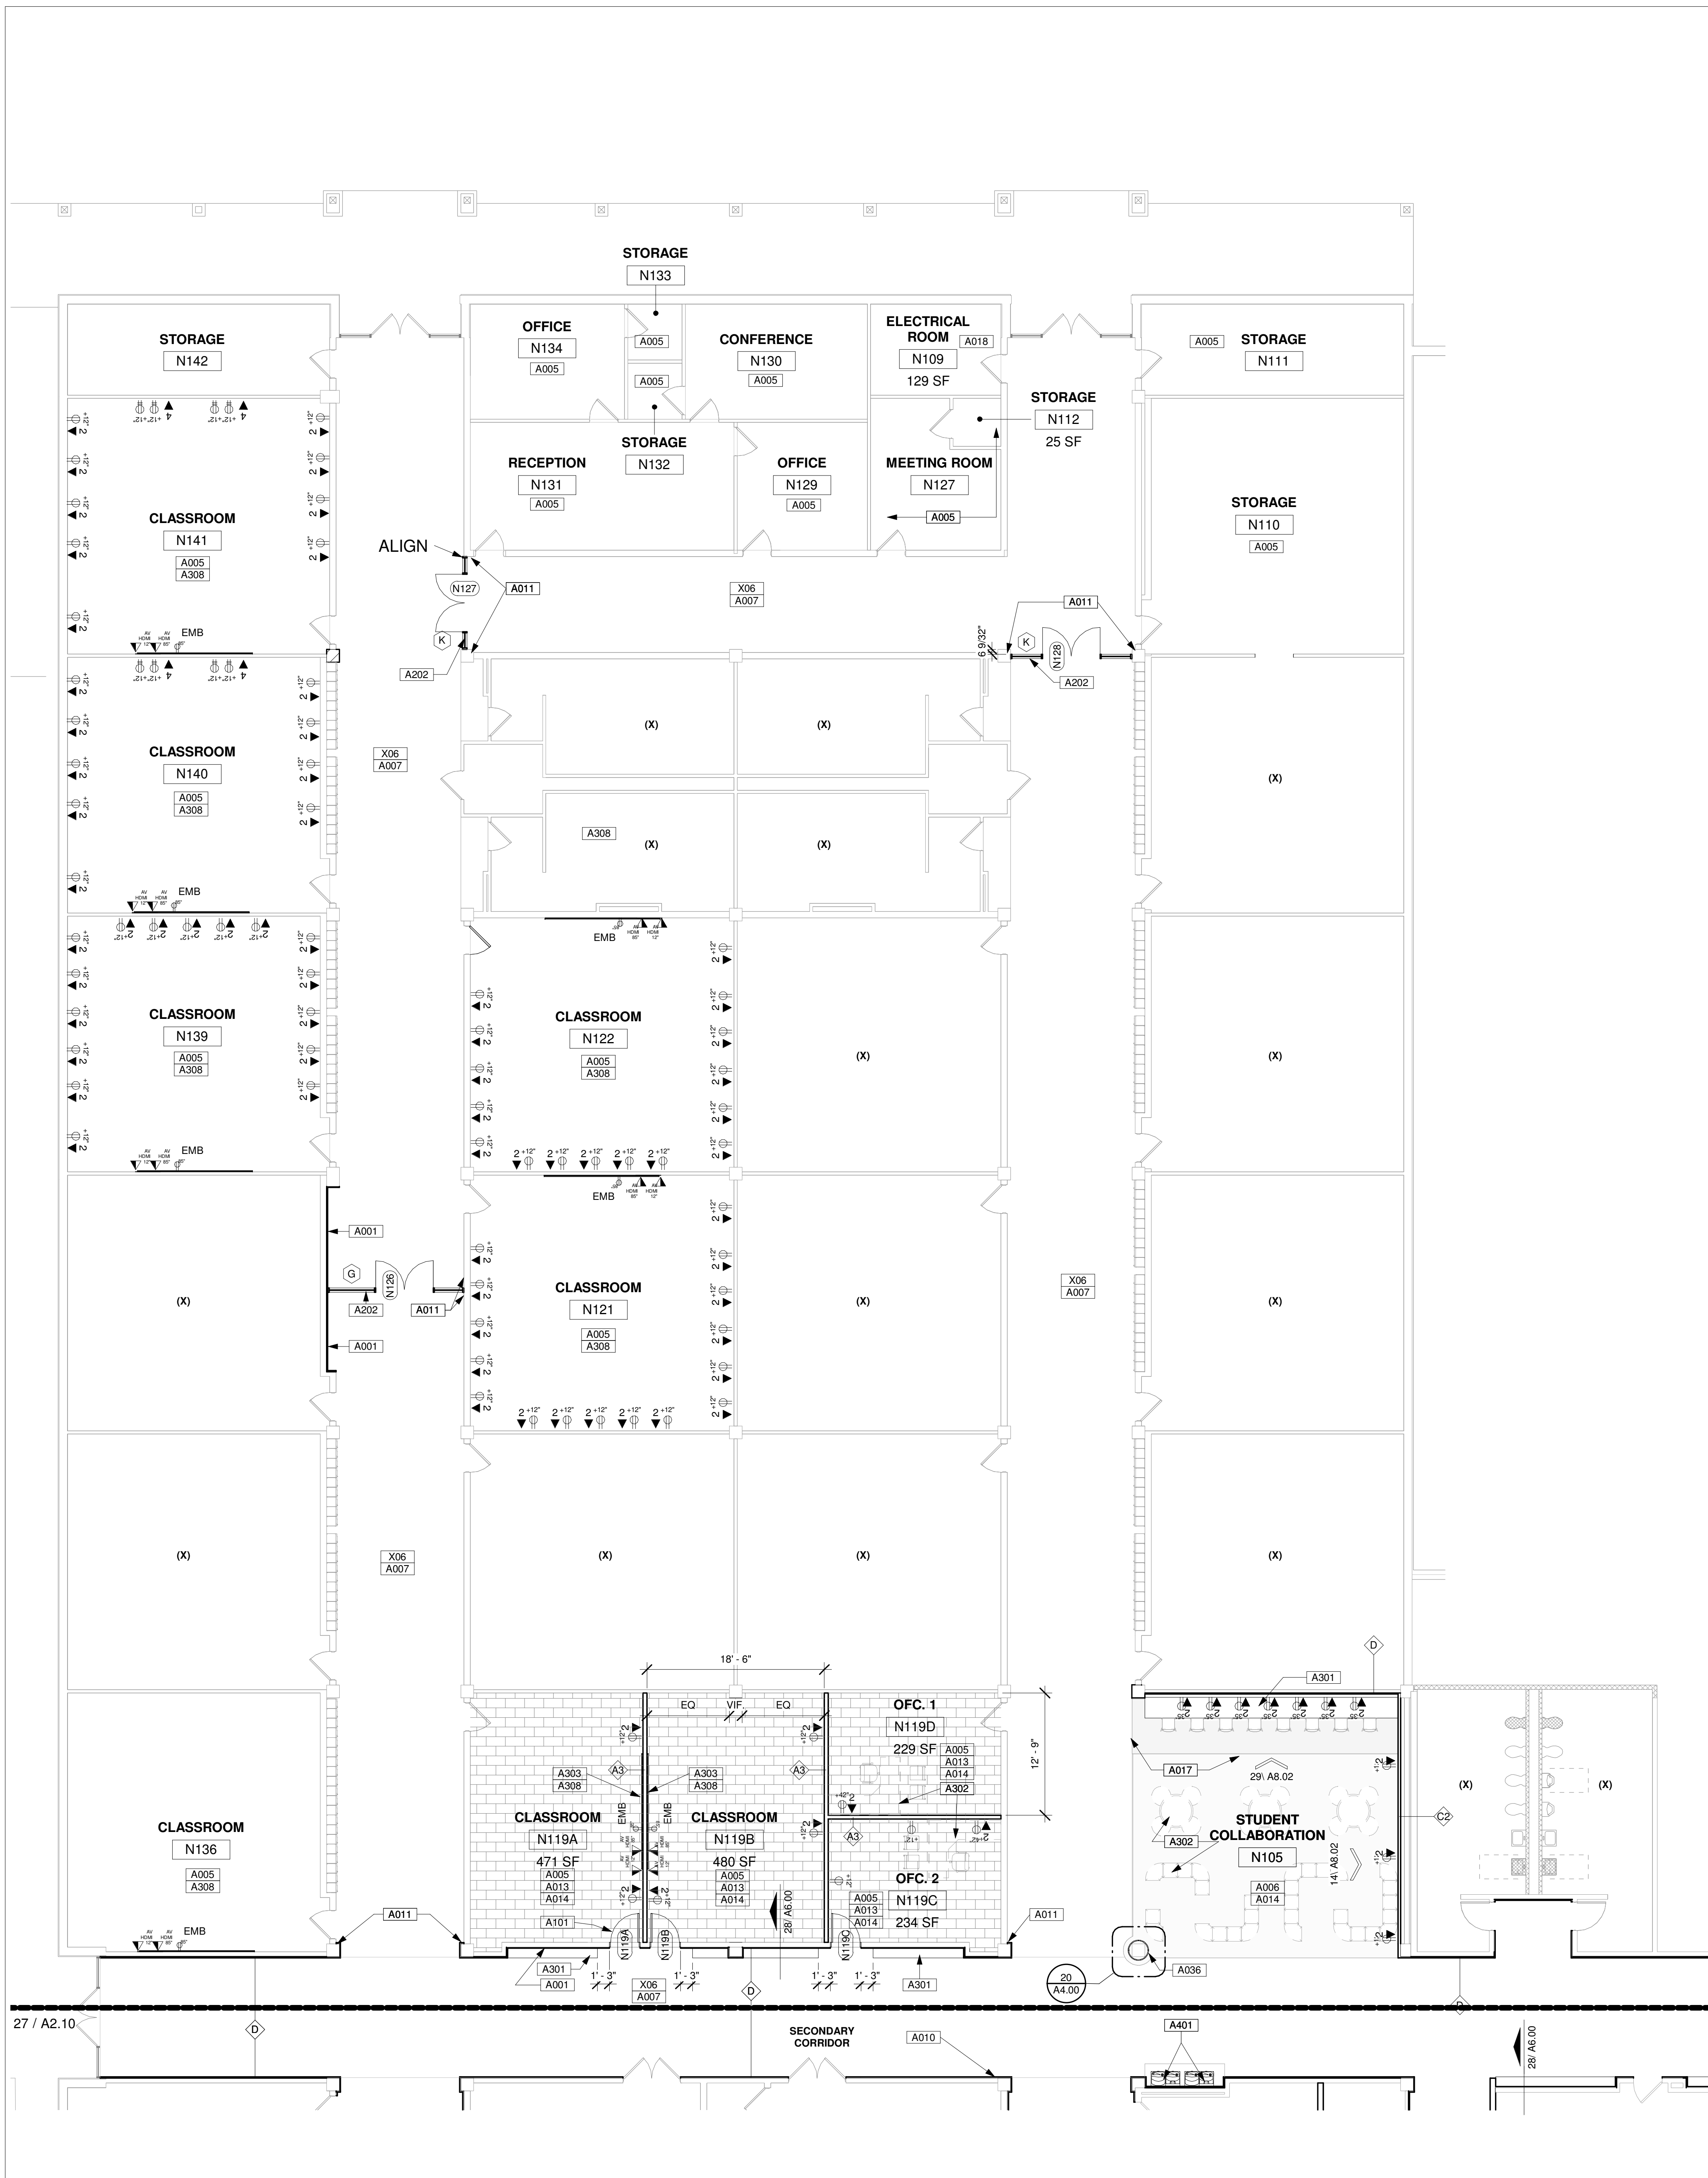

26 CONSTRUCTION PLAN - MAGNET SCHOOL - NORTH
Scale: 1/8" = 1'-0"

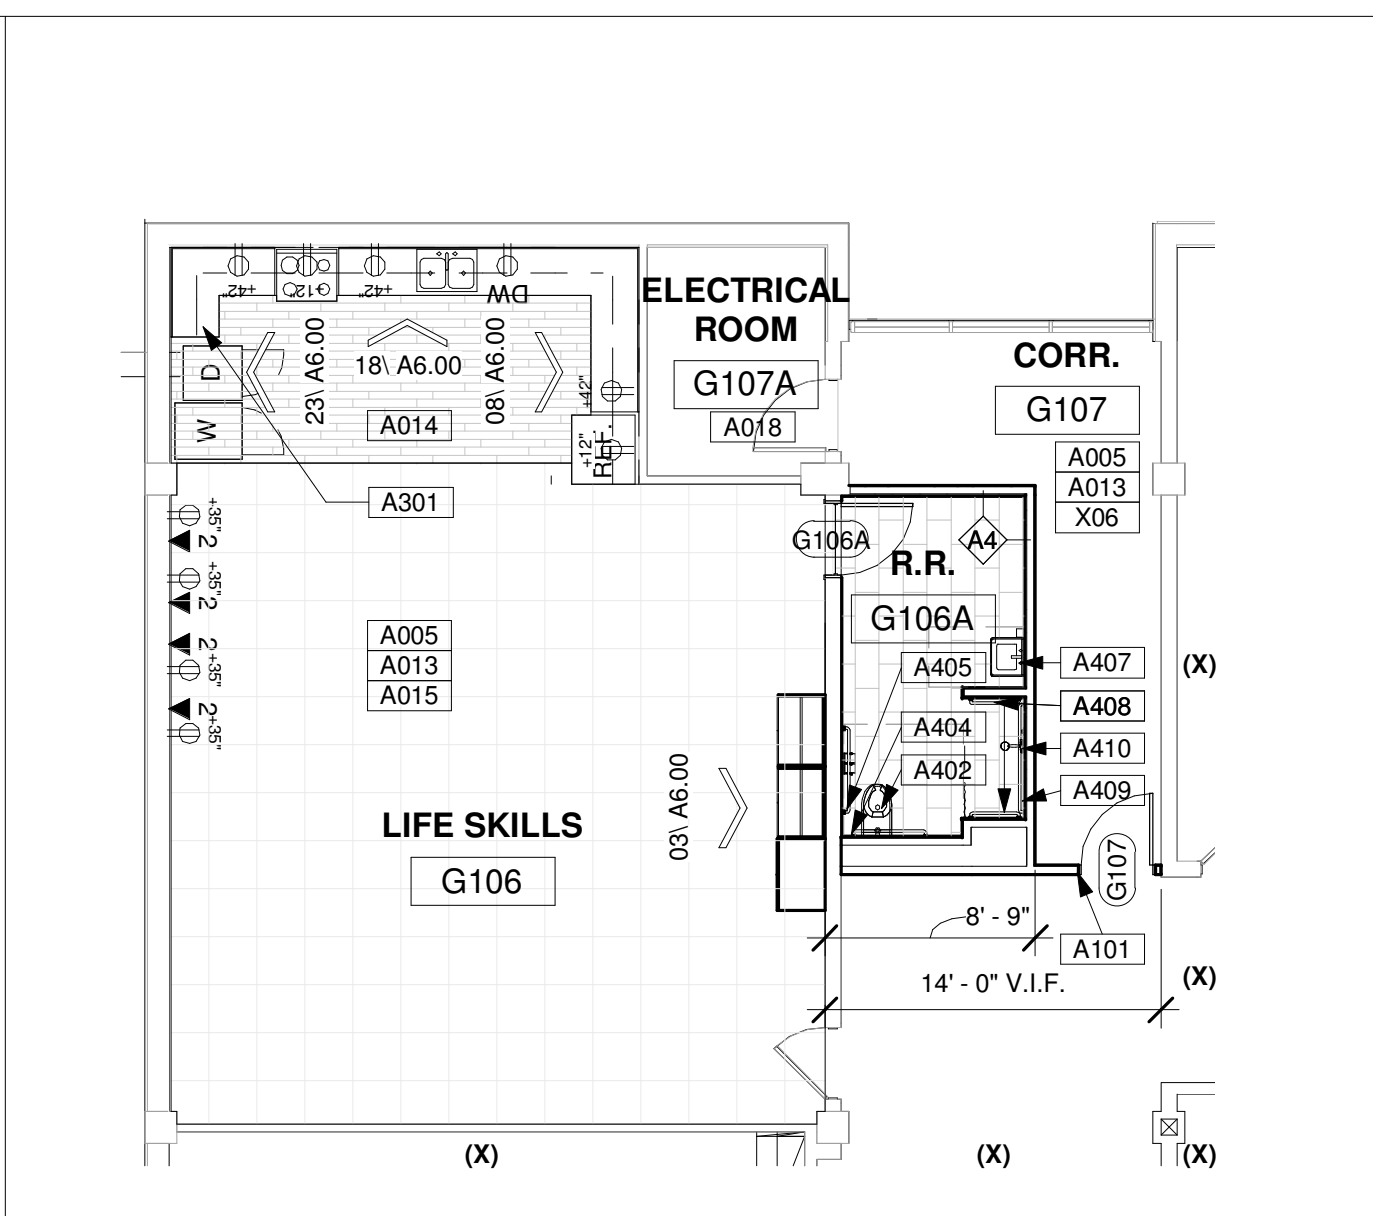

10 LIFE SKILLS PLAN
Scale: 1/8" = 1'-0"

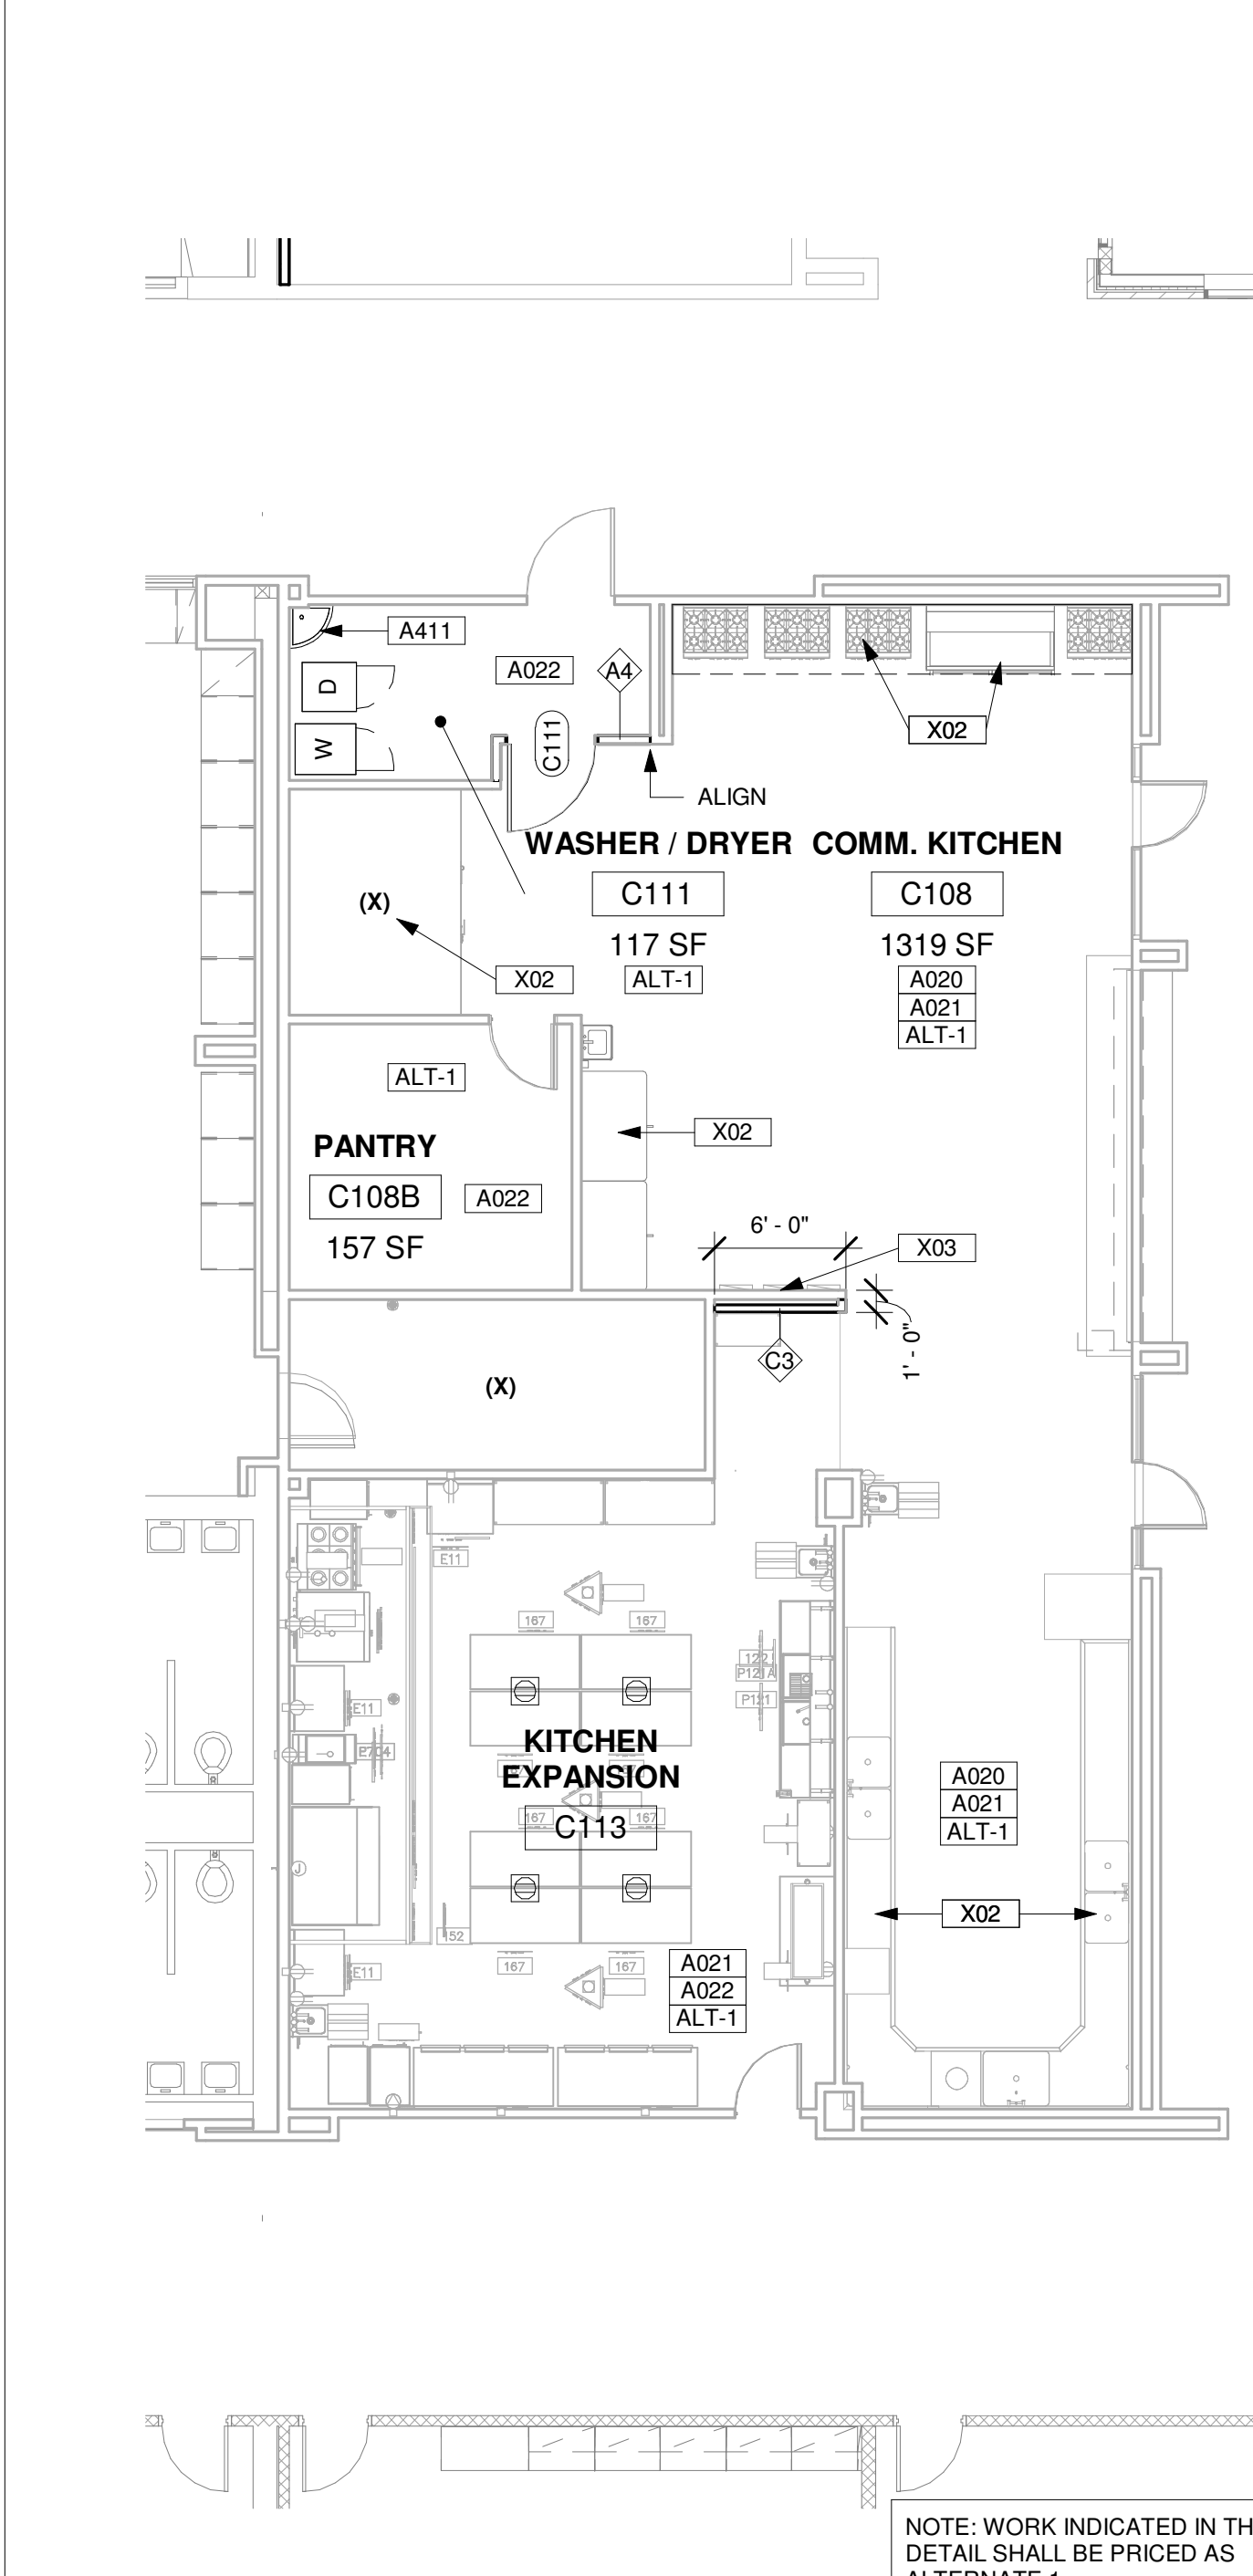

07 CTE KITCHEN PLAN
Scale: 1/8" = 1'-0"

- Dimension & Alignment Support Notes:**
- ALIGN 1:** Align face of new construction w/face of existing.
 - ALIGN 2:** Align Centerline of new construction w/Centerline of existing.
 - ALIGN 3:** Align grid/alignment grid w/existing grid.
 - LEVEL 1:** Ensure top of new construction is level w/existing surface.
 - LEVEL 2:** Level floor & surface to receive new construction.
 - LEVEL 3:** Ensure the top of grade is level w/surrounding ground.
- Construction & Condition Support Notes:**
- HANDLE 1:** Handle item w/care and store for owner's review.
 - HANDLE 2:** Handle remaining building, pavement, fence, or item w/care.
 - HANDLE 3:** Handle re-located items with care. DISCONNECT 1, FIXW.
 - FIXW:** Fix floor/wall/ceiling/item where construction was removed and prepare the area to receive new construction. Ensure the top of grade is level w/surrounding ground & maintain positive slope towards drain, gutter, and storm system away from building.
 - FIX:** Fix floor/wall/ceiling/item where construction was removed and prepare the area to an acceptable condition. Ensure the top of grade is level w/surrounding ground & maintain positive slope towards drain, gutter, and storm system away from building.
 - PREP:** Prepare the site where construction was removed, and prepare the ground to an acceptable condition.
 - INFORM:** Inform Architect prior to the start of this work.
 - CONNECT 1:** Connect new construction to existing, ensure continuity and structural integrity. Ensure the top of new construction is level w/existing surface.
 - CONNECT 2:** Connect remaining item to the new structure, and ensure structural integrity while meeting local Codes. Handle remaining buildings, pavement, fence, and other items w/care.
 - DISCONNECT:** Disconnect and conceal all pipes, electrical cables, data cables, and conduits where construction is removed.
 - ENGINEER 1:** Professional engineering supervision is required for this work.
 - SHOW:** Provide shop drawings for this work.
 - REFERENCE:** Refer to photo # for the existing condition at this location.
 - SLOPE:** Maintain positive slope towards drains, gutters, and storm systems and away from the building.
 - PROTECT 1:** Protect items to remain, including any buildings, furniture, sidewalks, roofs, utilities, and other items during the Demolition and Construction phases.
 - EGRESS:** Maintain safe and unobstructed egress routes from areas adjacent to the Demolition site. Comply with all Applicable Codes.
 - OPERATE:** Refer to Landscape Drawings & Specs for removing trees. Ensure school operation will not be interrupted.
 - ENSURE 1:** Ensure all egress routes and utilities required for school operation are protected. Ensure school operation will not be interrupted.
 - ENSURE 2:** Ensure all egress routes to drain as intended, and that downspouts indicated to remain are protected to maintain normal flow at all times during demolition and construction. Protect items to remain including any buildings, furniture, sidewalks, and other items during demolition and construction.
 - ENSURE 3:** Ensure system is water-tight. Provide additional flashing & sealants as needed.
 - PHASE 1:** Work within this area may occur in phase ONE.
 - PHASE 2:** Work within this area may occur in phase TWO.

05 SUPPORT NOTES
Scale: NTS

- A001 INSTALL FURRED PARTITIONS (TYPE D PER SHEET A030) OVER OAU WALLS WHERE LOCKERS WERE REMOVED. PROVIDE RUBBER BASE AND PAINT TO MATCH ADJACENT WALLS. RE: FINISH SCHEDULE & DETAILS. (HANDLE 1; HANDLE 2; FIXW; FIX 1)
- A005 PAINT ENTIRE AREA. FOR CLASSROOMS, USE ACCENT PAINT COLOR TBD ON TEACHING WALL. MARKERBOARD IS LOCATED. RE: FINISH SCHEDULE. (HANDLE 2; FIXW)
- A006 REHAB DECK AND STRUCTURE ABOVE. CLEAN AND PAINT. (HANDLE 2; FIXW)
- A007 PAINT WALL TO UNDERSIDE OF DECK ABOVE. RE: FINISH SCHEDULE & INTERIOR ELEVATIONS. (HANDLE 2; FIXW)
- A010 PROVIDE ONE OUTER LAYER OF IMPACT RESISTANCE GYP BD ONLY ON CORRIDORS AND PUBLIC AREAS. FURRED PARTITIONS BEHIND MILLWORK NEED NOT HAVE IMPACT RESISTANT GYP.
- A011 REFINISH ADJACENT SURFACES TO LIKE-NEW CONDITION. RE: SPECS. (HANDLE 2; FIXW)
- A013 PROVIDE NEW CEILING TILE AND GRID AT SAME HEIGHT AS EXISTING CEILING. RE: FINISH SCHEDULE. WHERE ROOM HAS CHANGED PLAN ARRANGEMENT, CENTER GRID ON NEW WALLS UNLESS INDICATED OTHERWISE. WHERE ROOM REMAINS THE SAME IN PLAN, CENTER GRID TO MATCH PREVIOUS UNLESS INDICATED OTHERWISE.
- A014 PROVIDE NEW LVT FLOORING AS INDICATED IN FINISH SCHEDULE.
- A015 PROVIDE NEW CARPET FLOORING AS INDICATED IN FINISH SCHEDULE.
- A017 SCREENED LINE REPRESENTS FLOOR MATERIAL TRANSITION. ALIGN AS SHOWN TO FURRED PARTITIONS ADJACENT OR AT LOCATION DIMENSIONED FROM FACE OF WALL. RE: FINISH SCHEDULE FOR MORE INFORMATION.
- A018 NO NEW FINISHES OR ARCHITECTURAL WORK IN ELECTRICAL, MECHANICAL, AND JANITORS ROOMS. RE: MEP DRAWINGS FOR SCOPE.
- A020 CLEAN EXISTING QUARRY TILE FLOORS, INCLUDING GROUT IN KITCHEN. RE: DEMOLITION PLANS FOR FURTHER INFORMATION. (HANDLE 2)
- A021 PROVIDE NEW FRP PANELS ON ALL WALLS AT KITCHEN. IN EXISTING AND NEW AREAS, EXCLUDING EXISTING STAINLESS STEEL SURFACES, BOTTOM OF PANELS SHALL ALIGN TO TOP OF BASE. TOP OF PANELS SHALL BE 8'-0" ABOVE TOP OF QUARRY TILE BASE. FRP SHALL BE TRIMMED AROUND ALL EXISTING WALL MOUNTED ACCESSORIES, SWITCHES, AND OTHER WALL MOUNTED ITEMS.
- A022 PROVIDE NEW EPOXY FLOORING, SLIP RESISTANT AND ACCEPTABLE FOR USE IN COMMERCIAL KITCHEN APPLICATIONS, COLOR TO MATCH EXISTING QUARRY TILE ADJACENT.
- A036 PROVIDE COLUMN WRAP AS SPECIFIED.
- A101 NEW DOOR AND FRAME AS SCHEDULED. HARDWARE AS SPECIFIED.
- A202 NEW STOREFRONT CURTAIN WALL. RE: WINDOW TYPES.
- A301 NEW MILLWORK. RE: MILLWORK DETAILS & SPECS. (HANDLE 2; FIXW)
- A302 DASHED, SCREENED ITEMS ARE FFE AND N.I.C. (FURNITURE, LIBRARY SHELVES, AND OTHER EQUIPMENT INDICATED FOR REFERENCE ONLY.)
- A303 MARKER BOARD (MB) OR ELECTRONIC MARKER BOARD (EMB). NOTE: ELECTRONIC MARKER BOARDS CONSIST OF MARKERBOARDS AND OF WALL-MOUNTED SMART PROJECTORS. RE: SPEC.
- A308 RE: DEMOLITION DRAWINGS FOR REMOVAL OF EXISTING CEILING PROJECTORS AND REQUIREMENTS FOR NEW OF WALL-MOUNTED SMART PROJECTORS. RE: MEP DRAWINGS.
- A401 PAIR OF ELECTRIC DRINKING FOUNTAINS (EDF) ON WALL. ADA COMPLIANT VERSION WITH NO RECESSED MECHANISM. SPOUT HEIGHT, CLEARANCES, AND OTHER DIMENSIONS SHALL MEET REQUIREMENTS OF 2012 TAS 602.7. PROVIDE BLOCKING SUPPORT AS NEEDED. RE: MEP DWGS FOR MORE INFORMATION. (PROTECT 1; FIXW; CONNECT 1)
- A402 TOILET FIXTURE WITH SEAT HEIGHT AND CLEARANCES TO MEET REQUIREMENTS OF 2012 TAS. PROVIDE NEW CARRIERS AS NEEDED. RE: MEP DWGS FOR MORE INFORMATION. (CONNECT 1; FIXW)
- A404 36" HANDICAPPED GRAB BAR @ 34" A.F.F. AND LOCATION REQUIRED TO COMPLY WITH 2012 TAS 604.5 PROVIDE BLOCKING SUPPORT AS NEEDED. (CONNECT 1; FIXW)
- A405 42" HANDICAPPED GRAB BAR @ 34" A.F.F. AND LOCATION REQUIRED TO COMPLY WITH 2012 TAS 604.5 PROVIDE BLOCKING SUPPORT AS NEEDED. (CONNECT 1; FIXW)
- A407 WALL HUNG LAVATORY @ 34" A.F.F. (HOLD) WITH MIRROR ABOVE AND SOAP DISPENSER ADJACENT. RE: TYPICAL ELEVATIONS. COMPLY WITH 2012 TAS 608. (CONNECT 1; FIXW)
- A408 24" HANDICAPPED GRAB BAR @ 34" A.F.F. AND LOCATION REQUIRED TO COMPLY WITH 2012 TAS 609.4. PROVIDE BLOCKING SUPPORT AS NEEDED. (CONNECT 1; FIXW)
- A409 54" HANDICAPPED GRAB BAR @ 34" A.F.F. AND LOCATION REQUIRED TO COMPLY WITH 2012 TAS 609.4. PROVIDE BLOCKING SUPPORT AS NEEDED. (CONNECT 1; FIXW)
- A410 SHOWER CONTROLS AND NOZZLE. RE: PLUMBING DRAWINGS. INSTALL AT HEIGHTS TO COMPLY WITH 2012 TAS 608.5.2. (CONNECT 1; FIXW)
- A411 NEW MOP SINK. RE: PLUMBING DRAWINGS.
- ALT-1 WORK INDICATED IS TO BE DONE AS ALTERNATE 1. RE: 27/A030 FOR MORE INFORMATION.
- X02 EXISTING EQUIPMENT (PROTECT 1)
- X03 EXISTING SHUTOFFS / ELECTRICAL PANELS. FIELD VERIFY. RE: MEP DRAWINGS. (PROTECT 1)
- X06 EXISTING TERRAZZO OR OTHER FLOORING TO REMAIN. V.I.F. (PROTECT 1; HANDLE 2)

02 CONSTRUCTION KEYNOTES
Scale: NTS

1. HANDLE STRUCTURE OF EXISTING BUILDING WITH CARE. NO WORK SHOULD HAVE ANY EFFECT ON THE STRUCTURAL INTEGRITY OF THE BUILDING. REPORT TO THE ARCHITECT ANY INDICATIONS OF STRUCTURAL DAMAGE.
2. PROTECT THROUGHOUT DEMOLITION AND CONSTRUCTION ALL ITEMS INDICATED TO REMAIN INCLUDING BUT NOT LIMITED TO BUILDINGS AND OTHER STRUCTURES, FLOORING, WALLS, CEILINGS, FINISHES, MEP/SECURITY SYSTEMS, UTILITIES, MILLWORK, ETC.
3. FIELD VERIFY ALL CONDITIONS PRIOR TO CONSTRUCTION, PARTICULARLY IN AREAS OF WORK.
4. REPORT TO THE ARCHITECT ANY UNFORESEEN CONDITIONS OR AS-BUILT CONDITIONS NOT REFLECTED IN THE DRAWINGS, THAT COULD AFFECT THE WORK.
5. MAINTAIN SAFE AND UNRESTRICTED ACCESS AND EGRESS ROUTES FOR OCCUPIED AREAS ADJACENT TO WORK AREA, IN ACCORDANCE WITH APPLICABLE CODES.
6. ALL DIMENSIONS TO WALLS ARE TO FINISH-FACE OF WALL UNLESS INDICATED OTHERWISE. (SIDE INDICATED GRAPHICALLY IN THE DRAWINGS).
7. PROVIDE NECESSARY BLOCKING AT WALLS FOR ALL PLUMBING FIXTURES, EQUIPMENT, MILLWORK, AND ACCESSORIES.
8. PLANS INDICATE HORIZONTAL DIMENSIONS ONLY. REFER TO ELEVATIONS & SECTIONS FOR VERTICAL DIMENSIONS.
9. PROVIDE PARTITION CURBS FOR MECH./ELEC. ROOM'S PERIMETER, TYP. UNLESS OTHERWISE NOTED.
10. UNLESS INDICATED OTHERWISE, ALL NEW WORK IN THIS PROJECT IS TO BE ACCESSIBLE IN ACCORDANCE WITH THE MOST RECENT EDITION OF THE TEXAS ACCESSIBILITY STANDARDS. REFER TO ACCESSIBILITY REQUIREMENTS ON SHEETS A010 AND A030 FOR MORE INFORMATION.
11. REFER TO DOOR AND WINDOW DETAILS FOR DIMENSIONS AT OPENINGS.
12. REFER TO DEMOLITION DRAWINGS FOR DEMOLITION INFORMATION.
13. REFER TO CODE ANALYSIS INFORMATION SHEET A020 FOR EXTENT OF EXTENDED FIRE-SPRINKER SYSTEM.

01 GENERAL CONSTRUCTION NOTES
Scale: NTS

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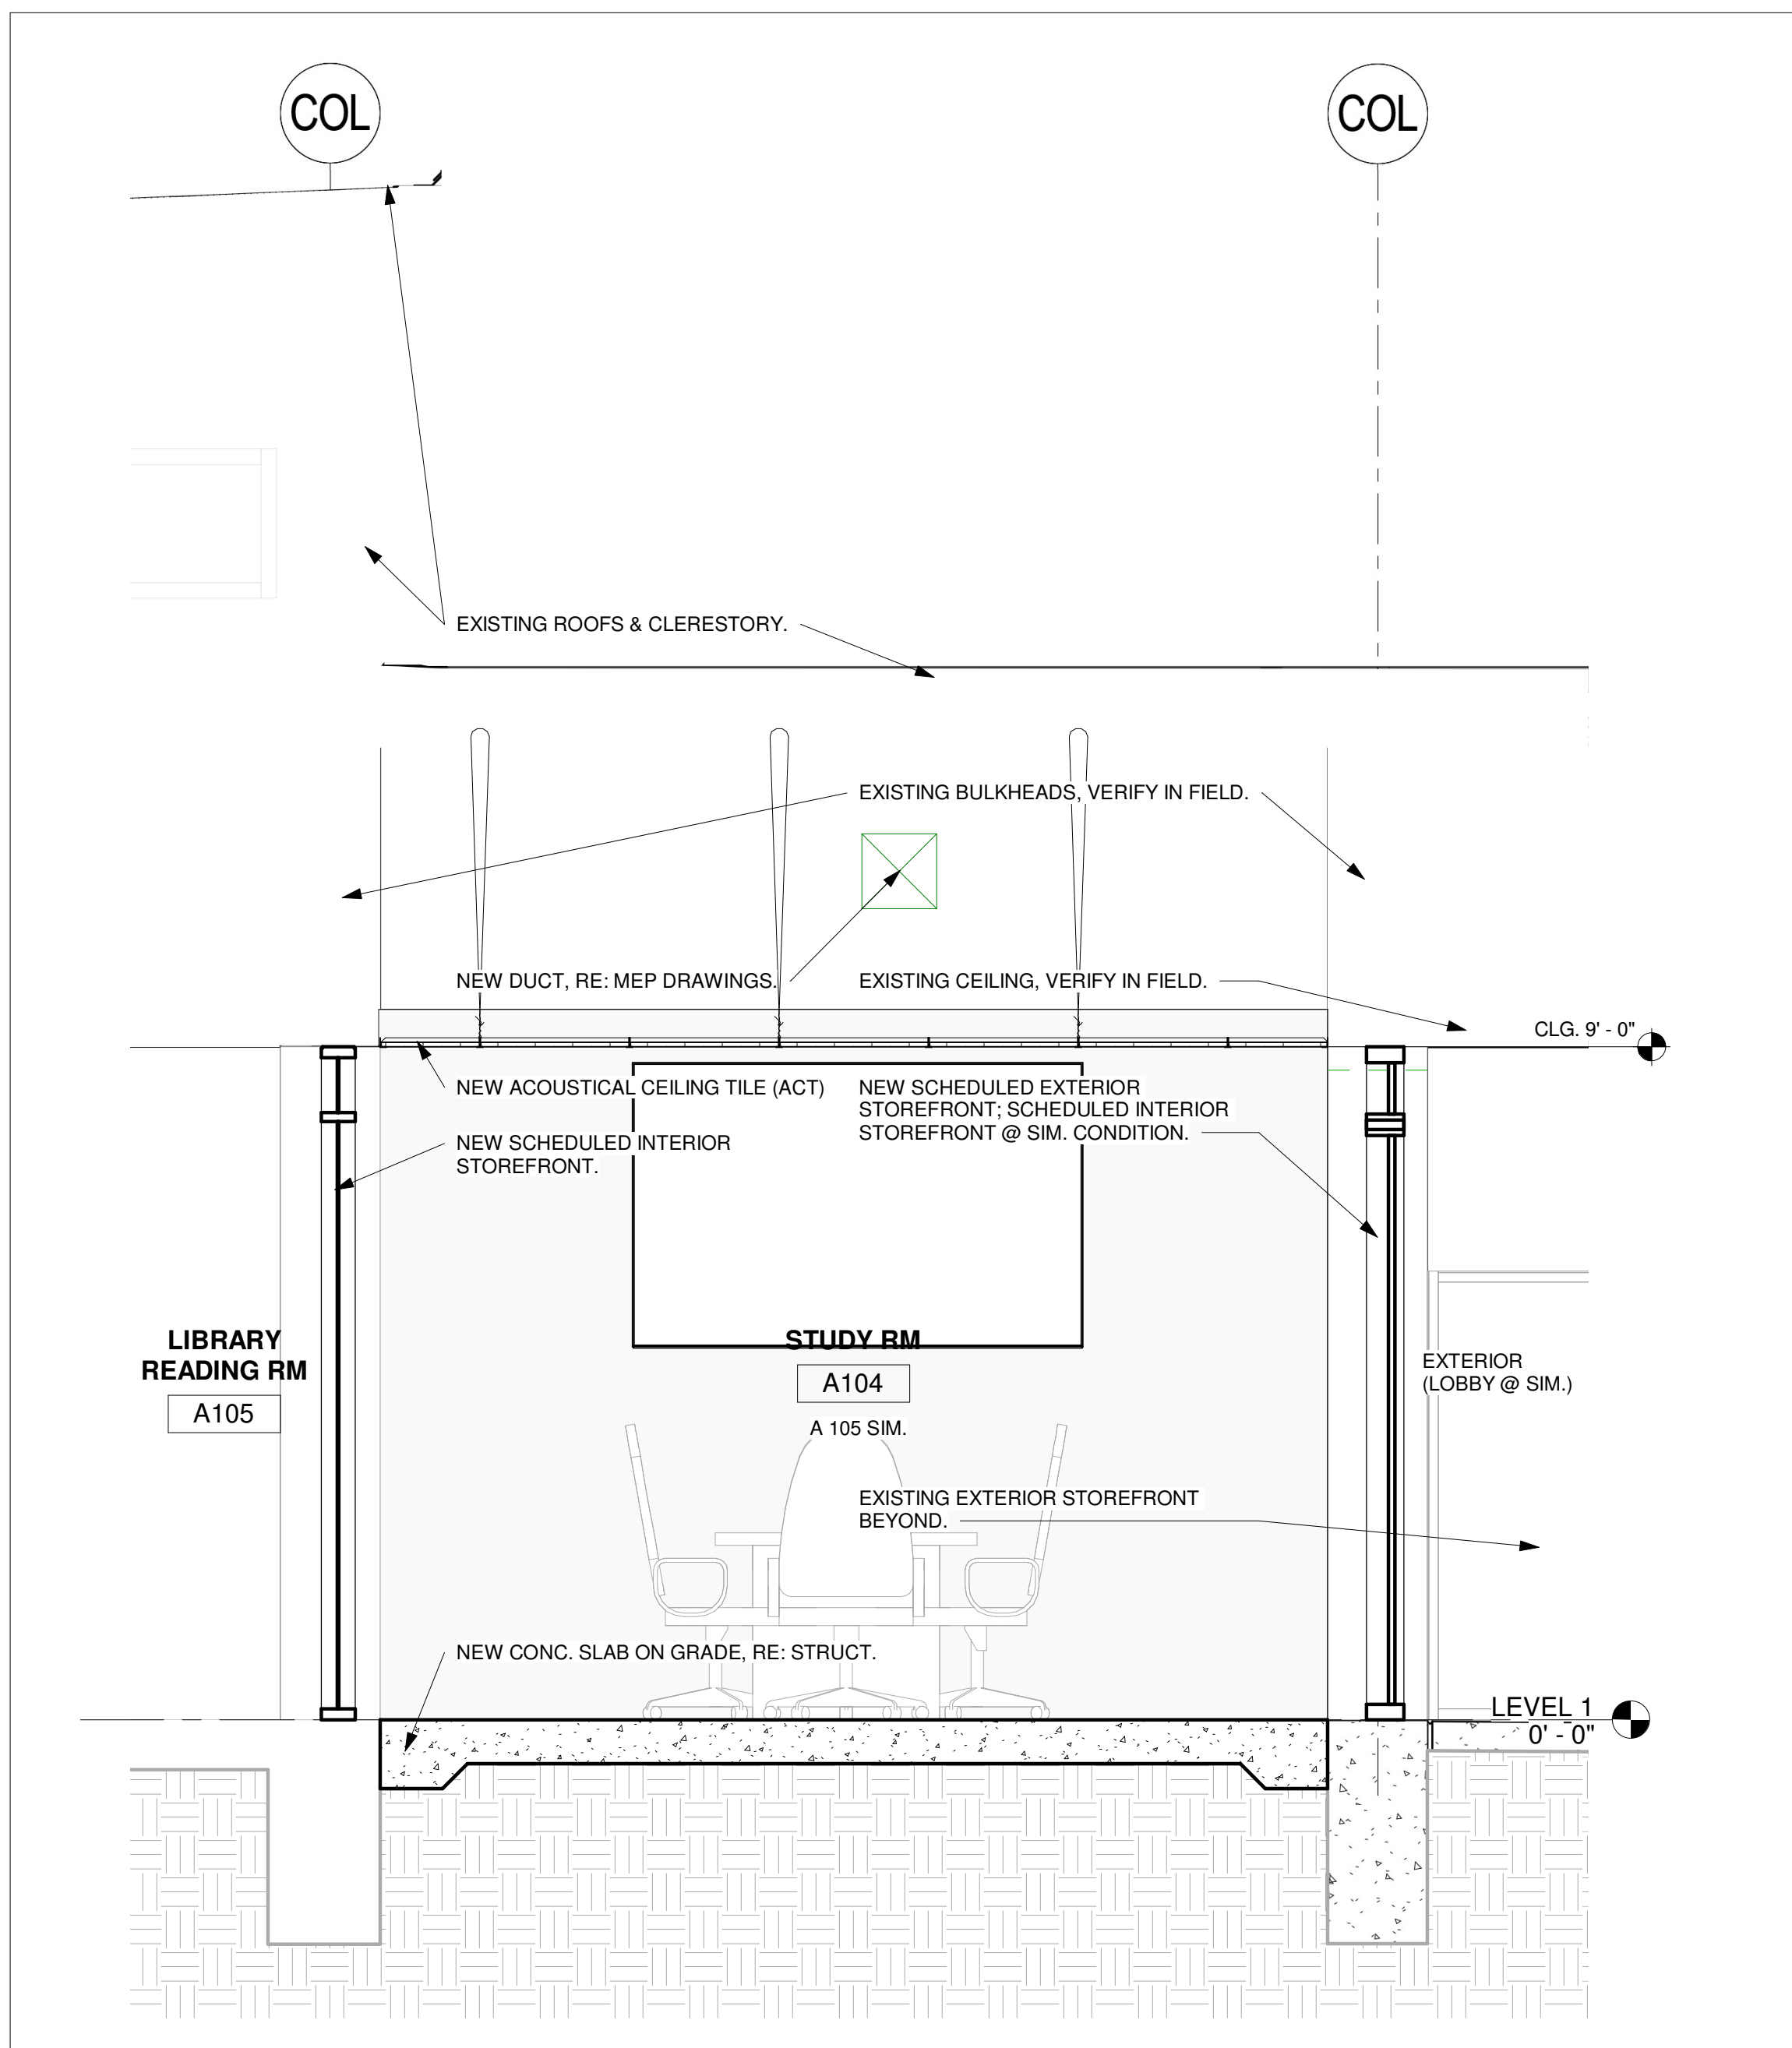
PROFESSIONAL SEAL:

A PROJECT FOR:
STAFFORD HIGH SCHOOL & MAGNET SCHOOL RENOVATIONS
1625 STAFFORDSHIRE ROAD,
STAFFORD, TX 77477


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	03/13/2020	ISSUE FOR BID, PERMIT, & CONSTRUCTION

KEY PLAN
TRUE NORTH
PLAN NORTH


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Drawn By	LT
Checked By	AW
Approved By	MS
Drawing Title	PLAN AT MAGNET SCHOOL - NORTH
Drawing Number	A2.11




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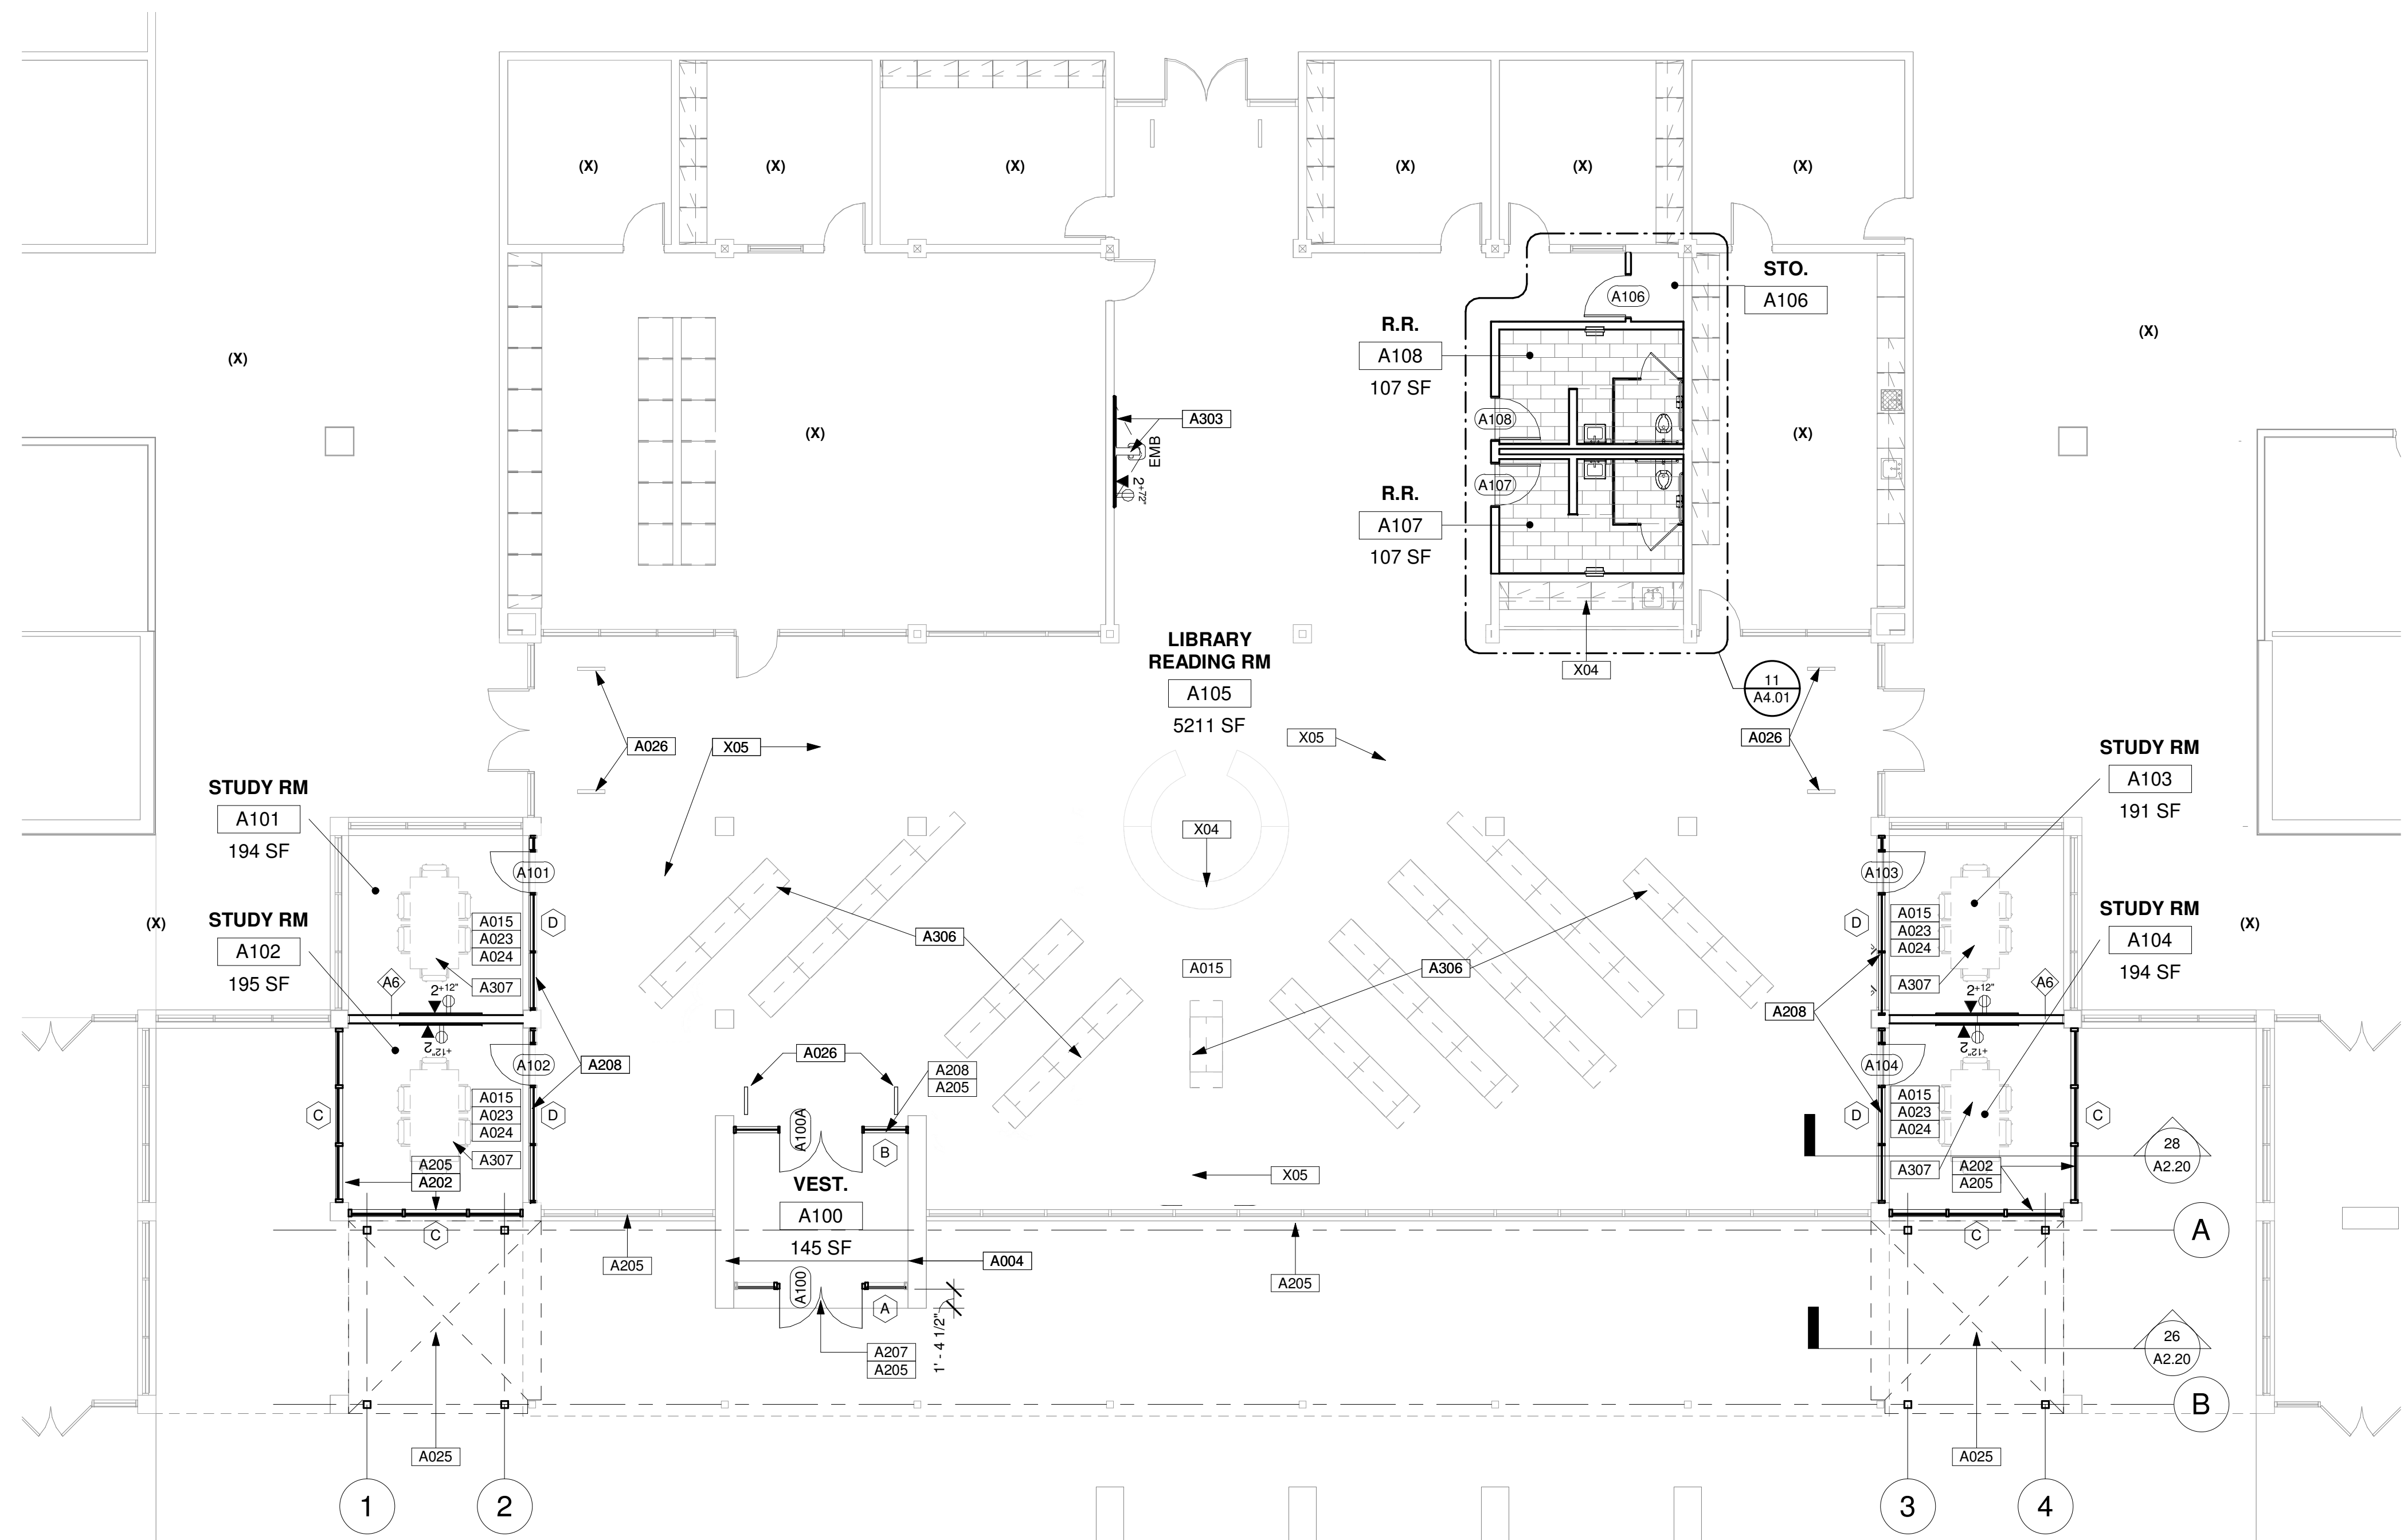
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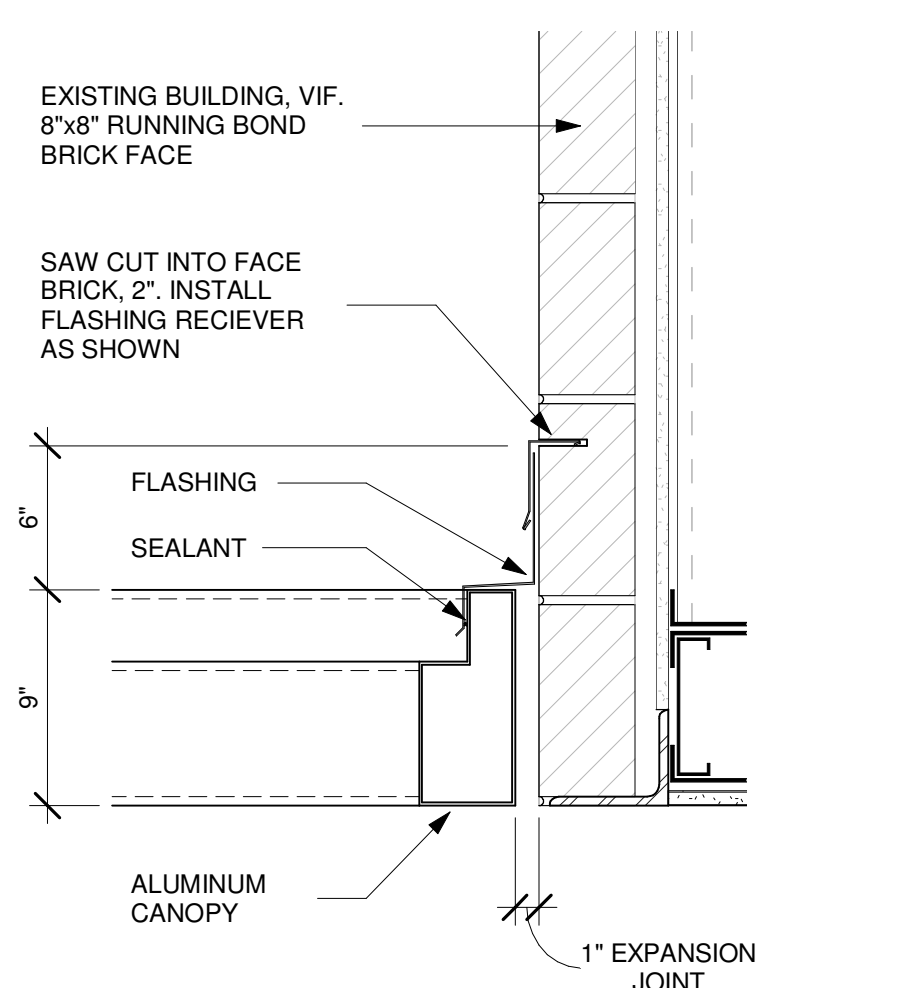
20 NEW CANOPIES AT LIBRARY
Scale: 1/4" = 1'-0"

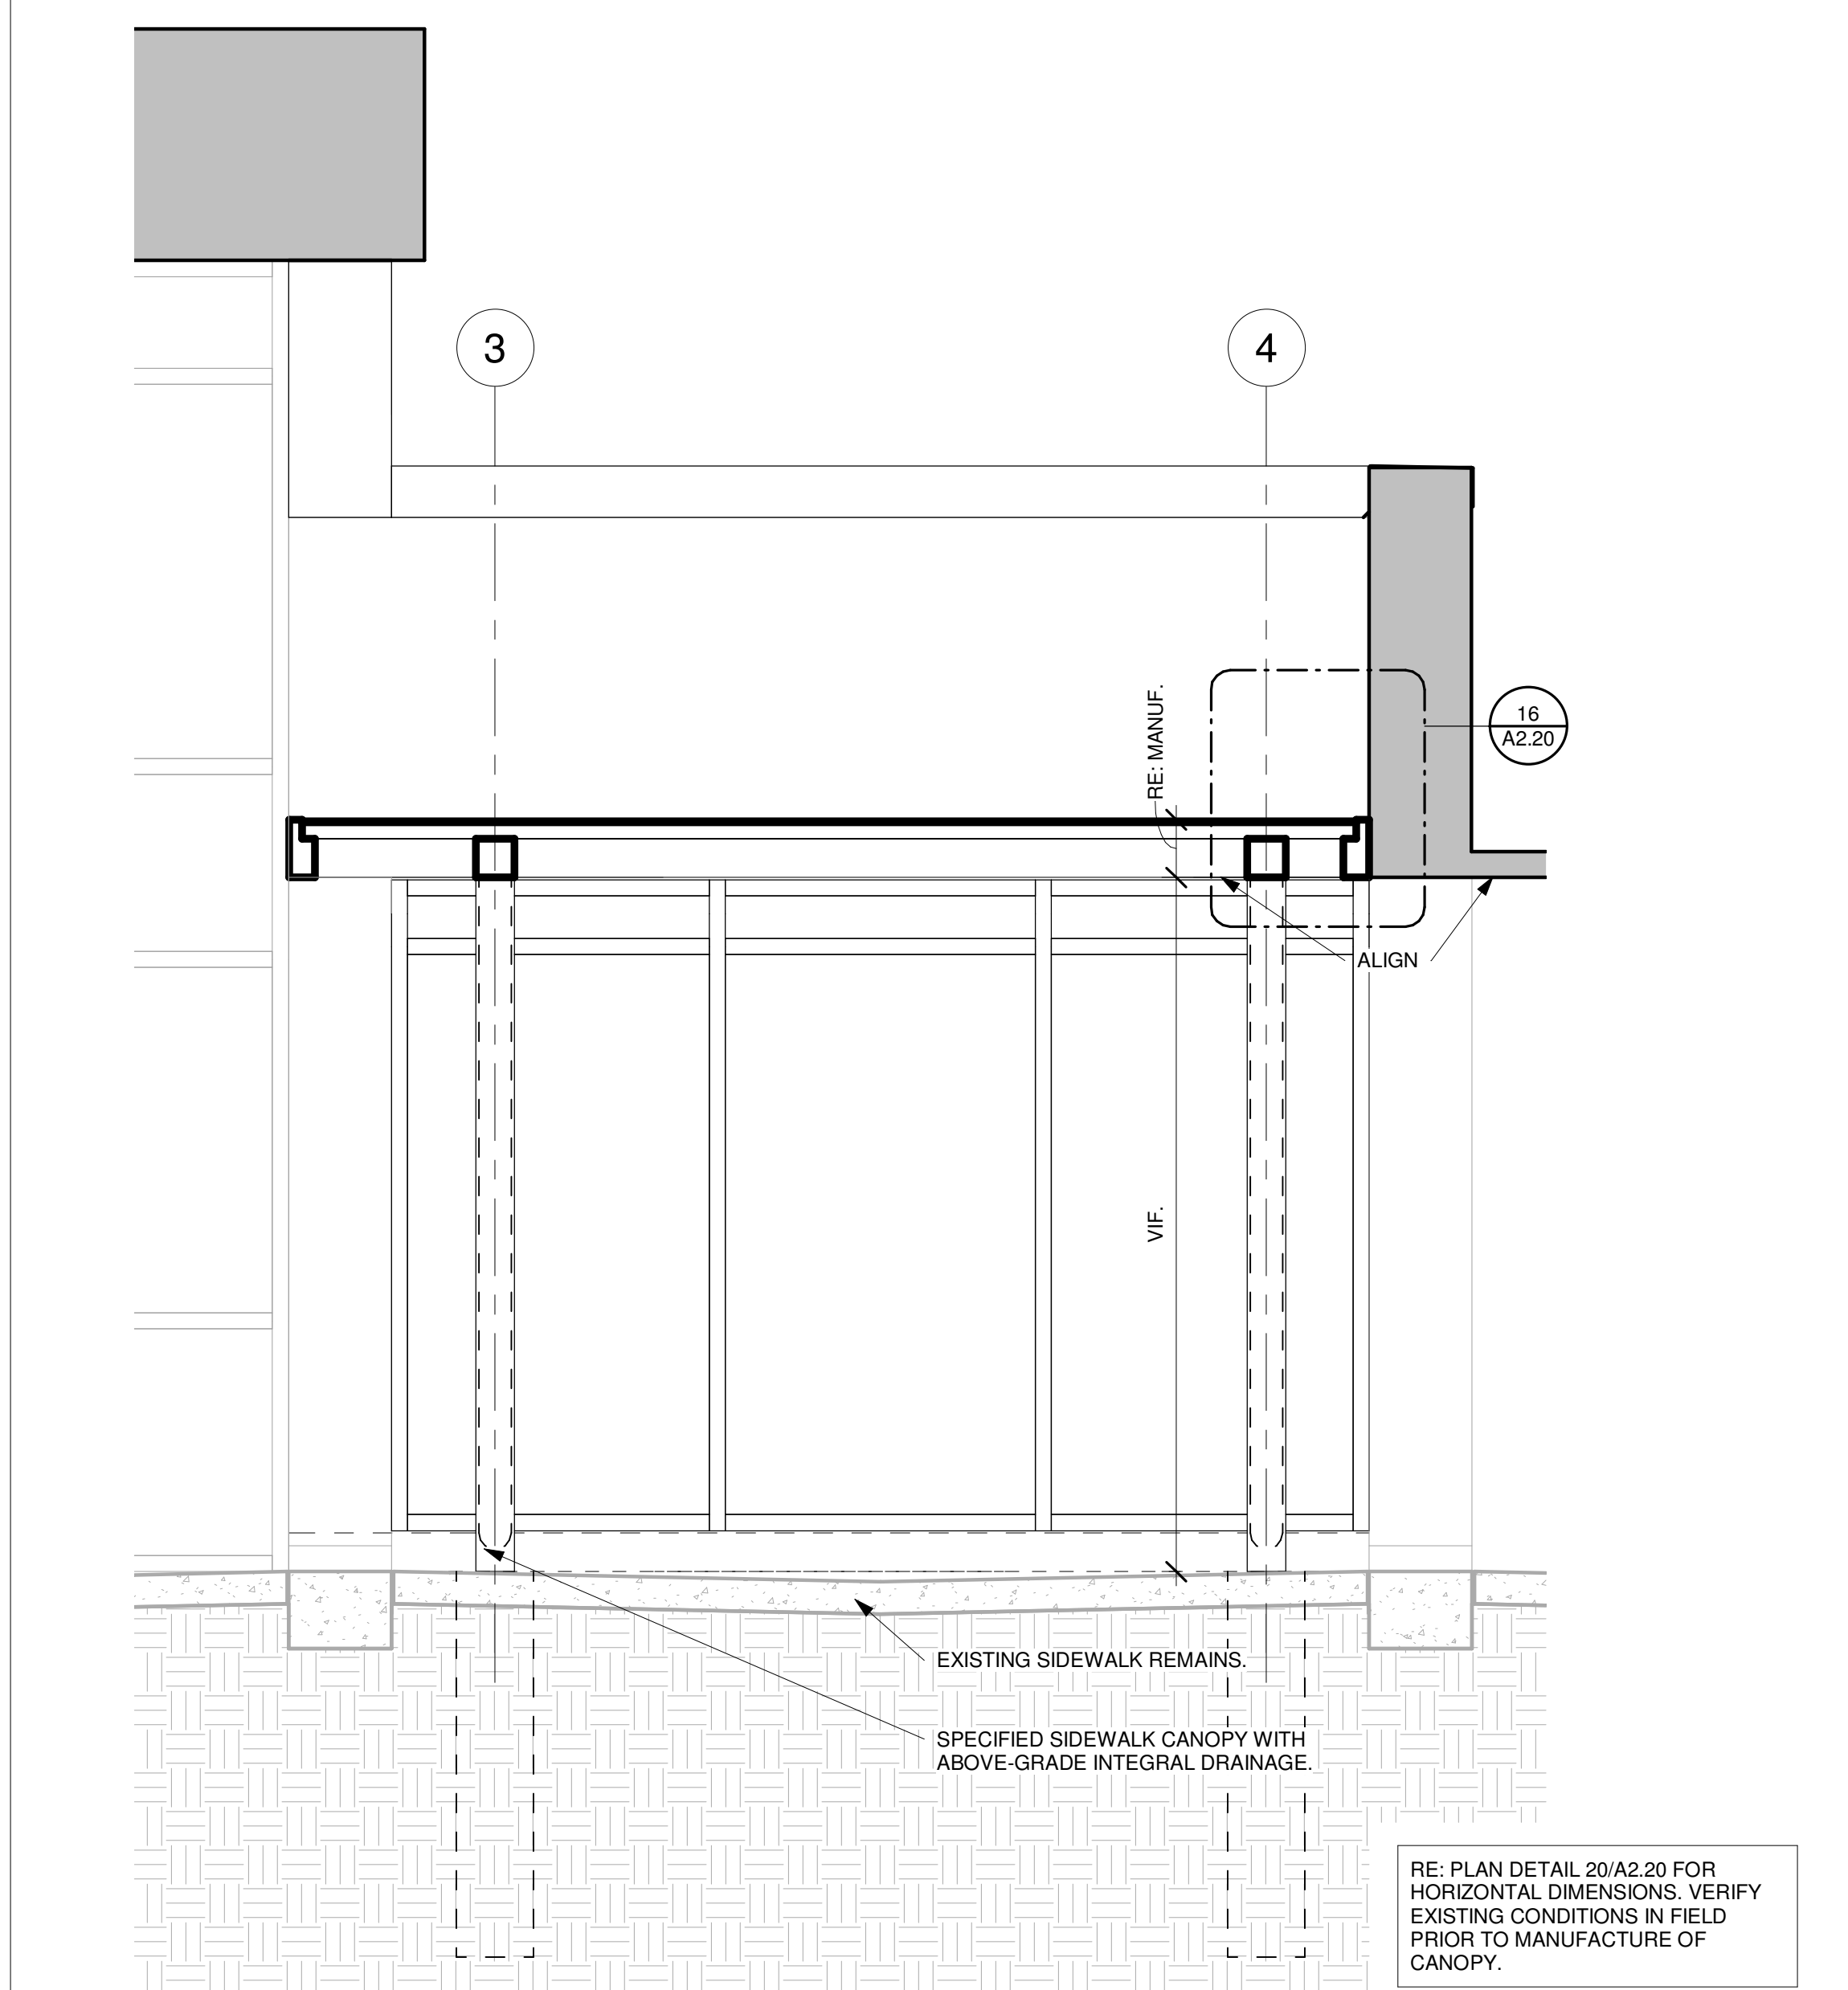

15 LEGEND
Scale: NTS

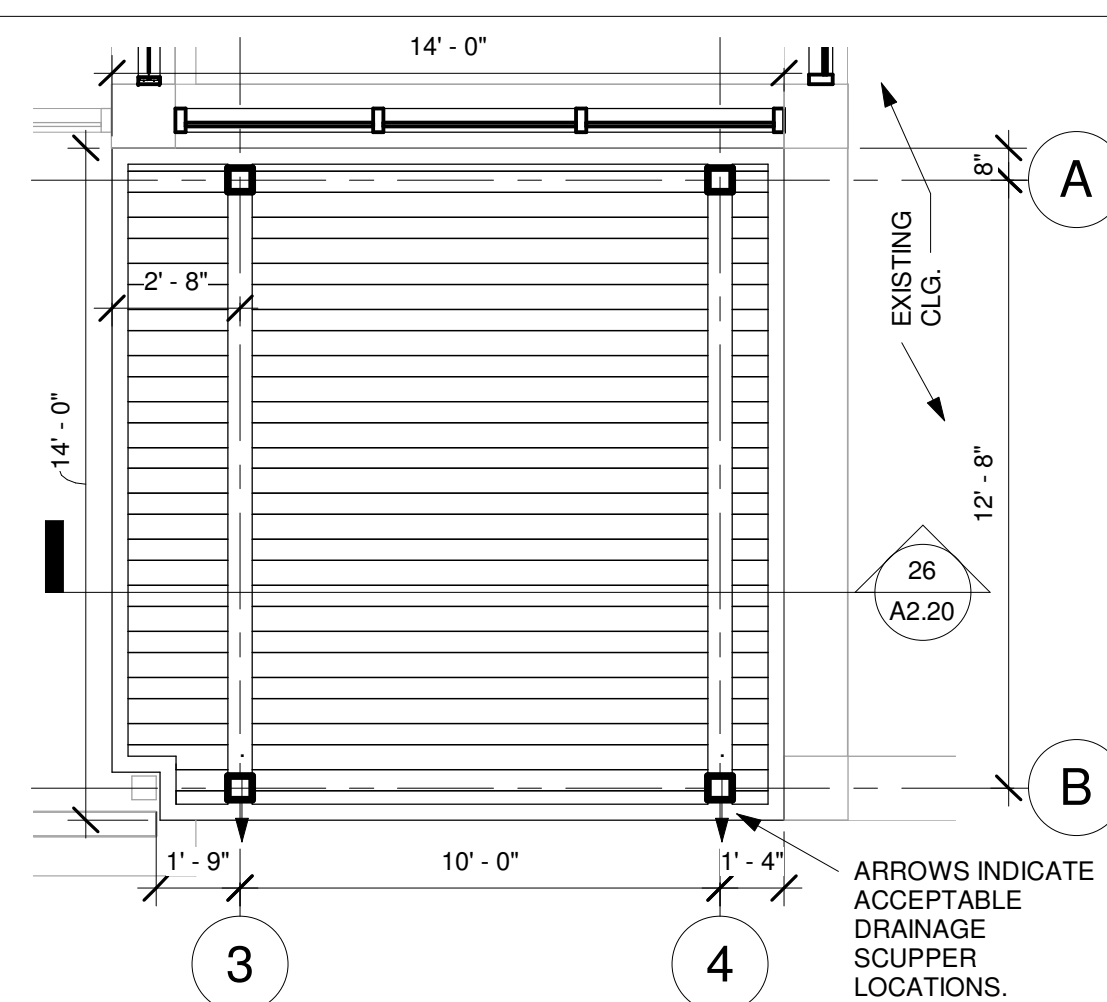

17 ENLARGED CONSTRUCTION PLAN - LIBRARY / CANOPY
Scale: 1/8" = 1'-0"

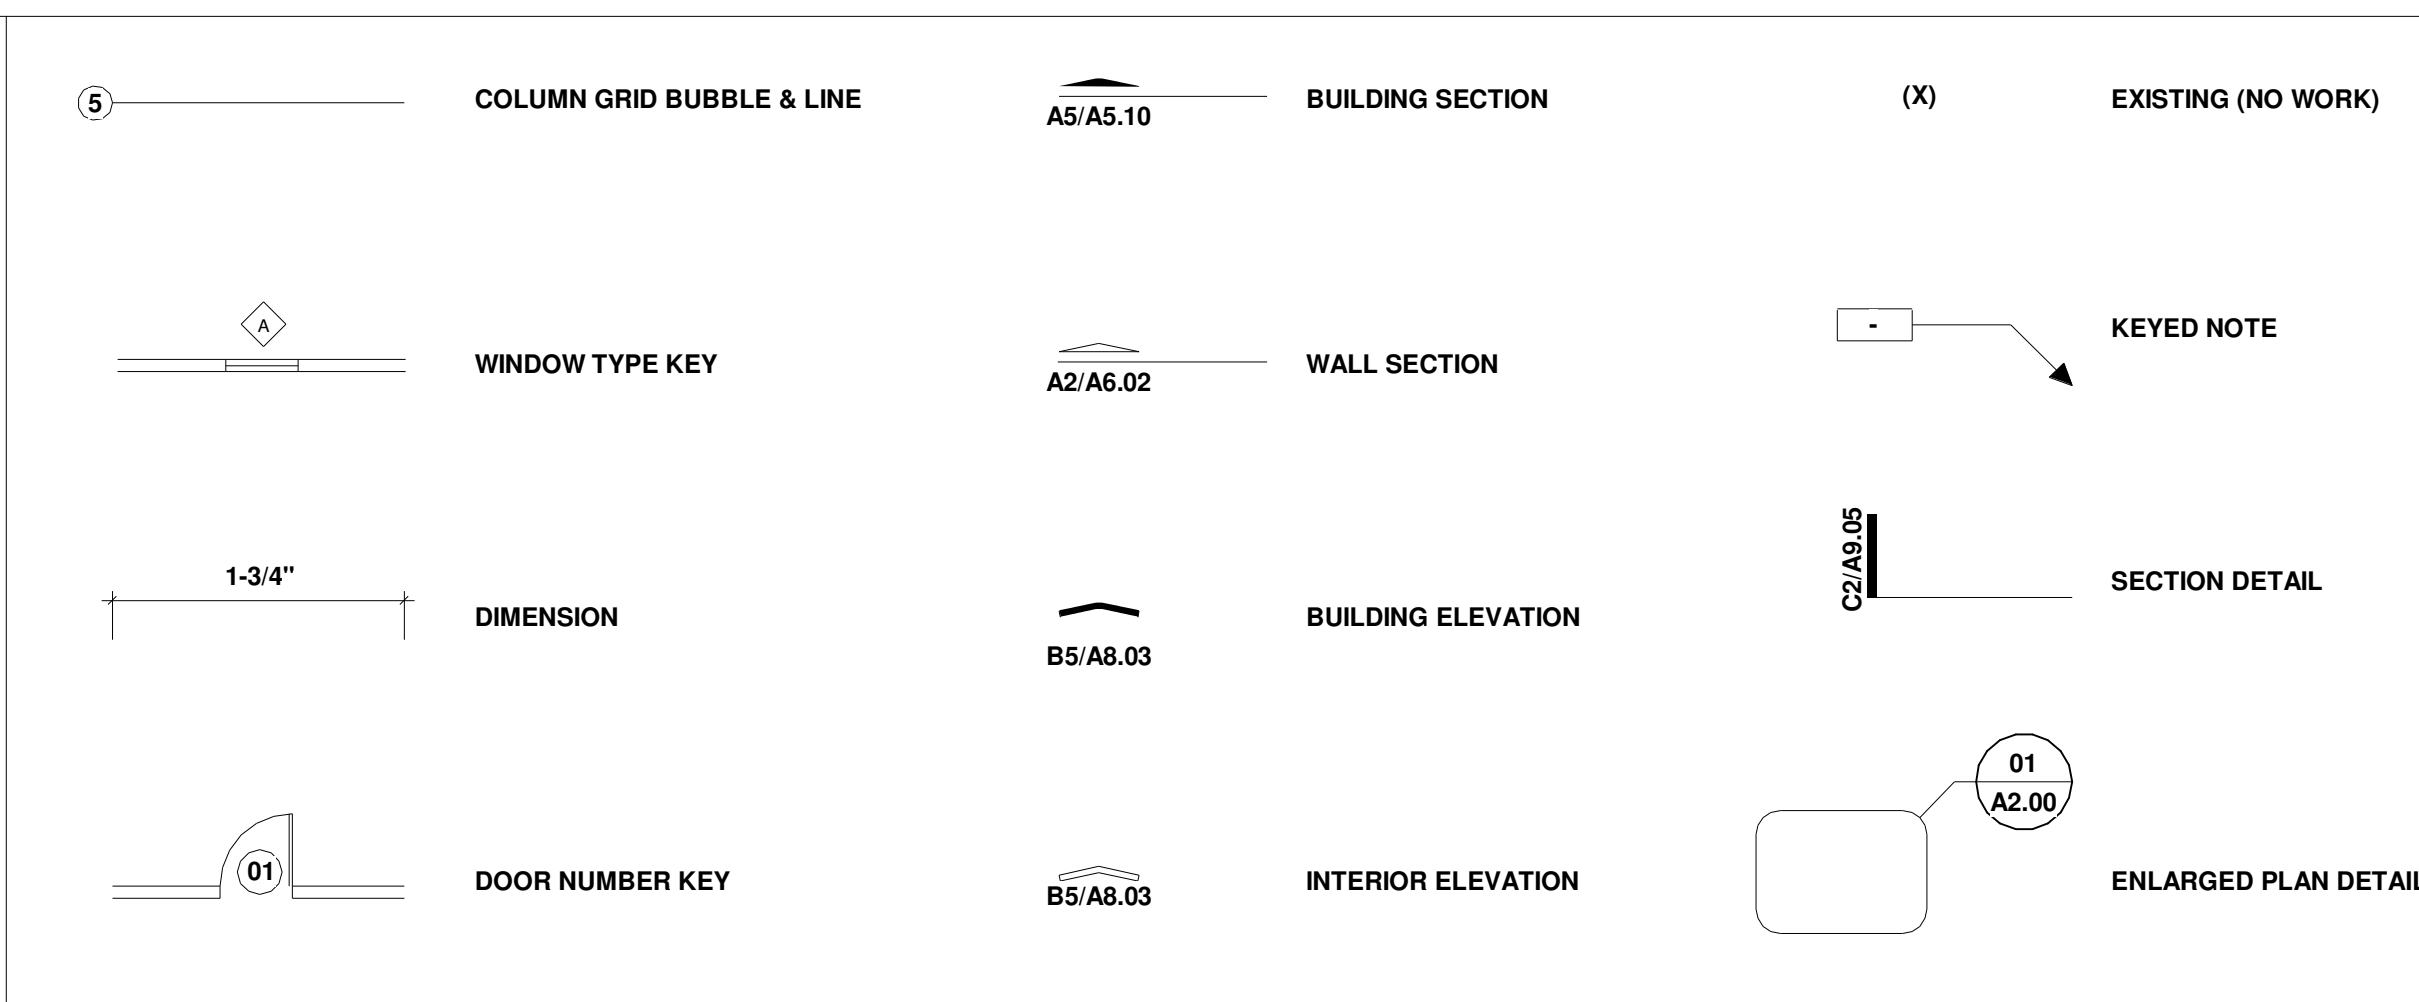

16 CANOPY DETAIL
Scale: 1/2" = 1'-0"

Dimension & Alignment Support Notes:
ALIGN 1: Align face of new construction w/face of existing.
ALIGN 2: Align centerline of new construction w/centerline of existing.
ALIGN 3: Align gridline/line and existing grid.
LEVEL 1: Ensure top of new construction is level w/existing surface.
LEVEL 2: Level floor & surface to receive new construction.
LEVEL 3: Ensure the top of grade is level w/surrounding ground.

Construction & Condition Support Notes:
HANDLE 1: Handle item w/care, and store for owner review.
HANDLE 2: Handle remaining building, pavement, fence, or item w/care.
HANDLE 3: Handle re-located items w/care. DISCONNECT 1, FIXW.
FIXW: Fix floor/wall/ceiling/item where construction was removed and prepare the area to receive new construction. Ensure the top of grade is level w/surrounding ground & maintain positive slope towards drain, gutter, and storm system away from building.
REMOVE: Prepare the site where construction was removed, and ensure structural integrity while meeting local Codes. Handle remaining buildings, pavement, fence, and other items w/care.
DISCONNECT: Disconnect and conceal all pipes, electrical cables, data cables, and conduits where construction is removed.
ENGINEER 1: Professional engineering supervision is required for this work.
SPEC: Provide shop drawings for this work.
REFERENCE: Refer to prior sheets for the existing condition at this location.
SLOPE: Maintain positive slope towards drains, gutters, and storm systems and away from the building.
PROTECT: Protect items to remain, including any buildings, furniture, sidewalks, roofs, utilities, and other items during the Demolition and Construction phases.
EGRESS: Maintain safe and unrestricted egress routes from areas adjacent to the Demolition site. Comply with all applicable Codes.
TREE: Refer to Landscape Drawings & Specs for removing trees.
OPERATE: Ensure all trades and utilities required for school operation are protected. Ensure school operation will not be interrupted.
ENSURE: Ensure all stages to drain as intended, and that downspouts indicated to remain are protected in accordance with the Demolition and Construction phases. Protect items to remain including any buildings, furniture, sidewalks, roofs, utilities, and other items during demolition and construction.
PHASE 1: Work within this area may occur in phase ONE.
PHASE 2: Work within this area may occur in phase TWO.

11 SUPPORT NOTES
Scale: NTS

A004 REHAB EXISTING WOOD SIDING & PAINT. RE: SPECS. (HANDLE 2, FIXW)
A015 PROVIDE NEW CARPET FLOORINGS AS INDICATED IN FINISH SCHEDULE.
A023 NEW FLOOR SLAB FUSH WITH LIBRARY SLAB. RE: STRUCTURAL DRAWINGS
A024 PROVIDE NEW CEILING TILE AND GRID AT SPECIFIED HEIGHT. RE: CEILING PLAN; FINISH SCHEDULE. CENTER GRID IN ROOM UNLESS INDICATED OTHERWISE.
A025 12"x12" (VIE) AVADAX CANOPY SYSTEM W/ FOUR 6"x6" ALUMINUM COLUMNS AND ABOVE-GRADE DRAINAGE AT LOCATIONS INDICATED IN DETAIL.
A026 ANTI THEFT SECURITY GATE AS SPECIFIED. CENTER ON DOOR OPENING.
A020 NEW STOREFRONT/CURTAIN WALL. RE: WINDOW TYPES.
A025 INSTALL SECURITY FILM ON INDICATED PANELS ON THE INTERIOR SIDE OF WINDOW, STOREFRONT OR CURTAIN WALL GLAZING, OR ALGL. DOOR. RE: DOOR SCHEDULE. RE: WINDOW TYPES. RE: SPECS.
A027 MODIFY EXISTING STOREFRONT & INSTALL EXISTING NEW DOOR TO MATCH EXISTING ALUMINUM FRAME & GLASS RE: DOOR OPENING SCHEDULE. (HANDLE 2, FIXW)
A028 NEW INTERIOR ALUM. STOREFRONT FLOOR TO CEILING ABOVE. (FIXW)
A033 MARKER BOARD (MB) OR ELECTRONIC MARKER BOARD (EMB). NOTE: ELECTRONIC MARKER BOARD: CONSIST OF MARKERBOARDS AND OFC WALL MOUNTED SMART PROJECTORS. RE: SPEC.
A036 NEW LIBRARY STACKS, CFO, MAX 42" HIGH (SHOWN IS 68 X 48"x14"x42" UNITS AND 8 X 28"x14"x42" UNITS. TO BE VERIFIED WITH OWNER PRIOR TO SUBMITTAL AND PURCHASE.
A037 PROVIDE NEW FURNITURE AT INDICATED ROOMS/SPACES. FURNITURE TO BE COORDINATED WITH OWNER PRIOR TO SUBMITTAL AND PURCHASE. FURNITURE INDICATED IN DRAWINGS IS FOR REFERENCE AND SCOPE ONLY.
X04 EXISTING MILLWORK (PROTECT 1)
X05 EXISTING FURNITURE TO BE REMOVED AND RELOCATED IN THIS SPACE AS INDICATED ON THE NEW CONSTRUCTION PLAN. (PROTECT 1)

06 KEYNOTES
Scale: NTS

1. HANDLE STRUCTURE OF EXISTING BUILDING WITH CARE. NO WORK SHOULD HAVE ANY AFFECT ON THE STRUCTURAL INTEGRITY OF THE BUILDING. REPORT TO THE ARCHITECT ANY INDICATIONS OF STRUCTURAL DAMAGE.
2. PROTECT THROUGHOUT DEMOLITION AND CONSTRUCTION ALL ITEMS INDICATED TO REMAIN INCLUDING BUT NOT LIMITED TO: BUILDINGS AND OTHER STRUCTURES, FLOORING, WALLS, CEILING, FINISHES, MEP/ SECURITY SYSTEMS, UTILITIES, MILLWORK, ETC.
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9. PROVIDE PARTITION CURBS FOR MECH./ELEC. ROOMS PERIMETER, TYP. UNLESS OTHERWISE NOTED.
10. UNLESS INDICATED OTHERWISE, ALL NEW WORK IN THIS PROJECT IS TO BE ACCESSIBLE IN ACCORDANCE WITH THE MOST RECENT EDITION OF THE TEXAS ACCESSIBILITY STANDARDS. REFER TO ACCESSIBILITY REQUIREMENTS ON SHEETS A0.00 AND A0.00 FOR MORE INFORMATION.
11. REFER TO DOOR AND WINDOW DETAILS FOR DIMENSIONS AT OPENINGS.
12. REFER TO DEMOLITION DRAWINGS FOR DEMOLITION INFORMATION.
13. REFER TO CODE ANALYSIS INFORMATION SHEET A0.20 FOR EXTENT OF EXTENDED FIRE-SPRINKLER SYSTEM.

01 GENERAL NOTES - CONSTRUCTION
Scale: NTS




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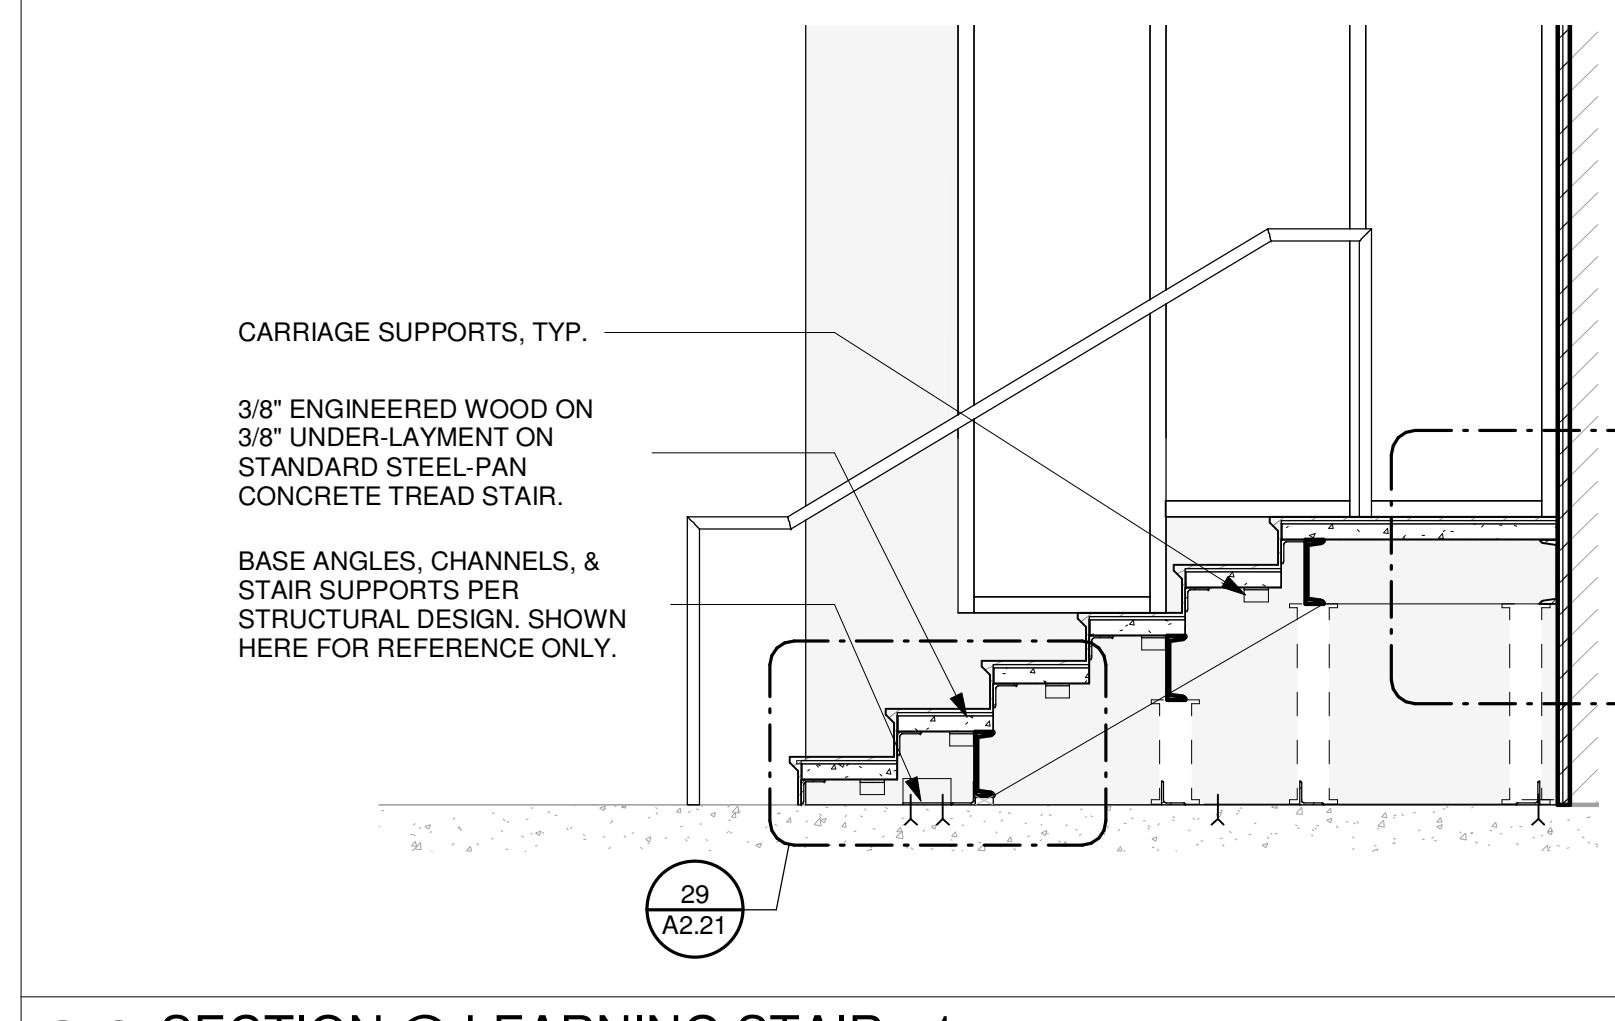
A PROJECT FOR:
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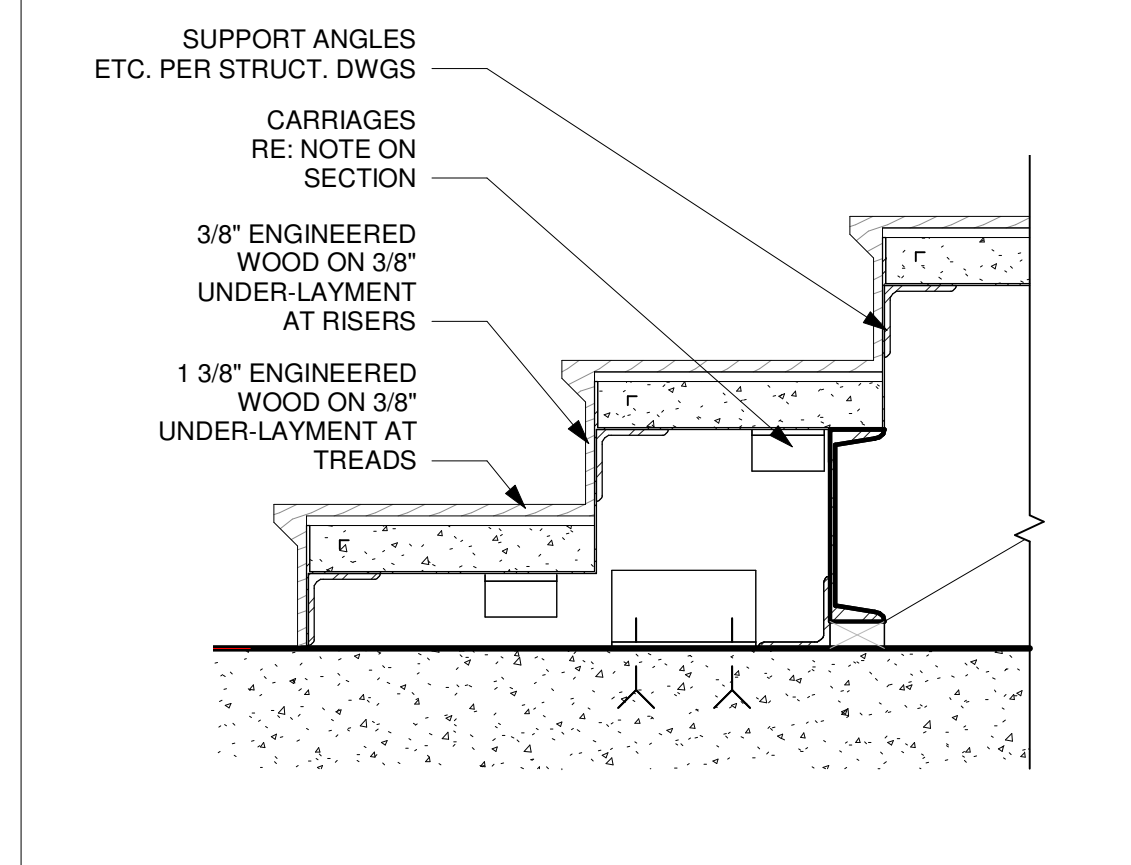


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Drawn By	LT
Checked By	AW
Approved By	MS
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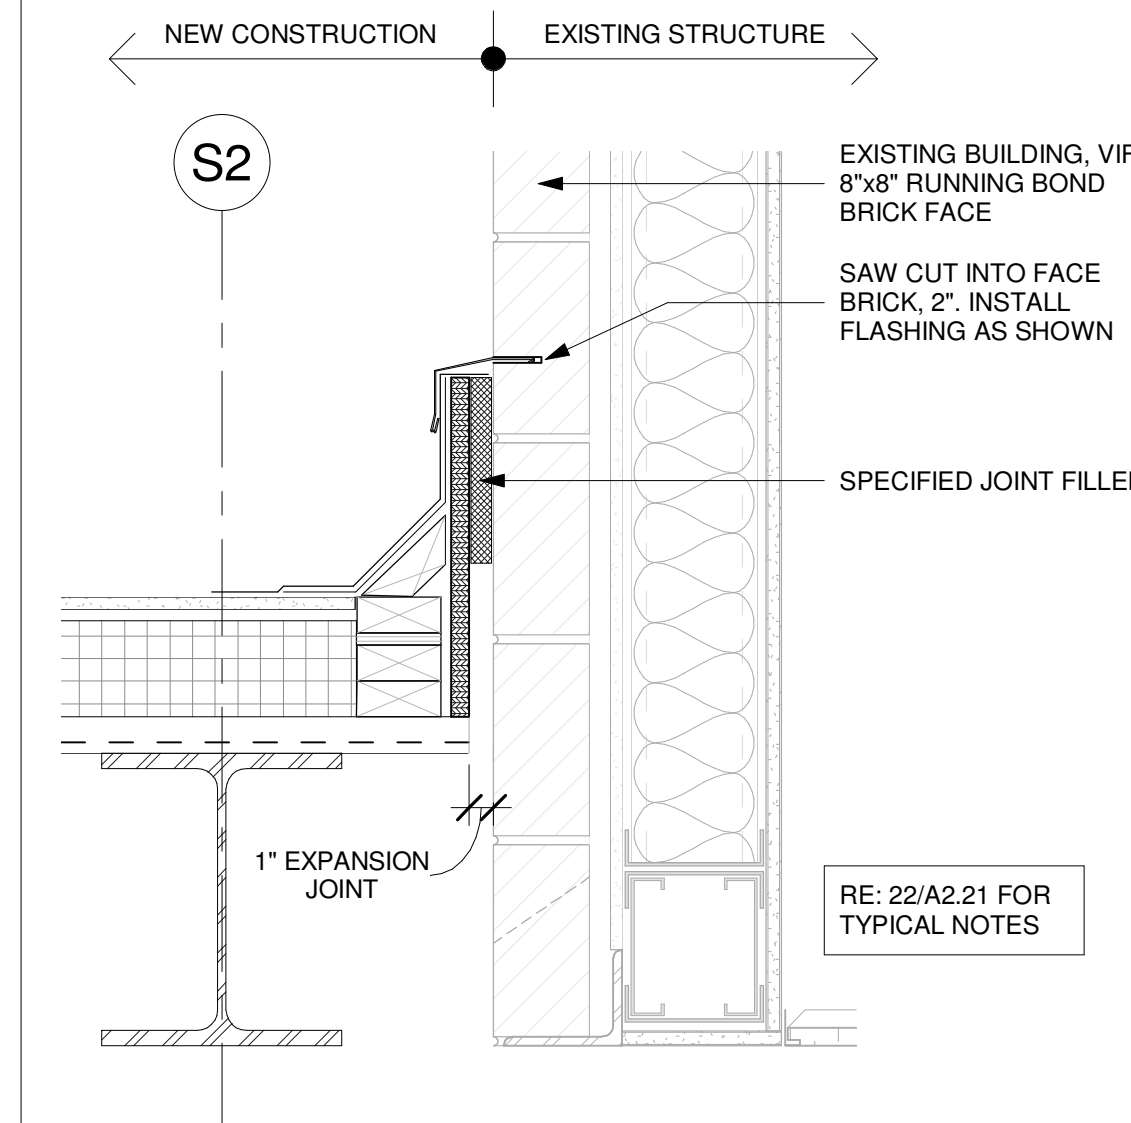
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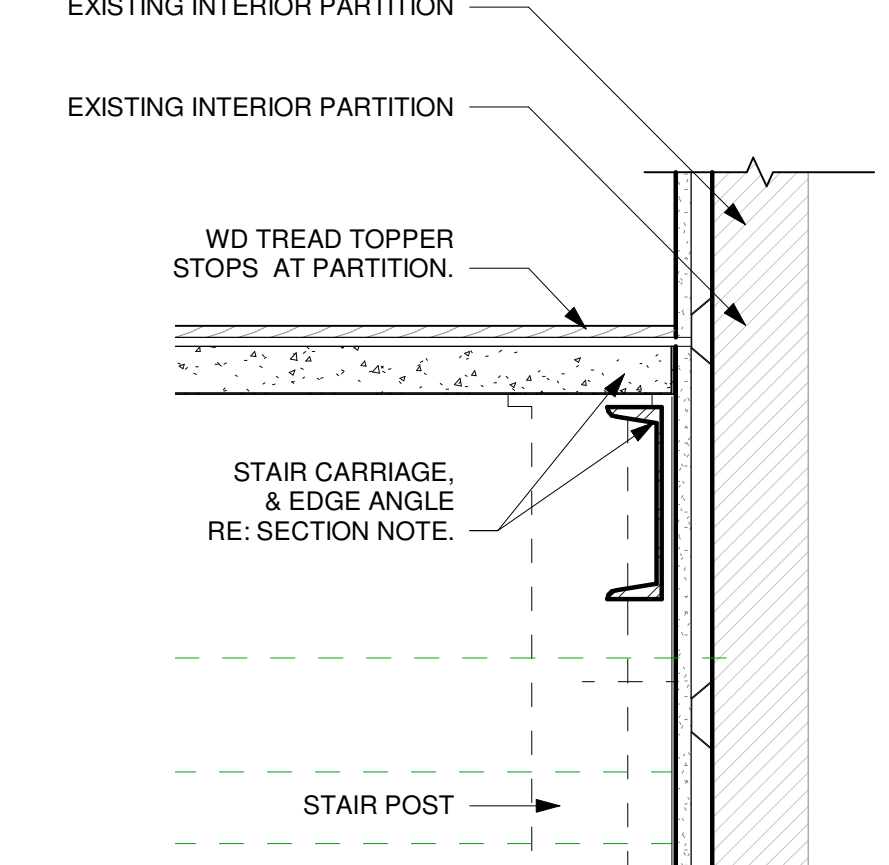
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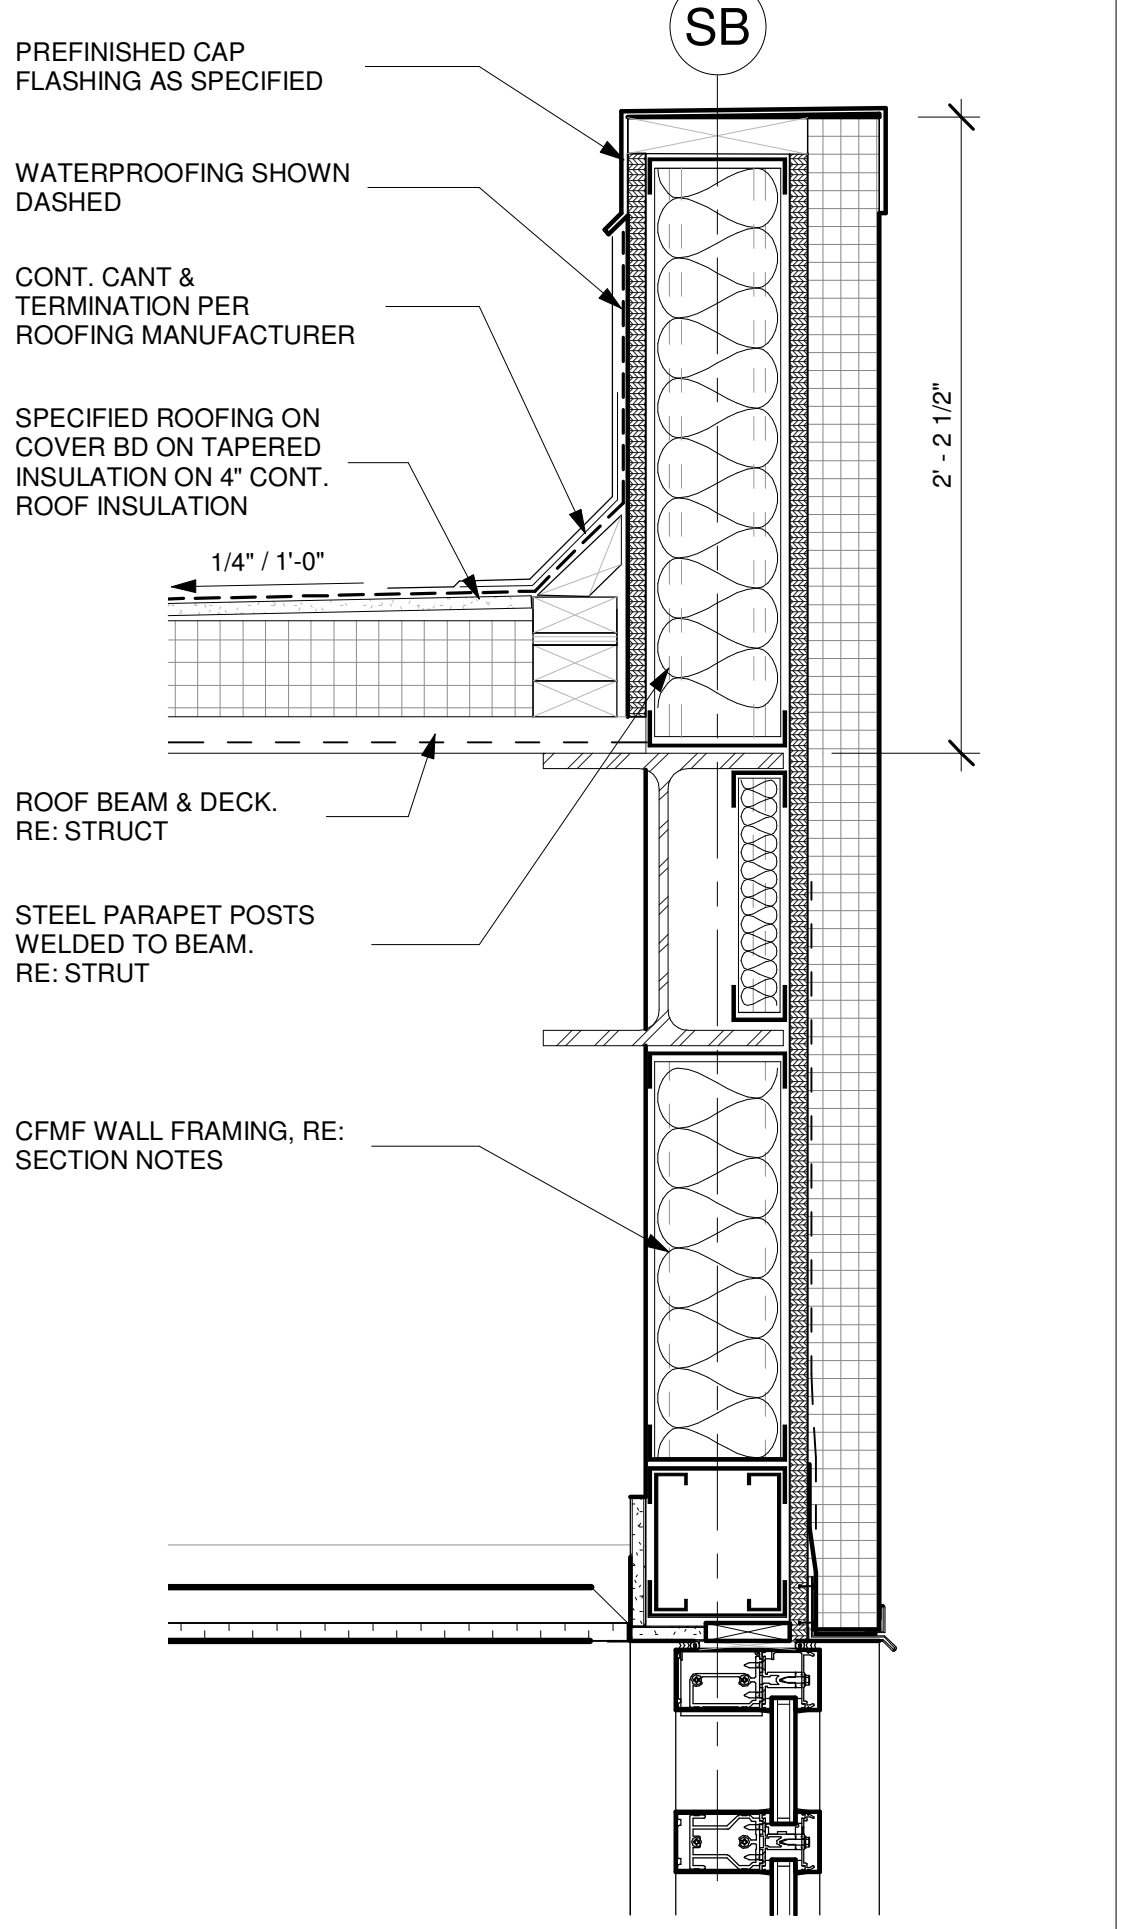
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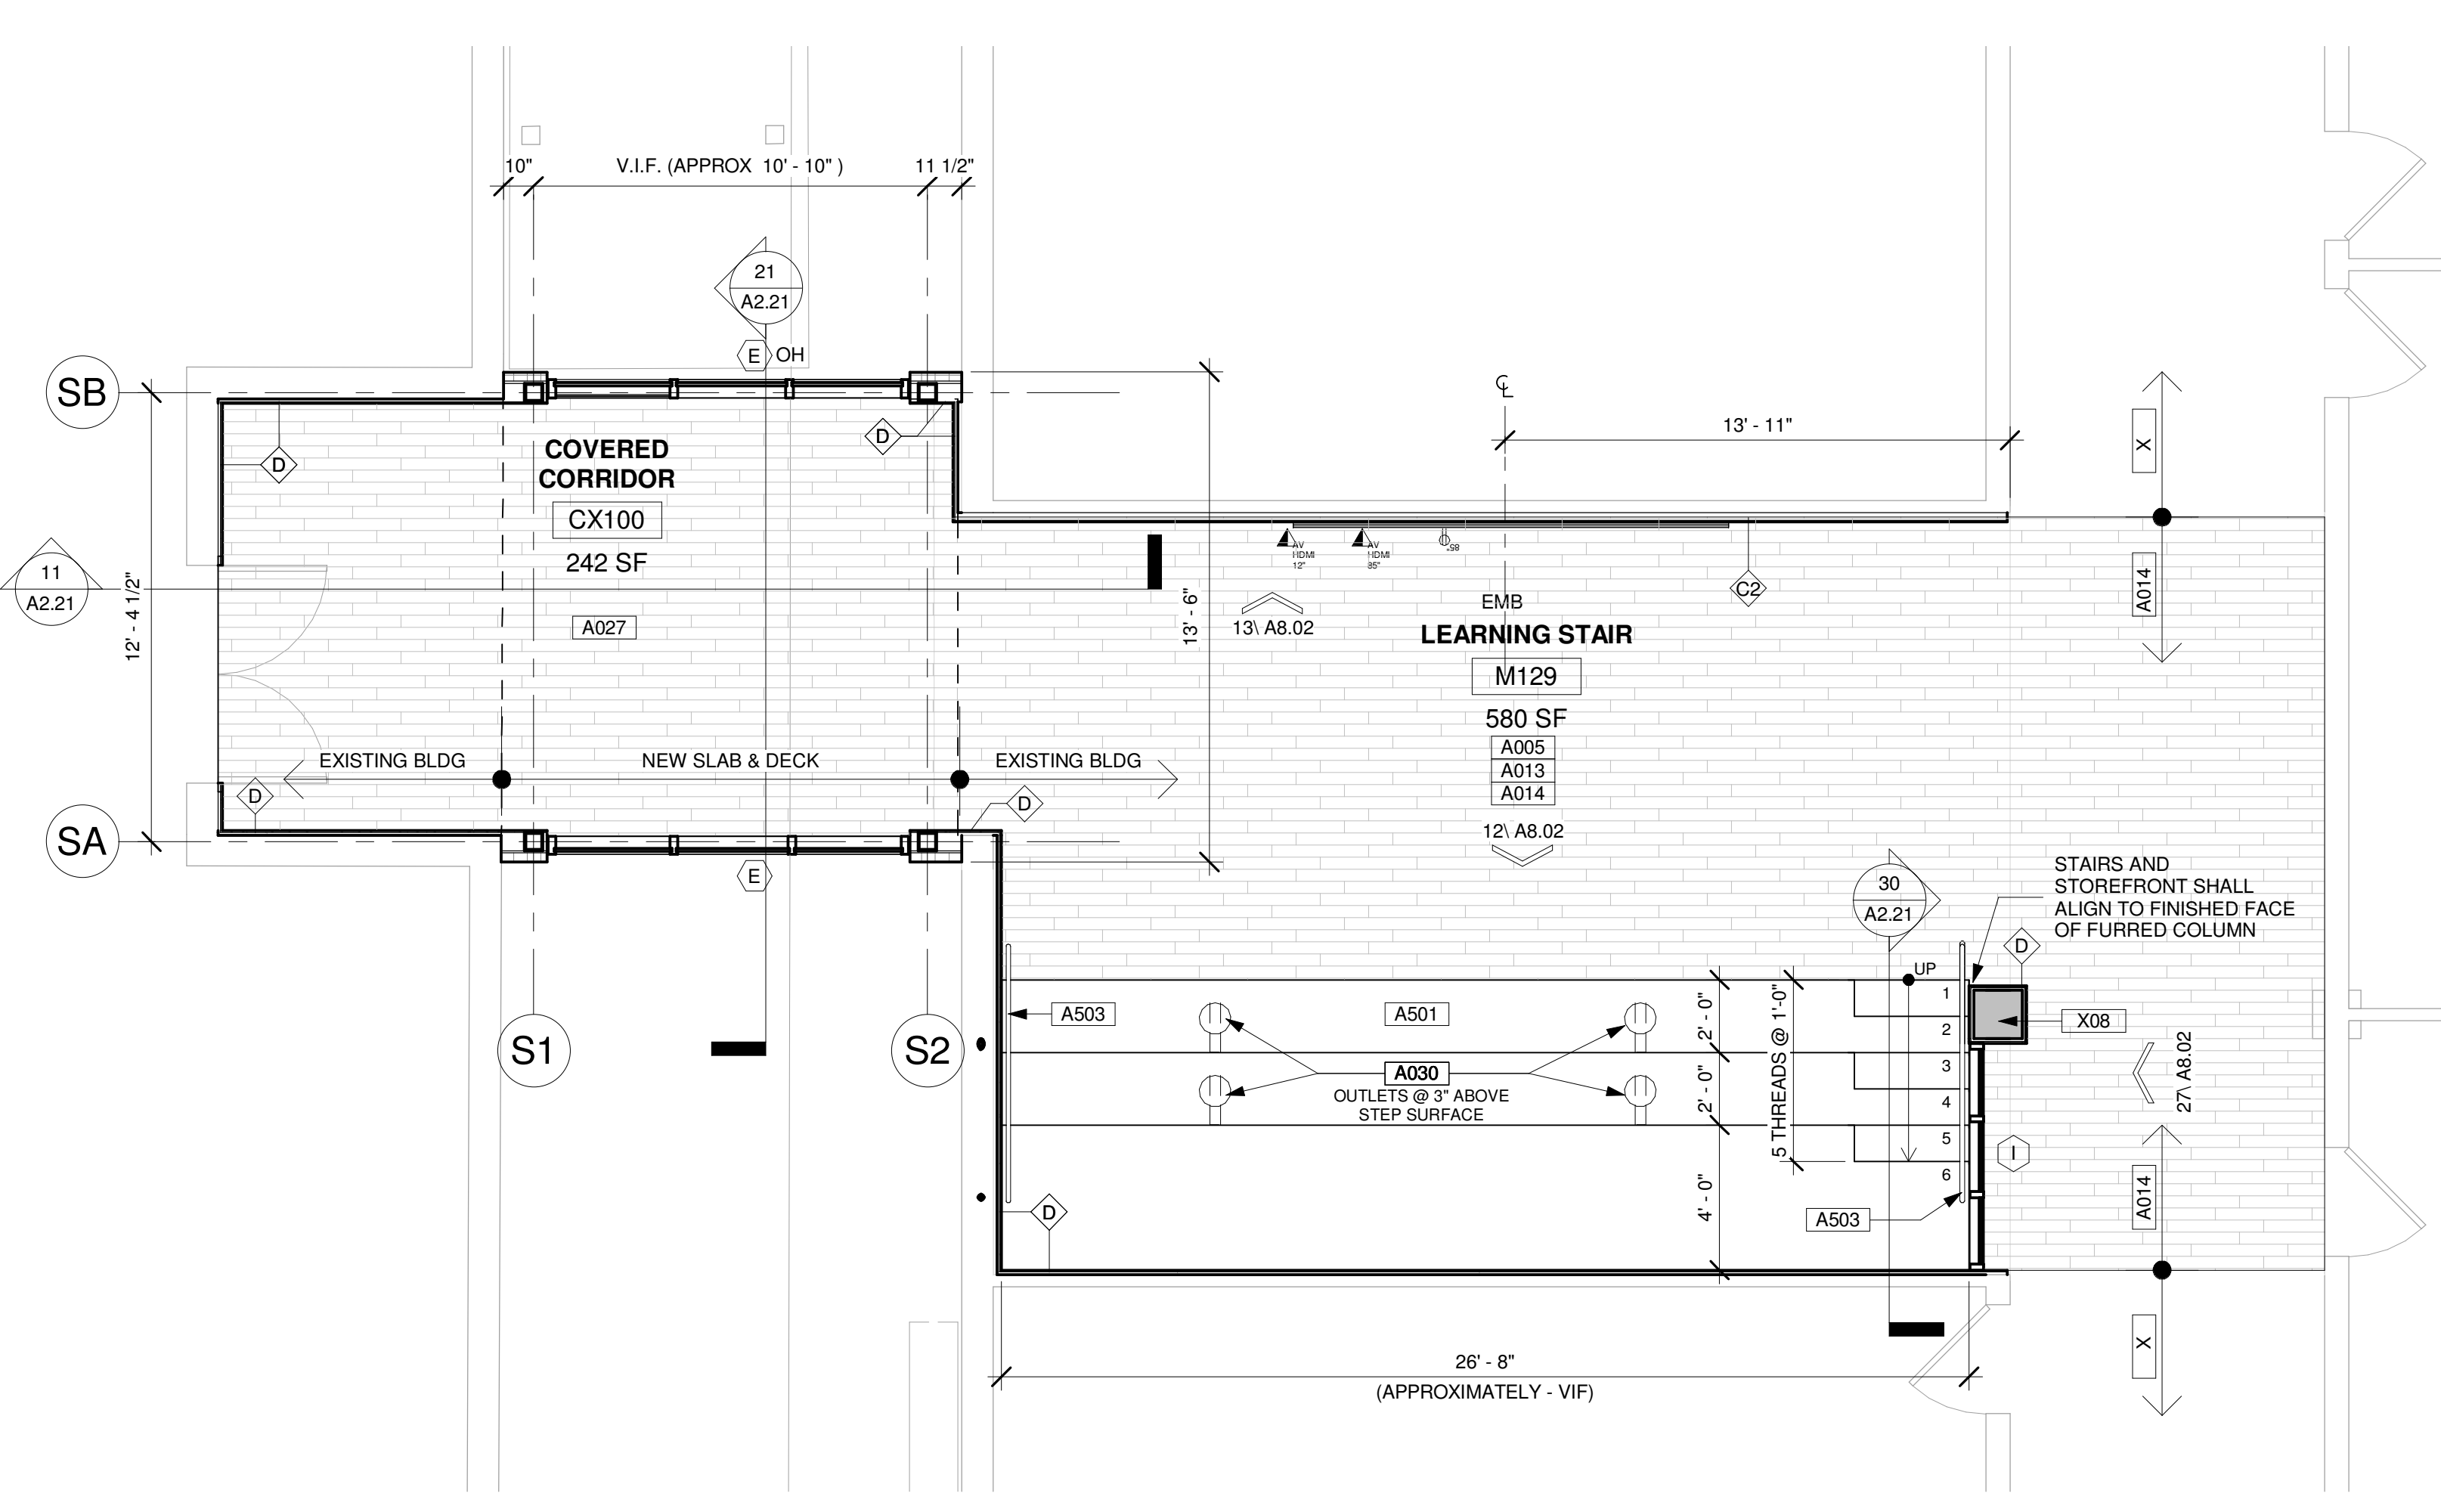
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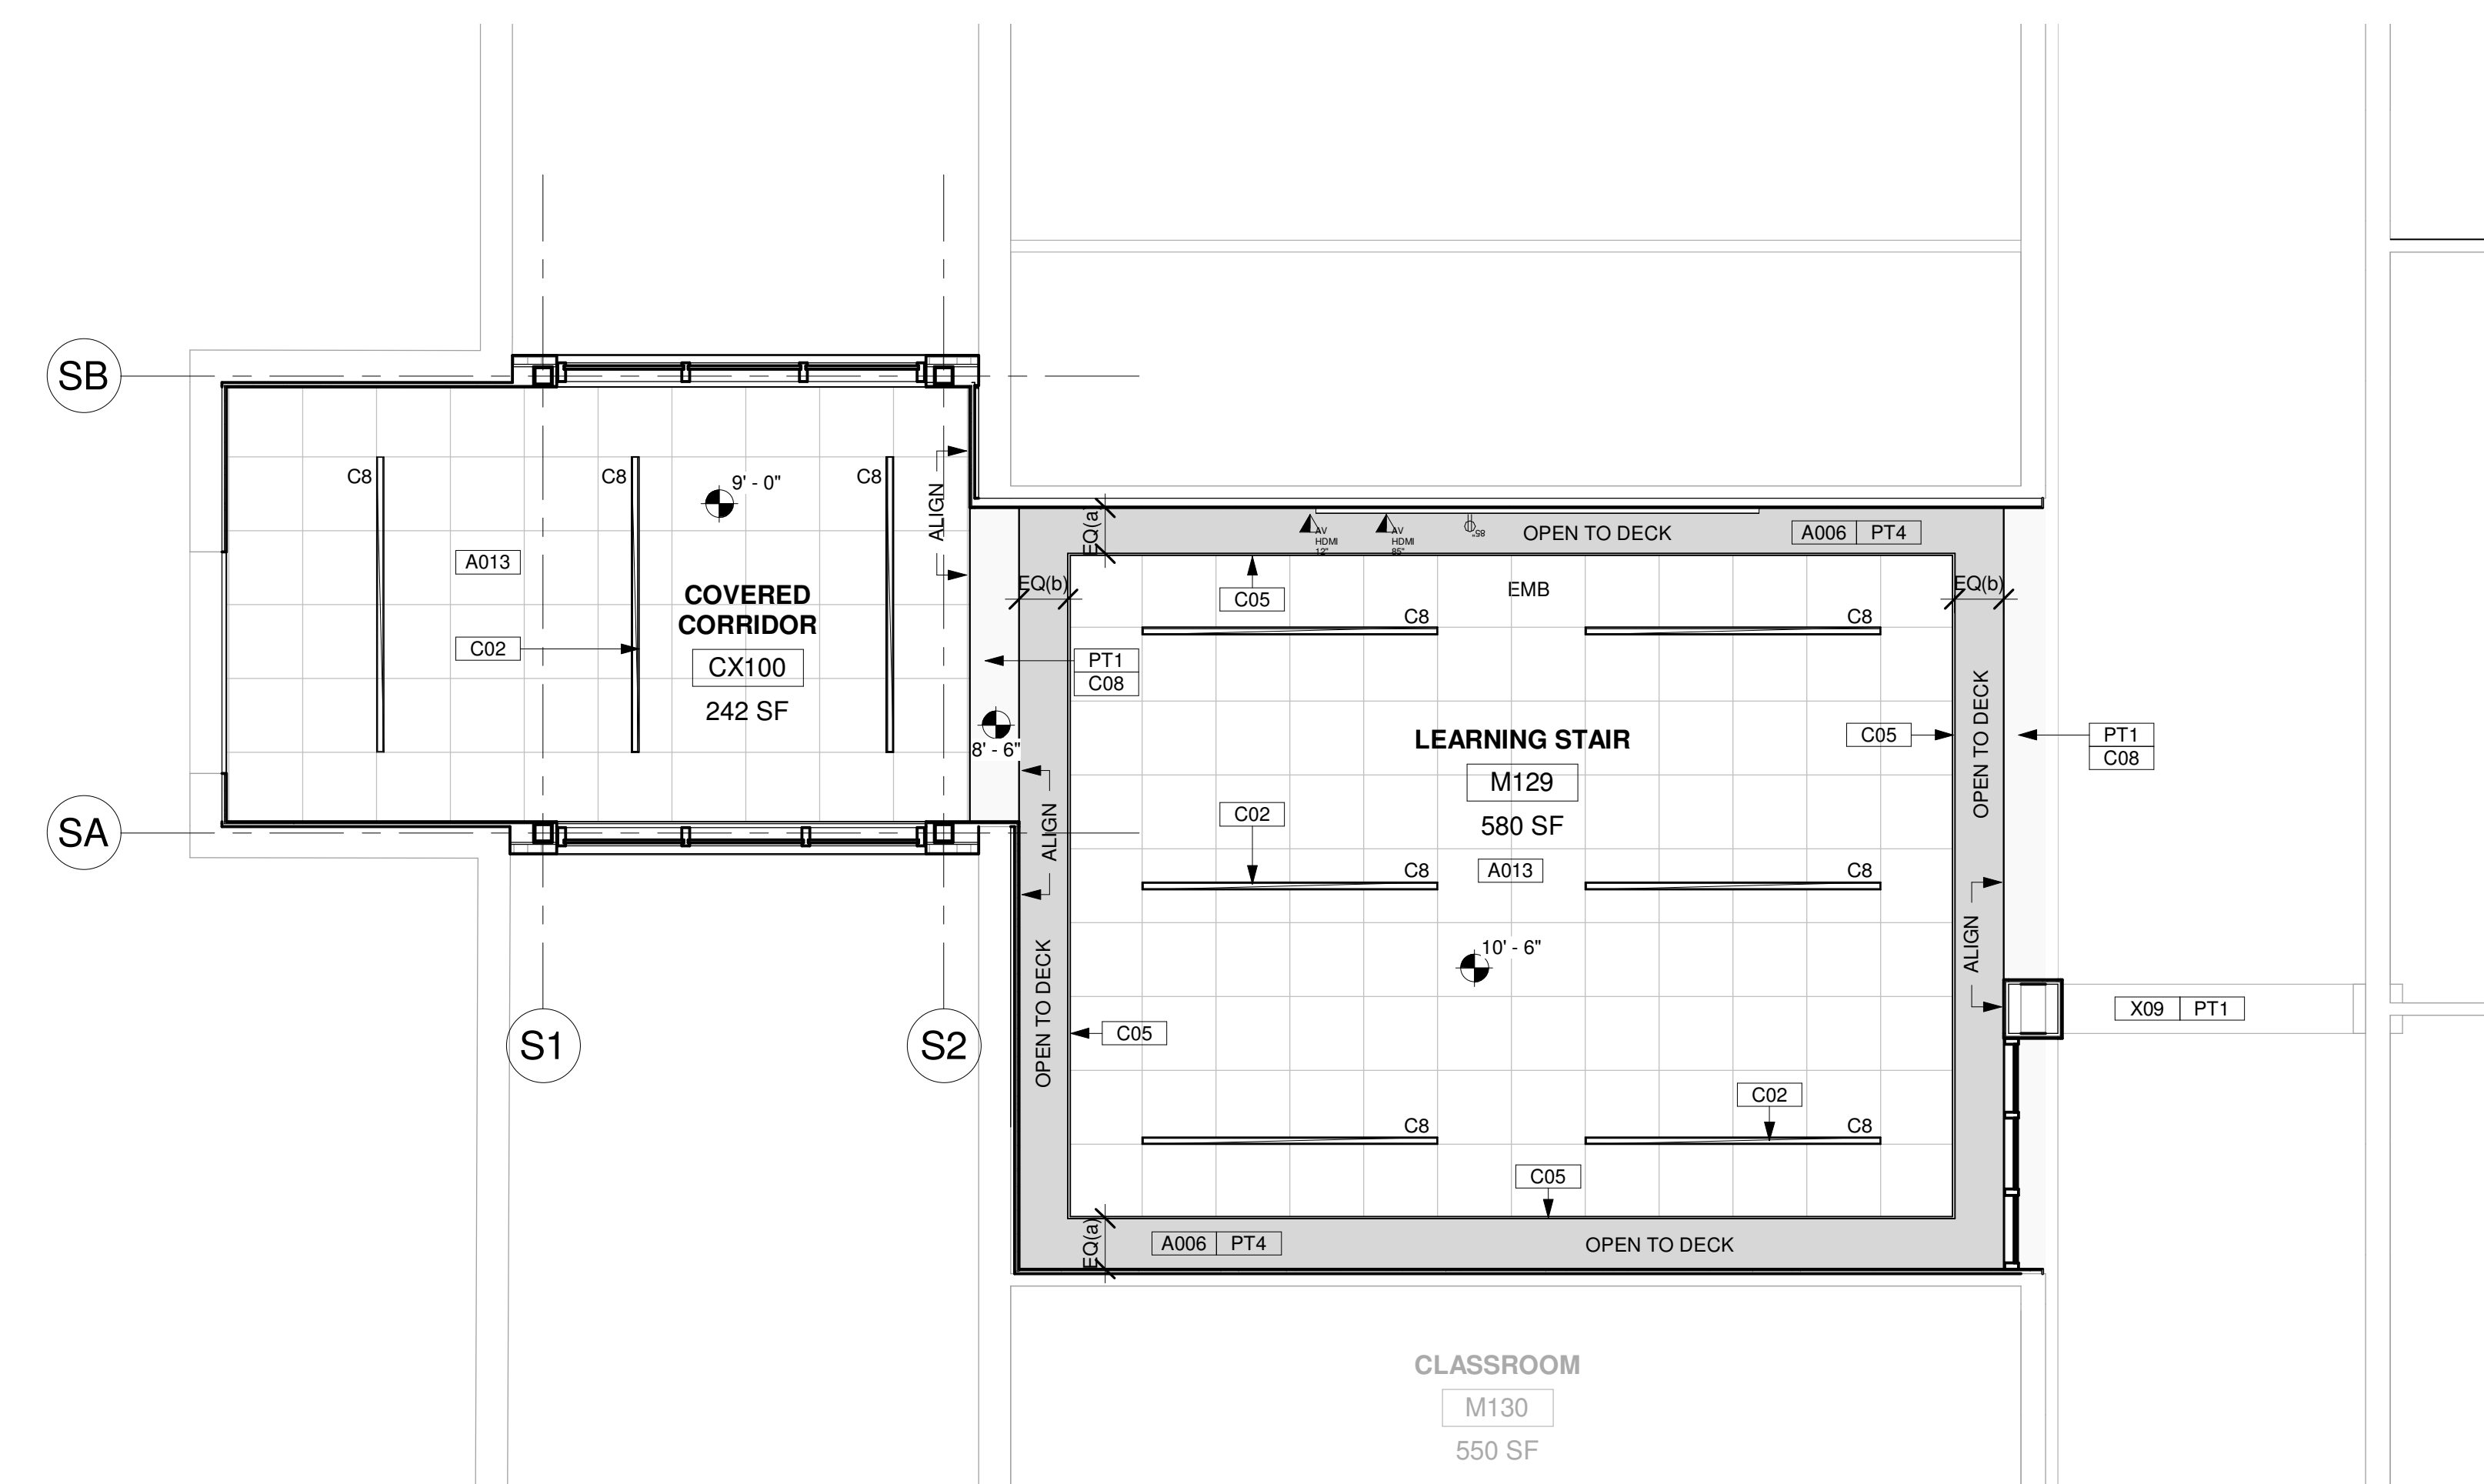
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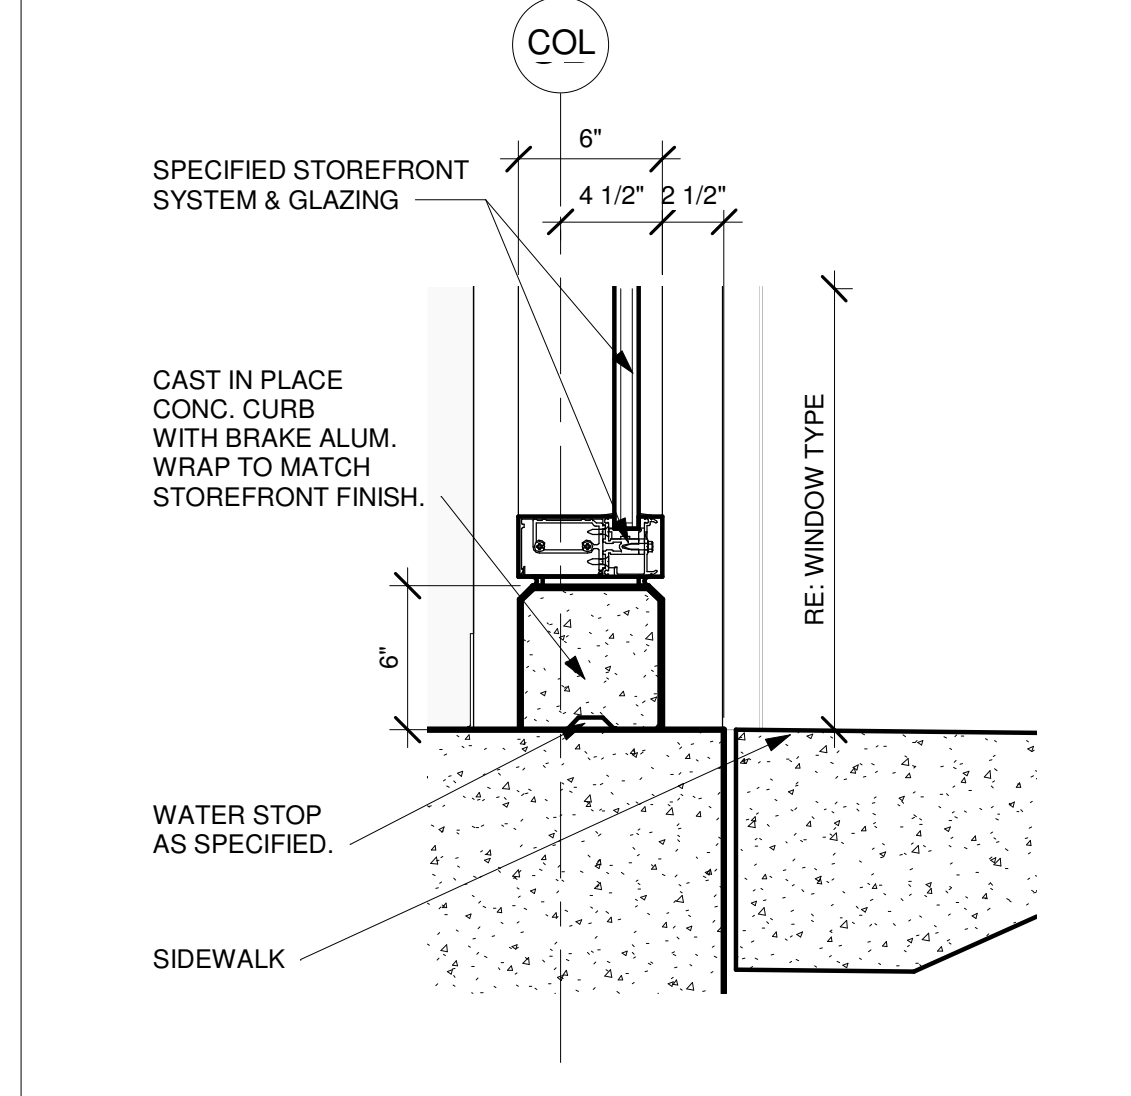
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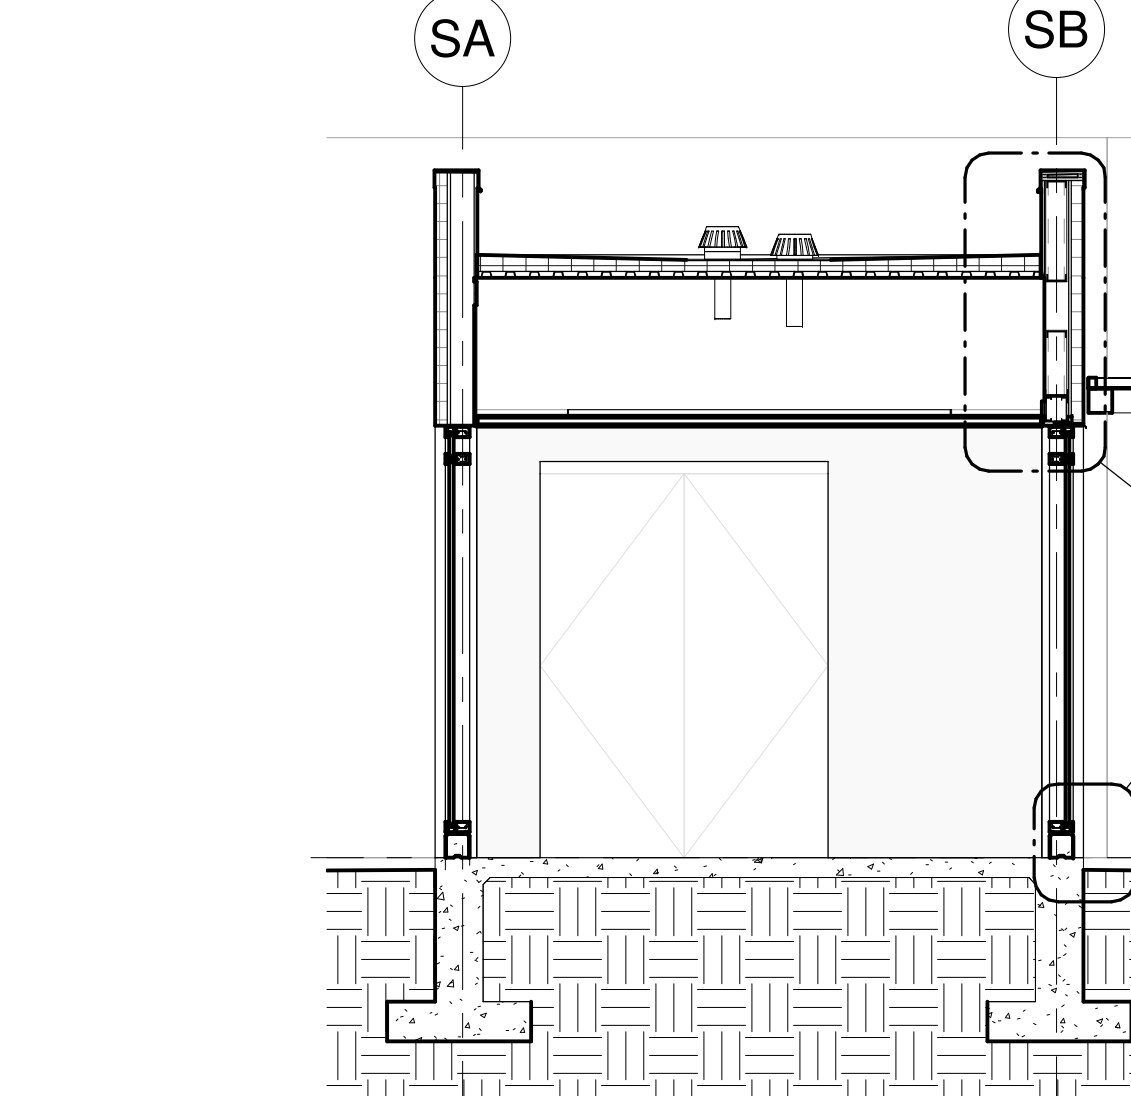
19 ENLARGED CONSTRUCTION PLAN - LEARNING STAIR
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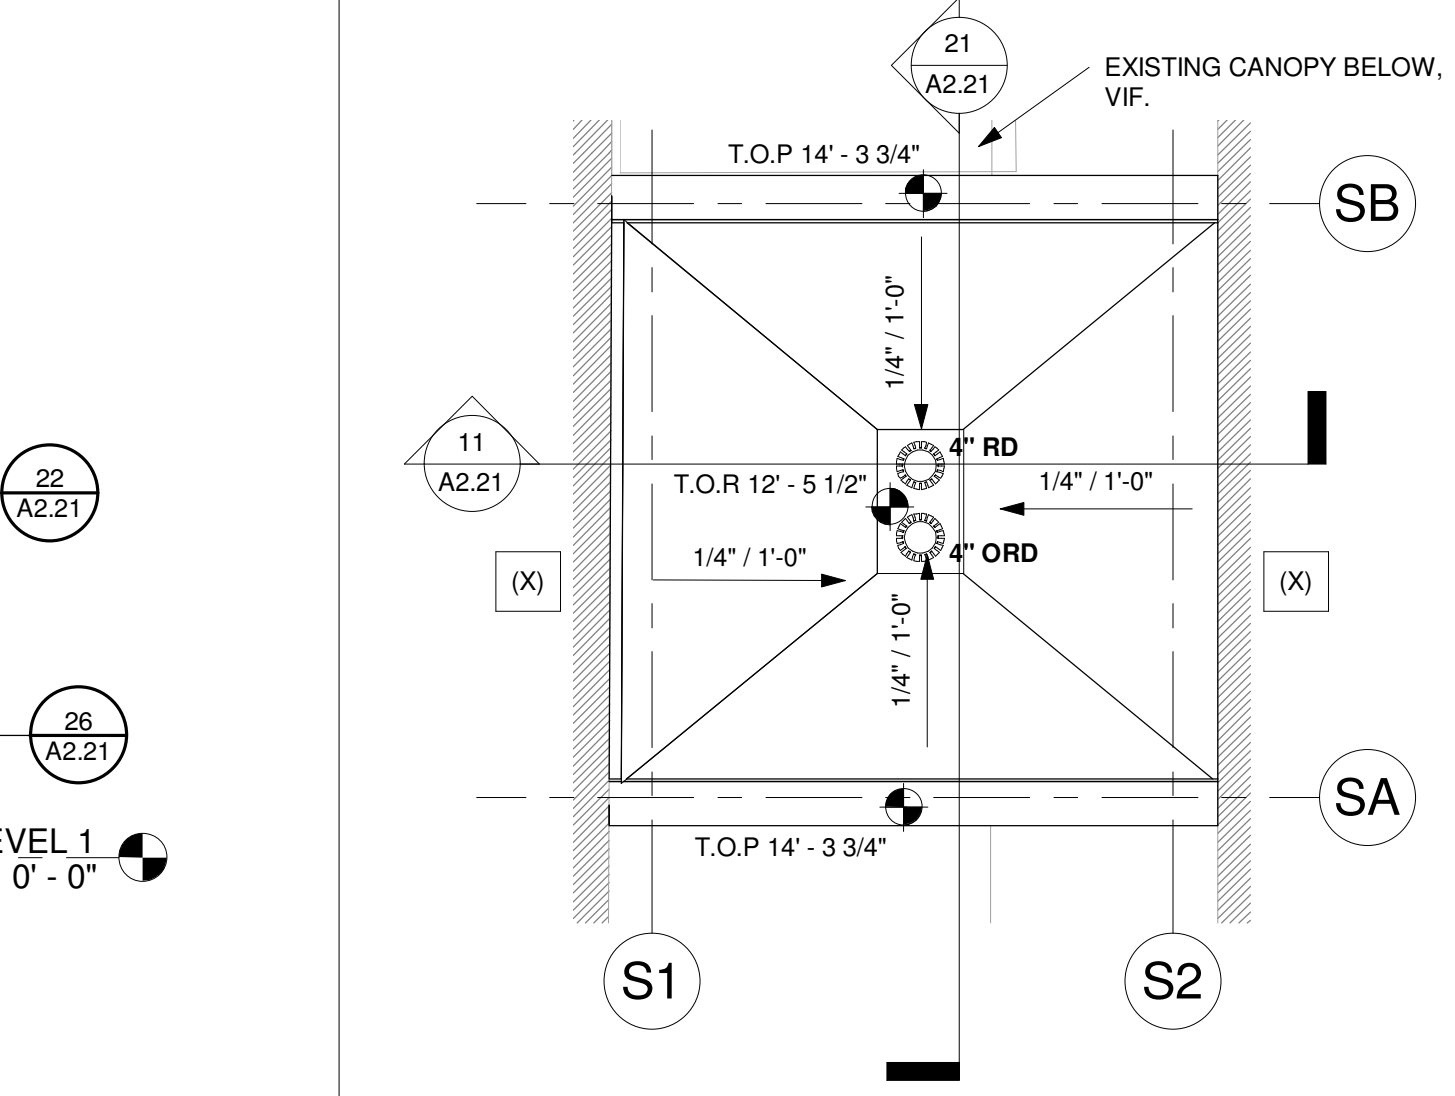
17 ENLARGED CEILING PLAN - LEARNING STAIR
Scale: 1/4" = 1'-0"




26 SILL @ EXT. STOREFRONT
Scale: 1 1/2" = 1'-0"

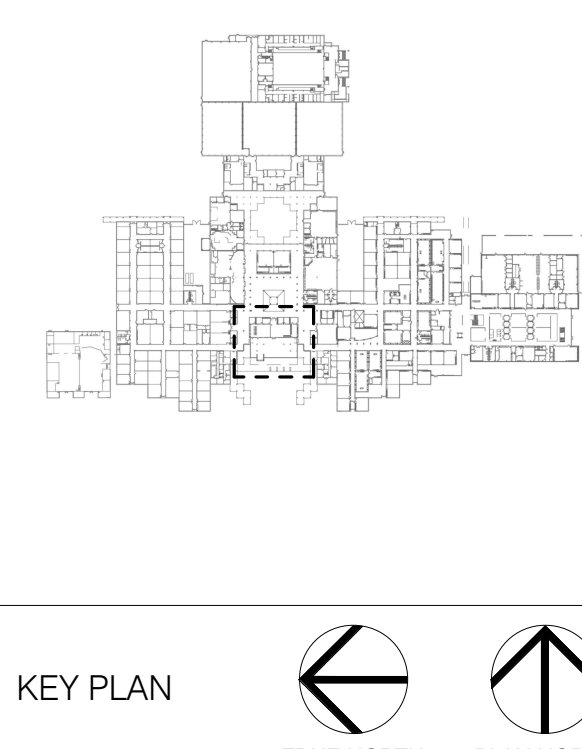


21 CANOPY SECTION
Scale: 1/4" = 1'-0"



16 CONNECTOR ROOF PLAN
Scale: 1/4" = 1'-0"

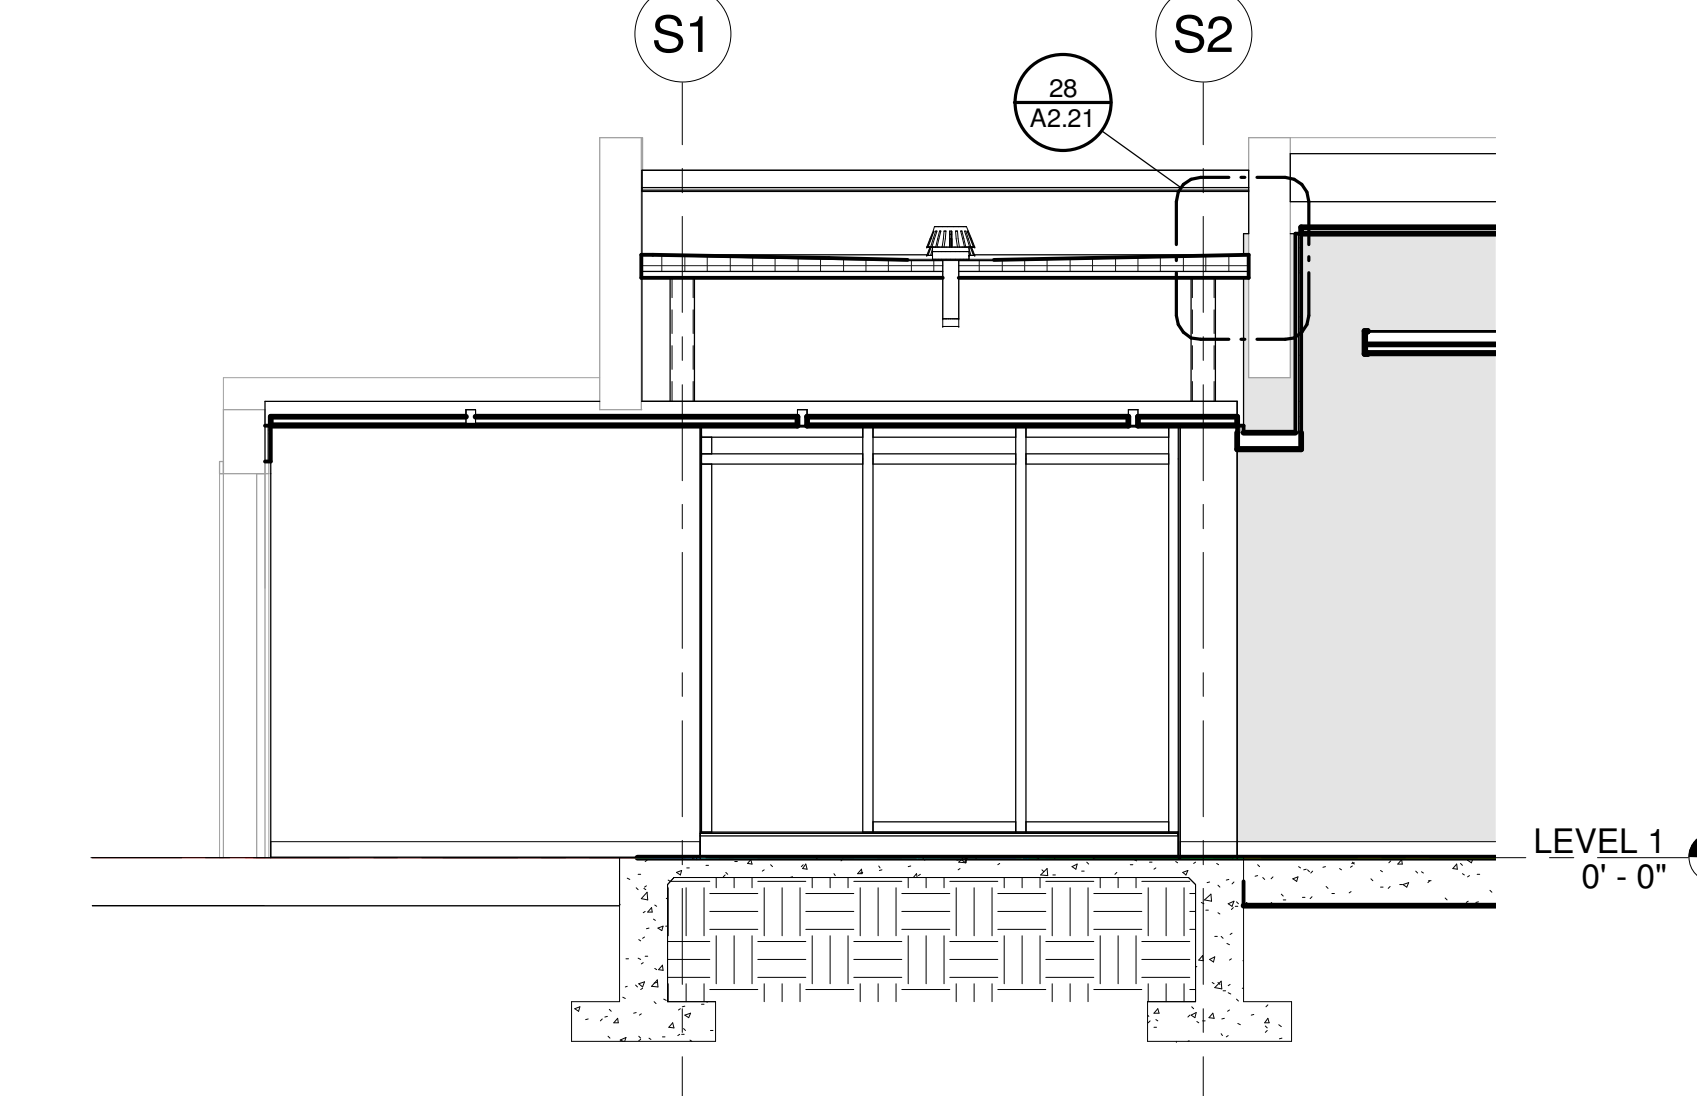

11 CONNECTOR SECTION
Scale: 1/4" = 1'-0"

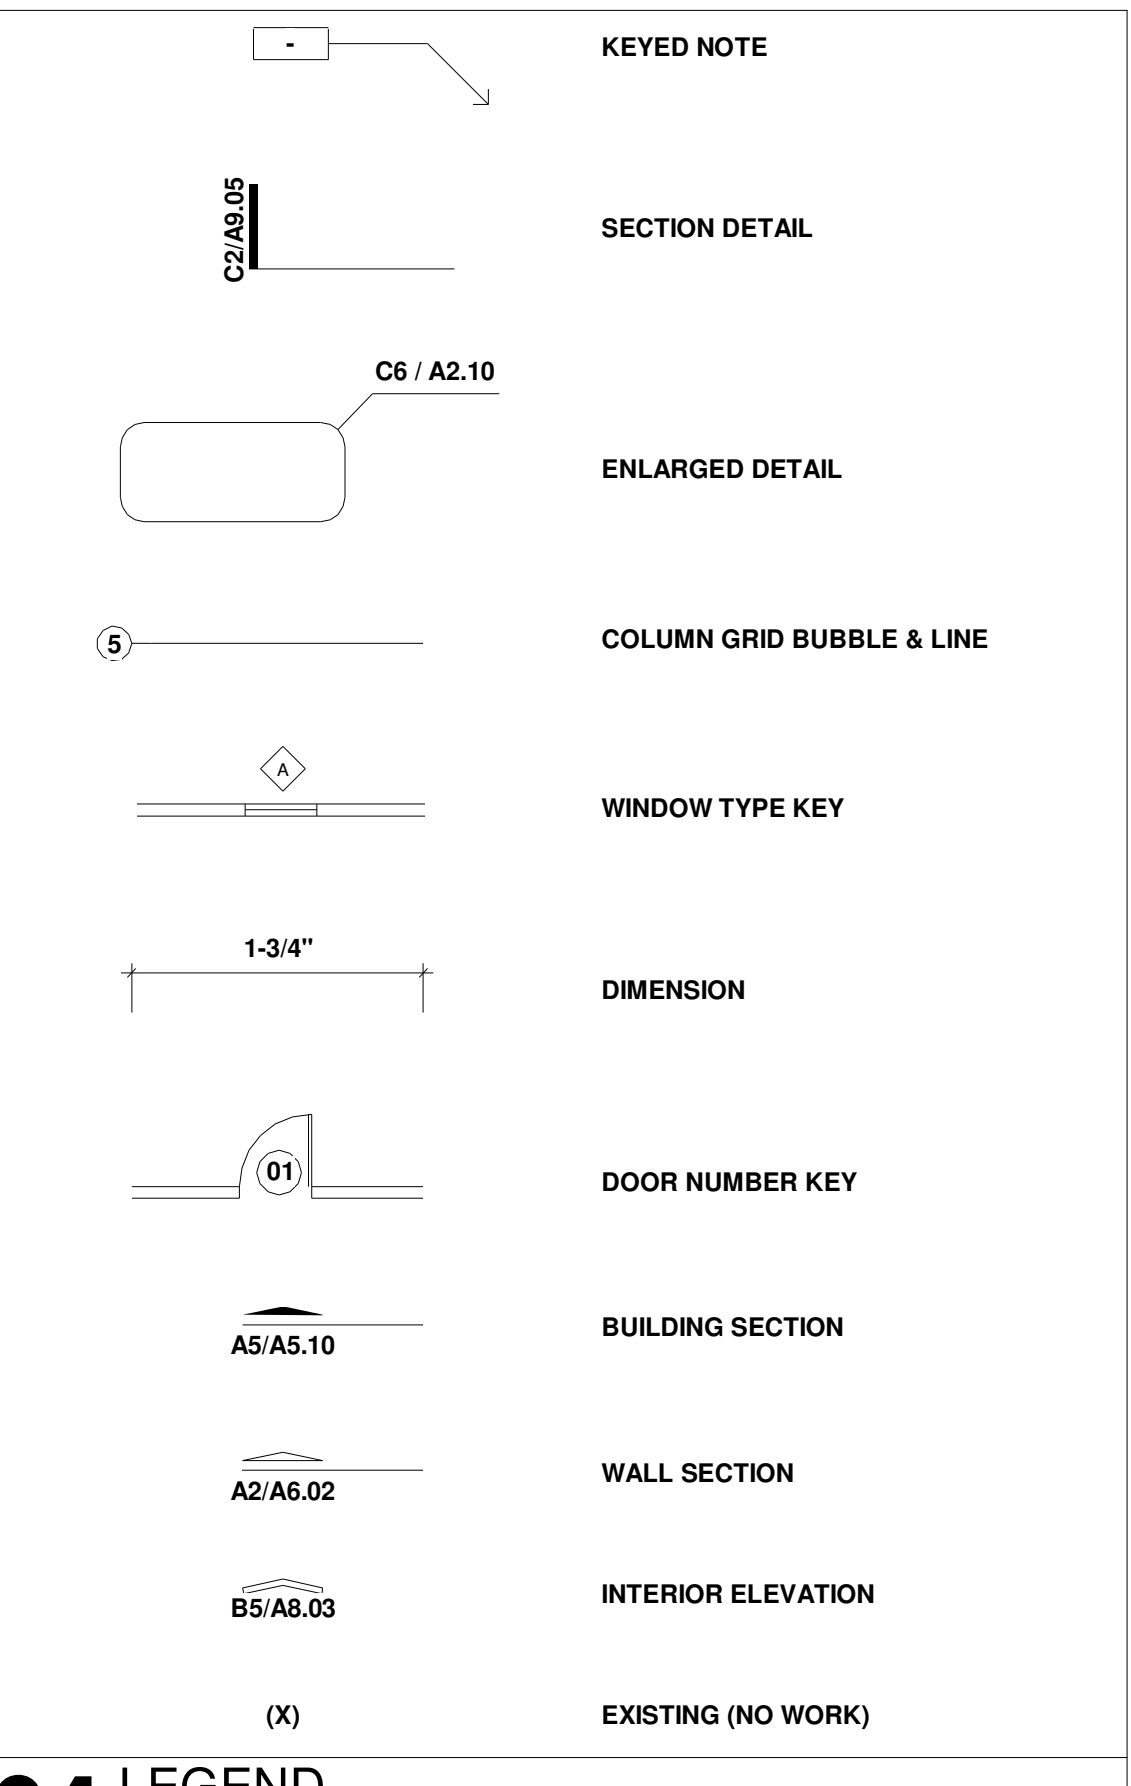

04 LEGEND
Scale: NTS

Dimension & Alignment Support Notes:
ALIGN 1: Align face of new construction w/face of existing.
ALIGN 2: Align centerline of new construction w/centerline of existing.
ALIGN 3: Align gridline grid w/existing grid.
LEVEL 1: Ensure top of new construction is level w/existing surface.
LEVEL 2: Level floor & surface to receive new construction.
LEVEL 3: Ensure the top of grade is level w/surrounding ground.

Construction & Condition Support Notes:
HANDLE 1: Handle item w/care, and store for owner reuse.
HANDLE 2: Handle remaining building, pavement, fence, or trim w/care.
HANDLE 3: Handle re-located items with care. DISCONNECT 1, FIXW.
FIXW: The floor/wall/ceiling/trim where construction was removed and prepare the area to receive new construction. Ensure the top of grade is level w/surrounding ground & maintain positive slope towards drain, gutter, and storm system away from building.
FIXU: Fix floor/wall/ceiling/trim where construction was removed and prepare the area to an acceptable condition. Ensure the top of grade is level w/surrounding ground & maintain positive slope towards drain, gutter, and storm system away from building.
PROTECT: Prepare the site where construction was removed, and prepare the ground to an acceptable condition. Items achieved prior to the start of this work.
SITE1: Connect new construction to existing, ensure continuity and structural integrity. Ensure the top of new construction is level w/existing surface.
SITE2: Connect remaining items to the new structure, and ensure structural integrity while meeting local Codes. Handle remaining buildings, pavement, fences, and other items w/care.
DISCONNECT: Disconnect and conceal all pipes, electrical cables, data cables, and conduct where construction is removed.
ENGINEER1: Professional engineering supervision is required for this work.
SHOP1: Provide shop drawings for this work.
REFERENCE: Refer to price for the existing condition at the location.
SLOPE1: Maintain positive slope towards drains, gutters, and storm systems and away from the building.
PROTECT1: Protect items to remain, including any buildings, furniture, sidewalks, roots, utilities, and other items during the Demolition and Construction phases.
EGRESS: Maintain safe and unrestricted egress routes from areas adjacent to the Demolition site. Comply with all applicable Codes.
TREE1: Refer to Landscape Drawings & Specs for removing trees.
OPERATE: Ensure all routes and utilities required for school operation are protected. Ensure school operation will not be interrupted.
ENSURE1: Ensure all slopes to drain as intended, and that downspouts indicated to remain are protected to maintain normal flow at all times during demolition and construction. Protect items to remain including any buildings, furniture, sidewalks, roots, utilities, and other items during demolition and construction.
ENSURE2: Ensure system is water-tight. Provide additional flashing & seals as needed.
PHASE1: Work within this area may occur in phase ONE.
PHASE2: Work within this area may occur in phase TWO.

03 SUPPORT NOTES
Scale: NTS

- A005 PAINT ENTIRE AREA FOR CLASSROOMS. USE ACCENT PAINT COLOR TRD ON TEACHING WALL. MARKERBOARD IS LOCATED. RE: FINISH SCHEDULE. (HANDLE 2; FIXW)
- A006 REHAB DECK AND STRUCTURE ABOVE, CLEAN, AND PAINT. (HANDLE 2; FIXW)
- A013 PROVIDE NEW CEILING TILE AND GRID AT SAME HEIGHT AS EXISTING CEILING. RE: FINISH SCHEDULE. WHERE ROOM HAS CHANGED PLAN ARRANGEMENT, CENTER GRID ON NEW WALLS UNLESS INDICATED OTHERWISE. WHERE ROOM REMAINS THE SAME IN PLAN, CENTER GRID TO MATCH PREVIOUS UNLESS INDICATED OTHERWISE.
- A014 PROVIDE NEW LVT FLOORING AS INDICATED IN FINISH SCHEDULE.
- A027 NEW CONNECTOR WITH STEEL STRUCTURE, METAL ROOF, CONCRETE SLAB & FOUNDATION, AND ALUMINUM STOREFRONT WALLS.
- A030 NEW OUTLETS/DATAPORTS AS SPECIFIED. RE: PLANS, ELECTRICAL DRAWINGS.
- A501 LEARNING STAIR: WOOD VENEER OVER STEEL STAIR SUBSTRUCTURE. RE: DETAILS. (ENGINEER 1; SHOP 1)
- A503 1-1/2" DIA. METAL HANDRAIL @ 38" A.F.F. FLOOR MOUNTED THROUGH WOOD VENEER TO STEEL STAIR BELOW. PROVIDE ESTUCCOON TO MATCH FINISH OF RAIL. (SHOP 1)
- C02 SCHEDULED RECESSED LINEAR LIGHT FIXTURE. RCP INDICATES TYPE. RE: ELECTRICAL DRAWINGS.
- C05 PERIMETER TRIM AS SPECIFIED AROUND CLOUD CEILING.
- C08 GYP. BD. BULKHEAD: 1 LAYER GYP. ON 3-5/8" MTL. STUDS @ 16# O.C. SUSPENDED FROM STRUCTURE ABOVE TO ALIGN TO ADJACENT CEILINGS UNLESS OTHERWISE NOTED. (ALIGN 1)
- PT1 PAINT (FIELD).
- PT4 PAINT (ACCENT 4).
- X08 EXISTING STRUCTURAL COLUMNS SHALL NOT BE AFFECTED BY NEW WORK. V.I.F. (PROTECT 1)
- X09 EXISTING BULKHEAD FURR DOWN. CONTRACTOR TO VERIFY IN FIELD.


02 KEYNOTES
Scale: NTS

1. HANDLE STRUCTURE OF EXISTING BUILDING WITH CARE. NO WORK SHOULD HAVE ANY AFFECT ON THE STRUCTURAL INTEGRITY OF THE BUILDING. REPORT TO THE ARCHITECT ANY INDICATIONS OF STRUCTURAL DAMAGE.
2. PROTECT THROUGHOUT DEMOLITION AND CONSTRUCTION ALL ITEMS INDICATED TO REMAIN INCLUDING BUT NOT LIMITED TO: BUILDINGS AND OTHER STRUCTURES, FLOORING, WALLS, CEILINGS, FINISHES, MEP/ SECURITY SYSTEMS, UTILITIES, MILLWORK, ETC.
3. FIELD VERIFY ALL CONDITIONS PRIOR TO CONSTRUCTION, PARTICULARLY IN AREAS OF WORK.
4. REPORT TO THE ARCHITECT ANY UNFORESEEN CONDITIONS OR AS-BUILT CONDITIONS NOT REFLECTED IN THE DRAWINGS. THAT COULD AFFECT THE WORK.
5. MAINTAIN SAFE AND UNRESTRICTED ACCESS AND EGRESS ROUTES FOR OCCUPIED AREAS ADJACENT TO WORK AREAS IN ACCORDANCE WITH APPLICABLE CODES.
6. ALL DIMENSIONS TO WALLS ARE TO FINISH FACE OF WALL UNLESS INDICATED OTHERWISE. (SIDE INDICATED GRAPHICALLY IN THE DRAWINGS).
7. PROVIDE NECESSARY BLOCKING AT WALLS FOR ALL PLUMBING FIXTURES, EQUIPMENT, MILLWORK, AND ACCESSORIES.
8. PLANS INDICATE HORIZONTAL DIMENSIONS ONLY. REFER TO ELEVATIONS & SECTIONS FOR VERTICAL DIMENSIONS.
9. PROVIDE PARTITION CURBS FOR MECH/ELEC. ROOMS PERIMETER, TYP. UNLESS OTHERWISE NOTED.
10. UNLESS INDICATED OTHERWISE, ALL NEW WORK IN THIS PROJECT IS TO BE ACCESSIBLE IN ACCORDANCE WITH THE MOST RECENT EDITION OF THE TEXAS ACCESSIBILITY STANDARDS. REFER TO ACCESSIBILITY REQUIREMENTS ON SHEETS A010 AND A0130 FOR MORE INFORMATION.
11. REFER TO DOOR AND WINDOW DETAILS FOR DIMENSIONS AT OPENINGS.
12. REFER TO DEMOLITION DRAWINGS FOR DEMOLITION INFORMATION.
13. REFER TO CODE ANALYSIS INFORMATION SHEET A020 FOR EXTENT OF EXTENDED FIRE-SPRINKLER SYSTEM.

01 GENERAL NOTES - CONSTRUCTION
Scale: NTS




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A PROJECT FOR:
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 1625 STAFFORDSHIRE ROAD, STAFFORD, TX 77477
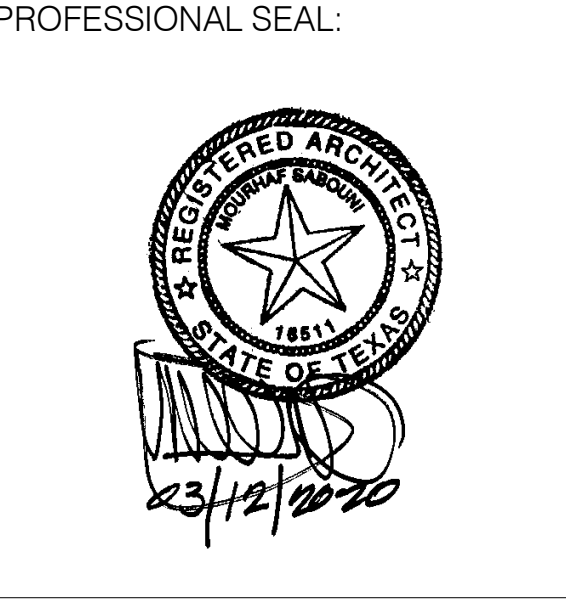
#	Date	ISSUED FOR
	03/13/2020	ISSUE FOR BID, PERMIT, & CONSTRUCTION




Project Number	19006-A
Drawn By	LT
Checked By	AW
Approved By	MS
Drawing Title	PLANS & DETAILS AT CONNECTOR

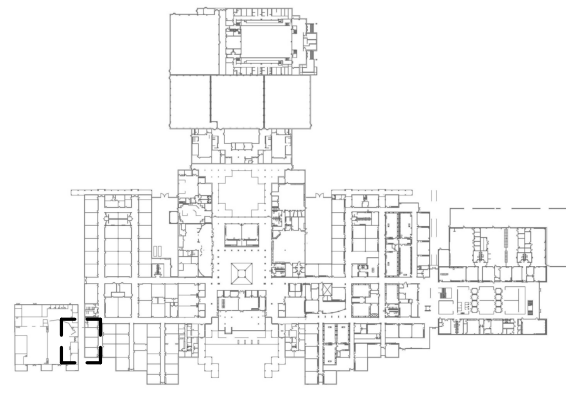Drawing Number **A2.21**





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A PROJECT FOR:
STAFFORD HIGH SCHOOL & MAGNET SCHOOL RENOVATIONS
 1625 STAFFORDSHIRE ROAD, STAFFORD, TX 77477

#	Date	ISSUED FOR
1	03/13/2020	ISSUE FOR BID, PERMIT, & CONSTRUCTION

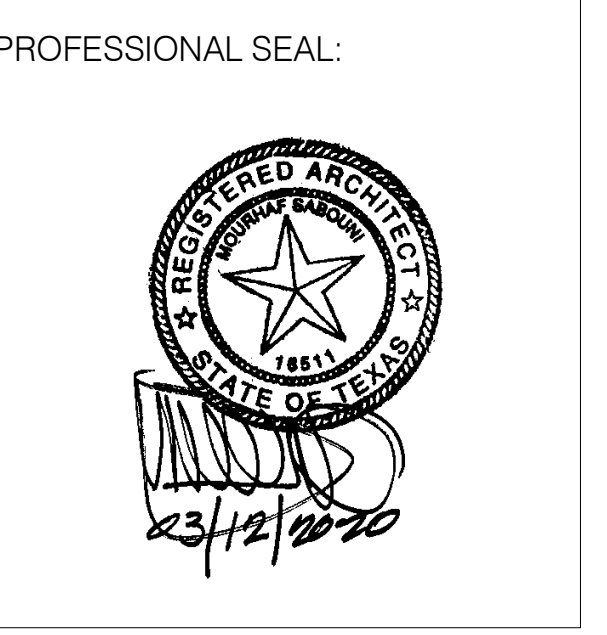


Project Number	19006-A
Drawn By	LT
Checked By	AW
Approved By	MS
Drawing Title	CEILING PLAN AT MAGNET SCHOOL - SOUTH
Drawing Number	A2.50

- A006 REHAB DECK AND STRUCTURE ABOVE. CLEAN AND PAINT. (HANDLE 2, FIXW)
- A013 PROVIDE NEW CEILING TILE AND GRID AT SAME HEIGHT AS EXISTING CEILING. RE-FINISH SCHEDULE. WHERE ROOM HAS CHANGED PLAN ARRANGEMENT, CENTER GRID ON NEW WALLS UNLESS INDICATED OTHERWISE. WHERE ROOM REMAINS THE SAME IN PLAN, CENTER GRID TO MATCH PREVIOUS UNLESS INDICATED OTHERWISE.
- A031 NEW CEILING MOUNTED OUTLET AND POWER CORD REEL. RE: CEILING PLANS, ELECTRICAL DRAWINGS.
- A308 RE: DEMOLITION DRAWINGS FOR REMOVAL OF EXISTING CEILING PROJECTORS AND REQUIREMENTS FOR NEW CFO WALL MOUNTED SMART PROJECTORS. RE: MEP DRAWINGS.
- C011 SCHEDULED 2X4 OR 2X2 LIGHT FIXTURE. RCP INDICATES TYPE. RE: ELECTRICAL DRAWINGS.
- C02 SCHEDULED RECESSED LINEAR LIGHT FIXTURE. RCP INDICATES TYPE. RE: ELECTRICAL DRAWINGS.
- C03 SCHEDULED RECESSED 4'X4' SQUARE LIGHT FIXTURE. RCP INDICATES TYPE. RE: ELECTRICAL DRAWINGS.
- C04 SCHEDULED DECORATIVE PENDANT LIGHT FIXTURE. RCP INDICATES TYPE. PENDANTS HANG TO 10' 0" A.F.F. OR 18" BELOW THE CEILING OR LOWEST DUCT, WHICHEVER IS LESS. PENDANTS SHALL IN NO CASES HANG BELOW 9'-0" RE: ELECTRICAL DRAWINGS.
- C05 PERIMETER TRIM AS SPECIFIED AROUND CLOUD CEILING.
- C07 GYP. BD. CEILINGS - 1 LAYER GYP. ON CEILING-FURRING CHANNELS AT 24" O.C. MAX ON 1'-10" MTL. STUDS AT 48" O.C. MAX IN PERPENDICULAR DIRECTION. SUSPENDED WITH WIRE HANGERS FROM STRUCTURE ABOVE AT 48" O.C. MAX. CEILING AT 9'-0" A.F.F. UNLESS INDICATED OTHERWISE.
- C08 GYP. BD. BULKHEAD - 1 LAYER GYP. ON 3/8" MTL. STUDS @ 16x16 O.C. SUSPENDED FROM STRUCTURE ABOVE TO ALIGN TO ADJACENT CEILINGS UNLESS OTHERWISE NOTED. (ALIGN 1)
- X09 EXISTING BULKHEAD FURR DOWN. CONTRACTOR TO VERIFY IN FIELD.

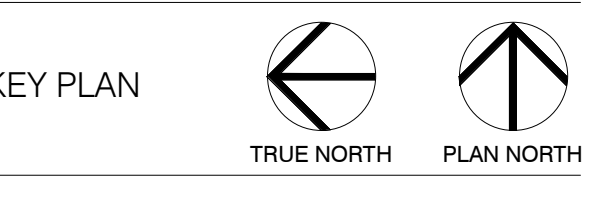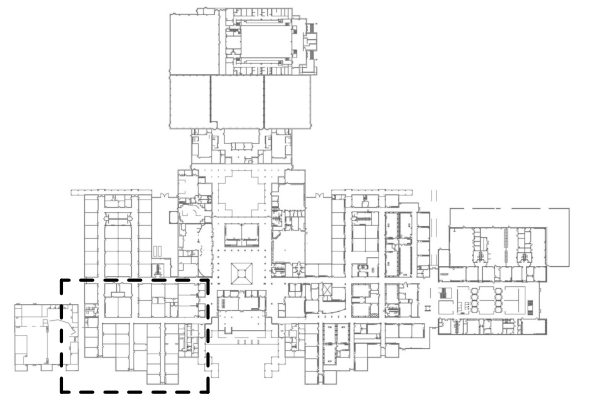04 KEYNOTES
 Scale: NTS

1. EXTEND ALL SUPPLY AND RETURN AIR DUCTS THROUGH THE NEW CEILING AND WALLS. REBALANCE AS NECESSARY TO MAINTAIN FULL FUNCTIONALITY OF HVAC SYSTEM.
2. ADJUST/RELOCATE ALL DUCTS, DIFFUSERS, CABLES, SECURITY DEVICES, AND OTHER DEVICES THAT CONFLICT WITH NEW CEILING, WALLS, AND OTHER CONSTRUCTION.
3. ALL CLOUD CEILINGS TO HAVE 4" EXTRUDED ALUMINUM PERIMETER TRIM. RE: SPEC.
4. ALL GYPSUM CEILINGS TO BE 10' - 0" A.F.F. UNLESS INDICATED OTHERWISE.
5. ALL RESTROOM GYPSUM CEILINGS TO BE 9' - 0" A.F.F. UNLESS INDICATED OTHERWISE.
6. ALL ACOUSTICAL LAY-IN CEILINGS TO BE 10' - 0" A.F.F. AND CENTERED WITHIN EACH ROOM UNLESS INDICATED OTHERWISE.
7. ALL LIGHT FIXTURES INSTALLED IN GYP. BD. CEILING ARE TO BE CENTERED WITHIN THE ROOM UNLESS INDICATED OTHERWISE.
8. ALL LIGHT FIXTURES AND OTHER EQUIPMENT THAT IS INSTALLED IN ACOUSTICAL CEILING TILE SHALL BE CENTERED ON A CEILING TILE.
9. ALL LIGHT FIXTURES AT MECHANICAL, ELECTRICAL, AND OTHER ROOMS CONTAINING LARGE EQUIPMENT ARE REFERRED TO QUANTITY ONLY. LOCATIONS SHALL BE COORDINATED WITH EQUIPMENT BY GC IN FIELD.
10. CEILING PLANS INDICATE ARCHITECTURAL LIGHTING ONLY. RE: MEP/FIRE DRAWINGS FOR EMERGENCY LIGHTING, STROBES, ETC.
11. EXTEND/ADJUST FIRE SPRINKLER HEADS & PIPES TO ACCOMMODATE THE NEW CEILING & CONSTRUCTION.
12. FIRE SPRINKLER AND ALARM SYSTEMS IN OCCUPIED AREAS SHALL REMAIN FULLY FUNCTIONAL THROUGHOUT THE CONSTRUCTION OF THE PROJECT. UNLESS PERMISSION IS GRANTED BY OWNER, AND COORDINATED WITH APPLICABLE LOCAL AUTHORITIES, CONTACT ARCHITECT AT ONCE IF COMPLETION OF WORK WILL REQUIRE SHUTTING DOWN SPRINKLER OR ALARM SYSTEMS.
13. REFER TO SPECIFICATIONS FOR CEILING TILE MATERIALS AND EQUIPMENT TYPES.

01 GENERAL NOTES - CEILINGS
 Scale: NTS

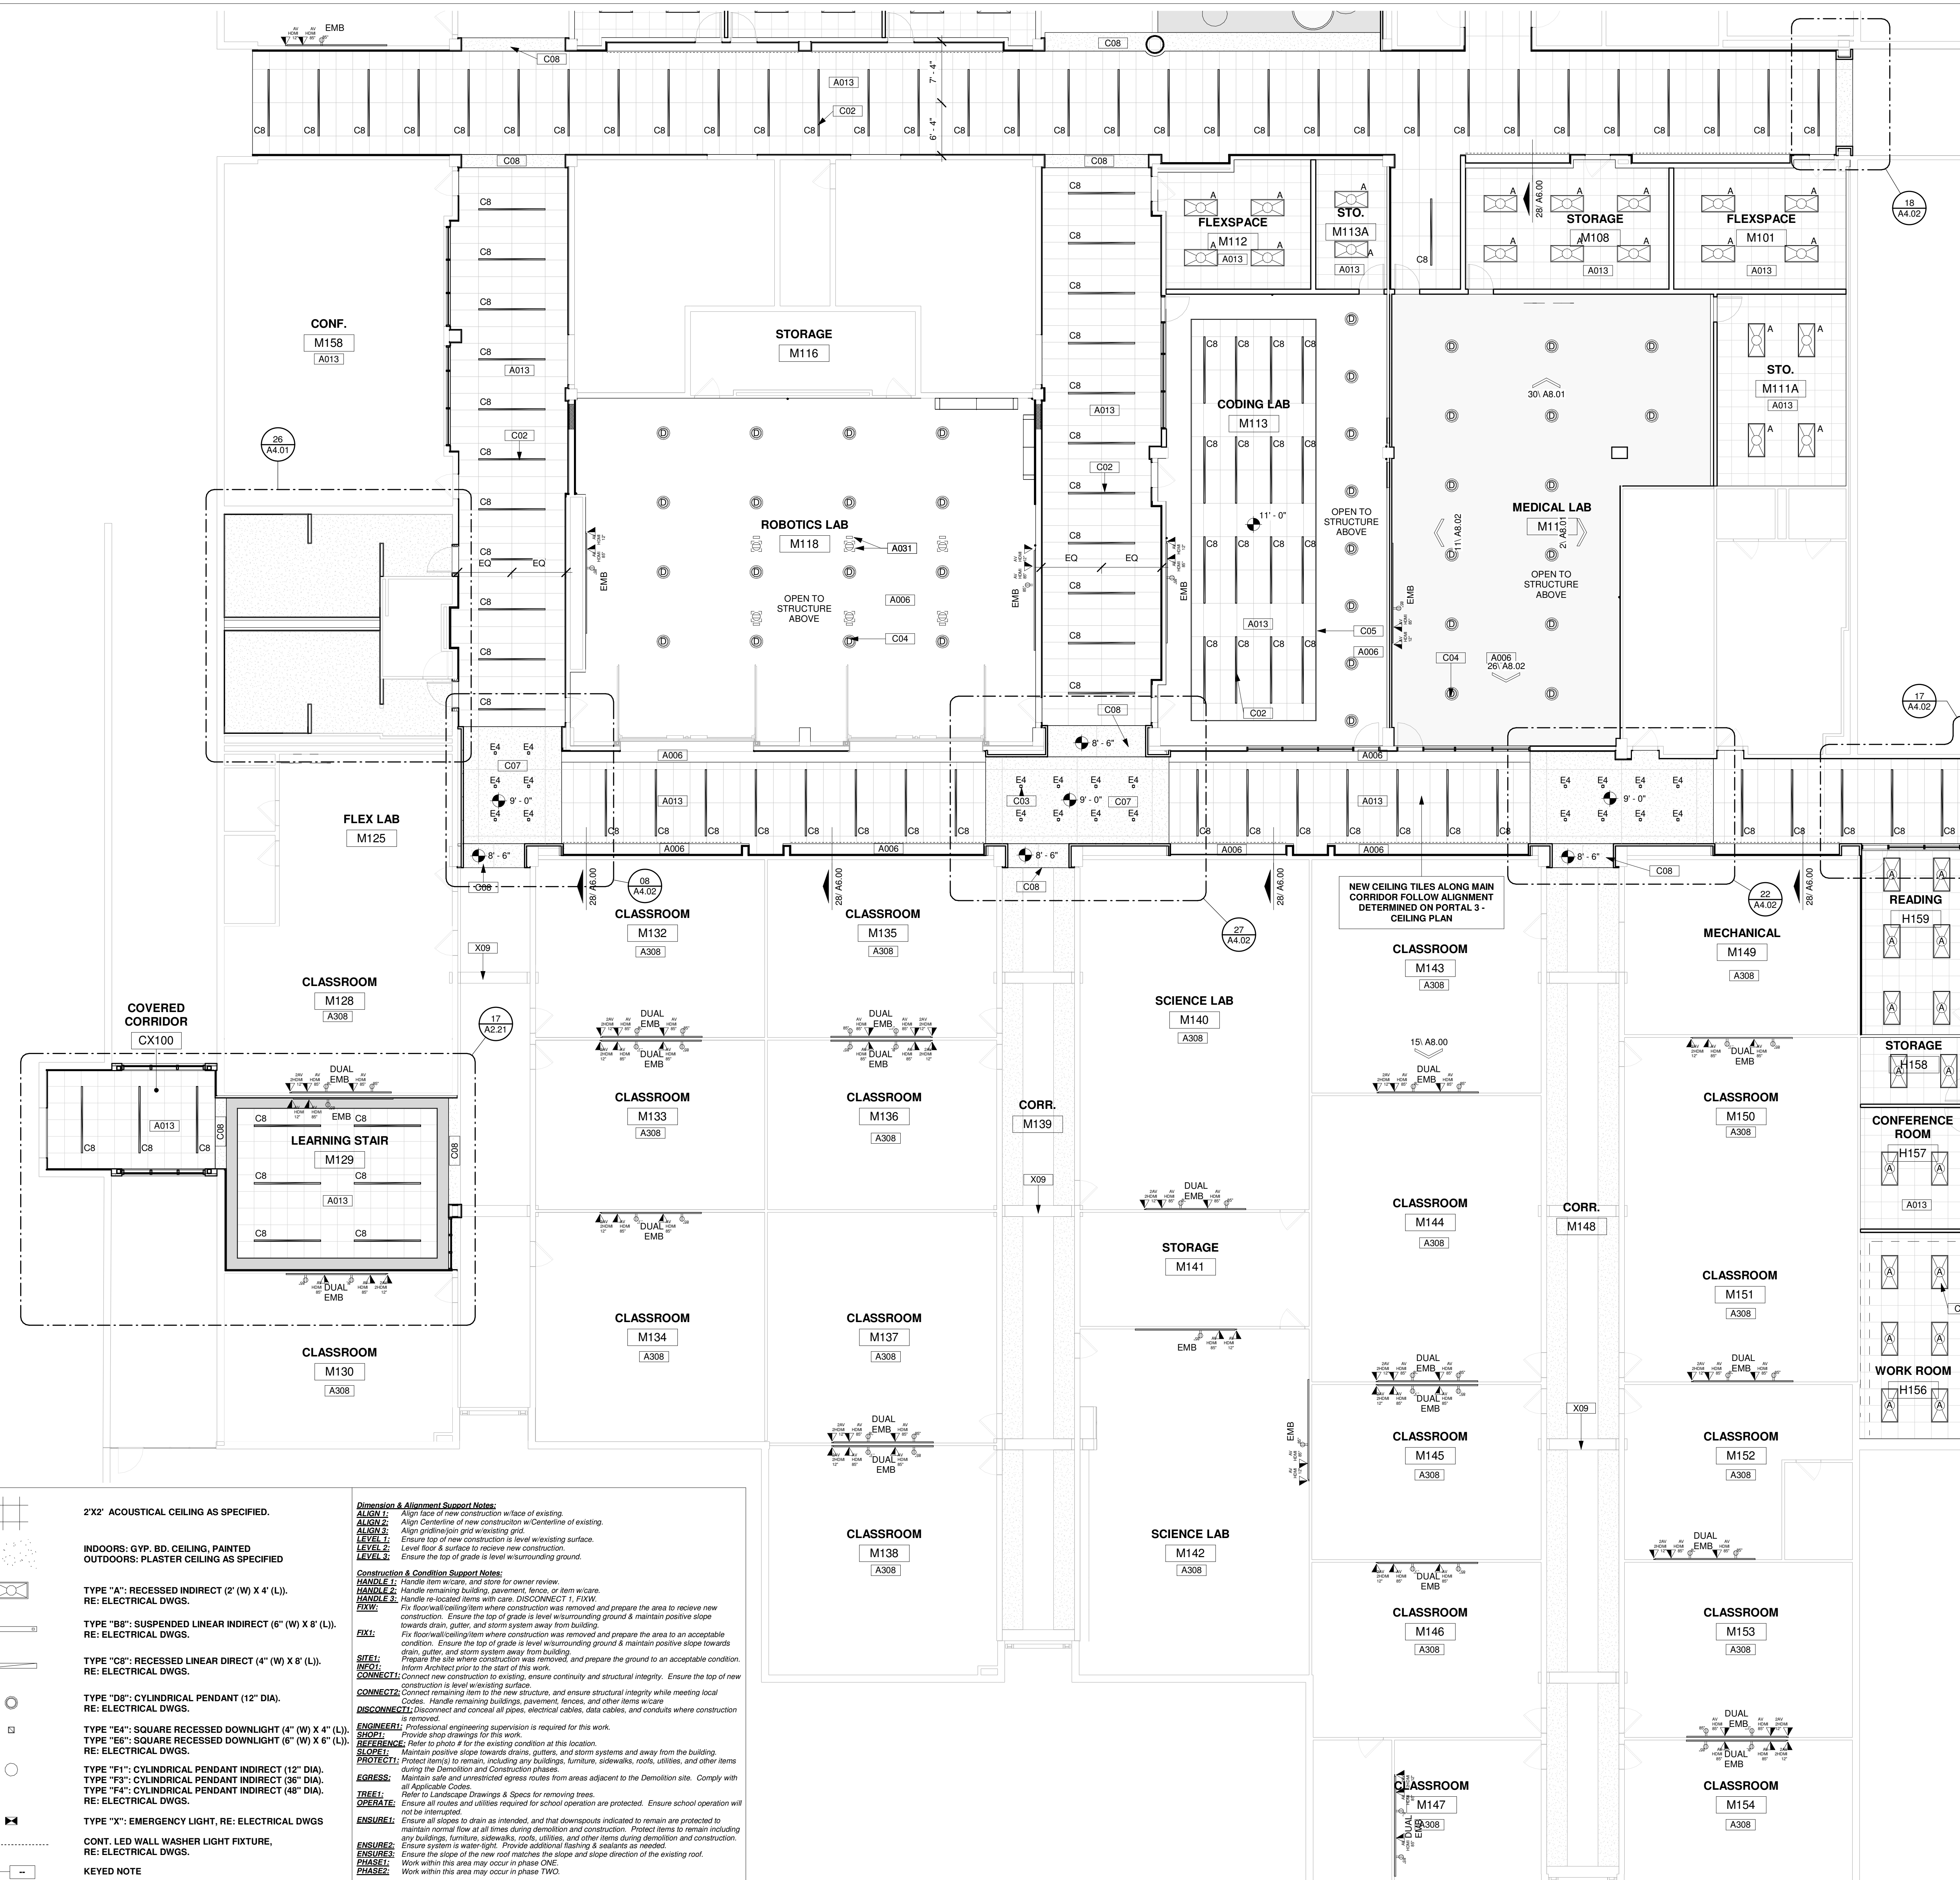

26 CEILING LEGEND
 Scale: NTS


21 SUPPORT NOTES
 Scale: NTS

16 ENLARGED CEILING PLAN AT MAGNET SCHOOL - SOUTH
 Scale: 1/8" = 1'-0"

Dimension & Alignment Support Notes:
ALIGN 1: Align face of new construction w/face of existing.
ALIGN 2: Align centerline of new construction w/centerline of existing.
ALIGN 3: Align gridline and existing grid.
LEVEL 1: Ensure top of new construction is level w/existing surface.
LEVEL 2: Level floor & surface to receive new construction.
LEVEL 3: Ensure the top of grade is level w/surrounding ground.
Construction & Condition Support Notes:
HANDLE 1: Handle item w/care, and store for owner review.
HANDLE 2: Handle remaining building, pavement, fence, or item w/care.
HANDLE 3: Handle re-located items w/care. DISCONNECT 1, FIXW.
FIXW: Fix floor/wall/ceiling item where construction was removed and prepare the area to receive new construction. Ensure the top of grade is level w/surrounding ground & maintain positive slope towards drain, gutter, and storm system away from building.
FIXL: Fix floor/wall/ceiling item where construction was removed and prepare the area to an acceptable condition. Ensure the top of grade is level w/surrounding ground & maintain positive slope towards drain, gutter, and storm system away from building.
PREP: Prepare the site where construction was removed, and prepare the ground to an acceptable condition.
REMOVE: Remove construction to existing, ensure continuity and structural integrity. Ensure the top of new construction is level w/existing surface.
RELOCATE: Relocate remaining items to the new structure, and ensure structural integrity while meeting local Codes. Handle remaining buildings, pavement, fences, and other items w/care during the Demolition and Construction phases.
SECURE: Secure remaining engineering supervision is required for this work.
SHOP: Provide shop drawings for this work.
VERIFY: Refer to plans & for the existing condition at this location.
SLOPE: Maintain positive slope towards drains, gutters, and storm systems and away from the building.
PROTECT: Protect items to remain, including any buildings, furniture, sidewalks, roofs, utilities, and other items w/care during the Demolition and Construction phases.
EGRESS: Maintain safe and unrestricted egress routes from areas adjacent to the Demolition site. Comply with all Applicable Codes.
TREE: Refer to Landscape Drawings & Specs for removing trees.
OPERATE: Ensure all routes and utilities required for school operation are protected. Ensure school operation will not be interrupted.
UNSURE: Ensure all slopes to drain as intended, and that downspouts indicated to remain are protected to maintain normal flow at all times during demolition and construction. Protect items to remain including any buildings, furniture, sidewalks, roofs, utilities, and other items during demolition and construction.
WATER: Ensure system is water-tight. Provide additional flashing & sealants as needed.
ENSURE: Ensure the slope of the new roof matches the slope and slope direction of the existing roof.
PHASE 1: Work within this area may occur in phase ONE.
PHASE 2: Work within this area may occur in phase TWO.

INDOORS: GYP. BD. CEILING, PAINTED
OUTDOORS: PLASTER CEILING AS SPECIFIED
TYPE "A": RECESSED INDIRECT (2" W) X 4" (L). RE: ELECTRICAL DWGS.
TYPE "B8": SUSPENDED LINEAR INDIRECT (6" W) X 8" (L). RE: ELECTRICAL DWGS.
TYPE "C8": RECESSED LINEAR DIRECT (4" W) X 8" (L). RE: ELECTRICAL DWGS.
TYPE "D8": CYLINDRICAL PENDANT (12" DIA). RE: ELECTRICAL DWGS.
TYPE "E4": SQUARE RECESSED DOWNLIGHT (4" W) X 4" (L).
TYPE "E6": SQUARE RECESSED DOWNLIGHT (6" W) X 6" (L). RE: ELECTRICAL DWGS.
TYPE "F1": CYLINDRICAL PENDANT INDIRECT (12" DIA).
TYPE "F3": CYLINDRICAL PENDANT INDIRECT (36" DIA).
TYPE "F4": CYLINDRICAL PENDANT INDIRECT (48" DIA). RE: ELECTRICAL DWGS.
TYPE "X": EMERGENCY LIGHT, RE: ELECTRICAL DWGS
CONT. LED WALL WASHER LIGHT FIXTURE, RE: ELECTRICAL DWGS.
KEYED NOTE

DATE PLOTTED: 03/12/2020 09:58 AM

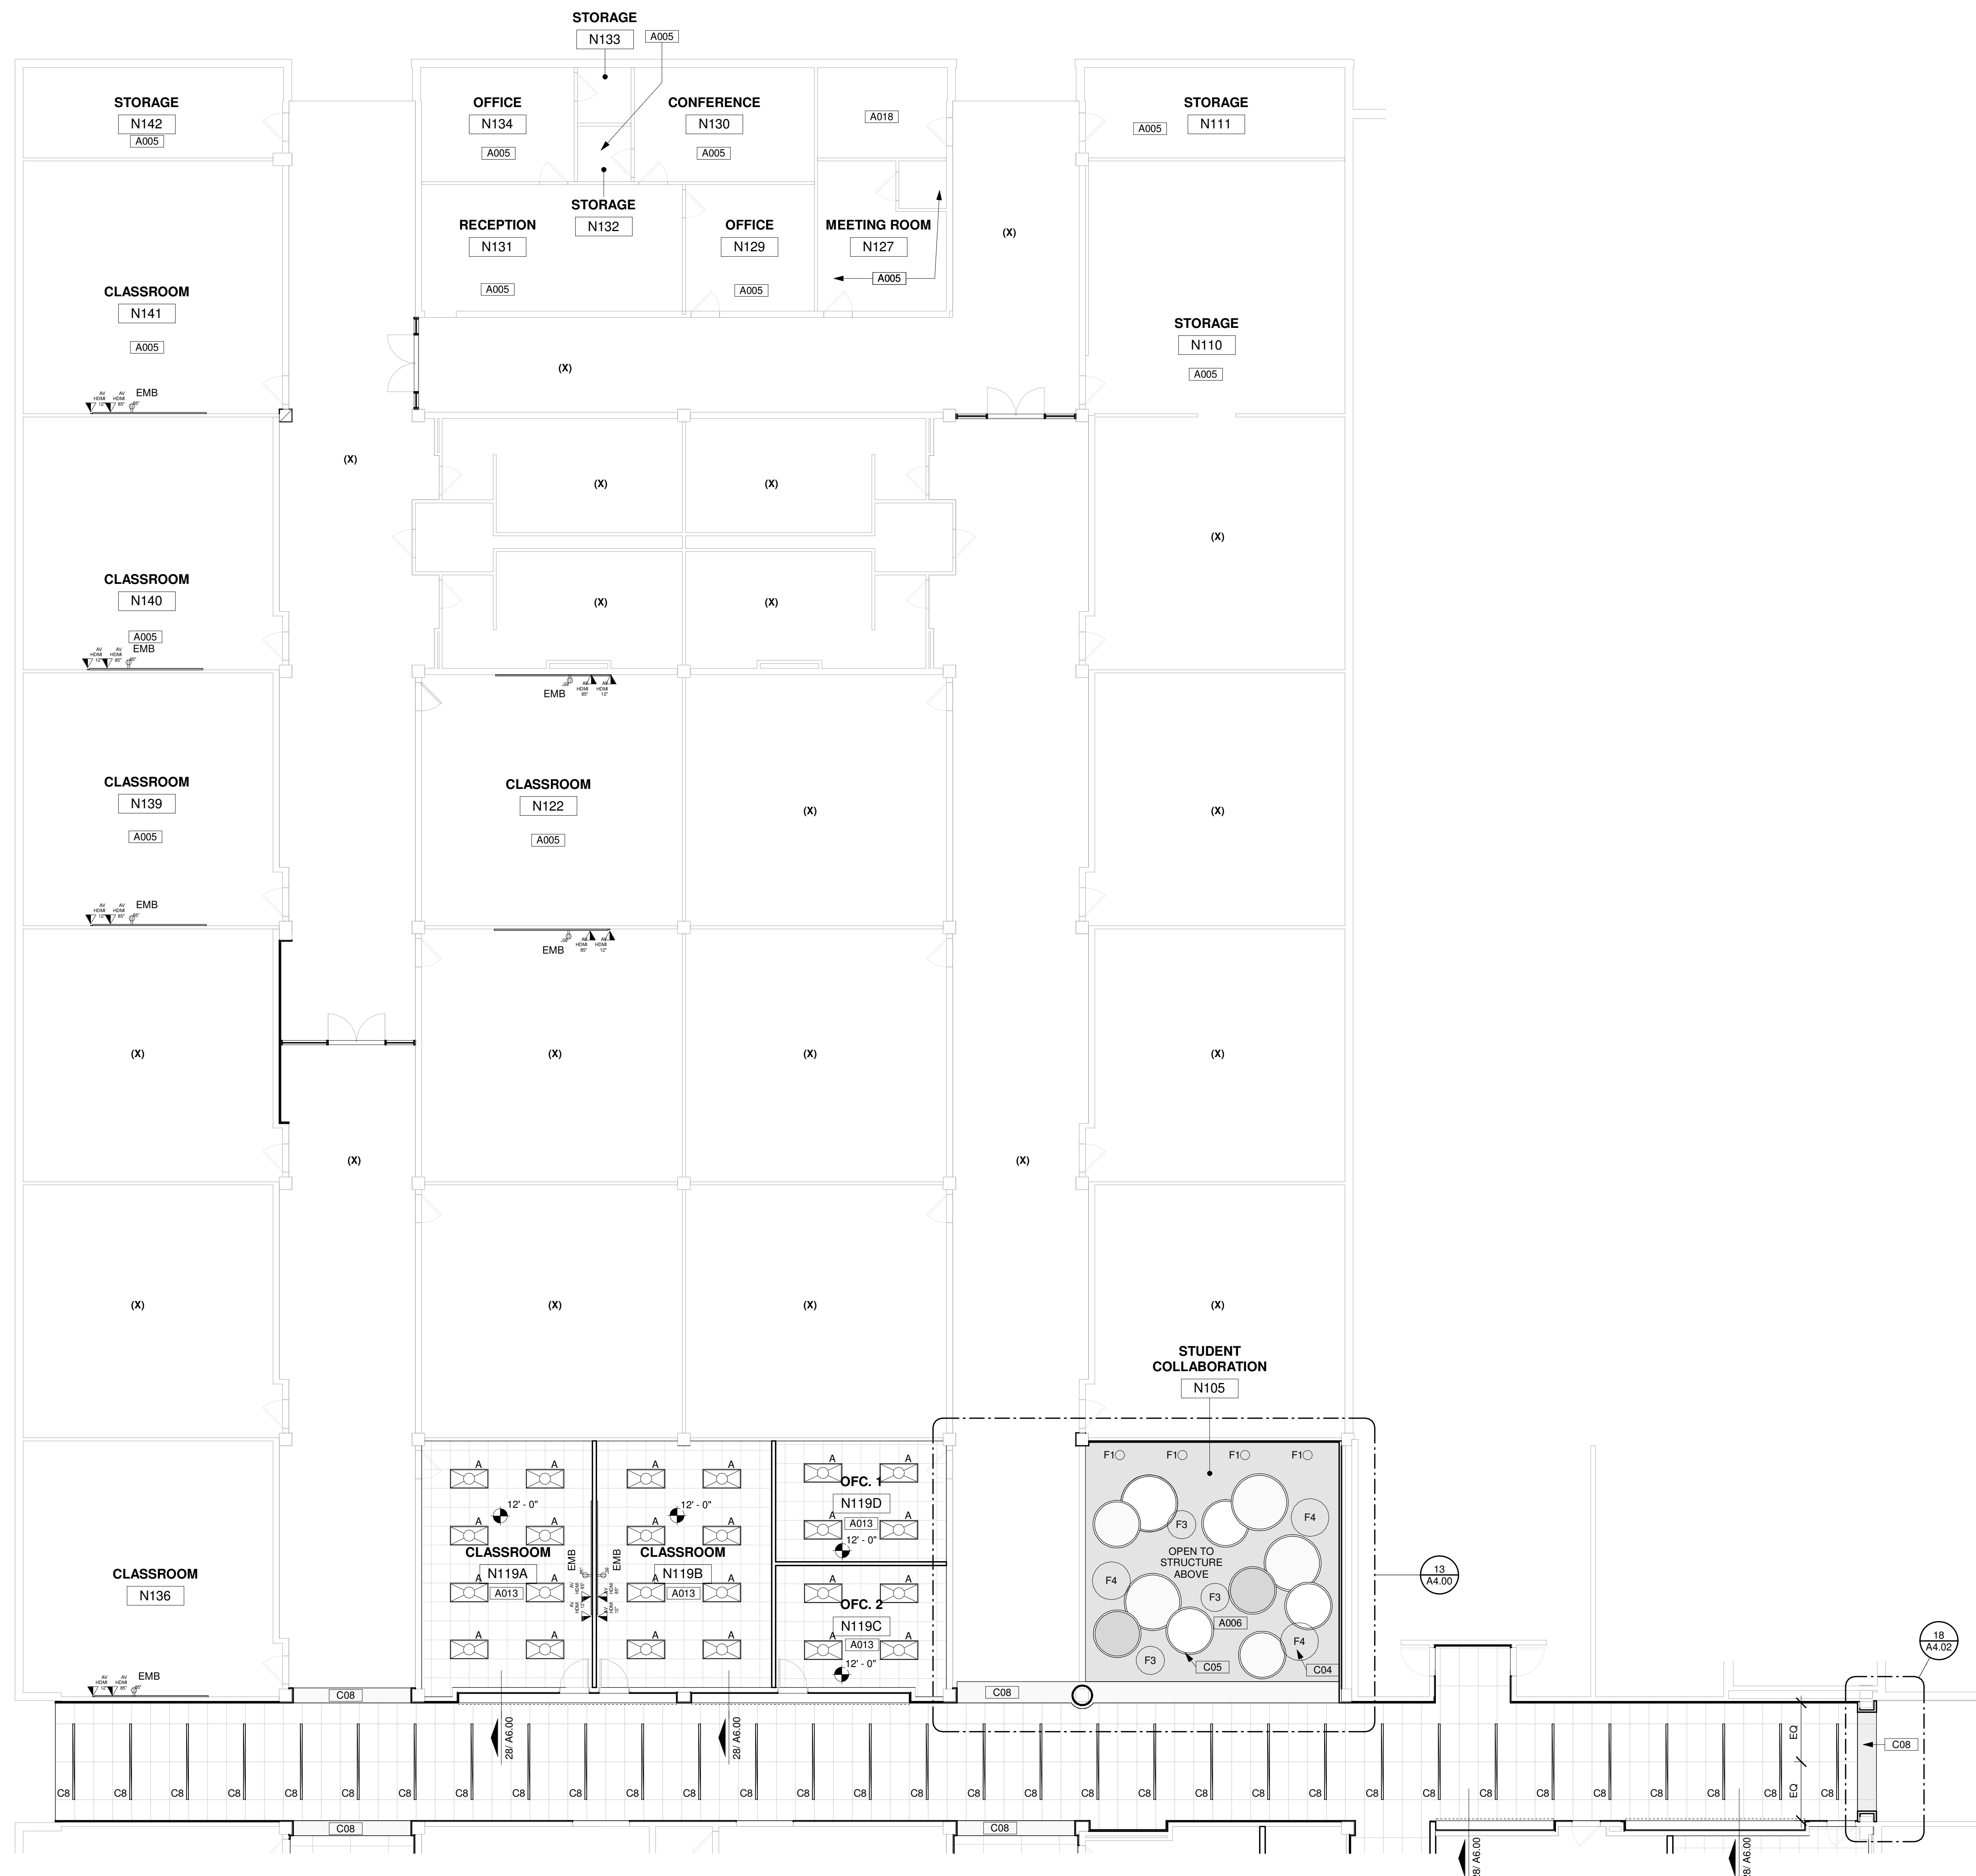

26 ENLARGED CEILING PLAN AT MAGNET SCHOOL - NORTH
 Scale: 1/8" = 1'-0"

- 2'X2'** ACOUSTICAL CEILING AS SPECIFIED.
 INDOORS: GYP. BD. CEILING, PAINTED
 OUTDOORS: PLASTER CEILING AS SPECIFIED
- TYPE "A":** RECESSED INDIRECT (2' (W) X 4' (L)).
 RE: ELECTRICAL DWGS.
- TYPE "B8":** SUSPENDED LINEAR INDIRECT (6" (W) X 8' (L)).
 RE: ELECTRICAL DWGS.
- TYPE "C8":** RECESSED LINEAR DIRECT (4" (W) X 8' (L)).
 RE: ELECTRICAL DWGS.
- TYPE "D8":** CYLINDRICAL PENDANT (12" DIA).
 RE: ELECTRICAL DWGS.
- TYPE "E4":** SQUARE RECESSED DOWNLIGHT (4" (W) X 4" (L)).
TYPE "E8": SQUARE RECESSED DOWNLIGHT (6" (W) X 6" (L)).
 RE: ELECTRICAL DWGS.
- TYPE "F1":** CYLINDRICAL PENDANT INDIRECT (12" DIA).
TYPE "F3": CYLINDRICAL PENDANT INDIRECT (36" DIA).
TYPE "F4": CYLINDRICAL PENDANT INDIRECT (48" DIA).
 RE: ELECTRICAL DWGS.
- TYPE "X":** EMERGENCY LIGHT, RE: ELECTRICAL DWGS
- CONT. LED WALL WASHER LIGHT FIXTURE,
 RE: ELECTRICAL DWGS.

05 CEILING LEGEND
 Scale: NTS

Dimension & Alignment Support Notes:
ALIGN 1: Align face of new construction w/face of existing.
ALIGN 2: Align Centerline of new construction w/Centerline of existing.
ALIGN 3: Align gridline/line grid w/existing grid.
LEVEL 1: Ensure top of new construction is level w/existing surface.
LEVEL 2: Level floor & surface to receive new construction.
LEVEL 3: Ensure the top of grade is level w/surrounding ground.

Construction & Condition Support Notes:
HANDLE 1: Handle iron w/ware, and stone for owner review.
HANDLE 2: Handle remaining building, pavement, fence, or iron w/ware.
HANDLE 3: Handle re-located items with care. DISCONNECT 1, FIXW.
FIXX: Fix floor/wall/ceiling/iron where construction was removed and prepare the area to receive new construction. Ensure the top of grade is level w/surrounding ground & maintain positive slope towards drain, gutter, and storm system away from building.
FIXL: Fix floor/wall/ceiling/iron where construction was removed and prepare the area to an acceptable condition. Ensure the top of grade is level w/surrounding ground & maintain positive slope towards drain, gutter, and storm system away from building.
SITEP: Prepare the site where construction was removed, and prepare the ground to an acceptable condition.
INFO1: Inform Architect prior to the start of this work.
CONNECT: Connect new construction to existing, ensure continuity and structural integrity. Ensure the top of new construction is level w/existing surface.
CONNECT2: Connect remaining items to the new structure, and ensure structural integrity while meeting local Codes. Handle remaining buildings, pavement, fences, and other items w/ware.
DISCONNECT: Disconnect and conceal all pipes, electrical cables, data cables, and conduits where construction is removed.
ENGINEER1: Professional engineering supervision is required for this work.
SHEET: Provide shop drawings for this work.
REFERENCE: Refer to photo # for the existing condition at this location.
SLOPE1: Maintain positive slope towards drains, gutters, and storm systems and away from the building.
PROTECT: Protect items to remain, including any buildings, furniture, sidewalks, roofs, utilities, and other items during the Demolition and Construction phases.
EXPRESS: Maintain safe and unobstructed access routes from areas adjacent to the Demolition site. Comply with all Applicable Codes.
TREE1: Refer to Landscape Drawings & Specs for removing trees.
OPERATE: Ensure all routes and utilities required for school operation are protected. Ensure school operation will not be interrupted.
ENSURE1: Ensure all slopes to drain as intended, and that downspouts indicated to remain are protected to maintain normal flow at all times during demolition and construction. Protect items to remain including any buildings, furniture, sidewalks, roofs, utilities, and other items during demolition and construction.
ENSURE2: Ensure system is water-tight. Provide additional flashing & sealants as needed.
EXPOSURE: Ensure the slope of the new roof matches the slope and direction of the existing roof.
PHASE1: Work within this area may occur in phase ONE.
PHASE2: Work within this area may occur in phase TWO.

03 SUPPORT NOTES
 Scale: NTS

- A005** PAINT ENTIRE AREA, FOR CLASSROOMS, USE ACCENT PAINT COLOR TBD ON TEACHING WALL. MARKERBOARD IS LOCATED. RE-FINISH SCHEDULE. (HANDLE 2; FIXW)
- A006** REHAB DECK AND STRUCTURE ABOVE, CLEAN, AND PAINT. (HANDLE 2; FIXW)
- A013** PROVIDE NEW CEILING TILE AND GRID AT SAME HEIGHT AS EXISTING CEILING, RE-FINISH SCHEDULE. WHERE ROOM HAS CHANGED PLAN ARRANGEMENT, CENTER GRID ON NEW WALLS UNLESS INDICATED OTHERWISE. WHERE ROOM REMAINS THE SAME IN PLAN, CENTER GRID TO MATCH PREVIOUS UNLESS INDICATED OTHERWISE.
- A018** NO NEW FINISHES OR ARCHITECTURAL WORK IN ELECTRICAL, MECHANICAL, AND JANITORS ROOMS. RE: MEP DRAWINGS FOR SCOPE.
- C04** SCHEDULED DECORATIVE PENDANT LIGHT FIXTURE. RCP INDICATES TYPE. PENDANTS HANG TO 10'-0" A.F.F. OR 18" BELOW THE CEILING OR LOWEST DUCT, WHICHEVER IS LESS. PENDANTS SHALL IN NO CASES HANG BELOW 9'-0". RE: ELECTRICAL DRAWINGS.
- C05** PERIMETER TRIM AS SPECIFIED AROUND CLOUD CEILING.
- C08** GYP. BD. BULKHEAD: 1 LAYER GYP. ON 3-5/8" MTL. STUDS @ 1686 O.C. SUSPENDED FROM STRUCTURE ABOVE TO ALIGN TO ADJACENT CEILINGS UNLESS OTHERWISE NOTED. (ALIGN 1)

02 KEYNOTES
 Scale: NTS

1. MAINTAIN POSITIVE SLOPE AWAY FROM BUILDING WALLS, PARAPETS, ROOFTOP UNITS, AND OTHER ROOFTOP EQUIPMENT AT ALL AREAS WHERE ROOF WORK IS DONE. COORDINATE W/ ROOFING MANUFACTURER FOR MEANS AND METHODS.
2. EXISTING ROOFTOP EQUIPMENT INDICATED TO REMAIN, SHALL BE PROTECTED.
3. ALL NEW EXPOSED METAL FLASHING/TRIM PIECES ARE TO BE 24GA PRE-FINISHED GALV STEEL, UNLESS NOTED OTHERWISE. PAINT ALL EXPOSED METAL FLASHING/TRIM PIECES THAT ARE NOT PRE-FINISHED, AS WELL AS ALL EXPOSED MISC STEEL PIECES. TYP.
4. ALL NEW WOOD BLOCKING AT ROOF EDGES, RIDGES, ETC ARE TO BE FABRICATED FROM CONTINUOUS 2X4 FIRE TREATED WOOD BLOCKING; 2X4 IS MIN SIZE; PROVIDE LARGER WHERE REQUIRED.
5. ALL NEW GUTTERS TO BE PREFINISHED 24GA, GALV STEEL. GUTTERS ARE 6"X6" TYP. UNLESS NOTED OTHERWISE. PROVIDE PAINTED 1/4" X 1" 12" GALV STEEL BENT PLATE BRACKETS & 1/4GA X 1" GALV STEEL SPACERS AT 36"OC MAX - STAGGER WITH EACH OTHER AT 18"OC TYP. AT ALL GUTTERS, PROVIDE PREFINISHED GUTTER EXPANSION JOINTS & PAINTED SCREENS PER S/MACNA; TYP. PROVIDE PREFINISHED GALV STEEL 24GA FASCIA ON ALL GUTTERS.
6. WHETHER INDICATED OR NOT ON THESE DRAWINGS, PROVIDE AND INSTALL WALK-PADS AT ALL NEW AND EXISTING SERVICEABLE ROOFTOP EQUIPMENT, AND AT MAINTENANCE PANELS, ROOF HATCHES, LADDERS, TROPS AND SCISSORS, AND OTHER AREAS OF MEMBRANE ROOF THAT ARE EXPECTED TO RECEIVE FOOT TRAFFIC.
7. UNLESS INDICATED OTHERWISE, WALK-PADS SHALL BE 36" WIDE MIN. AROUND ROOF HATCHES AND MECHANICAL EQUIPMENT, 48" WIDE MIN. WHERE USED TO CREATE A PATH ON THE ROOF, AND 22"X12" MIN. AT OTHER LOCATIONS.
8. PROVIDE TAPERED INSULATION CRICKETS (1/4" PER FOOT MIN SLOPE) AT HIGH SIDE OF ALL MECHANICAL UNITS, ROOF HATCHES, CURBS, AND OTHER ROOF PENETRATIONS, TO SHED WATER AWAY AND TO INSURE POSITIVE ROOF DRAINAGE.
9. VERIFY ELEVATION OF PRIMARY ROOF DRAINS RELATIVE TO OVERFLOW DRAINS PRIOR TO INSTALLATION OF DRAINS.
10. VERIFY INSULATION REQUIRED TO MAINTAIN SLOPE, PRIOR TO INSTALLATION.
11. TAPERED INSULATION TO HAVE 1/4" PER FOOT MIN SLOPE TO DRAIN UNLESS INDICATED OTHERWISE.
12. REFER TO MEP AND STRUCTURAL DWGS FOR LOCATIONS OF ROOFTOP MECHANICAL EQUIPMENT AND ADDITIONAL INFO.

01 GENERAL NOTES - CEILINGS
 Scale: NTS


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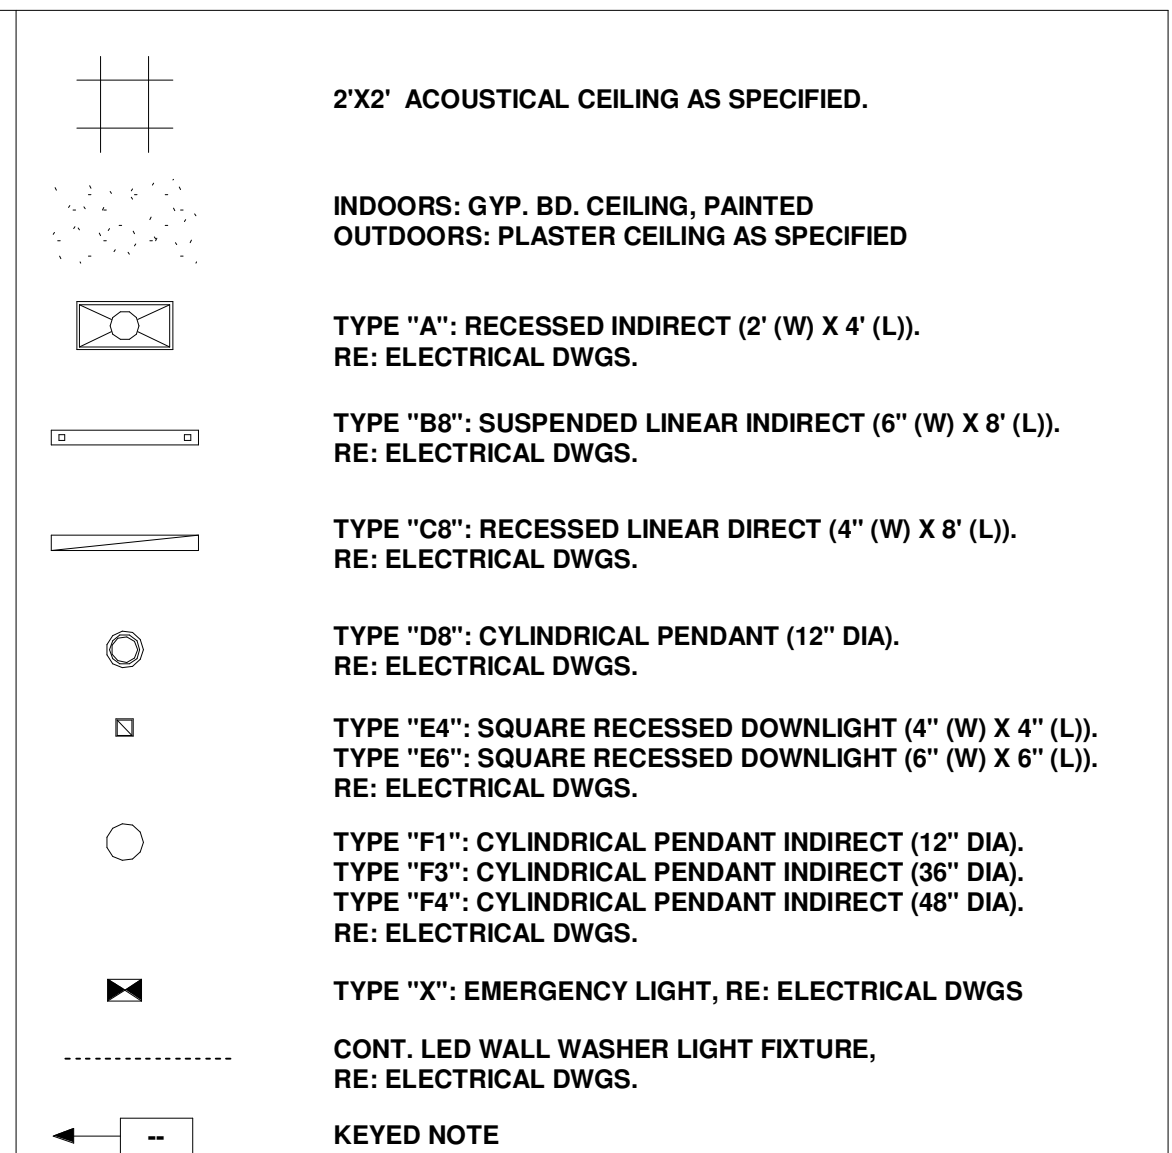
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Drawing Title
**CEILING PLAN AT
 MAGNET SCHOOL -
 NORTH**

Drawing Number
A2.51




05 CEILING LEGEND

Scale: NTS

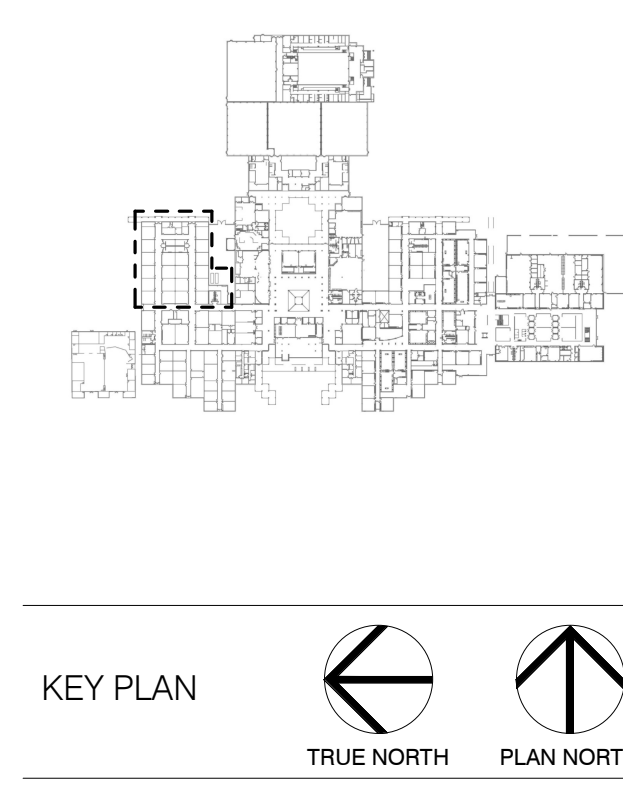- Dimension & Alignment Support Notes:**
ALIGN 1: Align face of new construction w/face of existing.
ALIGN 2: Align Centerline of new construction w/Centerline of existing.
ALIGN 3: Align grid/section grid w/existing grid.
LEVEL 1: Ensure top of new construction is level w/existing surface.
LEVEL 2: Level floor & surface to receive new construction.
LEVEL 3: Ensure the top of grade is level w/surrounding ground.
- Construction & Condition Support Notes:**
HANDLE 1: Handle item as-is, and store for owner review.
HANDLE 2: Handle remaining building, pavement, fence, or item w/care.
HANDLE 3: Handle re-located items w/care. **DISCONNECT 1:** FIXW.
FIXW: Fix floor/wall/ceiling item where construction was removed and prepare the area to receive new construction. Ensure the top of grade is level w/surrounding ground & maintain positive slope towards drain, gutter, and storm system away from building.
FIXL: Fix floor/wall/ceiling item where construction was removed and prepare the area to an acceptable condition. Ensure the top of grade is level w/surrounding ground & maintain positive slope towards drain, gutter, and storm system away from building.
PREP: Prepare the site where construction was removed, and prepare the ground to an acceptable condition.
REMOVE: Inform Architect prior to the start of this work.
CONNECT: Connect new construction to existing, ensure continuity and structural integrity. Ensure the top of new construction is level w/existing surface.
CONNECT1: Connect remaining item to the new structure, and ensure structural integrity while meeting local Codes. Handle remaining buildings, pavement, fences, and other items w/care.
DISCONNECT: Disconnect and conceal all pipes, electrical cables, data cables, and conduits where construction is removed.
ENGINEER1: Professional engineering supervision is required for this work.
EXIST: Provide shop drawings for this work.
REFERENCE: Refer to photo # for the existing condition at this location.
SLOPE 1: Maintain positive slope towards drains, gutters, and storm systems and away from the building.
PROTECT: Protect item(s) to remain, including any buildings, furniture, sidewalks, roofs, utilities, and other items during the Demolition and Construction phases.
EGRESS: Maintain safe and unrestricted egress routes from areas adjacent to the Demolition site. Comply with all Applicable Codes.
REFER: Refer to Landscape Drawings & Specs for removing trees.
OPERATE: Ensure all routes and utilities required for school operation are protected. Ensure school operation will not be interrupted.
ENURE1: Ensure all slopes to drain as intended, and that downspouts indicated to remain are protected to maintain normal flow at all times during demolition and construction. Protect items to remain including any buildings, furniture, sidewalks, roofs, utilities, and other items during demolition and construction.
ENSURE2: Ensure systems are water-tight. Provide additional flashing & sealants as needed.
ENSURE3: Ensure the slope of the new roof matches the slope and slope direction of the existing roof.
PHASE1: Work within this area may occur in phase ONE.
PHASE2: Work within this area may occur in phase TWO.



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03 SUPPORT NOTES

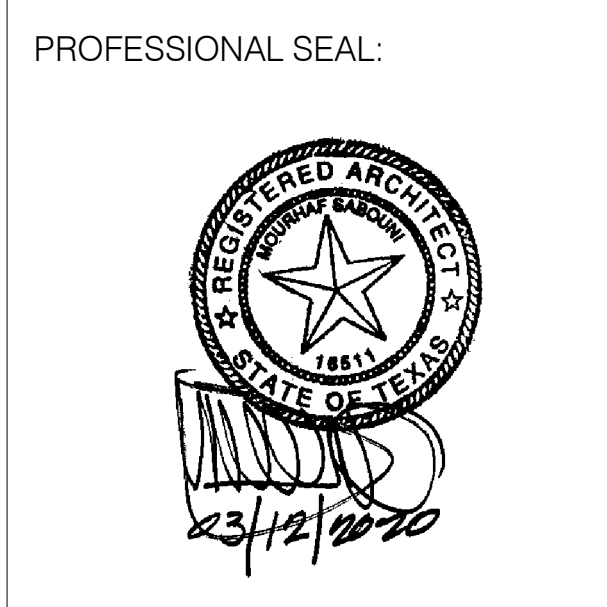Scale: NTS

- A006 REHAB DECK AND STRUCTURE ABOVE. CLEAN AND PAINT. (HANDLE 2, FIXW)
- A024 PROVIDE NEW CEILING TILE AND GRID AT SPECIFIED HEIGHT, RE: CEILING PLAN; FINISH SCHEDULE. CENTER GRID IN ROOM UNLESS INDICATED OTHERWISE.
- A036 PROVIDE COLUMN WRAP AS SPECIFIED.
- C08 GYP. BD. BULKHEAD: 1 LAYER GYP. ON 3-5/8" MTL. STUDS @ 16#6 O.C. SUSPENDED FROM STRUCTURE ABOVE TO ALIGN TO ADJACENT CEILINGS UNLESS OTHERWISE NOTED. (ALIGN 1)
- PT1 PAINT (FIELD).
- PT4 PAINT (ACCENT 4).
- PT7 PAINT (ACCENT 7).
- PT11 PAINT (ACCENT 11).
- X08 EXISTING STRUCTURAL COLUMNS SHALL NOT BE AFFECTED BY NEW WORK. V.I.F. (PROTECT 1)






02 KEYNOTES

Scale: NTS

- HANDLE STRUCTURE OF EXISTING BUILDING WITH CARE. NO WORK SHOULD HAVE ANY AFFECT ON THE STRUCTURAL INTEGRITY OF THE BUILDING. REPORT TO THE ARCHITECT ANY INDICATIONS OF STRUCTURAL DAMAGE.
- PROTECT THROUGHOUT DEMOLITION AND CONSTRUCTION ALL ITEMS INDICATED TO REMAIN INCLUDING BUT NOT LIMITED TO: BUILDINGS AND OTHER STRUCTURES, FLOORING, WALLS, CEILINGS, FINISHES, MEP/ SECURITY SYSTEMS, UTILITIES, MILLWORK, ETC.
- FIELD VERIFY ALL CONDITIONS PRIOR TO CONSTRUCTION, PARTICULARLY IN AREAS OF WORK.
- REPORT TO THE ARCHITECT ANY UNFORESEEN CONDITIONS OR AS-BUILT CONDITIONS NOT REFLECTED IN THE DRAWINGS, THAT COULD AFFECT THE WORK.
- MAINTAIN SAFE AND UNRESTRICTED ACCESS AND EGRESS ROUTES FOR OCCUPIED AREAS ADJACENT TO WORK AREA, IN ACCORDANCE WITH APPLICABLE CODES.
- ALL DIMENSIONS TO WALLS ARE TO FINISH FACE OF WALL UNLESS INDICATED OTHERWISE, (SIDE INDICATED GRAPHICALLY IN THE DRAWINGS).
- PROVIDE NECESSARY BLOCKING AT WALLS FOR ALL PLUMBING FIXTURES, EQUIPMENT, MILLWORK, AND ACCESSORIES.
- PLANS INDICATE HORIZONTAL DIMENSIONS ONLY. REFER TO ELEVATIONS & SECTIONS FOR VERTICAL DIMENSIONS.
- PROVIDE PARTITION CURBS FOR MECH/ELEC. ROOMS PERIMETER, TYP. UNLESS OTHERWISE NOTED.
- UNLESS INDICATED OTHERWISE, ALL NEW WORK IN THIS PROJECT IS TO BE ACCESSIBLE IN ACCORDANCE WITH THE MOST RECENT EDITION OF THE TEXAS ACCESSIBILITY STANDARDS. REFER TO ACCESSIBILITY REQUIREMENTS ON SHEETS A0.60 AND A0.30 FOR MORE INFORMATION.
- REFER TO DOOR AND WINDOW DETAILS FOR DIMENSIONS AT OPENINGS.
- REFER TO DEMOLITION DRAWINGS FOR DEMOLITION INFORMATION.
- REFER TO CODE ANALYSIS INFORMATION SHEET A0.20 FOR EXTENT OF EXTENDED FIRE-SPRINKLER SYSTEM.

01 GENERAL NOTES - CONSTRUCTION

Scale: NTS

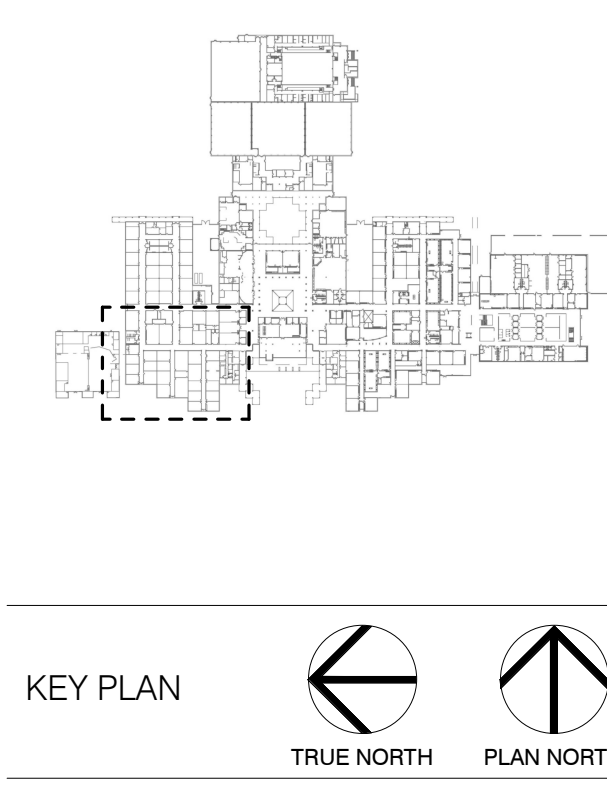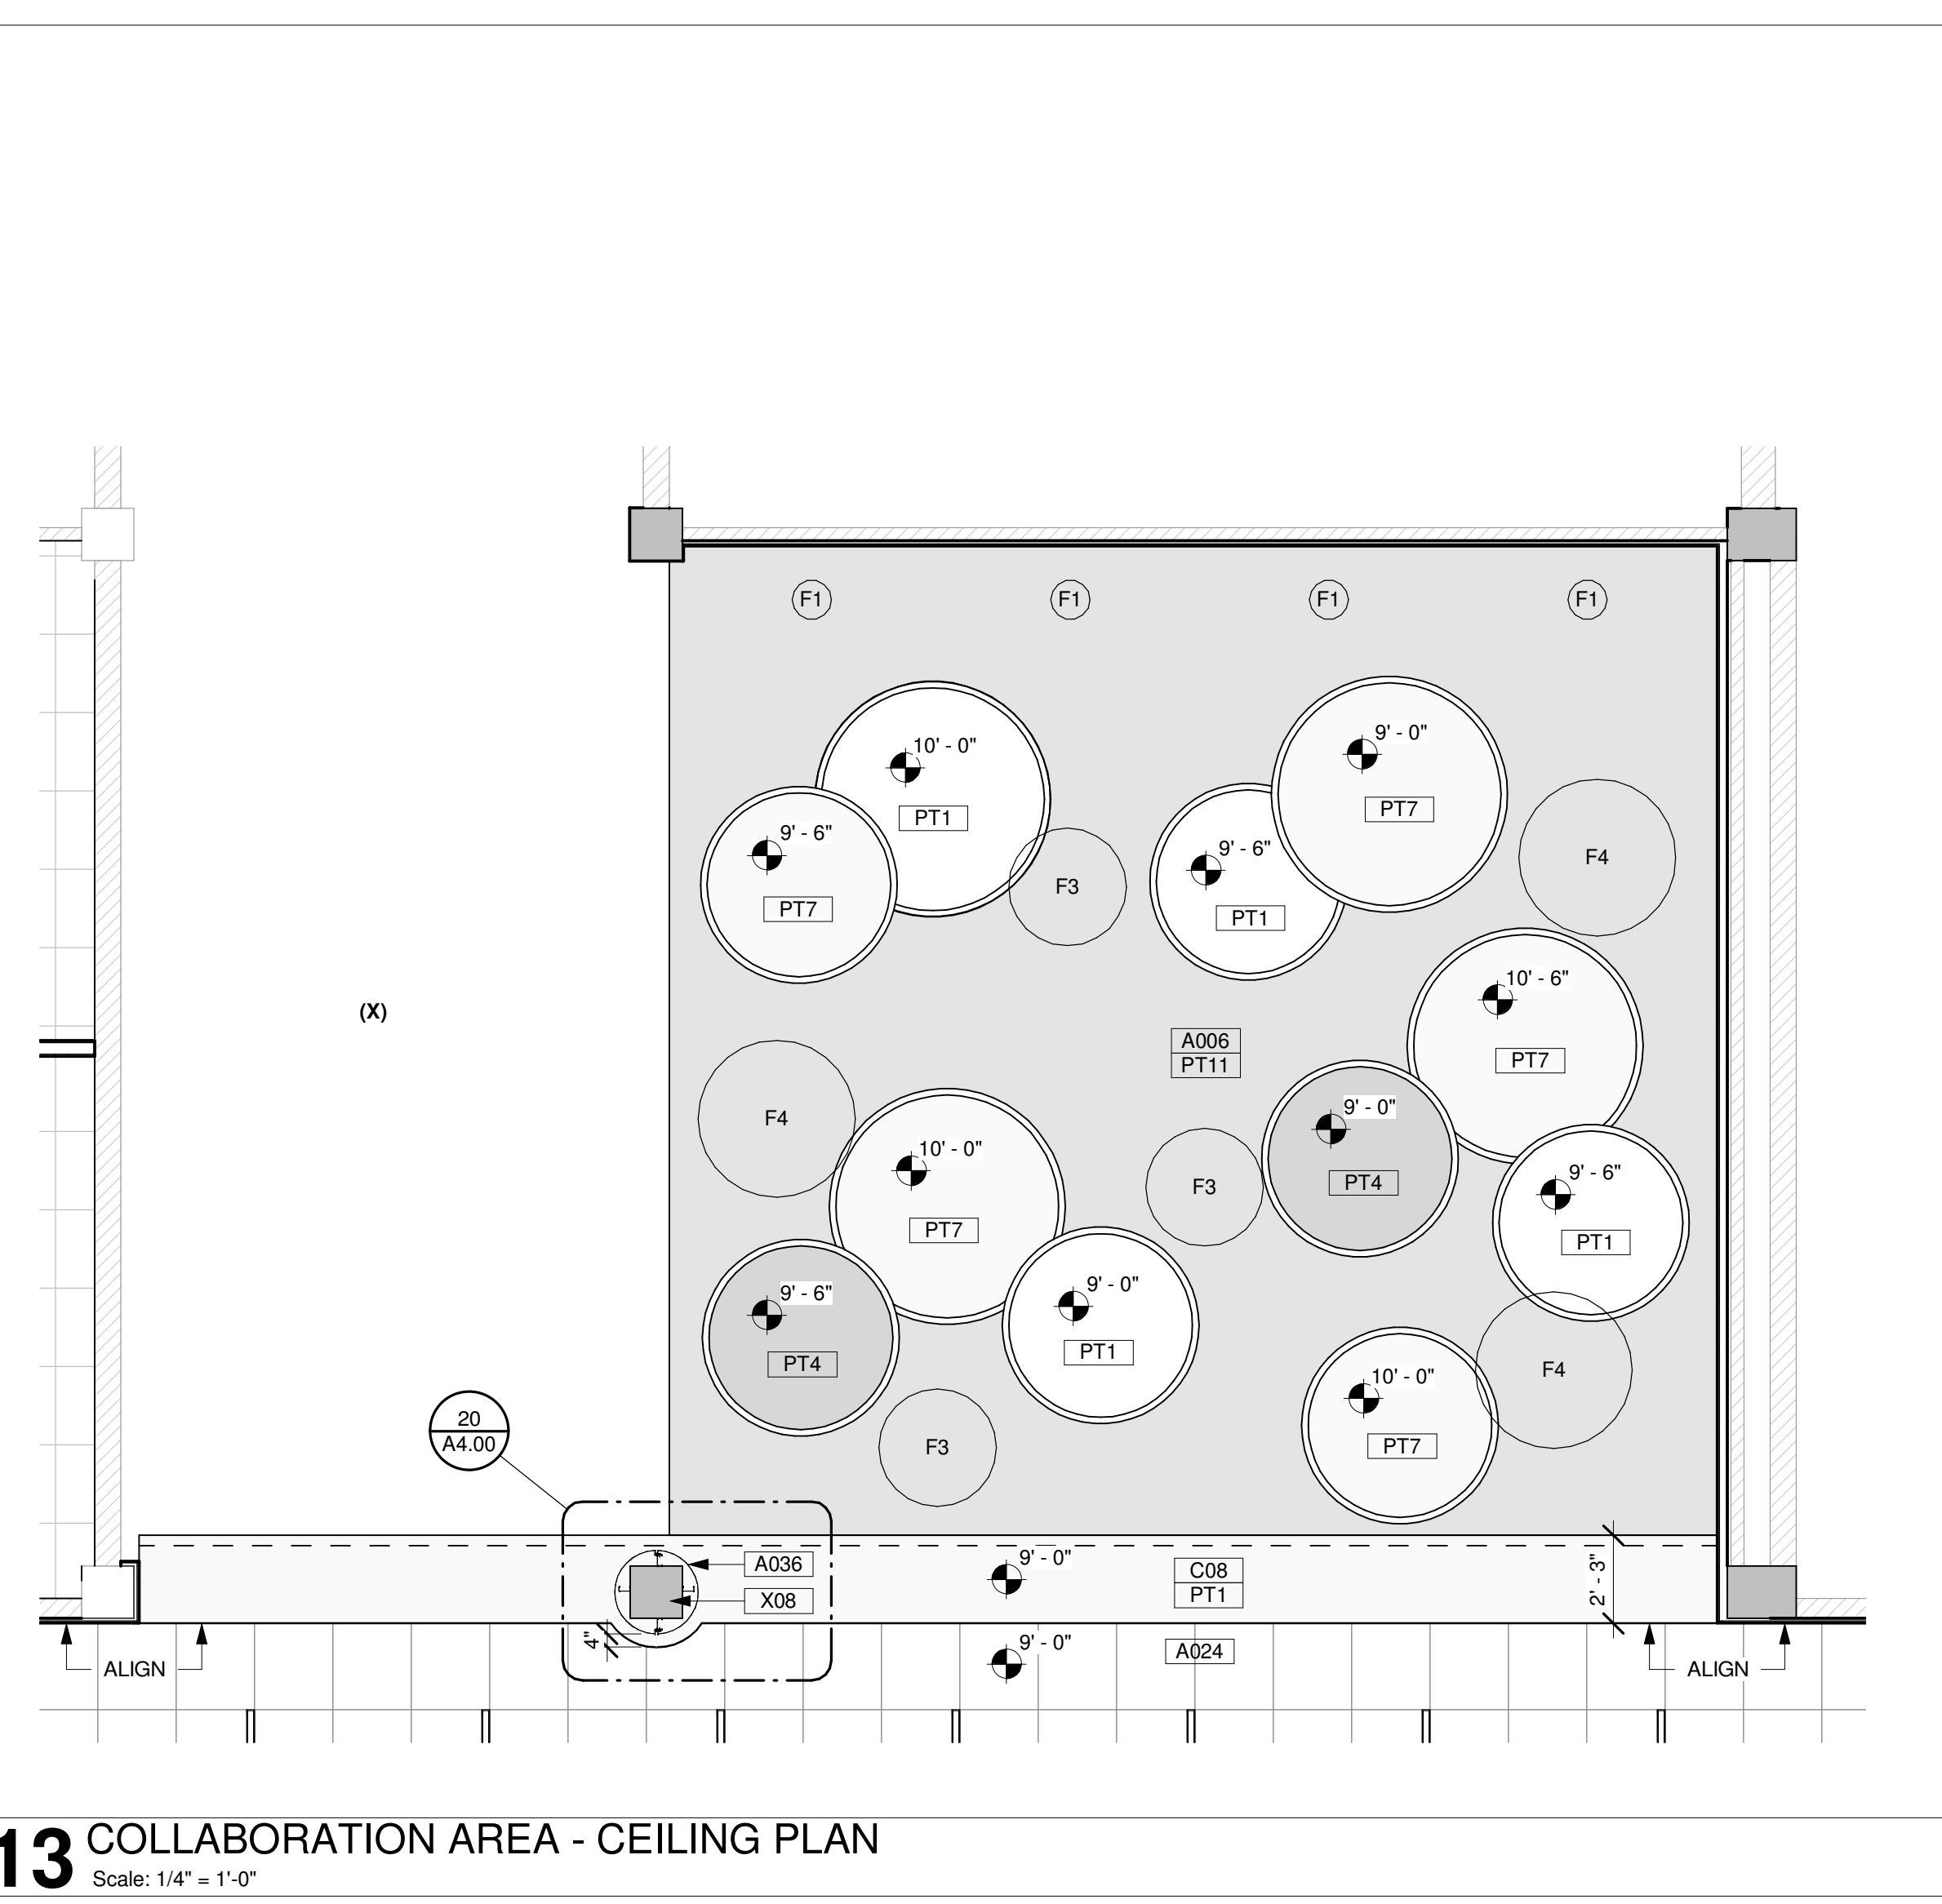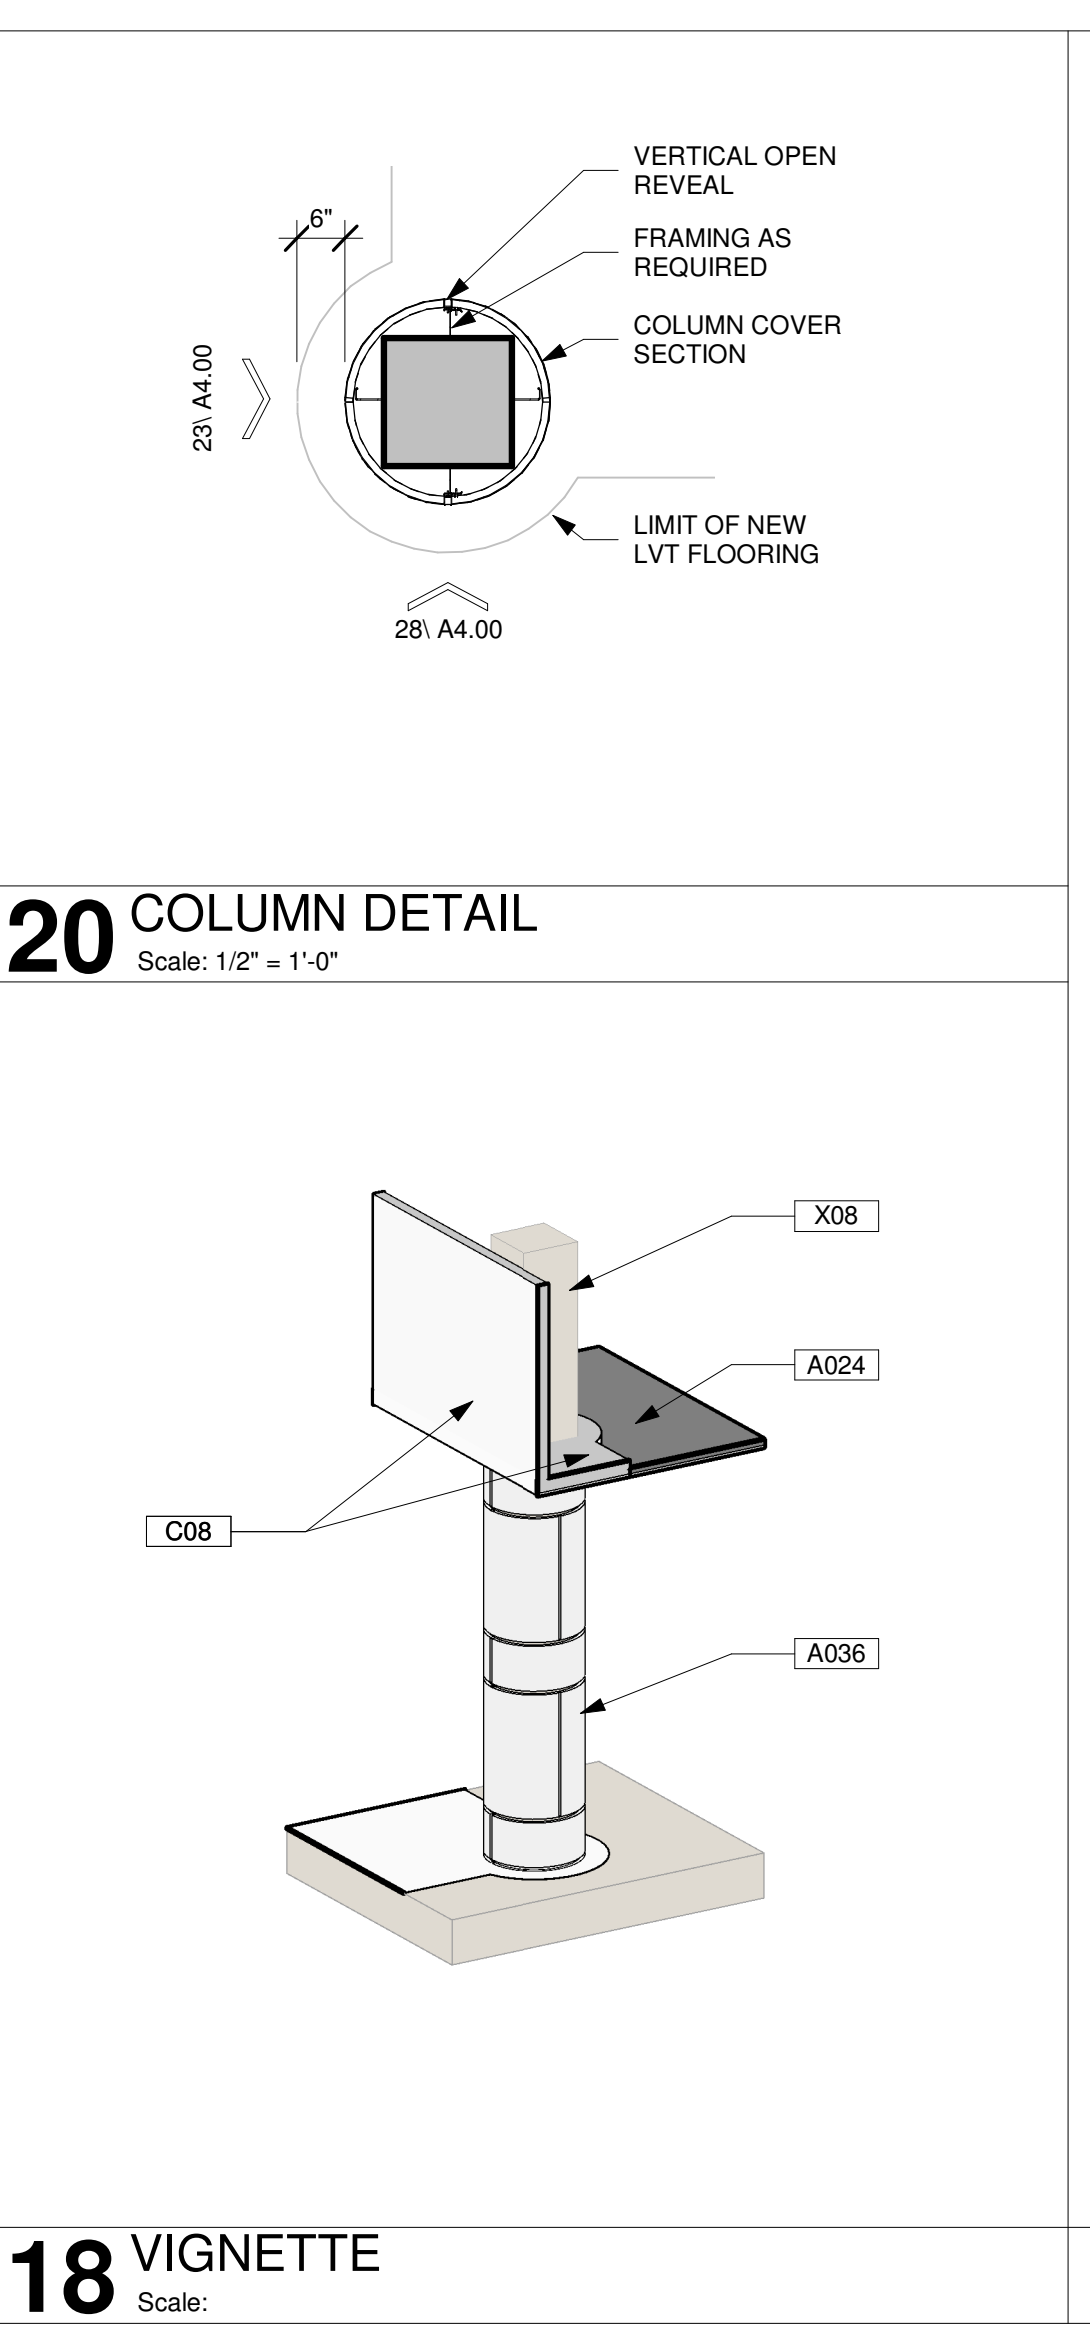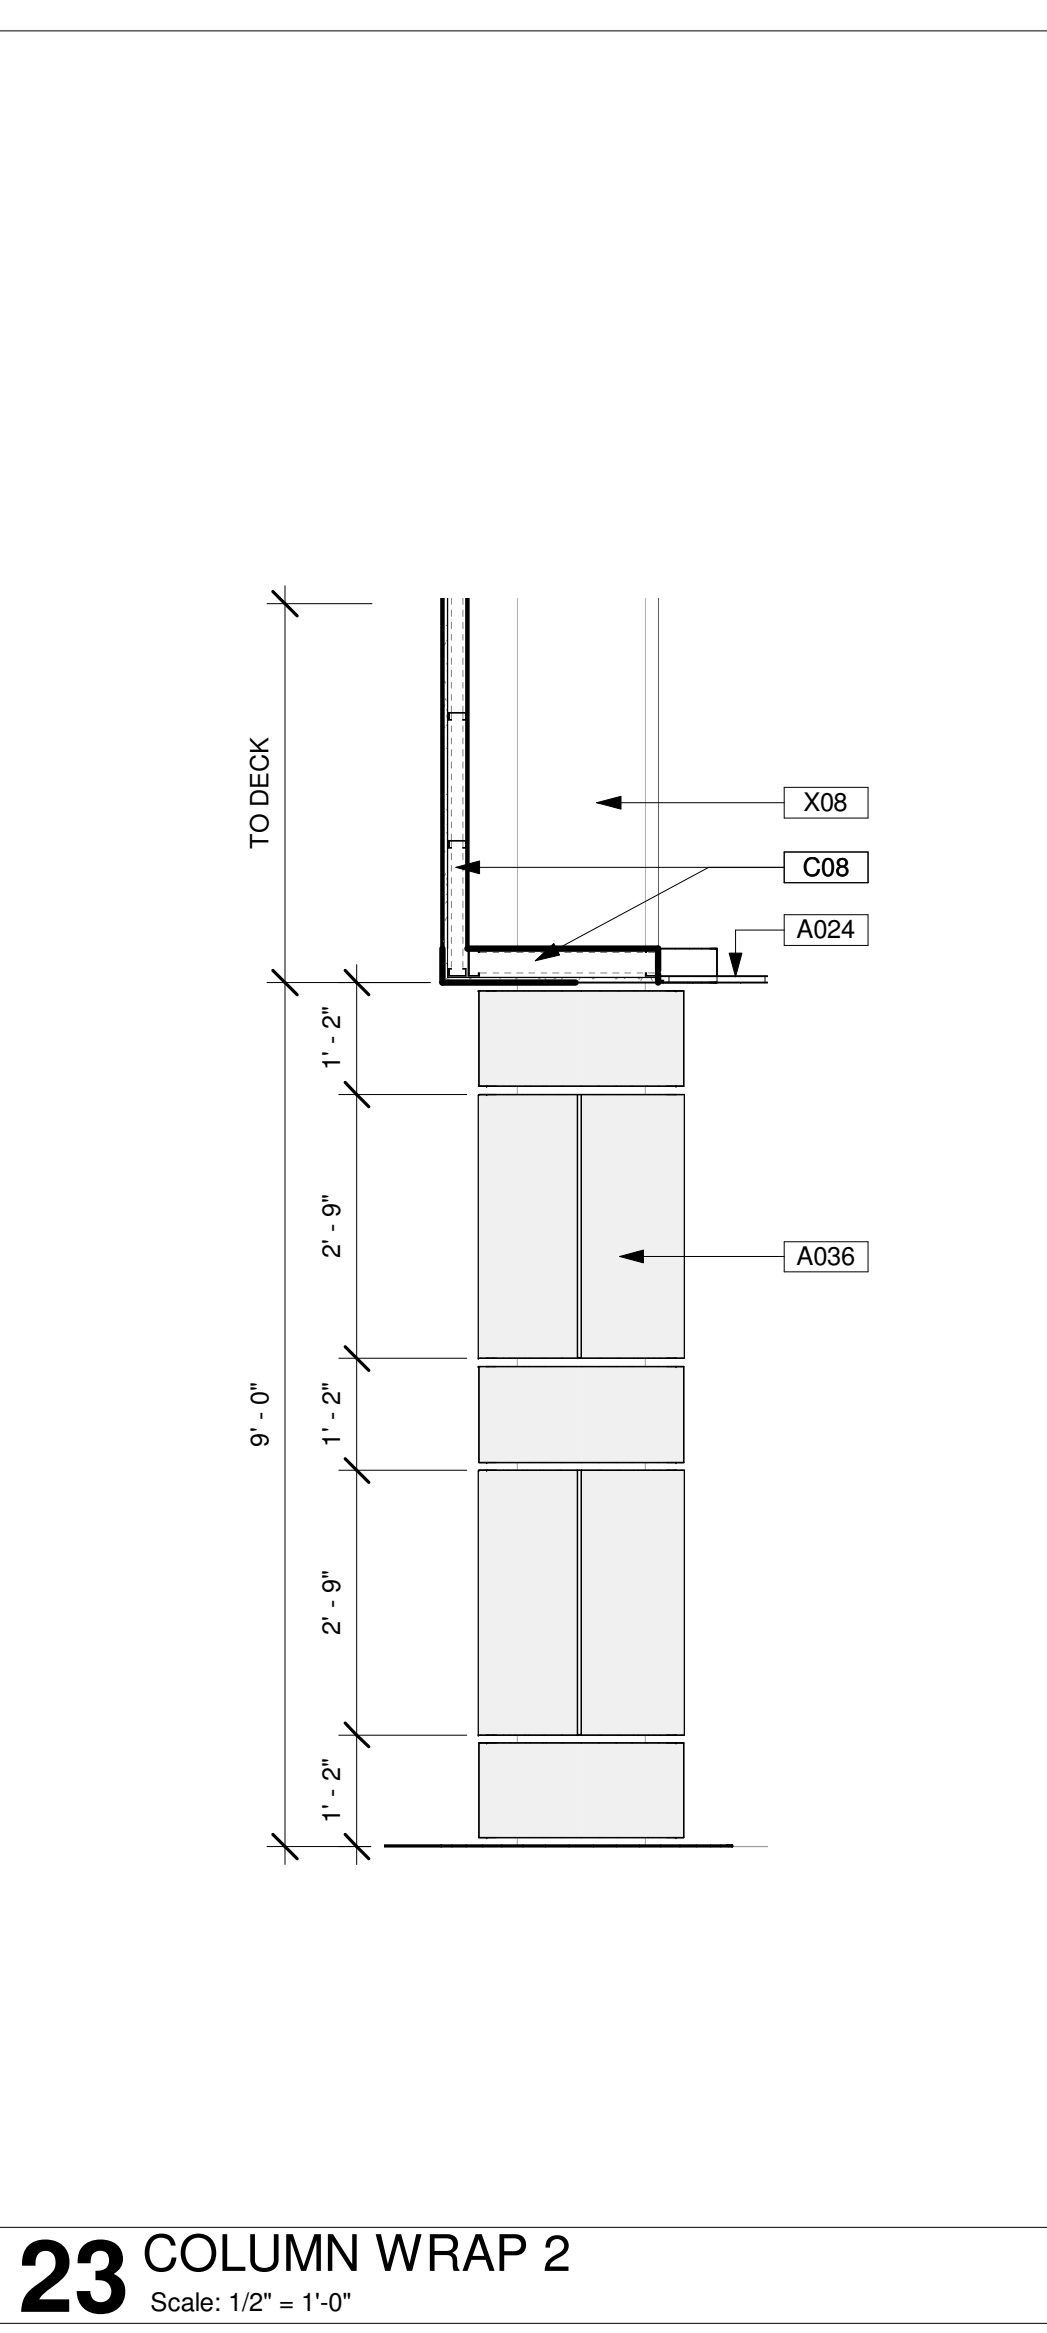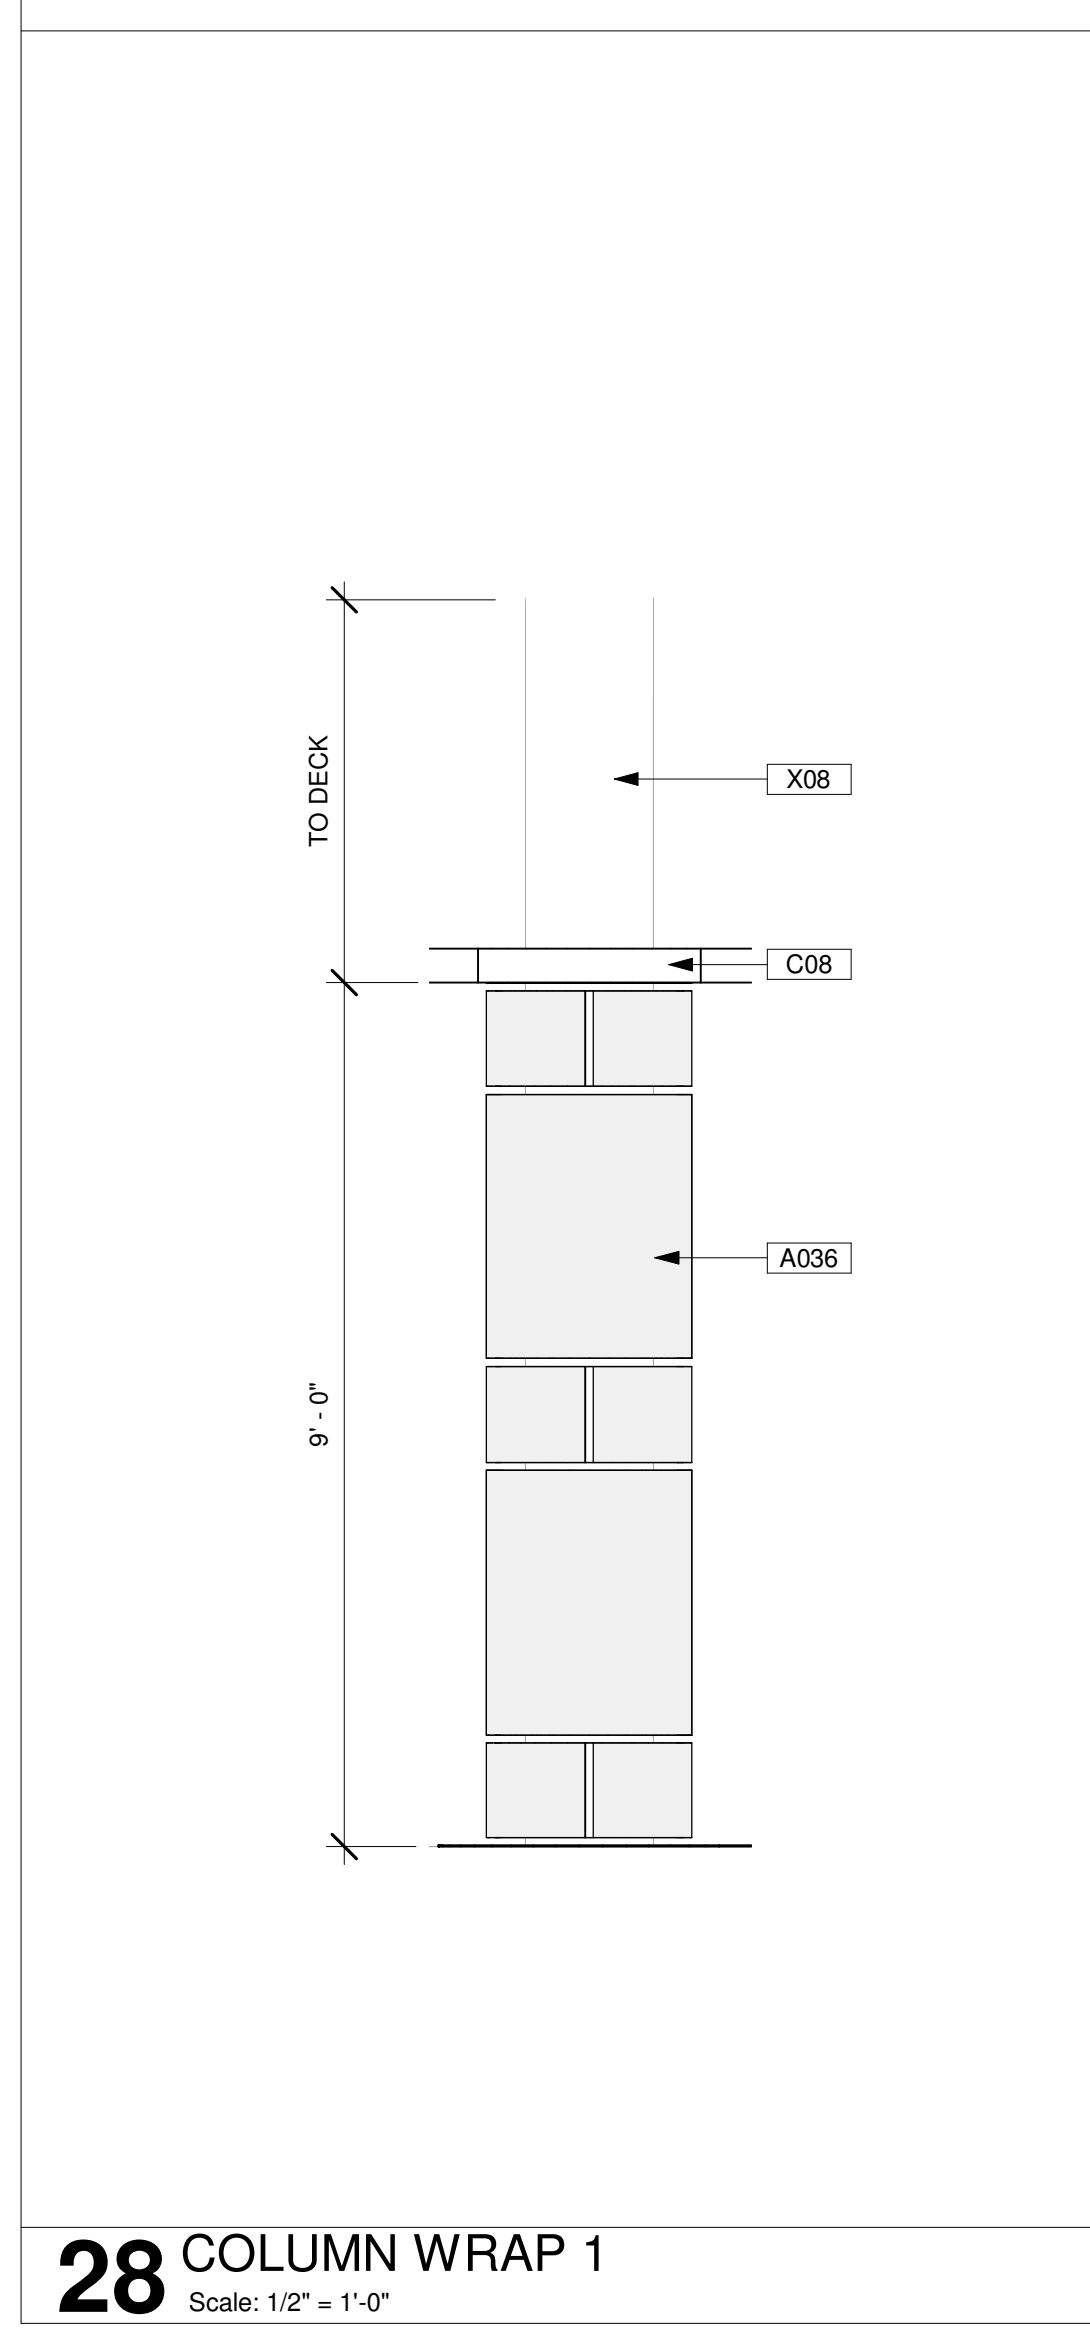

Project Number	19006-A
Drawn By	LT
Checked By	AW
Approved By	MS
Drawing Title	ENLARGED PLANS & DETAILS
Drawing Number	A4.00



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PROFESSIONAL SEAL:





A PROJECT FOR:

STAFFORD
HIGH SCHOOL
& MAGNET
SCHOOL
RENOVATIONS

1625 STAFFORDSHIRE
ROAD,
STAFFORD, TX 77477

#	Date	ISSUED FOR
	03/13/2020	ISSUE FOR BID, PERMIT, & CONSTRUCTION

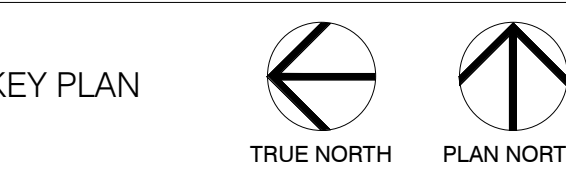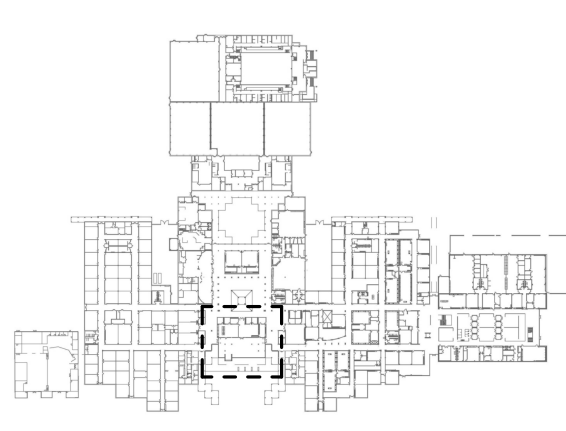

Project Number	19006-A
Drawn By	LT
Checked By	AW
Approved By	MS

ENLARGED PLANS & DETAILS - RESTROOMS

Drawing Number **A4.01**

Dimension & Alignment Support Notes:
ALIGN 1: Align face of new construction w/face of existing.
ALIGN 2: Align centerline of new construction w/centerline of existing.
ALIGN 3: Align gridline of new construction w/centerline of existing.
LEVEL 1: Ensure top of new construction is level w/existing surface.
LEVEL 2: Level floor & surface to receive new construction.
LEVEL 3: Ensure the top of grade is level w/surrounding ground.

Construction & Condition Support Notes:
HANDLE 1: Handle item w/care, and store for owner review.
HANDLE 2: Handle remaining building, pavement, fence, or item w/care.
HANDLE 3: Handle re-located items with care. DISCONNECT 1, FIXW.
FIXW: Fix floor/wall/celling item where construction was removed and prepare the area to receive new construction. Ensure the top of grade is level w/surrounding ground & maintain positive slope towards drain, gutter, and storm system away from building.
FIXC: Fix floor/wall/celling item where construction was removed and prepare the area to receive new construction. Ensure the top of grade is level w/surrounding ground & maintain positive slope towards drain, gutter, and storm system away from building.
REMOVE: Remove item from site. Prepare the area to receive new construction. Ensure the top of grade is level w/surrounding ground & maintain positive slope towards drain, gutter, and storm system away from building.
CONNECT: Connect new construction to existing, ensure continuity and structural integrity. Ensure the top of new construction is level w/existing surface.
DISCONNECT: Disconnect remaining item to the new structure, and ensure structural integrity while meeting local Codes. Handle remaining building, pavement, fence, and other items w/care.
DISCONNECT 1: Disconnect and conceal all pipes, electrical cables, data cables, and conduits where construction is removed.
ENGINEER 1: Professional engineering supervision is required for this work.
SHOP: Provide shop drawings for this work.
REFERENCE: Refer to phase # for the existing condition at this location.
SLOPE: Maintain positive slope towards drains, gutters, and storm systems and away from the building.
PROTECT: Protect items to remain, including any buildings, furniture, sidewalks, roofs, utilities, and other items during the Demolition and Construction phases.
EGRESS: Maintain safe and unobstructed egress routes from areas adjacent to the Demolition site. Comply with all Applicable Codes.
TREE 1: Refer to Landscape Drawings & Specs for removing trees.
COBALT: Ensure all routes and utilities required for school operation are protected. Ensure school operation will not be interrupted.
ENSURE 1: Ensure all slopes to drain as intended, and that downspouts indicated to remain are protected to maintain normal flow at all times during demolition and construction. Protect items to remain including any buildings, furniture, sidewalks, roofs, utilities, and other items during demolition and construction.
ENSURE 2: Ensure system is water-tight. Provide additional flashing & sealants as needed.
ENSURE 3: Ensure the slope of the new roof matches the slope and slope direction of the existing roof.
PHASE 1: Work within this area may occur in phase ONE.
PHASE 2: Work within this area may occur in phase TWO.


03 SUPPORT NOTES
Scale: NTS

A411 REFINISH ADJACENT SURFACES TO LIKE-NEW CONDITION. RE: SPECS. (HANDLE 2, FIXW)
A434 PROVIDE NEW TILE FLOORING AND WALL TILING AS INDICATED IN FINISH SCHEDULE, PLANS AND ELEVATIONS.
A437 PROVIDE NEW STAINLESS STEEL SINK (CONNECT).
A401 PAIR OF ELECTRIC DRINKING FOUNTAINS (EDF): ON WALL, ADA COMPLIANT VERSION WITH NO RECESSED MOUNTING. SPOUT HEIGHT, CLEARANCES, AND OTHER DIMENSIONS SHALL MEET REQUIREMENTS OF 2012 TAS 602.7. PROVIDE BLOCKING SUPPORT AS NEEDED. RE: MEP DWGS FOR MORE INFORMATION. (PROTECT 1, FIXW, CONNECT 1)
A404 36" HANDICAPPED GRAB BAR @ 34" A.F.F. AND LOCATION REQUIRED TO COMPLY WITH 2012 TAS 604.5 PROVIDE BLOCKING SUPPORT AS NEEDED. (CONNECT 1, FIXW)
A405 42" HANDICAPPED GRAB BAR @ 34" A.F.F. AND LOCATION REQUIRED TO COMPLY WITH 2012 TAS 604.5 PROVIDE BLOCKING SUPPORT AS NEEDED. (CONNECT 1, FIXW)
A413 SEMI-RECESSED PAPER TOWEL DISPENSER WITH WASTE RECEPTACLE
A414 WALL MOUNTED SOAP DISPENSER
A415 TOILET PAPER DISPENSER
A416 MIRROR
CTB1 CERAMIC TILE BASE
CTB2 CERAMIC TILE BASE
CTW1 CERAMIC WALL TILE
CTW5 CERAMIC WALL TILE
PT1 PAINT (FIELD).


02 KEYNOTES
Scale: NTS

- HANDLE STRUCTURE OF EXISTING BUILDING WITH CARE. NO WORK SHOULD HAVE ANY AFFECT ON THE STRUCTURAL INTEGRITY OF THE BUILDING. REPORT TO THE ARCHITECT ANY INDICATIONS OF STRUCTURAL DAMAGE.
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- REFER TO DOOR AND WINDOW DETAILS FOR DIMENSIONS AT OPENINGS.
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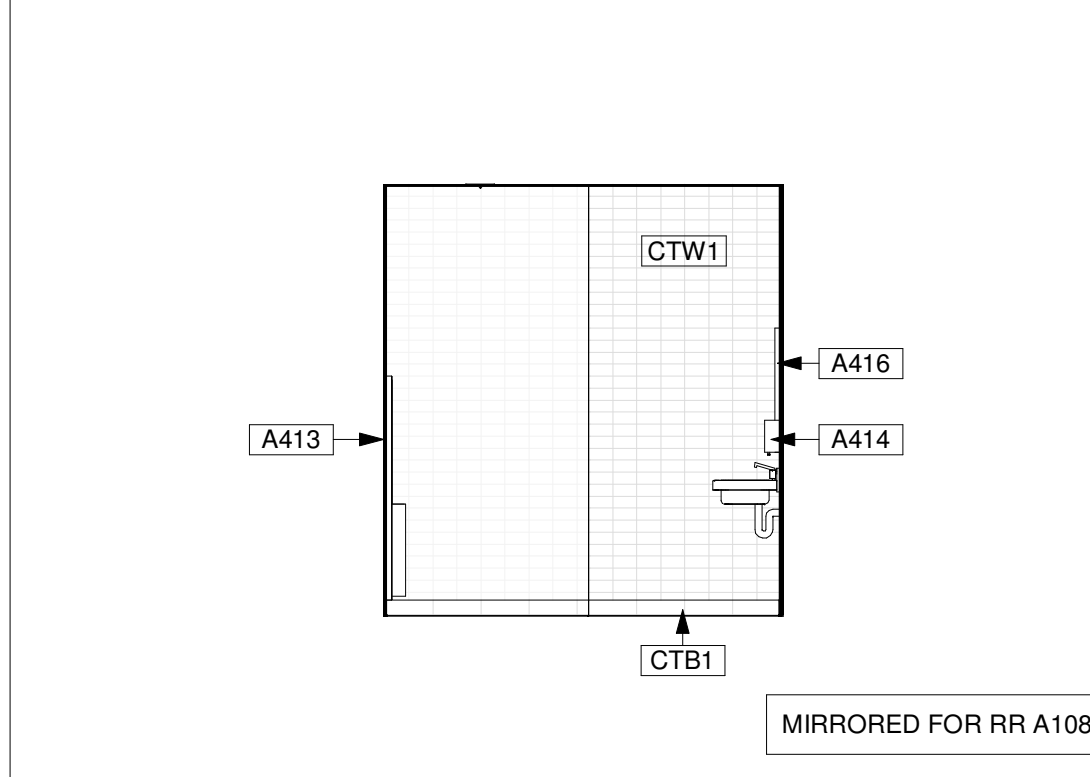
09 ENLARGED FINISH PLAN - ADMIN R.R.
Scale: 1/4" = 1'-0"

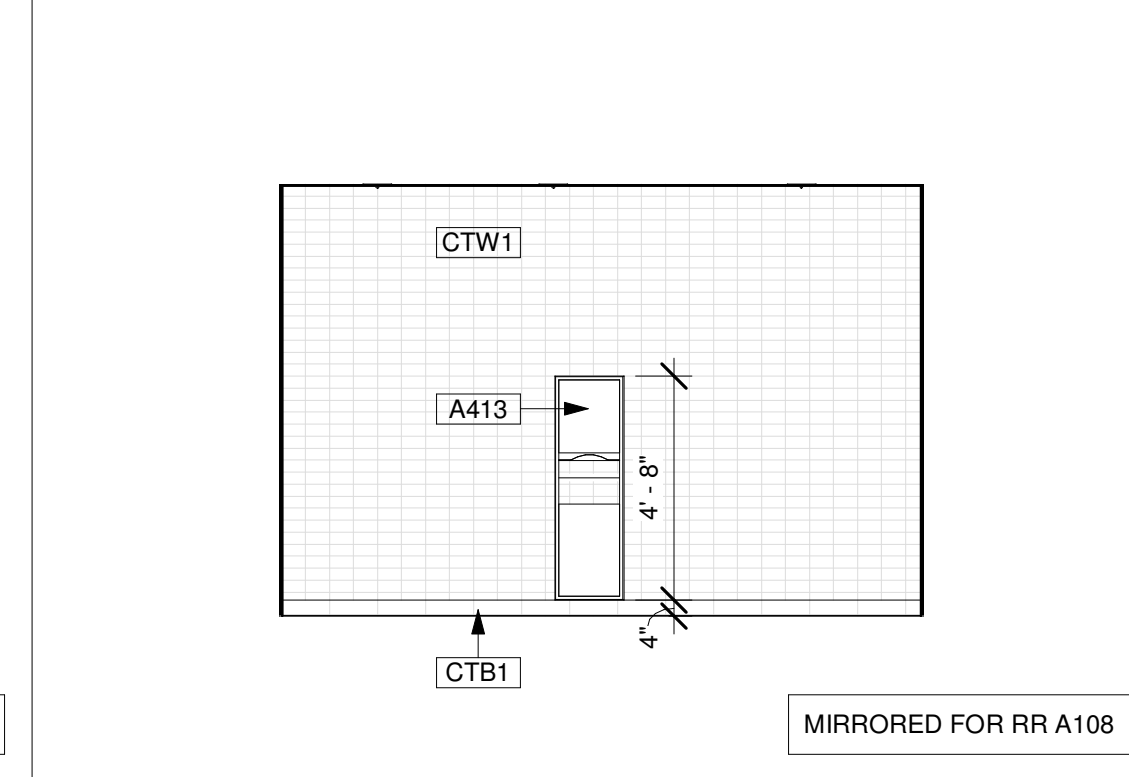


08 LIBRARY RR ELEVATION - 3
Scale: 1/4" = 1'-0"

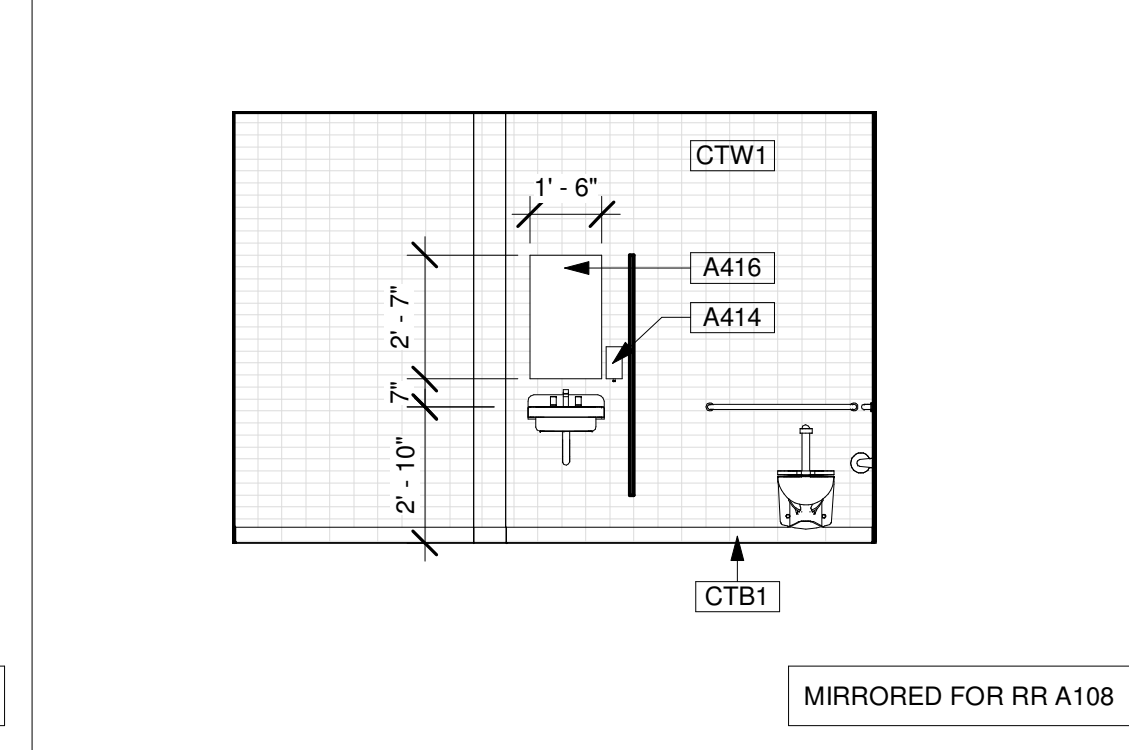


14 ENLARGED PLAN - ADMIN R.R.
Scale: 1/4" = 1'-0"




13 LIBRARY RR ELEVATION - 4
Scale: 1/4" = 1'-0"

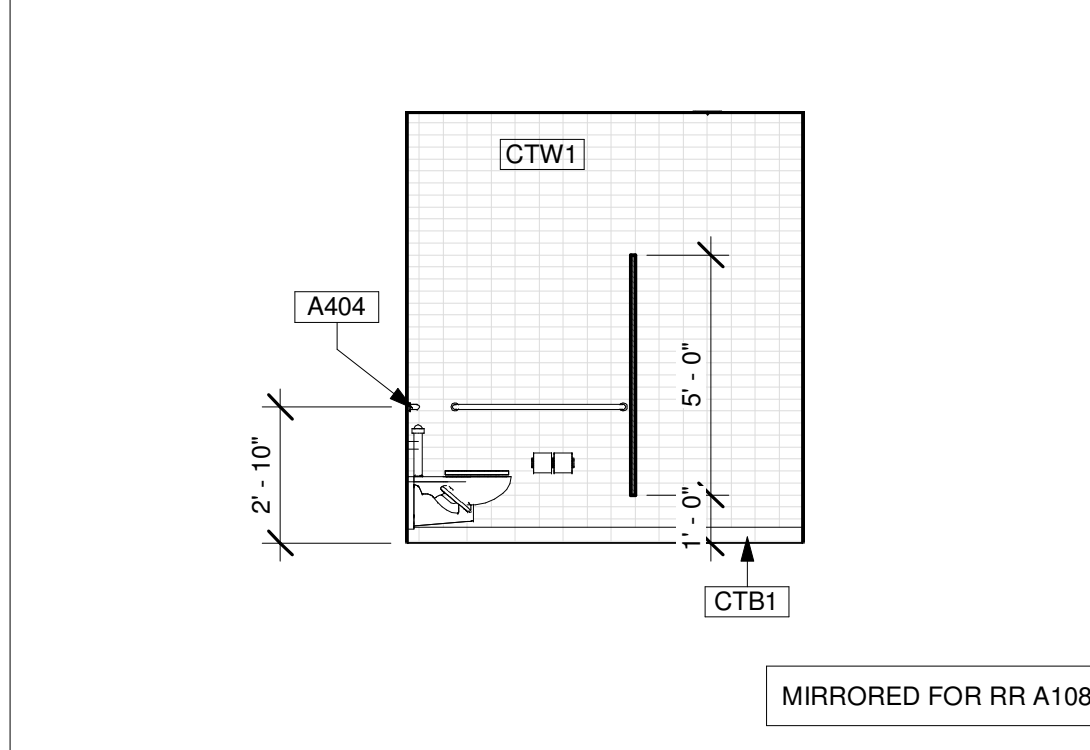


19 ADMIN RR. W ELEVATION - 1
Scale: 1/4" = 1'-0"

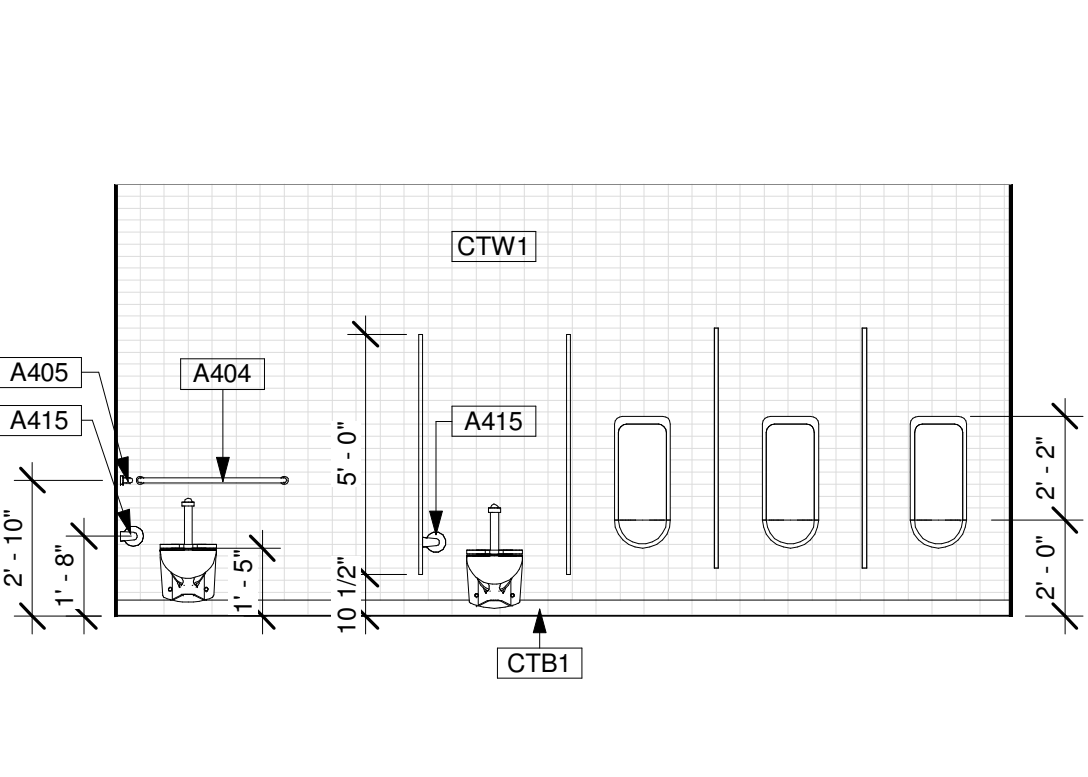


24 ADMIN RR. W ELEVATION - 2
Scale: 1/4" = 1'-0"

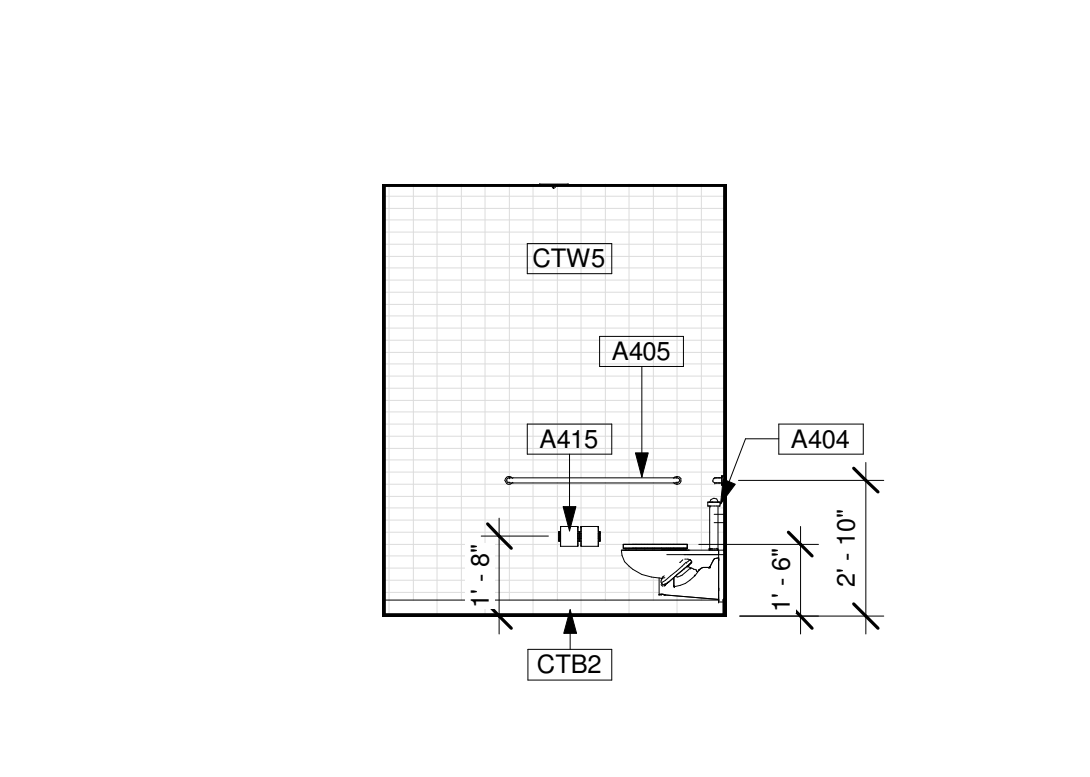


29 ADMIN RR. W ELEVATION - 3
Scale: 1/4" = 1'-0"

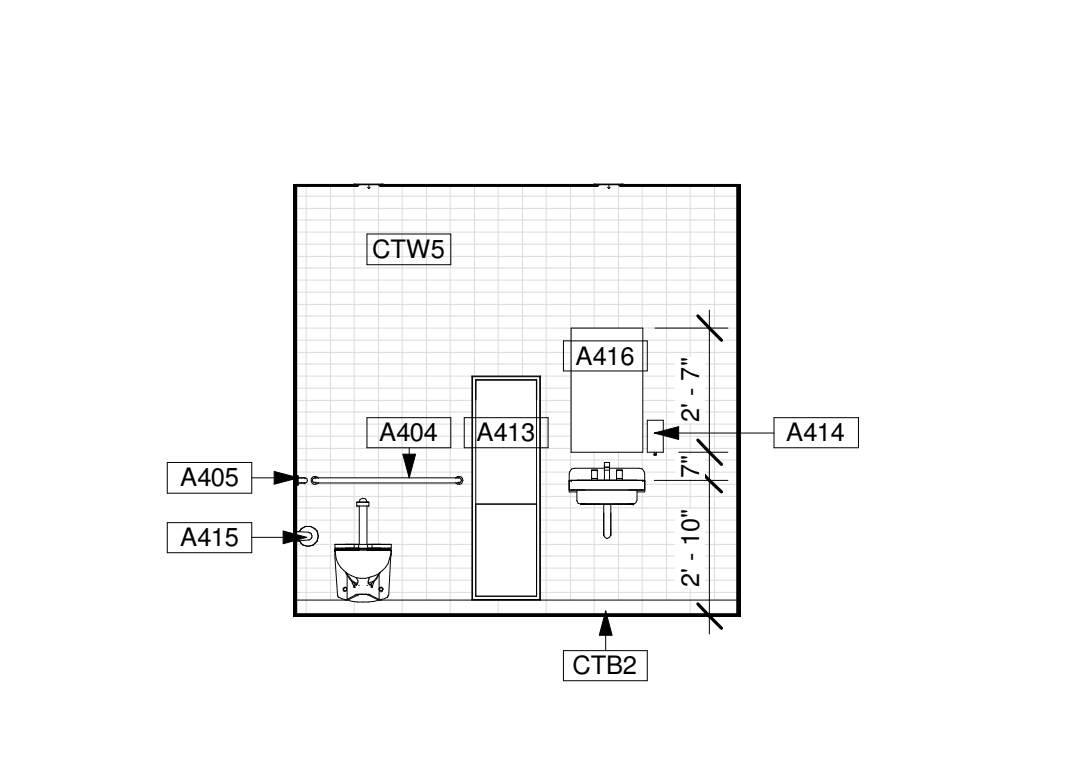


07 LIBRARY RR ELEVATION - 1
Scale: 1/4" = 1'-0"

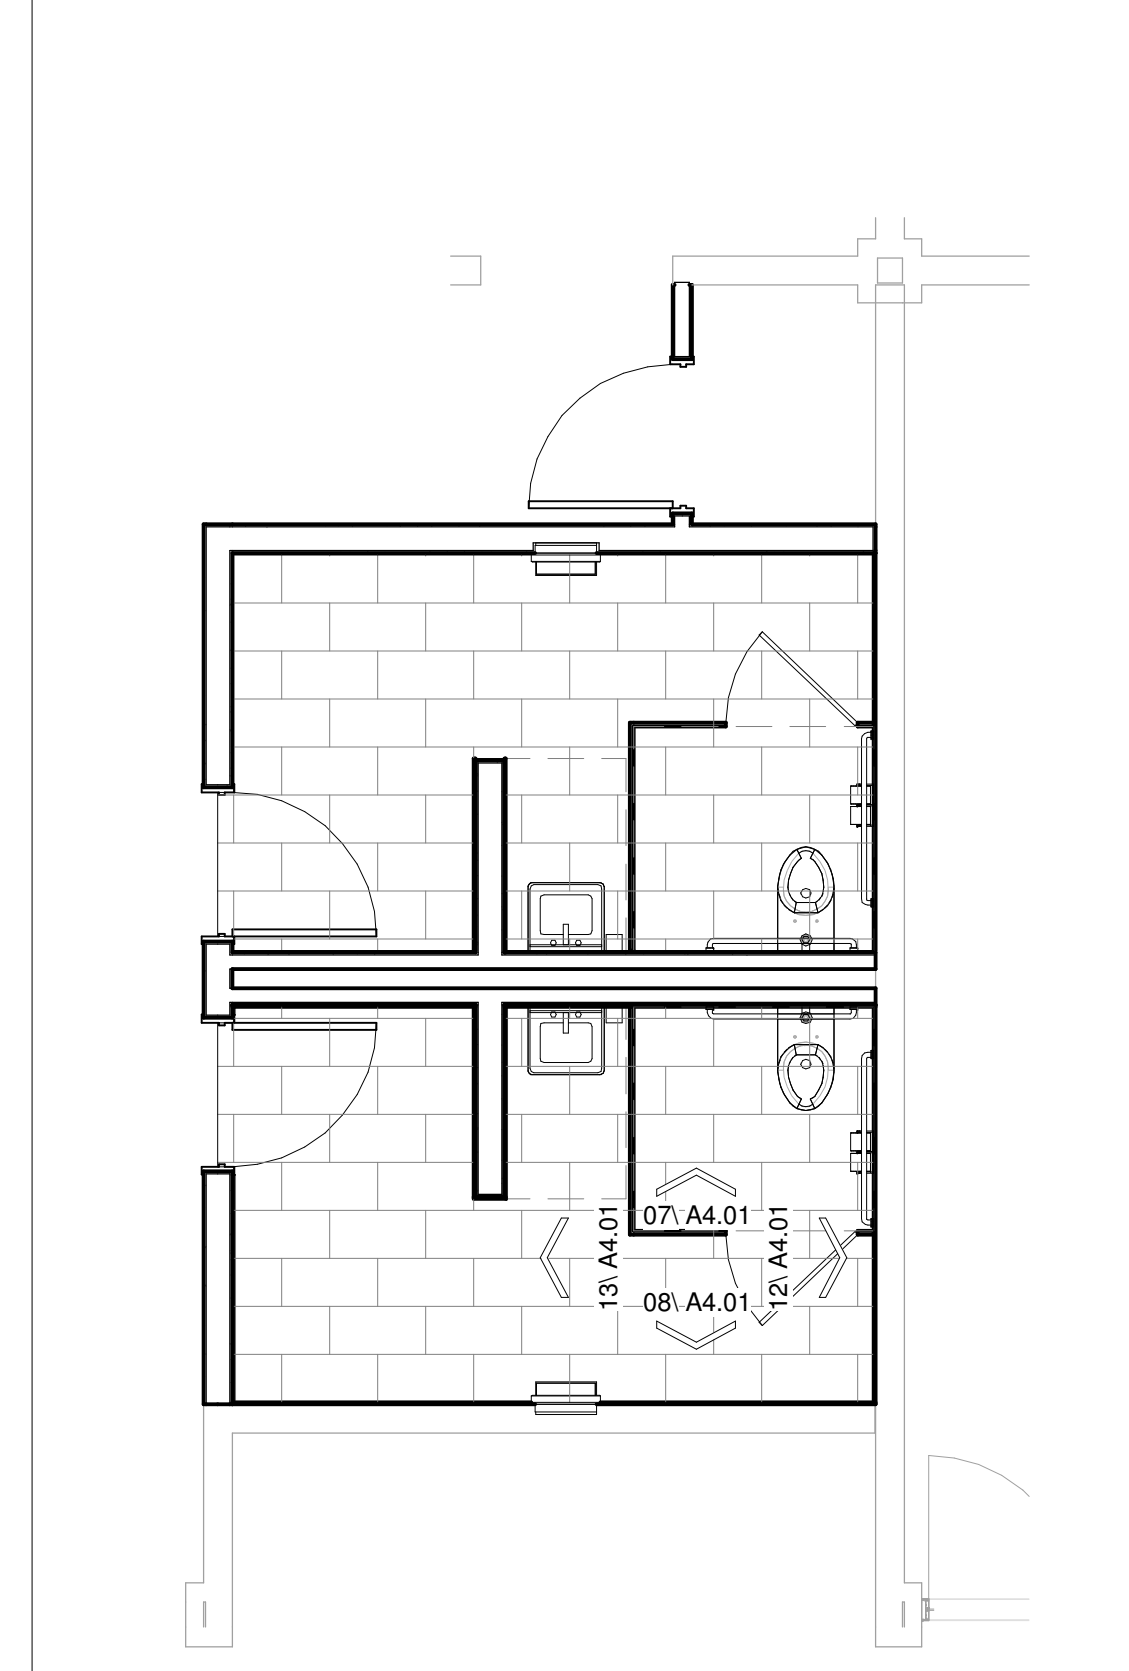


12 LIBRARY RR ELEVATION - 2
Scale: 1/4" = 1'-0"

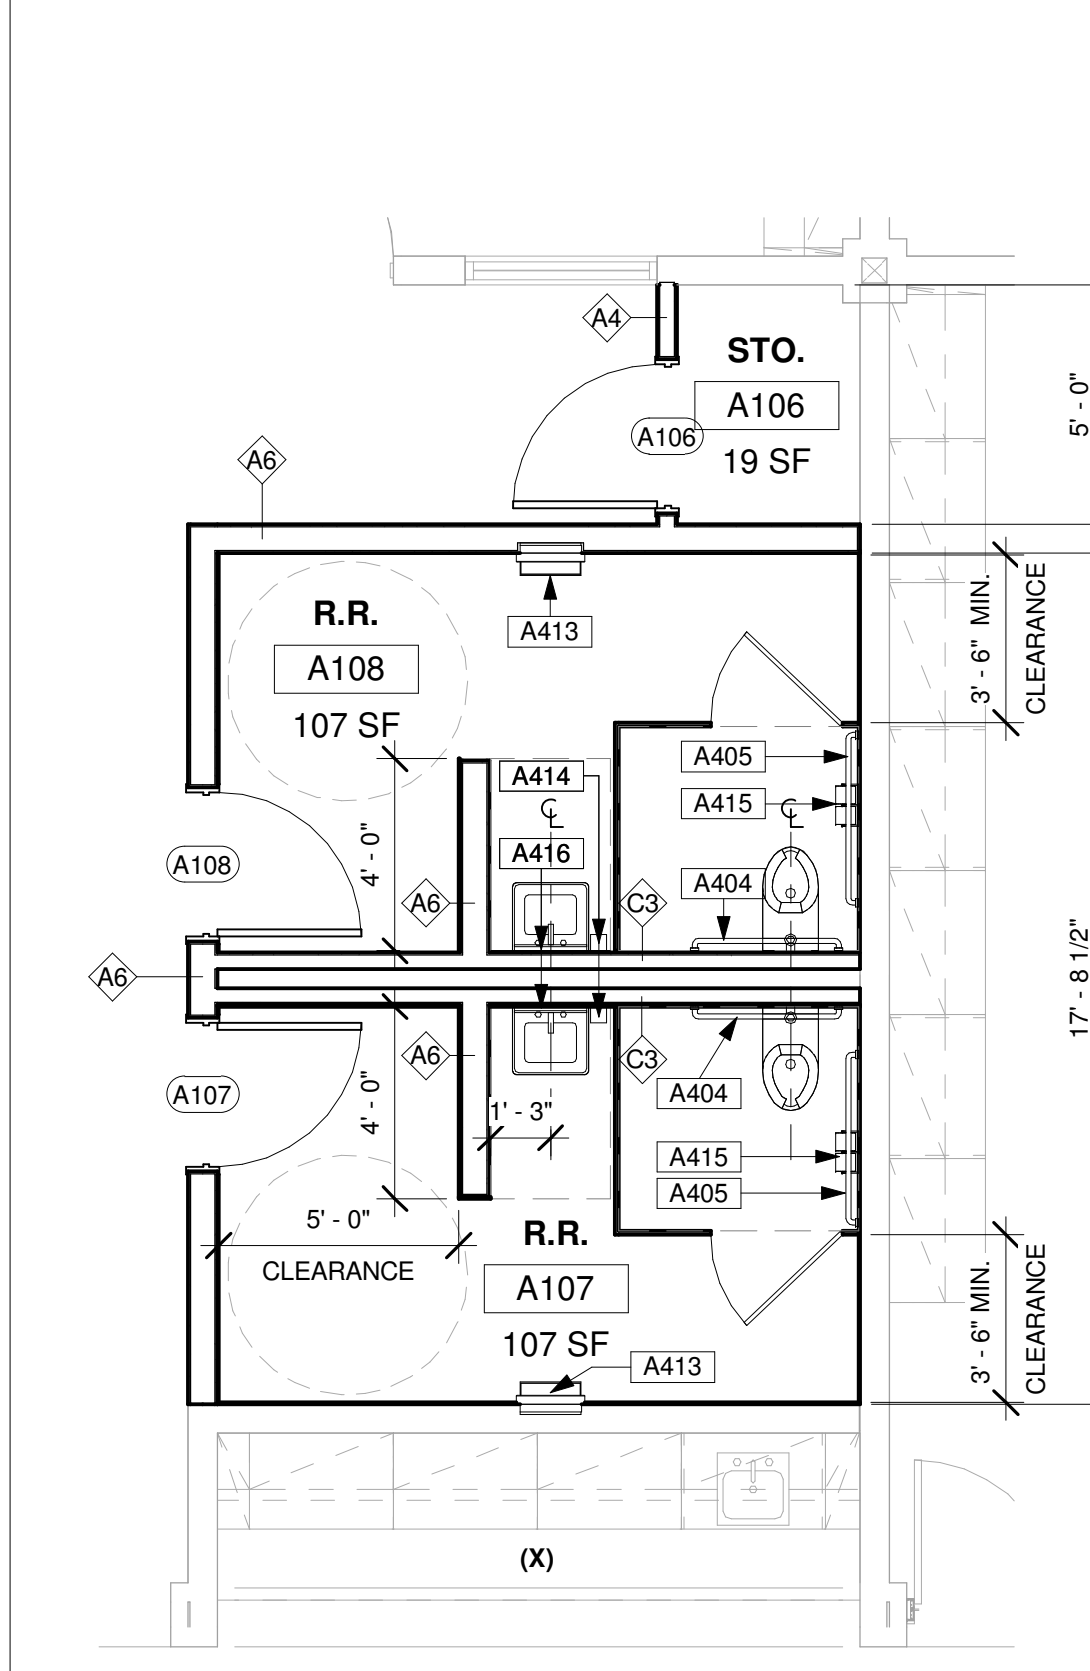


17 MAGNET RR ELEVATION - 1
Scale: 1/4" = 1'-0"

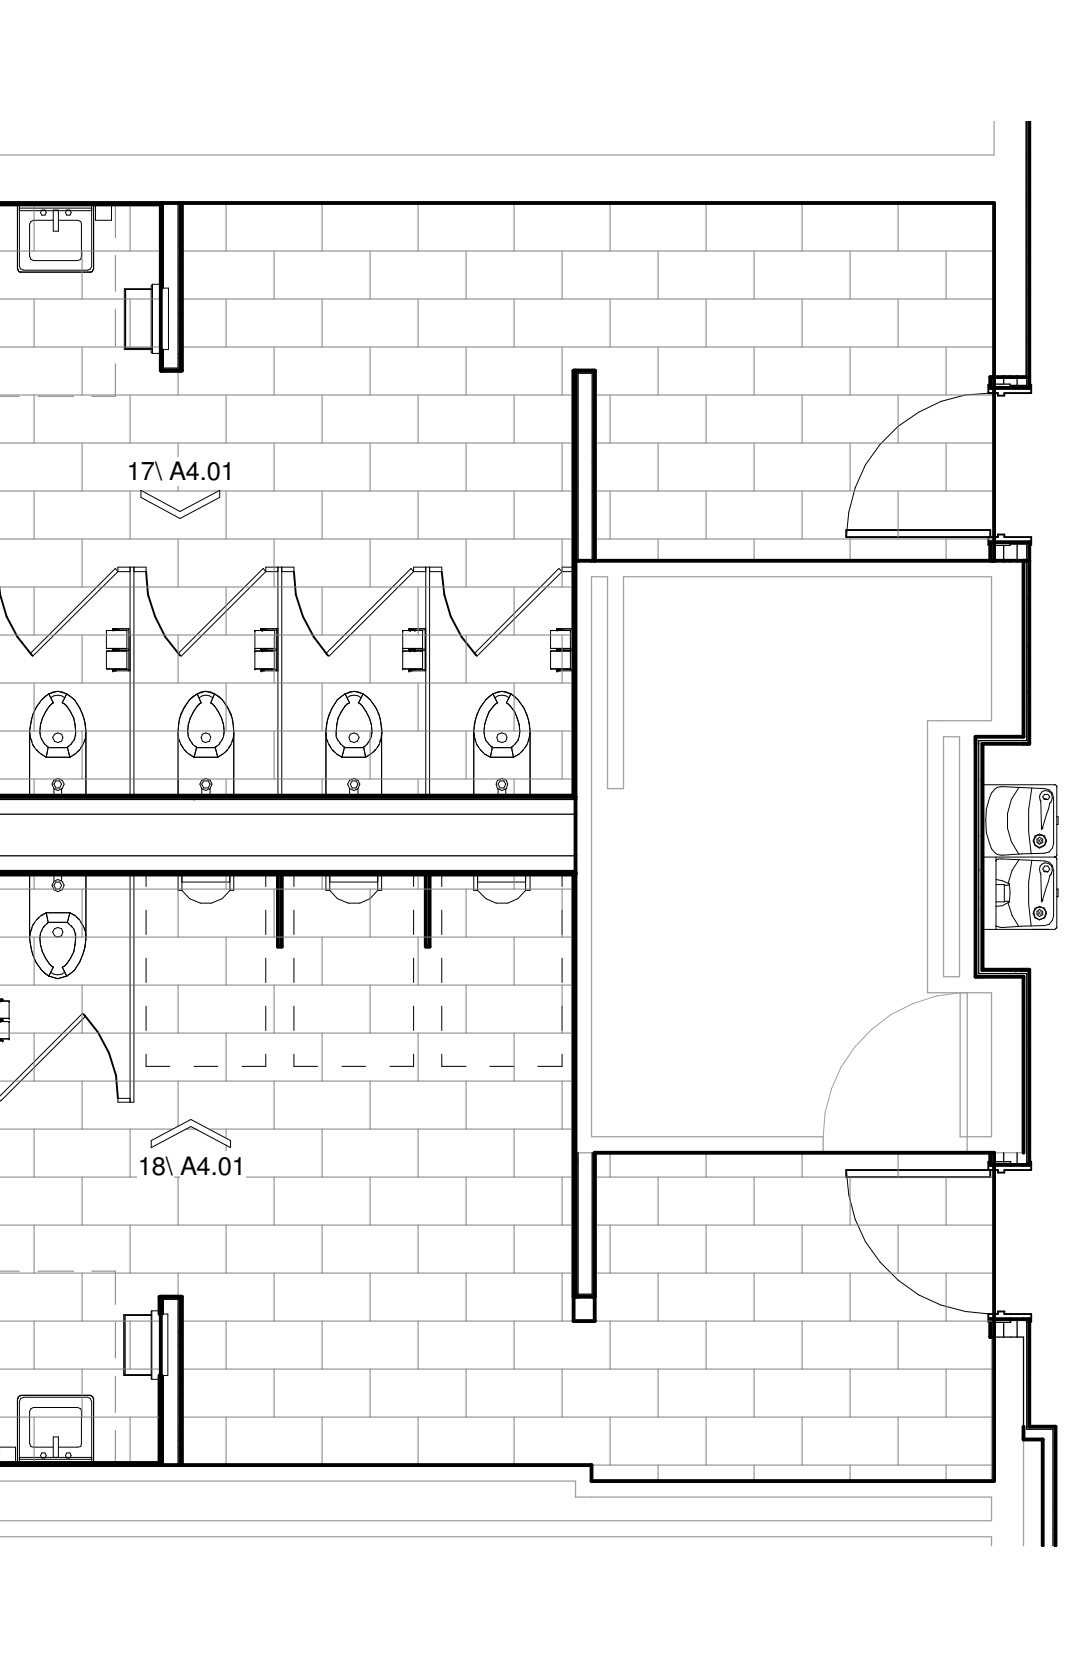

22 MAGNET RR ELEVATION - 2
Scale: 1/4" = 1'-0"

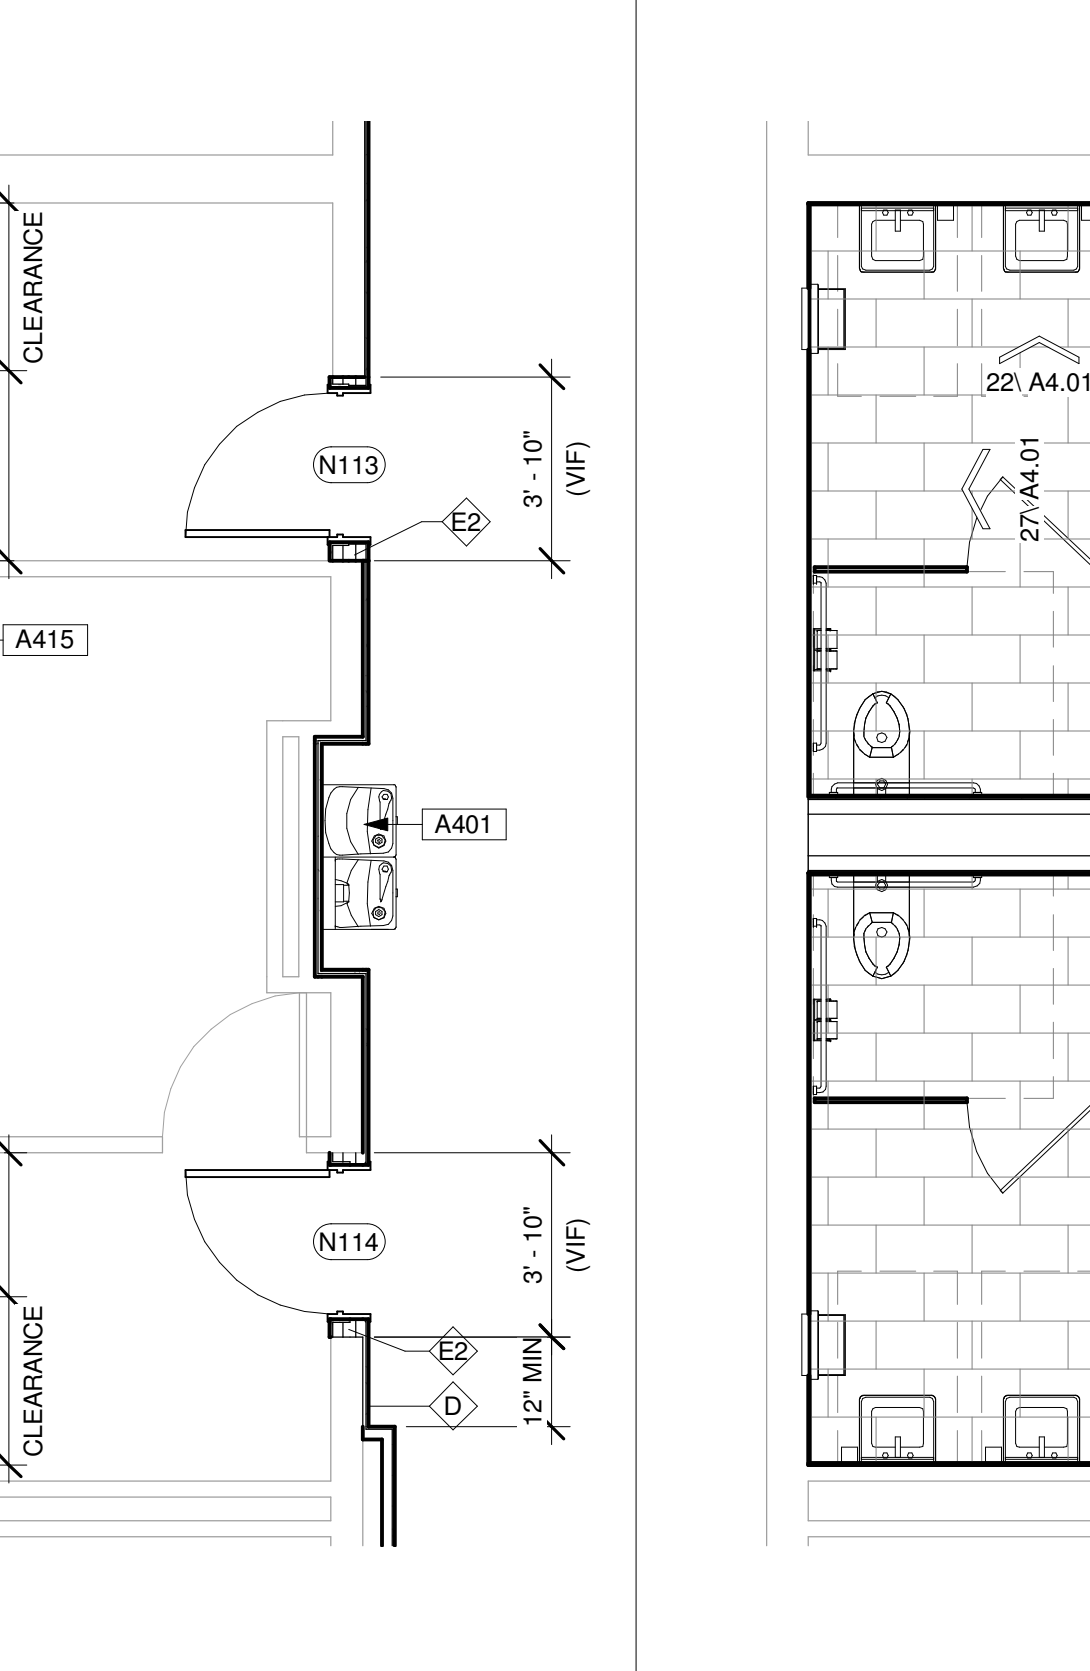

27 MAGNET RR ELEVATION - 3
Scale: 1/4" = 1'-0"

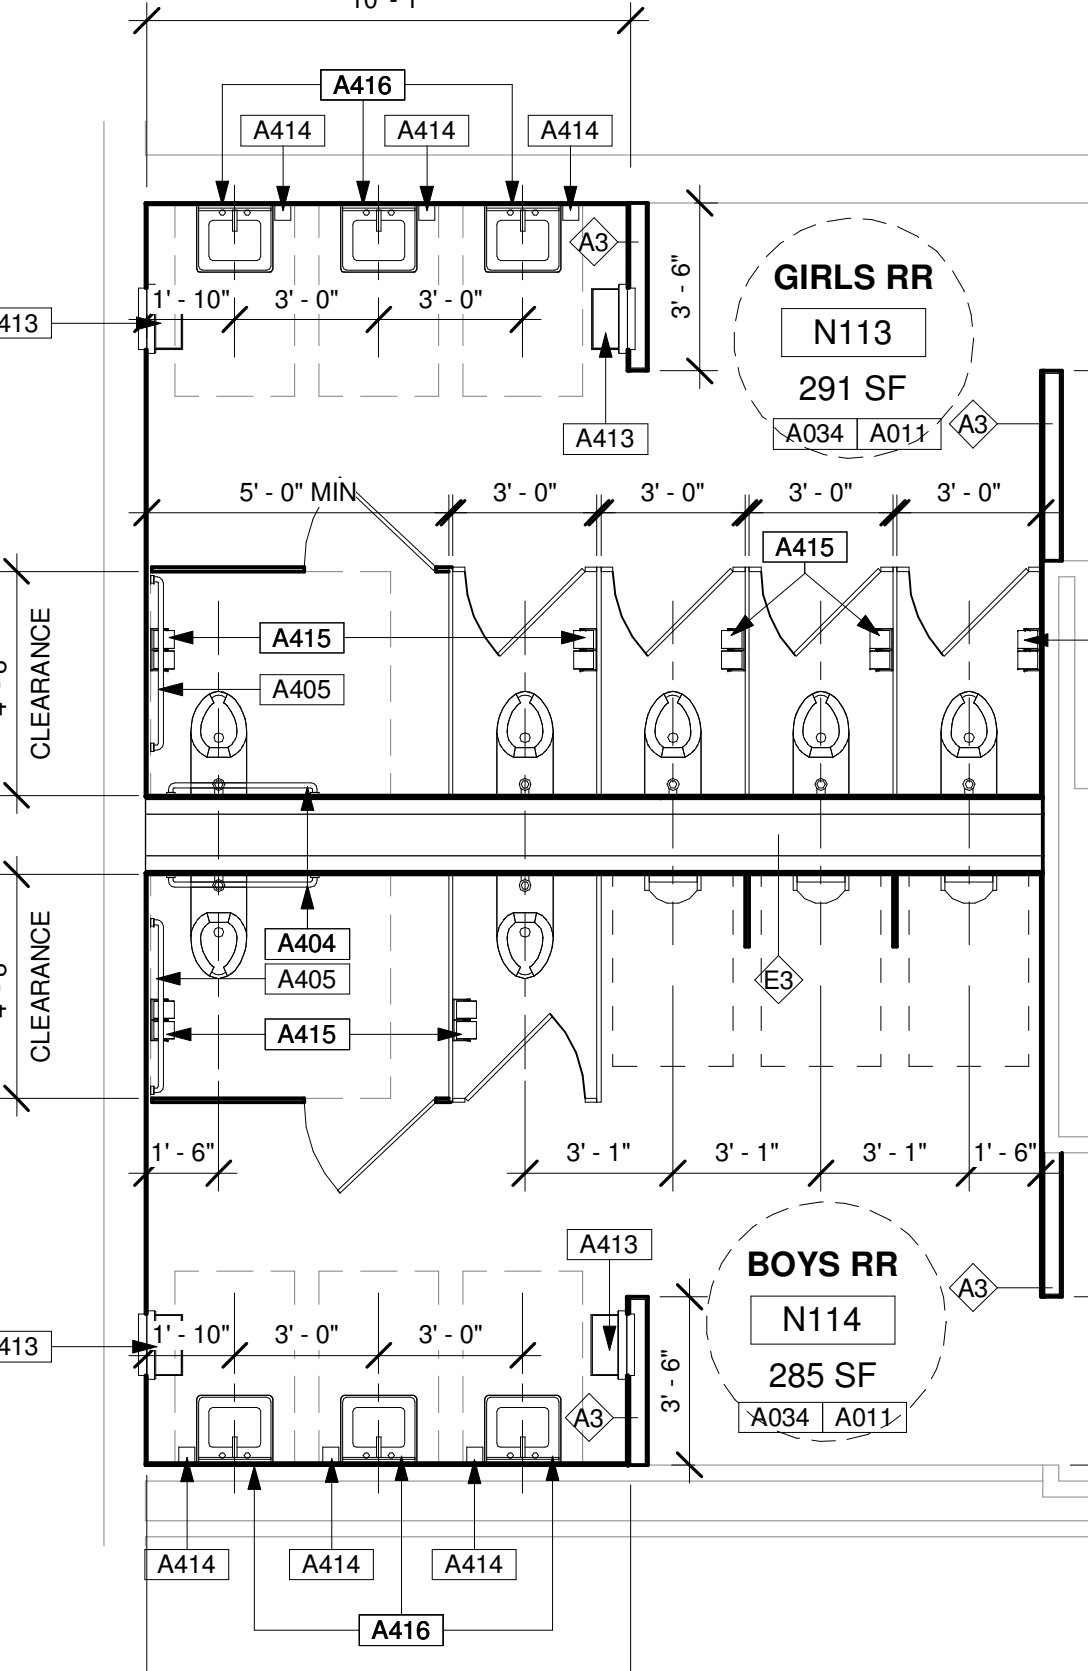

11 ENLARGED PLAN - LIBRARY R.R.
Scale: 1/4" = 1'-0"



21 ENLARGED PLAN - MAGNET R.R. FINISH PLAN
Scale: 1/4" = 1'-0"




26 ENLARGED PLAN - MAGNET R.R.
Scale: 1/4" = 1'-0"




20 ADMIN RR. T ELEVATION - 1
Scale: 1/4" = 1'-0"




25 ADMIN RR. T ELEVATION - 2
Scale: 1/4" = 1'-0"

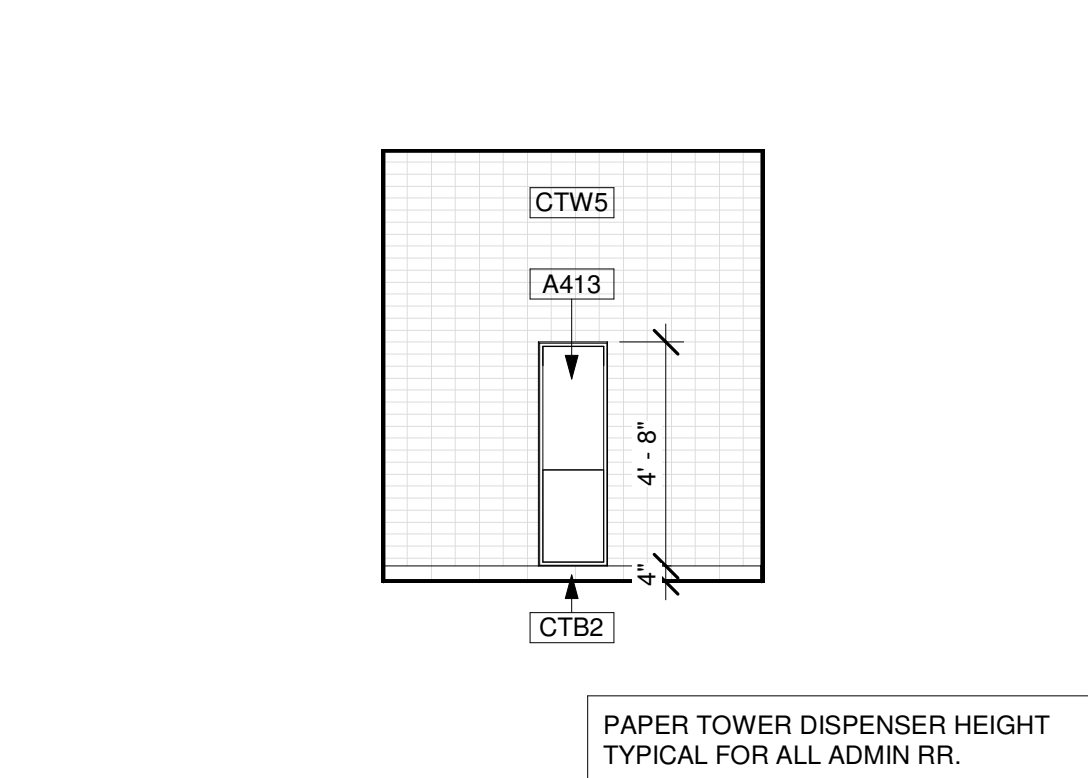

20 ADMIN RR. T ELEVATION - 1
Scale: 1/4" = 1'-0"

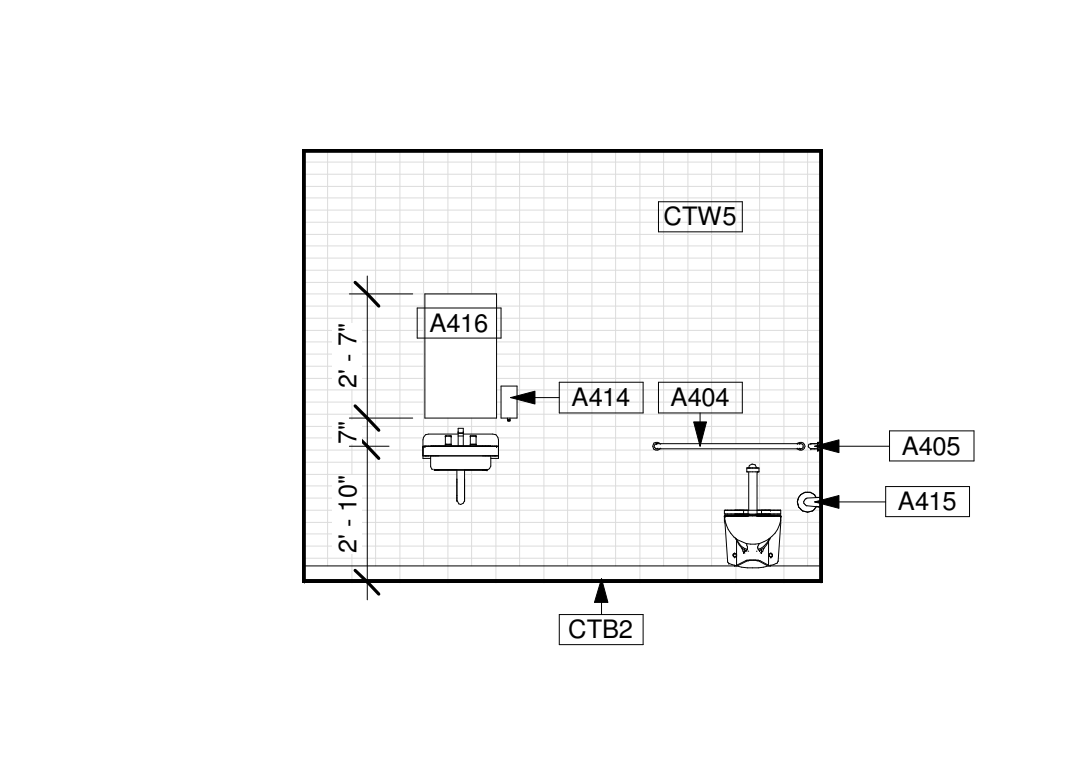

25 ADMIN RR. T ELEVATION - 2
Scale: 1/4" = 1'-0"

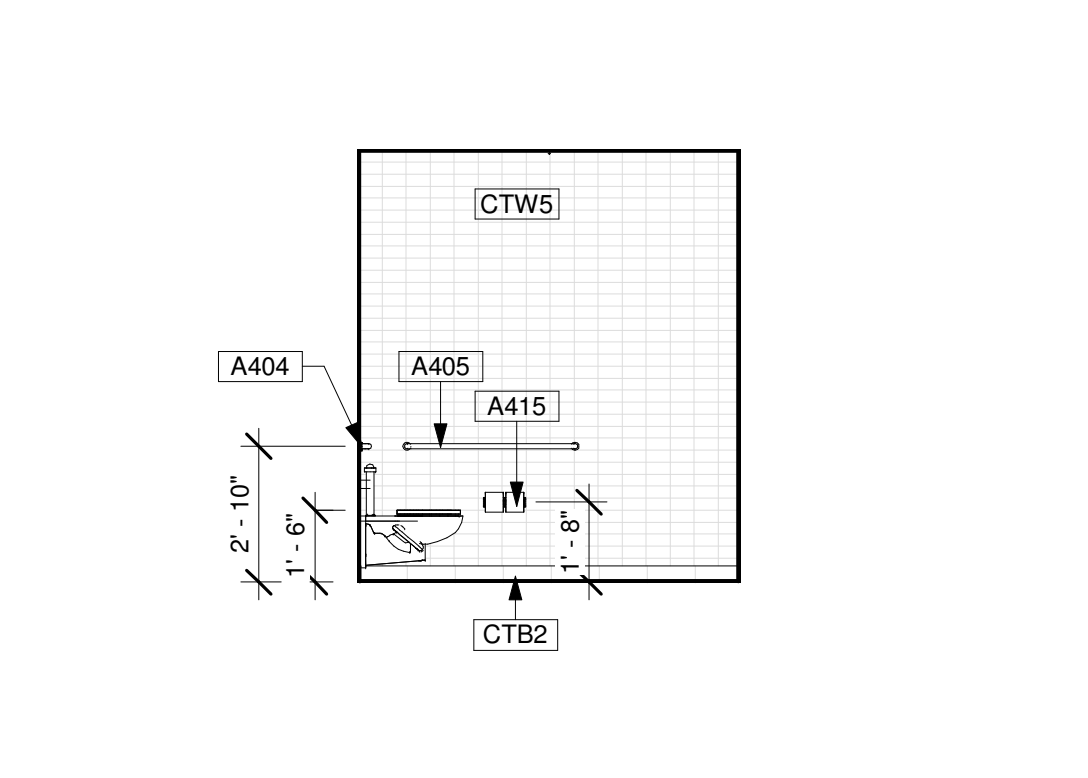

PAPER TOWER DISPENSER HEIGHT
TYPICAL FOR ALL ADMIN RR.



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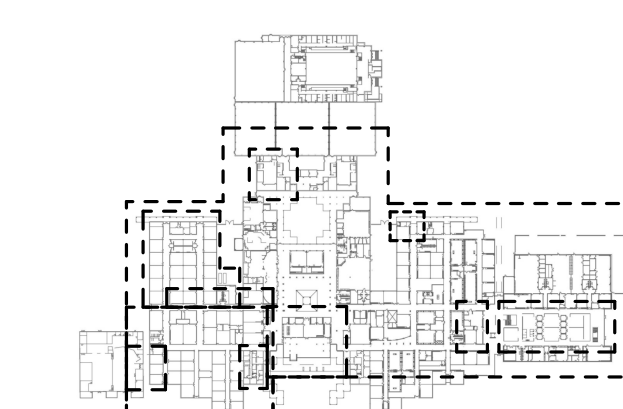


A PROJECT FOR:

**STAFFORD
HIGH SCHOOL
& MAGNET
SCHOOL
RENOVATIONS**

1625 STAFFORDSHIRE
ROAD,
STAFFORD, TX 77477

#	Date	ISSUED FOR
	03/13/2020	ISSUE FOR BID, PERMIT, & CONSTRUCTION



KEY PLAN
TRUE NORTH
PLAN NORTH

Project Number	19006-A
Drawn By	LT
Checked By	AW
Approved By	MS
Drawing Title	ENLARGED PLANS & DETAILS - PORTALS

Drawing Number **A4.02**

Dimension & Alignment Support Notes:
ALIGN 1: Align face of new construction w/face of existing.
ALIGN 2: Align centerline of new construction w/centerline of existing.
ALIGN 3: Align gridline on grid w/existing grid.
LEVEL 1: Ensure top of new construction is level w/existing surface.
LEVEL 2: Level floor & surface to replace new construction.
LEVEL 3: Ensure the top of grade is level w/surrounding ground.
Construction & Condition Support Notes:
HANDLE 1: Handle item w/care, and store for owner review.
HANDLE 2: Handle remaining building, pavement, fence, or item w/care.
HANDLE 3: Handle re-located items with care. DISCONNECT 1, FIXW construction. Ensure the top of grade is level w/surrounding ground & maintain positive slope towards drain, gutter, and storm system away from building.
FIXW: Fix floor/wall/ceiling item where construction was removed and prepare the area to an acceptable condition. Ensure the top of grade is level w/surrounding ground & maintain positive slope towards drain, gutter, and storm system away from building.
PREP: Prepare the site where construction was removed, and prepare the ground to an acceptable condition.
INFORM: Inform Architect prior to the start of this work.
CONNECT: Connect new construction to existing, ensure continuity and structural integrity. Ensure the top of new construction is level w/existing surface.
DISCONNECT: Disconnect remaining items to the new structure, and ensure structural integrity while meeting local Codes. Handle remaining buildings, pavement, fences, and other items w/care.
CONCEAL: Disconnect and conceal all pipes, electrical cables, data cables, and conduits where construction is removed.
ENGINEER: Professional engineering supervision is required for this work.
SHOP: Provide shop drawings for this work.
REFERENCE: Refer to photo # for the existing condition at this location.
SLOPE: Maintain positive slope towards drains, gutters, and storm systems and away from the building.
PROTECT: Protect items to remain, including any buildings, furniture, sidewalks, roofs, utilities, and other items during the Demolition and Construction phases.
EGRESS: Maintain safe and unobstructed egress routes from areas adjacent to the Demolition site. Comply with all Applicable Codes.
TRAIL: Refer to Landscape Drawings & Specs for remaining trees.
OPERATE: Ensure all outlets and utilities required for school operation are protected. Ensure school operation will not be interrupted.
ENSURE: Ensure all slopes to drain as intended, and that downspouts indicated to remain are protected to maintain normal flow at all times during demolition and construction. Protect items to remain including any buildings, furniture, sidewalks, roofs, utilities, and other items during demolition and construction.
ENSURE: Ensure system is water-tight. Provide additional flashing & sealants as needed.
PHASE: Work within this area may occur in phase ONE.
PHASE: Work within this area may occur in phase TWO.

03 SUPPORT NOTES

Scale: NTS

A024 PROVIDE NEW CEILING TILE AND GRID AT SPECIFIED HEIGHT, RE. CEILING PLAN; FINISH SCHEDULE. CENTER GRID IN ROOM UNLESS INDICATED OTHERWISE.

A301 NEW MILLWORK; RE. MILLWORK DETAILS & SPECS. HANDLE 2; FIXW

A312 PROVIDE NEW QUARTZ COUNTERTOP @ OPENING LOCATION

C07 GYP BD. CEILING; 1 LAYER GYP ON 3-5" MTL. STUDS @ 16" O.C. MAX ON 1-1/2" MTL. STUDS AT 48" O.C. MAX IN PERPENDICULAR DIRECTION; SUSPENDED WITH WIRE HANGERS FROM STRUCTURE ABOVE AT 48" O.C. MAX. CEILING AT 9'-0" A.F.F. UNLESS INDICATED OTHERWISE.

C08 GYP BD. BULKHEAD; 1 LAYER GYP ON 3-5" MTL. STUDS @ 16" O.C. SUSPENDED FROM STRUCTURE ABOVE TO ALIGN TO ADJACENT CEILING UNLESS OTHERWISE NOTED. (ALIGN 1)

PT1 PAINT (FIELD).

PT2 PAINT (ACCENT 2).


PT3 PAINT (ACCENT 3).

02 KEYNOTES

- Scale: NTS
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 - REFER TO DOOR AND WINDOW DETAILS FOR DIMENSIONS AT OPENINGS.
 - REFER TO DEMOLITION DRAWINGS FOR DEMOLITION INFORMATION.
 - REFER TO CODE ANALYSIS INFORMATION SHEET A0.20 FOR EXTENT OF EXTENDED FIRE-SPRINKLER SYSTEM.


01 GENERAL NOTES - CONSTRUCTION

Scale: NTS

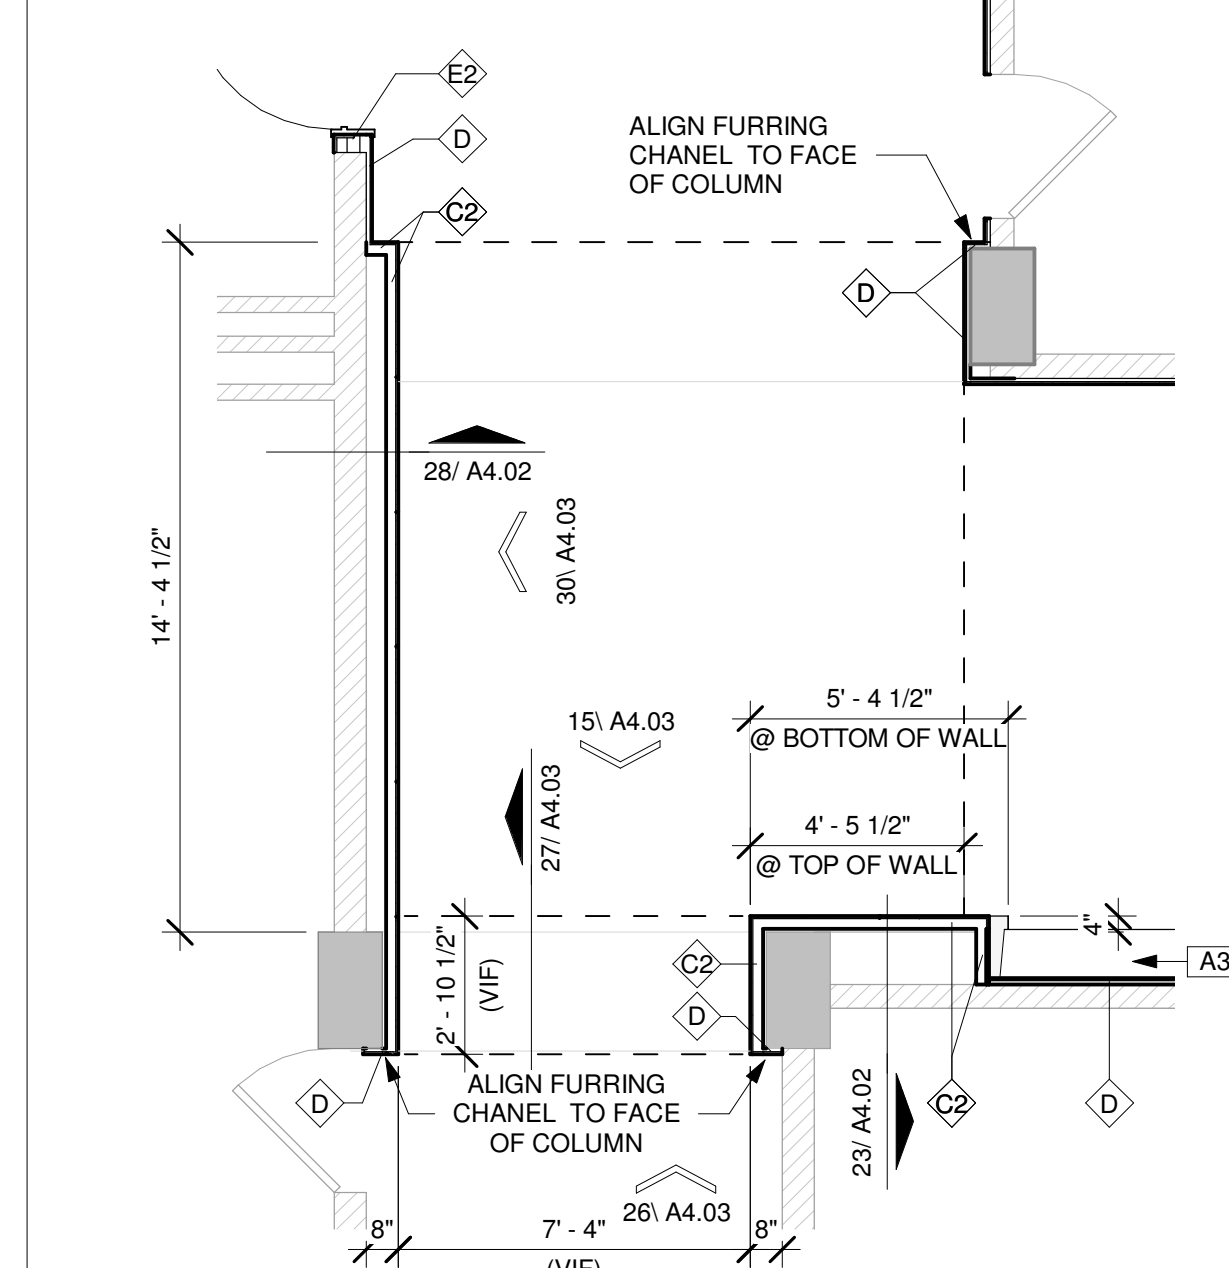


07 PORTAL 4 - PLAN

Scale: 1/4" = 1'-0"

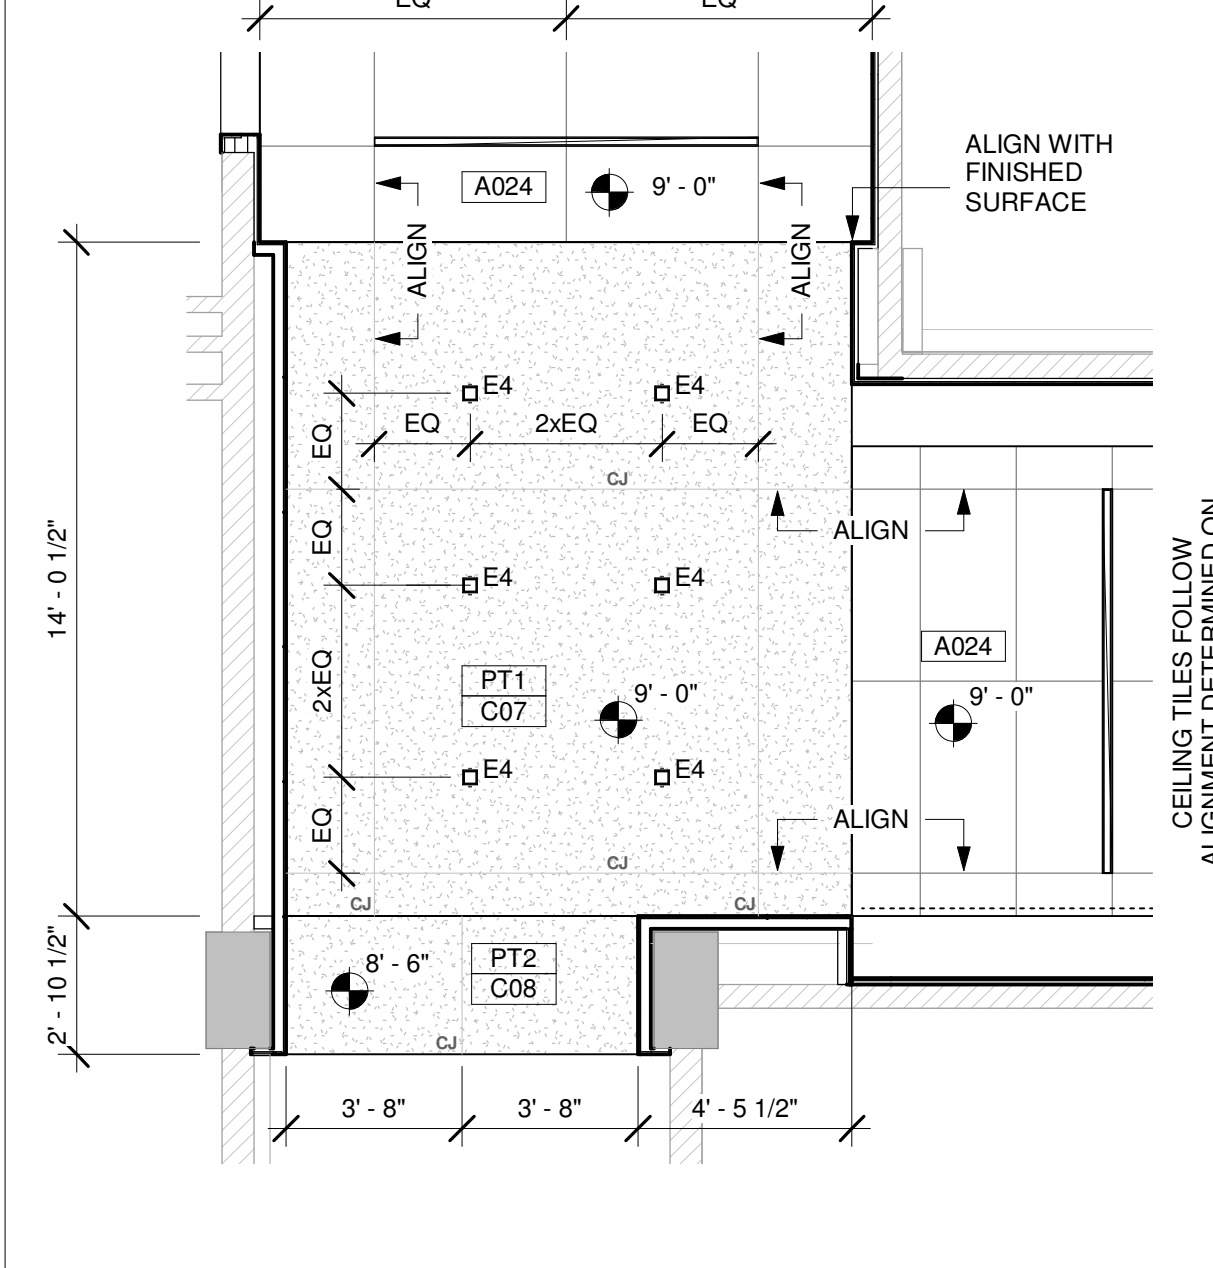


08 PORTAL 4 - CEILING PLAN

Scale: 1/4" = 1'-0"

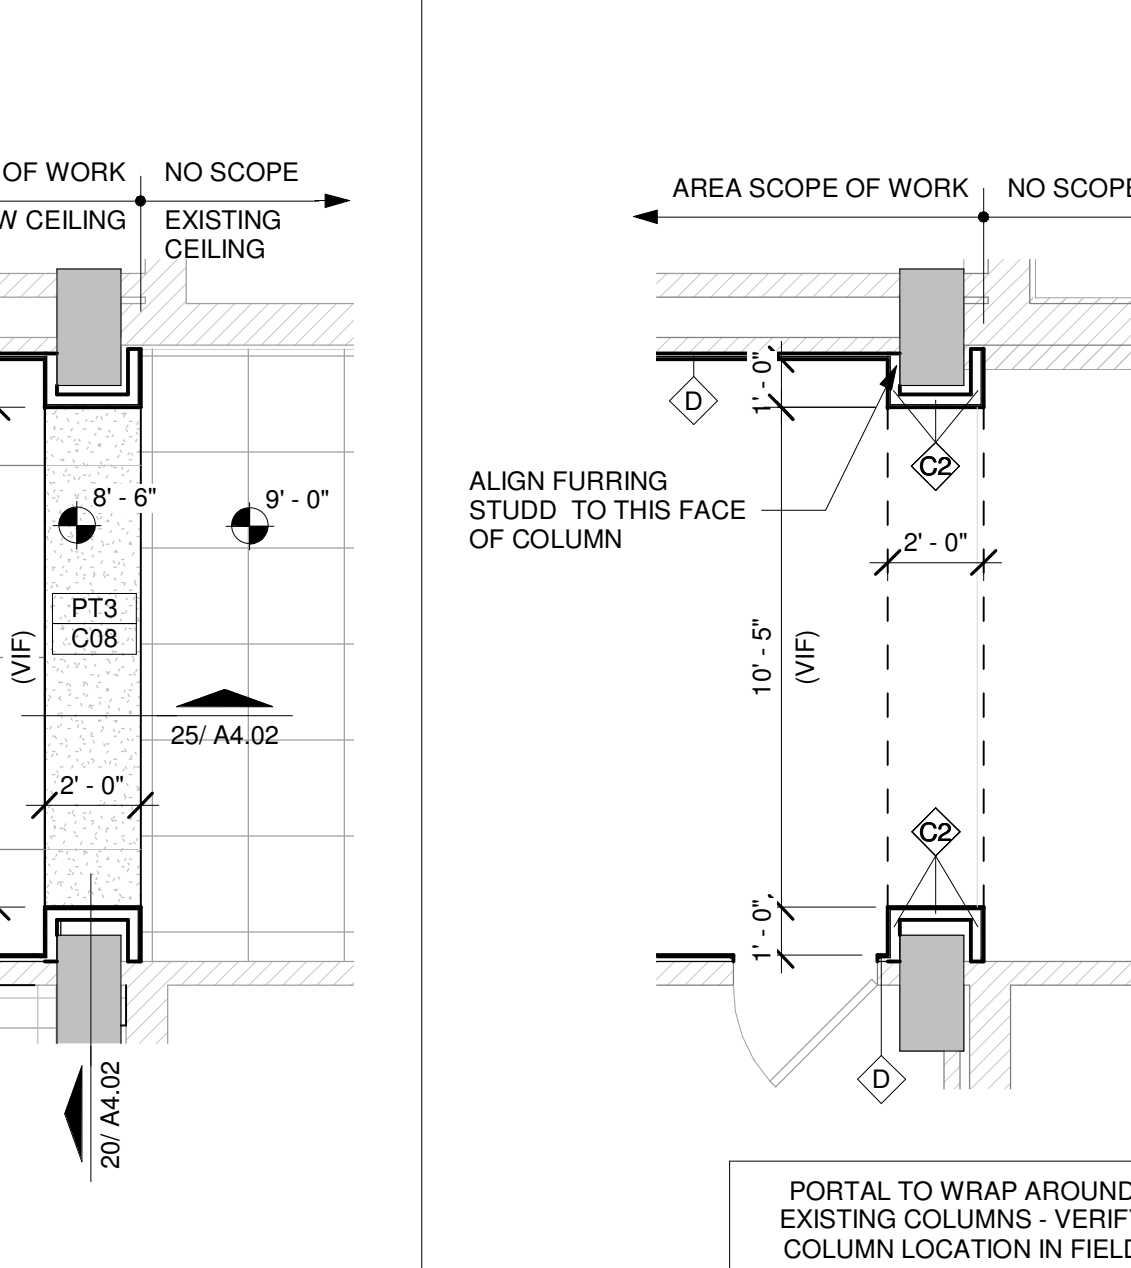


13 PORTAL 5 - PLAN

Scale: 1/4" = 1'-0"

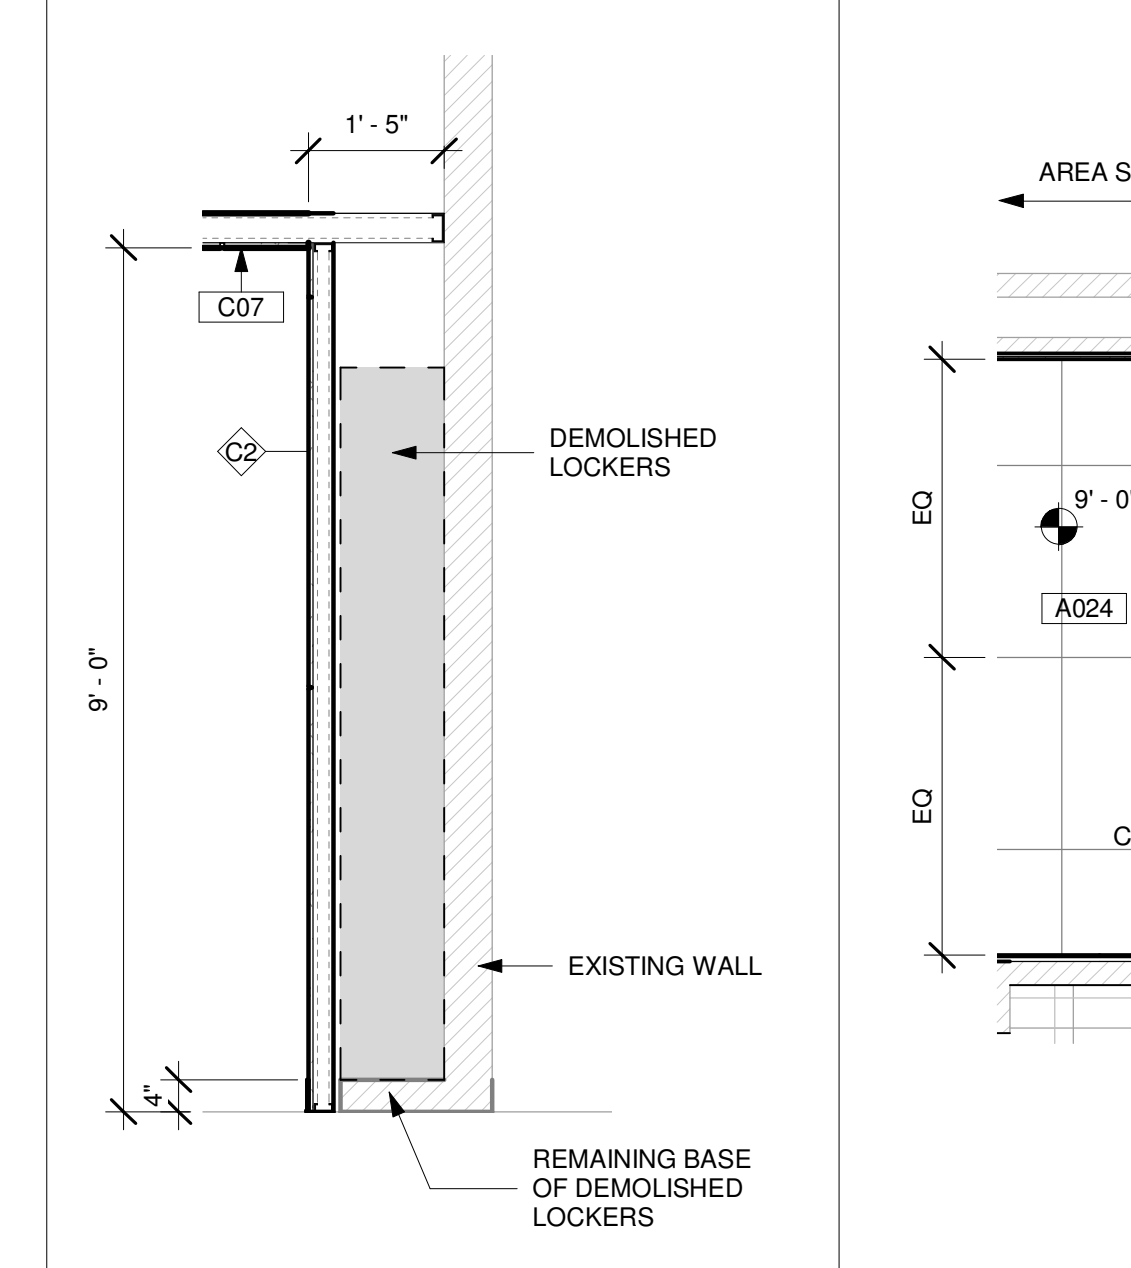


23 DETAIL 3 - PORTAL TYP

Scale: 1/2" = 1'-0"

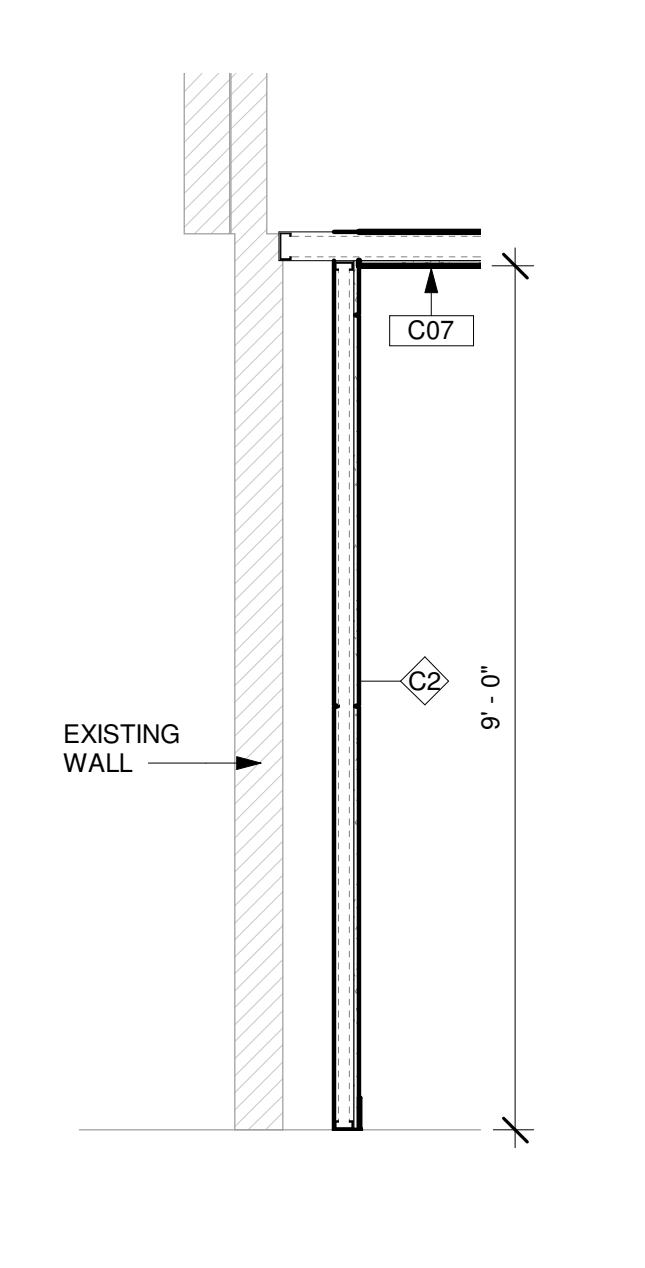


28 DETAIL 4 - PORTAL TYP

Scale: 1/2" = 1'-0"

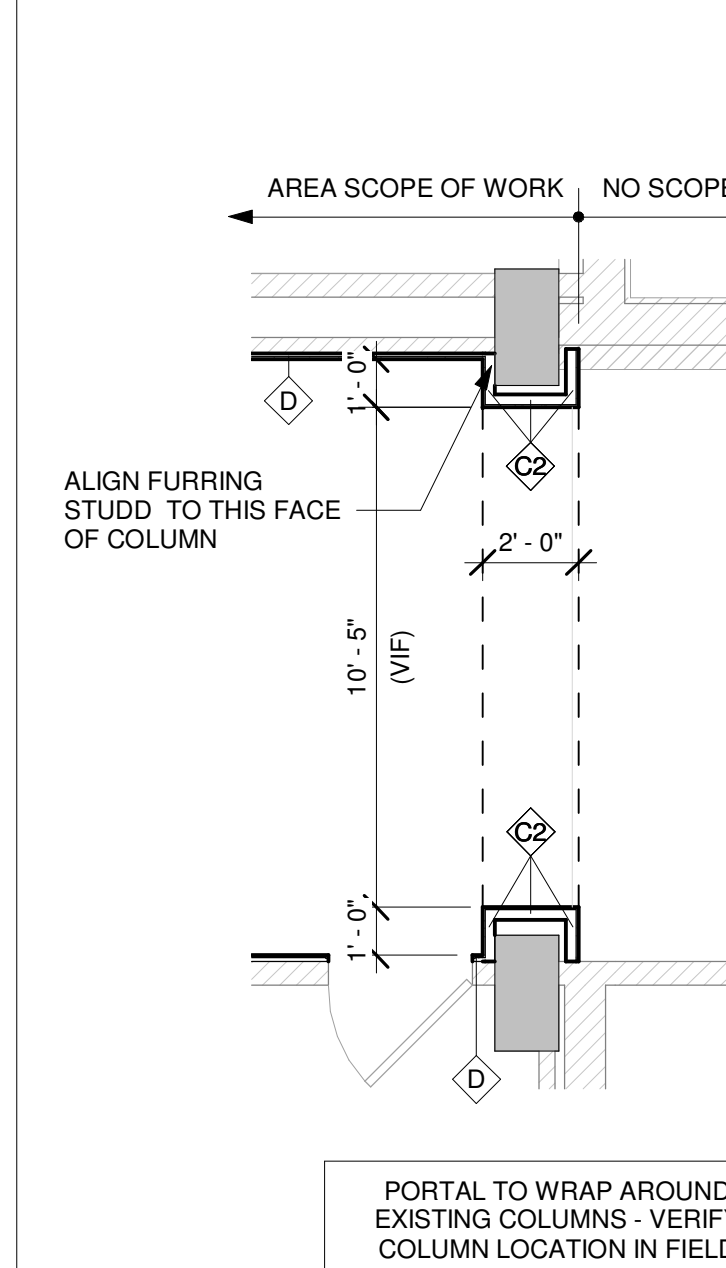


15 CORNER GUARD DETAIL

Scale: 3" = 1'-0"

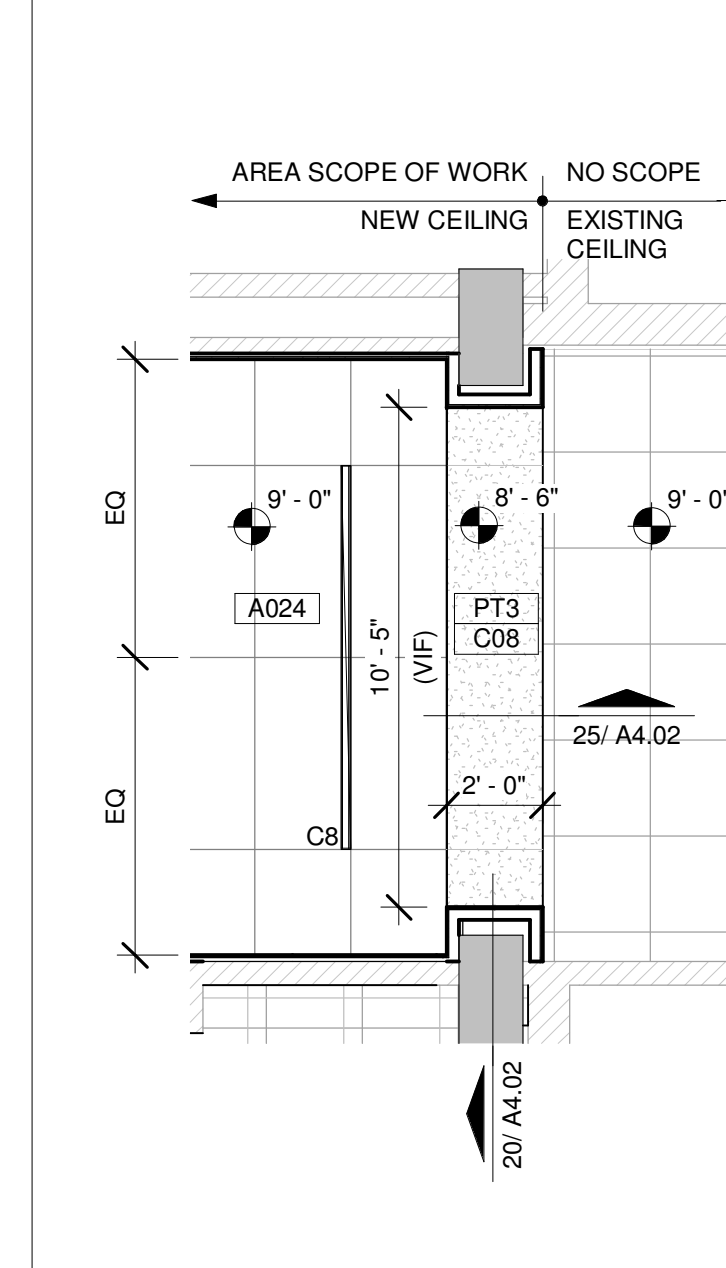


18 PORTAL 5 - CEILING PLAN

Scale: 1/4" = 1'-0"

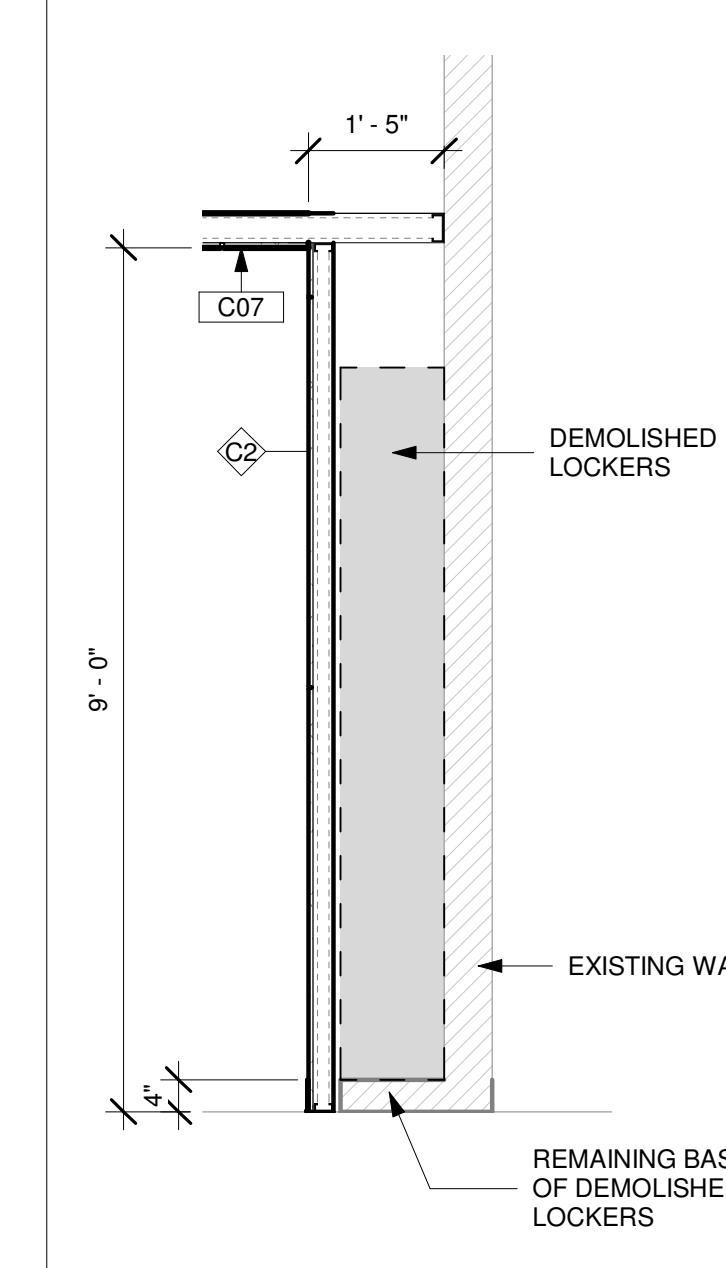

25 PORTAL DETAIL 4

Scale: 1/2" = 1'-0"

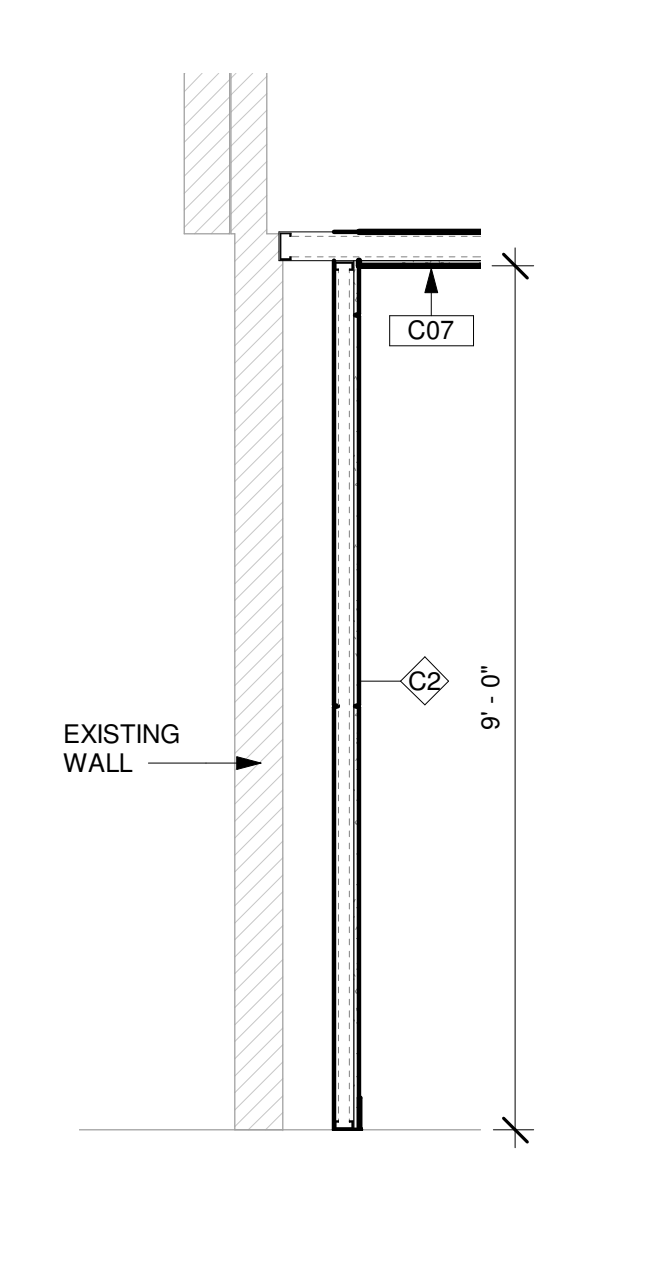

30 PORTAL DETAIL 3

Scale: 1/2" = 1'-0"

26 PORTAL 3 - PLAN

Scale: 1/4" = 1'-0"

22 PORTAL 2 - CEILING PLAN

Scale: 1/4" = 1'-0"

17 PORTAL 1 - CEILING PLAN

Scale: 1/4" = 1'-0"

27 PORTAL 3 - CEILING PLAN

Scale: 1/4" = 1'-0"

21 PORTAL 2 - PLAN

Scale: 1/4" = 1'-0"

11 PORTAL 1 - PLAN

Scale: 1/4" = 1'-0"

THIS DETAIL IS TYPICAL FOR ALL FURRED EXPOSED CORNERS ON CORRIDORS AND PUBLIC AREAS. FURRED PARTITIONS BEHIND MILLWORK NEED NOT HAVE CORNER GUARD.

PORTAL TO WRAP AROUND EXISTING COLUMNS - VERIFY COLUMN LOCATION IN FIELD

NOTE: ALL CEILING DIMENSIONS SHOULD BE VERIFIED IN FIELD ONCE THE WALL FURRINGS ARE PUT INTO PLACE. PRIOR TO CEILING CONSTRUCTION.

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PROFESSIONAL SEAL:




A PROJECT FOR:

**STAFFORD
HIGH SCHOOL
& MAGNET
SCHOOL
RENOVATIONS**

1625 STAFFORDSHIRE
ROAD,
STAFFORD, TX 77477

Date ISSUED FOR
03/13/2020 ISSUE FOR BID,
PERMIT, &
CONSTRUCTION

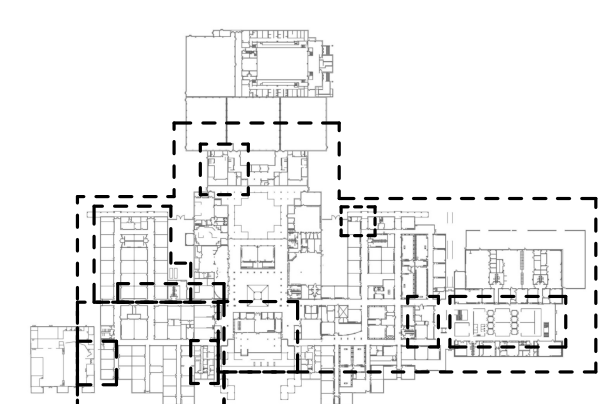


KEY PLAN
TRUE NORTH
PLAN NORTH


Project Number 19006-A
Drawn By LT
Checked By AW
Approved By MS

Drawing Title
**ENLARGED PLANS &
DETAILS - PORTALS**


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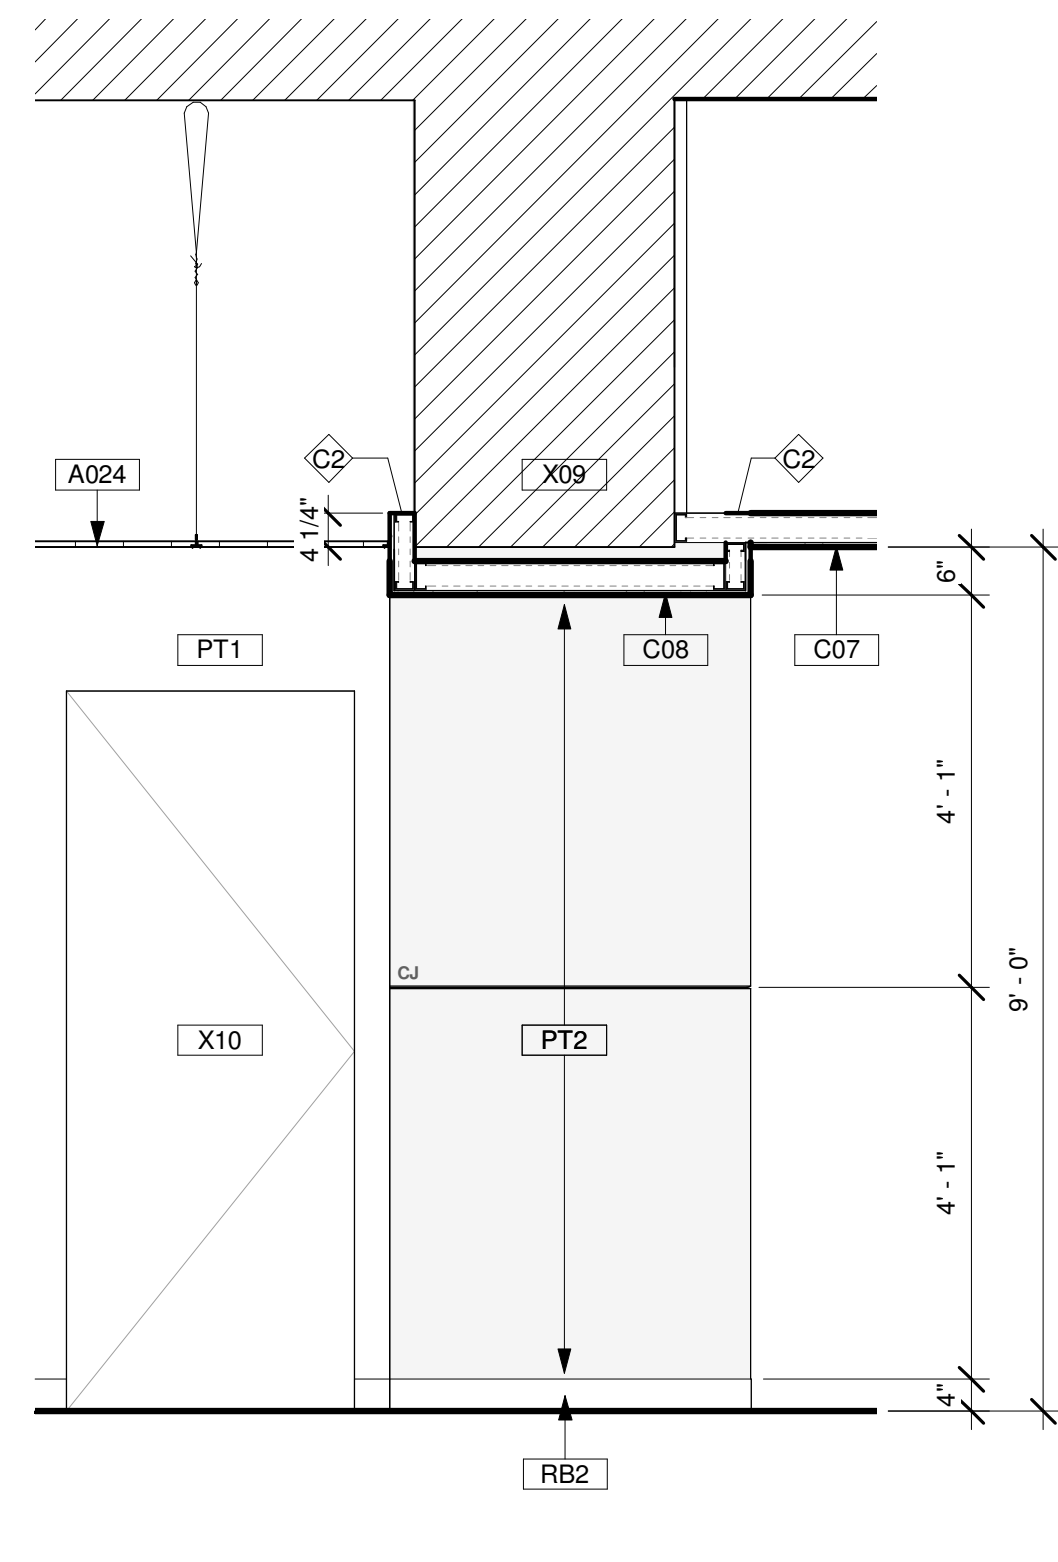
30 PORTAL 4 - WEST ELEVATION
Scale: 1/2" = 1'-0"

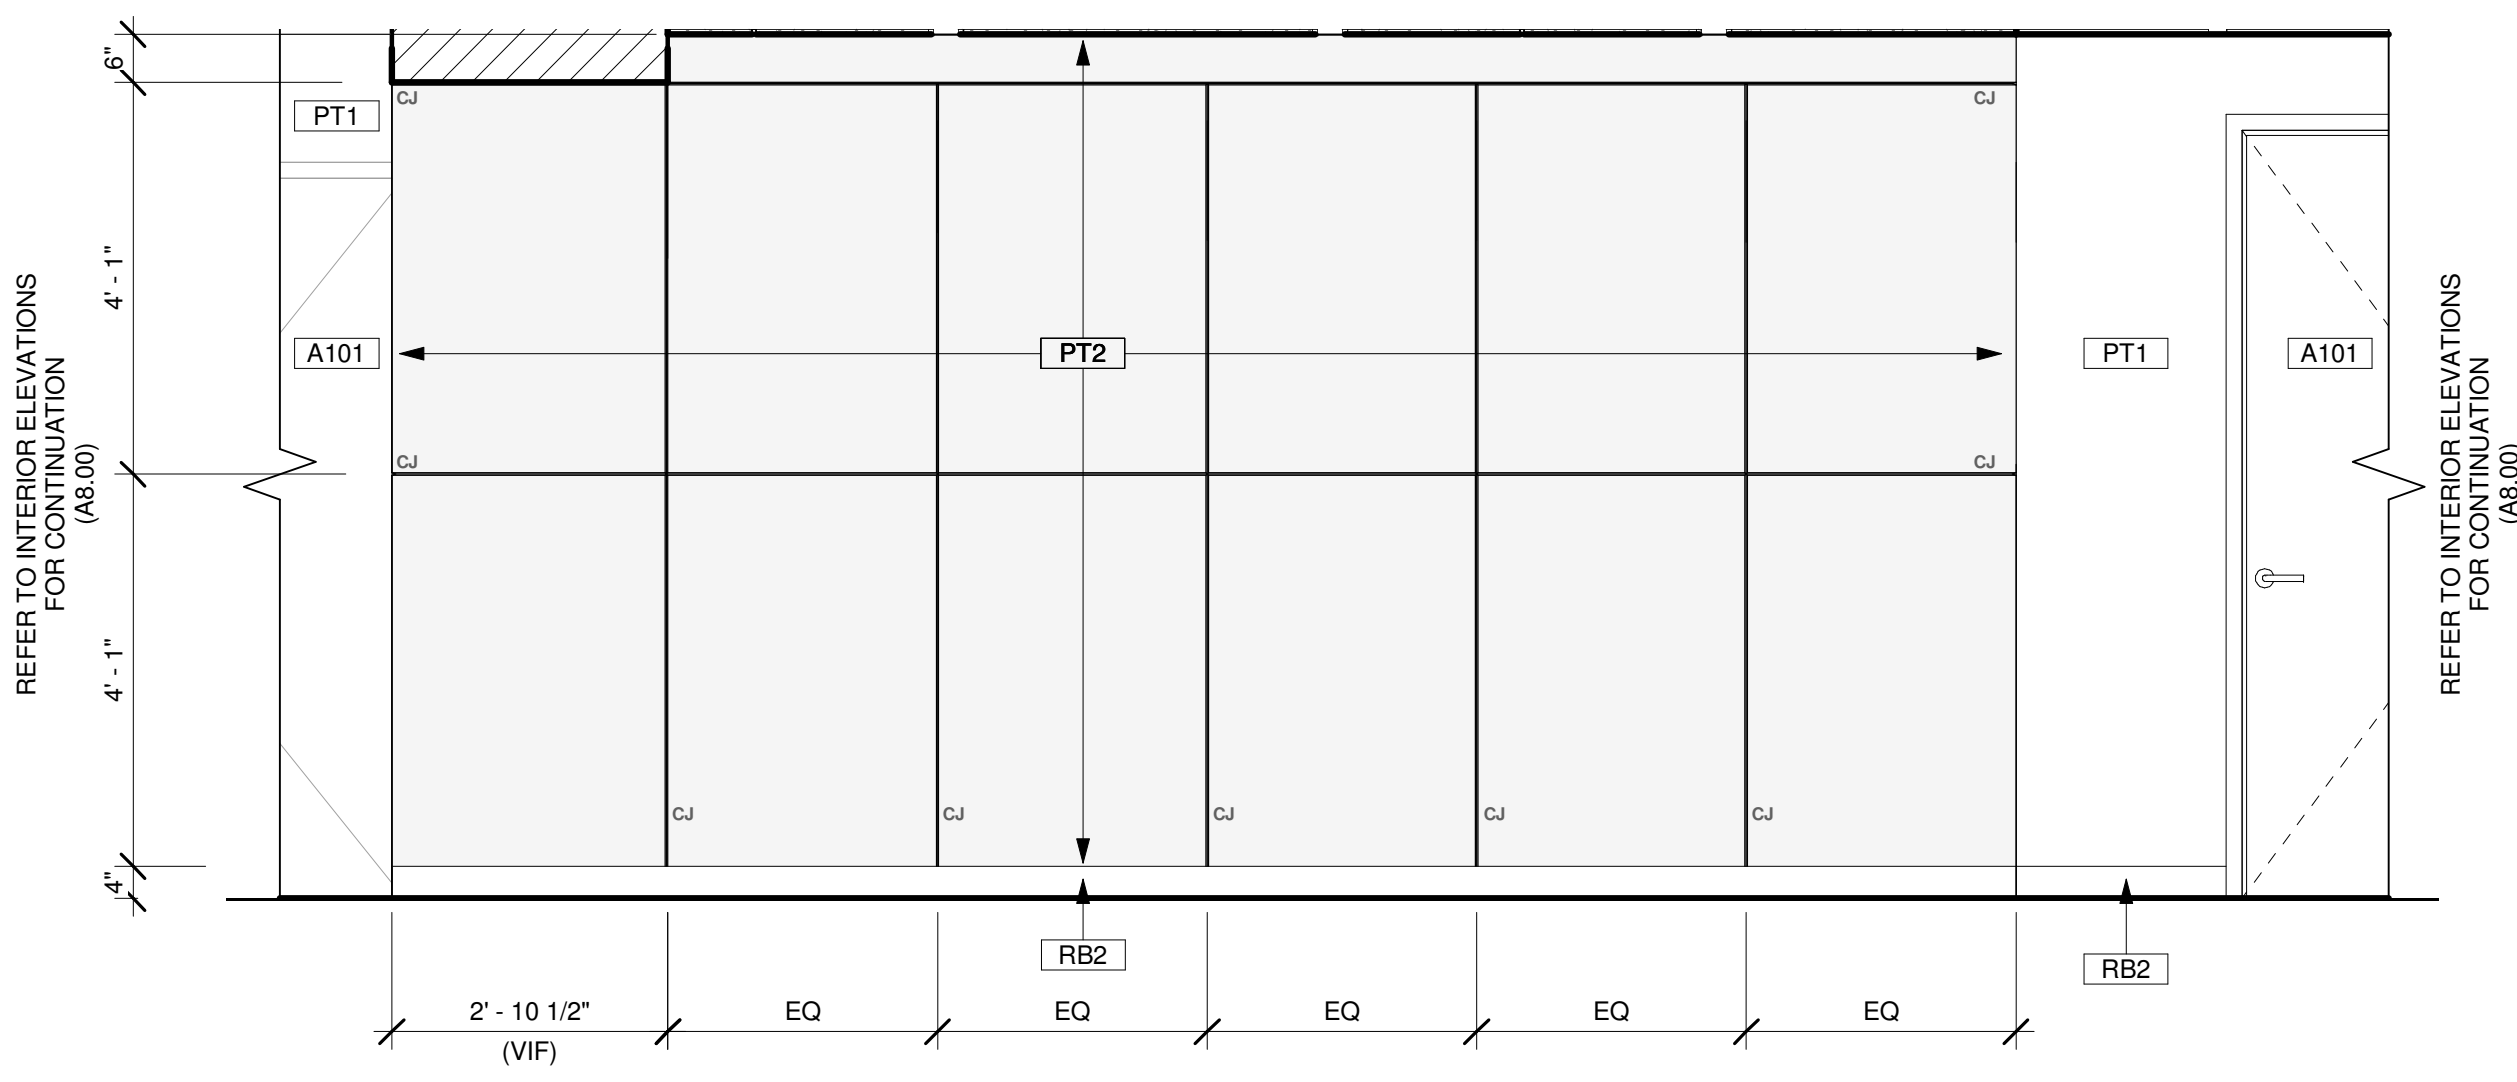


15 PORTAL 4 - SOUTH ELEVATION
Scale: 1/2" = 1'-0"

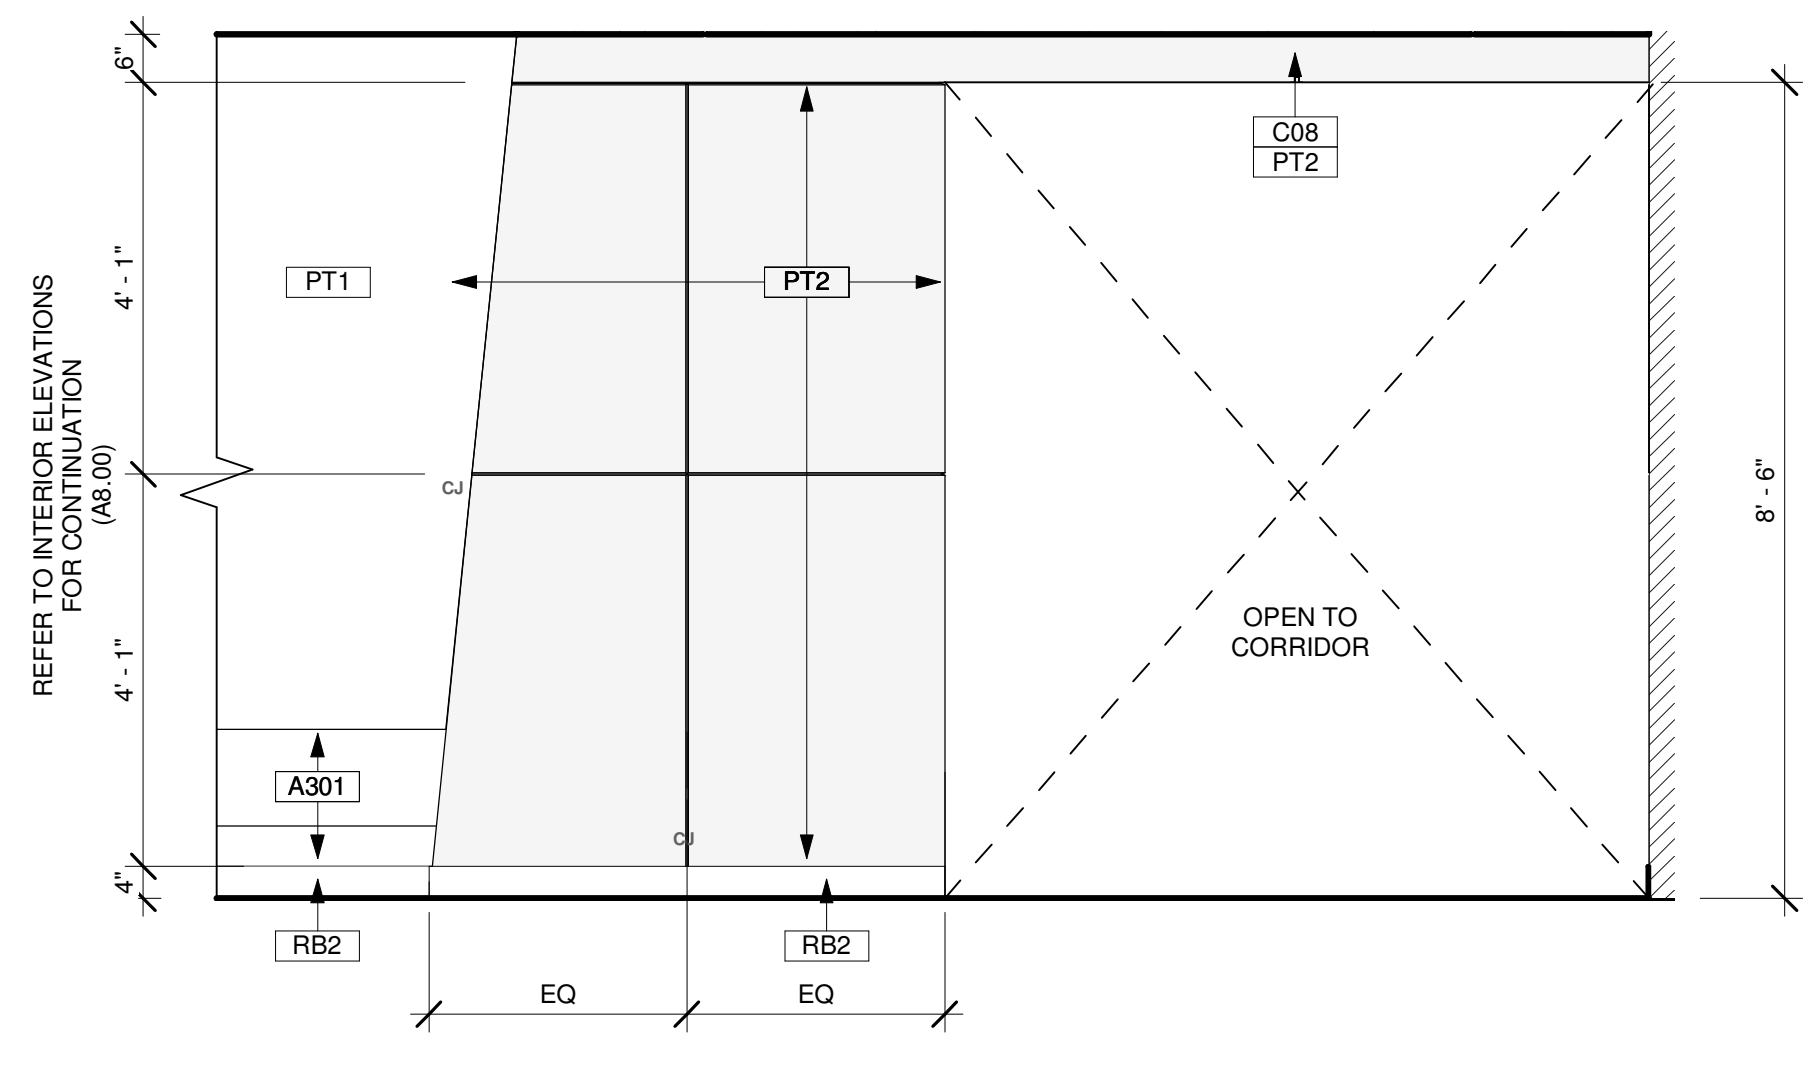


27 DETAIL 2 - PORTAL TYP
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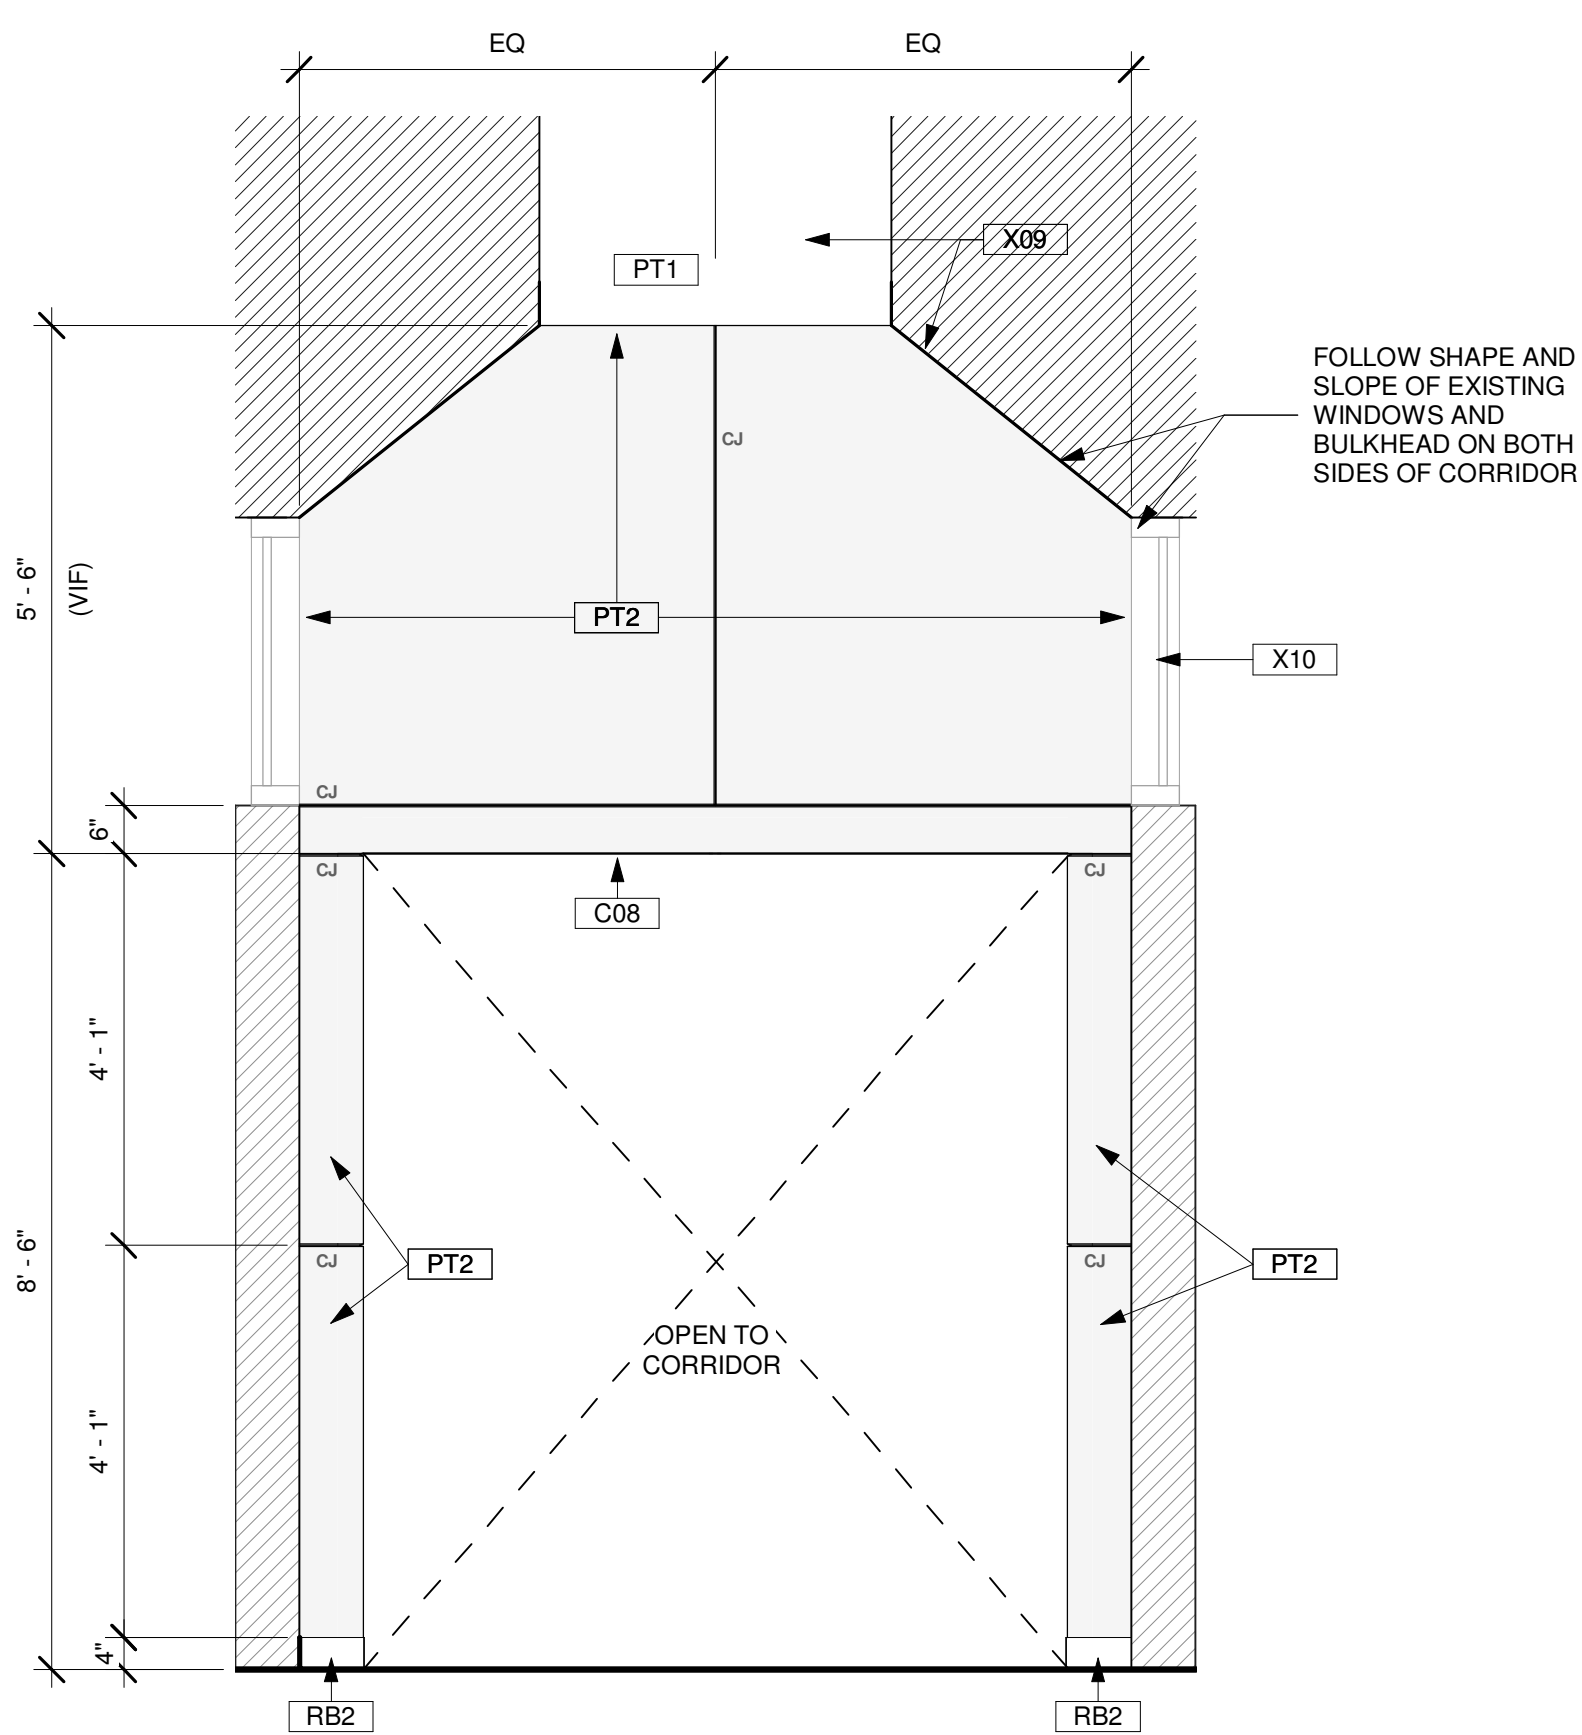
22 DETAIL 1 - PORTAL 3
Scale: 1/2" = 1'-0"

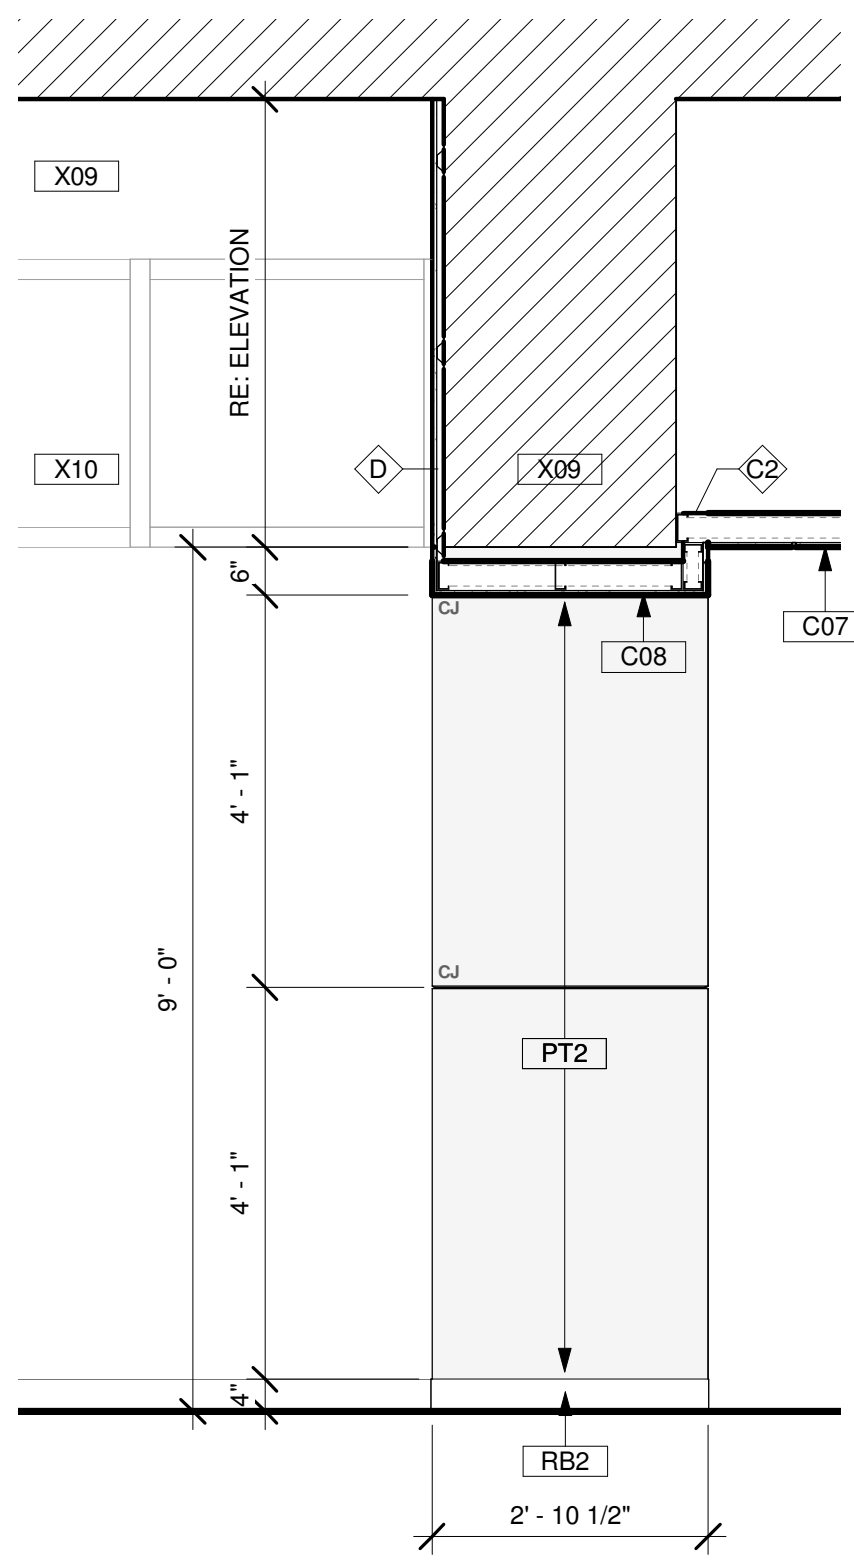


18 PORTAL 2,3 - SOUTH ELEVATION
Scale: 1/2" = 1'-0"

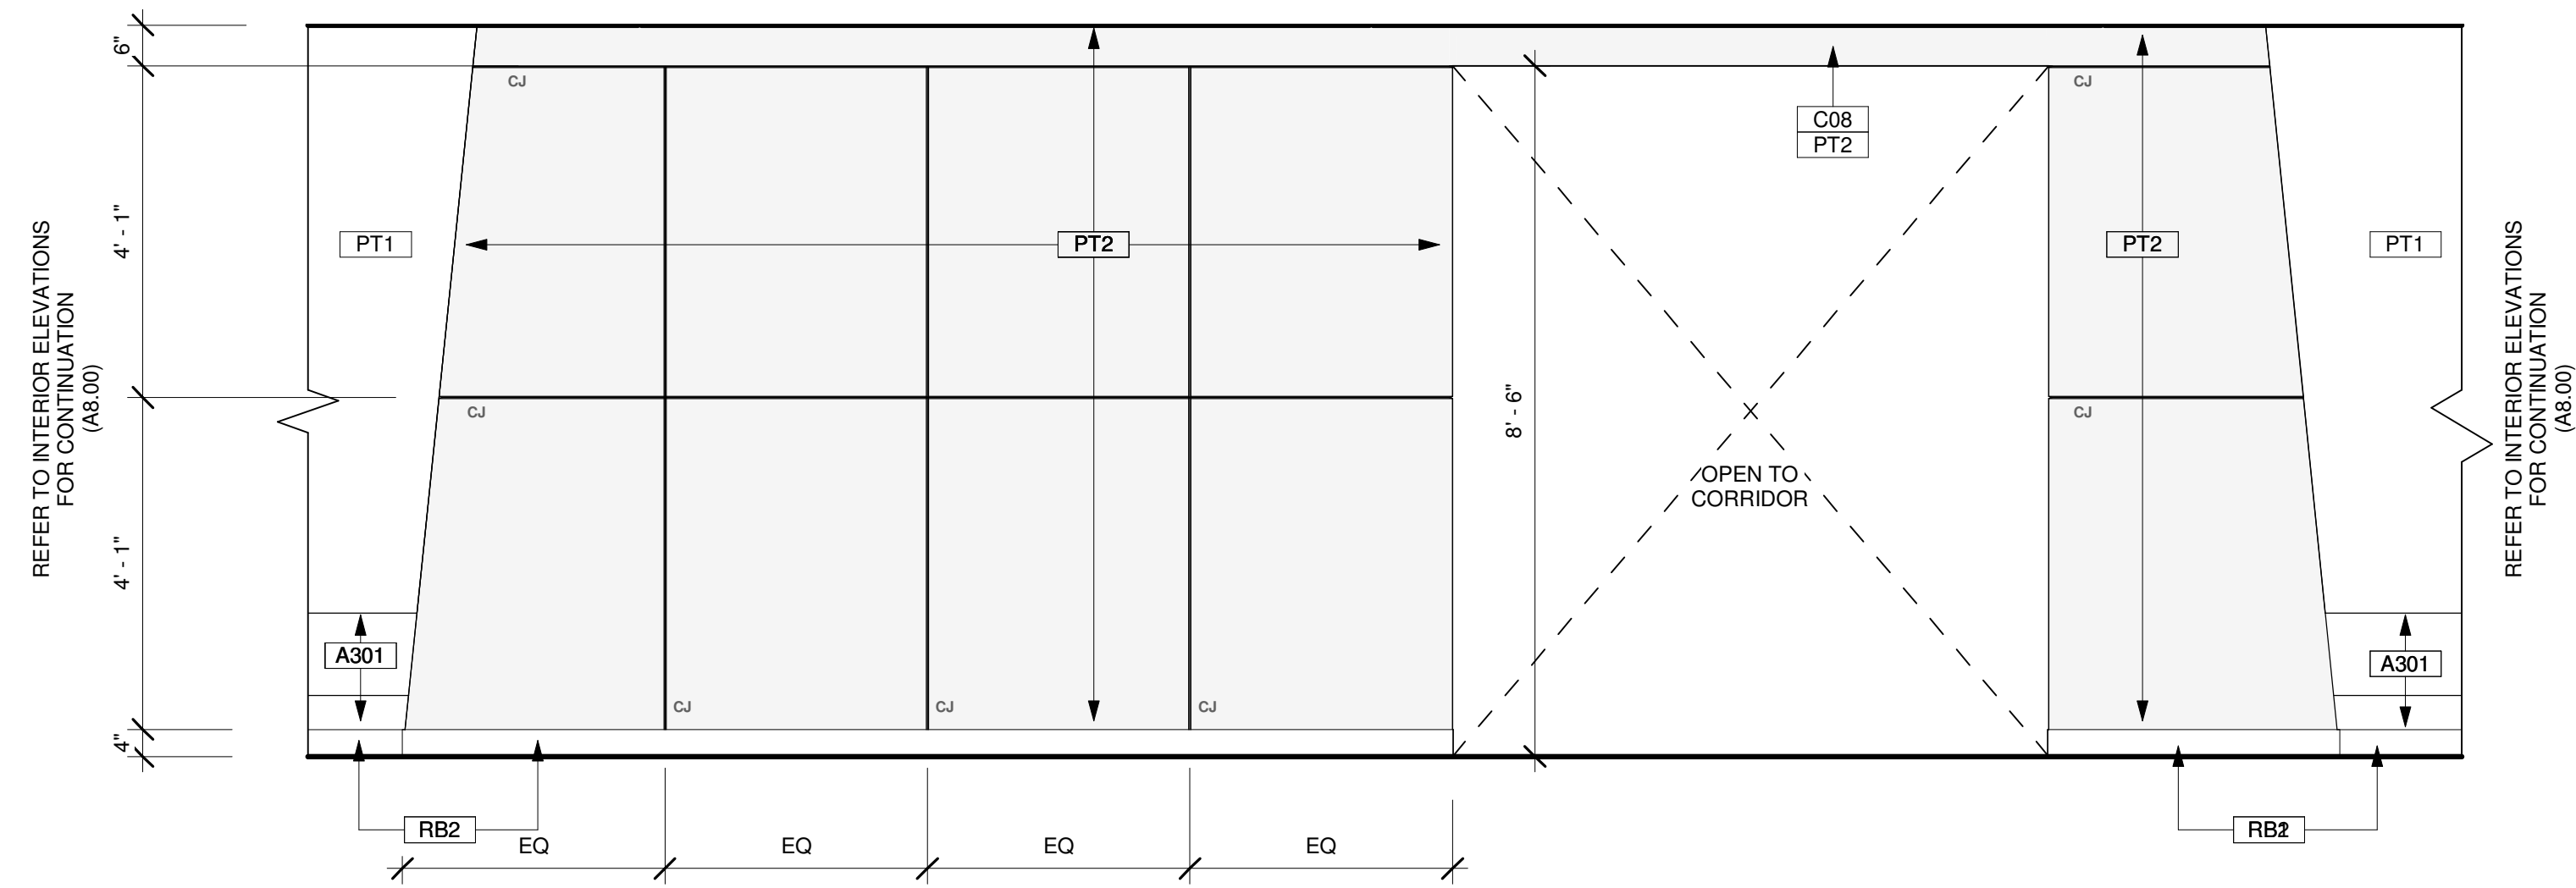

17 PORTAL 3 - NORTH ELEVATION
Scale: 1/2" = 1'-0"

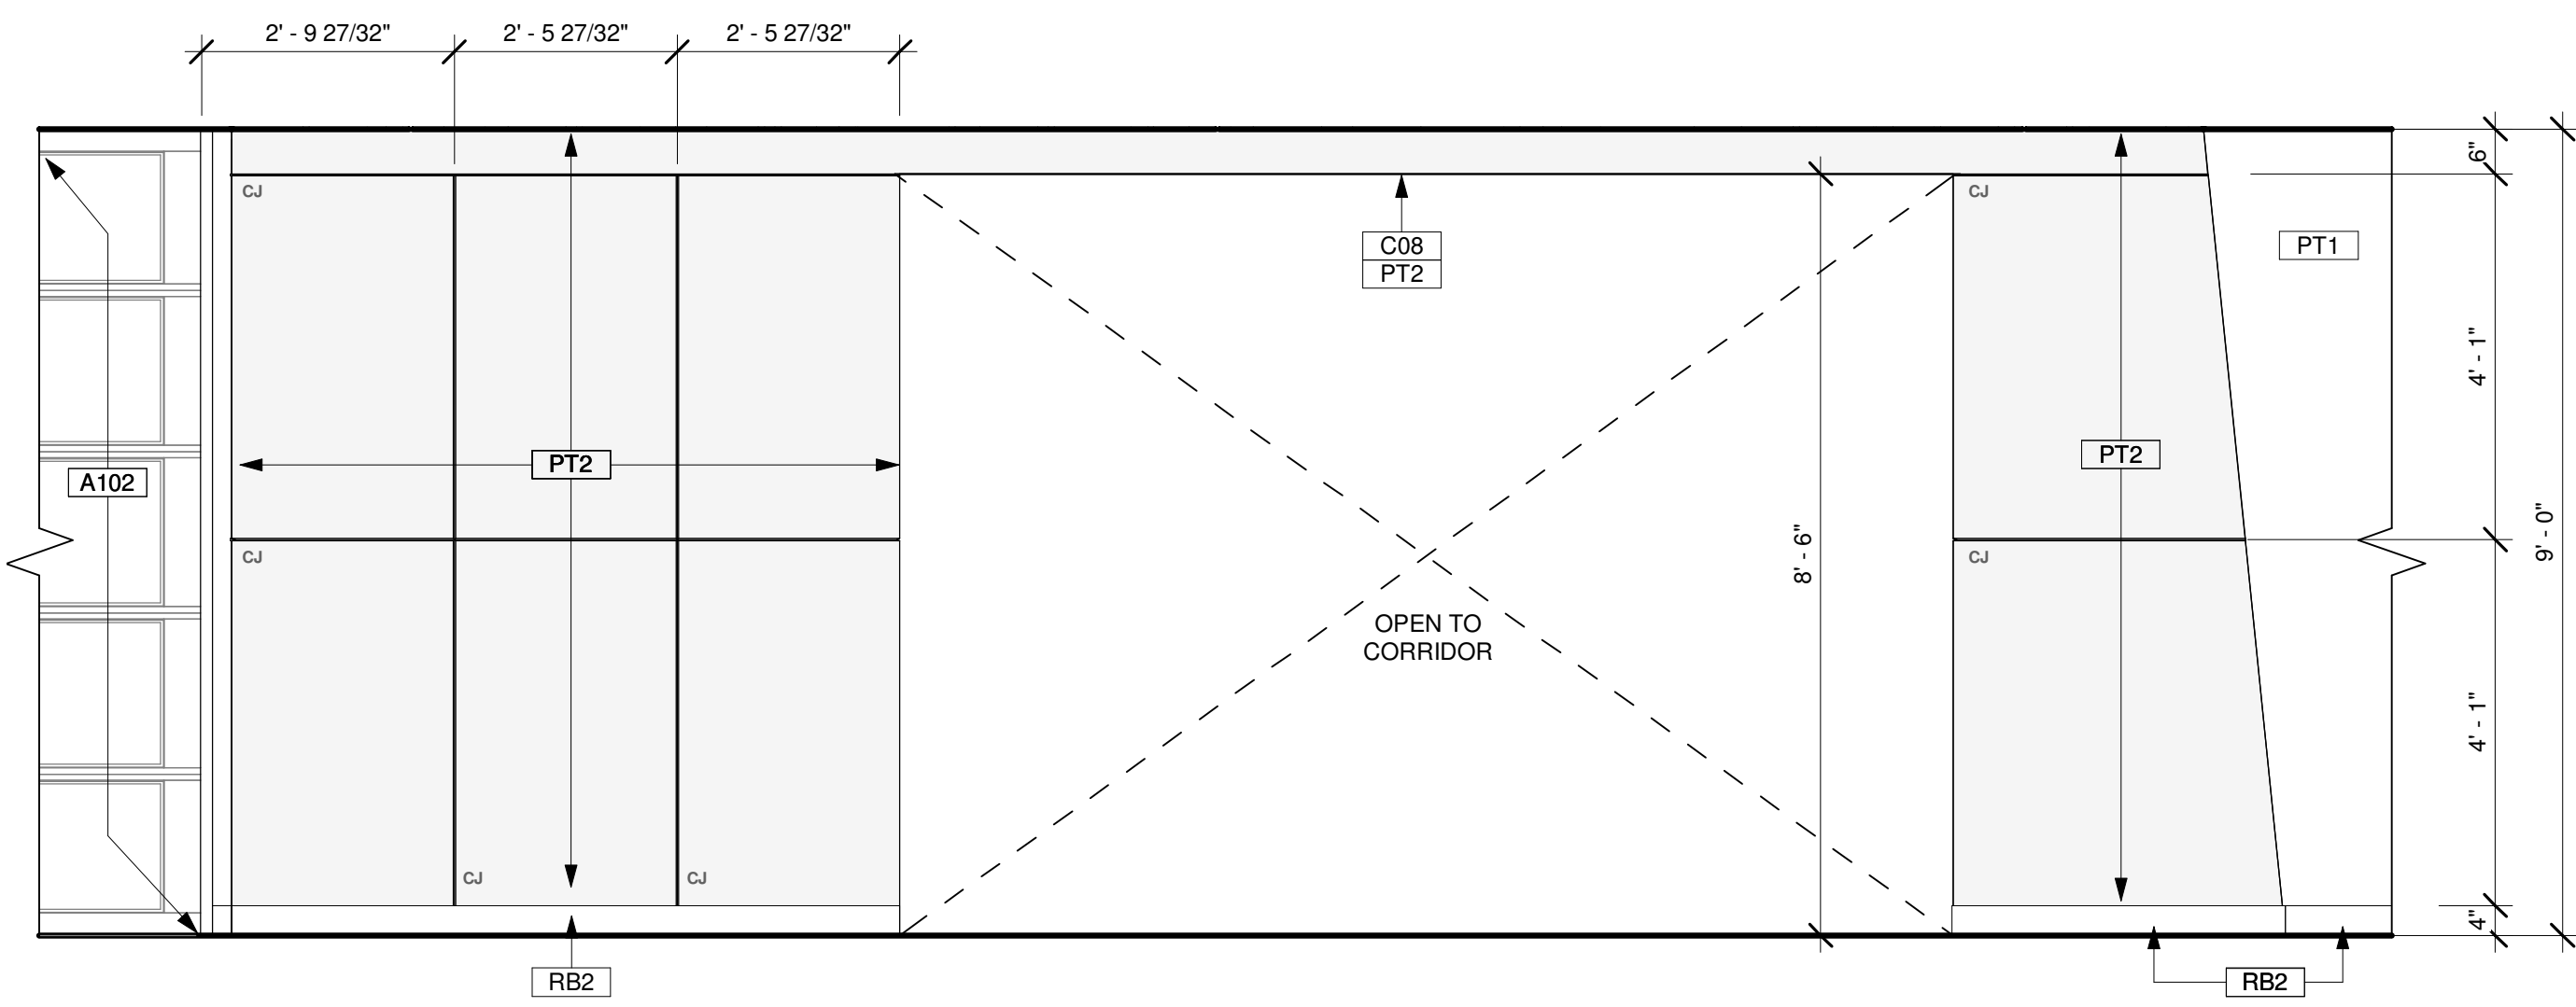

26 PORTAL 2,3 - ELEVATION
Scale: 1/2" = 1'-0"

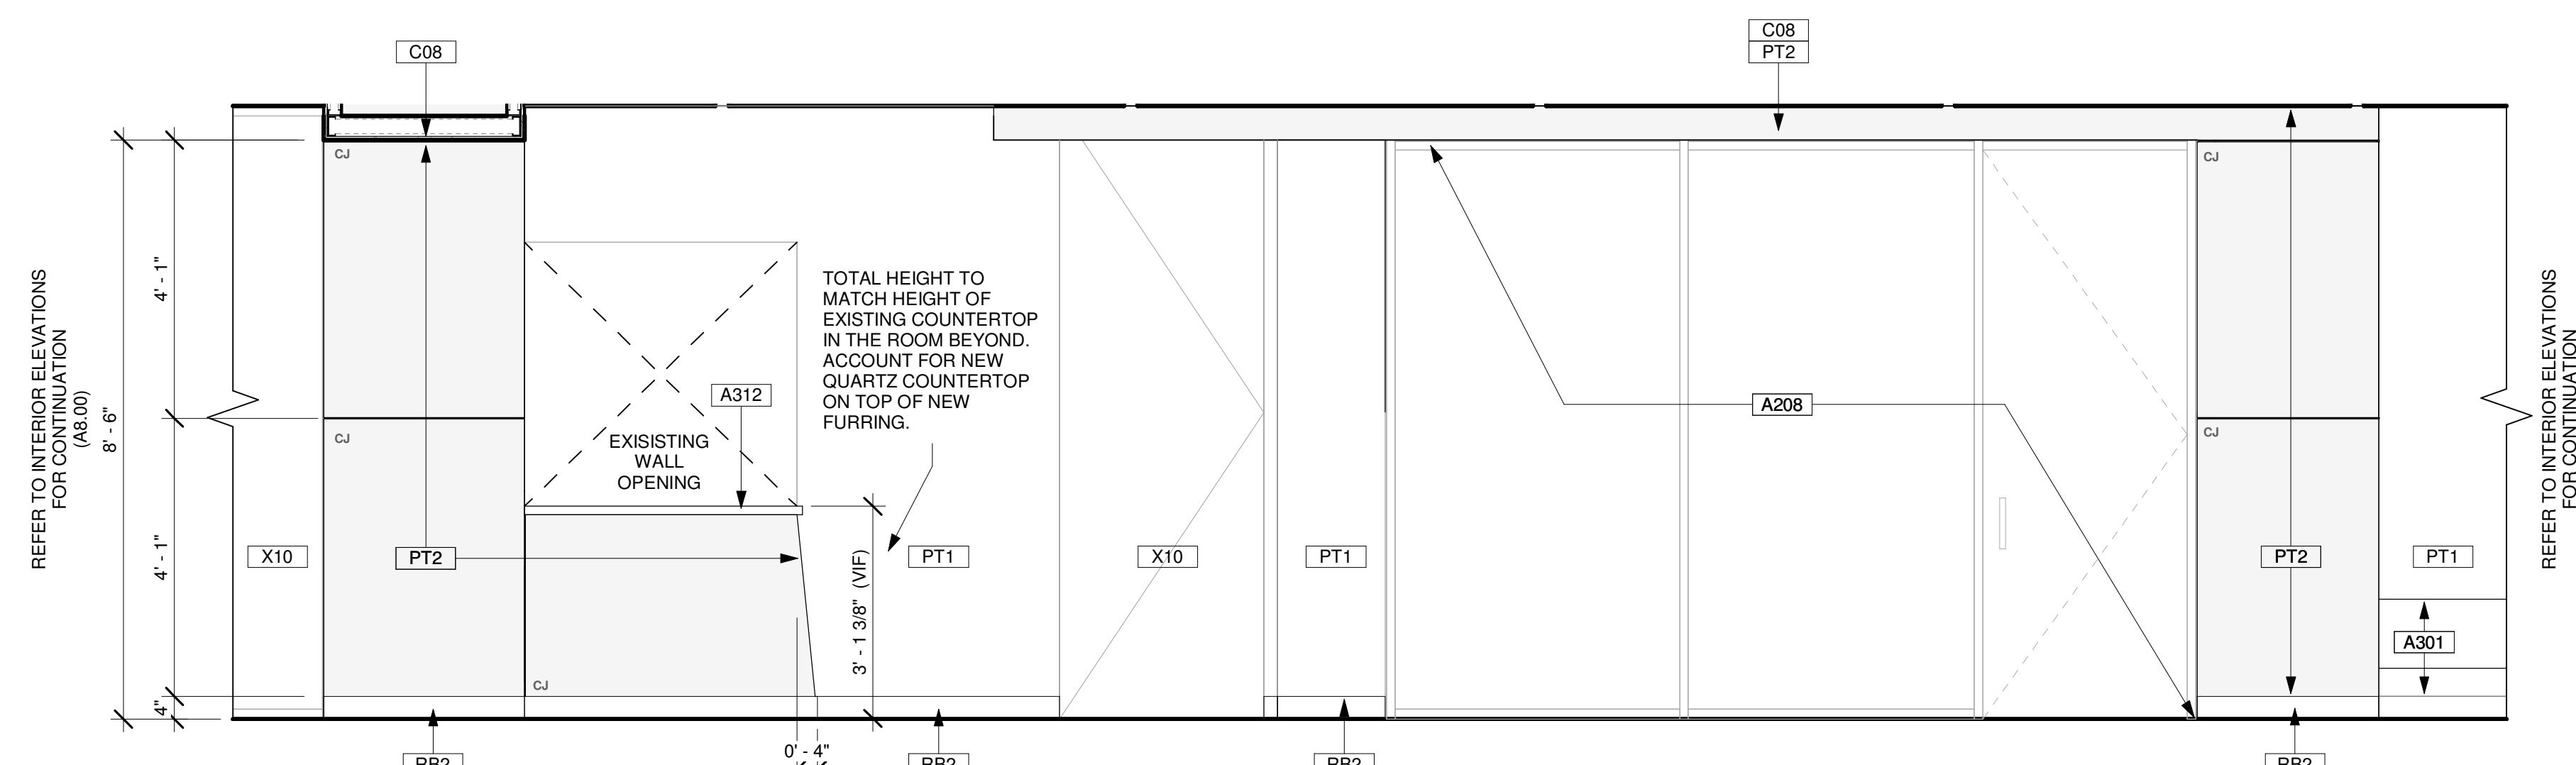

16 PORTAL 1 - SOUTH ELEVATION
Scale: 1/2" = 1'-0"

Dimension & Alignment Support Notes:
ALIGN 1: Align face of new construction w/face of existing.
ALIGN 2: Align Centerline of new construction w/Centerline of existing.
ALIGN 3: Align gridline/join grid w/existing grid.
LEVEL 1: Ensure top of new construction is level w/existing surface.
LEVEL 2: Level floor & surface to receive new construction.
LEVEL 3: Ensure the top of grade is level w/surrounding ground.

Construction & Condition Support Notes:
HANDLE 1: Handle item w/trace and store for owner review.
HANDLE 2: Handle remaining building, pavement, fence, or item w/care.
HANDLE 3: Handle re-located items with care. DISCONNECT 1, FIX/W.
FIX/W: Fix floor/wall/ceiling item where construction was removed and prepare the area to receive new construction. Ensure the top of grade is level w/surrounding ground & maintain positive slope towards drain, gutter, and storm system away from building.
FIX: Fix floor/wall/ceiling item where construction was removed and prepare the area to an acceptable condition. Ensure the top of grade is level w/surrounding ground & maintain positive slope towards drain, gutter, and storm system away from building.
INFORM: Inform Architect prior to the start of this work.
PREPARE: Prepare the site where construction was removed, and prepare the ground to an acceptable condition. Ensure the top of grade is level w/surrounding ground & maintain positive slope towards drain, gutter, and storm system away from building.
CONNECT: Connect remaining item to the new structure, and ensure structural integrity while meeting local Codes. Handle remaining buildings, pavement, fences, and other items w/care.
DISCONNECT: Disconnect and conceal all pipes, electrical cables, data cables, and conduits where construction is removed.

ENGINEER 1: Professional engineering supervision is required for this work.
SNIP: Provide shop drawings for this work.
REFERENCE: Refer to photo # for the existing condition at this location.
SLOPE: Maintain positive slope towards drains, gutters, and storm systems and away from the building.
PROTECT 1: Protect items to remain, including any buildings, furniture, sidewalks, roots, utilities, and other items during the Demolition and Construction phases.
EGRESS: Maintain safe and unrestricted egress routes from areas adjacent to the Demolition site. Comply with all Applicable Codes.
REFER: Refer to Landscaping Drawings & Specs for removing trees.
OPERATE: Ensure all routes and utilities required for school operation are protected. Ensure school operation will not be interrupted.
ENSURE 1: Ensure all slopes to drain as intended, and that downspouts indicated to remain are protected to maintain normal flow at all times during demolition and construction. Protect items to remain including any buildings, furniture, sidewalks, roots, utilities, and other items during demolition and construction.
ENSURE 2: Ensure system is water-tight. Provide additional flashing & sealants as needed.
ENSURE 3: Ensure the slope of the new roof matches the slope and slope direction of the existing roof.
PHASE 1: Work within this area may occur in phase ONE.
PHASE 2: Work within this area may occur in phase TWO.

03 SUPPORT NOTES
Scale: NTS

- A024 PROVIDE NEW CEILING TILE AND GRID AT SPECIFIED HEIGHT. RE. CEILING PLAN; FINISH SCHEDULE. CENTER GRID IN ROOM UNLESS INDICATED OTHERWISE.
- A101 NEW DOOR AND FRAME AS SCHEDULED. HARDWARE AS SPECIFIED.
- A102 OVERHEAD GARAGE DOOR. RE. 19/A5.00. RE. DOOR SCHEDULE FOR DIMENSIONS.
- A208 NEW INTERIOR ALUM. STOREFRONT FLOOR TO CEILING ABOVE. (FIX/W)
- A301 NEW MILLWORK. RE. MILLWORK DETAILS & SPECS. (HANDLE 2, FIX/W)
- A312 PROVIDE NEW QUARTZ COUNTERTOP @ OPENING LOCATION
- C07 GYP. BD. CEILING: 1 LAYER GYP. ON CEILING FURRING CHANNELS AT 24" O.C. MAX ON 1-1/2" MTL. STUDS AT 48" O.C. MAX IN PERPENDICULAR DIRECTION. SUSPENDED WITH WIRE HANGERS FROM STRUCTURE ABOVE AT 48" O.C. MAX. CEILING AT 9'-0" AFF. UNLESS INDICATED OTHERWISE.
- C08 GYP. BD. BULKHEAD: 1 LAYER GYP. ON 3-5/8" MTL. STUDS @ 16#6 O.C. SUSPENDED FROM STRUCTURE ABOVE TO ALIGN TO ADJACENT CEILINGS UNLESS OTHERWISE NOTED. (ALIGN 1)
- PT1 PAINT (FIELD).
- PT2 PAINT (ACCENT 2).
- RB1 RUBBER BASE
- RB2 RUBBER BASE
- X08 EXISTING BULKHEAD FLURR DOWN. CONTRACTOR TO VERIFY IN FIELD.
- X10 EXISTING DOOR / WINDOW. FIELD VERIFY. (PROTECT 1)

02 KEYNOTES
Scale: NTS

- HANDLE STRUCTURE OF EXISTING BUILDING WITH CARE. NO WORK SHOULD HAVE ANY AFFECT ON THE STRUCTURAL INTEGRITY OF THE BUILDING. REPORT TO THE ARCHITECT ANY INDICATORS OF STRUCTURAL DAMAGE.
- PROTECT THROUGHOUT DEMOLITION AND CONSTRUCTION ALL ITEMS INDICATED TO REMAIN INCLUDING BUT NOT LIMITED TO: BUILDINGS AND OTHER STRUCTURES, FLOORING, WALLS, CEILINGS, FINISHES, MEP, SECURITY SYSTEMS, UTILITIES, MILLWORK, ETC.
- FIELD VERIFY ALL CONDITIONS PRIOR TO CONSTRUCTION, PARTICULARLY IN AREAS OF WORK.
- REPORT TO THE ARCHITECT ANY UNFORESEEN CONDITIONS OR AS-BUILT CONDITIONS NOT REFLECTED IN THE DRAWINGS, THAT COULD AFFECT THE WORK.
- MAINTAIN SAFE AND UNRESTRICTED ACCESS AND EGRESS ROUTES FOR OCCUPIED AREAS ADJACENT TO WORK AREA, IN ACCORDANCE WITH APPLICABLE CODES.
- ALL DIMENSIONS TO WALLS ARE TO FINISH FACE OF WALL UNLESS INDICATED OTHERWISE. (SIDE INDICATED DRAWINGS APPLY IN THE DRAWINGS).
- PLANS INDICATE HORIZONTAL DIMENSIONS ONLY. REFER TO ELEVATIONS & SECTIONS FOR VERTICAL DIMENSIONS.
- PROVIDE NECESSARY BLOCKING AT WALLS FOR ALL PLUMBING FIXTURES, EQUIPMENT, MILLWORK, AND ACCESSORIES.
- PLANS INDICATE HORIZONTAL DIMENSIONS ONLY. REFER TO ELEVATIONS & SECTIONS FOR VERTICAL DIMENSIONS.
- PROVIDE PARTITION CURBS FOR MECH./ELEC. ROOM'S PERIMETER, TYP. UNLESS OTHERWISE NOTED.
- UNLESS INDICATED OTHERWISE, ALL NEW WORK IN THIS PROJECT IS TO BE ACCESSIBLE IN ACCORDANCE WITH THE MOST RECENT EDITION OF THE TEXAS ACCESSIBILITY STANDARDS. REFER TO ACCESSIBILITY REQUIREMENTS ON SHEETS A3.00 AND A3.30 FOR MORE INFORMATION.
- REFER TO DOOR AND WINDOW DETAILS FOR DIMENSIONS AND OPENINGS.
- REFER TO DEMOLITION DRAWINGS FOR DEMOLITION INFORMATION.
- REFER TO CODE ANALYSIS INFORMATION SHEET A2.20 FOR EXTENT OF EXTENDED FIRE-SPRINKLER SYSTEM.

01 GENERAL NOTES - CONSTRUCTION
Scale: NTS



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PROFESSIONAL SEAL:




A PROJECT FOR:

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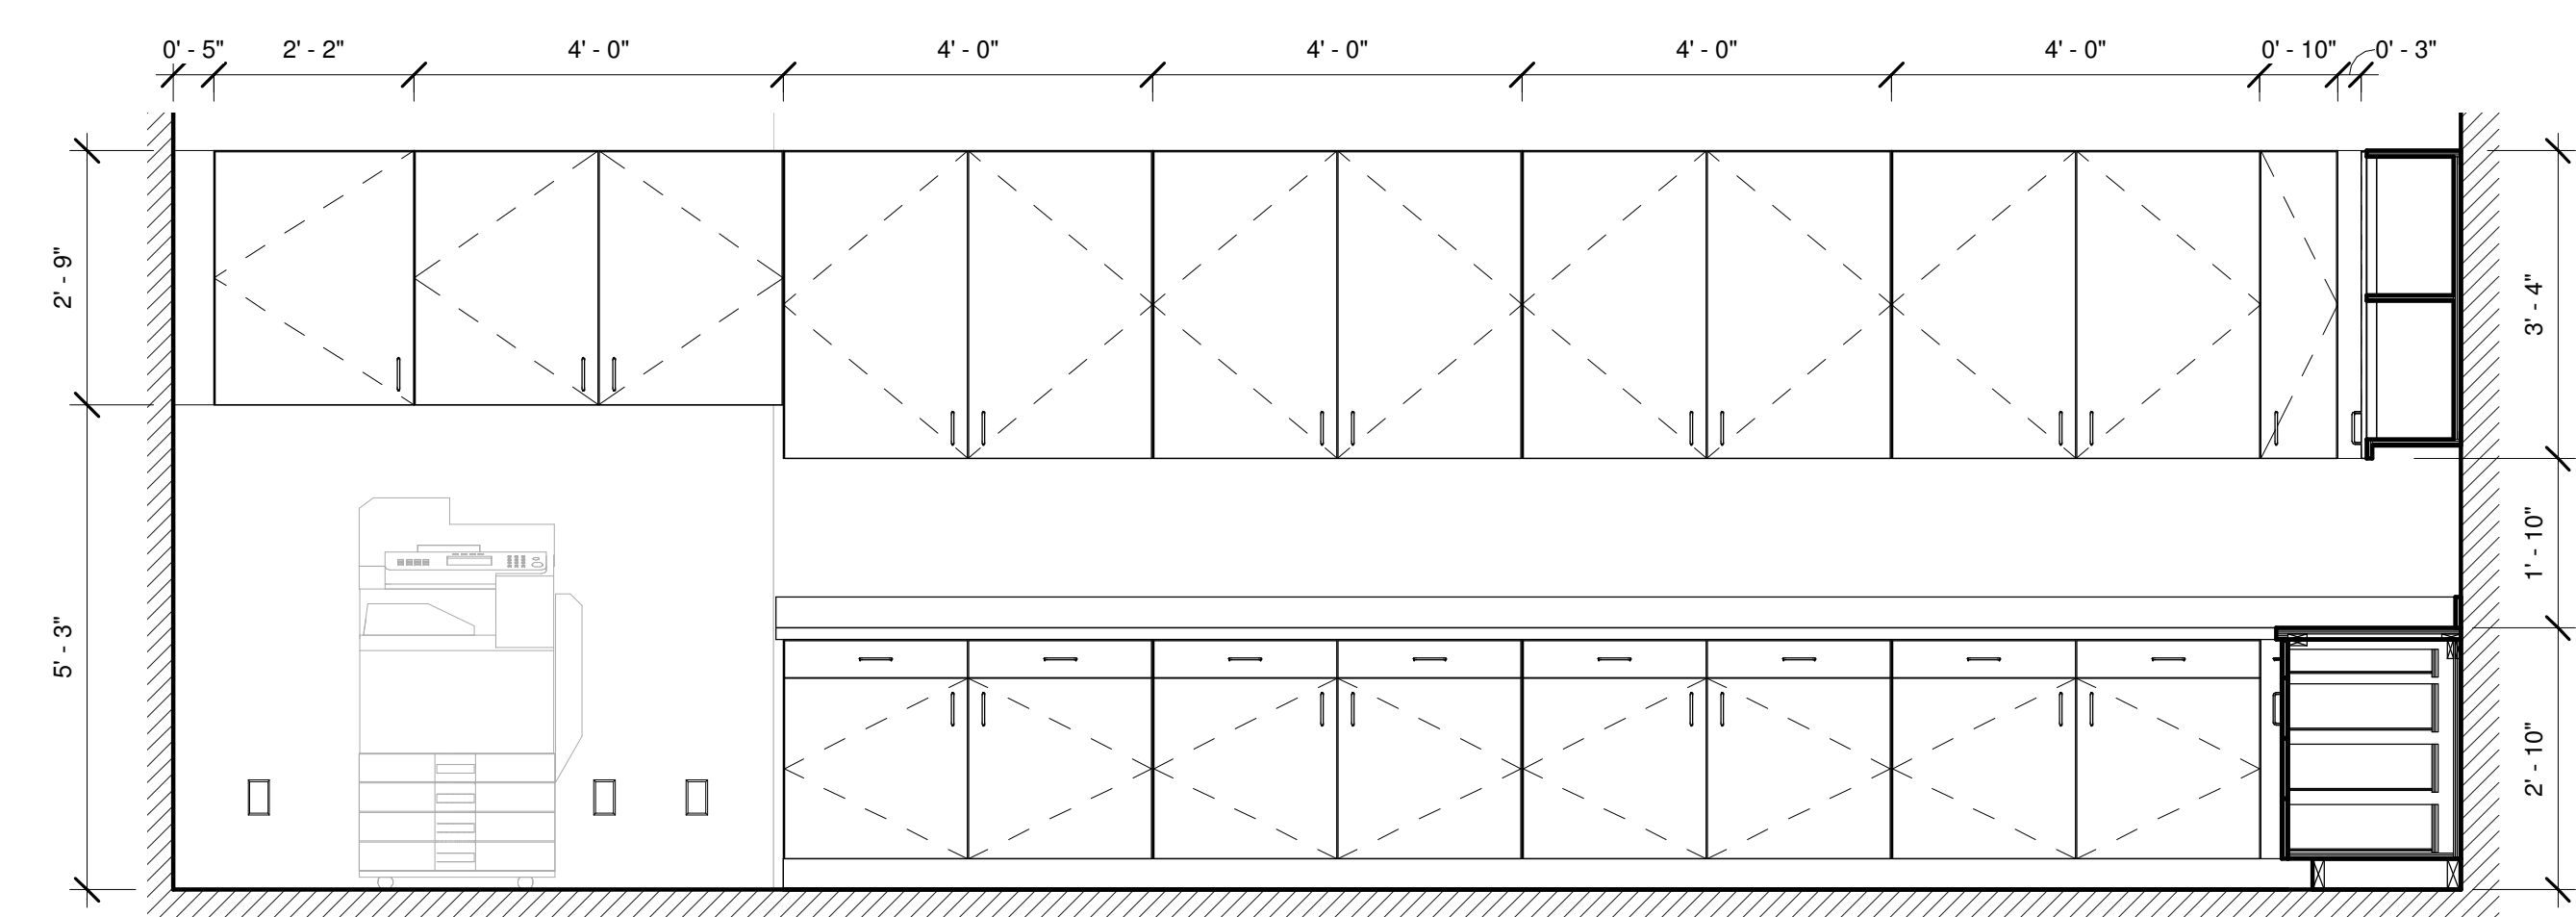
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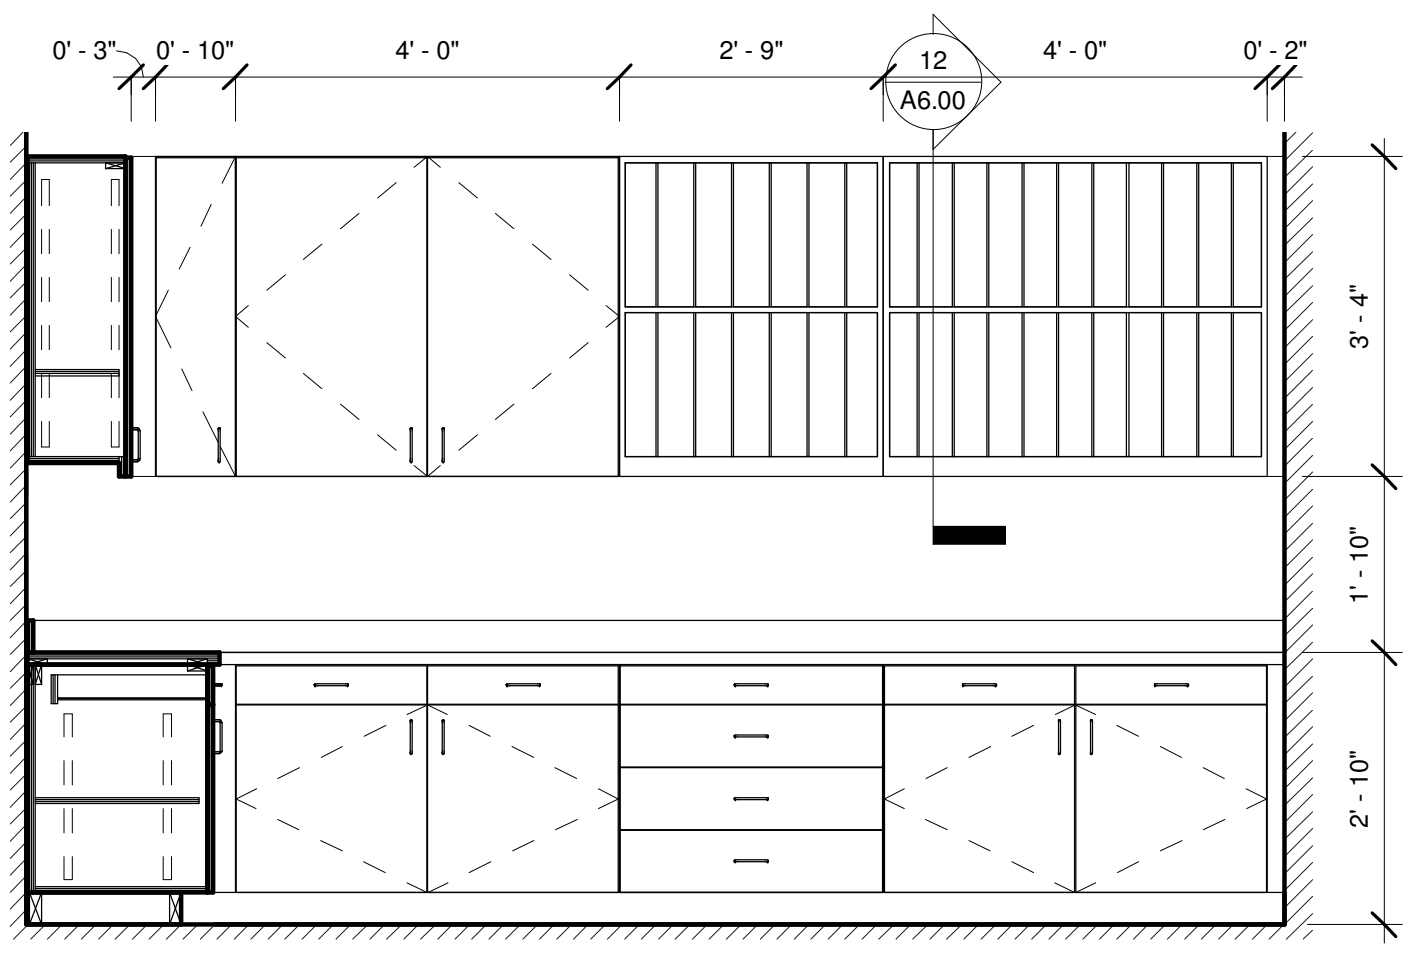


KEY PLAN
TRUE NORTH PLAN NORTH


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Drawn By	LT
Checked By	AW
Approved By	MS
Drawing Title	MILLWORK / CASEWORK ELEVATIONS & DETAILS
Drawing Number	A6.00

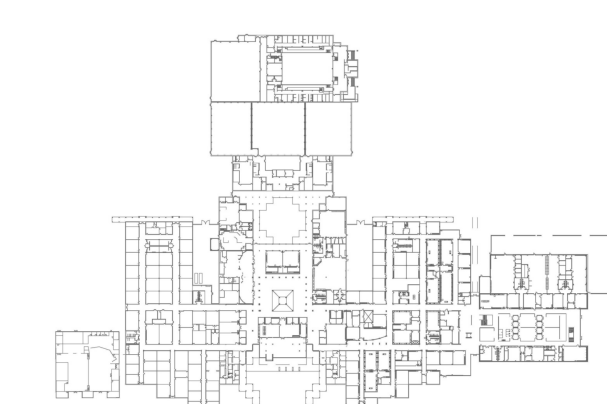


30 MILLWORK ELEVATION - WORK ROOM - 1
Scale: 1/2" = 1'-0"




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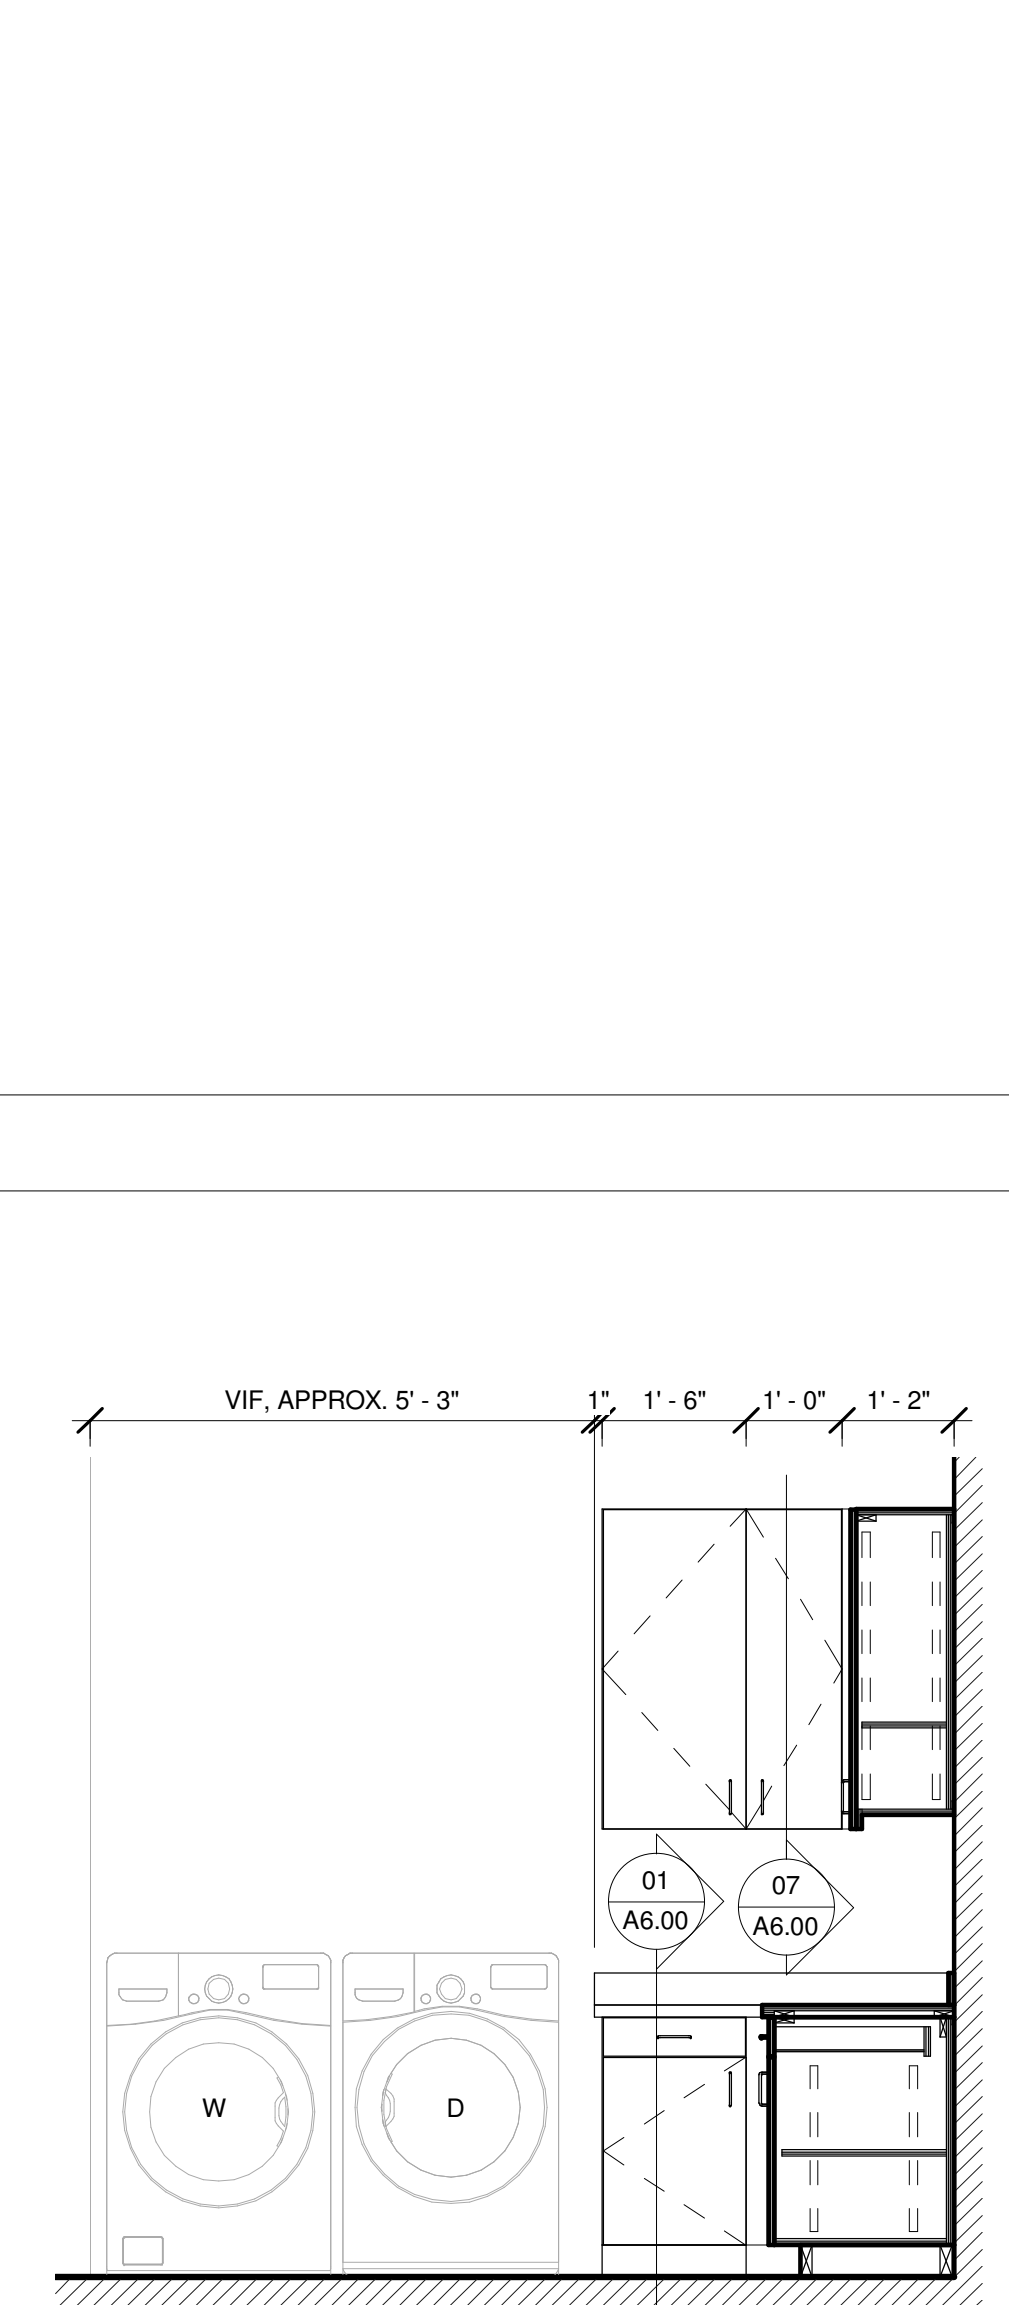
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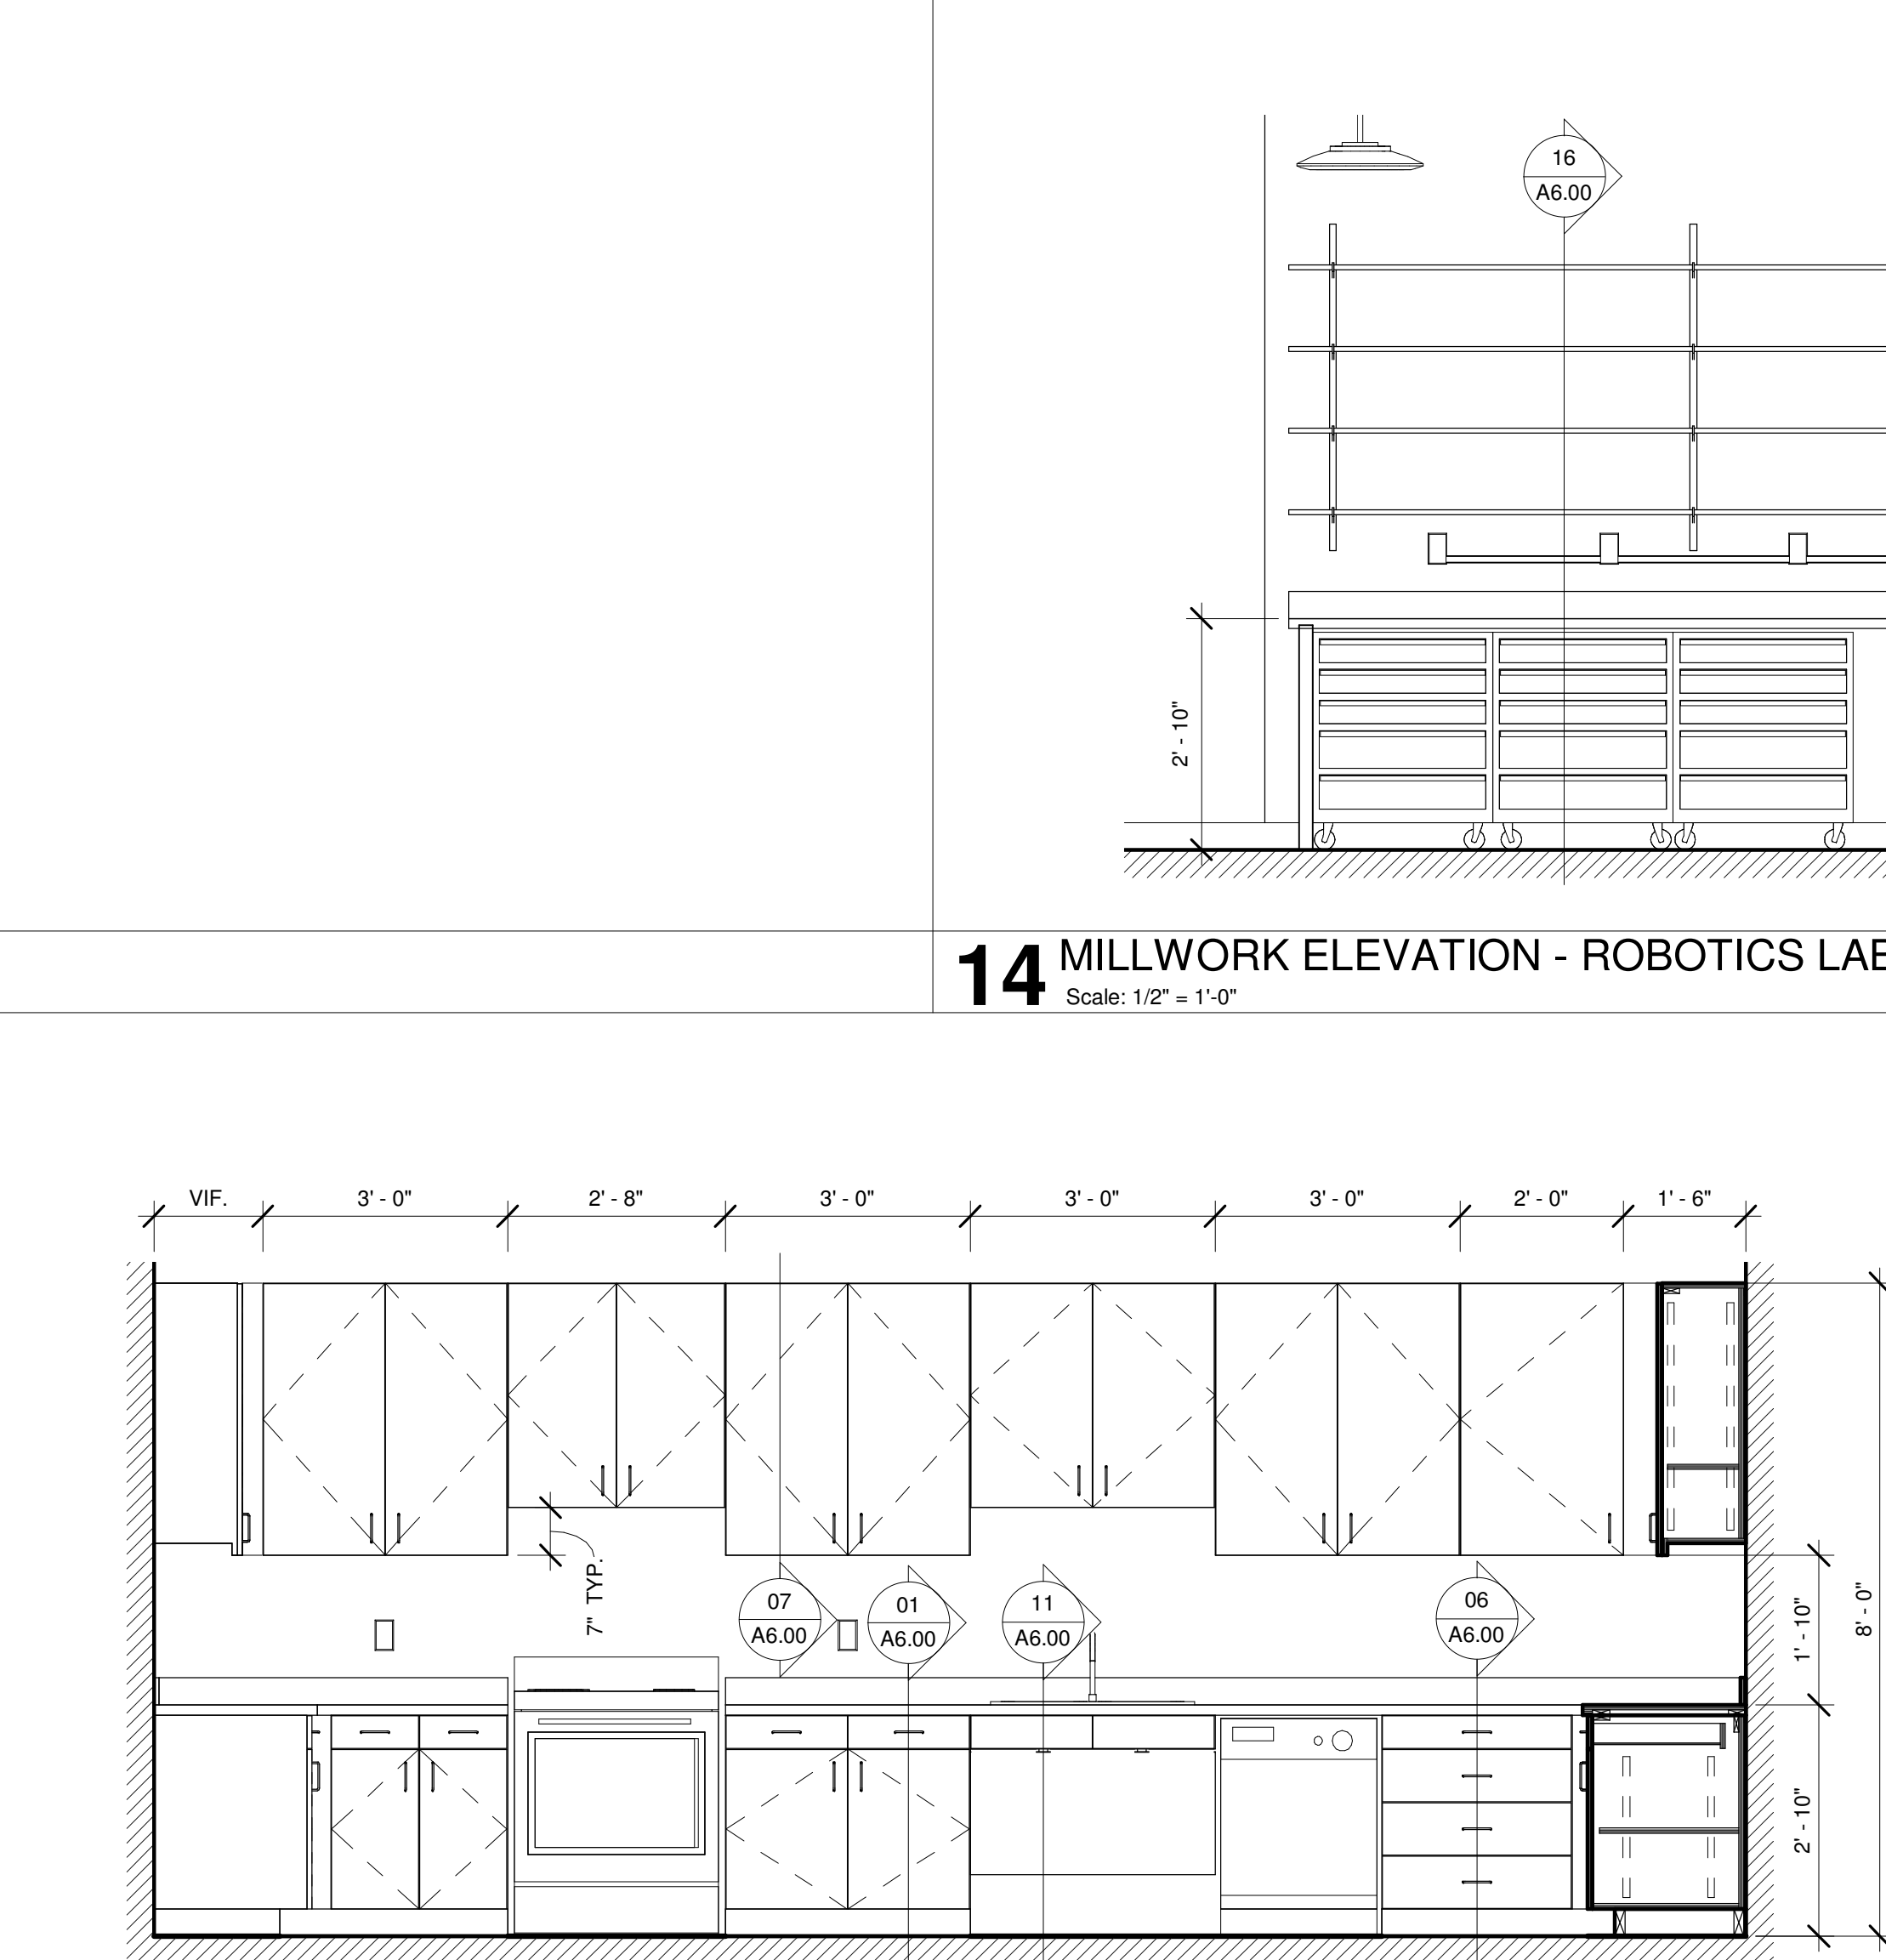
05 MILLWORK ELEV - FLEX & MEDICAL LAB
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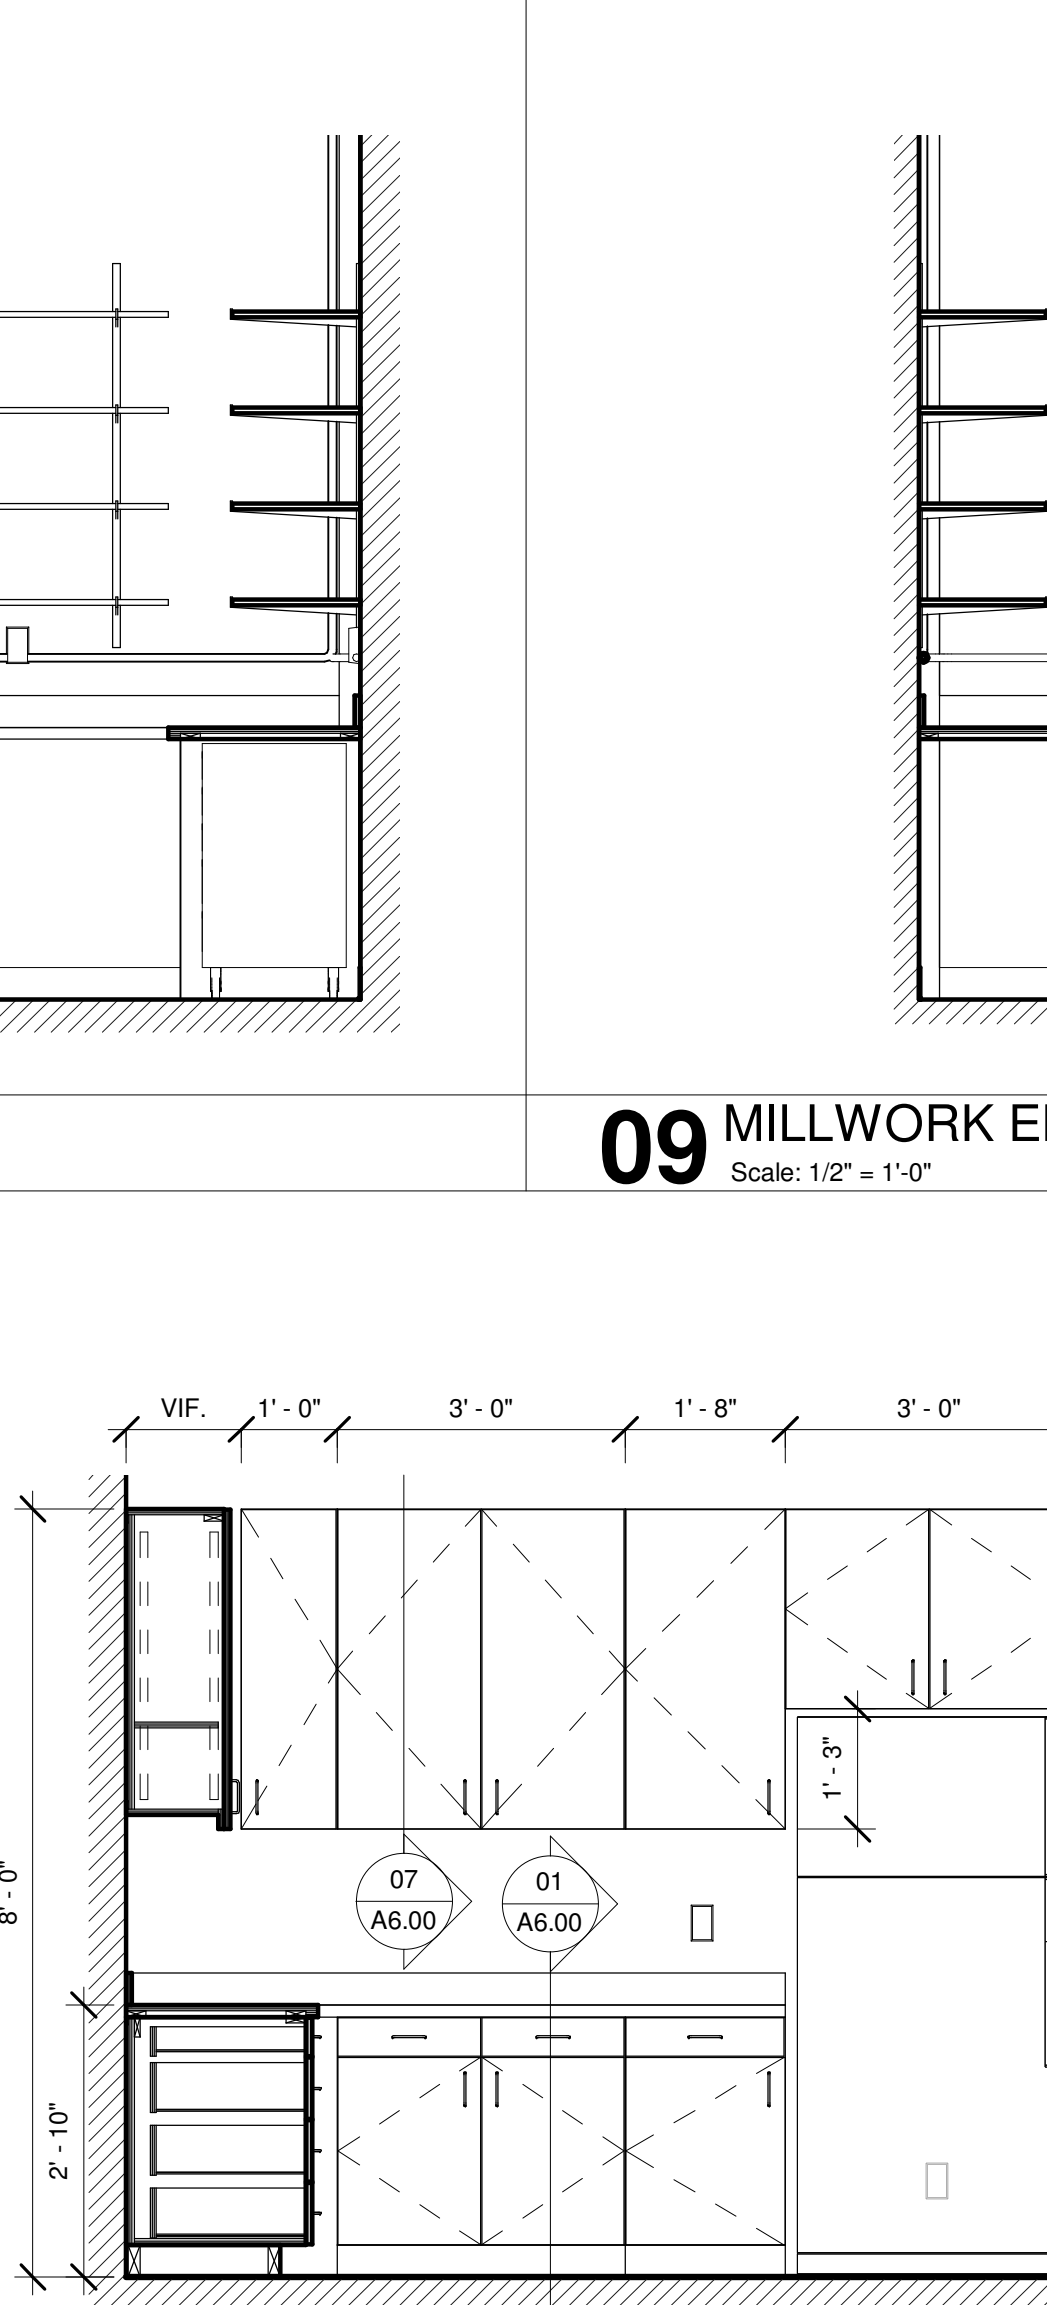
28 TYP. DETAIL @ REMOVED LOCKERS
Scale: NTS

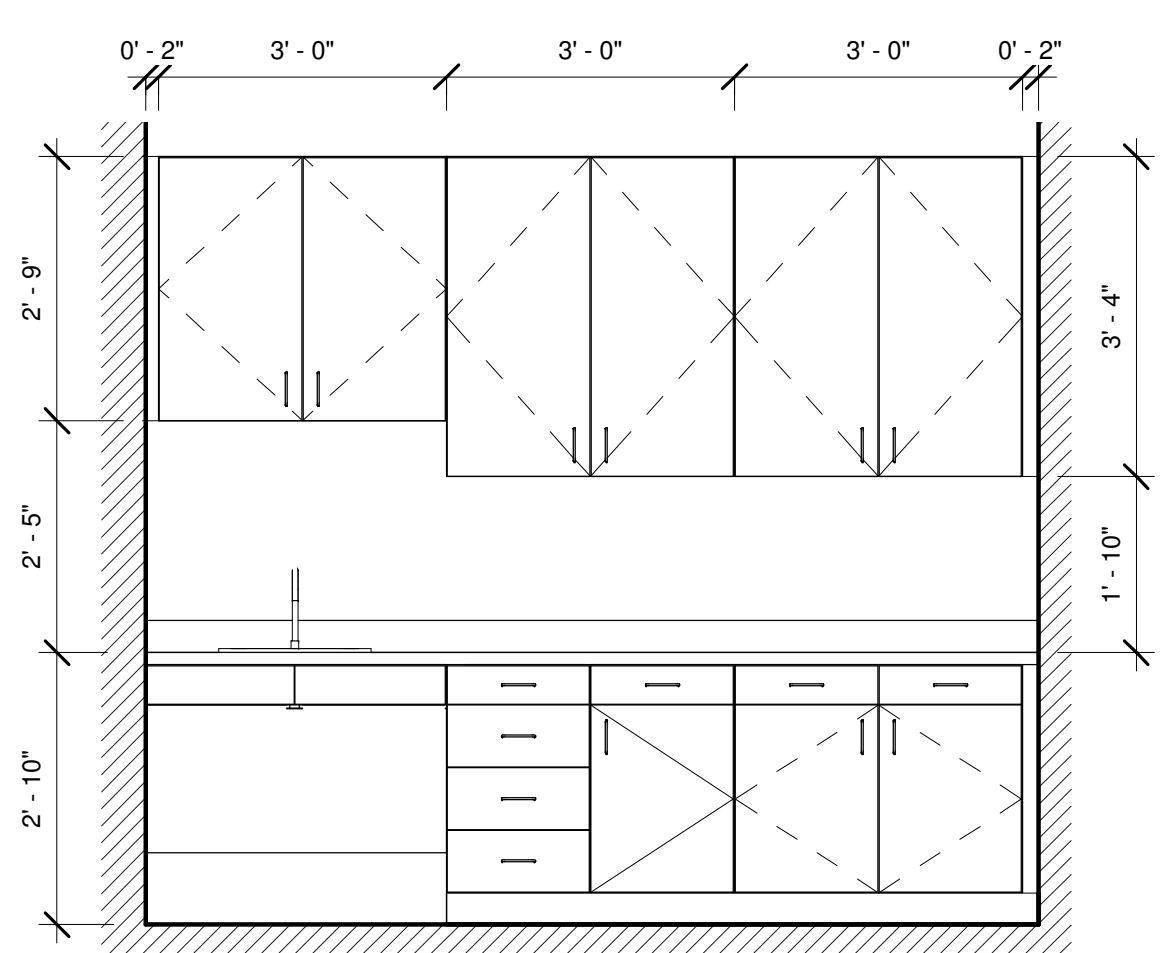


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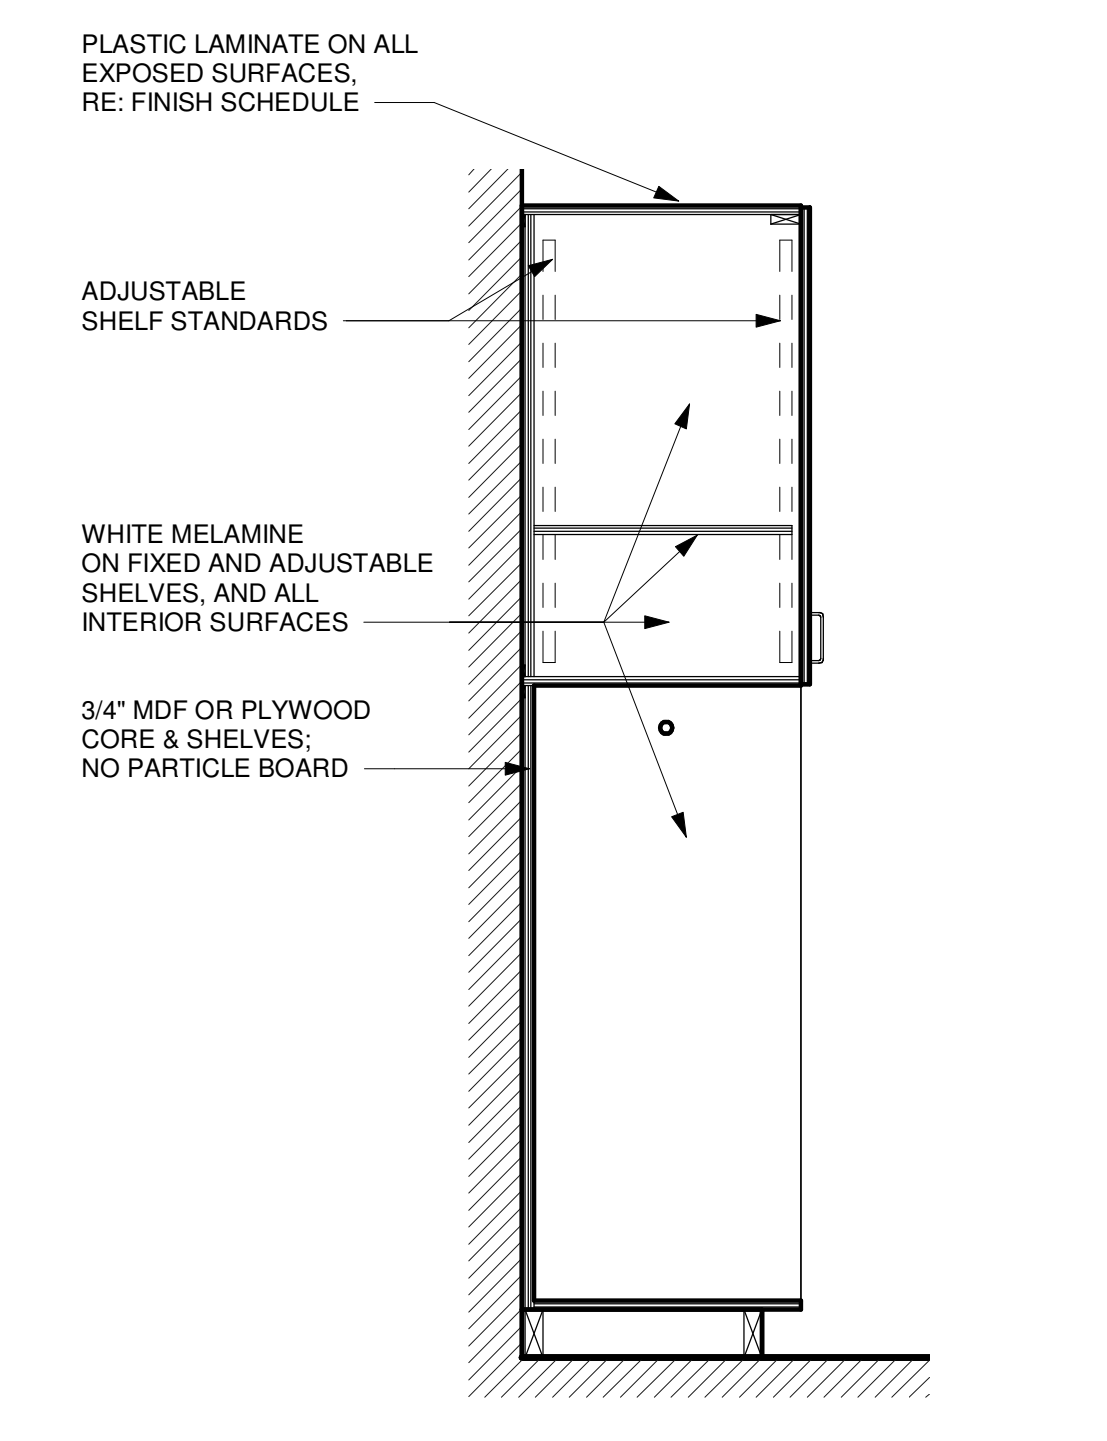
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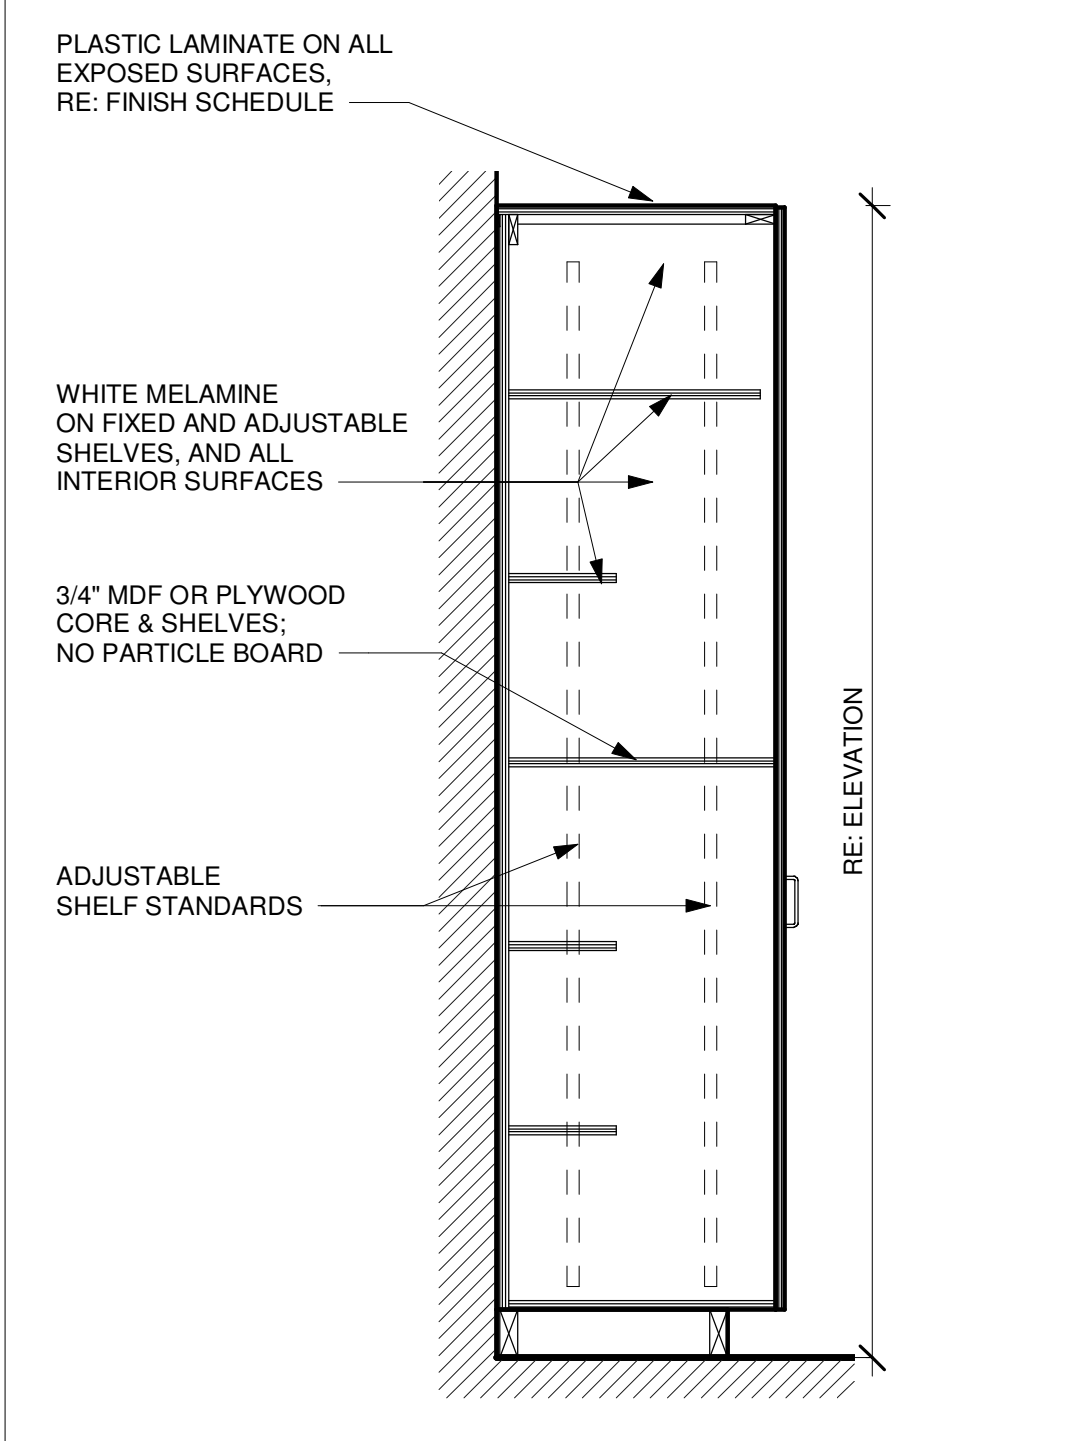
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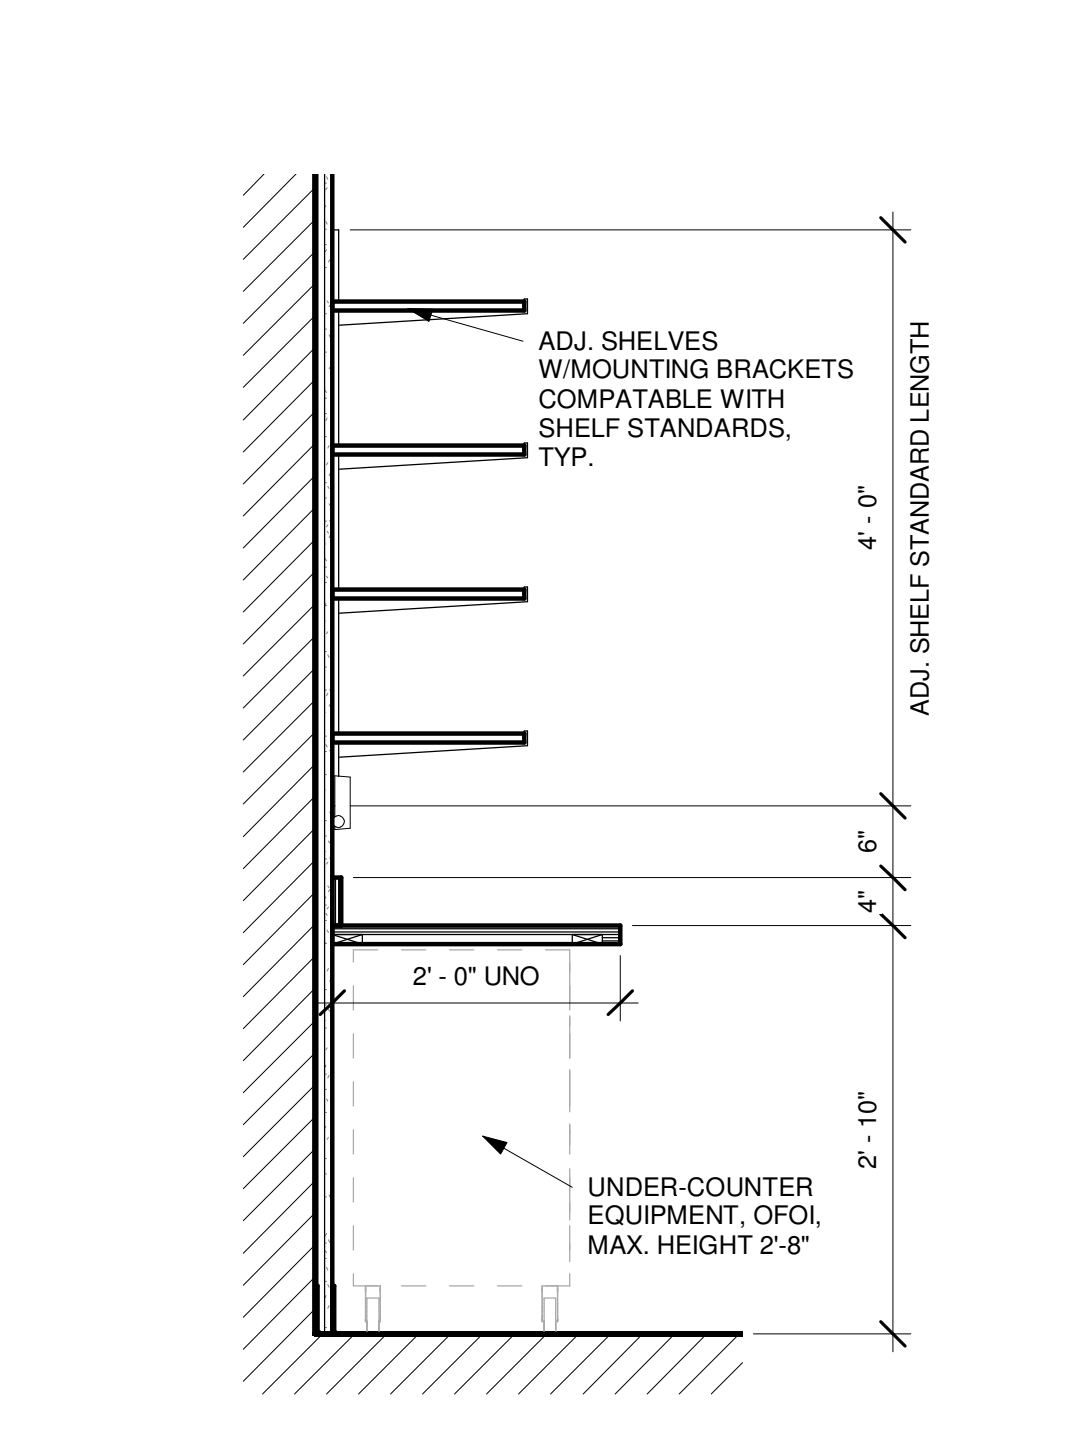
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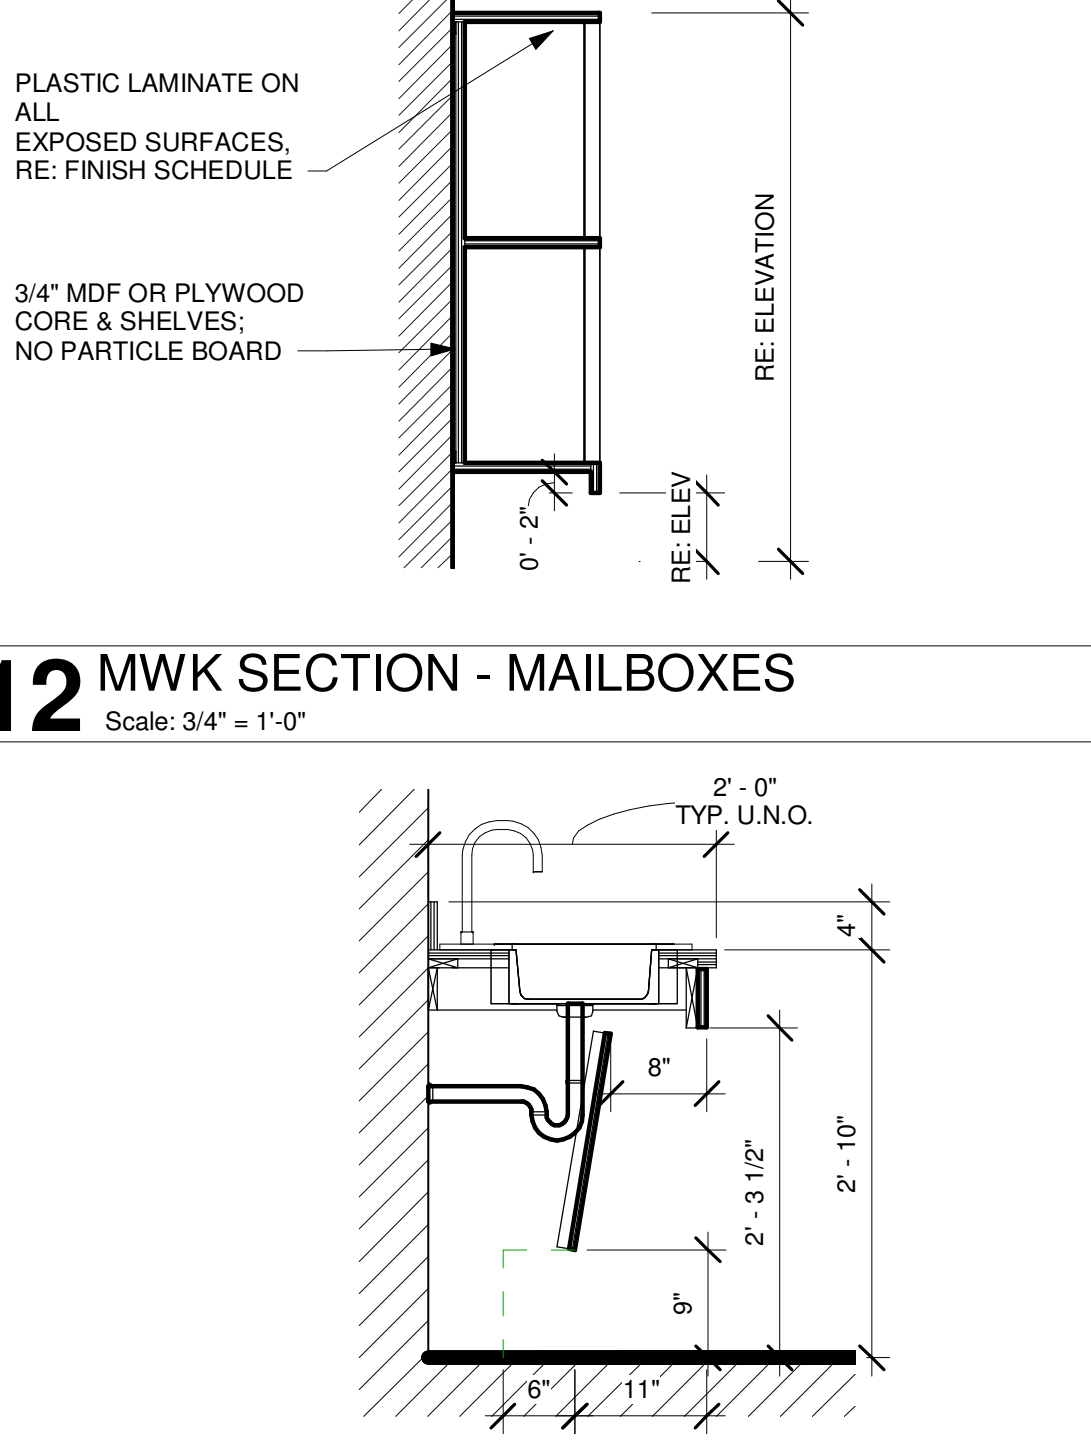
26 MWK SECTION - ARMOIR W/ HANGERS
Scale: 3/4" = 1'-0"

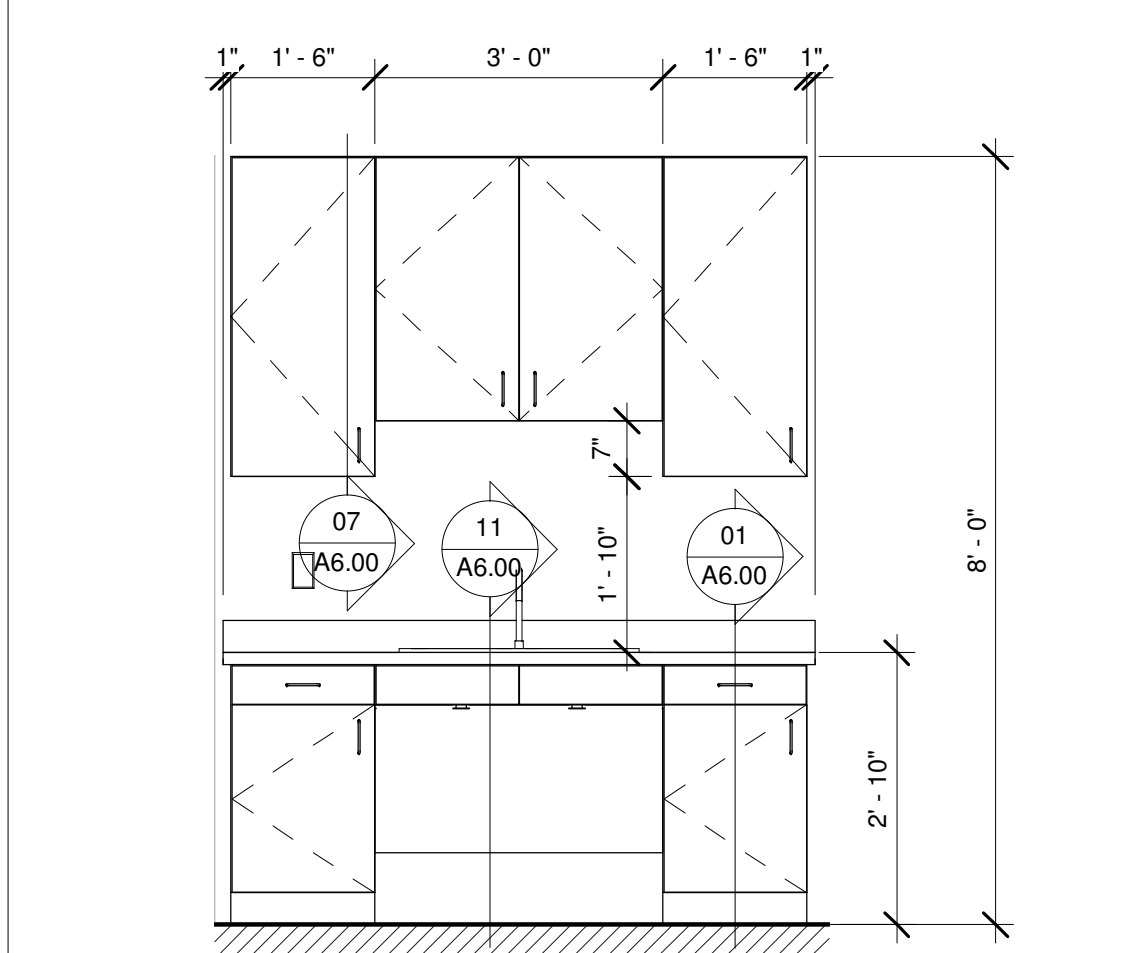


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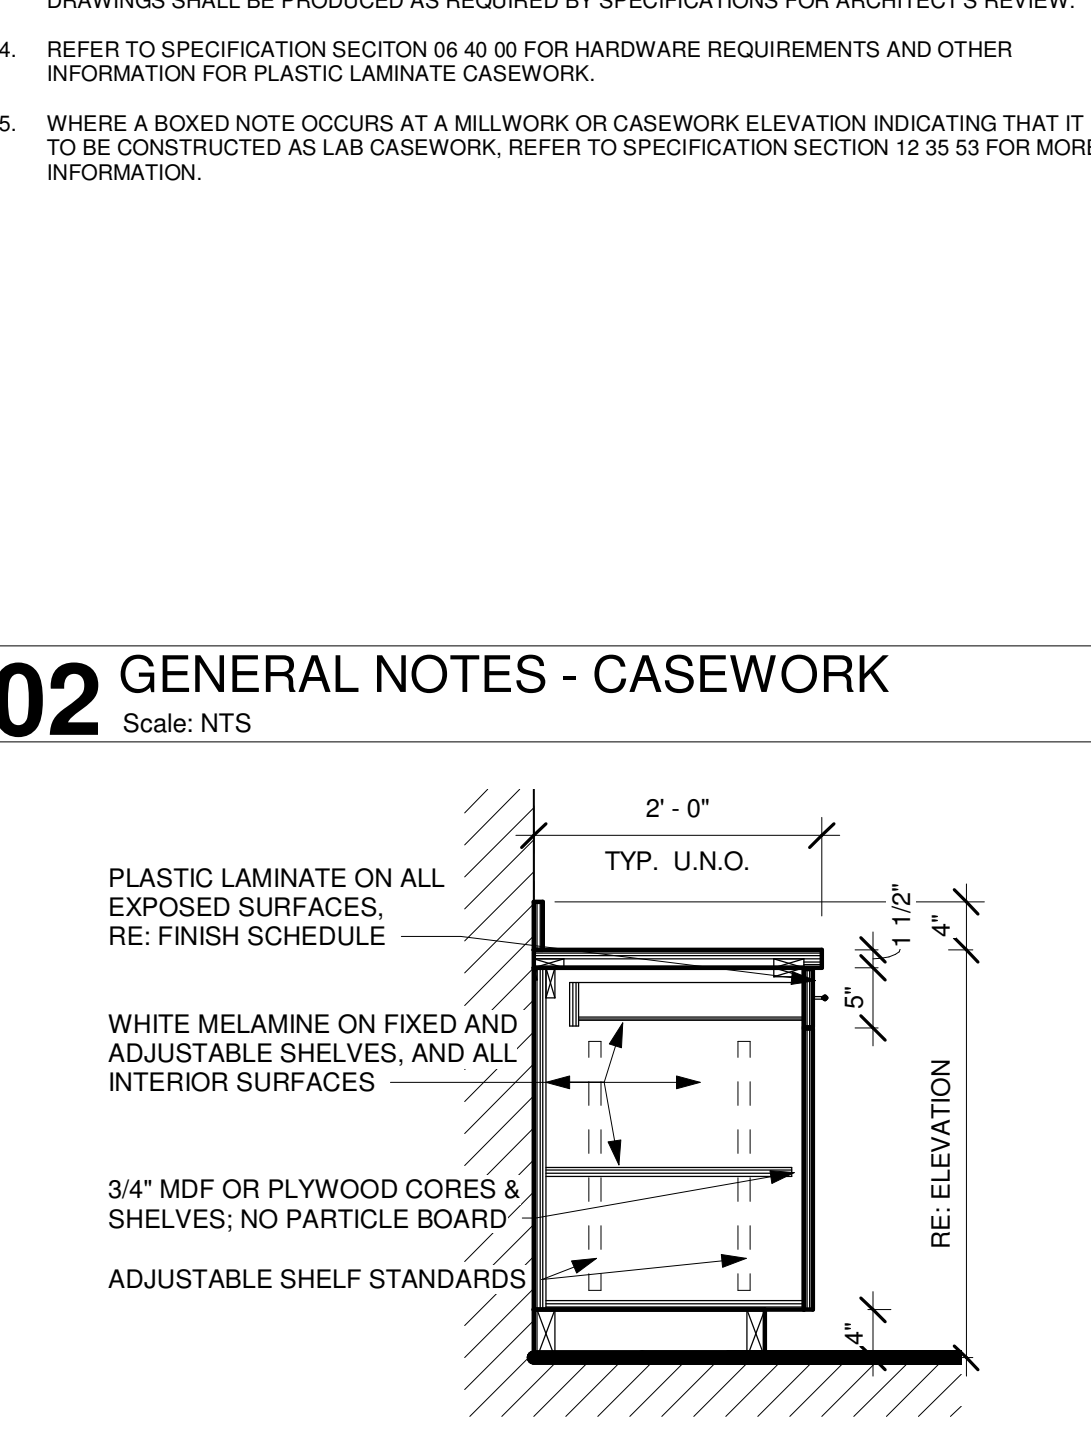
16 MWK SECTION - METAL SHELVES
Scale: 3/4" = 1'-0"

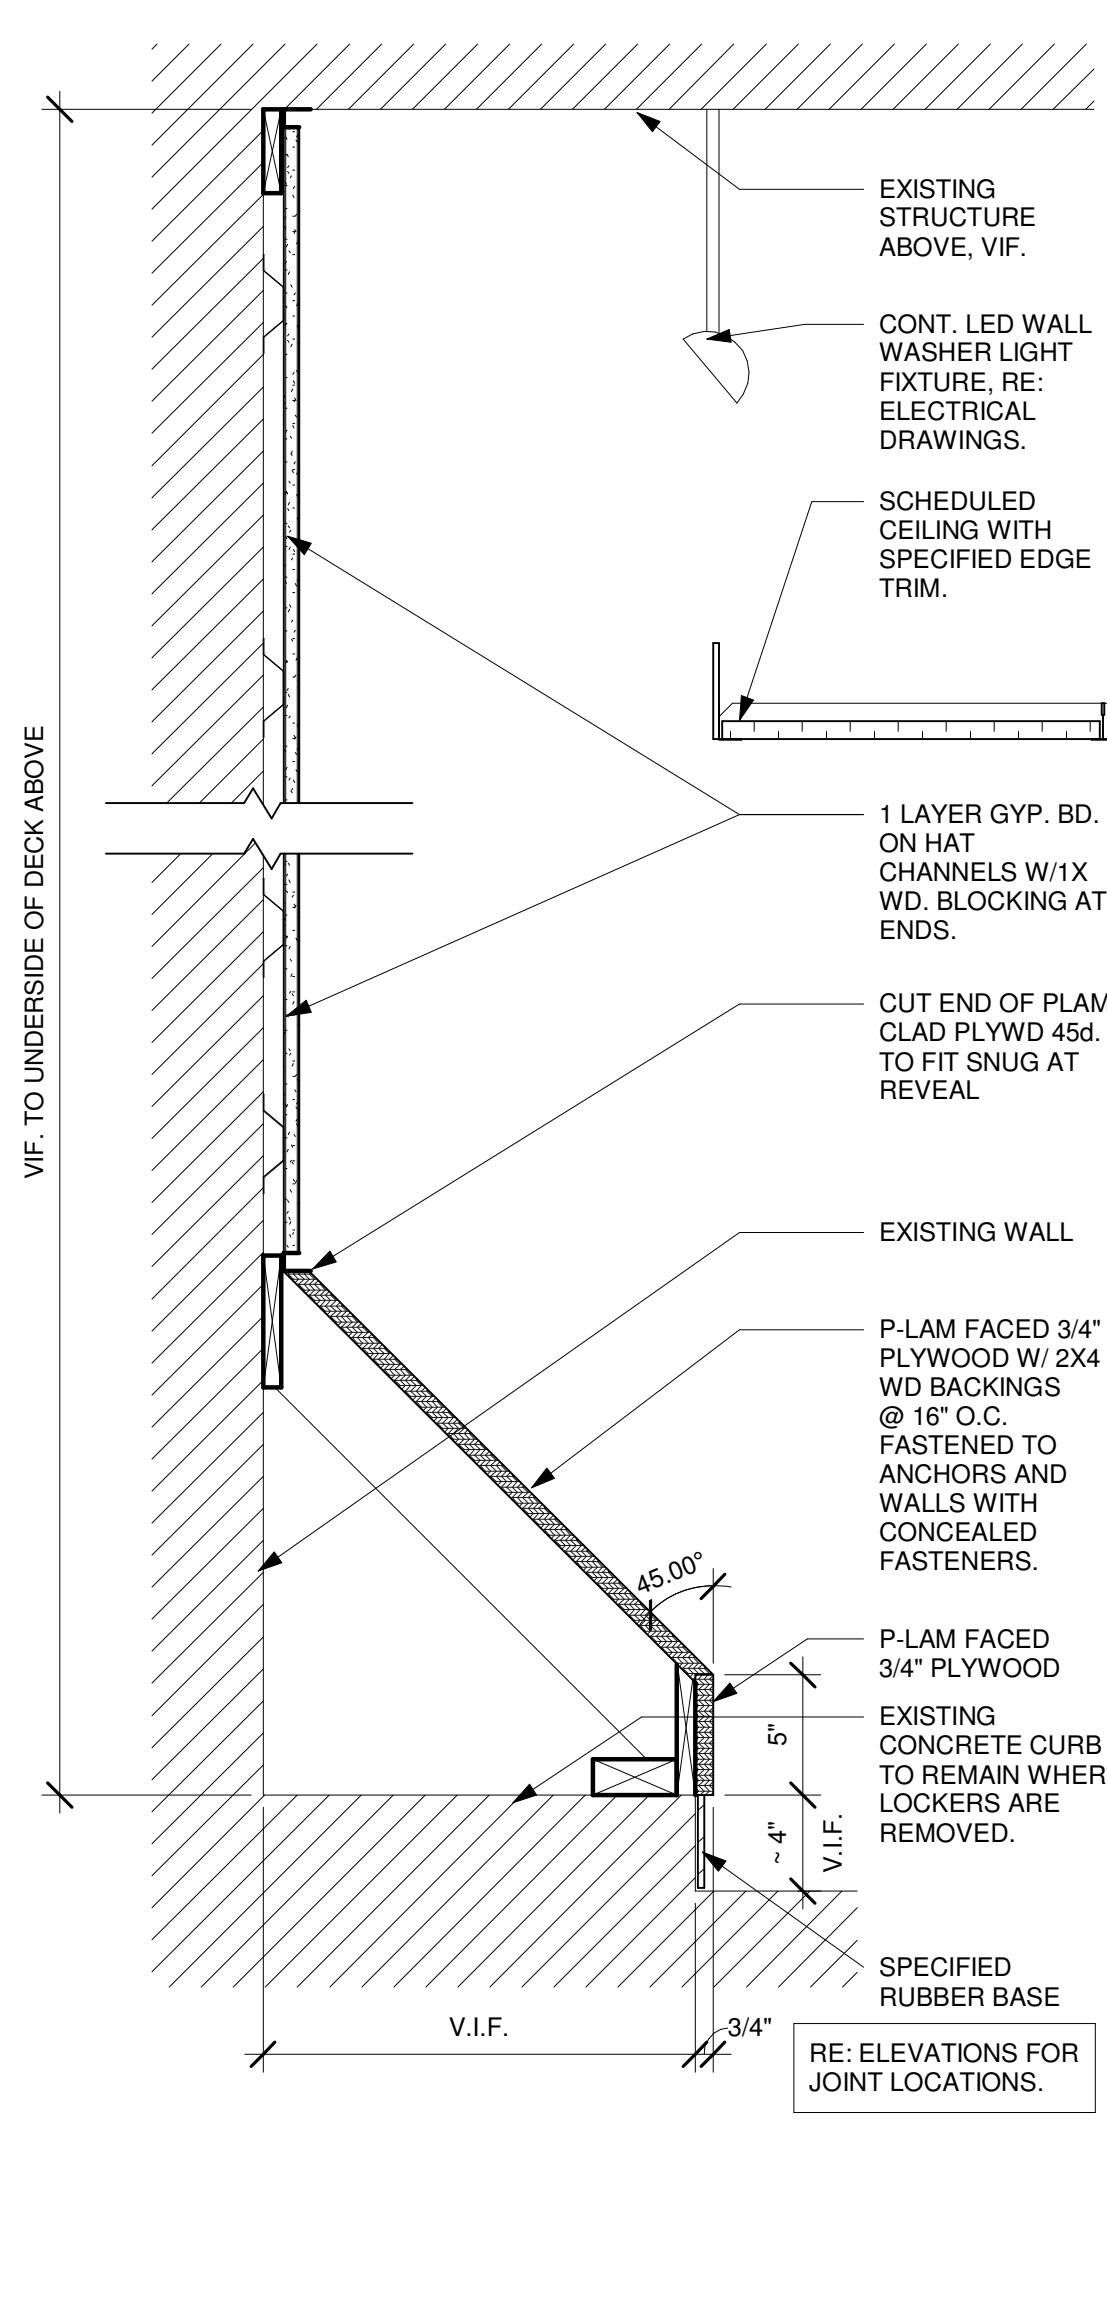

12 MWK SECTION - MAILBOXES
Scale: 3/4" = 1'-0"

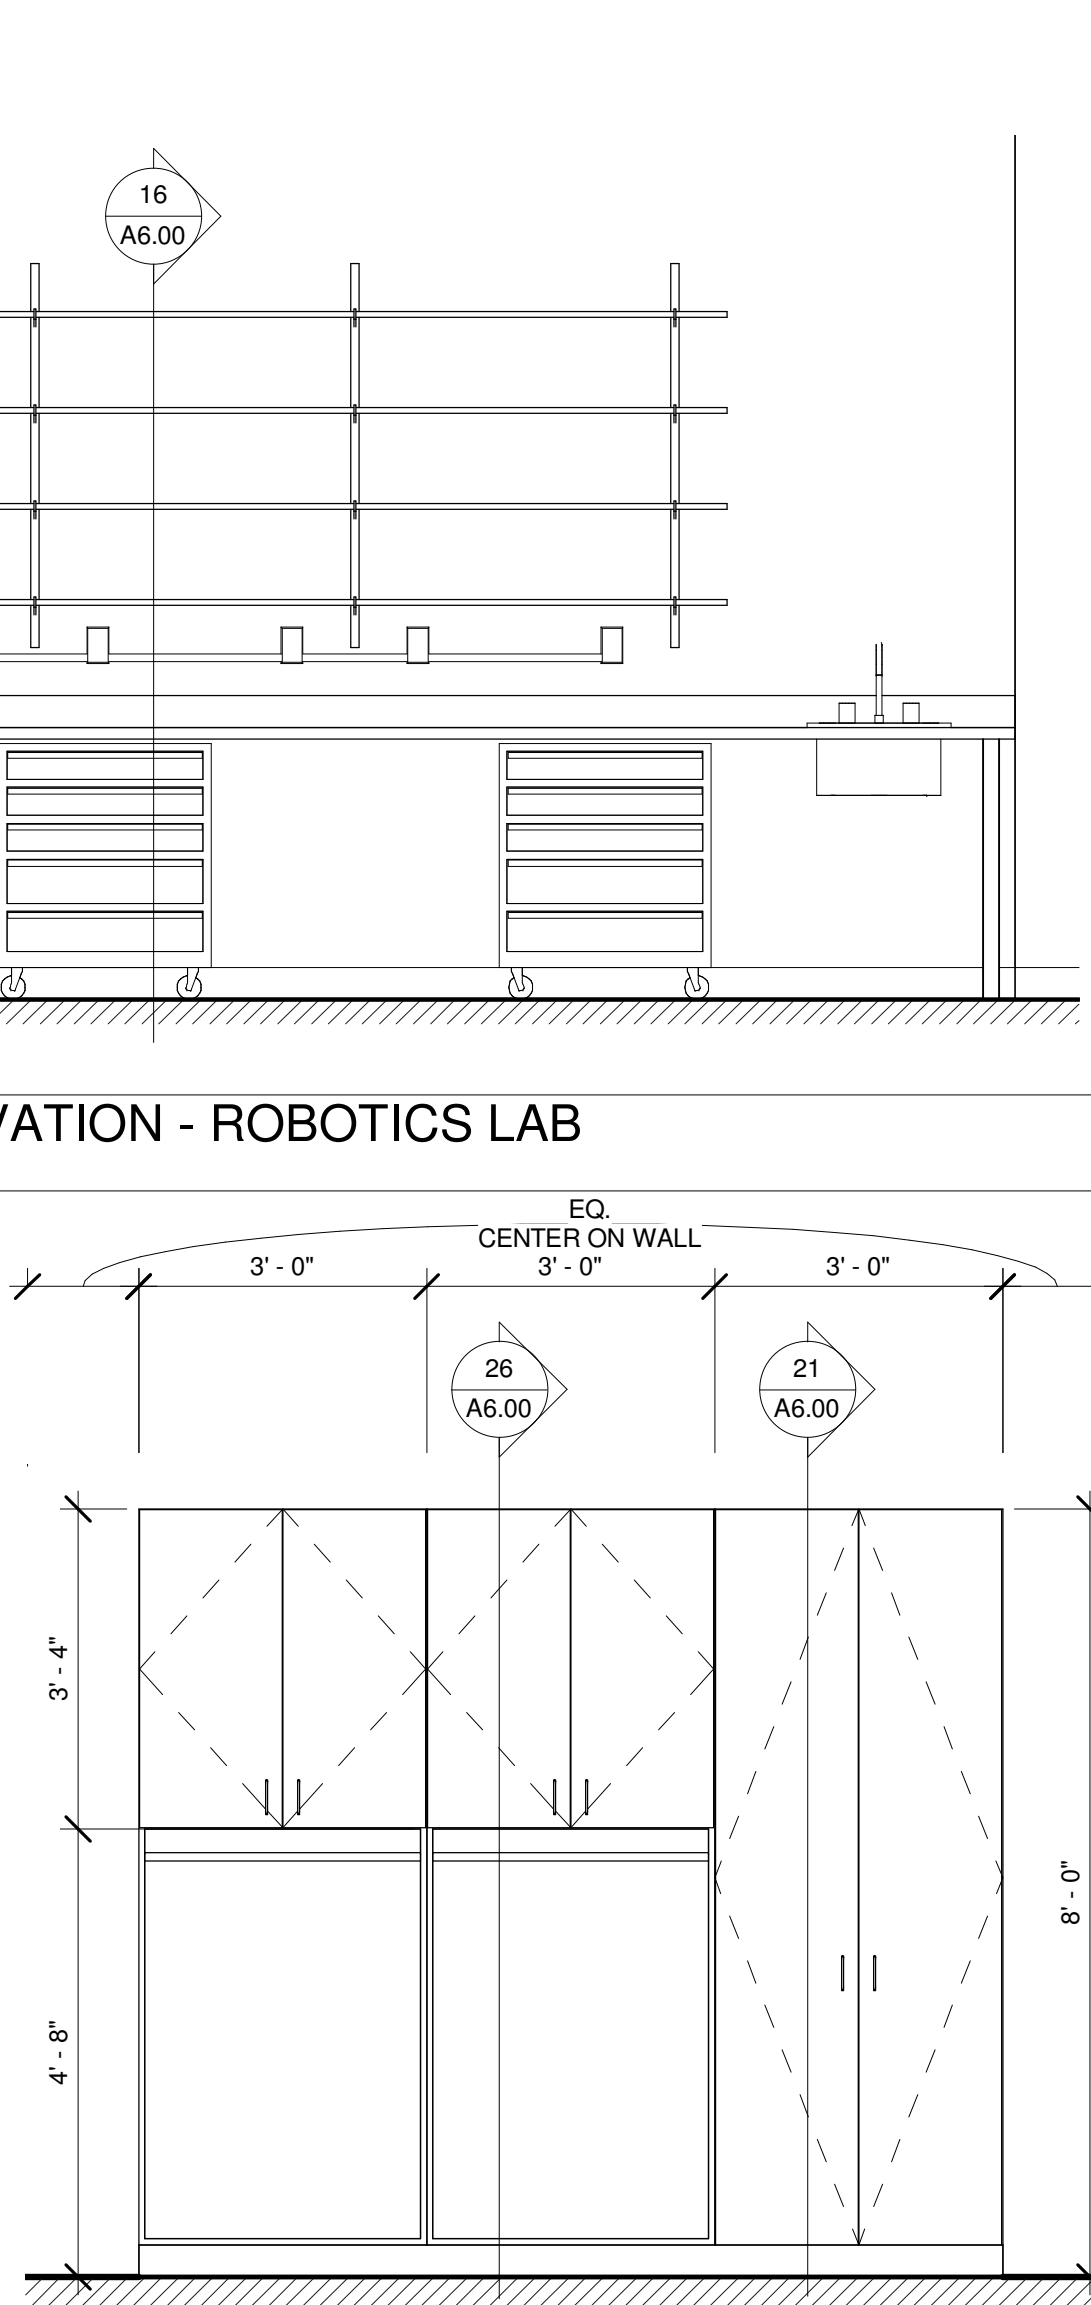

07 MWK SECTION - UPPER CABINET
Scale: 3/4" = 1'-0"

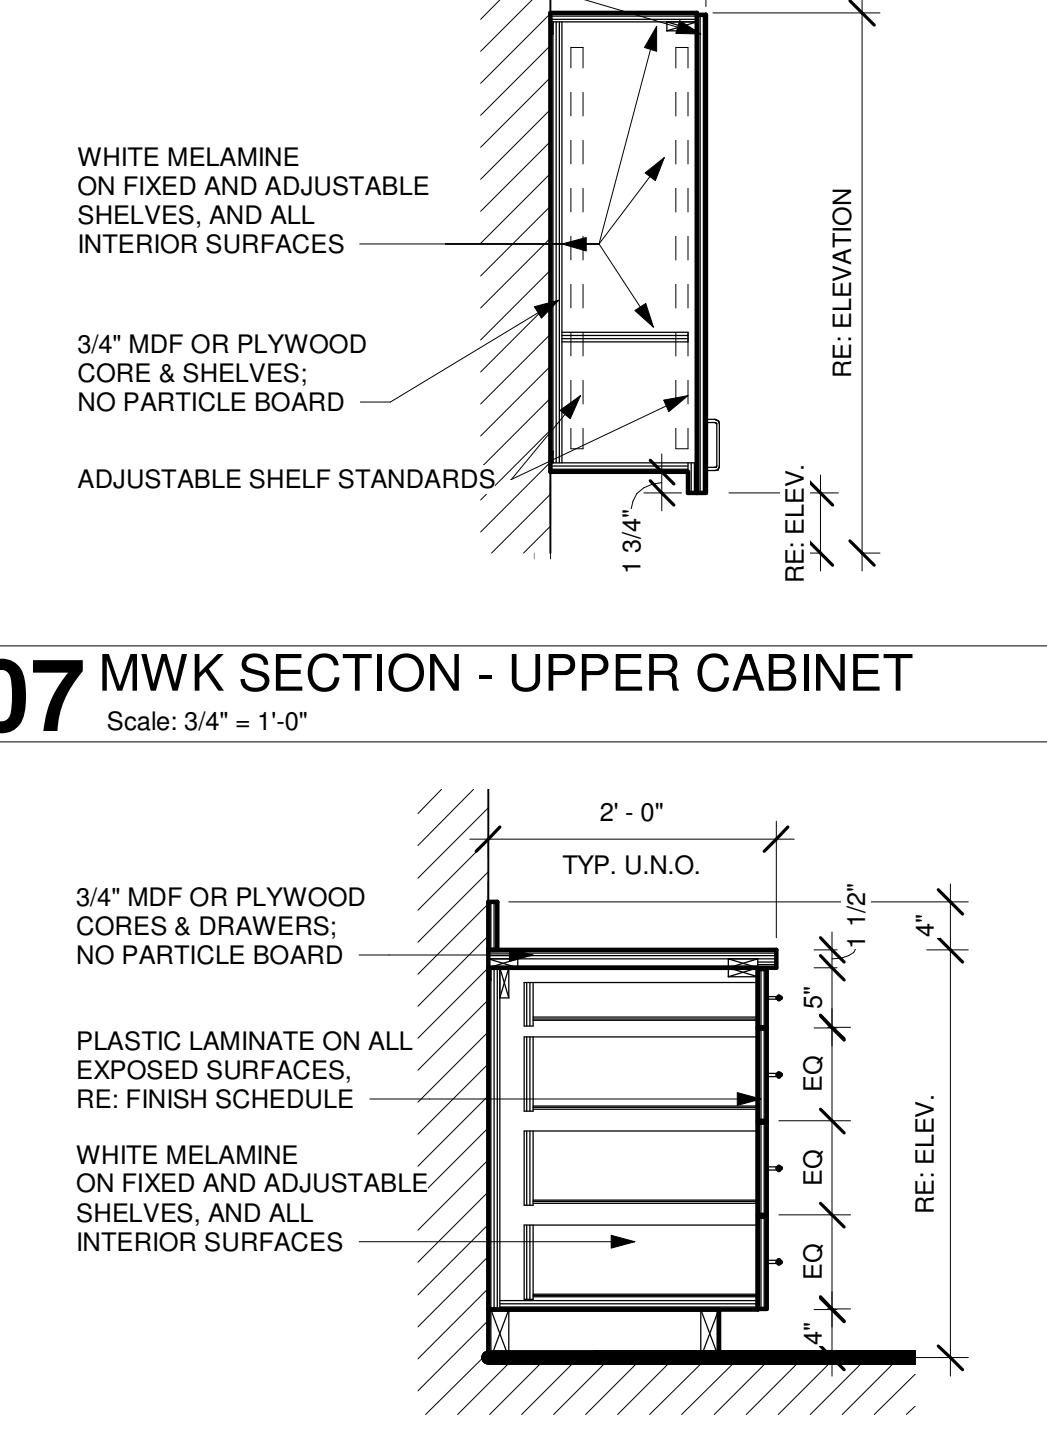

02 GENERAL NOTES - CASEWORK
Scale: NTS

26 MWK SECTION - ARMOIR W/ HANGERS
Scale: 3/4" = 1'-0"

21 MWK SECTION - ARMOIR
Scale: 3/4" = 1'-0"

16 MWK SECTION - METAL SHELVES
Scale: 3/4" = 1'-0"

12 MWK SECTION - MAILBOXES
Scale: 3/4" = 1'-0"

07 MWK SECTION - UPPER CABINET
Scale: 3/4" = 1'-0"

02 GENERAL NOTES - CASEWORK
Scale: NTS



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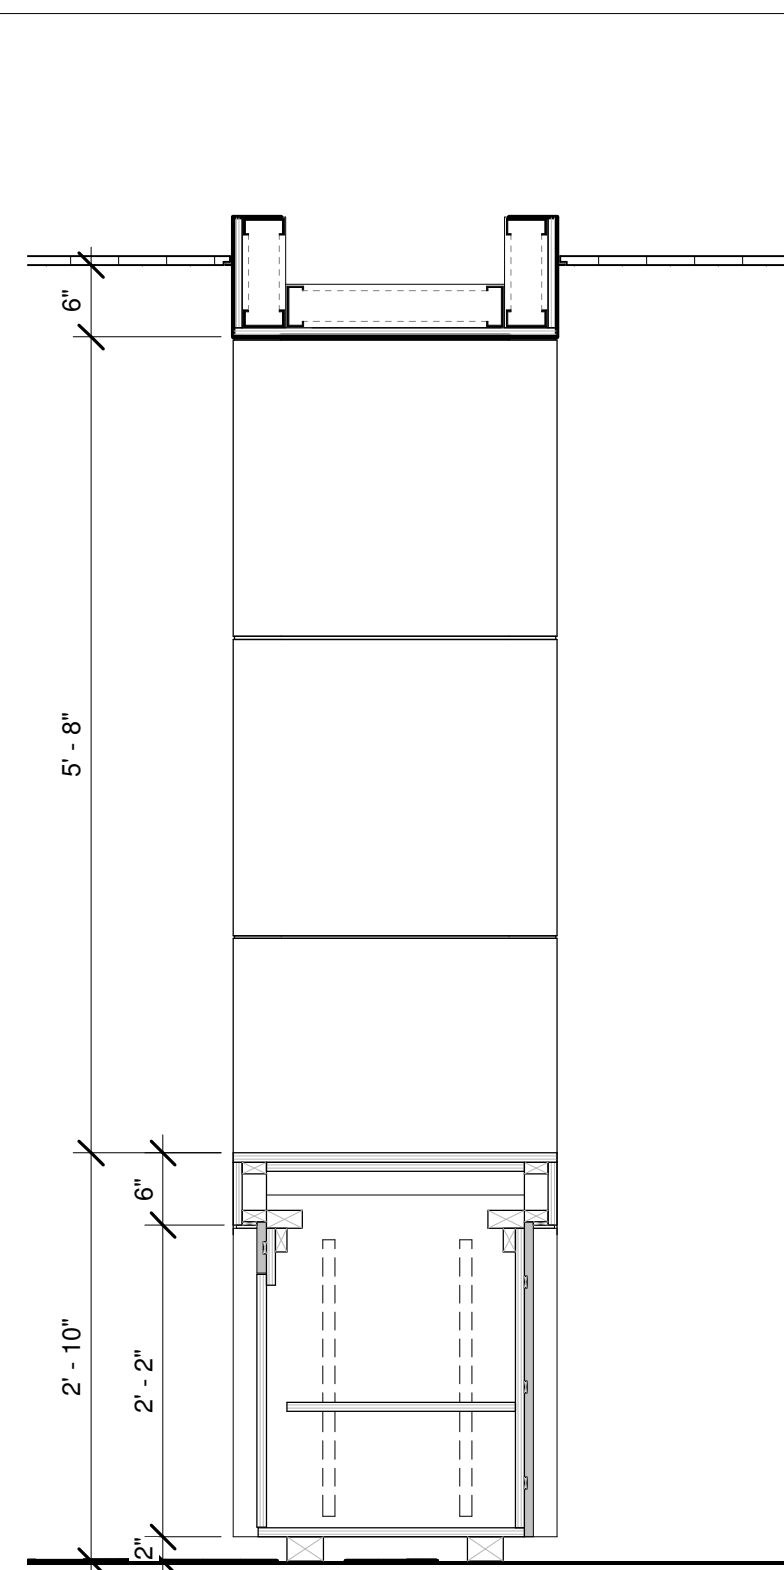


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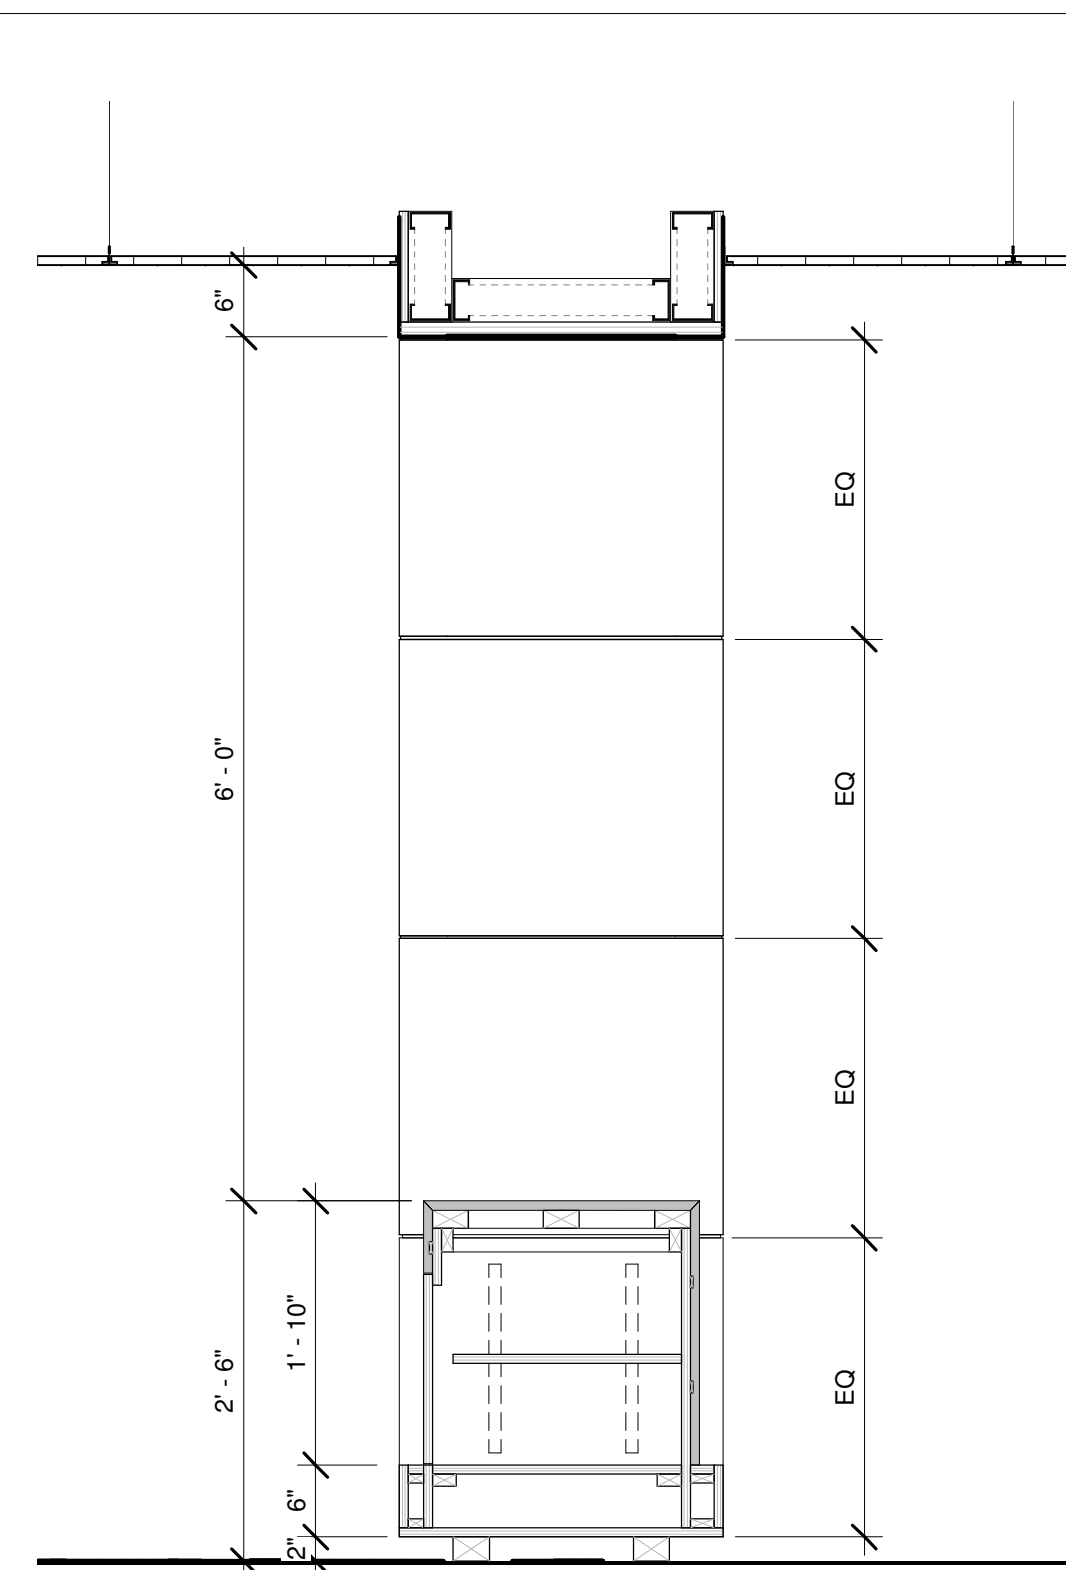
STAFFORD
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1625 STAFFORDSHIRE
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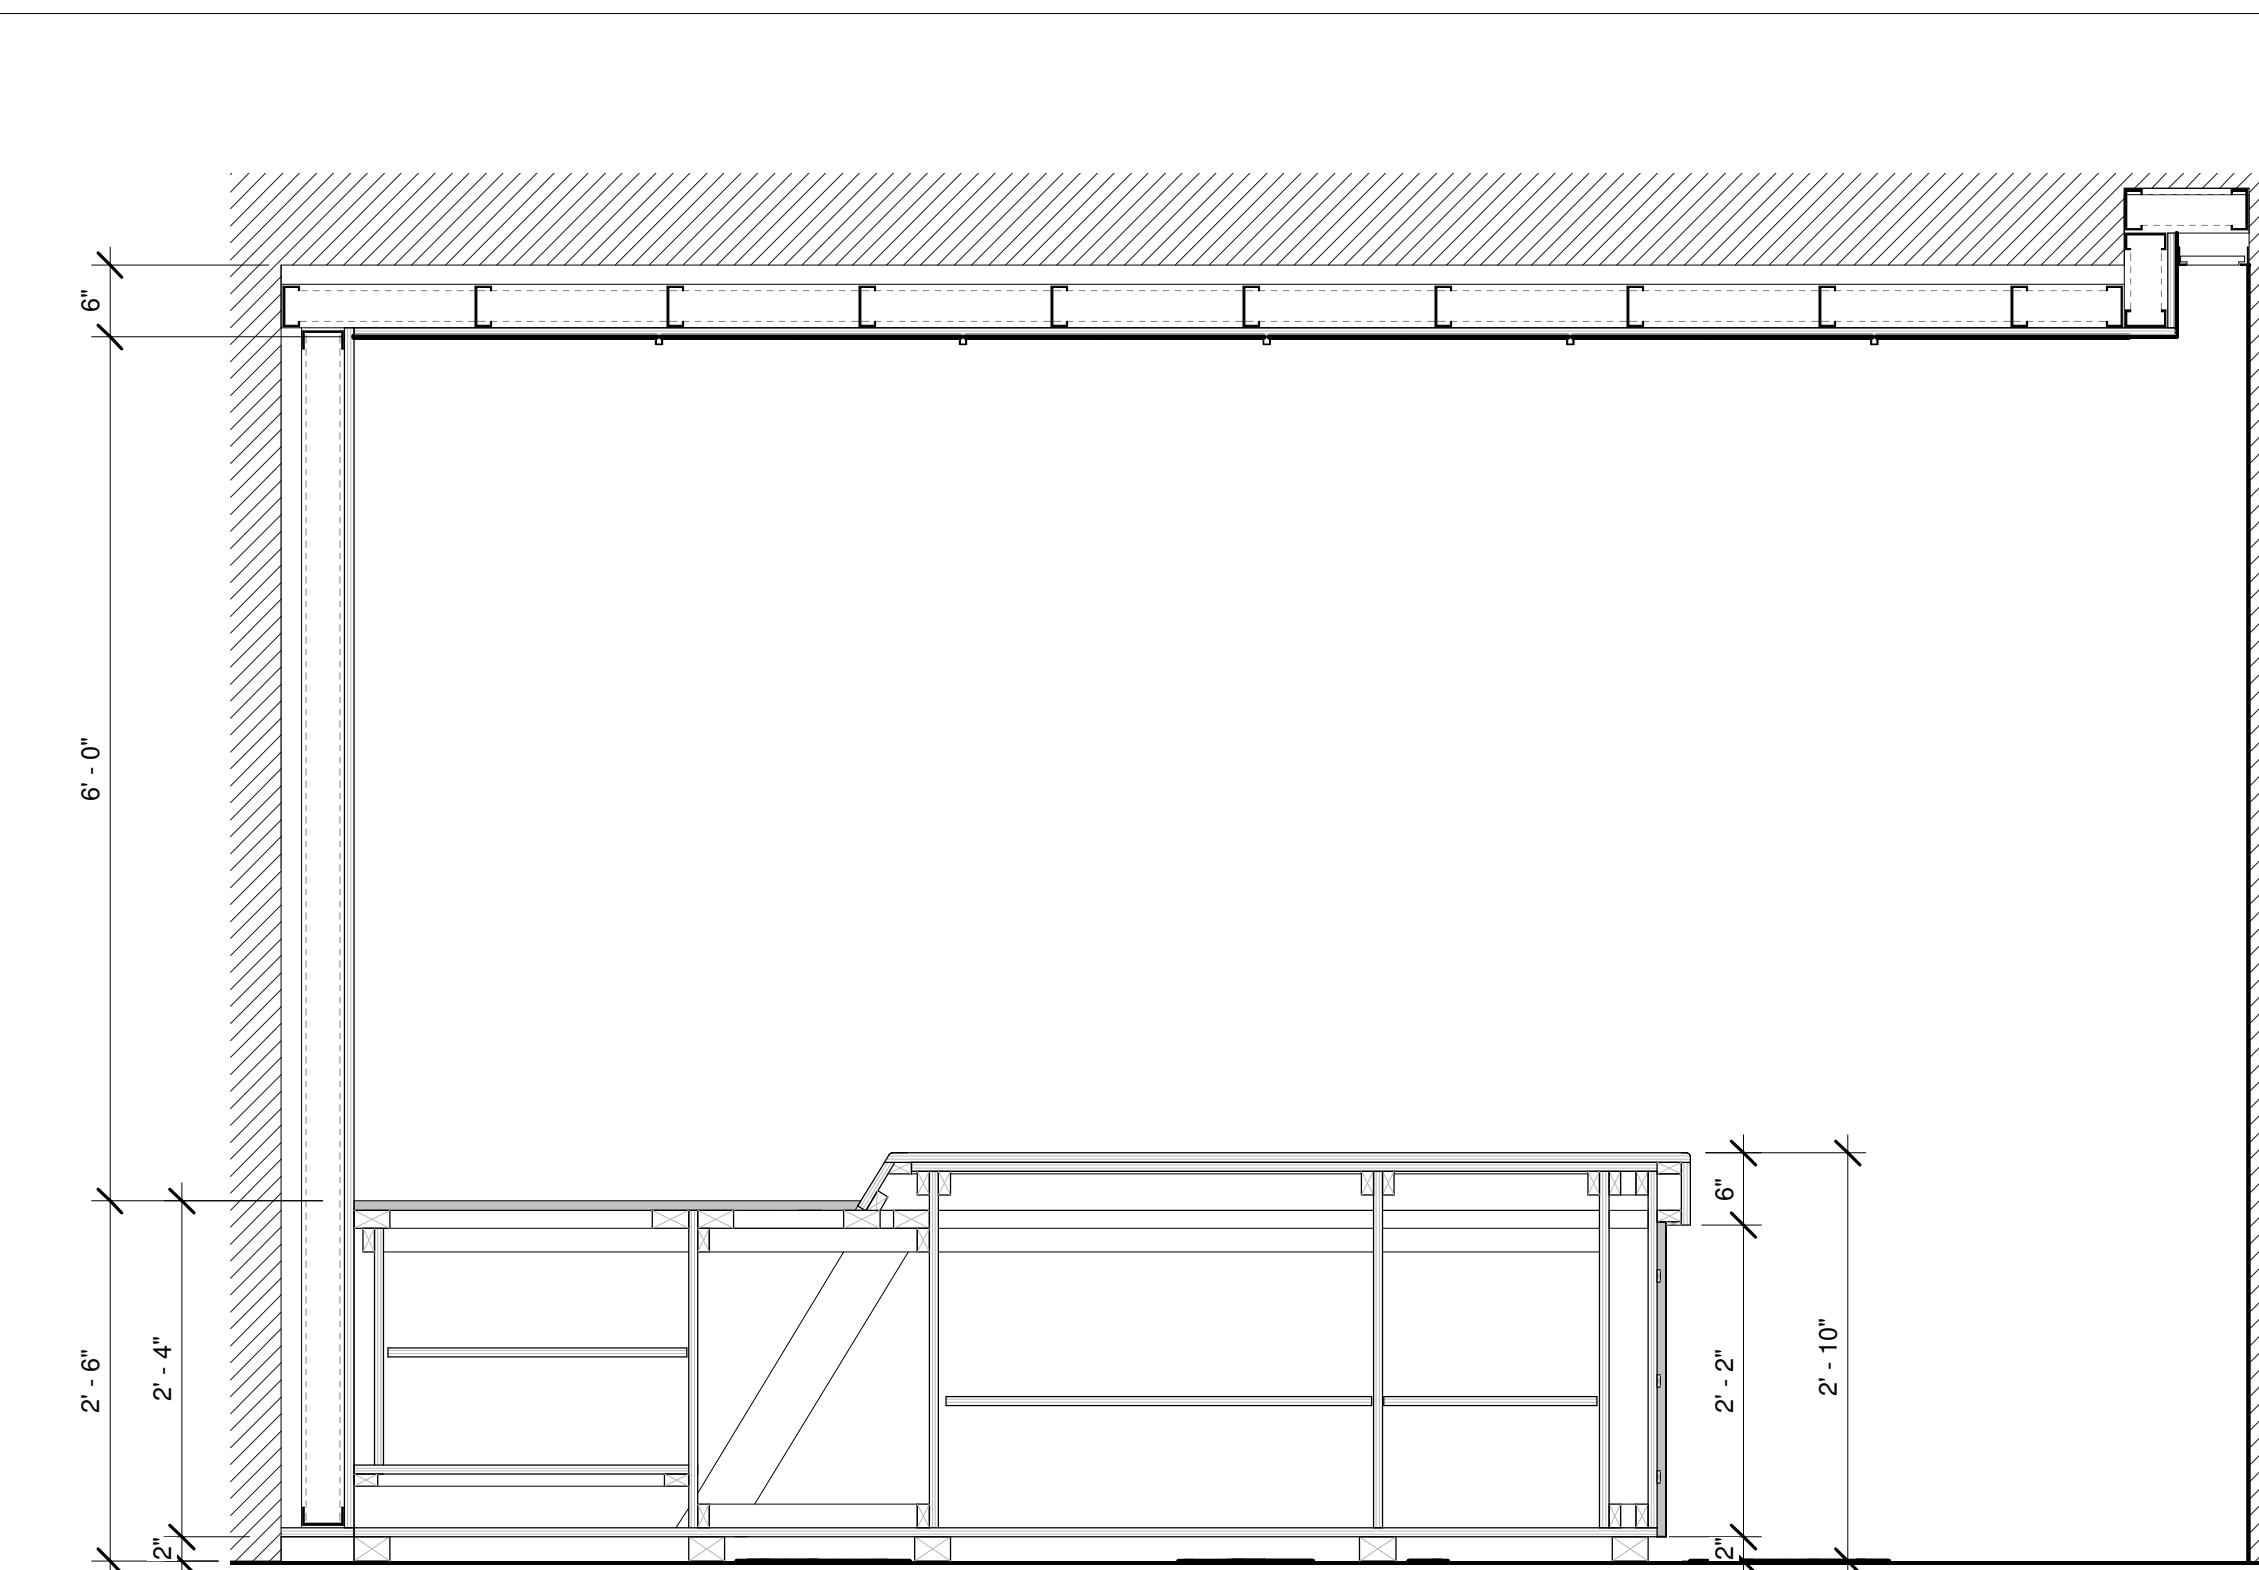
#	Date	ISSUED FOR
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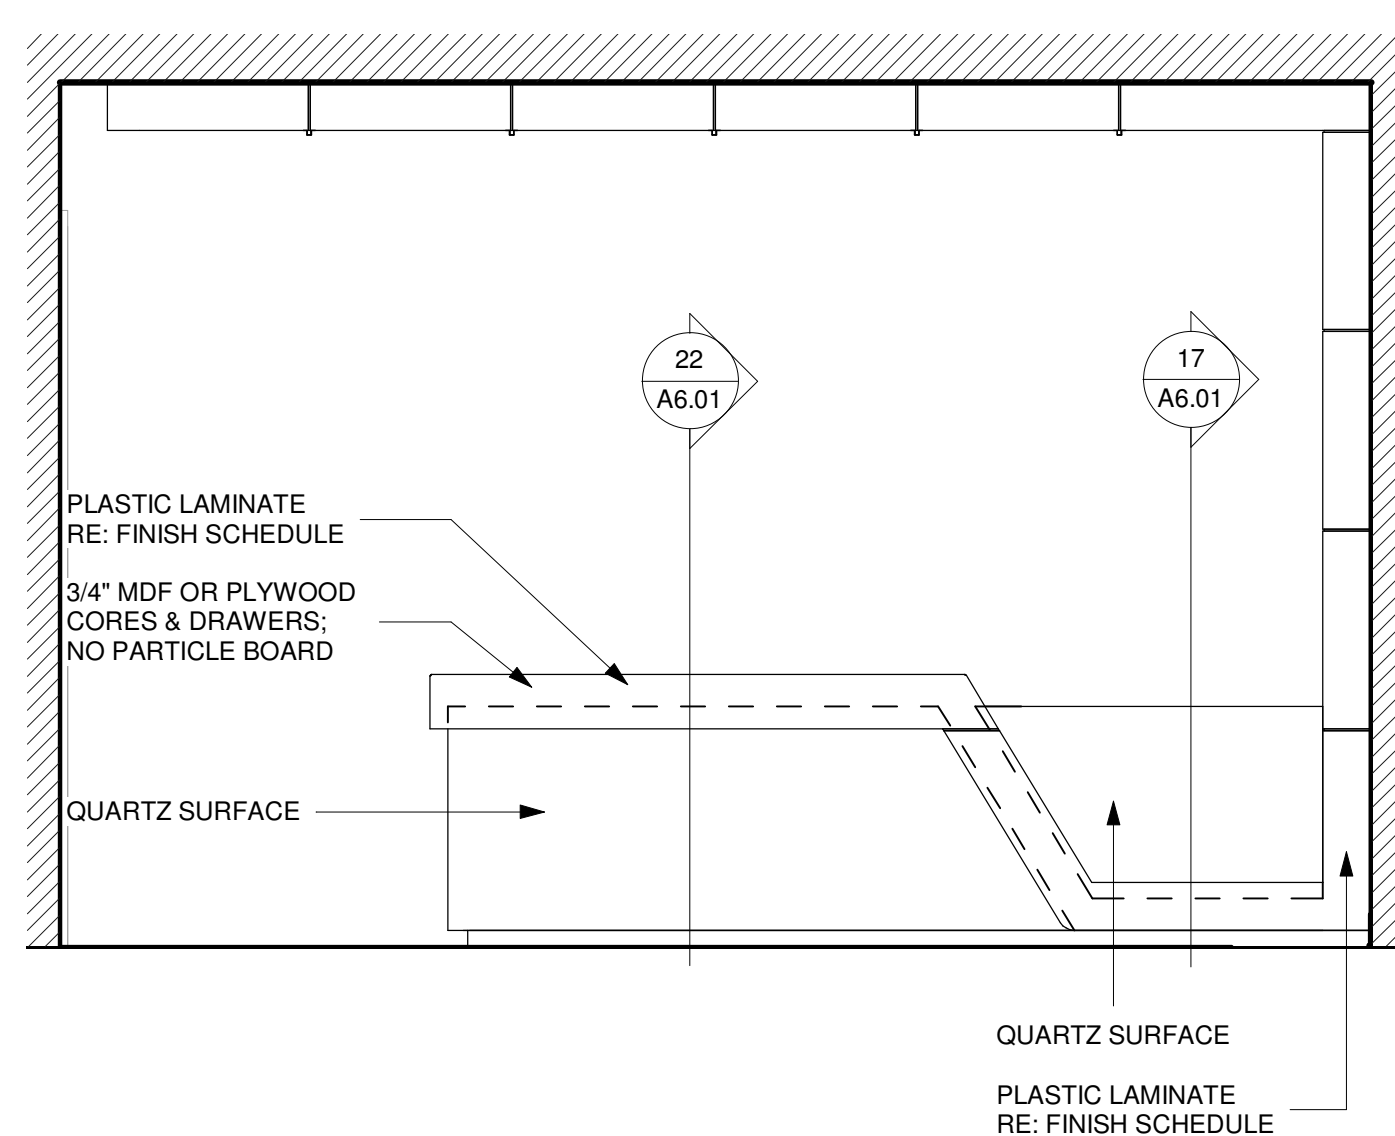
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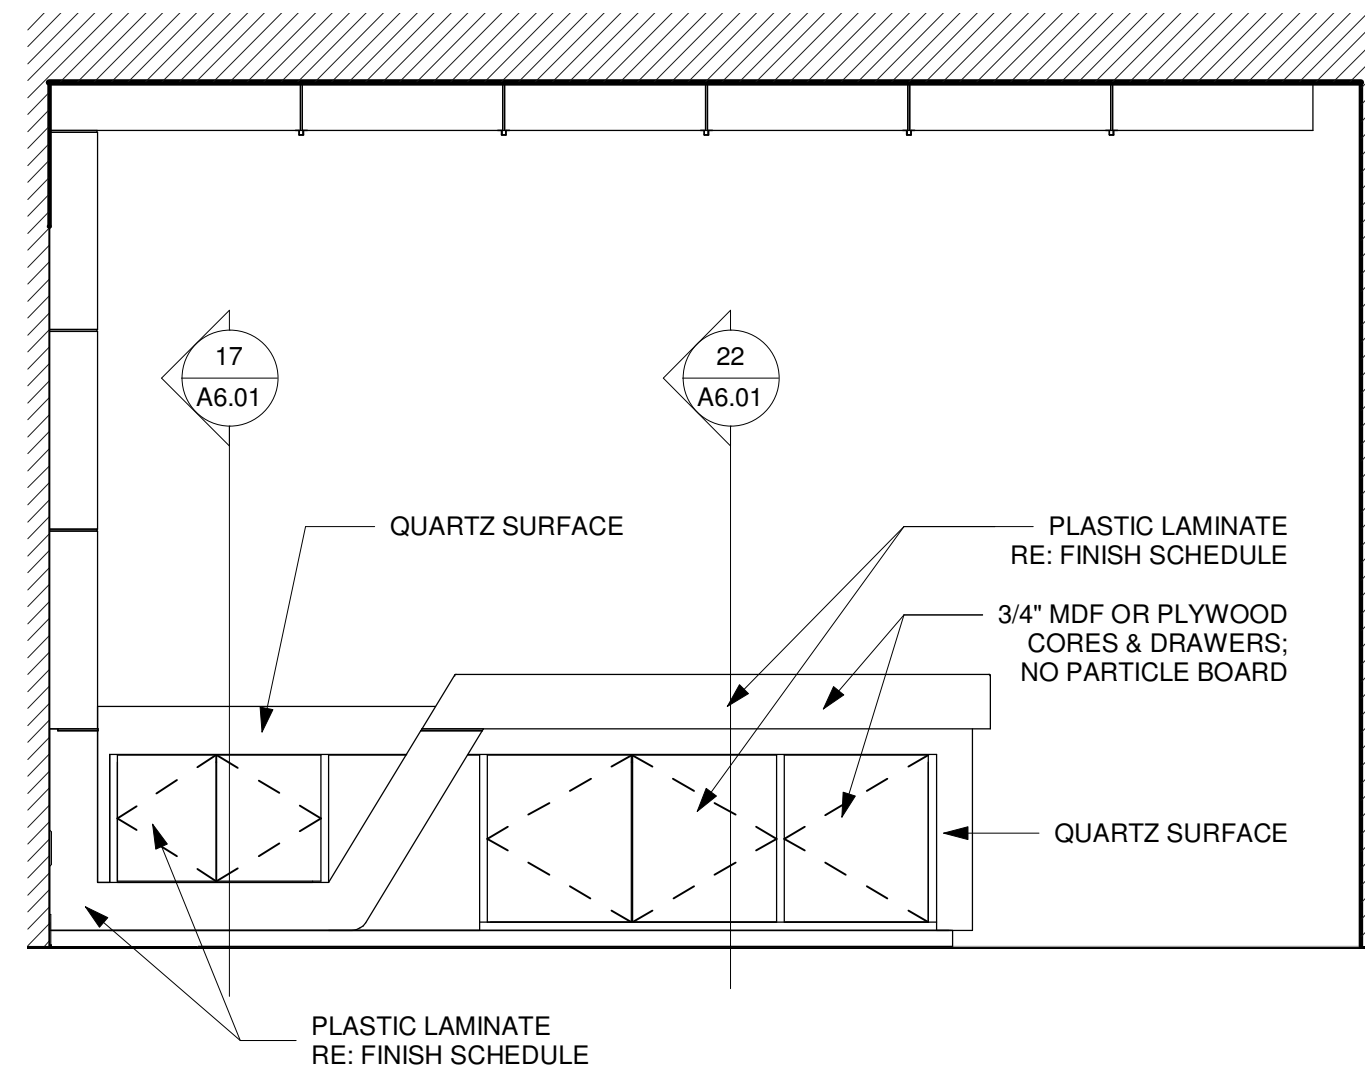
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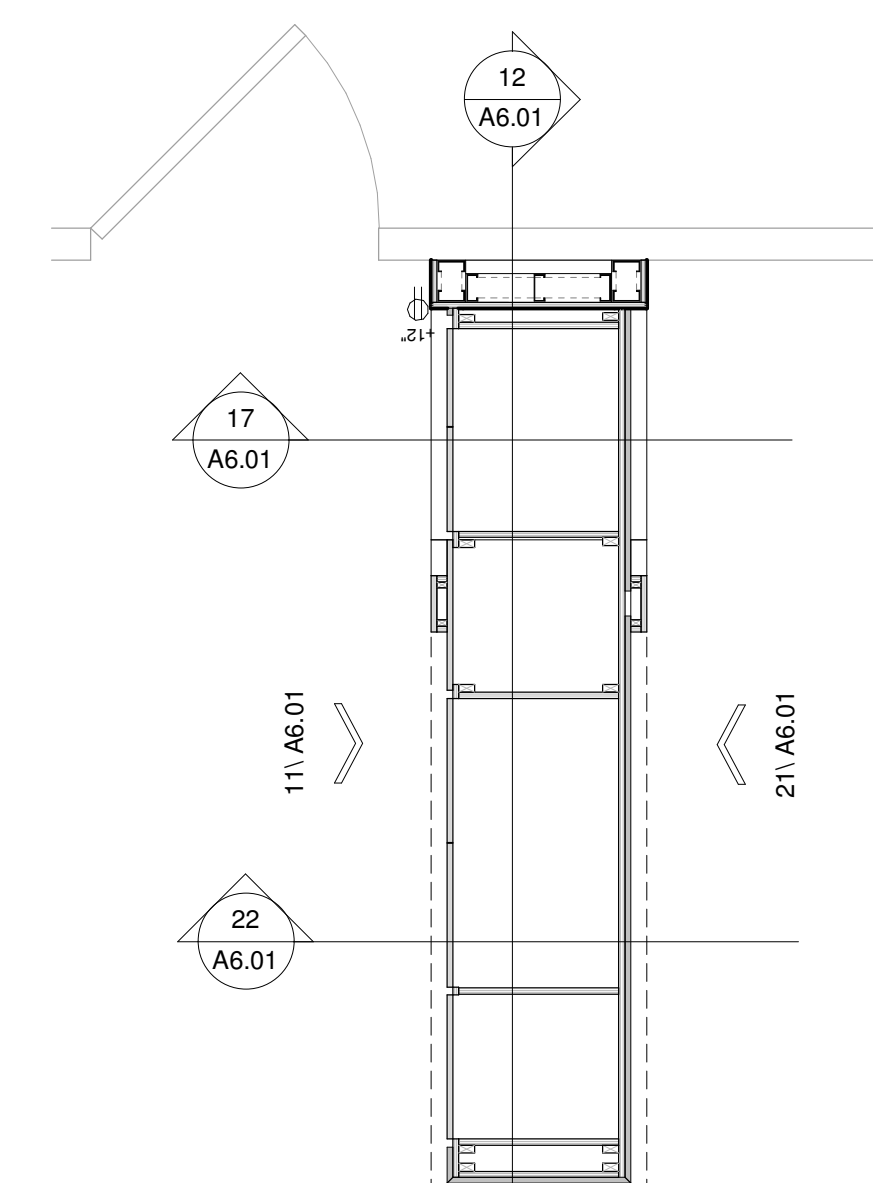
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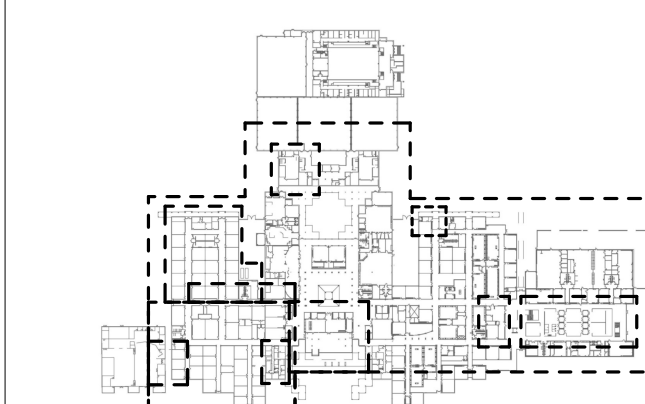
21 RECEPTION DESK ELEVATION
Scale: 1/2" = 1'-0"



11 RECEPTION DESK ELEVATION
Scale: 1/2" = 1'-0"



06 RECEPTION DESK
Scale: 1/2" = 1'-0"



KEY PLAN
TRUE NORTH
PLAN NORTH

Project Number	19006-A
Drawn By	LT
Checked By	AW
Approved By	MS

Drawing Title
**MILLWORK / CASEWORK
ELEVATIONS & DETAILS**

Drawing Number
A6.01



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PROFESSIONAL SEAL:




A PROJECT FOR:

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1625 STAFFORDSHIRE
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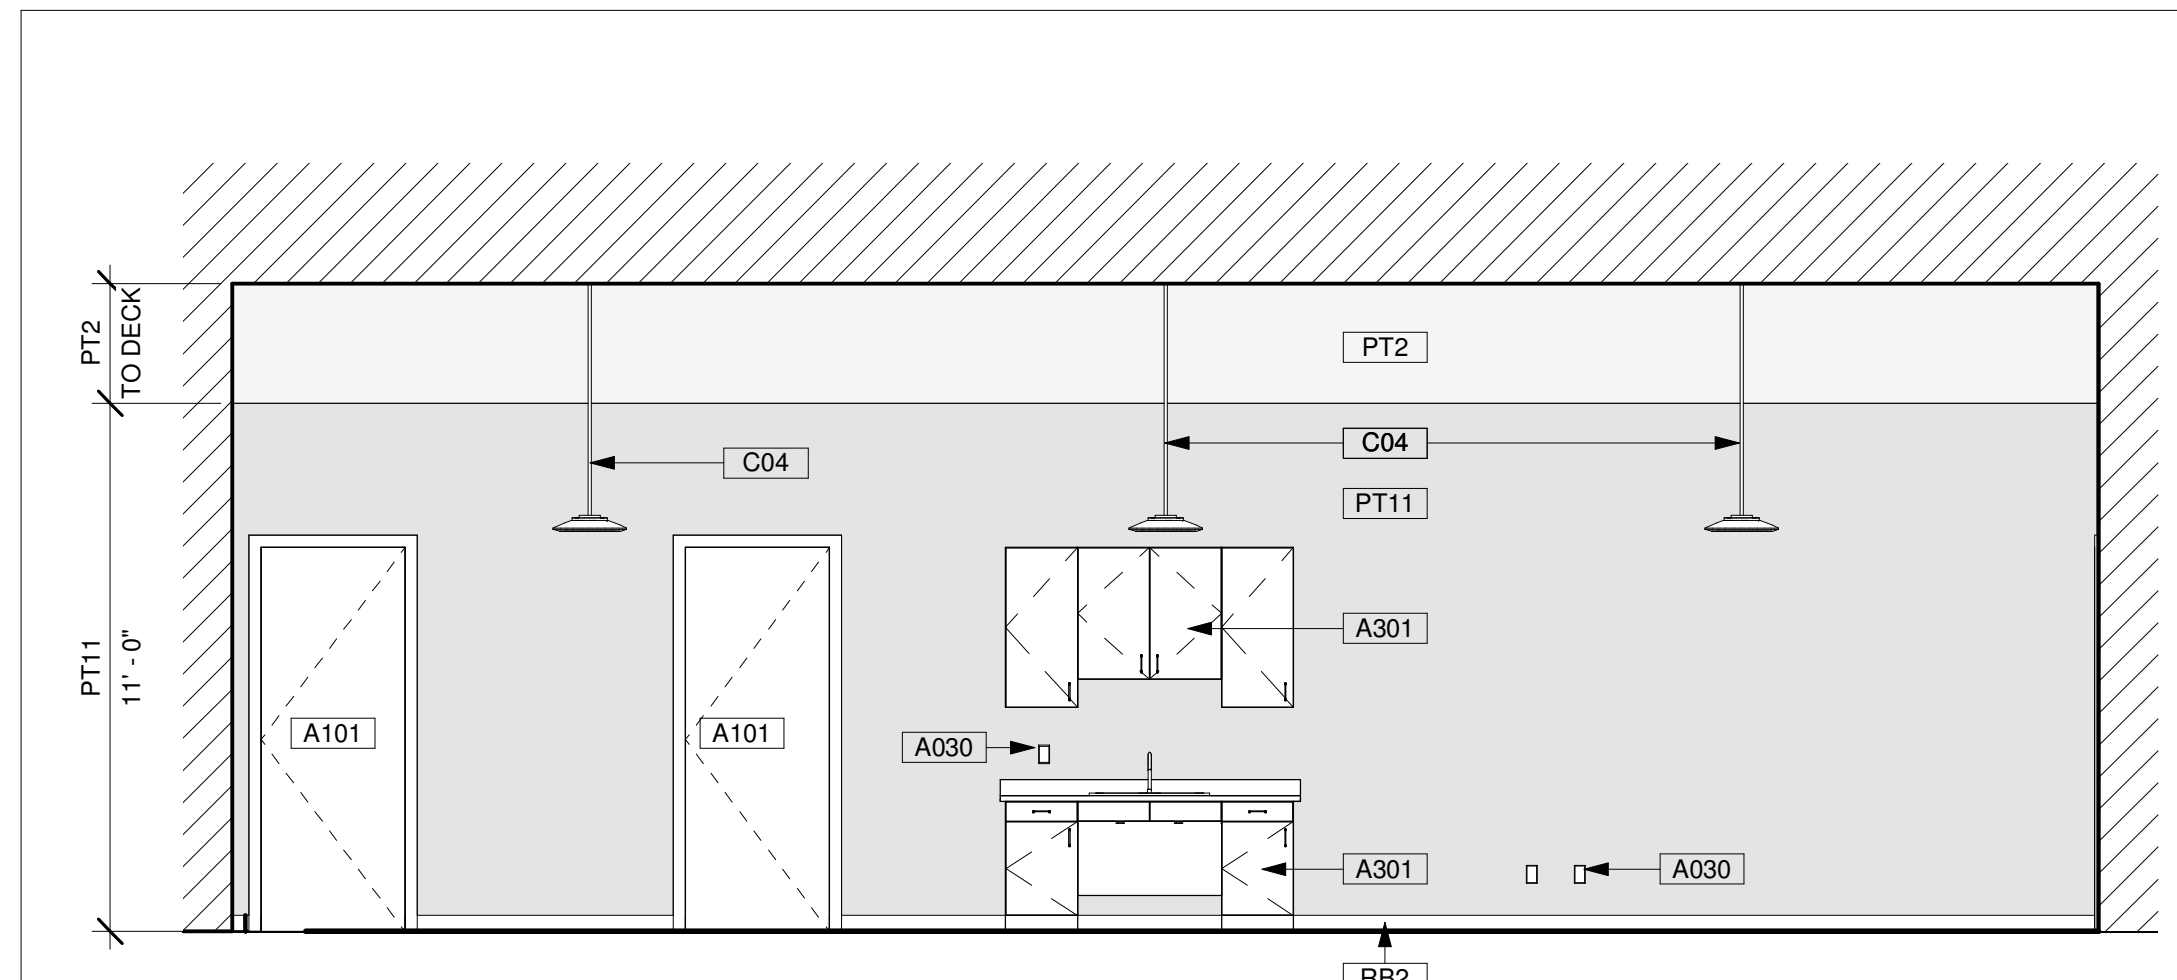
#	Date	ISSUED FOR
	03/13/2020	ISSUE FOR BID, PERMIT, & CONSTRUCTION




KEY PLAN
TRUE NORTH
PLAN NORTH

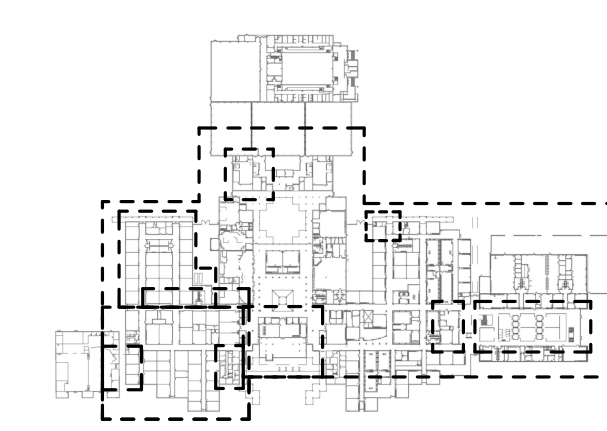Project Number	19006-A
Drawn By	LT
Checked By	AW
Approved By	MS
Drawing Title	INTERIOR ELEVATIONS


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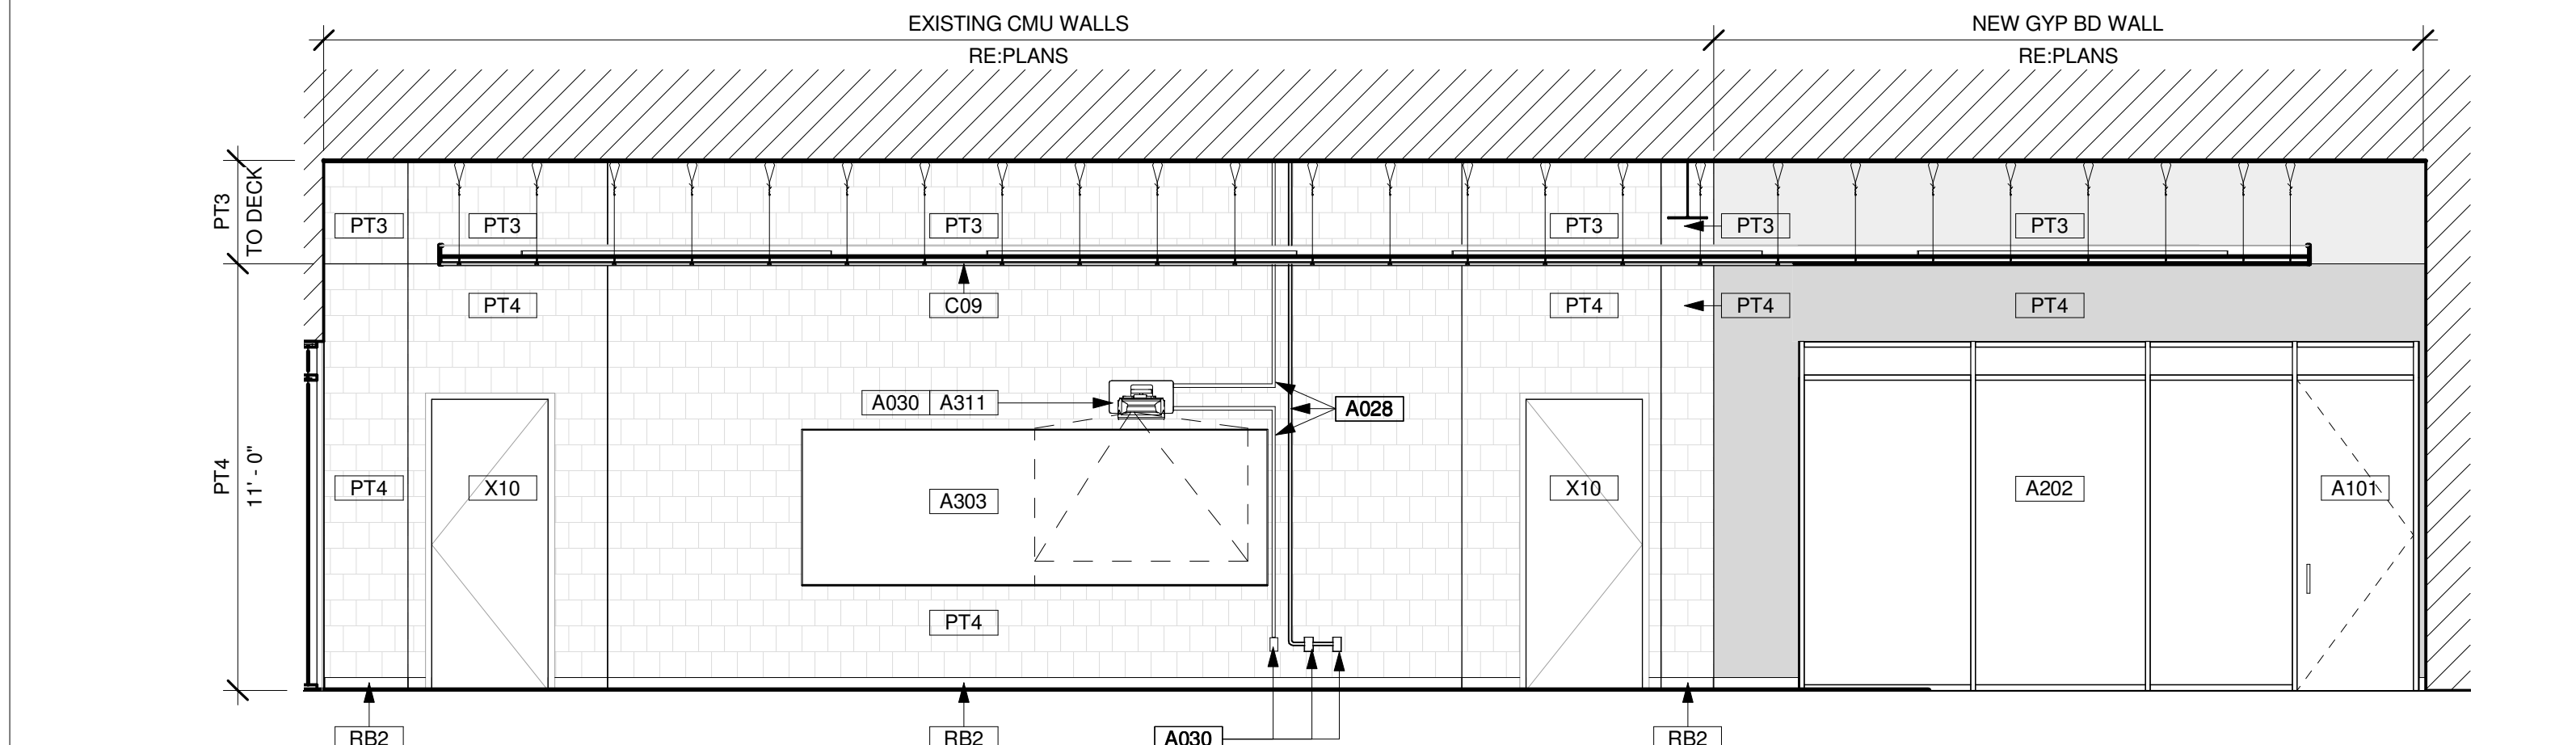
30 MEDICAL LAB - NORTH
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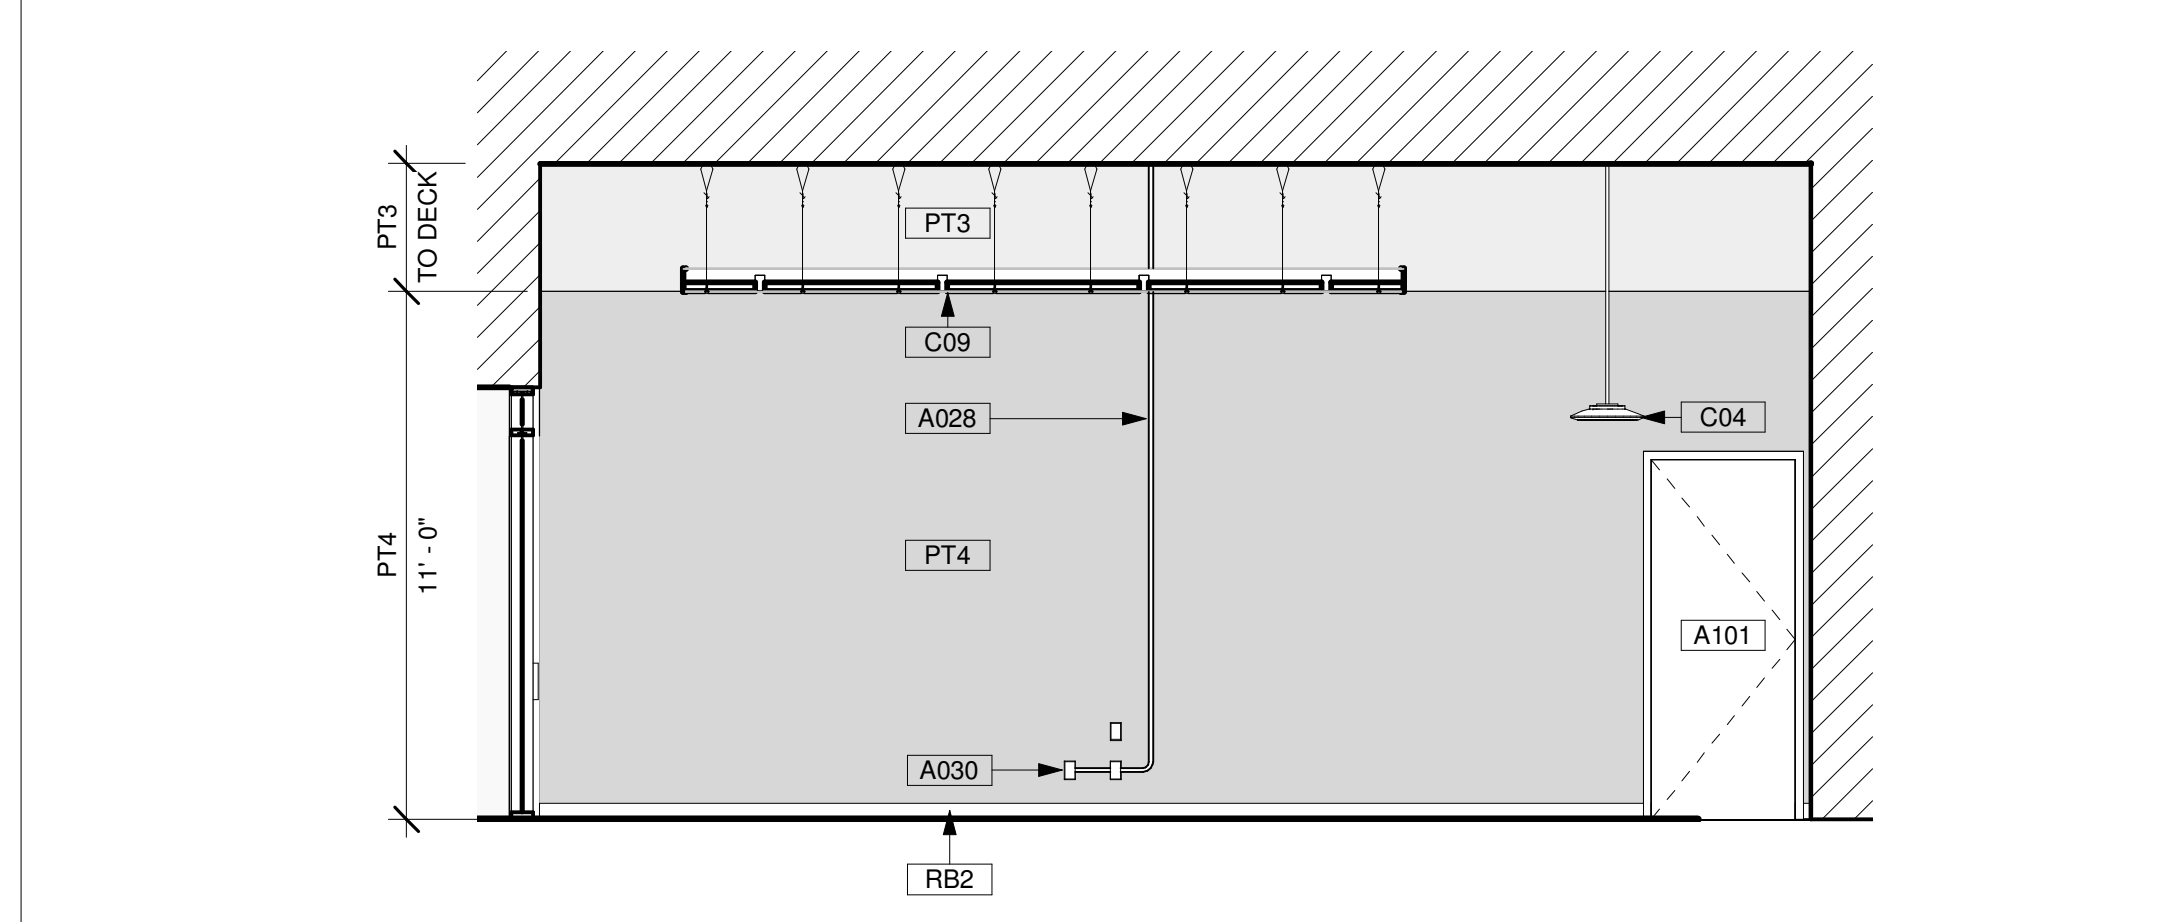
2 MEDICAL LAB - EAST
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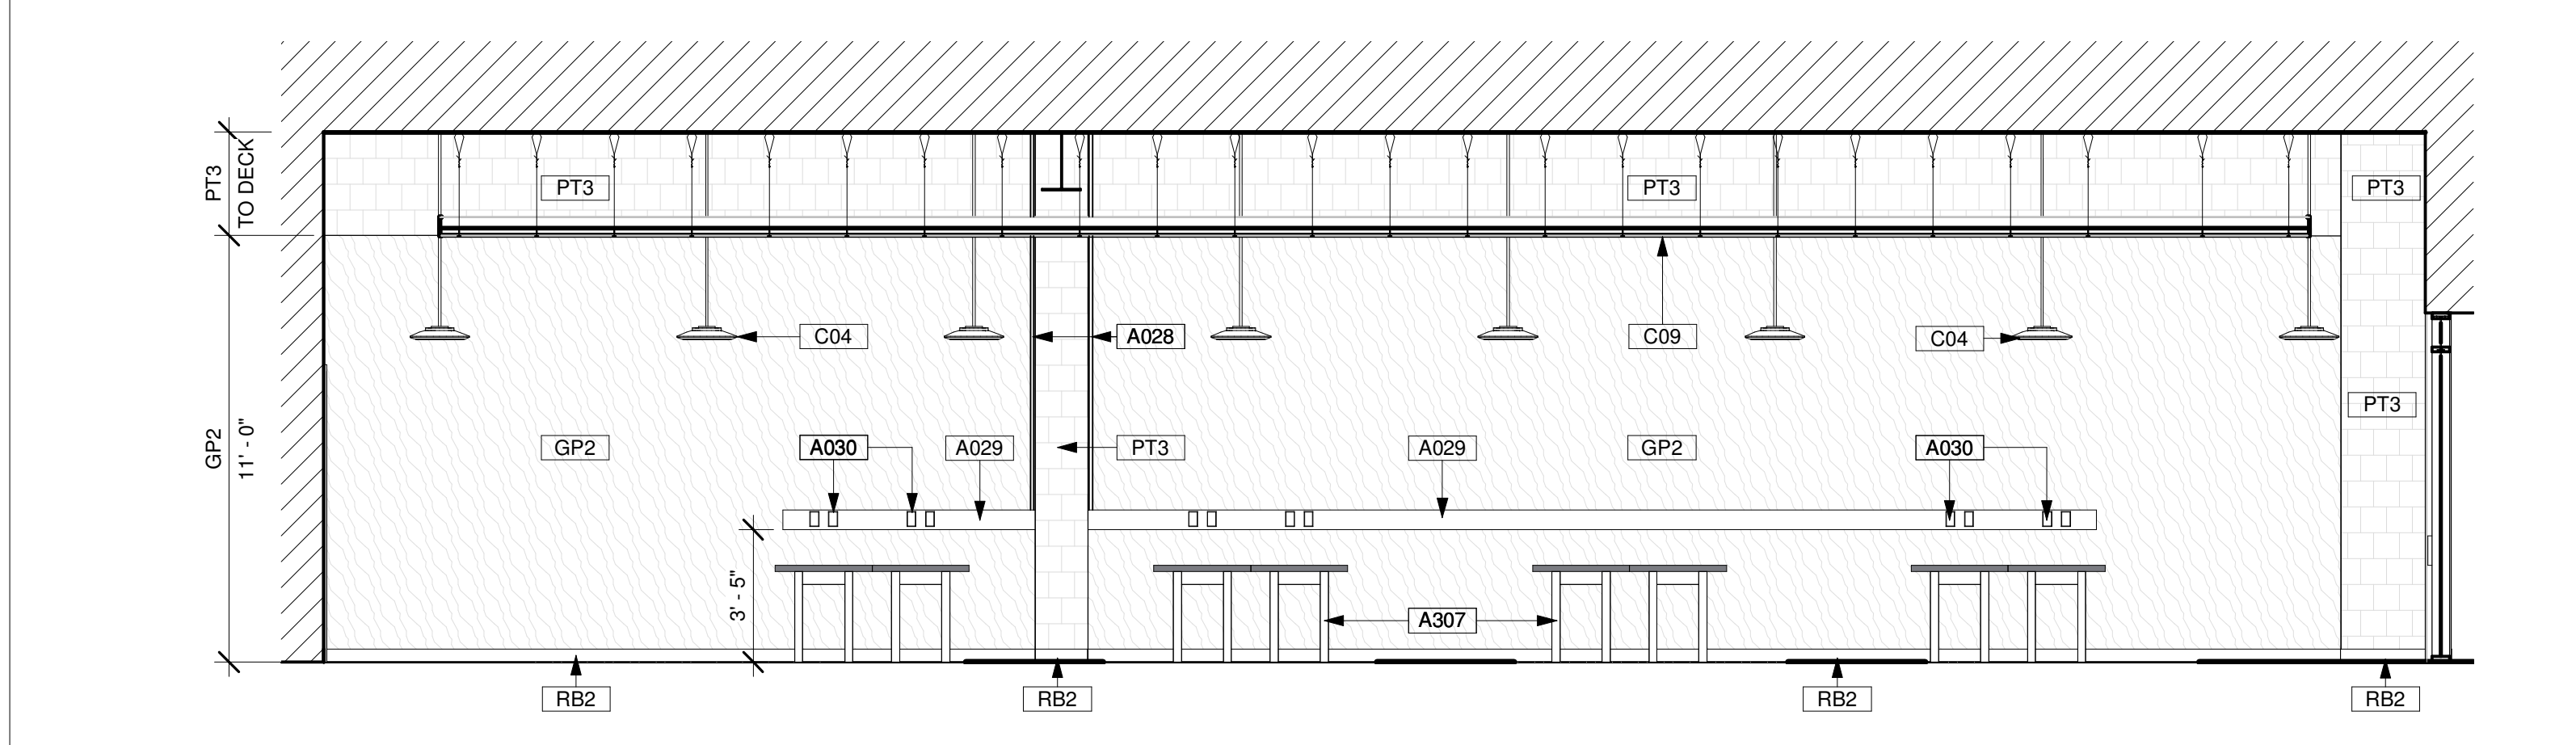
29 CODING LAB - SOUTH
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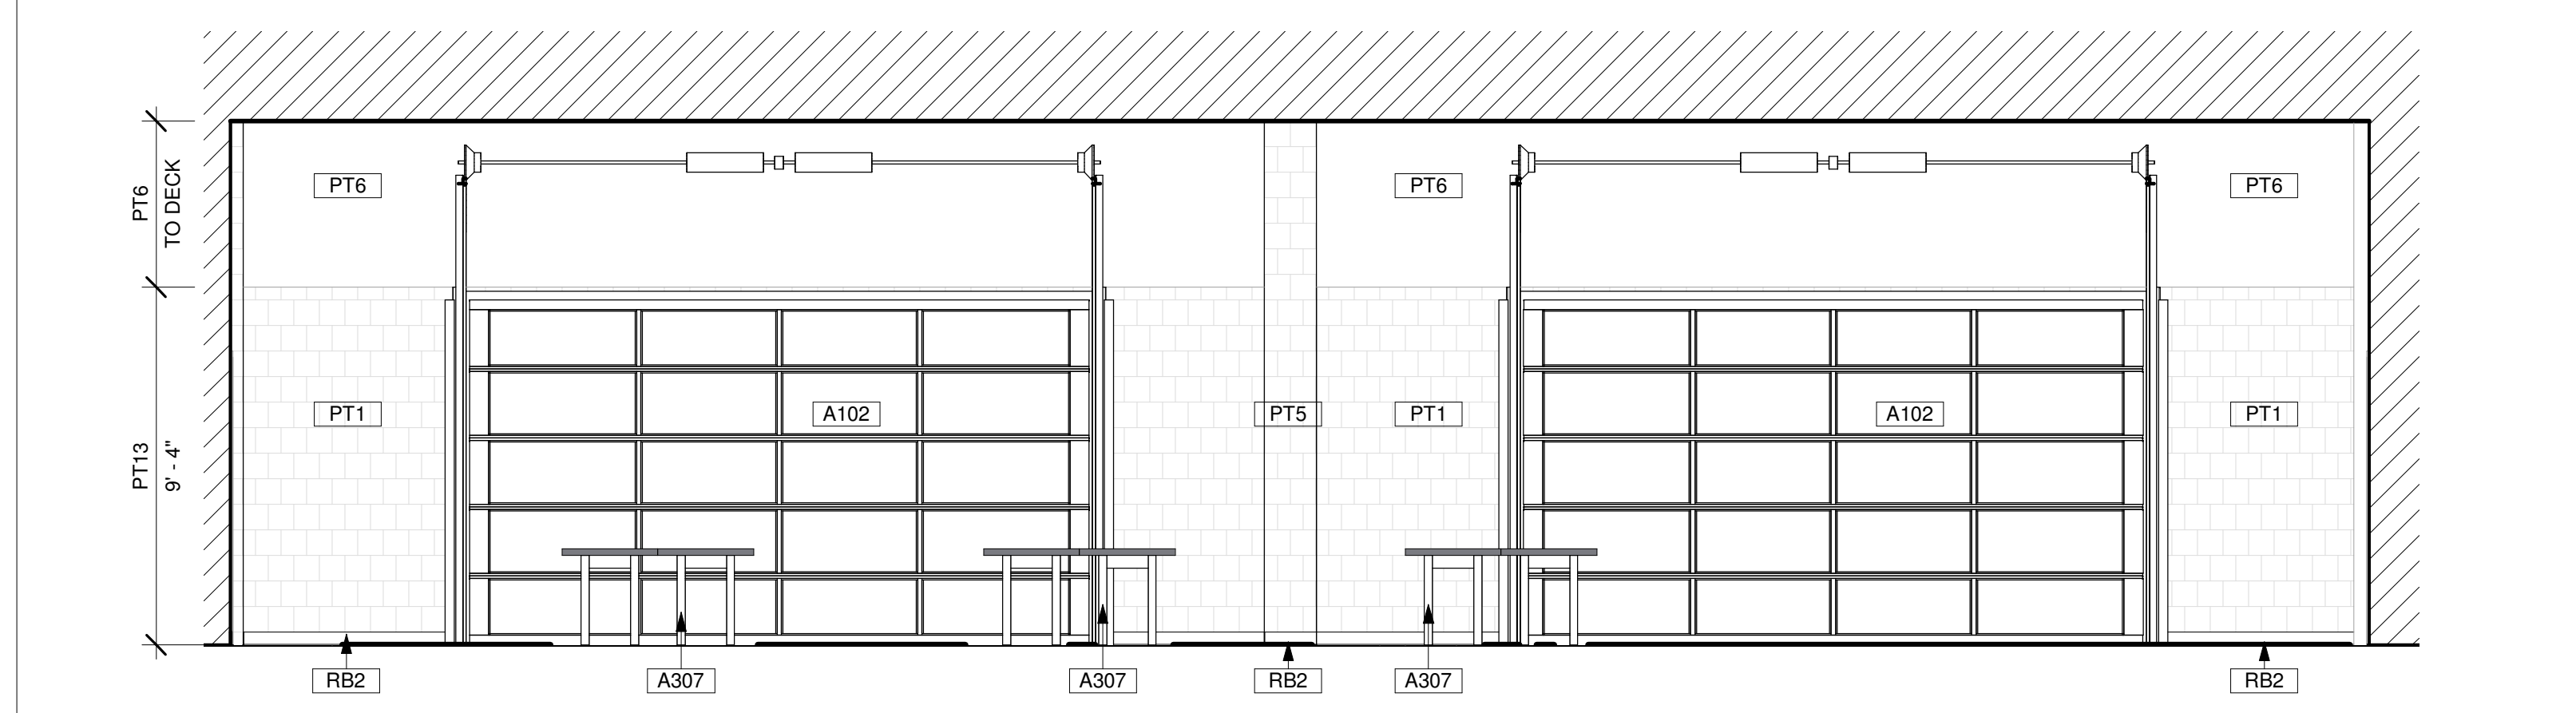
19 CODING LAB - WEST
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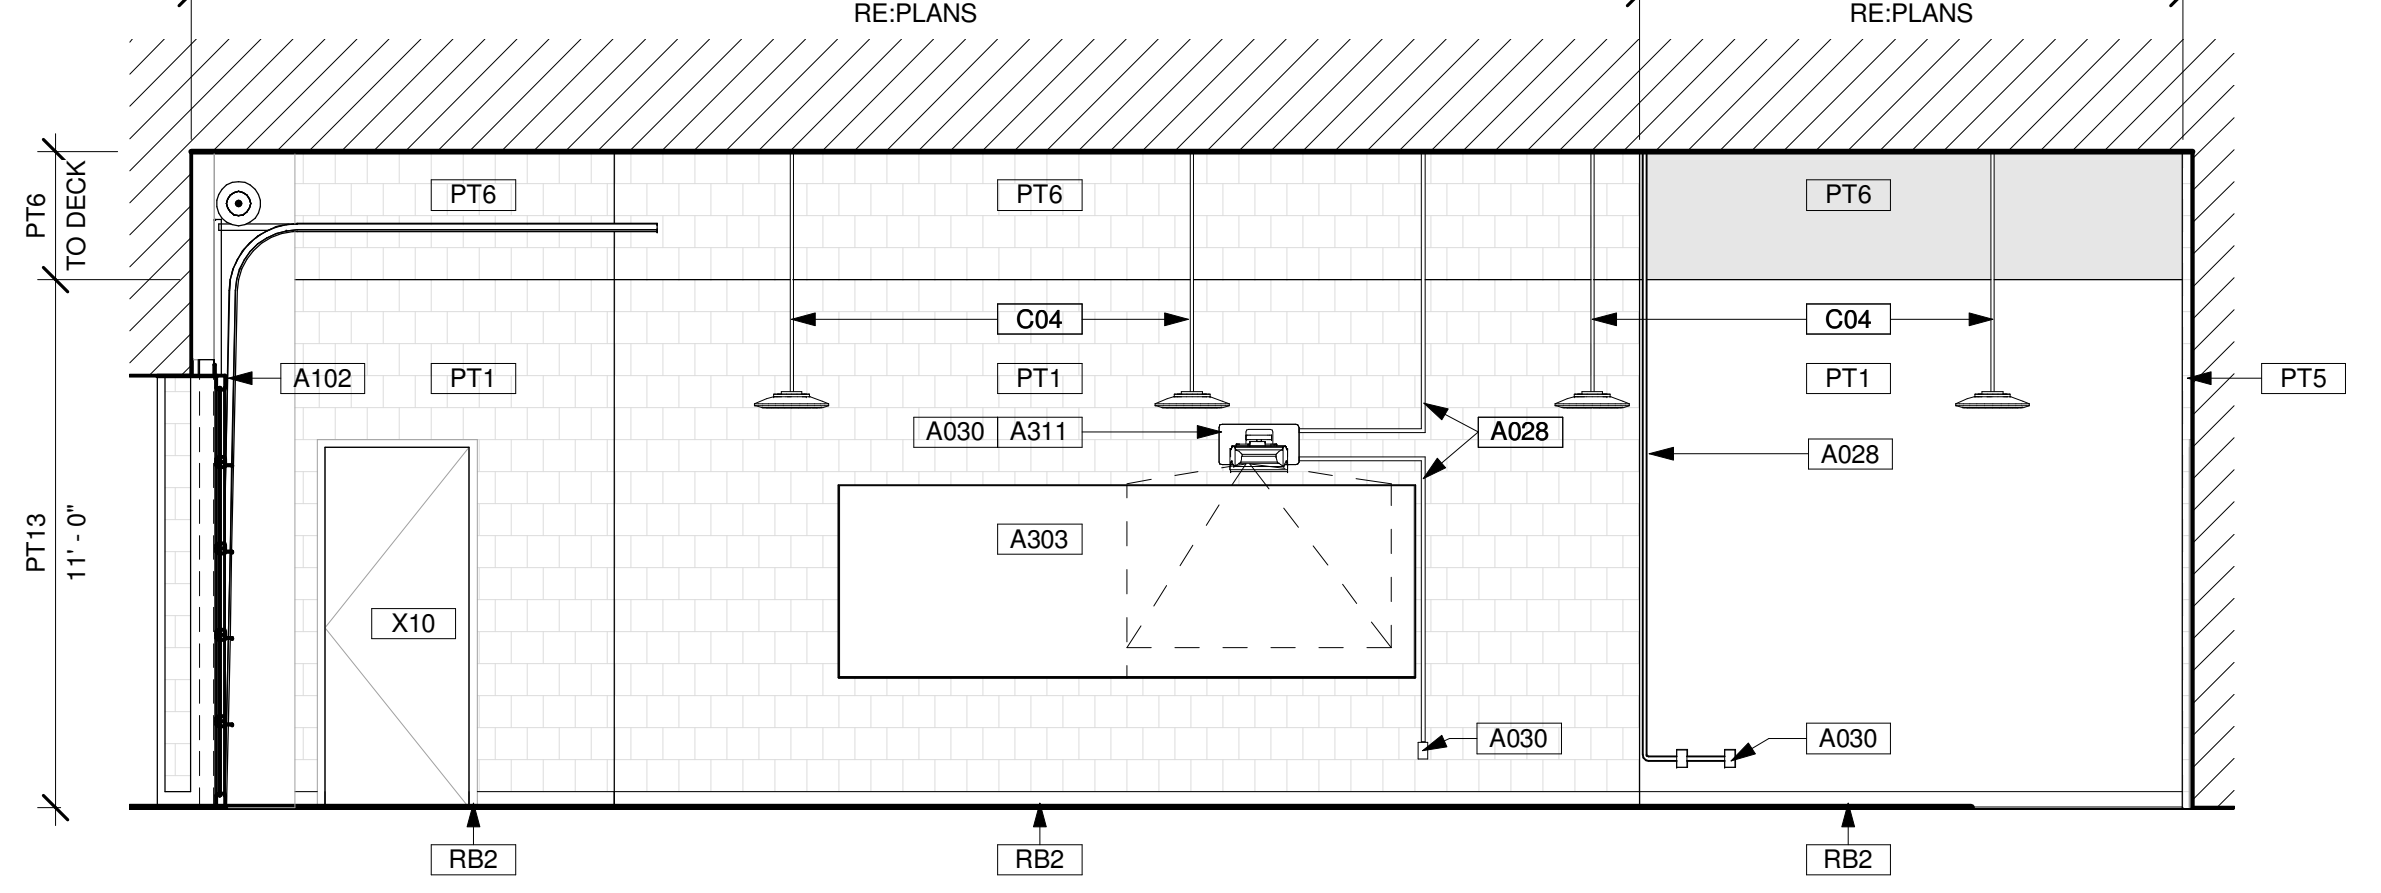
28 CODING LAB - NORTH
Scale: 1/4" = 1'-0"




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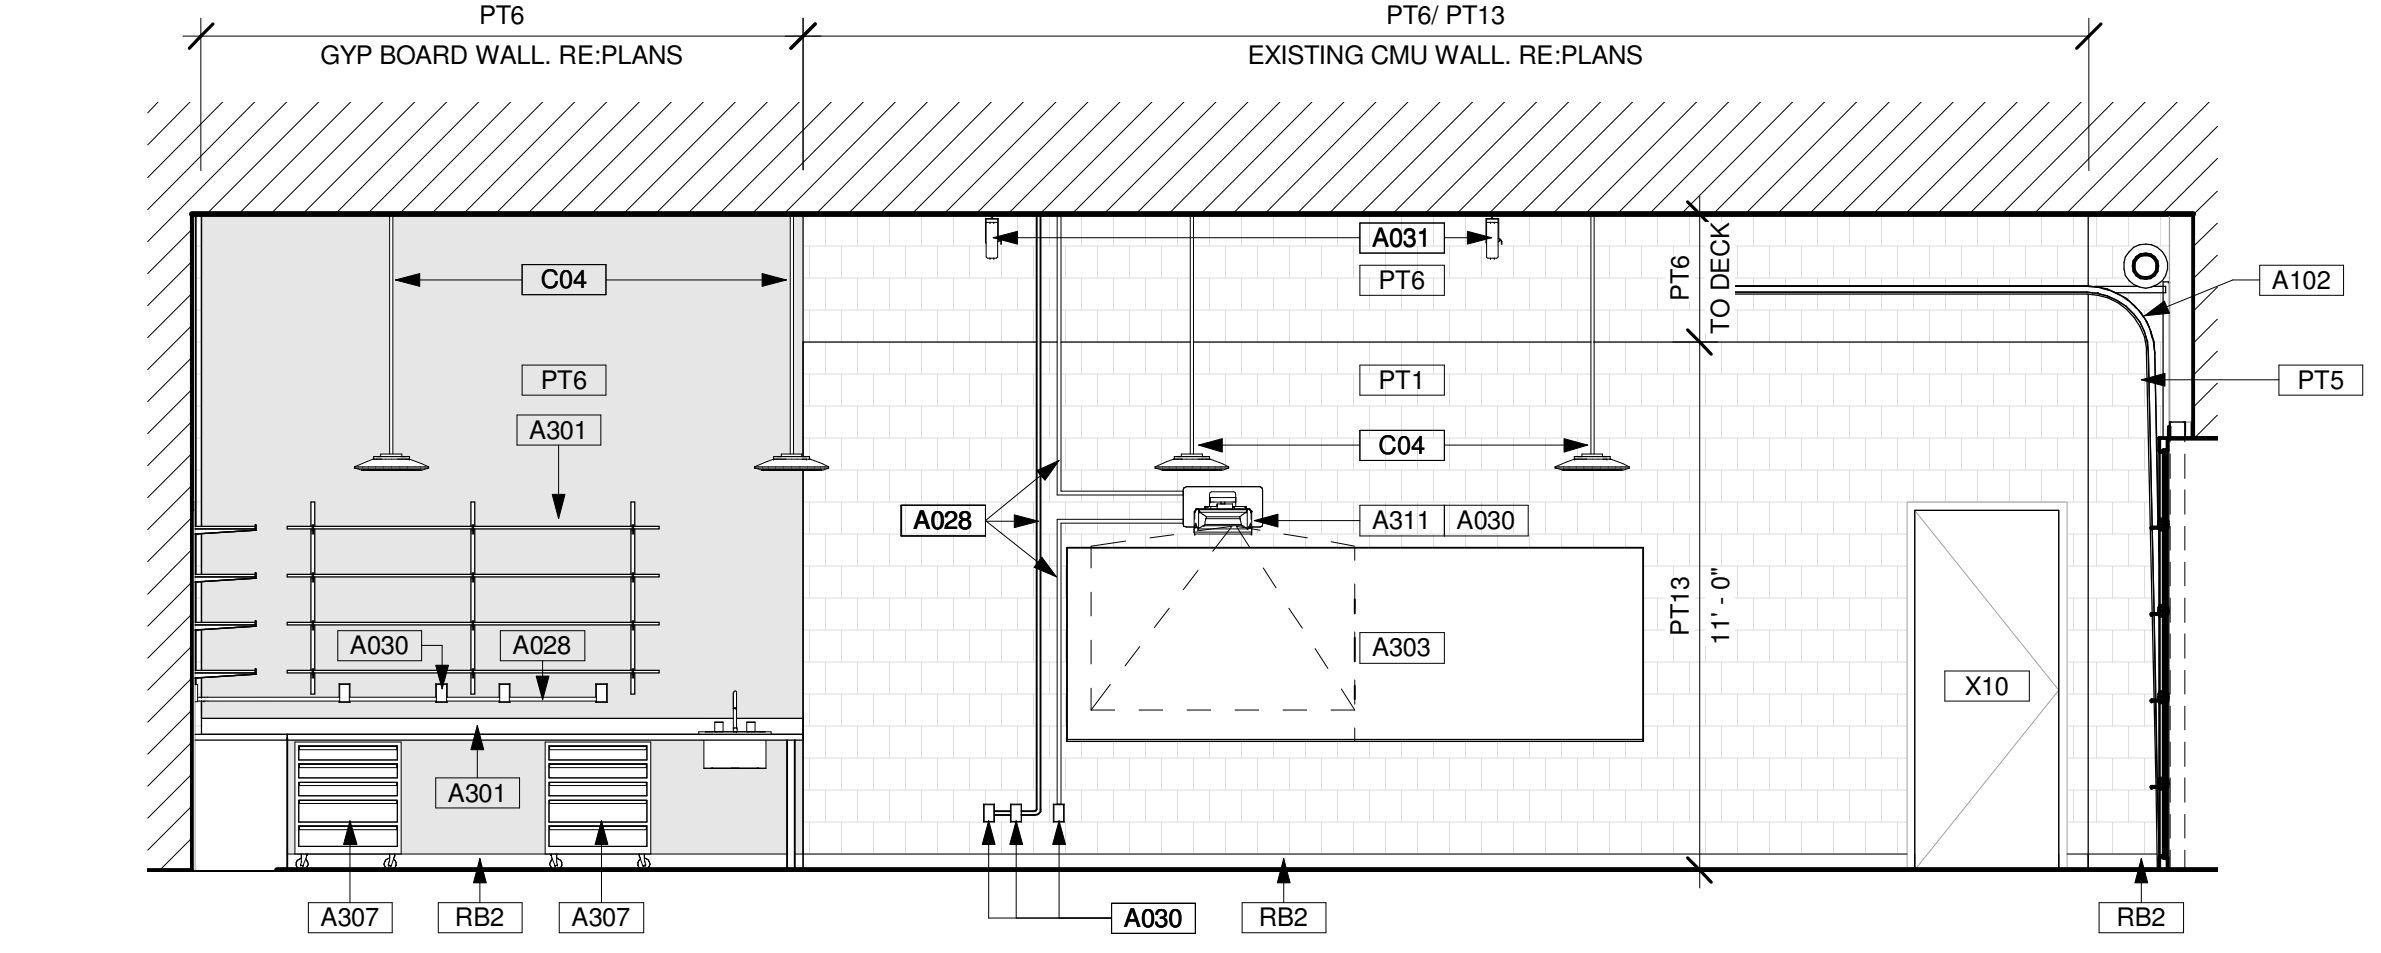
27 ROBOTICS LAB SOUTH
Scale: 1/4" = 1'-0"

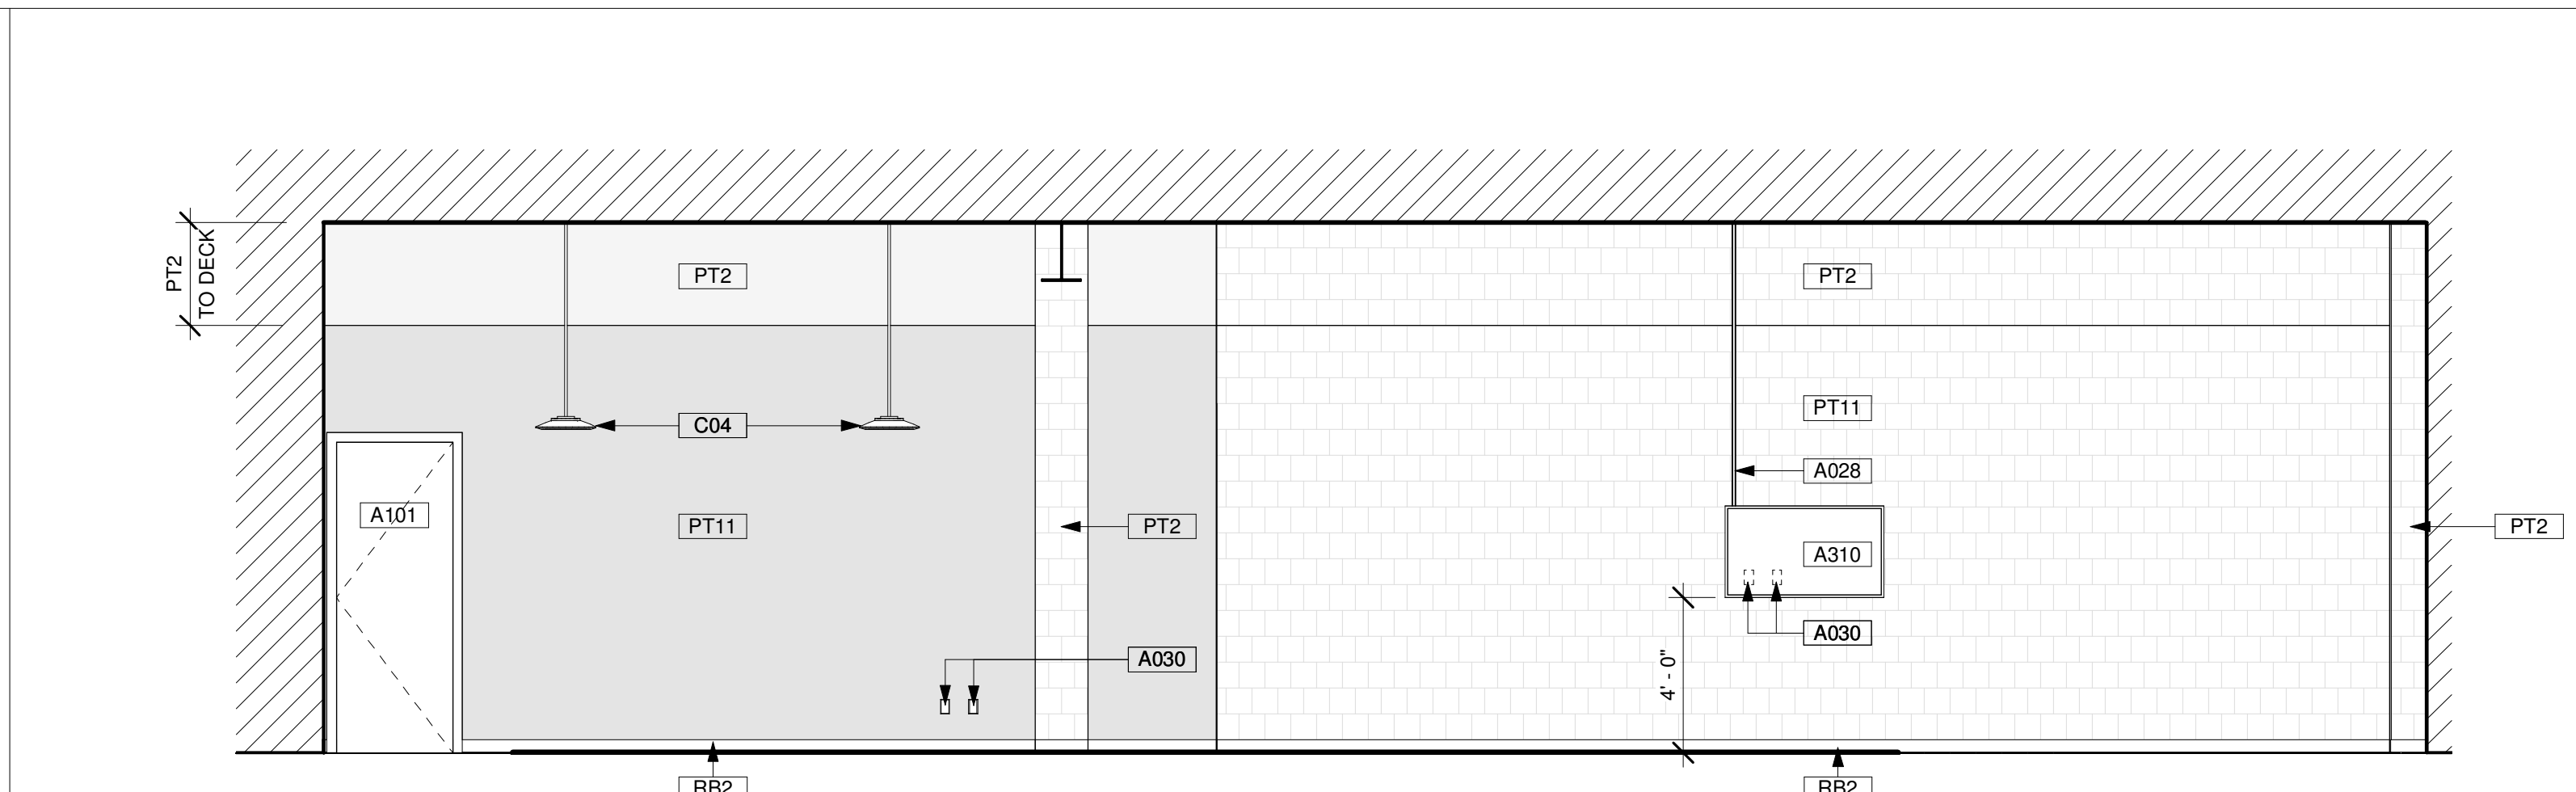

12 ROBOTICS LAB WEST
Scale: 1/4" = 1'-0"

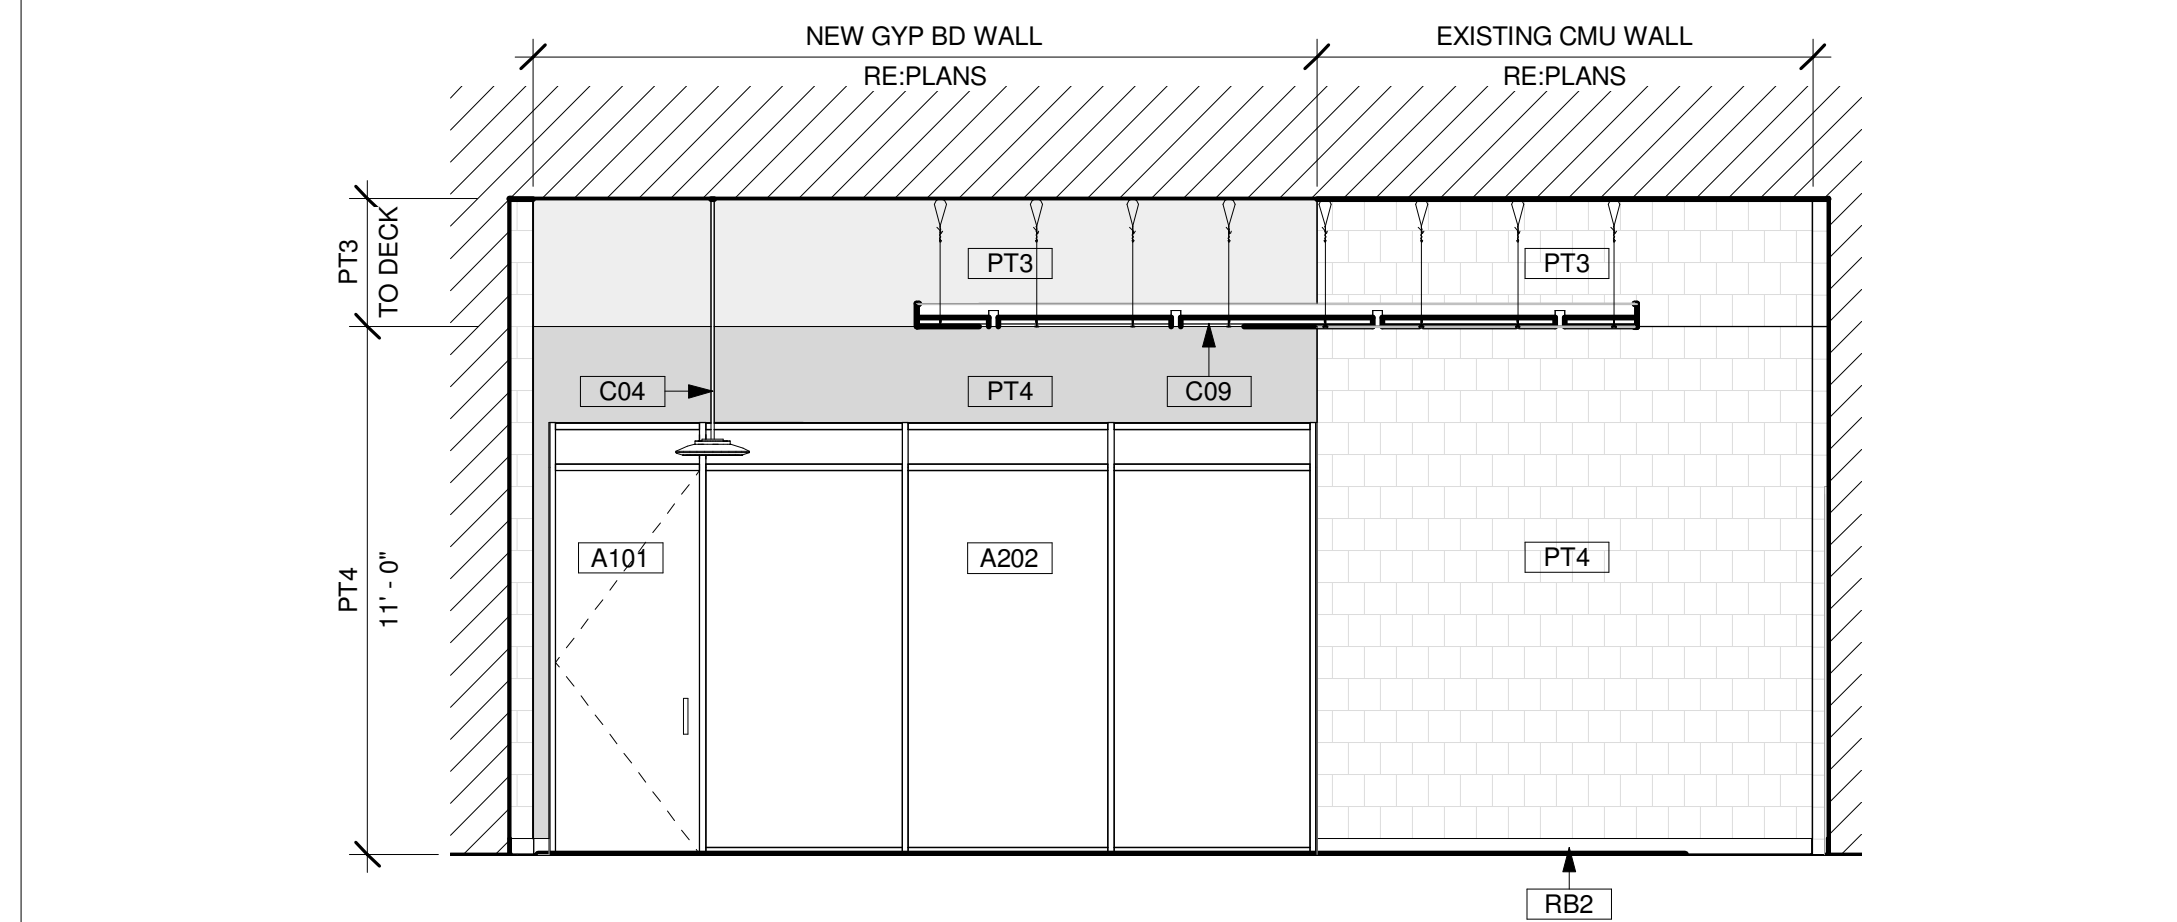

26 ROBOTICS LAB NORTH
Scale: 1/4" = 1'-0"

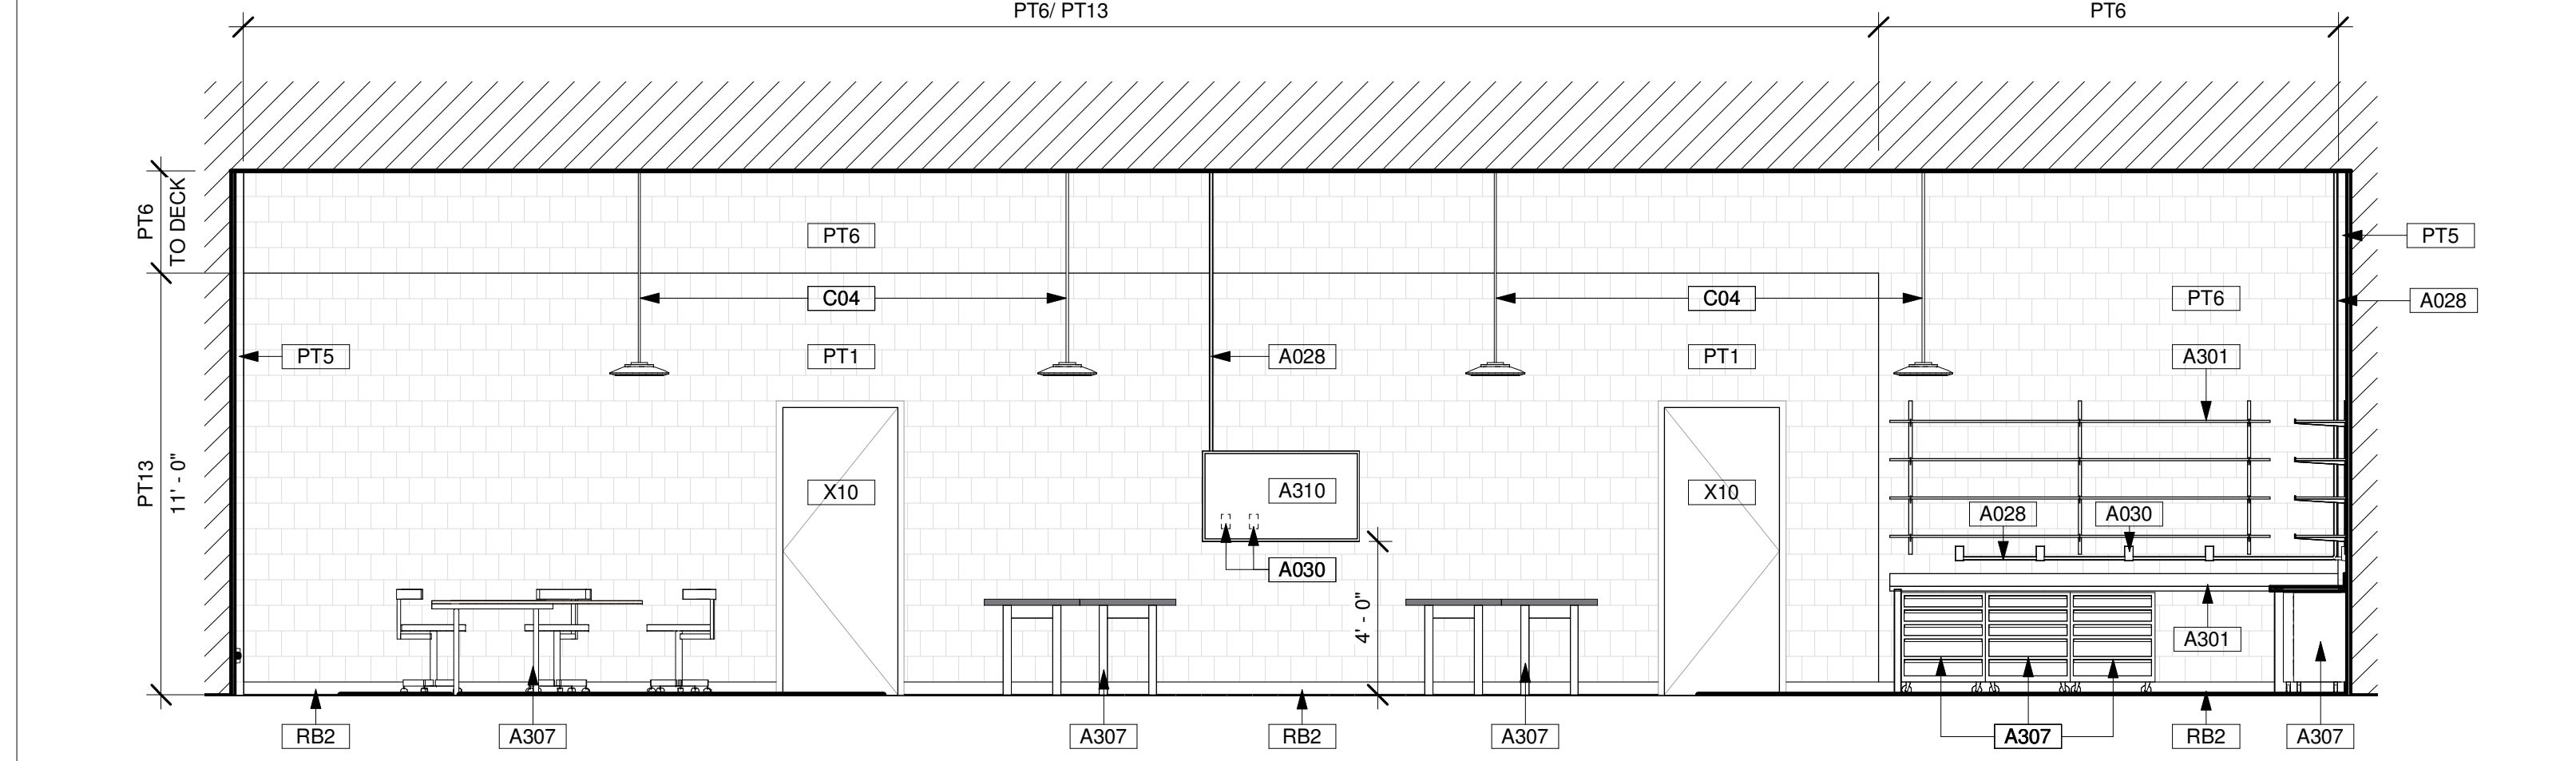

11 ROBOTICS LAB EAST
Scale: 1/4" = 1'-0"

Dimension & Alignment Support Notes:
ALIGN 1: Align face of new construction w/face of existing.
ALIGN 2: Align Centerline of new construction w/Centerline of existing.
ALIGN 3: Align gradeline and existing grad.
LEVEL 1: Ensure top of new construction is level w/existing surface.
LEVEL 2: Level floor & surface to receive new construction.
LEVEL 3: Ensure the top of grade is level w/surrounding ground.

Construction & Condition Support Notes:
HANDLE 1: Handle item w/care, and store for owner re-use.
HANDLE 2: Handle remaining building, pavement, fence, or item w/care.
HANDLE 3: Handle re-located items w/care. DISCONNECT 1, FIXW.
FIXW: Fix floor/wall/ceiling/item where construction was removed and prepare the area to receive new construction. Ensure the top of grade is level w/surrounding ground & maintain positive slope towards drain, gutter, and storm system away from building.
DEM: Fix floor/wall/ceiling/item where construction was removed and prepare the area to receive new construction. Ensure the top of grade is level w/surrounding ground & maintain positive slope towards drain, gutter, and storm system away from building.
DISCONNECT 1: Disconnect new construction to existing, ensure continuity and structural integrity. Ensure the top of new construction is level w/existing surface.
CONNECT: Connect remaining item to the new structure, and ensure structural integrity while meeting local Codes. Handle remaining buildings, pavement, fences, and other items w/care.
DISCONNECT 2: Disconnect and conceal all pipes, electrical cables, data cables, and conduits where construction is removed.
ENGINEER: Professional engineering supervision is required for this work.
SHOP: Provide shop drawings for this work.
REFERENCE: Refer to photo # for the existing condition at this location.
SLOPE: Maintain positive slope towards drains, gutters, and storm systems and away from the building.
PROTECT: Protect items to remain, including any buildings, furniture, sidewalks, roofs, utilities, and other items during the Demolition and Construction phases.
EGRESS: Maintain safe and unrestricted egress routes from areas adjacent to the Demolition site. Comply with all Applicable Codes.
TREE: Refer to Landscape Drawings & Specs for removing trees.
DEBRIS: Ensure all debris and utilities required for school operations are protected. Ensure school operation will not be interrupted.
ENSURE: Ensure the slope of the new roof matches the slope and slope direction of the existing roof.
PHASE 1: Work within this area may occur in phase ONE.
PHASE 2: Work within this area may occur in phase TWO.

03 SUPPORT NOTES
Scale: NTS

- A028 NEW EXPOSED CONDUIT FOR POWER/DATA AS SPECIFIED. RE: PLANS, ELECTRICAL DRAWINGS.
- A029 NEW WALL TRACK FOR POWER/DATA AS SPECIFIED. RE: PLANS, ELECTRICAL DRAWINGS.
- A030 NEW OUTLETS/DATAPORTS AS SPECIFIED. RE: PLANS, ELECTRICAL DRAWINGS.
- A031 NEW CEILING MOUNTED OUTLET AND POWER CORD REEL. RE: CEILING PLANS, ELECTRICAL DRAWINGS.
- A101 NEW DOOR AND FRAME AS SCHEDULED. HARDWARE AS SPECIFIED.
- A102 OVERHEAD GARAGE DOOR. RE: 19A5.00 RE: DOOR SCHEDULE FOR DIMENSIONS.
- A202 NEW STOREFRONT CURTAIN WALL. RE: WINDOW TYPES.
- A301 NEW MILLWORK. RE: MILLWORK DETAILS & SPECS. (HANDLE 2; FIXW)
- A303 MARKER BOARD (MB) OR ELECTRONIC MARKER BOARD (EMB). NOTE: ELECTRONIC MARKER BOARDS CONSIST OF MARKERBOARDS AND OFC WALL MOUNTED SMART PROJECTORS. RE: SPEC.
- A307 PROVIDE NEW FURNITURE AT INDICATED ROOMS/SPACES. FURNITURE TO BE COORDINATED WITH OWNER PRIOR TO SUBMITTAL AND PURCHASE. FURNITURE INDICATED IN DRAWINGS IS FOR REFERENCE AND SCOPE ONLY.
- A310 INTERACTIVE MONITOR AS SPECIFIED.
- A311 NEW WALL MOUNTED PROJECTOR AS SPECIFIED.
- C04 SCHEDULED DECORATIVE PENDANT LIGHT FIXTURE. RCP INDICATES TYPE. PENDANTS HANG TO 10'-0" A.F.F. OR 18" BELOW THE CEILING OR LOWEST DUCT, WHICHEVER IS LESS. PENDANTS SHALL IN NO CASES HANG BELOW 9'-0". RE: ELECTRICAL DRAWINGS.
- C09 CLOUD CEILING SUSPENDED WITH WIRE HANGERS FROM STRUCTURE ABOVE AT 48" O.C. MAX. FOR MATERIAL AND MOUNTING HEIGHT SEE CEILING PLANS.
- GP2 GRAPHIC PRINT 2
- PT1 PAINT (FIELD).
- PT2 PAINT (ACCENT 2).
- PT3 PAINT (ACCENT 3).
- PT4 PAINT (ACCENT 4).
- PT5 PAINT (ACCENT 5).
- PT6 PAINT (ACCENT 6).
- PT11 PAINT (ACCENT 11).
- RB2 RUBBER BASE
- X10 EXISTING DOOR / WINDOW. FIELD VERIFY. (PROTECT 1)

02 KEYNOTES
Scale: NTS

1. ELEVATIONS INDICATE VERTICAL DIMENSIONS ONLY. REFER TO FLOOR PLANS FOR HORIZONTAL DIMENSIONS.
2. FIELD VERIFY CONDITIONS PRIOR TO CONSTRUCTION. NOTIFY THE ARCHITECT OF ANY DISCREPANCIES.
3. REFER TO FLOOR PLANS FOR DOOR & WINDOW KEYS.
4. REFER TO FLOOR PLANS FOR SECTION AND DETAIL KEYS.
5. EQUALLY SPACE CONTROL JOINTS (CJ) AT SPANS NOT TO EXCEED 20' - 0" O.C. UNLESS JOINT LOCATIONS ARE OTHERWISE DIMENSIONED.
6. REFER/COORDINATE WITH ROOF PLAN FOR DOWNSPOUTS, ROOF/OVERFLOW DRAINS, GUTTERS, SCUPPERS, AND LADDER LOCATIONS.
7. PAINT STEEL ACCESS LADDERS AND SCUPPERS TO MATCH COLOR OF ADJACENT WALL SURFACE.
8. ALL EXPOSED METAL DOORS OTHER THAN PRE-FINISHED TO BE PAINTED SIMILAR TO ADJACENT WALL UNLESS OTHERWISE INDICATED.
9. REFER TO WINDOW AND DOOR TYPES. SHEETS A5.00 & A5.01 FOR MORE INFO.
10. REFER TO SPECIFICATIONS FOR MORE INFORMATION ON MATERIALS AND FINISHES.

01 GENERAL NOTES - ELEVATIONS
Scale: NTS

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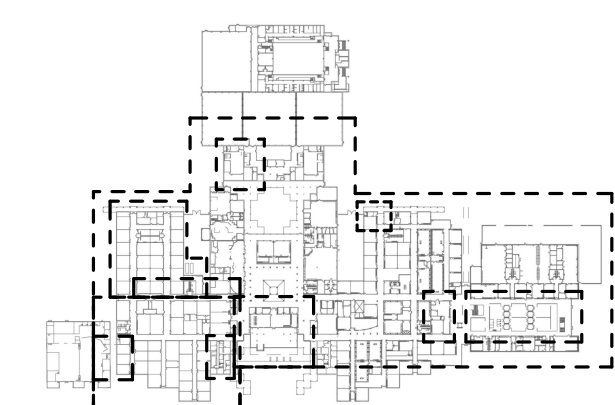
STRUCTURAL ENGINEERS
DALLY ASSOCIATES
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PROFESSIONAL SEAL:**A PROJECT FOR:**

**STAFFORD
HIGH SCHOOL
& MAGNET
SCHOOL
RENOVATIONS**

1625 STAFFORDSHIRE
ROAD,
STAFFORD, TX 77477


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	03/13/2020	ISSUE FOR BID, PERMIT, & CONSTRUCTION







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Drawn By	LT
Checked By	AW
Approved By	MS
Drawing Title	

INTERIOR ELEVATIONS







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**30 ELEVATION @ READING ROOM - WEST**
Scale: 1/4" = 1'-0"

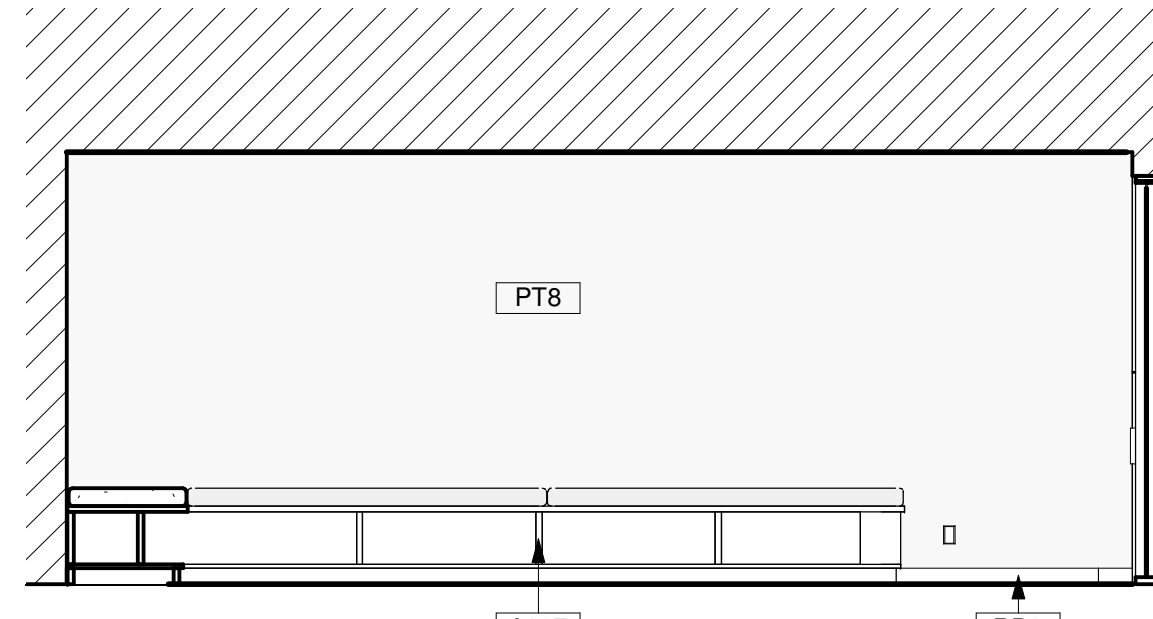NOTE: EAST WALL TO RECEIVE SAME MATERIAL/COLOR TREATMENT AS WEST WALL.

**25 ELEVATION @ READING ROOM - SOUTH**
Scale: 1/4" = 1'-0"**29 STUDENT COLLABORATION @ NORTH WALL**
Scale: 1/4" = 1'-0"**14 STUDENT COLLABORATION @ EAST WALL**
Scale: 1/4" = 1'-0"**28 ELEVATION @ RECEPTION - NORTH**
Scale: 1/4" = 1'-0"

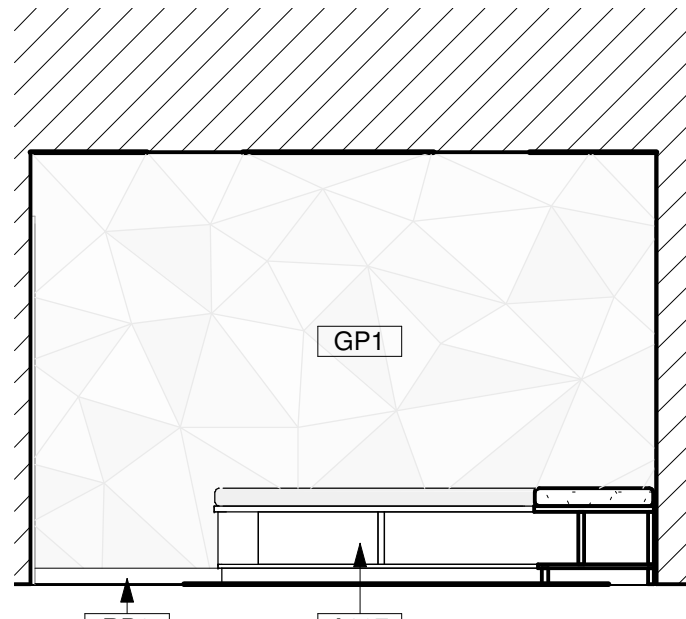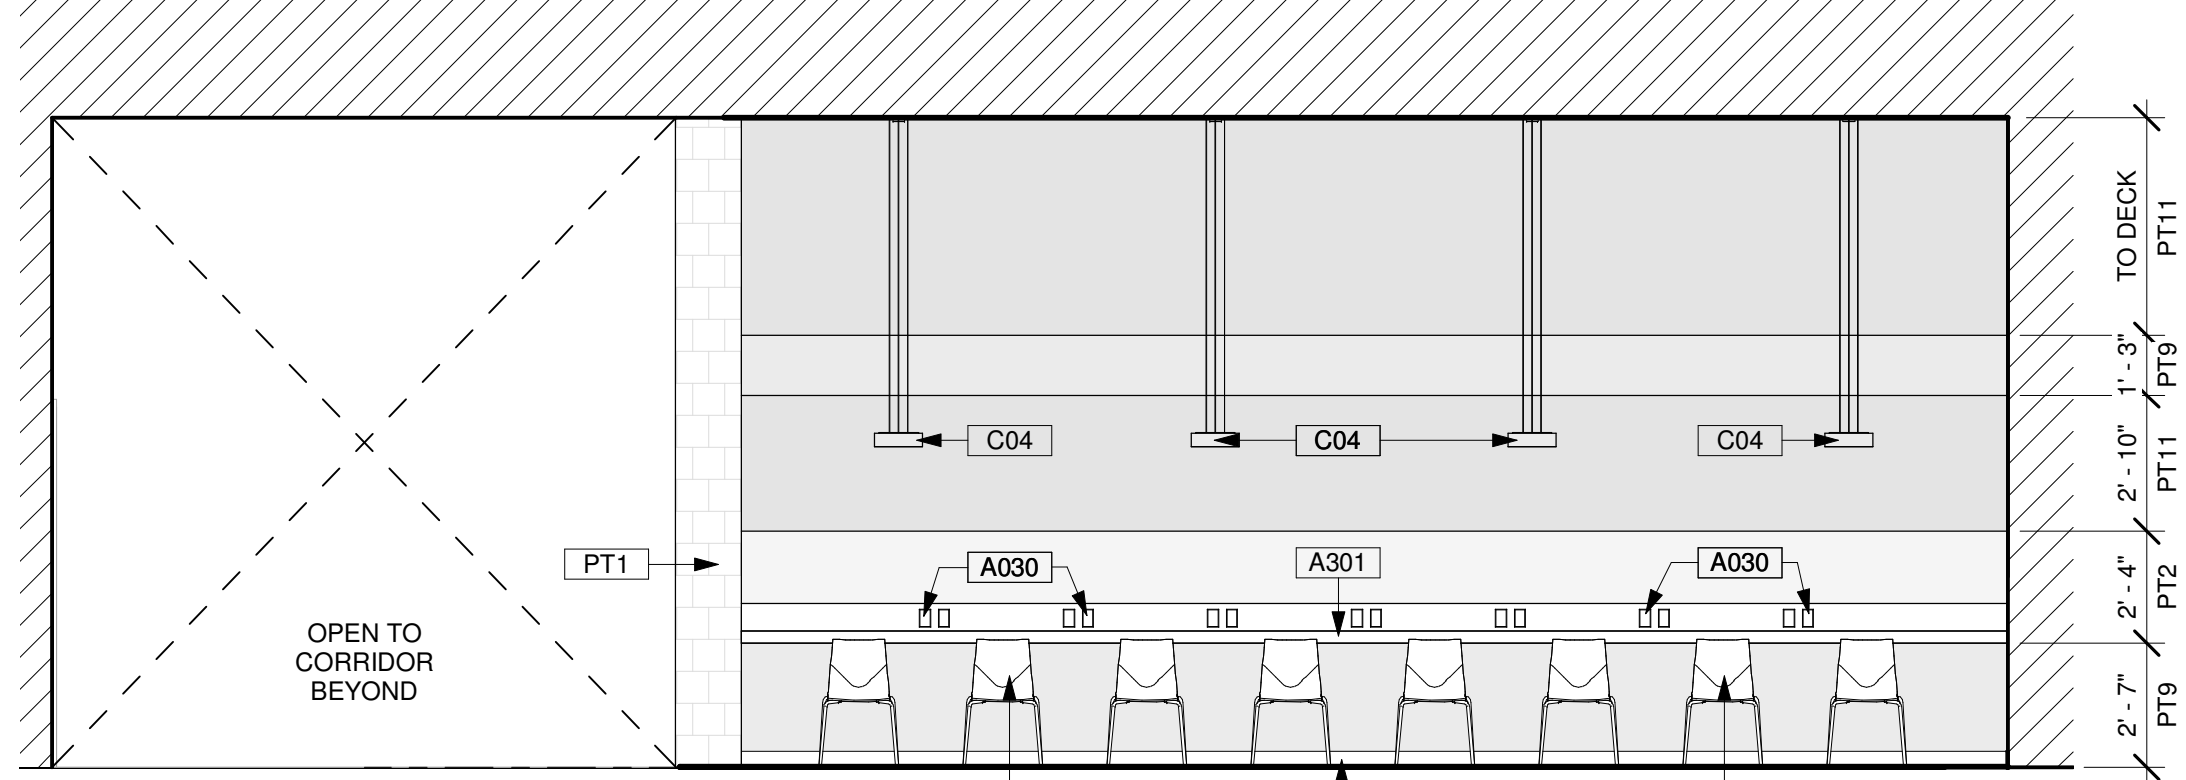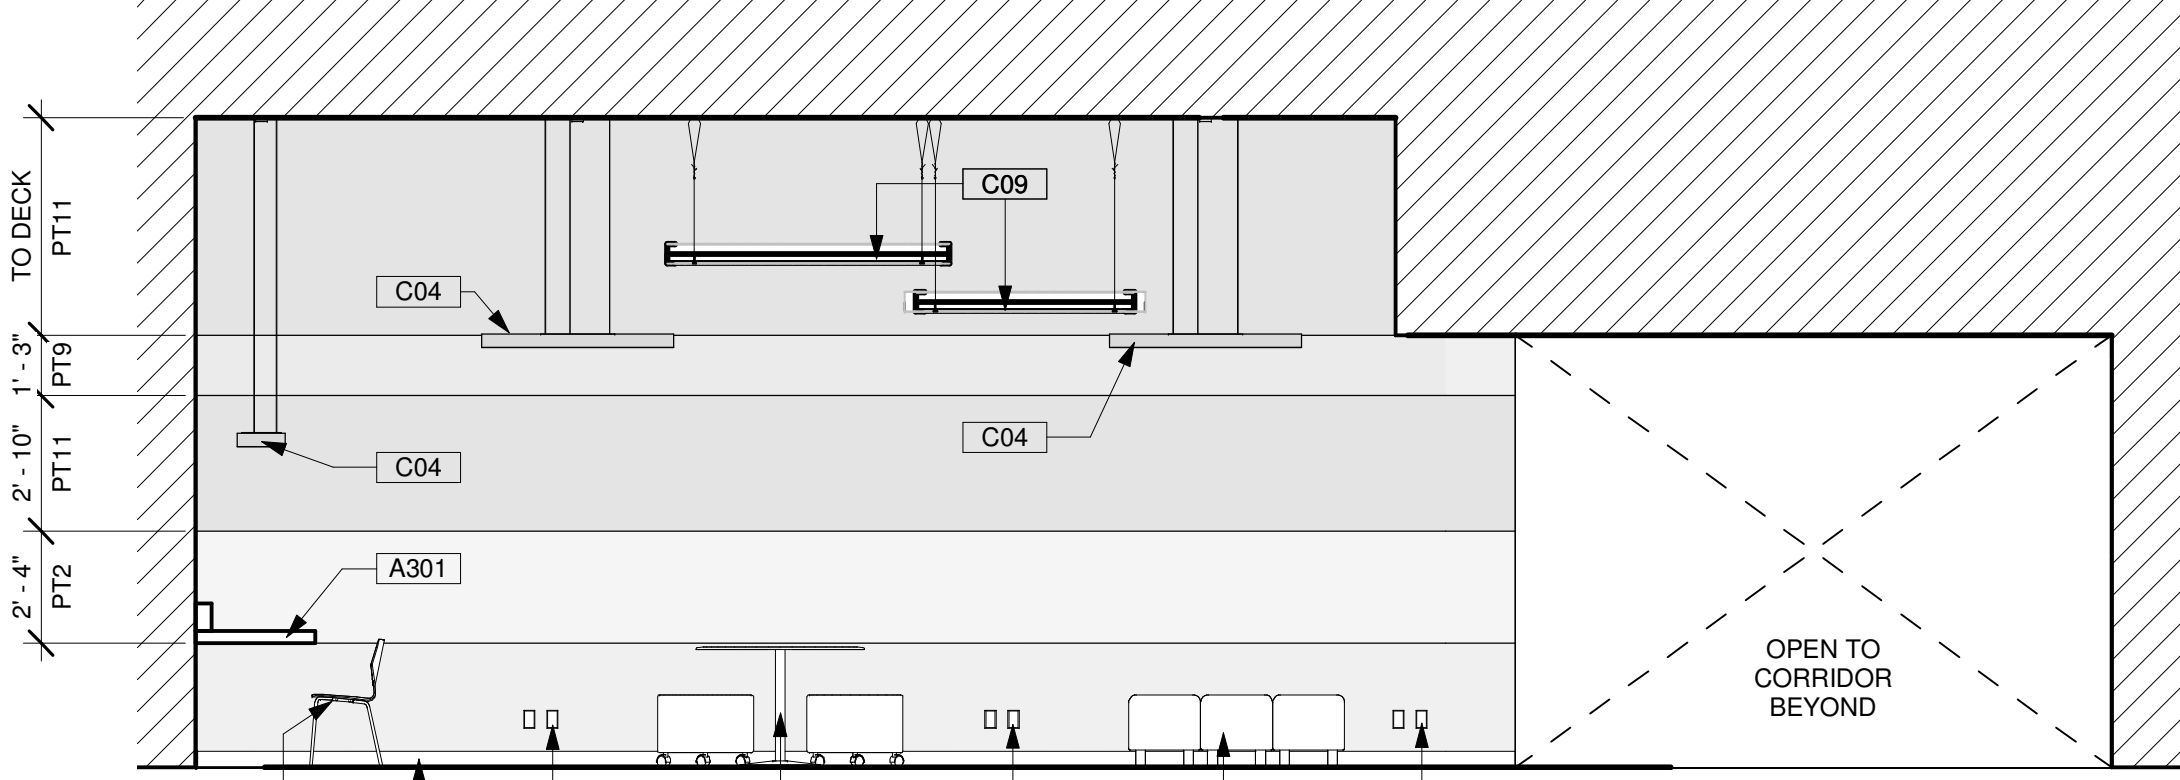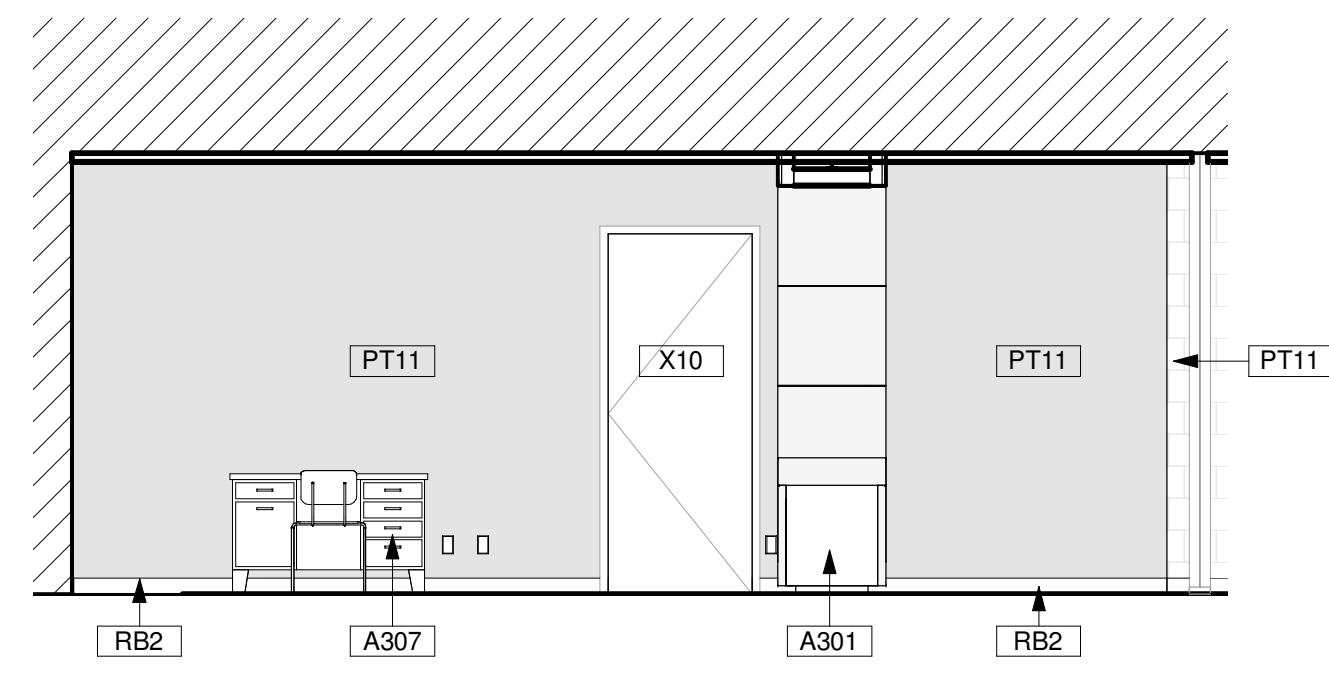NOTE: SOUTH WALL TO RECEIVE SAME MATERIAL/COLOR TREATMENT AS NORTH WALL.

**18 ELEVATION @ RECEPTION - WEST**
Scale: 1/4" = 1'-0"**13 CONNECTOR AND LEARNING STAIRS - NORTH WALL**
Scale: 1/4" = 1'-0"**27 LEARNING STAIRS - WEST WALL**
Scale: 1/4" = 1'-0"**12 LEARNING STAIRS - SOUTH WALL**
Scale: 1/4" = 1'-0"**26 MEDICAL LAB - SOUTH**
Scale: 1/4" = 1'-0"**11 MEDICAL LAB - WEST**
Scale: 1/4" = 1'-0"

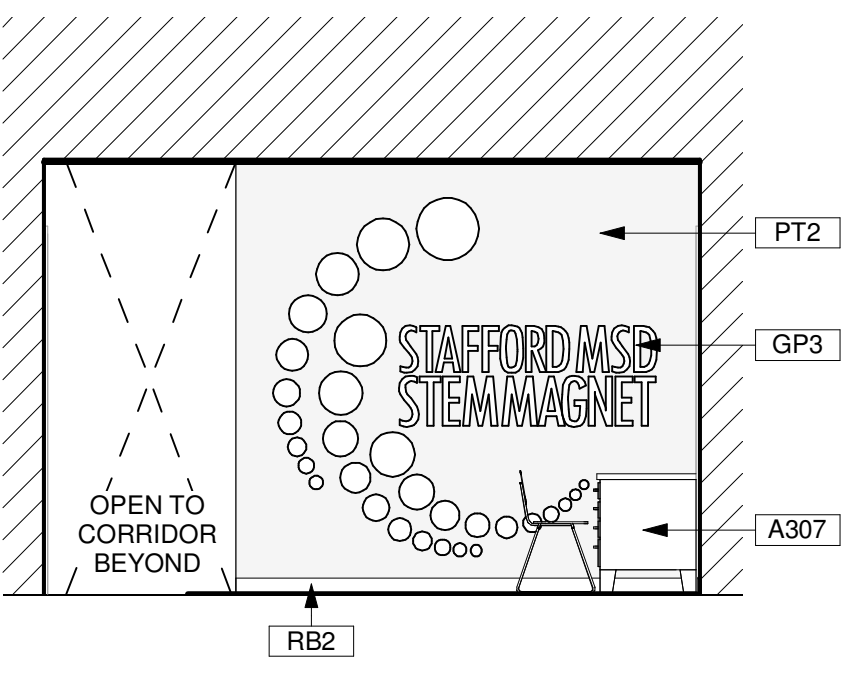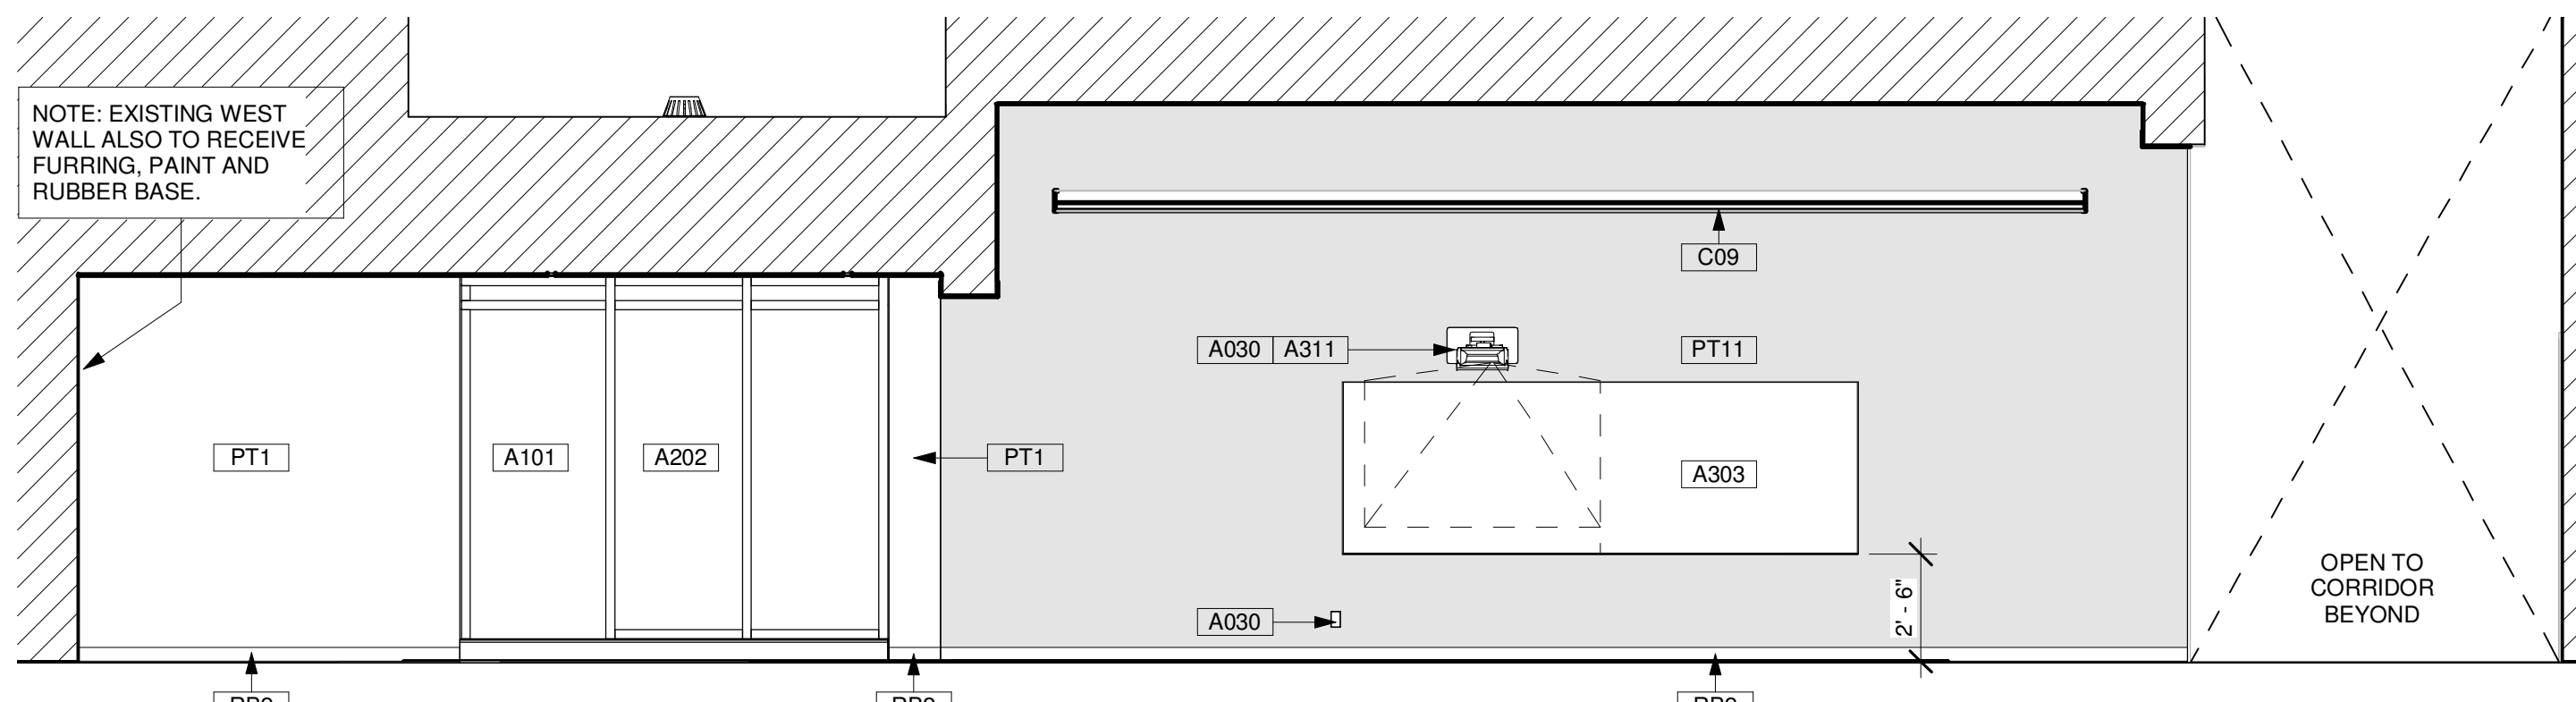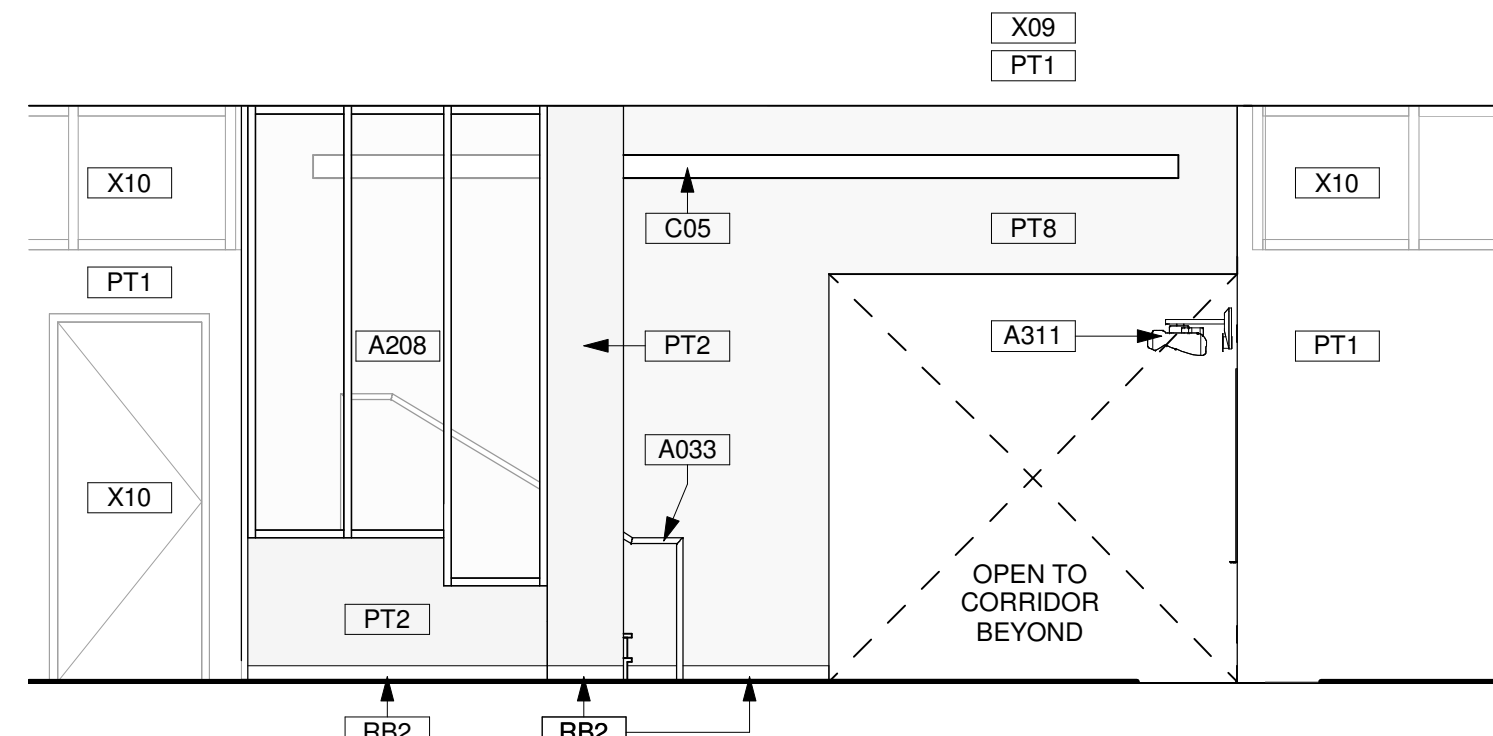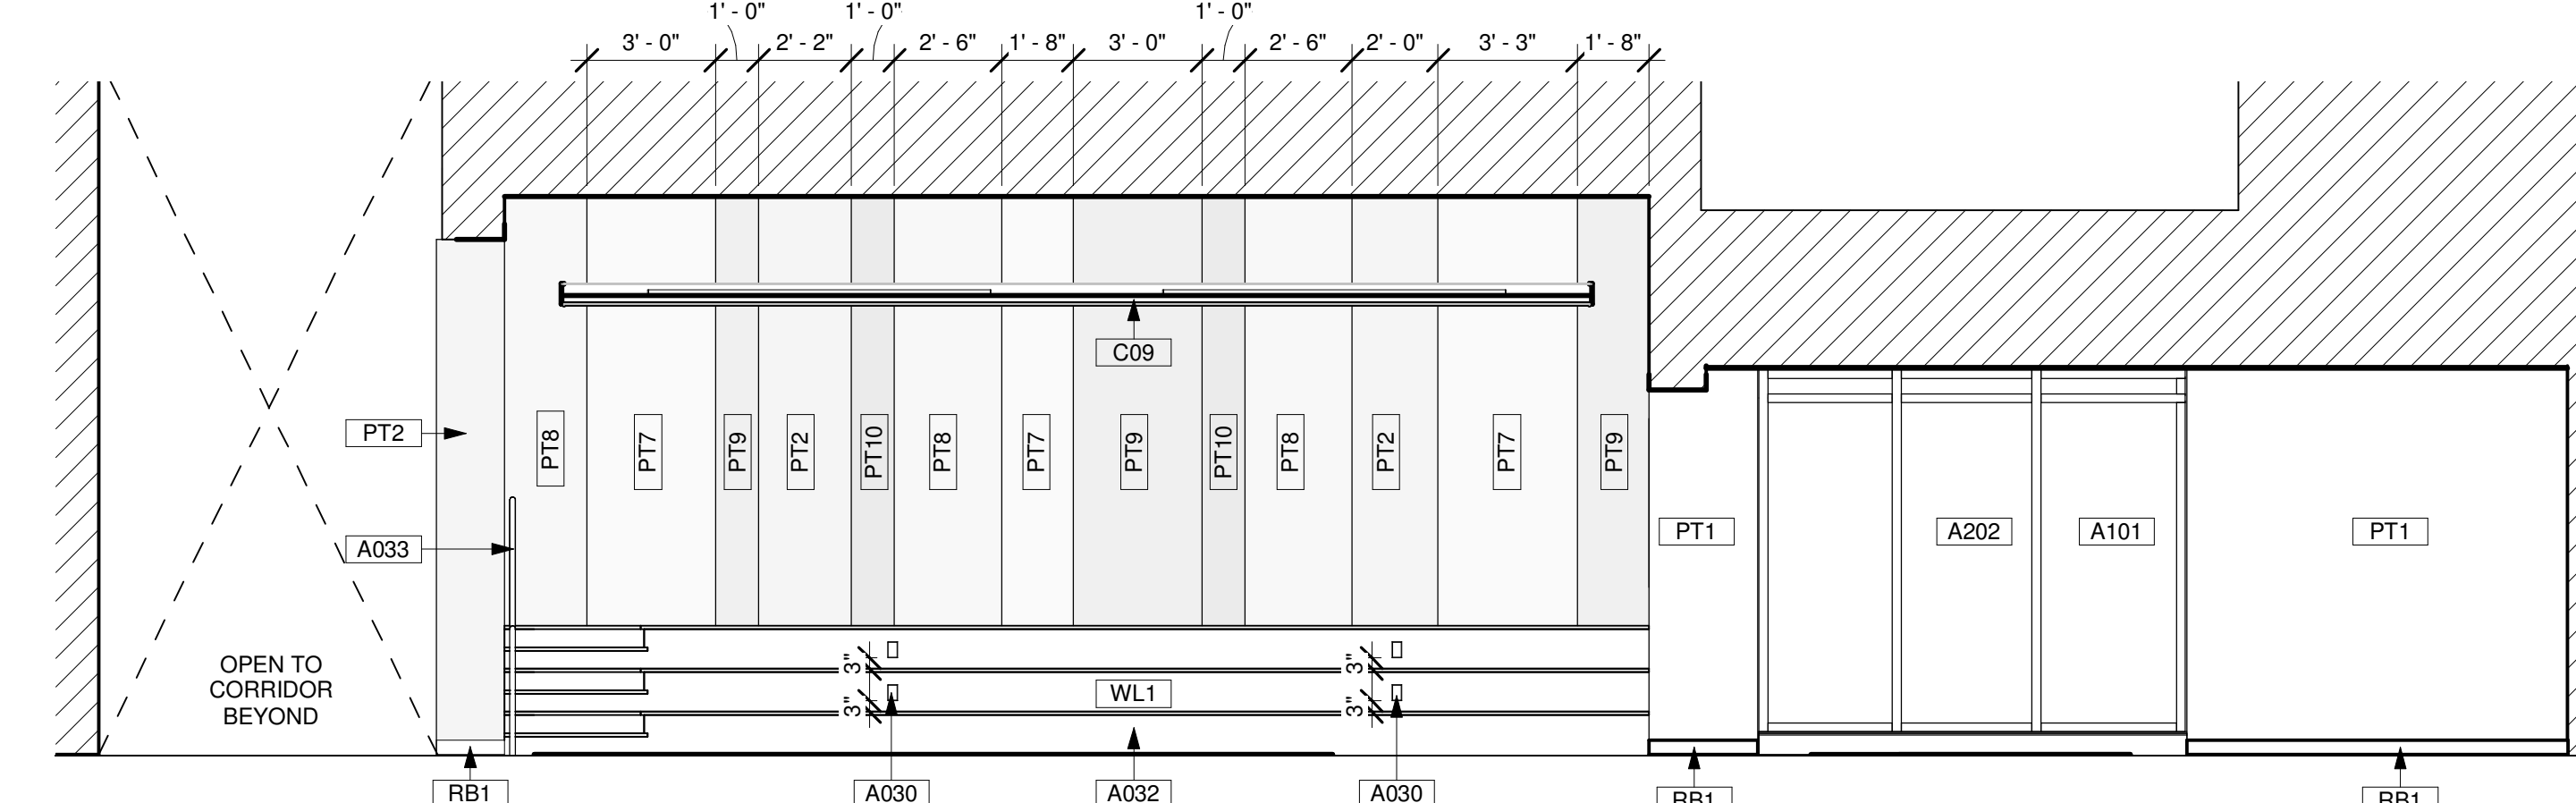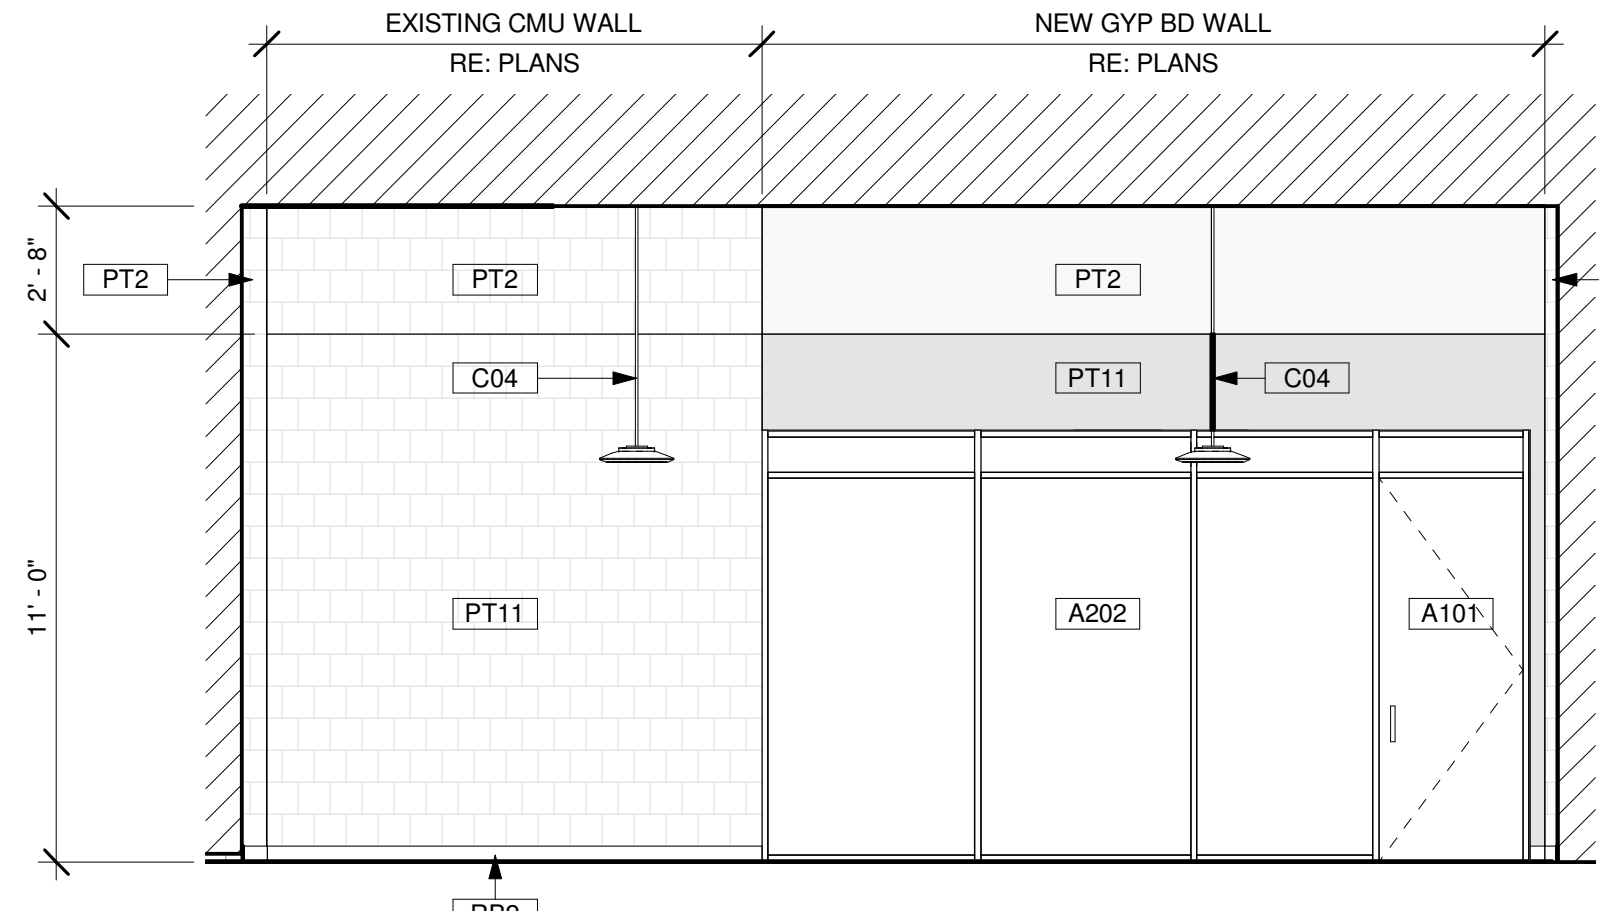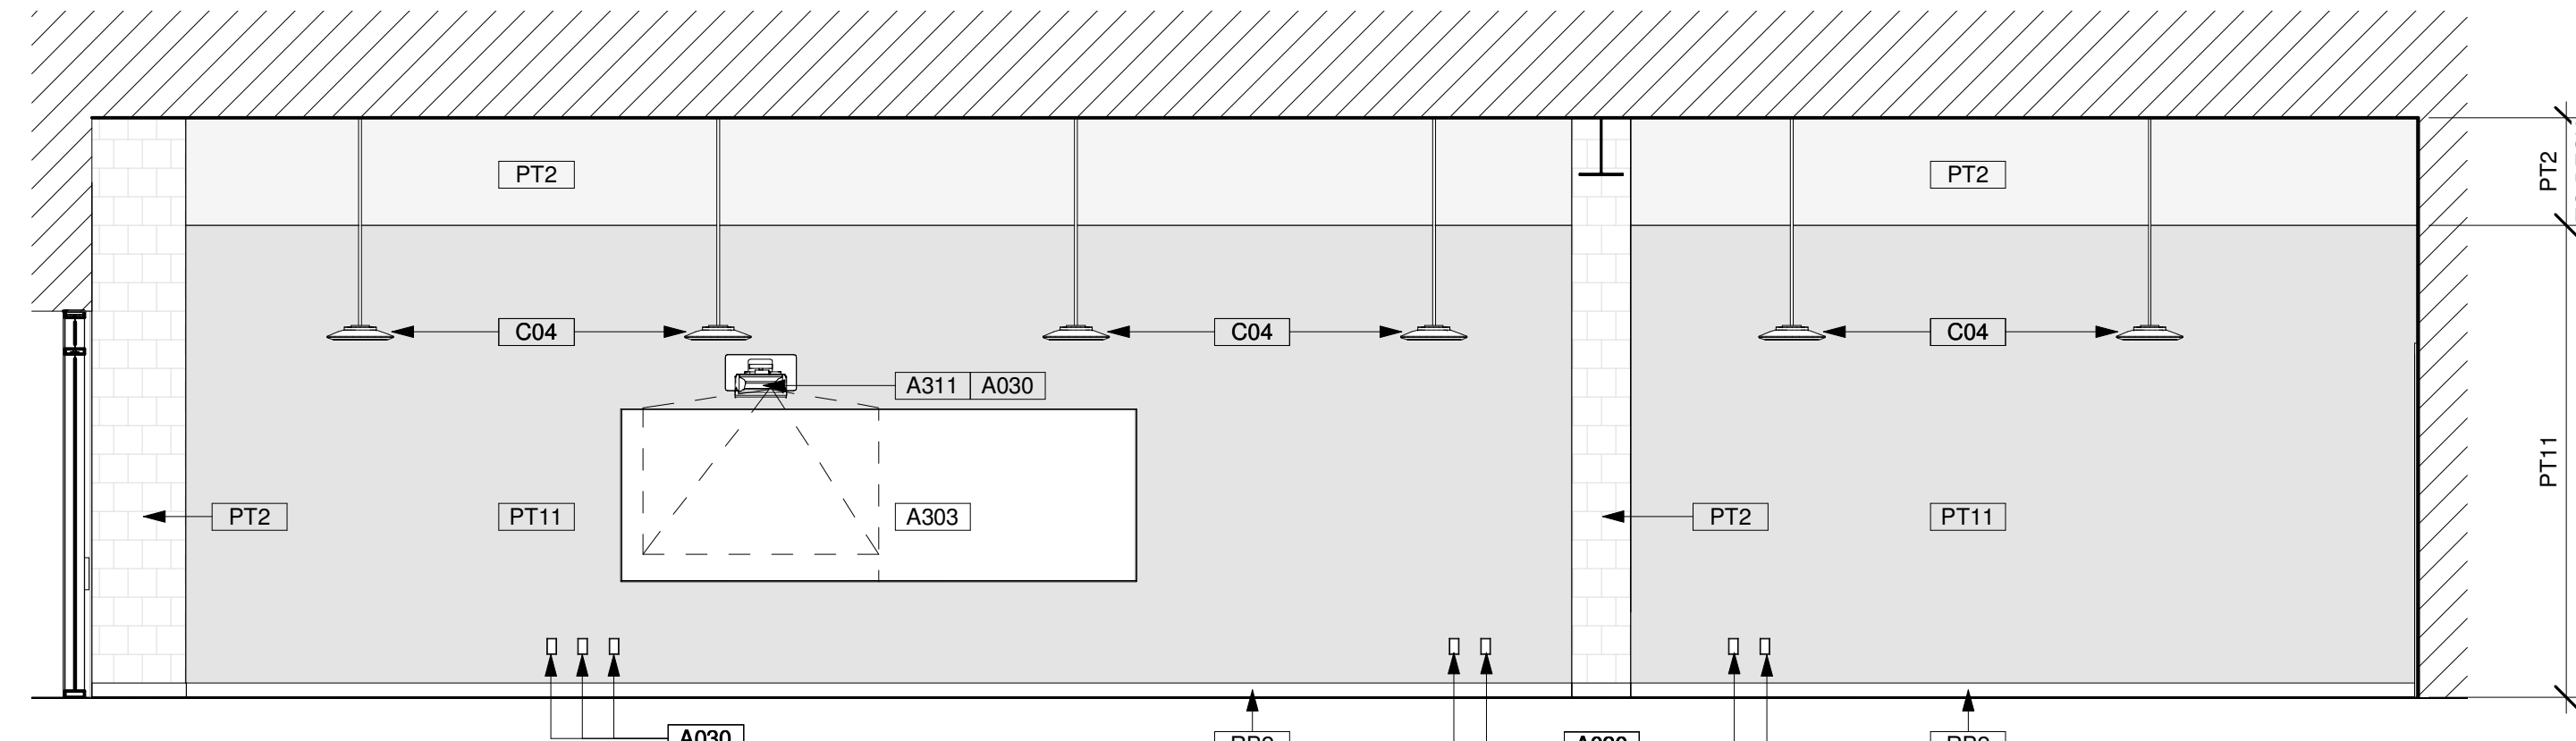- Dimension & Alignment Support Notes:**
- ALIGN 1:** Align face of new construction w/face of existing.
 - ALIGN 2:** Align Centerline of new construction w/Centerline of existing.
 - ALIGN 3:** Align gridline and existing grid.
 - LEVEL 1:** Ensure top of new construction is level w/existing surface.
 - LEVEL 2:** Level floor & surface to receive new construction.
 - LEVEL 3:** Ensure the top of grade is level w/surrounding ground.
- Construction & Condition Support Notes:**
- HANDLE 1:** Handle item w/cares, and store for owner review.
 - HANDLE 2:** Handle remaining building, pavement, fence, or item w/cares.
 - HANDLE 3:** Handle re-located items with care. DISCONNECT 1, FIXW.
 - FIXW:** Fix floor/wall/ceiling item where construction was removed and prepare the area to receive new construction. Ensure the top of grade is level w/surrounding ground & maintain positive slope towards drain, gutter, and storm system away from building.
 - FIXP:** Fix floor/wall/ceiling item where construction was removed and prepare the area to receive new construction. Ensure the top of grade is level w/surrounding ground & maintain positive slope towards drain, gutter, and storm system away from building.
 - DISCONNECT 1:** Disconnect and conceal all pipes, electrical cables, data cables, and conduits where construction is level w/existing surface.
 - DISCONNECT 2:** Disconnect and conceal all pipes, electrical cables, data cables, and conduits where construction is removed.
- ENGINEER:** Professional engineering supervision is required for this work.
- SHOP:** Provide shop drawings for this work.
- REFERENCE:** Refer to photo for the existing condition at this location.
- SLOPE:** Maintain positive slope towards drains, gutters, and storm systems and away from the building.
- PROTECT:** Protect items to remain, including any buildings, furniture, sidewalks, roofs, utilities, and other items during the Demolition and Construction phases.
- EGRESS:** Maintain safe and unrestricted egress routes from areas adjacent to the Demolition site. Comply with all Applicable Codes.
- TABLE:** Refer to Landscape Drawings & Specs for removing trees.
- GENERAL:** Ensure all slopes to drain as intended, and that downspouts indicated to remain are protected to maintain normal flow at all times during demolition and construction. Protect items to remain including any buildings, furniture, sidewalks, roofs, utilities, and other items during demolition and construction.
- ENSURE:** Ensure the slope of the new roof matches the slope and slope direction of the existing roof.
- PHASE 1:** Work within this area may occur in phase ONE.
- PHASE 2:** Work within this area may occur in phase TWO.

03 SUPPORT NOTES

Scale: NTS

- A030 NEW OUTLETS/DATAPORTS AS SPECIFIED. RE: PLANS, ELECTRICAL DRAWINGS.
- A032 NEW LEARNING STAIRS, RE-PLANS.
- A033 PROVIDE TUBULAR SS HANDRAIL. RE-PLANS.
- A101 NEW DOOR AND FRAME AS SCHEDULED. HARDWARE AS SPECIFIED.
- A202 NEW STOREFRONT CURTAIN WALL. RE: WINDOW TYPES.
- A208 NEW INTERIOR ALUM. STOREFRONT FLOOR TO CEILING ABOVE. (EXIST)
- A301 NEW MILLWORK. RE: MILLWORK DETAILS & SPECS. (HANDLE 2: FIXW)
- A303 MARKER BOARD (MB) OR ELECTRONIC MARKER BOARD (EMB). NOTE: ELECTRONIC MARKER BOARDS CONSIST OF MARKERBOARDS AND OF WALL MOUNTED SMART PROJECTORS. RE: SPEC.
- A307 PROVIDE NEW FURNITURE AT INDICATED ROOMS/SPACES. FURNITURE TO BE COORDINATED WITH OWNER PRIOR TO SUBMITTAL AND PURCHASE. FURNITURE INDICATED IN DRAWINGS IS FOR REFERENCE AND SCOPE ONLY.
- A311 NEW WALL MOUNTED PROJECTOR AS SPECIFIED.
- C04 SCHEDULED DECORATIVE PENDANT LIGHT FIXTURE. RCP INDICATES TYPE. PENDANTS HANG TO 10'-0" A.F.F. OR 18" BELOW THE CEILING OR LOWEST DUCT, WHICHEVER IS LESS. PENDANTS SHALL IN NO CASES HANG BELOW 8'-0" RE: ELECTRICAL DRAWINGS.
- C05 PERIMETER TRIM AS SPECIFIED AROUND CLOUD CEILING.
- C09 CLOUD CEILING SUSPENDED WITH WIRE HANGERS FROM STRUCTURE ABOVE AT 48" O.C. MAX. FOR MATERIAL AND MOUNTING HEIGHT SEE CEILING PLANS.
- GP1 GRAPHIC PRINT 1
- GP3 GRAPHIC PRINT OF SCHOOL LOGO
- PT1 PAINT (FIELD).
- PT2 PAINT (ACCENT 2).
- PT7 PAINT (ACCENT 7).
- PT8 PAINT (ACCENT 8).
- PT9 PAINT (ACCENT 9).
- PT10 PAINT (ACCENT 10).
- PT11 PAINT (ACCENT 11).
- RB1 RUBBER BASE
- RB2 RUBBER BASE
- WL1 WOOD GRAIN LAMINATE
- X09 EXISTING BULKHEAD FLURR DOWN. CONTRACTOR TO VERIFY IN FIELD.
- X10 EXISTING DOOR / WINDOW. FIELD VERIFY. (PROTECT 1)


02 KEYNOTES

Scale: NTS

- ELEVATIONS INDICATE VERTICAL DIMENSIONS ONLY. REFER TO FLOOR PLANS FOR HORIZONTAL DIMENSIONS.
- FIELD VERIFY CONDITIONS PRIOR TO CONSTRUCTION. NOTIFY THE ARCHITECT OF ANY DISCREPANCIES.
- REFER TO FLOOR PLANS FOR DOOR & WINDOW KEYS.
- REFER TO FLOOR PLANS FOR SECTION AND DETAIL KEYS.
- EQUALLY SPACE CONTROL JOINTS (CJ) AT SPANS NOT TO EXCEED 20" O.C. UNLESS JOINT LOCATIONS ARE OTHERWISE DIMENSIONED.
- REFER COORDINATE WITH ROOF PLAN FOR DOWNSPOUTS, ROOF/COVERFLOW DRAINS, GUTTERS, SCUPPERS, AND LADDER LOCATIONS.
- PAINT STEEL ACCESS LADDERS AND SCUPPERS TO MATCH COLOR OF ADJACENT WALL SURFACE.
- ALL EXPOSED METAL DOORS OTHER THAN PRE-FINISHED TO BE PAINTED SIMILAR TO ADJACENT WALL UNLESS OTHERWISE INDICATED.
- REFER TO WINDOW AND DOOR TYPES, SHEETS A5.00 & A5.01 FOR MORE INFO.
- REFER TO SPECIFICATIONS FOR MORE INFORMATION ON MATERIALS AND FINISHES.

01 GENERAL NOTES - ELEVATIONS


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- NOTES:**
- REFER TO AISC - MANUAL OF STEEL CONSTRUCTION (SECTION 1).
 - ALLOWABLE WELD CAPACITY IS BASED UPON A BEAM WEB THICKNESS OF 1/2" FOR A36 MATERIAL AND 3/8" FOR ASTM A572, GRADE 50 MATERIAL. REDUCE THIS CAPACITY PROPORTIONALLY FOR A LESSER WEB THICKNESS.
 - THE SUPPORTING PLATE CAPACITY SHALL BE BASED UPON AN ALLOWABLE LOAD PER BOLT OF 65 KIPS PER INCH OF PLATE THICKNESS FOR A36 MATERIAL OR 73 KIPS PER INCH OF PLATE THICKNESS FOR ASTM A572, GRADE 50 MATERIAL. FOR BEAM CONNECTIONS ON TWO SIDES, THE SUM OF THE LOADS PER BOLT SHALL BE CONSIDERED.
 - FOR COPED BEAM CONNECTIONS, THE CAPACITY OF THE NET SHEAR AREA OF THE WEB SHALL BE VERIFIED.
 - THE CAPACITY OF THE CONNECTION SHALL BE THE LESSER VALUE OF THE ALLOWABLE BOLT CAPACITY, ALLOWABLE WELD CAPACITY, SUPPORTING PLATE CAPACITY OR THE WEB NET SHEAR AREA CAPACITY.
 - AT DOUBLE CONNECTIONS (WHEN BEAMS FRAME OPPOSITE EACH OTHER) PROVIDE A TEMPORARY SEAT ANGLE WITH (2) 3/4" BOLTS UNDER THE FIRST BEAM END, TO WEB OR FLANGE, PER OSHA REQUIREMENTS.

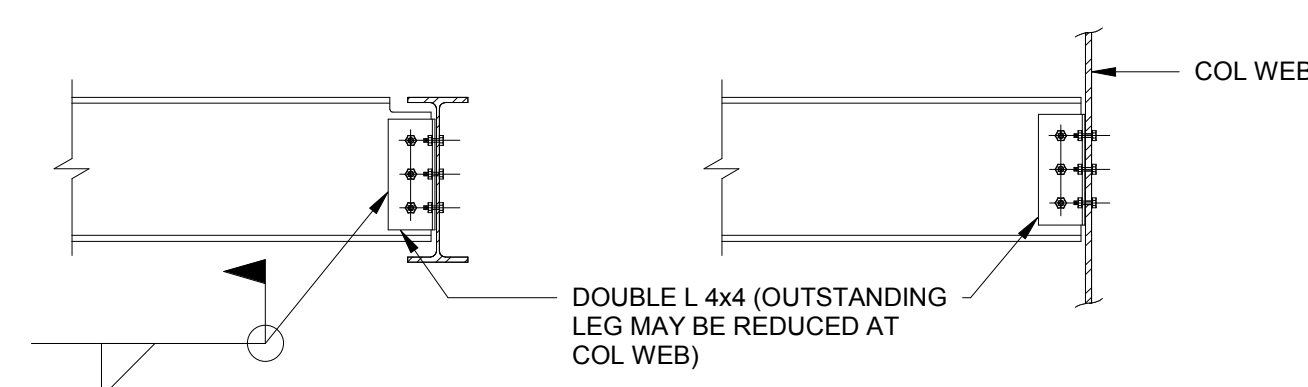1 BEAM TO BEAM CONNECTION


N.T.S.



- NOTES:**
- CONN. TO BE ADEQUATE FOR AXIAL BRACING FORCE = 1% OF WORKING COLUMN LOAD IN ADDITION TO END REACTION DETERMINED PER STEEL GENERAL NOTES SHEET (U.N.O. ON DWG.) ALLOWABLE STRESS CAN BE INCREASED 1/3 FOR THIS CONDITION. COLUMN LOAD WILL BE FURNISHED OR CAN BE DETERMINED FROM AISC MANUAL FOR FLOOR TO FLOOR HEIGHT.
 - SINGLE PLATE CONNECTION IS ALLOWED ONLY WHEN AXIAL FORCE BRACING THE COLUMN IS LESS THAN 20 KIPS. THE DESIGN OF SINGLE PLATE CONNECTION WITH AXIAL FORCE LESS THAN 20 KIPS, SHOULD BE SUBSTANTIATED BY CALCULATION AND IS SUBJECT TO ENGINEER'S APPROVAL.
 - AT FIELD WELDED CONNECTIONS, PROVIDE L4x4x3/8" x COLUMN WIDTH (SEAT ANGLE), PER OSHA REQUIREMENTS.

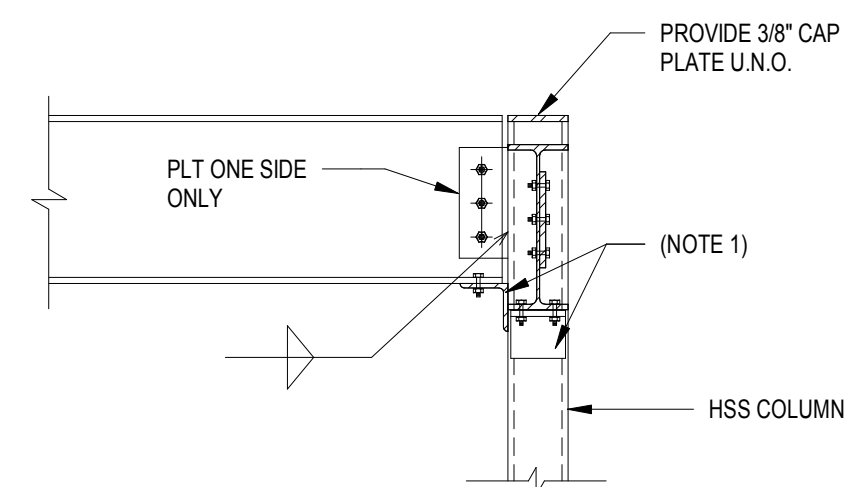
2 BEAM TO COLUMN CONNECTION

N.T.S.

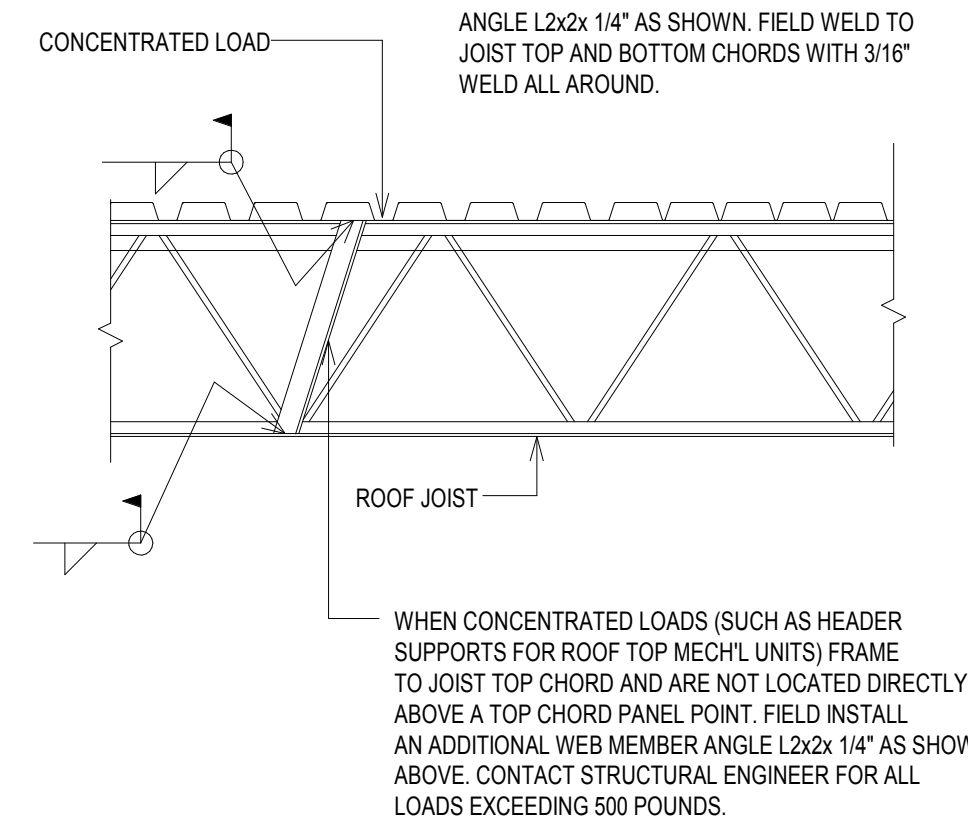


3 LOAD OFFSET FROM JOIST PANEL POINT

3/4" = 1'-0"

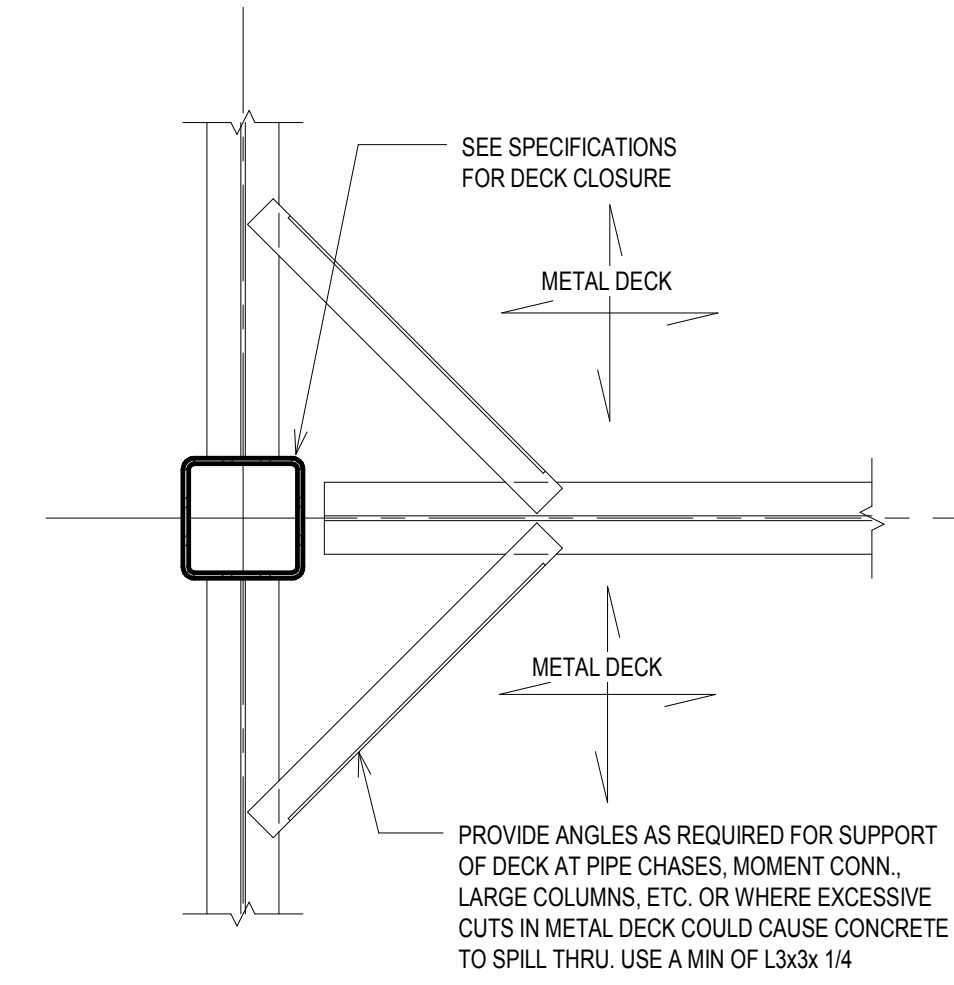

4 TYP. DETAIL FOR SUPPORT OF METAL DECK AT COL

3/4" = 1'-0"

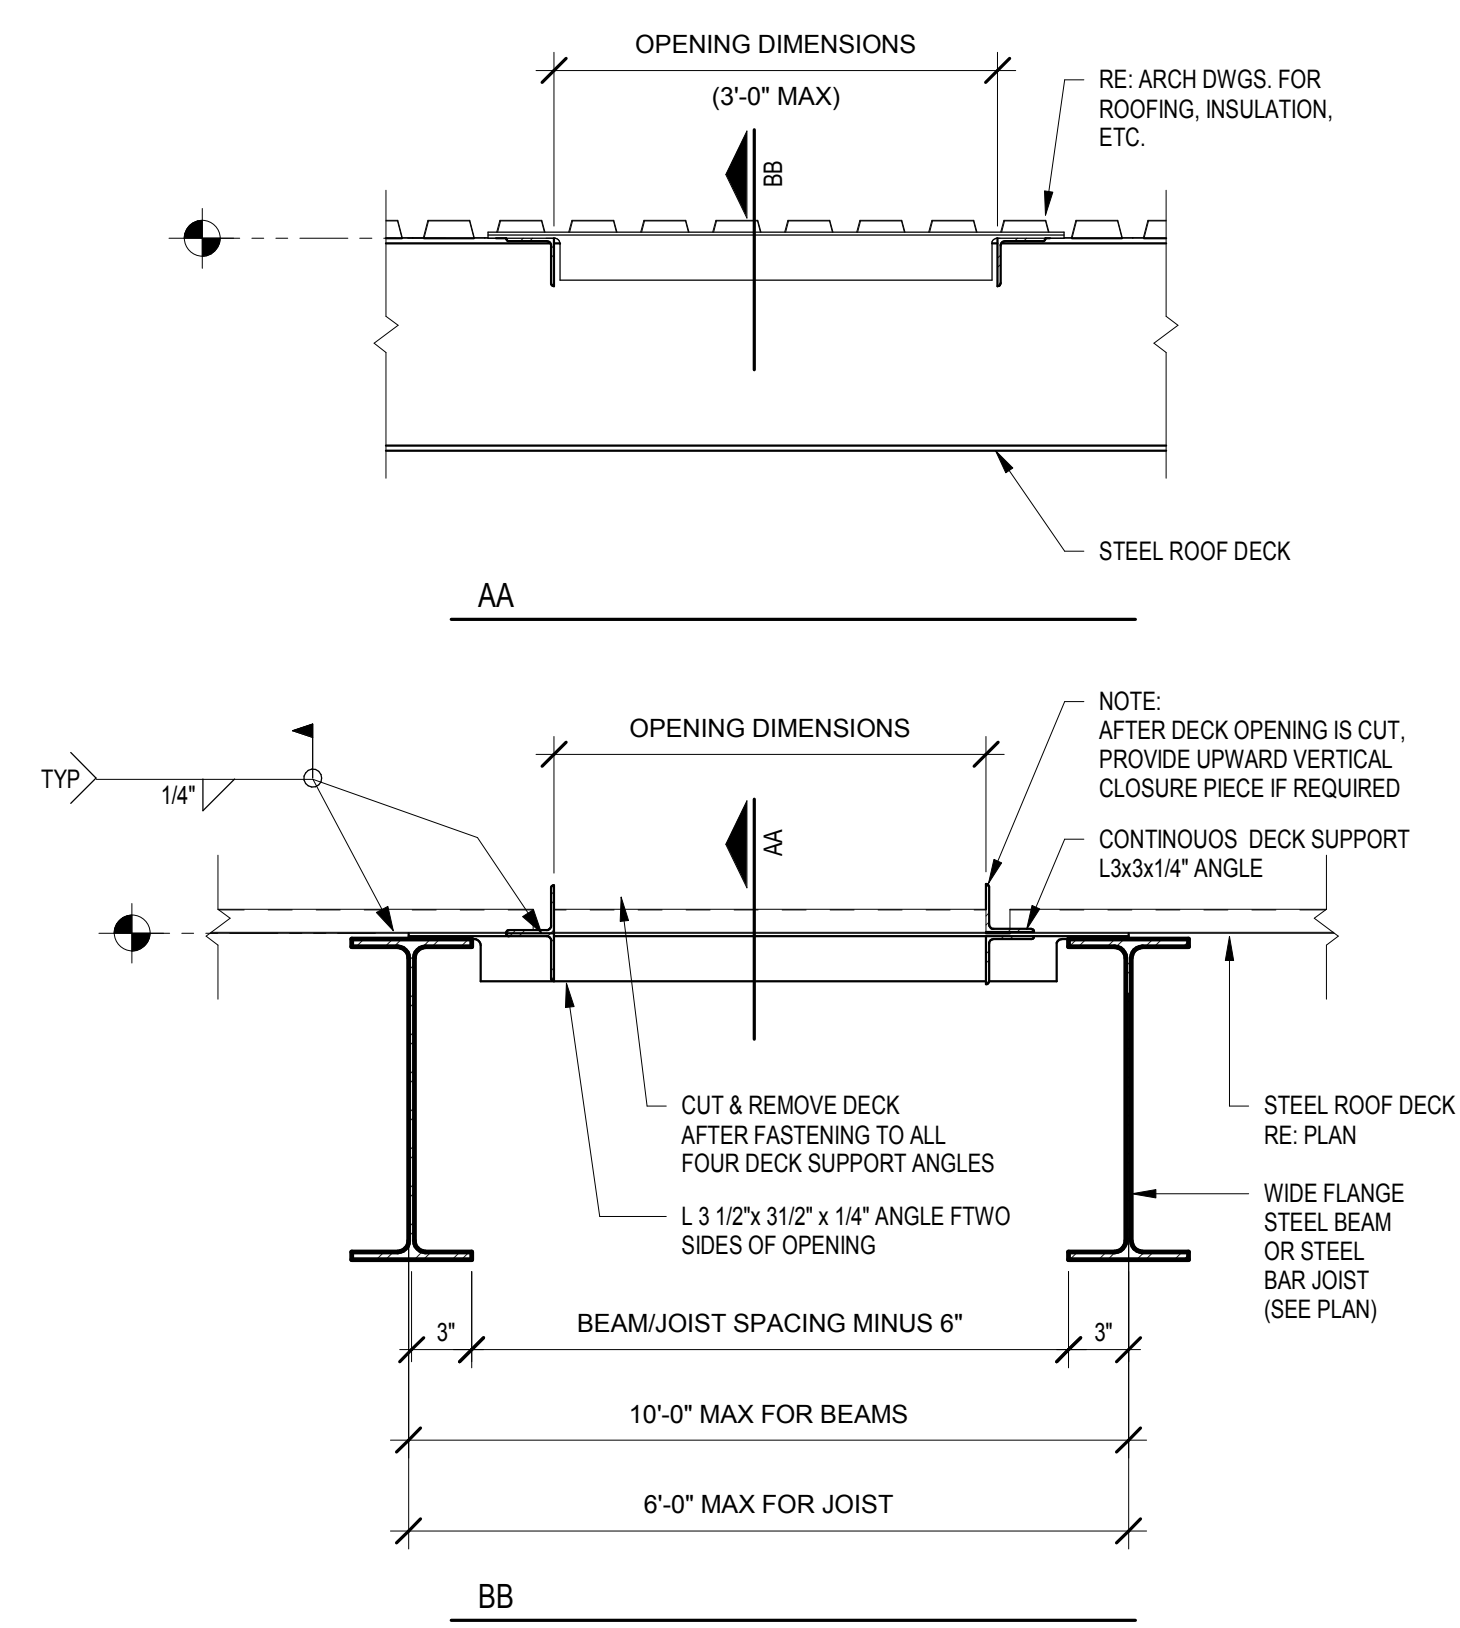

- NOTES:**
- THESE DETAILS APPLY TO ALL OPENINGS WITH A DIMENSION GREATER THAN 12"
 - THESE DETAILS APPLY TO FLOOR DRAINS, ROOF DRAINS, & OVERFLOW DRAINS.
 - NOTE THAT ANGLE FRAME AND OPENING MAY BE REQUIRED THAT ARE NOT INDICATED ON THE STRUCTURAL DRAWINGS.
 - COORDINATE WITH ARCHITECTURAL & M.E.P. DRAWINGS FOR SLEEVES, CURBS, INSERTS, ETC. NOT INDICATED ON THE STRUCTURAL DRAWINGS.
 - THE LOCATION OF SLEEVES & OR OPENINGS SHALL BE SUBMITTED TO ASA DALLY INC. FOR REVIEW.
 - HEAVIER STRUCTURAL MEMBERS MAY BE REQUIRED FOR OPENINGS LARGER THAN INDICATED IN THIS DETAIL.

5 TYPICAL FRAMING OPENING AT

3/4" = 1'-0"

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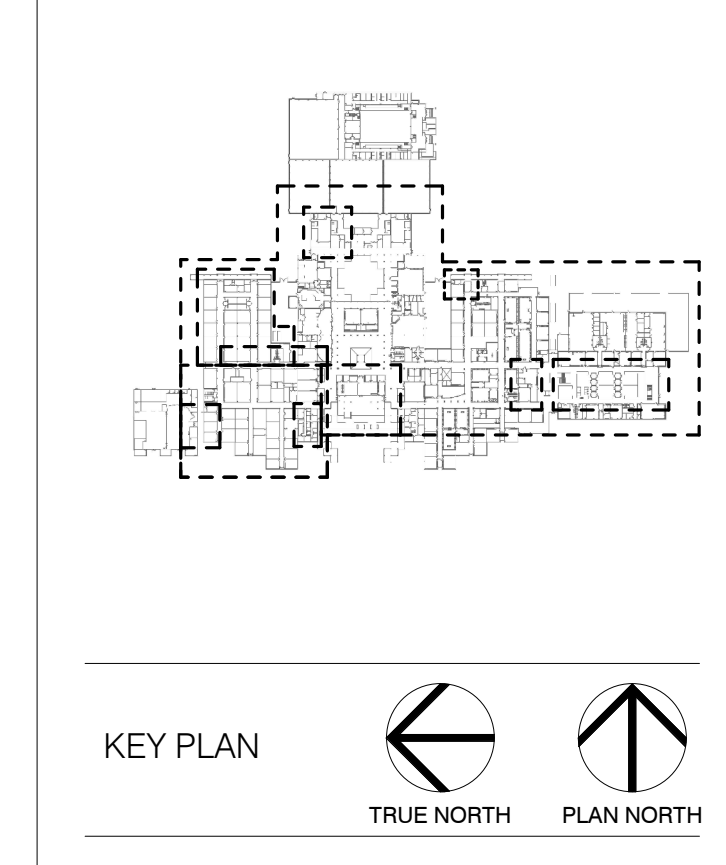
PROFESSIONAL SEAL:

A PROJECT FOR:

STAFFORD HIGH SCHOOL & MAGNET SCHOOL RENOVATIONS

1625 STAFFORDSHIRE ROAD
STAFFORD, TX 77477

#	Date	ISSUED FOR
1	03-12-2020	Issue for Bid, Permit and Construction



Project Number	19006-A
Drawn By	JGC
Checked By	LM
Approved By	LM
Drawing Title	TYPICAL FRAMING DETAILS
Drawing Number	S501

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+ ASSOCIATES
STRUCTURAL | CIVIL

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T 713 337 8881
Texas Registered Engineering Firm
F-003426
PROJECT: 19-366-00

190006-19-366-00


CONSULTANTS:
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PROFESSIONAL SEAL:

 3/12/20





A PROJECT FOR:
**STAFFORD
 HIGH SCHOOL
 & MAGNET
 SCHOOL
 RENOVATIONS**
 1625 STAFFORDSHIRE
 ROAD
 STAFFORD, TX 77477

#	Date	ISSUED FOR
	03-12-2020	Issue for Bid, Permit and Construction

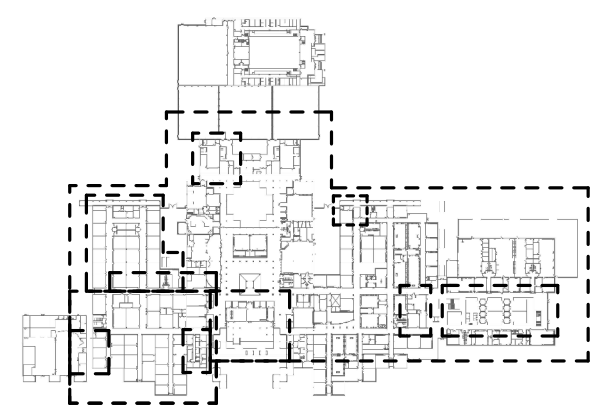

Project Number	19006-A
Drawn By	JGC
Checked By	LM
Approved By	LM
Drawing Title	FRAMING DETAILS
Drawing Number	S510

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 Texas Registered Engineering Firm
 F-003426
 PROJECT: 19-366-00

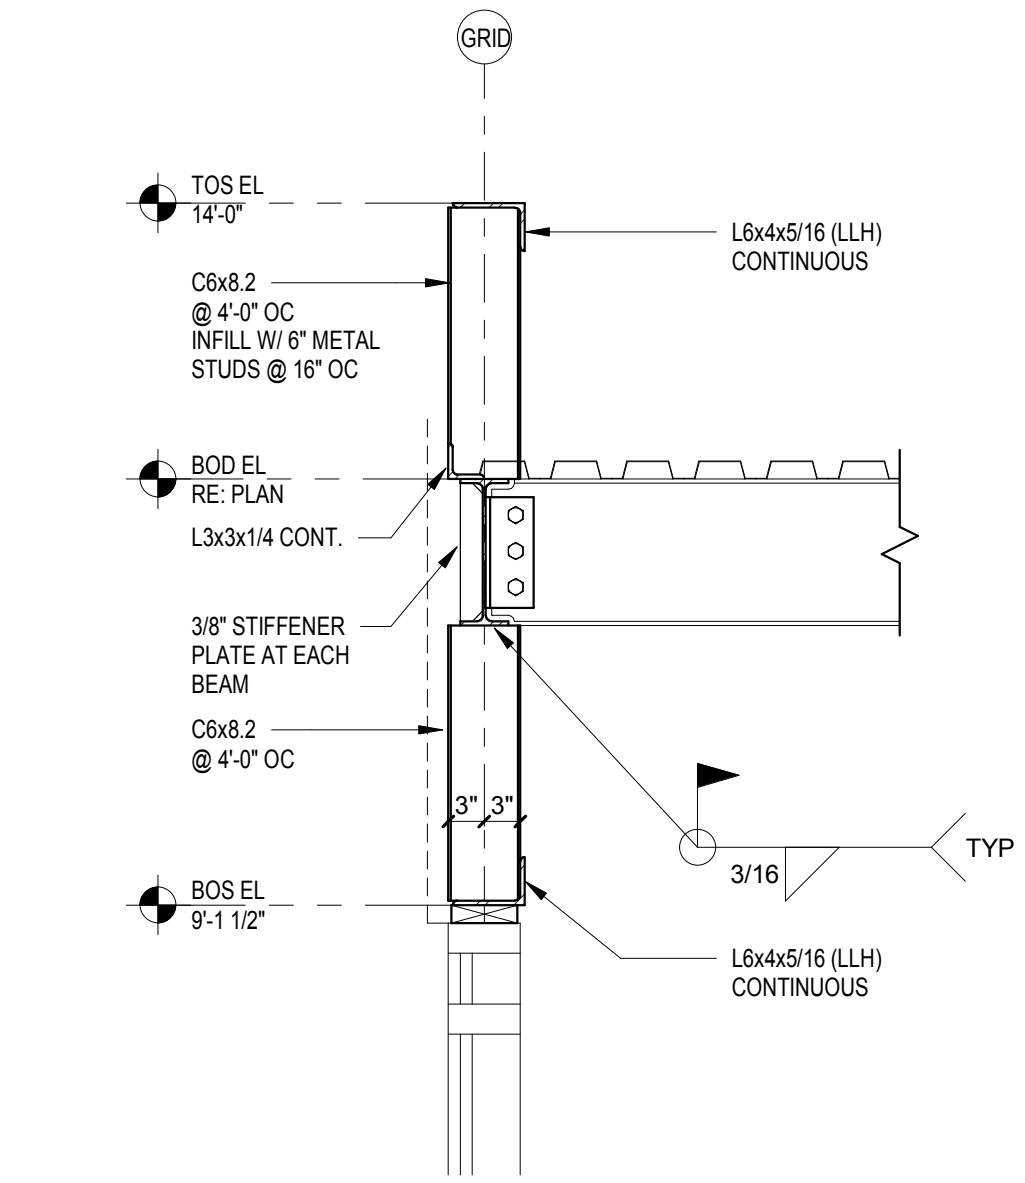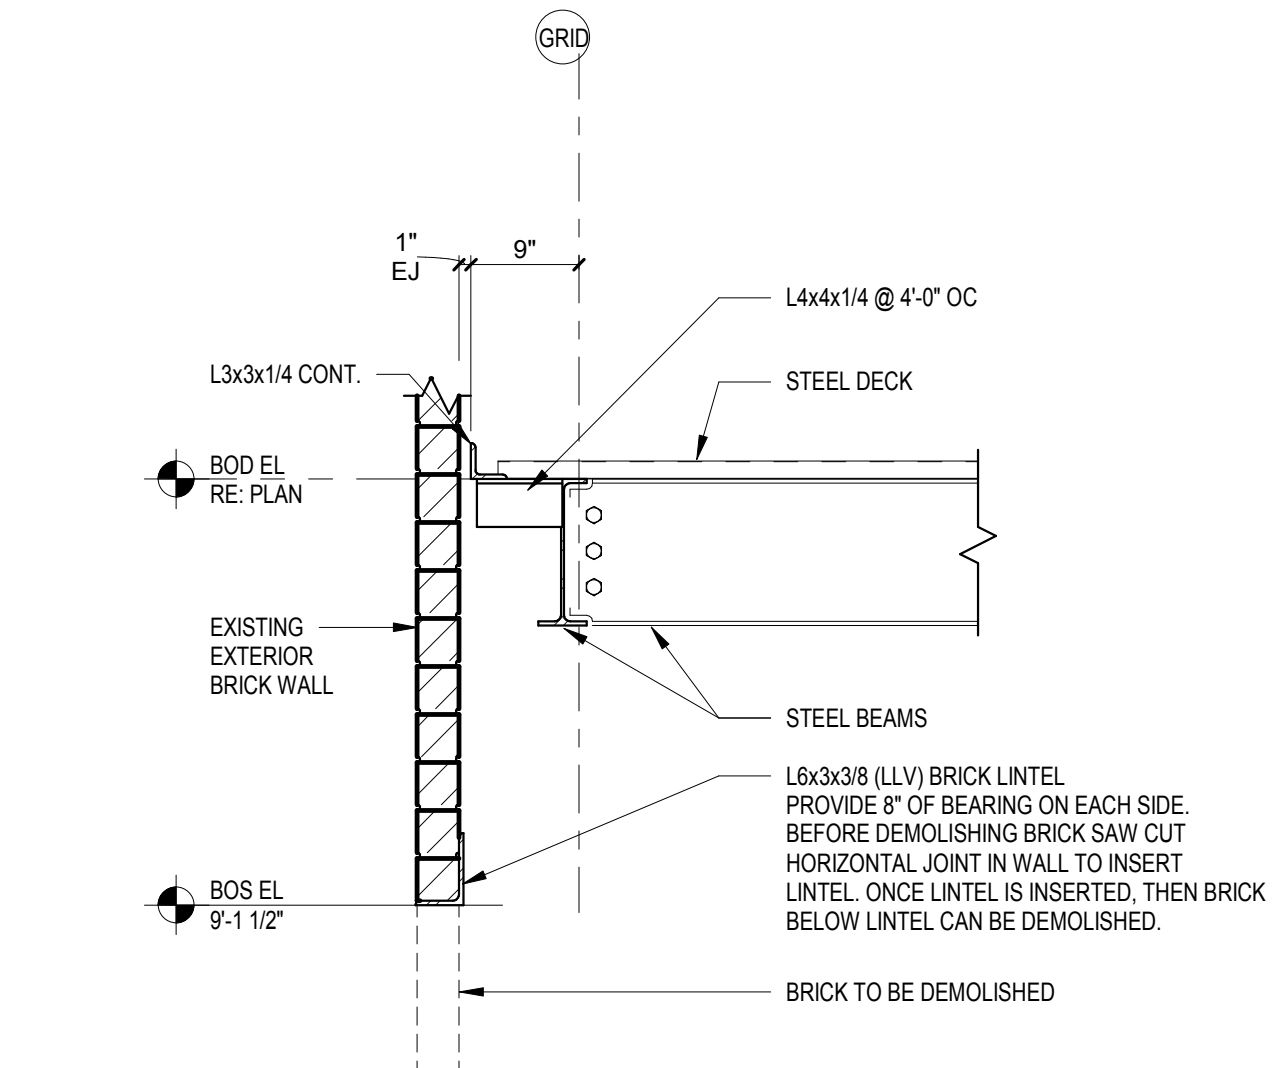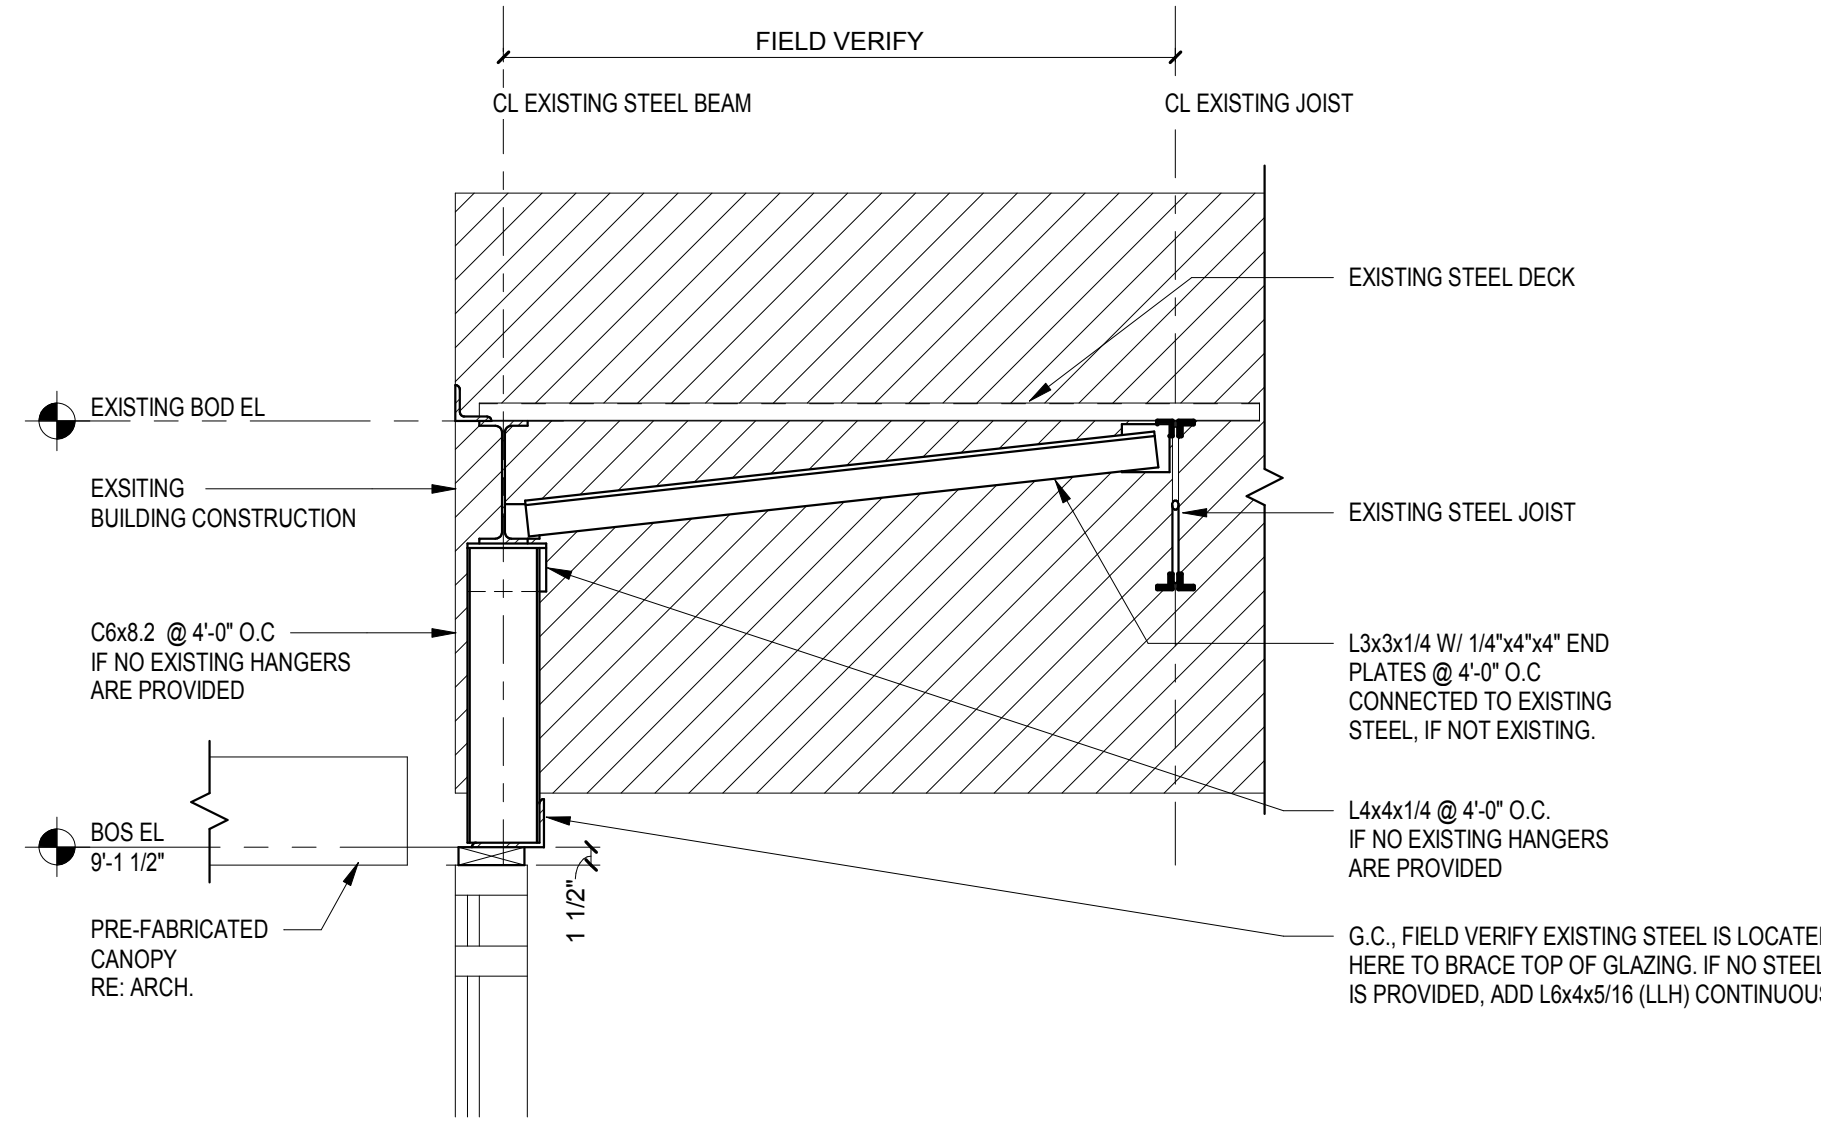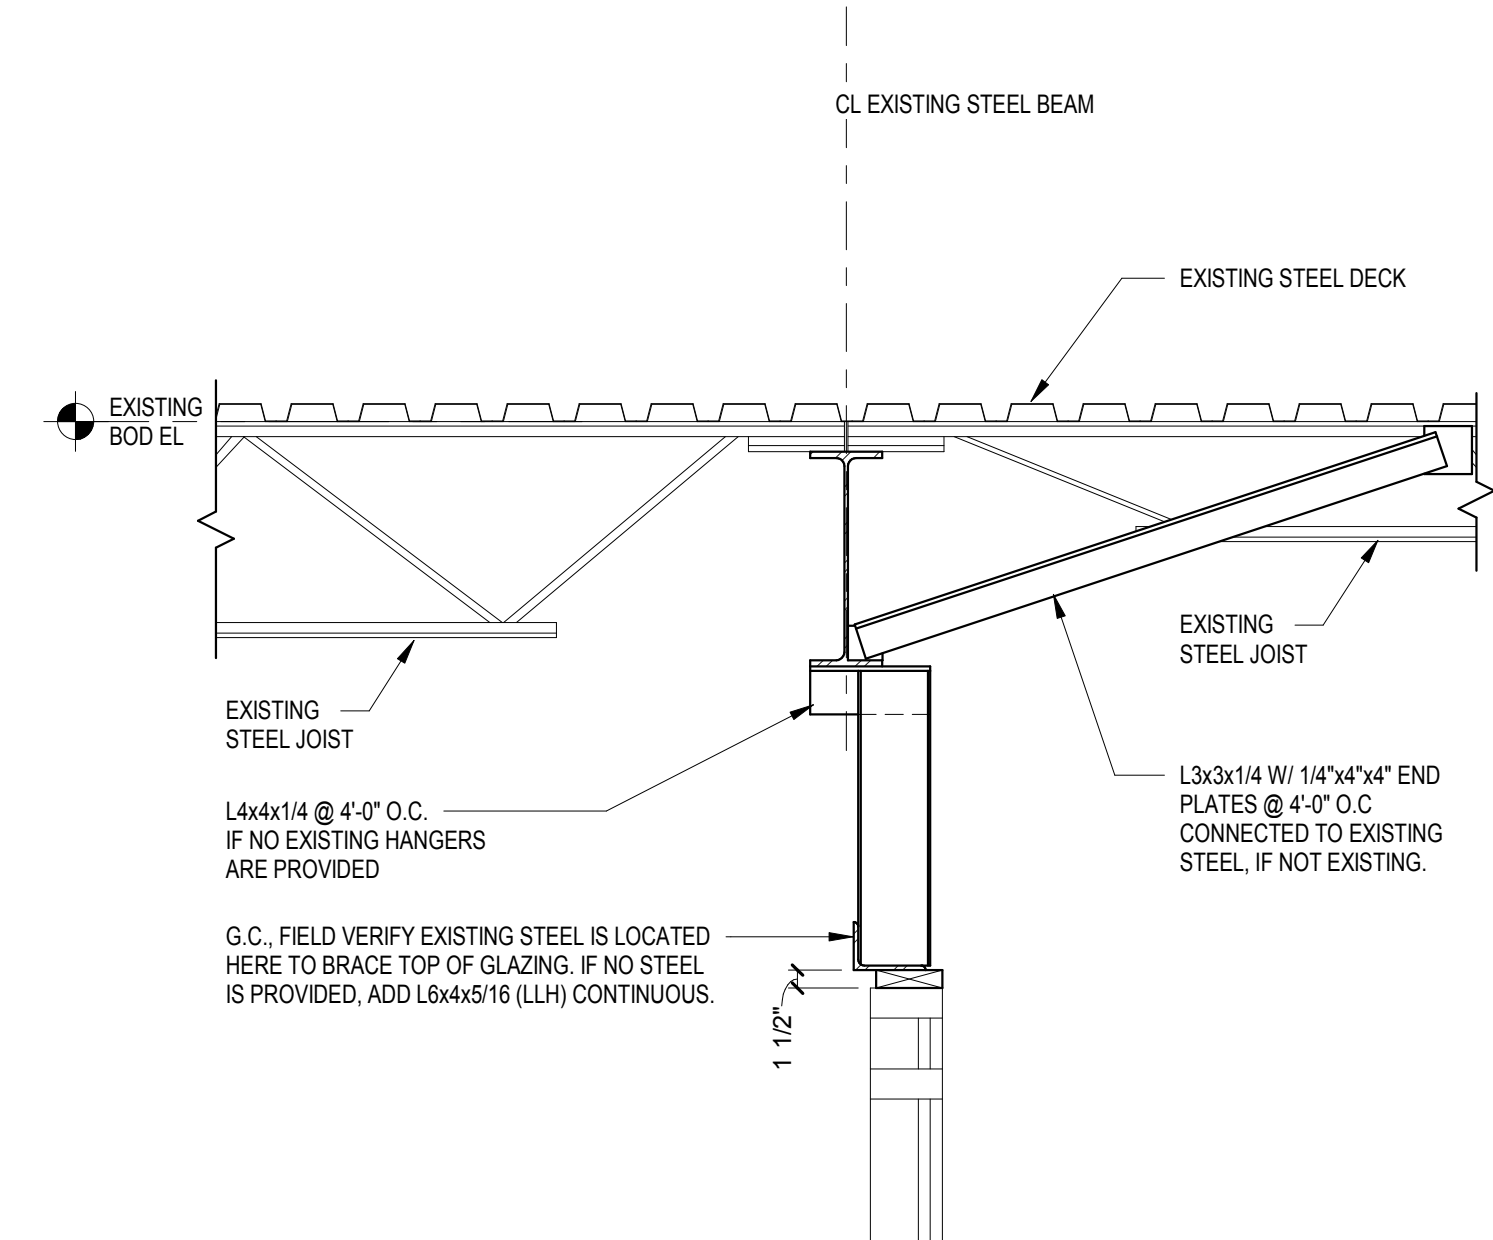



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WWW.INFRASTRUCTURE.COM

PROFESSIONAL SEAL:




A PROJECT FOR:

**STAFFORD
HIGH SCHOOL
& MAGNET
SCHOOL
RENOVATIONS**

1625 STAFFORDSHIRE
ROAD,
STAFFORD, TX 77477

#	Date	ISSUED FOR
1	2020/01/31	90% CD
2	2020/03/02	98% CD Review
3	2020/03/12	Issue for Bid, Permit, and Construction

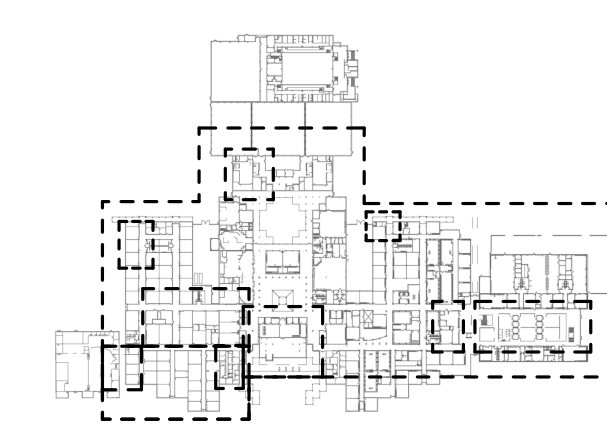

Project Number	19006-A
Drawn By	LT
Checked By	AW
Approved By	MS


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**LEVEL-1 KITCHEN -
HVAC**

Drawing Number
M1.01


KEYNOTE LEGEND

1	24X24 SUPPLY AIR DUCT FROM KSF-NHS-2 ON ROOF.
2	22X22 EXHAUST DUCT UP TO KEF-NHS-2 ON ROOF. PROVIDE MIN 16 GAUGE STAINLESS STEEL DUCT WITH ALL SEAMS AND JOINTS WELDED. PROVIDE CLEANOUT AT EVERY CHANGE OF ELEVATION. PROVIDE 2 HOUR RATED FIRE WRAP SIMILAR TO 3M FIRE BARRIER DUCT WRAP #15+ ENTIRE LENGTH OF EXHAUST DUCT.
3	DEMO EXISTING TERMINAL UNIT, ASSOCIATED DUCTWORK AND DIFFUSERS.
4	DEMO EXISTING DIFFUSER AND ASSOCIATED BRANCH DUCT.
5	CONNECT INLET DUCT TO MAIN SUPPLY AIR DUCT. FIELD VERIFY EXACT LOCATION.
6	RELOCATE EXISTING HOOD'S OPERATION SWITCH TO ACCESSIBLE LOCATION. COORDINATE WITH ARCHITECT.
7	EXISTING DUCTWORK TO REMAIN.
8	6" ROUND DRYER EXHAUST UP TO ROOF. TERMINATE WITH WEATHER CAP.

NOTE: WORK INDICATED IN THIS DETAIL SHALL BE PRICED AS ALTERNATE 1

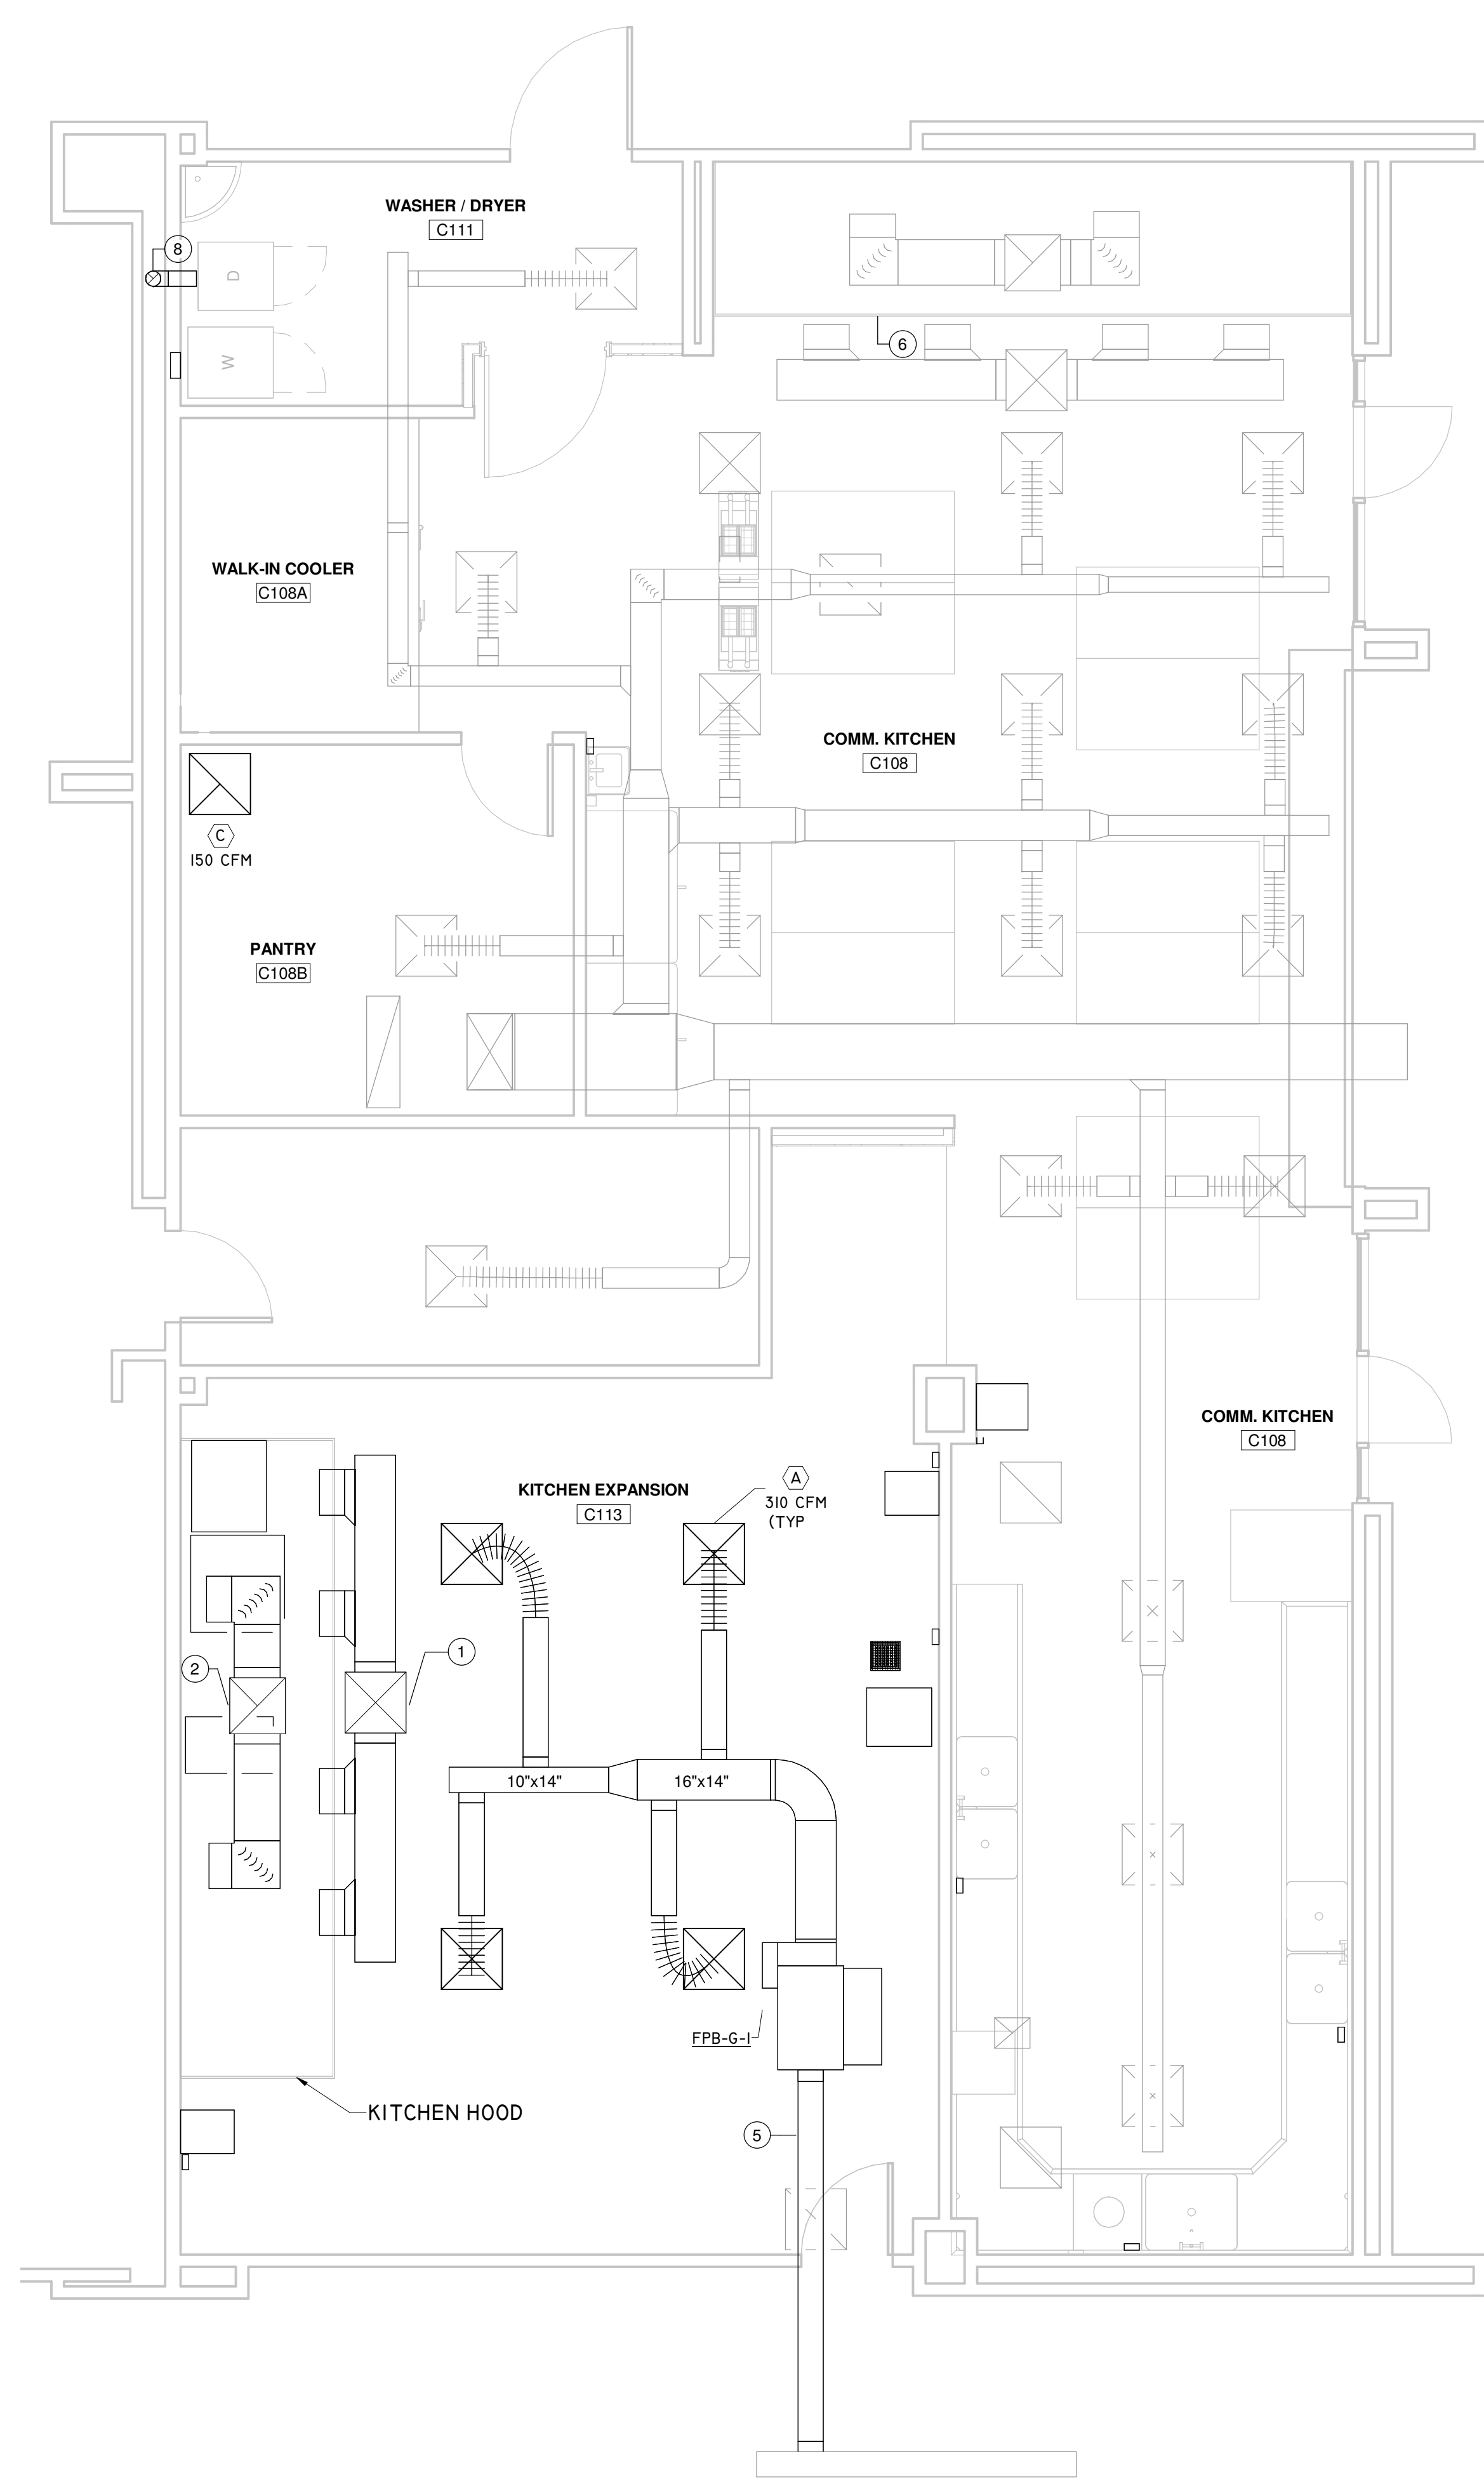

2 ENLARGED PROPOSED PLAN - AREA G - HVAC
Scale: 1/4" = 1'-0"

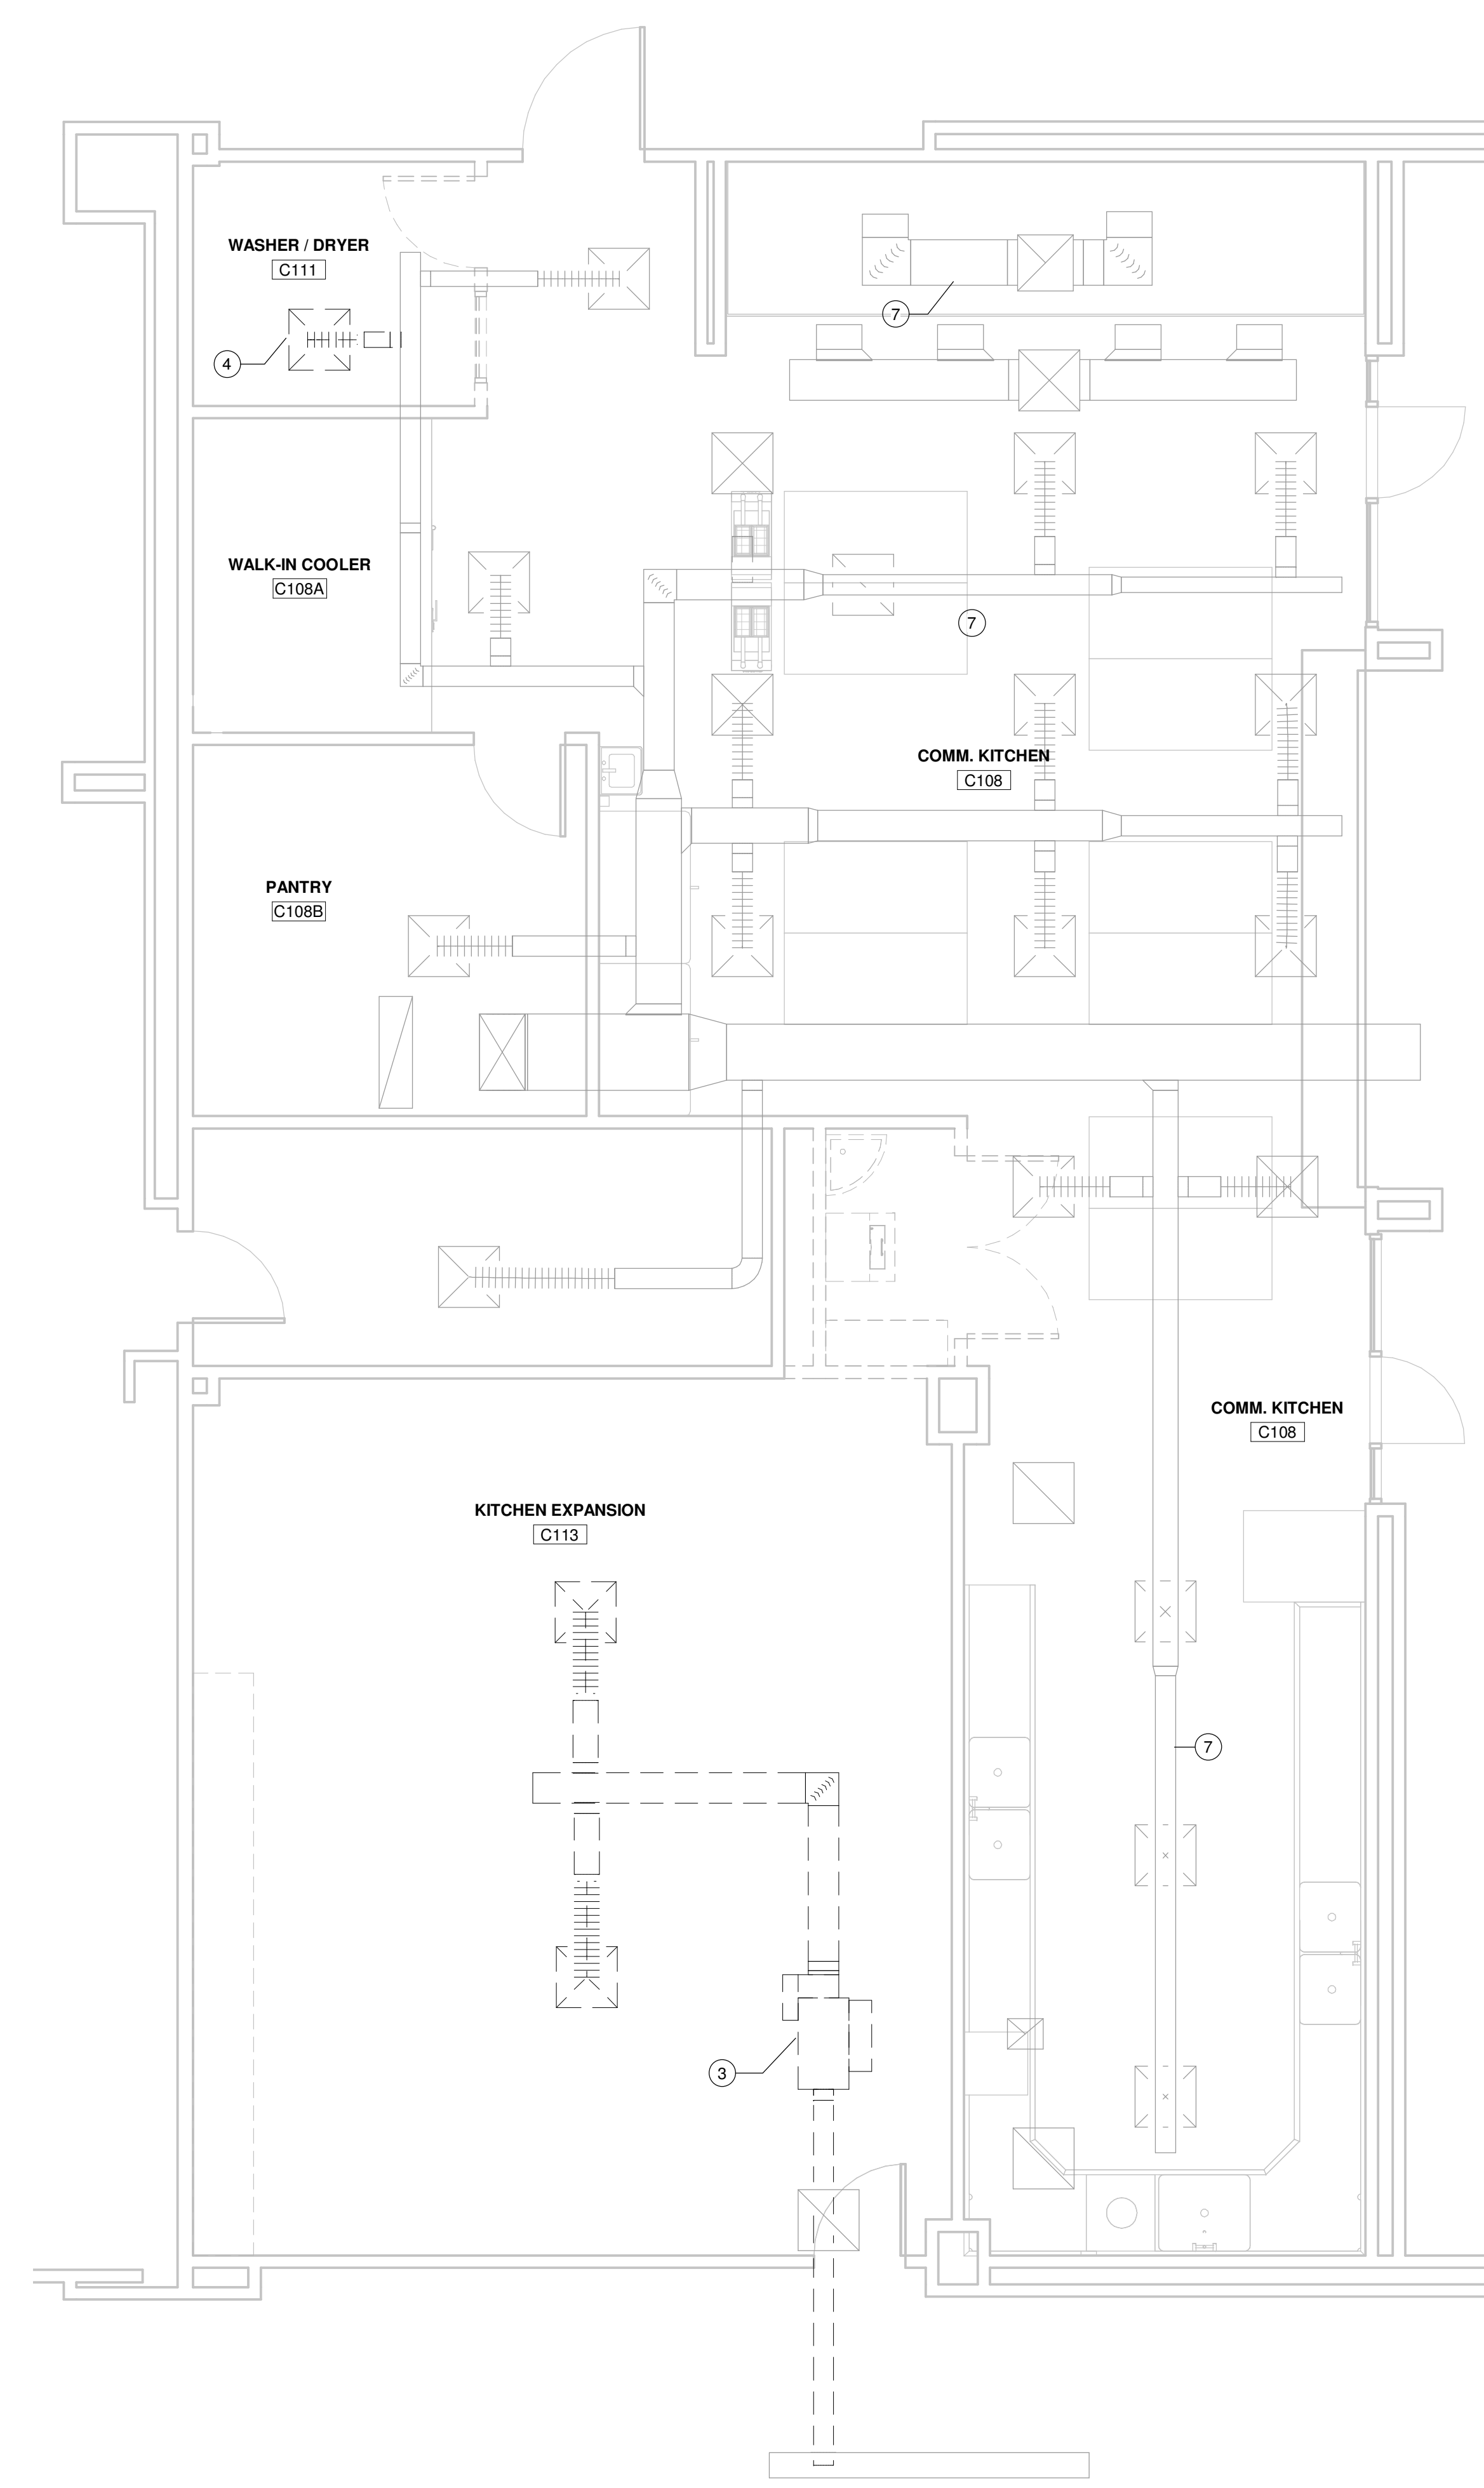

1 ENLARGED DEMOLITION PLAN - AREA G - HVAC
Scale: 1/4" = 1'-0"



AUTOARCH Architects, LLC.

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PROFESSIONAL SEAL:




A PROJECT FOR:

**STAFFORD
HIGH SCHOOL
& MAGNET
SCHOOL
RENOVATIONS**

1625 STAFFORDSHIRE
ROAD,
STAFFORD, TX 77477

#	Date	ISSUED FOR
1	2020/01/31	90% CD
2	2020/03/02	98% CD Review
3	2020/03/12	Issue for Bid, Permit, and Construction

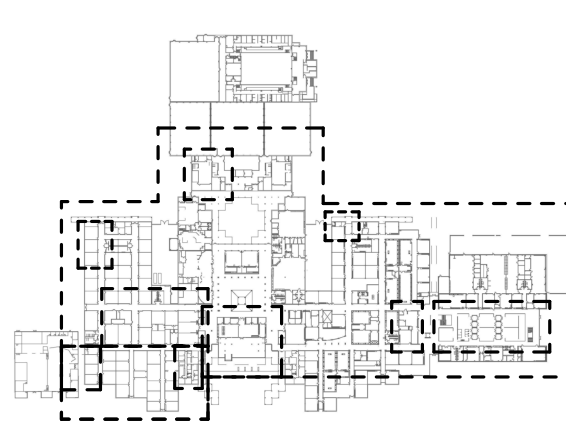

KEY PLAN

Project Number	19006-A
Drawn By	LT
Checked By	AW
Approved By	MS

LEVEL-1 LAB B2 - HVAC


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GENERAL NOTES:


- EXTEND EXISTING FIRE ALARM LINES INTO RENOVATED AREAS. INSTALL NEW SPRINKLER HEADS AND COORDINATE SPRINKLER HEAD TYPE WITH THE INSTALLED CEILING. FINAL SPRINKLER SYSTEM DESIGN SHALL BE DONE BY CERTIFIED PROFESSIONAL.

KEYNOTE LEGEND

1	DEMO EXISTING DIFFUSERS AND ASSOCIATED DUCTWORK UP TO TERMINAL UNIT.
2	EXISTING TERMINAL UNIT TO REMAIN.
3	DEMO EXISTING RETURN AIR GRILLE.

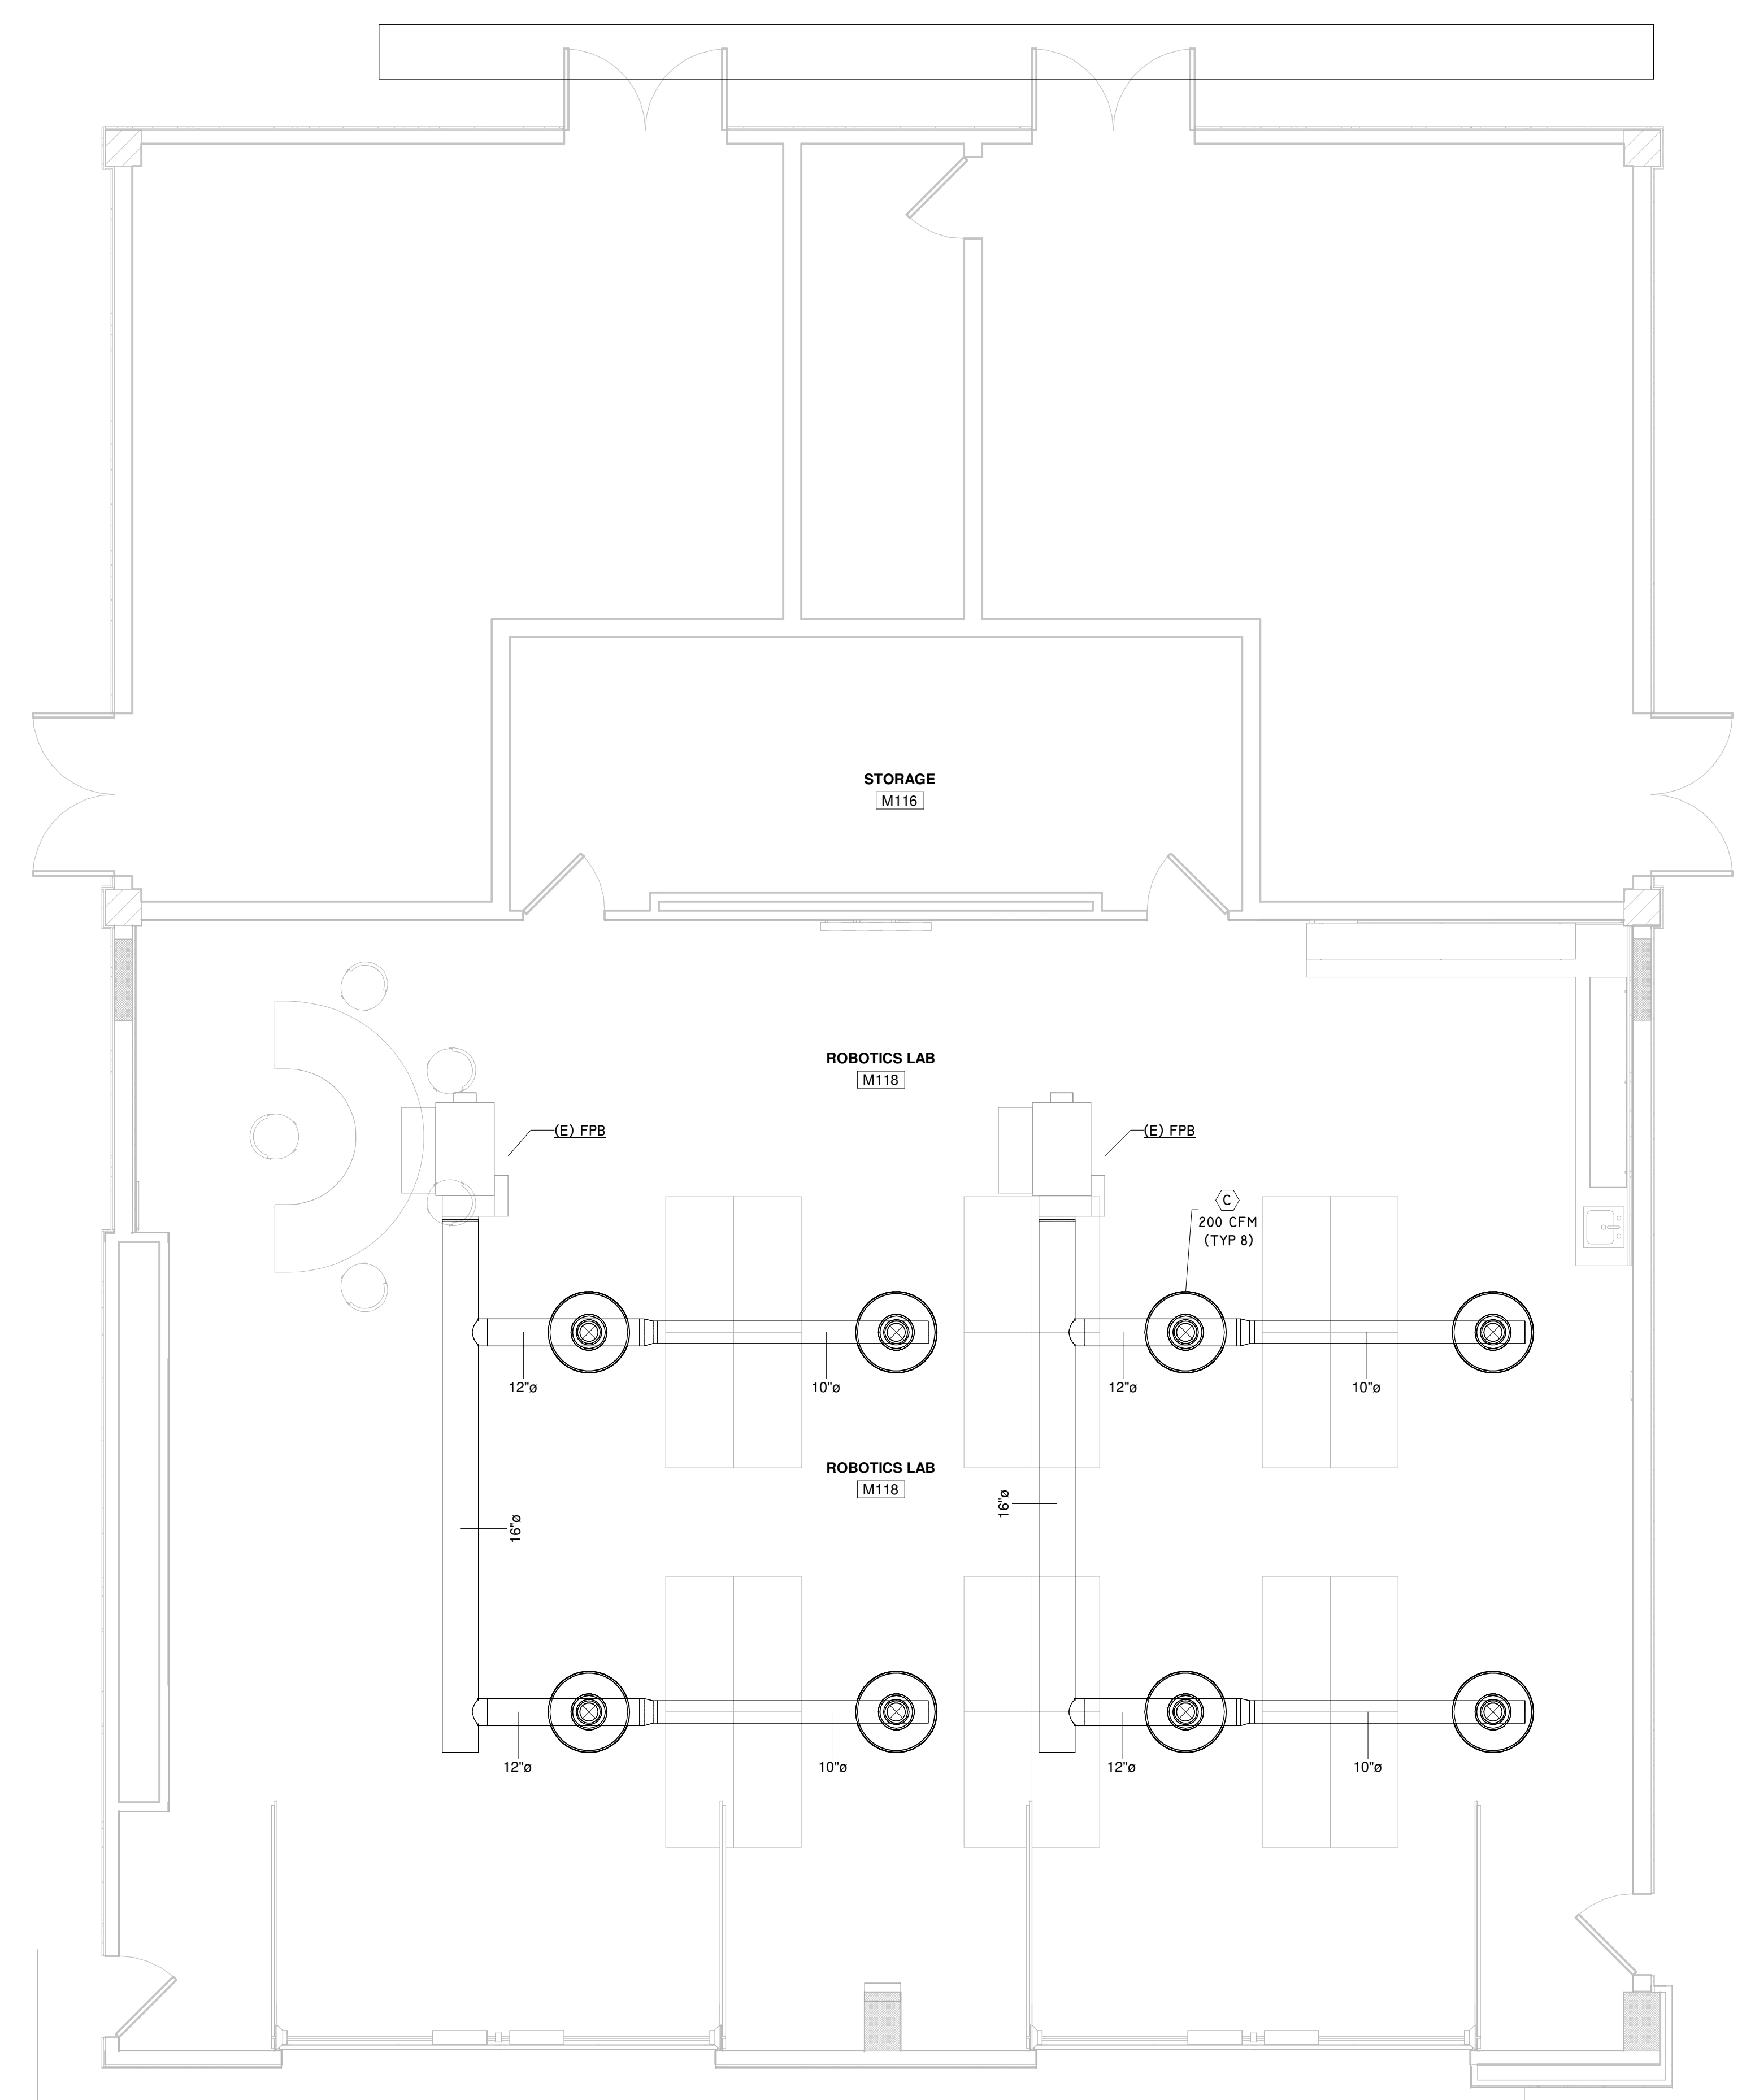

2 ENLARGED PROPOSED PLAN - AREA B2 - HVAC
Scale: 1/4" = 1'-0"

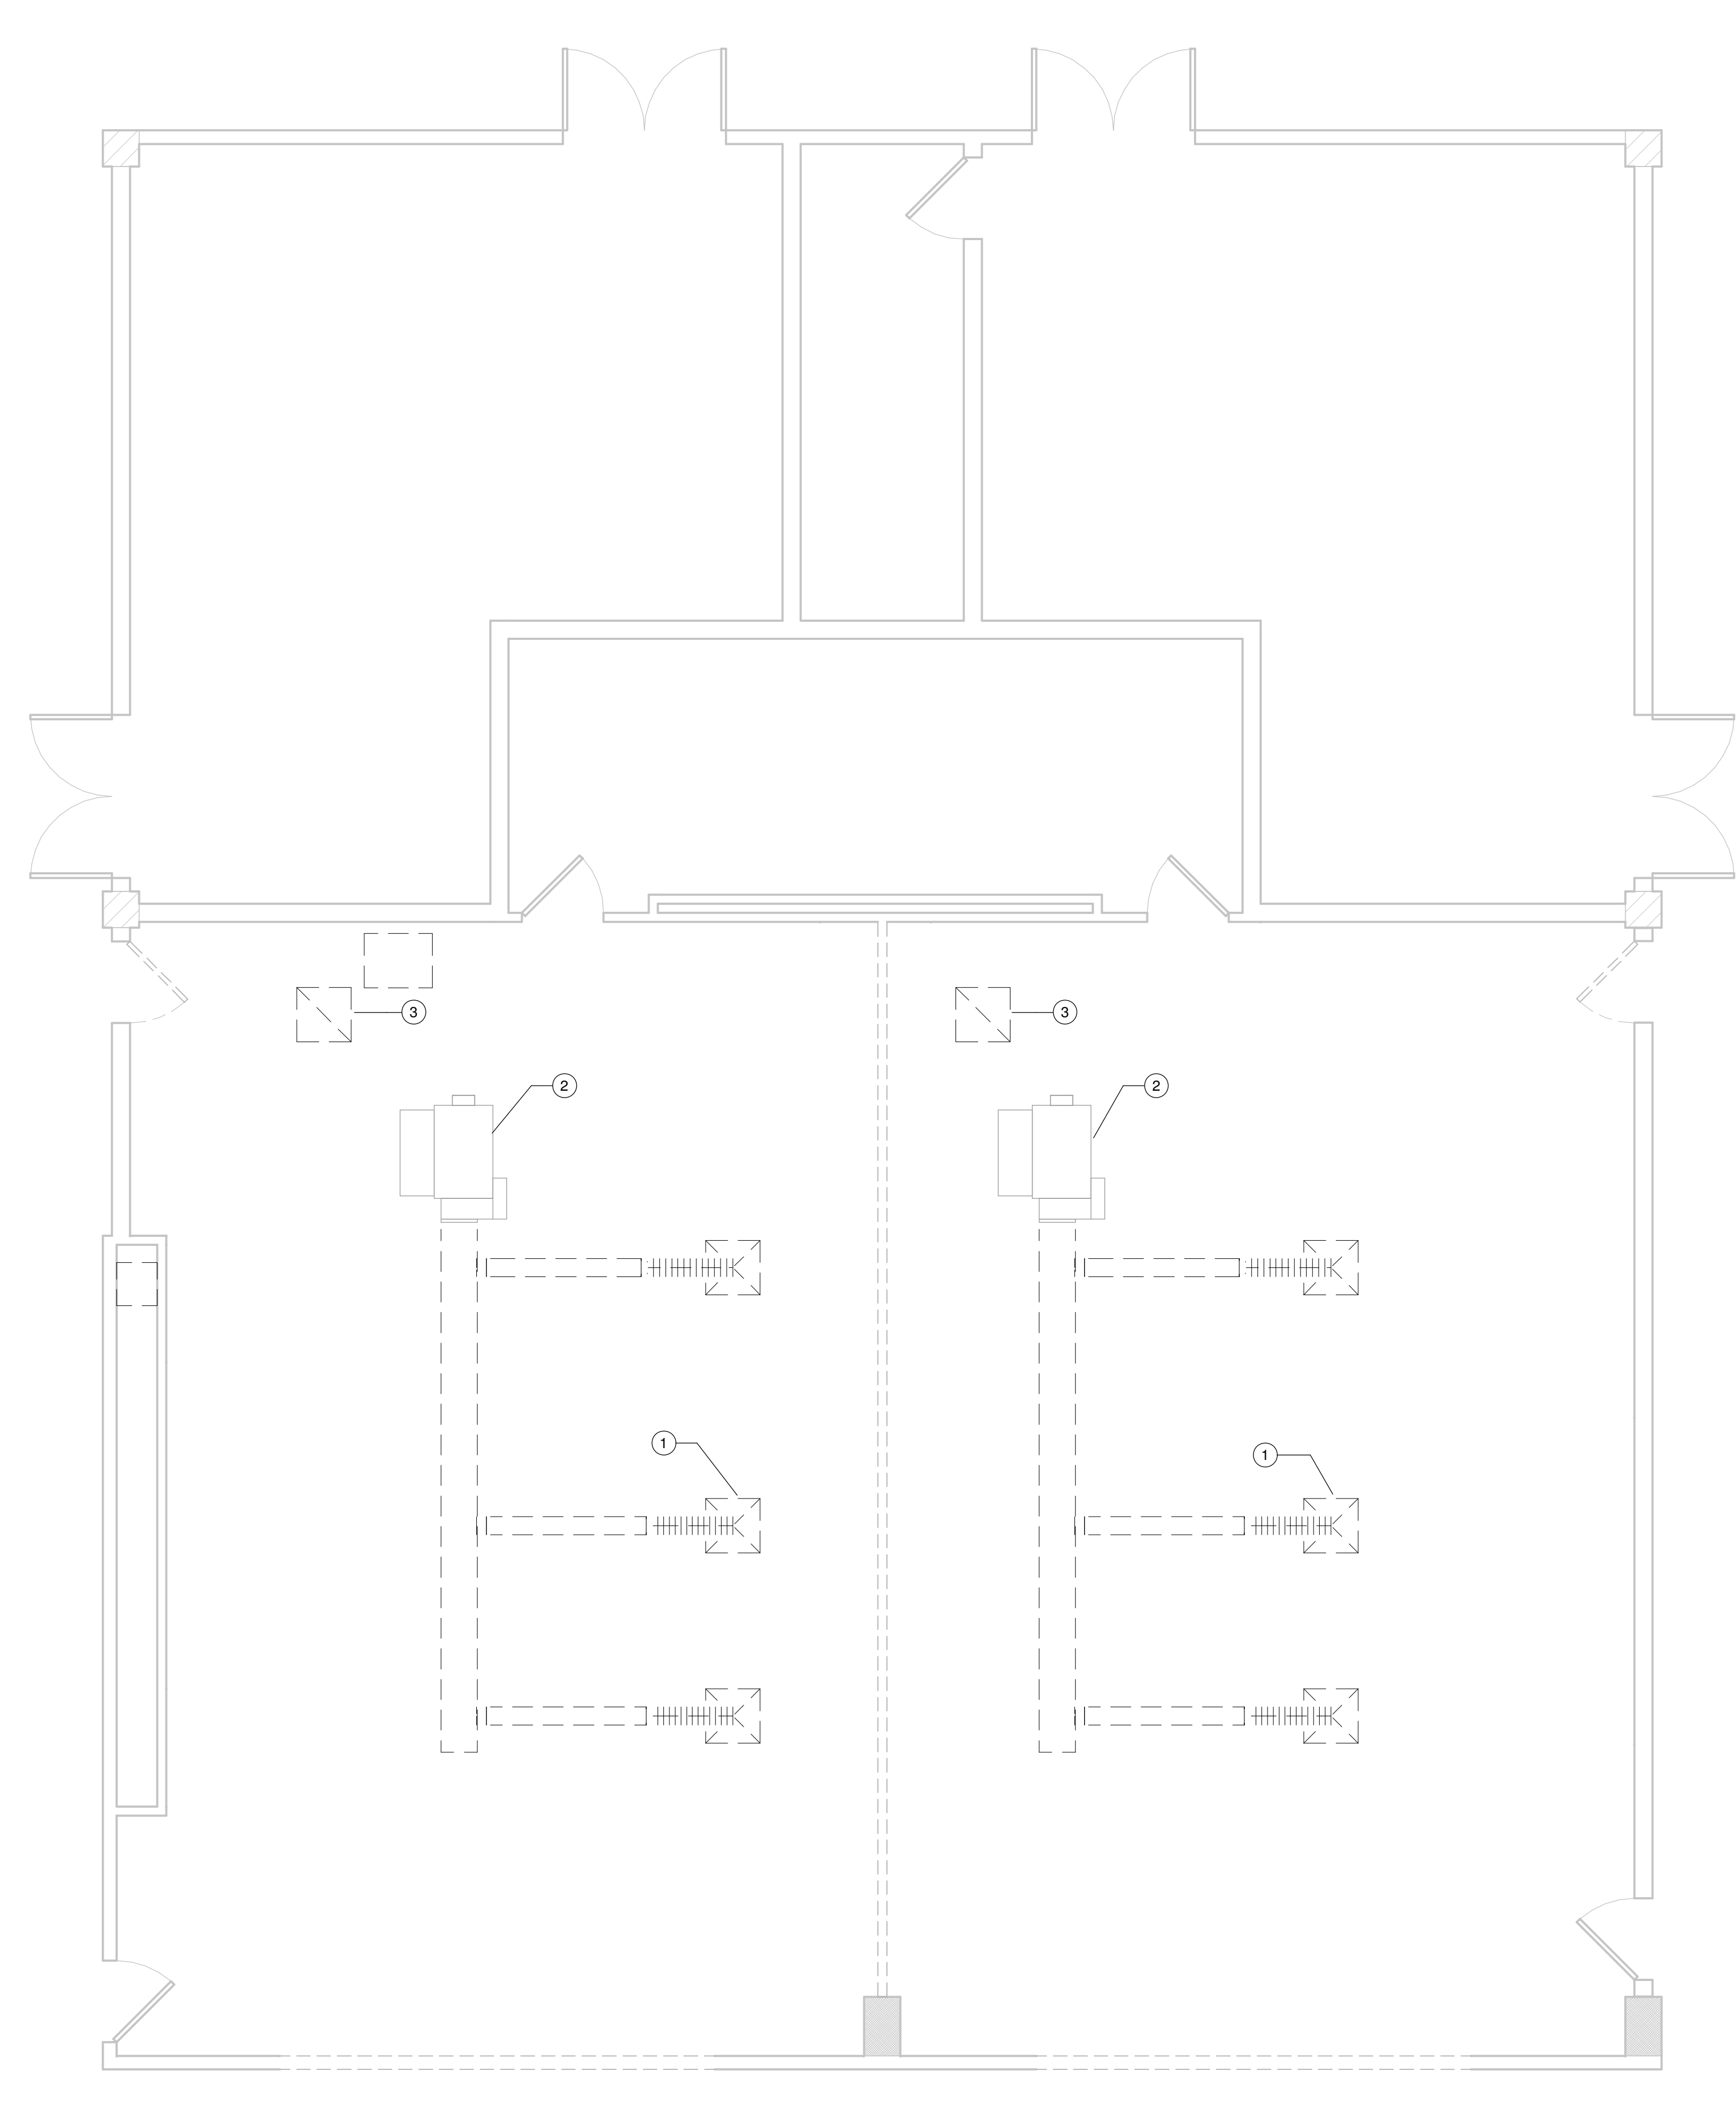

1 ENLARGED DEMOLITION PLAN - AREA B2 - HVAC
Scale: 1/4" = 1'-0"



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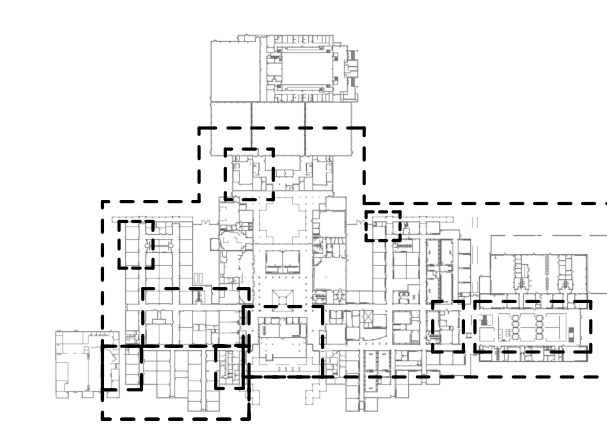


A PROJECT FOR:

**STAFFORD
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& MAGNET
SCHOOL
RENOVATIONS**

1625 STAFFORDSHIRE
ROAD,
STAFFORD, TX 77477

#	Date	ISSUED FOR
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3	2020/03/12	Issue for Bid, Permit, and Construction



Project Number	19006-A
Drawn By	LT
Checked By	AW
Approved By	MS

Drawing Title
**LEVEL-1 LIFE SKILLS -
HVAC**


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GENERAL NOTES:


- EXTEND EXISTING FIRE ALARM LINES INTO RENOVATED AREAS. INSTALL NEW SPRINKLER HEADS AND COORDINATE SPRINKLER HEAD TYPE WITH THE INSTALLED CEILING. FINAL SPRINKLER SYSTEM DESIGN SHALL BE DONE BY CERTIFIED PROFESSIONAL.

KEYNOTE LEGEND

1	CONNECT TO EXISTING EXHAUST FAN.
2	DEMO EXISTING SUPPLY AIR DUCT AS SHOWN. CAP AND SEAL EXISTING PORTION OF THE SUPPLY AIR DUCT.
3	DEMO EXISTING DIFFUSER AND ASSOCIATED BRANCH DUCT.

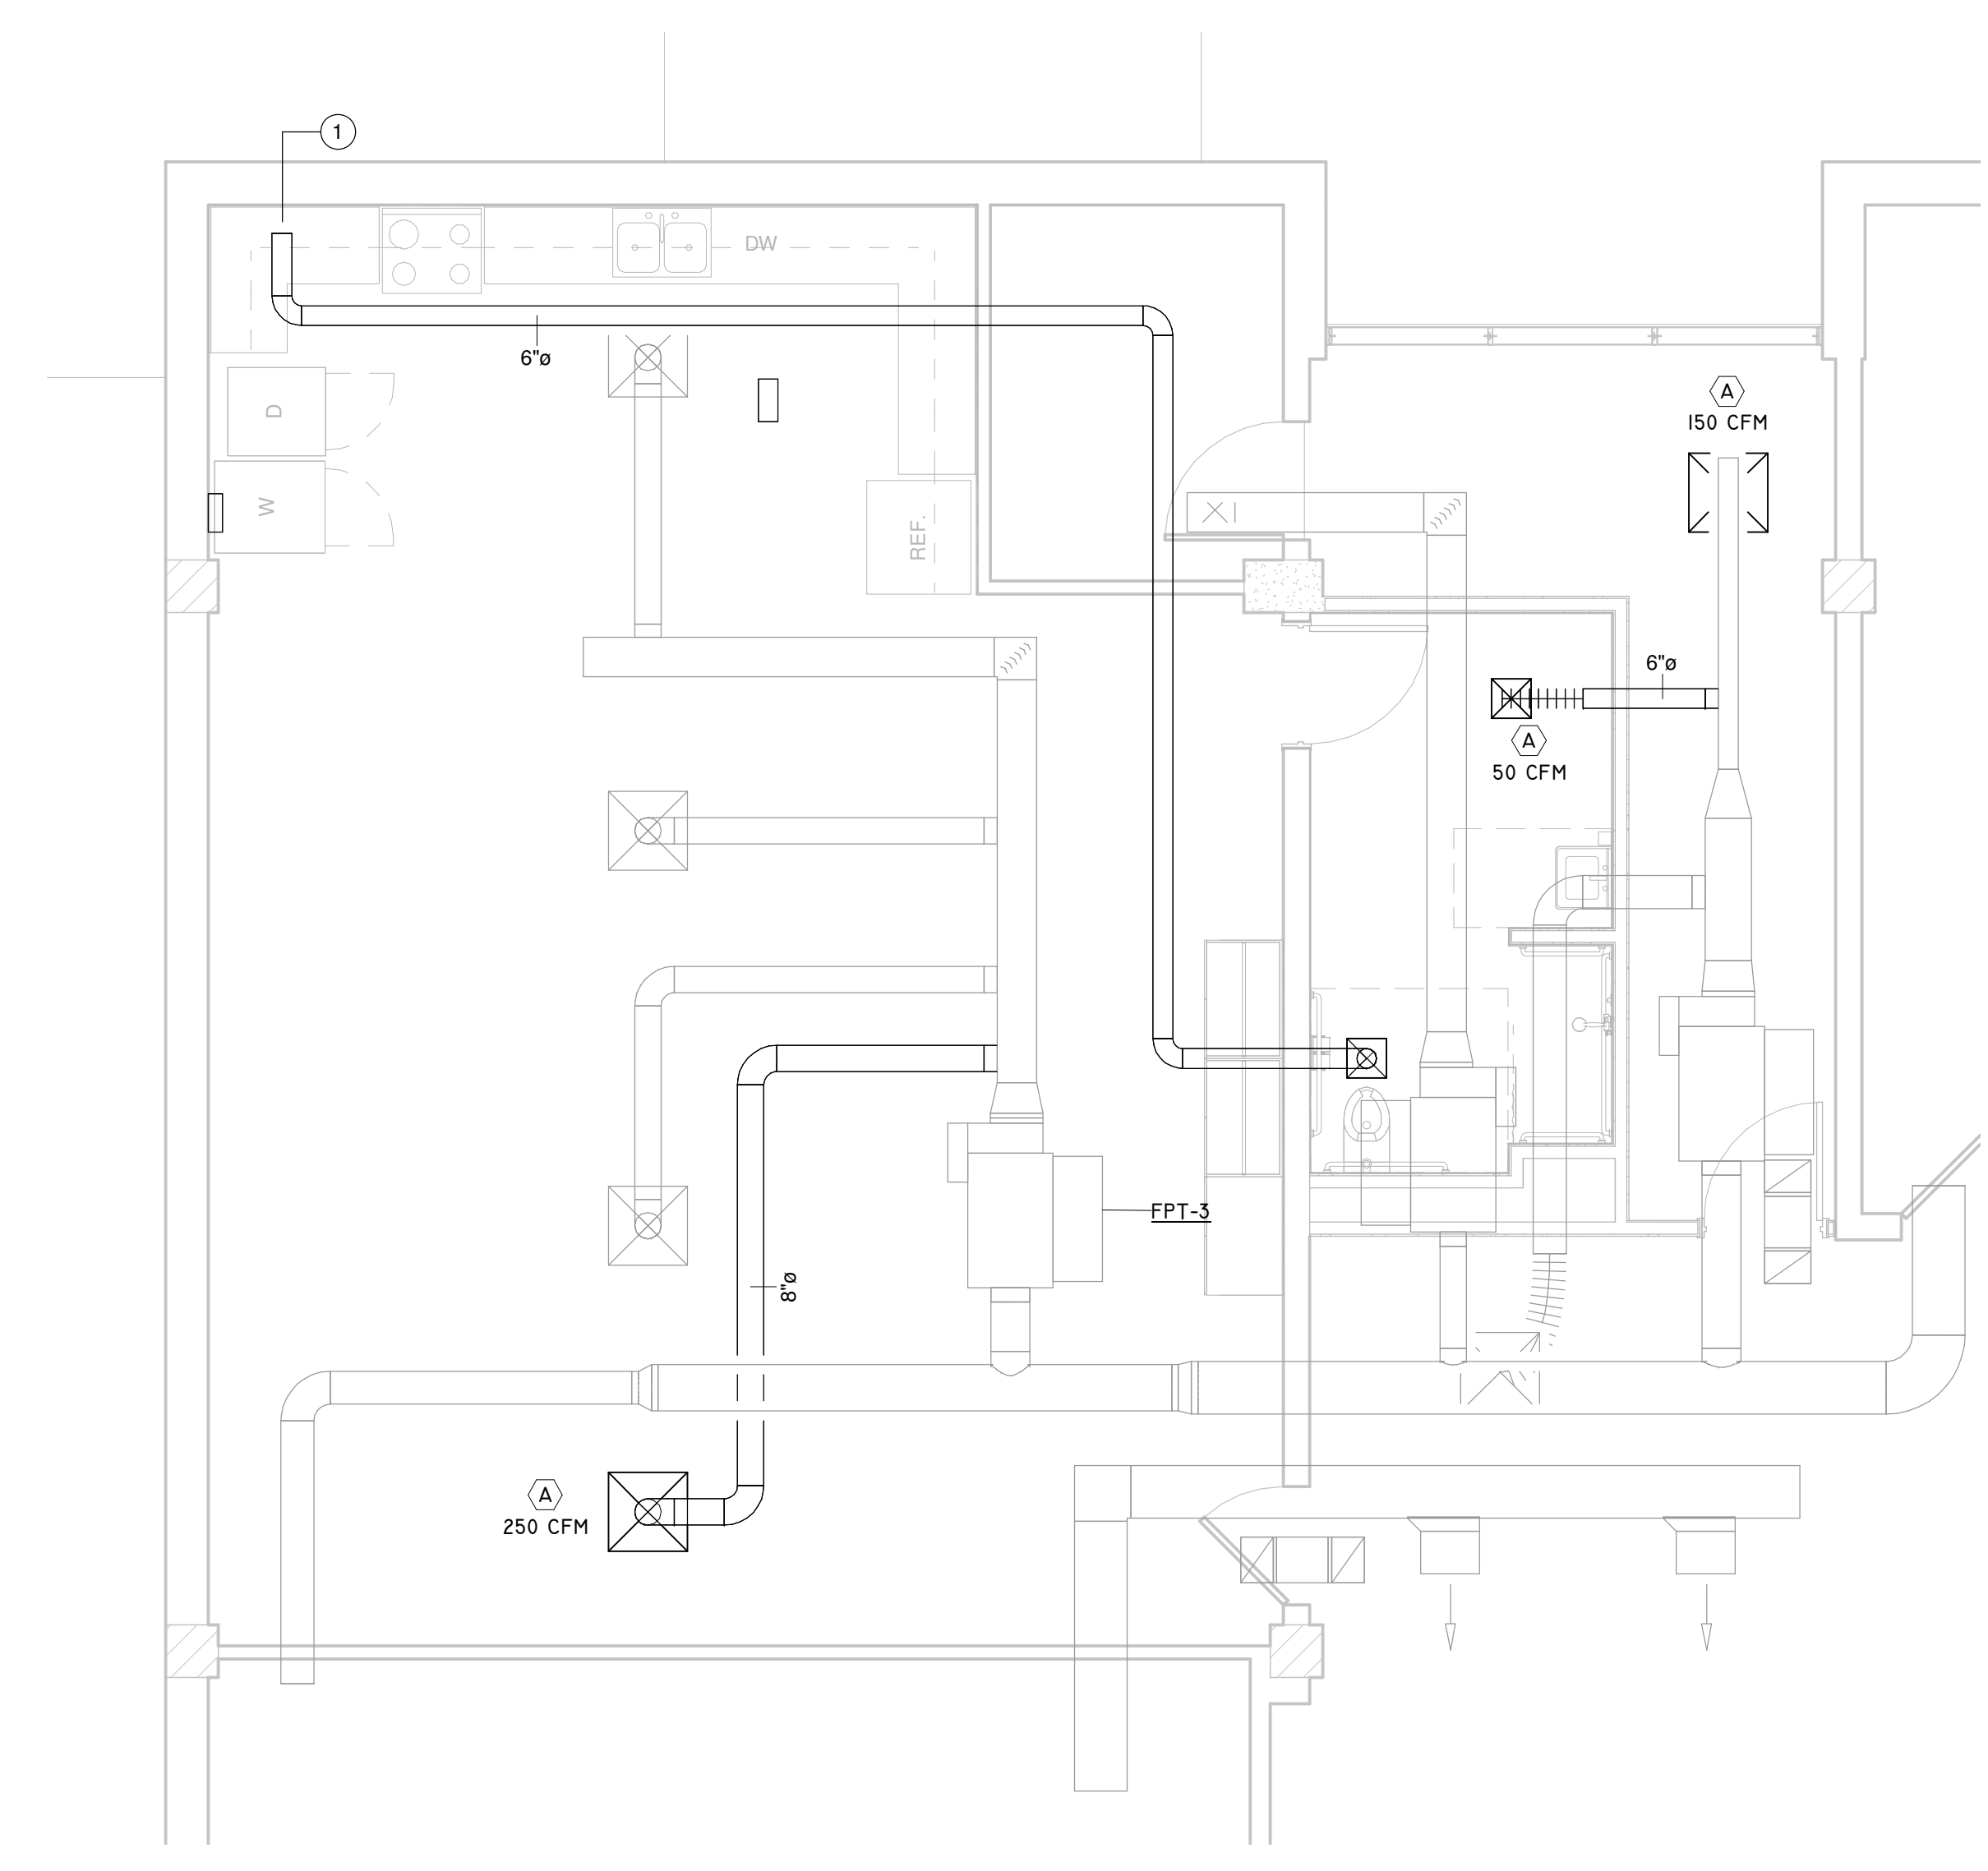

2 ENLARGED PROPOSED PLAN - AREA E - HVAC
Scale: 1/4" = 1'-0"

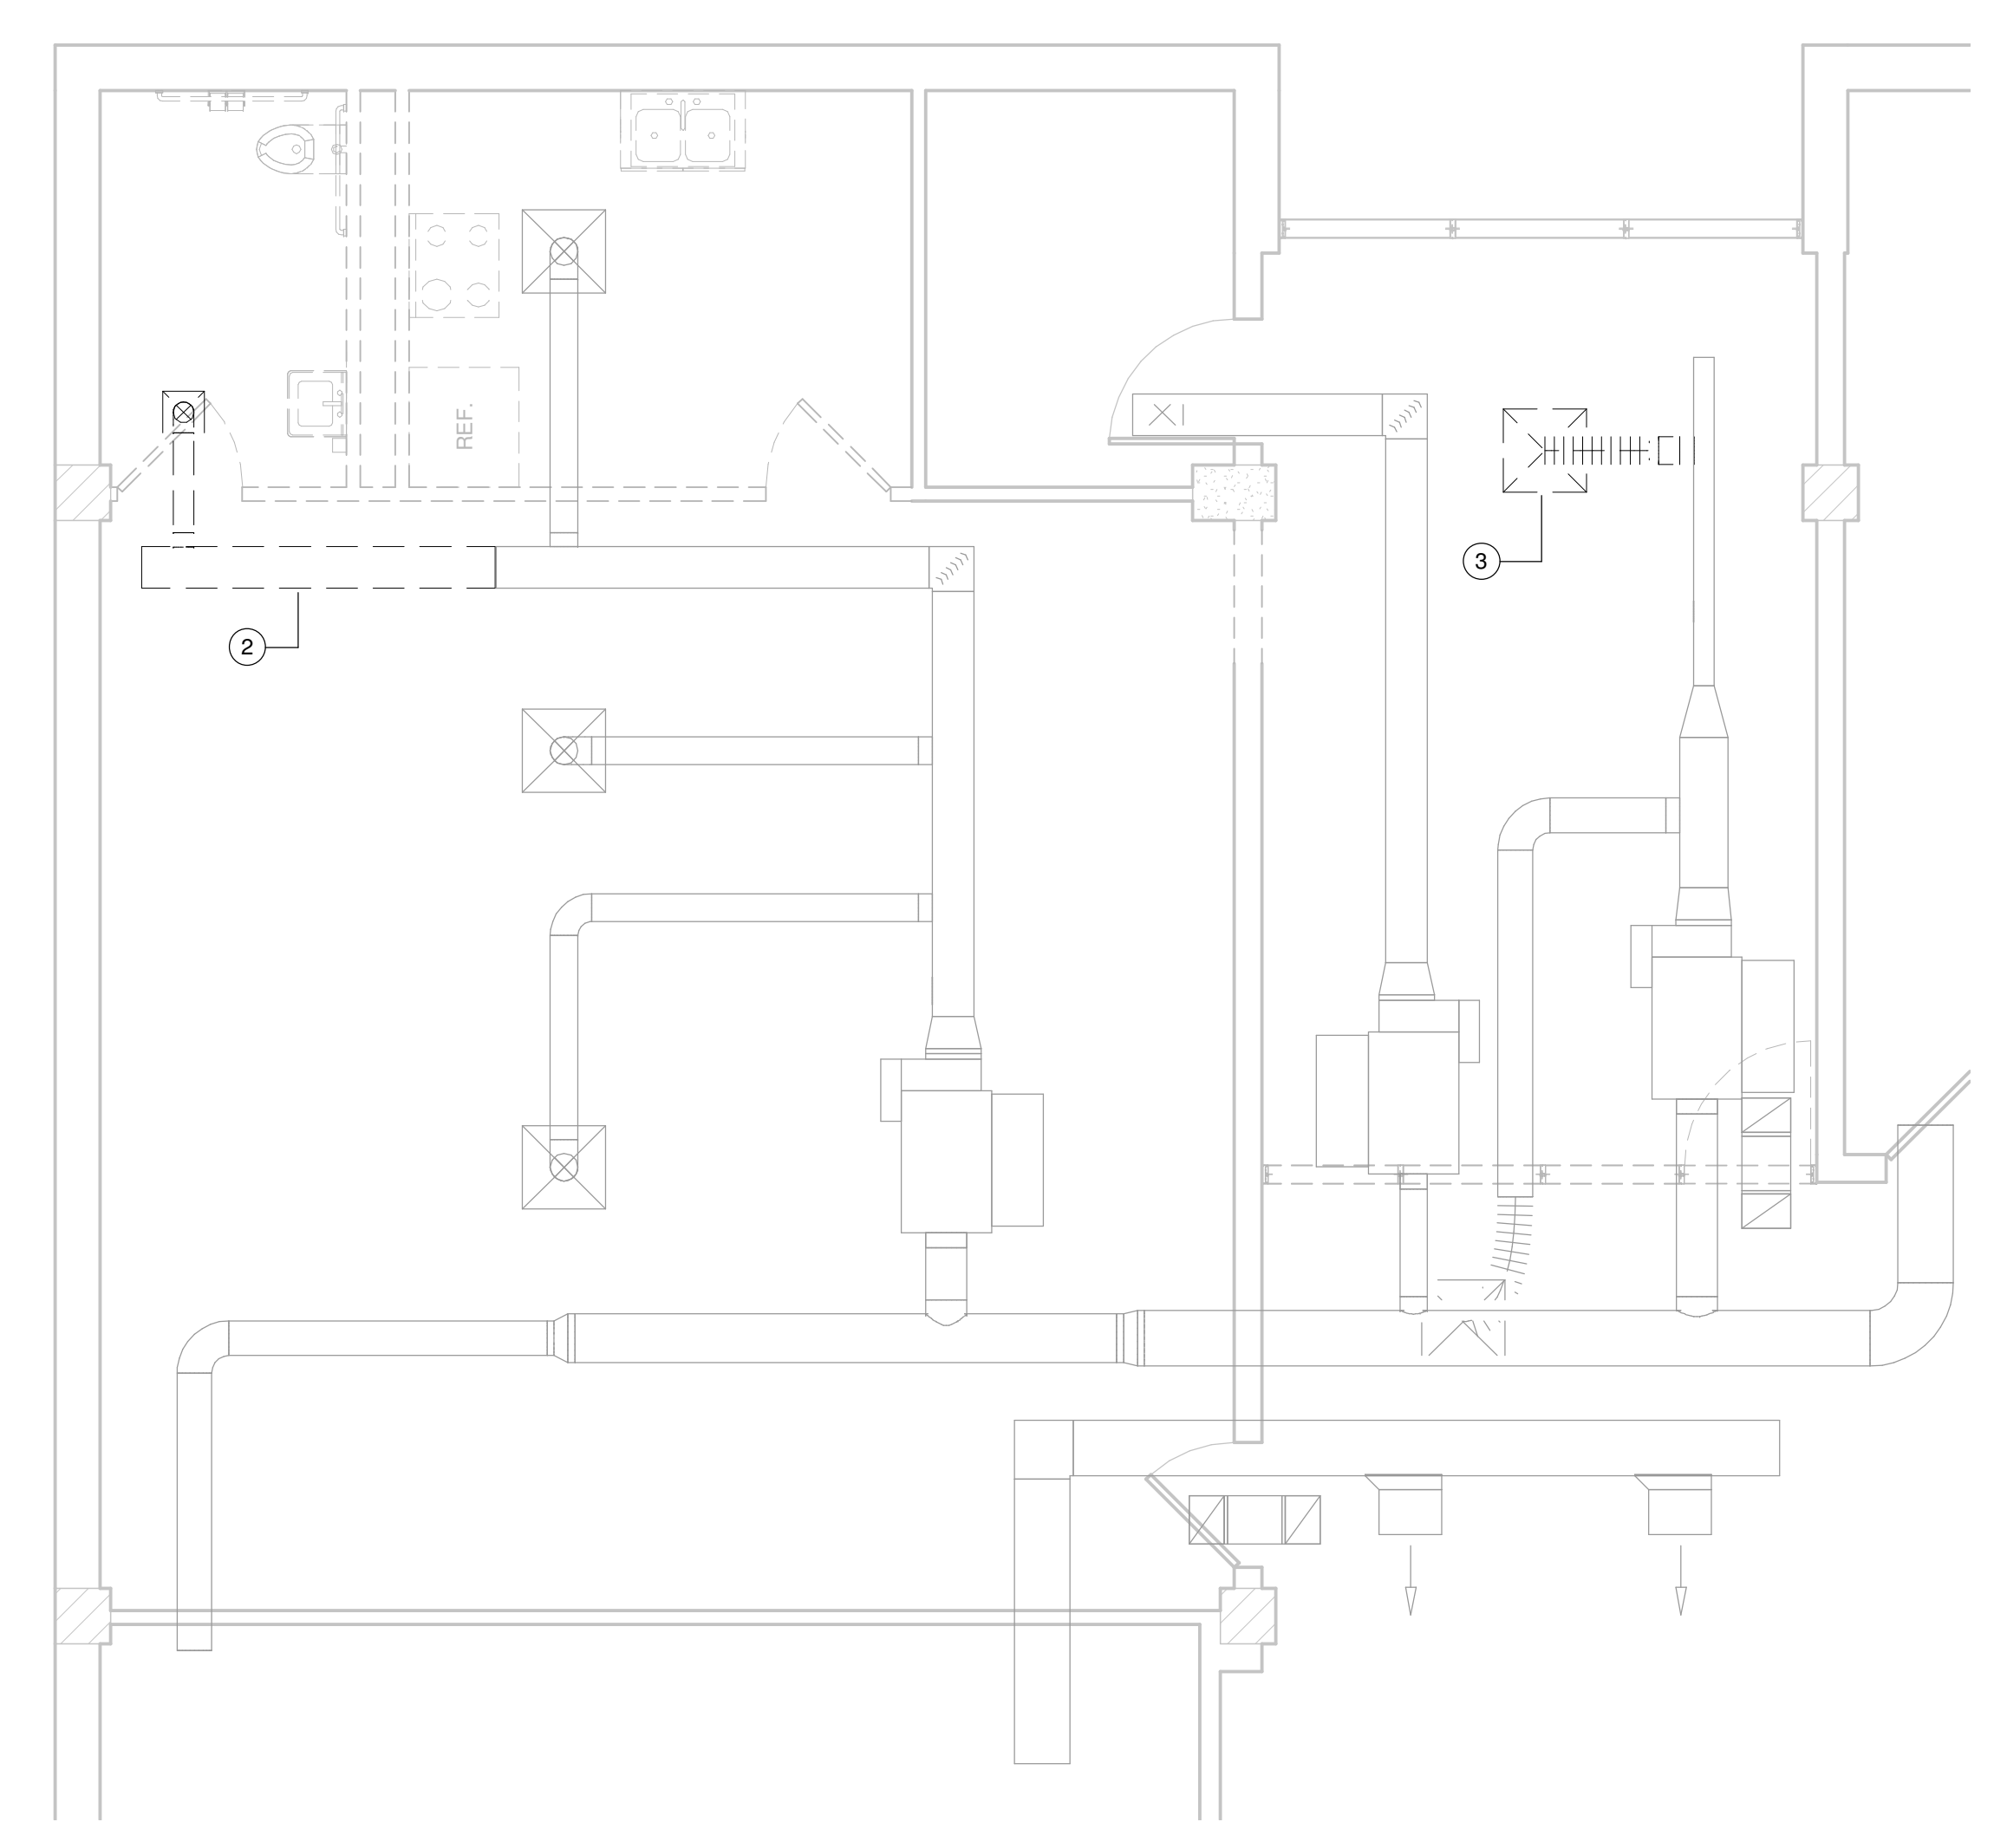

1 ENLARGED DEMOLITION PLAN - AREA E - HVAC
Scale: 1/4" = 1'-0"



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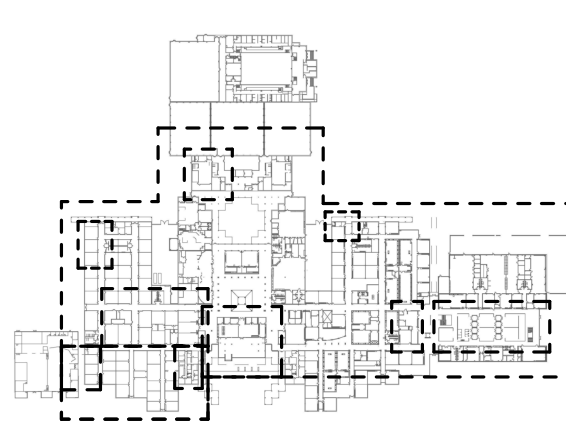


A PROJECT FOR:

**STAFFORD
HIGH SCHOOL
& MAGNET
SCHOOL
RENOVATIONS**

1625 STAFFORDSHIRE
ROAD,
STAFFORD, TX 77477

#	Date	ISSUED FOR
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KEY PLAN
TRUE NORTH
PLAN NORTH

Project Number	19006-A
Drawn By	LT
Checked By	AW
Approved By	MS

LEVEL-1 LAB B3 - HVAC


Drawing Number
M1.04

GENERAL NOTES:

- EXTEND EXISTING FIRE ALARM LINES INTO RENOVATED AREAS. INSTALL NEW SPRINKLER HEADS AND COORDINATE SPRINKLER HEAD TYPE WITH THE INSTALLED CEILING. FINAL SPRINKLER SYSTEM DESIGN SHALL BE DONE BY CERTIFIED PROFESSIONAL.

KEYNOTE LEGEND

1	DEMO EXISTING DIFFUSERS AND ASSOCIATED DUCTWORK UP TO TERMINAL UNIT.
2	EXISTING TERMINAL UNIT TO REMAIN.
3	DEMO EXISTING RETURN AIR GRILLE.

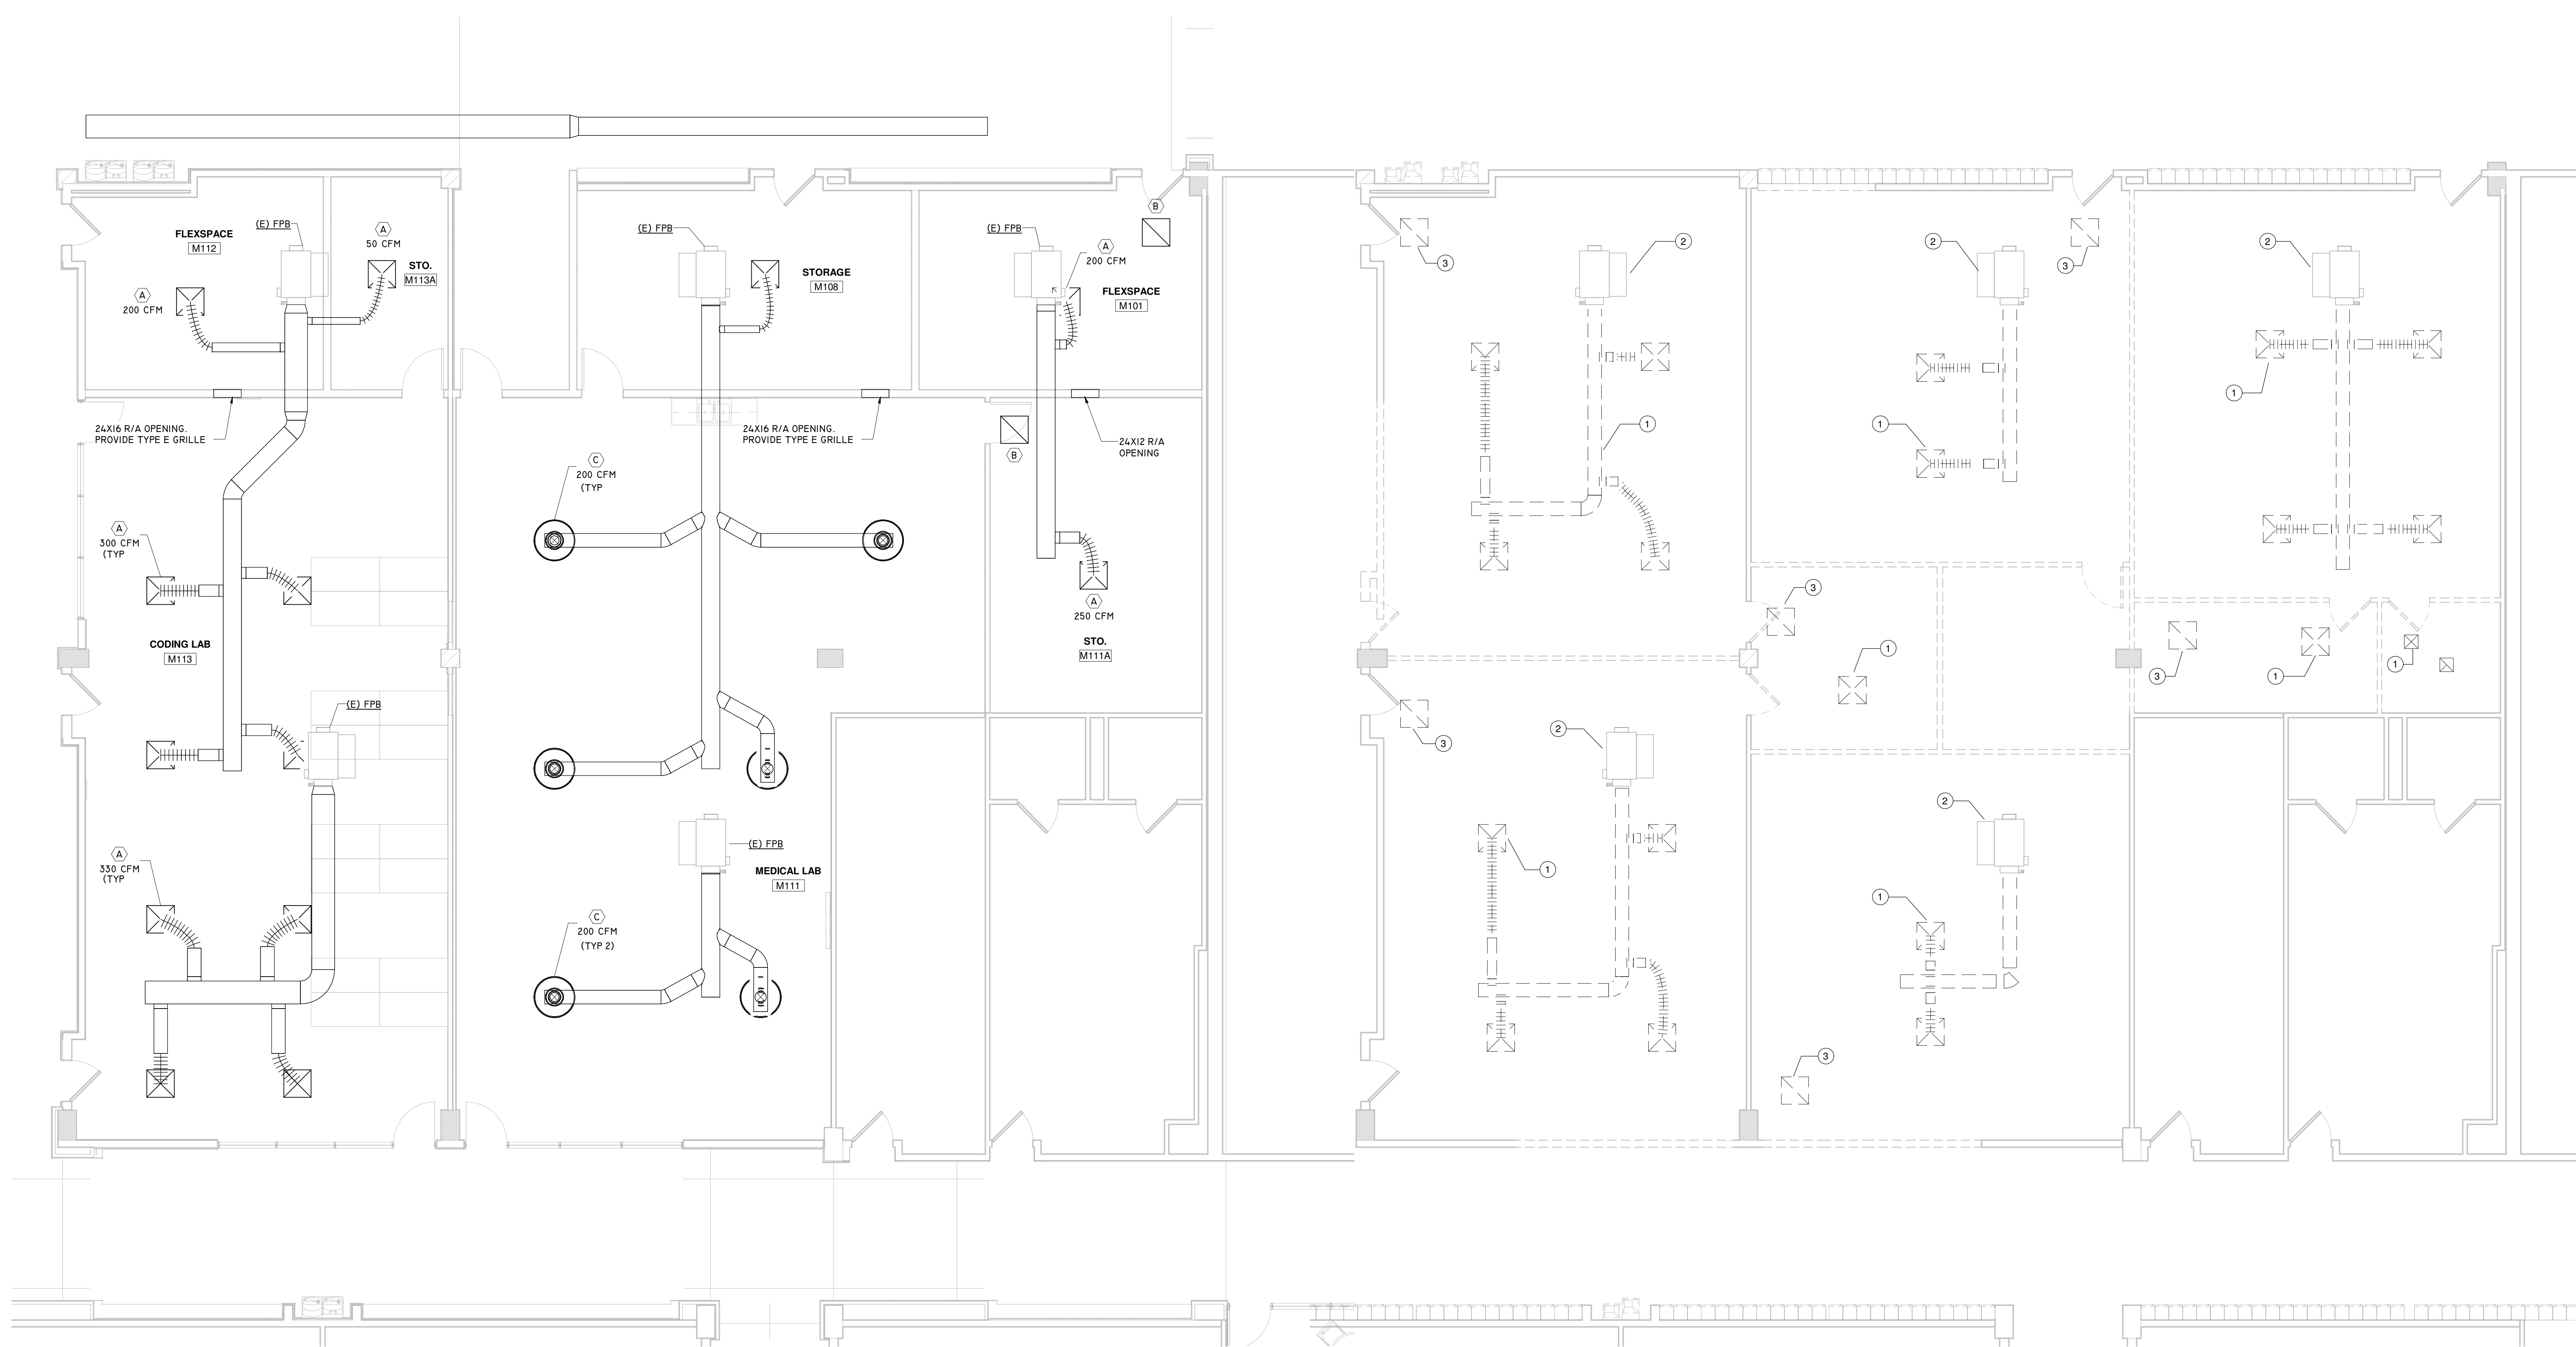

2 ENLARGED PROPOSED PLAN - AREA B3 - HVAC
Scale: 3/16" = 1'-0"

1 ENLARGED DEMOLITION PLAN - AREA B3 - HVAC
Scale: 3/16" = 1'-0"



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CONSULTANTS:


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PROFESSIONAL SEAL:





A PROJECT FOR:

**STAFFORD
HIGH SCHOOL
& MAGNET
SCHOOL
RENOVATIONS**


1625 STAFFORDSHIRE
ROAD,
STAFFORD, TX 77477
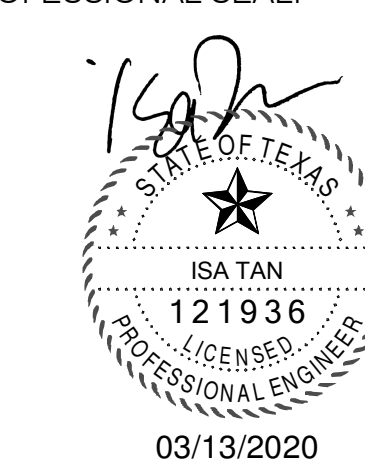
#	Date	ISSUED FOR
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2	2020/03/02	98% CD Review
3	2020/03/12	Issue for Bid, Permit, and Construction

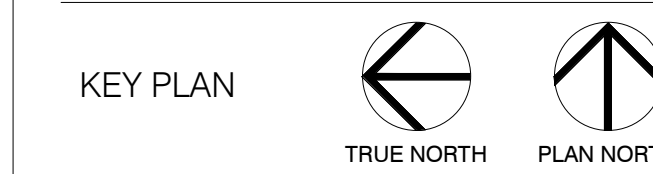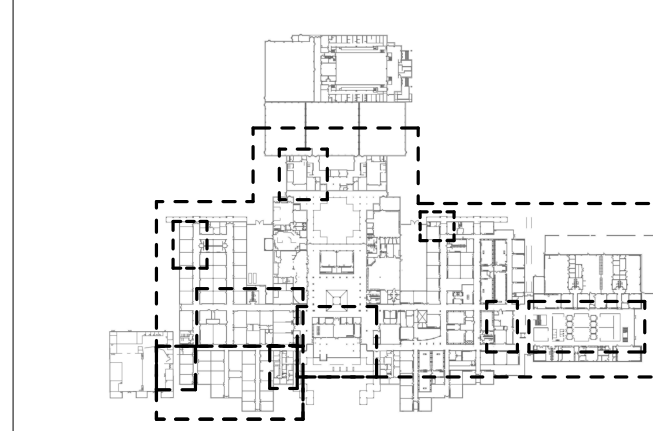


GENERAL NOTES:
1. EXTEND EXISTING FIRE ALARM LINES INTO RENOVATED AREAS. INSTALL NEW SPRINKLER HEADS AND COORDINATE SPRINKLER HEAD TYPE WITH THE INSTALLED CEILING. FINAL SPRINKLER SYSTEM DESIGN SHALL BE DONE BY CERTIFIED PROFESSIONAL.

KEYNOTE LEGEND	
1	EXISTING DIFFUSER TO REMAIN.
2	DEMO EXISTING BRANCH DUCT UP TO MAIN DUCT.
3	RECONNECT FAN POWER TERMINAL TO EXISTING CIRCUIT. MATCH AND EXTEND FEEDER AS REQUIRED. UTILIZE EXISTING DISCONNECTING MEANS.

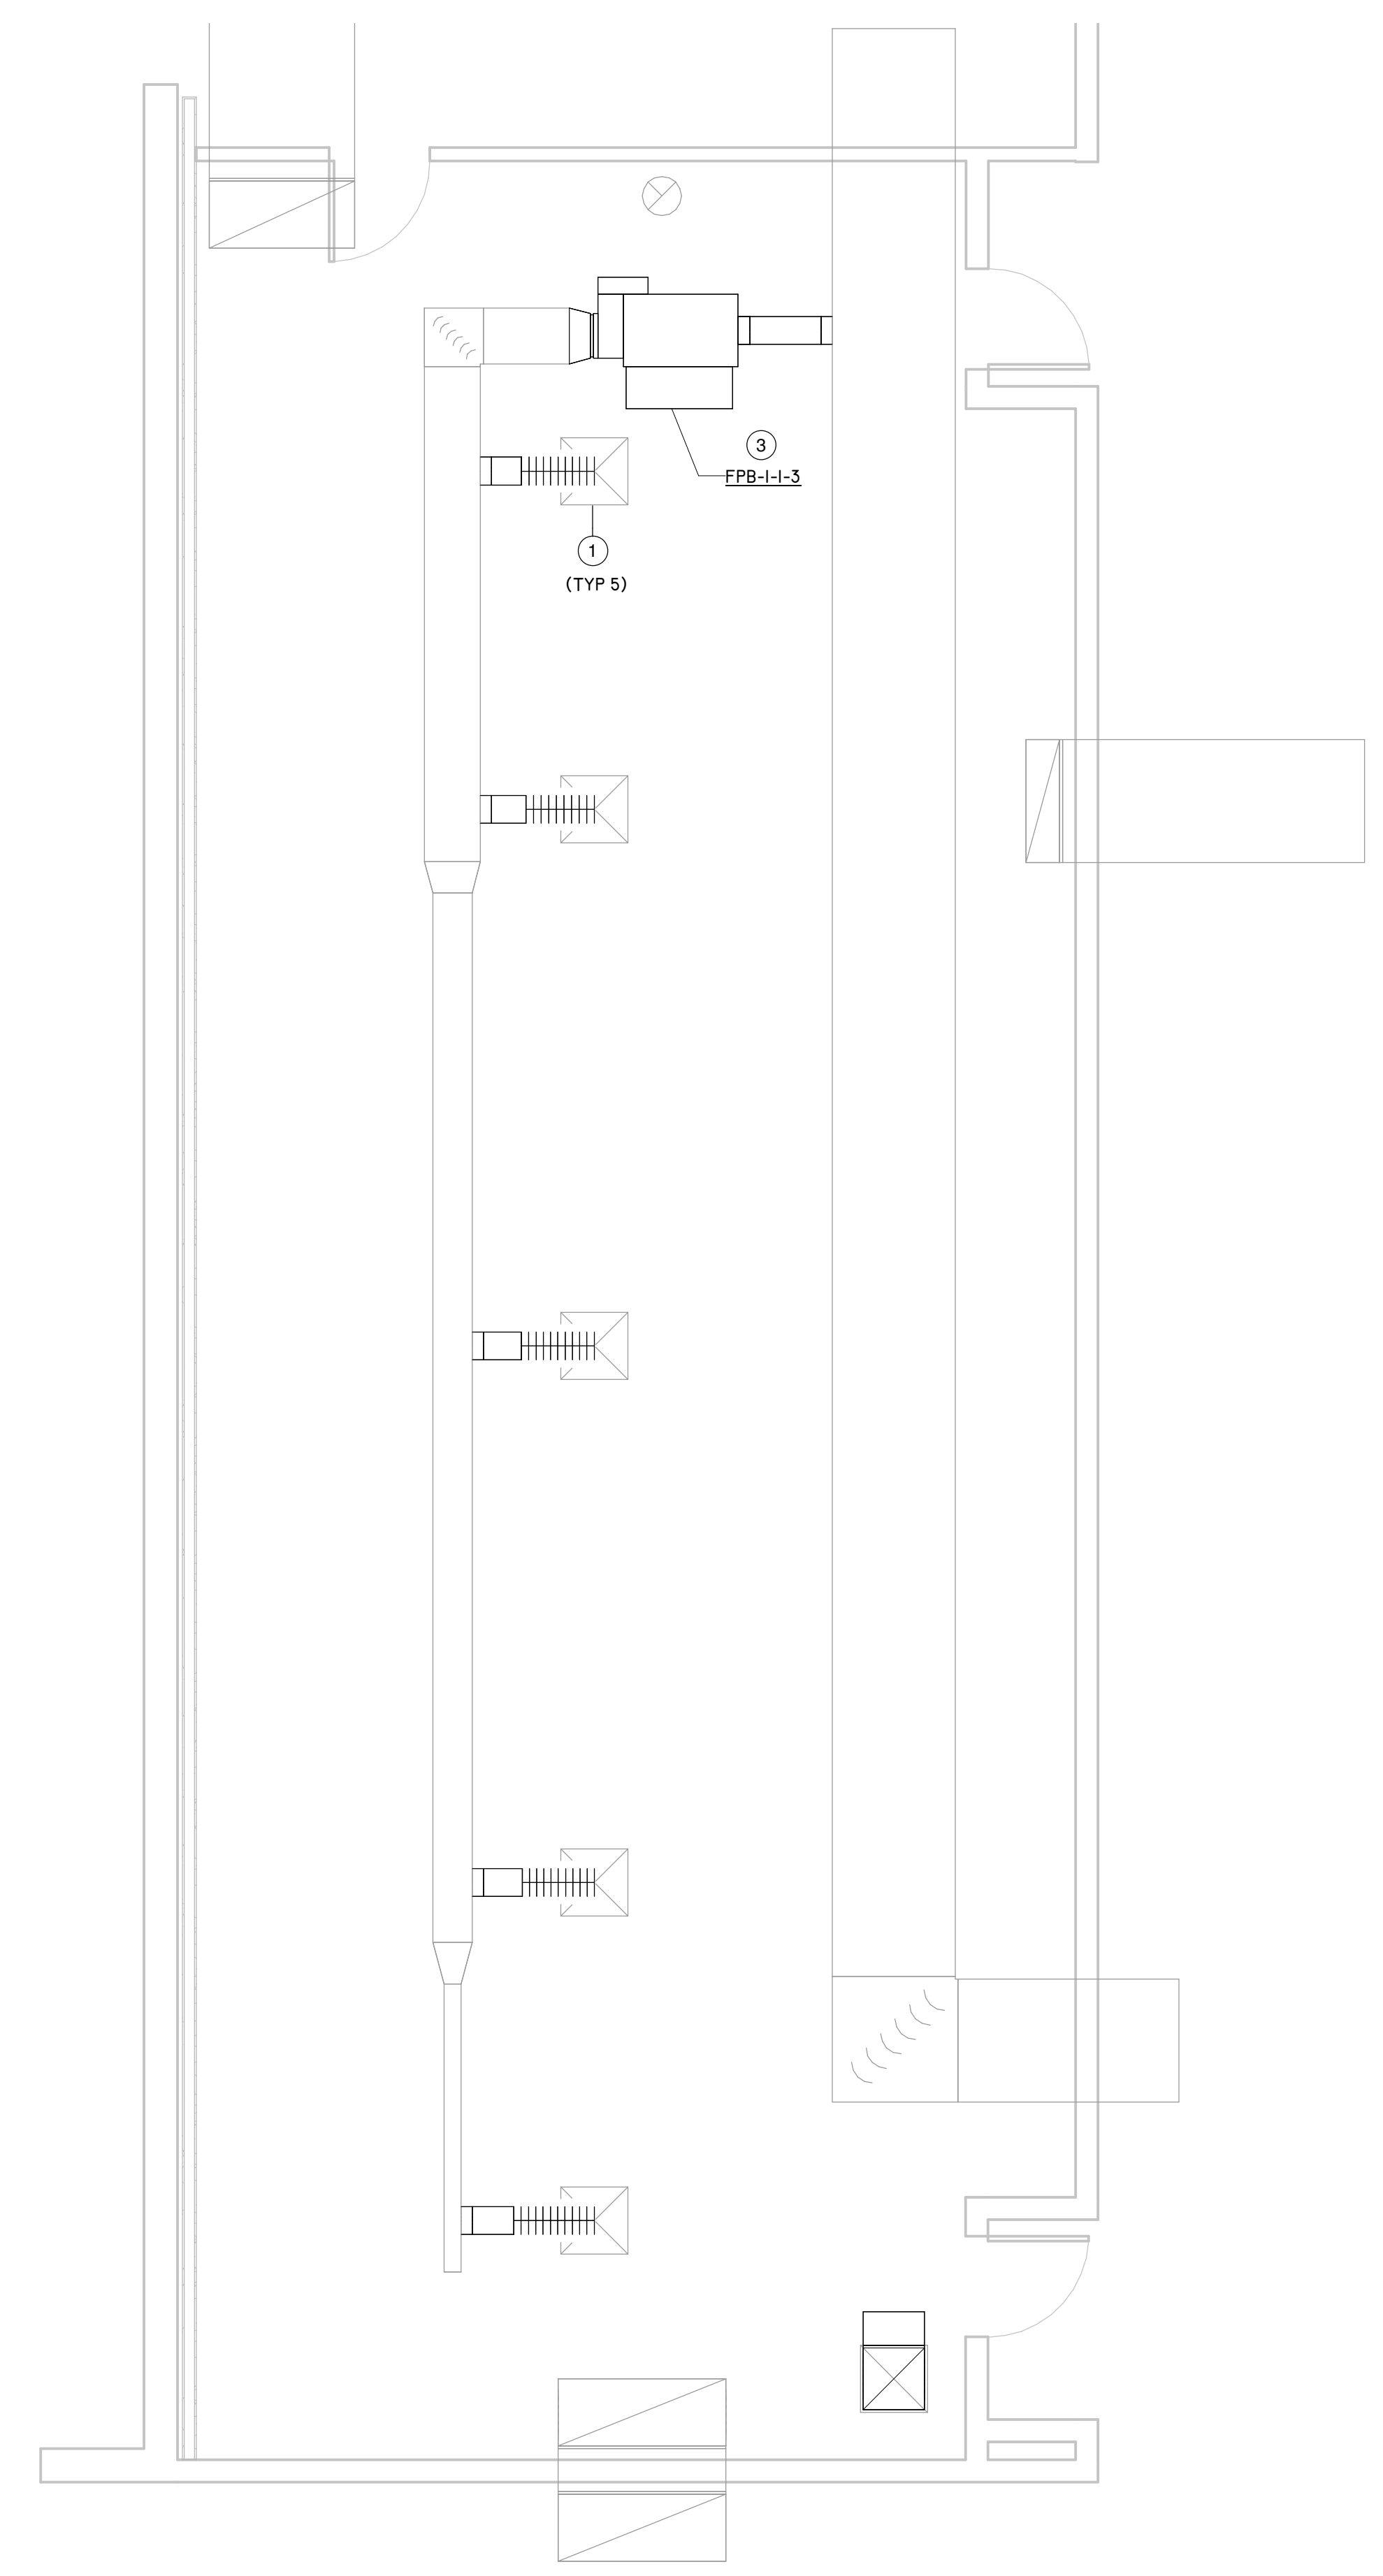

2 ENLARGED PROPOSED PLAN - AREA F - HVAC
Scale: 1/4" = 1'-0"

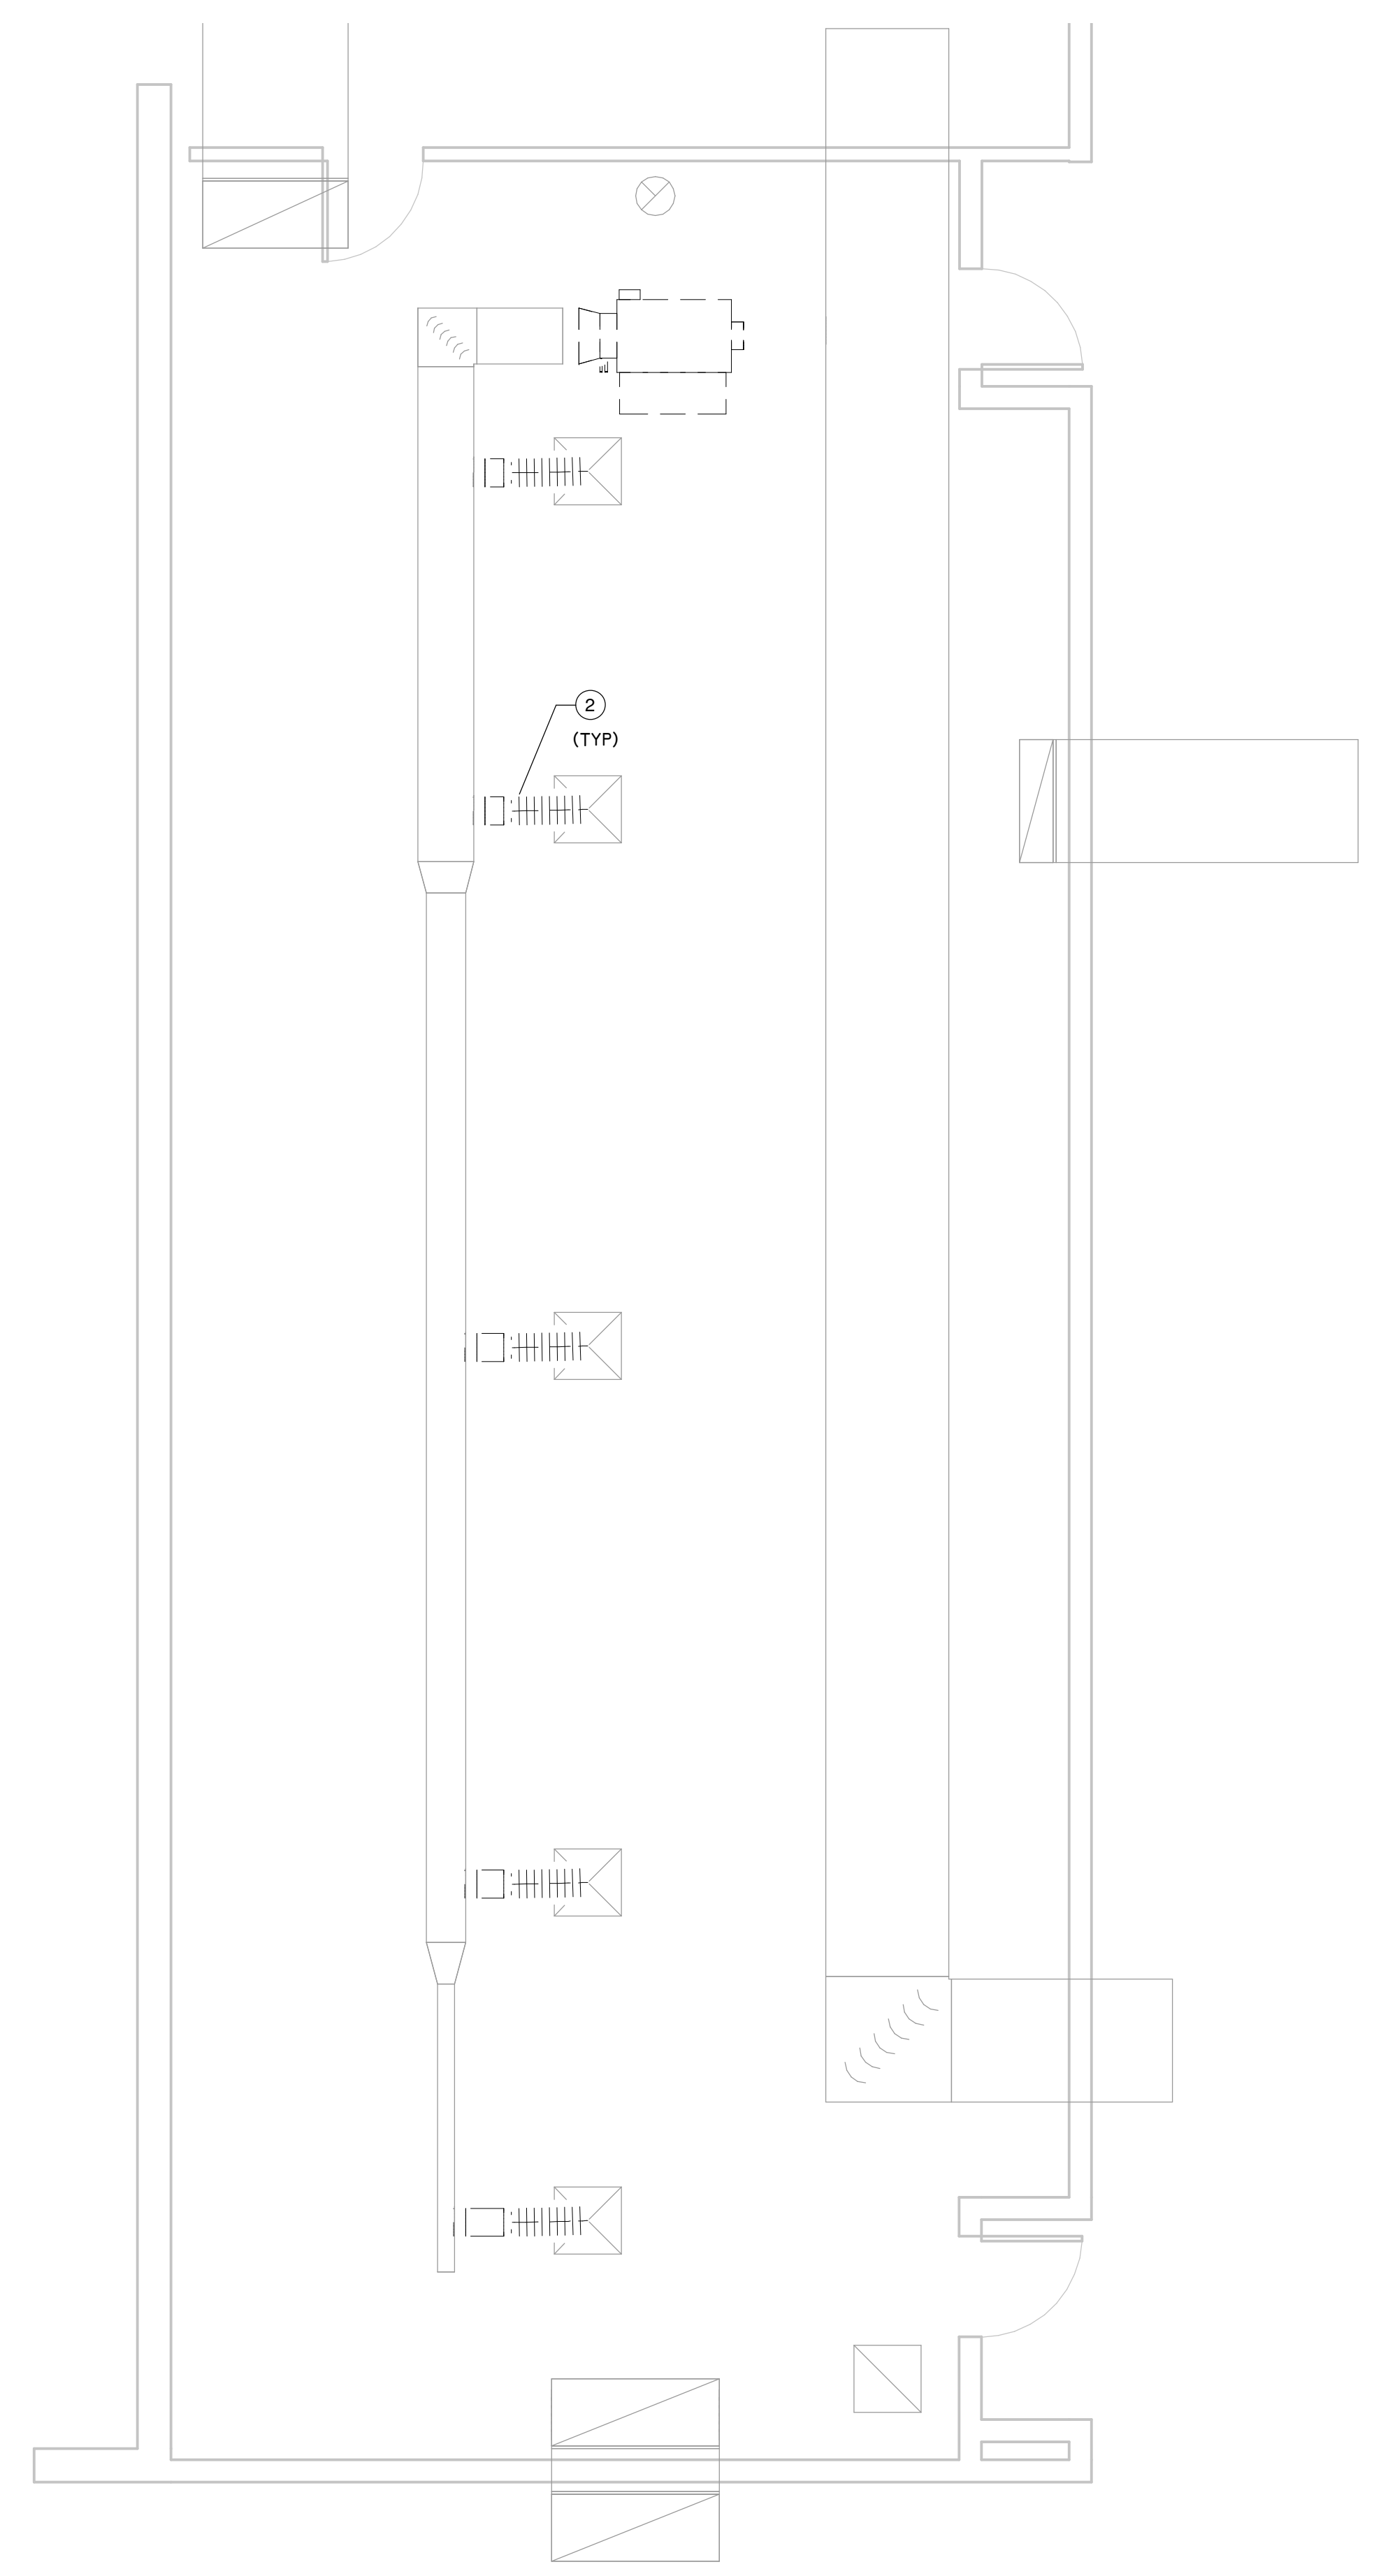

1 ENLARGED DEMOLITION PLAN - AREA F - HVAC
Scale: 1/4" = 1'-0"

Project Number	19006-A
Drawn By	LT
Checked By	AW
Approved By	MS
Drawing Title	LEVEL-1 GREEN ROOM - HVAC
Drawing Number	M1.05



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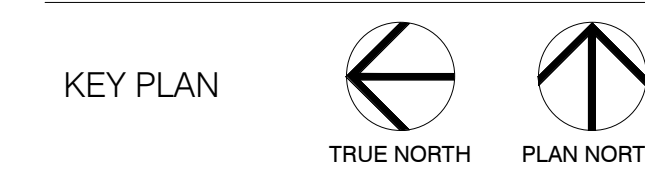
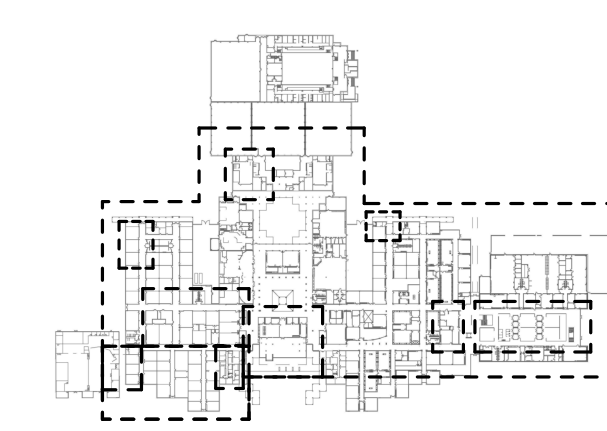


A PROJECT FOR:

**STAFFORD
HIGH SCHOOL
& MAGNET
SCHOOL
RENOVATIONS**

1625 STAFFORDSHIRE
ROAD,
STAFFORD, TX 77477

#	Date	ISSUED FOR
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2	2020/03/02	98% CD Review
3	2020/03/12	Issue for Bid, Permit, and Construction



Project Number	19006-A
Drawn By	LT
Checked By	AW
Approved By	MS
Drawing Title	

LEVEL-1 LIBRARY


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GENERAL NOTES:


- EXTEND EXISTING FIRE ALARM LINES INTO RENOVATED AREAS. INSTALL NEW SPRINKLER HEADS AND COORDINATE SPRINKLER HEAD TYPE WITH THE INSTALLED CEILING. FINAL SPRINKLER SYSTEM DESIGN SHALL BE DONE BY CERTIFIED PROFESSIONAL.

KEYNOTE LEGEND

1	CONNECT TO RTU-HS-1. FIELD VERIFY EXACT LOCATION.
2	REMOVE EXISTING DIFFUSER. CLEAN AND STORE FOR REUSE.
3	DEMO EXISTING SUPPLY AIR DUCT AS SHOWN. CAP AND SEAL EXISTING PORTION OF THE SUPPLY AIR DUCT.
4	8" ROUND EXHAUST DUCT UP TO EF-C-1 ON ROOF.
5	RELOCATE EXISTING DIFFUSER AS SHOWN. SET AIR FLOW RATE TO MATCH EXISTING VALUE.

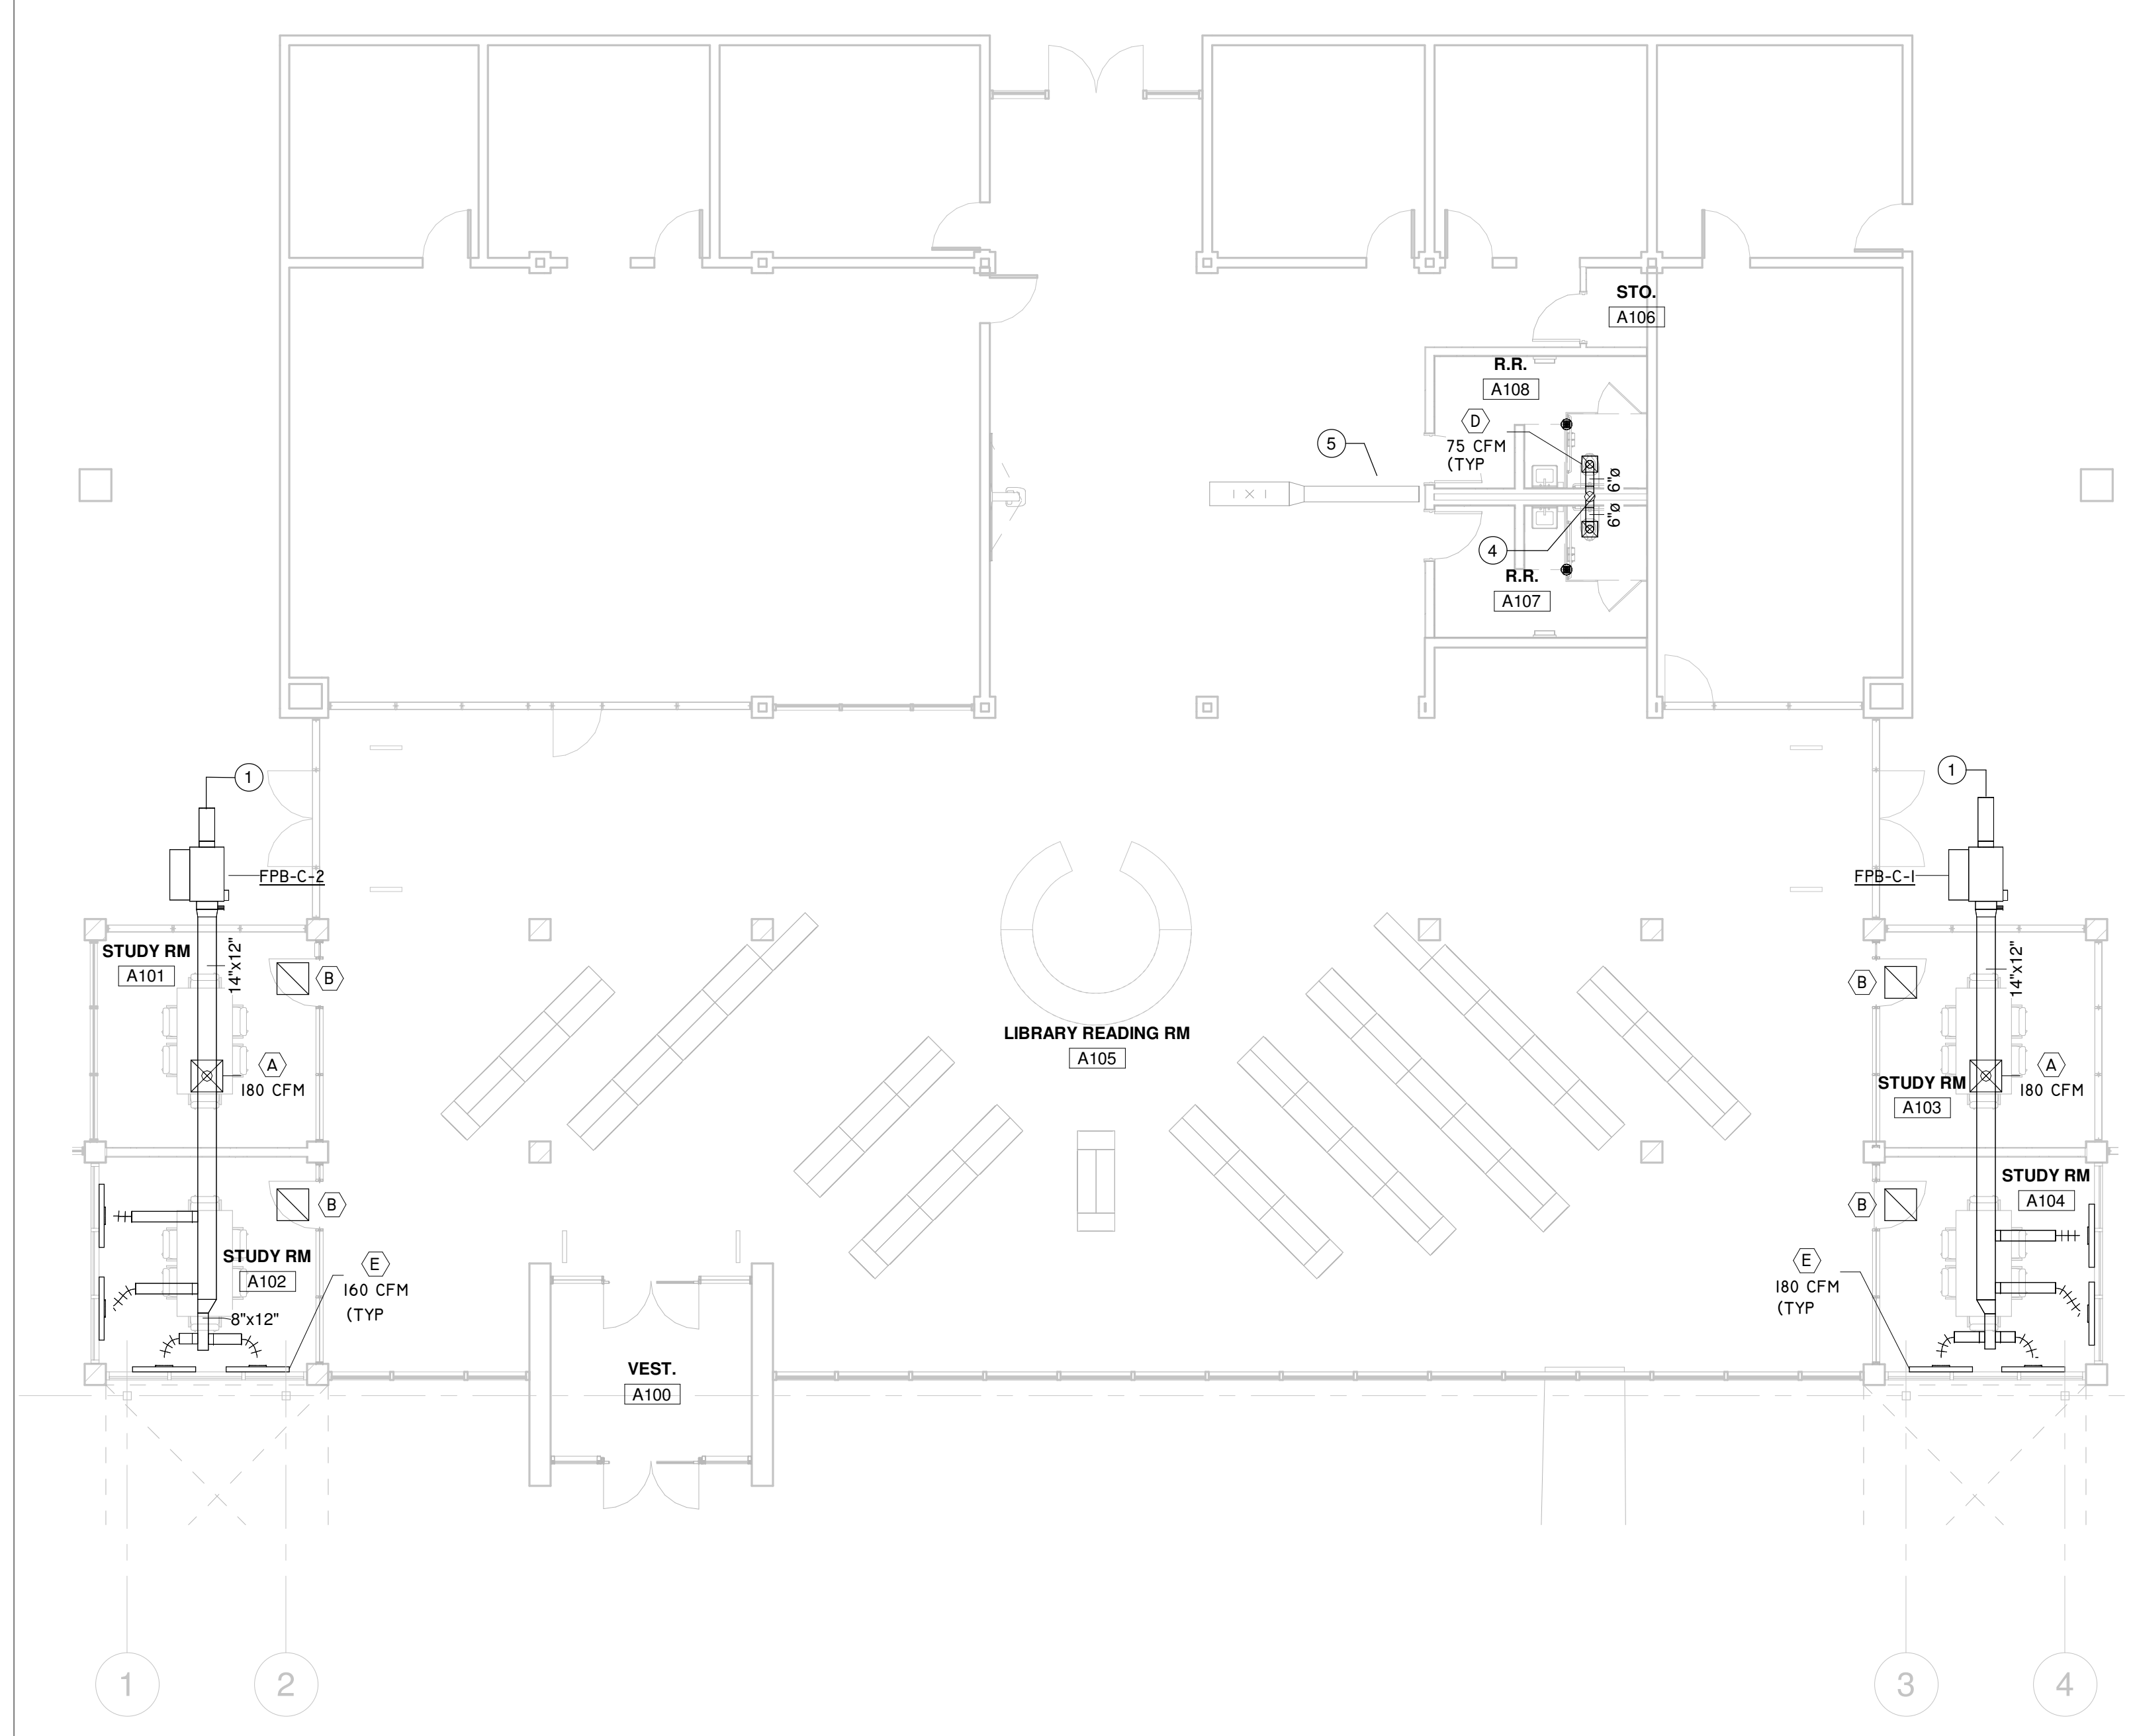


1 ENLARGED PROPOSED PLAN - AREA C - HVAC
Scale: 1/8" = 1'-0"

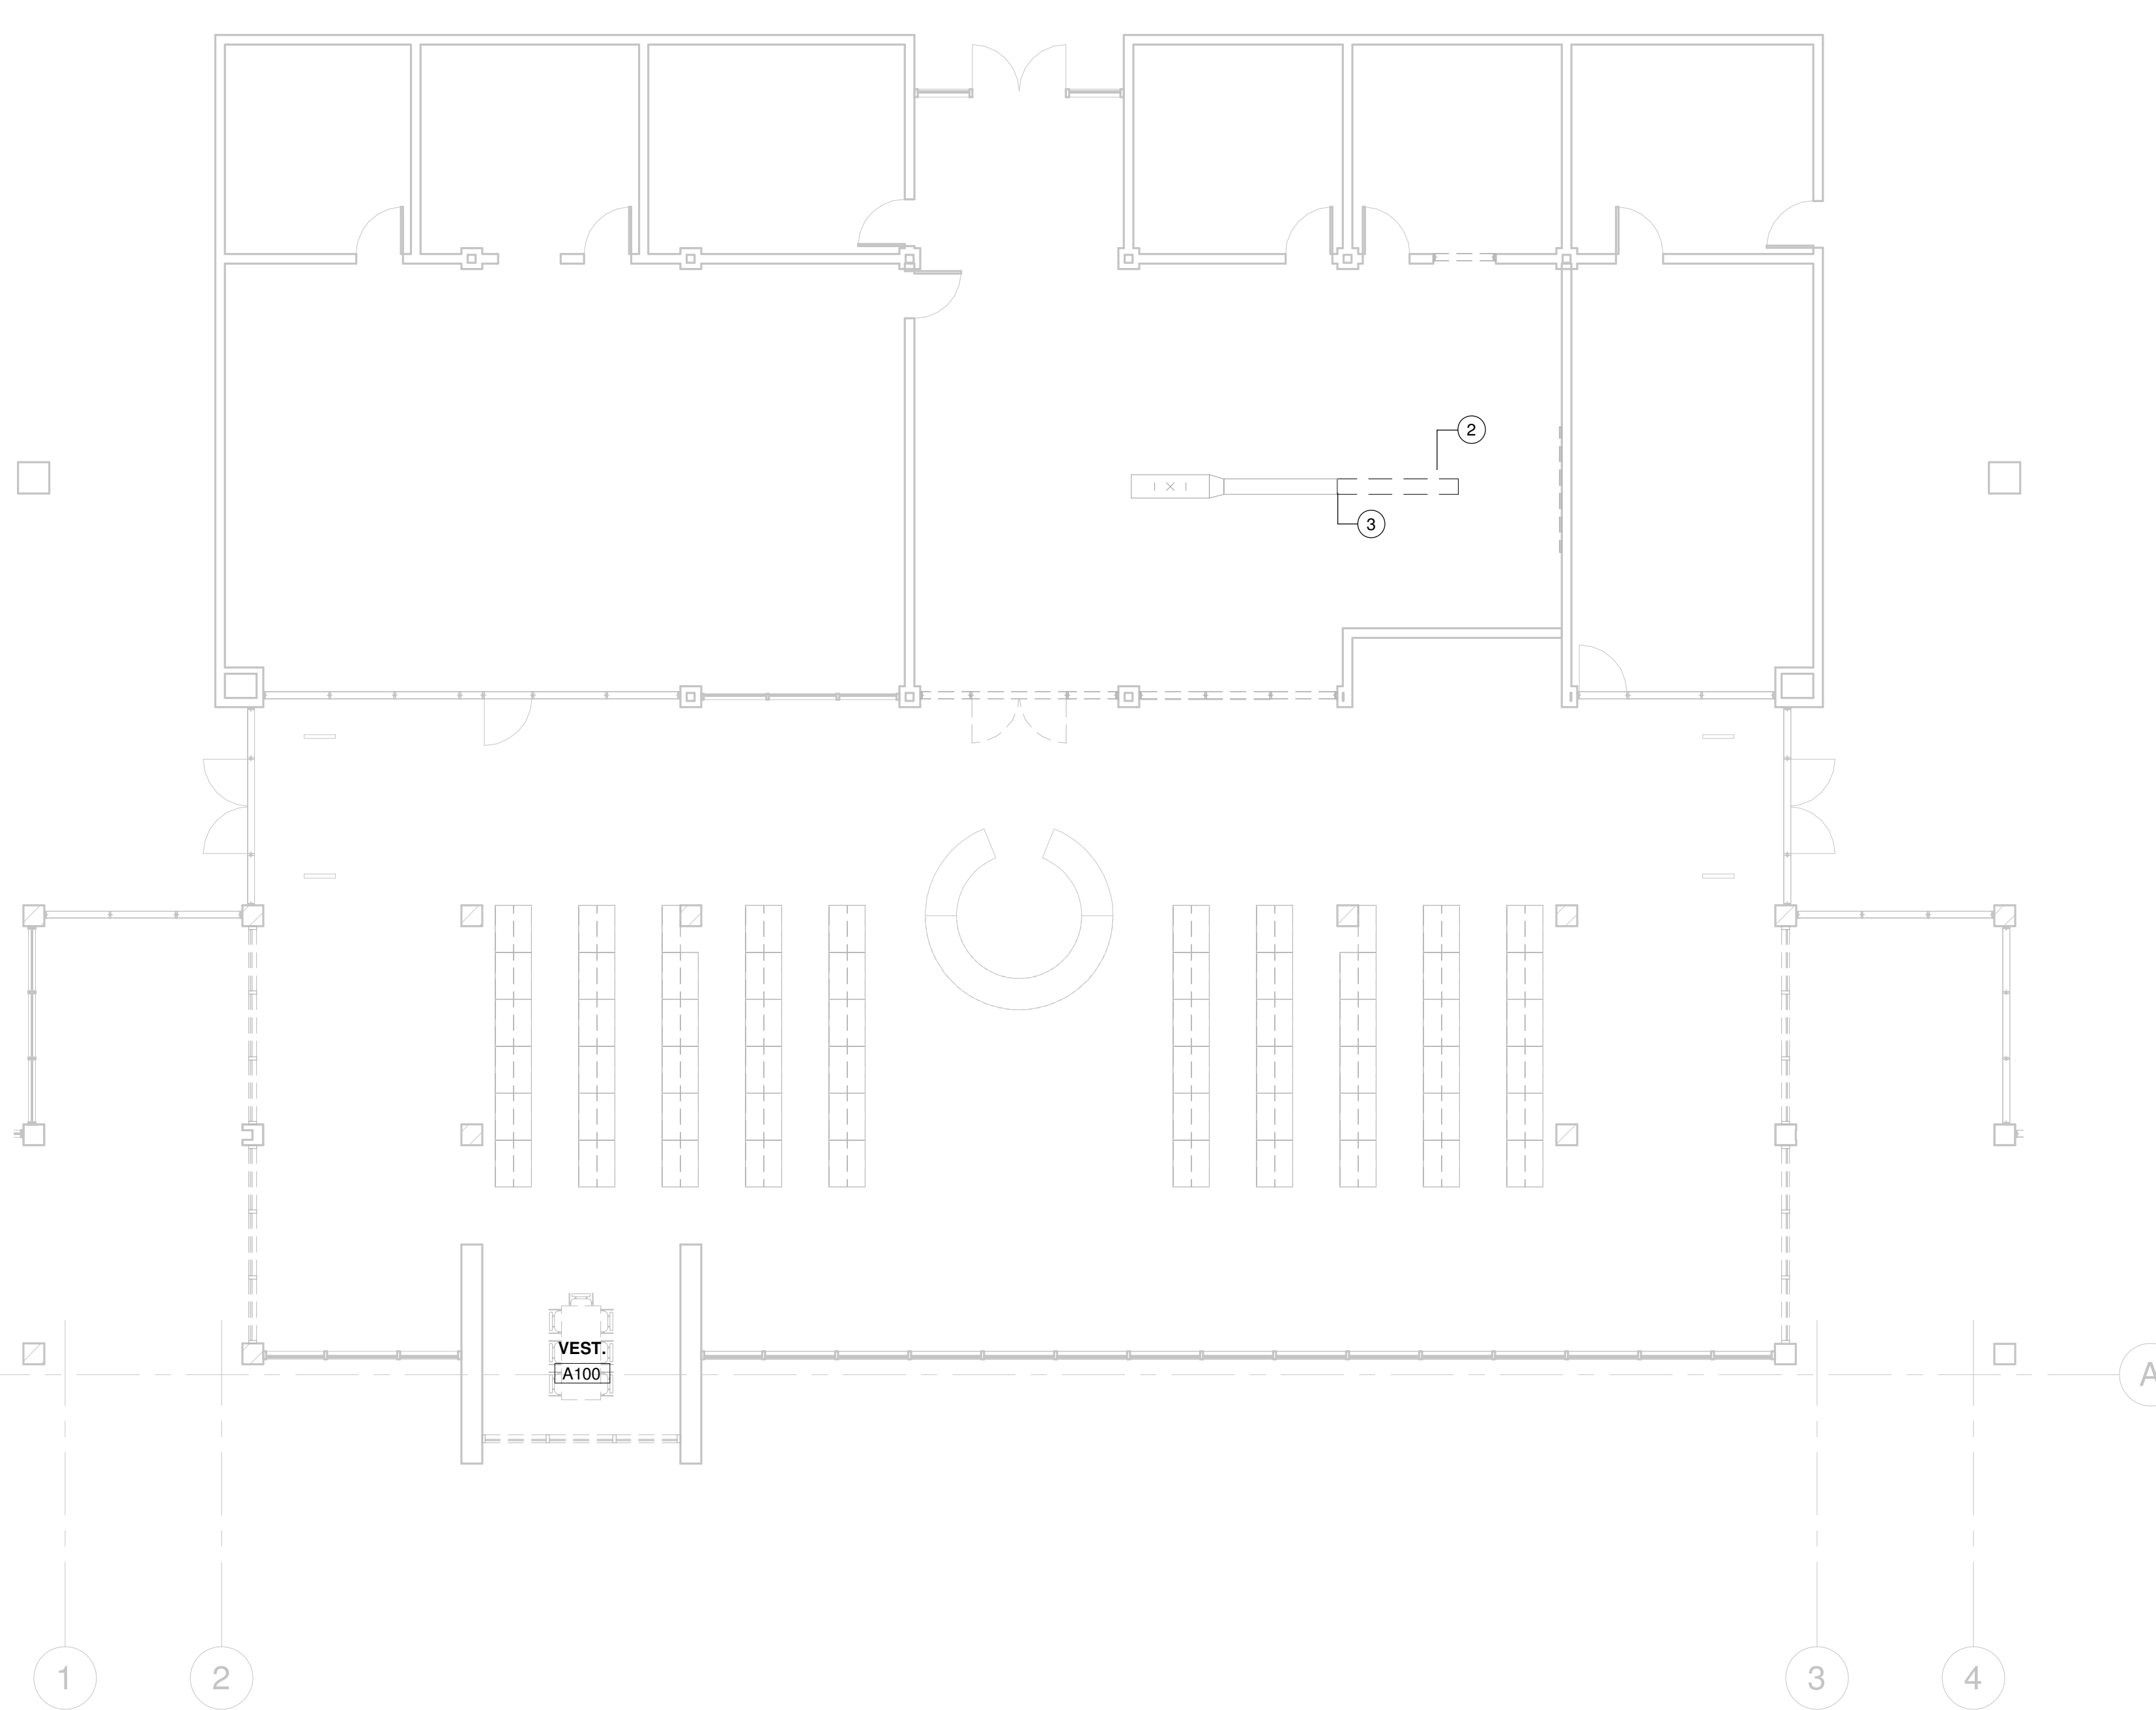

2 ENLARGED DEMOLITION PLAN - AREA C - HVAC
Scale: 1/8" = 1'-0"

GENERAL NOTES:

I. EXTEND EXISTING FIRE ALARM LINES INTO RENOVATED AREAS. INSTALL NEW SPRINKLER HEADS AND COORDINATE SPRINKLER HEAD TYPE WITH THE INSTALLED CEILING. FINAL SPRINKLER SYSTEM DESIGN SHALL BE DONE BY CERTIFIED PROFESSIONAL.

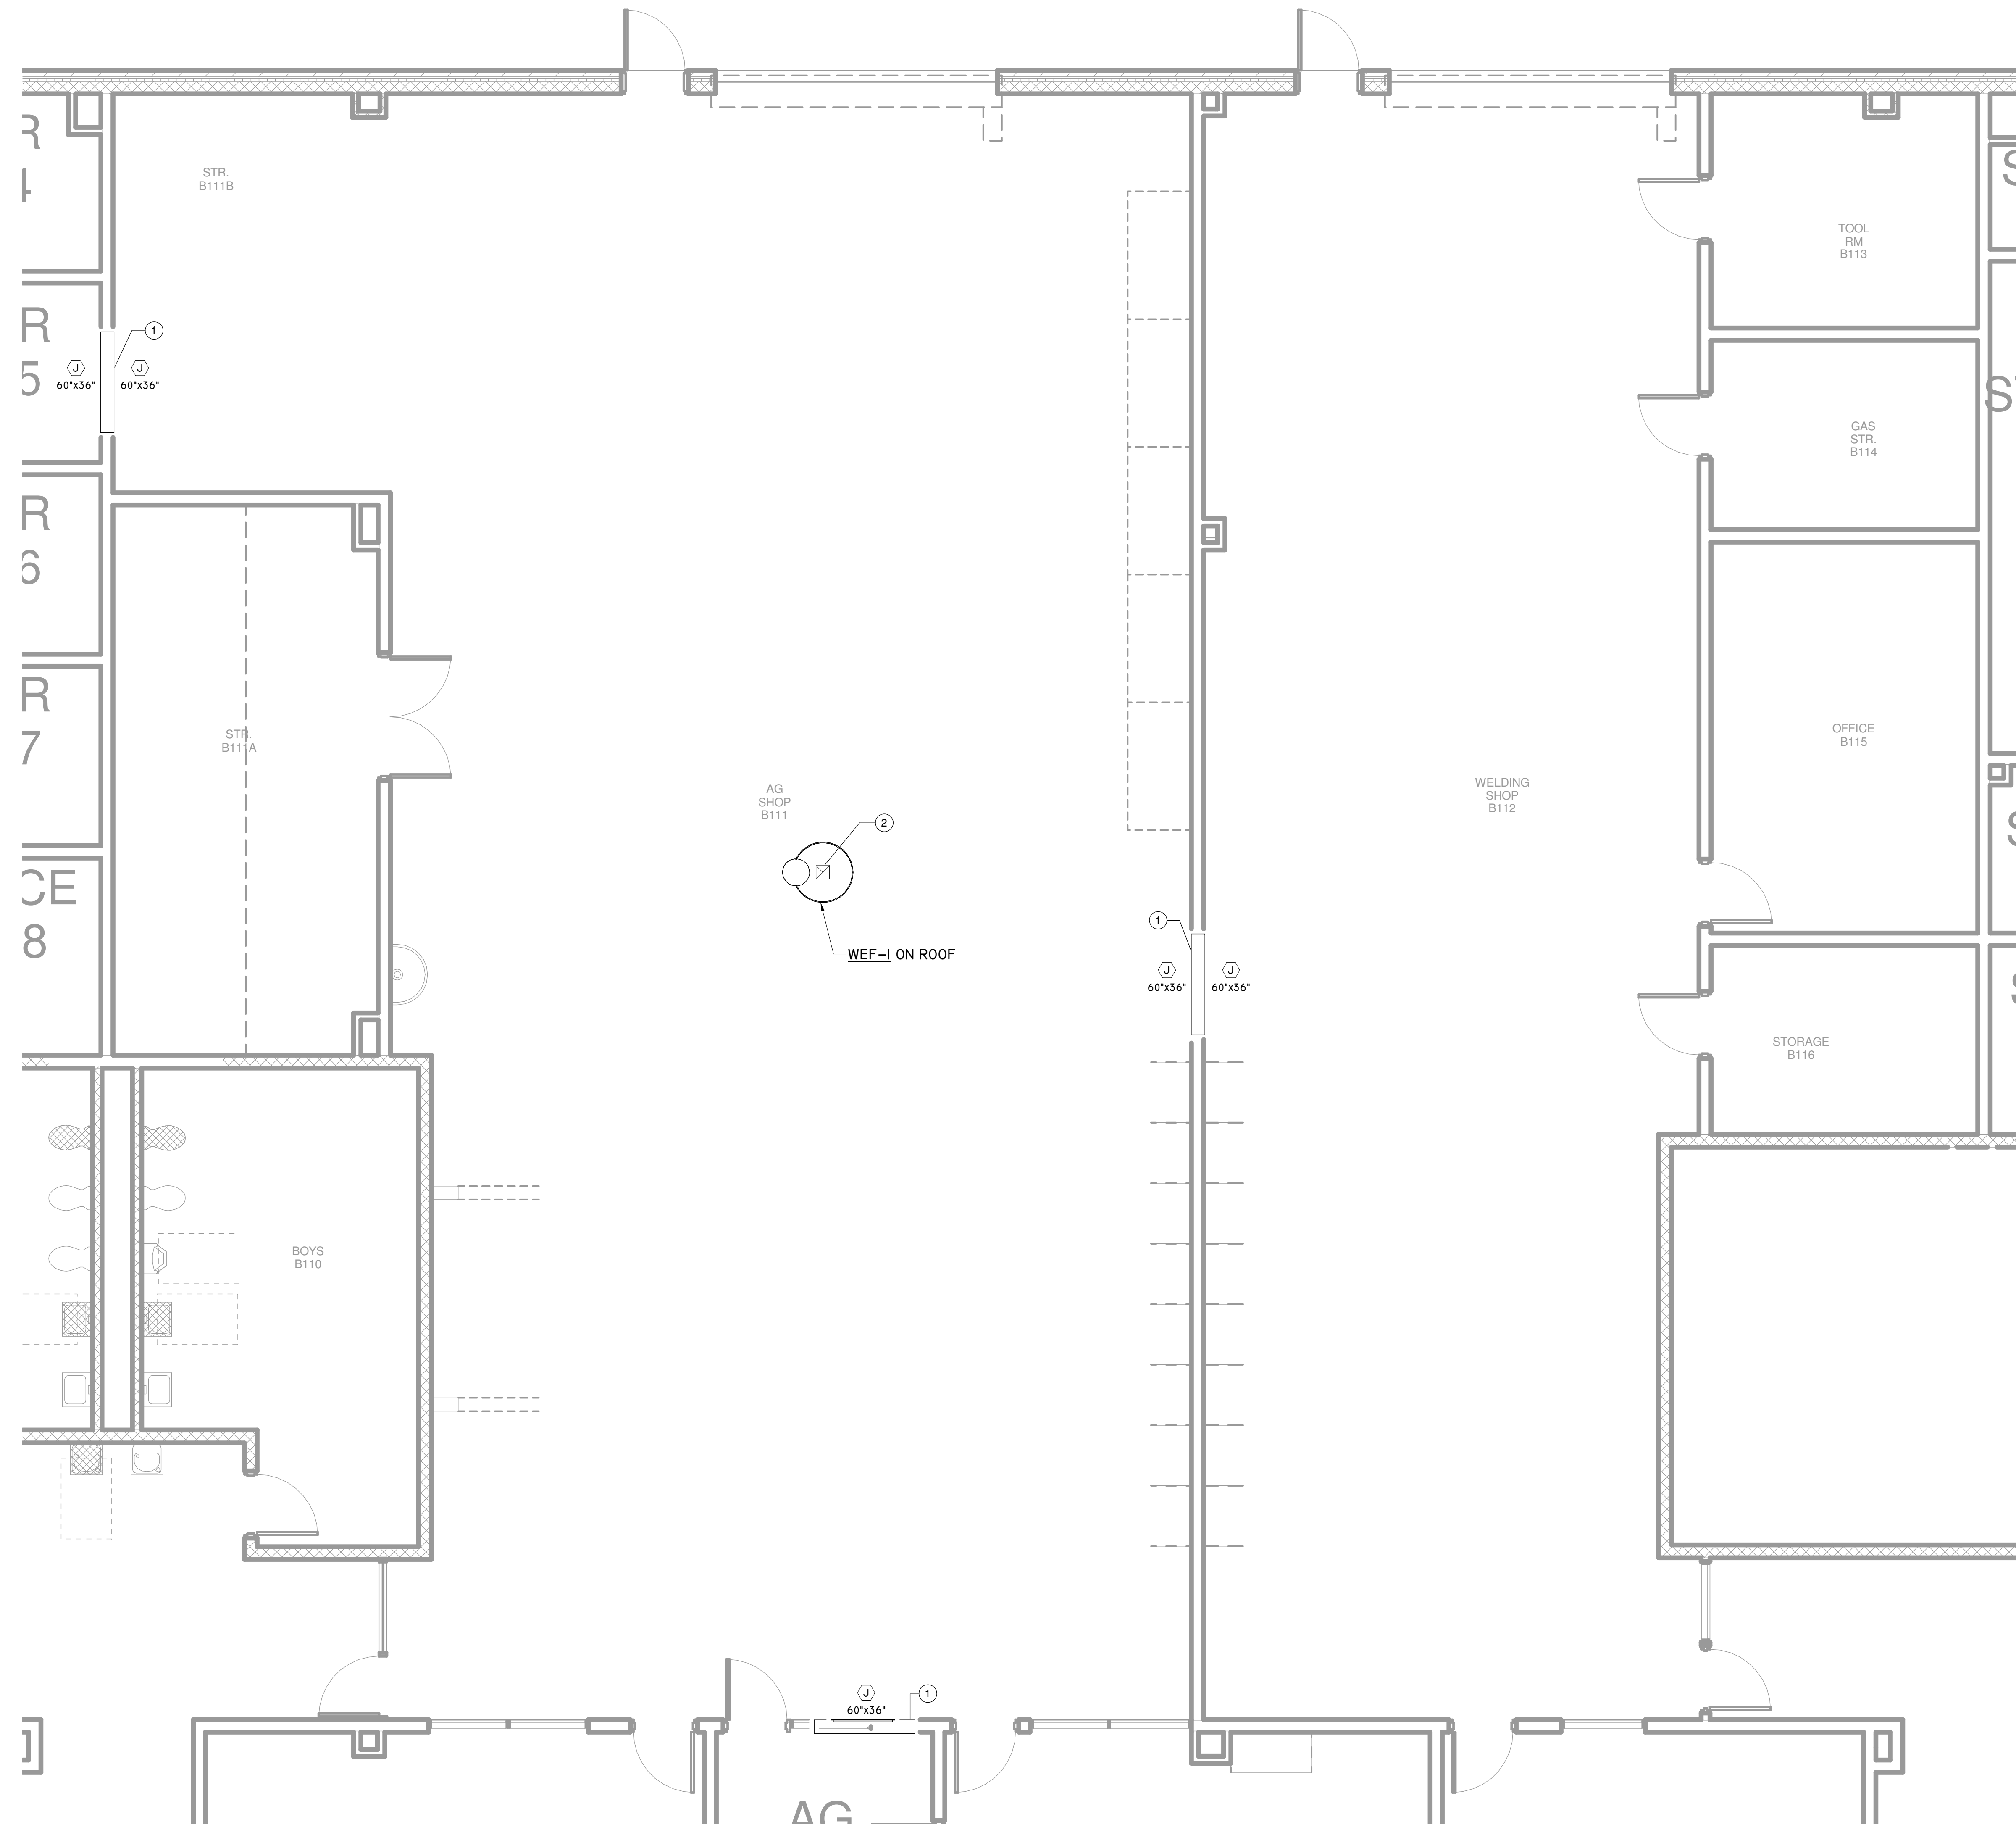

1 ENLARGED PROPOSED PLAN - AREA I - HVAC
Scale: 1/4" = 1'-0"



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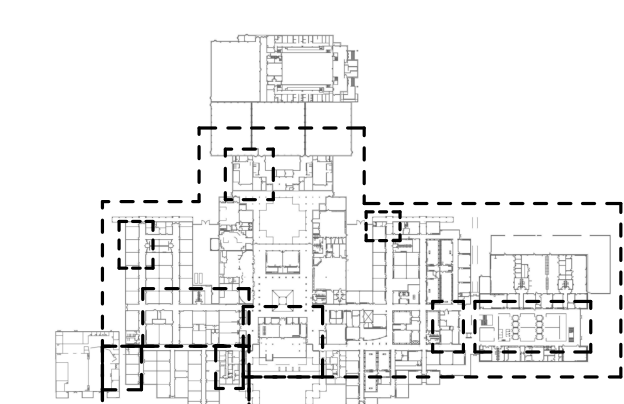


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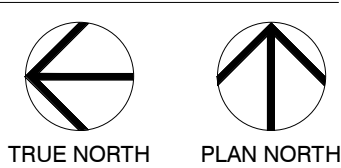
**STAFFORD
HIGH SCHOOL
& MAGNET
SCHOOL
RENOVATIONS**

1625 STAFFORDSHIRE
ROAD,
STAFFORD, TX 77477

#	Date	ISSUED FOR
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KEY PLAN



Project Number	19006-A
Drawn By	LT
Checked By	AW
Approved By	MS

LEVEL-1 WELDING LAB

Drawing Number **M1.07**

EXISTING PANEL TO REMAIN

PANEL: LE
LOCATION: ELEC ROOM - M155
WIRE SIZE, LOAD DESCRIPTION, LOAD TYPE, CONNECTED, FACTOR, DEMAND, TOTALS

EXISTING PANEL TO REMAIN

PANEL: LG
LOCATION: ELEC ROOM
WIRE SIZE, LOAD DESCRIPTION, LOAD TYPE, CONNECTED, FACTOR, DEMAND, TOTALS

EXISTING PANEL TO REMAIN

PANEL: LC
LOCATION: ELEC ROOM - M155
WIRE SIZE, LOAD DESCRIPTION, LOAD TYPE, CONNECTED, FACTOR, DEMAND, TOTALS

EXISTING PANEL TO REMAIN

PANEL: LF
LOCATION: ELEC ROOM
WIRE SIZE, LOAD DESCRIPTION, LOAD TYPE, CONNECTED, FACTOR, DEMAND, TOTALS




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A PROJECT FOR:
STAFFORD HIGH SCHOOL & MAGNET SCHOOL RENOVATIONS
1625 STAFFORDSHIRE ROAD, STAFFORD, TX 77477

Revision table with columns: #, Date, Issued For



Project Information table: Project Number (19006-A), Drawn By (LT), Checked By (AW), Approved By (MS), Drawing Title (PANEL SCHEDULES), Drawing Number (E0.03)

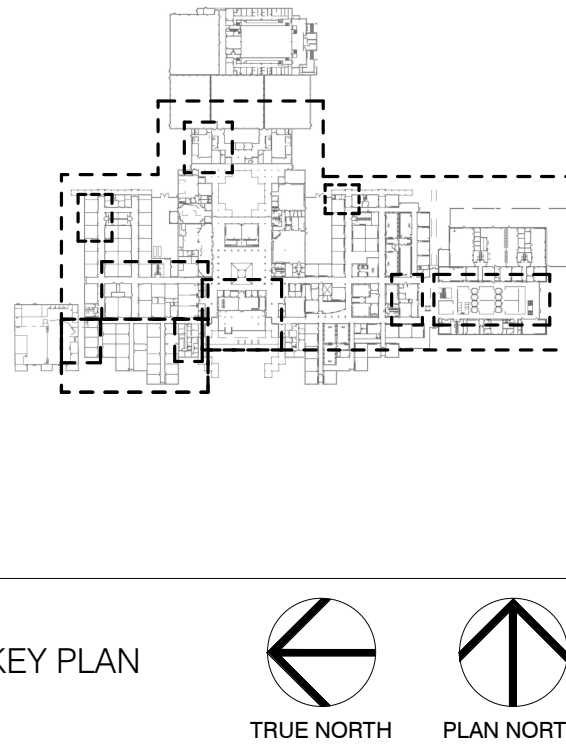EXISTING PANEL TO REMAIN

PANEL: HA
LOCATION: ELEC ROOM - N109
FED FROM:
Table with columns: WIRE SIZE, LOAD DESCRIPTION, LOAD TYPE, TRIP RATE / P, CKT NO, A (kVA), B (kVA), C (kVA), CKT NO, P / TRIP RATE, LOAD TYPE, LOAD DESCRIPTION, WIRE SIZE.

EXISTING PANEL TO REMAIN

PANEL: BL2A
LOCATION: MEZZANINE ELECTRICAL ROOM
FED FROM:
Table with columns: WIRE SIZE, LOAD DESCRIPTION, LOAD TYPE, TRIP RATE / P, CKT NO, A (kVA), B (kVA), C (kVA), CKT NO, P / TRIP RATE, LOAD TYPE, LOAD DESCRIPTION, WIRE SIZE.

EXISTING PANEL TO REMAIN

PANEL: BH1
LOCATION: MECH B100
FED FROM:
Table with columns: WIRE SIZE, LOAD DESCRIPTION, LOAD TYPE, TRIP RATE / P, CKT NO, A (kVA), B (kVA), C (kVA), CKT NO, P / TRIP RATE, LOAD TYPE, LOAD DESCRIPTION, WIRE SIZE.

NEW PANEL

PANEL: GA
LOCATION: ELEC ROOM - N109
FED FROM: TGA
Table with columns: WIRE SIZE, LOAD DESCRIPTION, LOAD TYPE, TRIP RATE / P, CKT NO, A (kVA), B (kVA), C (kVA), CKT NO, P / TRIP RATE, LOAD TYPE, LOAD DESCRIPTION, WIRE SIZE.

EXISTING PANEL TO REMAIN

PANEL: BH2
LOCATION: MEZZANINE ELECTRICAL ROOM
FED FROM:
Table with columns: WIRE SIZE, LOAD DESCRIPTION, LOAD TYPE, TRIP RATE / P, CKT NO, A (kVA), B (kVA), C (kVA), CKT NO, P / TRIP RATE, LOAD TYPE, LOAD DESCRIPTION, WIRE SIZE.



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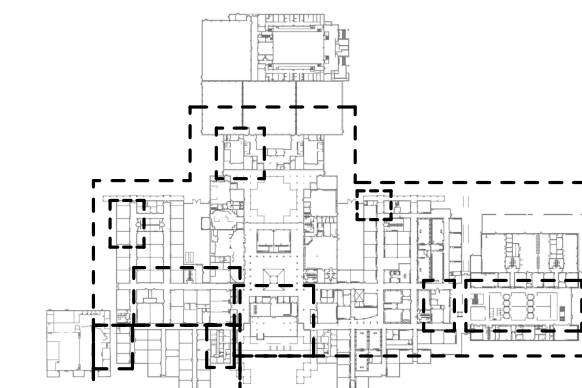
03/13/2020

A PROJECT FOR:

STAFFORD
HIGH SCHOOL
& MAGNET
SCHOOL
RENOVATIONS

1625 STAFFORDSHIRE
ROAD,
STAFFORD, TX 77477

Table with columns: #, Date, ISSUED FOR
1 2020/01/31 90% CD
2 2020/03/02 98% CD Review
3 2020/03/12 Issue for Bid, Permit, and Construction



KEY PLAN
TRUE NORTH
PLAN NORTH

Table with columns: Project Number, Drawn By, Checked By, Approved By, Drawing Title
Project Number 19006-A
Drawn By LT
Checked By AW
Approved By MS
Drawing Title

PANEL SCHEDULES

Drawing Number E0.04



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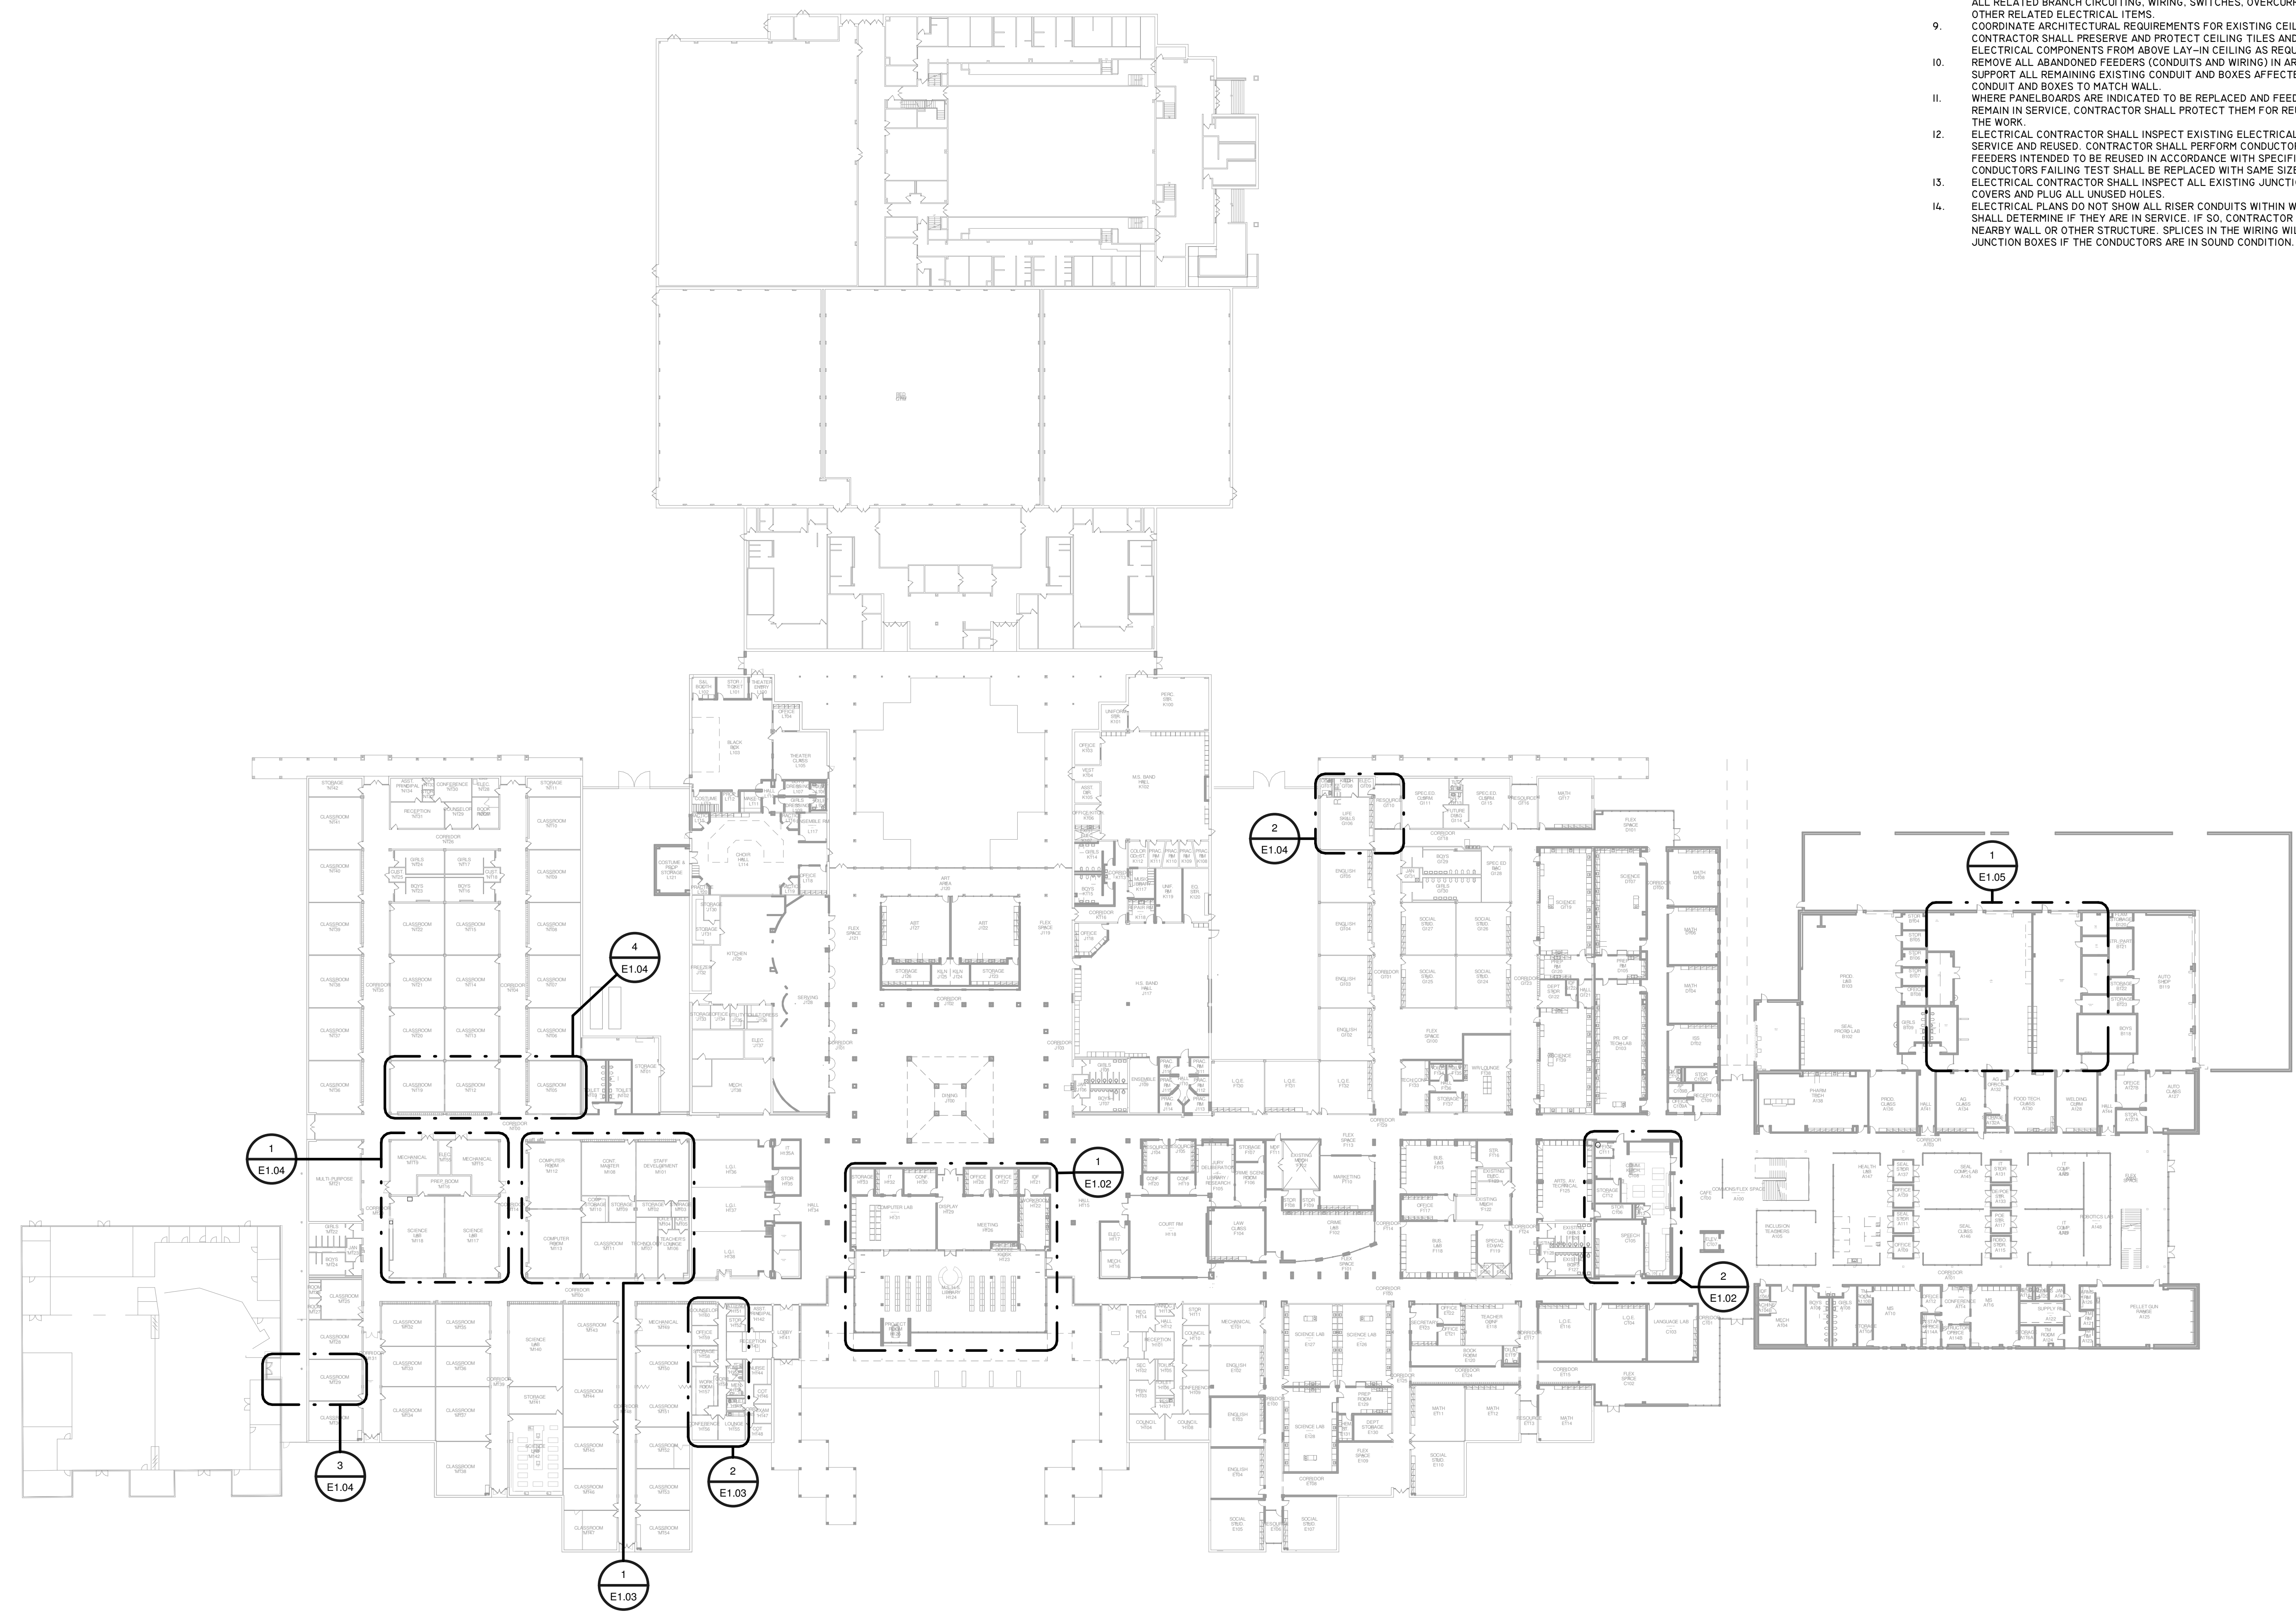
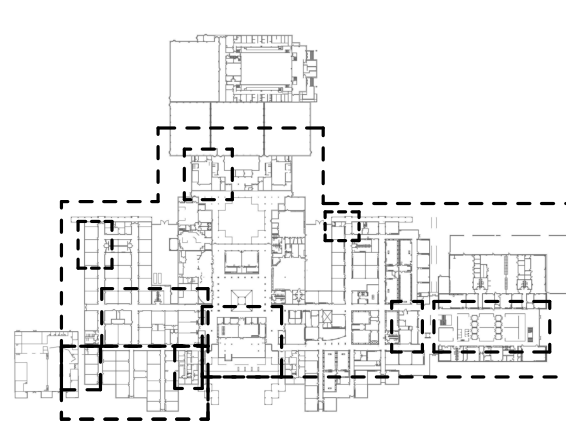
03/13/2020

A PROJECT FOR:

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RENOVATIONS**

**1625 STAFFORDSHIRE
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ELECTRICAL GENERAL DEMOLITION NOTES

1. ELECTRICAL CONTRACTOR SHALL REMOVE ELECTRICAL EQUIPMENT AS INDICATED BY KEY NOTES AND AS REQUIRED BY SCOPE OF DEMOLITION WORK. REFER TO ARCHITECTURAL DRAWINGS FOR ALL WALLS DESIGNATED FOR REMOVAL.
2. BEFORE ANY ELECTRICAL EQUIPMENT OR OUTLET REMOVAL, IDENTIFY AND DISCONNECT THE POWER SUPPLY TO IT. VERIFY WITH OWNER LOADS THAT MUST REMAIN IN SERVICE AND DO NOT DISCONNECT THESE.
3. REMOVE ALL RELATED LINE SIDE AND LOAD SIDE FEEDERS (WIRES AND CONDUITS) IN ENTIRETY FOR EQUIPMENT INDICATED OR REQUIRED TO BE REMOVED.
4. LEAVE OVERCURRENT PROTECTION DEVICE FOR EQUIPMENT INDICATED TO BE REMOVED IN PLACE UNLESS NOTED OTHERWISE.
5. ALL REMOVED EQUIPMENT IS PROPERTY OF OWNER AND SHALL BE STORED AT OWNER DESIGNATED LOCATION FOR INSPECTION. CONTRACTOR IS RESPONSIBLE FOR REMOVAL AND DISPOSAL OF EQUIPMENT OWNER DOES NOT INTEND TO KEEP, STORE, OR REUSE.
6. REMOVE ALL ELECTRICAL, TELEPHONE, AND DATA OUTLETS IN WALLS DESIGNATED FOR DEMOLITION ON ARCHITECTURAL AND/OR ELECTRICAL PLANS. REMOVE RELATED CIRCUITS SERVING THE DEVICES IN THEIR ENTIRETY. VERIFY ALL ABANDONED DATA CABLES ABOVE CEILINGS AND IN OTHER PLENUMS WITH OWNER AND REMOVE THEM AS DIRECTED BY OWNER.
7. WHERE EXISTING OUTLETS AND DEVICES (RECEPTACLES OR LUMINAIRES) TO REMAIN IN SERVICE SHARE SAME BRANCH CIRCUIT AS OUTLETS (RECEPTACLES OR LUMINAIRES) TO BE REMOVED. ELECTRICAL CONTRACTOR SHALL ENSURE CONTINUITY OF THE EXISTING AFTER REMOVAL. THIS CONDITION MAY NOT HAVE BEEN IDENTIFIED ON ELECTRICAL DEMOLITION DRAWINGS. ELECTRICAL CONTRACTOR SHALL FIELD VERIFY SUCH CONDITION.
8. LUMINAIRES SHALL BE REMOVED AS INDICATED ON ARCHITECTURAL REFLECTED CEILING OR ELECTRICAL DEMOLITION PLANS. DISPOSE OF ALL FIXTURES AND LAMPS OWNER DOES NOT INTEND TO KEEP. REMOVE ALL RELATED BRANCH CIRCUITING, WIRING, SWITCHES, OVERCURRENT PROTECTION DEVICES, AND ALL OTHER RELATED ELECTRICAL ITEMS.
9. COORDINATE ARCHITECTURAL REQUIREMENTS FOR EXISTING CEILING GRID SYSTEM. ELECTRICAL CONTRACTOR SHALL PRESERVE AND PROTECT CEILING TILES AND SUPPORTING 'S WHEN REMOVING ELECTRICAL COMPONENTS FROM ABOVE LAY-IN CEILING AS REQUIRED.
10. REMOVE ALL ABANDONED FEEDERS (CONDUITS AND WIRING) IN AREA OF CONSTRUCTION. PROPERLY SUPPORT ALL REMAINING EXISTING CONDUIT AND BOXES AFFECTED. PAINT REUSED AND EXPOSED CONDUIT AND BOXES TO MATCH WALL.
11. WHERE PANELBOARDS ARE INDICATED TO BE REPLACED AND FEEDER AND BRANCH CIRCUITS ARE TO REMAIN IN SERVICE, CONTRACTOR SHALL PROTECT THEM FOR REUSE DURING CONSTRUCTION PHASE OF THE WORK.
12. ELECTRICAL CONTRACTOR SHALL INSPECT EXISTING ELECTRICAL CIRCUITS INDICATED TO REMAIN IN SERVICE AND REUSED. CONTRACTOR SHALL PERFORM CONDUCTOR INSULATION TESTING IN ALL MAIN FEEDERS INTENDED TO BE REUSED IN ACCORDANCE WITH SPECIFICATION REQUIREMENTS. ALL CONDUCTORS FAILING TEST SHALL BE REPLACED WITH SAME SIZE AS EXISTING.
13. ELECTRICAL CONTRACTOR SHALL INSPECT ALL EXISTING JUNCTION BOXES AND REPLACE MISSING COVERS AND PLUG ALL UNUSED HOLES.
14. ELECTRICAL PLANS DO NOT SHOW ALL RISER CONDUITS WITHIN WALLS. WHEN FOUND, CONTRACTOR SHALL DETERMINE IF THEY ARE IN SERVICE. IF SO, CONTRACTOR SHALL RELOCATE THEM TO A NEW NEARBY WALL OR OTHER STRUCTURE. SPLICES IN THE WIRING WILL BE PERMITTED IN SUITABLE JUNCTION BOXES IF THE CONDUCTORS ARE IN SOUND CONDITION.

1 FLOOR PLAN - LEVEL 1 - POWER - DEMO
Scale: 1" = 40'-0"

Project Number	19006-A
Drawn By	LT
Checked By	AW
Approved By	MS
Drawing Title	OVERALL DEMOLITION PLAN - POWER
Drawing Number	E1.01



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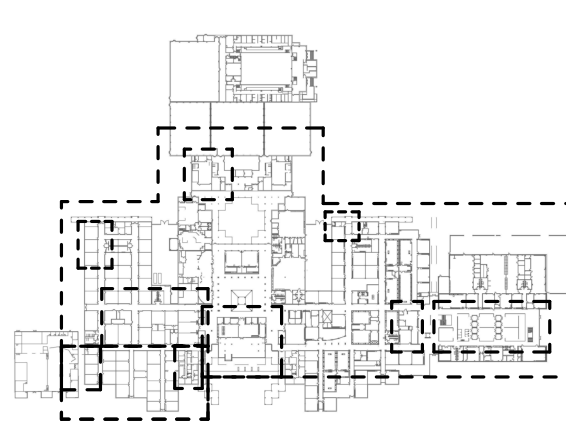


A PROJECT FOR:

**STAFFORD
HIGH SCHOOL
& MAGNET
SCHOOL
RENOVATIONS**

1625 STAFFORDSHIRE
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#	Date	ISSUED FOR
1	2020/01/31	90% CD
2	2020/03/02	98% CD Review
3	2020/03/12	Issue for Bid, Permit, and Construction



KEY PLAN
TRUE NORTH
PLAN NORTH


Project Number	19006-A
Drawn By	LT
Checked By	AW
Approved By	MS

ENLARGED DEMOLITION
PLAN - POWER


Drawing Number
E1.02

KEYNOTE LEGEND

1	REMOVE ANY DEVICES AND FEEDERS IN DEMOLISHED WALLS.
2	DEMO CIRCUIT BACK TO PANEL AND LABEL BREAKER SPARE.
3	REMOVE DEVICE AND COVER.

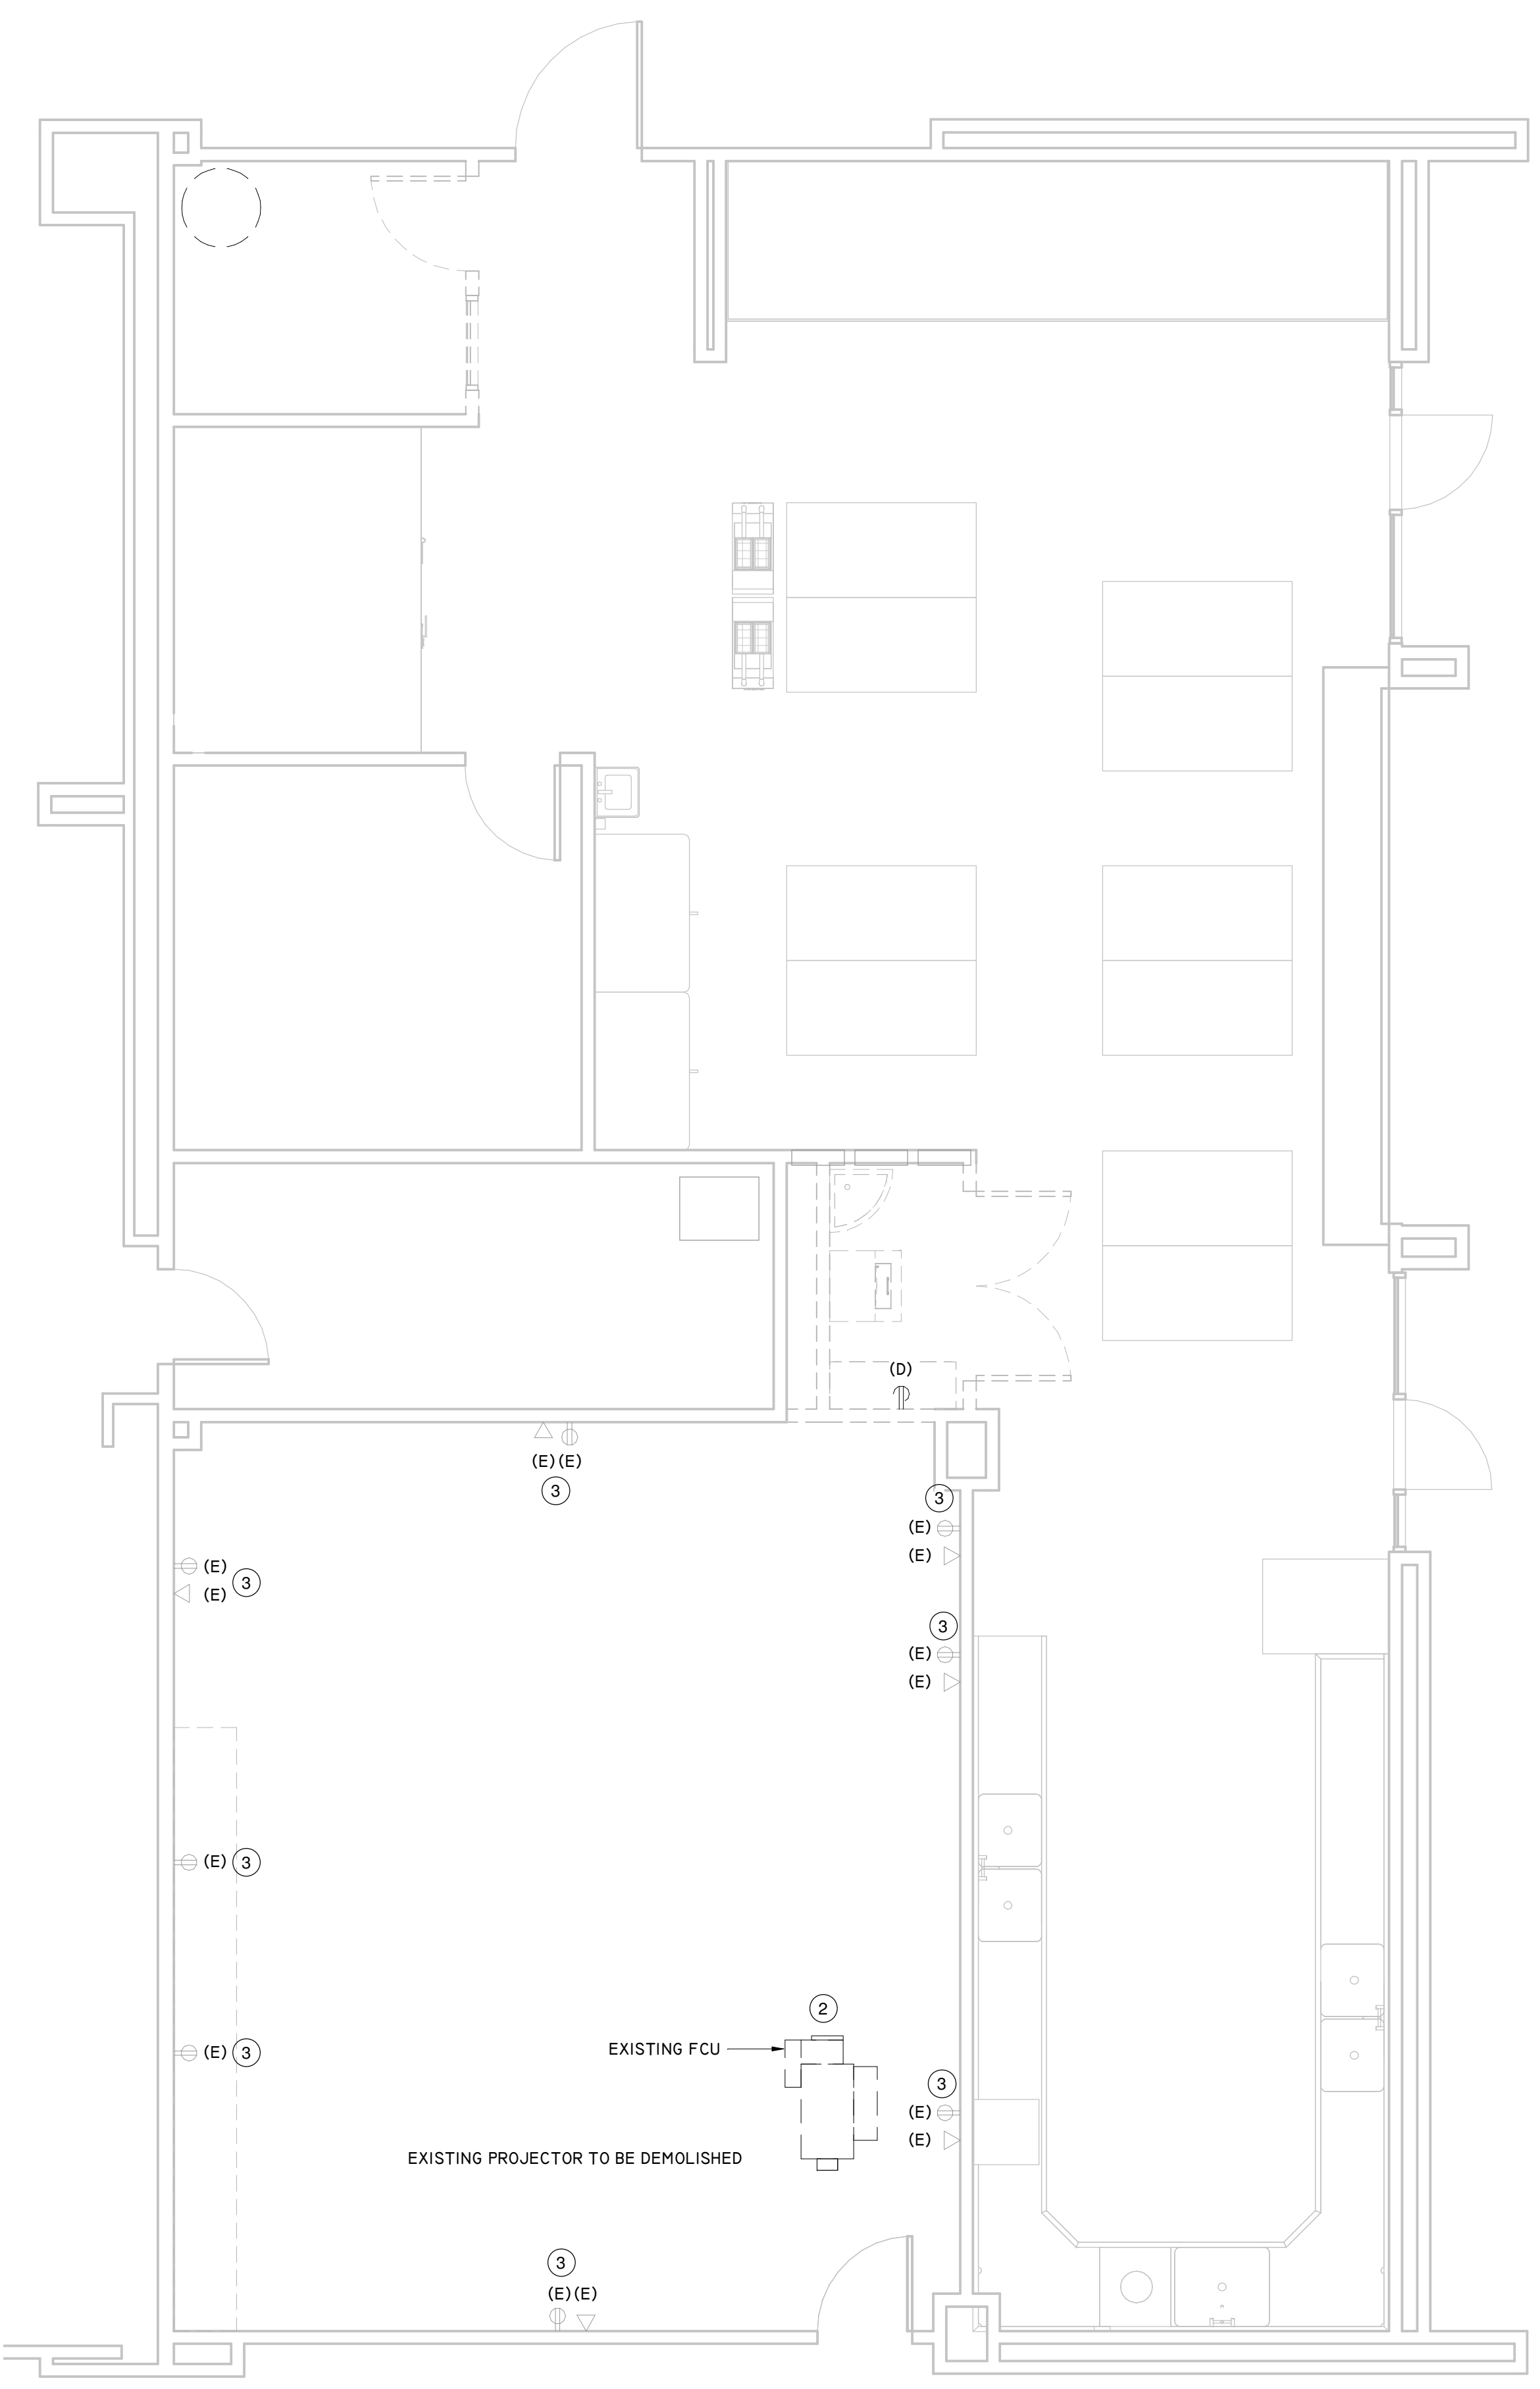

2 ENLARGED DEMOLITION PLAN - AREA G - POWER
Scale: 1/4" = 1'-0"

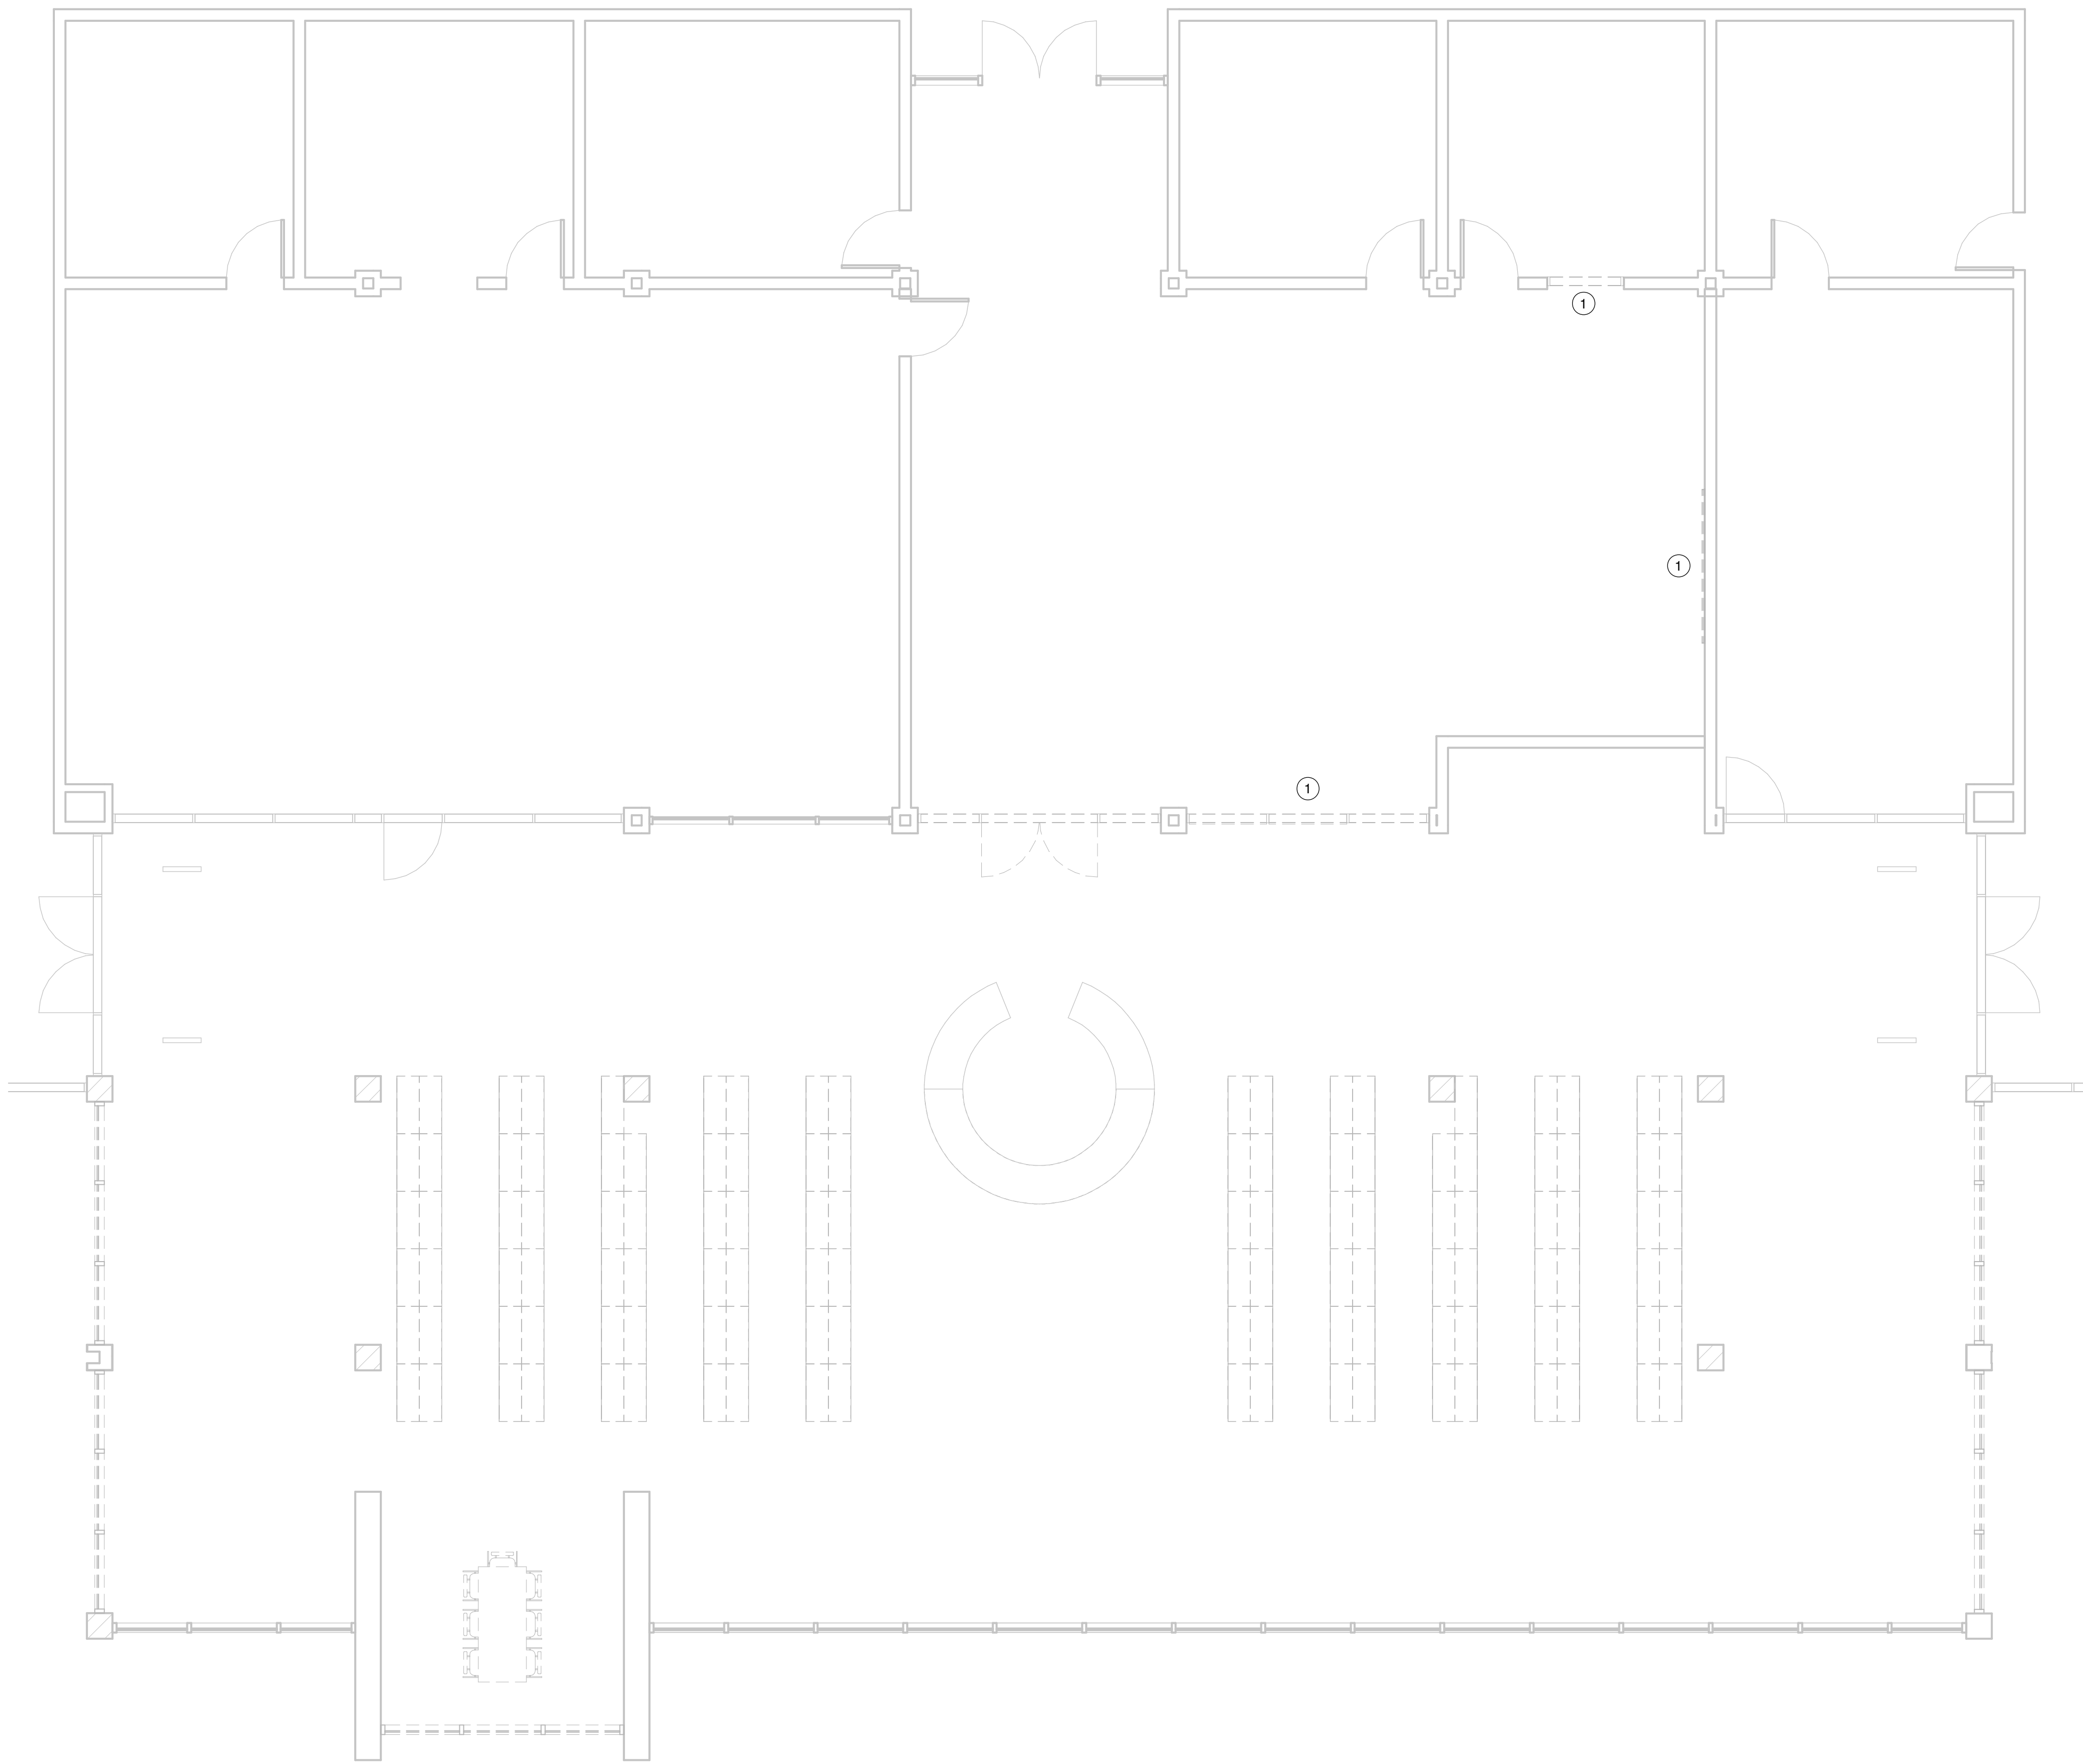

1 ENLARGED DEMOLITION PLAN - AREA C - POWER
Scale: 3/16" = 1'-0"



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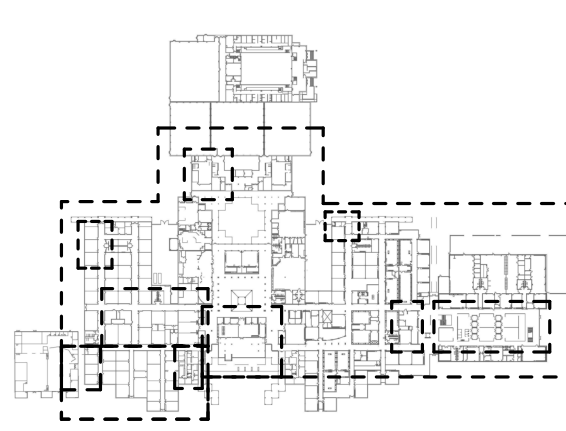


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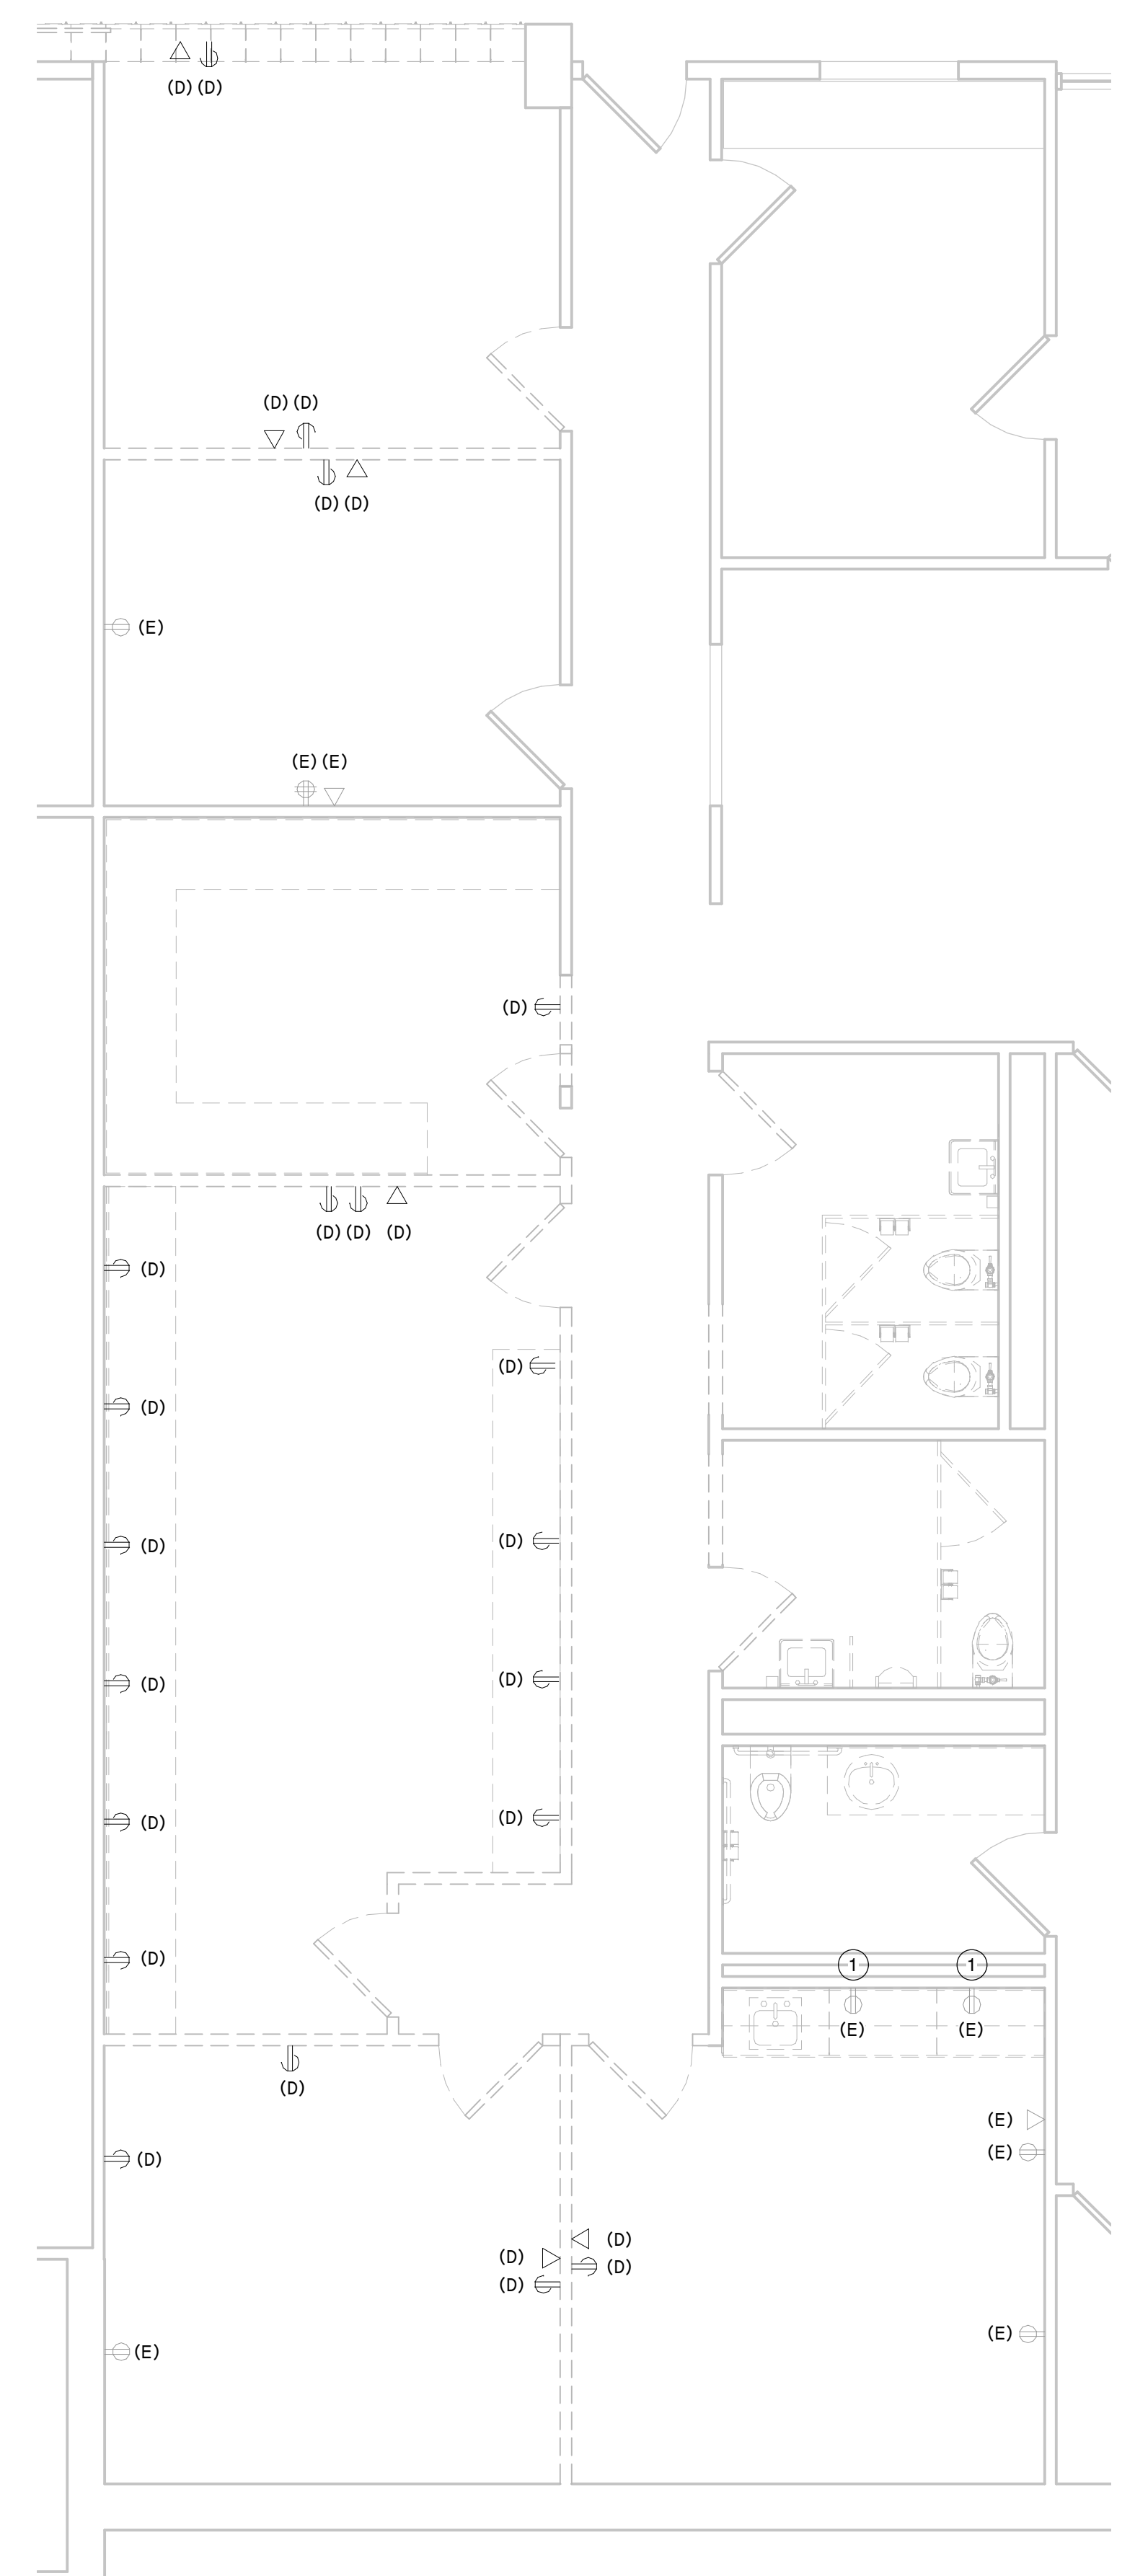
KEY PLAN
TRUE NORTH
PLAN NORTH

Project Number	19006-A
Drawn By	LT
Checked By	AW
Approved By	MS


**ENLARGED DEMOLITION
PLAN - POWER**

Drawing Number **E1.03**



KEYNOTE LEGEND	
1	REMOVE DEVICE AND COVER.
2	DEMOLISH EXISTING DRINKING FOUNTAIN. PROTECT EXISTING CIRCUIT FOR RECONNECTION IN SAME PLACE.




2 ENLARGED DEMOLITION PLAN - AREA B5 - POWER
Scale: 1/4" = 1'-0"

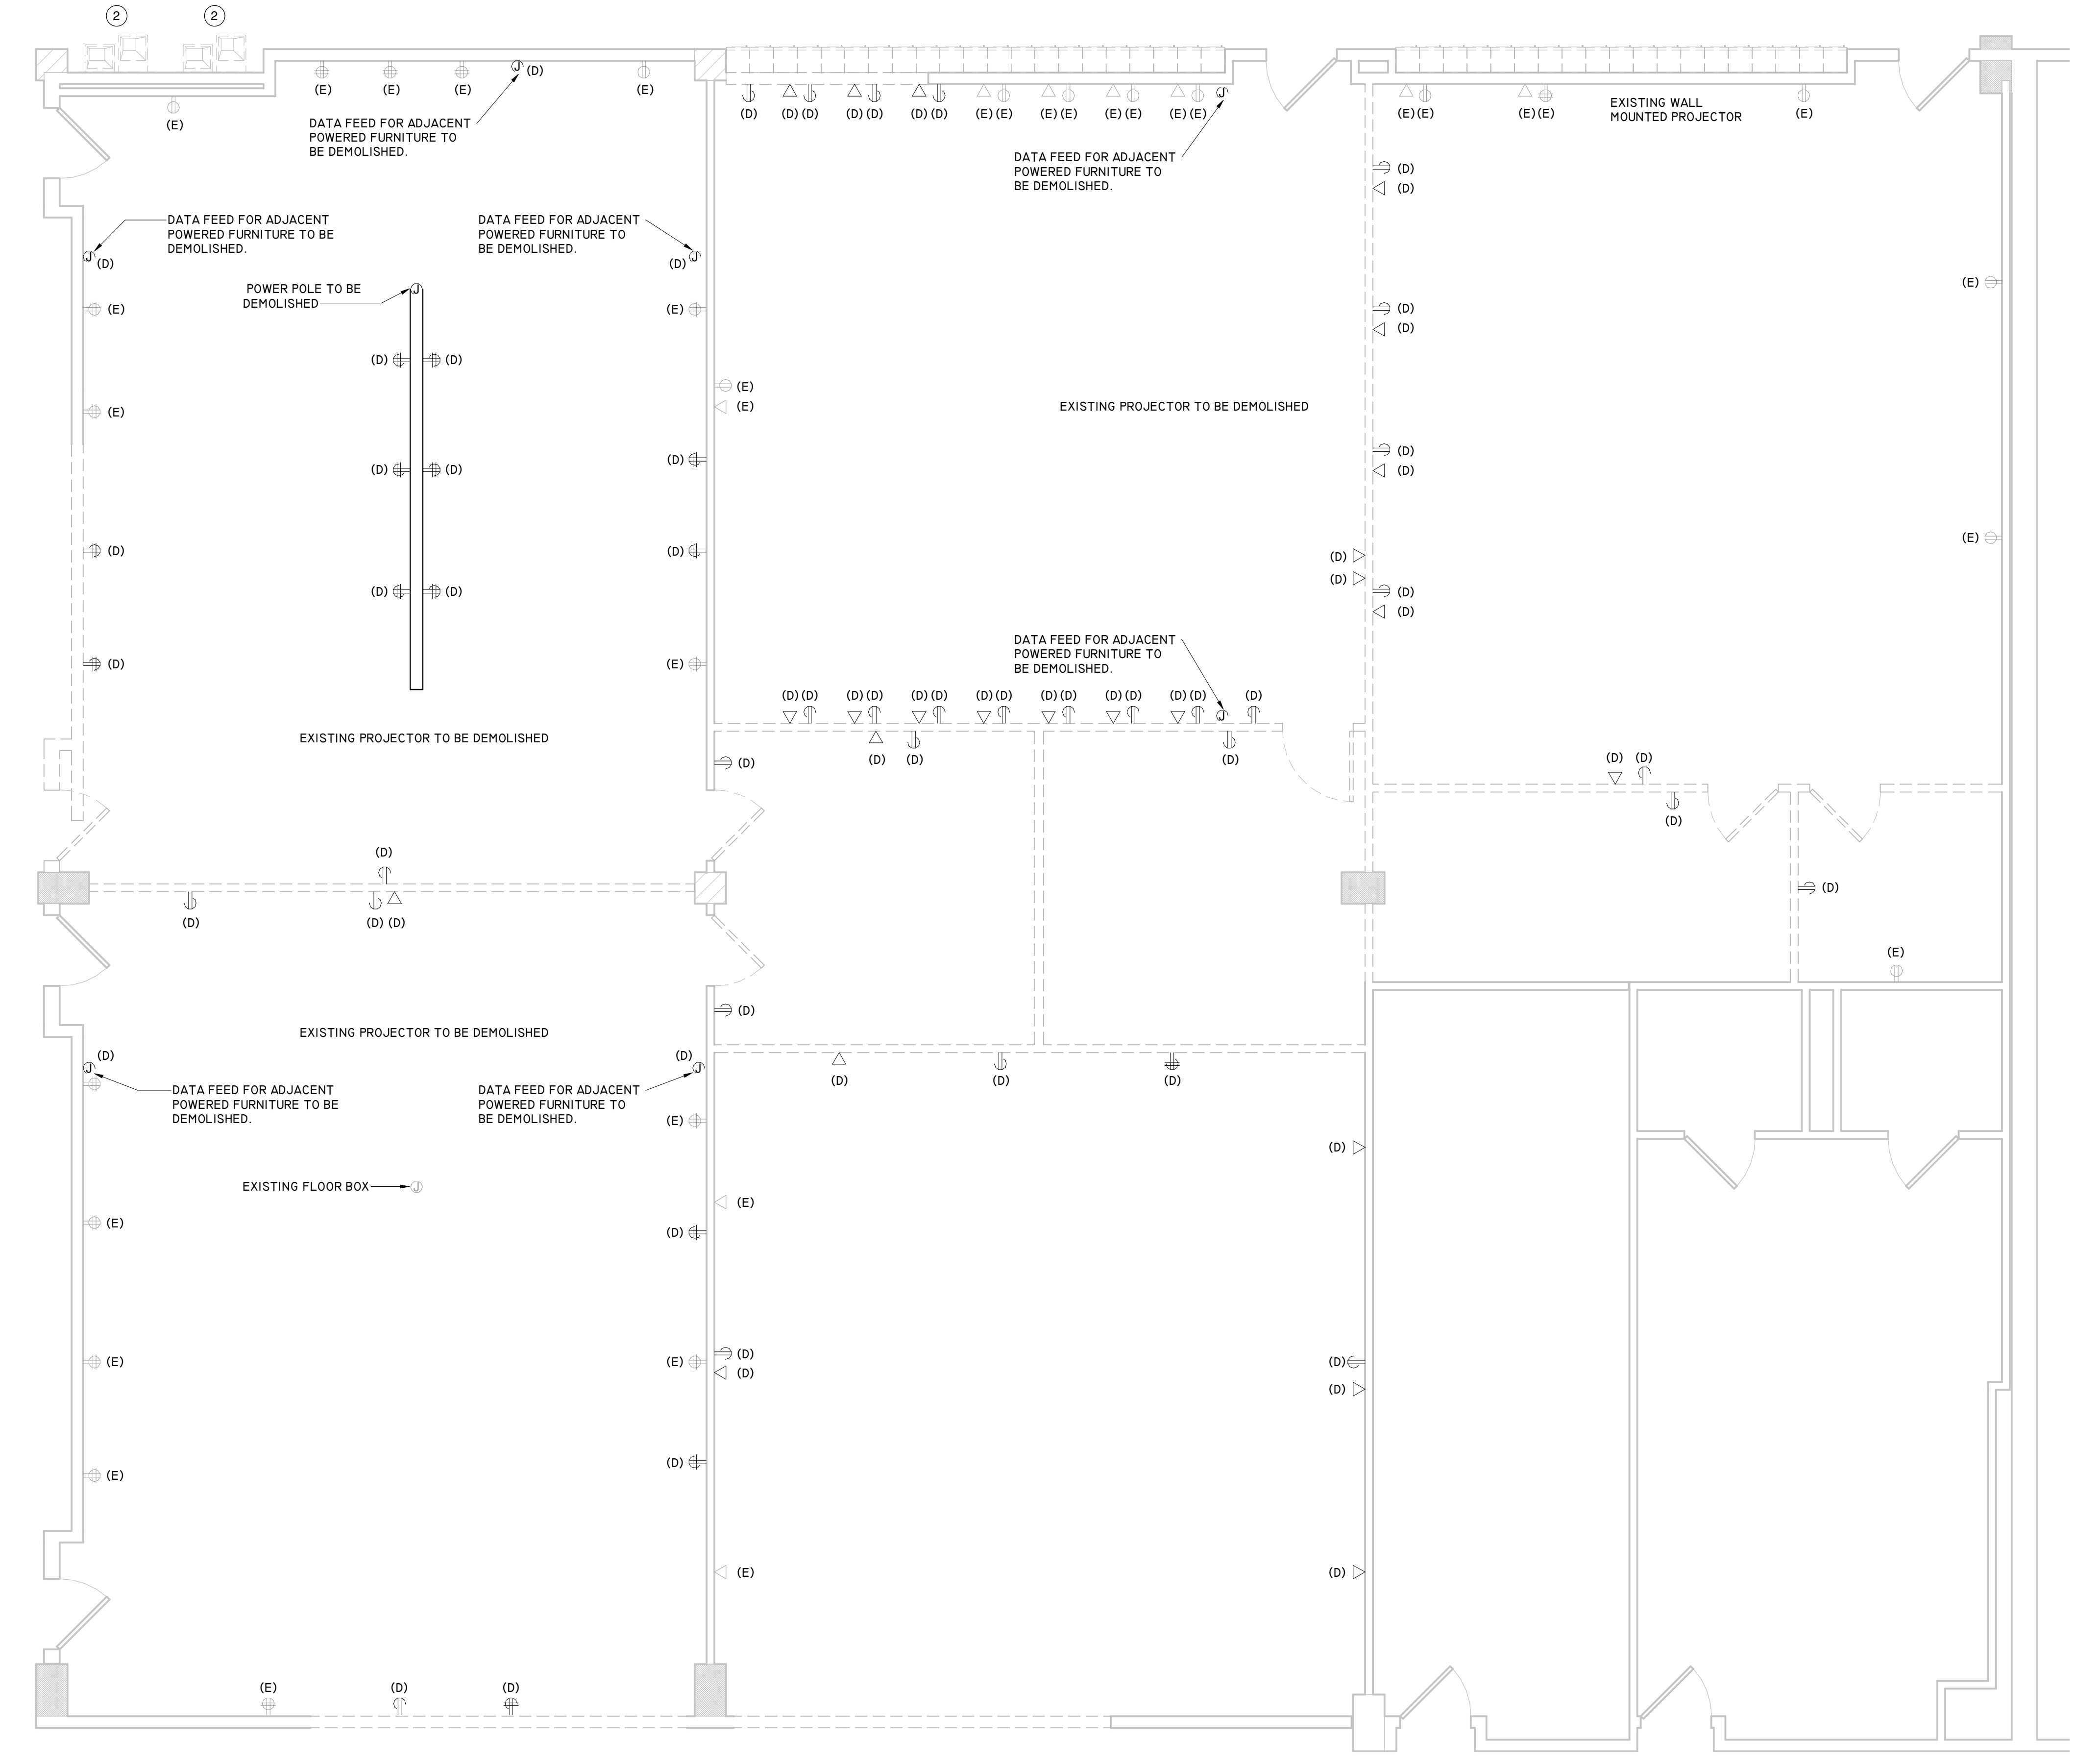


1 ENLARGED DEMOLITION PLAN - AREA B3 - POWER
Scale: 1/4" = 1'-0"

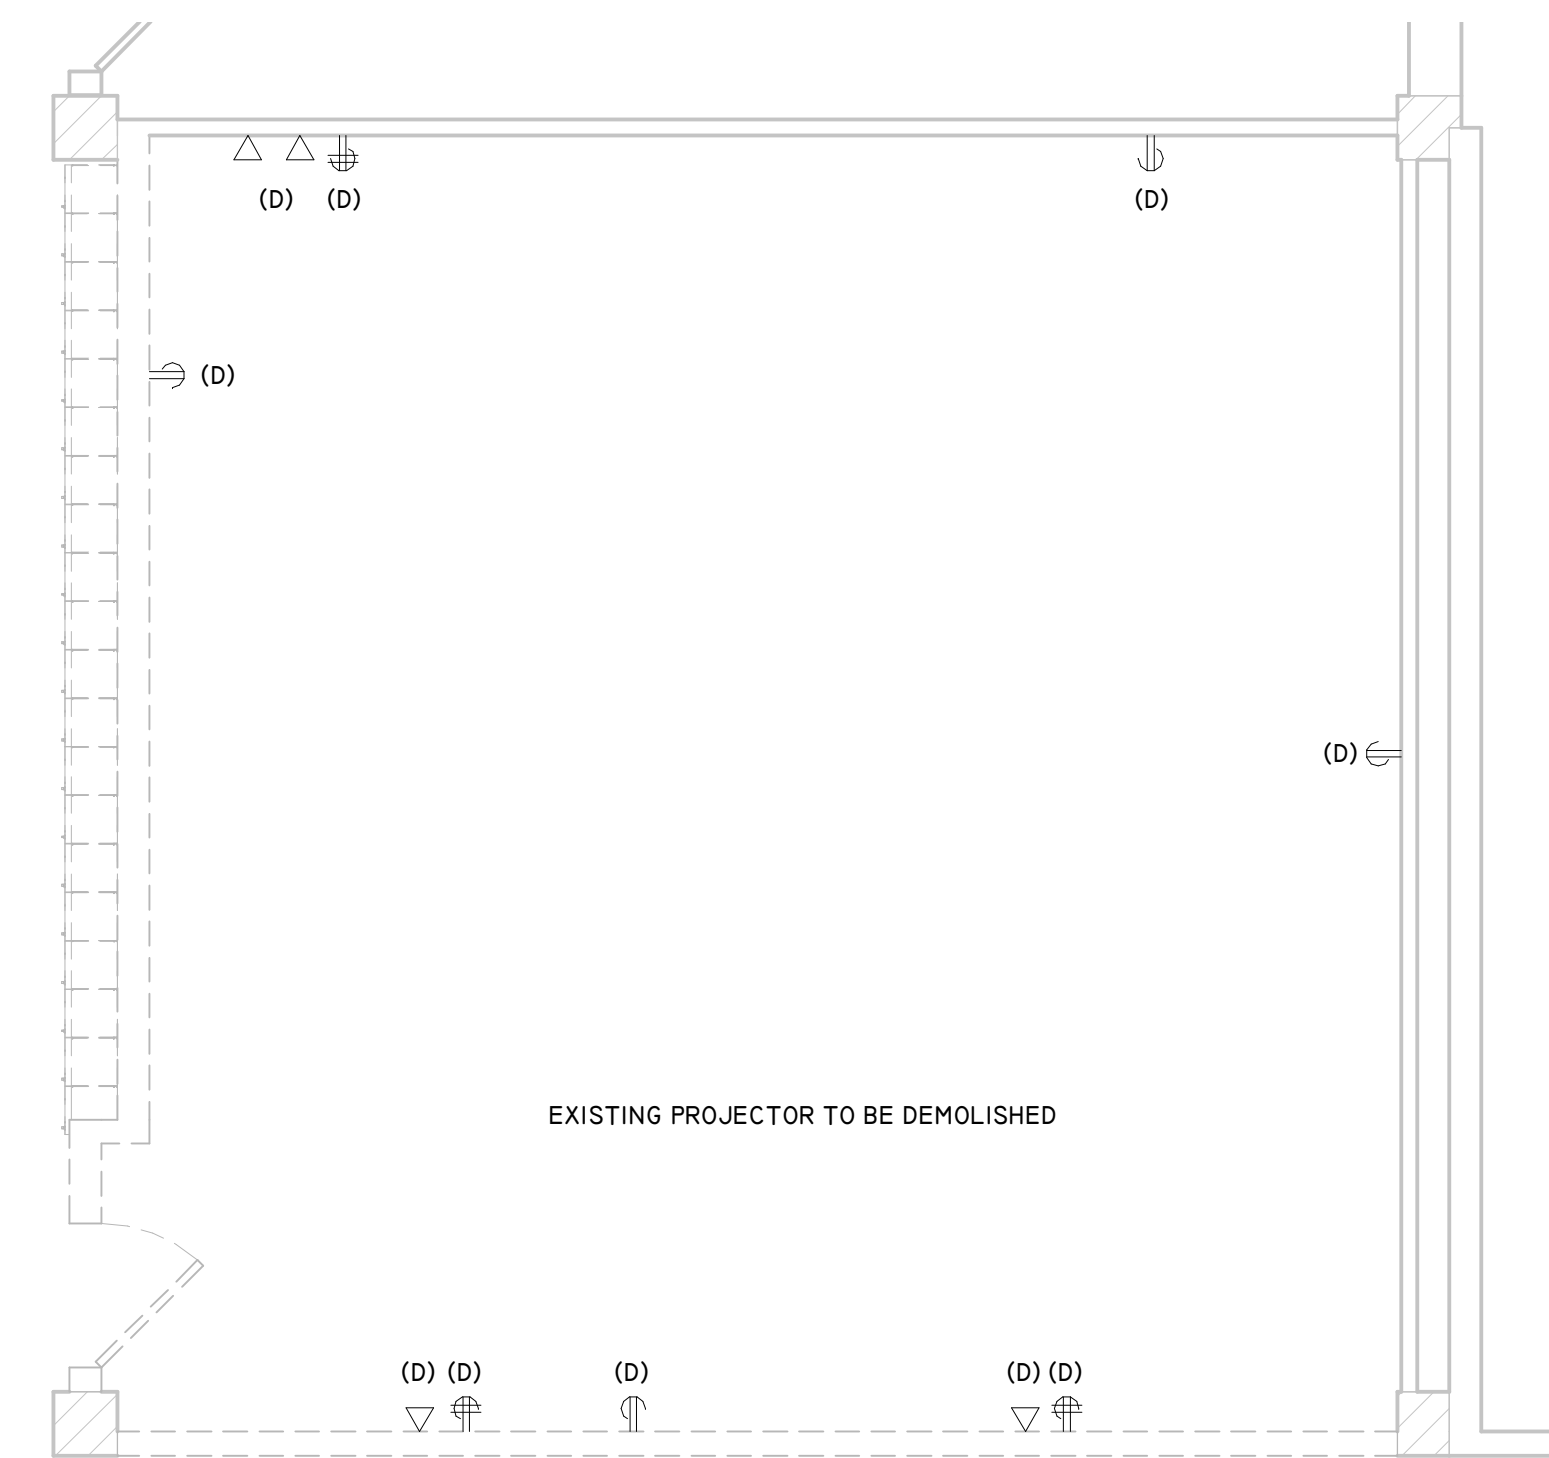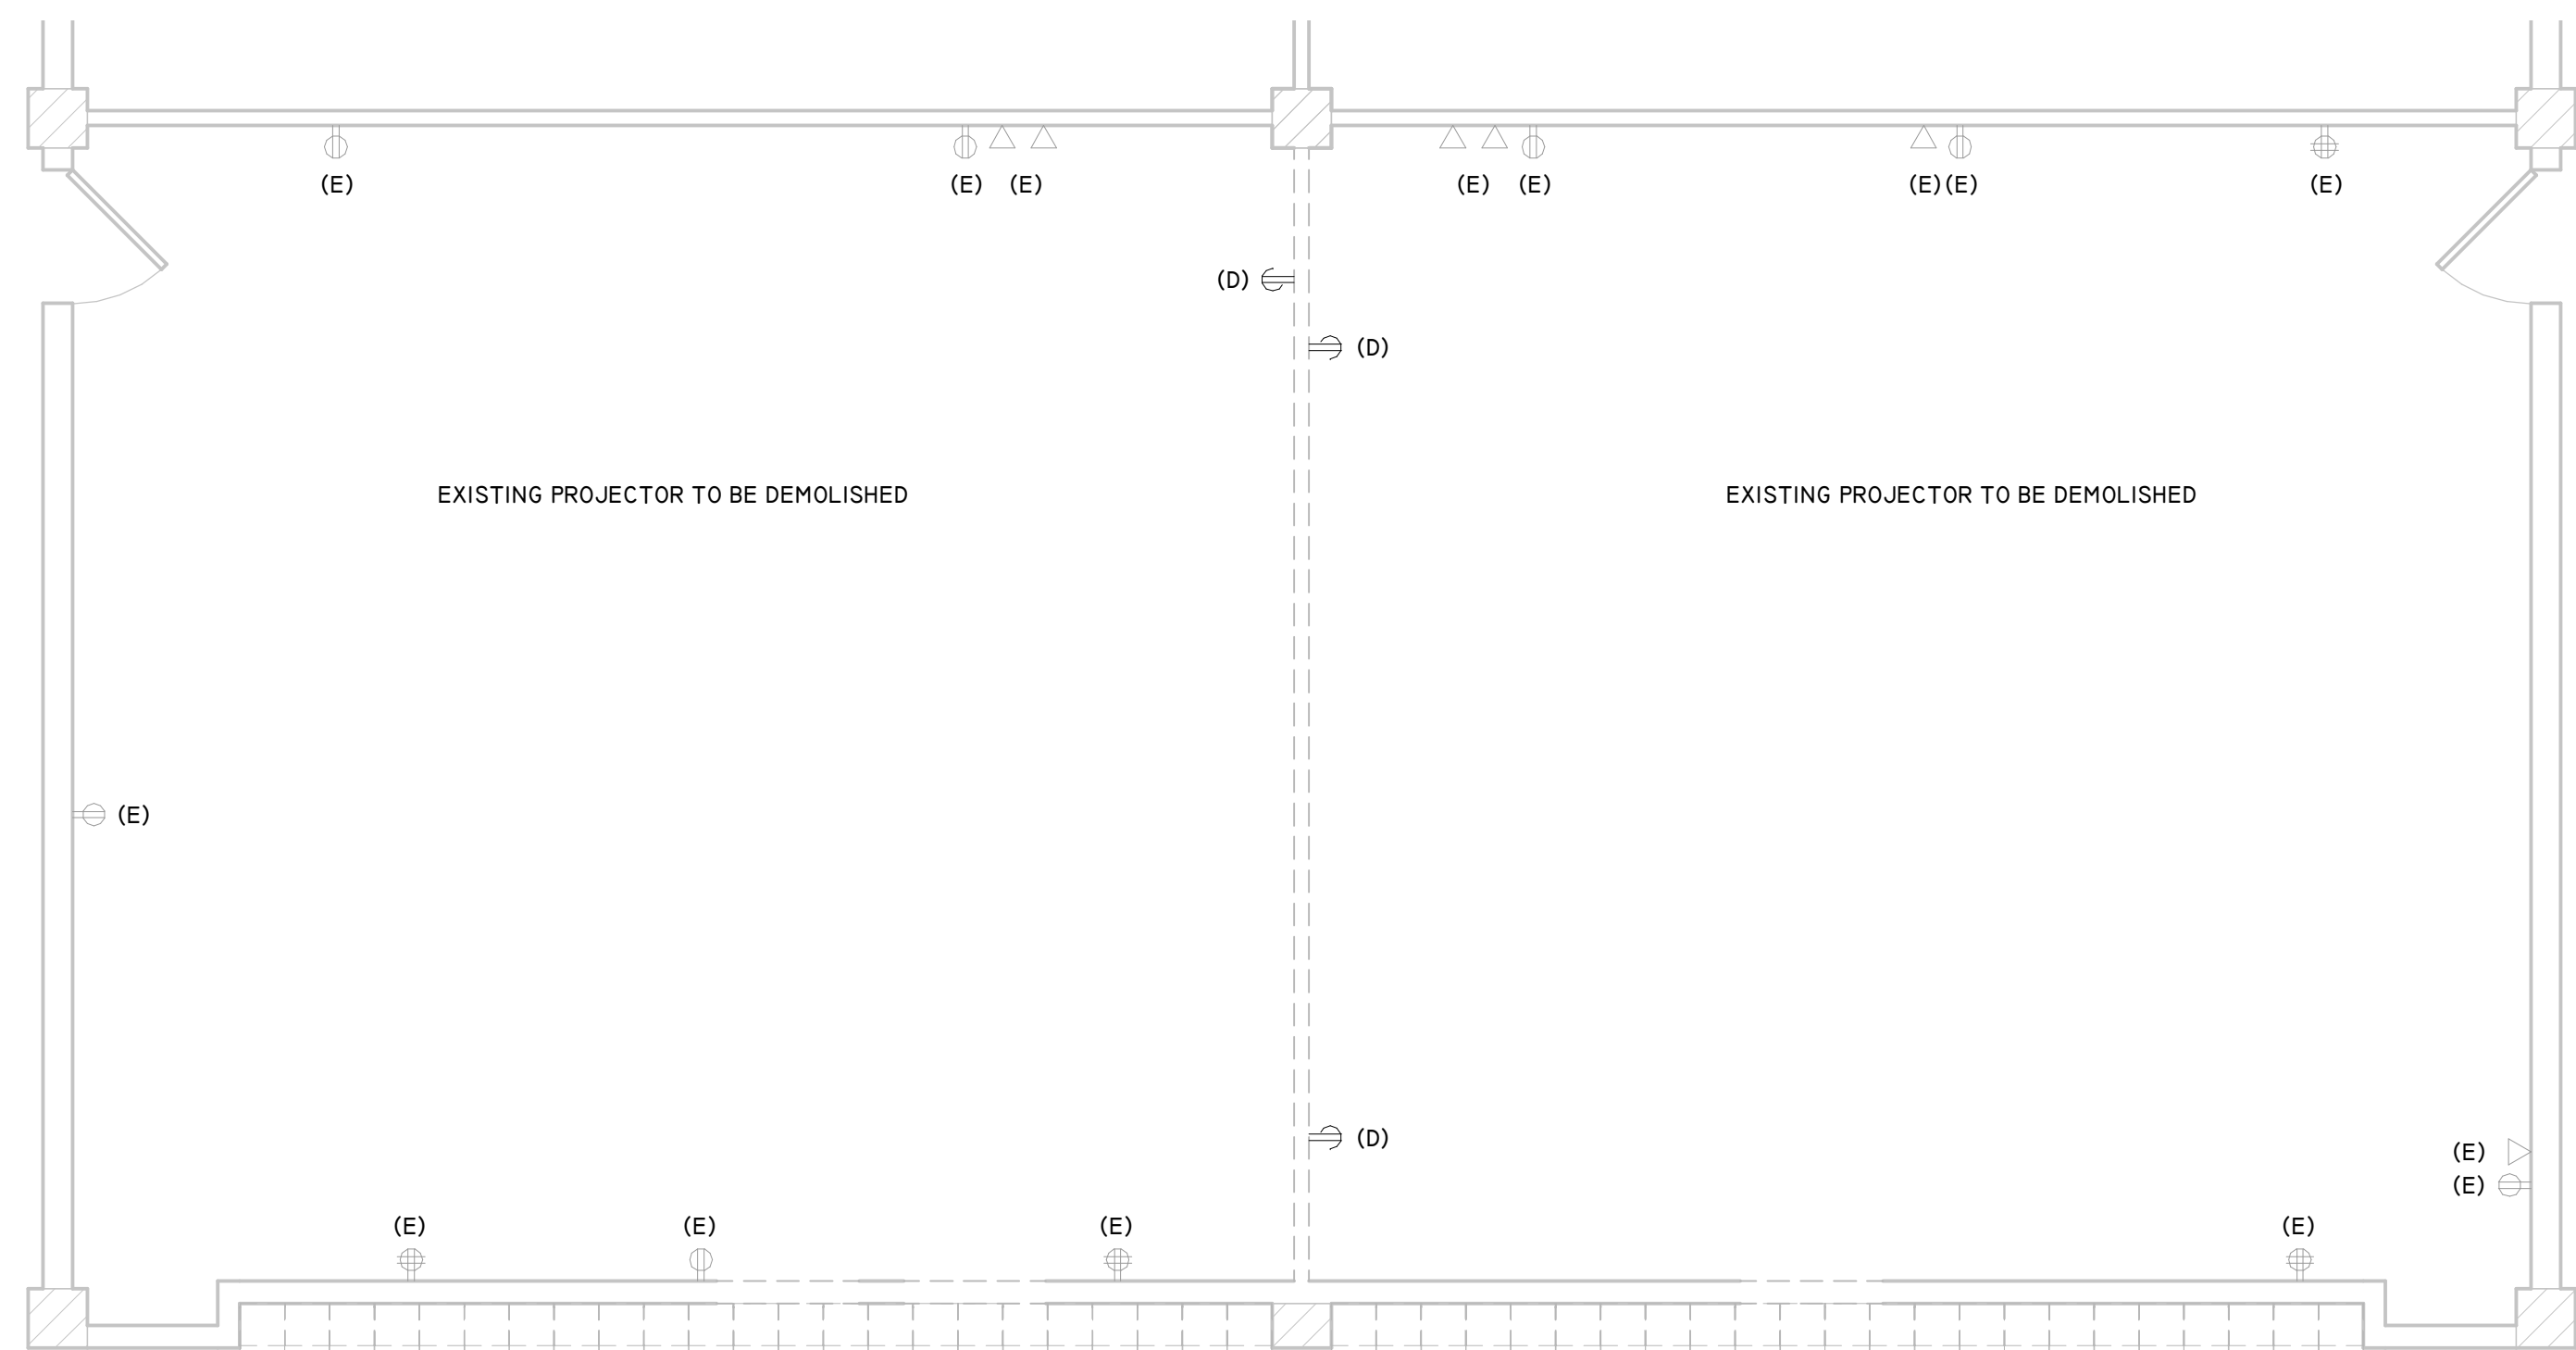


4 ENLARGED DEMOLITION PLAN - AREA B4 - POWER
Scale: 1/4" = 1'-0"

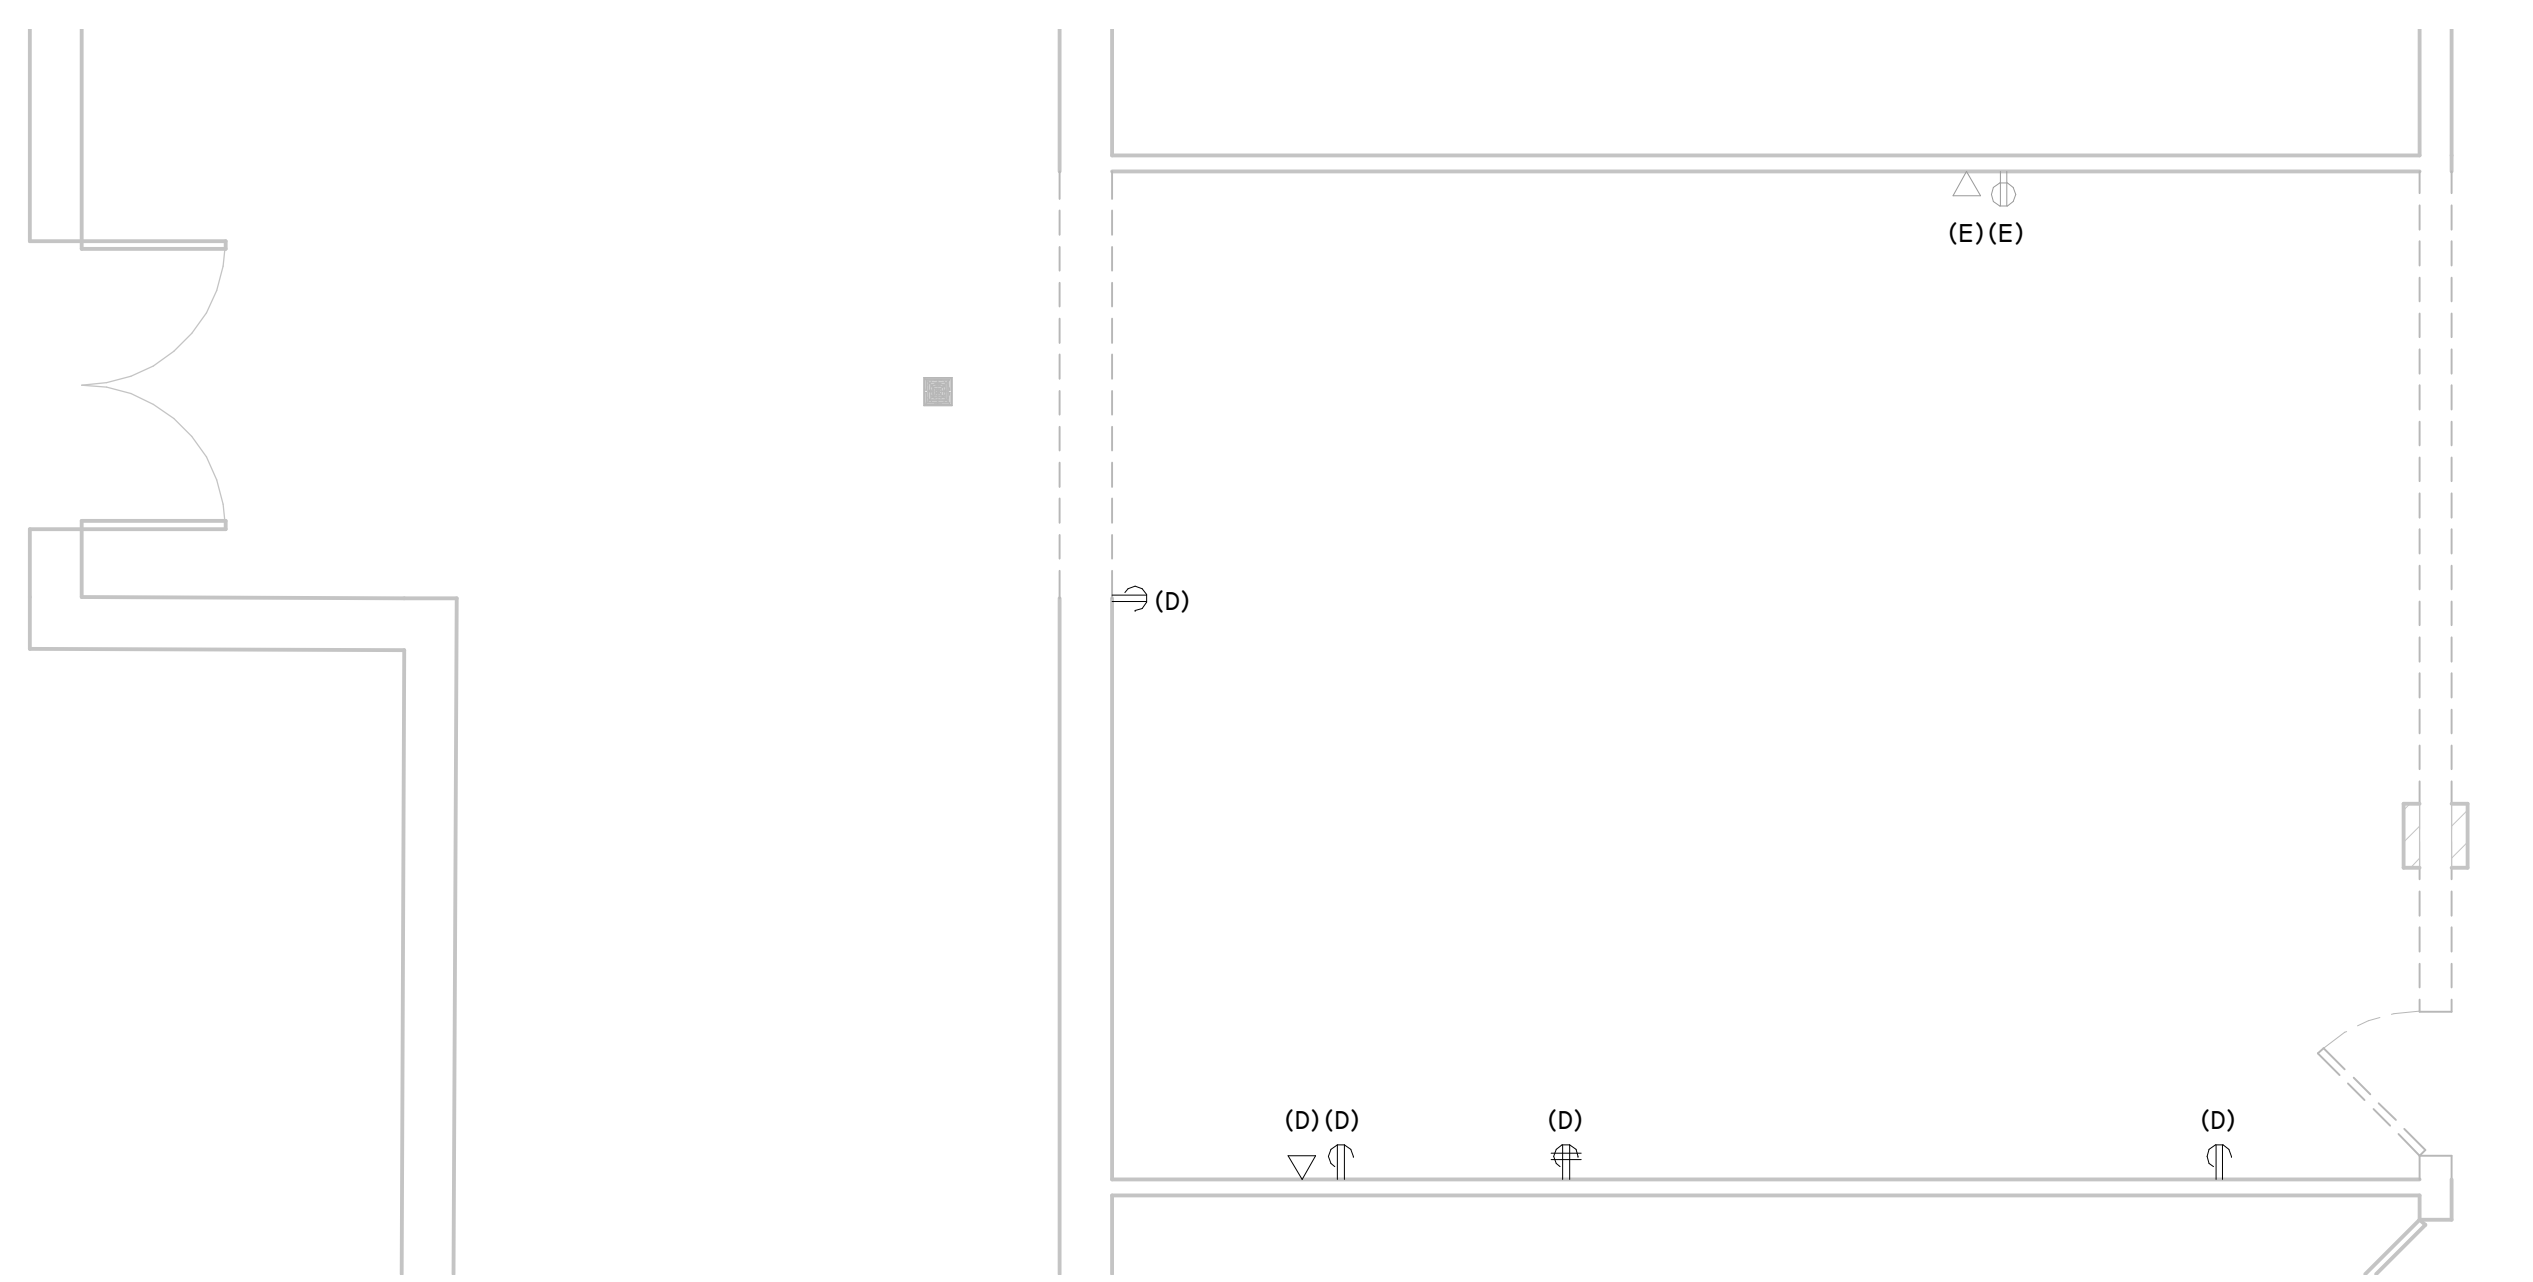

3 ENLARGED DEMOLITION PLAN - AREA B1 - POWER
Scale: 1/4" = 1'-0"

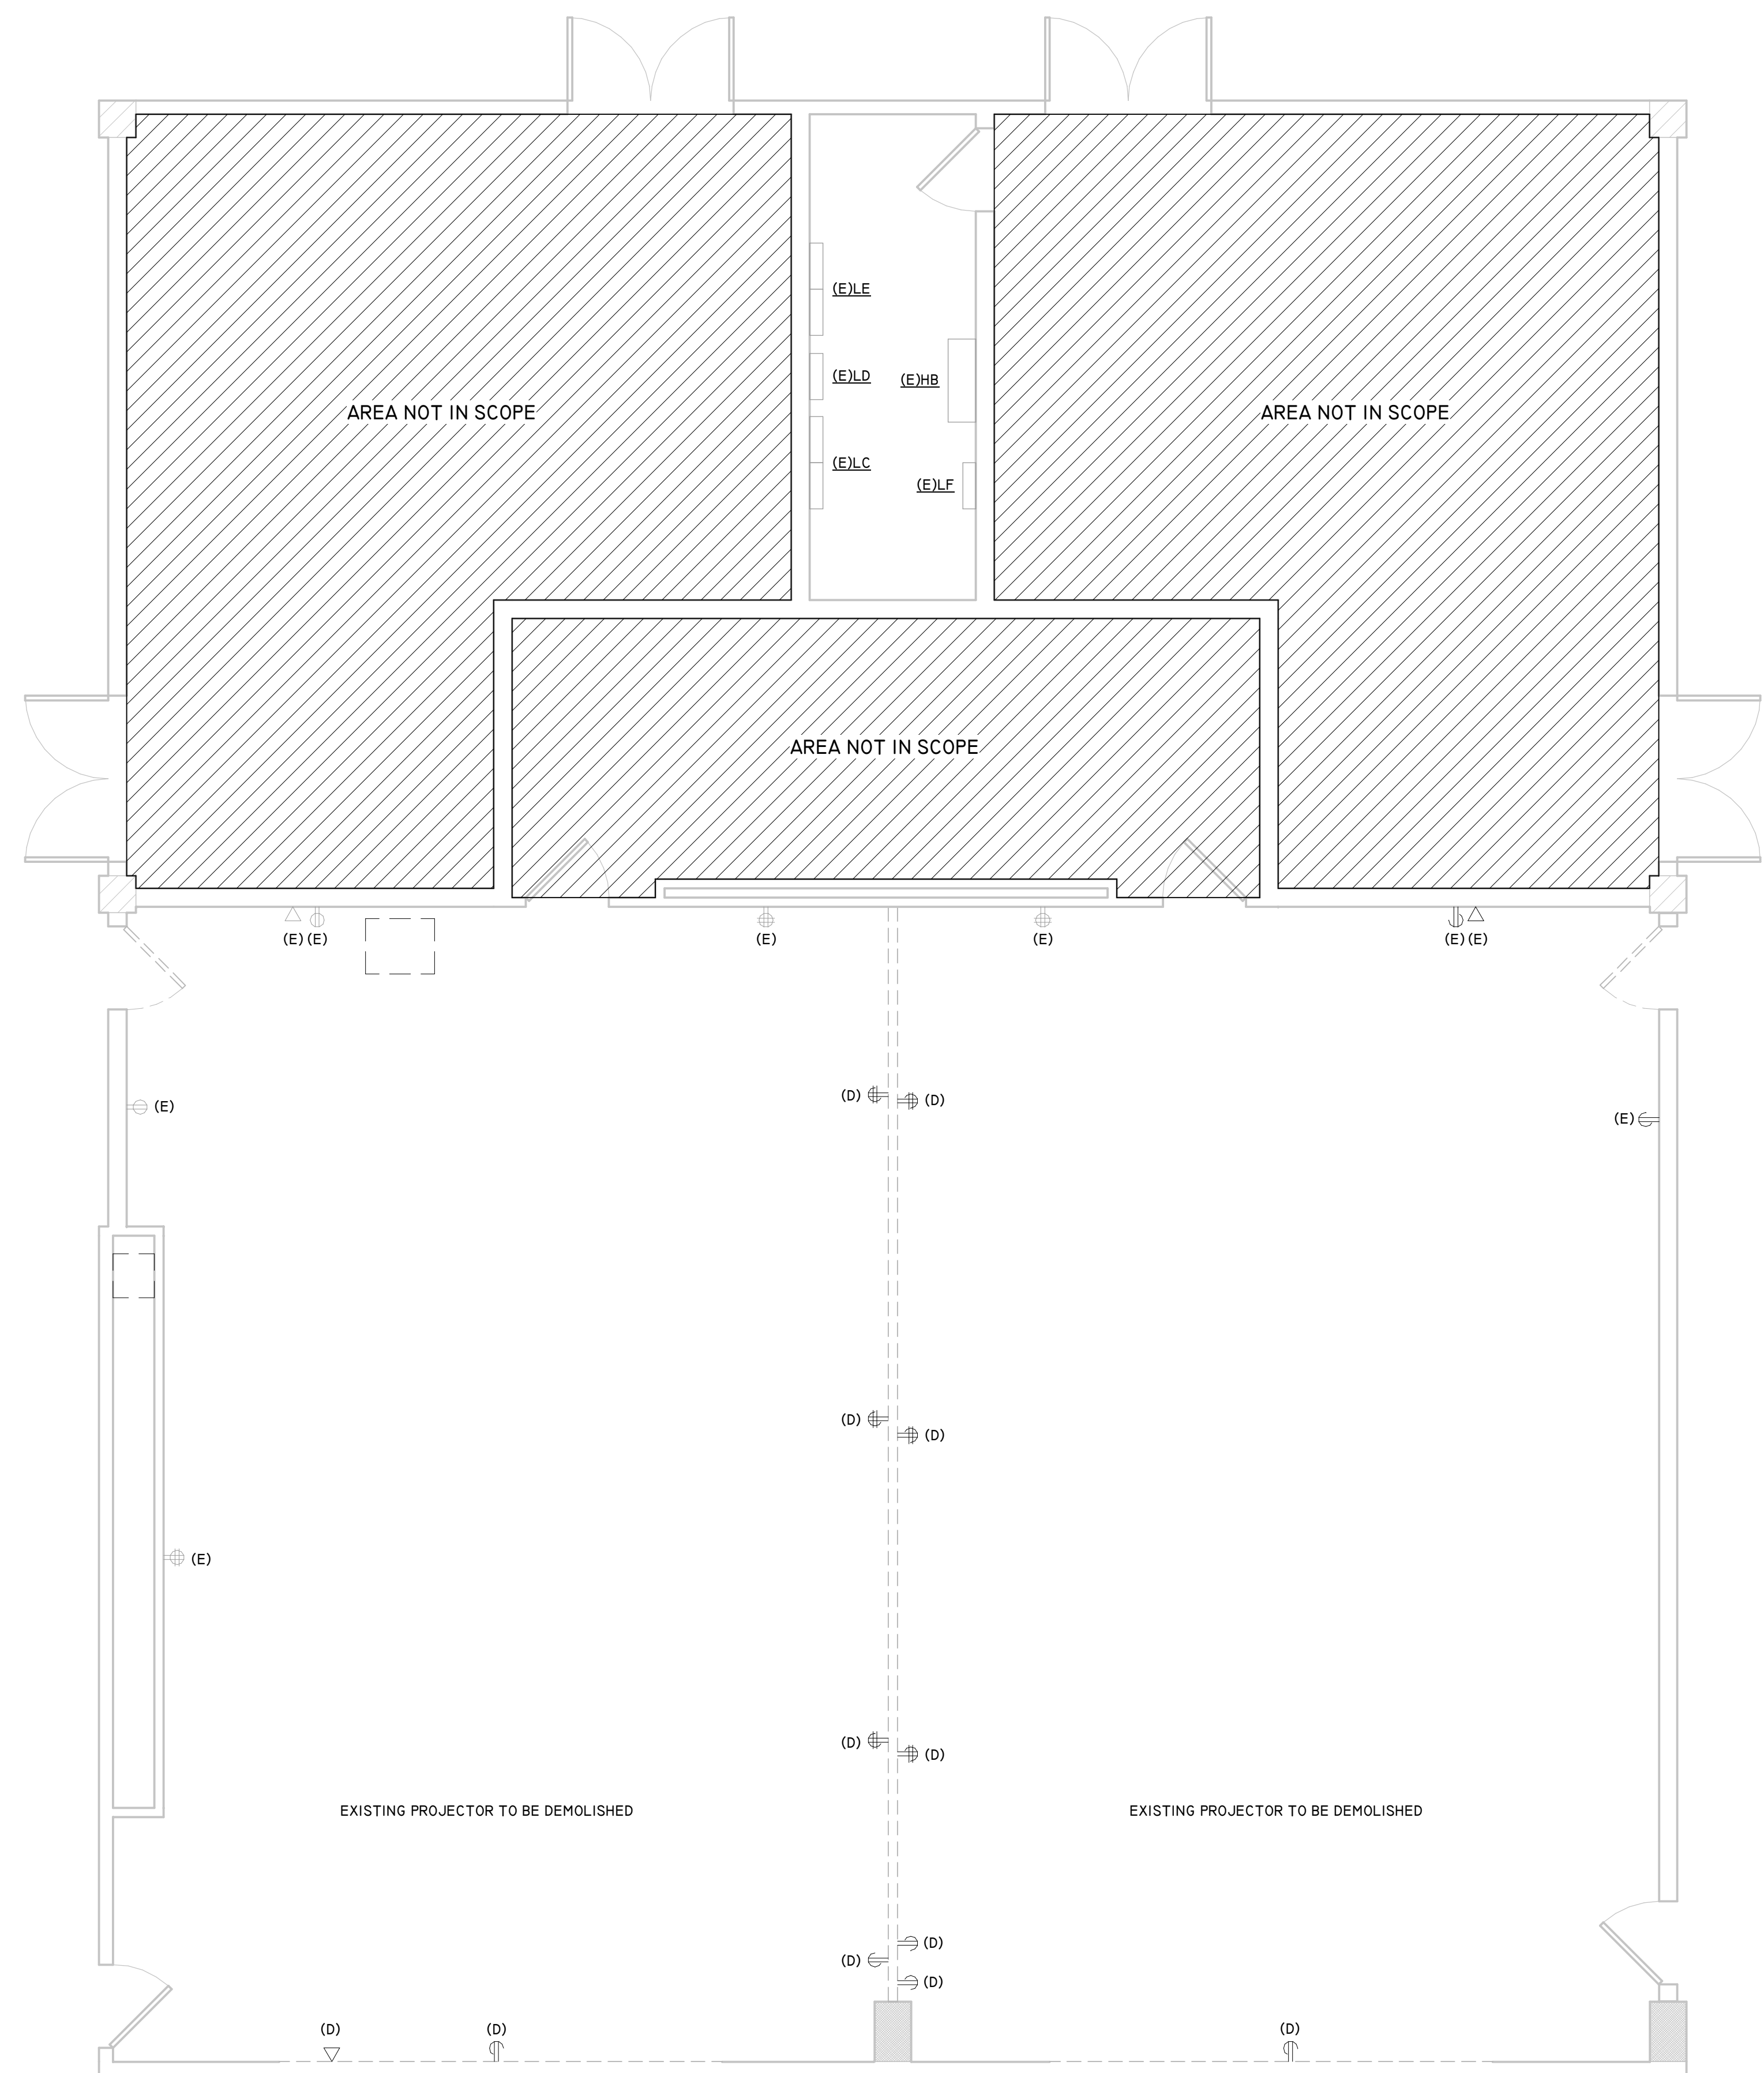

1 ENLARGED DEMOLITION PLAN - AREA B2 - POWER
Scale: 1/4" = 1'-0"

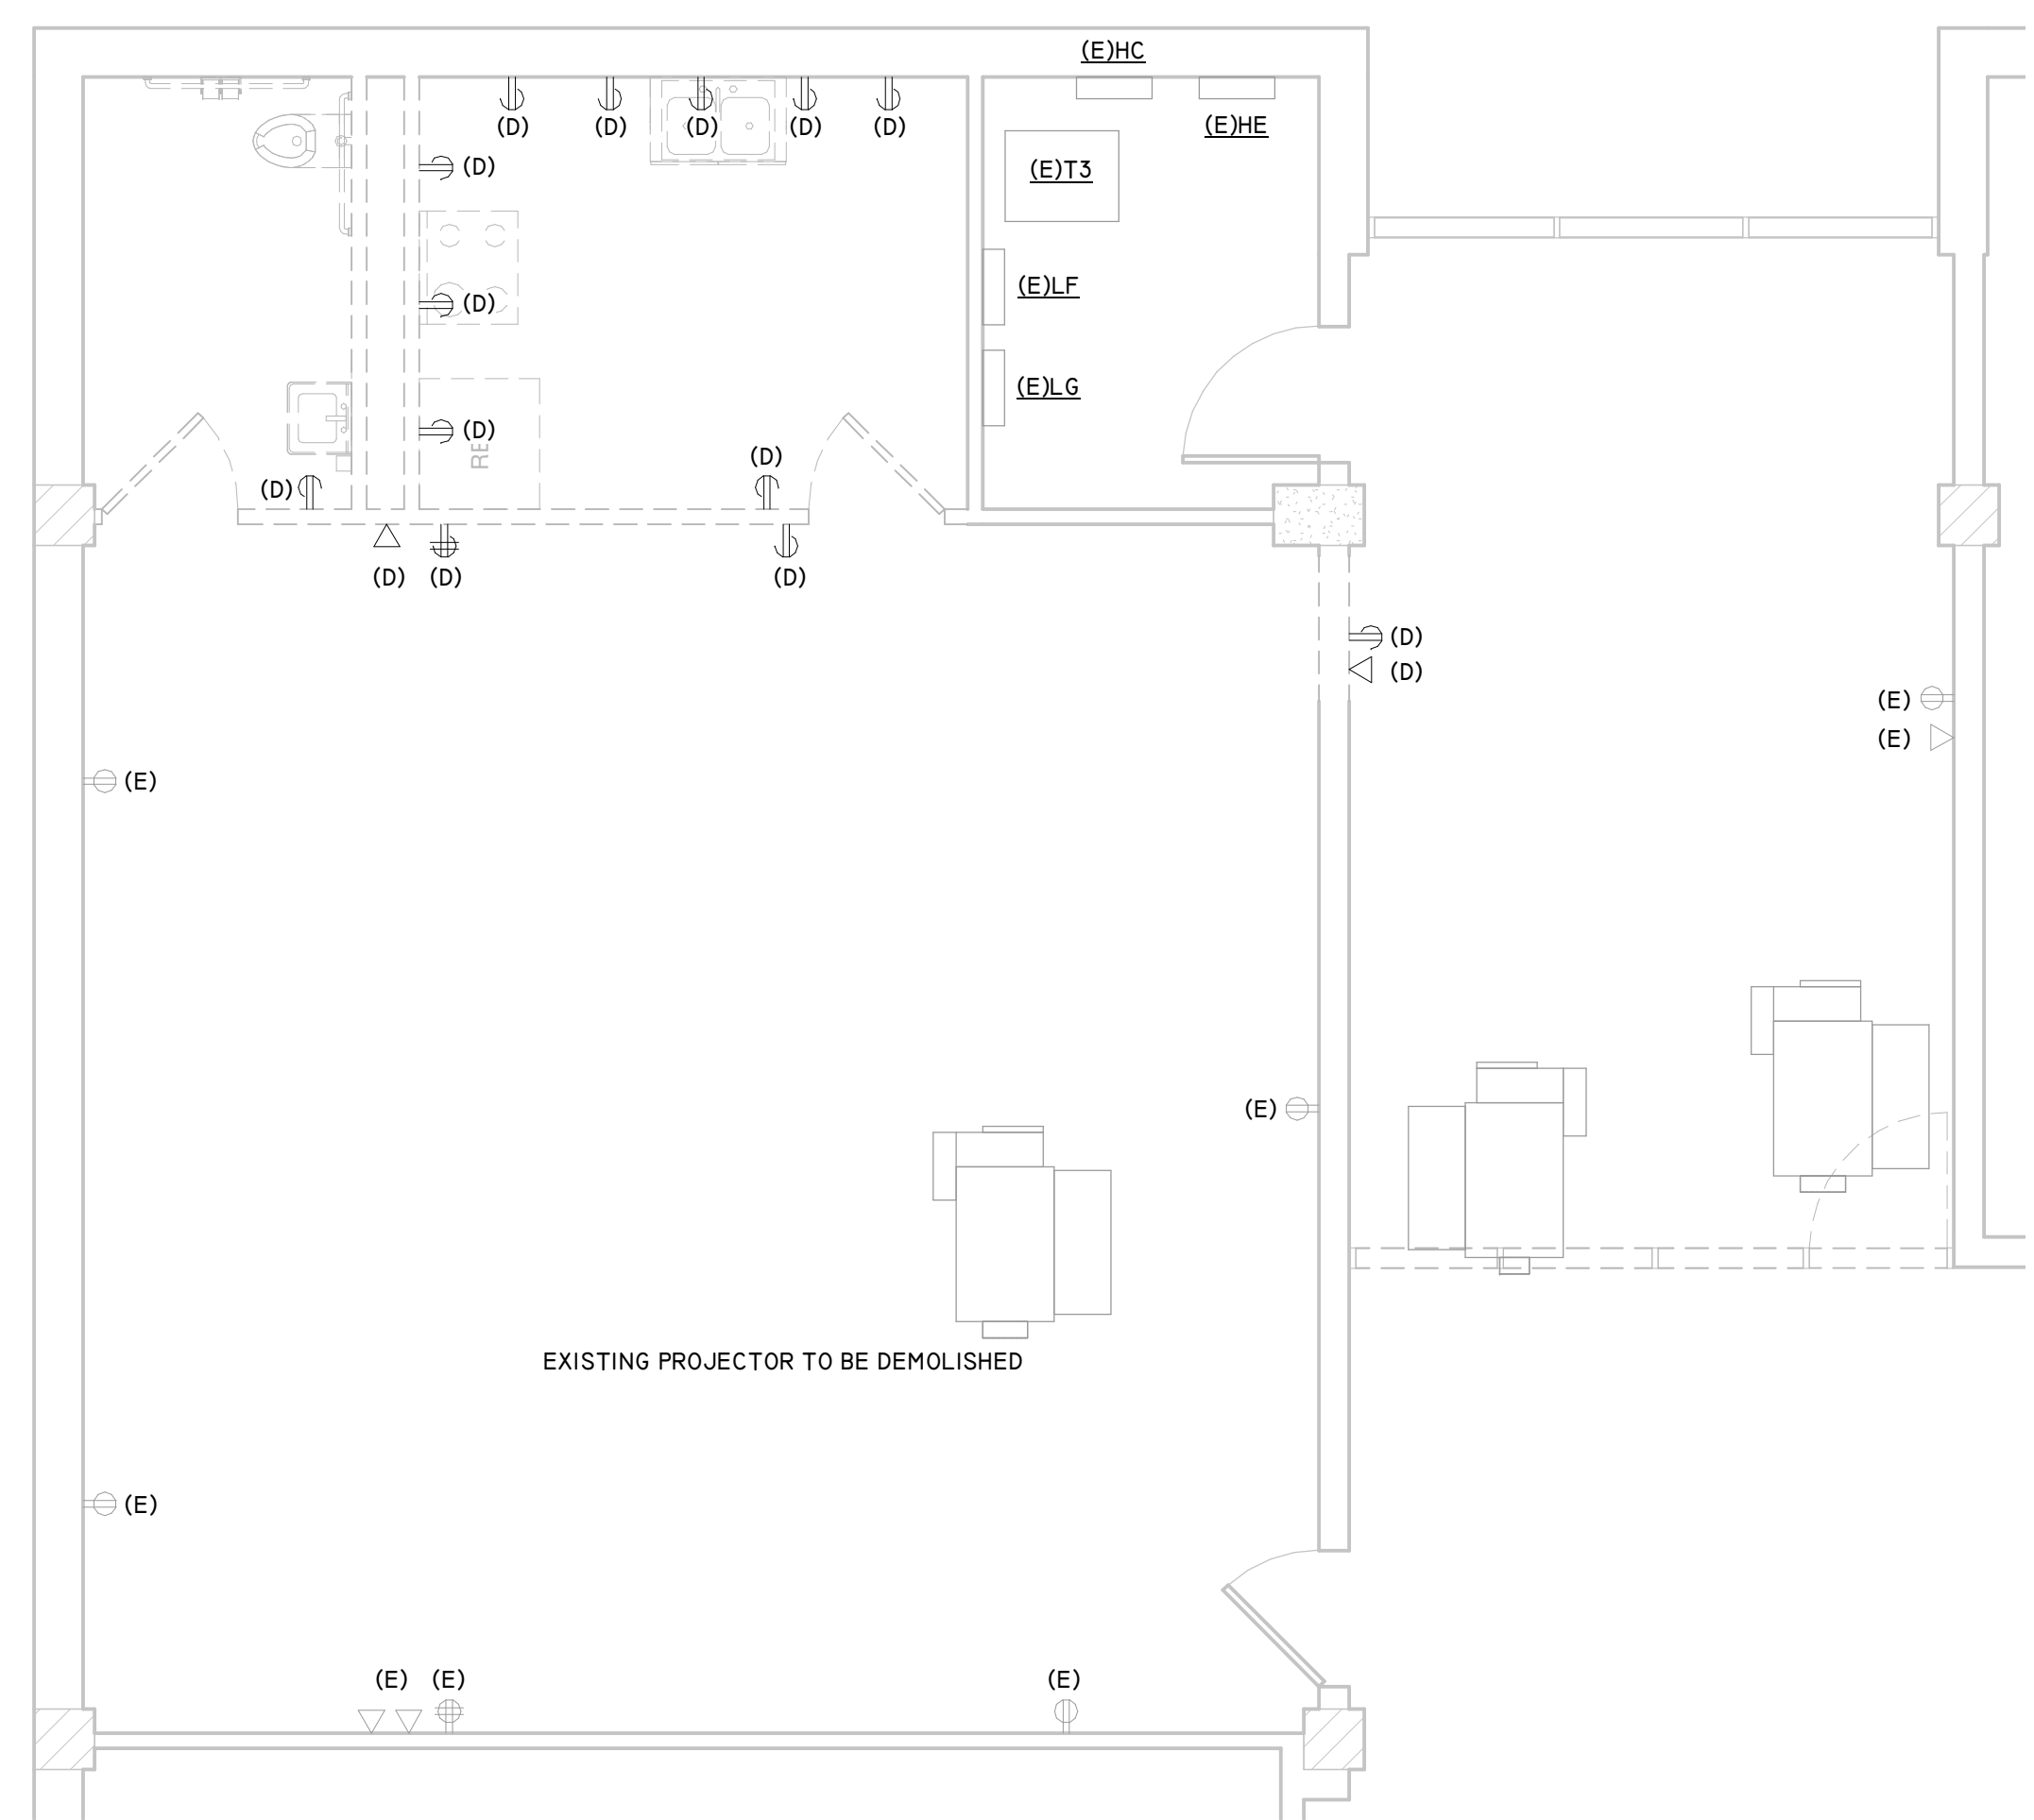

2 ENLARGED DEMOLITION PLAN - AREA E - POWER
Scale: 1/4" = 1'-0"



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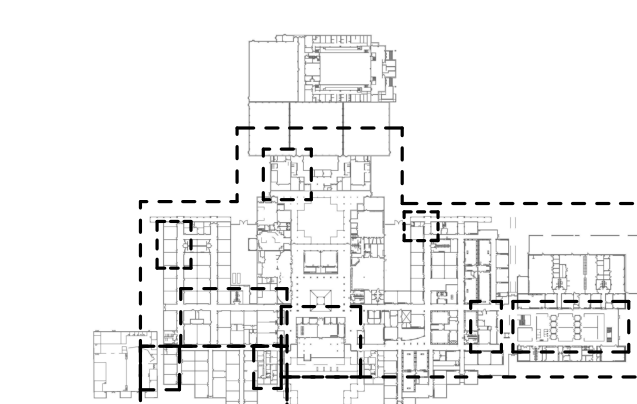
03/13/2020

A PROJECT FOR:

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RENOVATIONS**

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Project Number	19006-A
Drawn By	LT
Checked By	AW
Approved By	MS
Drawing Title	
ENLARGED DEMOLITION PLAN - POWER	
Drawing Number	E1.04



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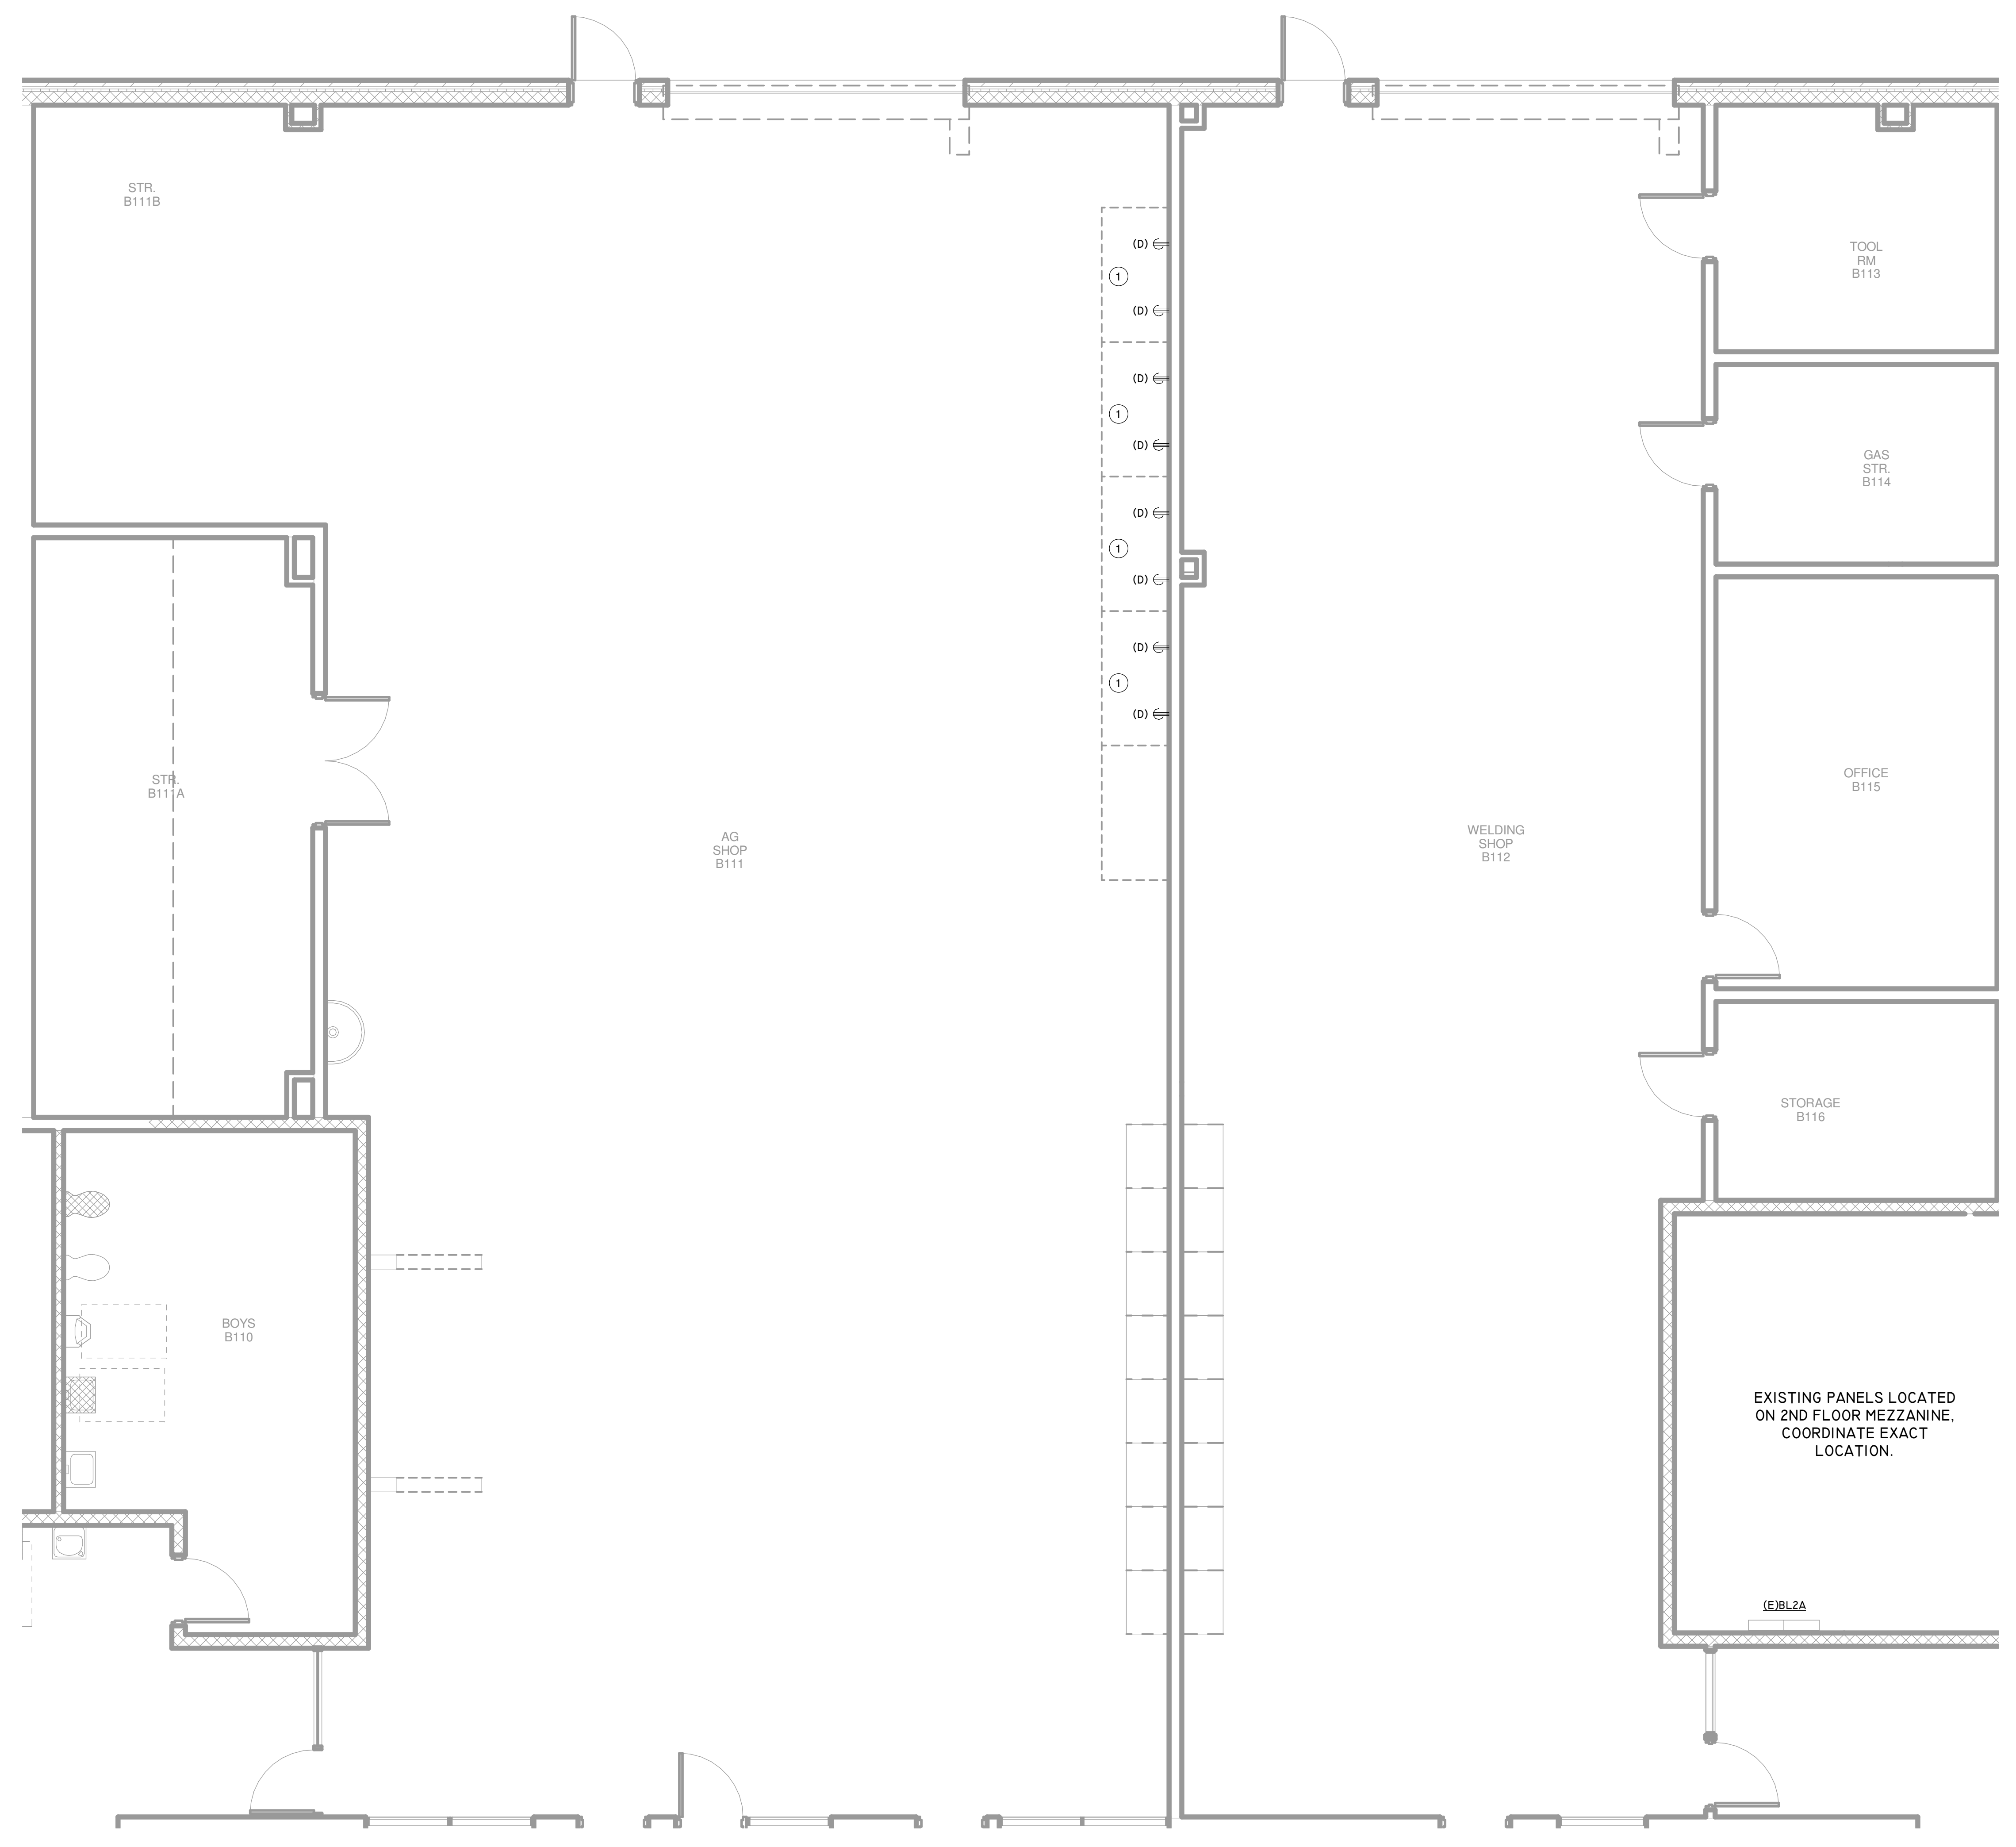
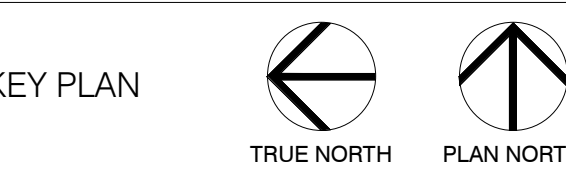
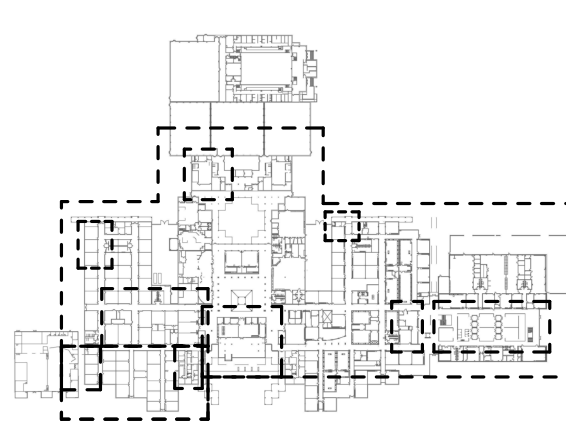


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RENOVATIONS**

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1 ENLARGED DEMOLITION PLAN - AREA I - POWER
Scale: 1/4" = 1'-0"

Project Number	19006-A
Drawn By	LT
Checked By	AW
Approved By	MS
Drawing Title	

**ENLARGED DEMOLITION
PLAN - POWER**

Drawing Number **E1.05**

3/12/2020 12:55:15 PM



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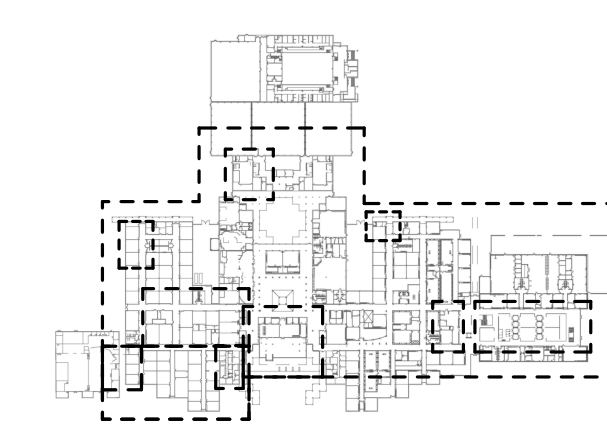
03/13/2020

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RENOVATIONS**


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ELECTRICAL GENERAL DEMOLITION NOTES

- ELECTRICAL CONTRACTOR SHALL REMOVE ELECTRICAL EQUIPMENT AS INDICATED BY KEY NOTES AND AS REQUIRED BY SCOPE OF DEMOLITION WORK. REFER TO ARCHITECTURAL DRAWINGS FOR ALL WALLS DESIGNATED FOR REMOVAL.
- BEFORE ANY ELECTRICAL EQUIPMENT OR OUTLET REMOVAL, IDENTIFY AND DISCONNECT THE POWER SUPPLY TO IT. VERIFY WITH OWNER LOADS THAT MUST REMAIN IN SERVICE AND DO NOT DISCONNECT THESE.
- REMOVE ALL RELATED LINE SIDE AND LOAD SIDE FEEDERS (WIRES AND CONDUITS) IN ENTIRETY FOR EQUIPMENT INDICATED OR REQUIRED TO BE REMOVED.
- LEAVE OVERCURRENT PROTECTION DEVICE FOR EQUIPMENT INDICATED TO BE REMOVED IN PLACE UNLESS NOTED OTHERWISE.
- ALL REMOVED EQUIPMENT IS PROPERTY OF OWNER AND SHALL BE STORED AT OWNER DESIGNATED LOCATION FOR INSPECTION. CONTRACTOR IS RESPONSIBLE FOR REMOVAL AND DISPOSAL OF EQUIPMENT OWNER DOES NOT INTEND TO KEEP, STORE, OR REUSE.
- REMOVE ALL ELECTRICAL, TELEPHONE, AND DATA OUTLETS IN WALLS DESIGNATED FOR DEMOLITION ON ARCHITECTURAL AND/OR ELECTRICAL PLANS. REMOVE RELATED CIRCUITS SERVING THE DEVICES IN THEIR ENTIRETY. VERIFY ALL ABANDONED DATA CABLES ABOVE CEILINGS AND IN OTHER PLENUMS WITH OWNER AND REMOVE THEM AS DIRECTED BY OWNER.
- WHERE EXISTING OUTLETS AND DEVICES (RECEPTACLES OR LUMINAIRES) TO REMAIN IN SERVICE SHARE SAME BRANCH CIRCUIT AS OUTLETS (RECEPTACLES OR LUMINAIRES) TO BE REMOVED. ELECTRICAL CONTRACTOR SHALL ENSURE CONTINUITY OF THE EXISTING AFTER REMOVAL. THIS CONDITION MAY NOT HAVE BEEN IDENTIFIED ON ELECTRICAL DEMOLITION DRAWINGS. ELECTRICAL CONTRACTOR SHALL FIELD VERIFY SUCH CONDITION.
- LUMINAIRES SHALL BE REMOVED AS INDICATED ON ARCHITECTURAL REFLECTED CEILING OR ELECTRICAL DEMOLITION PLANS. DISPOSE OF ALL FIXTURES AND LAMPS OWNER DOES NOT INTEND TO KEEP. REMOVE ALL RELATED BRANCH CIRCUITING, WIRING, SWITCHES, OVERCURRENT PROTECTION DEVICES, AND ALL OTHER RELATED ELECTRICAL ITEMS.
- COORDINATE ARCHITECTURAL REQUIREMENTS FOR EXISTING CEILING GRID SYSTEM. ELECTRICAL CONTRACTOR SHALL PRESERVE AND PROTECT CEILING TILES AND SUPPORTING T'S WHEN REMOVING ELECTRICAL COMPONENTS FROM ABOVE LAY-IN CEILING AS REQUIRED.
- REMOVE ALL ABANDONED FEEDERS (CONDUITS AND WIRING) IN AREA OF CONSTRUCTION. PROPERLY SUPPORT ALL REMAINING EXISTING CONDUIT AND BOXES AFFECTED. PAINT REUSED AND EXPOSED CONDUIT AND BOXES TO MATCH WALL.
- WHERE PANELBOARDS ARE INDICATED TO BE REPLACED AND FEEDER AND BRANCH CIRCUITS ARE TO REMAIN IN SERVICE, CONTRACTOR SHALL PROTECT THEM FOR REUSE DURING CONSTRUCTION PHASE OF THE WORK.
- ELECTRICAL CONTRACTOR SHALL INSPECT EXISTING ELECTRICAL CIRCUITS INDICATED TO REMAIN IN SERVICE AND REUSED. CONTRACTOR SHALL PERFORM CONDUCTOR INSULATION TESTING IN ALL MAIN FEEDERS INTENDED TO BE REUSED IN ACCORDANCE WITH SPECIFICATION REQUIREMENTS. ALL CONDUCTORS FAILING TEST SHALL BE REPLACED WITH SAME SIZE AS EXISTING.
- ELECTRICAL CONTRACTOR SHALL INSPECT ALL EXISTING JUNCTION BOXES AND REPLACE MISSING COVERS AND PLUG ALL UNUSED HOLES.
- ELECTRICAL PLANS DO NOT SHOW ALL RISER CONDUITS WITHIN WALLS. WHEN FOUND, CONTRACTOR SHALL DETERMINE IF THEY ARE IN SERVICE. IF SO, CONTRACTOR SHALL RELOCATE THEM TO A NEW NEARBY WALL OR OTHER STRUCTURE. SPLICES IN THE WIRING WILL BE PERMITTED IN SUITABLE JUNCTION BOXES IF THE CONDUCTORS ARE IN SOUND CONDITION.



1 OVERALL DEMOLITION PLAN - LIGHTING
Scale: 1" = 40'-0"

Project Number	19006-A
Drawn By	LT
Checked By	AW
Approved By	MS

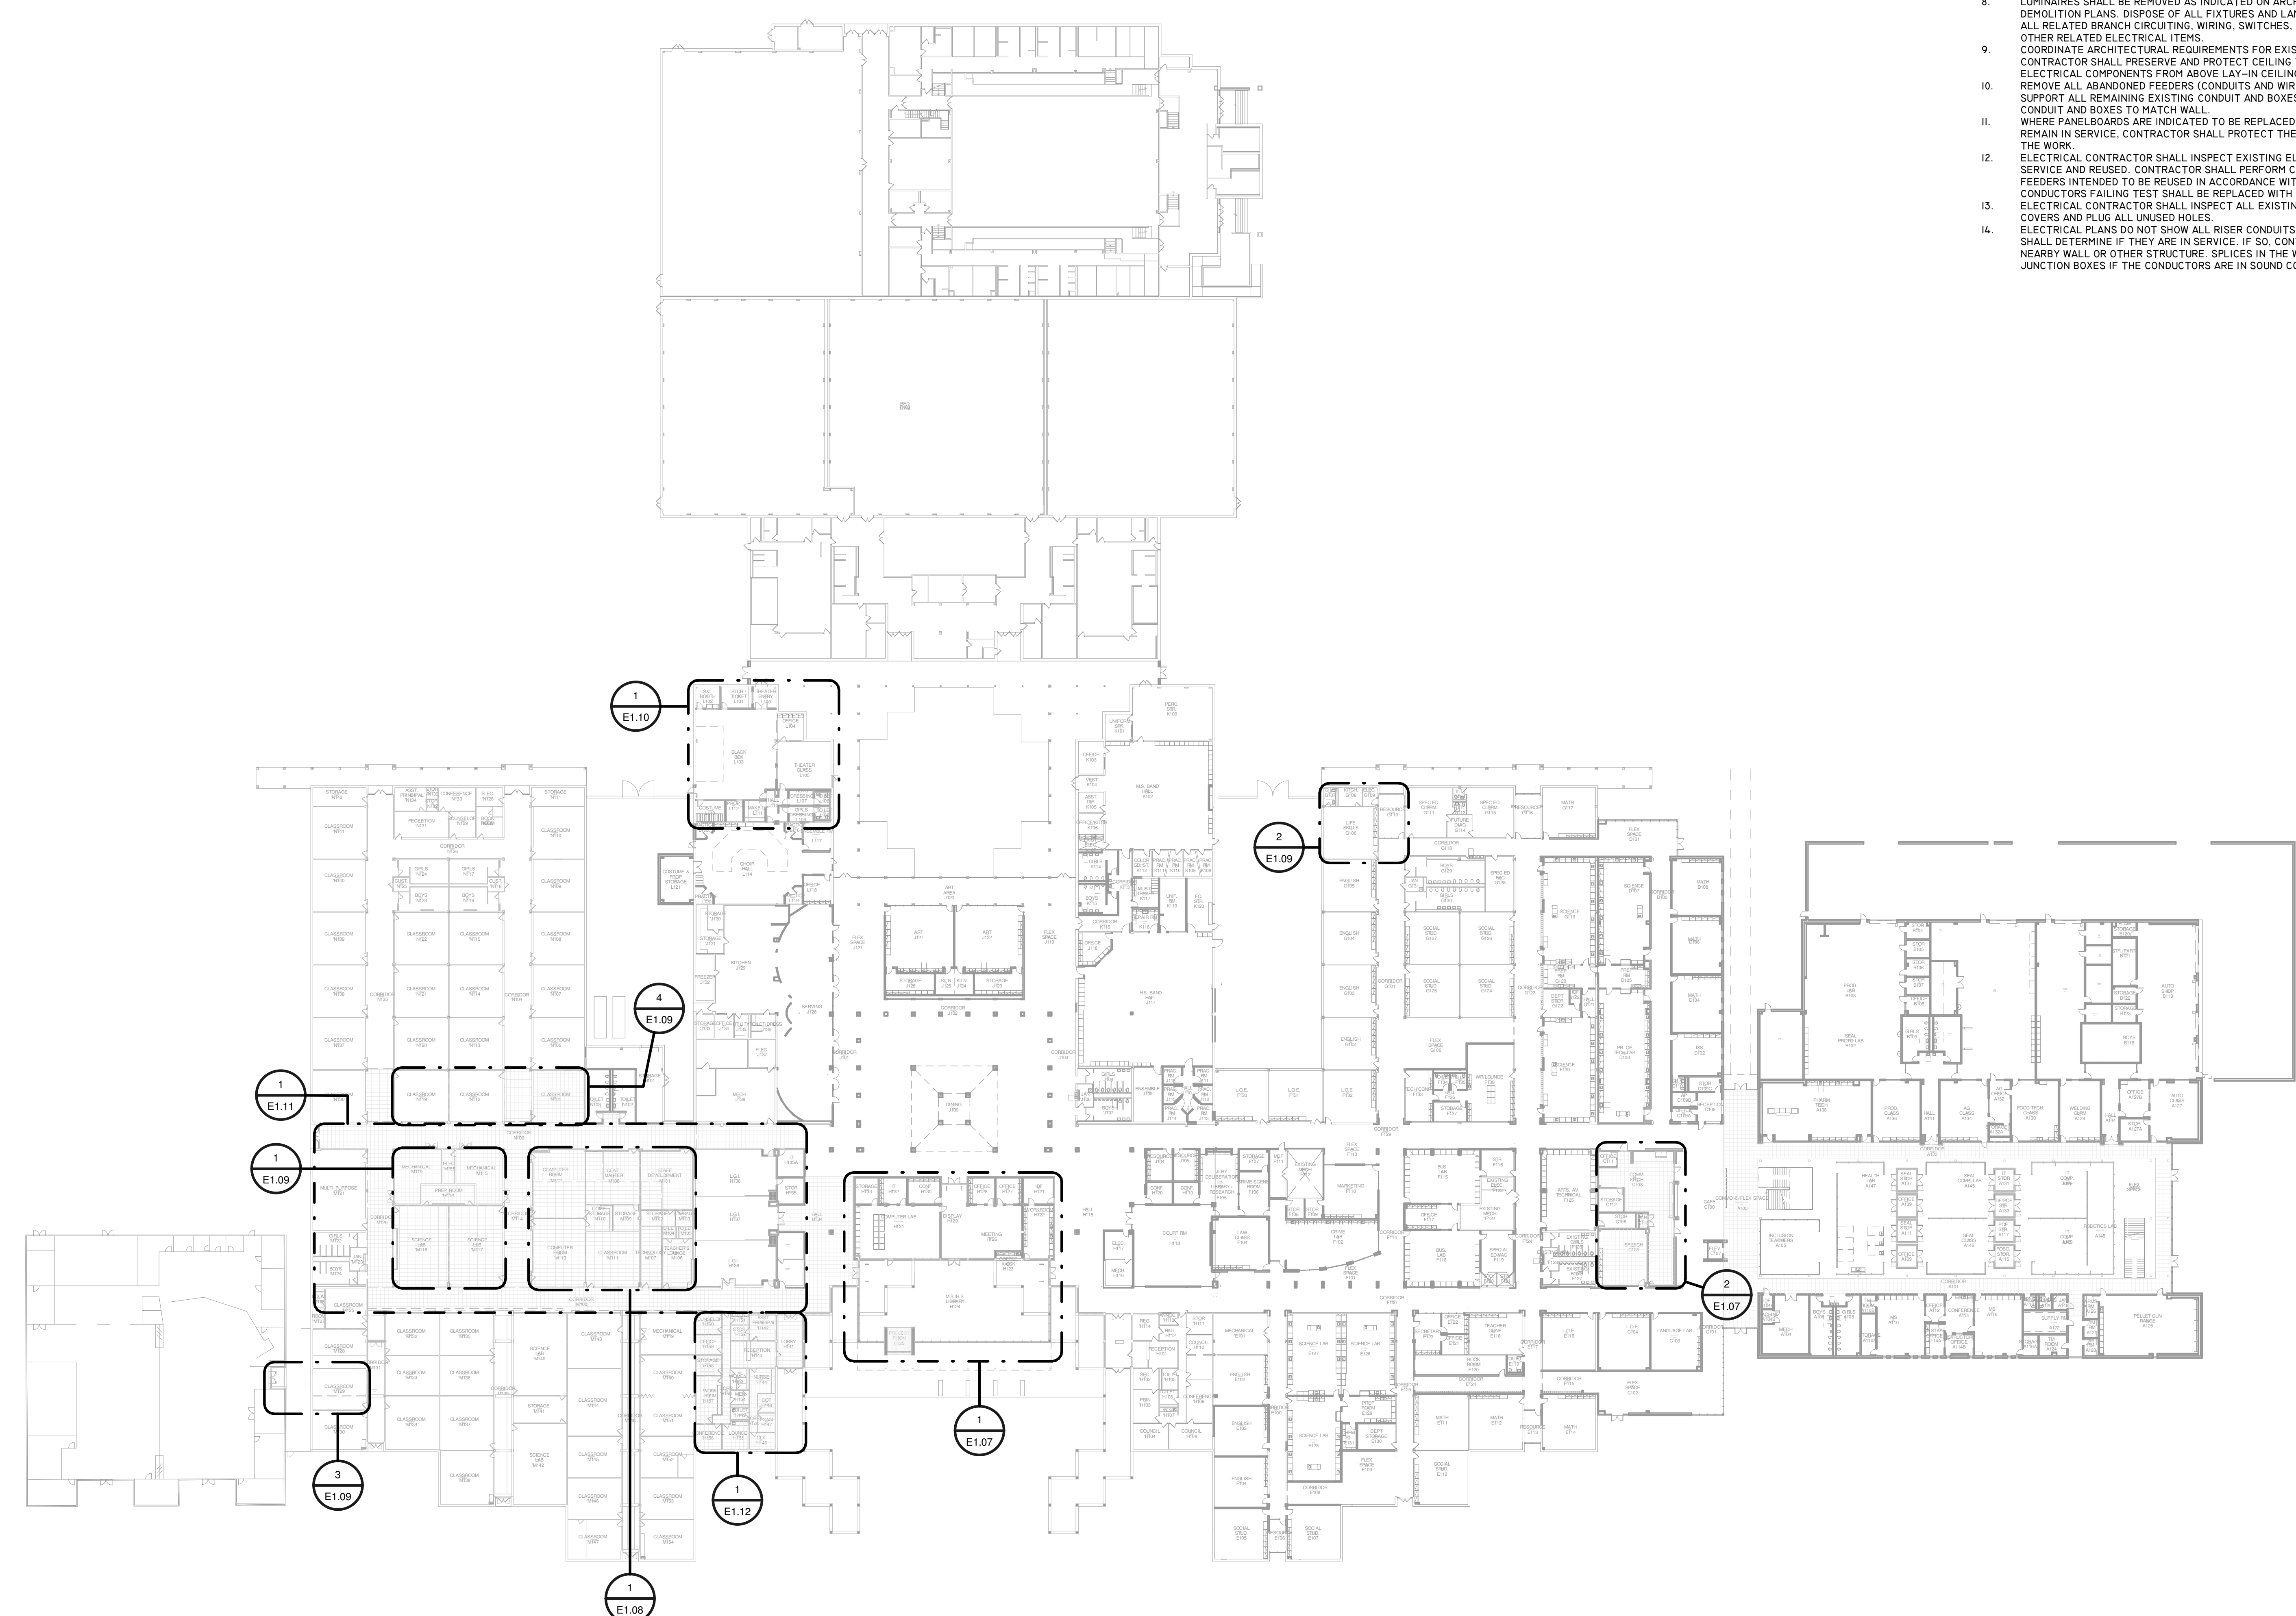Drawing Title
**OVERALL DEMOLITION
PLAN - LIGHTING**

Drawing Number
E1.06



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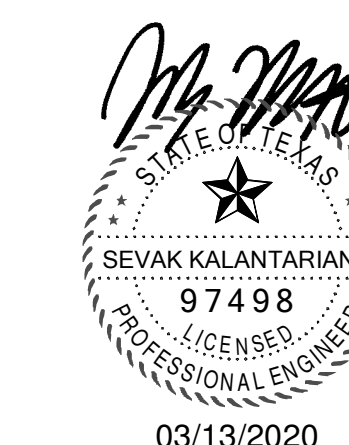
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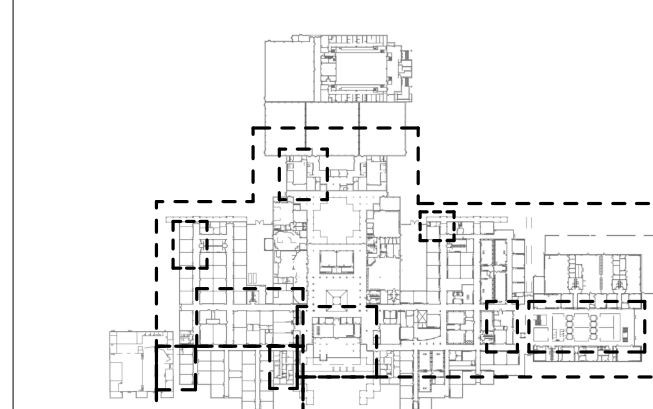


A PROJECT FOR:

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RENOVATIONS**

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3	2020/03/12	Issue for Bid, Permit, and Construction




KEY PLAN
TRUE NORTH
PLAN NORTH


Project Number	19006-A
Drawn By	LT
Checked By	AW
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**ENLARGED DEMOLITION
PLAN - LIGHTING**

Drawing Number **E1.07**

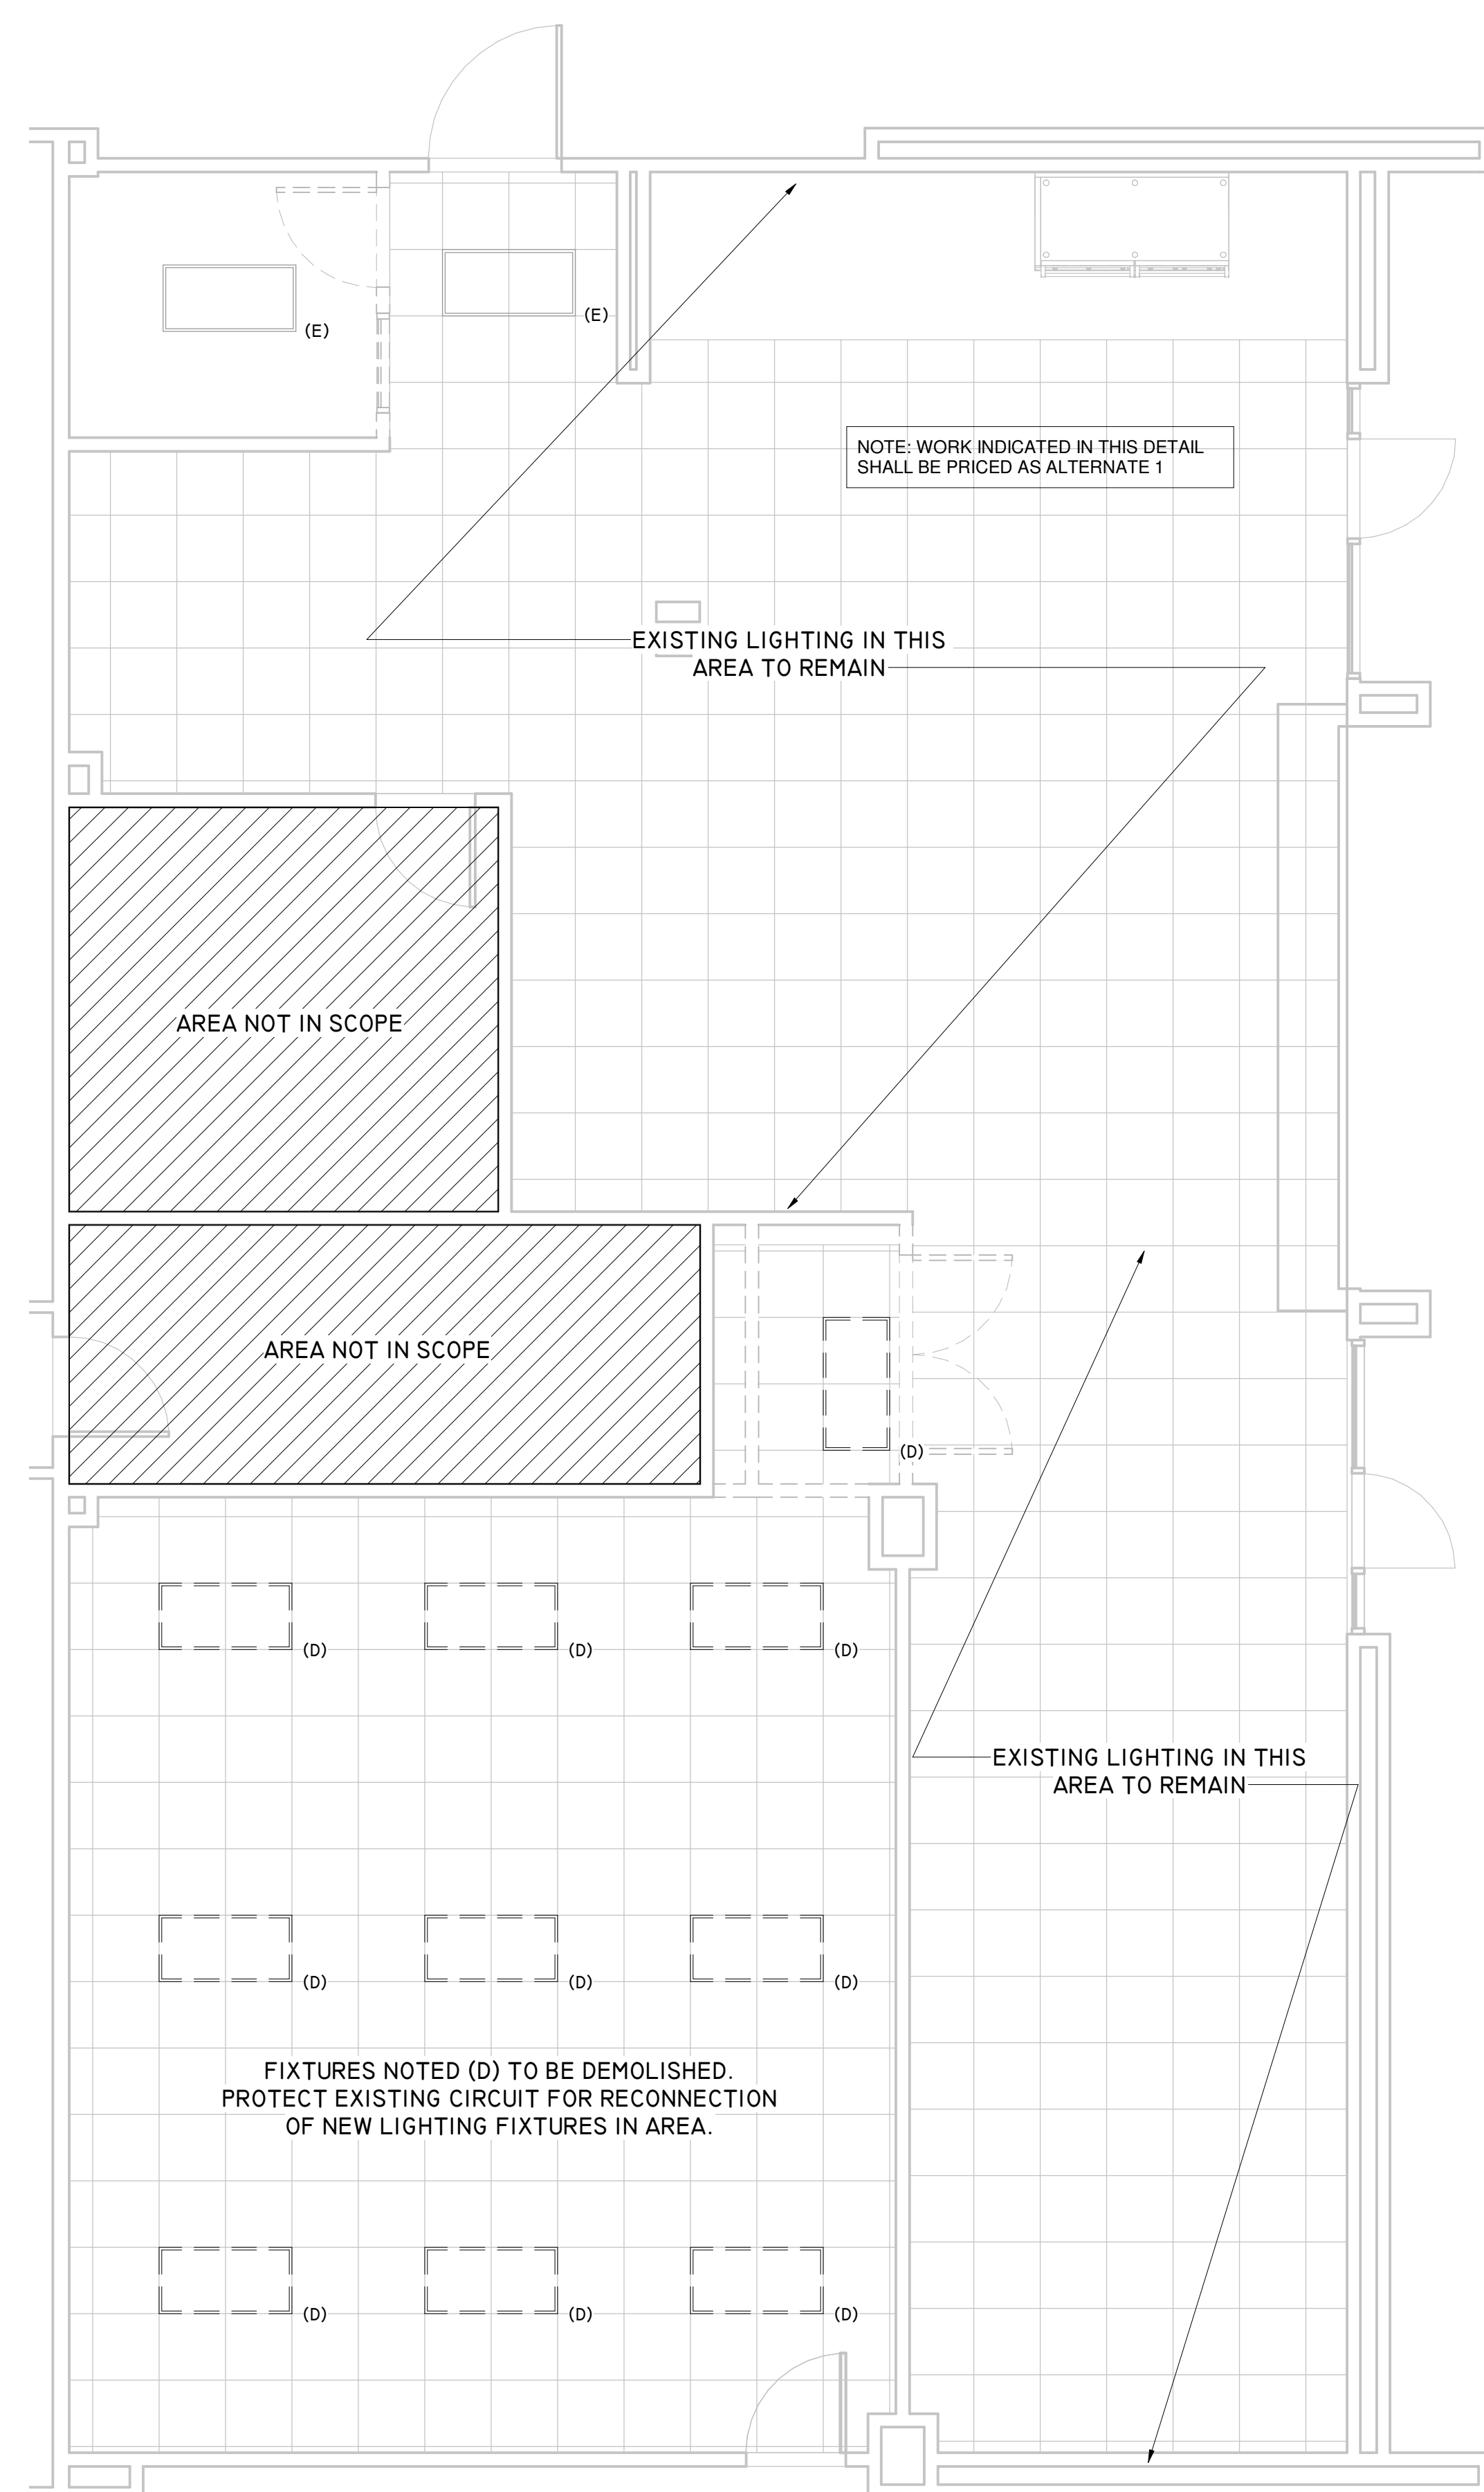

2 ENLARGED DEMOLITION PLAN - AREA G - LIGHTING
Scale: 1/4" = 1'-0"

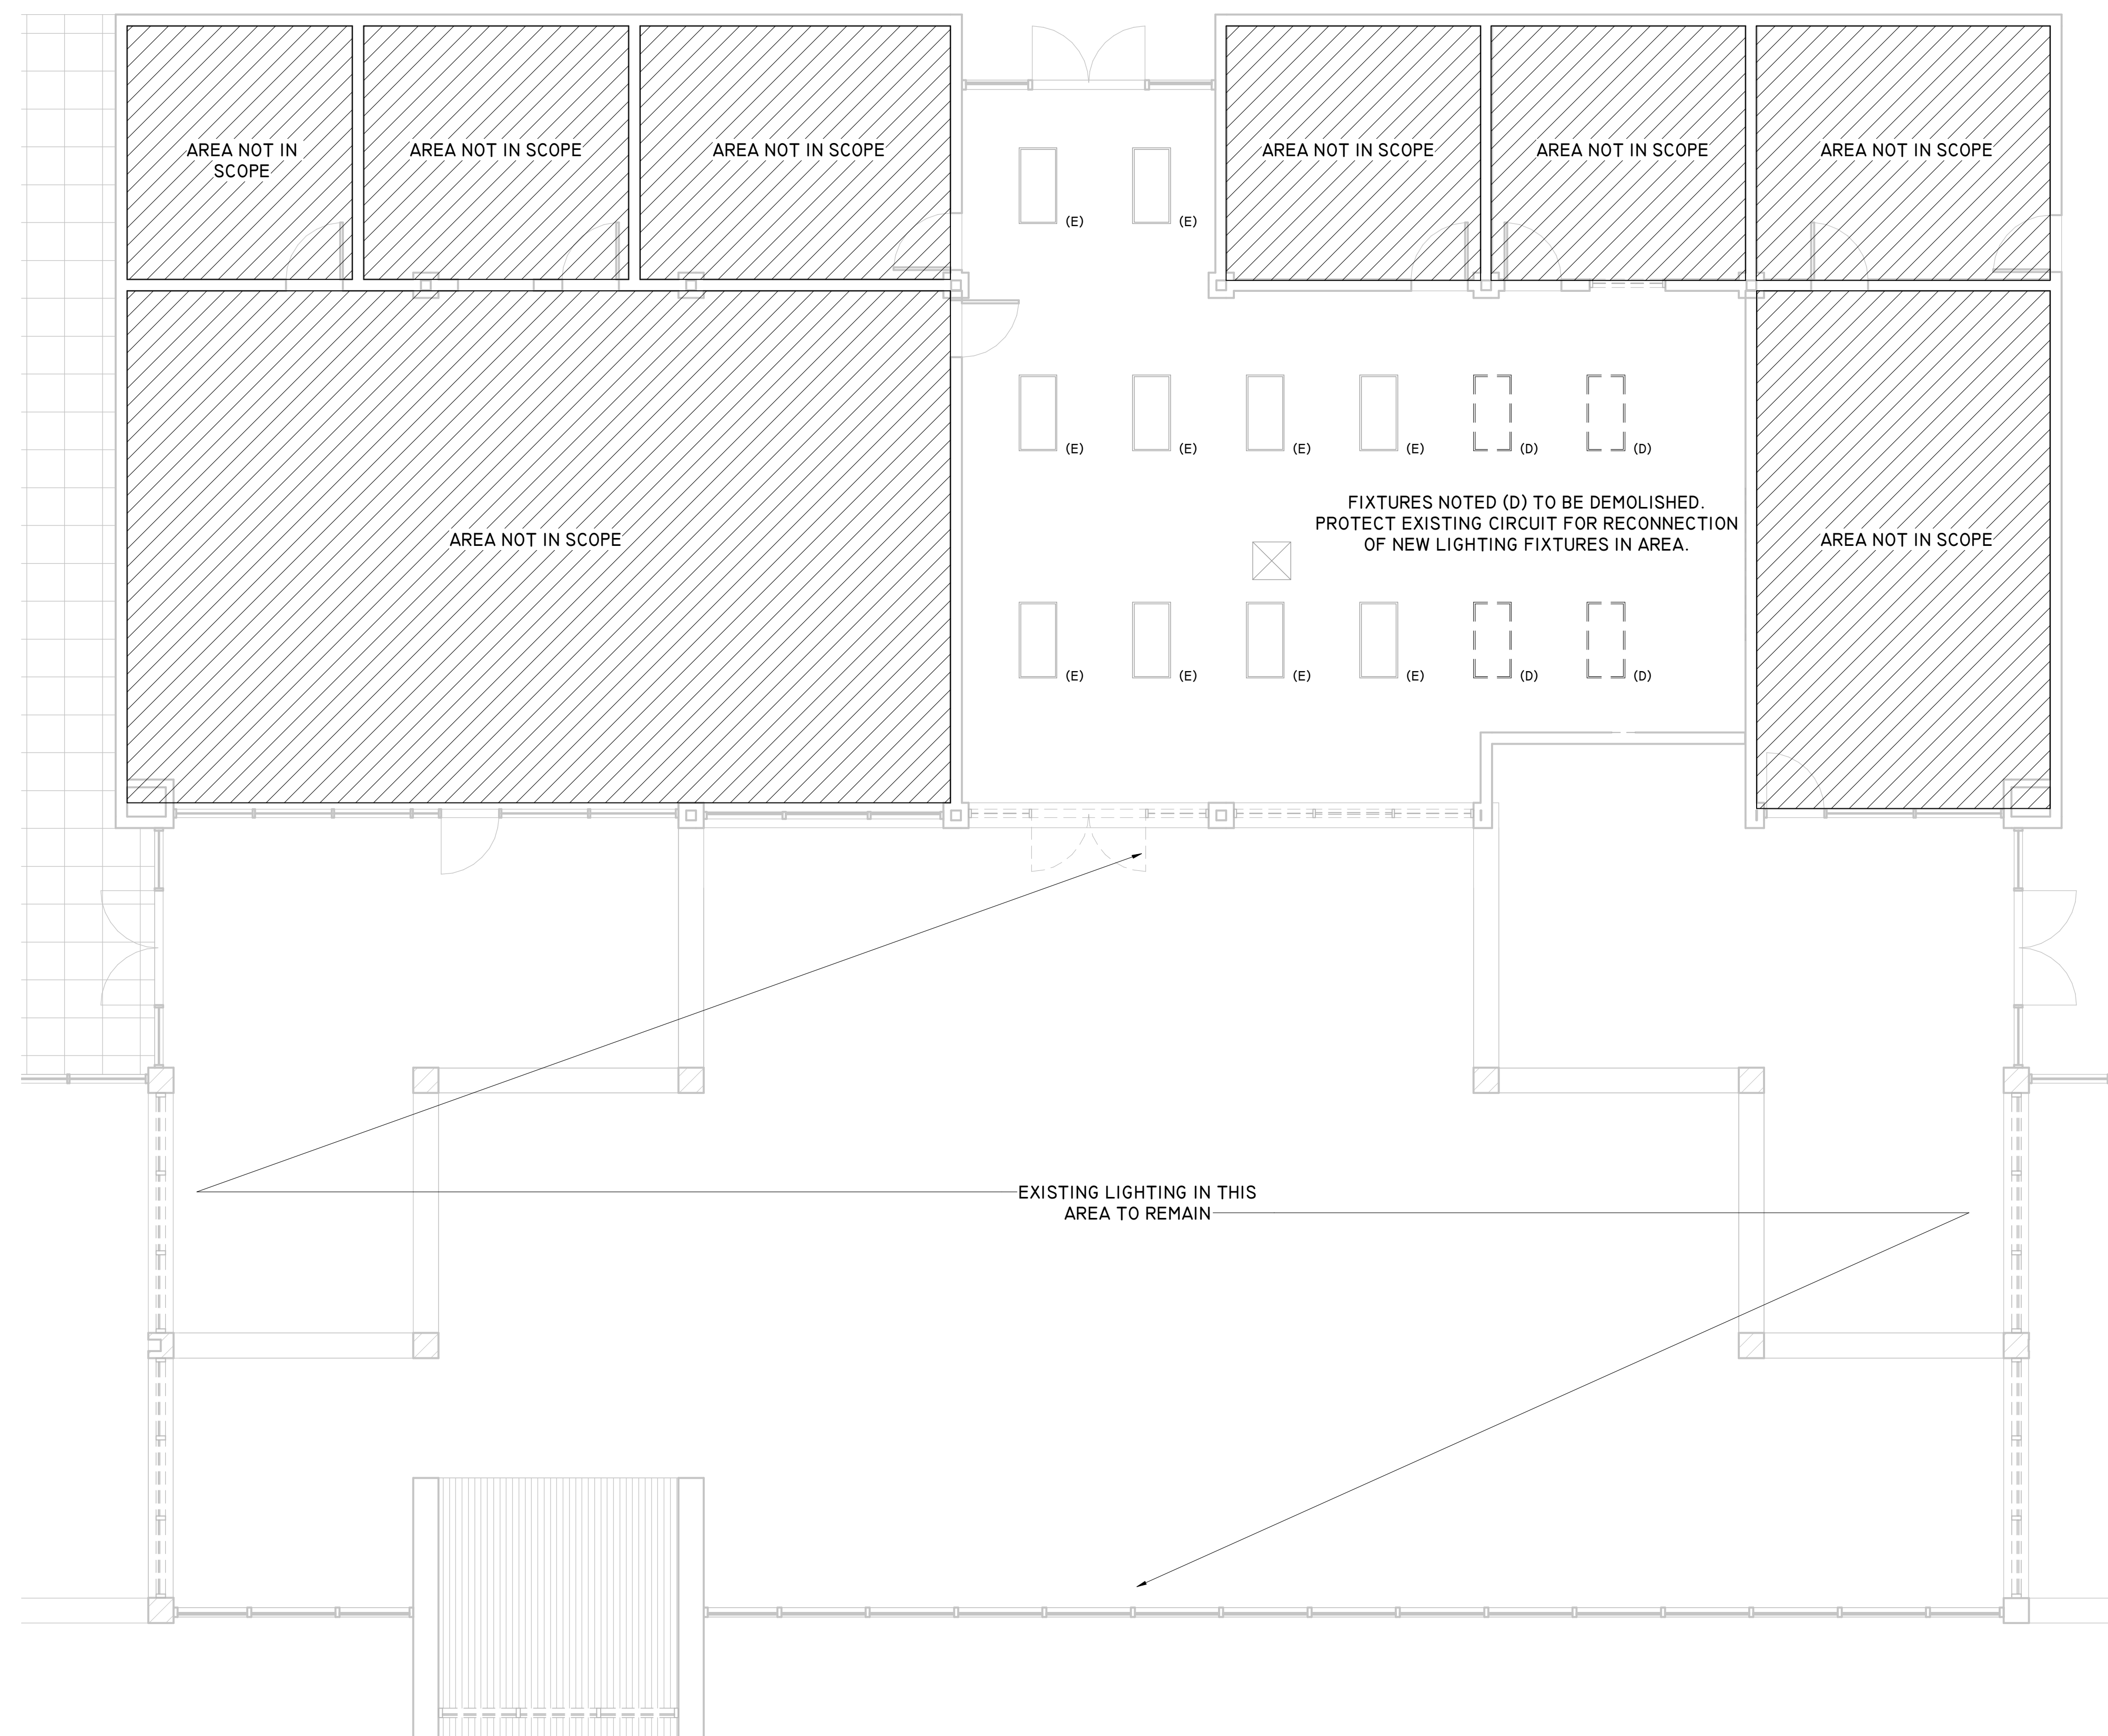

1 ENLARGED DEMOLITION PLAN - AREA C - LIGHTING
Scale: 3/16" = 1'-0"



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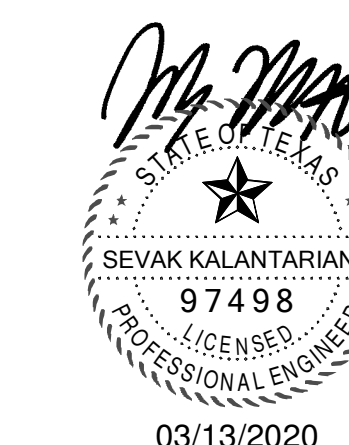
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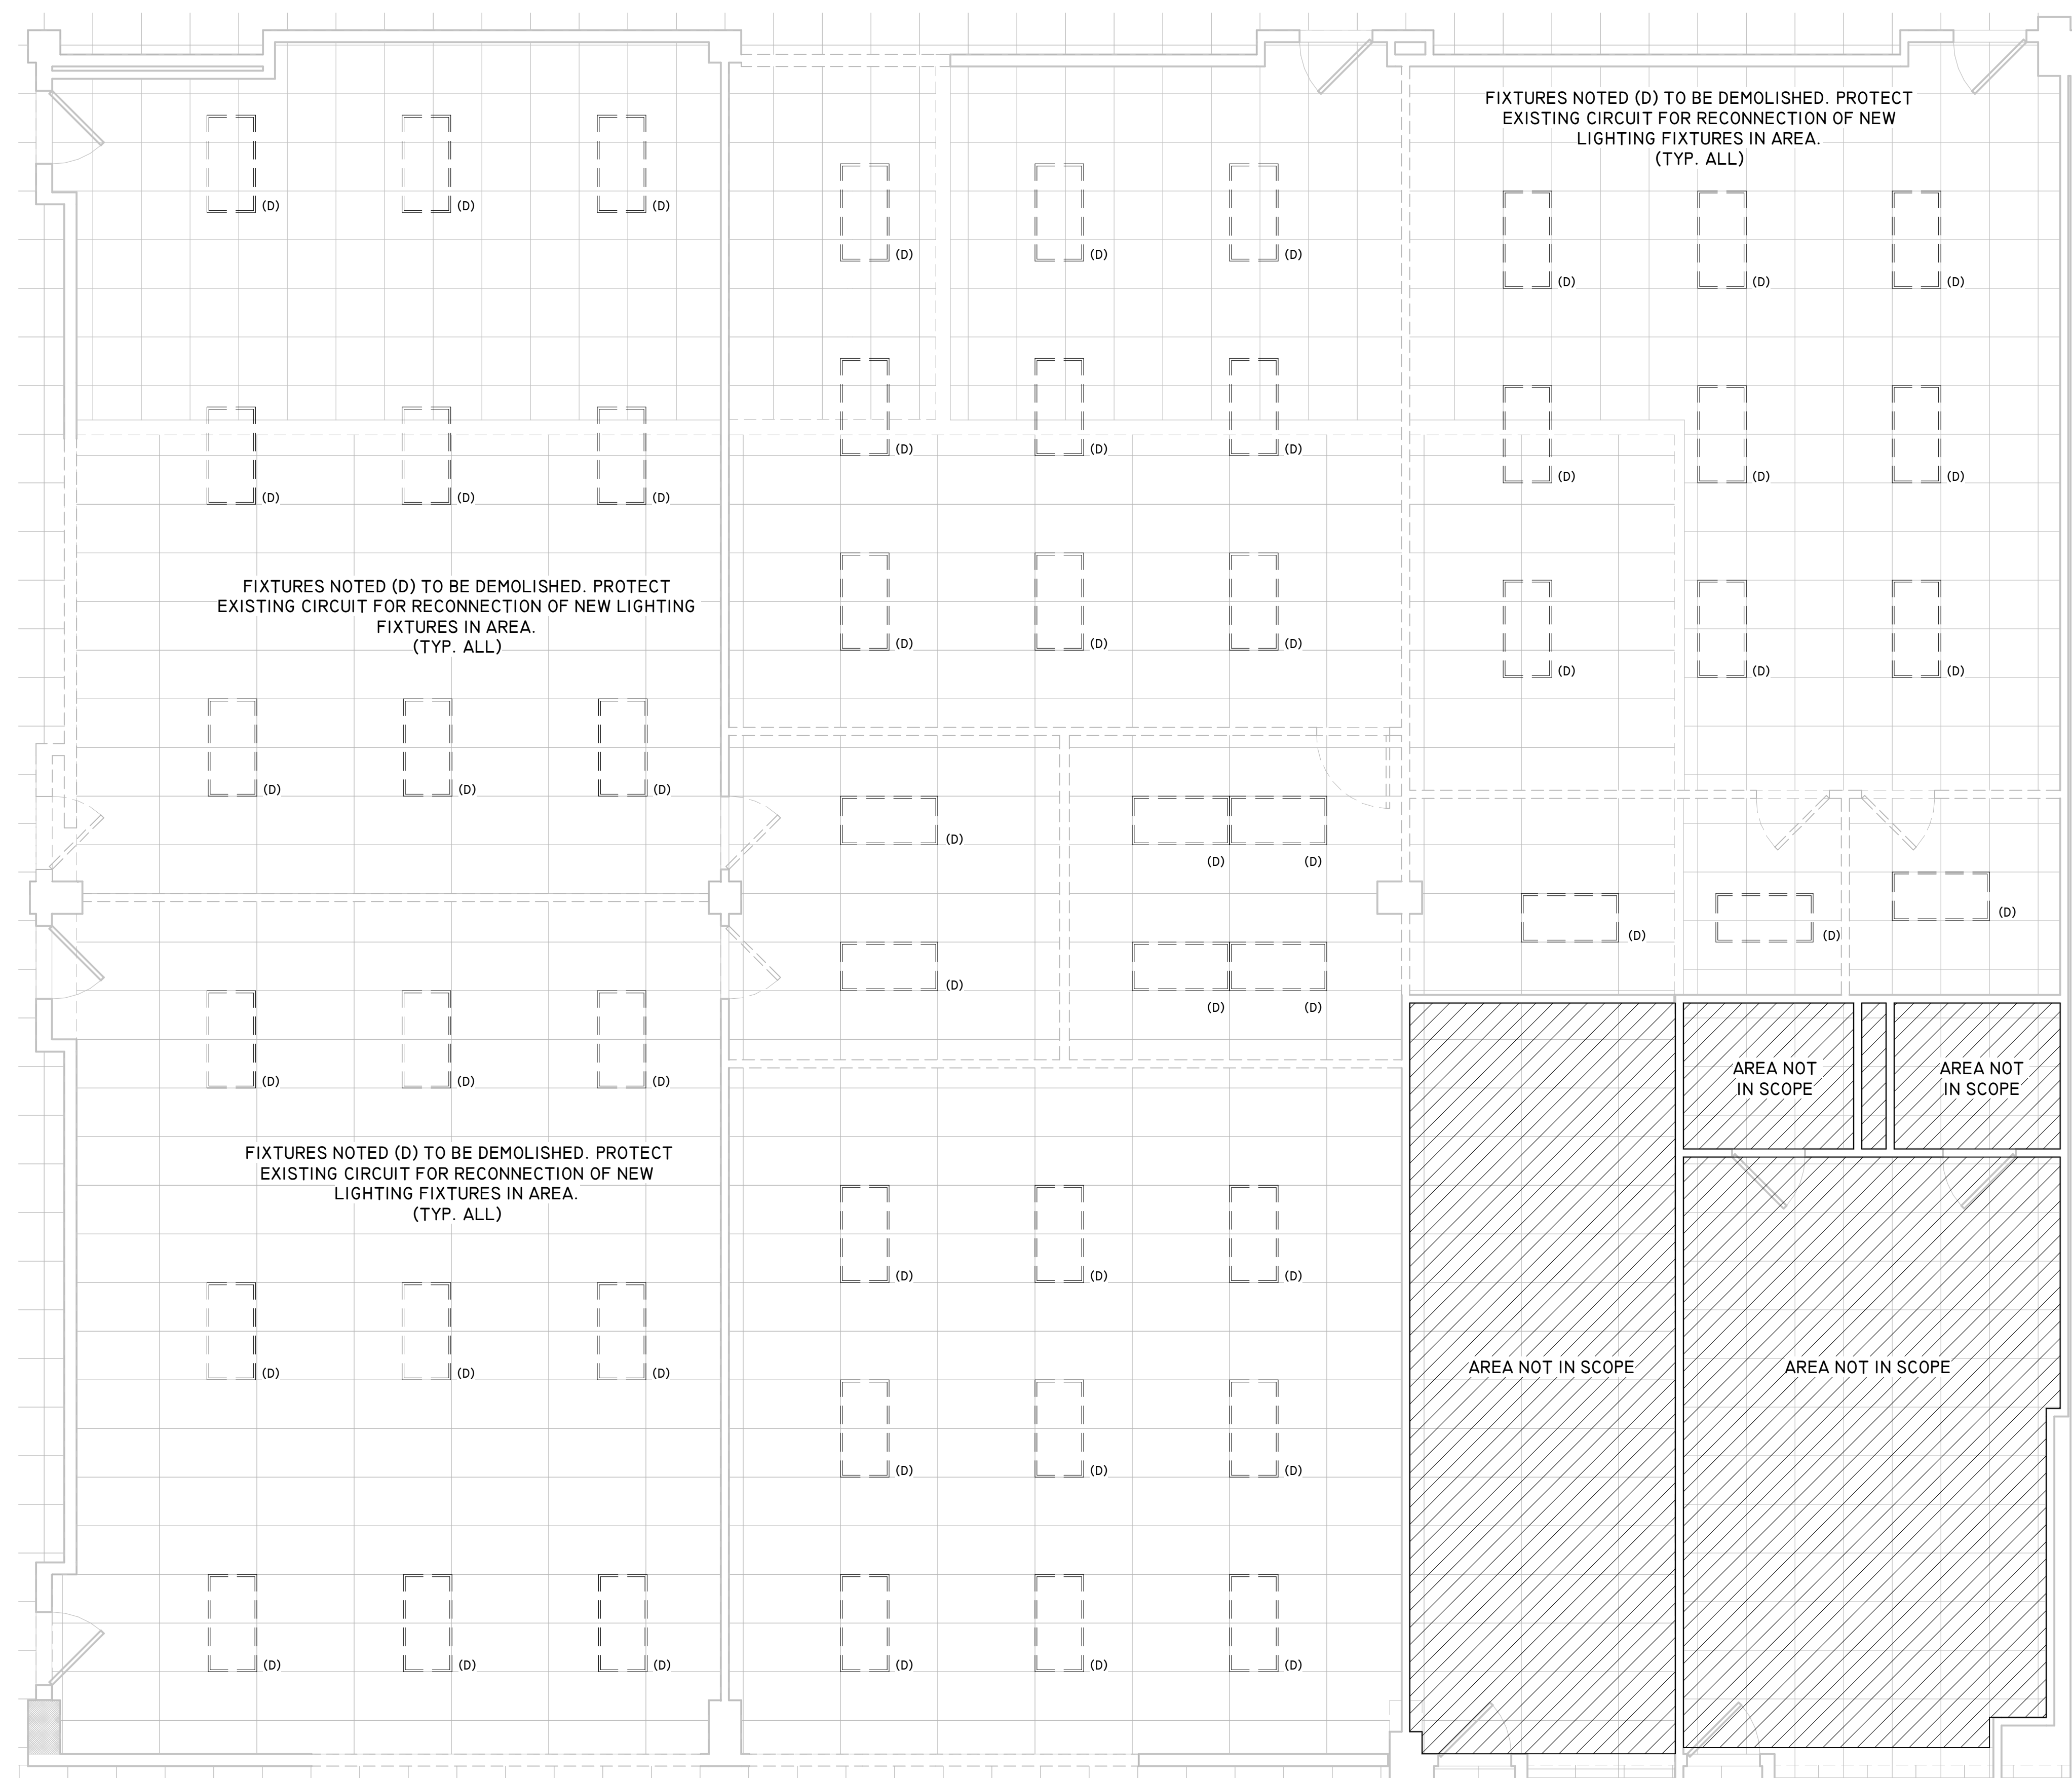


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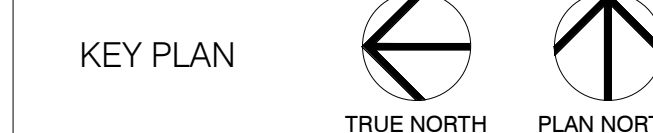
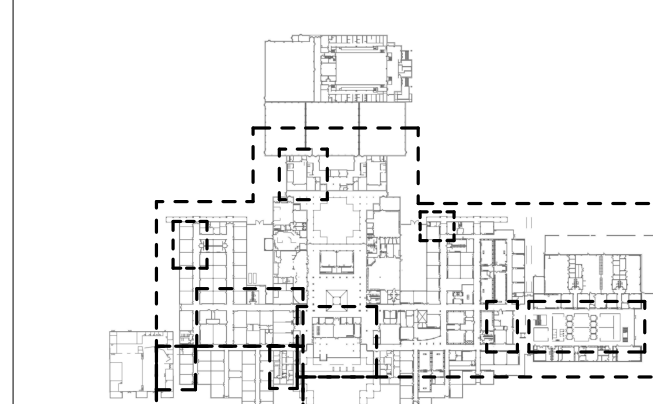
**STAFFORD
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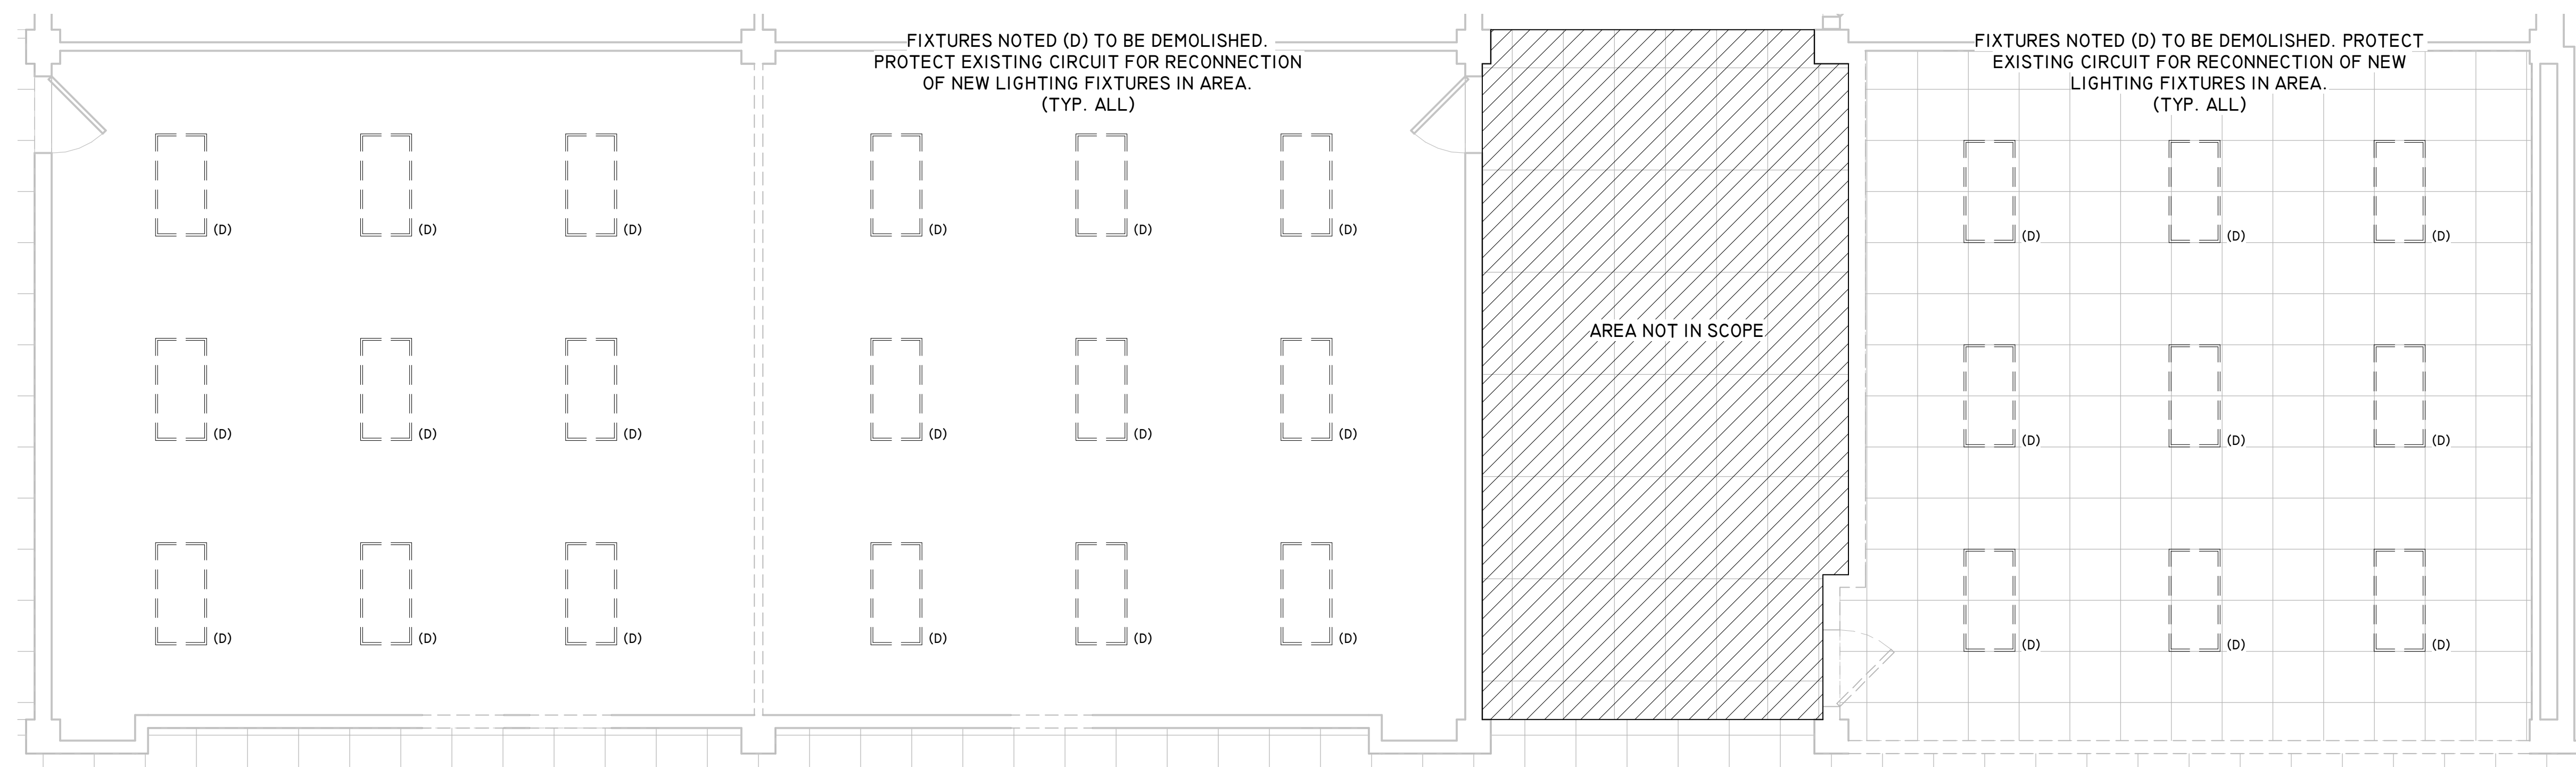
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Scale: 1/4" = 1'-0"




Project Number	19006-A
Drawn By	LT
Checked By	AW
Approved By	MS

**ENLARGED DEMOLITION
PLAN - LIGHTING**


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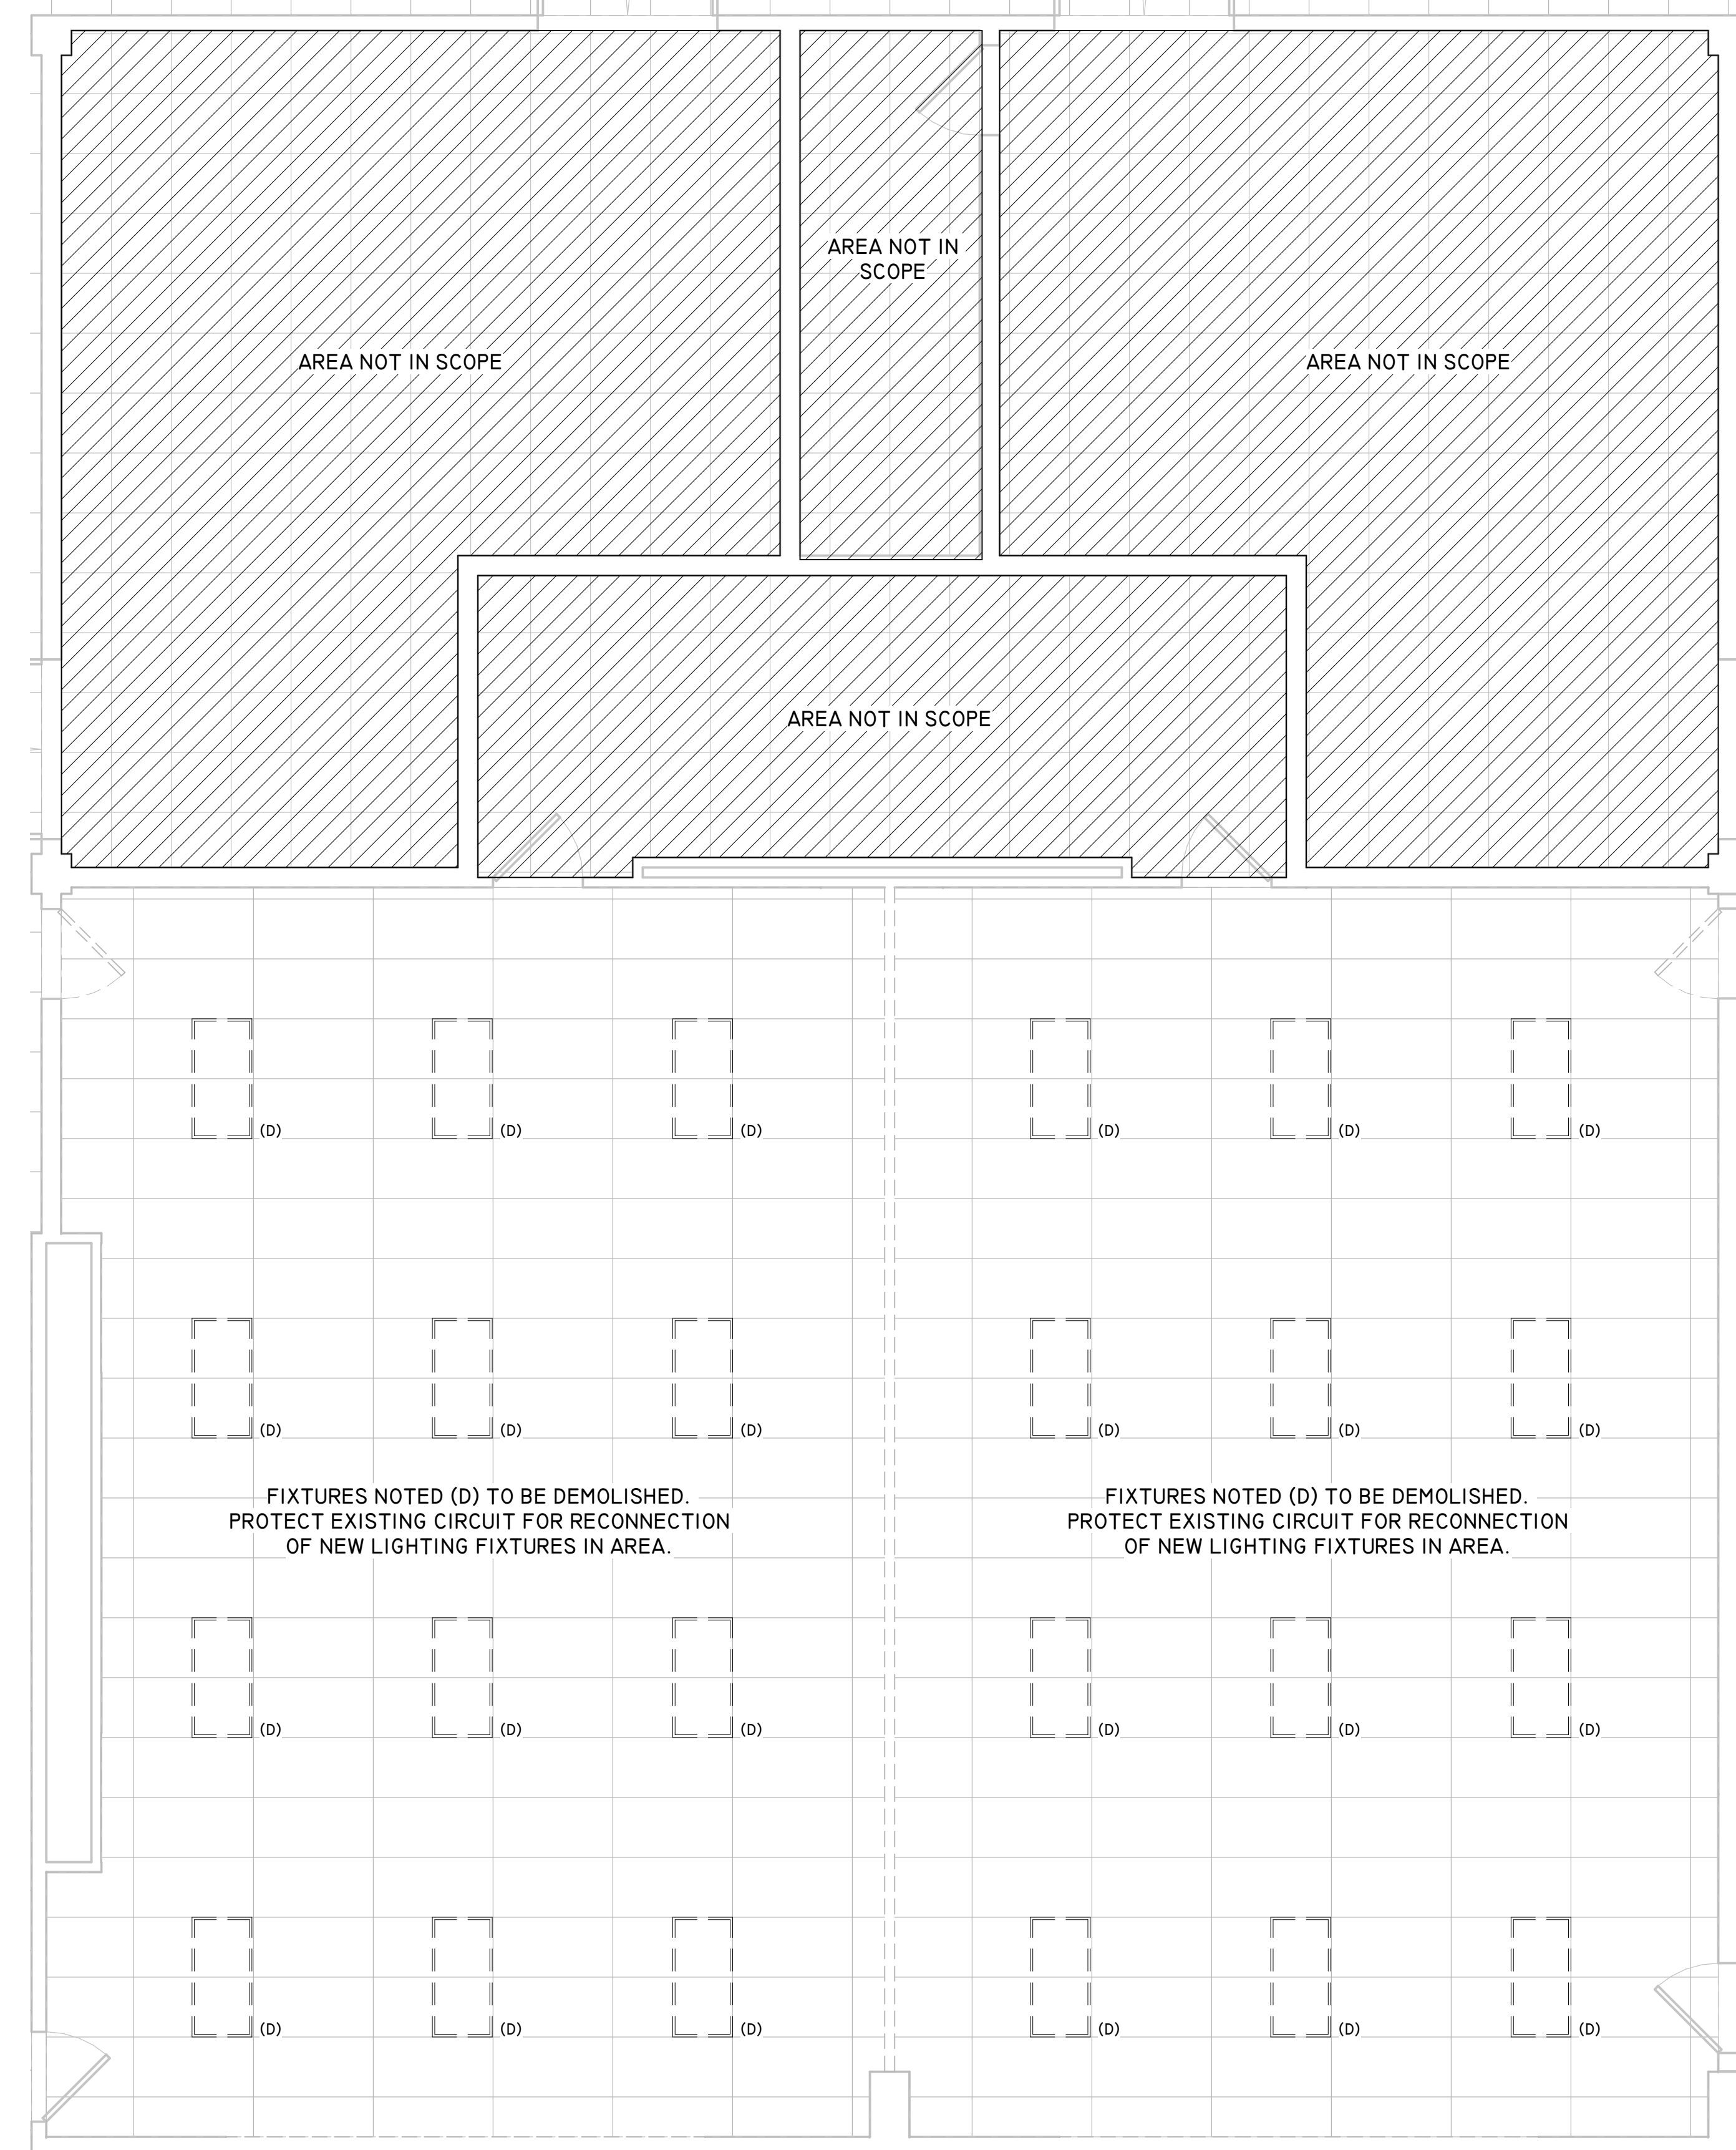
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Scale: 1/4" = 1'-0"



3 ENLARGED DEMOLITION PLAN - AREA B1 - LIGHTING
Scale: 1/4" = 1'-0"

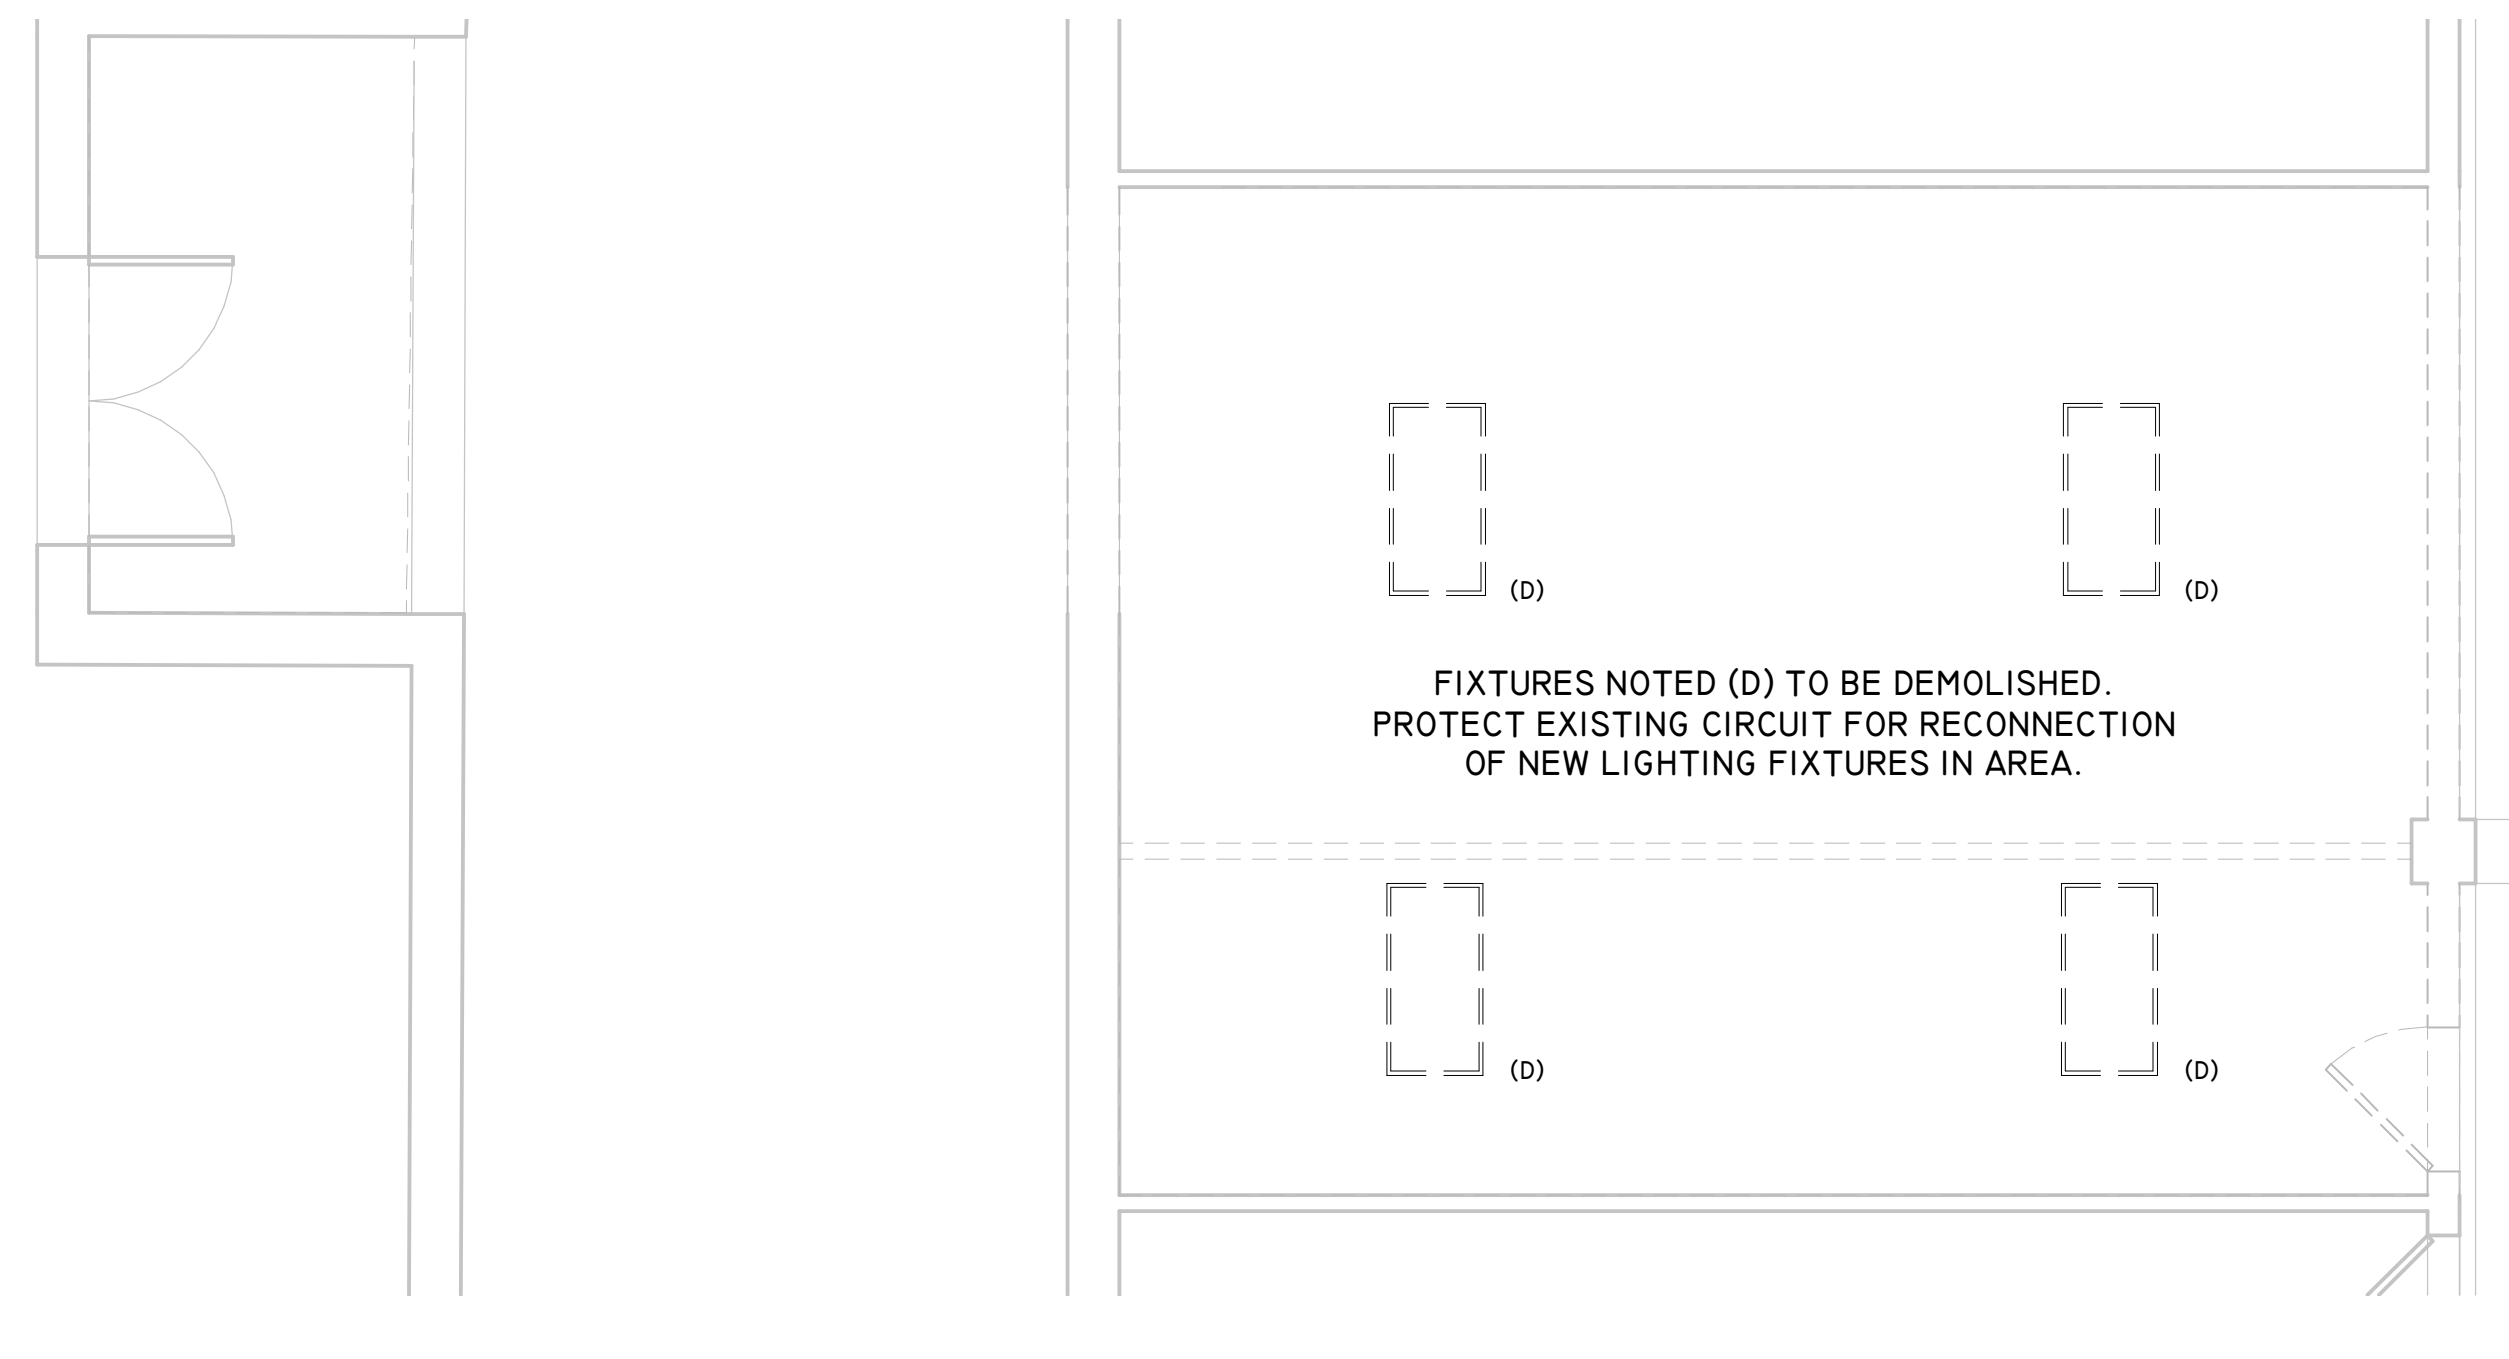

2 ENLARGED DEMOLITION PLAN - AREA E - LIGHTING
Scale: 1/4" = 1'-0"

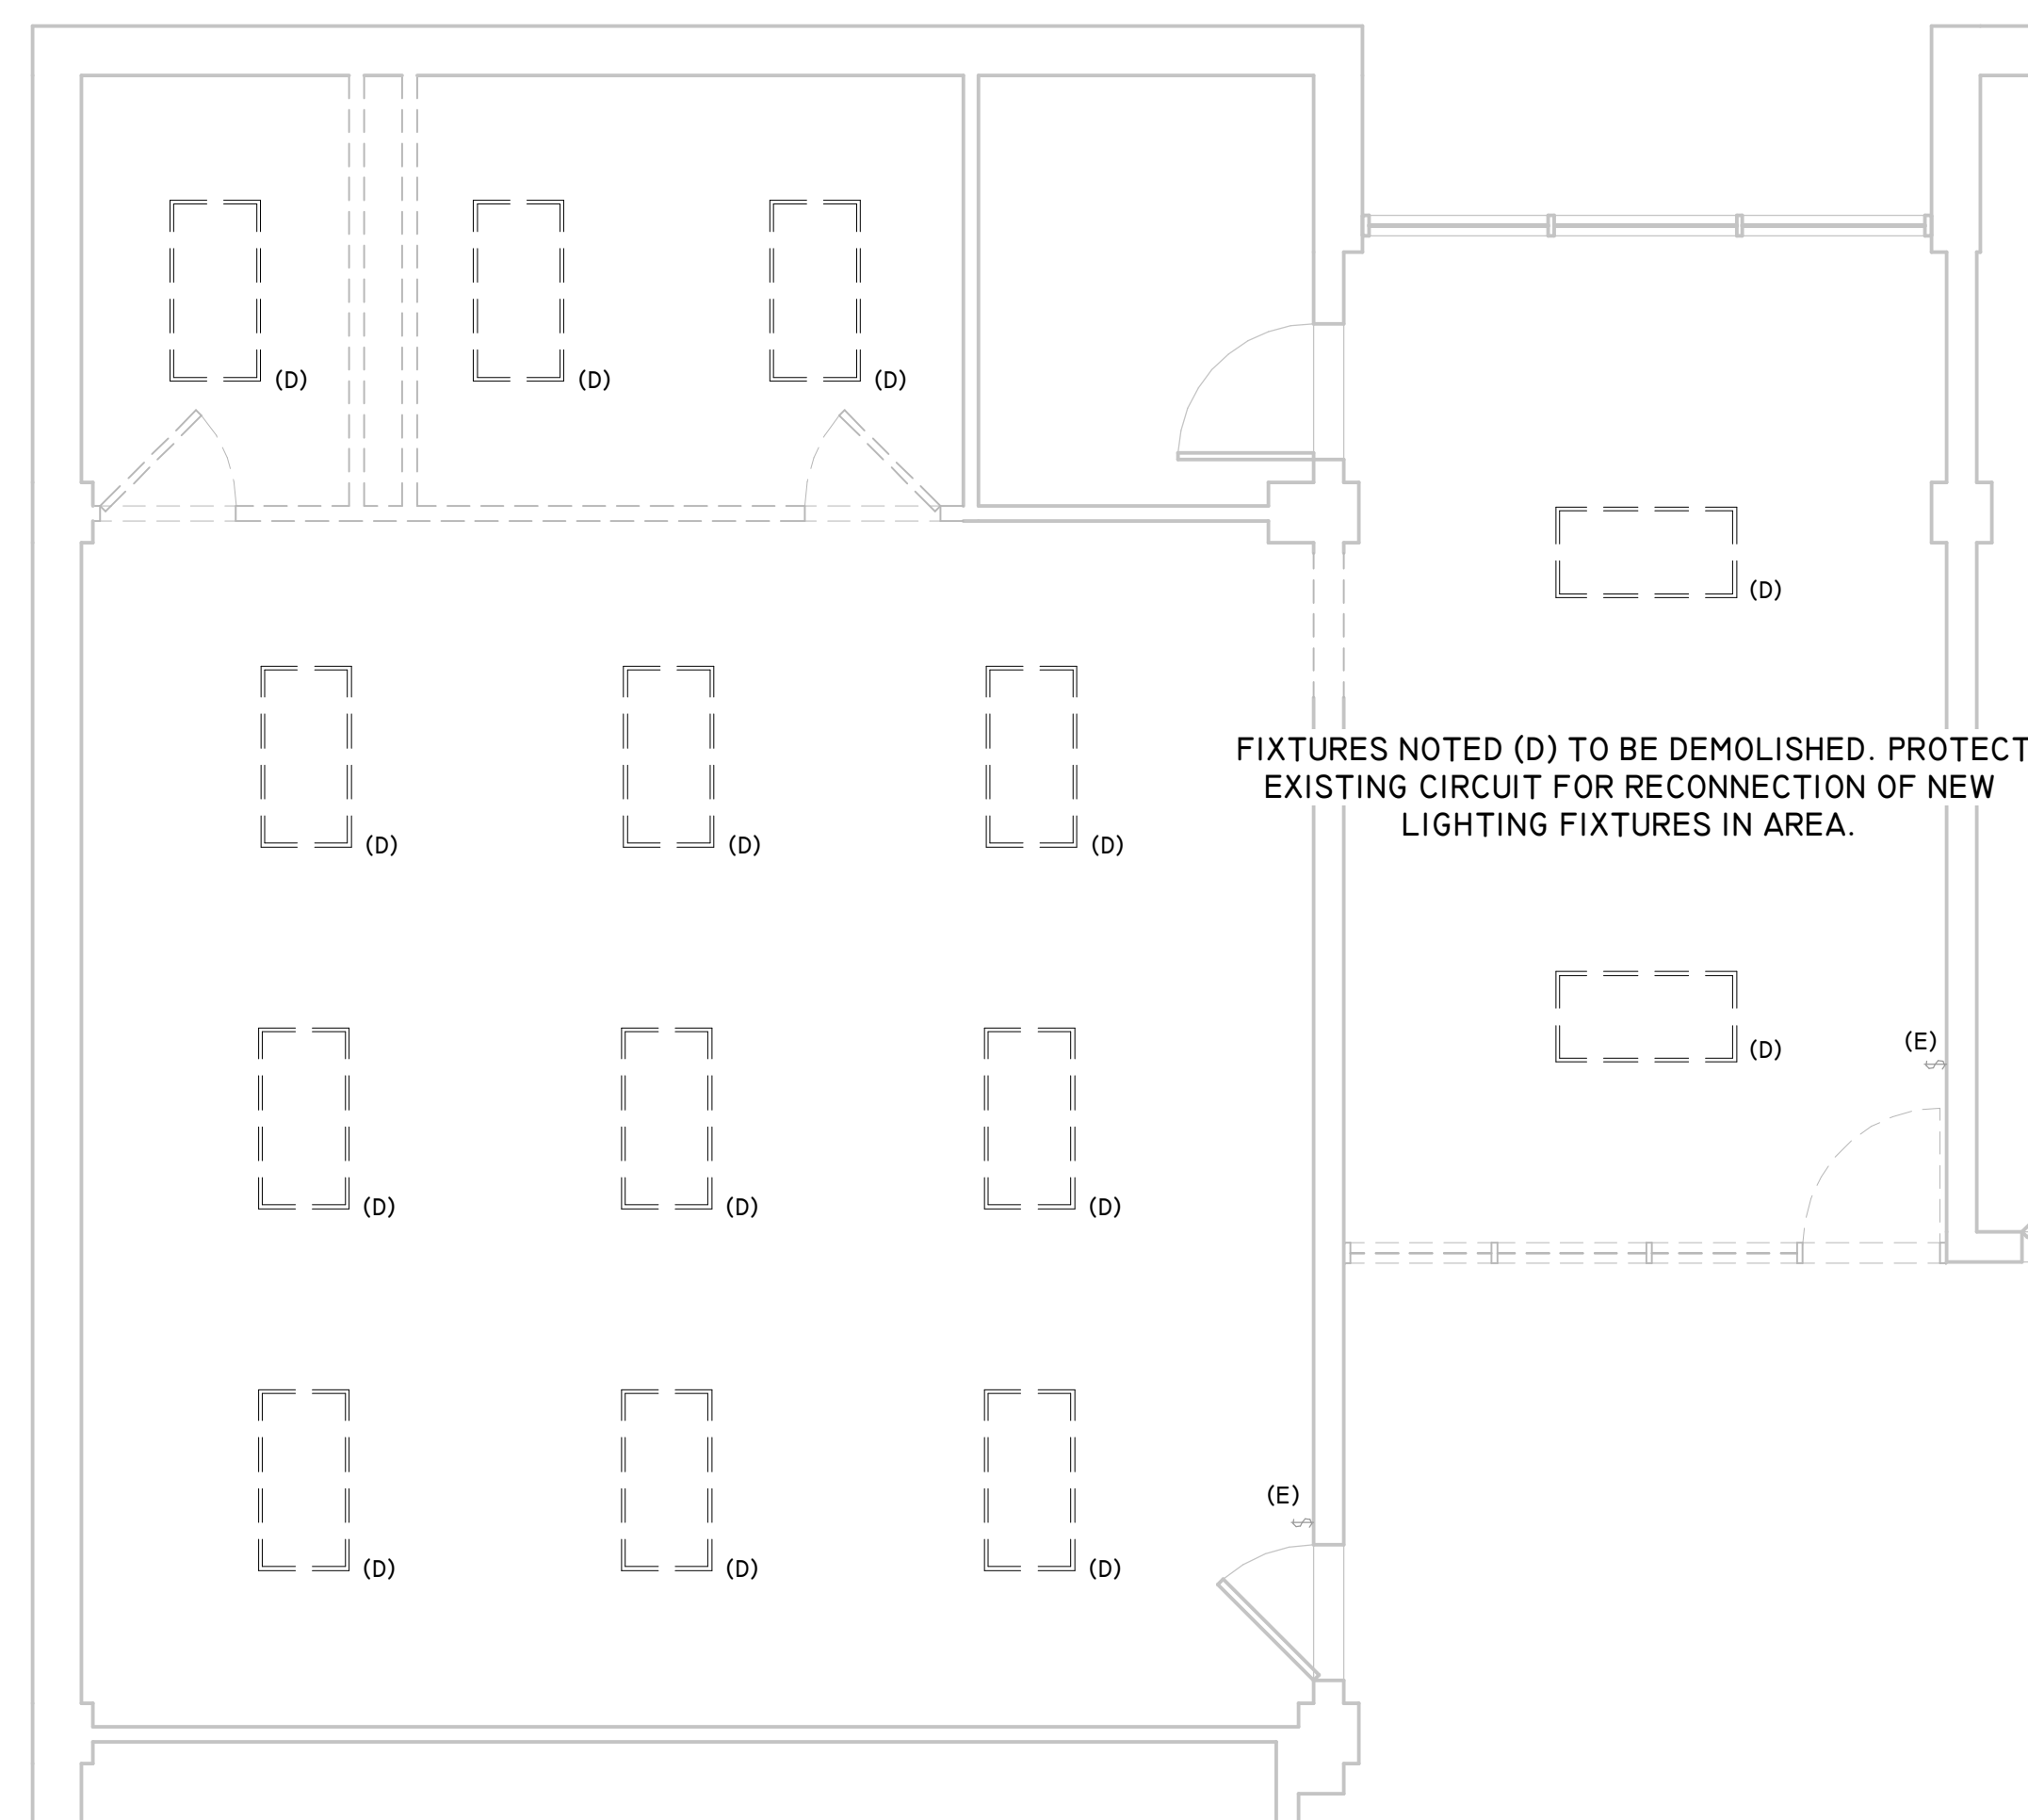

1 ENLARGED DEMOLITION PLAN - AREA B2 - LIGHTING
Scale: 1/4" = 1'-0"



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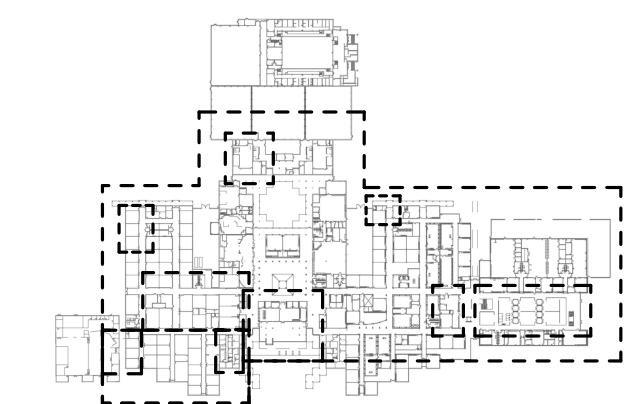
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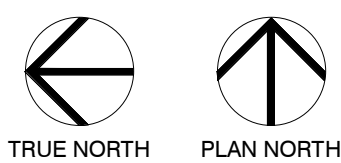
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KEY PLAN



Project Number	19006-A
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Approved By	MS

Drawing Title
**ENLARGED DEMOLITION
PLAN - LIGHTING**

Drawing Number
E1.09



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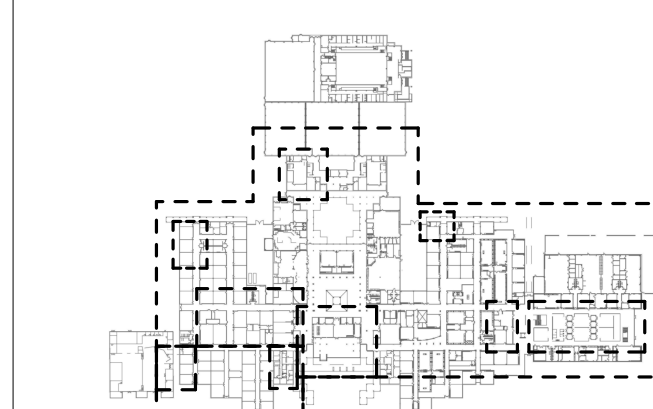


A PROJECT FOR:

**STAFFORD
HIGH SCHOOL
& MAGNET
SCHOOL
RENOVATIONS**

**1625 STAFFORDSHIRE
ROAD,
STAFFORD, TX 77477**

#	Date	ISSUED FOR
1	2020/01/31	90% CD
2	2020/03/02	98% CD Review
3	2020/03/12	Issue for Bid, Permit, and Construction



Project Number	19006-A
Drawn By	LT
Checked By	AW
Approved By	MS

**ENLARGED DEMOLITION
PLAN - LIGHTING**

Drawing Number **E1.11**





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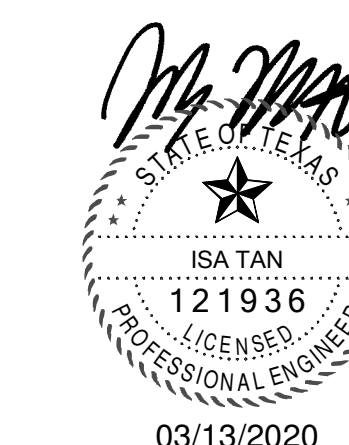
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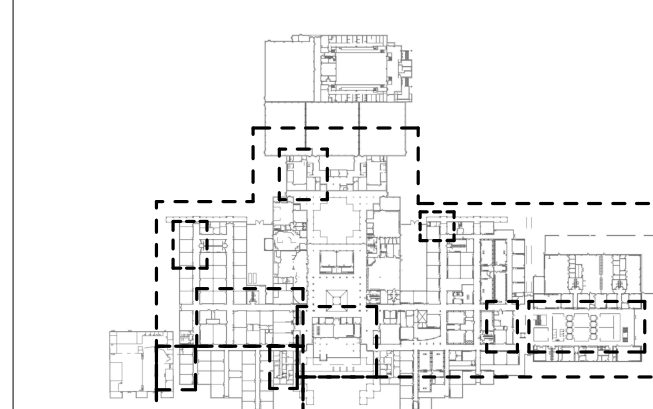


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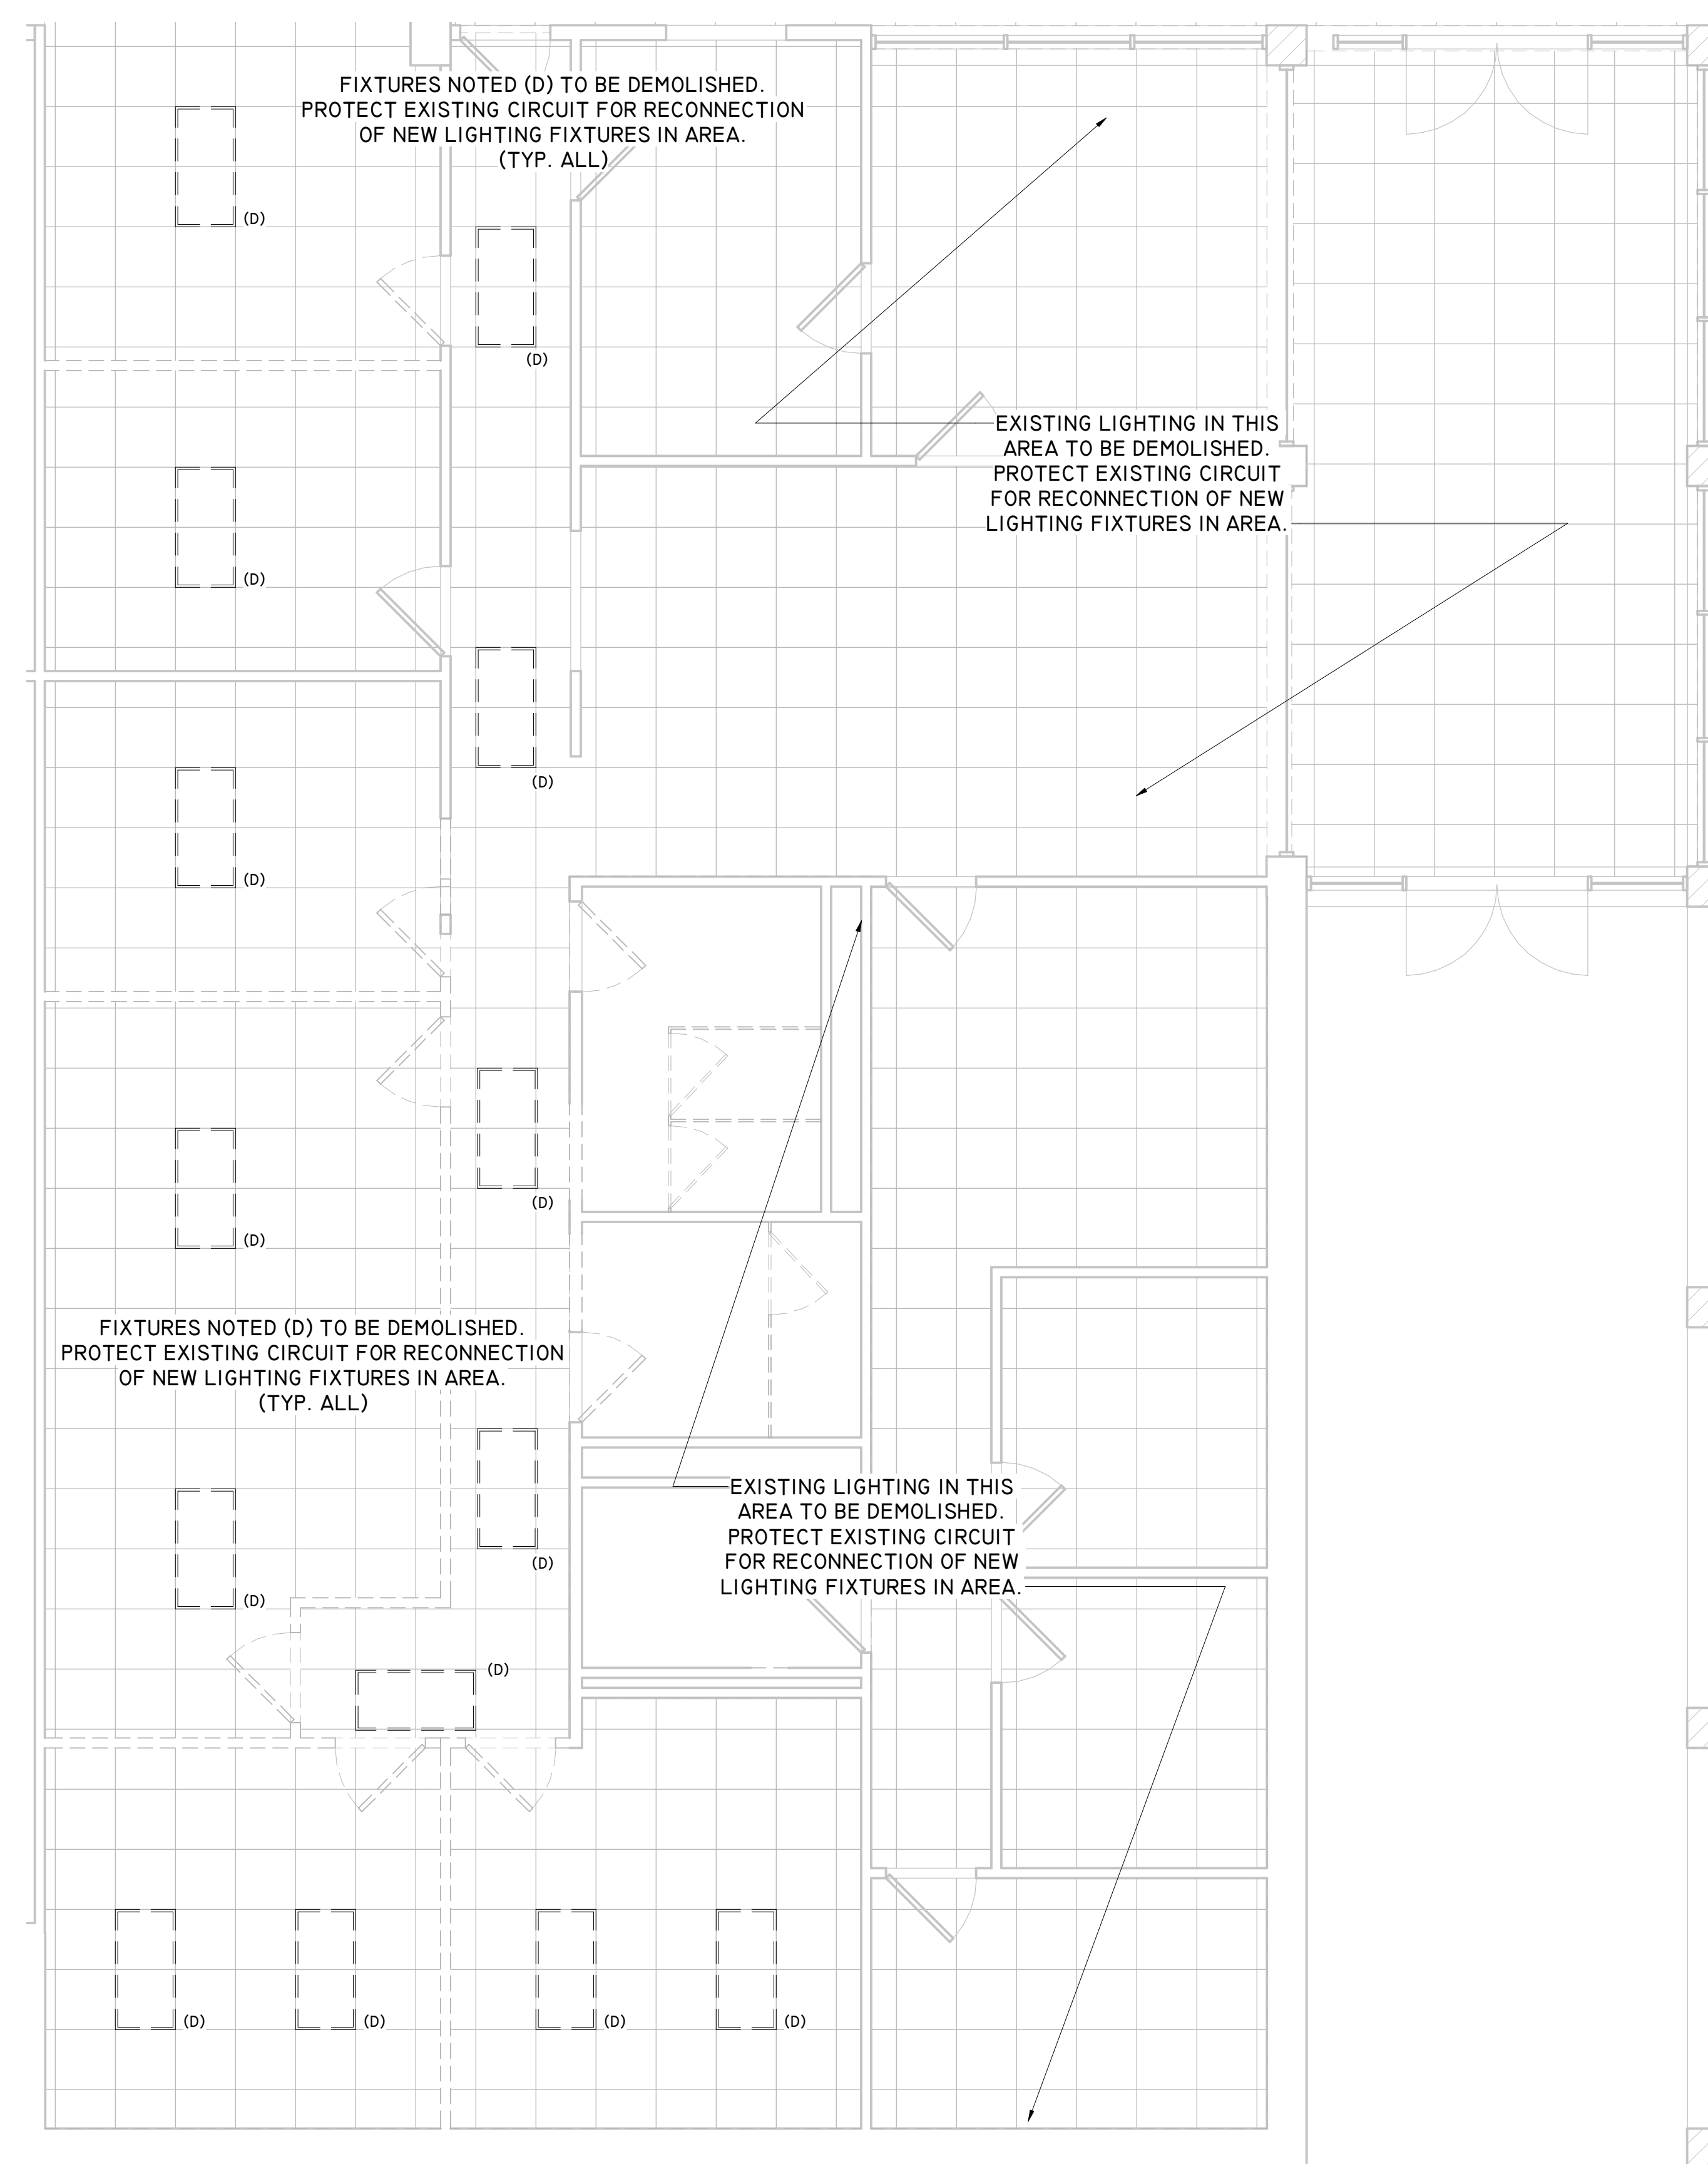
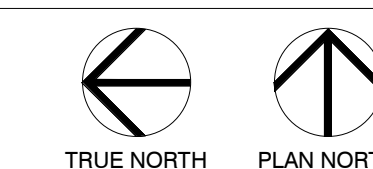
**STAFFORD
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KEY PLAN



1 ENLARGED DEMOLITION PLAN - AREA B5 - LIGHTING
Scale: 1/4" = 1'-0"

Project Number	19006-A
Drawn By	LT
Checked By	AW
Approved By	MS

Drawing Title
**ENLARGED DEMOLITION
PLANS - LIGHTING**

Drawing Number
E1.12



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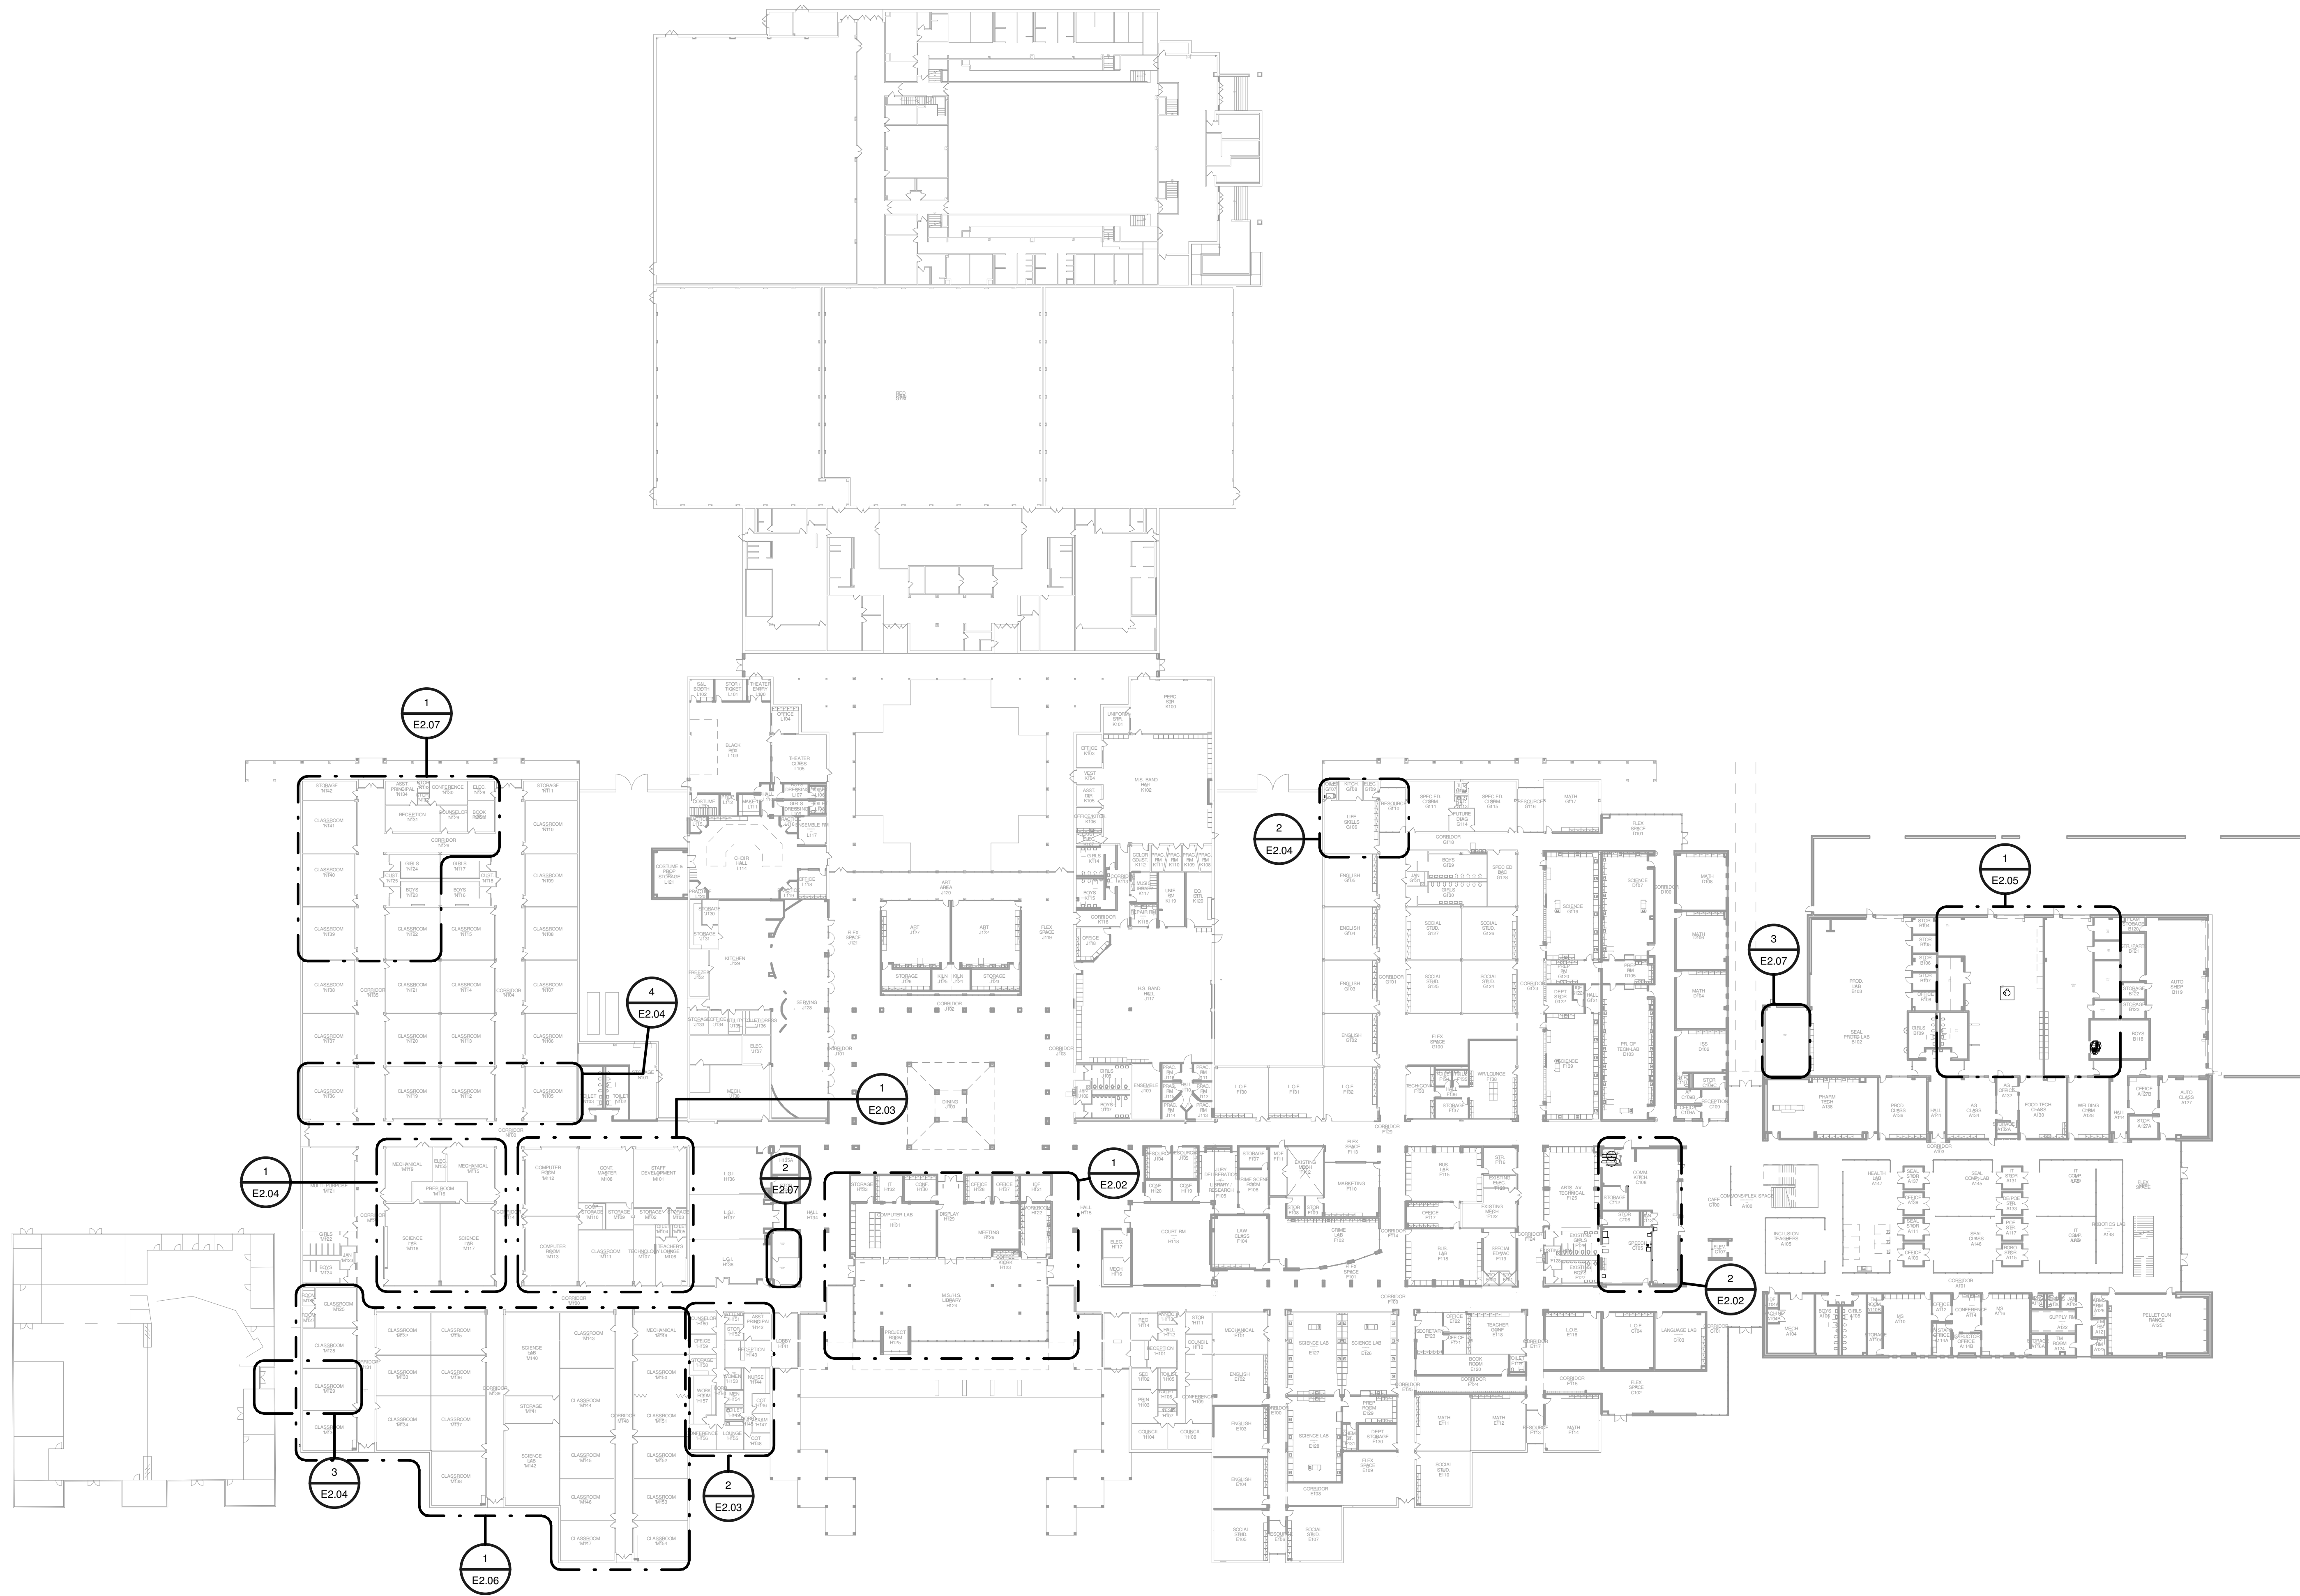


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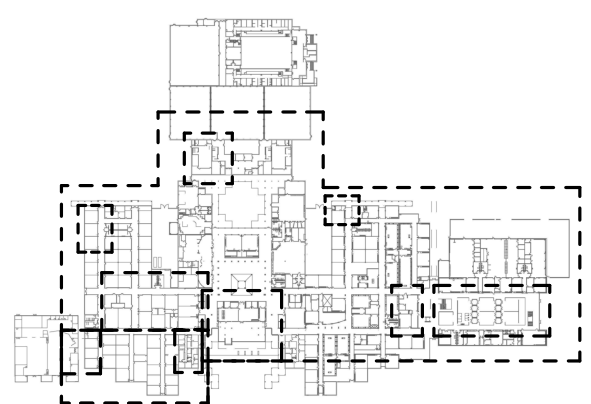
**STAFFORD
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1 FLOOR PLAN - LEVEL 1 - POWER
Scale: 1" = 40'-0"



Project Number	19006-A
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**OVERALL PROPOSED
PLAN - POWER**

Drawing Number **E2.01**



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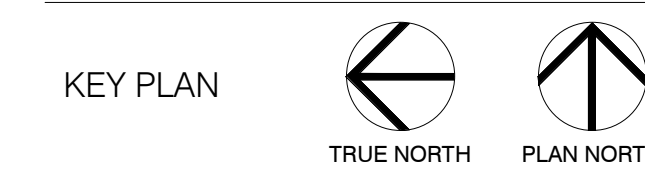
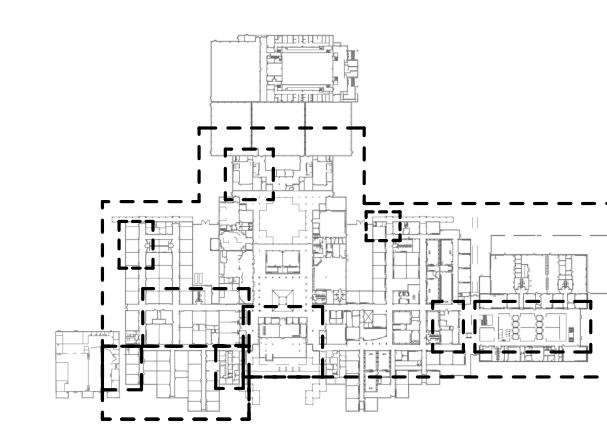


A PROJECT FOR:

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Project Number	19006-A
Drawn By	LT
Checked By	AW
Approved By	MS
Drawing Title	ENLARGED PROPOSED PLAN - POWER
Drawing Number	E2.02

ELECTRICAL GENERAL KITCHEN NOTES:

- DO NOT ROUGH-IN FROM THIS DRAWING. REFER TO THE CONTRACTOR'S DIMENSIONED DRAWINGS.
- VERIFY ALL ELECTRICAL CHARACTERISTICS WITH ARCHITECT'S ENGINEERING DRAWINGS.
- DIMENSIONS INDICATED ARE TO BE VERIFIED BY CONTRACTOR AND ADJUSTED AS REQUIRED BY FOODSERVICE EQUIPMENT AND/OR FIELD CONDITIONS.
- ACCESSORIES AND FITTINGS PROVIDED LOOSE WITH FOODSERVICE EQUIPMENT BY SECTION II 40 00. FIELD INSTALLED BY DIVISION 26.
- STAINLESS STEEL DISCONNECT SWITCH PROVIDED AND INSTALLED BY DIVISION 26.
- ALL ELECTRICAL CONNECTIONS BENEATH EXHAUST HOOD TO EXTEND TO SHUNT TRIP BREAKERS WITHIN ELECTRICAL PANEL BOX FOR SHUT-DOWN DURING FIRE MODE - BY DIVISION 26.
- DOOR HEATER(S) LIGHT(S) AND PRESSURE RELIEF PORT(S) PRE-WIRED TO JUNCTION BOX AT TOP OF COLD STORAGE ASSEMBLY BY SECTION II 40 00. FINAL CONNECTION BY DIVISION 26.
- (7) WIRES AND CONDUIT FROM CONDENSOR JUNCTION BOX AT COLD STORAGE REFRIGERATION RACK TO EVAPORATOR COIL JUNCTION BOX BY DIVISION 26.
- INTERCONNECT TO EXHAUST HOOD FAN(S) AND SWITCH BY DIVISION 26.
- INTERCONNECT TO EXHAUST HOOD LIGHT(S) AND SWITCH BY DIVISION 26.
- INTERCONNECT FIRE PROTECTION SYSTEM TO PANEL BOX SHUNT TRIP(S) AND BUILDING ALARM - BY DIVISION 26.
- RECEPTACLE(S) TO BE PRE-WIRED TO JUNCTION BOX OR LOAD CENTER FOR FINAL CONNECTION BY DIVISION 26.
- SECTION II 40 00 TO VERIFY UTILITY REQUIREMENTS OF EXISTING EQUIPMENT.
- EMPTY CONDUIT RUN FROM CASHIER STATION TO MANAGERS OFFICE FOR POS SYSTEM BY DIVISION 26. LOCATION OF MANAGERS OFFICE TO BE VERIFIED.


GENERAL NOTES:

- ALL RECEPTACLE COVER PLATES IN THE KITCHEN WILL BE 302-STAINLESS STEEL.
- ALL CONVENIENCE RECEPTACLES WILL BE GFI TYPE.
- THE ELECTRICAL CONTRACTOR WILL COORDINATE WITH THE KITCHEN CONSULTANT PLANS FOR FURTHER REQUIREMENTS AND CLARIFICATIONS. THE GENERAL CONTRACTOR MUST NOTIFY THE ARCHITECT/ENGINEER OF ANY CONFLICTS WHICH MAY ARISE BEFORE ANY WORK OR ROUGH-INS ARE MADE.


FIRE ALARM:

IT IS THE FIRE ALARM CONTRACTORS RESPONSIBILITY TO ENSURE THAT THE HOOD EQUIPMENT FIRE EXTINGUISHING SYSTEM (ANSUL SYSTEM) IS INTERCONNECTED TO THE FUEL/CURRENT SUPPLY SO THAT IT AUTOMATICALLY SHUTS DOWN SUPPLY TO ALL EQUIPMENT UNDER THE HOOD AND SUPPLY FANS FOR THE HOOD WHEN THE SYSTEM IS ACTIVATED. SOLENOID VALVES CONTROLLING FUEL GAS SUPPLY TO UNDERHOOD EQUIPMENT AND CIRCUITS FEEDING ELECTRICAL HEATING UNDER-HOOD EQUIPMENT SHALL BE CIRCUITED THROUGH PANEL LS. SUB-FED BY A SHUNT-TRIP BREAKER. REFER TO THE UNIFORM MECHANICAL CODE SECTION 510.2.4.2, NEC AND NFPA FOR APPLICABLE REQUIREMENTS. THE ELECTRICAL CONTRACTOR IS RESPONSIBLE FOR COORDINATION WITH THE FIRE ALARM CONTRACTOR AND INSTALLATION OF SHUNT TRIPS AND ANY NECESSARY APPARATUS FOR THE AUTOMATIC SHUTDOWN OF THE KITCHEN HOOD FANS AND DEVICES UNDER THE HOOD UPON ACTIVATION OF THIS SYSTEM. COORDINATE THIS WORK WITH THE FOOD SERVICE CONSULTANT.

KEYNOTE LEGEND	
1	COORDINATE FOR EXACT LOCATION OF LOW VOLTAGE TRANSFORMER (LOCATE ABOVE ACCESSIBLE CEILING) WHICH WILL PROVIDE POWER TO FLUSH VALVES AND AUTO SENSORS.
2	REPLACE DEVICE WITH GFCI DUPLEX WITH SS-302 COVERPLATE.
3	PROVIDE CORD REELS WITH 4-SOCKET NEMA 5-15R OUTLETS TO REACH UPPER SURFACE OF TABLE.
4	RELOCATE EXISTING WATER HEATER TO NEW LOCATION. RECONNECT WATER HEATER TO EXISTING CIRCUIT. MATCH AND EXTEND FEEDER AS REQUIRED. UTILIZE EXISTING DISCONNECTING MEANS.

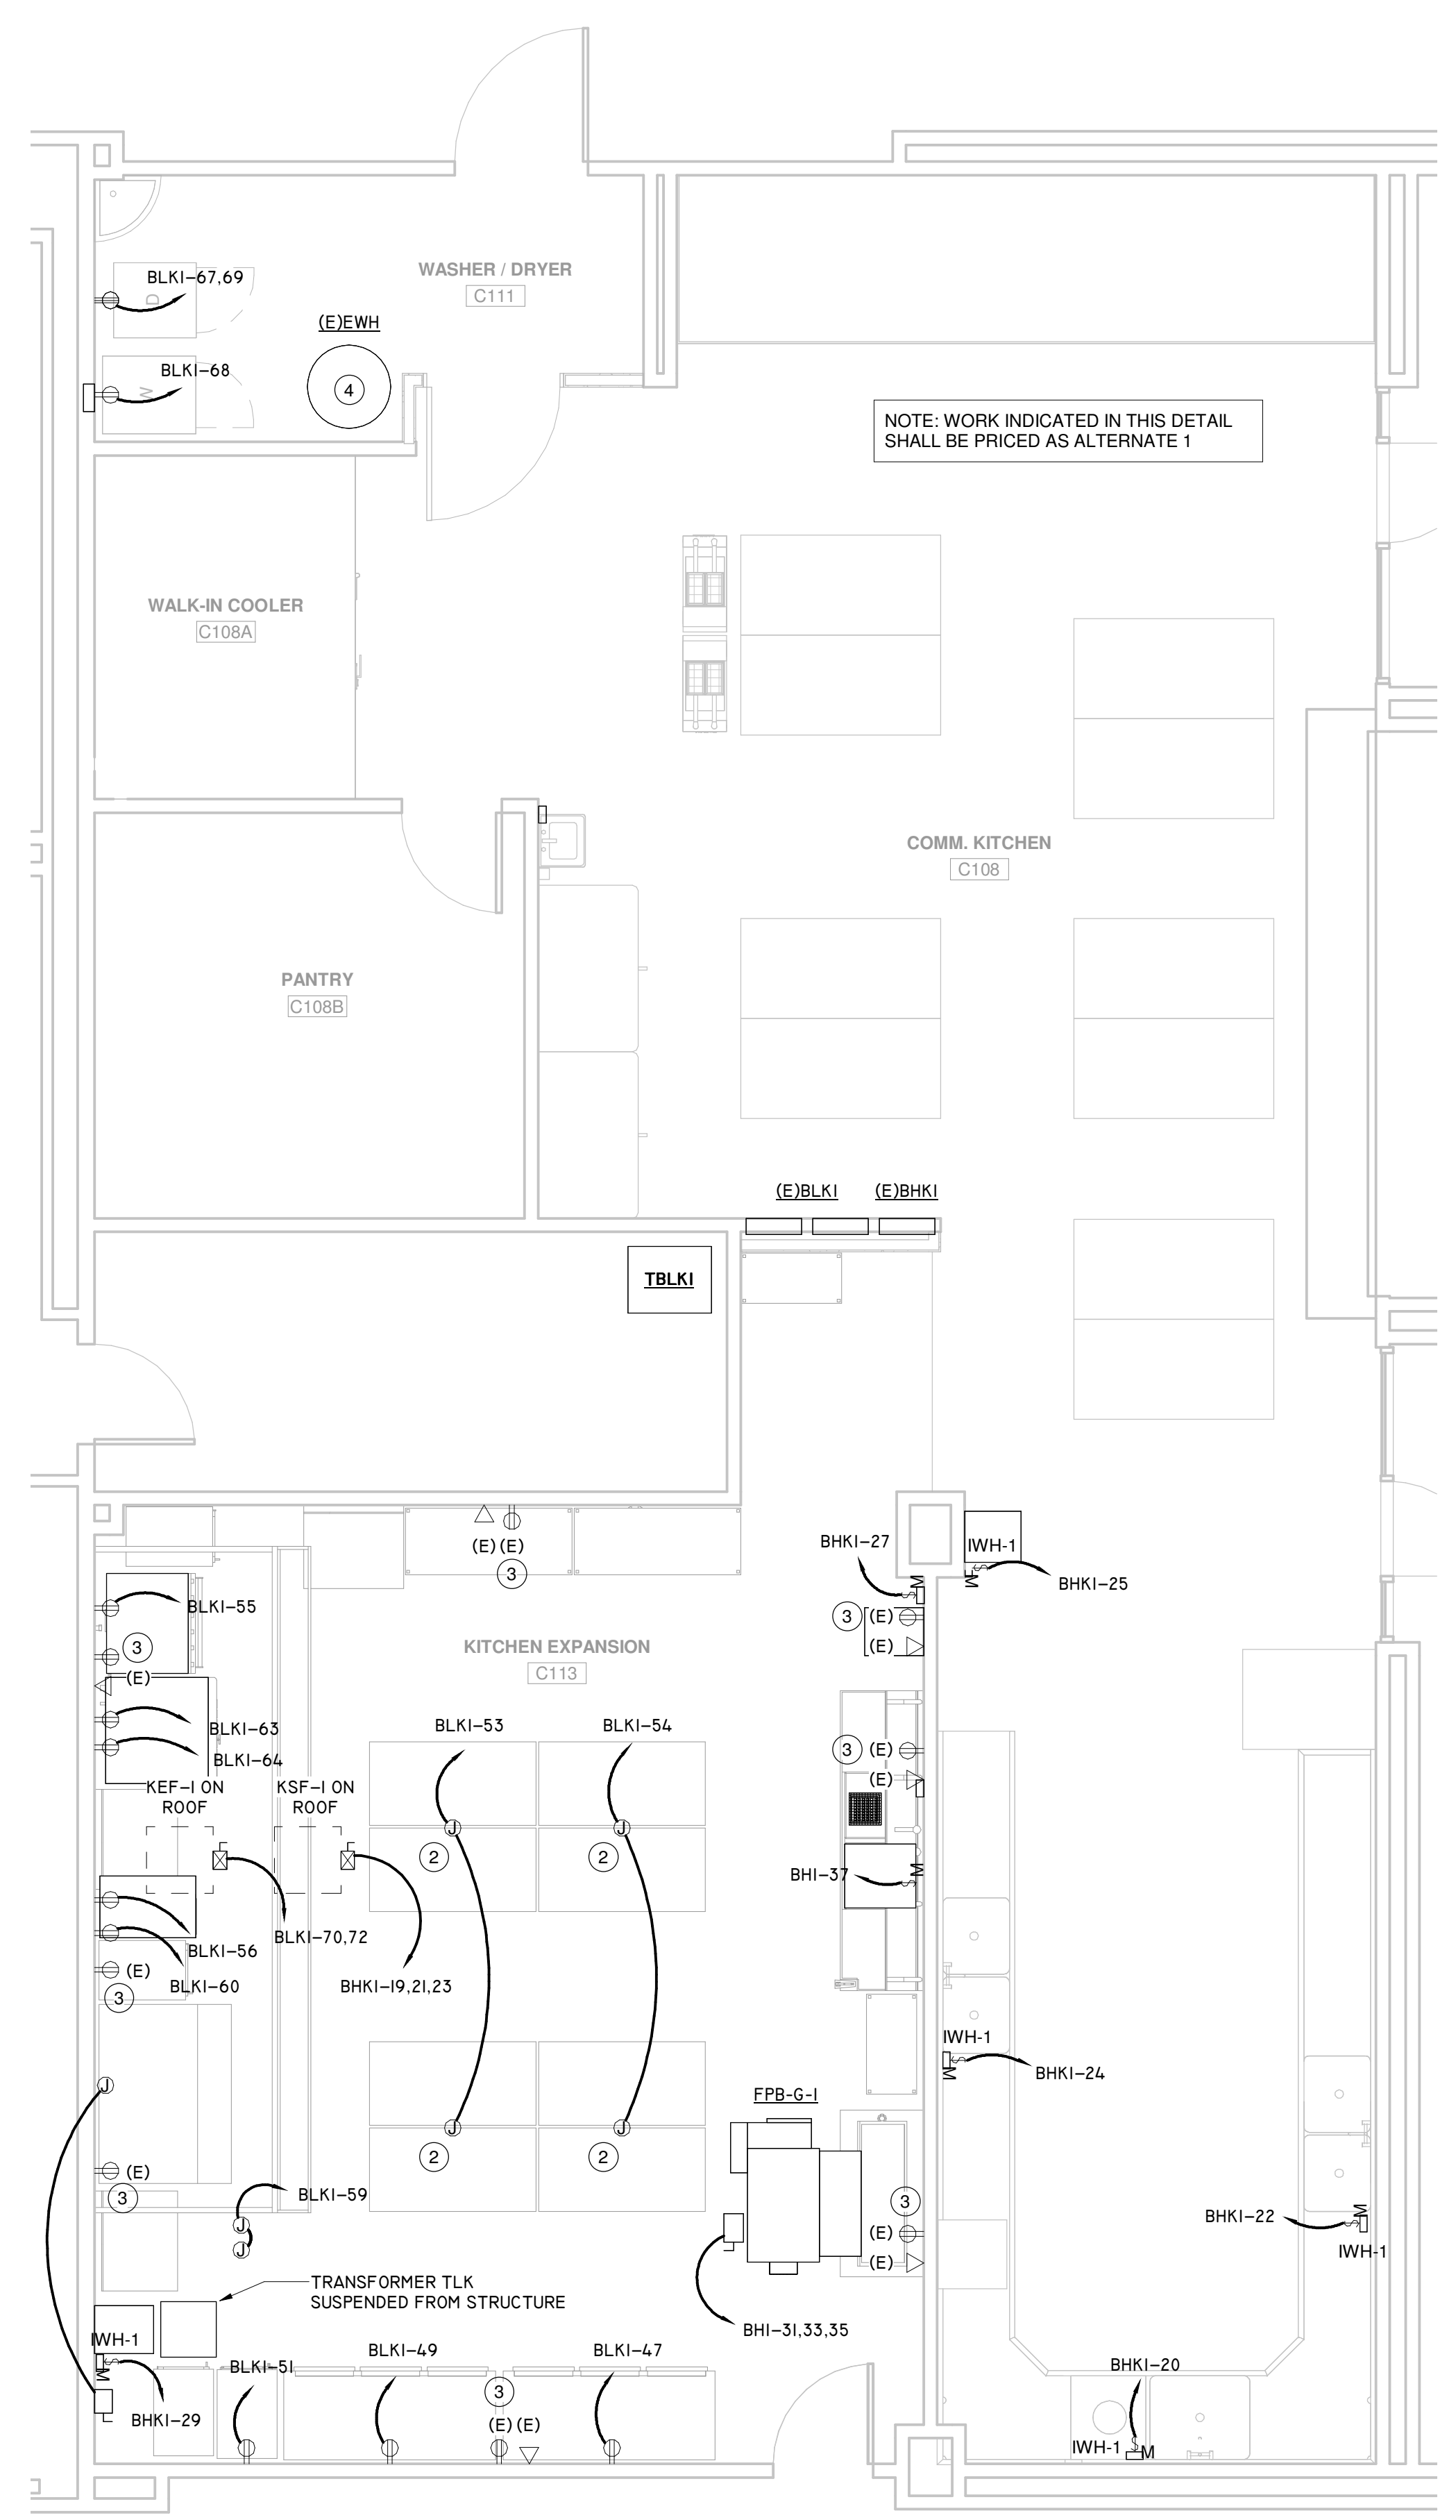

2 ENLARGED PROPOSED PLAN - AREA G - POWER
Scale: 3/16" = 1'-0"

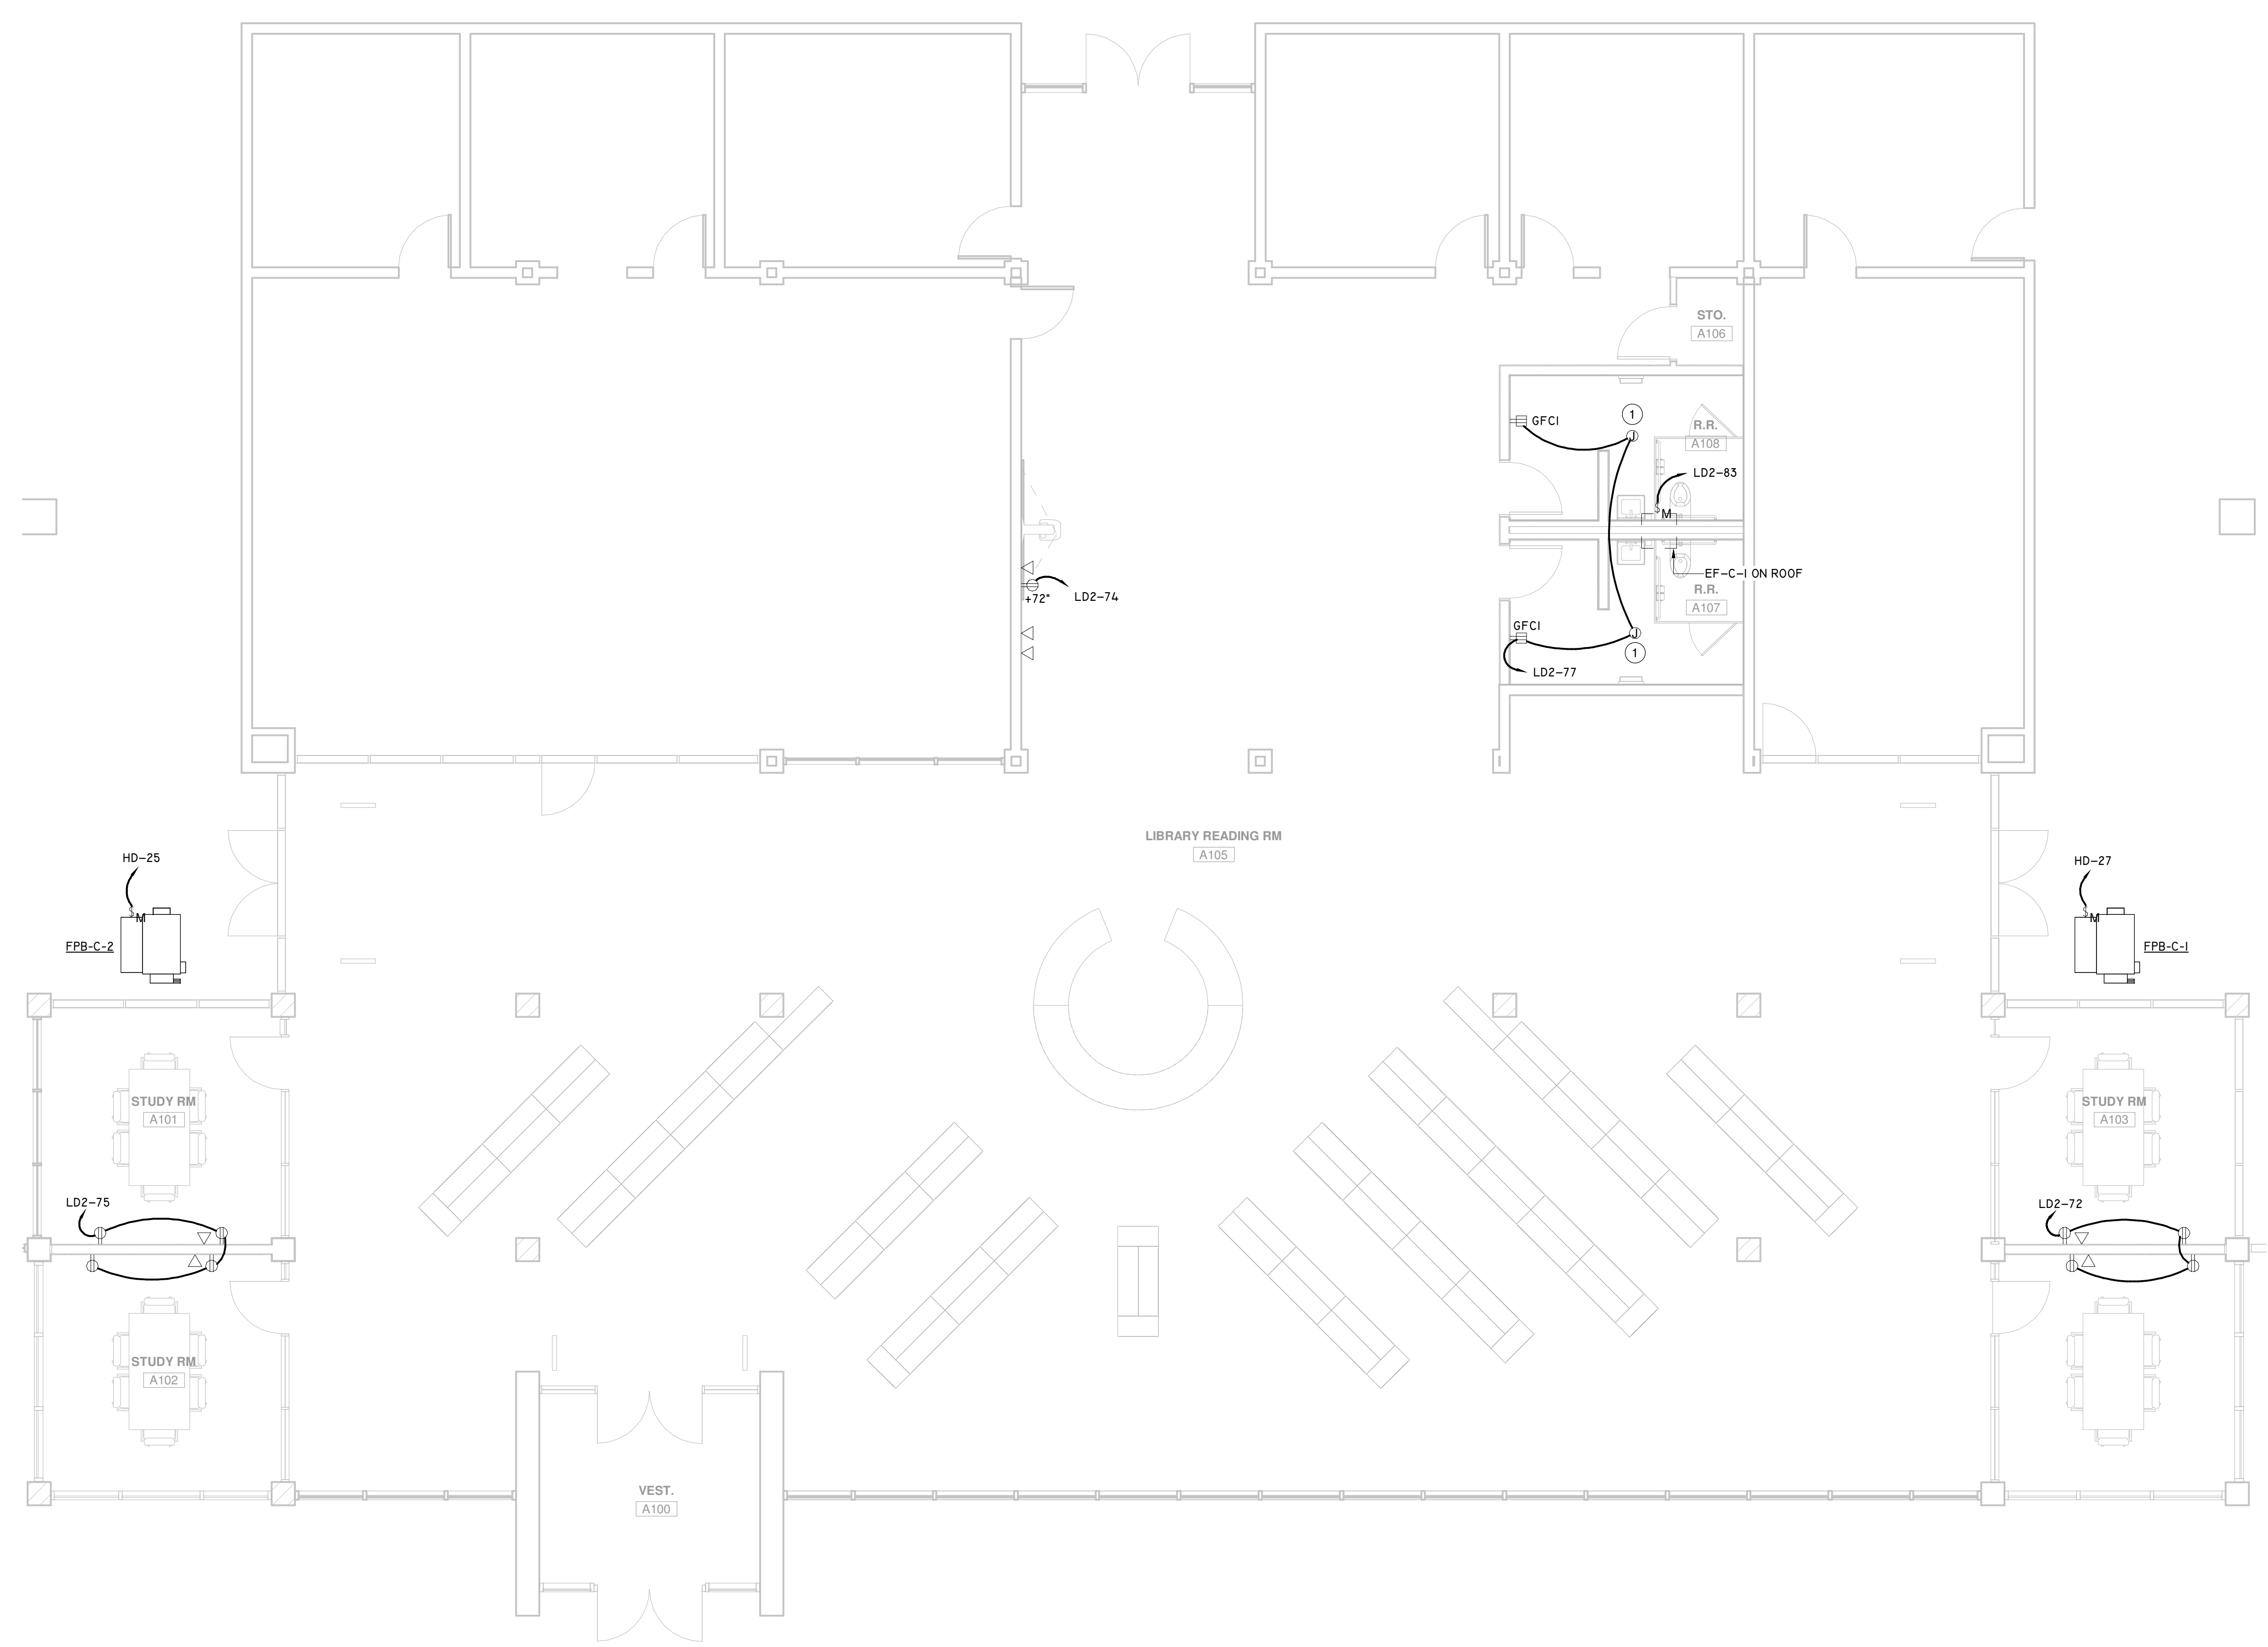

1 ENLARGED PROPOSED PLAN - AREA C - POWER
Scale: 3/16" = 1'-0"



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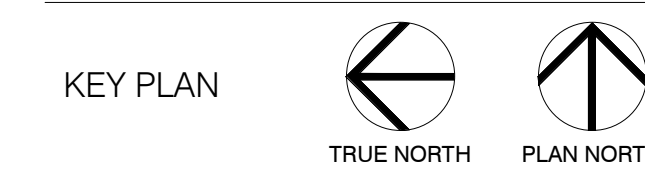
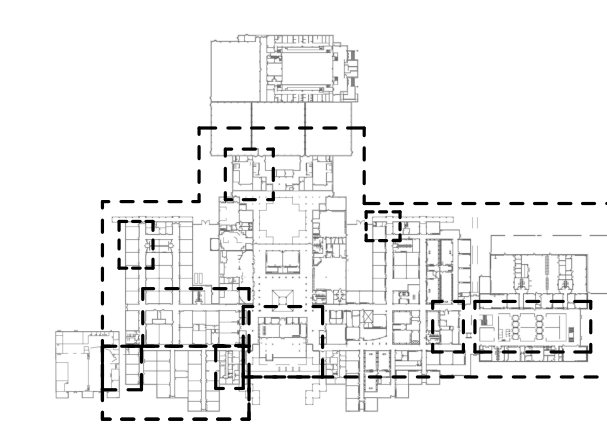
03/13/2020

A PROJECT FOR:

**STAFFORD
HIGH SCHOOL
& MAGNET
SCHOOL
RENOVATIONS**

1625 STAFFORDSHIRE
ROAD,
STAFFORD, TX 77477

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Checked By	AW
Approved By	MS

Drawing Title
**ENLARGED PROPOSED
PLAN - POWER**


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E2.03

KEYNOTE LEGEND


1	REPLACE DEVICE WITH GFCI DUPLEX WITH SS-302 COVERPLATE.
2	RECONNECT DRINKING FOUNTAIN TO EXISTING CIRCUIT. VERIFY BREAKER SERVING DRINKING FOUNTAIN IS GFCI TYPE.

ELECTRICAL GENERAL NOTES:

- ALL NEW RECEPTACLES IN THIS FACILITY ARE TO BE TAMPER-RESISTANT PER 2017 NEC SECTION 406.12.
- ALL CLASSROOM POWER, DATA, AND COMMUNICATION OUTLET LAYOUTS AND ELEVATIONS ARE TO BE COORDINATED WITH ARCHITECTURAL MILLWORK AND FURNITURE PLANS PRIOR TO ROUGH-IN.
- AT ALL CARD READER LOCATIONS, CONTRACTOR SHALL PROVIDE 1/2 INCH CONDUIT STUBBED OUT OF THE WALL. FLUSH WITH THE WALL SURFACE. ROUTE CONDUIT BACK TO THE NEAREST MFD/IDF ROOM.
- ALL RECEPTACLES SERVING ELECTRIC DRINKING FOUNTAINS SHALL BE CONNECTED TO A GFCI BREAKER IN PANEL ASSOCIATED WITH CIRCUIT.
- ALL RECEPTACLES MOUNTED ABOVE COUNTERTOPS AND WITHIN 6 FEET OF A WATER SOURCE OR BASIN SHALL BE GFCI TYPE.
- PROVIDE A 120V AND 208V OUTLET FOR ALL COMMERCIAL COPIERS. COORDINATE EXACT DEVICE TYPE WITH OWNER PRIOR TO PULLING BRANCH CIRCUIT WIRING.
- ELECTRICAL CONTRACTOR SHALL PROVIDE CONDUIT, OUTLET BOXES, JUNCTION BOXES, AND PULLSTRING FOR ALL TELEPHONE, DATA, CATV, SECURITY AND CAMERA OUTLETS. ALL OUTLET BOXES FOR IT/AV DEVICES SHALL COMPLY WITH SM55 IT STANDARDS.
- ELECTRICAL CONTRACTOR SHALL VERIFY DEVICE AND EQUIPMENT LOCATIONS WITH ARCHITECT PRIOR TO ROUGH-IN.

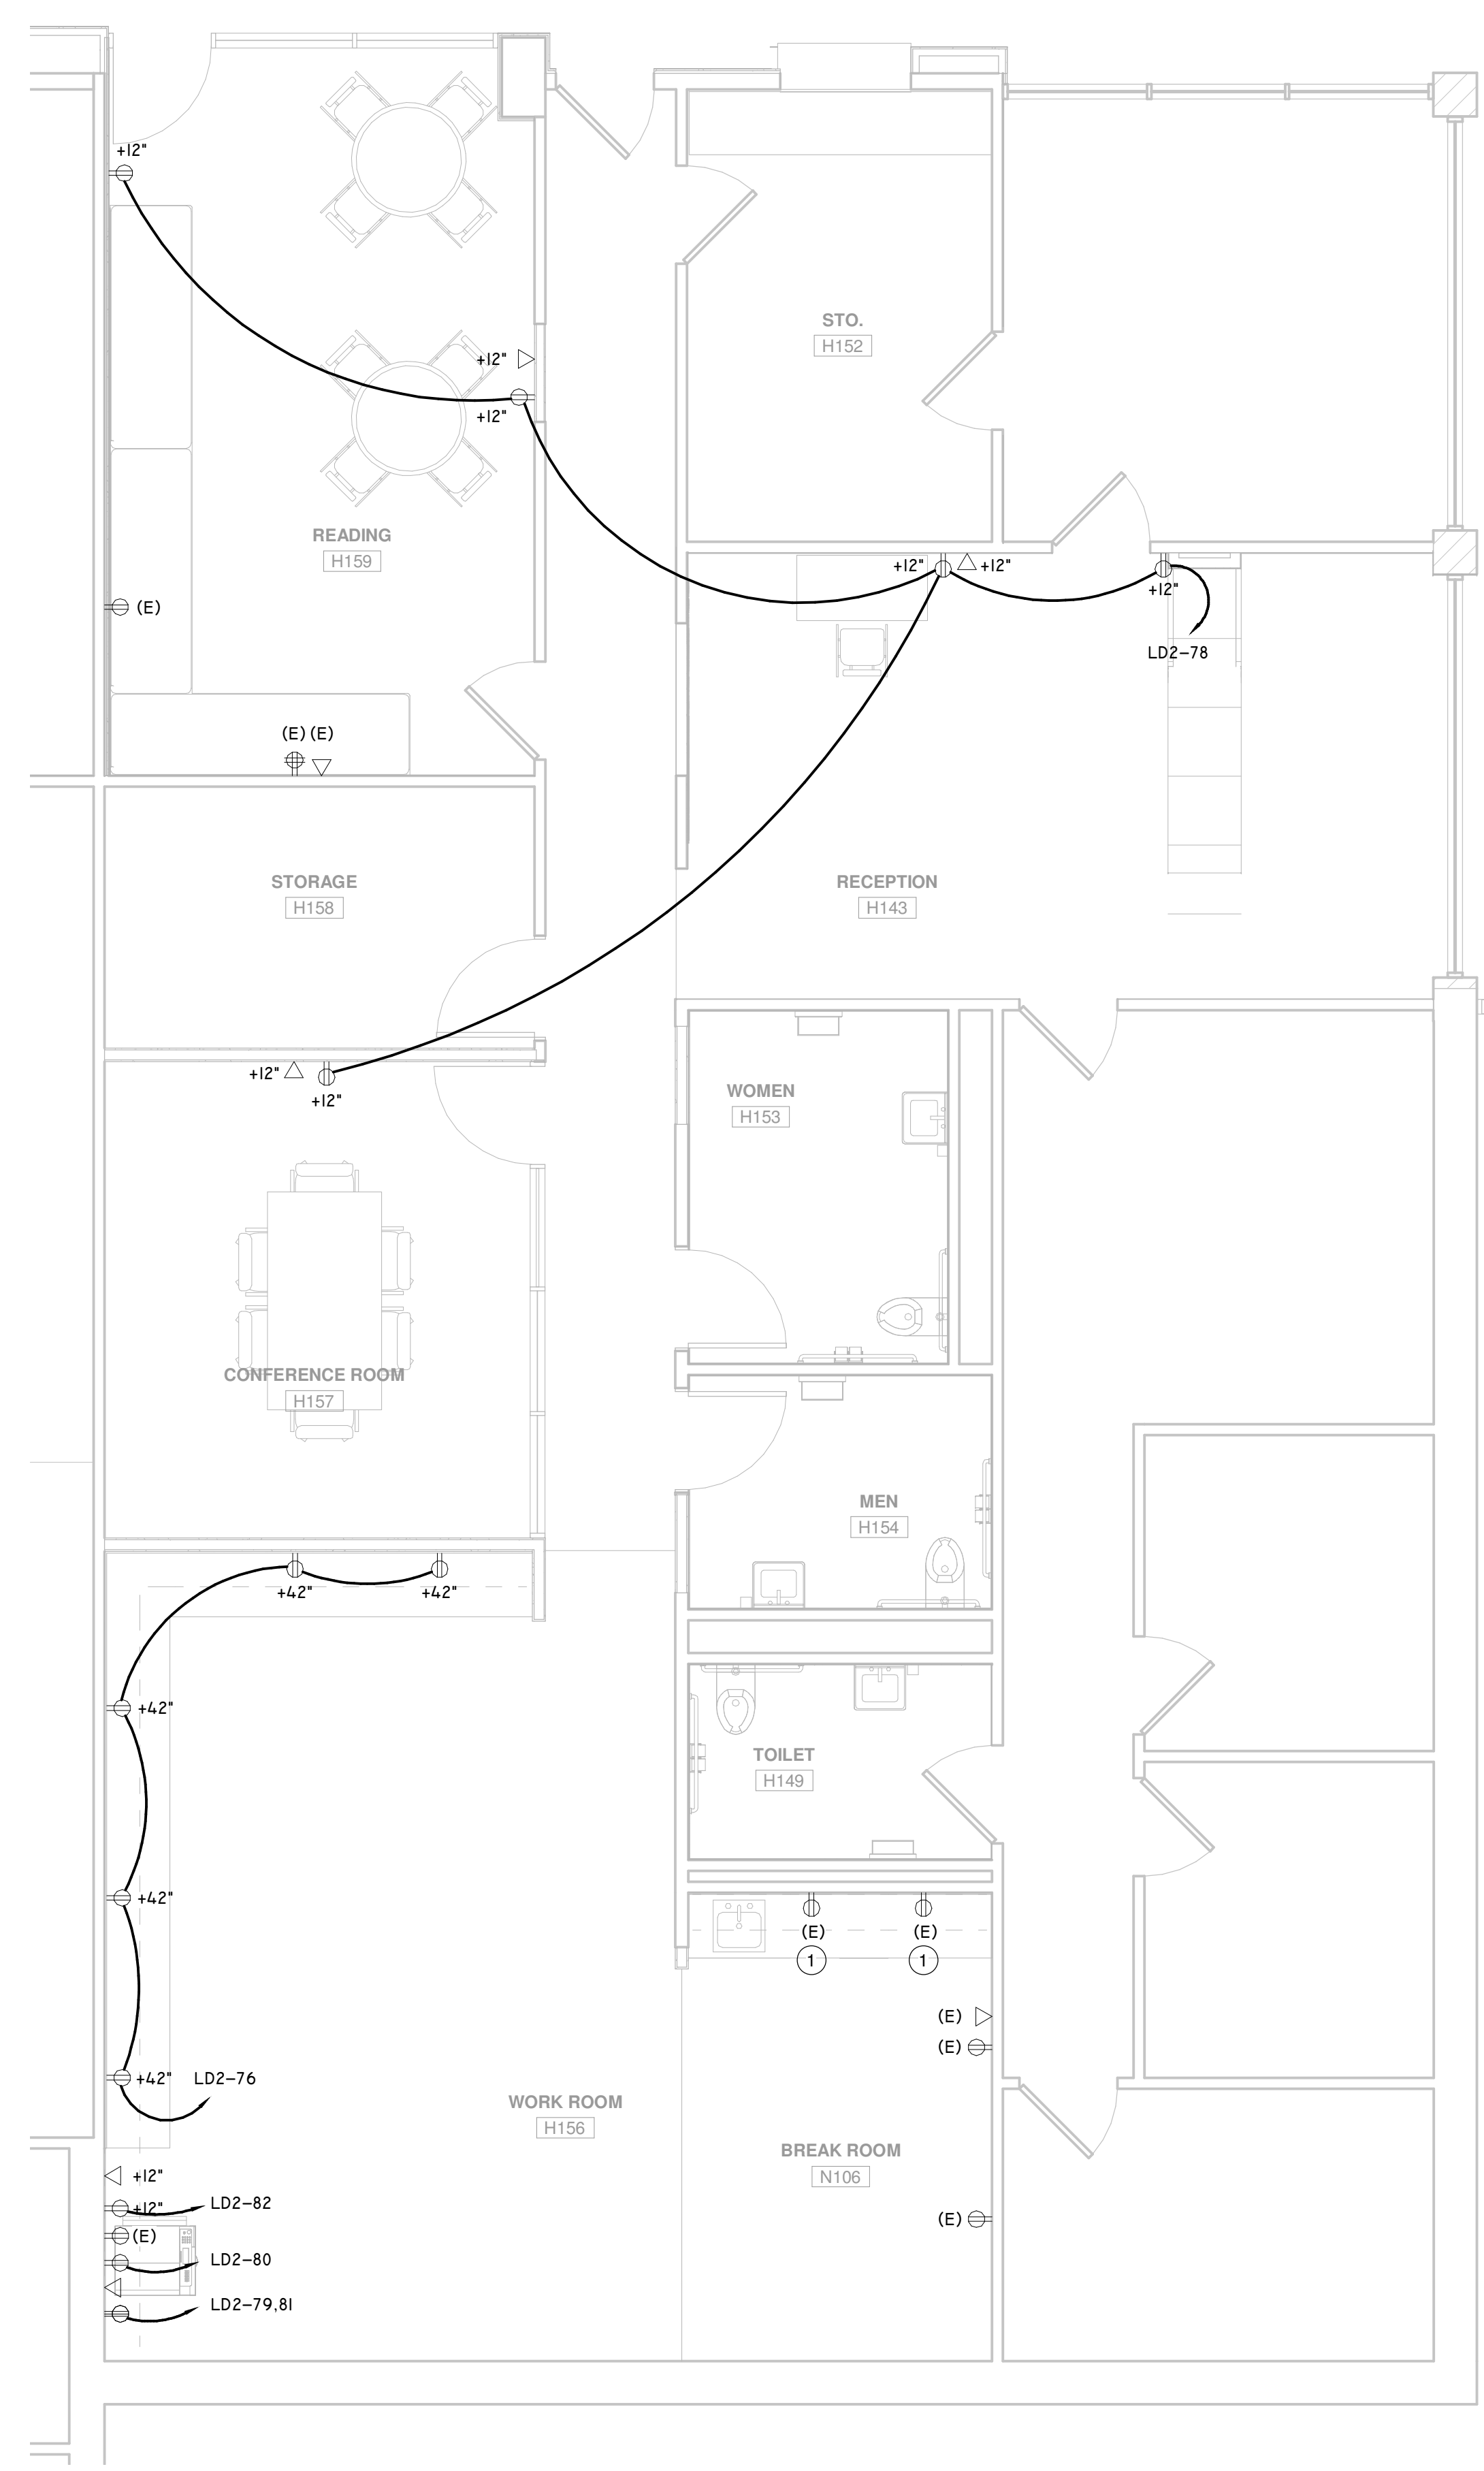

2 ENLARGED PROPOSED PLAN - AREA B5 - POWER
Scale: 1/4" = 1'-0"

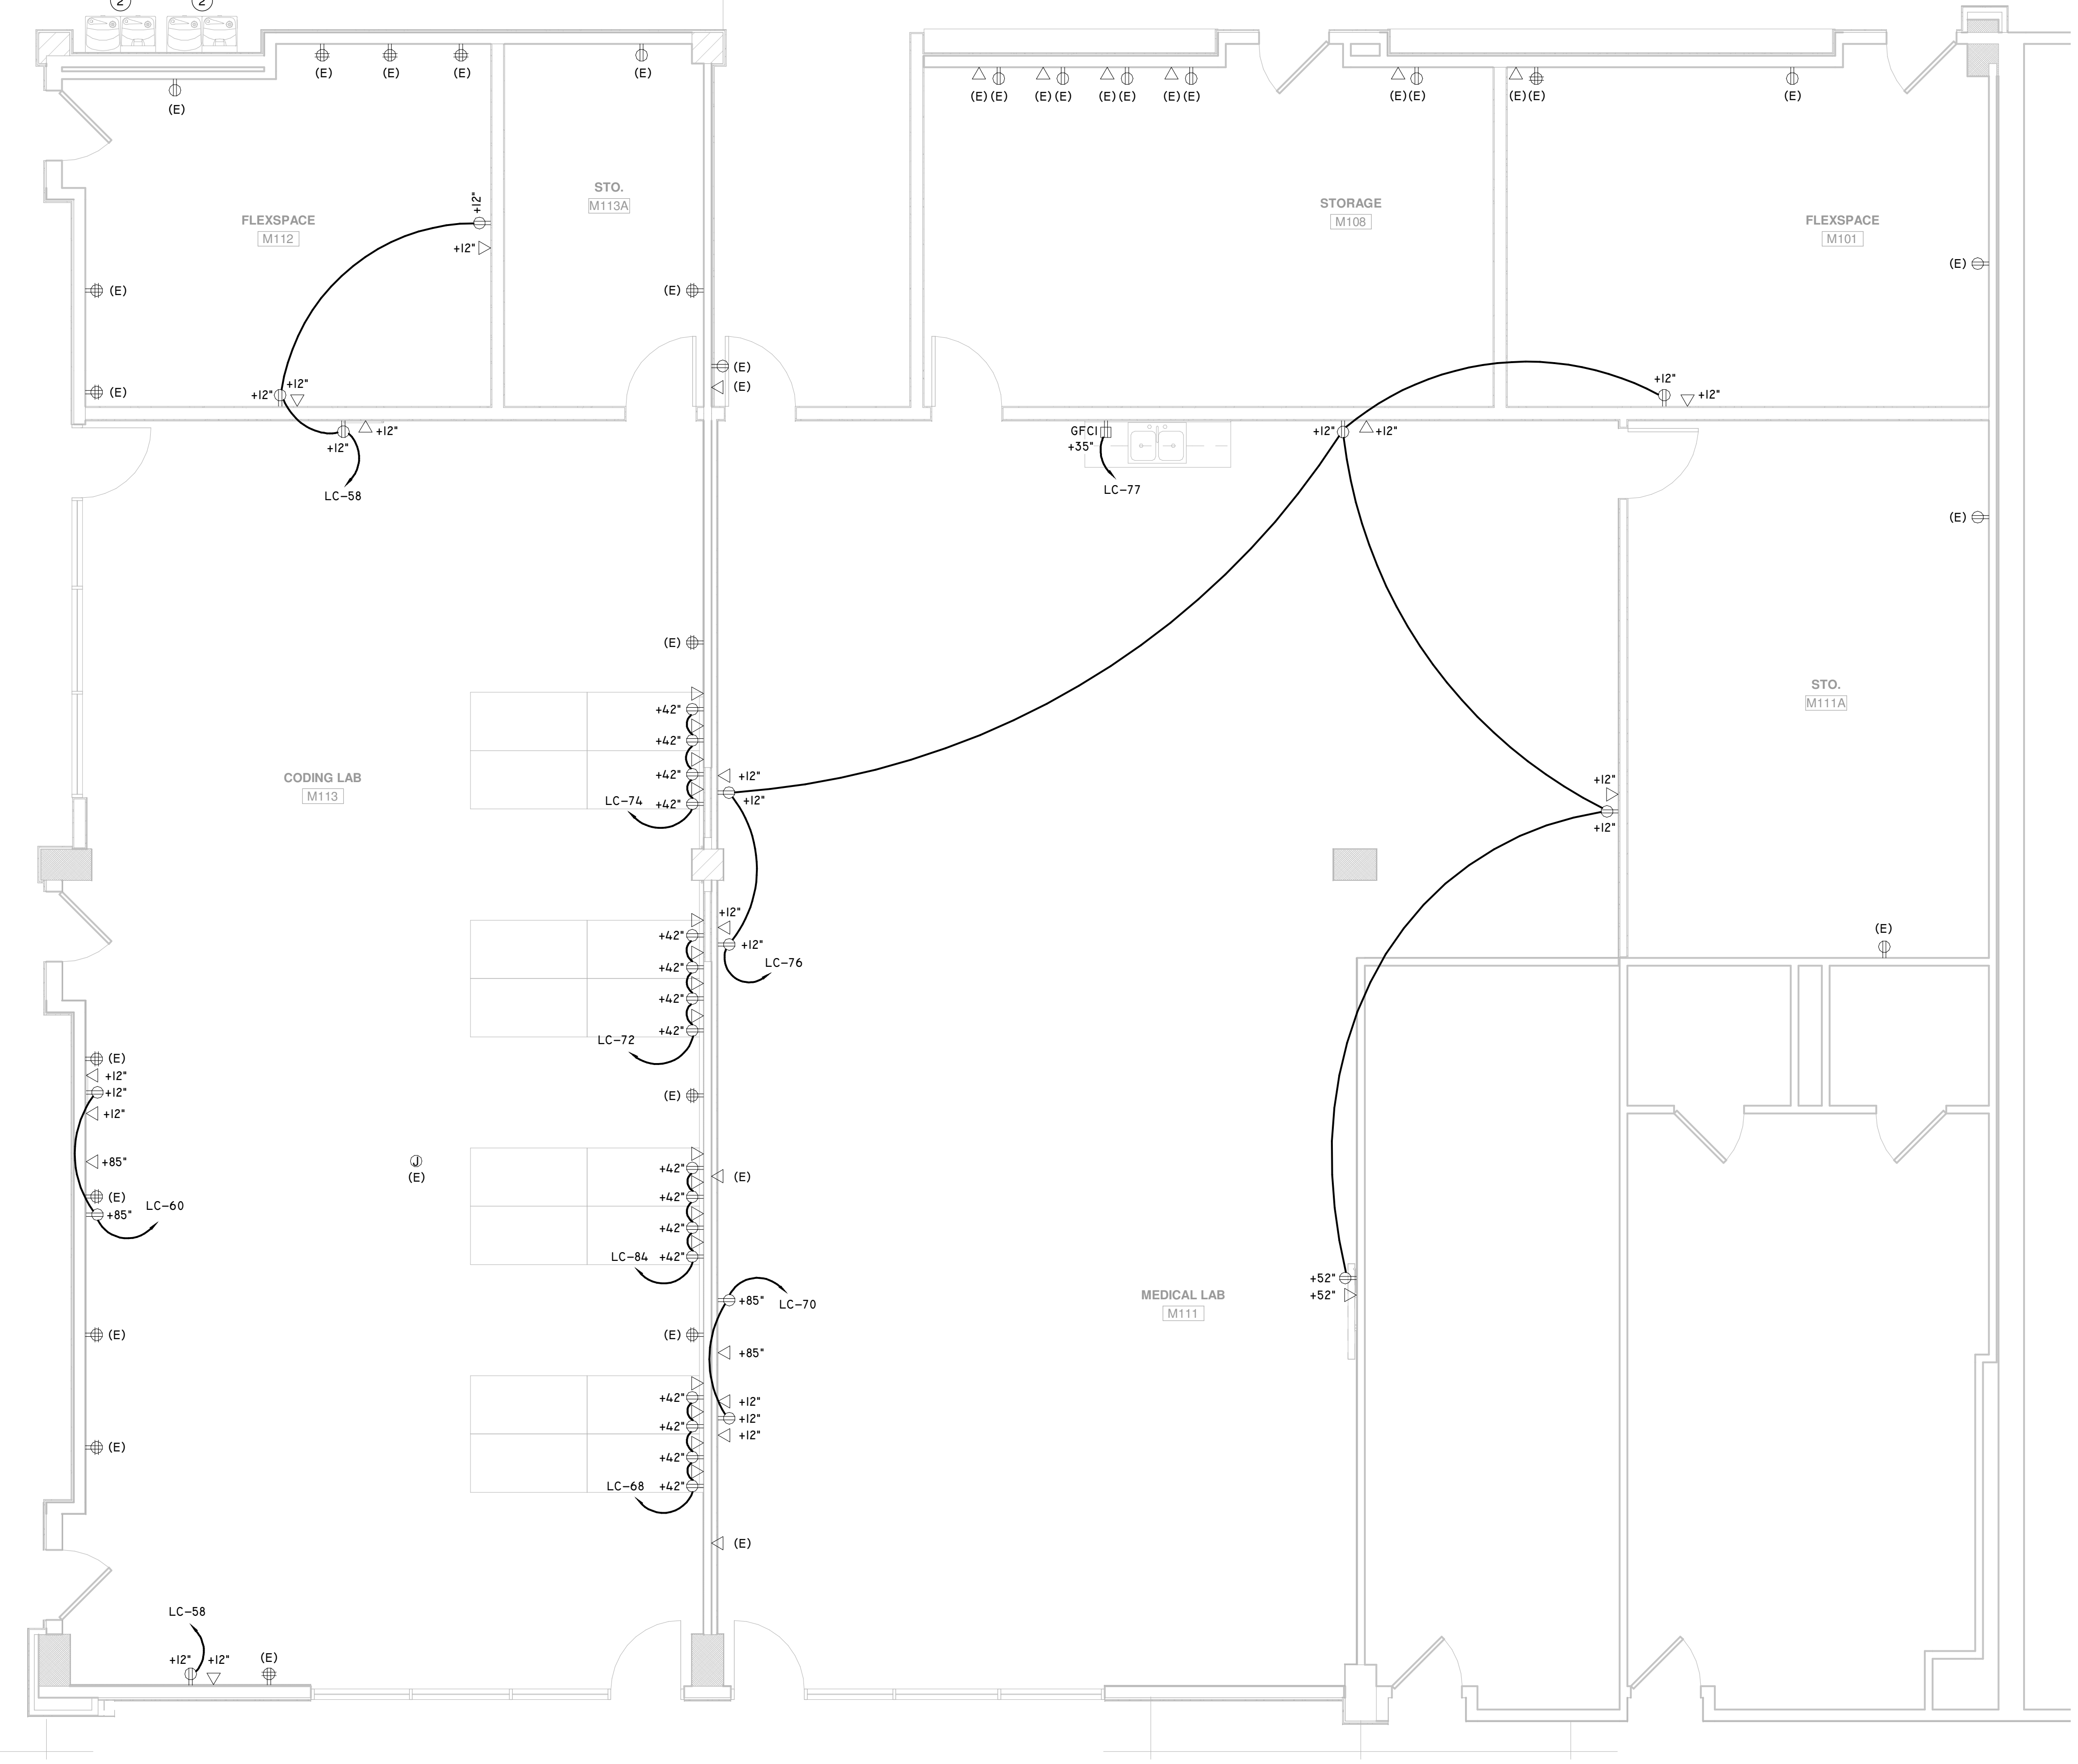

1 ENLARGED PROPOSED PLAN - AREA B3 - POWER
Scale: 1/4" = 1'-0"



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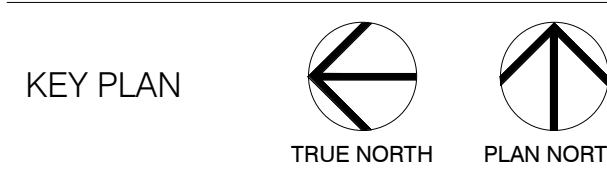
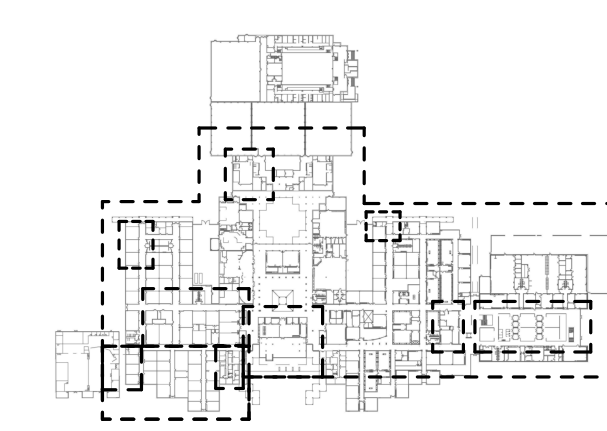
03/13/2020

A PROJECT FOR:

**STAFFORD
HIGH SCHOOL
& MAGNET
SCHOOL
RENOVATIONS**

1625 STAFFORDSHIRE
ROAD,
STAFFORD, TX 77477


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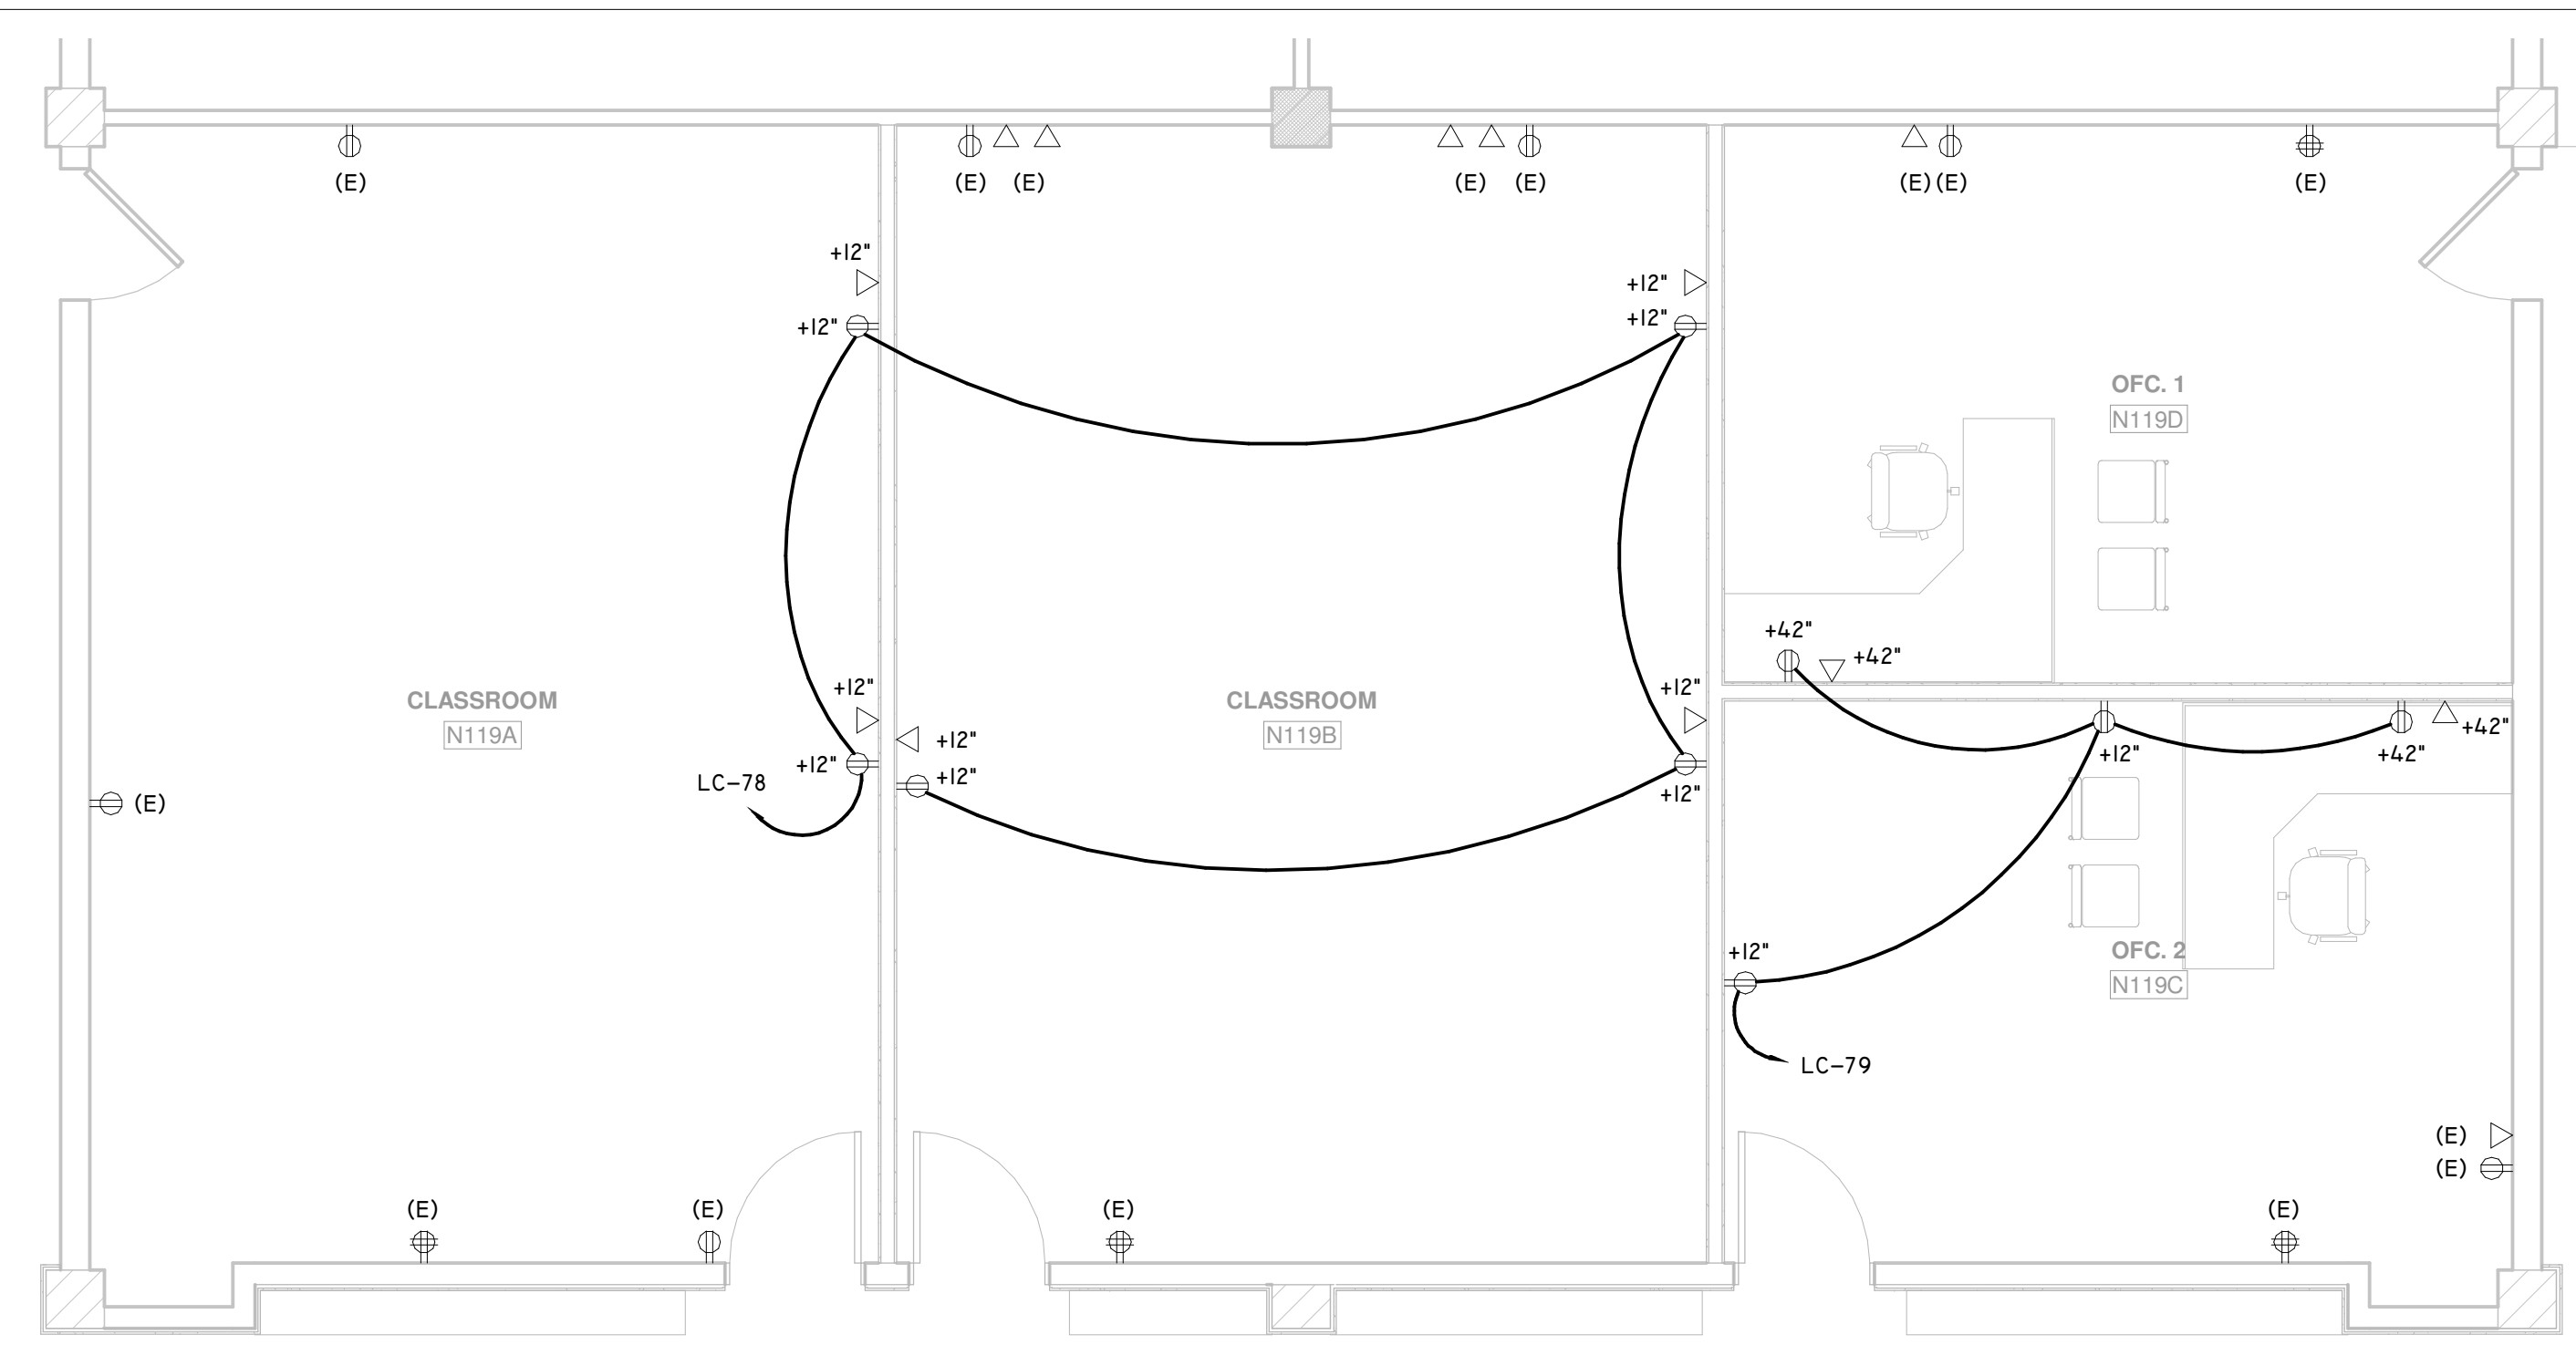
Project Number	19006-A
Drawn By	LT
Checked By	AW
Approved By	MS

Drawing Title
**ENLARGED PROPOSED
PLAN - POWER**


Drawing Number
E2.04



4 ENLARGED PROPOSED PLAN - AREA B4 - POWER
Scale: 1/4" = 1'-0"

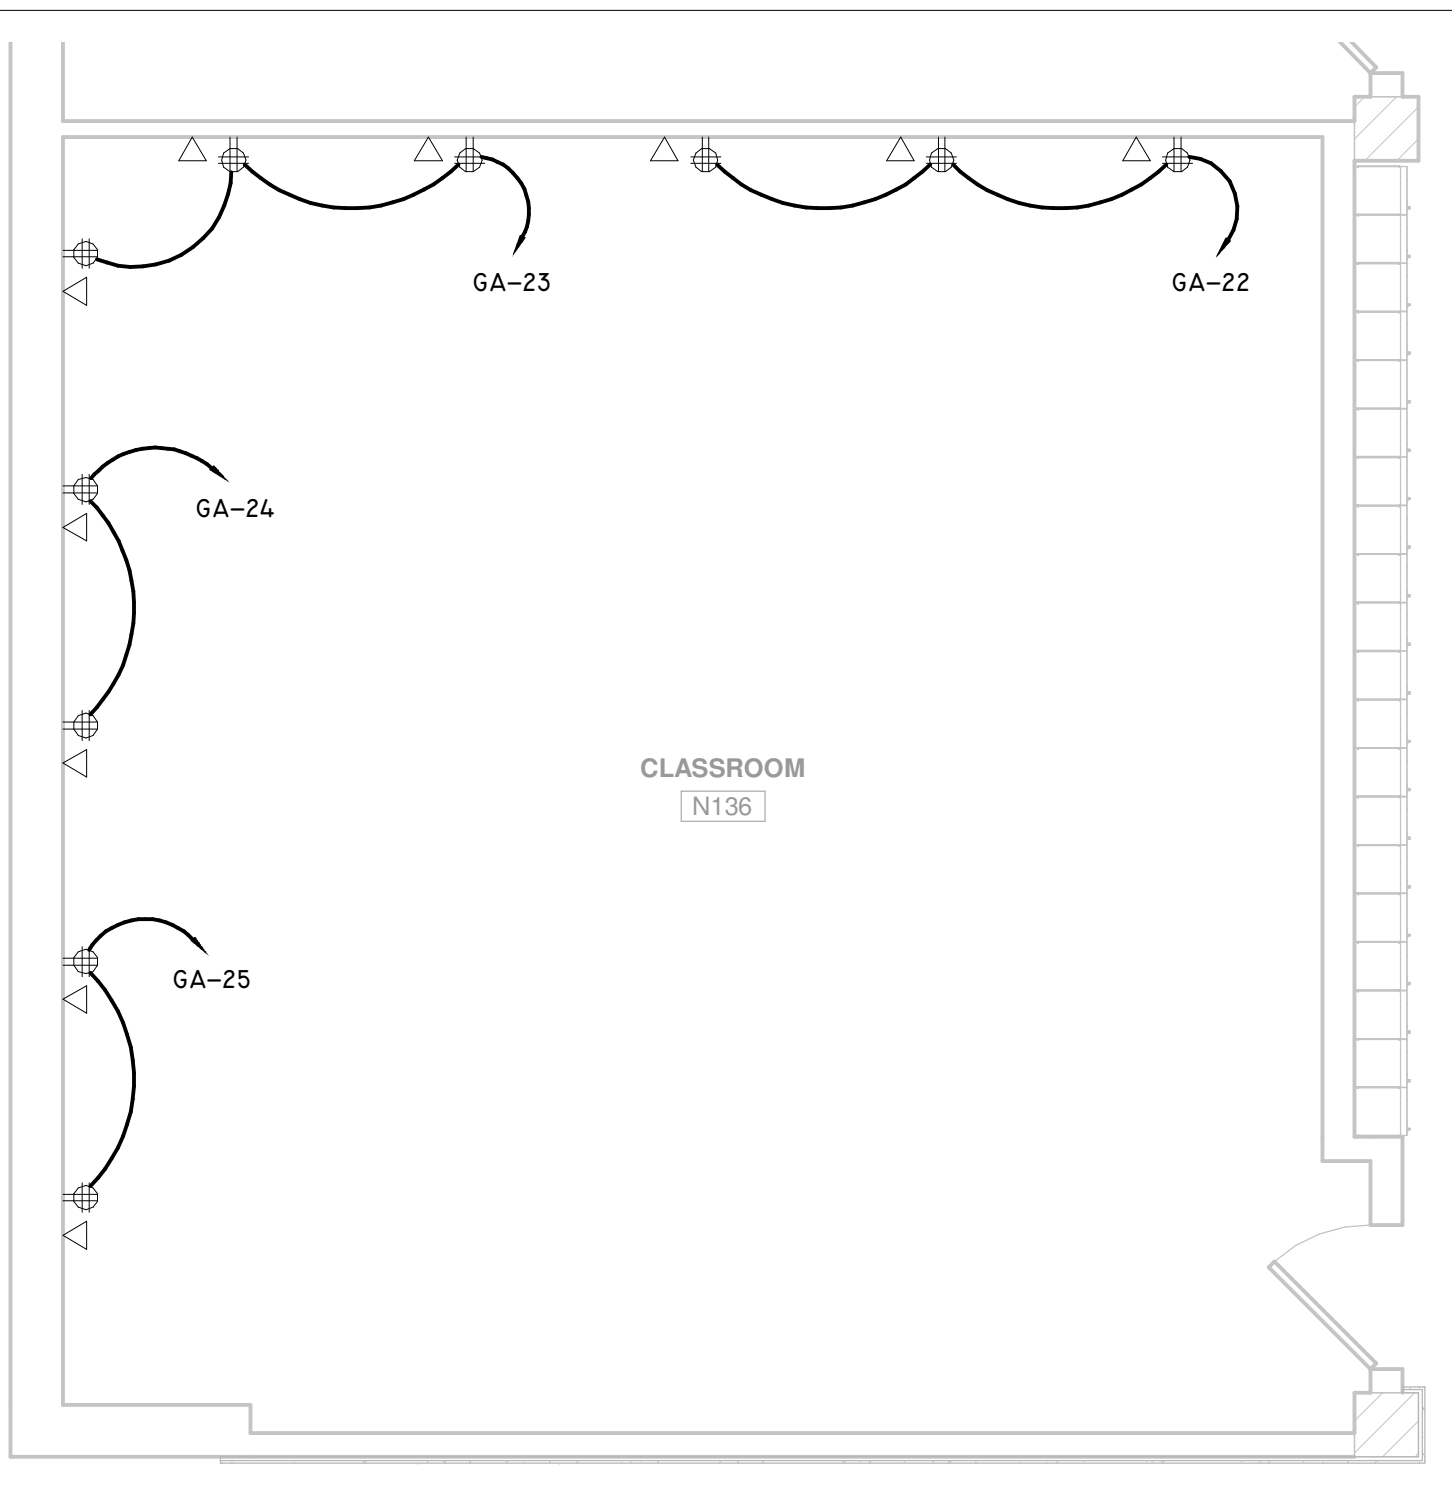

1 ENLARGED PROPOSED PLAN - AREA B2 - POWER
Scale: 1/4" = 1'-0"

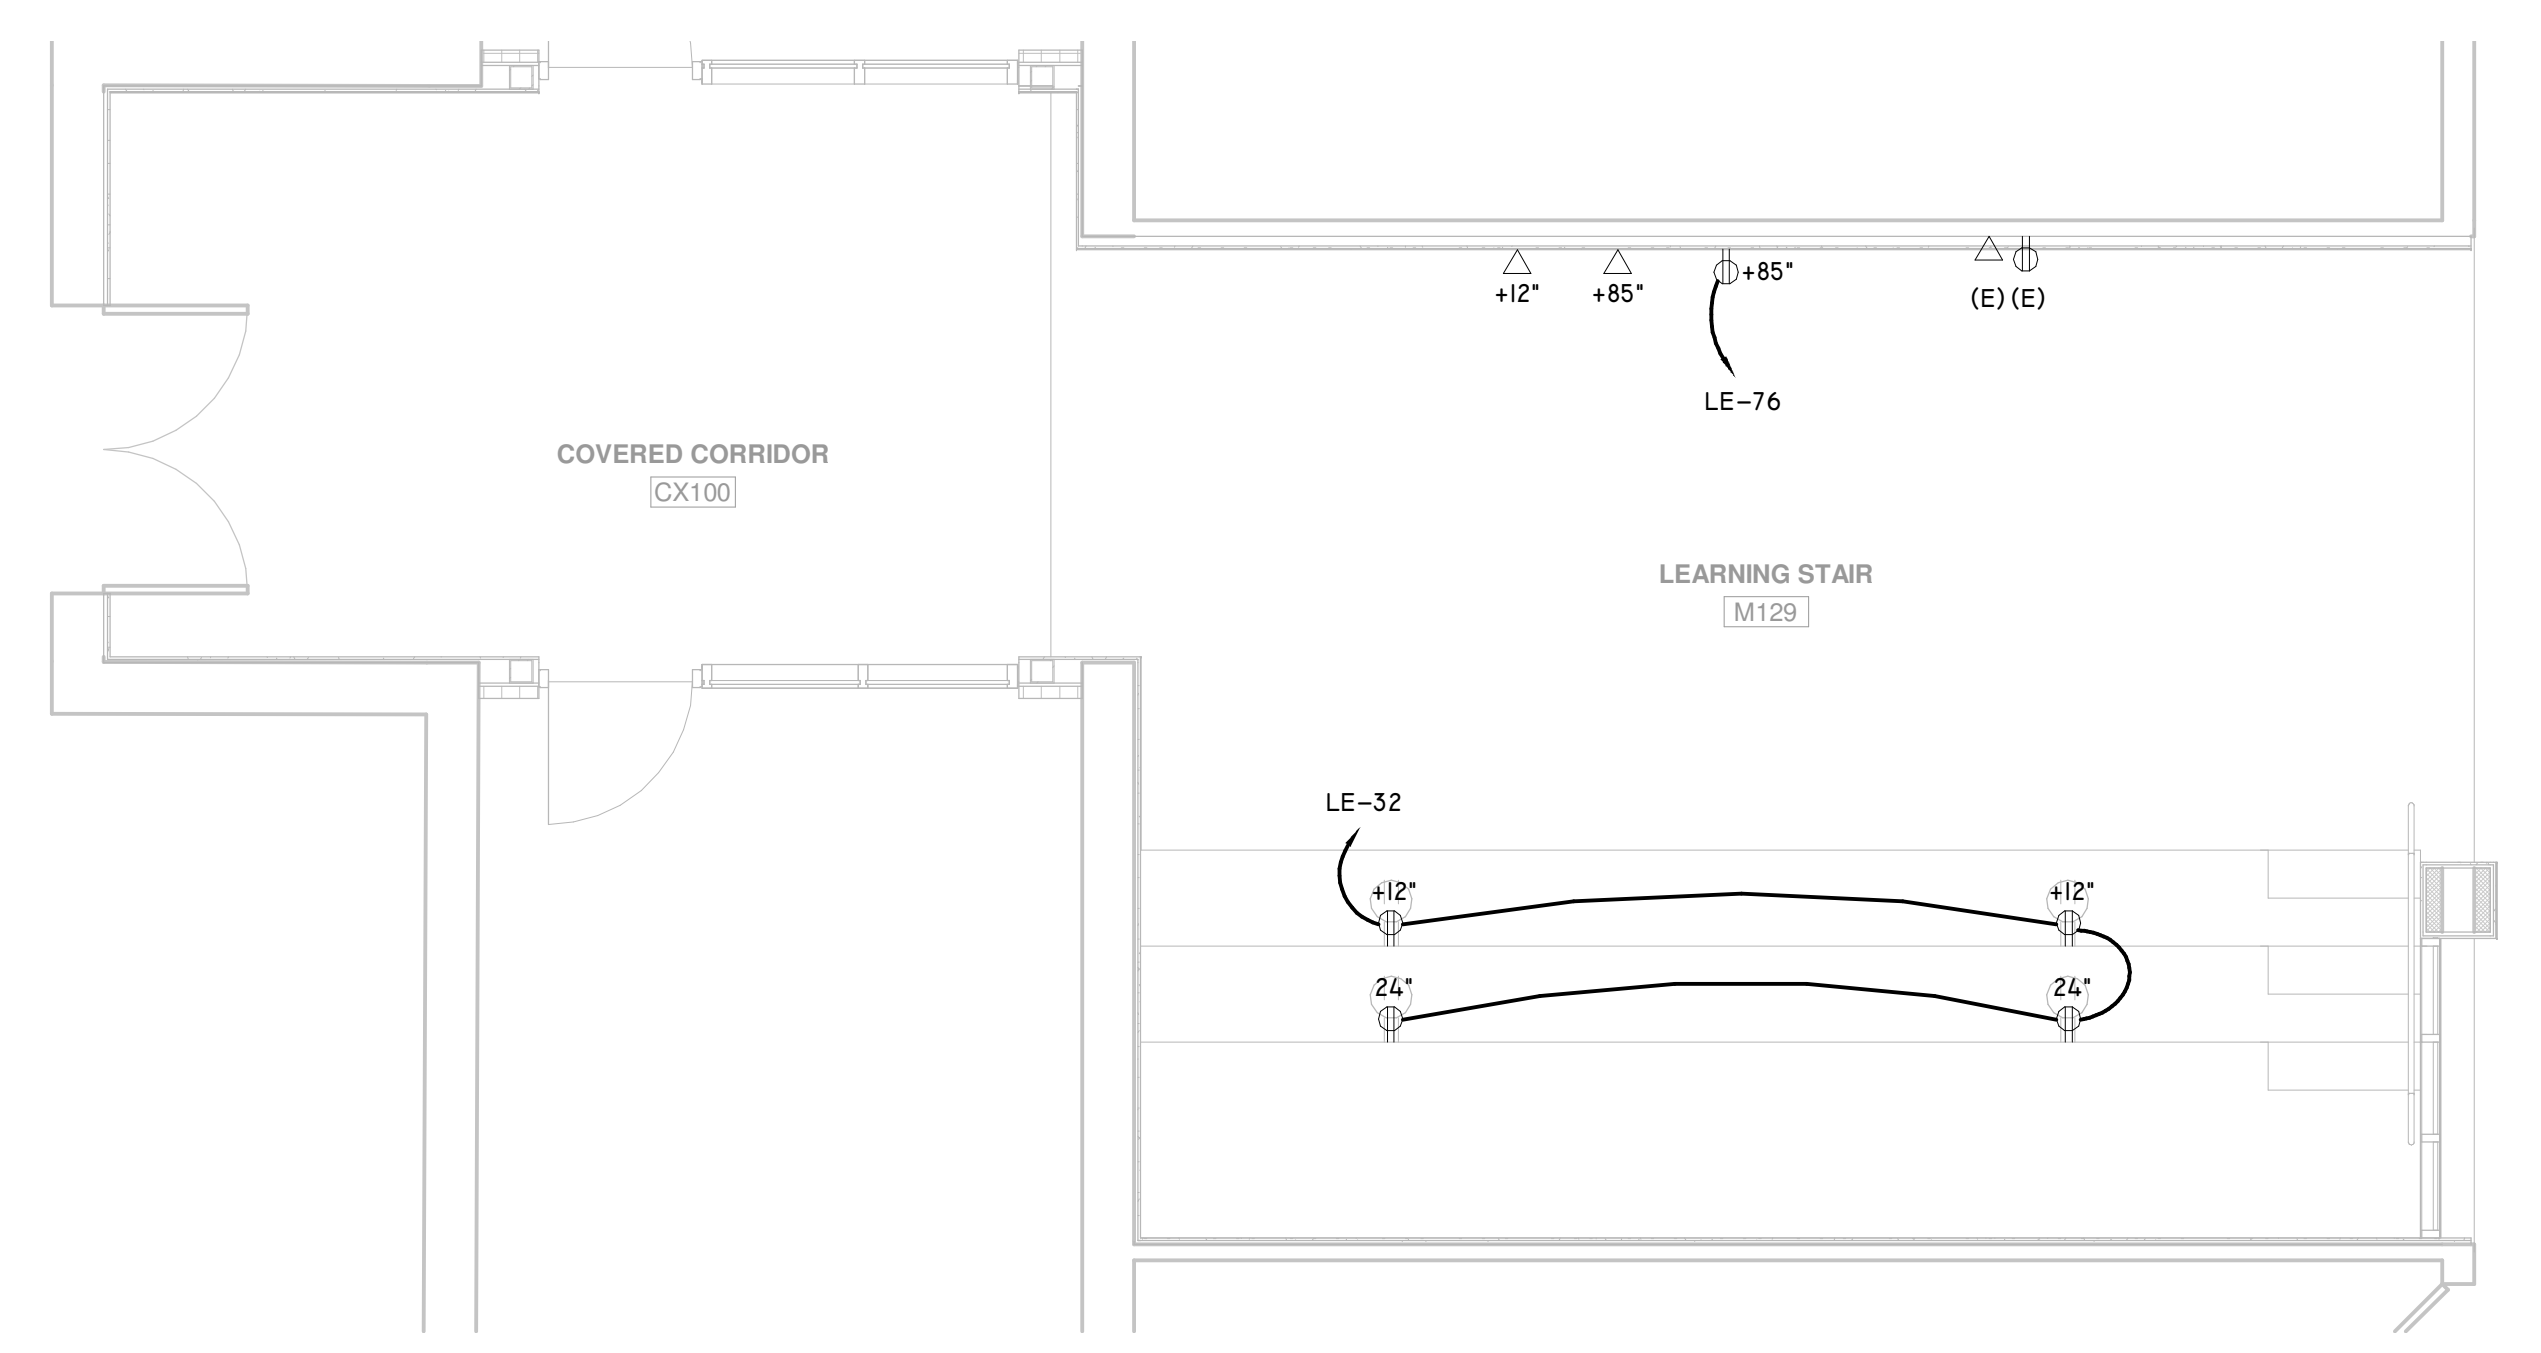


3 ENLARGED PROPOSED PLAN - AREA B1 - POWER
Scale: 1/4" = 1'-0"


- ELECTRICAL GENERAL NOTES:**
- ALL NEW RECEPTACLES IN THIS FACILITY ARE TO BE TAMPER-RESISTANT PER 2017 NEC SECTION 406.12
 - ALL CLASSROOM POWER, DATA, AND COMMUNICATION OUTLET LAYOUTS AND ELEVATIONS ARE TO BE COORDINATED WITH ARCHITECTURAL MILLWORK AND FURNITURE PLANS PRIOR TO ROUGH-IN
 - AT ALL CARD READER LOCATIONS, CONTRACTOR SHALL PROVIDE 1/2 INCH CONDUIT STUBBED OUT OF THE WALL, FLUSH WITH THE WALL SURFACE. ROUTE CONDUIT BACK TO THE NEAREST MDF/IDF ROOM.
 - ALL RECEPTACLES SERVING ELECTRIC DRINKING FOUNTAINS SHALL BE CONNECTED TO A GFCI BREAKER IN PANEL ASSOCIATED WITH CIRCUIT.
 - ALL RECEPTACLES MOUNTED ABOVE COUNTERS AND WITHIN 6 FEET OF A WATER SOURCE OR BASIN SHALL BE GFCI TYPE.
 - PROVIDE A 120V AND 208V OUTLET FOR ALL COMMERCIAL COPIERS. COORDINATE EXACT DEVICE TYPE WITH OWNER PRIOR TO PULLING BRANCH CIRCUIT WIRING.
 - ELECTRICAL CONTRACTOR SHALL PROVIDE CONDUIT, OUTLET BOXES, JUNCTION BOXES, AND PULLSTRING FOR ALL TELEPHONE, DATA, CATV, SECURITY AND CAMERA OUTLETS. ALL OUTLET BOXES FOR IT/AV DEVICES SHALL COMPLY WITH SMSO IT STANDARDS.
 - ELECTRICAL CONTRACTOR SHALL VERIFY DEVICE AND EQUIPMENT LOCATIONS WITH ARCHITECT PRIOR TO ROUGH-IN.

KEYNOTE LEGEND

1	COORDINATE FOR EXACT LOCATION OF LOW VOLTAGE TRANSFORMER (LOCATE ABOVE ACCESSIBLE CEILING) WHICH WILL PROVIDE POWER TO FLUSH VALVES AND AUTO SENSORS.
2	PROVIDE CORD REELS WITH 4-SOCKET NEMA 5-15R OUTLETS TO REACH UPPER SURFACE OF TABLE.

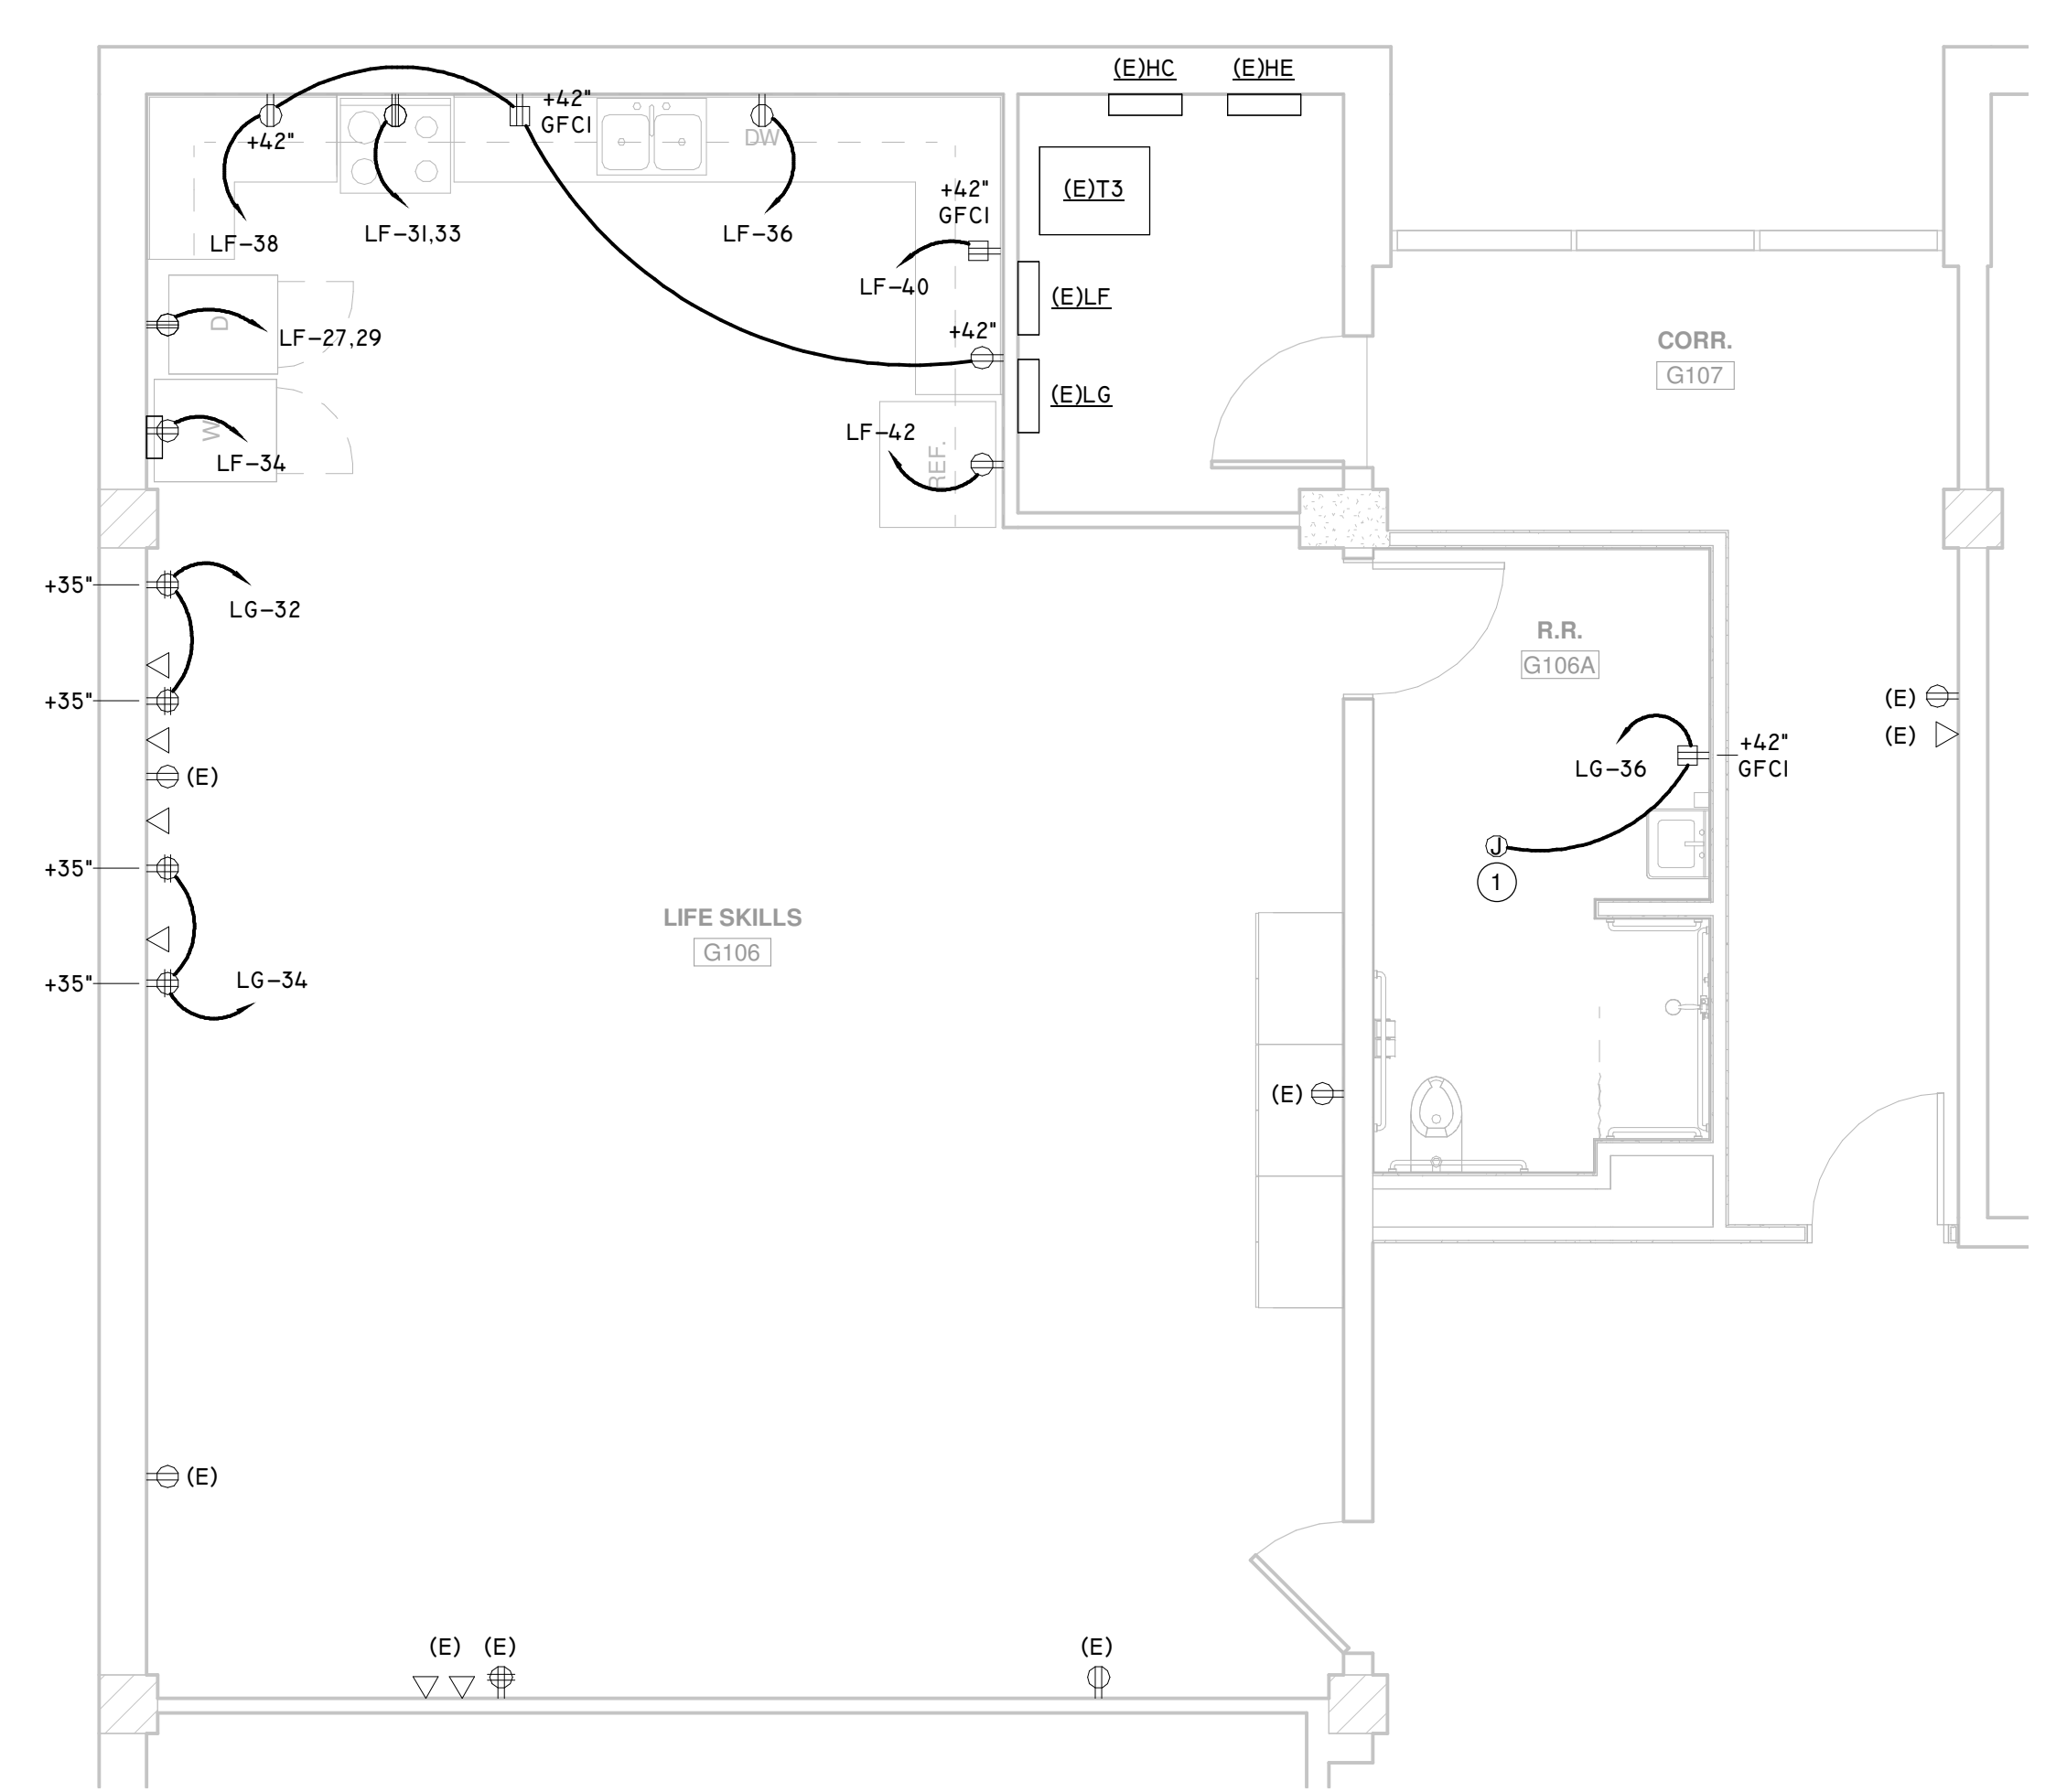

2 ENLARGED PROPOSED PLAN - AREA E - POWER
Scale: 1/4" = 1'-0"

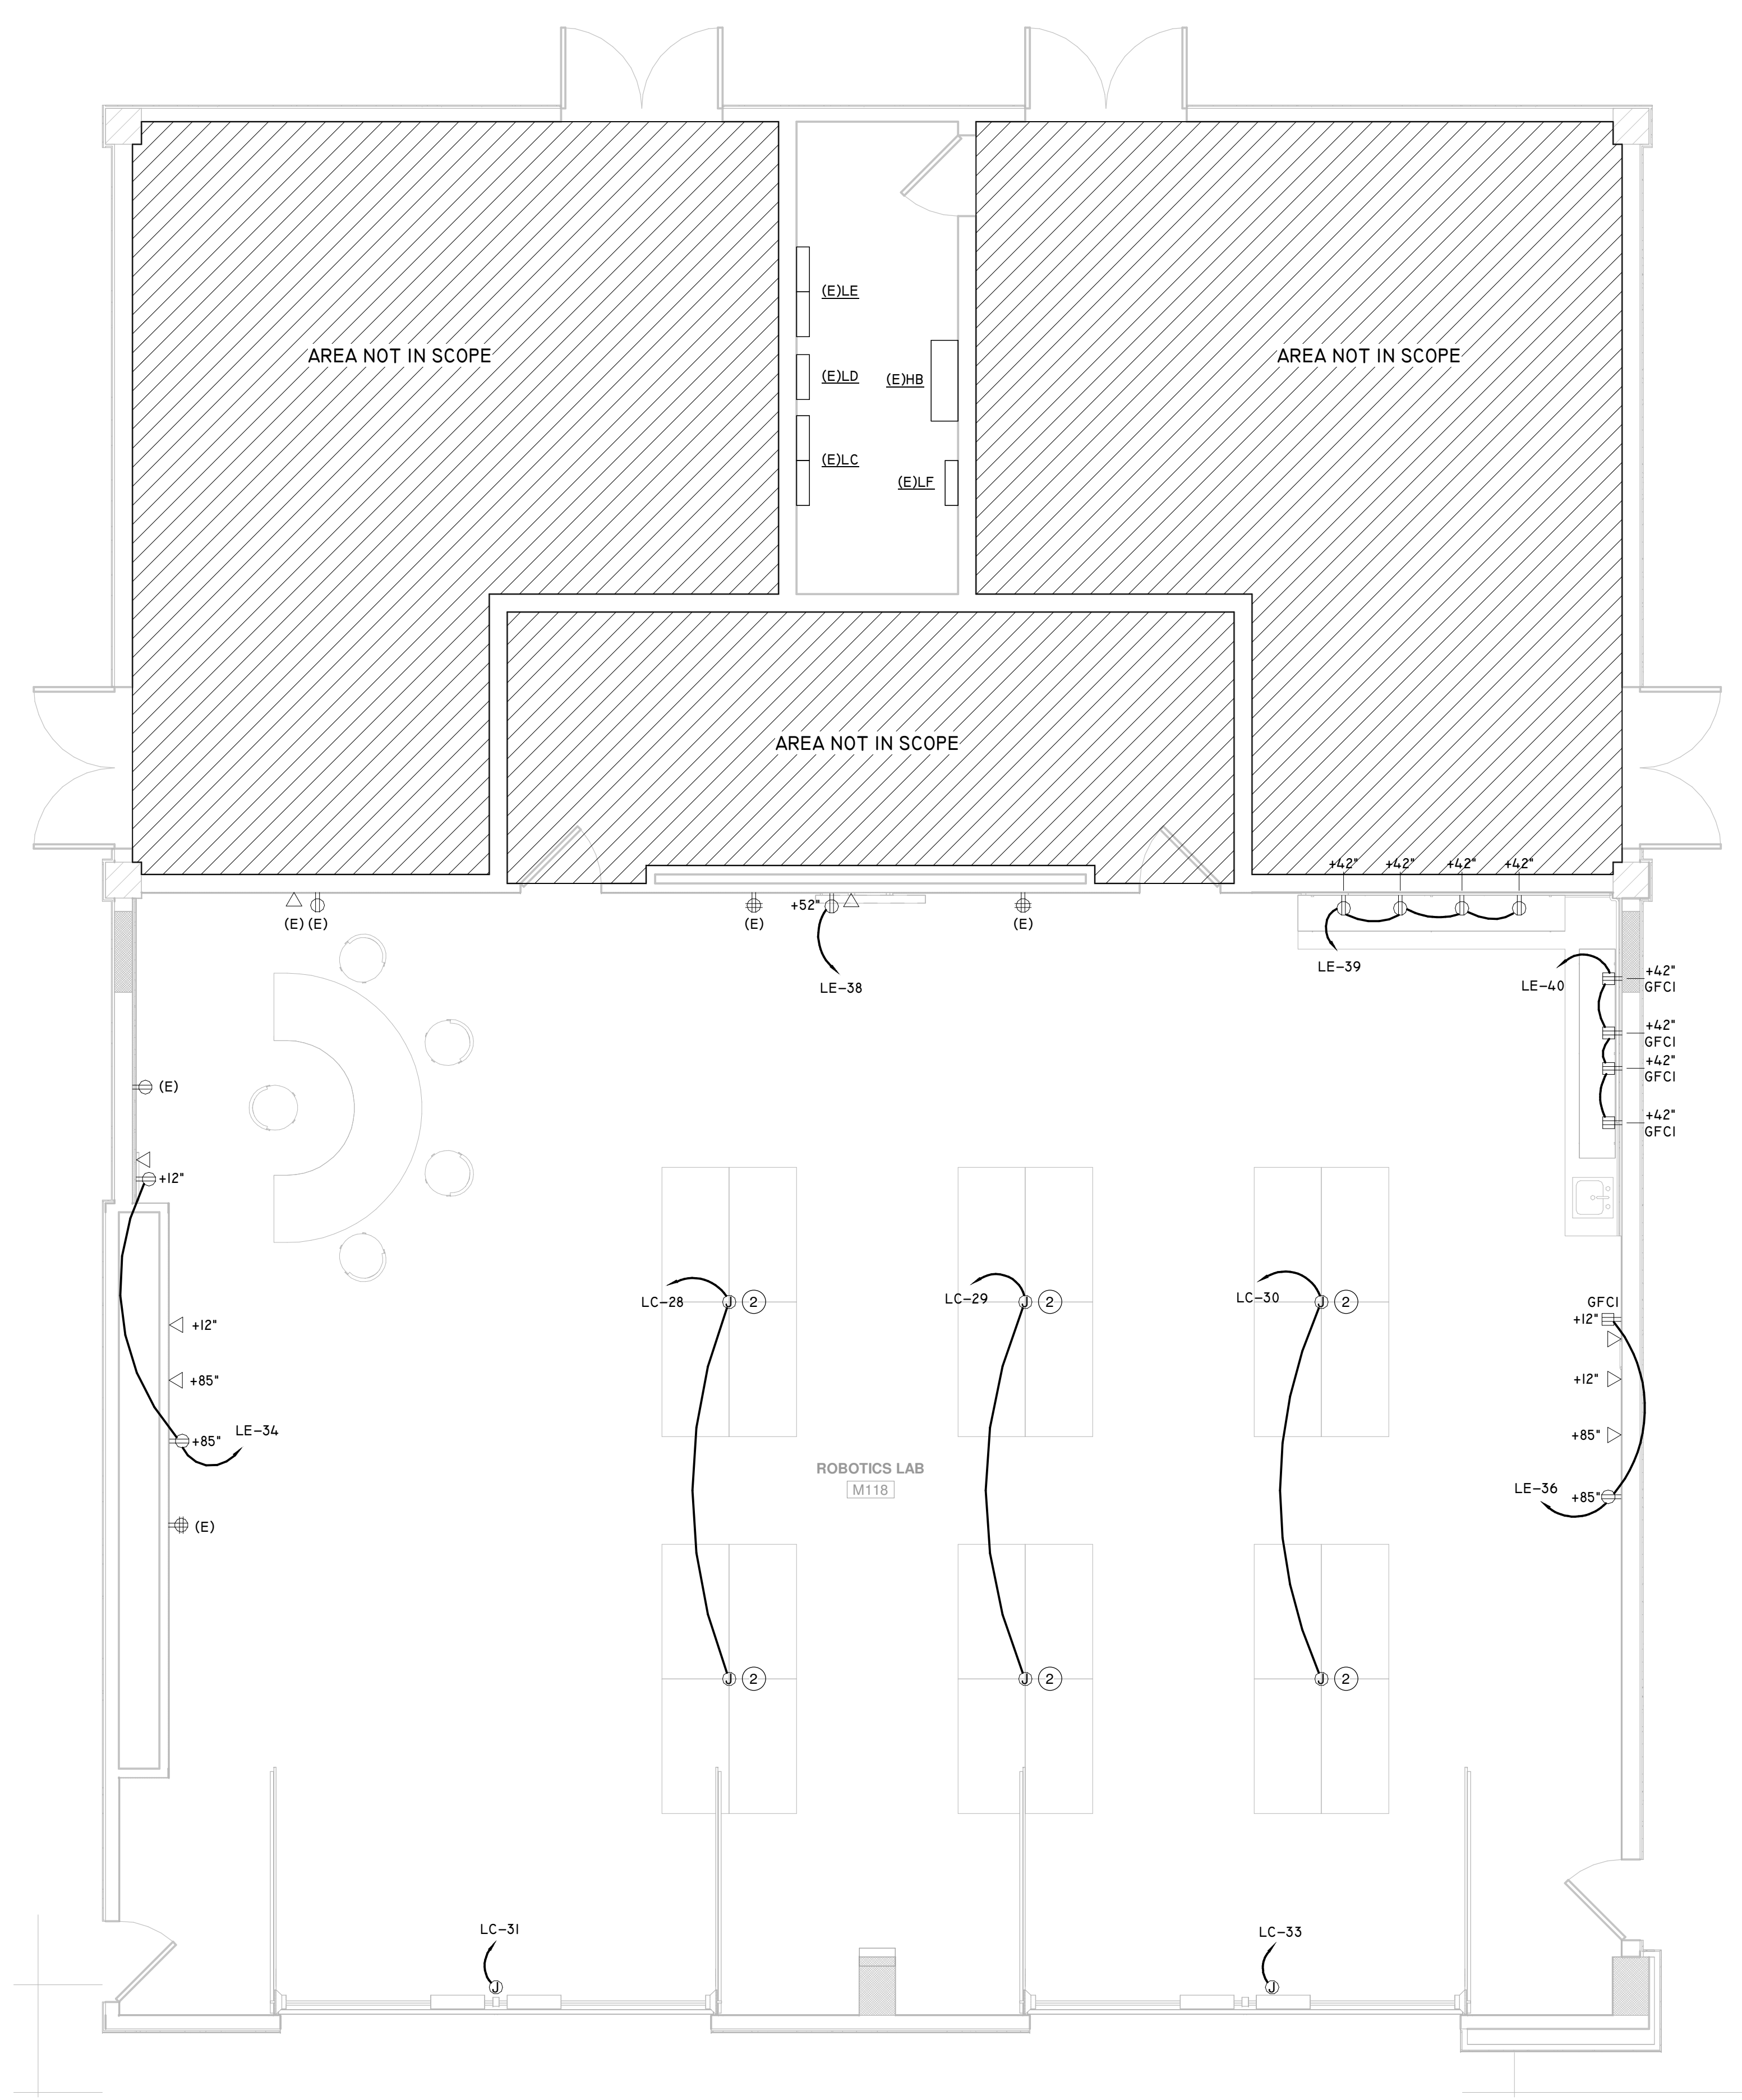

1 ENLARGED PROPOSED PLAN - AREA B2 - POWER
Scale: 1/4" = 1'-0"



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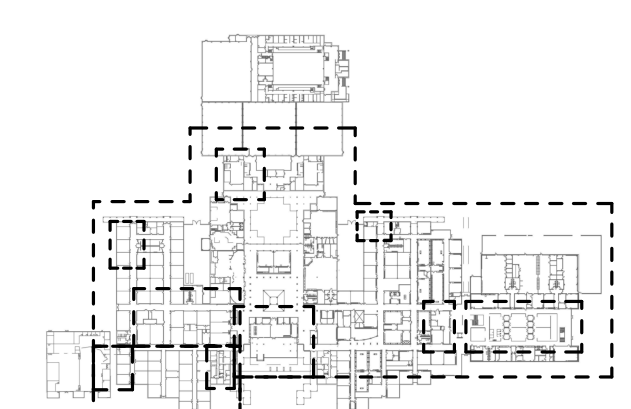


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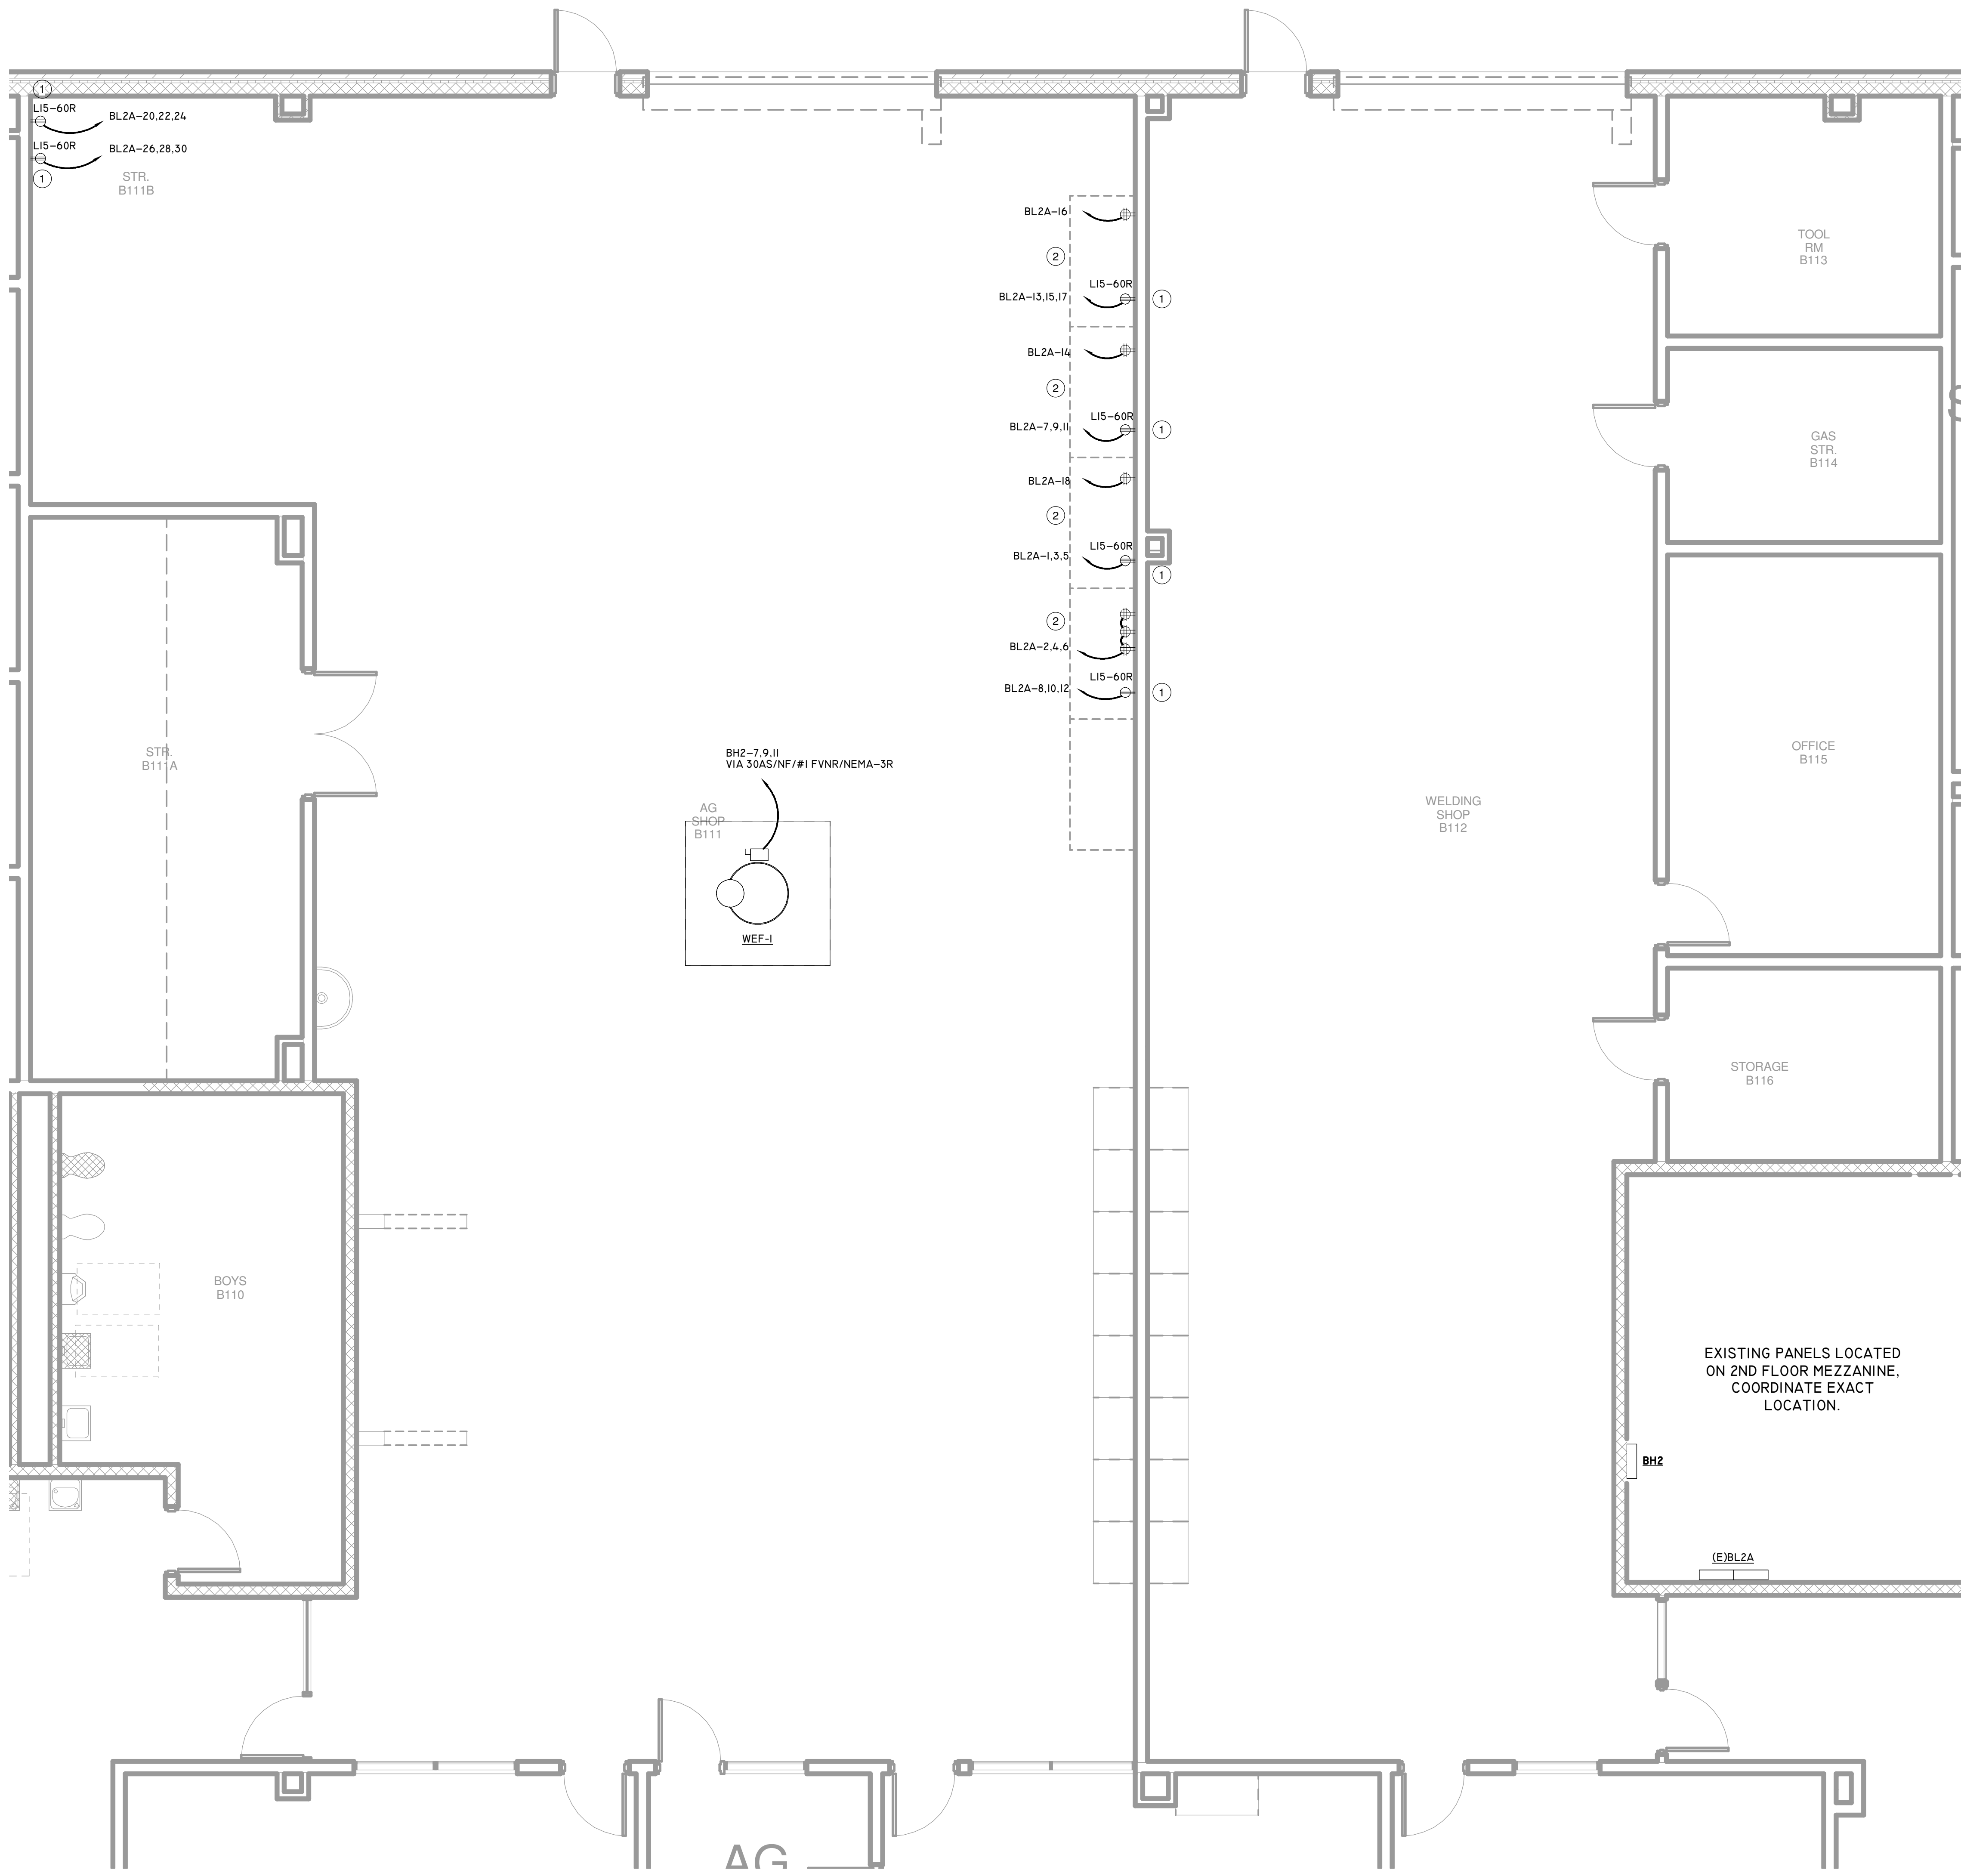
Drawing Title
**ENLARGED PROPOSED
PLAN - POWER**

Drawing Number
E2.05

KEYNOTE LEGEND	
1	PROVIDE NEW LEVITON #8460 NEMA 15-60R RECEPTACLE WITH STAINLESS STEEL COVER PLATE.
2	PROVIDE NEW TYPE SOOW 90°C. CORD WITH (4) #4 CONDUCTORS AND LEVITON #8462-F NEMA 15-60P PLUG END.

ELECTRICAL GENERAL NOTES:

- ALL NEW RECEPTACLES IN THIS FACILITY ARE TO BE TAMPER-RESISTANT PER 2017 NEC SECTION 406.12.
- ALL CLASSROOM POWER, DATA, AND COMMUNICATION OUTLET LAYOUTS AND ELEVATIONS ARE TO BE COORDINATED WITH ARCHITECTURAL MILLWORK AND FURNITURE PLANS PRIOR TO ROUGH-IN.
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- ALL RECEPTACLES SERVING ELECTRIC DRINKING FOUNTAINS SHALL BE CONNECTED TO A GFCI BREAKER IN PANEL ASSOCIATED WITH CIRCUIT.
- ALL RECEPTACLES MOUNTED ABOVE COUNTERTOPS AND WITHIN 6 FEET OF A WATER SOURCE OR BASIN SHALL BE GFCI TYPE.
- PROVIDE A 120V AND 208V OUTLET FOR ALL COMMERCIAL COPIERS. COORDINATE EXACT DEVICE TYPE WITH OWNER PRIOR TO PULLING BRANCH CIRCUIT WIRING.
- ELECTRICAL CONTRACTOR SHALL PROVIDE CONDUIT, OUTLET BOXES, JUNCTION BOXES, AND PULLSTRING FOR ALL TELEPHONE, DATA, CATV, SECURITY AND CAMERA OUTLETS. ALL OUTLET BOXES FOR IT/AV DEVICES SHALL COMPLY WITH SMOS IT STANDARDS.
- ELECTRICAL CONTRACTOR SHALL VERIFY DEVICE AND EQUIPMENT LOCATIONS WITH ARCHITECT PRIOR TO ROUGH-IN.



1 ENLARGED PROPOSED PLAN - AREA I - POWER
Scale: 1/4" = 1'-0"



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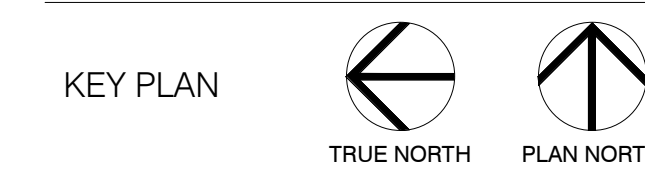
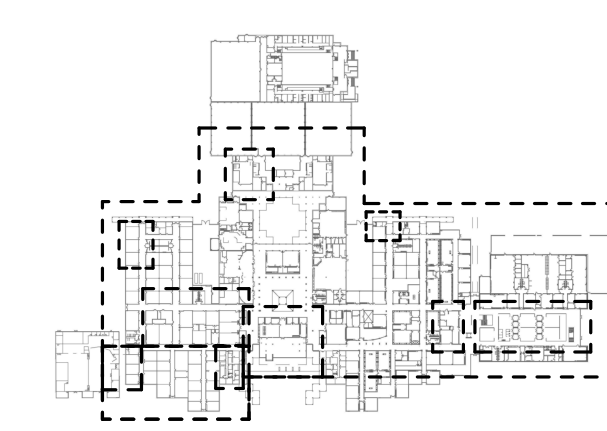
03/13/2020

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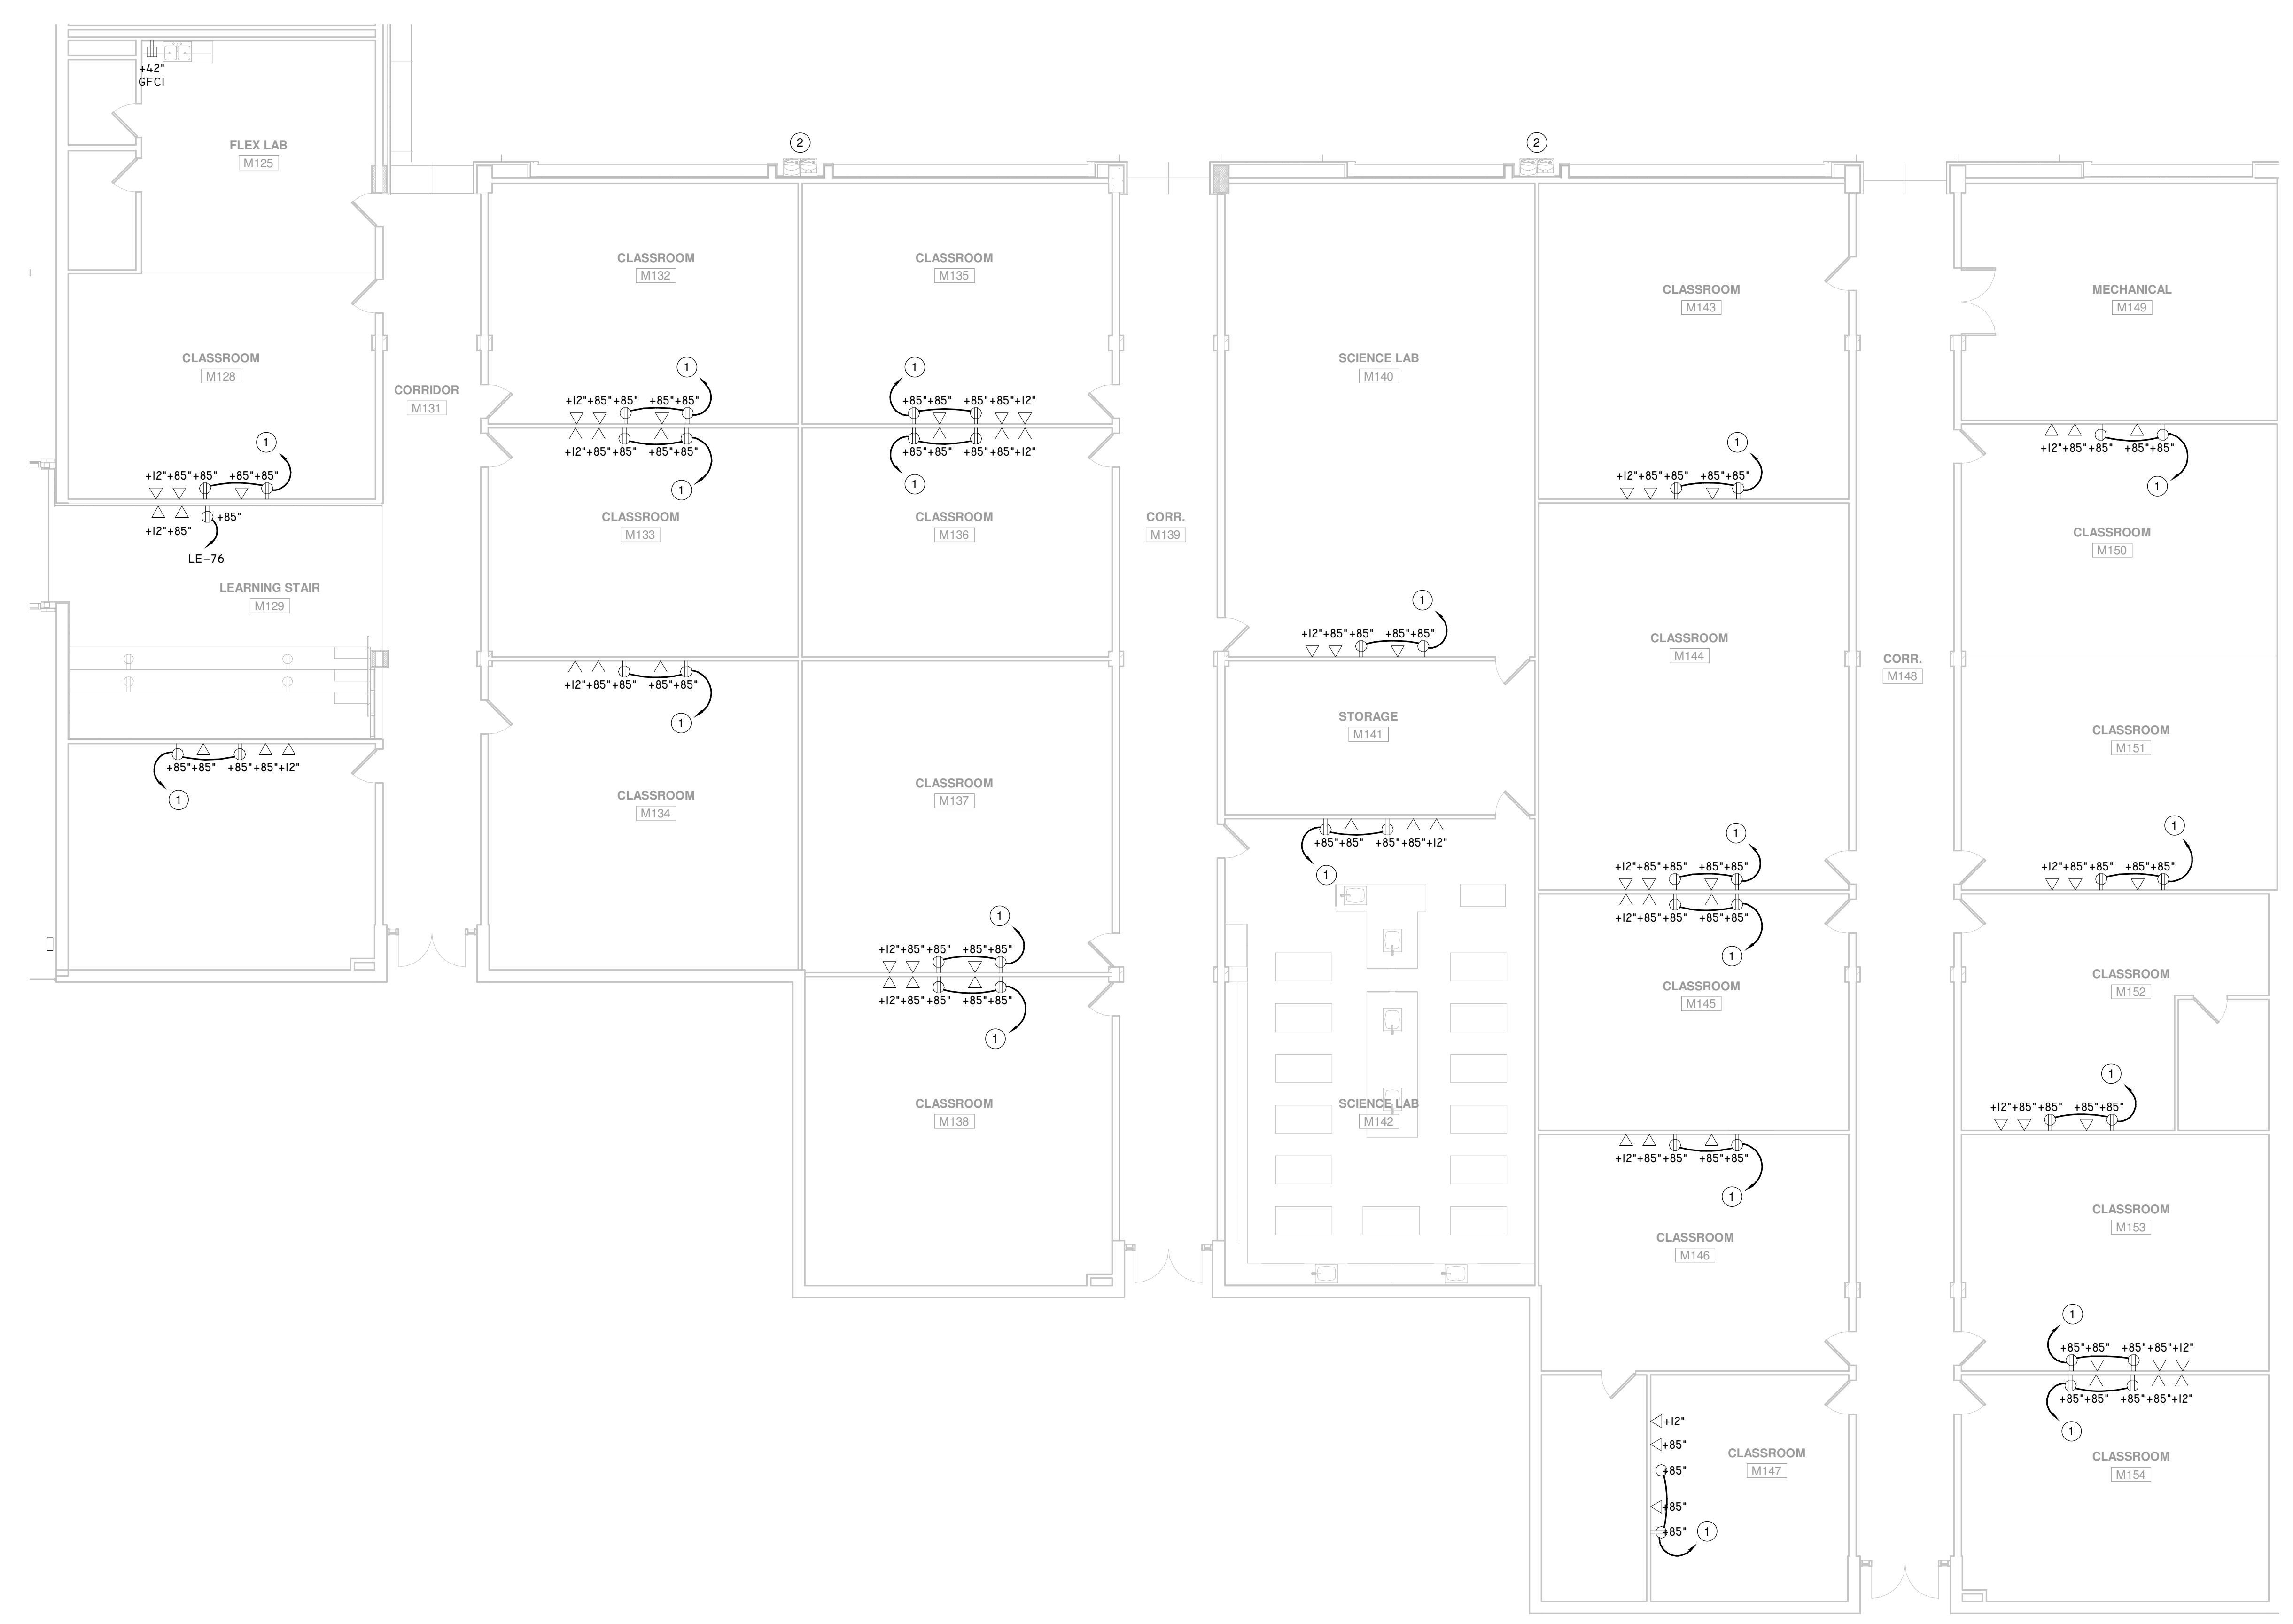


KEYNOTE LEGEND

1	UTILIZE EXISTING PROJECTOR CIRCUIT FOR NEW WALL MOUNTED PROJECTOR AND CONNECT TO NEW DUPLEXES.
2	RECONNECT DRINKING FOUNTAIN TO EXISTING CIRCUIT. VERIFY BREAKER SERVING DRINKING FOUNTAIN IS GFCI TYPE.

ELECTRICAL GENERAL NOTES:

- ALL NEW RECEPTACLES IN THIS FACILITY ARE TO BE TAMPER-RESISTANT PER 2017 NEC SECTION 406.12.
- ALL CLASSROOM POWER, DATA, AND COMMUNICATION OUTLET LAYOUTS AND ELEVATIONS ARE TO BE COORDINATED WITH ARCHITECTURAL MILLWORK AND FURNITURE PLANS PRIOR TO ROUGH-IN.
- AT ALL CARD READER LOCATIONS, CONTRACTOR SHALL PROVIDE 1/2 INCH CONDUIT STUBBED OUT OF THE WALL. FLUSH WITH THE WALL SURFACE. ROUTE CONDUIT BACK TO THE NEAREST MOP/DIF ROOM.
- ALL RECEPTACLES SERVING ELECTRIC DRINKING FOUNTAINS SHALL BE CONNECTED TO A GFCI BREAKER IN PANEL ASSOCIATED WITH CIRCUIT.
- ALL RECEPTACLES MOUNTED ABOVE COUNTERS AND WITHIN 6 FEET OF A WATER SOURCE OR BASIN SHALL BE GFCI TYPE.
- PROVIDE A 120V AND 208V OUTLET FOR ALL COMMERCIAL COPIERS. COORDINATE EXACT DEVICE TYPE WITH OWNER PRIOR TO PULLING BRANCH CIRCUIT WIRING.
- ELECTRICAL CONTRACTOR SHALL PROVIDE CONDUIT, OUTLET BOXES, JUNCTION BOXES, AND PULLSTRING FOR ALL TELEPHONE, DATA, CATV, SECURITY AND CAMERA OUTLETS. ALL OUTLET BOXES FOR IT/AV DEVICES SHALL COMPLY WITH SM55 IT STANDARDS.
- ELECTRICAL CONTRACTOR SHALL VERIFY DEVICE AND EQUIPMENT LOCATIONS WITH ARCHITECT PRIOR TO ROUGH-IN.



1 ENLARGED PROPOSED PLAN - AREA B - POWER

Scale: 1/8" = 1'-0"

Project Number	19006-A
Drawn By	LT
Checked By	AW
Approved By	MS

Drawing Title
**ENLARGED PROPOSED
PLAN - POWER**

Drawing Number
E2.06



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INFRASTRUCTURE ASSOCIATES
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STRUCTURAL ENGINEERS
DALLY ASSOCIATES
713-337-8881



INFRASTRUCTURE ASSOCIATES, INC.
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PROFESSIONAL SEAL:




03/13/2020

A PROJECT FOR:

**STAFFORD
HIGH SCHOOL
& MAGNET
SCHOOL
RENOVATIONS**

1625 STAFFORDSHIRE
ROAD,
STAFFORD, TX 77477

#	Date	ISSUED FOR
1	2020/01/31	90% CD
2	2020/03/02	98% CD Review
3	2020/03/12	Issue for Bid, Permit, and Construction

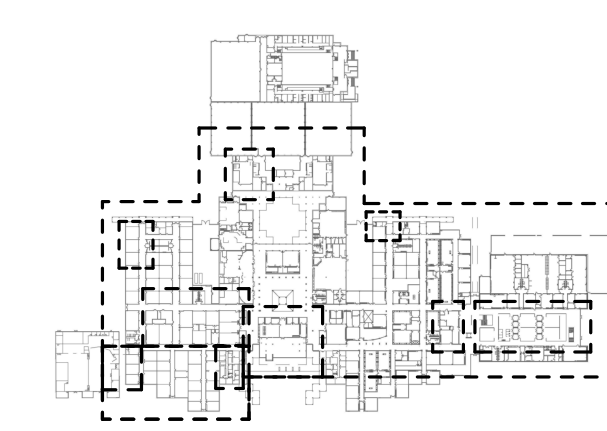

KEY PLAN
TRUE NORTH
PLAN NORTH


Project Number	19006-A
Drawn By	LT
Checked By	AW
Approved By	MS

Drawing Title
**ENLARGED PROPOSED
PLAN - POWER**


Drawing Number
E2.07

ELECTRICAL GENERAL NOTES:


1. ALL NEW RECEPTACLES IN THIS FACILITY ARE TO BE TAMPER-RESISTANT PER 2017 NEC SECTION 406.12.
2. ALL CLASSROOM POWER, DATA, AND COMMUNICATION OUTLET LAYOUTS AND ELEVATIONS ARE TO BE COORDINATED WITH ARCHITECTURAL MILLWORK AND FURNITURE PLANS PRIOR TO ROUGH-IN.
3. AT ALL CARD READER LOCATIONS, CONTRACTOR SHALL PROVIDE 1/2 INCH CONDUIT STUBBED OUT OF THE WALL, FLUSH WITH THE WALL SURFACE. ROUTE CONDUIT BACK TO THE NEAREST MDF/IDF ROOM.
4. ALL RECEPTACLES SERVING ELECTRIC DRINKING FOUNTAINS SHALL BE CONNECTED TO A GFCI BREAKER IN PANEL ASSOCIATED WITH CIRCUIT.
5. ALL RECEPTACLES MOUNTED ABOVE COUNTERS AND WITHIN 6 FEET OF A WATER SOURCE OR BASIN SHALL BE GFCI TYPE.
6. PROVIDE A 120V AND 208V OUTLET FOR ALL COMMERCIAL COPIERS. COORDINATE EXACT DEVICE TYPE WITH OWNER PRIOR TO PULLING BRANCH CIRCUIT WIRING.
7. ELECTRICAL CONTRACTOR SHALL PROVIDE CONDUIT, OUTLET BOXES, JUNCTION BOXES, AND PULLSTRING FOR ALL TELEPHONE, DATA, CATV, SECURITY AND CAMERA OUTLETS. ALL OUTLET BOXES FOR IT/AV DEVICES SHALL COMPLY WITH SMSD IT STANDARDS.
8. ELECTRICAL CONTRACTOR SHALL VERIFY DEVICE AND EQUIPMENT LOCATIONS WITH ARCHITECT PRIOR TO ROUGH-IN.

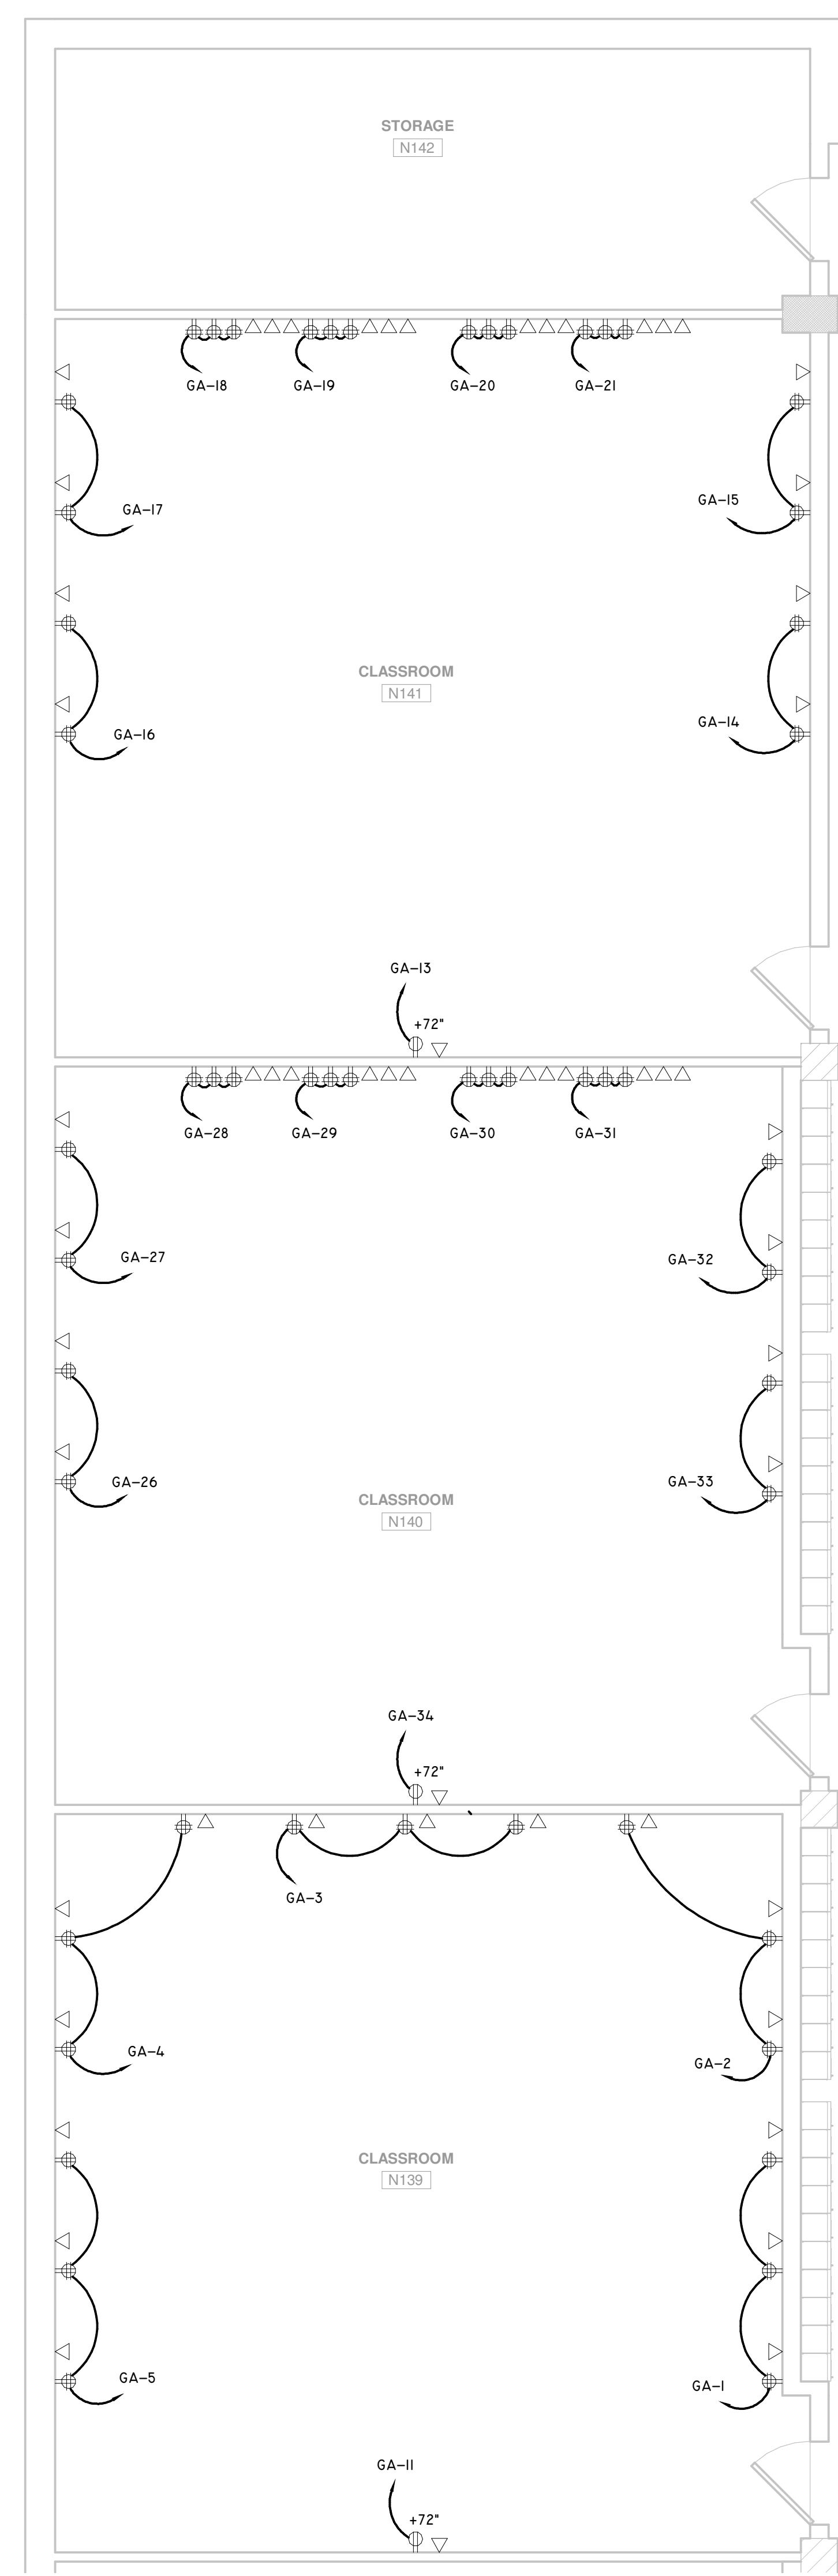

1 ENLARGED PROPOSED PLAN - AREA B6 - POWER
Scale: 1/4" = 1'-0"

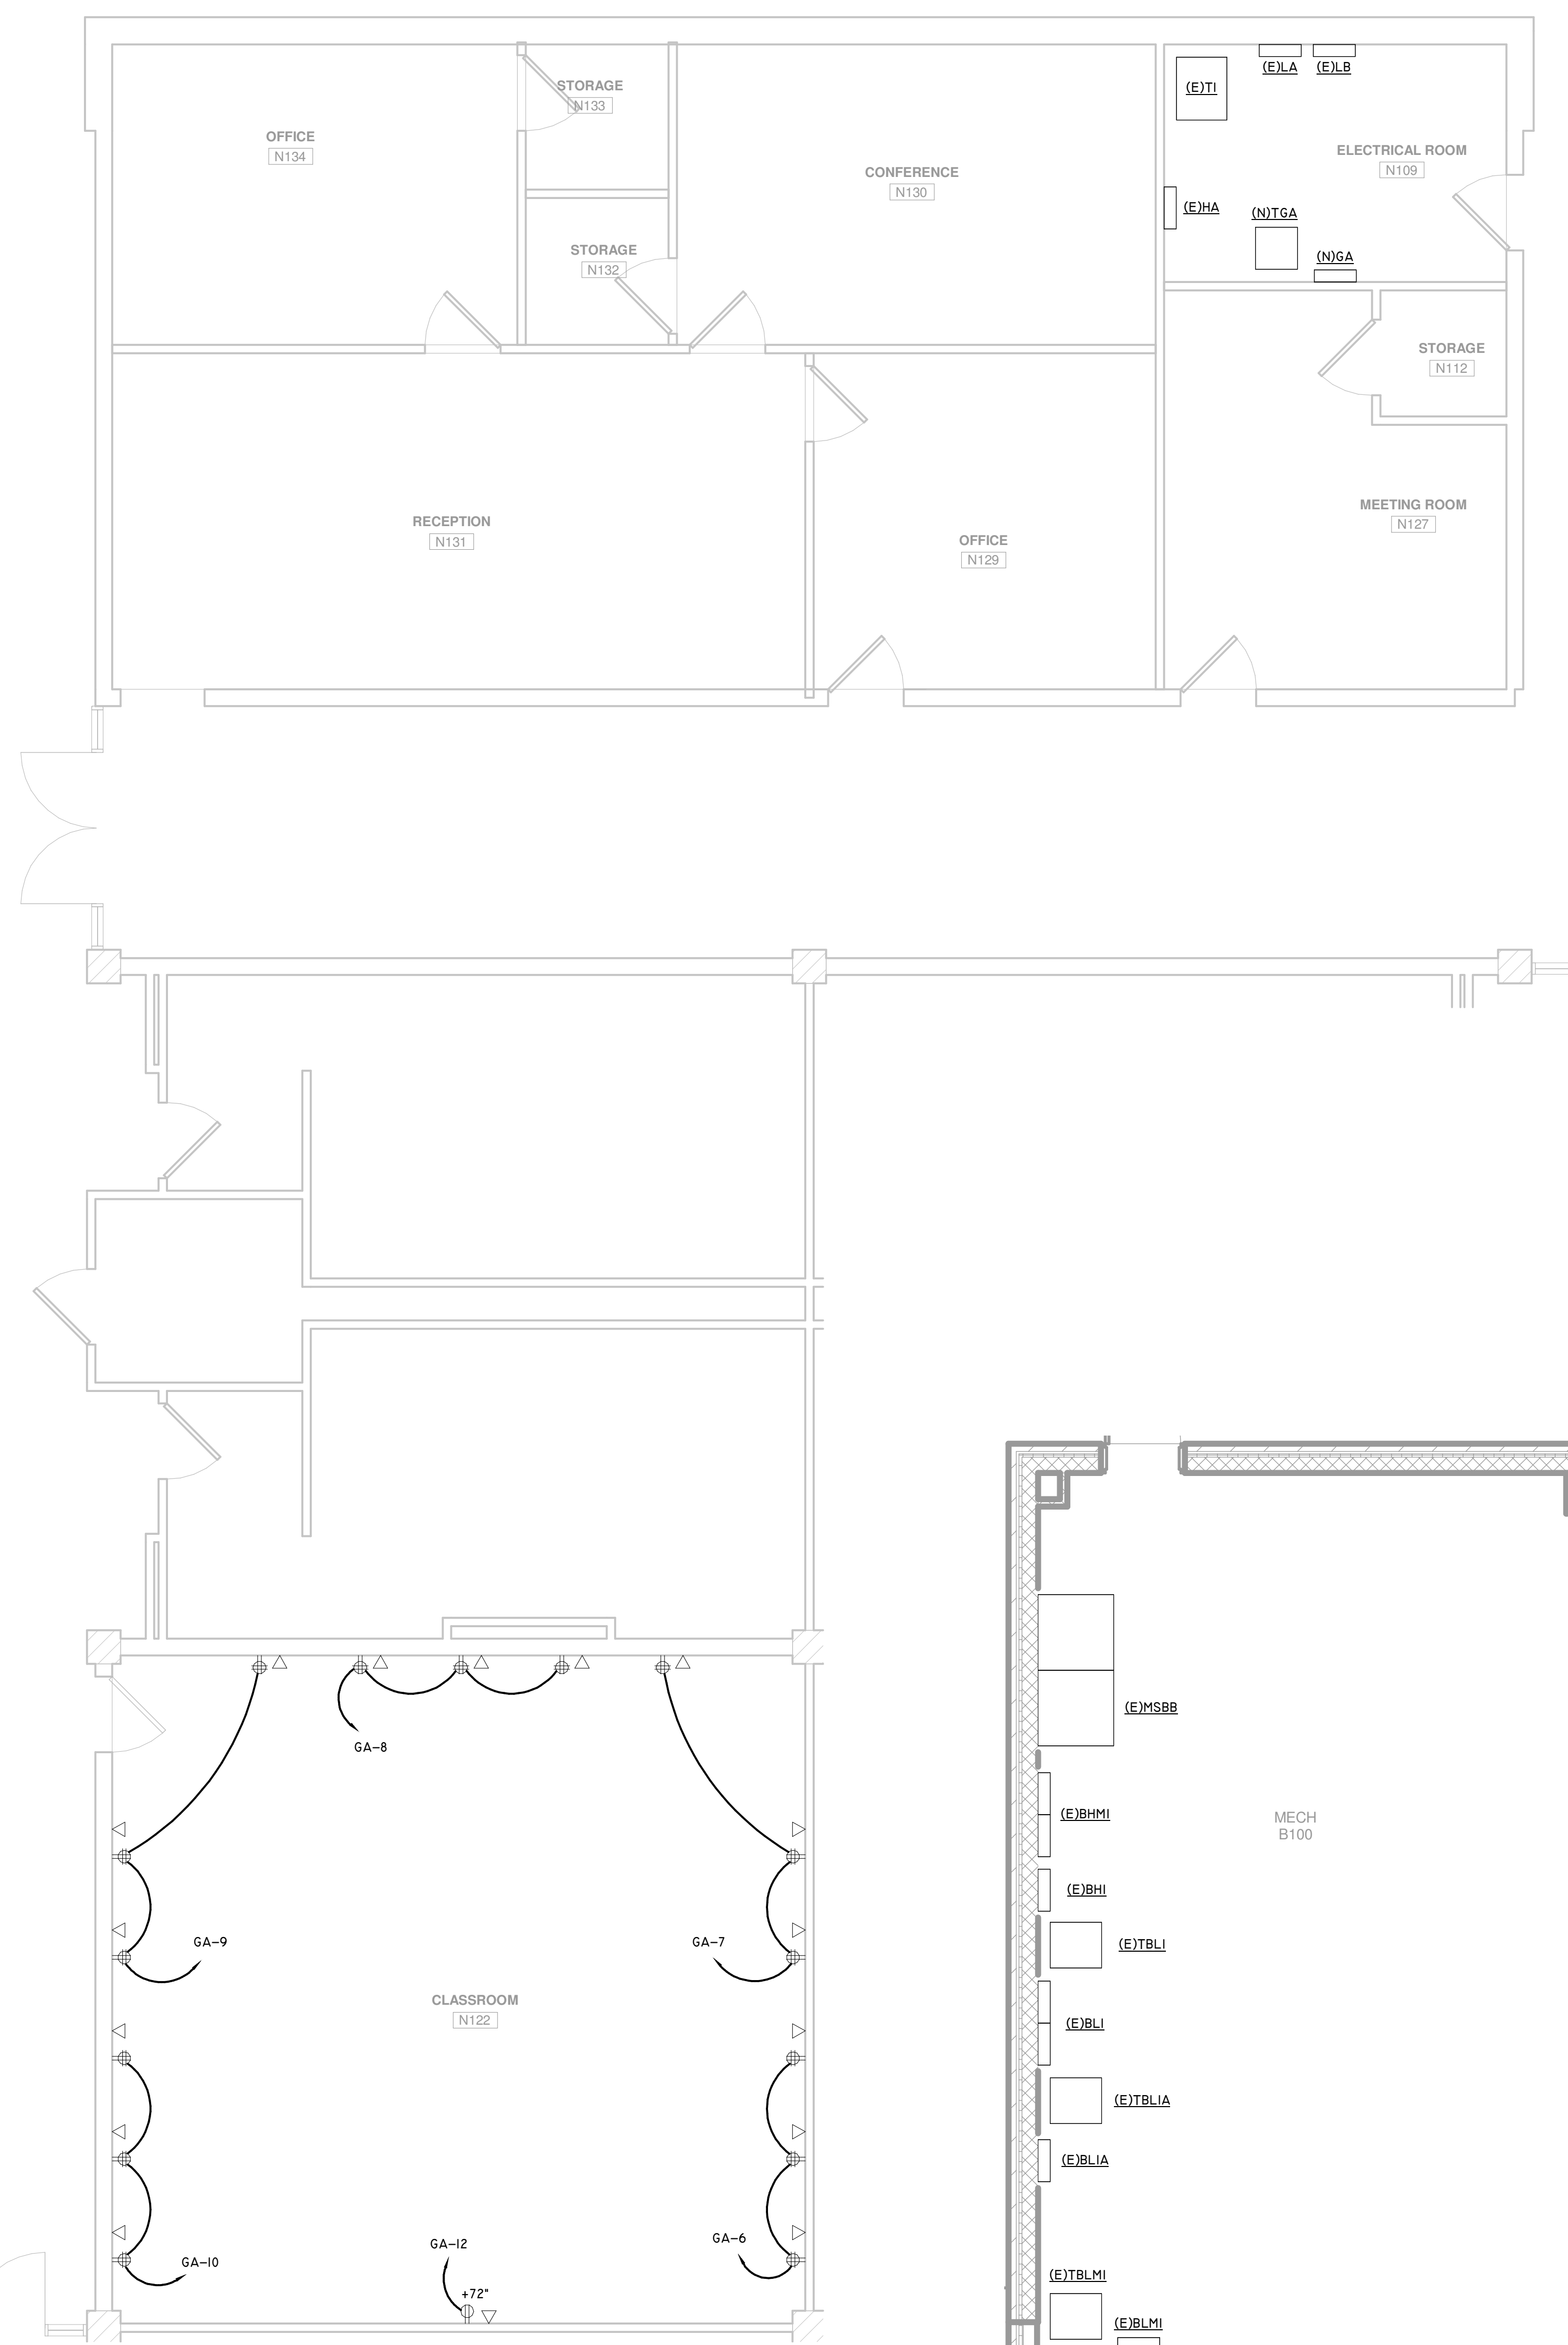

3 ENLARGED PLAN - MECH. B100
Scale: 1/4" = 1'-0"

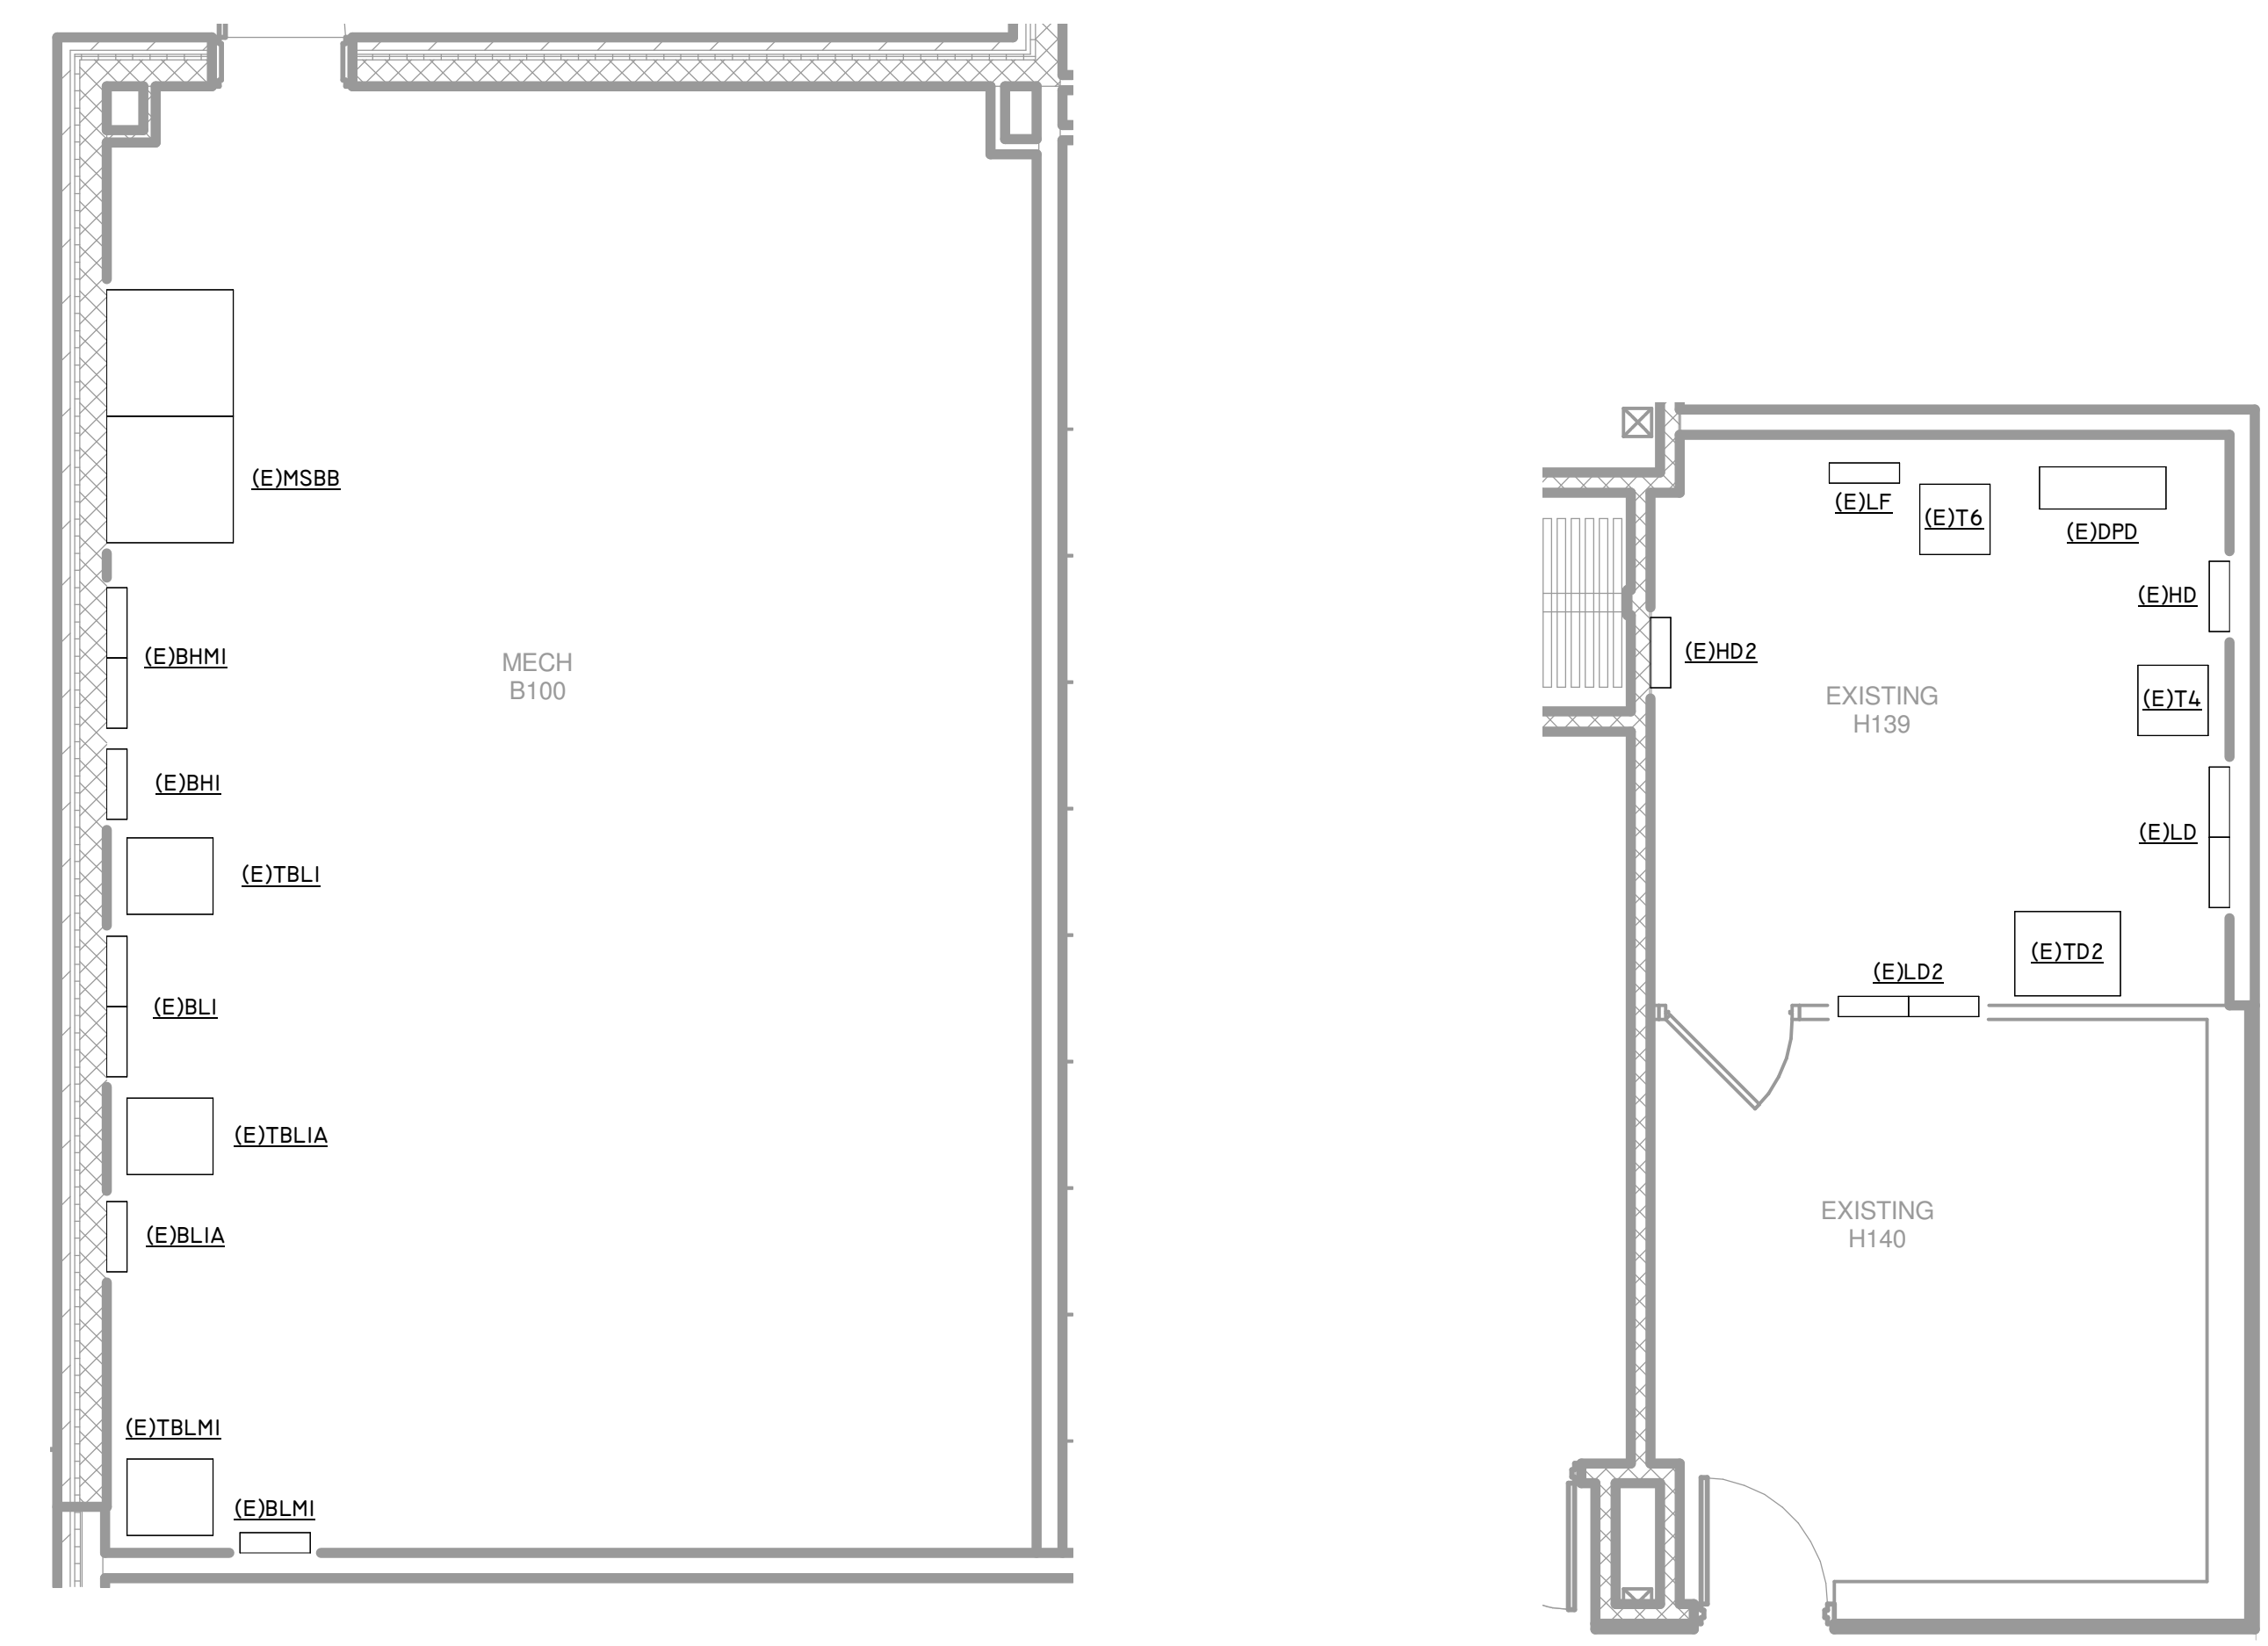

2 ENLARGED PLAN - LIBRARY ELECTRICAL ROOM
Scale: 1/4" = 1'-0"



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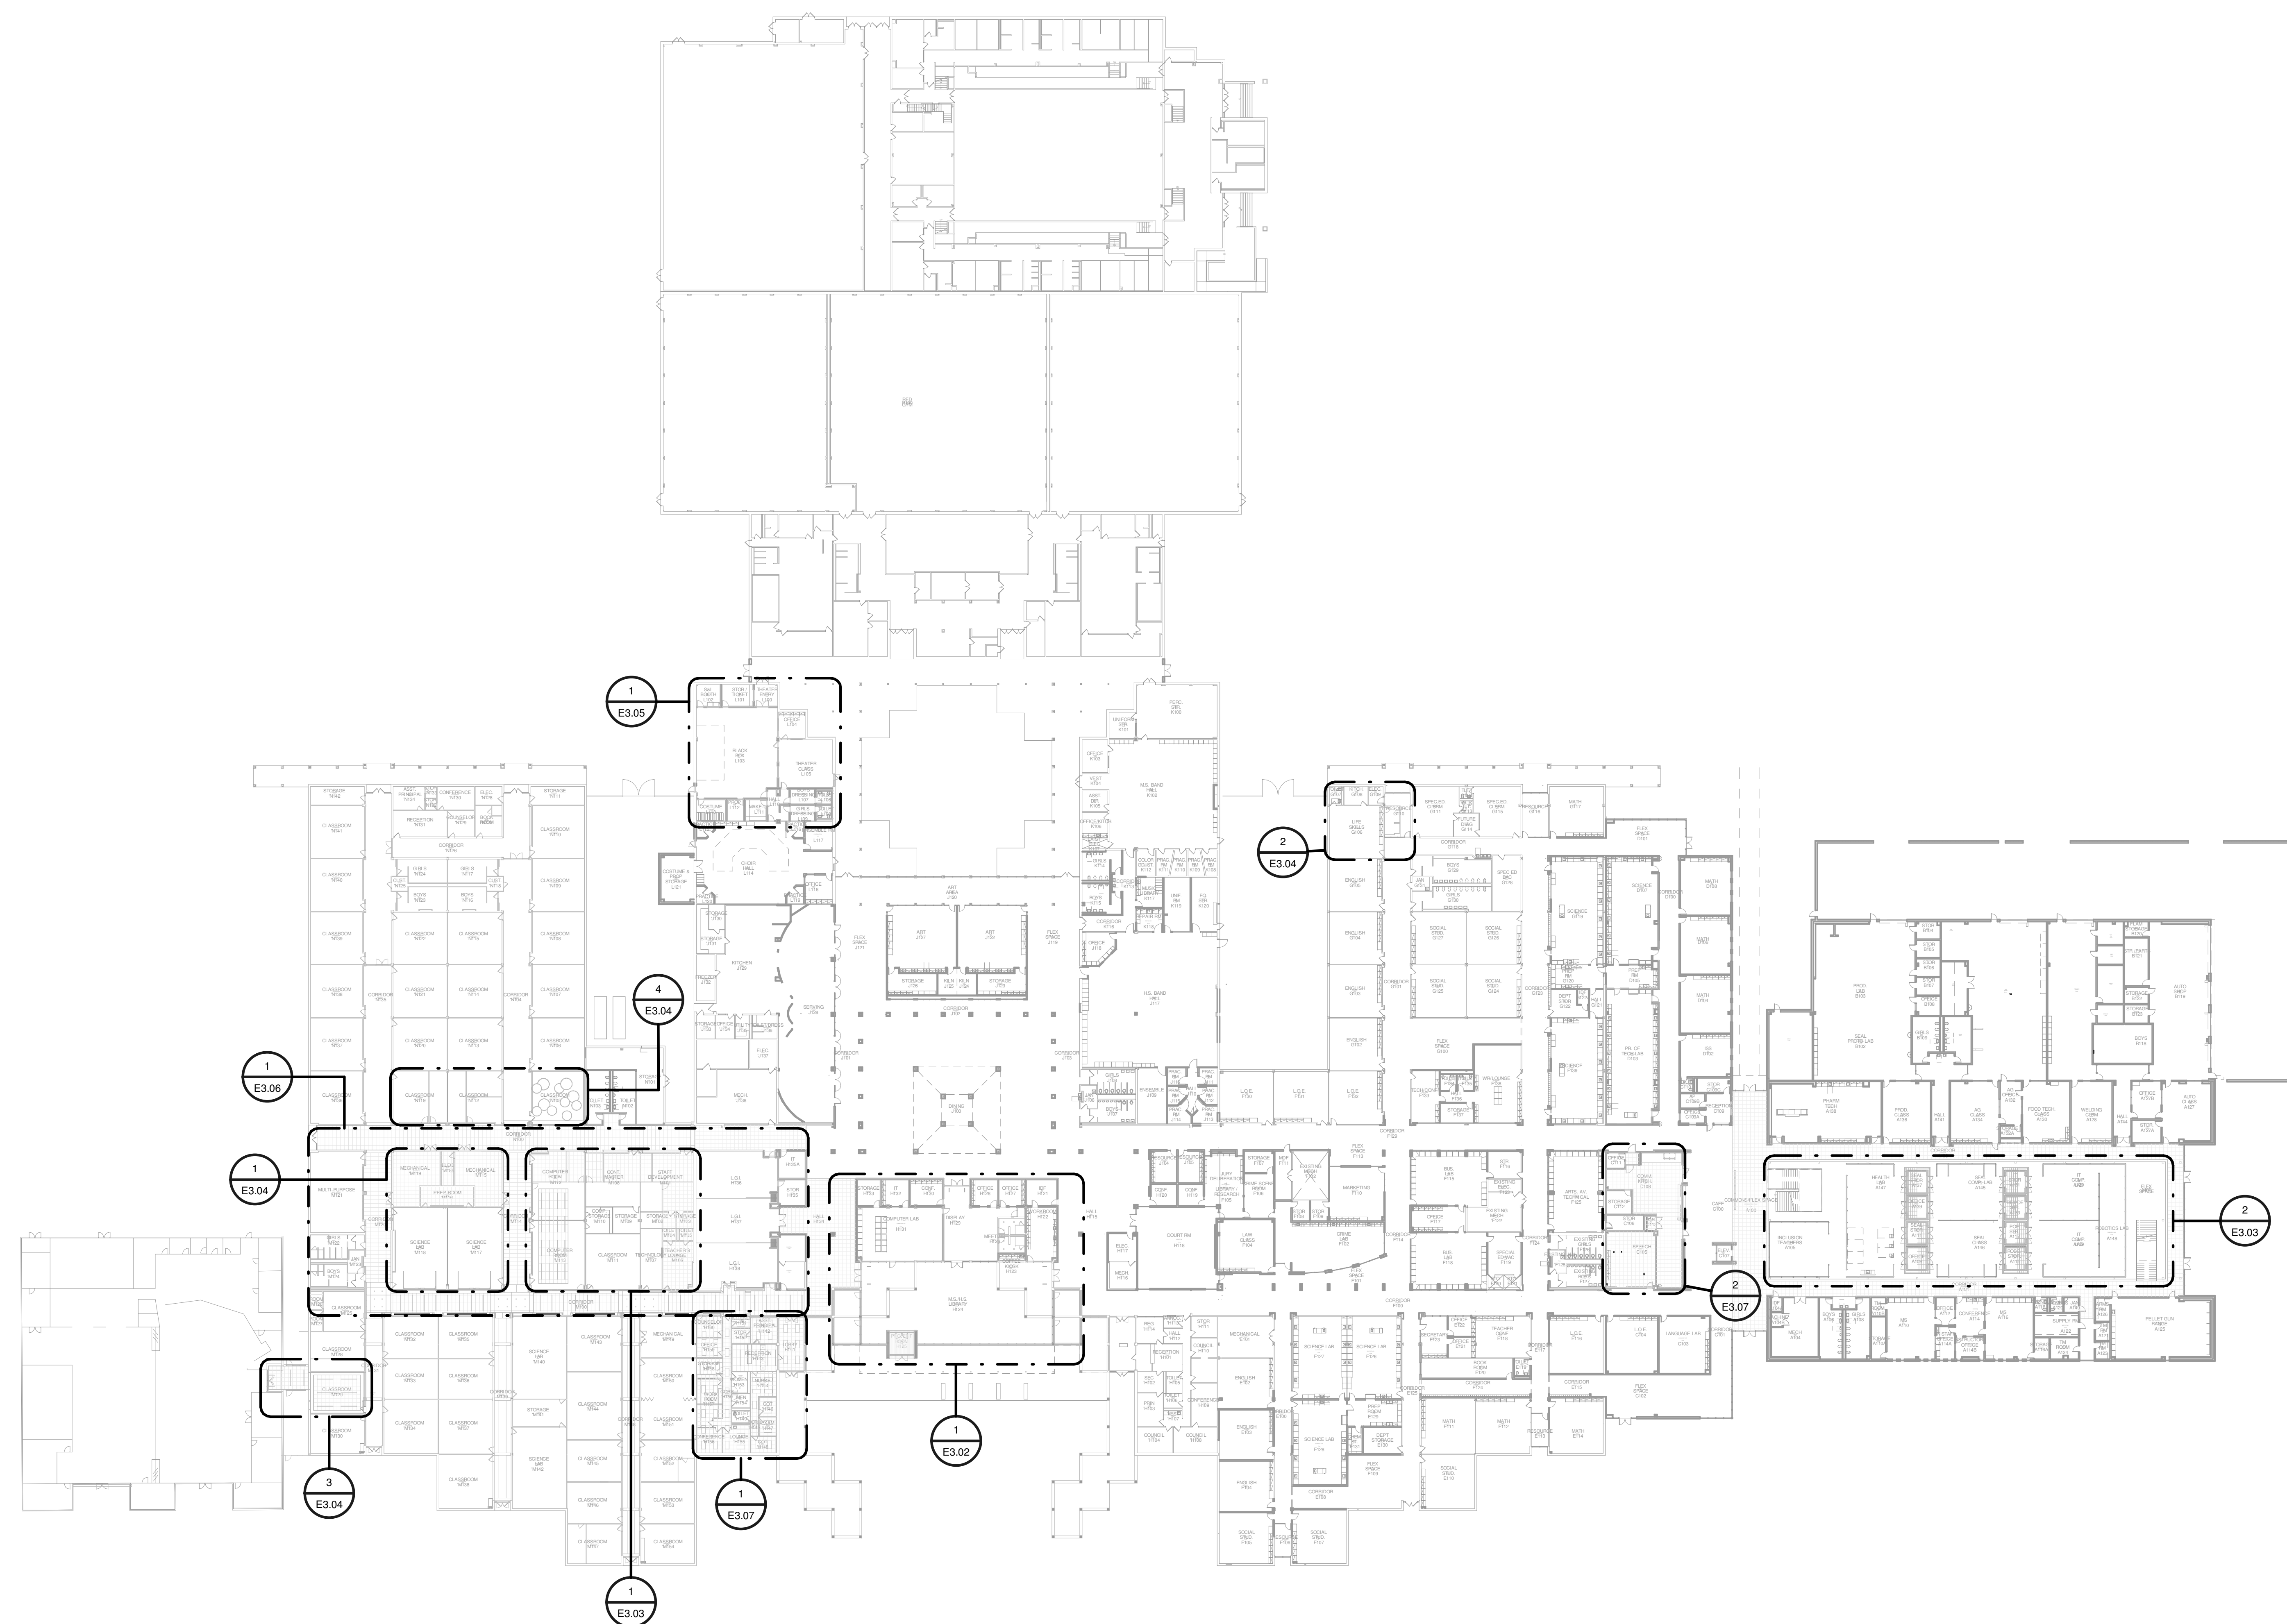
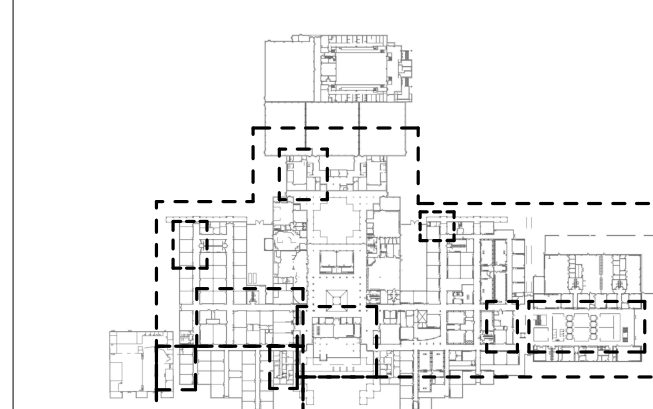


A PROJECT FOR:

**STAFFORD
HIGH SCHOOL
& MAGNET
SCHOOL
RENOVATIONS**

1625 STAFFORDSHIRE
ROAD,
STAFFORD, TX 77477

#	Date	ISSUED FOR
1	2020/01/31	90% CD
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1 OVERALL PROPOSED PLAN - LIGHTING
Scale: 1" = 40'-0"

Project Number	19006-A
Drawn By	LT
Checked By	AW
Approved By	MS
Drawing Title	OVERALL PROPOSED PLAN - LIGHTING
Drawing Number	E3.01



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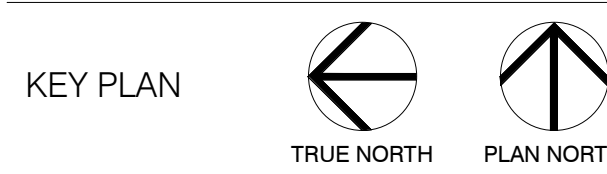
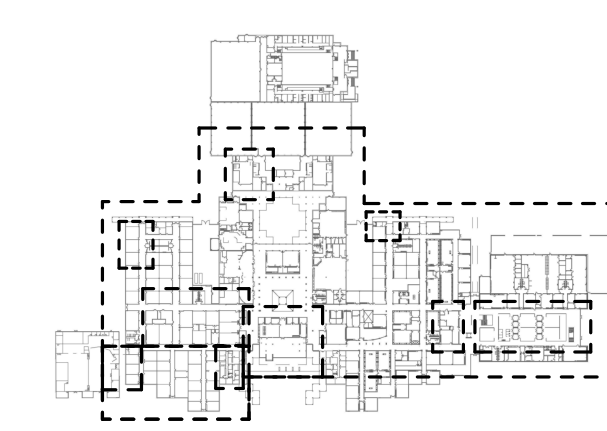


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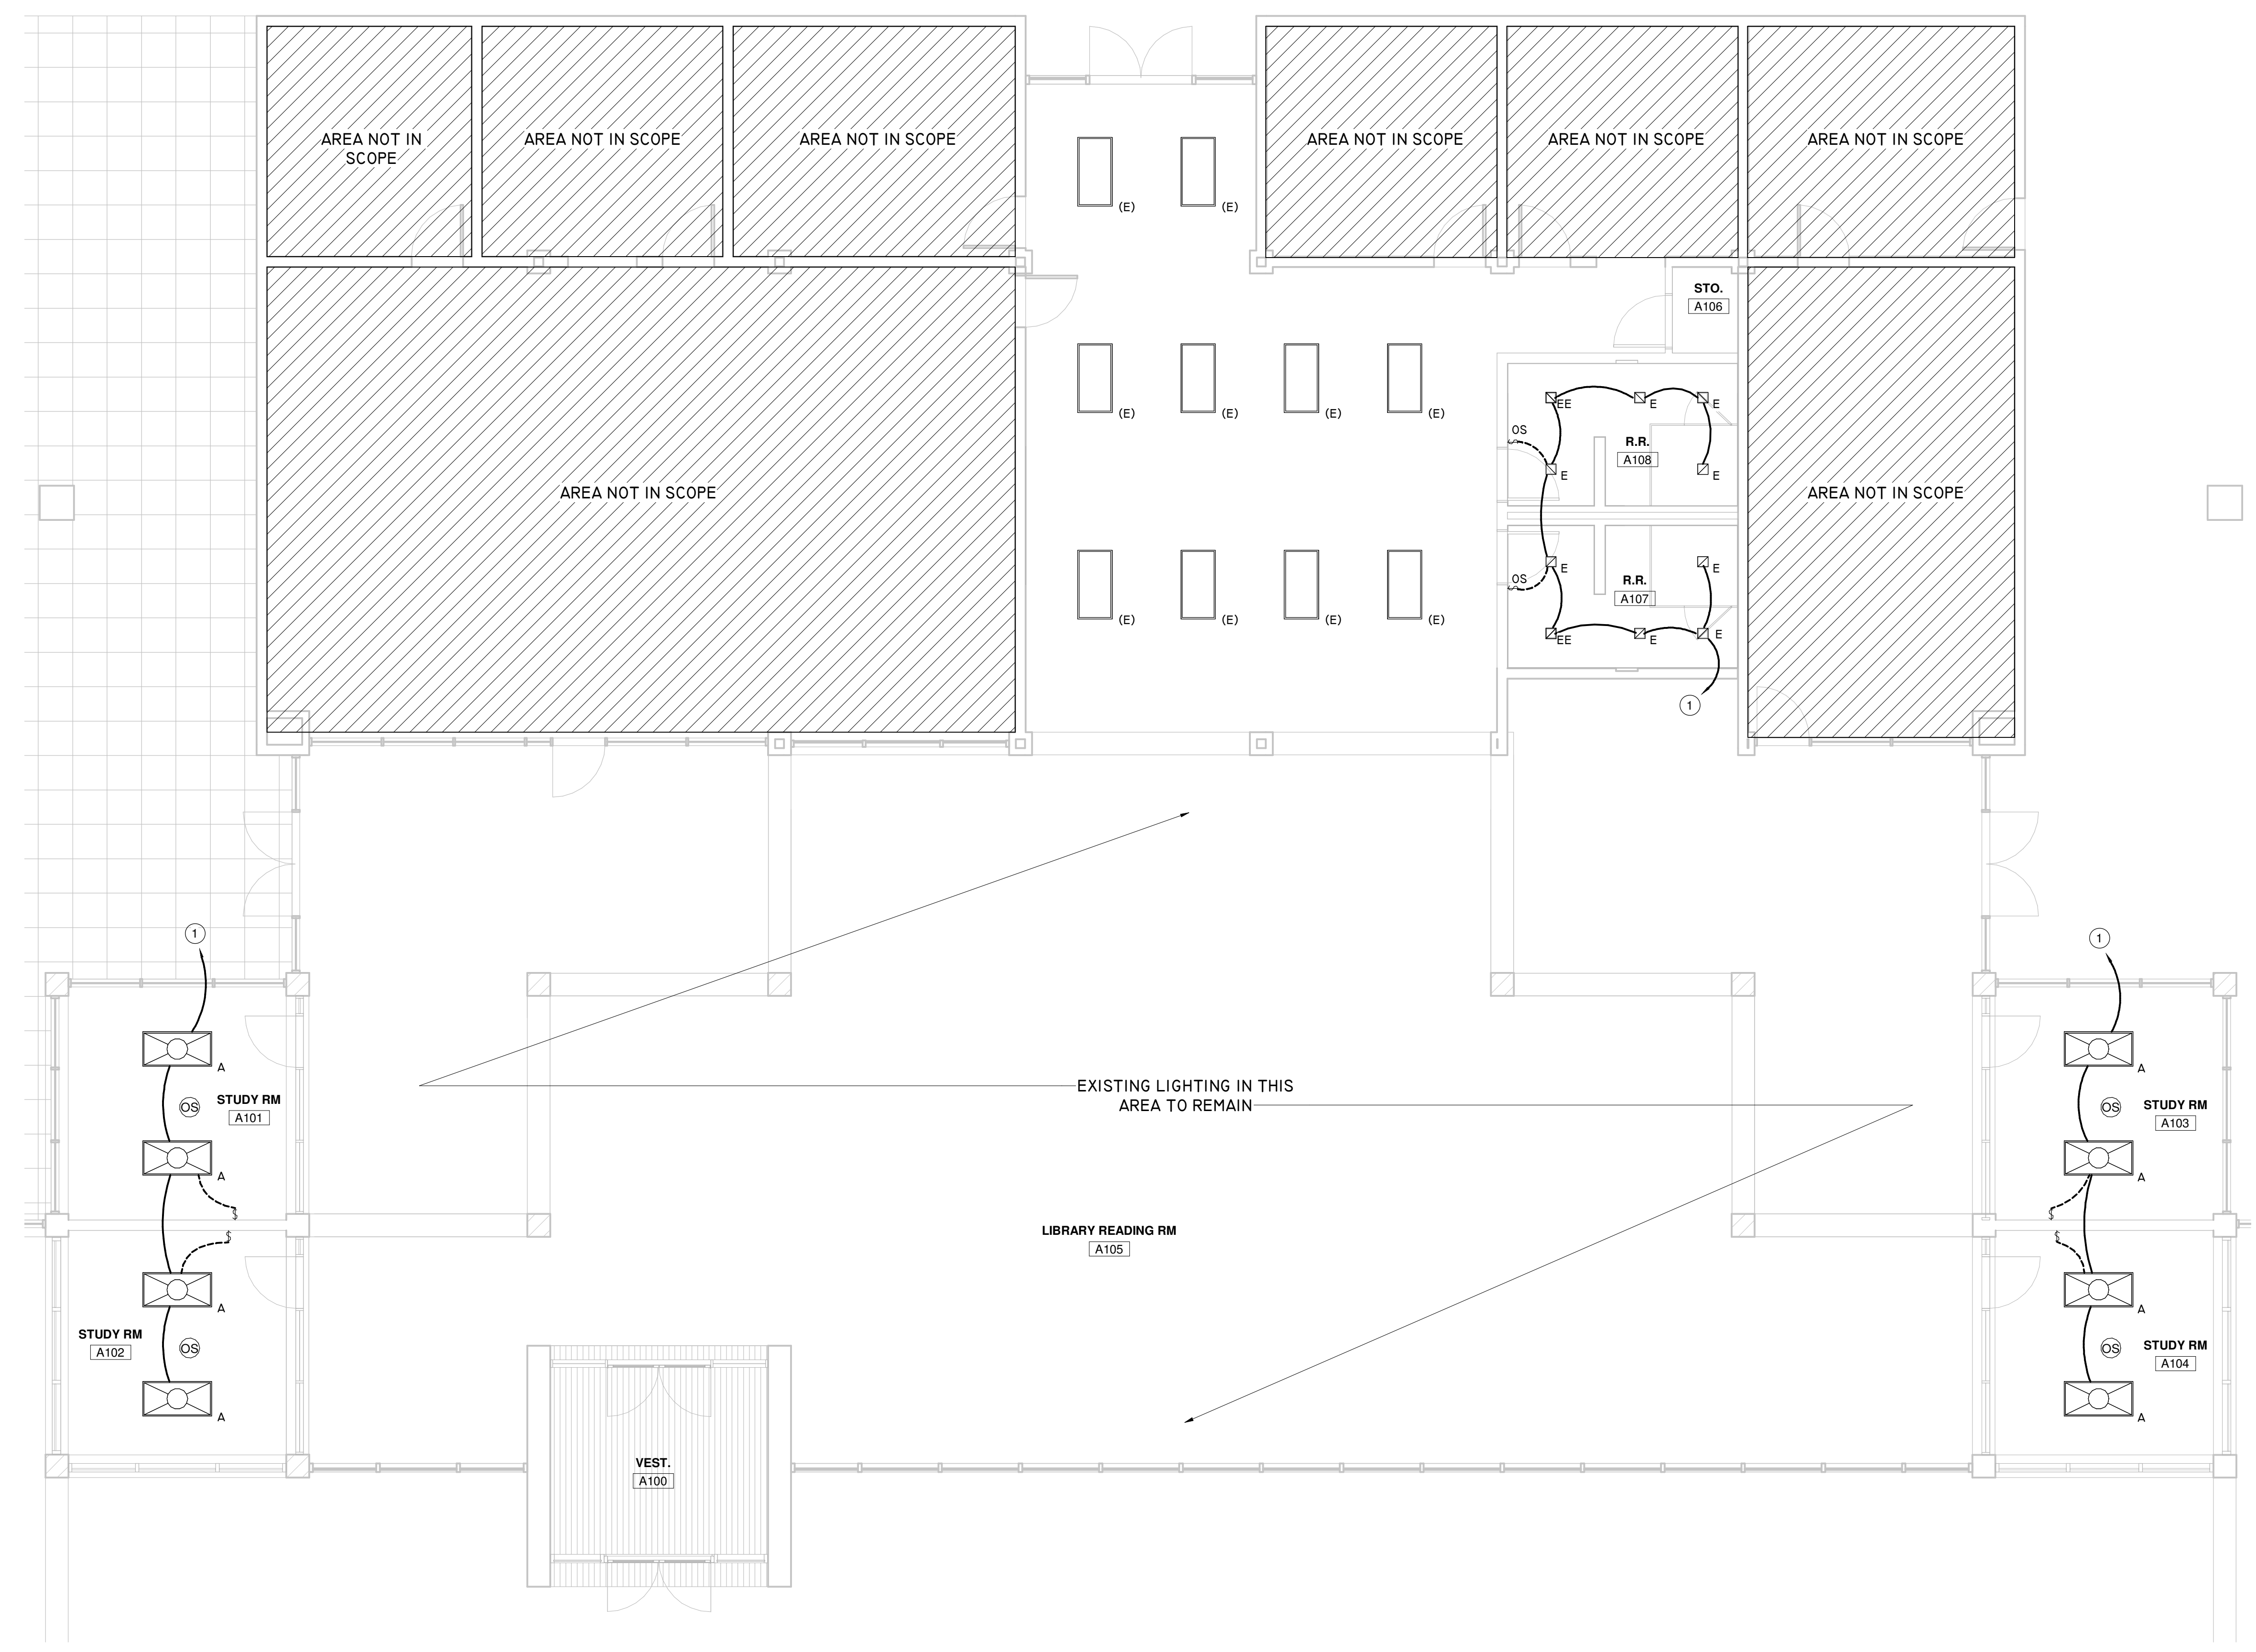
**STAFFORD
HIGH SCHOOL
& MAGNET
SCHOOL
RENOVATIONS**

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ROAD,
STAFFORD, TX 77477

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KEYNOTE LEGEND	
	CONNECT NEW LIGHTING FIXTURES TO NEAREST LIGHTING CIRCUIT WITH AVAILABLE CAPACITY TO SUPPORT THE ADDITIONAL LOAD.



1 ENLARGED PROPOSED PLAN - AREA C - LIGHTING
Scale: 3/16" = 1'-0"

Project Number	19006-A
Drawn By	LT
Checked By	AW
Approved By	MS
Drawing Title	ENLARGED PROPOSED PLAN - LIGHTING
Drawing Number	E3.02


KEYNOTE LEGEND

CONNECT NEW LIGHTING FIXTURES TO NEAREST LIGHTING CIRCUIT WITH AVAILABLE CAPACITY TO SUPPORT THE ADDITIONAL LOAD.

NOTE: WORK INDICATED IN THIS DETAIL SHALL BE PRICED AS ALTERNATE 4

2 ENLARGED PROPOSED PLAN - AREA H - LIGHTING

Scale: 1/8" = 1'-0"

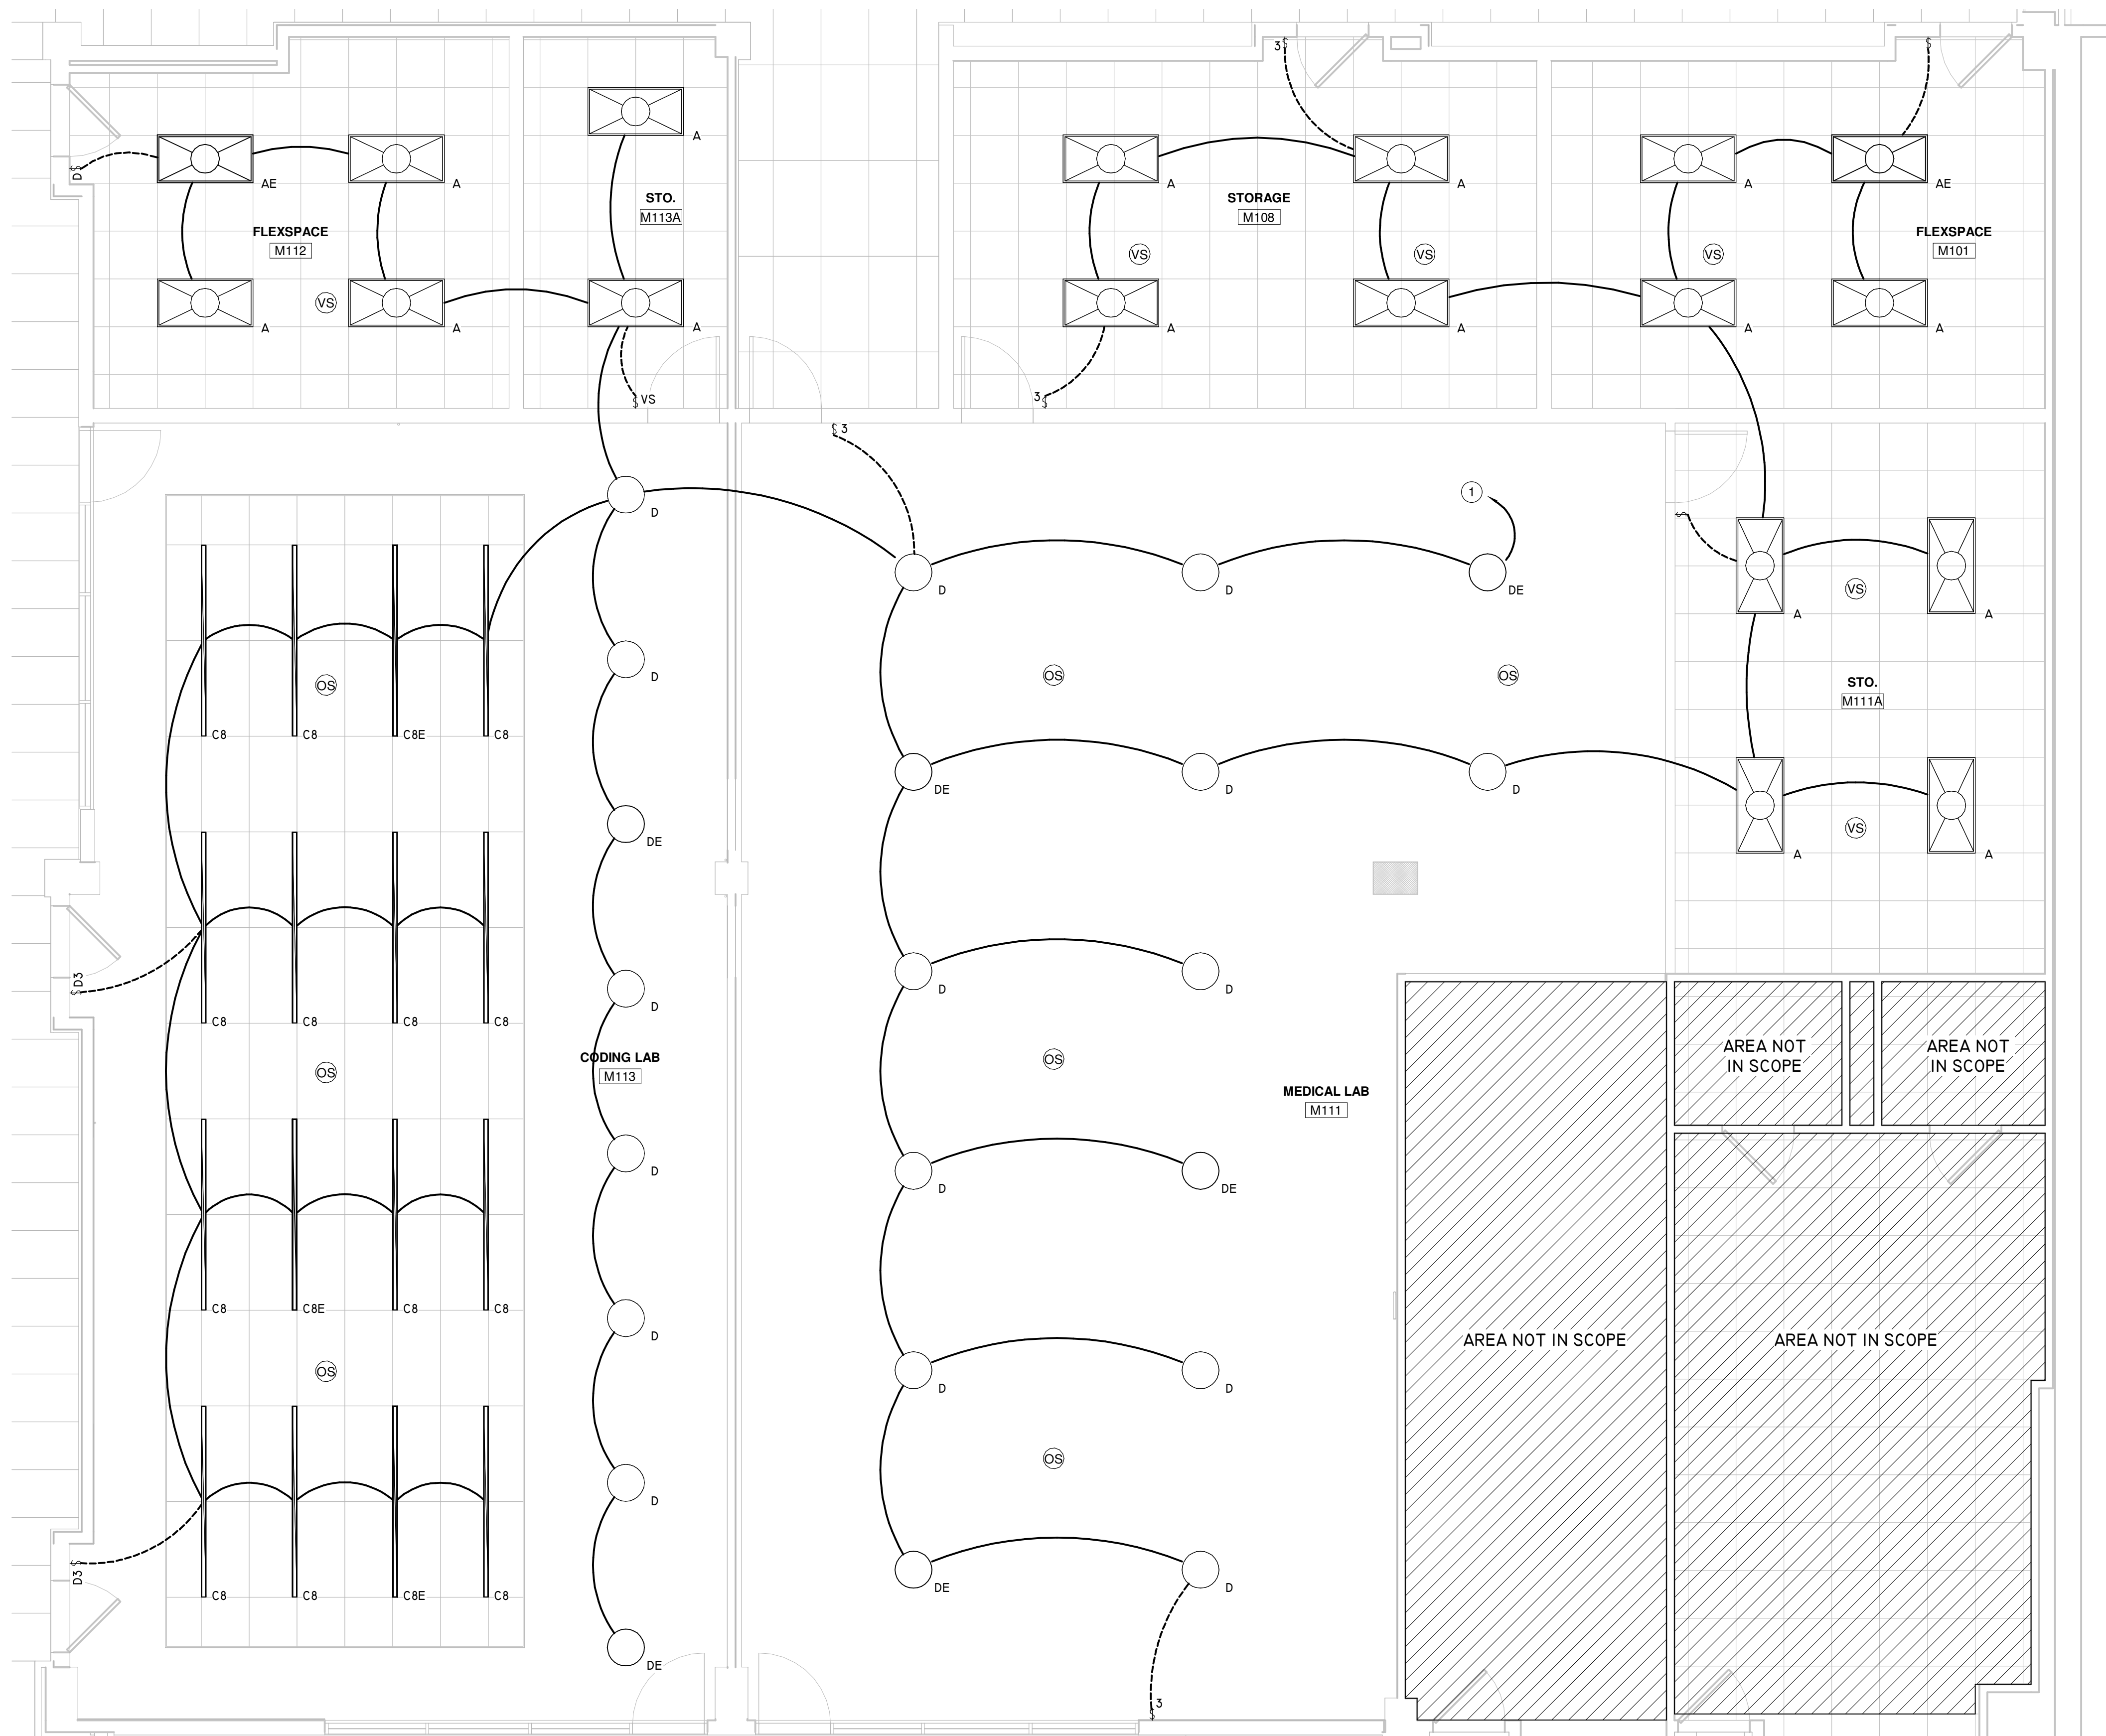

1 ENLARGED PROPOSED PLAN - AREA B3 - LIGHTING

Scale: 1/4" = 1'-0"



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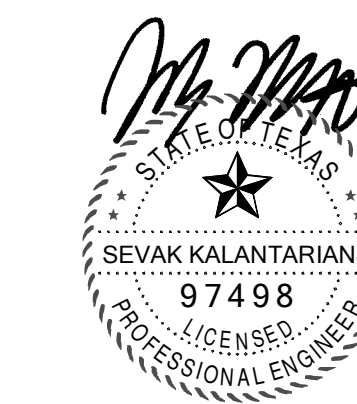
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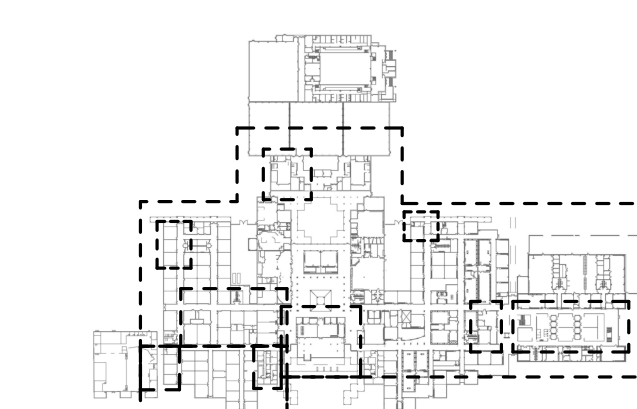
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A PROJECT FOR:

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HIGH SCHOOL
& MAGNET
SCHOOL
RENOVATIONS**

1625 STAFFORDSHIRE
ROAD,
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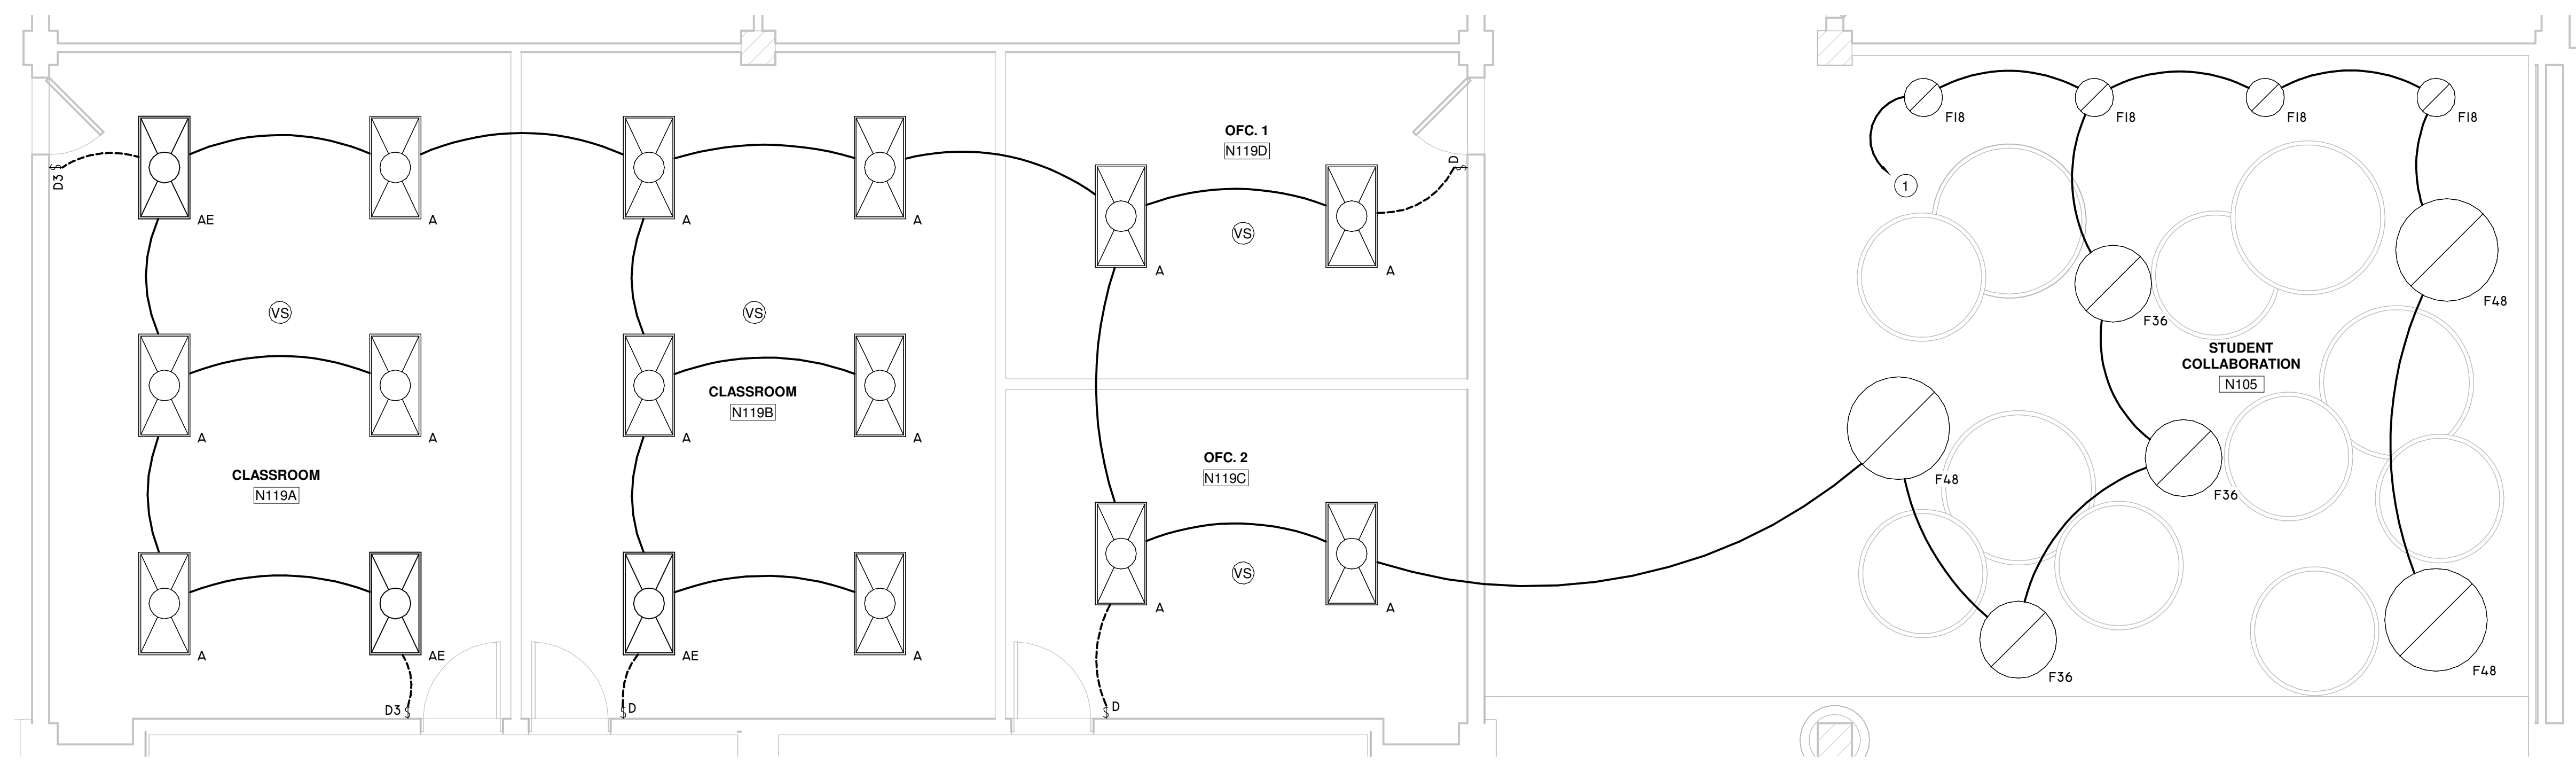
#	Date	ISSUED FOR
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KEY PLAN
TRUE NORTH
PLAN NORTH

Project Number	19006-A
Drawn By	LT
Checked By	AW
Approved By	MS
Drawing Title	ENLARGED PROPOSED PLAN - LIGHTING


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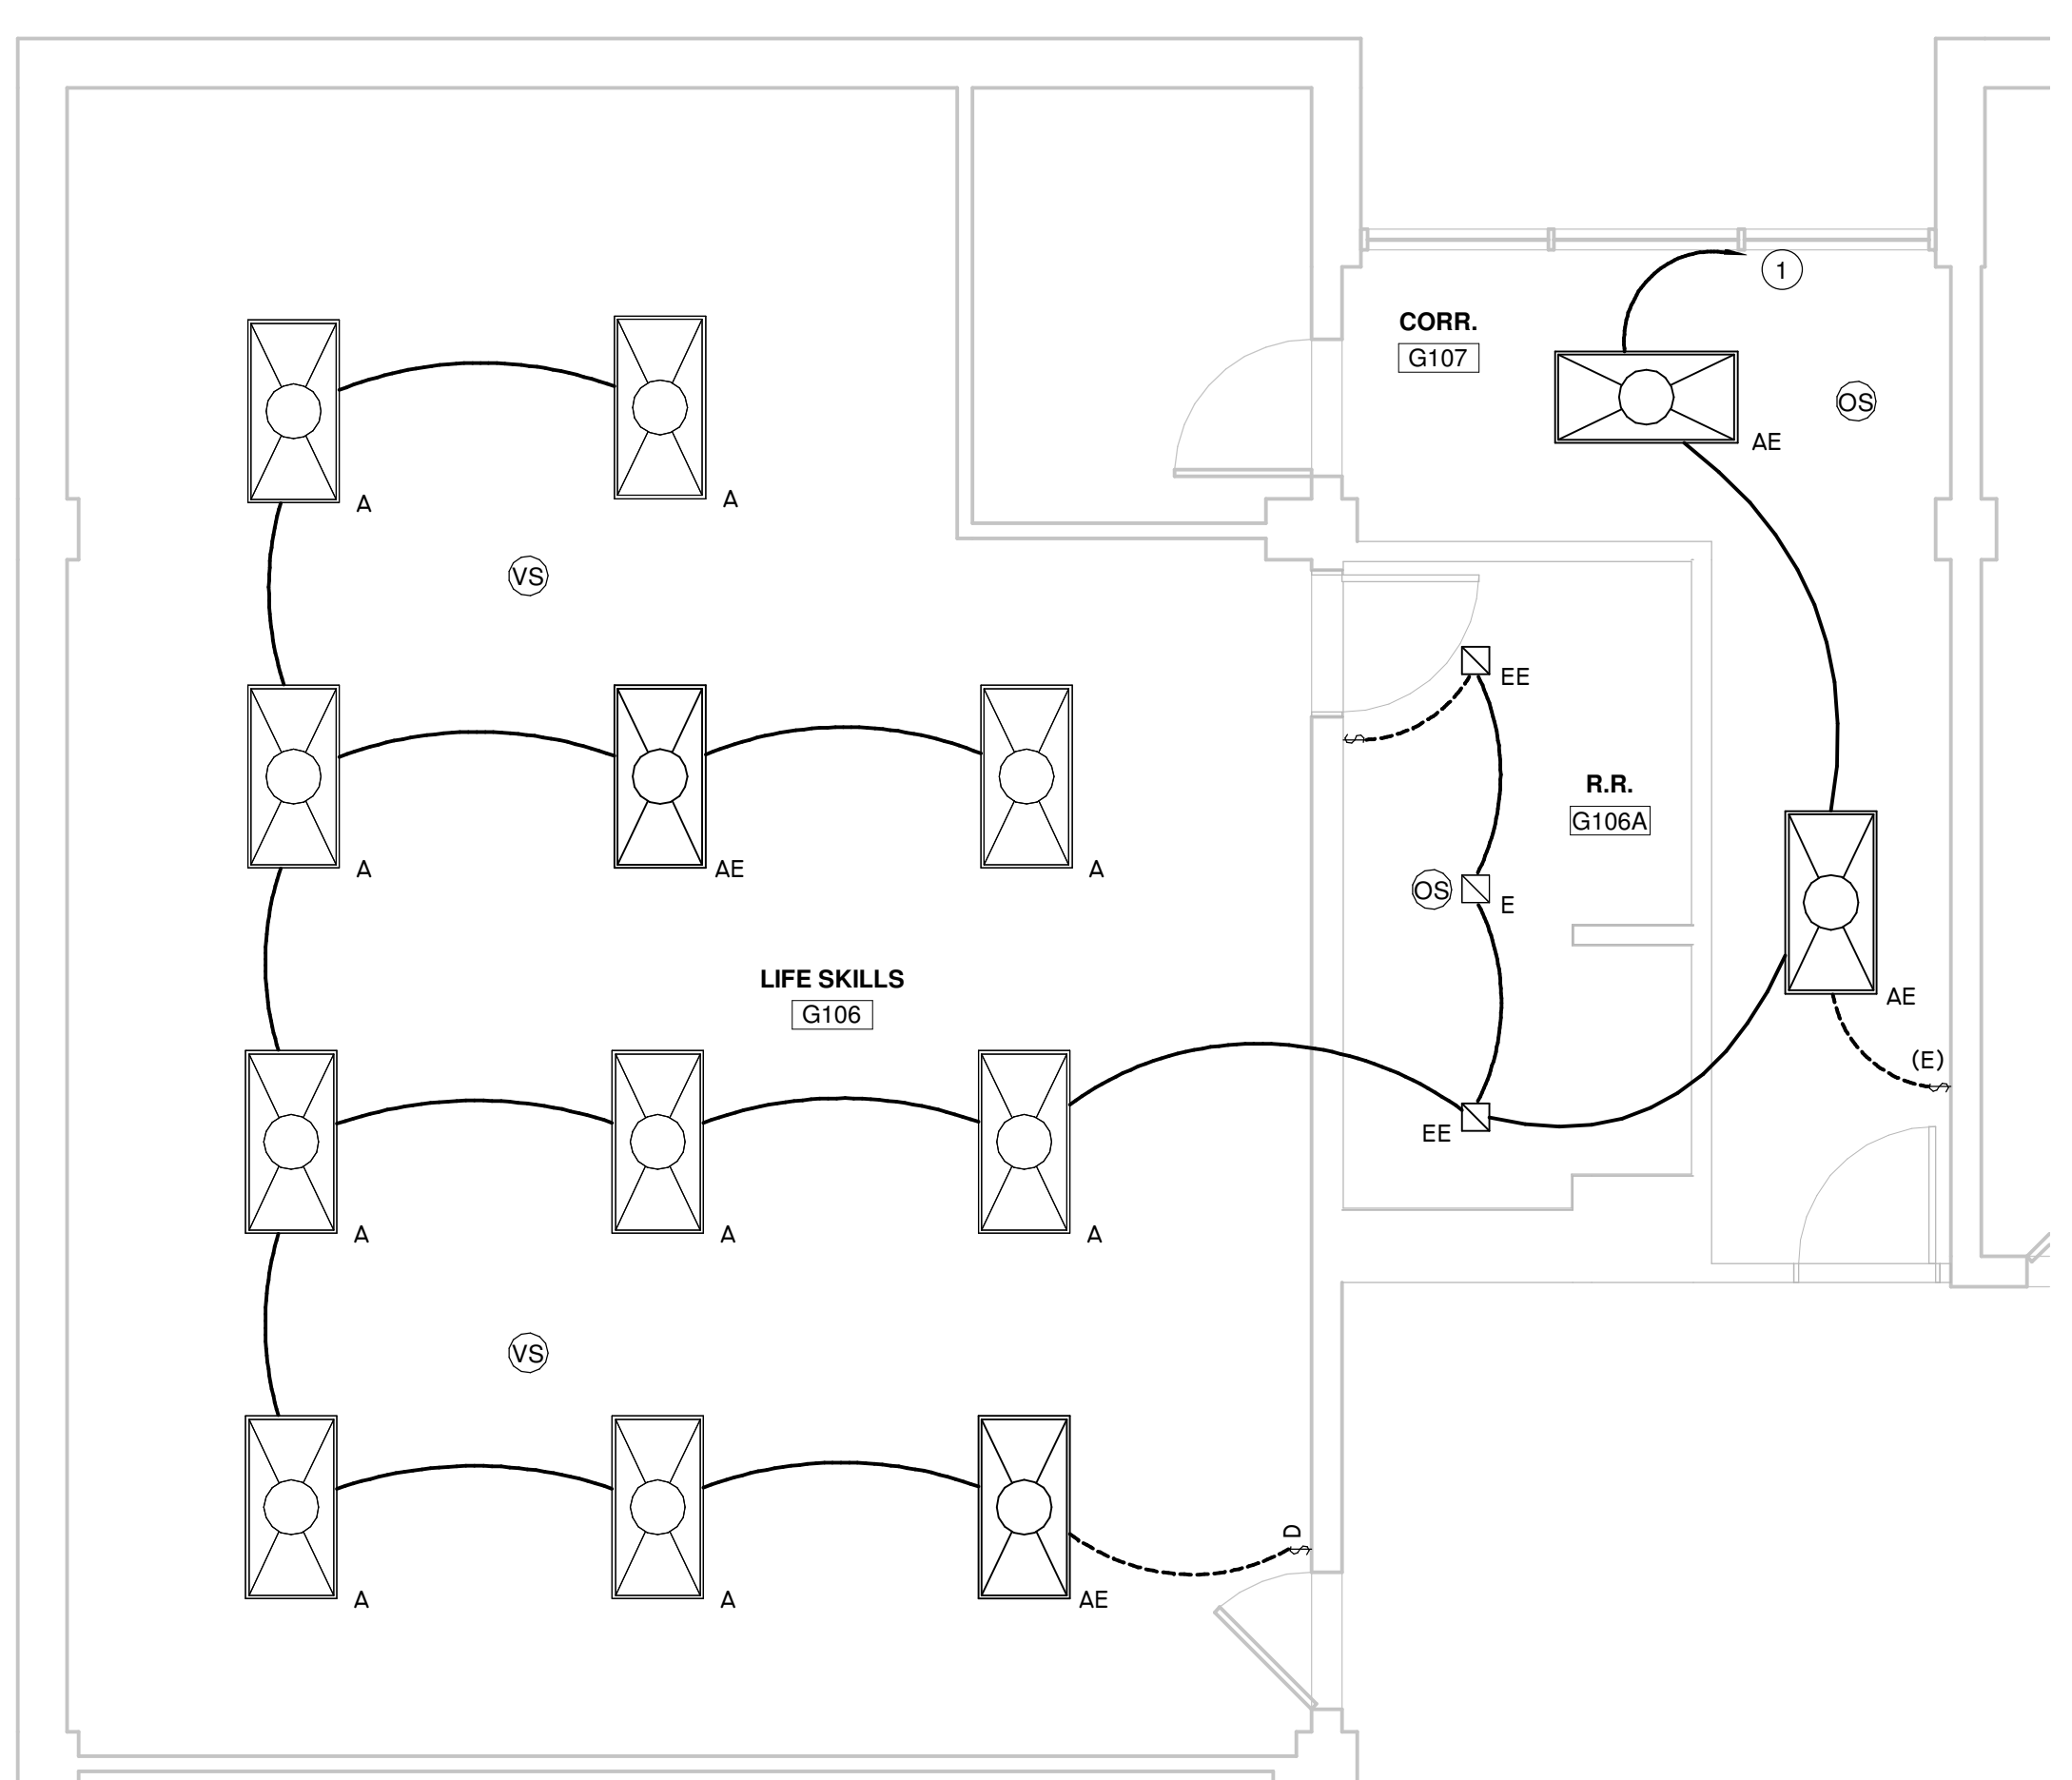
KEYNOTE LEGEND

CONNECT NEW LIGHTING FIXTURES TO NEAREST LIGHTING CIRCUIT WITH AVAILABLE CAPACITY TO SUPPORT THE ADDITIONAL LOAD.


4 ENLARGED PROPOSED PLAN - AREA B4 - LIGHTING
Scale: 1/4" = 1'-0"



3 ENLARGED PROPOSED PLAN - AREA B1 - LIGHTING
Scale: 1/4" = 1'-0"

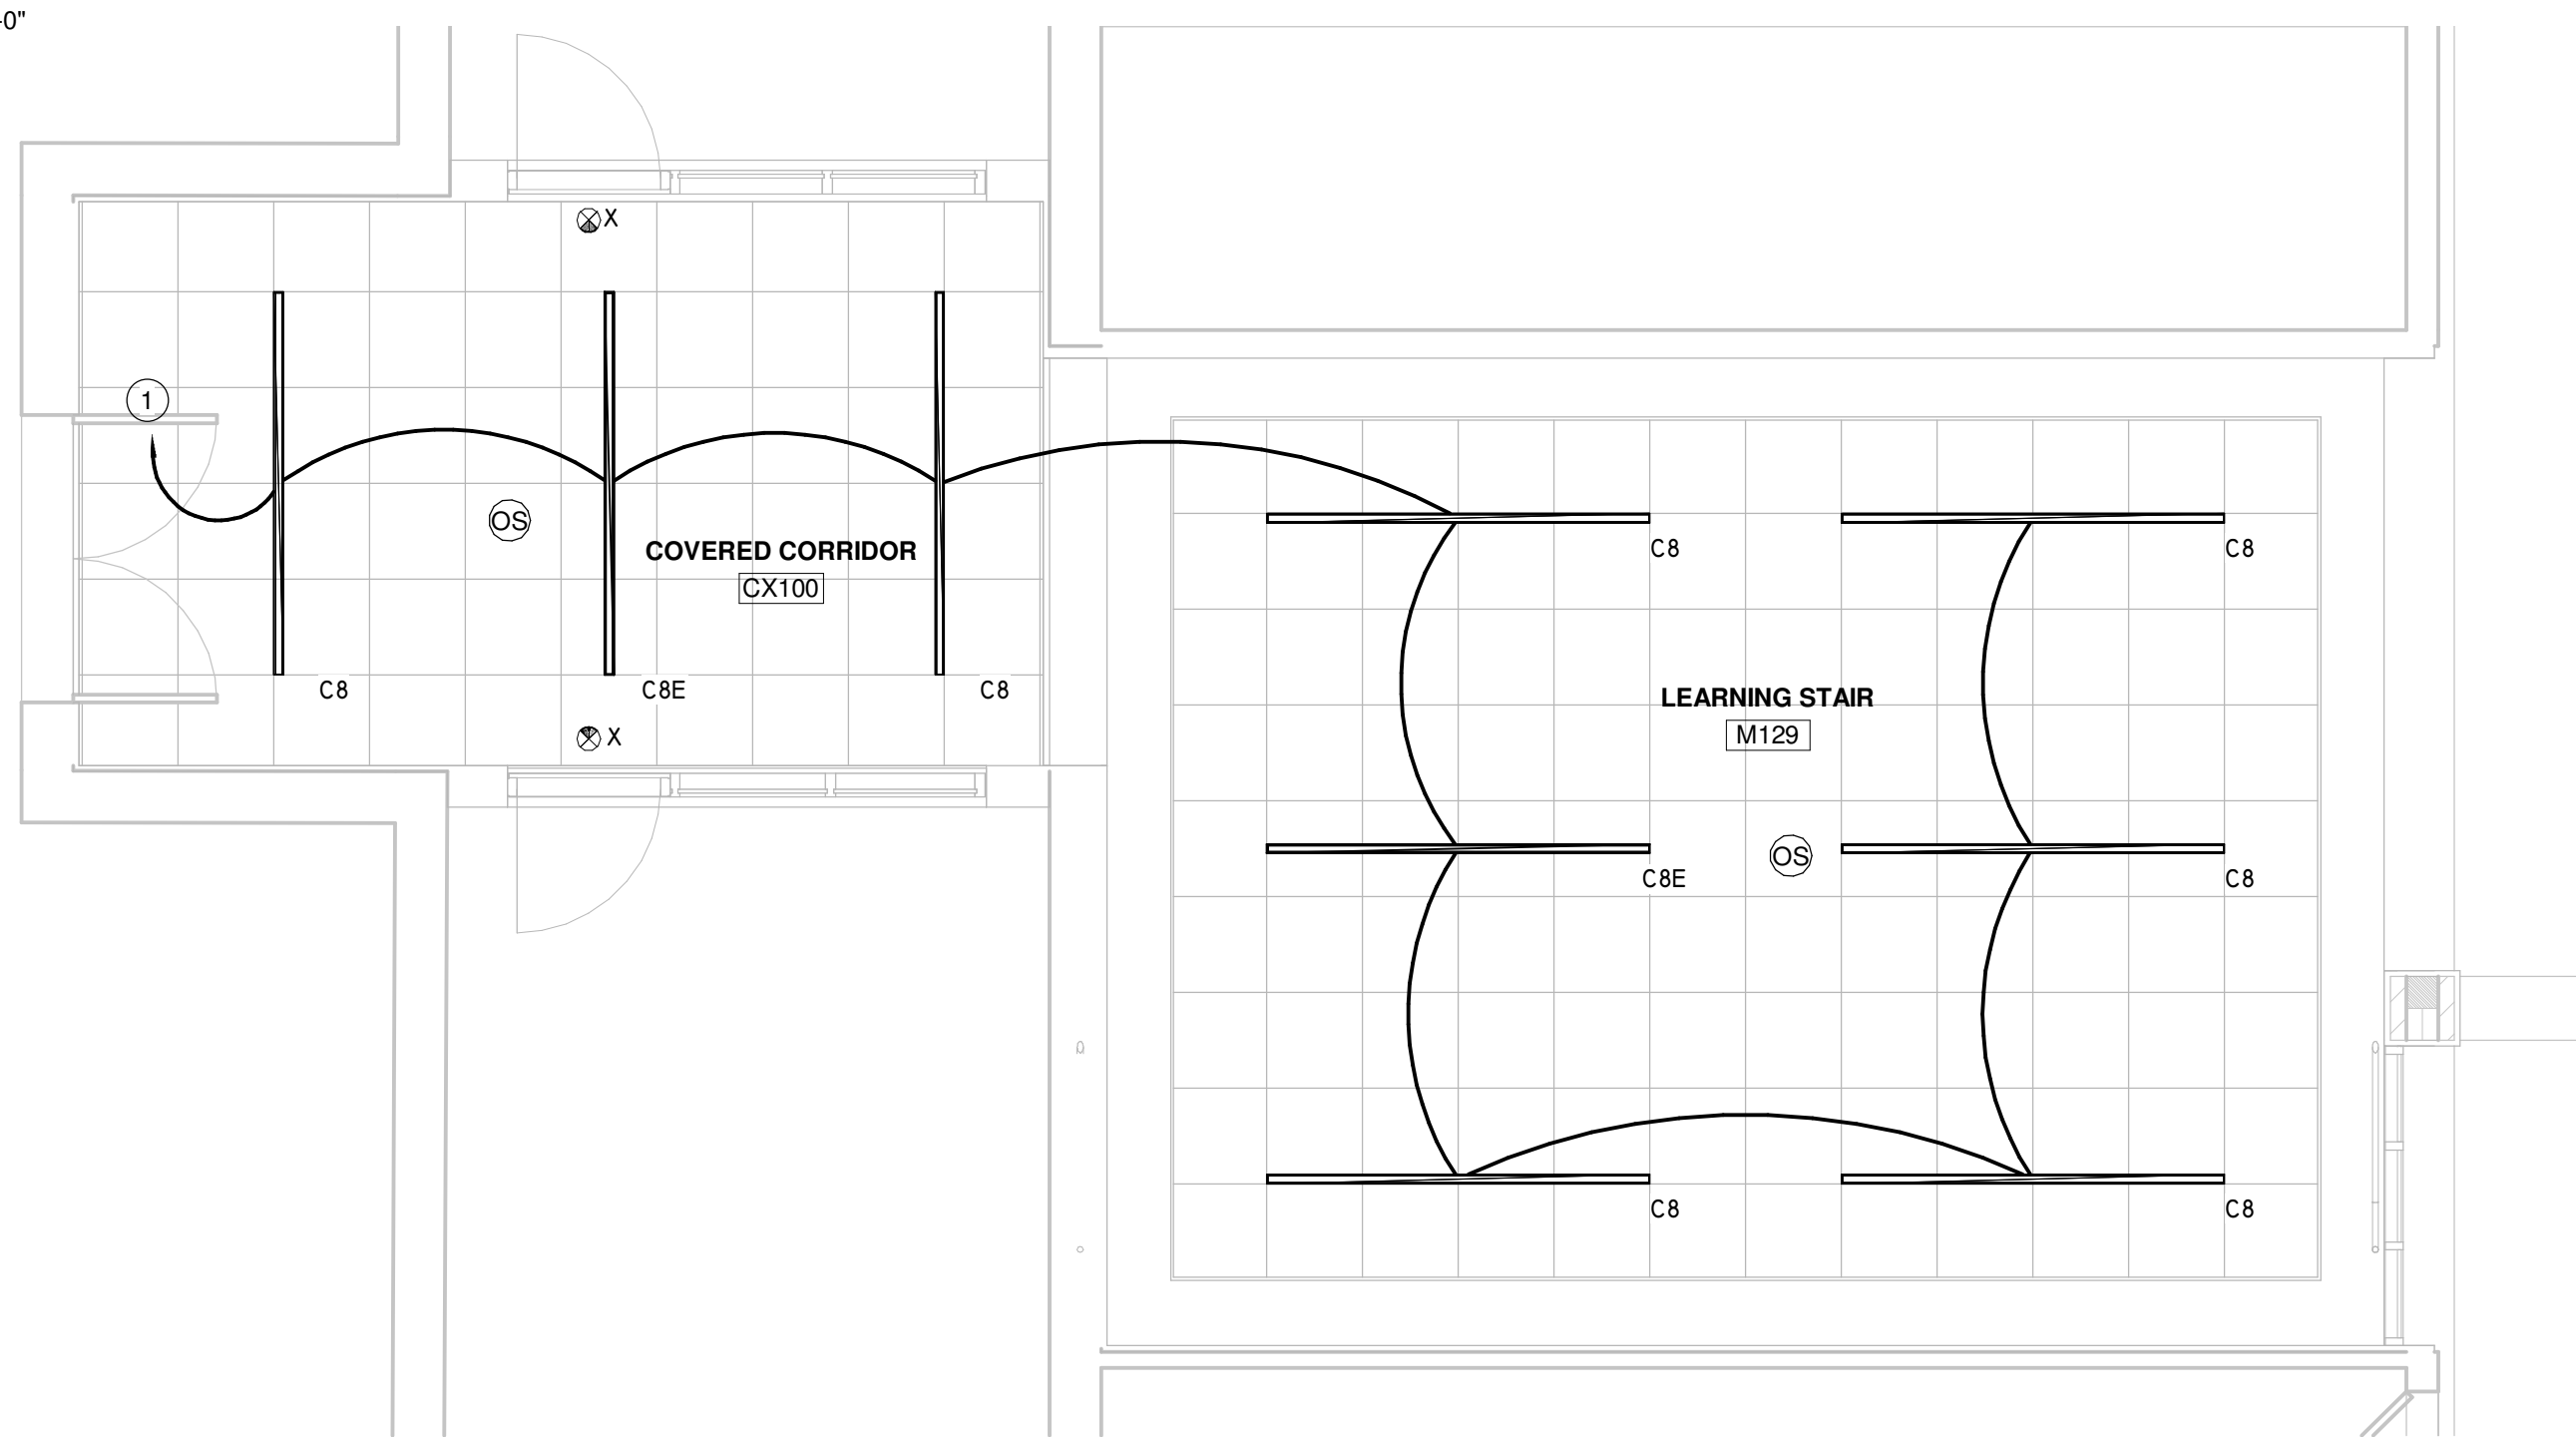

2 ENLARGED PROPOSED PLAN - AREA E - LIGHTING
Scale: 1/4" = 1'-0"

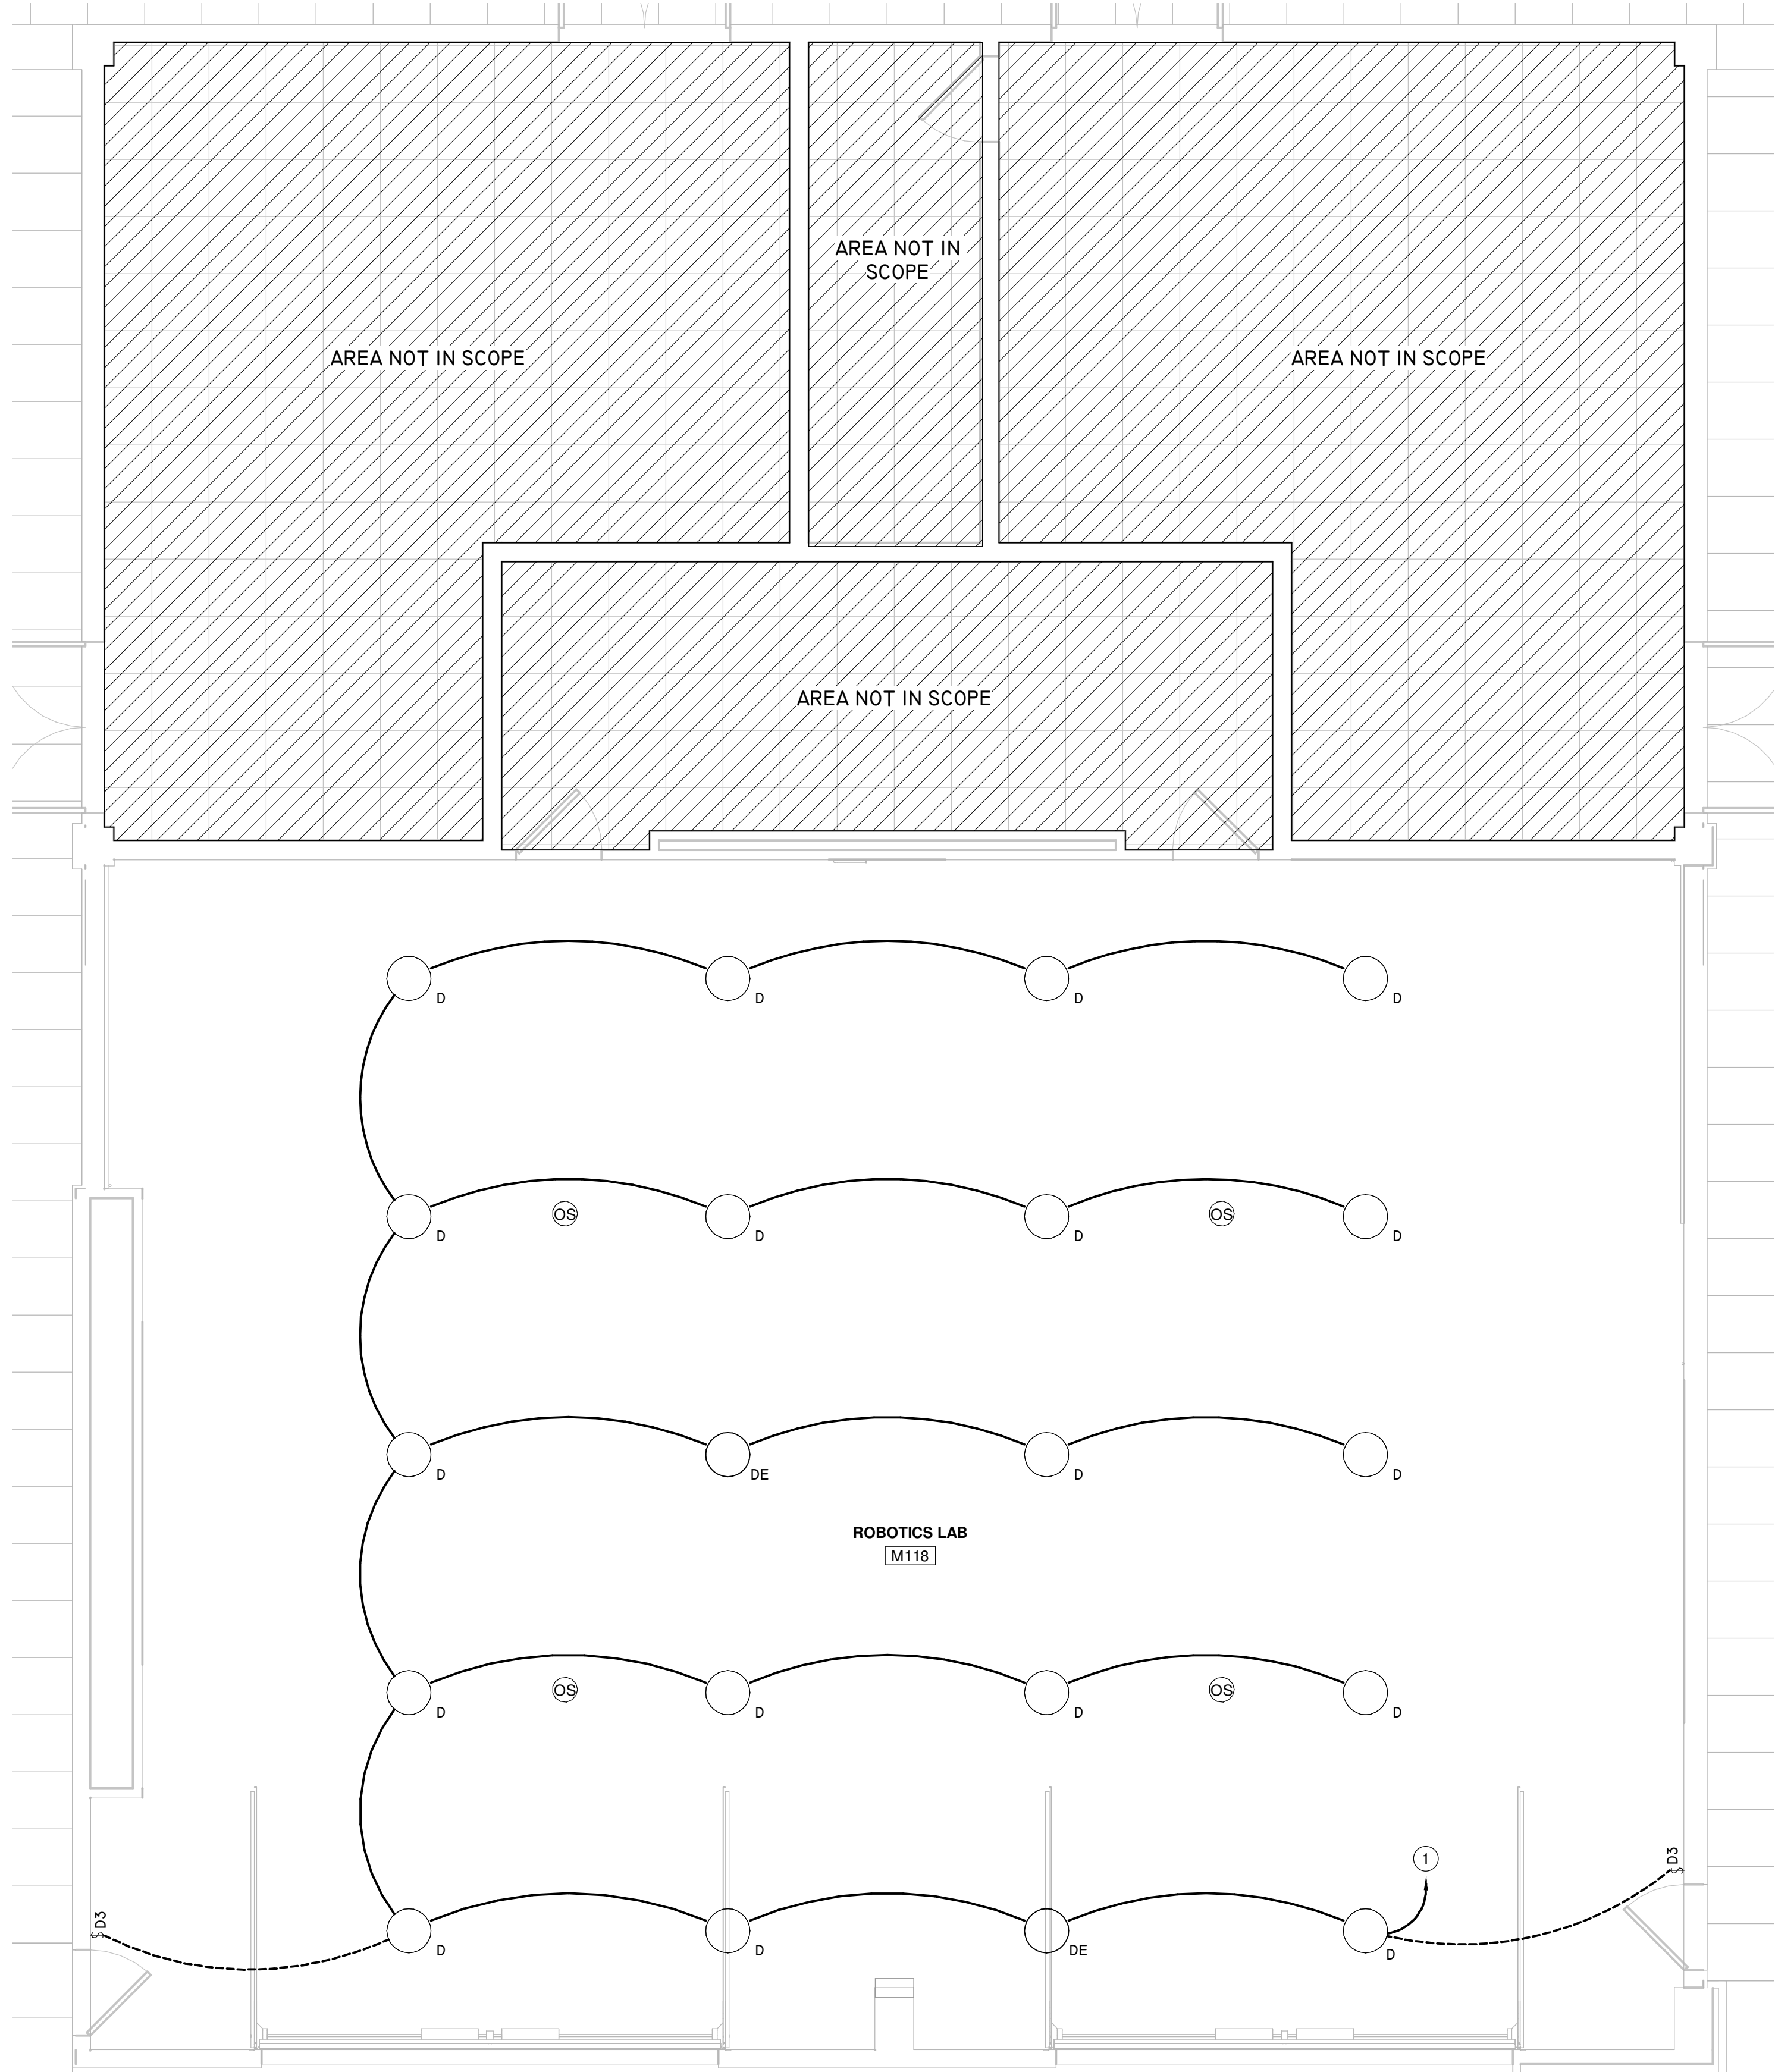

1 ENLARGED PROPOSED PLAN - AREA B2 - LIGHTING
Scale: 1/4" = 1'-0"

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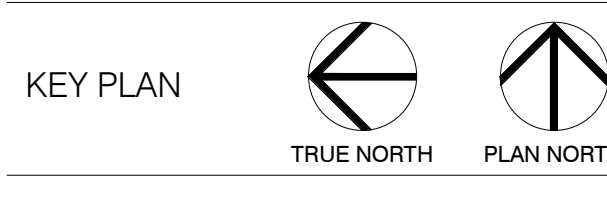
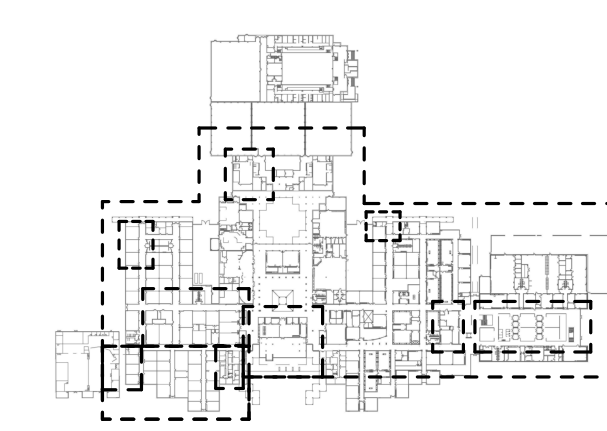
PROFESSIONAL SEAL:

A PROJECT FOR:

**STAFFORD
HIGH SCHOOL
& MAGNET
SCHOOL
RENOVATIONS**


1625 STAFFORDSHIRE
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STAFFORD, TX 77477

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1	2020/01/31	90% CD
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Project Number	19006-A
Drawn By	LT
Checked By	AW
Approved By	MS
Drawing Title	ENLARGED PROPOSED PLAN - LIGHTING
Drawing Number	E3.04

STAGE DIMMING SYSTEM CONTROL DETAIL



TL1 ETC COLORSOURCE SPOT LED WITH C-CLAMP, 36 DEGREE EDLT LENS TUBE, DMX CABLE, POWERCON TO EDISON OR PASS THROUGH CABLE, SAFETY CABLE, AND SMOOTH WASH DIFFUSER

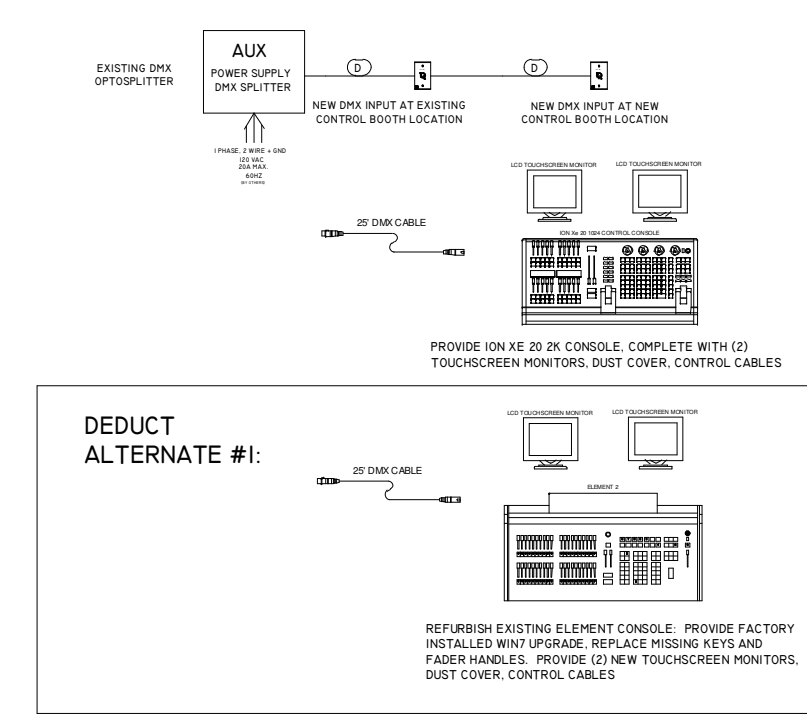TL2 ETC COLOR SOURCE PAR DEEP BLUE WITH C-CLAMP, WFL LENS, DMX CABLE, POWERCON TO EDISON OR PASS THROUGH CABLE, SAFETY CABLE

DEDUCT ALTERNATE #1: TL2 EXISTING ETC RESIRE D40 FIXTURES. CLEAN, TEST AND SEND ALL MALFUNCTIONING FIXTURES BACK TO ETC FOR REPAIR. PROVIDE WFL LENSES. PROVIDE POWERCON PASS THROUGH CABLES AND DMX CABLES AS NEEDED TO PLUG IN ALL FIXTURES IN NEW LOCATIONS.

TL3 ETC RELIVE SPOT WITH CLAMP, DMX CABLE, POWERCON TO EDISON OR PASS THROUGH CABLE, SAFETY CABLE

THEATRICAL CONTRACTOR IS RESPONSIBLE FOR ASSESSING SITE CONDITIONS AND PROVIDING ALL NECESSARY CABLES AND ACCESSORIES TO MAKE THIS A COMPLETE AND WORKING SYSTEM.


- NOTES:**
- REFER TO SPECIFICATIONS
 - ELECTRICAL CONTRACTOR SHALL INSTALL DMX INPUT AND PROVIDE AND INSTALL ALL CONDUIT AND LOW VOLTAGE CABLE FOR PERMANENT INSTALLATION.
 - THEATRICAL CONTRACTOR SHALL TERMINATE LOW VOLTAGE CABLE AND CHECK ALL EXISTING DMX INFRASTRUCTURE AND REPAIR AS NEEDED
 - THEATRICAL CONTRACTOR SHALL PROVIDE AND INSTALL ALL PORTABLE EQUIPMENT. THEATRICAL CONTRACTOR SHALL ADDRESS, NAME AND FOCUS ALL FIXTURES TO A LIGHT STANDING PLAN AND DOCUMENTED IN DRAWING. WITH THIS AREA, COORDINATE STAGE SPACE AND AREA LOCATION WITH HIRSHL, TEACHER ADJUST FINAL FIXTURE LOCATIONS AS NEEDED TO PROVIDE UL PLST. ADDITIONAL WORKING LEFTOVER BEING FIXTURES MAY BE MAID FOR DMX SUPPORT BY REPLACEMENT FIXTURES BY THE DIRECTION OF THE OWNER'S REP. EXISTING PRESH FIXTURES SHALL BE REMOVED AND DISPOSED OF OR IF REQUESTED BY OWNER, TRENCH OVER TO OWNER FOR REUSE IN OTHER FACILITIES
 - THEATRICAL CONTRACTOR SHALL SET UP AND PROGRAM THE LIGHTING CONTROL CONSOLE. PROVIDE INITIAL CHANNEL PATCH CABLES TO GET CLASSES STARTED AND PROVIDE TRAINING IN THE CONSOLE USE. ALL FIXTURES SHALL BE LABELED IN PATCH WITH FOCUS INFORMATION. CONSOLE SETUP SHALL INCLUDE A PAPER SHEET WITH FIXTURE PURPOSE AND AREA LABELED
 - AT THE CONCLUSION OF THE PROJECT, THEATRICAL CONTRACTOR SHALL PROVIDE COMPLETE SYSTEM DOCUMENTATION TO OWNER INCLUDING BUT NOT LIMITED TO: (A) AS-BUILT TAGS AND FOCUS PLAN DRAWN TO SCALE WITH FIXTURE TYPES AND NUMBERS INDICATED, (B) HUNG LAMP PRINTOUTS WITH ALL CHANNEL, ADDRESS, AND FOCUS INFORMATION LISTED, (C) USB STIX WITH "BARET" SHOW FILE SAVED ON IT THAT INCLUDES THE PATCH AND MUSIC WHEELS AND SEVERAL MUSIC CUES SUITABLE FOR LEARN UP, REHEARSAL, LIGHTING, AND CLASSROOM PRESENTATIONS
 - ALL OVERHEAD PIPES INSTALLED SHALL BE 1" SCHEDULE 40 BLACK IRON PAINTED BLACK UNLESS OTHERWISE NOTED. PIPES SHALL BE INSTALLED WITH WATED PROOF COIL CHAIN AND PIPE CLAMP SO PIPE WILL NOT TWIST
 - DMX CONTROL WIRE SHALL BE BLENDED 1/2 IN. CAT5E IN CONDUIT TO AN ACCEPTABLE ALTERNATE. ALL CONTROL WIRE SHALL BE IN CONDUIT, DO NOT SUBSTITUTE WIRE TYPES WITHOUT CONSULT THE MANUFACTURER. FOR A LIST OF APPROVED WIRE THE SUBSTITUTIONS, OR FOR ANY OTHER QUESTIONS, CONTACT THE MANUFACTURER'S REP AT 733-4372-4300
 - ALL CIRCUITS SHALL HAVE GROUND-FREED NEUTRALS
 - LOW VOLTAGE TERMINATIONS, SYSTEM STARTUP, PROGRAMMING, AND TRAINING TO BE PROVIDED BY AN ETC AUTHORIZED SERVICE CENTER. CONTACT 733-4372-4300 FOR SYSTEM STARTUP. 3 HOURS PRIOR TO DESIRED DATE TO SCHEDULE
 - NEW LED FIXTURES SHALL HAVE A 5 YEAR COMPLETE WARRANTY, AND A 10 YEAR WARRANTY ON THE LIGHT ARRAY

NOTE: POSITIONS SHOWN ARE FOR ILLUSTRATION ONLY. COORDINATE FINAL POSITIONS WITH OWNER REP AND ADAPT TO CURTAIN LOCATIONS, MECHANICAL EQUIPMENT, AND SITE CONDITIONS

REPAIR/REPLACE EXISTING CONDUIT. PROVIDE FACTORY INSTALLED AND SPACED TIEBACK HOOKS ETC AND PAPER HANDS. PROVIDE TO NEW TOUCHSCREEN MONITORS AND CONSOLE CONTROL CABLES

CONTROL WIRING LEGEND	
SYMBOL	DESCRIPTION
(Symbol: Circle with dot)	DMX
(Symbol: Square with dot)	DMX
(Symbol: Triangle with dot)	DMX
(Symbol: Diamond with dot)	DMX
(Symbol: Hexagon with dot)	DMX
(Symbol: Octagon with dot)	DMX

ELECTRONIC THEATRE CONTROLS, INC.
2327 PRAIRIE VIEW BL. WHEATON, MI 48091
Phone (313) 437-4300
Web: www.etcconnect.com

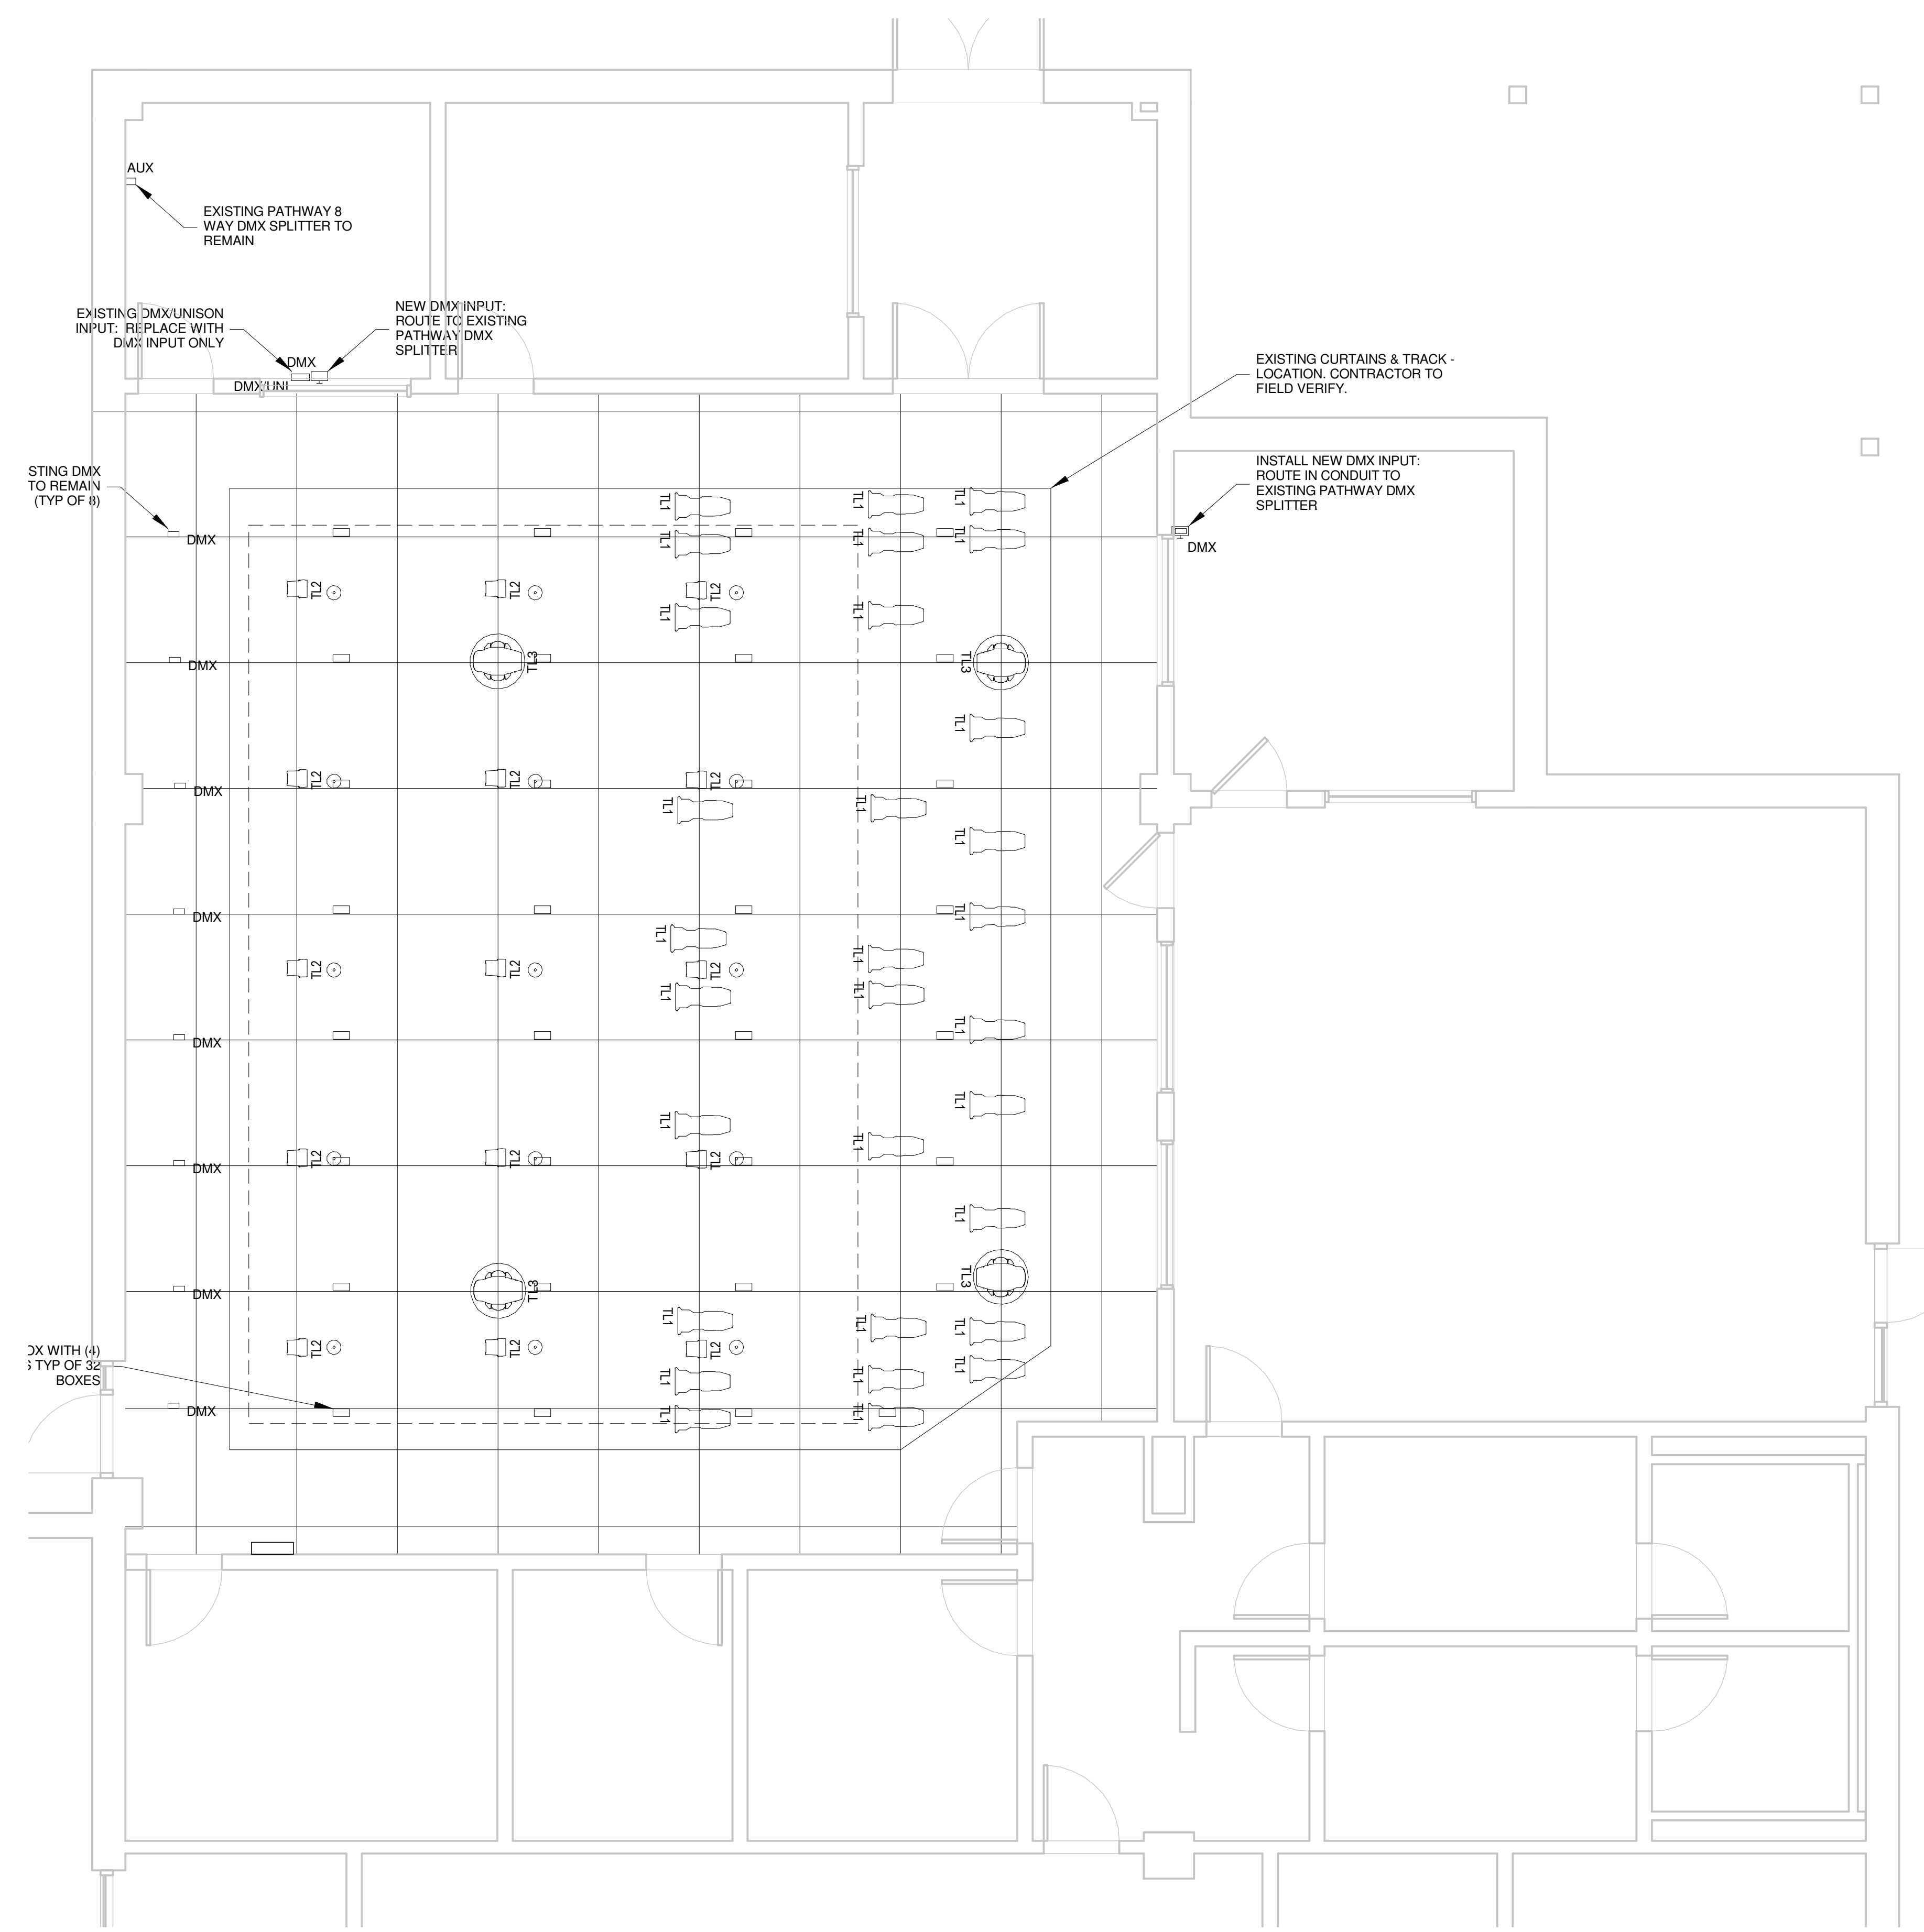

1 ENLARGED PROPOSED PLAN - AREA D - LIGHTING
Scale: 1/4" = 1'-0"



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STRUCTURAL ENGINEERS
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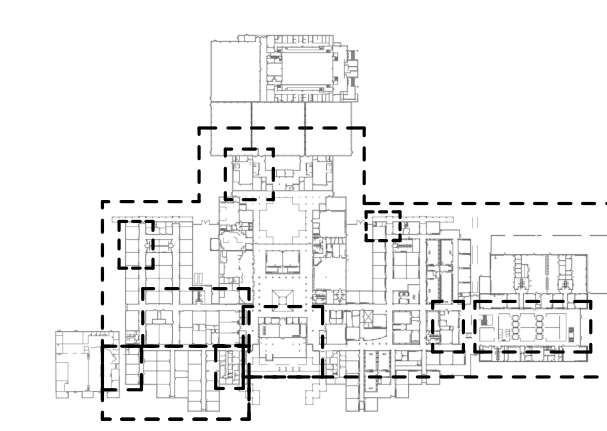


PROFESSIONAL SEAL:

SEVAK KALANTARIANS
97498
PROFESSIONAL ENGINEER
03/13/2020

A PROJECT FOR:
**STAFFORD
HIGH SCHOOL
& MAGNET
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RENOVATIONS**
1625 STAFFORDSHIRE
ROAD,
STAFFORD, TX 77477

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KEY PLAN
TRUE NORTH
PLAN NORTH

Project Number	19006-A
Drawn By	LT
Checked By	AW
Approved By	MS
Drawing Title	ENLARGED PROPOSED PLAN - LIGHTING

Drawing Number
E3.05



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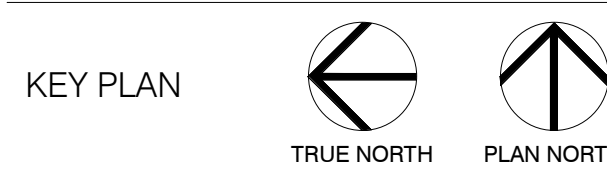
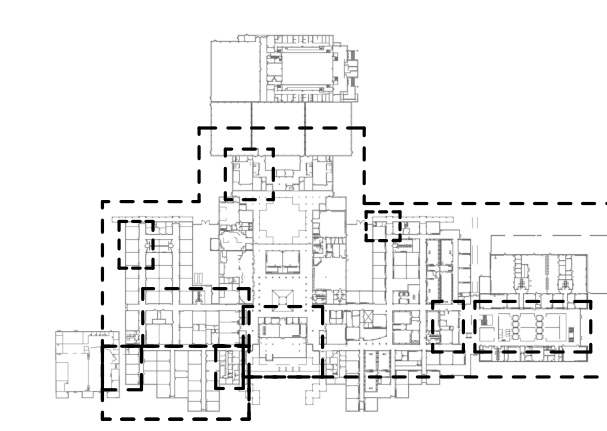


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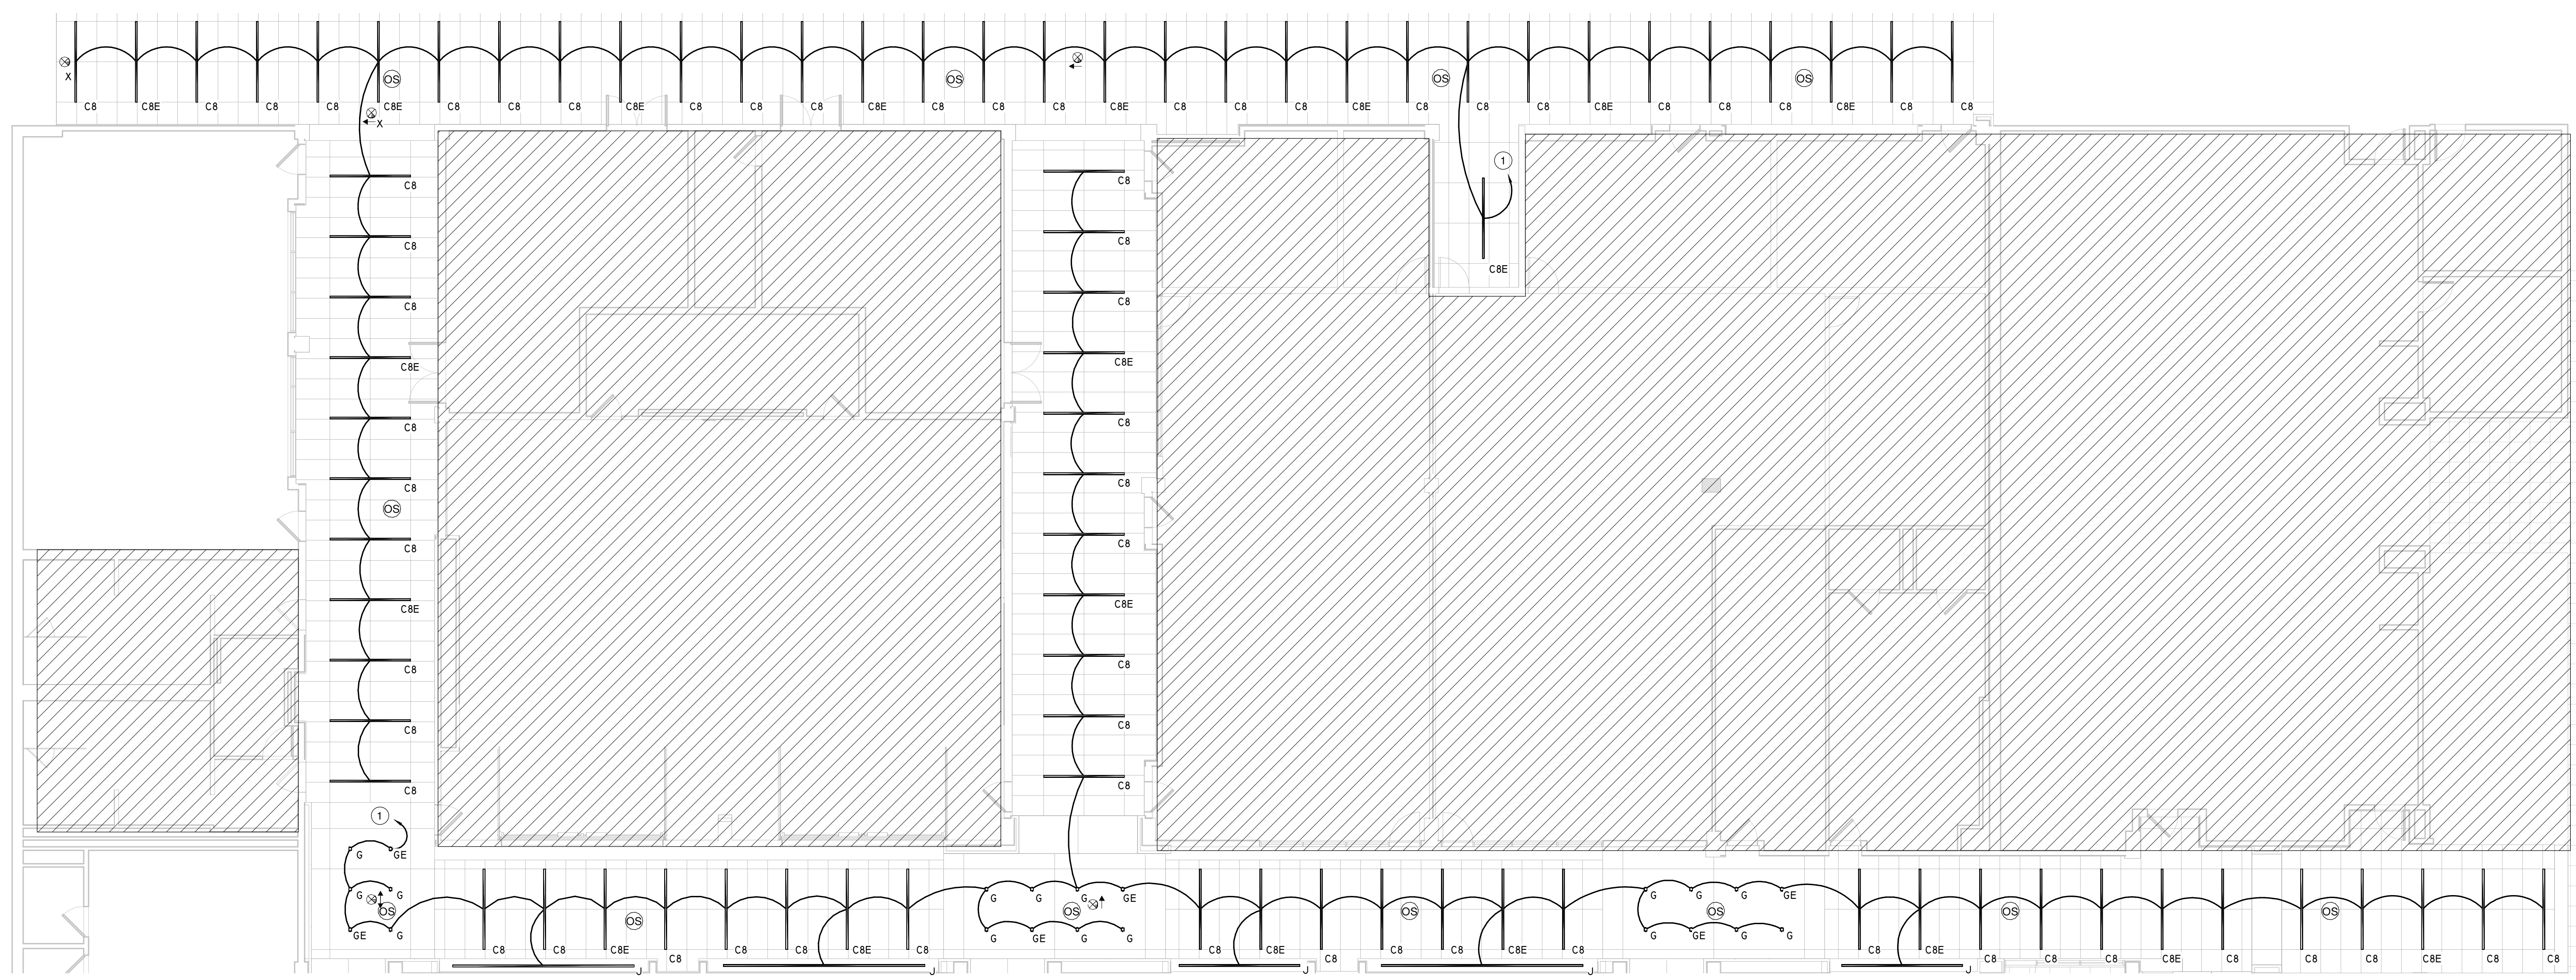
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RENOVATIONS**

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KEYNOTE LEGEND	
1	CONNECT NEW LIGHTING FIXTURES TO NEAREST LIGHTING CIRCUIT WITH AVAILABLE CAPACITY TO SUPPORT THE ADDITIONAL LOAD.



1 ENLARGED PROPOSED PLAN - AREA B - LIGHTING
Scale: 1/8" = 1'-0"

Project Number	19006-A
Drawn By	LT
Checked By	AW
Approved By	MS
Drawing Title	ENLARGED PROPOSED PLAN - LIGHTING
Drawing Number	E3.06



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PROFESSIONAL SEAL:





A PROJECT FOR:

**STAFFORD
HIGH SCHOOL
& MAGNET
SCHOOL
RENOVATIONS**

1625 STAFFORDSHIRE
ROAD,
STAFFORD, TX 77477

#	Date	ISSUED FOR
1	2020/01/31	90% CD
2	2020/03/02	98% CD Review
3	2020/03/12	Issue for Bid, Permit, and Construction

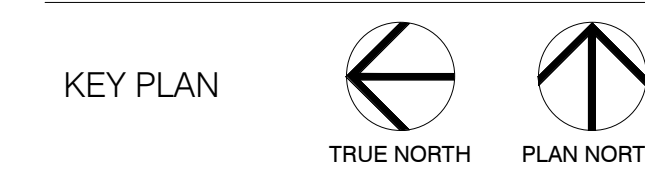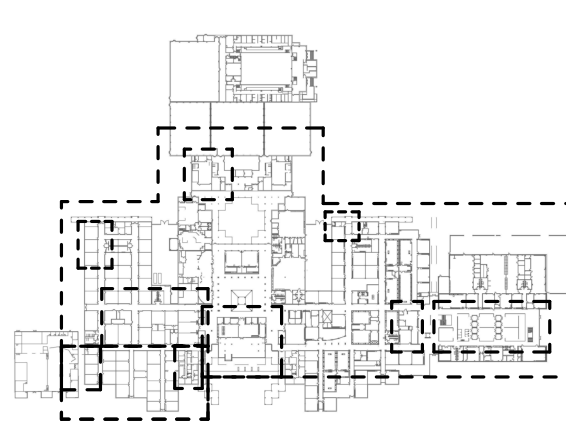


Project Number	19006-A
Drawn By	LT
Checked By	AW
Approved By	MS


**ENLARGED PROPOSED
PLAN - LIGHTING**

Drawing Number **E3.07**


KEYNOTE LEGEND	
	CONNECT NEW LIGHTING FIXTURES TO NEAREST LIGHTING CIRCUIT WITH AVAILABLE CAPACITY TO SUPPORT THE ADDITIONAL LOAD.

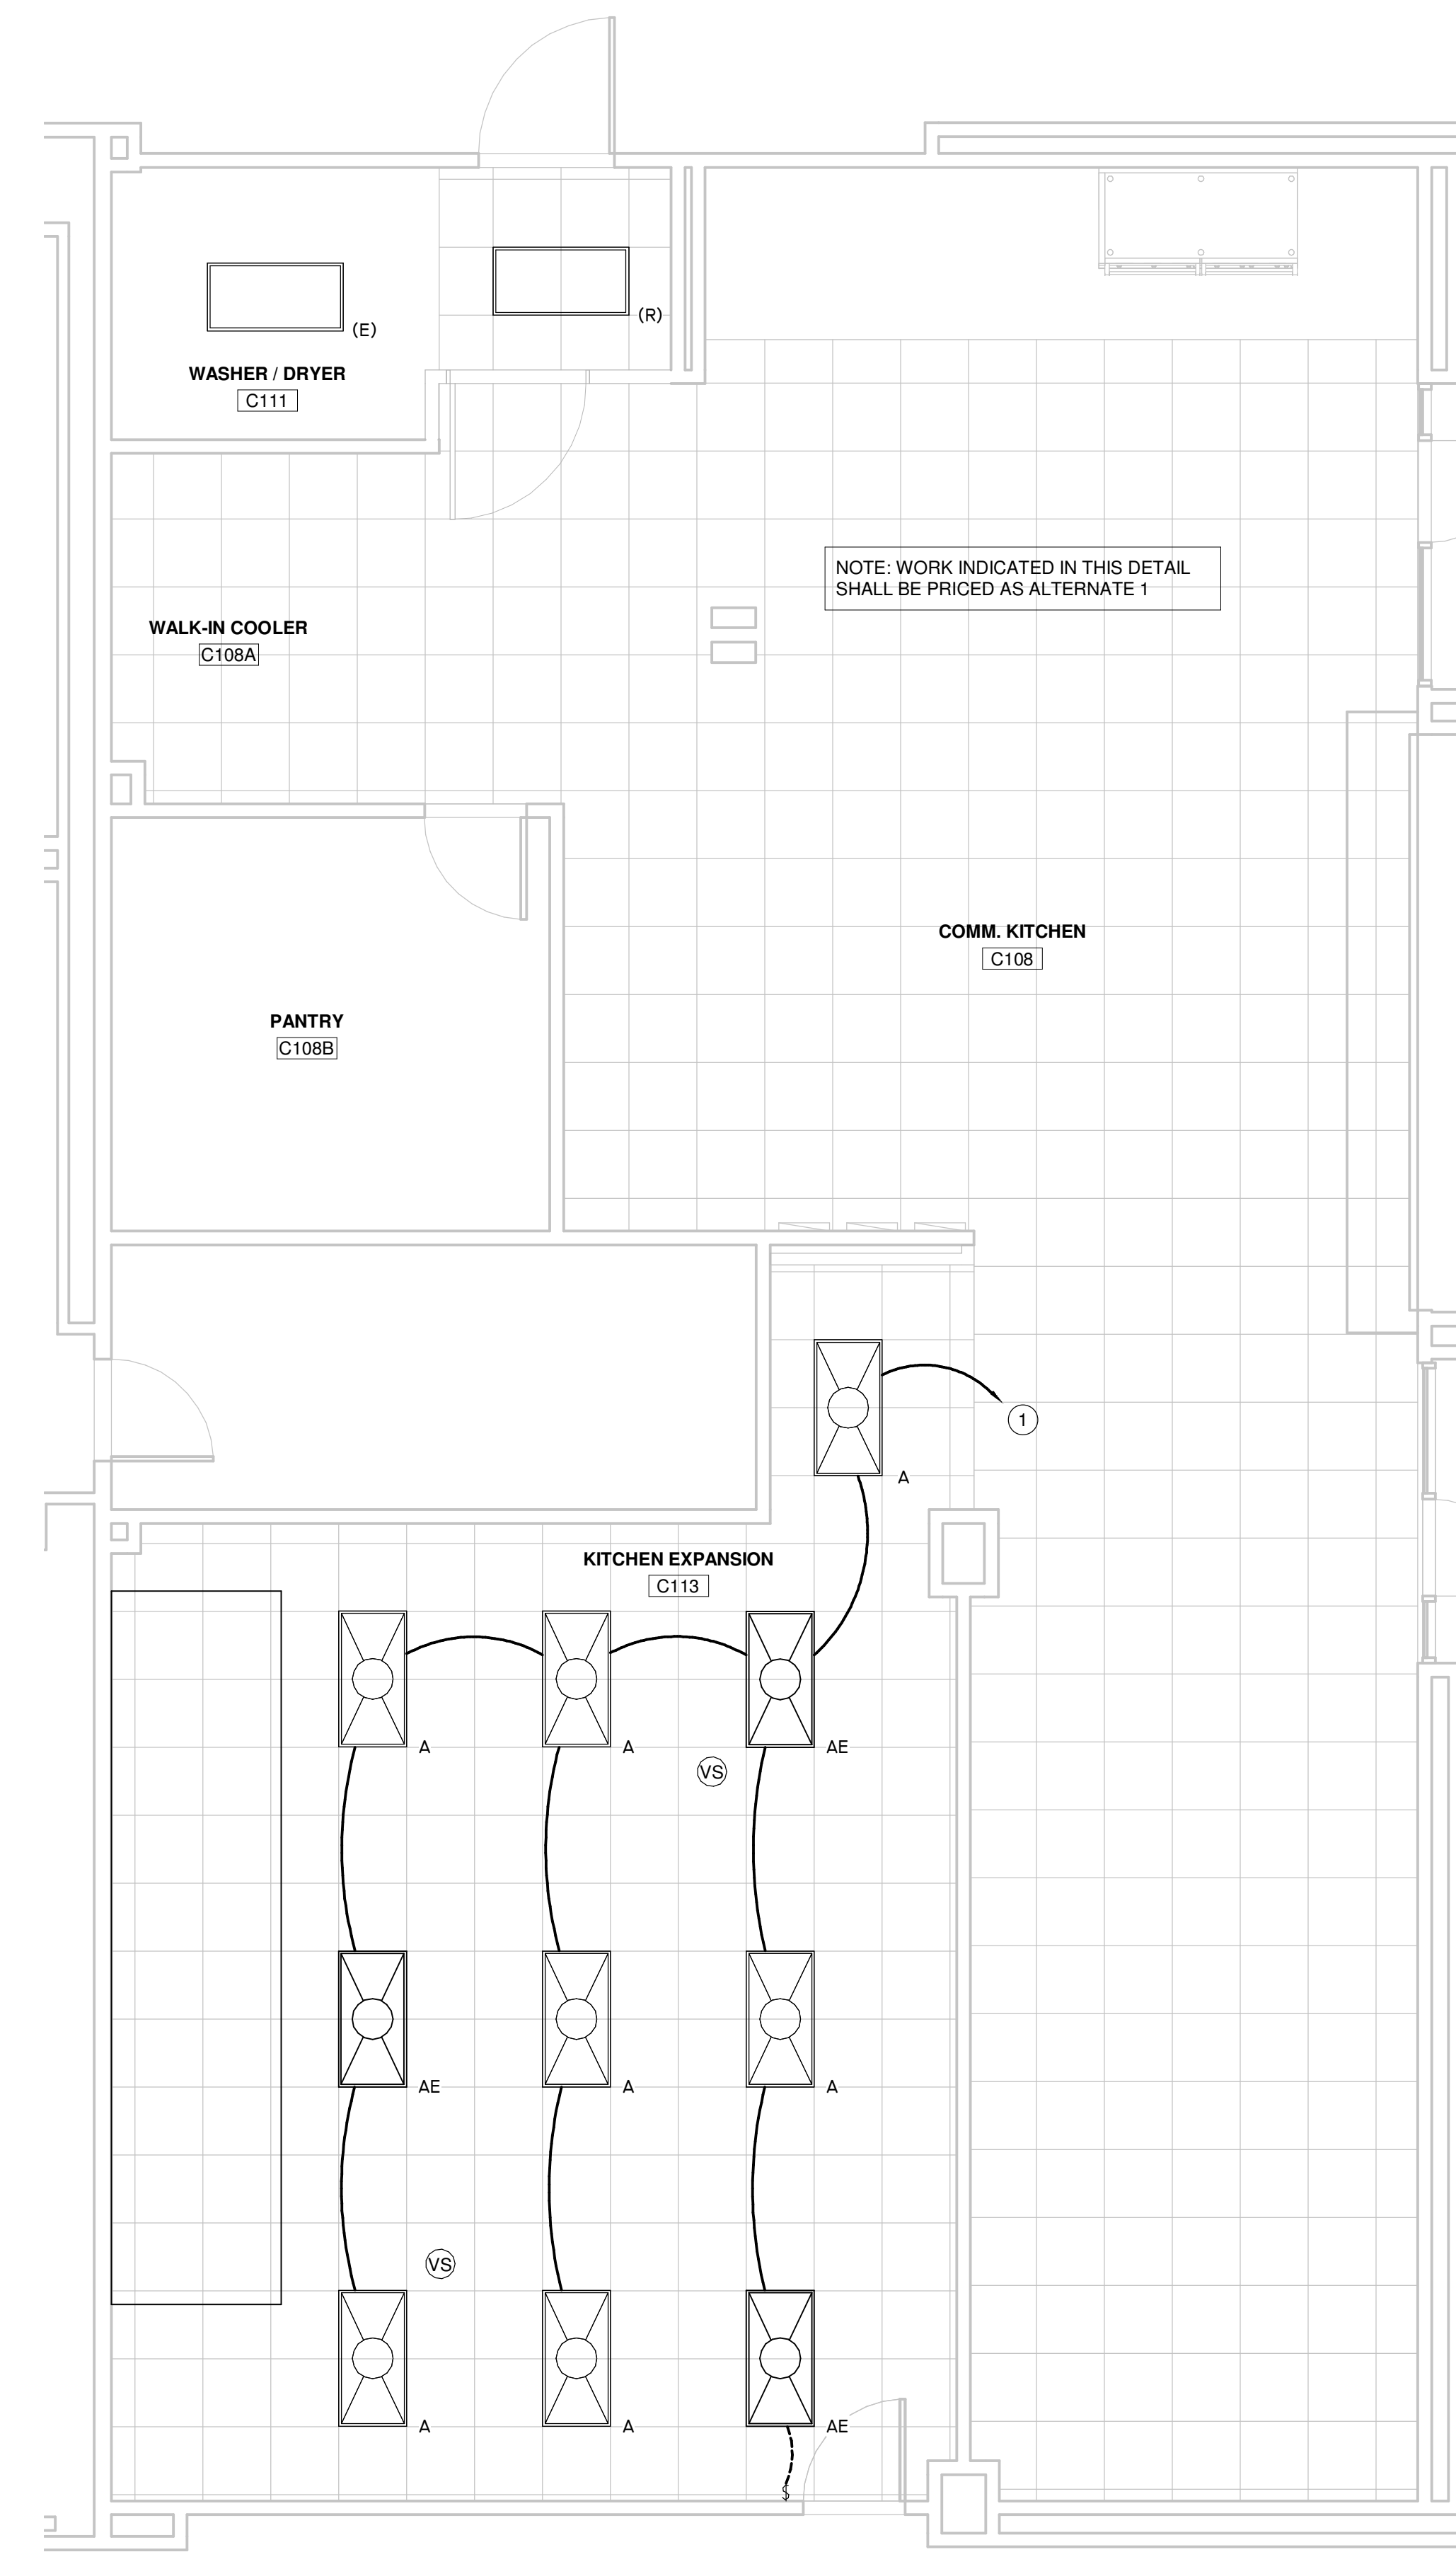


2 ENLARGED PROPOSED PLAN - AREA G - LIGHTING
Scale: 1/4" = 1'-0"

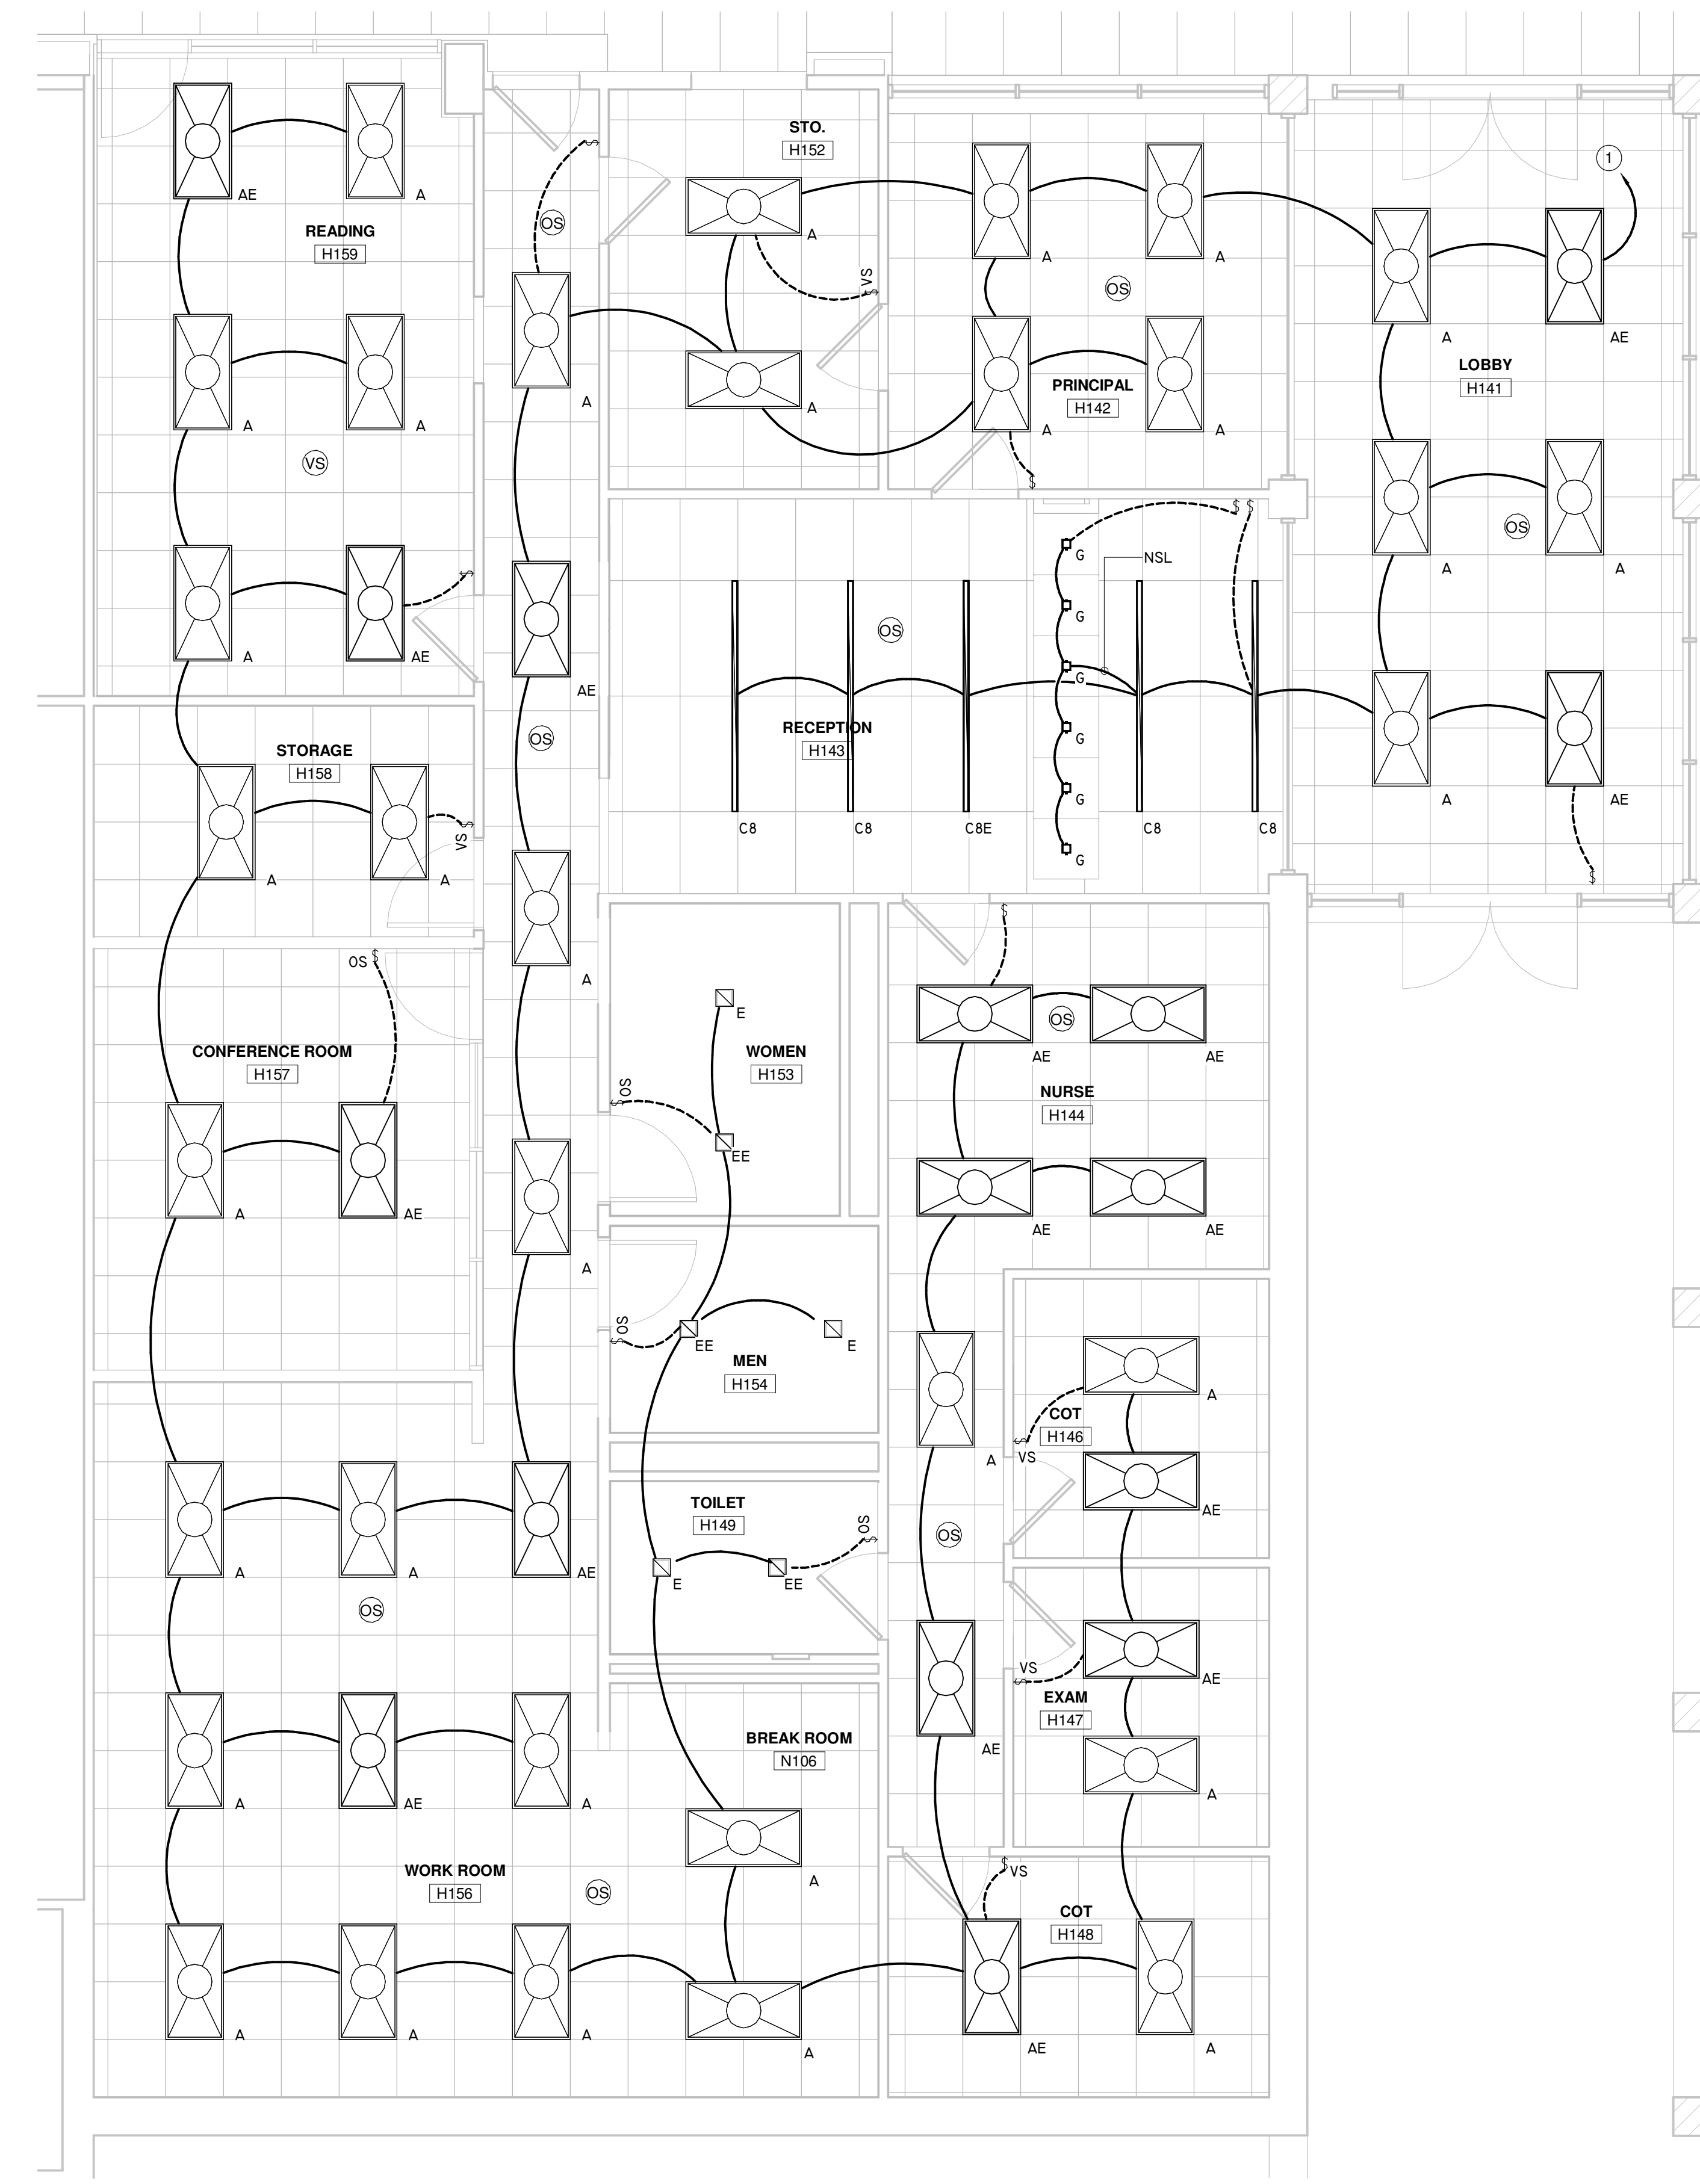


1 ENLARGED PROPOSED PLAN - AREA B5 - LIGHTING
Scale: 1/4" = 1'-0"

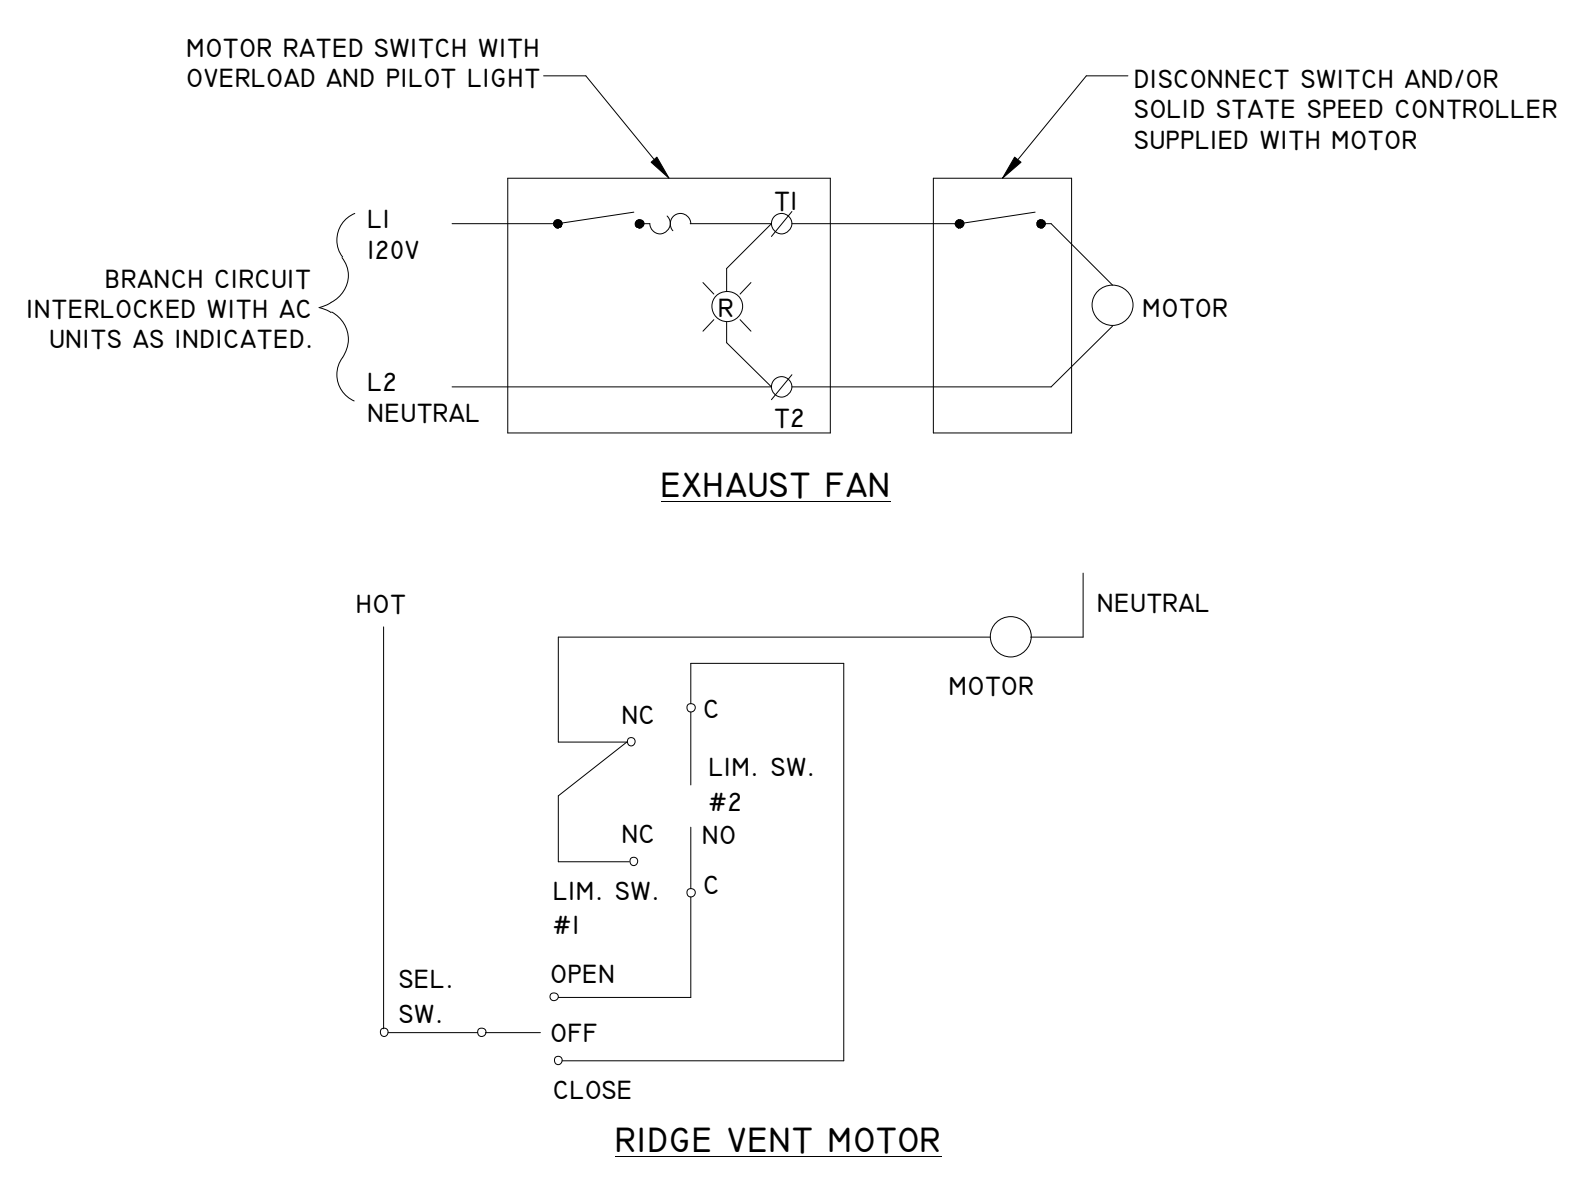


DETAIL - SINGLE PHASE MOTOR CONTROL NOT TO SCALE 16

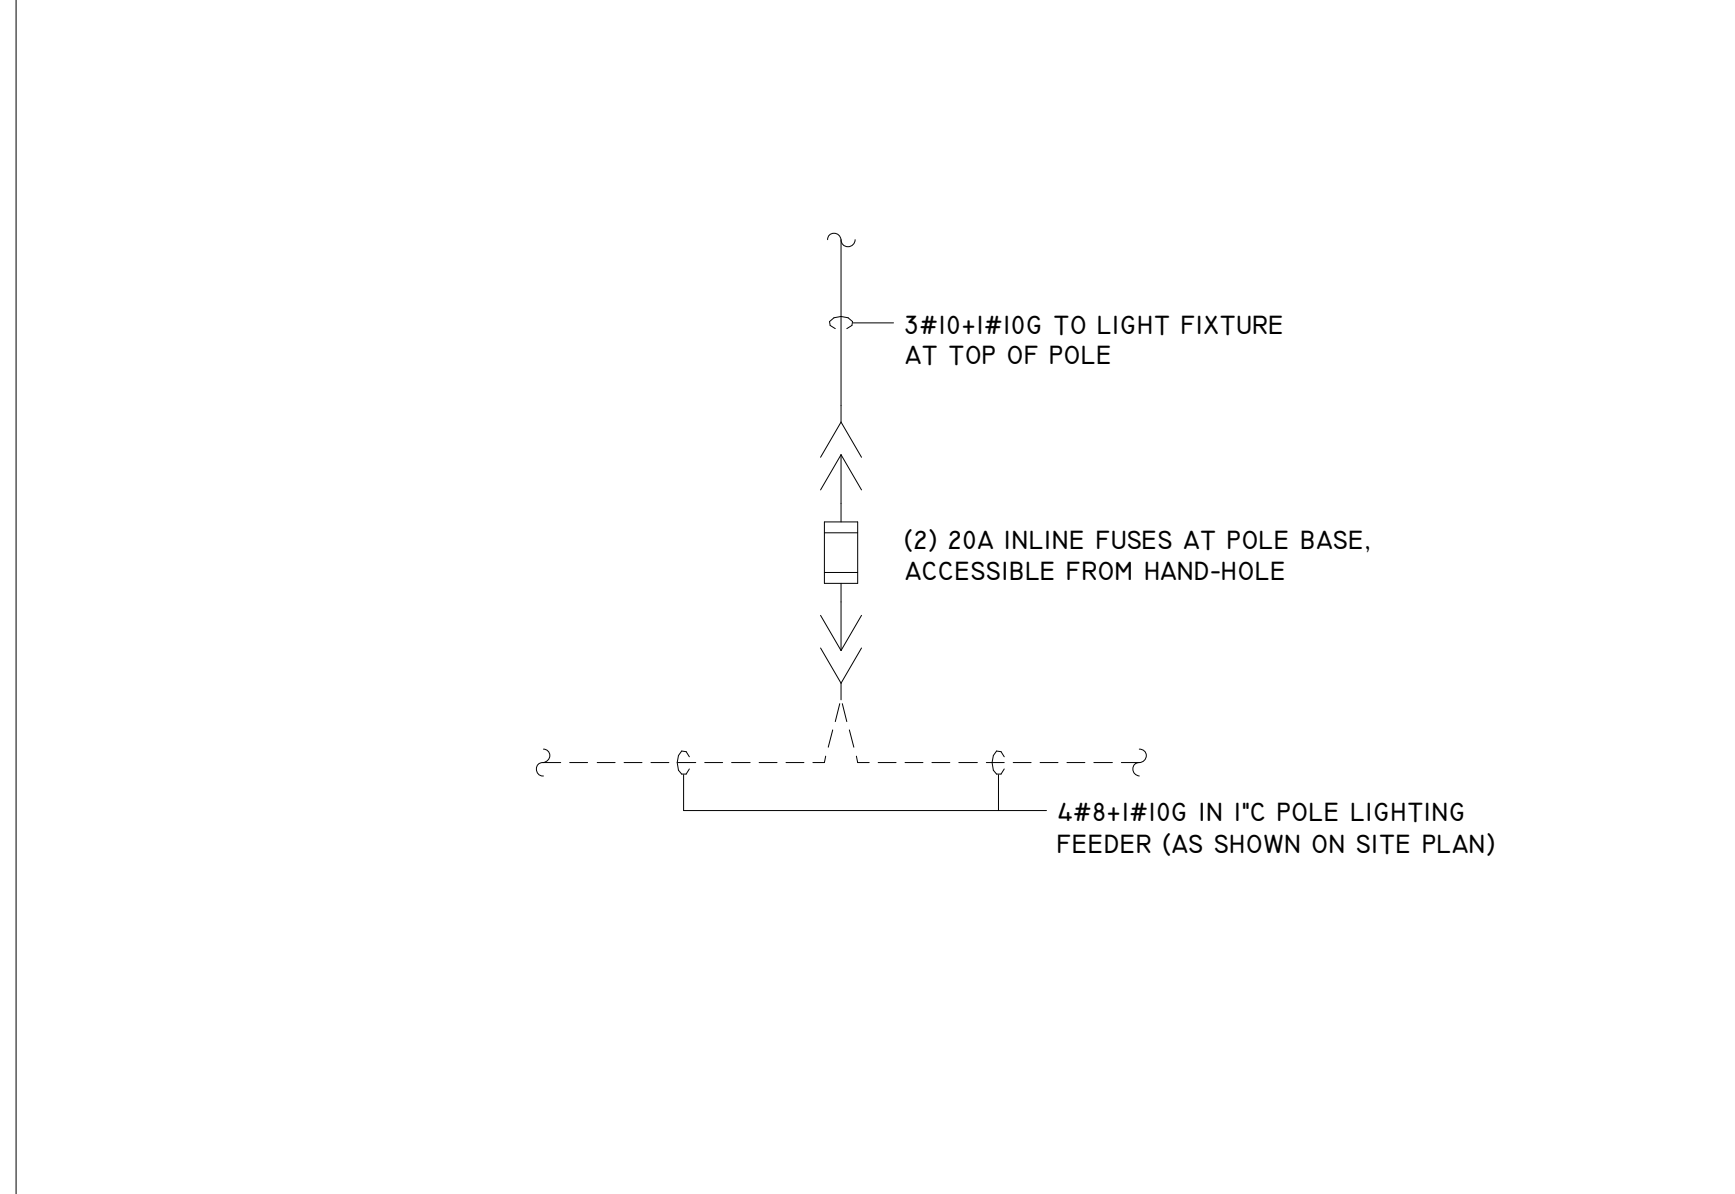


DETAIL - POLE LIGHT WIRING DIAGRAM AT BASE NOT TO SCALE 12

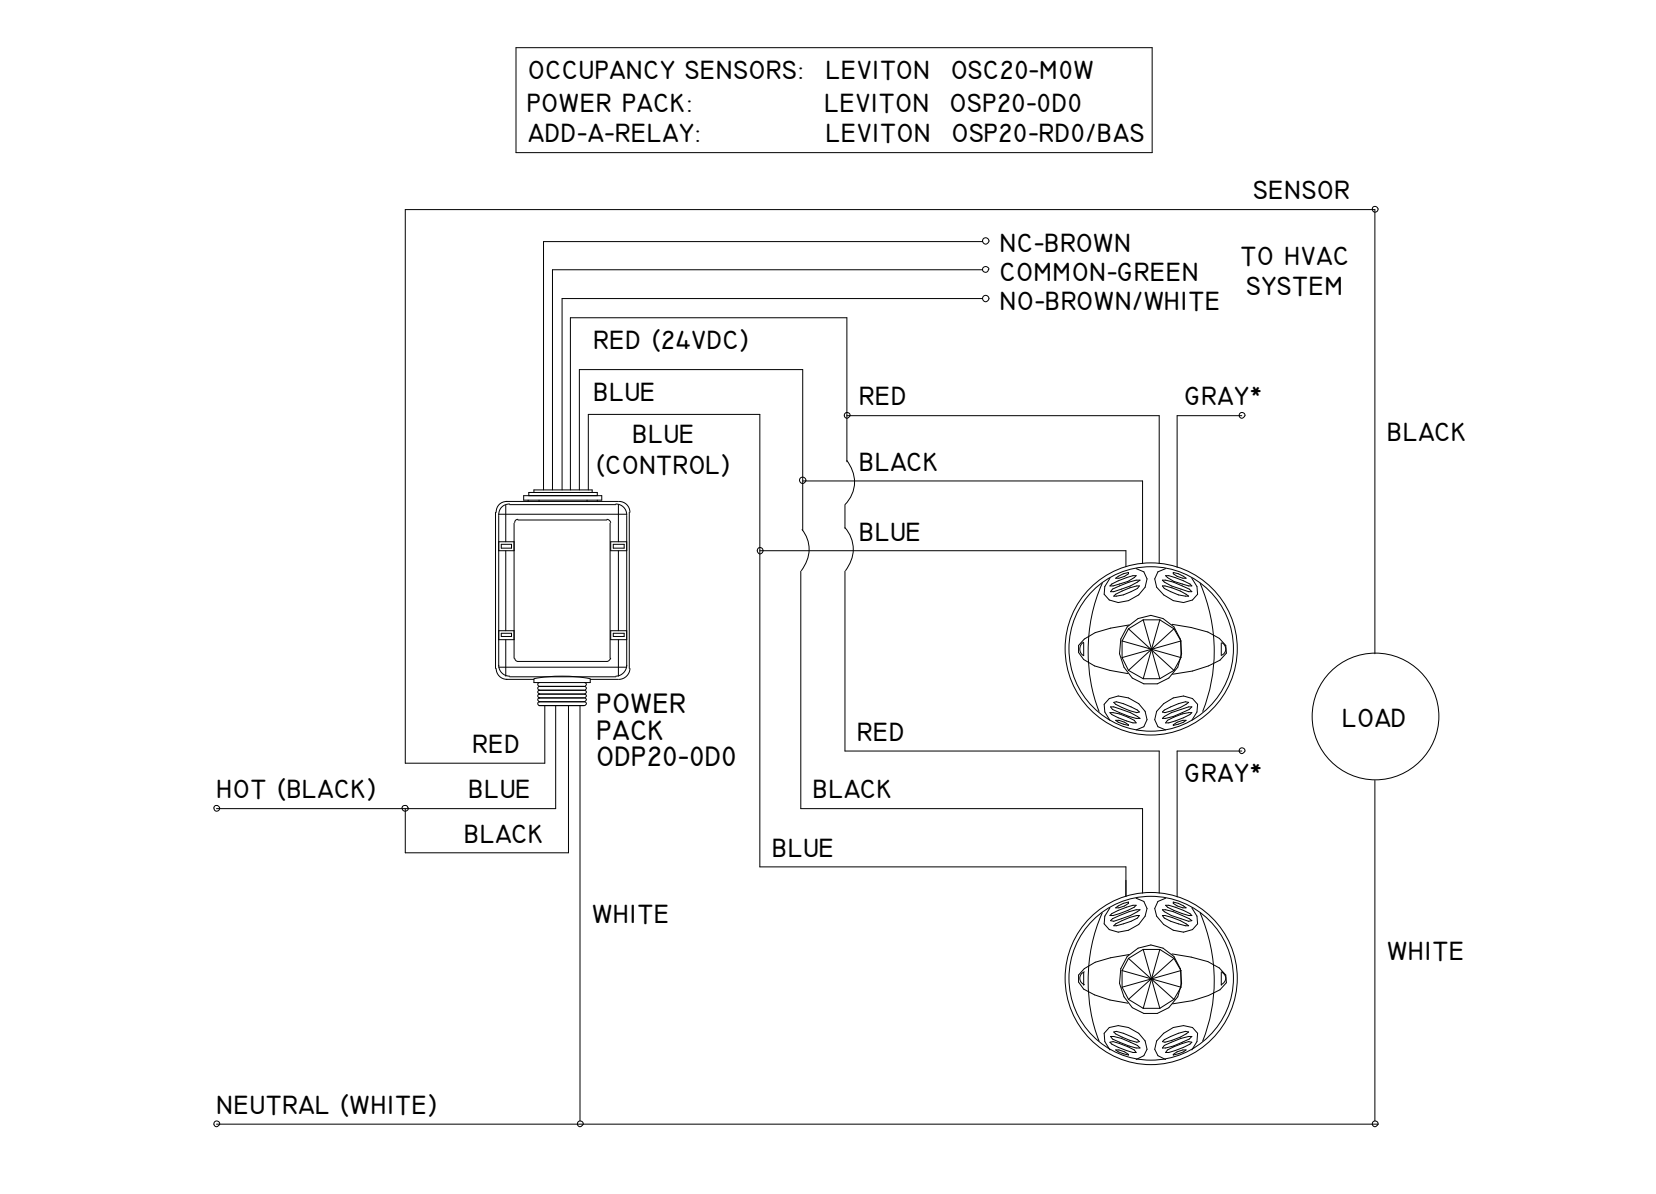


DETAIL - CEILING OCCUPANCY SENSOR NOT TO SCALE 8

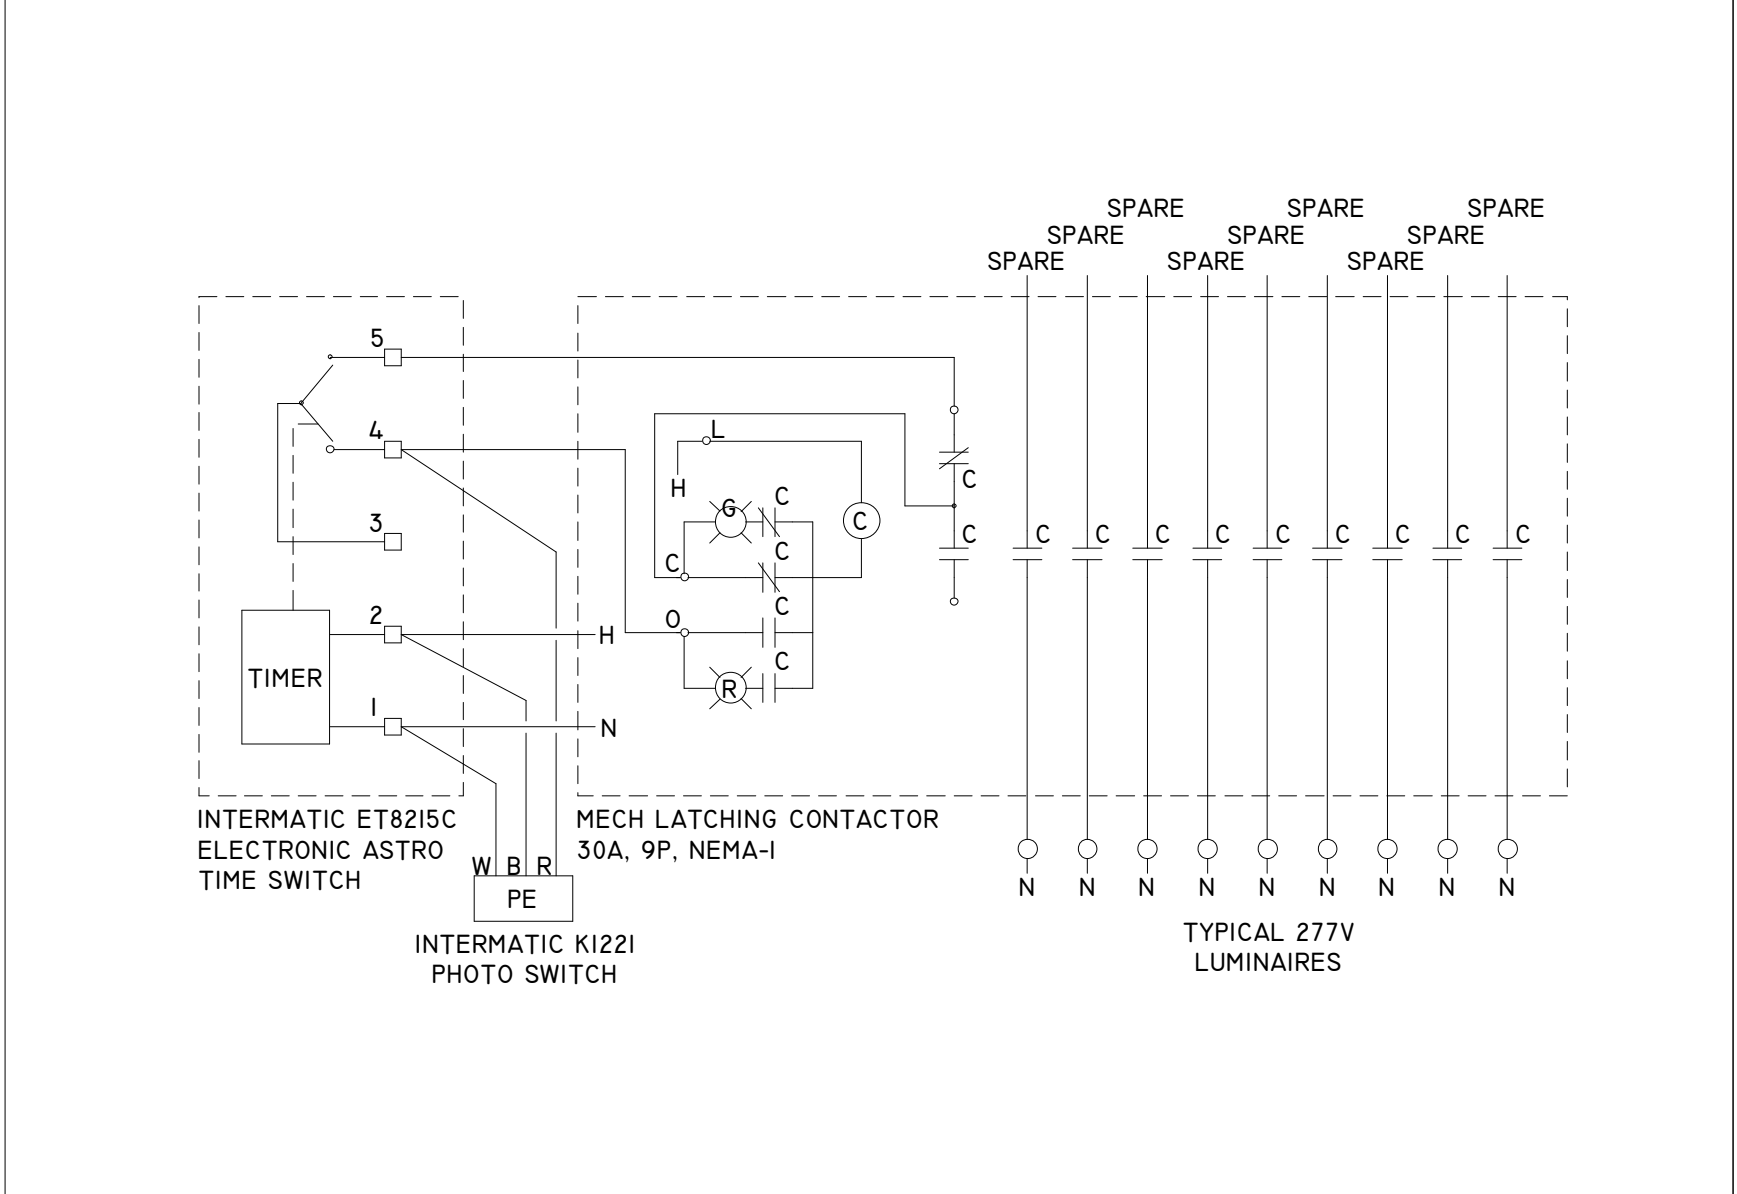


DETAIL - LIGHTING CONTACTER NOT TO SCALE 4

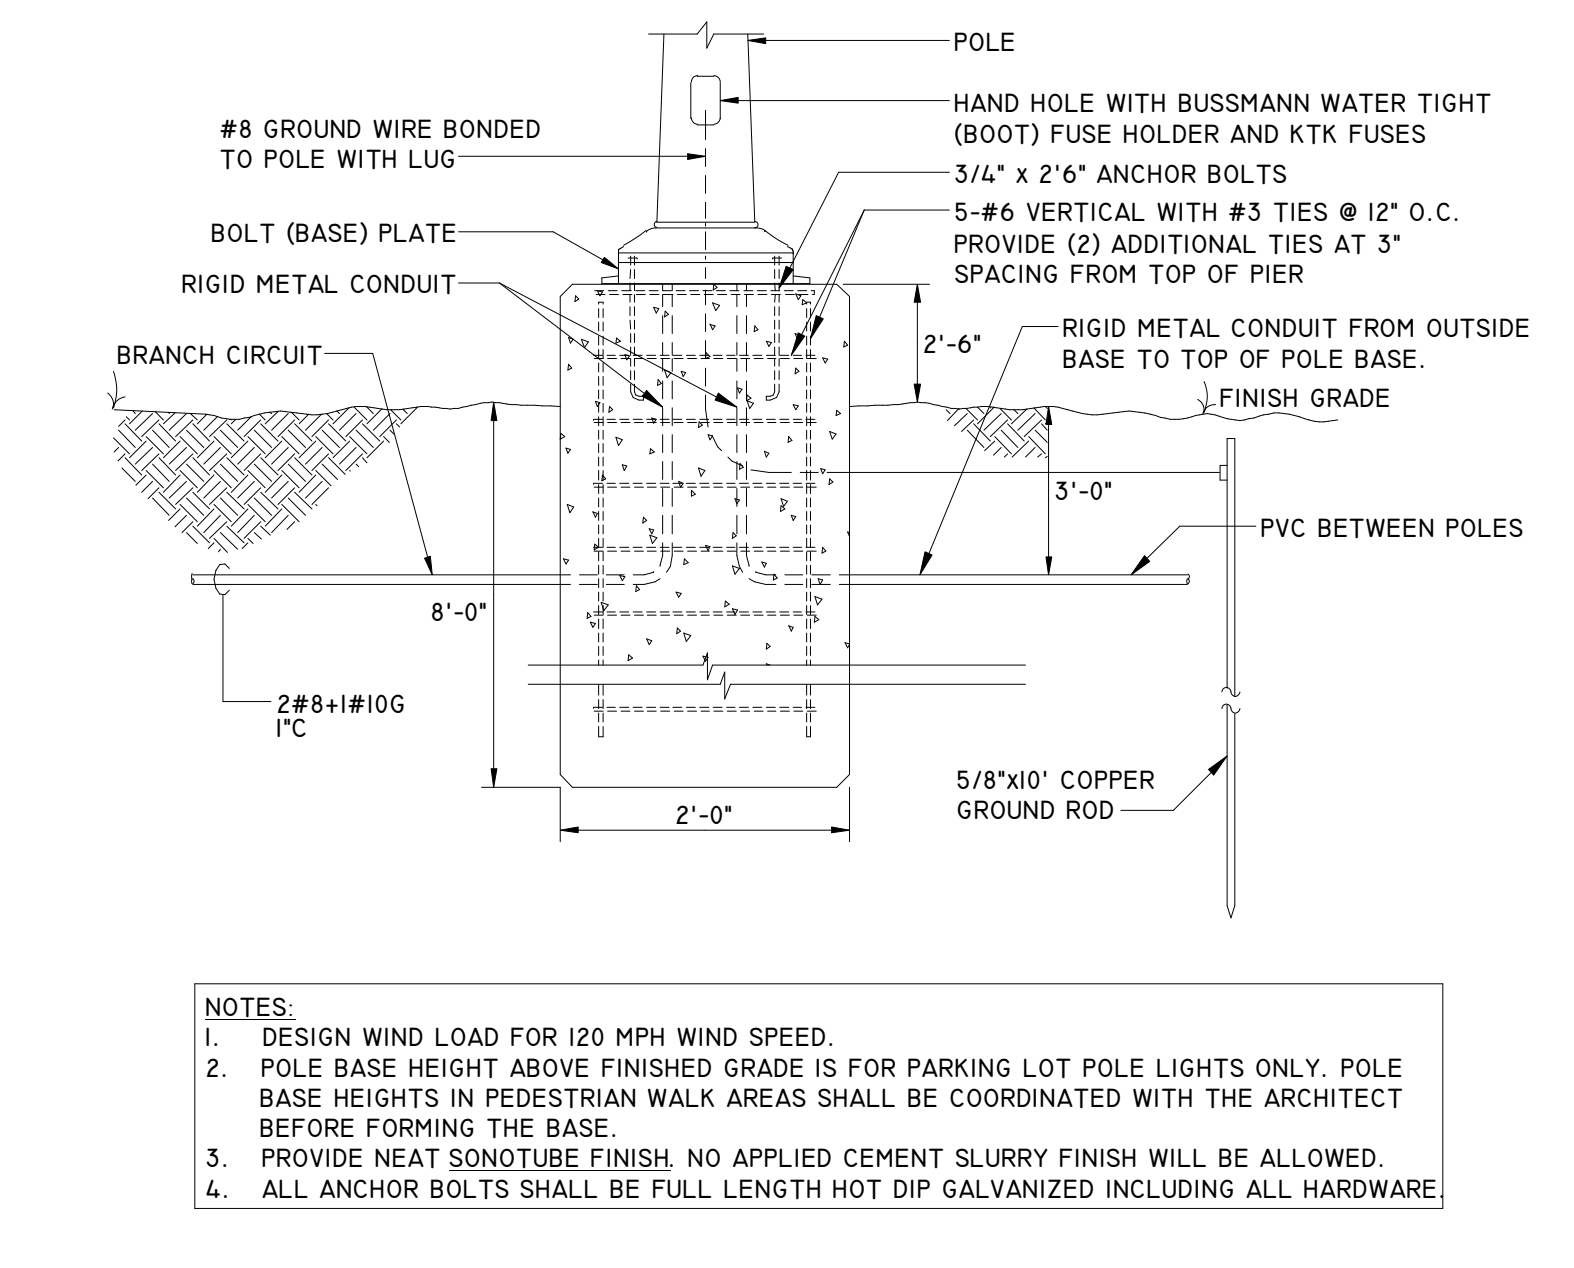


DETAIL - POLE BASE NOT TO SCALE 15

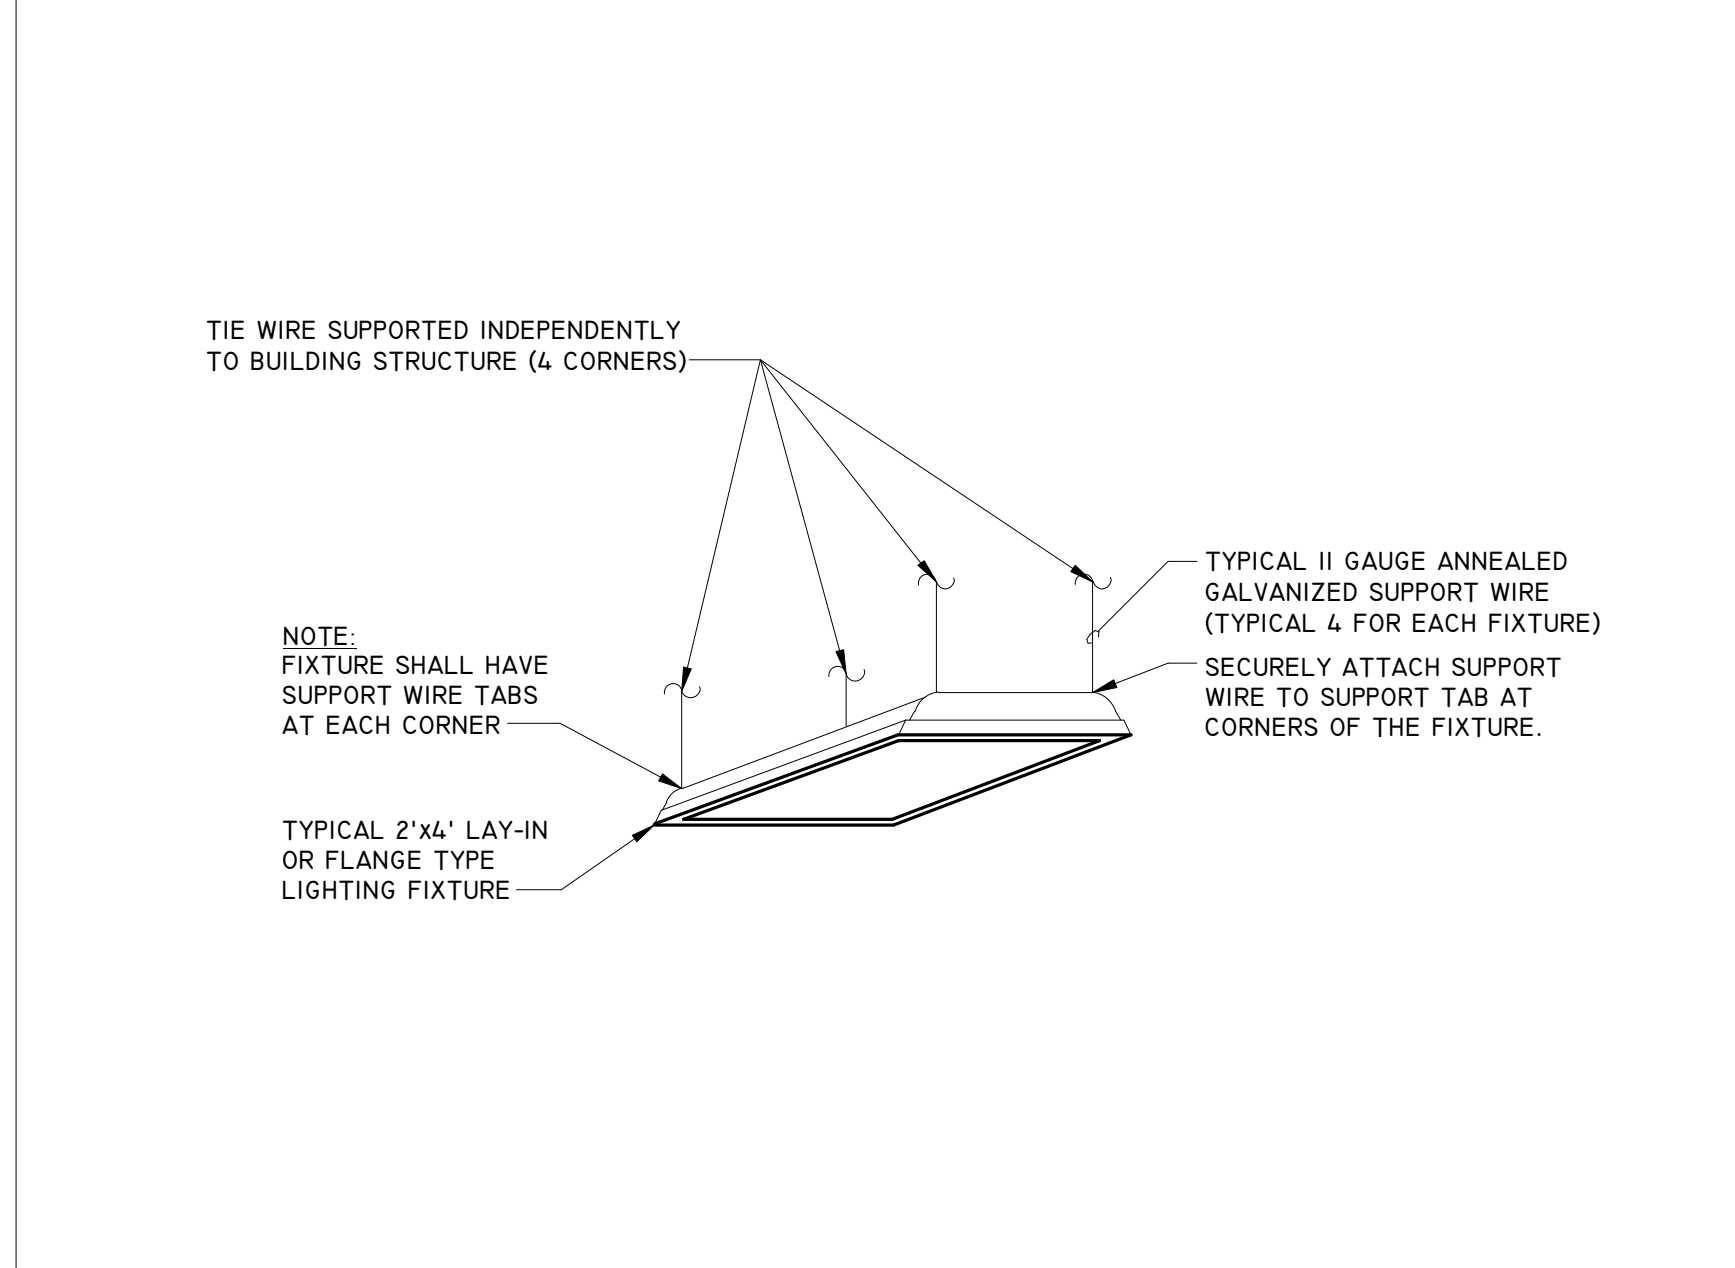


DETAIL - FIXTURE SUPPORT NOT TO SCALE 11

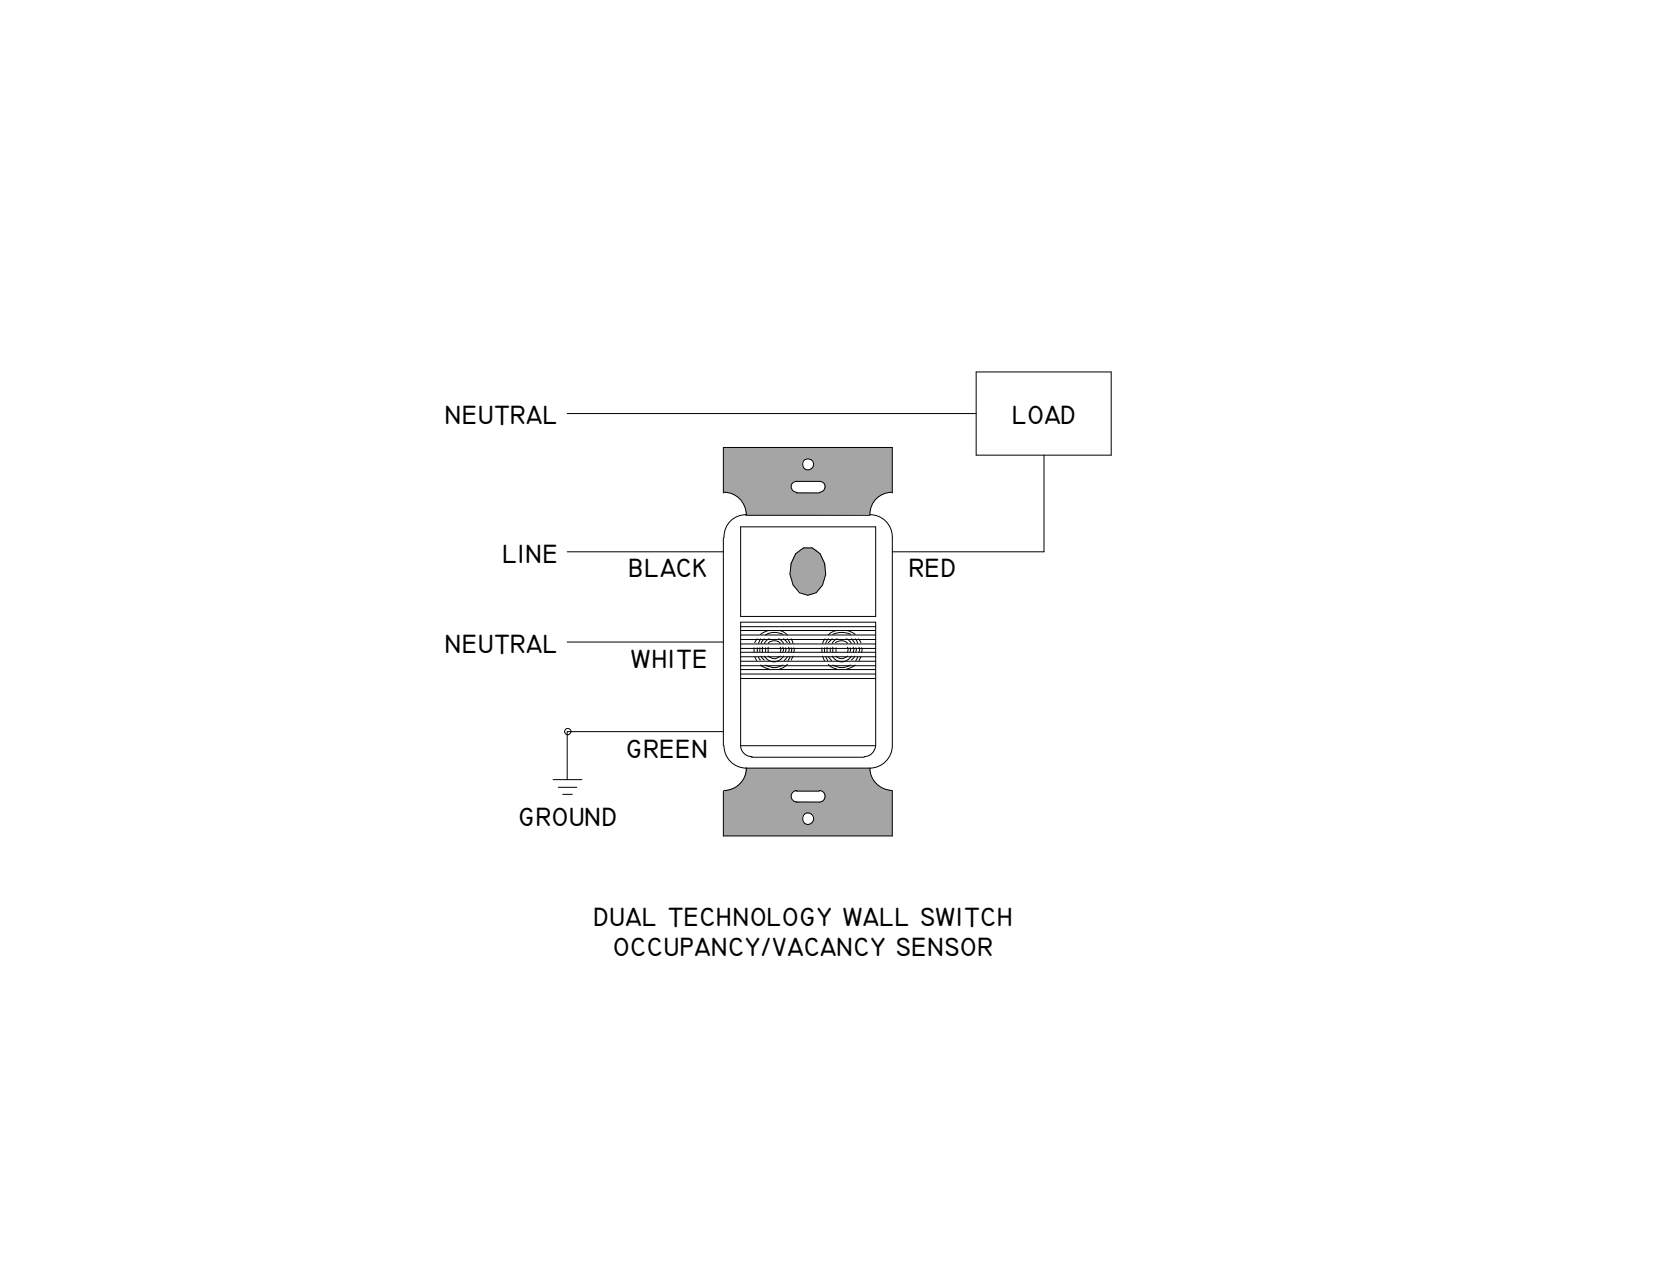


DETAIL - WALL OCCUPANCY / VACANCY SENSOR SWITCH NOT TO SCALE 7

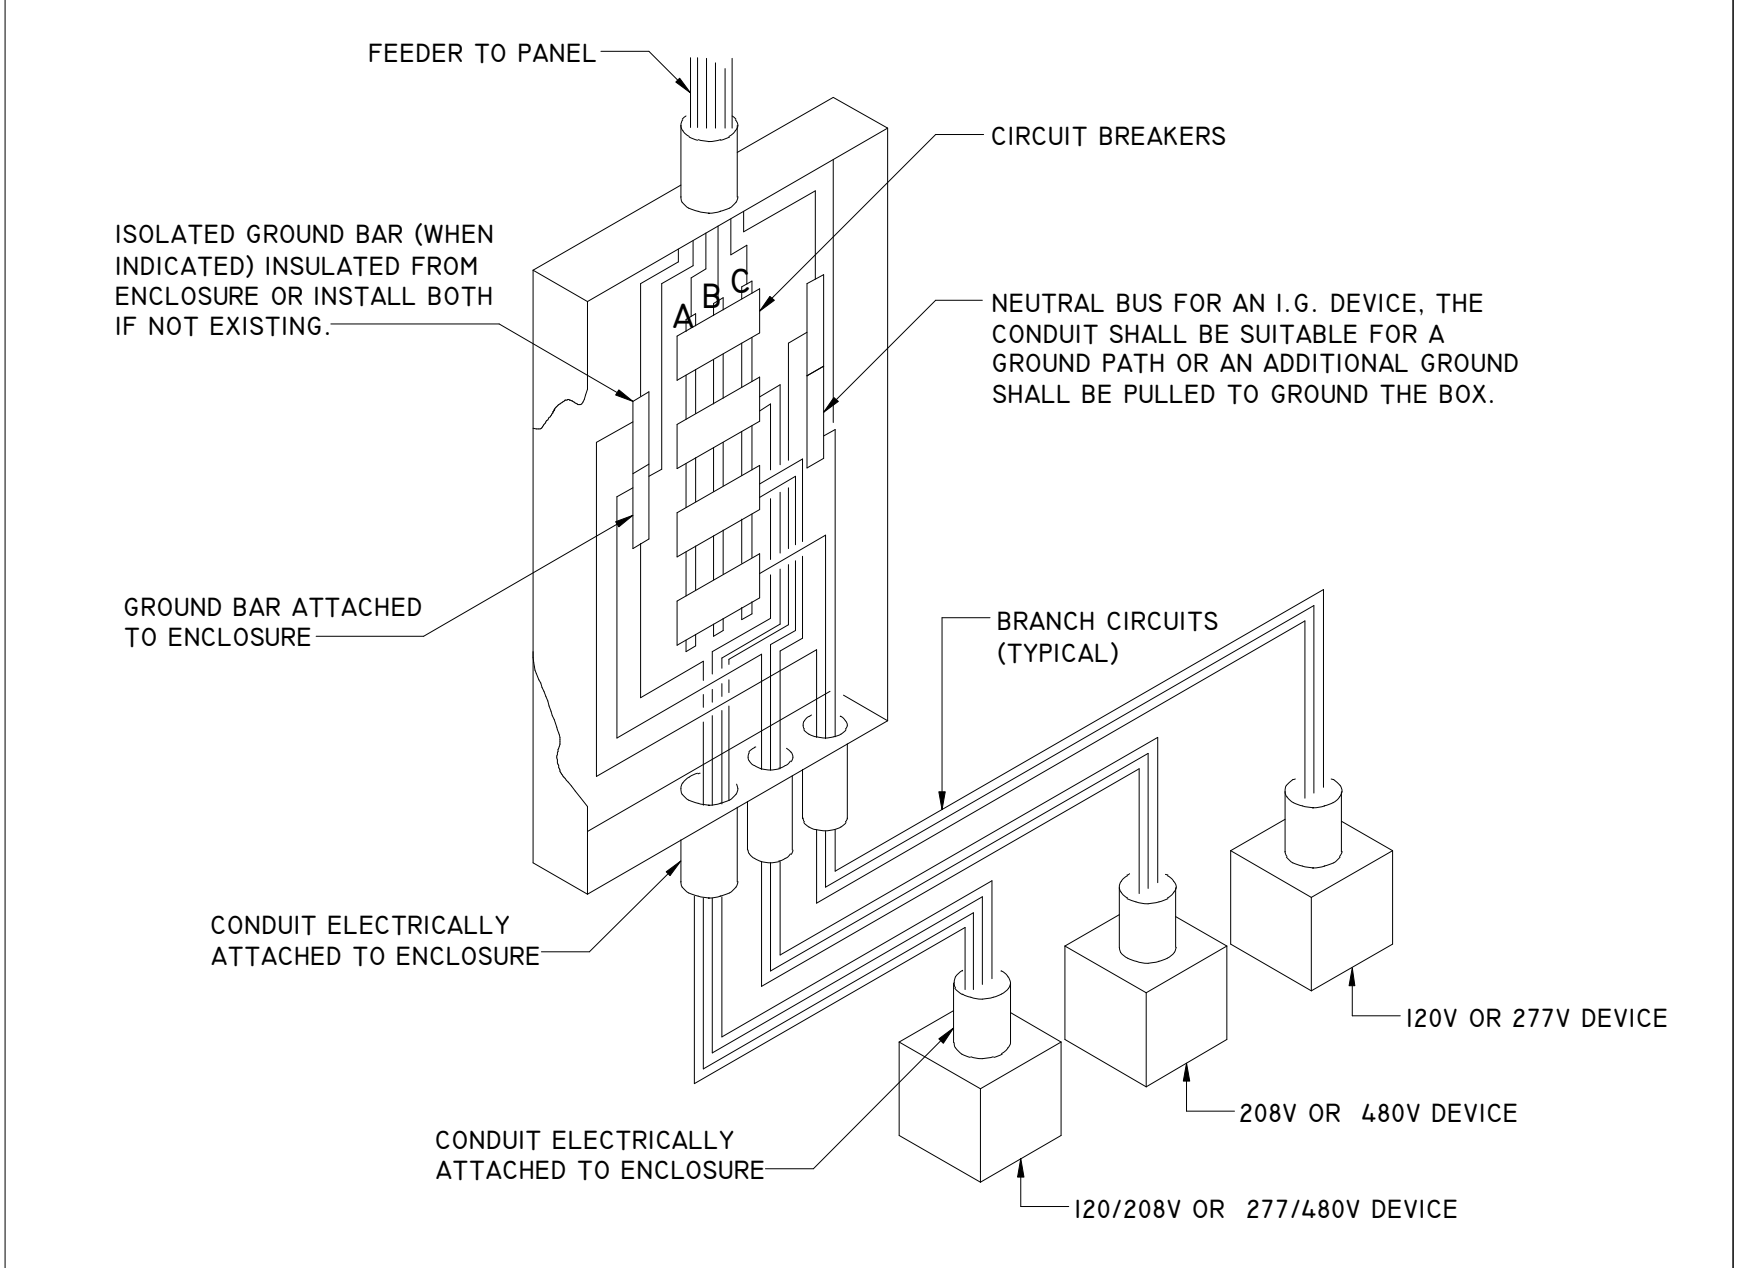


DETAIL - PANEL GROUNDING NOT TO SCALE 3

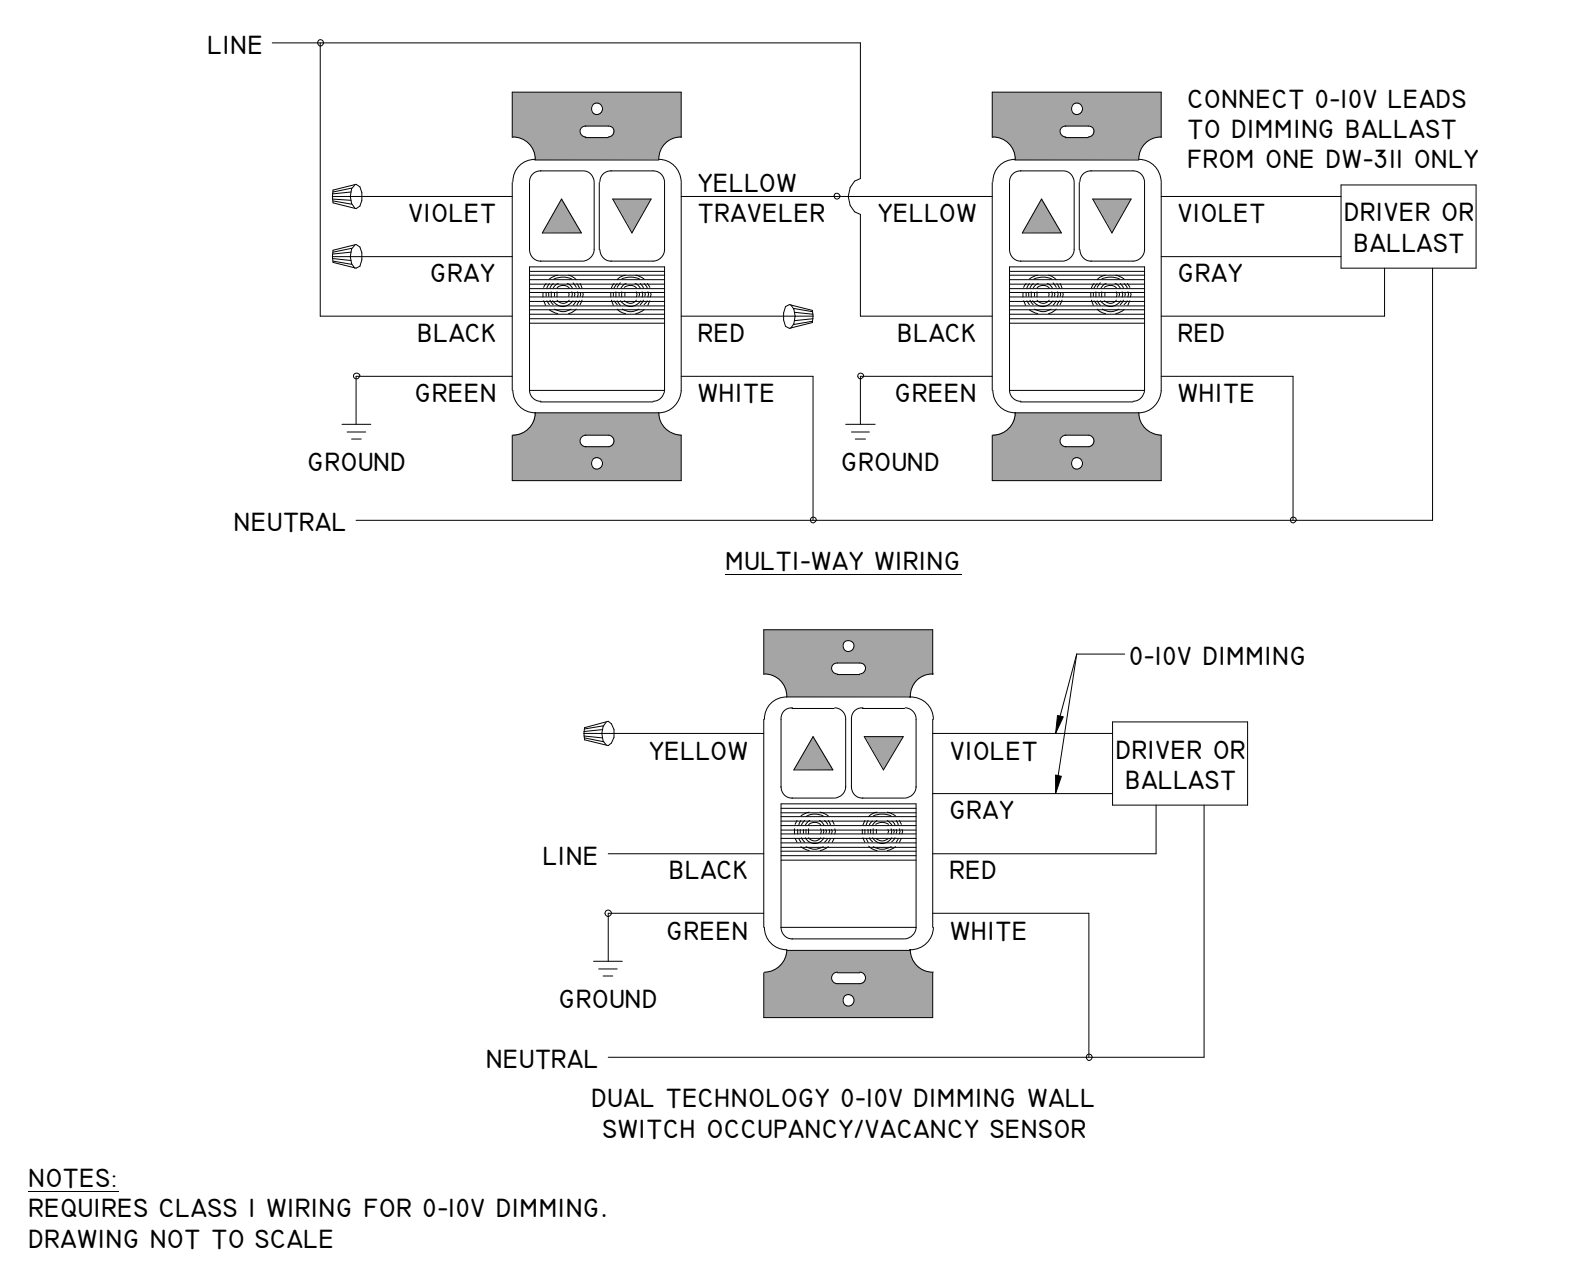


DETAIL - DIMMING WALL SWITCH OCCUPANCY/VACANCY SENSOR NOT TO SCALE 14

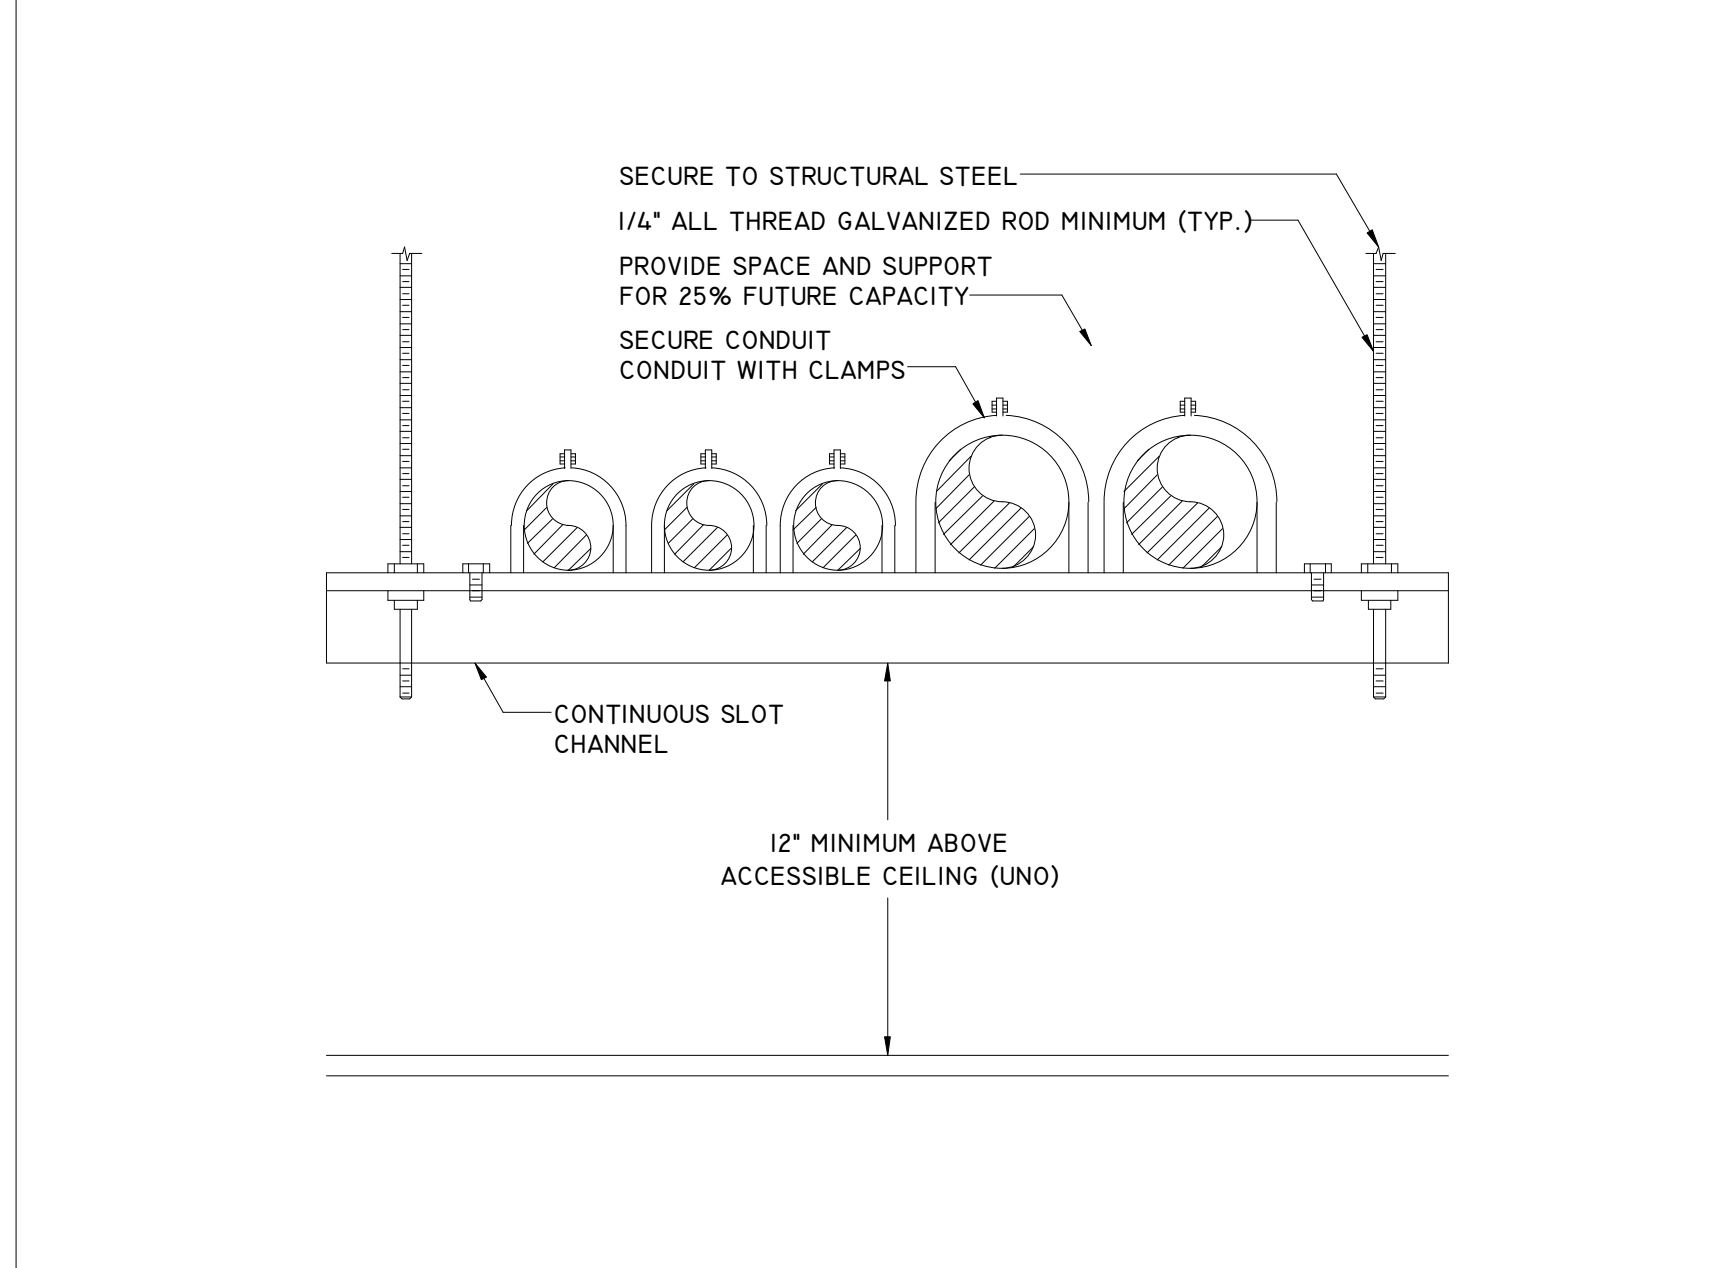


DETAIL - CONDUIT RACK NOT TO SCALE 10

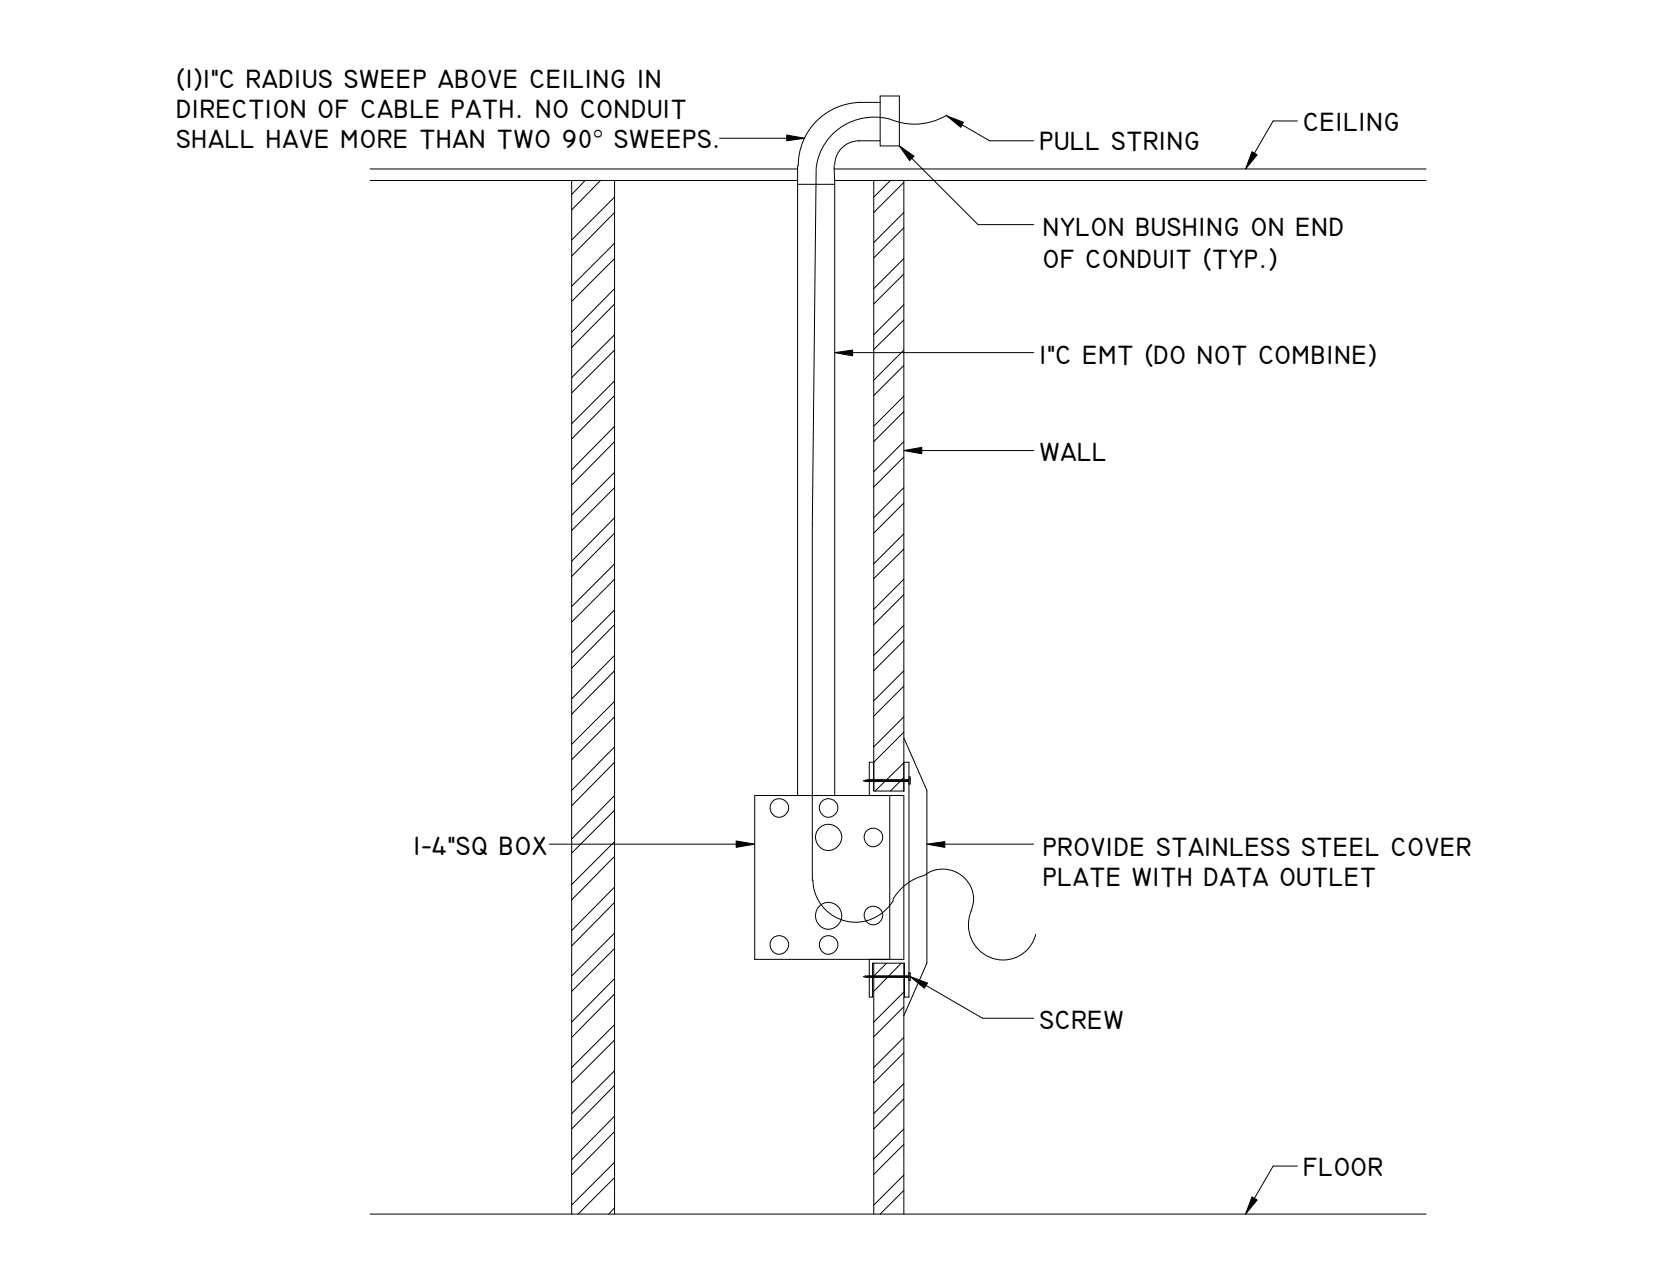


DETAIL - DATA OUTLETS NOT TO SCALE 6

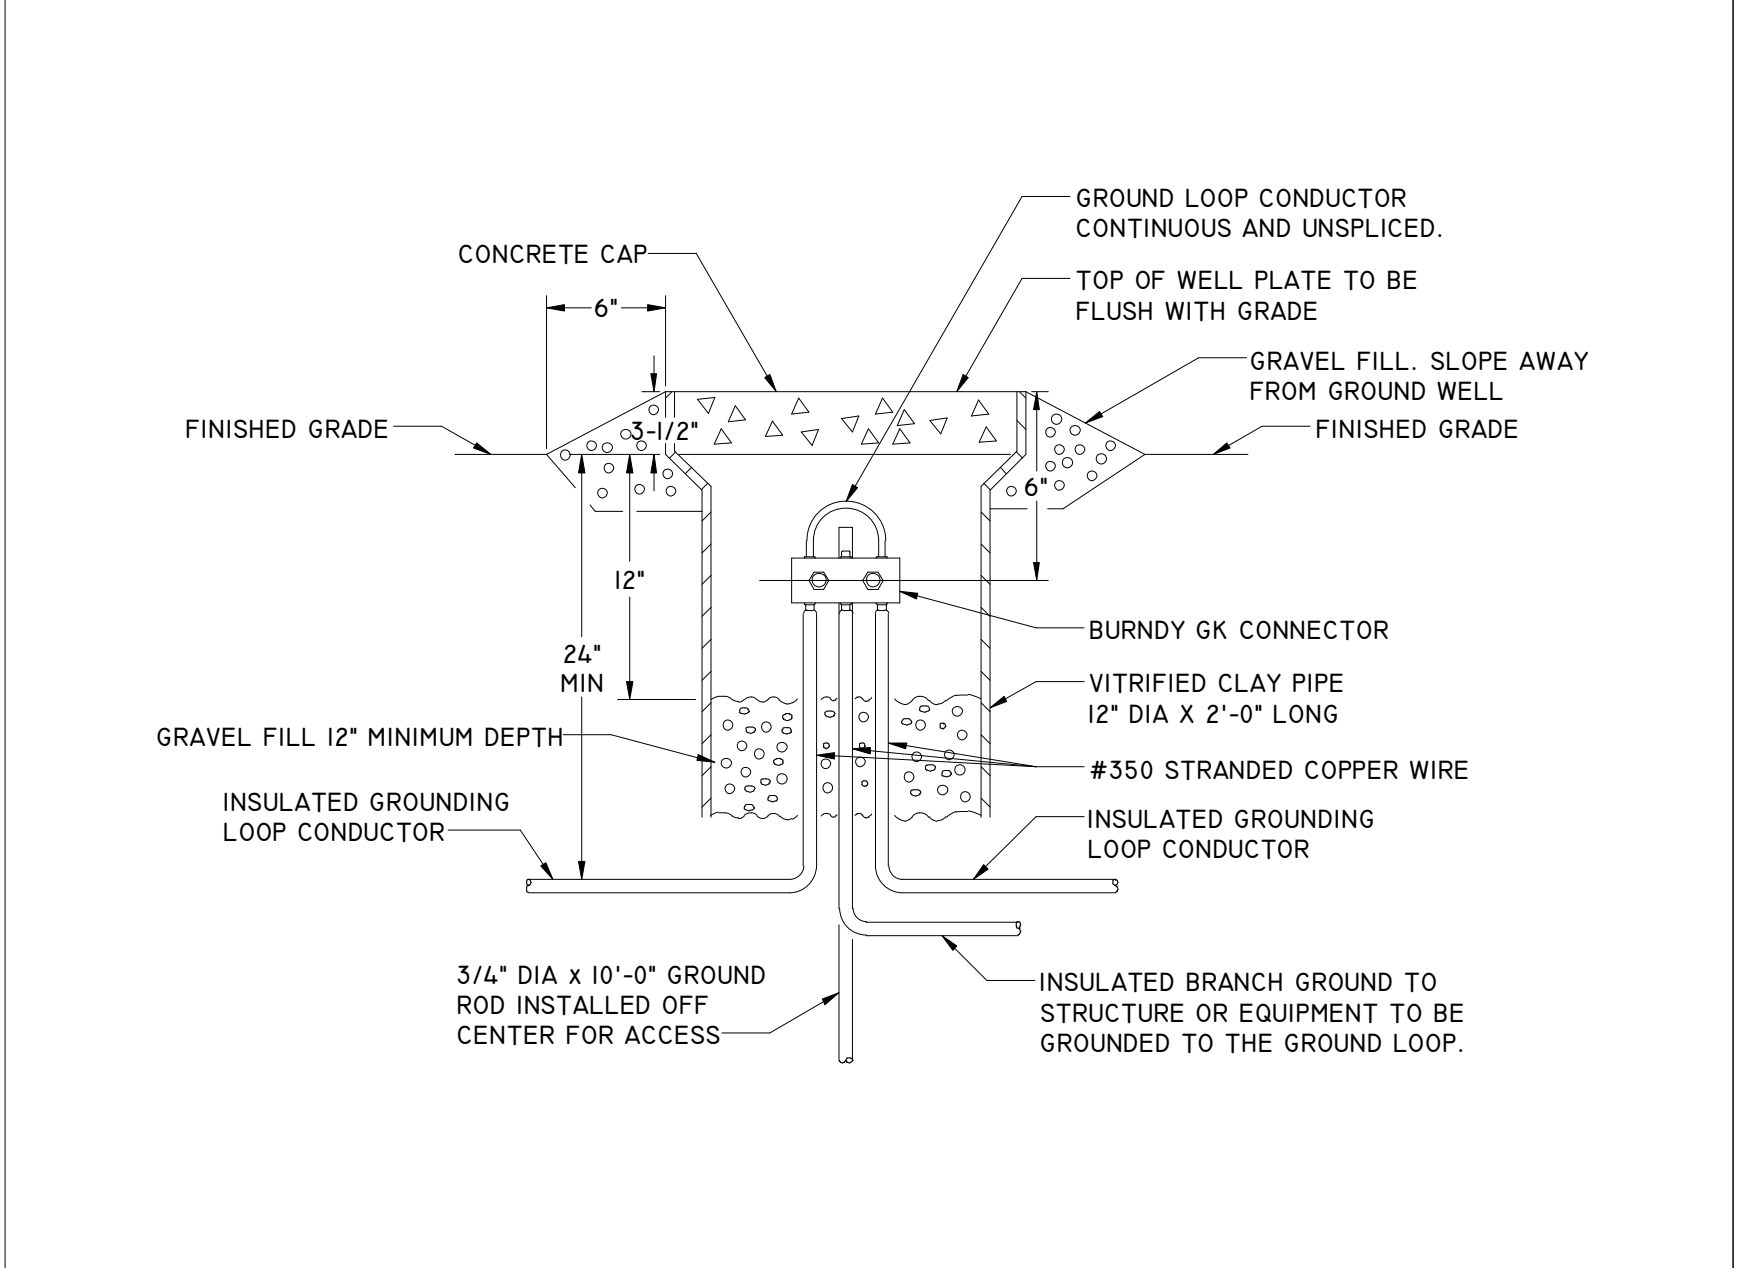


DETAIL - GROUNDING WELL NOT TO SCALE 2

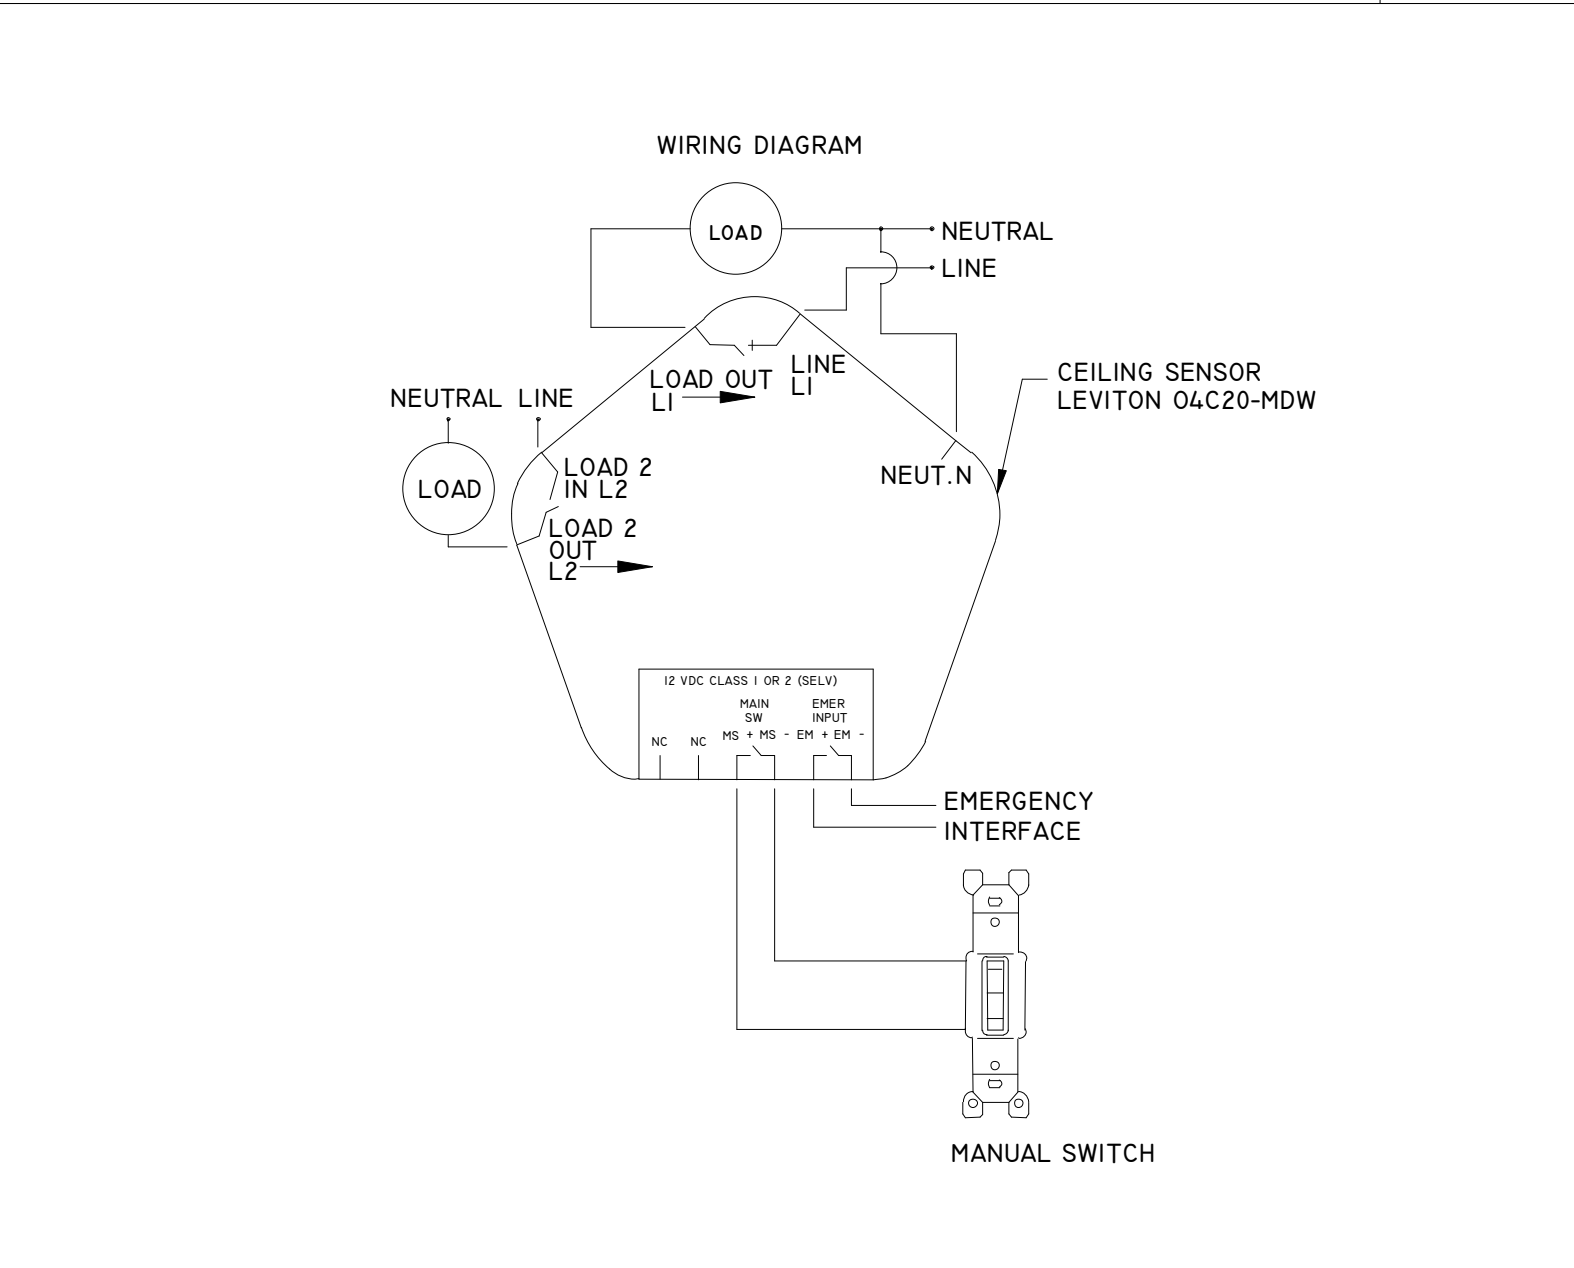


DETAIL - CEILING VACANCY SENSOR NOT TO SCALE 13

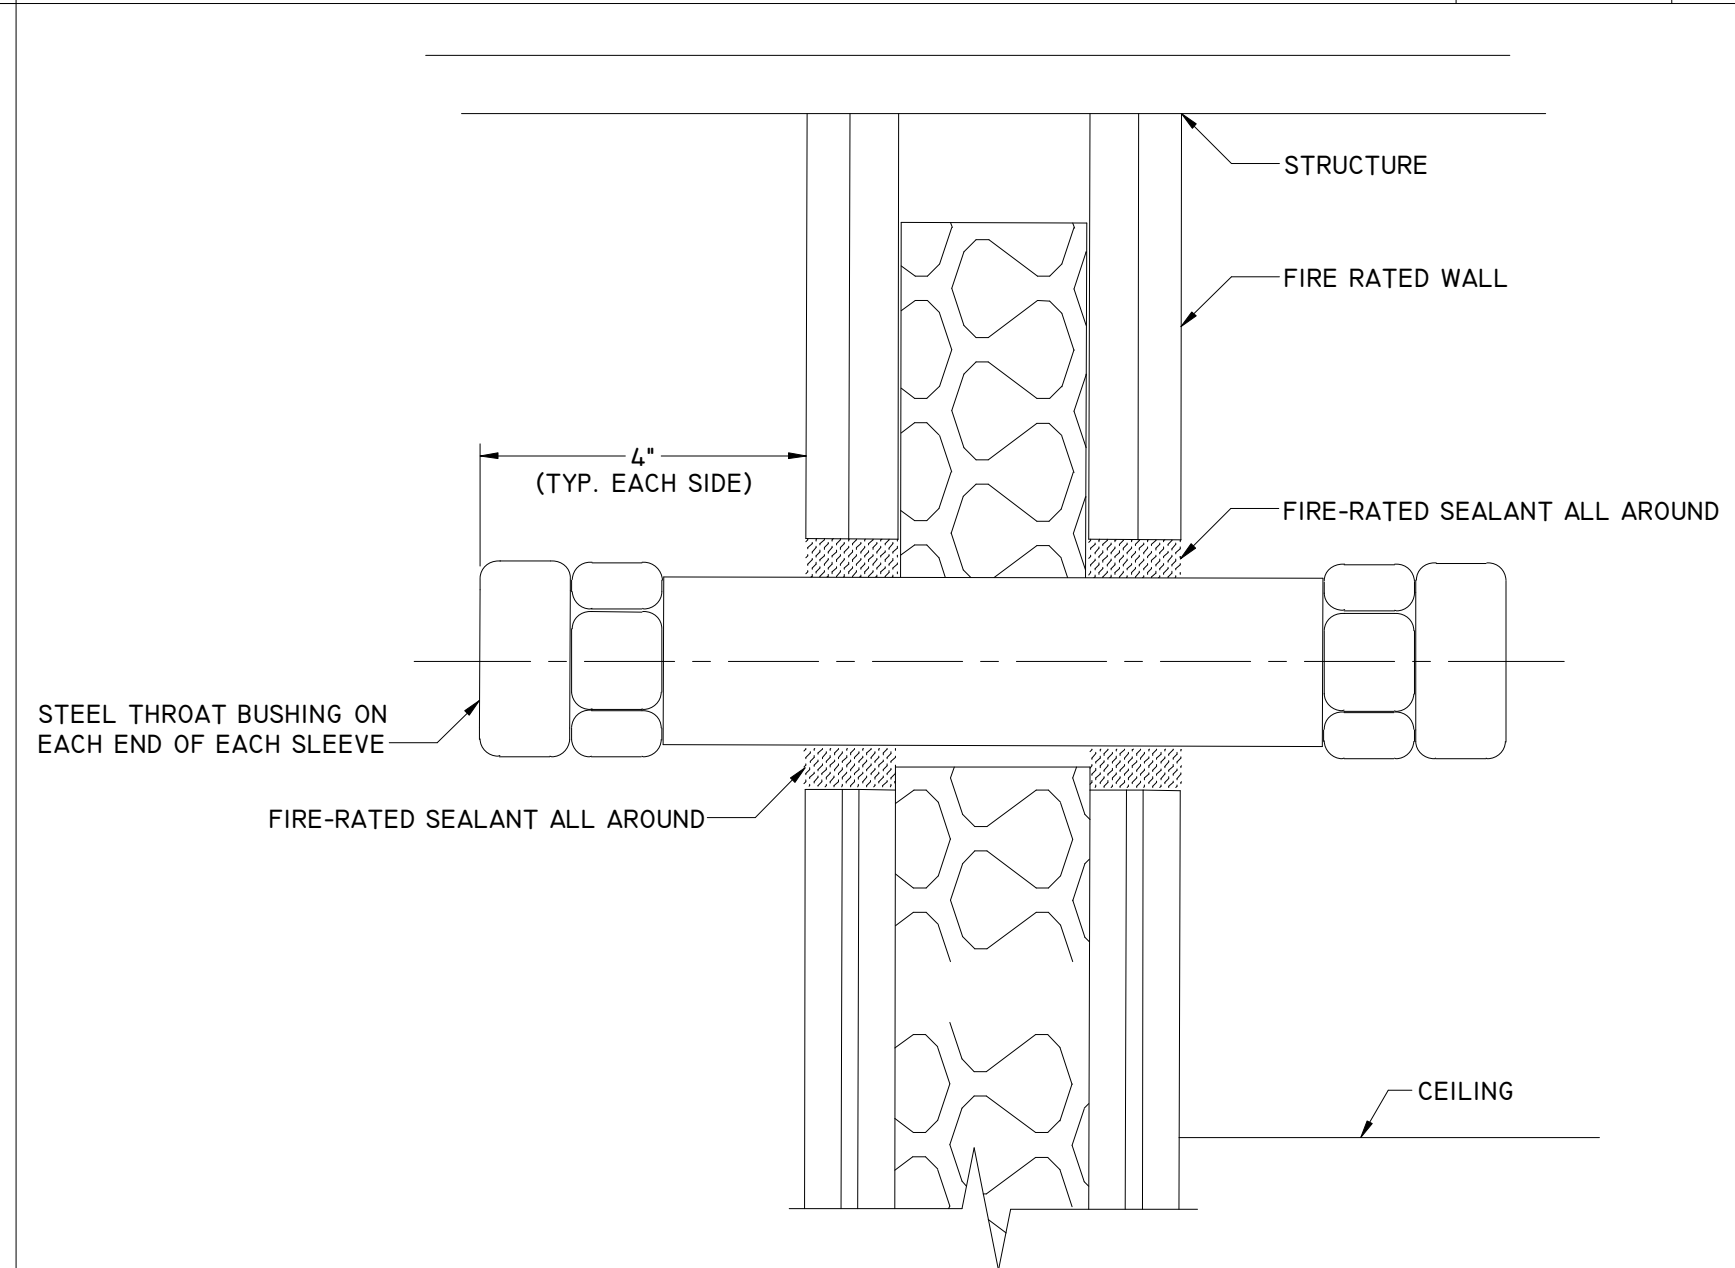

DETAIL - WALL SLEEVE NOT TO SCALE 9

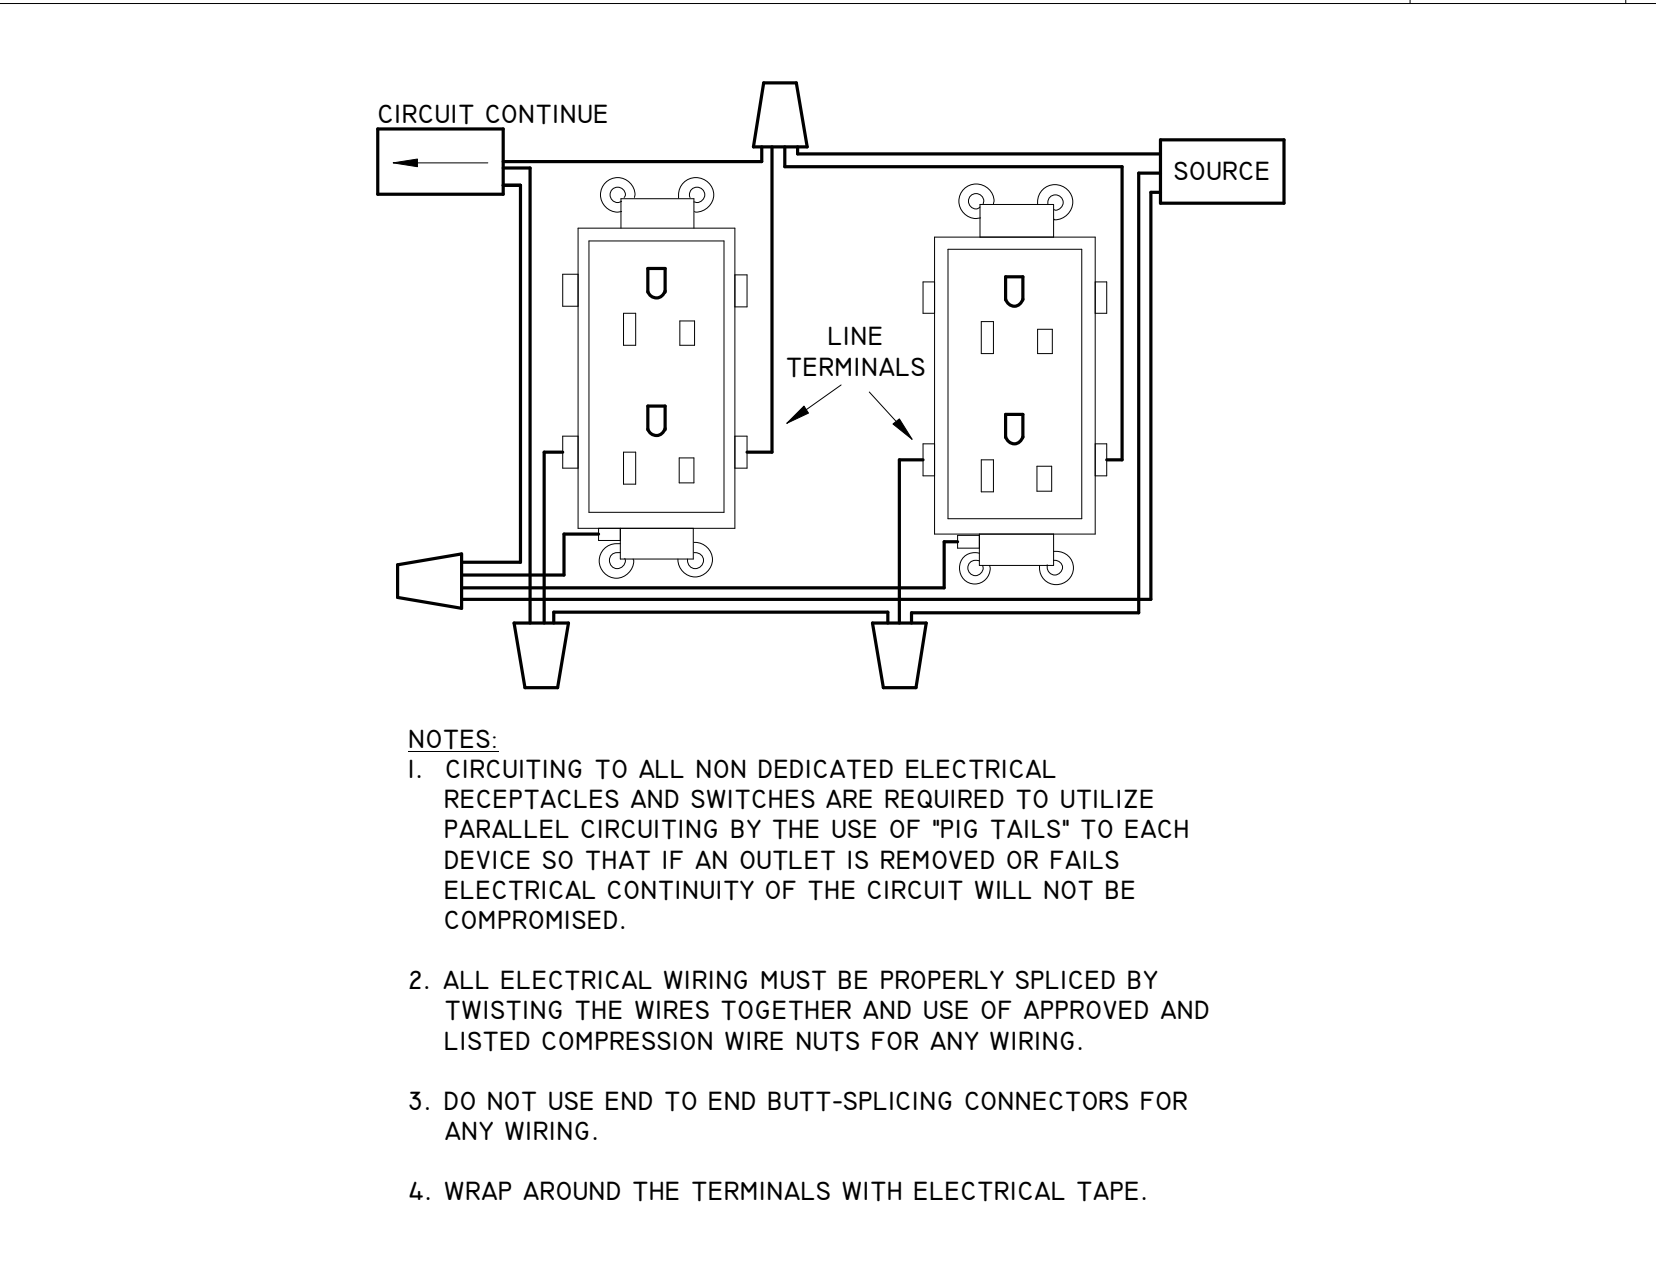

DETAIL - PIGTAIL RECEPTACLE WIRING NOT TO SCALE 5


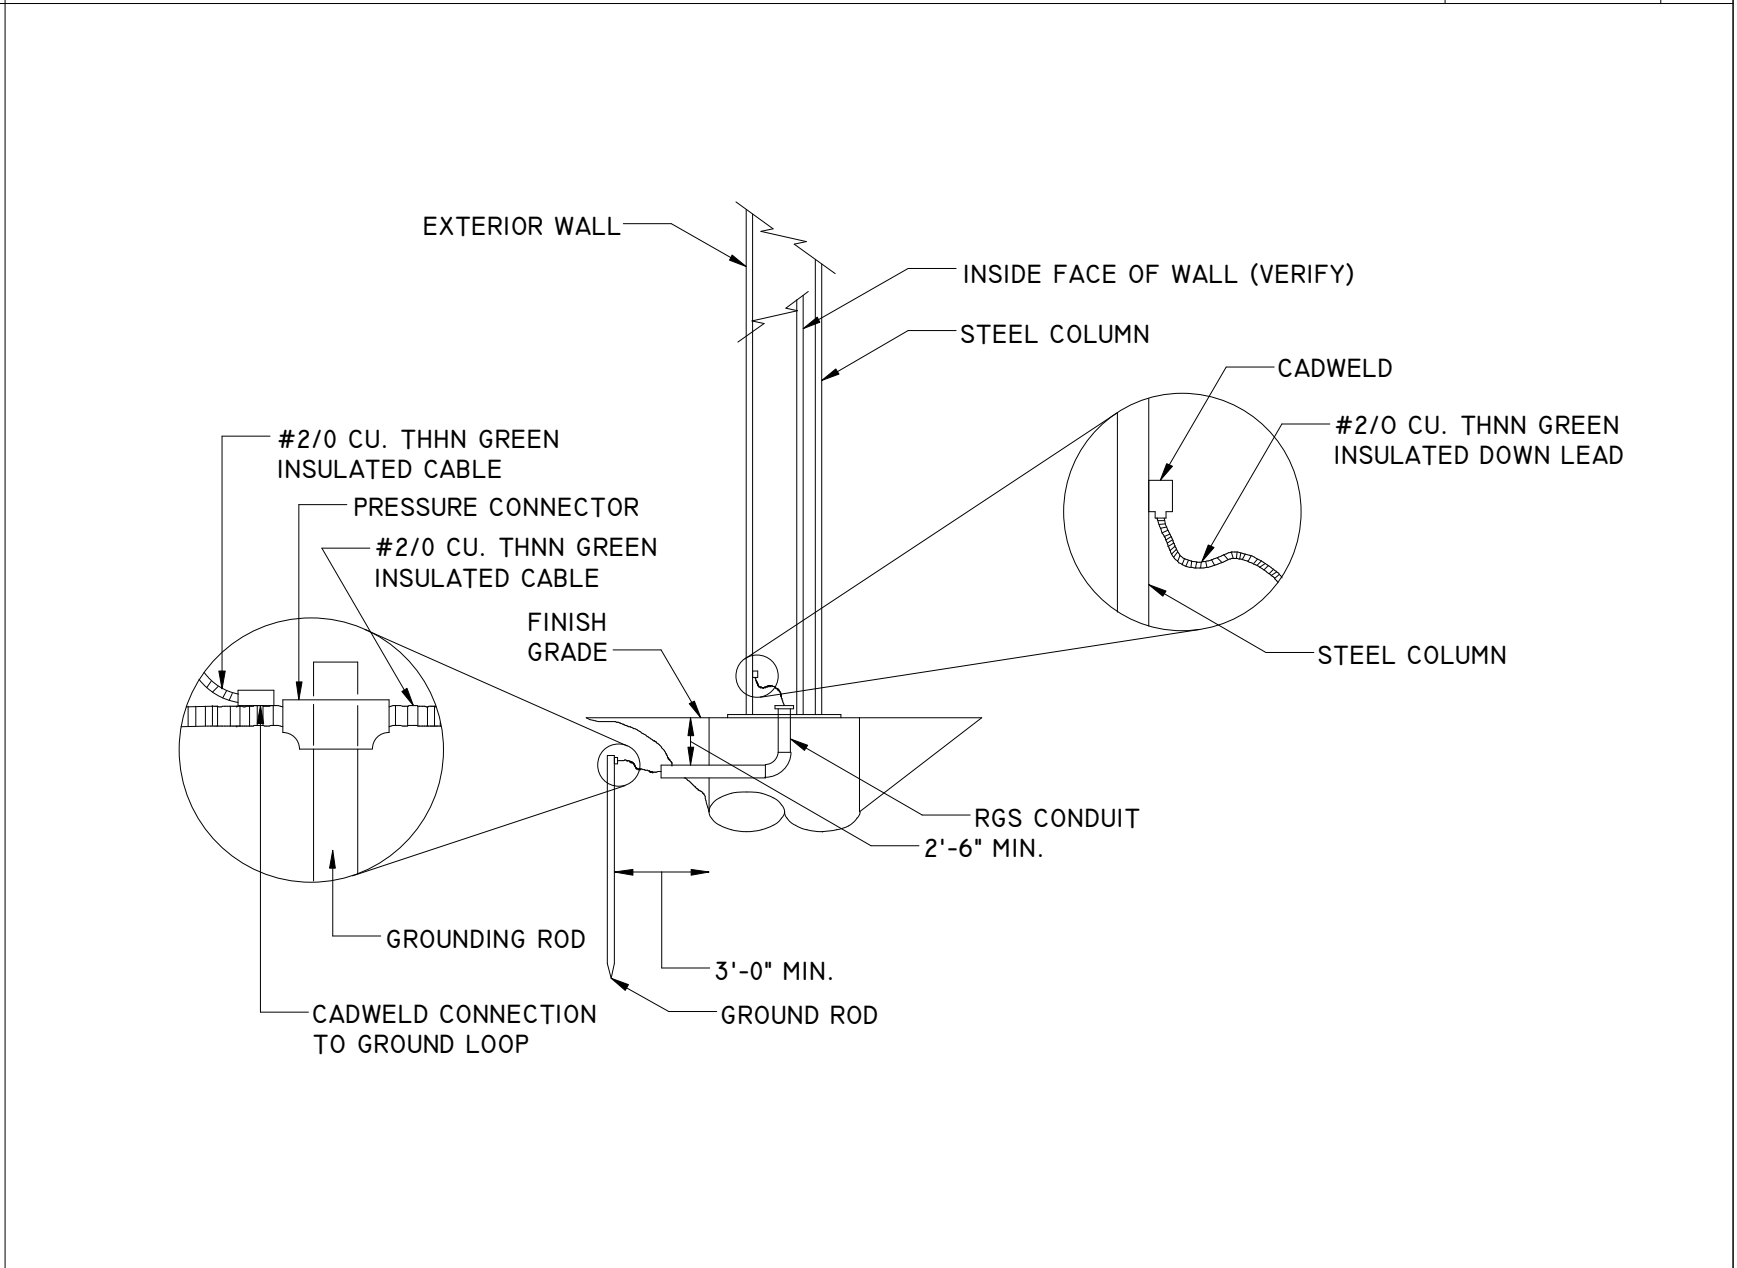


DETAIL - GROUND LOOP NOT TO SCALE 1



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Project Number	19006-A
Drawn By	LT
Checked By	AW
Approved By	MS
Drawing Title	

DETAILS

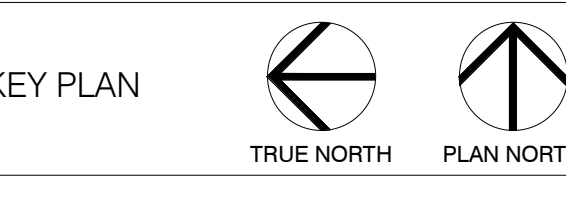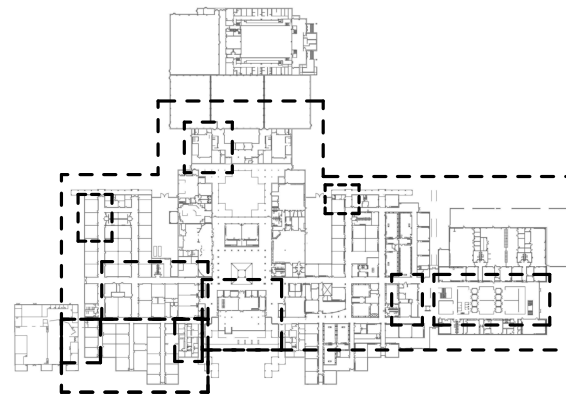Drawing Number **E4.01**



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INFRASTRUCTURE ASSOCIATES, INC.
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TELE: HOUSTON TX 713-622-0120
(713) 622-0120 PH. (713) 622-0551 FAX
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PROFESSIONAL SEAL:




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Project Number	19006-A
Drawn By	LT
Checked By	AW
Approved By	MS
Drawing Title	

PLUMBING DEMO


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GENERAL NOTES:


I. ALL PLUMBING FIXTURES SHALL BE EXISTING TO REMAIN UNLESS OTHERWISE NOTED.

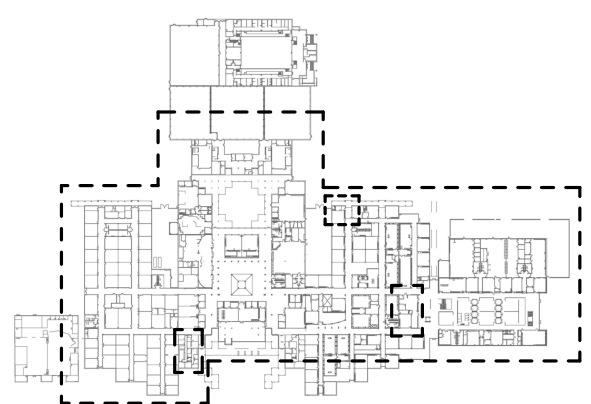KEYNOTE LEGEND


1	REMOVE EXISTING PLUMBING FIXTURE AT THIS LOCATION AND ASSOCIATED PIPING. REMOVE WATER, WASTE, VENT AND ASSOCIATED APPARATUS BACK TO ACTIVE MAIN OR BRANCH. REFER TO NEW WORK PLANS FOR ADDITIONAL INFORMATION. WHERE APPLICABLE, REMOVE WASTE BACK TO BEYOND FINISH FLOOR CAP AND SEAL. AS REQUIRED, SAW CUT FLOOR AS REQUIRED. REFER TO ARCHITECTURAL PLANS FOR FINISHES IF NONE REPAIR SLAB, FLOORS, WALLS, CEILING AND ETC. TO MATCH EXISTING.
2	REMOVE EXISTING WATER HEATER TO BE RELOCATED. DEMO ALL ASSOCIATED HOT WATER PIPING AND DEMO COLD WATER PIPING BACK TO ACTIVE MAIN.
3	REMOVE EXISTING ELECTRIC DRINKING FOUNTAIN AT THIS LOCATION. DEMO WALLS, CEILING, AND SLAB AS NECESSARY. PROTECT EXISTING CIRCUIT FOR RECONNECTION OF NEW DRINKING FOUNTAIN. REFER TO ARCHITECTURAL PLANS FOR FINISHES IF NONE REPAIR SLAB, FLOORS, WALLS, CEILING AND ETC. TO MATCH EXISTING. CONTRACTOR SHALL FIELD VERIFY THAT SUPPORTS / CARRIERS ARE IN PRISTINE CONDITION. "NO RUST / AND UP TO CODE" IF SUPPORTS ARE NOT UP TO CODE AND/OR HAVE RUST THE CONTRACTOR SHALL PROVIDE AN ALLOWANCE TO REPLACE SUPPORTS / CARRIER.

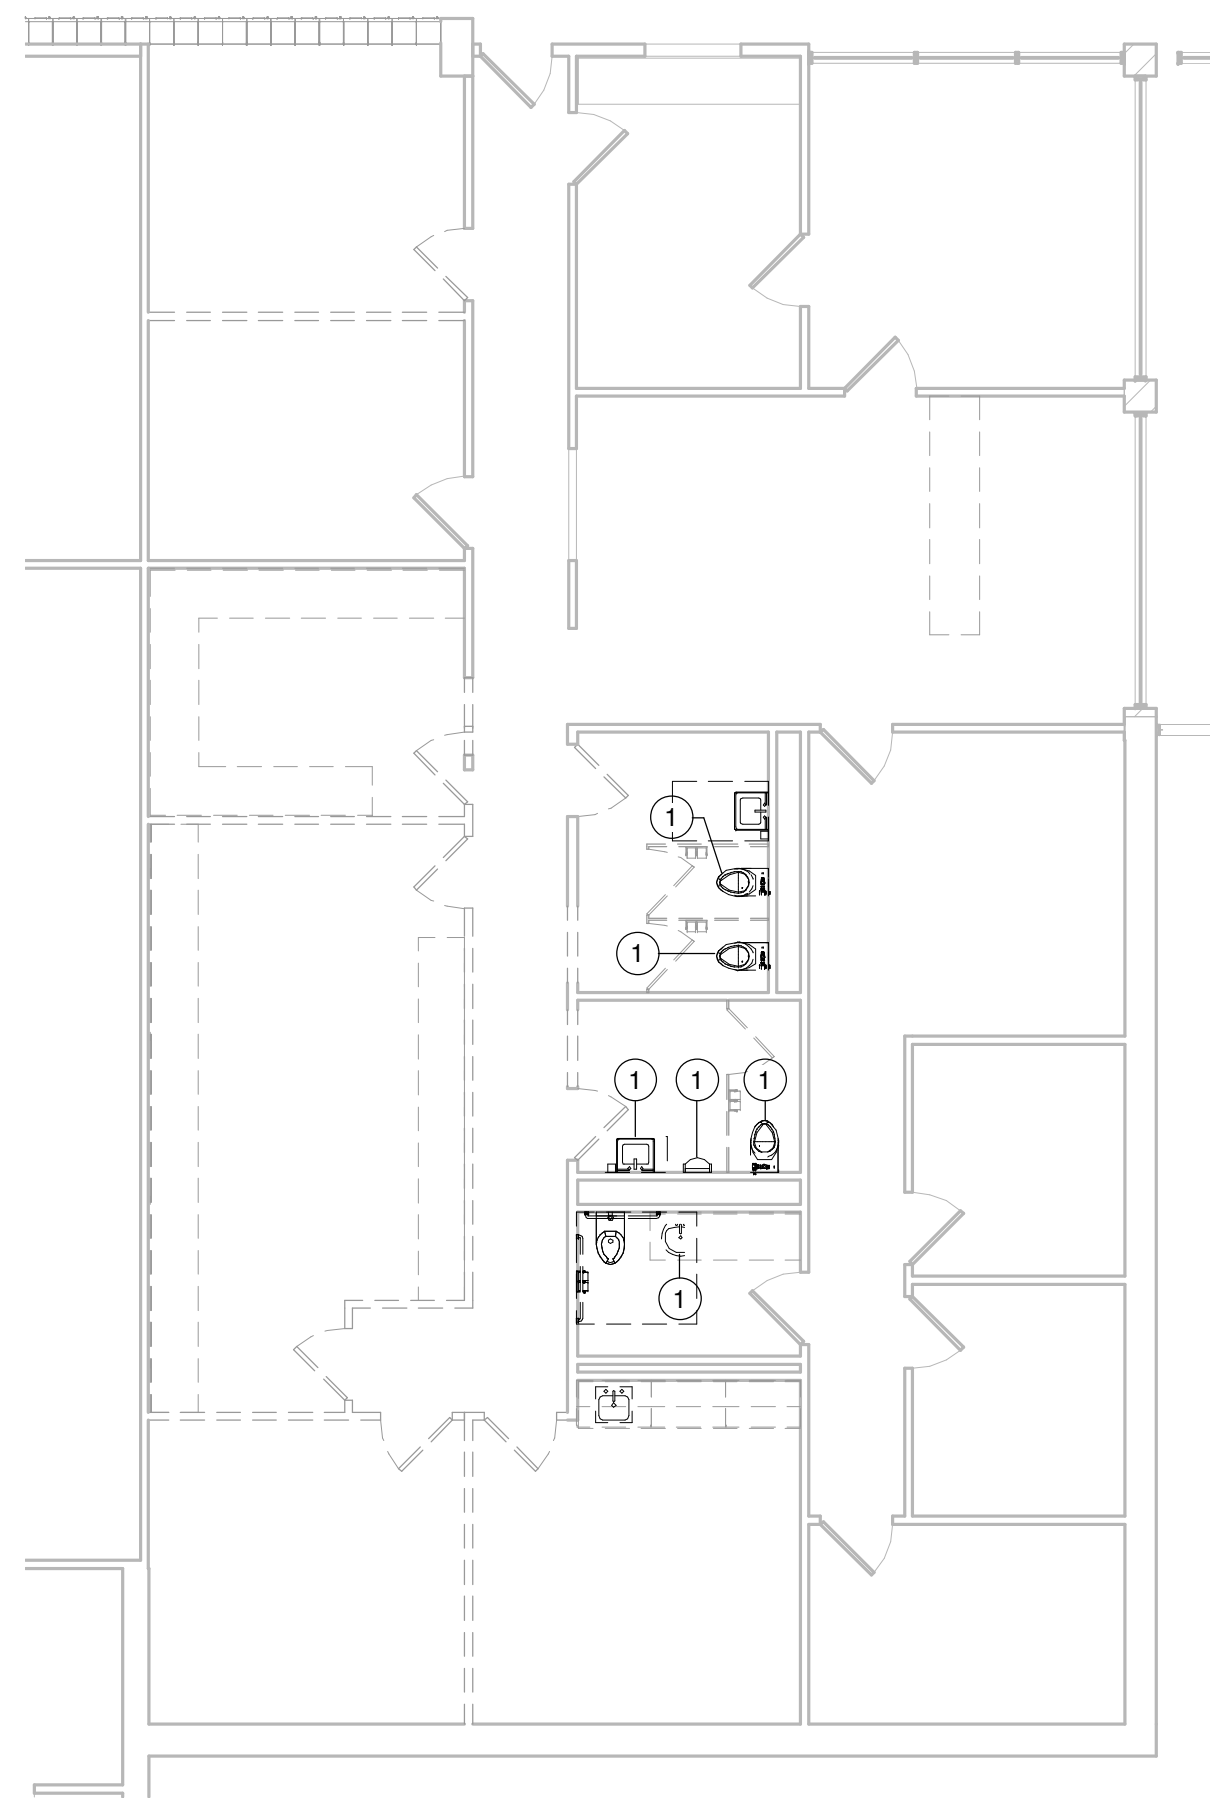


3 FLOOR PLAN - ADMIN - DEMO
Scale: 1/8" = 1'-0"

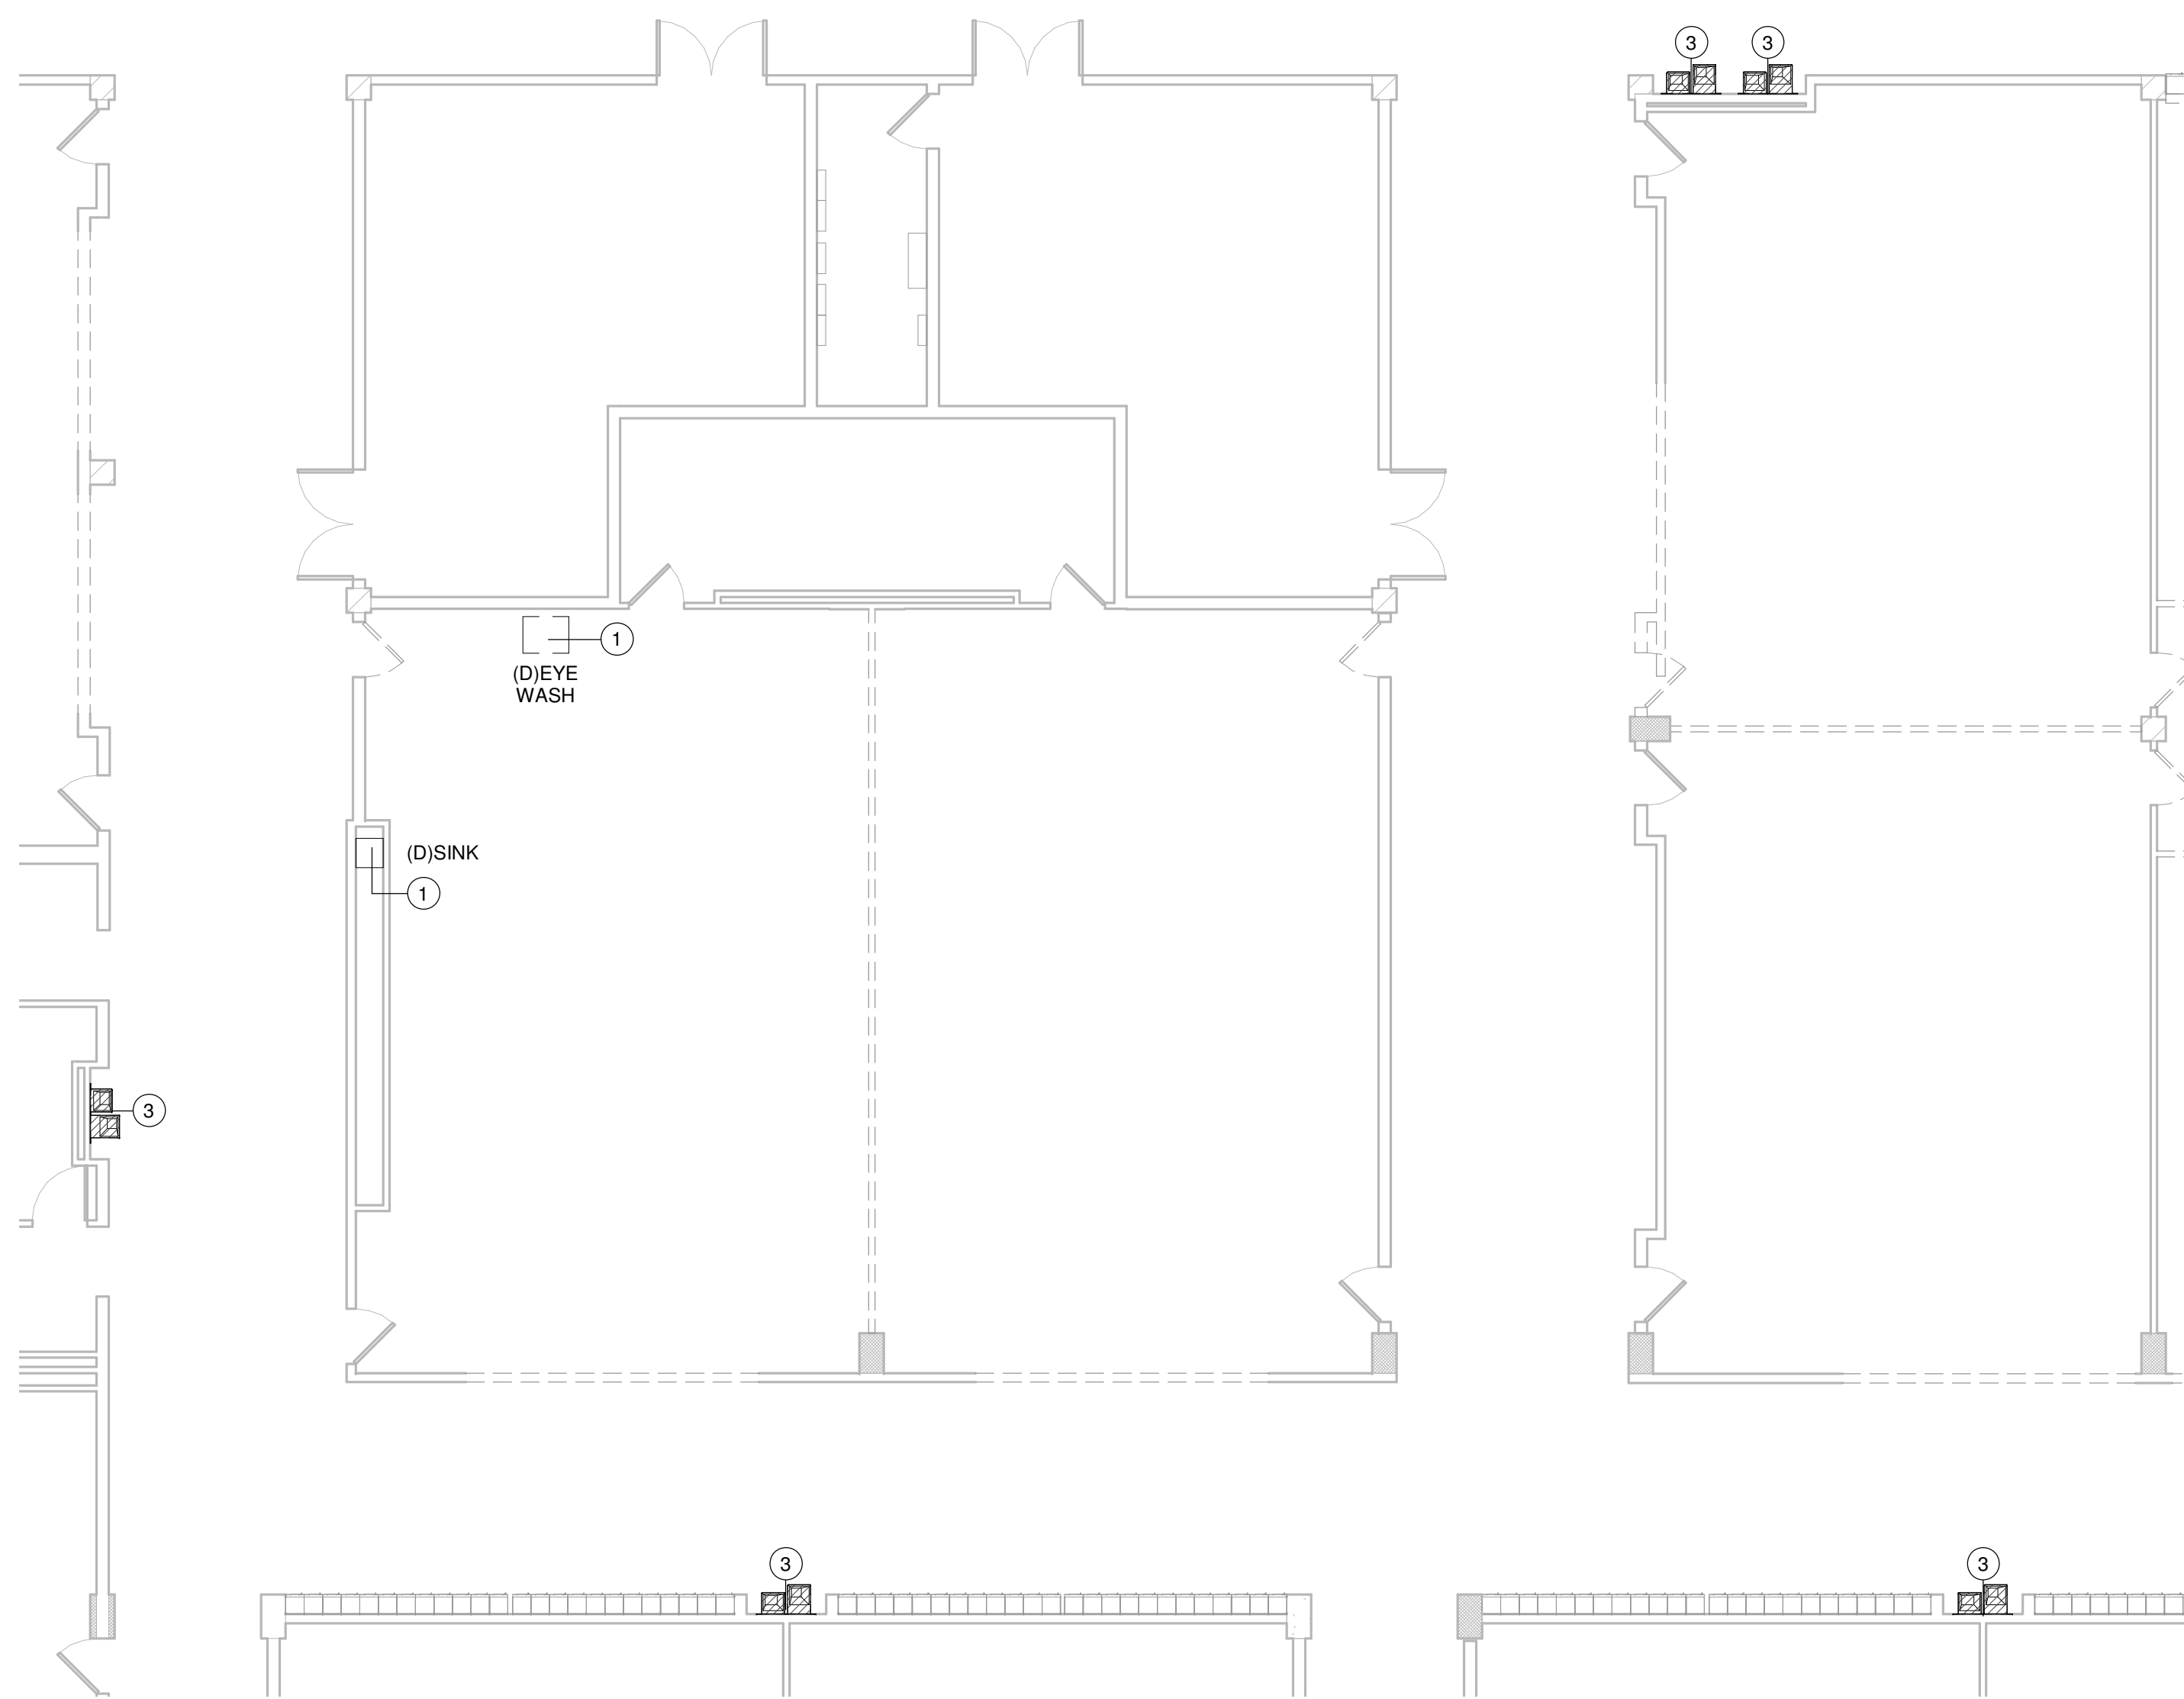

1 FLOOR PLAN - SANITARY - HALLWAY FOUNTAINS - DEMO
Scale: 1/8" = 1'-0"

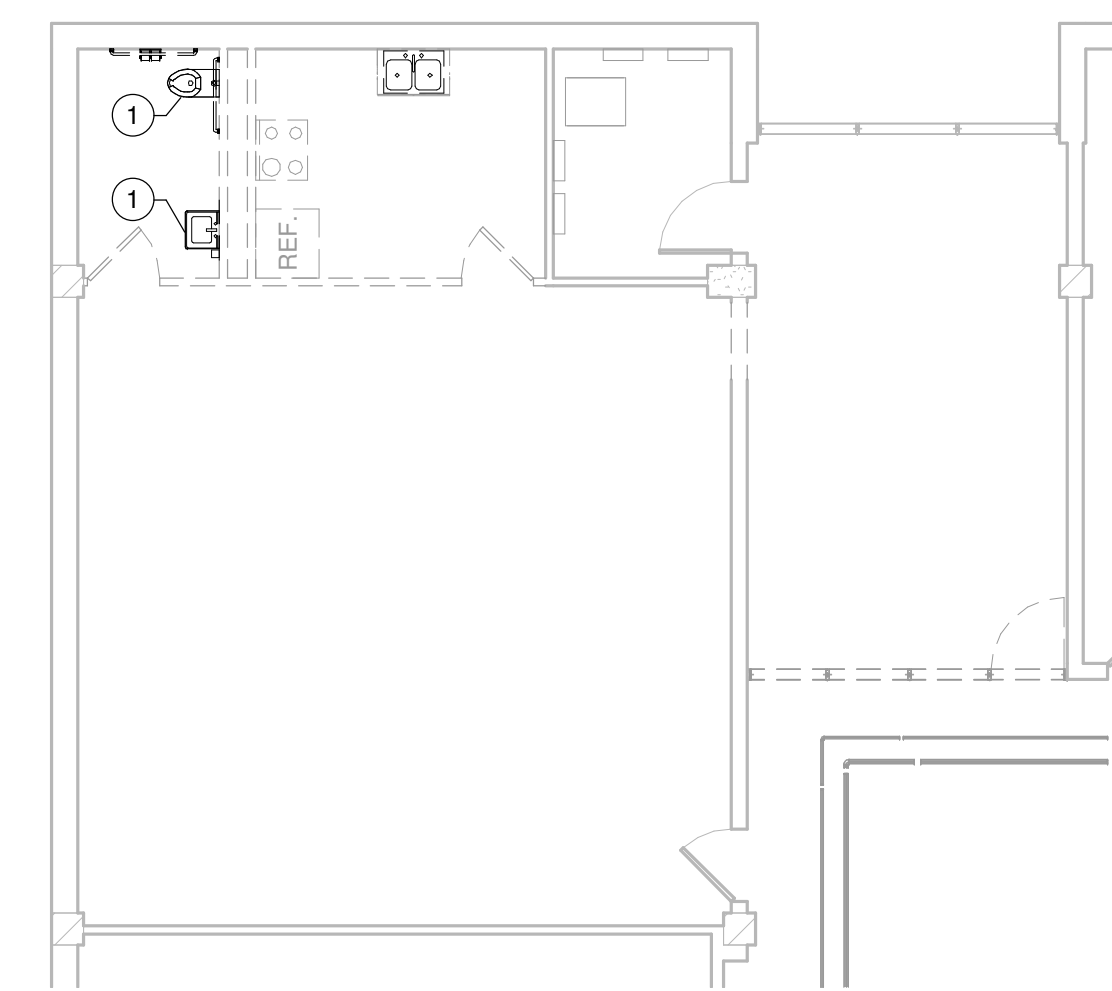

2 FLOOR PLAN - LIFE SKILLS - DEMO
Scale: 1/8" = 1'-0"

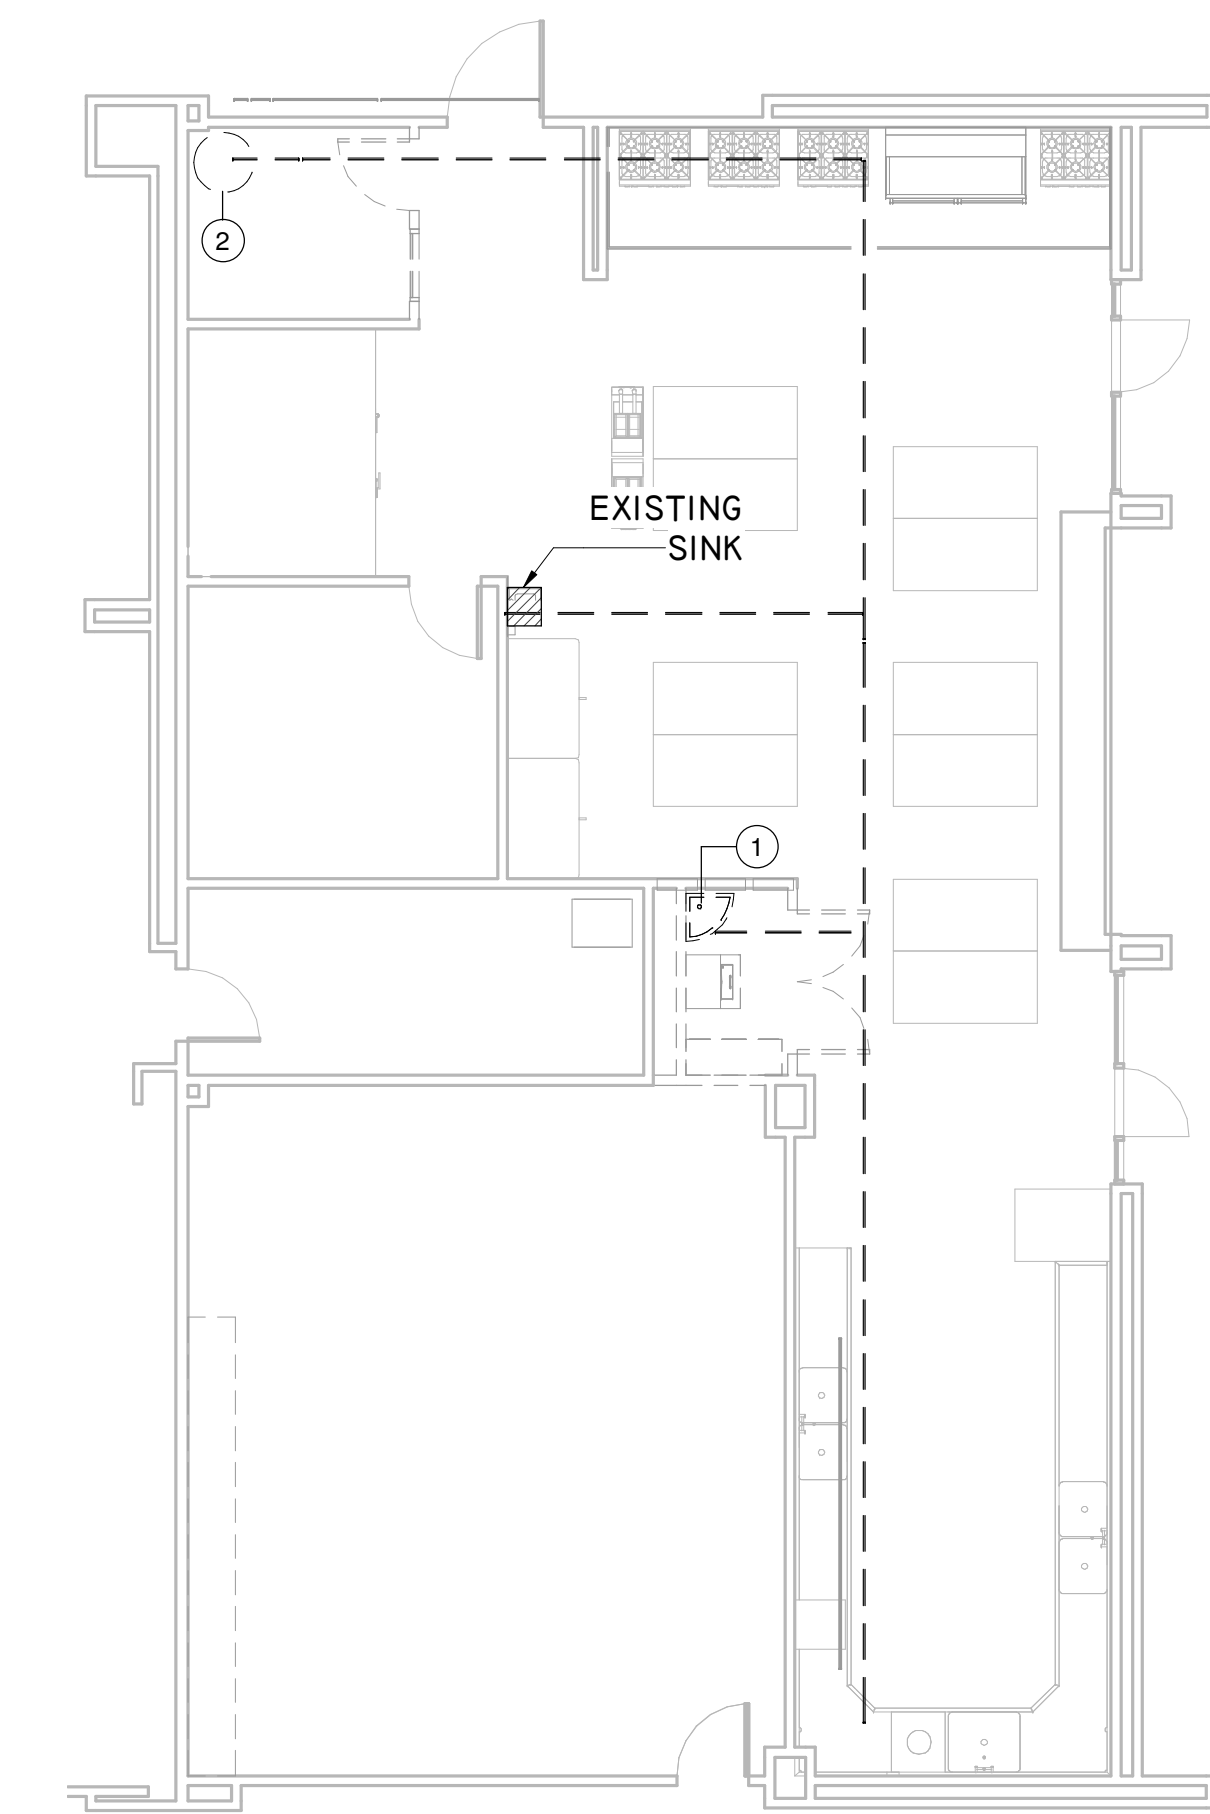

4 FLOOR PLAN - KITCHEN - DEMO
Scale: 1/8" = 1'-0"



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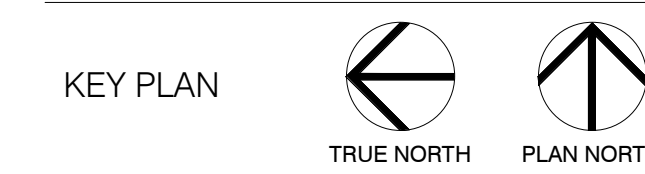
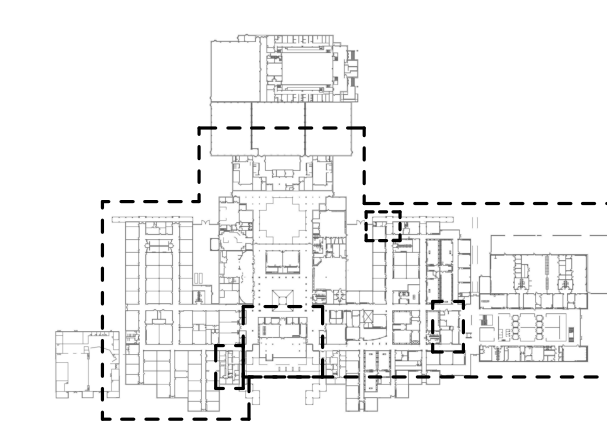
PROFESSIONAL SEAL:



A PROJECT FOR:
**STAFFORD
HIGH SCHOOL
& MAGNET
SCHOOL
RENOVATIONS**

1625 STAFFORDSHIRE
ROAD,
STAFFORD, TX 77477



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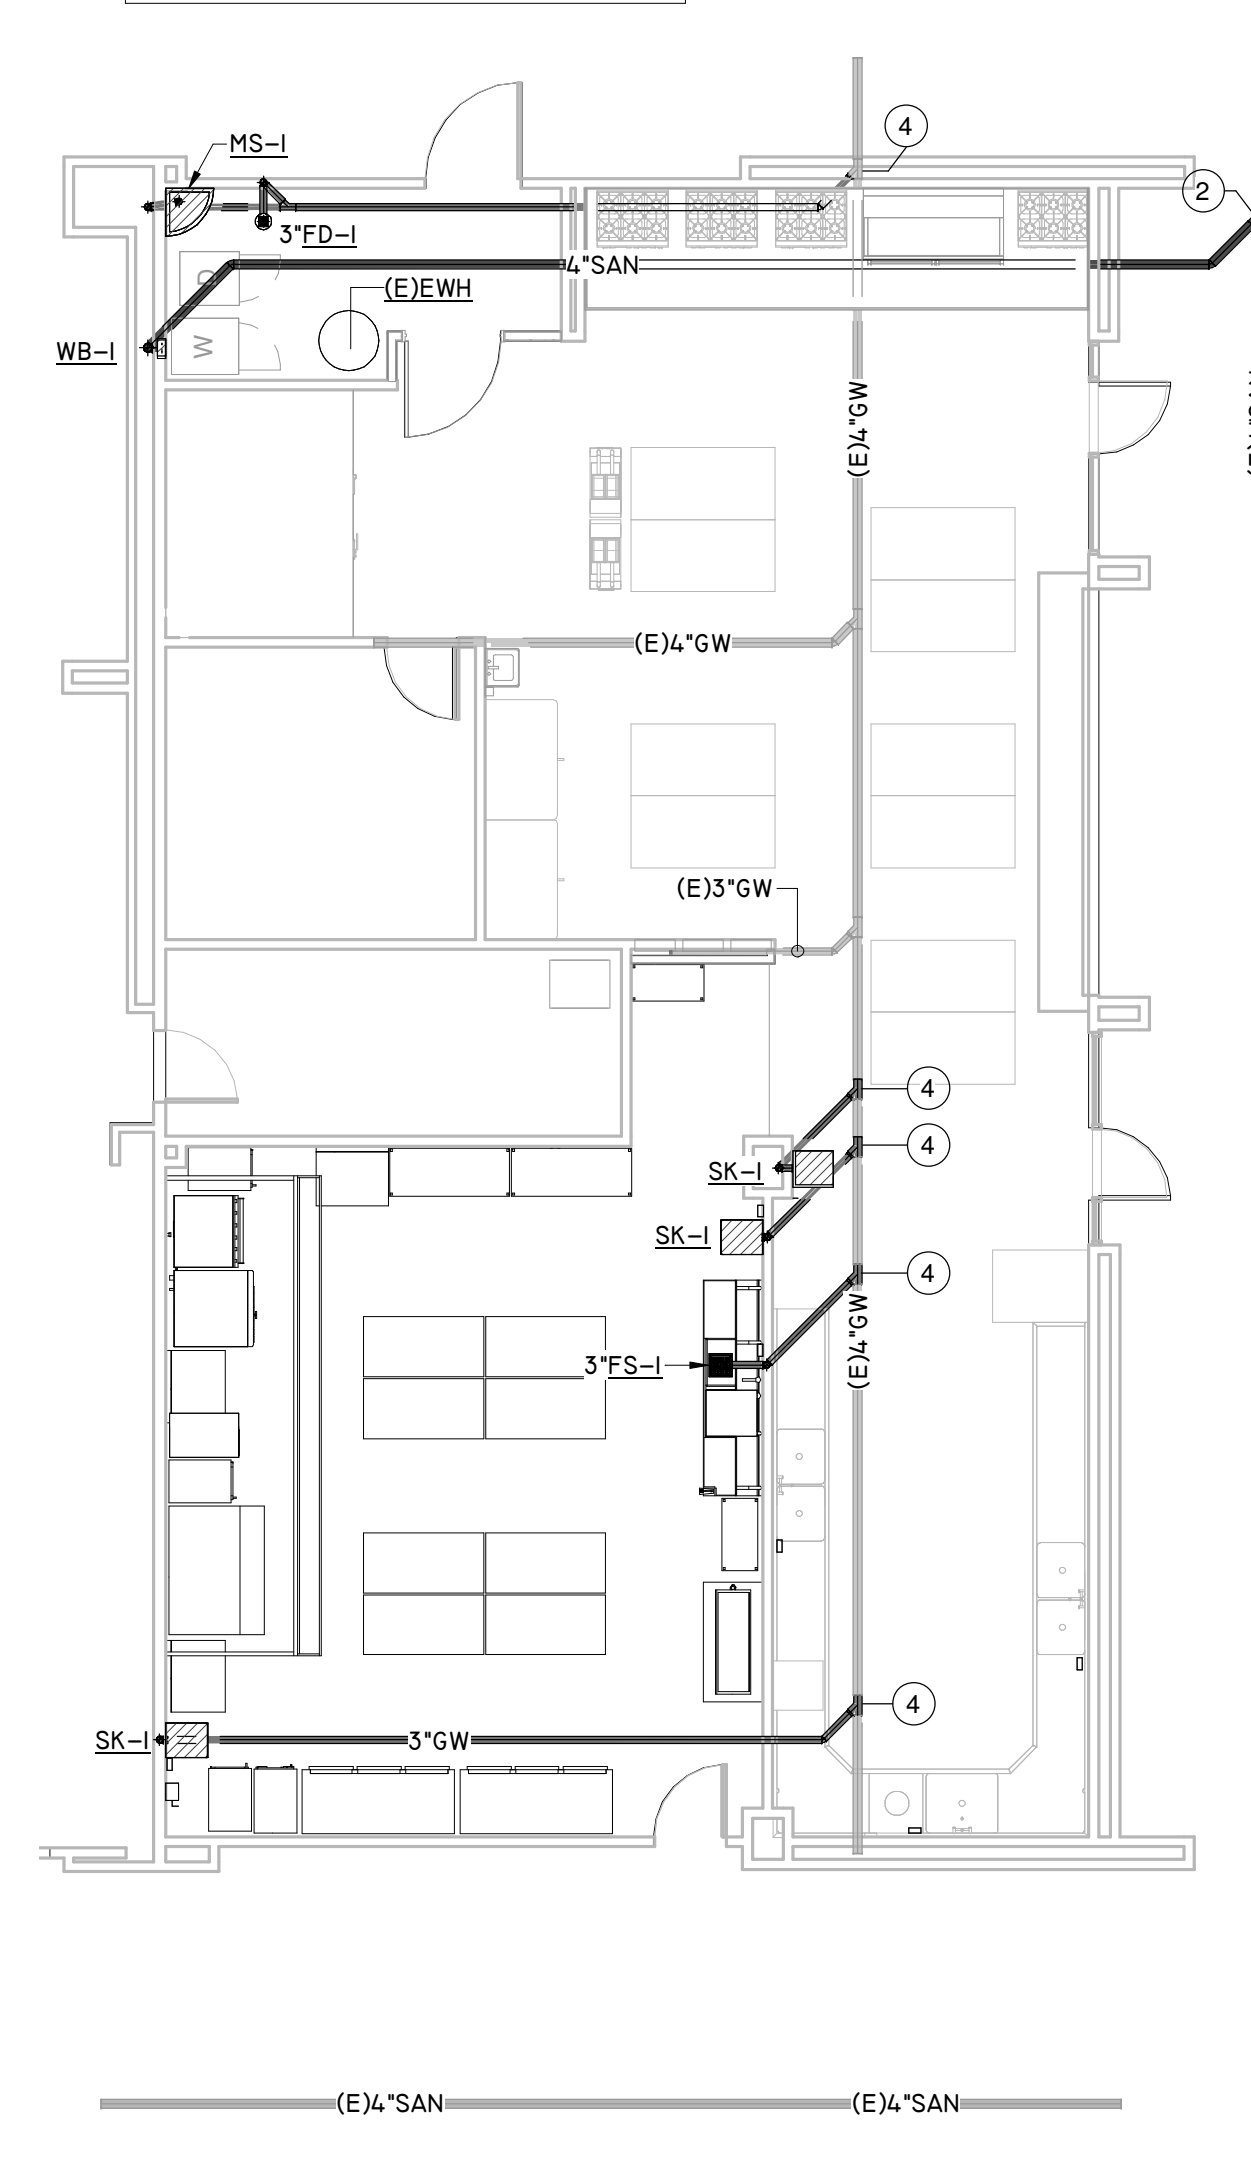
Project Number	19006-A
Drawn By	LT
Checked By	AW
Approved By	MS
Drawing Title	PLUMBING PROPOSED SANITARY
Drawing Number	P2.01

GENERAL NOTE:
SAW CUT EXISTING FLOORS/WALLS AS NECESSARY TO ACCOMMODATE THE INSTALLATION OF THE NEW PIPING SHOWN. REPAIR FLOOR, WALLS, CEILING AND ROOF TO MATCH EXISTING COORDINATE WITH ARCHITECT, MEP SYSTEMS AND STRUCTURE.


KEYNOTE LEGEND	
1	CONTRACTOR SHALL FOLLOW THE MANUFACTURE INSTALLATION GUIDE FOR CONNECTING THE DISHWASHER AT THIS LOCATION. ROUTE WATER AND WASTE TO AND FROM SINK PROVIDE AIR GAP AT THE SINK.
2	ROUTE SAN WASTE LINE TO EXISTING SAN WASTE LINE APPROXIMATELY THIS POINT. FIELD VERIFY EXACT LOCATION, SIZE, DIRECTION OF FLOW AND DEPTH OF BURY OF EXISTING PIPE.
3	PROPOSED PLUMBING FIXTURE SHALL RECONNECT TO EXISTING WATER & SANITARY LINES AS REQUIRED. PATCH AND REPAIR WALL, FLOOR, TILE AND ETC. REFER TO ARCHITECTURAL DRAWINGS FOR FINISHES. IF NONE MATCH EXISTING.
4	ROUTE GW WASTE LINE TO EXISTING GREASE WASTE LINE APPROXIMATELY THIS POINT. FIELD VERIFY EXACT LOCATION, SIZE, DIRECTION OF FLOW AND DEPTH OF BURY OF EXISTING PIPE.




5 FLOOR PLAN - MEDICAL CLASS - SANITARY
Scale: 1/8" = 1'-0"

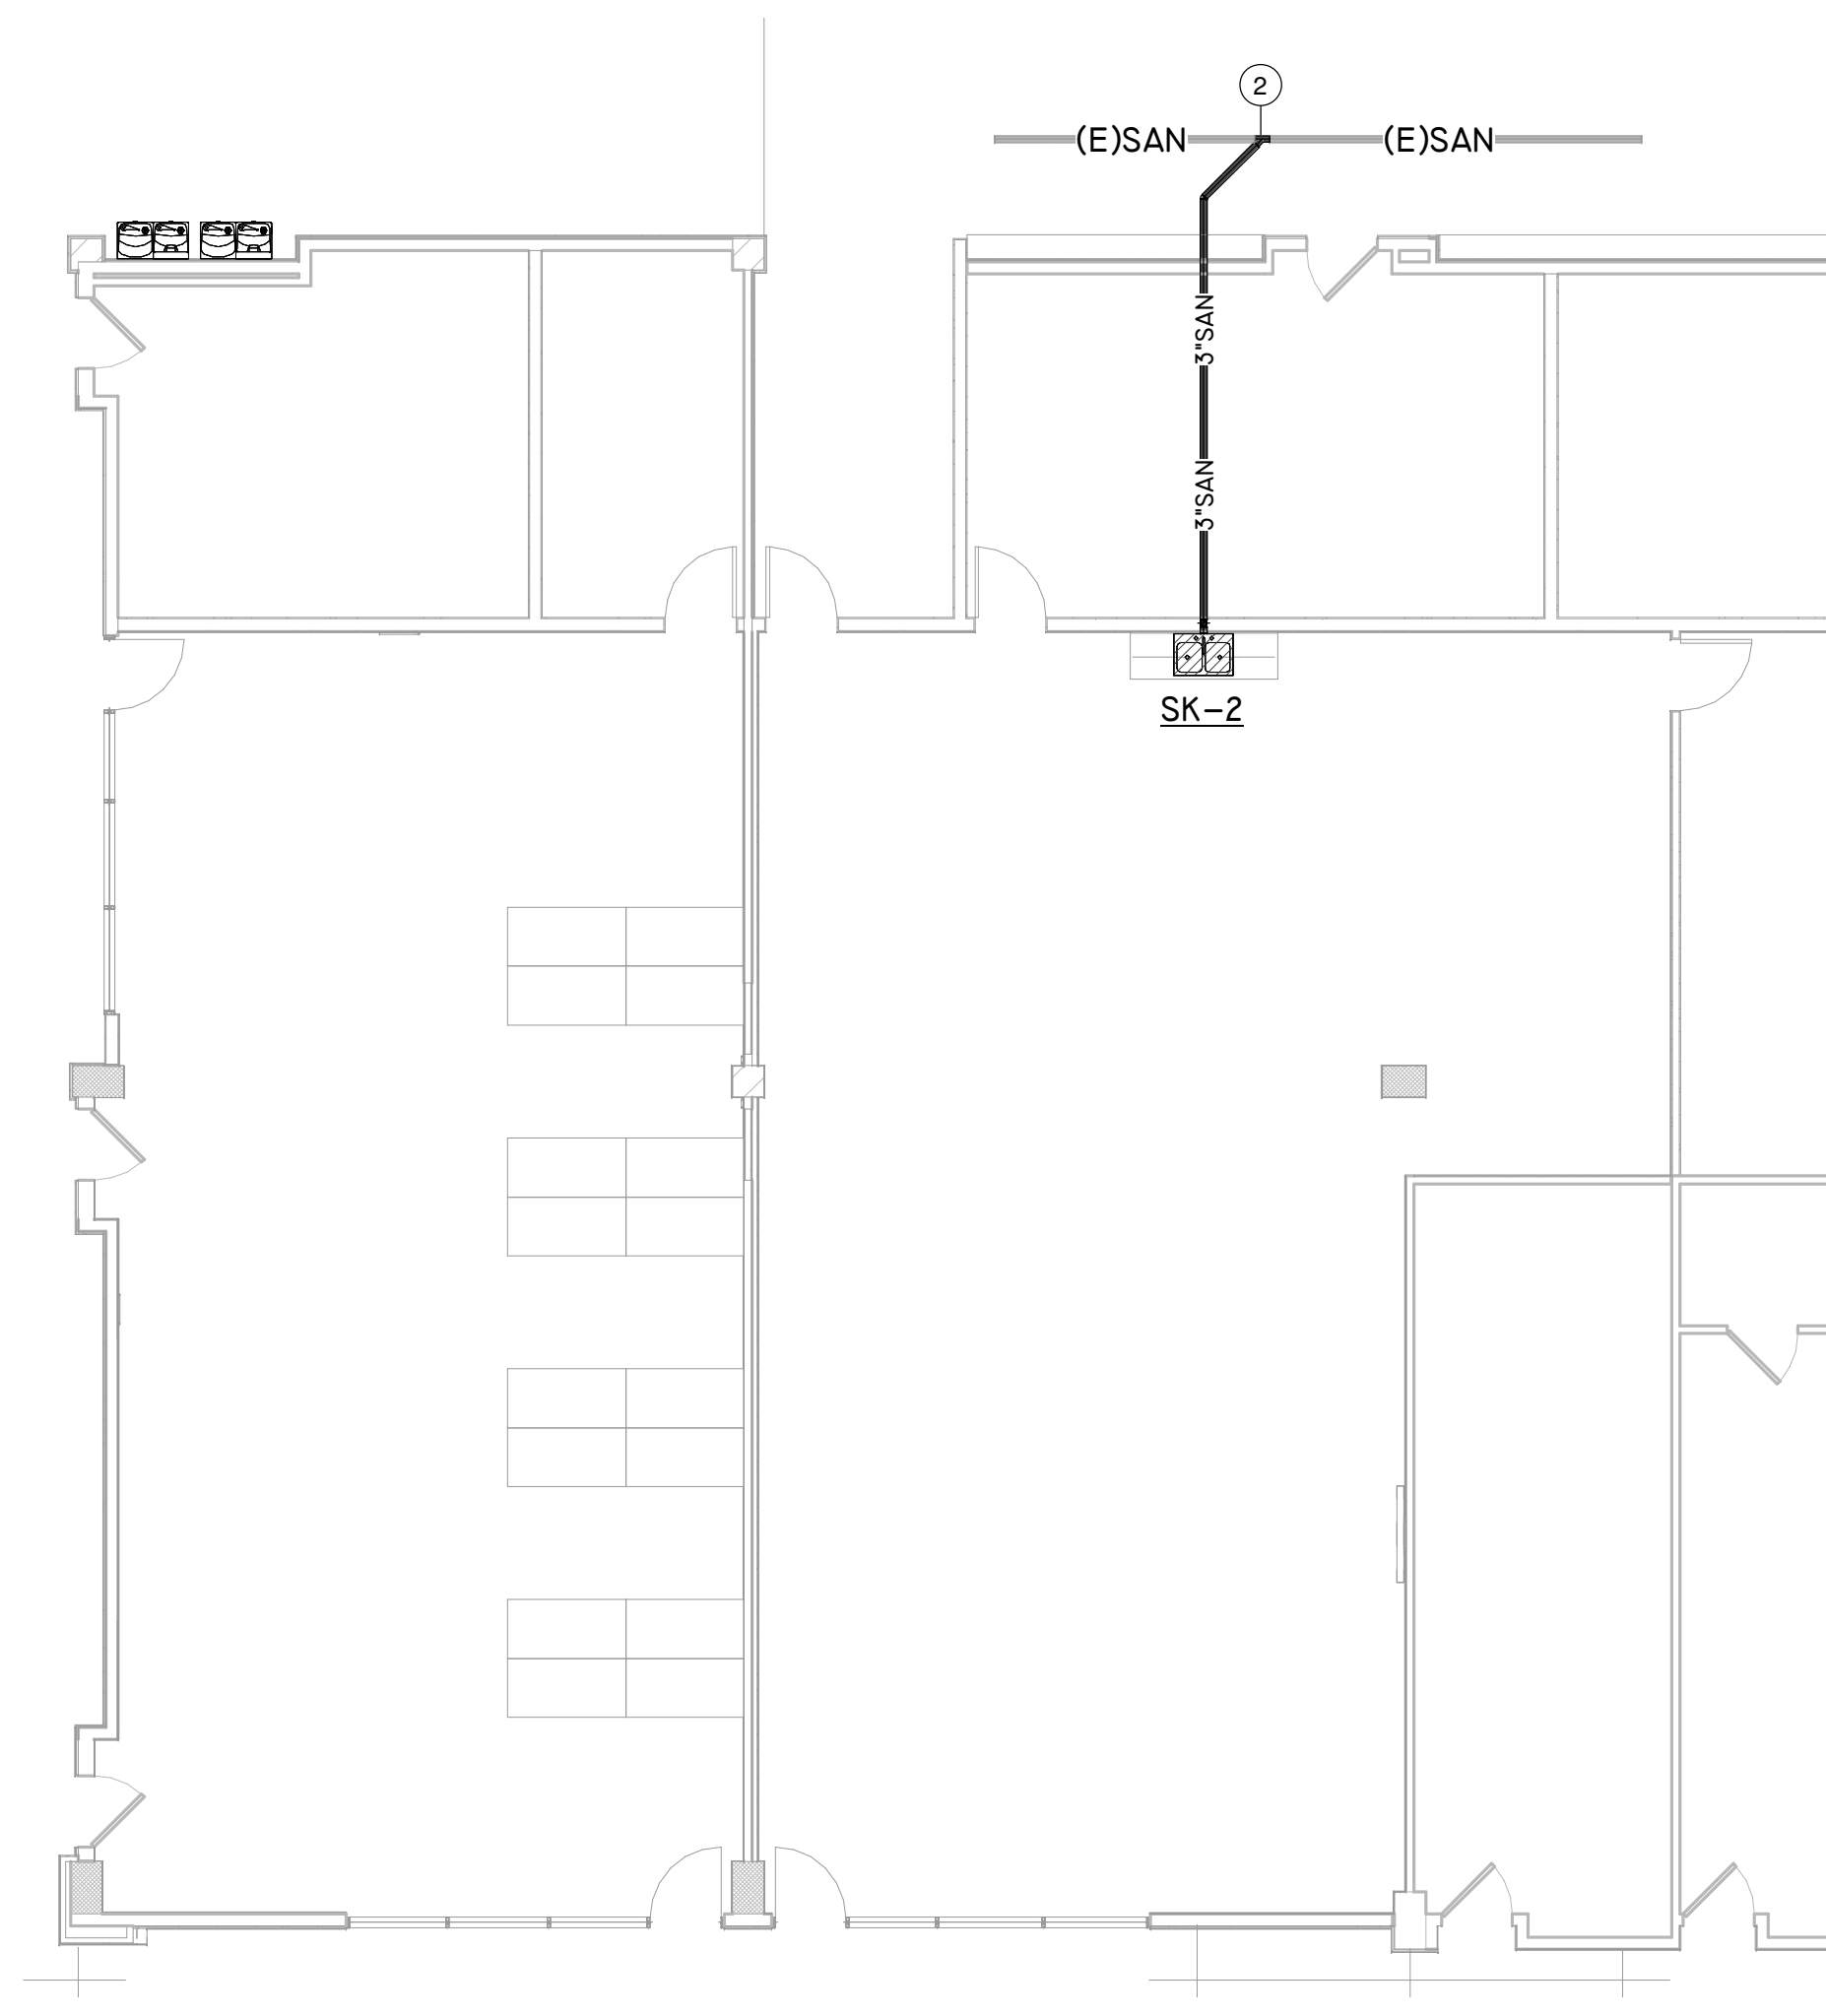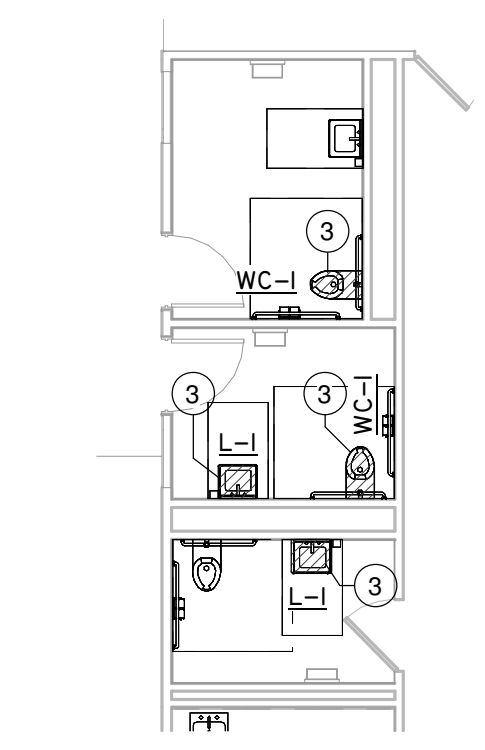


4 FLOOR PLAN - KITCHEN - SANITARY
Scale: 1/8" = 1'-0"

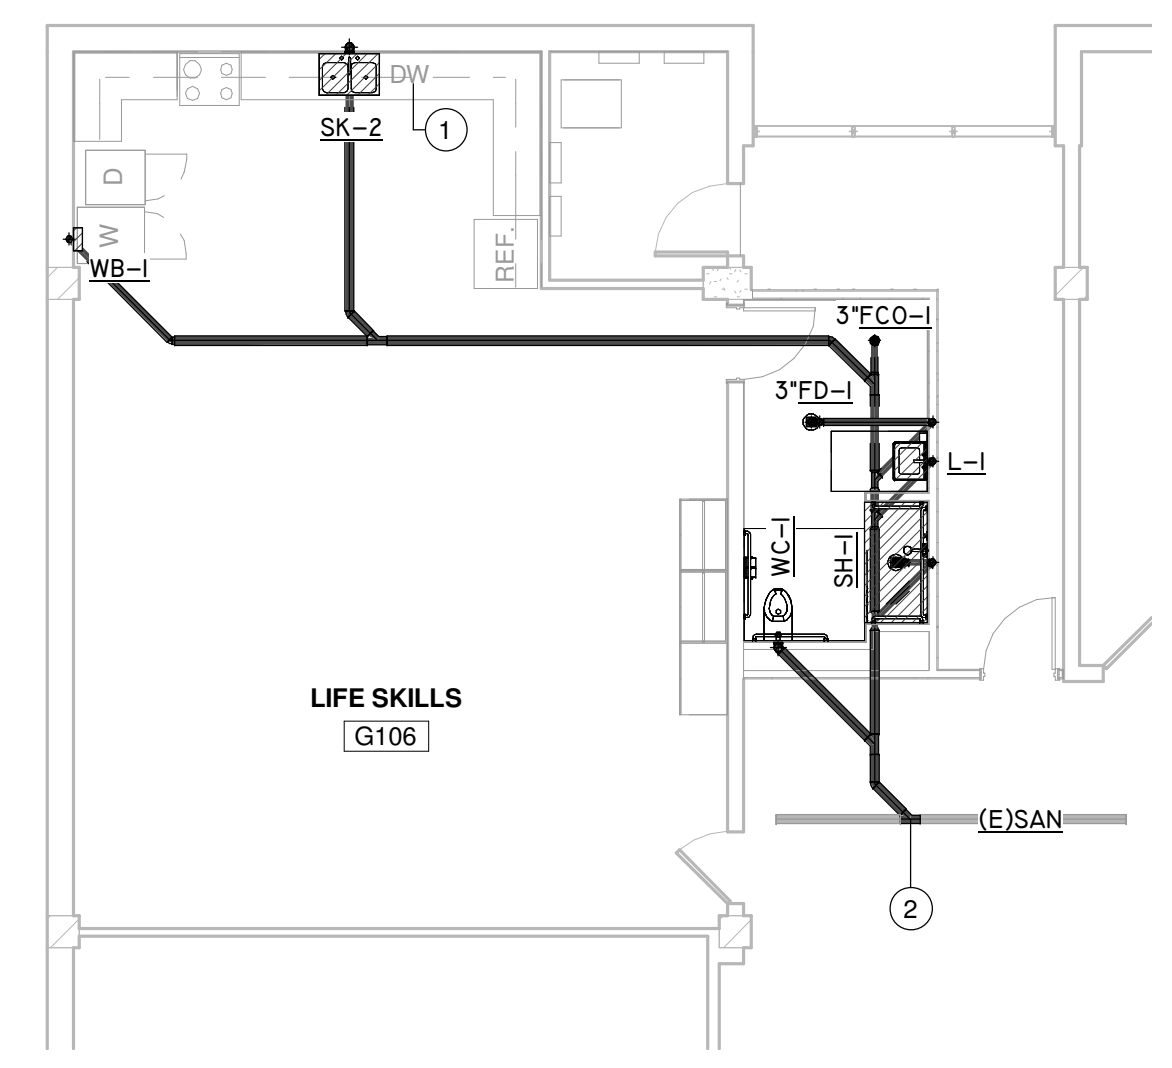

3 FLOOR PLAN - LIFE SKILLS - SANITARY
Scale: 1/8" = 1'-0"

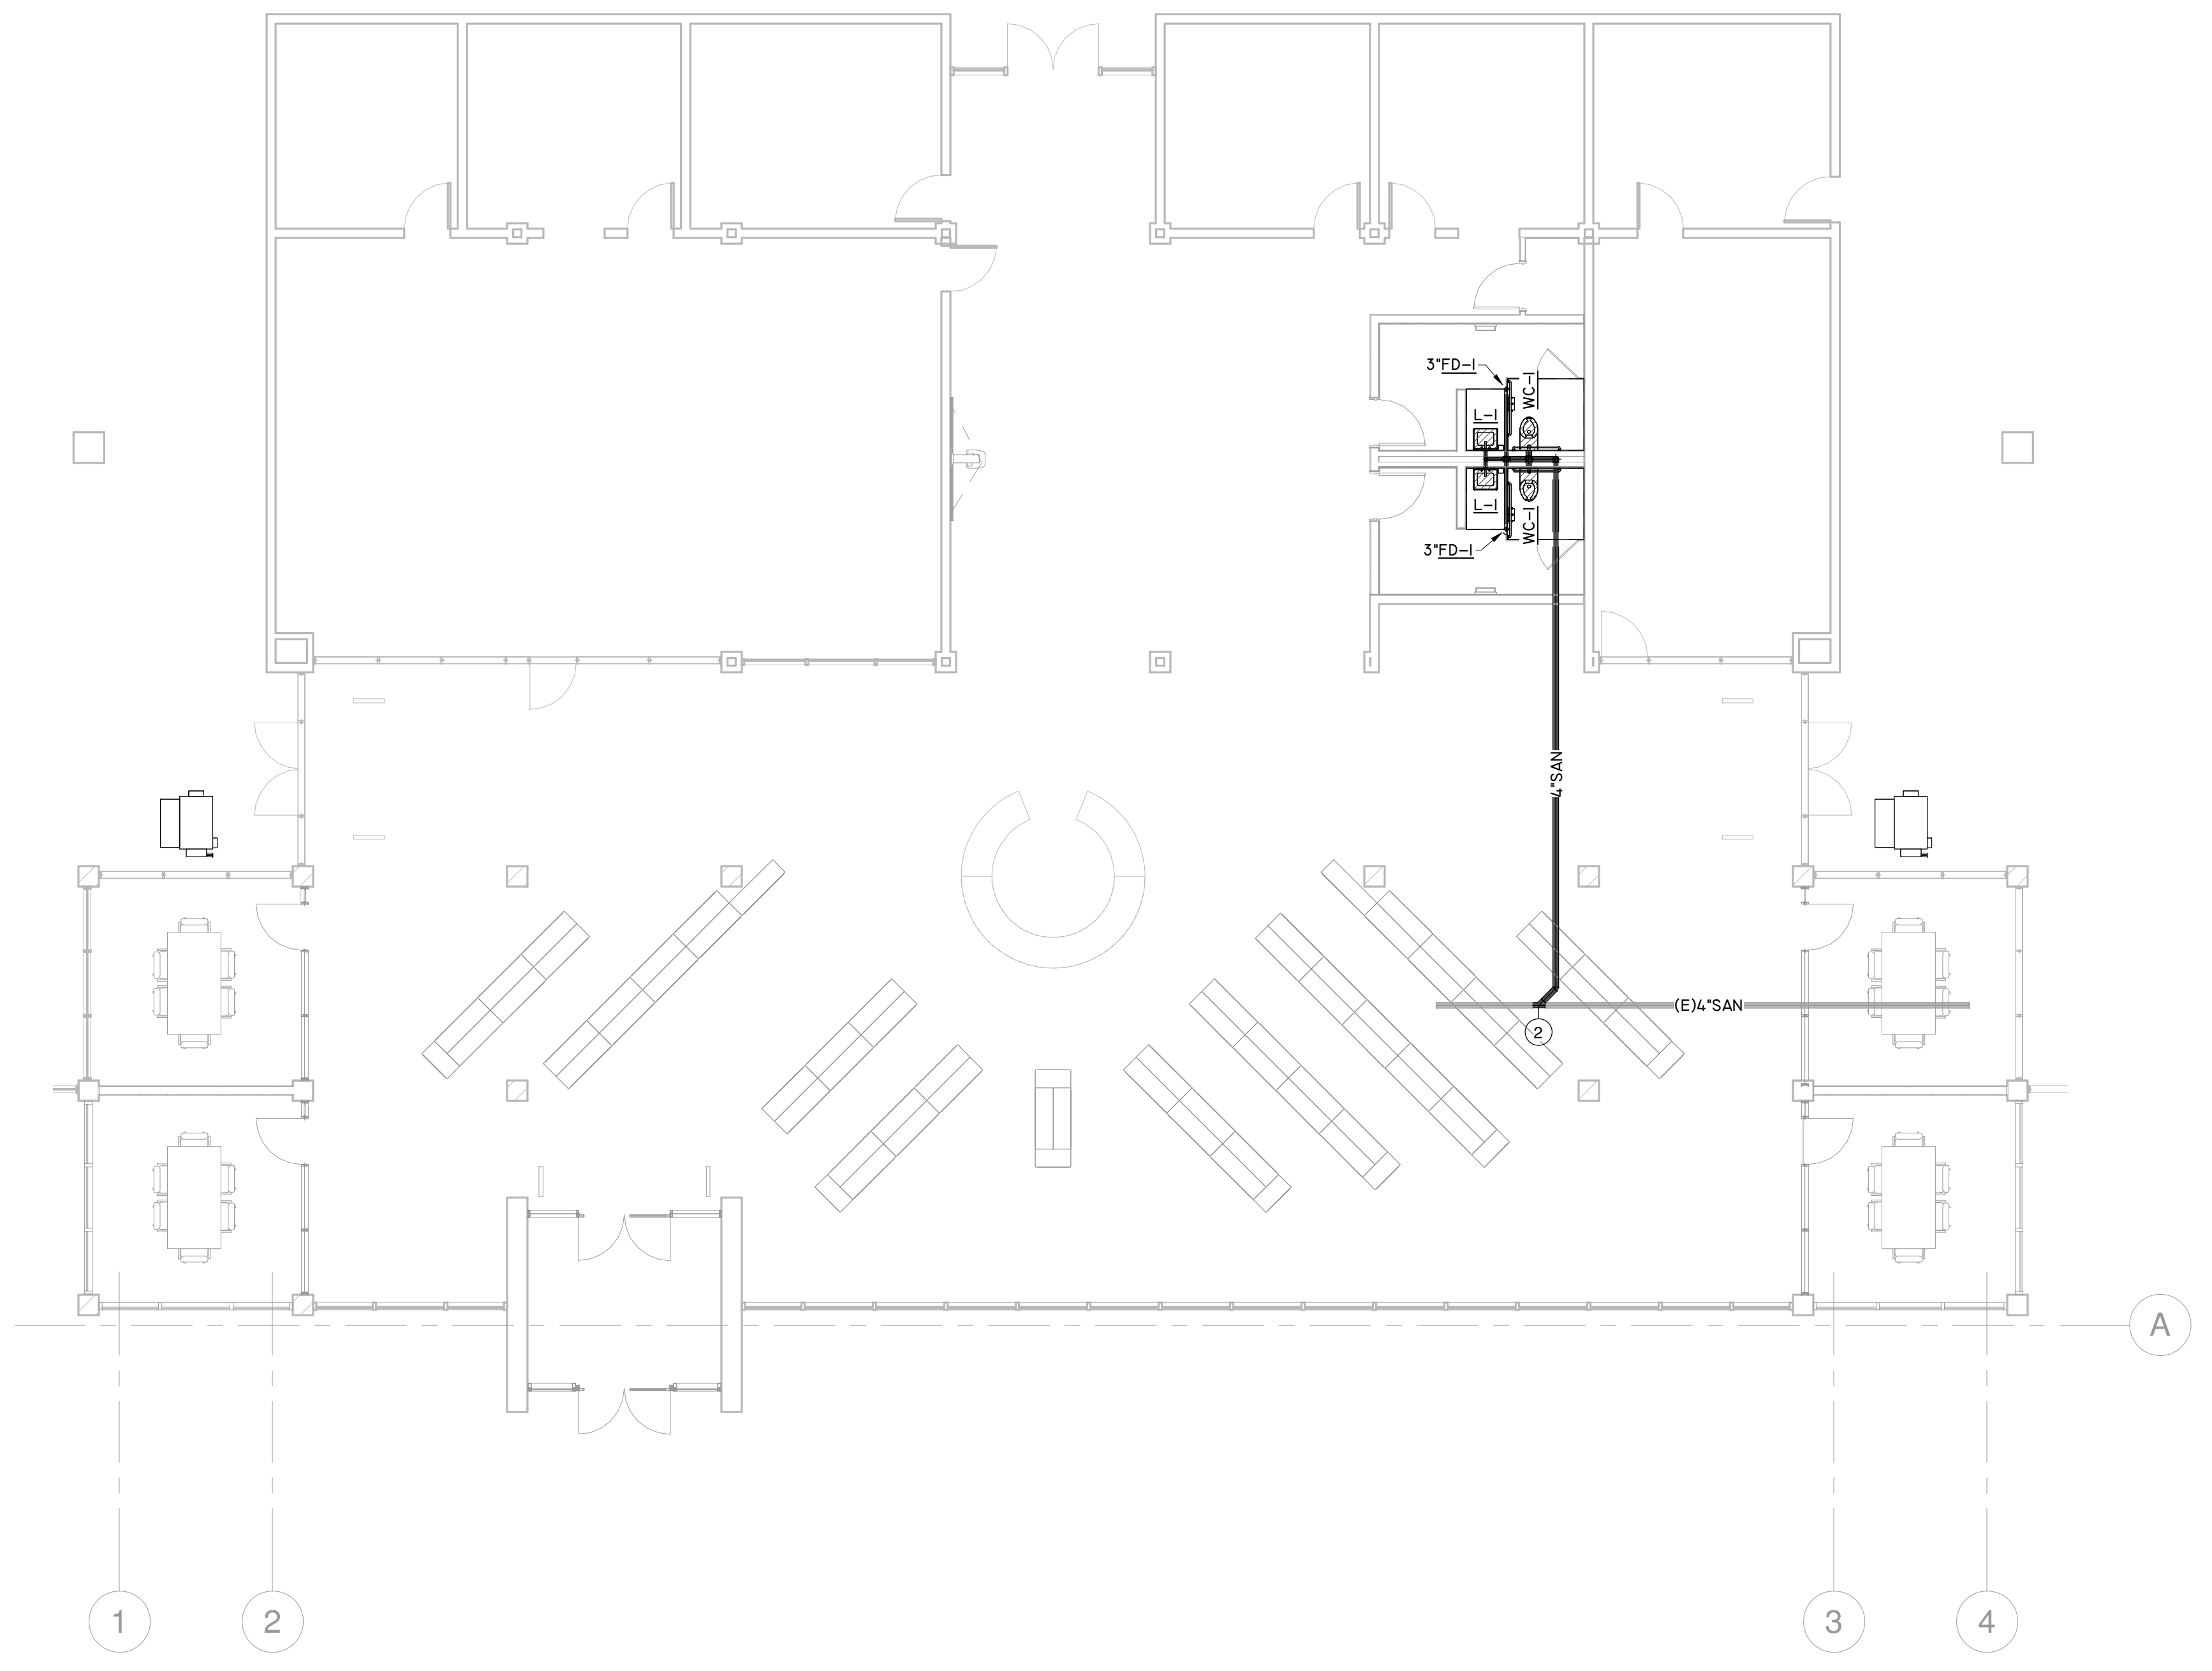

2 FLOOR PLAN - LIBRARY - SANITARY
Scale: 1/8" = 1'-0"

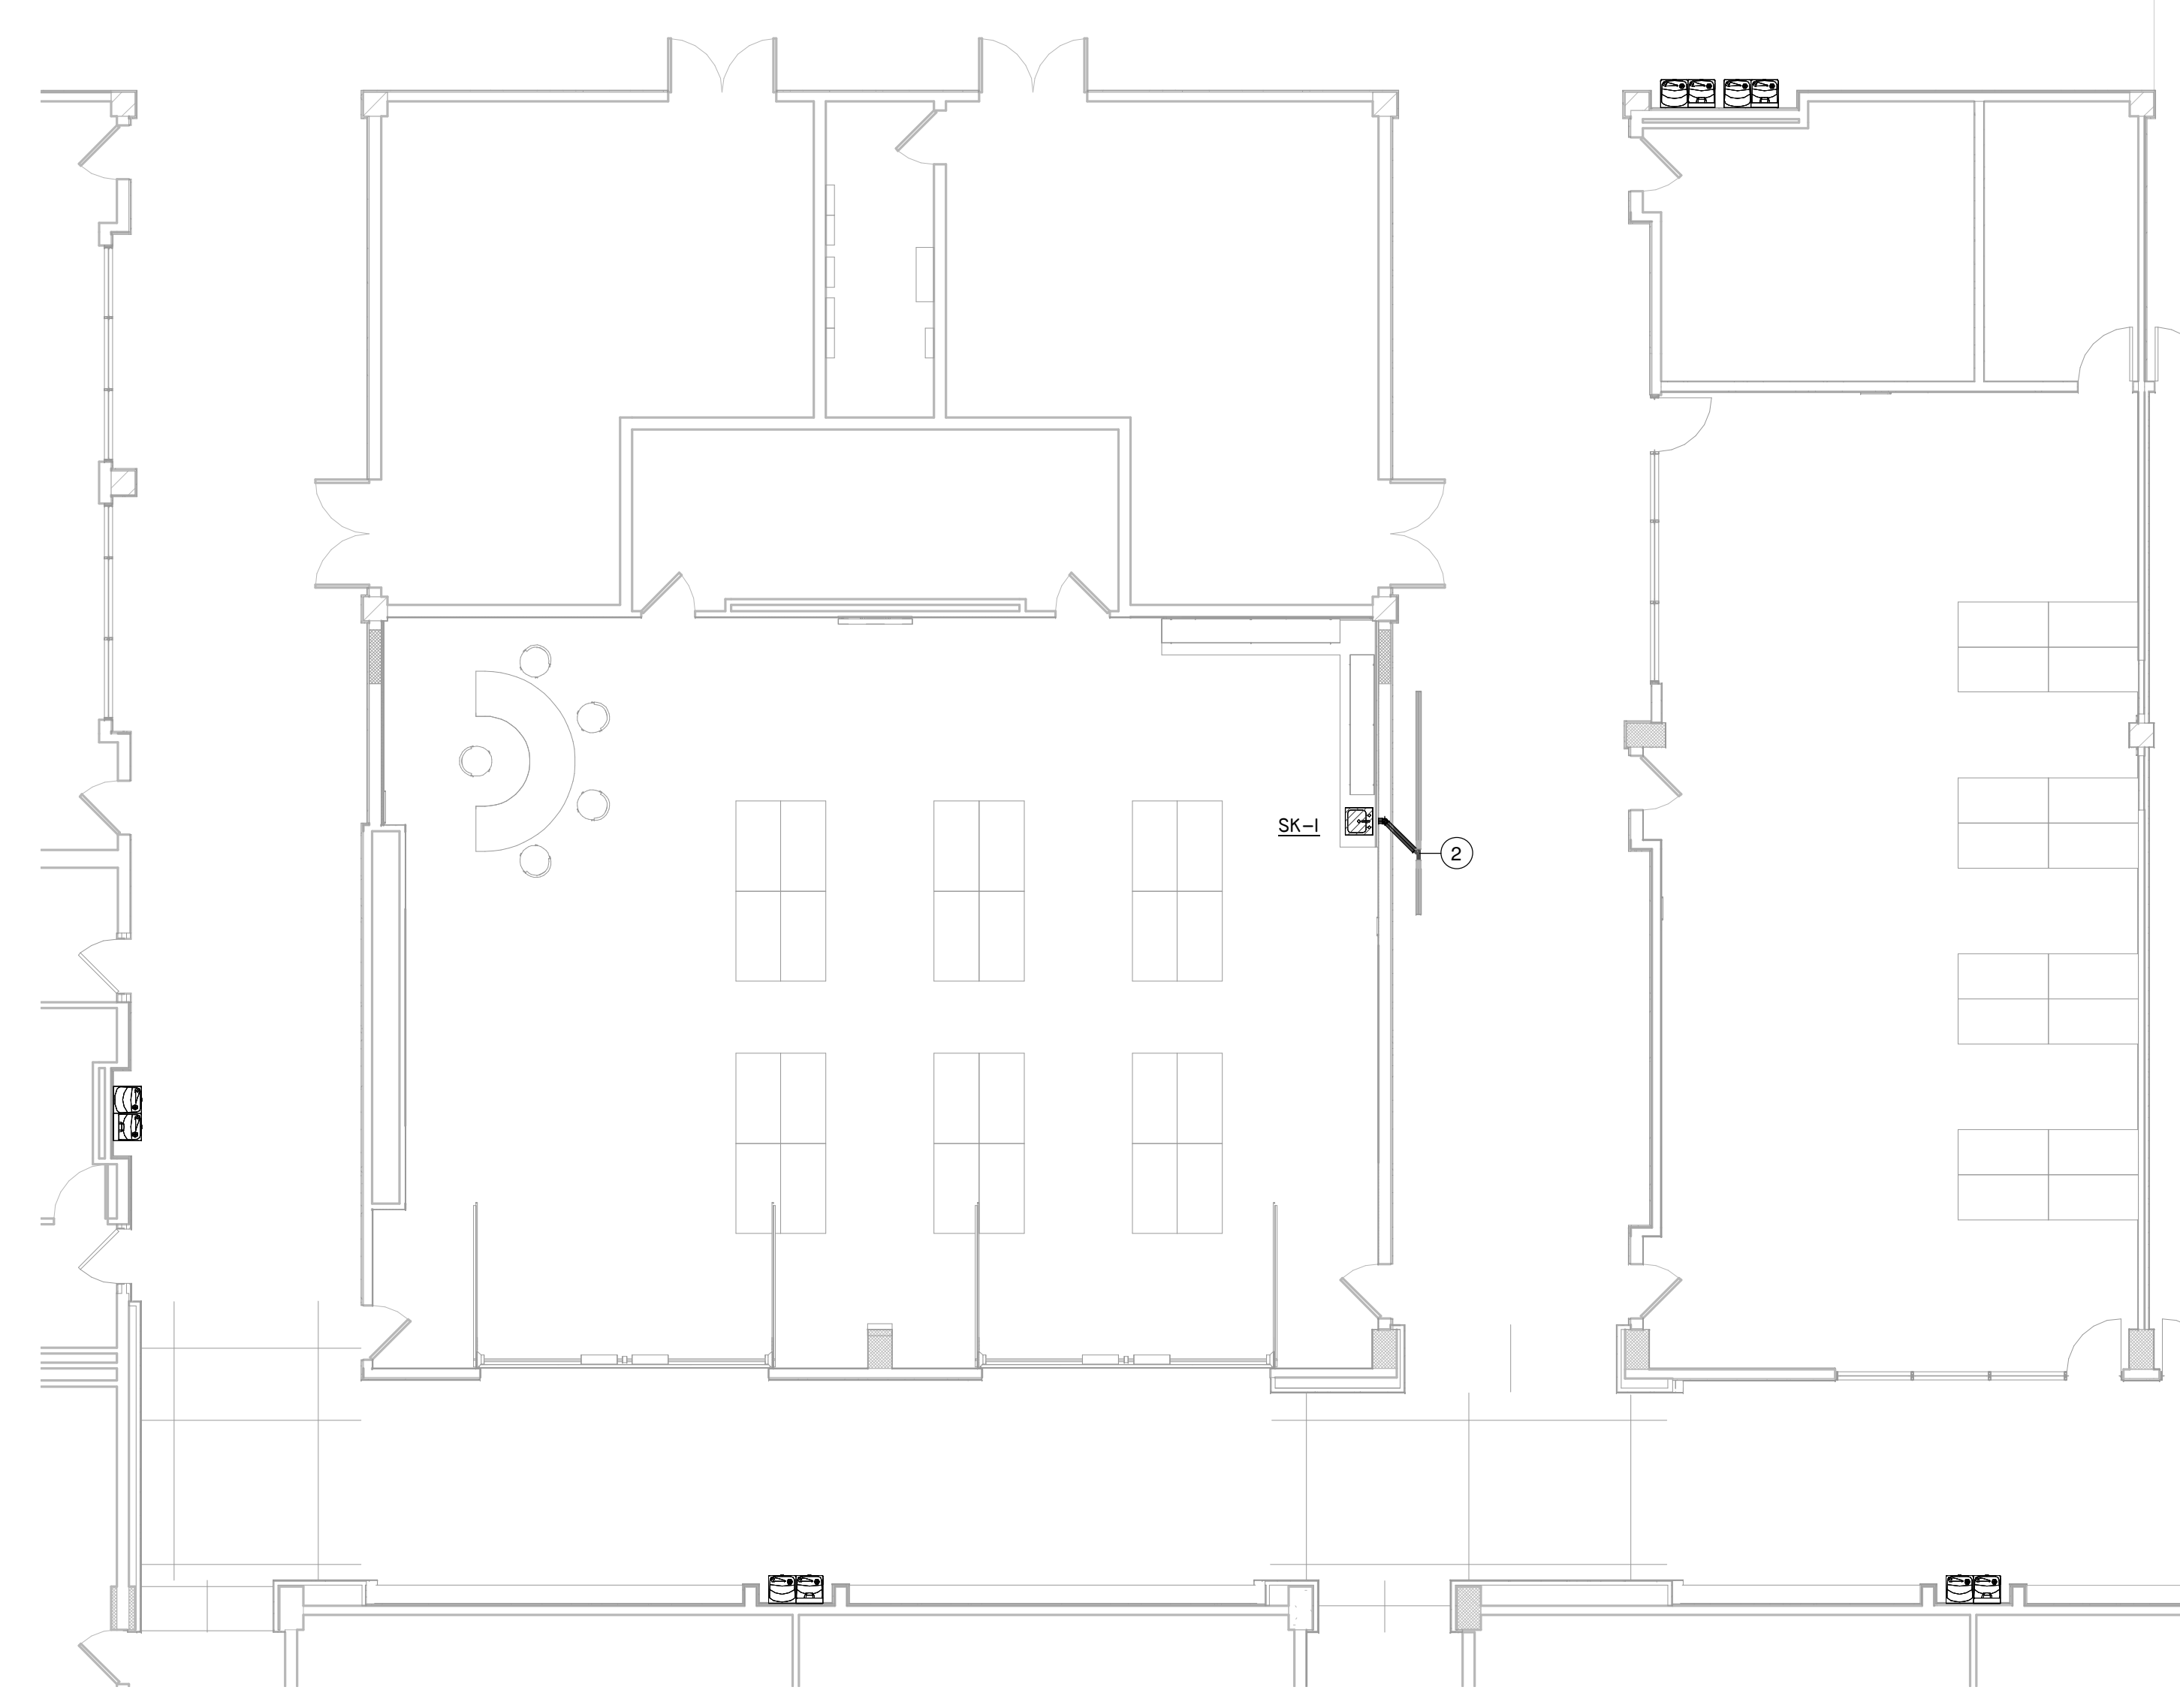

1 FLOOR PLAN - SANITARY - HALLWAY FOUNTAINS
Scale: 1/8" = 1'-0"

NOTE: WORK INDICATED IN THIS DETAIL SHALL BE PRICED AS ALTERNATE 1



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PROFESSIONAL SEAL:





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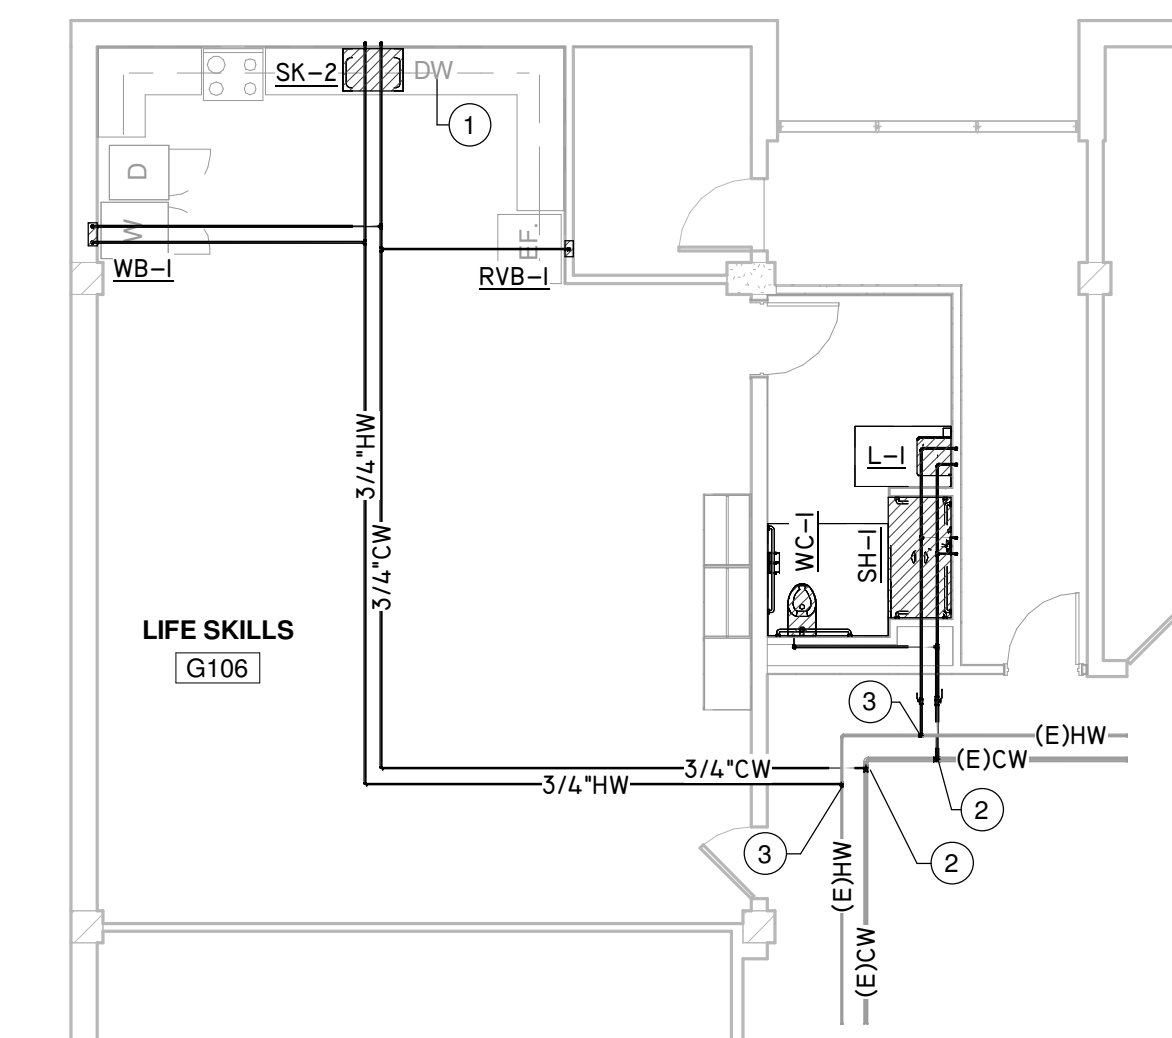


Project Number	19006-A
Drawn By	LT
Checked By	AW
Approved By	MS
Drawing Title	PLUMBING PROPOSED DOMESTIC


Drawing Number **P3.01**

KEYNOTE LEGEND	
1	CONTRACTOR SHALL FOLLOW THE MANUFACTURE INSTALLATION GUIDE FOR CONNECTING THE DISHWASHER AT THIS LOCATION. ROUTE WATER AND WASTE TO AND FROM SINK PROVIDE AIR GAP AT THE SINK.
2	ROUTE CW LINE TO EXISTING COLD WATER LINE APPROXIMATELY THIS POINT. FIELD VERIFY EXACT LOCATION AND SIZE OF EXISTING PIPE.
3	ROUTE HW LINE TO EXISTING COLD WATER LINE APPROXIMATELY THIS POINT. FIELD VERIFY EXACT LOCATION AND SIZE OF EXISTING PIPE.
4	INSTALL INSTANTANEOUS WATER HEATER UNDERNEATH SINK. ROUTE CW LINE TO INSTANTANEOUS WATER HEATER.
5	PROPOSED ELECTRIC DRINKING FOUNTAIN (EDF-1) SHALL RECONNECT TO EXISTING WATER & SANITARY LINES AS REQUIRED. PATCH AND REPAIR WALL, FLOOR, TILE AND ETC. REFER TO ARCHITECTURAL DRAWINGS FOR FINISHES. IF NONE MATCH EXISTING.
6	RELOCATE EXISTING WATER HEATER TO EXACT LOCATION AND RE PIPE.
7	PROVIDE LK399A FLOOR MOUNTED FOOT PEDAL WITH 1/2" IPS AND FEMALE INLETS AND OUTLETS. CONNECT FOOT PEDAL TO EXISTING SINK FAUCET. PROVIDE ALL NECESSARY ACCESSORIES FOR FULLY FUNCTIONAL OPERATION.

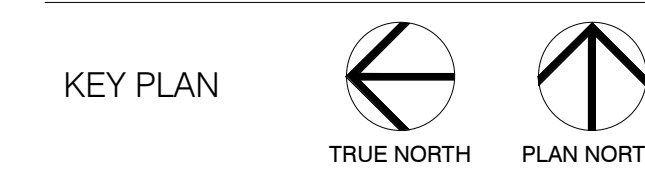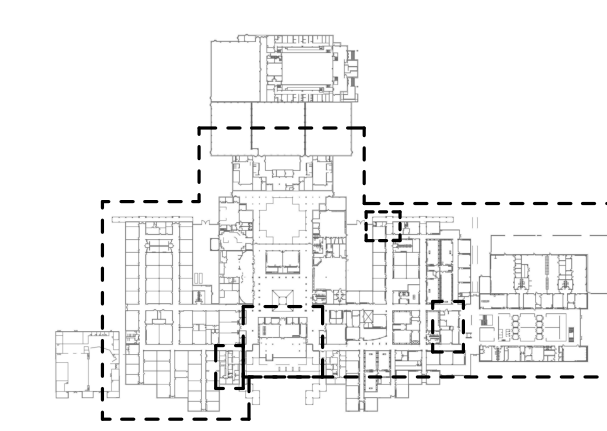
NOTE: WORK INDICATED IN THIS DETAIL SHALL BE PRICED AS ALTERNATE 1




3 FLOOR PLAN - LIFE SKILLS - DOMESTIC
Scale: 1/8" = 1'-0"

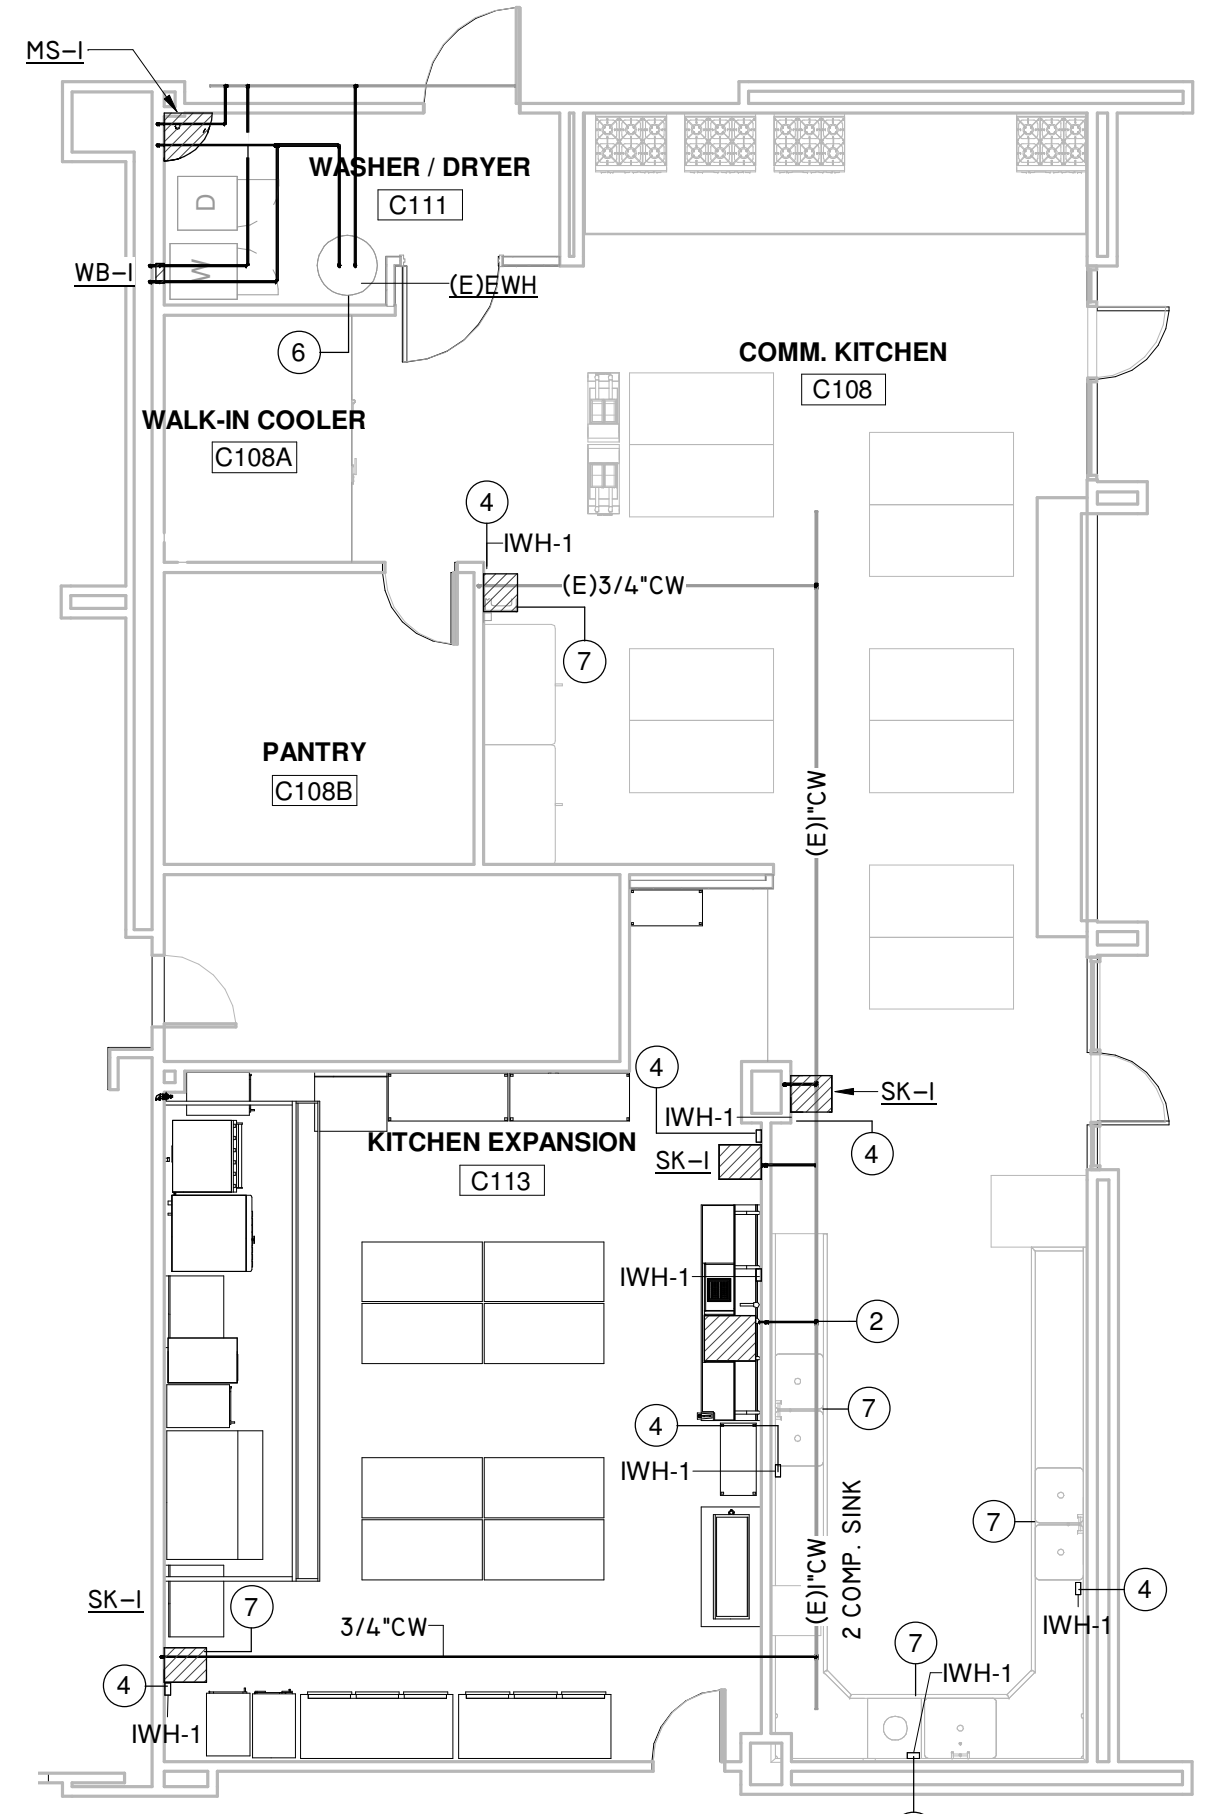


4 FLOOR PLAN - KITCHEN - DOMESTIC
Scale: 1/8" = 1'-0"

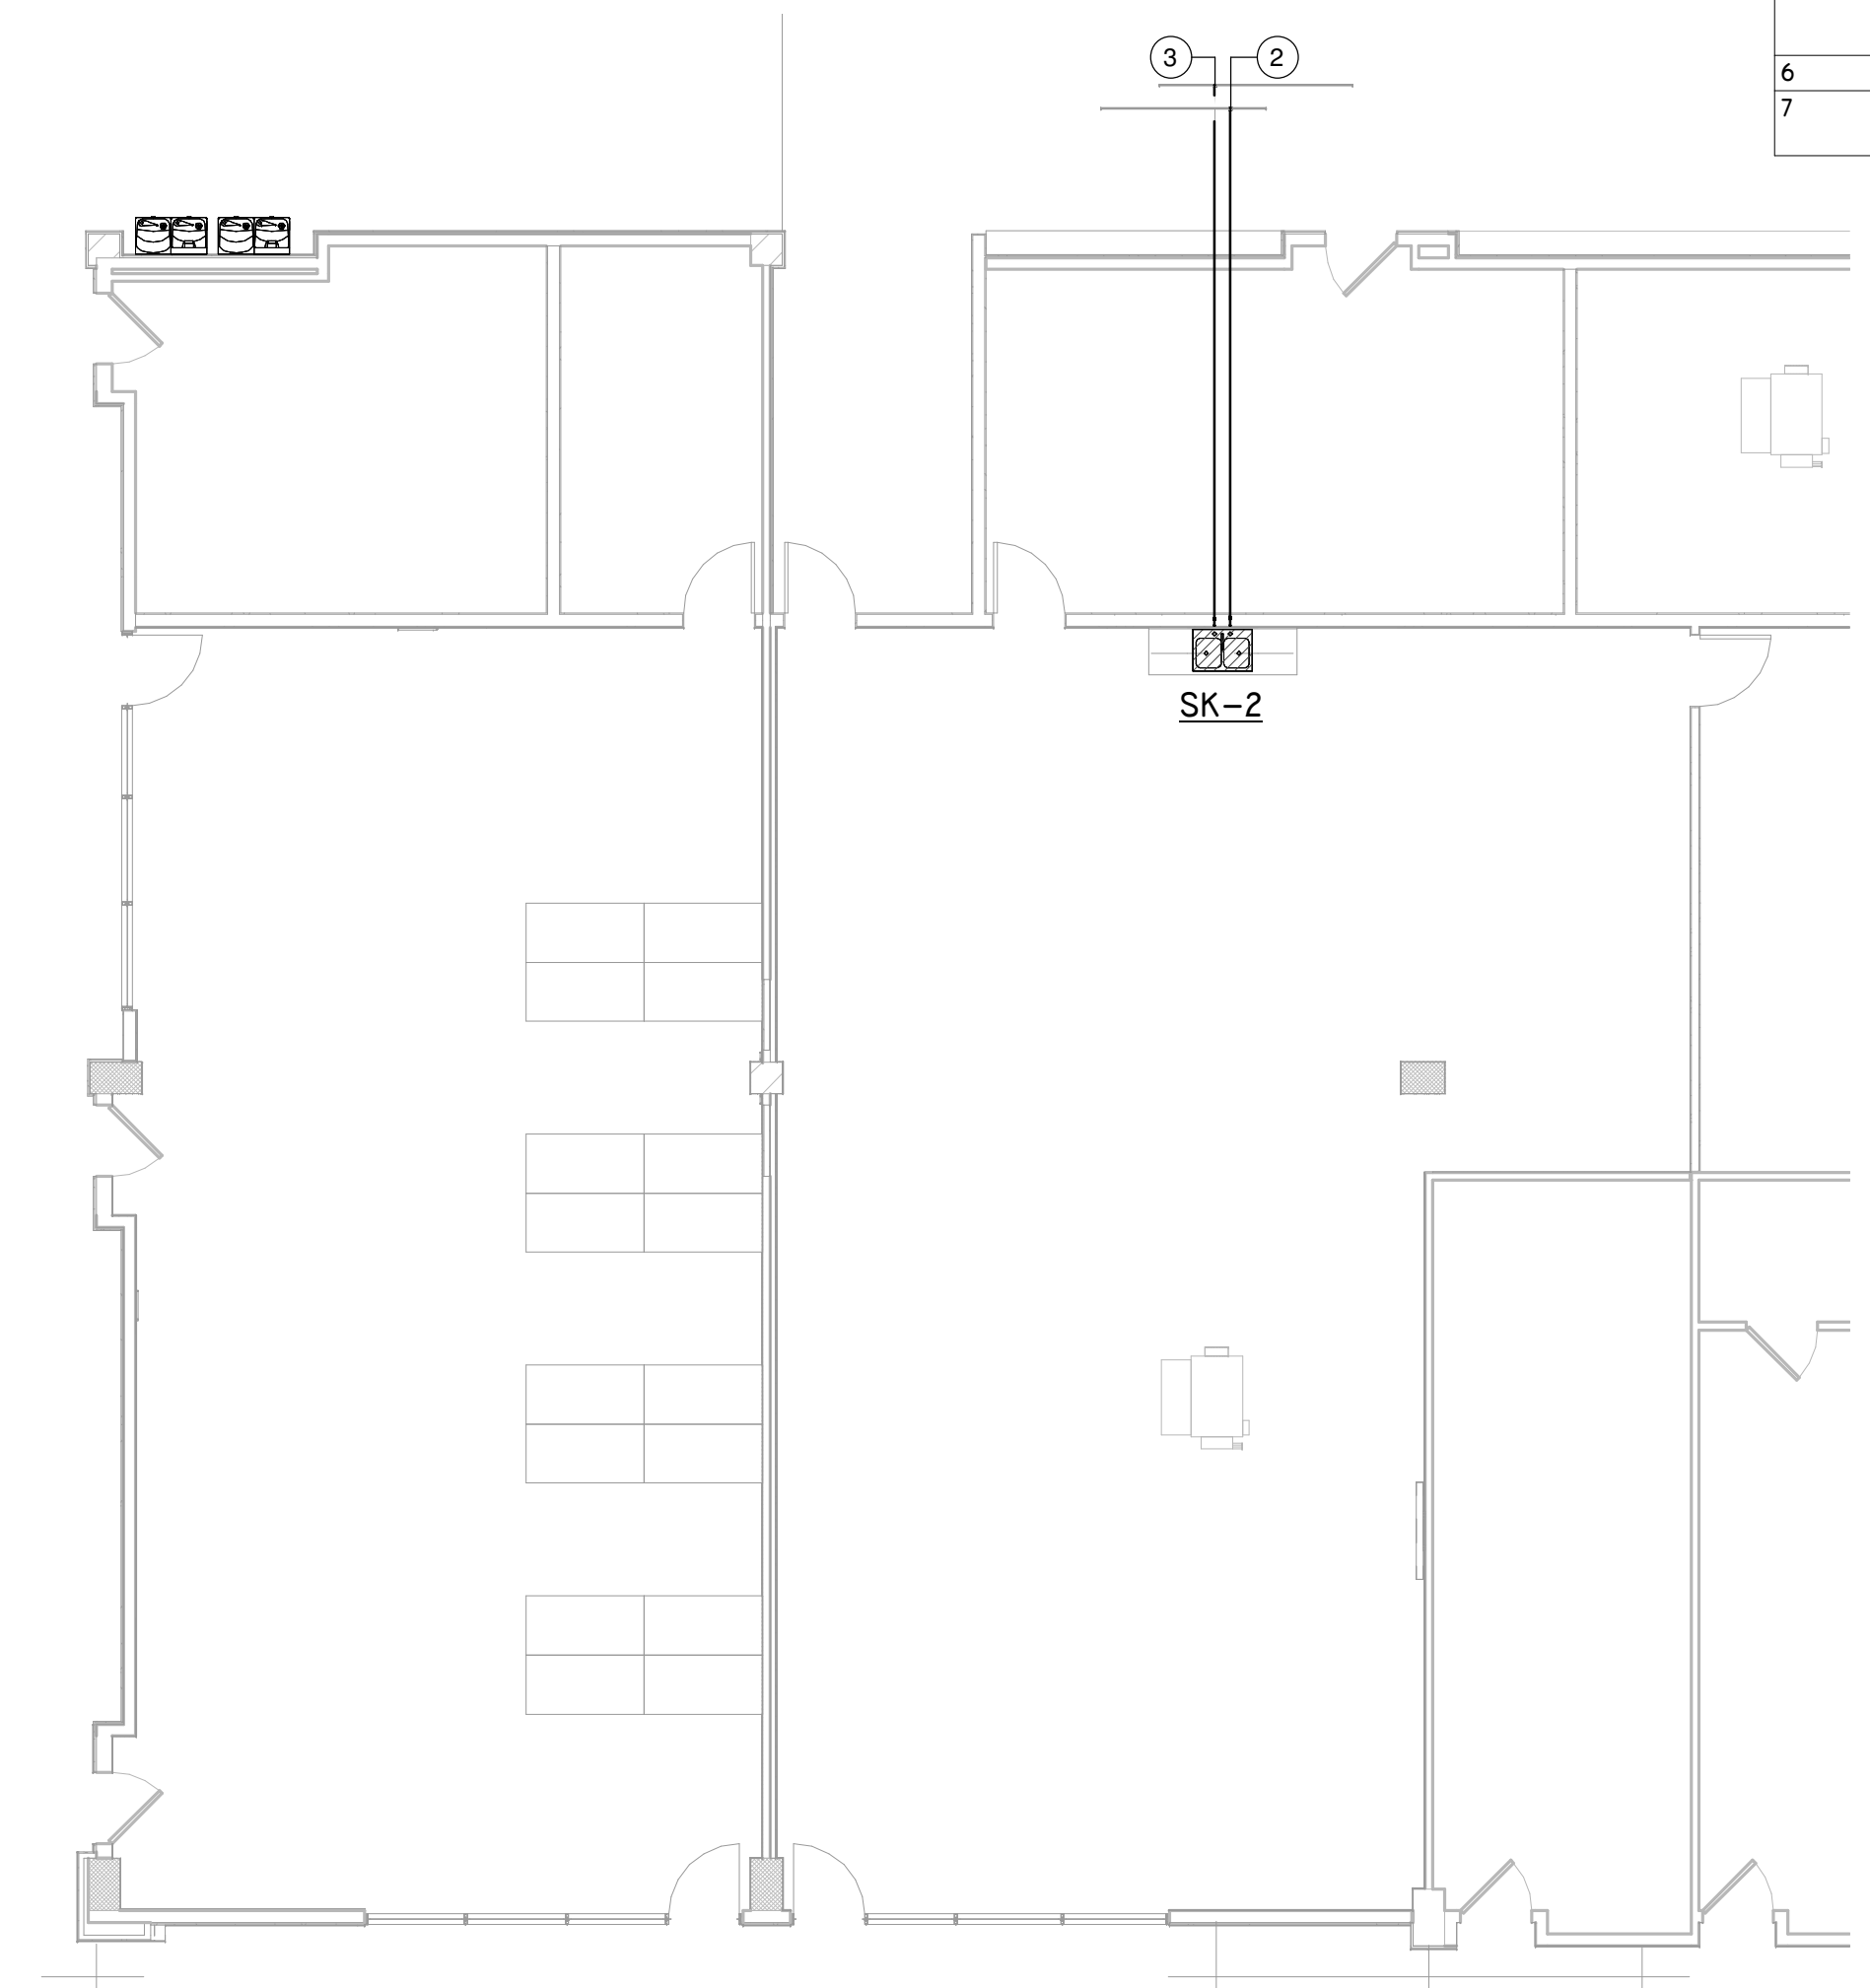

5 FLOOR PLAN - MEDICAL CLASS - DOMESTIC
1/8" = 1'-0"

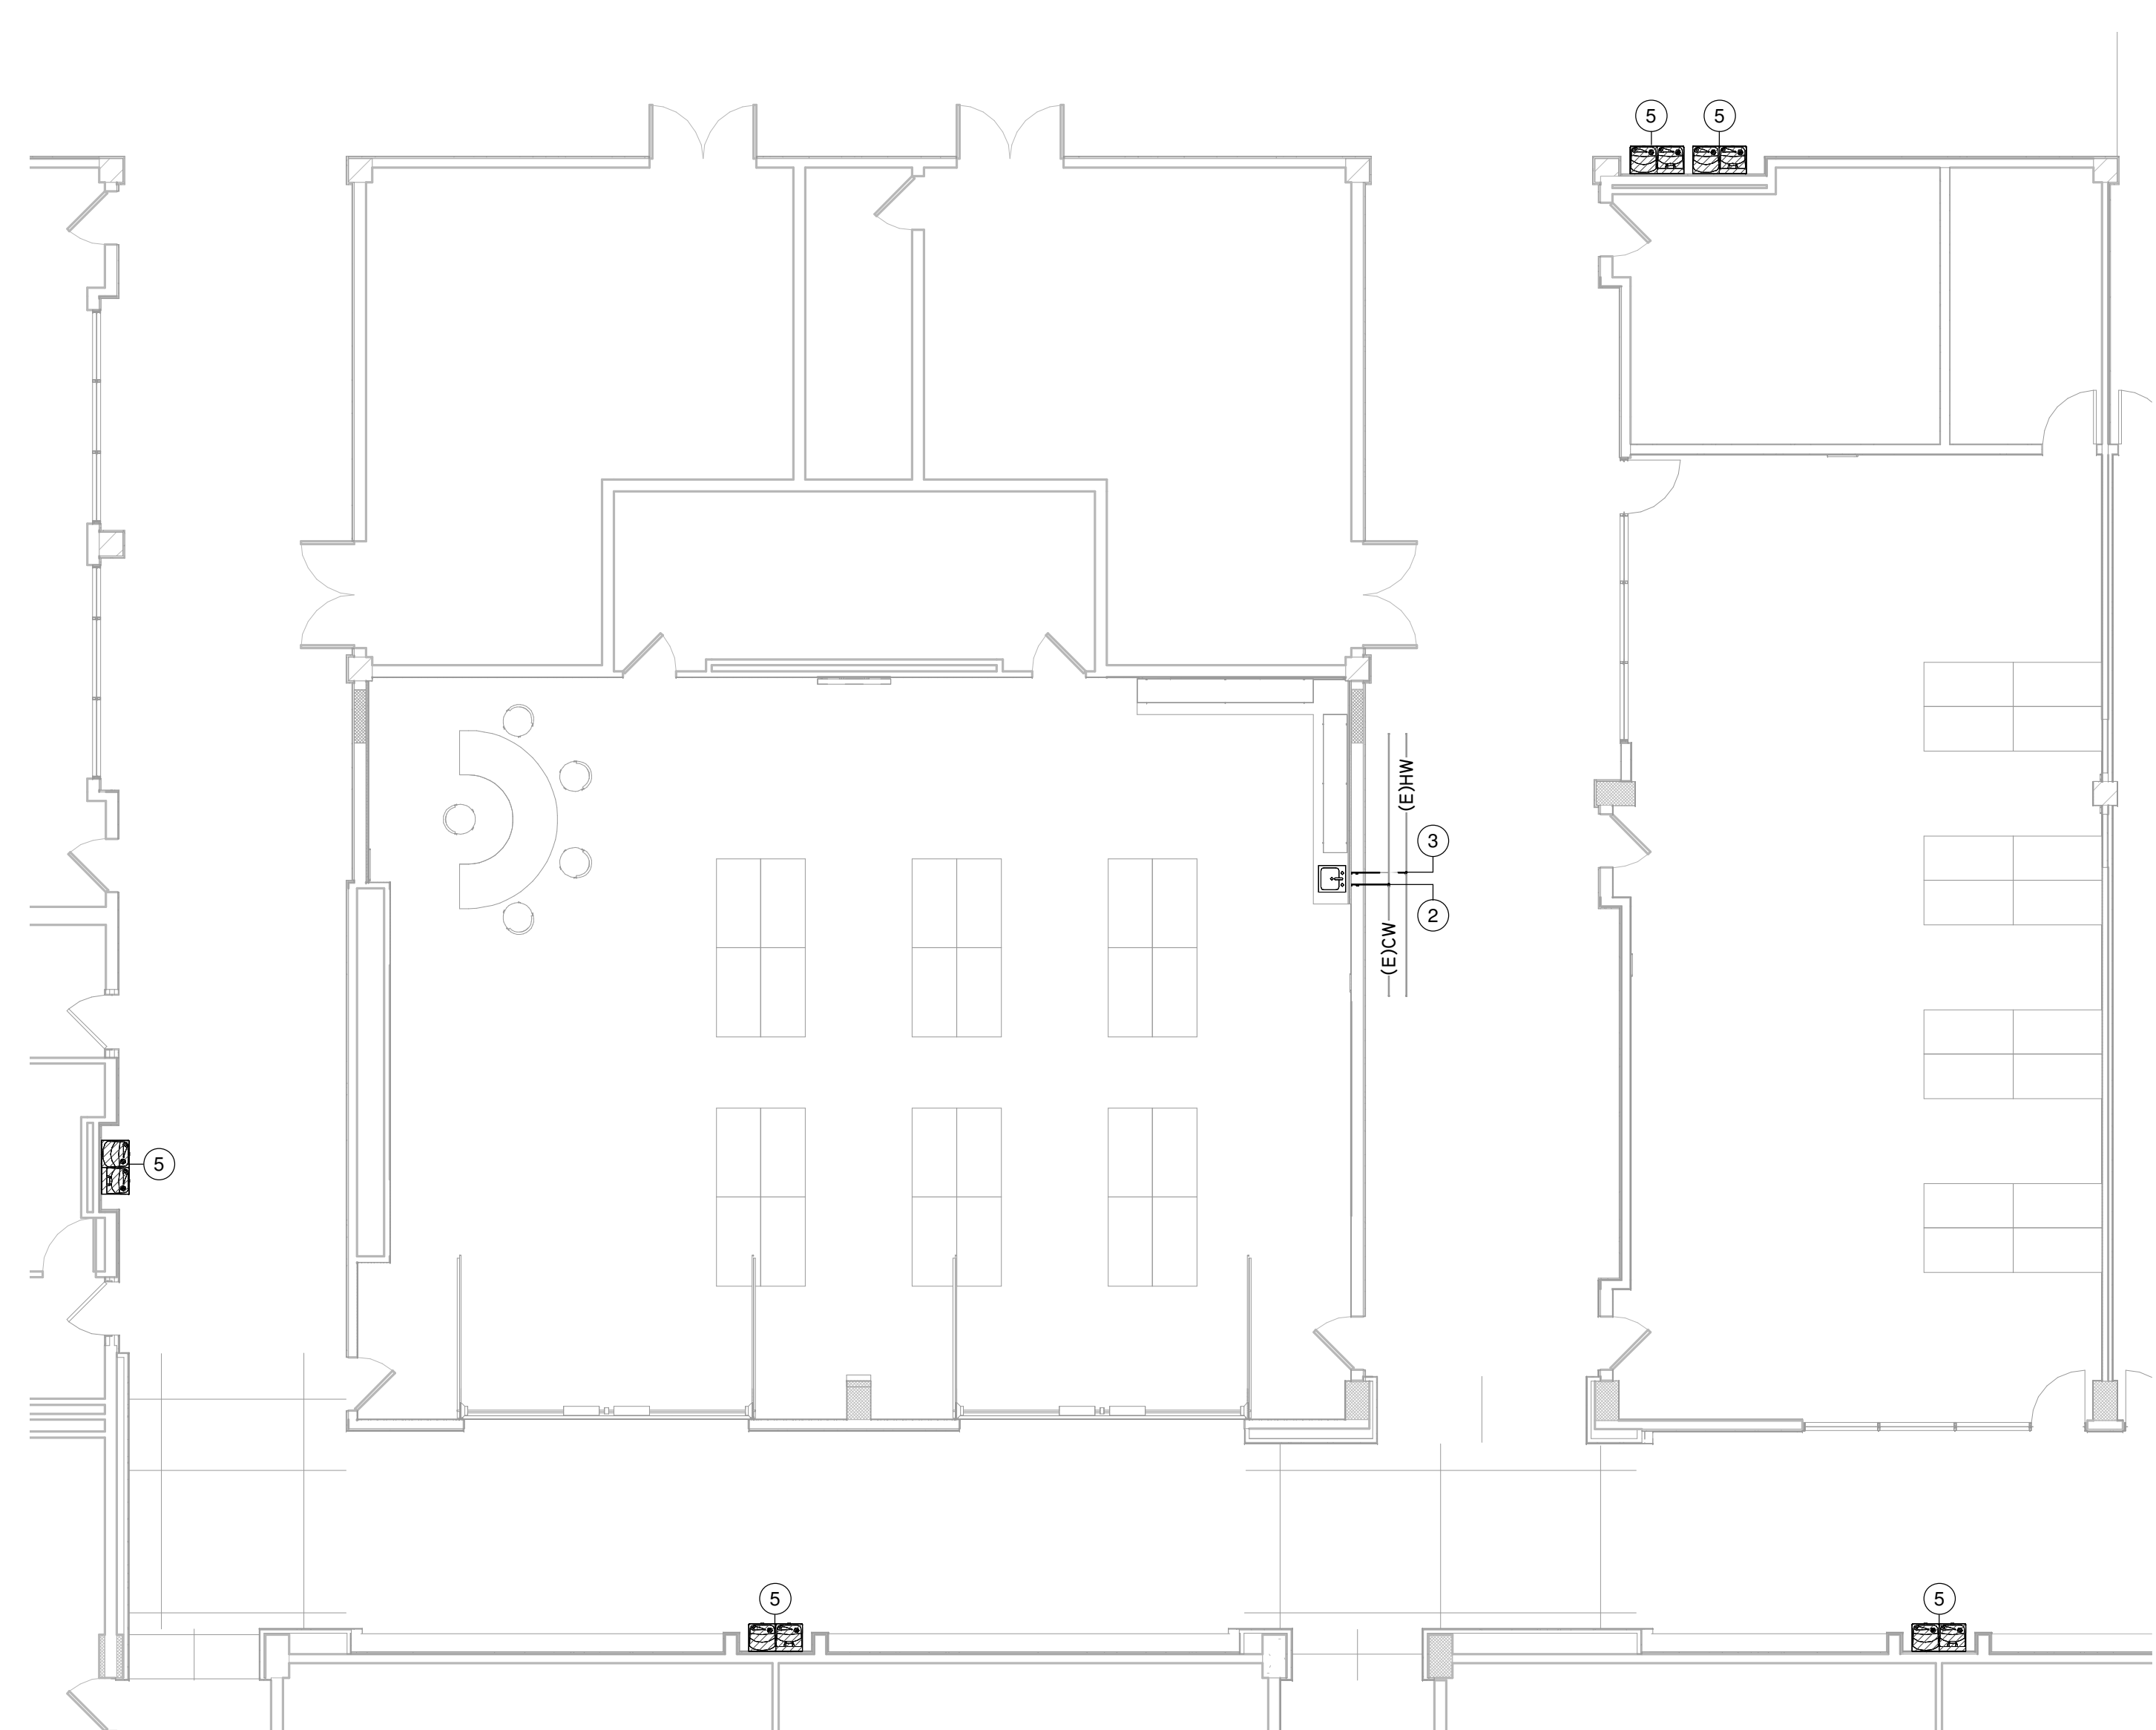

1 FLOOR PLAN - HALLWAY FOUNTAINS
Scale: 1/8" = 1'-0"

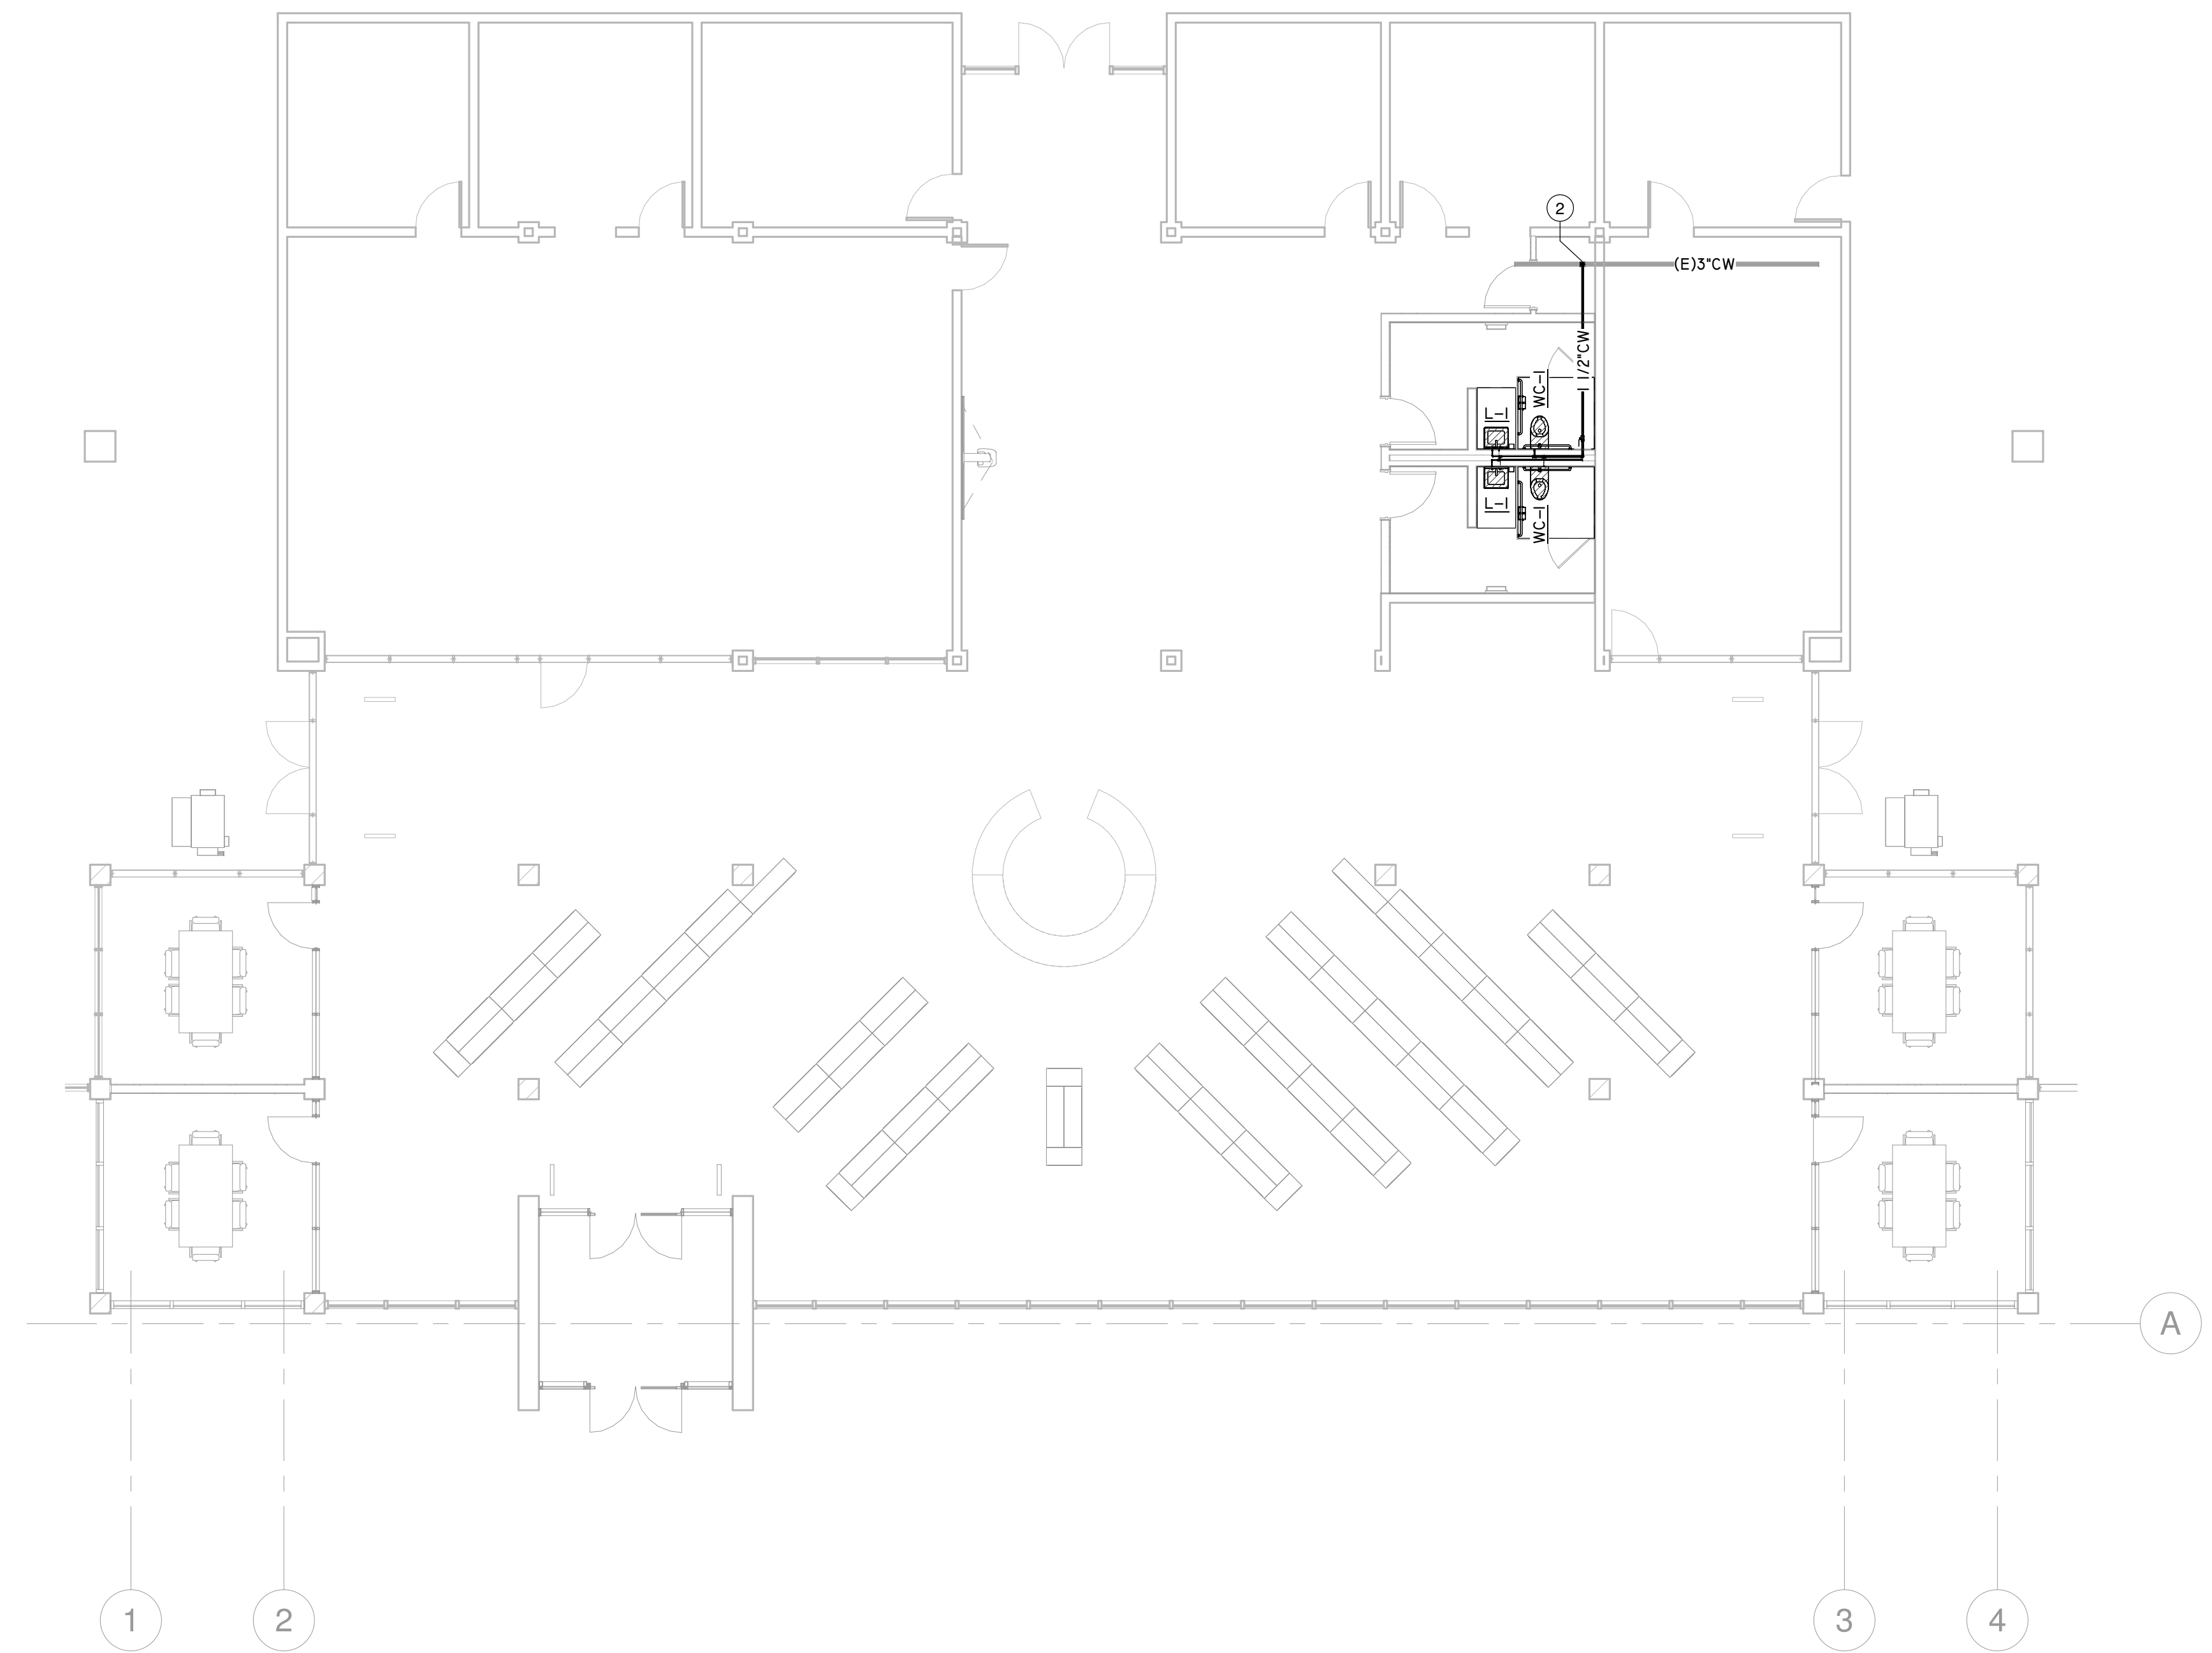

2 FLOOR PLAN - LIBRARY - DOMESTIC
Scale: 1/8" = 1'-0"



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PROFESSIONAL SEAL:




A PROJECT FOR:

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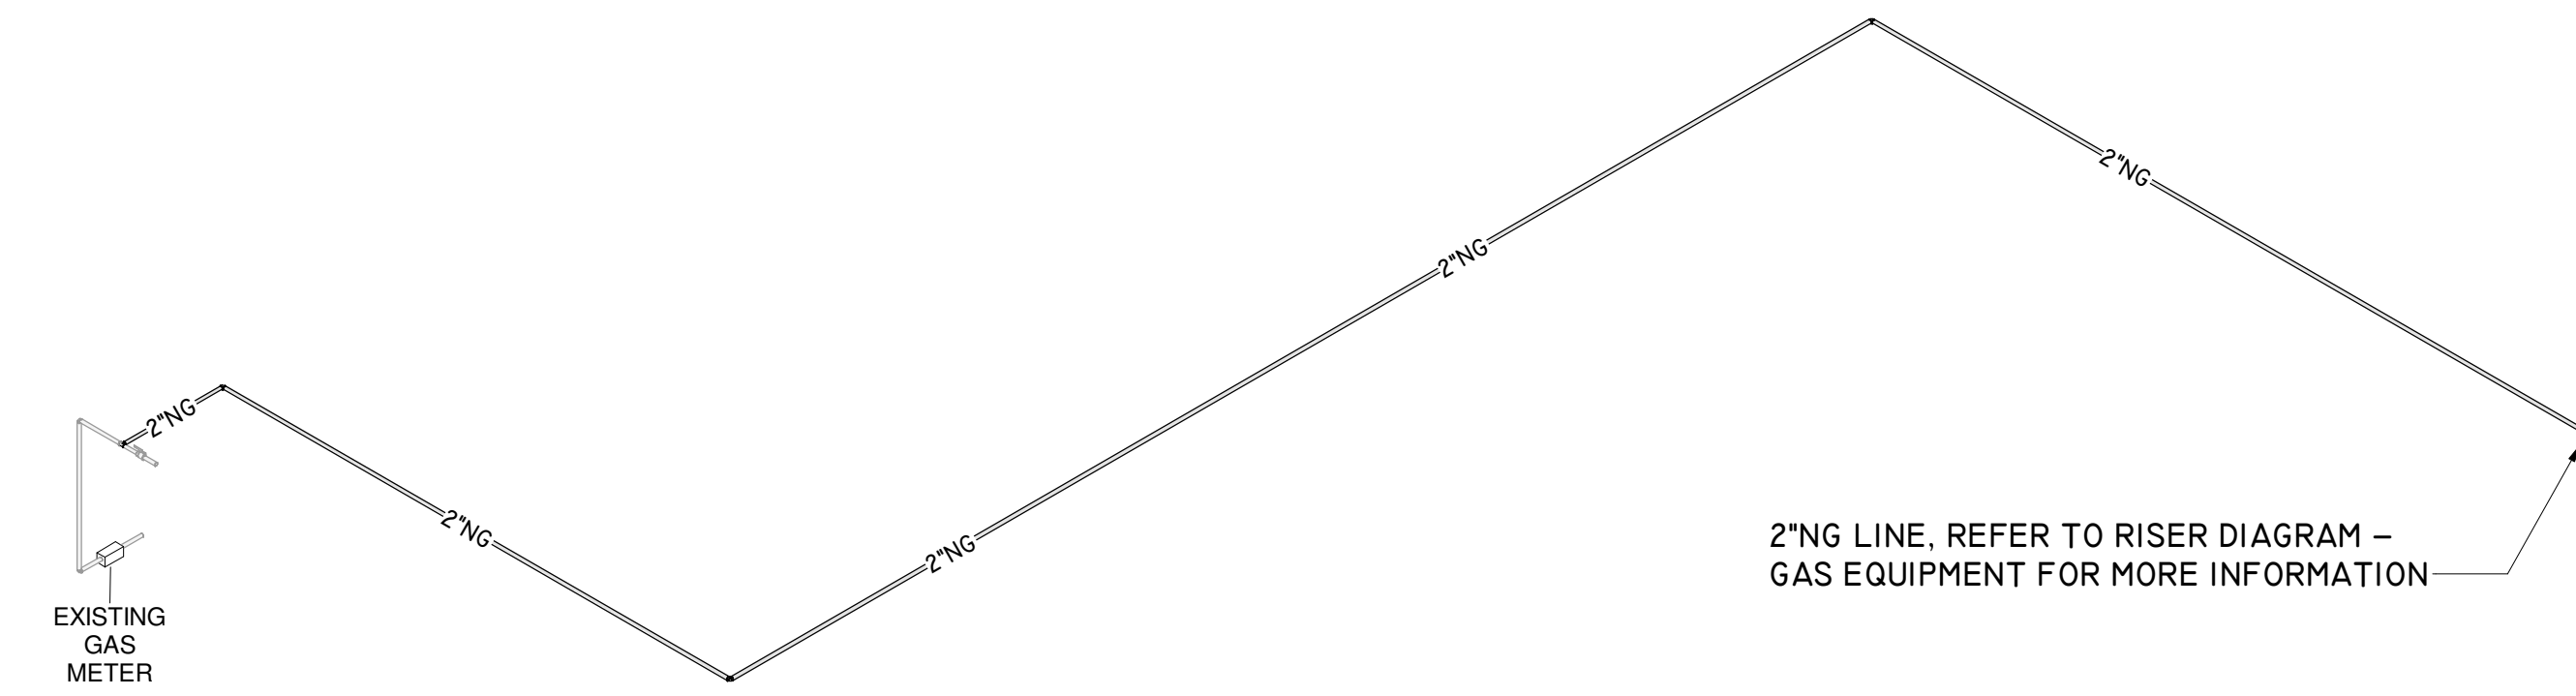
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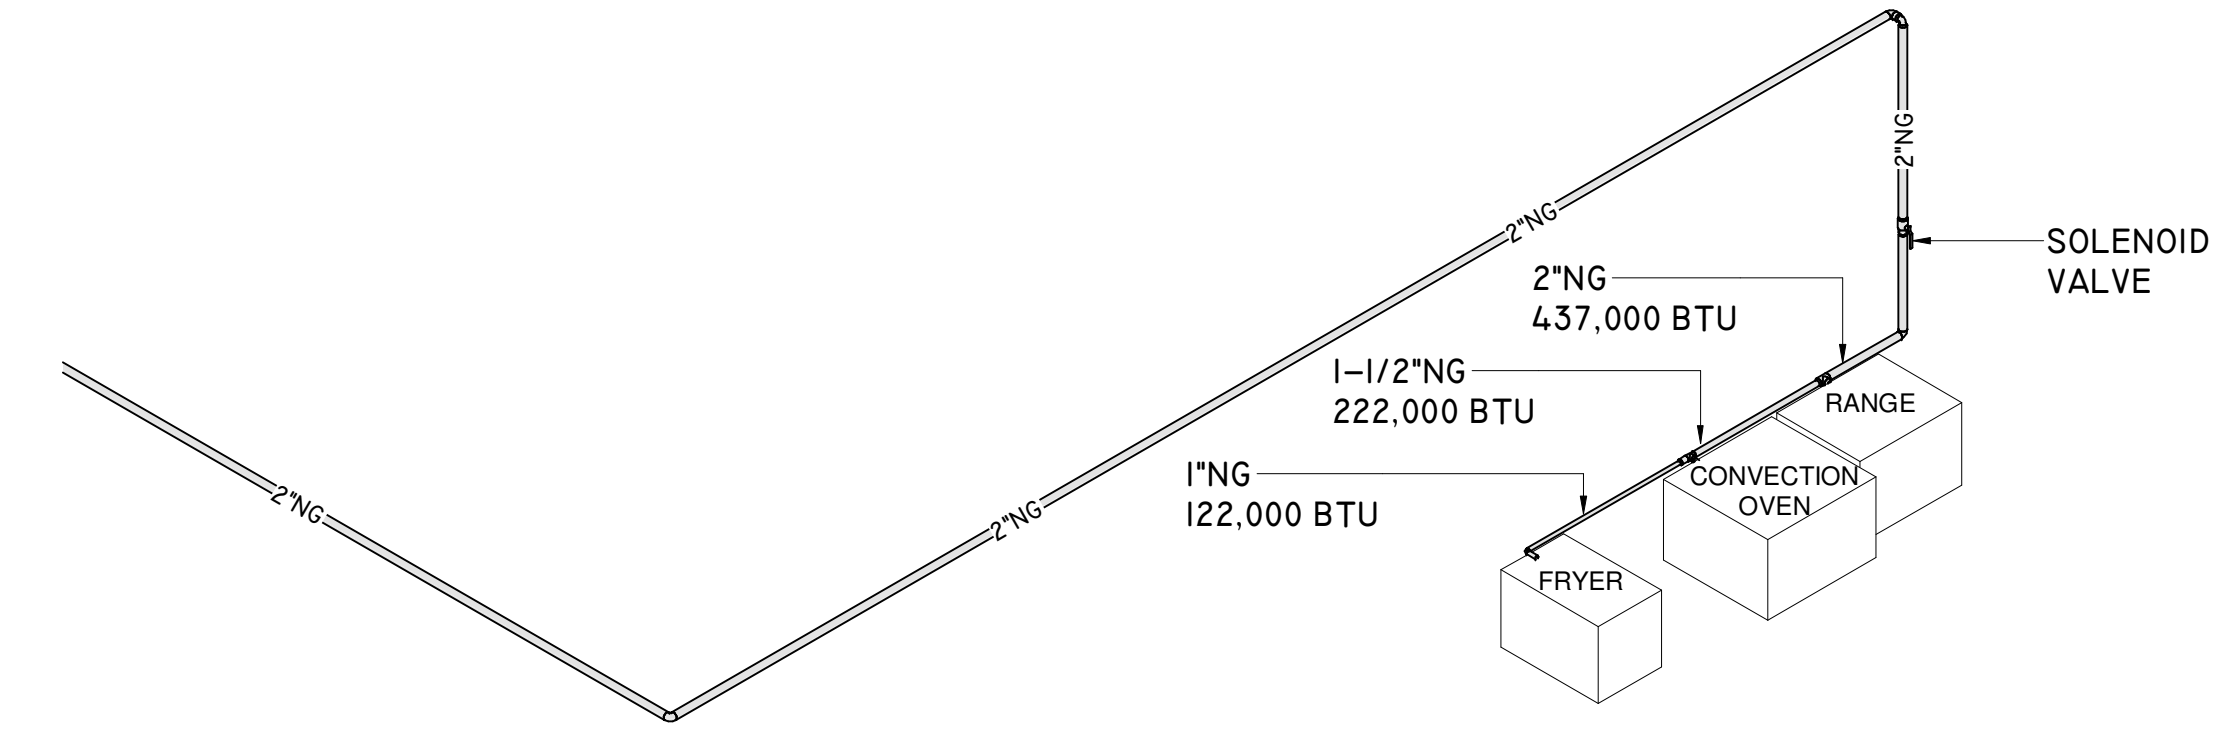
FOODSERVICE PLUMBING SCHEDULE

PSIZE	GAS SERVICE TO	LOCATION	BTU INPUT
3/4"	CONVECTION OVEN	KITCHEN	100,000
3/4"	RANGE	KITCHEN	215,000
3/4"	FRYER	KITCHEN	122,000

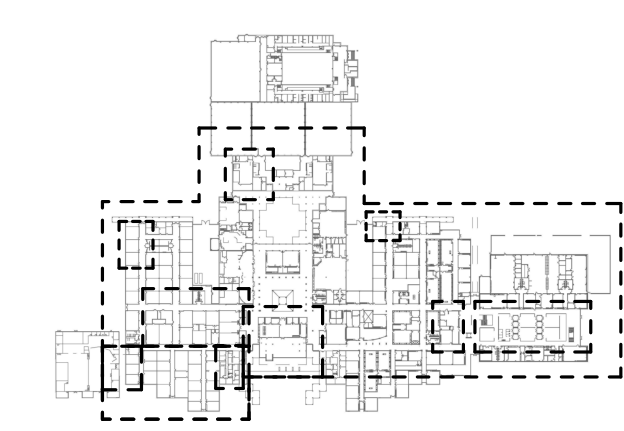


3 RISER DIAGRAM - GAS

Scale:




4 RISER DIAGRAM - GAS EQUIPMENT

Scale:

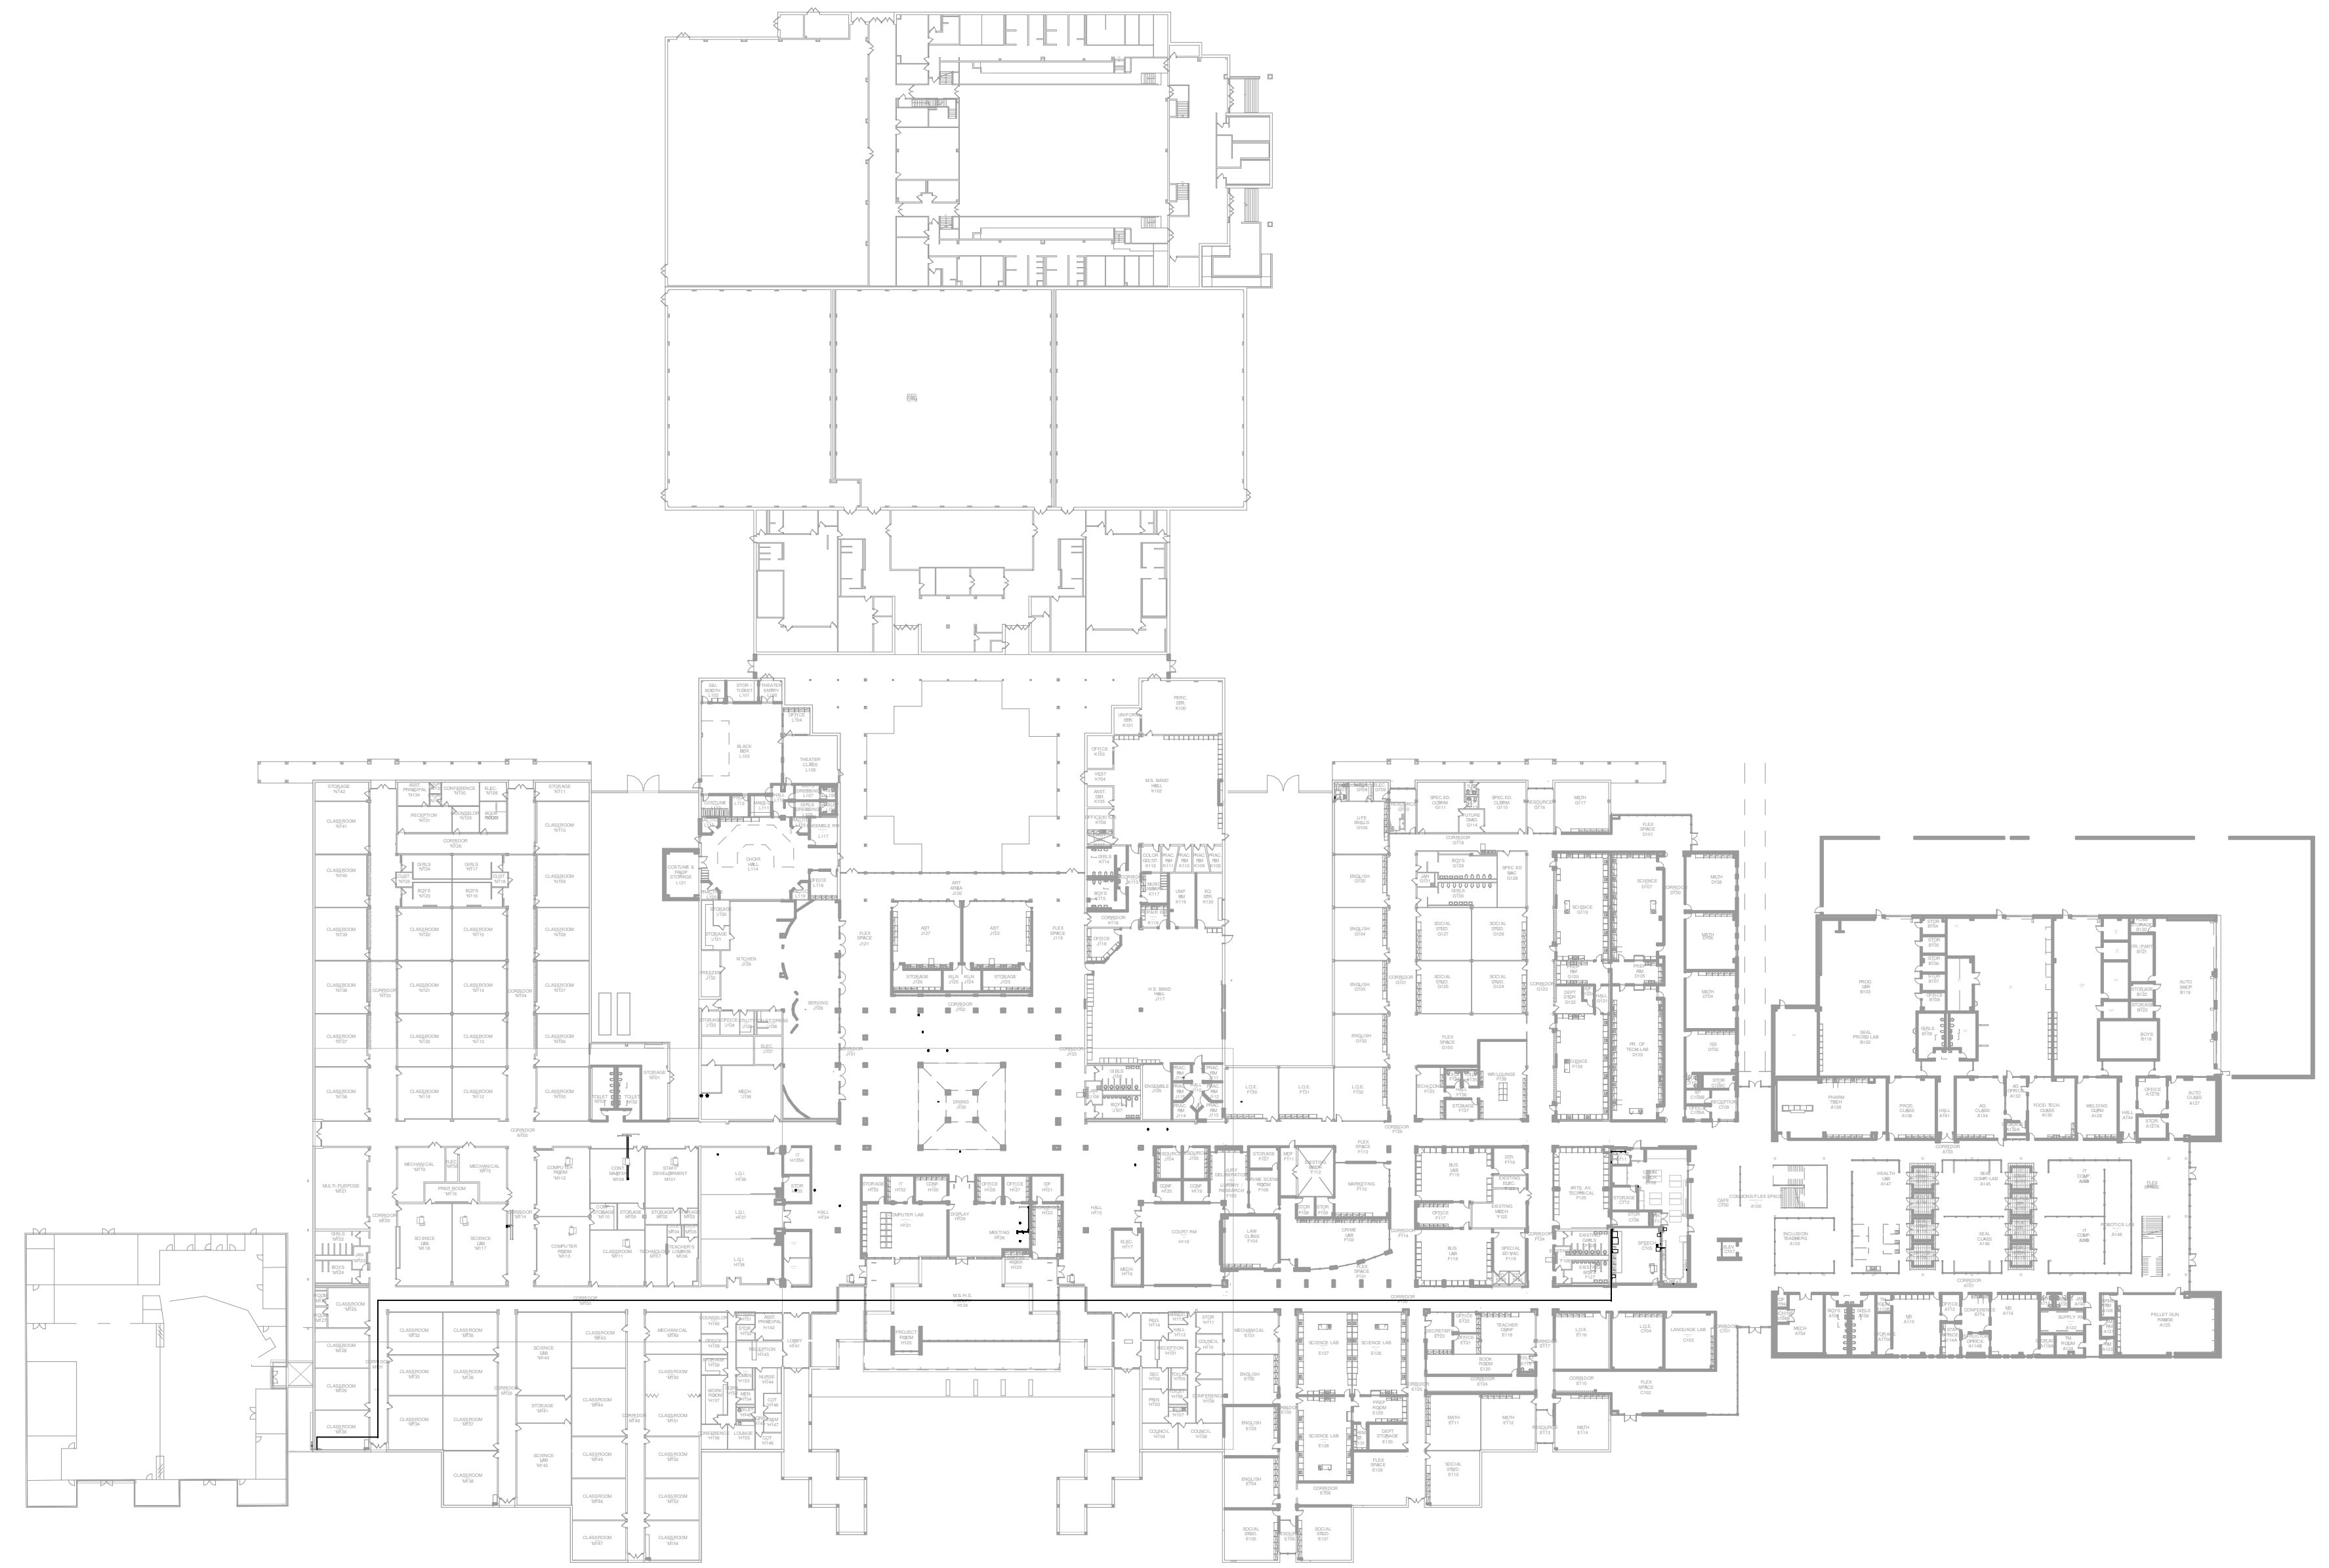

1 OVERALL FLOOR PLAN - GAS

Scale:

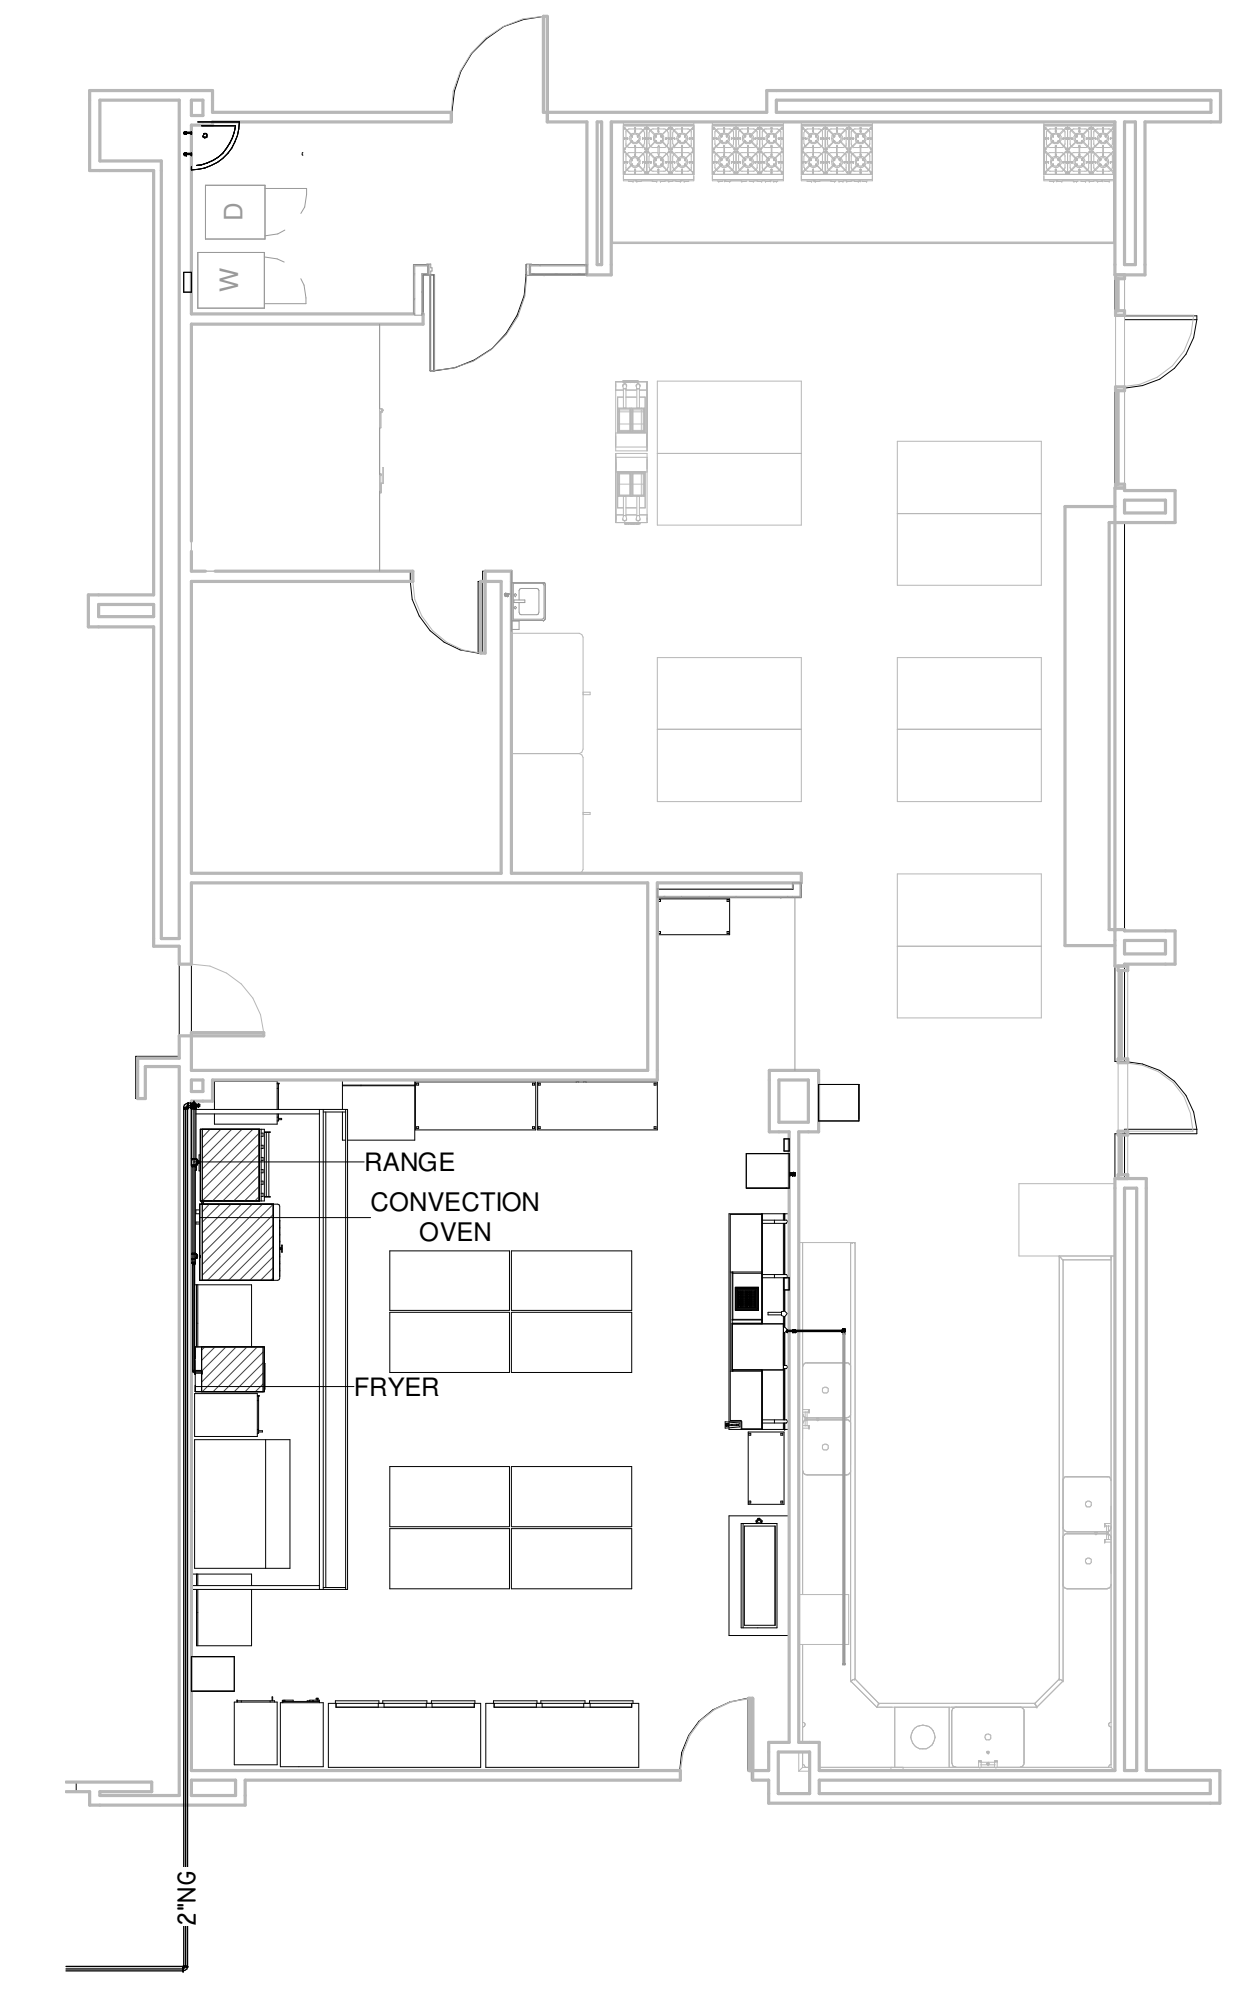

2 FLOOR PLAN - KITCHEN - GAS

Scale: 1/8" = 1'-0"

Project Number	19006-A
Drawn By	LT
Checked By	AW
Approved By	MS

Drawing Title
**PLUMBING PROPOSED
GAS**

Drawing Number
P3.02



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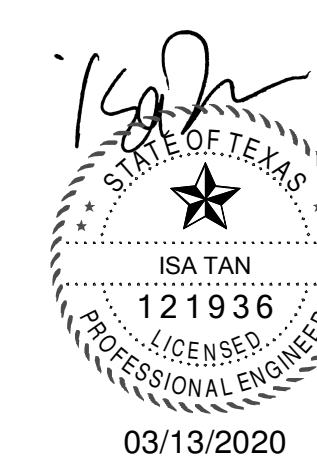
MEP ENGINEERS
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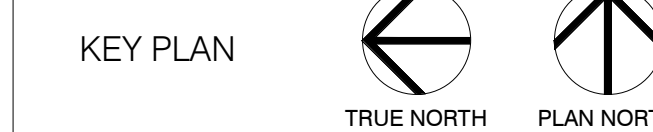
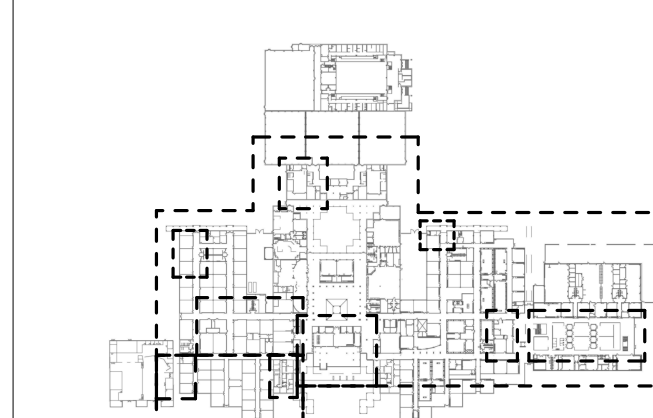


A PROJECT FOR:

**STAFFORD
HIGH SCHOOL
& MAGNET
SCHOOL
RENOVATIONS**

**1625 STAFFORDSHIRE
ROAD,
STAFFORD, TX 77477**


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2	2020/03/02	98% CD Review
3	2020/03/12	Issue for Bid, Permit, and Construction




Project Number	19006-A
Drawn By	LT
Checked By	AW
Approved By	MS

**RISER DIAGRAMS -
SANITARY**


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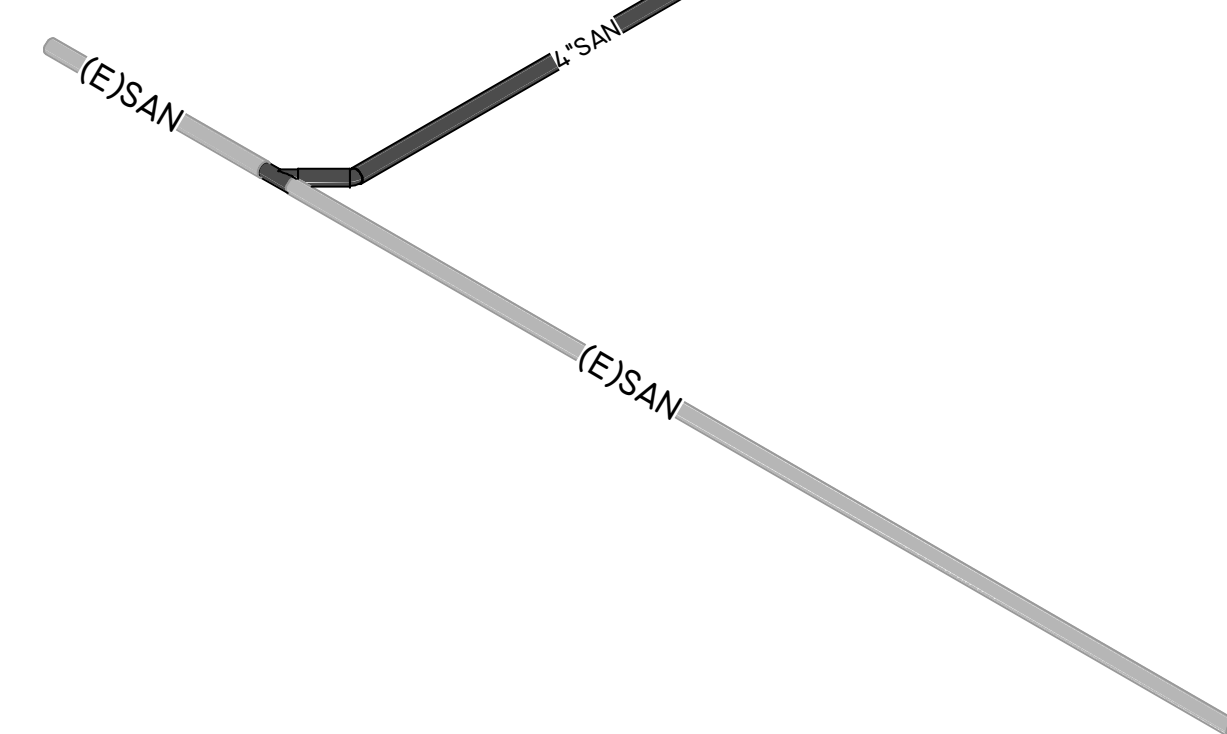
4 RISER DIAGRAM - LIFE SKILLS
Scale:

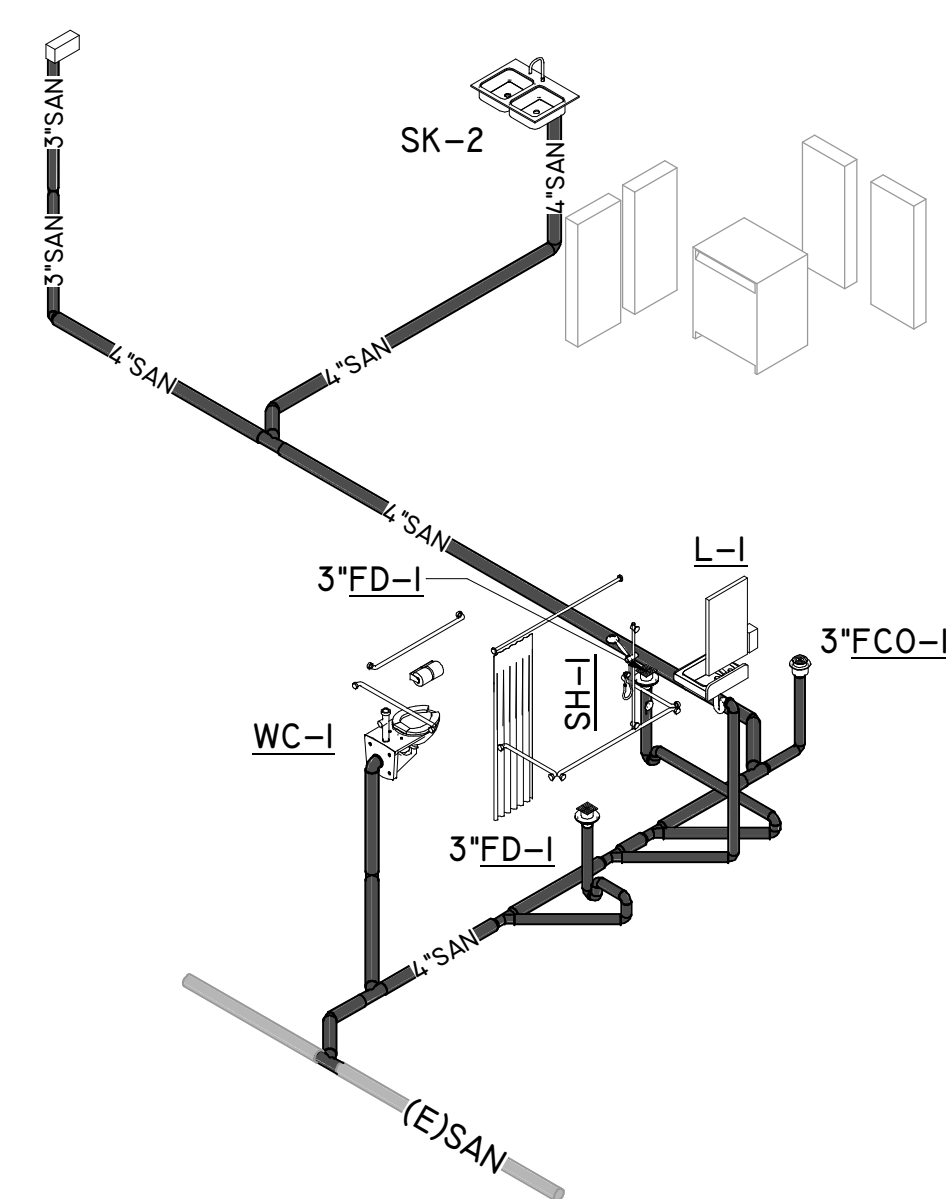


5 RISER DIAGRAM - MEDICAL ROOM
Scale:

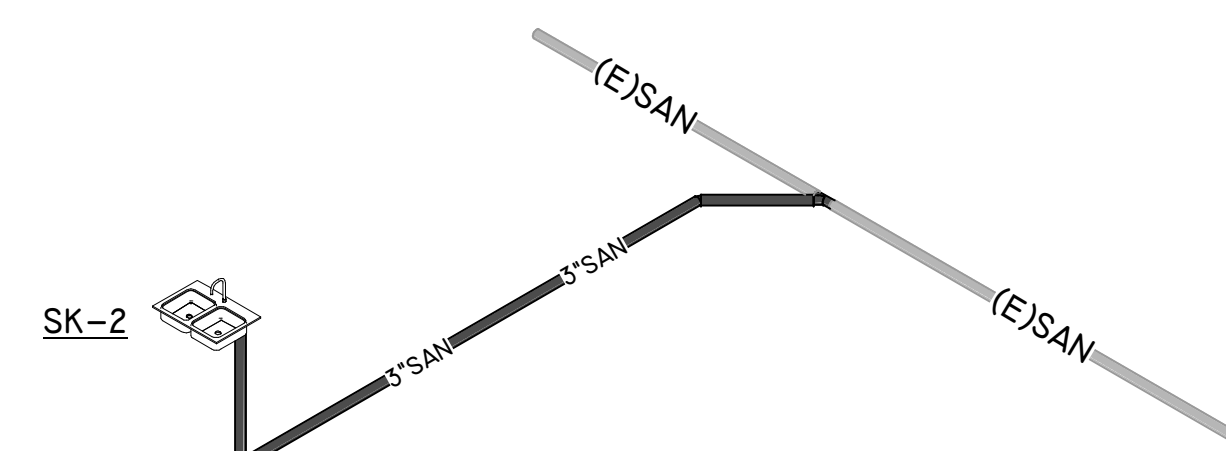

1 RISER DIAGRAM - LAB B2
Scale:

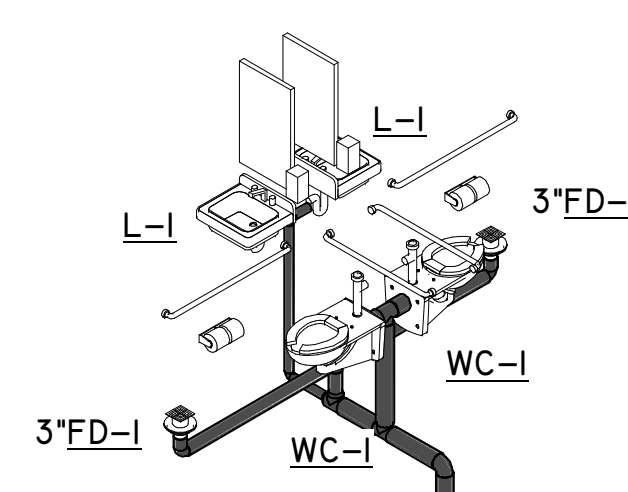

2 RISER DIAGRAM - LIBRARY RESTROOM
Scale:

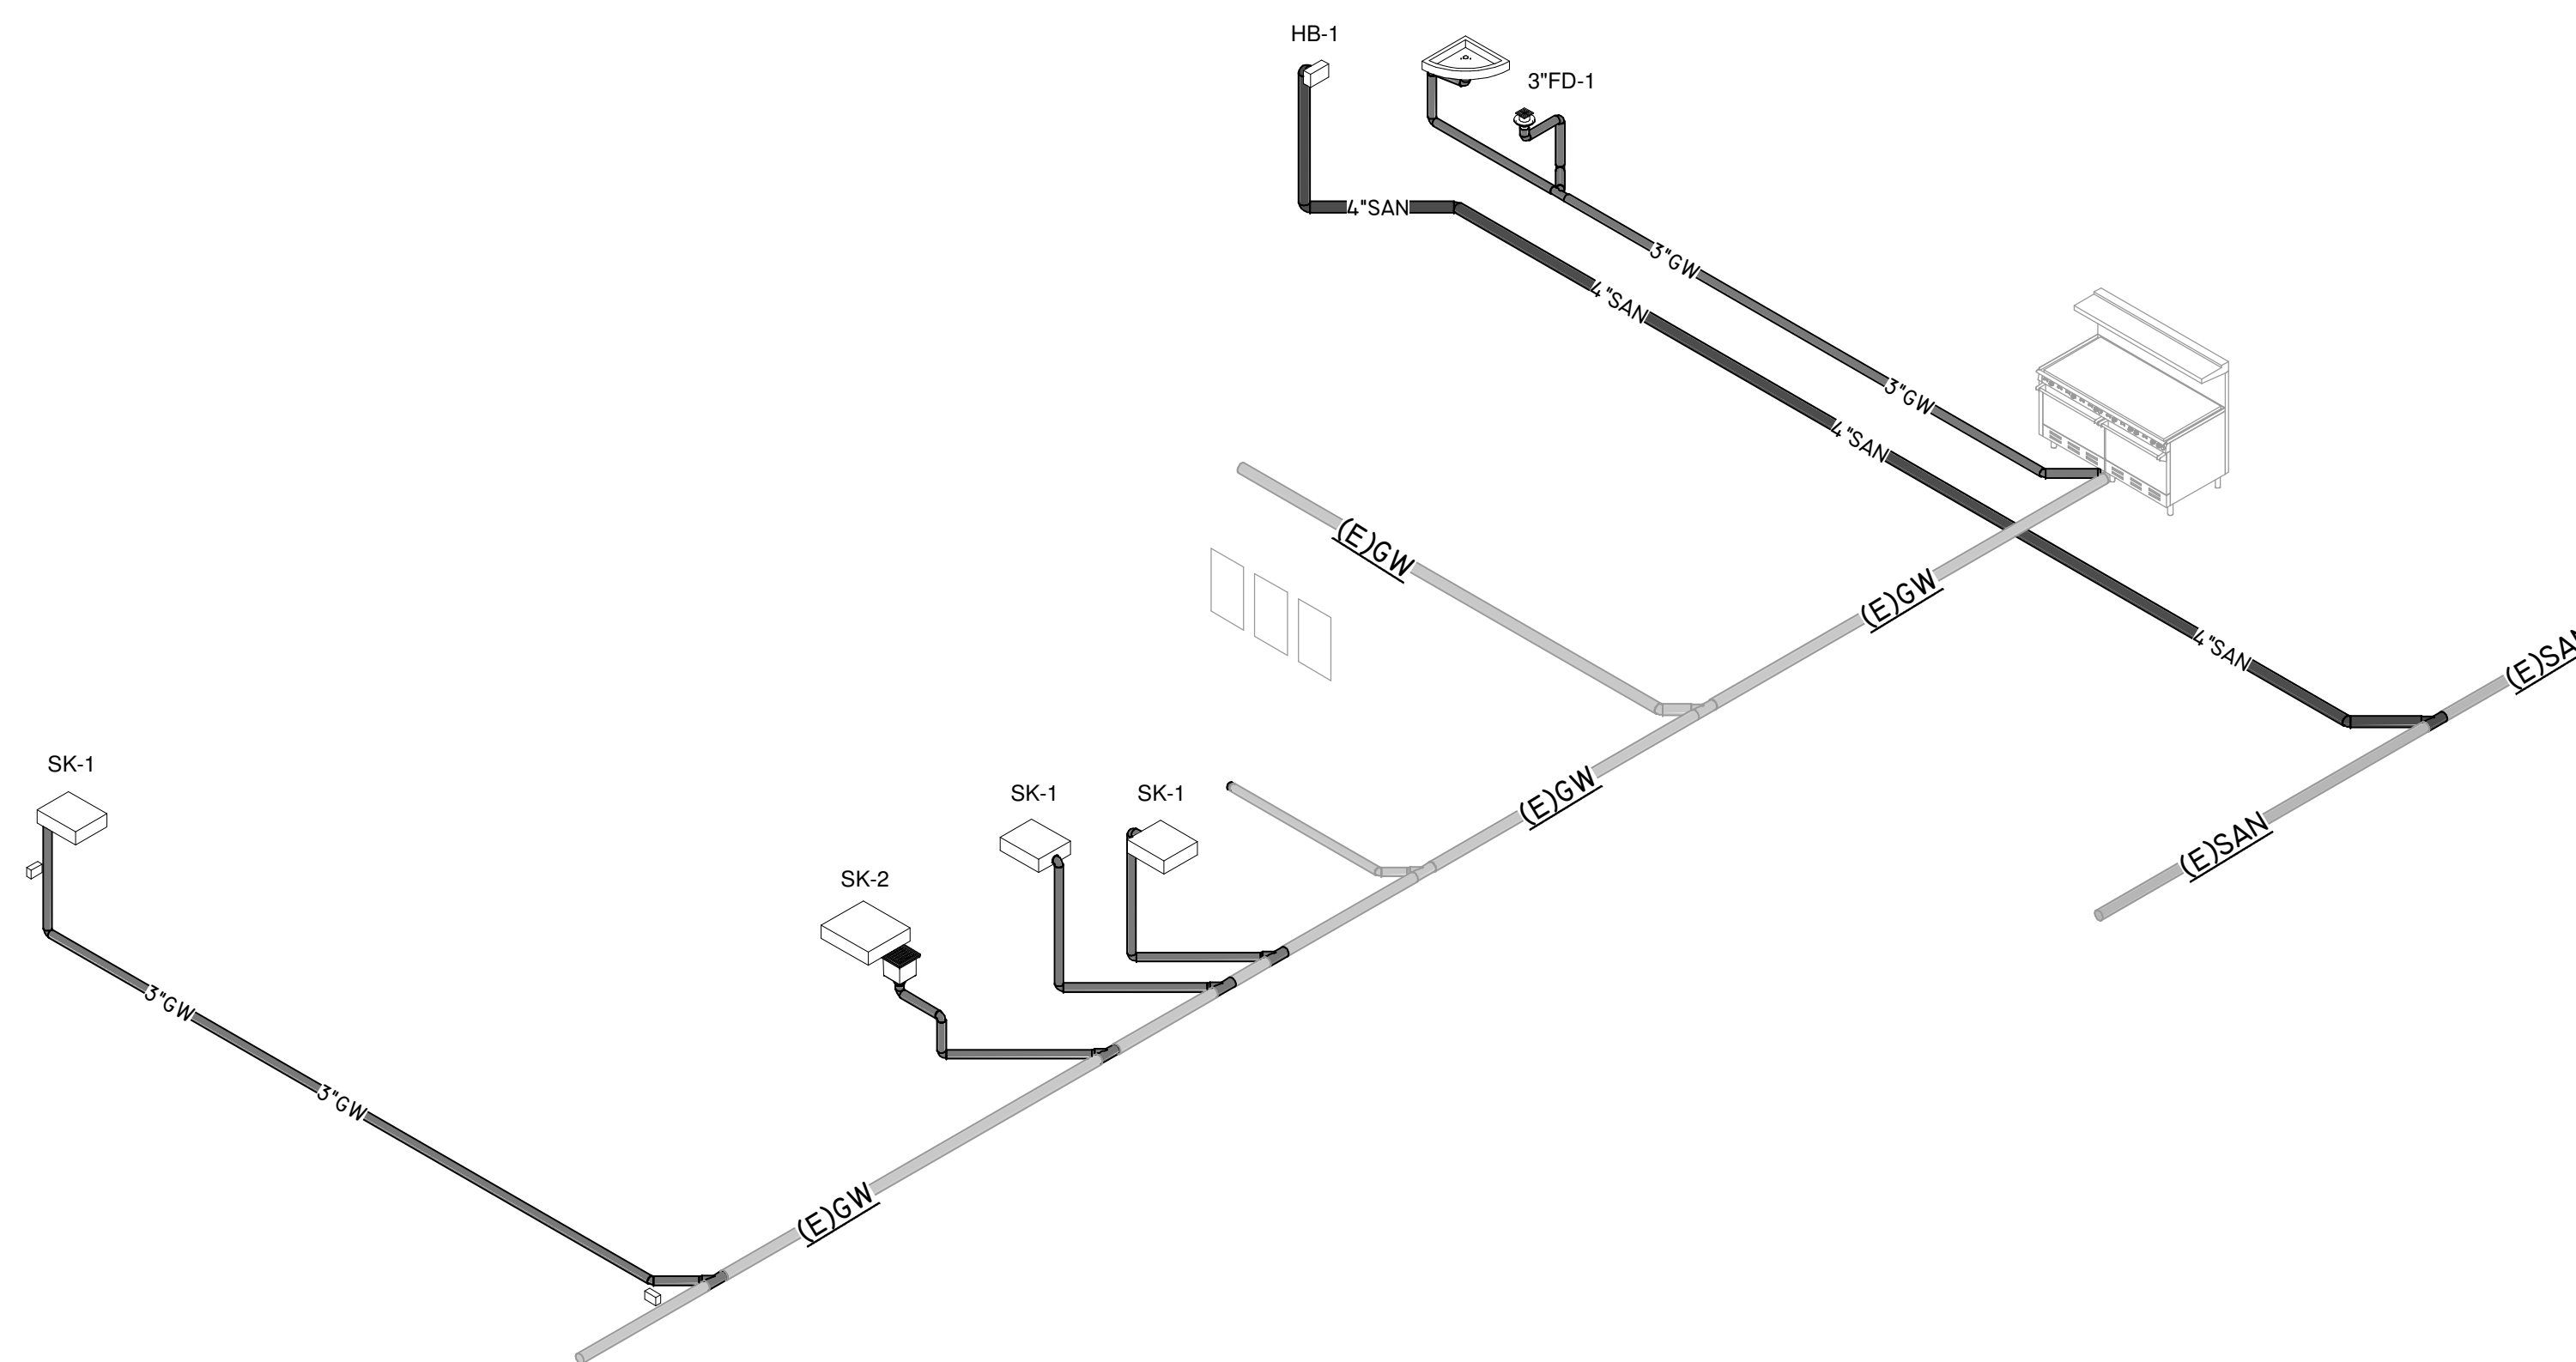


3 RISER DIAGRAM - KITCHEN
Scale:



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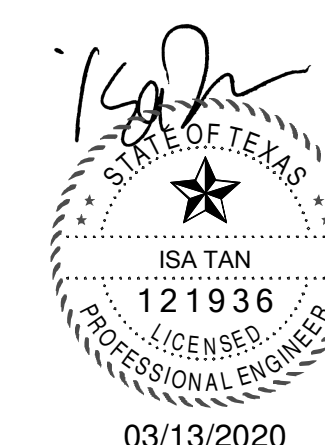
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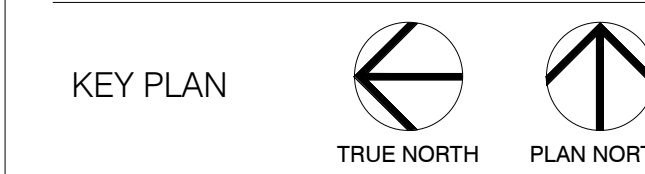
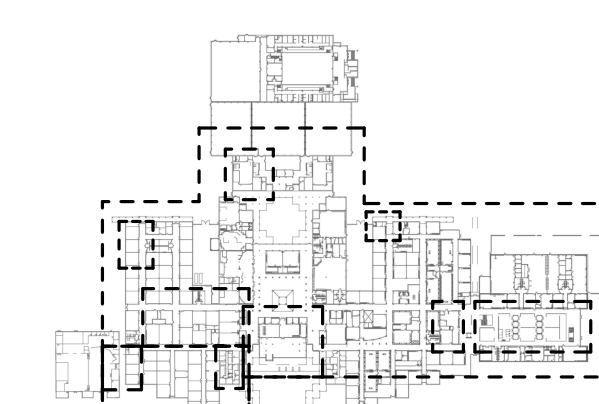


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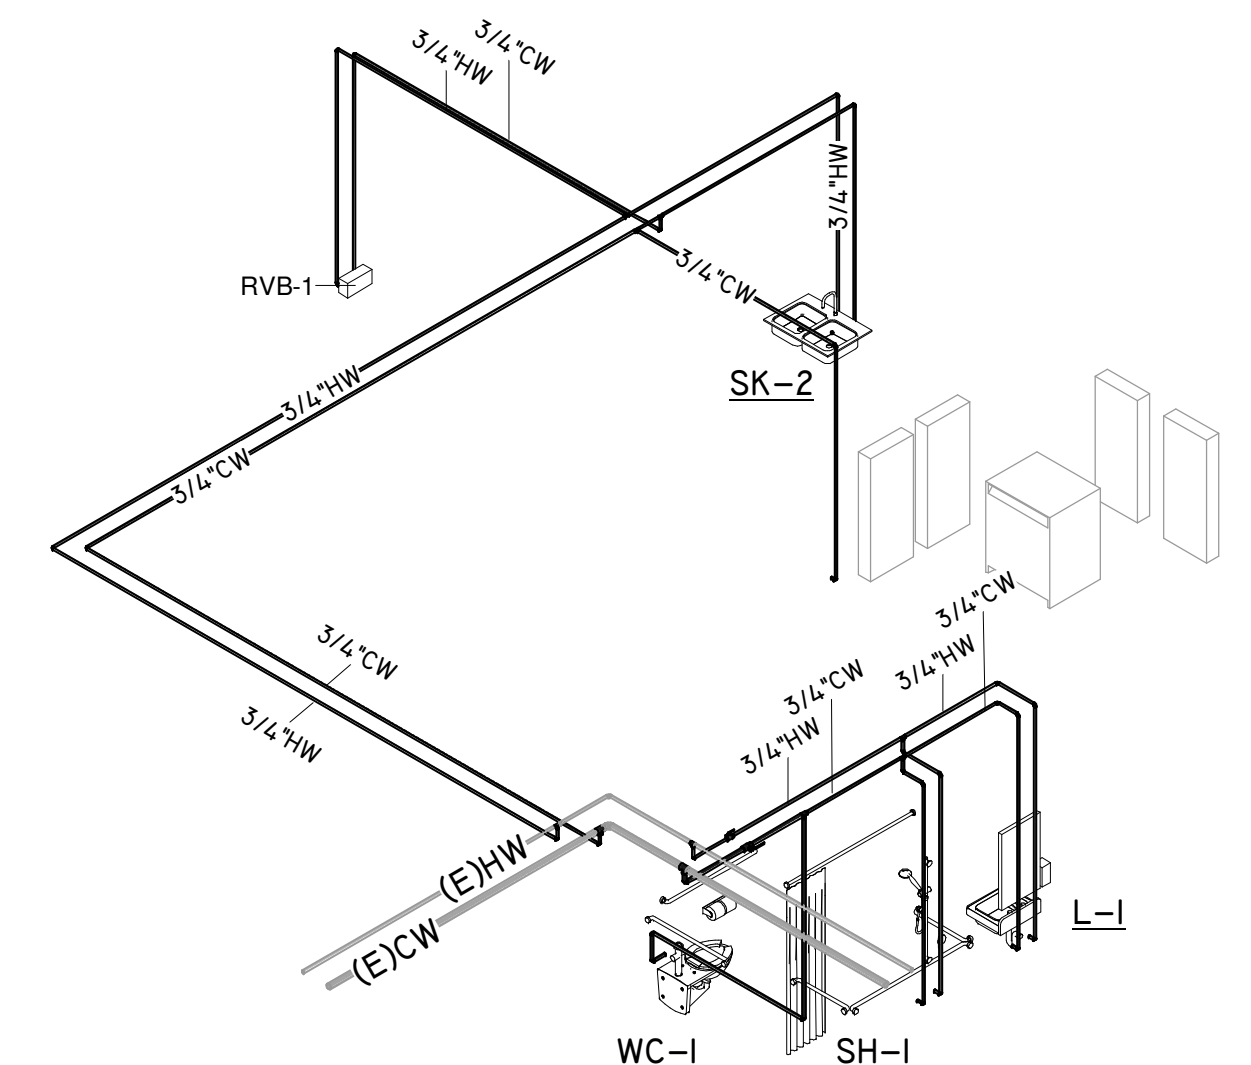
STAFFORD
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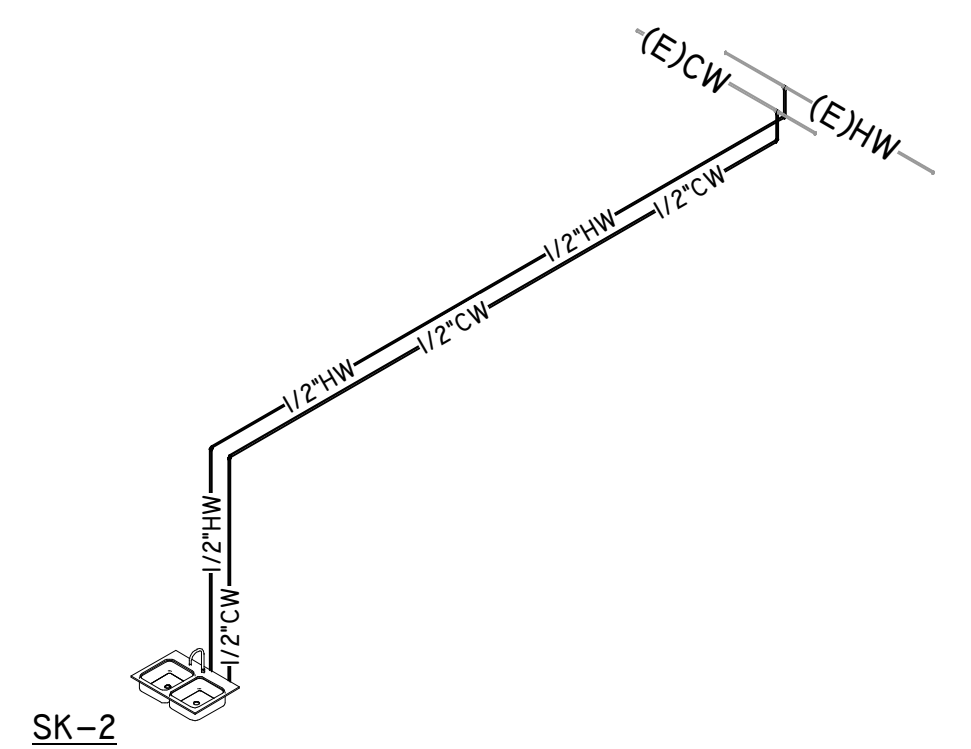
#	Date	ISSUED FOR
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3	2020/03/12	Issue for Bid, Permit, and Construction

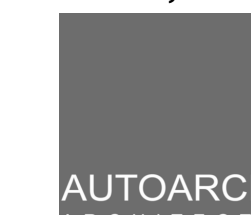


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Scale:




5 RISER DIAGRAM - MEDICAL ROOM - DOMESTIC
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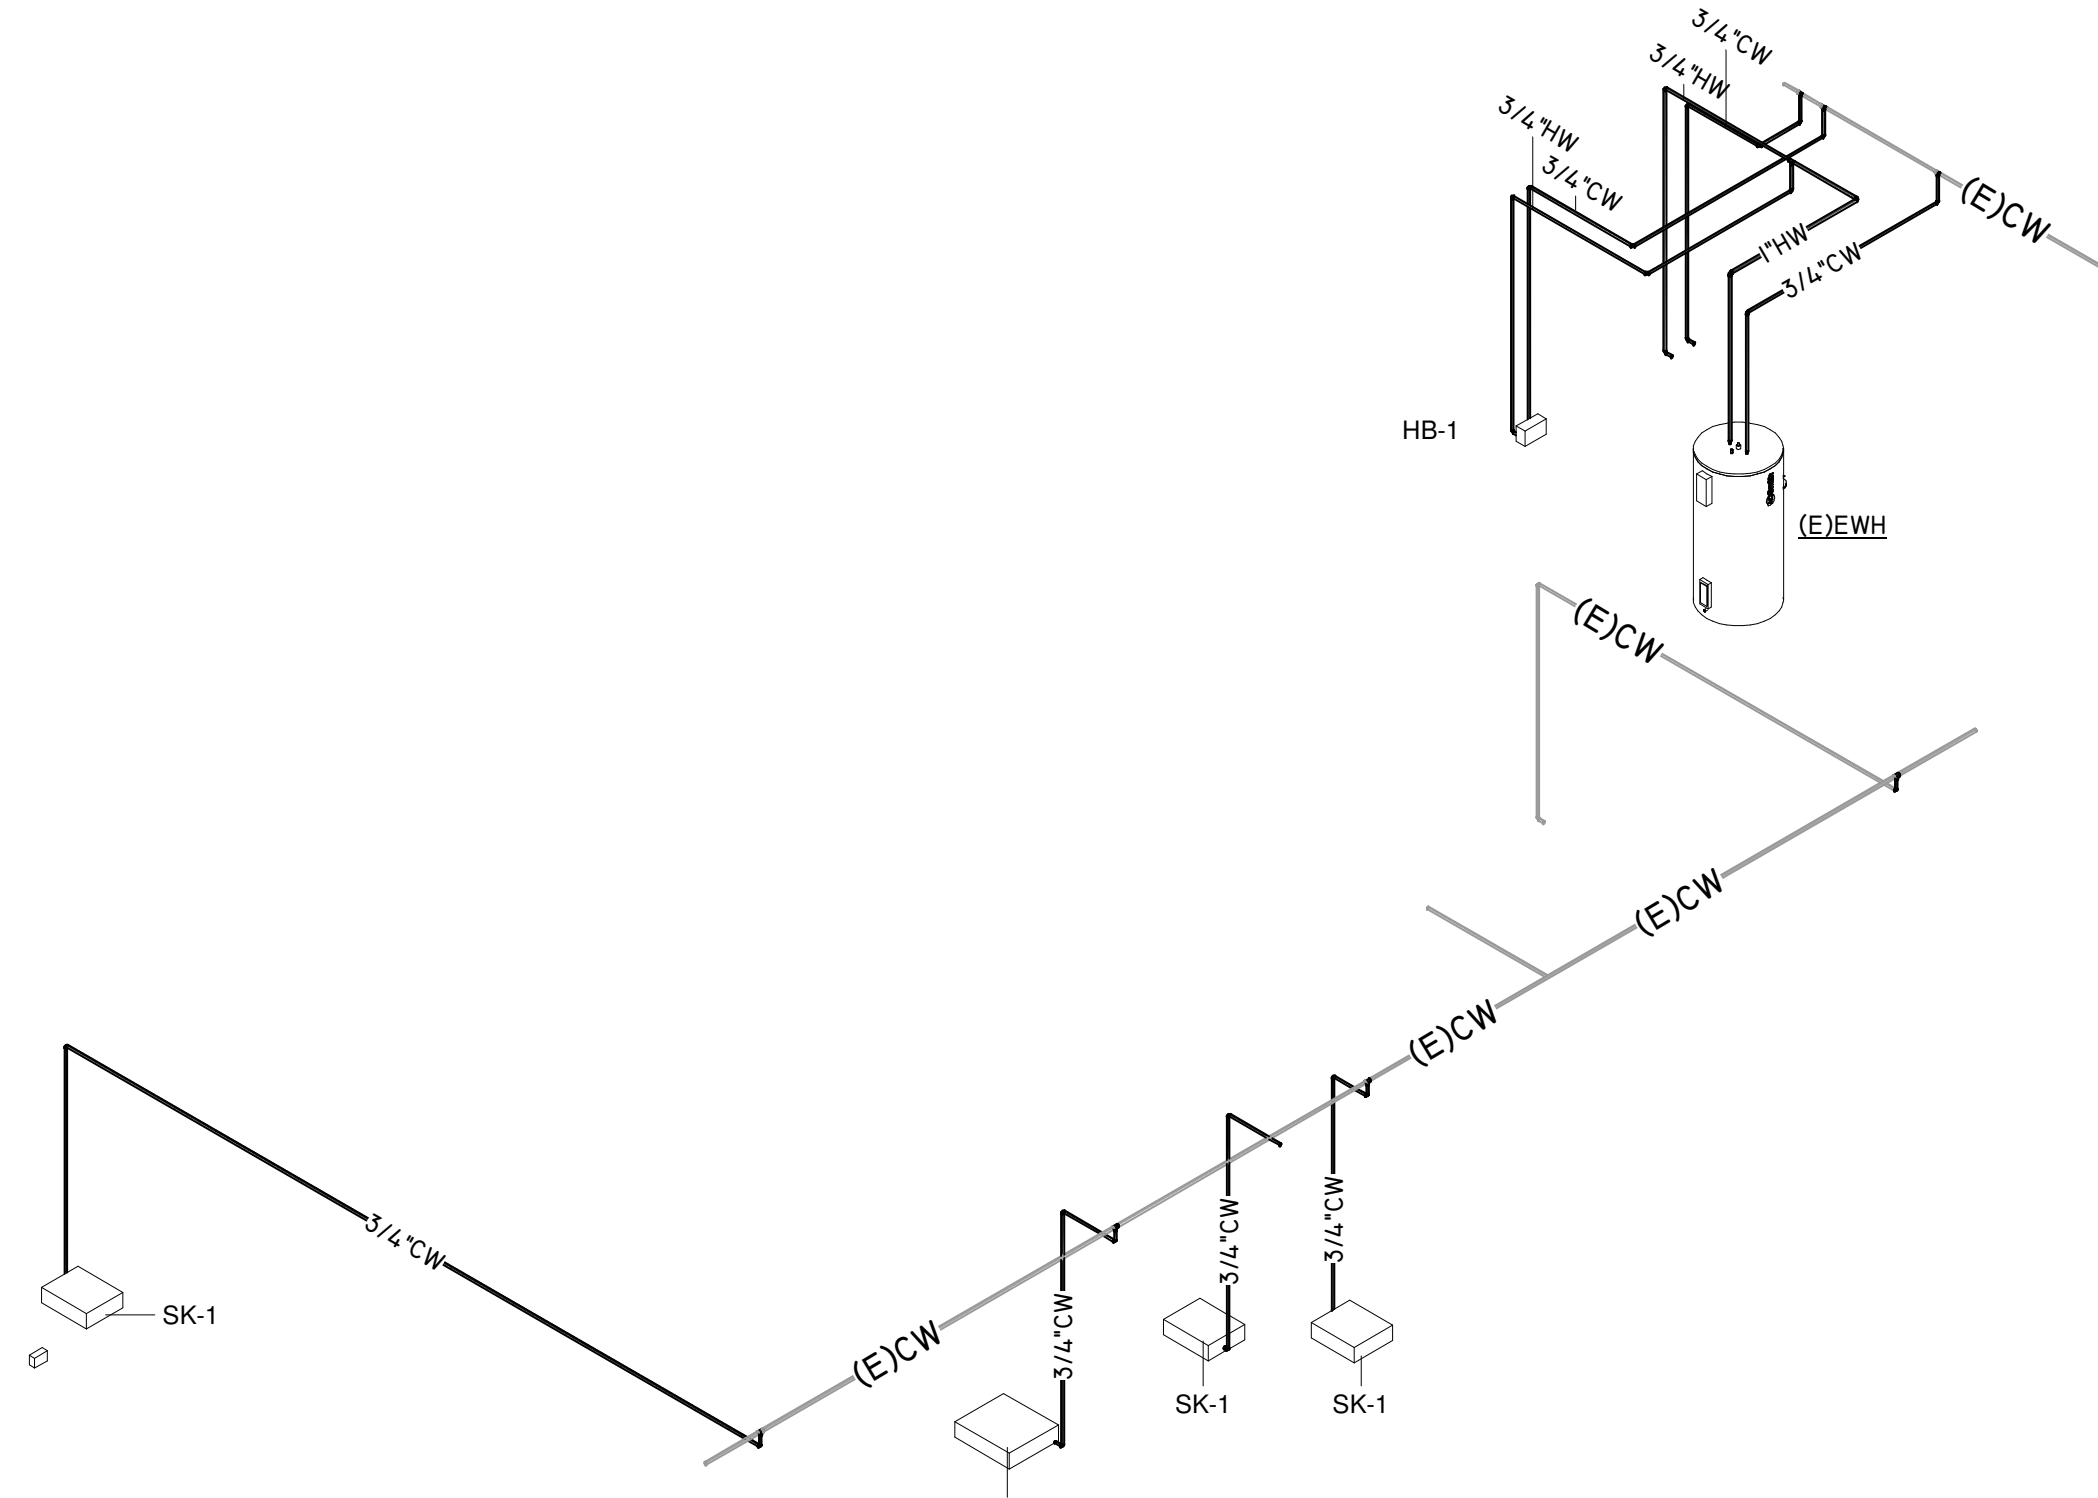
1 RISER DIAGRAM - LAB B2- DOMESTIC
Scale:



2 RISER DIAGRAM - LIBRARY RESTROOM - DOMESTIC
Scale:

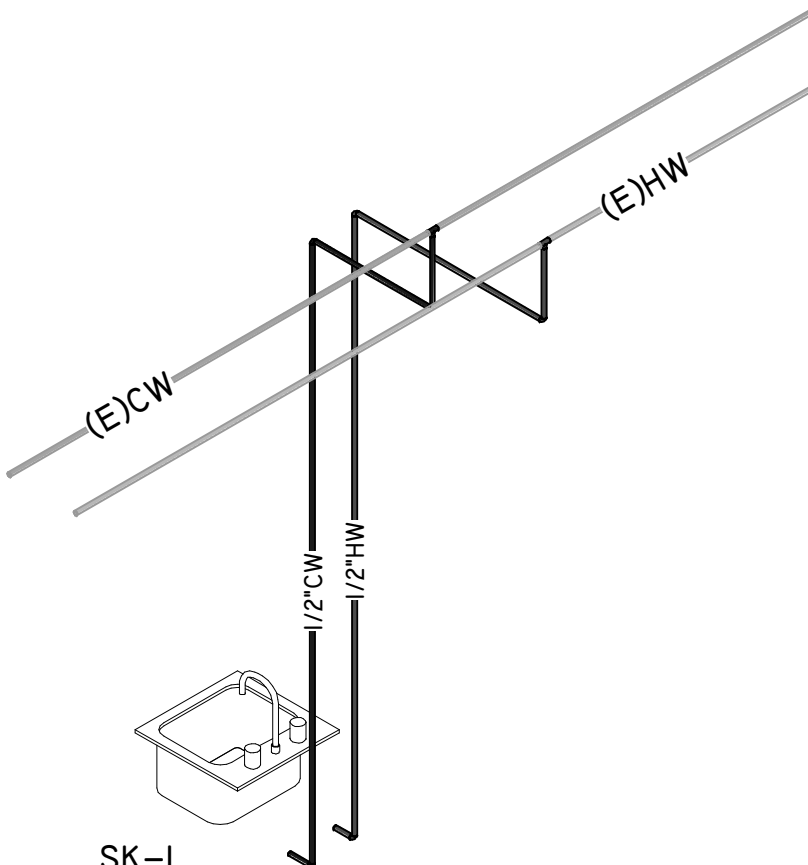

3 RISER DIAGRAM - KITCHEN - DOMESTIC
Scale:

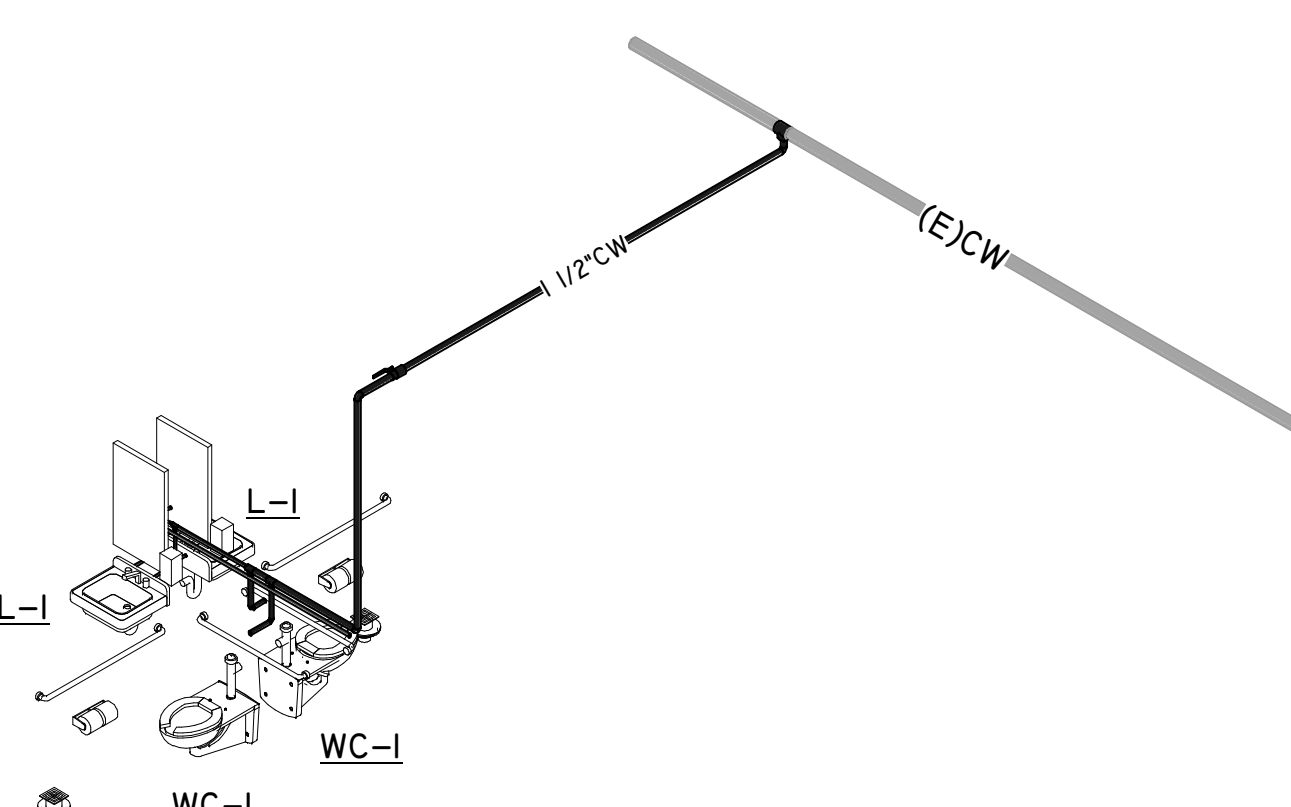

Project Number	19006-A
Drawn By	LT
Checked By	AW
Approved By	MS
Drawing Title	RISER DIAGRAMS - DOMESTIC

Drawing Number **P4.02**



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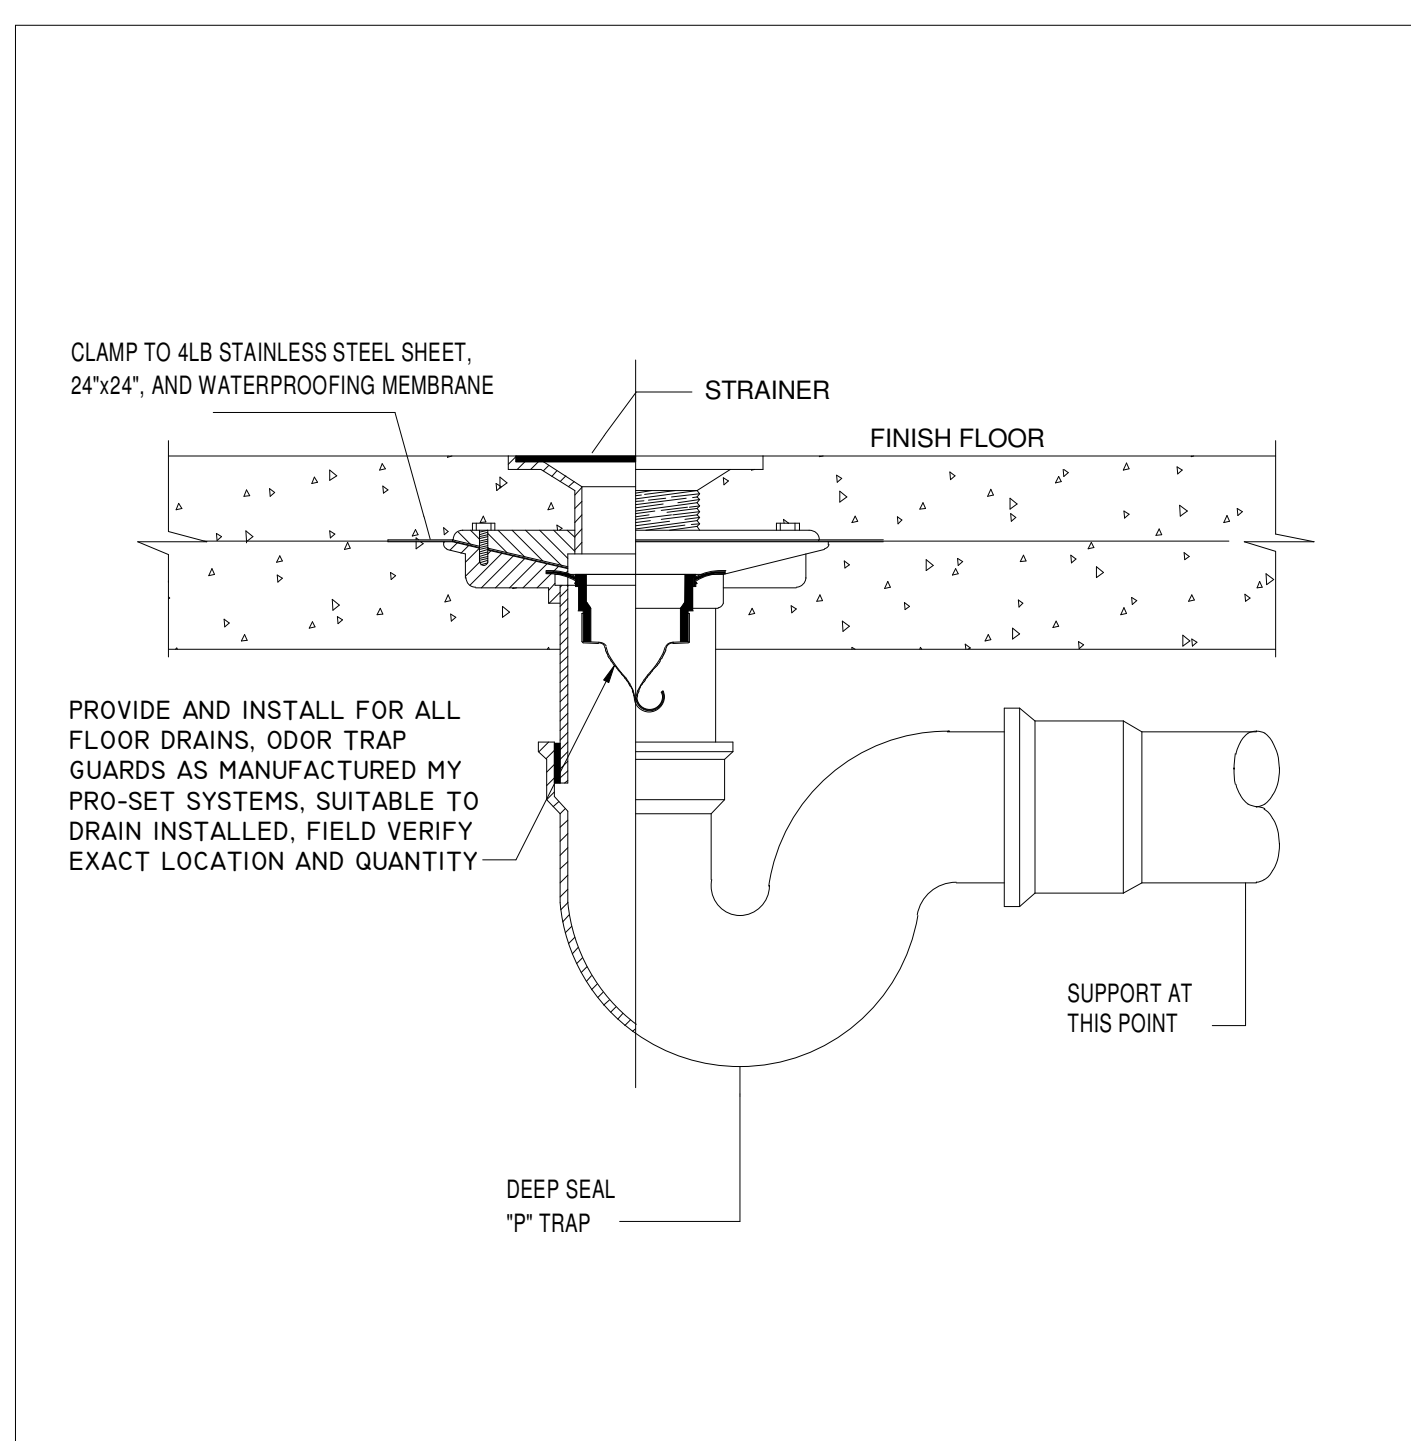
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A PROJECT FOR:


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SCHOOL
RENOVATIONS

1625 STAFFORDSHIRE
ROAD,
STAFFORD, TX 77477


#	Date	ISSUED FOR
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2	2020/03/02	98% CD Review
3	2020/03/12	Issue for Bid, Permit, and Construction




FLOOR DRAIN DETAIL WITH TRAP GUARD NOT TO SCALE 0

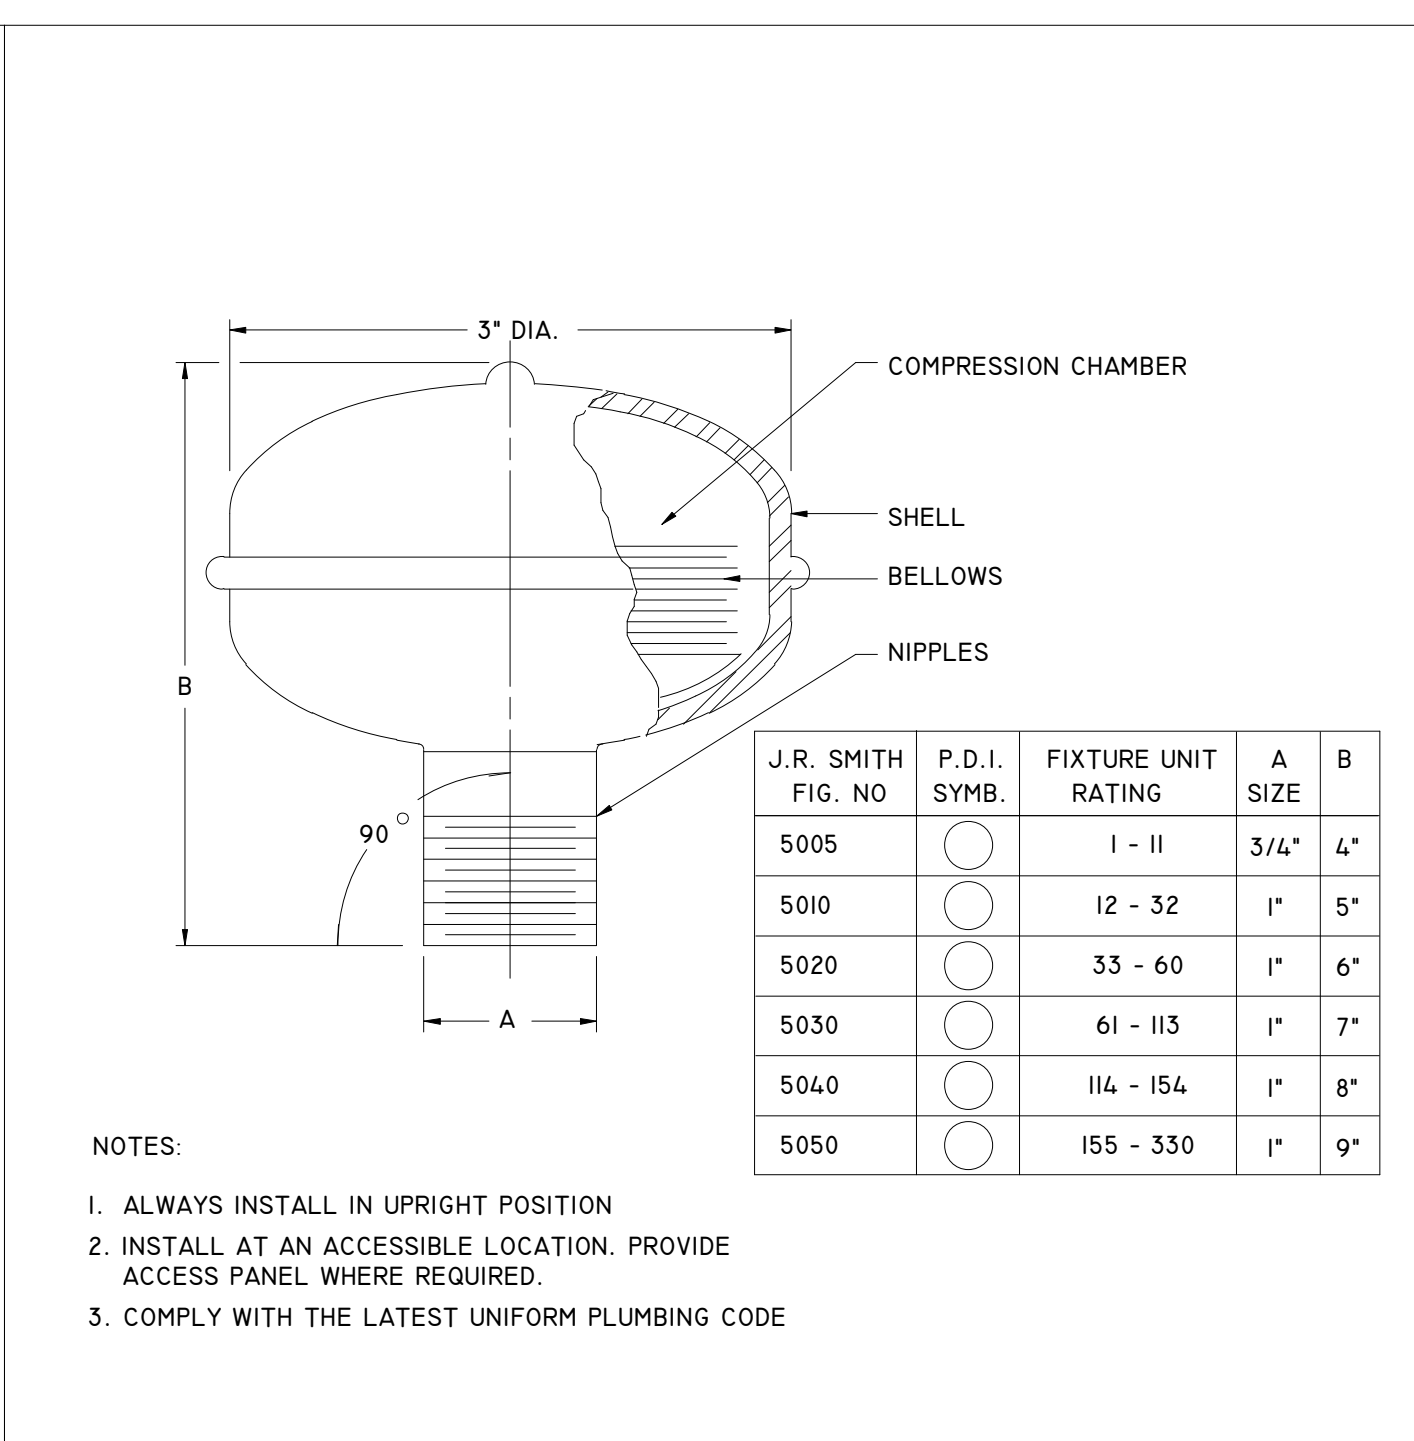


WATER HAMMER ARRESTERS NOT TO SCALE 4

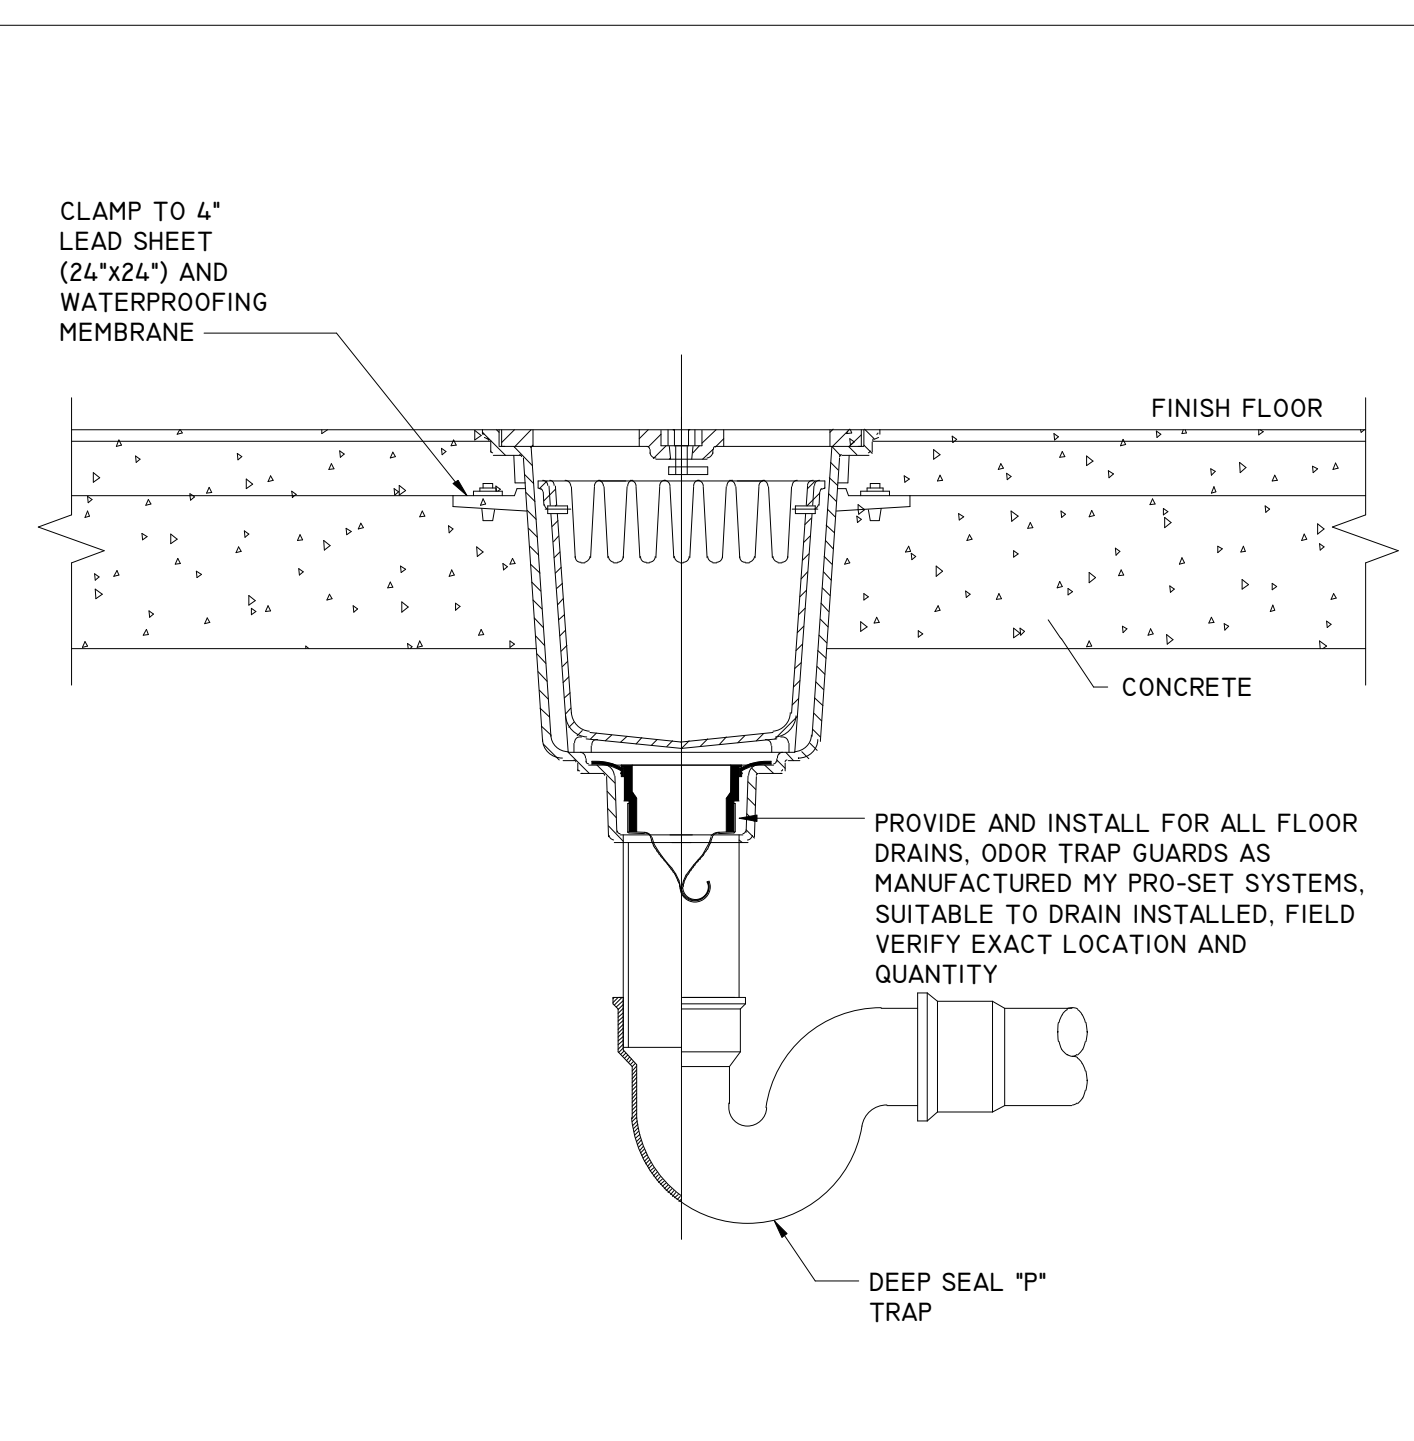


FLOOR SINK WITH TRAP GUARD (FS-1) NOT TO SCALE 2

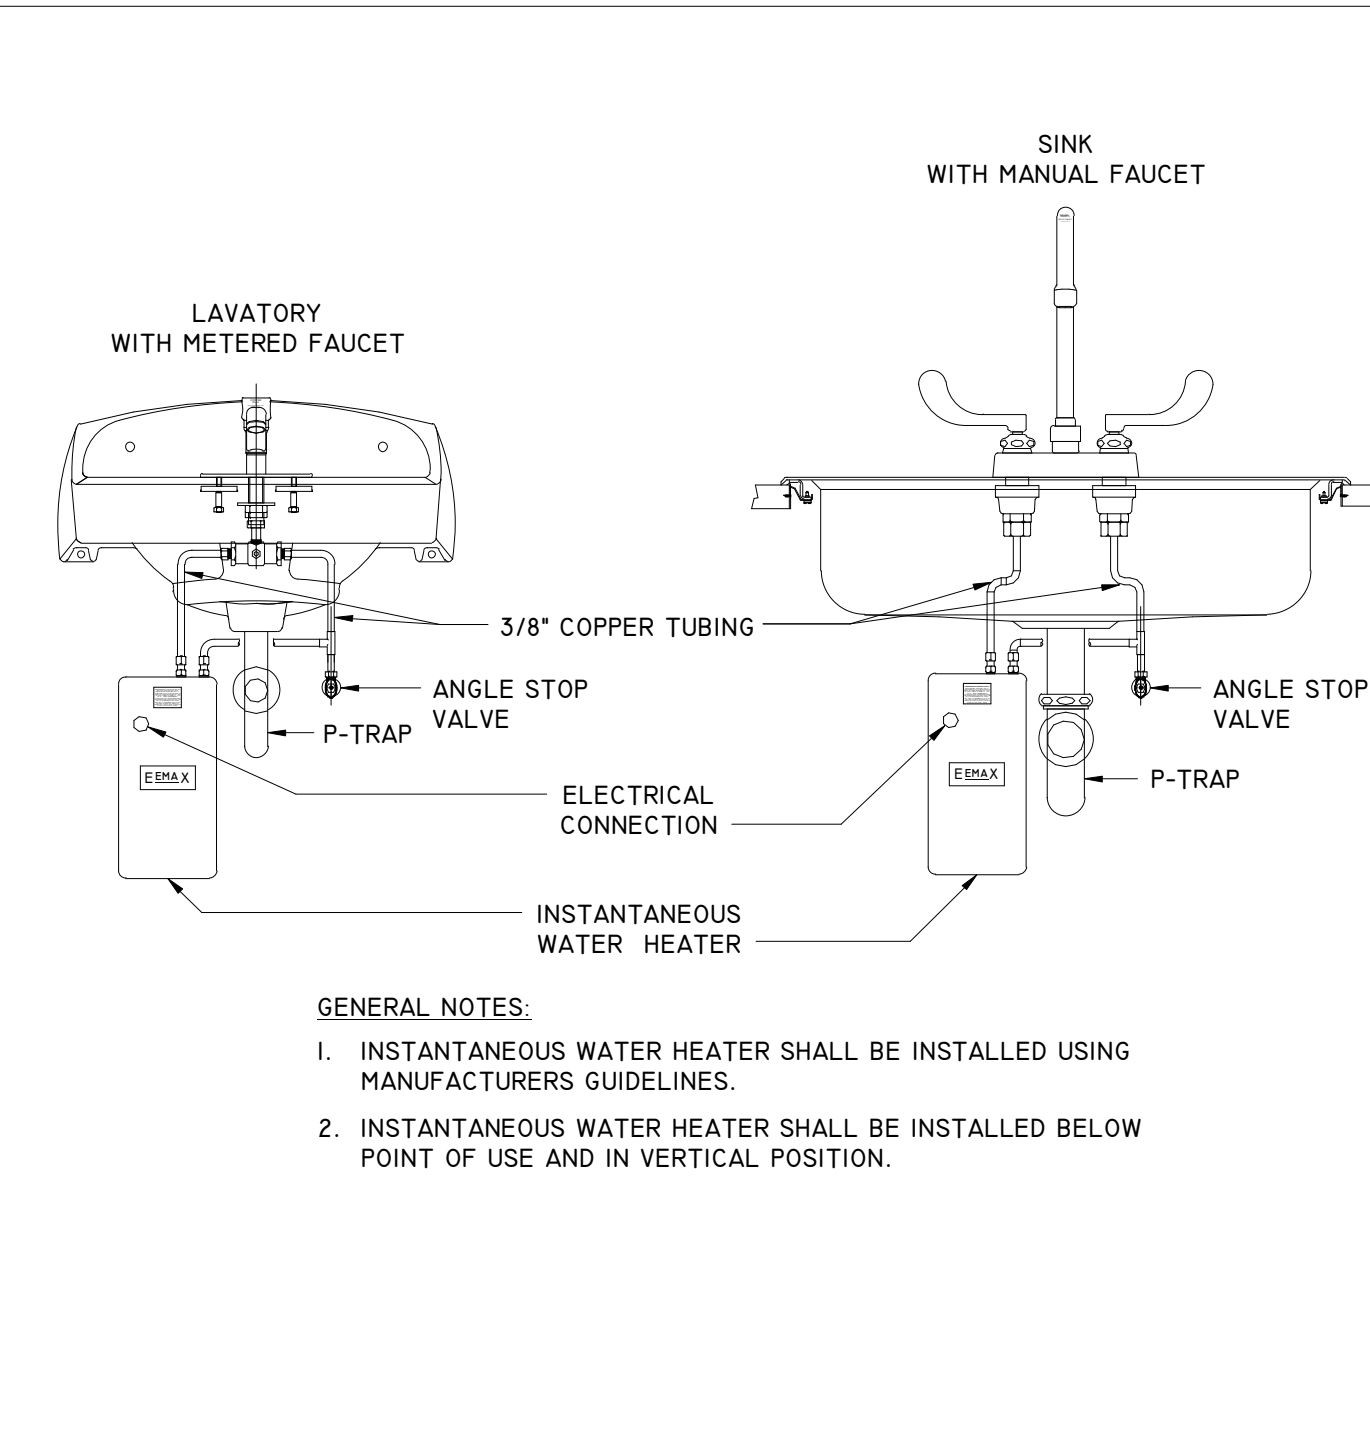


INSTANTANEOUS ELECTRIC WATER HEATER DETAIL (IWH-) NOT TO SCALE 0

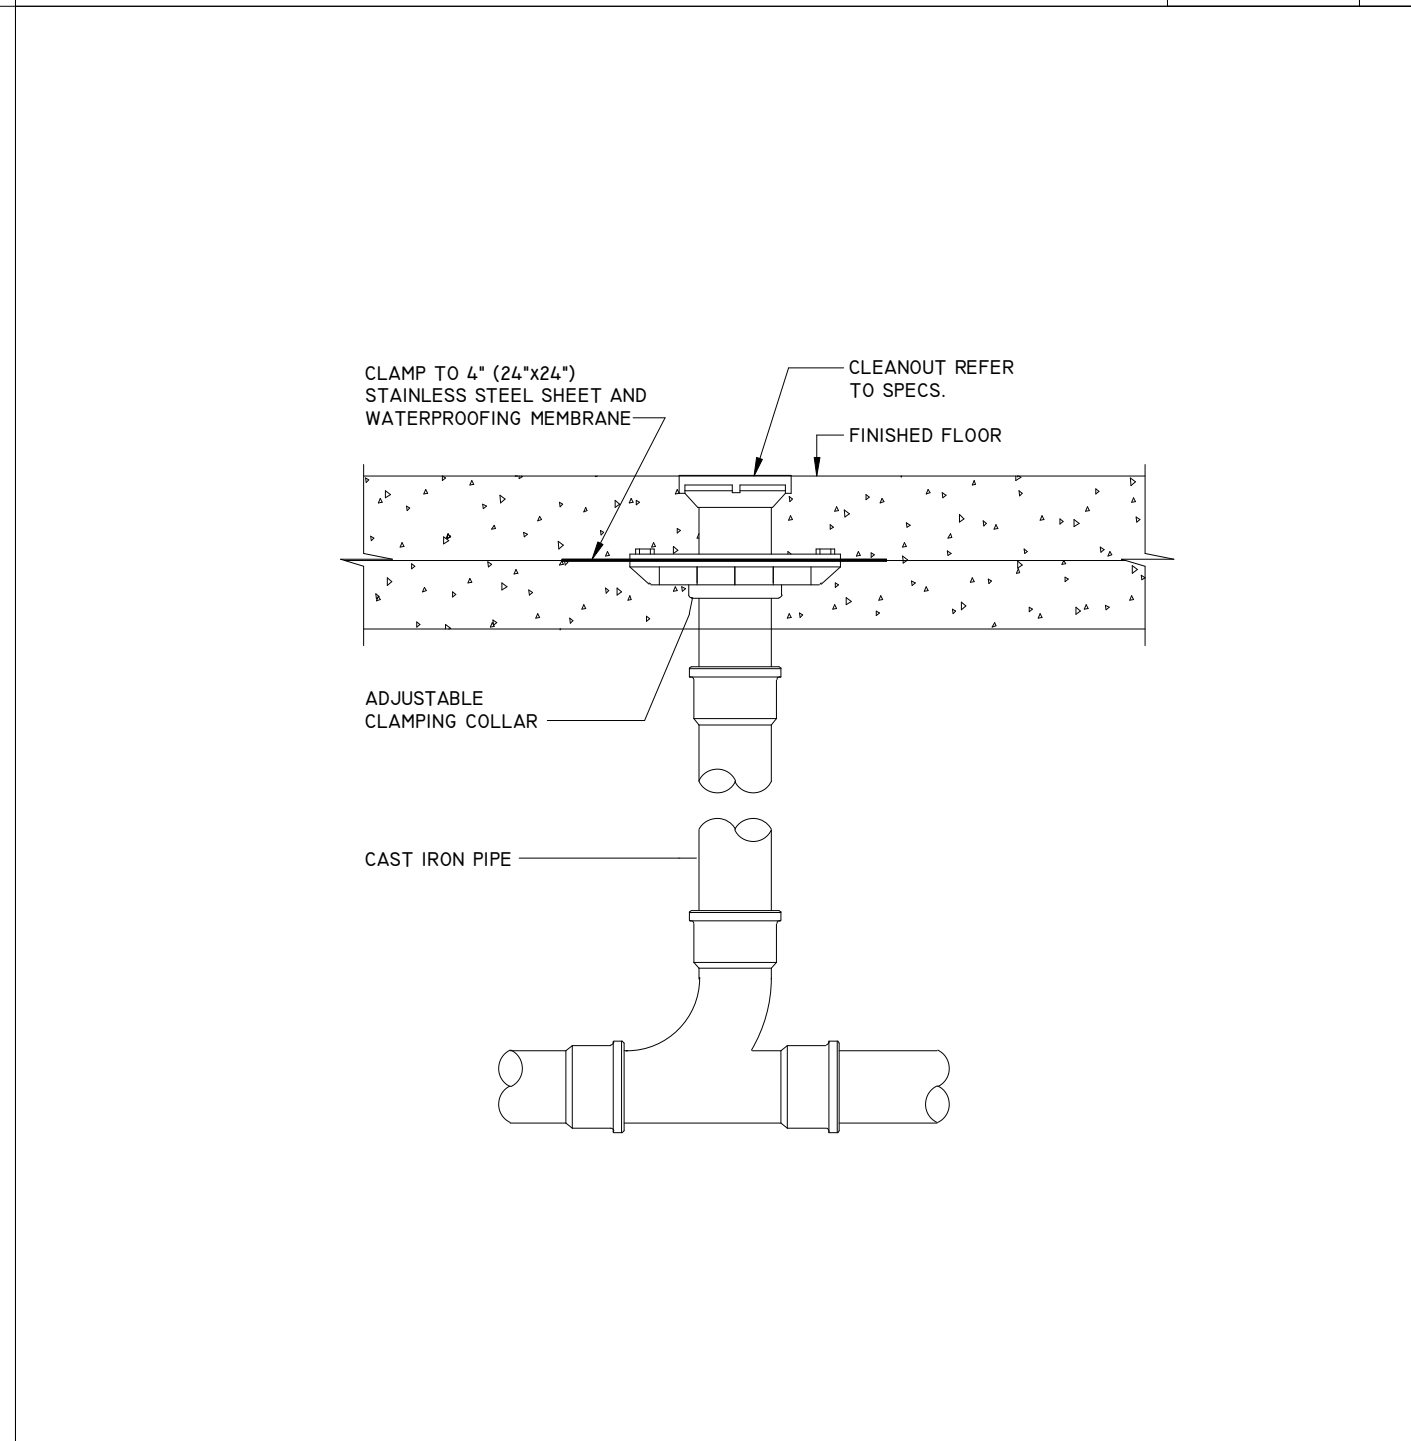



FLOOR CLEANOUT DETAIL (FCO-I) NOT TO SCALE 0

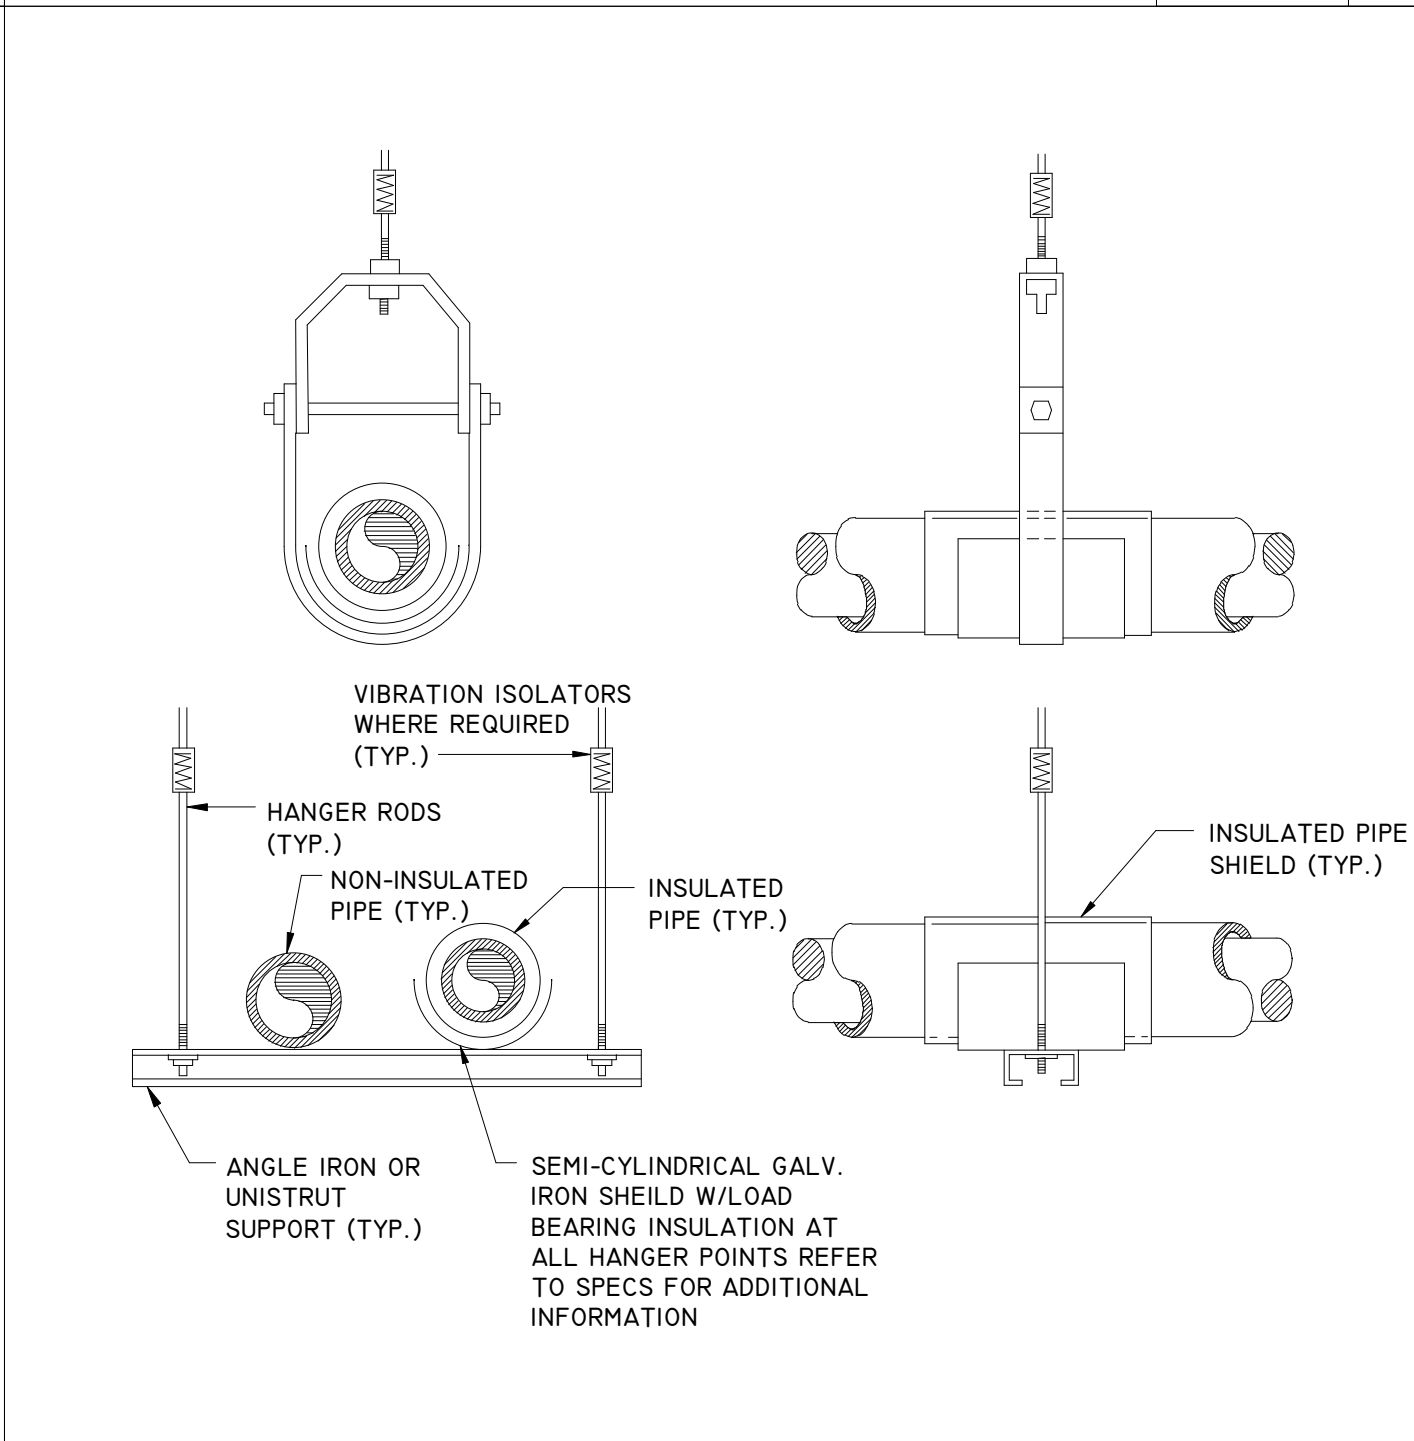

PIPE HANGER DETAIL NOT TO SCALE 3

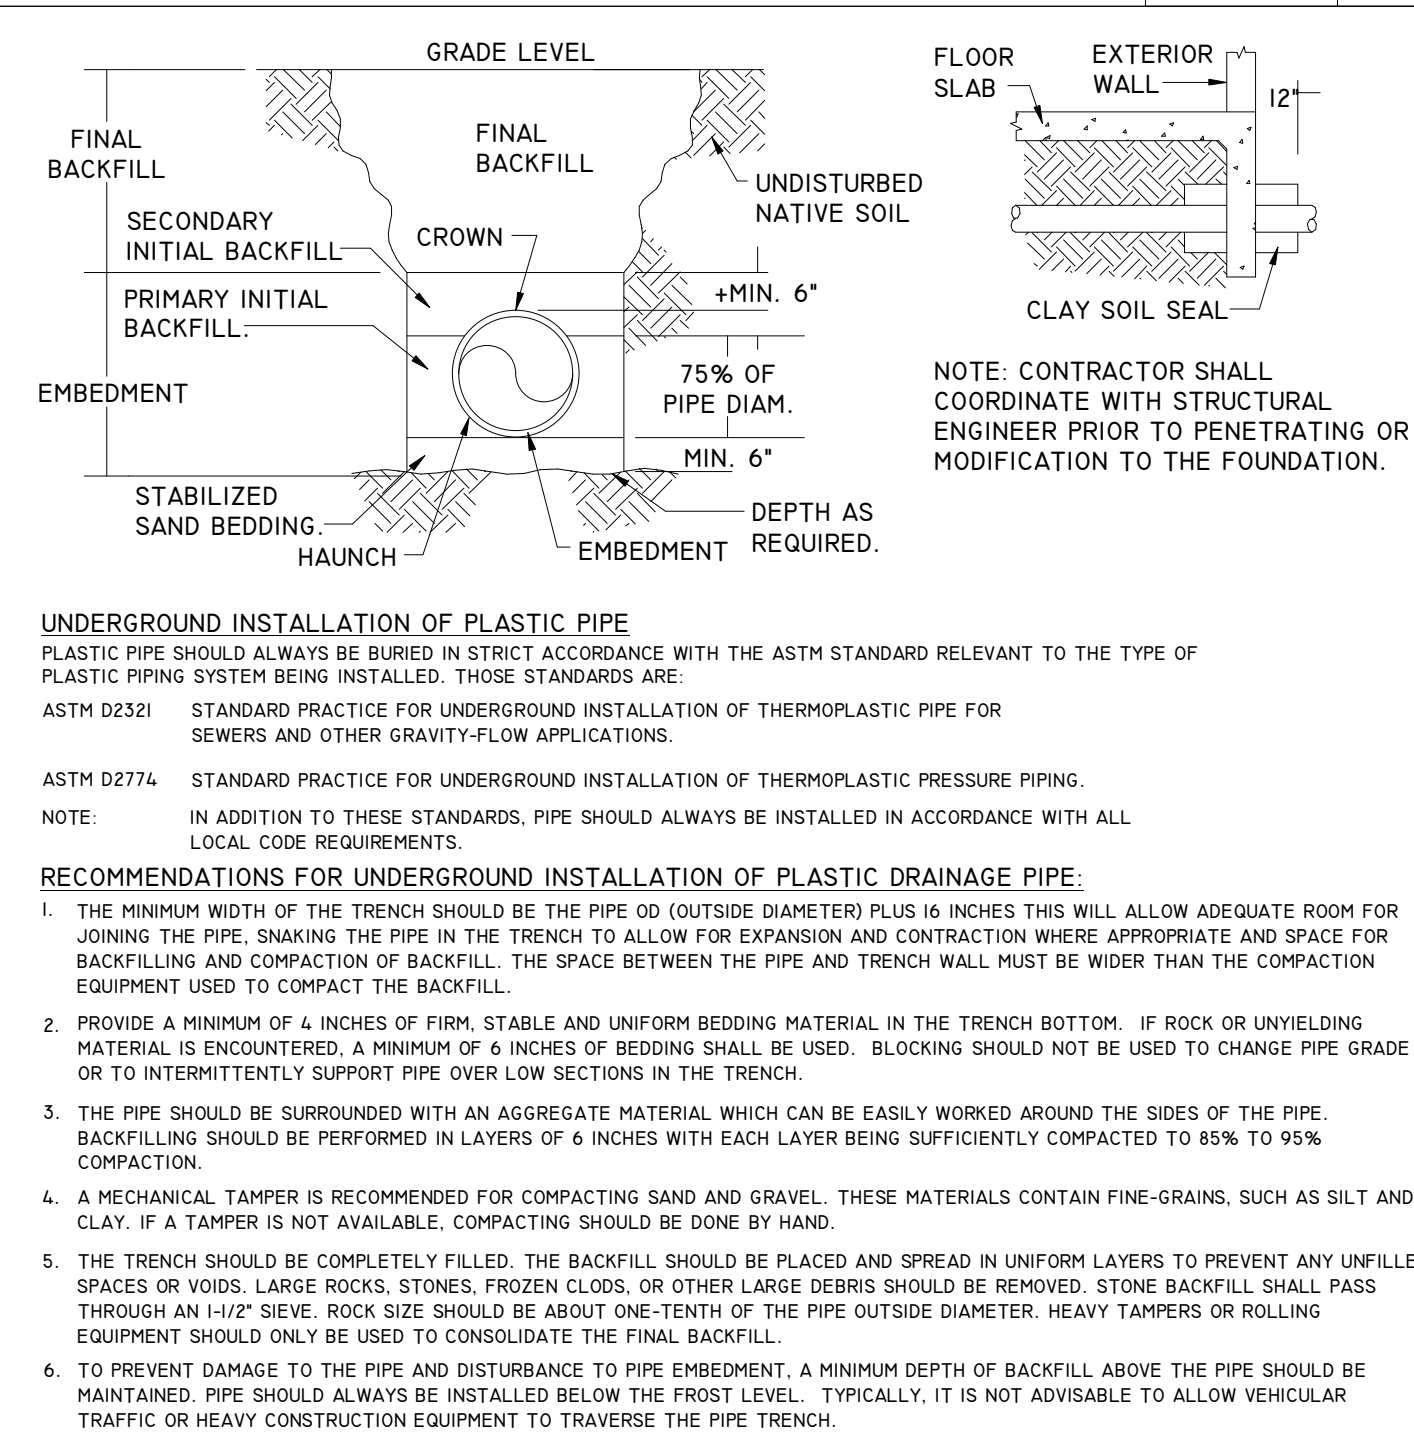

BACKFILL PIPING DETAIL NOT TO SCALE 1

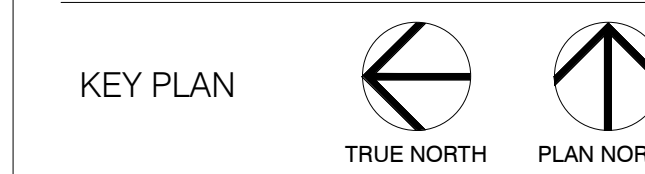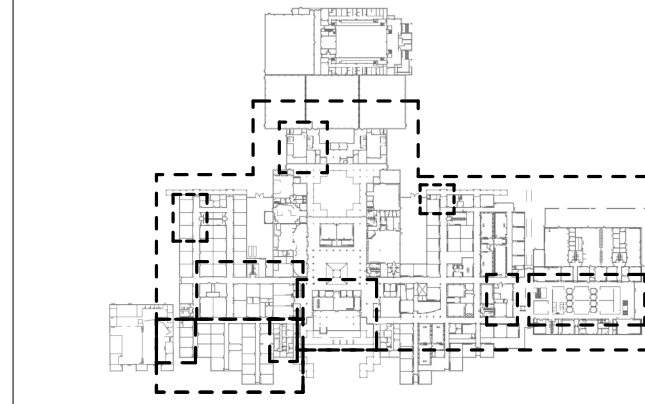

Project Number	19006-A
Drawn By	LT
Checked By	AW
Approved By	MS
Drawing Title	DETAILS
Drawing Number	P5.01



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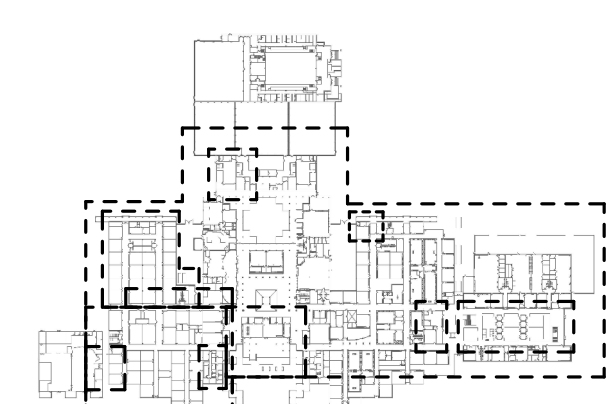
PROFESSIONAL SEAL:

A PROJECT FOR:

STAFFORD HIGH SCHOOL & MAGNET SCHOOL RENOVATIONS


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#	Date	ISSUED FOR
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KEY PLAN
TRUE NORTH
PLAN NORTH


Project Number	19006-A
Drawn By	LT
Checked By	AW
Approved By	MS
Drawing Title	FS EQUIPMENT PLAN
Drawing Number	K1




1 FOODSERVICE EQUIPMENT PLAN
1/4" = 1'-0"

FOODSERVICE EQUIPMENT SCHEDULE			
R	QTY	FDP DESCRIPTION	FDP REMARKS
104	2	STORAGE SHELVING	METRO MAX Q 36"W X 18"D X 74"H
107	2	STORAGE SHELVING	METRO MAX Q 60"W X 24"D X 74"H
122	1	TWO COMPARTMENT SINK	TABCO #9-923636RL
130	2	WORKTABLE	TABCO #KSLAG-303-X
137	3	SPEED RACK	CHANNEL #53C
139	1	MOBILE HEATED CABINET	WINHOLT #INHPL-1836C-DGT
151	1	FIRE PROTECTION SYSTEM	BY MECH. CONTRACTOR
152	1	EXHAUST HOOD	BY MACH. CONTRACTOR
161	1	CONVECTION OVEN	VULCAN #VC66GD
167	8	STUDENT WORKTABLE	TABCO #SLAG-305-X
192	1	REACH-IN REFRIGERATOR	TRAUENSEN #3200
195	1	REACH-IN FREEZER	TRAUENSEN #G3100
262	3	HAND SINK	TABCO #7-PS-18
616	1	DOUBLE DECK OVEN	RADIANCE #RBD0-43
632	1	SIX BURNER RANGE	VULCAN #VUL36SA-6B
644	4	ELECTRIC HOSE REEL	SAFELITE #4040-4201; PROVIDED BY DIV. 26
704	1	FRYER BATTERY	EXISTING
801	1	DEMO TABLE	TABCO #VSS-DT-365
802	1	WORKTABLE	TABCO #KSLAG-302-X
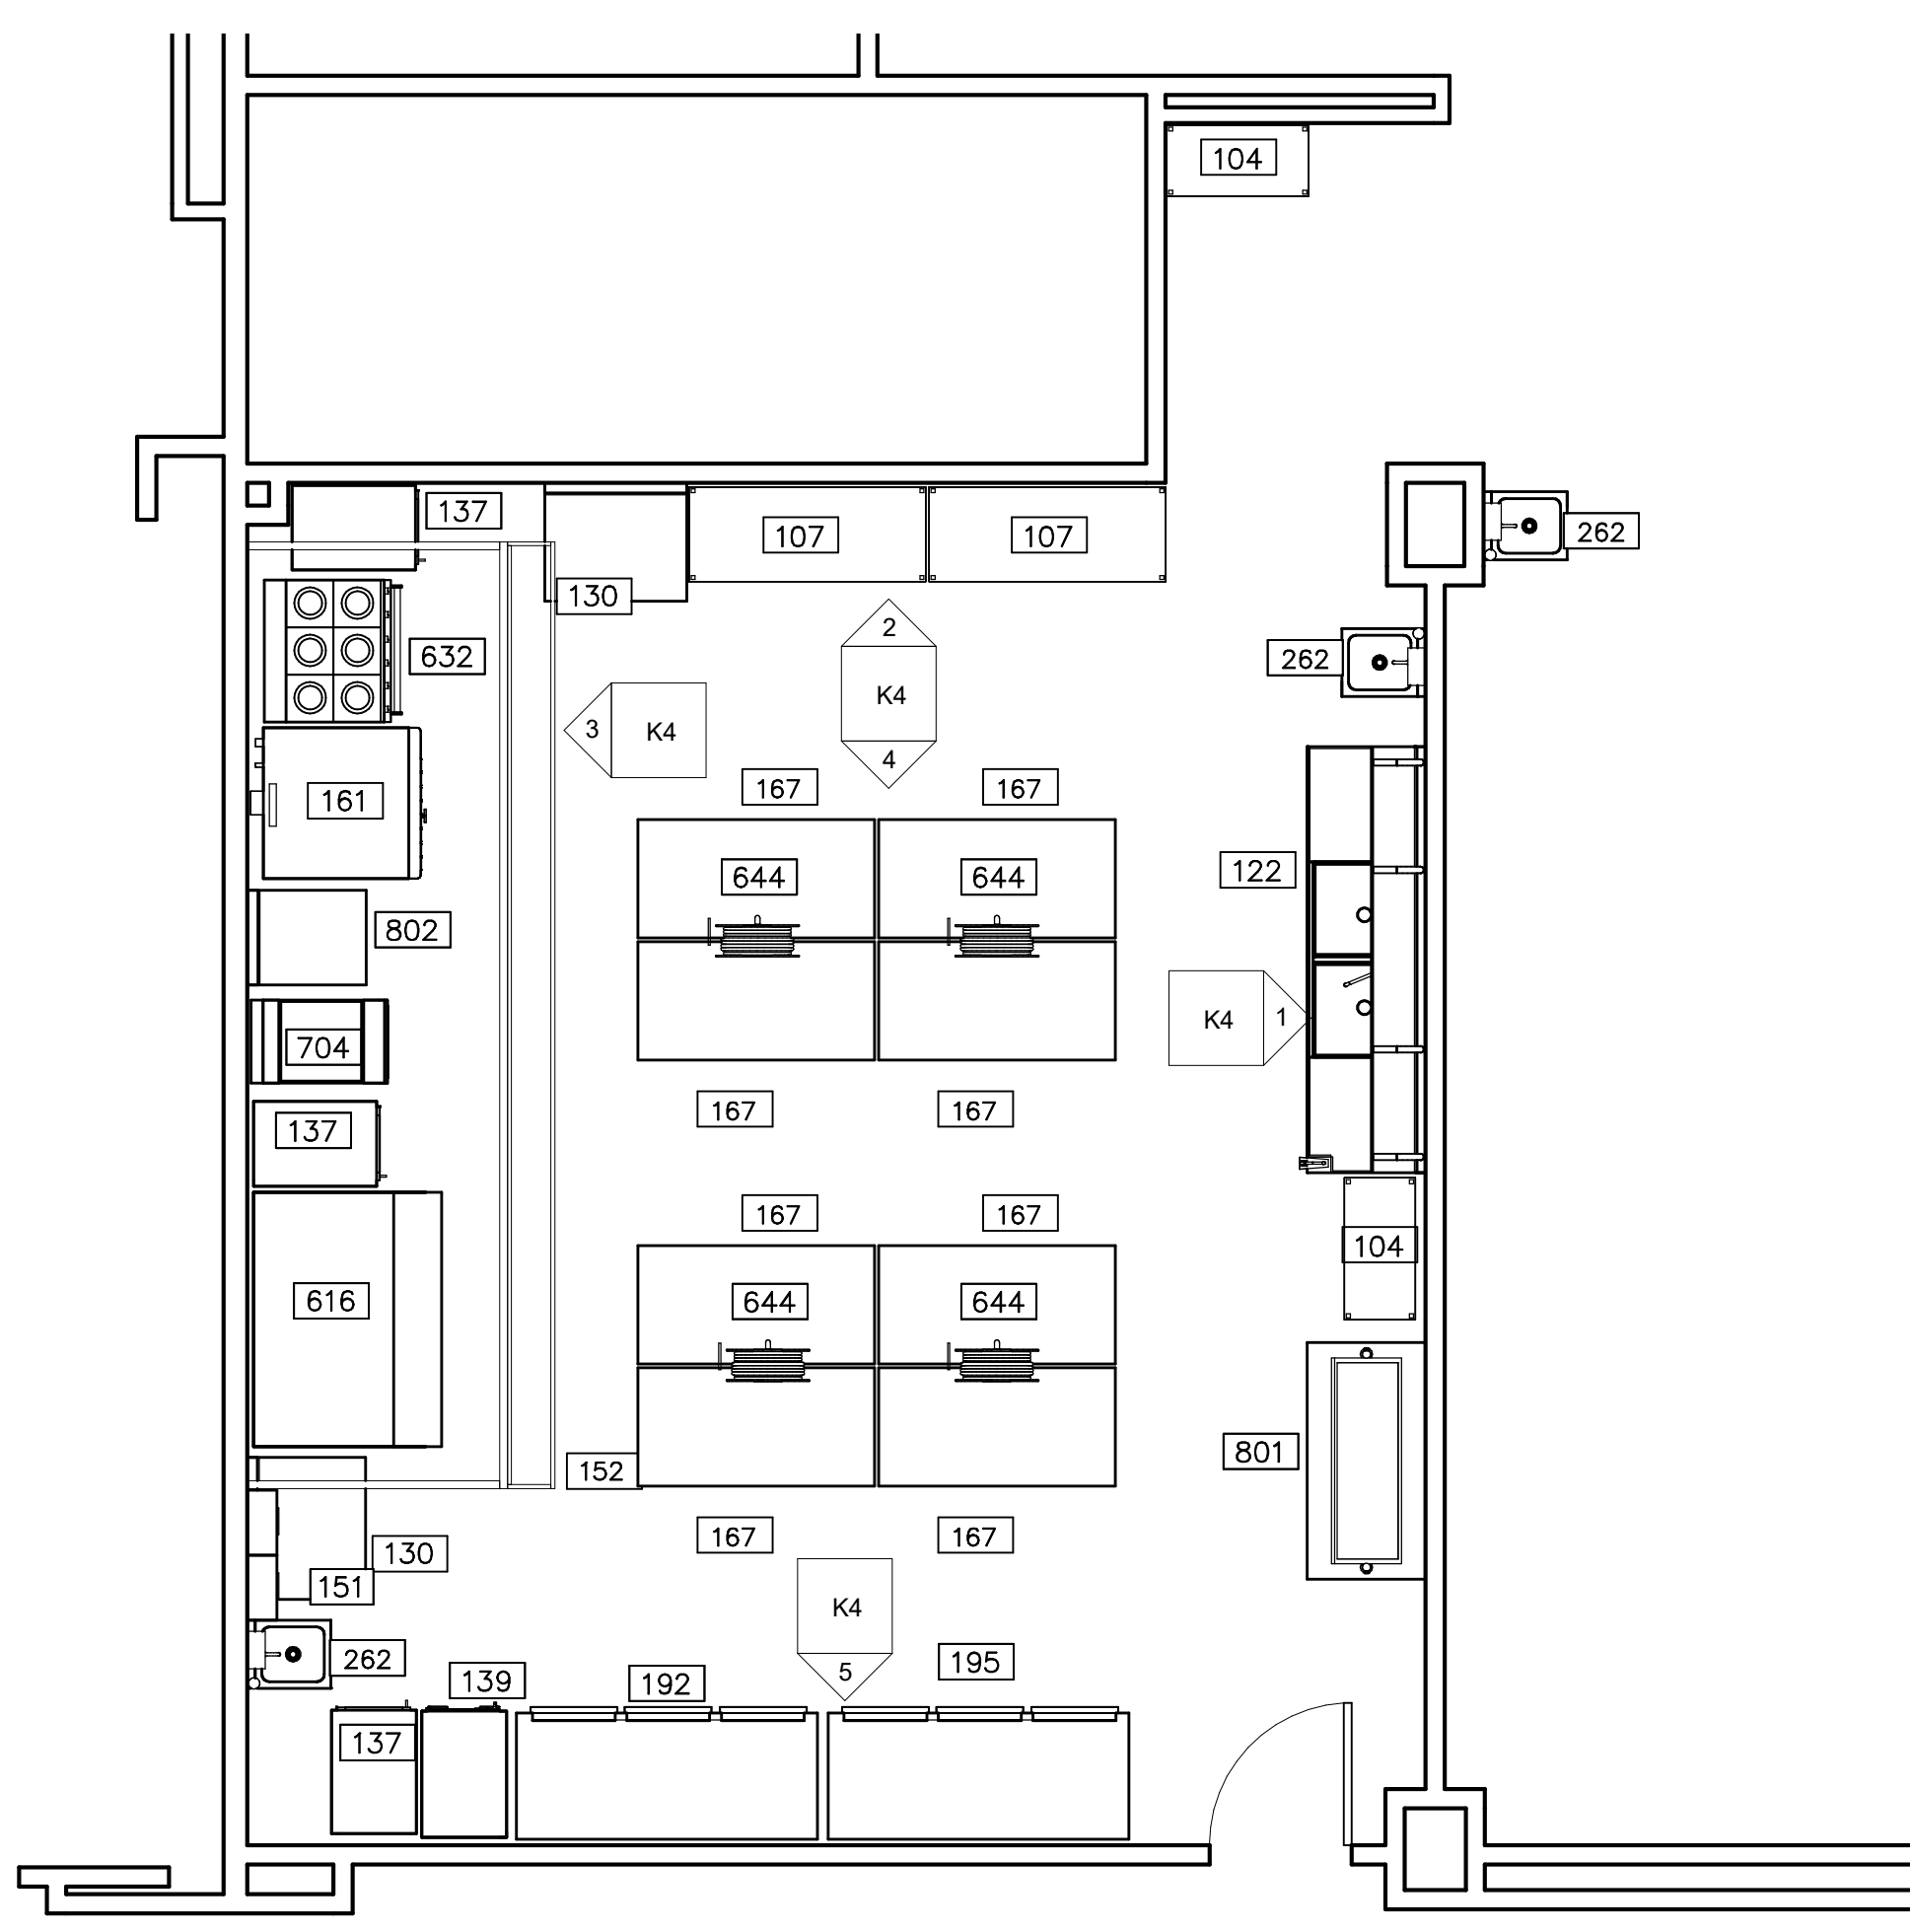
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2 FS EQUIPMENT MODEL

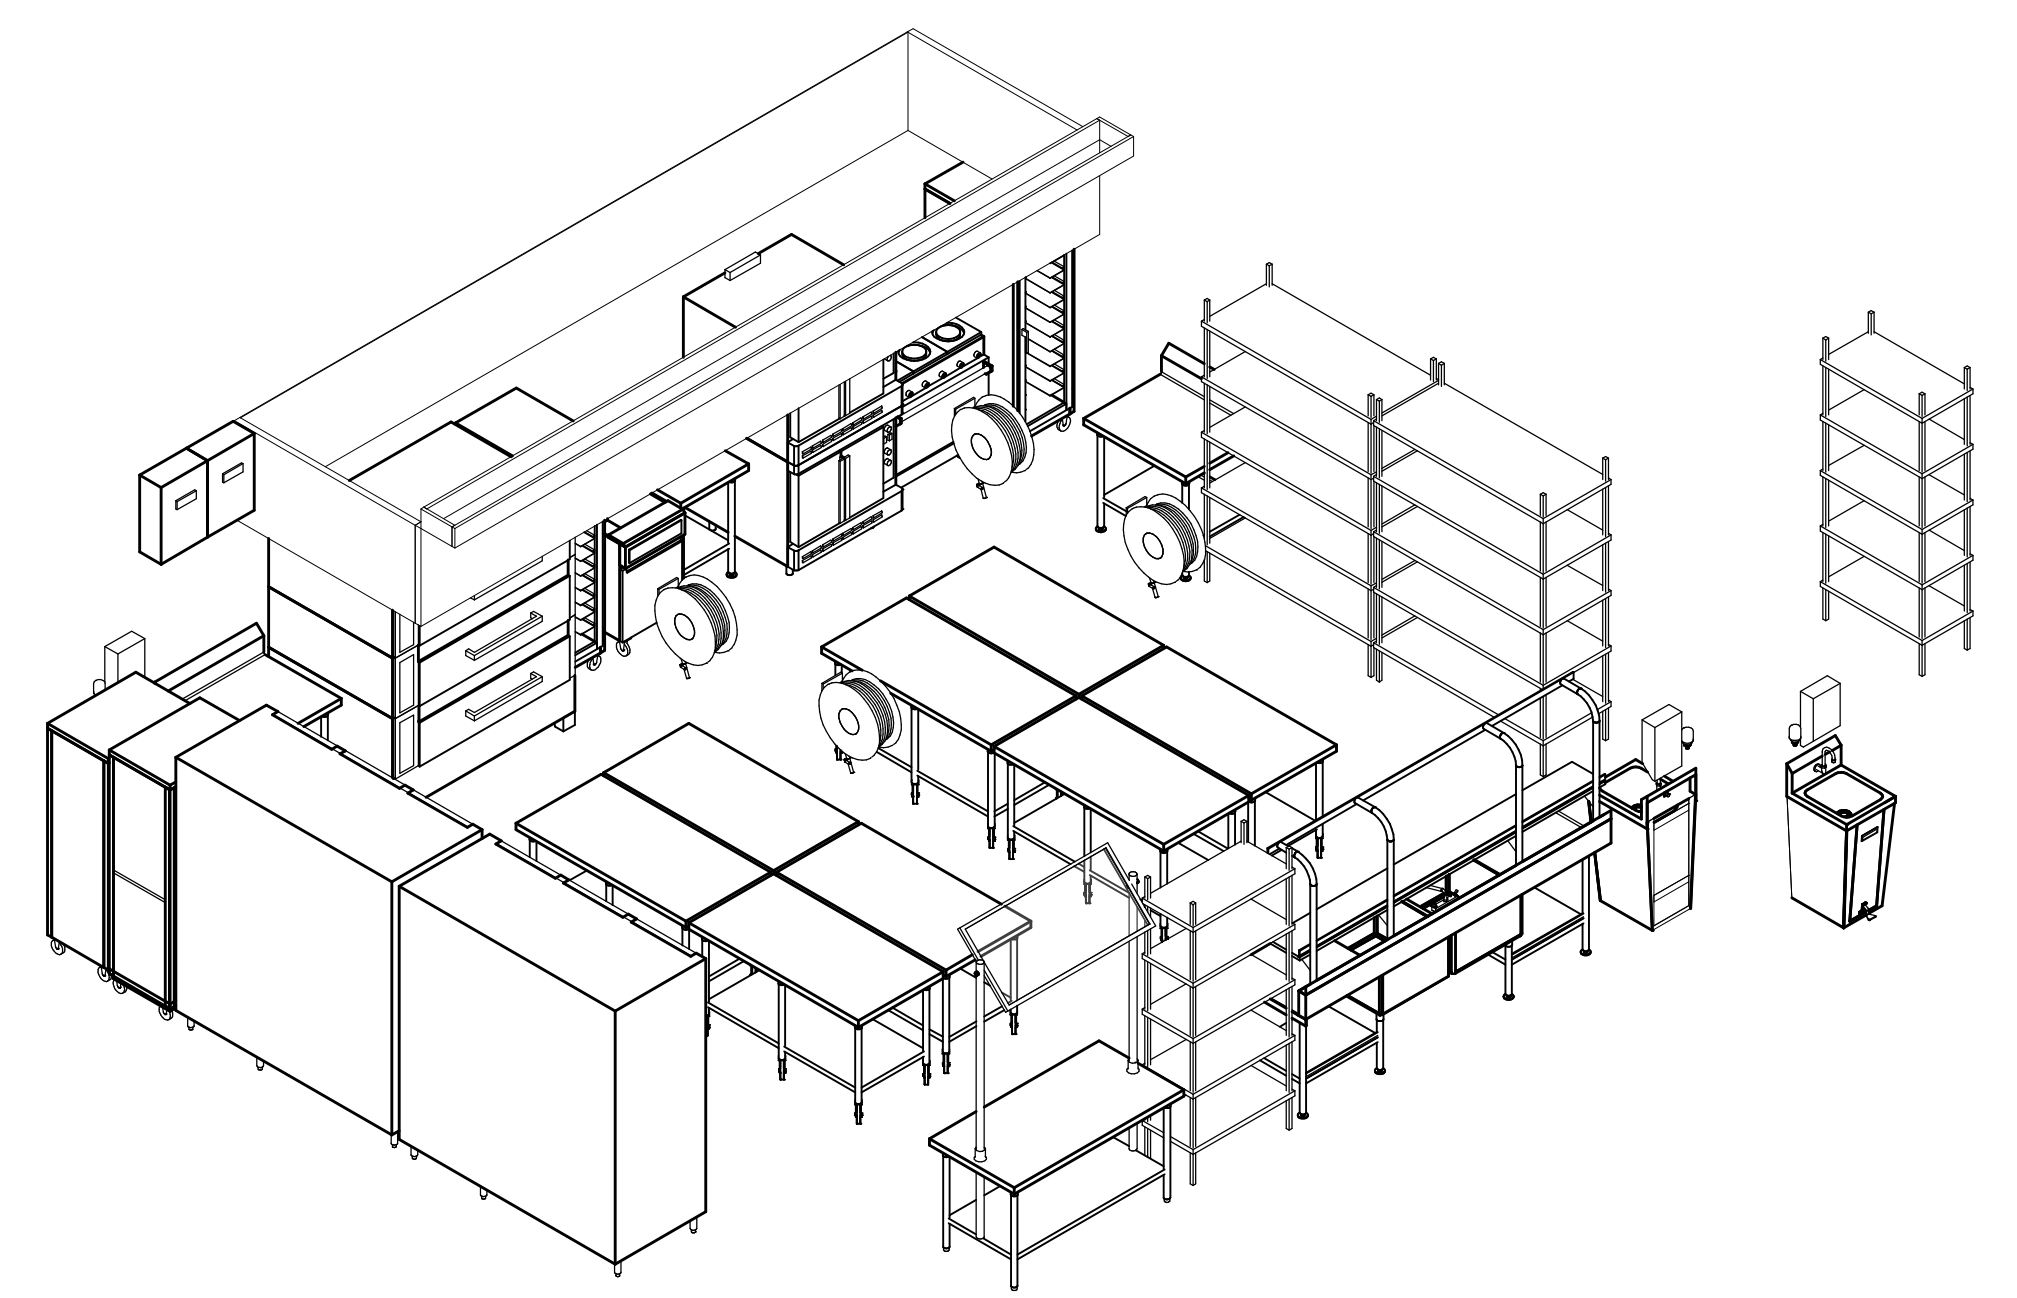

3 FS FACILITY MODEL

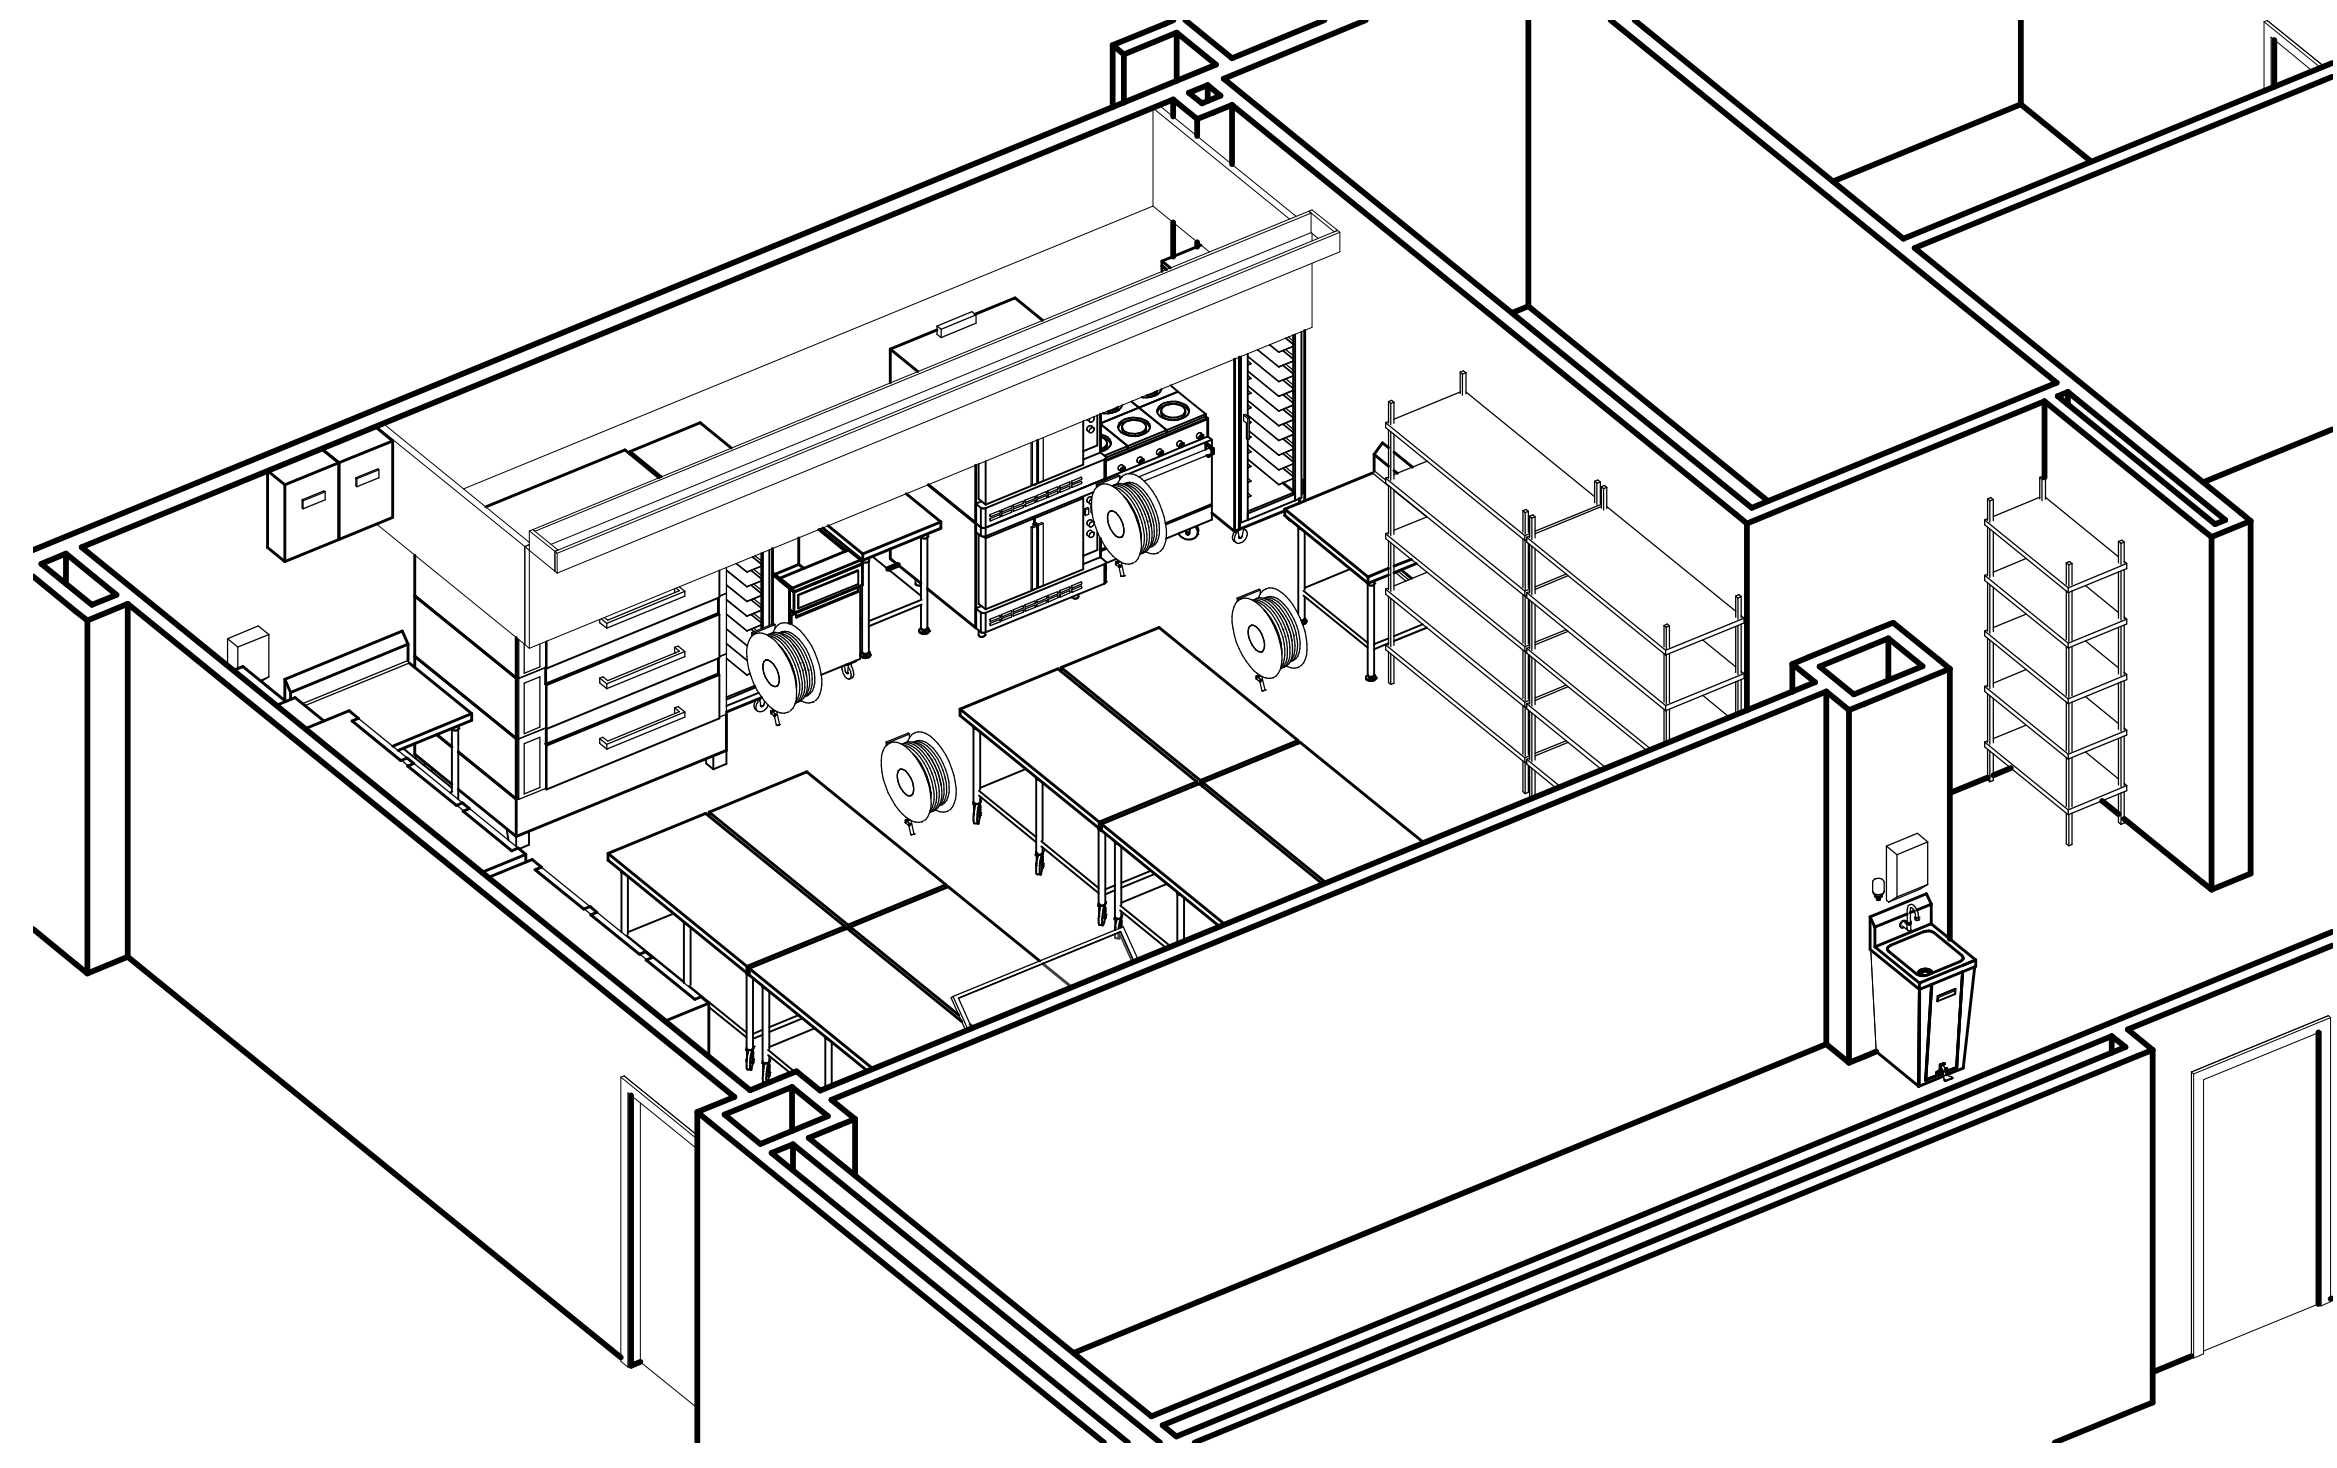



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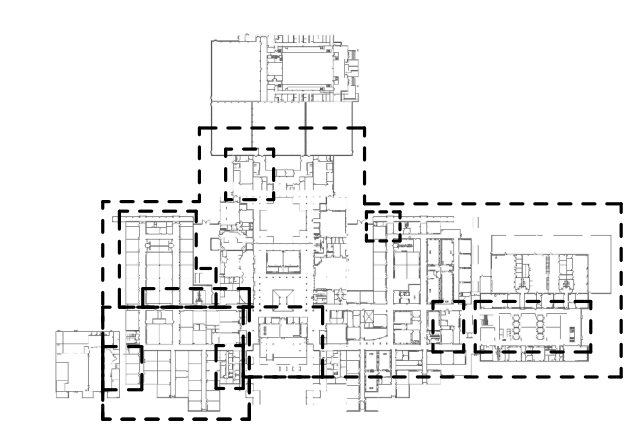
PROFESSIONAL SEAL:

A PROJECT FOR:

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HIGH SCHOOL
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SCHOOL
RENOVATIONS

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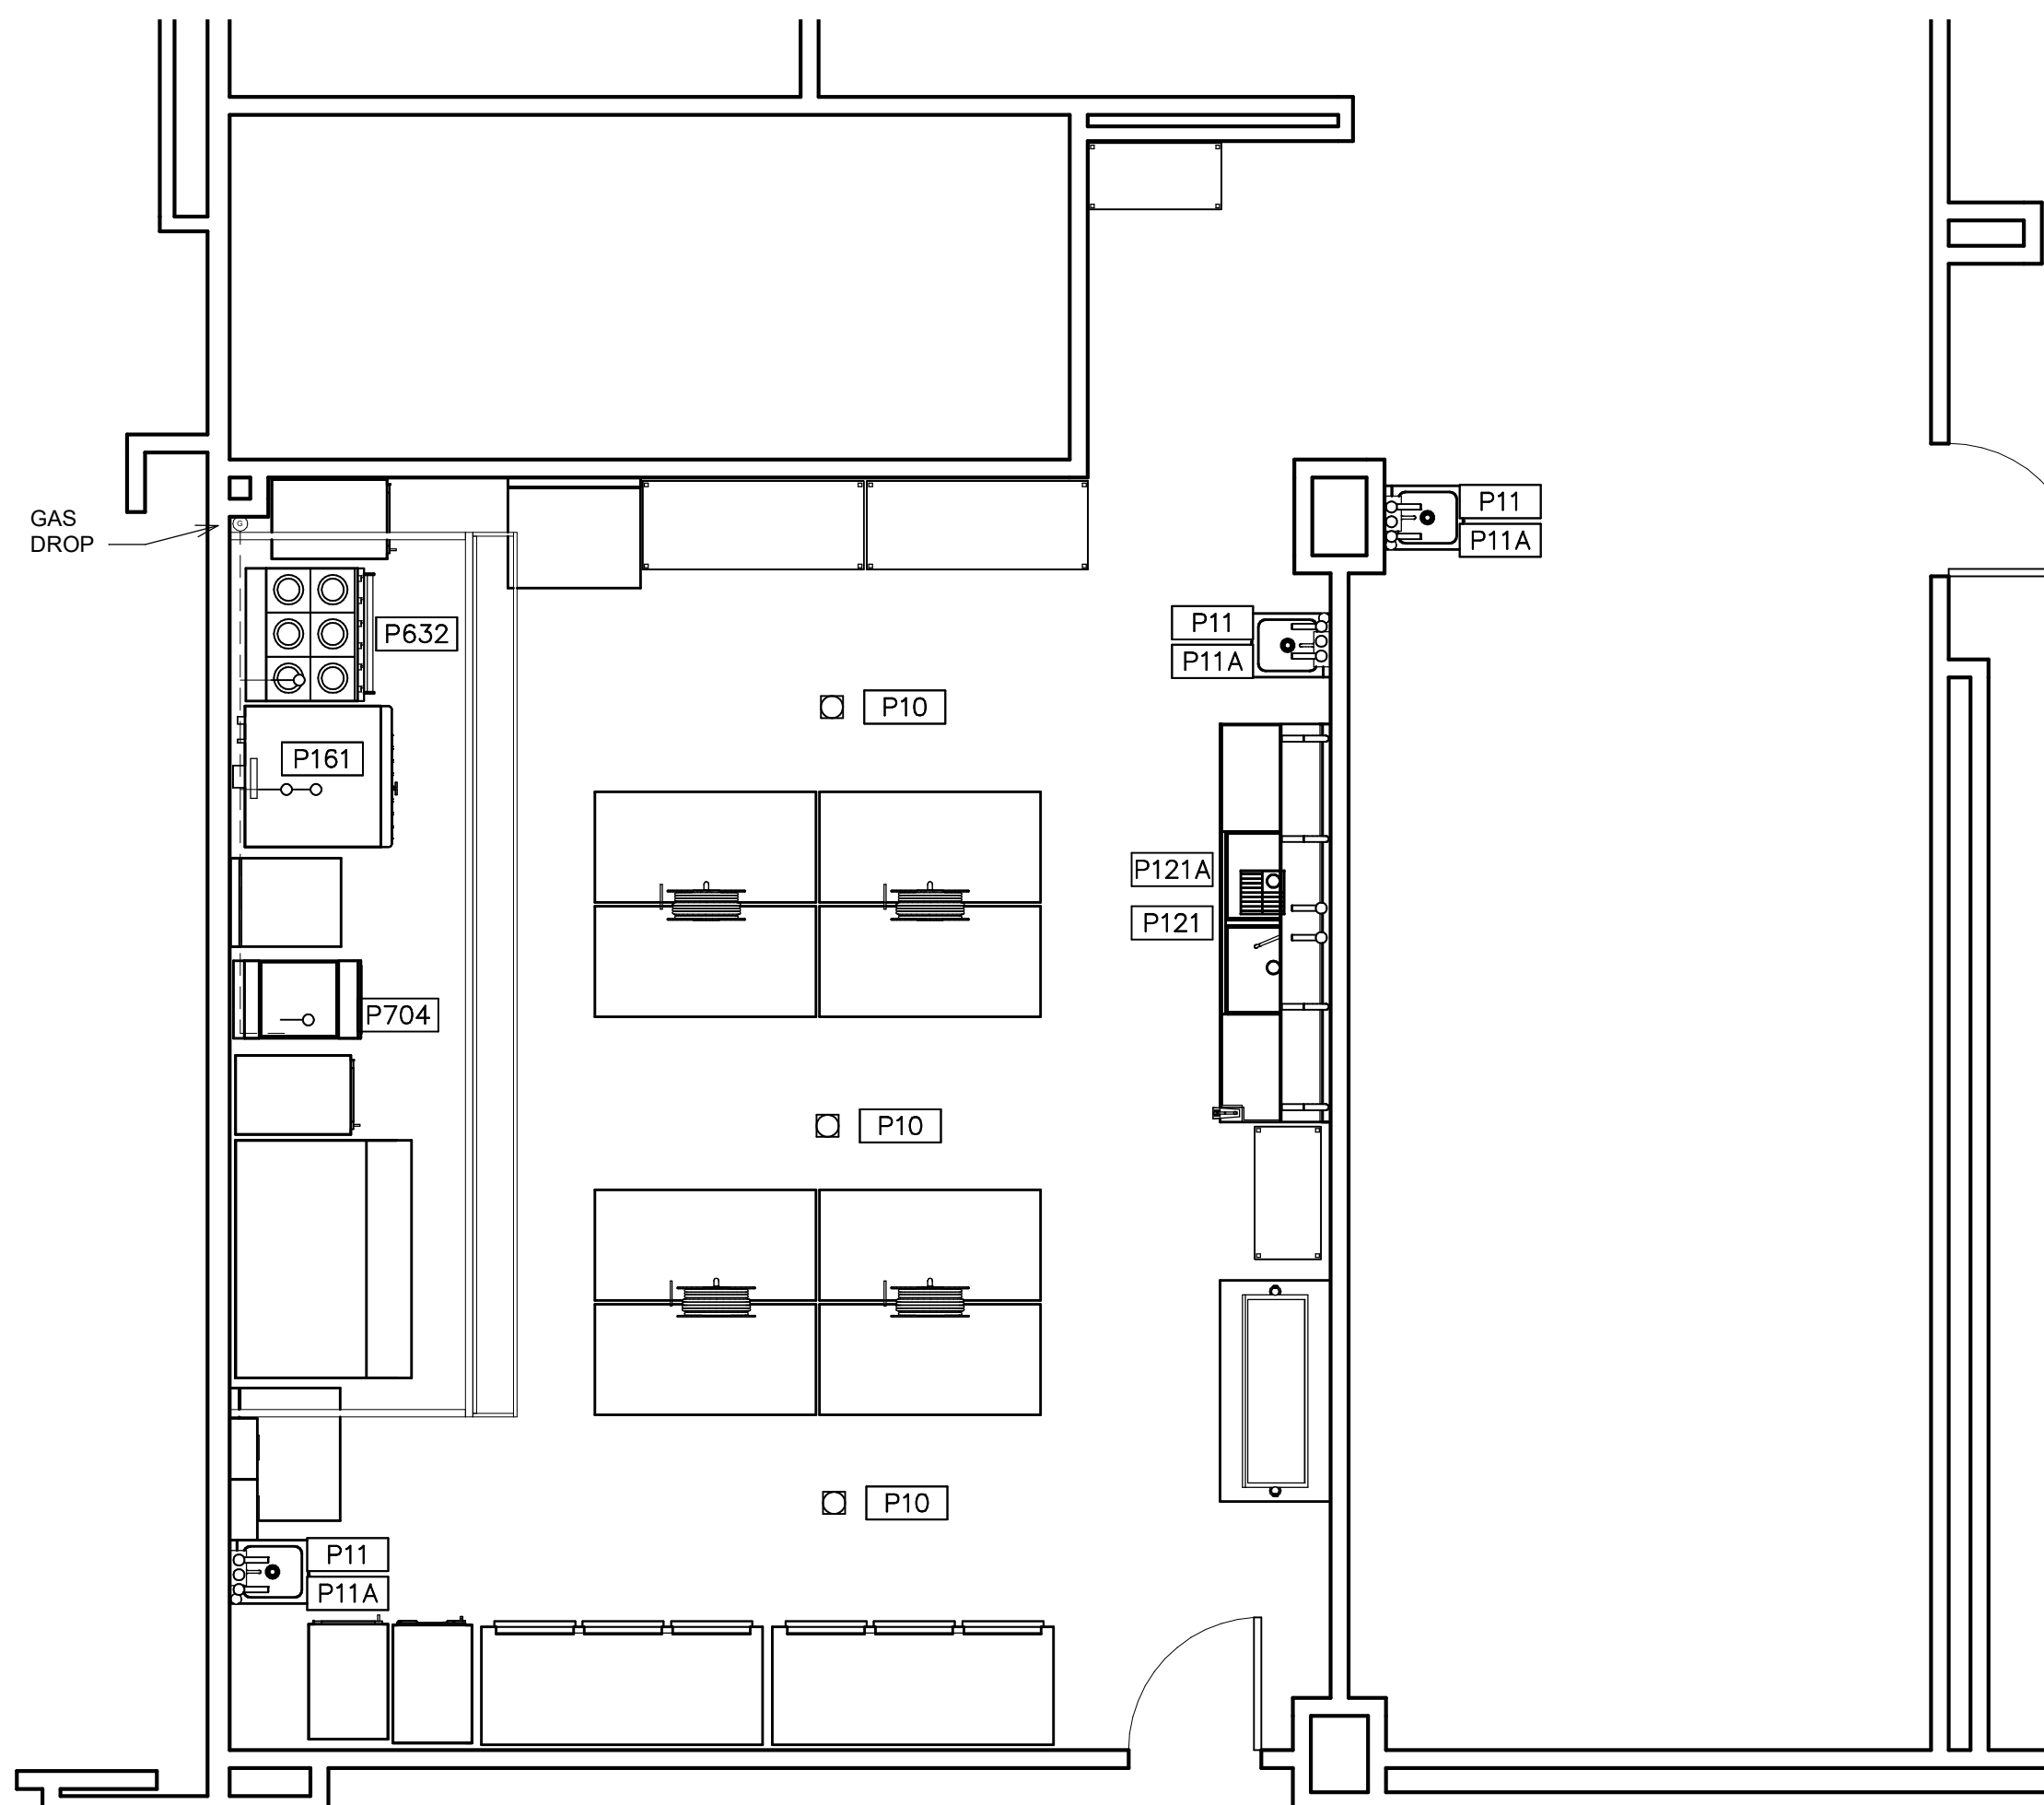
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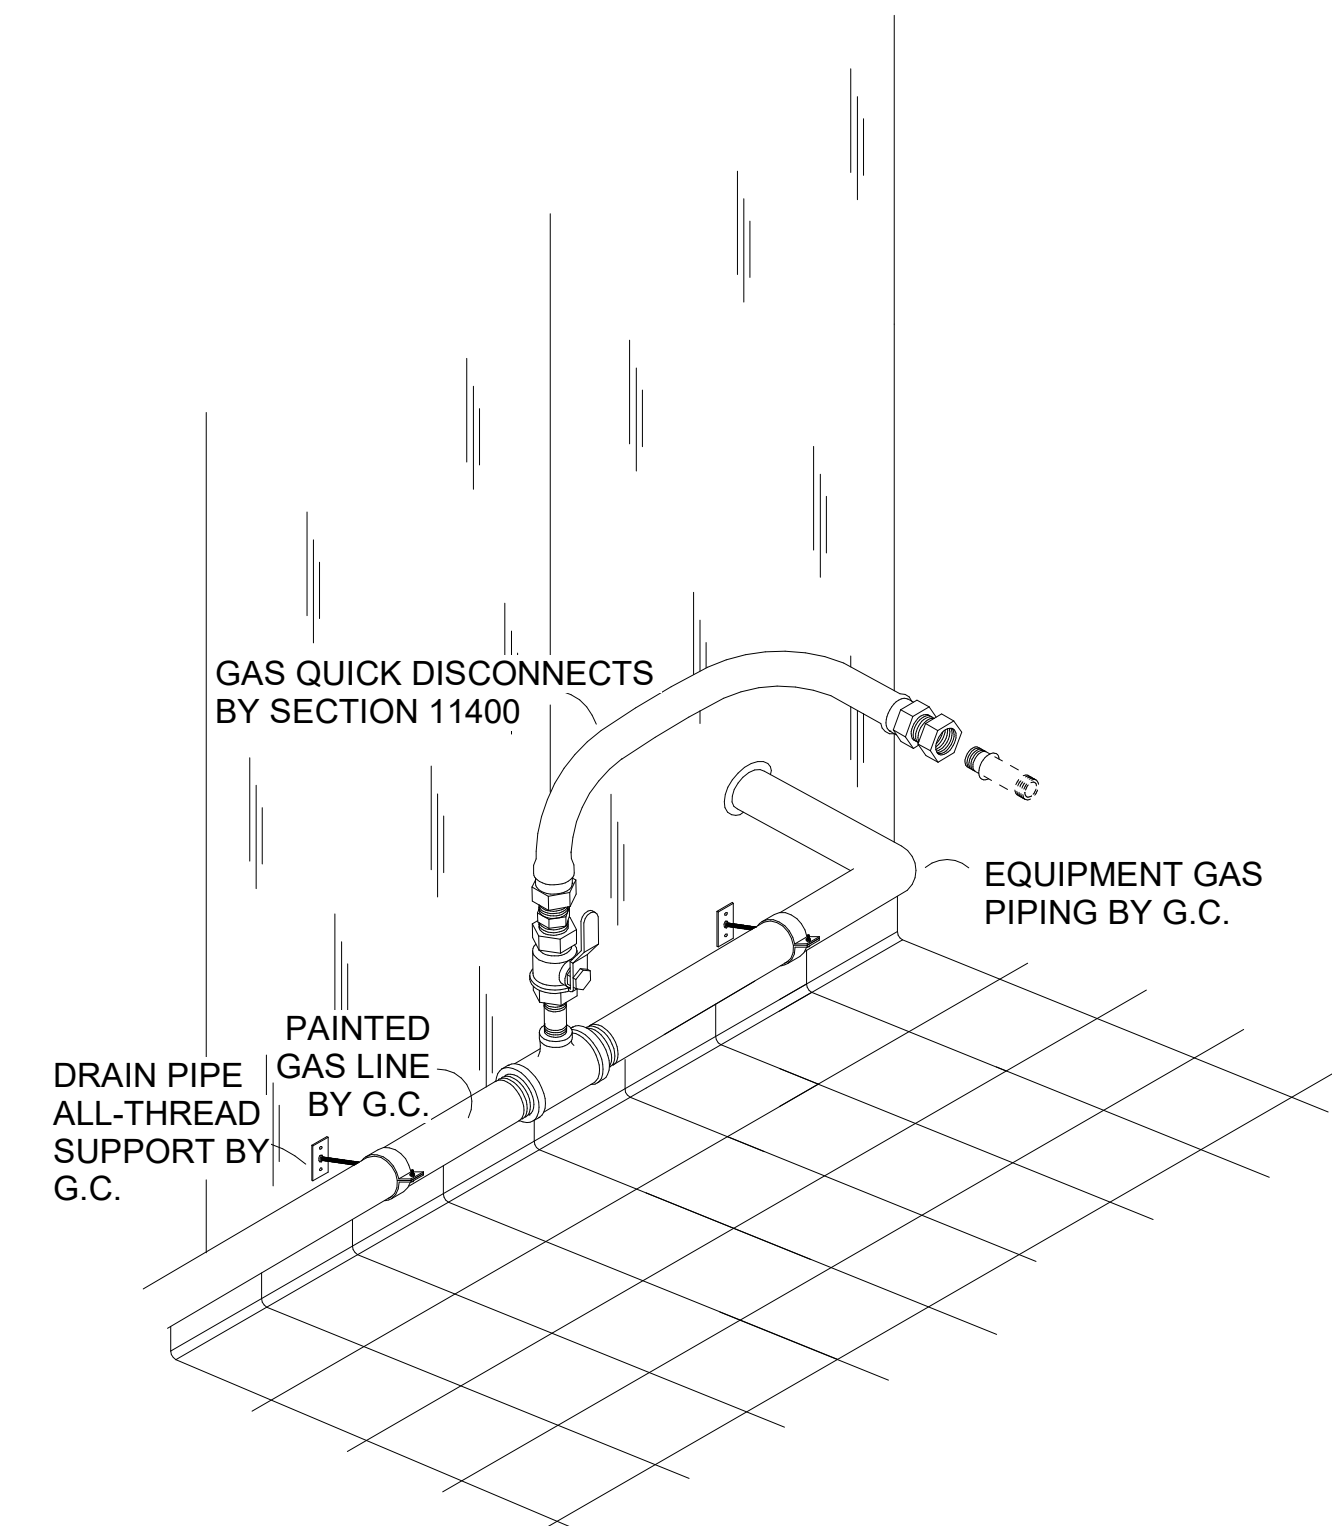
KEY PLAN
TRUE NORTH
PLAN NORTH

Project Number	19006-A
Drawn By	LT
Checked By	AW
Approved By	MS
Drawing Title	FS PLUMBING PLAN
Drawing Number	K2


FOODSERVICE PLUMBING SCHEDULE						
FDP PNO	FDP PSIZE	FDP PCONN	FDP PSERVICE TO	FDP PLOC	FDP PAFF	FDP PREMARKS
P10	VERIFY	FLOOR DRAIN	GENERAL AREA DRAIN	FLOOR	VERIFY	LOCATE PER ENGINEER'S DRAWING
P11	1/2"	H & C WATER	FAUCET	WALL	18"	FURNISHED BY SECTION 11 40 00; INSTALLED BY DIV. 22
P11A	1 1/2"	DIRECT DRAIN	HAND SINK	WALL	15"	FURNISHED BY SECTION 11 40 00; INSTALLED BY DIV. 22
P121	3/4"	H & C WATER	FAUCET	WALL	13"	BTC: RE: NOTE #3
P121A	12" SQ.	FLOOR SINK	SINK	FLOOR	0"	3/4 GRATE - RE: NOTE #4
P161	(2)3/4"	NATURAL GAS	CONVECTION OVEN	WALL	18"/36"	BTC: RE: NOTE #3 & #9 - 50 MBTU/HR EACH
P632	3/4"	NATURAL GAS	RANGE	WALL	18"	BTC: RE: NOTE #3 & #9 - 215MBTU/HR
P704	3/4"	NATURAL GAS	FRYER	WALL	24"	BTC: RE: NOTE #3 & #9 122 MBTU /HR EACH



4 FOODSERVICE PLUMBING CONNECTION
PLAN
1/4" = 1'-0"



7 GAS DISCONNECT DETAIL
N.T.S.

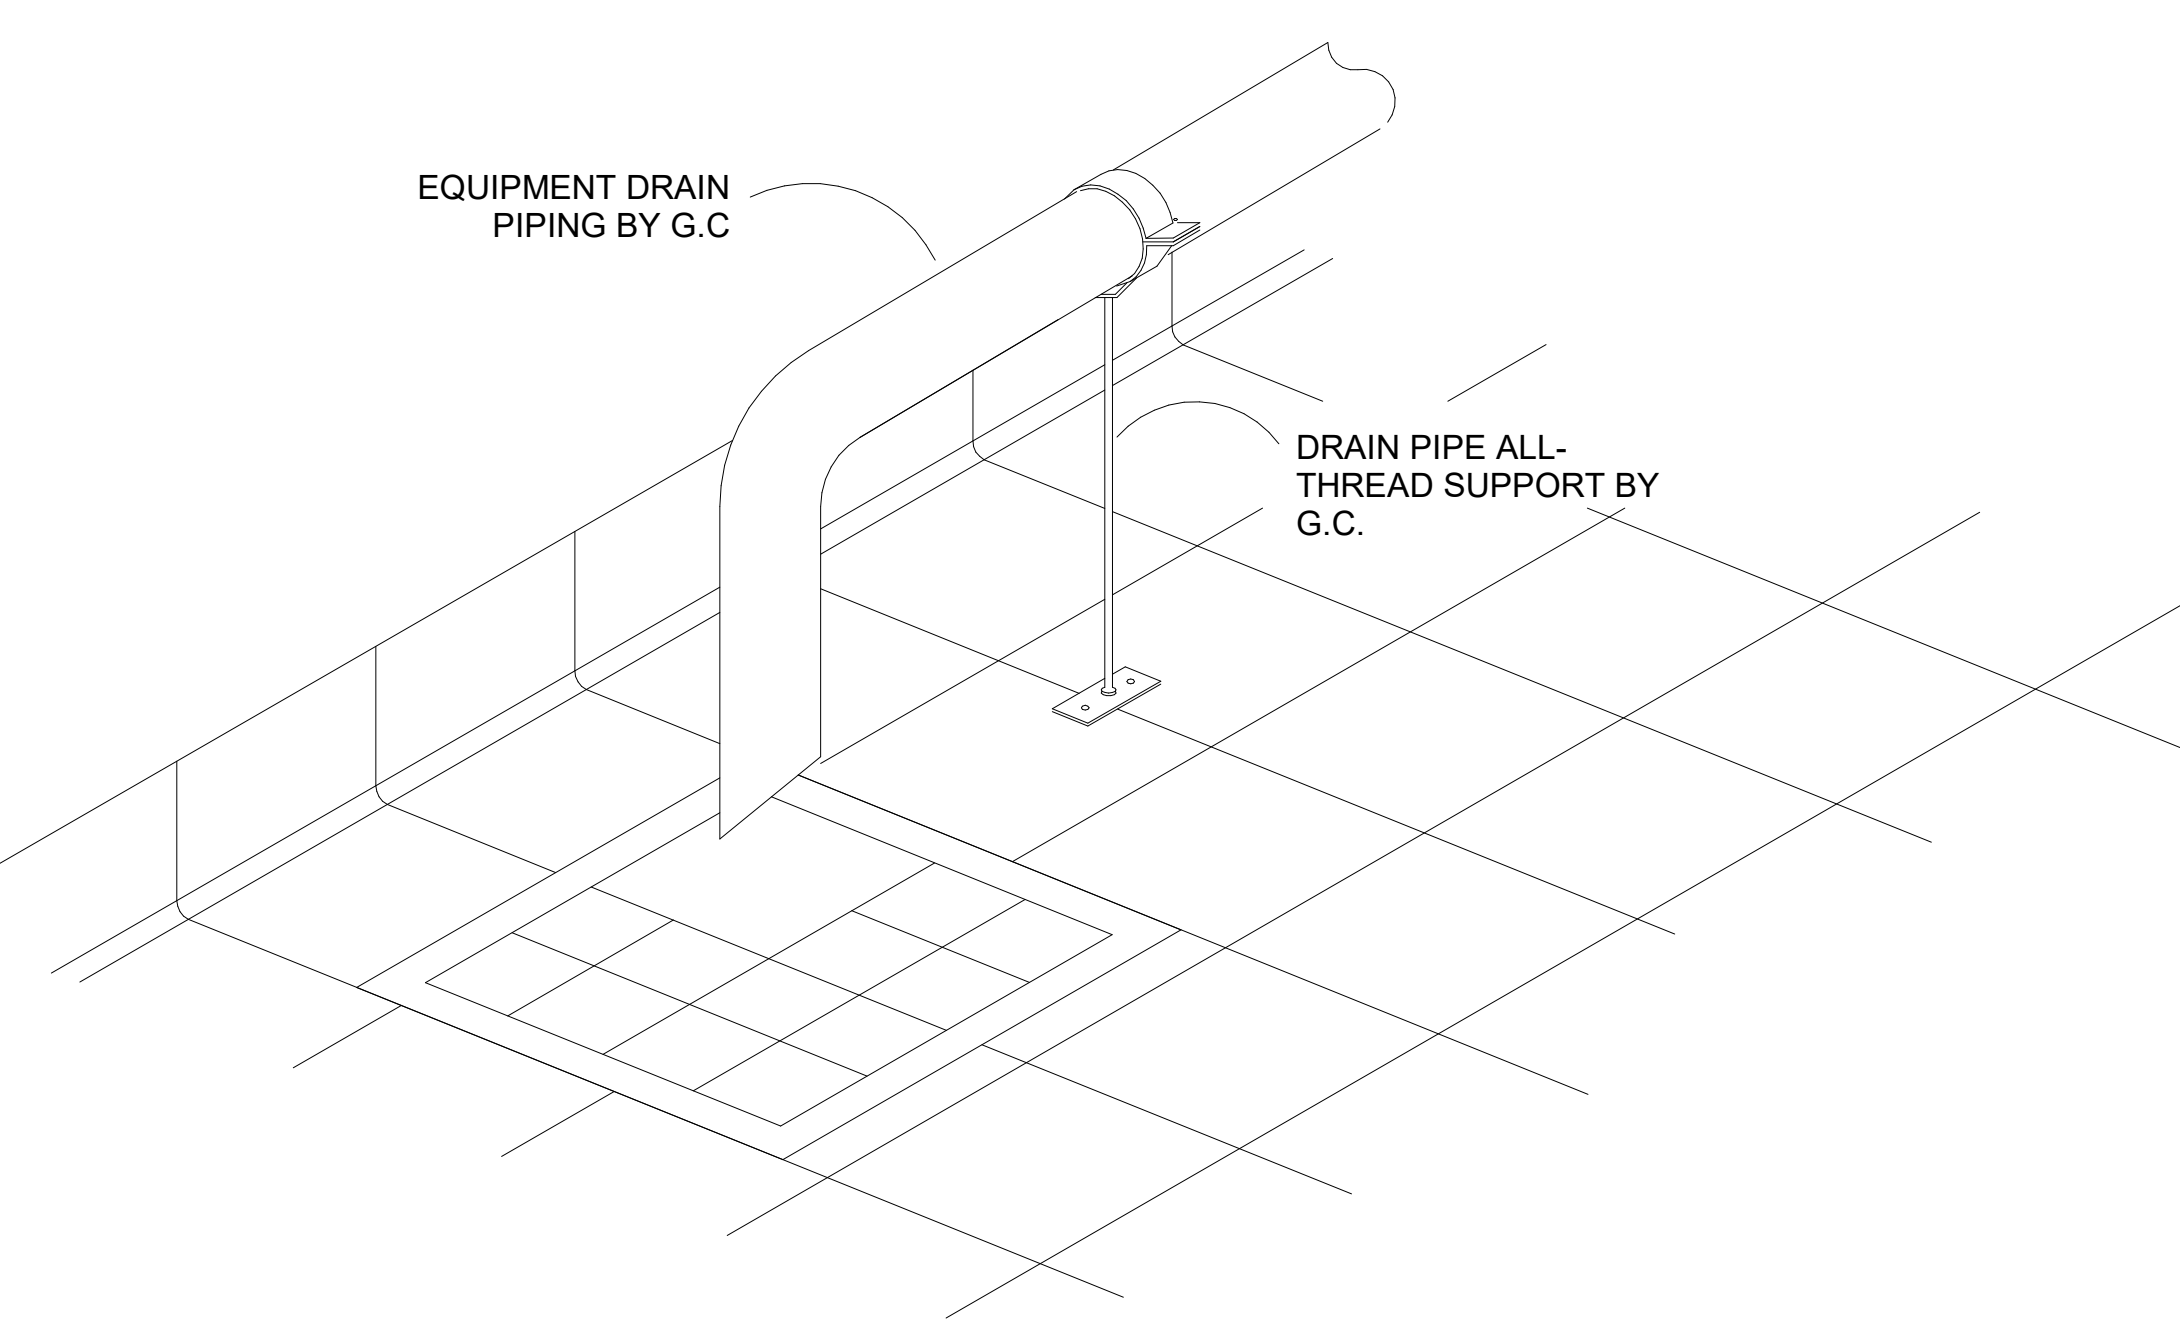

6 DRAIN PIPING FASTENER DETAIL
N.T.S.

PLUMBING SYMBOLS			
HW	HOT WATER	IW	INDIRECT WASTE (EXTEND TO F.D.)
CW	COLD WATER	FFD	FUNNEL FLOOR DRAIN
HTW	180 F HOT WATER	EVC	EXHAUST VENT CONNECTION
CWS	CHILLED WATER	SVC	SUPPLY VENT CONNECTION
C	GAS SUPPLY	FR	DIRECT-CONNECTED FLUE RISER
SS	STEAM SUPPLY	PS	PIPE SLEEVE
CR	CONDENSATE RETURN	AFF	ABOVE FINISHED FLOOR
DR	DRAIN	ST	STUB UP/OUT
FD	FLOOR DRAIN	BTC	BRANCH TO CONN. ON EQUIP
FS	FLOOR SINK	DFA	DROP FROM ABOVE

3 PLUMBING SYMBOLS
NONE

NOTE: WATER AND DRAIN CONNECTIONS INDICATED ARE THOSE REQUIRED FOR THE FOODSERVICE EQUIPMENT AND THOSE REQUIRED FOR SUPPORT EQUIPMENT FURNISHED BY DIVISION 22. FOR ADDITIONAL WATER AND DRAIN REQUIREMENTS REFER TO MECHANICAL DRAWINGS.

NOTE: REFER TO ELECTRICAL/MECHANICAL DRAWINGS FOR REQUIREMENTS OF EXHAUST FANS AND MAKE-UP AIR HANDLERS AND LOCATION OF AN INTERLOCK AND START/STOP CONTROLS TO BE LOCATED WITHIN FOODSERVICE AREA BY DIVISION 22.

2 PLUMBING COORDINATION NOTES
N.T.S.

- DO NOT ROUGH-IN FROM THIS DRAWING. REFER TO THE FOODSERVICE EQUIPMENT SUPPLIER'S DIMENSIONED SHOP DRAWINGS.
- DIMENSIONS INDICATED ARE TO BE VERIFIED BY FOODSERVICE EQUIPMENT SUPPLIER AND ADJUSTED AS REQUIRED BY EQUIPMENT AND/OR FIELD CONDITIONS.
- ACCESSORIES PROVIDED LOOSE WITH FOODSERVICE EQUIPMENT BY SECTION 11 40 00 TO BE FIELD INSTALLED BY DIVISION 22.
- DRAINAGE AND PIPING SYSTEMS TO BE CLEANED PRIOR TO FINAL CONNECTION WITH FOODSERVICE EQUIPMENT.
- HAND LAVATORY PROVIDED BY SECTION 11 40 00 AND INSTALLED BY DIVISION 22. DW. 22 TO PROVIDE HOT WATER TEMPERING VALVE, IF REQ'D.
- JANITOR SINK/FAUCET PROVIDED AND INSTALLED BY DIVISION 22.
- INTERCONNECTION OF 1/2" CW TO PRE-RINSE AND DISPOSER'S CONE/BODY INLETS PIPED THRU SOLENOID AND VACUUM BREAKER BY DIVISION 22.
- ENGINEER TO VERIFY W/ LOCAL CODE TO BYPASS OR PIPE THRU GREASE TRAP AND/OR INTERCEPTOR.
- 6" W.C. AT EQUIPMENT. MECHANICAL GAS SHUT-OFF VALVE BY SECTION 11 40 00. FINAL CONNECTION TO EQUIPMENT AND INSTALLATION OF MECHANICAL GAS VALVE BY DIVISION 22.
- ALL EXHAUST HOOD CONNECTIONS AND CONDENSATE CONNECTIONS FURNISHED INSTALLED BY DIVISION 22.
- ALL EXPOSED FIRE SYSTEM PIPING TO BE CHROME PLATED OR STAINLESS STEEL.
- NUMBER NOT USED.
- ALL PIPING WITHIN COUNTER BODY OR UNDER FABRICATED COUNTERS TO BE RUN TO A CONNECTION POINT BELOW COUNTER BODY BY SECTION 11 40 00. FINAL CONNECTION BY DIVISION 22.
- NUMBER NOT USED.
- QUICK DISCONNECTS TO BE SUPPLIED BY SECTION 11 40 00 WALL GAS & WATER EQUIPMENT.
- PROTECTIVE DEVICES TO PROTECT AGAINST BACK FLOW. BACK SYPHONAGE SHALL BE INSTALLED AT ALL FIXTURES AND EQUIPMENT WHERE BACKFLOW AND/OR BACKSYPHONAGE MAY OCCUR AND WHERE A MINIMUM AIR GAP CANNOT BE PROVIDED BETWEEN THE WATER TO THE FIXTURE OR EQUIPMENT AND ITS FLOODLEVEL. RM. TO BE PROVIDED AND INSTALLED BY DIVISION 22. VACUUM BREAKERS, WHEN FURNISHED WITH EQUIPMENT, SHALL OVERRIDE ABOVE, IF ACCEPTABLE WITH APPLICABLE CODES, BUT DIV. 22 TO PIPE WHEN NOT PREPARED BY FACTORY. INTERCONNECT THRU WATER FILTER TO EQUIPMENT BY DIVISION 22.
- BACKFLOW PREVENTION BY DIVISION 22

1 PLUMBING GENERAL NOTES
NONE



3/13/2020 1:05:27 PM



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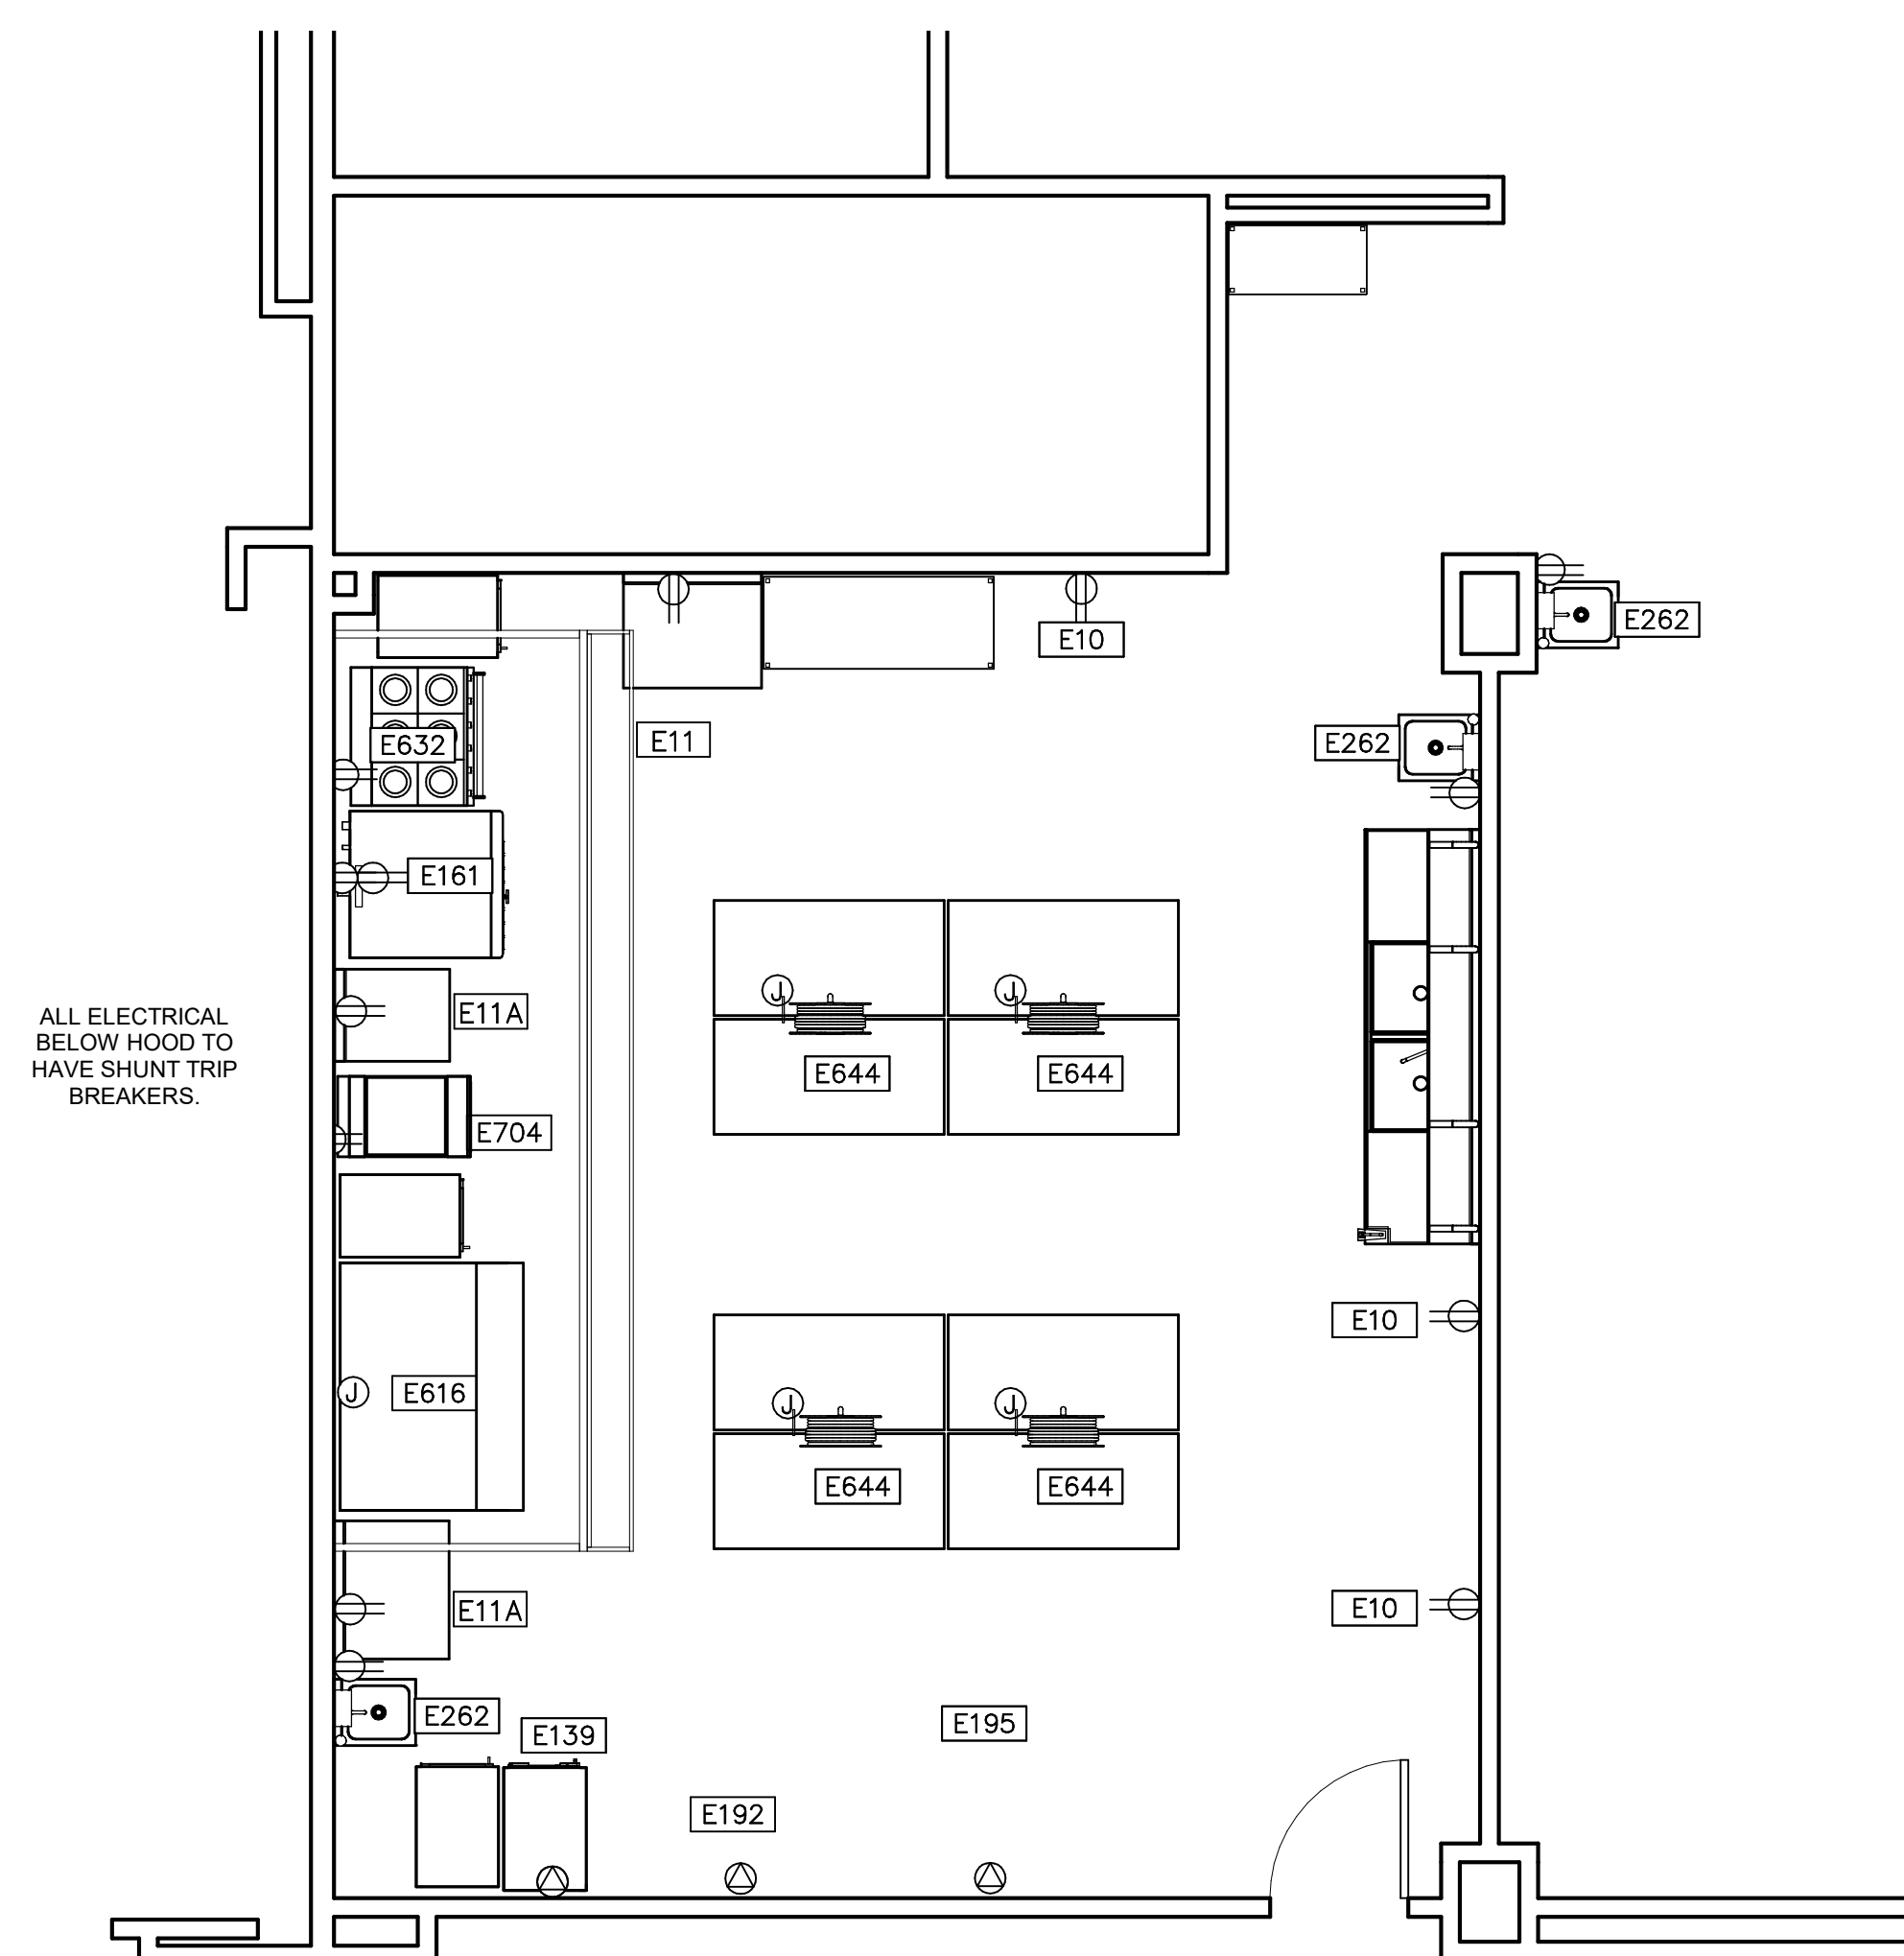
PROFESSIONAL SEAL:

A PROJECT FOR:

STAFFORD
HIGH SCHOOL
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SCHOOL
RENOVATIONS

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#	Date	ISSUED FOR
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ALL ELECTRICAL BELOW HOOD TO HAVE SHUNT TRIP BREAKERS.

FOODSERVICE ELECTRICAL CONNECTION PLAN
1/4" = 1'-0"

FOODSERVICE ELECTRICAL SCHEDULE								
FDP ENO	FDP ECONN	FDP ELOAD	FDP EVOLT	FDP EPH	FDP ESERVICE TO	FDP ELOC	FDP EAFF	FDP EREMARKS
E10	DR	16.0A	120	1	CONVENIENCE OUTLET	WALL	24"	---
E11	DR	16.0A	120	1	CONVENIENCE	WALL	47"	MOUNT HORIZONTAL
E11A	DR	16.0A	120	1	CONVENIENCE	WALL	47"	SHUNT TRIP BREAKER BY DIV. 26
E139	SR	15.0A	120	1	MOBILE HEATED CABINET	WALL	47"	---
E161	(2)DR	7.7A EA.	120	1	CONVECTION OVEN	WALL	24"/48"	SHUNT TRIP BREAKER
E192	SR	10.7A	120	1	REACH-IN REFRIGERTOR	WALL	90"	---
E195	SR	16.0A	120	1	FREEZER	WALL	90"	---
E262	DR	16.0A	120	1	HAND SINK EYE	WALL	24"	MOUNT HORIZONTAL
E616	JB	65.0A	220	3	DECK OVEN	WALL	24"	BTC; RE: NOTE #4 & #6
E632	DR	4.0A	120	1	6 BURNER RANGE	WALL	24"	SHUNT TRIP BREAKER
E644	JB	16.0A	120	1	EQUIPMENT	CLG	VERIFY	BTC; PROVIDED AND INSTALLED BY DIV. 26
E704	DR	16.0A	120	1	FRYER	WALL	24"	SHUNT TRIP BREAKER PROVIDED AND INSTALLED BY DIVISION 26

SCR	CONDUIT STUB BTC ON RECEPT FURNISH WITH EQUIPMENT	CC	CONDUIT FOR COMPUTER CABLES
CS	CONDUIT STUB UP/OUT FOR DIRECT CONNECTION	BTC	BRANCH TO CONNECTION ON EQUIPMENT
DR	20 AMP DUPLEX RECEPTACLE (MOUNT HORIZONTAL)	WPR	20 AMP WEATHERPROOF RECEPTACLE (SPRING COVER)
SR	SINGLE PURPOSE RECEPTACLE	FPB	FIRE PROTECTION BUZZER
SR	SINGLE PURPOSE RECEPT. 20V 1PH	BSC	BEVERAGE SYSTEM CONDUIT
FR	FLUSH FLOOR RECEPTACLE	DFA	DROP FROM ABOVE
PMR	PEDESTAL MOUNTED RECEPTACLE	AFF	ABOVE FINISH FLOOR
DCR	DROP CORD RECEPTACLE	CSJB	JUNCTION BOX ON PEDSTAL
JB	JUNCTION BOX ON CEILING	DS	DISCONNECT SWITCH
JB	JUNCTION BOX IN WALL		
JB/DS	JUNCTION BOX WITH DISCONNECT BY DIV.26	JB/DS	CONDUIT STUB-UP WITH DISCONNECT BY DIV.26

NOTE: ELECTRICAL CONNECTIONS INDICATED ARE THOSE REQUIRED FOR THE FOODSERVICE EQUIPMENT AND THOSE REQUIRED FOR SUPPORT EQUIPMENT FURNISHED BY DIVISION 26. FOR ADDITIONAL REQUIREMENTS REFER TO ELECTRICAL ENGINEER'S DRAWINGS.


3 ELECTRICAL SYMBOLS
NONE

2 ELECTRICAL COORDINATION NOTES
NTS

- DO NOT ROUGH-IN FROM THIS DRAWING. REFER TO THE CONTRACTOR'S DIMENSIONED DRAWINGS.
- VERIFY ALL ELECTRICAL CHARACTERISTICS WITH ENGINEERING DRAWINGS.
- DIMENSIONS INDICATED ARE TO BE VERIFIED BY CONTRACTOR AND ADJUSTED AS REQUIRED BY FOODSERVICE EQUIPMENT AND/OR FIELD CONDITIONS.
- ACCESSORIES AND FITTINGS PROVIDED LOOSE WITH FOODSERVICE EQUIPMENT BY SECTION 11 40 00. FIELD INSTALLED BY DIVISION 26.
- STAINLESS STEEL DISCONNECT SWITCH PROVIDED AND INSTALLED BY DIVISION 26.
- ALL ELECTRICAL CONNECTIONS BENEATH EXHAUST HOOD TO EXTEND TO SHUNT TRIP BREAKERS WITHIN ELECTRICAL PANEL BOX FOR SHUT-DOWN DURING FIRE MODE - BY DIVISION 26.
- N/A

- N/A
- INTERCONNECT TO EXHAUST HOOD FAN(S) AND SWITCH BY DIVISION 26.
- INTERCONNECT TO EXHAUST HOOD LIGHT(S) AND SWITCH BY DIVISION 26.
- INTERCONNECT FIRE PROTECTION SYSTEM TO PANEL BOX SHUNT TRIP(S) AND BUILDING ALARM - BY DIVISION 26.

1 ELECTRICAL GENERAL NOTES
NONE

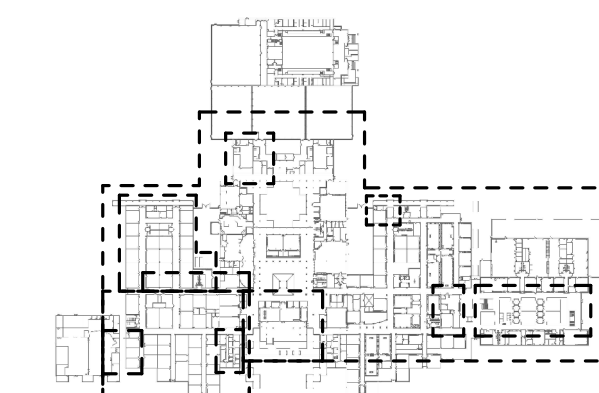

KEY PLAN
TRUE NORTH
PLAN NORTH

Project Number	19006-A
Drawn By	LT
Checked By	AW
Approved By	MS
Drawing Title	

FS ELECTRICAL PLAN

Drawing Number
K3





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- STRUCTURAL ENGINEERS
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713-337-8881
- FOODSERVICE
FOODSERVICE DESIGN PROFESSIONALS
281-350-2323



PROFESSIONAL SEAL:

A PROJECT FOR:

**STAFFORD
HIGH SCHOOL
& MAGNET
SCHOOL
RENOVATIONS**

1625 STAFFORDSHIRE
ROAD,
STAFFORD, TX 77477


#	Date	ISSUED FOR
1	3-13-2020	ISSUE FOR BID, PERMIT & CONSTRUCTION

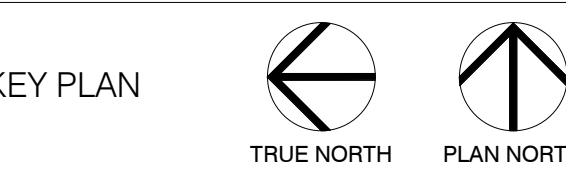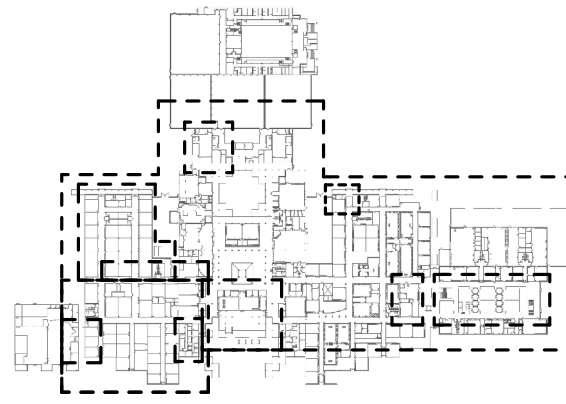


Project Number	19006-A
Drawn By	LT
Checked By	AW
Approved By	MS
Drawing Title	

FS ELEVATIONS


Drawing Number **K4**

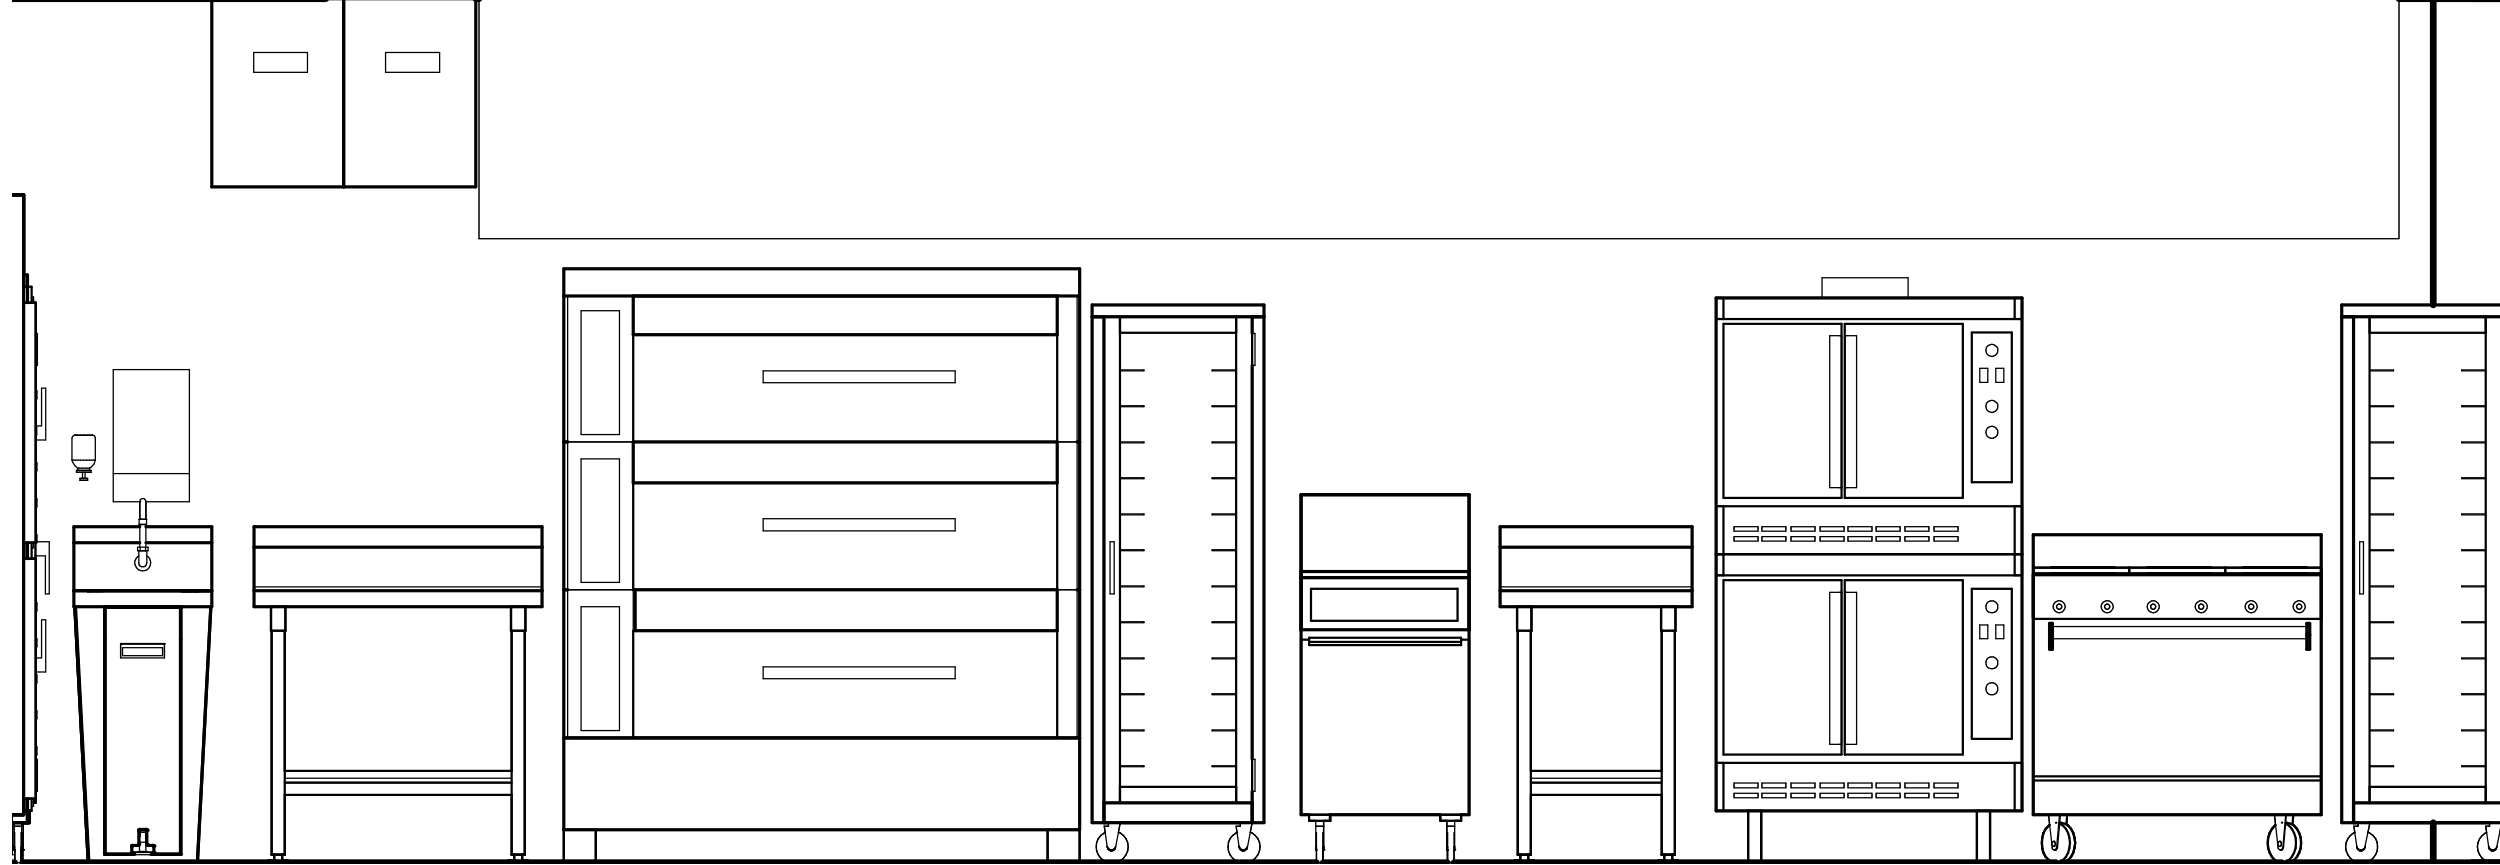


③ ELEVATION @ PRODUCTION LINE
1/2" = 1'-0"

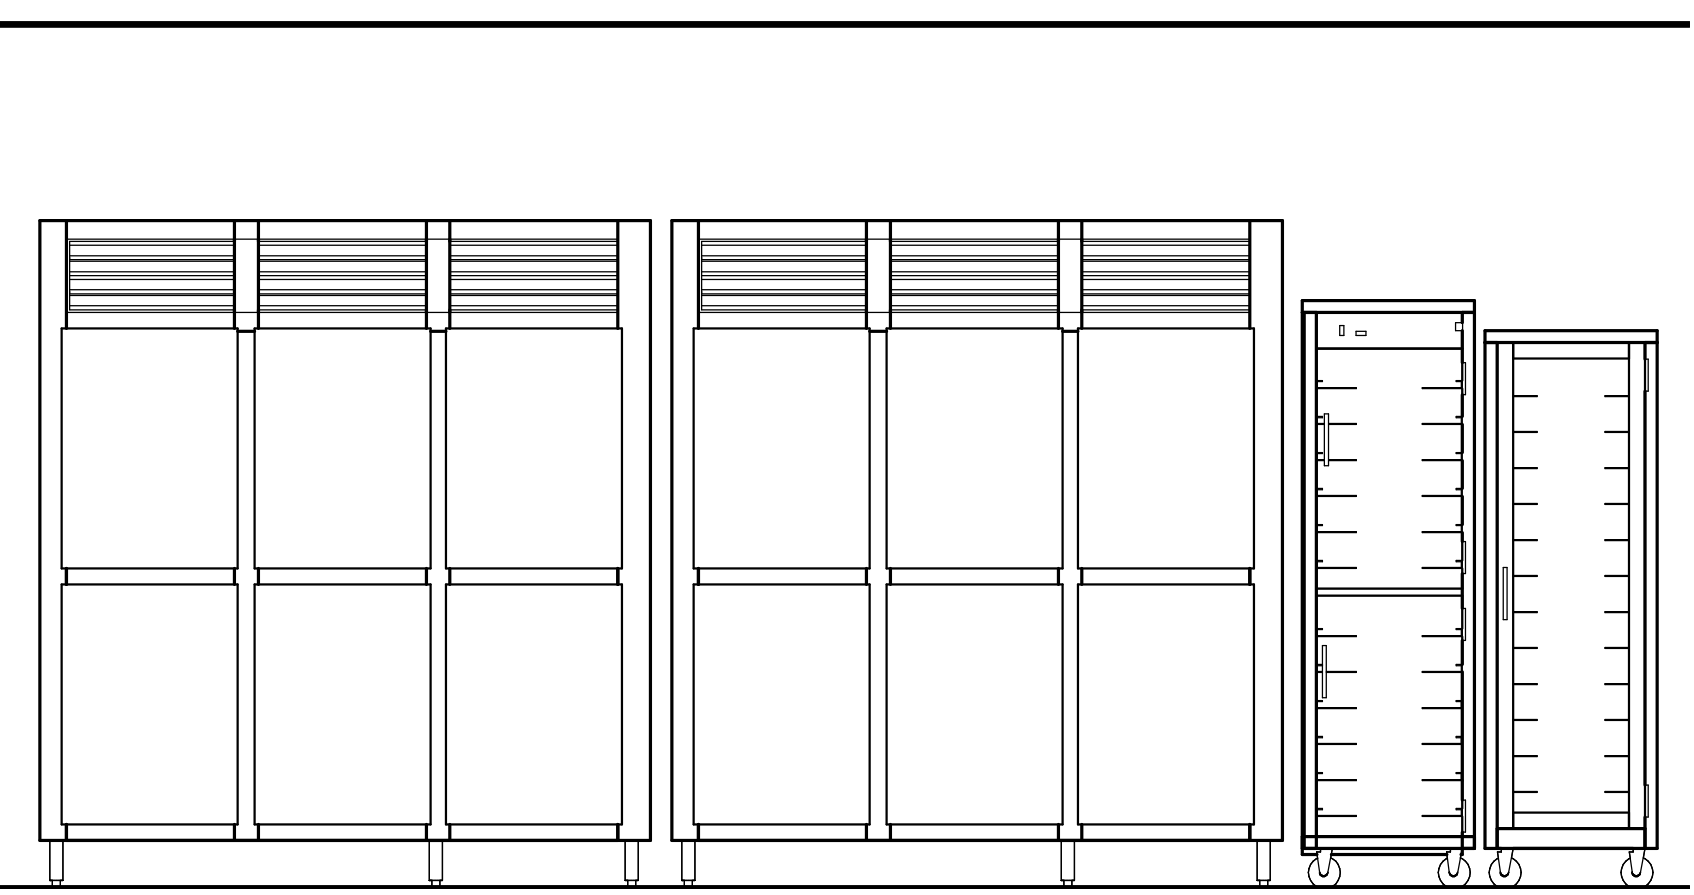


⑤ ELEVATION @ HOLDING CABINETS
1/2" = 1'-0"

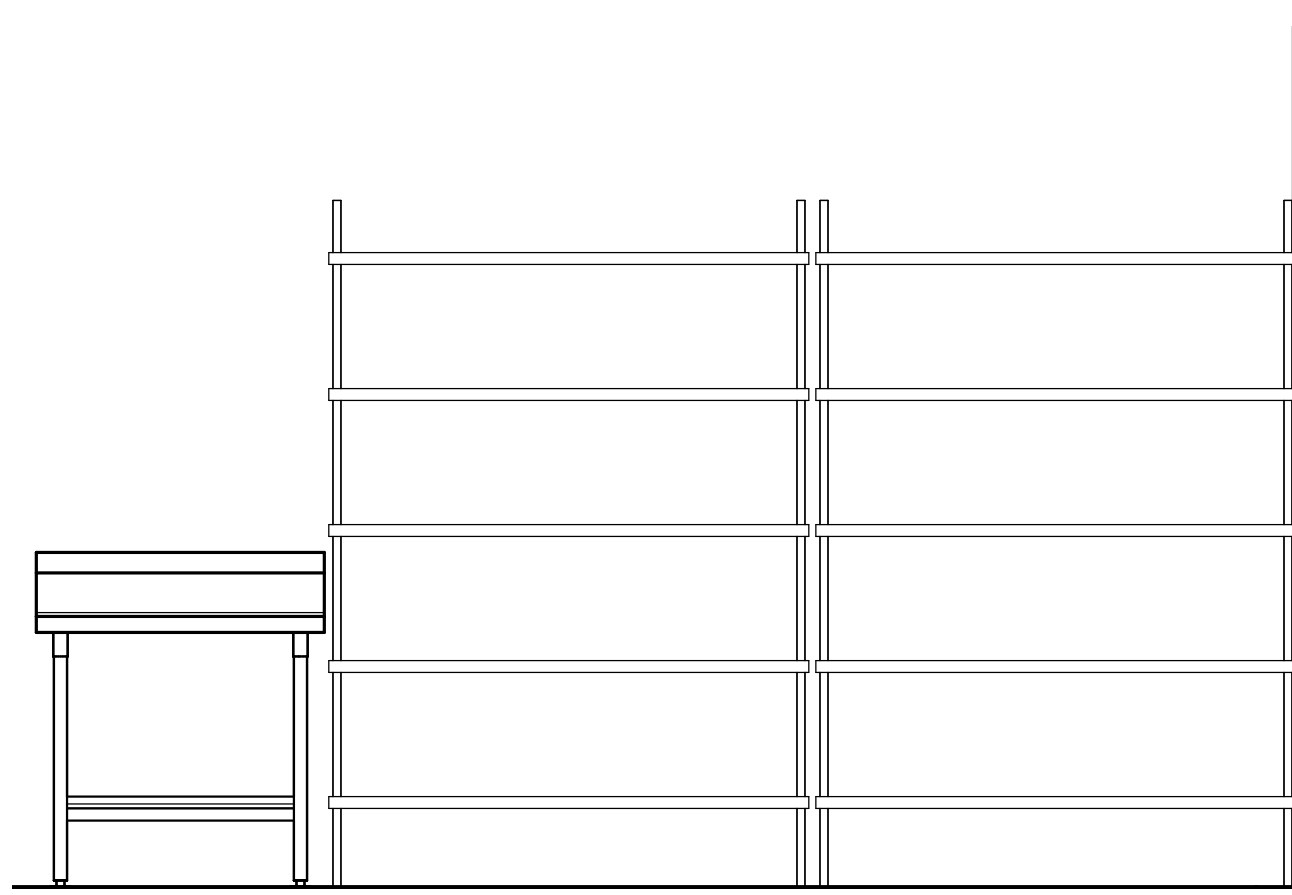

② ELEVATION @ EQUIPMENT STORAGE
1/2" = 1'-0"

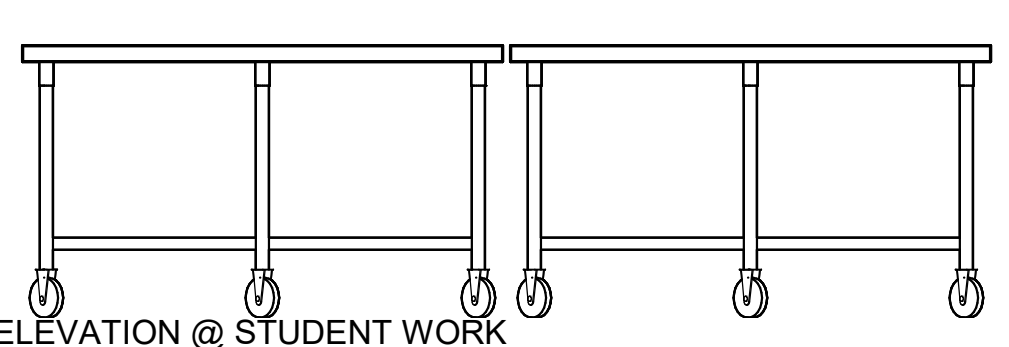

④ ELEVATION @ STUDENT WORK
STATION
1/2" = 1'-0"

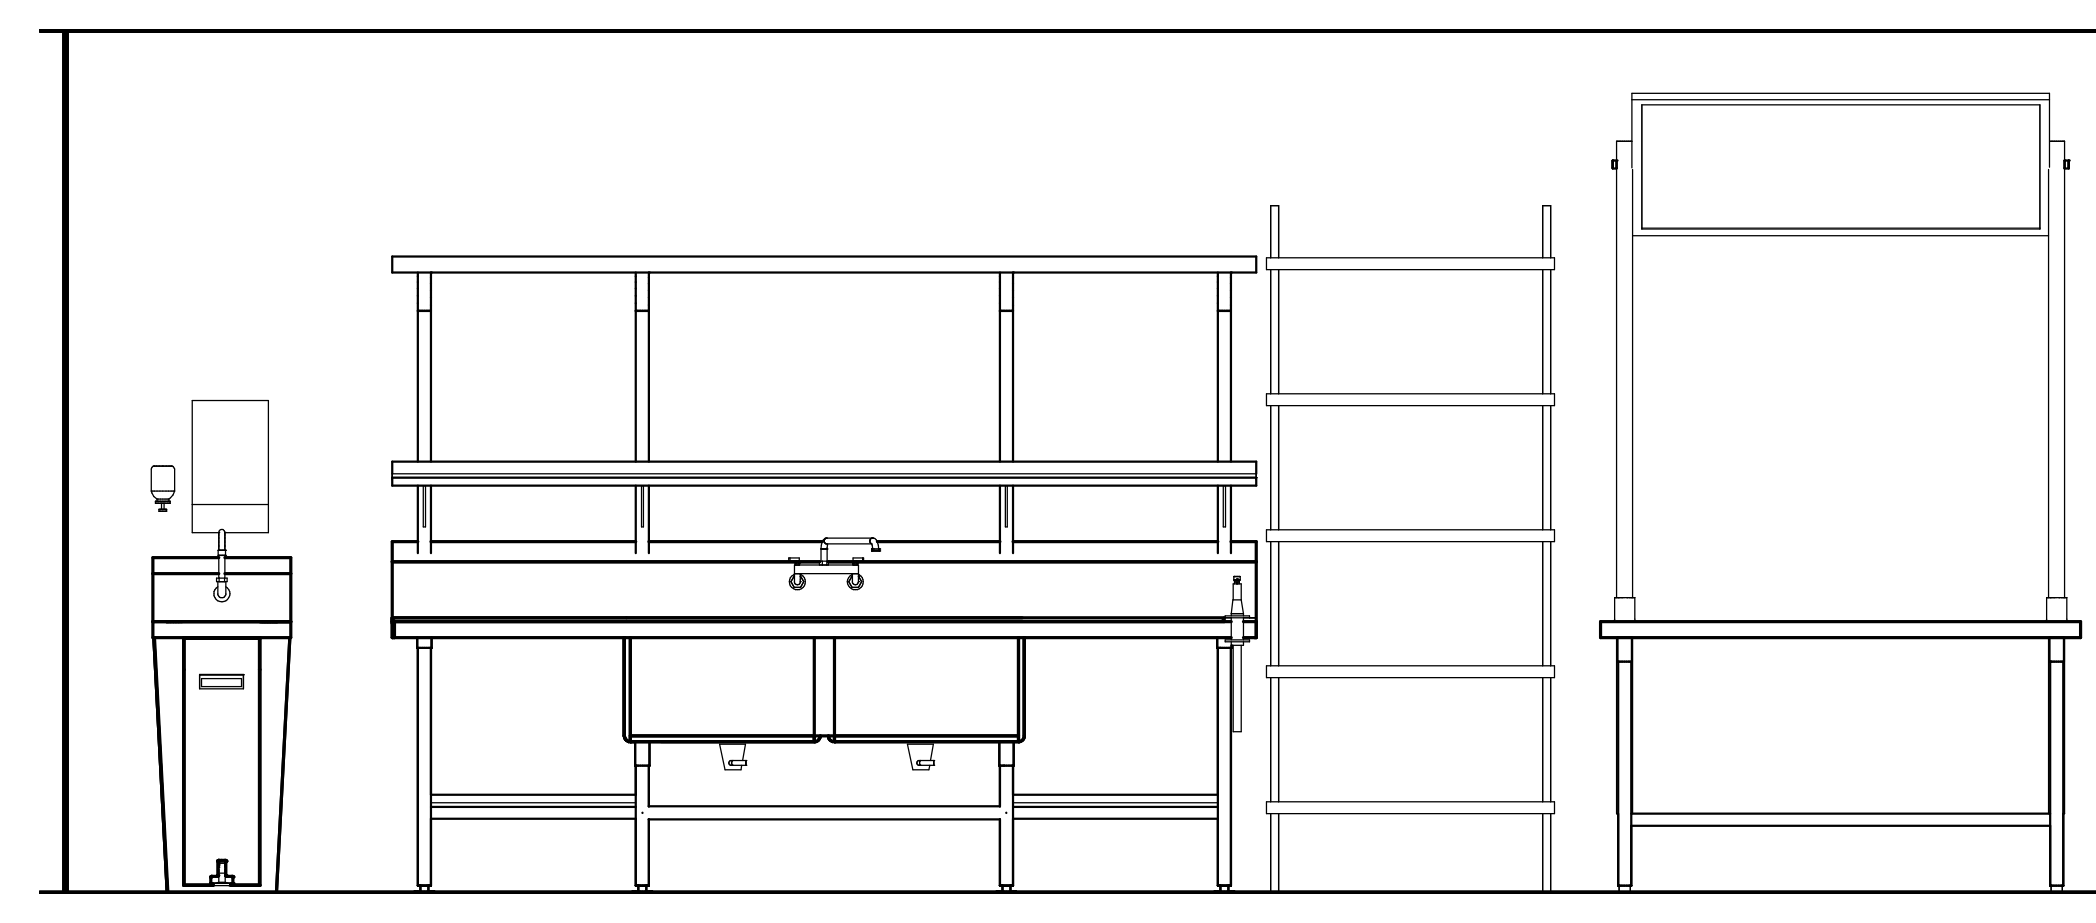

① ELEVATION @ PREP AREA
1/2" = 1'-0"





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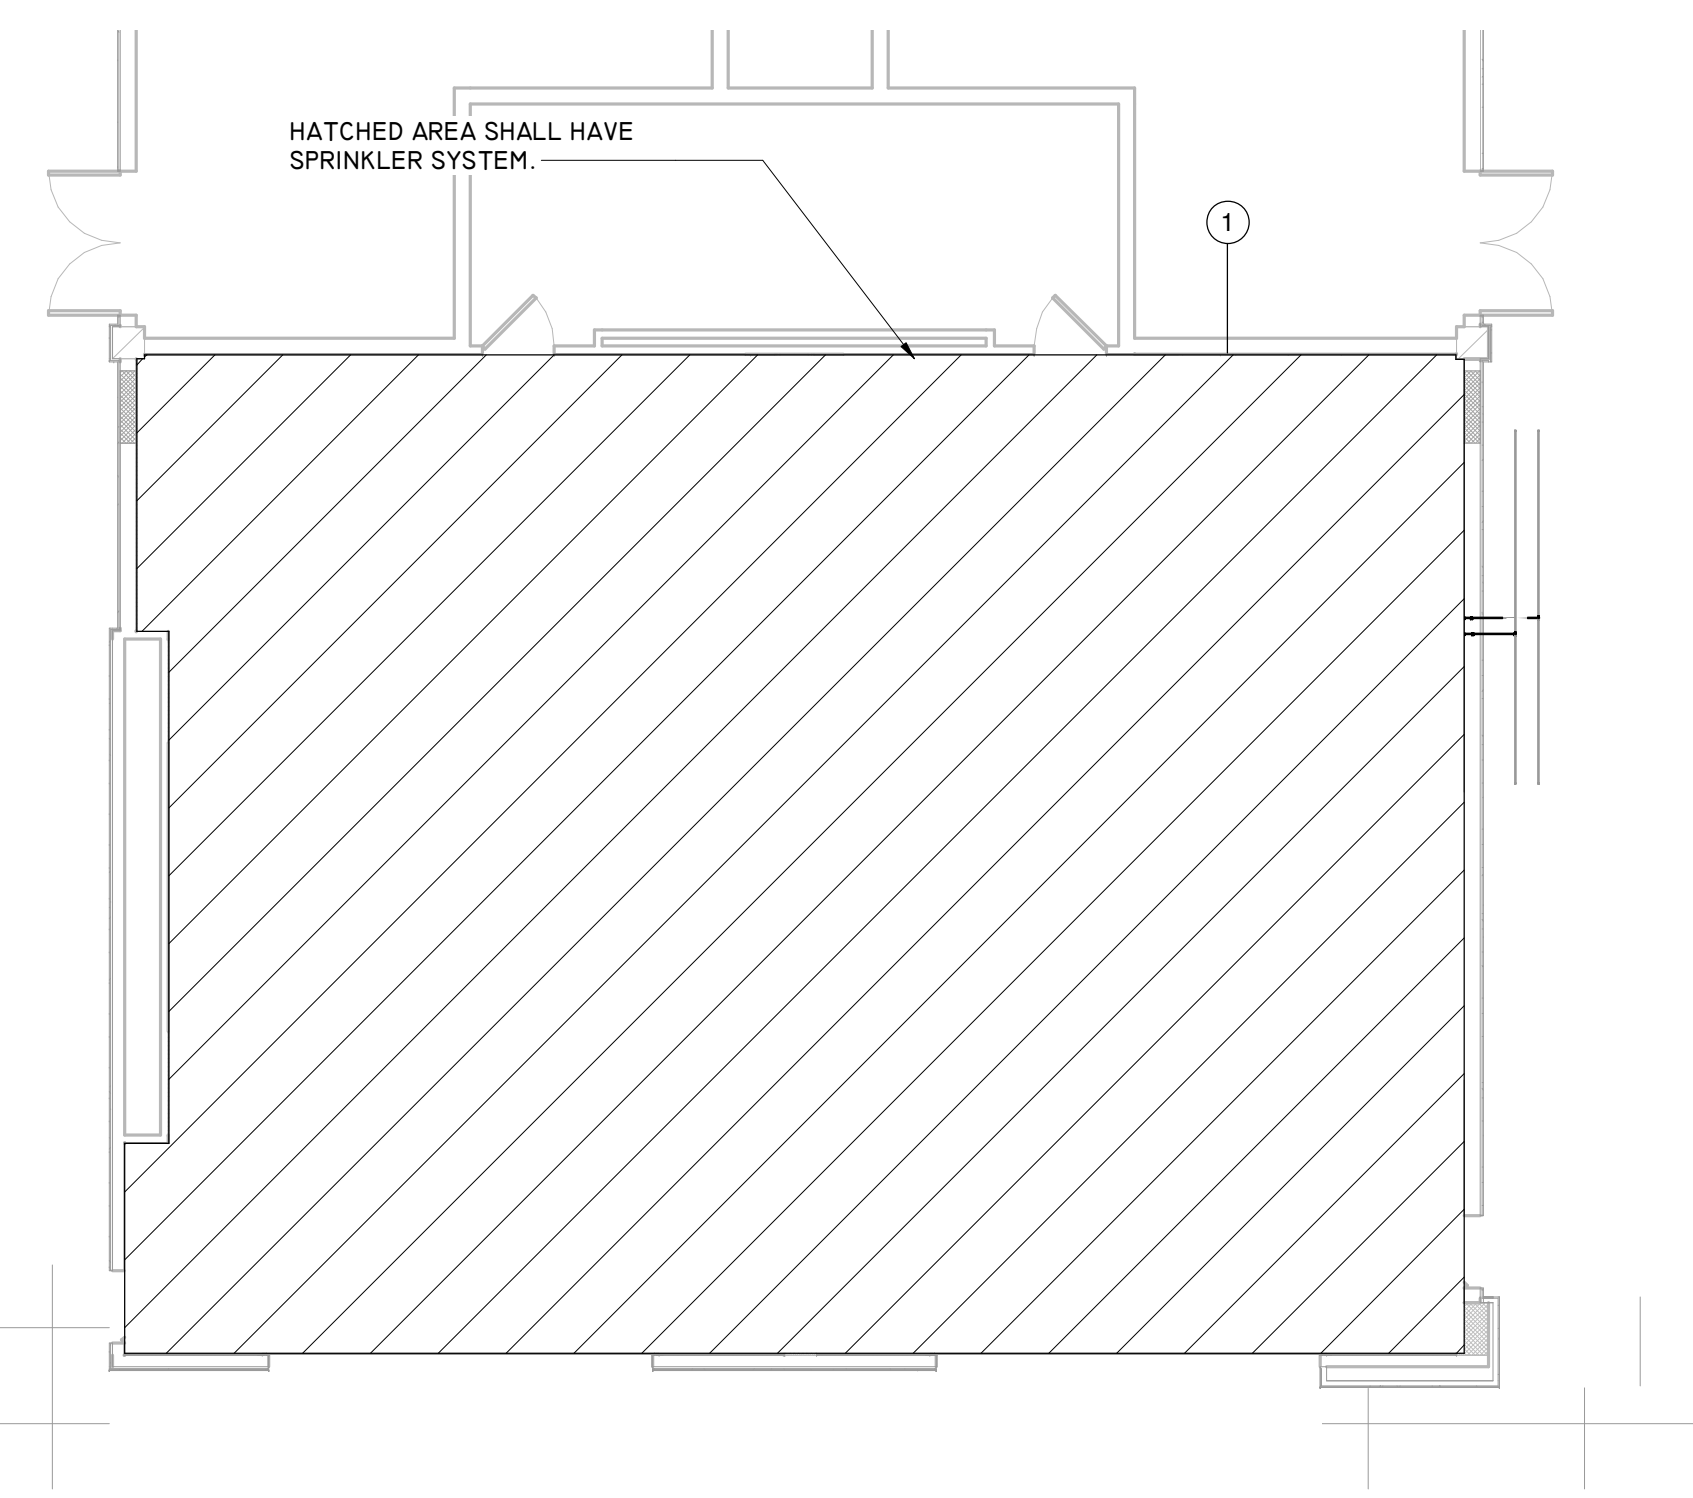


GENERAL NOTES


1. RE-LOCATE EXISTING FIRE SPRINKLER HEADS IN THIS AREA TO ACCOMMODATE THE NEW WALLS AND CEILING GRID. ADJUST PIPING AS NECESSARY. LOCATIONS OF SPRINKLER HEADS SHALL BE VERIFIED AND DESIGNED IN ACCORDANCE WITH NFPA 13, AND LOCAL CITY FIRE DEPARTMENT. SPRINKLER SPACING AND PIPING SHALL BE DESIGNED BY A LOCAL RME.

KEYNOTE LEGEND


1 PROVIDE NEW SPRINKLER HEADS TO SERVE RENOVATED CLASSROOM/CORRIDOR AREA AND EXTEND EXISTING SPRINKLER LINES TO SERVE NEW HEADS. FINAL DESIGN SHALL BE DONE BY A LOCAL RME.




4 FLOOR PLAN - LAB B2 - FIRE PROTECTION
Scale: 1/8" = 1'-0"

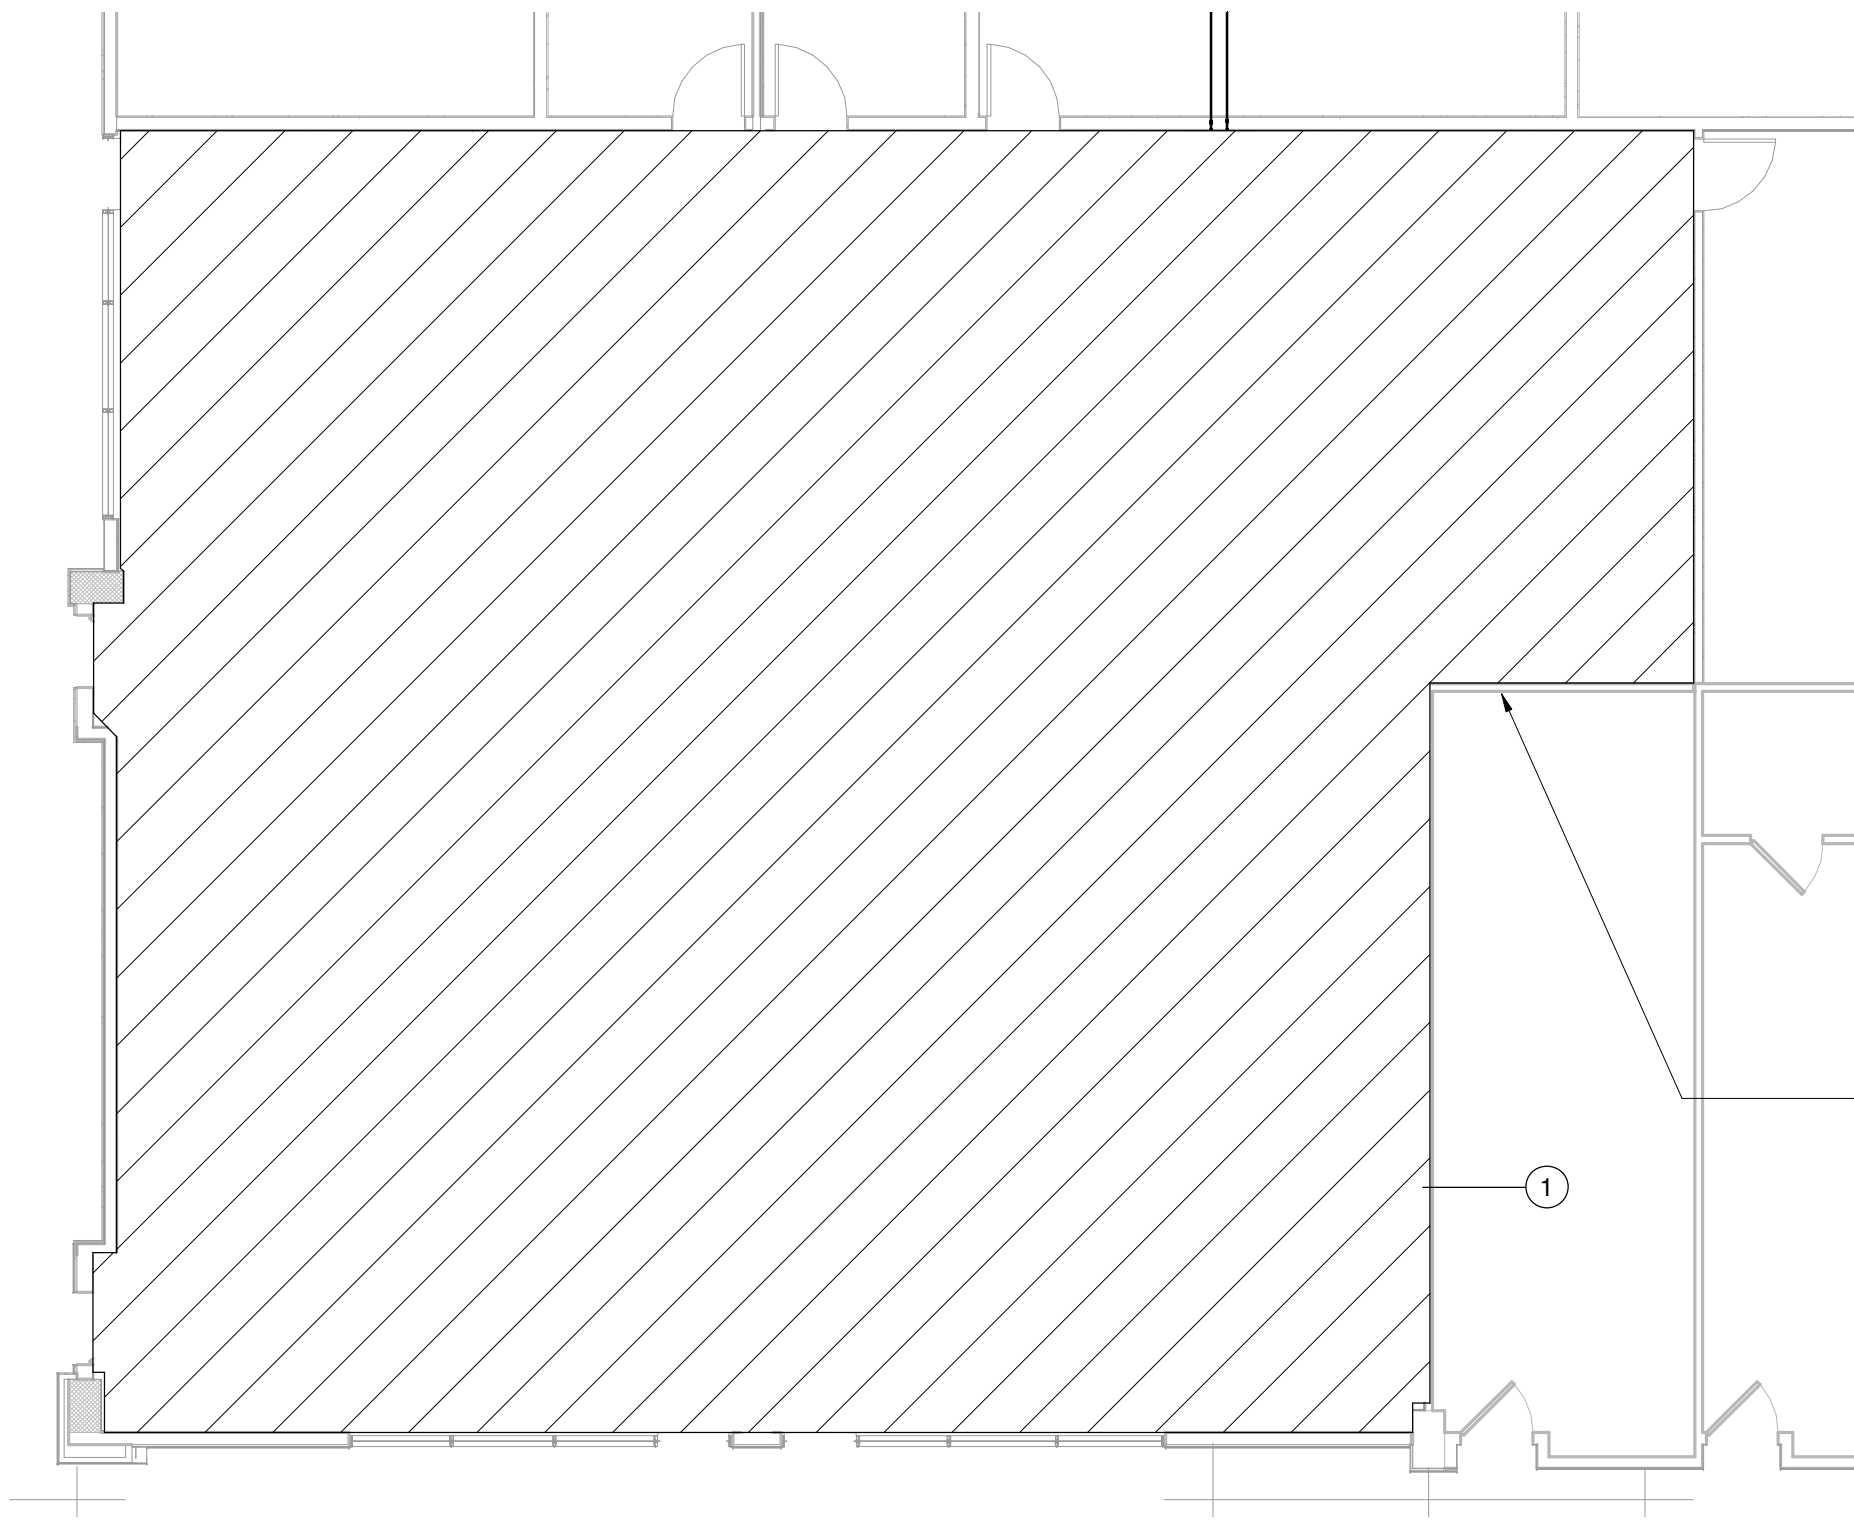


5 FLOOR PLAN - MEDICAL CLASS - FIRE PROTECTION
Scale: 1/8" = 1'-0"

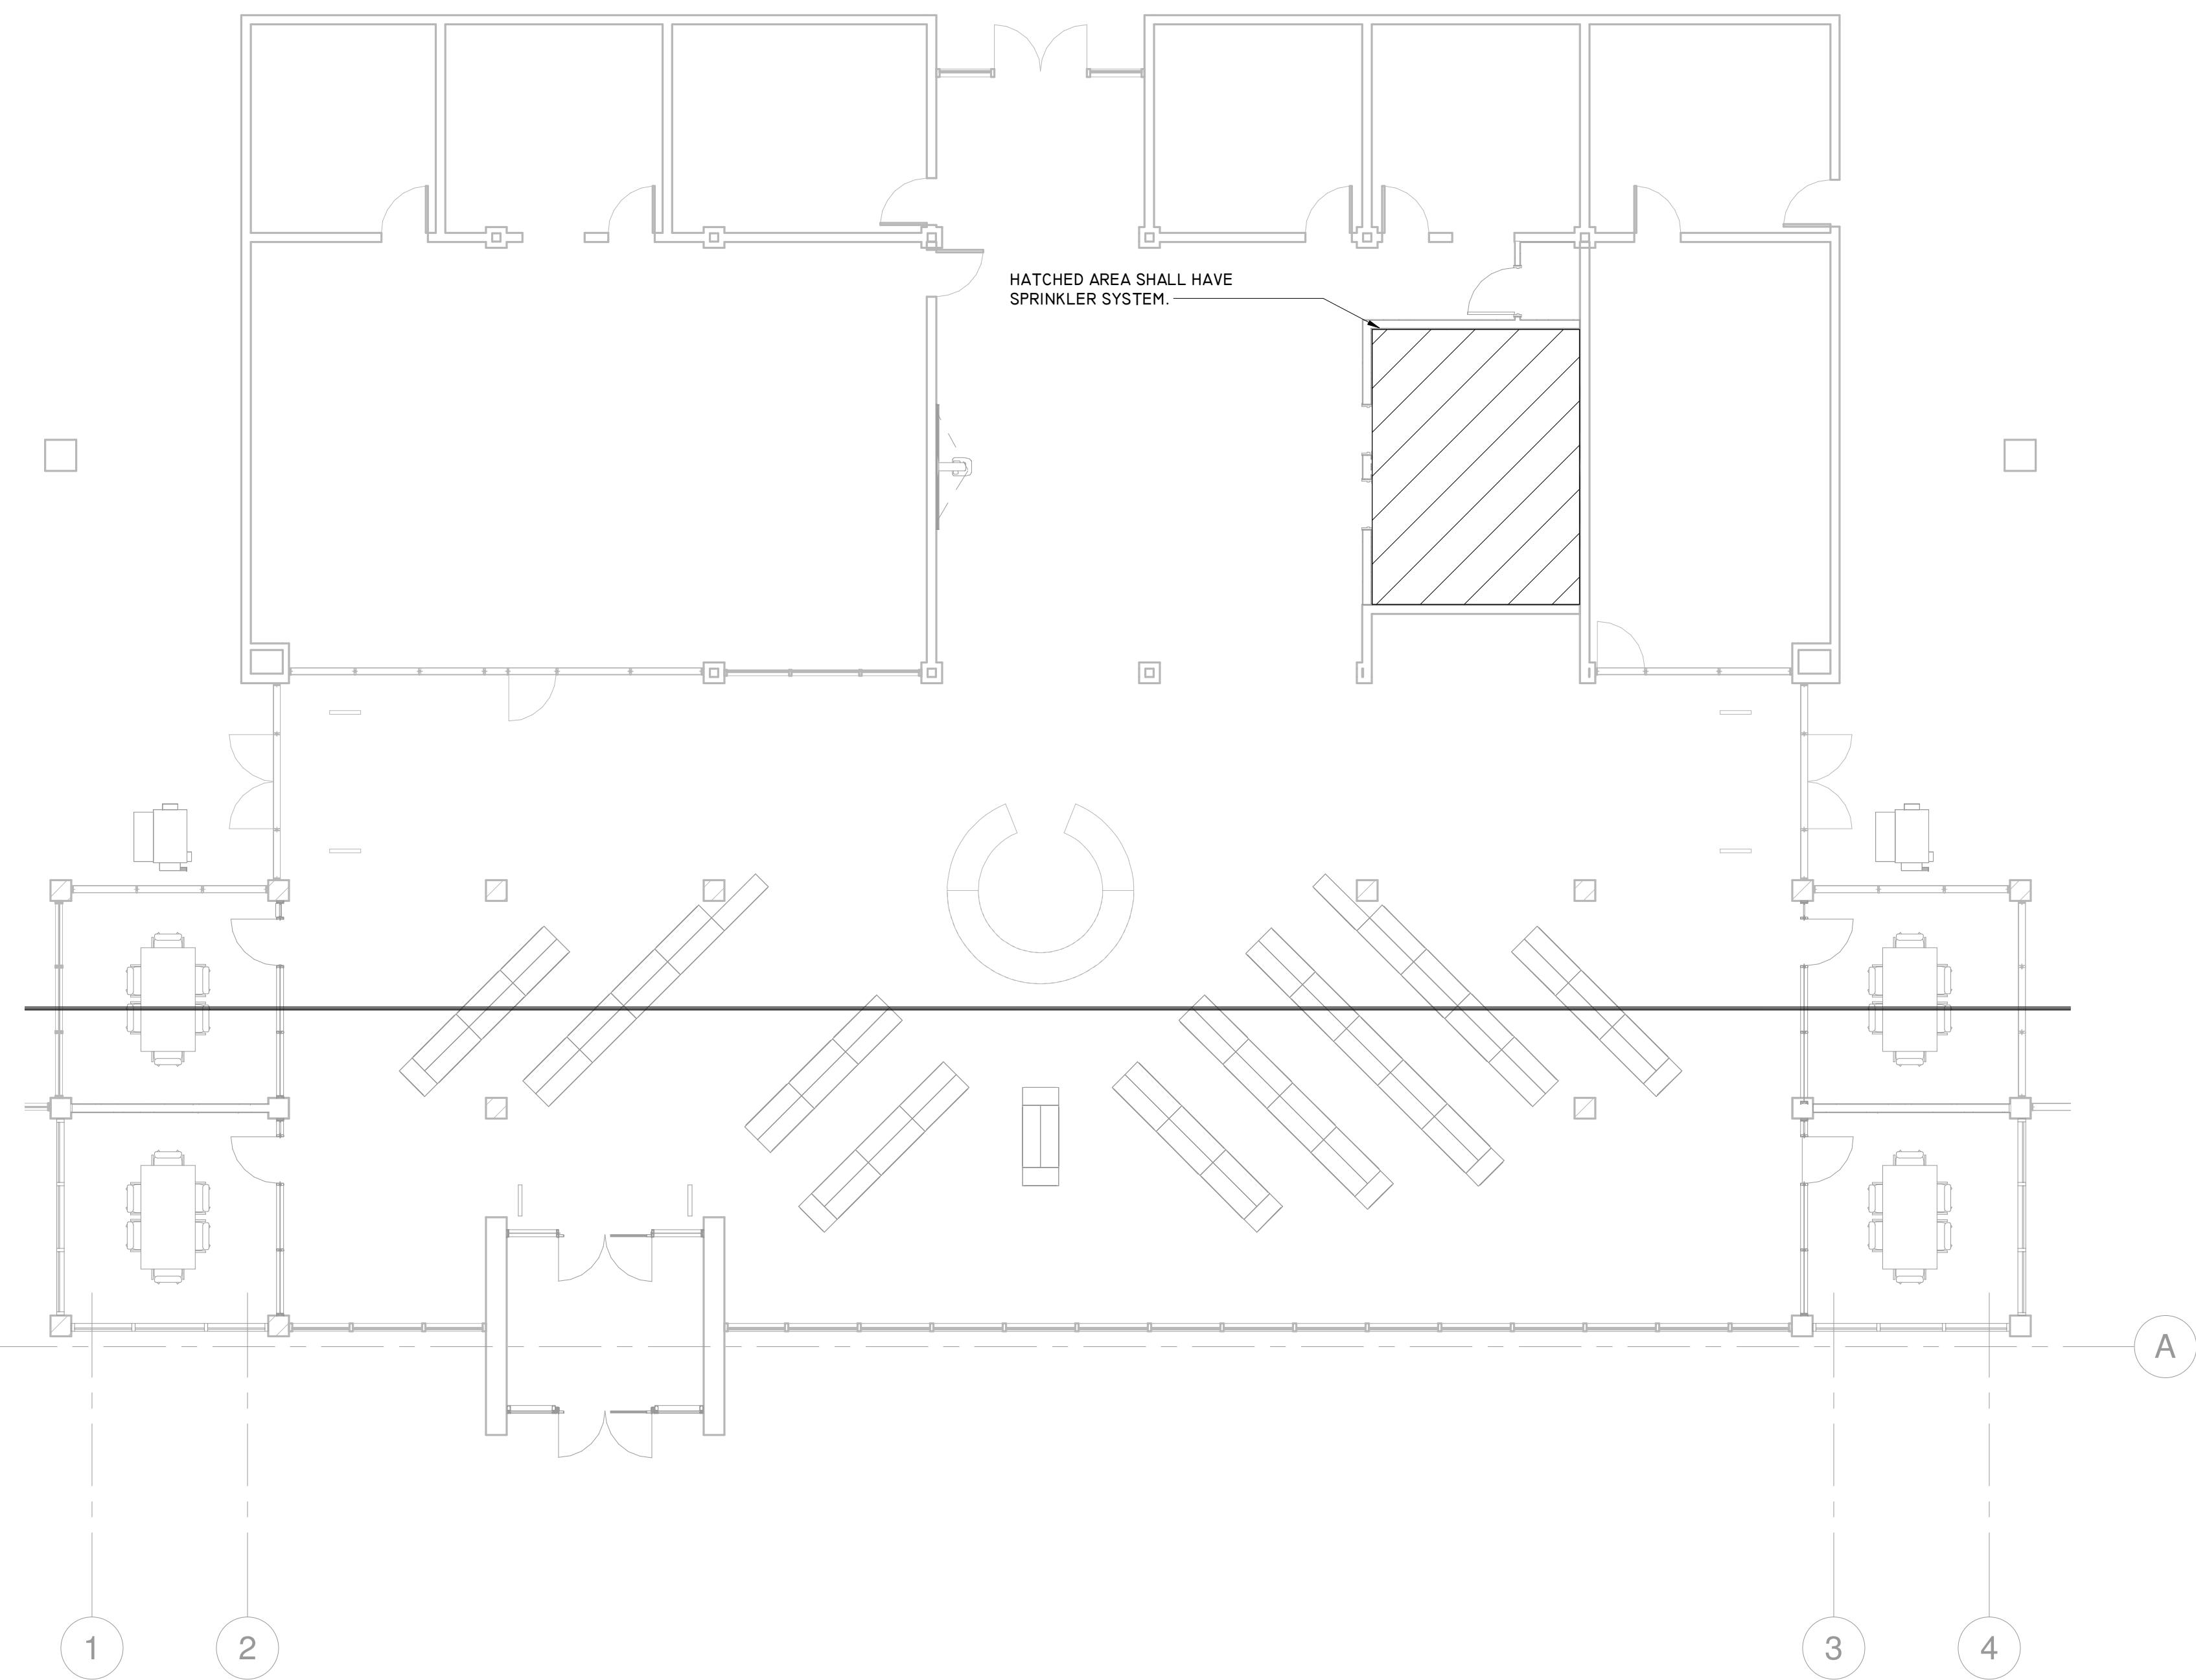

3 FLOOR PLAN - LIBRARY - FIRE PROTECTION
Scale: 1/8" = 1'-0"

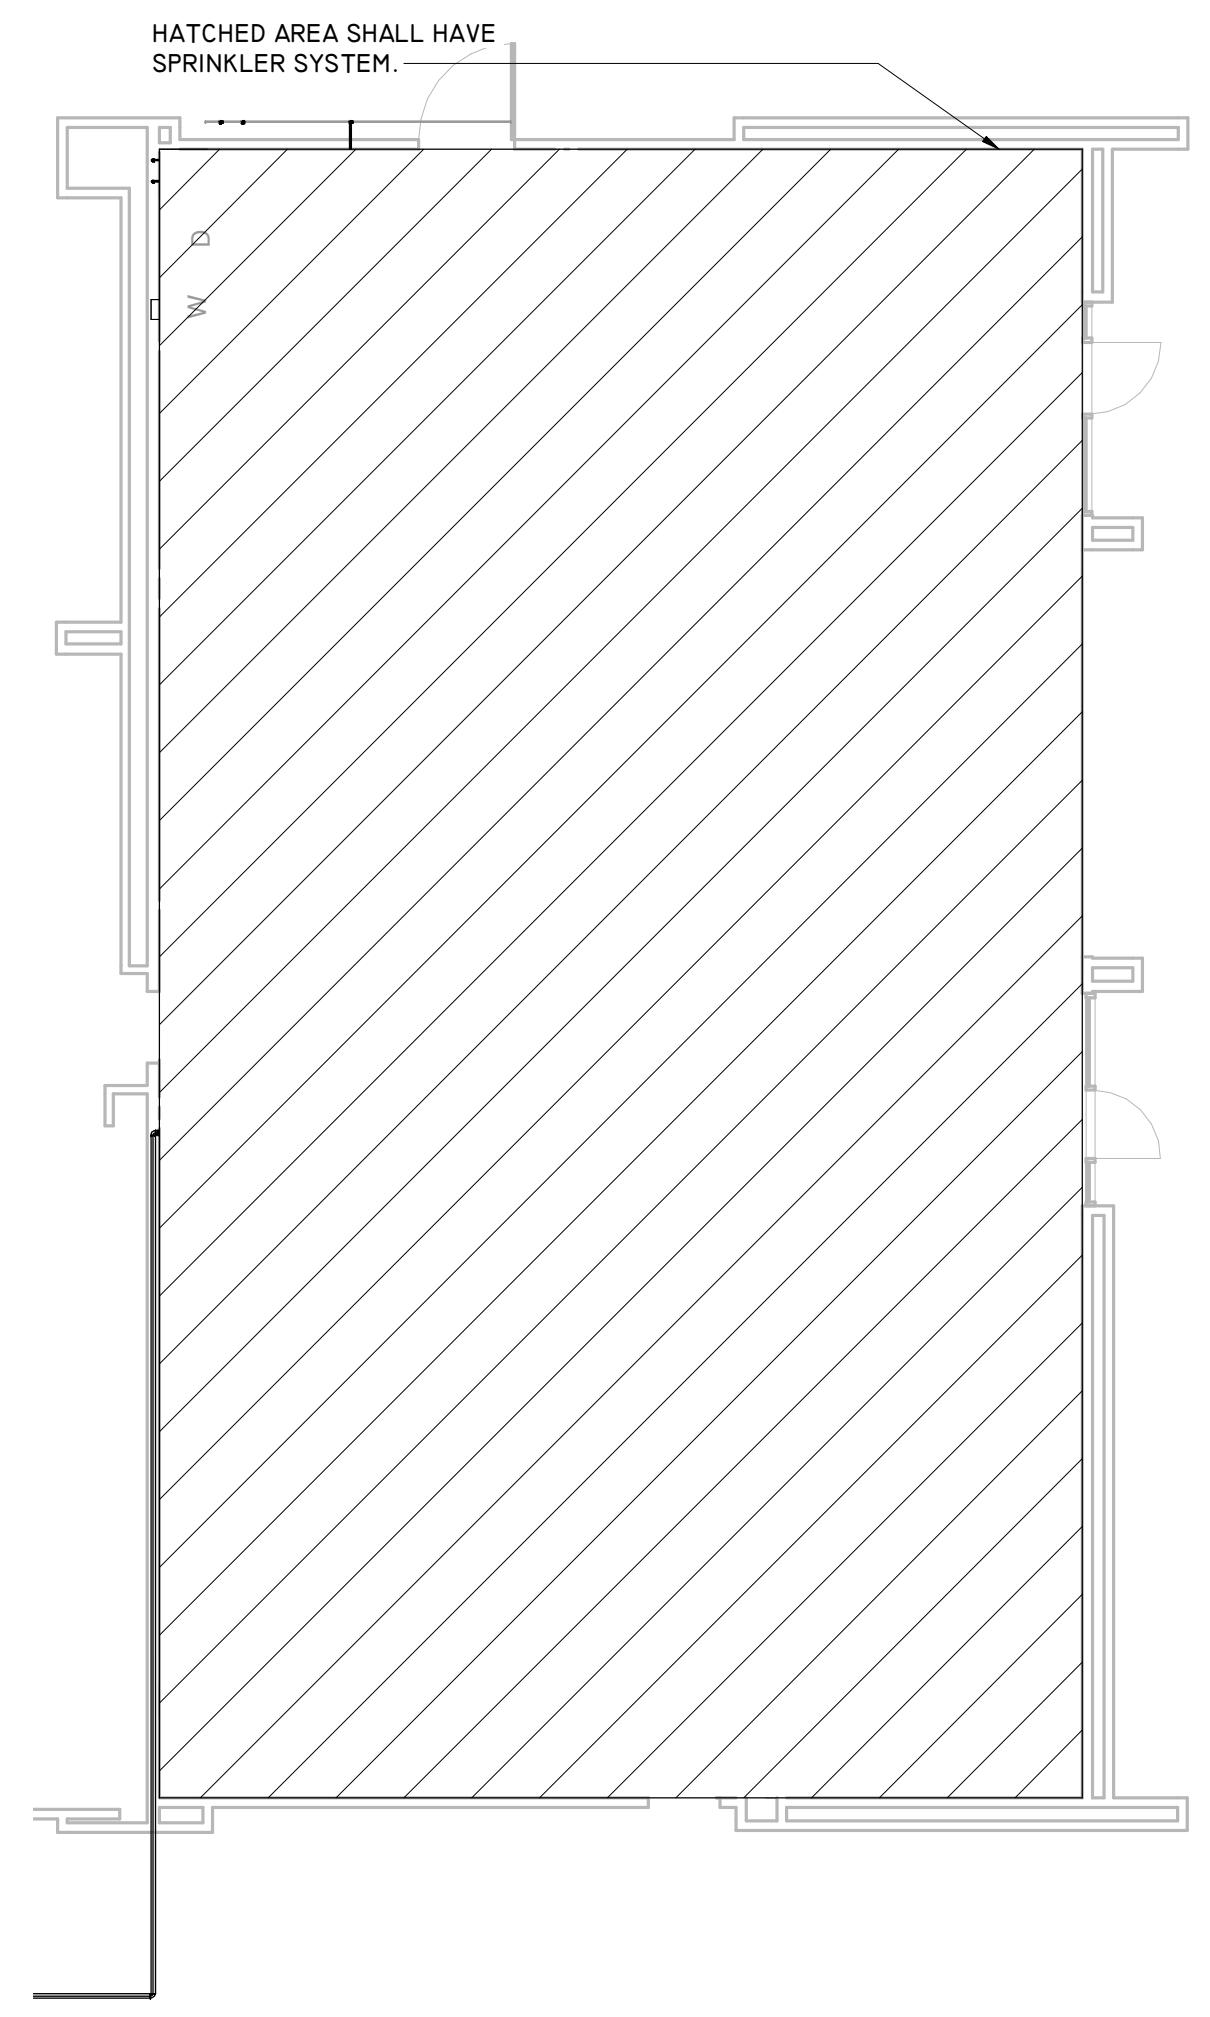

2 FLOOR PLAN - KITCHEN - FIRE PROTECTION
Scale: 1/8" = 1'-0"

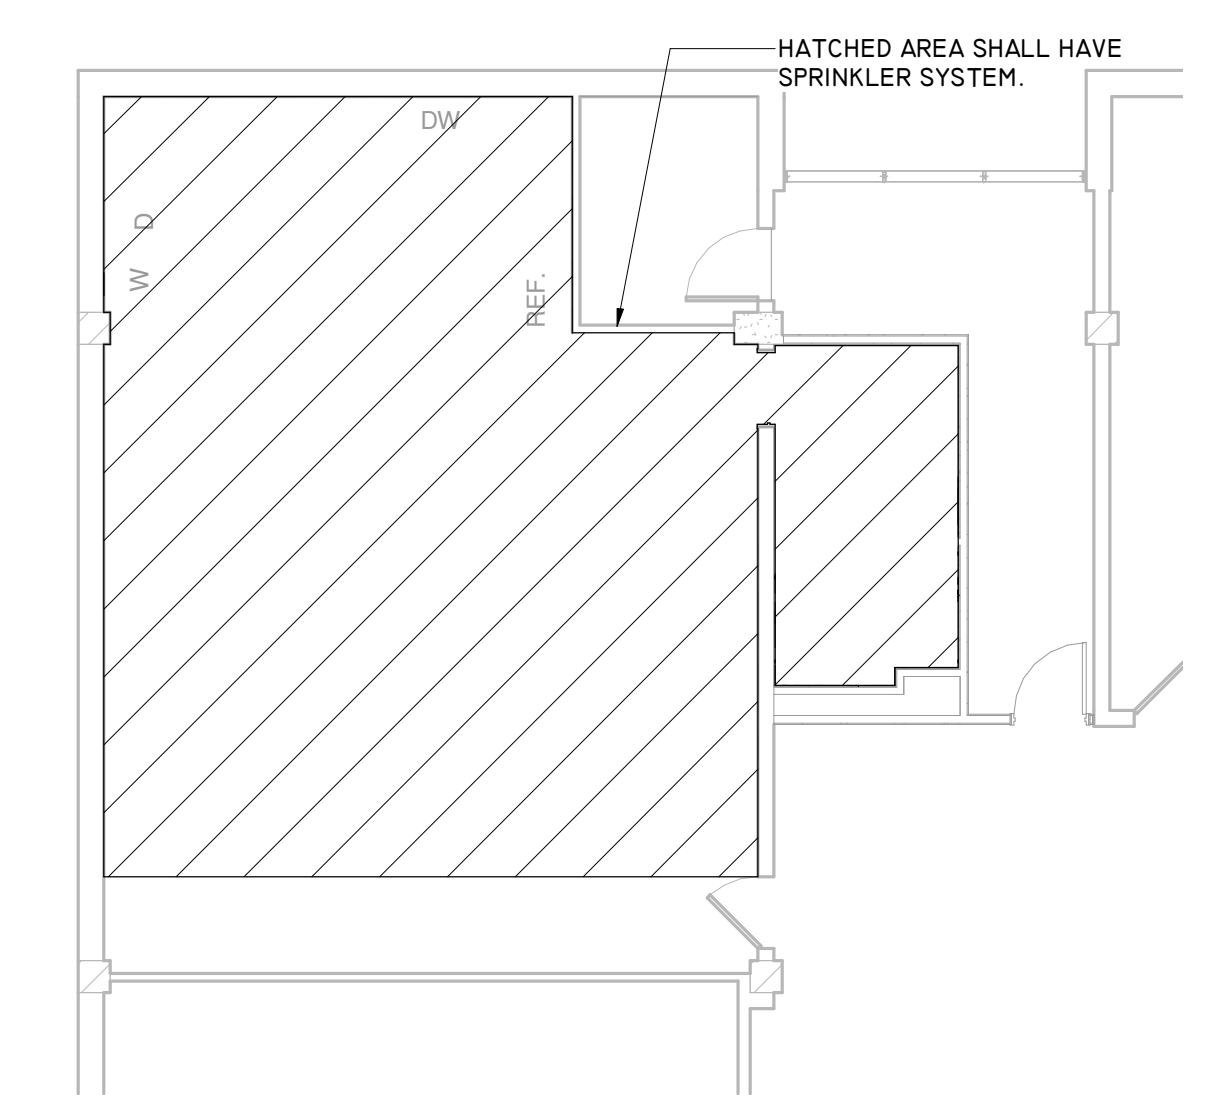

1 FLOOR PLAN - LIFE SKILLS - FIRE PROTECTION
Scale: 1/8" = 1'-0"

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PROFESSIONAL SEAL:




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RENOVATIONS**

1625 STAFFORDSHIRE
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STAFFORD, TX 77477

#	Date	ISSUED FOR
1	2020/01/31	90% CD
2	2020/03/02	98% CD Review
3	2020/03/12	Issue for Bid, Permit, and Construction

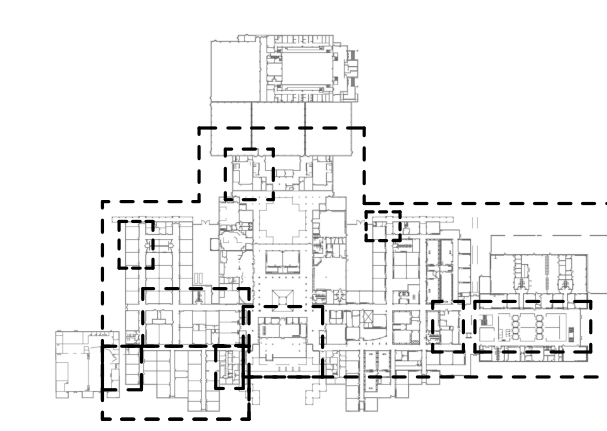

KEY PLAN
TRUE NORTH PLAN NORTH

Project Number	19006-A
Drawn By	LT
Checked By	AW
Approved By	MS
Drawing Title	

FIRE PROTECTION PLAN

Drawing Number **FP1.01**