TOKAY HIGH SCHOOL - NEW GYM BUILDING

1111 W, CENTURY BLVD LODI, CALIFORNIA 95240




SHEET INDEX								
ISSUE DATE	SHEET NUMBER	SHEET NAME						
GENERAL								
1/7/19	G0.0	TITLE SHEET						
ARCHITECT	URE							
1/7/19	A2.20	FLOOR PLAN						
1/7/19	A2.40	REFLECTED CEILING PLAN						
1/7/19	A2.50	ROOF PLAN						
1/7/19	A3.10	EXTERIOR ELEVATION						
1/7/19	A3.20	BUILDING SECTION						
1/7/19	A5.01	INTERIOR ELEVATIONS						
1/7/19	A5.02	INTERIOR ELEVATIONS						
TECHNOLO	GΥ							
1/7/19	T1.01	TECHNOLOGY SYMBOL SHEET						
1/7/19	T2.02	TECHNOLOGY GYM						

ADDITIVE ALTERNATES

#1 PROVIDE MECHANICALLY GRINDED POLISHED CONCRETE (LOBBY, TEAM ROOM 1, TEAM ROOM 2). GRADE A - LIGHT SAND (CREAM): POLISHING ONLY THE PORTLAND CEMEMNT PASTE AT THE SURFACE WITHOUT EXPOSING SMALL, MEDIUM, OR LARGE AGGREGATES. DYES ARE NOT ALLOWED AS AN ACCEPTABLE LEVEL OF GRINDING. LEVEL 2 SHEEN: SATIN FINISH (MODERATE GLOSS) AS DETERMINED BY A GLOSS READING OF 11-25 (150 GRIT METAL BONDED DIAMONDS, 50, 120, 220, 400 GRIT RESIN DIAMONDS). TWO COATS OF HARDENER COEFFICIENT OF FRICTION 0.6 MINIMUM.

#2 MECHANICAL SCREEN ON LOWER ROOF AT EACH END OF THE PRACTICE GYM ROOM.

FOR REFERENCE ONLY

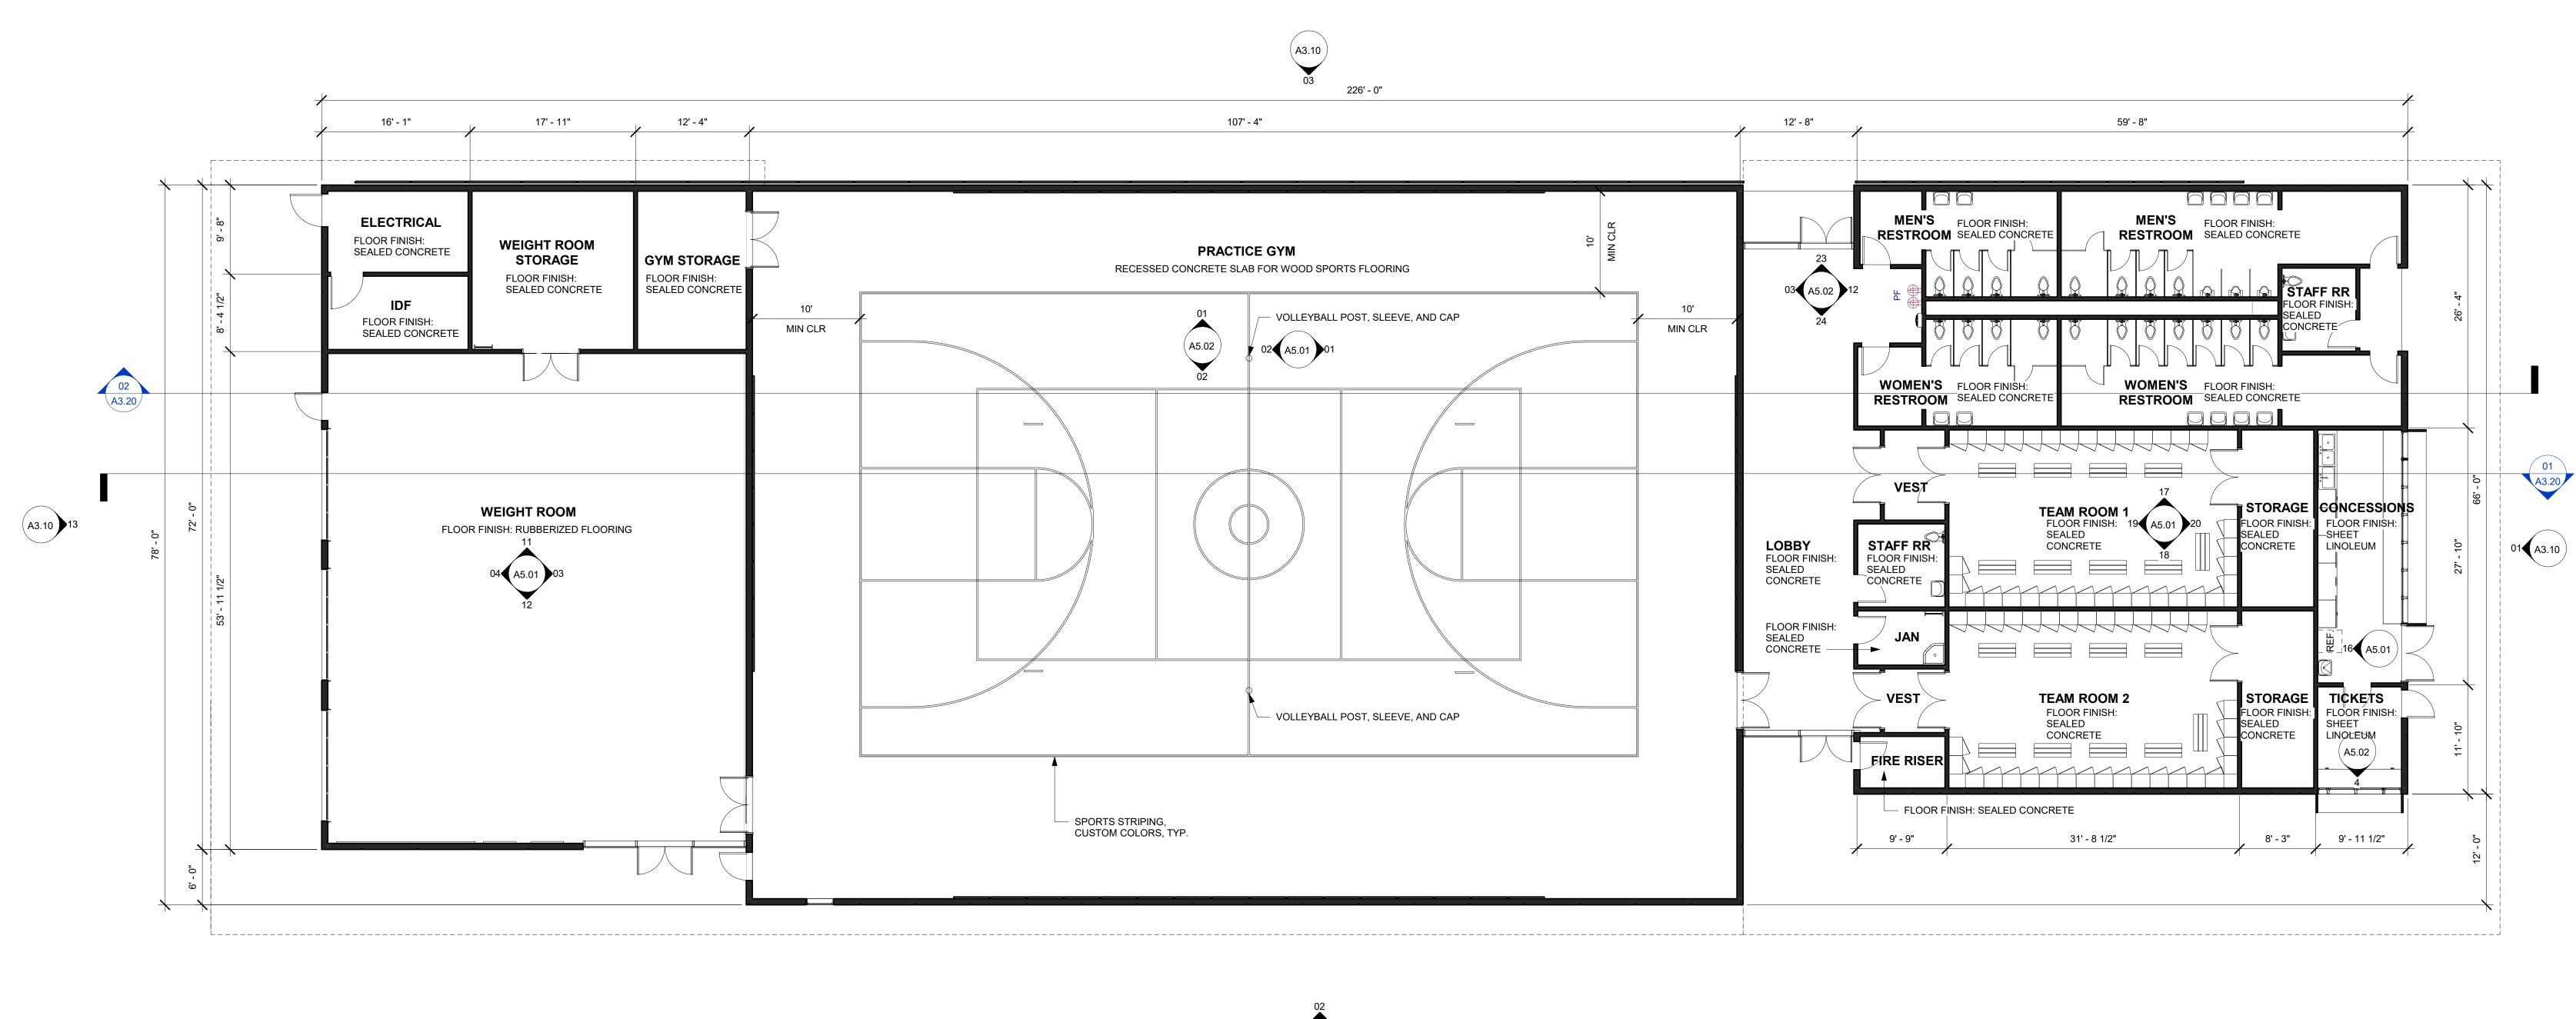

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Revision

mittal Date


Job. No.	1818010
Date	JAN 07,2019
Checked by	RW
Scale	1/8" = 1'-0"

FLOOR PLAN

A2.20

4/01/ 41/01/



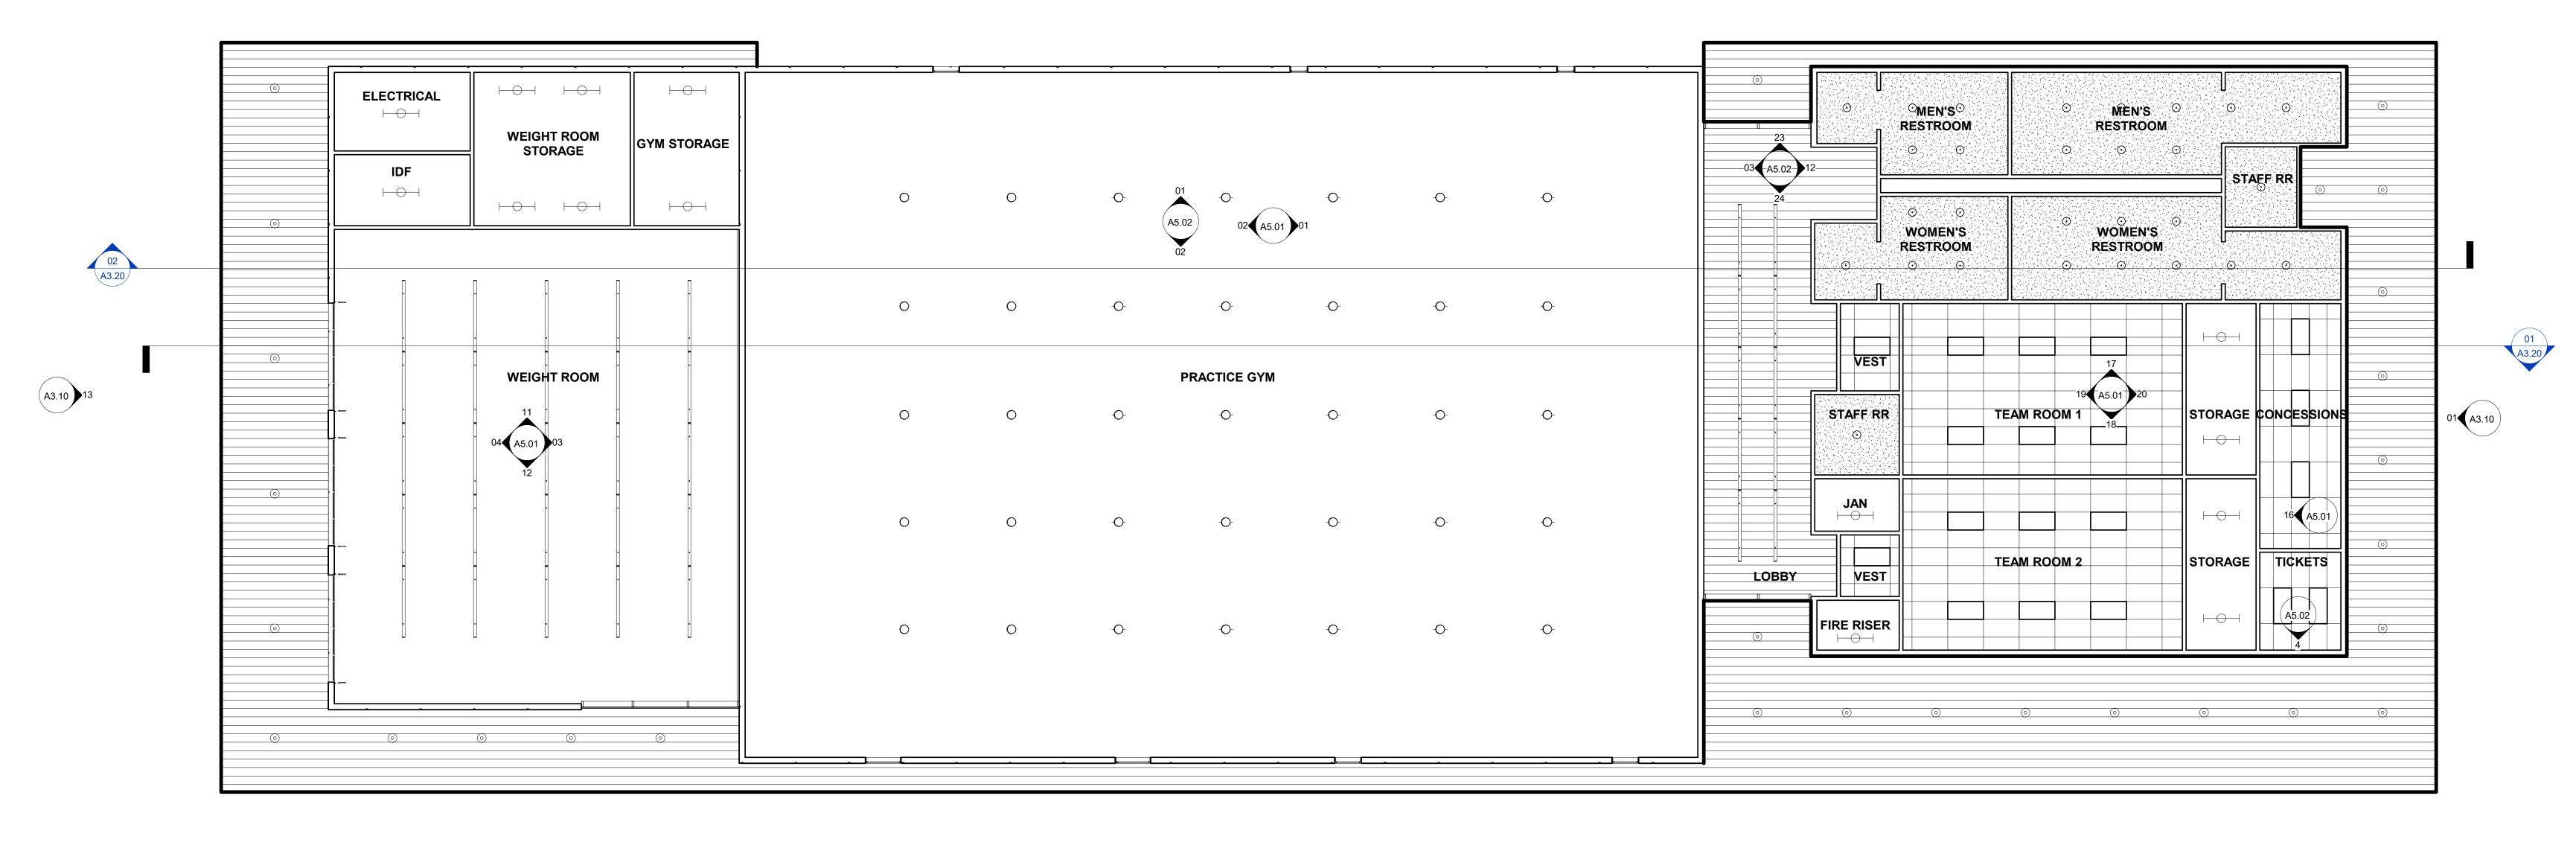

02 (A3.10)

OTA
OPEN TO STRUCTURE ABOVE

2'X4' ACOUSTICAL CEILING GRID

GYPSUM BD., PAINTED TYP.

FIBER CEMENT RUSTIC SERIES VENTED CEDARMILL SOFFIT PANEL, BUTT JOINT, 12" WIDE, .25" THICK, COUNTERSUNK GALVANIZED FASTENER (PREFINISHED: OLD CHERRY)

LED 6" RECESSED CAN FIXTURE

2'X4' LED PENDANT, UTILITY FIXTURE, AT OPEN CEILING CONDITIONS


12" PENDANT MOUNTED CYLINDER LED

8' PEDANT MOUNTED LINEAR TUBE LED


2'X4' LED, LAY-IN FIXTURE

REFLECTED CEILING PLAN	1/8" = 1'-0"	01


p. 949. 261.1001 w. Ipainc.com 1818010 JAN 07,2019 1/8" = 1'-0" REFLECTED CEILING PLAN A2.40

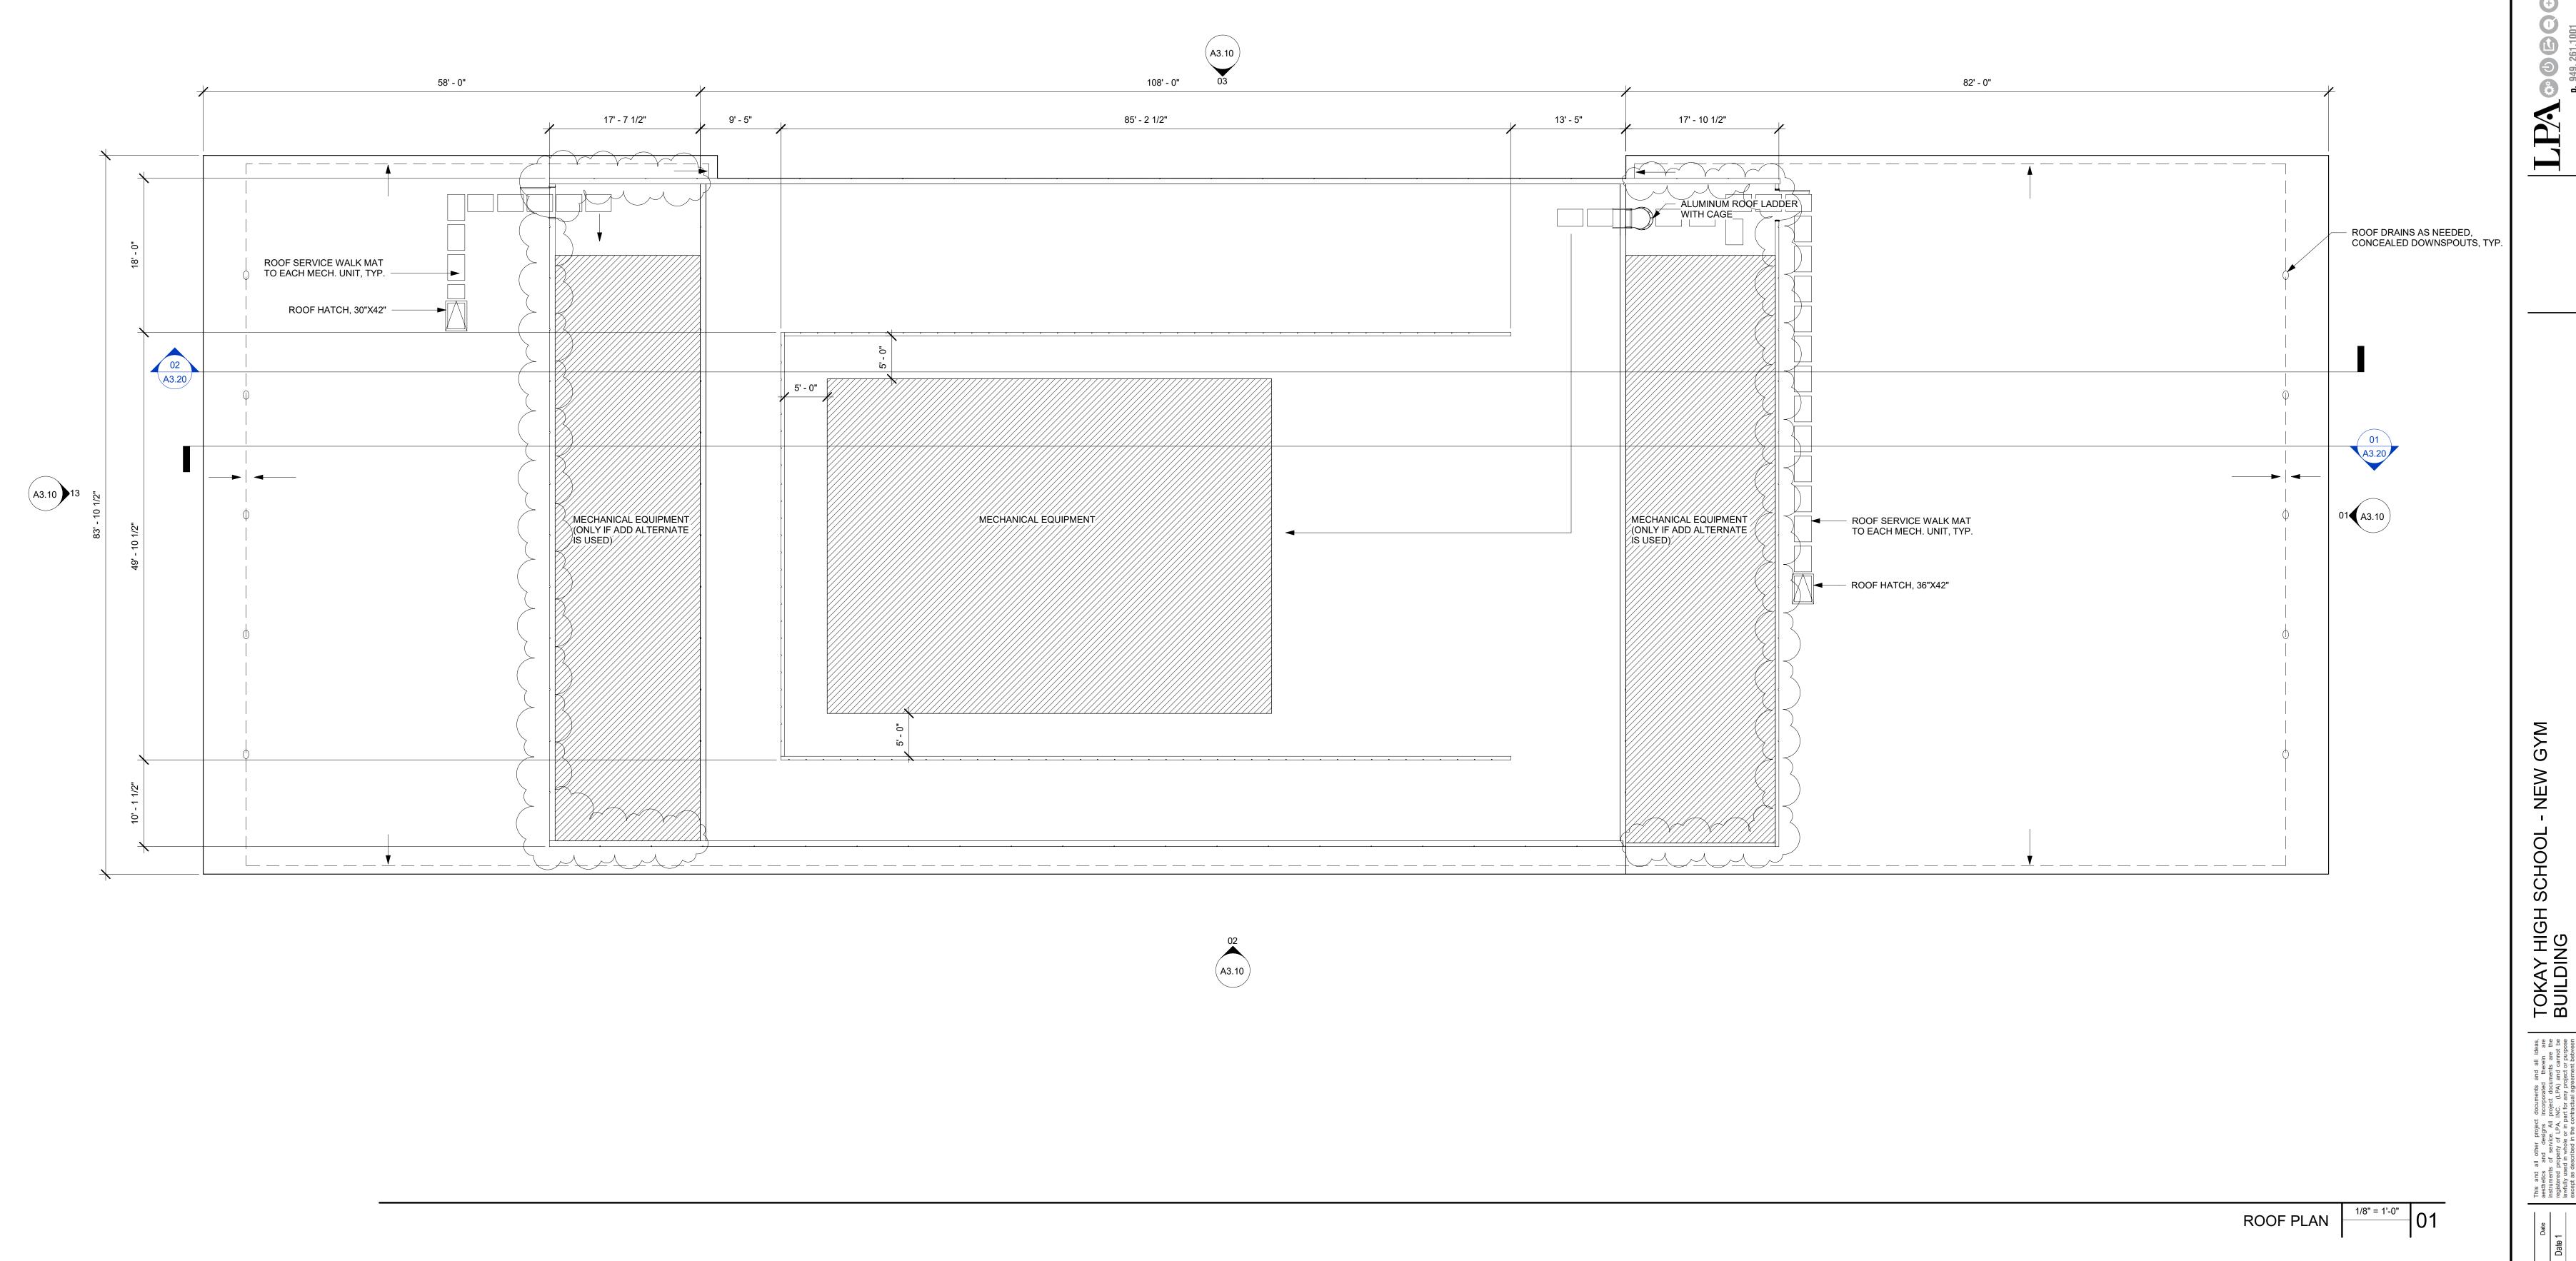


1818010 JAN 07,2019 Checker 1/8" = 1'-0" ROOF PLAN A2.50

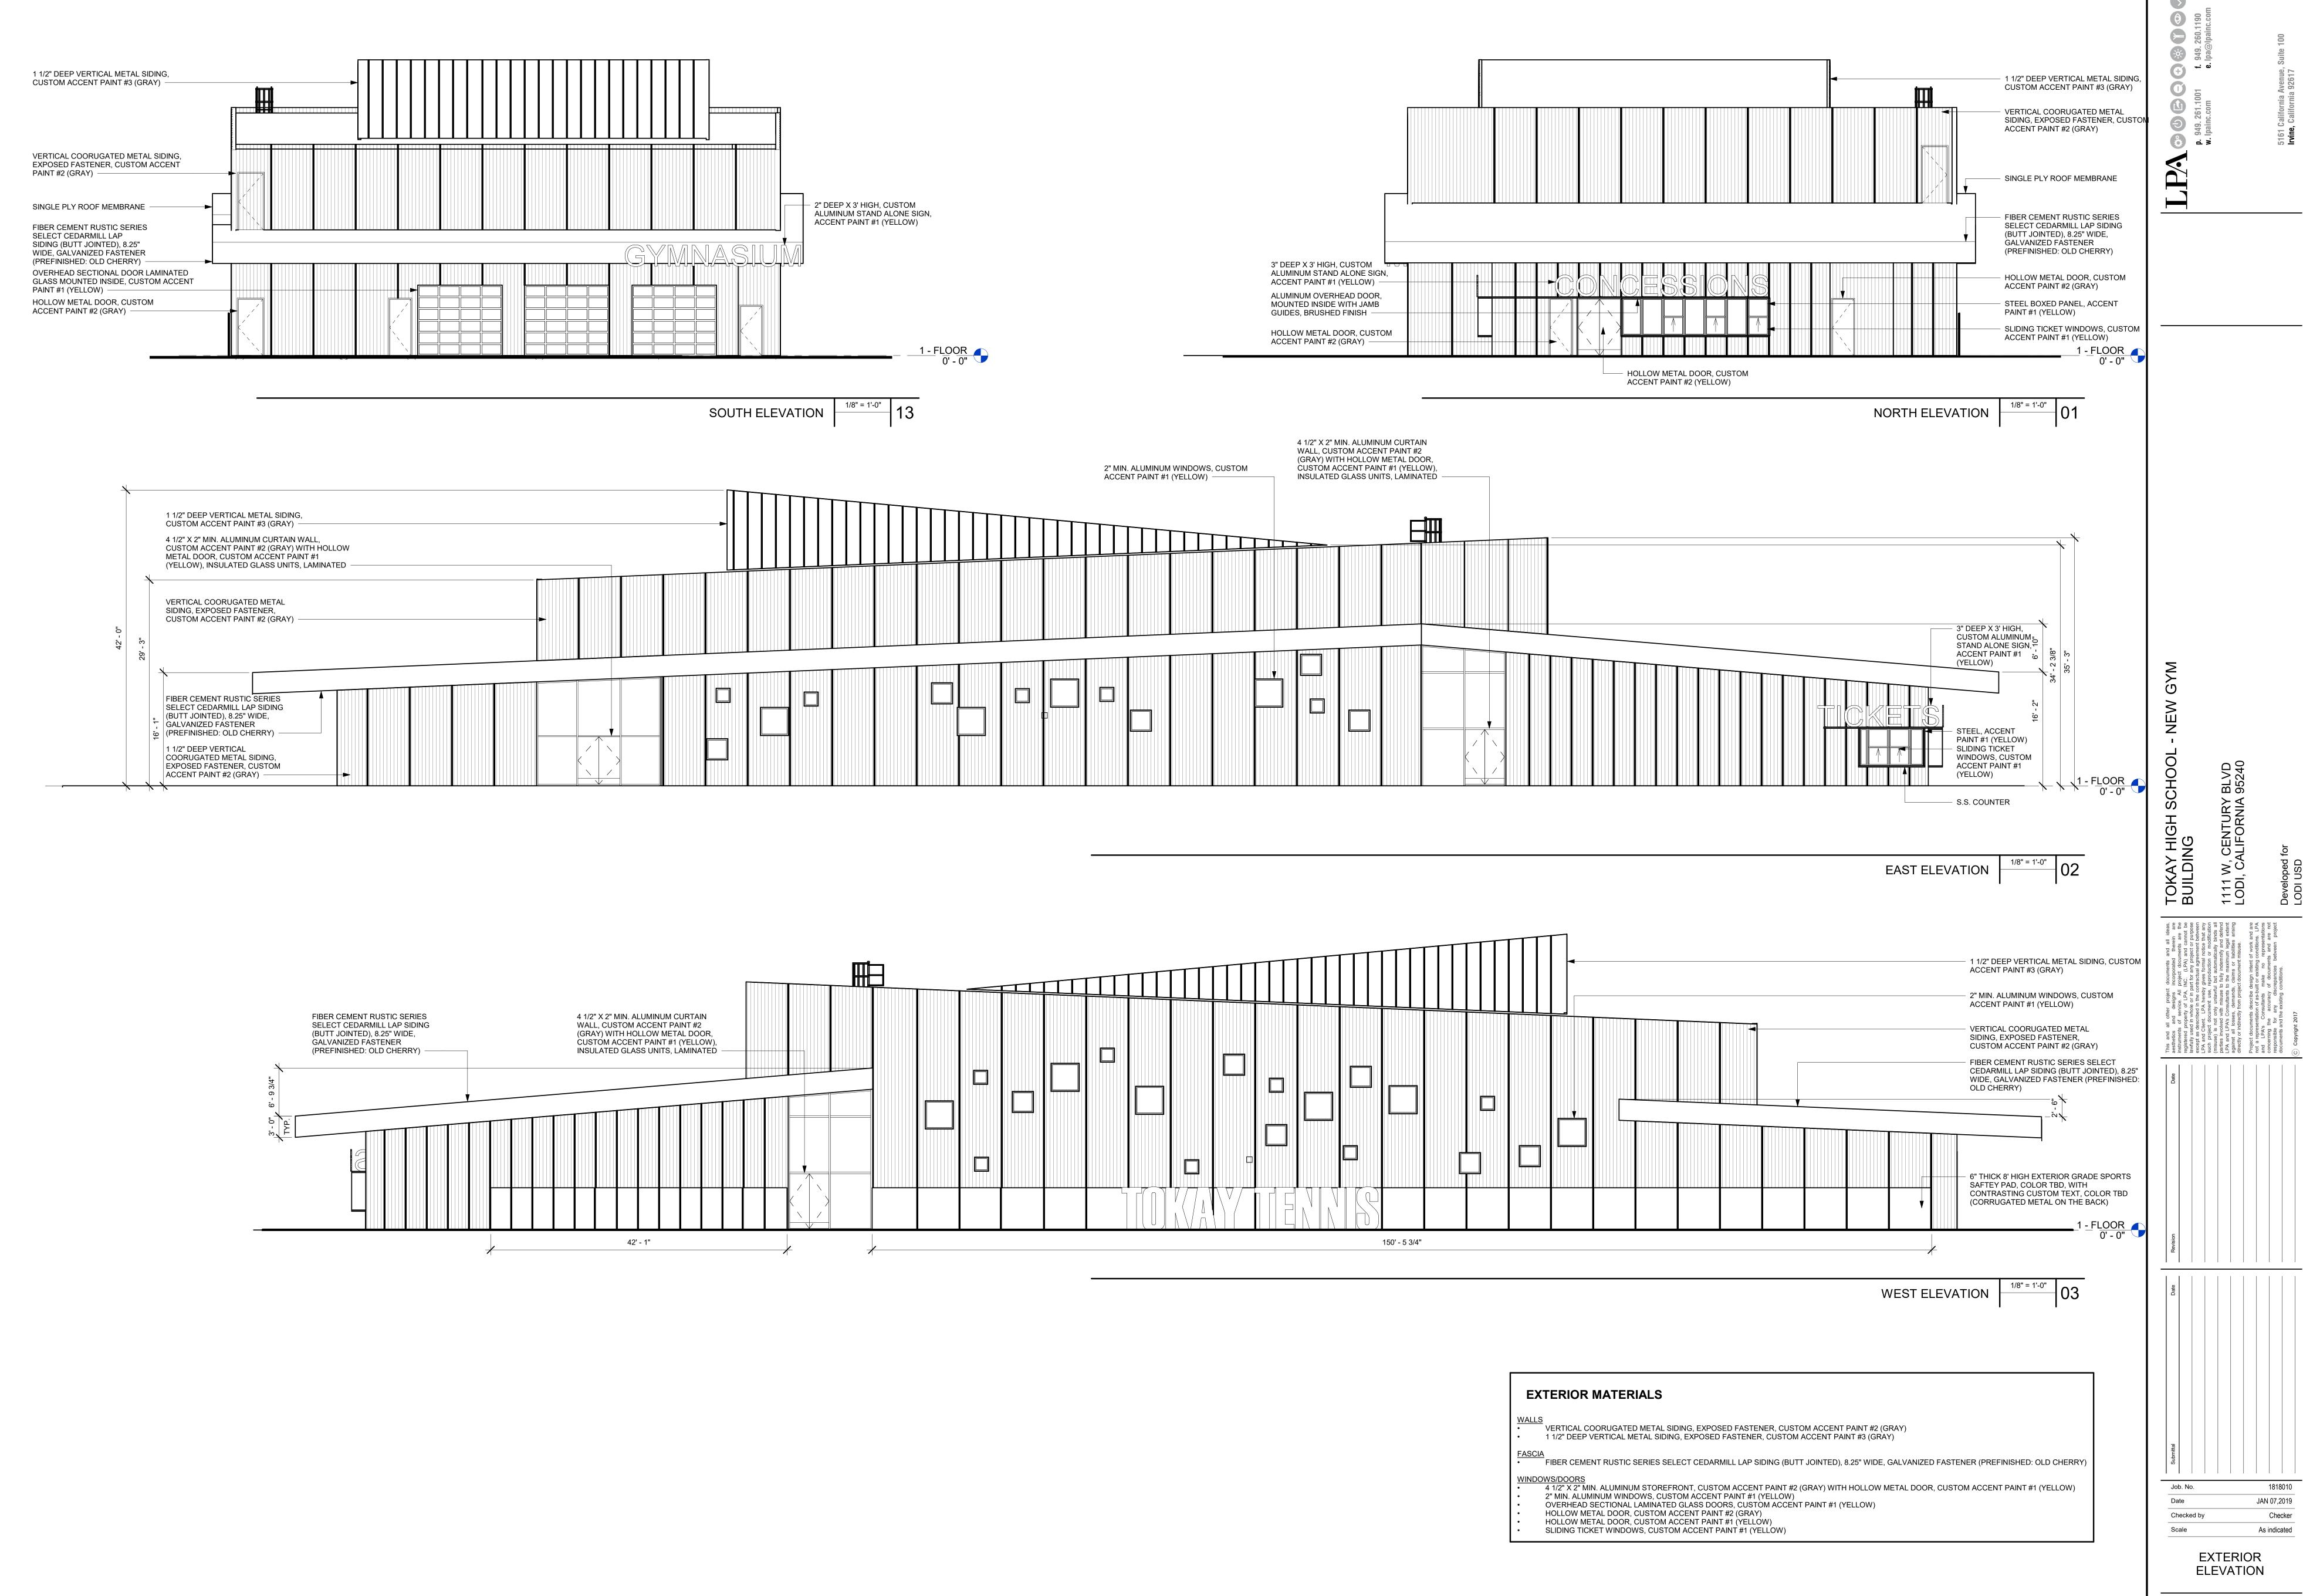

A3.10

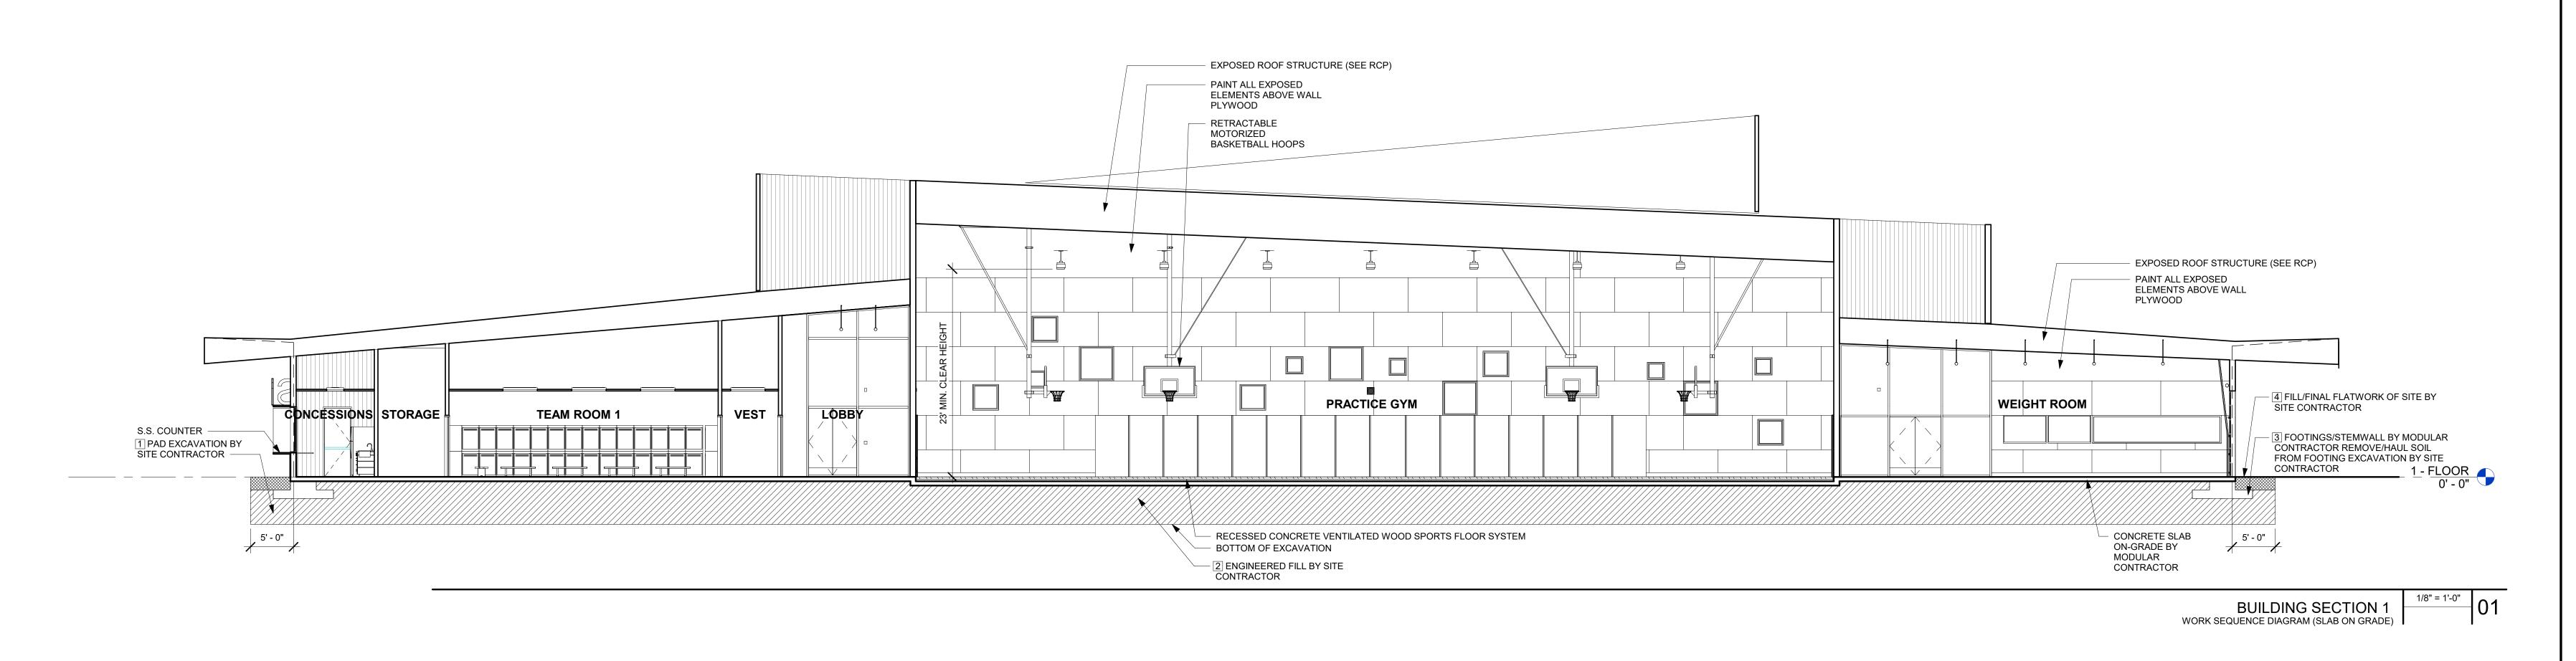

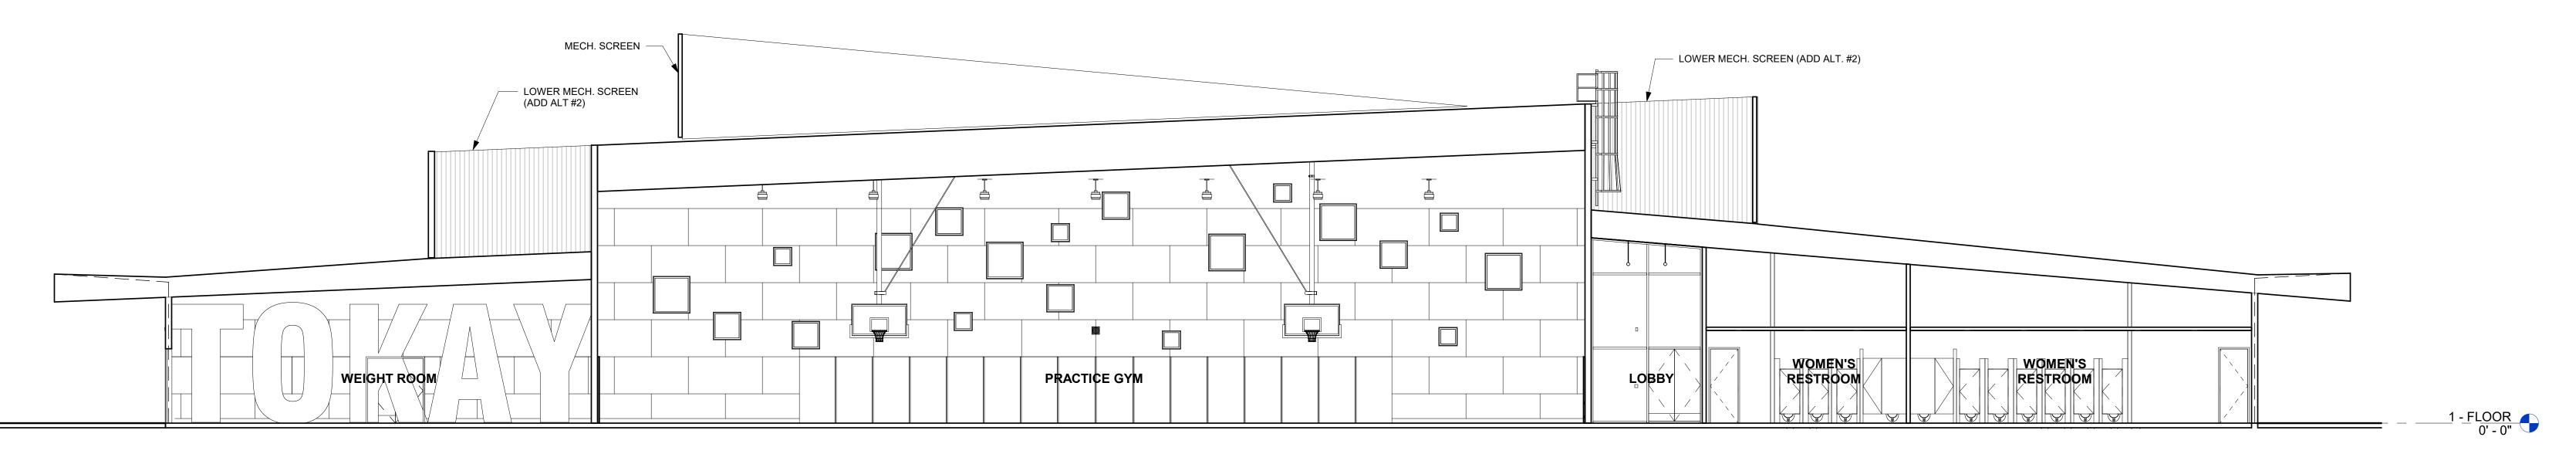

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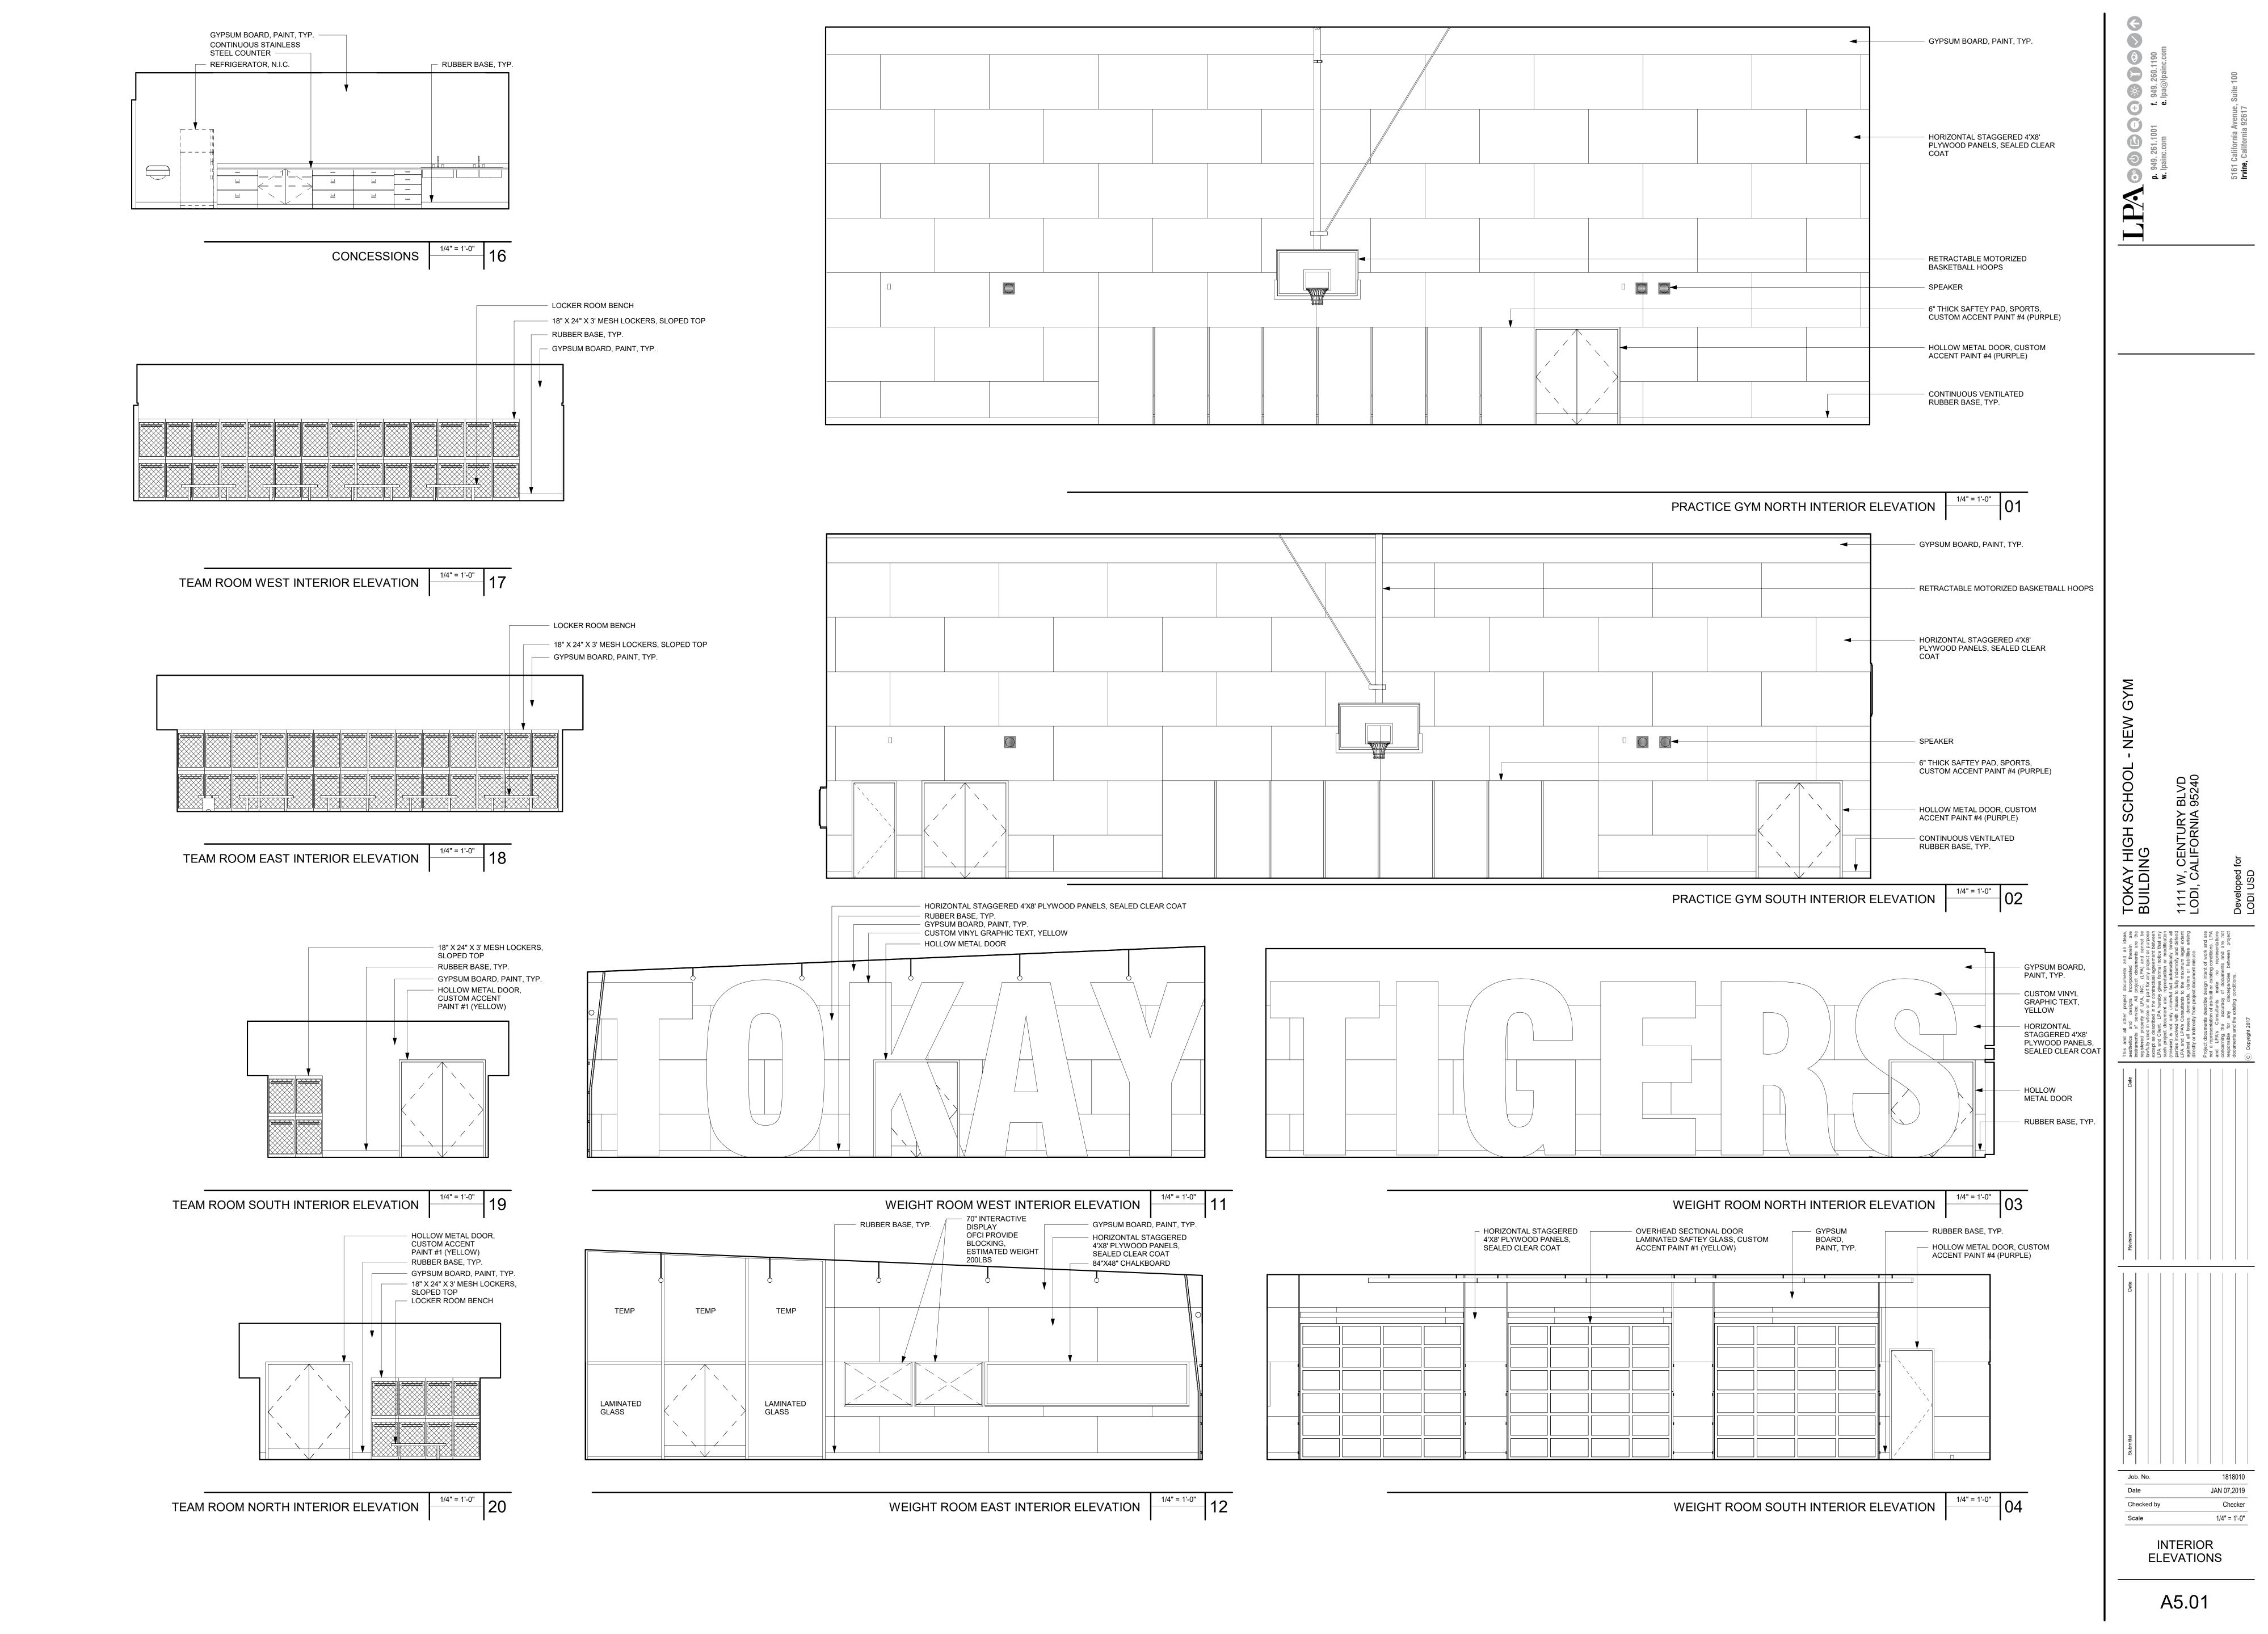
BUILDING SECTION 2


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> 1818010 JAN 07,2019 1/8" = 1'-0"

> > BUILDING SECTION

A3.20



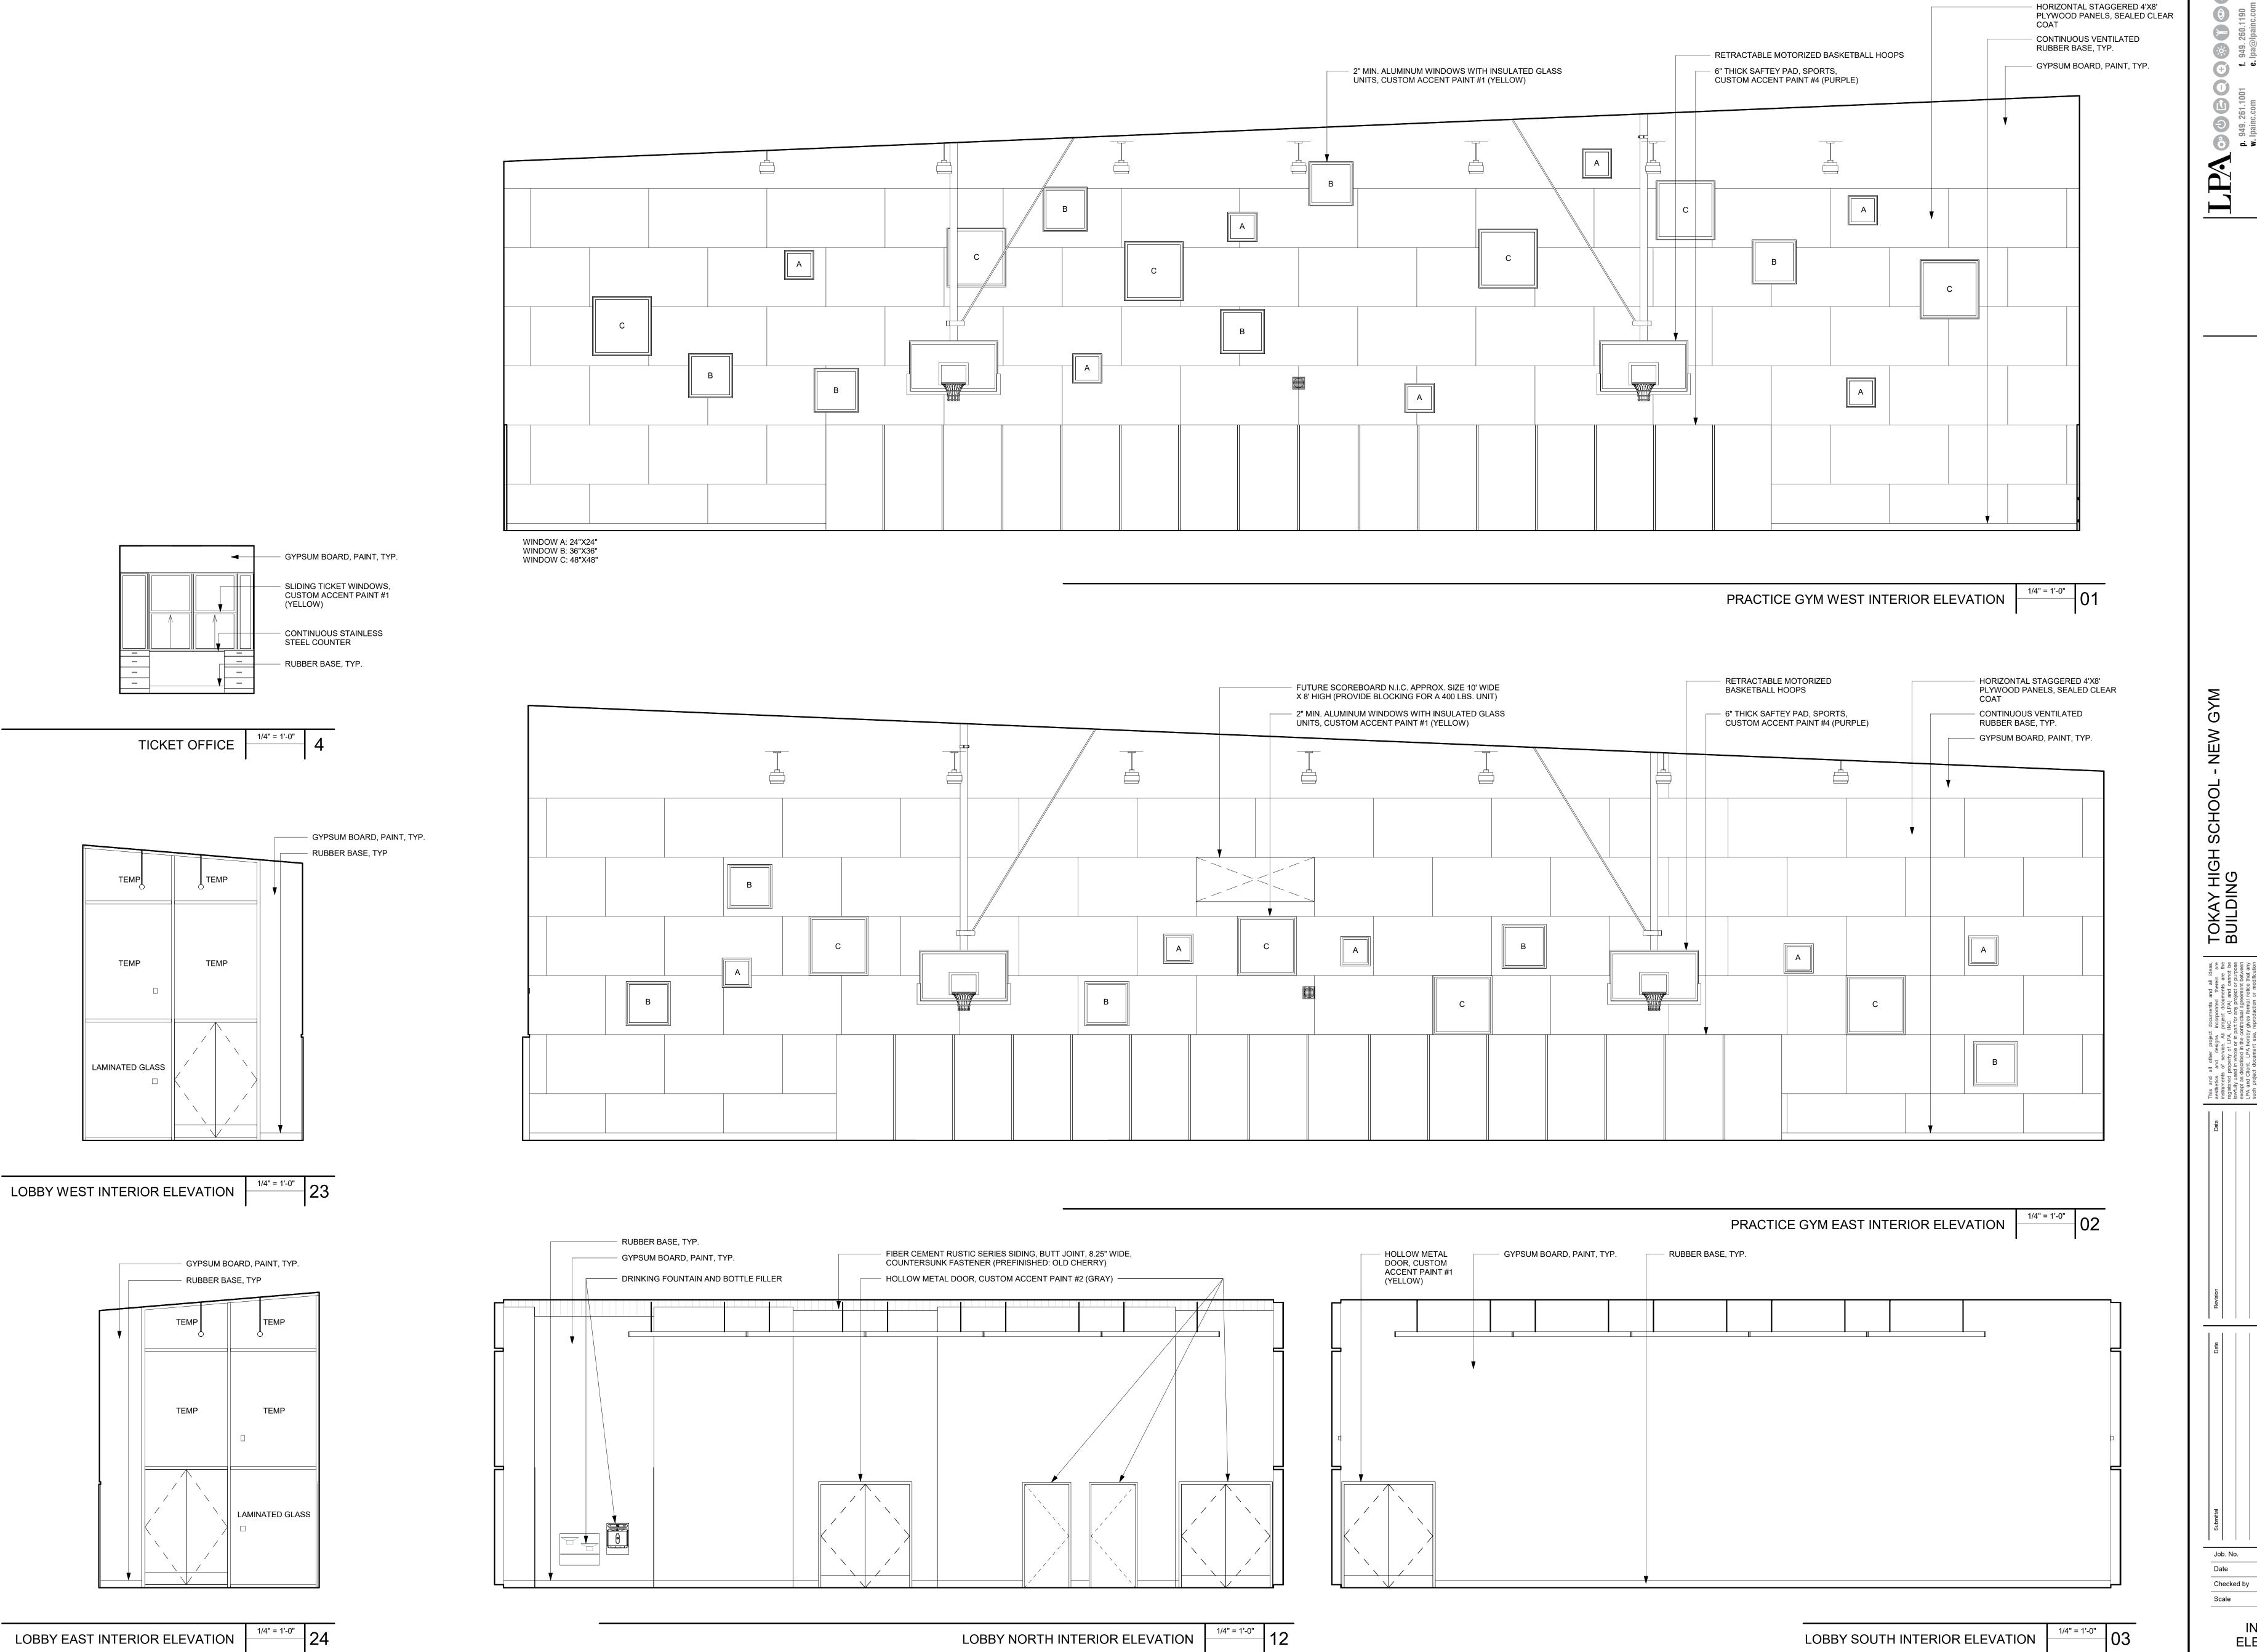

The support documents and support and support documents and support support documents and support documents an

ABOVE FINISHED COUNTER TOP

CONTRACTOR FURNISHED OWNER INSTALLED

CONTRACTOR FURNISHED CONTRACTOR INSTALLED

ABOVE FINISHED FLOOR

AMERICAN WIRE GAUGE

ABOVE FINISH GRADE

ACCESS POINT

ARCHITECTURAL

AUDIO VISUAL

BACK BONE

CONDUIT

CATEGORY

CENTERLINE

CIRCUIT

CEILING

CABLE TRAY

EXISTING TO REMAIN

ENTRANCE FACILITY

ELECTRIC VEHICLE FIRE ALARM

EQUIPMENT GROUND

ELECTRICAL METALLIC TUBING

FIRE ALARM ANNUNCIATOR PANEL

FIRE ALARM TERMINAL CABINET

GFCI GROUND FAULT CIRCUIT INTERRUPTING

INFORMATION TECHNOLOGY

MAIN DISTRIBUTION FRAME

MAIN POINT OF ENTRANCE

INTERMEDIATE DISTRIBUTION FACILITY

NEMA NATIONAL ELECTRICAL MANUFACTURERS ASSOCIATION

OWNER FURNISHED CONTRACTOR INSTALLED

OWNER FURNISHED OWNER INSTALLED

PUBLIC ADDRESS SYSTEM (PAGING)

POLYVINYL CHLORIDE CONDUIT

STRUCTURED CABLING SYSTEMS

TELECOMMUNICATIONS GROUNDING BUS BAR TELECOMMUNICATIONS MAIN GROUNDING BUS BAR

SPECIAL MOUNTING HEIGHT

TELECOMMUNICATIONS

TELECOMMUNICATIONS ROOM

UNLESS OTHERWISE NOTED

UNDERGROUND PULL BOX

WIRELESS ACCESS POINT

WEATHERPROOF

FIRE ALARM REMOTE ANNUNCIATOR

FIRE ALARM CONTROL AND INDICATING PANEL

FIRE ALARM CONTROL PANEL

EMPTY CONDUIT

ELECTRICAL

ELEVATOR

FLOOR BOX

FIBER OPTIC

G, GND GROUND

HEIGHT

J, J-BOX JUNCTION BOX

MECHANICAL

MULTI-MODE

MOUNTING

NTS NOT TO SCALE

MANUFACTURER

NEC NATIONAL ELECTRICAL CODE

OUTSIDE PLANT

PULL BOX

PHASE

PAIR

PORT

POWER

SLEEVE

PANEL

POINT OF SALE

PATCH PANEL

ROUGH IN ONLY

SINGLE MODE

SPECIFICATION

SYSTEM

TYPICAL TELEVISION

VOICE

WALL

TELEPHONE

TAMPER PROOF

VOLUME CONTROL

RIGID METAL CONDUIT

MECH

MFG

MM

OFOI

OSP

Ø, PH

PNL

POS

PP

PR

PRT

PWR

RIO

SLV

SM

SPEC

SYS

TEL

TELE

TGB

TYP

VC

UON

UPB

FIBER OPTIC CABLE

COPPER

AWG

CAT

CFOI

CFCI

C/L

CKT

CLG

ELEC

ELEV

FATC

FARA

FB

PER

G VENDOR N/A

MFG. TABLE N/A

DETAIL

SPEC.

949.

CONFORM TO STATE AND LOCAL CODES FOR THE ROUGH-IN AND INSTALLATION OF COMMUNICATION SYSTEMS. THIS INCLUDES, BUT NOT LIMITED TO, MEETING CODES CONCERNING CONDUIT, CABLE (PLENUM OR NON-PLENUM), CABLE INSTALLATION, DEVICE LOCATIONS, WALL PENETRATIONS, AND FIREPROOFING SLEEVES AND CONDUITS.

ELECTRICAL CONTRACTOR TO CONFIRM ALL ROUGH-IN, AND EQUIPMENT LOCATION REQUIREMENTS WITH THE COMMUNICATION CONTRACTOR.

COMMUNICATION AND ELECTRICAL CONTRACTORS TO

GENERAL CONTRACTOR TO COORDINATE STRUCTURAL MOUNTING REQUIREMENTS WITH COMMUNICATION CONTRACTOR. THIS INCLUDES, BUT IS NOT LIMITED TO, CEILING, WALL, AND FLOOR MOUNTED EQUIPMENT.

GENERAL CONTRACTOR TO COORDINATE INSTALLATION SCHEDULE WITH COMMUNICATION CONTRACTOR.

COMMUNICATION CONTRACTOR TO RECEIVE AND STORE ALL QUIPMENT AND MATERIALS AND DELIVER THEM TO THE CONSTRUCTION SITE ON A JUST-IN-TIME BASIS. PROVIDE STORAGE FOR COMMUNICATIONS EQUIPMENT THAT NEEDS TO REMAIN ON-SITE.

ELECTRICAL CONTRACTOR TO PROVIDE AND INSTALL GROUNDING AND BONDING SYSTEM IN COMMUNICATION EQUIPMENT ROOMS AND IT EQUIPMENT SERVER ROOMS. USE A MINIMUM #6 AWG STRANDED COPPER BONDING CONDUCTOR TO BE INSTALLED AROUND THE PERIMETER OF THESE ROOMS.

BACKBOX REQUIREMENTS ARE FOR PLANNING PURPOSES ONLY. GENERAL CONTRACTOR TO COORDINATE ACTUAL BACKBOX REQUIREMENTS WITH VENDOR SHOP DRAWINGS.

COORDINATE WITH ARCHITECTURAL ELEVATIONS.

CONDUITS TO, (a) CONTAIN NO CONTINUOUS SECTIONS LONGER THAN 30M (98 FT.), AND, (b) CONTAIN NO MORE THAN (2) 90° BENDS OR (1) REVERSE BEND WITHOUT INSTALLING A PULLBOX. CONDUITS IN PLACE OF PULLBOXES ARE UNACCEPTABLE.

CONDUITS TO CONTAIN PLASTIC OR NYLON PULL TAPE RATED AT 200 LBS. WITH A MINIMUM OF 5 FEET OF EXTRA PULL TAPE COILED AT EACH END.

CONDUIT BEND RADIUS TO BE (a) A MINIMUM OF 6 TIMES THE INTERNAL CONDUIT DIAMETER FOR CONDUITS 2" IN DIAMETER OR LESS, AND, (b) 10 TIMES THE INTERNAL CONDUIT DIAMETER FOR CONDUITS MORE THAN 2" IN

TERMINATE CONDUITS AND SLEEVES THAT PROTRUDE THROUGH STRUCTURAL FLOORS 2"-3" ABOVE FLOOR SURFACE. INSTALL BUSHINGS AND BELL ENDS ON CONDUITS, AS REQUIRED .

FLEX CONDUIT IS GENERALLY UNACCEPTABLE FOR USE AS COMMUNICATIONS CONDUIT EXCEPT AT SEISMIC JOINTS AND AS APPROVED IN WRITING BY ENGINEER.

SLAB OR IN-SLAB CONDUITS TO BE INSTALLED IN A MANNER THAT PREVENTS WATER INFILTRATION OF CONDUIT. IT IS CONTRACTOR'S RESPONSIBILITY TO ENSURE GROUND WATER, RAIN WATER OR CONSTRUCTION WATER IS PREVENTED FROM ENTERING AND/OR REMOVED FROM THE CONDUITS PRIOR TO PLACEMENT OF COMMUNICATIONS CABLES. SEE SITE UTILITY PLAN NOTES FOR ADDITIONAL UNDERGROUND COMMUNICATIONS CONDUIT SEALING REQUIREMENTS.

PULLBOXES TO BE SIZED AND INSTALLED PER ANSI/TIA 569C. PULLBOXES FOR UNDER FLOOR CONDUIT RUNS ARE NOT PERMITTED UNLESS OTHERWISE NOTED. PULLBOXES FOR OVERHEAD CONDUIT RUNS TO BE LOCATED ABOVE ACCESSIBLE CEILINGS WITHIN THE ACCESSIBLE CEILING SPACE AND SUPPORTED INDEPENDENTLY FROM STRUCTURE AND CONDUIT SUPPORTS. PULLBOXES FOR ROOF MOUNTED OR EXTERIOR ABOVE GRADE APPLICATIONS TO BE NEMA 3 RATED. PULLBOXES TO BE SIZED ACCORDING TO THE FOLLOWING:

CONDUIT SIZE	WIDTH	LENGTH	DEPTH	WIDTH INCREASE PER ADDITIONAL CONDUIT
1"	4"	16"	3"	2"
2"	8"	36"	4"	5"
3"	12"	48"	5"	6"
4"	15"	60"	8"	8"

CONDUITS TO EXIT PULLBOX ON THE WALL OPPOSITE THE WALL ENTERED. PROVIDE LABELING OF EACH CONDUIT PER GENERAL ELECTRICAL SPECIFICATIONS.

COORDINATE MOUNTING DIMENSIONS FOR ELECTRICAL DEVICES AND SWITCHES WITH ARCHITECTURAL INTERIOR ELEVATIONS PRIOR TO ROUGH-IN. 22. COORDINATE PENETRATIONS WITH STRUCTURAL PLANS AND DETAILS.

ATTACH CEILING MOUNTED DEVICES TO FINISHED CEILING. REFER TO REFLECTIVE CEILING PLAN FOR HEIGHT. U.O.N.

SYMBOLS	INTERCOM, PAGING SYMBOLS	BACK BOX	MTG. HT. TO C/L	POWER
HPAS	FLUSH WALL MOUNTED PAGING SPEAKER	G	15' AFF, UON	N/A
PAS	CEILING MOUNTED PAGING SPEAKER, INSTALL (1) CATEGORY 6 CABLE.	PER MFG. SPEC.	CEILING	N/A
VC	VOLUME CONTROL	PER MFG. SPEC.	46" AFF	N/A
INT ()	INTERCOM STATION, (D)=DOOR STATION (M)=MASTER STATION (S)=SUBMASTER STATION	PER MFG. SPEC.	PER VENDOR DETAIL	N/A
	L" CONDUIT STUD LID WITH DUSHING S" ADOVE ACCESSE		IC LION	

PROVIDE 1" CONDUIT STUB-UP WITH BUSHING 6" ABOVE ACCESSIBLE CEILING UON

SYMBOLS	SECURITY SYMBOLS	BACK BOX	MTG. HT. TO C/L	P
MD	WALL MOUNTED MOTION DETECTOR	PER MFG. SPEC.	10' AFF	
MD	CEILING MOUNTED MOTION DETECTOR	PER MFG. SPEC.	FINISHED CEILING	
K	KEYPAD	PER MFG. SPEC.	46" AFF	
⊳H⊲	INTRUSION SECURITY HORN	MFG. SPEC.	11' AFF	
CR	CARD READER, INSTALL (1) 3/4" CONDUIT STUB UP 6" ABOVE ACCESSIBLE CEILING SPACE.	А	46" AFF	
CRL	CARD READER LOCK	PER MFG. SPEC.	PER VENDOR DETAIL	
EH	EMERGENCY HELP PUSHBUTTON	В	46" AFF	
EA	EMERGENCY HELP BUTTON ANNUNCIATOR	PER MFG. SPEC.	46" AFF	
DP	DOORBELL PUSHBUTTON	PER MFG. SPEC.	46" AFF	
РВ	PANIC BUTTON	PER MFG. SPEC.	SEE PLANS	
DC	DOOR CONTACT ALARM SENSOR, COORDINATE WITH DOOR HARDWARE. PROVIDE PATHWAY TO DOOR JAMB	PER MFG. SPEC.	PER VENDOR DETAIL	
CK	CARD READER WITH KEYPAD	PER MFG. SPEC.	PER VENDOR DETAIL	
ссти⊲	CCTV CAMERA. INSTALL (1) CATEGORY 6 CABLE	G	9' AFF, UNDER SOFFIT, UON	N S

PROVIDE 1" CONDUIT STUB-UP WITH BUSHING 6" ABOVE ACCESSIBLE CEILING UON

SYMBOLS	CLOCK SYMBOLS	BACK BOX	MTG. HT. TO C/L	POWER
Ф	DIGITAL IP CLOCK: (1) CATEGORY 6 CABLE.	PER MFG. SPEC.	8' 6" AFF	N/A
	BATTERY CLOCK OPERATED OFCI PART NO. E56BAQD304BF-J18. PAS SPEAKER (1) CATEGORY 6 CABLE. INSTALL (1) 1" CONDUIT TO ACCESSIBLE CEILING SPACE	PER MFG. SPEC.	8' 6" AFF	N/A

国中	E56BAQD304BF-J18. PAS SPEAKER (1) CATEGORY 6 CABLE. INSTALL (1) 1" CONDUIT TO ACCESSIBLE CEILING SPACE	MFG. SPEC.	8' 6" AFF	N/A					
ROVIDE 1	1" CONDUIT STUB-UP WITH BUSHING 6" ABOVE ACCESSIE	BLE CEILIN	IG UON						
FERENCE	TECHNOLOGY SYSTEMS BACKBOX	LEGENI)						
Α	RACO #695 OR EQUAL: 1-GANG BACKBOX,3-3/4" HIGH, 1-31/32" WIDE & 3-1/2" DEEP.								
В	RACO #696 OR EQUAL: 2-GANG BACKBOX, 3-3/4" HIGH, 3-3/8" WIDE & 3-1/2" DEEP.								
С	RACO #697 OR EQUAL: 3-GANG BACKBOX, 3-3/4" HIGH, 5	5-19/32" W	IDE & 3-1/2"	DEEP.					
D	RACO #698 OR EQUAL: 4-GANG BACKBOX, 3-3/4" HIGH, 7	'-13/32" W	IDE & 3-1/2"	DEEP.					
Е	RACO #699 OR EQUAL: 5-GANG BACKBOX, 3-3/4" HIGH, 9-7/32" WIDE & 3-1/2" DEEP.								
F	STEEL CITY #72171 OR EQUAL: 4-11/16" HIGH, 4-11/16" WIDE & 2-1/8" DEEP. BACKBOX WITH STEEL CITY #72-C-14 SINGLE DEVICE COVER.								
G	RANDAL #TB-55057: 5 IN. SQUARE X 2.875 IN. DEEP META RANDAL #D-51G034 3/4" SINGLE GANG EXTENSION RING	_	OM BRACKE	BOX					
J	SPIDER BOX AFB-501-8 GANG FLOOR BOX. PROVIDE (1) VOLTAGE SYSTEMS CABLING.	1-1/2" COI	NDUITS FOF	RLOW					


OWER	SYMBOLS	VOICE AND DATA SYMBOLS	BACK BOX	MTG. HT. TO C/L	POWER
N/A	H	UNIVERSAL CABLING OUTLET. STANDARD CONFIGURATION IS (2) CATEGORY 6 CABLES. NO DISTINCTION BETWEEN VOICE AND DATA.	G	18" AFF	N/A
N/A	(#)	UNIVERSAL CABLING OUTLET. (#) = NUMBER OF CATEGORY 6 CABLES, OTHER THAN STANDARD CONFIGURATION.	G	18" AFF	N/A
N/A	—	UNIVERSAL CABLING OUTLET ABOVE COUNTER. STANDARD CONFIGURATION IS (2) CATEGORY 6 CABLES.	G	6" AFC	N/A
N/A	◄ (#)	UNIVERSAL CABLING OUTLET ABOVE COUNTER. (#) = NUMBER OF CATEGORY 6 CABLES, OTHER THAN STANDARD CONFIGURATION.	G	6" AFC	N/A
		UNIVERSAL CABLING FLOOR OUTLET. STANDARD CONFIGURATION IS (2) CATEGORY 6 CABLES.	PER MFG. SPEC.	FLOOR	N/A
OWER N/A	(#)	UNIVERSAL CABLING FLOOR OUTLET. (#) = NUMBER OF CATEGORY 6 CABLES, OTHER THAN STANDARD CONFIGURATION.	PER MFG. SPEC.	FLOOR	N/A
N/A	•	UNIVERSAL CABLING CEILING OUTLET. STANDARD CONFIGURATION IS (2) CATEGORY 6 CABLES. INCLUDE (1) 2-PORT SUFACE MOUNT BOX.	PER MFG. SPEC.	ABOVE CEILING	N/A
N/A	(#)	UNIVERSAL CABLING CEILING OUTLET. (#) = NUMBER OF CATEGORY 6 CABLES, OTHER THAN STANDARD CONFIGURATION.	PER MFG. SPEC.	CEILING	N/A
N/A N/A	-\$-	CEILING MOUNTED (OFCI) WIRELESS ACCESS POINT. INSTALL (2) CATEGORY 6A CABLES USING A UNIVERSAL TOOL-FREE PLUG.	N/A	CEILING	N/A
N/A	WAP 🛨	WALL MOUNTED (OFCI) WIRELESS ACCESS POINT. INSTALL (2) CATEGORY 6A CABLES USING A UNIVERSAL TOOL-FREE PLUG.	G	15' AFF, UON	N/A
N/A	K	VOICE OUTLET. (1) CATEGORY 6 CABLE.	G	18" AFF	N/A
N/A	K∣W	WALL TELEPHONE OUTLET. (1) CATEGORY 6 CABLE.	G	46" AFF	N/A
N/A N/A	K∣ATM	DEDICATED ATM MODEM OUTLET. (1) CATEGORY 6 CABLE.	G	18" AFF	N/A
N/A	PROVIDE	MIN. 1" CONDUIT STUB-UP WITH BUSHING 6" ABOVE ACCESS	BIBLE CEIL	ING UON	
N/A	SYMBOLS	AUDIOVISUAL SYMBOLS	BACK BOX	MTG. HT. TO	POWER
PER MFG.	AVC	AV CONTROLS. INSTALL (1) CATEGORY 6 CABLE TO PROJECTOR. INSTALL (1) 1" CONDUIT. STUB UP 6" ABOVE ACCESSIBLE CEILING SPACE.	G	46" AFF	N/A
SPEC.	AVI	AV INPUT PLATE. INSTALL (1) HDMI CABLE, INSTALL (1) 1.25" CONDUIT STUB UP 6" ABOVE ACCESSIBLE CEILING SPACE.	G	18" AFF	N/A
OWER	AV2	AV / DATA INPUT PLATE. INSTALL (1) HDMI CABLE TO WALL MOUNT TV, INCLUDE (2) CATEGORY 6 CABLE FROM IDF TO WALL OUTLET. COORDINATE HEIGHT WITH ELECTRICAL. INSTALL (1) 1.25" CONDUIT STUB UP 6" ABOVE ACCESSIBLE CEILING SPACE.		18" AFF	N/A
N/A	AV3	EMPTY	G	PER VENDOR DETAIL	N/A
	(S)	CEILING MOUNTED AV SPEAKER. CONNECT CABLING TO AUDIO DEVICE LOCATED IN ROOM.	PER MFG. SPEC.	CEILING	N/A
	HS	FLUSH WALL MOUNTED AV SPEAKER. CONNECT CABLING TO AUDIO DEVICE LOCATED IN ROOM.	PER MFG. SPEC.	15' AFF	N/A
EP.	(M)	CEILING MOUNTED MICROPHONE	PER MFG. SPEC.	CEILING	N/A
EEP.	TV1	OFCI - WALL-MOUNTED TV INSTALL (1) CATEGORY 6 INSTALL (1) 1.25" CONDUIT STUB UP 6" ABOVE ACCESSIBLE CEILING SPACE.	G	60" AFF	N/A

EMPTY

PROVIDE 1" CONDUIT STUB-UP WITH BUSHING 6" ABOVE ACCESSIBLE CEILING, UON

TECHNOLOGY SYMBOL SCHEDULE

TOKAY HIGH SCHOOL - NEW GYM	BUILDING			1111 W. CENTURY BLVD	LODI, CALIFORNIA 95240				Developed for	LODI USD
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TOKAY HIGH SCHOOL BUILDING 1818010 JAN 07,2019 Checker 1/8" = 1'-0" TECHNOLOGY GYM T2.02
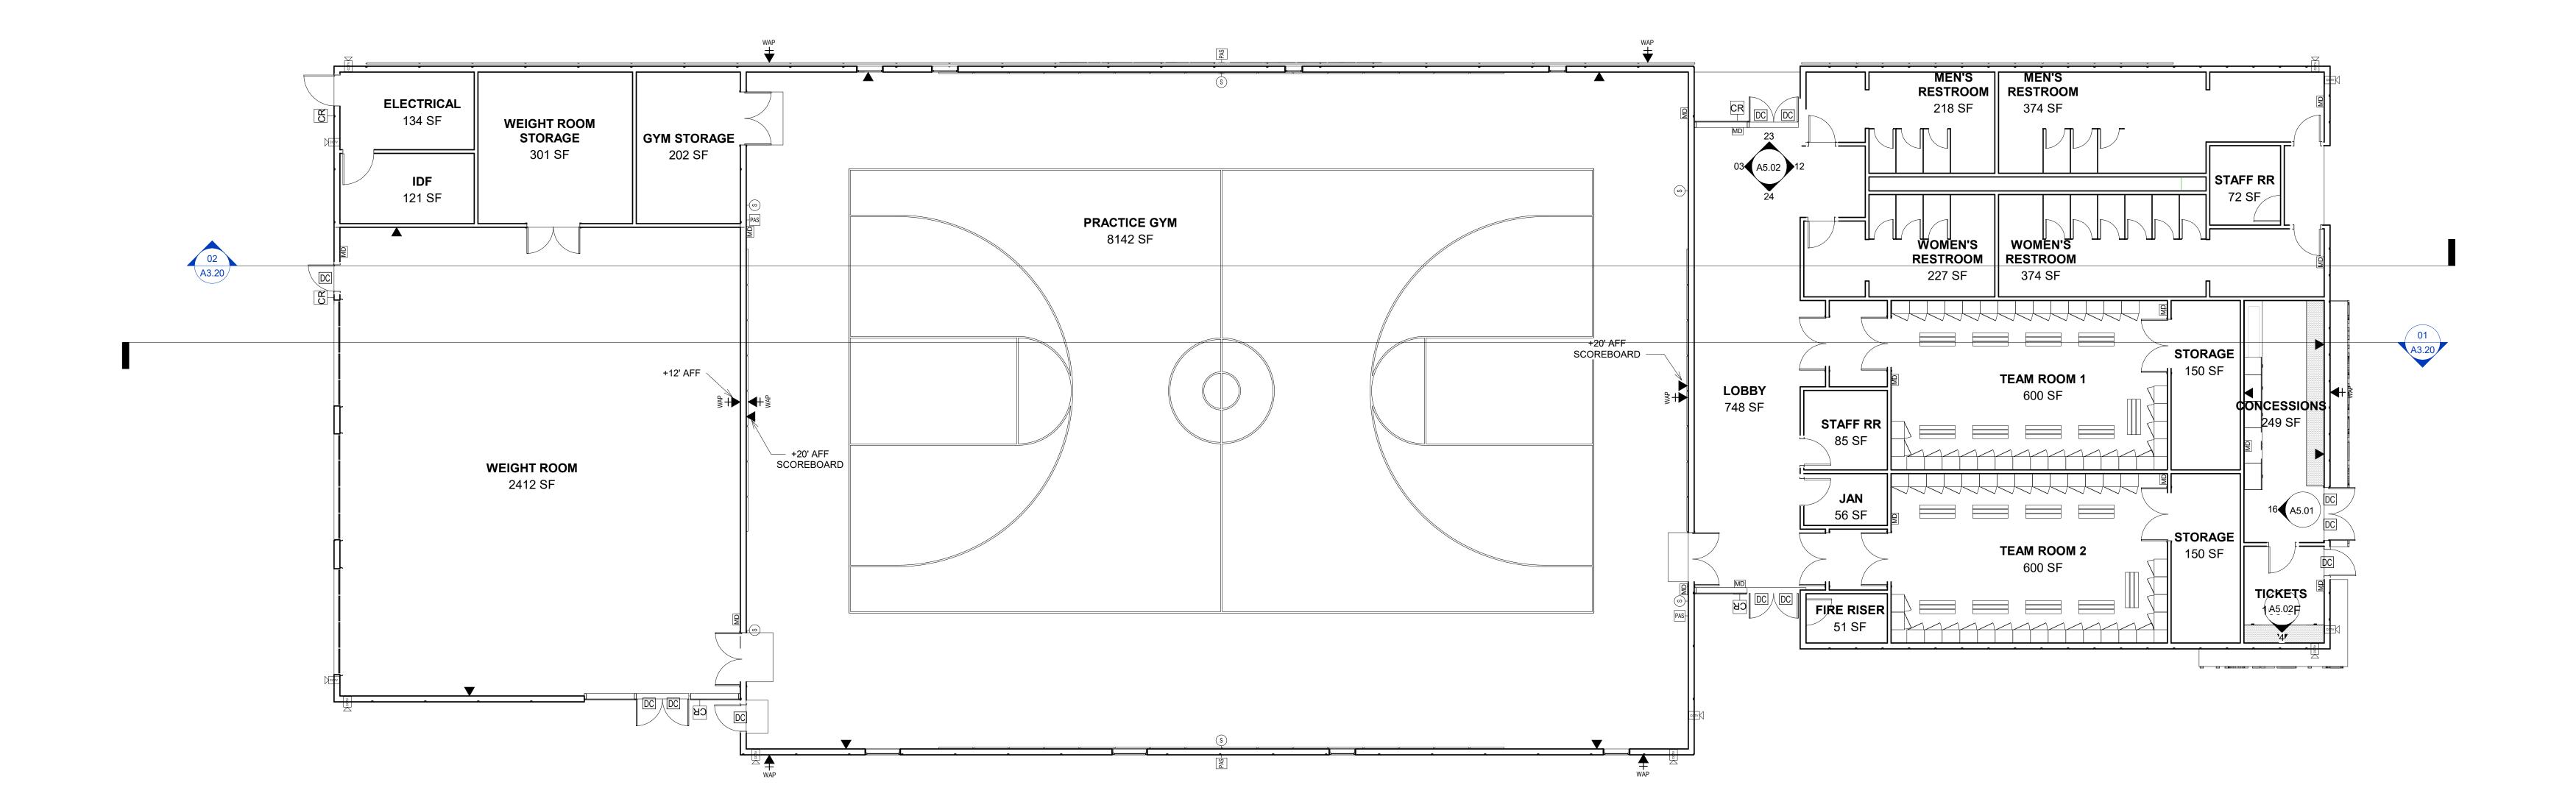
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